



Detail Wall Build-Up Section : Typical Opaque 1

SCALE: 11/2" = 1'-0"

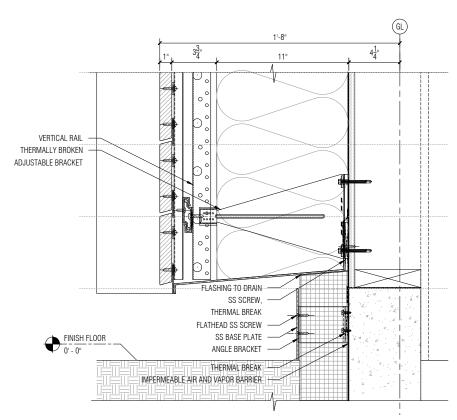

Detail Wall Build-Up Section : Opaque 1 at Ground

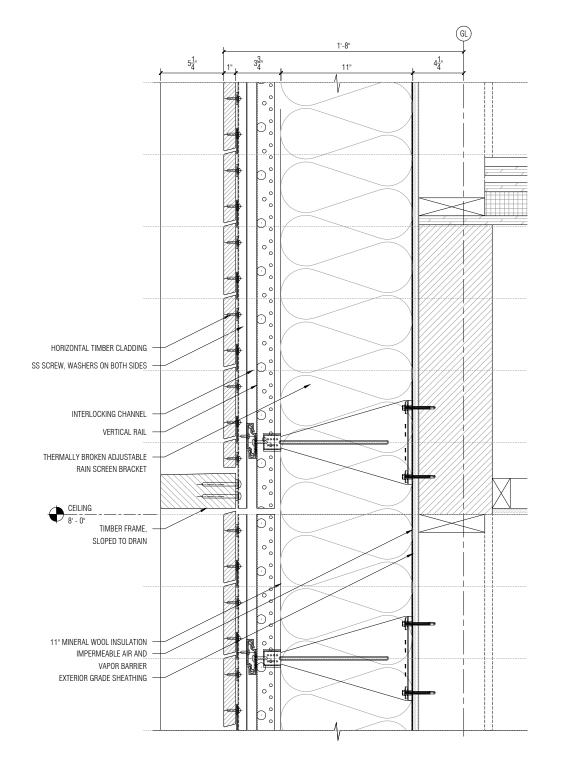

Detail Wall Build-Up Section : Opaque 1 at Floor transition

	0	ISSUED	DATE
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PROJECT PHASE


**Construction Documents** 


## Front

20 JAY ST. SUITE 920 BROOKLYN, NEW YORK 11201 TEL 212 242 2220 FAX 212 242 2253

# Storm King Arts Center

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NO ISSUED DATE PROJECT PHASE Construction Documents
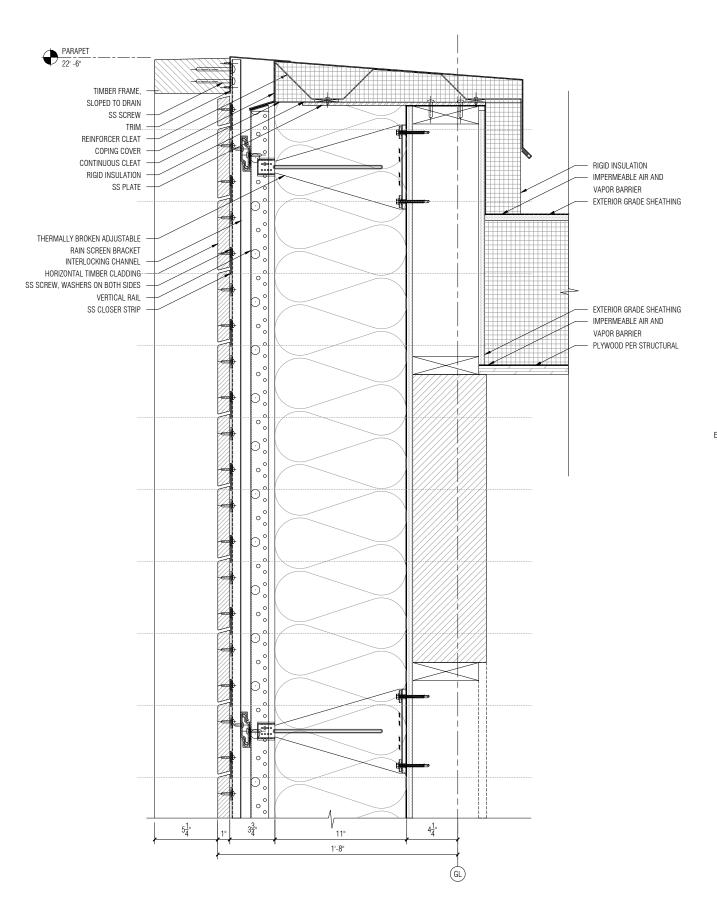
### Front

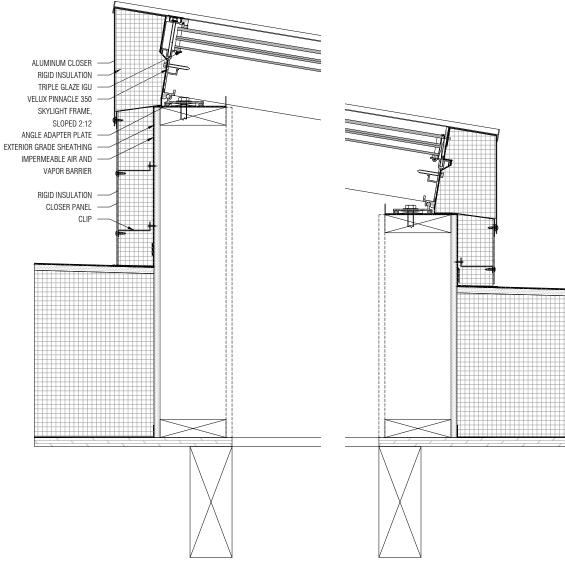20 JAY ST. SUITE 920 BROOKLYN, NEW YORK 11201 TEL 212 242 2220 FAX 212 242 2253

# Storm King Arts Center


## ADMIN BUILDING Facade Build Up

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Detail Wall Build-Up Section : Opaque 1 at Parapet SCALE: 11/2" = 1'-0"


Detail Roof : Skylight Sill

Detail Roof Build-Up Section : Skylight Head SCALE: 11/2" = 1'-0"

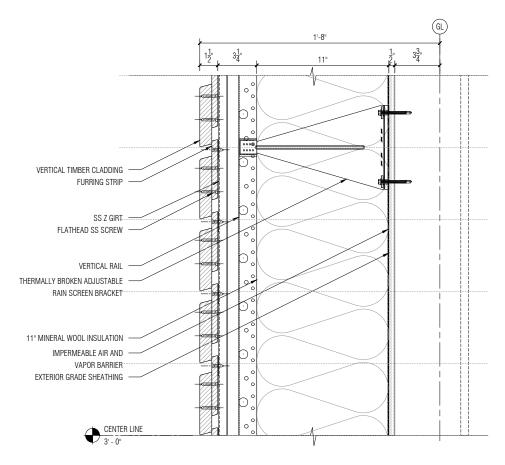


Detail Wall Build-Up Section : Typical Opaque 2

SCALE: 11/2" = 1'-0"

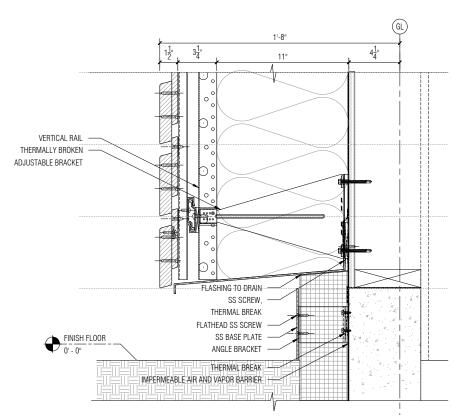

Detail Wall Build-Up Section : Opaque 2 at Ground

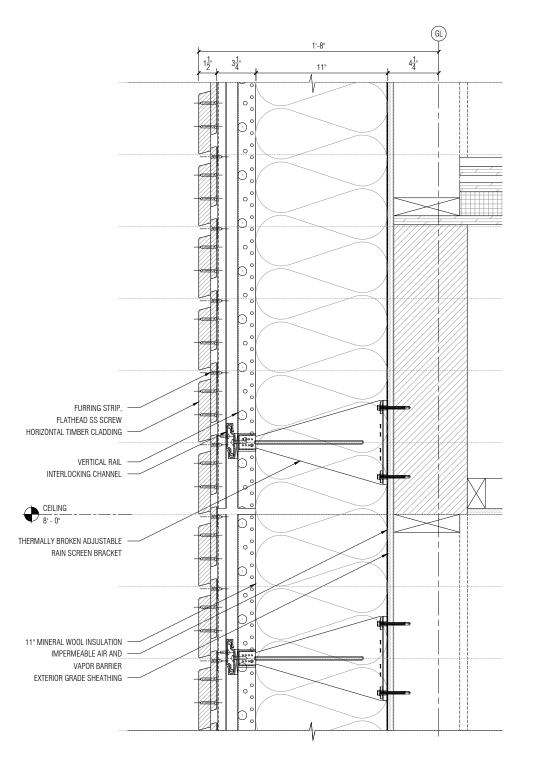

Detail Wall Build-Up Section : Opaque 2 at Floor transition

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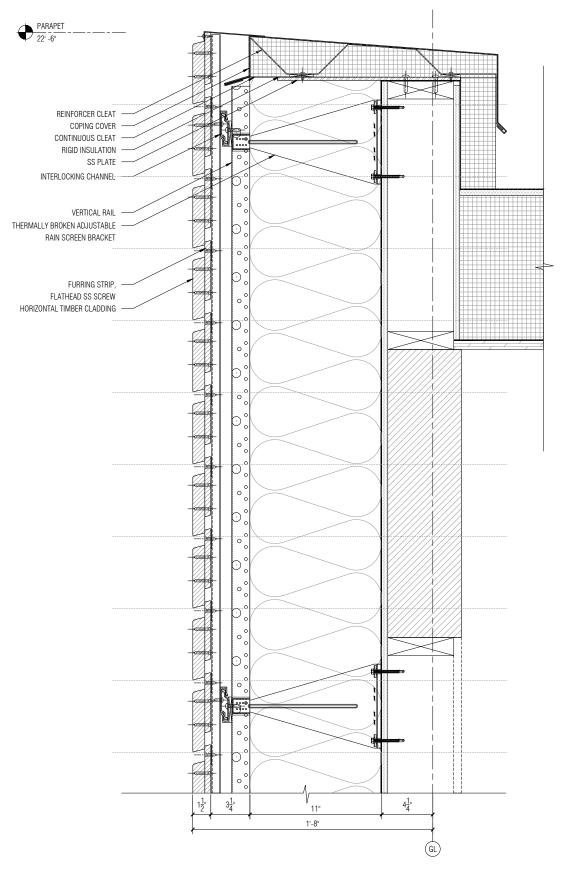
**Construction Documents** 

## Front

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Detail Wall Build-Up Section : Opaque 2 at Parapet SCALE: 11/2" = 1'-0"


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**Construction Documents** 


Front 20 JAY ST. SUITE 920 BROOKLYN, NEW YORK 11201 TEL 212 242 2220 FAX 212 242 2253

# Storm King Arts Center


DATE	SCALE
11/05/2020	NOTED
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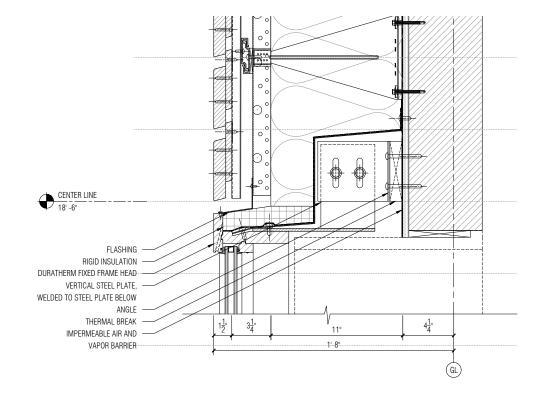
Detail Wall Build-Up Section : Operable Head SCALE: 11/2" = 1'-0"

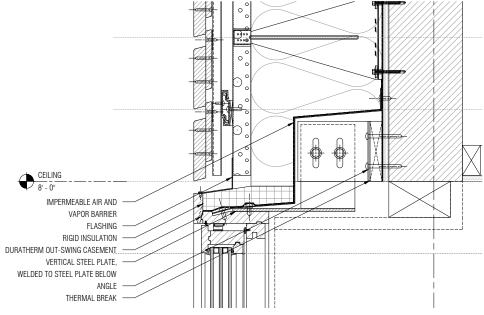


Detail Wall Build-Up Section : Fixed to Operable SCALE: 11/2" = 1'-0"

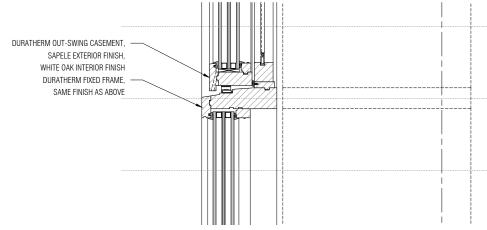

Detail Wall Build-Up Section : Fixed Base at Slab

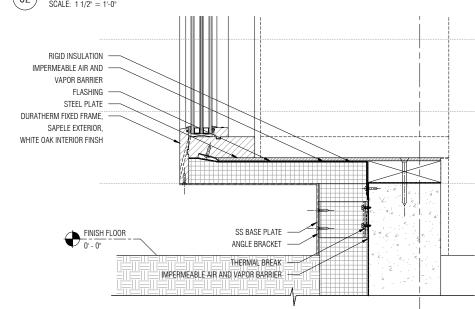

Detail Wall Build-Up Section: Fixed Head

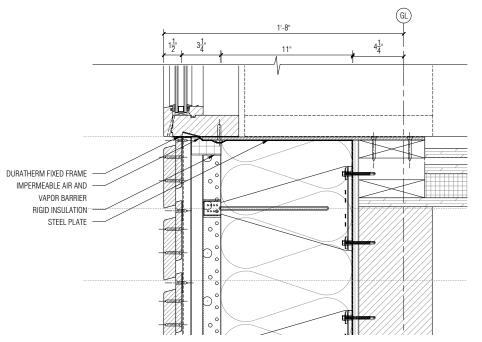

Detail Wall Build-Up Section : Fixed Base at Slab

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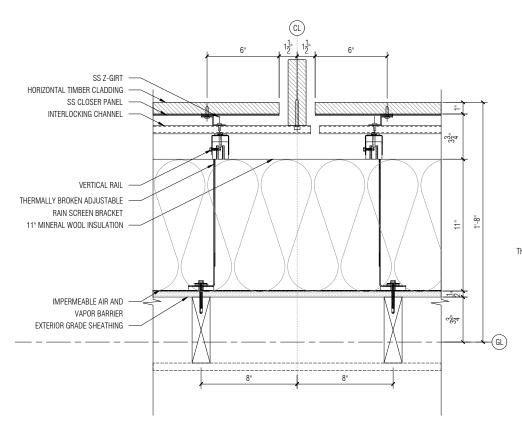
### **Construction Documents**

### Front

20 JAY ST. SUITE 920 BROOKLYN, NEW YORK 11201 TEL 212 242 2220 FAX 212 242 2253

# Storm King Arts Center

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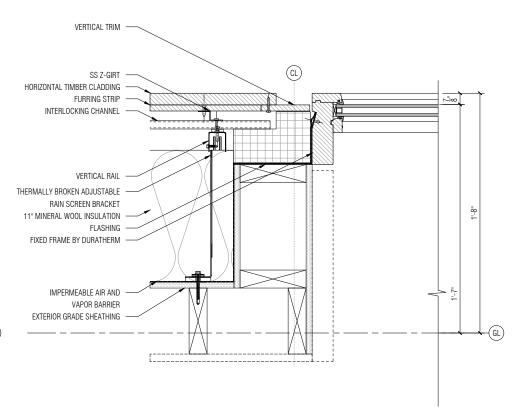
GL HORIZONTAL TIMBER CLADDING SS CLOSER PANEL INTERLOCKING CHANNEL 11" MINERAL WOOL INSULATION VERTICAL RAIL THERMALLY BROKEN ADJUSTABLE RAIN SCREEN BRACKET IMPERMEABLE AIR AND VAPOR BARRIER EXTERIOR GRADE SHEATHING

Detail Wall Build-Up Plan: Typical Opaque 1

VERTICAL TRIM -SS Z-GIRT HORIZONTAL TIMBER CLADDING FURRING STRIP INTERLOCKING CHANNEL VERTICAL RAIL THERMALLY BROKEN ADJUSTABLE RAIN SCREEN BRACKET 11" MINERAL WOOL INSULATION -IMPERMEABLE AIR AND -VAPOR BARRIER EXTERIOR GRADE SHEATHING

Detail Wall Build-Up Plan: Typical Opaque 2

Detail Wall Build-Up Plan : Opaque 1 and Opaque 2 Interface



Detail Wall Build-Up Plan: Opaque 2 to Glazing


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Con	struction D	ocuments


## Front

20 JAY ST. SUITE 920 BROOKLYN, NEW YORK 11201 TEL 212 242 2220 FAX 212 242 2253


# Storm King Arts Center

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Detail Wall Section Build-Up : Ground SCALE: 1 1/2" = 1'-0"

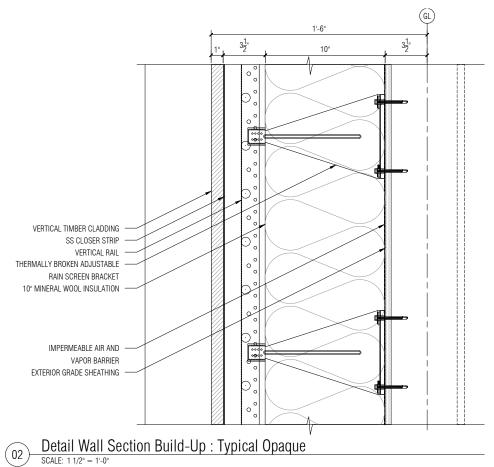

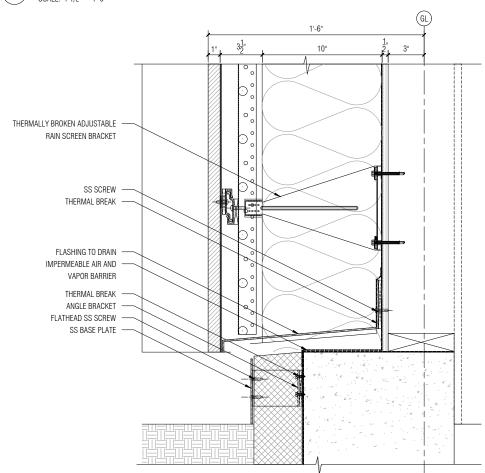Detail Wall Section Build-Up : Floor transition SCALE: 1 1/2" = 1'-0"

NO ISSUED PROJECT PHASE

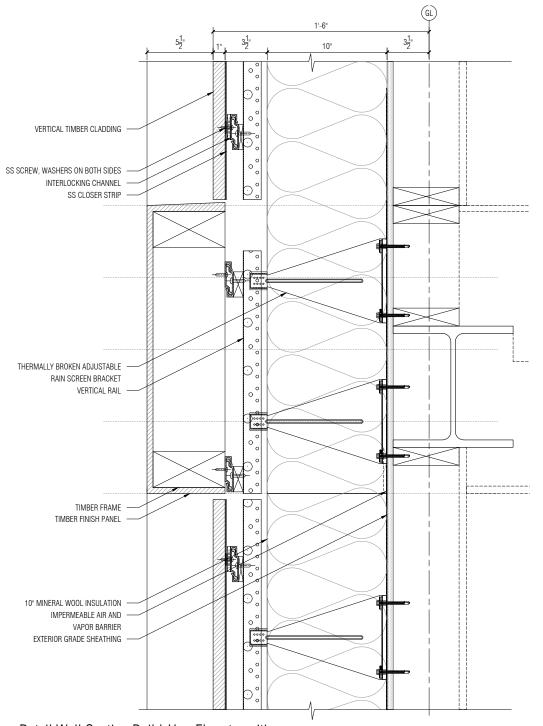**Construction Documents** 

## Front


20 JAY ST. SUITE 920 BROOKLYN, NEW YORK 11201 TEL 212 242 2220 FAX 212 242 2253


# Storm King Arts Center

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Detail Wall Section Build-Up : Roof Edge SCALE: 1 1/2" = 1'-0"

DATE

## Front

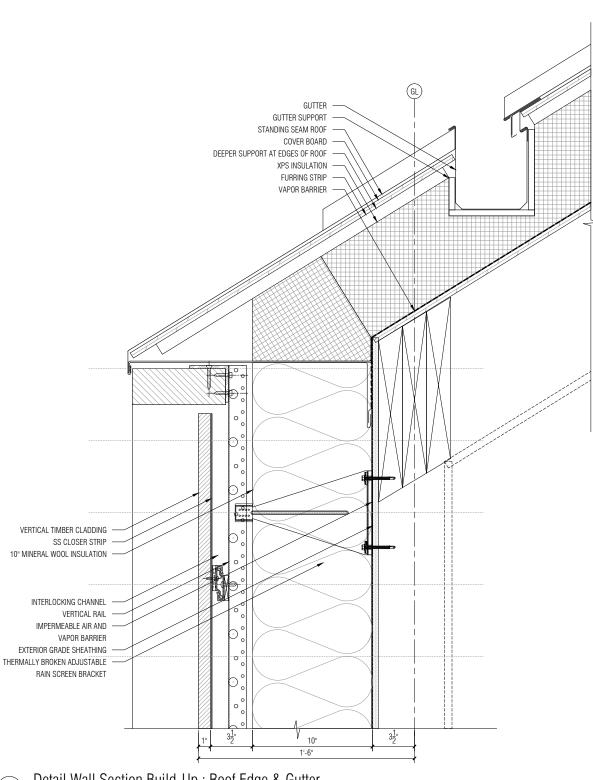
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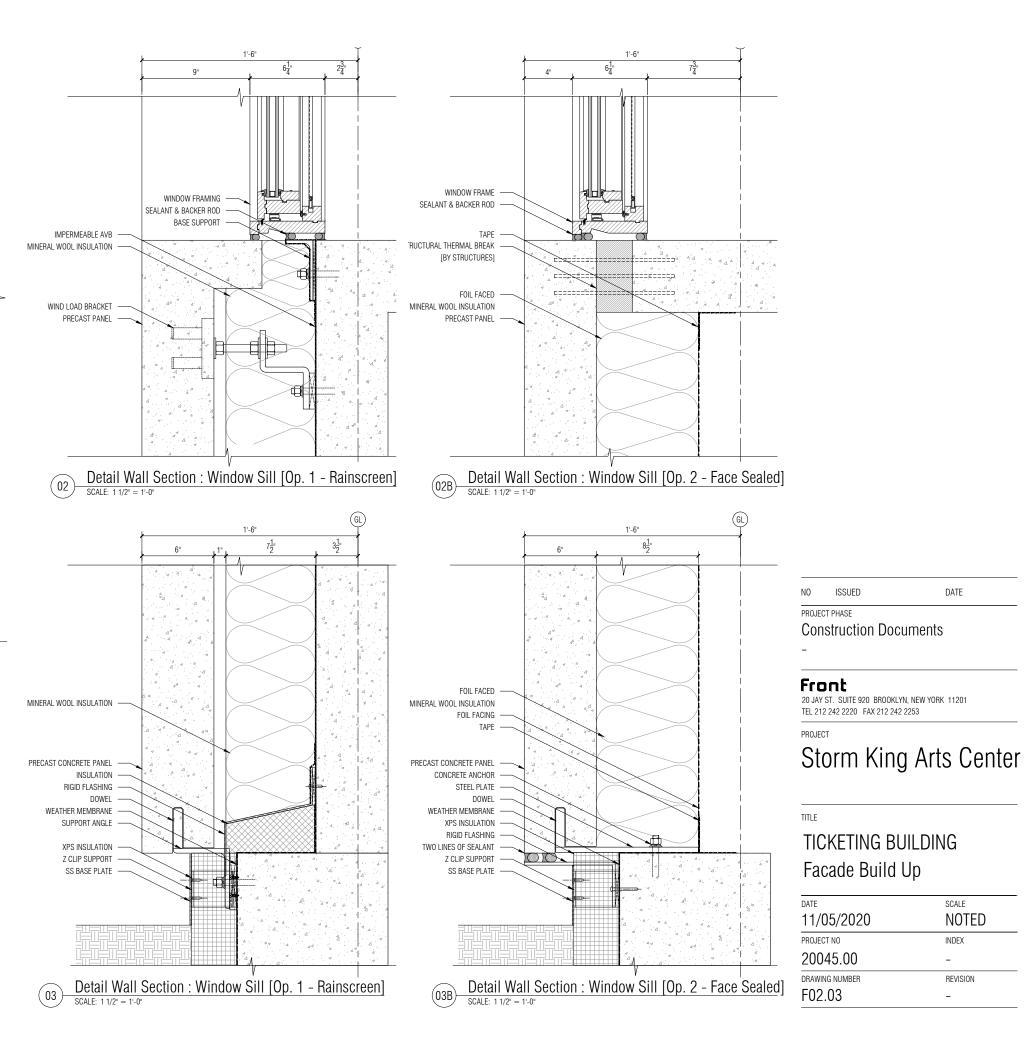
# Storm King Arts Center
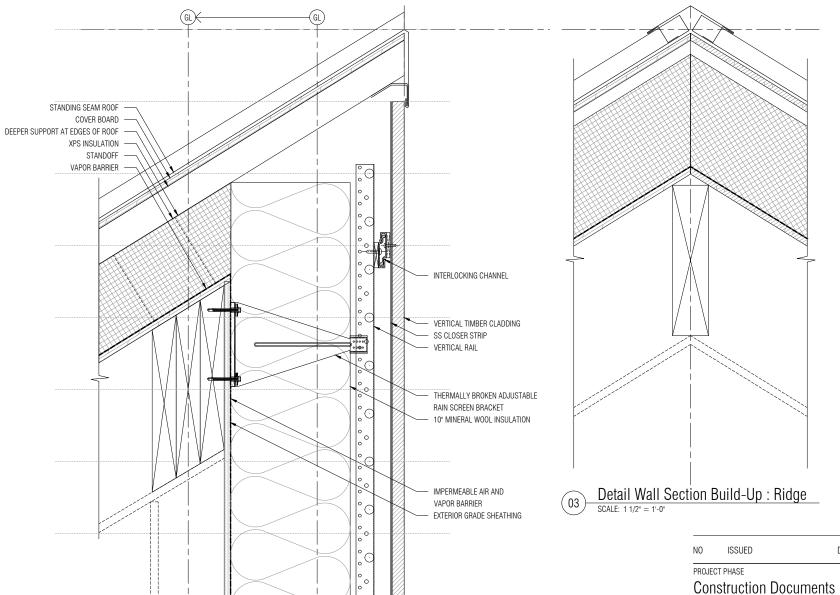
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Detail Wall Section Build-Up : Roof Edge & Gutter SCALE: 1 1/2" = 1'-0"






DATE

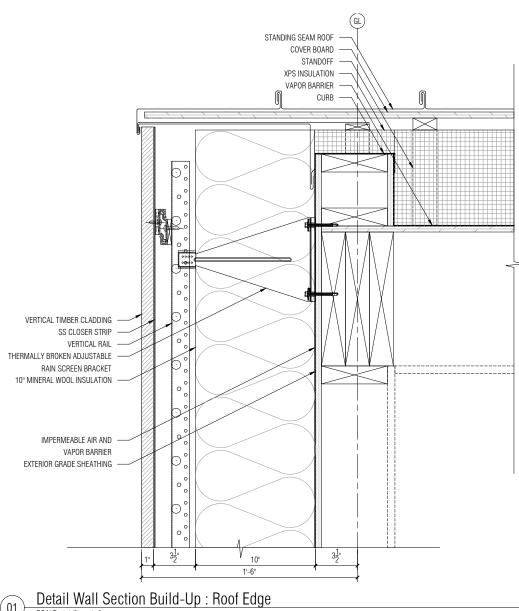SCALE

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## Front

20 JAY ST. SUITE 920 BROOKLYN, NEW YORK 11201 TEL 212 242 2220 FAX 212 242 2253


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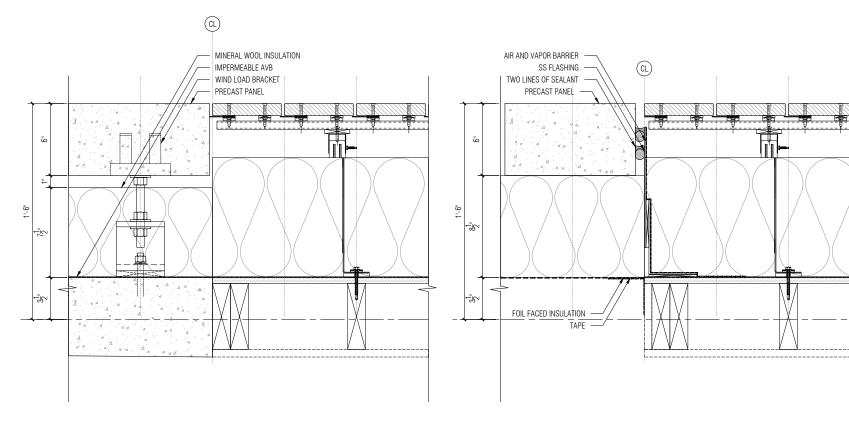
# Storm King Arts Center

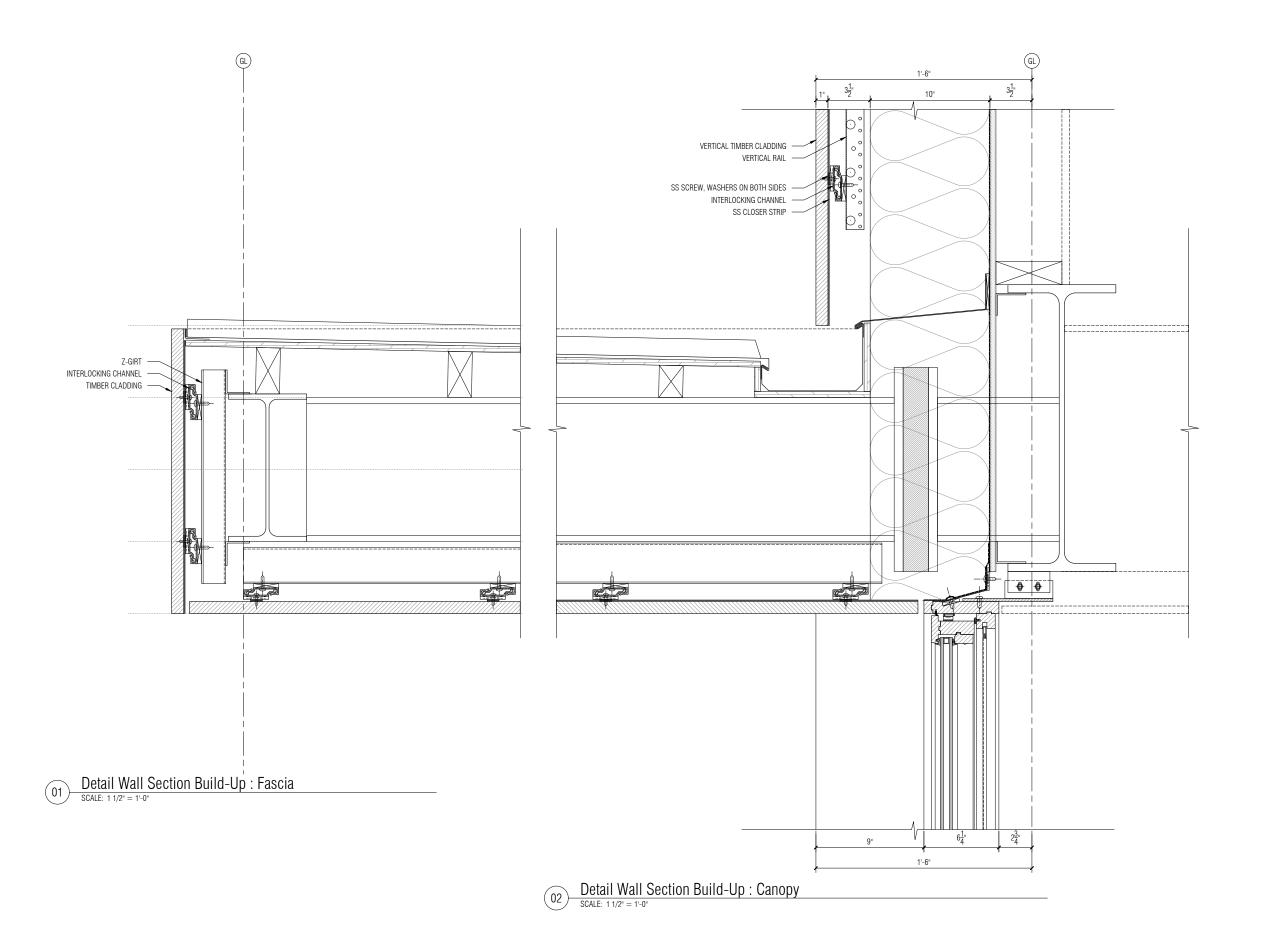
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# TICKETING BUILDING Facade Build Up

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Detail Wall Build-Up Plan : Timber Facade to Window Jamb

SCALE: 1 1/2" = 1'-0"

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### Front
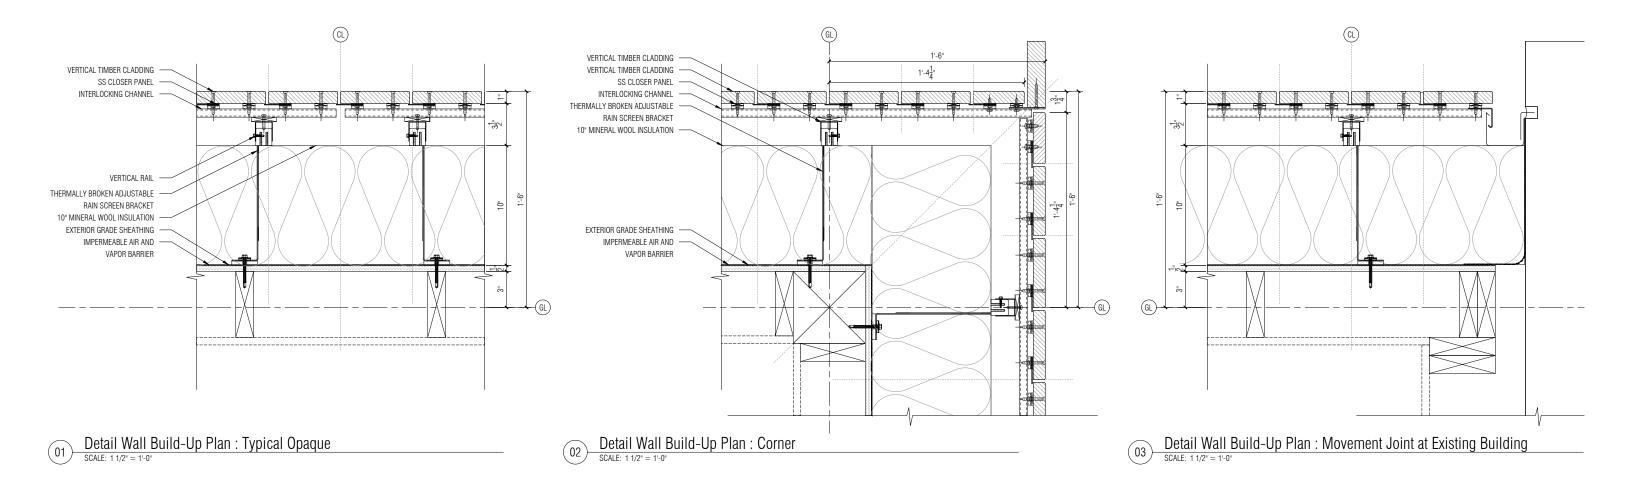
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# Storm King Arts Center

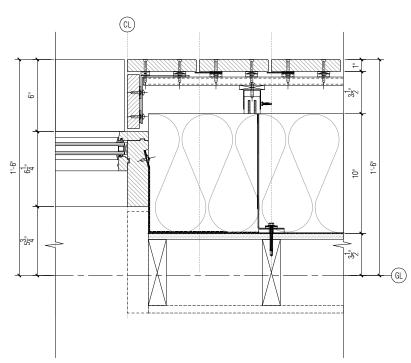
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# TICKETING BUILDING Facade Build Up


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Detail Wall Plan : Timber to Precast [Op. 1 - Rain Screen]


Detail Wall Plan: Timber to Precast [Op. 2 - Face Sealed]




Detail Wall Build-Up Section : Typical Opaque

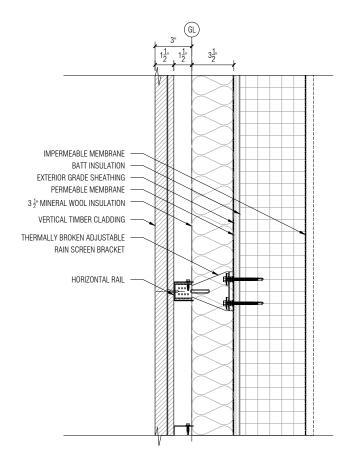

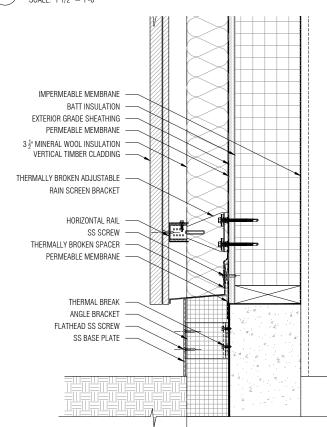
Detail Wall Build-Up Section : Ground

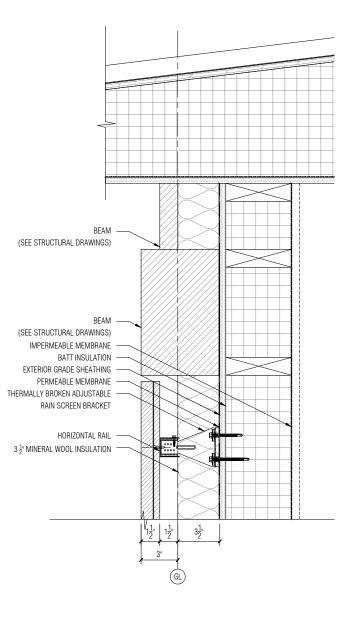

Detail Wall Section Build-Up : Roof Transition

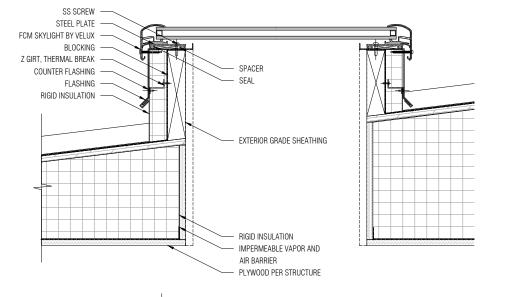

Detail Roof Build-Up Section : Skylight

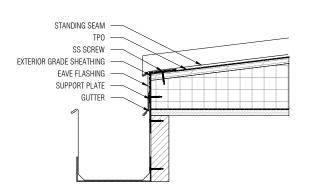

Detail Roof Build-Up Section : Gutter

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### **Construction Documents**

### Front

20 JAY ST. SUITE 920 BROOKLYN, NEW YORK 11201 TEL 212 242 2220 FAX 212 242 2253


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# Storm King Arts Center

TITLE


# POND PAVILION Facade Build Up

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Detail Wall Build-Up Section : Fixed Head

SCALE: 1 1/2" = 1'-0"

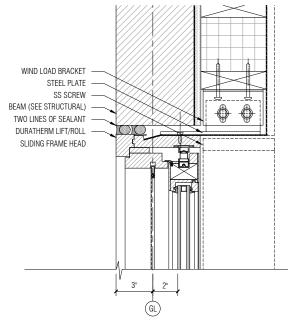

O1 Detail Wall Build-Up Section : Fixed Base at Slab

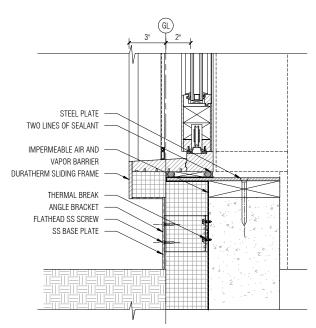SCALE: 1 1/2" = 1"-0"

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Front

20 JAY ST. SUITE 920 BROOKLYN, NEW YORK 11201 TEL 212 242 2220 FAX 212 242 2253


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# Storm King Arts Center


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## POND PAVILION Facade Build Up

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Detail Wall Build-Up Plan : Corner SCALE: 11/2" = 1'-0"



Detail Wall Build-Up Plan : Typical Opaque SCALE: 11/2" = 1'-0"
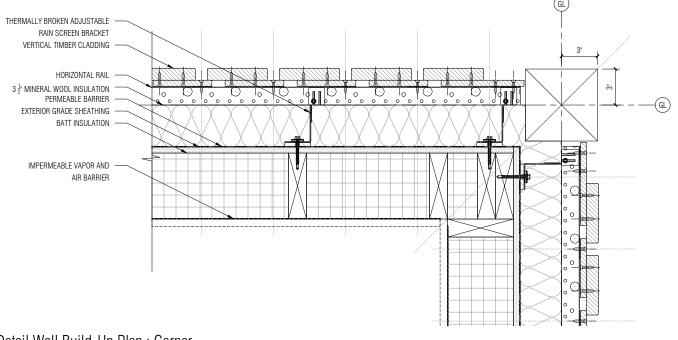
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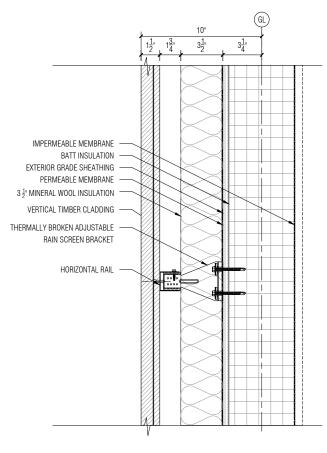
## **Construction Documents**

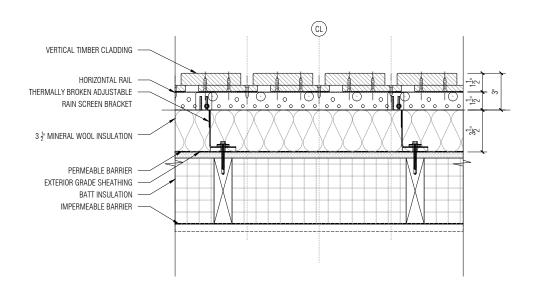
Front 20 JAY ST. SUITE 920 BROOKLYN, NEW YORK 11201 TEL 212 242 2220 FAX 212 242 2253

# Storm King Arts Center

## POND PAVILION Facade Build Up


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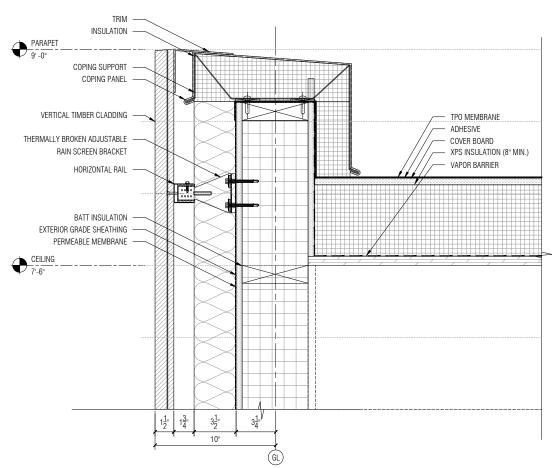


# Detail Roof Section Build-Up : Skylight SCALE: 11/2" = 1'-0"

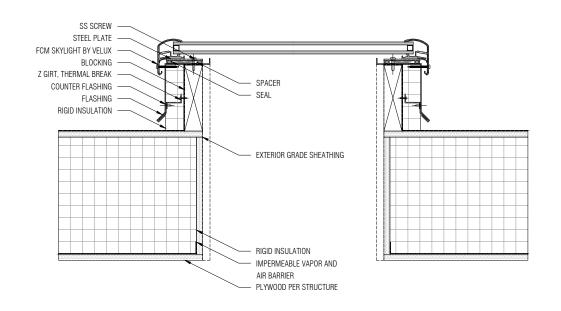Detail Wall Build-Up Section: Typical Opaque



Detail Wall Build-Up Section: Ground

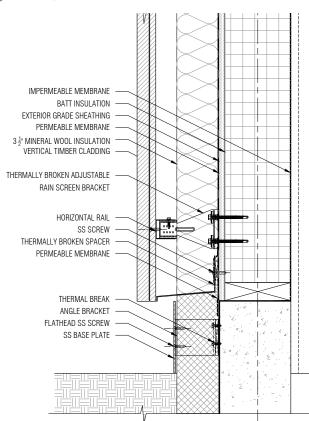

Detail Wall Section Build-Up: Parapet

NO ISSUED

**Construction Documents** 

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## Front


20 JAY ST. SUITE 920 BROOKLYN, NEW YORK 11201 TEL 212 242 2220 FAX 212 242 2253

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## **RESTROOM** Facade Build Up

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(CL) VERTICAL TIMBER CLADDING HORIZONTAL RAIL THERMALLY BROKEN ADJUSTABLE RAIN SCREEN BRACKET  $3\frac{1}{2}$  MINERAL WOOL INSULATION PERMEABLE BARRIER EXTERIOR GRADE SHEATHING BATT INSULATION IMPERMEABLE BARRIER

Detail Wall Build-Up Plan : Typical Opaque SCALE: 11/2" = 1'-0"

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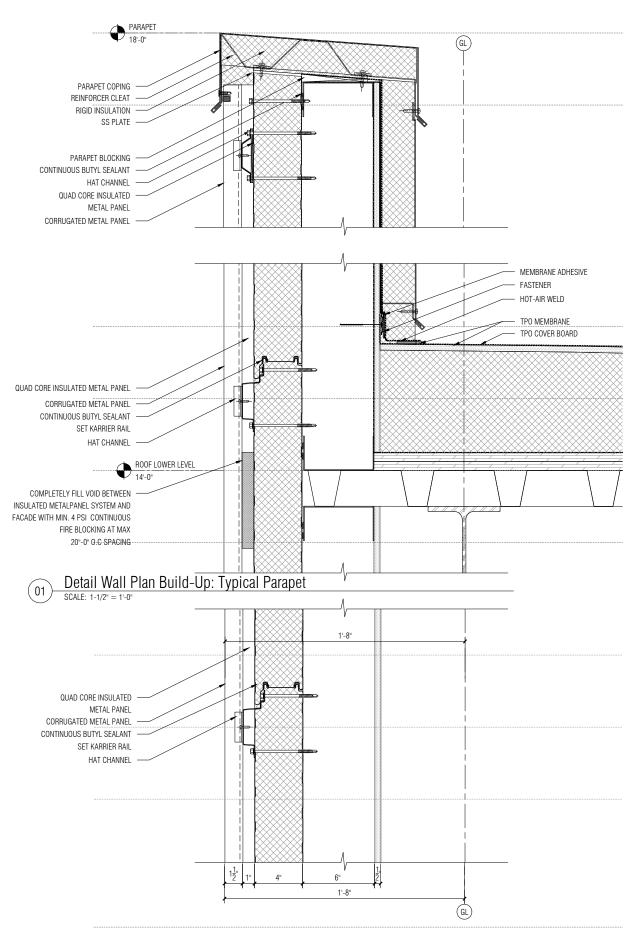
**Construction Documents** 

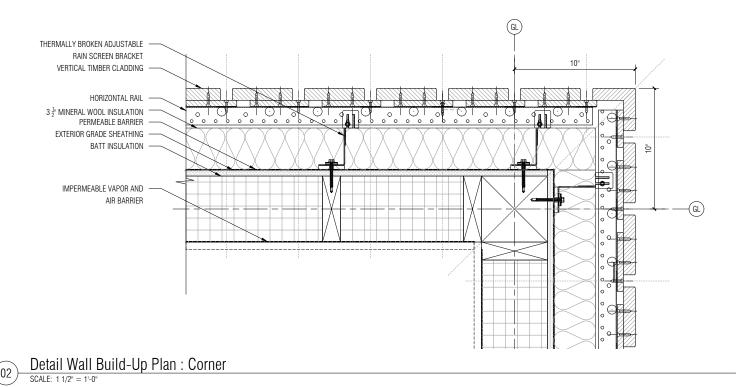
Front 20 JAY ST. SUITE 920 BROOKLYN, NEW YORK 11201 TEL 212 242 2220 FAX 212 242 2253

# Storm King Arts Center

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Detail Wall Plan Build-Up: Scupper

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Front


20 JAY ST. SUITE 920 BROOKLYN, NEW YORK 11201 TEL 212 242 2220 FAX 212 242 2253
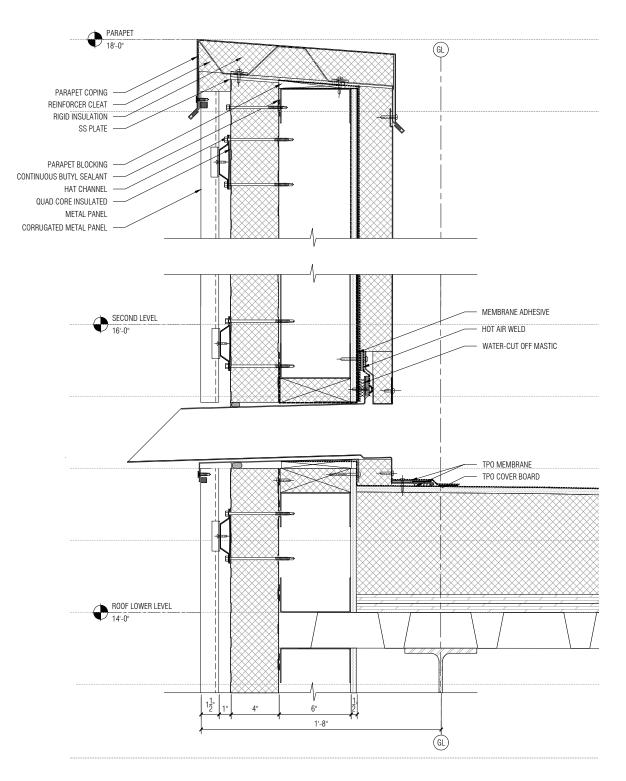
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## **CFM BUILDING** Facade Build Up

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QUAD CORE INSULATED METAL PANEL — COMPLETELY FILL VOID BETWEEN INSULATED METAL -PANEL SYSTEM AND FACADE WITH MIN. 4 PSI CONTINUOUS FIRE BLOCKING AT MAX 20"-0" O.C SPACING HAT CHANNEL AA 4325 SERIES WINDOW Detail Wall Plan Build-Up: Typical Fixed Window Head Detail Wall Plan Build-Up: Typical Fixed Window Sill

SCALE: 1-1/2" = 1'-0" QUAD CORE INSULATED METAL PANEL CORRUGATED METAL PANEL HAT CHANNEL CONTINUOUS BUTYL SEALANT PARAPET 18'-0"

CORRUGATED METAL PANEL

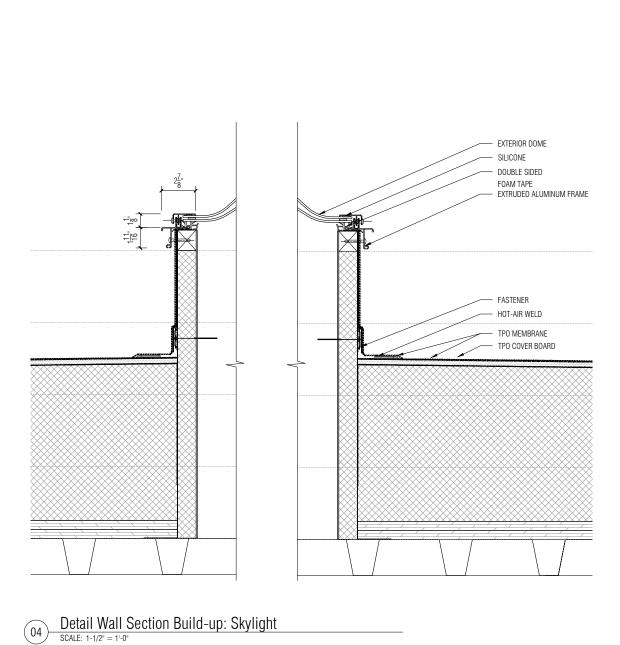Detail Wall Plan Build-Up: Typical Base
SCALE: 1-1/2" = 1'-0"

CFM BUILDING Facade Build Up

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F05.02 -

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NO ISSUED

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Front


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# Storm King Arts Center


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O1 Detail Wall Plan Build-Up: Typical Opaque

SCALE: 1-1/2" = 1'-0"



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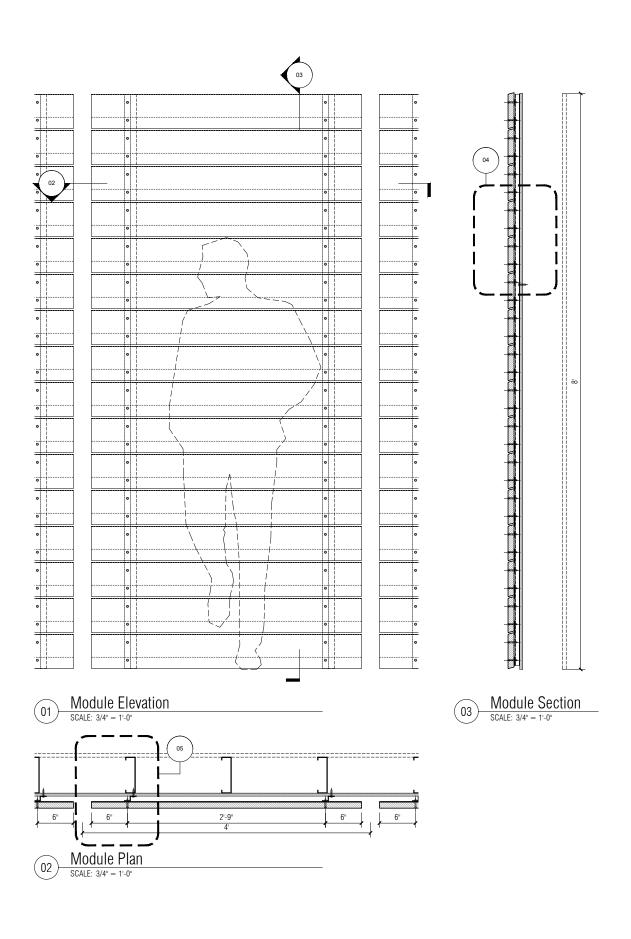
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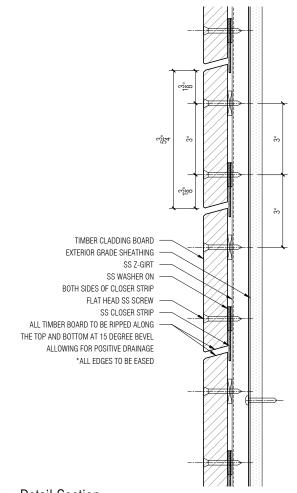
# Storm King Arts Center
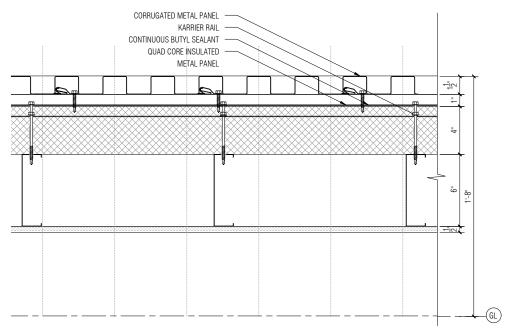
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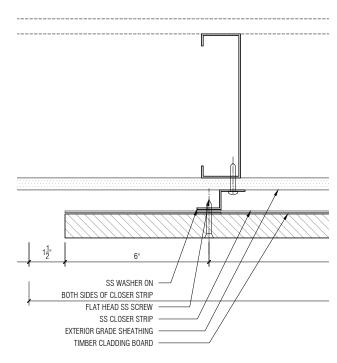
## CFM BUILDING Facade Build Up
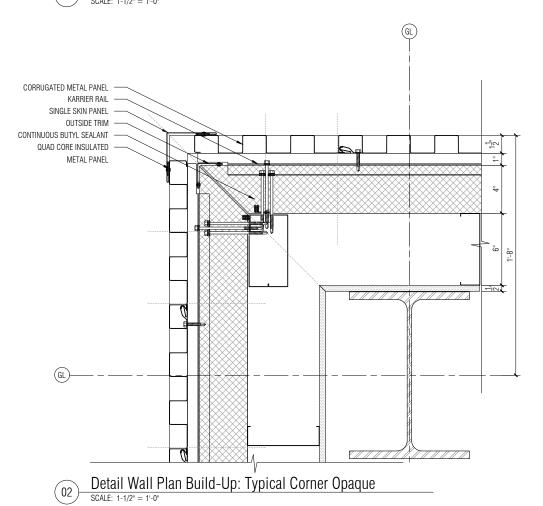
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**Detail Section** 



Detail Plan

FRONT RECOMMENDS THAT THE TOP AND BOTTOM EDGES OF THE COMPONENTS ARE WEATHERED AT 15 DEGREES FOR BETTER LONGEVITY, BY ALLOWING FOR POSITIVE DRAINAGE ALONG ALL HORIZONTAL SURFACES

- ALL HOLES TO BE PRE-DRILLED
- •BOARDS TO BE EITHER 4 FEET OR 2 FEET LONG TO ALLOW USE OF OFF CUTS.
- •ALL FASTENERS OUTBOARD OF THE AIR AND VAPOR
- BARRIER TO BE SS-316.
   SCREW DRIVE TO BE EITHER TORX OR ALLEN WITH BAKED PAINT. COLOR BY ARCHITECTS.
- PANEL DIMENSIONS CAN EITHER BE 4' x 8' OR 4' x 4' TO ALLOW FOR EASIER ACCESS TO THE PANELS.

NO ISSUED DATE PROJECT PHASE

### Construction Documents


## Front

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# Storm King Arts Center

## VMU: Horizontal Cladding Option 1A - Site Assembled

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F0A.01	-

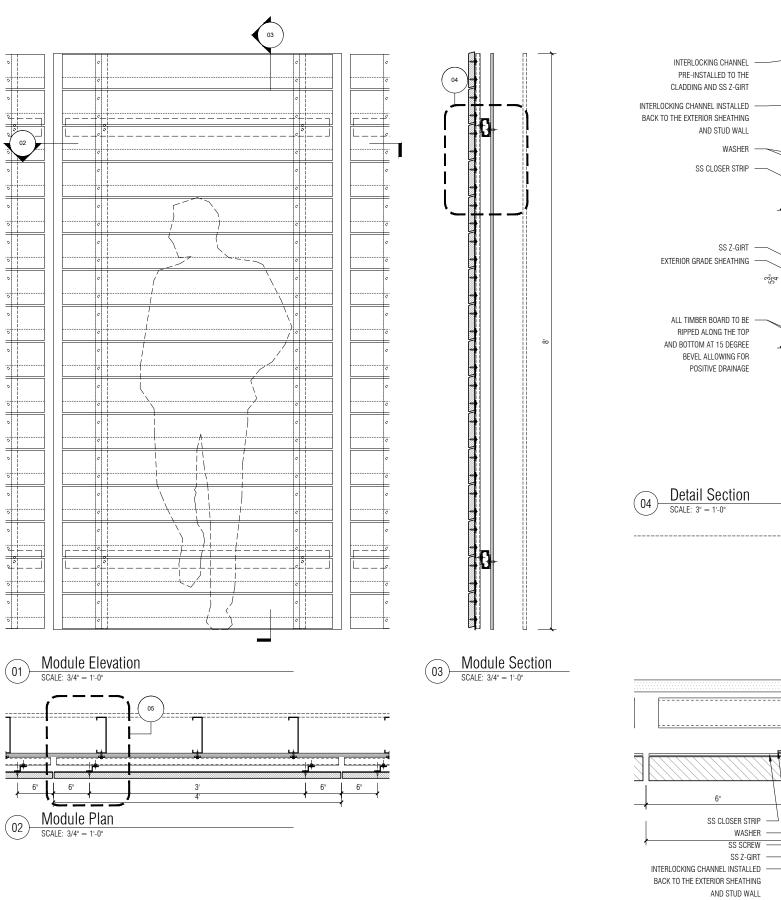

#### NOTES:

• ALL HOLES TO BE PRE-DRILLED

- •BOARDS TO BE EITHER 4 FEET OR 2 FEET LONG TO ALLOW USE OF OFF CUTS.
- •ALL FASTENERS OUTBOARD OF THE AIR AND VAPOR BARRIER TO BE SS-316.
  • SCREW DRIVE TO BE EITHER TORX OR ALLEN WITH BAKED
- PAINT. COLOR BY ARCHITECTS.
- PANEL DIMENSIONS CAN EITHER BE 4' x 8' OR 4' x 4' TO ALLOW FOR EASIER ACCESS TO THE PANELS.

NO ISSUED DATE

PROJECT PHASE

### **Construction Documents**


### Front

20 JAY ST. SUITE 920 BROOKLYN, NEW YORK 11201 TEL 212 242 2220 FAX 212 242 2253


# Storm King Arts Center


## VMU: Horizontal Cladding Option 1B - Panelized System

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F0A.02	-

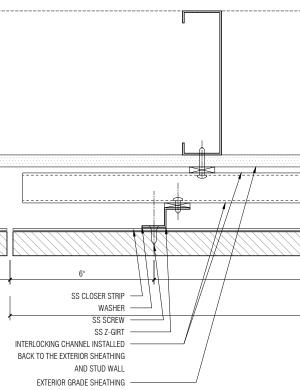

Detail Plan SCALE: 3" = 1'-0"

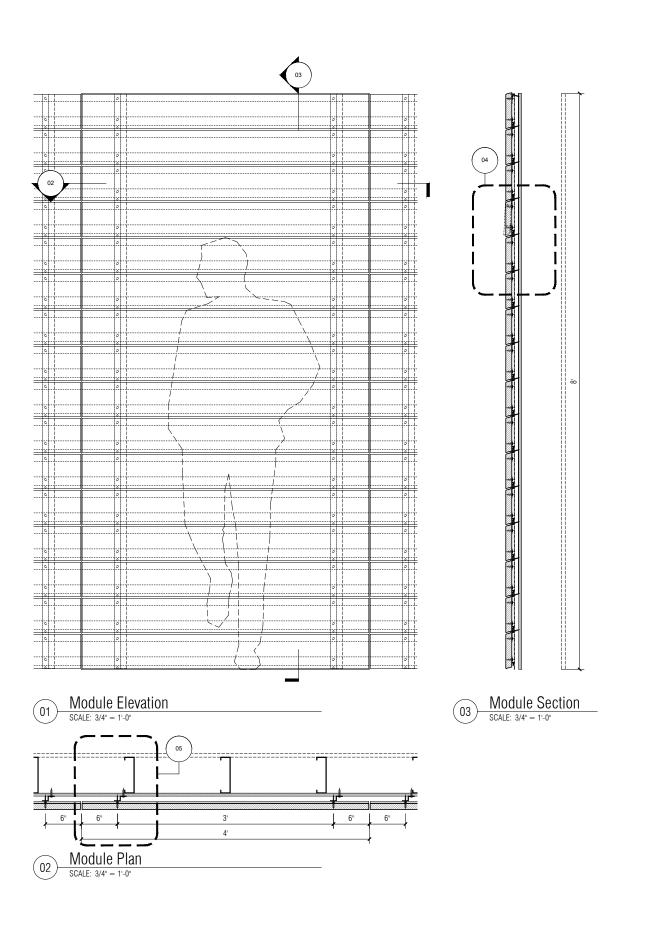

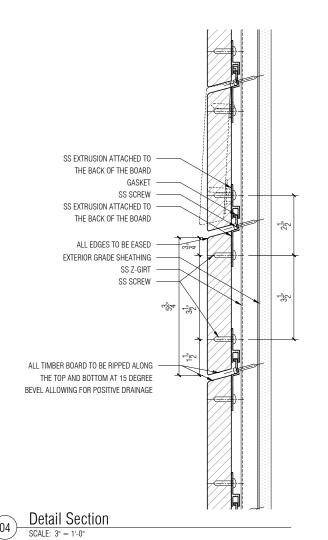

SS EXTRUSION ATTACHED TO THE BACK OF THE BOARD SS SCREW, 6" FROM THE END OF BOARD SS Z-GIRT EXTERIOR GRADE SHEATHING

Detail Plan

FRONT RECOMMENDS THAT THE TOP AND BOTTOM EDGES OF THE COMPONENTS ARE WEATHERED AT 15 DEGREES FOR BETTER LONGEVITY, BY ALLOWING FOR POSITIVE DRAINAGE ALONG ALL HORIZONTAL SURFACES

#### NOTES:

- ALL HOLES TO BE PRE-DRILLED
- •BOARDS TO BE EITHER 4 FEET OR 2 FEET LONG TO ALLOW USE OF OFF CUTS.
- •ALL FASTENERS OUTBOARD OF THE AIR AND VAPOR
- BARRIER TO BE SS-316.
   SCREW DRIVE TO BE EITHER TORX OR ALLEN WITH BAKED PAINT. COLOR BY ARCHITECTS.
- PANEL DIMENSIONS CAN EITHER BE 4' x 8' OR 4' x 4' TO ALLOW FOR EASIER ACCESS TO THE PANELS.

NO ISSUED DATE

PROJECT PHASE

### **Construction Documents**


## Front

20 JAY ST. SUITE 920 BROOKLYN, NEW YORK 11201 TEL 212 242 2220 FAX 212 242 2253

# Storm King Arts Center

## VMU: Horziontal Cladding Option 2A - Site Assembled

DATE	SCALE
11/05/2020	NOTED
PROJECT NO	INDEX
20045.00	-
DRAWING NUMBER	REVISION
F0A.03	_

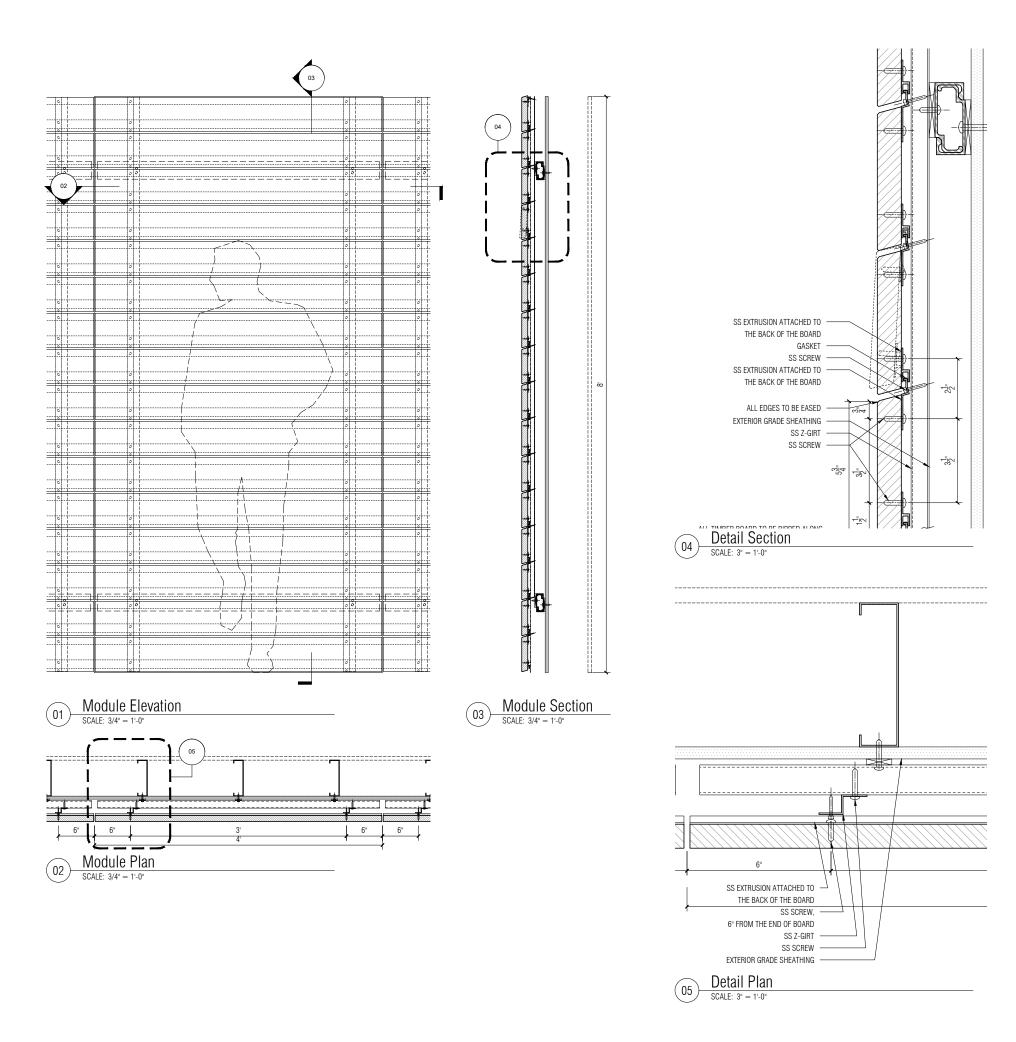

• ALL HOLES TO BE PRE-DRILLED

•BOARDS TO BE EITHER 4 FEET OR 2 FEET LONG TO ALLOW USE OF OFF CUTS.

•ALL FASTENERS OUTBOARD OF THE AIR AND VAPOR

BARRIER TO BE SS-316.
• SCREW DRIVE TO BE EITHER TORX OR ALLEN WITH BAKED PAINT. COLOR BY ARCHITECTS.

PANEL DIMENSIONS CAN EITHER BE 4' x 8' OR 4' x 4' TO ALLOW FOR EASIER ACCESS TO THE PANELS.

NO ISSUED DATE

PROJECT PHASE

### **Construction Documents**


## Front


20 JAY ST. SUITE 920 BROOKLYN, NEW YORK 11201 TEL 212 242 2220 FAX 212 242 2253

# Storm King Arts Center


## VMU: Horziontal Cladding Option 2B - Panelized System

DATE	SCALE
11/05/2020	NOTED
PROJECT NO	INDEX
20045.00	-
DRAWING NUMBER	REVISION
F0A.04	-

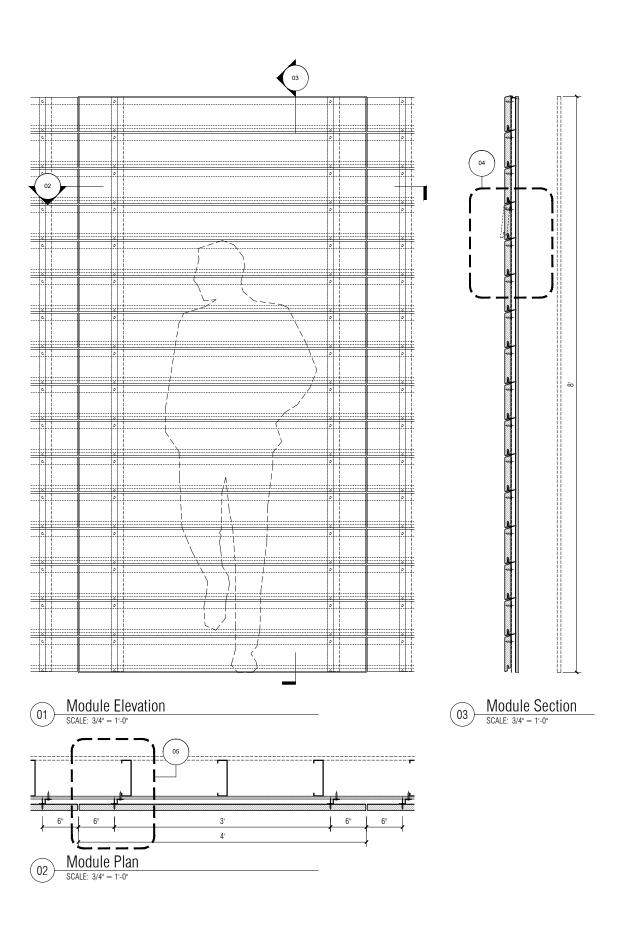

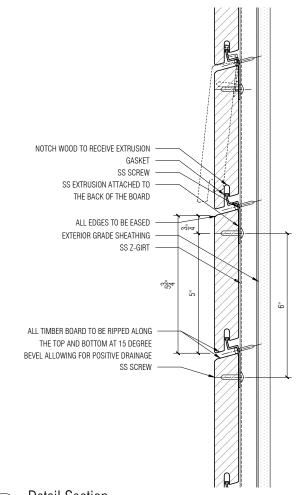

**Detail Section** 

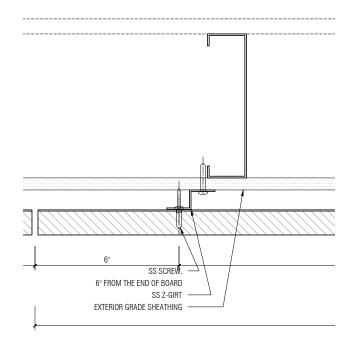

Detail Plan

FRONT RECOMMENDS THAT THE TOP AND BOTTOM EDGES OF THE COMPONENTS ARE WEATHERED AT 15 DEGREES FOR BETTER LONGEVITY, BY ALLOWING FOR POSITIVE DRAINAGE ALONG ALL HORIZONTAL SURFACES

- ALL HOLES TO BE PRE-DRILLED
- •BOARDS TO BE EITHER 4 FEET OR 2 FEET LONG TO ALLOW USE OF OFF CUTS.
- ALL FASTENERS OUTBOARD OF THE AIR AND VAPOR
  BARRIER TO BE SS-316.
   SCREW DRIVE TO BE EITHER TORX OR ALLEN WITH BAKED
  PAINT. COLOR BY ARCHITECTS.
- PANEL DIMENSIONS CAN EITHER BE 4' x 8' OR 4' x 4' TO ALLOW FOR EASIER ACCESS TO THE PANELS.

NO ISSUED DATE

PROJECT PHASE

### Construction Documents


## Front


20 JAY ST. SUITE 920 BROOKLYN, NEW YORK 11201 TEL 212 242 2220 FAX 212 242 2253

# Storm King Arts Center


## VMU: Horziontal Cladding Option 3A - Site Assembled

DATE 11/05/2020	scale NOTED
PROJECT NO	INDEX
20045.00	-
DRAWING NUMBER	REVISION
F0A.05	-

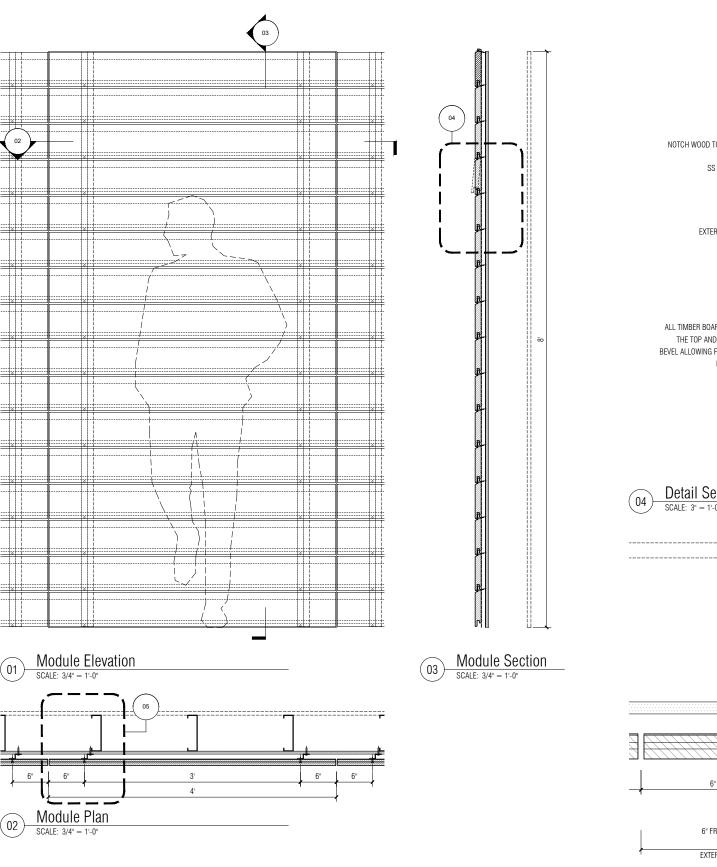

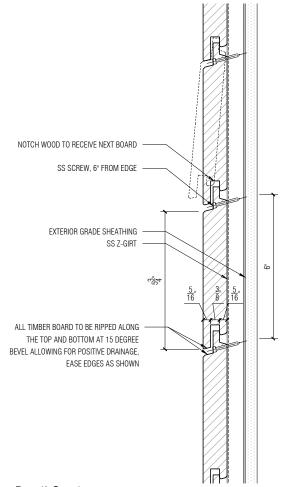

**Detail Section** 

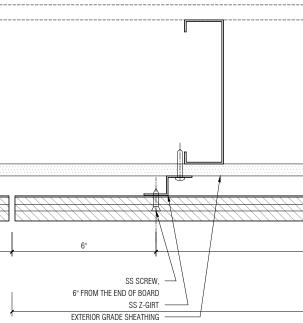

Detail Plan

FRONT RECOMMENDS THAT THE TOP AND BOTTOM EDGES OF THE COMPONENTS ARE WEATHERED AT 15 DEGREES FOR BETTER LONGEVITY, BY ALLOWING FOR POSITIVE DRAINAGE ALONG ALL HORIZONTAL SURFACES

- ALL HOLES TO BE PRE-DRILLED
- •BOARDS TO BE EITHER 4 FEET OR 2 FEET LONG TO ALLOW USE OF OFF CUTS.
- ALL FASTENERS OUTBOARD OF THE AIR AND VAPOR
  BARRIER TO BE SS-316.
   SCREW DRIVE TO BE EITHER TORX OR ALLEN WITH BAKED
  PAINT. COLOR BY ARCHITECTS.
- PANEL DIMENSIONS CAN EITHER BE 4' x 8' OR 4' x 4' TO ALLOW FOR EASIER ACCESS TO THE PANELS.

NO ISSUED DATE

PROJECT PHASE

### Construction Documents


## Front


20 JAY ST. SUITE 920 BROOKLYN, NEW YORK 11201 TEL 212 242 2220 FAX 212 242 2253


# Storm King Arts Center

## VMU: Horziontal Cladding Option 3B - Site Assembled

DATE	SCALE
11/05/2020	NOTED
PROJECT NO	INDEX
20045.00	-
DRAWING NUMBER	REVISION
F0A.06	-

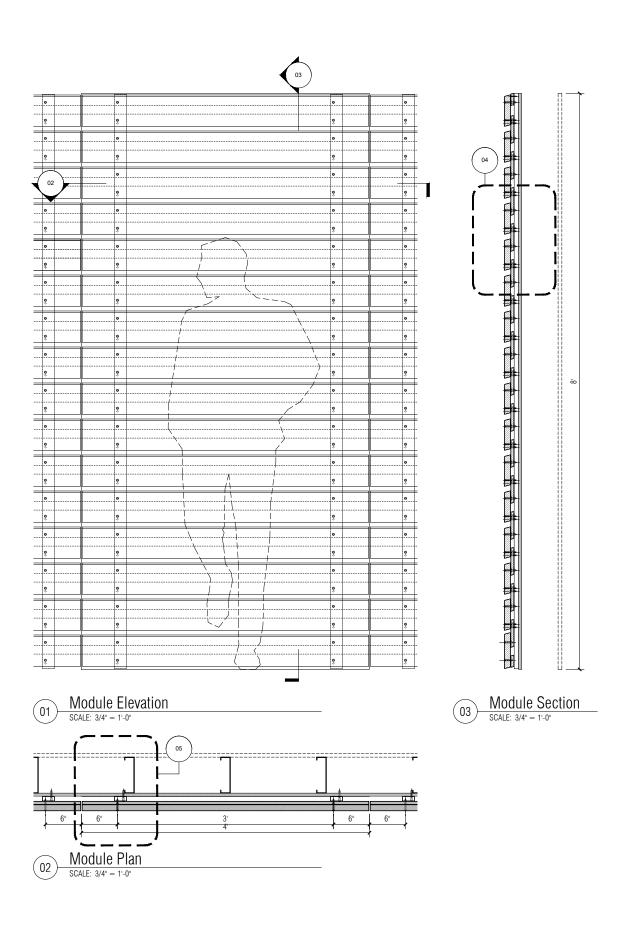

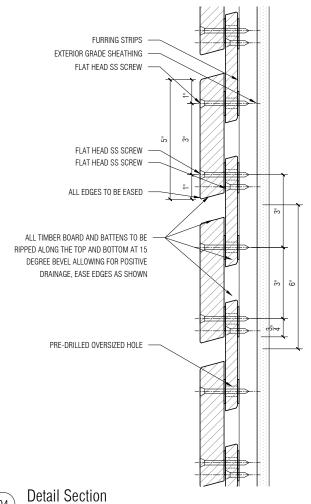

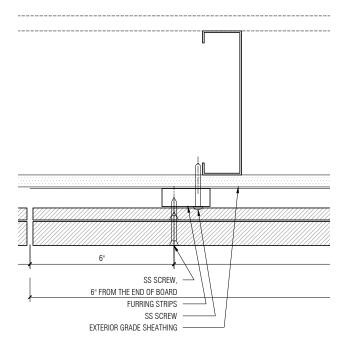

Detail Plan

FRONT RECOMMENDS THAT THE TOP AND BOTTOM EDGES OF THE COMPONENTS ARE WEATHERED AT 15 DEGREES FOR BETTER LONGEVITY, BY ALLOWING FOR POSITIVE DRAINAGE ALONG ALL HORIZONTAL SURFACES

- ALL HOLES TO BE PRE-DRILLED
- •BOARDS TO BE EITHER 4 FEET OR 2 FEET LONG TO ALLOW USE OF OFF CUTS.
- •ALL FASTENERS OUTBOARD OF THE AIR AND VAPOR
- BARRIER TO BE SS-316.
   SCREW DRIVE TO BE EITHER TORX OR ALLEN WITH BAKED PAINT. COLOR BY ARCHITECTS.
- PANEL DIMENSIONS CAN EITHER BE 4' x 8' OR 4' x 4' TO ALLOW FOR EASIER ACCESS TO THE PANELS.

NO ISSUED DATE PROJECT PHASE

### **Construction Documents**


### Front


20 JAY ST. SUITE 920 BROOKLYN, NEW YORK 11201 TEL 212 242 2220 FAX 212 242 2253

# Storm King Arts Center

## VMU: Horziontal Cladding Option 4 - Site Assembled

DATE 11/05/2020	scale NOTED
PROJECT NO	INDEX
20045.00	-
DRAWING NUMBER	REVISION
F0A.07	-

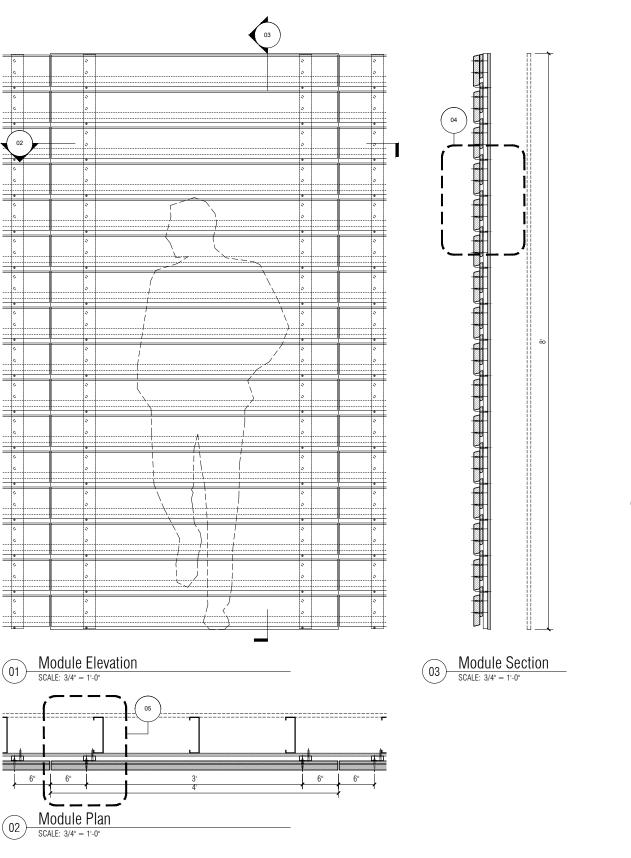

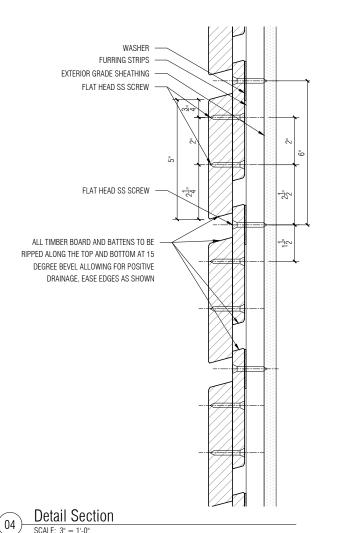

6" FROM THE END OF BOARD FURRING STRIPS SS SCREW EXTERIOR GRADE SHEATHING

Detail Plan

FRONT RECOMMENDS THAT THE TOP AND BOTTOM EDGES OF THE COMPONENTS ARE WEATHERED AT 15 DEGREES FOR BETTER LONGEVITY, BY ALLOWING FOR POSITIVE DRAINAGE ALONG ALL HORIZONTAL SURFACES

- ALL HOLES TO BE PRE-DRILLED
- •BOARDS TO BE EITHER 4 FEET OR 2 FEET LONG TO ALLOW USE OF OFF CUTS.
- ALL FASTENERS OUTBOARD OF THE AIR AND VAPOR
  BARRIER TO BE SS-316.
   SCREW DRIVE TO BE EITHER TORX OR ALLEN WITH BAKED
  PAINT. COLOR BY ARCHITECTS.
- PANEL DIMENSIONS CAN EITHER BE 4' x 8' OR 4' x 4' TO ALLOW FOR EASIER ACCESS TO THE PANELS.

NO ISSUED DATE

PROJECT PHASE

### Construction Documents


## Front


20 JAY ST. SUITE 920 BROOKLYN, NEW YORK 11201 TEL 212 242 2220 FAX 212 242 2253

# Storm King Arts Center


## VMU: Horziontal Cladding Option 5A - Site Assembled

DATE	SCALE
11/05/2020	NOTED
PROJECT NO	INDEX
20045.00	-
DRAWING NUMBER	REVISION
F0A.08	-

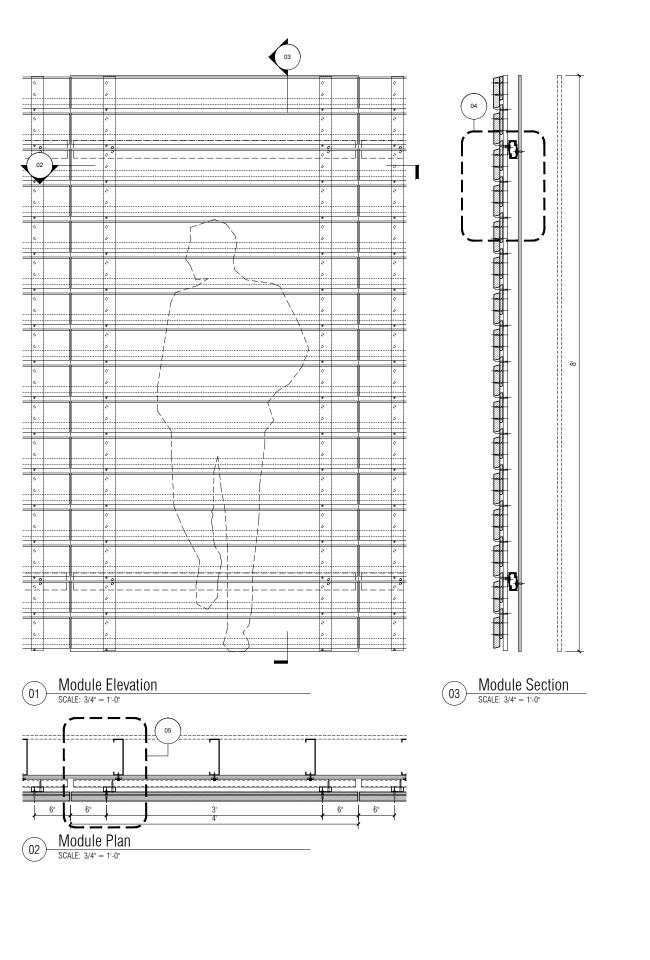

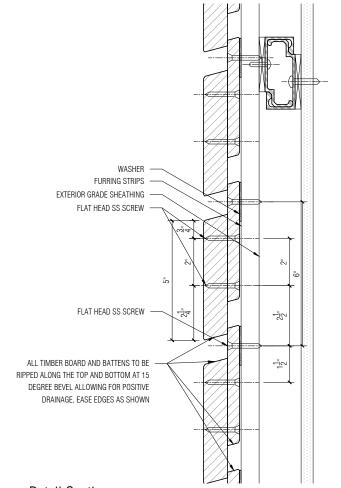

**Detail Section** 

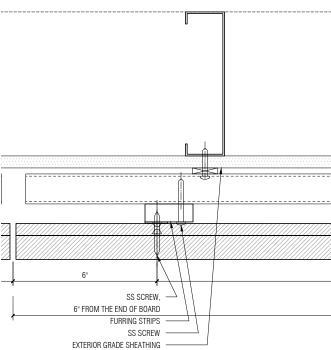

Detail Plan

FRONT RECOMMENDS THAT THE TOP AND BOTTOM EDGES OF THE COMPONENTS ARE WEATHERED AT 15 DEGREES FOR BETTER LONGEVITY, BY ALLOWING FOR POSITIVE DRAINAGE ALONG ALL HORIZONTAL SURFACES

- ALL HOLES TO BE PRE-DRILLED
- •BOARDS TO BE EITHER 4 FEET OR 2 FEET LONG TO ALLOW USE OF OFF CUTS.
- ALL FASTENERS OUTBOARD OF THE AIR AND VAPOR
  BARRIER TO BE SS-316.
   SCREW DRIVE TO BE EITHER TORX OR ALLEN WITH BAKED
  PAINT. COLOR BY ARCHITECTS.
- PANEL DIMENSIONS CAN EITHER BE 4' x 8' OR 4' x 4' TO ALLOW FOR EASIER ACCESS TO THE PANELS.

NO ISSUED DATE

PROJECT PHASE

### **Construction Documents**


## Front

20 JAY ST. SUITE 920 BROOKLYN, NEW YORK 11201 TEL 212 242 2220 FAX 212 242 2253

# Storm King Arts Center

## VMU: Horziontal Cladding Option 5B - Panelized System

DATE	SCALE
11/05/2020	NOTED
PROJECT NO	INDEX
20045.00	-
DRAWING NUMBER	REVISION
F0A.09	-

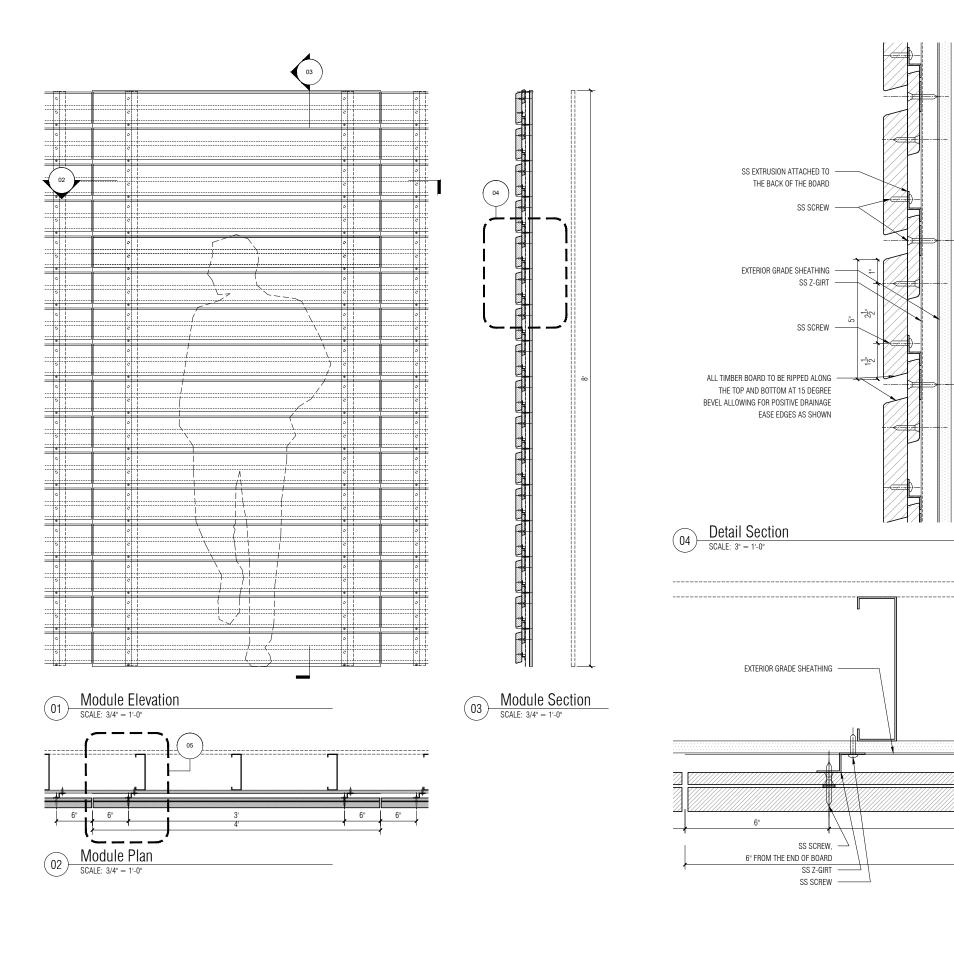

• ALL HOLES TO BE PRE-DRILLED

•BOARDS TO BE EITHER 4 FEET OR 2 FEET LONG TO ALLOW USE OF OFF CUTS.

•ALL FASTENERS OUTBOARD OF THE AIR AND VAPOR

BARRIER TO BE SS-316.
 SCREW DRIVE TO BE EITHER TORX OR ALLEN WITH BAKED PAINT. COLOR BY ARCHITECTS.

PANEL DIMENSIONS CAN EITHER BE 4' x 8' OR 4' x 4' TO ALLOW FOR EASIER ACCESS TO THE PANELS.

NO ISSUED DATE

PROJECT PHASE

### **Construction Documents**


## Front


20 JAY ST. SUITE 920 BROOKLYN, NEW YORK 11201 TEL 212 242 2220 FAX 212 242 2253

# Storm King Arts Center


## VMU: Horziontal Cladding Option 6A - Site Assembled

DATE	SCALE
11/05/2020	NOTED
PROJECT NO	INDEX
20045.00	-
DRAWING NUMBER	REVISION
F0A.10	-

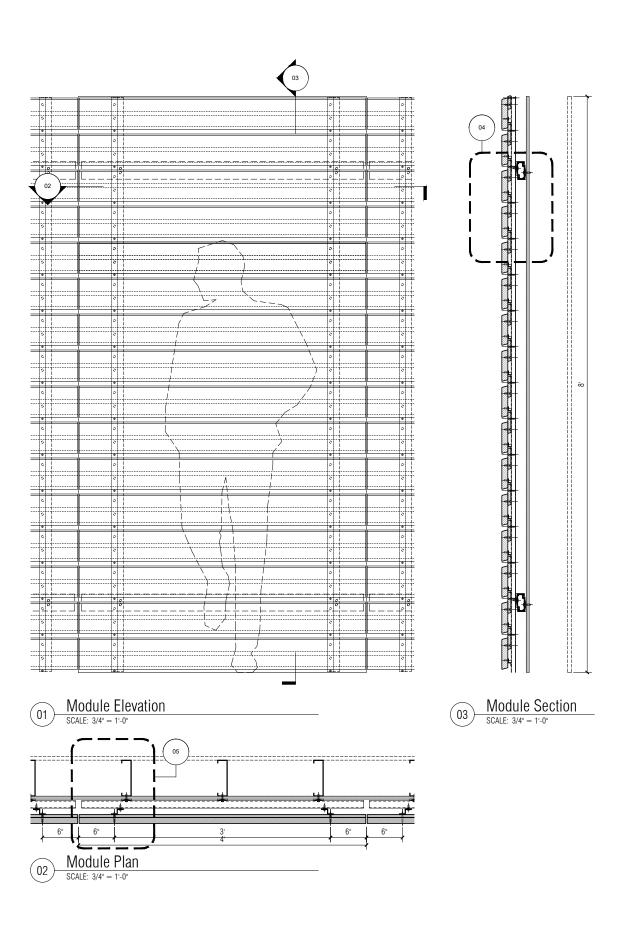

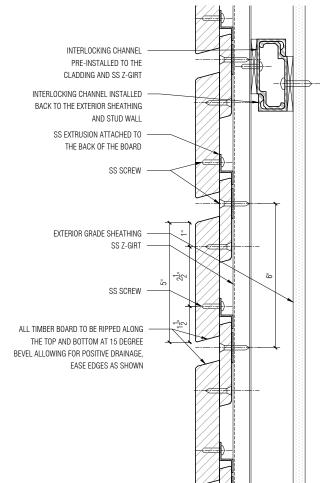

**Detail Section** 

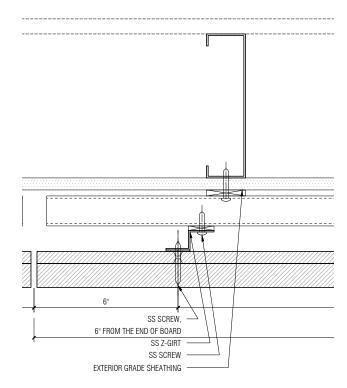

Detail Plan

FRONT RECOMMENDS THAT THE TOP AND BOTTOM EDGES OF THE COMPONENTS ARE WEATHERED AT 15 DEGREES FOR BETTER LONGEVITY, BY ALLOWING FOR POSITIVE DRAINAGE ALONG ALL HORIZONTAL SURFACES

#### NOTES:

- ALL HOLES TO BE PRE-DRILLED
- •BOARDS TO BE EITHER 4 FEET OR 2 FEET LONG TO ALLOW USE OF OFF CUTS.
- •ALL FASTENERS OUTBOARD OF THE AIR AND VAPOR
- BARRIER TO BE SS-316.
   SCREW DRIVE TO BE EITHER TORX OR ALLEN WITH BAKED PAINT. COLOR BY ARCHITECTS.
- PANEL DIMENSIONS CAN EITHER BE 4' x 8' OR 4' x 4' TO ALLOW FOR EASIER ACCESS TO THE PANELS.

NO ISSUED DATE

PROJECT PHASE

### **Construction Documents**


### Front

20 JAY ST. SUITE 920 BROOKLYN, NEW YORK 11201 TEL 212 242 2220 FAX 212 242 2253

# Storm King Arts Center

## VMU: Horziontal Cladding Option 6B - Panelized System

DATE	SCALE
11/05/2020	NOTED
PROJECT NO	INDEX
20045.00	_
DRAWING NUMBER	REVISION
F0A.11	_

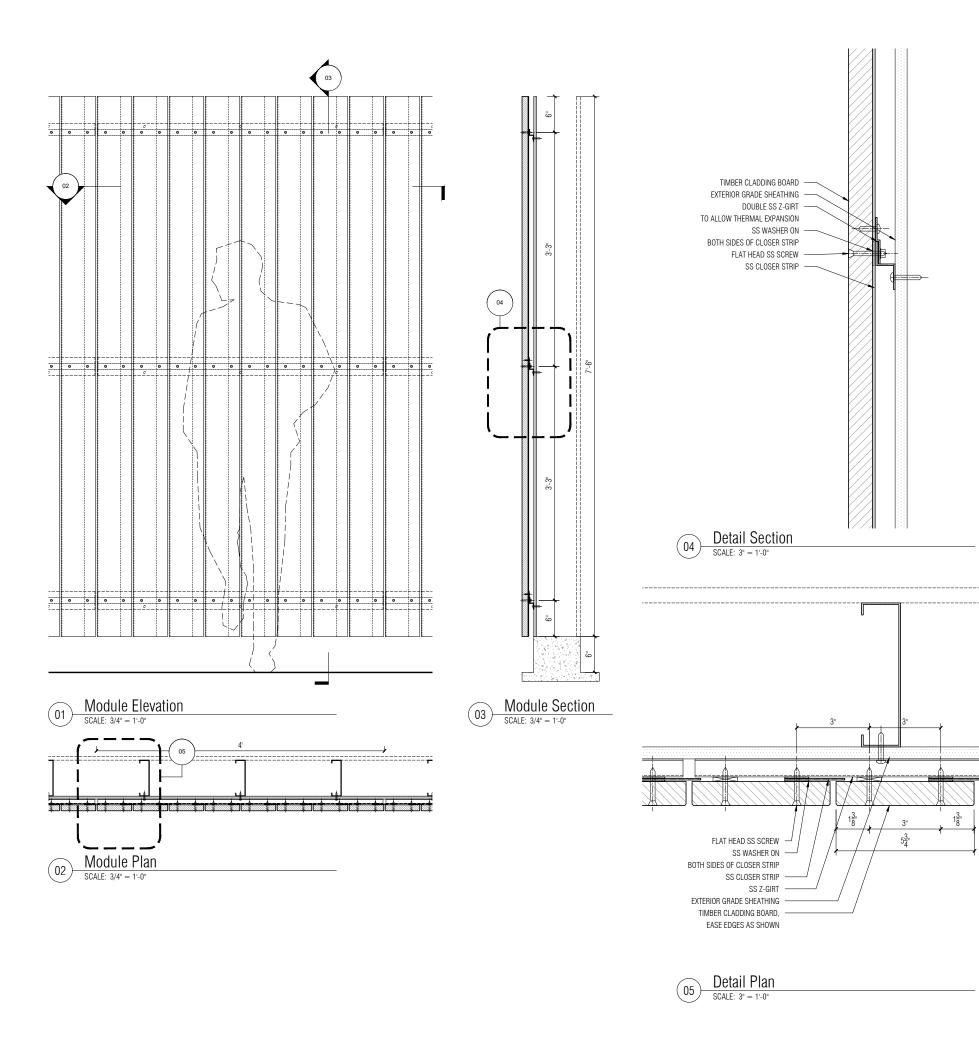

• ALL HOLES TO BE PRE-DRILLED

•BOARDS TO BE EITHER 4 FEET OR 2 FEET LONG TO ALLOW USE OF OFF CUTS.

•ALL FASTENERS OUTBOARD OF THE AIR AND VAPOR

BARRIER TO BE SS-316.
• SCREW DRIVE TO BE EITHER TORX OR ALLEN WITH BAKED PAINT. COLOR BY ARCHITECTS.

PANEL DIMENSIONS CAN EITHER BE 4' x 8' OR 4' x 4' TO ALLOW FOR EASIER ACCESS TO THE PANELS.

NO ISSUED DATE

PROJECT PHASE

### **Construction Documents**


## Front

20 JAY ST. SUITE 920 BROOKLYN, NEW YORK 11201 TEL 212 242 2220 FAX 212 242 2253

# Storm King Arts Center

## VMU: Vertical Cladding Option 1A: Site Assembled

DATE 11/05/2020	scale NOTED
PROJECT NO	INDEX
20045.00	-
DRAWING NUMBER	REVISION
F0B.01	-

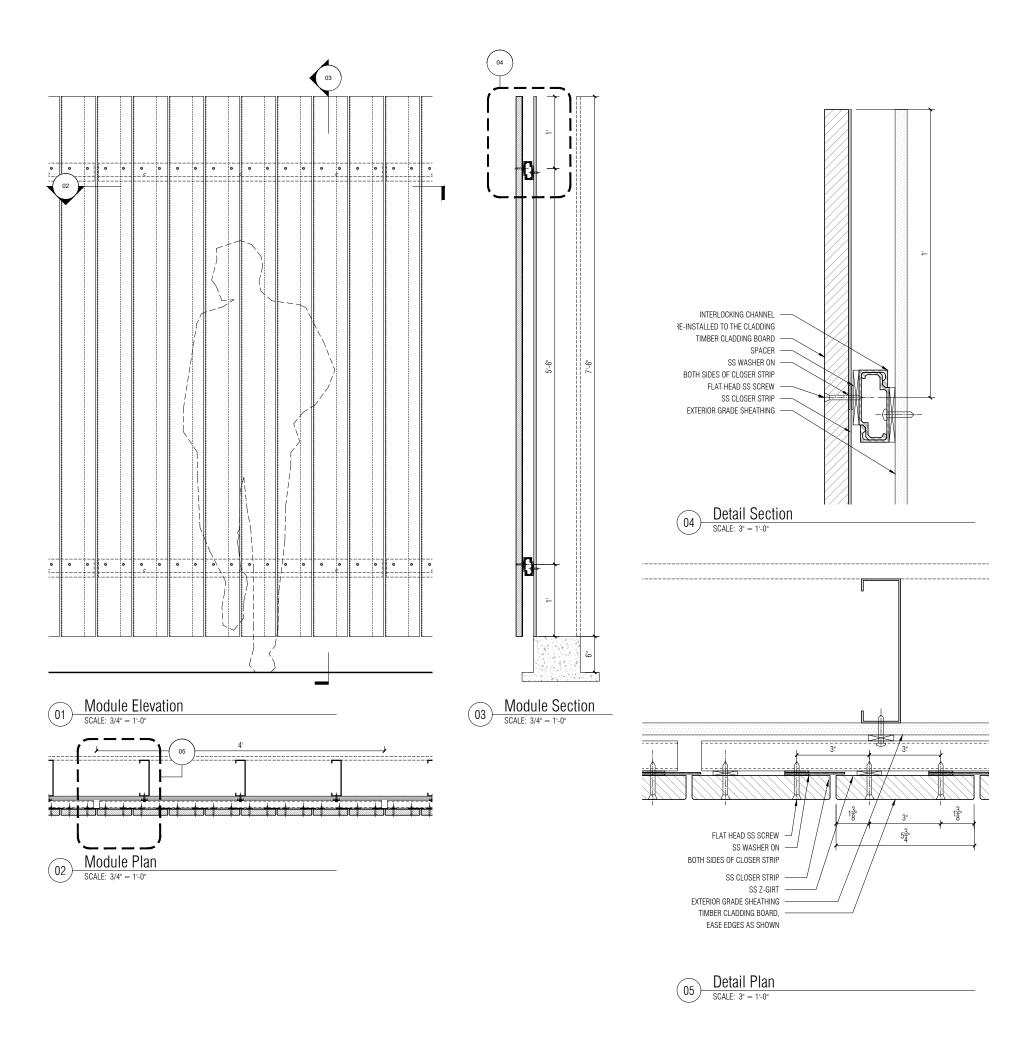

- ALL HOLES TO BE PRE-DRILLED
- •BOARDS TO BE EITHER 4 FEET OR 2 FEET LONG TO ALLOW USE OF OFF CUTS.
- •ALL FASTENERS OUTBOARD OF THE AIR AND VAPOR
- BARRIER TO BE SS-316.
   SCREW DRIVE TO BE EITHER TORX OR ALLEN WITH BAKED PAINT. COLOR BY ARCHITECTS.
- PANEL DIMENSIONS CAN EITHER BE 4' x 8' OR 4' x 4' TO ALLOW FOR EASIER ACCESS TO THE PANELS.

NO ISSUED DATE

PROJECT PHASE

### **Construction Documents**


## Front

20 JAY ST. SUITE 920 BROOKLYN, NEW YORK 11201 TEL 212 242 2220 FAX 212 242 2253

# Storm King Arts Center

## VMU: Vertical Cladding Option 1B: Panelized System

DATE 11/05/2020	scale NOTED
PROJECT NO	INDEX
20045.00	-
DRAWING NUMBER	REVISION
F0B.02	-

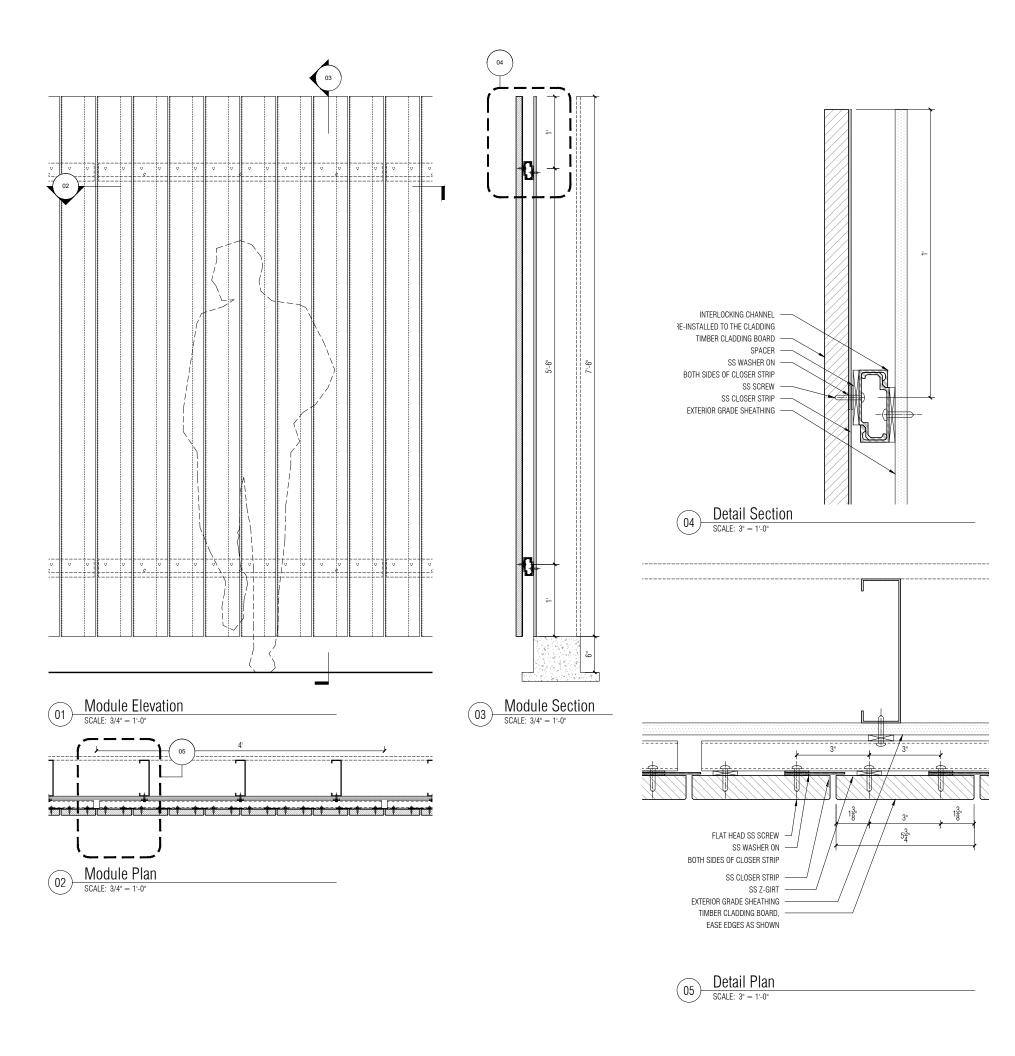

- ALL HOLES TO BE PRE-DRILLED
- •BOARDS TO BE EITHER 4 FEET OR 2 FEET LONG TO ALLOW USE OF OFF CUTS.
- •ALL FASTENERS OUTBOARD OF THE AIR AND VAPOR BARRIER TO BE SS-316.
  • SCREW DRIVE TO BE EITHER TORX OR ALLEN WITH BAKED
- PAINT. COLOR BY ARCHITECTS.
- PANEL DIMENSIONS CAN EITHER BE 4' x 8' OR 4' x 4' TO ALLOW FOR EASIER ACCESS TO THE PANELS.

NO ISSUED DATE

PROJECT PHASE

### **Construction Documents**


## Front

20 JAY ST. SUITE 920 BROOKLYN, NEW YORK 11201 TEL 212 242 2220 FAX 212 242 2253

# Storm King Arts Center

## VMU: Vertical Cladding Option 1C - Panelized System

DATE 11/05/2020	scale NOTED
PROJECT NO	INDEX
20045.00	-
DRAWING NUMBER	REVISION
F0B.03	-

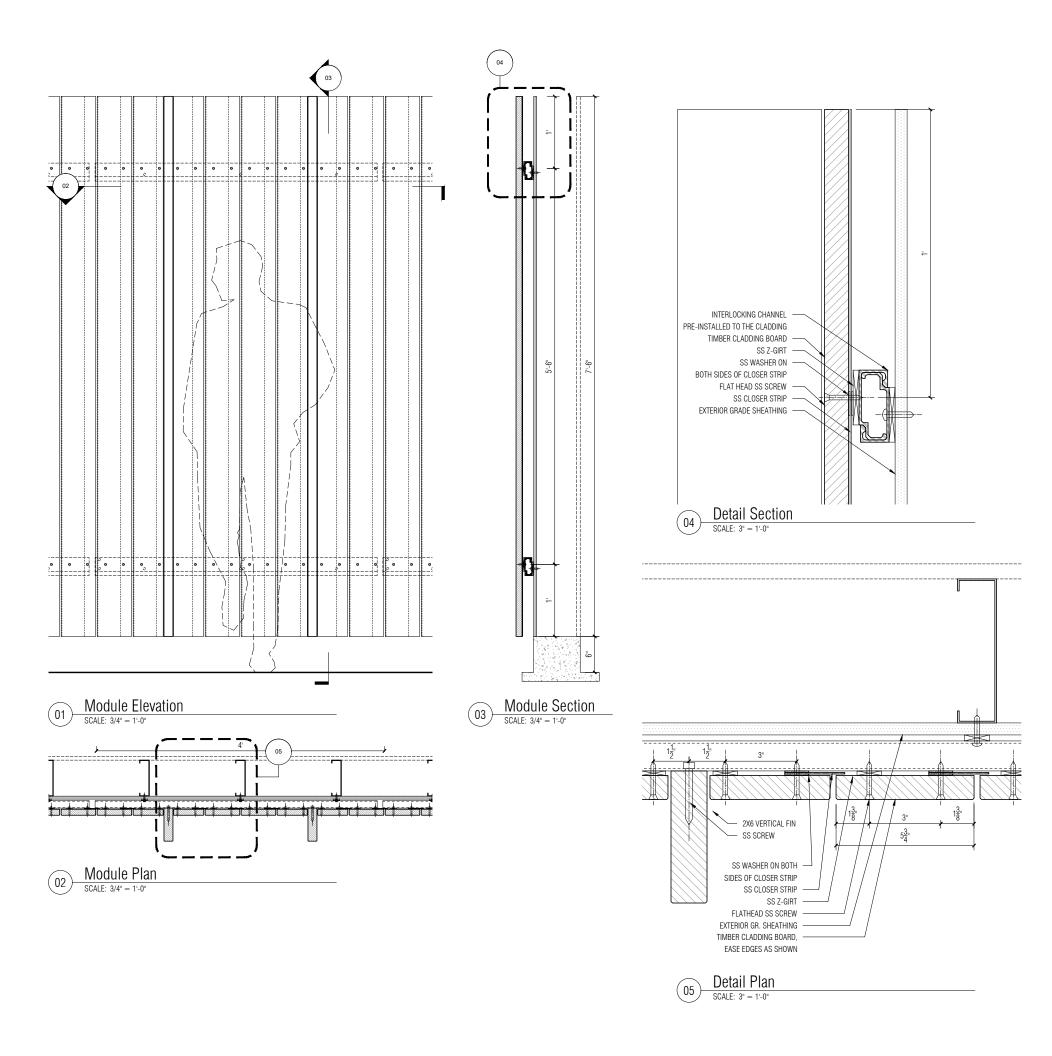

#### NOTES:

• ALL HOLES TO BE PRE-DRILLED

- •BOARDS TO BE EITHER 4 FEET OR 2 FEET LONG TO ALLOW USE OF OFF CUTS.
- ALL FASTENERS OUTBOARD OF THE AIR AND VAPOR BARRIER TO BE SS-316.
- •SCREW DRIVE TO BE EITHER TORX OR ALLEN WITH BAKED PAINT. COLOR BY ARCHITECTS.
- PANEL DIMENSIONS CAN EITHER BE 4' x 8' OR 4' x 4' TO ALLOW FOR EASIER ACCESS TO THE PANELS.

NO ISSUED DATE

PROJECT PHASE

### **Construction Documents**

### Front

20 JAY ST. SUITE 920 BROOKLYN, NEW YORK 11201 TEL 212 242 2220 FAX 212 242 2253


PROJECT

# Storm King Arts Center

TITLE

# VMU: Vertical Cladding Option 1D - Panelized System

DATE 11/05/2020	scale NOTED
PROJECT NO	INDEX
20045.00	-
DRAWING NUMBER	REVISION
F0B.04	_

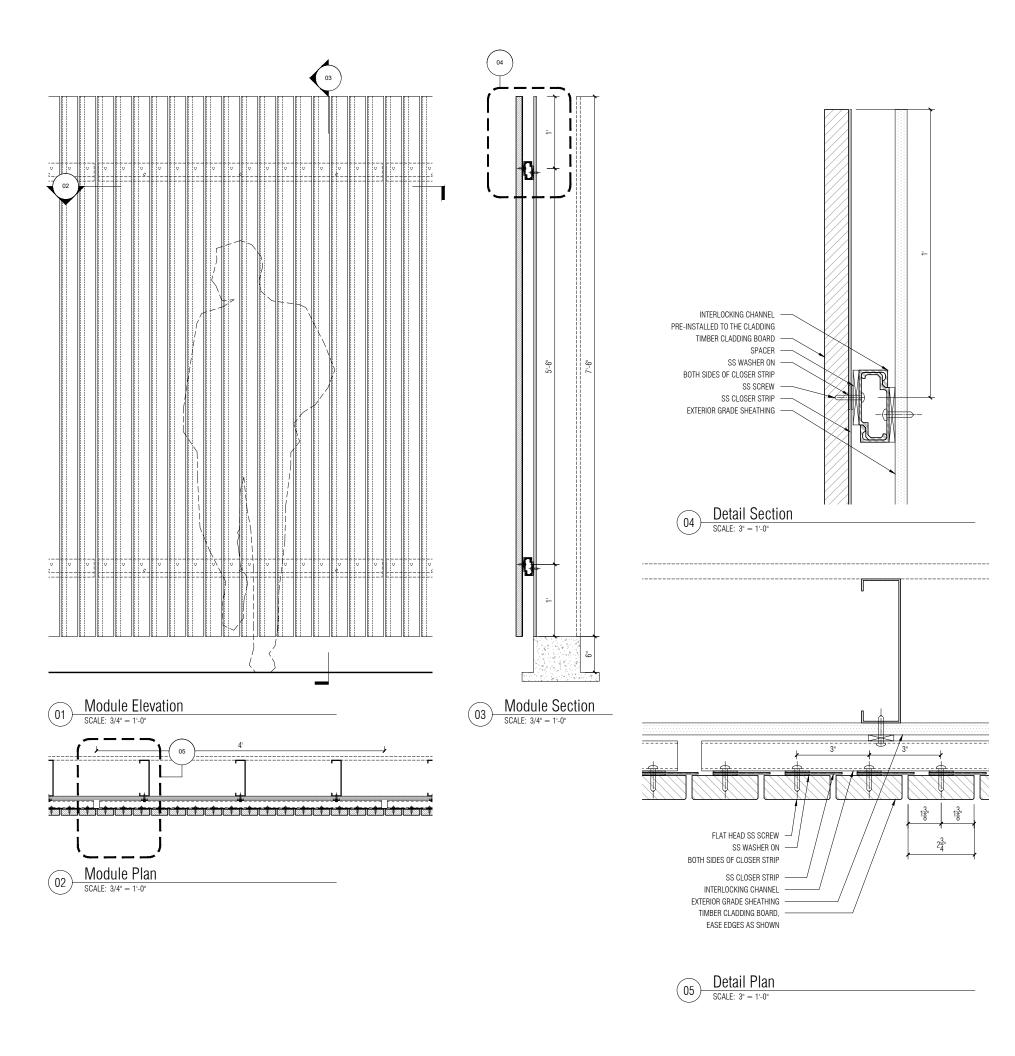

- ALL HOLES TO BE PRE-DRILLED
- •BOARDS TO BE EITHER 4 FEET OR 2 FEET LONG TO ALLOW USE OF OFF CUTS.
- •ALL FASTENERS OUTBOARD OF THE AIR AND VAPOR
- BARRIER TO BE SS-316.
   SCREW DRIVE TO BE EITHER TORX OR ALLEN WITH BAKED PAINT. COLOR BY ARCHITECTS.
- PANEL DIMENSIONS CAN EITHER BE 4' x 8' OR 4' x 4' TO ALLOW FOR EASIER ACCESS TO THE PANELS.

NO ISSUED DATE

PROJECT PHASE

### **Construction Documents**


## Front

20 JAY ST. SUITE 920 BROOKLYN, NEW YORK 11201 TEL 212 242 2220 FAX 212 242 2253

# Storm King Arts Center

## VMU: Vertical Cladding Option 1E - Panelized System

DATE 11/05/2020	scale NOTED
PROJECT NO	INDEX
20045.00	-
DRAWING NUMBER	REVISION
F0B.05	-

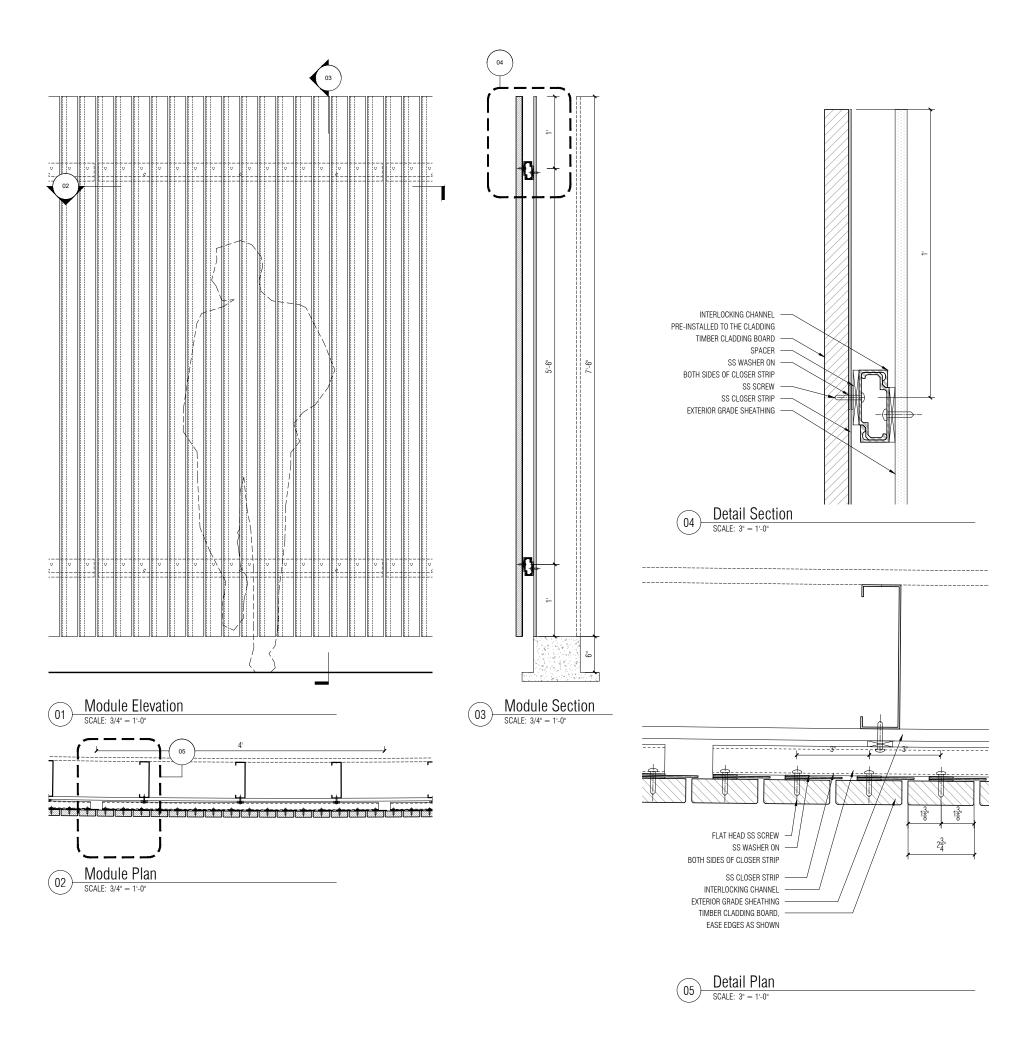

- ALL HOLES TO BE PRE-DRILLED
- •BOARDS TO BE EITHER 4 FEET OR 2 FEET LONG TO ALLOW USE OF OFF CUTS.
- •ALL FASTENERS OUTBOARD OF THE AIR AND VAPOR
- BARRIER TO BE SS-316.
   SCREW DRIVE TO BE EITHER TORX OR ALLEN WITH BAKED PAINT. COLOR BY ARCHITECTS.
- PANEL DIMENSIONS CAN EITHER BE 4' x 8' OR 4' x 4' TO ALLOW FOR EASIER ACCESS TO THE PANELS.

NO ISSUED DATE

PROJECT PHASE

### **Construction Documents**


## Front

20 JAY ST. SUITE 920 BROOKLYN, NEW YORK 11201 TEL 212 242 2220 FAX 212 242 2253

# Storm King Arts Center

## VMU: Vertical Cladding Option 1G - Panelized System

DATE 11/05/2020	scale NOTED
PROJECT NO	INDEX
20045.00	-
DRAWING NUMBER	REVISION
F0B.07	_

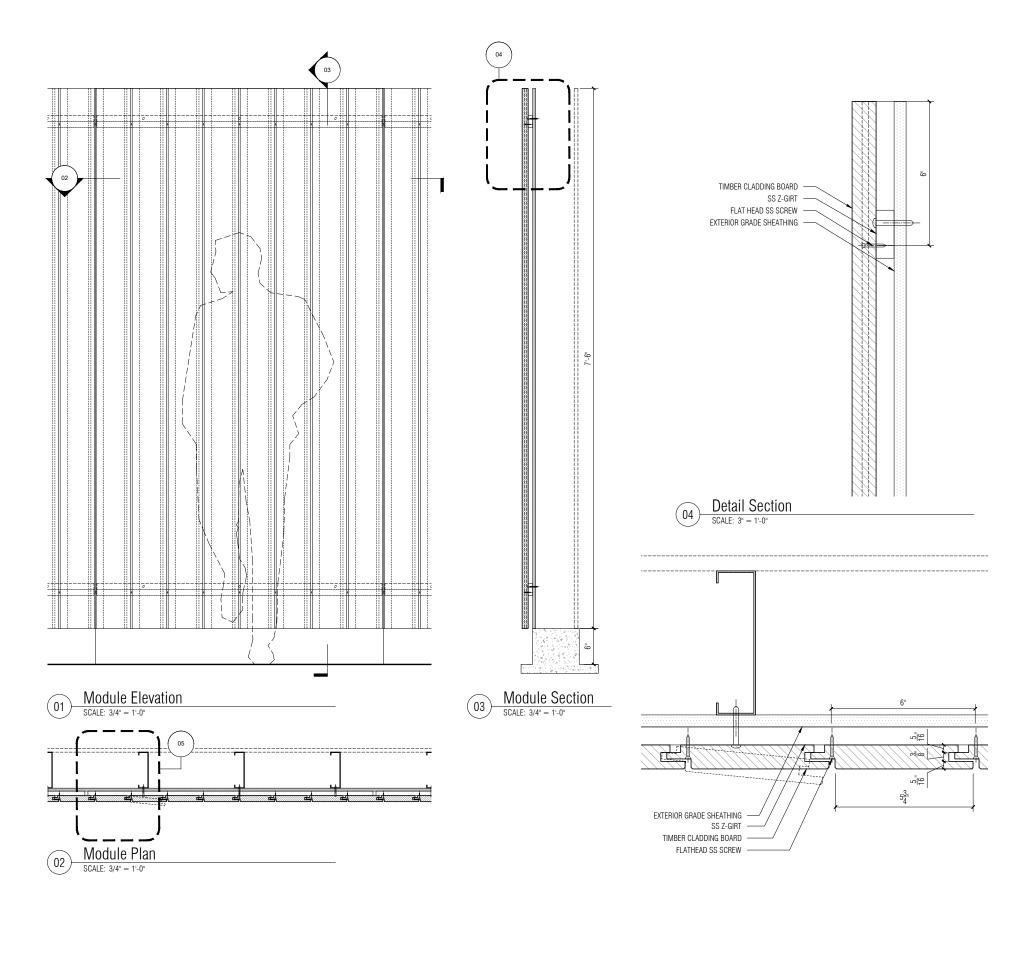

- ALL HOLES TO BE PRE-DRILLED
  BOARDS TO BE EITHER 4 FEET OR 2 FEET LONG TO ALLOW USE OF OFF CUTS.
- ALL FASTENERS OUTBOARD OF THE AIR AND VAPOR
  BARRIER TO BE SS-316.
   SCREW DRIVE TO BE EITHER TORX OR ALLEN WITH BAKED
  PAINT. COLOR BY ARCHITECTS.
- PANEL DIMENSIONS CAN EITHER BE 4' x 8' OR 4' x 4' TO ALLOW FOR EASIER ACCESS TO THE PANELS.

NO ISSUED DATE

PROJECT PHASE

### Construction Documents


## Front

20 JAY ST. SUITE 920 BROOKLYN, NEW YORK 11201 TEL 212 242 2220 FAX 212 242 2253

# Storm King Arts Center

## VMU: Vertical Cladding Option 2 - Site Assembled

DATE 11/05/2020	scale NOTED
PROJECT NO	INDEX
20045.00	-
DRAWING NUMBER	REVISION
F0B.08	-

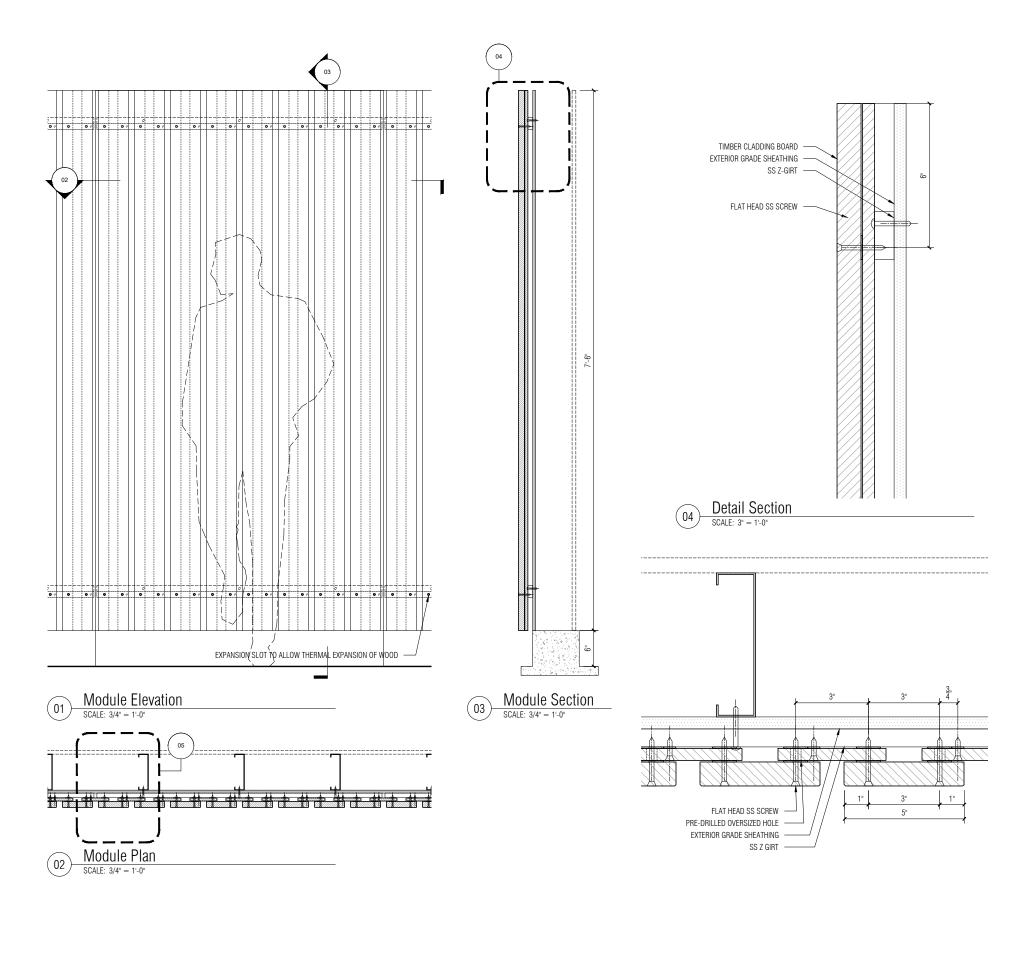

- ALL HOLES TO BE PRE-DRILLED
- •BOARDS TO BE EITHER 4 FEET OR 2 FEET LONG TO ALLOW USE OF OFF CUTS.
- •ALL FASTENERS OUTBOARD OF THE AIR AND VAPOR
- BARRIER TO BE SS-316.
   SCREW DRIVE TO BE EITHER TORX OR ALLEN WITH BAKED PAINT. COLOR BY ARCHITECTS.
- PANEL DIMENSIONS CAN EITHER BE 4' x 8' OR 4' x 4' TO ALLOW FOR EASIER ACCESS TO THE PANELS.

NO ISSUED DATE

PROJECT PHASE

### Construction Documents


## Front

20 JAY ST. SUITE 920 BROOKLYN, NEW YORK 11201 TEL 212 242 2220 FAX 212 242 2253

# Storm King Arts Center

## VMU: Vertical Cladding Option 3 - Site Assembled

DATE 11 /05 /2020	scale NOTED
11/05/2020	ווטובט
PROJECT NO	INDEX
20045.00	_
DRAWING NUMBER	REVISION
F0B.09	-

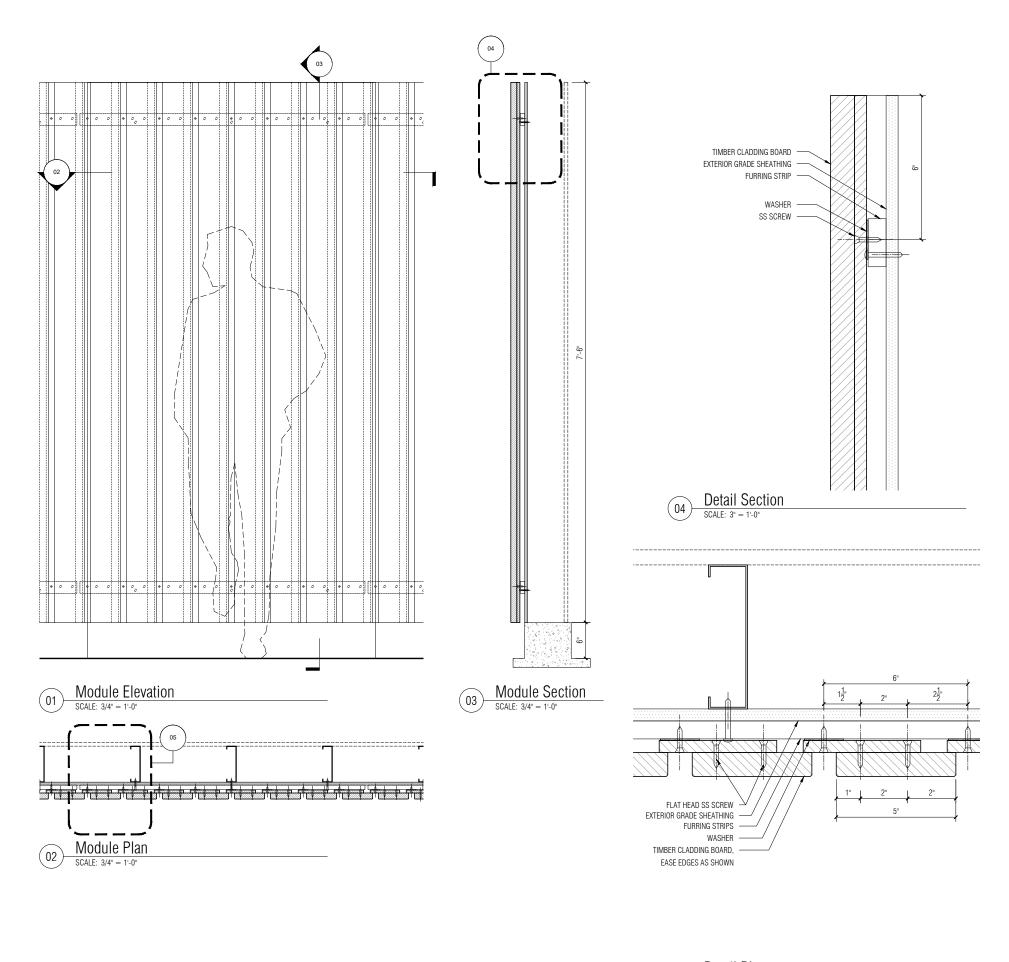

- ALL HOLES TO BE PRE-DRILLED
- •BOARDS TO BE EITHER 4 FEET OR 2 FEET LONG TO ALLOW USE OF OFF CUTS.
- •ALL FASTENERS OUTBOARD OF THE AIR AND VAPOR BARRIER TO BE SS-316.
  • SCREW DRIVE TO BE EITHER TORX OR ALLEN WITH BAKED
- PAINT. COLOR BY ARCHITECTS.
- PANEL DIMENSIONS CAN EITHER BE 4' x 8' OR 4' x 4' TO ALLOW FOR EASIER ACCESS TO THE PANELS.

NO ISSUED DATE

PROJECT PHASE

### Construction Documents


## Front

20 JAY ST. SUITE 920 BROOKLYN, NEW YORK 11201 TEL 212 242 2220 FAX 212 242 2253

# Storm King Arts Center

## VMU: Vertical Cladding Option 4A - Site Assembled

DATE	SCALE
11/05/2020	NOTED
PROJECT NO	INDEX
20045.00	_
DRAWING NUMBER	REVISION
F0B.10	-

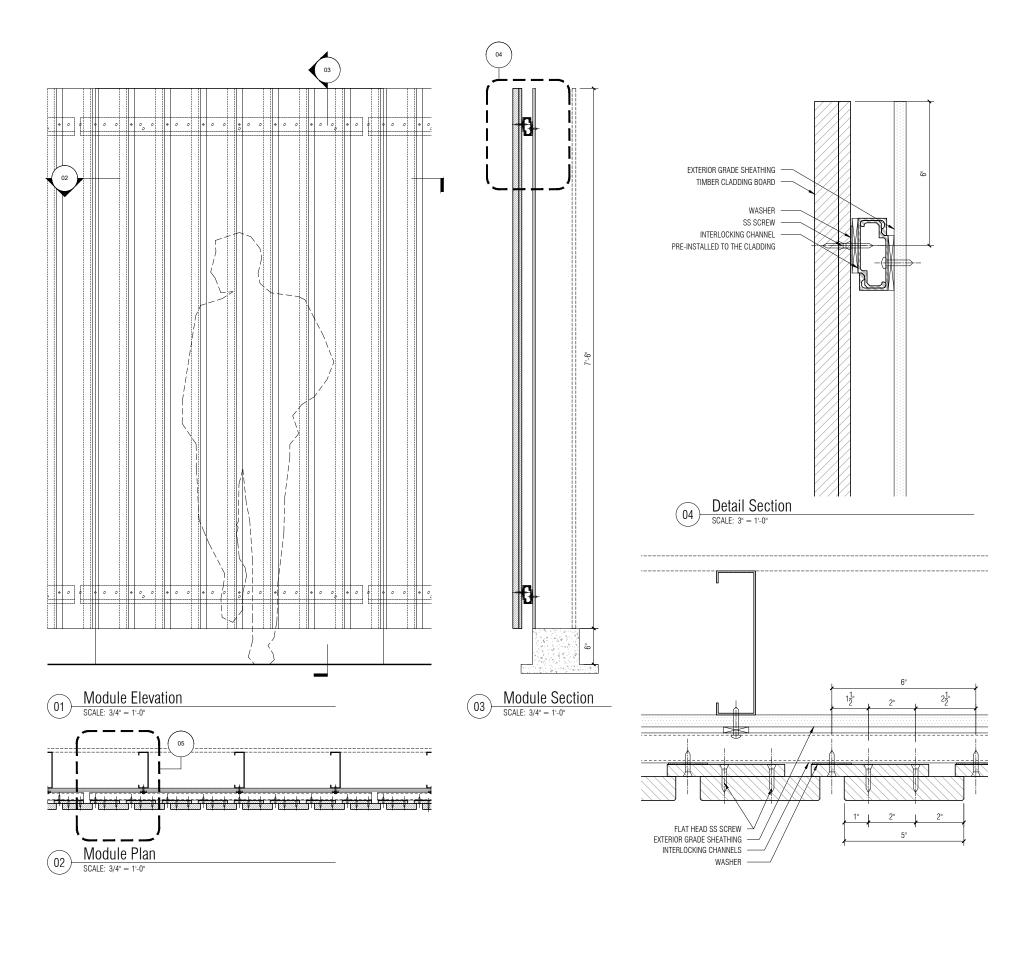

- ALL HOLES TO BE PRE-DRILLED
- •BOARDS TO BE EITHER 4 FEET OR 2 FEET LONG TO ALLOW USE OF OFF CUTS.
- •ALL FASTENERS OUTBOARD OF THE AIR AND VAPOR
- BARRIER TO BE SS-316.
   SCREW DRIVE TO BE EITHER TORX OR ALLEN WITH BAKED PAINT. COLOR BY ARCHITECTS.
- PANEL DIMENSIONS CAN EITHER BE 4' x 8' OR 4' x 4' TO ALLOW FOR EASIER ACCESS TO THE PANELS.

NO ISSUED DATE

PROJECT PHASE

### **Construction Documents**


## Front

20 JAY ST. SUITE 920 BROOKLYN, NEW YORK 11201 TEL 212 242 2220 FAX 212 242 2253

# Storm King Arts Center

## VMU: Vertical Cladding Option 4B - Panelized System

DATE 11/05/2020	scale NOTED
PROJECT NO	INDEX
20045.00	-
DRAWING NUMBER	REVISION
F0B.11	_

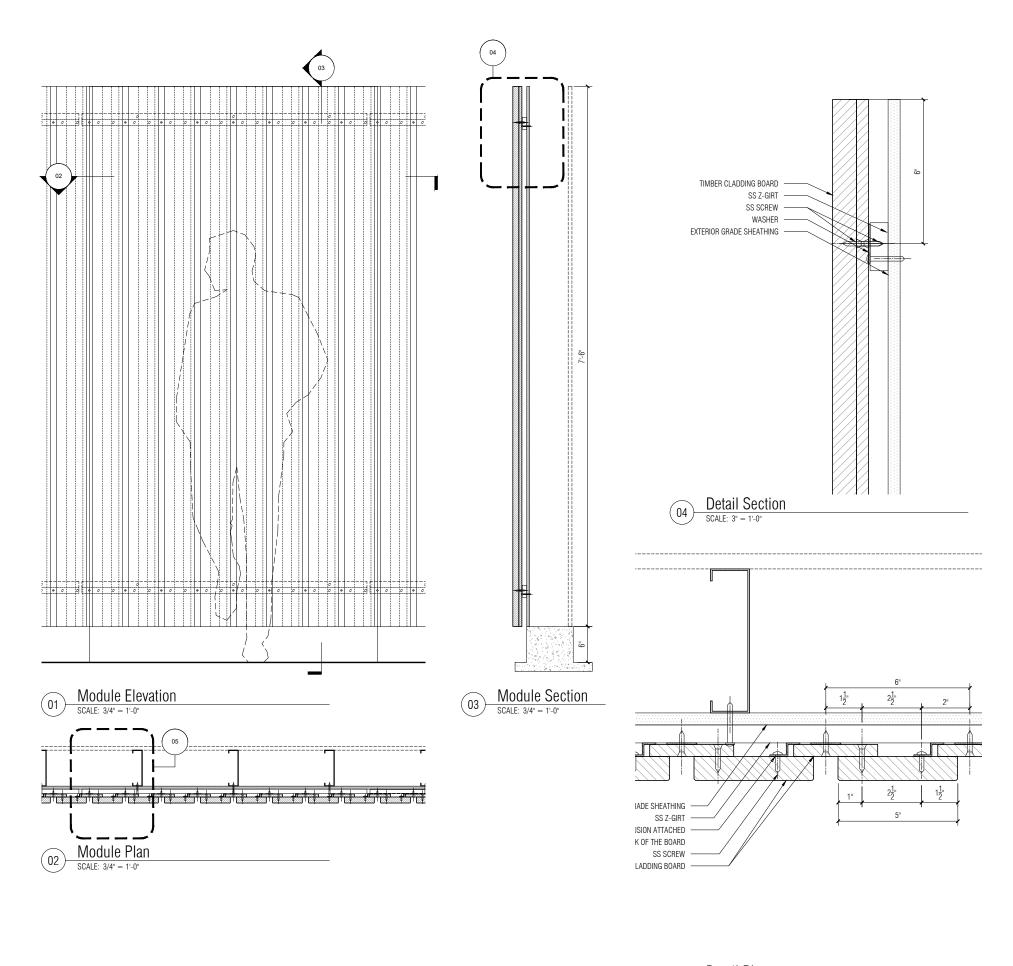

- ALL HOLES TO BE PRE-DRILLED
- •BOARDS TO BE EITHER 4 FEET OR 2 FEET LONG TO ALLOW USE OF OFF CUTS.
- •ALL FASTENERS OUTBOARD OF THE AIR AND VAPOR
- BARRIER TO BE SS-316.
   SCREW DRIVE TO BE EITHER TORX OR ALLEN WITH BAKED PAINT. COLOR BY ARCHITECTS.
- PANEL DIMENSIONS CAN EITHER BE 4' x 8' OR 4' x 4' TO ALLOW FOR EASIER ACCESS TO THE PANELS.

NO ISSUED DATE PROJECT PHASE

### Construction Documents


## Front

20 JAY ST. SUITE 920 BROOKLYN, NEW YORK 11201 TEL 212 242 2220 FAX 212 242 2253

# Storm King Arts Center

## VMU: Vertical Cladding Option 5A - Site Assembled

DATE	SCALE
11/05/2020	NOTED
PROJECT NO	INDEX
20045.00	-
DRAWING NUMBER	REVISION
F0B.12	-

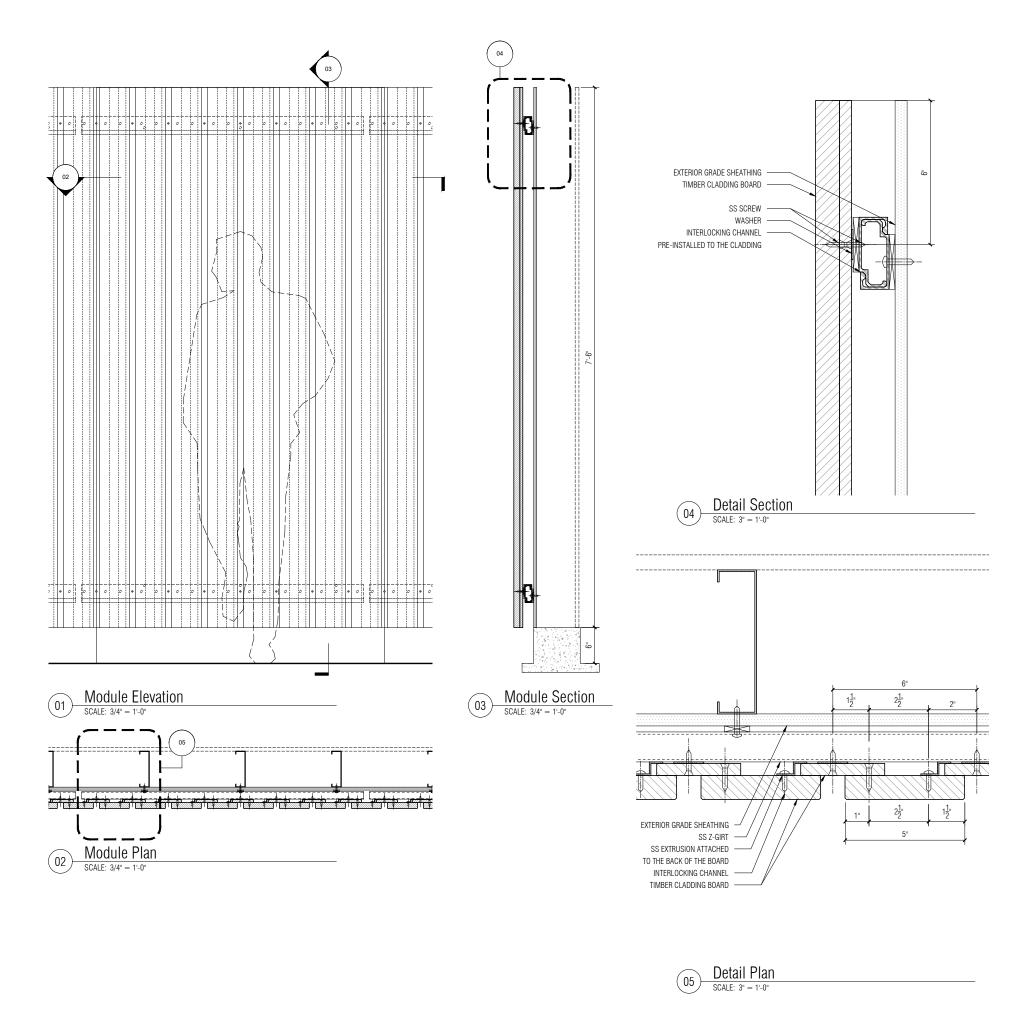

- ALL HOLES TO BE PRE-DRILLED
- •BOARDS TO BE EITHER 4 FEET OR 2 FEET LONG TO ALLOW USE OF OFF CUTS.
- •ALL FASTENERS OUTBOARD OF THE AIR AND VAPOR BARRIER TO BE SS-316.
  • SCREW DRIVE TO BE EITHER TORX OR ALLEN WITH BAKED
- PAINT. COLOR BY ARCHITECTS.
- PANEL DIMENSIONS CAN EITHER BE 4' x 8' OR 4' x 4' TO ALLOW FOR EASIER ACCESS TO THE PANELS.

NO ISSUED DATE

PROJECT PHASE

### **Construction Documents**

## Front

20 JAY ST. SUITE 920 BROOKLYN, NEW YORK 11201 TEL 212 242 2220 FAX 212 242 2253

# Storm King Arts Center

## VMU: Vertical Cladding Option 5B - Panelized System

DATE 11/05/2020	scale NOTED
PROJECT NO	INDEX
20045.00	_
DRAWING NUMBER	REVISION
F0B.13	-