

STORM KING ART CENTER POND PAVILION

50% CONSTRUCTION DOCUMENTS DRAWING SET NOVEMBER 6, 2020

Owner

Storm King Art Center
1 Museum Road
New Windsor, NY 12553
+1 (845) 534-3115

+1 (845) 534-3115

Design Architect

heneghan peng architects 14-16 Lord Edward Street Dublin, D02 YC63 +353 1 633 9000

Executive Architect
WXY Architecture + Urban Design
224 Centre Street, 5th Floor
New York, NY 10013

+1 (212) 219-1953

Landscape Architect

Gustafson Porter + Bowman 1 Cobham Mews London, MW1 9SB +44 020 7284 8950

Reed Hilderbrand LLC 33 Whitney Avenue, 3rd Floor New Haven, CT 06510

+1 (617) 923-2422

Structural & Lighting
ARUP

77 Water Street New York, NY 10005 +1 (212) 896-3000

MEPF & IT BuroHappold

100 Broadway #23 New York, NY 10005 +1 (212) 616-0228

Civil

VHB 100 Great Oaks Blvd., Suite 118

Albany, NY 12203 +1 (518) 389-3606

AV & Acoustics
LSTN Consultants
76 Beaver Street, 2nd Floor

New York, NY 10005 +1 (347) 788-0810

Facade
Front Inc.
100 E. Broadway Street, #501
New York, NY 10002
+1 (212) 242-2220

Key Plan

DescriptionDate50% Design Development02/24/20100% Design Development05/29/2050% Construction Documents11/06/20

Projec

Storm King Art Center Pond Pavilion

Sea

NOT FOR CONSTRUCTION

Drawing Title

Cover Sheet

Date 11/06/20

Scale Not to Scale

Drawing Number A-P-000

Sheet Size ARCH D

SHEET NUMBER	SHEET NAME	DESIGN DEVELOPMENT - 50%	DESIGN DEVELOPMENT - 100%	CONSTRUCTION DOCUMENTS - 50%	CONSTRUCTION DOCUMENTS - 90%	PERMIT SET
A-P-000	Cover Sheet	•	•	•		
A-P-001	Drawing List	•	•	•		
A-P-002	Abbreviations, Symbols, & General Notes	•	•	•		
A-P-003	Accessibility Summary		•	•		
A-P-004	Code Summary			•		
A-P-005	Occupancy Load & Exit Capacity		•	•		
A-P-006	Fire Ratings & Egress Distances		•	•		
A-P-007	Fire Extinguisher Locations			•		
A-P-011 A-P-012	Site Plan - Property	•	•	•		
A-P-012 A-X-091	Site Plan - Building Setting Out - Site	•	•	•		
A-X-091 A-P-092	Setting Out - Site			•		
A-P-093	Setting Out - Primary & Facade Grid			•		
A-P-101	Floor Plan - Ground Level	•	•	•		
A-P-102	Floor Plan - Roof Level	•	•	•		
A-P-111	RCP - Ground Level	•	•	•		
A-P-121	Enlarged Plan - Ground Level			•		
A-P-122	Enlarged Plan - Ground Level			•		
A-P-123	Enlarged Plan - Roof Level			•		
A-P-124	Enlarged Plan - Roof Level			•		
A-P-131	Enlarged RCP - Ground Level			•		
A-P-132 A-P-141	Enlarged RCP - Ground Level Finish Floor Plan - South Portion			•		
A-P-142	Finish Floor Plan - North Portion			•		
A-P-201	Building Elevations	•	•	•		
A-P-301	Building Sections	•	•	•		
A-P-302	Building Sections	•	•	•		
A-P-401	Wall Sections		•	•		
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A-P-421	Window & Louvre Details			•		
A-P-431	Door Details - Exterior			•		
A-P-432 A-P-433	Door Details - Exterior Door Details - Exterior			•		
A-P-433 A-P-601	Room Plans & Elevations - 101 & 102			•		
A-P-601 A-P-602	Room Plans & Elevations - 101 & 102 Room Plans & Elevations - 103 & 106			•		
A-P-603	Room Plans & Elevations - 107			•		
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A-P-611	Interior Details			•		
A-P-621 A-P-641	Door Details - Interior Millwork Details			•		
A-P-641 A-P-642	Millwork Details Millwork Details			•		
A-P-643	Millwork Details			•		
A-P-644	Millwork Details			•		
A-P-701	Room & Finish Schedule	•	•	•		
A-P-702	Window & Door Schedule	•	•	•		
A-P-703	Equipment Schedule	•	•	•		
A-P-704	Millwork & Furniture Schedule			•		
and the second s	Exterior Wall Types	•	•	•		
A-P-711 A-P-721	Interior Wall Types	•	•	•		+

SHEET	SHEET NAME	DESIGN DEVELOPMENT - 50%	DESIGN DEVELOPMENT - 100%	CONSTRUCTION DOCUMENTS - 50%	CONSTRUCTION DOCUMENTS - 90%	PERMIT SET
S-P-001	Structural Symbols and Abbreviations	•	•	•		
S-P-002	Structural General Notes, Sheet 1	•	•	•		
S-P-003	Structural General Notes, Sheet 2	•	•	•		
S-P-011 S-P-101	Structural Loading Plans	•	•	•		
S-P-101 S-P-301	Foundation Plan, Ground Level Framing Plan, Roof Level	•	•	•		
S-P-701	Structural Typ Foundation Details	•	•	•		
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S-P-721	Structural Typ Timber Details, Sheet 1	•	•	•		
S-P-722	Structural Typ Timber Details, Sheet 2	•	•	•		
S-P-801	Foundation Details		•	•		
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M-P-001	Abbreviations, Symbols, and Legends	•	•	•		
M-P-002	General Notes	•	•	•		
M-P-101	Duct Plan - Ground Level	•	•	•		
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M-P-401	Mechanical Sections		•	•		
M-P-501	Mechanical Details	•	•	•		
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M-P-503	Mechanical Details	•	•	•		
M-P-504 M-P-505	Mechanical Details Mechanical Details	•	•	•		
M-P-506	Mechanical Details	•	•	•		
M-P-507	Mechanical Details	•	•	•		
M-P-508	Mechanical Details	•	•	•		
M-P-601	Mechanical Schedules	•	•	•		
M-P-701	Duct Riser	•	•	•		
M-P-900	Site Controls Plan			•		
P-P-001	Abbreviations, Symbols, and Legends	•	•	•		
P-P-002	General Notes	•	•	•		
P-P-100	Piping Plan - Underslab	•	•	•		
P-P-101	Piping Plan - Ground Level	•	•	•		
P-P-102	Piping Plan - Roof Level	•	•	•		
P-P-501	Plumbing Details	•	•	•		
P-P-502	Plumbing Details	•	•	•		
P-P-503 P-P-504	Plumbing Details Plumbing Details	•	•	•		
P-P-601	Plumbing Schedules	•	•	•		
P-P-701	Domestic water Riser	•	•	•		
P-P-702	Drain & Vent Riser	•	•	•		
P-P-703	Storm Riser		•	•		
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E-P-001	Abbreviations, Symbols, and Legends	•	•	•		
E-P-002 E-P-003	General Notes General Notes	•	•	•		
E-P-003 E-P-101	Power Plan - Ground Level	•	•	•		
E-P-102	Power Plan - Roof Level		•	•		
E-P-201	Lighting Plan - Ground Level		•	•		
E-P-501	Electrical Details	•	•	•		
E-P-502	Electrical Details	•	•	•		
E-P-503	Electrical Details	•	•	•		
E-P-504	Electrical Details	•	•	•		
E-P-601 E-P-701	Electrical Schedules Electrical Riser	•	•	•		
E-P-701 E-P-900	Site Plan - Property - Electrical Power	-	_	•		
E-P-911	Site Plan - Building - Lighting			•		
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FA-P-001	Abbreviations, Symbols, and General Notes	•	•	•		
FA-P-101	Fire Alarm Plan - Ground Level			•		
FA-P-701	Fire Alarm Riser	•	•	•		
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IT-P-001 IT-P-101	Abbreviations, Symbols and Legends Telecom Plan - Ground Level			•		
IT-P-101	Telecom RCP - Ground Level			•		
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IT-P-900 Site Plan - Property - Telecom

IT-P-501 Telecom Details

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+1 (212) 219-1953

Landscape Architect
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1 Cobham Mews
London, MW1 9SB
+44 020 7284 8950

Reed Hilderbrand LLC 33 Whitney Avenue, 3rd Floor New Haven, CT 06510 +1 (617) 923-2422

Structural & Lighting ARUP 77 Water Street New York, NY 10005 +1 (212) 896-3000

MEPF & IT
BuroHappold
100 Broadway #23
New York, NY 10005

New York, NY 10005 +1 (212) 616-0228 Civil VHB

100 Great Oaks Blvd., Suite 118 Albany, NY 12203 +1 (518) 389-3606

AV & Acoustics LSTN Consultants 76 Beaver Street, 2nd Floor New York, NY 10005 +1 (347) 788-0810

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+1 (212) 242-2220

Key Plan

DescriptionDate50% Design Development02/24/20100% Design Development05/29/2050% Construction Documents11/06/20

Storm King
Art Center

Project

Storm King

Art Center

Seal


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Drawing Title
Drawing List


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Sheet Size	ARCH D


General Notes

- 1. No work shall commence without first obtaining any required permits or approvals from applicable regulating agencies of the State of New York and Town of Cornwall.
- All work shall comply with the requirements of the State Uniform Fire Prevention and Building Code of the Codes Rules and Regulations of
- the State of New York and any other applicable state regulations. 3. All work shall comply with the Zoning Law of the Town of Cornwall and any other applicable local regulations.
- 4. All work relating to waste water disposal shall be approved by the Town of Cornwall and shall comply with all applicable regulations.
- All work shall be performed by contractors and subcontractors licensed to work in the State of New York including, but not limited to, the following trades: general contracting, surveying, site work, concrete erection, steel fabrication and erection, general electrical, general plumbing, and mechanical equipment installation.
- All contractors and subcontractors shall carry general liability and worker's compensation insurance as required by the Town of Cornwall, the State of New York and other regulating agencies.
- Contractors and subcontractors shall provide certificates of insurance. 7. The Contractor shall file all applications, pay for all necessary permits and secure certificates of occupancy for the Work.
- All necessary provisions for installation of primary electrical service shall be made in conjunction with and to the required specifications of the Local Gas and Electric Companies.
- All materials for construction located on site shall be segregated and neatly stored out of the path of construction operations and shall be protected from damage by all hazards including weather, ground moisture and construction activities until use.
- 10. Unless otherwise indicated, all material furnished and incorporated into the Work shall be new, unused and of quality standard to the industry for first class work of similar nature and character. Materials shall be installed in accordance with the manufacturers' recommendations and best standard of the trades involved.
- 11. The Contractor shall be responsible for the protection of all existing buildings and other installations that are to remain intact while performing the Work.
- 12. Where adjacent structures are occupied or to be preserved, the Contractor shall take every precaution to safeguard the structural integrity of the walls, roofing, entrance and exit of the adjacent building and to provide, if required, temporary waterproofing and parging to protect it. The Contractor shall also take every precaution to ensure that damage, noise, dust and interruptions to adjacent structures will be kept to a minimum.
- 13. The Contractor shall visit the site and be knowledgeable of conditions thereon, comply with Specification Sections in Division 1 and 2 for specific requirements for survey of existing site conditions and conduct of excavation and ensuing construction activities prior to proceeding with the Work.
- 14. The Contractor shall verify accuracy of survey information and shall perform additional site surveys to ensure accurate placement of buildings on the site. See survey for geo-location information.
- 15. All dimensions shall have preference over scale. Do not scale these drawings.
- All dimensions shall be verified in the field prior to proceeding with the Work. The Architect shall be notified of any discrepancies.
- 17. Plan dimensions are shown to the centerline of columns and the finished face of walls unless noted otherwise. Elevation and section dimensions are shown relative to finish floor levels which are referenced to building elevation above sea level. See survey for elevation information.
- 18. Where discrepancies exist between drawings of various disciplines, notify the Architect of these discrepancies prior to construction. Consult the Architect before proceeding with work in any area requiring clarification. In case of conflict in documents, specifications or general requirements, the most stringent is to be required.
- 19. Details shown are intended to describe scope and profile. Where details have not been provided, the Work is intended to be similar in character to those areas detailed. Where specific dimensions, details or design intent cannot be determined, consult the Architect prior to proceeding with the Work.
- 20. The Work in these drawings in intended to show scope of penetrations, slab and wall openings required to accommodate mechanical, electrical and plumbing trades. However, the Contractor shall coordinate all penetrations, slab and wall openings required by these trades before proceeding with the Work.
- 21. All pipes, bus ducts, risers and other elements that penetrate floor slabs shall be installed in a manner that will preserve the fire resistive and structural integrity of the building.
- 22. Not all Specifications Divisions are referenced on the sheet legend notes. Multiple divisions may apply to each note. Reference the specific specification for related sections.
- Each legend references that particular sheet it is on and may not correspond to other sheets.


Symbol Legend

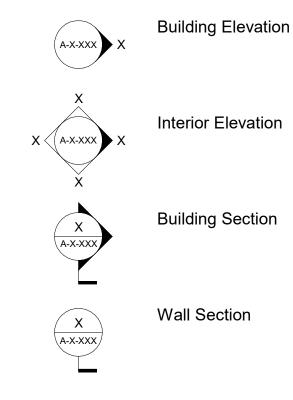

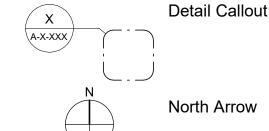

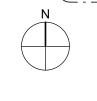


Room Tag

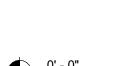



ROOM NAME

Elevation Marker

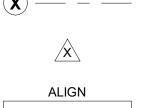

Grid Line

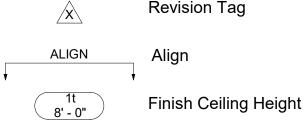

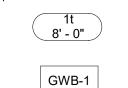

Finish Type





Window Type




Door Number

Wall Type




Construction Above

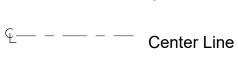

Match Line

Material Indicators

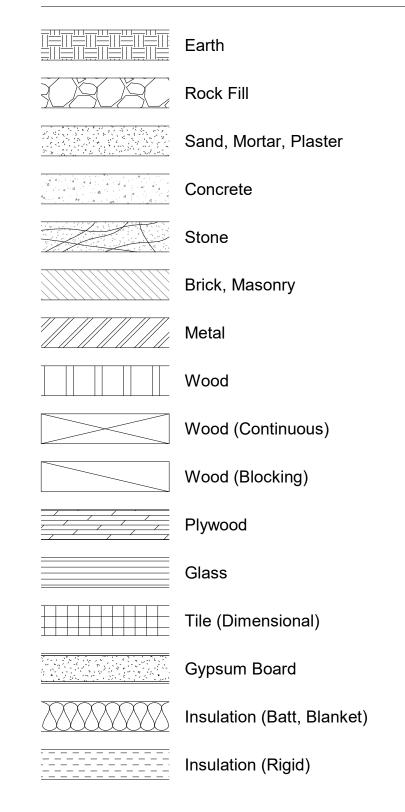

Abbreviations

ADJ

AFF

ALUM Aluminum AS REQ'D As Required Batten Cabinet CLG Ceiling COL Column CONST Construction DIAM Diameter **ELEC** Electric(al) EQ Equal EX Existing Finished Floor FΗ Full Height FΜ Field Measure FO "Face of" or "Finish Opening" **GWB** Gypsum Wall Board HC Hollow Core HDF High-Density Fiberboard **HDWD** Hardwood НМ Hollow Metal LAM Laminated MDF Medium-Density Fiberboard MTL Metal NIC Not in Contract NTS Not to Scale OC On Center OPP HAND Opposite Hand Partial Height PL GL Plate Glass PL LAM Plastic Laminate Plywood PLY PNL Panel RO Rough Opening RVL Reveal SDL Saddle SIM Similar SS Stainless Steel T&B Top & Bottom TOH Top of Head TOS Top of Sill TYP Typical UC Undercut UNO Unless Otherwise Noted VGB Vertical Grab Bar VIF Verify in Field W/ With W/O Without Waterproof

Adjacent or Adjustable

Above Finished Floor

Storm King Art Center 1 Museum Road New Windsor, NY 12553 +1 (845) 534-3115

Design Architect

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Structural & Lighting ARUP 77 Water Street New York, NY 10005

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New York, NY 10005 +1 (212) 616-0228 Civil

VHB

100 Great Oaks Blvd., Suite 118 Albany, NY 12203 +1 (518) 389-3606 **AV & Acoustics**

LSTN Consultants 76 Beaver Street, 2nd Floor New York, NY 10005 +1 (347) 788-0810

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Key Plan

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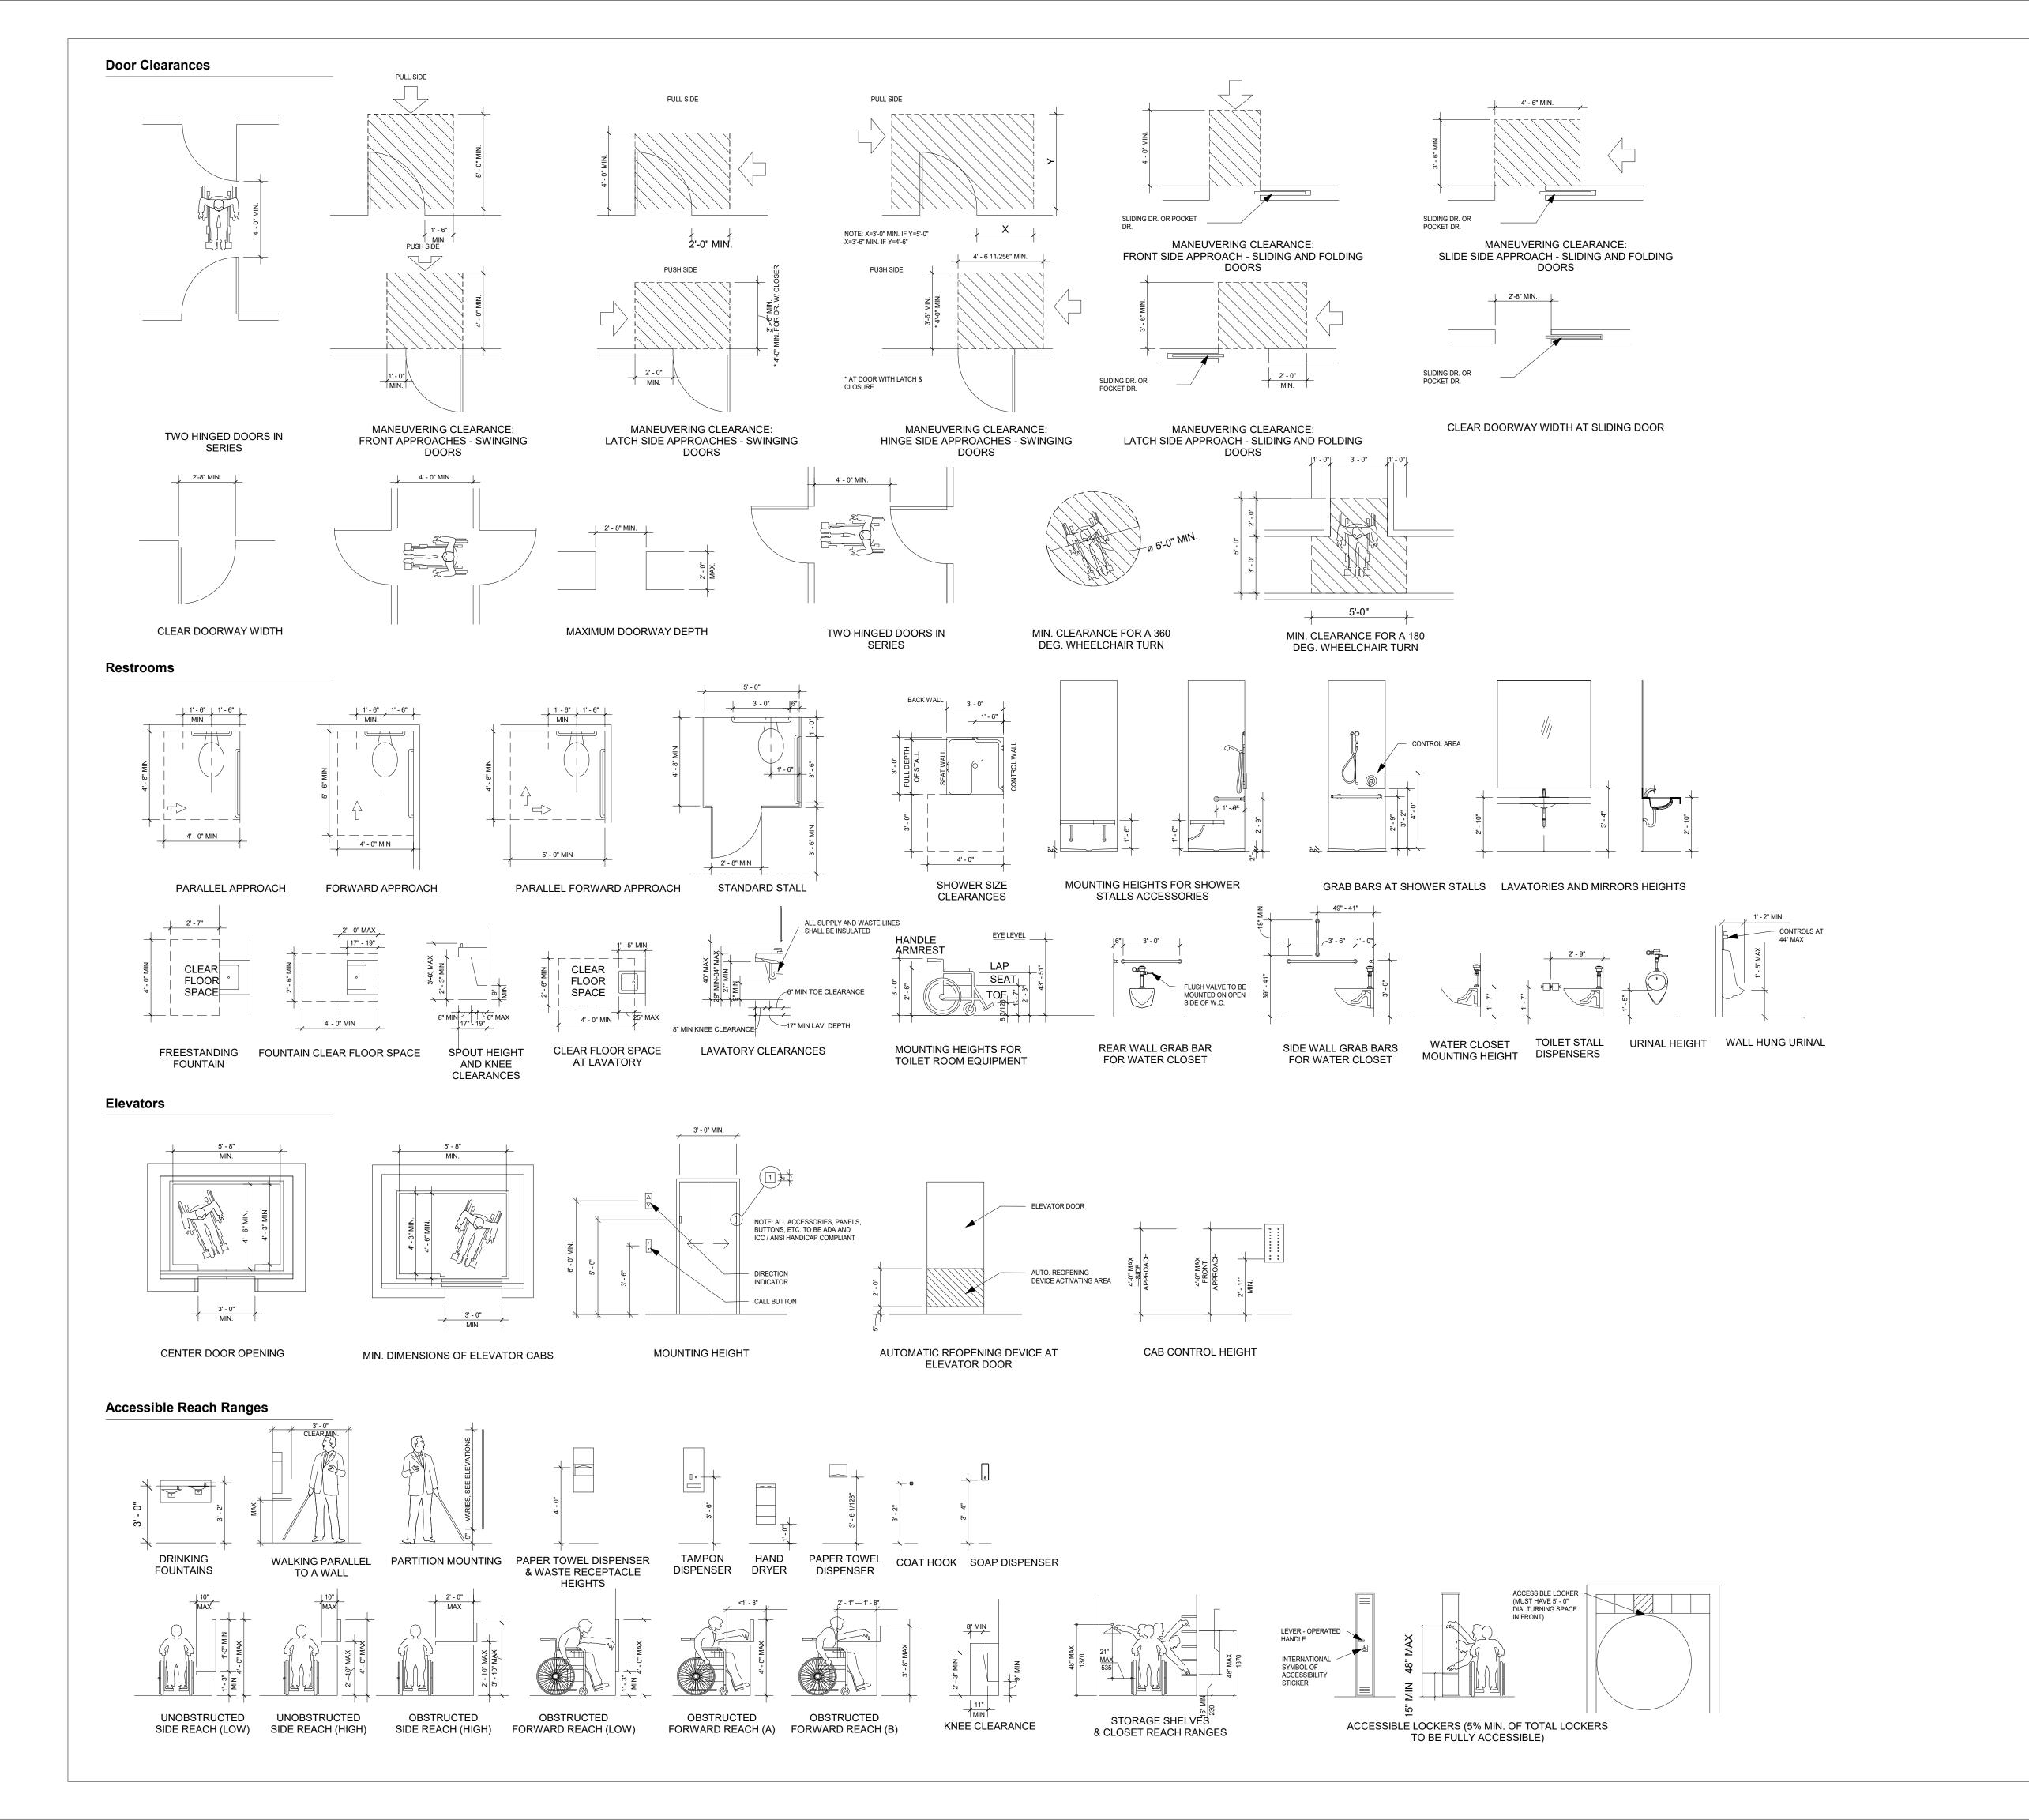
Project

Storm King Art Center **Pond Pavilion**

Seal

NOT FOR CONSTRUCTION **Drawing Title** Abbreviations, Symbols, & General Notes

Date	11/06/20
Scale	Not to Scale
Drawing Number	A-P-002
Sheet Size	ARCH D



Accessibility Summary

Buildings and facilities shall be designed and constructed to be accessible in accordance with the Federal 2010 ADA Standards for Accessible Design. Refer to the 2010 ADA Standards for Accessible Design using chapter reference for clarifications and exceptions.

204 Protruding Objects Protruding objects on circulation paths shall comply with 307.

210 Stairways

Interior and exterior stairs that are part of a means of egress shall comply with 504.

211 Drinking Fountains Where drinking fountains are provided on an exterior site, on a floor, or within a secured area they shall be provided in accordance with 211.

213.3 Plumbing Fixtures and Accessories

Plumbing fixtures and accessories provided in a toilet room or bathing room required to comply with 213.2 shall comply with 213.3

213 Toilet Facilities and Bathing **Facilities**

Where toilet facilities and bathing facilities are provided, they shall comply with 213.

225 Storage Storage facilities shall comply with 225

227 Sales and Service Where provided, check-out aisles, sales counters, service counters, food service lines, queues, and waiting lines shall comply with 227 and 904.

303 Changes in Level Where changes in level are permitted

in floor or ground surfaces, they shall comply with 303.

404 Doors, Doorways, and Gates. Doors, doorways, and gates that are part of an accessible route shall comply with 404.

404.2.4.4 Floor or Ground Surface. Floor or ground surface within required maneuvering clearances shall comply with 302.

405 Ramps

Ramps on accessible routes shall comply with 405. Changes in level other than the running slope and cross slope are not permitted on ramp runs

407 Elevators

Elevators shall comply with 407 and with ASME A17.1 (incorporated by reference, see "Referenced Standards" in Chapter 1). They shall be passenger elevators as classified by ASME A17.1. Elevator operation shall be automatic.

502 Parking Spaces

Car and van parking spaces shall comply with 502. Where parking spaces are marked with lines, width measurements of parking spaces and access aisles shall be made from the centerline of the markings

505 Handrails

Handrails provided along walking surfaces complying with 403, required at ramps complying with 405, and required at stairs complying with 504 shall comply with 505.

703.7.2 Symbols The international symbol of accessibility shall comply with figure 703.7.2.1.

802.1 Wheelchair Spaces Wheelchair spaces shall comply with

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100 Great Oaks Blvd., Suite 118 Albany, NY 12203 +1 (518) 389-3606

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Key Plan

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Storm King Art Center **Pond Pavilion**

Seal

NOT FOR CONSTRUCTION **Drawing Title** Accessibility

Date	11/06/20
Scale	Not to Scale
Drawing Number	A-P-003
Sheet Size	ARCH D

Summary

Applicable Codes & Standards

2020 Building Code of New York State (adopted from IBC 2018 with amendments) **Building Code** Code of the Town of Cornwall, NY

Energy Conservation Code

2020 Energy Conservation Code of New York State (adopted from IECC 2018 with amendments)

Fire Code 2020 Fire Code of New York State

(adopted from IFC 2018 with amendments)

2020 Mechanical Code of New York State (adopted from IMC 2018 with amendments)

2020 Plumbing Code of New York State Plumbing Code (adopted from IPC 2018 with amendments)

2010 ADA Standards Accessibility

Zoning Resolution of the Town of Cornwall, NY Zoning

Zoning & Land Use

Mechanical Code

Section, Block, Lot 30-1-1.1, 30-1-1.4, 30-1-1.5, 30-1-4.22, 30-1-11, 30-1-13, 30-1-14, 30-1-4.2, 30-1-62, 30-1-63, 30-1-64, 30-1-8, 30-1-86, 30-1-87, 30-1-88, 34-1-108, 34-1-9.1, 34-1-9.2,


30-1-9, 34-1-6.1

Zoning District Designation Mountain and Conservation Residence District (MCR)

Zoning Use Group Use Group C

Bulk Regulations

	Allowable	Proposed
Minimum Usable Lot Area	5 acres	539 acres
Required Lot Width	200'	>200'
Minimum Front Yard Depth	70'	80'
Required Minimum Side Yard	70'	150'
Required Total Side Yard	140'	525'
Minimum Required Road Frontage	150'	1,300'
Maximum Building Height	40' -0"	10' - 6 1/4"
Maximum Development Coverage	15%	5%
Maximum Building Coverage Percent	4%	0.3%
Floor Area Ratio	0.08	0.0044

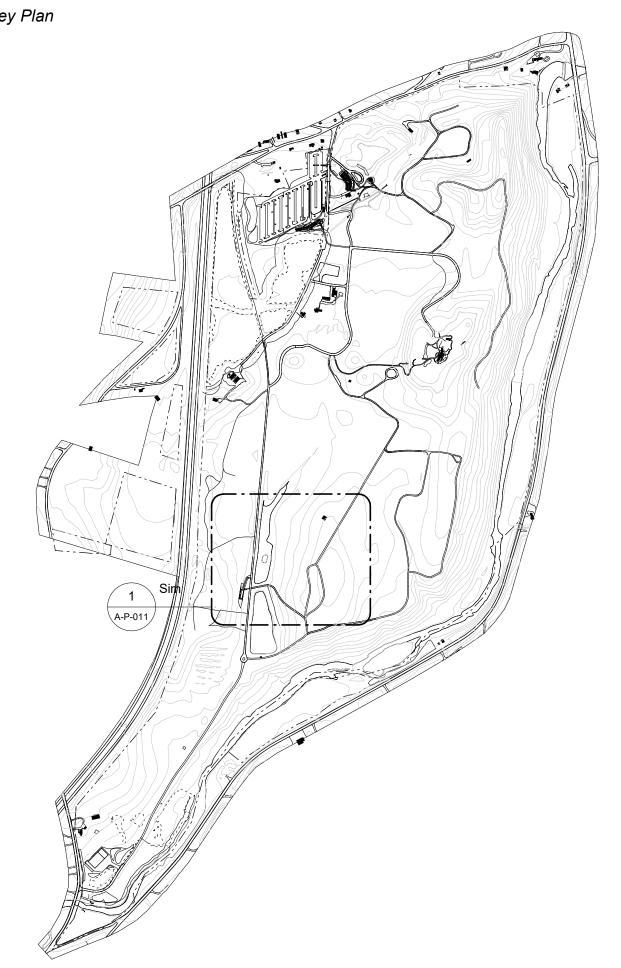

Building Classification & Code Summary

Type V-B Construction Type

Occupancy Classification B - Business (Food establishments <2,500SF)

Automatic Sprinkler System Not Provided

Emergency Alarm/Voice Communications Not Provided

5A

Chapter 5: General Building Heights and Areas

Climate Zone

	Allowable	Proposed	Reference	
Maximum Building Height (feet)	40' - 0"	10' - 6 1/4"	504.3	
Maximum Building Height (stories)	2	1	504.4	
Maximum Allowable Area (A _a) Allowable Area Factor (A _t) Area Factor Increase (I _f)	15,750 SF 9,000 SF 75%	1,350 SF N/A N/A	506.2.1 506.2 506.3.3	

Chapter 6: Types of Construction

	Allowable	Proposed	Reference
Minimum Fire-Resistance Rating Req.			Table 601
Primary Structural Frame	0 hours	N/A	
Exterior Bearing Walls	0 hours	N/A	
Interior Bearing Walls	0 hours	N/A	
Exterior Non-bearing walls/partitions	0 hours	N/A	
Interior Non-bearing walls/partitions	0 hours	N/A	
Floor Construction	0 hours	N/A	
Roof Construction	0 hours	N/A	

Chapter 7: Fire and Smoke Protection Features

	Allowable	Proposed	Reference
Minimum Fire-Resistance Rating Req.			
Fire Walls	2 hours	N/A	706.4a
Fire Barriers	varies		707
Shaft Enclosures (<4 stories)	1 hour	N/A	713.4
Machine Room Enclosure	1 hour	N/A	3005.4
Interior Exit Stairways	1 hour	N/A	1023.2
Fire Partitions	1 hour	N/A	708.3

Chapter 8: Interior Finishes

	Allowable	Proposed	Reference
Interior Wall and Ceiling Finish Req. Interior Exit Stairways Corridors Exit Access Stairway Enclosures Rooms and Enclosed Spaces	В В В С	N/A N/A N/A C or better	803.1.2 Table 803.13b Table 803.13 Table 803.13 Table 803.13

Chapter 9: Fire Protection and Life Safety Systems

	Allowable	Proposed	Reference
Automatic Sprinkler System	Not Required	Not Provided	903.2
Portable Fire Extinguishers (Type A)			906
Min. extinguisher rating	2-A (or two 1-A)		Table 906.3(1)
Max. floor area per unit of A	3,000 SF		Table 906.3(1)
Max. floor area for extinguisher	11,250 SF		Table 906.3(1)
Max. travel distance to extinguisher	75' - 0"		Table 906.3(1)
Portable Fire Extinguishers (Type B)			906
Max. travel distance to extinguisher	30' - 0" (5-B)	N/A	Table 906.3(2)
Max. travel distance to extinguisher	50' - 0" (10-B)	N/A	Table 906.3(2)
Manual Fire Alarm Boxes	Not Required	Not Provided	907.2.2

Chapter 10: Means of Egress

	Allowable	Proposed	Reference
Maximum Common Path of Travel	75' - 0"		Table 1006.2.1
Min. Number of Access to Exits per Story	2	N/A	106.3.3
Maximum Exit Access Travel Distance	200' - 0"		Table 1017.2

Storm King Art Center 1 Museum Road New Windsor, NY 12553 +1 (845) 534-3115

Design Architect

heneghan peng architects 14-16 Lord Edward Street Dublin, D02 YC63 +353 1 633 9000

Executive Architect

WXY Architecture + Urban Design 224 Centre Street, 5th Floor New York, NY 10013 +1 (212) 219-1953

Landscape Architect

Gustafson Porter + Bowman 1 Cobham Mews London, MW1 9SB +44 020 7284 8950

33 Whitney Avenue, 3rd Floor New Haven, CT 06510

Reed Hilderbrand LLC

+1 (617) 923-2422 Structural & Lighting ARUP

77 Water Street New York, NY 10005

+1 (212) 896-3000 MEPF & IT

BuroHappold 100 Broadway #23 New York, NY 10005 +1 (212) 616-0228

Civil VHB

100 Great Oaks Blvd., Suite 118 Albany, NY 12203

+1 (518) 389-3606 **AV & Acoustics**

LSTN Consultants 76 Beaver Street, 2nd Floor New York, NY 10005 +1 (347) 788-0810

Facade

Front Inc. 100 E. Broadway Street, #501 New York, NY 10002 +1 (212) 242-2220

Key Plan

Description 50% Construction Documents

Storm King Art Center **Pond Pavilion**

NOT FOR CONSTRUCTION **Drawing Title** Code Summary

Date	11/06/20
Scale	As indicated
Drawing Number	A-P-004
Sheet Size	ARCH D

Area Name Area Occupancy		Building Code of New York State				
	Area	Occupancy	Occupancy	a Occupancy	Area Type	Floor Area / Occupant
Service	286 SF	В	Gross	200	2	
RR	42 SF	Circulation	Gross	100	1	
ADA/FAM RR	42 SF	Circulation	Gross	100	1	
RR	42 SF	Circulation	Gross	100	1	
RR	63 SF	Circulation	Gross	100	1	
Mechanical	22 SF	Circulation	Gross	100	1	
CUST	69 SF	S1	Gross	300	1	
Mechanical	14 SF	Circulation	Net	100	1	
Seating Area	534 SF	В	Gross	15	36	
Queuing Area	266 SF	В	Gross	7	39	
CUST	21 SF	S1		300	1	


Life Safety Legend		
← - >	Path of	Travel
	Non-Ra	ted Wall
	1-Hour	Rated Wall
	2-Hour l	Rated Wall
	3-Hour	Rated Wall
DOOR # ACTUAL OCCP LOADWIDTH PER WIDTH OCCP MAX OCCP LOAD	Door Eg	gress Tag
AREA NAME OCCUPANCY CATEGORY AREA (SF) AREA / OCCP OCCP LOAD	Area Oo	ecupancy Tag
TRAVEL PATH	Travel F	Path ID Tag
FE	Fire Ext	inguisher (Type A) Ta
FE	Fire Ext	inguisher (Type A-B)
	A-2	Assembly
	A-3	Assembly
	В	Business

F-1 Moderate Hazard

U Utility/Miscellaneous

Circulation

S-1 Moderate-Hazard Storage

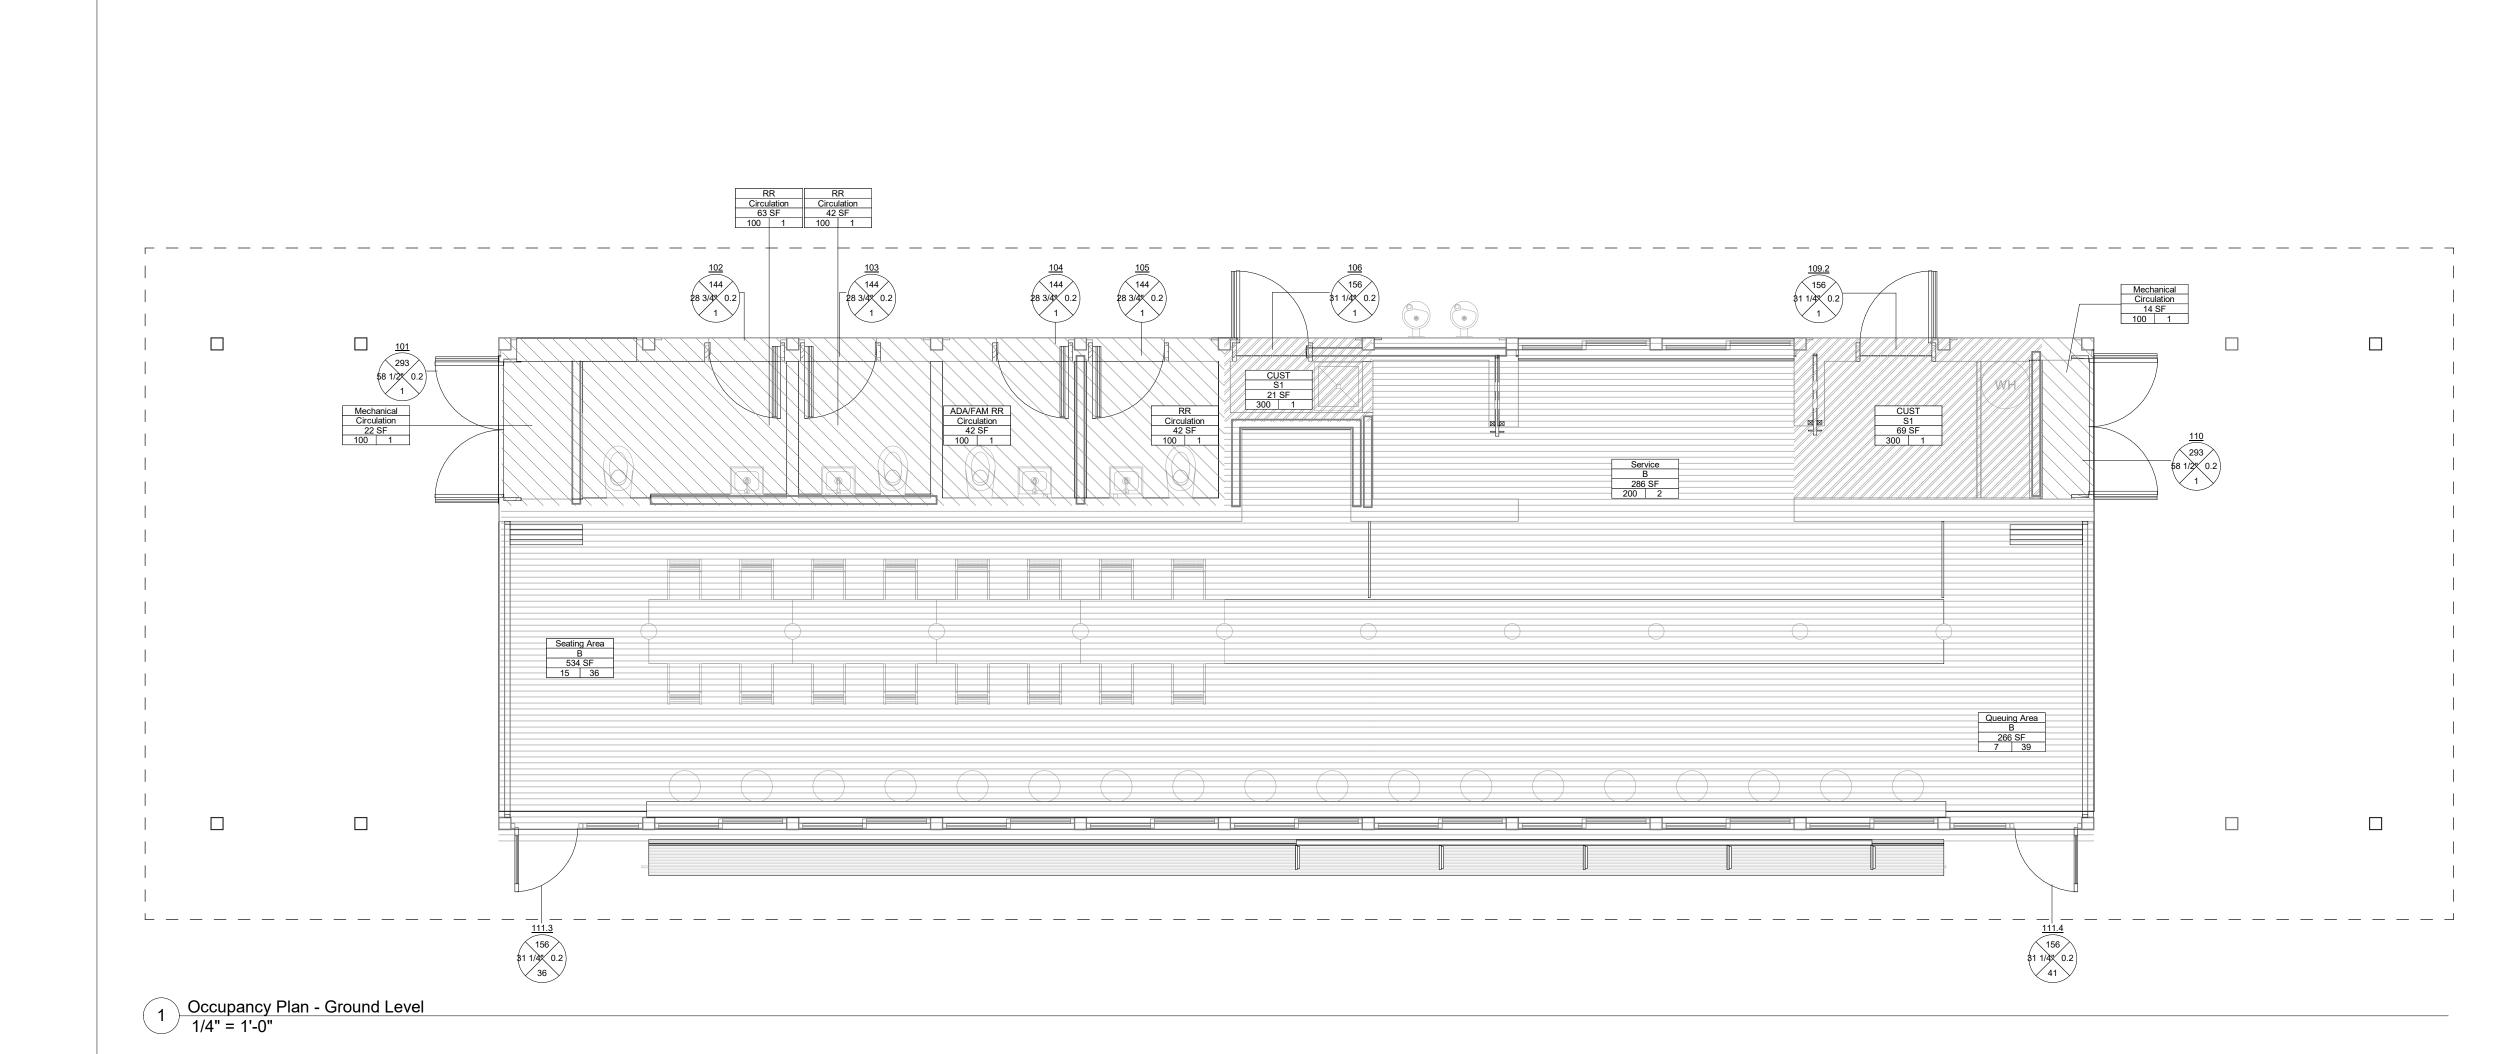

Storm King Art Center 1 Museum Road New Windsor, NY 12553 +1 (845) 534-3115 **Design Architect** heneghan peng architects 14-16 Lord Edward Street Dublin, D02 YC63 +353 1 633 9000 **Executive Architect** WXY Architecture + Urban Design 224 Centre Street, 5th Floor New York, NY 10013 +1 (212) 219-1953 Landscape Architect Gustafson Porter + Bowman 1 Cobham Mews London, MW1 9SB +44 020 7284 8950 Reed Hilderbrand LLC 33 Whitney Avenue, 3rd Floor New Haven, CT 06510 +1 (617) 923-2422 Structural & Lighting ARUP 77 Water Street New York, NY 10005 +1 (212) 896-3000 MEPF & IT BuroHappold 100 Broadway #23 New York, NY 10005 +1 (212) 616-0228 VHB 100 Great Oaks Blvd., Suite 118 Albany, NY 12203 +1 (518) 389-3606 AV & Acoustics LSTN Consultants 76 Beaver Street, 2nd Floor New York, NY 10005 +1 (347) 788-0810 Facade



Front Inc.

Key Plan

100 E. Broadway Street, #501

New York, NY 10002 +1 (212) 242-2220

Description Date
100% Design Development 05/29/20
50% Construction Documents 11/06/20

Storm King
Art Center

Project

Pond Pavilion

Seal


NOT FOR CONSTRUCTION


Drawing Title

Occupancy Load &

Exit Capacity

Date	11/06/20
Scale	1/4"=1'-0"
Drawing Number	A-P-005
Sheet Size	ARCH D

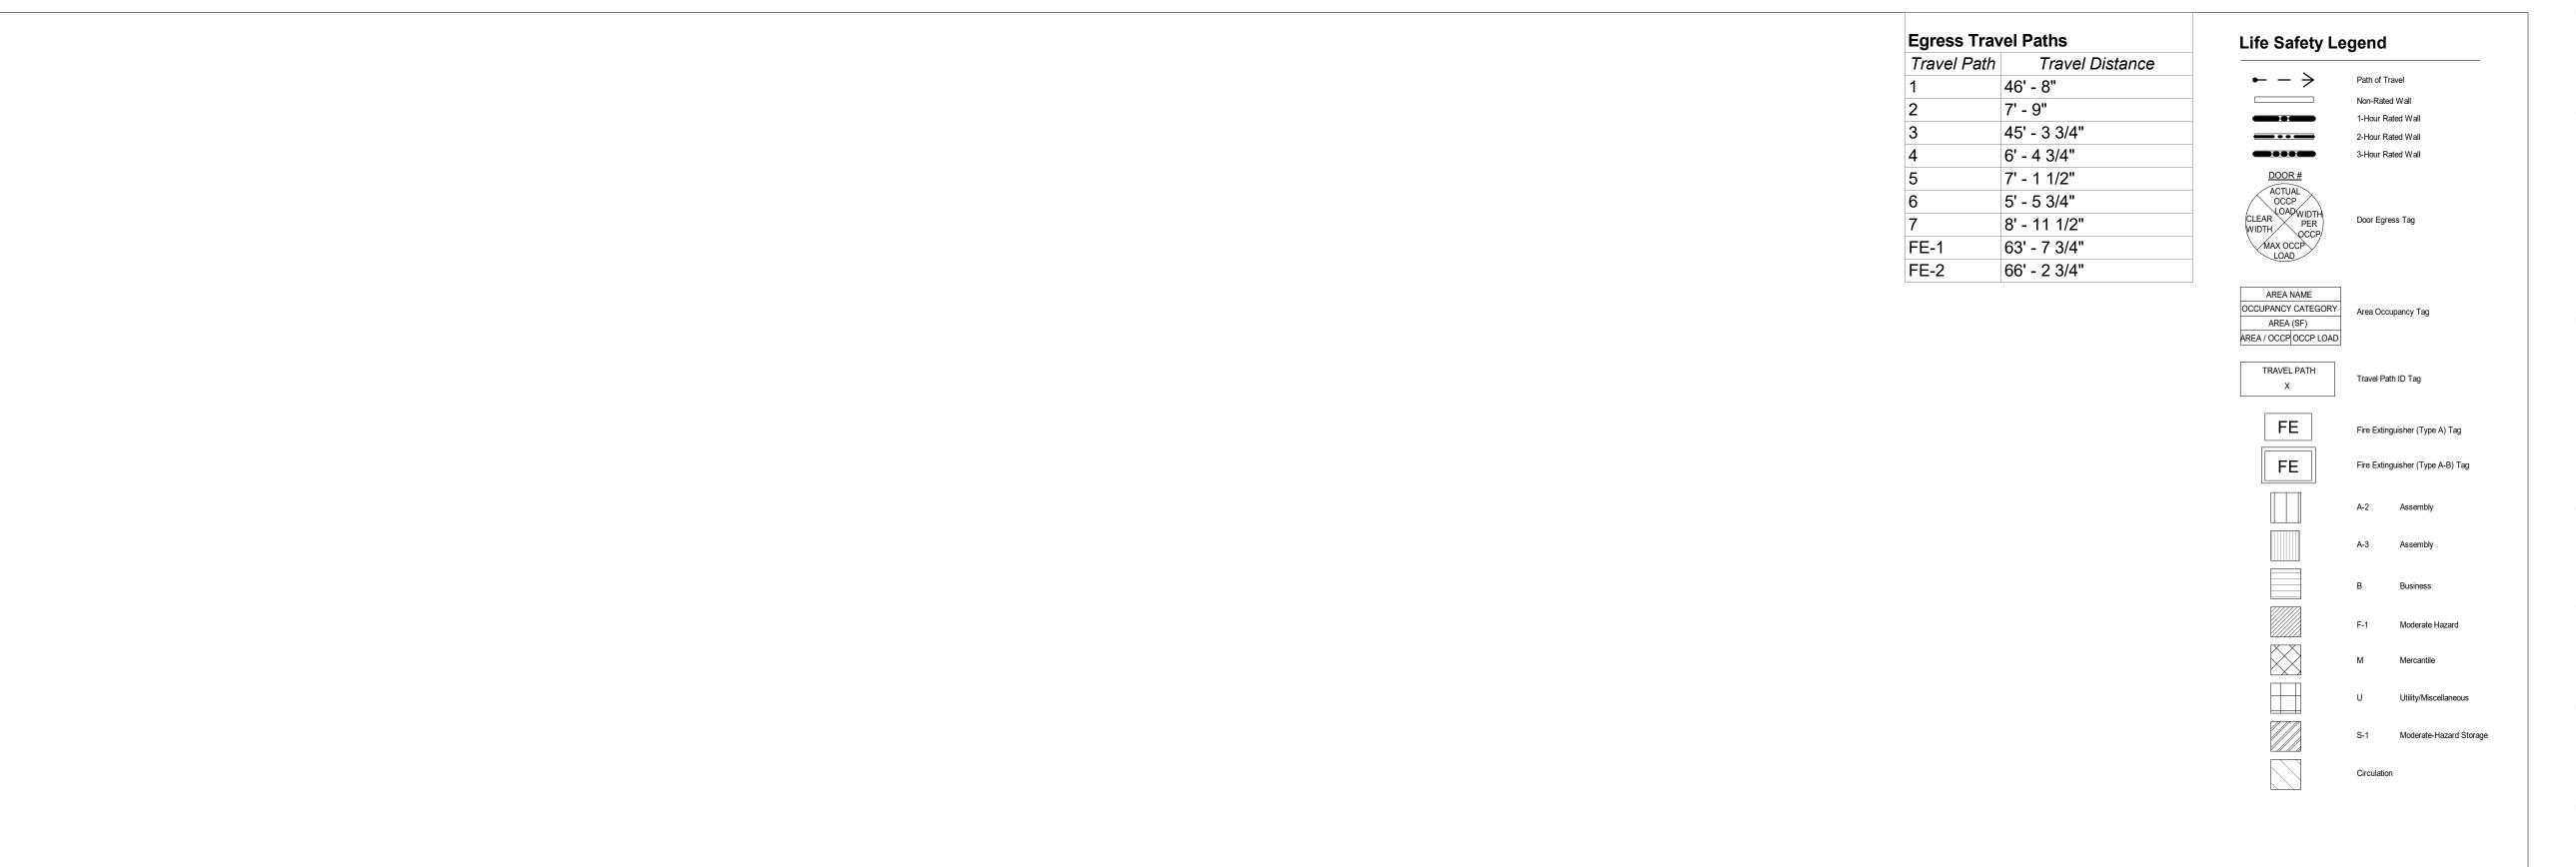

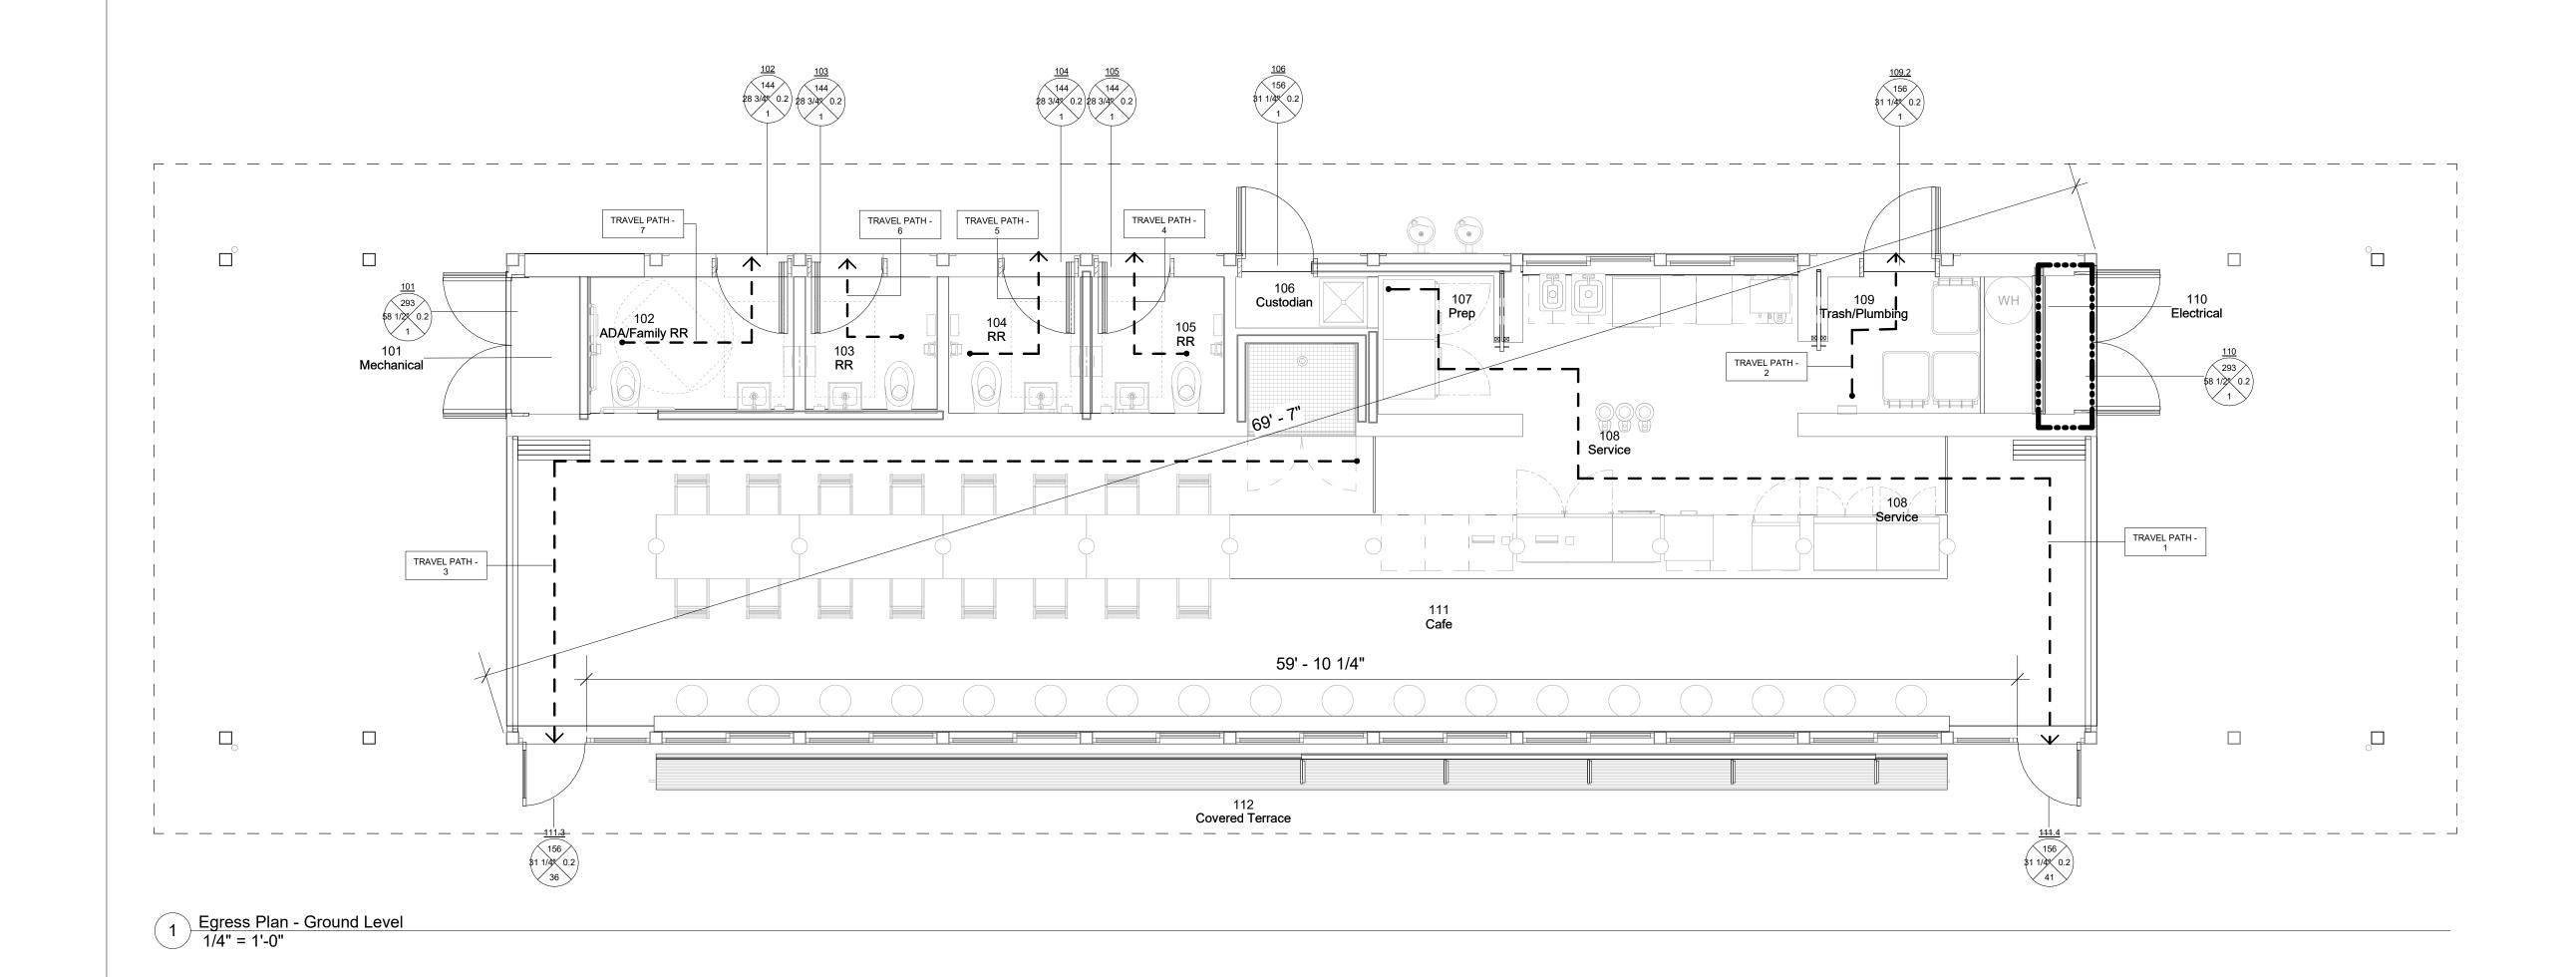

Owner Storm King Art Center 1 Museum Road New Windsor, NY 12553 +1 (845) 534-3115 **Design Architect** heneghan peng architects 14-16 Lord Edward Street Dublin, D02 YC63 +353 1 633 9000 **Executive Architect** WXY Architecture + Urban Design 224 Centre Street, 5th Floor New York, NY 10013 +1 (212) 219-1953 Landscape Architect Gustafson Porter + Bowman 1 Cobham Mews London, MW1 9SB +44 020 7284 8950 Reed Hilderbrand LLC 33 Whitney Avenue, 3rd Floor New Haven, CT 06510 +1 (617) 923-2422 Structural & Lighting ARUP 77 Water Street New York, NY 10005 +1 (212) 896-3000 MEPF & IT BuroHappold 100 Broadway #23 New York, NY 10005 +1 (212) 616-0228 VHB 100 Great Oaks Blvd., Suite 118 Albany, NY 12203 +1 (518) 389-3606 **AV & Acoustics** LSTN Consultants 76 Beaver Street, 2nd Floor New York, NY 10005 +1 (347) 788-0810 Facade Front Inc.

DescriptionDate100% Design Development05/29/2050% Construction Documents11/06/20

100 E. Broadway Street, #501

New York, NY 10002 +1 (212) 242-2220

Key Plan

Storm King
Art Center
Pond Pavilion

Seal


NOT FOR CONSTRUCTION

Drawing Title

Fire Ratings & Egress

Distances

Date	11/06/20
Scale	As indicated
Drawing Number	A-P-006
Sheet Size	ARCH D

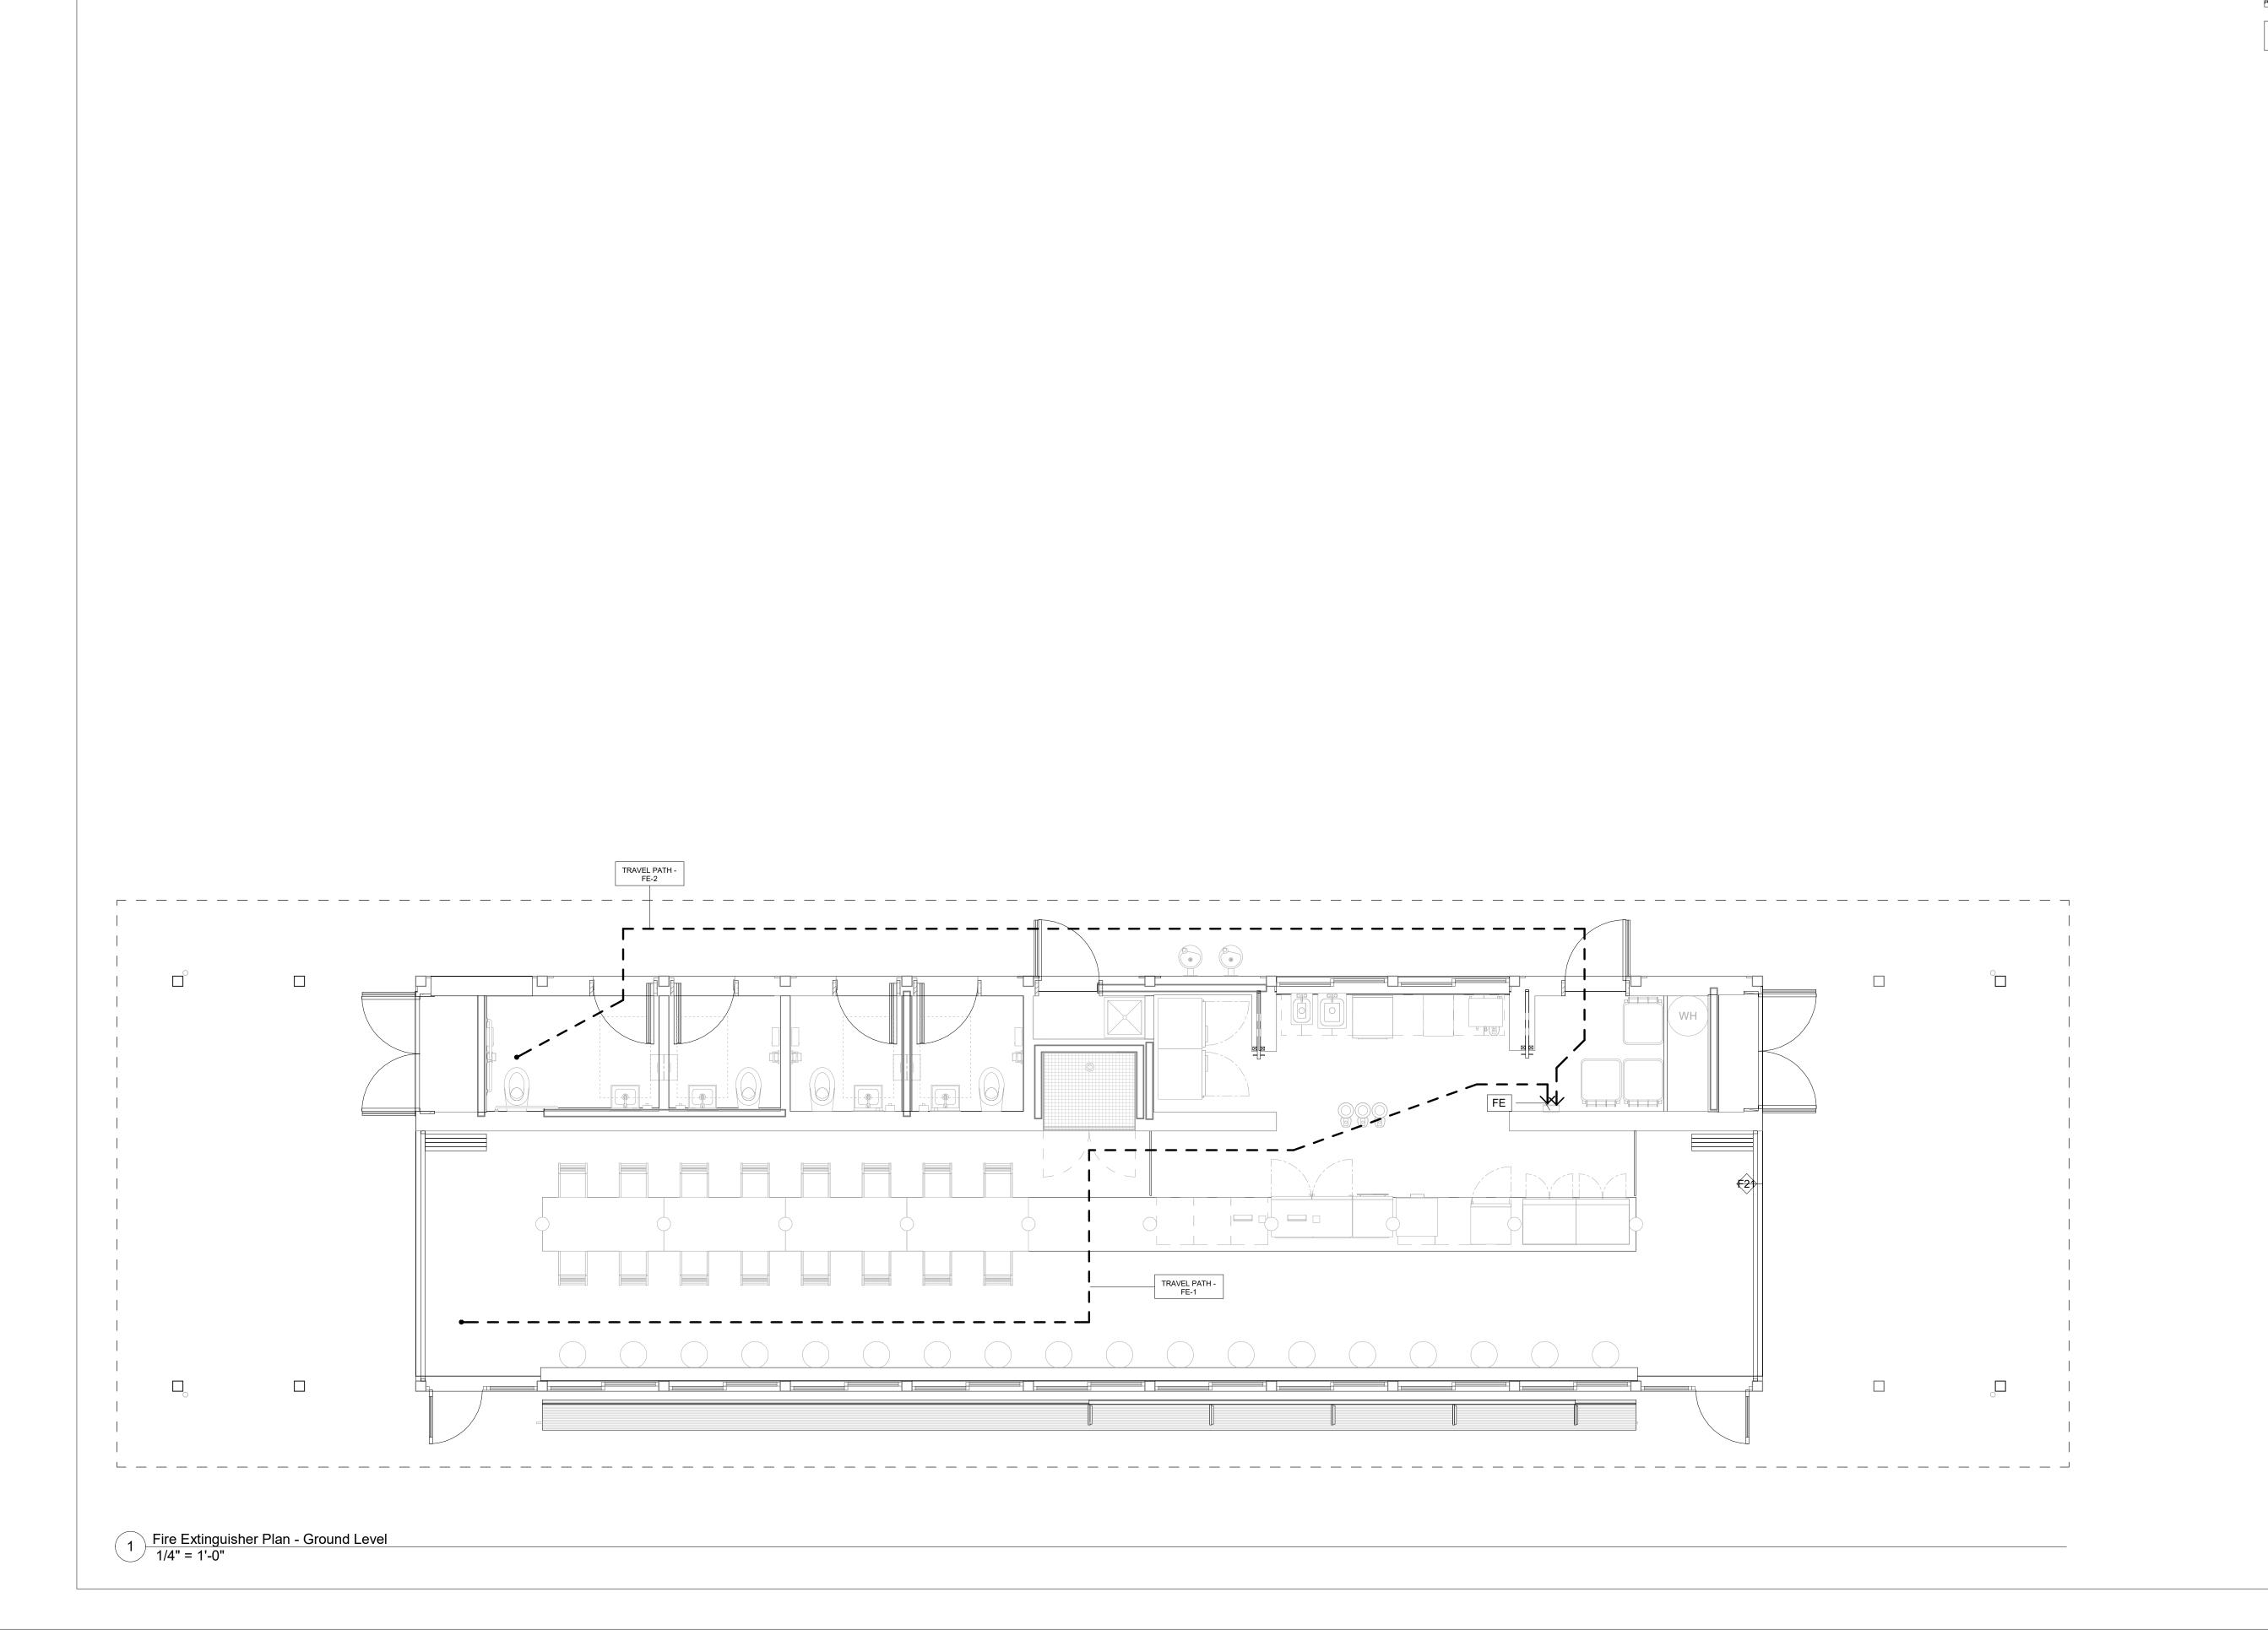


Travel Path Travel Distance FE-1 63' - 7 3/4"


FE Travel Paths


FE-2


66' - 2 3/4"

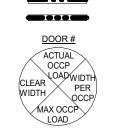





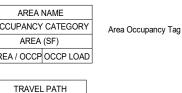

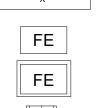

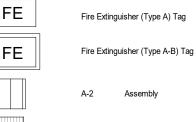

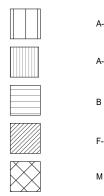

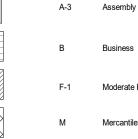





Circulation

Life Safety Legend


Non-Rated Wall 1-Hour Rated Wall 2-Hour Rated Wall 3-Hour Rated Wall


ACTUAL OCCP LOAD WIDTH PER WIDTH OCCP MAX OCCP LOAD

OCCUPANCY CATEGORY

Area Occupancy Tag AREA / OCCP OCCP LOAD

TRAVEL PATH Travel Path ID Tag Χ

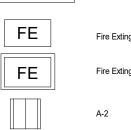

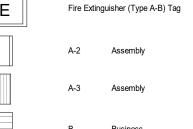





VHB 100 Great Oaks Blvd., Suite 118 Albany, NY 12203

Owner

Storm King Art Center

New Windsor, NY 12553

heneghan peng architects

14-16 Lord Edward Street

WXY Architecture + Urban Design

224 Centre Street, 5th Floor

Gustafson Porter + Bowman

33 Whitney Avenue, 3rd Floor

1 Museum Road

+1 (845) 534-3115

Design Architect

Dublin, D02 YC63

+353 1 633 9000

Executive Architect

New York, NY 10013

Landscape Architect

Reed Hilderbrand LLC

New Haven, CT 06510 +1 (617) 923-2422

Structural & Lighting

New York, NY 10005

+1 (212) 896-3000

100 Broadway #23 New York, NY 10005 +1 (212) 616-0228

ARUP

77 Water Street

MEPF & IT

BuroHappold

+1 (212) 219-1953

1 Cobham Mews

London, MW1 9SB +44 020 7284 8950

+1 (518) 389-3606 **AV & Acoustics** LSTN Consultants

76 Beaver Street, 2nd Floor New York, NY 10005 +1 (347) 788-0810 Facade

Front Inc.

100 E. Broadway Street, #501 New York, NY 10002 +1 (212) 242-2220

Key Plan



Description 50% Construction Documents

Storm King Art Center **Pond Pavilion**

NOT FOR CONSTRUCTION **Drawing Title** Fire Extinguisher Locations

Date	11/06/20
Scale	As indicated
Drawing Number	A-P-007
Sheet Size	ARCH D



Owner
Storm King Art Center

Storm King Art Center
1 Museum Road
New Windsor, NY 12553
+1 (845) 534-3115

Design Architect
heneghan peng architects
14-16 Lord Edward Street
Dublin, D02 YC63
+353 1 633 9000

Executive Architect
WXY Architecture + Urban Design
224 Centre Street, 5th Floor
New York, NY 10013
+1 (212) 219-1953

Landscape Architect

Gustafson Porter + Bowman 1 Cobham Mews London, MW1 9SB +44 020 7284 8950

Reed Hilderbrand LLC 33 Whitney Avenue, 3rd Floor New Haven, CT 06510 +1 (617) 923-2422

Structural & Lighting
ARUP
77 Water Street

New York, NY 10005 +1 (212) 896-3000 MEPF & IT

BuroHappold 100 Broadway #23 New York, NY 10005

+1 (212) 616-0228

Civil VHB

VHB 100 Great Oaks Blvd., Suite 118 Albany, NY 12203

+1 (518) 389-3606

AV & Acoustics

LSTN Consultants 76 Beaver Street, 2nd Floor New York, NY 10005 +1 (347) 788-0810

Facade
Front Inc.
100 E. Broadway Street, #501
New York, NY 10002
+1 (212) 242-2220

Key Plan



Description Date
50% Design Development 02/24
100% Design Development 05/29
50% Construction Documents 11/06

Project

Storm King Art Center Pond Pavilion

Sea

NOT FOR CONSTRUCTION

Drawing Title

Site Plan - Property

Date	11/06/20
Scale	1/64" = 1'-0"
Drawing Number	A-P-011
Sheet Size	ARCH D



Storm King Art Center 1 Museum Road New Windsor, NY 12553 +1 (845) 534-3115

Design Architect heneghan peng architects 14-16 Lord Edward Street

Dublin, D02 YC63 +353 1 633 9000 **Executive Architect** WXY Architecture + Urban Design 224 Centre Street, 5th Floor

New York, NY 10013 +1 (212) 219-1953 Landscape Architect

Gustafson Porter + Bowman 1 Cobham Mews London, MW1 9SB +44 020 7284 8950

Reed Hilderbrand LLC 33 Whitney Avenue, 3rd Floor New Haven, CT 06510 +1 (617) 923-2422

Structural & Lighting ARUP 77 Water Street New York, NY 10005

+1 (212) 896-3000 MEPF & IT

BuroHappold 100 Broadway #23 New York, NY 10005 +1 (212) 616-0228

Civil VHB

100 Great Oaks Blvd., Suite 118 Albany, NY 12203 +1 (518) 389-3606

AV & Acoustics LSTN Consultants 76 Beaver Street, 2nd Floor New York, NY 10005 +1 (347) 788-0810

Facade Front Inc. 100 E. Broadway Street, #501 New York, NY 10002 +1 (212) 242-2220

Key Plan



Description 50% Design Development 02/24/20 100% Design Development 05/29/20 50% Construction Documents

Storm King Art Center **Pond Pavilion**

NOT FOR CONSTRUCTION **Drawing Title** Site Plan - Building

Date	11/06/20
Scale	1/16" = 1'-0"
Drawing Number	A-P-012
Sheet Size	ARCH D



Owner
Storm King Art Center

Storm King Art Center
1 Museum Road
New Windsor, NY 12553
+1 (845) 534-3115

Design Architect
heneghan peng architects
14-16 Lord Edward Street
Dublin, D02 YC63
+353 1 633 9000

Executive Architect
WXY Architecture + Urban Design
224 Centre Street, 5th Floor
New York, NY 10013

+1 (212) 219-1953

Landscape Architect

Gustafson Porter + Bowman 1 Cobham Mews London, MW1 9SB +44 020 7284 8950

Reed Hilderbrand LLC 33 Whitney Avenue, 3rd Floor New Haven, CT 06510 +1 (617) 923-2422

Structural & Lighting ARUP 77 Water Street New York, NY 10005

New York, NY 10005 +1 (212) 896-3000 MEPF & IT

BuroHappold 100 Broadway #23 New York, NY 10005 +1 (212) 616-0228

Civil VHB

100 Great Oaks Blvd., Suite 118 Albany, NY 12203

+1 (518) 389-3606

AV & Acoustics
LSTN Consultants

76 Beaver Street, 2nd Floor New York, NY 10005 +1 (347) 788-0810

Facade
Front Inc.
100 E. Broadway Street, #501
New York, NY 10002
+1 (212) 242-2220

Key Plan



Description Date
50% Design Development 02/24/20
100% Design Development 05/29/20
50% Construction Documents 11/06/20


Storm King Art Center

Sea

NOT FOR CONSTRUCTION

Site Plan - Property -Setting Out

Date	11/06/20
Scale	1" = 400'-0"
Drawing Number	A-X-091
Sheet Size	ARCH D

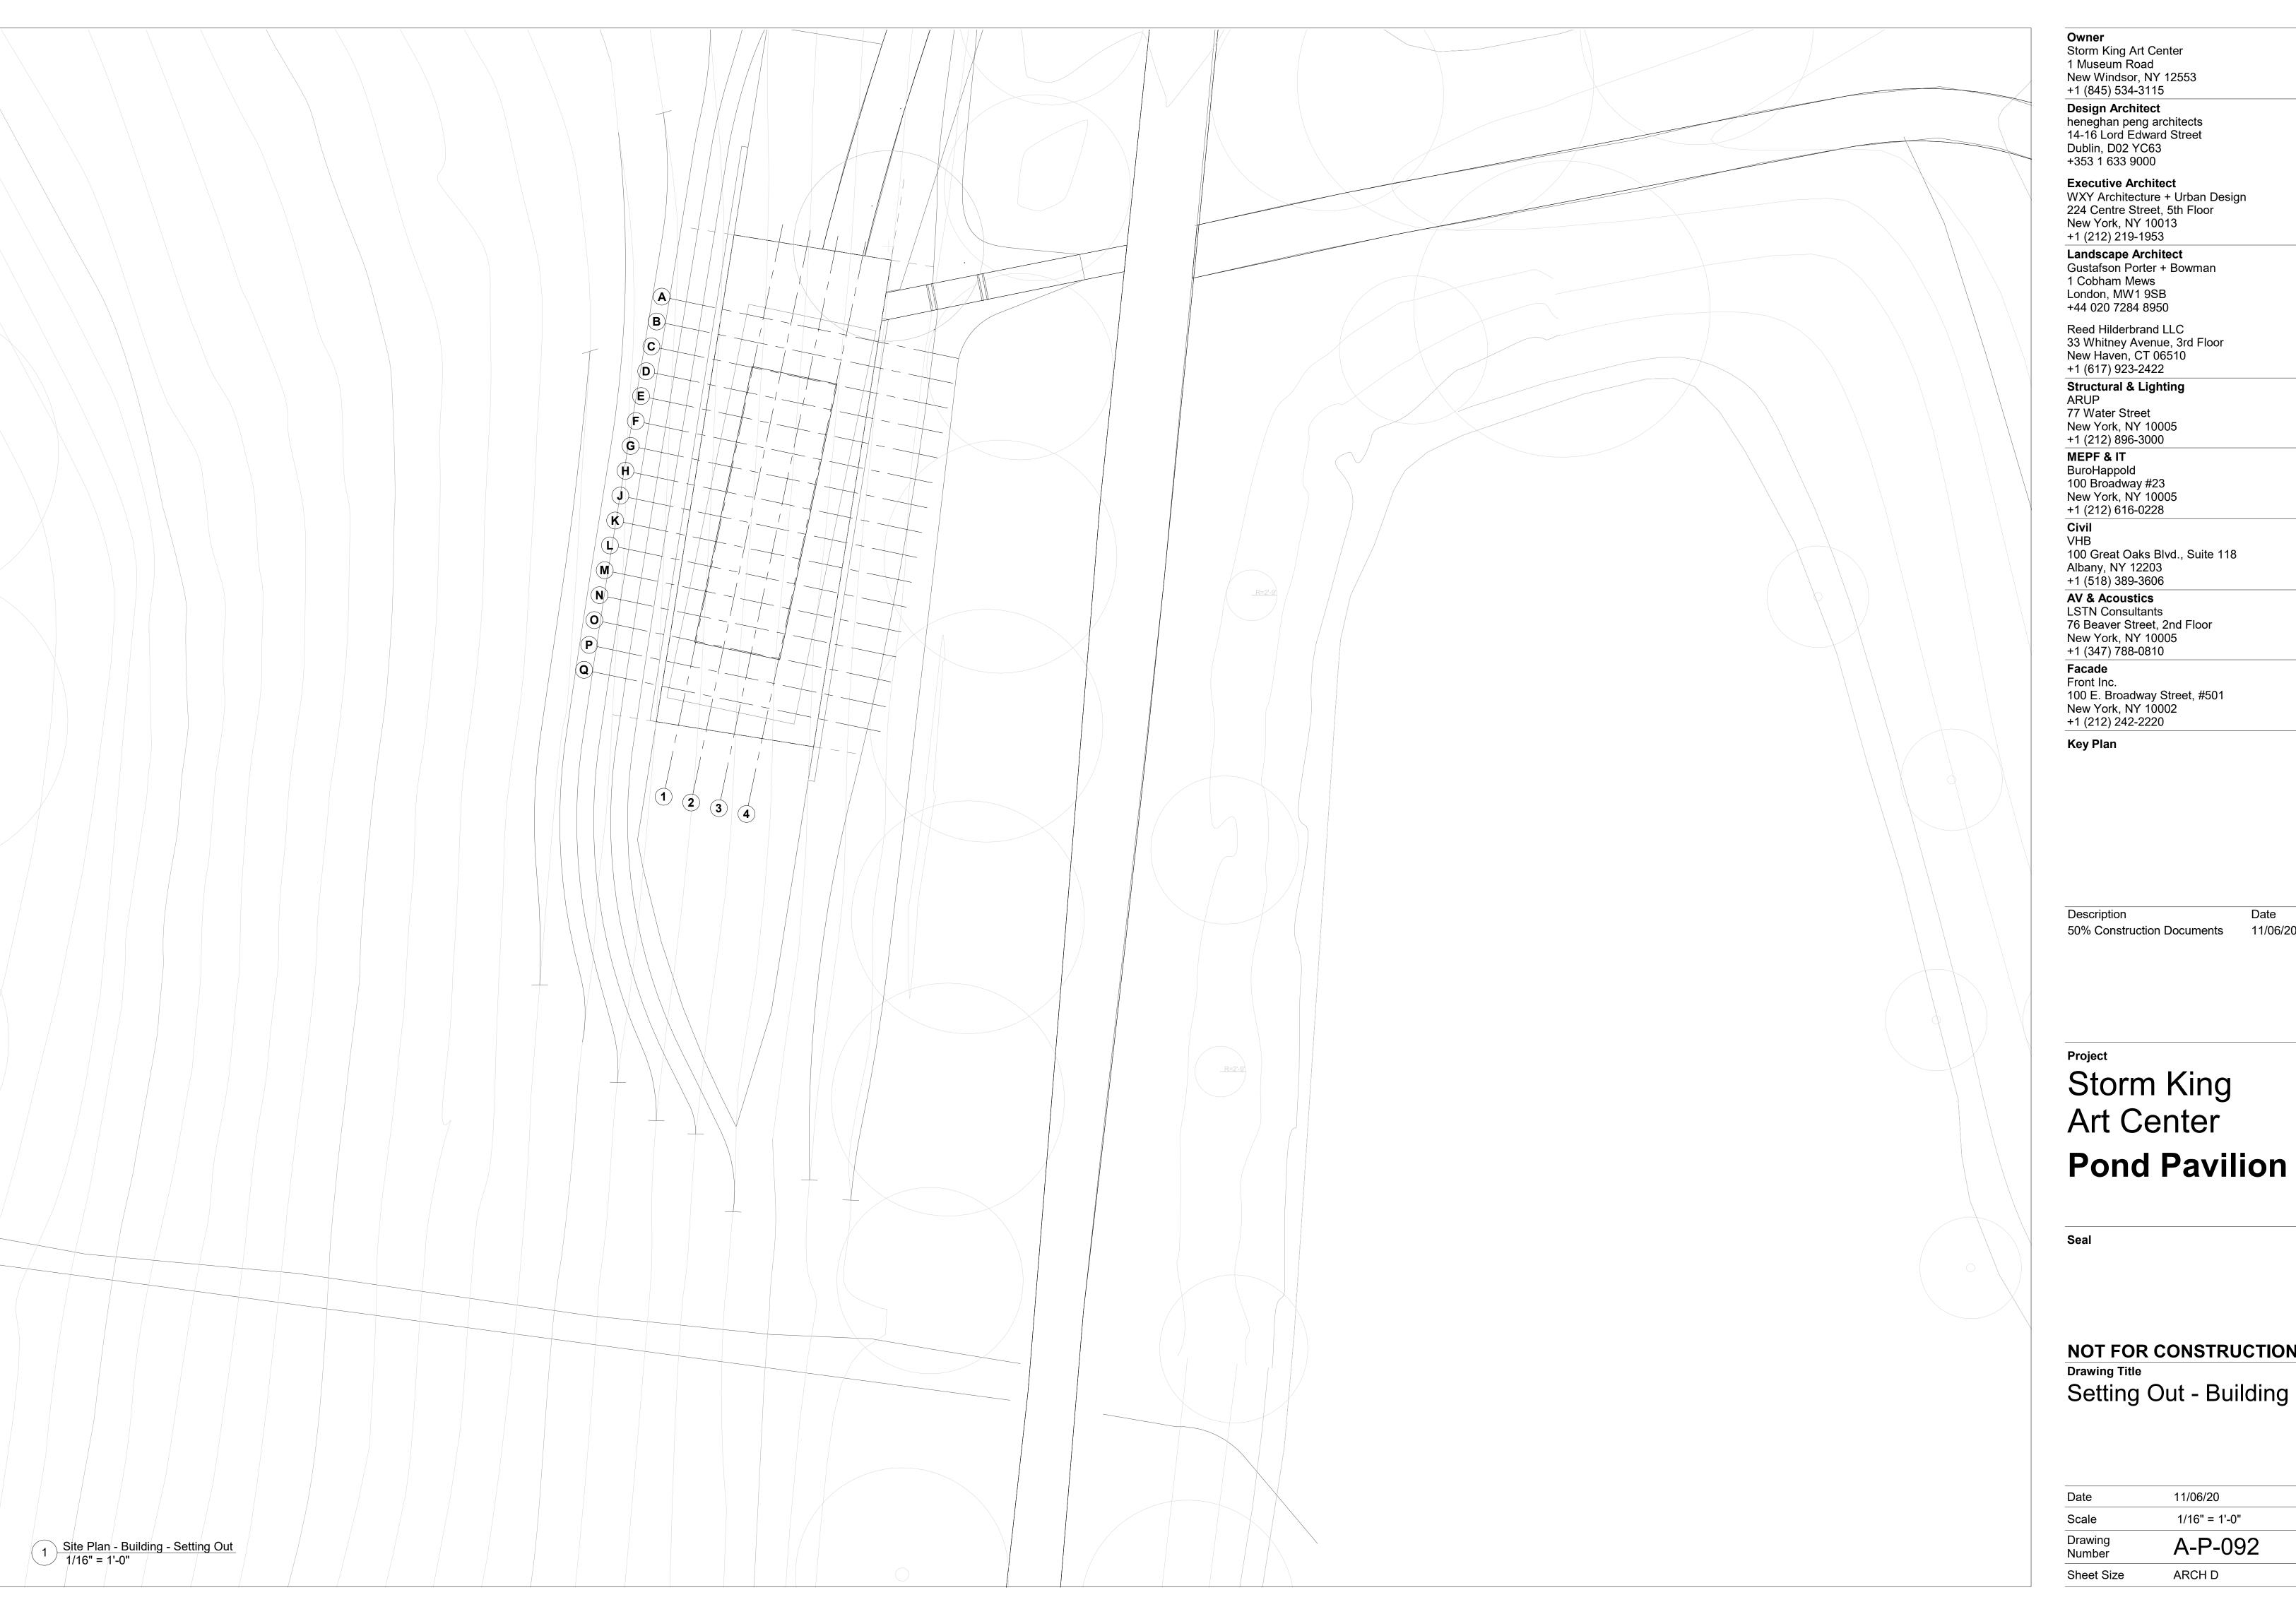

Storm King Art Center

1 Museum Road New Windsor, NY 12553 +1 (845) 534-3115

Design Architect heneghan peng architects 14-16 Lord Edward Street Dublin, D02 YC63 +353 1 633 9000

Executive Architect WXY Architecture + Urban Design 224 Centre Street, 5th Floor New York, NY 10013 +1 (212) 219-1953

Landscape Architect Gustafson Porter + Bowman 1 Cobham Mews London, MW1 9SB +44 020 7284 8950

Reed Hilderbrand LLC 33 Whitney Avenue, 3rd Floor New Haven, CT 06510 +1 (617) 923-2422

Structural & Lighting ARUP 77 Water Street

New York, NY 10005 +1 (212) 896-3000 MEPF & IT

BuroHappold 100 Broadway #23 New York, NY 10005 +1 (212) 616-0228

Civil VHB

100 Great Oaks Blvd., Suite 118 Albany, NY 12203 +1 (518) 389-3606

AV & Acoustics LSTN Consultants 76 Beaver Street, 2nd Floor New York, NY 10005 +1 (347) 788-0810

Facade Front Inc. 100 E. Broadway Street, #501 New York, NY 10002


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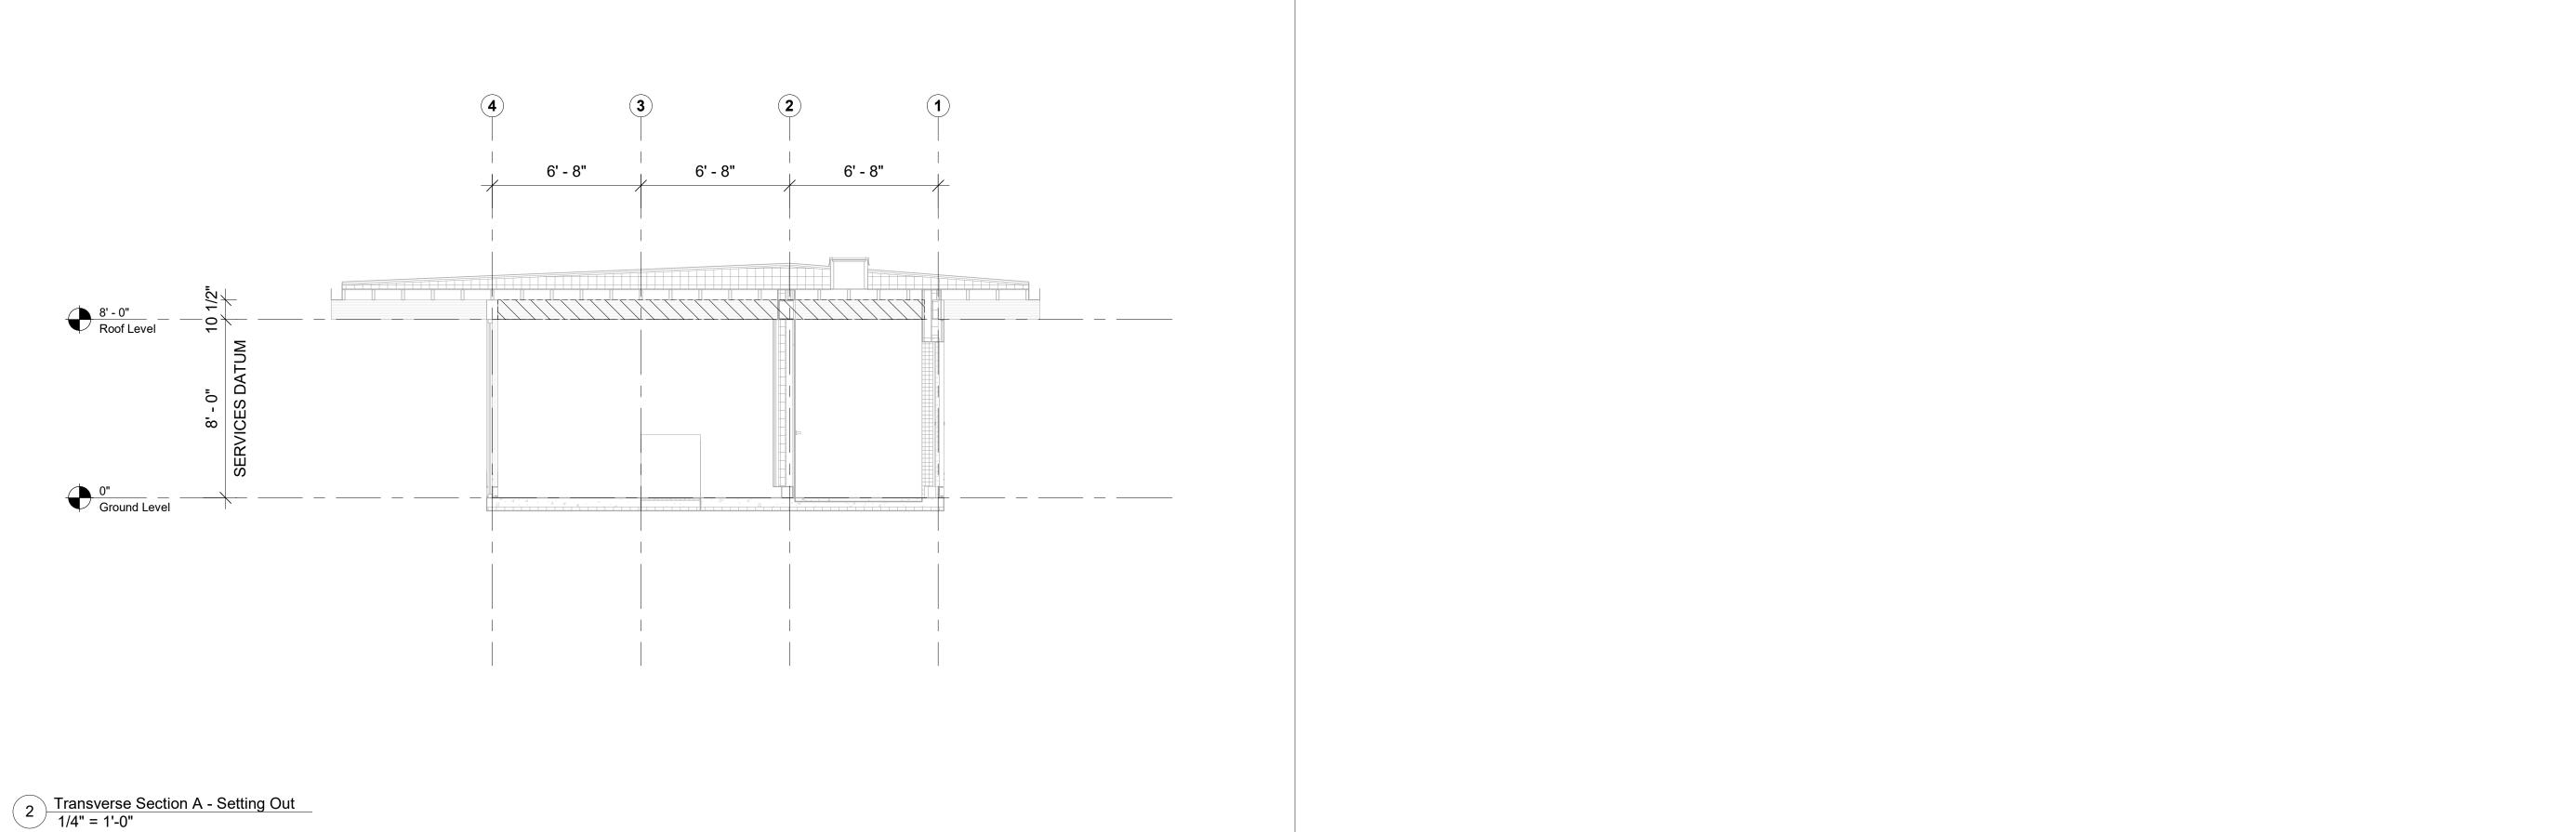
Description 50% Construction Documents

Storm King Art Center

NOT FOR CONSTRUCTION **Drawing Title** Setting Out - Building

Date	11/06/20
Scale	1/16" = 1'-0"
Drawing Number	A-P-092
Sheet Size	ARCH D



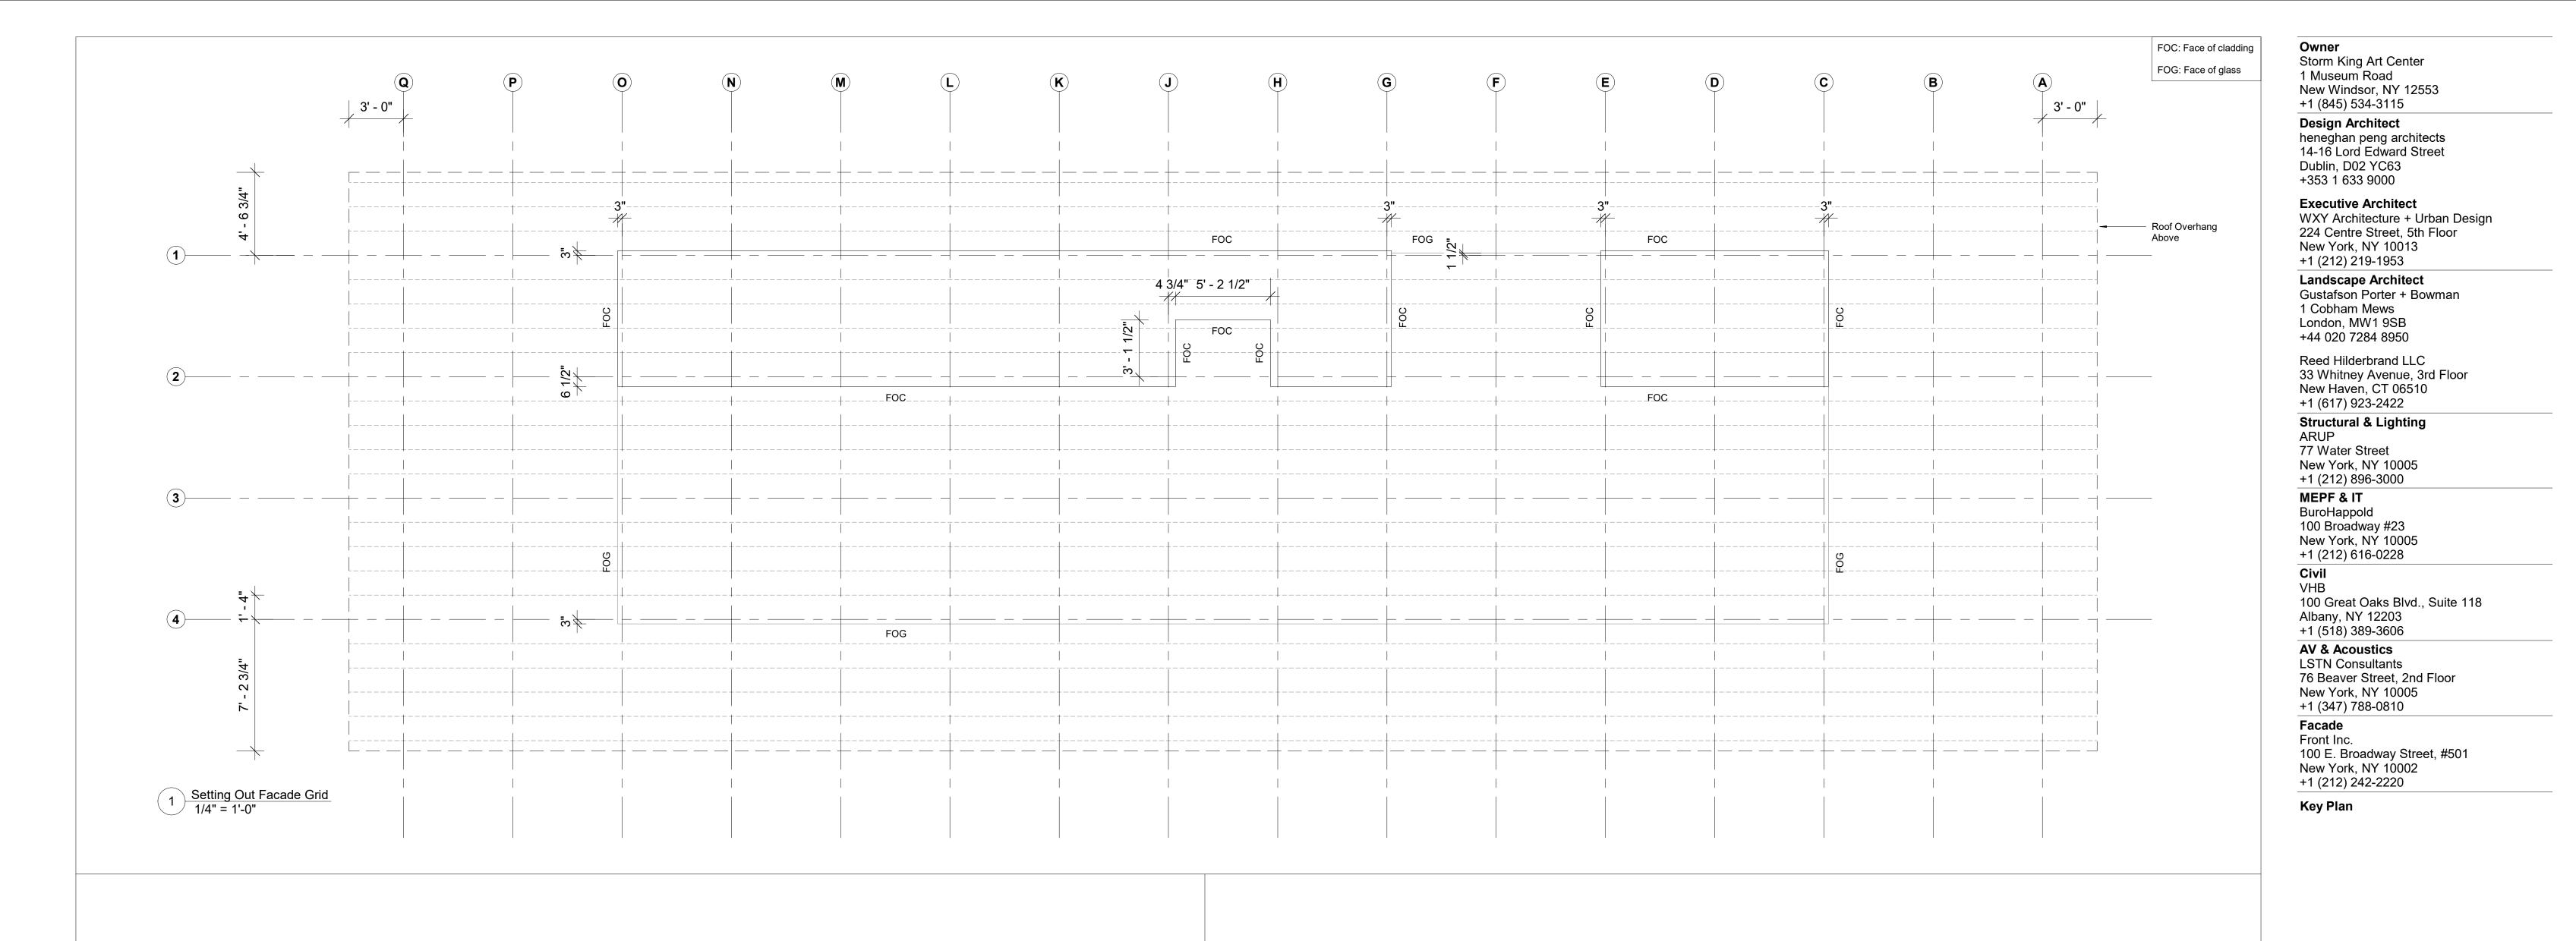

Description Date 50% Construction Documents 11/06

Storm King
Art Center

Project

Storm King

Art Pond Pavilion

Seal


NOT FOR CONSTRUCTION

Drawing Title

Setting Out - Primary

& Facade Grid

Date	11/06/20
Scale	1/4" = 1'-0"
Drawing Number	A-P-093
Sheet Size	ARCH D

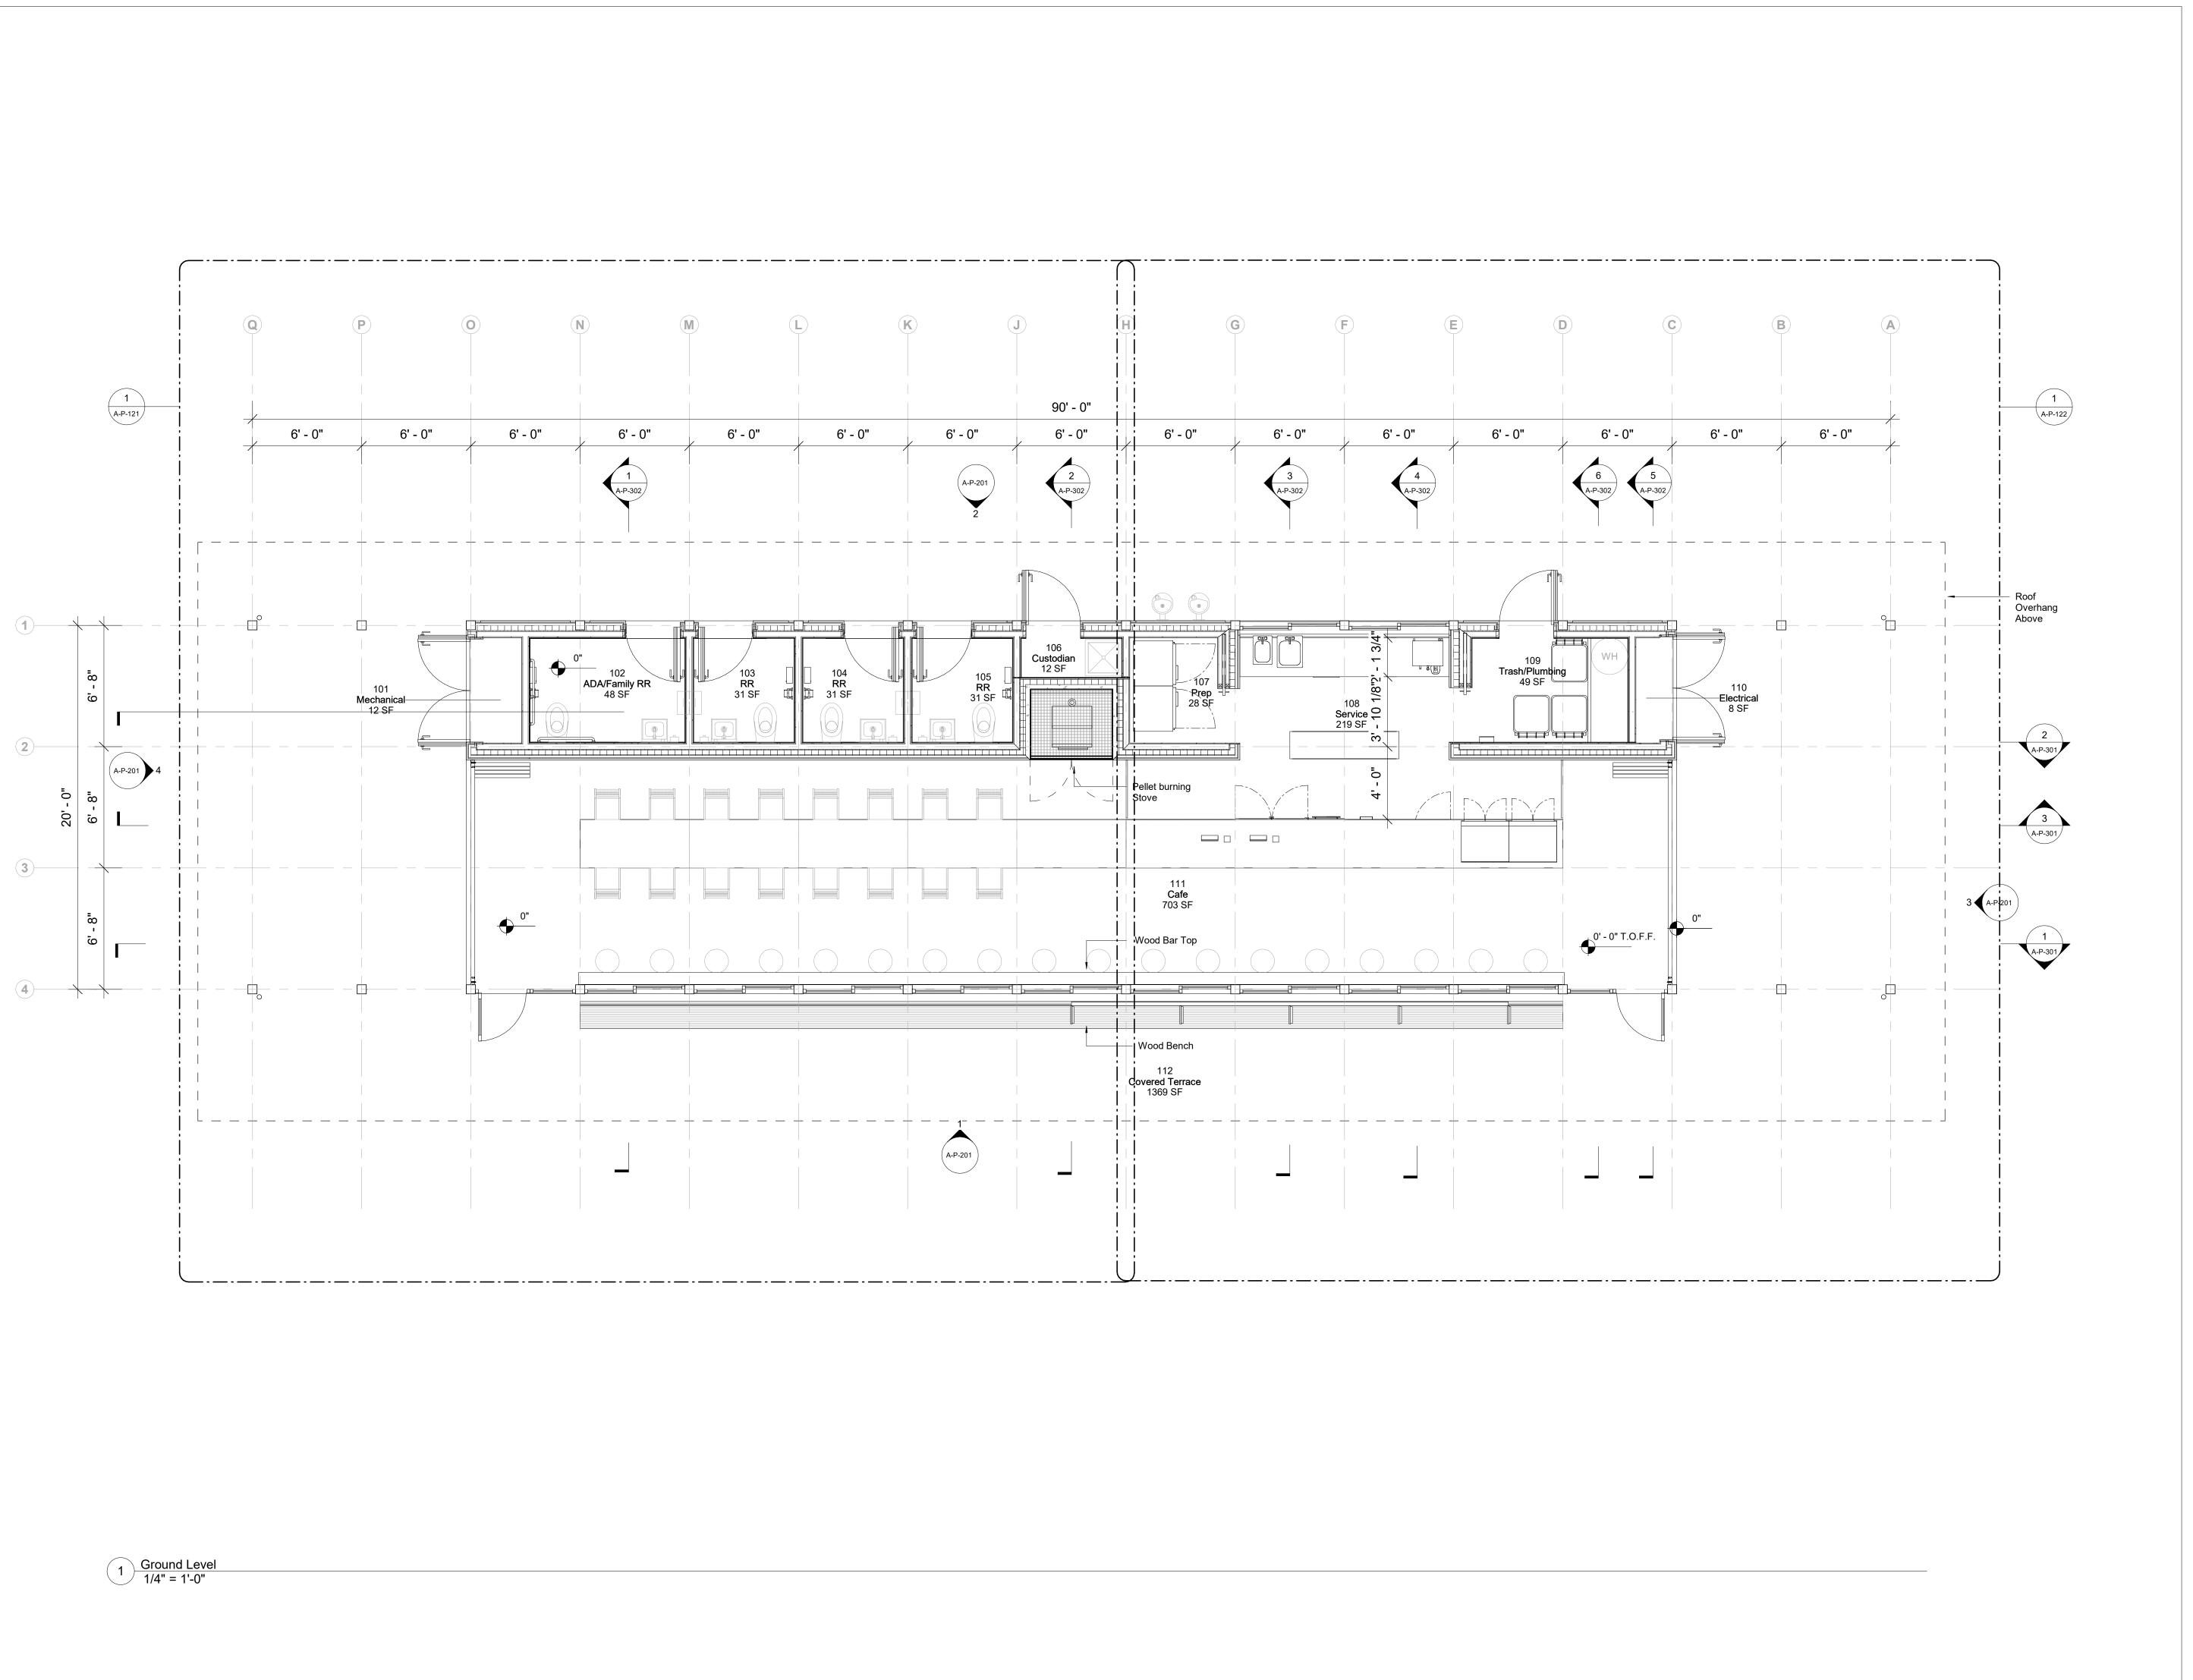

Owner
Storm King Art Center

Storm King Art Center
1 Museum Road
New Windsor, NY 12553
+1 (845) 534-3115

Design Architect
heneghan peng architects
14-16 Lord Edward Street
Dublin, D02 YC63
+353 1 633 9000

Executive Architect
WXY Architecture + Urban Design
224 Centre Street, 5th Floor
New York, NY 10013

+1 (212) 219-1953

Landscape Architect
Gustafson Porter + Bowman
1 Cobham Mews
London, MW1 9SB

+44 020 7284 8950

Reed Hilderbrand LLC
33 Whitney Avenue, 3rd Floor
New Haven, CT 06510
+1 (617) 923-2422

Structural & Lighting
ARUP
77 Water Street

New York, NY 10005 +1 (212) 896-3000 MEPF & IT

BuroHappold 100 Broadway #23 New York, NY 10005 +1 (212) 616-0228

New York, NY 10005 +1 (212) 616-0228 Civil VHB

100 Great Oaks Blvd., Suite 118 Albany, NY 12203 +1 (518) 389-3606

AV & Acoustics LSTN Consultants 76 Beaver Street, 2nd Floor New York, NY 10005 +1 (347) 788-0810

Facade
Front Inc.
100 E. Broadway Street, #501
New York, NY 10002
+1 (212) 242-2220

Key Plan



DescriptionDate50% Design Development02/24/20100% Design Development05/29/2050% Construction Documents11/06/20

Project


Storm King
Art Center
Pond Pavilion

Sea

NOT FOR CONSTRUCTION

Drawing Title
Floor Plan - Ground
Level

Date	11/06/20
Scale	1/4" = 1'-0"
Drawing Number	A-P-101
Sheet Size	ARCH D

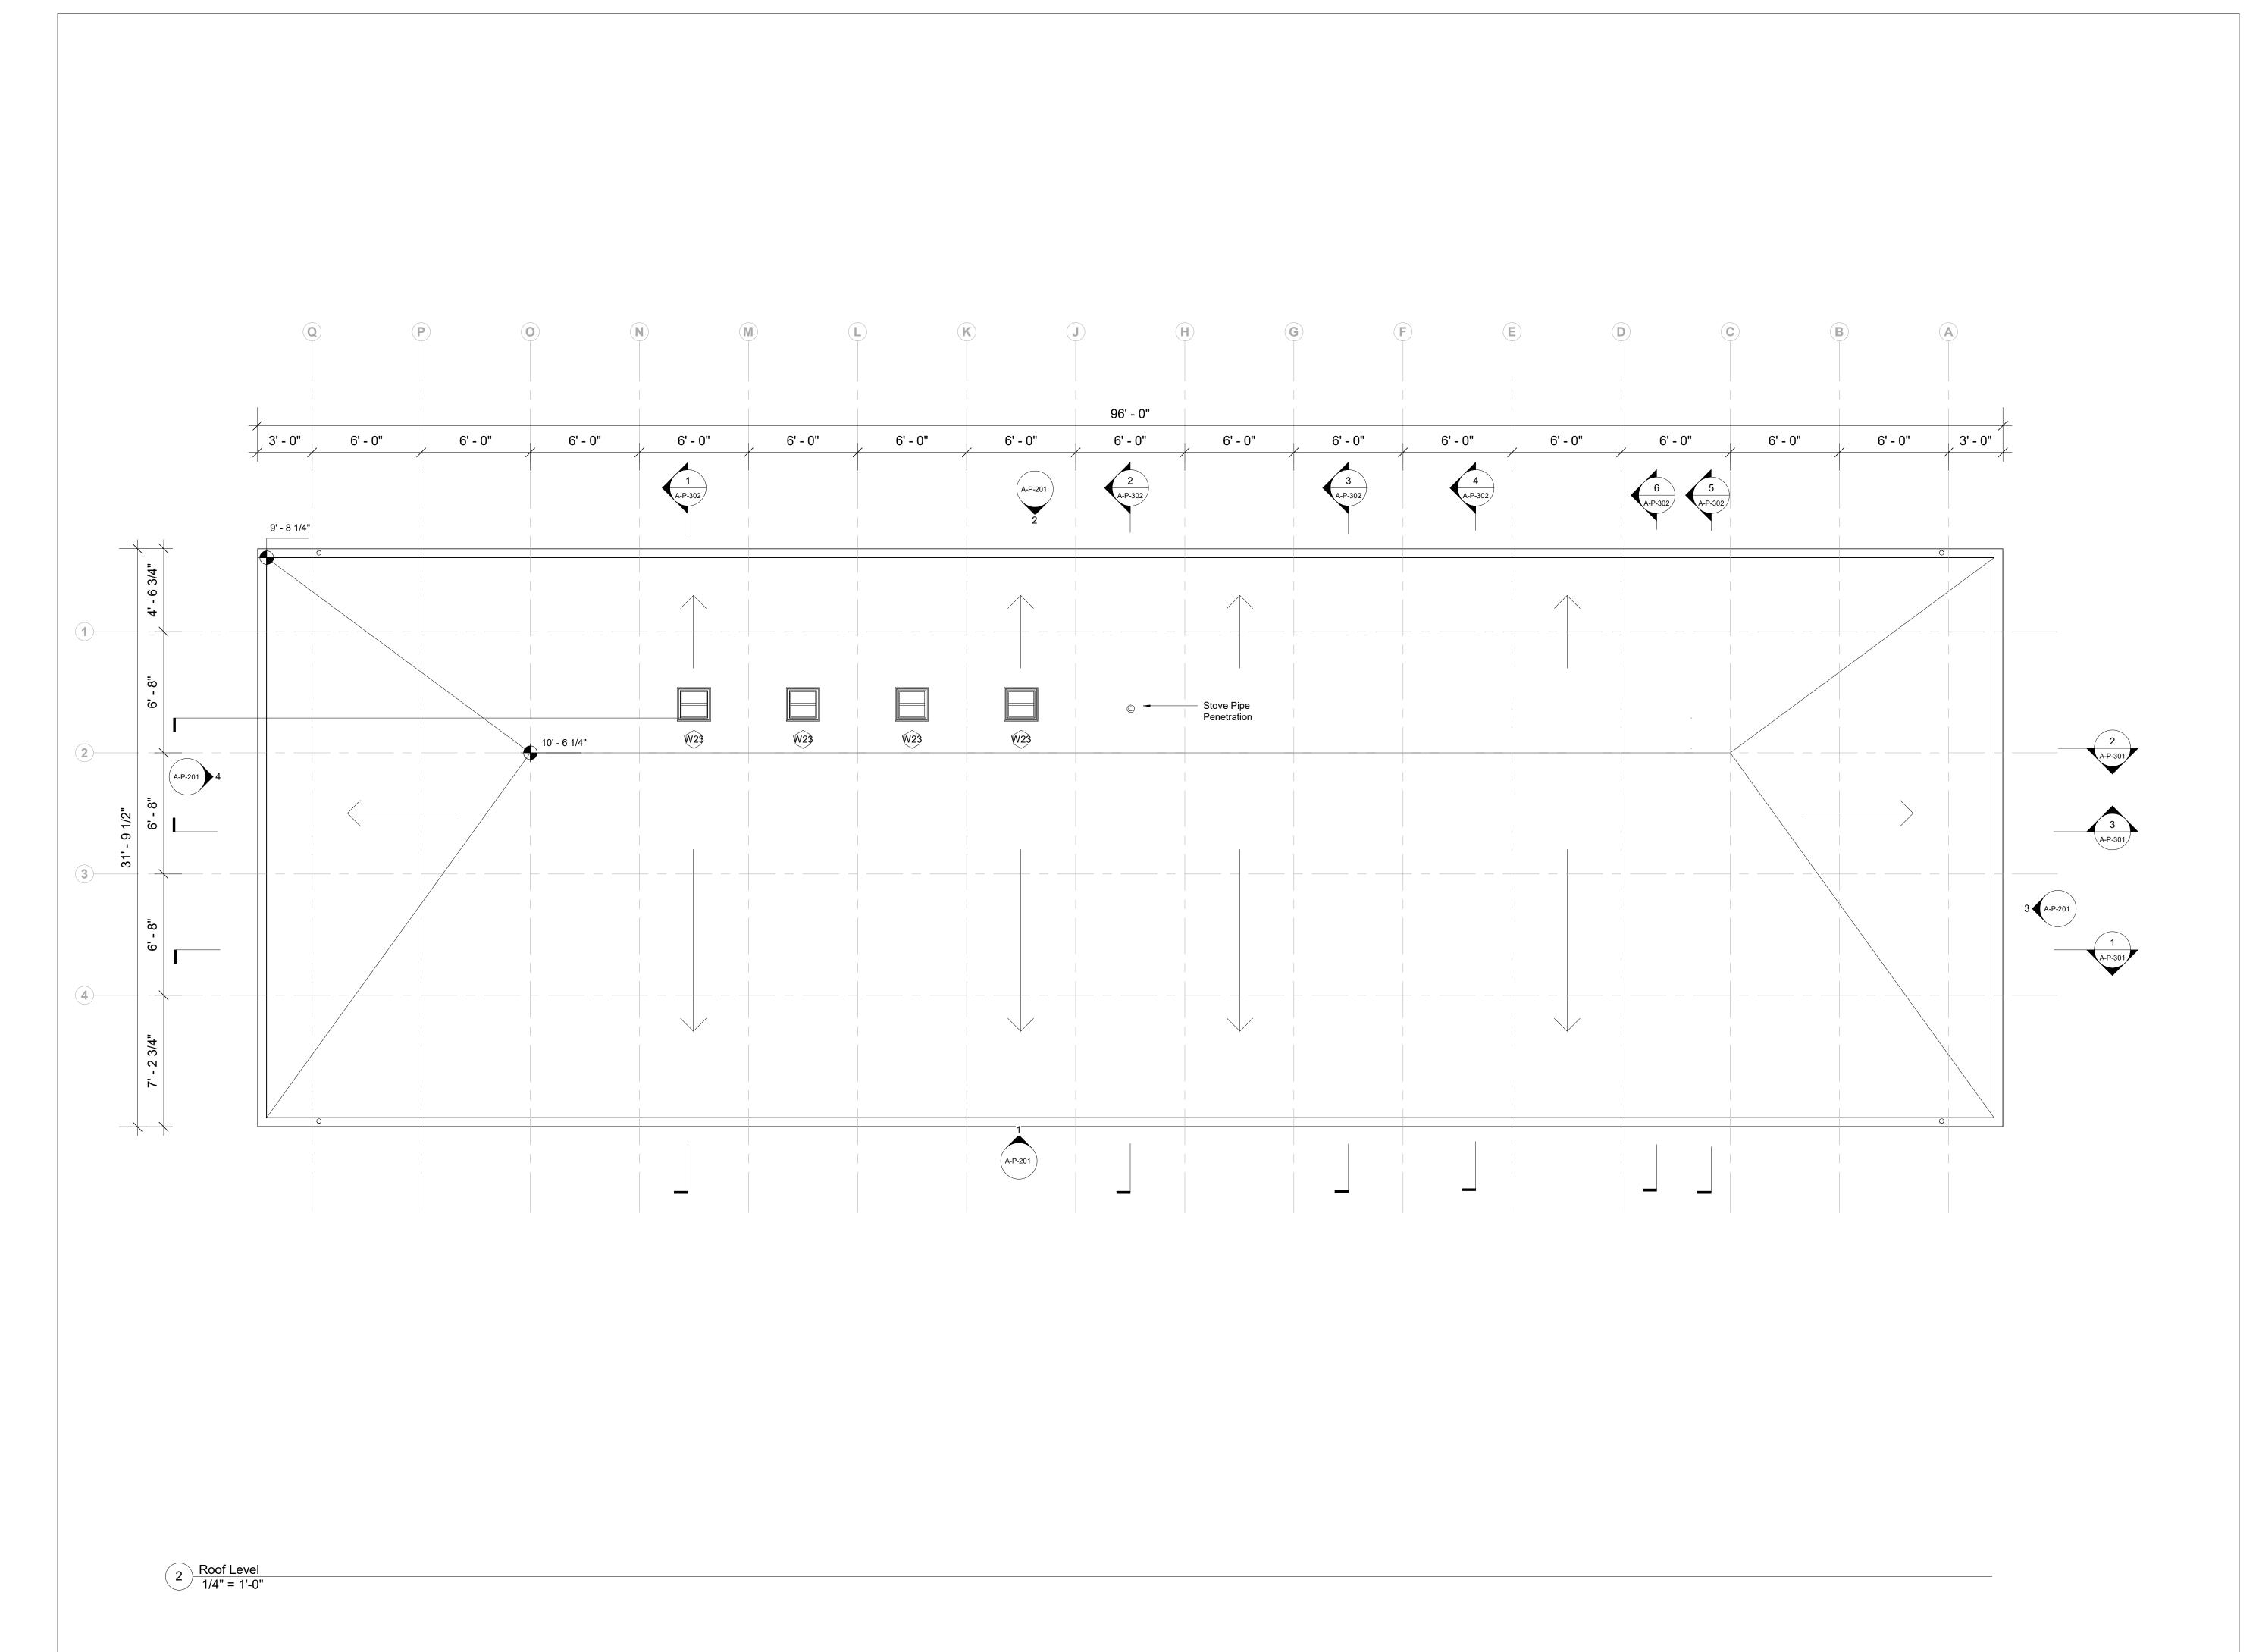

Storm King Art Center 1 Museum Road New Windsor, NY 12553 +1 (845) 534-3115

Design Architect heneghan peng architects 14-16 Lord Edward Street Dublin, D02 YC63 +353 1 633 9000

Executive Architect WXY Architecture + Urban Design 224 Centre Street, 5th Floor New York, NY 10013 +1 (212) 219-1953

Landscape Architect Gustafson Porter + Bowman 1 Cobham Mews

London, MW1 9SB

+44 020 7284 8950 Reed Hilderbrand LLC 33 Whitney Avenue, 3rd Floor New Haven, CT 06510

+1 (617) 923-2422 Structural & Lighting ARUP

77 Water Street New York, NY 10005 +1 (212) 896-3000 MEPF & IT

BuroHappold 100 Broadway #23 New York, NY 10005

+1 (212) 616-0228 Civil VHB

100 Great Oaks Blvd., Suite 118 Albany, NY 12203 +1 (518) 389-3606

AV & Acoustics LSTN Consultants 76 Beaver Street, 2nd Floor New York, NY 10005 +1 (347) 788-0810

Facade Front Inc. 100 E. Broadway Street, #501 New York, NY 10002 +1 (212) 242-2220

Key Plan




Description Date 50% Design Development 02/24/20 100% Design Development 05/29/20 50% Construction Documents 11/06/20

Storm King Art Center **Pond Pavilion**

NOT FOR CONSTRUCTION **Drawing Title** Floor Plan - Roof Level

Date	11/06/20
Scale	1/4" = 1'-0"
Drawing Number	A-P-102
Sheet Size	ARCH D

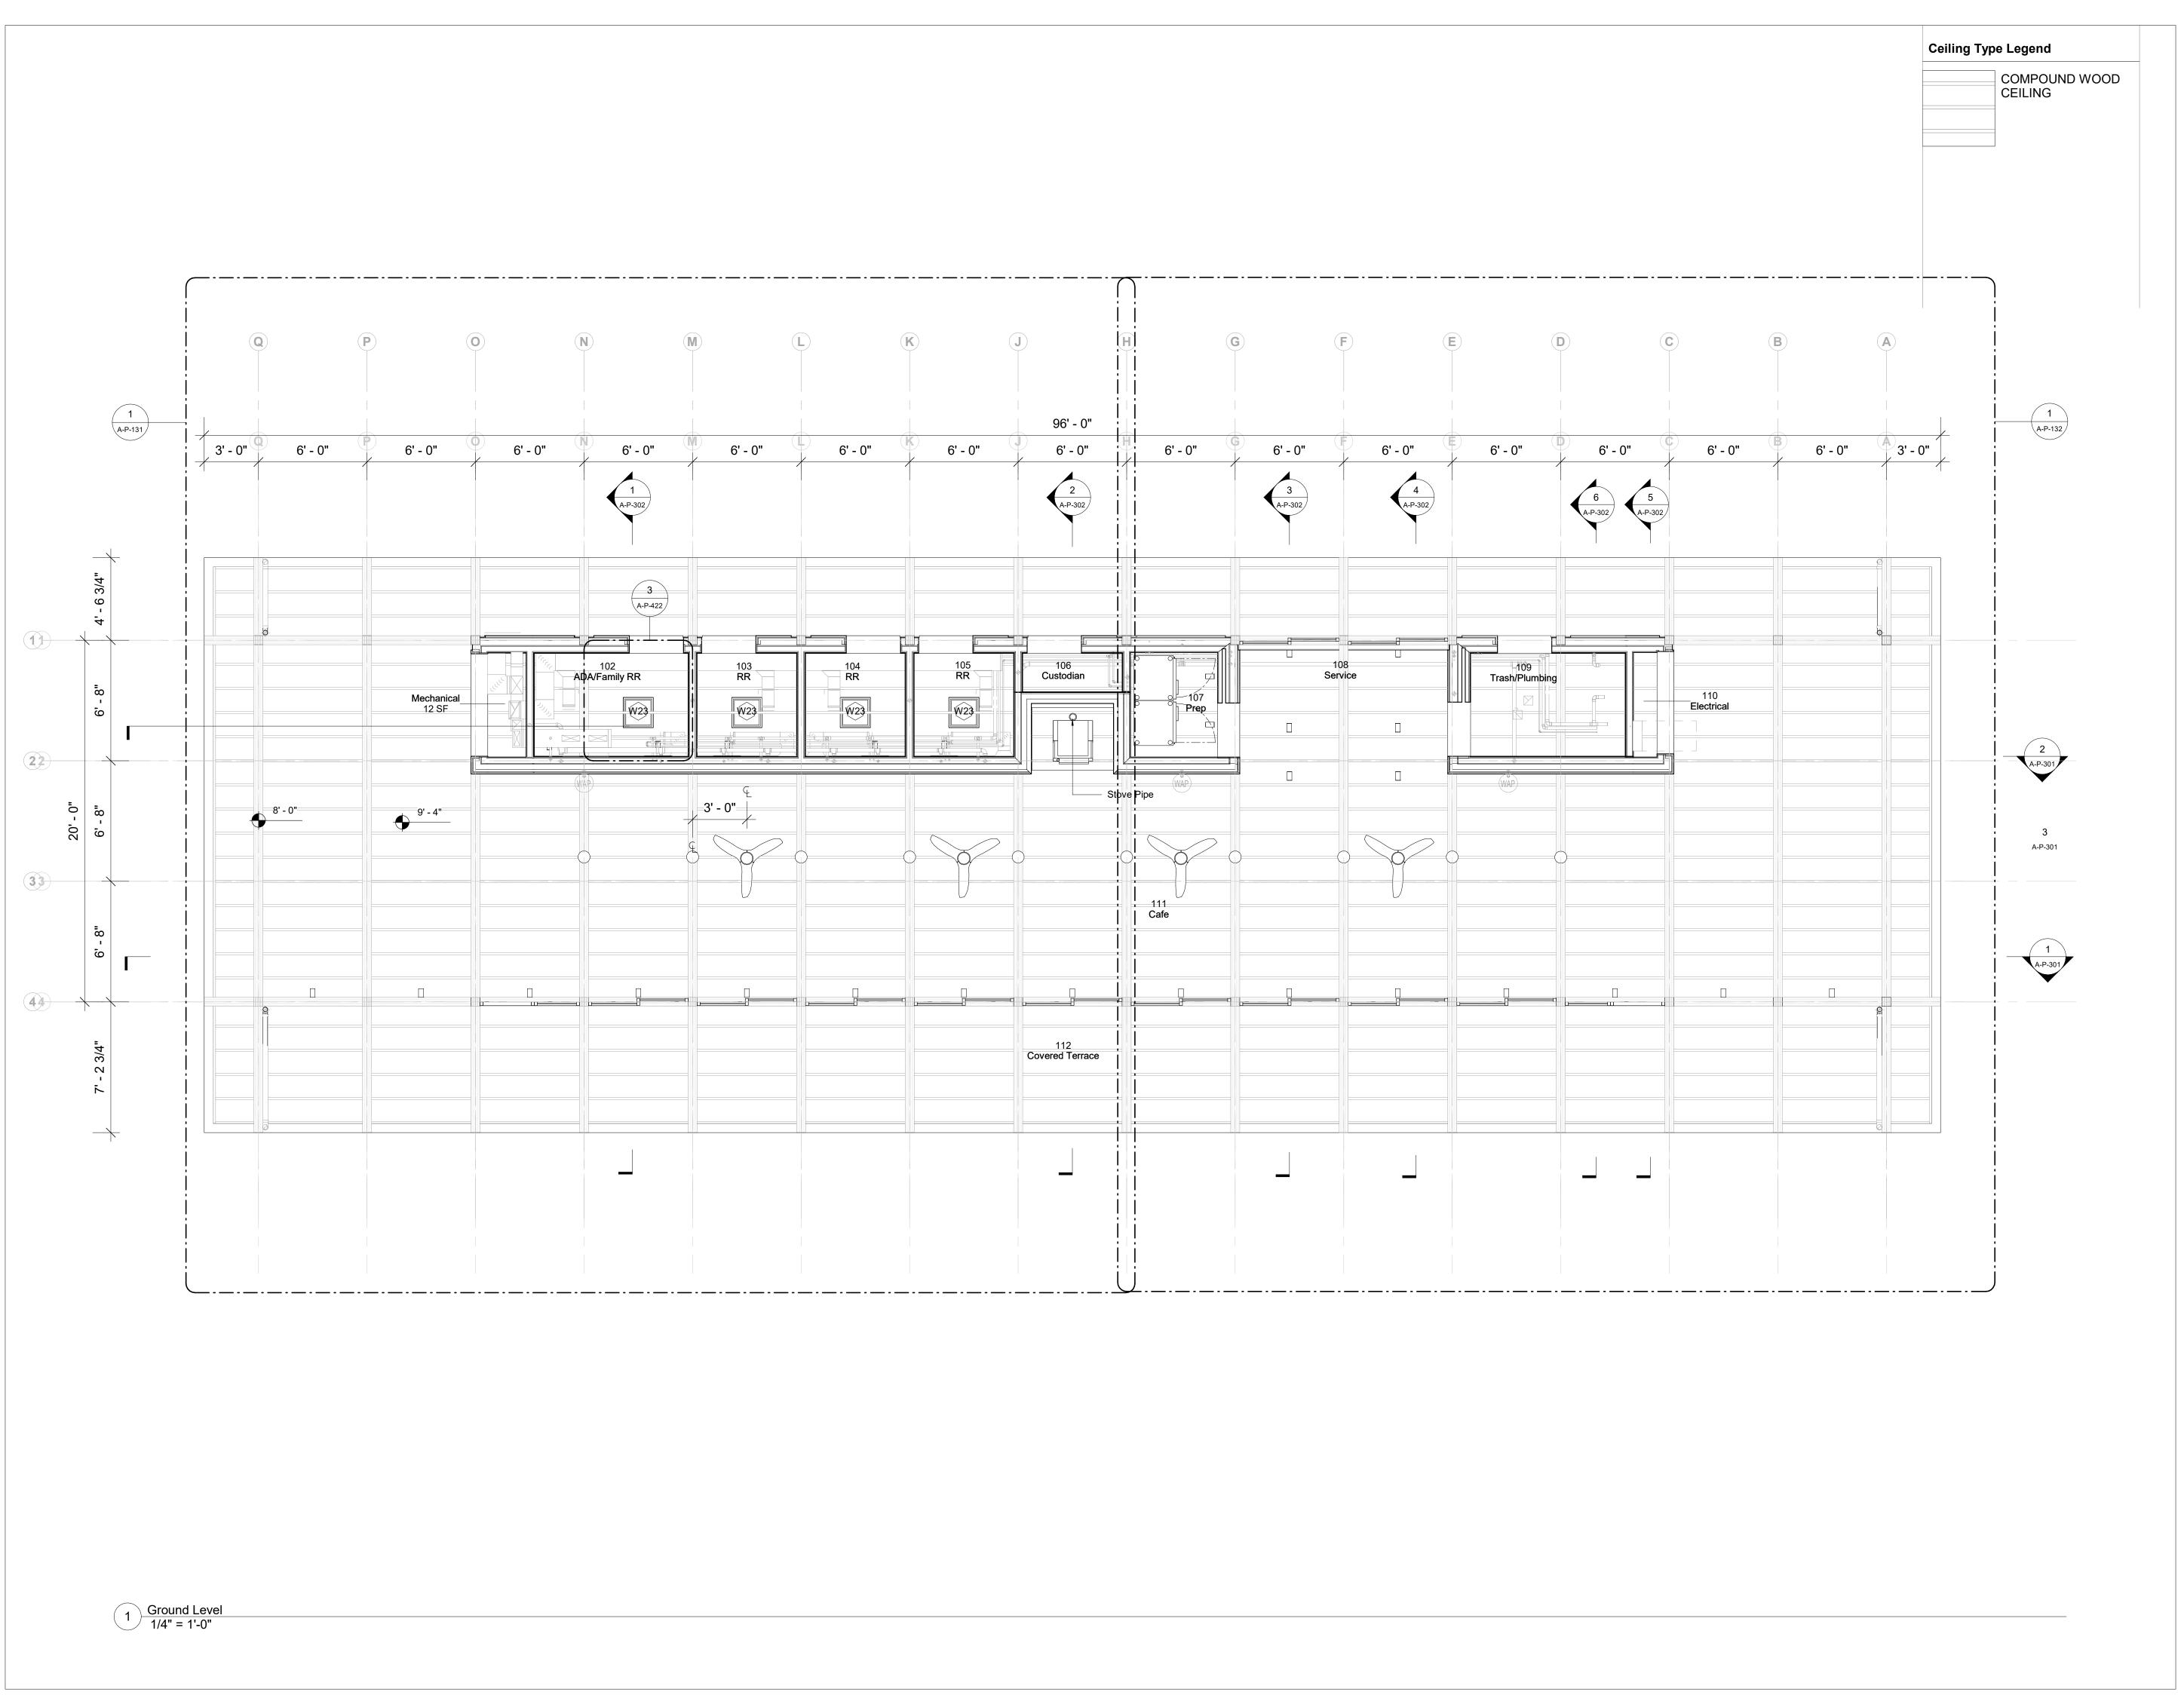

Owner
Storm King Art Center
1 Museum Road

1 Museum Road New Windsor, NY 12553 +1 (845) 534-3115

Design Architect
heneghan peng architects
14-16 Lord Edward Street
Dublin, D02 YC63
+353 1 633 9000

Executive Architect
WXY Architecture + Urban Design
224 Centre Street, 5th Floor
New York, NY 10013

+1 (212) 219-1953

Landscape Architect
Gustafson Porter + Bowman

1 Cobham Mews London, MW1 9SB

+44 020 7284 8950

Reed Hilderbrand LLC
33 Whitney Avenue, 3rd Floor

New Haven, CT 06510 +1 (617) 923-2422 Structural & Lighting

77 Water Street New York, NY 10005 +1 (212) 896-3000

MEPF & IT
BuroHappold
100 Broadway #23

New York, NY 10005 +1 (212) 616-0228 Civil

VHB 100 Great Oaks Blvd., Suite 118 Albany, NY 12203 +1 (518) 389-3606

AV & Acoustics LSTN Consultants 76 Beaver Street, 2nd Floor New York, NY 10005 +1 (347) 788-0810

Facade
Front Inc.
100 E. Broadway Street, #501
New York, NY 10002
+1 (212) 242-2220

Key Plan



DescriptionDate50% Design Development02/24/20100% Design Development05/29/2050% Construction Documents11/06/20


Project

Storm King
Art Center
Pond Pavilion

Seal

NOT FOR CONSTRUCTION
Drawing Title
RCP - Ground Level

Date	11/06/20
Scale	1/4" = 1'-0"
Drawing Number	A-P-111
Sheet Size	ARCH D

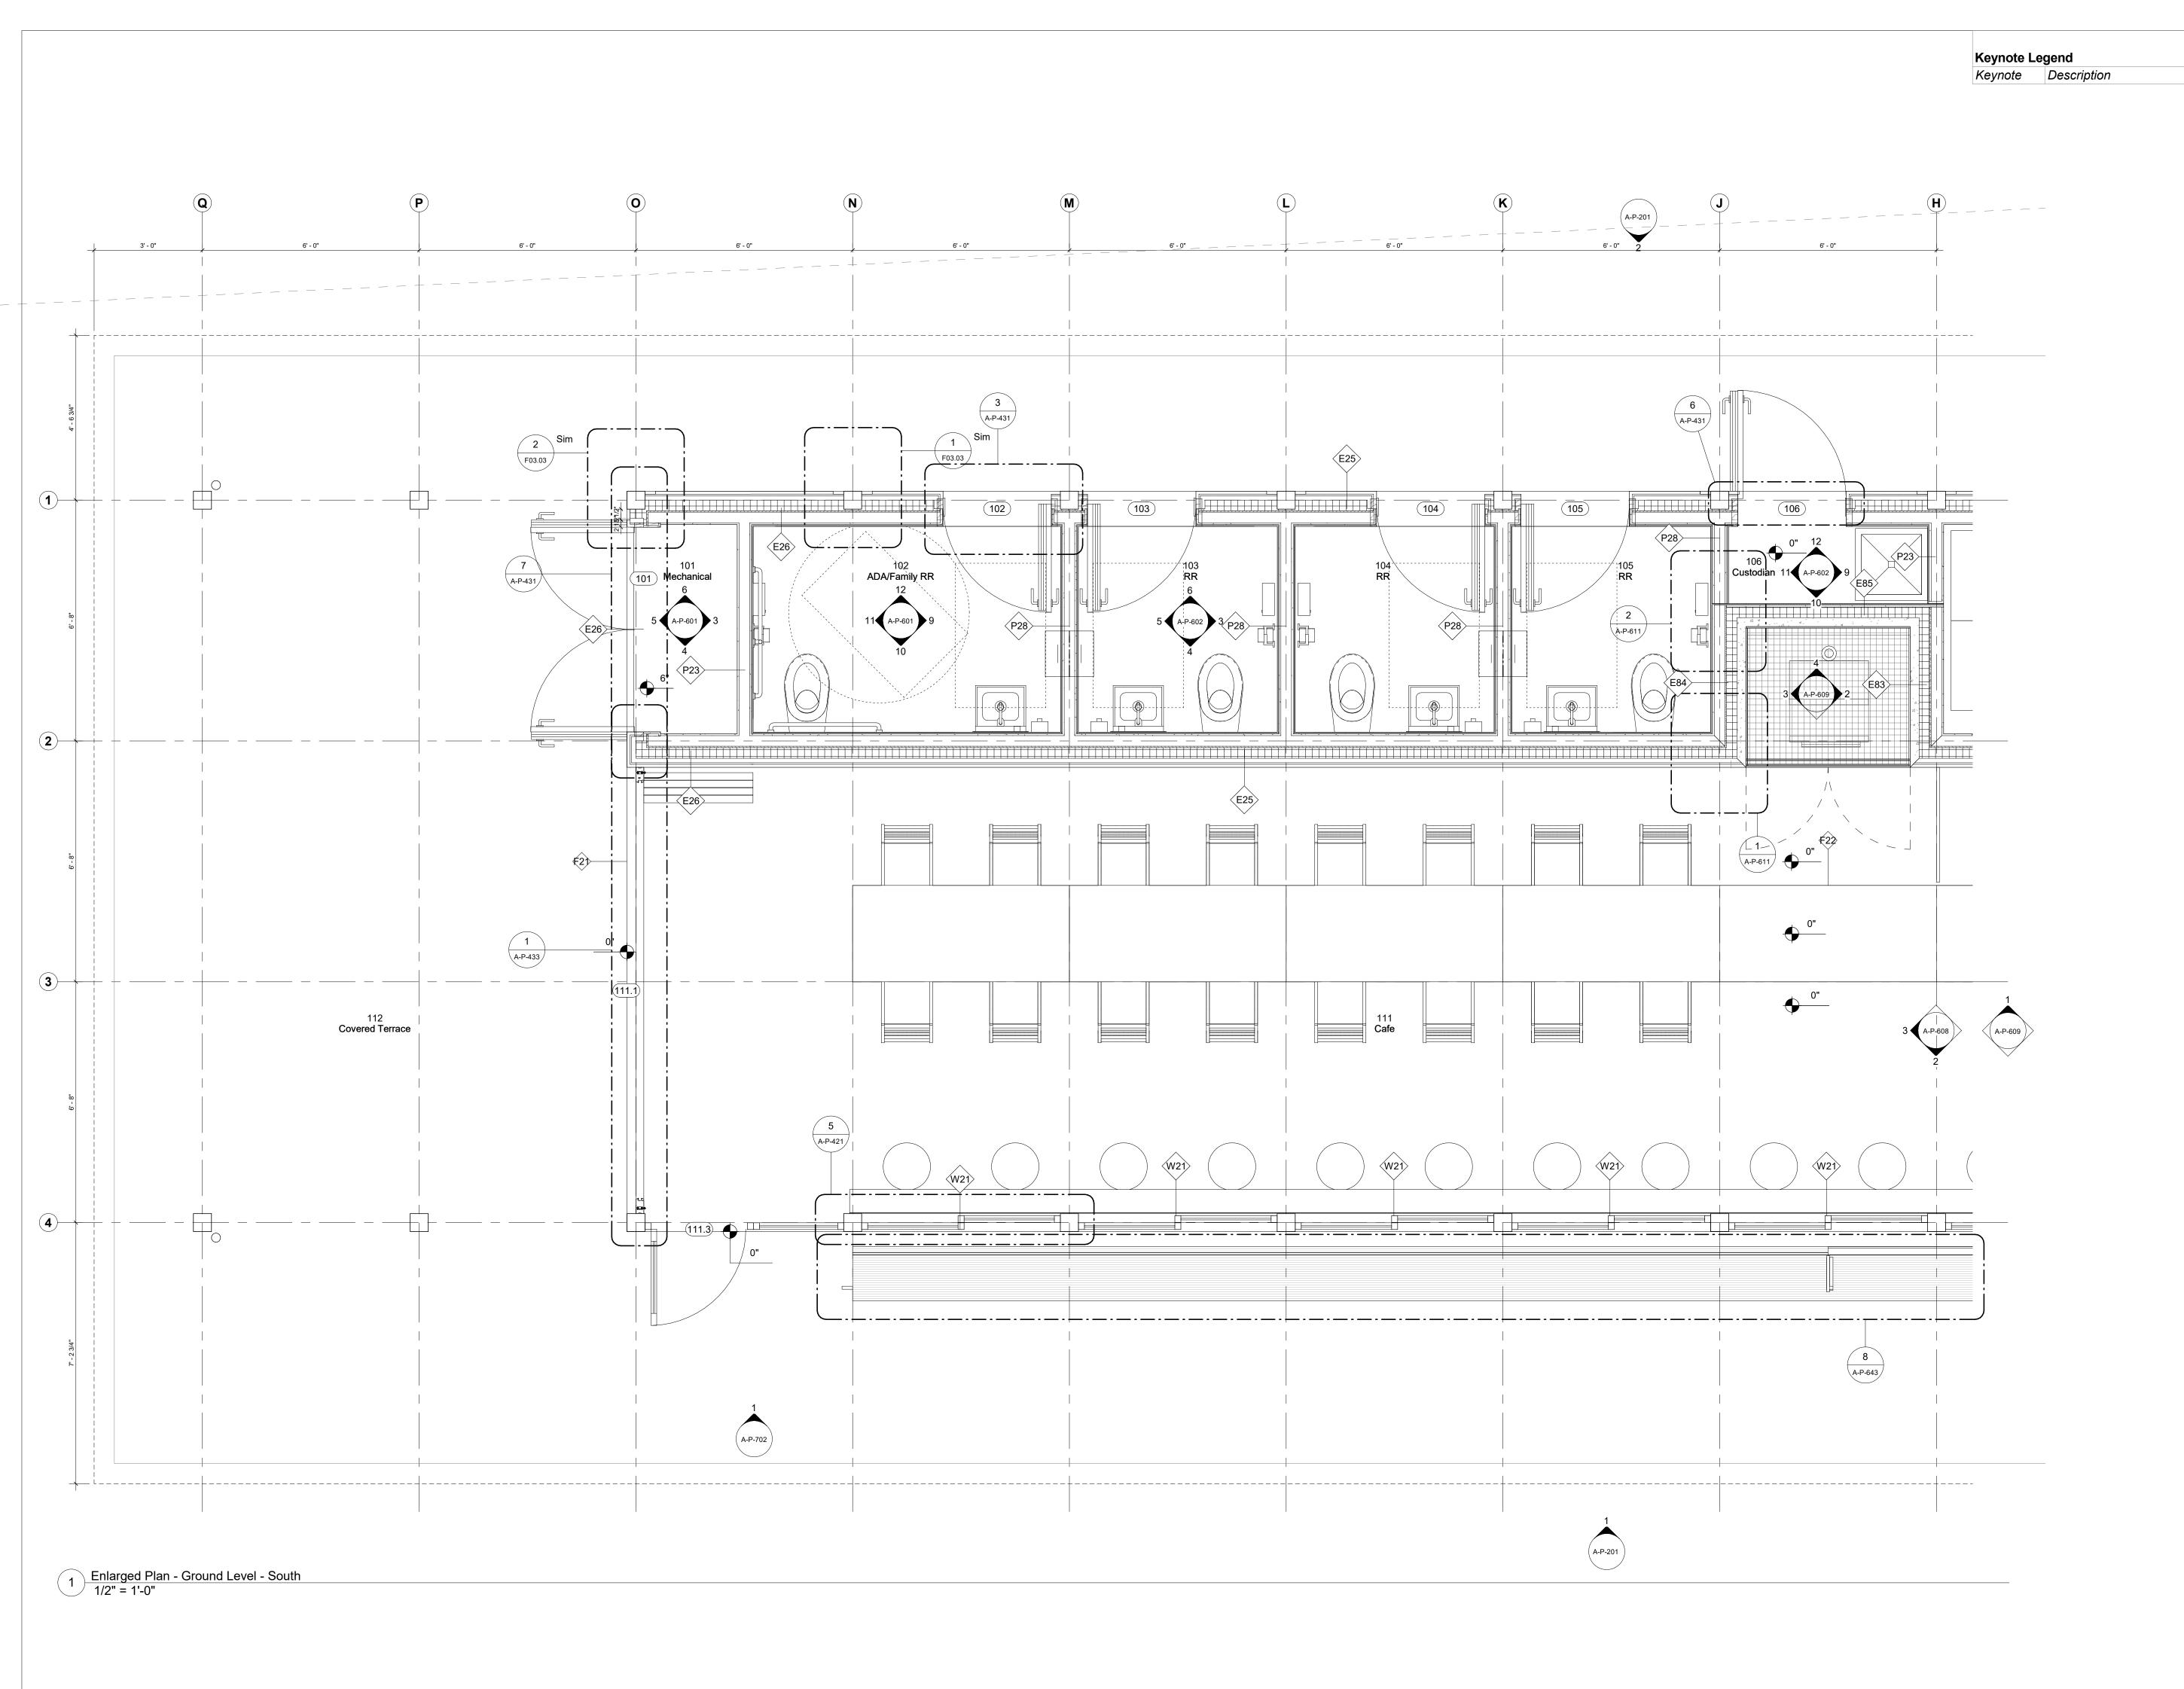

Owner
Storm King A

Storm King Art Center 1 Museum Road New Windsor, NY 12553 +1 (845) 534-3115

+353 1 633 9000

Design Architect
heneghan peng architects
14-16 Lord Edward Street
Dublin, D02 YC63

Executive Architect
WXY Architecture + Urban Design
224 Centre Street, 5th Floor
New York, NY 10013
+1 (212) 219-1953

Landscape Architect
Gustafson Porter + Bowman
1 Cobham Mews
London, MW1 9SB
+44 020 7284 8950

Reed Hilderbrand LLC 33 Whitney Avenue, 3rd Floor New Haven, CT 06510 +1 (617) 923-2422

+1 (617) 923-2422

Structural & Lighting
ARUP

77 Water Street
New York, NY 10005
+1 (212) 896-3000

MEPF & IT BuroHappold 100 Broadway #23 New York, NY 10005

+1 (212) 616-0228 Civil VHB

100 Great Oaks Blvd., Suite 118 Albany, NY 12203 +1 (518) 389-3606

AV & Acoustics
LSTN Consultants
76 Beaver Street, 2nd Floor
New York, NY 10005

+1 (347) 788-0810

Facade
Front Inc.
100 E. Broadway Street, #501
New York, NY 10002
+1 (212) 242-2220

Key Plan



Description Date 50% Construction Documents 11/06

Project

Storm King
Art Center
Pond Pavilion


Seal

NOT FOR CONSTRUCTION

Drawing Title

Enlarged Plan
Ground Level

Date	11/06/20
Scale	1/2" = 1'-0"
Drawing Number	A-P-121
Sheet Size	ARCH D

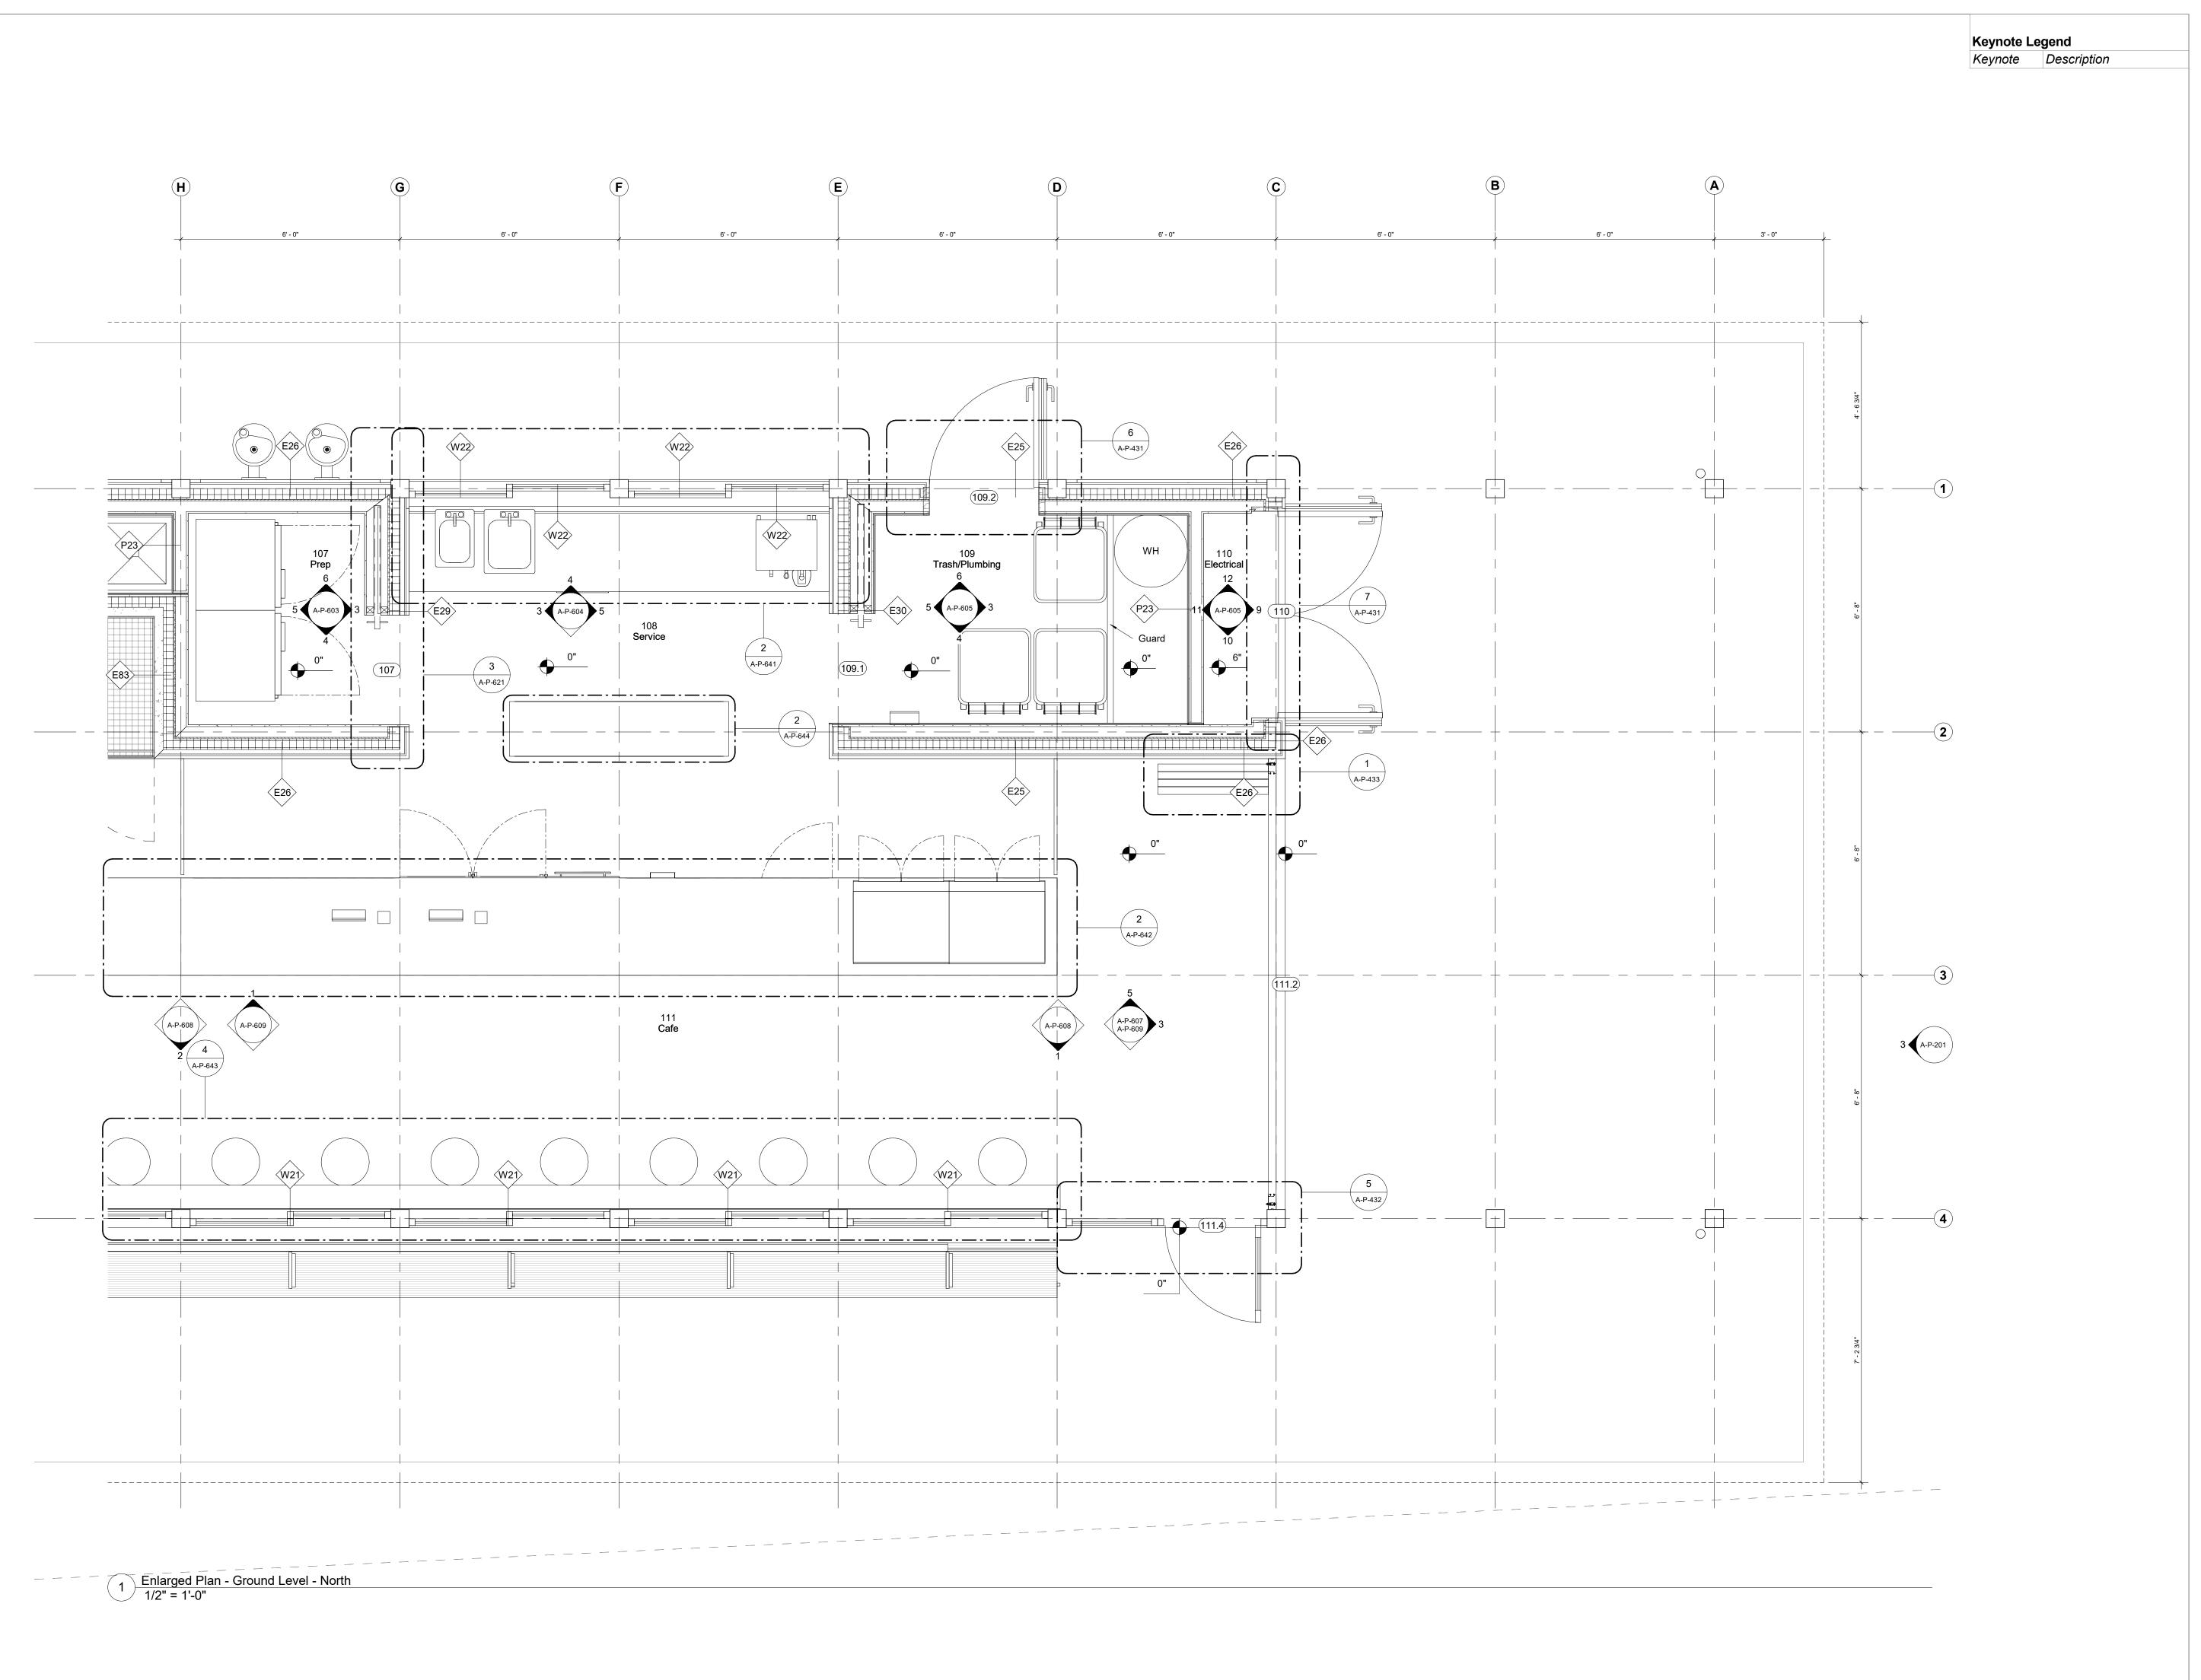

Owner Storm King Art C

Storm King Art Center 1 Museum Road New Windsor, NY 12553 +1 (845) 534-3115

Design Architect
heneghan peng architects
14-16 Lord Edward Street
Dublin, D02 YC63
+353 1 633 9000

Executive Architect
WXY Architecture + Urban Design
224 Centre Street, 5th Floor
New York, NY 10013
+1 (212) 219-1953

Landscape Architect
Gustafson Porter + Bowman
1 Cobham Mews
London, MW1 9SB
+44 020 7284 8950

Reed Hilderbrand LLC 33 Whitney Avenue, 3rd Floor New Haven, CT 06510 +1 (617) 923-2422

+1 (617) 923-2422

Structural & Lighting

ARUP

77 Water Street

77 Water Street
New York, NY 10005
+1 (212) 896-3000

MEPF & IT

BuroHappold
100 Broadway #23

New York, NY 10005 +1 (212) 616-0228 Civil

VHB 100 Great Oaks Blvd., Suite 118 Albany, NY 12203

+1 (518) 389-3606

AV & Acoustics
LSTN Consultants
76 Beaver Street, 2nd Floor
New York, NY 10005

+1 (347) 788-0810

Facade
Front Inc.
100 E. Broadway Street, #501
New York, NY 10002
+1 (212) 242-2220

Key Plan



Description Date 50% Construction Documents 11/06/2

Storm King
Art Center

Project

Storm King

Art Center


Sea

NOT FOR CONSTRUCTION

Drawing Title

Enlarged Plan
Ground Level

Date	11/06/20
0 1	4/01 41.01
Scale	1/2" = 1'-0"
Drawing	A D 400
Number	A-P-122
Sheet Size	ARCH D
	= -

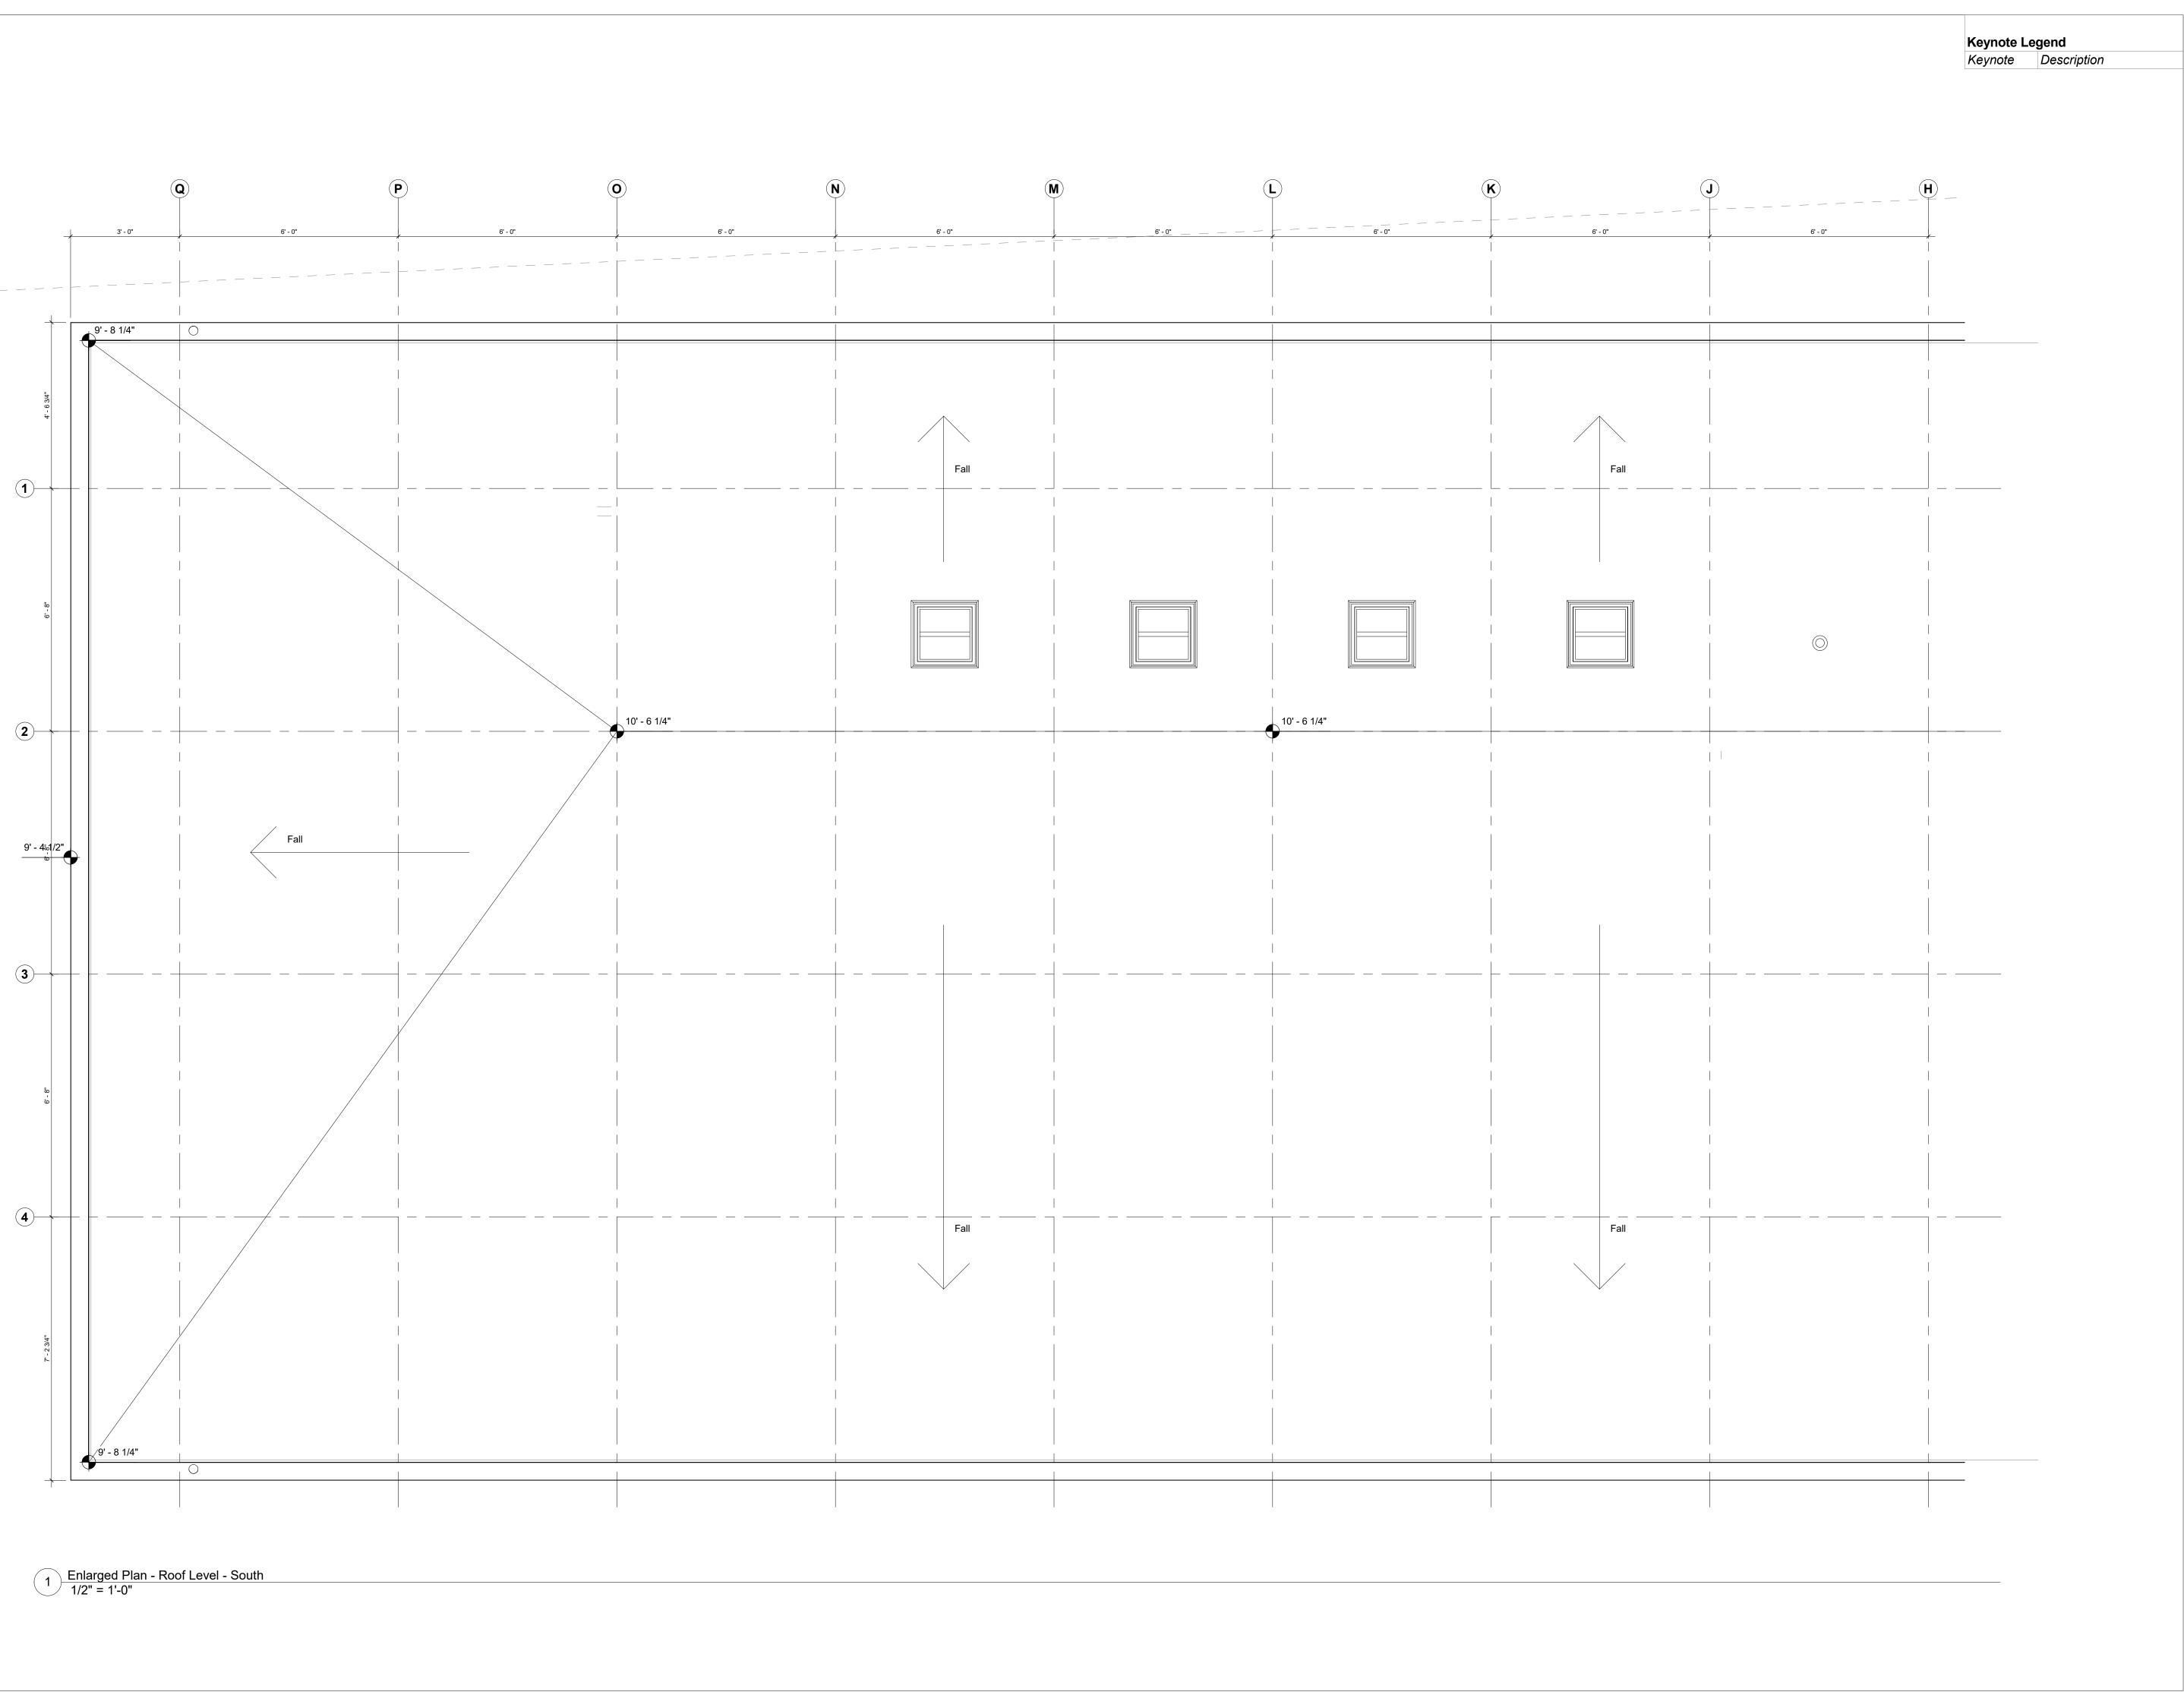

Storm King Art Center

1 Museum Road New Windsor, NY 12553 +1 (845) 534-3115

Design Architect heneghan peng architects 14-16 Lord Edward Street Dublin, D02 YC63

+353 1 633 9000 **Executive Architect** WXY Architecture + Urban Design 224 Centre Street, 5th Floor New York, NY 10013

+1 (212) 219-1953 Landscape Architect Gustafson Porter + Bowman 1 Cobham Mews

London, MW1 9SB +44 020 7284 8950 Reed Hilderbrand LLC 33 Whitney Avenue, 3rd Floor

New Haven, CT 06510 +1 (617) 923-2422

Structural & Lighting ARUP 77 Water Street New York, NY 10005

+1 (212) 896-3000 MEPF & IT

BuroHappold 100 Broadway #23 New York, NÝ 10005 +1 (212) 616-0228

Civil VHB

100 Great Oaks Blvd., Suite 118 Albany, NY 12203 +1 (518) 389-3606

AV & Acoustics LSTN Consultants 76 Beaver Street, 2nd Floor New York, NY 10005 +1 (347) 788-0810

Facade Front Inc. 100 E. Broadway Street, #501 New York, NY 10002 +1 (212) 242-2220

Key Plan




Description 50% Construction Documents

Storm King Art Center **Pond Pavilion**

NOT FOR CONSTRUCTION **Drawing Title** Enlarged Plan - Roof Level

Date	11/06/20
Scale	1/2" = 1'-0"
Drawing Number	A-P-123
Sheet Size	ARCH D

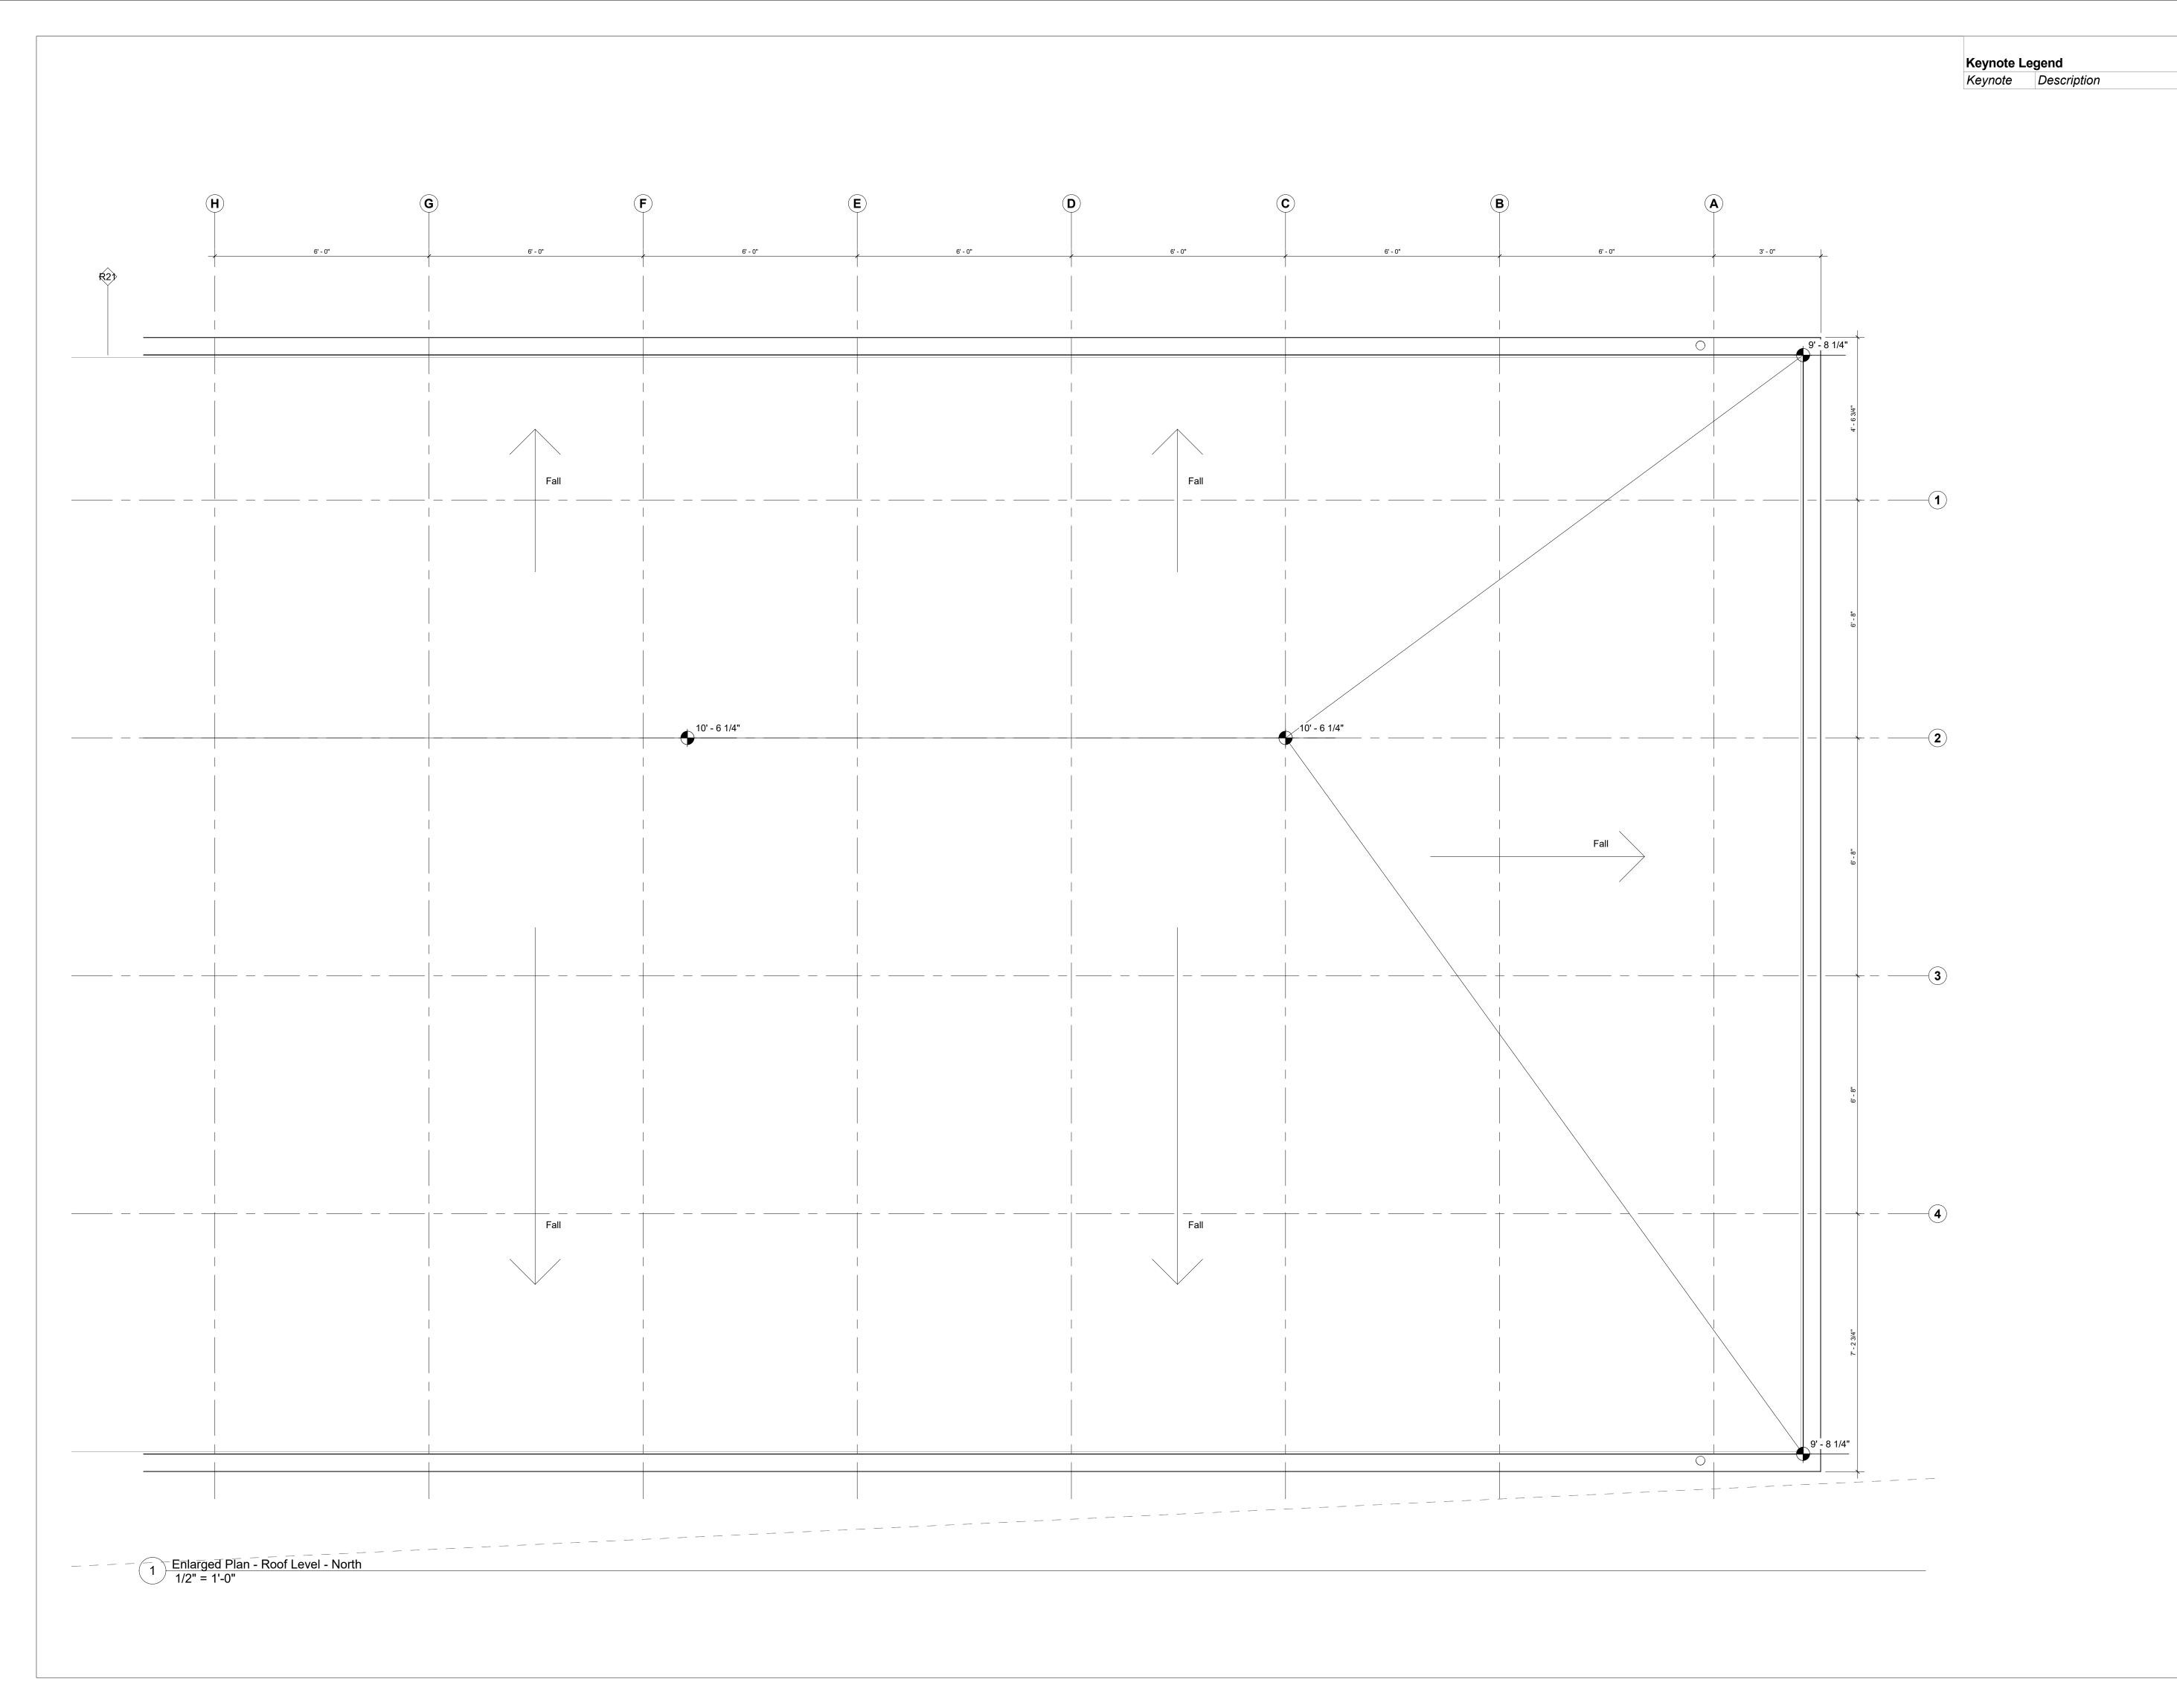

Storm King Art Center

1 Museum Road New Windsor, NY 12553 +1 (845) 534-3115

Design Architect heneghan peng architects 14-16 Lord Edward Street

Dublin, D02 YC63 +353 1 633 9000 **Executive Architect**

WXY Architecture + Urban Design 224 Centre Street, 5th Floor New York, NY 10013 +1 (212) 219-1953

Landscape Architect Gustafson Porter + Bowman 1 Cobham Mews London, MW1 9SB +44 020 7284 8950

Reed Hilderbrand LLC 33 Whitney Avenue, 3rd Floor New Haven, CT 06510 +1 (617) 923-2422

Structural & Lighting ARUP 77 Water Street

New York, NY 10005 +1 (212) 896-3000 MEPF & IT

BuroHappold 100 Broadway #23 New York, NY 10005

+1 (212) 616-0228 Civil VHB

100 Great Oaks Blvd., Suite 118 Albany, NY 12203 +1 (518) 389-3606

AV & Acoustics LSTN Consultants 76 Beaver Street, 2nd Floor New York, NY 10005 +1 (347) 788-0810

Facade Front Inc. 100 E. Broadway Street, #501 New York, NY 10002 +1 (212) 242-2220

Key Plan




50% Construction Documents

Storm King Art Center **Pond Pavilion**

NOT FOR CONSTRUCTION **Drawing Title** Enlarged Plan - Roof Level

Date	11/06/20
Scale	1/2" = 1'-0"
Drawing Number	A-P-124
Sheet Size	ARCH D

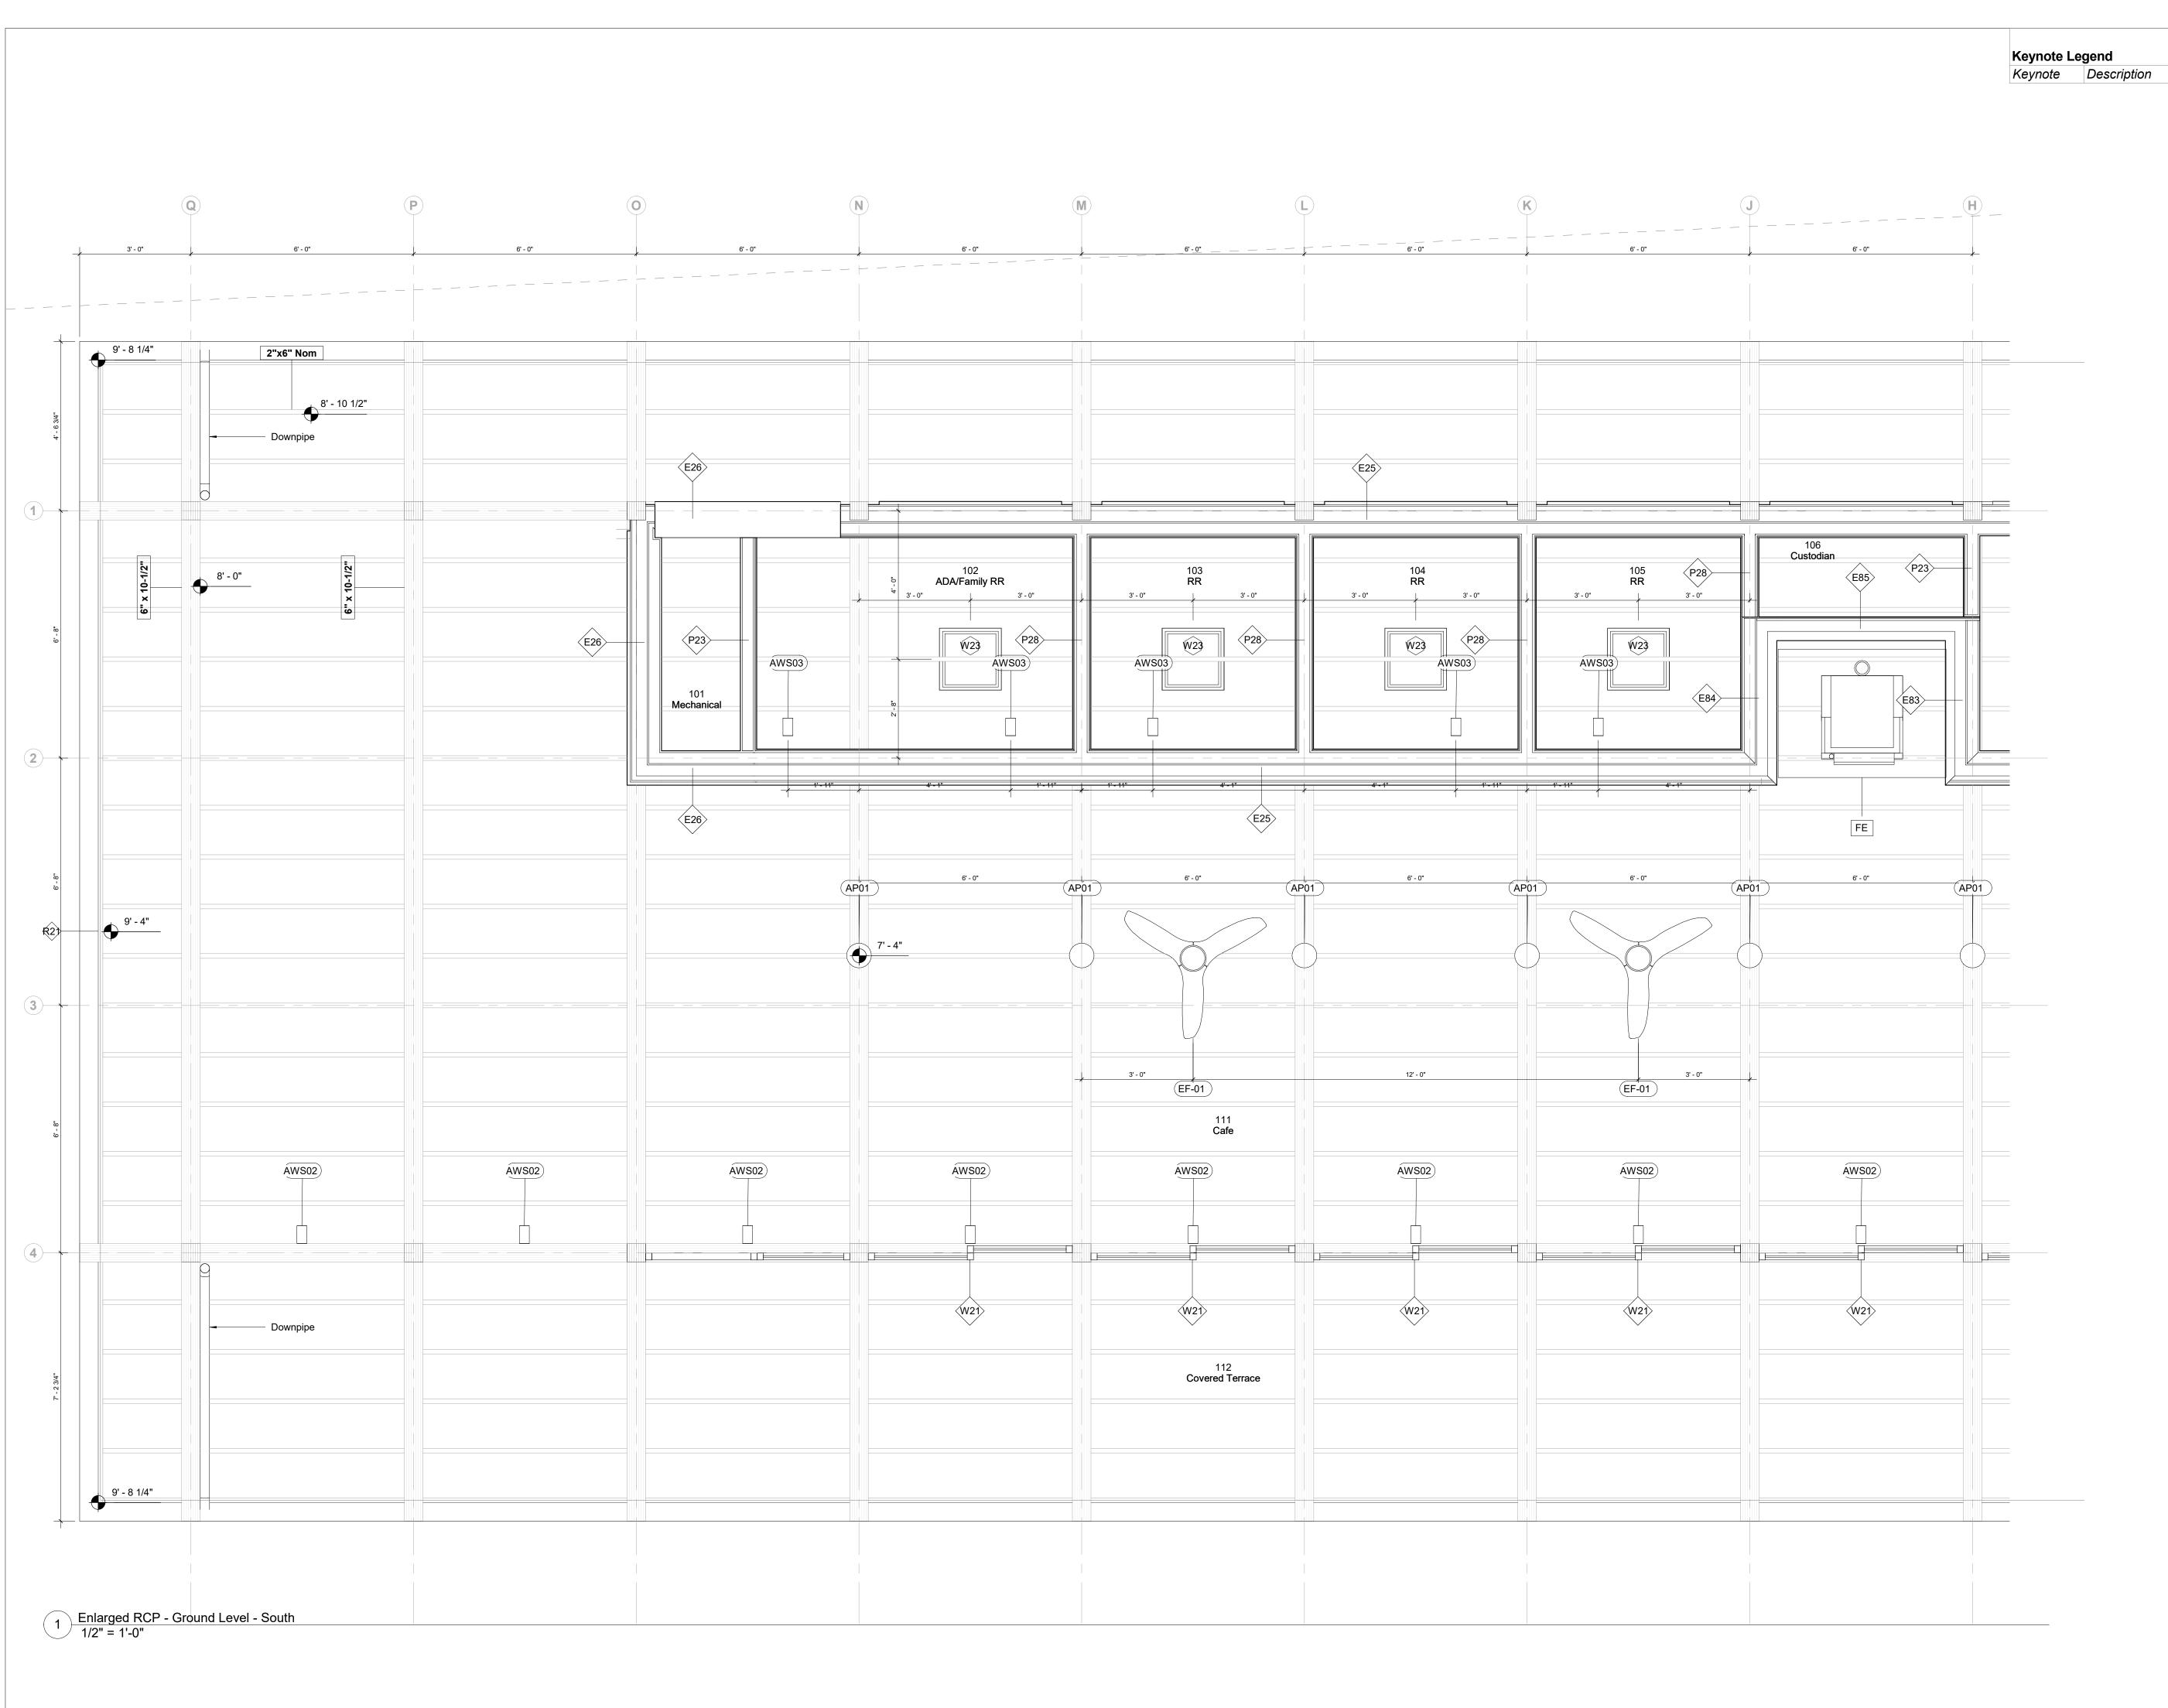

Storm King Art Center 1 Museum Road New Windsor, NY 12553 +1 (845) 534-3115

Design Architect
heneghan peng architects
14-16 Lord Edward Street
Dublin, D02 YC63
+353 1 633 9000

Executive Architect
WXY Architecture + Urban Design
224 Centre Street, 5th Floor
New York, NY 10013
+1 (212) 219-1953

Landscape Architect
Gustafson Porter + Bowman
1 Cobham Mews
London, MW1 9SB
+44 020 7284 8950

Reed Hilderbrand LLC 33 Whitney Avenue, 3rd Floor New Haven, CT 06510 +1 (617) 923-2422

Structural & Lighting
ARUP
77 Water Street

New York, NY 10005 +1 (212) 896-3000 MEPF & IT

BuroHappold 100 Broadway #23 New York, NY 10005 +1 (212) 616-0228

+1 (212) 616-0228 **Civil** VHB

100 Great Oaks Blvd., Suite 118 Albany, NY 12203 +1 (518) 389-3606

AV & Acoustics
LSTN Consultants
76 Beaver Street, 2nd Floor
New York, NY 10005
+1 (347) 788-0810

Facade
Front Inc.
100 E. Broadway Street, #501
New York, NY 10002
+1 (212) 242-2220

Key Plan



Description Date 50% Construction Documents 11/06/20

Project

Storm King
Art Center
Pond Pavilion


Sea

NOT FOR CONSTRUCTION

Drawing Title

Enlarged RCP
Ground Level

Date	11/06/20
Scale	1/2" = 1'-0"
Drawing Number	A-P-131
Sheet Size	ARCH D

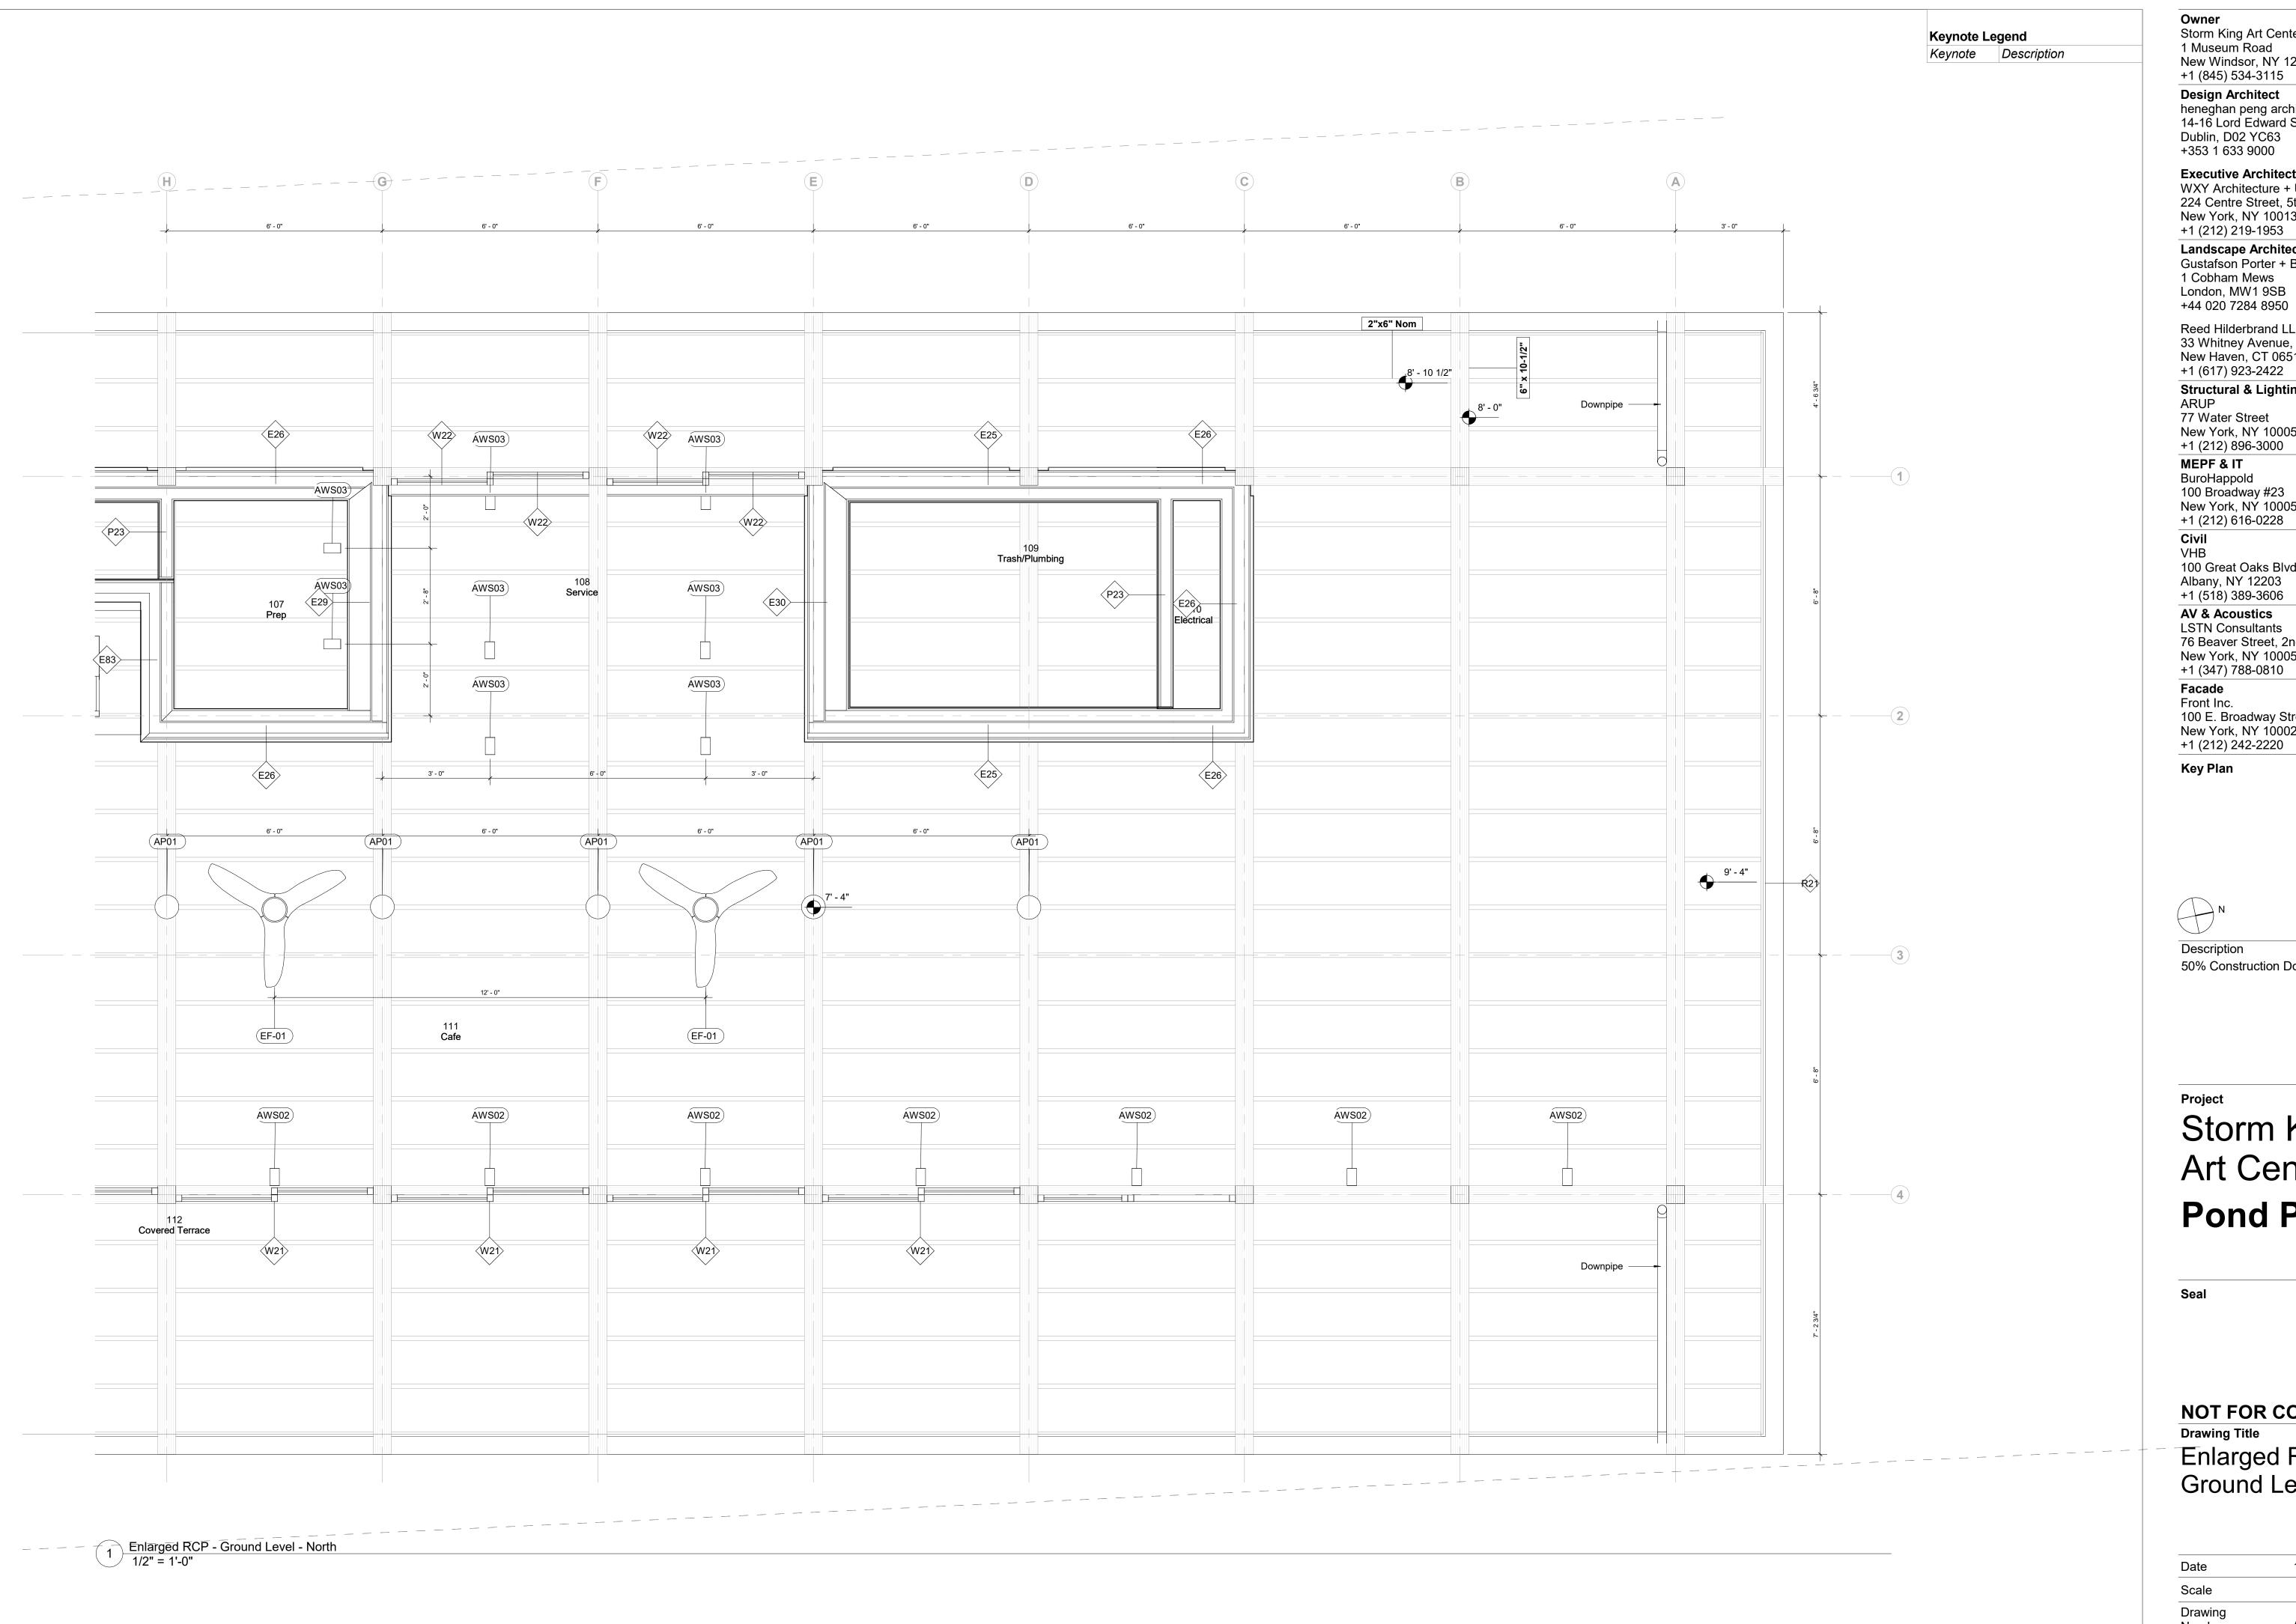

Storm King Art Center 1 Museum Road New Windsor, NY 12553 +1 (845) 534-3115

Design Architect heneghan peng architects 14-16 Lord Edward Street Dublin, D02 YC63 +353 1 633 9000

Executive Architect WXY Architecture + Urban Design 224 Centre Street, 5th Floor New York, NY 10013 +1 (212) 219-1953

Landscape Architect Gustafson Porter + Bowman 1 Cobham Mews London, MW1 9SB

Reed Hilderbrand LLC 33 Whitney Avenue, 3rd Floor New Haven, CT 06510

+1 (617) 923-2422 Structural & Lighting

77 Water Street New York, NY 10005 +1 (212) 896-3000

BuroHappold 100 Broadway #23 New York, NÝ 10005

+1 (212) 616-0228

100 Great Oaks Blvd., Suite 118 Albany, NY 12203 +1 (518) 389-3606

AV & Acoustics LSTN Consultants 76 Beaver Street, 2nd Floor New York, NY 10005 +1 (347) 788-0810

Facade Front Inc. 100 E. Broadway Street, #501 New York, NY 10002 +1 (212) 242-2220

Key Plan




Description 50% Construction Documents

Storm King Art Center

Pond Pavilion

NOT FOR CONSTRUCTION **Drawing Title** Enlarged RCP -Ground Level

11/06/20 1/2" = 1'-0" A-P-132 ARCH D Sheet Size

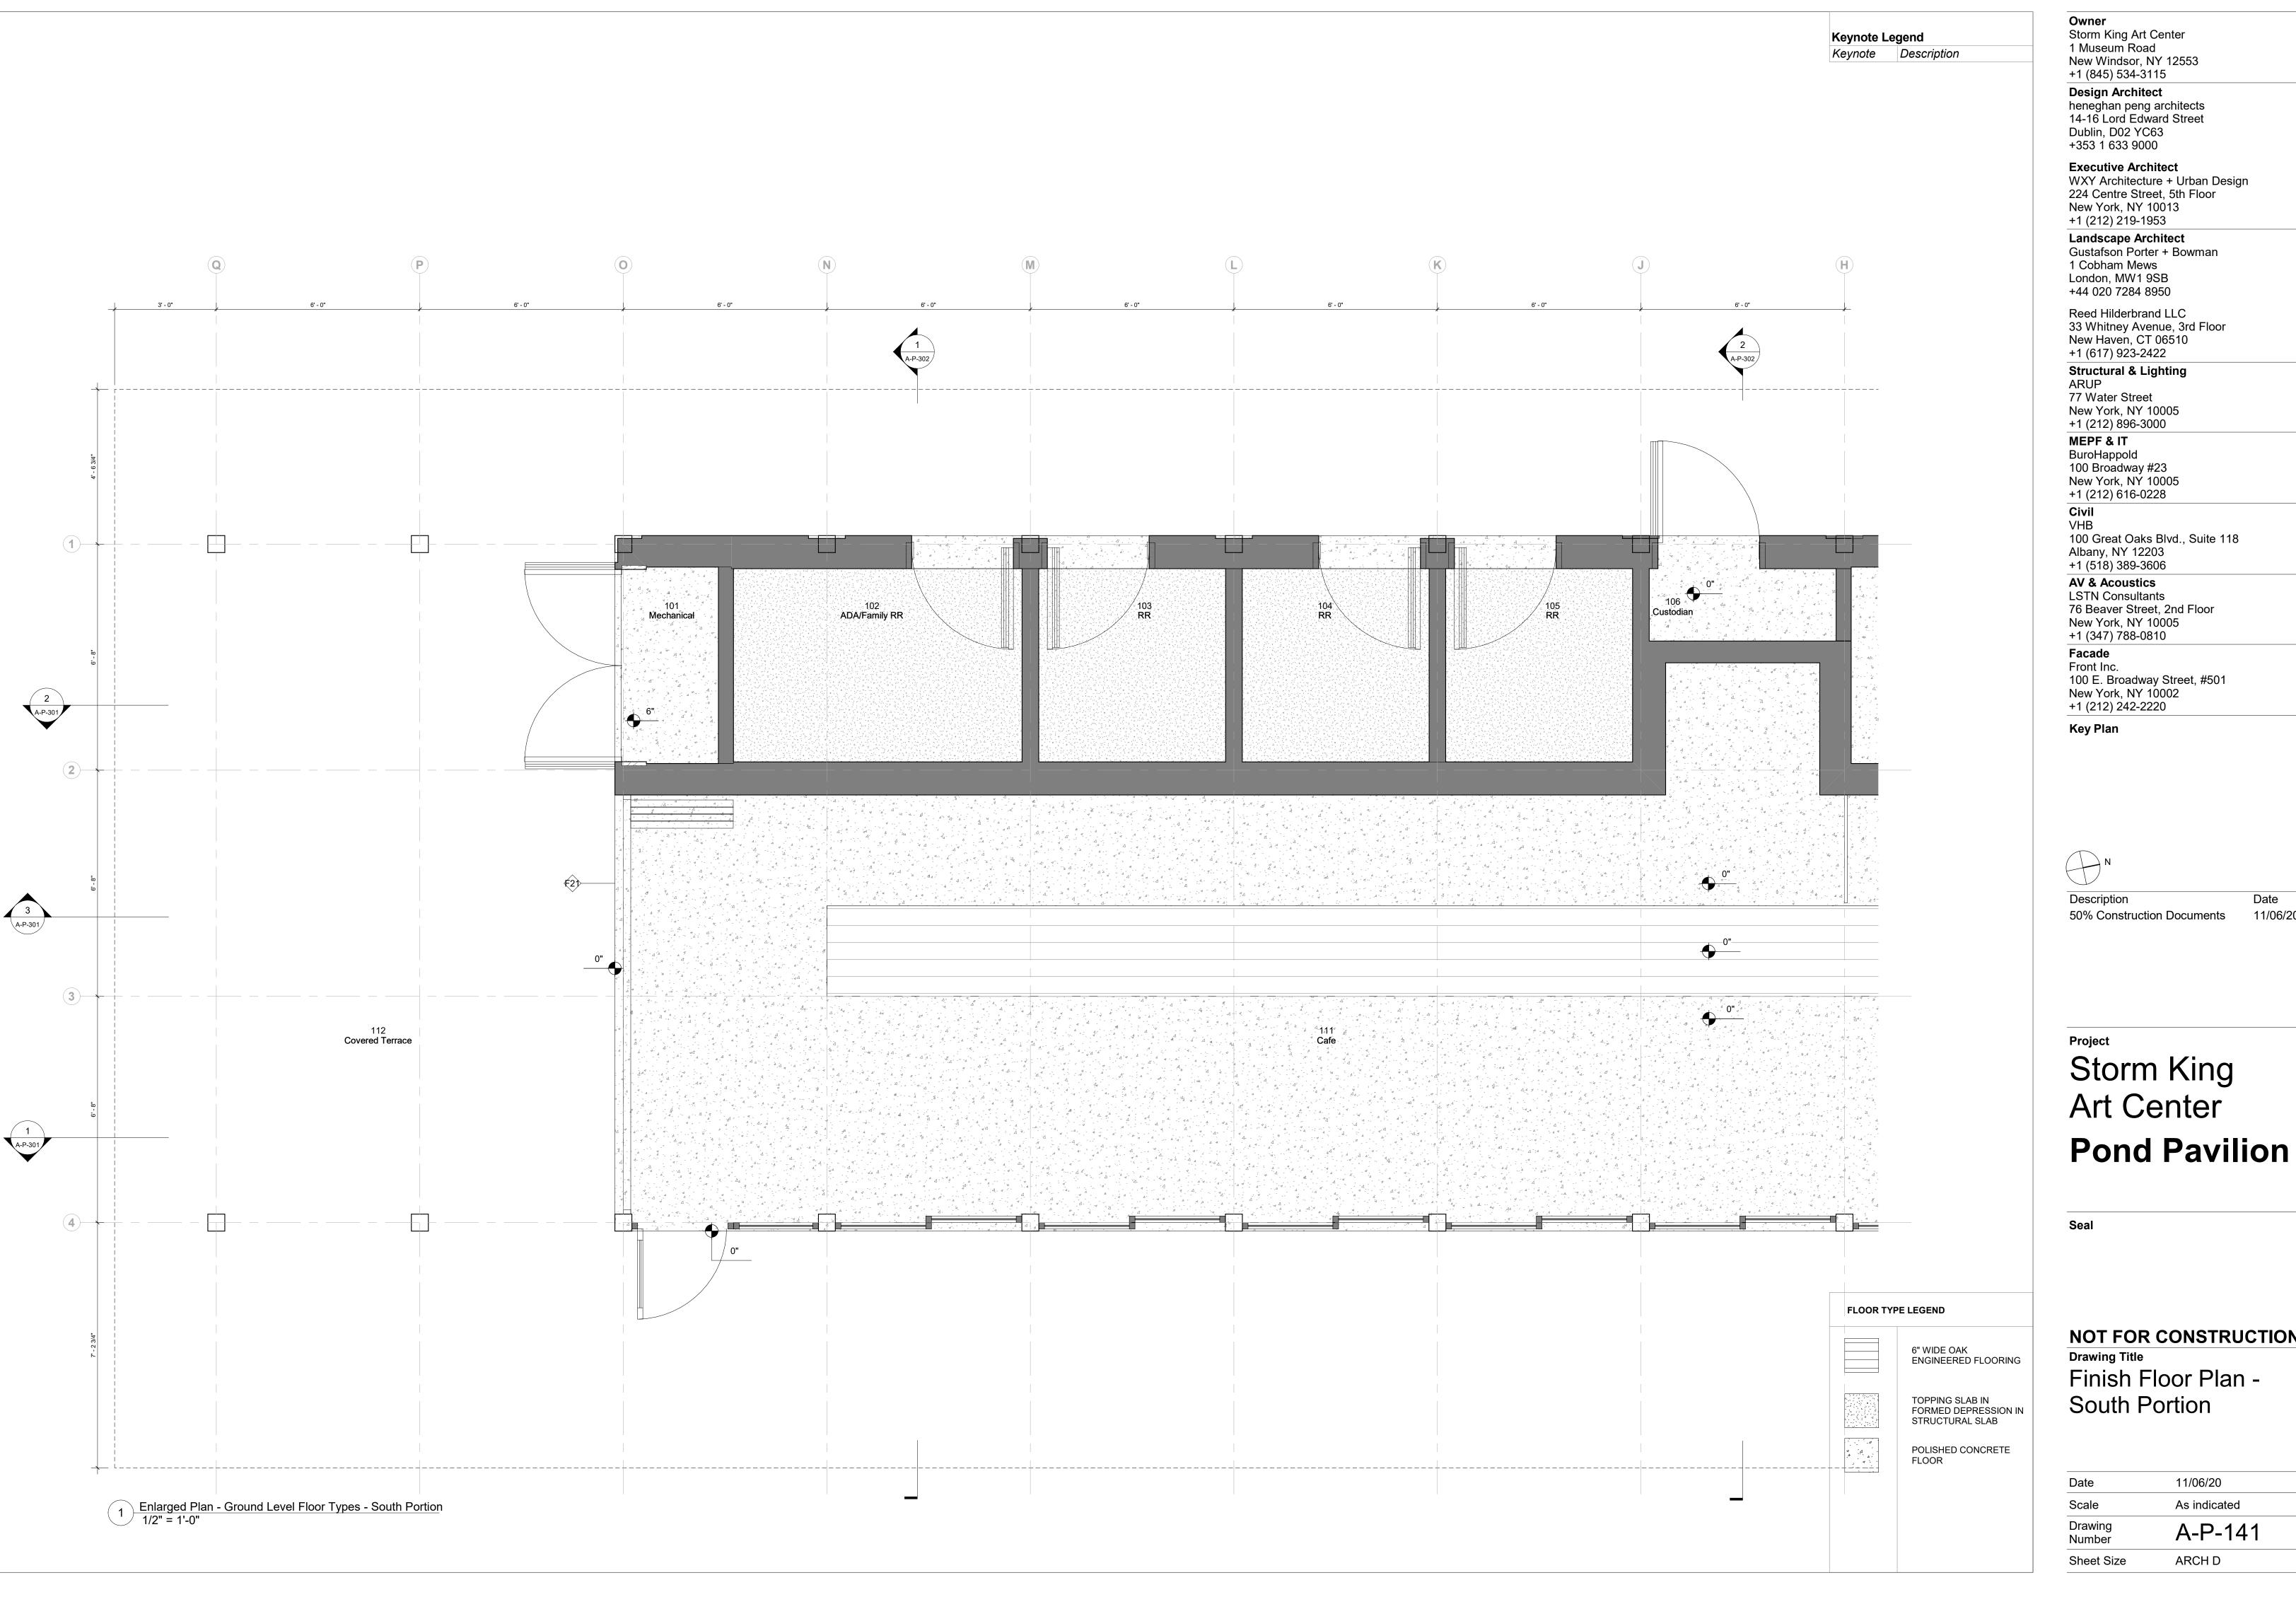


100 E. Broadway Street, #501

50% Construction Documents


NOT FOR CONSTRUCTION Finish Floor Plan -

Date	11/06/20
Scale	As indicated
Drawing Number	A-P-141
Sheet Size	ARCH D

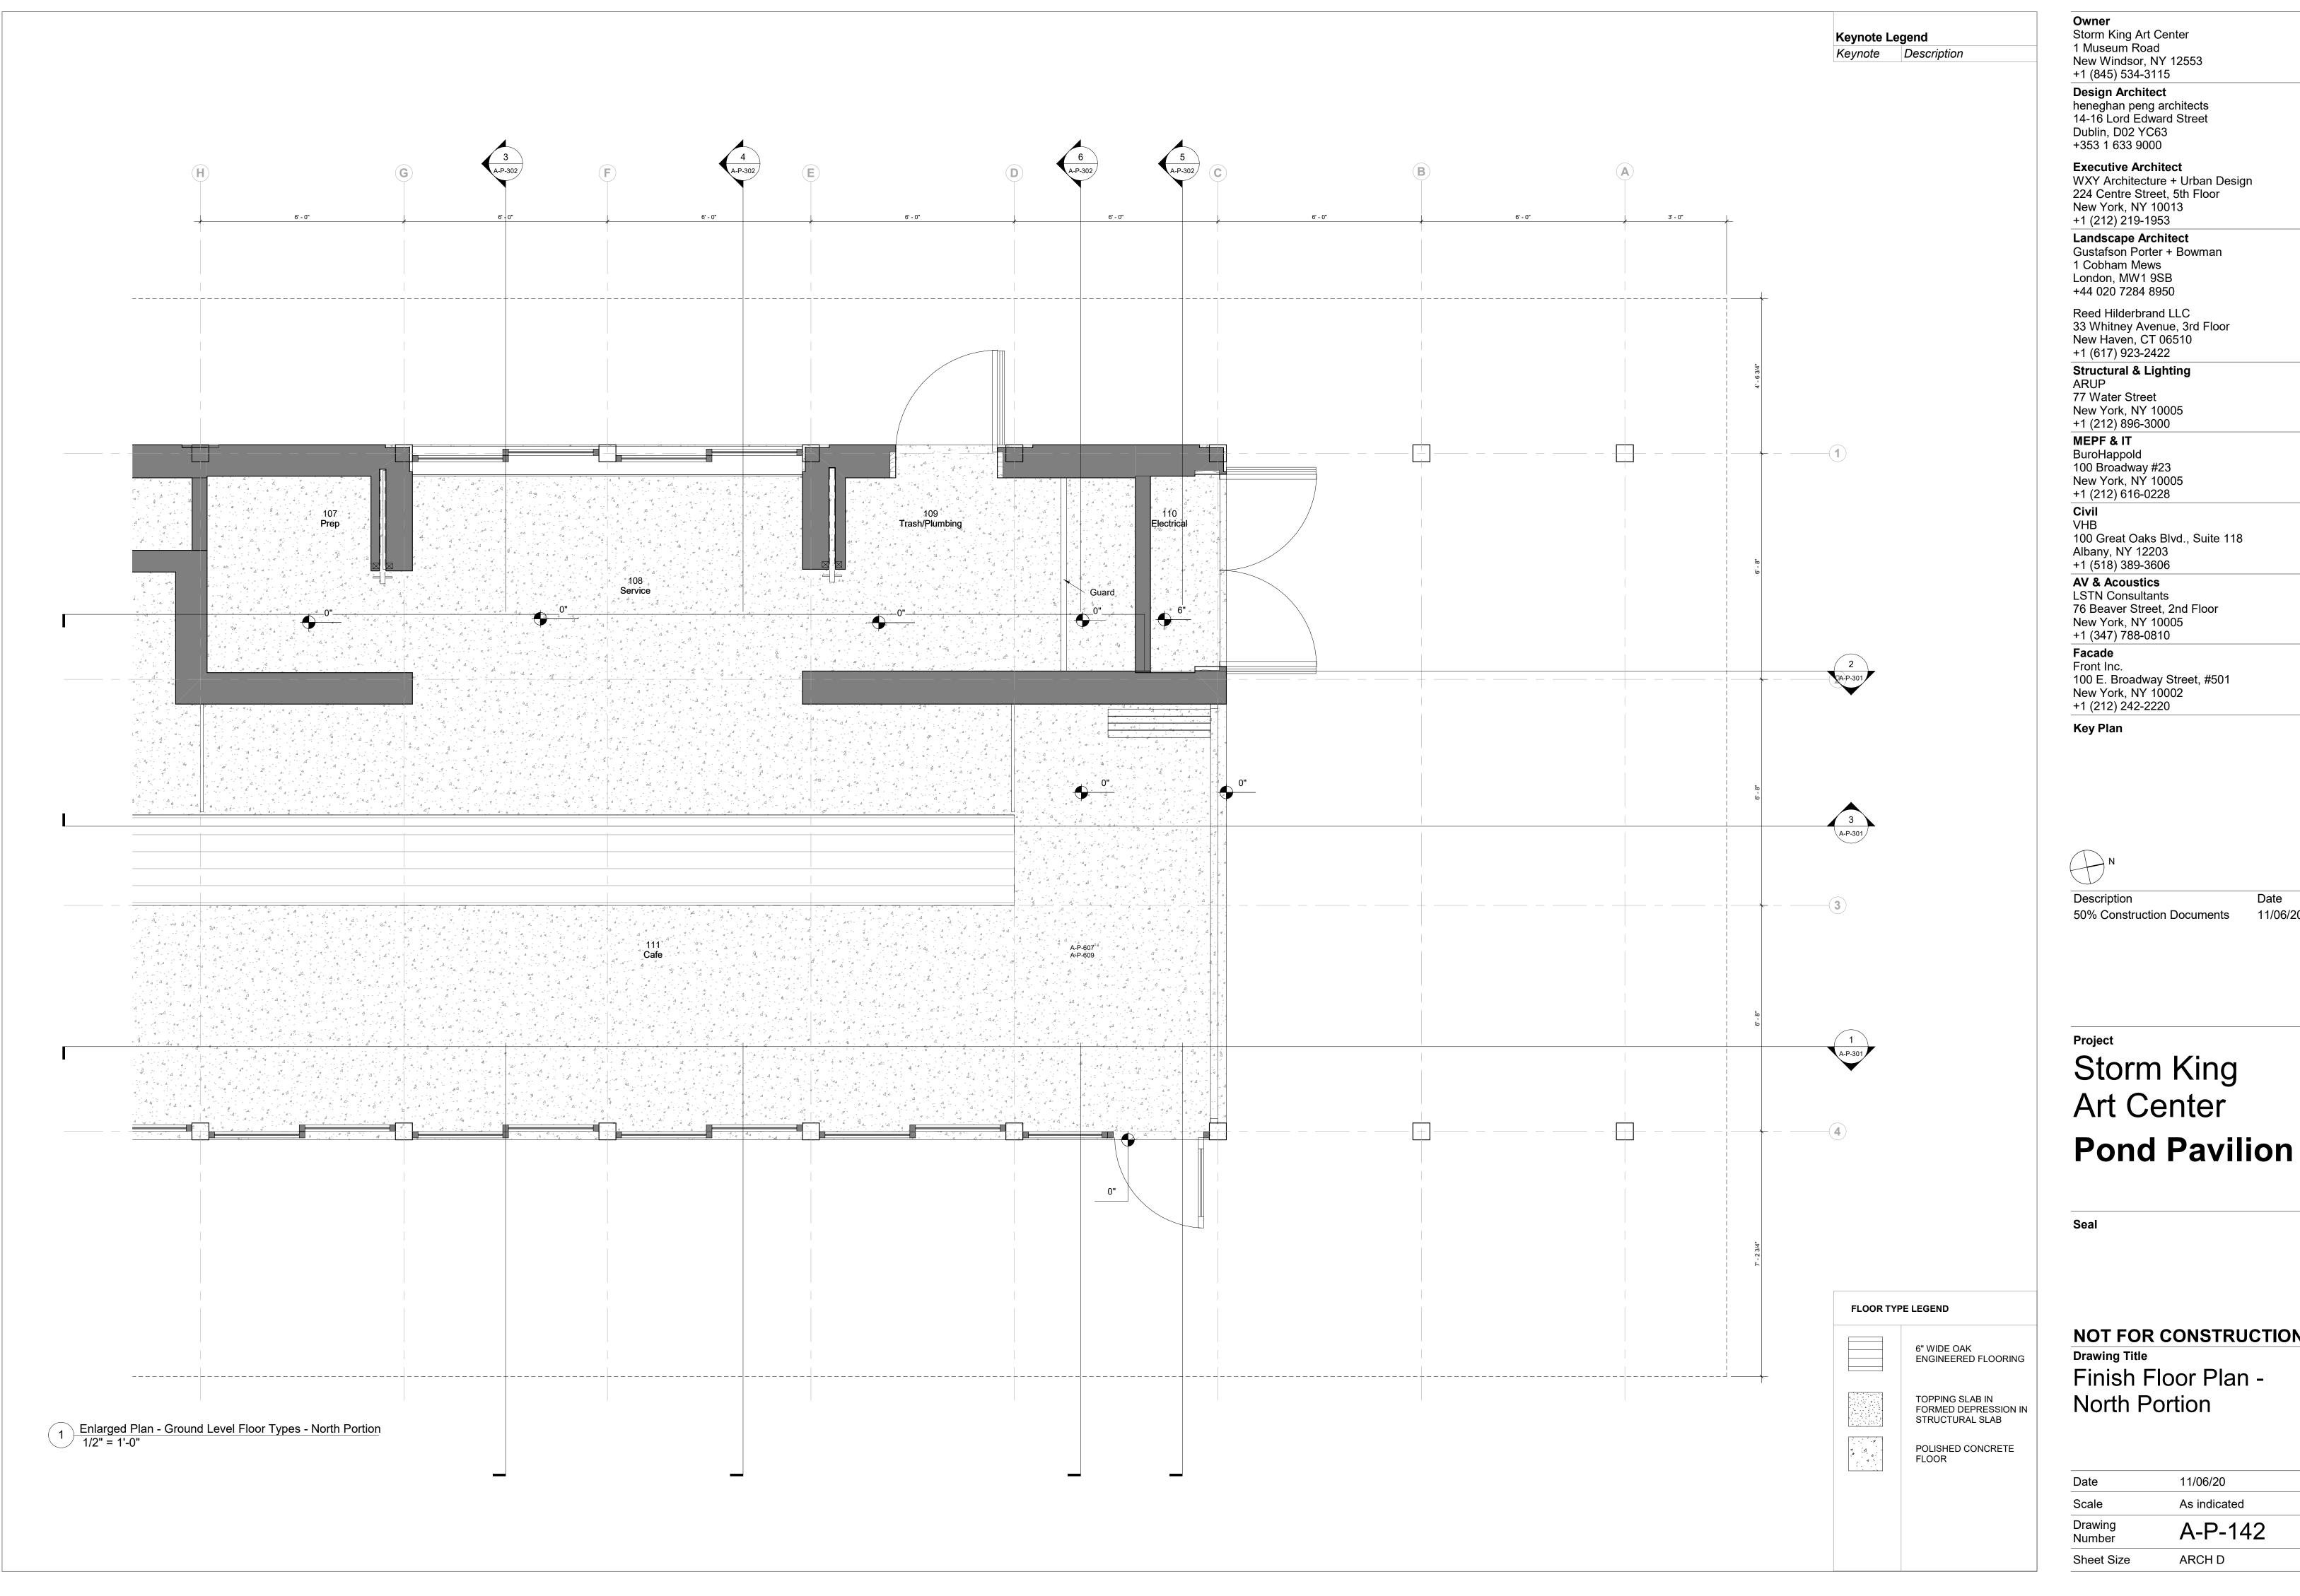

NOT FOR CONSTRUCTION Finish Floor Plan -

Date	11/06/20
Scale	As indicated
Drawing Number	A-P-142
Sheet Size	ARCH D

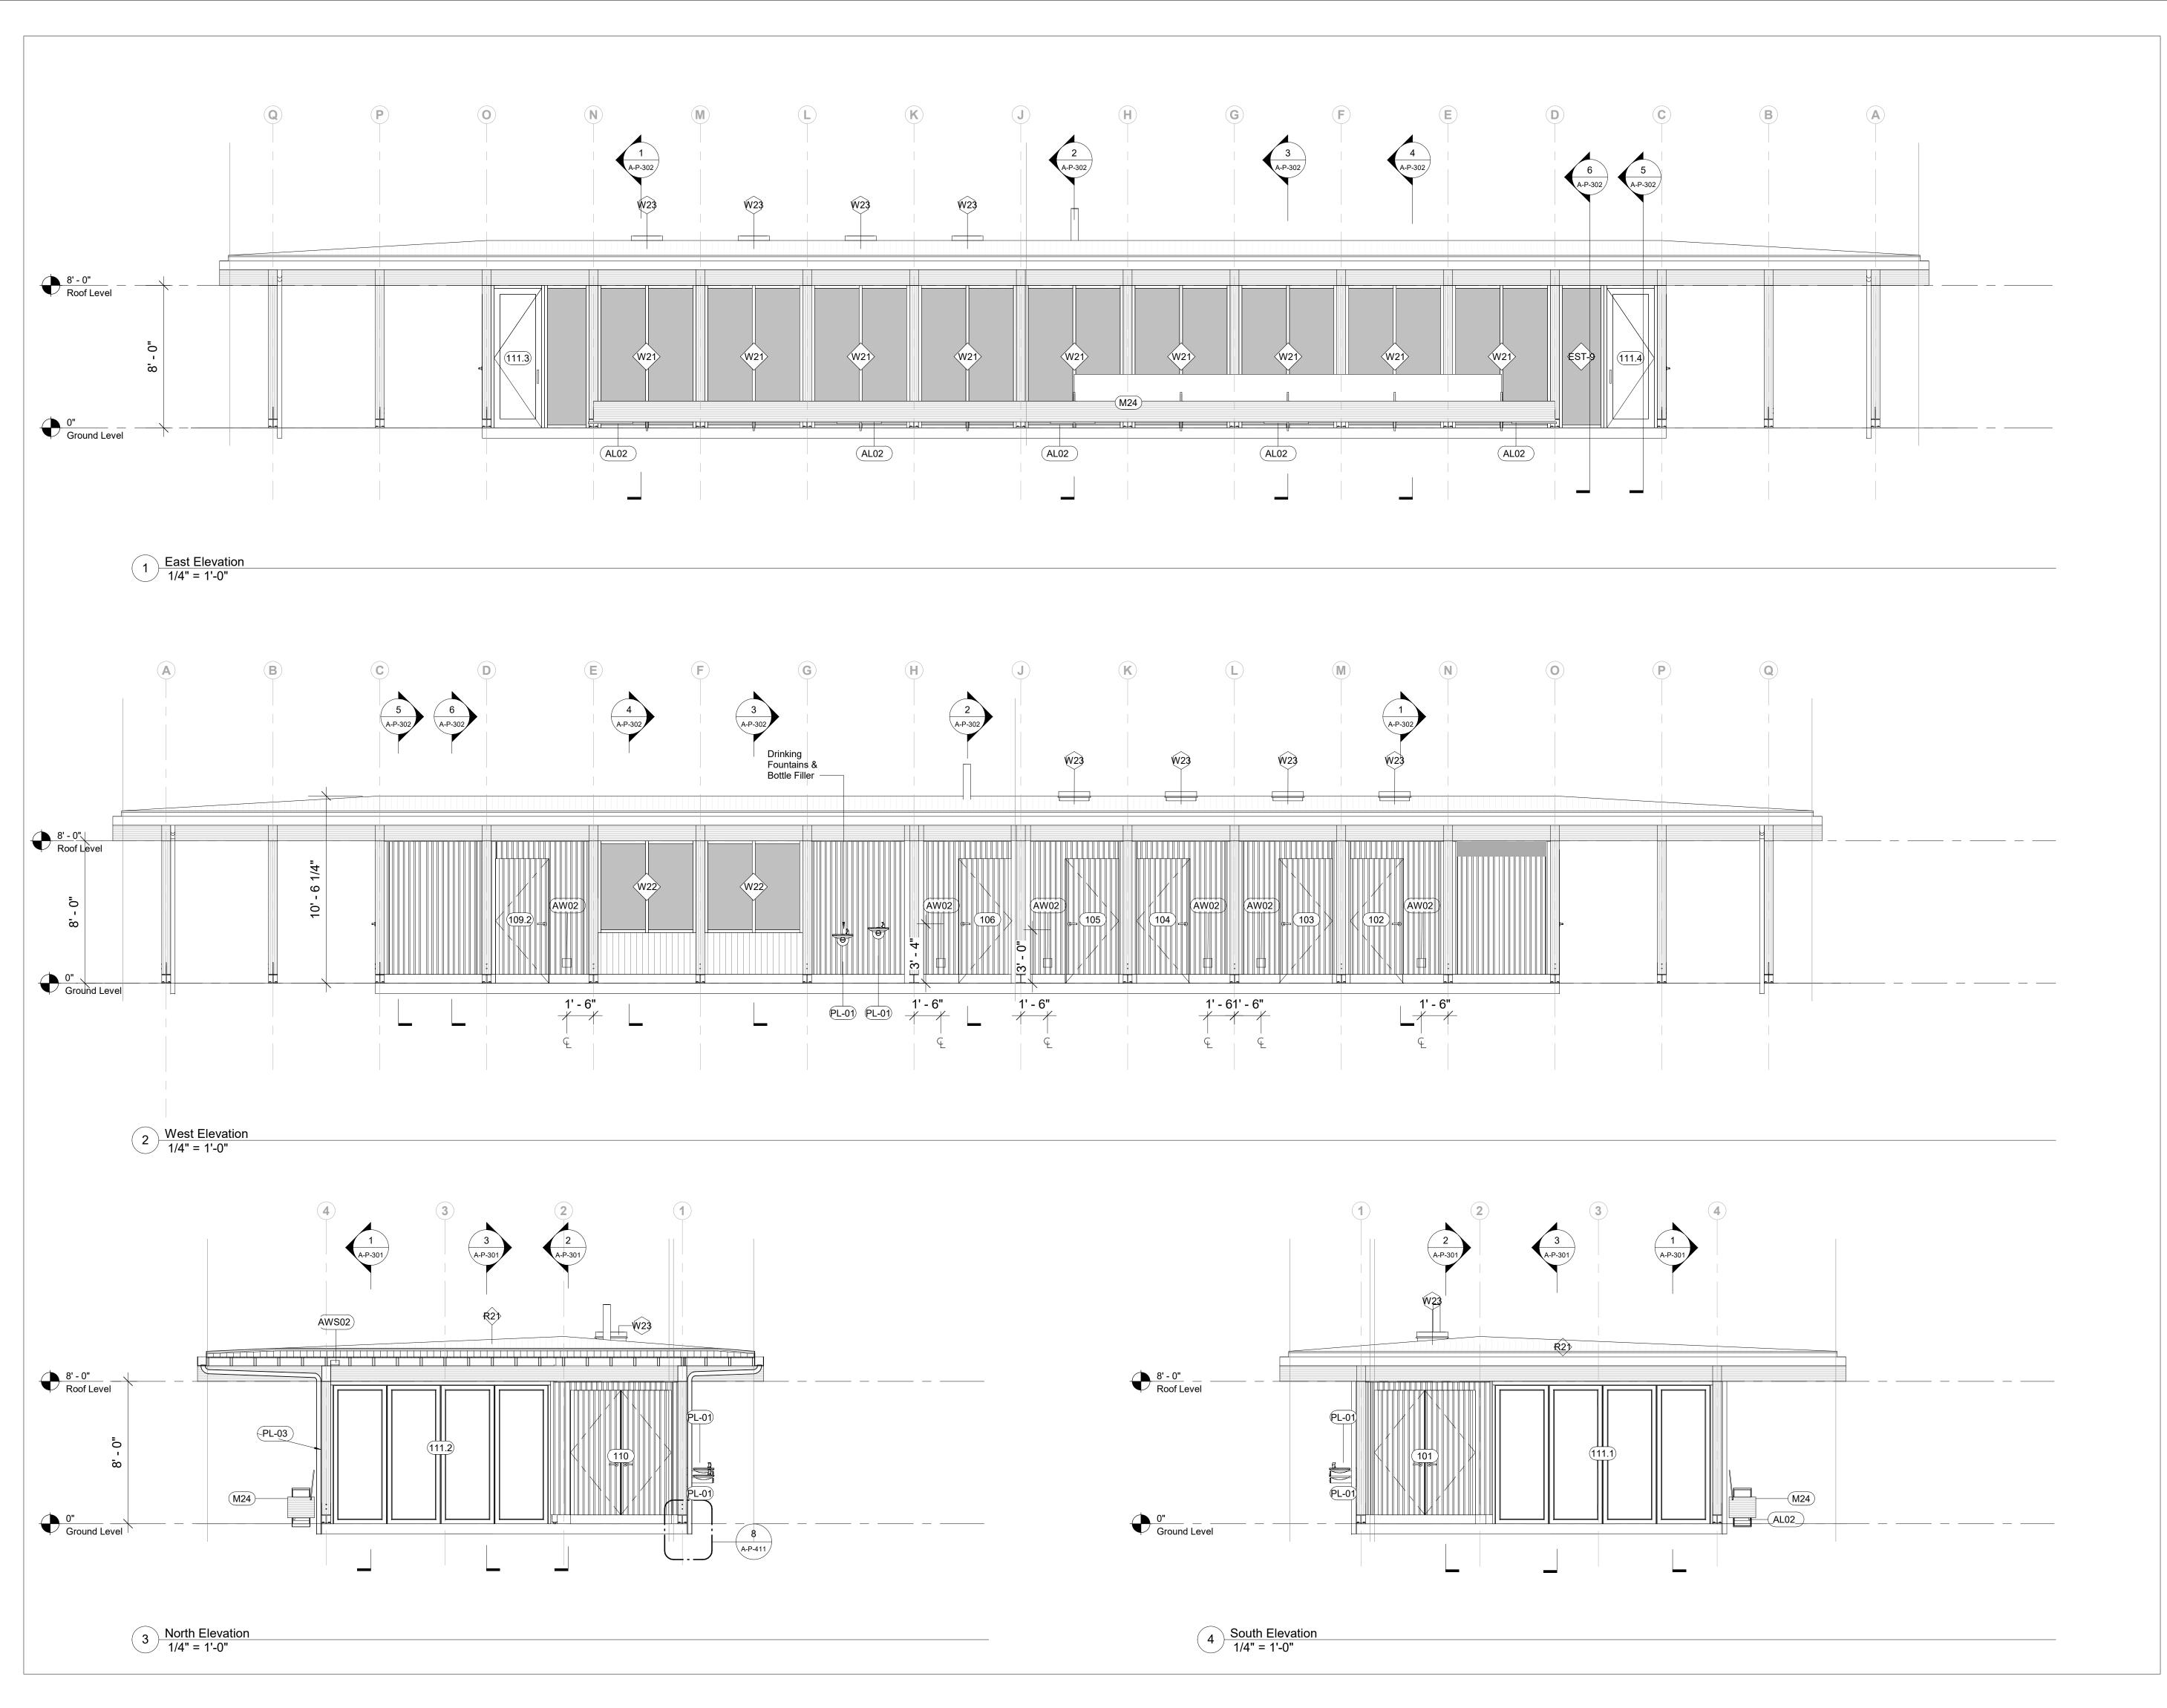

Owner
Storm King Art Center

Storm King Art Center

1 Museum Road

New Windsor, NY 12553

+1 (845) 534-3115

Design Architect
heneghan peng architects
14-16 Lord Edward Street
Dublin, D02 YC63
+353 1 633 9000

Executive Architect
WXY Architecture + Urban Design
224 Centre Street, 5th Floor
New York, NY 10013
+1 (212) 219-1953

Landscape Architect
Gustafson Porter + Bowman
1 Cobham Mews
London, MW1 9SB
+44 020 7284 8950

Reed Hilderbrand LLC 33 Whitney Avenue, 3rd Floor New Haven, CT 06510 +1 (617) 923-2422

Structural & Lighting ARUP 77 Water Street New York, NY 10005

New York, NY 10005 +1 (212) 896-3000 MEPF & IT BuroHappold

BuroHappoid 100 Broadway #23 New York, NY 10005 +1 (212) 616-0228

+1 (212) 616-0228

Civil
VHB

100 Great Oaks Blvd., Suite 118 Albany, NY 12203 +1 (518) 389-3606

AV & Acoustics
LSTN Consultants
76 Beaver Street, 2nd Floor
New York, NY 10005
+1 (347) 788-0810

Facade
Front Inc.
100 E. Broadway Street, #501
New York, NY 10002
+1 (212) 242-2220

Key Plan


DescriptionDate50% Design Development02/24/20100% Design Development05/29/2050% Construction Documents11/06/20

Storm King
Art Center
Pond Pavilion

Seal

NOT FOR CONSTRUCTION
Drawing Title
Building Elevations

Date	11/06/20
Scale	1/4" = 1'-0"
Drawing Number	A-P-201
Sheet Size	ARCH D

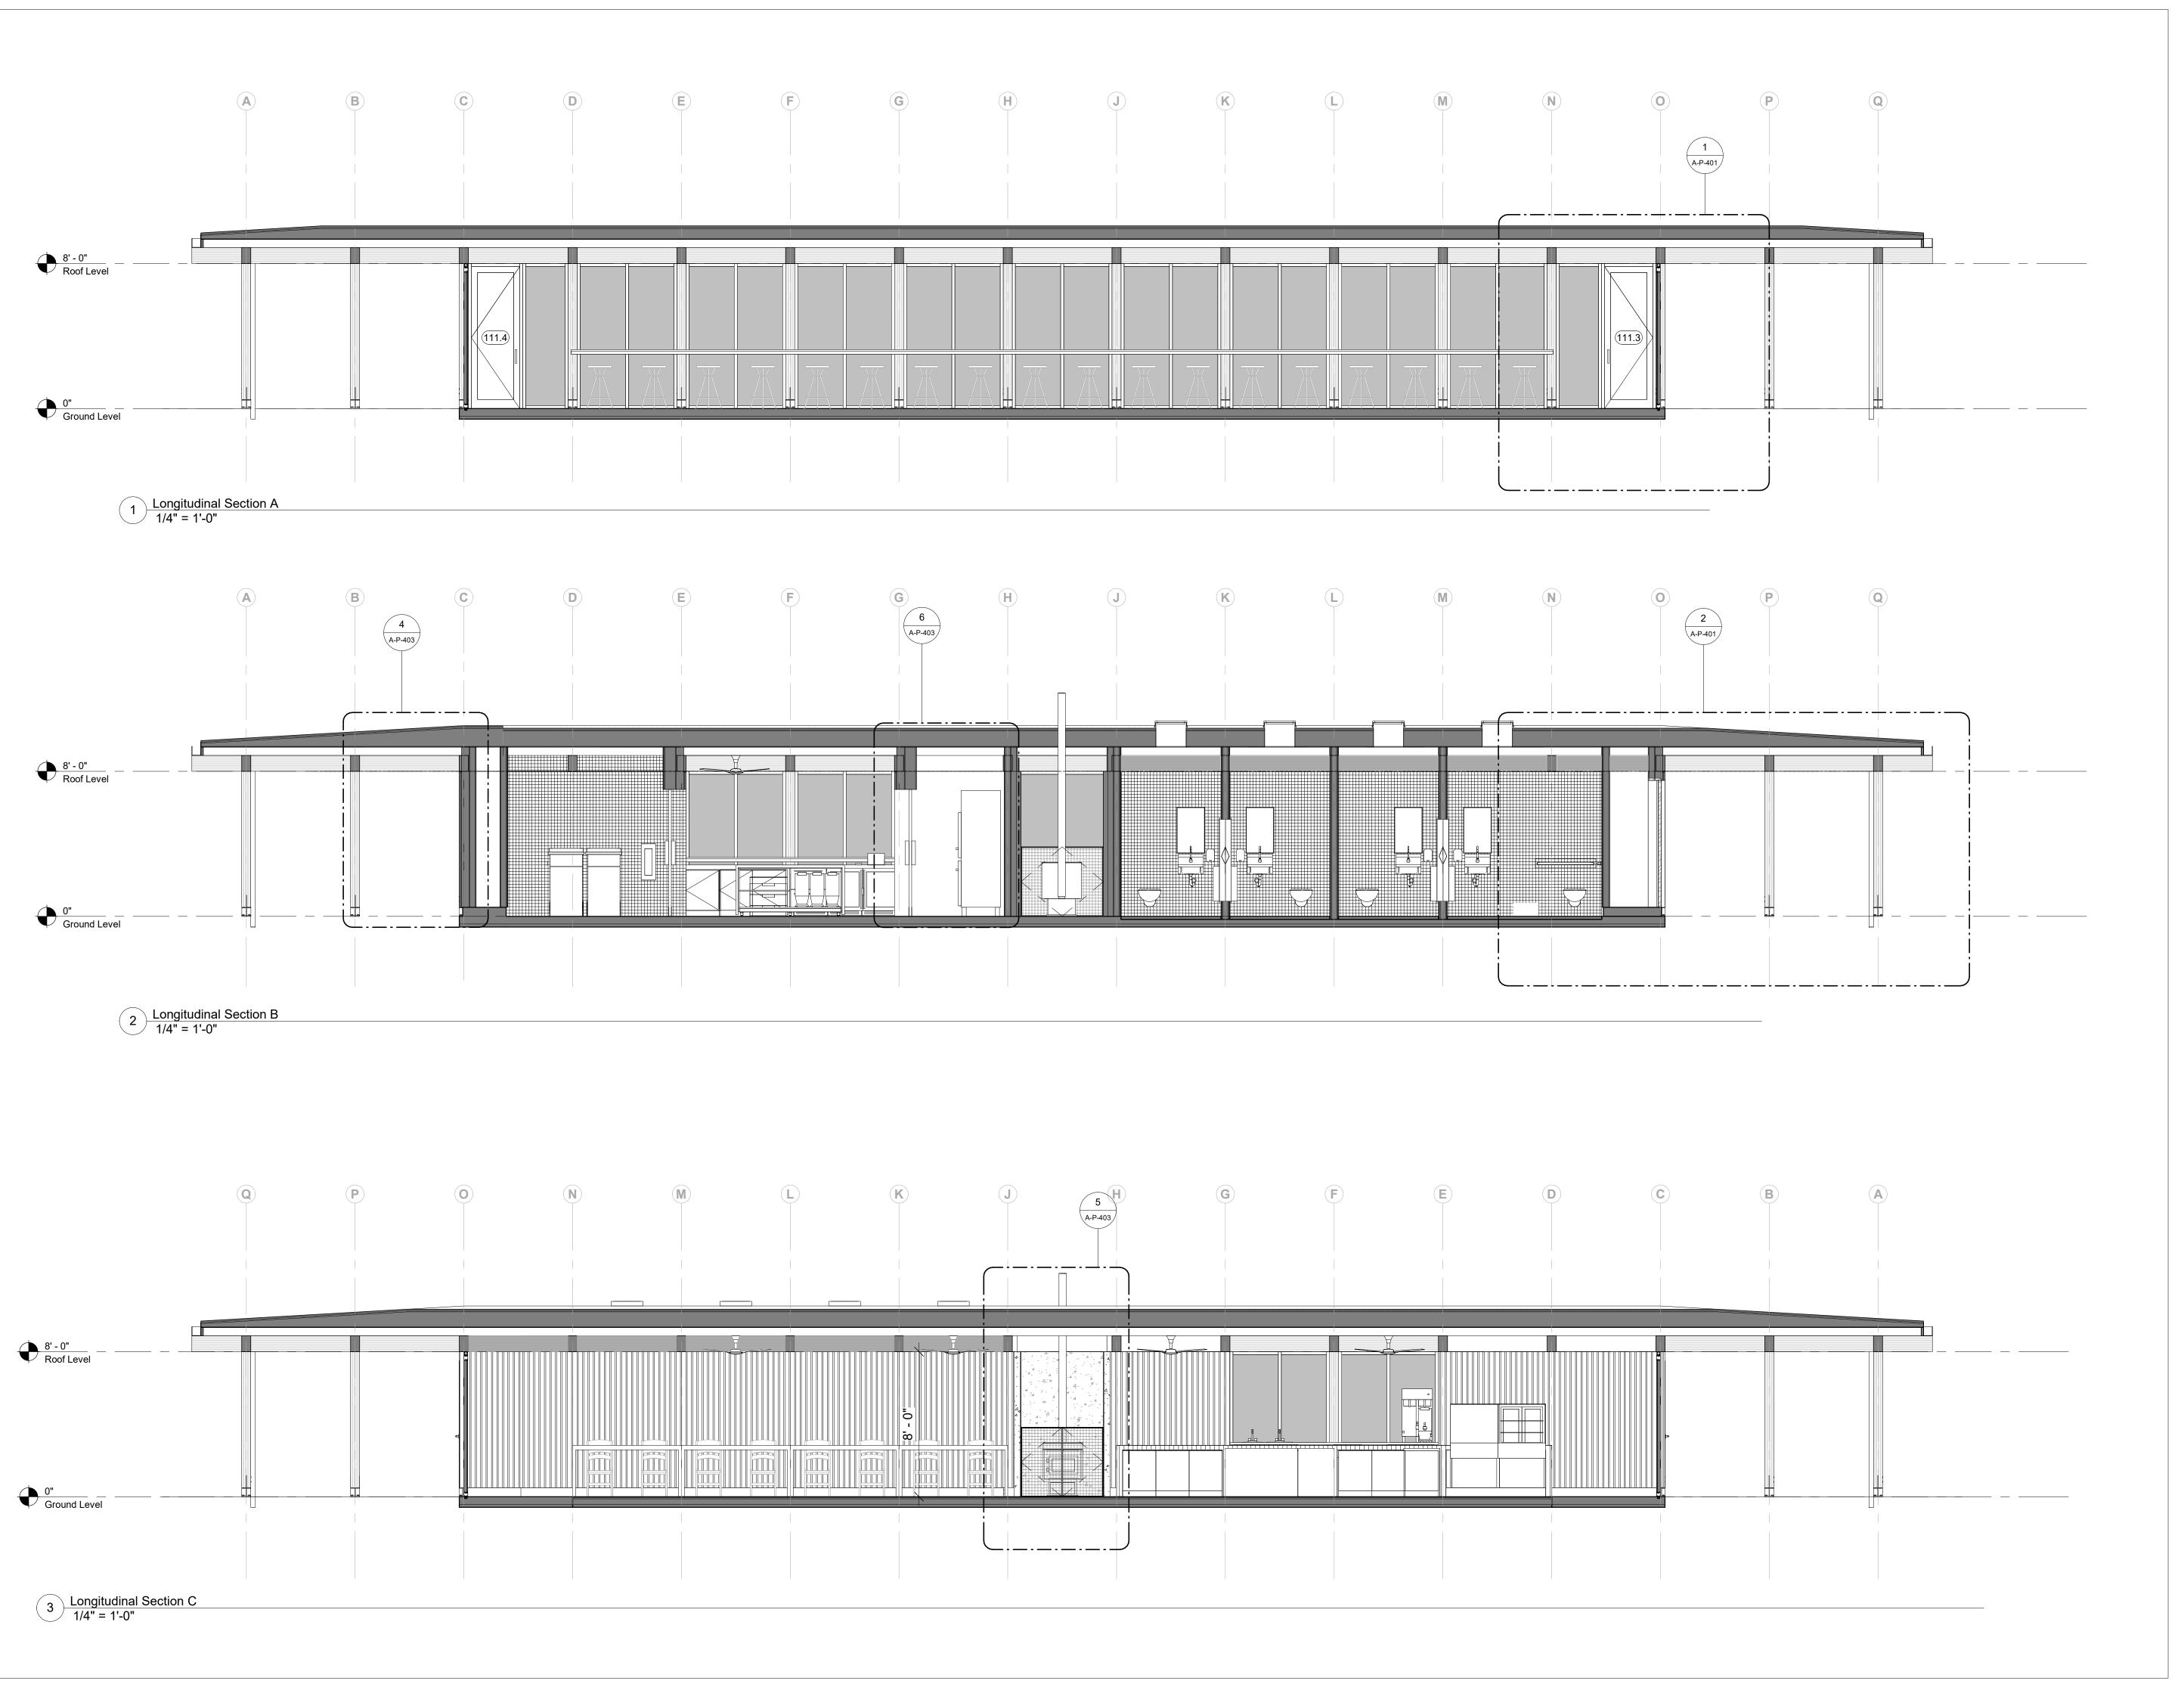

Owner
Storm King Art Center
1 Museum Road
New Windsor, NY 12553

+1 (845) 534-3115

Design Architect
heneghan peng architects
14-16 Lord Edward Street
Dublin, D02 YC63
+353 1 633 9000

+353 1 633 9000

Executive Architect

WXY Architecture + Urban Design
224 Centre Street, 5th Floor
New York, NY 10013

+1 (212) 219-1953

Landscape Architect
Gustafson Porter + Bowman
1 Cobham Mews
London, MW1 9SB

+44 020 7284 8950

Reed Hilderbrand LLC
33 Whitney Avenue, 3rd Floor
New Haven, CT 06510
+1 (617) 923-2422

Structural & Lighting
ARUP
77 Water Street

New York, NY 10005 +1 (212) 896-3000 MEPF & IT

BuroHappold 100 Broadway #23 New York, NY 10005 +1 (212) 616-0228

New York, NY 10005 +1 (212) 616-0228 Civil

VHB 100 Great Oaks Blvd., Suite 118 Albany, NY 12203 +1 (518) 389-3606

AV & Acoustics LSTN Consultants 76 Beaver Street, 2nd Floor New York, NY 10005 +1 (347) 788-0810

Facade
Front Inc.
100 E. Broadway Street, #501
New York, NY 10002
+1 (212) 242-2220

Key Plan

DescriptionDate50% Design Development02/24/20100% Design Development05/29/2050% Construction Documents11/06/20

Storm King
Art Center

Pond Pavilion

Sea

NOT FOR CONSTRUCTION
Drawing Title
Building Sections

Date	11/06/20
Scale	1/4" = 1'-0"
Drawing Number	A-P-301
Sheet Size	ARCH D



Owner
Storm King Art Center
1 Museum Road

New Windsor, NY 12553 +1 (845) 534-3115 Design Architect heneghan peng architects 14-16 Lord Edward Street

14-16 Lord Edward Street
Dublin, D02 YC63
+353 1 633 9000

Executive Architect

WXY Architecture + Urban Design 224 Centre Street, 5th Floor New York, NY 10013 +1 (212) 219-1953

Landscape Architect
Gustafson Porter + Bowman
1 Cobham Mews
London, MW1 9SB
+44 020 7284 8950

Reed Hilderbrand LLC 33 Whitney Avenue, 3rd Floor New Haven, CT 06510 +1 (617) 923-2422

Structural & Lighting
ARUP
77 Water Street

New York, NY 10005 +1 (212) 896-3000 MEPF & IT

BuroHappold 100 Broadway #23 New York, NY 10005

+1 (212) 616-0228 Civil VHB

100 Great Oaks Blvd., Suite 118 Albany, NY 12203 +1 (518) 389-3606 **AV & Acoustics**

LSTN Consultants
76 Beaver Street, 2nd Floor
New York, NY 10005
+1 (347) 788-0810

Facade

Front Inc. 100 E. Broadway Street, #501 New York, NY 10002 +1 (212) 242-2220

Key Plan


DescriptionDate50% Design Development02/24/20100% Design Development05/29/2050% Construction Documents11/06/20

Storm King
Art Center
Pond Pavilion

Seal

NOT FOR CONSTRUCTION
Drawing Title
Building Sections

Date	11/06/20
Scale	1/4" = 1'-0"
Drawing Number	A-P-302
Sheet Size	ARCH D

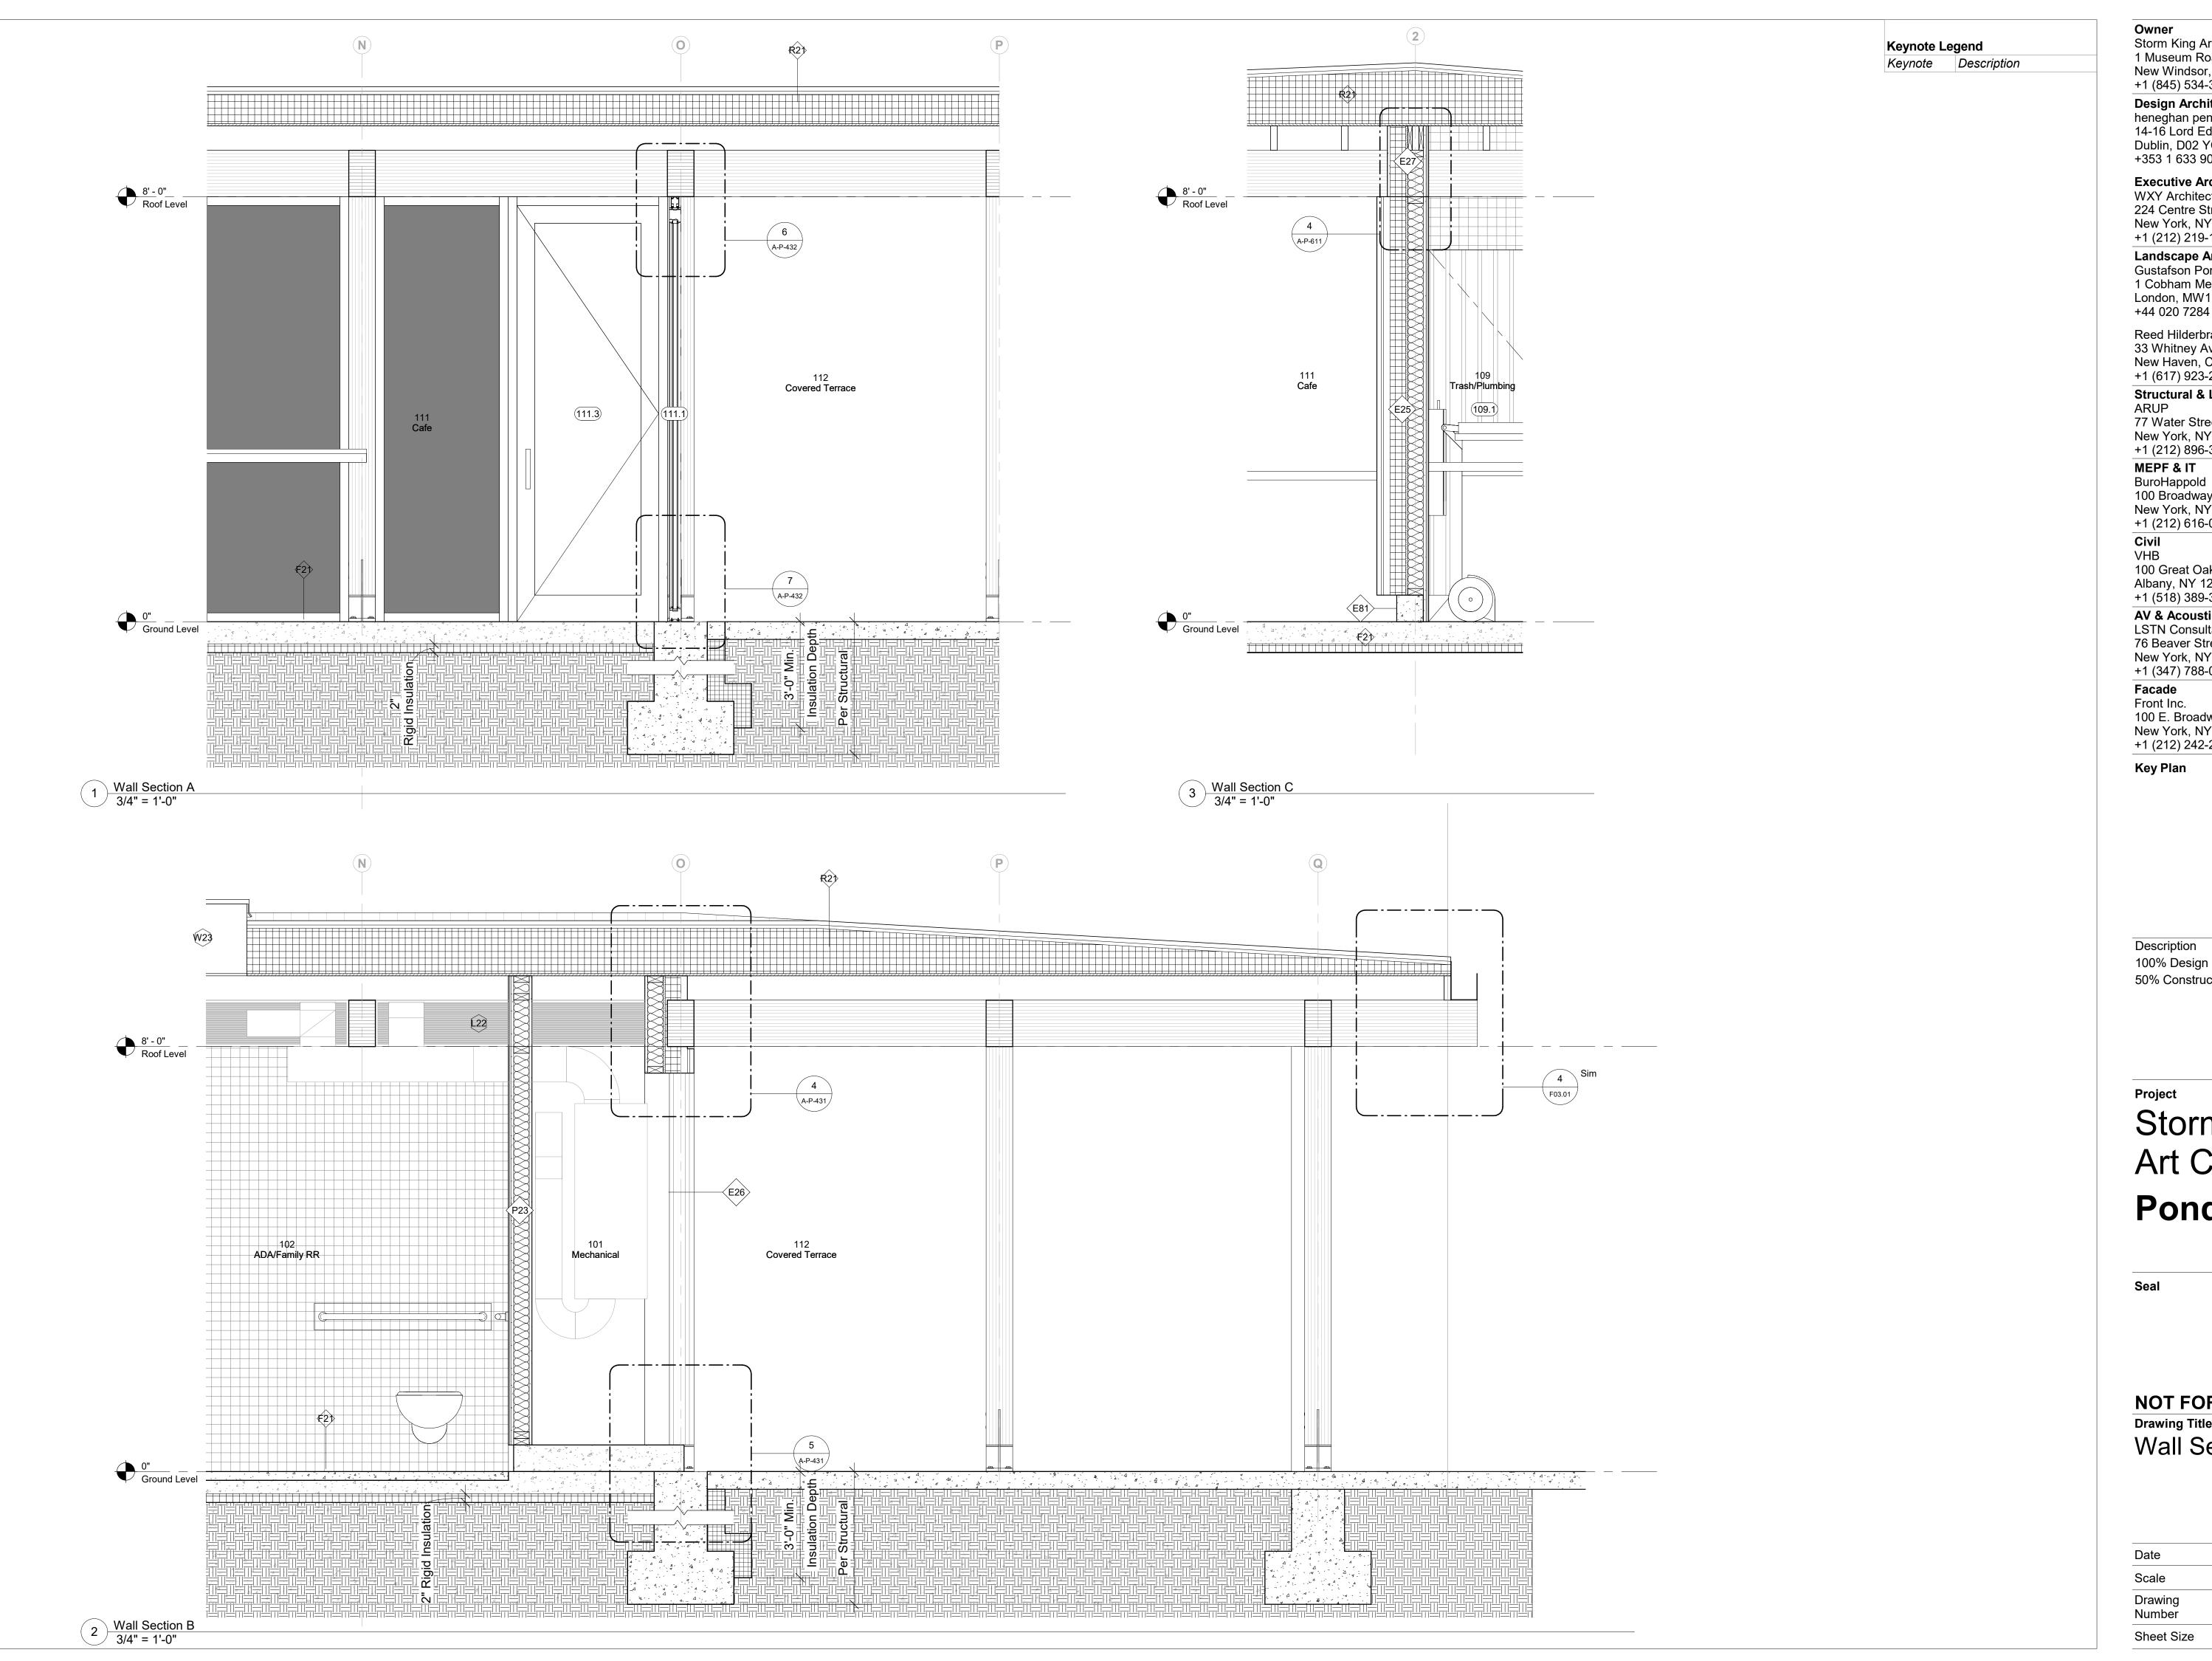

Storm King Art Center 1 Museum Road New Windsor, NY 12553 +1 (845) 534-3115

Design Architect heneghan peng architects

14-16 Lord Edward Street Dublin, D02 YC63 +353 1 633 9000 **Executive Architect**

WXY Architecture + Urban Design 224 Centre Street, 5th Floor New York, NY 10013 +1 (212) 219-1953

Landscape Architect Gustafson Porter + Bowman 1 Cobham Mews London, MW1 9SB +44 020 7284 8950

Reed Hilderbrand LLC 33 Whitney Avenue, 3rd Floor New Haven, CT 06510 +1 (617) 923-2422

Structural & Lighting ARUP 77 Water Street

New York, NY 10005 +1 (212) 896-3000 MEPF & IT

100 Broadway #23 New York, NY 10005 +1 (212) 616-0228

100 Great Oaks Blvd., Suite 118 Albany, NY 12203 +1 (518) 389-3606

AV & Acoustics LSTN Consultants 76 Beaver Street, 2nd Floor New York, NY 10005 +1 (347) 788-0810

Facade Front Inc. 100 E. Broadway Street, #501 New York, NY 10002 +1 (212) 242-2220


Key Plan

Description 100% Design Development 05/29/20 50% Construction Documents 11/06/20

Storm King Art Center **Pond Pavilion**

NOT FOR CONSTRUCTION Drawing Title Wall Sections

Date	11/06/20
Scale	3/4" = 1'-0"
Drawing Number	A-P-401
Sheet Size	ARCH D

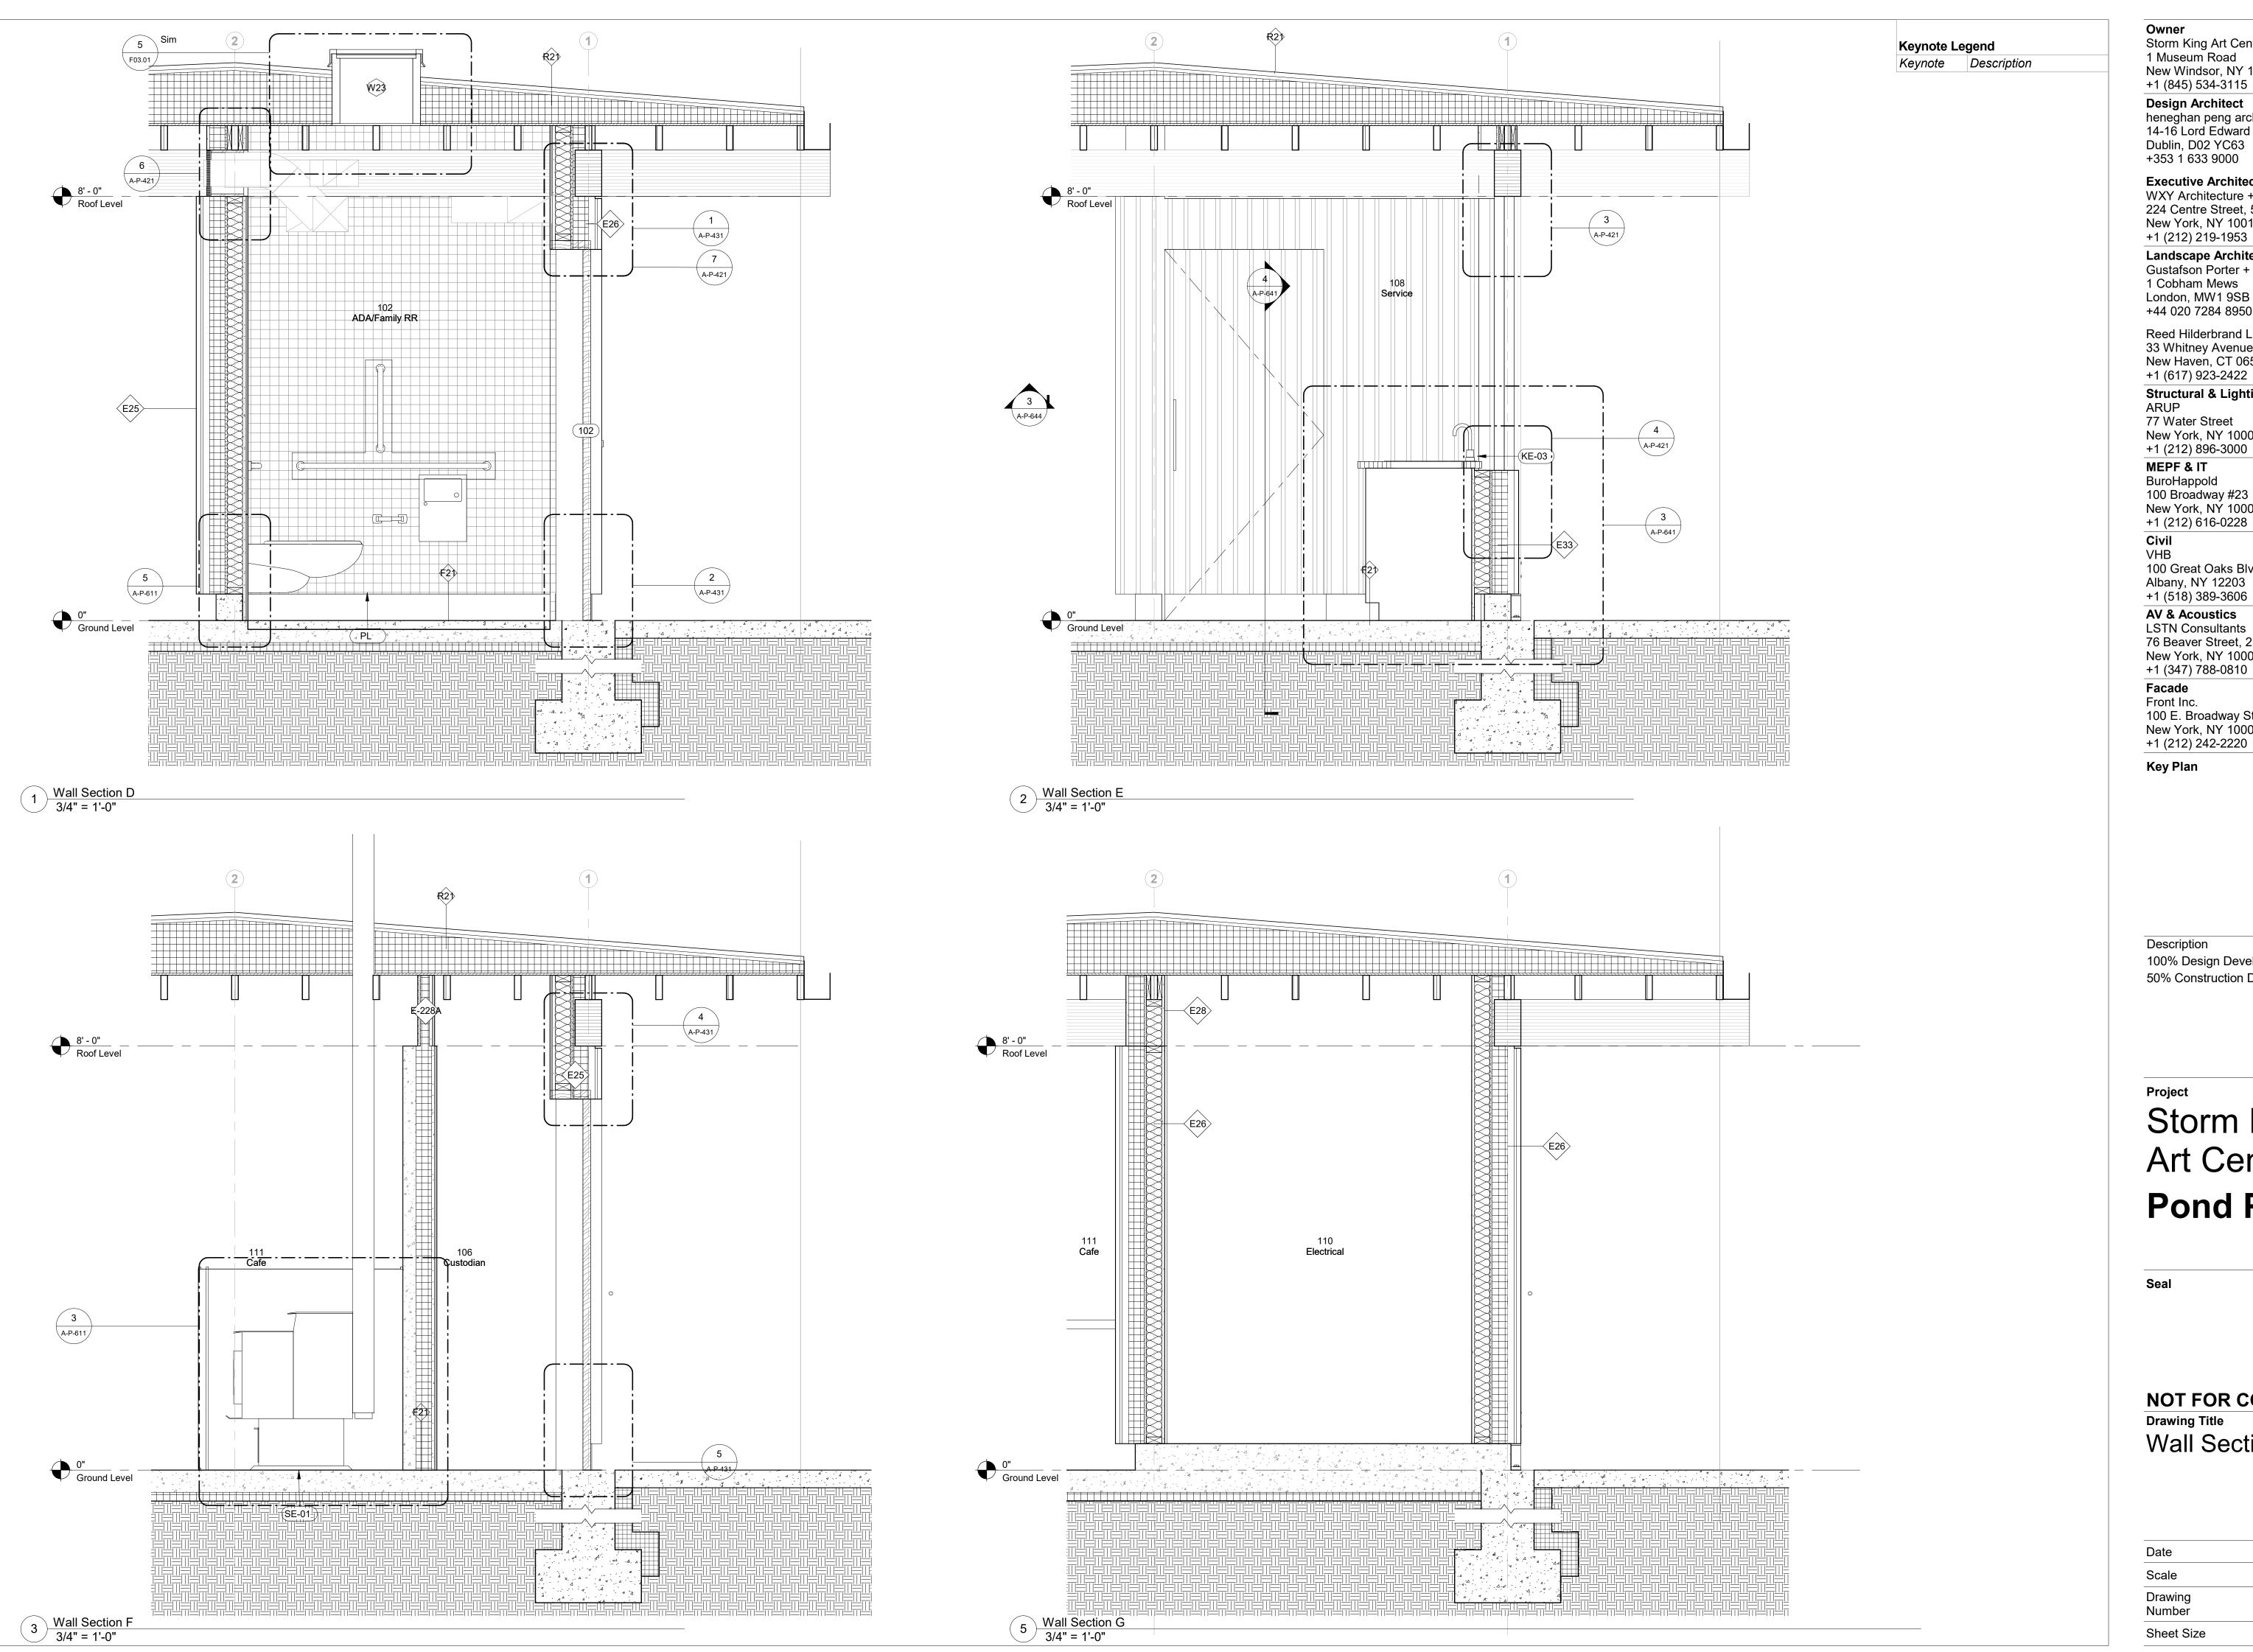

Storm King Art Center

1 Museum Road New Windsor, NY 12553 +1 (845) 534-3115

Design Architect heneghan peng architects 14-16 Lord Edward Street Dublin, D02 YC63 +353 1 633 9000

Executive Architect WXY Architecture + Urban Design 224 Centre Street, 5th Floor New York, NY 10013

Landscape Architect Gustafson Porter + Bowman 1 Cobham Mews London, MW1 9SB +44 020 7284 8950

Reed Hilderbrand LLC 33 Whitney Avenue, 3rd Floor New Haven, CT 06510 +1 (617) 923-2422

Structural & Lighting ARUP 77 Water Street New York, NY 10005

+1 (212) 896-3000 MEPF & IT BuroHappold

100 Broadway #23 New York, NY 10005 +1 (212) 616-0228

Civil VHB

100 Great Oaks Blvd., Suite 118 Albany, NY 12203 +1 (518) 389-3606

AV & Acoustics LSTN Consultants 76 Beaver Street, 2nd Floor New York, NY 10005 +1 (347) 788-0810

Facade Front Inc. 100 E. Broadway Street, #501 New York, NY 10002


Key Plan

Description 100% Design Development 50% Construction Documents

Storm King Art Center **Pond Pavilion**

NOT FOR CONSTRUCTION Drawing Title Wall Sections

11/06/20
3/4" = 1'-0"
A-P-402
ARCH D

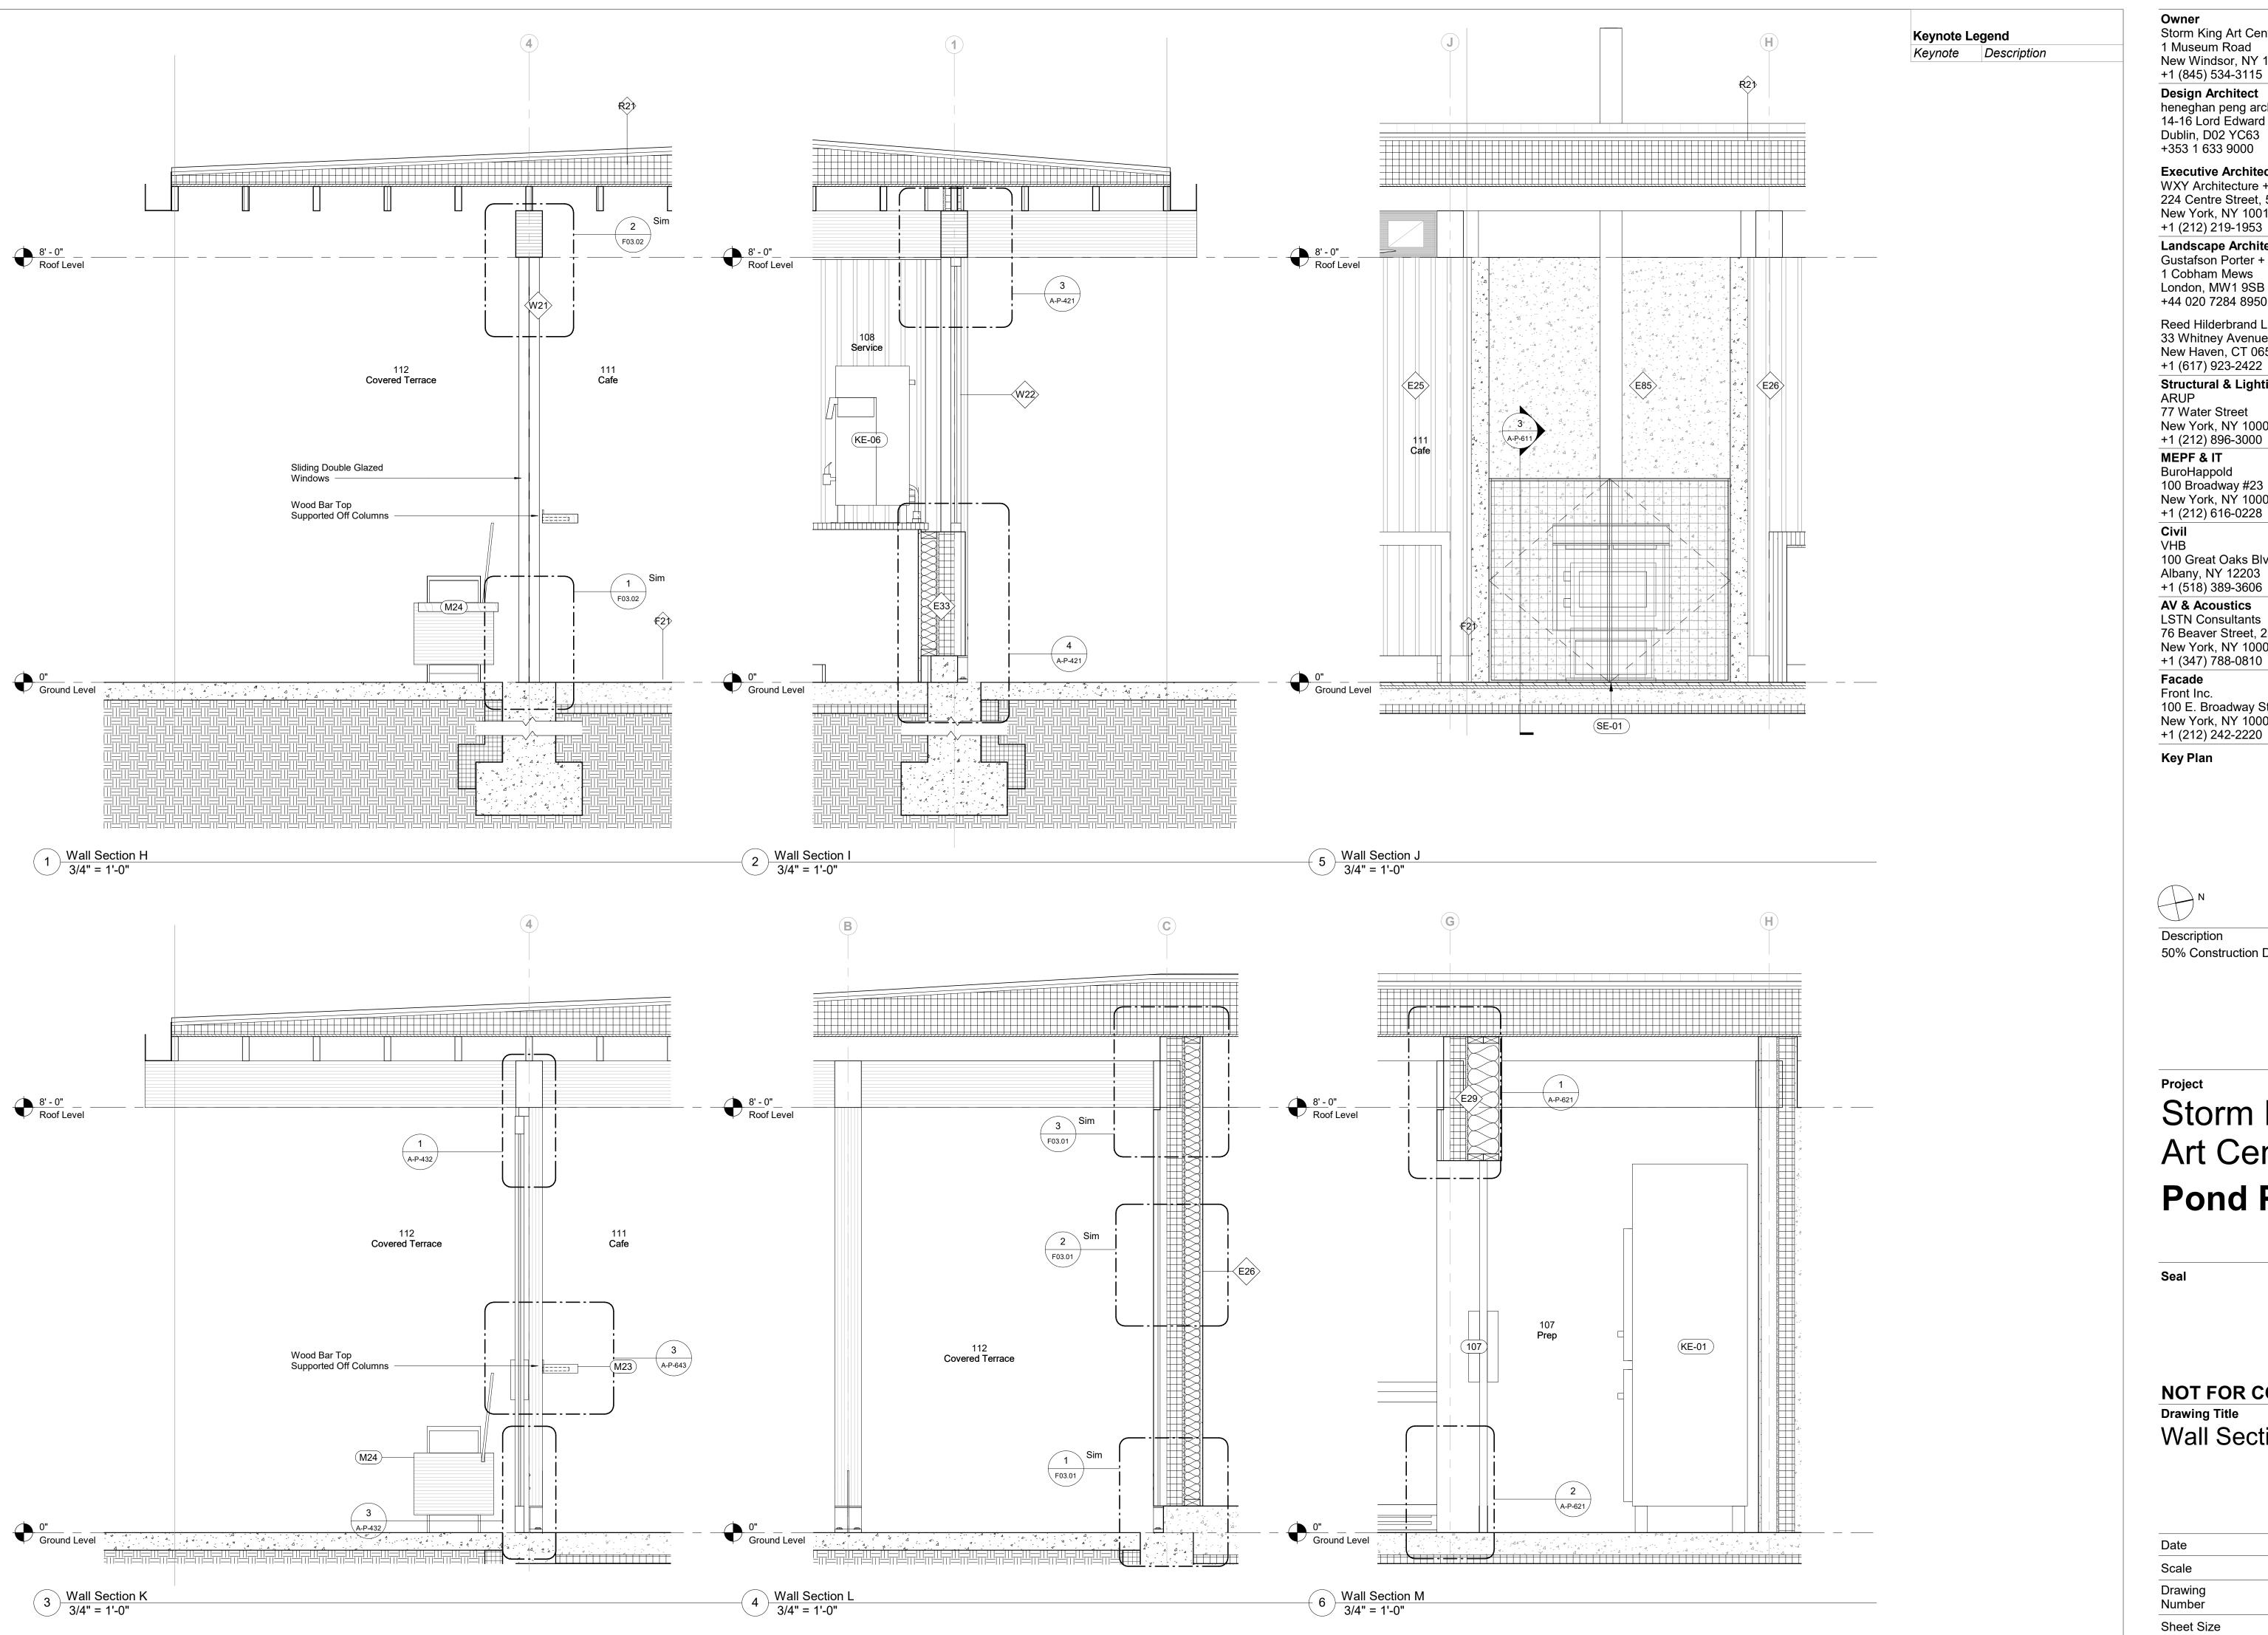

Storm King Art Center

1 Museum Road New Windsor, NY 12553 +1 (845) 534-3115

Design Architect heneghan peng architects 14-16 Lord Edward Street Dublin, D02 YC63 +353 1 633 9000

Executive Architect WXY Architecture + Urban Design 224 Centre Street, 5th Floor New York, NY 10013

Landscape Architect Gustafson Porter + Bowman

1 Cobham Mews London, MW1 9SB +44 020 7284 8950

Reed Hilderbrand LLC 33 Whitney Avenue, 3rd Floor New Haven, CT 06510 +1 (617) 923-2422

Structural & Lighting ARUP 77 Water Street

New York, NY 10005 +1 (212) 896-3000

MEPF & IT BuroHappold 100 Broadway #23

New York, NY 10005 +1 (212) 616-0228

Civil VHB

100 Great Oaks Blvd., Suite 118 Albany, NY 12203

+1 (518) 389-3606 **AV & Acoustics** LSTN Consultants

76 Beaver Street, 2nd Floor New York, NY 10005 +1 (347) 788-0810

Front Inc. 100 E. Broadway Street, #501 New York, NY 10002 +1 (212) 242-2220

Key Plan




Description 50% Construction Documents 11/06/20

Storm King Art Center **Pond Pavilion**

NOT FOR CONSTRUCTION Drawing Title Wall Sections

Date	11/06/20
Scale	3/4" = 1'-0"
Drawing Number	A-P-403
Sheet Size	ARCH D

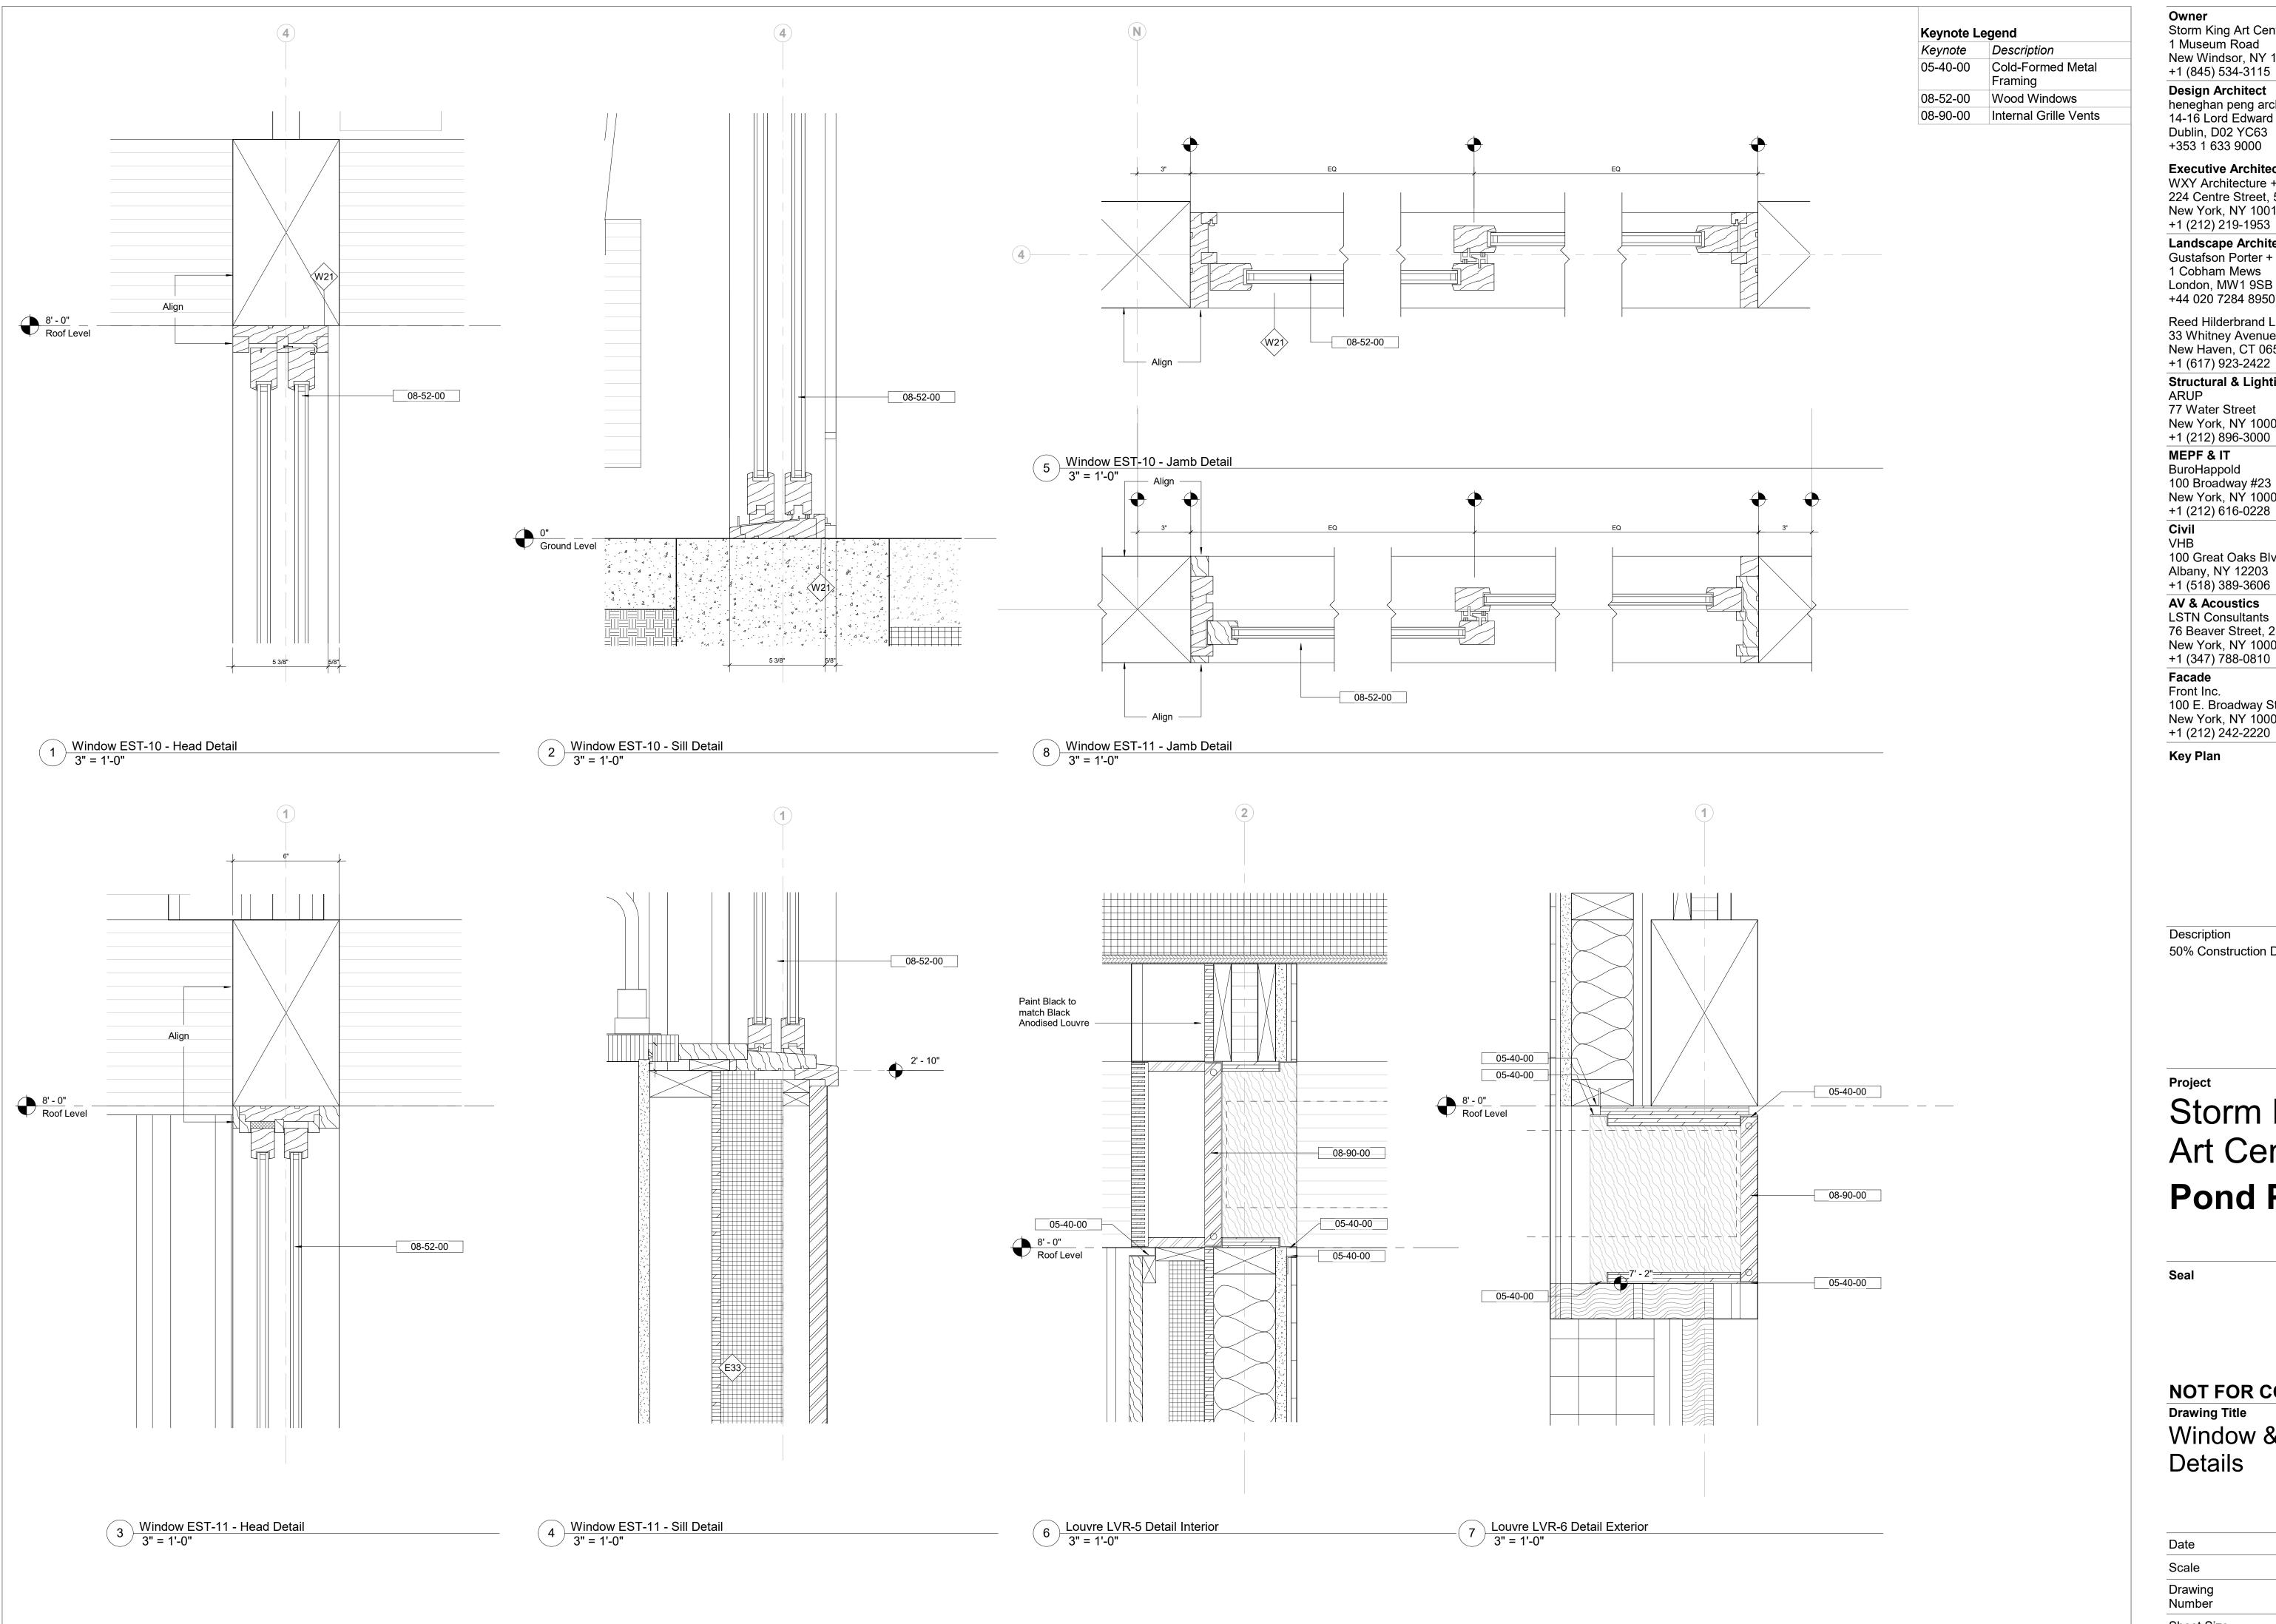

Storm King Art Center 1 Museum Road New Windsor, NY 12553

+1 (845) 534-3115 **Design Architect** heneghan peng architects 14-16 Lord Edward Street

+353 1 633 9000 **Executive Architect** WXY Architecture + Urban Design 224 Centre Street, 5th Floor New York, NY 10013

Landscape Architect Gustafson Porter + Bowman 1 Cobham Mews London, MW1 9SB +44 020 7284 8950

Reed Hilderbrand LLC 33 Whitney Avenue, 3rd Floor New Haven, CT 06510 +1 (617) 923-2422

Structural & Lighting ARUP 77 Water Street

New York, NY 10005 +1 (212) 896-3000 MEPF & IT

BuroHappold 100 Broadway #23 New York, NY 10005 +1 (212) 616-0228

Civil VHB

100 Great Oaks Blvd., Suite 118 Albany, NY 12203 +1 (518) 389-3606

AV & Acoustics LSTN Consultants 76 Beaver Street, 2nd Floor New York, NY 10005 +1 (347) 788-0810

Front Inc. 100 E. Broadway Street, #501 New York, NY 10002 +1 (212) 242-2220

Key Plan


Description 50% Construction Documents 11/06/20

Storm King Art Center

Pond Pavilion

NOT FOR CONSTRUCTION **Drawing Title** Window & Louvre Details

Date	11/06/20
Scale	3" = 1'-0"
Drawing Number	A-P-421
Sheet Size	ARCH D

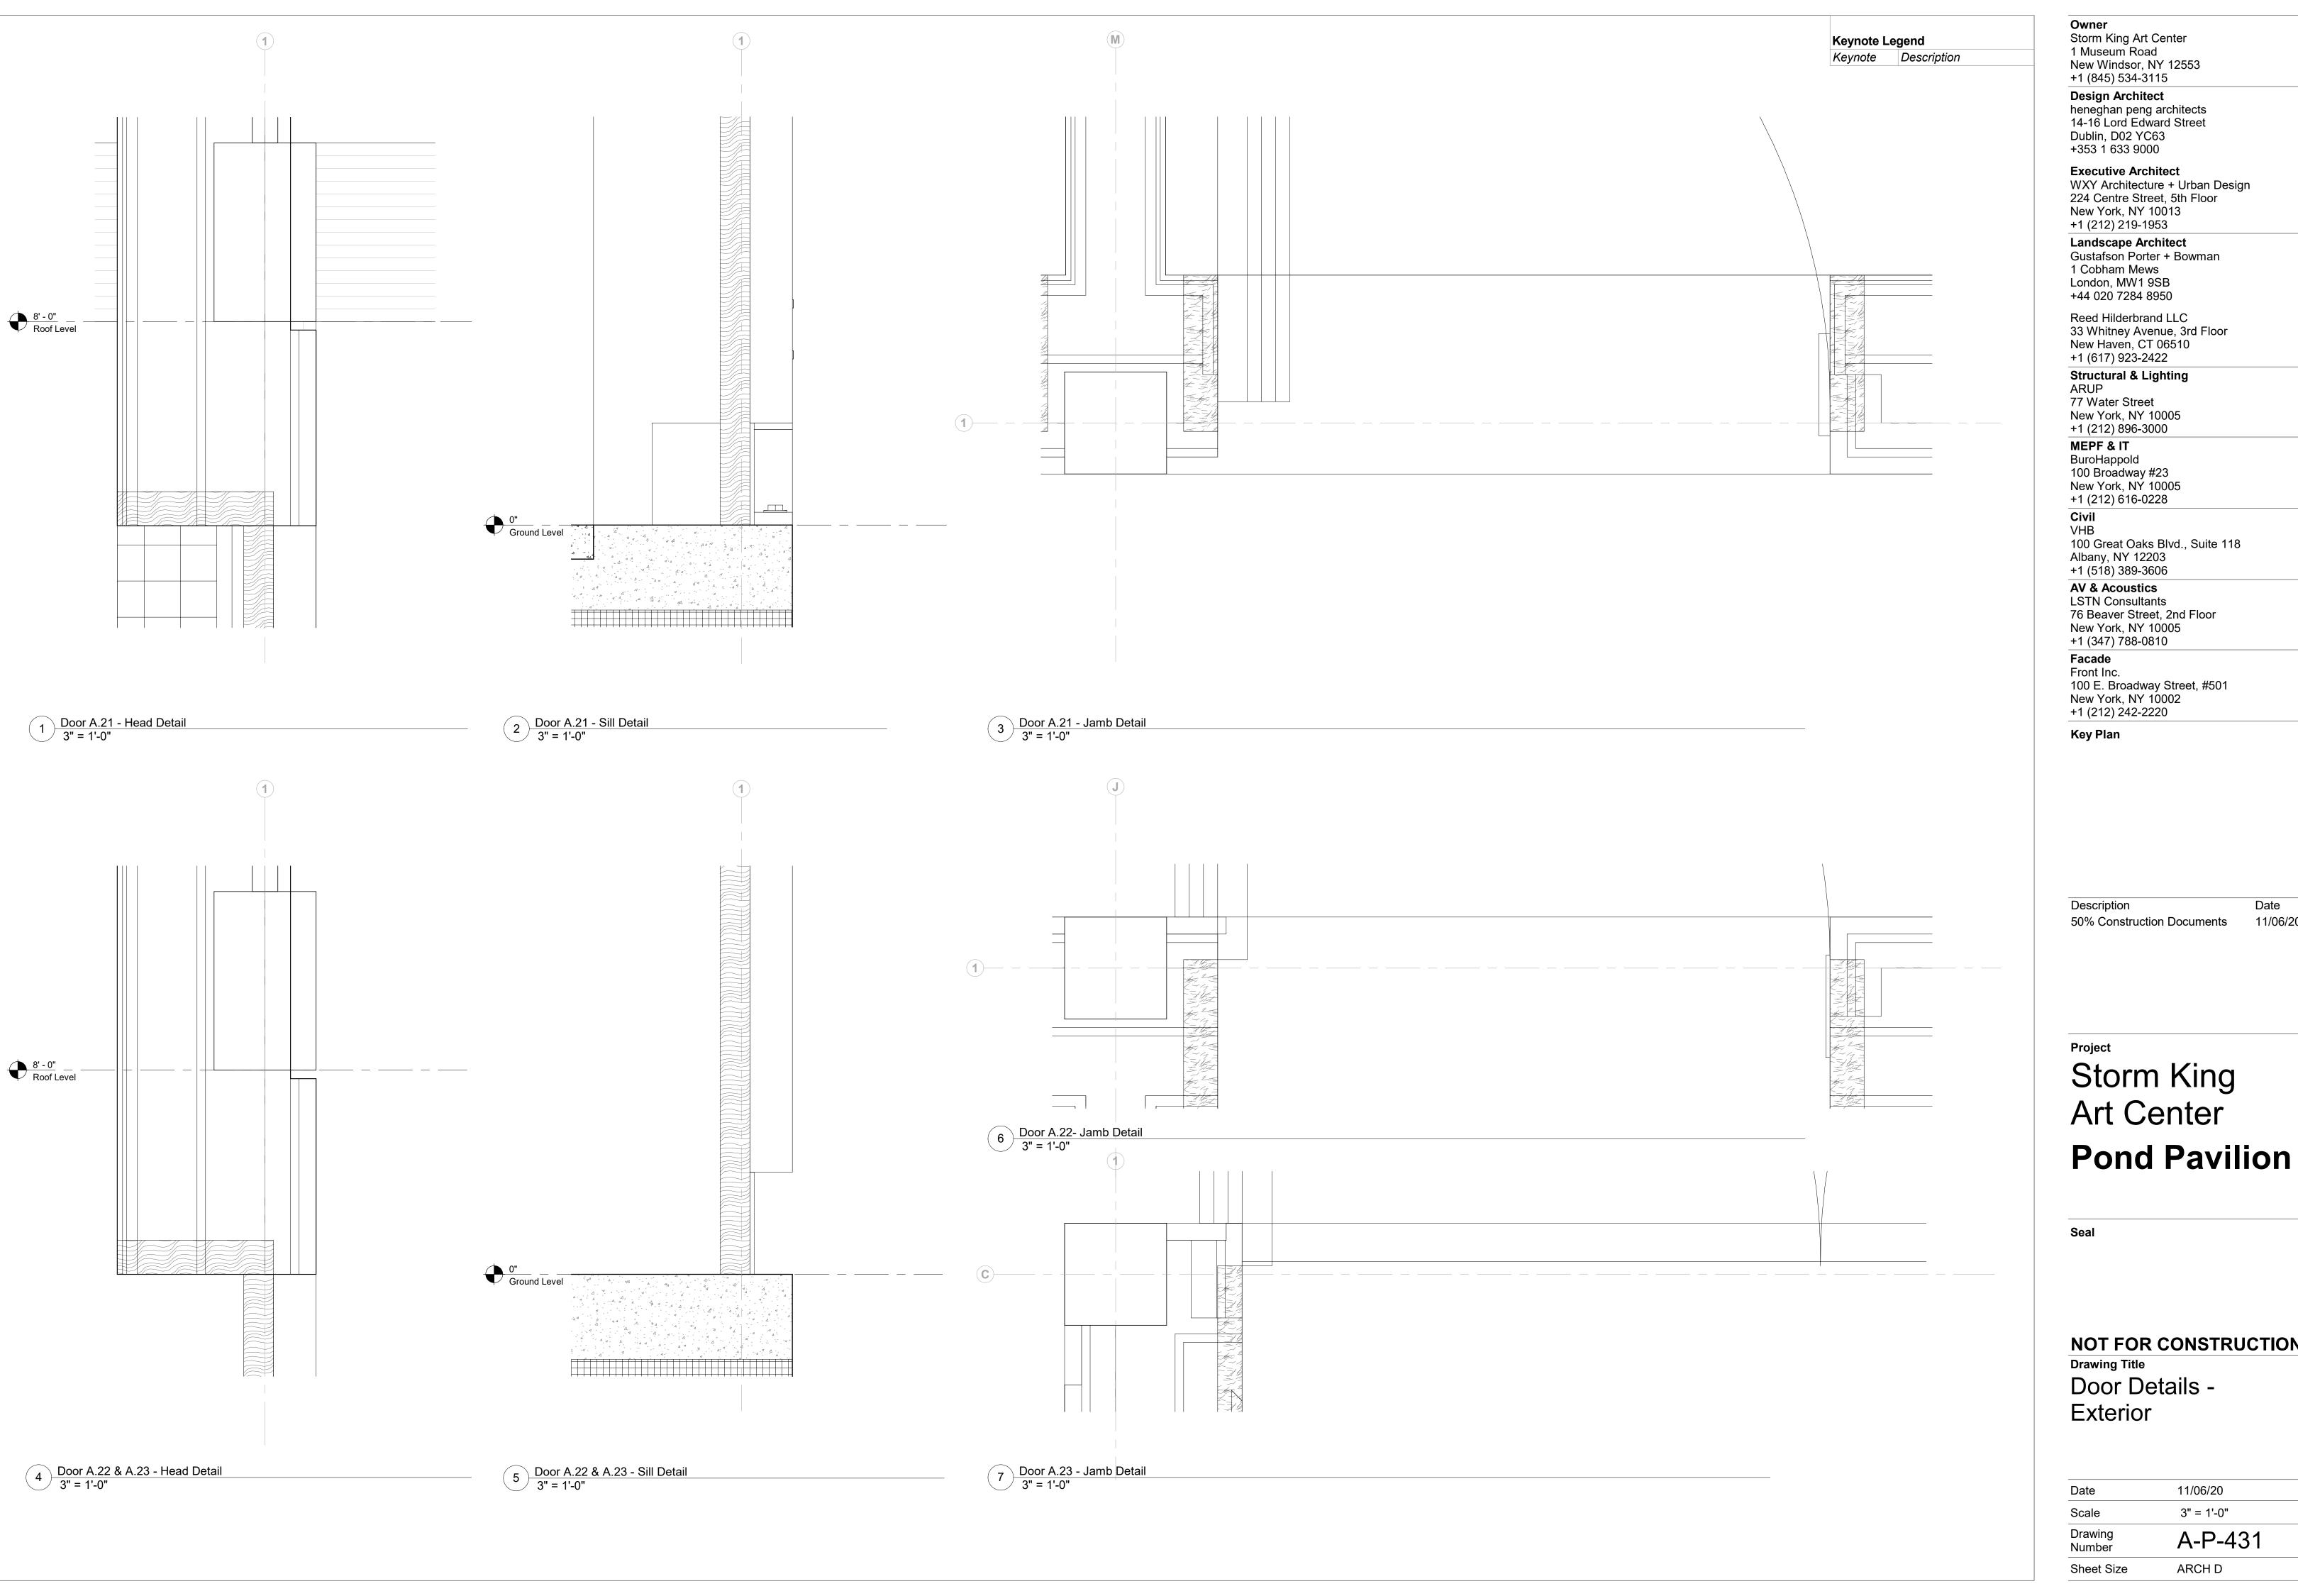

Storm King Art Center 1 Museum Road

New Windsor, NY 12553 +1 (845) 534-3115

heneghan peng architects 14-16 Lord Edward Street Dublin, D02 YC63

Executive Architect WXY Architecture + Urban Design 224 Centre Street, 5th Floor New York, NY 10013

Landscape Architect Gustafson Porter + Bowman London, MW1 9SB

Reed Hilderbrand LLC 33 Whitney Avenue, 3rd Floor New Haven, CT 06510

Structural & Lighting 77 Water Street

New York, NY 10005 +1 (212) 896-3000

BuroHappold 100 Broadway #23 New York, NY 10005

+1 (212) 616-0228

100 Great Oaks Blvd., Suite 118 Albany, NY 12203 +1 (518) 389-3606

AV & Acoustics LSTN Consultants 76 Beaver Street, 2nd Floor New York, NY 10005


100 E. Broadway Street, #501 New York, NY 10002

11/06/20

Storm King Art Center

NOT FOR CONSTRUCTION Door Details -

Date	11/06/20
Scale	3" = 1'-0"
Drawing Number	A-P-431
Sheet Size	ARCH D

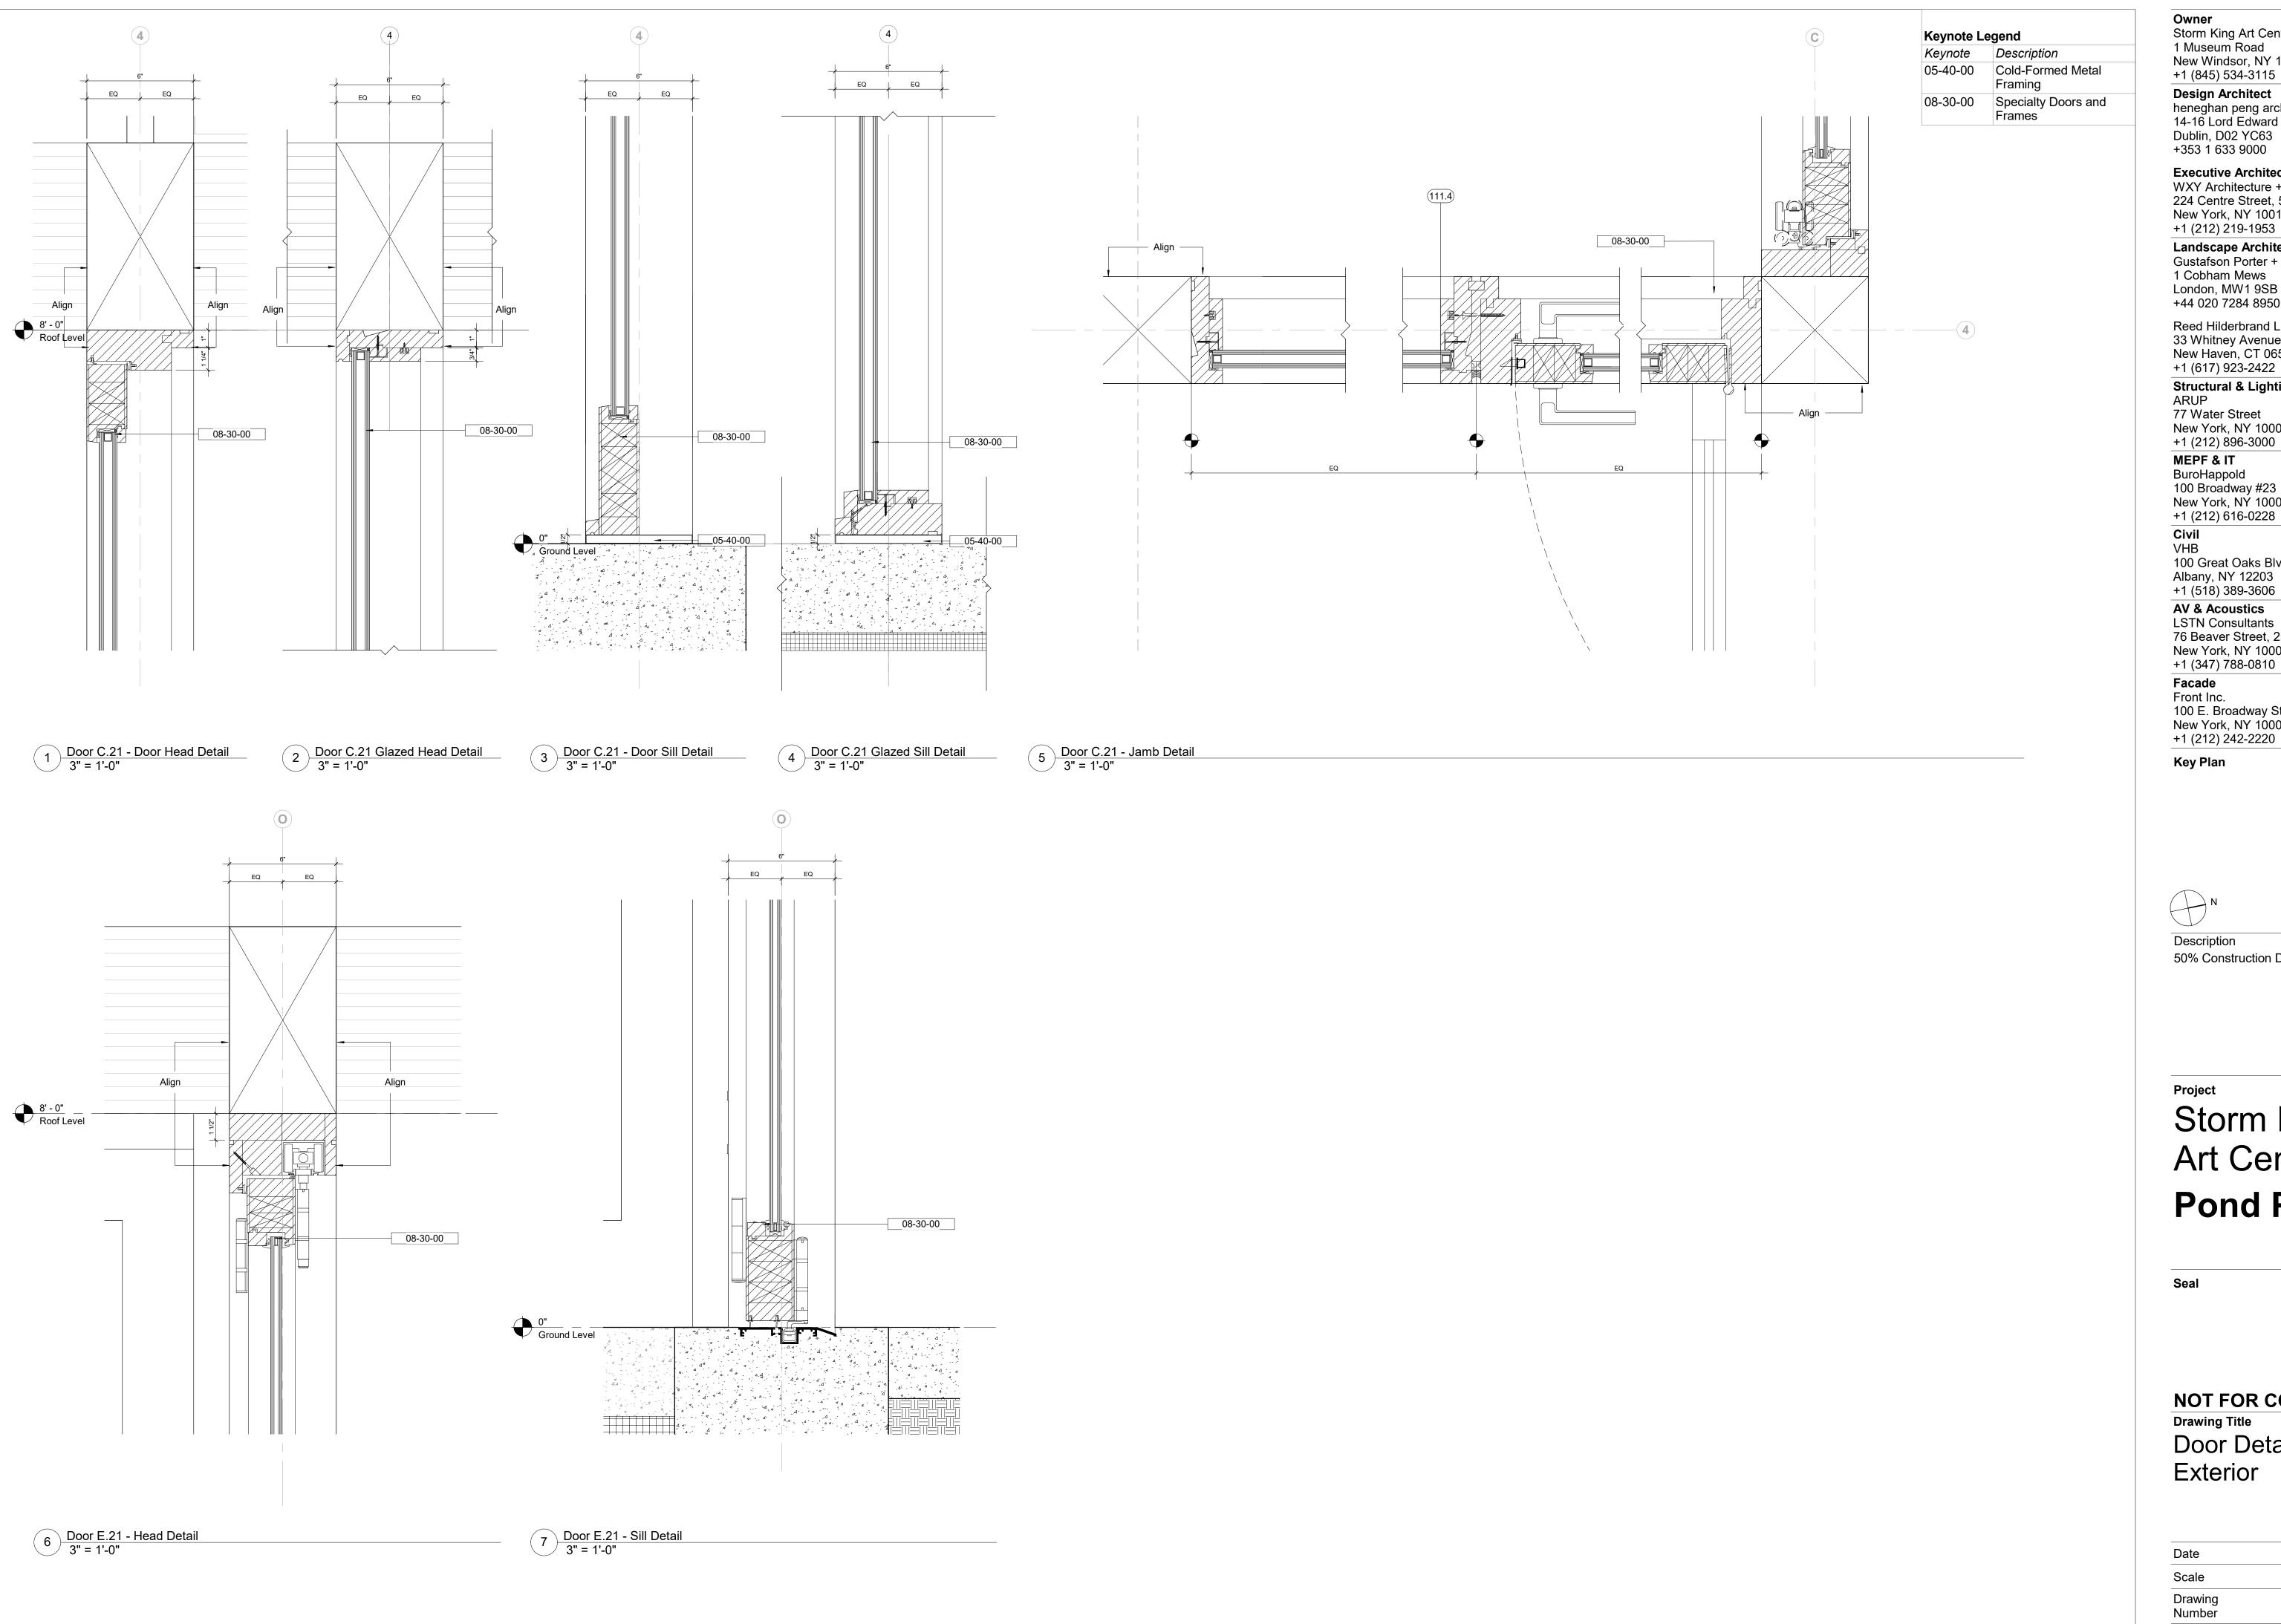

Storm King Art Center 1 Museum Road New Windsor, NY 12553

+1 (845) 534-3115 Design Architect heneghan peng architects 14-16 Lord Edward Street Dublin, D02 YC63

+353 1 633 9000 **Executive Architect** WXY Architecture + Urban Design 224 Centre Street, 5th Floor

New York, NY 10013 +1 (212) 219-1953 Landscape Architect Gustafson Porter + Bowman

London, MW1 9SB +44 020 7284 8950 Reed Hilderbrand LLC 33 Whitney Avenue, 3rd Floor

New Haven, CT 06510 +1 (617) 923-2422 Structural & Lighting

ARUP 77 Water Street New York, NY 10005 +1 (212) 896-3000

MEPF & IT BuroHappold 100 Broadway #23 New York, NY 10005

+1 (212) 616-0228 Civil

100 Great Oaks Blvd., Suite 118 Albany, NY 12203 +1 (518) 389-3606

AV & Acoustics LSTN Consultants 76 Beaver Street, 2nd Floor New York, NY 10005

Facade Front Inc. 100 E. Broadway Street, #501 New York, NY 10002 +1 (212) 242-2220

Key Plan




Description 50% Construction Documents

Storm King Art Center **Pond Pavilion**

NOT FOR CONSTRUCTION **Drawing Title** Door Details -Exterior

Date	11/06/20
Scale	3" = 1'-0"
Drawing Number	A-P-432
Sheet Size	ARCH D

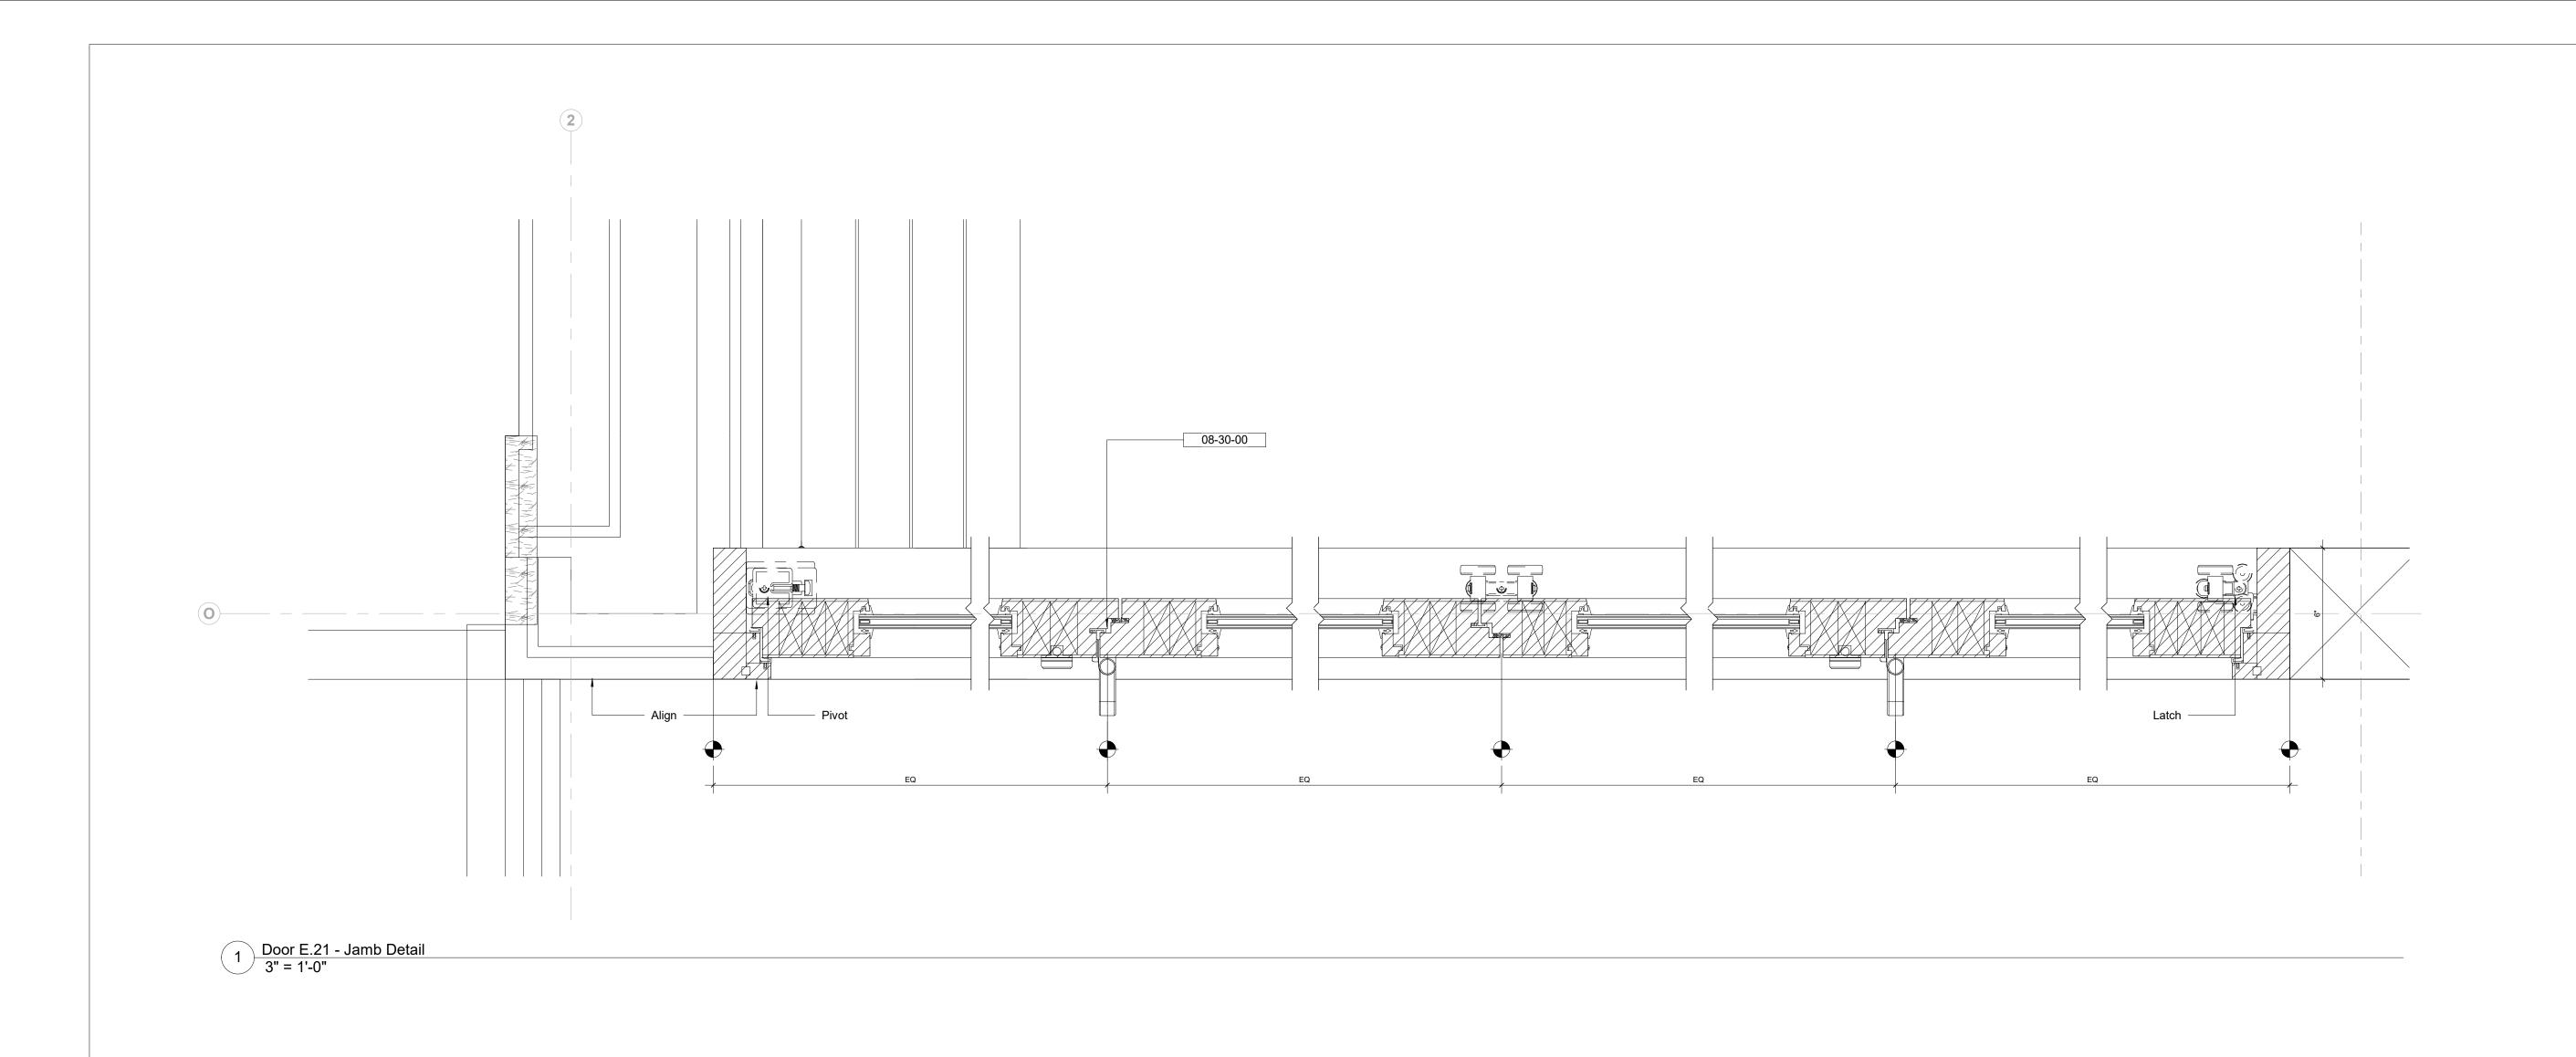

Storm King Art Center 1 Museum Road New Windsor, NY 12553

+1 (845) 534-3115 **Design Architect** heneghan peng architects 14-16 Lord Edward Street

Dublin, D02 YC63 +353 1 633 9000 **Executive Architect**

WXY Architecture + Urban Design 224 Centre Street, 5th Floor New York, NY 10013 +1 (212) 219-1953

Landscape Architect

Gustafson Porter + Bowman 1 Cobham Mews London, MW1 9SB +44 020 7284 8950

Reed Hilderbrand LLC 33 Whitney Avenue, 3rd Floor New Haven, CT 06510

+1 (617) 923-2422 Structural & Lighting ARUP

77 Water Street New York, NY 10005 +1 (212) 896-3000

MEPF & IT BuroHappold 100 Broadway #23 New York, NY 10005

+1 (212) 616-0228 Civil VHB

100 Great Oaks Blvd., Suite 118 Albany, NY 12203

+1 (518) 389-3606 **AV & Acoustics** LSTN Consultants

76 Beaver Street, 2nd Floor New York, NY 10005 +1 (347) 788-0810 Facade

Front Inc. 100 E. Broadway Street, #501 New York, NY 10002 +1 (212) 242-2220

Key Plan




Description 50% Construction Documents 11/06/20

Storm King Art Center **Pond Pavilion**

NOT FOR CONSTRUCTION **Drawing Title** Door Details -Exterior

Date	11/06/20
Scale	3" = 1'-0"
Drawing Number	A-P-433
Sheet Size	ARCH D

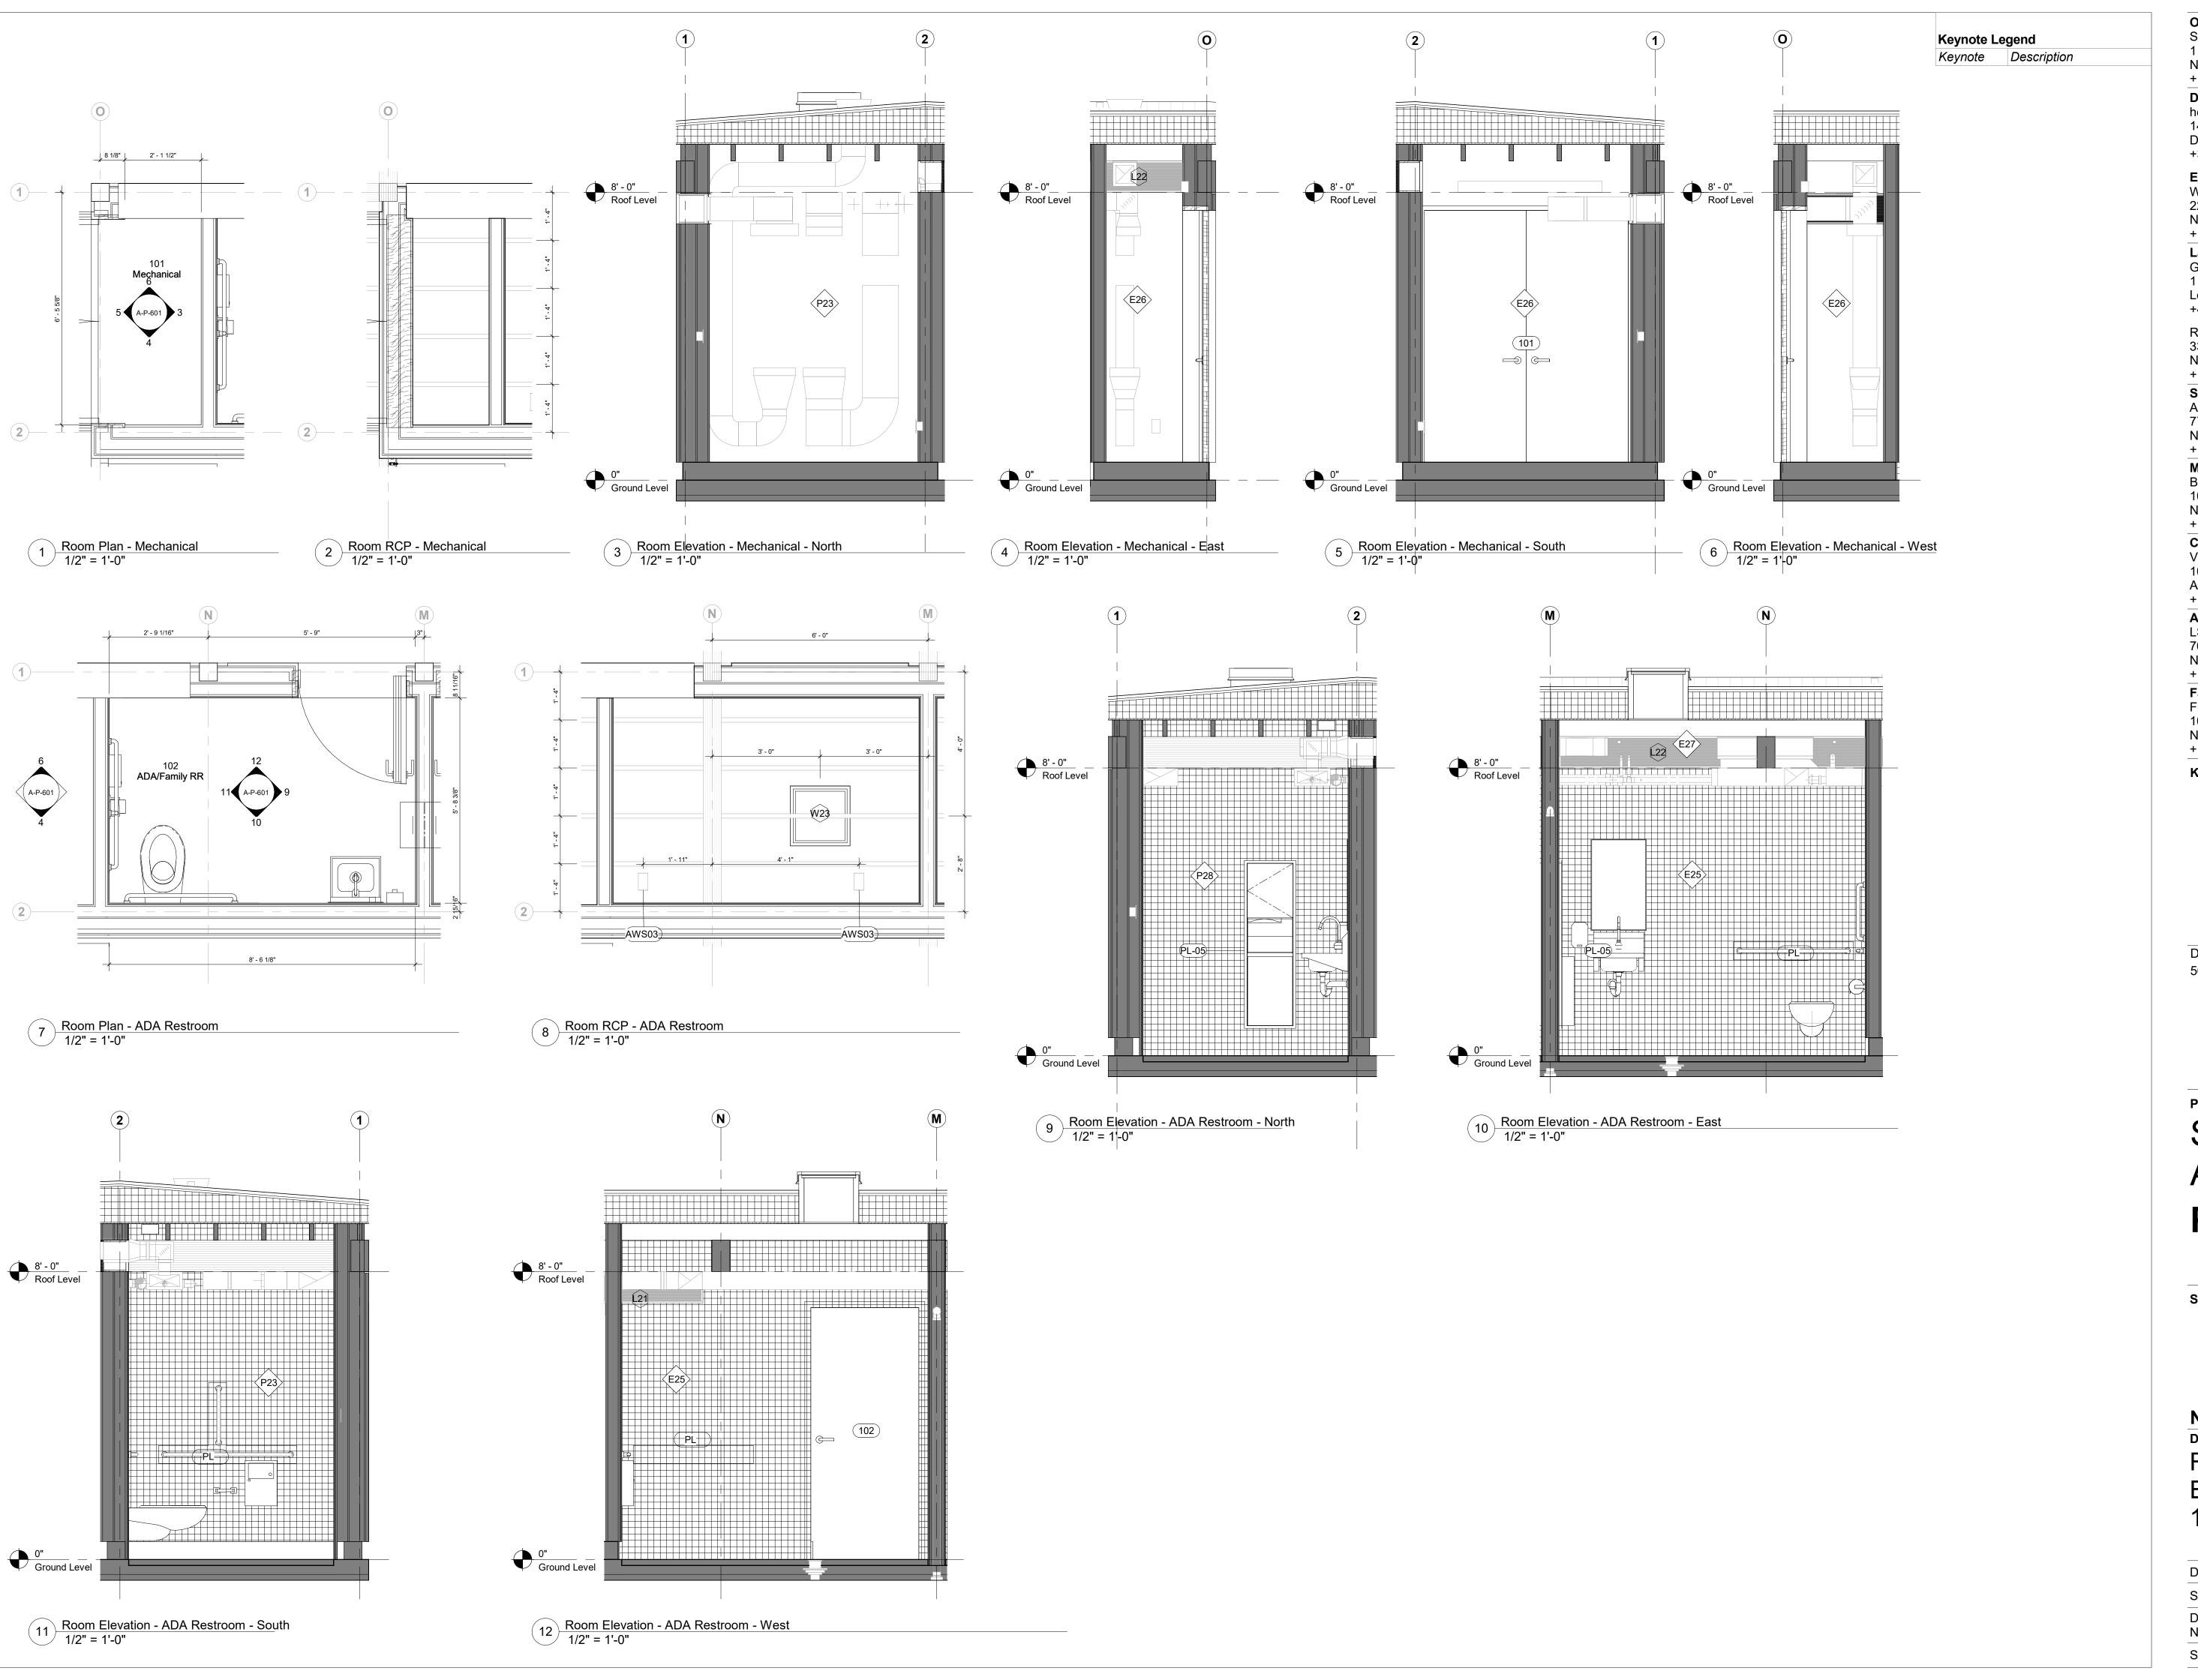

Storm King Art Center 1 Museum Road

New Windsor, NY 12553 +1 (845) 534-3115

Design Architect heneghan peng architects 14-16 Lord Edward Street Dublin, D02 YC63 +353 1 633 9000

Executive Architect WXY Architecture + Urban Design 224 Centre Street, 5th Floor New York, NY 10013 +1 (212) 219-1953

Landscape Architect Gustafson Porter + Bowman 1 Cobham Mews London, MW1 9SB +44 020 7284 8950

Reed Hilderbrand LLC 33 Whitney Avenue, 3rd Floor New Haven, CT 06510 +1 (617) 923-2422

Structural & Lighting ARUP 77 Water Street

New York, NY 10005 +1 (212) 896-3000 MEPF & IT

BuroHappold 100 Broadway #23 New York, NY 10005 +1 (212) 616-0228

Civil VHB

100 Great Oaks Blvd., Suite 118 Albany, NY 12203 +1 (518) 389-3606

AV & Acoustics LSTN Consultants 76 Beaver Street, 2nd Floor New York, NY 10005 +1 (347) 788-0810

Facade Front Inc. 100 E. Broadway Street, #501 New York, NY 10002 +1 (212) 242-2220


Key Plan

Description 50% Construction Documents 11/06/20

Project Storm King Art Center **Pond Pavilion**

NOT FOR CONSTRUCTION Drawing Title Room Plans & Elevations - 101 & 102

11/06/20
1/2" = 1'-0"
A-P-601
ARCH D

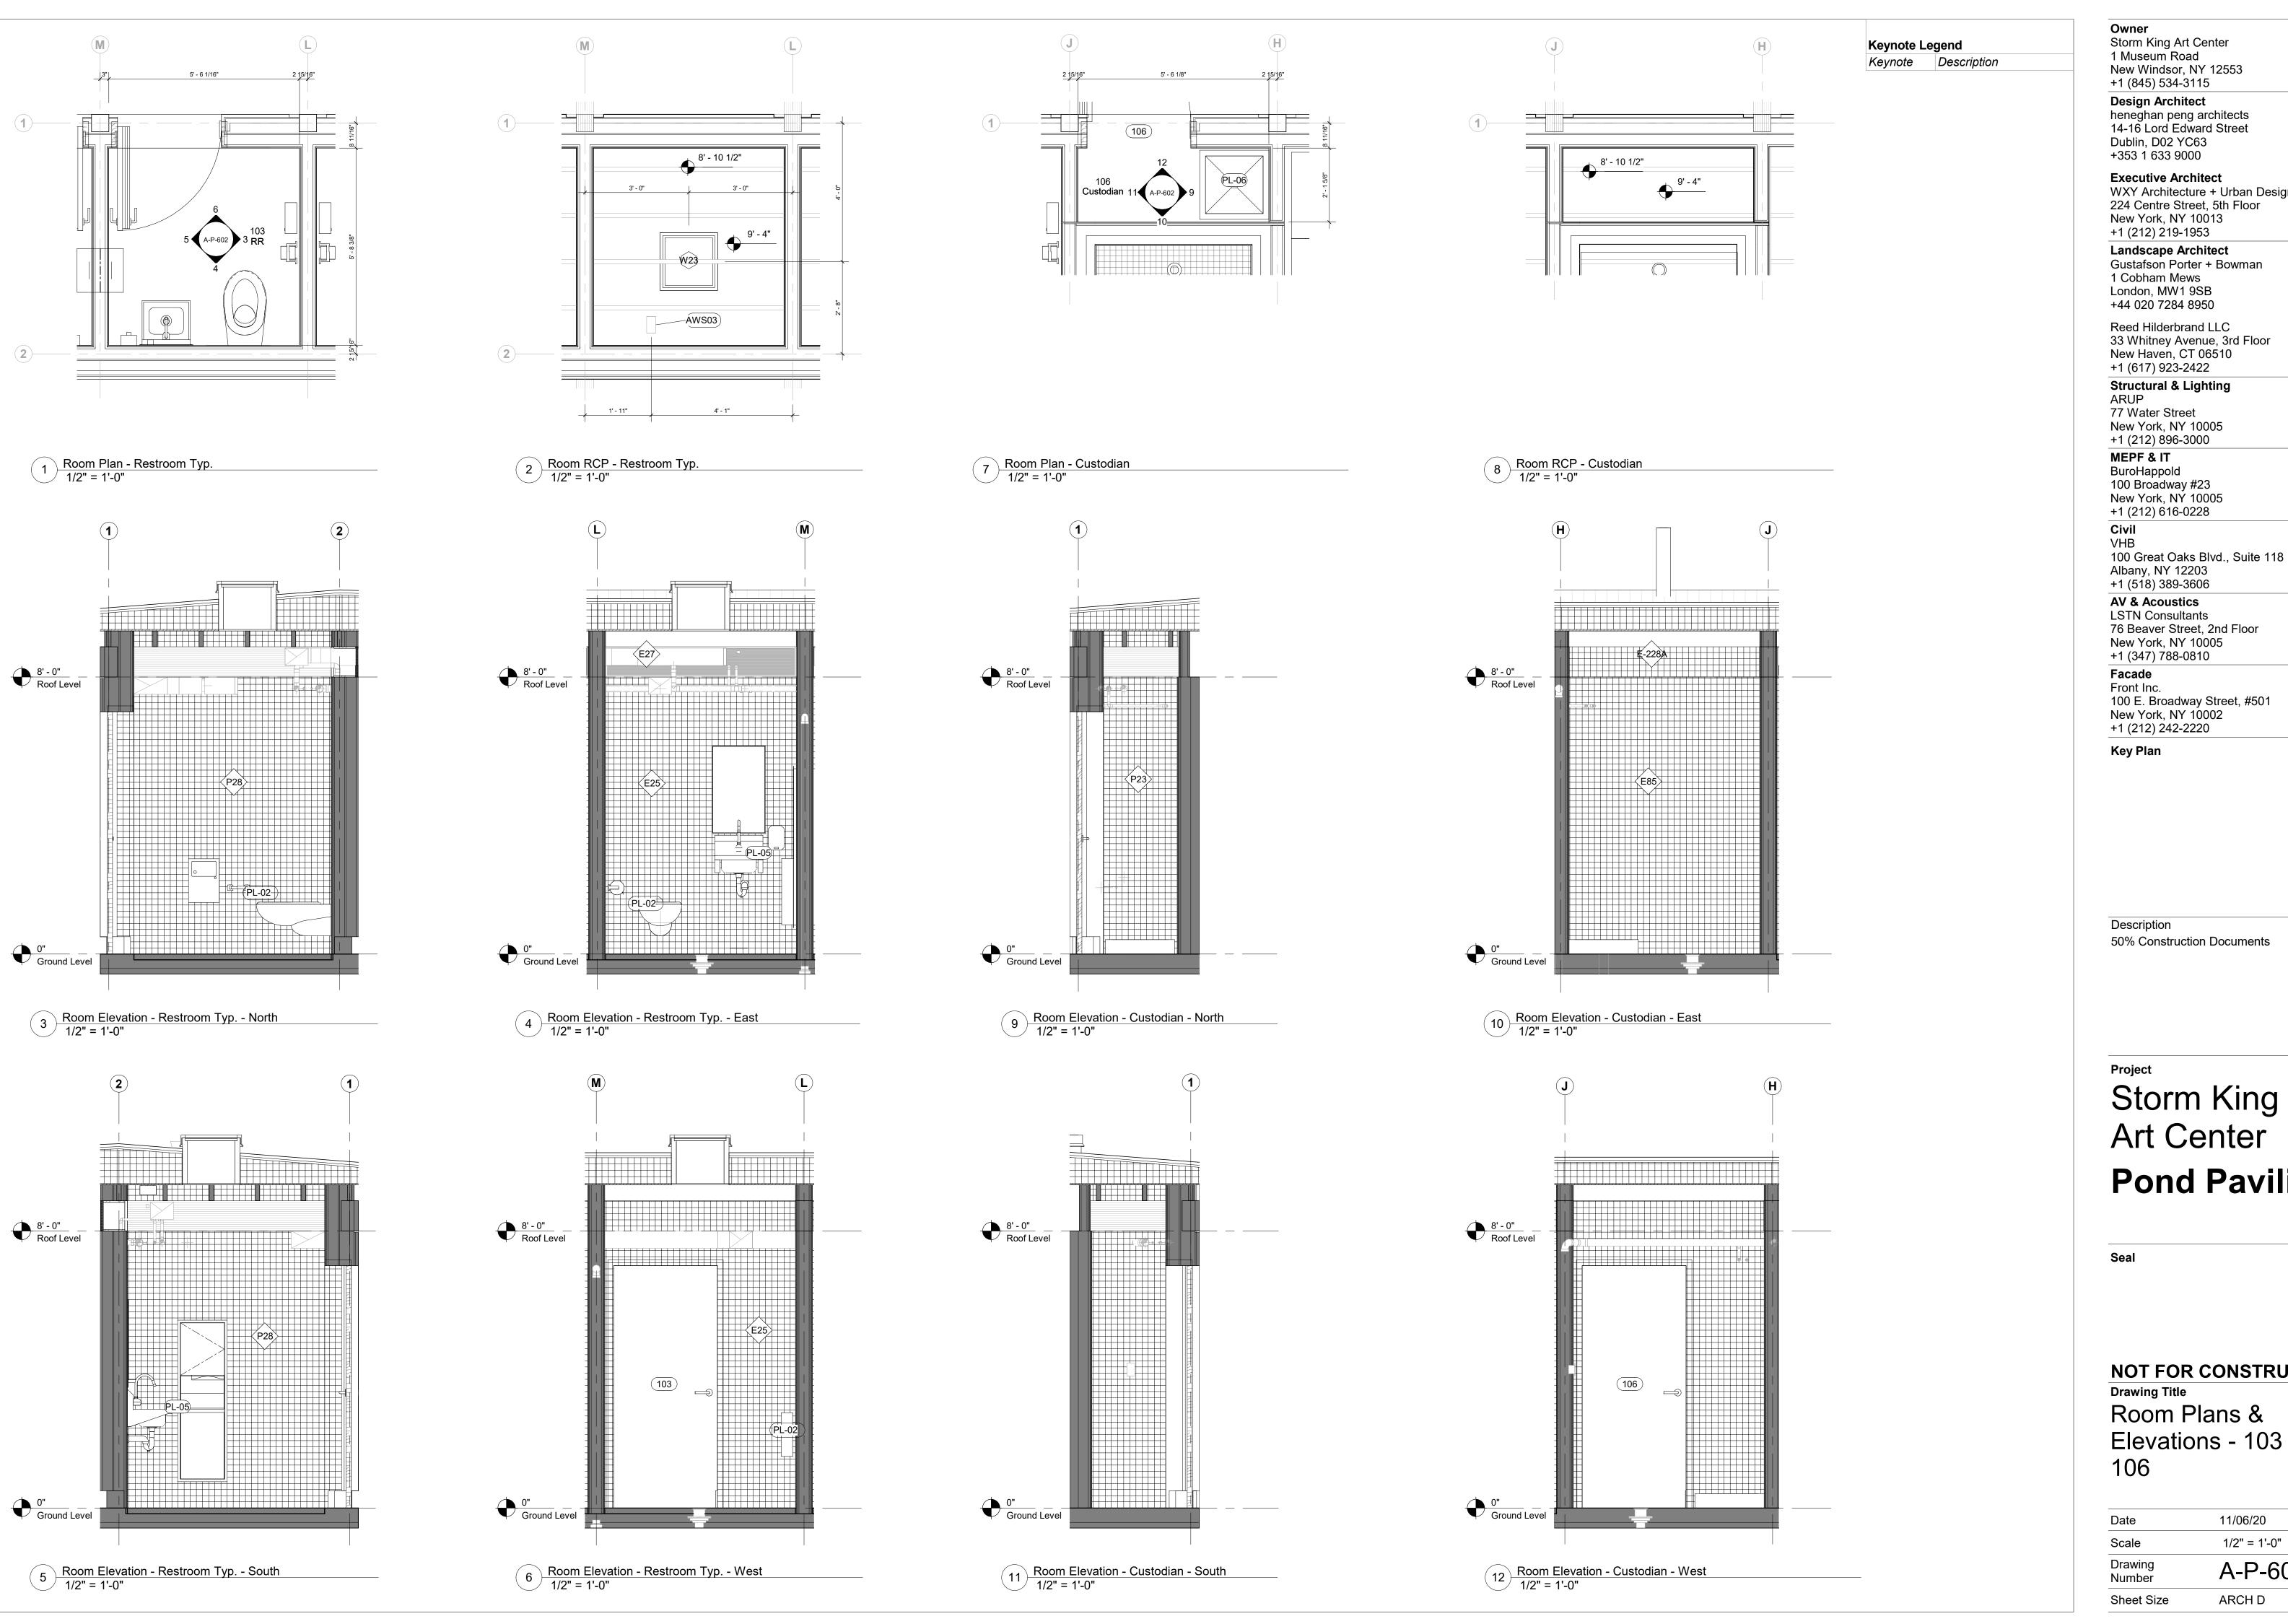

Storm King Art Center 1 Museum Road

New Windsor, NY 12553 +1 (845) 534-3115

Design Architect heneghan peng architects 14-16 Lord Edward Street Dublin, D02 YC63 +353 1 633 9000

Executive Architect WXY Architecture + Urban Design 224 Centre Street, 5th Floor New York, NY 10013 +1 (212) 219-1953

Landscape Architect Gustafson Porter + Bowman 1 Cobham Mews London, MW1 9SB +44 020 7284 8950

Reed Hilderbrand LLC 33 Whitney Avenue, 3rd Floor New Haven, CT 06510 +1 (617) 923-2422

Structural & Lighting ARUP 77 Water Street New York, NY 10005

+1 (212) 896-3000 MEPF & IT BuroHappold

100 Broadway #23 New York, NY 10005 +1 (212) 616-0228

Civil VHB

+1 (518) 389-3606 **AV & Acoustics** LSTN Consultants 76 Beaver Street, 2nd Floor

New York, NY 10005 +1 (347) 788-0810 Facade Front Inc. 100 E. Broadway Street, #501


Key Plan

Description 50% Construction Documents

Project Storm King Art Center **Pond Pavilion**

NOT FOR CONSTRUCTION Drawing Title Room Plans & Elevations - 103 & 106

Date	11/06/20
Scale	1/2" = 1'-0"
Drawing Number	A-P-602
Sheet Size	ARCH D

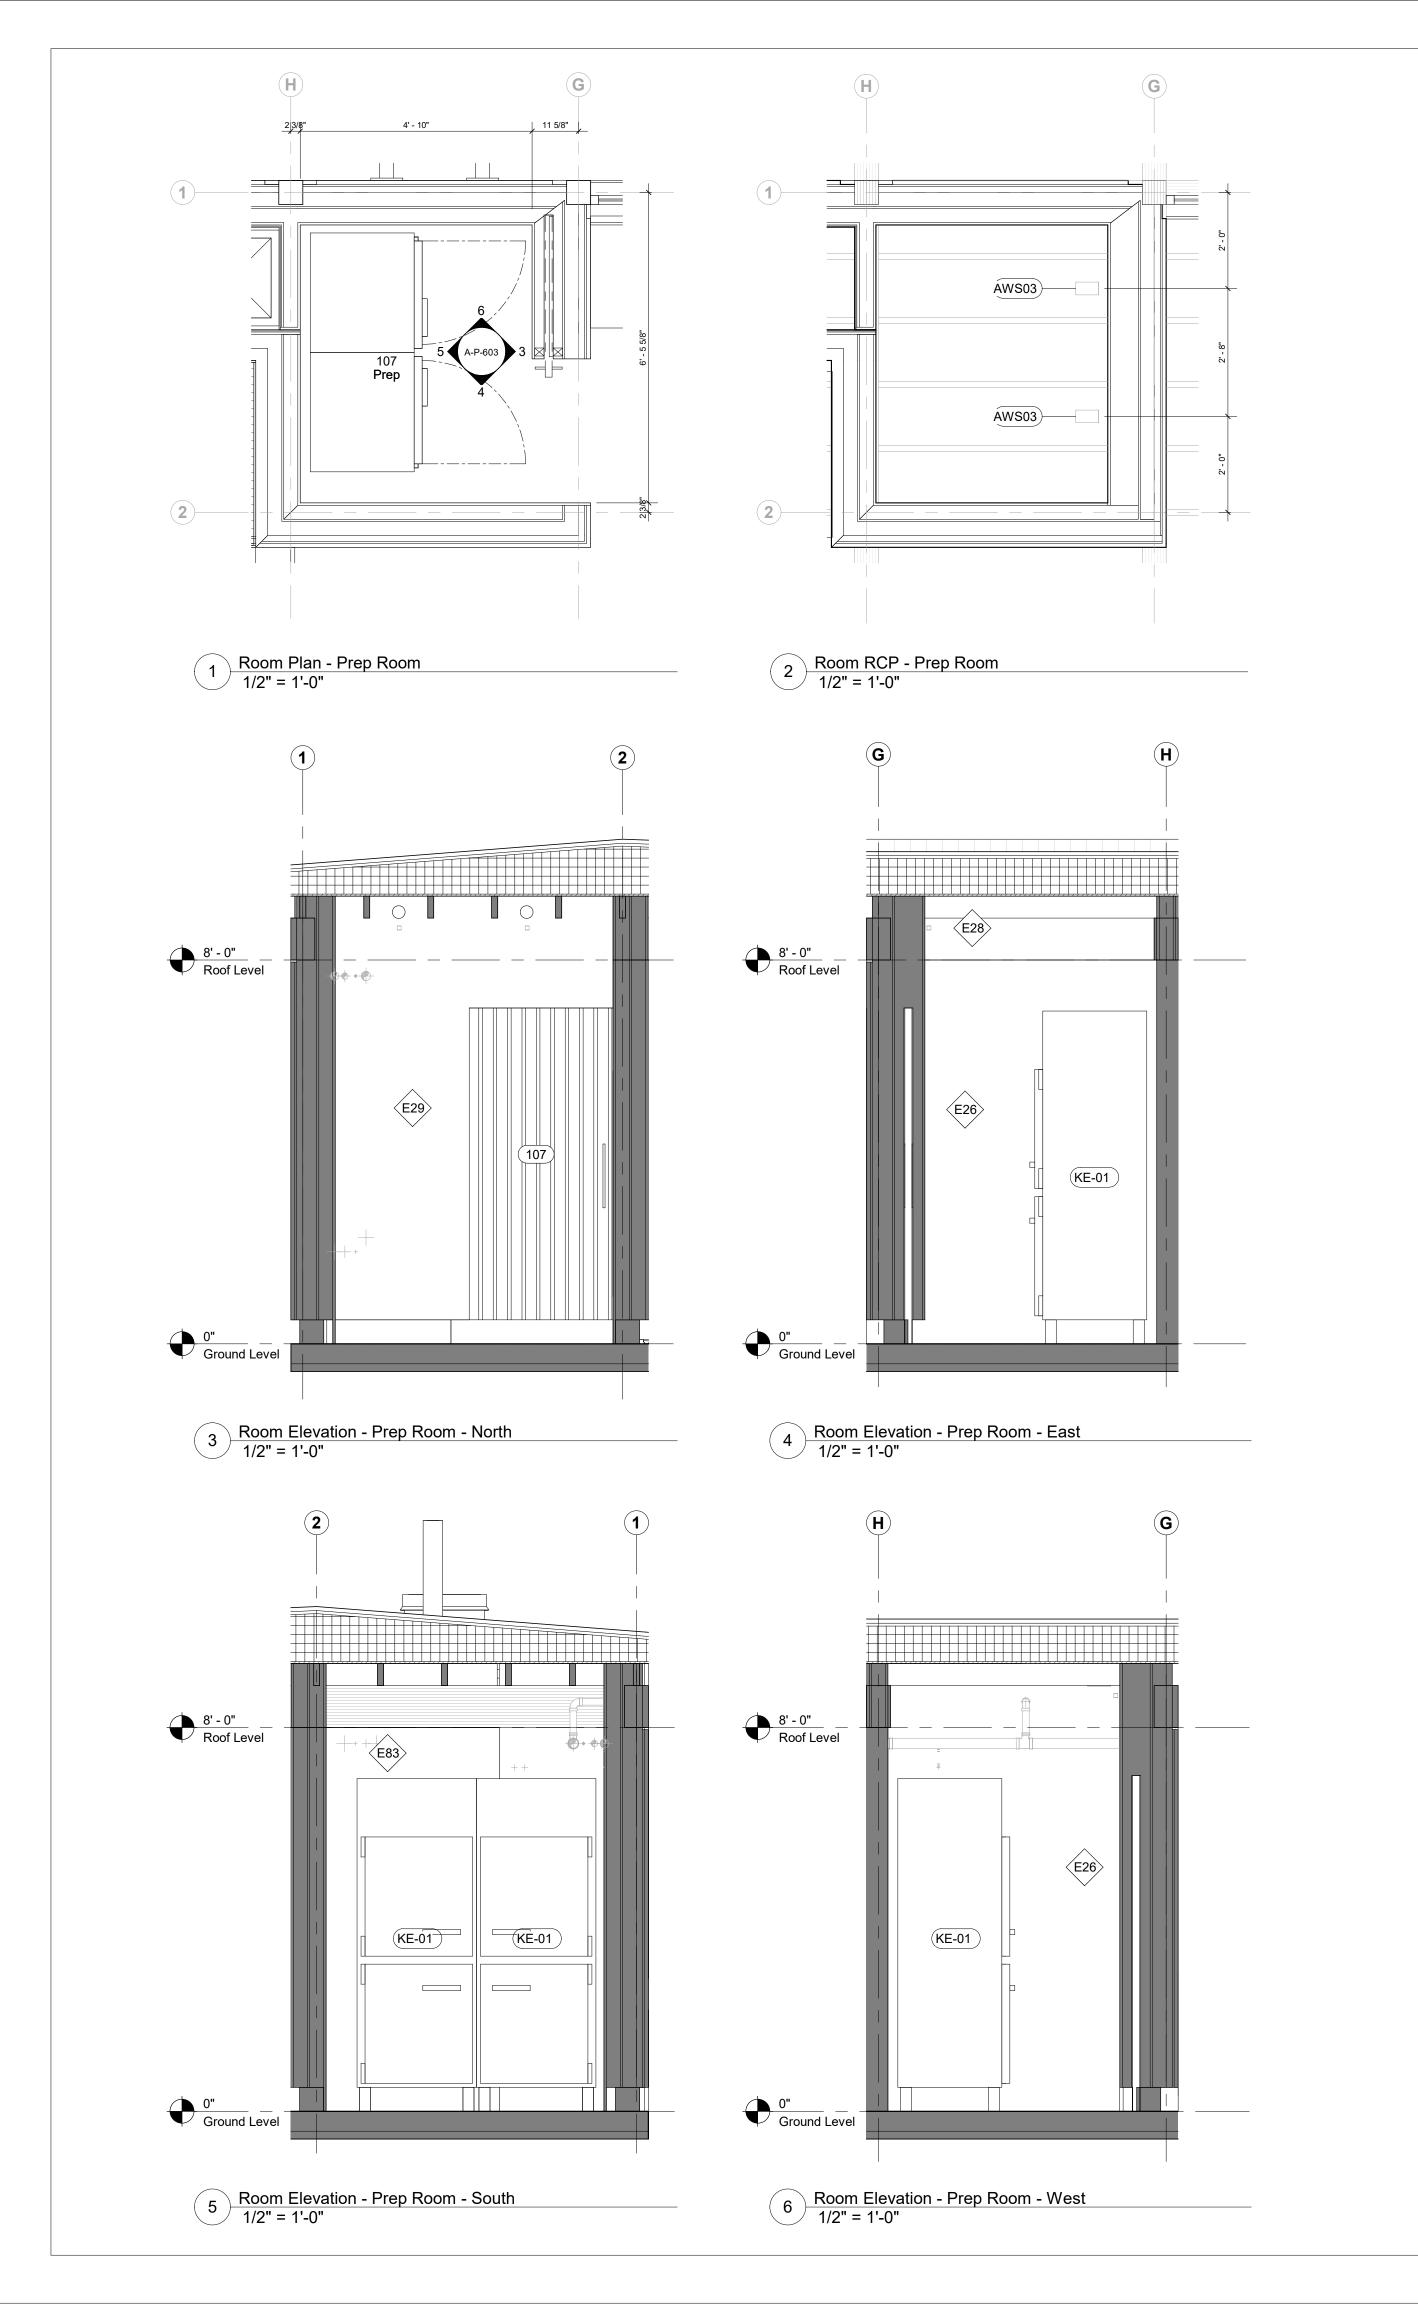

Keynote Legend

Keynote Description

Storm King Art Center
1 Museum Road
New Windsor, NY 12553
+1 (845) 534-3115

Design Architect
heneghan peng architects
14-16 Lord Edward Street
Dublin, D02 YC63

+353 1 633 9000

Executive Architect
WXY Architecture + Urban Design
224 Centre Street, 5th Floor
New York, NY 10013
+1 (212) 219-1953

Landscape Architect
Gustafson Porter + Bowman
1 Cobham Mews
London, MW1 9SB

+44 020 7284 8950

Reed Hilderbrand LLC
33 Whitney Avenue, 3rd Floor
New Haven, CT 06510
+1 (617) 923-2422

Structural & Lighting
ARUP
77 Water Street

New York, NY 10005 +1 (212) 896-3000 MEPF & IT

BuroHappold 100 Broadway #23 New York, NY 10005 +1 (212) 616-0228

New York, NY 10005 +1 (212) 616-0228 Civil VHB

100 Great Oaks Blvd., Suite 118 Albany, NY 12203 +1 (518) 389-3606

AV & Acoustics
LSTN Consultants
76 Beaver Street, 2nd Floor
New York, NY 10005
+1 (347) 788-0810

Facade
Front Inc.
100 E. Broadway Street, #501
New York, NY 10002
+1 (212) 242-2220

Key Plan



Description Date 50% Construction Documents 11/06/20

Project

Storm King Art Center Pond Pavilion

Seal


NOT FOR CONSTRUCTION

Drawing Title

Room Plans &

Elevations - 107

Date	11/06/20
Scale	1/2" = 1'-0"
Drawing Number	A-P-603
Sheet Size	ARCH D

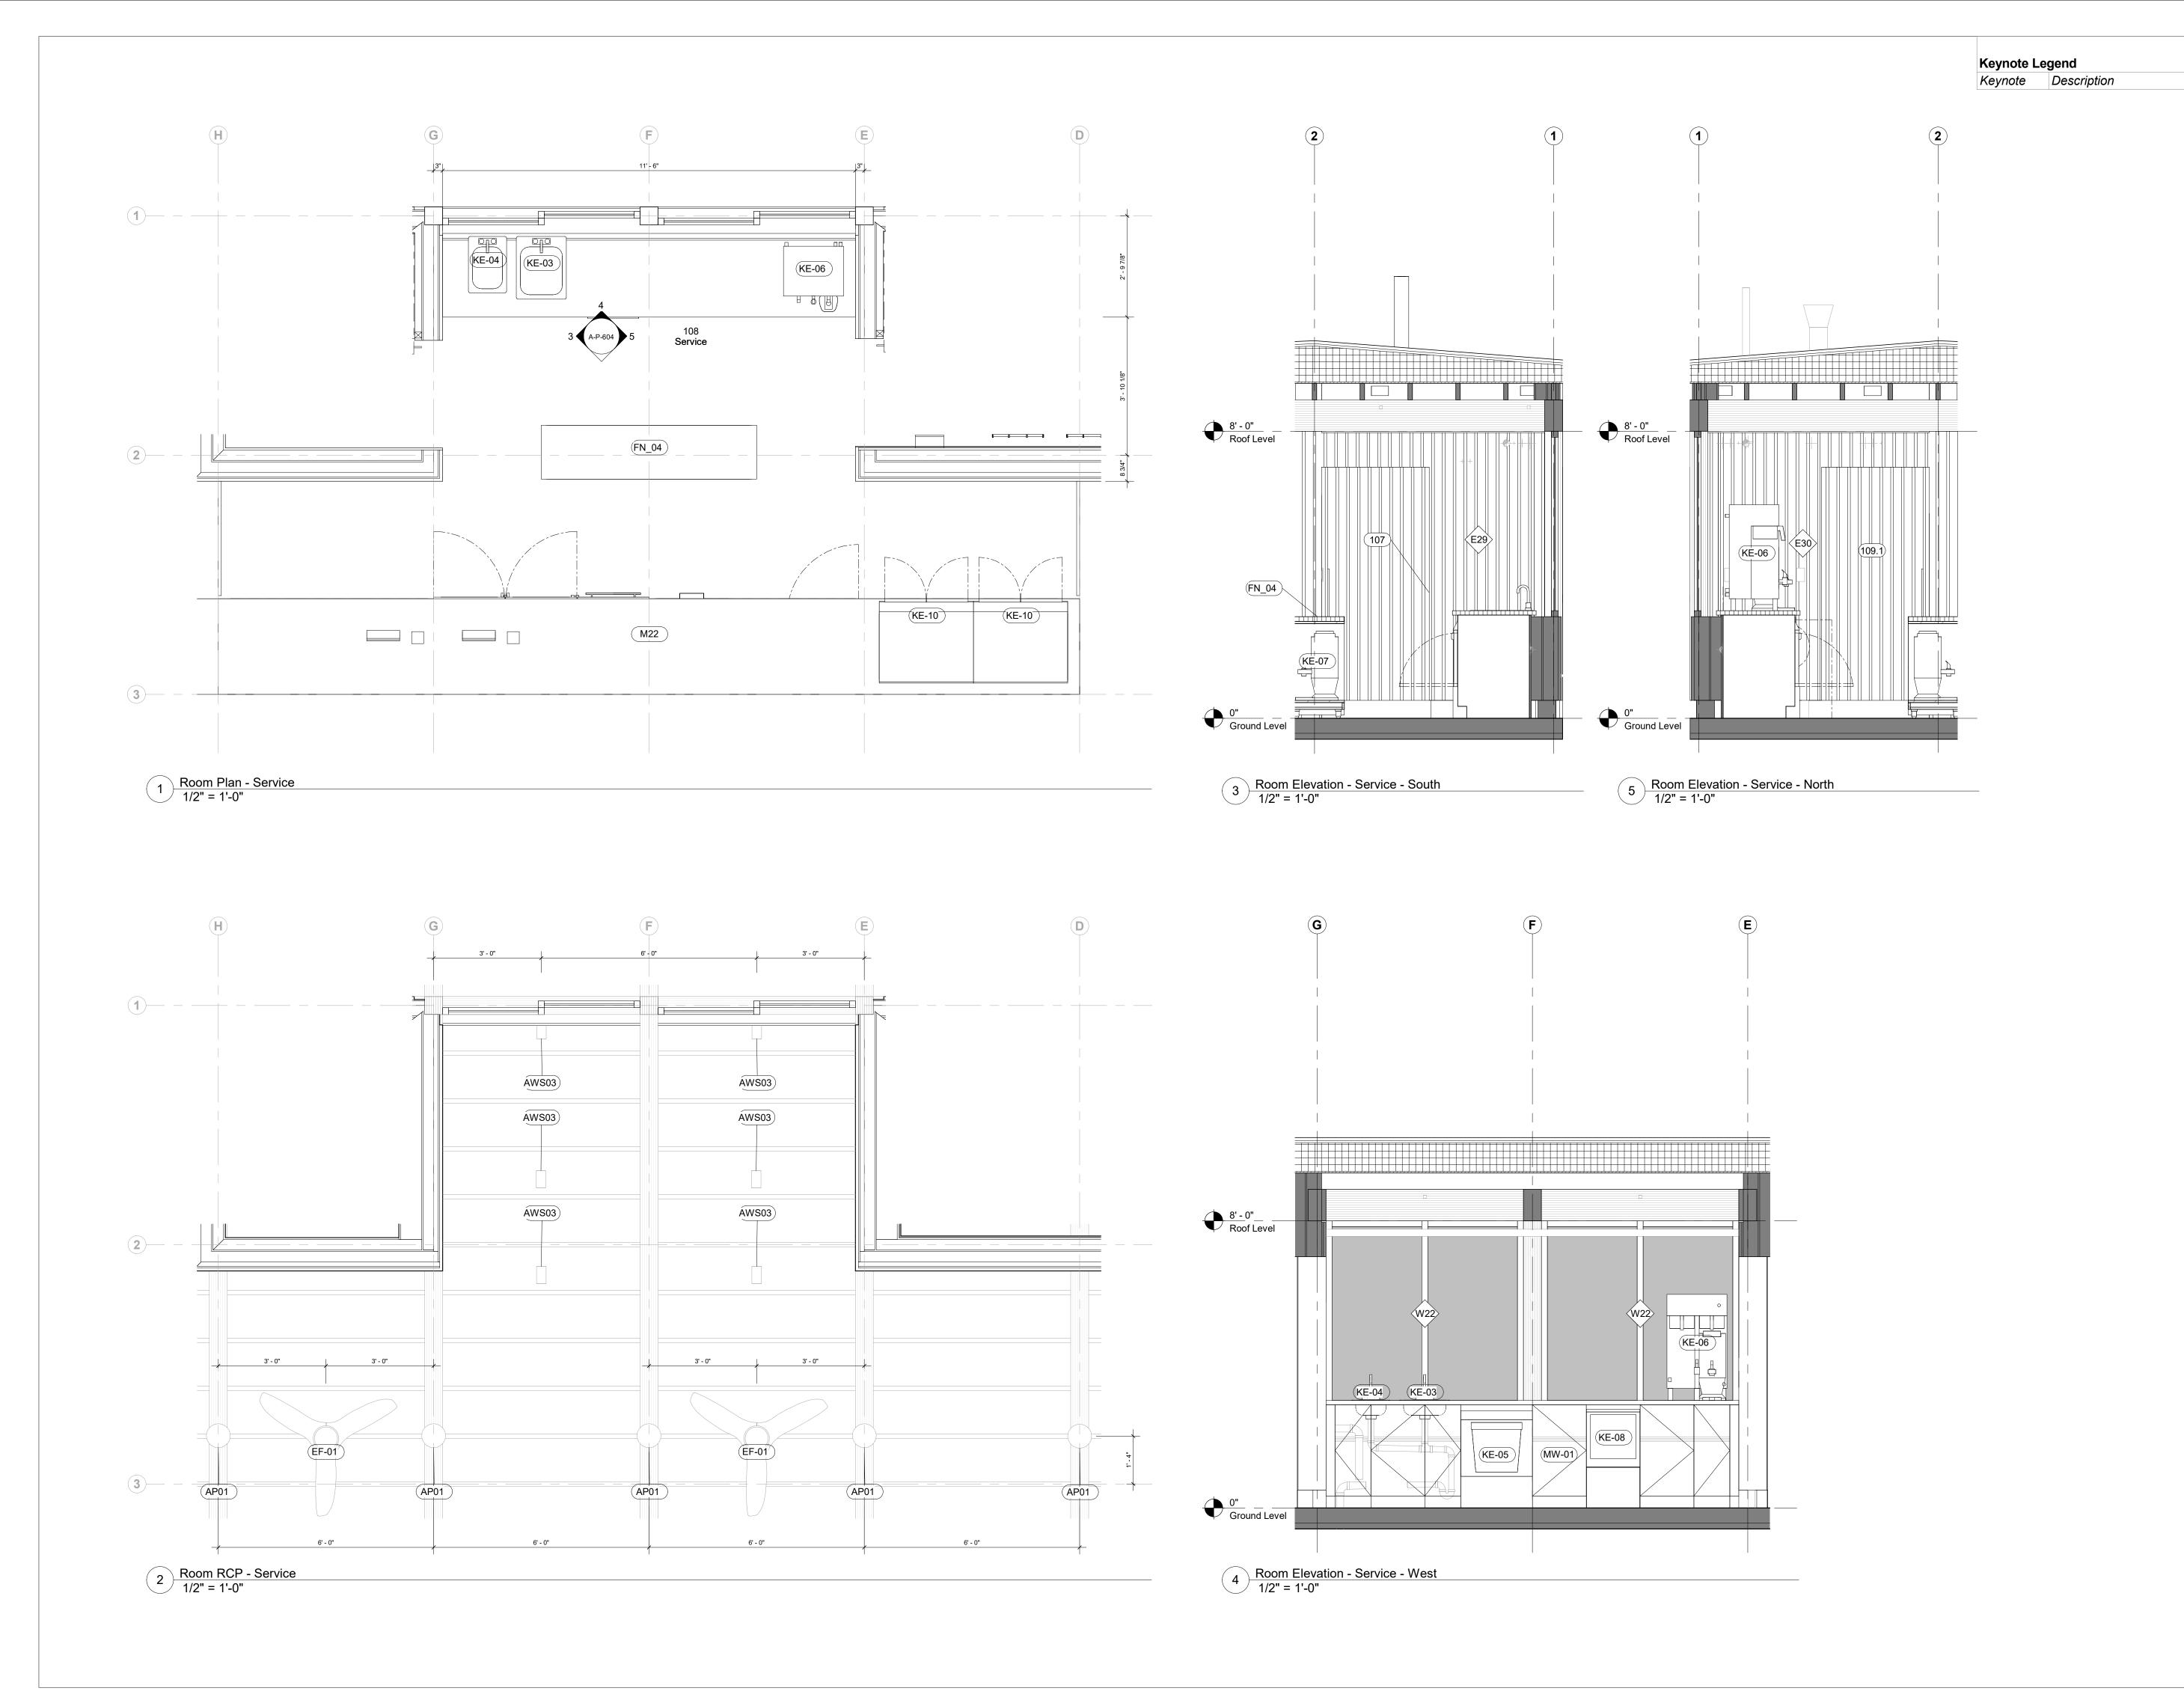

Owner
Storm King A

Storm King Art Center 1 Museum Road New Windsor, NY 12553 +1 (845) 534-3115

Design Architect
heneghan peng architects
14-16 Lord Edward Street
Dublin, D02 YC63
+353 1 633 9000

Executive Architect
WXY Architecture + Ui

WXY Architecture + Urban Design 224 Centre Street, 5th Floor New York, NY 10013 +1 (212) 219-1953

Landscape Architect
Gustafson Porter + Bowman
1 Cobham Mews
London, MW1 9SB
+44 020 7284 8950

Reed Hilderbrand LLC 33 Whitney Avenue, 3rd Floor New Haven, CT 06510 +1 (617) 923-2422

Structural & Lighting
ARUP
77 Water Street

New York, NY 10005 +1 (212) 896-3000 MEPF & IT

BuroHappold 100 Broadway #23 New York, NY 10005 +1 (212) 616-0228

+1 (212) 616-0228 Civil

VHB 100 Great Oaks Blvd., Suite 118 Albany, NY 12203

+1 (518) 389-3606

AV & Acoustics
LSTN Consultants
76 Beaver Street, 2nd Floor
New York, NY 10005

76 Beaver Street, 2nd Floor New York, NY 10005 +1 (347) 788-0810 Facade

Front Inc. 100 E. Broadway Street, #501 New York, NY 10002 +1 (212) 242-2220

Key Plan



Description Date 50% Construction Documents 11/06/20

Storm King
Art Center

Pond Pavilion

Seal


NOT FOR CONSTRUCTION

Drawing Title

Room Plans &

Elevations - 108

Date	11/06/20
Scale	1/2" = 1'-0"
Drawing Number	A-P-604
Sheet Size	ARCH D

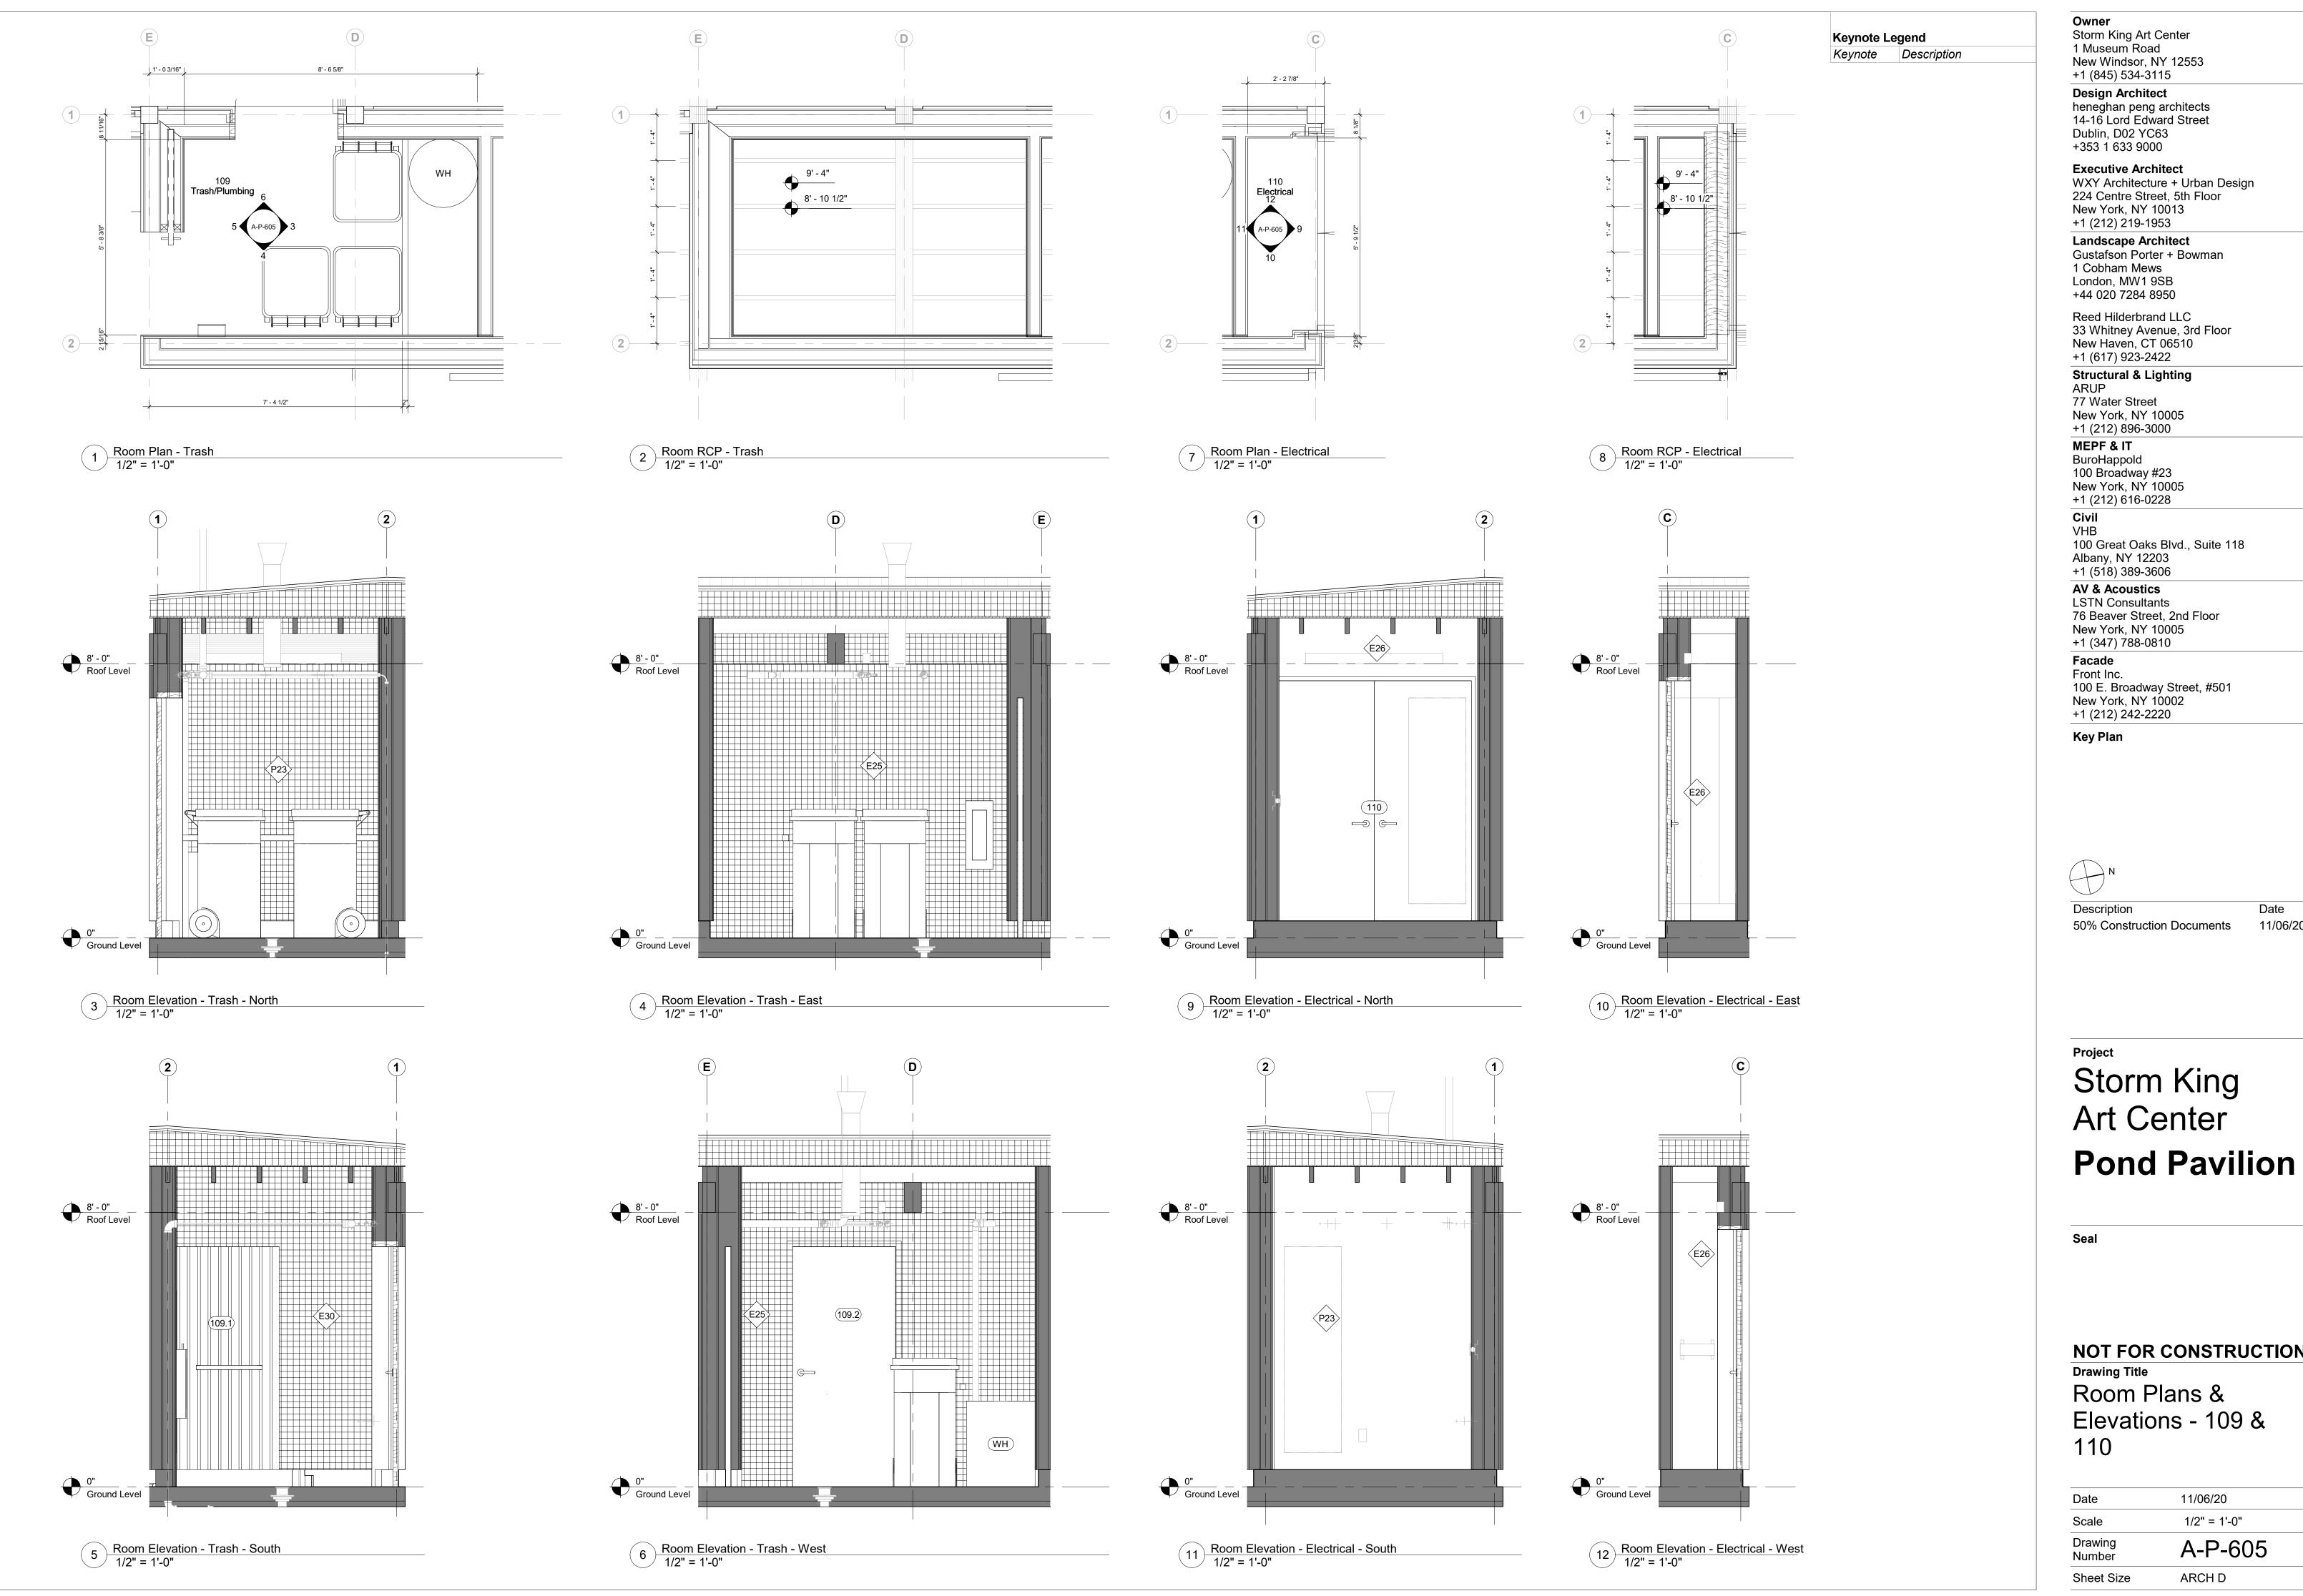

Storm King Art Center

1 Museum Road New Windsor, NY 12553 +1 (845) 534-3115

Design Architect heneghan peng architects 14-16 Lord Edward Street Dublin, D02 YC63 +353 1 633 9000

Executive Architect WXY Architecture + Urban Design 224 Centre Street, 5th Floor New York, NY 10013 +1 (212) 219-1953

Landscape Architect Gustafson Porter + Bowman 1 Cobham Mews London, MW1 9SB +44 020 7284 8950

Reed Hilderbrand LLC 33 Whitney Avenue, 3rd Floor New Haven, CT 06510 +1 (617) 923-2422

Structural & Lighting ARUP 77 Water Street

New York, NY 10005 +1 (212) 896-3000 MEPF & IT

BuroHappold 100 Broadway #23 New York, NY 10005 +1 (212) 616-0228

Civil VHB 100 Great Oaks Blvd., Suite 118 Albany, NY 12203

+1 (518) 389-3606 **AV & Acoustics** LSTN Consultants 76 Beaver Street, 2nd Floor New York, NY 10005

Facade Front Inc. 100 E. Broadway Street, #501 New York, NY 10002 +1 (212) 242-2220

Key Plan




Description 50% Construction Documents 11/06/20

Project Storm King Art Center

NOT FOR CONSTRUCTION Drawing Title Room Plans & Elevations - 109 & 110

Date	11/06/20
Scale	1/2" = 1'-0"
Drawing Number	A-P-605
Sheet Size	ARCH D

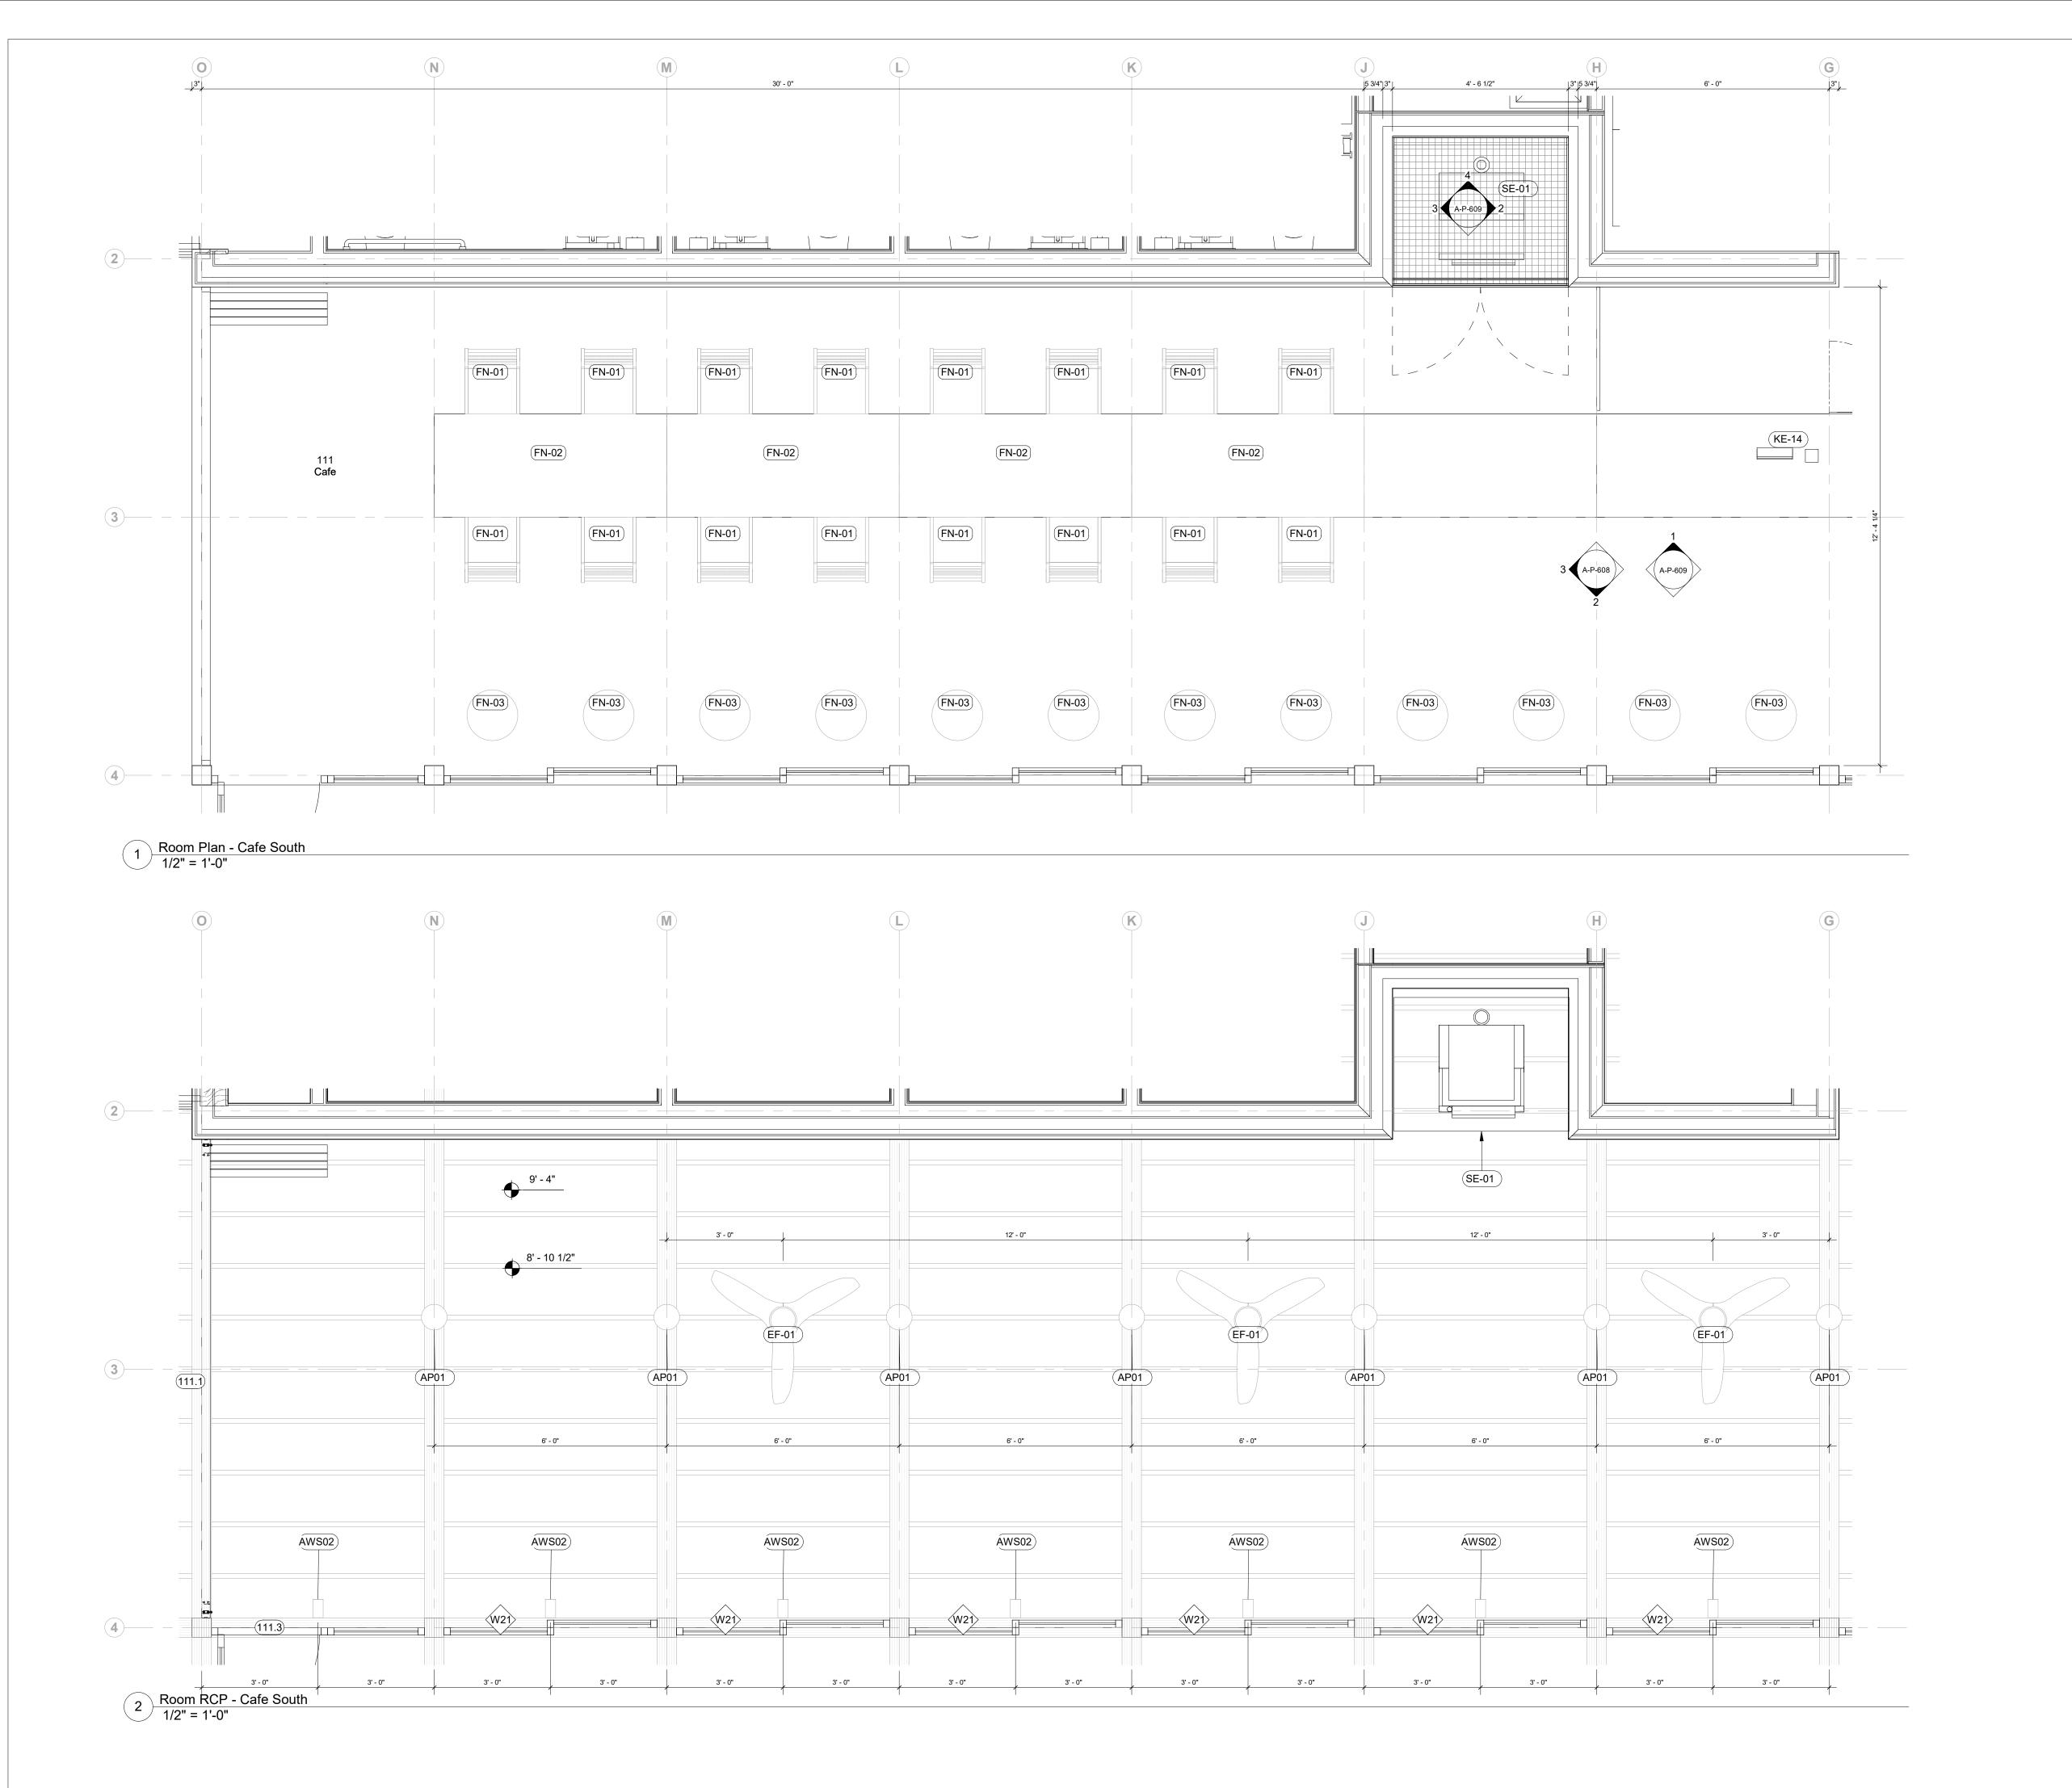

Keynote Legend

Keynote Description

Storm King Art Center

1 Museum Road New Windsor, NY 12553 +1 (845) 534-3115

Design Architect heneghan peng architects 14-16 Lord Edward Street Dublin, D02 YC63 +353 1 633 9000

Executive Architect WXY Architecture + Urban Design 224 Centre Street, 5th Floor New York, NY 10013 +1 (212) 219-1953

Landscape Architect Gustafson Porter + Bowman 1 Cobham Mews London, MW1 9SB +44 020 7284 8950

Reed Hilderbrand LLC 33 Whitney Avenue, 3rd Floor New Haven, CT 06510 +1 (617) 923-2422

Structural & Lighting ARUP 77 Water Street New York, NY 10005

+1 (212) 896-3000 MEPF & IT BuroHappold 100 Broadway #23

New York, NY 10005 +1 (212) 616-0228 Civil

VHB 100 Great Oaks Blvd., Suite 118 Albany, NY 12203 +1 (518) 389-3606

AV & Acoustics LSTN Consultants 76 Beaver Street, 2nd Floor New York, NY 10005 +1 (347) 788-0810

Facade Front Inc. 100 E. Broadway Street, #501 New York, NY 10002 +1 (212) 242-2220

Key Plan




Description 50% Construction Documents

Storm King Art Center

Pond Pavilion

NOT FOR CONSTRUCTION **Drawing Title** Room Plans - 111

Date	11/06/20
Scale	1/2" = 1'-0"
Drawing Number	A-P-606
Sheet Size	ARCH D

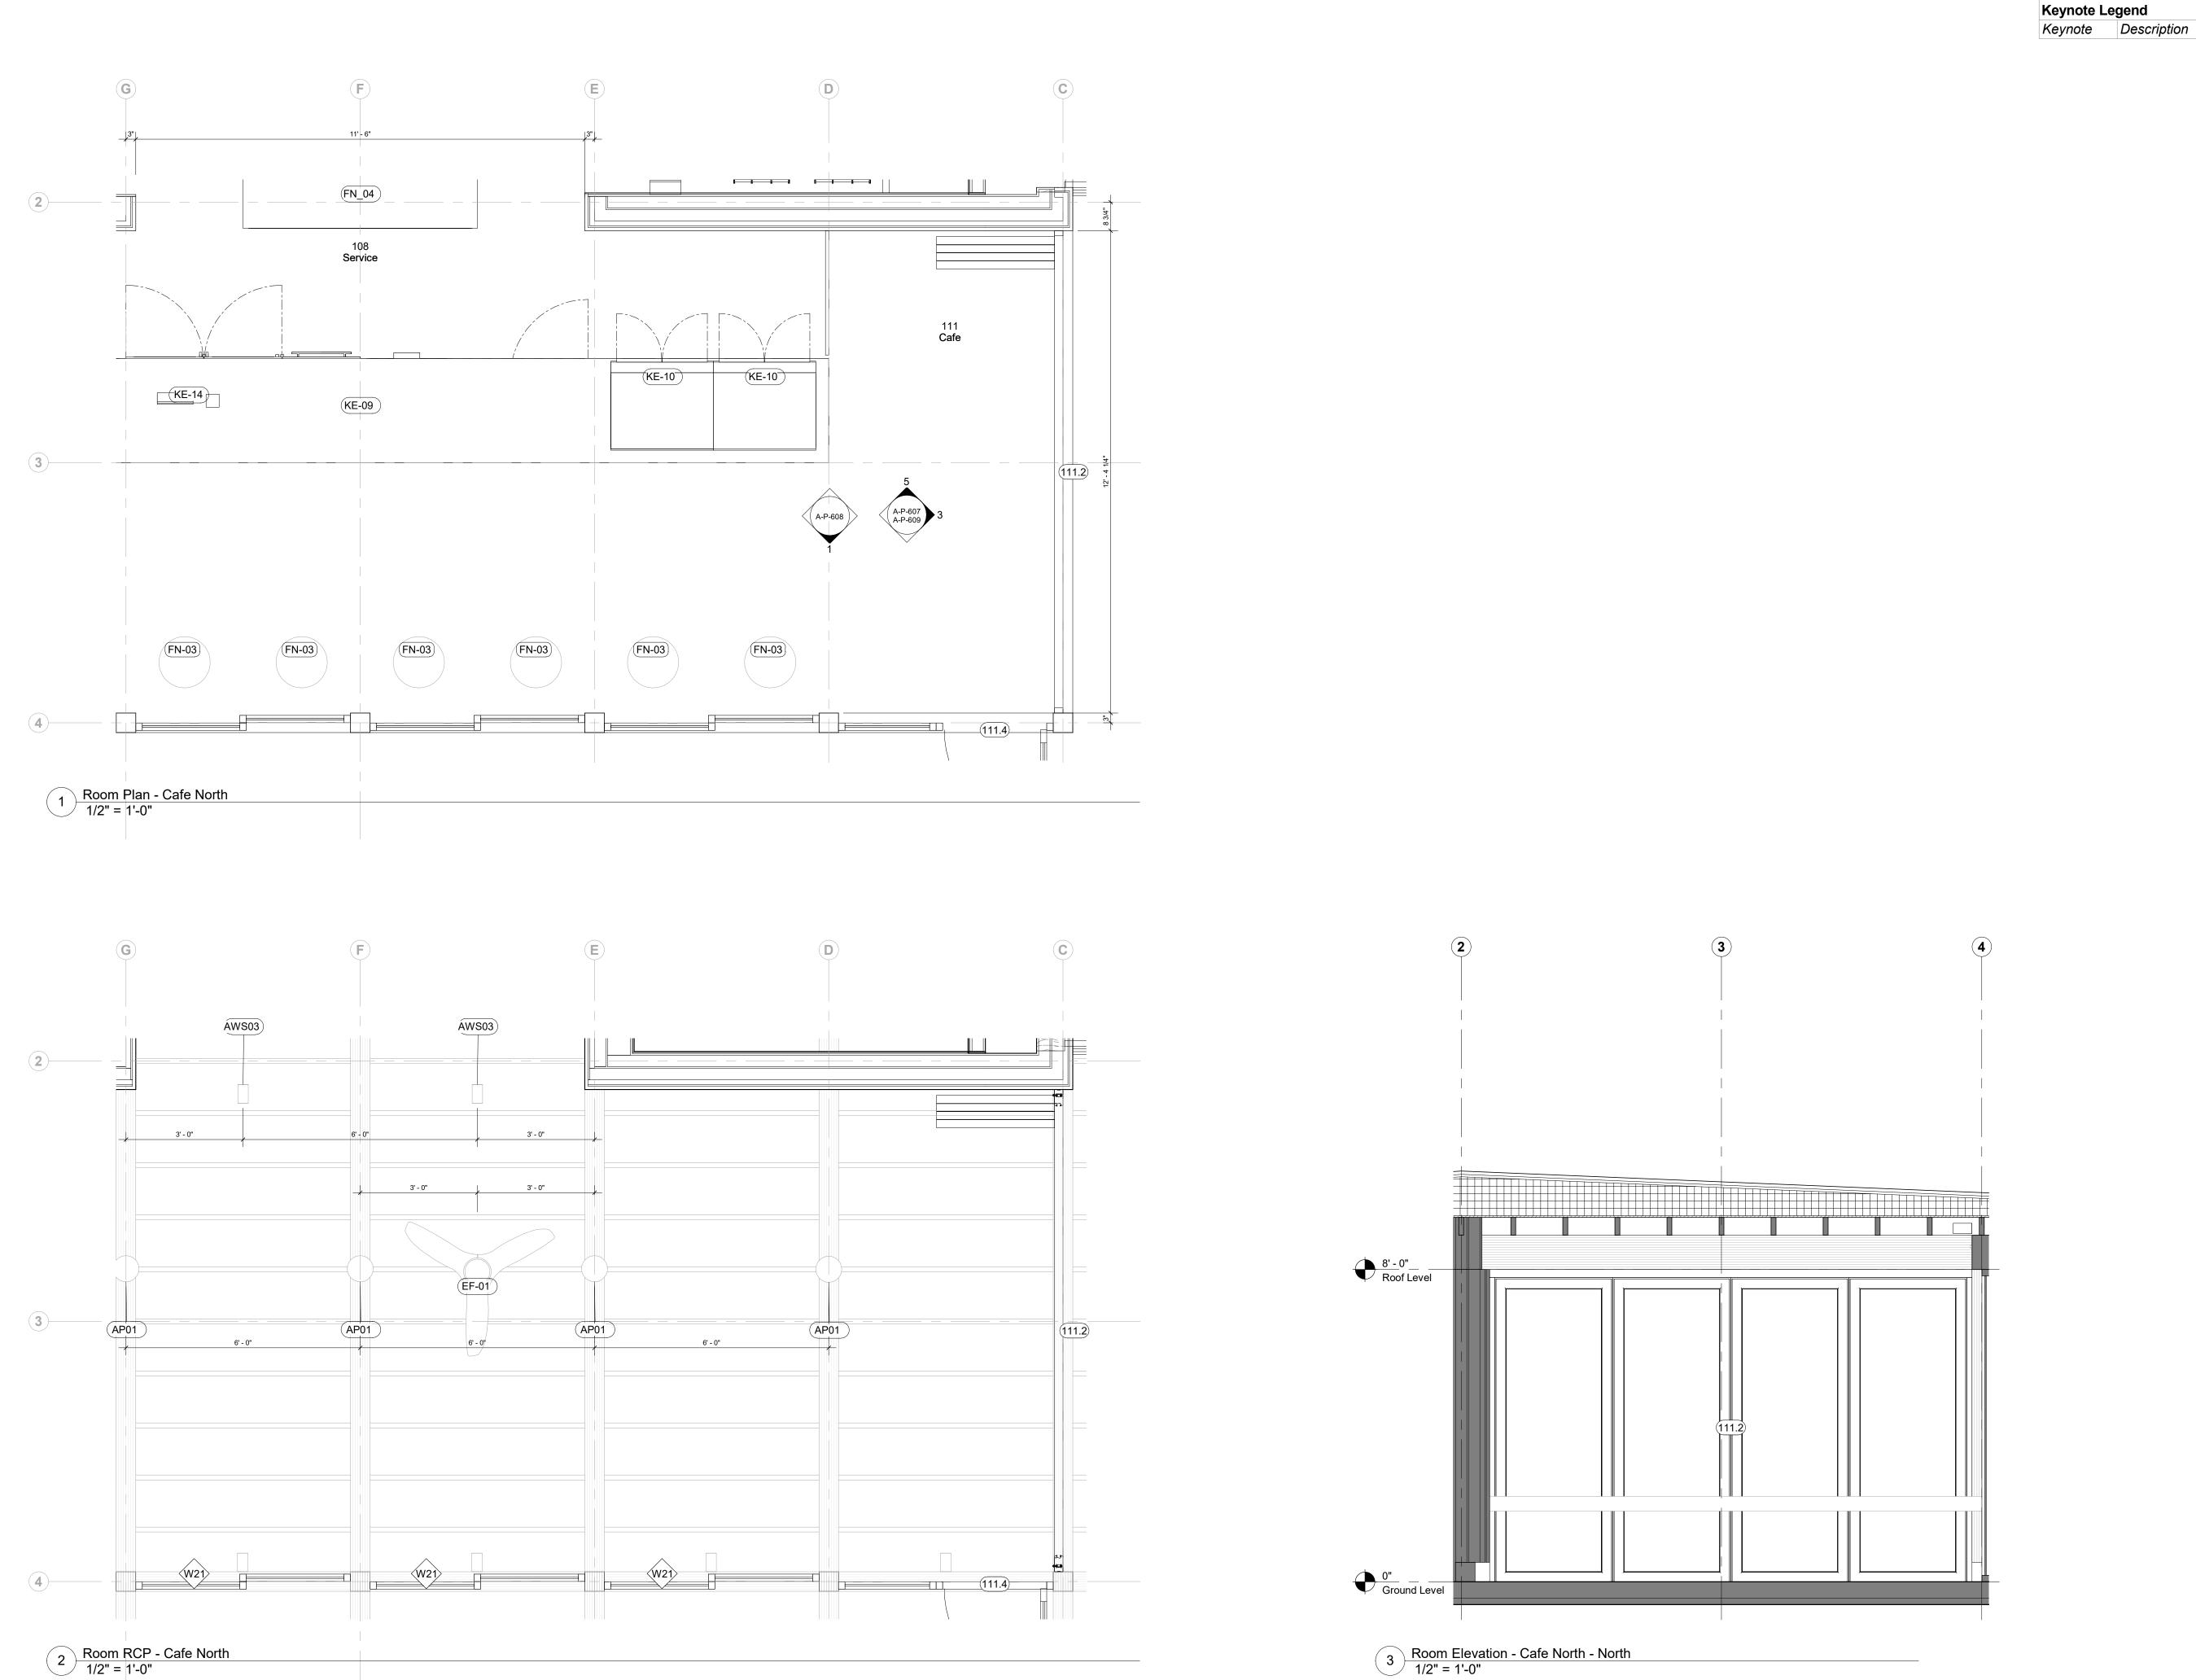

Storm King Art Center 1 Museum Road New Windsor, NY 12553 +1 (845) 534-3115

Design Architect heneghan peng architects 14-16 Lord Edward Street Dublin, D02 YC63 +353 1 633 9000

Executive Architect WXY Architecture + Urban Design 224 Centre Street, 5th Floor New York, NY 10013 +1 (212) 219-1953

Landscape Architect Gustafson Porter + Bowman 1 Cobham Mews London, MW1 9SB +44 020 7284 8950

Reed Hilderbrand LLC 33 Whitney Avenue, 3rd Floor New Haven, CT 06510 +1 (617) 923-2422

Structural & Lighting ARUP 77 Water Street New York, NY 10005 +1 (212) 896-3000

MEPF & IT BuroHappold 100 Broadway #23

New York, NY 10005 +1 (212) 616-0228 Civil

VHB 100 Great Oaks Blvd., Suite 118 Albany, NY 12203 +1 (518) 389-3606

AV & Acoustics LSTN Consultants 76 Beaver Street, 2nd Floor New York, NY 10005 +1 (347) 788-0810

Facade Front Inc. 100 E. Broadway Street, #501 New York, NY 10002 +1 (212) 242-2220

Key Plan





Description 50% Construction Documents 11/06/20

Storm King Art Center **Pond Pavilion**

NOT FOR CONSTRUCTION **Drawing Title** Room Plans & Elevations -111

Date	11/06/20
Scale	1/2" = 1'-0"
Drawing Number	A-P-607
Sheet Size	ARCH D

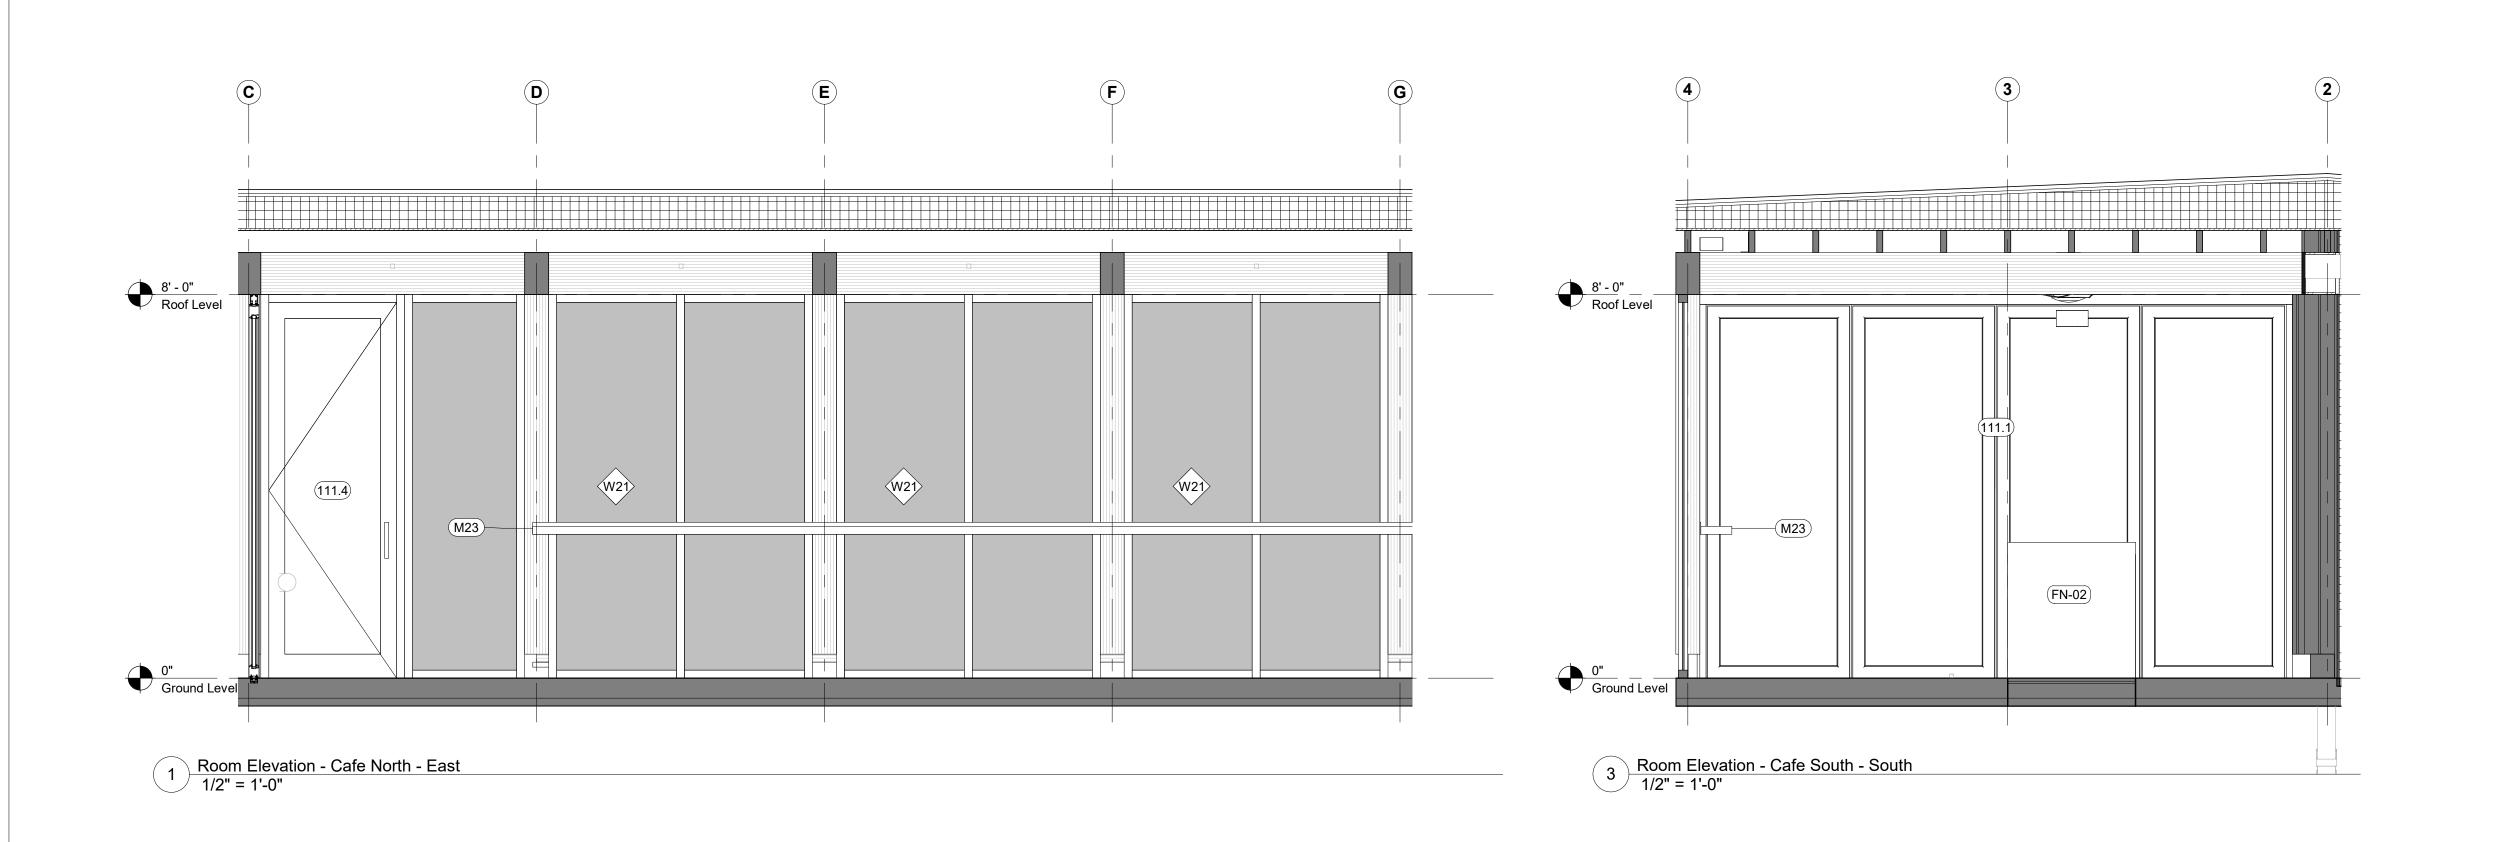

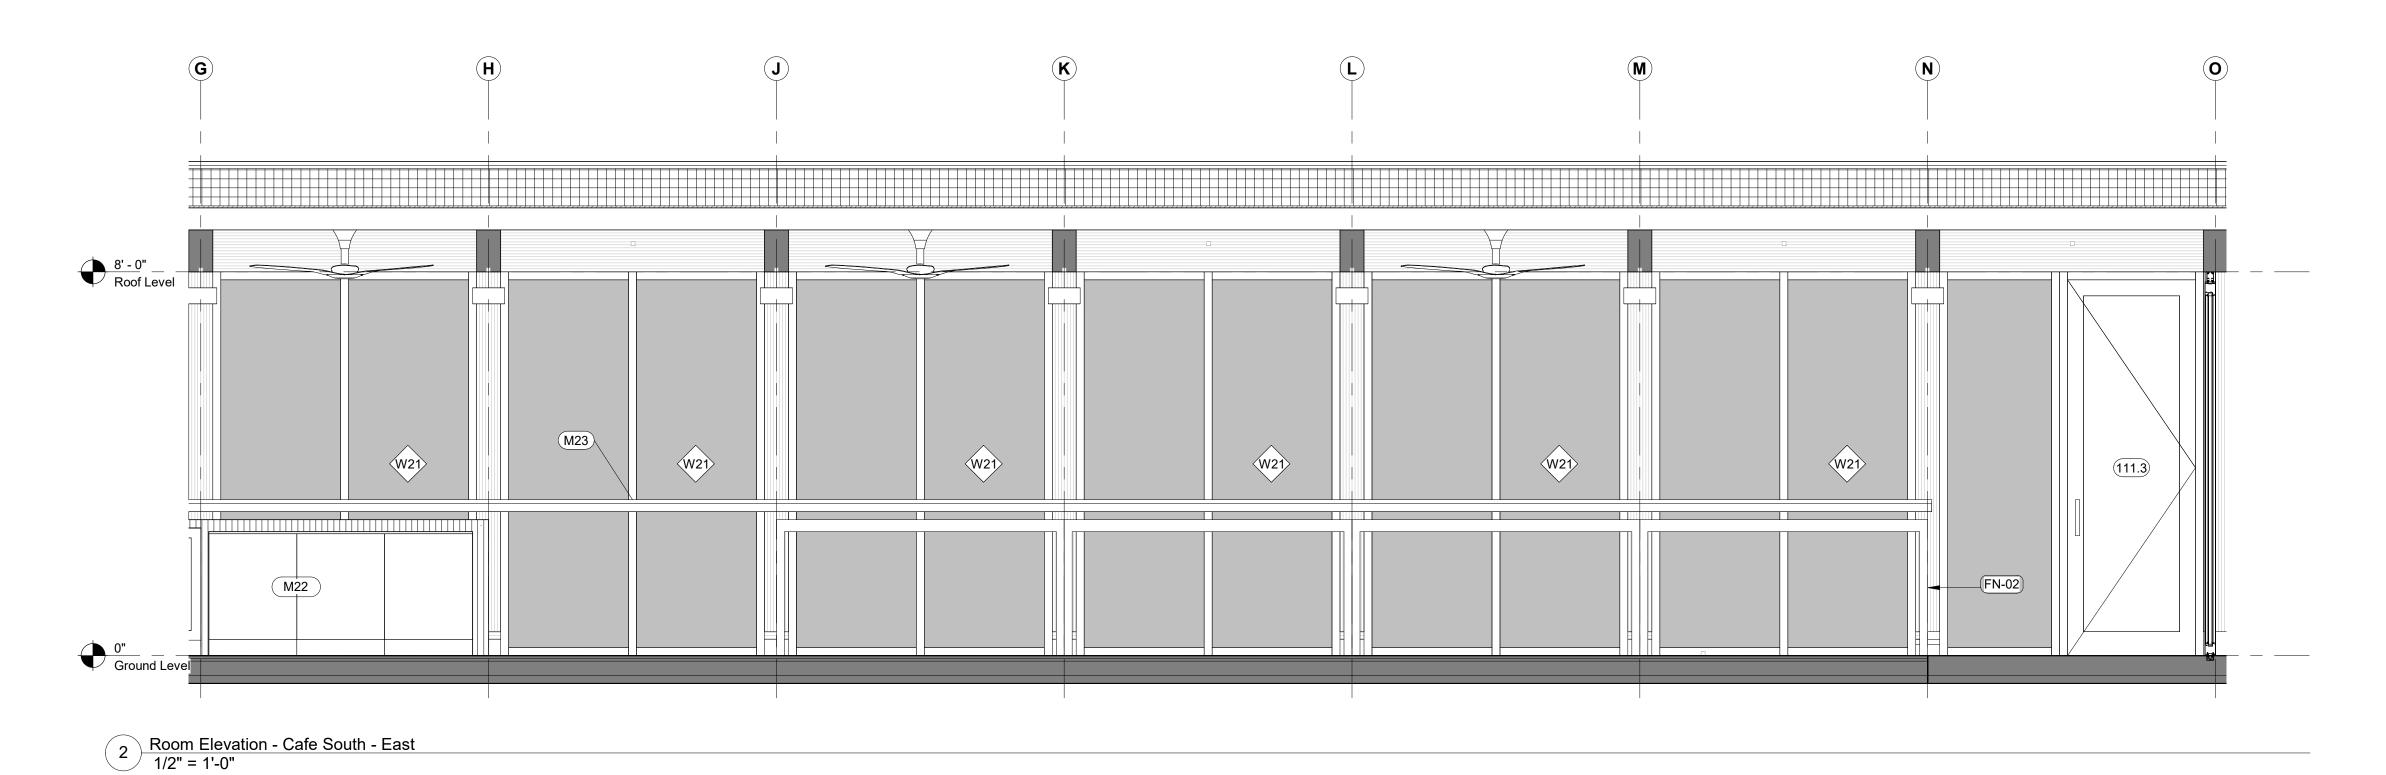

Keynote Legend

Keynote Description

Storm King Art Center 1 Museum Road

New Windsor, NY 12553 +1 (845) 534-3115 **Design Architect** heneghan peng architects 14-16 Lord Edward Street

Dublin, D02 YC63 +353 1 633 9000 **Executive Architect**

WXY Architecture + Urban Design 224 Centre Street, 5th Floor New York, NY 10013 +1 (212) 219-1953

Landscape Architect Gustafson Porter + Bowman 1 Cobham Mews London, MW1 9SB +44 020 7284 8950

Reed Hilderbrand LLC 33 Whitney Avenue, 3rd Floor New Haven, CT 06510 +1 (617) 923-2422

Structural & Lighting ARUP 77 Water Street

New York, NY 10005 +1 (212) 896-3000 MEPF & IT BuroHappold

100 Broadway #23 New York, NY 10005 +1 (212) 616-0228 Civil

VHB 100 Great Oaks Blvd., Suite 118 Albany, NY 12203

+1 (518) 389-3606 **AV & Acoustics** LSTN Consultants 76 Beaver Street, 2nd Floor New York, NY 10005 +1 (347) 788-0810

Facade Front Inc. 100 E. Broadway Street, #501 New York, NY 10002 +1 (212) 242-2220

Key Plan




Description 50% Construction Documents

Storm King Art Center **Pond Pavilion**

NOT FOR CONSTRUCTION **Drawing Title** Room Elevations -111

Date	11/06/20
Scale	1/2" = 1'-0"
Drawing Number	A-P-608
Sheet Size	ARCH D

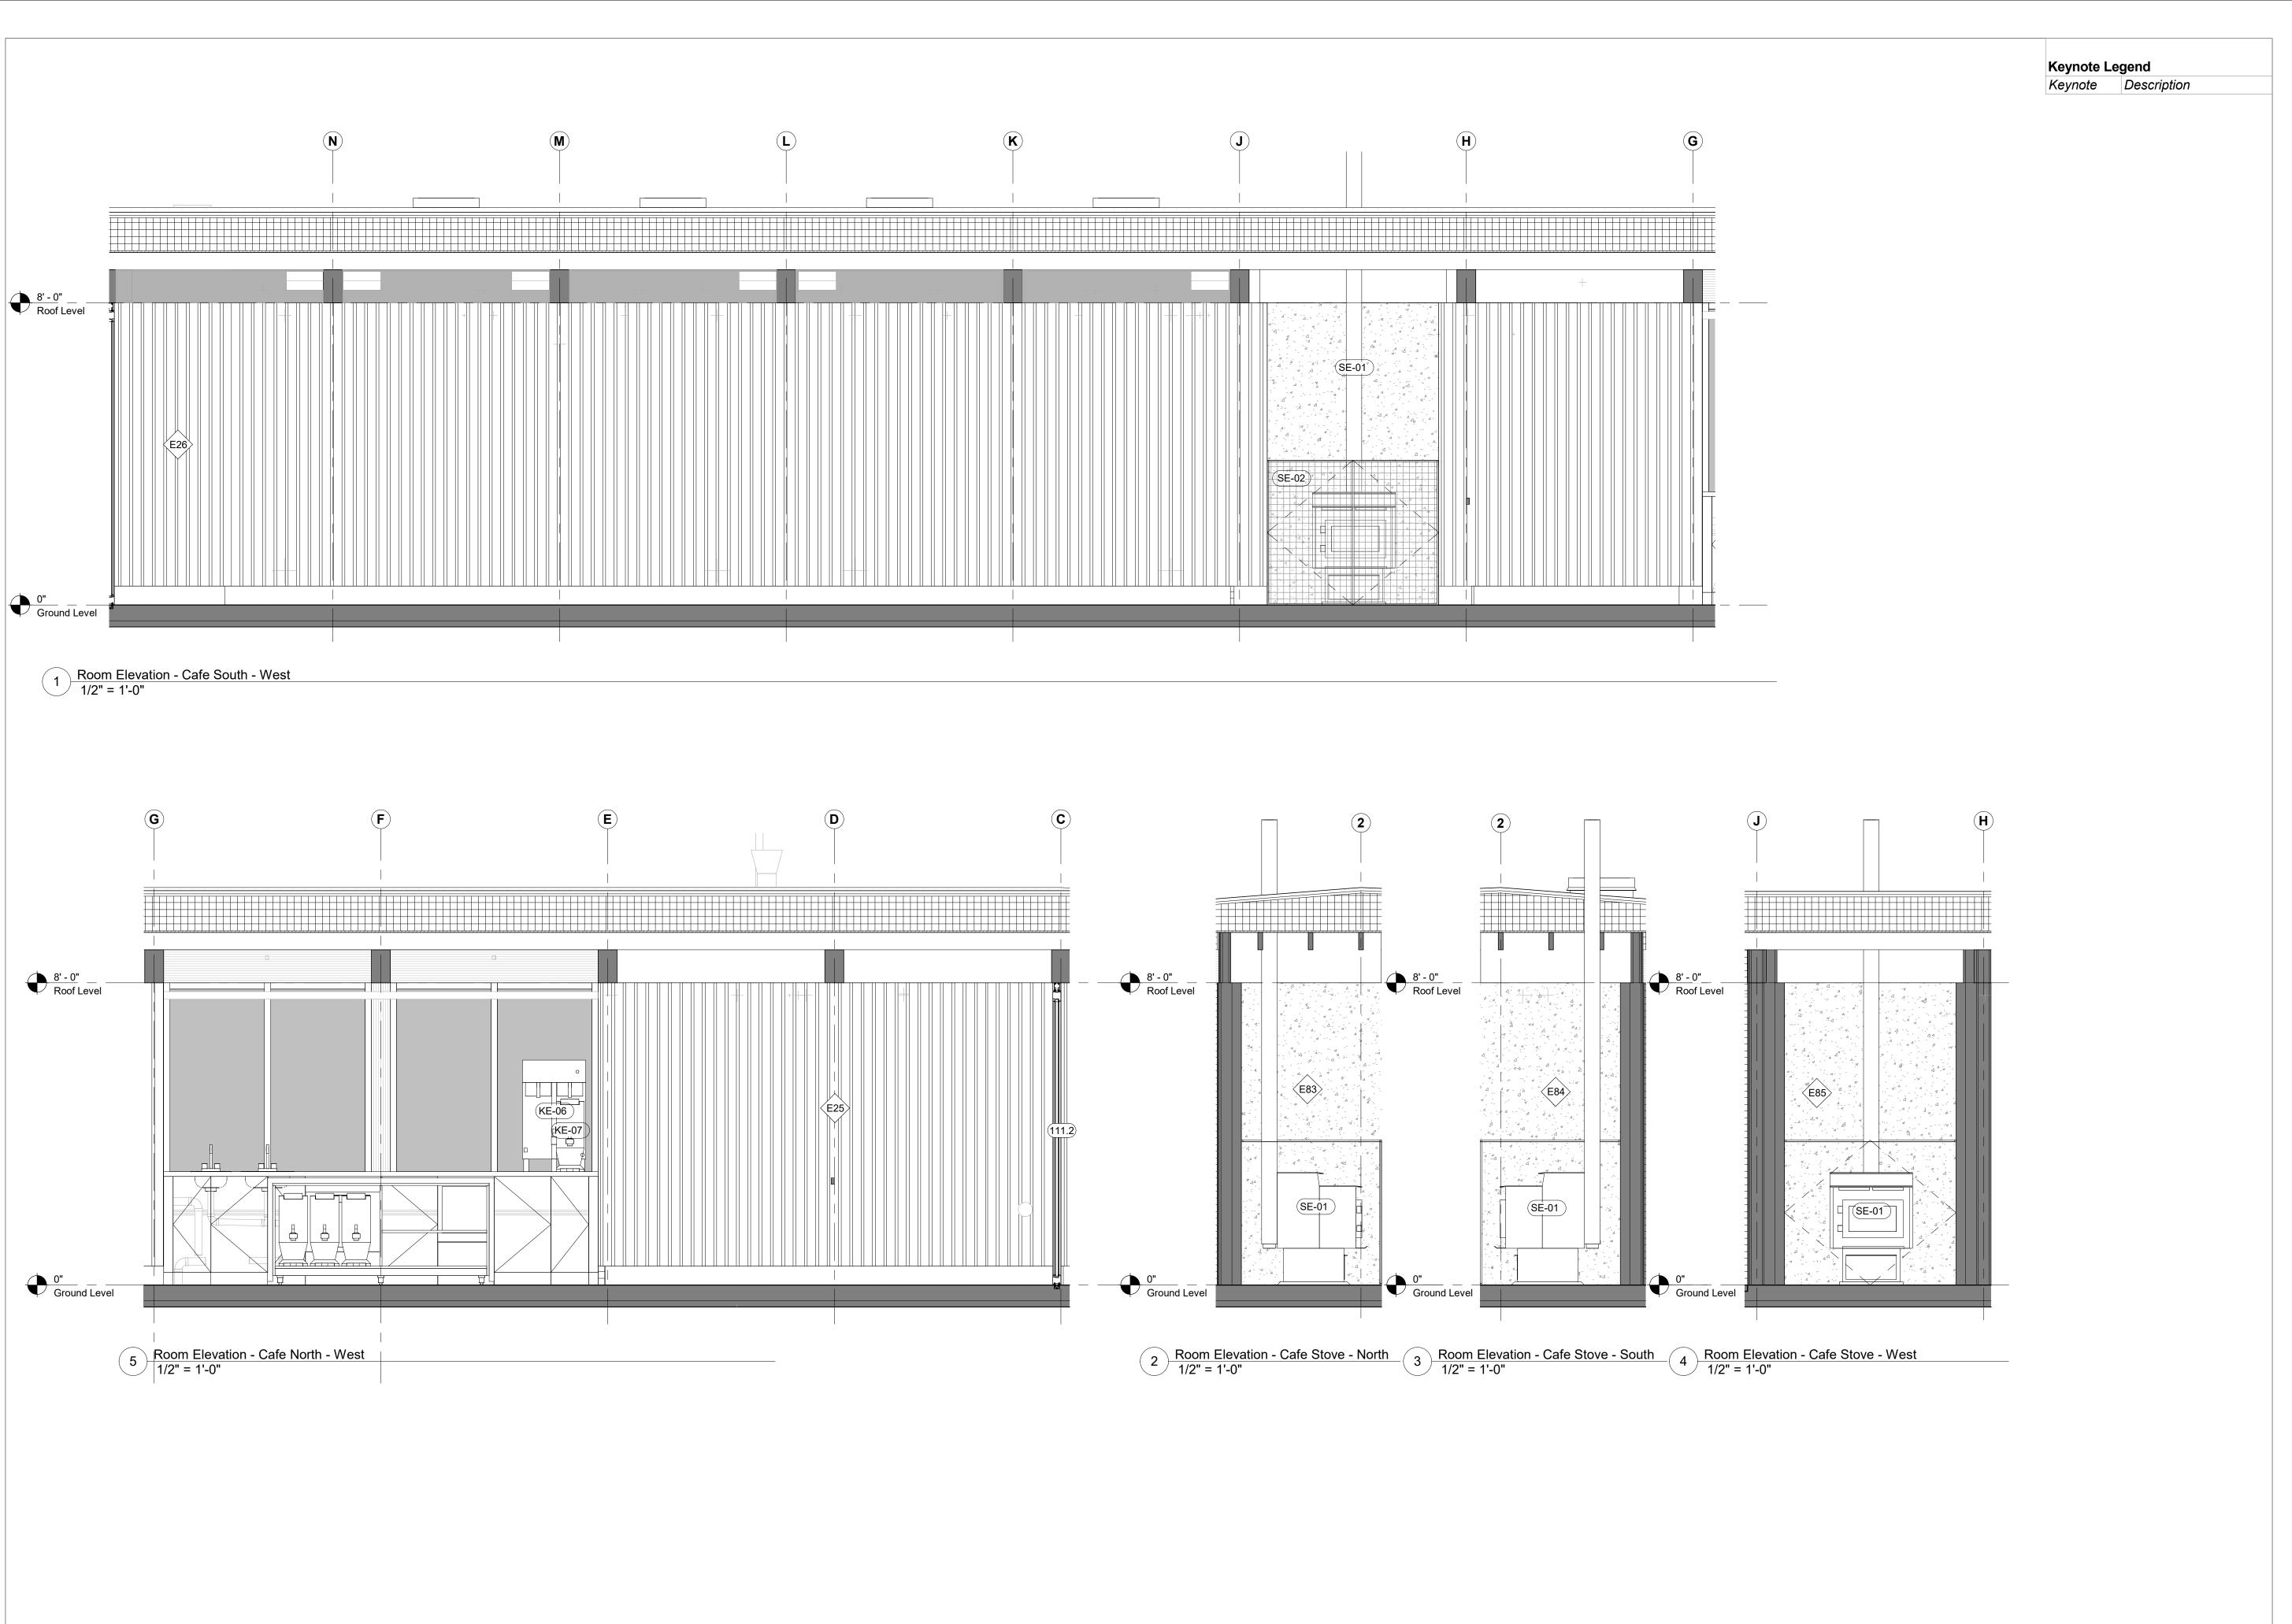

Owner
Storm King Art Center
1 Museum Road
New Windsor, NY 12553
+1 (845) 534-3115

Design Architect
heneghan peng architects
14-16 Lord Edward Street
Dublin, D02 YC63
+353 1 633 9000

Executive Architect
WXY Architecture + Urban Design
224 Centre Street, 5th Floor
New York, NY 10013
+1 (212) 219-1953

Landscape Architect

Gustafson Porter + Bowman 1 Cobham Mews London, MW1 9SB +44 020 7284 8950

Reed Hilderbrand LLC 33 Whitney Avenue, 3rd Floor New Haven, CT 06510 +1 (617) 923-2422

Structural & Lighting
ARUP
77 Water Street

77 Water Street
New York, NY 10005
+1 (212) 896-3000

MEPF & IT

BuroHappold 100 Broadway #23 New York, NY 10005

+1 (212) 616-0228 Civil

VHB 100 Great Oaks Blvd., Suite 118 Albany, NY 12203 +1 (518) 389-3606

AV & Acoustics
LSTN Consultants
76 Beaver Street, 2nd Floor
New York, NY 10005
+1 (347) 788-0810

Facade
Front Inc.
100 E. Broadway Street, #501
New York, NY 10002
+1 (212) 242-2220

Key Plan



Description Date 50% Construction Documents 11/06/20

Project

Storm King
Art Center
Pond Pavilion


Sea

NOT FOR CONSTRUCTION

Drawing Title

Room Elevations
111

Date	11/06/20
Scale	1/2" = 1'-0"
Drawing Number	A-P-609
Sheet Size	ARCH D

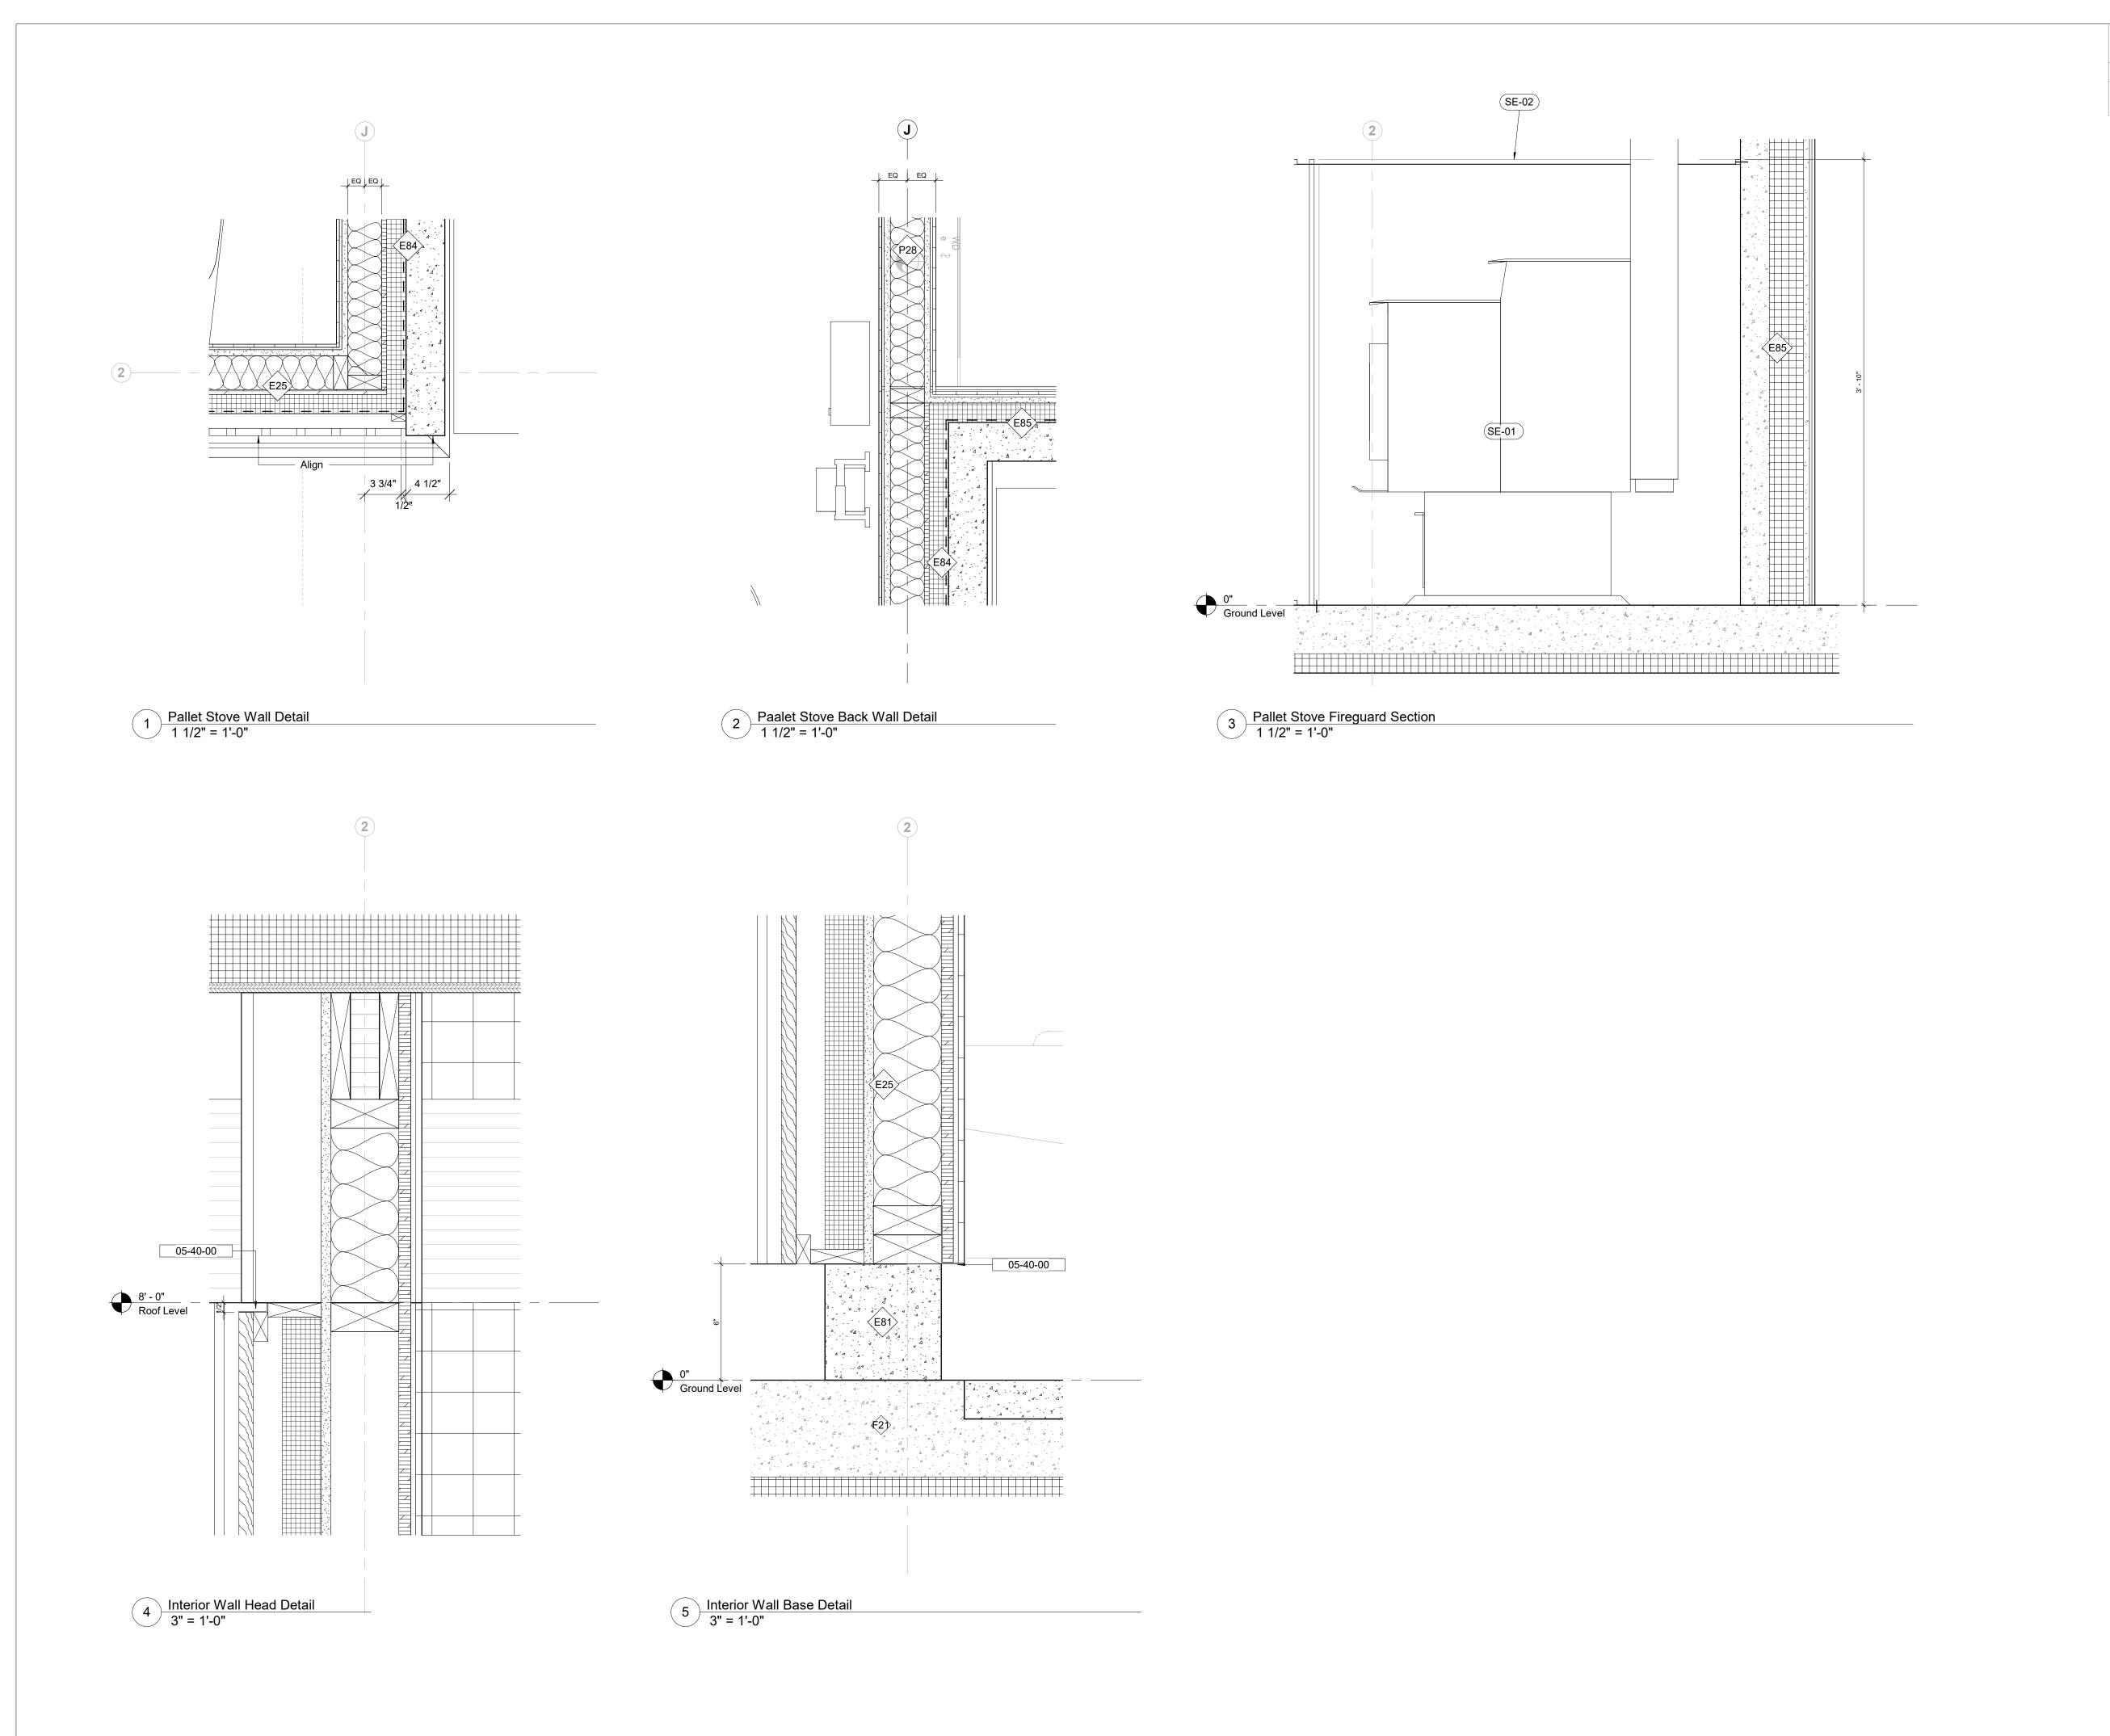

Keynote Legend

Keynote Description
05-40-00 Cold-Formed Me

05-40-00 Cold-Formed Metal Framing

Owner
Storm King Art Center
1 Museum Road
New Windsor, NY 12553
+1 (845) 534-3115

Design Architect
heneghan peng architects
14-16 Lord Edward Street
Dublin, D02 YC63

+353 1 633 9000

Executive Architect
WXY Architecture + Urban Design
224 Centre Street, 5th Floor
New York, NY 10013
+1 (212) 219-1953

Landscape Architect
Gustafson Porter + Bowman
1 Cobham Mews
London, MW1 9SB
+44 020 7284 8950

Reed Hilderbrand LLC 33 Whitney Avenue, 3rd Floor New Haven, CT 06510 +1 (617) 923-2422

Structural & Lighting ARUP 77 Water Street New York, NY 10005

+1 (212) 896-3000

MEPF & IT

BuroHappold

100 Broadway #23 New York, NY 10005 +1 (212) 616-0228

VHB 100 Great Oaks Blvd., Suite 118 Albany, NY 12203

+1 (518) 389-3606

AV & Acoustics
LSTN Consultants
76 Beaver Street, 2nd Floor
New York, NY 10005

+1 (347) 788-0810

Facade
Front Inc.
100 E. Broadway Street, #501
New York, NY 10002

+1 (212) 242-2220

Key Plan

Description Date 50% Construction Documents 11/06/20

Storm King
Art Center

Project

Storm King


Art Center

Seal

NOT FOR CONSTRUCTION

Drawing Title
Interior Details

Date	11/06/20
Scale	As indicated
Drawing Number	A-P-611

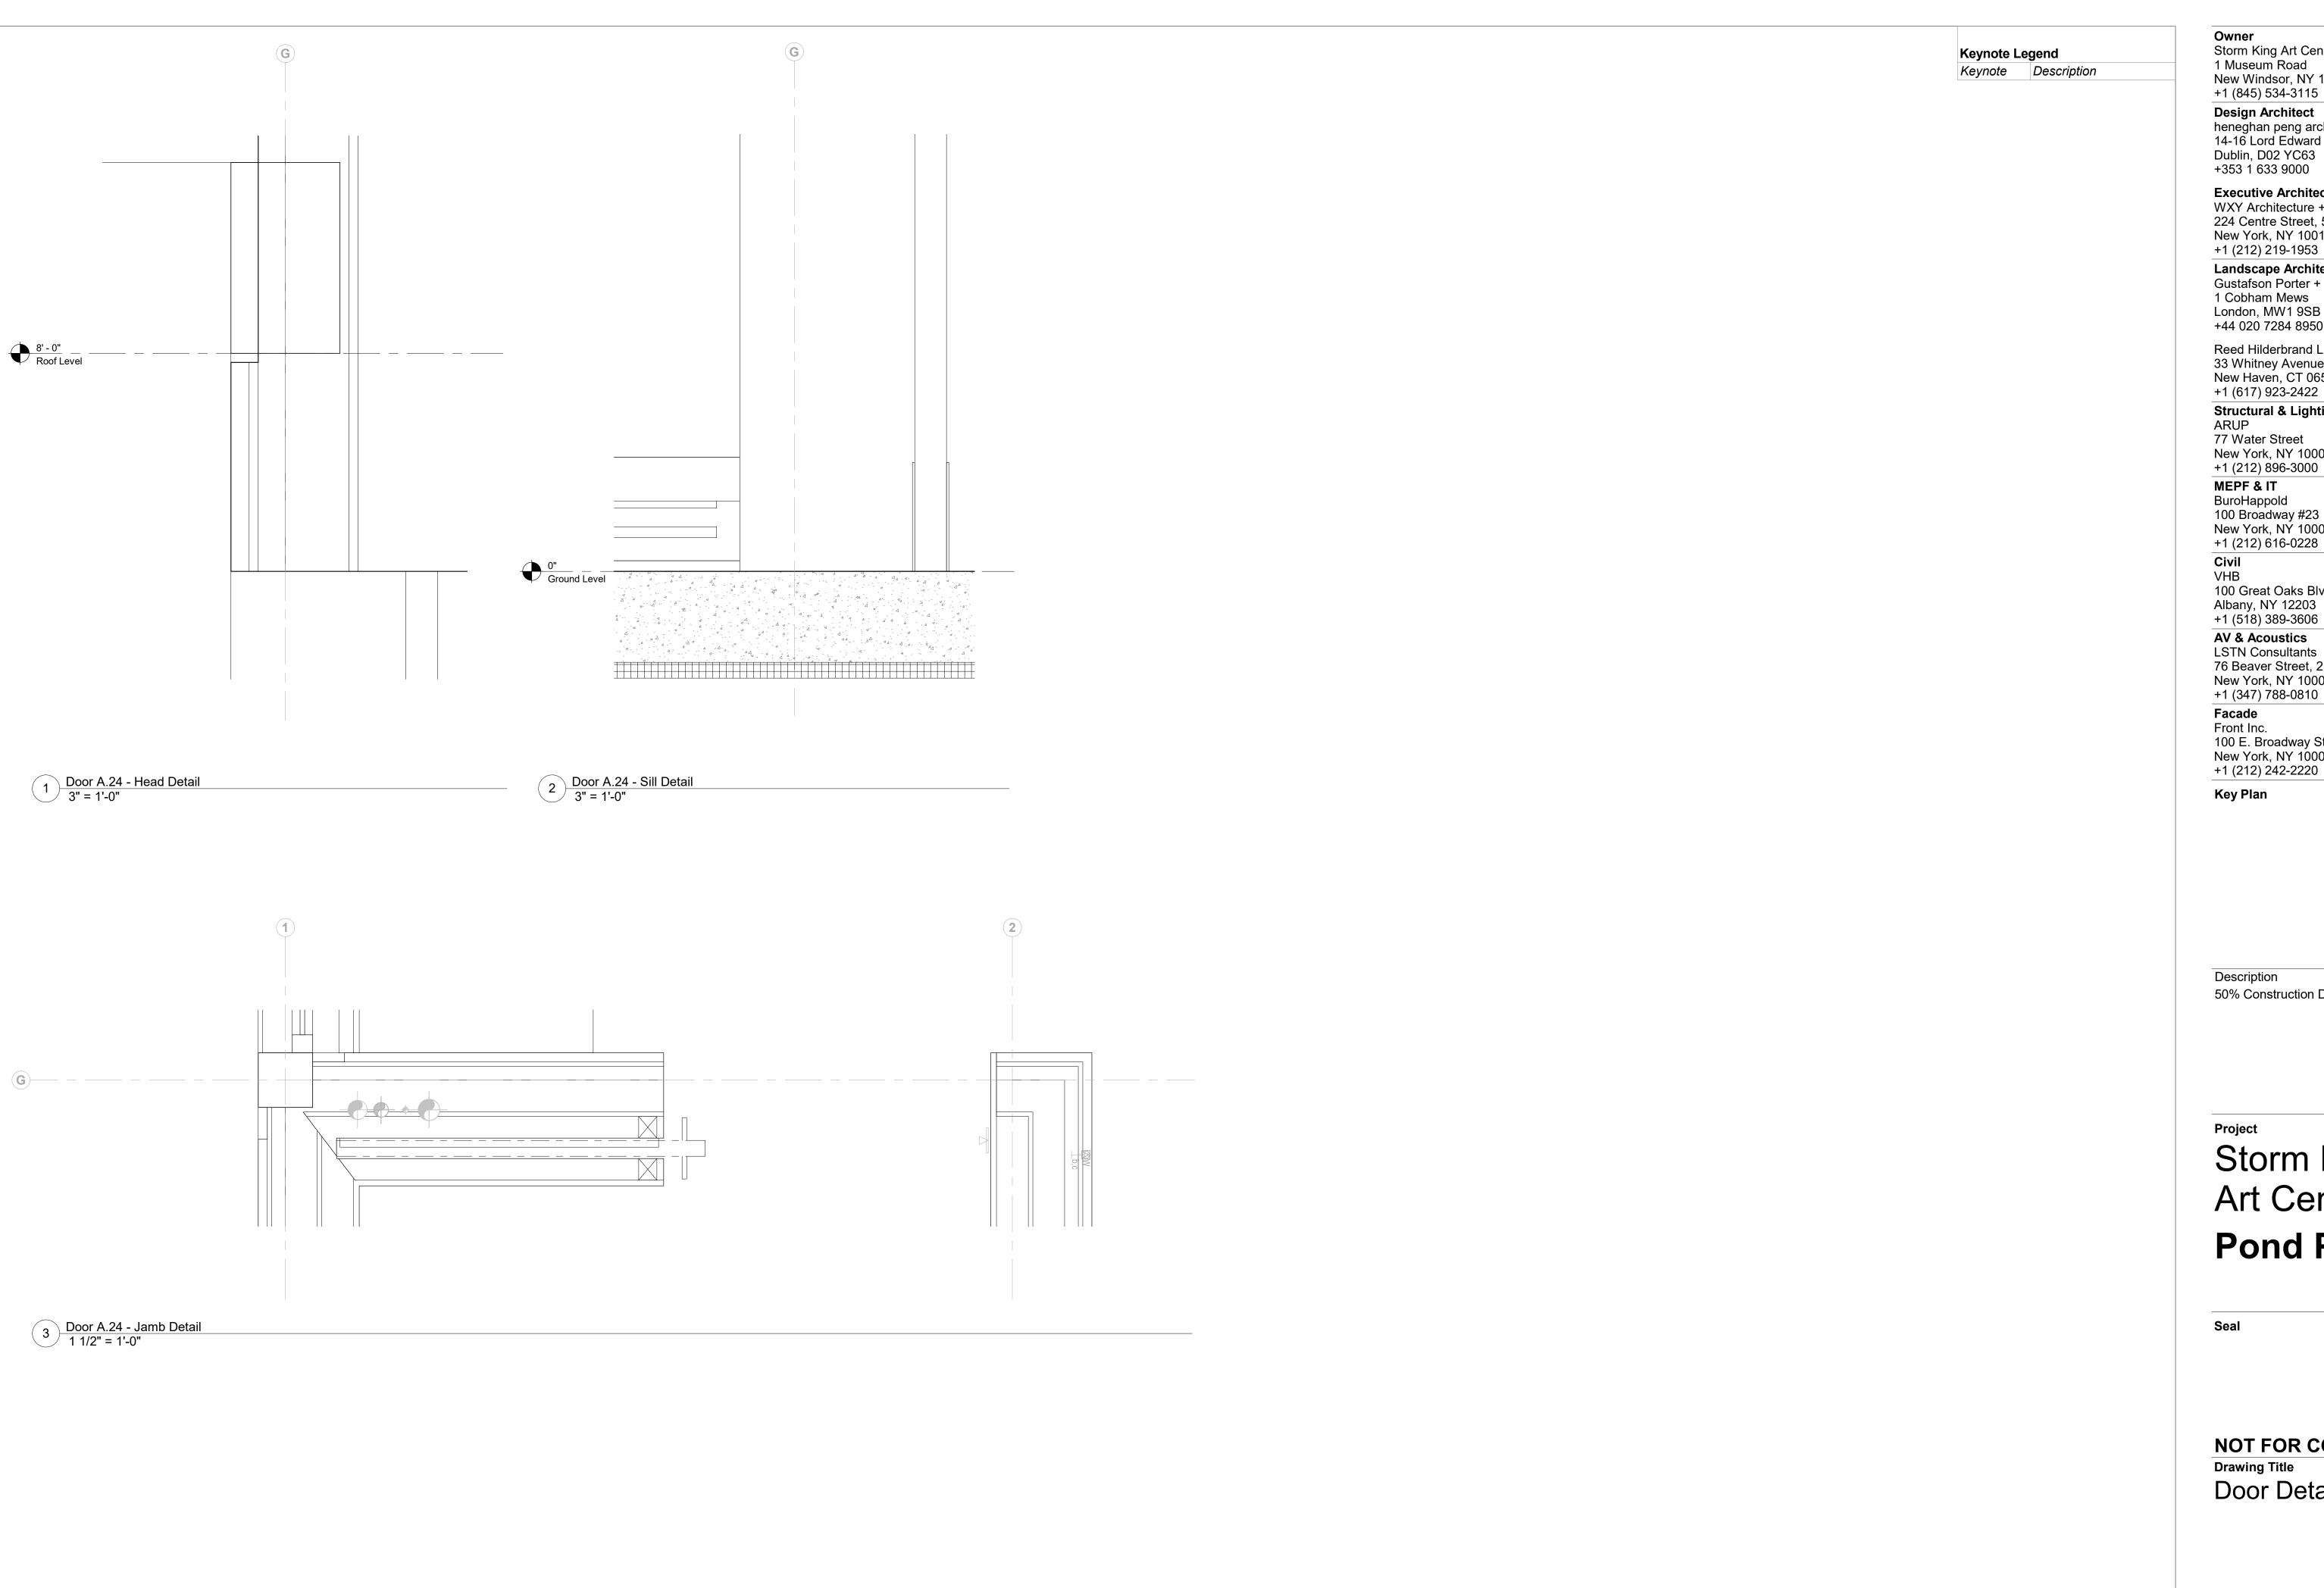

Storm King Art Center 1 Museum Road New Windsor, NY 12553 +1 (845) 534-3115

Design Architect heneghan peng architects 14-16 Lord Edward Street Dublin, D02 YC63

Executive Architect WXY Architecture + Urban Design 224 Centre Street, 5th Floor New York, NY 10013 +1 (212) 219-1953

Landscape Architect Gustafson Porter + Bowman

+44 020 7284 8950 Reed Hilderbrand LLC 33 Whitney Avenue, 3rd Floor New Haven, CT 06510

+1 (617) 923-2422 Structural & Lighting ARUP 77 Water Street

New York, NY 10005 +1 (212) 896-3000 MEPF & IT BuroHappold

100 Broadway #23 New York, NY 10005 +1 (212) 616-0228

Civil

100 Great Oaks Blvd., Suite 118 Albany, NY 12203 +1 (518) 389-3606

AV & Acoustics LSTN Consultants 76 Beaver Street, 2nd Floor New York, NY 10005

+1 (347) 788-0810 Facade Front Inc.

100 E. Broadway Street, #501 New York, NY 10002 +1 (212) 242-2220


Key Plan

Description 50% Construction Documents

Storm King Art Center **Pond Pavilion**

NOT FOR CONSTRUCTION **Drawing Title** Door Details - Interior

Date	11/06/20
Scale	As indicated
Drawing Number	A-P-621
Sheet Size	ARCH D

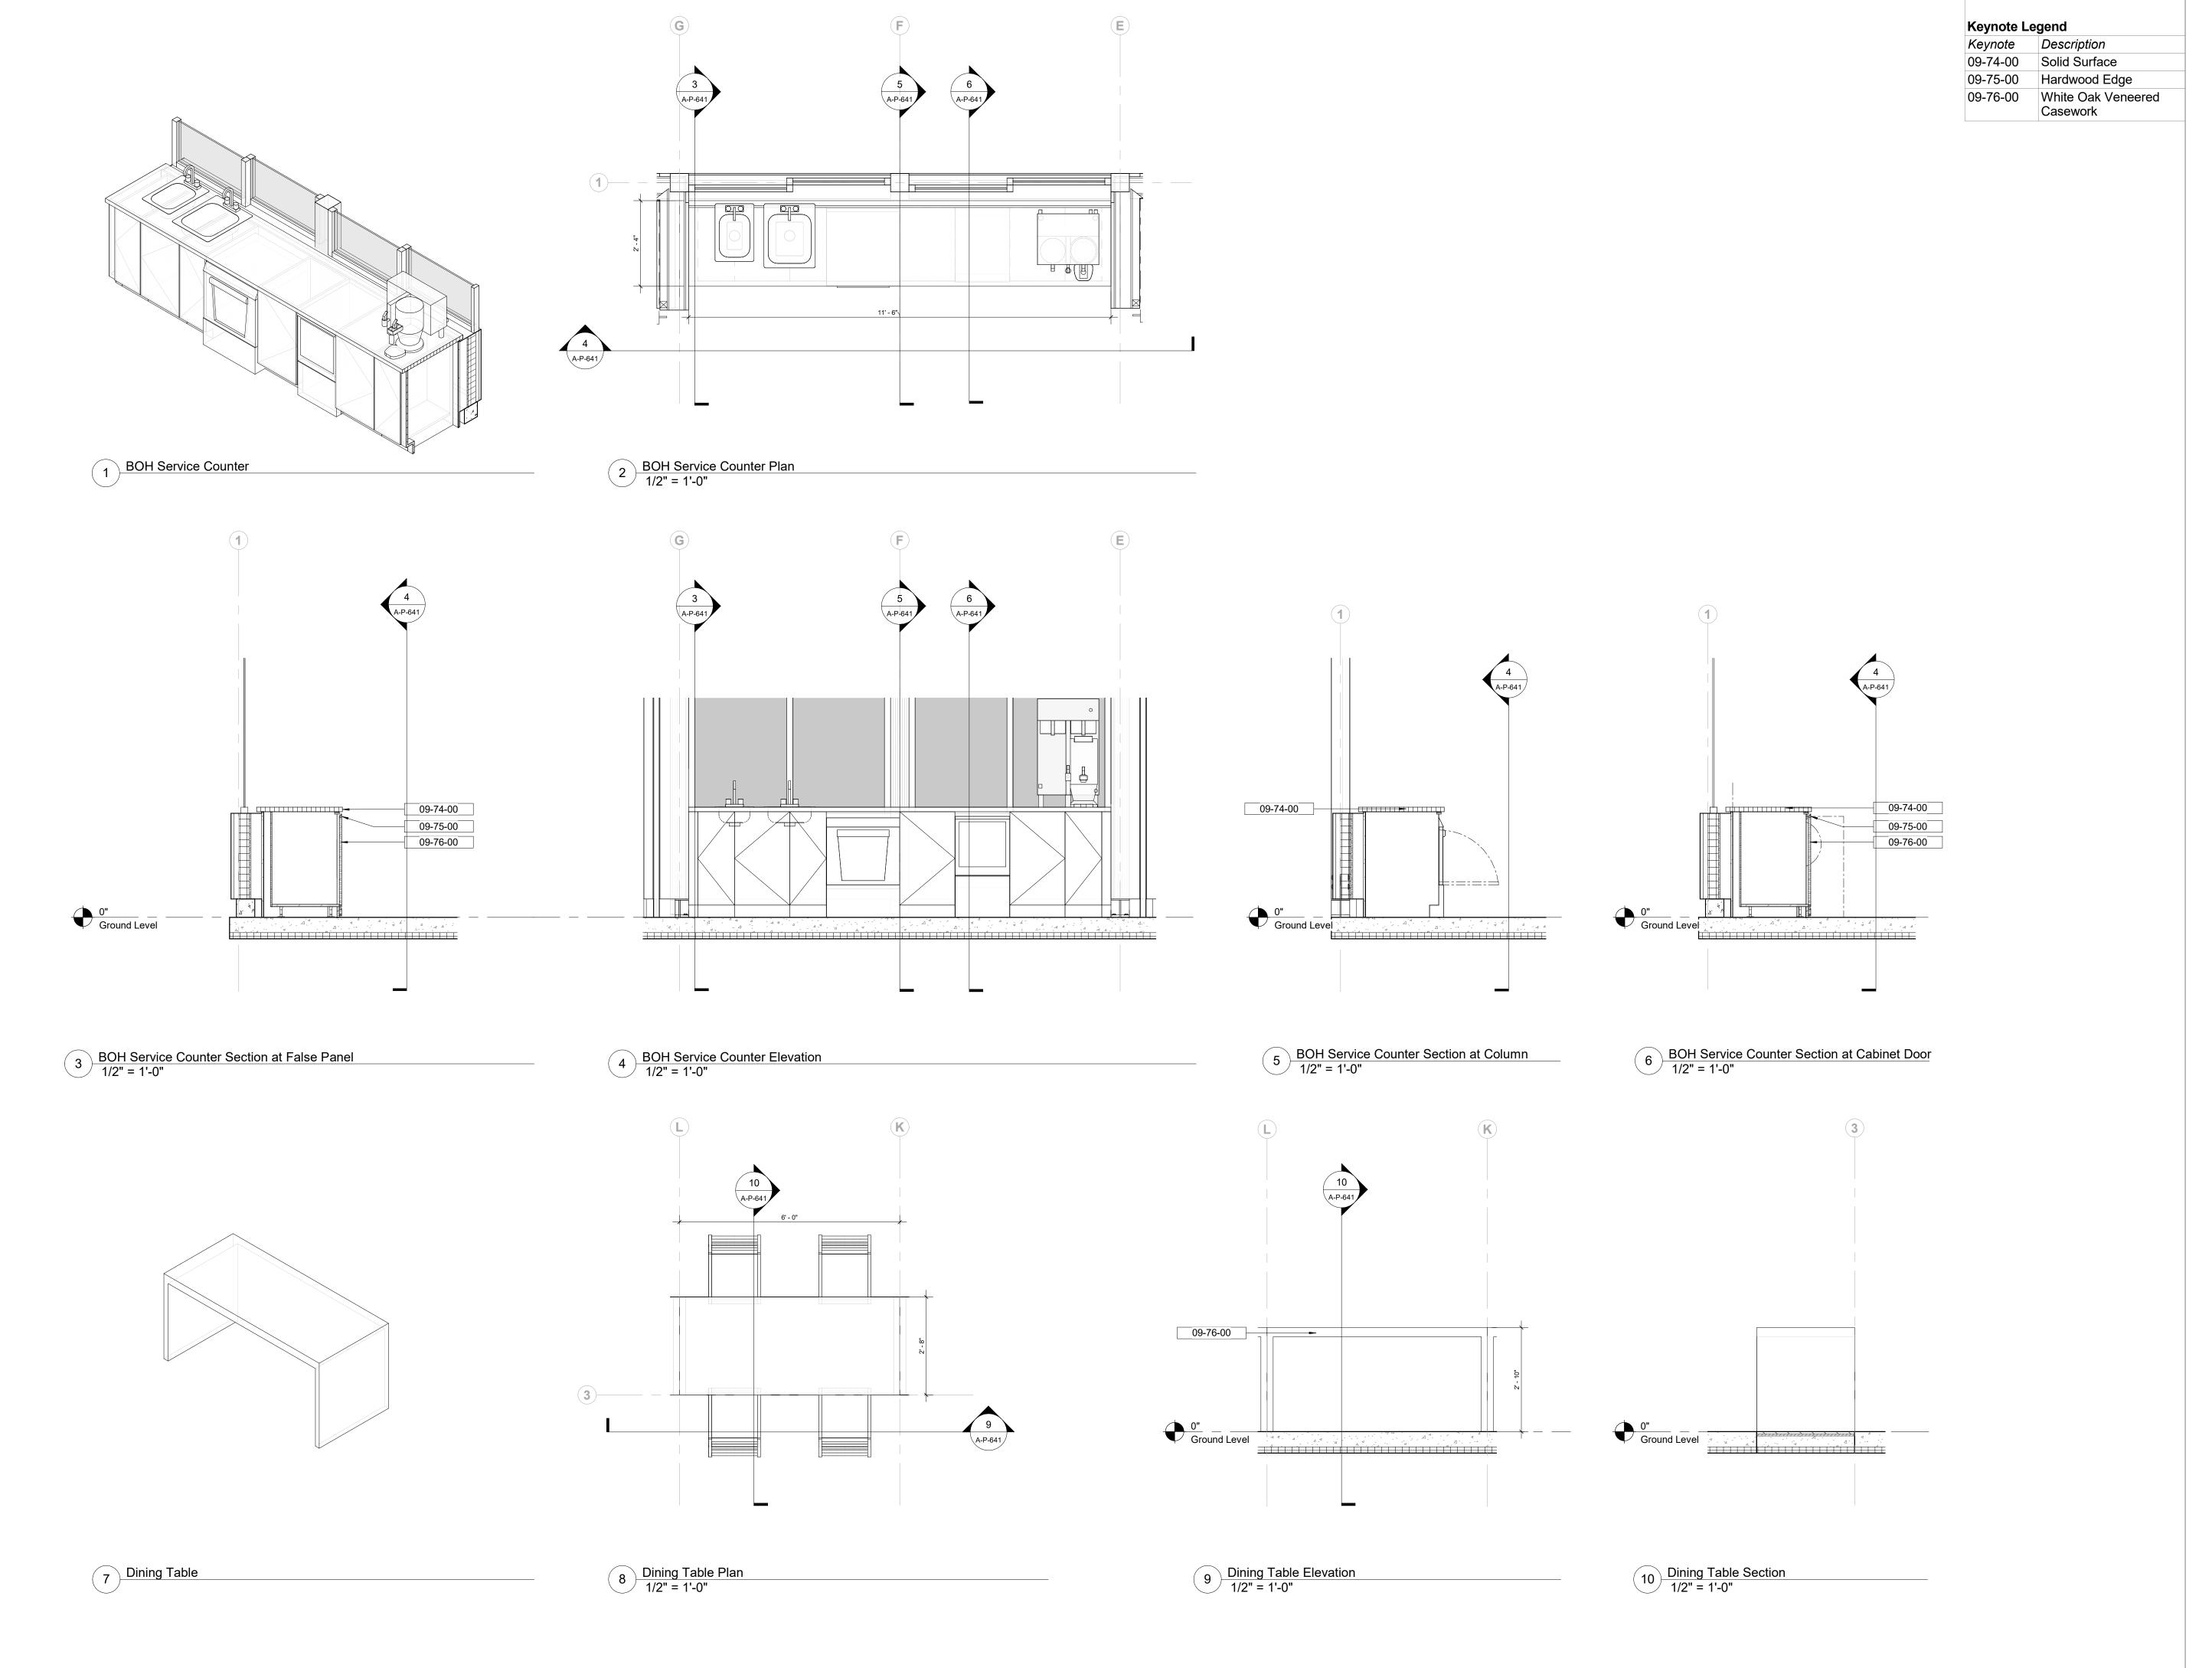

Owner
Storm King Art Center
1 Museum Road
New Windsor, NY 12553

+1 (845) 534-3115

Design Architect
heneghan peng architects
14-16 Lord Edward Street
Dublin, D02 YC63

+353 1 633 9000

Executive Architect
WXY Architecture + Urban Design
224 Centre Street, 5th Floor
New York, NY 10013
+1 (212) 219-1953

Landscape Architect
Gustafson Porter + Bowman
1 Cobham Mews
London, MW1 9SB
+44 020 7284 8950

Reed Hilderbrand LLC 33 Whitney Avenue, 3rd Floor New Haven, CT 06510 +1 (617) 923-2422

Structural & Lighting ARUP 77 Water Street New York, NY 10005 +1 (212) 896-3000

MEPF & IT
BuroHappold
100 Broadway #23
New York, NY 10005

New York, NY 10005 +1 (212) 616-0228

VHB 100 Great Oaks Blvd., Suite 118 Albany, NY 12203 +1 (518) 389-3606

AV & Acoustics
LSTN Consultants
76 Beaver Street, 2nd Floor
New York, NY 10005

+1 (347) 788-0810

Facade
Front Inc.
100 E. Broadway Street, #501
New York, NY 10002
+1 (212) 242-2220

Key Plan


Description Date 50% Construction Documents 11/06/20

Storm King
Art Center

Pond Pavilion

Seal

Date	11/06/20
Scale	1/2" = 1'-0"
Drawing Number	A-P-641
Sheet Size	ARCH D

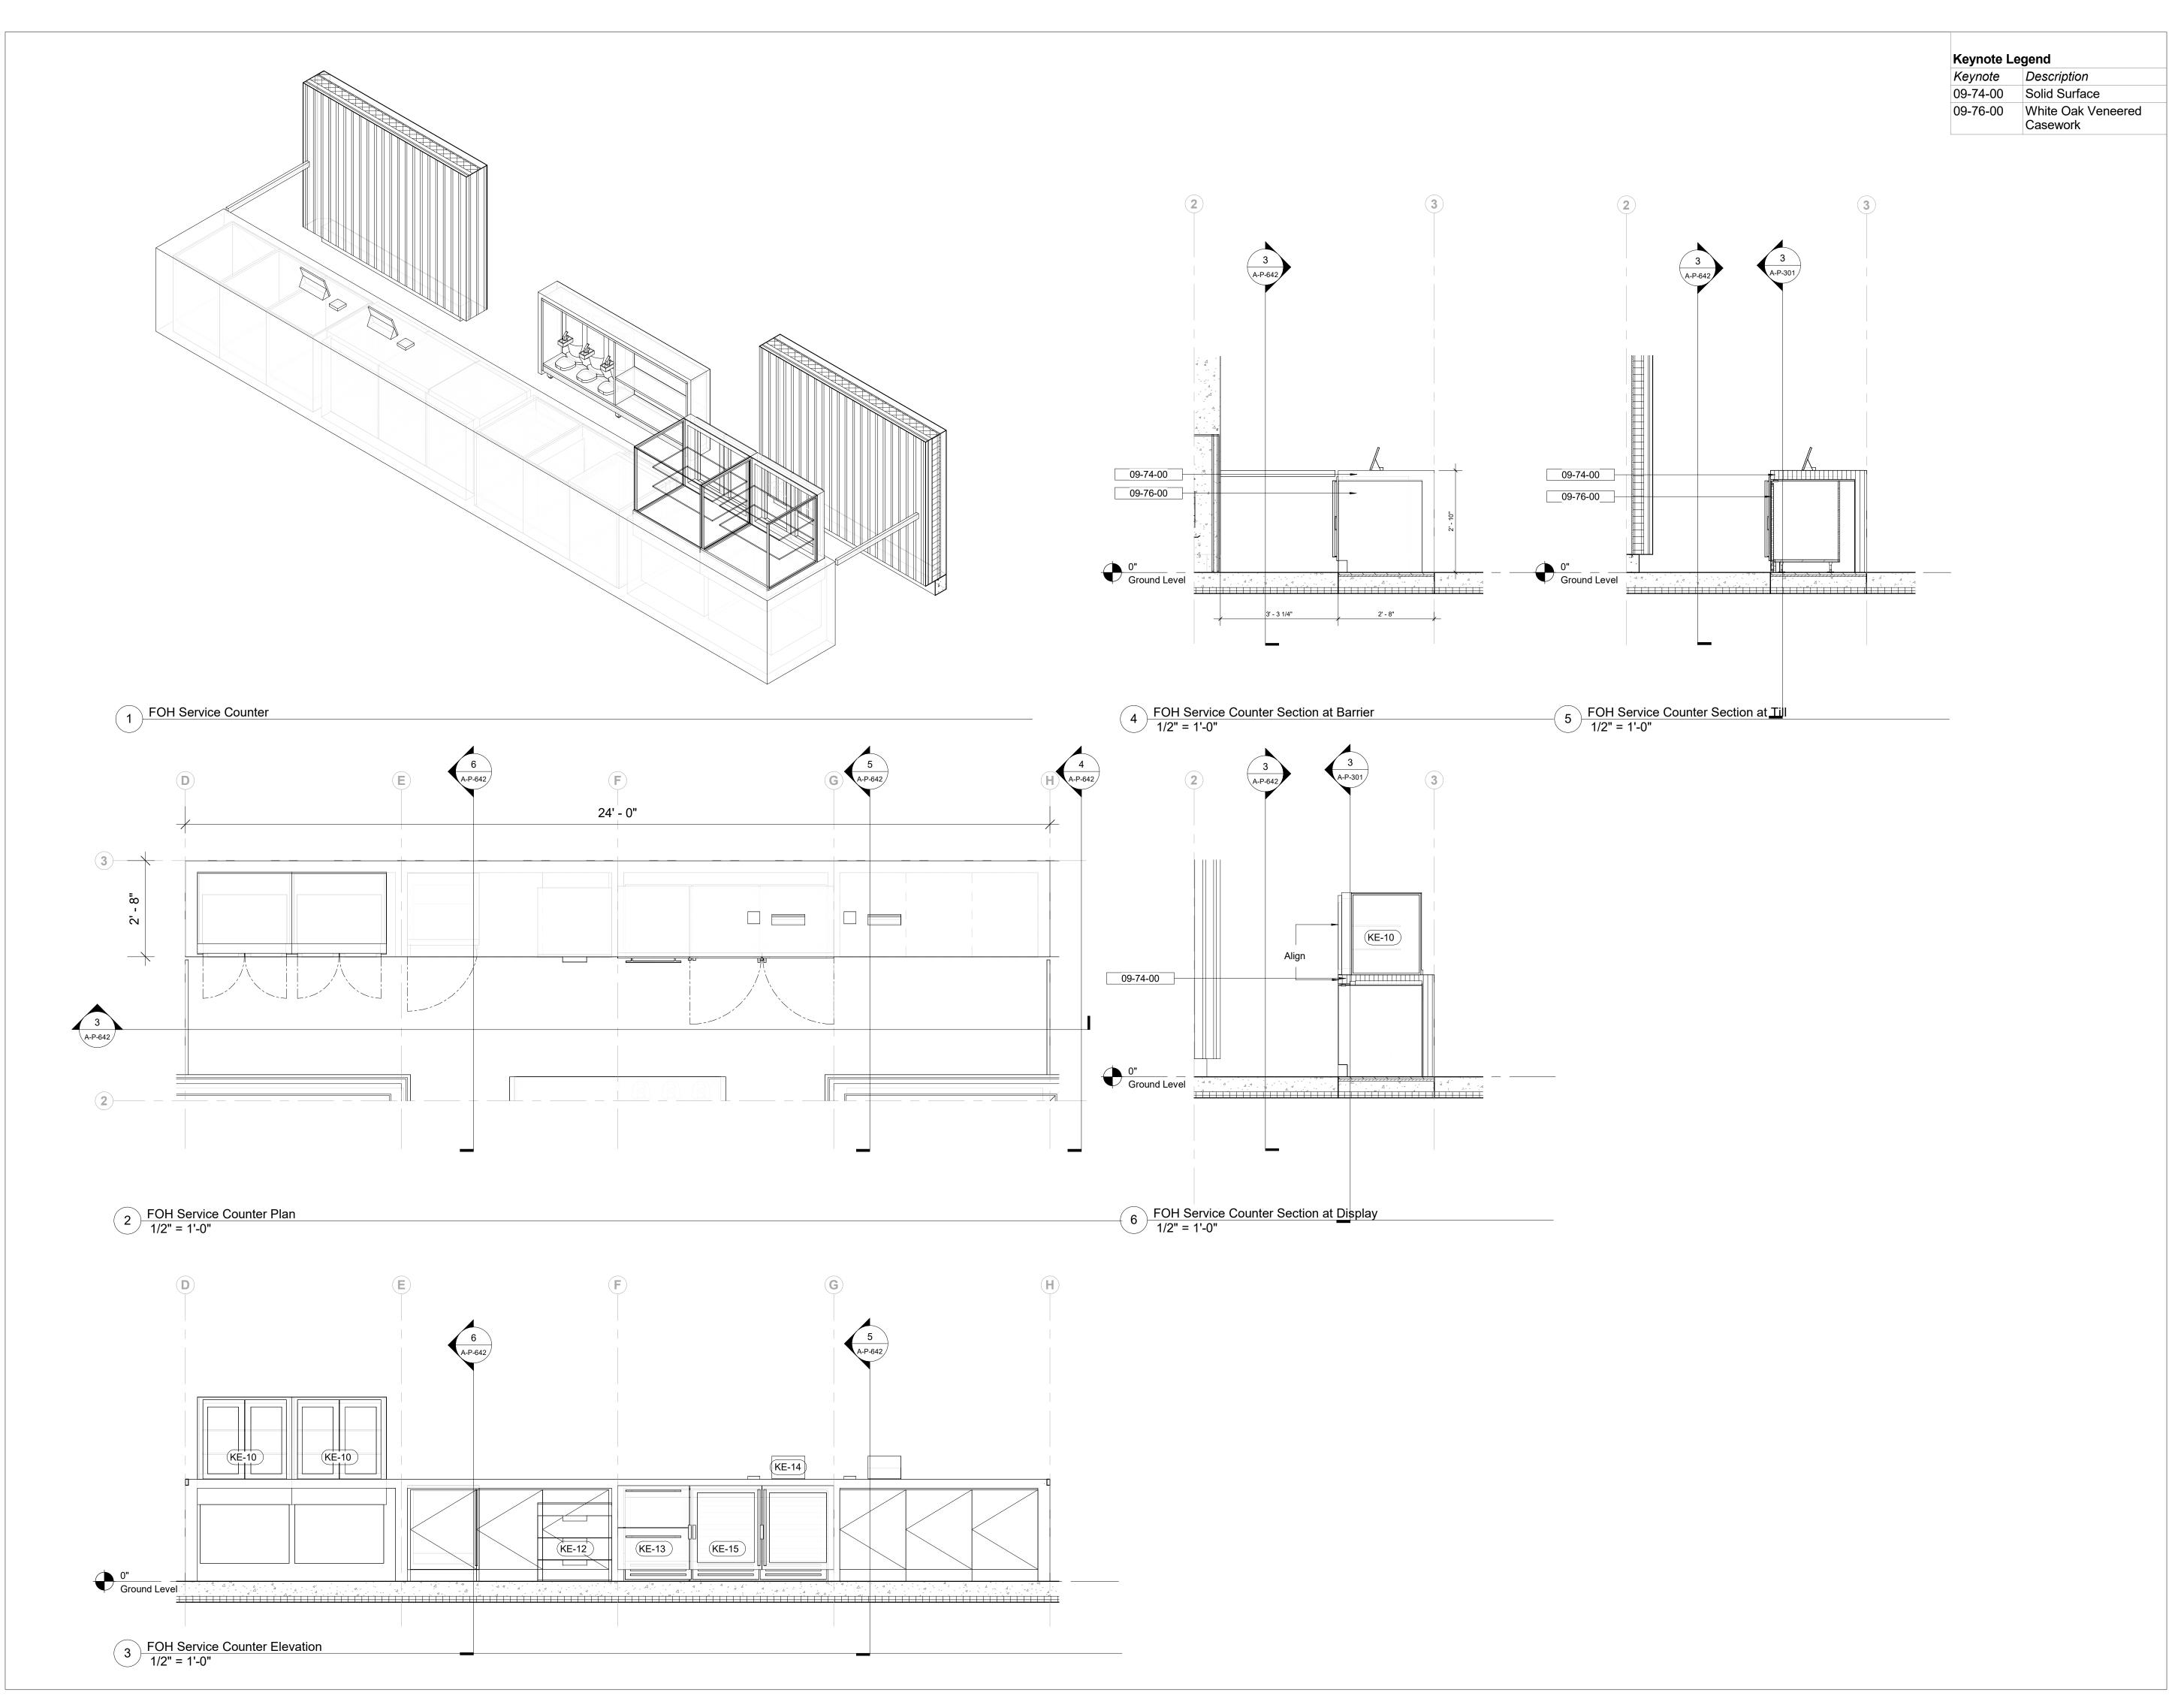

Owner
Storm King Art Center
1 Museum Road
New Windsor, NY 12553
+1 (845) 534-3115

Design Architect
heneghan peng architects
14-16 Lord Edward Street
Dublin, D02 YC63
+353 1 633 9000

Executive Architect
WXY Architecture + Urban Design
224 Centre Street, 5th Floor

New York, NY 10013 +1 (212) 219-1953 Landscape Architect

Gustafson Porter + Bowman 1 Cobham Mews London, MW1 9SB +44 020 7284 8950

Reed Hilderbrand LLC 33 Whitney Avenue, 3rd Floor New Haven, CT 06510 +1 (617) 923-2422

+1 (617) 923-2422

Structural & Lighting
ARUP

77 Water Street New York, NY 10005 +1 (212) 896-3000

MEPF & IT BuroHappold 100 Broadway #23 New York, NY 10005

+1 (212) 616-0228 Civil

VHB 100 Great Oaks Blvd., Suite 118 Albany, NY 12203

+1 (518) 389-3606

AV & Acoustics

LSTN Consultants
76 Beaver Street, 2nd Floor
New York, NY 10005
+1 (347) 788-0810

Facade Front Inc.

100 E. Broadway Street, #501 New York, NY 10002 +1 (212) 242-2220

Key Plan




Description Date 50% Construction Documents 11/06/20

Project

Storm King
Art Center
Pond Pavilion

Sea

Date	11/06/20
Scale	1/2" = 1'-0"
Drawing Number	A-P-642
Sheet Size	ARCH D

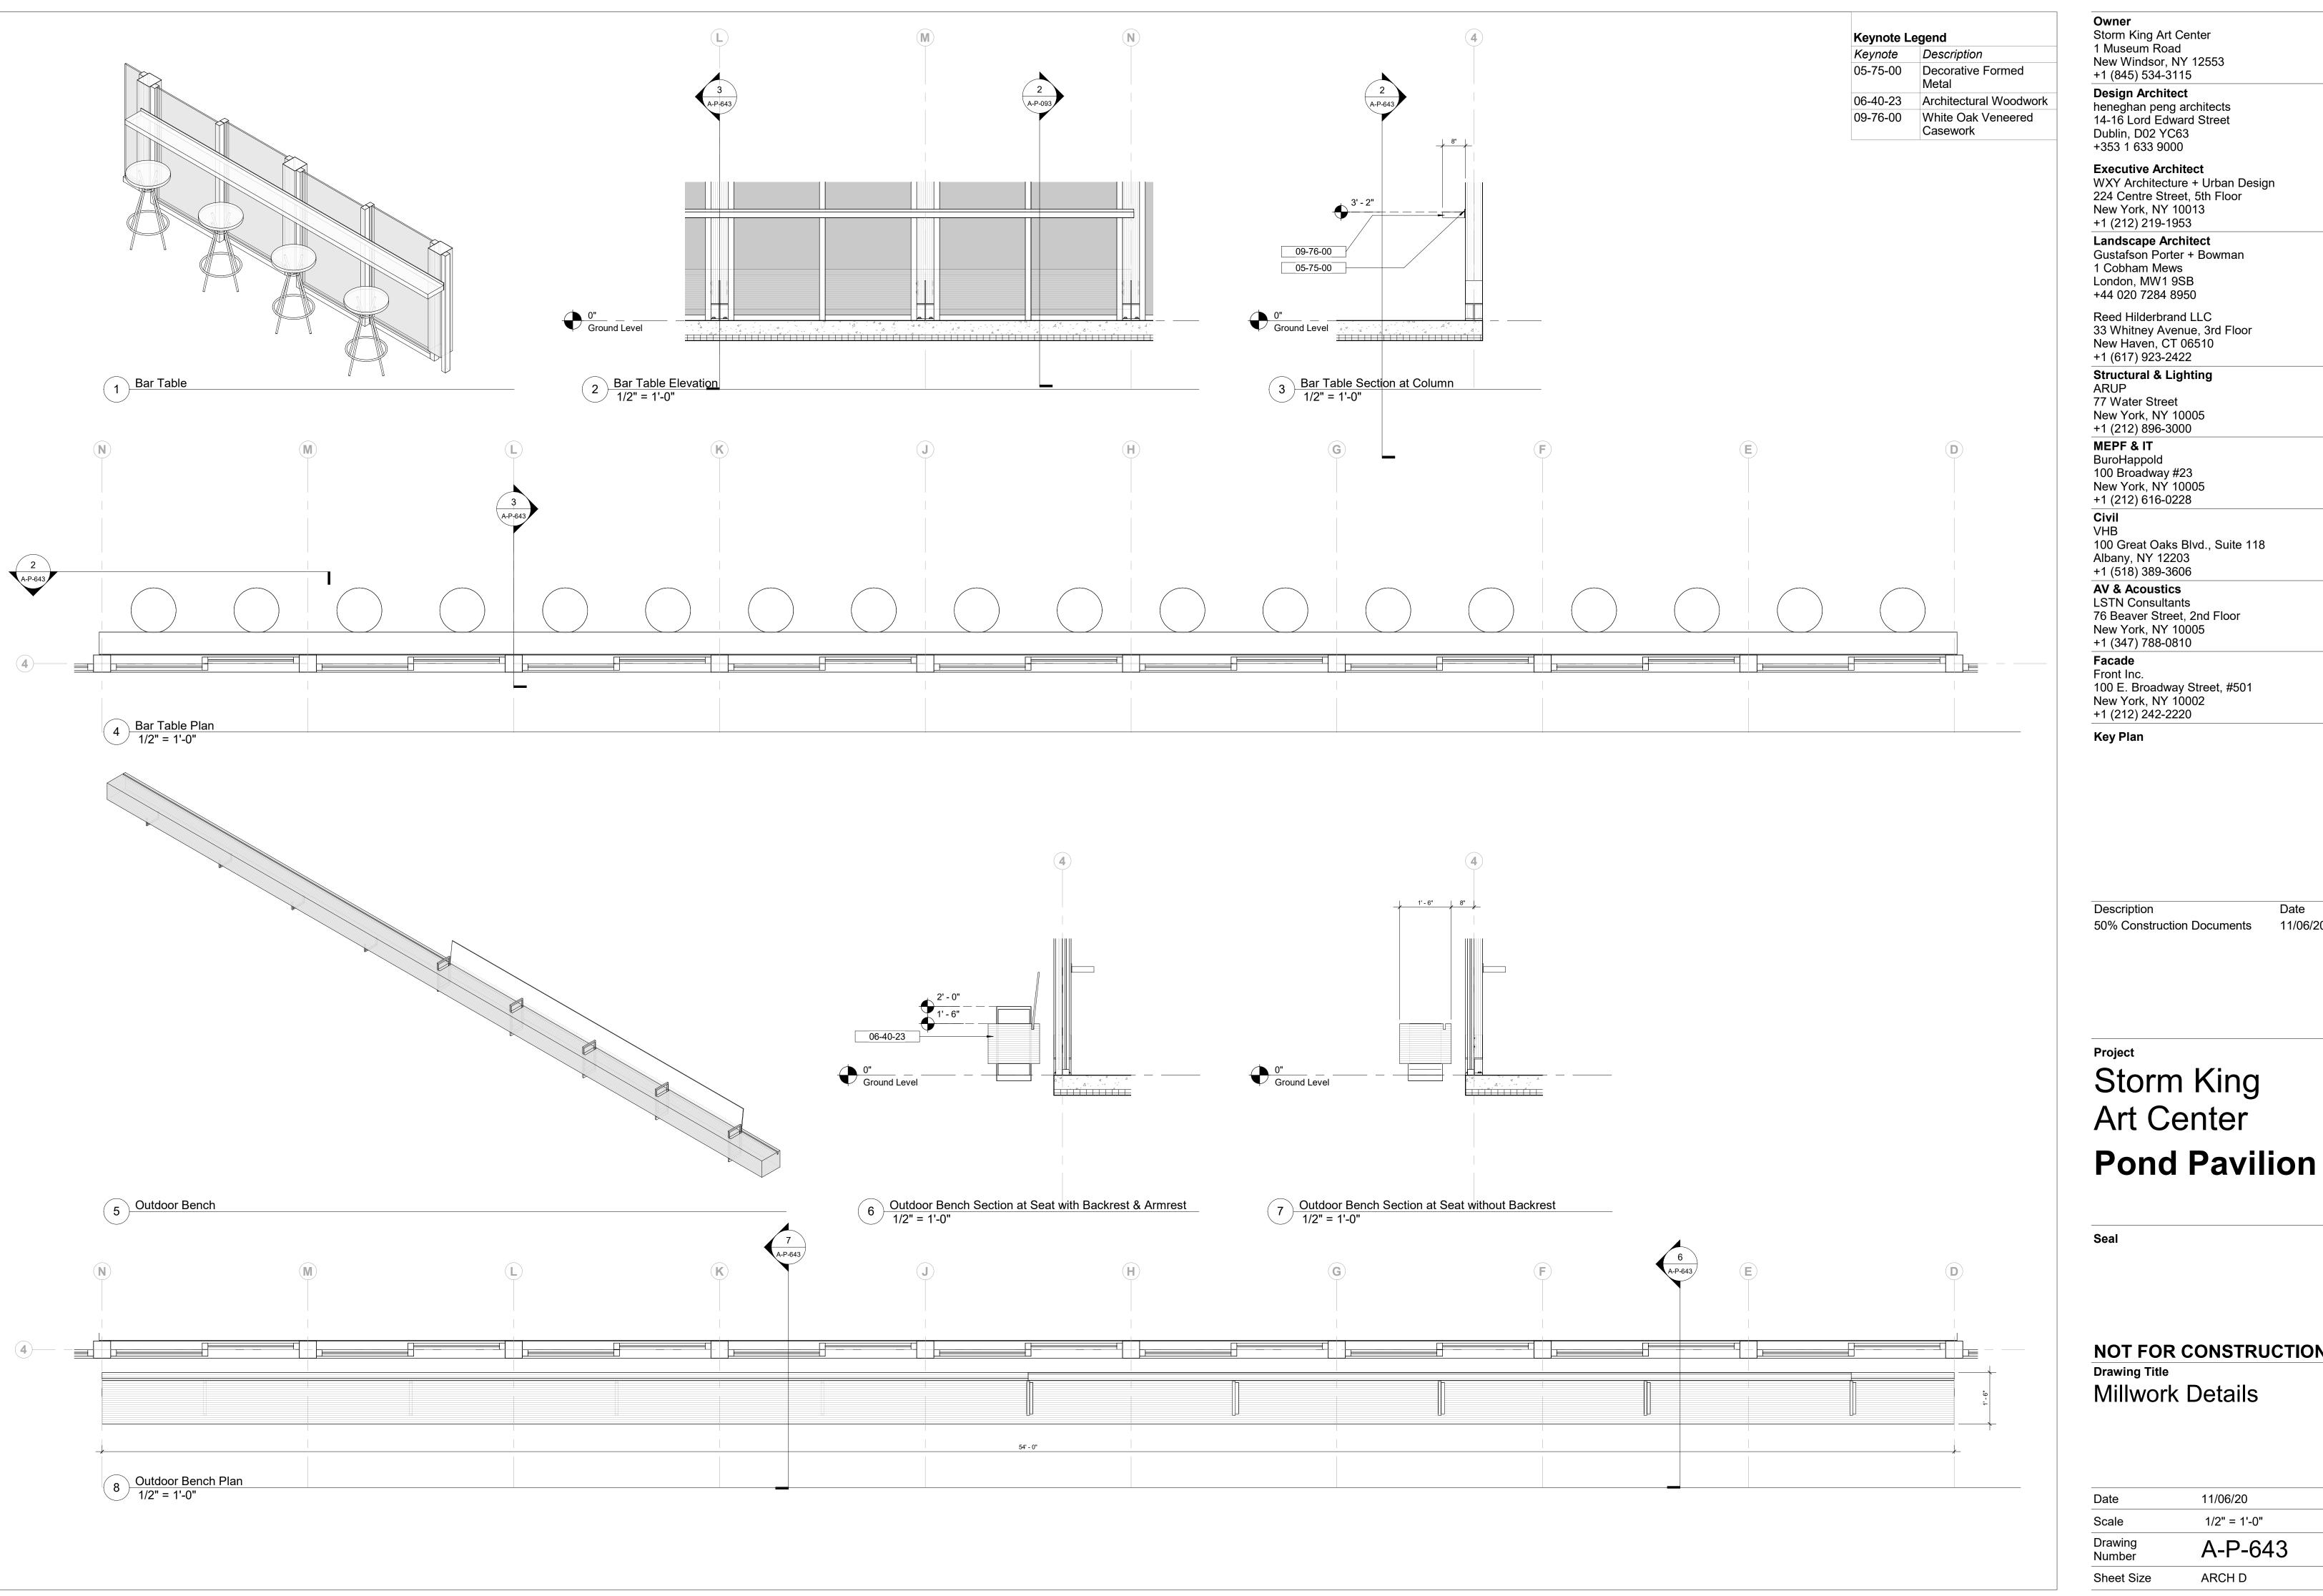

Storm King Art Center

1 Museum Road New Windsor, NY 12553 +1 (845) 534-3115

Design Architect heneghan peng architects 14-16 Lord Edward Street Dublin, D02 YC63 +353 1 633 9000

Executive Architect WXY Architecture + Urban Design 224 Centre Street, 5th Floor New York, NY 10013 +1 (212) 219-1953

Landscape Architect Gustafson Porter + Bowman 1 Cobham Mews London, MW1 9SB +44 020 7284 8950

Reed Hilderbrand LLC 33 Whitney Avenue, 3rd Floor New Haven, CT 06510 +1 (617) 923-2422

Structural & Lighting ARUP 77 Water Street New York, NY 10005

+1 (212) 896-3000 MEPF & IT BuroHappold 100 Broadway #23

New York, NY 10005 +1 (212) 616-0228

Civil VHB 100 Great Oaks Blvd., Suite 118 Albany, NY 12203

+1 (518) 389-3606 **AV & Acoustics** LSTN Consultants 76 Beaver Street, 2nd Floor


New York, NY 10005 +1 (347) 788-0810 Facade Front Inc. 100 E. Broadway Street, #501

Key Plan

Description 50% Construction Documents

Storm King Art Center

Date	11/06/20
Scale	1/2" = 1'-0"
Drawing Number	A-P-643
Sheet Size	ARCH D

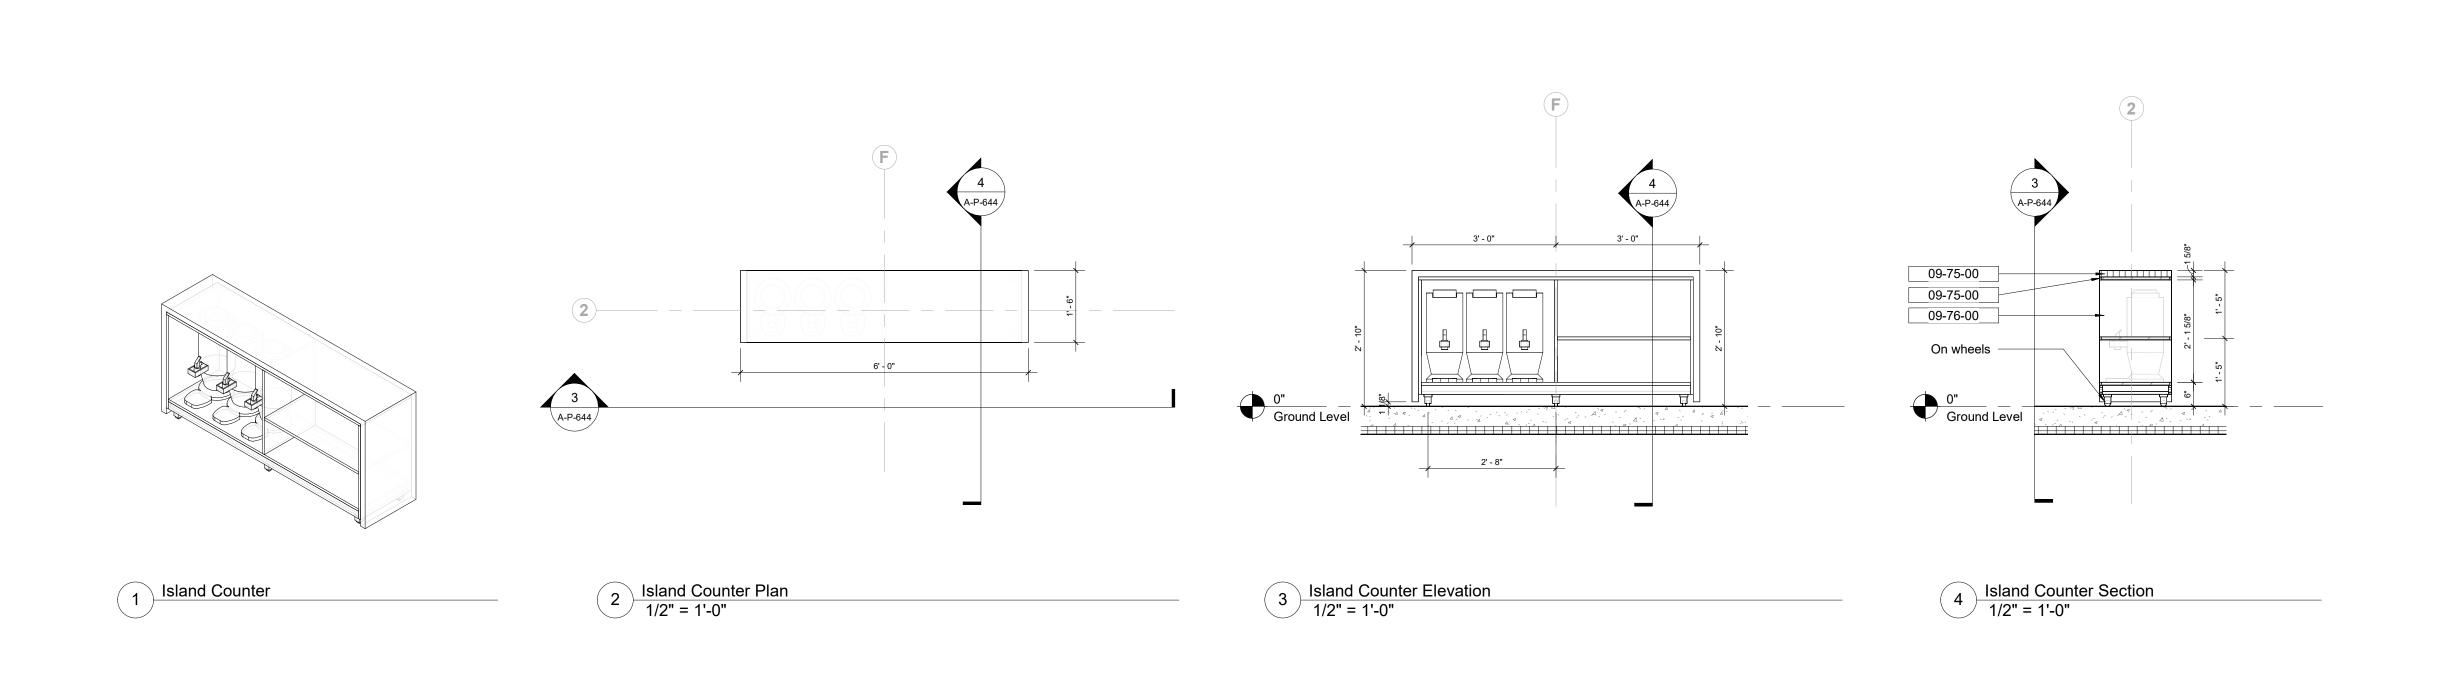

Keynote Legend

Keynote Description
09-75-00 Hardwood Edge
09-76-00 White Oak Veneered

Hardwood Edge
White Oak Veneered
Casework

New Windsor, NY 12553
+1 (845) 534-3115

Design Architect
heneghan peng architects
14-16 Lord Edward Street

heneghan peng architects 14-16 Lord Edward Street Dublin, D02 YC63 +353 1 633 9000

Storm King Art Center

1 Museum Road

Executive Architect
WXY Architecture + Urban Design
224 Centre Street, 5th Floor
New York, NY 10013
+1 (212) 219-1953

Landscape Architect
Gustafson Porter + Bowman
1 Cobham Mews
London, MW1 9SB
+44 020 7284 8950

Reed Hilderbrand LLC 33 Whitney Avenue, 3rd Floor New Haven, CT 06510 +1 (617) 923-2422

Structural & Lighting
ARUP
77 Water Street
New York, NY 10005

+1 (212) 896-3000

MEPF & IT

BuroHappold
100 Broadway #23


New York, NY 10005 +1 (212) 616-0228 Civil VHB

100 Great Oaks Blvd., Suite 118 Albany, NY 12203 +1 (518) 389-3606

AV & Acoustics LSTN Consultants 76 Beaver Street, 2nd Floor New York, NY 10005 +1 (347) 788-0810

Facade
Front Inc.
100 E. Broadway Street, #501
New York, NY 10002
+1 (212) 242-2220

Key Plan

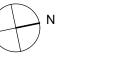

Description Date 50% Construction Documents 11/06/20

Storm King
Art Center

Project

Storm King

Art Center

Sea

Date	11/06/20
Scale	1/2" = 1'-0"
Drawing Number	A-P-644
Sheet Size	ARCH D

		Room Sched	ule	
Level	Number	Name	Occupancy	Room Are
Ground Level	101	Mechanical		12 SF
Ground Level	102	ADA/Family RR	U	48 SF
Ground Level	103	RR	U	31 SF
Ground Level	104	RR	U	31 SF
Ground Level	105	RR	U	31 SF
Ground Level	106	Custodian	В	12 SF
Ground Level	107	Prep		28 SF
Ground Level	108	Service	В	219 SF
Ground Level	109	Trash/Plumbing		49 SF
Ground Level	110	Electrical		8 SF
Ground Level	111	Cafe	В	703 SF
Ground Level	112	Covered Terrace	_	1369 SF

				Room Finish Sch	nedule				
ROOM NUMBER	ROOM NAME	FINISH - FLOOR	FINISH - BASE	FINISH - CEILING	FINISH - N WALL	FINISH - S WALL	FINISH - E WALL	FINISH - W WALL	COMMENTS
Ground Lev	rel								
101	Mechanical	Broom Finish Concrete	Painted Wood	Exposed Structural Plywood & Joists	Painted Gypsum	N/A	Painted Gypsum	Painted Gypsum	
102	ADA/Family RR	Polished Concrete	Tile To Floor	Exposed Structural Plywood & Joists	2" x 2" Wall Tile	2" x 2" Wall Tile	2" x 2" Wall Tile	2" x 2" Wall Tile	
103	RR	Polished Concrete	Tile To Floor	Exposed Structural Plywood & Joists	2" x 2" Wall Tile	2" x 2" Wall Tile	2" x 2" Wall Tile	2" x 2" Wall Tile	
104	RR	Polished Concrete	Tile To Floor	Exposed Structural Plywood & Joists	2" x 2" Wall Tile	2" x 2" Wall Tile	2" x 2" Wall Tile	2" x 2" Wall Tile	
105	RR	Polished Concrete	Tile To Floor	Exposed Structural Plywood & Joists	2" x 2" Wall Tile	2" x 2" Wall Tile	2" x 2" Wall Tile	2" x 2" Wall Tile	
106	Custodian	Polished Concrete	Painted Wood	Exposed Structural Plywood & Joists	2" x 2" Wall Tile	2" x 2" Wall Tile	2" x 2" Wall Tile	2" x 2" Wall Tile	
107	Prep	Polished Concrete	Painted Wood	Exposed Structural Plywood & Joists	Painted Gypsum	Painted Gypsum	Painted Gypsum	Painted Gypsum	
108	Service	Polished Concrete	Tile To Floor	Exposed Structural Plywood & Joists	Exterior Wood Cladding	Exterior Wood Cladding	N/A	Glazing	
109	Trash/Plumbing	Polished Concrete	Tile To Floor	Exposed Structural Plywood & Joists	2" x 2" Wall Tile	2" x 2" Wall Tile	2" x 2" Wall Tile	2" x 2" Wall Tile	
110	Electrical	Broom Finish Concrete	Painted Wood	Exposed Structural Plywood & Joists	N/A	Painted Gypsum	Painted Gypsum	Painted Gypsum	
111	Cafe	Polished Concrete & Hardwood Flooring	N/A	Exposed Structural Plywood & Joists	Foldable Glazing	Foldable Glazing	Exterior Wood Cladding	Exterior Wood Cladding	

Finish Schedule									
Specification Section	Key Name	Material	Manufacturer	Model/Series	Distributor	Size/Thickness	Finish	Color	Remarks
CARPET									
		RECESSED ENTRY MAT							
	CP-2 CP-3	CARPET TILE CARPET TILE							
	CP-4	CARPET TILE							
INTERIOR OF ACC 9									
INTERIOR GLASS &		STARPHIRE CLEAR GLASS							
	GL-2	BACKPAINTED GLASS / CAST							
	GL-3	BACKPAINTED GLASS / CAST							
	GL-4 GL-5	STARPHIRE MIRROR GLASS FROSTED GLASS PARTITION							
	GL-6	BACK-PAINTED GLASS							
						,	1	,	
METAL	MT-1	ALUMINUM (BUILDING FACADE)							
		BLACKENED STEEL							
	MT-3	STAINLESS STEEL							
PAINT & STAIN									
. Auti a OTAIN	PT-1	TYPICAL CEILING PAINT							
	PT-1A								
	PT-2 PT-3	TYPICAL WALL PAINT TYP TRIM, INTERIOR DOORS, BASE,							
		MILLWORK							
	PT-4	DRY ERASE PAINT							
	PT-5A								
	PT-6								
DI ACTED						,		-	
PLASTER	PL-1								
	PL-2								
							1		
PLASTIC LAMINATE	PLAM-1								
L	. =/ MVI · I								
RESILIENT FLOORII		LINIOLEUM SI COS TIL				1	ı	T	
	RF-1 RF-2	LINOLEUM FLOOR TILE RESILIENT FLOOR TILE							
	RF-3	RESILIENT FLOOR TILE							
	RF-4A	RUBBER / CORK TILE - DUPLICATE TL-7?							
	RF-4B RF-4C								
	NF-4C								
SOLID SURFACE MA									
		MARCITE MIXTURE QUARTZ SURFACE MATERIAL							
	SS-2	QUARTZ SURFACE MATERIAL							
				-				-	
STONE	ST-1	LIMESTONE							
	ST-2	MARBLE							
	ST-3								
TILE									
1166	TL-1	TERRAZZO TILE							
	TL-2	CERAMIC TILE							
	TL-3	CERAMIC TILE							
	TL-4 TL-5	CERAMIC TILE RECYCLED CERAMIC TILE							
	TL-6	GLASS MOSAIC							
	TL-7	CORK TILE							
WALLCOVERING									
	WC-1	WALLCOVERING							
	WC-2	WALLCOVERING							
	WC-3 WC-4	WALLCOVERING WALLCOVERING							
	1,,,,,,								
WINDOW TREATME		MOTORIZED DOLLET COLLET					ı	1	
	WT-1 WT-2	MOTORIZED ROLLER SHADE MOTORIZED ROLLER SHADE							
	1 2								
WOOD FLOOR	14/5= :	END OBAIN STORY TO COT					ı	1	
	WDF-1	END-GRAIN BLOCK FLOORING							
WOOD VENEER									
	WD-1	TEAK VENEER							
	WD-2	OAK VENEER							
		WALNUT VENEER							
	WD-3 WD-4	CEDAR VENEER							

Owner

Storm King Art Center
1 Museum Road
New Windsor, NY 12553

+1 (845) 534-3115

Design Architect

Design Architect
heneghan peng architects
14-16 Lord Edward Street
Dublin, D02 YC63
+353 1 633 9000

Executive Architect
WXY Architecture + Urban Design
224 Centre Street, 5th Floor
New York, NY 10013
+1 (212) 219-1953

Landscape Architect
Gustafson Porter + Bowman
1 Cobham Mews
London, MW1 9SB
+44 020 7284 8950

Reed Hilderbrand LLC 33 Whitney Avenue, 3rd Floor New Haven, CT 06510 +1 (617) 923-2422

Structural & Lighting
ARUP
77 Water Street
New York, NY 10005

+1 (212) 896-3000

MEPF & IT

BuroHappold
100 Broadway #23

100 Broadway #23
New York, NY 10005
+1 (212) 616-0228

Civil

VHB 100 Great Oaks Blvd., Suite 118 Albany, NY 12203 +1 (518) 389-3606

AV & Acoustics
LSTN Consultants
76 Beaver Street, 2nd Floor
New York, NY 10005
+1 (347) 788-0810

Facade
Front Inc.
100 E. Broadway Street, #501
New York, NY 10002
+1 (212) 242-2220

Key Plan

DescriptionDate50% Design Development02/24/20100% Design Development05/29/2050% Construction Documents11/06/20

Storm King Art Center

Pond Pavilion

Sea


NOT FOR CONSTRUCTION

Drawing Title


Room & Finish


Schedule


Date	11/06/20
Scale	Not to Scale
Drawing Number	A-P-701
Sheet Size	ARCH D

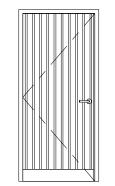



A21

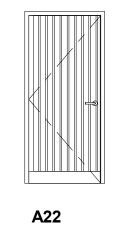

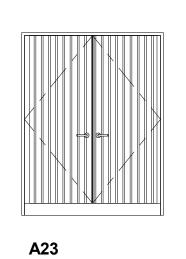


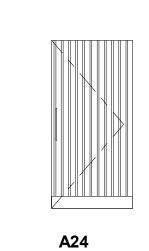


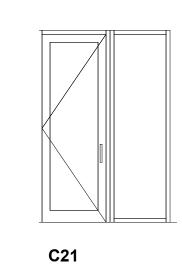


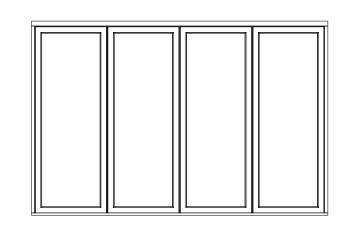



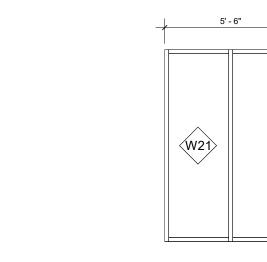

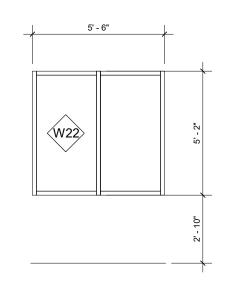

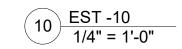



						Door Schedule					
Number	Door Type	Width	Height	Thickness	Door Material	Door Finish	Frame Material	Frame Finish	Fire Rating	Hardware Set	Comments
Ground Lev	/el										
101	A23	5' - 8"	7' - 6"	1 3/4"	Wood to Match Cladding	Waterproof Sealer	Wood	Waterproof Sealer	60 mins		
102	A21	3' - 0"	7' - 0"	1 3/4"	Wood to Match Cladding	Waterproof Sealer	Wood	Waterprrof Sealer	30 mins		
103	A21	3' - 0"	7' - 0"	1 3/4"	Wood to Match Cladding	Waterproof Sealer	Wood	Waterprrof Sealer	30 mins		
104	A21	3' - 0"	7' - 0"	1 3/4"	Wood to Match Cladding	Waterproof Sealer	Wood	Waterprrof Sealer	30 mins		
105	A21	3' - 0"	7' - 0"	1 3/4"	Wood to Match Cladding	Waterproof Sealer	Wood	Waterprrof Sealer	30 mins		
106	A22	3' - 0"	7' - 0"	1 3/4"	Wood to Match Cladding	Clear Wood Sealer	Wood	Clear Wood Sealer	30 mins		
107	A24	3' - 0"	7' - 0"	1 3/4"	Wood to Match Cladding	Waterproof Sealer	Wood	Waterproof Sealer	30 mins		
109.1	A24	3' - 0"	7' - 0"	1 3/4"	Wood to Match Cladding	Waterproof Sealer	Wood	Waterproof Sealer	30 mins		
109.2	A22	3' - 0"	7' - 0"	1 3/4"	Wood to Match Cladding	Clear Wood Sealer	Wood	Clear Wood Sealer	30 mins		
110	A23	5' - 8"	7' - 6"	1 3/4"	Wood to Match Cladding	Waterproof Sealer	Wood	Waterproof Sealer	60 mins		
111.1	E21	12' - 4 1/4"	8' - 0"	2 1/2"	Glass/Wood	Waterproof Sealer	Wood	Waterproof Sealer	30 mins		
111.2	E21	12' - 4 1/4"	8' - 0"	2 1/2"	Glass/Wood	Waterproof Sealer	Wood	Waterproof Sealer	30 mins		
111.3	C21	2' - 8"	7' - 10"	1 3/4"	Glass/Wood	Waterproof Sealer	Wood	Waterproof Sealer	30 mins		
111.4	C21	2' - 8"	7' - 10"	1 3/4"	Glass/Wood	Waterproof Sealer	Wood	Waterproof Sealer	30 mins		

	Window Schedule									
Window Type	Count	Description	Frame Material	Frame Finish	Heat Transfer Coefficient (U)	Thermal Resistance (R)				
W21	9	Full Height Sliding Window	Wood	Waterproof Sealer						
W22	2	Countertop Sliding Window	Wood	Waterproof Sealer						

LVR-6



	Skylight & Louvre Schedule												
Window Tag	Count	Description	Width	Height	Sill Height	Frame Material	Panel 1	Panel 2	Panel 3	Frame Finish	Heat Transfer Coefficient (U)	Solar Heat Gain Coefficient	Thermal Resistance (R)
L21	1	Louvre	5' - 0"	10"	7' - 1 1/2"								
L22	5	Louvre	5' - 6"	10 1/2"	0"								
W23	4	Skylight	1' - 8"	1' - 8"									

Storm King Art Center 1 Museum Road New Windsor, NY 12553

+1 (845) 534-3115 **Design Architect** heneghan peng architects 14-16 Lord Edward Street

Dublin, D02 YC63 +353 1 633 9000 **Executive Architect**

WXY Architecture + Urban Design 224 Centre Street, 5th Floor New York, NY 10013 +1 (212) 219-1953

Landscape Architect Gustafson Porter + Bowman 1 Cobham Mews London, MW1 9SB +44 020 7284 8950

Reed Hilderbrand LLC 33 Whitney Avenue, 3rd Floor New Haven, CT 06510

+1 (617) 923-2422 Structural & Lighting ARUP

77 Water Street New York, NY 10005 +1 (212) 896-3000

MEPF & IT BuroHappold 100 Broadway #23 New York, NY 10005 +1 (212) 616-0228

Civil VHB

100 Great Oaks Blvd., Suite 118 Albany, NY 12203

+1 (518) 389-3606 **AV & Acoustics** LSTN Consultants 76 Beaver Street, 2nd Floor New York, NY 10005

+1 (347) 788-0810 Facade Front Inc. 100 E. Broadway Street, #501 New York, NY 10002 +1 (212) 242-2220

Key Plan

Description 50% Design Development 02/24/20 100% Design Development 05/29/20 50% Construction Documents

Storm King Art Center

Pond Pavilion

NOT FOR CONSTRUCTION **Drawing Title** Window & Door Schedule

Date	11/06/20
Scale	1/4" = 1'-0"
Drawing Number	A-P-702
Sheet Size	ARCH D

	Equ	uipment & Accessories Lege	nd	
Type Mark	Item	ADA Compliant	Finish	Comments
	I			
EF-01	Fan Ceiling			
PL-01	Drinking Fountain			
PL-02	Toilet			
PL-03	Roof Downpipe			
PL-05	Vanity			
PL-06	Mop Sink			
SE-01	Pallet Stove			
SE-02	Fireguard			
TA-01	Paper Towel Dispenser			
TA-02	Mirror			
TA-04	Soap Dispenser			
TA-05	Grab Bar D			
TA-06	Grab Bar E			
TA-07	Toilet Paper Dispenser			
TA-10	Sanitary Napkin Dispenser			

KE-03 SKG_Service Sink Pond 1 KE-04 SKG_Service Sink Pond 1 KE-05 SKG_Dishwasher Pond 1 KE-06 SKG_Coffee Brewer Pond 1 KE-07 SKG_Coffee Dispenser Pond 4 KE-08 SKG_Ice Maker Pond 1 KE-09 SKG_POND_Service Counter_TIMBER 1 KE-10 SKG_Open Display Merchandiser Pond 2 KE-11 SKG_Refrigerator Undercounter Pond 1			
Type Mark	Item	Count	
KE-01	SKG Refrigerator Full Height Pond	2	
KE-02		1	
KE-03	SKG_Service Sink Pond	1	
KE-04	SKG_Service Sink Pond	1	
KE-05	SKG_Dishwasher Pond	1	
KE-06	SKG_Coffee Brewer Pond	1	
KE-07	SKG_Coffee Dispenser Pond	4	
KE-08	SKG_Ice Maker Pond	1	
KE-09	SKG_POND_Service Counter_TIMBER	1	
KE-10	SKG_Open Display Merchandiser Pond	2	
KE-11	SKG_Refrigerator Undercounter Pond	1	
KE-12	SKG_Warming Drawer Pond	1	
KE-13	SKG_Freezer Pond	1	
KE-14	POS System	2	
KE-15	SKG_Wine Cellar Cabinet Pond	1	

	Lighting Fixture Schedule									
Type Mark	Model	Fixture Finish Fixture Wattage	Electrical Data	Lamp	Lamp Correlated Color Temperature	Lamp Wattage	Comments			
AL02	XOOLUM IP67	19 W	120 V/1-19 VA	LED	3000K	8 W				
AP01	SORAA VIVID BR30	11 W	120 V/1-11 VA	LED	3000K	11 W				
AW02	22248	2 W	120 V/1-2 VA	LED		5 W				
AWS02	Palco In Out	9 W	48 V/1-9 VA	LED	3000K	9 W				
AWS03	Palco In Out	16 W	48 V/1-16 VA	LED	3000K	16 W				
	'		<u> </u>			-	<u>'</u>			
Ground Le	vel									
AWS03	Palco In Out	16 W	48 V/1-16 VA	LED	3000K	16 W				

Owner
Storm King Art Center
1 Museum Road
New Windsor, NY 12553
+1 (845) 534-3115

Design Architect
heneghan peng architects
14-16 Lord Edward Street
Dublin, D02 YC63
+353 1 633 9000

Executive Architect
WXY Architecture + Urban Design
224 Centre Street, 5th Floor
New York, NY 10013

+1 (212) 219-1953

Landscape Architect
Gustafson Porter + Bowman
1 Cobham Mews
London, MW1 9SB

+44 020 7284 8950

Reed Hilderbrand LLC
33 Whitney Avenue, 3rd Floor
New Haven, CT 06510

+1 (617) 923-2422

Structural & Lighting
ARUP
77 Water Street
New York, NY 10005

New York, NY 10005 +1 (212) 896-3000 MEPF & IT BuroHappold

100 Broadway #23
New York, NY 10005
+1 (212) 616-0228

Civil

VHB 100 Great Oaks Blvd., Suite 118 Albany, NY 12203 +1 (518) 389-3606

AV & Acoustics
LSTN Consultants
76 Beaver Street, 2nd Floor
New York, NY 10005
+1 (347) 788-0810

Facade
Front Inc.
100 E. Broadway Street, #501
New York, NY 10002
+1 (212) 242-2220

Key Plan

DescriptionDate50% Design Development02/24/20100% Design Development05/29/2050% Construction Documents11/06/20

Storm King
Art Center

Project

Storm King

Art Center

Seal

NOT FOR CONSTRUCTION
Drawing Title
Equipment Schedule

Date	11/06/20
Scale	Not to Scale
Drawing Number	A-P-703
Sheet Size	ARCH D

	Furniture Sc	hedule			
Type Mark	Item	Manufacturer	Material	Description	Count
FN-01	Outdoor_Dining_ChairSeaside_Casual_quot Charleston_Side_Chairquot_20663				16
FN-02	Pond Table Counter Height		Counter Top Solid Surface		4
FN-03	bar_stool_1869				18

	Millwork Schedule	
Type Mark	Item	Count
		T.
M22	Pond-Serving Cabinetry	1
M23	Exterior Bench2	1
M24	Exterior Bench8	1
MW-01	Pond-Service Cabinetry	1

Storm King Art Center 1 Museum Road New Windsor, NY 12553 +1 (845) 534-3115

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heneghan peng architects 14-16 Lord Edward Street Dublin, D02 YC63 +353 1 633 9000

Executive Architect WXY Architecture + Urban Design 224 Centre Street, 5th Floor New York, NY 10013

+1 (212) 219-1953 Landscape Architect

Gustafson Porter + Bowman 1 Cobham Mews London, MW1 9SB +44 020 7284 8950

Reed Hilderbrand LLC 33 Whitney Avenue, 3rd Floor New Haven, CT 06510 +1 (617) 923-2422

Structural & Lighting ARUP 77 Water Street

New York, NY 10005 +1 (212) 896-3000 MEPF & IT

BuroHappold 100 Broadway #23 New York, NÝ 10005 +1 (212) 616-0228

Civil VHB

100 Great Oaks Blvd., Suite 118 Albany, NY 12203

+1 (518) 389-3606 **AV & Acoustics**

LSTN Consultants 76 Beaver Street, 2nd Floor New York, NY 10005 +1 (347) 788-0810

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Key Plan




Description 50% Construction Documents 11/06/20

Storm King Art Center **Pond Pavilion**

NOT FOR CONSTRUCTION **Drawing Title** Millwork & Furniture Schedule

Date	11/06/20
Scale	
Drawing	A-P-704
Number	711 701

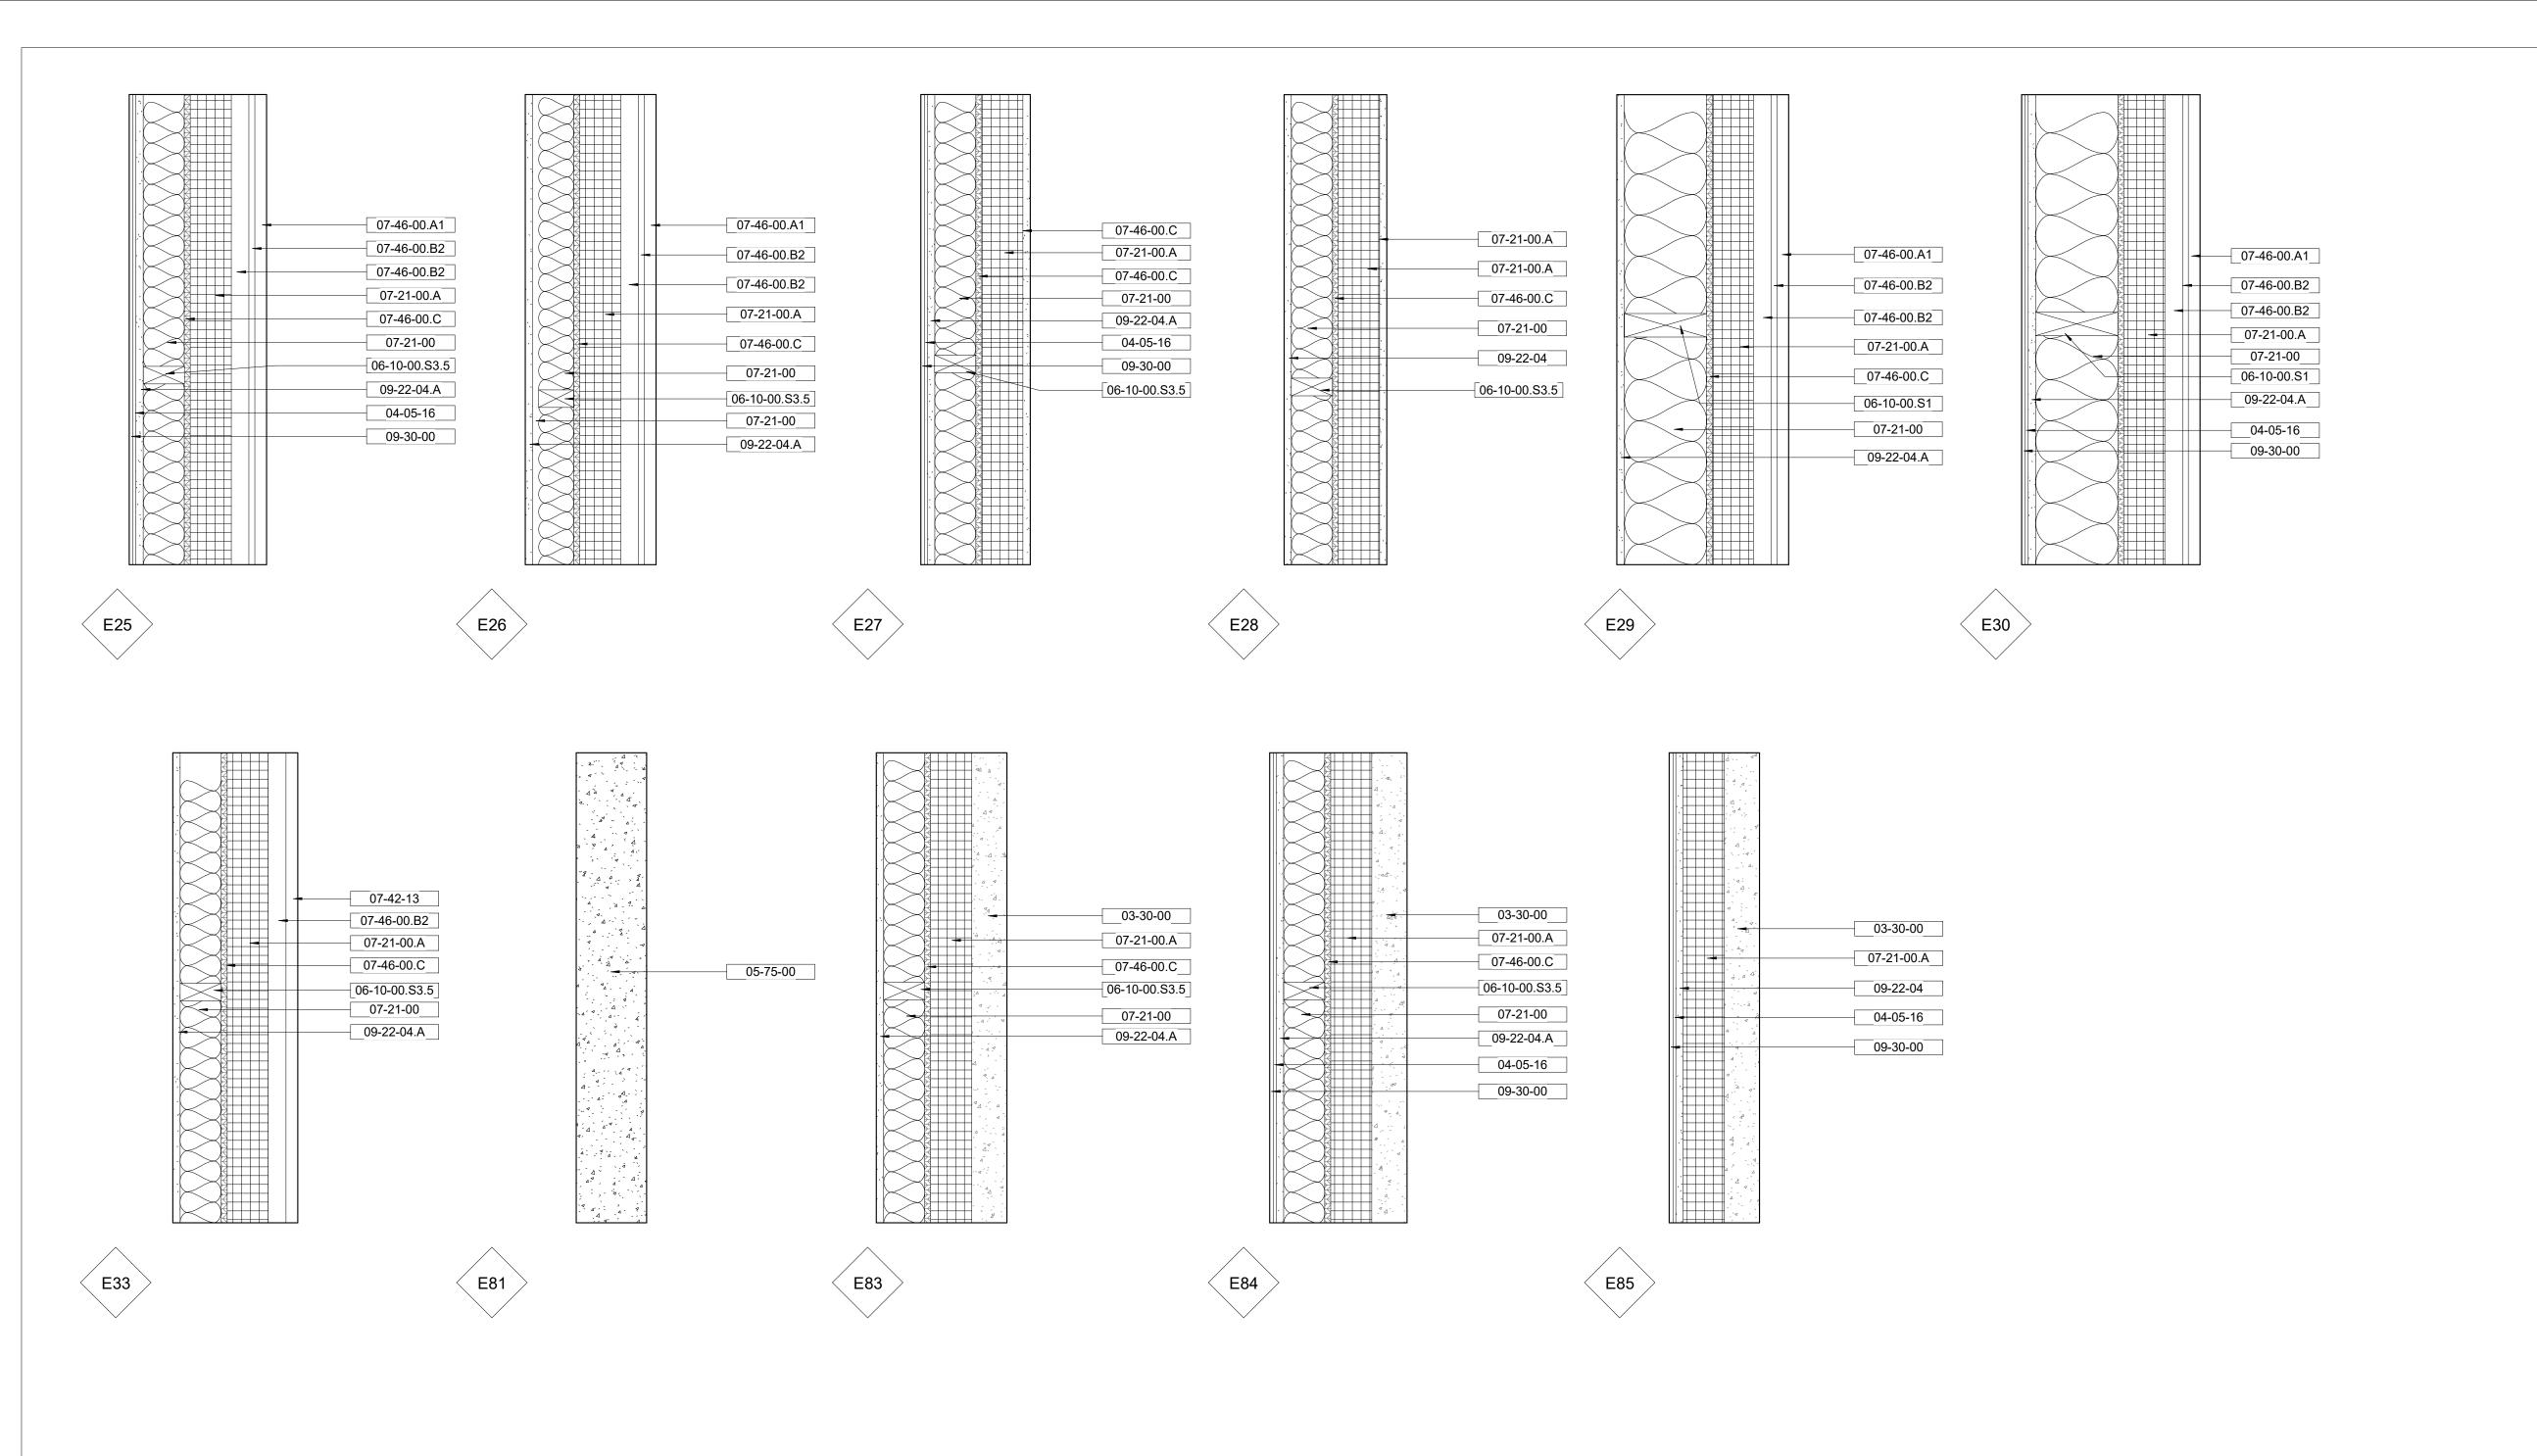

Keynote Le	gend
Keynote	Description
03-30-00	Cast-In-Place Concrete
04-05-16	
05-75-00	Decorative Formed Metal
06-10-00.S 1	Stud - 2x7" Nominal
06-10-00.S 3.5	Stud - 2x3.5" Nominal
07-21-00	Batt Insulation
07-21-00.A	Mineral Wool Insulation
07-42-13	Metal Wall Panels
07-46-00.A 1	Abodo 'Pearl' Board - 4x1" Nominal
07-46-00.B 2	Furring Strip - Pressure Treated - 2x3/4"
07-46-00.C	Plywood Sheating - 1/2"
09-22-04	5/8" Gypsum Wall Board
09-22-04.A	5/8" Gypsum Wall Board - Wet
09-30-00	2"x2" Matte Wall Tile

Owner Storm King Art Center 1 Museum Road New Windsor, NY 12553 +1 (845) 534-3115 **Design Architect** heneghan peng architects 14-16 Lord Edward Street Dublin, D02 YC63 +353 1 633 9000 **Executive Architect** WXY Architecture + Urban Design 224 Centre Street, 5th Floor New York, NY 10013 +1 (212) 219-1953 Landscape Architect Gustafson Porter + Bowman 1 Cobham Mews London, MW1 9SB +44 020 7284 8950 Reed Hilderbrand LLC 33 Whitney Avenue, 3rd Floor New Haven, CT 06510 +1 (617) 923-2422 Structural & Lighting ARUP 77 Water Street New York, NY 10005 +1 (212) 896-3000 MEPF & IT BuroHappold

100 Broadway #23 New York, NY 10005 +1 (212) 616-0228

Civil

VHB
100 Great Oaks Blvd., Suite 118
Albany, NY 12203
+1 (518) 389-3606

AV & Acoustics
LSTN Consultants
76 Beaver Street, 2nd Floor
New York, NY 10005
+1 (347) 788-0810

Facade

100 E. Broadway Street, #501

New York, NY 10002

+1 (212) 242-2220 Key Plan

Front Inc.


DescriptionDate50% Design Development02/24/20100% Design Development05/29/2050% Construction Documents11/06/20

Storm King
Art Center
Pond Pavilion

Sea

NOT FOR CONSTRUCTION
Drawing Title
Exterior Wall Types

Date	11/06/20
Scale	1 1/2" = 1'-0"
Drawing Number	A-P-711
Sheet Size	ARCH D

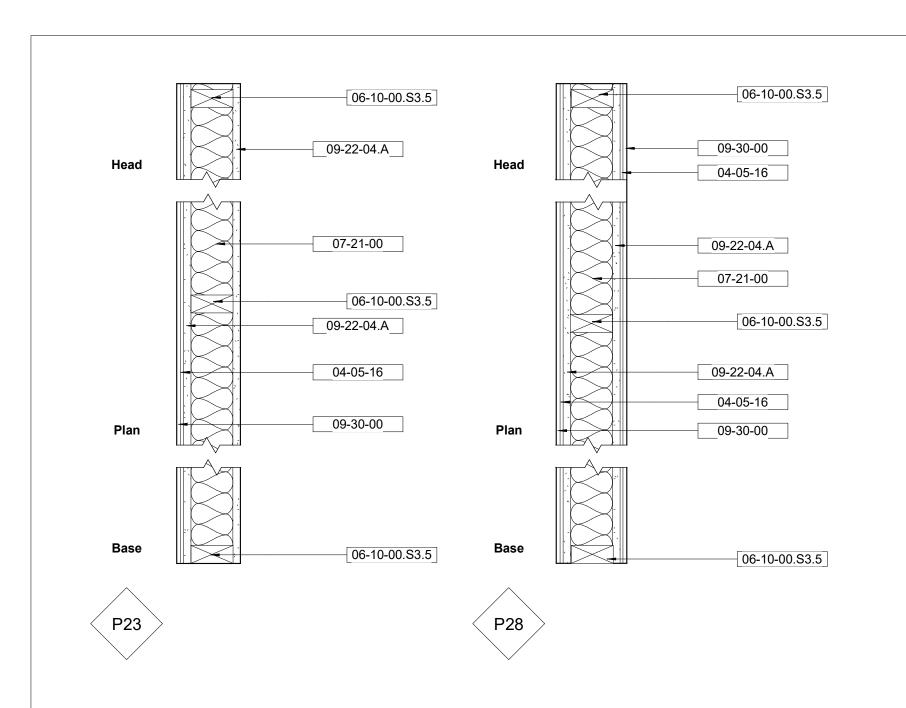

Keynote Legend Keynote Description 04-05-16 06-10-00.S | Stud - 2x3.5" Nominal 07-21-00 Batt Insulation 09-22-04.A | 5/8" Gypsum Wall Board 09-30-00 2"x2" Matte Wall Tile

Storm King Art Center 1 Museum Road New Windsor, NY 12553 +1 (845) 534-3115

Design Architect

heneghan peng architects 14-16 Lord Edward Street Dublin, D02 YC63 +353 1 633 9000

Executive Architect WXY Architecture + Urban Design 224 Centre Street, 5th Floor New York, NY 10013 +1 (212) 219-1953

Landscape Architect Gustafson Porter + Bowman 1 Cobham Mews London, MW1 9SB +44 020 7284 8950

Reed Hilderbrand LLC 33 Whitney Avenue, 3rd Floor New Haven, CT 06510 +1 (617) 923-2422

Structural & Lighting ARUP 77 Water Street New York, NY 10005 +1 (212) 896-3000

MEPF & IT BuroHappold 100 Broadway #23 New York, NY 10005

+1 (212) 616-0228 Civil VHB 100 Great Oaks Blvd., Suite 118

Albany, NY 12203 +1 (518) 389-3606

AV & Acoustics LSTN Consultants 76 Beaver Street, 2nd Floor New York, NY 10005 +1 (347) 788-0810 Facade

Front Inc. 100 E. Broadway Street, #501 New York, NY 10002 +1 (212) 242-2220


Key Plan

Description Date 50% Design Development 02/24/20 100% Design Development 05/29/20 50% Construction Documents

Storm King Art Center **Pond Pavilion**

NOT FOR CONSTRUCTION **Drawing Title** Interior Wall Types


11/06/20 1 1/2" = 1'-0" A-P-721 ARCH D Sheet Size

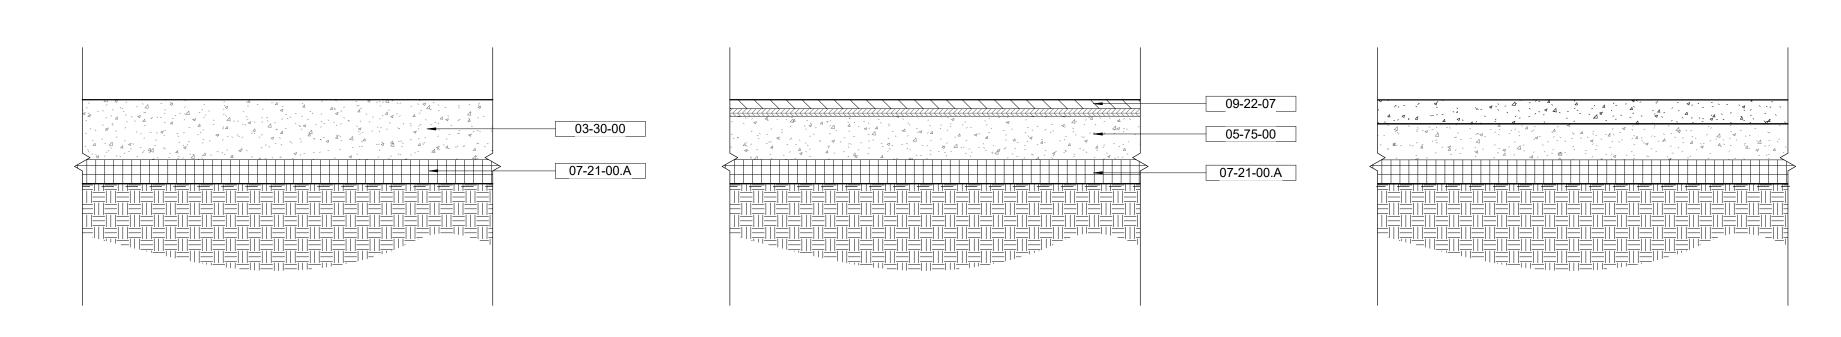


F21

5" Concrete Slab per Structural 8" rigid expanded polystyrene foam insulation Vapor Barrier 1/2" Timber Flooring
4 1/2" Concrete Slab per Structural
8" rigid expanded polystyrene foam insulation
Vapor Barrier

2" Topping Slab Concrete
In-Slab Electrical Matts
3" Concrete Slab per Structural
8" rigid expanded polystyrene foam insulation
Vapor Barrier

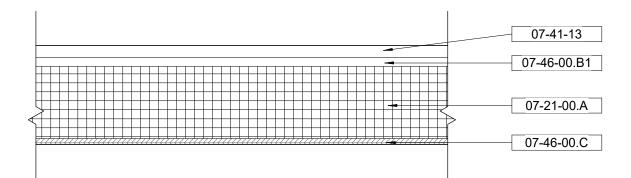

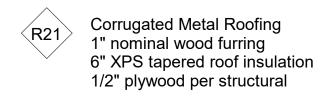

Keynote LegendKeynoteDescription03-30-00Cast-In-Place Concrete05-75-00Decorative Formed
Metal07-21-00.AMineral Wool Insulation07-41-13Metal Roofing07-46-00.BFurring Strip - Pressure
Treated Painted Black -
2x3/4"07-46-00.CPlywood Sheating - 1/2"09-22-07

1 Museum Road New Windsor, NY 12553 +1 (845) 534-3115 **Design Architect** heneghan peng architects 14-16 Lord Edward Street Dublin, D02 YC63 +353 1 633 9000 **Executive Architect** WXY Architecture + Urban Design 224 Centre Street, 5th Floor New York, NY 10013 +1 (212) 219-1953 Landscape Architect Gustafson Porter + Bowman 1 Cobham Mews London, MW1 9SB +44 020 7284 8950 Reed Hilderbrand LLC 33 Whitney Avenue, 3rd Floor New Haven, CT 06510 +1 (617) 923-2422 Structural & Lighting ARUP 77 Water Street New York, NY 10005 +1 (212) 896-3000 MEPF & IT BuroHappold 100 Broadway #23 New York, NY 10005 +1 (212) 616-0228 Civil VHB 100 Great Oaks Blvd., Suite 118 Albany, NY 12203 +1 (518) 389-3606 **AV & Acoustics** LSTN Consultants 76 Beaver Street, 2nd Floor New York, NY 10005 +1 (347) 788-0810 Facade Front Inc. 100 E. Broadway Street, #501 New York, NY 10002

Owner

Storm King Art Center

Key Plan

+1 (212) 242-2220

Description Date
100% Design Development 05/29/20
50% Construction Documents 11/06/20

Storm King
Art Center
Pond Pavilion

Seal

NOT FOR CONSTRUCTION

Drawing Title

Floor & Roof Types

Date	11/06/20
Scale	1 1/2" = 1'-0"
Drawing Number	A-P-731
Sheet Size	ARCH D

	SYMBOLS
SYMBOL	DESCRIPTION
[]	CAMBER
<>	NUMBER OF STUDS
()	TOP ELEVATION OF STRUCTURAL ELEMENT
((((STEEL BEAM
<u> </u>	STEEL JOIST
	BRACE FRAME
-	MOMENT CONNECTION
>	CANTILEVER MOMENT CONNECTION
•	DRAG CONNECTION
I ————————————————————————————————————	PLATE CONNECTION
7	STIFFENER PLATE CONNECTION
H	SPLICE
•	COLUMN STARTS ON THIS LEVEL
	COLUMN FINISHES BELOW THIS LEVEL
$\bigoplus_{\blacktriangledown}$	COLUMN HANGER
P P	COLUMN POST
S.	SLOPED COLUMN STARTS ON THIS LEVEL
S	SLOPED COLUMN FINISHES BELOW THIS LEVEL
S	SLOPED COLUMN CONTINUES THROUGH THIS LEVEL
	SLAB DROP
77777777	SLAB SLOPE
7777777	CHANGE IN SLAB THICKNESS
***/////\``	GROUND
	ONE WAY SPANNING SLAB
-	TWO WAY SPANNING SLAB
T/SL = X'-XX"	TOP OF SLAB ELEVATION
	WELD TYPE
	CONCRETE WALL (PLAN VIEW)
	CONCRETE BEAM (PLAN VIEW)
•	SETTING OUT POINT/WORK POINT
LEVEL	LEVEL

ABV.	DESCRIPTION ALTERNATE
	I ALTERNATE
BET	BETWEEN
BF	BOTH FACES
BLDG	BUILDING
ВМ	BEAM
ВОТ	BOTTOM
BPL BS	BASE PLATE BOTH SIDES
 В/ST	BOTTOM OF STEEL
	BOTTOM OF OTELL
С	CHANNEL
CANT	CANTILEVER
CJ	CONSTRUCTION JOINT
CJP CL	COMPLETE JOINT PENETRATION (WELD)
CLR	CENTERLINE CLEAR
COL	COLUMN
CONC	CONCRETE
CONN	CONNECTION
CONST	CONSTRUCTION
CONT	COVERBLATE
CPL CTRL JT	COVERPLATE CONTROL JOINT
OTTL UT	CONTROL DOMAI
D	DEPTH, DEEP, DECK
DEMO	DEMOLITION
DET	DETAIL
DIA	DIAMETER
DIAG DIM	DIAGONAL DIMENSION
DJ	DOWEL JOINT
DL	DEAD LOAD
DO	DITTO
DWG	DRAWING
_	
E EA	MODULUS OF ELASTICITY
EA EF	EACH FACE
EJ	EXPANSION JOINT
EL	ELEVATION
EMB	EMBEDMENT
EQ	EQUAL
EW EXIST	EACH WAY EXISTING
EXP	EXPANSION
EXT	EXTERIOR
FF	FAR FACE
FFL	FINISH FLOOR LEVEL
FDN FIN	FOUNDATION FINISHED
FL	FLOOR
FS	FAR SIDE
FT	FEET
FTG	FOOTING
FY	YIELD STRESS
GA	GAUGE
GALV	GALVANISED
GR	GRADE
Н	AXIAL FORCE, SEE P
HEX	HEXAGON, HEXAGONAL
HORIZ HP	HORIZONTAL HIGH POINT
HSB	HIGH-STRENGTH BOLT
HSS	HOLLOW STRUCTURAL SECTION
HT	HEIGHT
	W0/8= 5
ID	INSIDE DIAMETER
IF IJ	INSIDE FACE ISOLATION JOINT
IN	INCH
INT	INTERIOR
JT	JOINT
	I/ID 4000 LDC
K KSF	KIP = 1000 LBS KIPS PER SQUARE FOOT
I/OF	MI O I LITOQUANE FUUT

		ABBREVIATIONS
	ABV.	DESCRIPTION
	L	LENGTH
	LB	POUND
	LG	LONG
	LIN	LINEAR OR LINEAL
	LL	LIVE LOAD
	LLH	LONG LEG HORIZONTAL
	LLV	LONG LEG VERTICAL
	LP	LOW POINT
	LSL	LONG SLOTTED (BOLT HOLE)
	LT	LIGHT
	LW	LIGHT WEIGHT
		MOMENT FORCE
	M MD	MOMENT FORCE METAL DECK
N (WELD)	MF	MOMENT FRAME
(WELD)	MJ	MOVEMENT JOINT
	100	MCVEMENT CONT
	NF	NEAR FACE
	NIC	NOT IN CONTRACT
	NO	NUMBER
	NOM	NOMINAL
	NS	NEAR SIDE
	NTS	NOT TO SCALE
	NW	NORMAL WEIGHT
	OC	ON CENTER
	OD	OUTSIDE DIAMETER
	OF	OUTSIDE FACE
	ОН	OPPOSITE HAND
	OPNG	OPENING
	OPP	OPPOSITE
	OVS	OVERSIZE (BOLT HOLE)
		AVIAL FORCE
	P PCF	AXIAL FORCE POLINDS PER CURIC FOOT
	PERP	POUNDS PER CUBIC FOOT PERPENDICULAR
	PL	PLATE
	PP	PARTIAL PENETRATION (WELD)
	PSF	POUNDS PER SQUARE FOOT
	PSI	POUNDS PER SQUARE INCH
	PT	POINT
		-
	R	RADIUS
	REBAR	REINFORCING BAR
	REINF	REINFORCE(ING)
	REV	REVISION
	S	SLAB
	SIM	SIMILAR
	SL	SLAB
	SOG	SLAB ON GRADE
	SQ FT	SQUARE FOOT
	SQ IN	SQUARE INCH
	SS	STAINLESS STEEL
	SSL	SHORT SLOTTED (BOLT HOLE)
	STD	STANDARD
	STIFF	STIFFENER
	STRUCT	STEEL STRUCTURAL
	SINUCI	STRUCTURAL
	T&B	TOP & BOTTOM
	THK	THICK
	T/CONC	TOP OF CONCRETE
	T/D	TOP OF METAL DECK
	TOPG	TOPPING
	T/SL	TOP OF SLAB
	T/ST	TOP OF STEEL
N	TS	STRUCTURAL STEEL TUBE
	T/WALL	TOP OF WALL
	TYP	TYPICAL
	UON	UNLESS OTHERWISE NOTED
	V	SHEAR FORCE
	VERT, V	VERTICAL (FORCE)
	VIF	VERIFY IN FIELD
	W/	WITH
	W/O	WITHOUT
	WP	WORK POINT
	WWF	WELDED WIRE FABRIC
	XS	EXTRA STRONG (PIPE)

P	ABBREVIATIONS
BV.	DESCRIPTION
L,	LENGTH
LB	POUND
LG	LONG
LIN	LINEAR OR LINEAL
LL	LIVE LOAD
LLH	LONG LEG VERTICAL
LLV LP	LONG LEG VERTICAL LOW POINT
LSL	LONG SLOTTED (BOLT HOLE)
LT	LIGHT
LW	LIGHT WEIGHT
М	MOMENT FORCE
MD	METAL DECK
MF	MOMENT FRAME
MJ	MOVEMENT JOINT
NF	NEAR FACE
NIC	NOT IN CONTRACT
NO	NUMBER
NOM	NOMINAL
NS	NEAR SIDE
NTS	NOT TO SCALE
NW	NORMAL WEIGHT
00	ON CENTER
OD	OUTSIDE DIAMETER
OF OH	OUTSIDE FACE
OH PNG	OPPOSITE HAND OPENING
PNG DPP	OPPOSITE
DVS	OVERSIZE (BOLT HOLE)
Р	AXIAL FORCE
PCF	POUNDS PER CUBIC FOOT
ERP	PERPENDICULAR
PL	PLATE
PP	PARTIAL PENETRATION (WELD)
PSF	POUNDS PER SQUARE FOOT
PSI DT	POUNDS PER SQUARE INCH
PT	POINT
R	RADIUS
EBAR	REINFORCING BAR
EINF	REINFORCE(ING)
REV	REVISION
S	SLAB
SIM	SIMILAR
SL SOG	SLAB SLAB ON GRADE
Q FT	SQUARE FOOT
Q FI Q IN	SQUARE INCH
SS	STAINLESS STEEL
SSL	SHORT SLOTTED (BOLT HOLE)
STD	STANDARD
TIFF	STIFFENER
ST	STEEL
RUCT	STRUCTURAL
Γ&B	TOP & BOTTOM
THK	THICK
CONC T/D	TOP OF CONCRETE TOP OF METAL DECK
OPG	TOP OF METAL DECK TOPPING
OPG T/SL	TOPPING TOP OF SLAB
7/SL 7/ST	TOP OF SLAB TOP OF STEEL
TS	STRUCTURAL STEEL TUBE
WALL	TOP OF WALL
ГҮР	TYPICAL
JON	UNLESS OTHERWISE NOTED
.,	211-15-5-5-
V DT V	SHEAR FORCE
RT, V	VERTICAL (FORCE)
VIF	VERIFY IN FIELD
W/	WITH
N/O	WITHOUT
WP	WORK POINT
VWF	WELDED WIRE FABRIC

Owner Storm King Art Center 1 Museum Road New Windsor, NY 12553 +1 (845) 534-3115

Design Architect heneghan peng architects 14-16 Lord Edward Street Dublin, D02 YC63 +353 1 633 9000

Executive Architect WXY Architecture + Urban Design 224 Centre Street, 5th Floor New York, NY 10013

+1 (212) 219-1953 Landscape Architect Gustafson Porter + Bowman 1 Cobham Mews London, MW1 9SB

+44 020 7284 8950 Reed Hilderbrand LLC 33 Whitney Avenue, 3rd Floor New Haven, CT 06510 +1 (617) 923-2422

Structural & Lighting ARUP 77 Water Street New York, NY 10005 +1 (212) 896-3000

MEPF & IT BuroHappold 100 Broadway #23 New York, NÝ 10005

+1 (212) 616-0228 Civil VHB

100 Great Oaks Blvd., Suite 118 Albany, NY 12203 +1 (518) 389-3606

AV & Acoustics LSTN Consultants 76 Beaver Street, 2nd Floor New York, NY 10005 +1 (347) 788-0810

Facade Front Inc. 100 E. Broadway Street, #501 New York, NY 10002 +1 (212) 242-2220

Key Plan

Description Date 50% Design Development 02/24/20 100% Design Development 05/29/20 50% Construction Documents

Storm King Art Center **Pond Pavilion**

NOT FOR CONSTRUCTION **Drawing Title** Structural Symbols and Abbreviations

11/06/20 12" = 1'-0" S-P-001 ARCH D Sheet Size

GENERAL NOTES

- 1. ALL CONSTRUCTION SHALL BE IN ACCORDANCE WITH THE FOLLOWING:
- A. PROJECT GOVERNING CODE(S) AND STANDARDS.
- B. DRAWINGS. C. SPECIFICATIONS.
- 2. THE STRUCTURAL DRAWINGS ARE INTENDED TO WORK WITH AND BE COMPLEMENTARY TO THE PROJECT SPECIFICATIONS. REFER TO THE SPECIFICATIONS FOR ADDITIONAL REQUIREMENTS.
- 3. IN THE EVENT THAT CERTAIN DETAILS OF THE CONSTRUCTION ARE NOT FULLY SHOWN OR NOTED ON DRAWINGS, THEIR CONSTRUCTION SHALL BE OF THE SAME TYPE AS FOR SIMILAR CONDITIONS THAT ARE SHOWN OR NOTED, SUBJECT TO THE STRUCTURAL ENGINEER'S APPROVAL.
- 4. THE CONTRACTOR SHALL VERIFY ALL EXISTING CONDITIONS AND DIMENSIONS BEFORE COMMENCING WITH THE WORK AND NOTIFY THE ARCHITECT AND ENGINEER OF ANY DISCREPANCIES WITH THE INFORMATION SHOWN ON THE
- 5. THE CONTRACTOR SHALL USE STRUCTURAL DRAWINGS IN CONJUNCTION WITH ARCHITECTURAL, MECHANICAL, ELECTRICAL, PLUMBING, FIRE PROTECTION AND ALL OTHER RELEVANT CONSULTANT DRAWINGS.
- 6. SEE ARCHITECTURAL DRAWINGS FOR THE FOLLOWING:
- A. SIZE AND LOCATION OF ALL DOOR AND WINDOW OPENINGS, EXCEPT AS NOTED. B. SIZE AND LOCATION OF ALL INTERIOR AND EXTERIOR NON-BEARING PARTITIONS, FAÇADE, LOUVERS ETC., EXCEPT
- C. SIZE AND LOCATION OF ALL CONCRETE CURBS, FLOOR DRAINS, SLOPES, DEPRESSED AREAS, CHANGE IN LEVEL,
- CHAMFERS, GROOVES, INSERTS, ETC., EXCEPT AS SHOWN. D. SIZE AND LOCATION OF ALL FLOOR AND ROOF OPENINGS EXCEPT AS SHOWN.
- E. FLOOR AND ROOF FINISHES.
- EDGE OF SLAB LOCATIONS AROUND THE PERIMETER AND AT INTERIOR OPENINGS, EXCEPT AS SHOWN.
- G. DIMENSIONS NOT SHOWN ON THE STRUCTURAL DRAWINGS. H. STAIRS EXCEPT AS SHOWN.
- FIREPROOFING.
- K. MISCELLANEOUS STEEL REQUIRED FOR SUPPORT OF ARCHITECTURAL ELEMENTS.
- 7. SEE MECHANICAL, ELECTRICAL AND PLUMBING DRAWINGS FOR THE FOLLOWING:
- A. PIPE RUNS, SLEEVES, HANGERS, TRENCHES EXCEPT AS SHOWN OR NOTED.
- B. ELECTRICAL CONDUIT RUNS, BOXES, OUTLETS IN WALLS AND SLABS. CONDUITS SHALL NOT BE CAST IN CONCRETE
- MEMBERS UNLESS SPECIFICALLY INDICATED ON THE STRUCTURAL DRAWINGS. C. CONCRETE INSERTS FOR ELECTRICAL, MECHANICAL, OR PLUMBING FIXTURES.
- SIZE AND LOCATION OF EQUIPMENT PADS AND EQUIPMENT ANCHORAGE EXCEPT AS SHOWN OR NOTED E. ALL LIGHTNING PROTECTION AND/OR GROUND/EARTHING REQUIREMENTS INCLUDING ANY ASSOCIATED ITEMS
- EMBEDDED IN OR ATTACHED TO STRUCTURE. F. VERIFY AND COORDINATE ALL OPENINGS, EQUIPMENT PADS, SLEEVES AND INSERTS WITH REVIEWED SUBMITTALS, AND NOTIFY THE STRUCTURAL ENGINEER USING HIGHLIGHTED DRAWINGS PRODUCED TO SCALE WHERE THESE DEVIATE IN SIZE OR LOCATION FROM THE STRUCTURAL DRAWINGS.
- OPENINGS, POCKETS, ETC., LARGER THAN 6" SHALL NOT BE PLACED IN CONCRETE SLABS, DECKS, WALLS, UNLESS SPECIFICALLY DETAILED ON THE STRUCTURAL DRAWINGS. NOTIFY THE STRUCTURAL ENGINEER WHEN DRAWINGS BY OTHERS SHOW OPENINGS, POCKETS, ETC. LARGER THAN 6" WHICH ARE NOT SHOWN ON THE STRUCTURAL DRAWINGS BUT WHICH ARE LOCATED IN STRUCTURAL MEMBERS.
- DEPRESSIONS IN SLABS SHALL NOT BE PLACED UNLESS SPECIFICALLY SHOWN ON THE STRUCTURAL DRAWINGS. NOTIFY THE STRUCTURAL ENGINEER WHEN DRAWINGS BY OTHERS SHOW DEPRESSIONS WHICH ARE NOT SHOWN ON THE STRUCTURAL DRAWINGS BUT WHICH ARE LOCATED IN STRUCTURAL SLABS.
- 10. THE INFORMATION SHOWN FOR NON-STRUCTURAL ELEMENTS/FINISHES IS GIVEN FOR REFERENCE ONLY, THE CONTRACTOR SHALL REFER TO ARCHITECTURAL DRAWINGS FOR THIS INFORMATION.
- 11. SCALES NOTED ON STRUCTURAL DRAWINGS ARE FOR REFERENCE ONLY. NO DIMENSIONAL INFORMATION SHALL BE OBTAINED BY SCALING FROM THE DRAWINGS. THE CONTRACTOR SHALL VERIFY DIMENSIONS NOT NOTED WITH THE ARCHITECT PRIOR TO PROCEEDING WITH WORK.
- 12. CLADDING/FAÇADE/STAIR CONNECTIONS TO THE STRUCTURE SHALL NOT INTRODUCE TORSION AND UNACCEPTABLE LOAD ECCENTRICITIES TO STRUCTURAL MEMBERS. SUCH CONDITIONS SHOULD BE BROUGHT TO THE ATTENTION OF THE STRUCTURAL ENGINEER WHO MAY REQUIRE ADDITIONAL BRACING TO BE PROVIDED BY THE CLADDING/FAÇADE CONTRACTOR AT NO ADDITIONAL COST TO THE CONTRACT

CODES AND STANDARDS

- 1. WHERE CODES AND STANDARDS ARE REFERENCED IN THE CONTRACT DOCUMENTS, THEY SHALL BE THE LATEST EDITIONS, UNLESS NOTED OTHERWISE.
- 2. ALL WORK SHALL CONFORM TO THE REQUIREMENTS OF 2015 INTERNATIONAL BUILDING CODE (IBC) INCLUDING REFERENCE STANDARDS, ADDENDA AND APPENDICES WITH 2017 NEW YORK STATE UNIFORM CODE SUPPLEMENT.
- 3. IN ADDITION, THE FOLLOWING CODES, STANDARDS AND SPECIFICATIONS SHALL APPLY WHERE MORE STRINGENT AND AS MODIFIED BY THE BUILDING CODE:
- A. ACI 318-11: BUILDING CODE REQUIREMENTS FOR STRUCTURAL CONCRETE AND COMMENTARY.
- B. AISC: STEEL CONSTRUCTION MANUAL, 14TH EDITION. AISC 303-10: CODE OF STANDARD PRACTICE FOR STRUCTURAL STEEL BUILDINGS AND BRIDGE
- ANSI/AISC 360-10: SPECIFICATIONS FOR STRUCTURAL STEEL BUILDINGS.
- ASCE 7-10: MINIMUM DESIGN LOADS FOR BUILDINGS AND OTHER STRUCTURES. F. AWS D1.1/D1.1M:2010: STRUCTURAL WELDING CODE-STEEL.
- 4. THE ASTM STANDARDS REFERRED TO IN THE DRAWINGS AND SPECIFICATIONS AND USED IN DESIGN ARE THOSE INCLUDED AS REFERENCED STANDARDS TO THE PROJECT GOVERNING CODE(S). WHERE AN ASTM STANDARD HAS SUBSEQUENTLY BEEN REVISED, CONSTRUCTION SHALL COMPLY WITH BOTH THE LATEST EDITION OF THAT STANDARD AND THE EDITION OF THAT STANDARD REFERENCED IN DESIGN. WHERE IT IS NOT POSSIBLE TO SATISFY THE REQUIREMENTS OF BOTH EDITIONS OF THE STANDARDS DUE TO A CONFLICT BETWEEN THEM, NOTIFY THE ARCHITECT AND ENGINEER BEFORE PROCEEDING.

TEMPORARY WORK

- 1. ALL TEMPORARY WORK SHALL BE DESIGNED, INSTALLED AND CARRIED OUT BY THE CONTRACTOR IN ACCORDANCE WITH THE REQUIREMENTS OF THE PROJECT GOVERNING CODE(S).
- 2. THE DRAWINGS INDICATE THE COMPLETED STRUCTURE. THE CONTRACTOR IS FULLY RESPONSIBLE FOR ALL TEMPORARY MEASURES NECESSARY FOR ERECTION.
- 3. IT IS THE RESPONSIBILITY OF THE CONTRACTOR TO PROVIDE PROPER SHORING AND BRACING WHEREVER NECESSARY. ALL TEMPORARY SHORING/BRACING SHALL BE DESIGNED BY A CIVIL AND/OR STRUCTURAL ENGINEER REGISTERED IN NEW YORK STATE.
- 4. THE CONTRACTOR IS RESPONSIBLE FOR SUBMITTING THE SHORING DRAWINGS AND CALCULATIONS TO THE AUTHORITY HAVING JURISDICTION AS REQUIRED.
- CONSTRUCTION LOADS SHALL NOT EXCEED THE DESIGN LIVE LOADS PER SQUARE FOOT AS SHOWN ON THE DRAWINGS. PROVIDE SHORING AND/OR BRACING WHERE THE STRUCTURE HAS NOT ATTAINED ITS DESIGN STRENGTH.

DESIGN BASIS

- SUPERIMPOSED DEAD LOADS: REFER TO LOADING DIAGRAMS
- LIVE LOADS: REFER TO LOADING DIAGRAMS.
- WIND LOADS:

PARAMETER	VALUE
BASIC WIND SPEED, V	115 MPH
WIND IMPORTANCE FACTOR, I	1.00
WIND EXPOSURE CATEGORY	В
OCCUPANCY CATEGORY	II
GUST FACTOR, G = 0.85	0.85
DIRECTIONALITY FACTOR, Kd = 0.85	0.85

SNOW LOADS

PARAMETER	VALUE
GROUND SNOW LOAD	30 PSF
SNOW IMPORTANCE FACTOR, I	1.00
SNOW EXPOSURE CATEGORY	В
THERMAL FACTOR	0.9
UNBALACED DRIFT PER CODE	

SEISMIC LOADS:

PARAMETER	VALUE
SEISMIC IMPORTANCE FACTOR, I	1.00
SITE CLASS	D
Sms	0.360g
Sm1	0.164g
Sds	0.240g
Sd1	0.109g
OCCUPANCY CATEGORY	II
SEISMIC DESIGN CATEGORY	В
SEISMIC FORCE-RESISTING SYSTEM	CONCENTRIC BRACED FRAME
RESPONSE MODIFICATION COEFFICIENT, R	3.25
SEISMIC RESPONSE COEFFICIENT, Cs	
DESIGN BASE SHEAR, V	470KIP
SYSTEM OVERSTRENGTH FACTOR, Ω0	
DEFLECTION AMPLIFICATION FACTOR, Cd	
ANALYSIS PROCEDURE	EQUIVALENT LATERAL FORCE

FOUNDATIONS

- 1. THE FOUNDATION DESIGN IS BASED ON THE GEOTECHNICAL REPORT BY TECTONIC ENGINEERING & SURVEYING CONSULTANTS P.C. DATED JANUARY 3. 2020.
- 2. THE FOLLOWING PARAMETERS WERE USED IN THE DESIGN OF FOUNDATIONS:

THE TOLLOWING FAILAMETERS WELL OSED IN THE DESIGN O	I I OUNDATIONS.
PARAMETER	VALUE
BEARING PRESSURE, B/FTG < 4'-0" FROM EX GRADE	4000 PSF
BEARING PRESSURE, B/FTG > 4'-0" FROM EX GRADE	6000 PSF
BEARING PRESSURE, POND PAVILION	2000 PSF
SUBGRADE MODULUS	125 PCI

- 3. REFER TO THE GEOTECHNICAL REPORT FOR INFORMATION ON GENERAL SUBSURFACE PROFILES, SOIL PROPERTIES, EXISTING SITE FEATURES AND ALL OTHER CONDITIONS AFFECTING FOUNDATION INSTALLATION.
- 4. REFER TO THE GEOTECHNICAL REPORT FOR INFORMATION ON SUBGRADE PREPARATION FOR SLAB-ON-GRADE
- REFER TO THE GEOTECHNICAL REPORT FOR REQUIREMENTS FOR EXCAVATIONS, GRADING, COMPACTION AND BACKFILLING BEHIND WALLS RETAINING EARTH.
- 6. BACKFILLING AGAINST RETAINING/BASEMENT WALLS WHERE THERE IS GRADE ON BOTH SIDES OF THE WALL SHALL BE CARRIED OUT IN SUCH A MANNER THAT THE DIFFERENCE IN SOIL LEVEL IS NEVER MORE THAN 3.0 FEET.DO NOT PLACE BACKFILL BEHIND WALLS RETAINING EARTH BEFORE CONCRETE HAS ATTAINED FULL DESIGN STRENGTH UNLESS TEMPORARY BRACING IS PROVIDED.
- 7. BACKFILL SHALL NOT BE PLACED AGAINST WALLS RETAINING EARTH (OTHER THAN CANTILEVER WALLS) UNTIL THE ATTACHING FLOORS/SLABS (AT TOP AND BOTTOM OF THE WALL) ARE COMPLETELY IN PLACE AND HAVE ATTAINED FULL
- 8. NEW FOOTINGS WHICH ARE LOCATED IMMEDIATELY ADJACENT TO EXISTING FOOTINGS SHALL BE FOUNDED AT THE SAME ELEVATION AS THE EXISTING FOOTINGS UNLESS NOTED OTHERWISE. EXISTING ADJACENT FOOTINGS SHALL NOT BE UNDERMINED BY EXCAVATION OR NEW CONSTRUCTION.
- 9. WATER SHALL NOT BE ALLOWED TO STAND IN TRENCHES BEFORE OR AFTER CONCRETE IS PLACED. IF TRENCHES BECOME SOFTENED DUE TO RAIN OR OTHER WATER BEFORE THE FOOTINGS ARE CAST, THE GEOTECHNICAL ENGINEER SHALL REVIEW THE CONDITIONS AND PROVIDE THE NECESSARY MITIGATION REQUIREMENTS TO THE CONTRACTOR.
- 10. ALL EXCAVATIONS, COMPACTIONS AND BACKFILLING SHALL BE INSPECTED AND APPROVED BY THE GEOTECHNICAL ENGINEER BEFORE PLACEMENT OF CONCRETE.
- 11. REFER TO PLUMBING AND/OR CIVIL DRAWINGS FOR UNDER-FLOOR AND PERIMETER WALL DRAINAGE SYSTEMS AND SPECIAL GRANULAR FILL MATERIALS FOR SUCH DRAINAGE.

SUBMITTALS

- CONTRACTOR SHALL SUBMIT SHOP DRAWINGS AND CALCULATIONS AS BOTH SIGNED AND STAMPED BY A PROFESSIONAL ENGINEER AS REQUIRED BY THE SPECIFICATIONS, FOR ENGINEER'S APPROVAL.
- 2. ONLY SHOP DRAWINGS MARKED "NO EXCEPTIONS TAKEN", "REVISE AS NOTED" OR "SEE COMMENTS NOTED" MAY BE USED BY CONTRACTOR IN THE WORK. SHOP DRAWINGS MARKED "REJECTED" OR "RESUBMIT FOR REVIEW" SHALL BE CORRECTED AND COMPLETED AS REQUIRED AND RESUBMITTED TO THE ARCHITECT BEFORE THEY ARE USED IN THE
- CONTRACTOR SHALL PREPARE AND MAINTAIN A SCHEDULE OF ALL SUBMITTALS INCLUDING INTENDED DATES OF SUBMISSION AND NUMBER OF DRAWINGS TO BE SUBMITTED EACH WEEK.
- 4. THE CONTRACTOR SHALL BE AWARE THAT SUBMITTALS WILL BE REVIEWED IN THE ORDER IN WHICH THEY ARE RECEIVED. THE CONTRACTOR SHALL PLAN ACCORDINGLY.
- 5. SUBMIT ALL ITEMS IN ACCORDANCE WITH THE SPECIFICATIONS. THE ENGINEER RESERVES THE RIGHT TO NOT REVIEW ANY OTHER ITEMS.

CONCRETE

1. STRUCTURAL CONCRETE STRENGTHS AND TYPES USED IN THIS PROJECT SHALL BE AS FOLLOWS:

LOCATION IN STRUCTURE	f'c	DENSITY
SLAB ON GRADE	4000 PSI	150 PCF
LIGHTWEIGHT CONCRETE FILL ON METAL DECK (INCLUDING		
CURBS, EQUIPMENT PADS, ETC. ON METAL DECK SLABS)	4000 PSI	115 PCF
FOUNDATIONS (FOOTINGS, PILE CAPS, GRADE BEAMS)	4000 PSI	150 PCF
WALLS	4000 PSI	150 PCF
FORMED SLABS, COLUMNS AND BEAMS (INCLUDING CURBS,		
EQUIPMENT PADS, ETC. ON FORMED SLABS)	4000 PSI	150 PCF
ALL OTHER CONCRETE	4000 PSI	150 PCF

f'c IS THE 28-DAY COMPRESSIVE STRENGTH AS DEFINED IN ACI 318.

- 2. ALL CONCRETE MIXES SHALL COMPLY WITH THE REQUIREMENTS OF THE PROJECT GOVERNING CODE(S). MIX DESIGNS FOR EACH TYPE AND STRENGTH SHALL BE PREPARED BY CONTRACTOR ADN TESTED BY AN INDEPENDENT TESTING LABORATORY. THE MIX DESIGNS SHALL THEN BE SUBMITTED TO THE ENGINEER FOR REVIEW.
- 3. NORMAL WEIGHT AGGREGATE SHALL CONFORM TO THE REQUIREMENTS OF ASTM C33. LIGHTWEIGHT AGGREGATE SHALL CONFORM TO THE REQUIREMENTS OF ASTM C330 AND ASTM C157.
- 4. ALL CONSTRUCTION JOINTS SHALL BE CONSTRUCTED IN ACCORDANCE WITH THE TYPICAL CONSTRUCTION JOINT DETAILS SHOWN ON THE STRUCTURAL AND ARCHITECTURAL DRAWINGS.
- 5. CLEAN AND ROUGHEN TO 1/4" AMPLITUDE ALL CONCRETE CONSTRUCTION JOINT SURFACES AGAINST WHICH CONCRETE IS TO BE PLACED. ALL CONSTRUCTION JOINTS SHALL BE WETTED AND STANDING WATER SHALL BE REMOVED IMMEDIATELY BEFORE NEW CONCRETE IS PLACED. PROVIDE CLASS "B" SPLICE AT ALL REINFORCEMENT CROSSING CONSTRUCTION JOINTS, TYPICAL UNLESS NOTED OTHERWISE.
- 6. CONTRACTOR SHALL COORDINATE AND INSTALL ALL REQUIRED EMBEDDED ITEMS, SLEEVES, POCKETS, ETC. PRIOR TO CONCRETE PLACEMENT. PROVIDE SLEEVES FOR PLUMBING AND ELECTRICAL OPENINGS IN CONCRETE WALLS/SLABS BEFORE PLACING CONCRETE. DO NOT CUT ANY REINFORCING WHICH MAY CONFLICT. PIPES AND/OR CONDUITS SHALL NOT PASS THROUGH COLUMNS AND BEAMS UNLESS SPECIFICALLY DETAILED ON THE STRUCTURAL DRAWINGS.
- 7. CORING OF CONCRETE AFTER PLACEMENT IS NOT PERMITTED.
- 8. THE PROJECTING CORNERS OF COLUMNS, BEAMS, WALLS, ETC. SHALL BE FORMED WITH 3/4" CHAMFER, UNLESS NOTED OTHERWISE ON ARCHITECTURAL DRAWINGS.
- 9. THE CONTRACTOR SHALL NOTIFY THE TESTING AGENCY AND OWNER 48 HOURS BEFORE POURING OF CONCRETE FOR INSPECTION OF REINFORCEMENT LAYOUT. NO CONCRETE SHALL BE POURED UNLESS ALL REINFORCEMENT AND INSTALLATIONS HAVE BEEN INSPECTED AND APPROVED BY THE TESTING AGENCEY.
- 10. LOCATION OF CONSTRUCTION JOINTS SHALL BE AS INDICATED ON STRUCTURAL DRAWINGS.
- 11. CONCRETE CAST ON SLOPED SURFACES SHALL BEGIN AT THE LOWEST ELEVATION AND CONTINUE MONOLITHICALLY TOWARD THE HIGHER ELEVATION UNTIL THE INTENDED CAST IS COMPLETED.
- 12. NO ALUMINUM SHALL BE CAST IN CONCRETE
- 13. REFER TO ARCHITECTURAL DRAWINGS FOR FINISHING OF ALL EXPOSED CONCRETE SURFACES.
- 14. REINFORCING BARS SHALL CONFORM TO THE REQUIREMENTS OF ASTM A615, GRADE 60. REINFORCING BARS WHICH ARE TO BE WELDED SHALL CONFORM TO APPLICABLE ASTM AND AWS SPECIFICATIONS.
- 15. WELDED WIRE FABRIC SHALL CONFORM TO ASTM A185. USE ONLY FLAT SHEETS. MINIMUM LAP OF WELDED WIRE REINFORCEMENT SHALL BE 6" OR ONE FULL MESH PLUS 2", WHICHEVER IS GREATER.
- 16. PROVIDE DEVELOPMENT AND SPLICES OF REINFORCEMENT ACCORDING TO THE TYPICAL DETAILS TABLE. LAP SPLICES SHALL BE SECURELY TIED AT ALL SIDE AND END LAPS.
- 17. REINFORCING BARS MARKED AS "CONTINUOUS" SHALL BE TENSION SPLICED, UNLESS OTHERWISE SHOWN ON
- 18. REINFORCING BAR SPLICES SHALL BE MADE ONLY WHERE INDICATED ON THE DRAWINGS. WHERE SPLICE LOCATIONS ARE NOT SHOWN ON THE DRAWINGS. THE CONTRACTOR SHALL SHOW THEIR PROPOSED SPLICE LOCATIONS ON THE SHOP DRAWINGS
- 19. ALL BARS AT NON-CONTINUOUS ENDS SHALL HAVE A STANDARD HOOK
- 20. WELDING OF REINFORCING STEEL BARS SHALL BE IN ACCORDANCE WITH AWS D1.4. WELD REINFORCING BARS ONLY WHERE INDICATED ON THE DRAWINGS. TACK WELDING OR WELDING OF BARS TO PLATES, TEMPLATES, ETC. IS PROHIBITED, UNLESS SPECIFICALLY SHOWN ON THE STRUCTURAL DRAWINGS.
- 21. DOWELS CONNECTING WALLS OR COLUMNS TO FOUNDATIONS SHALL BE THE SAME GRADE, SIZE AND SPACING AS THE VERTICAL REINFORCING BARS IN THE WALLS OR COLUMNS, UNLESS NOTED OTHERWISE.
- 22. ALL DOWELS SHALL BE FULLY DEVELOPED IN TENSION UNLESS NOTED OTHERWISE
- 23. BARS SHALL NOT BE BENT OR TWISTED IN THE FIELD, UNLESS SPECIFICALLY DETAILED ON THE STRUCTURAL
- 24. ALL REINFORCING BARS, INSERTS, EMBEDS ETC. SHALL BE SECURELY HELD IN PLACE TO MAINTAIN THEIR POSITIONS WHILE CONCRETE IS POURED. PROVIDE SUITABLE CHAIRS, TIES, SPACERS, ADDITIONAL BARS AND STIRRUPS AS

Storm King Art Center 1 Museum Road New Windsor, NY 12553

+1 (845) 534-3115 Design Architect heneghan peng architects 14-16 Lord Edward Street

Dublin, D02 YC63

+353 1 633 9000 **Executive Architect** WXY Architecture + Urban Design 224 Centre Street, 5th Floor New York, NY 10013

+1 (212) 219-1953 Landscape Architect Gustafson Porter + Bowman

1 Cobham Mews London, MW1 9SB +44 020 7284 8950

Reed Hilderbrand LLC 33 Whitney Avenue, 3rd Floor New Haven, CT 06510 +1 (617) 923-2422

Structural & Lighting ARUP 77 Water Street

New York, NY 10005 +1 (212) 896-3000

MEPF & IT BuroHappold

100 Broadway #23 New York, NY 10005 +1 (212) 616-0228

100 Great Oaks Blvd., Suite 118 Albany, NY 12203

+1 (518) 389-3606 **AV & Acoustics** LSTN Consultants 76 Beaver Street, 2nd Floor

New York, NY 10005 +1 (347) 788-0810 Facade Front Inc.

100 E. Broadway Street, #501

New York, NY 10002

+1 (212) 242-2220

Key Plan

Description Date 50% Design Development 02/24/20 100% Design Development 05/29/20

50% Construction Documents

11/06/20

Storm King Art Center **Pond Pavilion**

NOT FOR CONSTRUCTION **Drawing Title** Structural General Notes, Sheet 1

Date	11/06/20
Scale	12" = 1'-0"
Drawing Number	S-P-002
Sheet Size	ARCH D

STRUCTURAL STEEL

1. STRUCTURAL STEEL MEMBERS SHALL CONFORM TO THE FOLLOWING UNLESS NOTED OTHERWISE:

SHAPE	GRADE	YIELD STRENGTH Fy (KSI)
WIDE FLANGE SHAPES	ASTM A992	50
TEES	ASTM A992	50
CHANNELS	ASTM A36	36
ANGLES	ASTM A36	36
PLATES	ASTM A572 GRADE 50	50
BARS	ASTM A500 GRADE 50	50
SQUARE & RECTANGULAR HSS	ASTM A500 GRADE B	46
ROUND HSS	ASTM A500 GRADE B	42
STEEL PIPE	ASTM A53 GRADE B	35

2. HIGH-STRENGTH BOLTS SHALL CONFORM TO THE FOLLOWING UNLESS NOTED OTHERWISE:

BOLT TYPE	REMARKS
ASTM A325	WHERE NOTED ON DRAWINGS
ASTM A490	WHERE NOTED ON DRAWINGS
ASTM A307 GRADE A	MACHINE BOLTS WHERE NOTED ON DRAWINGS

- 3. WHERE NON-SLIP CRITICAL BOLTS ARE SPECIFIED THEY SHALL BE TIGHTENED TO A SNUG TIGHT CONDITION. SEE DETAILS AND SCHEDULES FOR BOLT DIAMETERS AND SCHEDULES.
- 4. ALL BOLT HOLES SHALL BE STANDARD SIZE HOLES (1/16" LARGER IN DIAMETER THAN THE DIAMETER OF THE BOLT)
- 5. ALL BOLTS SPECIFIED AS SLIP CRITICAL BOLTS (A325-SC OR A490-SC) SHALL HAVE CLASS A FAYING SURFACES UNLESS NOTED OTHERWISE.
- 6. AT ALL SLIP CRITICAL CONNECTIONS SLIP IS CHECKED AT THE FACTORED LOAD LEVEL UNLESS NOTED OTHERWISE.
- 7. ALL STEEL MEMBERS FRAMING INTO CONCRETE WALLS/COLUMNS/BEAMS SHALL BE DETAILED TO SUIT CONCRETE FIELD TOLERANCES. COORDINATE WITH CONCRETE CONTRACTOR AND/OR CONDUCT FIELD SURVEYS AS NECESSARY PRIOR TO STEEL FABRICATION.
- 8. CUTTING AND DRILLING OF STRUCTURAL STEEL MEMBERS IN THE FIELD IS NOT PERMITTED.
- 9. NO OPENINGS AND/OR PENETRATIONS SHALL BE PLACED IN STEEL MEMBERS UNLESS SPECIFICALLY SHOWN AND DETAILED ON THE STRUCTURAL DRAWINGS.
- 10. ALL STEEL MEMBERS RELATED TO ELEVATORS SHALL BE COORDINATED WITH THE ELEVATOR CONTRACTOR PRIOR TO FABRICATION.
- 11. REFER TO SPECIFICATIONS FOR STEELWORK PROTECTION AND COATINGS.
- 12. SPLICES SHALL BE DESIGNED TO DEVELOP THE FULL CAPACITY OF THE MEMBER AT THE POINT OF SPLICE. SPLICES SHALL BE MADE ONLY AT LOCATIONS INDICATED ON DRAWINGS. FULL DETAIL AND BACK-UP CALCULATIONS OF SPLICES REQUIRE REVIEW AND APPROVAL BY THE ENGINEER.
- 13. CONTRACTOR SHALL PROVIDE ALL NECESSARY TEMPORARY BRACING, GUYING AND CONNECTION MEMBERS REQUIRED TO ERECT TEH STRUCTURE, MAINTAIN CORRECT ALIGNMENT AND SAFELY RESIST ALL REQUIRED COMBINATIONS OF DEAD, CONSTRUCTION, ERECTION, WIND AND OTHER LATERAL LOADS.
- 14. SHAPE AND SIZE GUSSET PLATES IN SUCH A MANNER AS TO CLEAR ALL ARCHITECTURAL FINISHES AND MECHANICAL FIXTURES (DUCTS, PIPES, ETC.).
- 15. WELDS SHALL BE MADE USING LOW-HYDROGEN ELECTRODES WITH MINIMUM TENSILE STRENGTH OF 70 KSI (E70XX ELECTRODES) UNLESS NOTED OTHERWISE.
- 16. WELD LENGTHS CALLED FOR ON DRAWINGS ARE THE NET EFFECTIVE LENGTH REQUIRED. WHERE LENGTH OF WELD IS NOT SHOWN IT SHALL BE THE FULL LENGTH OF JOINT.
- 17. ALL PARTIAL PENETRATION GROOVE WELD SIZES SHOWN ON THE DRAWINGS REFER TO THE EFFECTIVE THROAT THICKNESS.
- 18. FILLET WELD SIZES SHOWN ON DRAWINGS ARE MINIMUM SIZES. INCREASE WELD SIZE TO AWS MINIMUM SIZES BASED ON PLATE THICKNESSES. THE MINIMUM FILLET WELD SIZE SHALL BE 3/16".
- 19. THE CONTRACTOR SHALL DETERMINE THE SEQUENCE AND PROCEDURES OF WELDING TO MINIMIZE THE EFFECT WELD SHRINKAGE, RESIDUAL STRESSES AND TO MAINTAIN ERECTION TOLERANCES.
- 20. ALL STEEL EXPOSED TO WEATHER SHALL HAVE ADDITIONAL SEAL WELDING TO PROTECT THE MEMBERS (PIPES, TUBES, BUILT-UPS) AND THE CONNECTIONS FROM MOISTURE INFILTRATION. THESE ADDITIONAL SEAL WELDS SHALL BE SHOWN ON SHOP DRAWINGS.

TIMBER

- 1. MATERIALS AND WORKMANSHIP SHALL BE IN ACCORDANCE WITH PROJECT CODES(S) AND STANDARD(S).
- 2. ALL EXPOSED GLULAM AND LVL CLT SHALL BE ARCHITECTURAL GRADE
- 3. GLULAM PROPERTIES (24F-V1 SP/SP), MINIMUM AS FOLLOWS:
 - F_{bx}^+ = 2400 PSI F_{bx}^- = 1750 PSI (USE BALANCED LAYUP AT CANTILEVERED BEAMS)
 - $F_{cpx} = 650 \text{ PSI}$ $F_{vx} = 300 \text{ PSI}$
 - $E_x = 1.7X10^6 PSI$
 - $E_{x,MIN} = 0.9X10^6 PSI$
 - $F_t = 1100 \text{ PSI}$ $F_c = 1500 \text{ PSI}$ G = 0.55
- 4. GLULAM PROPERTIES (24F-V5 SP/SP), MINIMUM AS FOLLOWS:
- F_{bx}^+ = 2400 PSI F_{bx}^- = 24000 PSI (USE BALANCED LAYUP AT CANTILEVERED BEAMS)
 - $F_{cpx} = 740 PSI$
 - $F_{vx} = 300 \text{ PSI}$
 - $E_x = 1.7X10^6 PSI$ $E_{x,MIN} = 0.9X10^6 PSI$
 - $F_{t} = 1150 \text{ PSI}$
- F_c = 1600 PSI G = 0.55
- 5. LVL PROPERTIES (MICROLLAM 2.0E), MINIMUM AS FOLLOWS:
 - $F_{bx} = 2600 \text{ PSI}$ $F_{cpx} = 750 \text{ PSI}$
 - $F_{vx} = 285 \text{ PSI}$
 - $E_x = 2.0X10^6 PSI$
 - $E_{x,MIN} = 1.016535X10^6 PSI$ $F_t = 1895 PSI$
 - $F_c = 2510 \text{ PSI}$
- 6. ALL DETAILING, FABRICATION AND ERECTION SHALL CONFORM TO PROJECT CODE(S). PROVIDE CHECKED SHOP FABRICATION AND ERECTION DRAWINGS FOR REVIEW PRIOR TO FABRICATION.
- 7. ALL SAWN LUMBER SHALL BE STRESS GRADED DOUGLAS FIR LARCH, UNLESS OTHERWISE NOTED. ALL 2x STUDS SHALL BE STRESS GRADED DOUGLAS FIR LARCH. PROVIDE AIR DRY LUMBER WITH 19% MAXIMUM MOISTURE CONTENT.
- 8. ALL WOOD IN DIRECT CONTACT WITH THE GROUND, CONCRETE OR MASONRY SHALL BE TREATED WITH A PRESERVATIVE
- 9. ALL WALLS SHALL BE BOLTED TO FOUNDATIONS (CONCRETE OR CONCRETE BLOCK) WITH 5/8" DIAMETER x 12" MINIMUM ANCHOR BOLTS WITHIN 9" OF THE ENDS OF EACH WALL PANEL AND NOT MORE THAN 4'-0" ON CENTER OR (2)-5/16" MINIMUM DIAMETER SHOT PINS WITHIN 9" AND 10" RESPECTIVELY OF THE ENDS OF EACH WALL PANEL AND NOT MORE THAN 1'-6" ON CENTER MAXIMUM EXCEPT AS CALLED OUT FOR SHEAR WALLS.
- 10. ALL JOISTS AND RAFTERS SHALL BE BLOCKED AT SUPPORTS AND AT 8'-0" ON CENTER WITH 1X4 WOOD CROSS BRIDGING, SOLID 2X BLOCKING 2" SHALLOWER THAN JOISTS OR APPROVED METAL CROSS BRIDGING. BLOCKING AT ENDS MAY BE OMITTED WHERE JOISTS HANGERS APPROVED FOR USE WITHOUT SOLID BLOCKING ARE USED.
- 11. A DOUBLE PLATE MADE OF TWO MEMBERS OF THE SAME SIZE AS THE STUDS SHALL BE PLACED AT THE TOP OF EVERY BEARING PARTITION OR EXTERIOR WALL. SUCH DOUBLE PLATES SHALL BE LAPPED AT CORNER AND SPLICE JOINTS. THE UPPER AND LOWER MEMBERS AT SPLICE JOINTS SHALL BE AT LEAST FOUR FEET APART, SEE DETAIL XXXX.
- 12. SHEAR WALLS AND BEARING PARTITIONS SHALL BE FRAMED OF 2x6 STUDS AT 16" ON CENTER, UNLESS NOTED OTHERWISE. PROVIDE 2x SOLID BLOCKING AT MID HEIGHT OF STUD WALL (8'-0" MAX.)
- 13. USE DOUBLE STUDS OR 4x6 POSTS UNDER DOUBLE JOISTS OR 6x6 BEAMS, UNLESS OTHERWISE NOTED ON FRAMING PLANS.
- 14. ALL NAILING SCHEDULE SHALL BE DONE WITH COMMON NAILS. NAILING FOR DIAPHRAGMS AND ALL SHEAR WALLS SHALL BE INSPECTED BY THE INSPECTOR OF RECORD PRIOR TO COVERING.
- 15. ALL BOLTS IN WOOD SHALL BE UNFINISHED BOLTS CONFORMING TO ASTM A-307, UNLESS NOTED OTHERWISE. HOLES SHALL NOT BE MORE THAN 1/16" LARGER THAN THE BOLT DIAMETER. PROVIDE PLATE WASHERS AT ALL BOLTS.
- 16. PLYWOOD SHALL BE INTERIOR TYPE WITH EXTERIOR GLUE CONFORMING TO PSI-74 OF GRADE CALLED FOR BELOW AND LAID WITH FACE GRAIN PERPENDICULAR TO SUPPORTS. USE COMMON NAILS.
- A. ROOF AND FLOOR SHEATHING SHALL BE 3/4" PLYWOOD, STRUCT. I (STD.) NAILED WITH 10d NAILS AT 4" ON CENTER AT ALL DIAPHRAGM AND WALL BOUNDARIES. CONTINUOUS PANEL EDGES ARE BLOCKED, 10d NAILS AT 6" ON CENTER AT PLYWOOD PANEL EDGES AND 10d NAILS AT 12" ON CENTER TO INTERMEDIATE SUPPORTS. INDEX #48/24.
- B. PLYWOOD SHEATHING SHALL BE INSPECTED AND APPROVED BY THE INSPECTOR OF RECORD PRIOR TO COVERING
- C. SOLID BLOCKING AT EDGES ARE REQUIRED FOR PLYWOOD ONLY WHERE CALLED FOR ON DRAWINGS.

Owner

Storm King Art Center 1 Museum Road New Windsor, NY 12553

+1 (845) 534-3115

Design Architect

heneghan peng architects 14-16 Lord Edward Street Dublin, D02 YC63 +353 1 633 9000

Executive Architect
WXY Architecture + Urban Design
224 Centre Street, 5th Floor
New York, NY 10013

Landscape Architect

+1 (212) 219-1953

Gustafson Porter + Bowman 1 Cobham Mews London, MW1 9SB +44 020 7284 8950

Reed Hilderbrand LLC 33 Whitney Avenue, 3rd Floor New Haven, CT 06510 +1 (617) 923-2422

Structural & Lighting
ARUP
77 Water Street

77 Water Street
New York, NY 10005
+1 (212) 896-3000

MEPF & IT

BuroHappold 100 Broadway #23 New York, NY 10005 +1 (212) 616-0228

> **Civil** VHB

100 Great Oaks Blvd., Suite 118 Albany, NY 12203

+1 (518) 389-3606 AV & Acoustics

LSTN Consultants 76 Beaver Street, 2nd Floor New York, NY 10005

+1 (347) 788-0810 Facade

Front Inc. 100 E. Broadway Street, #501 New York, NY 10002 +1 (212) 242-2220

Key Plan

DescriptionDate50% Design Development02/24/20100% Design Development05/29/2050% Construction Documents11/06/20

Storm King
Art Center

Pond Pavilion

Sea

NOT FOR CONSTRUCTION

Drawing Title


Structural General
Notes, Sheet 2


 Date
 11/06/20

 Scale
 12" = 1'-0"

 Drawing Number
 S-P-003

 Sheet Size
 ARCH D

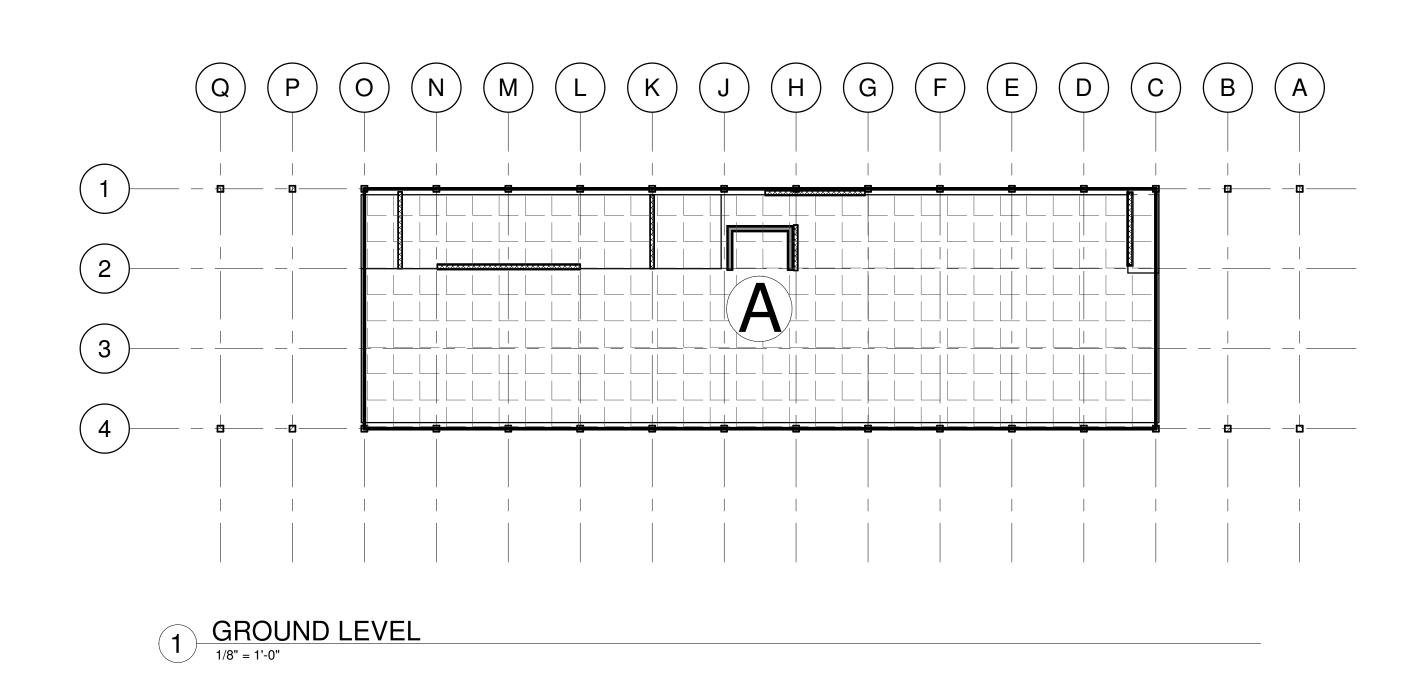

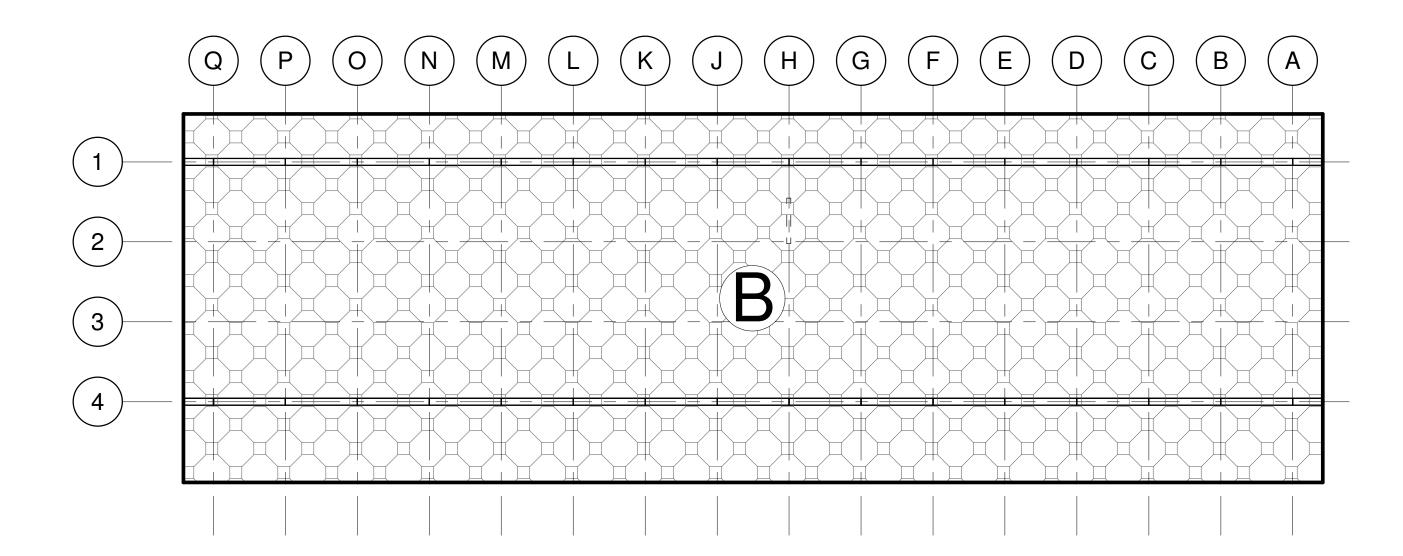

2 ROOF LEVEL

1/8" = 1'-0"

AREA	Α	В
DESCRIPTION	GROUND	ROOF
TOTAL DEAD LOAD (PSF)	20	20
LIVE LOAD (PSF)	100	20
SNOW LOAD (PSF)	-	21

NOTE: TIMBER SELF WEIGHT INCLUDED IN TOTAL DEAL LOAD ALLOWANCE

+1 (845) 534-3115 **Design Architect** heneghan peng architects 14-16 Lord Edward Street

Storm King Art Center 1 Museum Road

New Windsor, NY 12553

Dublin, D02 YC63 +353 1 633 9000

Executive Architect WXY Architecture + Urban Design 224 Centre Street, 5th Floor New York, NY 10013 +1 (212) 219-1953

Landscape Architect Gustafson Porter + Bowman 1 Cobham Mews London, MW1 9SB +44 020 7284 8950

Reed Hilderbrand LLC 33 Whitney Avenue, 3rd Floor New Haven, CT 06510 +1 (617) 923-2422

Structural & Lighting ARUP 77 Water Street

New York, NY 10005 +1 (212) 896-3000 MEPF & IT BuroHappold

100 Broadway #23 New York, NY 10005 +1 (212) 616-0228

Civil VHB 100 Great Oaks Blvd., Suite 118 Albany, NY 12203

+1 (518) 389-3606 **AV & Acoustics**

LSTN Consultants 76 Beaver Street, 2nd Floor New York, NY 10005 +1 (347) 788-0810 Facade

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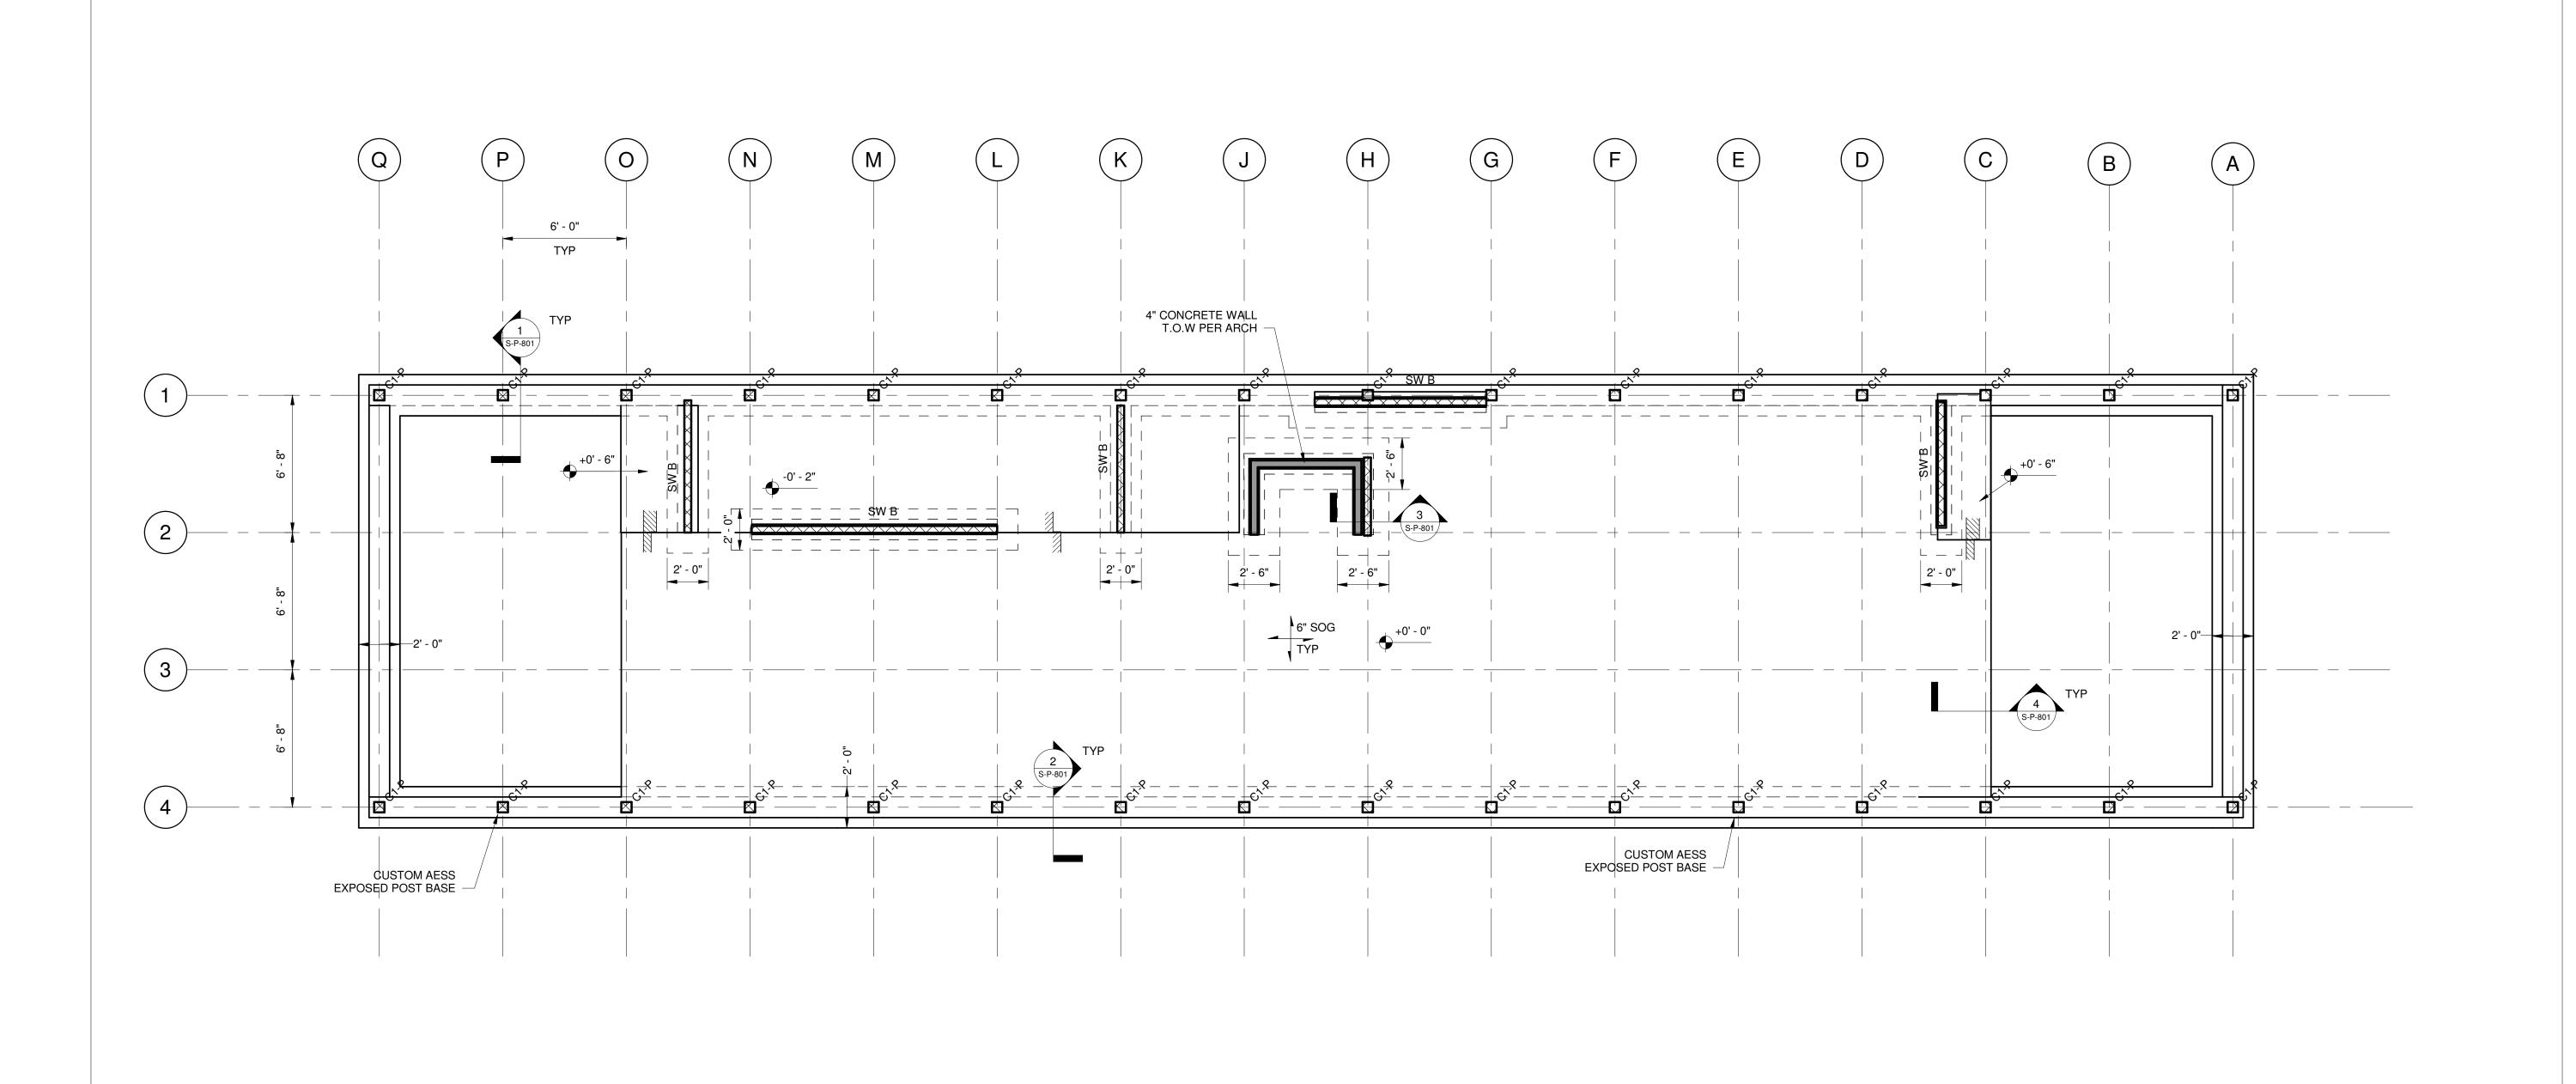
Key Plan

Description 50% Design Development 02/24/20 100% Design Development 05/29/20 50% Construction Documents

Storm King Art Center **Pond Pavilion**

NOT FOR CONSTRUCTION **Drawing Title** Structural Loading Plans

Date	11/06/20
Scale	As indicated
Drawing Number	S-P-011
Sheet Size	ARCH D



COLUMN SCHEDULE

MARK	TYPE/GRADE	SPECIES/GRADE	B_NOM [IN]	D_NOM [IN]	COMMENTS
C1-P	GLULAM	24F-V5 SP/SP	6	6	

1. FOR GENERAL NOTES AND

GRADE U.N.O.

AESS IS NOTED.

EXTENTS.

LOADING DIAGRAMS, REFER TO

DRAWINGS S-P-0XX SERIES.

3. B/FTG AT -3'-6" BELOW FINISHED

4. ALLOW FOR AESS CATEGORY 3,

AS DEFINED BY AISC, WHERE

5. PROVIDE CURB BELOW ALL SHEAR WALLS. FOR ALL OTHER CURBS

REFER TO TYPICAL DETAILS AND

ARCH FOR LOCATIONS AND

2. FOR TYPICAL DETAILS, REFER TO DRAWINGS S-P-7XX SERIES.

Storm King Art Center 1 Museum Road New Windsor, NY 12553

+1 (845) 534-3115 **Design Architect**

heneghan peng architects 14-16 Lord Edward Street Dublin, D02 YC63 +353 1 633 9000

Executive Architect WXY Architecture + Urban Design 224 Centre Street, 5th Floor New York, NY 10013 +1 (212) 219-1953

Landscape Architect Gustafson Porter + Bowman 1 Cobham Mews London, MW1 9SB +44 020 7284 8950

Reed Hilderbrand LLC 33 Whitney Avenue, 3rd Floor New Haven, CT 06510

+1 (617) 923-2422 Structural & Lighting ARUP 77 Water Street

New York, NY 10005 +1 (212) 896-3000 MEPF & IT

BuroHappold 100 Broadway #23 New York, NY 10005

+1 (212) 616-0228 Civil

VHB 100 Great Oaks Blvd., Suite 118 Albany, NY 12203 +1 (518) 389-3606

AV & Acoustics LSTN Consultants 76 Beaver Street, 2nd Floor New York, NY 10005

+1 (347) 788-0810 **Facade** Front Inc. 100 E. Broadway Street, #501 New York, NY 10002

Key Plan


+1 (212) 242-2220

Description Date 50% Design Development 02/24/20 100% Design Development 05/29/20 50% Construction Documents 11/06/20

Storm King Art Center **Pond Pavilion**

NOT FOR CONSTRUCTION **Drawing Title** Foundation Plan, **Ground Level**

Date	11/06/20
Scale	As indicated
Drawing Number	S-P-101
Sheet Size	ARCH D

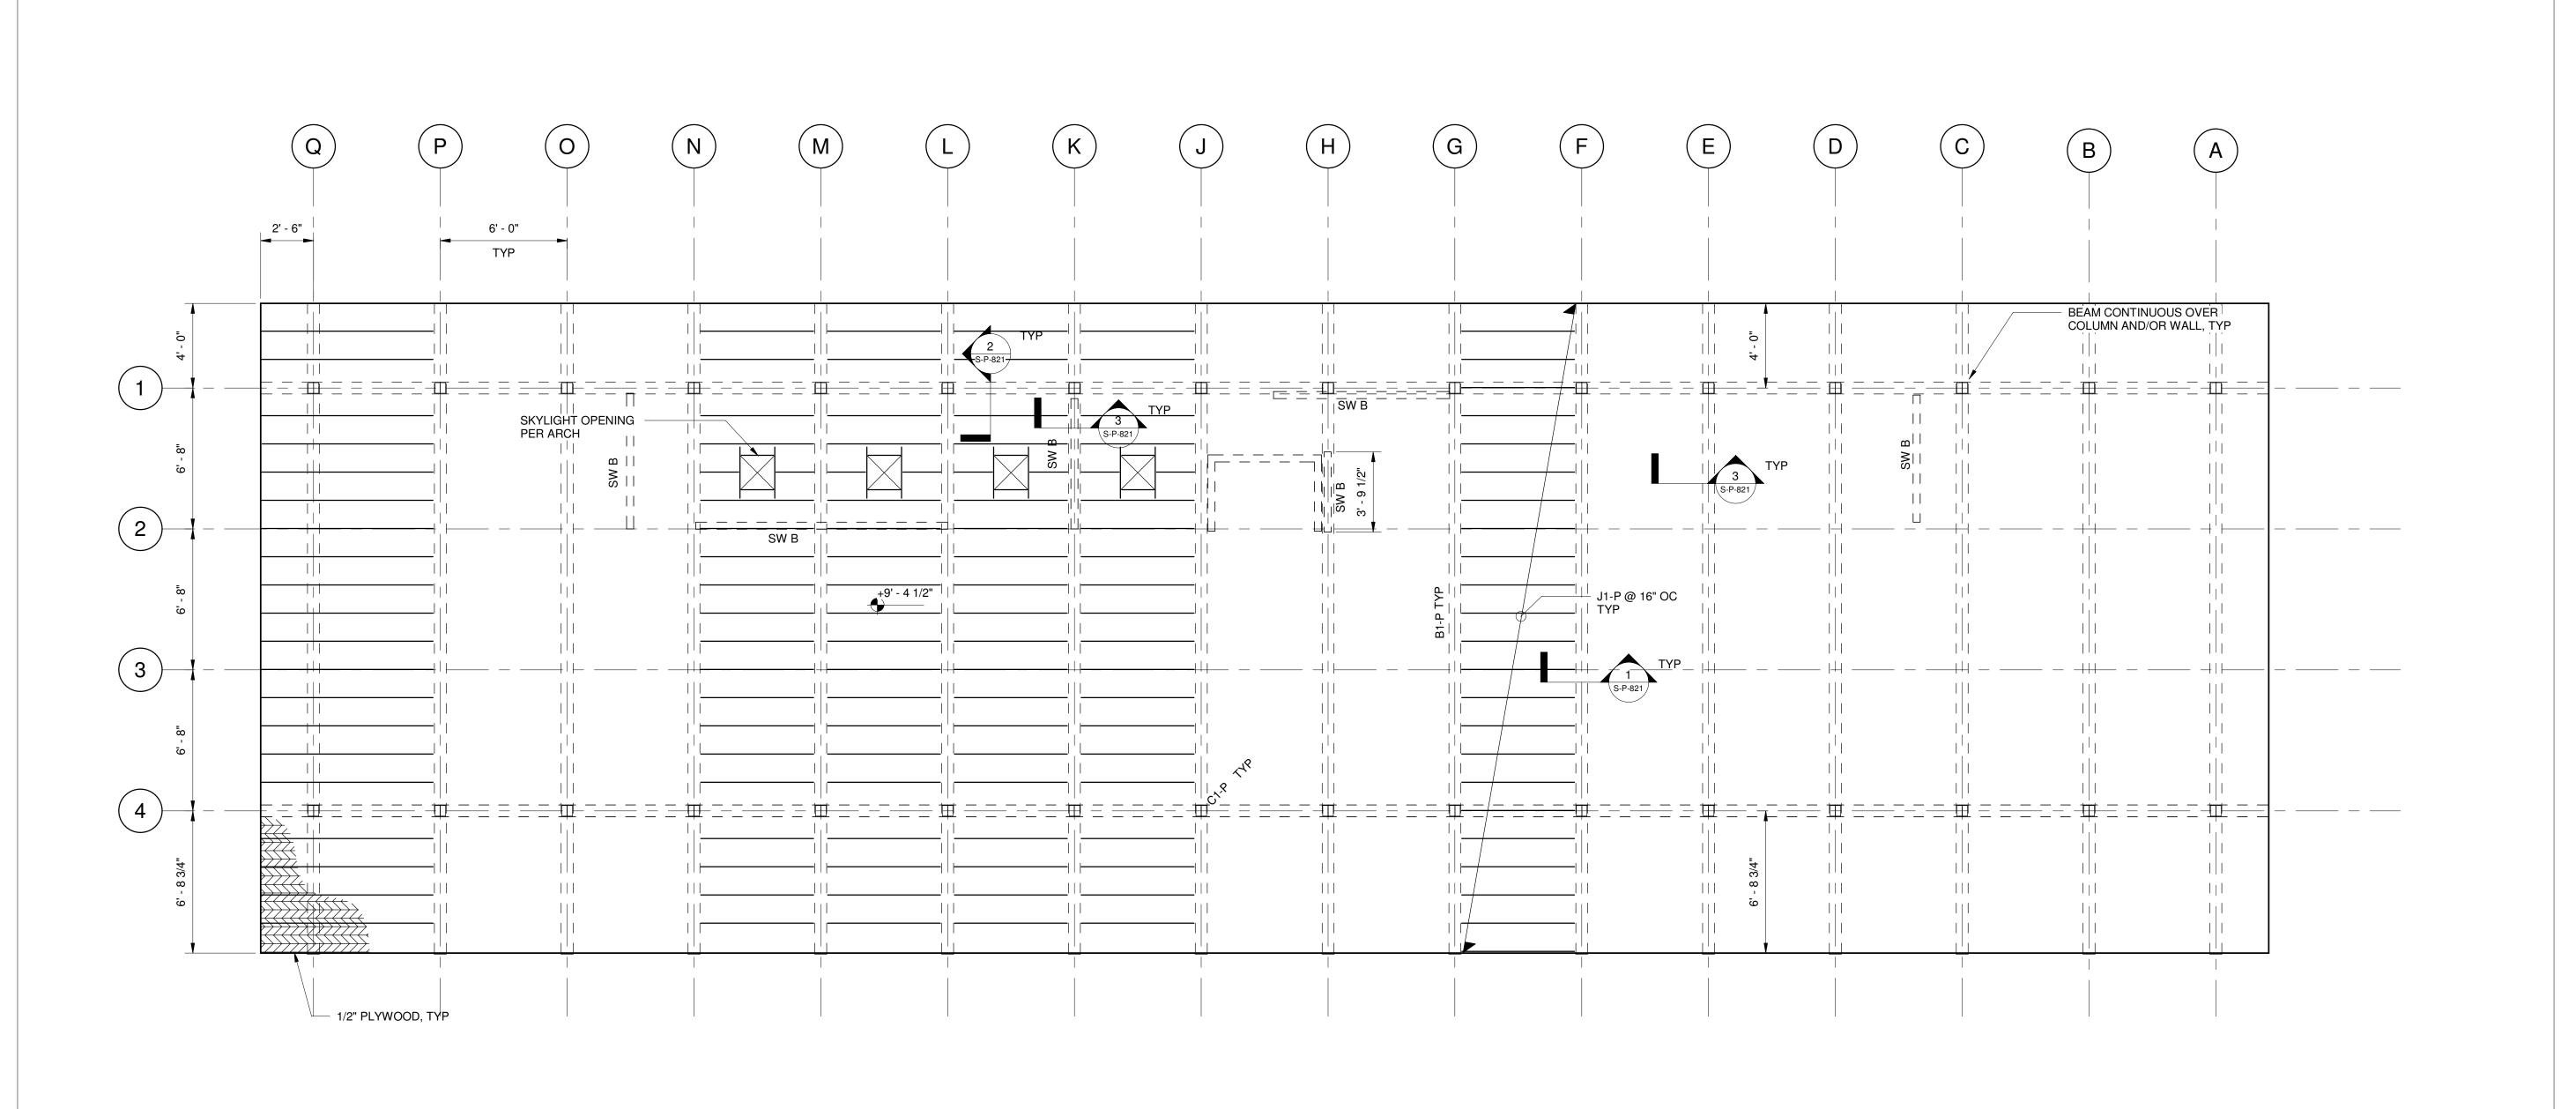

BEAM SCHEDULE MARK TYPE/GRADE SPECIES/ GRADE COMMENTS

6 3/4 10 1/2

JOIST SCHE	DULE				
MARK	TYPE/GRADE	SPECIES/GRADE	B_NOM [IN]	D_NOM [IN]	COMMENTS
J1-P	SAWN LUMBER	DOUGLAS FIR - LARCH	2	6	

24F-V5 SP/SP

GLULAM

COLUMN SCHEDULE						
MARK	TYPE/GRADE	SPECIES/GRADE	B_NOM [IN]	D_NOM [IN]	COMMENTS	
C1-P	GLULAM	24F-V5 SP/SP	6	6		

NOTES:

1. FOR GENERAL NOTES AND

LOADING DIAGRAMS, REFER TO

2. FOR TYPICAL DETAILS, REFER TO DRAWINGS S-P-7XX SERIES.

DRAWINGS S-P-0XX SERIES.

3. TOP OF JOIST ELEV IS BOT OF

PLYWOOD SHEATHING U.N.O.

4. ALL TIMBER TO BE RATED FOR EXTERIOR EXPOSURE.

TO-COLUMN CONNECTORS.

5. ALLOW FOR CUSTOM STEEL BEAM-

Storm King Art Center 1 Museum Road New Windsor, NY 12553 +1 (845) 534-3115

Design Architect

heneghan peng architects 14-16 Lord Edward Street Dublin, D02 YC63 +353 1 633 9000

Executive Architect WXY Architecture + Urban Design

224 Centre Street, 5th Floor New York, NY 10013 +1 (212) 219-1953 Landscape Architect

Gustafson Porter + Bowman 1 Cobham Mews London, MW1 9SB +44 020 7284 8950

Reed Hilderbrand LLC 33 Whitney Avenue, 3rd Floor New Haven, CT 06510 +1 (617) 923-2422

Structural & Lighting ARUP 77 Water Street

New York, NY 10005 +1 (212) 896-3000

MEPF & IT

BuroHappold 100 Broadway #23 New York, NY 10005 +1 (212) 616-0228

Civil

VHB 100 Great Oaks Blvd., Suite 118

+1 (518) 389-3606

Albany, NY 12203

AV & Acoustics LSTN Consultants 76 Beaver Street, 2nd Floor New York, NY 10005 +1 (347) 788-0810

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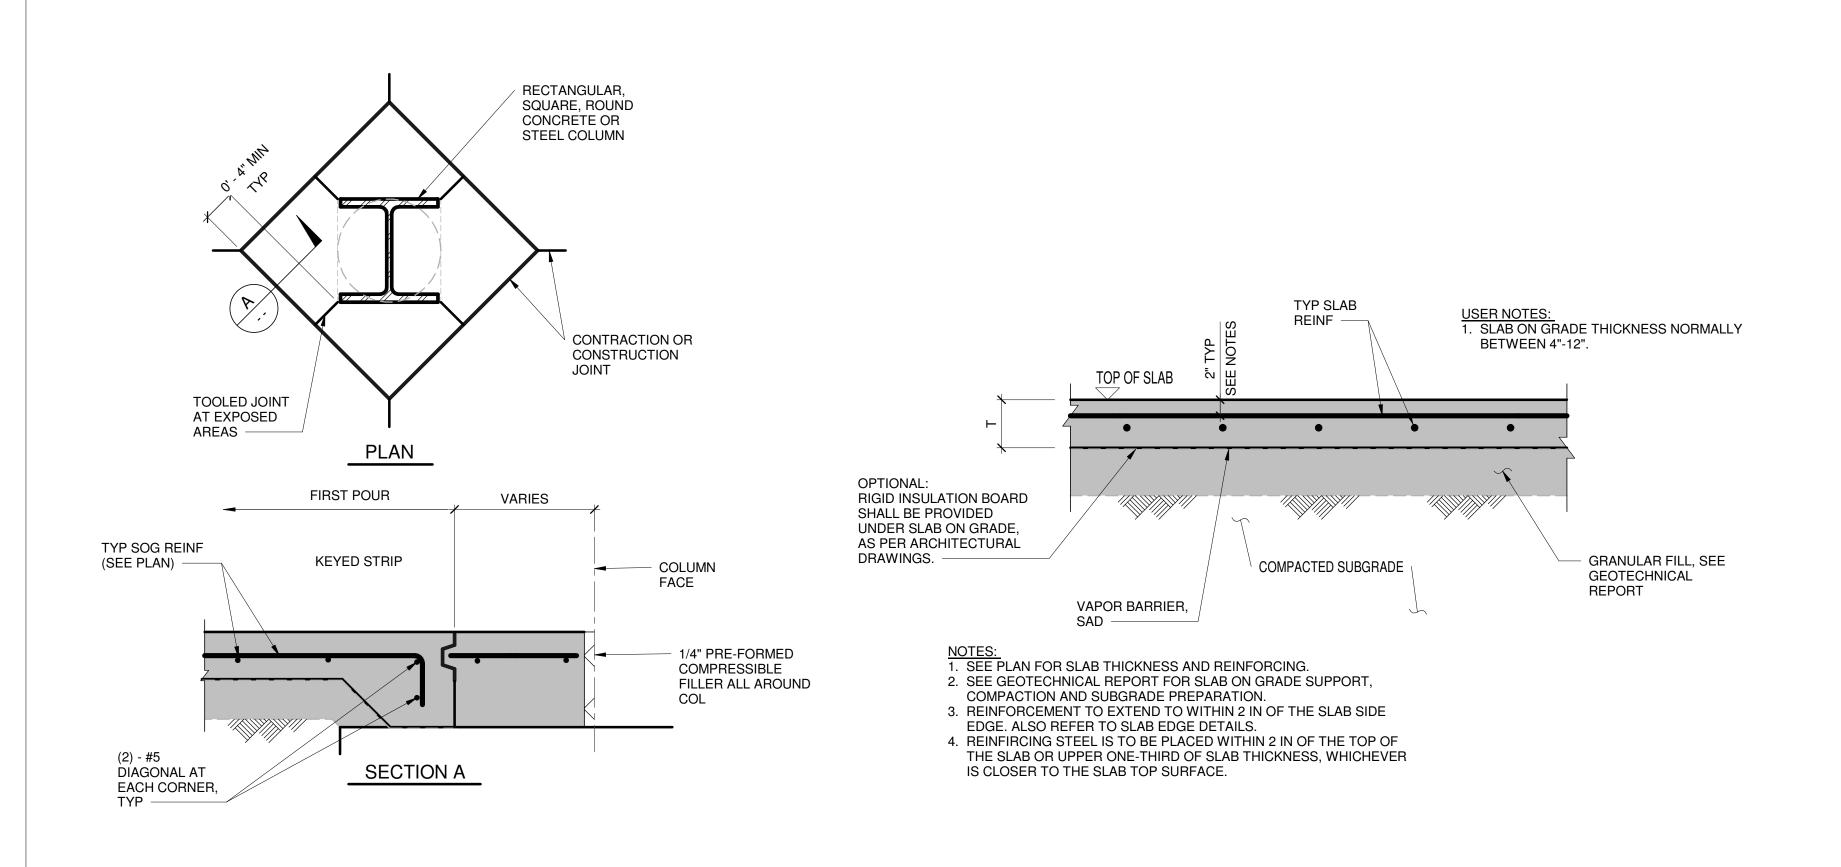
Key Plan


Description Date 50% Design Development 02/24/20 100% Design Development 05/29/20 11/06/20 50% Construction Documents

Storm King Art Center **Pond Pavilion**

NOT FOR CONSTRUCTION **Drawing Title** Framing Plan, Roof Level


Date	11/06/20
Scale	As indicated
Drawing Number	S-P-301
Sheet Size	ARCH D



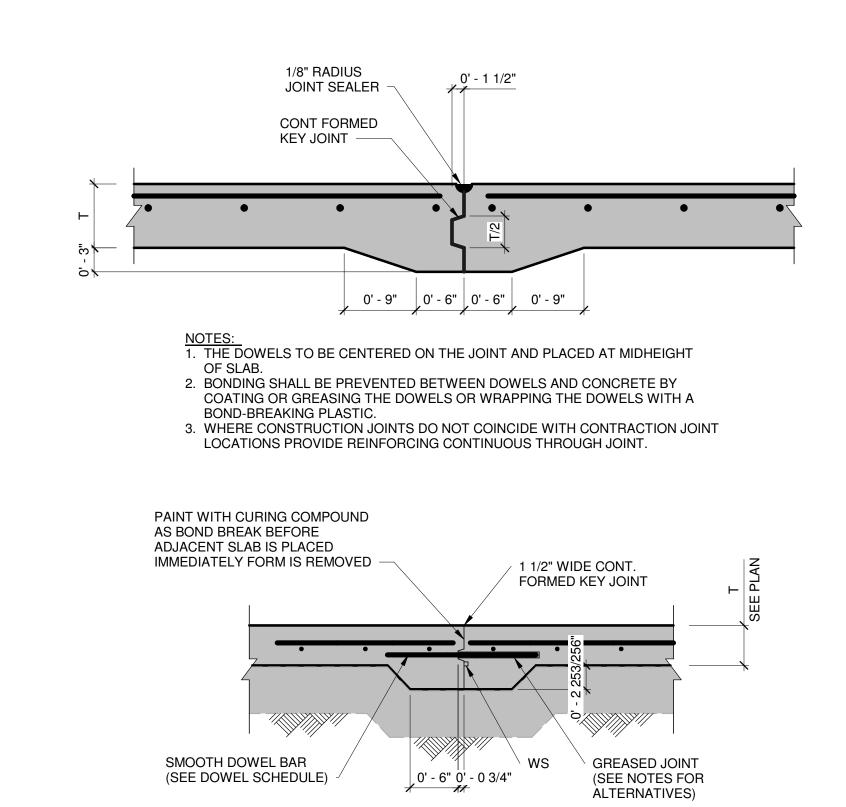

3 TYPICAL SLAB ON GRADE CONTROL AND CONSTRUCTION JOINTS

CONSTRUCTION JOINT

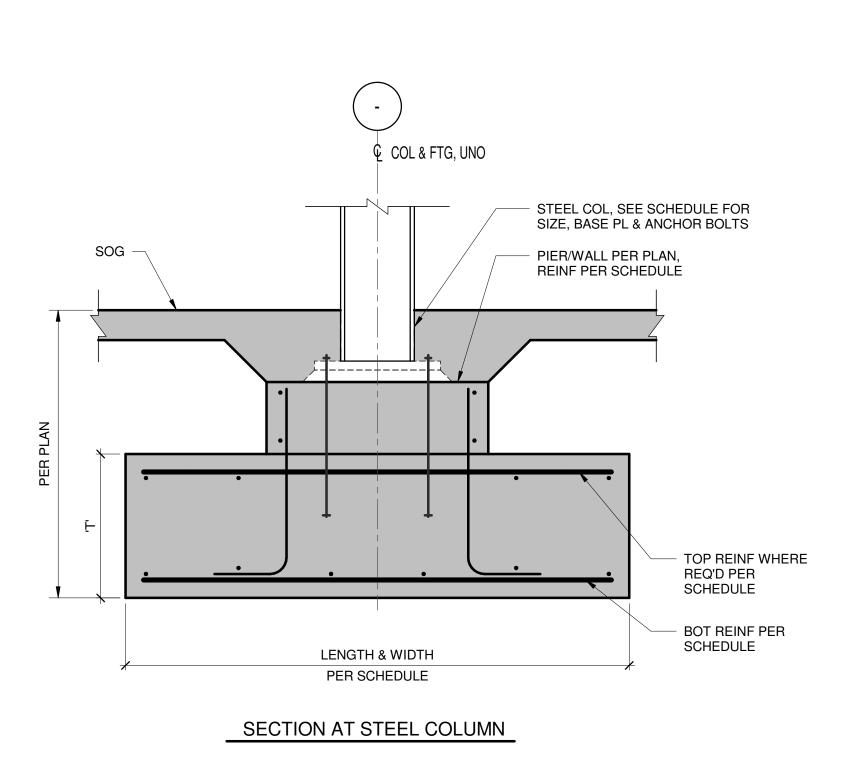

4 TYPICAL SPREAD FOOTING DETAILS


3/4" = 1'-0"


CONSTRUCTION JOINTS AT COLUMN SLAB ON GRADE

1" = 1'-0"

TYPICAL SLAB ON GRADE

1" = 1'-0"

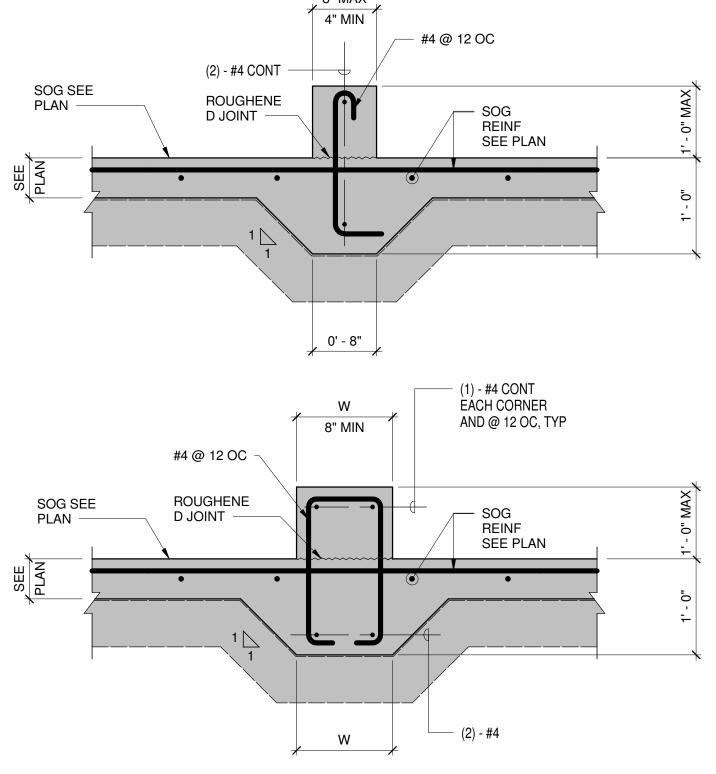

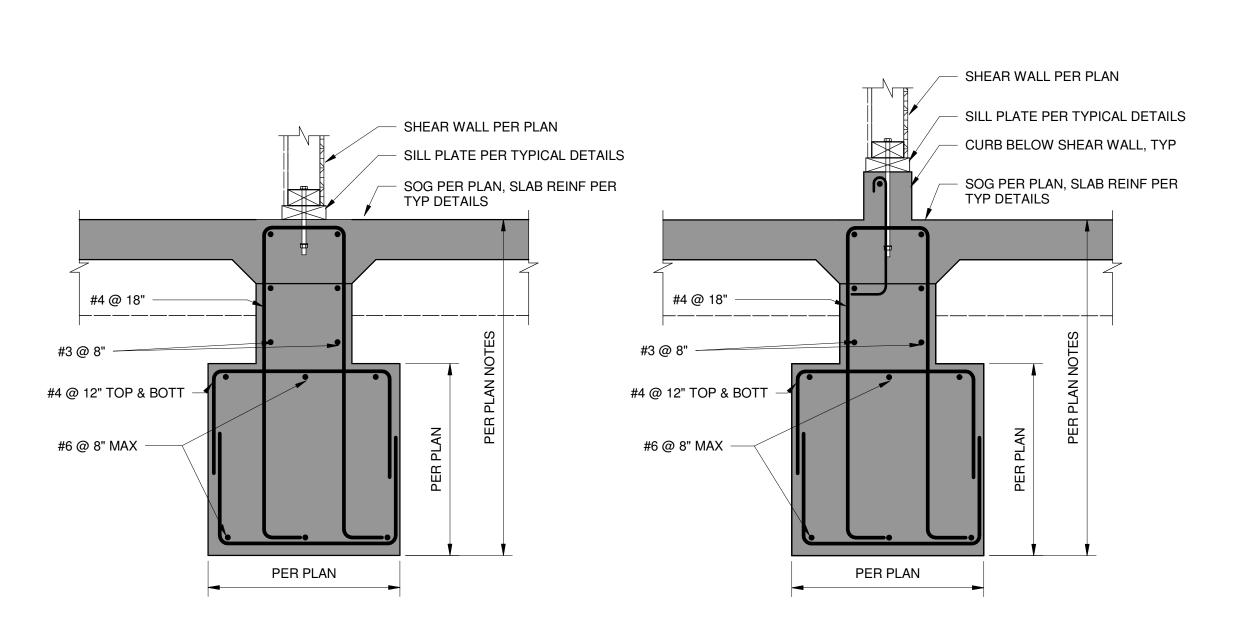

5 TYPICAL CONCRETE CURB ON GRADE

6 TYP FOOTING AT SHEAR WALL 7 TYP FOOTING AT SHEAR WALL WITH CURB

+1 (845) 534-3115 **Design Architect** heneghan peng architects 14-16 Lord Edward Street Dublin, D02 YC63 +353 1 633 9000 **Executive Architect** WXY Architecture + Urban Design 224 Centre Street, 5th Floor New York, NY 10013 +1 (212) 219-1953 Landscape Architect Gustafson Porter + Bowman 1 Cobham Mews London, MW1 9SB +44 020 7284 8950 Reed Hilderbrand LLC 33 Whitney Avenue, 3rd Floor New Haven, CT 06510 +1 (617) 923-2422 **Structural & Lighting** ARUP 77 Water Street New York, NY 10005 +1 (212) 896-3000 MEPF & IT BuroHappold 100 Broadway #23 New York, NY 10005 +1 (212) 616-0228 Civil VHB 100 Great Oaks Blvd., Suite 118 Albany, NY 12203 +1 (518) 389-3606 **AV & Acoustics** LSTN Consultants 76 Beaver Street, 2nd Floor New York, NY 10005 +1 (347) 788-0810

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Front Inc.

Key Plan

100 E. Broadway Street, #501

New York, NY 10002 +1 (212) 242-2220

Storm King Art Center

New Windsor, NY 12553

1 Museum Road

DescriptionDate50% Design Development02/24/20100% Design Development05/29/2050% Construction Documents11/06/20


Storm King
Art Center


Pond Pavilion


Seal


NOT FOR CONSTRUCTION
Drawing Title
Structural Typ
Foundation Details

Date	11/06/20
Scale	As indicated
Drawing Number	S-P-701
Sheet Size	ARCH D

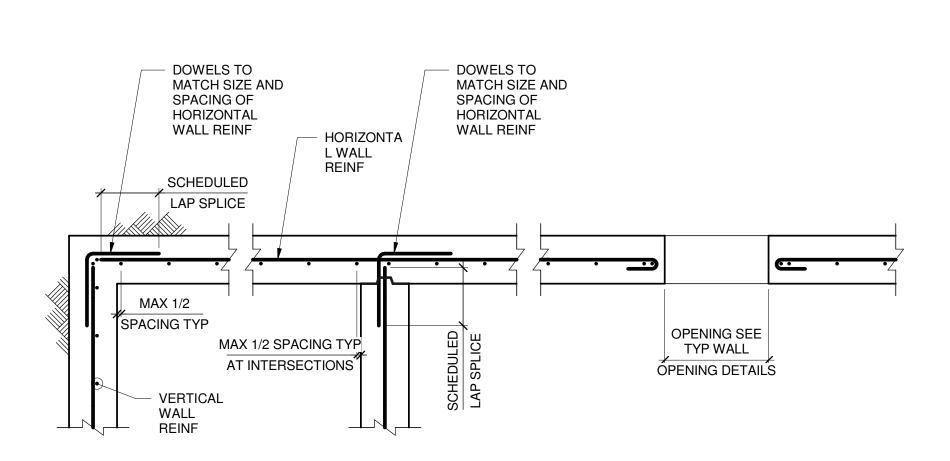

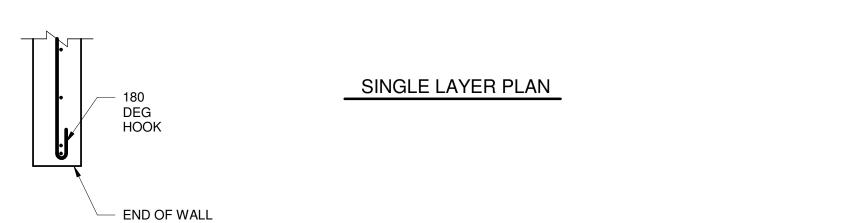

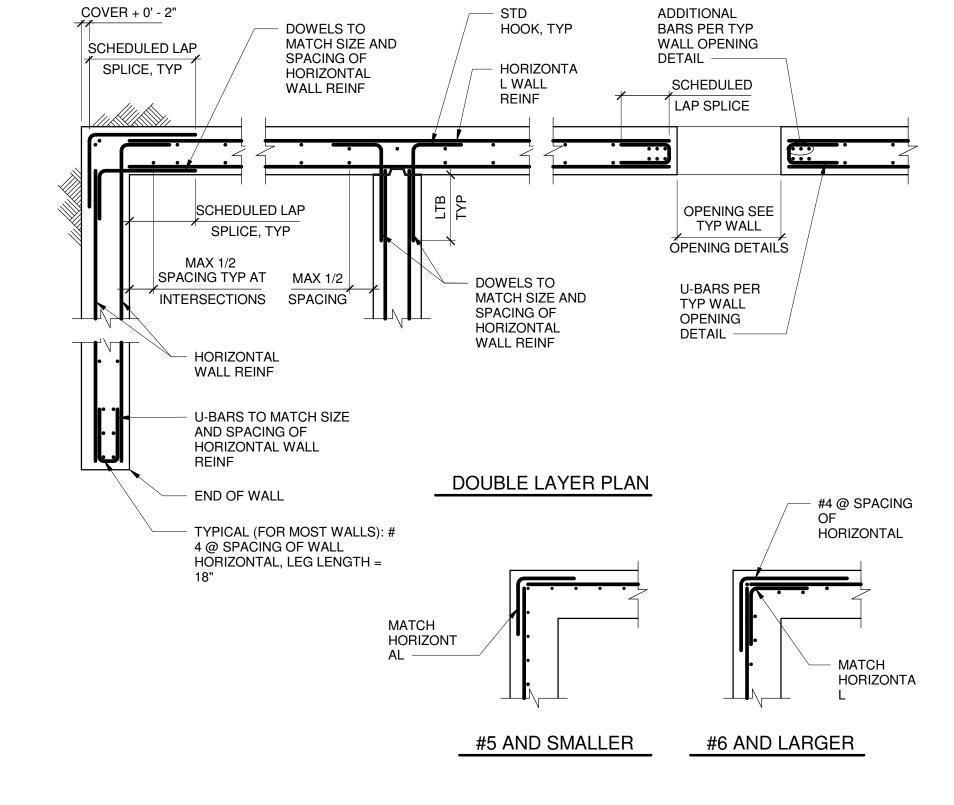

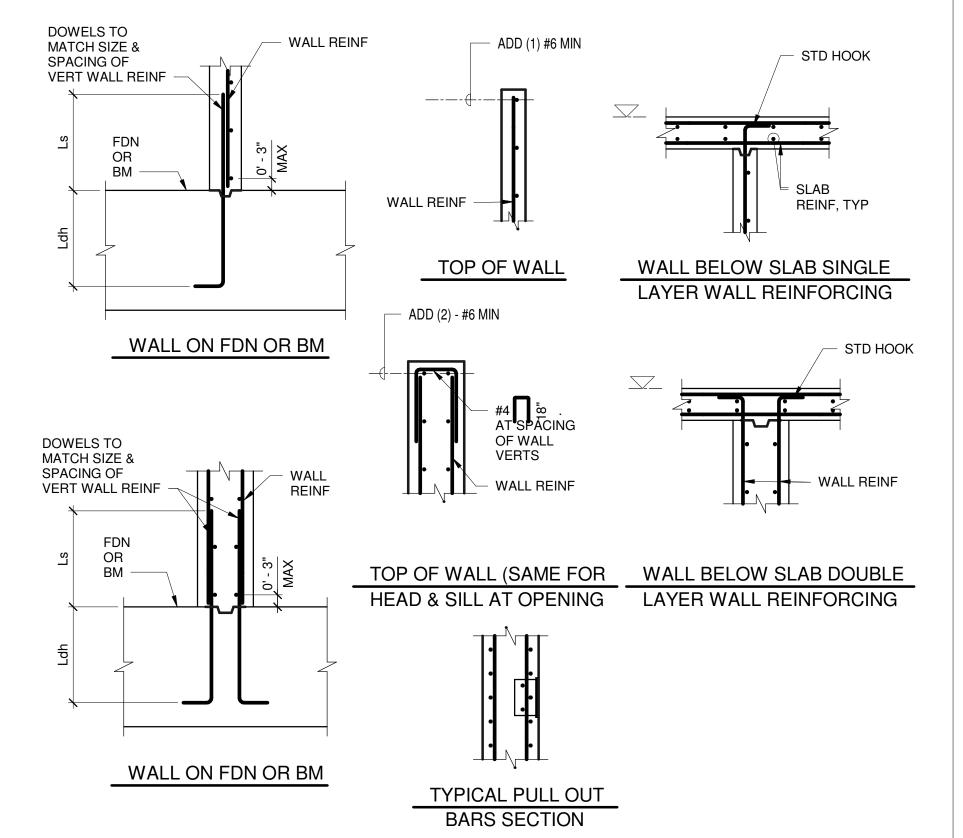

1 TYPICAL WALL REINFORCING DETAIL

1/2" = 1'-0"

2 TYPICAL WALL REINFORCING DETAIL

1/2" = 1'-0"

COVER + 0' - 2"

3 TYPICAL CONCRETE WALL REINFORCING SECTIONS

1/2" = 1'-0"

Description 50% Construction Documents 11/06/20

Storm King Art Center 1 Museum Road

+1 (845) 534-3115

Design Architect

Dublin, D02 YC63

+353 1 633 9000

Executive Architect

New York, NY 10013

Landscape Architect

+1 (212) 219-1953

1 Cobham Mews

London, MW1 9SB

+44 020 7284 8950

Reed Hilderbrand LLC

New Haven, CT 06510

Structural & Lighting

+1 (617) 923-2422

77 Water Street New York, NY 10005

MEPF & IT

Civil

VHB

Facade Front Inc.

Key Plan

BuroHappold

+1 (212) 896-3000

100 Broadway #23

Albany, NY 12203

+1 (518) 389-3606

LSTN Consultants

New York, NY 10005 +1 (347) 788-0810

New York, NY 10002

+1 (212) 242-2220

76 Beaver Street, 2nd Floor

100 E. Broadway Street, #501

AV & Acoustics

New York, NY 10005 +1 (212) 616-0228

100 Great Oaks Blvd., Suite 118

ARUP

New Windsor, NY 12553

heneghan peng architects

14-16 Lord Edward Street

WXY Architecture + Urban Design

224 Centre Street, 5th Floor


Gustafson Porter + Bowman


33 Whitney Avenue, 3rd Floor


Storm King Art Center **Pond Pavilion**

NOT FOR CONSTRUCTION **Drawing Title** Structural Typ Concrete Details

Date	11/06/20
Scale	1/2" = 1'-0"
Drawing Number	S-P-702
Sheet Size	ARCH D

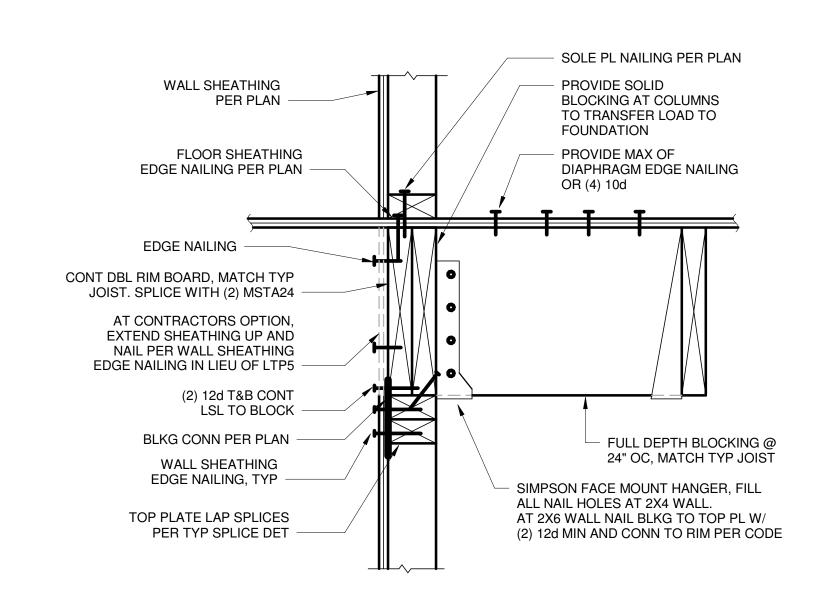


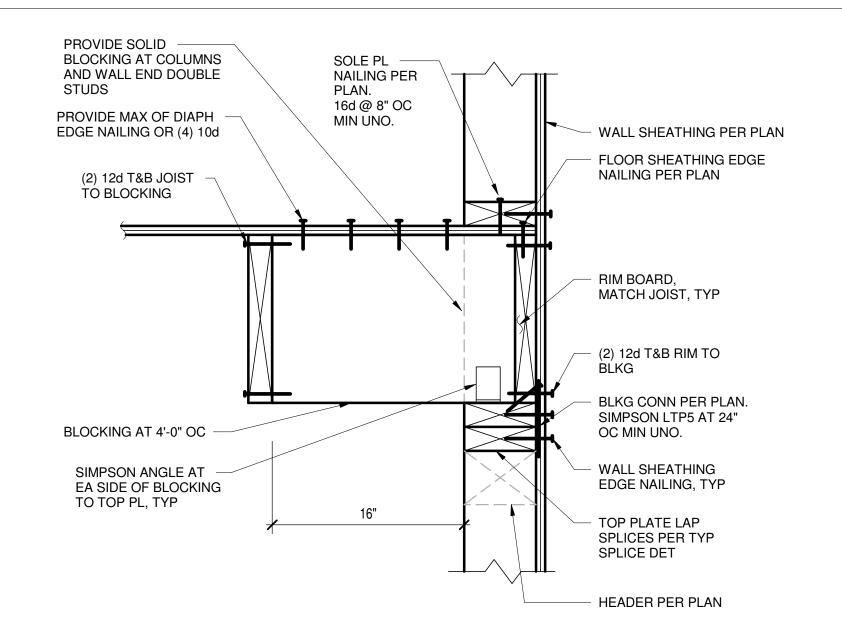

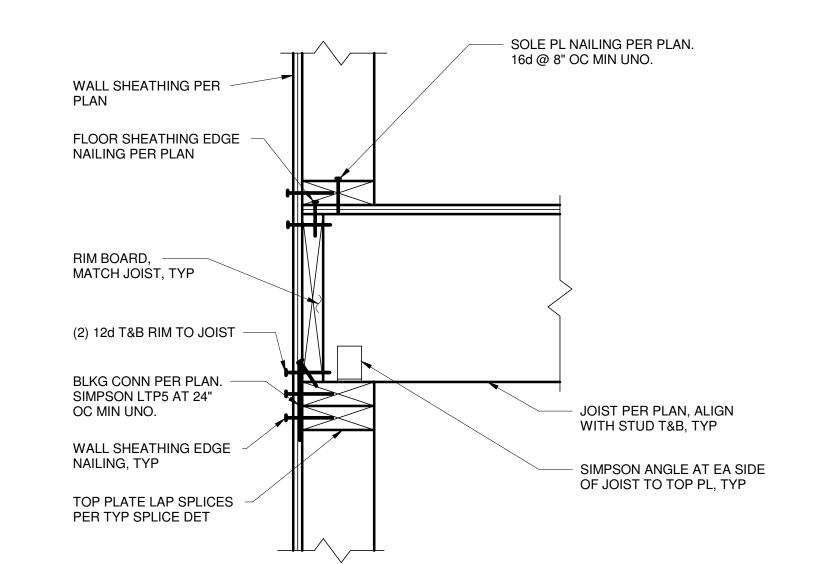

3 TYP JOIST PERPENDICULAR TO EXT WALL
1 1/2" = 1'-0"


TYP DETAIL AT JOIST PARALLEL TO SHEAR WALL

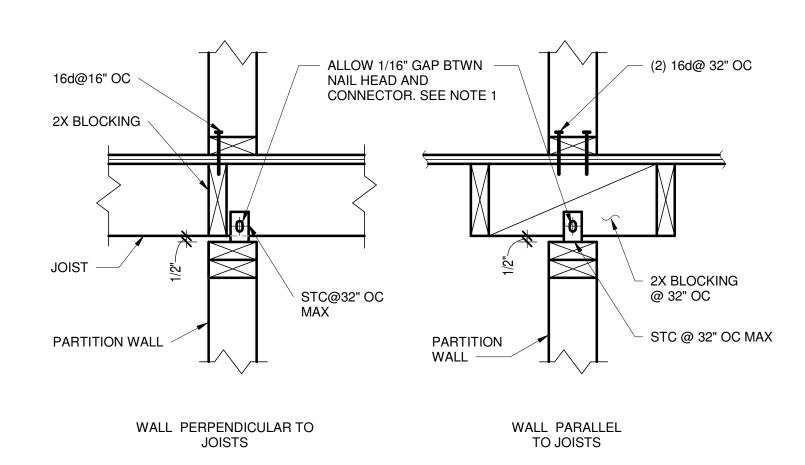

1. CONTRACTOR TO CHECK THAT CONNECTION DOES NOT SQUEAK WITH VERTICAL MOVEMENT


MINIMUM NUMBER OF NAILS PER SPLICE LENGTH BEARING WALL OR SHEAR NON-BEARING SIZE WALL/DRAG STRUT NON-SHEAR WALL 2X4 22 16d@16" OC 34 16d@16" OC 2X6, 2X8 3X4 36 16d@12" OC 16d@12" OC

2 TYP JOIST PARALLEL TO EXT WALL

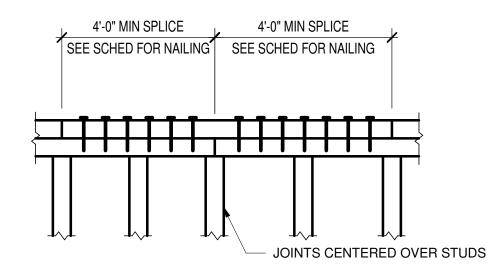

TYP PARTITION (NON-BEARING NON SHEAR WALL) CONN TO FLOOR

5 TYPICAL TOP PLATE/DRAG STRUT SPLICE

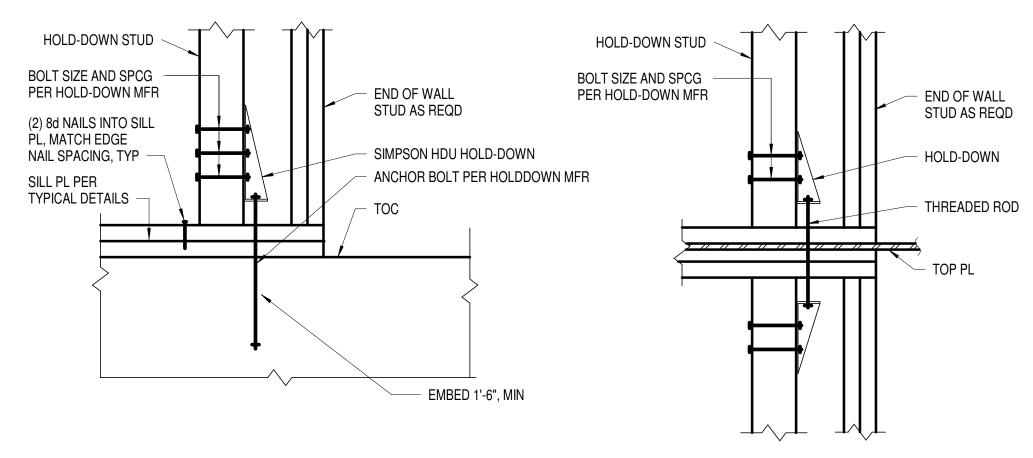

HOLD-DOWN AND **HOLD-DOWN STUDS** WHERE OCCUR 16d@16" OC, UNO **EDGE NAILING**


HOLD-DOWN TO TIMBER WALL BELOW

SEE PLANS FOR HOLD-DOWN LOCATIONS OTHER THAN ENDS OF WALLS. ALL HOLD DOWNS TO BE HDU4-SD2.5 U.N.O. 3. ALL ANCHOR BOLTS TYPICAL A307.

4. INSTALL PER SIMPSON STRONG TIE SPECIFICATIONS. VERTICAL WOOD MEMBER SHALL BE (2) 3X STUDS AT SHEAR WALLS WITH 3X STUDS.

TYPICAL HOLDOWN DETAILS AND SCHEDULE

HOLD-DOWN TO CONCRETE

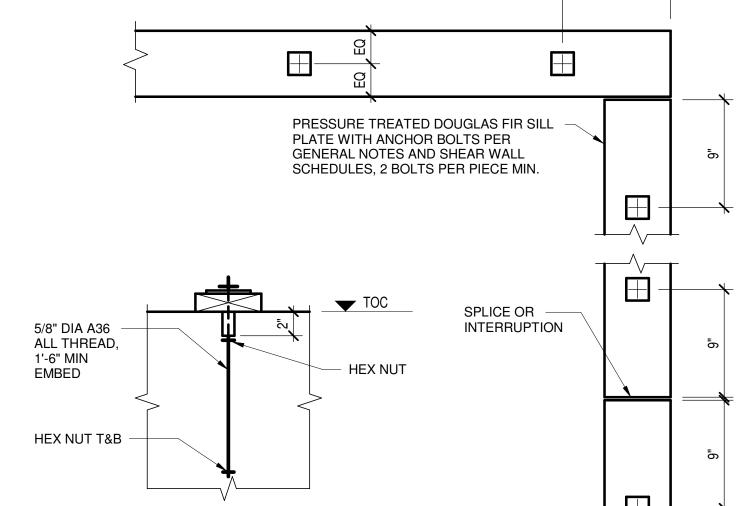

- 1. CONTRACTOR SHALL LOCATE ANCHOR TO MISS STUDS, POSTS, MULLIONS ETC.
- 2. A MINIMUM OF 3/4 INCH THREAD ENGAGEMENT INTO COUPLING NUT IS REQUIRED.

TYPICAL WOOD SILL PLATE

Storm King Art Center 1 Museum Road

New Windsor, NY 12553 +1 (845) 534-3115

Design Architect heneghan peng architects 14-16 Lord Edward Street Dublin, D02 YC63

+353 1 633 9000 **Executive Architect** WXY Architecture + Urban Design 224 Centre Street, 5th Floor New York, NY 10013

+1 (212) 219-1953 Landscape Architect Gustafson Porter + Bowman 1 Cobham Mews London, MW1 9SB

+44 020 7284 8950 Reed Hilderbrand LLC 33 Whitney Avenue, 3rd Floor New Haven, CT 06510

+1 (617) 923-2422 **Structural & Lighting** ARUP

77 Water Street New York, NY 10005 +1 (212) 896-3000

MEPF & IT BuroHappold 100 Broadway #23 New York, NY 10005

+1 (212) 616-0228 Civil VHB

100 Great Oaks Blvd., Suite 118 Albany, NY 12203

+1 (518) 389-3606 **AV & Acoustics**

LSTN Consultants 76 Beaver Street, 2nd Floor New York, NY 10005 +1 (347) 788-0810

Facade Front Inc. 100 E. Broadway Street, #501 New York, NY 10002 +1 (212) 242-2220


Key Plan

Description 02/24/20 50% Design Development 05/29/20 100% Design Development 50% Construction Documents 11/06/20

Storm King Art Center **Pond Pavilion**


NOT FOR CONSTRUCTION Drawing Title Structural Typ Timber Details, Sheet 1

Date	11/06/20
Scale	As indicated
Drawing Number	S-P-721
Sheet Size	ARCH D

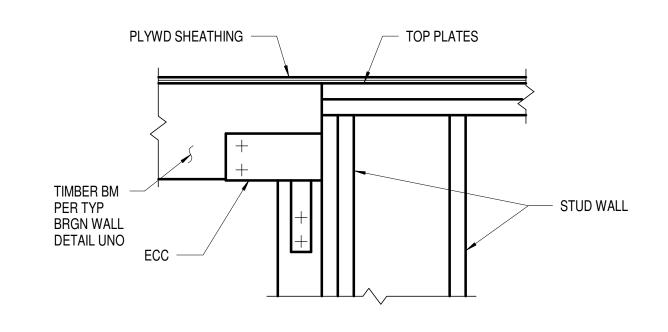

1 TYP TIMBER BM TO END OF STUD WALL

1" = 1'-0"

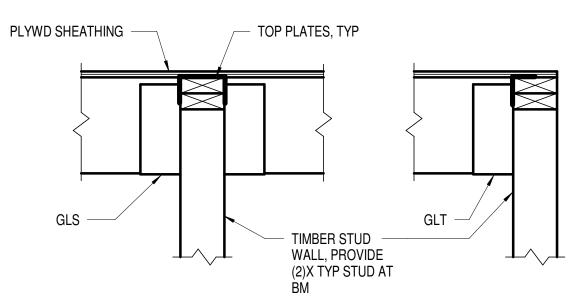

2 TYP TIMBER BM TO SIDE OF STUD WALL

1" = 1'-0"

ADDED STUD FOR BOLT

CONDITION AT END OF

HEAD COVERAGE

NAIL SIZE AND

SPCG AT PANEL

OVER ALT

EDGES PER SHEAR

WALL SCHED, DIST

NAIL SIZE AND SPCG AT

BUNDLED STUDS,

INTERMEDIATE

SCHED

WITH HOLD-DOWNS

OPENING

HEADER CONNECTOR

CONNECTOR


FRAMING MEMBERS

NAIL SIZE AND SPCG

AT PANEL EDGES PER

SHEAR WALL SCHED

PER SHEAR WALL

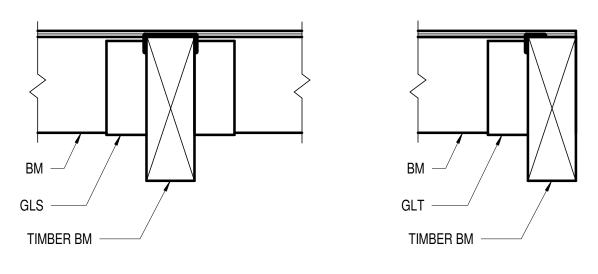

3 TYP TIMBER BM TO TIMBER BM

STUD SIZE

[NOMINAL]

2X6

|•| |•|

|•| |•| |

ADDED STUD

COVERAGE

END OF WALL

PANEL EDGE

BUNDLED STUD

SPLICE, SEE

SHEAR WALL

HOLD-DOWN

SCHEDULE

PANEL EDGE

PANEL EDGES

SOLID BLOCKING TO MATCH STUD SIZE AT

OPNG

TYPICAL

CONDITION AT

FOR BOLT HEAD

FASTENER TYPE PANEL EDGE

& SIZE

NUMBER AND SIZE OF BUNDLED STUDS REQD EA

(2) 2X TOP PLATES UNO, SPLICE PER TYP SPLICE DETAIL


END PER PLAN AND SHEAR WALL HOLD-DOWN

FASTENER SPACING

SHEATHING


SW A 15/32" STRUCT.

SW B 15/32" STRUCT.

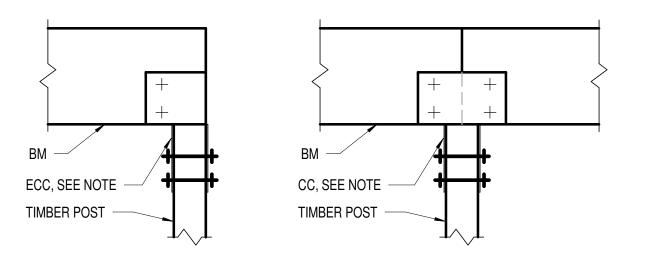


1. ROTATE STRAPS 90 DEGREES WHERE COLUMN DEPTH EXCEEDS AVAILABLE CONNECTOR DIMENSIONS.

TYP TIMBER BM TO TIMBER POST

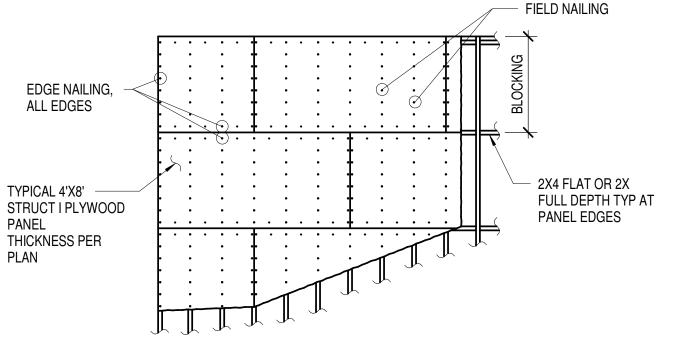


BLOCKED HORIZONTAL DIAPHRAGM 7 1/4" = 1'-0"

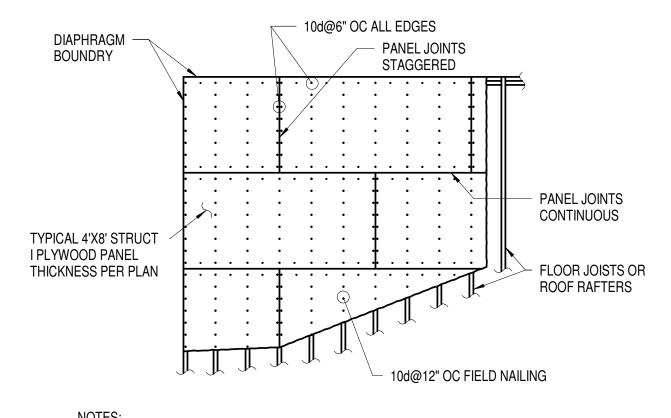

1. NAIL SHEATHING TO ALL STRUTS, STRUT BLOCKING AND SHEAR

UNBLOCKED HORIZONTAL DIAPHRAGM 1/4" = 1'-0"

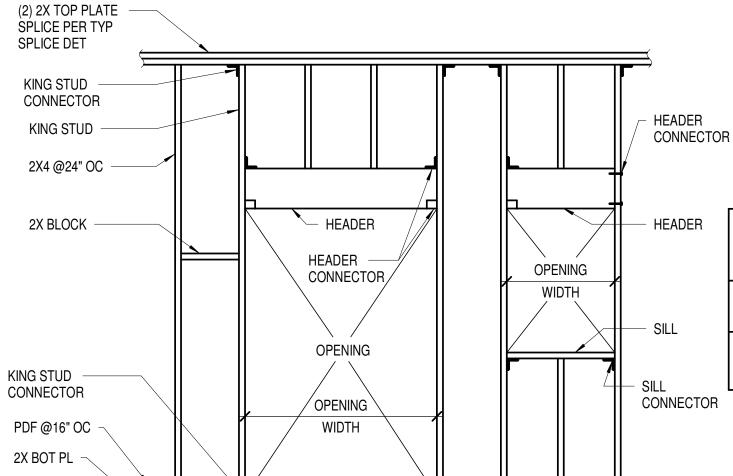

KING STUD **HEADER OPENING** SIZE CONNECTOR SIZE CONNECTOR SIZE (2) A35 OR FC4 2X4 >0'-4'-0" 4) 20d NAILS >4'-0"-8'-0" HH4 AND A35 (2) 2X4 FC4 (2) 2X4(6) 20d NAILS

1. NAIL MULTIPLE 2X STUDS FOR HEADER, SILL AND KING STUD TOGETHER WITH 16d AT 12" ON CENTER 2. MINIMUM NAILING SHALL BE PER THE IBC.

3. AT CONTRACTOR'S OPTION, USE .145" DIAMETER X 3/4" CONCRETE EMBEDMENT LOW VELOCITY POWDER DRIVEN FASTENER AT 16" ON CENTER. CONTRACTOR TO COORDINATE WITH POST TENSIONED TENDON.

EDGE NAILING EDGE NAILING **EDGE NAILING** 16d@12" OC **EDGE NAILING** 16d@12" OC 16d@12" OC EDGE NAILING **EDGE NAILING**

TYPICAL STUD WALL INTERSECTIONS

1" = 1'-0"

HEADER

HEADER

OPENING

OPENING

WIDTH

STUD

CONNECTØR

<u>PLAN</u>

WITHOUT HOLD-DOWNS

AT CONTRACTORS OPTION, USE (4) 20d IN LIEU OF HEADER

(2) 2X TOP PLATE SPLICE PER TYP

SPLICE DET

KING STUD

CONNECTOR

KING STUD

UNO

KING STUD

CONNECTOR

PDF @16" OC

2X BLOCK

2X4 AT INTERIOR,

2X6 AT EXTERIOR

KING STUD HEADER **OPENING** WIDTH SIZE CONNECTOR | SIZE | CONNECTOR SIZE CONNECTOR LVL 4 - ROOF (2) 2XFC (2) A35 >0'-4'-0" (2) 2X8LVL 2 - 3 (3) 2X LVL 4 - ROOF (3) 2X>4'-0"-6'-0" (2) 2X10(2) A35 LVL 2 - 3 LVL 4 - ROOF >6'-0"-8'-0" (2) 1 3/4"X11 7/8" (2) A35 4X6 (2) 2X A35 1.9 E LVL LVL 2 - 3 LVL 4 - ROOF >8'-0"-10'-0" (2) 1 3/4"X11 7/8" (2) A35 FC 4X8 A35 (2) 2X (2) 2X 1.9 E LVL LVL 2 - 3 6X6 LVL 4 - ROOF 4X8 >10'-0"-12'-0" (2) 1 3/4"X11 7/8" (2) 2X (2) A35 (2) 2X A35 1.9 E LVL LVL 2 - 3 6X6

6 TYPICAL SHEAR WALL FRAMING

. REFER TO GENERAL NOTES FOR BEARING WALL CONSTRUCTION FOR ALL WALL TYPES 2. NAIL MULTIPLE 2X STUDS FOR HEADER, SILL AND KING STUD TOGETHER WITH 16d AT 12" ON CENTER

3. MINIMUM NAILING SHALL BE PER THE IBC. 4. AT SHEAR WALL, USE STUD AND SILL MEMBER THICKNESS PER SHEAR WALL SCHEDULE.

TYPICAL TIMBER STUD BEARING WALL FRAMING

1/2" = 1'-0"

TYPICAL TIMBER STUD PARTITION (NON-BEARING) WALL FRAMING

1/2" = 1'-0"

1. NAIL SHEATHING TO ALL STRUTS, STRUT BLOCKING AND SHEAR WALLS BELOW WITH (3) ROWS OF EDGE NAILS, STAGGERED.

> Description 50% Design Development 100% Design Development 50% Construction Documents

WALLS BELOW WITH (2) ROWS OF EDGE NAILS, STAGGERED.

Project Storm King Art Center **Pond Pavilion**

02/24/20

05/29/20

11/06/20

Storm King Art Center 1 Museum Road

+1 (845) 534-3115

Design Architect

Dublin, D02 YC63 +353 1 633 9000

Executive Architect

New York, NY 10013

Landscape Architect

+1 (212) 219-1953

1 Cobham Mews

London, MW1 9SB

+44 020 7284 8950

Reed Hilderbrand LLC

New Haven, CT 06510 +1 (617) 923-2422

Structural & Lighting

New York, NY 10005 +1 (212) 896-3000

100 Broadway #23 New York, NY 10005

+1 (212) 616-0228

Albany, NY 12203

+1 (518) 389-3606

LSTN Consultants

+1 (347) 788-0810

Facade

Front Inc.

Key Plan

New York, NY 10005

New York, NY 10002

+1 (212) 242-2220

76 Beaver Street, 2nd Floor

100 E. Broadway Street, #501

AV & Acoustics

100 Great Oaks Blvd., Suite 118

77 Water Street

MEPF & IT

Civil

VHB

BuroHappold

ARUP

New Windsor, NY 12553

heneghan peng architects

14-16 Lord Edward Street

WXY Architecture + Urban Design


224 Centre Street, 5th Floor


Gustafson Porter + Bowman


33 Whitney Avenue, 3rd Floor


NOT FOR CONSTRUCTION Drawing Title Structural Typ Timber Details, Sheet 2

Date	11/06/20
Scale	As indicated
Drawing Number	S-P-722
Sheet Size	ARCH D

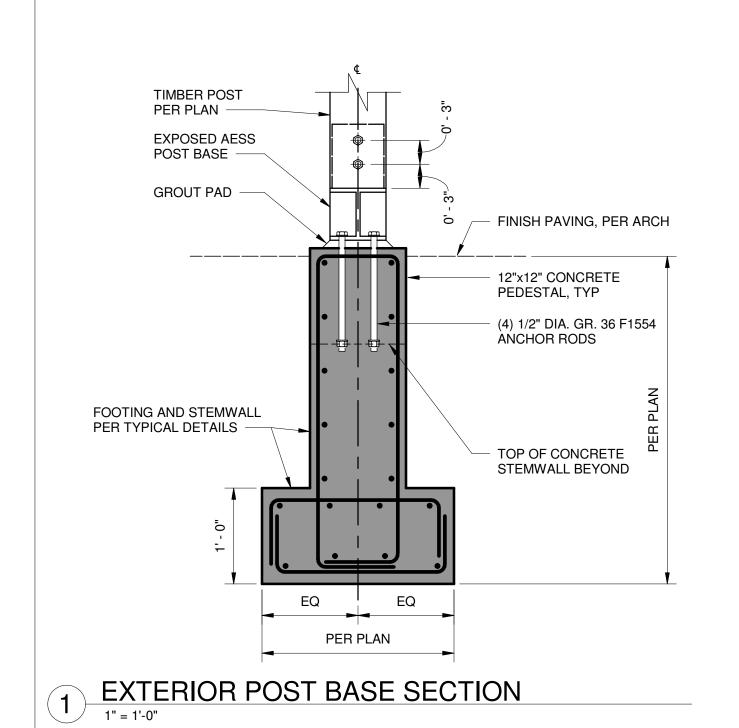

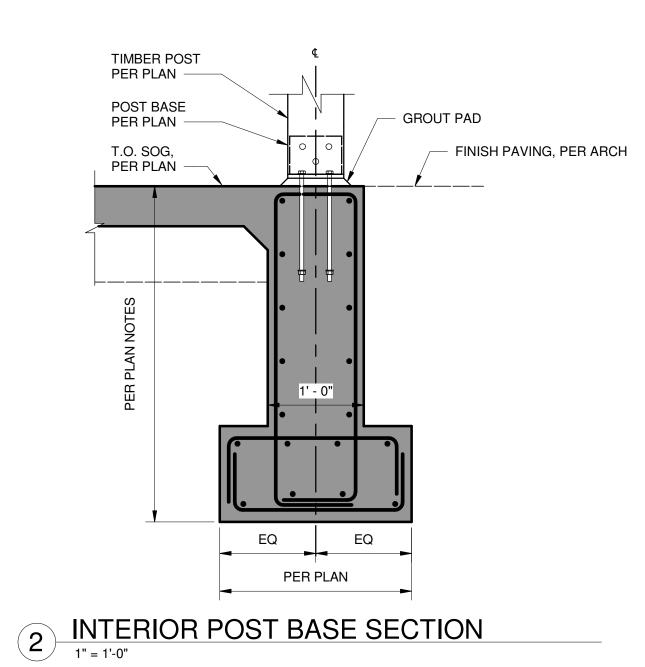

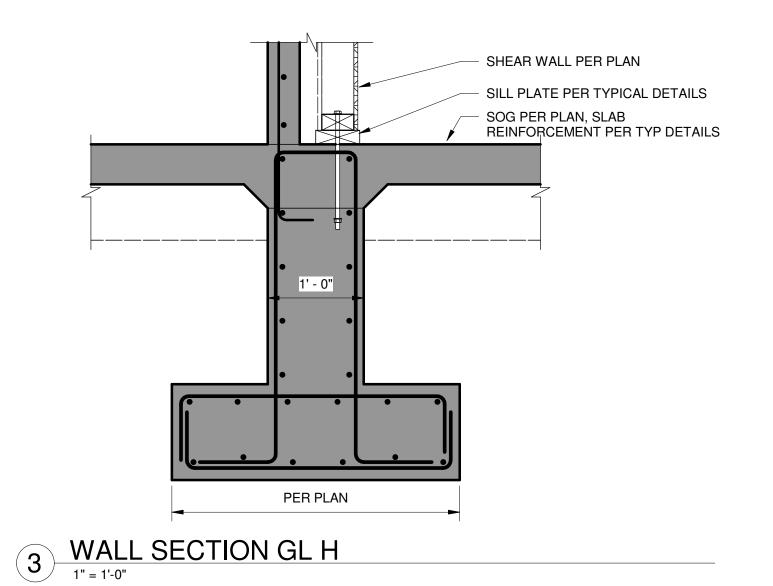

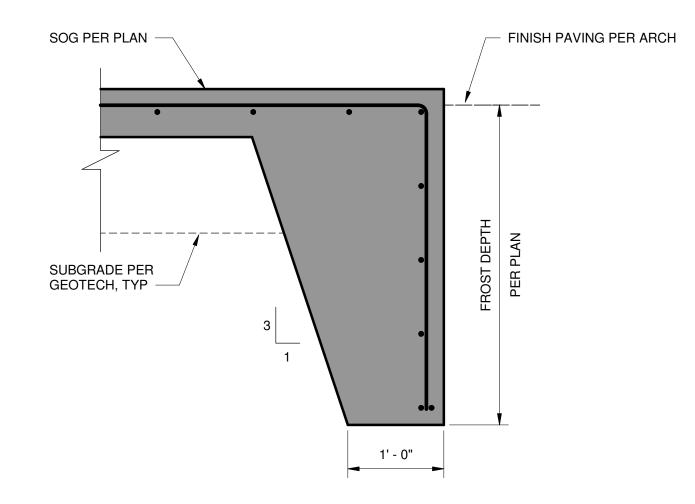

4 SLAB EDGE SECTION

1" = 1'-0"

Owner
Storm King Art Center

1 Museum Road New Windsor, NY 12553 +1 (845) 534-3115

Design Architect
heneghan peng architects
14-16 Lord Edward Street
Dublin, D02 YC63
+353 1 633 9000

Executive Architect
WXY Architecture + Urban Design
224 Centre Street, 5th Floor
New York, NY 10013

+1 (212) 219-1953

Landscape Architect
Gustafson Porter + Bowman
1 Cobham Mews
London, MW1 9SB

+44 020 7284 8950

Reed Hilderbrand LLC
33 Whitney Avenue, 3rd Floor
New Haven, CT 06510

New Haven, CT 06510 +1 (617) 923-2422 Structural & Lighting ARUP

77 Water Street
New York, NY 10005
+1 (212) 896-3000

MEPF & IT

MEPF & II BuroHappold 100 Broadway #23 New York, NY 10005 +1 (212) 616-0228

Civil VHB 100 Great Oaks Blvd., Suite 118 Albany, NY 12203

+1 (518) 389-3606

AV & Acoustics
LSTN Consultants
76 Beaver Street, 2nd Floor
New York, NY 10005
+1 (347) 788-0810

Facade
Front Inc.
100 E. Broadway Street, #501
New York, NY 10002
+1 (212) 242-2220

Key Plan

Description Date
100% Design Development 05/29/20
50% Construction Documents 11/06/20

Storm King
Art Center

Project

Storm King

Art Center


Sea


NOT FOR CONSTRUCTION

Drawing Title

Foundation Details


Date	11/06/20
Scale	1" = 1'-0"
Drawing Number	S-P-801
Sheet Size	ARCH D

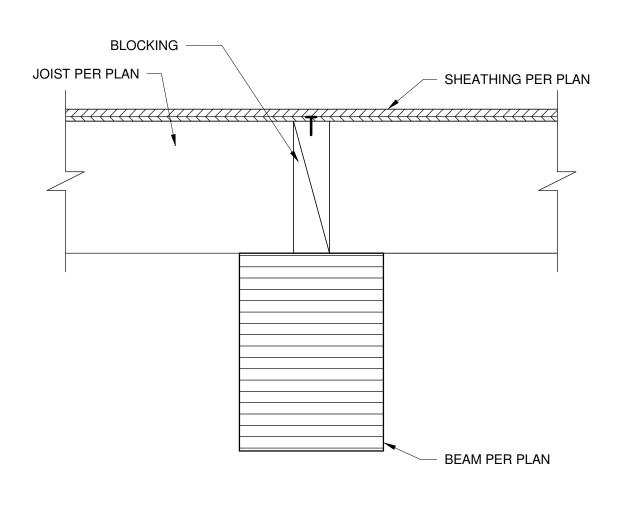


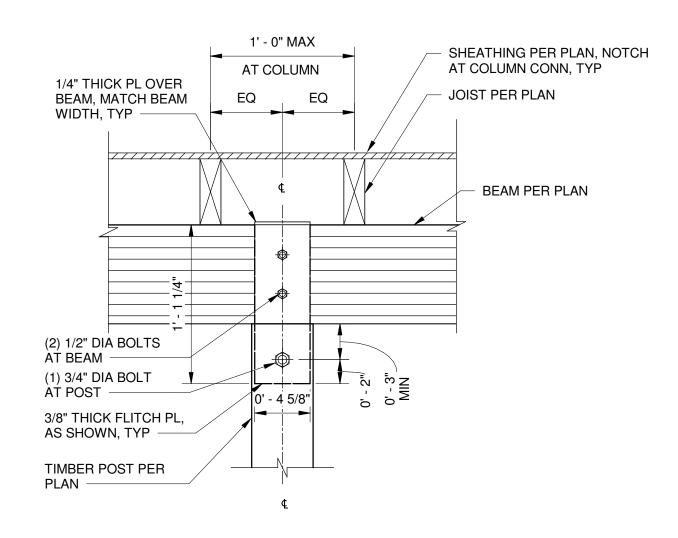

JOIST TO BEAM CONNECTION 3" = 1'-0"

2 POST TO BEAM CONNECTION 1 1/2" = 1'-0"

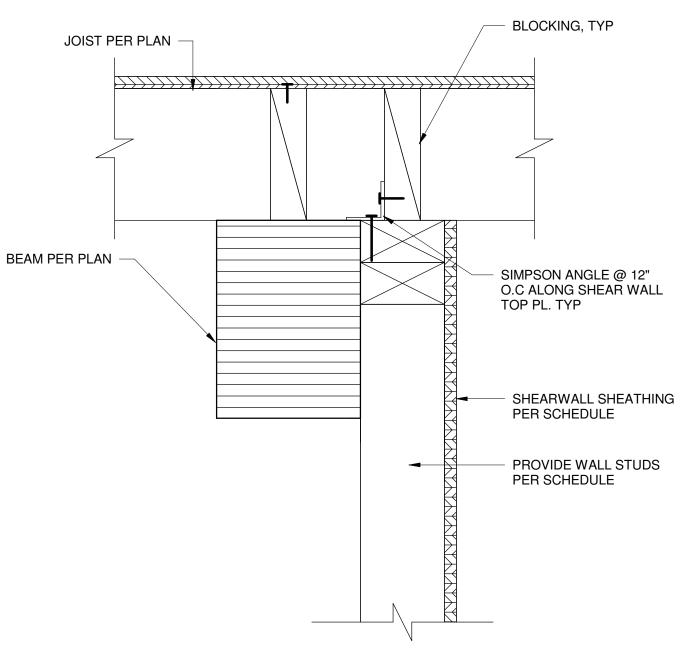

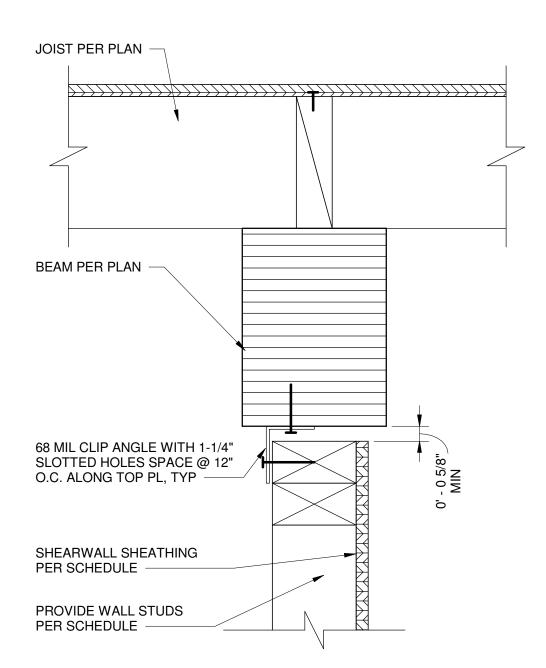

OFFSET FROM BEAM

ALIGNED WITH BEAM

3 SHEAR WALL TO BEAM 3" = 1'-0"

Storm King Art Center 1 Museum Road New Windsor, NY 12553

+1 (845) 534-3115 **Design Architect** heneghan peng architects

14-16 Lord Edward Street

Dublin, D02 YC63

+353 1 633 9000 **Executive Architect** WXY Architecture + Urban Design 224 Centre Street, 5th Floor New York, NY 10013

+1 (212) 219-1953 Landscape Architect Gustafson Porter + Bowman

1 Cobham Mews London, MW1 9SB +44 020 7284 8950

Reed Hilderbrand LLC 33 Whitney Avenue, 3rd Floor New Haven, CT 06510 +1 (617) 923-2422

Structural & Lighting ARUP 77 Water Street New York, NY 10005

+1 (212) 896-3000 MEPF & IT

BuroHappold 100 Broadway #23 New York, NY 10005 +1 (212) 616-0228

Civil VHB

100 Great Oaks Blvd., Suite 118 Albany, NY 12203 +1 (518) 389-3606

AV & Acoustics LSTN Consultants 76 Beaver Street, 2nd Floor New York, NY 10005 +1 (347) 788-0810

Facade Front Inc. 100 E. Broadway Street, #501 New York, NY 10002 +1 (212) 242-2220

Key Plan

Description Date 100% Design Development 05/29/20 50% Construction Documents 11/06/20

Storm King Art Center **Pond Pavilion**

NOT FOR CONSTRUCTION **Drawing Title** Timber Details

Date	11/06/20
Scale	As indicated
Drawing Number	S-P-821
Sheet Size	ARCH D

ABV.	ABOVE	LRD	LINEAR RETURN DIFFUSER (CEILING, WALL, SILL, OR FLOOP
AC	AIR CONDITIONER	LSD	LINEAR SUPPLY DIFFUSER (CEILING, WALL, SILL, OR FLOOR
AD	ACCESS DOOR	LTHW	LOW TEMPERATURE HOT WATER
AFF	ABOVE FINISHED FLOOR	LVL	LEVEL
AHU	AIR HANDLING UNIT	LWS	LOUVER WITH WIRE SCREEN
AL	ACOUSTICAL LINING	LWT	LEAVING WATER TEMPERATURE
ALD	AUTOMATIC LOUVER DAMPER (MOTORIZED)	MAT	MIXED AIR TEMPERATURE
ATC	AUTOMATIC LOUVER DAWFER (MOTORIZED) AUTOMATIC TEMPERATURE CONTROL		MAXIMUM
		MAX MBH	THOUSAND BTU PER HOUR
B.D.D.	BACK DRAFT DAMPER	MBTU	BRITISH THERMAL UNIT (1000 BTU)
BMS	BUILDING MANAGEMENT SYSTEM		
BOD	BOTTOM OF DUCT	MIN	MINIMUM MASONDY OPENING (WALL OPENING)
BHP	BRAKE HORSE POWER	MO (WO)	MASONRY OPENING (WALL OPENING)
BRD	BAROMETRIC RELIEF DAMPER	NC	NORMALLY CLOSED
BTU	BRITISH THERMAL UNIT	NFA	NET FREE AREA
CC	COOLING COIL	NIC	NOT IN THIS CONTRACT
CD	CEILING DIFFUSER	NO	NORMALLY OPEN
CFM	CUBIC FEET PER MINUTE	NTS	NOT TO SCALE
CG	CEILING GRILLE	OA	OUTSIDE AIR
CO2	CARBON DIOXIDE	OAT	OUTSIDE AIR TEMPERATURE
CHW	CHILLED WATER	OBD	OPPOSED BLADE DAMPER
СО	CLEAN OUT	OED	OPEN ENDED DUCT
COD	CABLE OPERATED VOLUME DAMPER	Р	PUMP
CDP	CONDENSATE DRAIN PIPING	PHC	PRE-HEAT COIL
CP	CONDENSATE PUMP RETURN	PHX	PLATE & FRAME HEAT EXCHANGE
CAV	CONSTANT AIR VOLUME TERMINAL	PSI	POUNDS PER SQUARE INCH (GAUGE)
DN	DOWN	RA	RETURN AIR
EAT	ENTERING AIR TEMPERATURE	RF	RETURN FAN
EXH FN	EXHAUST FAN	RHC	REHEAT COIL
EHC	ELECTRIC HEATING COIL		
EV	EXPANSION VESSEL/EXPANSION TANK	RPM RR	REVOLUTIONS PER MINUTE RETURN REGISTER
		RX	RECYCLING ROOM EXHAUST
EWT	ENTERING WATER TEMPERATURE		
ETK	EXPANSION TANK	SA SCHW	SUPPLY AIR SECONDARY CHILLED WATER
FC	FLEXIBLE CONNECTION		
FCU	FAN COIL UNIT	SD	SMOKE DAMPER
FD/AD	FIRE DAMPER/ACCESS DOOR	SD/ALD	SMOKE DAMPER AND AUTOMATIC LOUVER COMBINATION
FD/GA	FIRE DAMPER/GRILLE ACCESS	SF	SUPPLY FAN
FTR 	FIN TUBE RADIATOR	SG	SUPPLY GRILLE
FL	FLOOR	ST	SOUND TRAP
FLA	FULL LOAD AMPS	SEF	SMOKE EXHAUST FAN
FSD	FIRE SMOKE DAMPER	TOD	TOP OF DUCT
FSD/AD	FIRE SMOKE DAMPER/ACCESS DOOR	TF	TRANSFER FAN
FSD/GA	FIRE SMOKE DAMPER/GRILLE ACCESS	TG	TOP GRILLE
GPM	GALLONS PER MINUTE	TR	TOP REGISTER
GX	GENERAL EXHAUST	TD	TRANSFER DUCT
HC	HEATING COIL	TRX	TRASH EXHAUST
HHW	HEATING HOT WATER	TX	TOILET EXHAUST
HPS	HIGH PRESSURE STEAM	UH	UNIT HEATER
HP	HORSE POWER	VAV	VARIABLE AIR VOLUME
HX	HEAT EXCHANGER (SHELL & TUBE)	VD	VOLUME DAMPER
ID	INSIDE DIMENSION	VFD	VARIABLE FREQUENCY DRIVE
	KILOWATT	WMS	WIRE MESH SCREEN
KW			WALLST THE COLL CONTACT IN

HVAC SYMB	OLS (DUCTWORK)	HVAC SYME	BOLS (DUCTWORK)
	RECTANGULAR DUCT SUPPLY	H H	TERMINAL UNIT - ACTIVE CH HORIZONTAL ABOVE CEILIN
	RECTANGULAR DUCT RETURN		EQUIPMENT SCHEDULES) TERMINAL UNIT - ACTIVE CH ABOVE CEILING MOUNTED (
	RECTANGULAR DUCT EXHAUST	V N	SCHEDULES) TERMINAL UNIT - AIRFLOW
\otimes	ROUND DUCT SUPPLY		TYPE)
	ROUND DUCT RETURN	→ [_]	TERMINAL UNIT - FAN BOOS
\bigcirc	ROUND DUCT EXHAUST	Н	LINT TRAP
	FALT OVAL DUCT SUPPLY		DUCT MOUNTED COIL
	FLAT OVAL DUCT RETURN		DUCT MOUNTED UVGI
	FLAT OVAL DUCT EXHAUST	X X X X X X X X X X	DUCT MOUNTED HUMIDIFIE
	DOUBLE WALL DUCTWORK		
	DUCT WITH ACOUSTIC LINING		
	DUCT WRAPPED WITH FIRE RATED INSULATION		
<i>→</i>			
X" TH	BRANCH DUCT WITH RADIUSED SIDE SPLIT - RECTANGULAR DUCT		
→ 	BRANCH DUCT TAP, SINGLE BOOT - RECTANGULAR DUCT		
→ +	BRANCH DUCT TAP, DOUBLE BOOT - RECTANGULAR DUCT		
→ 	BRANCH DUCT TAP, SINGLE BOOT - ROUND & FLAT OVAL DUCT		
→ 	BRANCH DUCT TAP, DOUBLE BOOT - ROUND & FLAT OVAL DUCT		
	FLEXIBLE DUCT		
	FLEXIBLE CONNECTION		
AD	ACCESS DOOR		
C.O.	CLEAN OUT		
<u> </u>	DUCT THROUGH BEAM PENETRATION		
	AUTOMATIC DAMPER - OPPOSED BLADE		
	AUTOMATIC DAMPER - PARALLEL BLADE		
 FSD	FIRE SMOKE DAMPER		
	FIRE DAMPER		
BD.D	BACKDRAFT DAMPER		
BR.D	BAROMETRIC DAMPER		
A2	SQUARE CEILING DIFFUSER (SHADED SECTORS		
B2	ROUND CEILING DIFFUSER (SHADED SECTORS		
⊕ _{C2}	ROUND FLOOR DIFFUSER (UFAD)		
C2 ←	REGISTER - SIDEWALL/CEILING/FLOOR - SUPPLY		
	REGISTER/GRILLE - SIDEWALL/CEILING/FLOOR -		
	RETURN/EXHAUST		
→	WALL TRANSFER GRILLES LINEAR DIFFUSER/GRILLE - SUPPLY/RETUN/EXHAUST (UNSHADED SECTIONS INDICATE ACTIVE LINEAR,		
	SHADED SECTIONS INDICATE BLANK OFF) PLENUM FOR LINEAR DIFFUSER/GRILLE		
(SD)	DUCT SMOKE DETECTOR		
(FS)	DUCT FIRESTAT		
A			
	AIRFLOW STATION SOUND TRAP		
	ACOUSTIC TRANSFER DUCT		
	TERMINAL UNIT - VAV BOX - WITH/WITHOUT HEATING COIL TERMINAL UNIT - FAN COIL UNIT		
	TERMINAL UNIT - FAN COIL UNIT TERMINAL UNIT - FAN POWERED BOX WITH/WITHOUT		
	HEATING COIL		
	TERMINAL UNIT - FAN POWERED CHILLED BEAM - WITH HEATING & COOLING COILS		
	TERMINAL UNIT - ACTIVE CHILLED BEAM - CEILING		

S (DUCTWORK)	HVAC SYME	BOLS (PIPING)	HVAC SY	MBOLS (PIPING)
TERMINAL UNIT - ACTIVE CHILLED BEAM - HORIZONTAL ABOVE CEILING MOUNTED (SEE EQUIPMENT SCHEDULES)	0	PIPE TURNING UP		CICUTOL ACC
TERMINAL UNIT - ACTIVE CHILLED BEAM - VERTICAL ABOVE CEILING MOUNTED (SEE EQUIPMENT	o	PIPE TURNING DOWN		SIGHTGLASS
SCHEDULES) TERMINAL UNIT - AIRFLOW REGULATOR (SLIP IN TYPE)	<u> </u>	SLOPE RISE IN DIRECTION OF FLOW		SIGHTGLASS WITH MOISTURE INDICATOR (REFRIGERANT)
TERMINAL UNIT - FAN BOOSTER UNIT (UFAD)	—————————————————————————————————————	SLOPE DROP IN DIRECTION OF FLOW		FILTER-DRYER
LINT TRAP		PIPE THROUGH BEAM PENETRATION	(D)	LEAK DETECTOR, PROBE TYPE
DUCT MOUNTED COIL		WALL SLEEVE WITH WATER STOP	LD	LEAK DETECTOR, CABLE TYPE
DUCT MOUNTED UVGI		ELBOW		METER
DUCT MOUNTED HUMIDIFIER		TEE	<u></u>	AIR VENT (MANUAL)
		BRANCH PIPE TOP CONNECTION		Y-STRAINER WITH HOSE END
	- Î	BRANCH PIPE BOTTOM CONNECTION		Y-STRAINER WITH BLOW OFF BALL VALVE
		REDUCER/INCREASER CONCENTRIC		Y-STRAINER
		REDUCER/DECREASER ECCENTRIC	\ \ \ \ \ \ \ \ \ \ \ \ \ \ \ \ \ \ \	DRAIN VALVE WITH CAPPED HOSE END
	—	UNION	<u>X</u>	
	——————————————————————————————————————	FLANGED JOINT		DUPLEX BASKET STRAINER
	———————————————————————————————————————	BLIND FLANGE		NOISE SUPRESSOR (STEAM PRV)
		END CAP	¹	TEMPERATURE GAUGE
		PIPE GUIDE	0	PRESSURE GAUGE W/ PIGTAIL AND PETCOCK
	\otimes	PIPE ANCHOR	++	FLEXIBLE COUPLING
	— •	BALL VALVE - MANUAL (LEVER HANDLE)		
	─	BALL VALVE - MANUAL (TEE HANDLE)		PIPE IN PIPE (FUEL OIL)
	<u> </u>	BALL VALVE - MOTORIZED	AS	HEAT TRACED PIPE
		GENERAL DUTY ISOLATION VALVE (SEE SPEC FOR TYPE)		AIR SEPARATOR
		GATE VALVE		EXPANSION TANK
	— >	GLOBE VALVE	XT	LAI ANGION PANIC
	—\ ~	BUTTERFLY VALVE - MANUAL		OUEM QUOT EFEDED
		BUTTERFLY VALVE - MOTORIZED		CHEM SHOT FEEDER
		ORBIT VALVE		SHELL AND TUBE HEAT EXCHANGER
		FLOWSETTER VALVE (BALANCING)		
		CARTRIDGE FLOW BALANCER		PLATE AND FRAME HEAT EXCHANGER
		PRESSURE REDUCING VALVE		PUMP
	-	PLUG VALVE		
		CHECK VALVE (SWING TYPE)	-	
		CHECK VALVE (SILENT TYPE, CENTER GUIDED)		
	→PICV	PRESSURE INDEPENDENT CONTROL VALVE (PICV)	CONTRO	LS SYMBOLS
		2 WAY CONTROL VALVE	T	THERMOSTAT
		3 WAY CONTROL VALVE (MIXING TYPE)	Т	TEMPERATURE SENSOR
		3 WAY CONTROL VALVE (DIVERTING TYPE)	Н	HUMIDISTAT
	<u> </u>	SOLENOID VALVE	Н	HUMIDITY SENSOR
		RELIEF VALVE	(0)	CARBON MONOXIDE SENSOR
	——————————————————————————————————————	BACKFLOW PREVENTOR	(CO2)	CARBON DIOXIDE SENSOR
		BACKFLOW PREVENTER (RPZ TYPE)	NO2	NITROGEN DIOXIDE SENSOR
	A .	AIR VENT (AUTOMATIC)	H1)	HYDROGEN SENSOR
		TEMPERATURE GAUGE (DUCT MOUNTED)	R	REFRIGERANT SENSOR
	0 0	PRESSURE GAUGE W/ PIGTAIL AND PETCOCK	EPO	EMERGENCY POWER OFF SWITCH
	н			TEMPERATURE GAUGE WITH PIPE WELL

Owner Storm King Art Center 1 Museum Road New Windsor, NY 12553 +1 (845) 534-3115 Design Architect heneghan peng architects 14-16 Lord Edward Street Dublin, D02 YC63 +353 1 633 9000 **Executive Architect** WXY Architecture + Urban Design 224 Centre Street, 5th Floor New York, NY 10013 +1 (212) 219-1953 Landscape Architect Gustafson Porter + Bowman 1 Cobham Mews London, MW1 9SB +44 020 7284 8950 Reed Hilderbrand LLC 33 Whitney Avenue, 3rd Floor New Haven, CT 06510 +1 (617) 923-2422 Structural & Lighting ARUP 77 Water Street New York, NY 10005 +1 (212) 896-3000 MEPF & IT BuroHappold 100 Broadway #23 New York, NÝ 10005 +1 (212) 616-0228 Civil VHB 100 Great Oaks Blvd., Suite 118 Albany, NY 12203 +1 (518) 389-3606 AV & Acoustics LSTN Consultants 76 Beaver Street, 2nd Floor New York, NY 10005 +1 (347) 788-0810 Facade Front Inc. 100 E. Broadway Street, #501 New York, NY 10002

Description	Date
50% Design Development	02/24/20
100% Design Development	05/29/20
50% Construction Documents	11/06/20

+1 (212) 242-2220

Key Plan

Project Storm King Art Center **Pond Pavilion**

NOT FOR CONSTRUCTION **Drawing Title** Abbreviations, Symbols, and Legends

Date	11/06/20
Scale	Not to Scale
Drawing Number	M-P-001
Sheet Size	ARCH D

A. GENERAL NOTES

1. EXECUTE THE WORK IN THE BEST AND MOST THOROUGH MANNER AND TO THE SATISFACTION OF THE CONSULTING ENGINEER, WHO WILL JOINTLY INTERPRET THE MEANING OF THE DRAWINGS AND SPECIFICATIONS AND SHALL HAVE THE POWER TO REJECT ANY WORK AND MATERIALS, WHICH IN THEIR JUDGMENT ARE NOT IN FULL ACCORDANCE THEREWITH.

2. EXCEPT FOR CHANGES AS MAY BE SPECIFICALLY APPROVED BY THE CONSULTING ENGINEERS, IN ACCORDANCE WITH ALTERNATES OF OPTIONS STATED HEREINAFTER, ALL WORK MUST BE IN FULL ACCORDANCE WITH THE INTENT OF THE PLANS AND SPECIFICATIONS, COMPLETE IN EVERY WAY AND READY FOR SATISFACTORY AND EFFICIENT OPERATION WHEN DELIVERED TO THE OWNER.

3. WHERE DISAGREEMENTS OCCUR BETWEEN THE PLANS AND THE SPECIFICATIONS, OR WITHIN EITHER DOCUMENT ITSELF, THE ITEM OR ARRANGEMENT OF BETTER QUALITY, GREATER QUANTITY OR HIGHER COST SHALL BE INCLUDED IN THE BASE BID.

4. THE CONTRACTOR COVENANTS AND AGREES THAT THEY AND THEIR SUBCONTRACTORS AND THEY AND THEIR AGENTS, SERVANTS AND EMPLOYEES WILL PROVIDE AND MAINTAIN A SAFE PLACE TO WORK AND THAT THEY AND THEIR WILL COMPLY WITH ALL LAWS AND REGULATIONS OF ANY GOVERNMENTAL AUTHORITY HAVING JURISDICTION THEREOF AND THE CONTRACTOR AGREES TO INDEMNIFY, DEFEND AND HOLD HARMLESS THE CONSULTING ENGINEER, ARCHITECT AND OWNER FROM AND AGAINST ANY LIABILITY, LOSS, DAMAGE OR EXPENSE, INCLUDING ATTORNEY'S FEES ARISING FROM FAILURE OR ALLEGED FAILURE ON THE PART OF THE CONTRACTOR, THEIR SUBCONTRACTORS AND THEY AND THEIR AGENTS, SERVANTS AND EMPLOYEES TO PROVIDE AND MAINTAIN A SAFE PLACE TO WORK OR TO COMPLY WITH ALL LAWS AND REGULATIONS OF ANY GOVERNMENTAL AUTHORITY HAVING JURISDICTION THEREOF.

5. THE CONTRACTOR AND EACH SUBCONTRACTOR COVENANTS AND AGREES TO INDEMNIFY, DEFEND AND HOLD HARMLESS THE CONSULTING ENGINEER, ARCHITECT AND OWNER FROM AND AGAINST ANY LIABILITY, LOSS. DAMAGE OR EXPENSE, INCLUDING ATTORNEY'S ARISING FROM A FAILURE OR ALLEGED FAILURE ON THE PART OF THE CONTRACTOR, THEIR SUBCONTRACTORS AND THEY AND THEIR AGENTS, SERVANTS AND EMPLOYEES PROPERLY TO DISCHARGE THE OBLIGATIONS ASSUMED BY HIM OR THEM IN THE PERFORMANCE OF THE WORK, INCLUDING ANY ACT OR OMISSION ALLEGEDLY RESULTING IN DEATH OR PERSONAL INJURY OR PROPERTY DAMAGE OR IMPROPER CONSTRUCTION, CONSTRUCTION TECHNIQUES OR THE USE OF IMPROPER OR INAPPROPRIATE MATERIAL OR TOOLS.

6. THE CONTRACTOR AGREES THAT ANY CONTROVERSY OR DISPUTE TO WHICH THE CONTRACTOR, THE ARCHITECT, AND THE CONSULTING ENGINEERS ARE PARTIES SHALL BE SUBMITTED TO ARBITRATION FOR DECISION IN ACCORDANCE WITH THE RULES OF SUCH ASSOCIATION FOR CONSTRUCTION INDUSTRY DISPUTES ALL SUBCONTRACTORS LIKEWISE AGREE TO SUBMIT TO SUCH ARBITRATION ANY DISPUTE BETWEEN OR AMONG THEM. THE CONTRACTOR. THE ARCHITECT AND THE CONSULTING ENGINEERS. AND THE CONTRACTOR AGREES TO MAKE AVAILABLE TO THE CONSULTING ENGINEERS ON DEMAND SIGNED COPIES OF THE CONTRACT BETWEEN THE OWNER AND THE CONTRACTOR AND BETWEEN THE CONTRACTOR AND THEIR SUBCONTRACTORS. THE CONTRACTOR AND EACH SUBCONTRACTOR AGREE THAT BY SUBMITTING A BID WHICH IS ACCEPTED, THIS PARAGRAPH SHALL BE DEEMED A WRITTEN AGREEMENT TO SUBMIT ANY CONTROVERSY THEREAFTER ARISING ARBITRATION.

7. ALL WORK SHALL BE DONE IN CONFORMANCE WITH ALL GOVERNING CODES, INCLUDING AMENDMENTS, BULLETINS, ETC., AS WELL AS STANDARDS OF INSTALLATION AND EQUIPMENT ESTABLISHED FOR THE BUILDINGS, AND REQUIREMENTS OF THE OWNER.

8. OBTAIN ALL NECESSARY PERMITS AND APPROVAL FROM GOVERNING AUTHORITIES AND FILE ALL NECESSARY FORMS. PAY ALL INSPECTION FEES.

9. COORDINATE SCHEDULING OF ALL WORK TO BE PERFORMED WITH OWNER AND/OR THEIR AGENT AND INCLUDE ALL NECESSARY PREMIUM TIME REQUIRED FOR SHUTDOWNS, WORK IN OCCUPIED AREAS, ETC.

10. BEFORE COMMENCING WORK, EXAMINE ALL ADJOINING WORK ON WHICH THIS WORK IS IN ANY WAY DEPENDENT FOR PERFECT WORKMANSHIP ACCORDING TO THE INTENT OF THIS SPECIFICATION, AND REPORT TO THE CONSTRUCTION MANAGER ANY CONDITION WHICH PREVENTS PERFORMANCE OF FIRST-CLASS WORK. NO "WAIVER OF RESPONSIBILITY" FOR INCOMPLETE, INADEQUATE OR DEFECTIVE ADJOINING WORK WILL BE CONSIDERED UNLESS NOTICE HAS BEEN FILED BEFORE SUBMITTAL OF A PROPOSAL.

11. COORDINATE ALL WORK WITH OTHER TRADES TO INSURE INSTALLATION IS MADE IN ACCORDANCE WITH THE CONTRACT DOCUMENTS.

12. FURNISH ADEQUATE LIABILITY INSURANCE AND BONDING AS REQUIRED BY OWNER.

13. INCLUDE ALL LABOR, MATERIALS, AND APPURTENANCES REQUIRED FOR THE FURNISHING, INSTALLING AND TESTING OF ALL WORK. COMPLETE AND MAKE READY FOR OPERATION IN A MANNER SATISFACTORY TO THE ARCHITECT AND CONSULTING ENGINEER, ALL WORK SHOWN ON DRAWINGS AND SPECIFIED HEREIN.

14. ALL WORK SHALL BE GUARANTEED FOR TWO (2) FULL YEARS FROM THE DATE WHEN THE OWNER HAS ISSUED A "CERTIFICATE OF SUBSTANTIAL COMPLETION".

15. PROVIDE TEMPERATURE CONTROL DEVICES FOR ALL EQUIPMENT, THERMAL ZONE. HEATING & COOLING COILS AND EACH

16. DIMENSIONS INDICATED ON THESE DRAWINGS ARE CLEAR, INSIDE DIMENSIONS.

17. CONTRACTOR SHALL ALLOW FOR ADEQUATE FLEXIBLE DUCT AND PIPE CONNECTIONS. CONNECTION SHALL CONFORM TO THE REQUIREMENTS OF THE MECHANICAL DETAILS AND SPECIFICATIONS.

18. IN ADDITION TO ROTATING EQUIPMENT CONNECTIONS, FLEXIBLE ACOUSTIC ISOLATION, BUILDING CONNECTIONS SHALL OCCUR AT ALL MOVEMENT JOINTS, AND AT ALL "BOX-IN BOX" CONSTRUCTION. COORDINATE REQUIREMENTS WITH ALL OTHER DRAWINGS.

19. ALL SUSPENDED EQUIPMENT TO BE HUNG WITH VIBRATION ISOLATORS PER SPECIFICATION SECTION. MECHANICAL DETAILS AND

20. CONTRACTOR SHALL FAMILIARIZE HIMSELF WITH THE VIBRATION ISOLATION REQUIREMENTS IN THE SPECIFICATIONS & STANDARD DETAILS.

21. PROVIDE FIRE DAMPERS WHEN CROSSING RATED WALLS. REFER TO RATED WALL LOCATIONS AND ARCHITECTURAL DRAWINGS FOR FIRE TYPES.

22. BUILDING SMOKE PURGE SYSTEMS SHALL COMPLY WITH THE REQUIREMENTS OF ANY LOCAL AHJ

23. SUPPORT ANCHORS SECURED TO THE BOTTOM OF FLOOR SLABS SHALL BE OF THE DROP-IN OR SLEEVE ANCHOR VARIETY. POWDER CHARGED ANCHORING METHODS SHALL NOT BE USED.

24. COORDINATE WITH ARCHITECT FOR FINAL LOCATIONS OF ALL THERMOSTATS PRIOR TO INSTALLATION AND SEEK ENGINEER CONFIRMATION.

25. ALL CONTROL POWER WIRING AND TRANSFORMERS FOR DAMPERS, ACTUATORS, VAV PANELS, ETC SHALL BE PROVIDED BY THE CONTROLS CONTRACTOR. BOXES, CONTROL POWER FOR CONTROL DEVICES SHALL BE DERIVED FROM SOURCE DESIGNATED BY THE ELECTRICAL CONTRACTOR.

26. PROVIDE ACCESS PANELS IN CEILINGS FOR ACCESS TO EQUIPMENT WHERE NECESSARY. CONTRACTOR SHALL ALLOW FOR ADEQUATE ACCESS FOR ALL BALANCING COMPONENTS AND HVAC EQUIPMENT. ENSURE ALL MECHANICAL ELEMENTS ARE A MINIMUM 8" ABOVE FALSE CEILING.

27. ALL MECHANICAL EQUIPMENT SHALL BE MOUNTED ON HOUSEKEEPING PADS AS INDICATED IN THE DRAWINGS COMPLETE WITH ACOUSTIC AND VIBRATION MOUNTS AS INDICATED IN THE STANDARD DETAILS.

28. ALL SUPPLY & RETURN / EXHAUST GRILLES SHALL BE VISION PROOF WHERE REQUIRED.

29. REFER TO ARCHITECTS DRAWINGS FOR CEILING AND FLOOR MOUNTED GRILLE & DIFFUSER SETTING OUT

30. THESE DRAWINGS ARE DIAGRAMMATIC IN NATURE. REFERENCE ARCHITECTURAL DRAWINGS FOR DIMENSIONS/RELATIONSHIPS OF ALL EXPOSED ELEMENTS. COORDINATE ALL HIDDEN WORK WITH ALL OTHER TRADES AND WITH THE FINAL DIMENSIONED LAYOUT OF ELEMENTS FROM ALL TRADES PRIOR TO THE START OF ANY WORK. REPORT ANY CONFLICTS TO ARCHITECT FOR RESOLUTION PRIOR TO START OF ANY WORK.

31. ALLOW FOR ACCESS GRATINGS TO EQUIPMENT AND DAMPERS HIGHER THAN 10 FEET ABOVE FLOOR LEVEL

32. PROVIDE ACCESS PANEL IN CEILINGS FOR ACCESS TO EQUIPMENT WHERE NECESSARY. REFER TO ARCHITECTS CEILING PLANS AND DETAILS.

33. DRAIN LINES FROM ROOF MOUNTED EQUIPMENT SHALL BE PIPED TO THE NEAREST ROOF DRAIN.

B MECHANICAL DUCTWORK

1. COMBINATION FIRE SMOKE DAMPERS SHALL BE INSTALLED WHEREVER DUCTWORK PENETRATES A SHAFT

2. MAXIMUM LENGTH OF FLEXIBLE DUCTWORK BETWEEN BRANCH AND AIR TERMINAL SHALL BE 3'-0".

3. PROVIDE VOLUME DAMPERS IN BRANCH AND RUN OUT DUCTWORK FOR ALL AIR OUTLETS AND INLETS. WHERE DAMPERS ARE ABOVE NON-ACCESSIBLE CEILINGS OR ARE WITHIN CONSTRUCTION, CABLE OPERATED, WORM-GEAR TYPE, REMOTE NON-ACCESSIBLE VOLUME DAMPERS SHALL BE PROVIDED.

4. PROVIDE 1" INTERNAL DUCT ACOUSTICAL & THERMAL LINING (TYPE: JOHNS MANVILLE PERMACOTE LINACOUSTIC R-300 TYPE II BOARD OR EQUAL AND APPROVED) ON ALL SUPPLY DUCTWORK FOR THE FIRST 18ft FROM SUPPLY FAN.

5. SUPPORT ANCHORS SECURED TO THE BOTTOM OF FLOOR SLABS SHALL BE OF THE DROP-IN OR SLEEVE ANCHOR VARIETY. POWDER CHARGED ANCHORING METHODS SHALL NOT BE USED.

6. PROVIDE DUCT ACCESS DOORS AND CEILING ACCESS PANELS FOR ALL FIRE, SMOKE AND, COMBINATION FIRE/SMOKE DAMPERS. CEILING ACCESS PANELS SHALL BE COORDINATED WITH ARCHITECTS REQUIREMENTS.

7. PROVIDE SMOKE DETECTORS IN ALL DUCTWORK WHERE REQUIRED BY CODE. COORDINATE ALL SMOKE DETECTORS WITH THE ELECTRICAL CONTRACTOR AND THE FIRE ALARM.

8. AIR OUTLETS LOCATED IN HIGH CEILINGS SHALL BE FIELD ADJUSTED FOR OPTIMUM DRAFT AND THROW

9. ALL EXPOSED DUCTWORK SHALL BE INTERNALLY LINED, CLEAN, STICKER FREE AND FREE OF DEFORMITIES

10. LINEAR FLOOR GRILLES AND DIFFUSERS SHALL BE SHOWN ON ARCHITECTURAL DRAWINGS AND SHALL BE

11. MOUNT ALL SIDEWALL REGISTERS AT THE SAME ELEVATION OR AS SHOWN ON ARCHITECTURAL DRAWINGS.

THE DESIGN REQUIREMENTS SHOWN ON THE MECHANICAL DRAWINGS AND SCHEDULES. 13. APPROVED COORDINATION DRAWINGS TO BE USED FOR ELEVATIONS AND LOCATIONS OF DUCTWORK AND

12. ALL SUPPLY AND RETURN GRILLES AND OPENINGS MUST BE COORDINATED WITH ARCHITECTURE USING

14. ALL OPEN ENDED DUCTS TO HAVE WIRE MESH SCREENS.

15. OUTDOOR AIR OPENINGS WITHIN 10' OF CONTAMINANTS SHALL POSITIONED TO CONFORM TO ASHRAE 62.1

16. ALL AIR PLENUM SHALL BE 18 GAGE SHEET METAL.

C MECHANICAL PIPEWORK

1. ALL PIPING TO ALLOW FOR EXPANSION BY MEANS OF EXPANSION LOOP AND PIPE ANCHORS.

2. ALL GAS-FIRED APPLIANCES SHALL BE VENTED IN ACCORDANCE WITH NFPA-54, REFERENCED IN THE NYC BUILDING CODE AND WITH LOCAL E-DESIGNATION CODE.

3. PROVIDE GAS SAFETY SHUT-OFF VALVES ON BOTH THE FIRM AND INTERRUPTIBLE GAS MAINS LOCATED IN THE BOILER ROOM. THE CONTRACTOR SHALL PRESSURE TEST ALL PIPING AS PER THE SPECIFICATION.

4. ALL PIPING IN UNHEATED AREAS OR OUTSIDE SHALL BE HEAT TRACED.

5. COORDINATE WITH PLUMBING CONTRACTOR FOR ALL GAS CONNECTIONS TO GAS FIRED EQUIPMENT.

6. DRAIN LINES FROM CEILING MOUNTED EQUIPMENT SHALL BE PIPED TO THE NEAREST FLOOR DRAIN OR SANITARY LINE.

7. HEAT TRACE ALL HEATING HOT WATER PIPE LOCATED ABOVE GRADE OUTSIDE OF BUILDINGS, OR IN

8. ALL PIPING PASSING THROUGH MASONRY WALLS SHALL HAVE A SLEEVE, SEE SPECIFICATIONS.

9. ALL PIPING PASSING THROUGH FIRE-RATED WALLS SHALL HAVE A FIRE-RATED SLEEVE - SEE

10. REFRIGERANT PIPE INSULATION AND VAPOR BARRIERS SHALL BE CONTINUOUS THROUGH PIPE HANGERS. 11. ALL BLACK STEEL PIPE HANGERS SHALL BE PAINTED PRIOR TO INSTALLATION.

12. PROVIDE A STRAIGHT RUN OF PIPING AT PUMP SUCTIONS OF LENGTH AT LEAST 5 PIPE DIAMETERS.

D. DIRECT DIGITAL CONTROL (DDC) OVERAL SYSTEM

(BASES OF DESIGN: DISTECH CONTROLS BY AUTOMATED BUILDING SOLUTIONS CONTRACTOR SHALL INCLUDE A NEW AND OPEN COMMUNICATION PROTOCOL STATE OF THE ART DIRECT DIGITAL CONTROL (DDC) SYSTEM. COMPOSEDOF AN OPERATING SYSTEM CAPABLE TO TREND READING DATA, ALARM CONTROL SETPOINTS OUT OF RANGE, SCHEDULE SPECIAL AND REGULAR EVENTS AND DISPLAY 3D GRAPHICS. THIS OPERATING SYSTEM SHALL BE HOSTED BY A RACK SERVER WITH ALL THE NECESSARY ACCESSORIES IN ORDER TO BE SEATED INTO THE OWNER'S BUILDING IT NETWORK OR DEDICATED DDC FOR PASSWORD PROTECTED REMOTE ACCESS AND ACT AS A VIRTUAL SERVER. THE OPERATING DDC SYSTEM SHALL BE THE LATEST VENDOR'S VERSION AND ANY FUTURE UPGRADES SHALL BE INCLUDED AS PART OF THE SCOPE FOR AT LEAST THE PERIOD OF THE WARRANTY. THE SYSTEM SHALL SUPPORT API PROTOCOLS

TRAINING SHALL BE INCLUDED AND IT SHALL INCLUDE THREE PHASES:

1. A GENERAL SYSTEM OVERALL TRAINING.

3. FOLLOW UP TRAINING -THIS FOLLOW UP TRAINING SHALL BE SIX MONTHS AFTER FINAL CONSTRUCTION.

THE DDC SYSTEM SHALL INCLUDE DATA MANAGER CONTROLLERS PER EACH LEVEL OR FLOOR WITH NETWORK LOOPS OF A MINIMUM OF 64 DEVICES OR UNITARY CONTROLLERS. THE DDC SYSTEM ALSO SHALL BE CAPABLE OF EXPANSION. DEDICATED UNITARY CONTROLLERS SHALL BE PROVIDED FORALL TYPE OF MECHANICAL SYSTEMS AS WELL AS ALL THE ASSOCIATED END DEVICES. EACH DDC CONTROLLER SHALL HAVE UNIVERSAL INPUTS AND OUTPUTS.

CONTROLS WILL HAVE THE CAPABILITY OF TREND LOGGING SPECIFIC PARAMETERS IN ORDER TO COMMISSION THE SYSTEM AND TRACK ENERGY COSTS AS REQUIRED (THIS INCLUDES ANY METERING STRATEGIES REQUIRED BY LEED E.G. MEASUREMENT & VERIFICATION). IT IS ENVISAGED THAT AN ENERGY "DASHBOARD" WILL BE PROVIDED IN THE FACILITY FOR THE BUILDING MANAGERS TO VIEW THE CURRENT ENERGY USAGE AND HISTORICAL ENERGY USAGE AND BE CONFIGURE PER THE OWNER'S DIRECTION.

THE DDC SYSTEM SHALL HAVE INTEGRATION CAPABILITIES: THE INTENT OF THE INTEGRATION IS TO FORM THE ABILITY TO HAVE A SINGLE ACCESS TO ALL INTEGRATED SYSTEMS. THIS IS NOT LIMITED TO THE FOLLOWING: BOILER MASTER PANELS, VRF INTERFACES, CHILLERS, CRAC UNITS, VFD'S, GAS AND WATER FLOW METERS, WATER TREATMENT SYSTEM, SECURITY, ACCESS CONTROL, CCTV, VIDEO SURVEILLANCE, LIGHTING CONTROL, UPS/BATTERY POWER SYSTEM, ATS SWITCHES, POWER METERS, DIGITAL SIGNAGE, ELEVATOR CONTROLS AND PACKAGED HVAC EQUIPMENT SUCH AS AHUS AND RTUS. ALTHOUGHALL FEATURES MAY NOT BE INSTALLED IN THIS PROJECT, THE DDC SHALL HAVE THE CAPABILITY. IF NECESSARY THE DDC SYSTEM SHALL ALSO BE CAPABLE TO MANAGE WIRELESS COMMUNICATION SYSTEMS. THIS APPLIES TO DATA-MANAGERS AS WELL AS UNITARY CONTROLLERS AND CRITICAL SENSORS.

THE DDC VENDOR SHALL INCLUDE A SEQUENCE OF OPERATIONS GRAPHIC AND DEDICATED PAGE(S). ALL THE SEQUENCES SHOULD BE IN A SEPARATE PART OF THE NAVIGATION TREE. BUT ALSO ORGANIZED BY INDIVIDUAL ROOM, BY AHU EQUIPMENT, AND/OR BY SYSTEM. THE SEQUENCE SHOULD BE THE AS-BUILT

SEQUENCE THAT MATCHES EXACTLY WHAT IS PROGRAMMED. AS COMMISSIONING OCCURS AND SEQUENCE CHANGES ARE MADE, THESE PAGES SHALL BE UPDATED.

THE DDC SYSTEM SHALL BE CAPABLE TO ACT AS "THE DRIVER" IN COLLECTING DATA, MONITOR PERFOMANCE AND ENERGY USAGE OF SEVERAL THIRD PARTY SYSTEM VIA DDC INTEGRATION. THE DDC SYSTEM SHALL HAVE INTEGRATION CAPABILITIES, THE INTENT OF THE INTEGRATION IS TO FORM THE ABILITY TO HAVE A SINGLE ACCESS TO ALL INTEGRATED SYSTEMS. THIS IS NOT LIMITED TO THE FOLLOWING: HEAT PUMPS, AIR HANDLING UNITS, VRF INTERFACES, FAN COIL UNITS UNITS, UNIT HEATERS, VFD'S, WATER FLOW METERS, WATER TREATMENT SYSTEM, SECURITY, ACCESS CONTROL, CCTV, VIDEO SURVEILLANCE, LIGHTING CONTROL, UPS/BATTERY POWER SYSTEM, ATS SWITCHES, POWER METERS, DIGITAL SIGNAGE, ELEVATOR CONTROLS, SHADES AND PACKAGED HVAC EQUIPMENT SUCH AS AHUS AND RTUS. IF NECESSARY THE DDC SYSTEM SHALL ALSO BE CAPABLE TO MANAGE WIRELESS COMMUNICATION SYSTEMS THIS APPLIES TO DATA-MANAGERS AS WELL AS UNITARY CONTROLLERS AND CRITICAL SENSORS.

1. THE DDC CONTRACTOR SHALL FURNISH AND INSTALL ALL STATE OF THE ART HARDWARE AND ALL THE LATEST OPERATING AND APPLICATIONS SOFTWARE NECESSARY TO PERFORM THE CONTROL SEQUENCES OF OPERATION AS CALLED FOR IN THIS SPECIFICATION.

2. AS A MINIMUM, ONE DEDICATED DDCP SHALL BE PROVIDED FOR EACH MAIN HVAC EQUIPMENT (AHU, RTU, WATER SYSTEMS, VAV, FAN POWEREDVAV BOXES, FCU), IT IS ACCEPTABLE TO HAVE EXPANSION DDC CONTROLLER WITHIN THE SAME SYSTEM DDCP.

3. ALL SETPOINTS INDICATED IN THE SEQUENCES SHALL BE ADJUSTABLE AT THE FRONT END DDC MAIN SOFTWARE SYSTEM OR ANY USER INTERFACE STATION CONNECTED TO ANY MAIN DATA MANAGER

4. UNLESS OTHERWISED NOTED, THE DDC SYSTEM ARCHITECTURE SHALL TIE INTO THE BUILDING IT INFRASTRUCTURE AND IT SHALL INTERACT BETWEEN EACH OTHER FOR REMOTE ACCESS. BUILDING IT SHALL PROVIDE STATIC IP ADDRESS AS REQUIRE BY THE DDC CONTRACTOR DDC DESIGN.

5. THE DDC CONTRACTOR SHALL COMPLY WITH ALL BUILDING IT INFRASTRUCTURE SECURITY POLICIES FROM REMOTE ACCESS. 6. UNLESS OTHERWISE NOTED. THE DDC CONTRACTOR SHALL PROVIDE, FOR THE PRIMARY NETWORK, AN

INDIVIDUAL ETHERNET VERTICAL HOMERUNS FROM DDC SERVER SWITCH/HUB TO EACH DATA MANAGER OR PRIMARY CONTROLLER AS LONG AS ETHERNET MAXIMUM DISTANCE LIMITATION ARE NOT EXCEEDED. 7. THE DDC CONTRACTOR SHALL BE RESPONSIBLE TO FOLLOW ALL THE TECHNICAL REQUIREMENTS IN A DDC SYSTEM ARCHITECTURE DESIGN FOR DISTANCE LIMITATIONS ON ETHERNET AND FIBER NETWORK. ALL ETHERNET SWITCHES OR FIBER TO ETHERNET CONVERTERS AND ASSOCIATED ACCESSORIES TO BE FURNISH BY THE DDC CONTRACTOR. THE DDC VENDOR SHALL PROVIDE PRIMARLY 24VAC POWER INPUT SWITCHES OR

8. THE DDC BMS SYSTEM SHALL ALLOW THE DISTRIBUTION OF SYSTEM FUNCTIONS SUCH AS MONITORING AND CONTROL AND GRAPHICAL USER INTERFACE ETC. ACROSS THE NETWORK TO ACHIEVE MAXIMUM FLEXIBILITY. ACCESSIBILITY AND PERFORMANCE.

9. IT IS NOT ACCEPTABLE TO UTILIZE THE NETWORK TO SEND CRITICAL DATA REQUIRED BY A CONTROL ALGORITHM FROM ONE CONTROLLER TO ANOTHER, CRITICAL DATA SHALL BE A DIRECT HARDWIRE INPUT TO THE CONTROLLER CONTAINING THE CONTROL ALGORITHM. IF MULTIPLE CONTROLLERS REQUIRE THE SAME PIECE OF DATA FOR A CONTROL ALGORITHM, THE DATA SHALL BE A DIRECT HARDWIRE INPUT TO EACH

10. IT IS NOT ACCEPTABLE TO RESTRICTED ACCESS TO DDC SYSTEM DATA BY THE HARDWARE CONFIGURATION OF THE BMS. HARDWARE CONFIGURATION OF THE BMS NETWORK SHALL BE TOTALLY OPEN AND TRANSPARENT TO THE USER WHEN ACCESSING DATA OR DEVELOPING CONTROL PROGRAMS 11 THE DDC CONTRACTOR BMS DESIGN SHALL BE MADE TO ALLOW THE CO-EXISTENCE OF CURRENT (IF APPLICABLE) AND FUTURE EXPANSION OF DATA MANAGER CONTROLLERS AND PERSONAL COMPUTER

OPERATOR WORKSTATIONS ON THE SAME PRIMARY NETWORK. 12. IT IS NOT ACCEPTABLE TO RESTRICTED ACCESS TO A DDC SYSTEM DATA BY THE HARDWARE CONFIGURATION OF THE BMS. HARDWARE CONFIGURATION OF THE BMS NETWORK SHALL BE TOTALLY OPEN AND TRANSPARENT TO THE USER WHEN ACCESSING DATA OR DEVELOPING CONTROL PROGRAMS. 13. THE DDC CONTRACTOR SHALL PROVIDE NETWORK WIRING AS REQUIRED TO ENSURE TOTAL SYSTEM OPERATION AND COMMUNICATION WITHOUT INTERRUPTION, EVEN IF THE NETWORK WIRING IS OPEN IN ONE (1)

LOCATION. 14. THE PRIMARY NETWORK SHALL ALLOW ANY DATA MANAGER CONTROL PANEL TO ACCESS ANY DATA FROM. OR SEND CONTROL COMMANDS AND ALARM REPORTS DIRECTLY TO, ANY OTHER PRIMARY CONTROL PANEL OR COMBINATION OF CONTROLLERS ON THE NETWORK WITHOUT DEPENDENCE UPON A CENTRAL OR INTERMEDIATE PROCESSING DEVICE.

15. THE PEER-TO-PEER NETWORK SHALL ALSO ALLOW ANY PRIMARY CONTROL PANEL TO ACCESS, EDIT, MODIFY, ADD, DELETE, BACK UP, RESTORE ALL SYSTEM POINT DATABASE AND ALL PROGRAMS, ASSIGN PASSWORD ACCESS AND CONTROL PRIORITIES TO EACH SYSTEM INDIVIDUALLY. THE LOGON PASSWORD (AT ANY PC WORKSTATION OR PORTABLE OPERATOR TERMINAL) SHALL ENABLE THE OPERATOR TO MONITOR, ADJUST AND CONTROL ONLY THE SYSTEM THAT THE OPERATOR IS AUTHORIZED FOR. 16. A RACK SERVER WITH BUILT-IN MONITOR SHALL BE FURNISHED LOADED WITH THE DDC CONTRACTOR OPERATING BUILDING MANAGEMENT SYSTEM (BMS) SOFTWARE PLUS ALL THE NECESSARY ACCESSORIES FOR MOUNTING AND CONNECTING TO AN IT NETWORK. AN ADDITIONAL UI STATION TO ACCESS DDC SERVER AT THE MAIN LOCATION POINTS OF CONTROL OF THE DDC SYSTEM SHOULD BE ALSO PROVIDED AND SET UP BY THE

17. ALL GLOBAL COMMON INFORMATION (OUTSIDE AIR TEMP & HUMIDITY, ETC) SHALL BE MEASURED AND COMMUNICATED FROM THE CENTRAL WEATHER STATION.

18. WEATHER STATION SHALL BE VAISALA WXT536 & IT SHALL BE PROVIDED WITH ALL NECESSARY ACCESSORIES TO MEASURE PRESSURE, TEMPERATURE, HUMIDITY, RAIN, WIND. INTERFACE CONNECTIVITY AS WELL AS HARDWIRE TERMINATIONS ARE ACCEPTABLE.

19. THE DDC CONTRACTOR SHALL FURNISH COMMUNICATIONS INTERFACE (INCLUDING NECESSARY SOFTWARE) BETWEEN THE DDC SYSTEM AND EACH MANUFACTURER SUPPLIED CONTROL PANEL SPECIFIED. THE DDC SYSTEM SHALL BE CAPABLE OF READING AND DISPLAYING ALL DATA USED BY THE MANUFACTURER'S CONTROL PANEL. SOFTWARE INTERFACE SHALL BE THROUGH LONMARK/BACNET/MOD BUS COMPLIANT PROTOCOL. WHERE THE DDC SYSTEM IS REQUIRED TO CONTROL THE OPERATION OF THE EQUIPMENT, PROVIDE INPUT AND OUTPUT INTERFACE AS REQUIRED.

20. DDC SYSTEM SHALL BE EXPANDABLE WITHOUT HAVING TO PHYSICALLY RECONFIGURE THE NETWORK. 21. AN UNINTERRUPTIBLE POWER SUPPLY (UPS) SHALL BE PROVIDED AND INSTALLED BY THE DDC CONTRACTOR FOR EACH OF THE FOLLOWING DEVICES THAT ARE POWERED BY THE BMS INCLUDING; NETWORK SWITCHES, BMS PRIMARY CONTROL PANEL, BMS SECONDARY CONTROL PANEL, OPERATOR'S WORKSTATION, PRINTER AND FIELD DEVICE. EACH UPS SHALL POWER THE DEVICE FOR A MINIMUM OF 30 MINUTES, IN THE CASE OF POWER

22. EACH UPS SHALL BE PROVIDED WITH DRY CONTACTS FOR STATUS, RECOMMENDED MANUFACTURER: FUNCTIONAL DEVICES PART# PSH850-UPS-STAT.

1. ALL OPERATOR WORKSTATIONS AND DATA MANAGER CONTROLLERS SHALL DIRECTLY RESIDE ON A NETWORK SUCH THAT COMMUNICATIONS (I.E., ABILITY TO ACCESS, EDIT, MODIFY, ADD, DELETE, BACK UP, REPORT, TREND, RESTORE ALL SYSTEM POINT DATABASE AND ALL PROGRAMS) MAY BE EXECUTED DIRECTLY BETWEEN SERVERS, PRIMARY CONTROL PANELS, AND OPERATOR WORKSTATIONS ON A PEER-TO-PEER BASIS. 2. ALL OPERATOR DEVICES EITHER NETWORK RESIDENT OR CONNECTED VIA INTRANET AND INTERNET, SHALL HAVE THE ABILITY TO ACCESS ALL POINT STATUS AND APPLICATION REPORT DATA OR EXECUTE CONTROL FUNCTIONS FOR ANY AND ALL OTHER DEVICES VIA THE PRIMARY NETWORK OR THE SECONDARY NETWORK. 3. ACCESS TO DATA SHALL BE BASED UPON LOGICAL IDENTIFICATION OF BUILDING EQUIPMENT 4. THE PRIMARY NETWORK SHALL PROVIDE A HIGH-SPEED DATA TRANSFER RATES FOR ALARM REPORTING, QUICK REPORT GENERATION FROM MULTIPLE CONTROLLERS AND UPLOAD/DOWNLOAD EFFICIENCY BETWEEN NETWORK DEVICES. SYSTEM PERFORMANCE SHALL INSURE THAT AN ALARM OCCURRING AT ANY CONTROL

5. THE PRIMARY NETWORK SHALL PROVIDE MESSAGE AND ALARM BUFFERING TO PREVENT INFORMATION FROM BEING LOST, ERROR DETECTION, CORRECTION AND RE-TRANSMISSIONTO GUARANTEE DATA INTEGRITY. 6. THE PRIMARY NETWORK SHOULD BE CAPABLE TO DO SYNCHRONIZATION OF REAL-TIME CLOCKS BETWEEN SERVER, PRIMARY CONTROL PANELS, AND OPERATOR WORKSTATIONS, INCLUDING AUTOMATIC DAYLIGHT

PANEL IS DISPLAYED AT ANY PC WORKSTATION, STANDALONE ALARM PRINTER AND/OR CONTROL PANEL WITHIN

SAVINGS TIME CORRECTIONS. 7. THE DDC CONTRACTOR SHALL PROVIDE NETWORK WIRING AS REQUIRED TO ENSURE TOTAL SYSTEM OPERATION AND COMMUNICATION WITHOUT INTERRUPTION, EVEN IF THE NETWORK WIRING IS OPEN IN ONE (1)

LOCATION. 8. THE PRIMARY NETWORK SHALL ALLOW THE PRIMARY CONTROL PANELS TO ACCESS ANY DATA FROM, OR SEND CONTROL COMMANDS AND ALARM REPORTS DIRECTLY TO, ANY OTHER PRIMARY CONTROL PANEL OR COMBINATION OF CONTROLLERS ON THE NETWORK WITHOUT DEPENDENCE UPON A CENTRAL OR INTERMEDIATE PROCESSING DEVICE.

9. THE PRIMARY CONTROL PANEL SHALL SEND ALARM REPORTS TO MULTIPLE OPERATOR WORKSTATIONS WITHOUT DEPENDENCE UPON A CENTRAL OR INTERMEDIATE PROCESSING DEVICE. 10. THE PEER-TO-PEER NETWORK SHALL ALSO ALLOW ANY DATA MANAGER CONTROL PANEL TO ACCESS, EDIT, MODIFY, ADD, DELETE, BACK UP, RESTORE ALL SYSTEM POINT DATABASE AND ALL PROGRAMS, ASSIGN PASSWORD ACCESS AND CONTROL PRIORITIES TO EACH SYSTEM INDIVIDUALLY. THE LOGON PASSWORD (AT ANY PC WORKSTATION OR PORTABLE OPERATOR TERMINAL) SHALL ENABLE THE OPERATOR TO MONITOR, ADJUST AND CONTROL ONLY THE SYSTEM THAT THE OPERATOR IS AUTHORIZED FOR.

1. THIS NETWORK SHALL CONNECT AND SUPPORT STAND-ALONE SECONDARY CONTROL PANELS AND SHALL COMMUNICATE BI-DIRECTIONALLY WITH THE PRIMARY NETWORK THROUGH ANY DATA MANAGER CONTROL PANELS FOR TRANSMISSION OF GLOBAL DATA. SUFFICIENT NUMBER OF DATA MANAGER CONTROL PANELS SHALL BE PROVIDED FOR CONNECTION OF SECONDARY NETWORKS BASED ON QUANTITY OF SECONDARY CONTROLS PANELS AND DISTANCE LIMITATIONS.

2. SECONDARY CONTROL PANELS SHALL BE ARRANGED ON THE SECONDARY NETWORK IN A FUNCTIONAL RELATIONSHIP MANNER WITH THE DATAMANAGER CONTROL PANELS. FOR EXAMPLE, A VAV SECONDARY CONTROL PANEL ON A SECONDARY NETWORK OF A PRIMARY CONTROL PANEL THAT IS CONTROLLING THE VAV'S CORRESPONDING AHU. PRIMARY CONTROL PANEL HARDWARE (DATA MANAGER)

PRIMARY CONTROL PANEL HARDARE (DATA MANAGER) 1. PROVIDE ONE (1) DATA MANAGER OR PRIMARY CONTROL PANEL AT EACH FLOOR OR LEVEL TO MONITOR AND

SEQUENCING EQUIPMENT WITHIN ASSOCIATED FLOOR. 2. IT IS NOT ACCEPTABLE TO HAVE (1) DATA MANAGER OR PRIMARY CONTROLLER SERVING SEVERAL FLOORS UNLESS THE MECHANICAL EQUIPMENT IS INTERACTING WITH EACH OTHER FOR EXAMPLE: AN AHU UNIT IS LOCATED ON THE FIRST FLOOR AND ALL ASSOCIATED VAV BOXES ARE ON A SECOND FLOOR IF THIS IS THE CASE THEN IT IS ACCEPTABLE.

3. HVAC EQUIPMENT THAT INTERACT WITH EACH OTHER SHALL BE WITHIN THE SAME DATA MANAGER OR PRIMARY CONTROLLER.

4. DATA MANAGER CONTROLLER SHALL BE ASHRAE 135 COMPLIANCE AND USE THE LATEST VERSION OF BACNET/ASHRAE 135 PROTOCOL AND COMMUNICATE USING ISO 8802-3 (ETHERNET) DATALINK/PHYSICAL LAYER

5. ALL PRIMARY CONTROL PANELS SHALL BE INSTALLED WITH 30% SPARE MEMORY CAPACITY FOR FUTURE CONNECTIONS. PROVIDE ALL HARDWARE MODULES, SOFTWARE MODULES, PROCESSORS, POWER SUPPLIES, REPEATERS ETC. REQUIRED TO ENSURE ADDING A CONTROLLER TO THE SPARE MEMORY. 6. PROVIDE ALL PROCESSORS, POWER SUPPLIES AND COMMUNICATION CONTROLLERS SO THAT THE IMPLEMENTATION OF ADDING A CONTROLLER TO THE SPARE MEMORY ONLY REQUIRES THE ADDITION OF THE APPROPRIATE: END DEVICES AND FIELD WIRING.

7. THE DATA MANAGER OR PRIMARY NETWORK CONTROLLER SHALL BE PROVIDED WITH ALL COMMUNICATION CARDS NEEDED FOR PROJECT INCLUDING CARDS FOR SPARE PORTS LEFT ON CONTROLLER. 8. EACH DATA MANAGER SHALL BE EQUIPPED TO MONITOR ALL INDUSTRY STANDARD TYPES OF INTERFACE PROTOCOLS WITHOUT THE ADDITION OF EQUIPMENT TO THE DATA MANAGER CONTROL PANEL OR ADDITIONAL SOFTWARE DRIVERS.

9. THE OPERATOR SHALL HAVE THE ABILITY TO MANUALLY OVERRIDE AUTOMATIC OR CENTRALLY EXECUTED COMMANDS AT THE DATA MANAGER OR PRIMARY CONTROL PANELS VIA A DISPLAY MOUNTED ON THE FRONT DOOR (FOR EXAMPLE: DISTECH CONTROLS' HORYZON-C DISPLAYS OR EQUAL). 10. EACH DATA MANAGER PRIMARY CONTROL PANEL SHALL CONTINUOUSLY PERFORM SELF-DIAGNOSTICS ON ALL HARDWARE MODULES AND NETWORKCOMMUNICATIONS. THE PRIMARY CONTROL PANEL SHALL PROVIDE BOTH LOCAL AND REMOTE ANNUNCIATION OF ANY DETECTED COMPONENT FAILURES, OR REPEATED FAILURE

1. FURNISH SOFTWARE TO FORM COMPLETE OPERATING SYSTEM FOR BUILDING AND ENERGY

MANAGEMENT.DATA MANAGER SOFTWARE 2. DDC SOFTWARE SHALL BE CAPABLE TO HOST AN UNLIMITED AMOUNT OF DATA MANAGER OR PRIMARY CONTROLLER FOR EXPANDABILITY (E.G., EC-NET 4 SUPERVISOR UNL OR EQUAL). 3. ALL PROGRAMS POINTS SHALL BE IDENTIFIED BY A 30 CHARACTER NAME AND A 16 CHARACTER POINT DESCRIPTOR. THE SAME NAMES SHALL BE DISPLAYED AT BOTH THE DATA MANAGER CONTROL PANEL(S) (VIA PORTABLE TERMINAL) AND THE VIRTUAL RACK SERVER OR ANY UI WORKSTATION(S). MULTI-SYSTEM

CONSISTENCY ON POINT NAMES SHOULD BE MAINTAINED. 4. TREND DATA SHALL BE STORED AT THE DATAMANAGER CONTROL PANELS AND AUTOMATICALLY UPLOADED TO THE VIRTUAL DDC RACK SERVER.

5. UPLOADS SHALL OCCUR BASED ON USER-DEFINED INTERVALS, MANUAL COMMANDS, OR AUTOMATICALLY WHEN THE TREND BUFFER IS 80% FULL. ALL TREND DATA SHALL BE AVAILABLE FOR USE IN ANY 3RD PARTY PERSONAL COMPUTER APPLICATIONS LOCATED IN THE DDC.

SECONDARY CONTROL PANEL HARDWARE

TO ESTABLISH COMMUNICATION WITH ANY SYSTEM.

1. EACH SECONDARY CONTROL PANEL SHALL OPERATE AS A STAND-ALONE CONTROLLER CAPABLE OF PERFORMING ITS USER SELECTABLE CONTROL ROUTINES INDEPENDENTLY OF ANY OTHER CONTROLLER IN THE SYSTEM. EACH SECONDARY CONTROL PANEL SHALL BE A MICROPROCESSOR-BASED, MULTI-TASKING, REAL-TIME DIGITAL CONTROL PROCESSOR.

2. EACH SECONDARY CONTROLLER SHALL INCLUDE ALL POINT INPUTS AND OUTPUTS NECESSARY TO PERFORM THE SPECIFIED CONTROL SEQUENCES. THE SECONDARY CONTROLLER SHALL ACCEPT INPUT AND PROVIDE OUTPUT SIGNALS THAT COMPLY WITH INDUSTRY STANDARDS, CONTROLLERS UTILIZING PROPRIETARY CONTROL SIGNALS SHALL NOT BE ACCEPTABLE, OUTPUTS MAY BE UTILIZED EITHER FOR 2-STATE, MODULATING, FLOATING OR PROPORTIONAL CONTROL, ALLOWING FOR

ADDITIONAL SYSTEM FLEXIBILITY. 3. CONTROL APPLICATIONS. OPERATING PROGRAMS SHALL BE FIELD-SELECTABLE FOR SPECIFIC APPLICATIONS. IN ADDITION, SPECIFIC APPLICATIONS MAY BE MODIFIED TO MEET THE USER'S EXACT CONTROL STRATEGY REQUIREMENTS, ALLOWING FOR ADDITIONAL SYSTEM FLEXIBILITY. CONTROLLERS THAT REQUIRE FACTORY CHANGES OF ALL APPLICATIONS ARE NOT ACCEPTABLE.

4. CONTROLLERS SHALL INCLUDE ALL POINT INPUTS AND OUTPUTS NECESSARY TO PERFORM THE SPECIFIED CONTROL SEQUENCES. AS A MINIMUM, 50% OF THE POINT OUTPUTS SHALL BE OF THE UNIVERSAL TYPE; THAT IS, THE OUTPUTS MAY BE UTILIZED EITHER AS MODULATING OR TWO-STATE, ALLOWING FOR ADDITIONAL SYSTEM FLEXIBILITY. IN LIEU OF UNIVERSAL OUTPUTS, PROVIDE A MINIMUM OF 50% SPARE OUTPUTS OF EACH TYPE VIA ADDITIONAL POINT TERMINATION BOARDS OR CONTROLLERS. ANALOG OUTPUTS SHALL BE INDUSTRY STANDARD, ALLOWING FOR INTERFACE TO A VARIETY OF END DEVICES. TERMINAL EQUIPMENT CONTROLLERS UTILIZING PROPRIETARY CONTROL SIGNALS AND ACTUATORS SHALL NOT BE ACCEPTABLE. 5. PROVIDE A SECONDARY CONTROL PANEL FOR EACH OF THE FOLLOWING TYPES OF EQUIPMENT (IF

APPLICABLE): • ROOFTOP UNITS (UNLESS IT HAS BEEN SPECIFIED AS A FACTORY PROVIDED SECONDARY CONTROLLER WITH INTEGRATED CAPABILITY) • AHU (UNLESS IT HAS BEEN SPECIFIED AS A FACTORY PROVIDED SECONDARY CONTROLLER WITH INTEGRATED

CAPABILITY) VARIABLE AIR VOLUME (VAV) BOXES. VRF CONDENSING UNITS AND FAN COIL UNITS

 HEAT EXCHANGER SYSTEM. HEAT PUMP SYSTEMS HYDRONIC PUMPS RADIANT FLOOR SYSTEM

SECONDARY NETWORK COMMUNICATIONS ABILITY.

PERIMETER HEATING CONTROLS

• AC UNITS (UNLESS IT IS A FACTORY PROVIDED SECONDARY CONTROLLER WITH INTEGRATED CAPABILITY) UNIT/CABINET UNIT HEATERS. EXHAUST FANS.

 OTHER TERMINAL CRITICAL EQUIPMENT. 6. EACH SECONDARY CONTROL PANEL SHALL, AT A MINIMUM, BE PROVIDED WITH: APPROPRIATE NEMA RATED ENCLOSURE FOR ITS APPLICATION. A STAND-ALONE REAL-TIME DIGITAL CONTROL MICROPROCESSOR MODULE

 POWER SUPPLIES AS REQUIRED FOR ALL ASSOCIATED MODULES, SENSORS, ACTUATORS, ETC. • EXPANSION CAPABILITIES 7. THERE SHALL BE PROVISIONS FOR BURO HAPPOLD TO HAVE REMOTE ACCESS VIA A USERNAME AND

PASSWORD TO THE DDC SYSTEM FOR THE COLLECTION OF DATA PERFOMANCE OF ALL SYSTEM.

• BUILT-IN DISPLAY OR DOOR MOUNTED TYPE (WITH THE EXCEPTION OF VAV CONTROLLERS)

1 Museum Road

Storm King Art Center New Windsor, NY 12553

+1 (845) 534-3115 Design Architect

heneghan peng architects 14-16 Lord Edward Street Dublin, D02 YC63 +353 1 633 9000

Executive Architect WXY Architecture + Urban Design 224 Centre Street, 5th Floor New York, NY 10013 +1 (212) 219-1953

Landscape Architect Gustafson Porter + Bowman 1 Cobham Mews London, MW1 9SB +44 020 7284 8950

Reed Hilderbrand LLC 33 Whitney Avenue, 3rd Floor New Haven, CT 06510 +1 (617) 923-2422

Structural & Lighting ARUP 77 Water Street

New York, NY 10005 +1 (212) 896-3000

MEPF & IT BuroHappold

100 Broadway #23 New York, NY 10005 +1 (212) 616-0228

Civil VHB

100 Great Oaks Blvd., Suite 118

Albany, NY 12203 +1 (518) 389-3606

AV & Acoustics LSTN Consultants 76 Beaver Street, 2nd Floor New York, NY 10005

+1 (347) 788-0810 Facade

Front Inc. 100 E. Broadway Street, #501 New York, NY 10002 +1 (212) 242-2220

Key Plan

Date Description 02/24/20 50% Design Development 100% Design Development 05/29/20

11/06/20


50% Construction Documents

Project

Storm King Art Center **Pond Pavilion**

NOT FOR CONSTRUCTION **Drawing Title General Notes**

11/06/20 Date Not to Scale Scale Drawing M-P-002 Number ARCH D Sheet Size

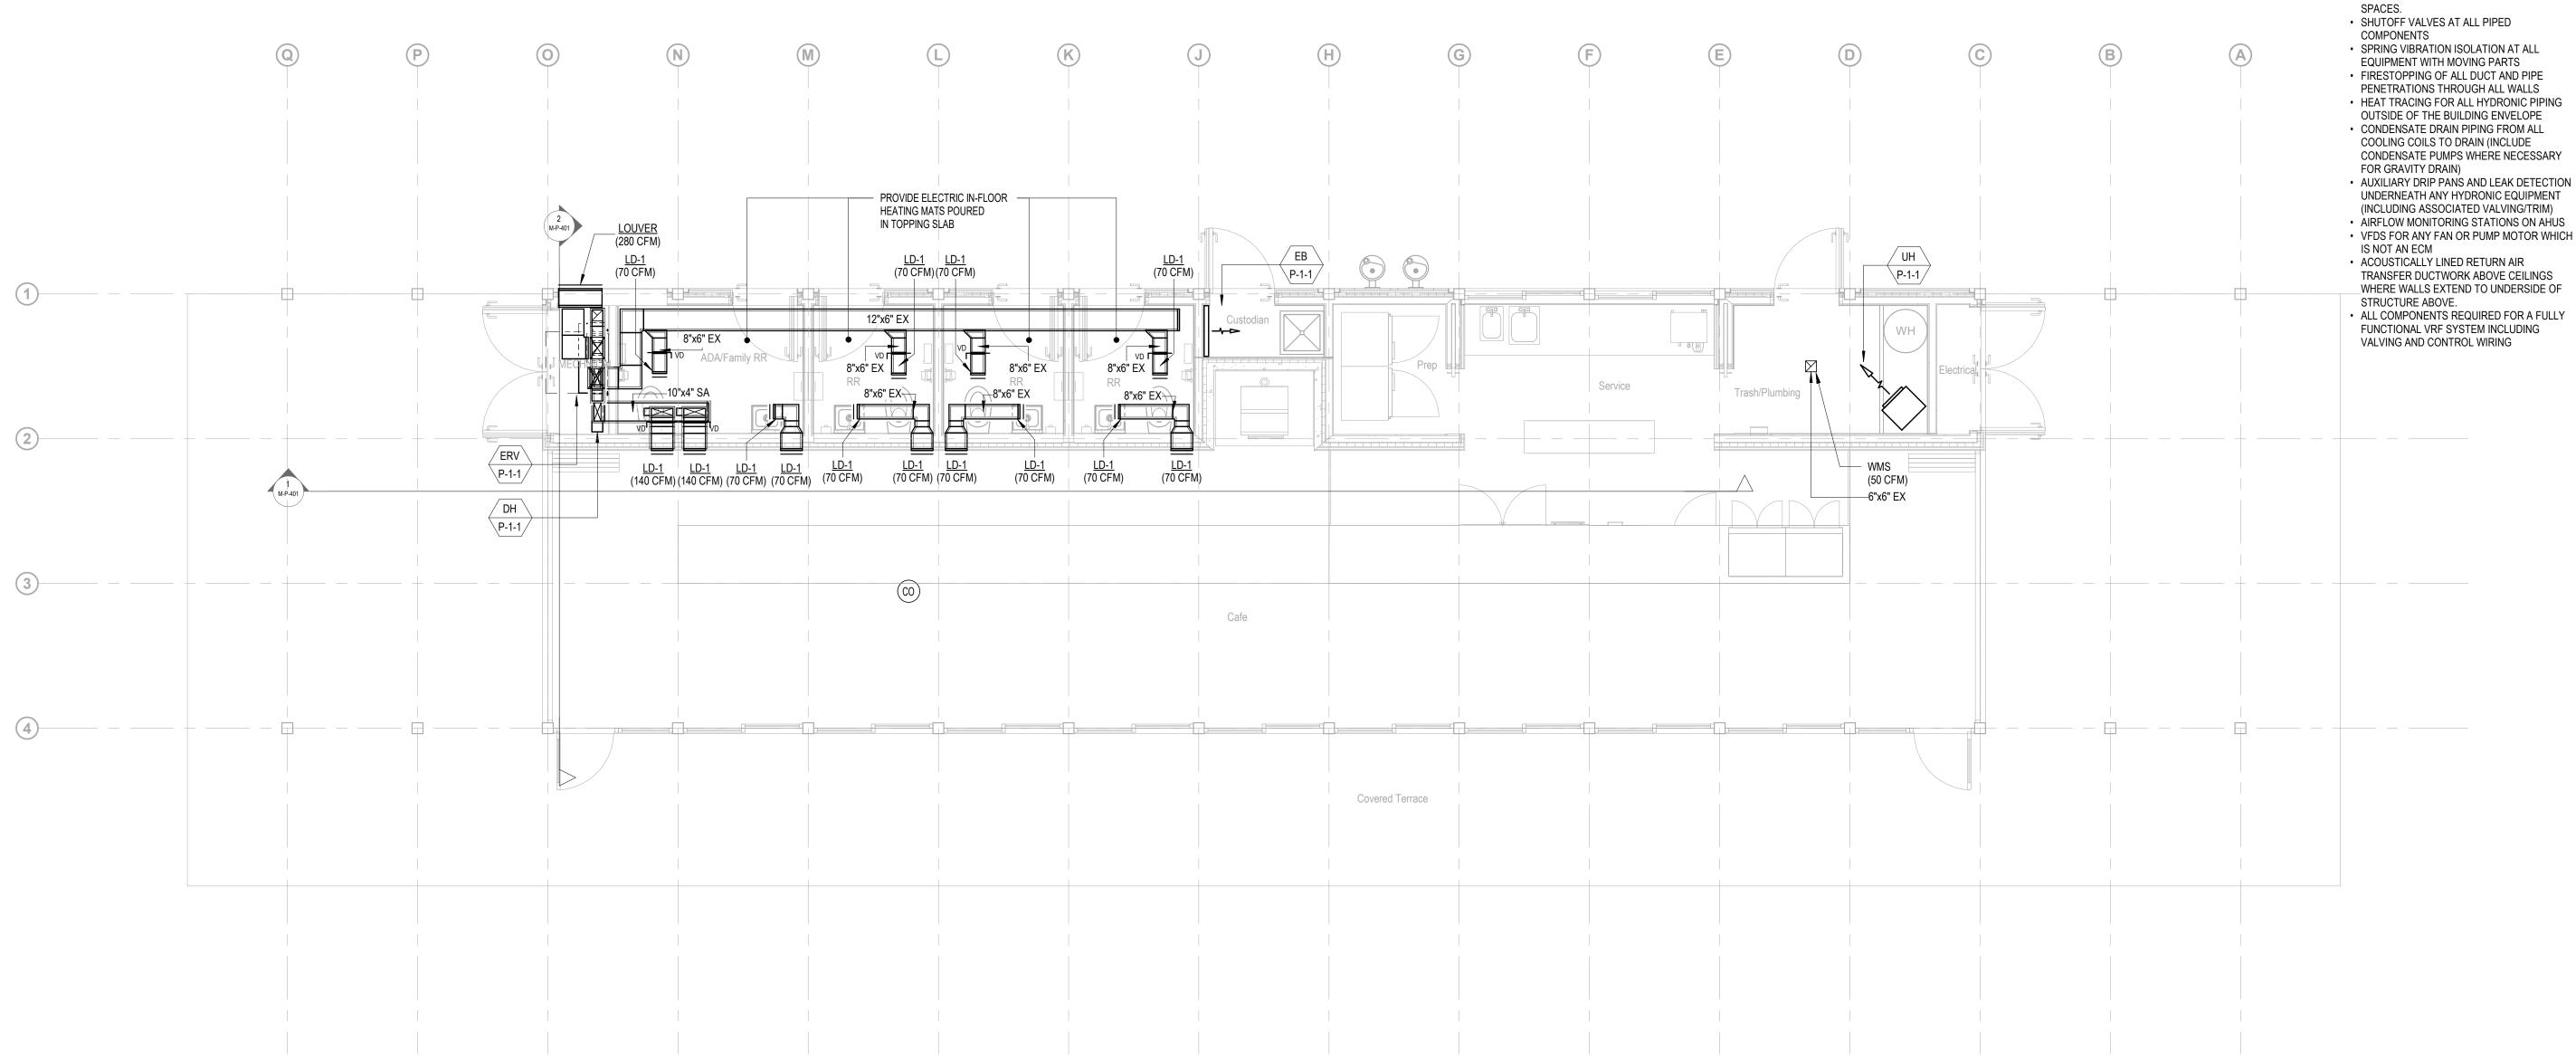

GENERAL NOTES

CONSTRUCTION DOCUMENTS LEVEL. WHERE DETAIL IS NOT YET SHOWN, PROVIDE ALL COMPONENTS REQUIRED FOR A FULLY FUNCTIONAL HVAC SYSTEM INCLUDING, BUT NOT

- LIMITED TO: THERMOSTATS FOR ALL ZONES ASSOCIATED WITH HEATING AND COOLING UNITS
- FACTORY PACKAGED CONTROLS FOR ALL
- COMPLEX EQUIPMENT. FULL STORM KING FACILITY CENTRAL BUILDING MANAGEMENT SYSTEM, CONNECTING ALL CURRENT AND FUTURE BUILDINGS, AS DESCRIBED ON THE
- MECHANICAL COVER SHEET BALANCING DAMPERS AT ALL AIR TERMINALS ACOUSTIC DUCT LINING 10FT UPSTREAM AND
- DOWNSTREAM OF ALL FANS DUCT SILENCERS AT ALL DUCT CONNECTIONS TO AIR HANDLING UNITS AND
- ROOF MOUNTED UNITS FIRE DAMPERS AND FIRE/SMOKE DAMPERS AT ALL DUCT PENETRATIONS THROUGH
- INSULATION ON ALL AIR DUCT, HYDRONIC PIPES AND REFRIGERANT PIPES
- DOUBLE-WALL CONSTRUCTION ON ALL EXPOSED DUCT VISIBLE FROM OCCUPIED
- SHUTOFF VALVES AT ALL PIPED
- SPRING VIBRATION ISOLATION AT ALL

RATED WALLS.

- FIRESTOPPING OF ALL DUCT AND PIPE PENETRATIONS THROUGH ALL WALLS
- OUTSIDE OF THE BUILDING ENVELOPE CONDENSATE DRAIN PIPING FROM ALL
- AUXILIARY DRIP PANS AND LEAK DETECTION
- UNDERNEATH ANY HYDRONIC EQUIPMENT (INCLUDING ASSOCIATED VALVING/TRIM) AIRFLOW MONITORING STATIONS ON AHUS
- ACOUSTICALLY LINED RETURN AIR TRANSFER DUCTWORK ABOVE CEILINGS
- ALL COMPONENTS REQUIRED FOR A FULLY FUNCTIONAL VRF SYSTEM INCLUDING

DRAWINGS ARE PRESENTED HERE AT A 50%

- **Design Architect** heneghan peng architects 14-16 Lord Edward Street CO2 SENSORS IN ALL DENSELY OCCUPIABLE
 - Dublin, D02 YC63 +353 1 633 9000

+1 (845) 534-3115

Storm King Art Center 1 Museum Road

New Windsor, NY 12553

Owner

- **Executive Architect** WXY Architecture + Urban Design 224 Centre Street, 5th Floor New York, NY 10013 +1 (212) 219-1953
- Landscape Architect Gustafson Porter + Bowman 1 Cobham Mews London, MW1 9SB
- +44 020 7284 8950 Reed Hilderbrand LLC 33 Whitney Avenue, 3rd Floor New Haven, CT 06510
- +1 (617) 923-2422 Structural & Lighting
- ARUP 77 Water Street New York, NY 10005
- +1 (212) 896-3000 MEPF & IT BuroHappold
- 100 Broadway #23 New York, NY 10005
- +1 (212) 616-0228 Civil VHB
- 100 Great Oaks Blvd., Suite 118 Albany, NY 12203
- +1 (518) 389-3606 **AV & Acoustics** WHERE WALLS EXTEND TO UNDERSIDE OF
 - LSTN Consultants 76 Beaver Street, 2nd Floor New York, NY 10005
 - +1 (347) 788-0810 Facade
 - Front Inc. 100 E. Broadway Street, #501 New York, NY 10002 +1 (212) 242-2220
 - **Key Plan**




Description	Date
50% Design Development	02/24/
100% Design Development	05/29/
50% Construction Documents	11/06/

Project

Storm King Art Center **Pond Pavilion**

NOT FOR CONSTRUCTION **Drawing Title** Duct Plan - Ground Level

Date	11/06/20
Scale	1/4" = 1'-0"
Drawing Number	M-P-101
Sheet Size	ARCH D

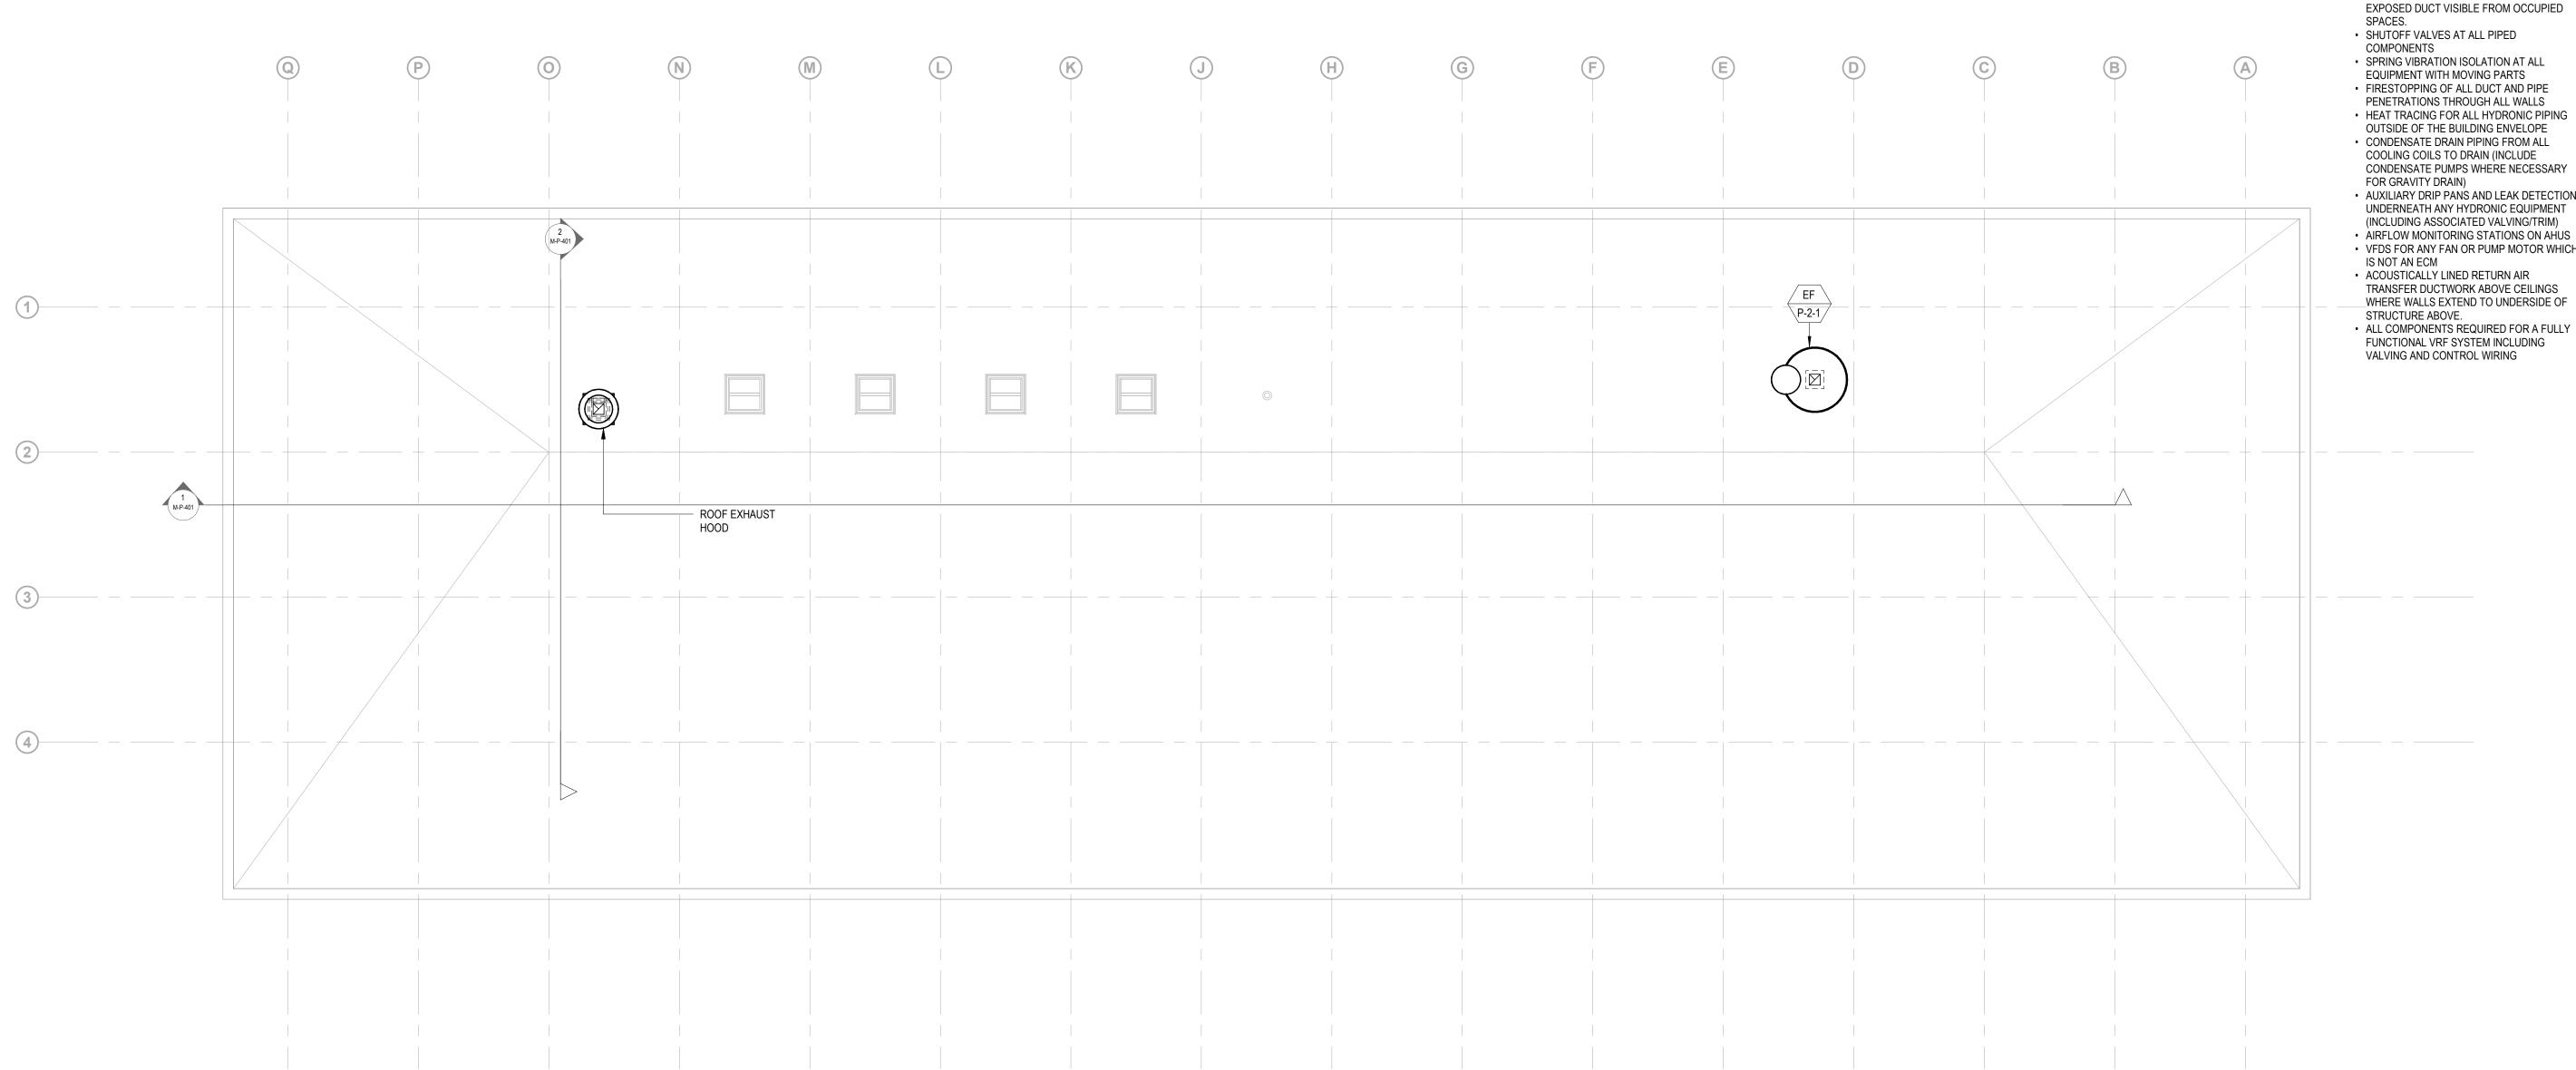

GENERAL NOTES

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- TRANSFER DUCTWORK ABOVE CEILINGS __WHERE WALLS EXTEND TO UNDERSIDE OF

Storm King Art Center 1 Museum Road New Windsor, NY 12553 +1 (845) 534-3115

Design Architect

Owner

heneghan peng architects 14-16 Lord Edward Street Dublin, D02 YC63 +353 1 633 9000

Executive Architect WXY Architecture + Urban Design 224 Centre Street, 5th Floor New York, NY 10013 +1 (212) 219-1953

Landscape Architect Gustafson Porter + Bowman 1 Cobham Mews London, MW1 9SB +44 020 7284 8950

Reed Hilderbrand LLC 33 Whitney Avenue, 3rd Floor New Haven, CT 06510

+1 (617) 923-2422 Structural & Lighting ARUP

77 Water Street New York, NY 10005 +1 (212) 896-3000

MEPF & IT BuroHappold 100 Broadway #23

New York, NY 10005 +1 (212) 616-0228 Civil

VHB

100 Great Oaks Blvd., Suite 118 Albany, NY 12203

+1 (518) 389-3606 **AV & Acoustics** LSTN Consultants

76 Beaver Street, 2nd Floor New York, NY 10005 +1 (347) 788-0810

Facade Front Inc. 100 E. Broadway Street, #501 New York, NY 10002 +1 (212) 242-2220

Key Plan




Description Date 50% Design Development 02/24/20 100% Design Development 05/29/20 50% Construction Documents 11/06/20

Project

Storm King Art Center **Pond Pavilion**


NOT FOR CONSTRUCTION **Drawing Title** Duct Plan - Roof Level

Date	11/06/20
Scale	1/4" = 1'-0"
Drawing Number	M-P-102
Sheet Size	ARCH D

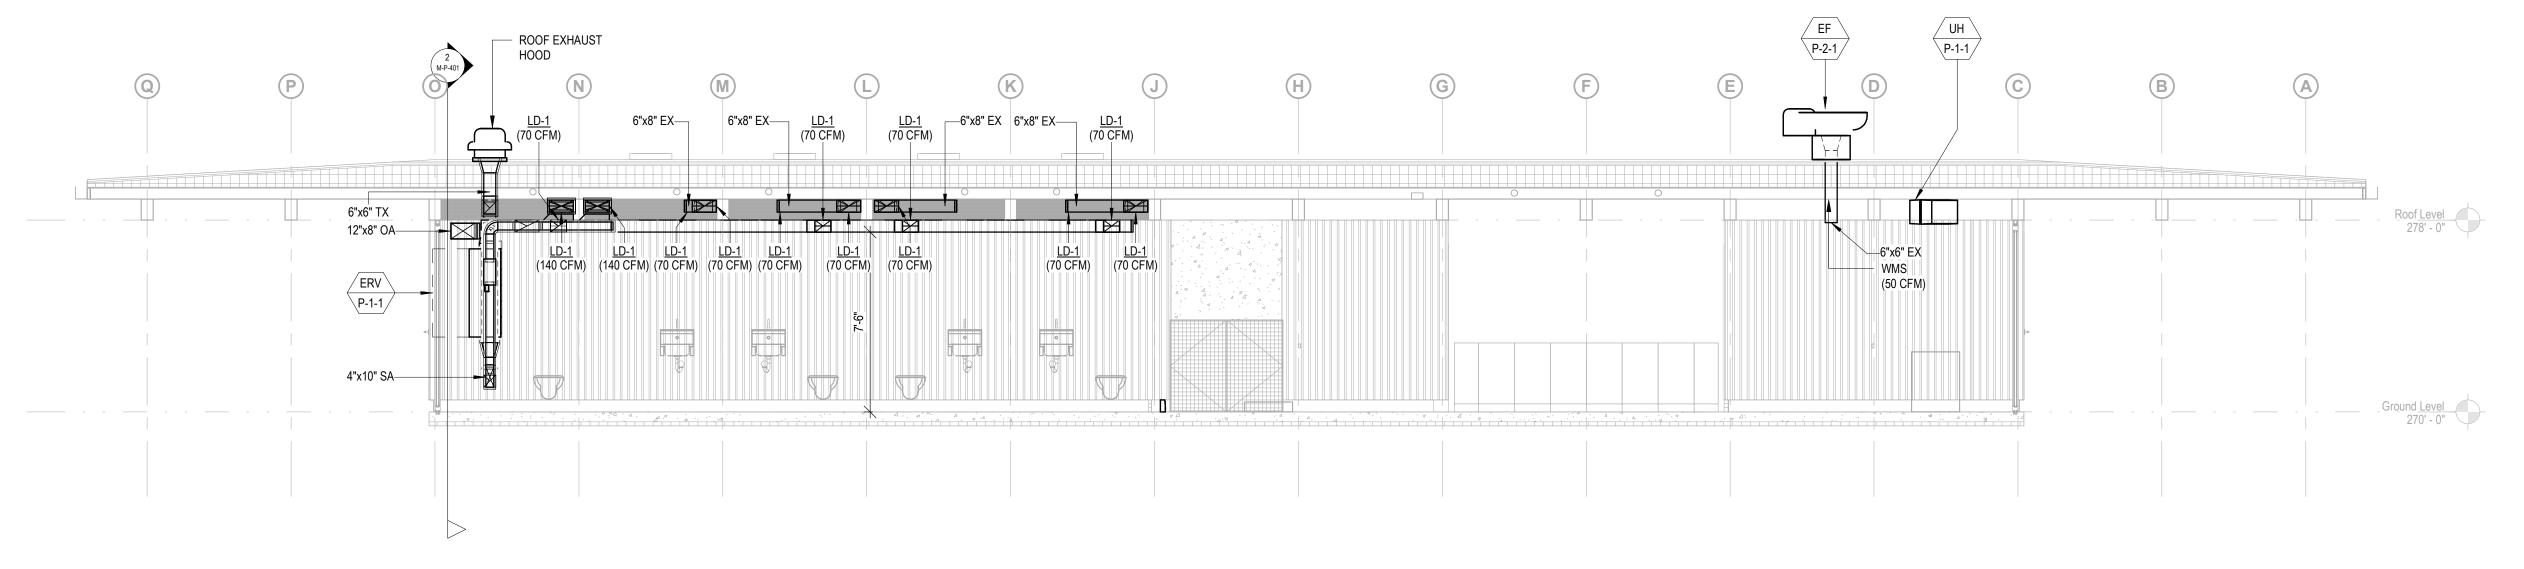

MECHANICAL SECTION - POND PAVILLION

SCALE 1/4" = 1'-0"

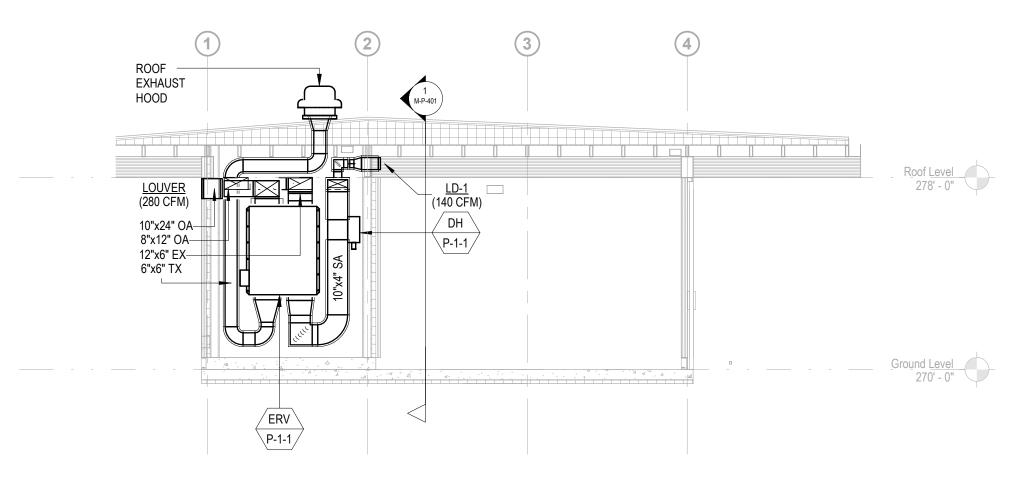

2 MECHANICAL SECTION - MER ROOM

SCALE 1/4" = 1'-0"

Owner
Storm King Art Center
1 Museum Road
New Windsor, NY 12553
+1 (845) 534-3115

Design Architect
heneghan peng architects
14-16 Lord Edward Street
Dublin, D02 YC63
+353 1 633 9000

Executive Architect
WXY Architecture + Urban Design
224 Centre Street, 5th Floor
New York, NY 10013
+1 (212) 219-1953

Landscape Architect
Gustafson Porter + Bowman
1 Cobham Mews
London, MW1 9SB
+44 020 7284 8950

Reed Hilderbrand LLC 33 Whitney Avenue, 3rd Floor New Haven, CT 06510 +1 (617) 923-2422

Structural & Lighting
ARUP
77 Water Street

New York, NY 10005 +1 (212) 896-3000 MEPF & IT BuroHappold

100 Broadway #23 New York, NY 10005 +1 (212) 616-0228

Civil VHB

100 Great Oaks Blvd., Suite 118 Albany, NY 12203

+1 (518) 389-3606

AV & Acoustics

LSTN Consultants
76 Beaver Street, 2nd Floor
New York, NY 10005
+1 (347) 788-0810

Facade
Front Inc.
100 E. Broadway Street, #501
New York, NY 10002

+1 (212) 242-2220

Key Plan

DescriptionDate100% Design Development05/29/2050% Construction Documents11/06/20

Storm King
Art Center

Project


Storm King

Art Center

Sea

NOT FOR CONSTRUCTION
Drawing Title
Mechanical Sections

Date	11/06/20
Scale	1/4" = 1'-0"
Drawing Number	M-P-401
Sheet Size	ARCH D

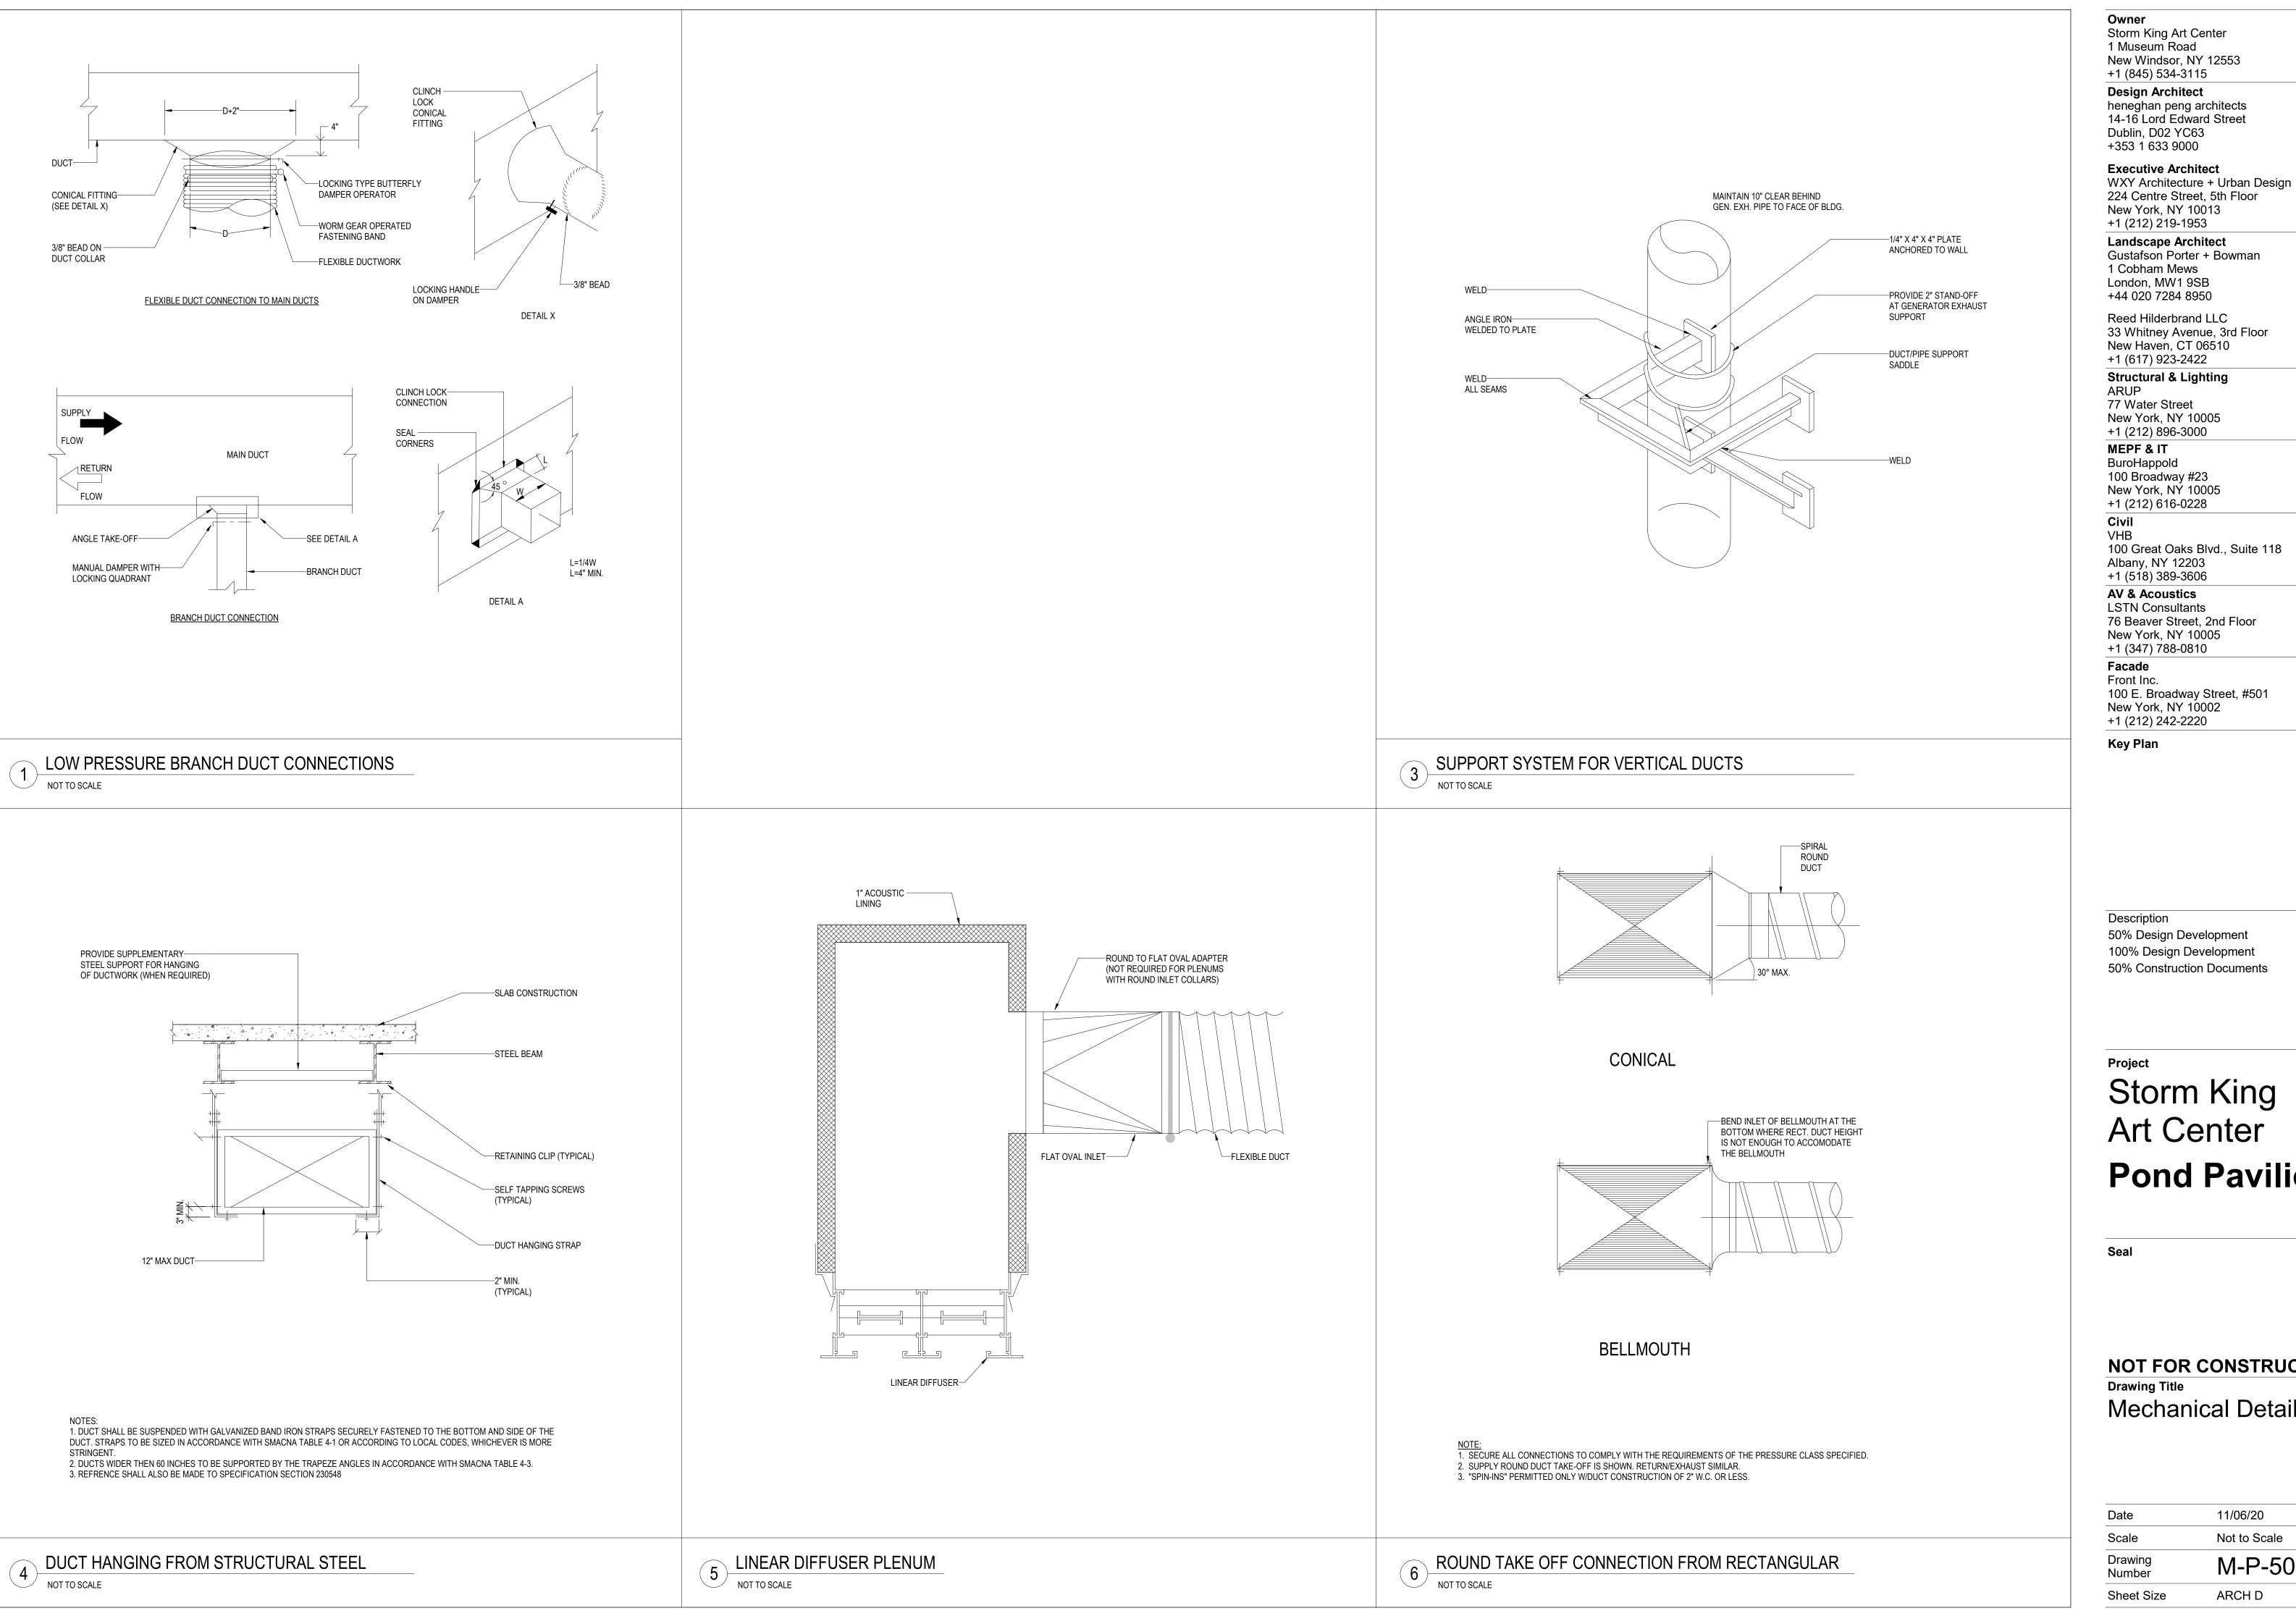

+1 (845) 534-3115 **Design Architect** heneghan peng architects

14-16 Lord Edward Street Dublin, D02 YC63 +353 1 633 9000 **Executive Architect**

224 Centre Street, 5th Floor New York, NY 10013 +1 (212) 219-1953 **Landscape Architect** Gustafson Porter + Bowman

London, MW1 9SB +44 020 7284 8950 Reed Hilderbrand LLC

33 Whitney Avenue, 3rd Floor New Haven, CT 06510 +1 (617) 923-2422

Structural & Lighting ARUP 77 Water Street

+1 (212) 896-3000 MEPF & IT BuroHappold

100 Broadway #23 New York, NY 10005 +1 (212) 616-0228

VHB 100 Great Oaks Blvd., Suite 118

Albany, NY 12203 +1 (518) 389-3606

AV & Acoustics LSTN Consultants 76 Beaver Street, 2nd Floor

+1 (347) 788-0810 Facade Front Inc. 100 E. Broadway Street, #501

Key Plan

Description Date 50% Design Development 02/24/20

05/29/20


11/06/20

Project

Storm King Art Center **Pond Pavilion**

NOT FOR CONSTRUCTION **Drawing Title** Mechanical Details

11/06/20 Date Not to Scale Scale Drawing M-P-501 Number ARCH D Sheet Size

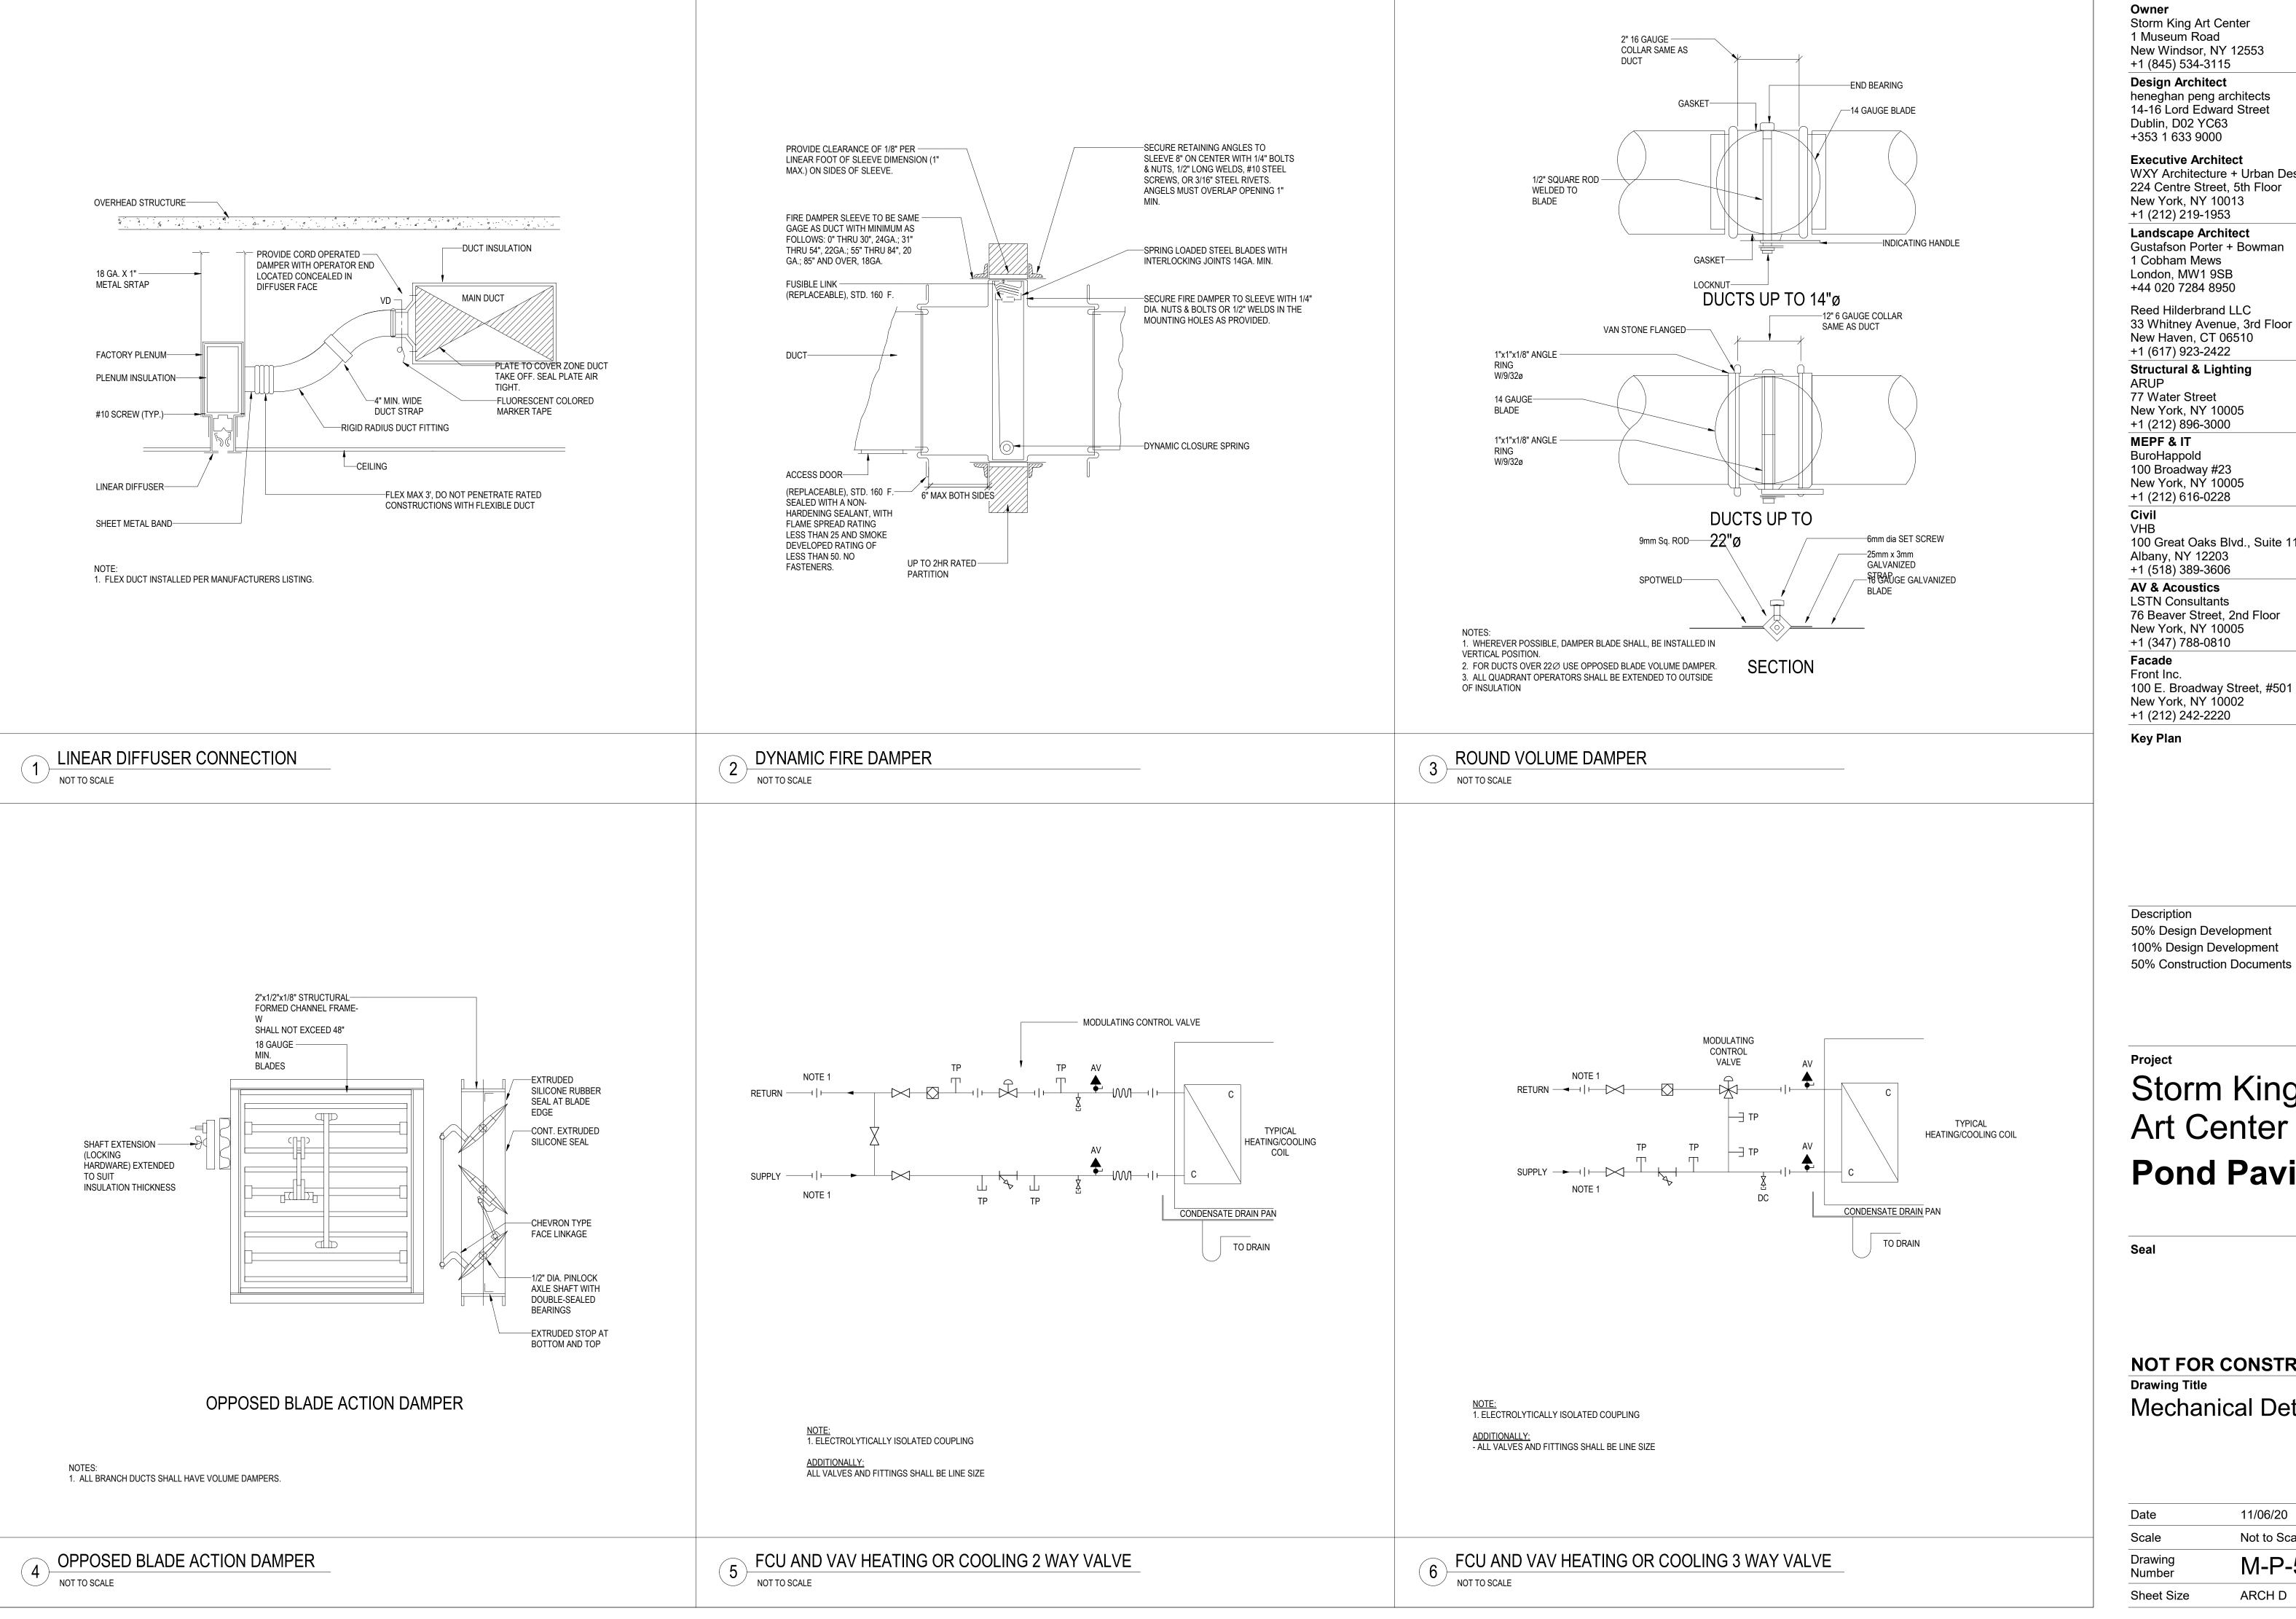

+1 (845) 534-3115 **Design Architect**

heneghan peng architects 14-16 Lord Edward Street Dublin, D02 YC63 +353 1 633 9000

WXY Architecture + Urban Design 224 Centre Street, 5th Floor New York, NY 10013 +1 (212) 219-1953 Landscape Architect Gustafson Porter + Bowman

+44 020 7284 8950 Reed Hilderbrand LLC 33 Whitney Avenue, 3rd Floor

New Haven, CT 06510 +1 (617) 923-2422

ARUP 77 Water Street New York, NY 10005

MEPF & IT BuroHappold 100 Broadway #23

New York, NY 10005 +1 (212) 616-0228

100 Great Oaks Blvd., Suite 118

Albany, NY 12203 +1 (518) 389-3606

AV & Acoustics LSTN Consultants 76 Beaver Street, 2nd Floor New York, NY 10005 +1 (347) 788-0810

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100 E. Broadway Street, #501 New York, NY 10002 +1 (212) 242-2220

Key Plan

Description Date 50% Design Development 02/24/20 100% Design Development 05/29/20


11/06/20


Project

Storm King Art Center **Pond Pavilion**

NOT FOR CONSTRUCTION **Drawing Title** Mechanical Details

11/06/20 Not to Scale Scale Drawing M-P-502 Number Sheet Size ARCH D

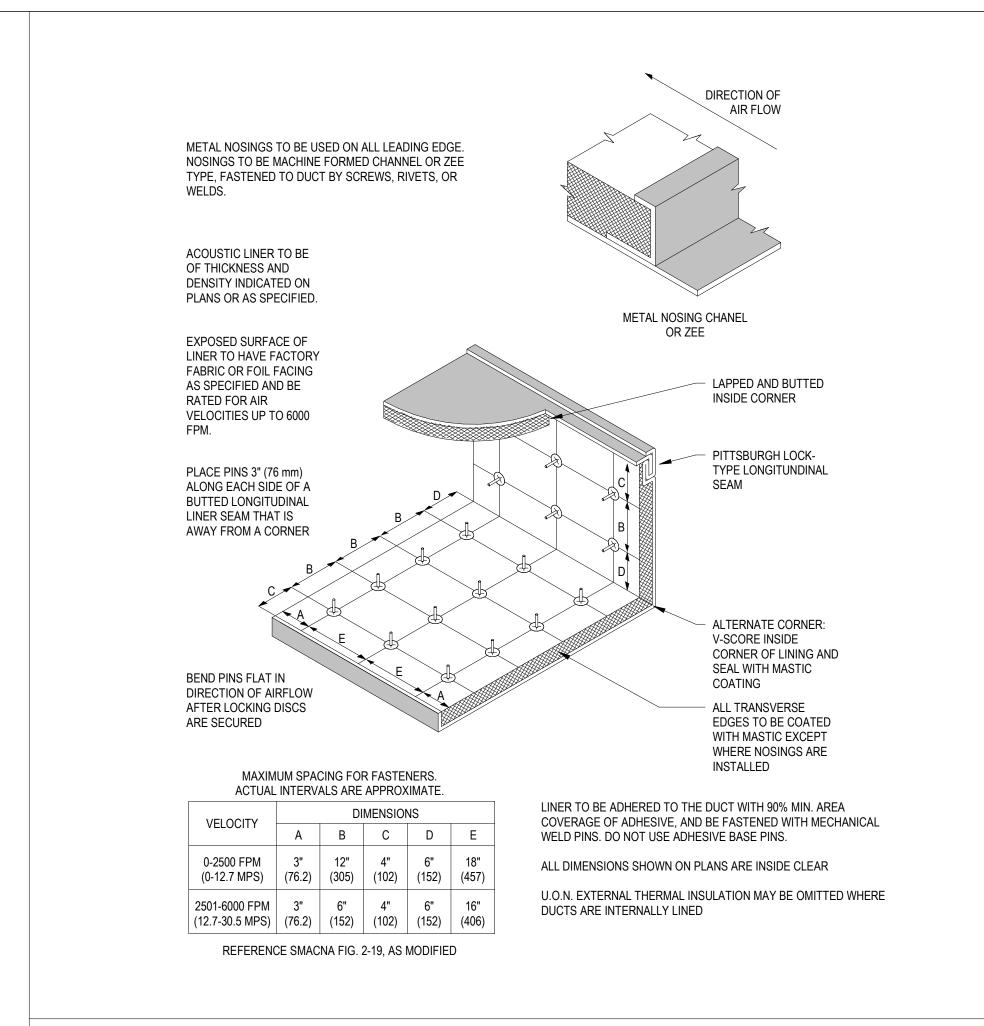

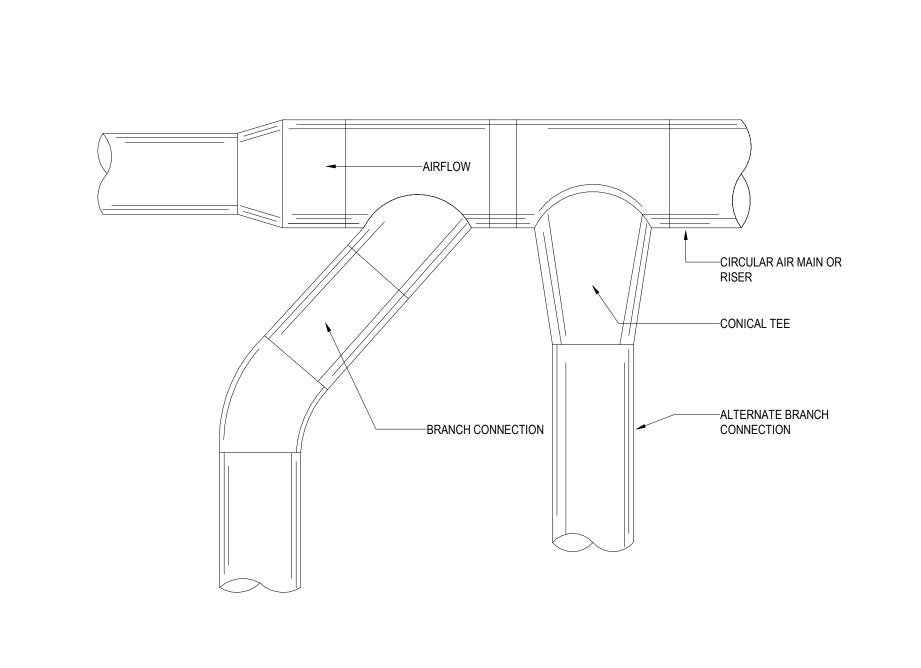

DUCTWORK ACOUSTIC LINING

NOT TO SCALE CIRCULAR DUCT CONNECTIONS

PROVIDE CLEARANCE OF 1/8" PER --IF MANDATED BY LOCAL AUTHORITY LINEAL FOOT OF SLEEVE DIMENSION HAVE JURISDICTION, PROVIDE (1" MAX.) ON SIDES OF SLEEVE. SEALANT APPROVED BY DAMPER MANUFACTURER TO SEAL RETAINING ANGLES TO RATED PARTITION DAMPER SLEEVE TO BE SAME GAGE — -SECURE RETAINING ANGLES TO AS DUCT WITH MINIMUM AS FOLLOWS: SLEEVE 8" ON CENTER WITH 1/4" 0" THRU 30", 24GA.; BOLTS & NUTS, 1/2" LONG WELDS, #10 31" THRU 54", 22GA.; STEEL SCREWS, 55" THRU 84", 20 GA.; OR 3/16" STEEL RIVETS. ANGLES MUST 85" AND OVER, 18GA. OVERLAP OPENING 1" MIN. -CONNECTING DUAL HEAT SENSOR -FIRESTAT IN DAMPER F**Ø** -CONNECTING ACCESS DOOR-FLEX —— LINK CONDUIT OVER CENTER DAMPER OPERATOR -LOCKING LINK OUTSIDE THE DUCT (COORDINATE LOCATION FOR ACCESS & SERVICING) BREAK AWAY CONNECTION, SEALED WITH A NON-HARDENING SEALANT, WITH FLAME SPREAD RATING LESS SIDES -NOTE: FLASHING REQUIRED ON THAN 25 AND SMOKE ONE SIDE ONLY DEVELOPED RATING OF LESS -RATED PARTITION THAN 50. NO FASTENERS. NOTES: HI-TEMP -DAMPER 1. DAMPER TO BE U.L. LABELED N.F.P.A. 90A APPROVED. HEAT **ACTUATOR** SENSOR 2. N.F.P.A. APPROVED INSTALLATION DETAILS TO BE PART OF SUBMISSION OF COMBINATION FIRE & SMOKE DAMPER FOR FCC -APPROVAL, WHICH SHALL MEET N.F.P.A. STANDARD 90A. **OVERRIDE** SMOKE -3. DETAILS SHOWN ARE FOR COMBINATION FIRE SMOKE -HEAT DETECTOR DAMPERS IN HORIZONTAL DUCTWORK. FOR DAMPERS IN SENSOR OR SIGNAL

VERTICAL DUCTWORK, DETAIL IS SIMILAR. 4. INSTALL DAMPER IN ACCORDANCE WITH MANUFACTURERS REQUIREMENTS.

5. ACTUATOR TO HAVE AN ADDRESSABLE DAMPER POSITION

INDICATOR.

-ACOUSTICAL LINING WHERE REQUIRED LOW PRESSURE SUPPLY ROUND DUCT

MANUAL VOLUME DAMPER WITH ---L.P. RECTANGULAR X-CFM / SUPPLY DUCT MAIN 3/8" SQ. ROD (TYP) LOCKING TYPE INDICATOR QUADRANT ON HAT SECTION AIR FLOW_ END BEARING (TYP) DUCT BRANCH-—DUCT SEALANT 45°∠ON SHEET -—1/3 W. (5" MIN.) METAL TRIM PIECE 20 DEG. MAX TO RETAIN -45 DEG. CL MAIN DUCT-ACOUSTIC LINING INCH COLLAR -BELLMOUTH CONNECTION MANUAL VOLUME **⟨**If LOW DAMPER CLAMP--ACOUSTIC LINING ROUND FLEXIBLE WHERE REQUIRED DUCTWORK 6'-0" MAX. LENGTH; LOW PRESSURE SUPPLY NEW YORK CITY: MAX. LENGTH 3'-0" RECTANGULAR DUCT

FURNISH THIS TYPE CONNECTION WHEN SINGLE-LINE

DUCTWORK IS INDICATED AS THIS FOR LBRANCHES

WITH LESS THAN 25% OF THE TOTAL AIR FLOW.

NOTE:

-MANUAL VOLUME DAMPER OUTSIDE RADIUS EQUAL TO 2T INSIDE RADIUS EQUAL TO T THROAT SIZE **EQUALS T** CFM —ACOUSTIC LINING WHERE REQUIRED NOTES:

1. FURNISH THIS TYPE CONNECTION WHEN SINGLE-LINE

THAN 25% OF THE TOTAL AIR FLOW.

3. T=X (BRANCH DUCT)x W Y (TOTAL CFM)

DUCTWORK IS INDICATED AS THIS FOR BRANCHES WITH LESS

2. THIS TYPE OF CONNECTION MUST BE USED WHEN W 36 IN.

5 LOW PRESSURE SUPPLY CONNECTION DETAILS

NOT TO SCALE

FLEXIBLE DUCT CONNECTIONS ARE ONLY

PERMITTED IN AREAS WITH PNC-35 OR GREATER.

NOTE:

Owner Storm King Art Center 1 Museum Road

New Windsor, NY 12553 +1 (845) 534-3115 **Design Architect**

Executive Architect

London, MW1 9SB

heneghan peng architects 14-16 Lord Edward Street Dublin, D02 YC63 +353 1 633 9000

WXY Architecture + Urban Design 224 Centre Street, 5th Floor New York, NY 10013 +1 (212) 219-1953 **Landscape Architect** Gustafson Porter + Bowman 1 Cobham Mews

+44 020 7284 8950 Reed Hilderbrand LLC 33 Whitney Avenue, 3rd Floor New Haven, CT 06510

+1 (617) 923-2422 **Structural & Lighting** ARUP

77 Water Street New York, NY 10005 +1 (212) 896-3000 MEPF & IT

BuroHappold 100 Broadway #23 New York, NY 10005

+1 (212) 616-0228 Civil VHB

100 Great Oaks Blvd., Suite 118 Albany, NY 12203

+1 (518) 389-3606 **AV & Acoustics** LSTN Consultants

76 Beaver Street, 2nd Floor New York, NY 10005 +1 (347) 788-0810

Facade Front Inc. 100 E. Broadway Street, #501 New York, NY 10002 +1 (212) 242-2220

Key Plan

Description Date 02/24/20 50% Design Development 100% Design Development 05/29/20

11/06/20

50% Construction Documents

Project Storm King Art Center **Pond Pavilion**

NOT FOR CONSTRUCTION **Drawing Title** Mechanical Details

11/06/20 Date Not to Scale Scale Drawing M-P-503 Number ARCH D Sheet Size


COMBINATION FIRE AND SMOKE DAMPER NOT TO SCALE

WIRING DIAGRAM

FROM FCC

OPEN & CLOSED

LIGHT CONTACTS

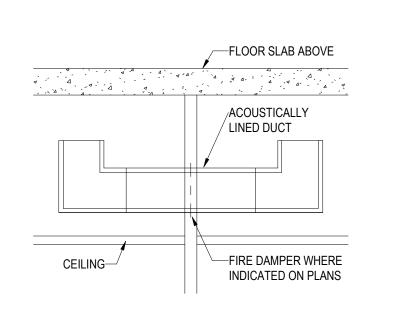

NOTES:


SIZE.


- 1. REFER TO DRAWINGS AND SPECIFICATIONS FOR ACOUSTICAL INSULATION THICKNESS AND DENSITY.
- 2. PROVIDE TRANSFER DUCT WHERE INDICATED ON
- 4. FOR AIR QUANTITIES IN EXCESS OF 2000 CFM USE

3. REFER TO SCHEDULE BELOW FOR TRANSFER DUCT


- MULTIPLE TRANSFER DUCTS
- 5. TRANSFER DUCT SIZES ARE INSIDE CLEAR

6. EQUIVALENT DUCT SIZES	ALLOWED
TRANSFER AIR QUANTITY (CFM)	TRANSFER AIR DUCT SIZE (W x H)
0-500	18 x 10
501-1000	20 x 18
1001-1500	30 x 20
1501-2000	30 x 24

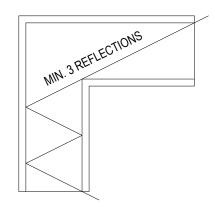


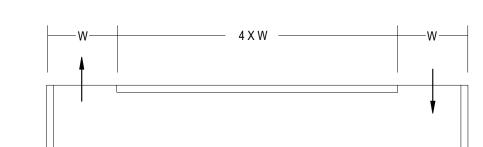


ACOUSTIC AIR TRANSFER DUCT

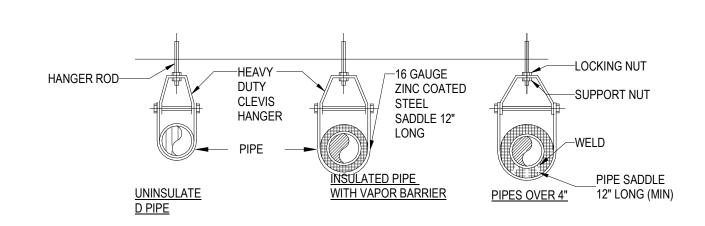

MAXIMUM SPACING RETWEEN	5/8 7/	10 710	
MAXIMUM SPACING BETWEEN 6 7 9 10 11 12 14		/8 7/8	
PIPE SUPPORT-FEET	16 17	7 19	
MAXIMUM SPACING BETWEEN 6 6 8 9 10 10 12	14 14	4 16	

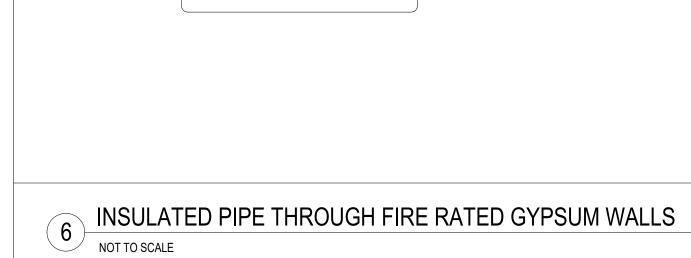

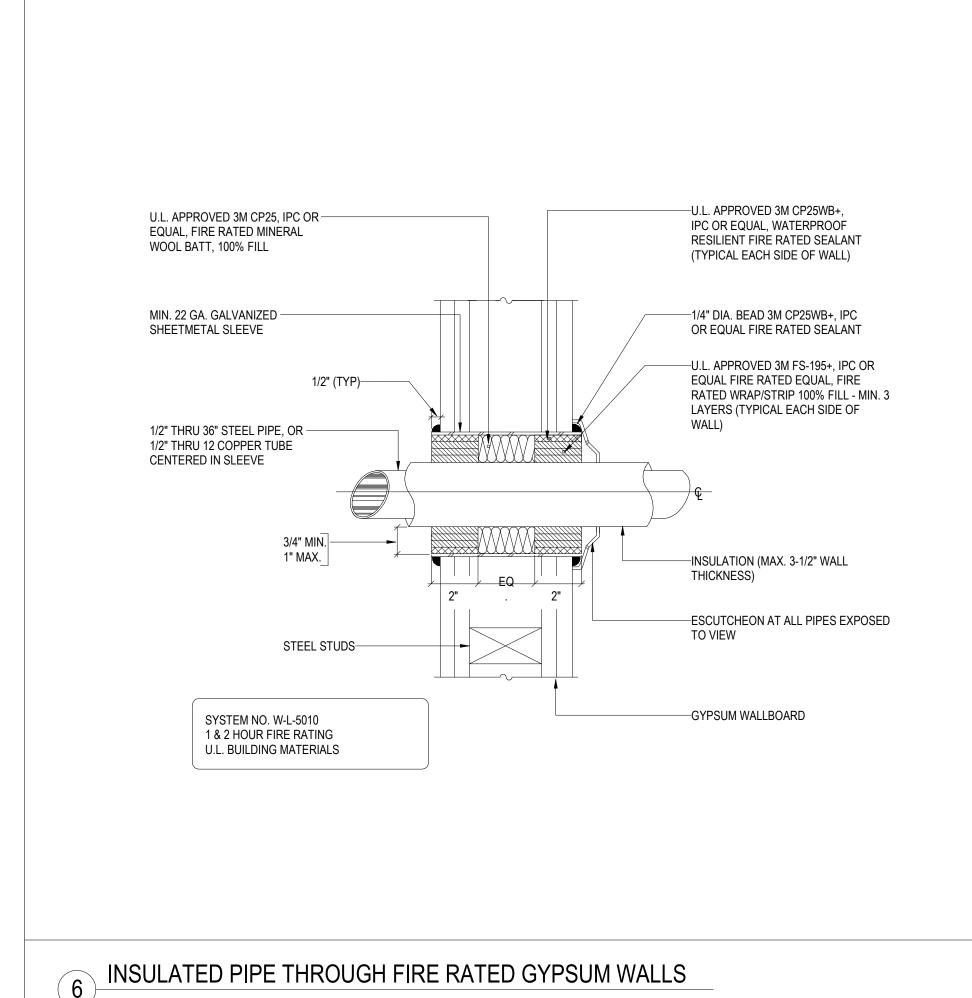

Owner Storm King Art Center 1 Museum Road New Windsor, NY 12553

+1 (845) 534-3115 **Design Architect** heneghan peng architects 14-16 Lord Edward Street Dublin, D02 YC63

+353 1 633 9000 **Executive Architect** WXY Architecture + Urban Design 224 Centre Street, 5th Floor New York, NY 10013

+1 (212) 219-1953 Landscape Architect Gustafson Porter + Bowman 1 Cobham Mews London, MW1 9SB +44 020 7284 8950

Reed Hilderbrand LLC 33 Whitney Avenue, 3rd Floor New Haven, CT 06510 +1 (617) 923-2422

Structural & Lighting ARUP

77 Water Street New York, NY 10005 +1 (212) 896-3000

MEPF & IT BuroHappold

100 Broadway #23 New York, NY 10005 +1 (212) 616-0228

Civil VHB

100 Great Oaks Blvd., Suite 118

Albany, NY 12203 +1 (518) 389-3606

AV & Acoustics LSTN Consultants

76 Beaver Street, 2nd Floor New York, NY 10005 +1 (347) 788-0810

Facade

Front Inc. 100 E. Broadway Street, #501 New York, NY 10002 +1 (212) 242-2220

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11/06/20

50% Construction Documents


Project


Storm King Art Center **Pond Pavilion**

Seal

NOT FOR CONSTRUCTION **Drawing Title** Mechanical Details

11/06/20 Date Scale Not to Scale Drawing M-P-504 Number ARCH D Sheet Size

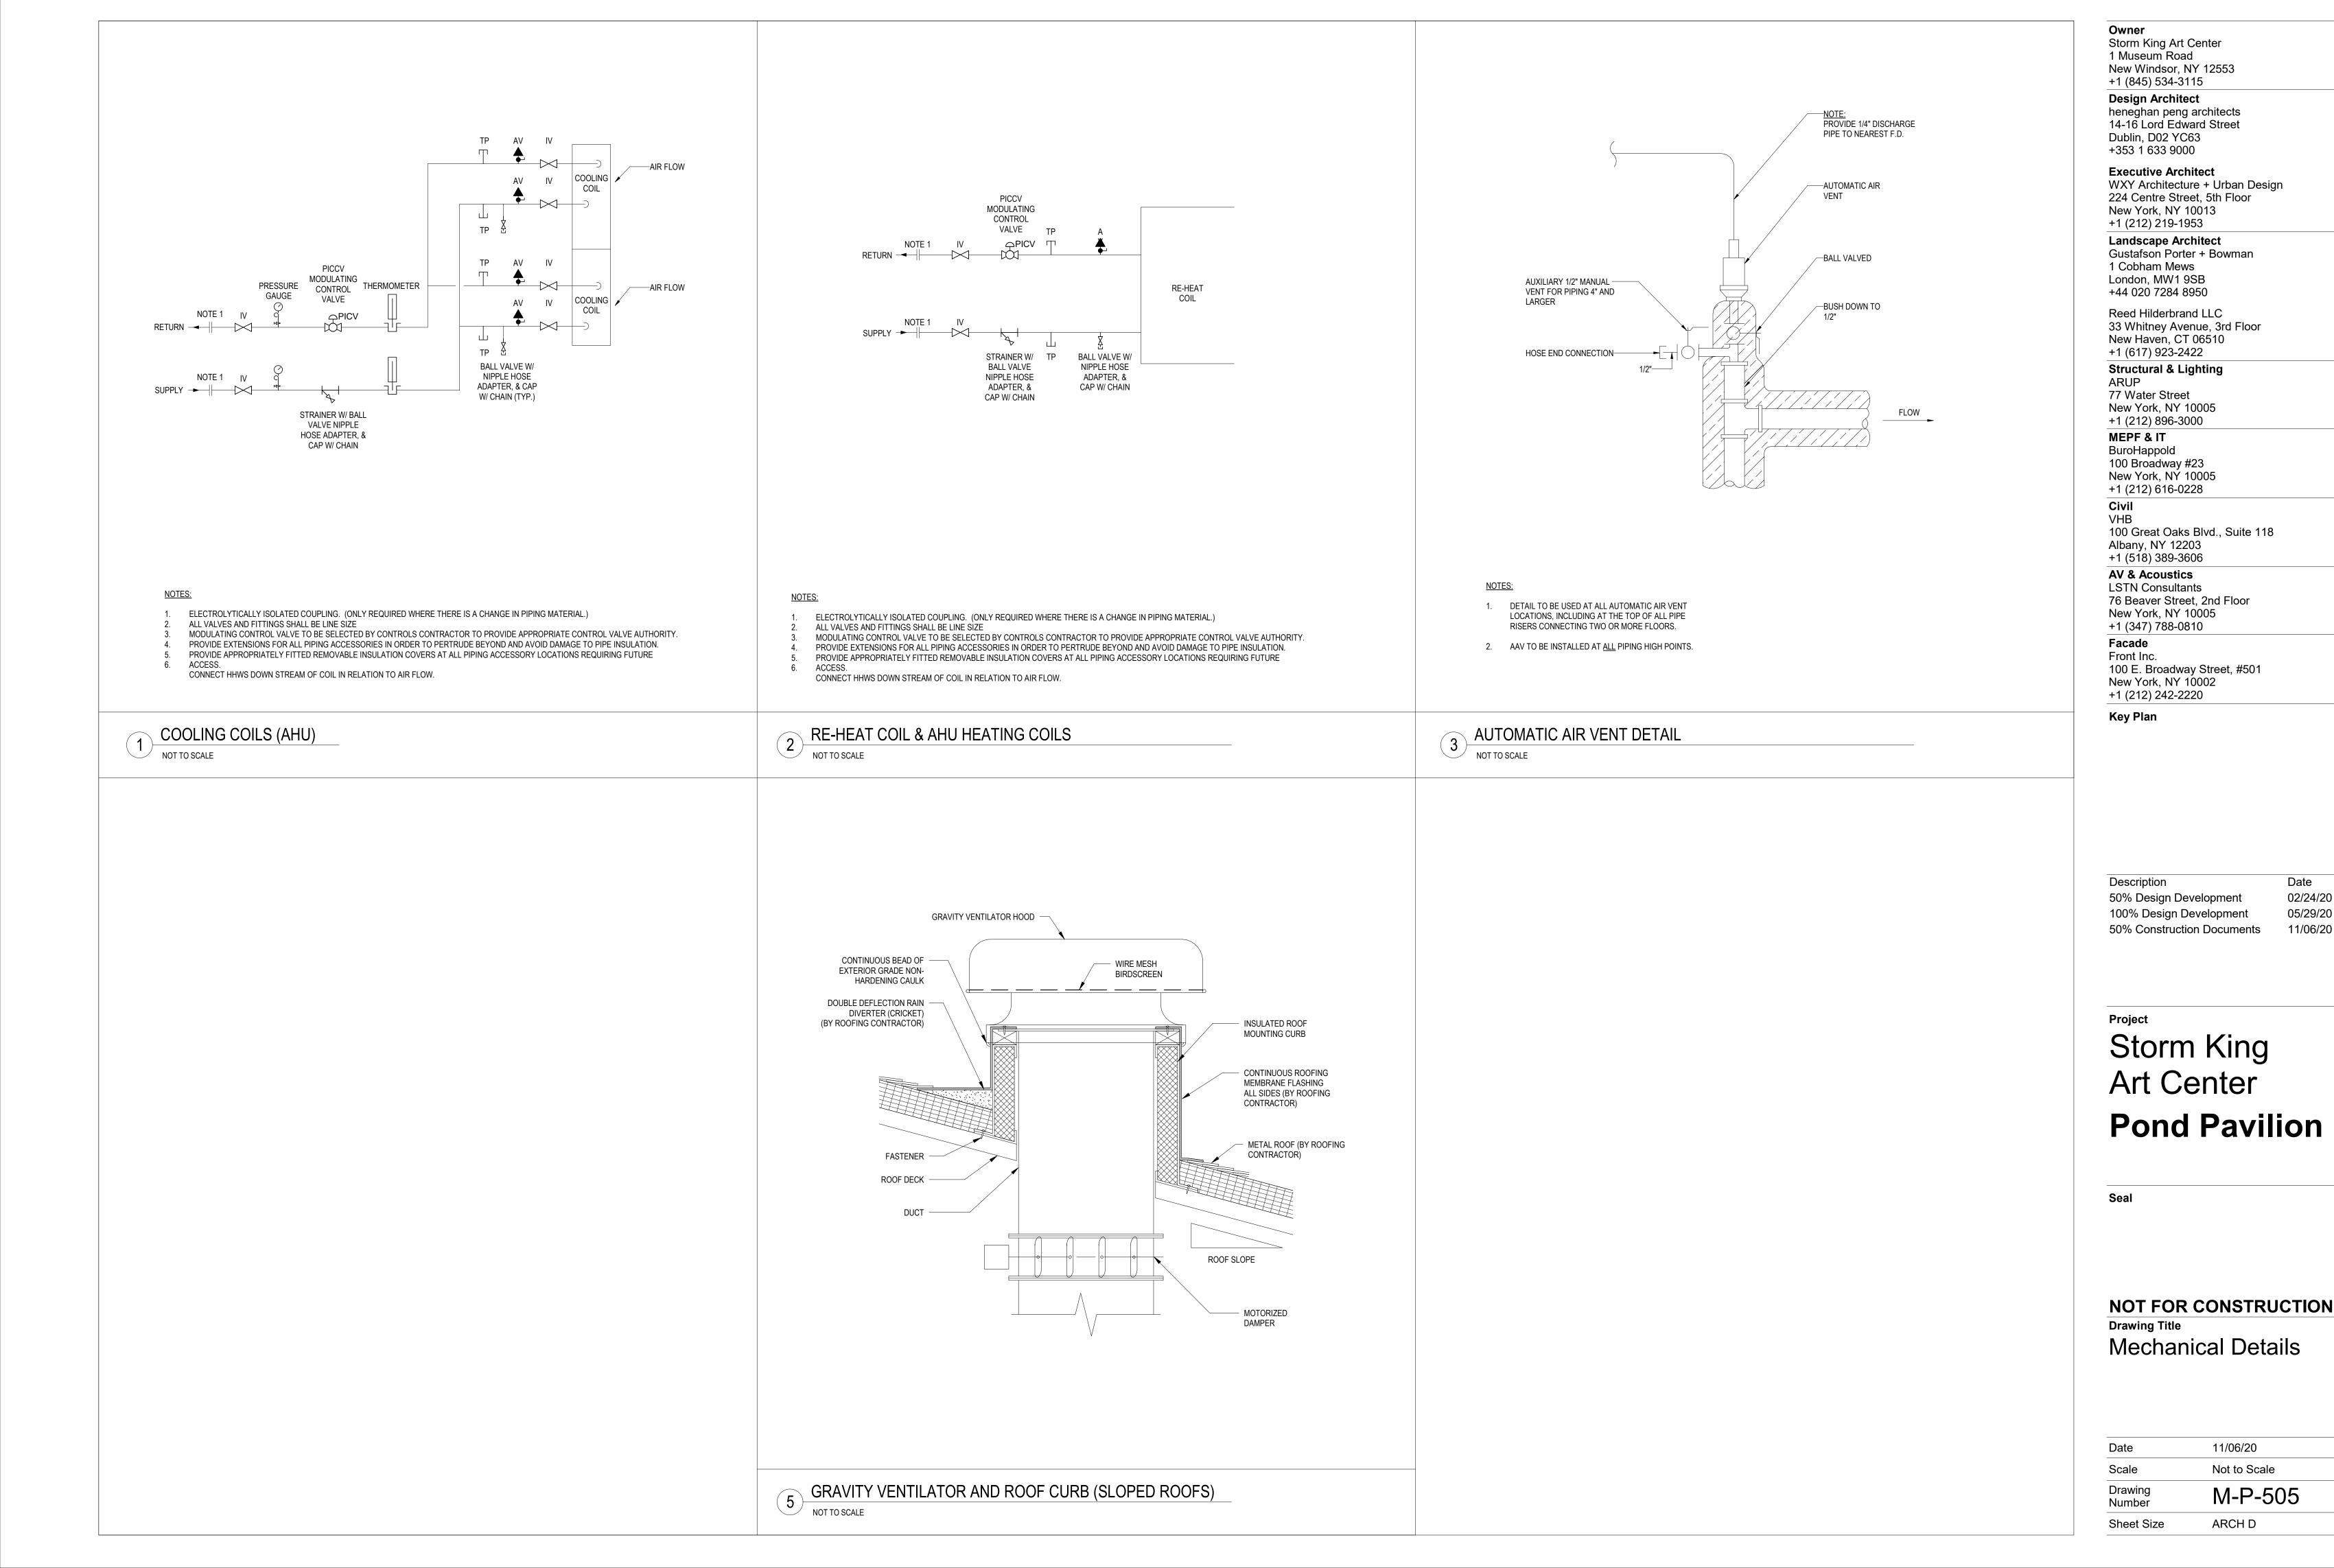

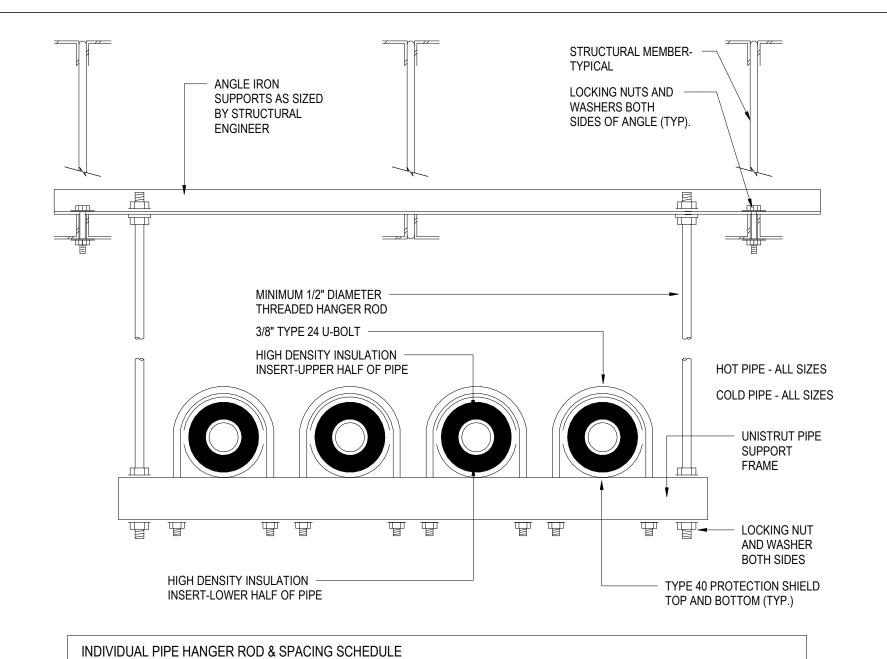



NOMINAL PIPE OR TUBE SIZE- INCHES	3/4	1	1 1/2	2	2 1/2	3	4	5	6	8	
HANGER ROD SIZE-INCHES	3/8	3/8	3/8	3/8	1/2	1/2	5/8	5/8	7/8	7/8	
MAXIMUM SPACING BETWEEN INCHES	6	7	9	10	11	12	14	16	17	19	
MAXIMUM SPACING BETWEEN CU, TUBE SUPPORT IN FEET	6	6	8	9	10	10	12	14	14	16	

TRAPEZE HANGER ROD SPACING SHALL BE BASED ON SPACING OF SMALLEST PIPE ON TRAPEZE. TRAPEZE SHALL BE DESIGNED WITH A SAFETY OF 5 FOR CENTER OF SPAN CONCENTRATED LOAD. METHOD OF HANGING, TYPE OF INSERT, BEAM CLAMP, ROD, ETC. MUST BE APPROVED BY STRUCTURAL ENGINEER PER SHOP DRAWINGS

1 TRAPEZE PIPE HANGER (MULTIPLE PIPES) NOT TO SCALE

4 DUCT PENETRATING NON - RATED WALLS

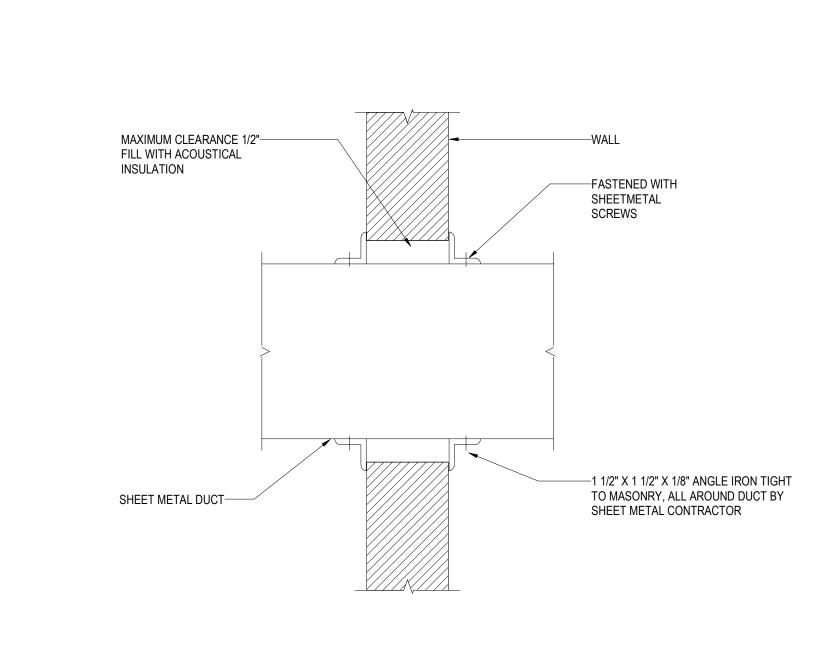

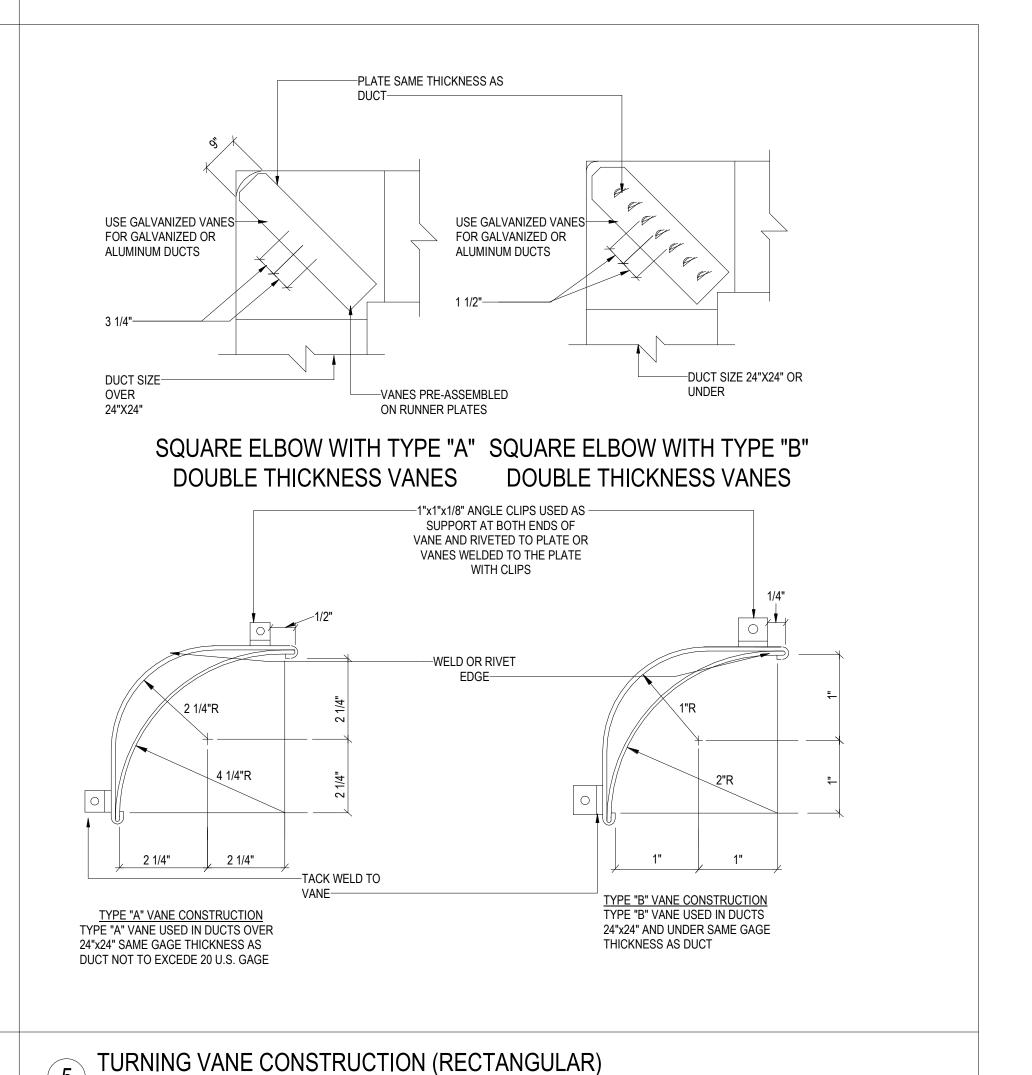

New Windsor, NY 12553 +1 (845) 534-3115 **Design Architect** heneghan peng architects 14-16 Lord Edward Street Dublin, D02 YC63 +353 1 633 9000 **Executive Architect** WXY Architecture + Urban Design 224 Centre Street, 5th Floor New York, NY 10013 +1 (212) 219-1953 Landscape Architect Gustafson Porter + Bowman 1 Cobham Mews London, MW1 9SB +44 020 7284 8950 Reed Hilderbrand LLC 33 Whitney Avenue, 3rd Floor New Haven, CT 06510 +1 (617) 923-2422 Structural & Lighting ARUP 77 Water Street New York, NY 10005 +1 (212) 896-3000 MEPF & IT BuroHappold 100 Broadway #23 New York, NY 10005 +1 (212) 616-0228 Civil VHB 100 Great Oaks Blvd., Suite 118 Albany, NY 12203 +1 (518) 389-3606 **AV & Acoustics** LSTN Consultants 76 Beaver Street, 2nd Floor New York, NY 10005 +1 (347) 788-0810 Facade Front Inc. 100 E. Broadway Street, #501 New York, NY 10002 +1 (212) 242-2220 Key Plan

Owner

Storm King Art Center

1 Museum Road

Description Date 50% Design Development 02/24/20 100% Design Development 05/29/20 50% Construction Documents 11/06/20


Project Storm King Art Center **Pond Pavilion**


NOT FOR CONSTRUCTION **Drawing Title** Mechanical Details

11/06/20 Date Scale Not to Scale Drawing M-P-506 Number ARCH D Sheet Size


	OUT INCOMPRESSIE INSULATING BLOCK AT HANGER	BLE
PIPE DIAMETER	SHIELD LENGT H	SHIELD THICKNESS USSG
UP TO 3"	6"	18

IN	INCOMPRESSIBLE SULATING K AT HANGER	
PIPE DIAMETER	SHIELD LENGT H	SHIELD THICKNESS USSG
UP TO 3"	12"	18

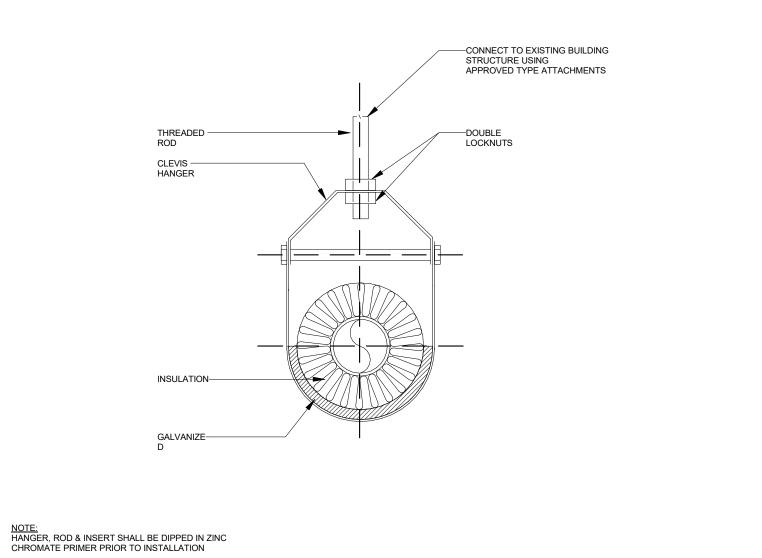

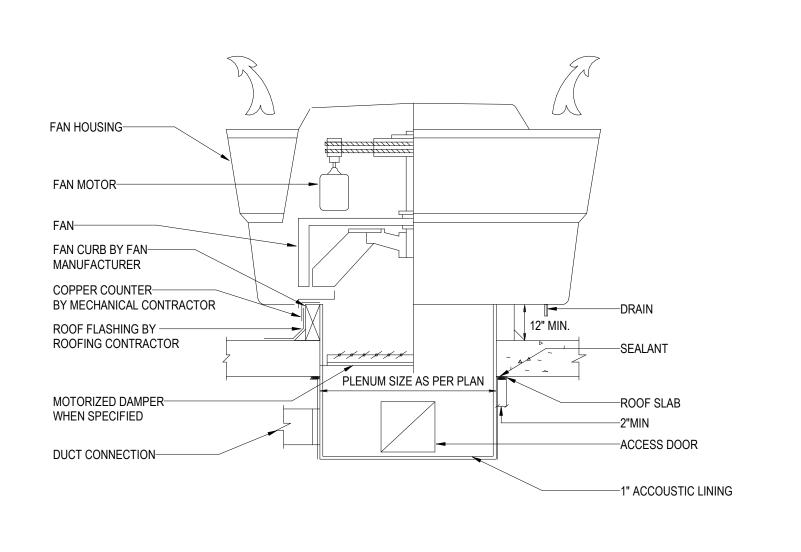

CONDENSATE	PIPE SIZE
EQUIPMENT CAPACITY	MIN. PIPE SIZE
TONS	INCH
UP TO 20	3/4
21-40	1
41-90	1 1/4
91-125	1 1/2
126-250	2

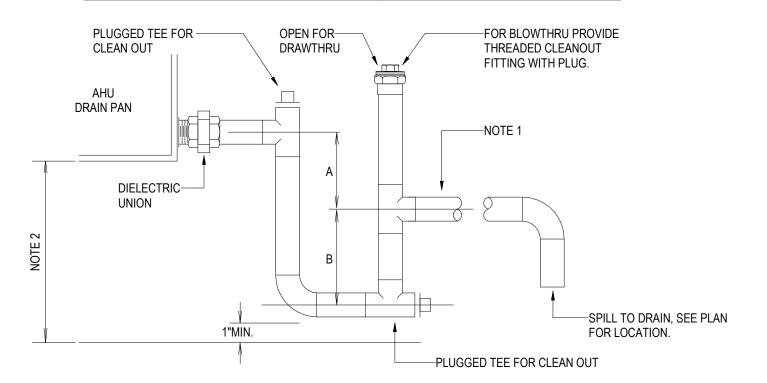

DRAWTHRU:

A = GREATER OF 4" OR 1/2" PLUS AHU TOTAL PRESSURE IN INCHES-WC

BLOWTHRU:

B = GREATER OF 4" OR 1/2" PLUS AHU TOTAL PRESSURE IN INCHES-WC

1. REF. PLAN DWG'S FOR CONDENSATE DRAIN PIPE SIZE, (1"MIN. AT EACH AHU DRAIN CONNECTION POINT). REF. SPECIFICATIONS FOR PIPE AND INSULATION MATERIAL REQUIREMENTS.

2. AHU TO BE ELEVATED ON HOUSEKEEPING PAD OR MOUNTING STRUCTURE AS REQUIRED FOR TRAP HEIGHT ABOVE FLOOR

1 TYPICAL INSULATION OF PIPES SMALLER THAN 3

NOT TO SCALE

ROOF EXHAUST FAN UPBLAST

MECHANICAL UNIT CONDENSATE DRAIN

NOT TO SCALE

Executive Architect WXY Architecture + Urban Design 224 Centre Street, 5th Floor New York, NY 10013 +1 (212) 219-1953

Landscape Architect Gustafson Porter + Bowman 1 Cobham Mews London, MW1 9SB +44 020 7284 8950

Owner

Storm King Art Center 1 Museum Road

+1 (845) 534-3115 **Design Architect**

Dublin, D02 YC63 +353 1 633 9000

New Windsor, NY 12553

heneghan peng architects 14-16 Lord Edward Street

Reed Hilderbrand LLC 33 Whitney Avenue, 3rd Floor New Haven, CT 06510 +1 (617) 923-2422

Structural & Lighting ARUP 77 Water Street

+1 (212) 896-3000 MEPF & IT BuroHappold

New York, NY 10005

100 Broadway #23 New York, NY 10005 +1 (212) 616-0228

Civil VHB

100 Great Oaks Blvd., Suite 118 Albany, NY 12203

+1 (518) 389-3606

AV & Acoustics LSTN Consultants 76 Beaver Street, 2nd Floor New York, NY 10005

+1 (347) 788-0810 Facade

Front Inc. 100 E. Broadway Street, #501 New York, NY 10002 +1 (212) 242-2220

Key Plan


Description Date 50% Design Development 02/24/20 100% Design Development 05/29/20 50% Construction Documents 11/06/20

Project

Storm King Art Center **Pond Pavilion**

NOT FOR CONSTRUCTION **Drawing Title** Mechanical Details

11/06/20 Date Not to Scale M-P-507 Number ARCH D Sheet Size

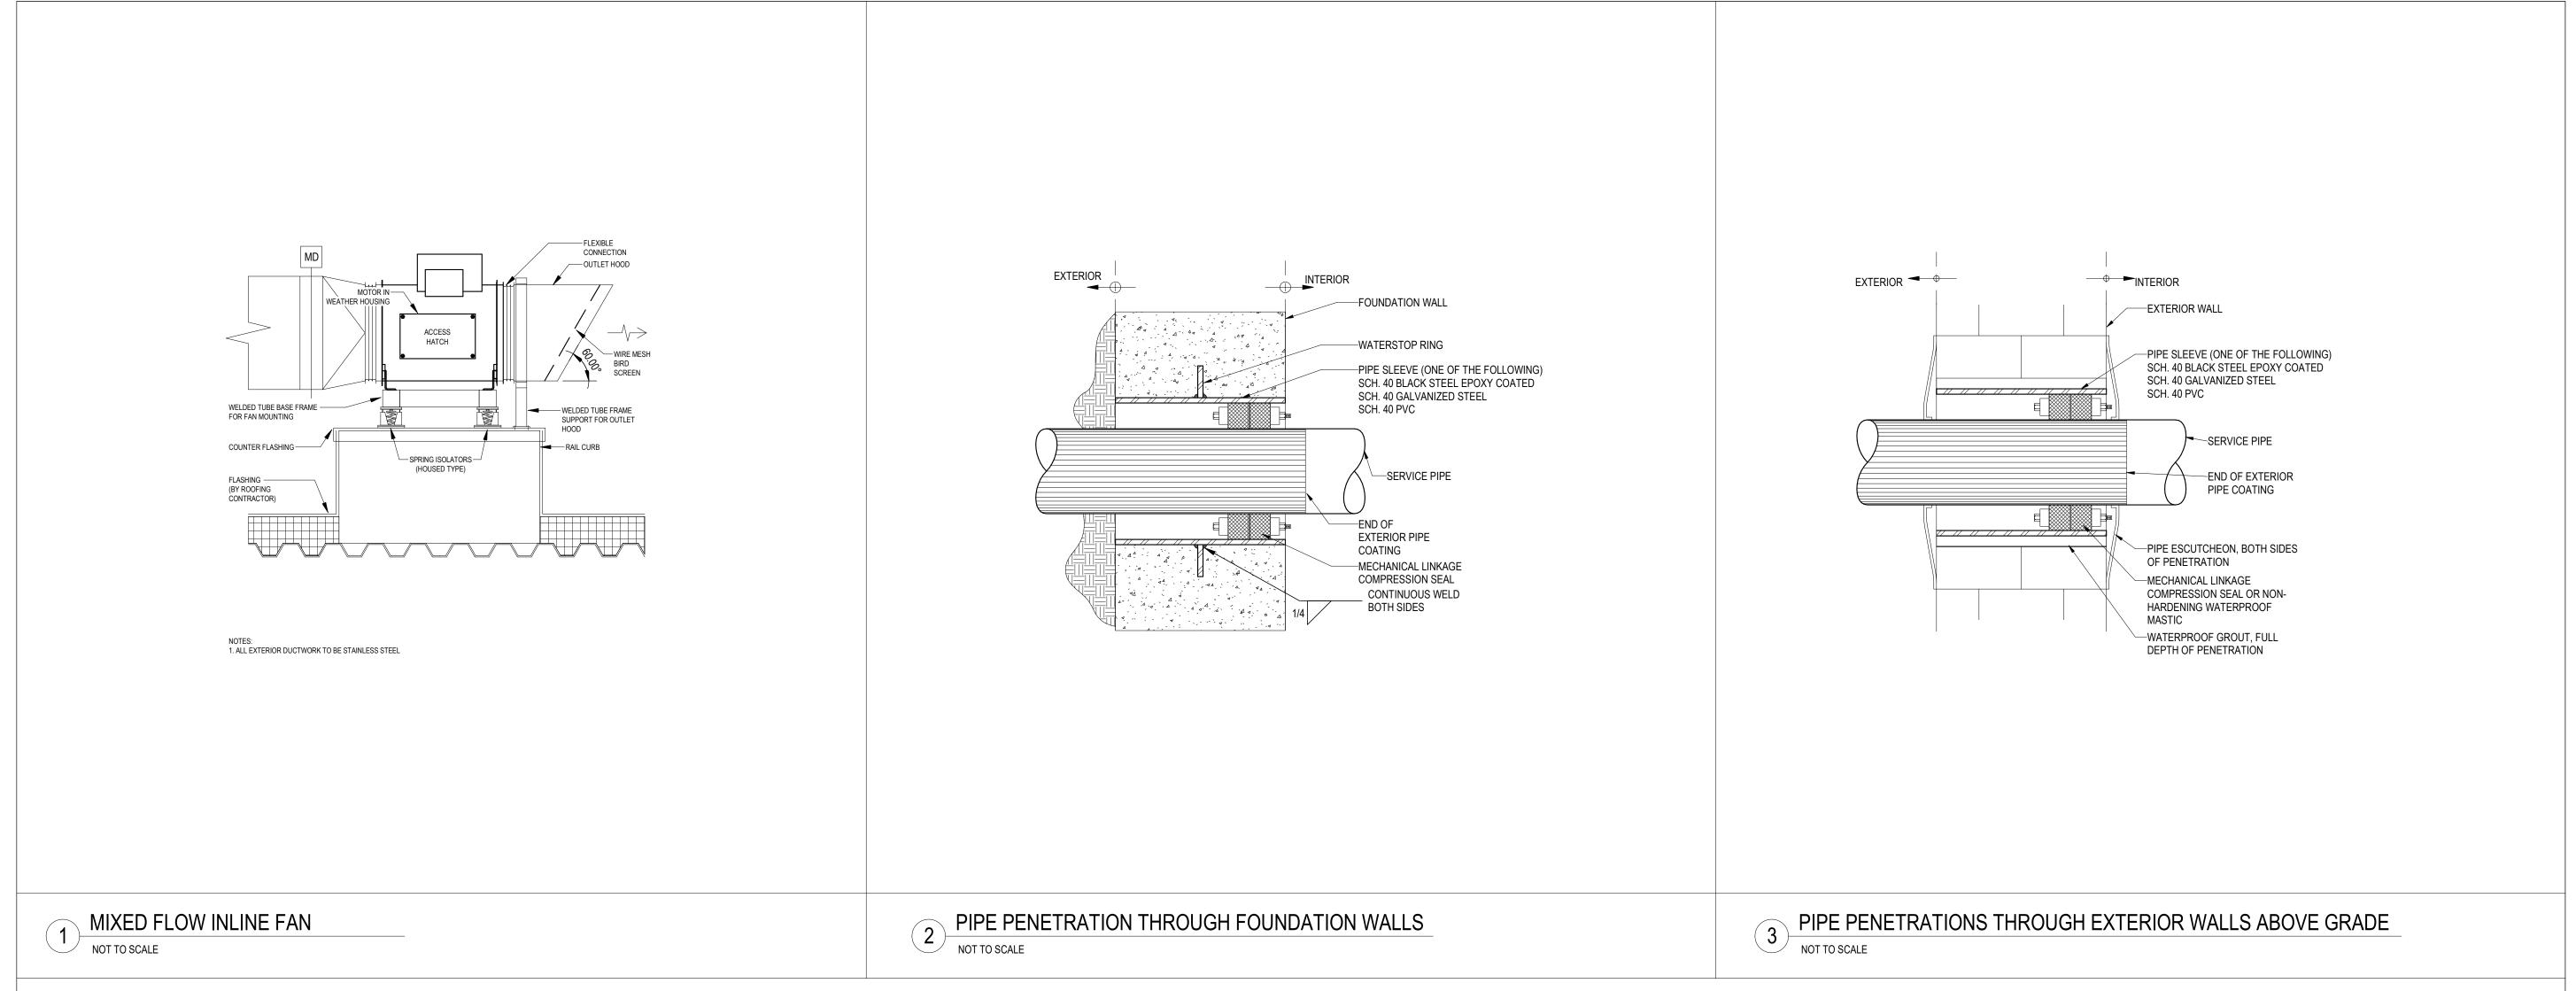

Owner
Storm King Art Center
1 Museum Road
New Windsor, NY 12553
+1 (845) 534-3115

Design Architect
heneghan peng architects
14-16 Lord Edward Street
Dublin, D02 YC63
+353 1 633 9000

Executive Architect
WXY Architecture + Urban Design
224 Centre Street, 5th Floor
New York, NY 10013
+1 (212) 219-1953

Landscape Architect
Gustafson Porter + Bowman
1 Cobham Mews
London, MW1 9SB
+44 020 7284 8950

Reed Hilderbrand LLC 33 Whitney Avenue, 3rd Floor New Haven, CT 06510

+1 (617) 923-2422
Structural & Lighting
ARUP

+1 (212) 896-3000

MEPF & IT

BuroHappold
100 Broadway #23

New York, NY 10005

100 Broadway #23 New York, NY 10005 +1 (212) 616-0228 Civil

77 Water Street

VHB 100 Great Oaks Blvd., Suite 118 Albany, NY 12203

+1 (518) 389-3606

AV & Acoustics

LSTN Consultants
76 Beaver Street, 2nd Floor
New York, NY 10005
+1 (347) 788-0810

Facade Front Inc. 100 E. Broadway Street, #501 New York, NY 10002

Key Plan

+1 (212) 242-2220

DescriptionDate50% Design Development02/24/20100% Design Development05/29/2050% Construction Documents11/06/20

Project

Storm King
Art Center
Pond Pavilion

Sea

NOT FOR CONSTRUCTION
Drawing Title
Mechanical Details

Date 11/06/20

Scale Not to Scale

Drawing Number M-P-508

Sheet Size ARCH D

								M	1 - E	NEF	RGY	REC	M - ENERGY RECOVERY UNIT SCHEDULE																											
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DESIGNATION	SERVICE	LOCATION	SUPPLY AIR QUANTITY (CFM)	EXHAUST AIR QUANTITY (CFM)	SUPPLY AIR QUANTITY ENTERING WHEEL (CFM)	% EFFECTIVENESS WINTER/SUMMER	CFM	EXTERNAL STATIC PRESSURE (IN WG)	HP	CFM	EXTERNAL STATIC PRESSURE (IN WG)	웊	FLA/MOTOR	VOLTAGE	PHASE	FREQ	MCA	SINGLE POINT CONNECTION	APPROXIMATE WEIGHT (LB)	MANUFACTURER	MODEL NUMBER	REMARKS																		
ERV - P-1-1	SEE DRAWINGS	MECH RM	200	200	200	50	200	1	0.5	200	1	0.5		120 V	1	60	18 A	Yes	325	RENEWAIRE	1XINV																			

M - FAN S	CHEDULE	<u> </u>												
				VG)					MOTOR/ELECTRIC	AL DATA				
DESIGNATION	SERVICE	LOCATION	AIR QUANTITY (CFM)	EXTERNAL STATIC PRESSURE (IN WG)	MAX FAN SPEED (RPM)	FAN TYPE	HP	RPM	VOLTAGE	PHASE	FREQUENCY	MANUFACTURER		REMARKS
EF-P-2-1	TRASH	ROOF	50	0.2	1300	CENTRIFUGAL	0.01	1300	115 V	1	60	GREENHECK	G-060-G	

M - ELEC	TRIC DUC	T HEATER	R SCH	EDUL	E				
DESIGNATION DH-P-1-1	SERVICE SEE DRAWINGS	LOCATION MECH RM	₩ 200	a EAT (°F)	70°F)	S CAPACITY (kW)	MANUFACTURER RENEWAIRE	MODEL NUMBER EK	REMARKS

M - UNIT H															
				-M)		FAN		ELECTF	RIC COIL						
DESIGNATION	SERVICE	LOCATION	TYPE	AIR QUANTITY (CI	VOLTAGE	PHASE	FREQUENCY	CAPACITY (MBH)	EAT (°F)	CAPACITY (kW)	MODEL NUMBER	MANUFACTURER	REMARKS		
UH - P-1-1	TRASH RM	TRASH RM	ELECTRIC	250	208 V	3	60	10.3	55 °F	3	ASHU0383CTCHAR	OXFORD			

M - ELEC	TRIC BAS	EBOARD S	SCHEDULI	E										
				(Mc			ELECTRICAL							
DESIGNATION	SERVICE	LOCATION	TYPE	MAXIMUM FACE VELOCITY (FI	kW	VOLTAGE	# OF POLES	FREQUENCY	# OF CONTROL STEPS	EB LENGTH	CONTROL BY	MANUFACTURER		REMARKS
l EB - P-1-1	CUSTODIAN	CUSTODIAN	ELECTRIC		0.75	208 V	3			2' - 4"	THERMOSTAT	JAGA	TEMPO	

M - DIFFU	JSER AND	GRILLE S	CHE	DULE	=					
DESIGNATION	USAGE	MAX CFM/FT	MAX NC	FACE SIZE	DIFFUSER HEIGHT (IN)	SLOT SIZE	LENGTH (IN)	MANUFACTURER	MODEL NUMBER	REMARKS
LD-1	SUPPLY/RETURN	170 CFM	25	-	6"	-	-	PRICE	LBP CORE 15A	

+1 (845) 534-3115

Design Architect
heneghan peng architects
14-16 Lord Edward Street

Dublin, D02 YC63 +353 1 633 9000 **Executive Architect** WXY Architecture + Urban Design 224 Centre Street, 5th Floor

New York, NY 10013 +1 (212) 219-1953 Landscape Architect Gustafson Porter + Bowman 1 Cobham Mews London, MW1 9SB +44 020 7284 8950

Reed Hilderbrand LLC 33 Whitney Avenue, 3rd Floor New Haven, CT 06510 +1 (617) 923-2422

+1 (617) 923-2422
Structural & Lighting
ARUP

77 Water Street New York, NY 10005 +1 (212) 896-3000 MEPF & IT

BuroHappold 100 Broadway #23 New York, NY 10005 +1 (212) 616-0228

Civil VHB

100 Great Oaks Blvd., Suite 118

Albany, NY 12203 +1 (518) 389-3606

AV & Acoustics
LSTN Consultants
76 Beaver Street, 2nd Floor

New York, NY 10005 +1 (347) 788-0810

Facade Front Inc. 100 E. Broadway Street, #501 New York, NY 10002

+1 (212) 242-2220 Key Plan

DescriptionDate50% Design Development02/24/20100% Design Development05/29/2050% Construction Documents11/06/20

Project

Storm King
Art Center
Pond Pavilion

Sea


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Drawing Title

Mechanical

Schedules

Date	11/06/20
Scale	Not to Scale
Drawing Number	M-P-601
Sheet Size	ARCH D

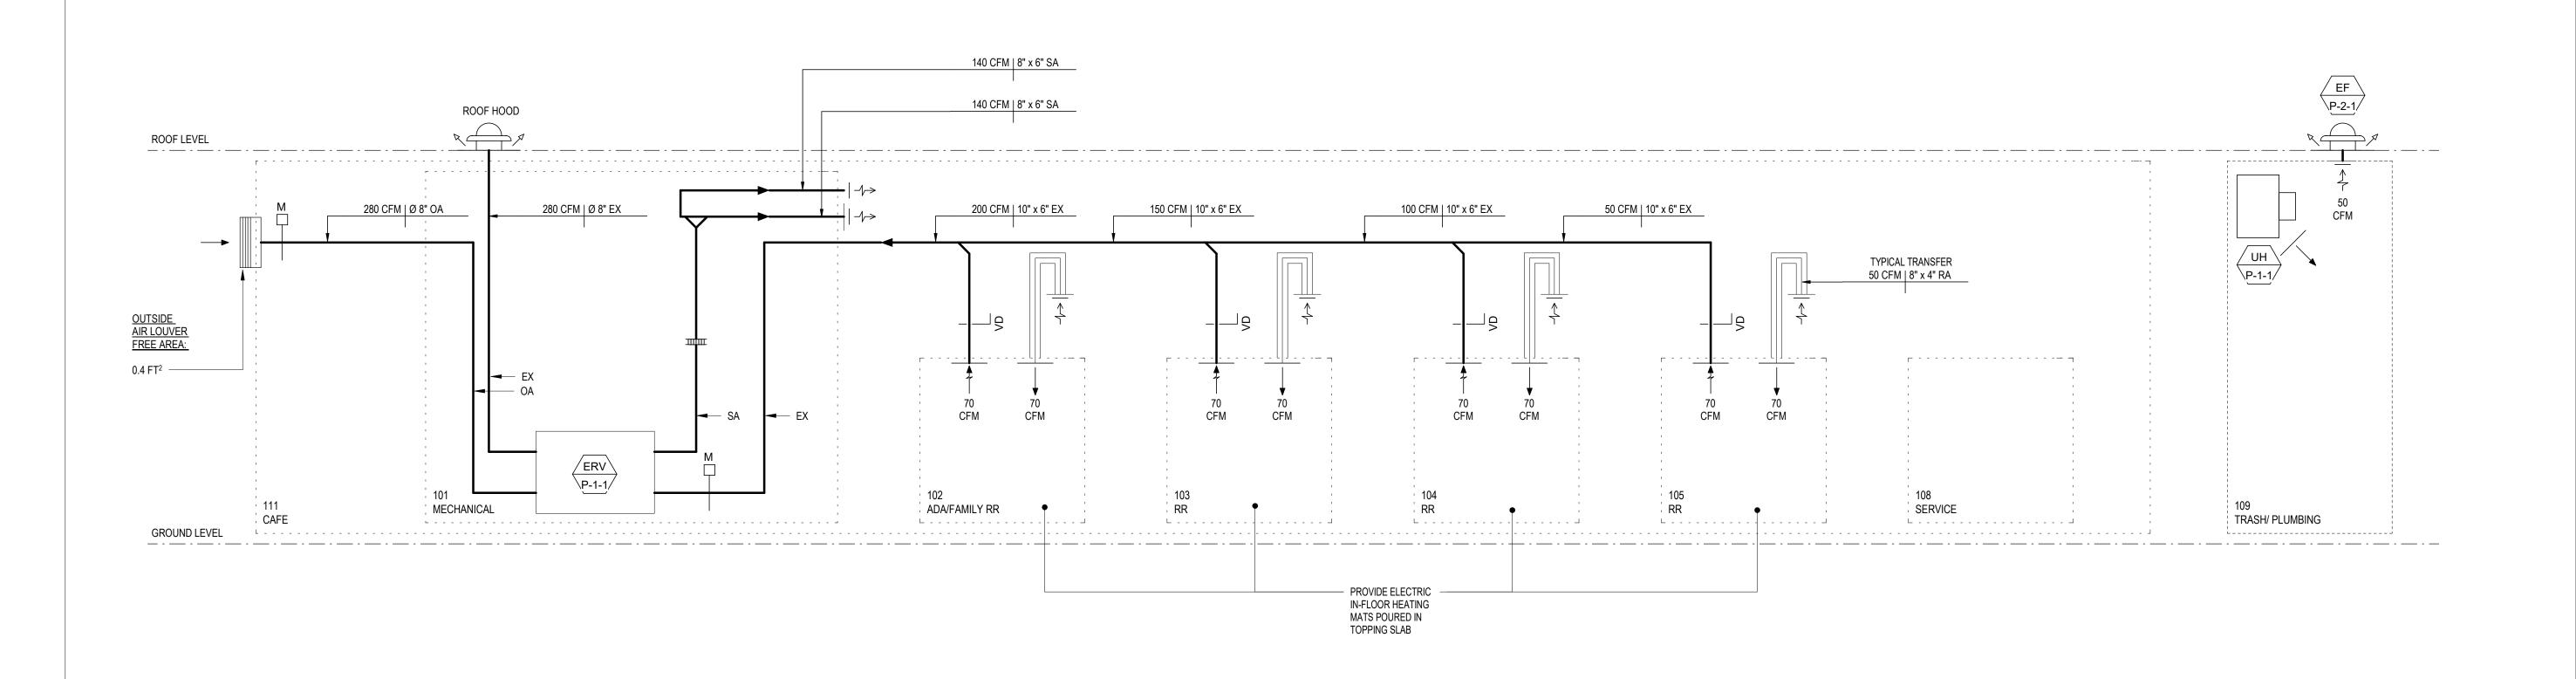

Owner
Storm King Art Center
1 Museum Road
New Windsor, NY 12553
+1 (845) 534-3115

Design Architect

heneghan peng architects 14-16 Lord Edward Street Dublin, D02 YC63 +353 1 633 9000

Executive Architect
WXY Architecture + Urban Design
224 Centre Street, 5th Floor
New York, NY 10013
+1 (212) 219-1953

Landscape Architect
Gustafson Porter + Bowman
1 Cobham Mews
London, MW1 9SB
+44 020 7284 8950

Reed Hilderbrand LLC 33 Whitney Avenue, 3rd Floor New Haven, CT 06510 +1 (617) 923-2422

Structural & Lighting
ARUP

New York, NY 10005 +1 (212) 896-3000 **MEPF & IT**

77 Water Street

BuroHappold 100 Broadway #23 New York, NY 10005 +1 (212) 616-0228

Civil VHB

100 Great Oaks Blvd., Suite 118 Albany, NY 12203

+1 (518) 389-3606

AV & Acoustics
LSTN Consultants
76 Beaver Street, 2nd Floor
New York, NY 10005

New York, NY 10005 +1 (347) 788-0810 Facade

Front Inc. 100 E. Broadway Street, #501 New York NY 10002

New York, NY 10002 +1 (212) 242-2220

Key Plan

Description Date
50% Design Development 02/24/20
100% Design Development 05/29/20
50% Construction Documents 11/06/20


Storm King Art Center

Pond Pavilion

Se

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Drawing Title
Duct Riser

Date	11/06/20
Scale	12" = 1'-0"
Drawing Number	M-P-701
Sheet Size	ARCH D

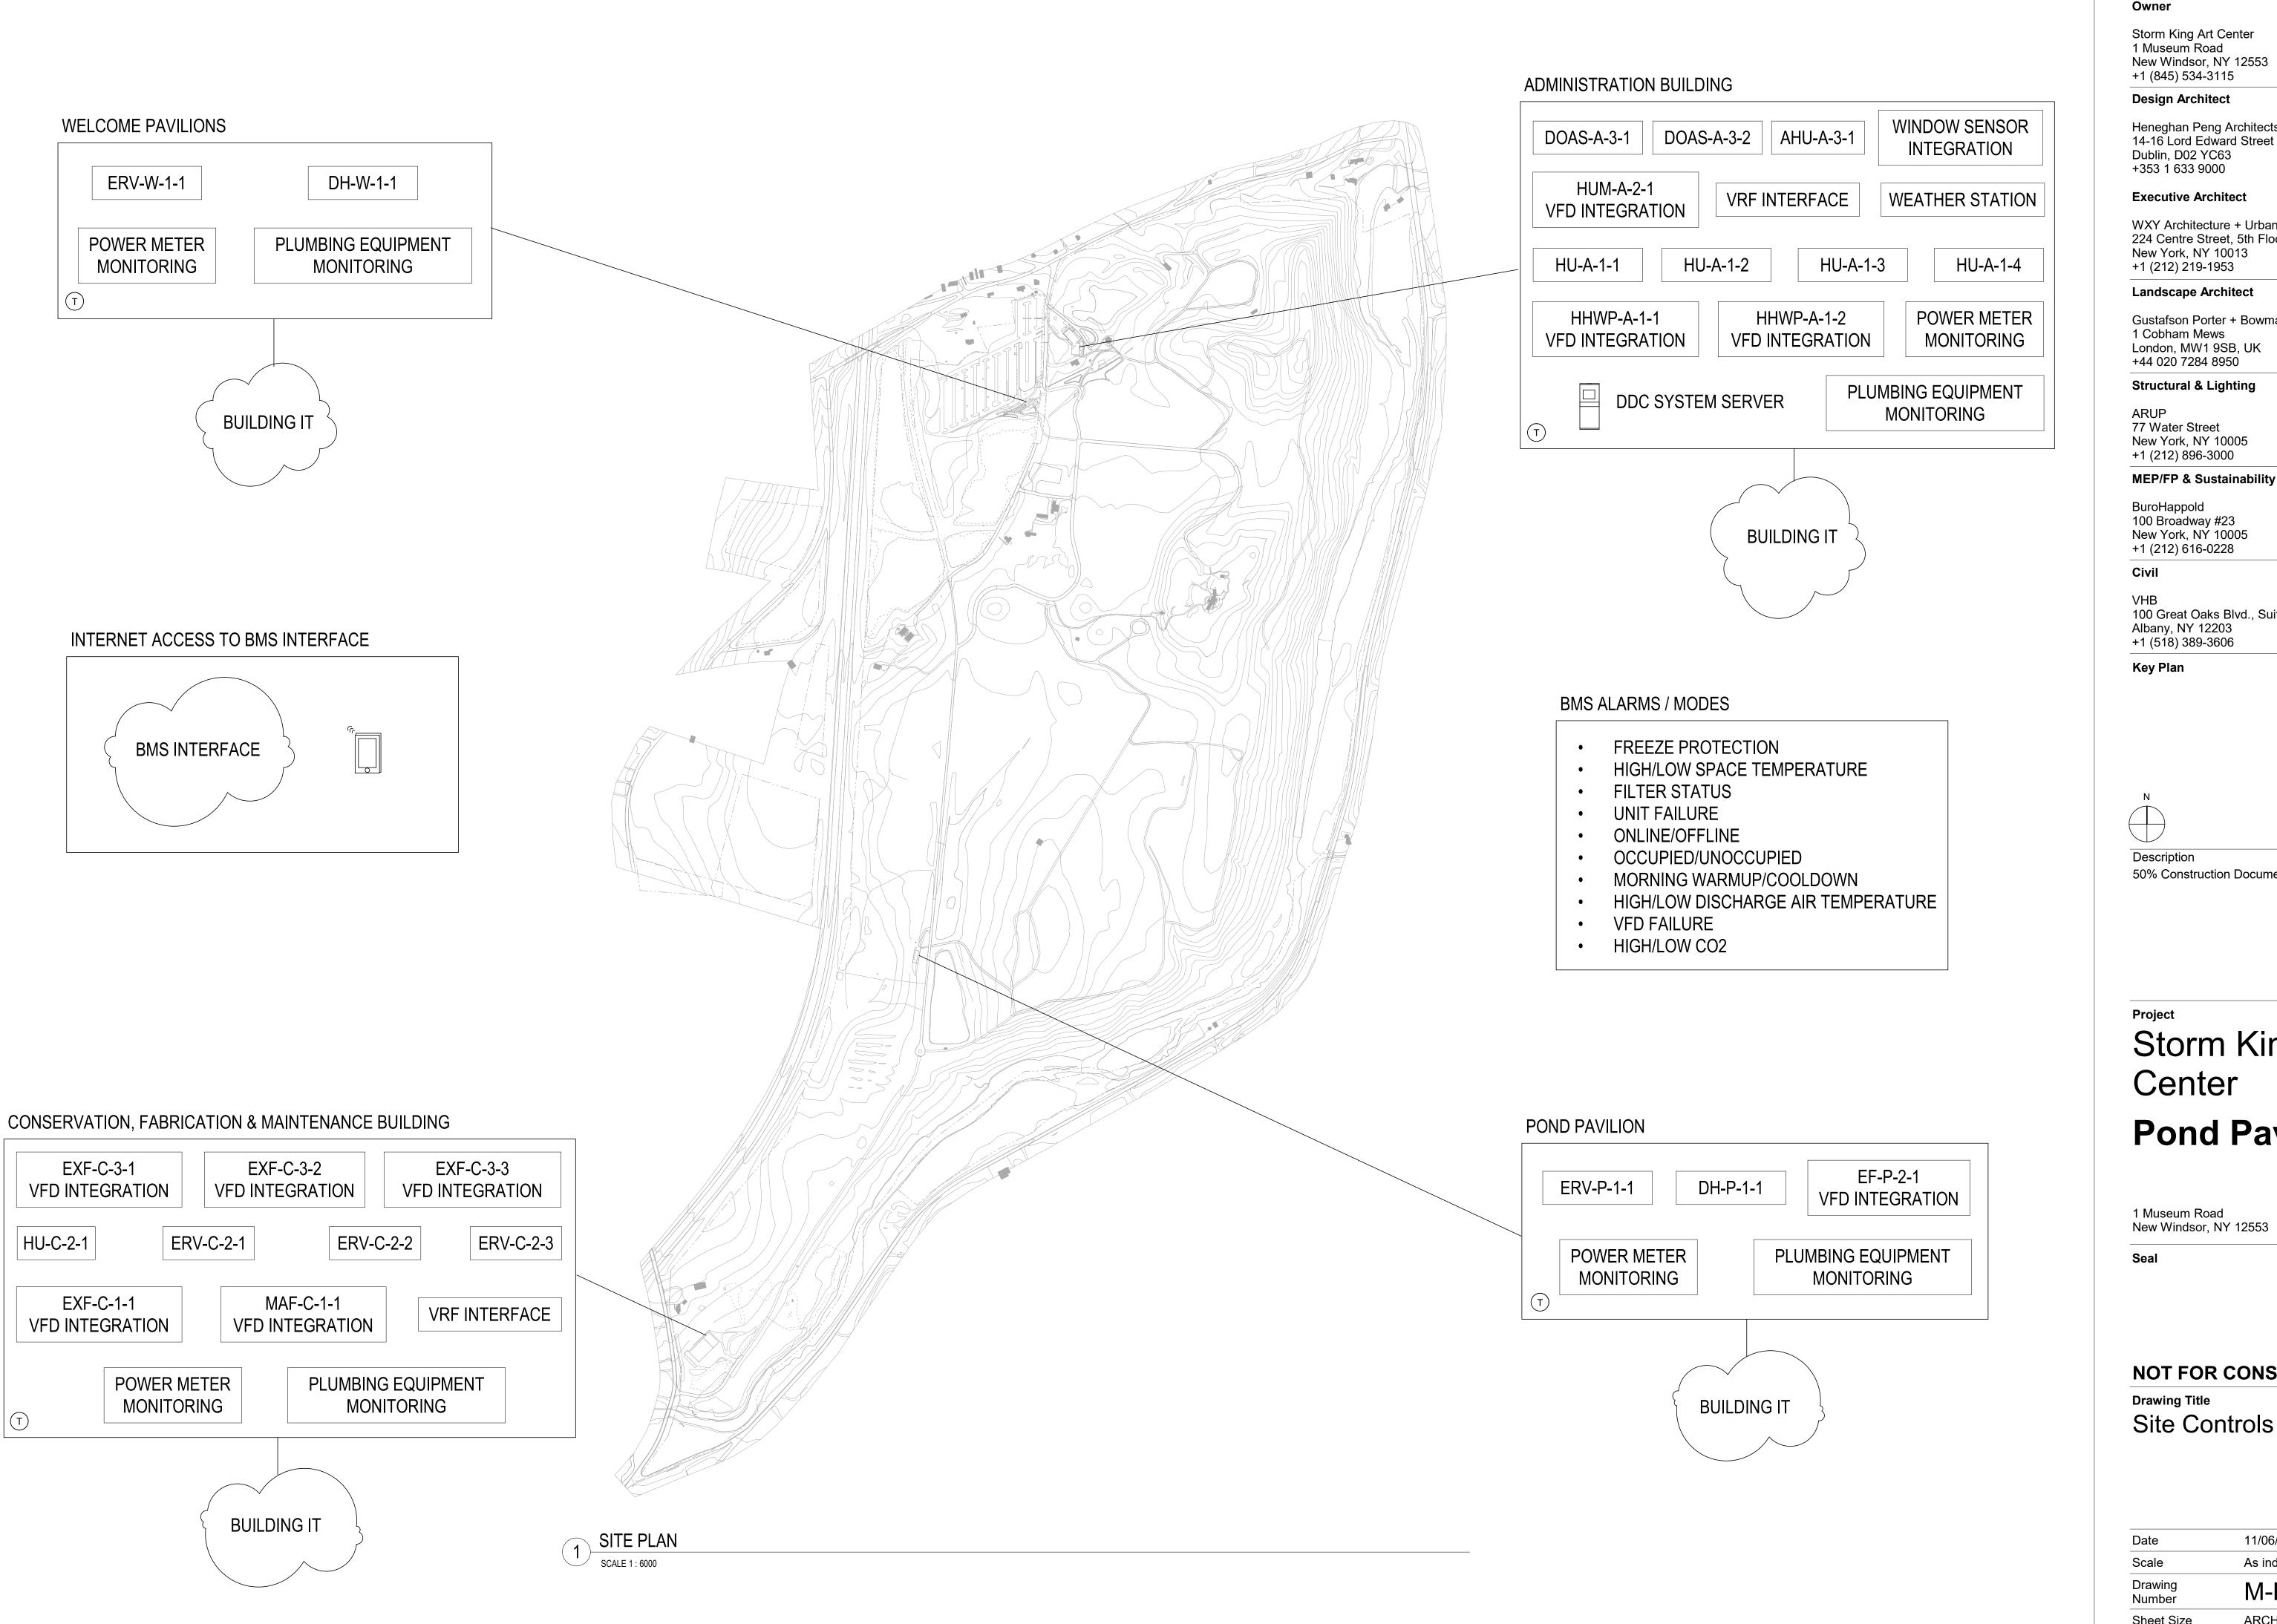

Owner

Storm King Art Center 1 Museum Road New Windsor, NY 12553 +1 (845) 534-3115

Design Architect

Heneghan Peng Architects 14-16 Lord Edward Street Dublin, D02 YC63 +353 1 633 9000

Executive Architect

WXY Architecture + Urban Design 224 Centre Street, 5th Floor New York, NY 10013 +1 (212) 219-1953

Landscape Architect

Gustafson Porter + Bowman 1 Cobham Mews London, MW1 9SB, UK +44 020 7284 8950

Structural & Lighting

ARUP 77 Water Street New York, NY 10005

+1 (212) 896-3000

BuroHappold 100 Broadway #23 New York, NY 10005 +1 (212) 616-0228

Civil

100 Great Oaks Blvd., Suite 118 Albany, NY 12203

Key Plan



Description

50% Construction Documents

Project

Storm King Art Center **Pond Pavilion**

1 Museum Road New Windsor, NY 12553

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Drawing Title Site Controls Plan

Date	11/06/20
Scale	As indicated
Drawing Number	M-P-900
Sheet Size	ARCH D

ABBF	REVIATIONS
AD	AREA DRAIN
BFP	BACKFLOW PREVENTOR
ВТ	BATHTUB
CI	CAST IRON
CL	CENTER LINE
CLG	CEILING
CO	CLEANOUT
CODP	CLEANOUT DECK PLATE
COMP	CLEAN OUT WALL PLATE
COVP	COLUMN
CP	CONTROL PANEL
CW	COLD WATER
DCV	DOUBLE CHECK VALVE
DCDA	DOUBLE CHECK DETECTOR ASSEMBLY
DF	DRINKING FOUNTAIN
DFU	DRAINAGE FIXTURE UNIT
DIA	DIAMETER
DN	PIPE DOWN THRU FLOOR
DR	DRAIN
DW	DISH WASHER
DWG	DRAWING
EL	ELEVATION
ELEC	ELECTRIC
ETBR	EXISTING TO BE REMOVED
ETR	EXISTING TO REMAIN
EWC	ELECTRIC WATER COOLER
EWH	ELECTRIC WATER HEATER
EXIST	EXISTING
F	FIRE SERVICE
FAI	FRESH AIR INTAKE
FD	FLOOR DRAIN
FFD	FUNNEL FLOOR DRAIN
FL	FLOOR
FU	FIXTURE UNIT
FS	FLOOR SINK
G	GAS
GAL	GALLON
GC	GENERAL CONTRACTOR
GI	GREASE INTERCEPTOR
GM	GAS METER
GV	GATE VALVE
GW	GRAY WASTE
HB	HOSE BIB
HC HVAC	HANDICAPPED HEATING VENTUATION & AIR CONDITIONING
HW	HEATING, VENTILATION & AIR CONDITIONING HOT WATER
	-
HWH	HOT WATER HEATER HOT WATER RETURN
IG	IRRIGATION PIPING
IE	INVERT ELEVATION
IW	INDIRECT WASTE
JS	JANITOR SINK

	KITCHEN SINK
	LEADER
	LAVATORY
	LOW PRESSURE
	MAXIMUM
	MINIMUM
	MASTER GAS CONTRAL VALVE
	METER INLET CONTROL VALVE
	MOP SINK
	NON-FREEZE WALL HYDRANT
	NOT IN CONTRACT
	NOT TO SCALE
	OVERFLOW DRAIN
	OUTSIDE SCREW & YOKE
	PRESSURE GAUGE
	PLUMBING
	PLUGGED OUTLET
	POINT OF ENTRY
	PANTRY SINK
	ROOF DRAIN
	REFRIGERATOR
	REDUCED PRESSURE ZONE
	ROOM
	SOIL
	SHOCK OBSORBER
N	SANITARY
	STORM DRAIN
	SEWAGE EJECTOR
	SUMP PUMP
	SHOWER
	SPECIFICATIONS
_	SQUARE FEET
	TRENCH DRAIN
	THERMOSTATIC MIXING VALVE
	TRAP
	TYPICAL
	URINAL
	VENT
- 1	
_	VENT THROUGH ROOF
	VACUUM BREAKER
	VACUUM BREAKER WASTE
	VACUUM BREAKER WASTE WATER CLOSET
	VACUUM BREAKER WASTE WATER CLOSET WALL HUNG
	VACUUM BREAKER WASTE WATER CLOSET WALL HUNG WATER HAMMER ARRESTER
	VACUUM BREAKER WASTE WATER CLOSET WALL HUNG

PLUMBIN	IG SYMBOLS
SYMBOL	DESCRIPTION
SAN	PROPOSED
SAN	SANITARY PIPING BELOW GRADE EXISTING
SAN	PROPOSED CANUTARY WASTE (O.O.D.W.)
SAN	SANITARY WASTE (S OR W) EXISTING
▼ ST ▼ SD	PROPOSED
ST SD	STORM DRAINAGE (ST) EXISTING
▼ OD	PROPOSED
OD	OVERFLOW STORM DRAINAGE EXISTING
	PROPOSED
<u> </u>	EXISTING VENT
	PROPOSED
CW	DOMESTIC COLD WATER EXISTING
HW	PROPOSED
_ 	DOMESTIC HOT WATER EXISTING
HWR	PROPOSED
HWR	DOMESTIC HOT WATER RETURN EXISTING
<u> </u>	PROPOSED
<u>√</u> G	NATURAL GAS EXISTING
GW	RAINWATER REUSE
SED	
<u> </u>	SEWAGE EJECTOR DISCHARGE
PD	PUMP DISCHARGE PIPING
GRW	GRAY WATER (LA ONLY)
GW	GREASE WASTE
SCW	SOFTENED WATER
PW	PURIFIED WATER
CA	
OX	COMPRESSED AIR
	OXYGEN
N N	NITROGEN
LV	LAB VACUUM
√ LA	LAB AIR
LG	LAB GAS
TW	TEPID WATER
<u>'</u>	DEMOVE EVICTING DIDING
-XX-	REMOVE EXISTING PIPING
	PIPING WITH ELECTRIC TRACE HEATING
\rightarrow	PIPING INTERRUPTED OR TO BE CONTINUED
—	CAP OR END OF PIPE
P400 xxx	SECTION SHEET No.
P	SECTION NUMBER SYSTEM DESCRIPTION PLUMBING RISER
# ST	SYSTEM DESCRIPTION
#	RISER NUMBER STORM RISER
G #	SYSTEM DESCRIPTION RISER NUMBER GAS RISER
P #	EQUIPMENT DESCRIPTION EQUIPMENT REFERENCE
•	POINT OF DISCONNECT
•	CONNECT NEW TO EXISTING
	HOT WATER BALANCING ASSEMBLY
 1	CLEANOUT
	CLEANOUT DECK PLATE
	DRAIN
○ ○ ○	HOUSE TRAP
	P-TRAP
	SHOCK ABSORBER
TP	TRAP PRIMER
	ARROW INDICATES DIRECTION OF FLOW
-0	ELBOW UP OR RISE
<i>→</i>	ELBOW DN OR DROP

SYMBOL	DESCRIPTION
-	BOTTOM CONNECTION
— — Р—	TOP CONNECTION
<u>'</u> ⊢	UNION SCREWED
	PIPE SLEEVE
	WATERPROOF PIPE SLEEVE
-0	NON FREEZE WALL HYDRANT
<i>⊸</i> >`	VALVE ON PIPE RISE
-KNK-	BACK FLOW PREVENTER
	DOUBLE CHECK DETECTOR ASSEMBLY (FIRE PROTECTION)
	REDUCED PRESSURE ZONE VALVE ASSEMBLY (FIRE PROTECTION)
	DOUBLE CHECK ASSEMBLY (FIRE PROTECTION)
	CHECK VALVE
	GATE VALVE
—ф—	BALL VALVE
<u> </u>	GAS VALVE
	GLOBE VALVE
	PRESSURE REDUCING VALVE
- <u>\$</u>	TEMPERATURE & PRESSURE RELIEF VALVE
	PRESSURE REGULATING VALVE
	THERMOSTATIC MIXING VALVE
7/24	VALVED CAPPED OUTLET
S	CURB VALVE
<u>—————————————————————————————————————</u>	SOLENOID VALVE
	OUTSIDE STEM AND YOKE VALVE OUTSIDE STEM AND YOKE VALVE W/ TAMPER
	SWITCH
	STRAINER
P	PRESSURE GAUGE
<u></u>	HOSE BIB
	VACUUM BREAKER
	THERMOMETER
—	PUMP
-0-	CIRCULATOR PUMP
5	SCHEMATIC PUMP
	FLOOR SINK
J L	VENT THRU ROOF
[M]	METER
[F]	FILTER
	FAI
	VENT INCREASER

	Owner Storm King Art Center 1 Museum Road New Windsor, NY 12553 +1 (845) 534-3115 Design Architect	
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	Reed Hilderbrand LLC 33 Whitney Avenue, 3rd Floor New Haven, CT 06510 +1 (617) 923-2422	
-	Structural & Lighting ARUP	
	77 Water Street New York, NY 10005 +1 (212) 896-3000	
	MEPF & IT BuroHappold 100 Broadway #23 New York, NY 10005 +1 (212) 616-0228	
	Civil VHB 100 Great Oaks Blvd., Suite 118 Albany, NY 12203 +1 (518) 389-3606	
	AV & Acoustics LSTN Consultants 76 Beaver Street, 2nd Floor New York, NY 10005 +1 (347) 788-0810	
	Facade Front Inc. 100 E. Broadway Street, #501 New York, NY 10002 +1 (212) 242-2220	
-	Key Plan	
	Description	Date
	50% Design Development	02/24/2
	100% Design Development50% Construction Documents	05/29/2 11/06/2

Description	Date
50% Design Development	02/24/20
100% Design Development	05/29/20
50% Construction Documents	11/06/20

Storm King Art Center **Pond Pavilion**

NOT FOR CONSTRUCTION Abbreviations,
Symbols, and
Legends

Date	11/06/20
Scale	Not to Scale
Drawing Number	P-P-001
Sheet Size	ARCH D

- CONTRACTOR SHALL VERIFY ALL DIMENSIONS AND JOB CONDITIONS AND SHALL REPORT TO ENGINEER ANY DISCREPANCIES OR OMISSIONS THAT WOULD INTERFERE WITH SATISFACTORY COMPLETION OF THE WORK.
- CONTRACTOR SHALL VISIT THE JOB SITE AND THOROUGHLY FAMILIARIZE THEMSELVES WITH ALL
- ALL WORK SHALL BE PERFORMED BY A LICENSED PLUMBING CONTRACTOR IN A FIRST CLASS WORKPERSON LIKE MANNER. THE COMPLETED SYSTEM SHALL BE FULLY OPERATIVE AND
- DESIGNATED TIMES UNDER BUILDING MANAGER'S SUPERVISION AND ONLY WITH THEIR
- WITH ARCHITECTURAL LAYOUTS, INCLUDING CEILING HEIGHTS.

- CONTRACTOR SHALL CARRY AND DOCUMENT LIABILITY, ACCIDENT AND PROPERTY DAMAGE INSURANCE AS REQUIRED BY COOPERATIVE CORPORATION AND OBSERVE THEIR PERMITTED
- CONTRACTOR SHALL EXERCISE EXTREME CARE IN PROTECTING AREAS ADJACENT TO CONSTRUCTION AREAS, SHALL FULLY PROTECT THEM FROM ANY DAMAGE RESULTING FROM CONTRACTOR'S WORKPERSONS, SUBCONTRACTORS OR AGENTS, AND SHALL BE RESPONSIBLE
- ALL DIMENSIONS GIVEN ARE FINISH DIMENSIONS UNLESS OTHERWISE STATED.
- REFER TO ARCHITECTURAL DRAWINGS FOR DIMENSIONS.UNLESS SPECIFICALLY STATED OTHERWISE, CONTRACTOR SHALL FURNISH ALL LABOR, MATERIALS, APPURTENANCES, EQUIPMENT AND SERVICES TO COMPLETE ALL WORK AS INDICATED ON DRAWINGS AND/OR SPECIFIED ON NOTES.
- DIRECTIONS WITH APPLICABLE CODES, INSTRUCTIONS AND RECOMMENDATIONS FOR ALL MATERIALS AND PROCESSES USED IN THIS CONTRACT. PROVIDE ALL FITTINGS, TRANSITIONS, VALVES, AND OTHER DEVICES REQUIRED FOR A COMPLETE WORKABLE INSTALLATION.
- UPON COMPLETION OF THE WORK, COMPLETELY CLEAN THE CONSTRUCTION AREA SUITABLE FOR THE OWNER'S USE, INCLUDING REMOVAL OF ALL LABELS (AFTER ARCHITECT'S INSPECTION), CLEANING OF ALL THE EQUIPMENT, CONSTRUCTION WORK, WINDOWS AND OTHER WORK, NEW AND OLD, IN THAT CONSTRUCTION AREA. MAINTENANCE MANUAL SHALL BE PROVIDED TO THE
- BUILDING DEPARTMENT APPROVED PLANS SHALL BE TURNED OVER TO OWNER AT THE COMPLETION OF THE JOB.
- STEEL WITH CHROME PLATED FINISH.
- YEAR, STARTING FROM DATE OF FINAL COMPLETION OF ALL WORK.
- PLUMBING CONTRACTOR SHALL OBTAIN THE BUILDINGS RULES AND REGULATIONS PRIOR TO BID
- ALL FIXTURES MUST BE PROVIDED WITH READILY ACCESSIBLE STOPS AND APPROPRIATELY MARKED ACCESS PANELS. COORDINATE LOCATIONS WITH GENERAL CONTRACTOR PRIOR TO
- PROVIDE ACCESS DOORS FOR SHUTOFF VALVES, SHOCK ABSORBERS, HOT WATER RETURN
- 28. CONTRACTOR TO VERIFY SYSTEM WORKING PRESSURE AND PROVIDE PRESSURE REDUCING

PLUMBING NOTES:

- EXISTING CONDITIONS PRIOR TO THE BEGINNING OF CONSTRUCTION.
- NOTIFY BUILDING MANAGER AT LEAST 48 HOURS BEFORE NEW WORK OR BEFORE SHUT DOWN OF EXISTING SERVICES. RISER SHUT DOWNS SHALL BE PERFORMED AT TENANT'S COST. AT
- CONTRACTOR SHALL BE RESPONSIBLE FOR ARRANGING WITH BUILDING MANAGEMENT FOR HANDLING MATERIALS, AS WELL AS FOR ALLOWABLE WORKING HOURS AND DELIVERIES.
- PLUMBING CONTRACTOR SHALL COORDINATE ALL WORK WITH RESPECT TO ALL OTHER TRADES, INCLUDING STRUCTURE AND CEILING HEIGHTS. CONTRACTOR SHALL COORDINATE ALL WORK
- CONTRACTOR SHALL SUBMIT ALL SHOP DRAWINGS AND MANUFACTURERS' CUTS AND SAMPLES TO ARCHITECT PRIOR TO COMMENCEMENT OF SUCH WORK.
- CONTRACT DRAWINGS ARE NOT TO BE SCALED.
- CONTRACTOR SHALL COMPLY WITH ALL NEW YORK STATE AND LOCAL BUILDING DEPARTMENT AND REGULATORY AGENCIES AND CODE REQUIREMENTS. BE RESPONSIBLE FOR SECURING ALL NECESSARY PERMITS AND APPROVALS OF ALL TRADES.
- FOR REPAIRING, CLEANING OR REPLACING ANY SUCH DAMAGE.
- UNLESS SPECIFICALLY STATED OTHERWISE, CONTRACTOR SHALL FOLLOW MANUFACTURERS'
- AT THE FINAL COMPLETION OF THE JOB, CONTRACTOR SHALL SUBMIT TO THE OWNER AND TO ENGINEER A NOTARIZED AFFIDAVIT STATING COMPLIANCE WITH ALL PROVISIONS OF THIS CONTRACT, INCLUDING ALL NOTES, EXCEPT FOR THOSE CHANGES SPECIFICALLY APPROVED IN WRITING BY THE ARCHITECT.
- VACUUM BREAKER AND RELATED PIPING SHALL BE INSTALLED BEHIND WALL; PROVIDE AN ACCESS PANEL TO THE VACUUM BREAKER. ALL EXPOSED PIPING AT THE PANTRY SHALL BE
- CONTRACTOR SHALL GUARANTEE ALL WORK PERFORMED UNDER THIS CONTRACT FOR ONE
- PROVIDE CLEANOUTS FOR CHANGES IN DIRECTION FOR ALL SANITARY PIPING.
- CONTRACTOR SHALL COORDINATE ALL FLOOR CORING SLEEVES AND FLOOR OPENINGS WITH STRUCTURAL DRAWINGS.
- ALL PIPING PENETRATIONS THROUGH WALLS OR CEILINGS SHALL BE PROVIDED WITH APPROPRIATE FIRE RETARDANT SEALANT AND ESCUTCHEONS.
- AND SHALL MEET ALL REQUIREMENTS. NO EXTRA MONEY WILL BE BE AWARDED FOR ANY WORK PERFORMED AND MATERIAL PURCHASED THAT DOES NOT MEET THE REQUIREMENTS.
- PLATFORMS, CURBS, AND FLASHINGS FOR PLUMBING EQUIPMENT SHALL BE AS INDICATED ON THE STRUCTURAL AND ARCHITECTURAL PLANS, UNLESS NOTED OTHERWISE. COORDINATE EXACT SIZES OF REQUIRED OPENINGS AND SUPPORTS FOR FURNISHED EQUIPMENT.
- PROVIDE DRAIN DRIP PANS UNDER ALL PLUMBING DRAINAGE PIPING TO BE INSTALLED WITHIN THE ELECTRICAL AND TELEPHONE EQUIPMENT, KITCHEN, PANTRY OR FOOD PREPARATION AND DINING ROOM CEILINGS. PROVIDE TELLTALE DRAINAGE PIPE AND SPILL OVER CLOSET FLOOR DRAIN OR SERVICE SINK.
- BALANCING RIGS, TRAP PRIMERS AND CLEANOUTS.
- VALVES WHERE APPLICABLE.
- 29. CONTRACTOR TO PROVIDE SHOCK ABSORBERS PRIOR TO ALL QUICK CLOSING VALVES.

Storm King Art Center 1 Museum Road

New Windsor, NY 12553 +1 (845) 534-3115

Design Architect

heneghan peng architects 14-16 Lord Edward Street Dublin, D02 YC63 +353 1 633 9000

Executive Architect WXY Architecture + Urban Design

224 Centre Street, 5th Floor New York, NY 10013 +1 (212) 219-1953

Landscape Architect

Gustafson Porter + Bowman 1 Cobham Mews London, MW1 9SB +44 020 7284 8950

Reed Hilderbrand LLC 33 Whitney Avenue, 3rd Floor New Haven, CT 06510

+1 (617) 923-2422 **Structural & Lighting**

ARUP 77 Water Street New York, NY 10005

+1 (212) 896-3000

MEPF & IT BuroHappold 100 Broadway #23

New York, NY 10005 +1 (212) 616-0228 Civil

VHB

100 Great Oaks Blvd., Suite 118 Albany, NY 12203

+1 (518) 389-3606 **AV & Acoustics**

LSTN Consultants 76 Beaver Street, 2nd Floor New York, NY 10005

+1 (347) 788-0810

Facade Front Inc.

100 E. Broadway Street, #501 New York, NY 10002 +1 (212) 242-2220

Key Plan


Date Description 02/24/20 50% Design Development 100% Design Development 05/29/20 50% Construction Documents 11/06/20

Project

Storm King Art Center Pond Pavilion

NOT FOR CONSTRUCTION **Drawing Title General Notes**

Date	11/06/20
Scale	Not to Scale
Drawing Number	P-P-002
Sheet Size	ARCH D

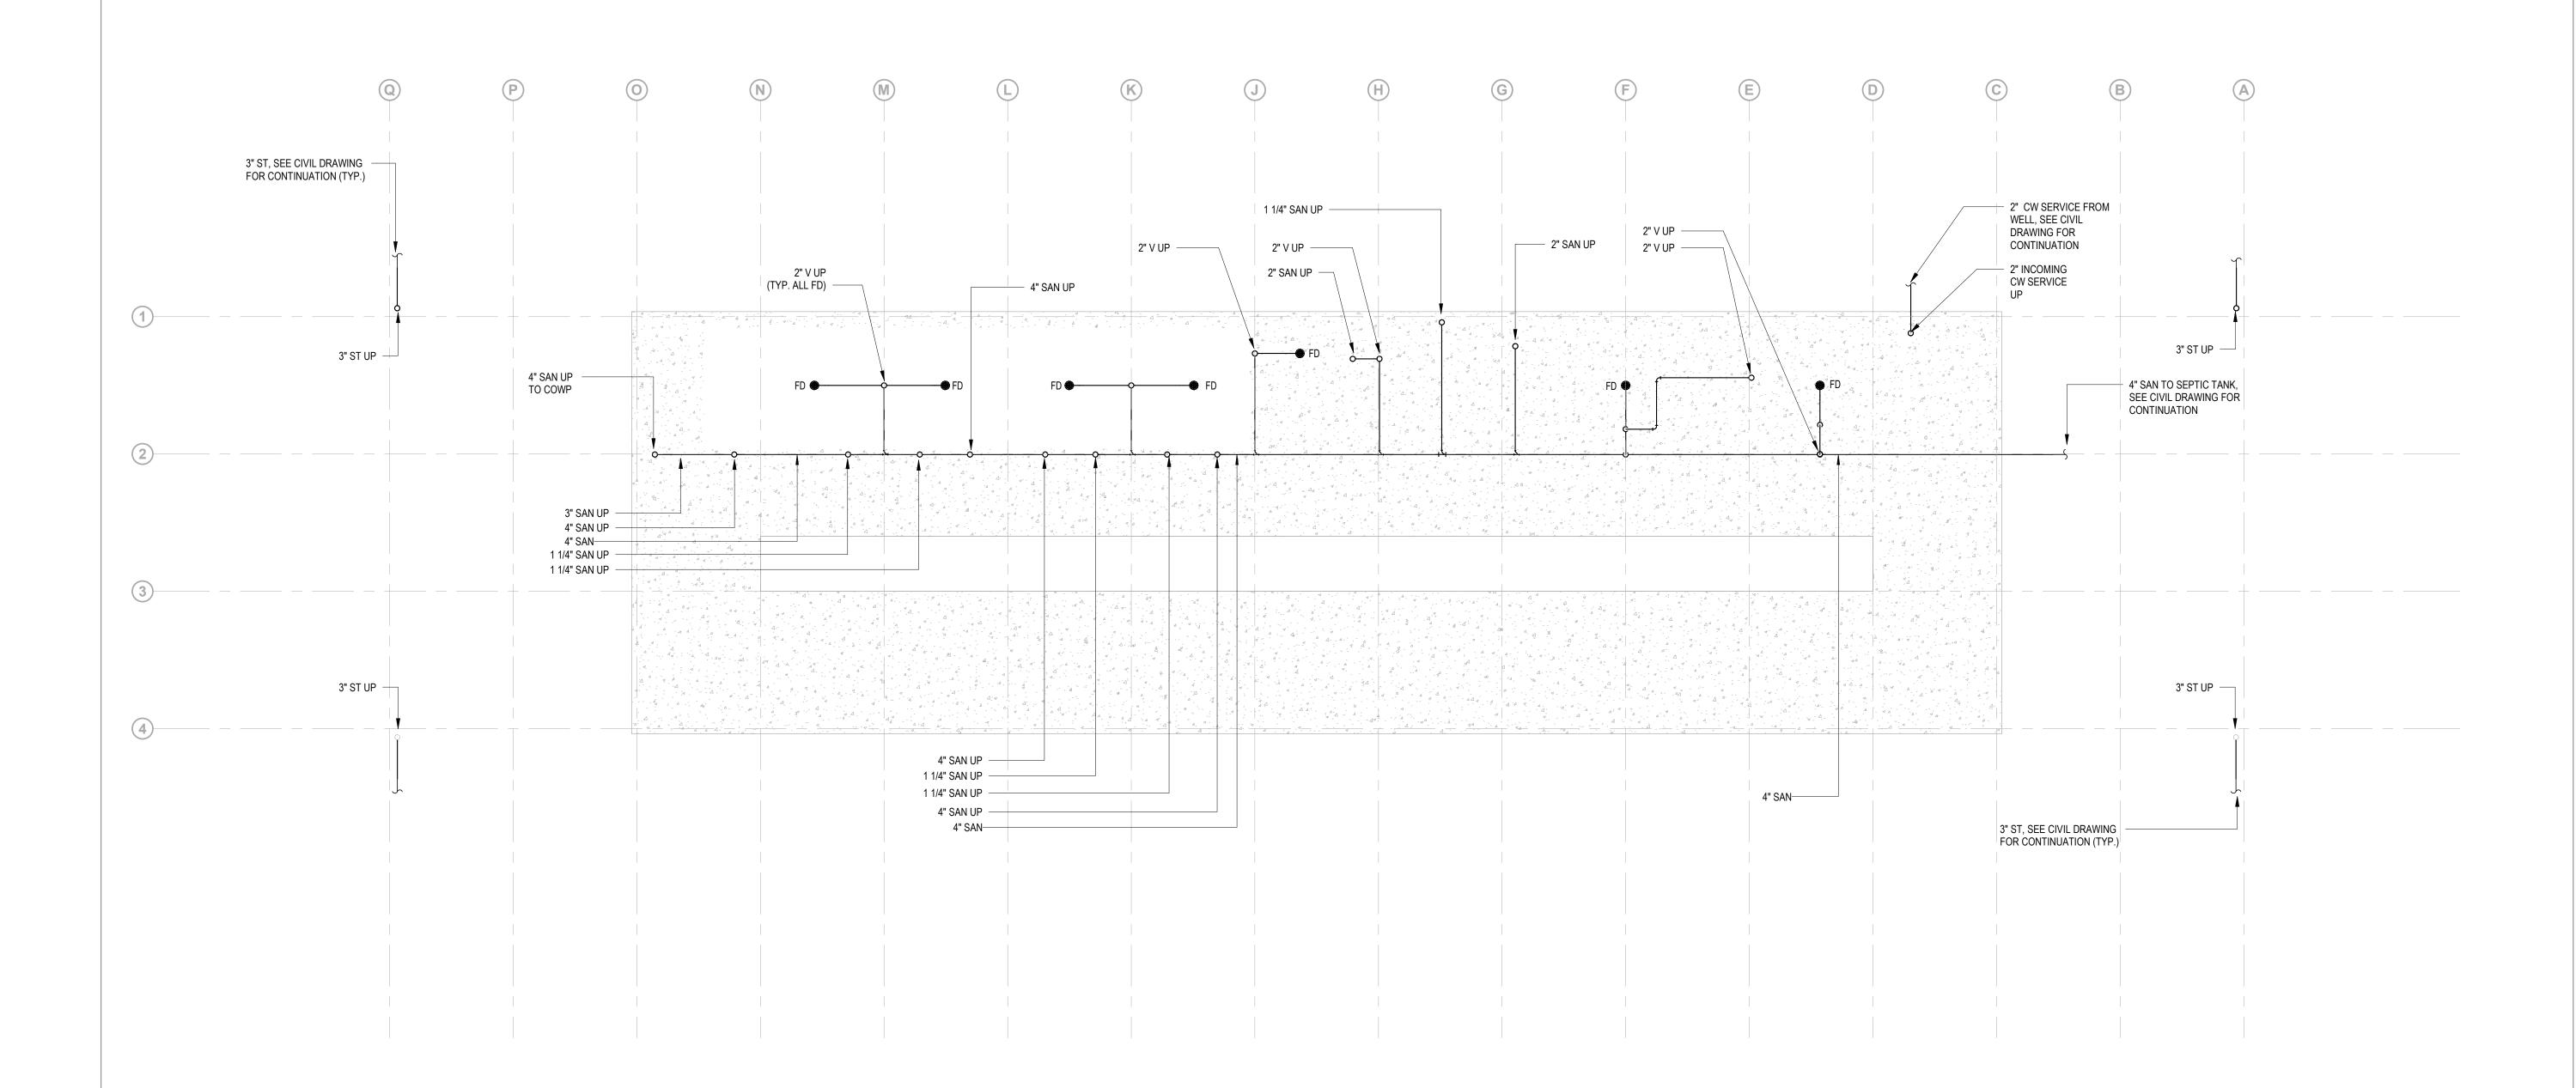

+1 (845) 534-3115

Design Architect
heneghan peng architects
14-16 Lord Edward Street
Dublin, D02 YC63
+353 1 633 9000

Executive Architect
WXY Architecture + Urban Design
224 Centre Street, 5th Floor
New York, NY 10013
+1 (212) 219-1953

Landscape Architect
Gustafson Porter + Bowman
1 Cobham Mews
London, MW1 9SB
+44 020 7284 8950

Reed Hilderbrand LLC 33 Whitney Avenue, 3rd Floor New Haven, CT 06510 +1 (617) 923-2422

Structural & Lighting
ARUP

77 Water Street New York, NY 10005 +1 (212) 896-3000

MEPF & IT
BuroHappold
100 Broadway #23

New York, NY 10005 +1 (212) 616-0228 Civil

VHB 100 Great Oaks B

100 Great Oaks Blvd., Suite 118 Albany, NY 12203

+1 (518) 389-3606

AV & Acoustics
LSTN Consultants
76 Beaver Street, 2nd Floor
New York, NY 10005

New York, NY 10005 +1 (347) 788-0810 Facade

Front Inc. 100 E. Broadway Street, #501 New York, NY 10002 +1 (212) 242-2220

Key Plan



Description Date
50% Design Development 02/24/20
100% Design Development 05/29/20

11/06/20

50% Construction Documents

Project

Storm King
Art Center
Pond Pavilion

Se


NOT FOR CONSTRUCTION

Drawing Title

Piping Plan
Underslab

Date	11/06/20
Scale	1/4" = 1'-0"
Drawing Number	P-P-100
Sheet Size	ARCH D

NOTES:
1. HEAT TRACE ALL CW, HW AND HWR
PIPEWORK WITHIN THE BUILDING
2. PROVIDE DOMESTIC WATER DRAIN DOWN
LOCATION IN EVENT OF POWER OUTAGE

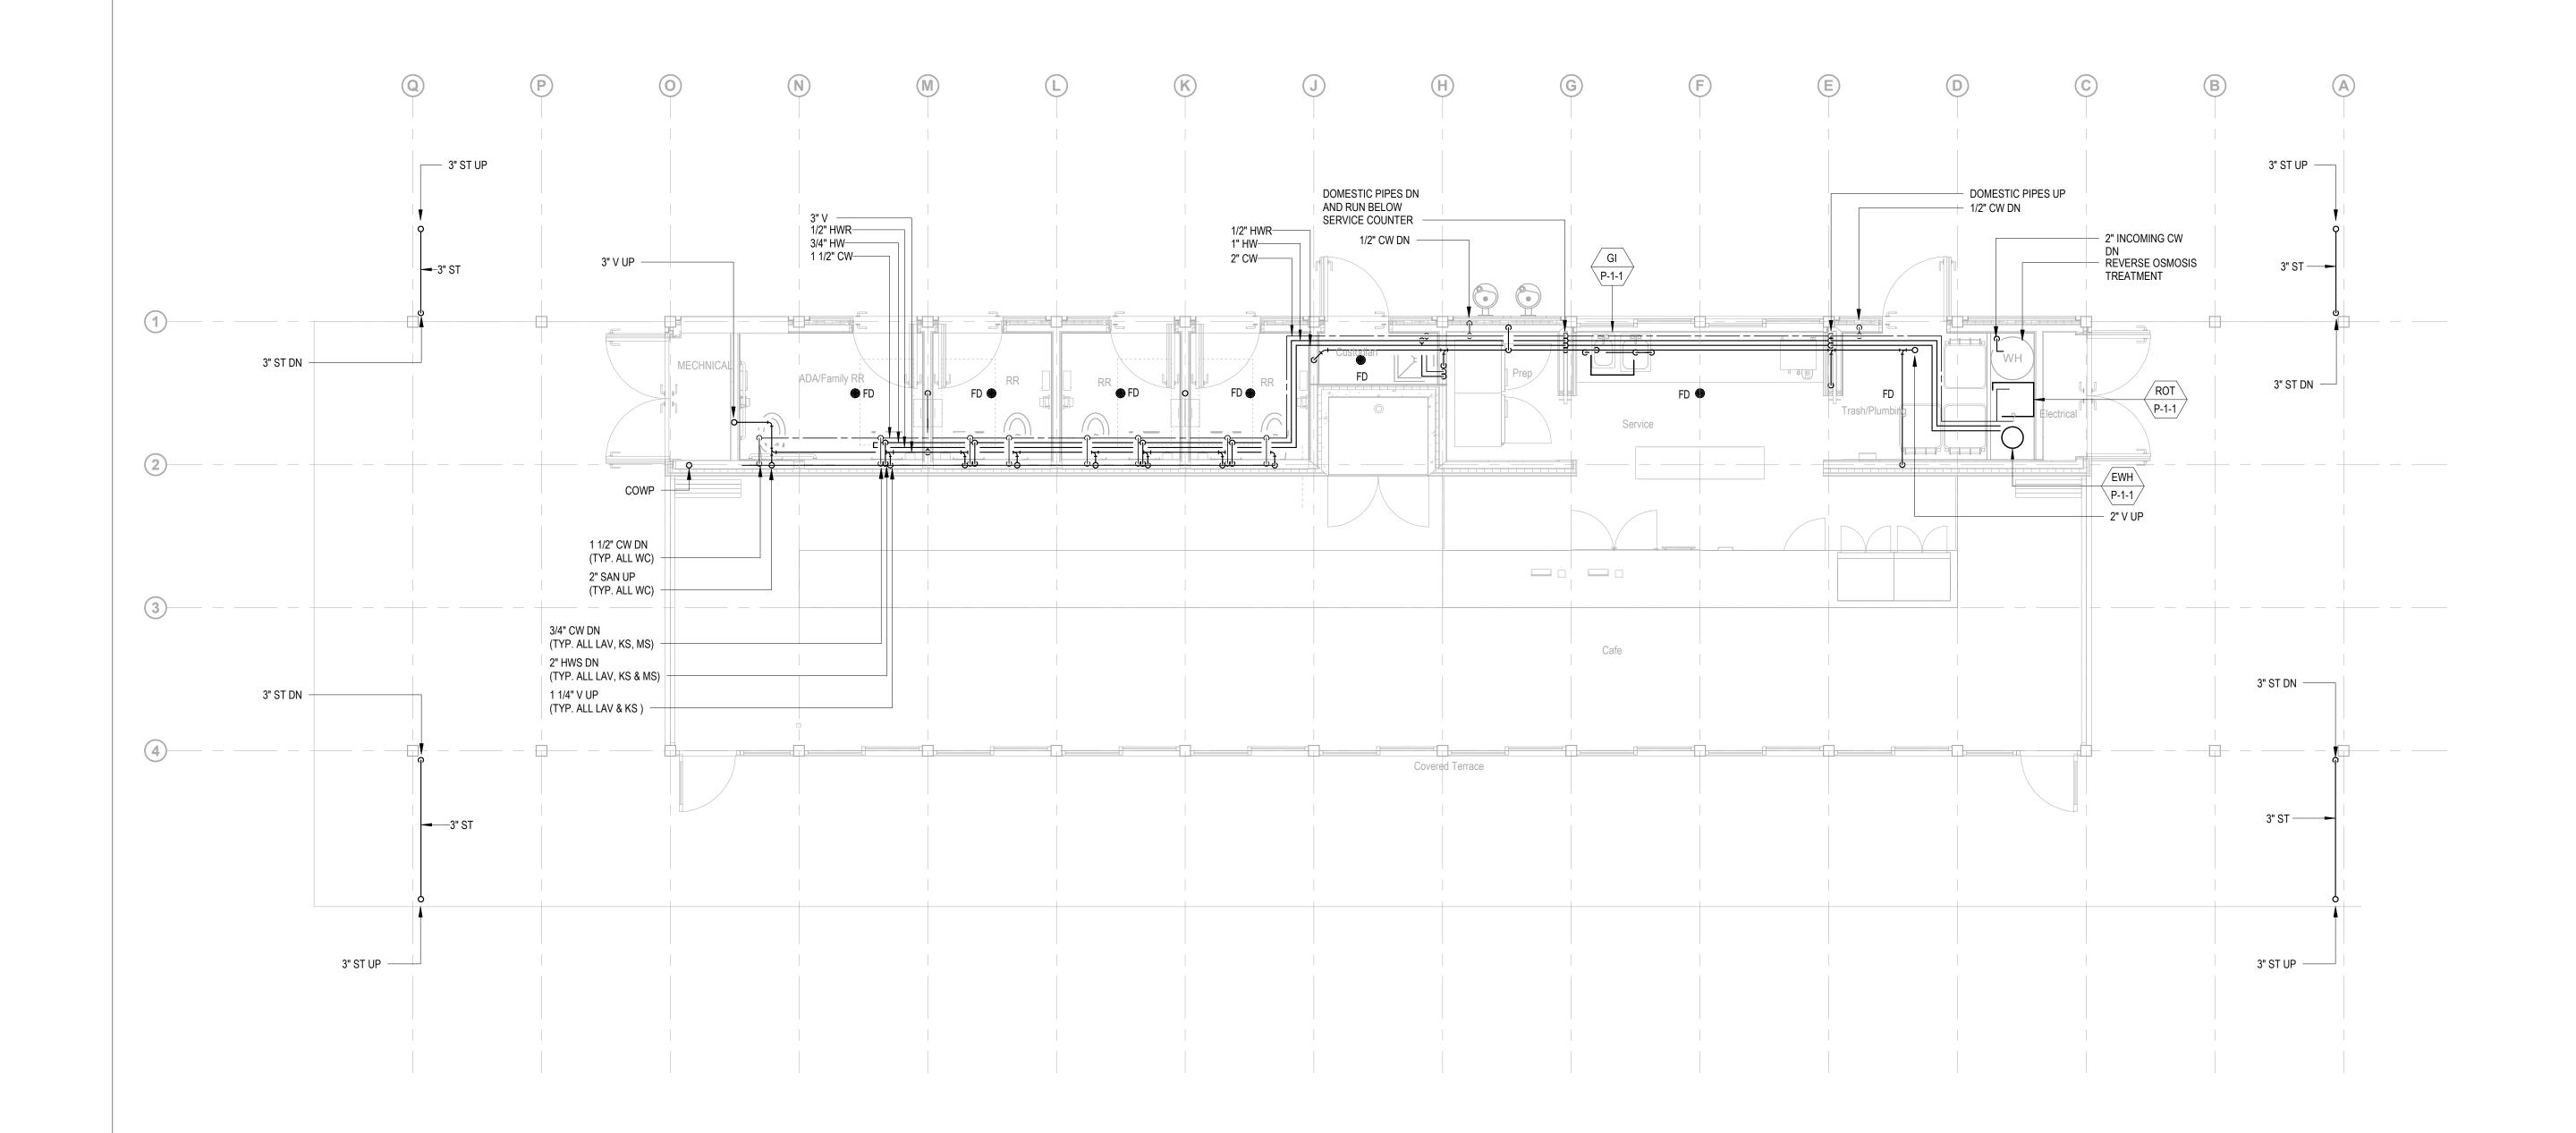

Owner
Storm King

Storm King Art Center 1 Museum Road New Windsor, NY 12553 +1 (845) 534-3115

Design Architect
heneghan peng architects
14-16 Lord Edward Street
Dublin, D02 YC63
+353 1 633 9000

Executive Architect
WXY Architecture + Urban Design
224 Centre Street, 5th Floor
New York, NY 10013
+1 (212) 219-1953

Landscape Architect
Gustafson Porter + Bowman
1 Cobham Mews
London, MW1 9SB
+44 020 7284 8950

Reed Hilderbrand LLC 33 Whitney Avenue, 3rd Floor New Haven, CT 06510 +1 (617) 923-2422

Structural & Lighting
ARUP

77 Water Street
New York, NY 10005
+1 (212) 896-3000

MEPF & IT
BuroHappold
100 Broadway #23

New York, NY 10005 +1 (212) 616-0228 Civil

100 Great Oaks Blvd., Suite 118 Albany, NY 12203

+1 (518) 389-3606

VHB

AV & Acoustics
LSTN Consultants
76 Beaver Street, 2nd Floor
New York NY 10005

New York, NY 10005 +1 (347) 788-0810 Facade

Front Inc. 100 E. Broadway Street, #501 New York, NY 10002 +1 (212) 242-2220

Key Plan



Description Date
50% Design Development 02/24/20
100% Design Development 05/29/20
50% Construction Documents 11/06/20


Project

Storm King
Art Center
Pond Pavilion

Sea

NOT FOR CONSTRUCTION
Drawing Title
Piping Plan - Ground
Level

Date	11/06/20
Scale	1/4" = 1'-0"
Drawing Number	P-P-101
Sheet Size	ARCH D

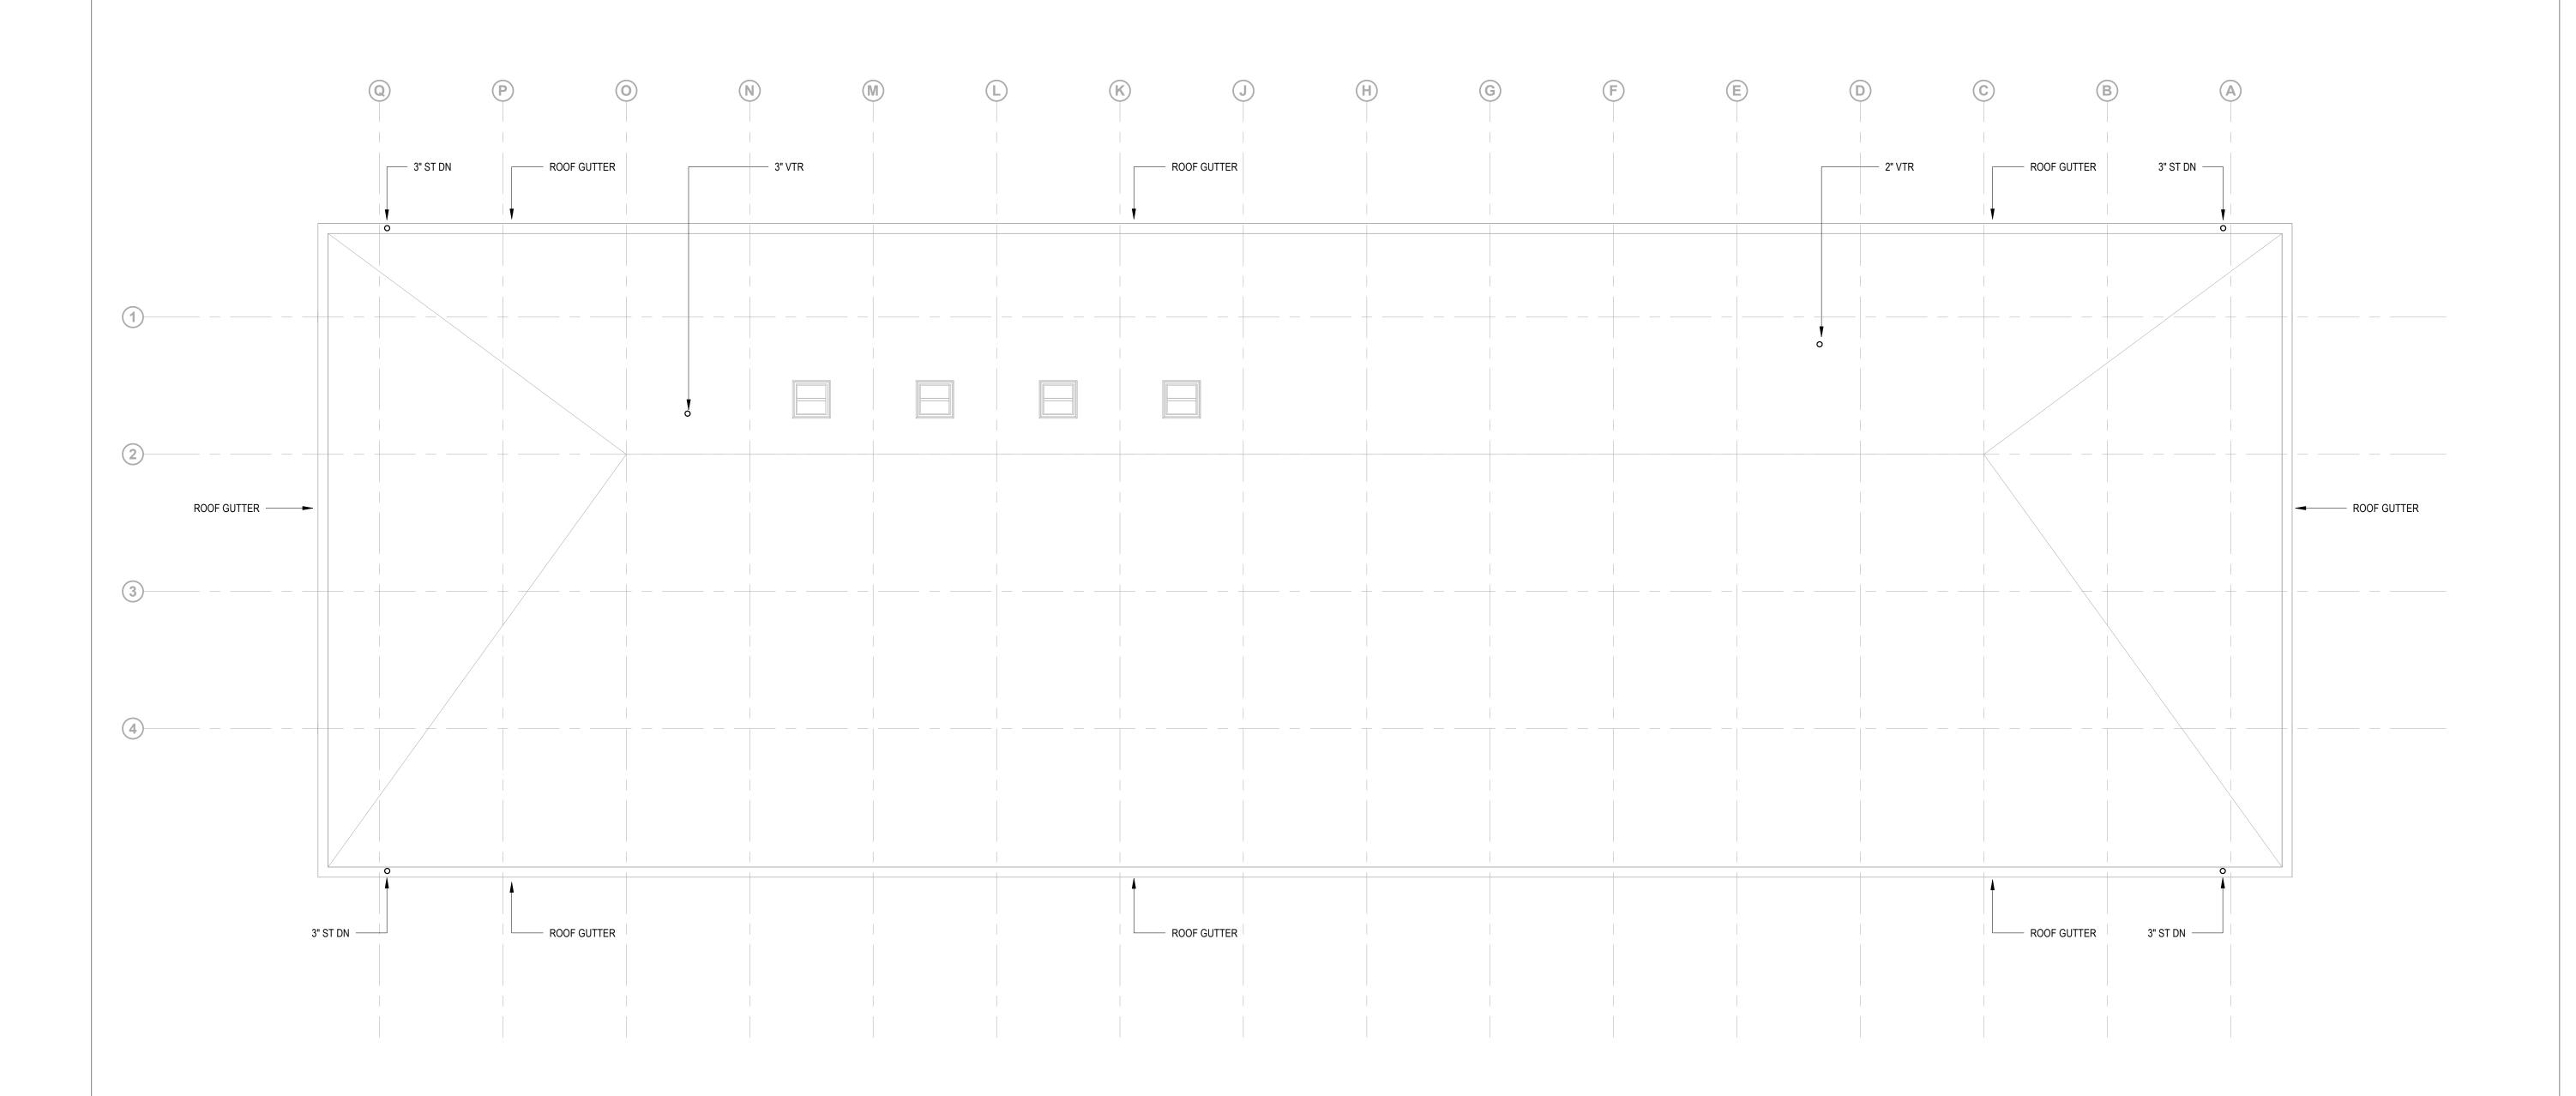

Owner
Storm King Art Center
1 Museum Road

1 Museum Road New Windsor, NY 12553 +1 (845) 534-3115

Design Architect
heneghan peng architects
14-16 Lord Edward Street
Dublin, D02 YC63
+353 1 633 9000

Executive Architect
WXY Architecture + Urban Design
224 Centre Street, 5th Floor
New York, NY 10013
+1 (212) 219-1953

Landscape Architect
Gustafson Porter + Bowman
1 Cobham Mews
London, MW1 9SB
+44 020 7284 8950

Reed Hilderbrand LLC 33 Whitney Avenue, 3rd Floor New Haven, CT 06510 +1 (617) 923-2422

Structural & Lighting
ARUP

New York, NY 10005 +1 (212) 896-3000 **MEPF & IT**

77 Water Street

BuroHappold 100 Broadway #23 New York, NY 10005

+1 (212) 616-0228 **Civil** VHB

100 Great Oaks Blvd., Suite 118 Albany, NY 12203

+1 (518) 389-3606

AV & Acoustics

LSTN Consultants
76 Beaver Street, 2nd Floor
New York, NY 10005
+1 (347) 788-0810

Facade
Front Inc.
100 E. Broadway Street, #501
New York, NY 10002

+1 (212) 242-2220

Key Plan



DescriptionDate50% Design Development02/24/20100% Design Development05/29/2050% Construction Documents11/06/20

Project

Storm King
Art Center
Pond Pavilion

Seal


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Drawing Title

Piping Plan - Roof

Level

Date	11/06/20
Scale	1/4" = 1'-0"
Drawing Number	P-P-102
Sheet Size	ARCH D

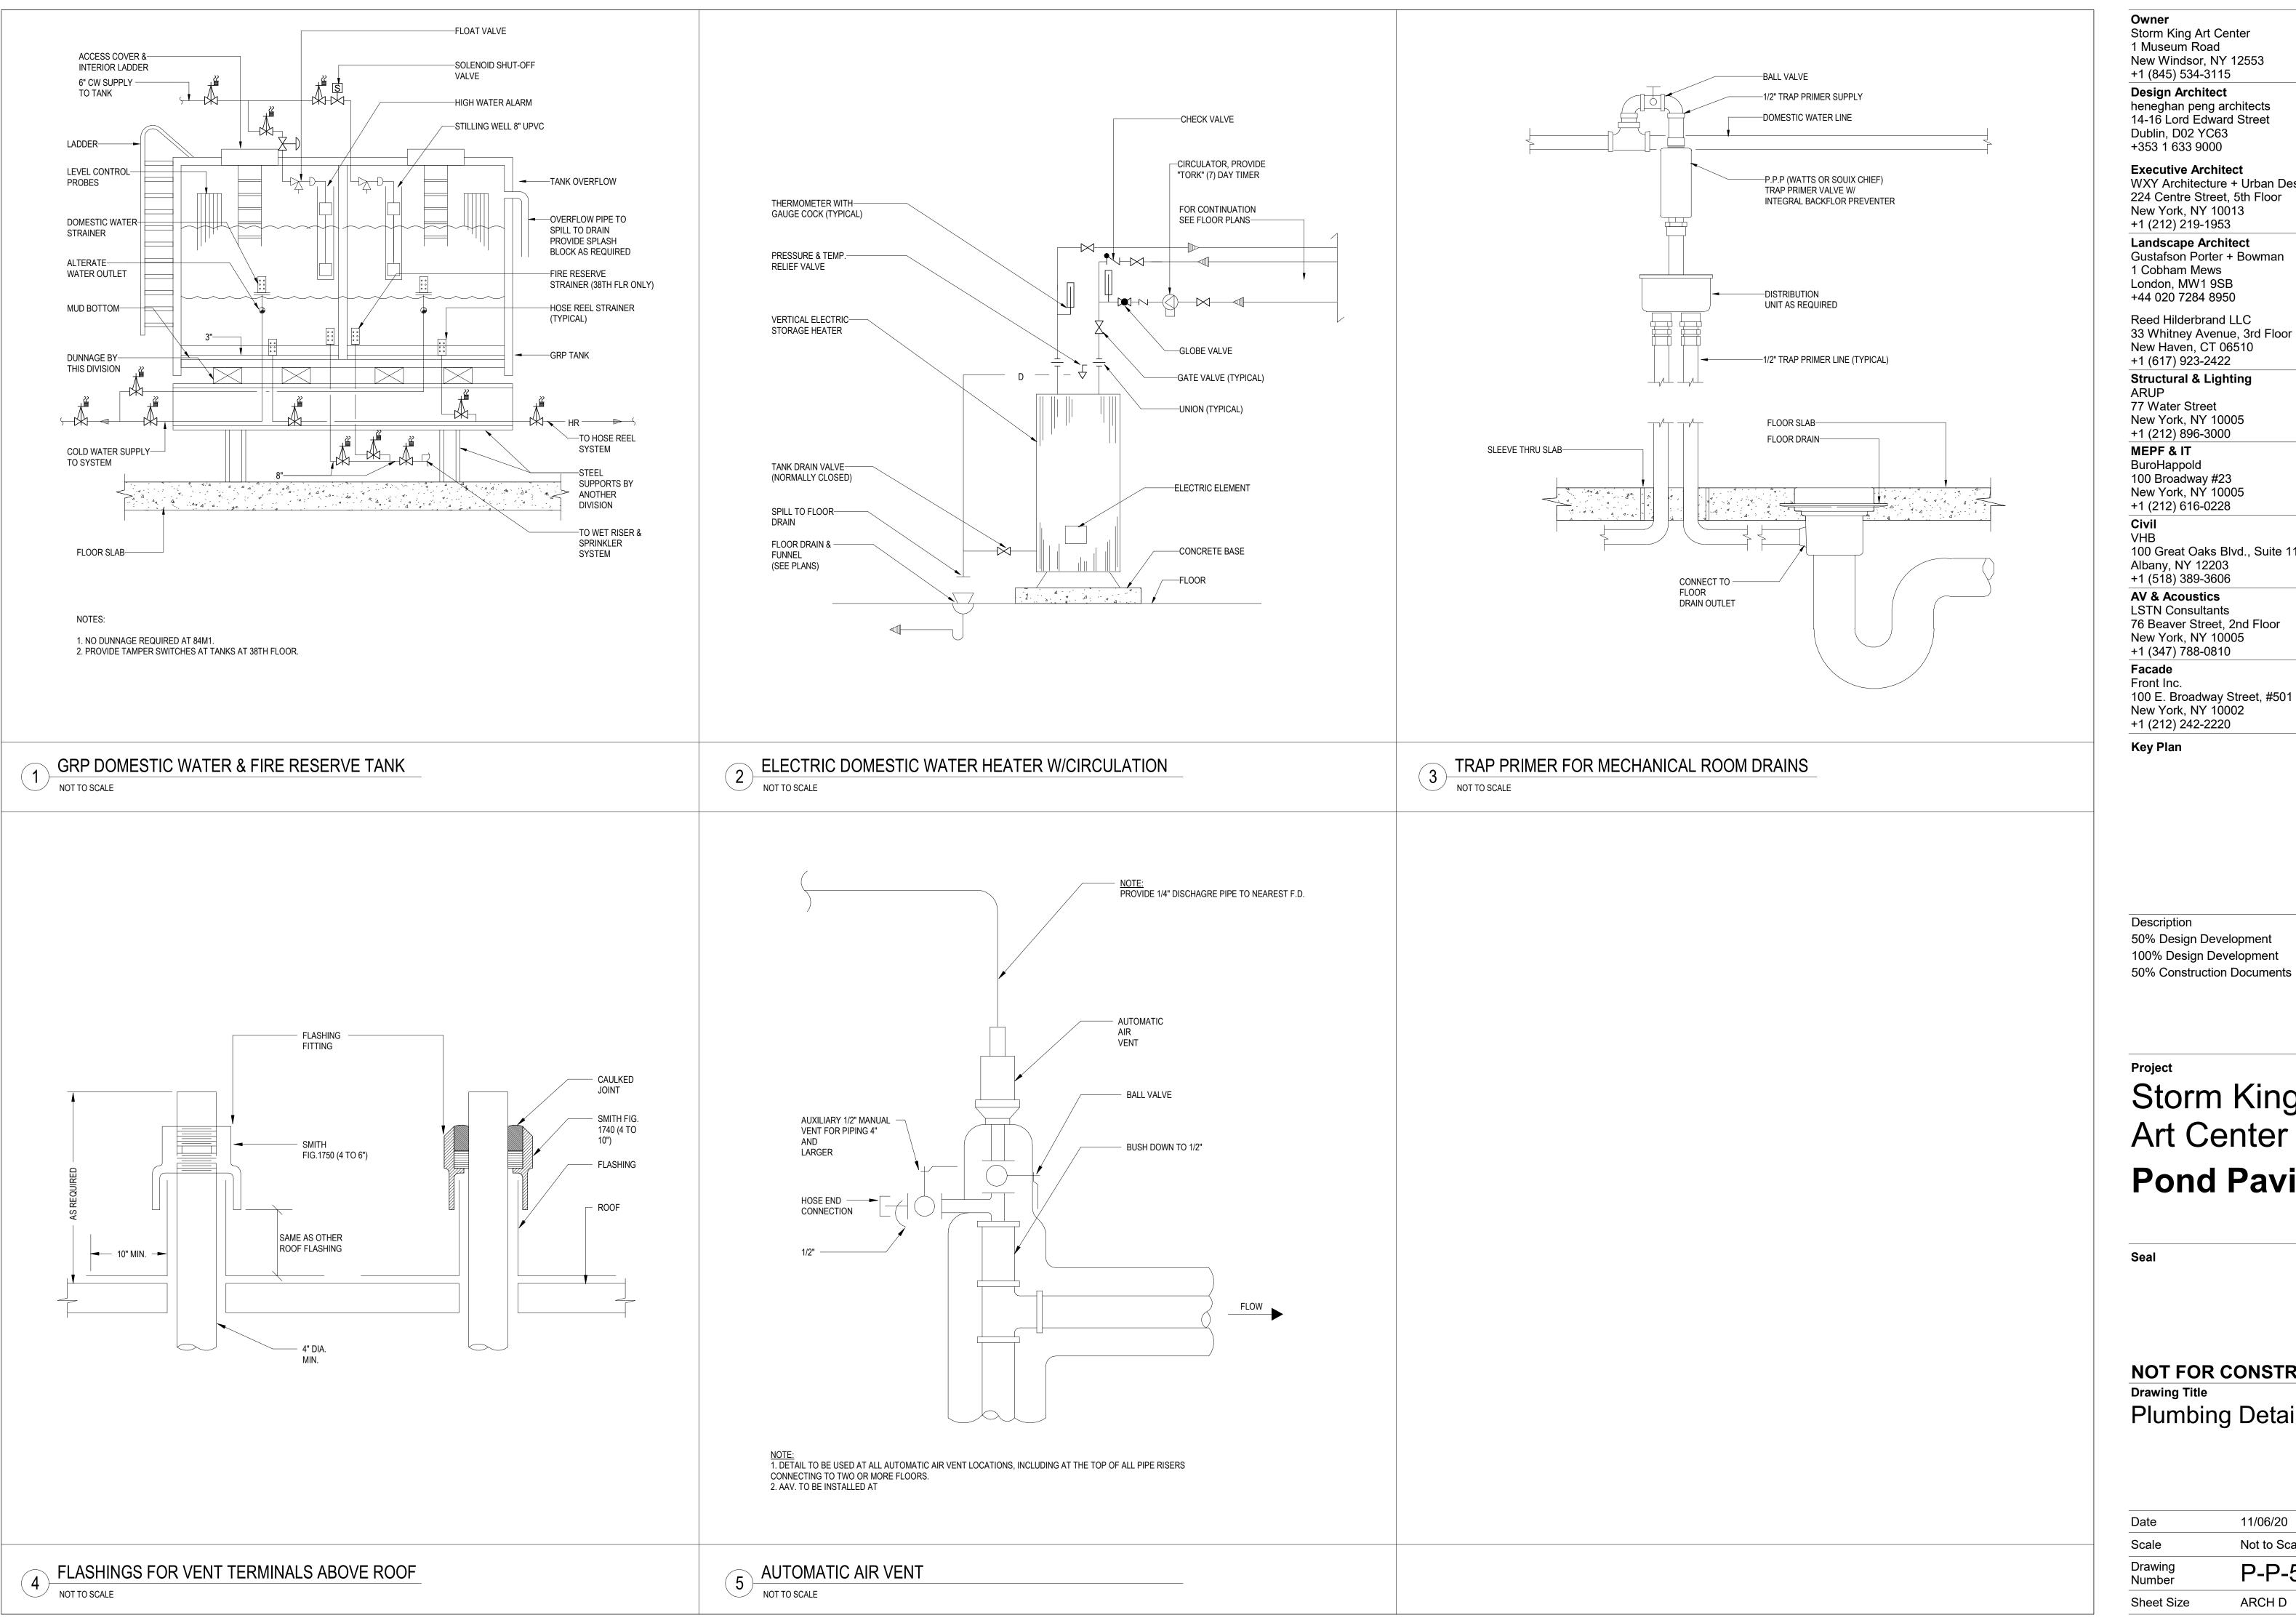

+1 (845) 534-3115 **Design Architect**

heneghan peng architects 14-16 Lord Edward Street Dublin, D02 YC63 +353 1 633 9000

Executive Architect WXY Architecture + Urban Design 224 Centre Street, 5th Floor New York, NY 10013 +1 (212) 219-1953

Landscape Architect Gustafson Porter + Bowman 1 Cobham Mews London, MW1 9SB +44 020 7284 8950

Reed Hilderbrand LLC 33 Whitney Avenue, 3rd Floor New Haven, CT 06510

+1 (617) 923-2422 Structural & Lighting ARUP

New York, NY 10005 +1 (212) 896-3000 MEPF & IT BuroHappold

100 Broadway #23 New York, NY 10005 +1 (212) 616-0228

VHB 100 Great Oaks Blvd., Suite 118

Albany, NY 12203 +1 (518) 389-3606

AV & Acoustics LSTN Consultants 76 Beaver Street, 2nd Floor New York, NY 10005 +1 (347) 788-0810

Front Inc. 100 E. Broadway Street, #501 New York, NY 10002

Key Plan

Description Date 50% Design Development 02/24/20 100% Design Development 05/29/20


11/06/20

Project

Storm King Art Center **Pond Pavilion**

NOT FOR CONSTRUCTION **Drawing Title** Plumbing Details

Date	11/06/20
Scale	Not to Scale
Drawing Number	P-P-501
Sheet Size	ARCH D

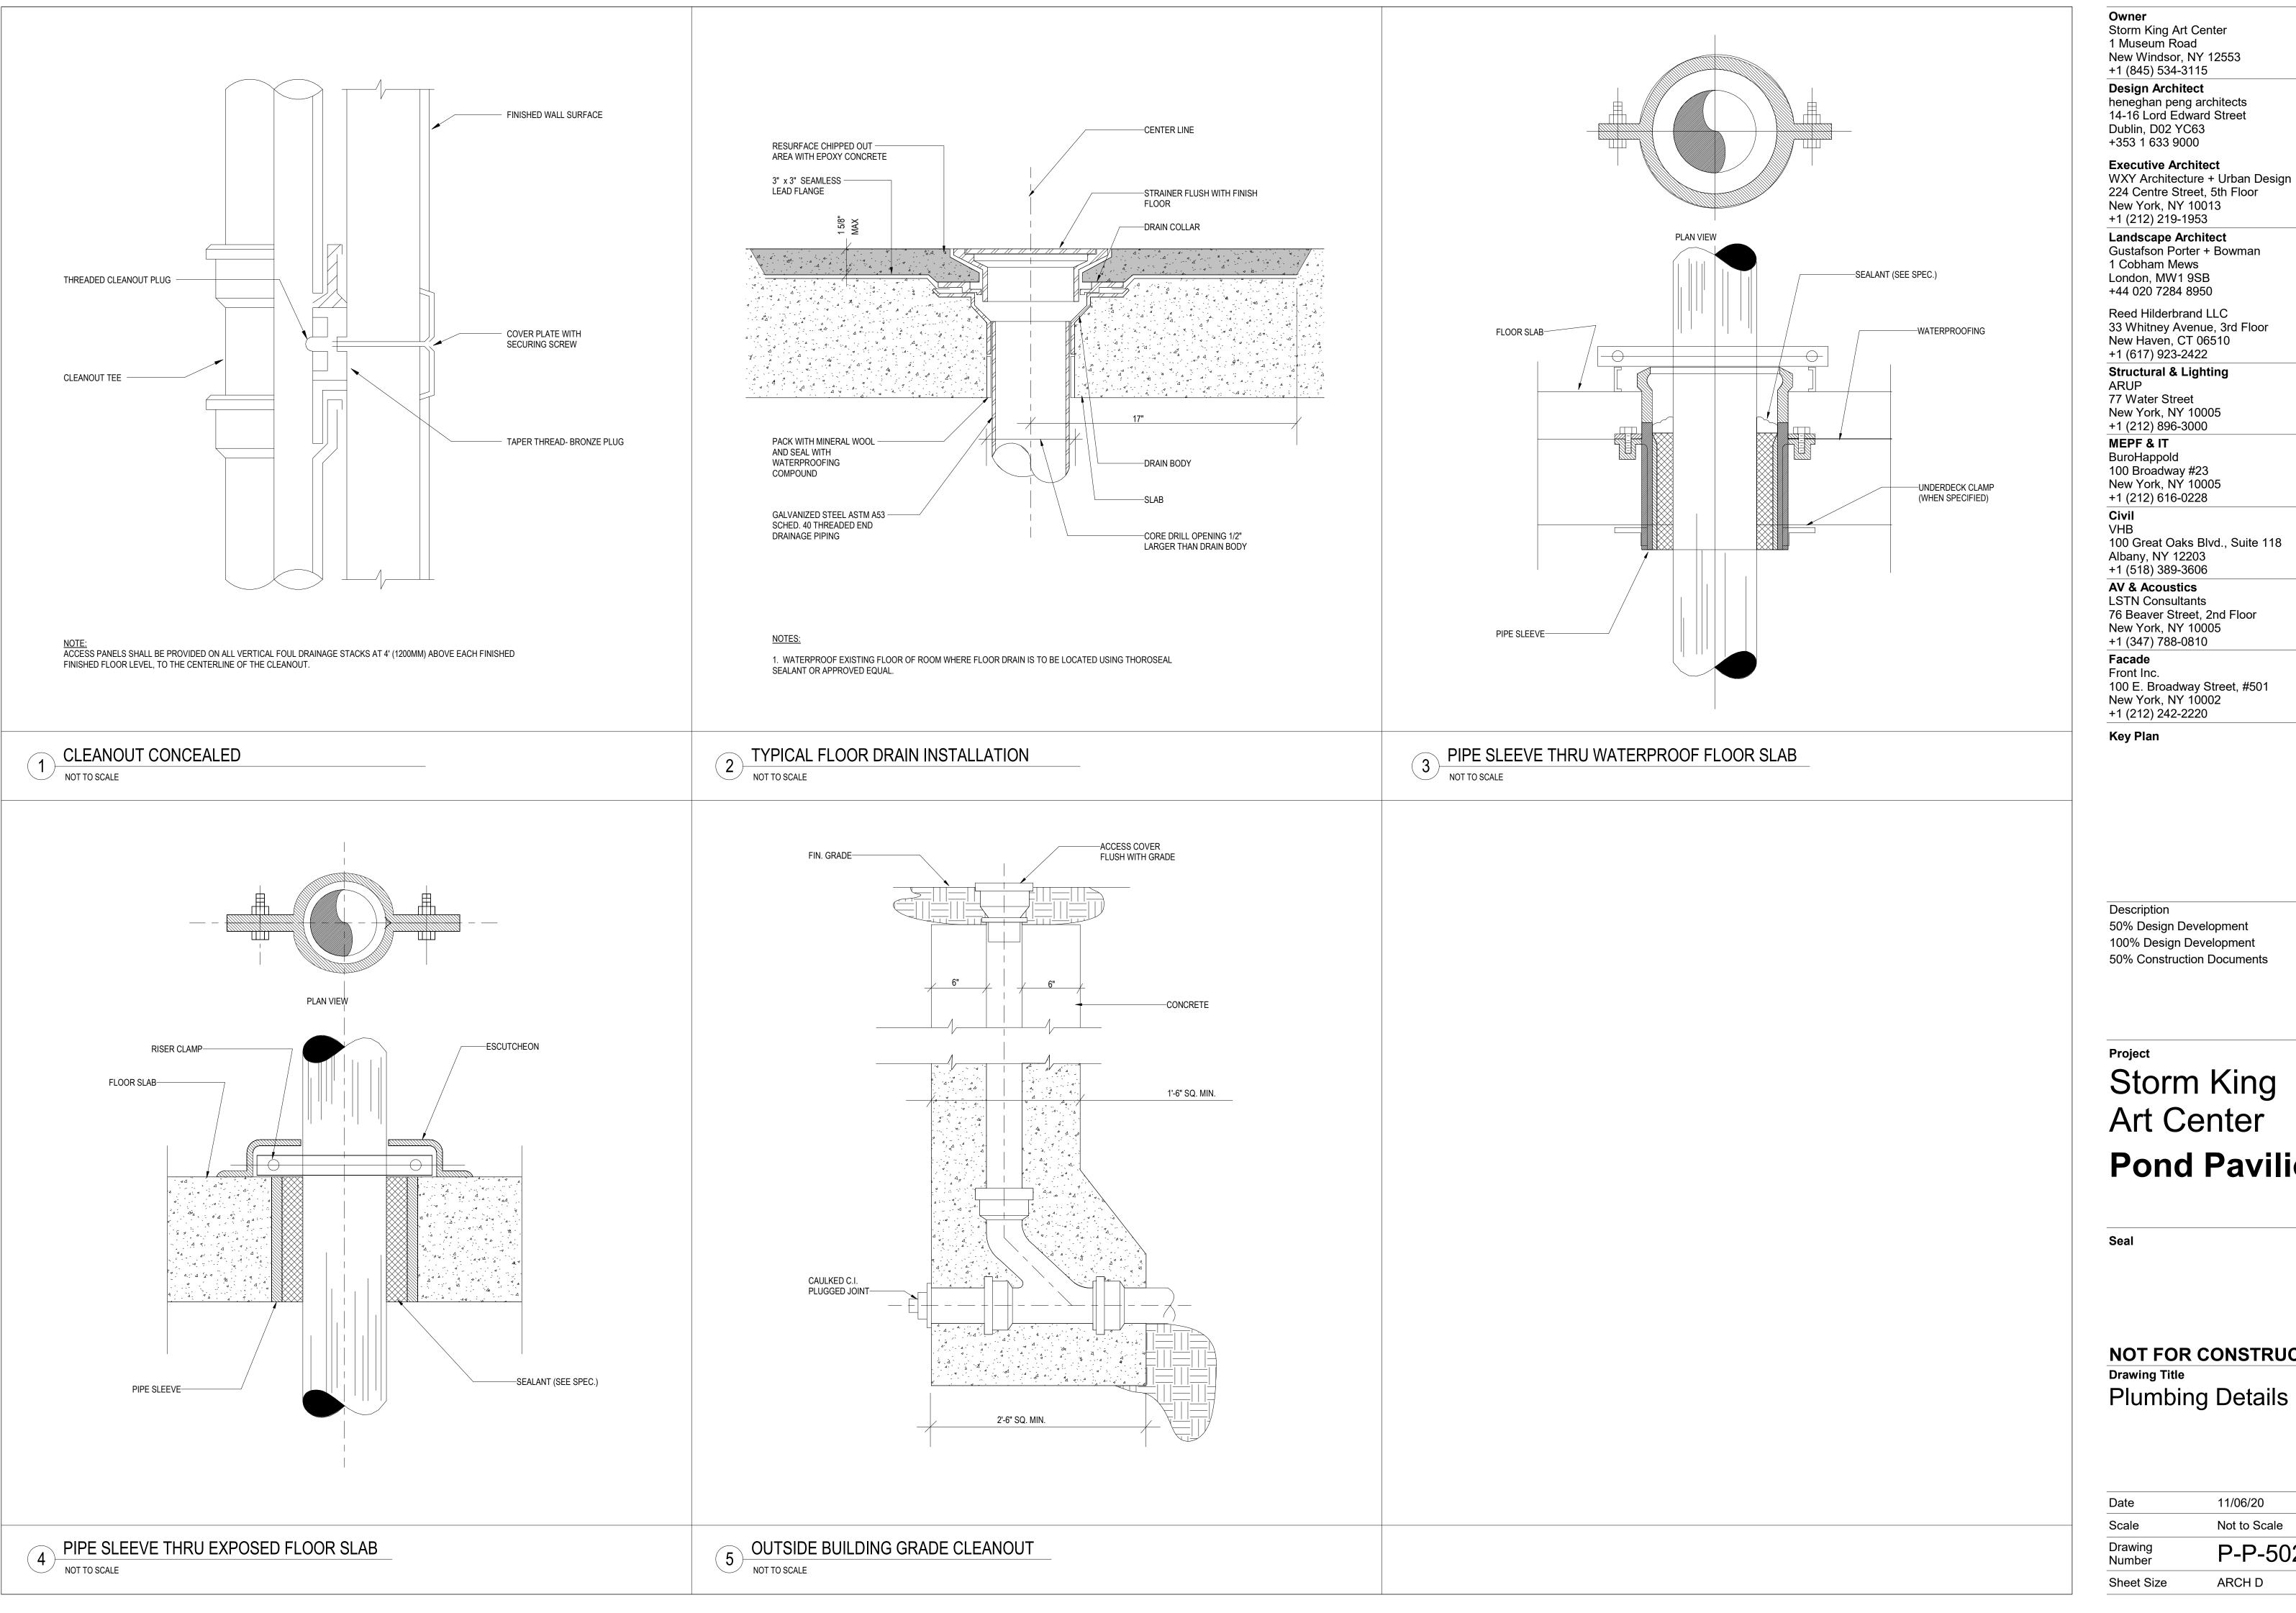

+1 (845) 534-3115 **Design Architect** heneghan peng architects 14-16 Lord Edward Street

Dublin, D02 YC63 +353 1 633 9000 **Executive Architect**

+1 (212) 219-1953 Landscape Architect Gustafson Porter + Bowman 1 Cobham Mews London, MW1 9SB

Reed Hilderbrand LLC 33 Whitney Avenue, 3rd Floor New Haven, CT 06510

+1 (617) 923-2422 Structural & Lighting ARUP

+1 (212) 896-3000 MEPF & IT BuroHappold

100 Broadway #23 New York, NY 10005 +1 (212) 616-0228

Civil VHB 100 Great Oaks Blvd., Suite 118

Albany, NY 12203 +1 (518) 389-3606

AV & Acoustics LSTN Consultants

76 Beaver Street, 2nd Floor New York, NY 10005 +1 (347) 788-0810 **Facade**

Front Inc. 100 E. Broadway Street, #501 New York, NY 10002 +1 (212) 242-2220


Key Plan

Description 50% Design Development 02/24/20 100% Design Development 05/29/20

Storm King Art Center **Pond Pavilion**

NOT FOR CONSTRUCTION **Drawing Title** Plumbing Details

Date	11/06/20				
Scale	Not to Scale				
Drawing Number	P-P-502				
Sheet Size	ARCH D				

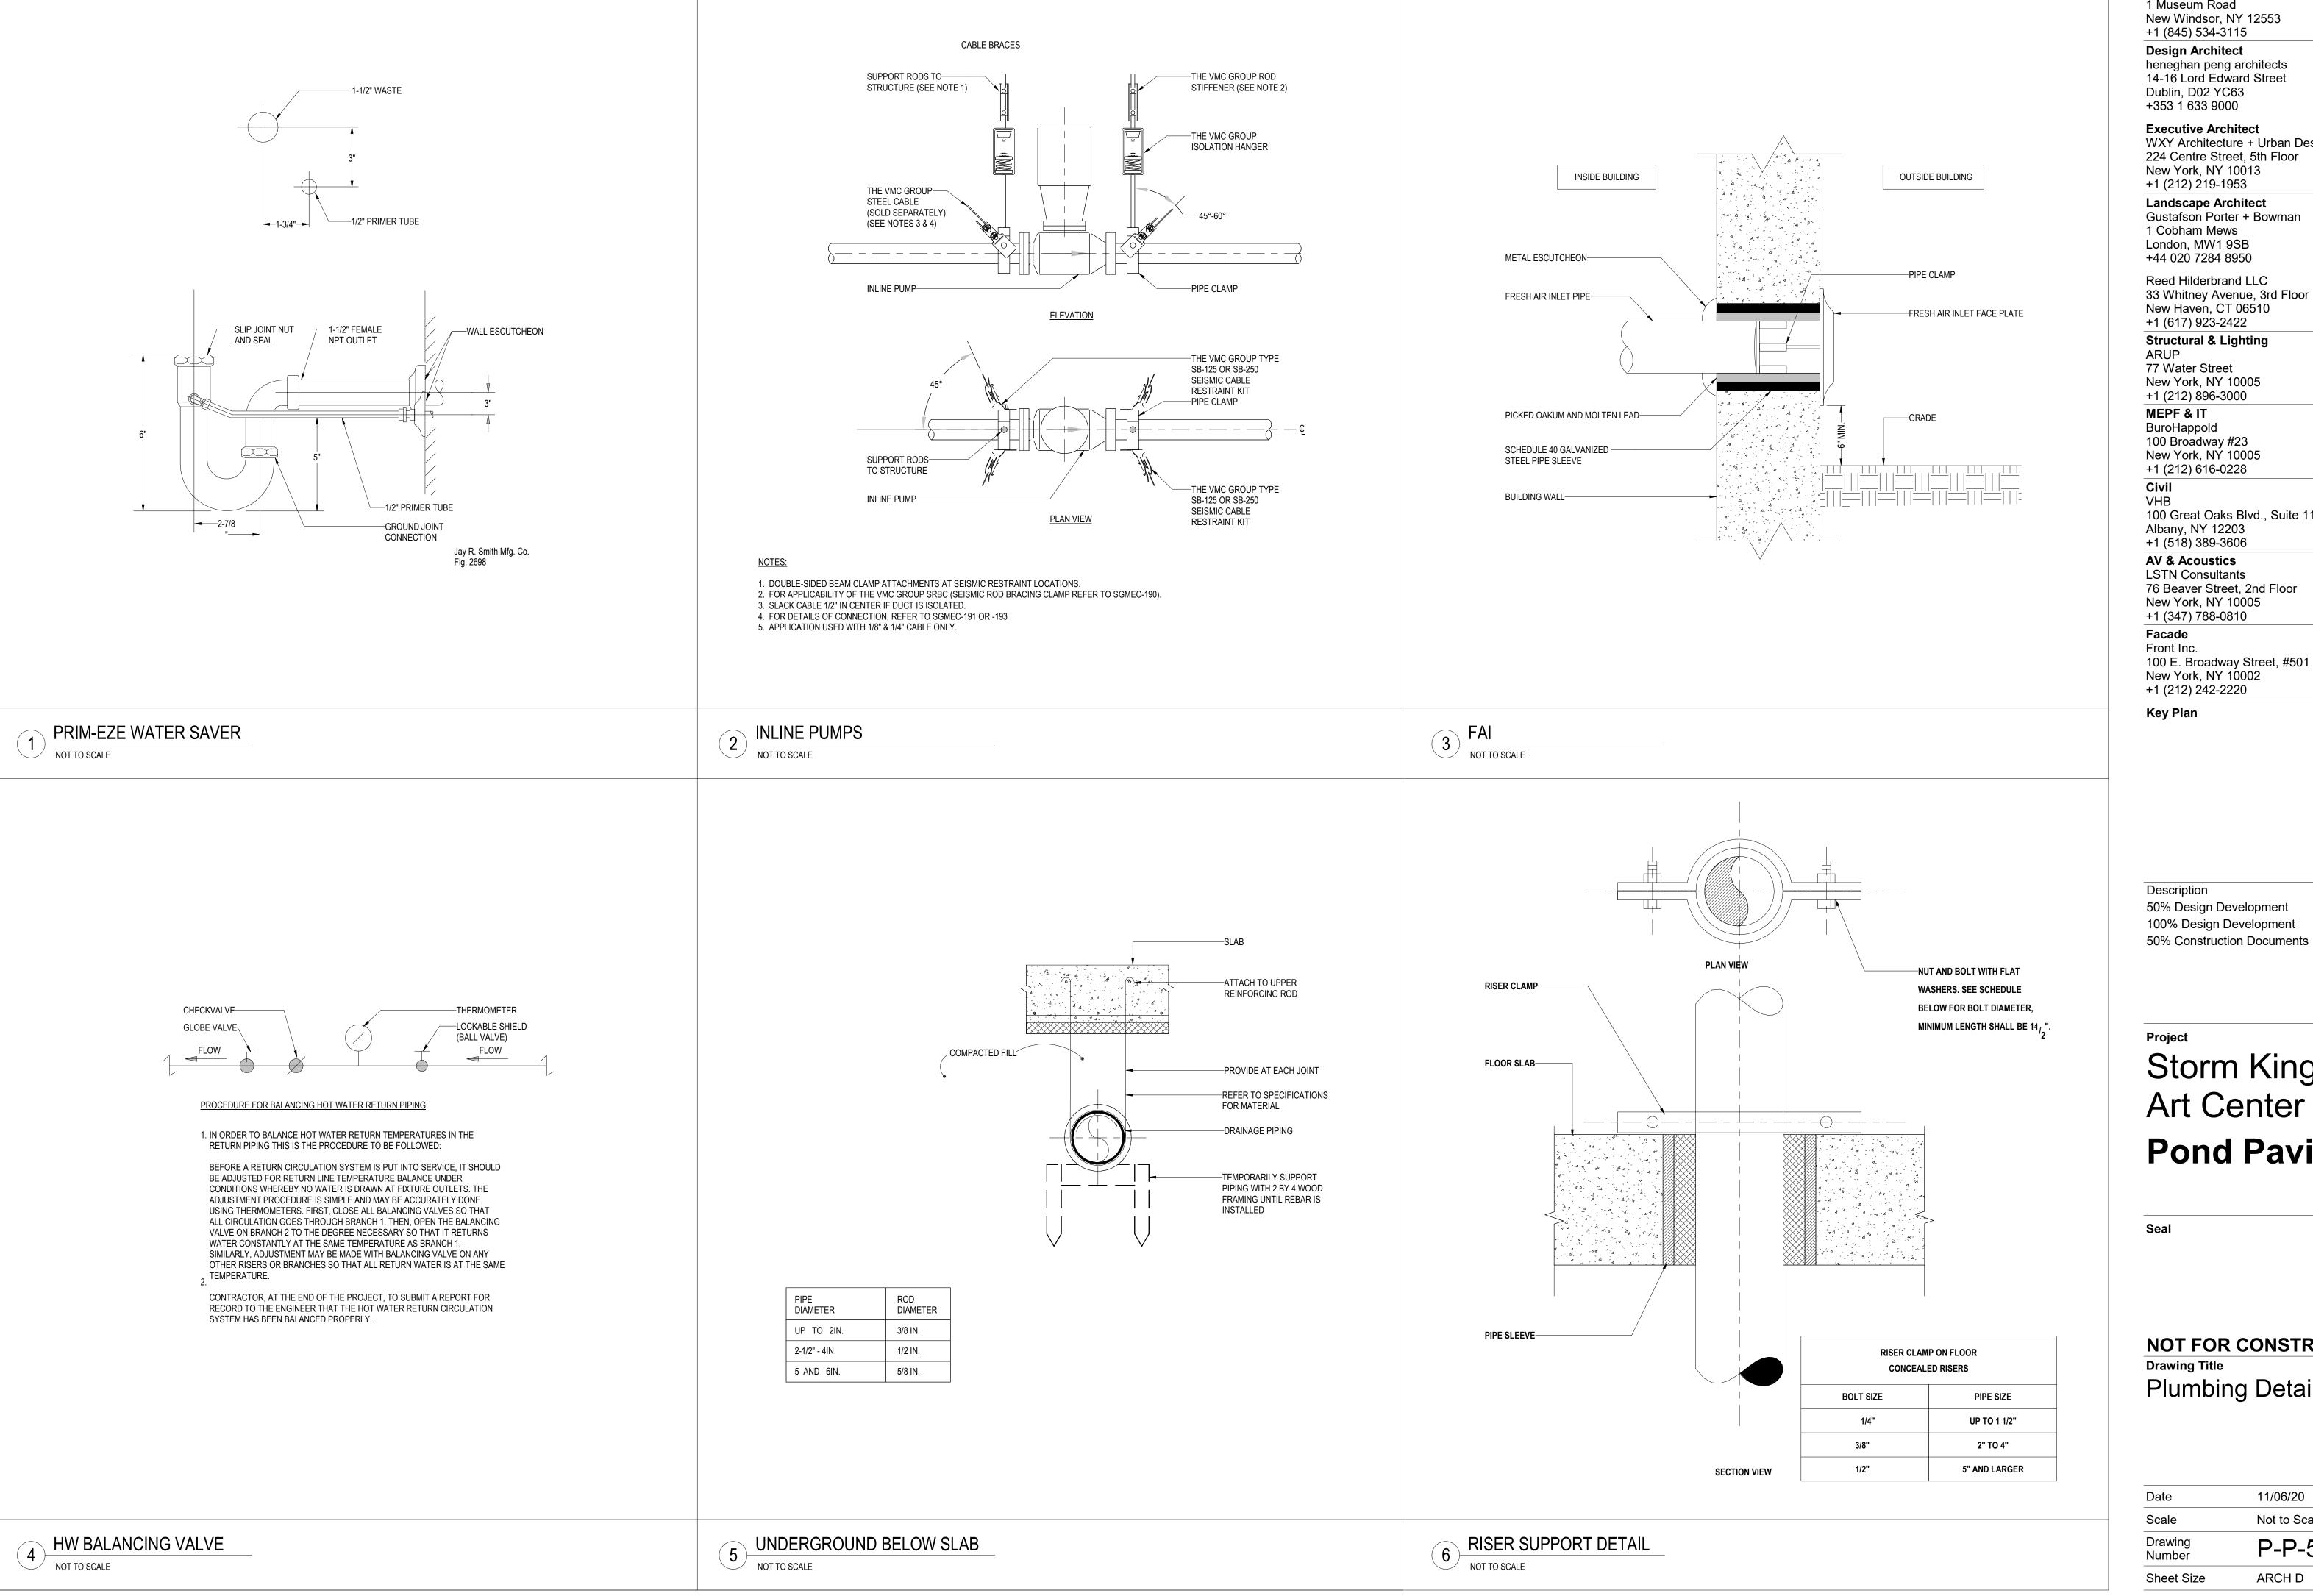

Design Architect heneghan peng architects 14-16 Lord Edward Street Dublin, D02 YC63

+353 1 633 9000 **Executive Architect** WXY Architecture + Urban Design 224 Centre Street, 5th Floor New York, NY 10013 +1 (212) 219-1953

Landscape Architect Gustafson Porter + Bowman 1 Cobham Mews London, MW1 9SB +44 020 7284 8950

Reed Hilderbrand LLC 33 Whitney Avenue, 3rd Floor New Haven, CT 06510

+1 (617) 923-2422 **Structural & Lighting**

New York, NY 10005 +1 (212) 896-3000 MEPF & IT

BuroHappold 100 Broadway #23 New York, NY 10005

+1 (212) 616-0228 Civil

100 Great Oaks Blvd., Suite 118

Albany, NY 12203 +1 (518) 389-3606

AV & Acoustics LSTN Consultants 76 Beaver Street, 2nd Floor

New York, NY 10005 +1 (347) 788-0810 Facade Front Inc.

100 E. Broadway Street, #501 New York, NY 10002 +1 (212) 242-2220

Key Plan

Description Date 02/24/20 50% Design Development 100% Design Development 05/29/20


11/06/20

Project

Storm King Art Center **Pond Pavilion**

NOT FOR CONSTRUCTION **Drawing Title** Plumbing Details

11/06/20 Date Not to Scale Scale Drawing P-P-503 Number ARCH D Sheet Size

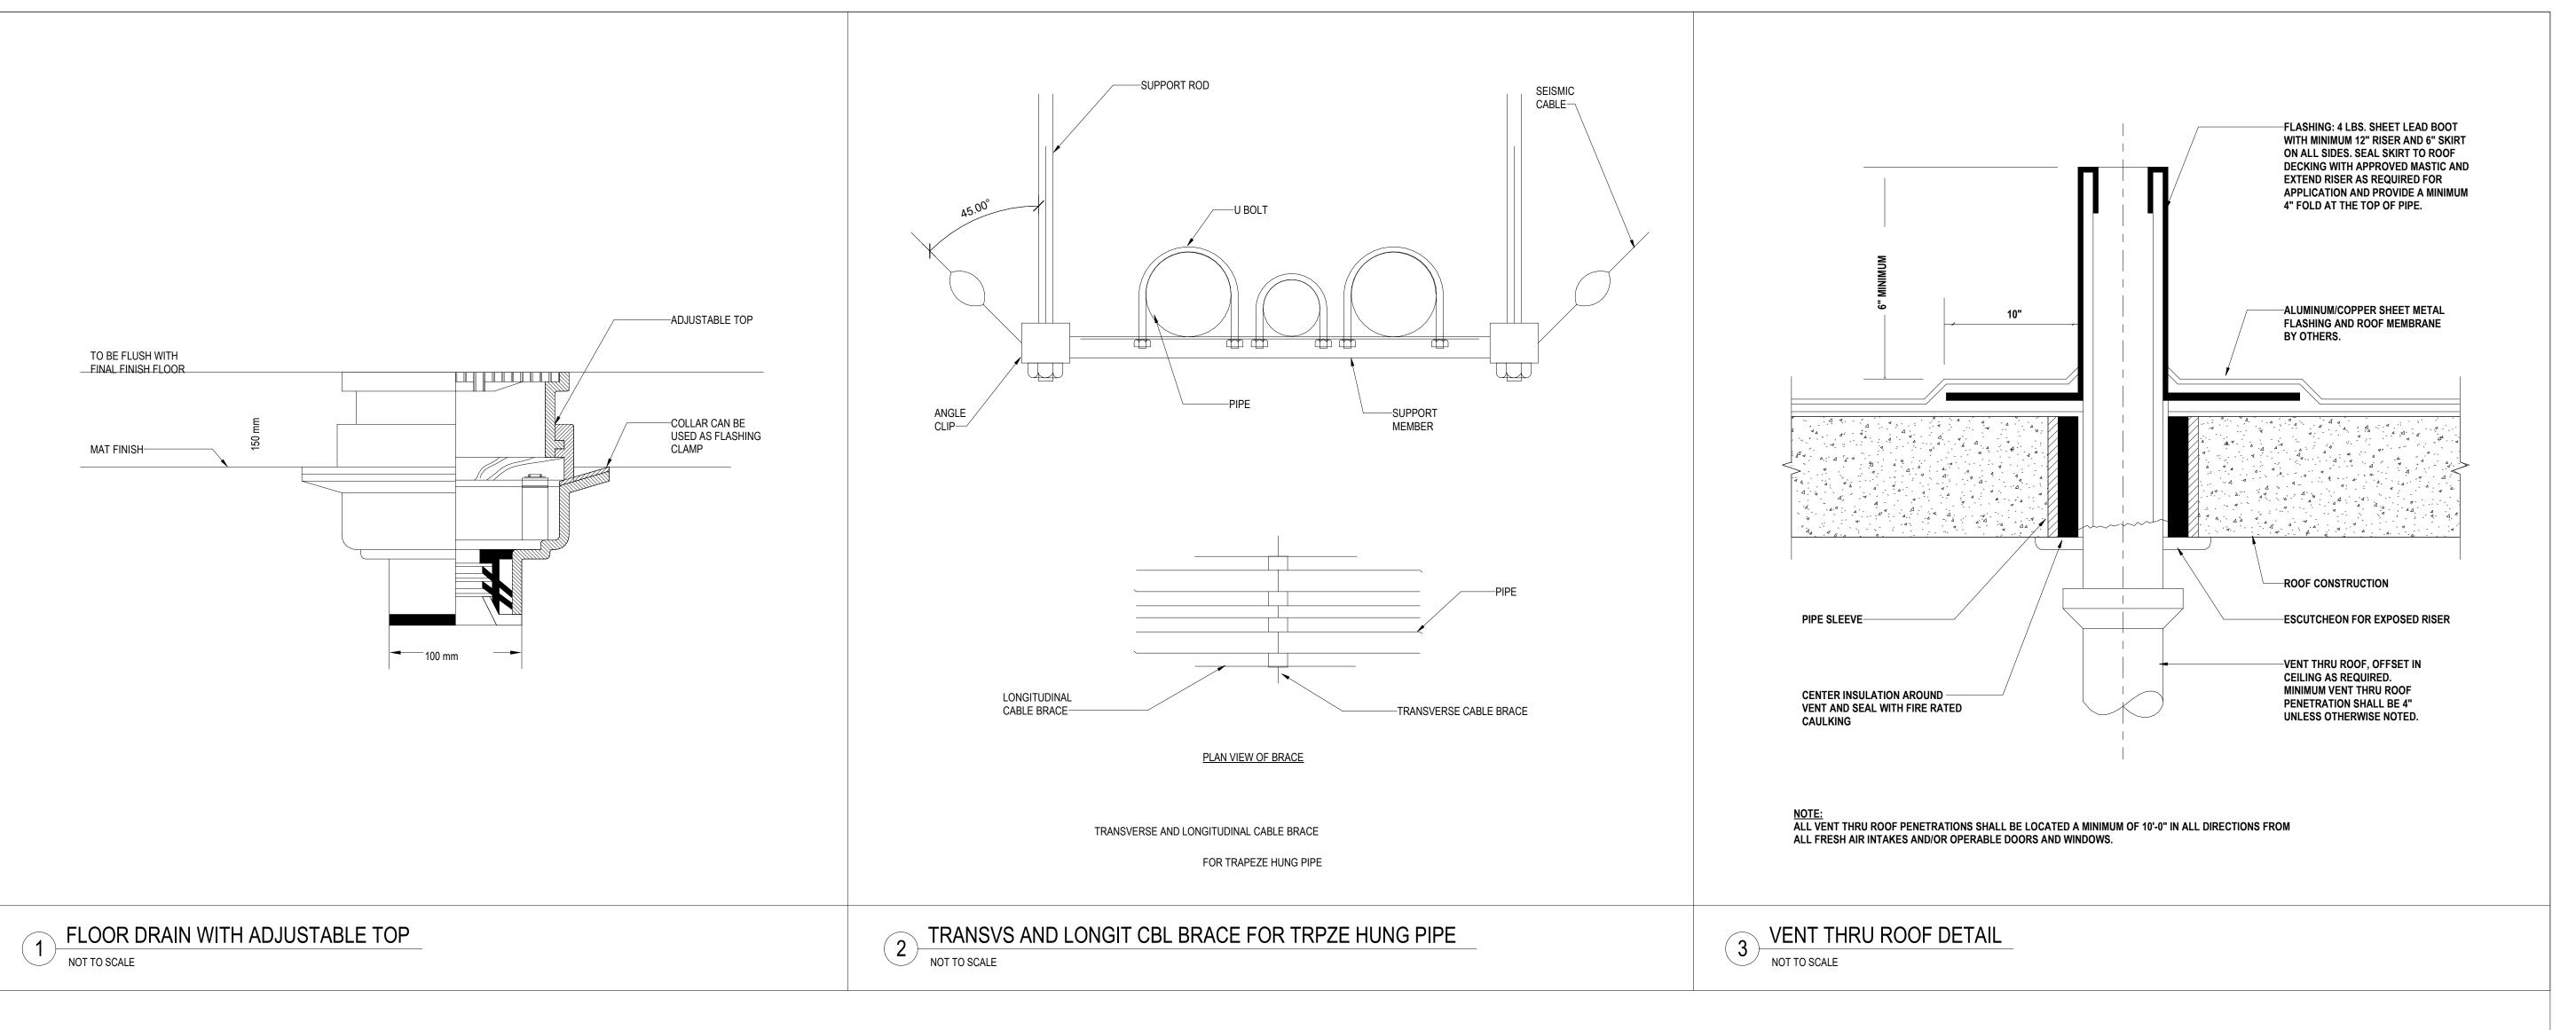

Storm King Art Center
1 Museum Road New Windsor, NY 12553 +1 (845) 534-3115

Design Architect heneghan peng architects 14-16 Lord Edward Street Dublin, D02 YC63 +353 1 633 9000

Owner

Executive Architect WXY Architecture + Urban Design 224 Centre Street, 5th Floor New York, NY 10013 +1 (212) 219-1953

Landscape Architect Gustafson Porter + Bowman 1 Cobham Mews London, MW1 9SB +44 020 7284 8950

Reed Hilderbrand LLC 33 Whitney Avenue, 3rd Floor New Haven, CT 06510 +1 (617) 923-2422

Structural & Lighting ARUP 77 Water Street

+1 (212) 896-3000 MEPF & IT BuroHappold

New York, NY 10005

100 Broadway #23 New York, NY 10005 +1 (212) 616-0228 Civil

VHB 100 Great Oaks Blvd., Suite 118

Albany, NY 12203 +1 (518) 389-3606

AV & Acoustics LSTN Consultants 76 Beaver Street, 2nd Floor New York, NY 10005 +1 (347) 788-0810

Facade Front Inc. 100 E. Broadway Street, #501 New York, NY 10002

+1 (212) 242-2220

Key Plan

Description Date 50% Design Development 02/24/20 100% Design Development 05/29/20 50% Construction Documents 11/06/20

Project

Storm King Art Center **Pond Pavilion**

NOT FOR CONSTRUCTION **Drawing Title** Plumbing Details

11/06/20 Date Not to Scale P-P-504 Number ARCH D Sheet Size

P - WATE	R HEATE	R SCH	HEDU	JLE							
DESIGNATION	LOCATION	STORAGE WATER TEMPERATURE	VOLUME	DIAMETER	HEIGHT/LENGTH	RECOVERY	TEMPERATURE RISE	ELECTRIC LOAD	MODEL NUMBER	MANUFACTURER	REMARKS
EWH-P-1-1	MECH RM	140	35	23"	32"		90	4.5 kW	E6-40L45DVB	AO Smith	PROVIDE THERMAL EXPANSION TANK SIMILAR AMTROL ST-5

P - REVE	RSE OSMO	SIS TREAT	TMENT PA	CKAGE SC	CHEDULE								
DESIGNATION	LOCATION	MANUFACTURER	MODEL NUMBER	SERVICE	QUANTITY				ELECTRICAL			SYSTEM WEIGHT	REMARKS
DESIGNATION	LOCATION	WANDI ACTORLIK	WODEL NOWBER	SLITTICE	QUANTITI	DEMAND (GPM)	FLA	FREQUENCY	KW	PHASE	VOLTAGE	(LBS)	REWARK
ROT	TRASH/PLUMBING		AR-5-2000	DOMESTIC WATER	1	6				1	220 V	115	

P - GREA	SE INTERCI	EPTOR SC	CHEDULE									
DESIGNATION	LOCATION	MANUFACTURER	MODEL NUMBER	TYPE	QUANTITY	FLOW (GPM)	CAPACITY (LBS)	VOLTAGE	FREQUENCY	AMPS	DIMENSIONS (LXWXH)	REMARKS
GI - P-1-1	TRASH/PLUMBING		PROCEPTOR 250		1	20						

+1 (845) 534-3115

Design Architect

heneghan peng architects 14-16 Lord Edward Street Dublin, D02 YC63 +353 1 633 9000

Executive Architect
WXY Architecture + Urban Design
224 Centre Street, 5th Floor
New York, NY 10013
+1 (212) 219-1953

Landscape Architect
Gustafson Porter + Bowman
1 Cobham Mews
London, MW1 9SB
+44 020 7284 8950

Reed Hilderbrand LLC 33 Whitney Avenue, 3rd Floor New Haven, CT 06510 +1 (617) 923-2422

Structural & Lighting
ARUP
77 Water Street

New York, NY 10005 +1 (212) 896-3000 MEPF & IT

BuroHappold 100 Broadway #23 New York, NY 10005 +1 (212) 616-0228

Civil VHB

100 Great Oaks Blvd., Suite 118

Albany, NY 12203 +1 (518) 389-3606

AV & Acoustics
LSTN Consultants
76 Beaver Street, 2nd Floor

New York, NY 10005 +1 (347) 788-0810

Facade Front Inc.

100 E. Broadway Street, #501 New York, NY 10002 +1 (212) 242-2220

Key Plan

DescriptionDate50% Design Development02/24/20100% Design Development05/29/2050% Construction Documents11/06/20

Project


Storm King
Art Center
Pond Pavilion

Sea

NOT FOR CONSTRUCTION
Drawing Title
Plumbing Schedules

Date	11/06/20
Scale	Not to Scale
Drawing Number	P-P-601
Sheet Size	ARCH D

ROOF LEVEL

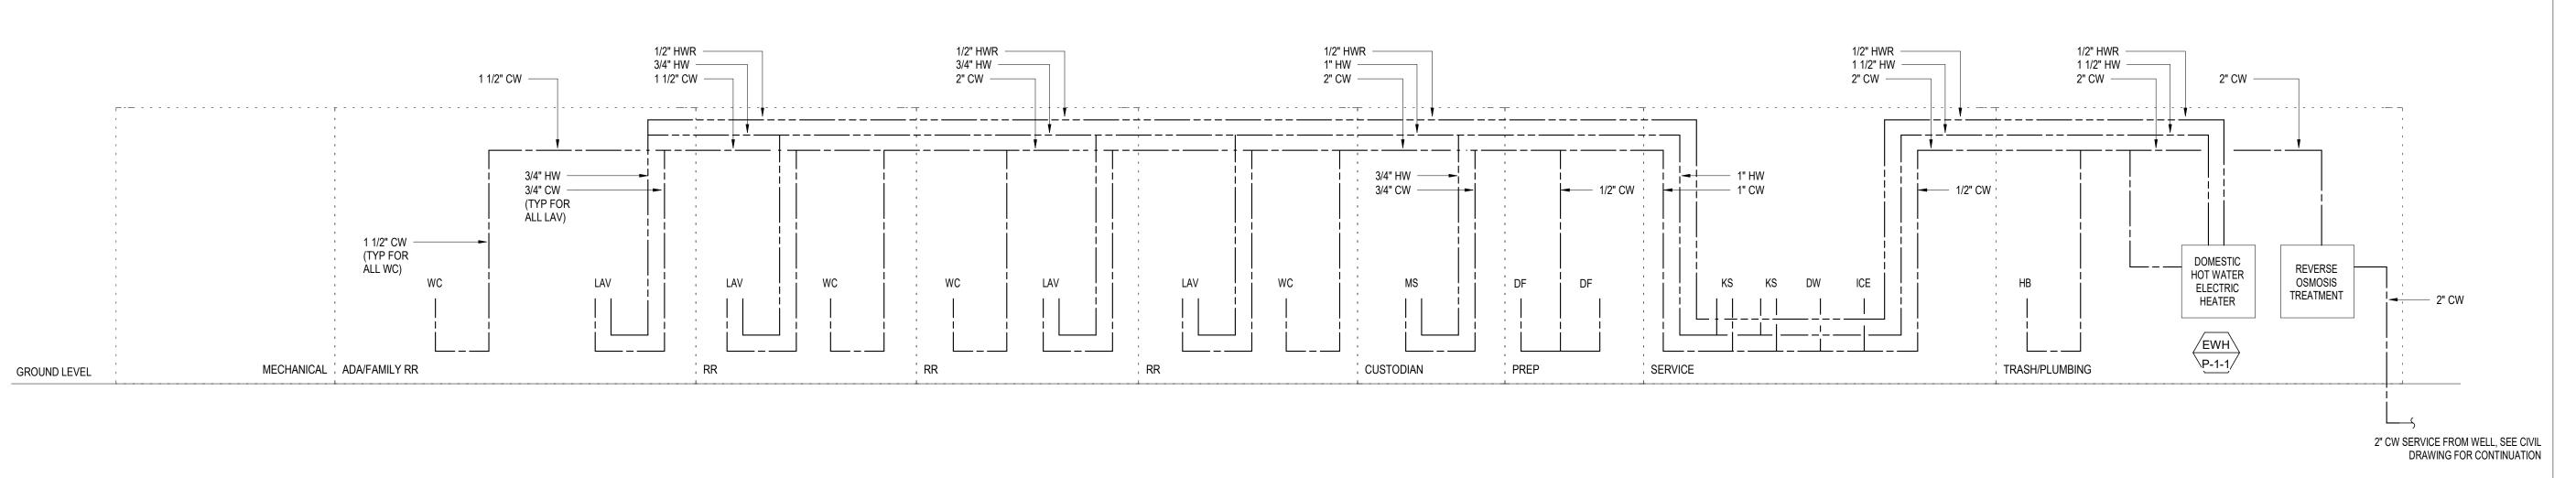

Owner
Storm King Art Center
1 Museum Road
New Windsor, NY 12553

+1 (845) 534-3115

Design Architect
heneghan peng architects
14-16 Lord Edward Street
Dublin, D02 YC63
+353 1 633 9000

Executive Architect
WXY Architecture + Urban Design
224 Centre Street, 5th Floor
New York, NY 10013
+1 (212) 219-1953

Landscape Architect
Gustafson Porter + Bowman
1 Cobham Mews
London, MW1 9SB
+44 020 7284 8950

Reed Hilderbrand LLC 33 Whitney Avenue, 3rd Floor New Haven, CT 06510

New Haven, C1 06510 +1 (617) 923-2422 Structural & Lighting

77 Water Street
New York, NY 10005
+1 (212) 896-3000

MEPF & IT

BuroHappold 100 Broadway #23 New York, NY 10005

+1 (212) 616-0228 **Civil** VHB

ARUP

100 Great Oaks Blvd., Suite 118

Albany, NY 12203 +1 (518) 389-3606

+1 (212) 242-2220

AV & Acoustics LSTN Consultants 76 Beaver Street, 2nd Floor New York, NY 10005

+1 (347) 788-0810

Facade
Front Inc.
100 E. Broadway Street, #501
New York, NY 10002

Key Plan

Description Date
50% Design Development 02/24/20
100% Design Development 05/29/20
50% Construction Documents 11/06/20


Project

Storm King
Art Center
Pond Pavilion

Sea

NOT FOR CONSTRUCTION
Drawing Title
Domestic water Riser

Date 11/06/20
Scale Not to Scale
Drawing Number P-P-701
Sheet Size ARCH D

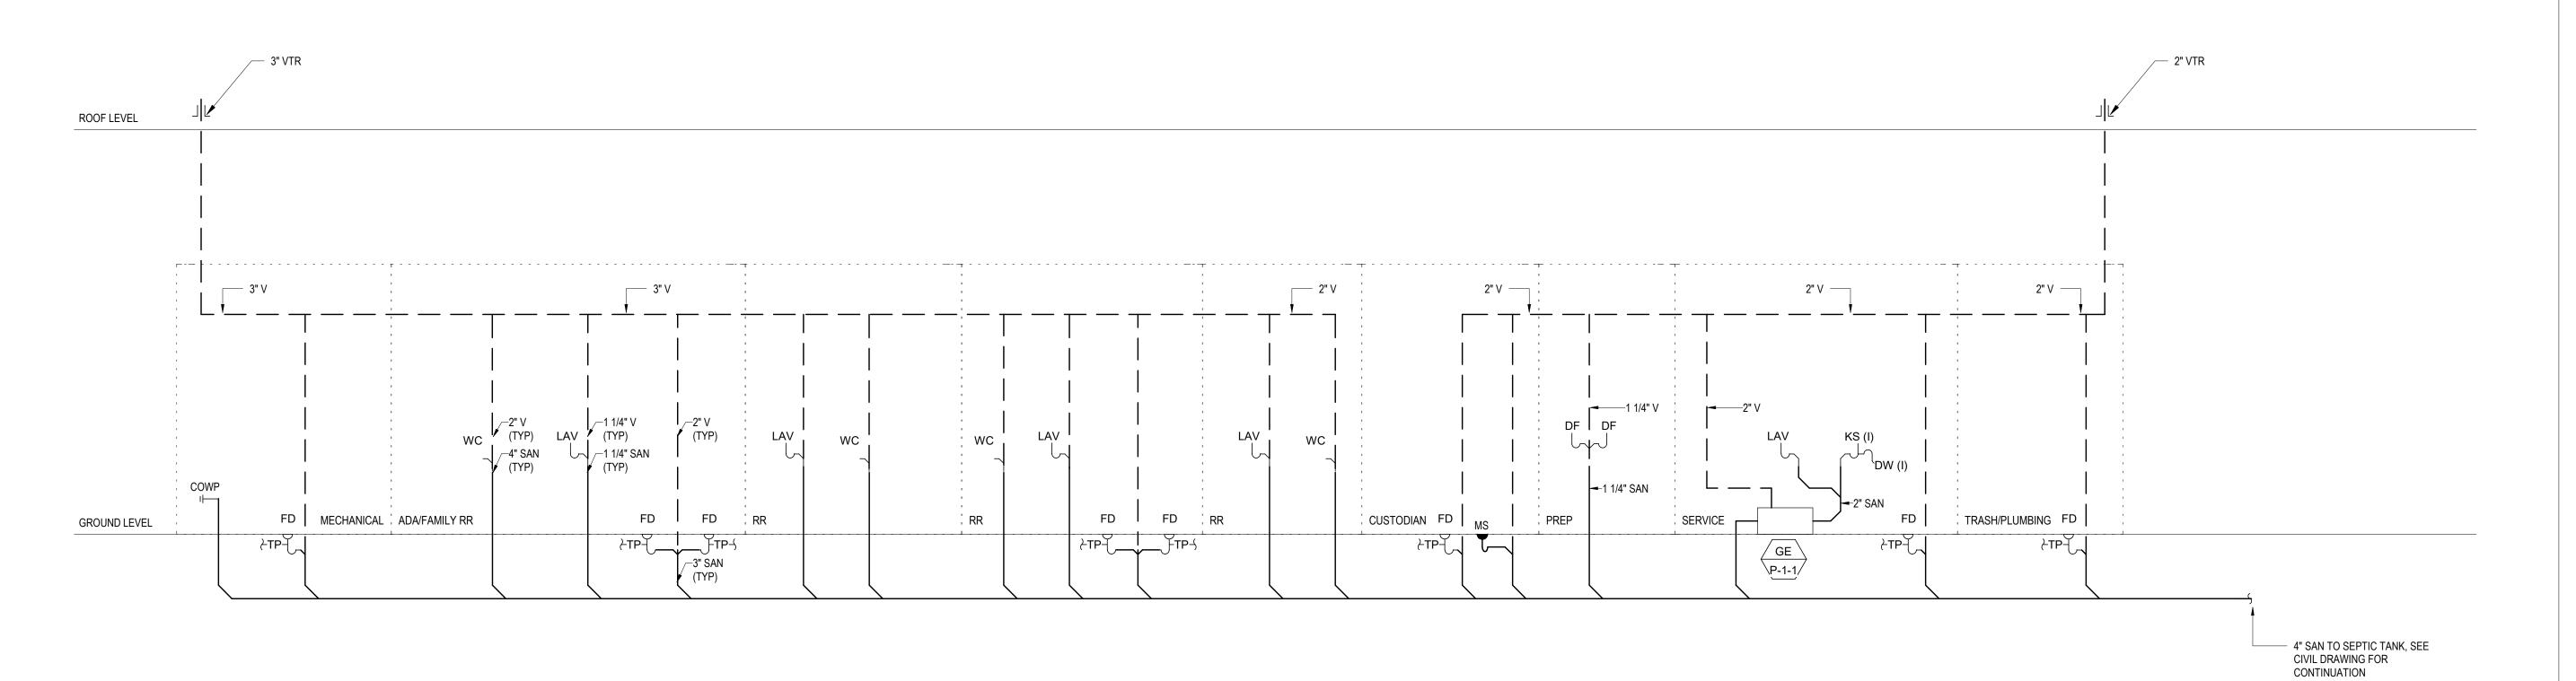

Owner
Storm King Art Center
1 Museum Road
New Windsor, NY 12553
+1 (845) 534-3115

Design Architect
heneghan peng architects
14-16 Lord Edward Street
Dublin, D02 YC63
+353 1 633 9000

Executive Architect
WXY Architecture + Urban Design
224 Centre Street, 5th Floor
New York, NY 10013
+1 (212) 219-1953

Landscape Architect
Gustafson Porter + Bowman
1 Cobham Mews
London, MW1 9SB
+44 020 7284 8950

Reed Hilderbrand LLC 33 Whitney Avenue, 3rd Floor New Haven, CT 06510 +1 (617) 923-2422

Structural & Lighting ARUP

77 Water Street
New York, NY 10005
+1 (212) 896-3000

MEPF & IT

BuroHappold 100 Broadway #23 New York, NY 10005

+1 (212) 616-0228 Civil

VHB 100 Great Oaks Blvd., Suite 118

Albany, NY 12203 +1 (518) 389-3606

AV & Acoustics
LSTN Consultants
76 Beaver Street, 2nd Floor

New York, NY 10005 +1 (347) 788-0810 Facade

Front Inc. 100 E. Broa

100 E. Broadway Street, #501 New York, NY 10002 +1 (212) 242-2220

Key Plan

DescriptionDate50% Design Development02/24/20100% Design Development05/29/20

11/06/20

50% Construction Documents


Project

Storm King
Art Center
Pond Pavilion

Sea

NOT FOR CONSTRUCTION
Drawing Title
Drain & Vent Riser

Date 11/06/20
Scale Not to Scale
Drawing Number P-P-702
Sheet Size ARCH D

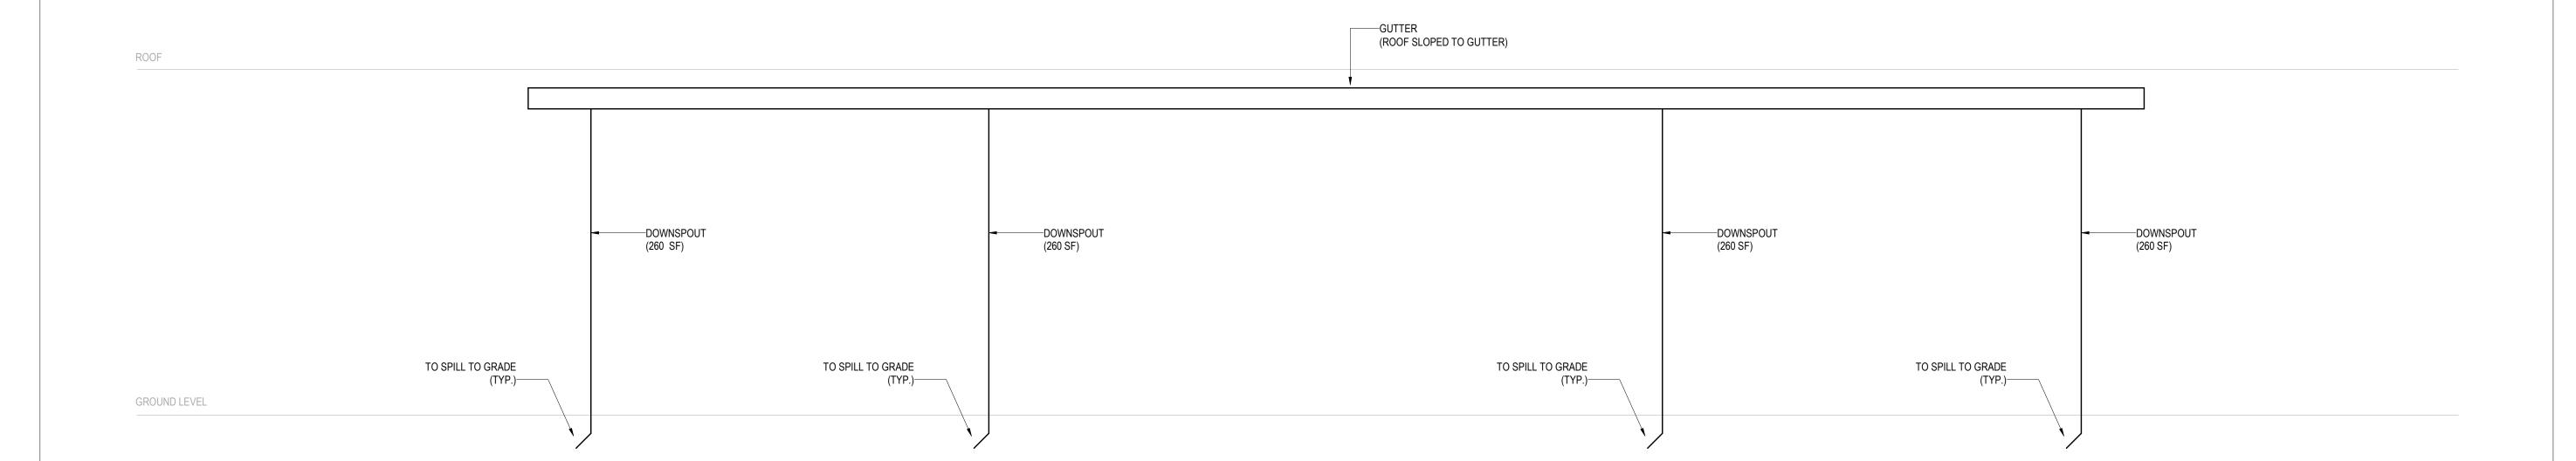

Owner
Storm King Art Center
1 Museum Road

New Windsor, NY 12553 +1 (845) 534-3115 Design Architect

Design Architect
heneghan peng architects
14-16 Lord Edward Street
Dublin, D02 YC63
+353 1 633 9000

Executive Architect
WXY Architecture + Urban Design
224 Centre Street, 5th Floor
New York, NY 10013
+1 (212) 219-1953

Landscape Architect
Gustafson Porter + Bowman
1 Cobham Mews
London, MW1 9SB
+44 020 7284 8950

Reed Hilderbrand LLC 33 Whitney Avenue, 3rd Floor New Haven, CT 06510 +1 (617) 923-2422

+1 (617) 923-2422
Structural & Lighting
ARUP

77 Water Street New York, NY 10005 +1 (212) 896-3000

MEPF & IT BuroHappold 100 Broadway #23 New York, NY 10005

+1 (212) 616-0228 **Civil** VHB

100 Great Oaks Blvd., Suite 118

Albany, NY 12203 +1 (518) 389-3606

AV & Acoustics LSTN Consultants 76 Beaver Street, 2nd Floor New York, NY 10005

+1 (347) 788-0810

Facade
Front Inc.

100 E. Broadway Street, #501 New York, NY 10002 +1 (212) 242-2220

Key Plan

DescriptionDate100% Design Development05/29/2050% Construction Documents11/06/20


Project

Storm King
Art Center
Pond Pavilion

Sea

NOT FOR CONSTRUCTION
Drawing Title
Storm Riser

Date	11/06/20
Scale	Not to Scale
Drawing Number	P-P-703
Sheet Size	ARCH D

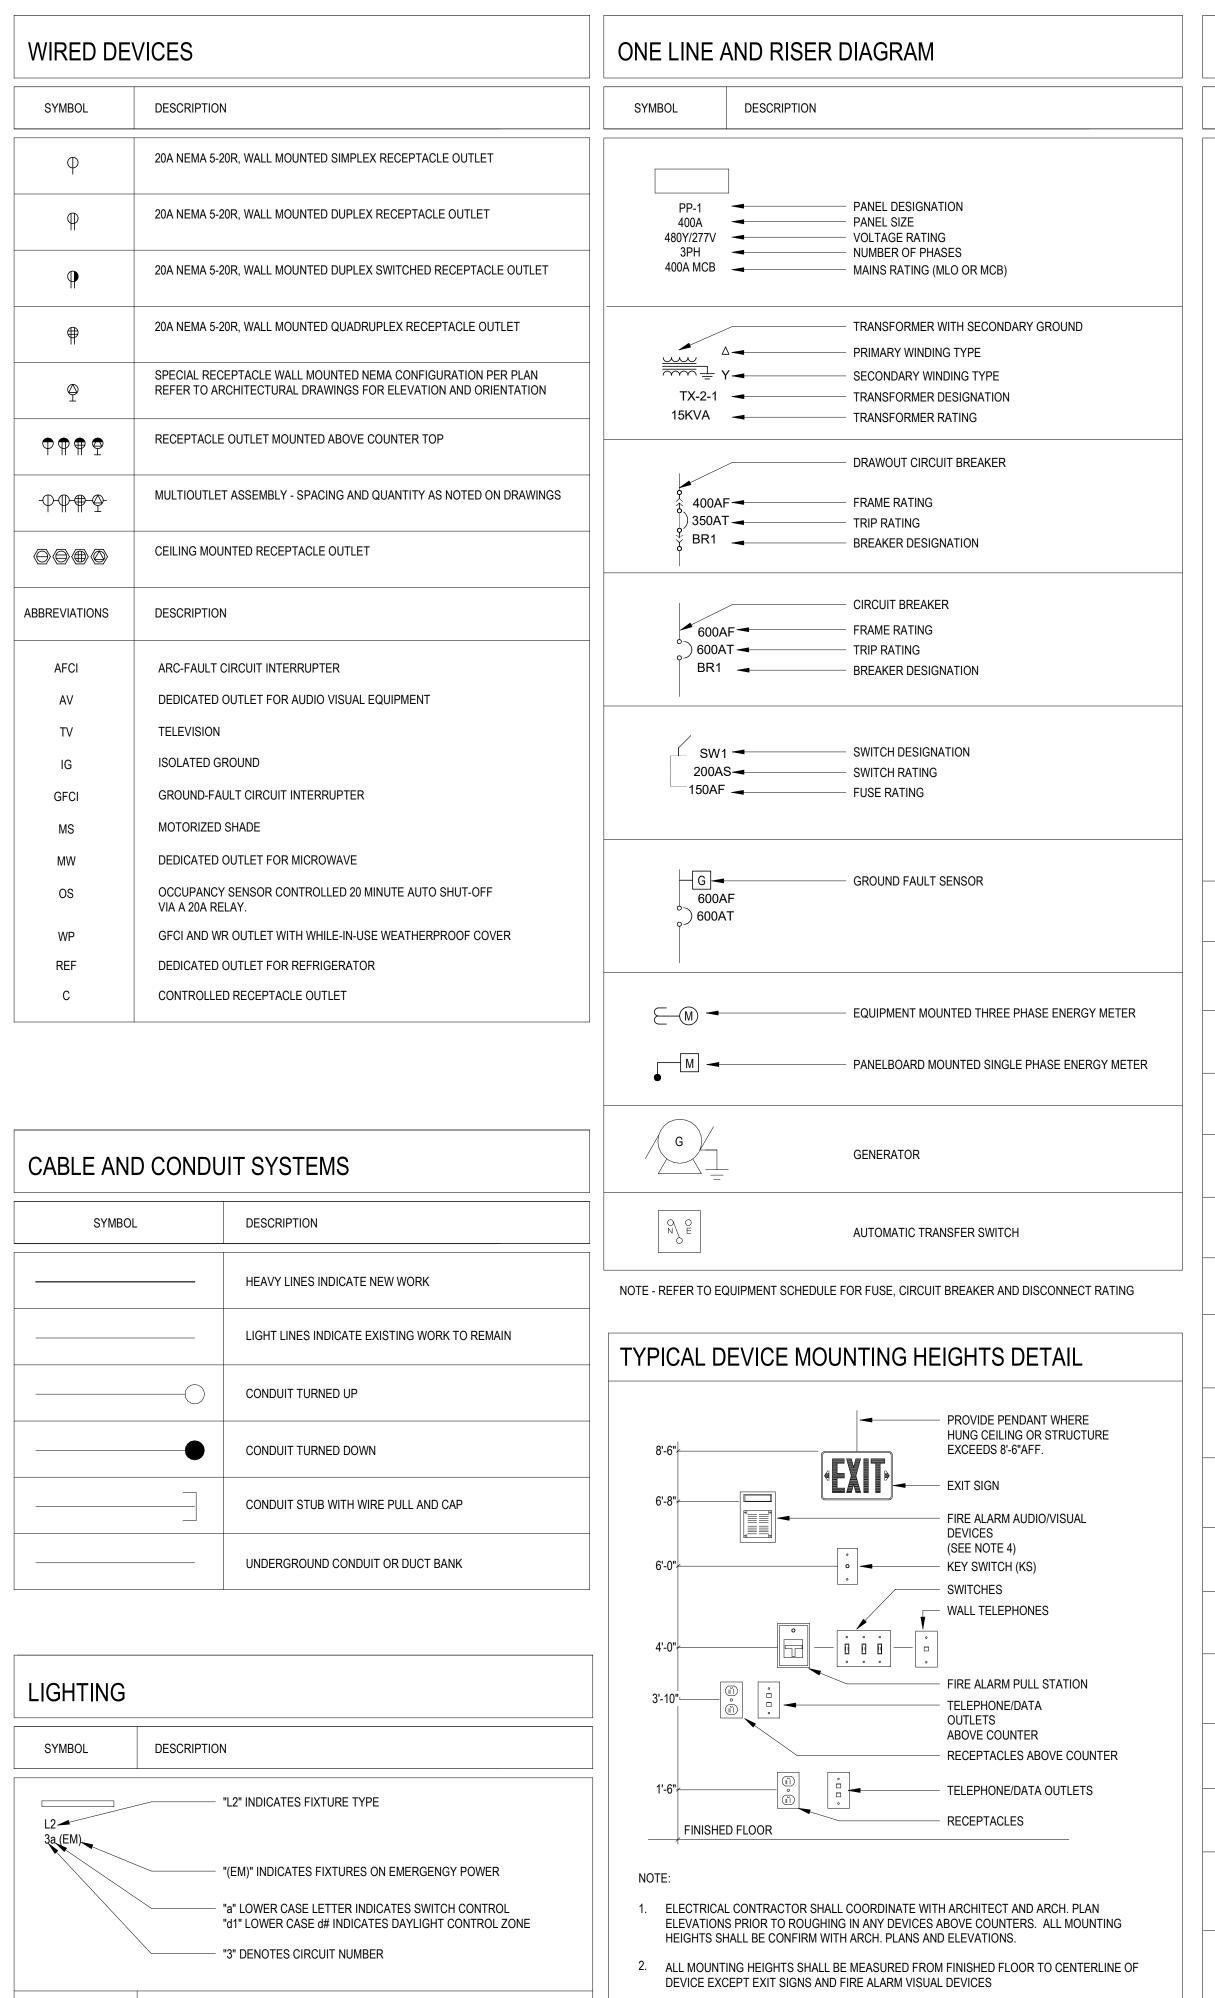

RECTANGULAR LIGHT FIXTURE

REFER TO ARCHITECTURAL EGRESS DRAWINGS FOR

ORIENTATION OF EXIT SIGN ARROWS AND FACES

CIRCULAR LIGHT FIXTURE


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3. DEVICES SHALL BE INSTALLED ON A COMMON VERTICAL CENTERLINE WHEREVER POSSIBLE

4. FIRE ALARM AUDIO/VISUAL DEVICE TO BE MOUNTED AT 6'-8" ABOVE FINISHED FLOOR OR AT

THE VISUAL PORTION OF THE DEVICE

6" BELOW FINISHED CEILING, WHICHEVER IS LOWER. DIMENSION IS TO THE BOTTOM OF

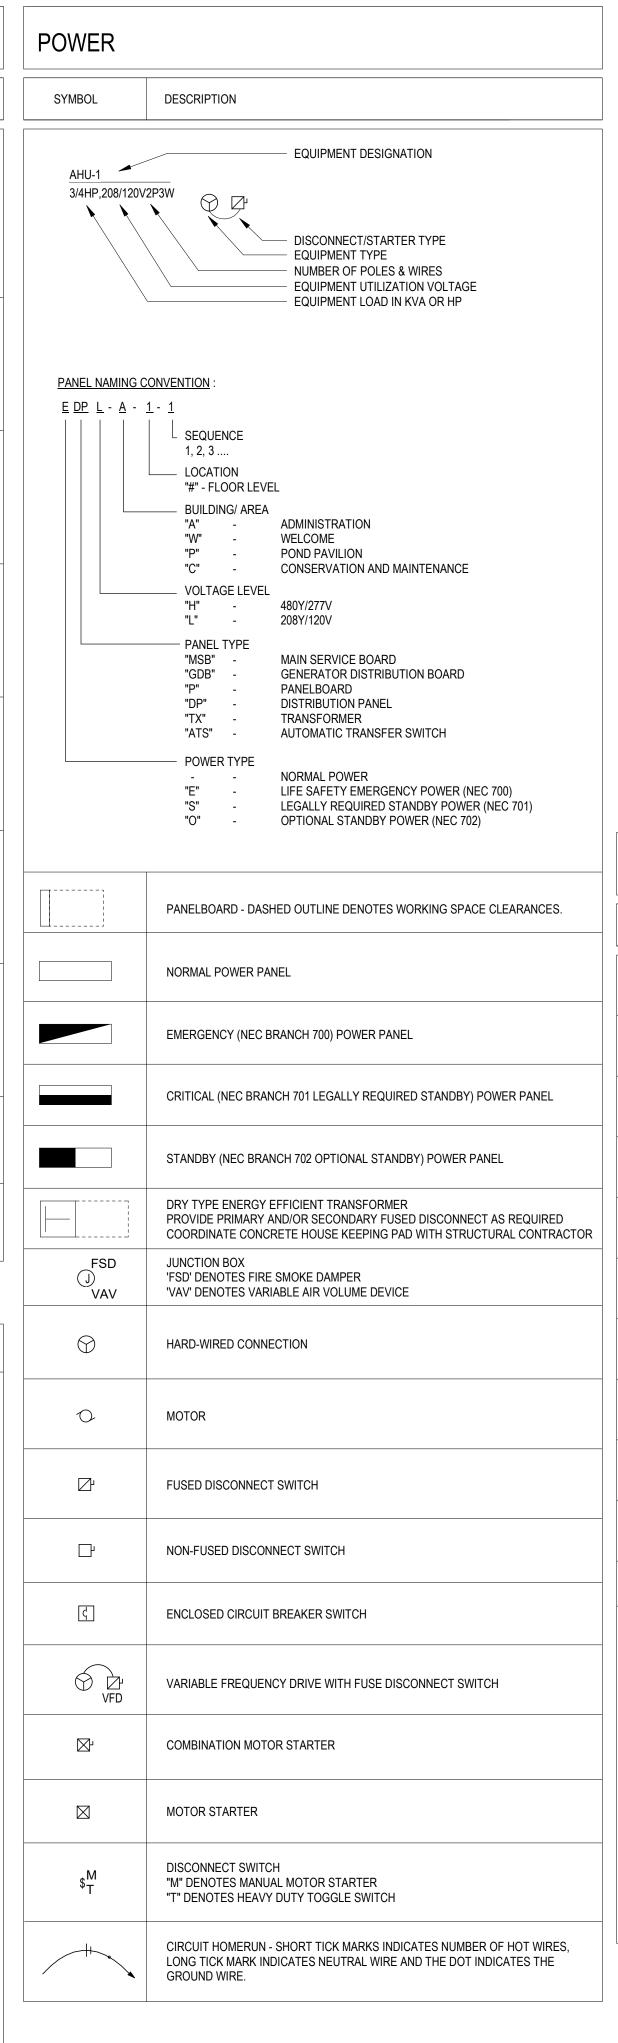

LIGHTNING	G PROTECTION	ELECTRIC	CAL ABBREVIATIONS
	AIR TERMINAL LOCATION	ABBREVIATION	DEFINITION
	7 art 12 twin v.c 2007 trion	A	AMPERE EDAME
•	CONNECTION	AF.F.	AMPERE FRAME ABOVE FINISHED FLOOR
 ₁	GROUNDING CONNECTION TO TRIPOD GROUNDING RING WITH INSPECTION TEST WELL	AHU	AIR HANDLING UNIT
	NAME WITH INCOME ENTROL VICES	AIC	AMPERE INTERRUPTING CAPACITY
	COUNTERPOISE LOOP BELOW GRADE. NO. LPC120 COPPER CABLE, U.L. LABELED, 29 ST., 17 GA., 192 LBS./1,000 FT., 59,450 CM.	AT ATS	AMPERE TRIP AUTOMATIC TRANSFER SWITCH
	(2# AWG)	BKR	BREAKER
	NO. LPC120 COPPER CABLE, U.L. LABELED, 29 ST., 17 GA., 192 LBS./1,000 FT., 59,450 CM. (2# AWG)	С	CONDUIT
		СВ	CIRCUIT BREAKER
	DOWN CONDUCTOR IN PVC CONDUIT	CCTV	CLOSED CIRCUIT TELEVISION
	GROUND CONNECTION TO BUILDING GROUNDING LOOP	COMM	COMMUNICATION CIRCUIT
		DIA	DIAMETER
	THRU-ROOF CABLE CONNECTION	DISC	DISCONNECT
\in	THRU-WALL LOCATION	DN	DOWN
		EC EM	EMERGENCY EMPTY CONDUIT
	STEEL COLUMN GROUNDING CONNECTION TO TRIPOD GROUNDING RING WITH INSPECTION TEST	EF	EXHAUST FAN
	WELL	ELEC	ELECTRICAL
		EMT	ELECTRICAL METAL TUBING
	GROUND CONNECTION TO BUILDING SERVICE PANEL FROM HANDHOLE	ETR	EXISTING EXISTING TO REMAIN
		FBO	FURNISHED BY OTHER
)	GROUND CONNECTION TO BUILDING STEEL WHERE	FDR	FEEDER
•——	REQUIRED	FLEX	FLEXIBLE
		FMC	FLEXIBLE METAL CONDUIT
		FSD FT	FIRE SMOKE DAMPER FEET OR FOOT
LIGHTING	CONTROL DEVICES	GND	GROUND
		GFCI	GROUND FAULT CIRCUIT INTERRUPTER
SYMBOL	DESCRIPTION	GSC	GALVANIZED STEEL CONDUIT
	LINE VOLTAGE LIGHT SWITCH	HP	HORSE POWER
\$ 3 a	LOWER CASE LETTER DENOTES LIGHTING ZONE "3" DENOTES THREE WAY SWITCH	HZ IMC	HERTZ INTERMEDIATE METAL CONDUIT
		IG	ISOLATED GROUND
●	CEILING MOUNTED PIR VACANCY SENSOR	KAIC	KILO-AMPS INTERUPTING CAPACITY
		KV	KILOVOLT
Φ	CEILING MOUNTED ULTRASOUND VACANCY SENSOR	KVA	KILOVOLT AMPERE KILOWATT
	CEILING MOUNTED DUAL TECH. VACANCY SENSOR	LTG	LIGHTING
⊚		MCB	MAIN CIRCUIT BREAKER
a \$	PIR OCCUPANCY SENSOR SWITCH	MCM,KCML	THOUSAND CIRCULAR MILS
<u>\$</u>	TIN OCCUPANCE SENSON SWITCH	MD ML	MOTORIZED DAMPER MAGNETIC DOOR HOLDER
A	ULTRASOUND OCCUPANCY SENSOR SWITCH	MLC	MOTOR LOGIC CONTROL
<u>\$</u>	SETTAGOOND GOOD ANOT SENGON OWITOH	MLO	MAIN LUGS ONLY
2 \$	DUAL TECH. OCCUPANCY SENSOR SWITCH	MTD	MOUNTED
Φ		MTG MTS	MOUNTING MANUAL TRANSFER SWITCH
	WALL MOUNTED PIR OCCUPANCY SENSOR	N N	NORMAL NORMAL
		NEMA	NATIONAL ELECTRICAL MANUFACTURERS ASSOCIATION
D	DAYLIGHT SENSOR SEE LIGHTING SPECIFICATION	NIC	NOT IN CONTRACT
\		NTS PC	NOT TO SCALE PERSONAL COMPUTER
	WALL MOUNTED PILOT LIGHT	PH,Ø	PHASE
ABBREVIATION	DESCRIPTION	PNL	PANEL
ADDITEVIATION	DECOMI HON	PWR	POWER
a	LOWER CASE LETTER DENOTES LIGHTING ZONE	RL	RELOCATED EXISTING DEVICE REFRIGERATOR
3	THREE WAY SWITCH	SCCR	SHORT CIRCUIT CURRENT RATING
4	FOUR WAY SWITCH	SD	SMOKE DAMPER
D	LINE VOLTAGE DIMMER SWITCH	SP	SMOKE PURGE
LD	LOW VOLTAGE DIMMER SWITCH	SS	STAINLESS STEEL TYPICAL
К	KEY OPERATED SWITCH	TVSS	TRANSIENT VOLTAGE SURGE SUPPRESSOR
LV	LOW VOLTAGE SWITCH	U/C	UNDERCOUNTER
SS	SCENE SET WALL STATION	UH	UNIT HEATER
0	OCCUPANCY SENSOR (AUTO ON/AUTO OFF)	U.O.N.	UNLESS OTHERWISE NOTED
V	VACANCY SENSOR (MANUAL ON/AUTO OFF)	V	VOLTAGE VIEWBOX
	1	VFD	VARIABLE FREQUENCY DRIVE
		W	WIRE
		WOS	WITHOUT SUBSTITUTION
		WP	WEATHERPROOF WEATHER-RESISTANT

	AIR TERMINAL LOCATION	А	AMPERE
	CONNECTION	AF	AMPERE FRAME
		A.F.F.	ABOVE FINISHED FLOOR
	GROUNDING CONNECTION TO TRIPOD GROUNDING RING WITH INSPECTION TEST WELL	AHU	AIR HANDLING UNIT
		AIC	AMPERE INTERRUPTING CAPACITY
	COUNTERPOISE LOOP BELOW GRADE. NO. LPC120 COPPER CABLE, U.L. LABELED, 29 ST., 17 GA., 192 LBS./1,000 FT., 59,450 CM.	AT	AMPERE TRIP
	(2# AWG)	ATS	AUTOMATIC TRANSFER SWITCH
	NO. LPC120 COPPER CABLE, U.L. LABELED, 29 ST., 17	BKR	BREAKER
	GA., 192 LBS./1,000 FT., 59,450 CM. (2# AWG)	С	CONDUIT
		СВ	CIRCUIT BREAKER
<u></u>	DOWN CONDUCTOR IN PVC CONDUIT	CCTV	CLOSED CIRCUIT TELEVISION
		СОММ	COMMUNICATION
	GROUND CONNECTION TO BUILDING GROUNDING LOOP	CKT	CIRCUIT
		DIA	DIAMETER
_	THRU-ROOF CABLE CONNECTION	DISC	DISCONNECT
		DN	DOWN
	THRU-WALL LOCATION	EM	EMERGENCY
		EC	EMPTY CONDUIT
`	STEEL COLUMN GROUNDING CONNECTION TO TRIPOD GROUNDING RING WITH INSPECTION TEST	EF	EXHAUST FAN
	WELL	ELEC	ELECTRICAL
		EMT	ELECTRICAL METAL TUBING
	GROUND CONNECTION TO BUILDING SERVICE	EX	EXISTING
*	PANEL FROM HANDHOLE	ETR	EXISTING TO REMAIN
		FBO	FURNISHED BY OTHER
	GROUND CONNECTION TO BUILDING STEEL WHERE	FDR	FEEDER
	REQUIRED	FLEX	FLEXIBLE
	T. C.	FMC	FLEXIBLE METAL CONDUIT
		FSD	FIRE SMOKE DAMPER
		FT FT	FEET OR FOOT
CO	NTROL DEVICES	GND	GROUND
		GFCI	GROUND FAULT CIRCUIT INTERRUPTER
DI	ESCRIPTION	GSC	GALVANIZED STEEL CONDUIT
		HP	HORSE POWER
	INE VOLTAGE LIGHT SWITCH OWER CASE LETTER DENOTES LIGHTING ZONE	HZ	HERTZ
	" DENOTES THREE WAY SWITCH	IMC	INTERMEDIATE METAL CONDUIT
		IG	ISOLATED GROUND
С	EILING MOUNTED PIR VACANCY SENSOR	KAIC	KILO-AMPS INTERUPTING CAPACITY
		KV	KILOVOLT
C	EILING MOUNTED ULTRASOUND VACANCY SENSOR	KVA	KILOVOLT AMPERE
	ELENO MODITED SETTINGUIS VIOLATION SETTING	KW	KILOWATT
01	THING MOUNTED BUILD TEGUL VACANOV OFNOOD	LTG	LIGHTING
	EILING MOUNTED DUAL TECH. VACANCY SENSOR	MCB	MAIN CIRCUIT BREAKER
		MCM,KCML	THOUSAND CIRCULAR MILS
PI	R OCCUPANCY SENSOR SWITCH	MD	MOTORIZED DAMPER
		ML	MAGNETIC DOOR HOLDER
		MLC	MOTOR LOGIC CONTROL
UL	TRASOUND OCCUPANCY SENSOR SWITCH	MLO	MAIN LUGS ONLY
			MOUNTED
DU	JAL TECH. OCCUPANCY SENSOR SWITCH	MTD	
		MTG	MOUNTING
14,	ALL MOUNTED DID OCCUDANCY SENSOD	MTS	MANUAL TRANSFER SWITCH
W	ALL MOUNTED PIR OCCUPANCY SENSOR	N	NORMAL
	DVI JOHT OFNOCE	NEMA	NATIONAL ELECTRICAL MANUFACTURERS ASSOCIATION
	AYLIGHT SENSOR EE LIGHTING SPECIFICATION	NIC	NOT IN CONTRACT
ļ		NTS	NOT TO SCALE
\	ALL MOUNTED PILOT LIGHT	PC	PERSONAL COMPUTER
"	, LE MOUNTED LIEUT EIGHT	PH,Ø	PHASE
	CODIDTION	PNL	PANEL
DI	ESCRIPTION	PWR	POWER
10	OWER CASE LETTER DENOTES LIGHTING ZONE	RL	RELOCATED EXISTING DEVICE
		REF	REFRIGERATOR
TI	HREE WAY SWITCH	SCCR	SHORT CIRCUIT CURRENT RATING
F	OUR WAY SWITCH	SD	SMOKE DAMPER
	INE VOLTAGE DIMMER SWITCH	SP	SMOKE PURGE
		SS	STAINLESS STEEL
L	OW VOLTAGE DIMMER SWITCH	TYP	TYPICAL
K	EY OPERATED SWITCH		
10	OW VOLTAGE SWITCH	TVSS	TRANSIENT VOLTAGE SURGE SUPPRESSOR
		U/C	UNDERCOUNTER
S	CENE SET WALL STATION	UH	UNIT HEATER
0	CCUPANCY SENSOR (AUTO ON/AUTO OFF)	U.O.N.	UNLESS OTHERWISE NOTED
	ACANCY SENSOR (MANUAL ON/AUTO OFF)	V	VOLTAGE
	NONTO FOLIVOUN (IVIMINUAL UNIAUTU UPF)	VB	VIEWBOX
		VFD	VARIABLE FREQUENCY DRIVE
		W	WIRE
			WITHOUT SUBSTITUTION
		WOS	William Cobollicitor
		WP WR	WEATHERPROOF WEATHER-RESISTANT

	+1 (845) 534-3115
	Design Architect heneghan peng architects 14-16 Lord Edward Street
	Dublin, D02 YC63 +353 1 633 9000
	Executive Architect WXY Architecture + Urban Design
	224 Centre Street, 5th Floor New York, NY 10013 +1 (212) 219-1953
	Landscape Architect Gustafson Porter + Bowman
	1 Cobham Mews London, MW1 9SB +44 020 7284 8950
	Reed Hilderbrand LLC 33 Whitney Avenue, 3rd Floor
	New Haven, CT 06510 +1 (617) 923-2422
	Structural & Lighting ARUP 77 Water Street
	New York, NY 10005 +1 (212) 896-3000
	MEPF & IT BuroHappold 100 Broadway #23
	New York, NY 10005 +1 (212) 616-0228
	Civil VHB
	100 Great Oaks Blvd., Suite 118 Albany, NY 12203 +1 (518) 389-3606
	AV & Acoustics LSTN Consultants
	76 Beaver Street, 2nd Floor New York, NY 10005 +1 (347) 788-0810
	Facade Front Inc.
	100 E. Broadway Street, #501 New York, NY 10002 +1 (212) 242-2220
	Key Plan
	Description Date 50% Design Development 02/24/20
	100% Design Development 05/29/20 50% Construction Documents 11/06/20
ATION	Storm King
	Art Center
	Pond Pavilion
	Seal
	NOT FOR CONSTRUCTION Drawing Title
	Abbreviations,
	Symbols, and
	Legends

11/06/20

ARCH D

Not to Scale

E-P-001

Date

Scale

Drawing

Number

Sheet Size

Storm King Art Center

New Windsor, NY 12553

1 Museum Road

+1 (845) 534-3115

A. CONTRACT PERFORMANCE

1. EXECUTE THE WORK IN THE BEST AND MOST THOROUGH MANNER AND TO THE SATISFACTION OF THE CONSULTING ENGINEER, WHO WILL JOINTLY INTERPRET THE MEANING OF THE DRAWINGS AND SPECIFICATIONS AND SHALL HAVE THE POWER TO REJECT ANY WORK AND MATERIALS. WHICH IN THEIR JUDGMENT ARE NOT IN FULL ACCORDANCE THEREWITH.

2. EXCEPT FOR CHANGES AS MAY BE SPECIFICALLY APPROVED BY THE CONSULTING ENGINEERS, IN ACCORDANCE WITH ALTERNATES OF OPTIONS STATED HEREINAFTER, ALL WORK MUST BE IN FULL ACCORDANCE WITH THE INTENT OF THE PLANS AND SPECIFICATIONS, COMPLETE IN EVERY WAY AND READY FOR SATISFACTORY AND EFFICIENT OPERATION WHEN DELIVERED TO THE

3. WHERE DISAGREEMENTS OCCUR BETWEEN THE PLANS AND THE SPECIFICATIONS, OR WITHIN EITHER DOCUMENT ITSELF, THE ITEM OR ARRANGEMENT OF BETTER QUALITY, GREATER QUANTITY OR HIGHER COST SHALL BE INCLUDED IN THE BASE BID.

4. THE DRAWINGS SHOW THE VARIOUS CONDUIT AND PIPING SYSTEMS SCHEMATICALLY. CONTRACTOR SHALL FURNISH AND INSTALL ALL NECESSARY JUNCTION BOXES, PULL BOXES, SUPPORT AND ACCESSORIES TO MEET APPLICABLE CODES, BUILDING STANDARDS AND FULFILL CONTRACT DOCUMENTS. NO ADDED COMPENSATION WILL BE PERMITTED FOR VARIATIONS DUE

5. THE CONTRACTOR COVENANTS AND AGREES THAT THEY AND THEIR SUBCONTRACTORS AND THEY AND THEIR AGENTS, SERVANTS AND EMPLOYEES WILL PROVIDE AND MAINTAIN A SAFE PLACE TO WORK AND THAT THEY WILL COMPLY WITH ALL LAWS AND REGULATIONS OF ANY GOVERNMENTAL AUTHORITY HAVING JURISDICTION THEREOF AND THE CONTRACTOR AGREES TO INDEMNIFY, DEFEND AND HOLD HARMLESS THE CONSULTING ENGINEER, ARCHITECT AND OWNER FROM AND AGAINST ANY LIABILITY, LOSS, DAMAGE OR EXPENSE, INCLUDING ATTORNEY'S FEES ARISING FROM FAILURE OR ALLEGED FAILURE ON THE PART OF THE CONTRACTOR, THEIR SUBCONTRACTORS AND THEIR AGENTS, SERVANTS AND EMPLOYEES TO PROVIDE AND MAINTAIN A SAFE PLACE TO WORK OR TO COMPLY WITH ALL LAWS AND REGULATIONS OF ANY GOVERNMENTAL AUTHORITY HAVING JURISDICTION THEREOF.

6. THE CONTRACTOR AND EACH SUBCONTRACTOR COVENANTS AND AGREES TO INDEMNIFY. DEFEND AND HOLD HARMLESS THE CONSULTING ENGINEER, ARCHITECT AND OWNER FROM AND AGAINST ANY LIABILITY, LOSS, DAMAGE OR EXPENSE, INCLUDING ATTORNEY'S ARISING FROM A FAILURE OR ALLEGED FAILURE ON THE PART OF THE CONTRACTOR. THEIR SUBCONTRACTORS AND THEIR AGENTS. SERVANTS AND EMPLOYEES PROPERLY TO DISCHARGE THE OBLIGATIONS ASSUMED BY THEM IN THE PERFORMANCE OF THE WORK, INCLUDING ANY ACT OR OMISSION ALLEGEDLY RESULTING IN DEATH OR PERSONAL INJURY OR PROPERTY DAMAGE OR IMPROPER CONSTRUCTION, CONSTRUCTION TECHNIQUES OR THE USE OF IMPROPER OR INAPPROPRIATE MATERIAL OR TOOLS.

7. THE CONTRACTOR AGREES THAT ANY CONTROVERSY OR DISPUTE TO WHICH THE CONTRACTOR, THE ARCHITECT, AND THE CONSULTING ENGINEERS ARE PARTIES SHALL BE SUBMITTED TO ARBITRATION FOR DECISION IN ACCORDANCE WITH THE RULES OF SUCH ASSOCIATION FOR CONSTRUCTION INDUSTRY DISPUTES. ALL SUBCONTRACTORS LIKEWISE AGREE TO SUBMIT TO SUCH ARBITRATION ANY DISPUTE BETWEEN OR AMONG THEM, THE CONTRACTOR, THE ARCHITECT AND THE CONSULTING ENGINEERS, AND THE CONTRACTOR AGREES TO MAKE AVAILABLE TO THE CONSULTING ENGINEERS ON DEMAND SIGNED COPIES OF THE CONTRACT BETWEEN THE OWNER AND THE CONTRACTOR AND BETWEEN THE CONTRACTOR AND THEIR SUBCONTRACTORS. THE CONTRACTOR AND EACH SUBCONTRACTOR AGREE THAT BY SUBMITTING A BID WHICH IS ACCEPTED, THIS PARAGRAPH SHALL BE DEEMED A WRITTEN AGREEMENT TO SUBMIT ANY CONTROVERSY THEREAFTER ARISING ARBITRATION.

8. ALL WORK SHALL BE DONE IN CONFORMANCE WITH THE FOLLOWING STANDARDS:

- A. THE NATIONAL ELECTRICAL CODE. B. THE NEW YORK STATE BUILDING CODE.
- C. THE REQUIREMENTS OF UNDERWRITERS' LABORATORIES INC. D. AMERICAN NATIONAL STANDARD INSTITUTE
- E. ILLUMINATING ENGINEERING SOCEITY F. CERTIFIED BALLAST MANUFACTURERS
- G. O.S.H.A. AND ALL AGENCIES HAVING JURISDICTION.

9. OBTAIN ALL NECESSARY PERMITS AND APPROVAL FROM GOVERNING AUTHORITIES AND FILE ALL NECESSARY FORMS. PAY ALL INSPECTION FEES.

10. COORDINATE SCHEDULING OF ALL WORK TO BE PERFORMED WITH OWNER AND/OR THEIR AGENT AND INCLUDE ALL NECESSARY PREMIUM TIME REQUIRED FOR SHUTDOWNS, WORK IN OCCUPIED AREAS, ETC.

11. ALL AREAS ASSOCIATED WITH WORK TO BE PERFORMED SHALL BE EXAMINED PRIOR TO BID SUBMISSION. NO ADDITIONAL COMPENSATION SHALL BE MADE FOR CONDITIONS FOUND DURING

12. BEFORE COMMENCING WORK, EXAMINE ALL ADJOINING WORK ON WHICH THIS WORK IS IN ANY WAY DEPENDENT FOR PERFECT WORKMANSHIP ACCORDING TO THE INTENT OF THIS SPECIFICATION, AND REPORT TO THE CONSTRUCTION MANAGER ANY CONDITION WHICH PREVENTS PERFORMANCE OF FIRST-CLASS WORK. NO "WAIVER OF RESPONSIBILITY" FOR INCOMPLETE, INADEQUATE OR DEFECTIVE ADJOINING WORK WILL BE CONSIDERED UNLESS NOTICE HAS BEEN FILED BEFORE SUBMITTAL OF A PROPOSAL.

13. COORDINATE ALL WORK WITH OTHER TRADES TO INSURE INSTALLATION IS MADE IN ACCORDANCE WITH THE CONTRACT DOCUMENTS.

14. FURNISH ADEQUATE LIABILITY INSURANCE AND BONDING AS REQUIRED BY OWNER.

15. INCLUDE ALL LABOR, MATERIALS, AND APPURTENANCES REQUIRED FOR THE FURNISHING. INSTALLING AND TESTING OF ALL WORK. COMPLETE AND MAKE READY FOR OPERATION IN A MANNER SATISFACTORY TO THE ARCHITECT AND CONSULTING ENGINEER, ALL WORK SHOWN ON DRAWINGS AND SPECIFIED HEREIN.

16. ALL WORK SHALL BE GUARANTEED FOR TWO (2) FULL YEARS FROM THE DATE WHEN THE OWNER HAS ISSUED A "CERTIFICATE OF SUBSTANTIAL COMPLETION".

INSTALLATION PROCEDURE

1. THIS CONTRACTOR'S WORK SHALL INCLUDE, BUT NOT BE LIMITED TO THE FOLLOWING: FURNISHING AND INSTALLATION OF ALL ELECTRICAL WORK, INCLUDING ELECTRICAL AND COMMUNICATIONS OUTLETS IN WALLS AND FLOOR, LIGHTING FIXTURES WITH LAMPS, SWITCHES, DIMMERS, EMERGENCY BATTERY UNITS, ETC., AND ASSOCIATED BRANCH CIRCUIT WIRING, DISCONNECT SWITCHES, SPECIAL RECEPTACLES, ETC. ALL SPECIAL EQUIPMENT, SUCH AS FANS, AIR CONDITIONING UNITS, COPIERS, ETC. WILL BE FURNISHED BY OTHERS (U.O.N.). WHERE EQUIPMENT REQUIRES PERMANENT CONNECTIONS, THESE CONNECTIONS SHALL BE PROVIDED WITH APPROPRIATE DISCONNECTING MEANS.

2. ELECTRICAL CONTRACTOR SHALL COORDINATE ALL WORK SHOWN ON DRAWINGS WITH OTHER TRADES TO ASSURE THAT ALL SYSTEMS ARE COMPLETE AND OPERATIONAL. THIS CONTRACTOR SHALL COORDINATE ALL EQUIPMENT LOCATIONS AND CONDUIT RUNS SUPPLIED AND/OR INSTALLED UNDER THIS SECTION TO AVOID CONFLICTS OR OBSTRUCTIONS TO OTHER TRADES. THIS CONTRACTOR SHALL PROVIDE ALL NECESSARY PULL BOXES, VERTICAL SUPPORT BOXES, AND CONDUIT OFFSETS REQUIRED TO ACCOMPLISH THE ABOVE NOTED COORDINATION AT NO ADDITIONAL COST TO THE OWNER, WHETHER OR NOT INDICATED ON PLANS. ALL VERTICAL SUPPORT BOXES, PULL BOXES, ETC. SHALL BE INSTALLED WHERE REQUIRED TO FACILITATE PULLS AND AT CODE REQUIRED INTERVALS, AT A MINIMUM.

3. CONDUIT RUNS INDICATED ON PLAN ARE FOR REFERENCE ONLY. EXACT LOCATIONS AND ELEVATION SHALL BE DETERMINED AFTER COORDINATION WITH OTHER TRADES. THIS CONTRACTOR SHALL SUPPLY, AS PART OF THEIR SHOP DRAWING SUBMISSION, THE EXACT LOCATION OF ALL CEILING MOUNTED EQUIPMENT AND CONDUIT RUNS INCLUDING PROPOSED LOCATIONS AND MEANS OF SUPPORT AS WELL AS THE EXPECTED LOAD CONCENTRATION AT THE POINTS OF ATTACHMENT. THE ABOVE NOTED INFORMATION SHALL BE REVIEWED BY THE STRUCTURAL ENGINEER BEFORE ANY WORK IS TO COMMENCE.

4. FURNISH AND INSTALL ALL NECESSARY CABLE SUPPORT BOXES, PULL BOXES AND CONDUIT SUPPORTS, WHERE NOTED AND AS REQUIRED BY APPLICABLE CODES. ALL LOW TENSION (COMMUNICATIONS, SECURITY, A/V, ETC.) CONDUIT, FIRE ALARM CONDUIT, ETC., WHICH HAVE RUNS IN EXCESS OF 100 FEET IN LENGTH AND/OR CONTAINING BENDS IN EXCESS OF 180 DEGREES SHALL BE PROVIDED WITH A PULLBOX. ALL PULLBOXES SHALL BE LABELED FOR THEIR INTENDED USE. DECALS SHALL BE PROVIDED TO INDICATE VOLTAGE LEVEL. FIRE ALARM SYSTEM BOXES SHALL BE PAINTED RED, AND ALL WIRE AND CABLE PROVIDED UNDER THIS SECTION SHALL BE TAGGED (WITH FEEDER OR BRANCH CIRCUIT DESIGNATION) AT ALL BOXES. WHERE CONDUIT BENDS ARE REQUIRED IN COMMUNICATIONS RACEWAY SYSTEMS, THE RADIUS OF THE RACEWAY BEND SHALL NOT BE LESS THAN TEN TIMES THE DIAMETER OF THE RACEWAY. PULL BOXES FOR COMMUNICATION RACEWAYS WILL BE PROVIDED IN STRAIGHT PULLS ONLY. LABEL EACH RACEWAY (PER TECHNOLOGY DEPT. REQUIREMENTS) EVERY 50 FEET HORIZONTALLY AND ON EACH FLOOR VERTICALLY. SUBMIT LABELING SYSTEM FOR REVIEW.

5. SURVEY EXISTING SPACE, CLOSETS AND PANELBOARDS TO VERIFY SUITABILITY OF INSTALLATION DESIGN INDICATED. ANY MODIFICATIONS NECESSARY TO COMPLY WITH THE DESIGN INTENT SHALL BE INCLUDED IN BID SUBMITTED AND SHALL BE HIGHLIGHTED SO THAT CONSIDERATION TO SAME IS GIVEN DURING BID EVALUATION. INCLUDED IN THIS REQUIREMENT, SHALL BE THE EVALUATION OF THE AVAILABILITY OF BRANCH CIRCUIT CAPACITY TO ACCOMMODATE THE NUMBER OF BRANCH CIRCUITS REQUIRED ON THE DESIGN DOCUMENTS. REROUTING OF CIRCUITS TO ALTERNATE PANELS WITHIN THE SAME CLOSET OR AREA, SHALL BE INCLUDED IN BID PROPOSAL. CIRCUIT NUMBERS INDICATED ARE FOR REFERENCE ONLY.

6. UNLESS SPECIFICALLY APPROVED, NO WIRES SHALL BE PULLED IN UNTIL THE CONDUIT SYSTEM IS COMPLETED. NO GREASE OR OIL SHALL BE USED TO FACILITATE THE PULLING OF WIRES; ONLY APPROVED PULLING COMPOUND SHALL BE USED. ALL WIRES SHALL BE CONTINUOUS BETWEEN OUTLET AND OUTLET, OR FROM PANELBOARD TO THE FIRST OUTLET. JOINTS THAT BECOME NECESSARY IN CIRCUIT WORK AT THE OUTLETS SHALL BE MADE WITH APPROVED PRESSURE CONNECTORS. ALL JOINTS SHALL BE COVERED WITH AN INSULATION EQUAL TO THAT ON THE CONDUCTORS. APPROVED PRESSURE CONNECTORS, IDEAL WINGNUTS, SCOTCH-LOCK, BUCHANAN, OR AS APPROVED, SHALL BE USED.

7. EXACT LOCATIONS AND MOUNTING HEIGHTS OF ALL LIGHTING FIXTURES, SWITCHES, WALL OUTLETS, ETC., SHALL BE IN ACCORDANCE WITH ARCHITECTURAL DRAWINGS. ANY DEVICE OR OUTLET WHICH IS SHOWN ON THE ARCHITECTURAL DRAWINGS AS EXISTING TO REMAIN, WHICH IS NOT SHOWN ON THE ELECTRICAL DRAWINGS, SHALL BE LEFT AS EXISTING AND RELOCATED TO A HEIGHT AS INDICATED ON THE ARCHITECTURAL DRAWINGS.

DEVICES, ETC.) WHICH ARE LOCATED ON WALL WHICH WILL BE RE-FINISHED (SEE ARCHITECTURAL DRAWINGS), SHALL BE TEMPORARILY REMOVED AND REINSTALLED TO MATCH NEW SURFACE CONDITIONS. PROVIDE ANY ADDITIONAL CABLING NEEDED TO RELOCATE AS REQUIRED.

8. ALL EXISTING DEVICES (RECEPTACLES, TEL/DATA OUTLETS, SWITCHES, FIRE ALARM SYSTEM

9. NO ELECTRICAL CONNECTIONS SHALL BE MADE TO, OR WORK PERFORMED ON, ENERGIZED

10. FINAL CONNECTIONS TO EQUIPMENT SHALL BE MADE ACCORDING TO VENDOR APPROVED

11. VERIFY ELECTRICAL REQUIREMENTS OF ALL EXISTING AND NEW EQUIPMENT TO BE USED. ALL SPECIAL PURPOSE OUTLETS INDICATED ON PLAN SHALL BE VERIFIED WITH EQUIPMENT MANUFACTURER PRIOR TO INSTALLATION, TO ENSURE PROPER WIRING AND COMPATIBILITY WITH ATTACHMENT PLUGS OR JUNCTION BOXES THAT MAY BE FURNISHED AS AN INTEGRAL PART OF

12. COORDINATE ALL LOCATIONS AND HEIGHTS OF STUB-UPS AND OUTLETS IN FIELD WITH VENDORS AND/OR FURNITURE MANUFACTURERS' APPROVED SHOP DRAWINGS. ALL RECEPTACLES ARE TO BE ACCESSIBLE.

13. ELECTRICAL CONTRACTOR SHALL VERIFY AVAILABILITY OF EXISTING CIRCUIT BREAKERS AFTER DEMOLITION OF EXISTING CONDITIONS TO MEET NEW REQUIREMENTS, AND REPORT ANY RESULTING DISCREPANCIES TO THE ARCHITECT AND CONSULTING ENGINEER IMMEDIATELY PRIOR TO PROCEEDING WITH WORK.

14. ALL RECEPTACLES SHALL BE ACCESSIBLE BELOW COUNTERS OR BEHIND EQUIPMENT. CONTRACTOR SHALL COORDINATE EXACT LOCATION OF EQUIPMENT RECEPTACLES WITH EQUIPMENT MANUFACTURER'S REQUIREMENTS AND THE LOCAL INSPECTOR.

15. ELECTRICAL CONTRACTOR SHALL PROVIDE DISCONNECTS FOR ALL EQUIPMENT PER CODE AND SHALL COORDINATE ALL DISCONNECT SWITCH REQUIREMENTS AND LOCATIONS WITH THE ELECTRICAL INSPECTOR, VENDORS APPROVED SHOP DRAWING AND FINAL EQUIPMENT

16. ELECTRICAL CONTRACTOR SHALL VERIFY PHASE LOAD BALANCING ON POWER PANELS UPON COMPLETION OF THE ELECTRICAL INSTALLATION. INCLUDE RE-DISTRIBUTION OF CIRCUITS WITHIN PANELS TO BALANCE WITHIN A 10% WINDOW (±5%).

17. ALL CONDUIT AND CABLE "HOMERUNS" SHALL CONSIST OF A SINGLE CIRCUIT PER CONDUIT FOR FEEDERS SERVED BY AN OVERCURRENT PROTECTIVE (OCP) DEVICE IN EXCESS OF 20 AMPERES, SINGLE POLE. WHERE WIRE AND CONDUIT BRANCH CIRCUITS SHARE A CONDUIT HOMERUN, (OCP LESS THAN OR EQUAL TO 20 AMPERES SINGLE POLE) THERE SHALL BE A MAXIMUM OF SIX CIRCUITS COMBINED IN A RACEWAY TO THE PANELBOARD, UNLESS OTHERWISE NOTED. ALL CONDUCTORS SHALL BE DERATED PER NATIONAL ELECTRICAL CODE (LATEST VERSION). COMBINING OF MULTIPLE HOMERUNS (MORE THAN SIX) IN A SINGLE CONDUIT SHALL NOT BE PERMITTED.

18. ALL CONDUIT SHOWN FOR INDOOR WORK SHALL BE EMT (3/4" MINIMUM) WITH SET-SCREW TYPE COUPLINGS UNLESS OTHERWISE NOTED OR PERMITTED BY THE BUILDING RULES AND

19. PROVIDE IMC CONDUIT WITH THREADED COUPLINGS WHERE REQUIRED BY CODE.

20. TYPE MC CABLE MAY BE UTILIZED FOR BRANCH LIGHTING AND RECEPTACLE CIRCUITRY. WHERE PERMITTED BY CODE AND PROVIDED THAT:

T IS IN ACCORDANCE WITH THE BUILDING RULES AND REGULATIONS.

CONTAINS AN INSULATED GROUND WIRE. CONDUIT IS RUN TO THE FIRST DEVICE DOWN-LINE OF THE PANEL (I.E.

RECEPTACLE, LIGHT FIXTURE, ETC.). SPLICE BOXES MOUNTED ADJACENT TO THE ELECTRICAL CLOSET SHALL NOT BE PERMITTED TO CONVERT FROM A CONDUIT HOMERUN TO TYPE MC CABLE.

21. INCLUDE ALL LABOR, MATERIALS, AND APPLICATIONS REQUIRED FOR THE FURNISHING. INSTALLING AND TESTING OF ALL WORK SHOWN ON THE DRAWINGS AND SPECIFIED HEREIN, IN A MANNER SATISFACTORY TO THE ARCHITECT.

22. ELECTRICAL CONTRACTOR SHALL BE RESPONSIBLE FOR DETERMINING EXISTING CIRCUITRY ORIGIN, DISTRIBUTION AND REVISING EXISTING CIRCUITRY TO COMPLY WITH NEW CIRCUITRY AS INDICATED ON PLANS.

23. ALL WORK AND/OR EQUIPMENT INSTALLED OUTDOORS SHALL BE APPROVED FOR USE IN WET

24. ALL WORK AND/OR EQUIPMENT IN MER'S SHALL BE SUITABLE FOR DAMP LOCATIONS.

25. WHERE CONDUITS, CABLE TRAY OR OTHER ELECTRICAL EQUIPMENT PENETRATE FIRE OR SMOKE RATED WALLS, PARTITIONS, FLOOR SLABS, ETC., THE SPACE BETWEEN THE SLEEVE OR CUTOUT AND THE ELECTRICAL EQUIPMENT SHALL BE CAULKED WITH A UL LISTED, INTUMESCENT TYPE, APPROVED FIRESTOP SYSTEM. SPACE BETWEEN THE SLEEVE OR CUTOUT AND THE ELECTRICAL EQUIPMENT SHALL BE SIZED IN ACCORDANCE WITH THE MANUFACTURER'S REQUIREMENTS FOR CONDUIT SIZE AND DAMMING MATERIAL THICKNESS FOR THE TYPE OF RATED CONSTRUCTION FOR WHICH THE SYSTEM IS TO BE USED. THE FIRESTOP SYSTEM SHALL BE AS MANUFACTURED BY 3M FIRE PROTECTION PRODUCTS OR AS APPROVED. SEE ARCHITECTURAL DRAWINGS FOR FIRE RATING OF WALLS AND FLOORS.

26. WHERE WORK IS ONGOING IN ELECTRICAL PANELS THE COVERS ARE NOT TO BE LEFT OFF UNLESS WORK IS CURRENTLY BEING PERFORMED ON THE PANEL. COVERS SHALL BE REPLACED EACH NIGHT AT THE END OF SHIFT.

27. TEMPORARY POWER FROM EXISTING PANELS FOR LIGHTS, DRILLS, WELDING EQUIPMENT, ETC. SHALL BE LABELED ON THE PANEL AND PRE-APPROVED BY BUILDING OWNER/MANAGER 48 HOURS PRIOR TO INSTALLATION.

C. ARCHITECT'S AND/OR ENGINEER'S REVIEW

1. SUBMIT SHOP DRAWINGS FOR REVIEW PRIOR TO THE START OF ANY WORK. ANY WORK OR EQUIPMENT INSTALLED PRIOR TO REVIEW OF SHOP DRAWINGS AND FOUND TO BE UNACCEPTABLE SHALL BE REMOVED AND MODIFIED AT THE CONTRACTOR'S SOLE EXPENSE INCLUDING ANY RESULTANT SCHEDULING DELAYS EXPERIENCED BY ANY TRADE.

2. THE ARCHITECT AND/OR ENGINEER WILL REVIEW SHOP DRAWINGS AND SAMPLES FOR CONFORMANCE WITH THE DESIGN CONCEPT OF THE PROJECT AND THE INFORMATION CONTAINED IN THE CONTRACT DOCUMENTS. THE ARCHITECT'S AND/OR ENGINEER'S REVIEW OF SHOP DRAWINGS AND SAMPLES IS ONLY FOR THE CONVENIENCE OF THE OWNER IN FOLLOWING THE WORK AND DOES NOT RELIEVE THE CONTRACTOR OF RESPONSIBILITY FOR DEVIATIONS FROM THE REQUIREMENTS OF THE CONTRACT DOCUMENTS. THE ARCHITECT'S AND/OR ENGINEER'S REVIEW SHALL NOT BE CONSTRUED AS A COMPLETE OR DETAILED CHECK OF THE WORK SUBMITTED, NOR SHALL IT RELIEVE THE CONTRACTOR OF RESPONSIBILITY FOR ERRORS OF ANY SORT IN THE SHOP DRAWINGS AND SAMPLES, OR FROM THE NECESSITY OF FURNISHING ANY WORK REQUIRED BY THE CONTRACT DOCUMENTS WHICH MAY HAVE BEEN OMITTED FROM SHOP DRAWING SUBMITTALS.

3. THE REVIEW OF A SEPARATE ITEM SHALL NOT INDICATE REVIEW OF THE COMPLETE ASSEMBLY IN WHICH IT FUNCTIONS. NOTHING IN THE ARCHITECT'S AND/OR ENGINEER'S REVIEW OF SHOP DRAWINGS AND SAMPLES SHALL BE CONSIDERED AS AUTHORIZING:

A DEPARTURE FROM CONTRACT DOCUMENTS OR SPECIFICATIONS, OR, ADDITIONAL COST TO THE OWNER, OR, INCREASED TIME FOR COMPLETION OF THE WORK.

4. NO PART OF THE WORK SHALL BE STARTED IN THE SHOP OR IN THE FIELD UNTIL THE ARCHITECT AND/OR ENGINEER HAS REVIEWED THE SHOP DRAWINGS AND SAMPLES FOR THAT PORTION OF THE WORK. THEREAFTER, THE WORK SHALL BE EXECUTED IN ACCORDANCE WITH THE CONTRACT DOCUMENTS AND THE INDICATED STATUS OF THE REVIEWED SHOP DRAWING.

5. SAMPLES SHALL BE SUBMITTED FOR REVIEW WHEN REQUESTED BY THE ARCHITECT AND/OR

6. TWO WEEKS AFTER AWARD OF CONTRACT SUBMIT A SHOP DRAWING LOG FOR REVIEW WITH SUBMITTAL DATES AND SUBMITTAL TYPE.

7. PROVIDE OPERATIONS AND MAINTENANCE MANUALS FOR ALL EQUIPMENT AND MATERIALS.

D. RECORD DRAWINGS

1. PREPARE AND FURNISH TO OWNER "AS BUILT" PLANS FOR ALL WORK INSTALLED. PROVIDE CAD DRAWINGS AND CAD FILES ON A COMPACT DISC COMPLETED IN THE LATEST VERSION OF AUTOCAD. ALL DRAWINGS SHALL BE IN A STYLE COMMENSURATE WITH THE ENGINEERING DESIGN. THE ENGINEERING DESIGN CAD DRAWINGS OR BACKGROUNDS WILL BE FURNISHED FOR USE TO THIS CONTRACTOR FOR THE PURPOSE OF THIS SUBMISSION (SUBMIT A CAD INDEMNIFICATION AGREEMENT).

2. DURING CONSTRUCTION, KEEP AN ACCURATE RECORD OF ALL DEVIATIONS BETWEEN THE WORK AS SHOWN ON DRAWINGS AND THAT WHICH IS ACTUALLY INSTALLED. THIS RECORD SET OF PRINTS SHALL BE KEPT AT JOB SITE FOR INSPECTION.

3. UPON COMPLETION OF THE INSTALLATION. SUBMIT ONE SET OF BLACK AND WHITE PRINTS OF THESE "AS-BUILT" RECORD DRAWINGS TO THE CONSULTING ENGINEER FOR REVIEW. AFTER REVIEW BY THE CONSULTING ENGINEER, MAKE NECESSARY CHANGES TO THESE PRINTS AND THEN DELIVER THEM TO THE OWNER FOR RECORD. FINAL PAYMENT WILL BE WITHHELD UNTIL COMPLETION OF "AS-BUILT" DRAWINGS.

4. AS-BUILT DRAWINGS SHALL CONTAIN EXACT ROUTING AND ELEVATIONS OF ALL CONDUIT BANKS, ACTUAL PANELBOARD CIRCUIT BREAKER POLE POSITIONS USED FOR EACH CIRCUIT, AND EXACT LOCATION OF ALL EQUIPMENT. ALL DIMENSIONS SHALL BE REFERENCED TO BUILDING STRUCTURE CENTERLINES.

E. EQUIPMENT SPECIFICATIONS

1. ALL EQUIPMENT AND MATERIALS SHALL BE NEW, UL LISTED AND SHALL CONFORM TO ANY ADDITIONAL LABELING, TESTING AND CONSTRUCTION REQUIREMENTS ESTABLISHED BY THE GOVERNING AUTHORITIES. SAME SHALL BE GUARANTEED FOR 1 YEAR SUBSEQUENT TO FINAL

2. ALL EQUIPMENT (ELECTRICAL AND MECHANICAL) SHALL BE SPECIFIED TO HAVE VOLTAGE RATINGS COMPATIBLE WITH THE PROVISIONS OF ANSI C84

3. ALL EXISTING EQUIPMENT TO BE RELOCATED, OR TO BE INSTALLED FROM STORAGE SHALL BE

4. ALL LOW TENSION CONDUIT FOR DATA, TELEPHONE, SECURITY, A/V, TELEVISION, ETC., SHALL BE 1" MINIMUM EMT OR ALUMINUM U.O.N. TERMINATE WITH BUSHED OPENING IN HUNG CEILING OR UNDER RAISED FLOOR. EMPTY FLEXIBLE CONDUIT SHALL NOT BE PERMITTED FOR LOW TENSION CABLING UNLESS WRITTEN APPROVAL IS OBTAINED FROM THE ARCHITECT AND ENGINEER. ALL LOW TENSION EMPTY CONDUIT SHALL BE PROVIDED WITH TRU-MEASURE TYPE DRAG LINES FOR FUTURE CABLE INSTALLATION.

5. ALL WALL MOUNTED TELEPHONE AND COMMUNICATIONS OUTLETS SHALL HAVE THE EMPTY CONDUIT STUBBED AND BUSHED INTO AN ACCESSIBLE AREA IN THE HUNG CEILING OR RAISED FLOOR. (NOTE: ACCESSIBLE AREA MAY BE OUTSIDE THE ROOM/AREA IF AN INACCESSIBLE CEILING

6. INTERMEDIATE METAL CONDUIT SHALL BE USED WHERE SUBJECTED TO ANY WATER OR MOISTURE CONDITIONS, OR WHERE BURIED IN SLAB.

7. PROVIDE CONDUIT EXPANSION FITTINGS TOGETHER WITH BONDING JUMPER AND SUITABLE SLEEVES WHERE REQUIRED. CONDUIT EXPANSION FITTING SHALL BE INSTALLED IN EACH CONDUIT RUN WHEREVER IT CROSSES AN EXPANSION JOINT IN THE STRUCTURE. THE EXPANSION FITTING SHALL BE INSTALLED ON ONE SIDE OF THE JOINT WITH ITS SLIDING SLEEVE END FLUSH WITH THE JOINT AND WITH A LENGTH OF BONDING JUMPER IN THE EXPANSION JOINT EQUAL TO AT LEAST THREE TIMES THE NORMAL WIDTH OF THE JOINT.

8. ALL 20A, SINGLE POLE, 120 VOLT OR 208 VOLT BRANCH CIRCUIT RUNS IN EXCESS OF 100 FEET FROM THE PANEL TO THE DEVICE SHALL BE PROVIDED WITH #10 MINIMUM AWG WIRE FOR ITS ENTIRE LENGTH.

9. JUNCTION OR PULL BOXES SHALL BE FURNISHED AND INSTALLED WHERE INDICATED ON PLANS AND WHEREVER ELSE SUCH A BOX MAY BE NECESSARY TO FACILITATE INSTALLATION OR CONFORM TO CODE REQUIREMENTS. COORDINATE LOCATIONS OF SAME WITH ARCHITECT FOR ACCESSIBILITY AND AESTHETIC CONSIDERATIONS. GENERALLY, JUNCTION BOXES AND PULL BOXES SHALL BE INSTALLED EVERY 100 FEET IN CONDUIT HORIZONTAL RUNS AND SHALL NOT BE EXPOSED IN FINISHED SPACES. ALL CABLES WITHIN PULL BOXES SHALL BE PROPERLY TAGGED FOR IDENTIFICATION. LABEL ALL CONDUITS WITH FEEDER DESIGNATION, AT ENTRY AND EXIT TO

10. PROVIDE A #10 AWG NEUTRAL FOR ALL 20A CIRCUITS WHERE EITHER TWO OR THREE PHASES SHARE A SINGLE CONDUCTOR NEUTRAL.

11. PROVIDE WIRE TROUGHS WHERE A RACEWAY IS REQUIRED TO ACCESS THE FLOOR SYSTEM.

12. INSULATING BUSHINGS OR INSULATING THROATS SHALL BE INSTALLED ON ALL FITTINGS.

13. COORDINATE WITH PUBLIC ADDRESS SYSTEM VENDOR FOR EMERGENCY CONTROL PANEL REQUIREMENTS.

14. ANY VFDS SHALL HAVE LINE AND LOAD SIDE POWER FILTERING.

F. LIGHTING FIXTURES

1. ALL FLUORESCENT LIGHT FIXTURES SHALL BE PROVIDED WITH HIGH POWER FACTOR, HIGH FREQUENCY ELECTRONIC BALLASTS. BALLASTS SHALL BE UL LISTED, CLASS P, SOUND RATED

2. ALL LIGHTING FIXTURES SHALL BE CONNECTED USING MAXIMUM 6 FOOT LENGTH OF FLEXIBLE METAL CONDUIT FROM ACCESSIBLE CEILING OUTLET BOX USING LOCK NUT TYPE FITTINGS WITH GROUNDING AS REQUIRED BY GOVERNING CODES. PROVIDE #12 GROUND

3. ALL EMERGENCY LIGHTING FIXTURES SHALL CONTAIN AN INTEGRAL EMERGENCY BATTERY UNIT, CONSISTING OF NICKEL-CADMIUM BATTERY AND AN AUTOMATIC SOLID STATE CHARGER WITH VISIBLE CHARGING LED. UNIT SHALL ILLUMINATE (1) ONE LAMP PER FIXTURE AT A NORMAL LAMP LUMEN OUTPUT OF 30 PERCENT MINIMUM RATED LUMEN OUTPUT FOR MINIMUM 90 MINUTES. EMERGENCY BATTERY UNIT SHALL BE AS MANUFACTURED BY LIGHT ALARMS ELECTRONICS CORP., EMERGI-LITE OR DUAL-LITE.

4. ALL EXIT SIGNS SHALL BE PROVIDED WITH AN EMERGENCY BATTERY BALLAST WITH 90 MINUTES (MIN.) OF BATTERY LIFE. BATTERY BALLAST SHALL BE SPECIFIC TO EXIT SIGN MANUFACTURER.

5. WHERE LIGHT FIXTURES ARE DENOTED AS EMERGENCY LIGHTS TO BE SWITCHED, A HOT LEG SHALL BE BROUGHT TO THE EMERGENCY BATTERY BALLAST TO SIGNAL AND CHARGE THE BATTERY BALLAST, WHETHER THE SWITCH LEG IS "ON" OR "OFF". THEREFORE, THE FIXTURE SHALL BE SWITCHABLE. EMERGENCY BATTERY BALLAST SHALL BE BODINE TYPE B50 FOR ALL 2'x4' FLUORESCENT FIXTURES AND BODINE TYPE B94 FOR ALL COMPACT FLUORESCENT DOWNLIGHTS.

6. BRANCH CIRCUITS SHALL IN ALL CASES CONTAIN THE NECESSARY NUMBER OF WIRES TO AFFORD THE SWITCH CONTROL INDICATED. ALL LIGHTING CIRCUITS WHICH ARE CONTROLLED BY DIMMERS SHALL NOT SHARE A NEUTRAL WITH ANOTHER CIRCUIT, BUT SHALL HAVE A SEPARATE NEUTRAL CONDUCTOR TO THE PANEL, WHETHER OR NOT INDICATED ON PLAN. EACH DIMMER SHALL BE SEPARATELY GANGED (FULLY ENCLOSED).

7. PROVIDE NEW LAMPS FOR ALL EXISTING FIXTURES WHICH HAVE BEEN RELOCATED.

8. ALL LIGHT FIXTURES SHALL BE SPECIFIED ON THE ELECTRICAL AND/OR ARCHITECTURAL DOCUMENTS. IT SHALL BE THIS CONTRACTORS RESPONSIBILITY TO OBTAIN THE EXACT FIXTURE SPECIFICATIONS FOR THE PROJECT PRIOR TO THE SUBMISSION OF BID. REGARDLESS OF WHERE THE FIXTURE, LAMPS AND BALLASTS ARE SPECIFIED, THIS CONTRACTOR SHALL INCLUDE HIGH POWER FACTOR/ENERGY EFFICIENT BALLASTS AND HIGH EFFICIENCY LAMPS WHICH MEET OR EXCEED THE REQUIREMENTS OF THE NEW YORK STATE CONSERVATION CONSTRUCTION CODE AND ANY CURRENT REBATE REQUIREMENTS FOR CON EDISON, NYSERDA, ETC. FOR ALL FIXTURE TYPES.

9. THIS CONTRACTOR SHALL BE RESPONSIBLE FOR COMPLETING AND FILING ALL LIGHTING REBATE FORMS, ON BEHALF OF THE CLIENT, AND IN COORDINATION WITH THE ENGINEER AND ARCHITECT, REQUIRED FOR A REBATE WITH THE GOVERNING AUTHORITY AND/OR UTILITY AS REQUIRED PRIOR TO THE PURCHASE OF FIXTURES IN ORDER TO ACHIEVE THE MAXIMUM REBATE AMOUNT. THIS CONTRACTOR SHALL ALSO INCLUDE FILING FOR MOTION/OCCUPANCY SENSORS, TIMECLOCKS, ETC. AS PART OF THE REBATE PROCESS WHERE APPLICABLE.

10. ALL FIXTURES DENOTED AS NIGHTLIGHTS SHALL BE FED WITH AN UNSWITCHED HOT LEG. ALL LIGHTING CIRCUITS SHOWN TO BE ROUTED VIA A LIGHTING CONTACTOR OR TIMECLOCK AND RELAY COMBINATION SHALL HAVE THE HOT LEG TAPPED AHEAD OF THE RELAY CONTACT IN ORDER TO FEED NIGHTLIGHTS, EMERGENCY BATTERY UNITS AND OCCUPANCY SENSORS SO THAT THE RELAY CONTACT DOES NOT AFFECT THE CIRCUIT LEG TO THESE DEVICES.

G. SLEEVES

1. PROVIDE SLEEVES FOR ALL CONDUIT PASSING THROUGH FLOORS, WALLS, PARTITIONS AND ROOFS. SLEEVED ASSEMBLIES SHALL BE APPROVED FOR INTENDED USE FOR ALL WATERPROOF INSTALLATIONS (ROOF, FOUNDATION WALL, ETC.). PROVIDE OZ GEDNEY ASSEMBLIES, OR AS REVIEWED.

2. PROVIDE SLEEVES WITH AN I.D. AT LEAST 1/2 INCH GREATER THAN OUTSIDE OF CONDUIT

3. WHERE PLENUM CABLING PENETRATES FIRE OR SMOKE RATED WALLS, PARTITIONS, FLOOR SLAB, ETC., PROVIDE SLEEVES (AS DESCRIBED HEREINBEFORE) THROUGH RATED CONSTRUCTION. ALL CABLING SHALL BE RUN THROUGH THESE SLEEVES. SLEEVES SHALL BE LOCATED AS REQUIRED AND SHALL BE FILLED WITH A UL LISTED, INTUMESCENT TYPE APPROVED FIRESTOP SYSTEM. QUANTITY OF CABLES, CONFIGURATIONS OF CABLES, ETC. SHALL BE IN ACCORDANCE WITH THE MANUFACTURER'S REQUIREMENTS FOR THE TYPE OF RATED CONSTRUCTION FOR WHICH THE SYSTEM IS TO BE USED. THE FIRESTOP SYSTEMS SHALL BE AS MANUFACTURED BY 3M FIRE PROTECTION PRODUCTS, SPEC SEAL FIRE STOP PRODUCTS OR AS APPROVED. SEE ARCHITECTURAL DRAWINGS FOR FIRE RATINGS OF WALLS AND FLOORS.

H. PANELBOARDS

1. ALL PANELBOARDS SHALL BE OF THE ENCLOSED TYPE, FLUSH OR SURFACE MOUNTED, AS REQUIRED, IN CODE GAUGE STEEL CABINETS, WITH STEEL TRIM, CONCEALED HINGES, DOORS AND FLUSH TYPE LOCKS, ALL KEYED ALIKE. PROVIDE DUAL CONCEALED HINGED DOORS (DOOR-IN-DOOR CONSTRUCTION) WITH TWO KEYED LATCHES, AND WITHOUT BOLTS OR SCREWS ON THE NON-HINGED SIDE OF THE DOOR. ALL EXISTING PANELS SHALL BE RETROFITTED WITH DOOR-IN-DOOR COVERS. PROVIDE FLUSH DOORS WHERE INDICATED ON DOCUMENTS (SEE ARCHITECTURAL DRAWINGS.)

2. ALL BUSES, INCLUDING NEUTRAL, SHALL BE ELECTRICAL GRADE HARD- DRAWN COPPER AND SIZED IN CONFORMANCE WITH NEMA STANDARDS. BUSES SHALL BE ARRANGED FOR SEQUENCE PHASING AND LOADS SHALL BE BALANCED AS EQUALLY AS POSSIBLE AMONGST THE THREE PHASES.

3. PANELBOARDS SHALL BE EQUIPPED WITH QUICK-MAKE, QUICK-BREAK FUSED SWITCHES OR BOLT-ON MOLDED CASE CIRCUIT BREAKERS, OF VOLTAGE REQUIRED, AND OF SIZE AND NUMBER OF POLES INDICATED ON THE SCHEDULES.

4. A TYPE WRITTEN DIRECTORY OF 5 INCHES x 8 INCHES WITH METAL FRAME AND LEXAN FACE SHALL BE PROVIDED ON THE INSIDE OF THE DOOR OF EACH CABINET, INDICATING THE LOAD SERVED BY EACH CIRCUIT. UTILIZE ARCHITECTURAL DRAWINGS TO INDICATE ROOM NAMES AND NUMBERS OF ALL EQUIPMENT SERVED. UPDATE PANEL DIRECTORIES OF ALL EXISTING PANELS.

5. POWER, LIGHTING AND UTILITY PANELS FOR 120/208 VOLT SHALL BE BOLT-ON CIRCUIT BREAKER TYPE UNLESS OTHERWISE NOTED. SINGLE POLE BRANCHES SHALL BE BOLT-ON TYPE OF AT LEAST 10,000 AMPERES RMS SYMMETRICAL INTERRUPTING CAPACITY (OR AS INDICATED ON THE DRAWINGS). MULTIPLE POLE BREAKERS SHALL BE COMMON TRIP, OF THE CAPACITY AND NUMBER OF POLES AS INDICATED IN SCHEDULES. PANELBOARDS SHALL BE EQUIPPED WITH 200% SOLID NEUTRAL BAR AND CONTAIN THE NUMBER OF POLES, OVERCURRENT DEVICES AND BUSED SPACES AS SPECIFIED IN SCHEDULE. PANELBOARDS SHALL INCLUDE A SEPARATE GROUND BUS ISOLATED FROM THE CASING. FUSIBLE TYPE PANELS SHALL CONFORM TO REQUIREMENTS OF ABOVE PARAGRAPH.

6. PROVIDE ISOLATED GROUND BUSES ON STAND-OFF ISOLATORS WHERE INDICATED ON

7. PROVIDE NEW CIRCUIT BREAKERS IN BOTH NEW AND EXISTING PANELS AS REQUIRED TO MEET THE SCHEDULES OR CIRCUIT DESIGN INTENT.

8. GUTTER SPACE SHALL BE INCREASED WHEN CONTAINING FEEDER TAPS.

9. PROVIDE WIRE TROUGHS WHERE ACCESS TO THE FLOOR SYSTEM IS REQUIRED.

10. WHERE SPACE LIMITATIONS REQUIRE REDUCED PANEL WIDTH, PROVIDE VERTICAL (SINGLE ROW) BREAKER TYPE PANELS AS PART OF THE INITIAL SCOPE PRICE.

11. ALL PANEL BUS BARS SHALL CONSIST OF A MINIMUM 1/8 INCH DEPTH COOPER BUS.

12. PROVIDE GFI TYPE BRANCH CIRCUIT BREAKERS FOR ALL CIRCUITS SERVING HEAT TRACING CIRCUITS, H-WATT CIRCUITS, FREEZE PROTECTION CIRCUITS, WINDOW WASHING CIRCUITS, OUTDOOR CIRCUITS, ETC. AND AS REQUIRED BY CODE.

Storm King Art Center 1 Museum Road New Windsor, NY 12553

+1 (845) 534-3115 Design Architect

heneghan peng architects 14-16 Lord Edward Street Dublin, D02 YC63 +353 1 633 9000

Executive Architect WXY Architecture + Urban Design 224 Centre Street, 5th Floor New York, NY 10013 +1 (212) 219-1953

Landscape Architect Gustafson Porter + Bowman 1 Cobham Mews London, MW1 9SB

Reed Hilderbrand LLC 33 Whitney Avenue, 3rd Floor New Haven, CT 06510 +1 (617) 923-2422

Structural & Lighting

+44 020 7284 8950

ARUP 77 Water Street New York, NY 10005 +1 (212) 896-3000

MEPF & IT

BuroHappold 100 Broadway #23 New York, NY 10005

> +1 (212) 616-0228 Civil VHB

100 Great Oaks Blvd., Suite 118

Albany, NY 12203 +1 (518) 389-3606

AV & Acoustics

LSTN Consultants 76 Beaver Street, 2nd Floor New York, NY 10005

+1 (347) 788-0810

Facade

Front Inc. 100 E. Broadway Street, #501 New York, NY 10002

Key Plan

+1 (212) 242-2220

Date Description 50% Design Development 02/24/20 100% Design Development 05/29/20

11/06/20

50% Construction Documents

Project

Storm King Art Center **Pond Pavilion**

NOT FOR CONSTRUCTION **Drawing Title General Notes**

Drawing Number	E-P-002
Scale	Not to Scale
Date	11/06/20

Sheet Size

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J. FUSES

- 1. ALL FUSES SHALL BE OF THE SAME MANUFACTURER, BUSSMANN, OR AS APPROVED, AND SHALL BE INSTALLED, AS REQUIRED, IN ALL CUTOUTS, PANELS AND SAFETY
- 2. UNLESS OTHERWISE NOTED, FUSES SHALL BE BUSSMAN TYPE LPN, LPS OR KRP-C.

K. OCCUPANCY SENSORS

1. OCCUPANCY SENSORS SHALL BE UTILIZED TO AUTOMATICALLY TURN OFF LIGHT FIXTURES WHEN THE AREA SENSED IS NOT OCCUPIED. OCCUPANCY SENSORS SHALL HAVE A TIME DELAY BEFORE TURNING OFF, WHICH SHALL BE CONTINUOUSLY ADJUSTABLE FROM 30 SECONDS TO 12 MINUTES. OCCUPANCY SENSORS SHALL HAVE A SENSITIVITY ADJUSTMENT TO MODIFY THE FIELD OF VIEW.

2. WALL MOUNTED OCCUPANCY SENSORS SHALL OPERATE AS FOLLOWS: RED LED WILL INDICATE WHEN UNIT IS BEING TRIGGERED PLUS IT WILL GLOW WHEN OFF TO FACILITATE LOCATION IN AN UNLIT ROOM. WALL MOUNTED AREA SENSORS SHALL UTILIZE PASSIVE INFRARED OPERATION. THE SENSOR SHALL EMIT A "BEEP" WARNING TONE BEFORE SHUTTING OFF. SENSOR OPERATION SHALL BE AS FOLLOWS: TAP TOP OF SWITCH TO TURN ON; AUTOMATIC TURN OFF; TAP BOTTOM OF SWITCH TO TURN OFF. SENSOR SHALL BE ABLE TO BE MOUNTED IN A SINGLE GANG WALL BOX AND BE GANGABLE WITH OTHER DESIGNER STYLE ELECTRICAL DEVICES AND FACEPLATES. SENSOR SHALL BE PROVIDED WITH A DESIGNER STYLE SCREWLESS FACEPLATE, COLOR AS SELECTED BY THE ARCHITECT.

3. CEILING MOUNTED AREA SENSOR SHALL UTILIZE PASSIVE INFRARED OPERATION. WHEN THE SENSOR DETECTS THE PRESENCE OF AN OCCUPANT. THE LIGHTS WILL AUTOMATICALLY TURN ON. IF NO OCCUPANT MOTION OCCURS WITHIN THE ADJUSTABLE TIME DELAY PERIOD, THE LIGHTS SHALL AUTOMATICALLY BE TURNED OFF. THE SENSOR SHALL HAVE A LED INDICATOR TO PROVIDE FEEDBACK TO THE POWER PACK WHEN DETECTING MOVEMENT AND SHALL HAVE A SENSITIVITY AND TIMING ADJUSTMENT. ALL COMPONENTS TO BE CONTAINED WITHIN A 1 INCH HIGH BY 6 INCH LONG WHITE PLASTIC HOUSING, USING FOUR (4) HEAD SENSORS AT FIXED ANGLES. PROVIDE THREE (3) FREQUENCY DEVICES FOR ALTERNATE PATTERN INSTALLATION. PROVIDE ACCOMPANYING SWITCHPACK WITH PROPER HEAD QUANTITY AS SPECIFIED BY MANUFACTURER. UNIT SHALL NOT DETECT MOTION THROUGH GLASS AND SHALL BE MOUNTED A MINIMUM OF SIX (6) FEET FROM STRONG AIR TURBULENT DEVICES.

L. LIGHTING CONTACTOR

1. THE REMOTE CONTROL LIGHTING CONTACTOR SHALL BE ELECTRICALLY OPERATED BY A DUAL-ACTING, SINGLE-SOLENOID MECHANISM THAT IS INHERENTLY INTERLOCKED AND MECHANICALLY HELD IN BOTH THE OPEN AND CLOSED POSITIONS. THE MAIN CONTACTS SHALL BE POWER DRIVEN IN BOTH DIRECTIONS. POSITIVE LOCKING AND CONTACT POSITIONS SHALL NOT BE DEPENDENT ON GRAVITY, HOOKS, LATCHES OR SEMI-PERMANENT MAGNETS.

2. THE REMOTE CONTROL LIGHTING CONTACTOR SHALL BE CAPABLE OF OPERATING IN ANY POSITION. PROVISIONS SHALL BE INCORPORATED FOR MANUAL OPERATION DURING INSPECTION AND MAINTENANCE.

3. THE REMOTE CONTROL LIGHTING CONTACTOR SHALL BE UNDERWRITERS' LABORATORIES LISTED UNDER UL 508. MAIN CONTACTS SHALL BE DOUBLE BREAK, CONTINUOUS DUTY RATED 20 AMPS TO 600 VOLTS AC, AND BE MARKED FOR BALLAST LIGHTING, TUNGSTEN AND GENERAL PURPOSE LOADS. LIGHTING CONTACTORS REQUIRING DERATING WHEN USED IN AN ENCLOSURE OR WITH TUNGSTEN LAMP LOADS SHALL NOT BE ACCEPTABLE.

4. THE REMOTE CONTROL LIGHTING CONTACTOR SHALL BE PROVIDED WITH CLAMP-TYPE, SELF-RISING TERMINAL PLATES FOR SOLDERLESS CONNECTION OF LINE, LOAD AND CONTROL CONDUCTORS. TERMINALS SHALL ACCEPT A WIRE RANGE OF #18 TO #10 AWG CU.

5. THE NUMBER OF POLES, UP TO A MAXIMUM OF 12, ON A SINGLE REMOTE CONTROL LIGHTING CONTACTOR, SHALL BE PROVIDED AS INDICATED ON PLANS.

6. THE REMOTE CONTROL LIGHTING CONTACTOR SHALL BE UL LISTED FOR THE FOLLOWING SHORT-CIRCUIT WITHSTAND CURRENT RATINGS WHEN COORDINATED WITH A UL-LISTED MOLDED CASE CIRCUIT BREAKER RATED 30 AMPERES: 10000 AMPS RMS SYMMETRICAL 600 VOLTS, 60HZ.

7. THE OPERATING COIL AND MAIN CONTACTS SHALL BE REPLACEABLE FROM THE FRONT WIHTOUT MAJOR DISASSEMBLY AND VISUAL INDICATION SHALL BE PROVIDED FOR EACH MAIN CONTACT.

8. PROVISIONS SHALL BE INCLUDED TO PERMIT REMOTE PILOT LAMP-TYPE VISUAL INDICATIONS WITHOUT THE NECESSITY FOR AUXILIARY CONTACTS OR ADDITIONAL

9. EACH REMOTE CONTROL LIGHTING CONTACTOR SHALL BE FURNISHED WITH AN OWNER'S MANUAL PROVIDING INSTALLATION AND OPERATING INSTRUCTIONS.

10. THE REMOTE CONTROL LIGHTING CONTACTOR SHALL BE AN ASCO 917 OR APPROVED EQUAL IN NEMA 1 ENCLOSURE.

M. TIME CLOCK

1. TIME CLOCK SHALL BE DIGITAL TYPE, WITH ASTRONOMIC AND PULSE SWITCHING CAPABILITY, LCD DISPLAY, AM/PM FORMAT, MANUAL OVERRIDE, SEPARATE SCHEDULING FOR EACH DAY OF THE WEEK, DIFFERENT DAILY SCHEDULES PROGRAMMABLE WITHIN

- 2. ENCLOSURE SHALL BE NEMA 1 TYPE.
- 3. TERMINALS SHALL BE CAPABLE OF RECEIVING #8AWG WIRE.
- 4. TIME CLOCK SHALL BE TORK MODEL DLC400BP OR APPROVED EQUAL.

N. GENERAL

1. OUTLET BOXES SHALL BE CODE GAUGE GALVANIZED STAMPED STEEL, 4 INCH SQUARE BY 1-1/2 INCHES DEEP FOR POWER AND 4 INCHES SQUARE BY 2-1/2 INCHES DEEP FOR COMMUNICATION, FIRMLY ANCHORED IN PLACE. BOX VOLUME SHALL BE AS REQUIRED BY GOVERNING CODES WITH BLANK COVERS PROVIDED FOR ALL BOXES USED FOR JUNCTION PURPOSES. GEM BOXES SHALL ONLY BE USED WHERE DIMENSIONAL RESTRAINTS EXIST AND WHERE THE CONTRACTOR HAS OBTAINED PERMISSION FROM THE ENGINEER. MULTI-GANG BOXES SHALL BE PROVIDED WITH EXTENSION COLLARS MOUNTED WITHIN 1/8 INCH OF OUTER SURFACE. WHERE OUTLET BOXES ARE SHOWN FOR FLUSH MOUNTED DEVICES, A SINGLE GANG PLASTER RING SHALL BE PROVIDED, AND MOUNTED WITHIN 1/8 INCH OF OUTER SURFACE.

2. DISCONNECT SWITCHES SHALL BE QMQB FUSIBLE OR NONFUSIBLE WITH CURRENT AND VOLTAGE RATING AS INDICATED ON PLANS. SWITCHES SHALL BE HORSEPOWER RATED, ENCLOSED TYPE, SUITABLE FOR PADLOCKING IN OPEN POSITION.

3. HORSEPOWER RATED THERMAL SWITCHES (BRYANT OR AS APPROVED) SHALL BE USED FOR ALL MOTOR CIRCUITS. ELECTRICAL CONTRACTOR SHALL INSTALL WHERE APPLICABLE TOGGLE SWITCHES FOR USE AS DISCONNECT. THESE SWITCHES SHALL BE "T" RATED FOR RESISTANCE LOADS AND "M" RATED FOR MOTOR LOADS.

4. STANDARD DUPLEX CONVENIENCE RECEPTACLES SHALL BE SPECIFICATION GRADE NEMA 5-15R, 5-20R, 2 POLE, 3 WIRE, GROUNDED, 15 OR 20 AMPERE RATED FOR DEVICES SHOWN ON A 15 OR 20 AMPERE CIRCUIT (RESPECTIVELY). PROVIDE DEVICES RATED TO THE EQUIVALENT CIRCUIT BREAKER SIZE UNLESS OTHERWISE NOTED. GROUND FAULT TYPE SHALL BE USED WHERE REQUIRED BY GOVERNING CODES INCLUDING ALL DEVICES SHOWN TO BE WITHIN SIX FEET OF A SINK/WATER.

5. SWITCHES SHALL BE FLUSH, SPECIFICATION GRADE, QUIET TUMBLER TYPE, GROUNDED, BEHIND COMMON PLATE WITH BARRIERED BACK BOX WHERE REQUIRED BY CODE FOR MULTIPLE CIRCUITS GREATER THAN 250 VOLTS. SINGLE POLE SWITCHES SHALL BE 20 AMPERES, 277 VOLT.

6. DEVICE TYPES, MANUFACTURERS AND COLORS SHALL BE SPECIFIED BY THE ARCHITECT. IF NO SPECIFICATION HAS BEEN PROVIDED, THIS CONTRACTOR SHALL OBTAIN ALL INFORMATION REGARDING THE ABOVE FROM THE ARCHITECT PRIOR TO THE SUBMISSION OF BID, OR SHALL INCLUDE THE ABILITY TO FURNISH ANY MANUFACTURER SELECTED BY THE ARCHITECT DURING THE SHOP DRAWING SUBMISSION PHASE.

7. DEVICE PLATES SHALL BE AS INDICATED ON THE ARCHITECTURAL DRAWINGS. COORDINATE EXACT COLOR WITH ARCHITECT.

8. ALL CABLE SHALL BE COPPER WITH THWN OR THHN INSULATION FOR HORIZONTAL APPLICATIONS AND XHHW FOR VERTICAL APPLICATIONS (I.E. WHEN PASSING THROUGH A CABLE SUPPORT BOX), EMPLOYED AT THE 75°C CODE RATED AMPACITY. NO SMALLER THAN No.12 AWG SHALL BE USED UNLESS SPECIFICALLY NOTED ON PLANS. COLOR CODING SHALL CONFORM TO CODE REQUIREMENTS. DERATE ALL CABLES PER LATEST VERSION OF THE NATIONAL ELECTRICAL CODE.

9. ALL CONDUCTORS #10 AND SMALLER SHALL BE SOLID CU CONDUCTORS. ALL CONDUCTORS #8 AND LARGER SHALL BE STRANDED COPPER.

10. ALL CABLING FURNISHED FOR INSTALLATION EXPOSED (NOT IN AN ENCLOSED RACEWAY) IN AN AIR PLENUM CEILING OR FLOOR SHALL BE APPROVED FOR USE BY GOVERNING AUTHORITIES, AND SHALL CONFORM TO UL 910 WITH A MINIMUM OF 125 DEGREES CELSIUS RATED JACKET.

11. ALL SUPPLIED LUGS FOR EQUIPMENT REQUIRING HARD-WIRED CONNECTIONS, ETC. SHALL BE DOUBLE INDENT, 2 BOLT HOLE, LONG BARREL AND COMPRESSION TYPE. PROVIDE DOUBLE INDENT "HEXAGONAL" COMPRESSION DIES AND TOOL (T & B OR BURNDY OR AS REVIEWED). MECHANICAL LUGS, SINGLE INDENT COMPRESSION TOOLS AND UNIVERSAL DIES SHALL NOT BE PERMITTED. ALL COMPRESSION TOOLS AND DIES SHALL BE MANUFACTURED BY THE LUG VENDOR.

12. ALL SUPPLIED IN-LINE SPLICE CONNECTORS. "T" CONNECTORS. ETC., SHALL BE DOUBLE INDENT (PER CONDUCTOR), LONG BARREL AND COMPRESSION TYPE. PROVIDE DOUBLE INDENT "HEXAGONAL" COMPRESSION DIES AND TOOL (T & B. BURNDY OR AS REVIEWED). MECHANICAL CONNECTORS. SINGLE INDENT COMPRESSION TOOLS AND UNIVERSAL DIES SHALL NOT BE PERMITTED. ALL COMPRESSION TOOLS AND DIES SHALL BE MANUFACTURED BY THE CONNECTOR VENDOR.

13. ALL NEW AND RELOCATED ELECTRIFIED FURNITURE SYSTEM COMPONENTS SHALL BE DISCONNECTED, RECEIVED, STORED, INSTALLED AND WIRED BY THIS CONTRACTOR IN ORDER TO CONFORM WITH THE DESIGN AS INDICATED ON THESE DRAWINGS AND THE ARCHITECTURAL DRAWINGS. ANY MODIFICATIONS TO FURNITURE SYSTEM NECESSARY TO COMPLY WITH LOCAL CODES AND INSTALLATION STANDARDS SHALL BE BROUGHT TO THE ATTENTION OF THE ARCHITECT PRIOR TO FIELD MODIFICATION AND ELECTRIFICATION.

14. ALL UPS SYSTEM RECEPTACLES OR RECEPTACLES DENOTED AS BEING ISOLATED GROUND TYPE SHALL BE PROVIDED WITH A GREEN ISOLATED GROUND WIRE. THIS CONTRACTOR SHALL PROVIDE A COMPLETE ISOLATED GROUND WIRE SYSTEM FROM THE LAST RECEPTACLE TO THE TRANSFORMER X/O POINT (WHERE THE SERVICE GROUND IS ESTABLISHED). THIS SHALL INCLUDE THE PROVISION OF ISOLATED GROUND WIRES AND BUS BARS IN NEW AND EXISTING DISTRIBUTION ALONG THE ENTIRE PATH AS STATED ABOVE, WHETHER OR NOT SHOWN ON THE PLANS. ALL ISOLATED GROUND CIRCUITS SHALL HAVE DEDICATED NEUTRAL AND GROUND WIRES. I.G. WIRES SHALL BE RUN WITH PHASE AND NEUTRAL CONDUCTORS. REPLACE EXISTING FEEDERS AS REQUIRED.

15. PROVIDE LOCAL DISCONNECTS FOR ALL MOTORS, HARD-WIRED PANTRY/KITCHEN EQUIPMENT AND HOT WATER HEATERS, WHETHER OR NOT SHOWN ON PLAN. DISCONNECTS SHALL BE SIZED PER THE OVERCURRENT PROTECTION AND LOCATED PER THE ENGINEER AND ARCHITECT.

16. PROVIDE A 120 VOLT DEDICATED CIRCUIT FOR EACH CONDENSATE PUMP FOR ALL AC UNITS. COORDINATE WITH THE ENGINEER, THE PANEL AND BREAKER POSITION, PRIOR TO INSTALLATION.

17. ALL EQUIPMENT MATERIALS SHALL BE NEW, UL LISTED AND SHALL CONFORM TO ANY ADDITIONAL LABELING, TESTING AND CONSTRUCTION REQUIREMENTS ESTABLISHED BY THE GOVERNING AUTHORITIES. SAME SHALL BE GUARANTEED FOR 1 YEAR SUBSEQUENT TO FINAL ACCEPTANCE.

18. ALL EQUIPMENT (ELECTRICAL AND MECHANICAL) SHALL BE SPECIFIED TO HAVE VOLTAGE RATINGS COMPATIBLE WITH THE PROVISIONS OF ANSI C84.

19. ALL WORK SHALL BE IN CONDUIT.

20. DISCONNECTS FOR INCOMING SERVICE SHALL BE SERVICE RATED.

O. UNIT PRICES

1. AT THE SUBMISSION OF BID, PROVIDE A COMPREHENSIVE UNIT PRICE LIST TO FURNISH AND INSTALL CABLE, CONDUIT, PANELS, TRANSFORMERS, DISCONNECTS, CIRCUIT BREAKERS, RECEPTACLES, FIXTURES, SWITCHES, ETC. THE LIST SHALL CONSIST, AS A MINIMUM, OF ALL TYPES AND SIZES OF EQUIPMENT AS INCLUDED IN THE BASE PROJECT. ONLY THOSE BIDS CONTAINING A UNIT PRICE LIST SHALL BE CONSIDERED UNLESS WRITTEN PERMISSION HAS BEEN GRANTED ON BEHALF OF THE OWNER, ARCHITECT, ENGINEER AND/OR CONSTRUCTION MANAGER (OR GENERAL CONTRACTOR).

Storm King Art Center 1 Museum Road New Windsor, NY 12553 +1 (845) 534-3115

Design Architect

heneghan peng architects 14-16 Lord Edward Street Dublin, D02 YC63 +353 1 633 9000

Executive Architect WXY Architecture + Urban Design 224 Centre Street, 5th Floor New York, NY 10013 +1 (212) 219-1953

Landscape Architect Gustafson Porter + Bowman 1 Cobham Mews London, MW1 9SB +44 020 7284 8950

Reed Hilderbrand LLC 33 Whitney Avenue, 3rd Floor New Haven, CT 06510 +1 (617) 923-2422

Structural & Lighting

ARUP 77 Water Street New York, NY 10005 +1 (212) 896-3000

MEPF & IT BuroHappold 100 Broadway #23 New York, NY 10005

+1 (212) 616-0228 Civil

VHB 100 Great Oaks Blvd., Suite 118

Albany, NY 12203 +1 (518) 389-3606

> AV & Acoustics LSTN Consultants 76 Beaver Street, 2nd Floor New York, NY 10005

+1 (347) 788-0810

Facade Front Inc.

100 E. Broadway Street, #501 New York, NY 10002 +1 (212) 242-2220

Key Plan


Description Date 50% Design Development 02/24/20 100% Design Development 05/29/20 50% Construction Documents 11/06/20

Project

Storm King Art Center **Pond Pavilion**

NOT FOR CONSTRUCTION **Drawing Title General Notes**

Date	11/06/20
Scale	12" = 1'-0"
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Sheet Size	ARCH D

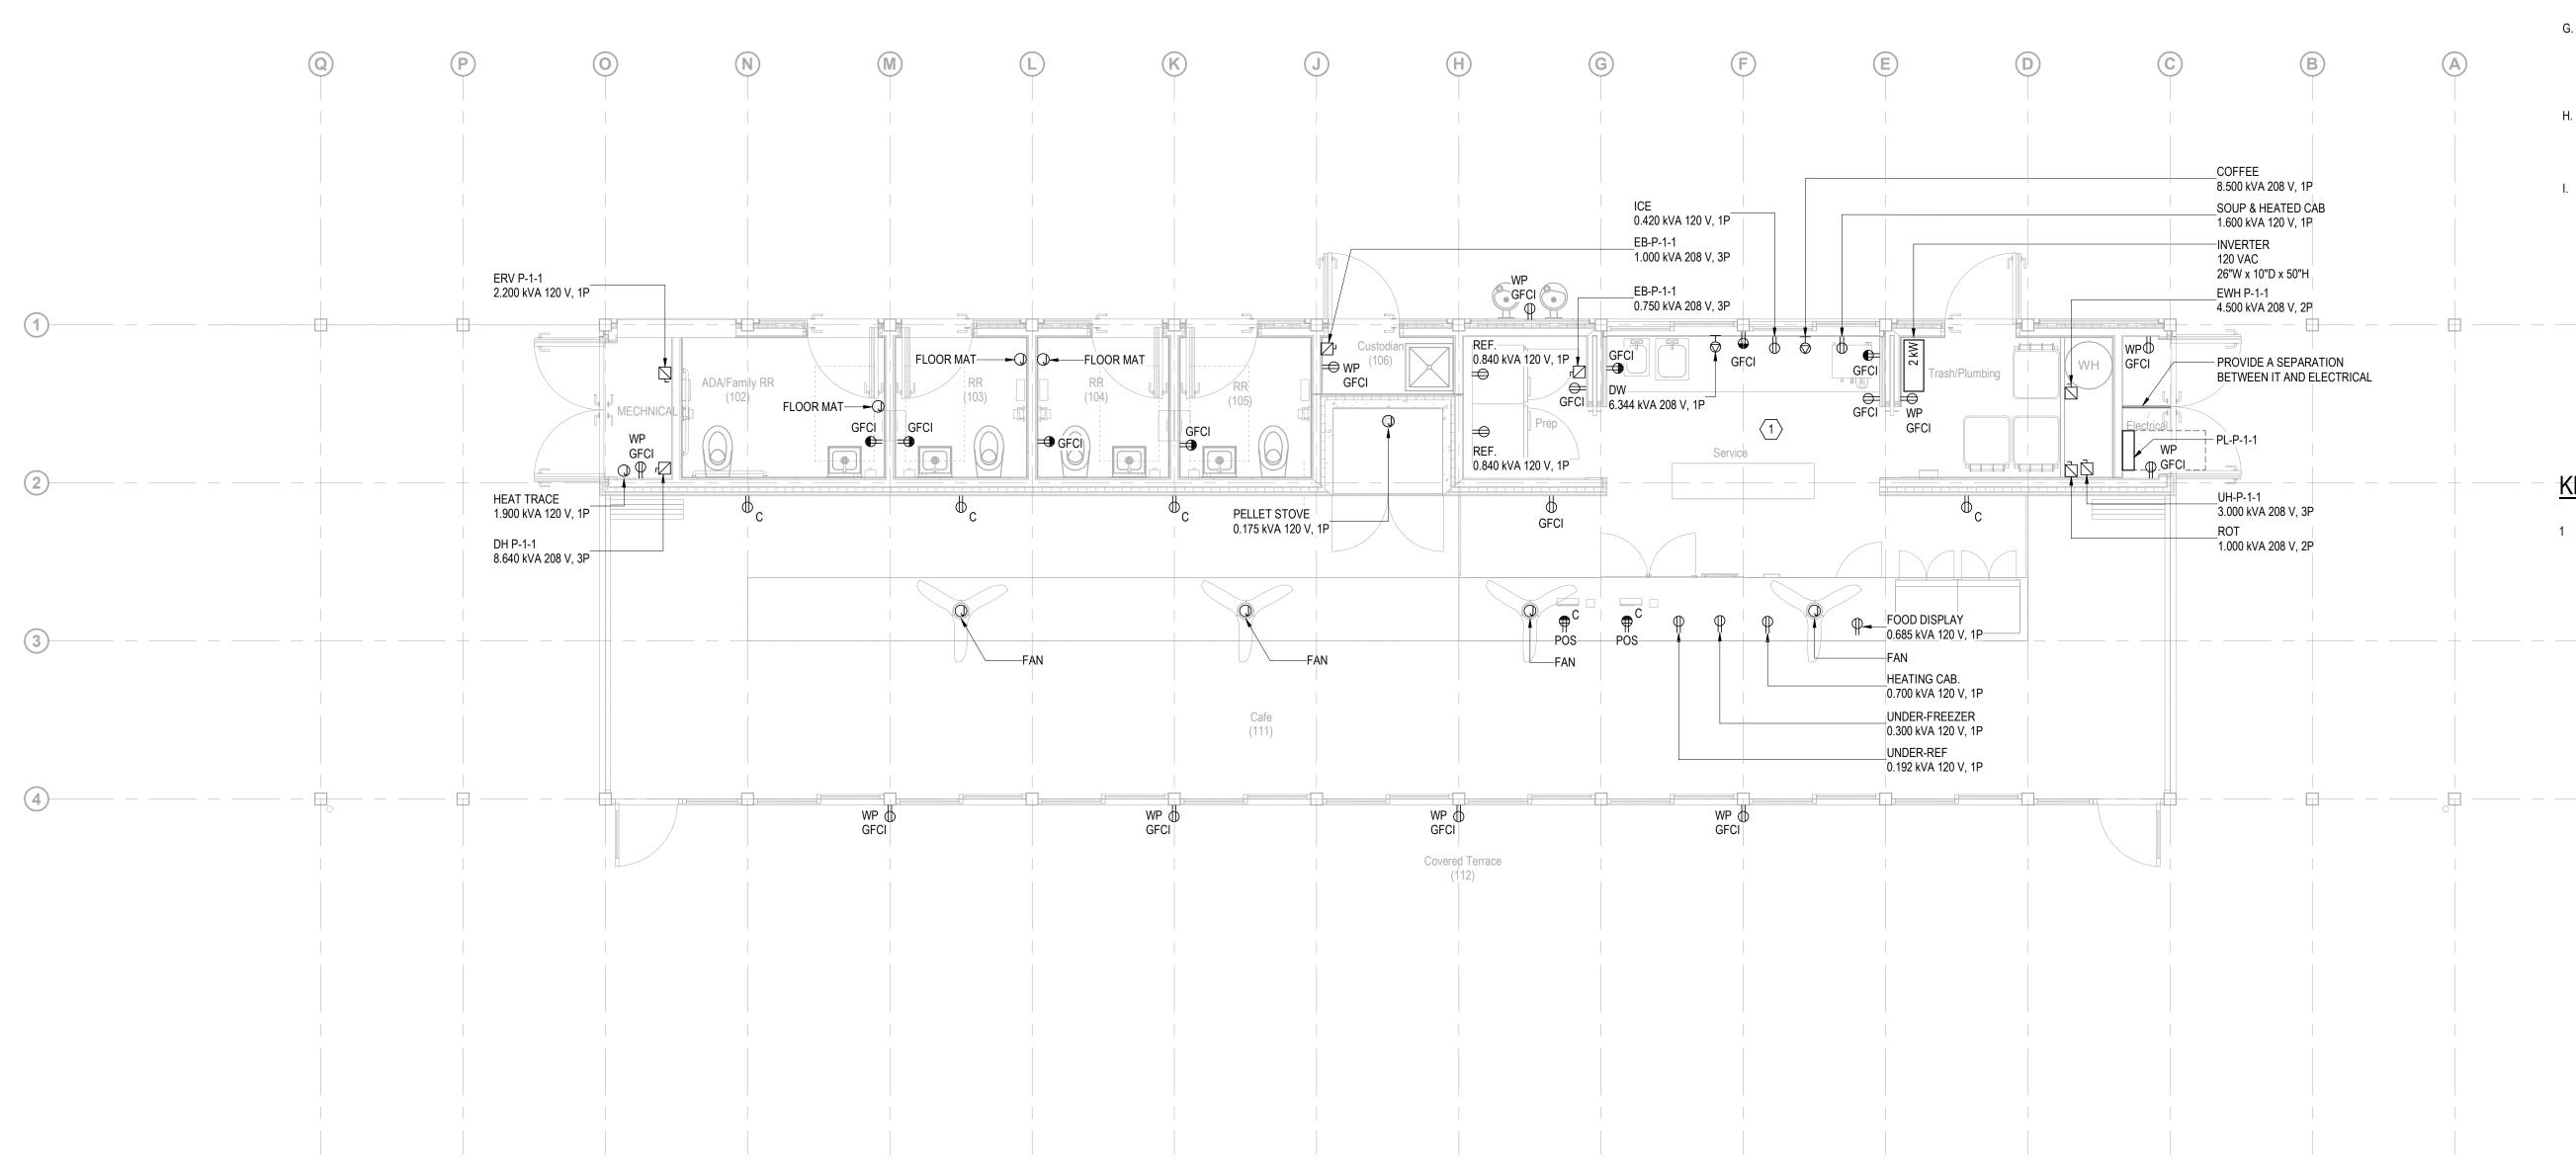

- EXTERIOR EQUIPMENT PROVIDE NEMA 3R MINIMUM RATING FOR ALL EXTERIOR AND ROOF MOUNTED EQUIPMENT INCLUDING DISCONNECT SWITCHES.
- AIR HANDLING UNITS (DOAS AND RTU) -PROVIDE (1) DEDICATED 20A-1P, 120V CIRCUIT PER AIR HANDLING UNIT FOR INTERNAL LIGHTING AND CONVENIENCE RECEPTACLE.
- (1) 20A-1P, 120V, GFCI WEATHERPROOF DUPLEX RECEPTACLE ON BUILDING FACADE EVERY 25'.

SERVERY EQUIPMENT - PROVIDE DEDICATED CIRCUITS TO RECEPTACLES INDICATED IN SERVICE AND AT CAFE COUNTER. FINAL QUANTITIES, LOCATIONS AND POWER REQUIREMENTS PENDING FINAL EQUIPMENT SELECTIONS. COORDINATE FINAL LOCATIONS WITH ARCHITECT PLANS AND ELVEATIONS AND OWNER SELECTED EQUIPMENT.

- A. FOR ALL SYSTEMS, PROVIDE ALLOWANCES FOR ALL COMPONENTS AND ACCESSORIES REQUIRED FOR A COMPLETE AND OPERATING SYSTEM.
- U.O.N. 20A-1P DUPLEX RECEPTACLES SHALL BE CIRCUITED TO NO MORE THAN (6) DUPLEX RECEPTACLES PER CIRCUIT.
- RESTROOM GFCI MAX. (4) DUPLEX GFCI RECEPTACLES PER CIRCUIT.
- AUTOMATIC FAUCET, TOILET AND DRINKING FOUNTAIN SENSORS -PROVIDE (1) 20A-1P, 120V GFCI PROTECTED CIRCUIT TO AUTOMATIC FAUCET AND TOILET SENSORS, MAX. (12) SENSORS PER CIRCUIT.
- HVAC EQUIPMENT PROVIDE (1) 20A-1P, 120V DUPLEX GFCI RECEPTACLE WITHIN 25FT OF ALL HVAC AND REFRIGERATION EQUIPMENT. PROVIDE WEATHERPROOF RECEPTACLE WITH 'WHILE IN USE' COVER IN EXTERIOR LOCATIONS.

- SITE CONVENIENCE POWER PROVIDE
- ROUTE ALL POWER FROM PANEL TO CAFE VIA IN-SLAB CONDUITS.

KEY NOTES

Owner Storm King Art Center

1 Museum Road New Windsor, NY 12553

+1 (845) 534-3115

Design Architect heneghan peng architects 14-16 Lord Edward Street Dublin, D02 YC63 +353 1 633 9000

Executive Architect WXY Architecture + Urban Design 224 Centre Street, 5th Floor New York, NY 10013 +1 (212) 219-1953

Landscape Architect Gustafson Porter + Bowman 1 Cobham Mews London, MW1 9SB +44 020 7284 8950

Reed Hilderbrand LLC 33 Whitney Avenue, 3rd Floor New Haven, CT 06510

+1 (617) 923-2422 Structural & Lighting ARUP

77 Water Street New York, NY 10005 +1 (212) 896-3000 MEPF & IT

BuroHappold 100 Broadway #23 New York, NY 10005 +1 (212) 616-0228

Civil VHB 100 Great Oaks Blvd., Suite 118

Albany, NY 12203 +1 (518) 389-3606 **AV & Acoustics**

LSTN Consultants 76 Beaver Street, 2nd Floor New York, NY 10005 +1 (347) 788-0810

Facade Front Inc. 100 E. Broadway Street, #501 New York, NY 10002 +1 (212) 242-2220

Key Plan




Description Date 50% Design Development 02/24/20 100% Design Development 05/29/20 50% Construction Documents 11/06/20

Project

Storm King Art Center **Pond Pavilion**

NOT FOR CONSTRUCTION **Drawing Title** Power Plan - Ground Level

Date	11/06/20
Scale	1/4" = 1'-0"
Drawing Number	E-P-101
Sheet Size	ARCH D

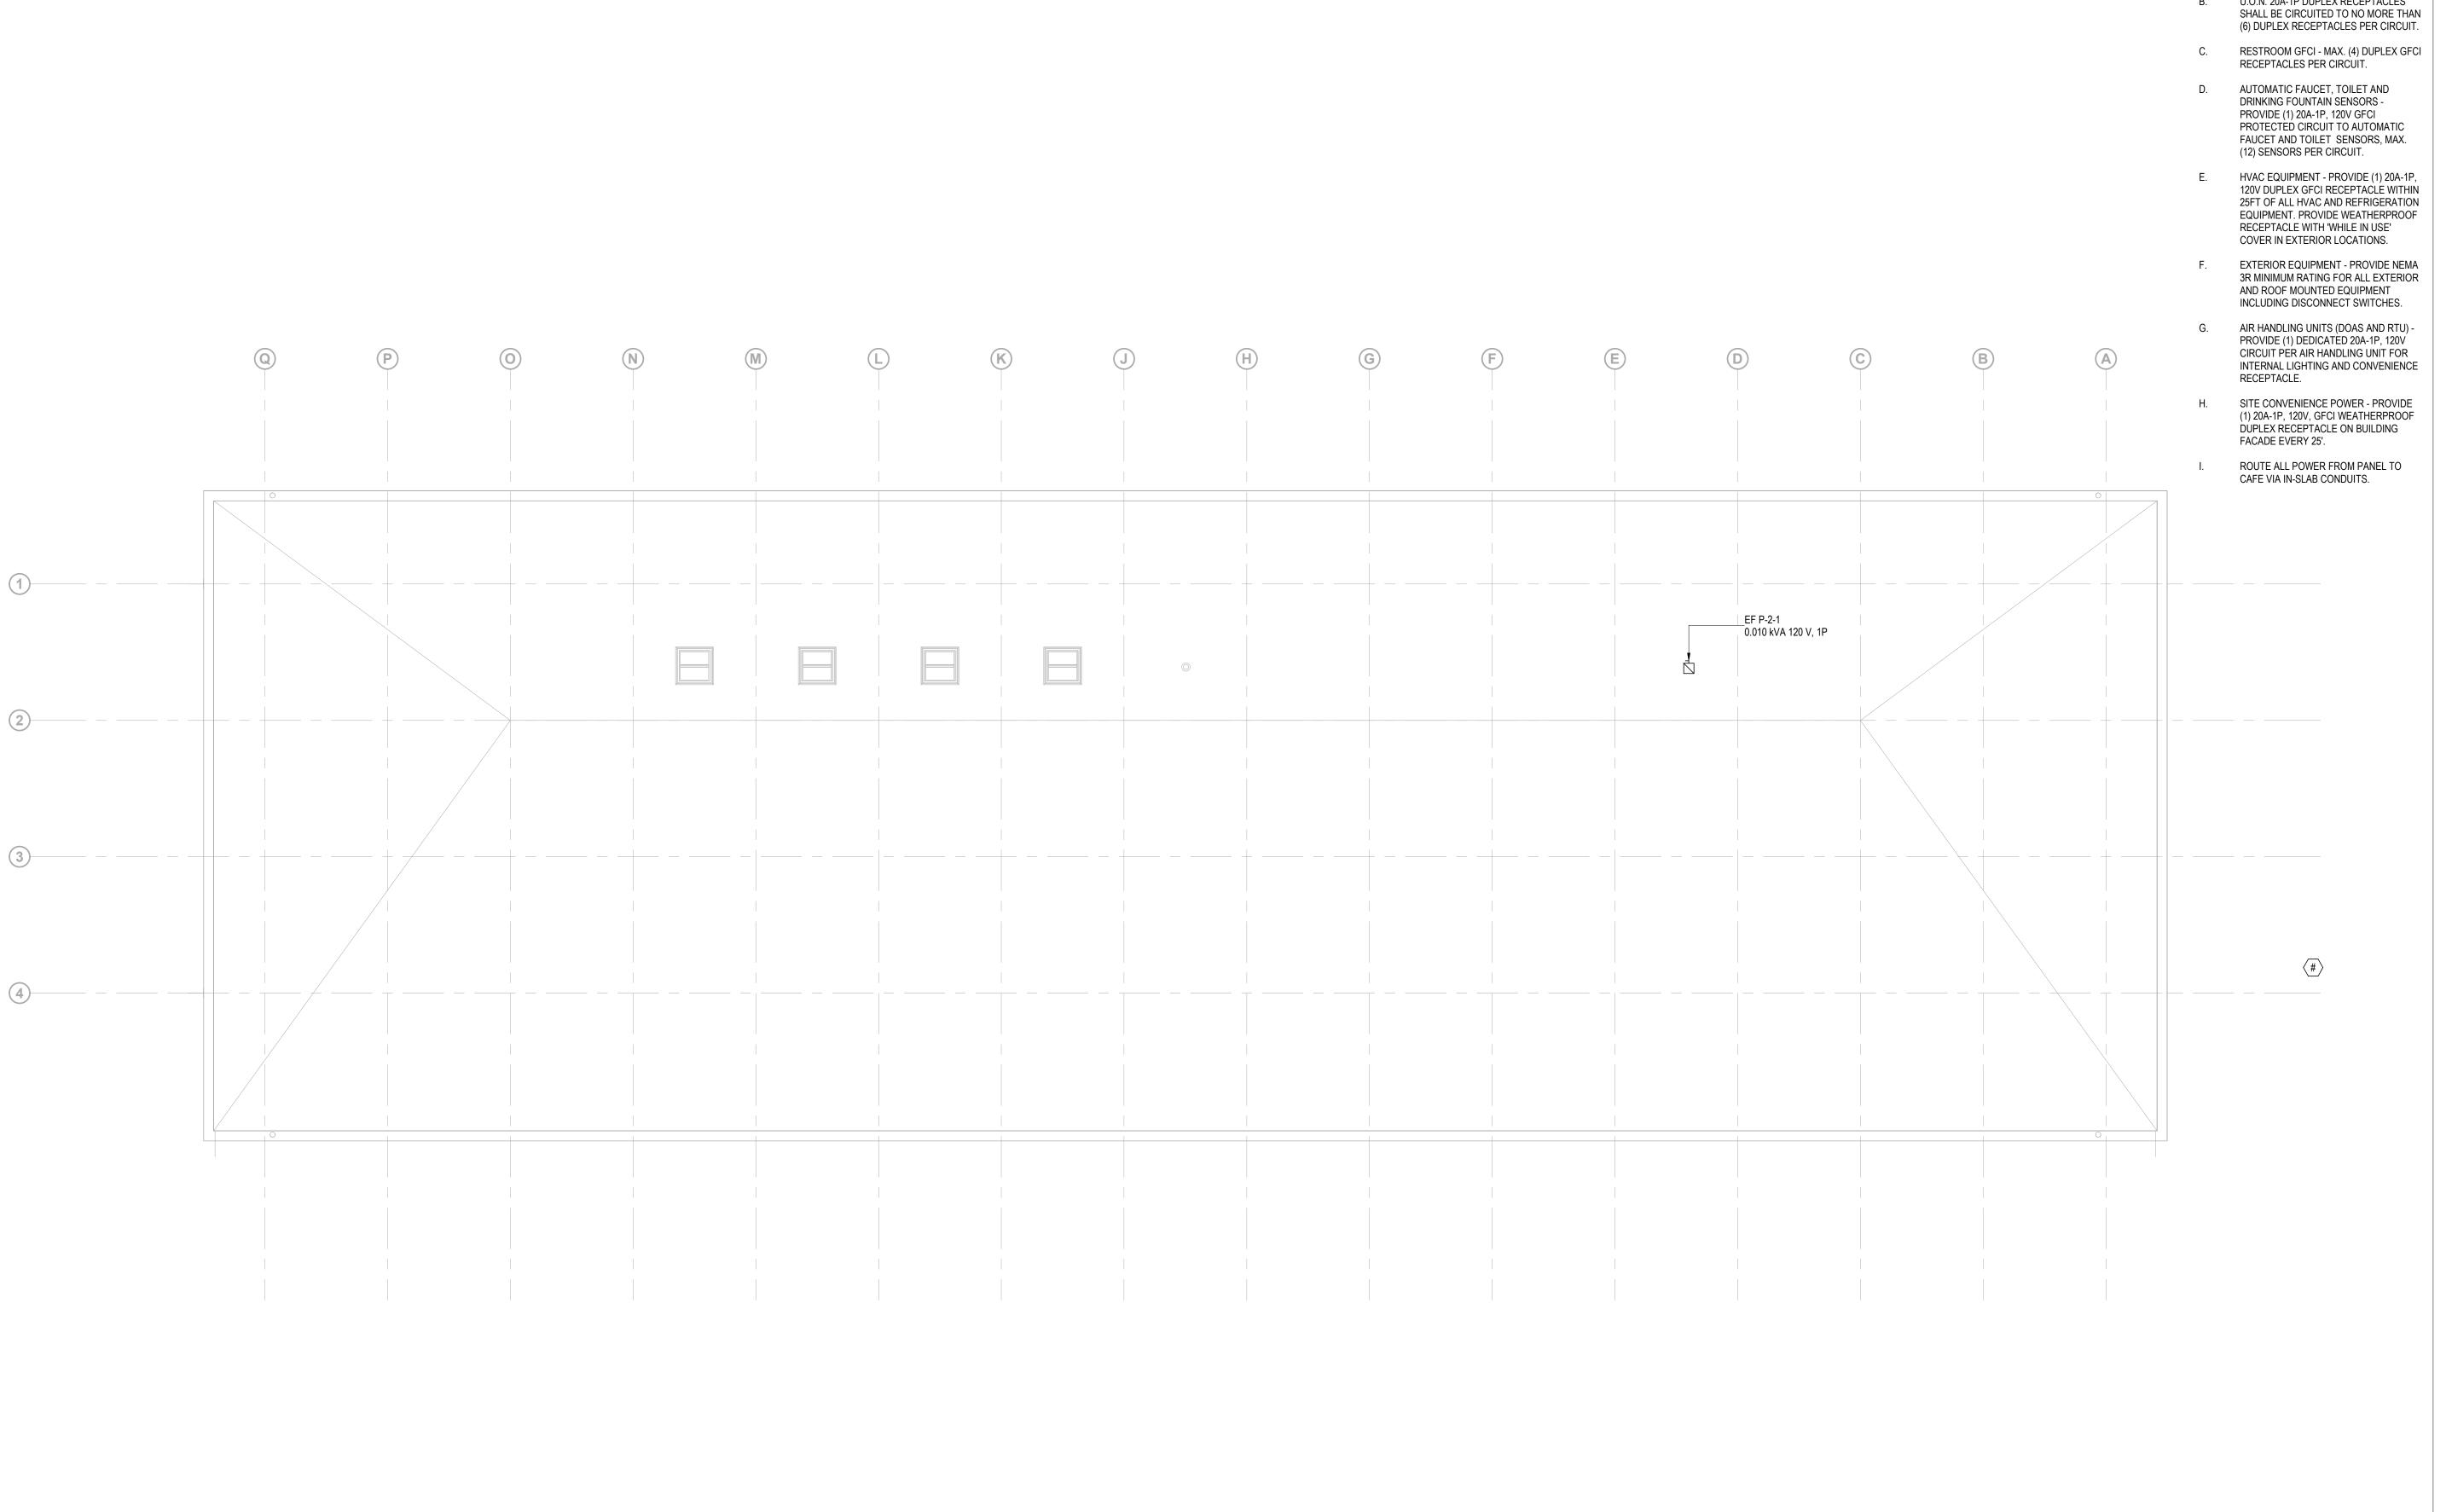

- A. FOR ALL SYSTEMS, PROVIDE ALLOWANCES FOR ALL COMPONENTS AND ACCESSORIES REQUIRED FOR A COMPLETE AND OPERATING SYSTEM.
- U.O.N. 20A-1P DUPLEX RECEPTACLES

New Haven, CT 06510 +1 (617) 923-2422

Structural & Lighting

Owner

Storm King Art Center 1 Museum Road

+1 (845) 534-3115

Design Architect

Dublin, D02 YC63 +353 1 633 9000

Executive Architect

New York, NY 10013

Landscape Architect

+1 (212) 219-1953

1 Cobham Mews

London, MW1 9SB

+44 020 7284 8950

Reed Hilderbrand LLC

New Windsor, NY 12553

heneghan peng architects

14-16 Lord Edward Street

WXY Architecture + Urban Design

224 Centre Street, 5th Floor

Gustafson Porter + Bowman

33 Whitney Avenue, 3rd Floor

ARUP 77 Water Street New York, NY 10005 +1 (212) 896-3000

MEPF & IT BuroHappold 100 Broadway #23

New York, NY 10005 +1 (212) 616-0228 Civil

VHB 100 Great Oaks Blvd., Suite 118

Albany, NY 12203 +1 (518) 389-3606 **AV & Acoustics**

LSTN Consultants 76 Beaver Street, 2nd Floor New York, NY 10005 +1 (347) 788-0810

Facade Front Inc.

100 E. Broadway Street, #501 New York, NY 10002 +1 (212) 242-2220

Key Plan



Description

100% Design Development 50% Construction Documents Date


05/29/20

Project

Storm King Art Center **Pond Pavilion**

NOT FOR CONSTRUCTION **Drawing Title** Power Plan - Roof Level

Date	11/06/20
Scale	1/4" = 1'-0"
Drawing Number	E-P-102
Sheet Size	ARCH D

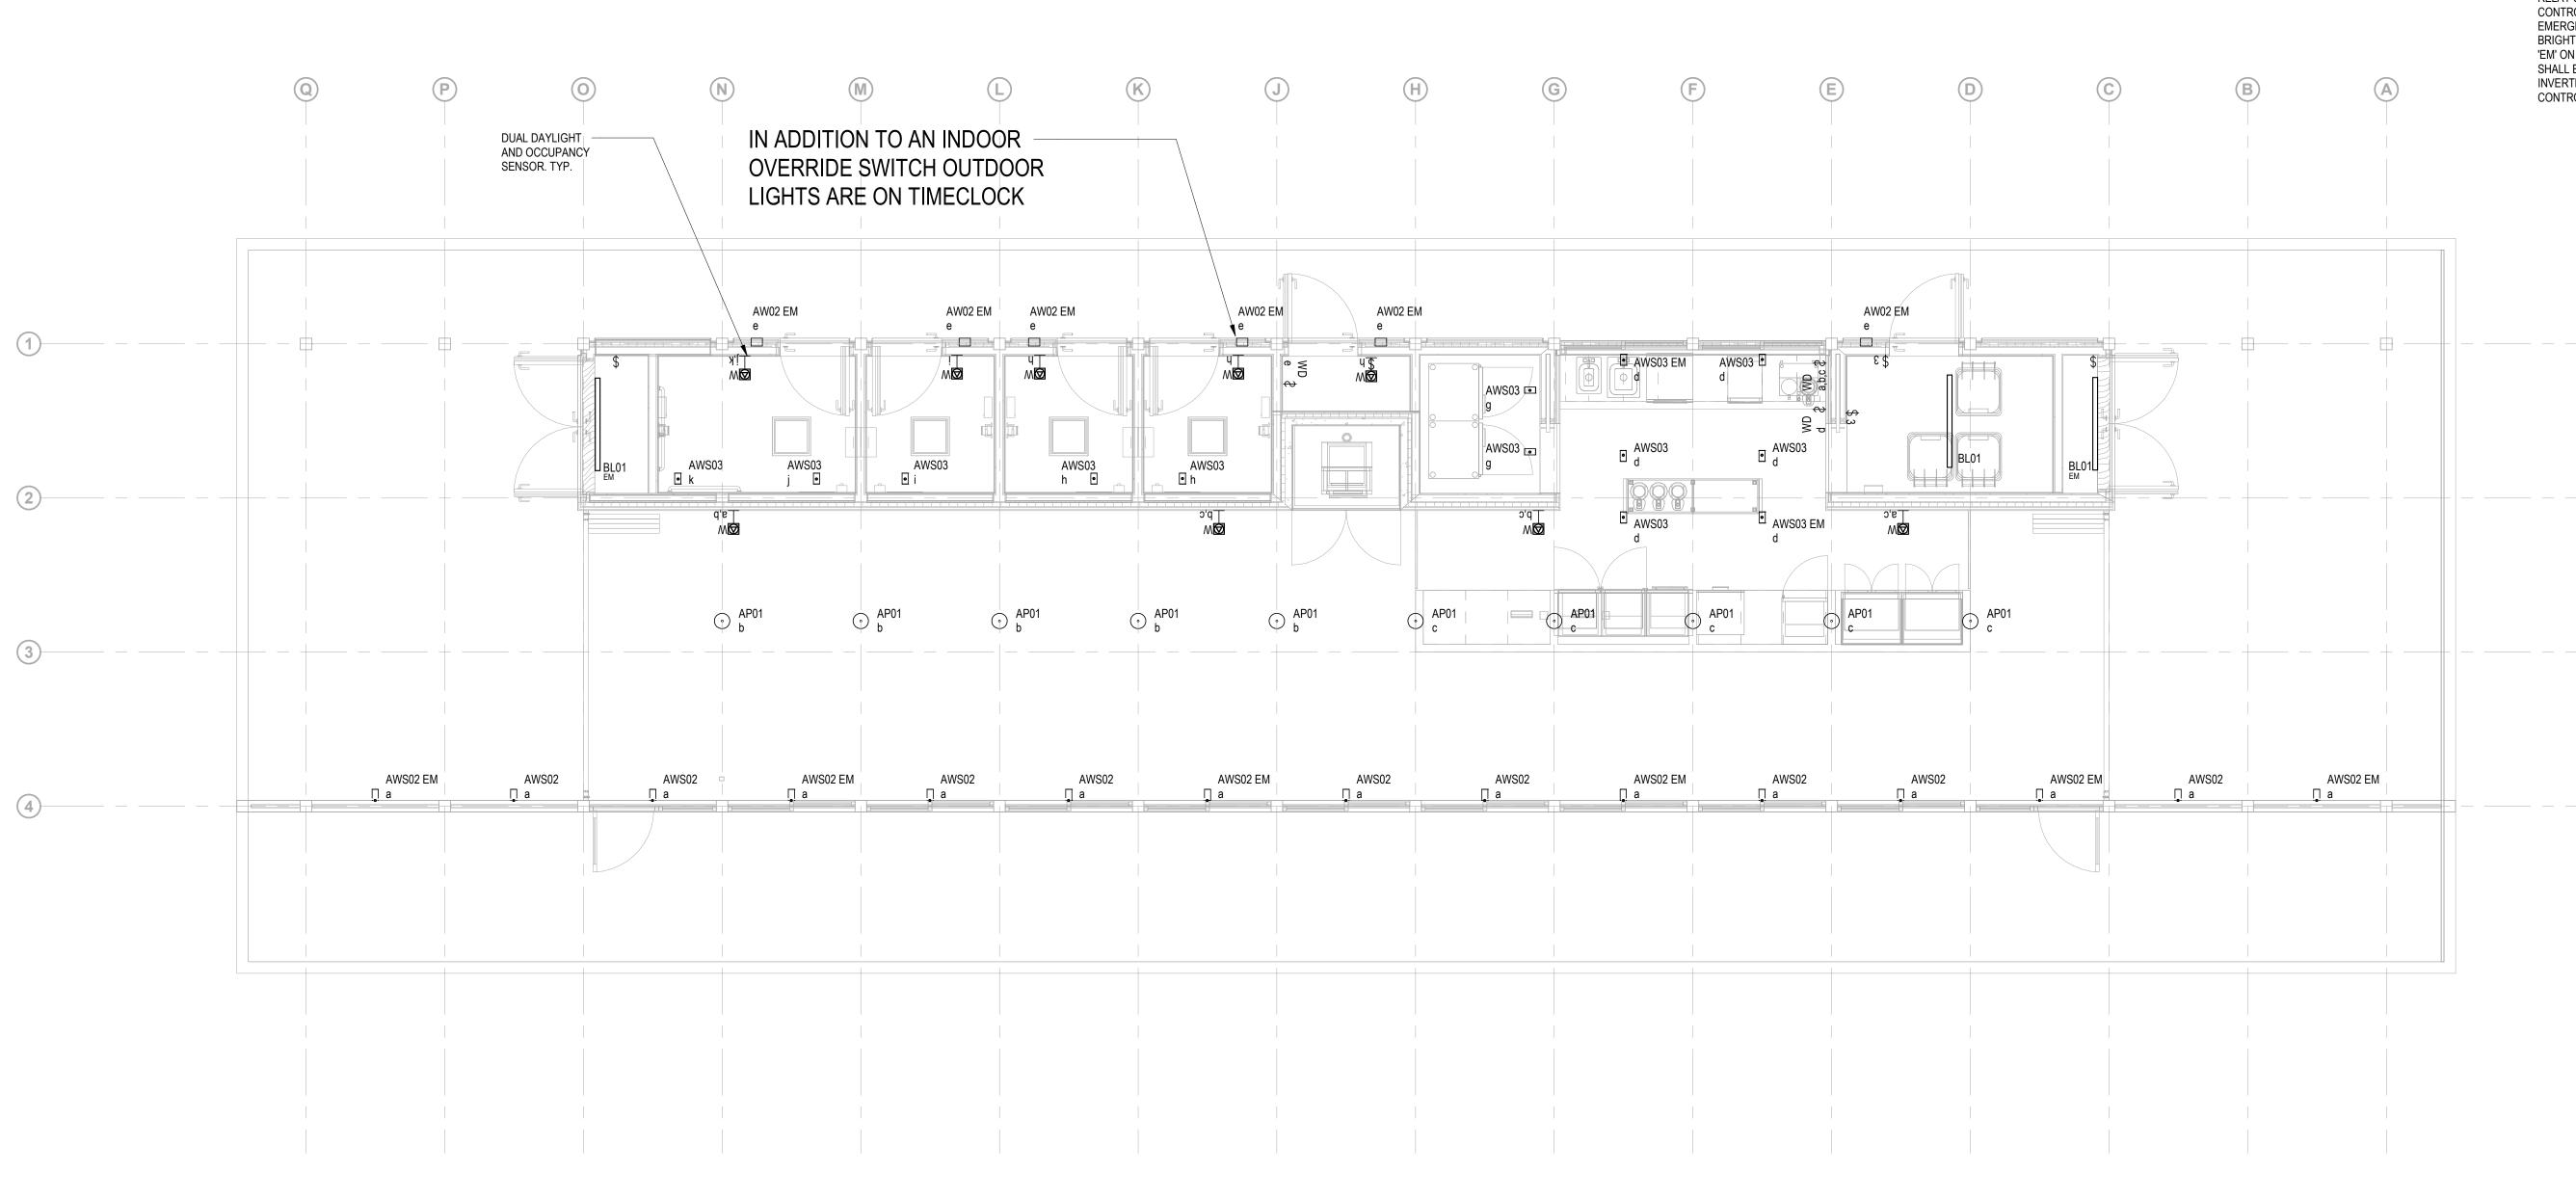

DESIGN DEVELOPMENT NOTES:

- PROVIDE AND INSTALL LOW VOLTAGE DIMMING WIRING FOR ALL CONTROL ZONES CONNECTED TO LIGHTING CONTROL SYSTEM INCLUDING SWITCHED-ONLY ZONES.
- FLOOR PLANS ARE DIAGRAMMATIC TO REPRESENT REQUIRED OCCUPANCY SENSORS AND SWITCHES TO ACHIEVE CONTROL INTENT. LIGHTING CONTROL PANELS, POWER PACKS, POWER SUPPLIES, WIRELESS RECEIVERS, INTERFACES, ETC. ARE NOT EXPLICITLY SHOWN ON PLOOR PLANS. PROVIDE ALL DEVICES AND ACCESSORIES FOR A COMPLETE SYSTEM TO ACHIEVE DESIGN INTENT. REFER TO LIGHTING CONTROL DETAILS FOR FURTHER INFORATION.
- WHEN NORMAL POWER IS AVAILABLE, LIGHT FIXTURES ON EMERGENCY POWER SHALL BE CONTROLLED WITH LIGHTING FIXTURES ON NORMAL POWER IN THE SAME ZONE. IN THE EVENT OF A POWER OUTAGE, EMERGENCY BYPASS RELAY SHALL OVERRIDE NORMAL CONTROL AND SWITCH FIXTURES ON EMERGENCY POWER TO FULL BRIGHTNESS. FIXTURES DESIGNATED 'EM' ON THE LIGHTING CONTROL SYSTEM SHALL BE CONNECTED TO BATTERY INVERTER. REFER TO LIGHTING CONTROL DETAILS.

Design Architect heneghan peng architects 14-16 Lord Edward Street Dublin, D02 YC63 +353 1 633 9000

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New Windsor, NY 12553

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Landscape Architect Gustafson Porter + Bowman 1 Cobham Mews London, MW1 9SB +44 020 7284 8950

Reed Hilderbrand LLC 33 Whitney Avenue, 3rd Floor New Haven, CT 06510

+1 (617) 923-2422

Structural & Lighting ARUP 77 Water Street

New York, NY 10005 +1 (212) 896-3000 MEPF & IT

BuroHappold

100 Broadway #23 New York, NY 10005 +1 (212) 616-0228

Civil VHB

100 Great Oaks Blvd., Suite 118 Albany, NY 12203 +1 (518) 389-3606

AV & Acoustics

LSTN Consultants 76 Beaver Street, 2nd Floor New York, NY 10005 +1 (347) 788-0810

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100 E. Broadway Street, #501 New York, NY 10002 +1 (212) 242-2220

Key Plan



Description


Date 100% Design Development 05/29/20 50% Construction Documents


Project

Storm King Art Center **Pond Pavilion**

NOT FOR CONSTRUCTION **Drawing Title** Lighting Plan -Ground Level

11/06/20
1/4" = 1'-0"
E-P-201
ARCH D

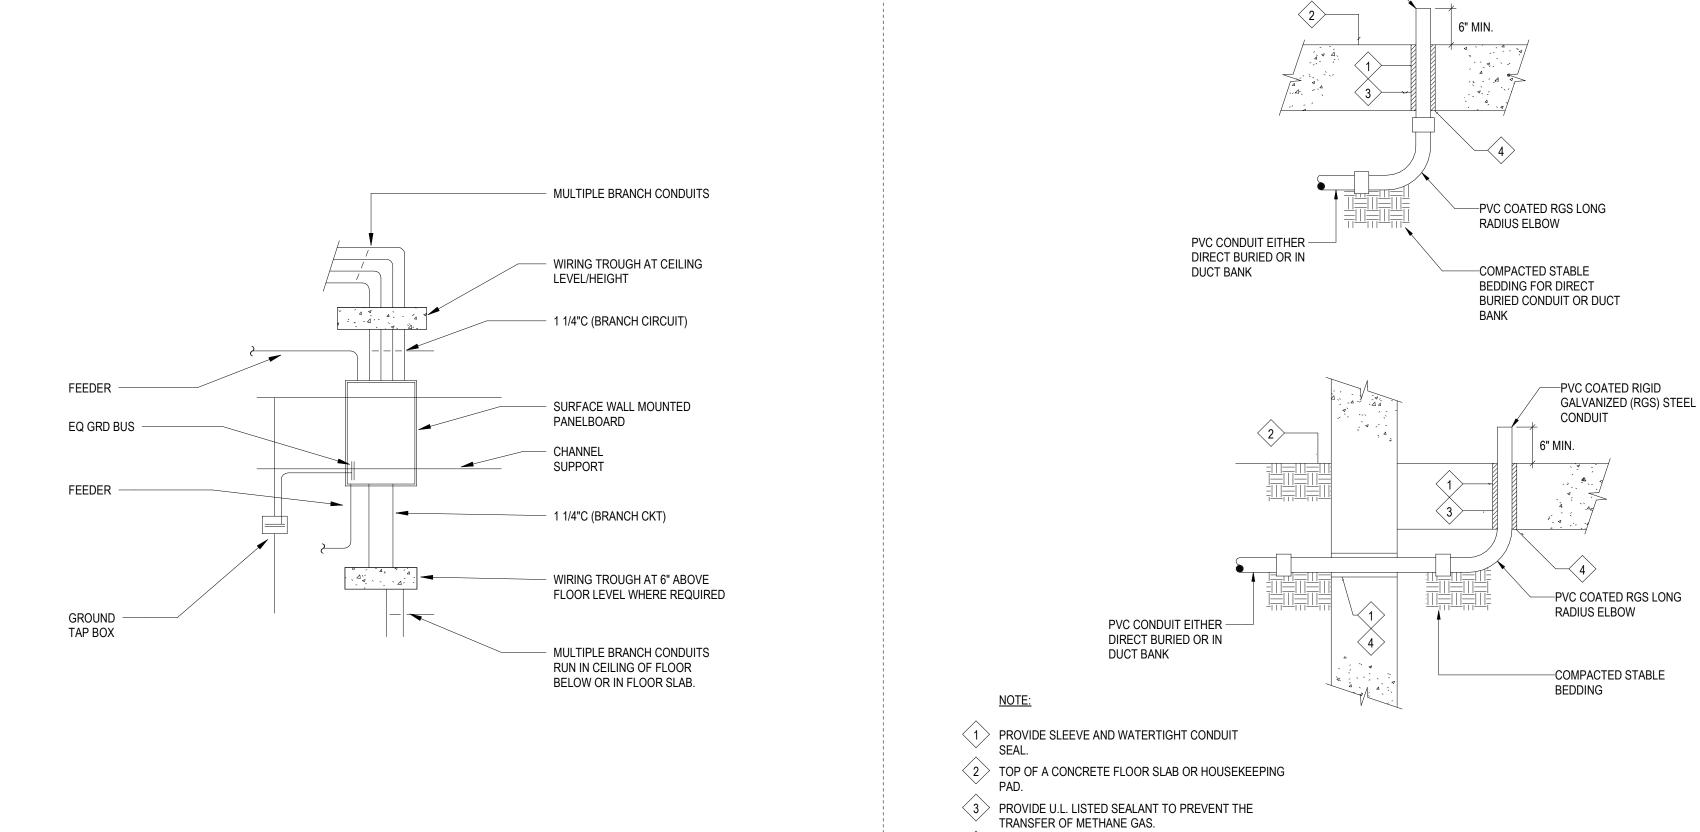

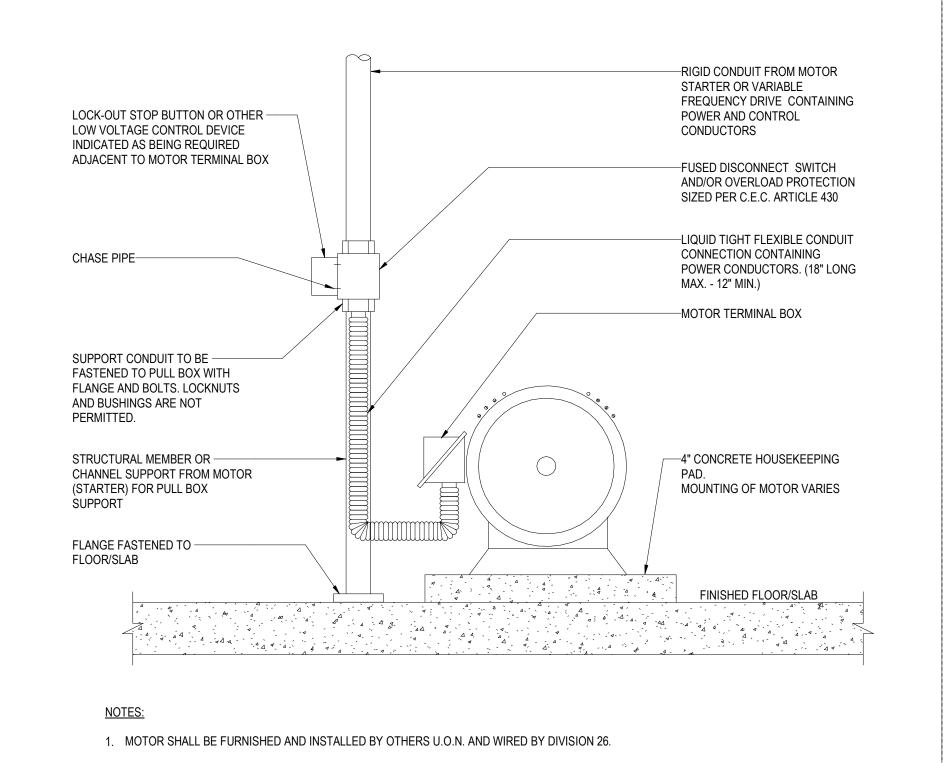

TYPICAL PANELBOARD INSTALLATION UL SYSTEM No. W-L-1164 GYPSUM WALL ASSEMBLY PER ARCHITECTURAL (1-HR OR 2-HR) STUDS NOT SHOWN-—UL LISTED FIRE SEALANT (SEE NOTE 1) (SEE NOTE 4) STEEL SLEEVE (SEE NOTE 2) -PENETRATING ITEM (SEE NOTE 3) UL LISTED FIRE SEALANT-(SEE NOTE 5) NOTES: 1. WOOD STUDS TO CONSIST OF NOMINAL 2" x 4" LUMBER. STEEL STUDS TO BE MINIMUM 2-1/2" WIDE. REFER TO ARCHITECTURAL DETAILS. 2. MAXIMUM 32" DIAMETER STEEL PIPE SLEEVE. MAXIMUM DIAMETER OPENING = 32" FOR STEEL STUD WALLS AND 14-1/2" FOR WOOD STUD WALLS. ANNULAR SPACE = 0" MINIMUM AND 1-7/8" MAXIMUM. 3. MAXIMUM 6" NOMINAL DIAMETER STEEL CONDUIT AND/OR MAXIMUM 4" NOMINAL DIAMETER EMT CONDUIT. 4. MINIMUM 5/8" DEPTH FOR 1-HR FIRE RATING AND 1-1/4" FOR 2-HR FIRE RATING HILTI FS-ONE INTUMESCENT FIRESTOP SEALANT OR EQUAL FLUSH WITH WALL. MATCH THE FIRE RATING OF ASSEMBLY PER ARCHITECTURAL DRAWINGS. 5. MINIMUM 1/2" BEAD HILTI FS-ONE INTUMESCENT FIRESTOP SEALANT OR EQUAL AT POINT OF CONTACT. 6. MAXIMUM 32" DIAMETER STEEL PIPE SLEEVE. MAXIMUM DIAMETER OPENING = 32" FOR STEEL STUD WALLS AND 14-1/2" FOR WOOD STUD WALLS. ANNULAR SPACE = 0" MINIMUM AND 1-7/8" MAXIMUM. 7. MAXIMUM 6" NOMINAL DIAMETER STEEL CONDUIT AND/OR MAXIMUM 4" NOMINAL DIAMETER EMT CONDUIT. 8. MINIMUM 5/8" DEPTH FOR 1-HR FIRE RATING AND 1-1/4" FOR 2-HR FIRE RATING HILTI FS-ONE INTUMESCENT FIRESTOP SEALANT OR EQUAL FLUSH WITH WALL. MATCH THE FIRE RATING OF ASSEMBLY PER ARCHITECTURAL DRAWINGS. 9. MINIMUM 1/2" BEAD HILTI FS-ONE INTUMESCENT FIRESTOP SEALANT OR EQUAL AT POINT OF CONTACT.

CONDUIT PENETRATION THRU RATED INTERIOR WALL

P-TOUCH CIRCUIT # IDENTIFICATION W. PANEL-CKT #. LP-3-1 PROVIDE COLOR FACEPLATE AND DEVICE AS DIRECTED BY ARCHITECT. PROVIDE ORANGE FACEPLATE AND DEVICE FOR EMERGENCY POWER RECEPTACLES ON: OPTIONAL STANDBY POWER, OR AS DIRECTED BY

PVC COATED RIGID GALVANIZED —

(RGS) STEEL CONDUIT

4 CONTRACTOR TO COORDINATE ALL PENETRATIONS

ON-GRADE FLOOR SLAB CONDUIT STUB-UP DETAILS

WITH STRUCTURAL ENGINEER.

TYPICAL FLOOR MOUNTED MOTOR CONNECTION

2. INSTALL FLEXIBLE CONDUIT SLACK-TO-THE-TOUCH TO ALLOW FREE MOTION OF THE MOTOR SKID.

Description Date 50% Design Development 02/24/20 100% Design Development 05/29/20 50% Construction Documents 11/06/20

Owner

Storm King Art Center 1 Museum Road

+1 (845) 534-3115 **Design Architect**

Dublin, D02 YC63 +353 1 633 9000

Executive Architect

New York, NY 10013

Landscape Architect

+1 (212) 219-1953

1 Cobham Mews

London, MW1 9SB

+44 020 7284 8950

Reed Hilderbrand LLC

New Haven, CT 06510

Structural & Lighting

New York, NY 10005

+1 (212) 896-3000

100 Broadway #23 New York, NY 10005

+1 (212) 616-0228

Albany, NY 12203

+1 (518) 389-3606

AV & Acoustics

LSTN Consultants

New York, NY 10005

New York, NY 10002 +1 (212) 242-2220

+1 (347) 788-0810

Facade

Front Inc.

Key Plan

76 Beaver Street, 2nd Floor

100 E. Broadway Street, #501

100 Great Oaks Blvd., Suite 118

+1 (617) 923-2422

77 Water Street

MEPF & IT

BuroHappold

ARUP

Civil

VHB

New Windsor, NY 12553

heneghan peng architects 14-16 Lord Edward Street

WXY Architecture + Urban Design

224 Centre Street, 5th Floor

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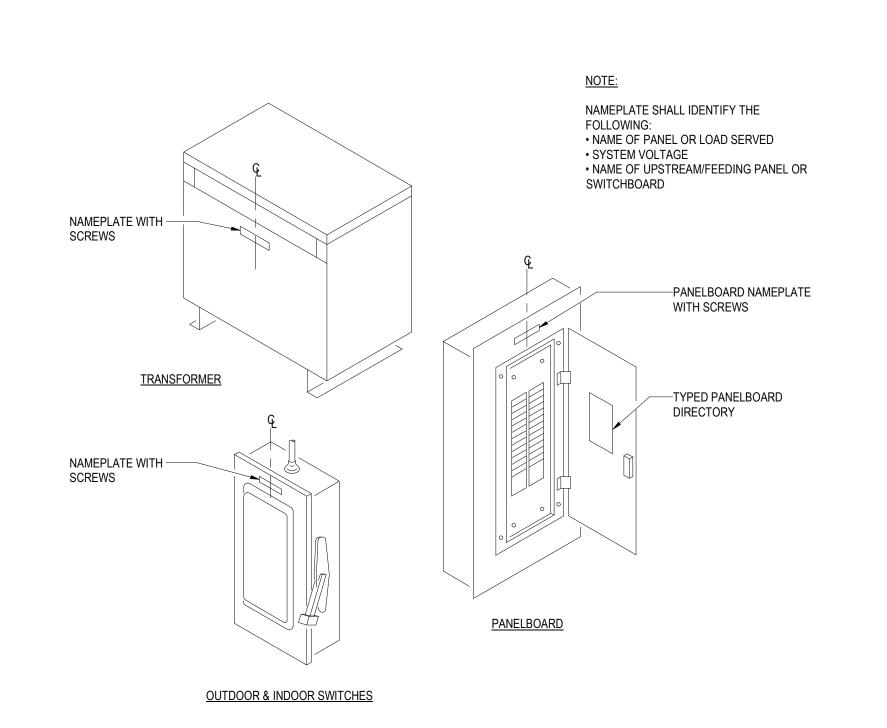
33 Whitney Avenue, 3rd Floor

Project Storm King Art Center **Pond Pavilion**

NOT FOR CONSTRUCTION **Drawing Title Electrical Details**


11/06/20 Date 12" = 1'-0" Scale Drawing E-P-501 Number ARCH D Sheet Size






NOTES:

- 1. REFER TO SPECIFICATION 260553 FOR LABELING REQUIREMENTS. 2. PROVIDE LAMINATED, ENGRAVED PLASTIC NAMEPLATES WITH % INCH HIGH LETTERS FOR ALL SWITCHGEAR, SWITCHBOARDS, MOTOR CONTROL CENTERS, TRANSFER SWITCHES, PANELBOARDS, SIGNAL SYSTEM EQUIPMENT CABINETS,
- AND TERMINAL CABINETS. 3. PROVIDE SIMILAR NAMEPLATES WITH 1/2 INCH HIGH LETTERS FOR TRANSFORMERS, TIME SWITCHES, INDIVIDUALLY MOUNTED BREAKERS, SWITCHES AND CONTROLS, SWITCHBOARDS, AND MOTOR CENTER BRANCH DEVICES. 4. ATTACH NAMEPLATES TO GEAR WITH SHEET METAL SCREWS. ADHESIVE MOUNTED NAMEPLATES ARE NOT ACCEPTABLE. 5. REFER TO SINGLE LINE DIAGRAMS AND SCHEDULES FOR ACTUAL DESIGNATIONS AND CIRCUIT NUMBERS THAT APPLY TO THIS

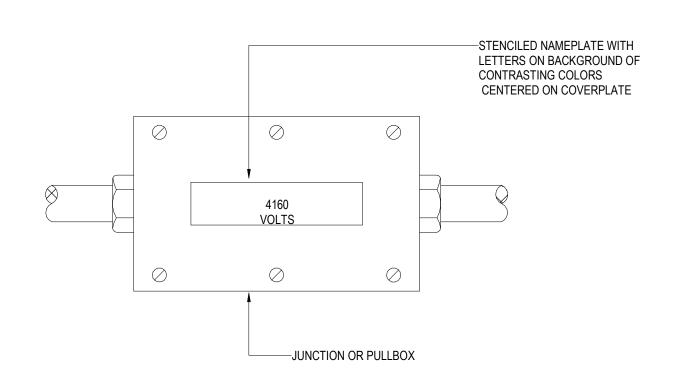

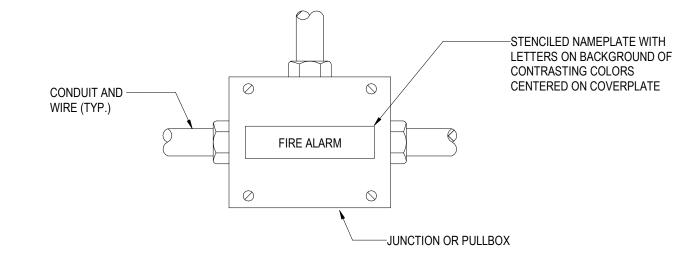


NOTES:

- 1. REFER TO SPECIFICATION 260553 FOR LABELING REQUIREMENTS. 2. PROVIDE READILY VISIBLE BLOCK LETTER STENCILED DESIGNATIONS FOR THE FOLLOWING WITH % INCH HIGH MINIMUM LETTERS ON BACKGROUND OF CONTRASTING COLORS: A. JUNCTION AND PULL BOXES OF SIGNAL AND COMMUNICATION SYSTEMS IDENTIFYING SYSTEM AND VOLTAGE.
- B. LIGHTING OUTLET AND JUNCTION BOXES: IDENTIFY VOLTAGE AND CIRCUITS CONTAINED WITHIN BOX. C. 480V OUTLET AND JUNCTION BOXES: 480V. IDENTIFY CIRCUIT(S). D. EACH 10 FOOT LENGTH OF MEDIUM VOLTAGE CONDUIT, EXPOSED OR IN ACCESSIBLE CEILING SPACE AND ASSOCIATED JUNCTION AND PULL BOXES: DANGER HIGH VOLTAGE
- E. FEEDER CONDUIT RUNS ON 25 FOOT CENTERS ON BOTH SIDES OF WALL AND FLOOR PENETRATIONS AND ABOVE DEMOUNTABLE CEILINGS. INDICATE CIRCUIT DESIGNATION AND NUMBER ON ALL FEEDERS. INDICATE SYSTEM ON ALL SIGNAL AND COMMUNICATIONS SYSTEM CONDUIT SIZED 1 1/2" AND LARGER.

IDENTIFICATION OF ELECTRICAL EQUIPMENT



IDENTIFICATION OF ELECTRICAL BOXES

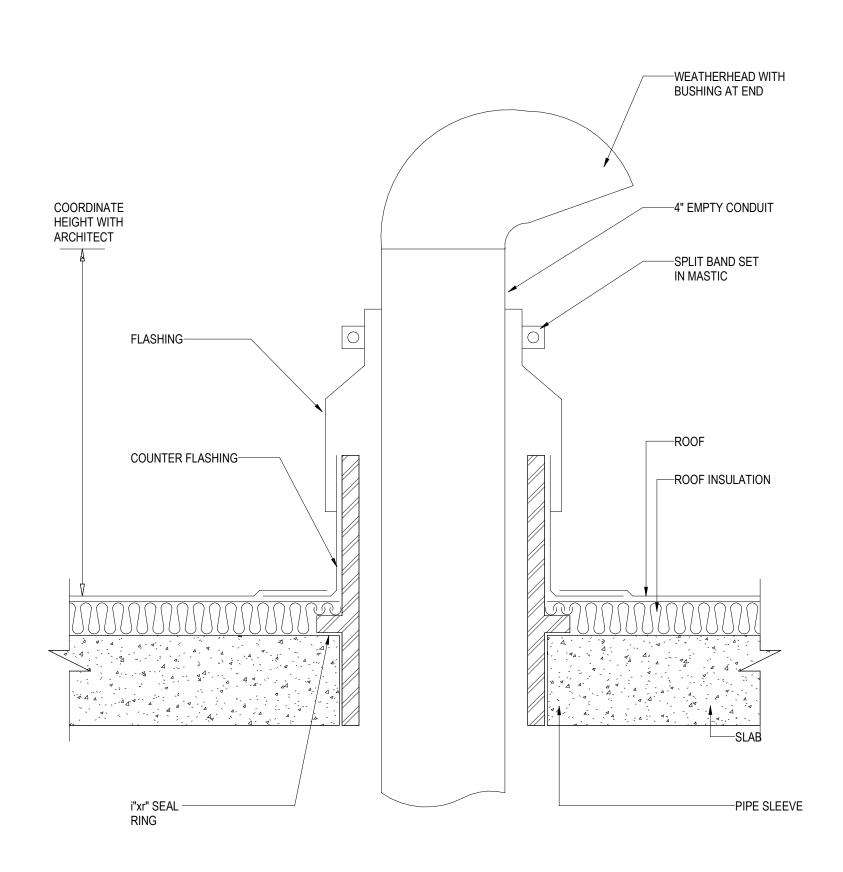

UL SYSTEM No. C-AJ-1291 -2-HR FIRE RATING FLOOR OR WALL ASSEMBLY - MIN. 2-1/2" THICK CONCRETE -CONDUIT OR SLEEVE (SEE NOTE TOP VIEW -MIN. 1" DEPTH HILTI MIN. 1/4" BEAD HILTI FS-ONE -INTUMESCENT FIRESTOP SEALANT OR NO. FS-ONE INTUMESCENT EQUAL AT POINT OF CONTACT ALL THE FIRESTOP SEALANT WAY AROUND CONDUIT OR SLEEVE TO OR EQUAL FLUSH PREVENT THE TRANSFER OF RADON WITH TOP OR **BOTTOM OF FLOOR** OR JUST ONE SIDE SECTION A-A NOTES: CONDUIT MAY BE CENTERED OR OFFSET IN HOLE. MAXIMUM DIAMETER OF HOLE OPENING IS 14 TEMPORARY FORMS MA BE REQUIRED TO SUPPORT THE FIRESTOP SEALANT WHILE IT CURES

- FOR CONDUIT SLEEVE INSTALLATIONS PROVIDE AROUND CONDUCTORS WITHIN SLEEVE.
- CONTRACTOR SHALL BE RESPONSIBLE FOR ALL PATCHING AND EXTERNAL FIRESTOPPING AROUND SLEEVES (WHERE APPLICABLE) AND CONDUIT.
- MAXIMUM 6" NOMINAL DIAMETER STEEL CONDUIT AND MAXIMUM 4" NOMINAL DIAMETER EMT

CONDUIT PENETRATION THRU ROOF DETAIL

CONDUIT THROUGH 2-HR CONCRETE WALL/SLAB

Date Description 02/24/20 50% Design Development 100% Design Development 05/29/20 50% Construction Documents 11/06/20

Owner

Storm King Art Center 1 Museum Road

+1 (845) 534-3115

Design Architect

Dublin, D02 YC63

+353 1 633 9000

Executive Architect

New York, NY 10013 +1 (212) 219-1953

Landscape Architect

Reed Hilderbrand LLC

New Haven, CT 06510 +1 (617) 923-2422

Structural & Lighting

New York, NY 10005 +1 (212) 896-3000

100 Broadway #23 New York, NY 10005 +1 (212) 616-0228

Albany, NY 12203

+1 (518) 389-3606

LSTN Consultants

New York, NY 10005

New York, NY 10002 +1 (212) 242-2220

+1 (347) 788-0810

Facade

Front Inc.

Key Plan

AV & Acoustics

100 Great Oaks Blvd., Suite 118

76 Beaver Street, 2nd Floor

100 E. Broadway Street, #501

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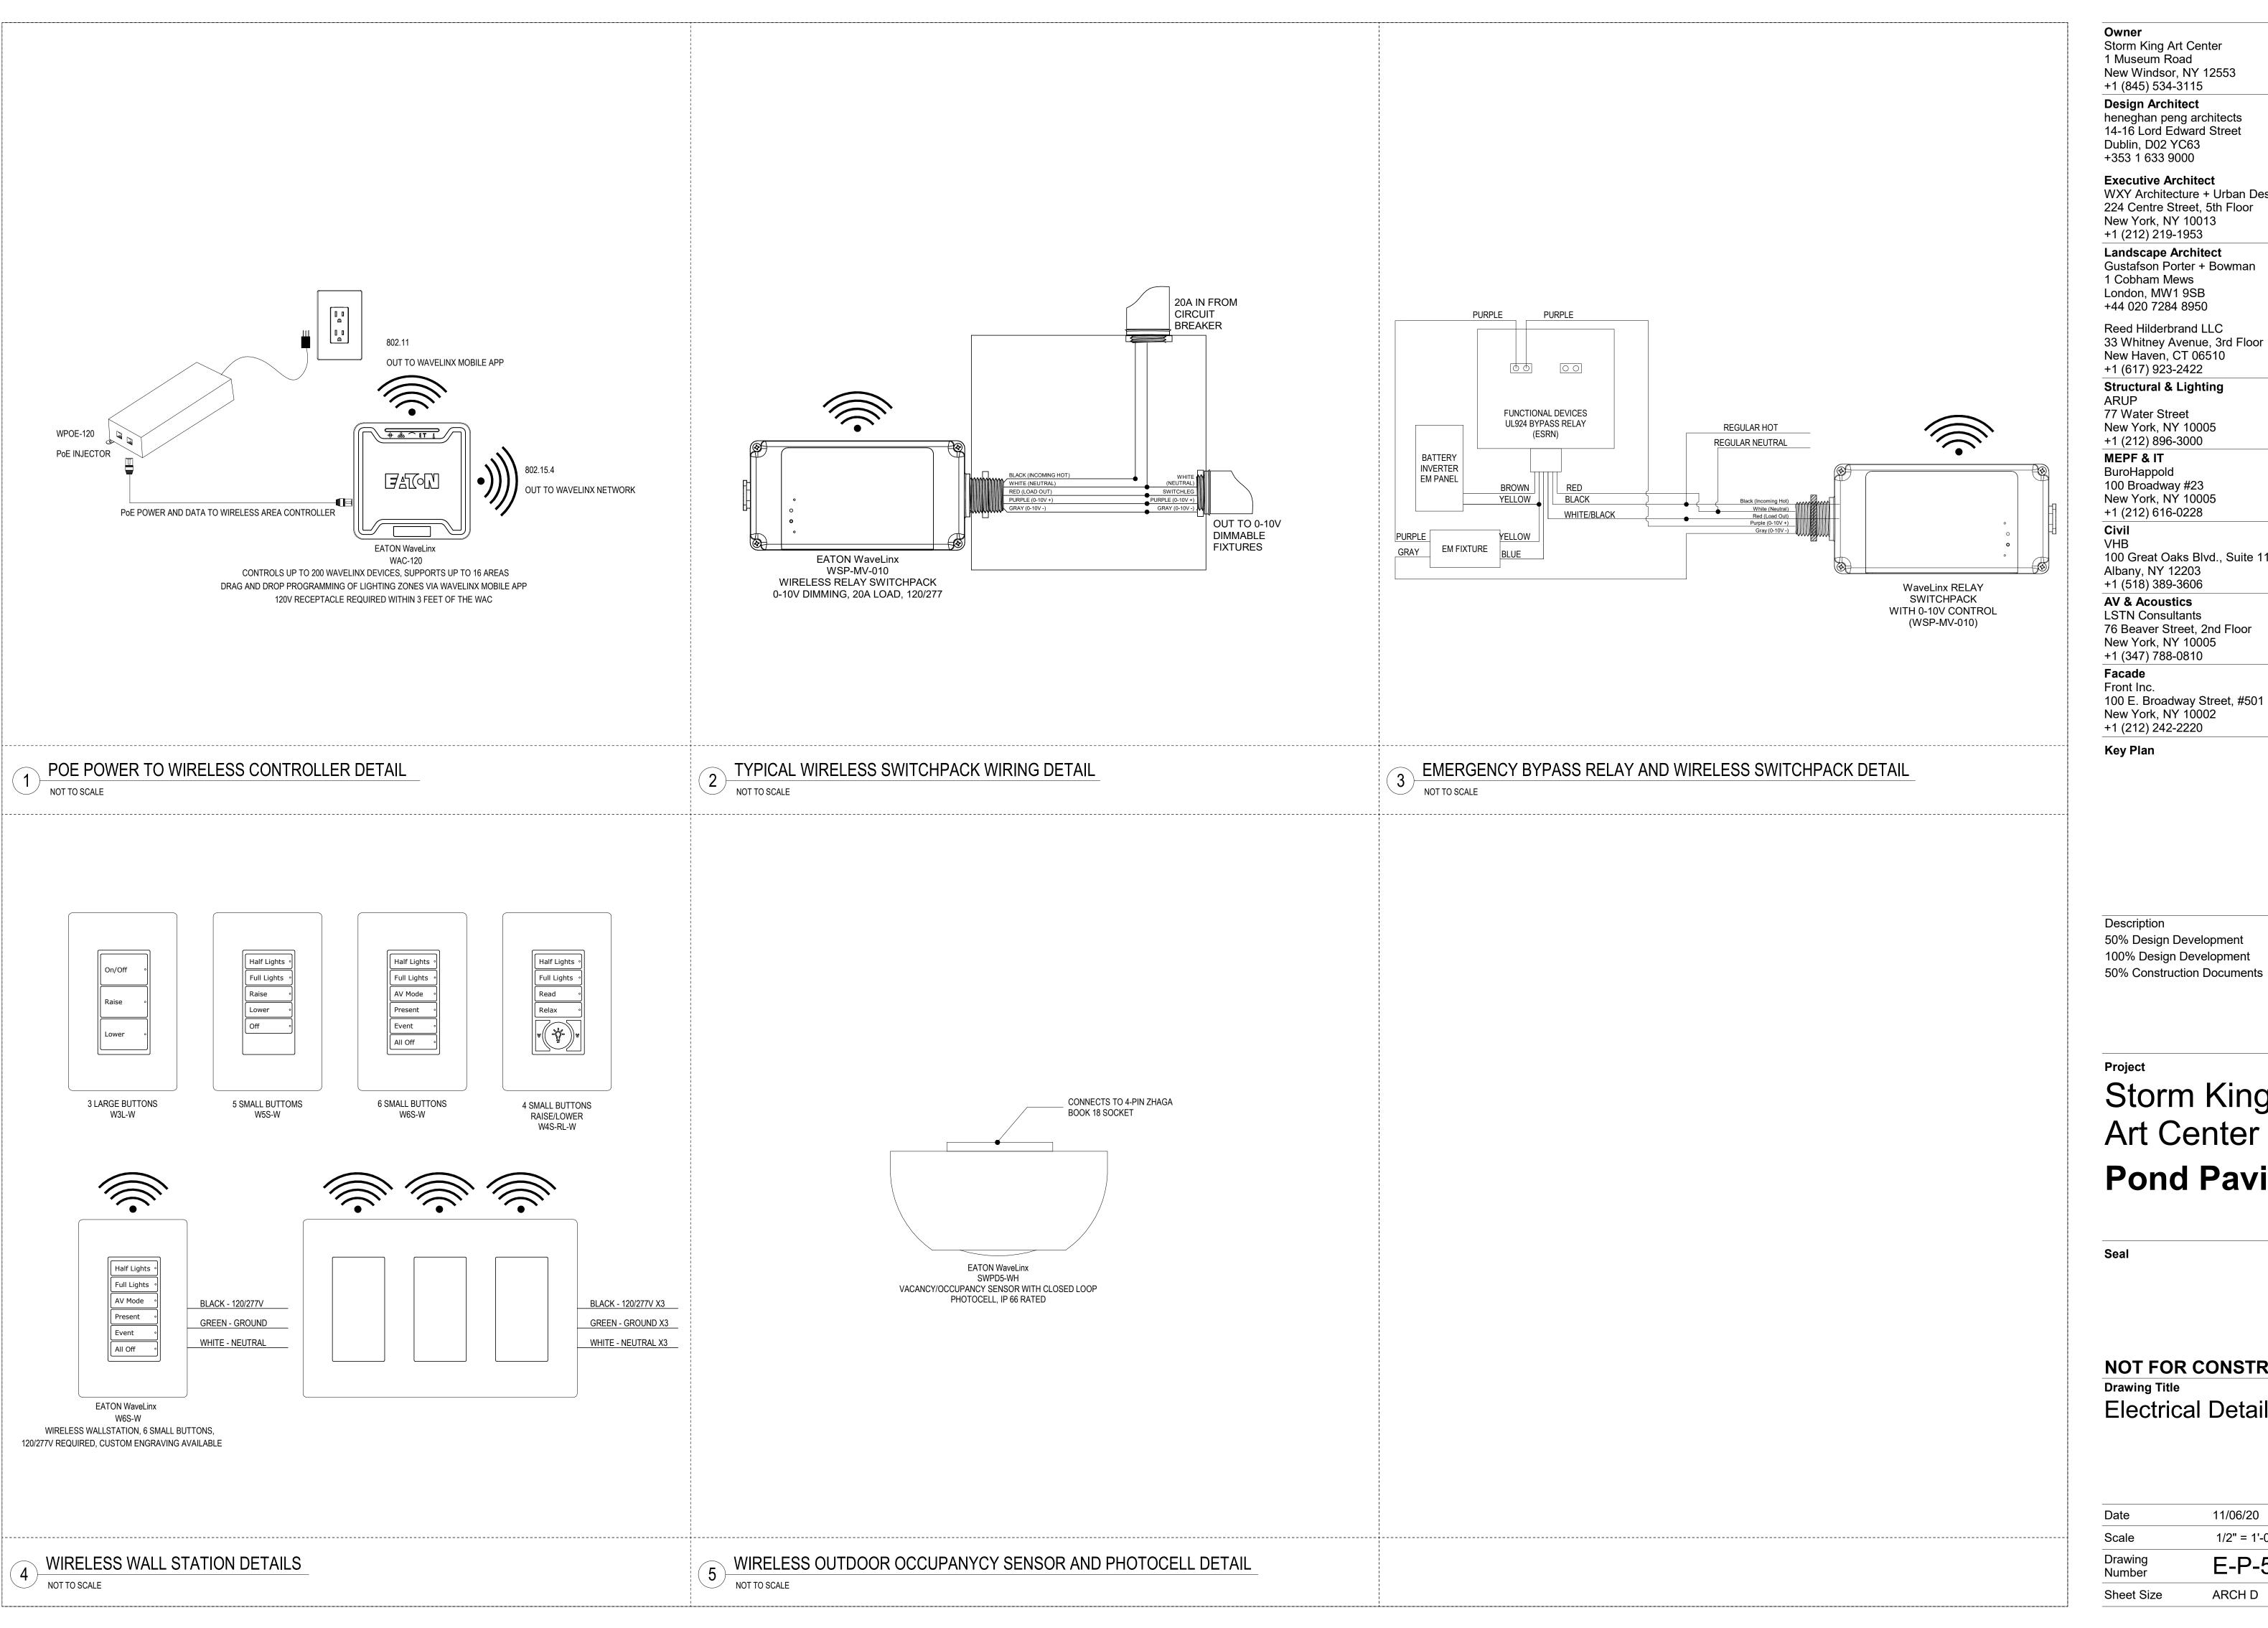
Project

Storm King Art Center **Pond Pavilion**

NOT FOR CONSTRUCTION **Drawing Title Electrical Details**

11/06/20 Date

12" = 1'-0" Scale Drawing E-P-502 Number ARCH D Sheet Size



Design Architect heneghan peng architects 14-16 Lord Edward Street Dublin, D02 YC63 +353 1 633 9000

Executive Architect WXY Architecture + Urban Design 224 Centre Street, 5th Floor New York, NY 10013 +1 (212) 219-1953

Landscape Architect Gustafson Porter + Bowman 1 Cobham Mews London, MW1 9SB

Reed Hilderbrand LLC 33 Whitney Avenue, 3rd Floor New Haven, CT 06510 +1 (617) 923-2422

Structural & Lighting ARUP 77 Water Street

+1 (212) 896-3000 MEPF & IT BuroHappold

100 Broadway #23 New York, NY 10005 +1 (212) 616-0228

100 Great Oaks Blvd., Suite 118 Albany, NY 12203 +1 (518) 389-3606

AV & Acoustics LSTN Consultants 76 Beaver Street, 2nd Floor New York, NY 10005

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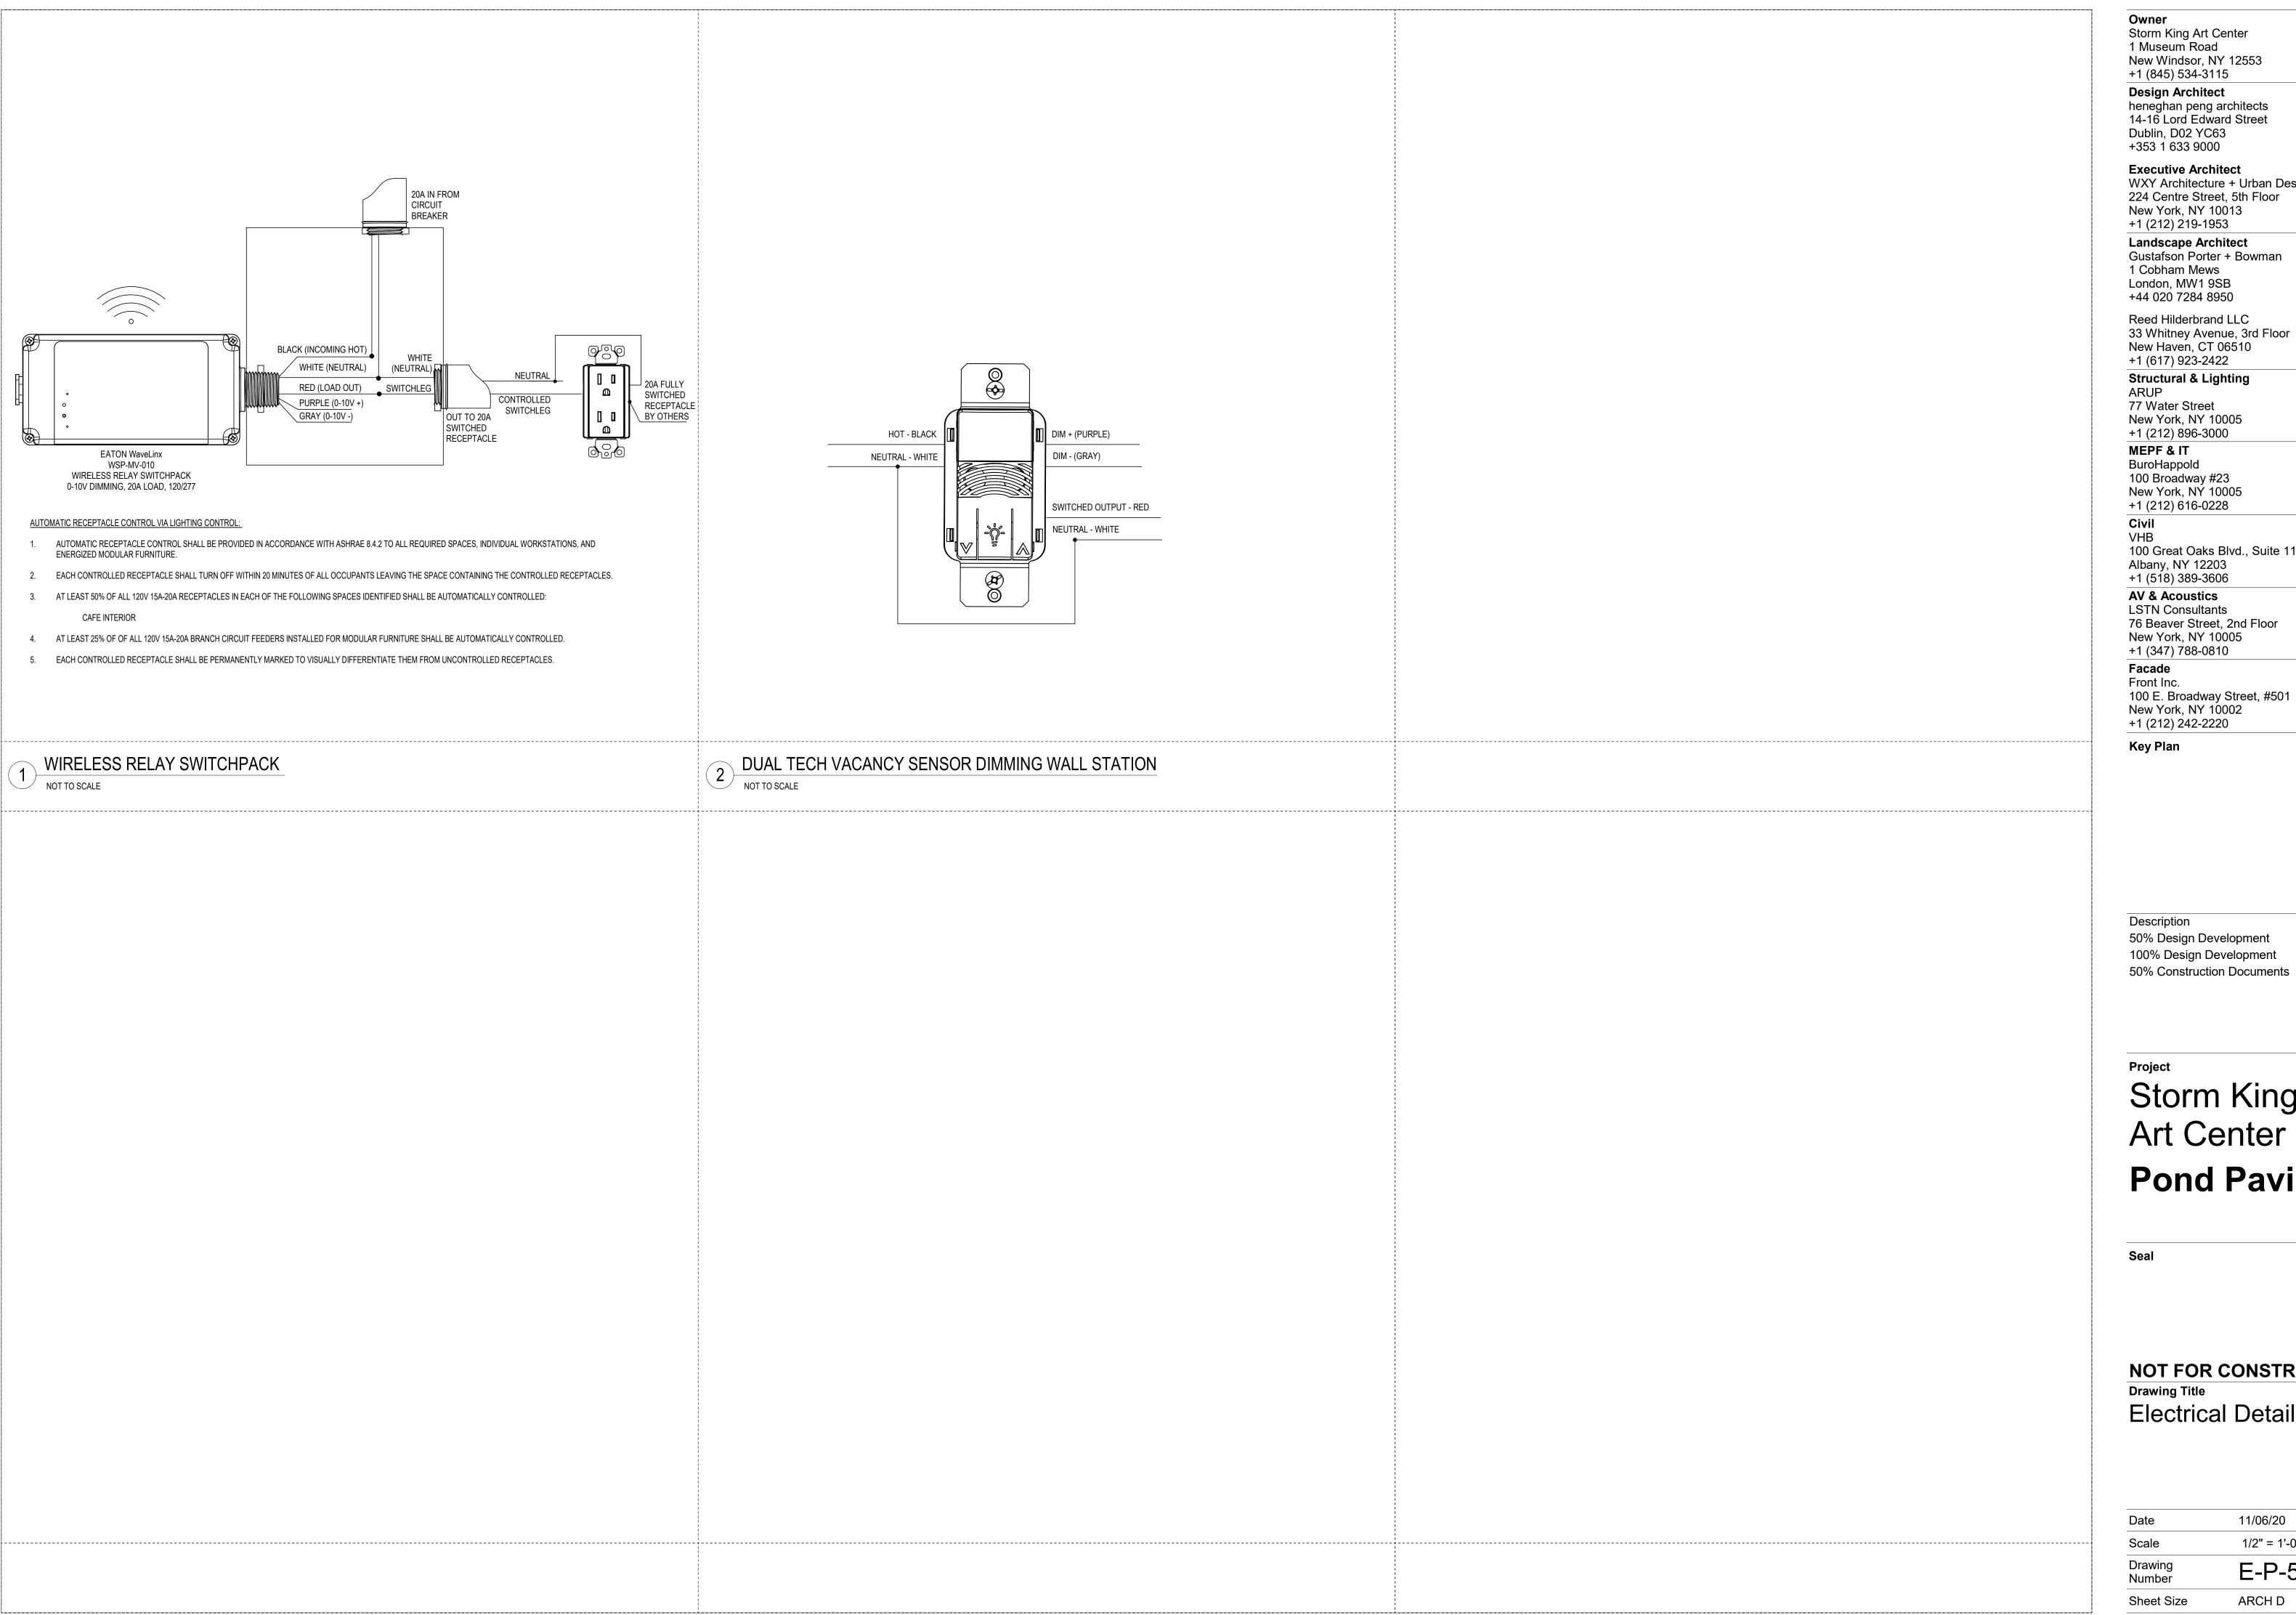
Description Date 50% Design Development 02/24/20 100% Design Development 05/29/20

11/06/20

Storm King Art Center **Pond Pavilion**

NOT FOR CONSTRUCTION **Drawing Title Electrical Details**

Date	11/06/20
Scale	1/2" = 1'-0"
Drawing Number	E-P-503
Sheet Size	ARCH D



> **Design Architect** heneghan peng architects 14-16 Lord Edward Street Dublin, D02 YC63

Executive Architect WXY Architecture + Urban Design 224 Centre Street, 5th Floor New York, NY 10013 +1 (212) 219-1953

Landscape Architect Gustafson Porter + Bowman 1 Cobham Mews London, MW1 9SB +44 020 7284 8950

Reed Hilderbrand LLC 33 Whitney Avenue, 3rd Floor New Haven, CT 06510 +1 (617) 923-2422

Structural & Lighting

77 Water Street New York, NY 10005 +1 (212) 896-3000

MEPF & IT BuroHappold 100 Broadway #23

New York, NY 10005 +1 (212) 616-0228

100 Great Oaks Blvd., Suite 118

Albany, NY 12203 +1 (518) 389-3606

AV & Acoustics LSTN Consultants 76 Beaver Street, 2nd Floor

New York, NY 10005 +1 (347) 788-0810

Front Inc. 100 E. Broadway Street, #501

New York, NY 10002 +1 (212) 242-2220

Key Plan

Description Date 50% Design Development 02/24/20 100% Design Development 05/29/20 11/06/20

Project

Storm King Art Center **Pond Pavilion**

NOT FOR CONSTRUCTION **Drawing Title Electrical Details**

11/06/20 1/2" = 1'-0" E-P-504

ARCH D

FEEDER	SCHEDULE
DEVICE	FEEDER
PL-P-1-1	(4) 3-1/2"C, 3-600kcmil, 600kcmil N, 300kcmil G
100	
CS-PG-1	1-1/2"C, 3#1, #1N, #8G

E - EQUIPMENT (MECHANICAL, F	PLUMBING, F	IRE PROTE	ECTION) S	CHEDUL	E		
EQUIPMENT	LEVEL	HP RATING	kVA	FLA	VOLTAGE	PHASE	POLES
DH P-1-1	Ground Level		8.640 kVA	24 A	208 V	3	3
DOMESTIC WATER RECIRC PUMPS	Ground Level	.5	1.180 kVA	10 A	120 V	1	1
DOMESTIC WATER WELL PUMP (CIVIL)	Ground Level	3	0.000 kVA	11 A	208 V	3	3
DW	Ground Level		6.344 kVA	31 A	208 V	0	1
EB-P-1-1	Ground Level		0.750 kVA	0 A	208 V	3	3
EB-P-1-1	Ground Level		1.000 kVA	0 A	208 V	3	3
EF P-2-1	Roof Level	1/2	0.010 kVA	0 A	120 V	1	1
ELECTRIC RESISTANCE HEAT TRACING PLUMBING PIPING	Ground Level		2.400 kVA	7 A	208 V	3	3
ERV P-1-1	Ground Level		2.200 kVA	18 A	120 V	1	1
EWH P-1-1	Ground Level		4.500 kVA	22 A	208 V	1	2
FAN	Ground Level		0.000 kVA	0 A	120 V	0	1
FAN	Ground Level		0.000 kVA	0 A	120 V	0	1
FAN	Ground Level		0.000 kVA	0 A	120 V	0	1
FAN	Ground Level		0.000 kVA	0 A	120 V	0	1
FLOOR MAT	Ground Level		0.400 kVA	4 A	120 V	0	1
FLOOR MAT	Ground Level		0.400 kVA	4 A	120 V	0	1
FLOOR MAT	Ground Level		0.400 kVA	4 A	120 V	0	1
HEAT TRACE	Ground Level		1.900 kVA	0 A	120 V	1	1
PELLET STOVE	Ground Level		0.175 kVA	0 A	120 V	0	1
ROT	Ground Level		1.000 kVA	0 A	208 V	1	2
SEWAGE REJECTOR PUMP (CIVIL)	Ground Level	3	0.000 kVA	11 A	208 V	3	3
JH-P-1-1	Ground Level		3.000 kVA	0 A	208 V	3	3
UH-P-1-1	Ground Level		3.000 kVA	0 A	208 V	3	3

E - KITCHEN EQUIPMENT							
EQUIPMENT	LEVEL	HP RATING	kVA	FLA	VOLTAGE	PHASE	POLES
OFFEE	Ground Level		8.500 kVA	35 A	208 V	0	1
OOD DISPLAY	Ground Level		0.685 kVA	6 A	120 V	0	1
EATING CAB.	Ground Level		0.700 kVA	6 A	120 V	0	1
DE CE	Ground Level		0.420 kVA	4 A	120 V	0	1
OS	Ground Level		0.360 kVA	0 A	120 V	0	1
OS	Ground Level		0.360 kVA	0 A	120 V	0	1
EF.	Ground Level		0.840 kVA	7 A	120 V	0	1
EF.	Ground Level		0.840 kVA	7 A	120 V	0	1
OUP & HEATED CAB	Ground Level		1.600 kVA	0 A	120 V	0	1
NDER-FREEZER	Ground Level		0.300 kVA	6 A	120 V	0	1
NDER-REF	Ground Level		0.192 kVA	2 A	120 V	0	1

BACK OF HOUSE LIGHTING FIXTURE SCHEDULE

							LAMPS			CONTROL	GE
FIXTURE TYPE	SYMBOL	FIXTURE DESCRIPTION	MANUFACTURER	CATALOG NUMBER	UNITS	QTY. PER UNIT	TYPE	WATTS	VOLTAGE	TYPE	TOTAL WATTA
BL01		4' SUSPENDED/SURFACE MOUNTED INDUSTRIAL	CREE - LS SERIES	LS4-25L-35K-120-10V	EACH	1	3500K LED	23 W	UNV	INTEGRAL 0-10V DIMMING	23 W

ROOM: Elec MOUNTING: SUF FED FROM: NOTE:		1				VOLTS: BUS AMPS: NEUTRAL:				A.I.C.: MCB: 300 A MCB LUGS: STANDARD				
CONDUIT & CONDUCTOR	CKT#		# OF POLES	CIRCUIT DESCRIPTION		A	В	С		CIRCUIT DESCRIPTION		CKT S BKR	CKT#	CONDUIT & CONDUCTOR
3/4"C,1#12,#12N,#12G		20 A	1	RECEPTACLES	180	0			CS-PG-	1	3	100	2	1-1/2"C,3#1,#1N,#8G
	3						0					-	4	
	5								0		-	 	6	
	7 9											+	10	
	11											+	12	
	13												14	
	15												16	
	17												18	
	19												20	
	21 23												22 24	
	25												26	
	27												28	
	29												30	
	31												32	
	33												34	
	35 37												36	
	39												38 40	
	41												42	
	43												44	
	45												46	
	47												48	
					180		0 VA	0 VA						
A.D. O. A.O.I.F.O.A.T.O.Y.			-	0011150750 : 0.10	2		0 A	0 A					TAL C	
DAD CLASSIFICATION				CONNECTED LOAD		DEMAND		CALCULATE				TC	TALS	
GHTING				0.000 kVA	10501.05	125%		0.000		_				
OTORS				0.000 kVA		EST + 100% F		0.000						
ECEPTACLES				0.180 kVA	100% FIRST		REMAINDER	0.180			TOTAL CONNECTED LOAD: 180 VA			
EATING/COOLING				0.000 kVA		100%		0.000					MAND: 180	
TCHEN				0.000 kVA	PER I	NEC TABLE 2	220.56	0.000		BALANCED	THREE P	HASE	AMPS: 0 A	l.
ONTINUOUS				0.000 kVA		125%		0.000						
ONCONTINUOUS				0.000 kVA		100%		0.000						
ONCOINCIDENTAL				0.000 kVA		0%		0.000) kVA					

GENERAL NOTES:

- A. PRELIMINARY EQUIPMENT SCHEDULE (MECHANICAL, PLUMBING, FIRE PROTECTION) PROVIDED FOR PRICING. REFER TO MECHANICAL, PLUMBING AND FIRE PROTECTION DRAWINGS FOR EQUIPMENT LOCATIONS. ALLOW FOR ALL FINAL CONNECTIONS WITH LOCAL DISCONNECT SWITCHES, OVERCURRENT PROTECTION AND HOOK UPS.
 - REFER TO LIGHTING FIXTURE SPECIFICATION FOR REFERENCED CONTROL NARRATIVE AND PRELIMINARY LIGHTING FIXTURE SCHEDULE.

Owner
Storm King Art Center
1 Museum Road
New Windsor, NY 12553

+1 (845) 534-3115

Design Architect
heneghan peng architects
14-16 Lord Edward Street
Dublin, D02 YC63
+353 1 633 9000

Executive Architect
WXY Architecture + Urban Design
224 Centre Street, 5th Floor
New York, NY 10013
+1 (212) 219-1953

Landscape Architect
Gustafson Porter + Bowman
1 Cobham Mews
London, MW1 9SB
+44 020 7284 8950

Reed Hilderbrand LLC 33 Whitney Avenue, 3rd Floor New Haven, CT 06510 +1 (617) 923-2422

Structural & Lighting
ARUP

77 Water Street New York, NY 10005 +1 (212) 896-3000

MEPF & IT BuroHappold 100 Broadway #23 New York, NY 10005

New York, NY 10005 +1 (212) 616-0228 Civil

VHB 100 Great Oaks Blvd., Suite 118

Albany, NY 12203 +1 (518) 389-3606

AV & Acoustics
LSTN Consultants
76 Beaver Street, 2nd Floor
New York, NY 10005

76 Beaver Street, 2nd Floo New York, NY 10005 +1 (347) 788-0810

Facade
Front Inc.
100 E. Broadway Street, #501
New York, NY 10002
+1 (212) 242-2220

Key Plan

DescriptionDate50% Design Development02/24/20100% Design Development05/29/2050% Construction Documents11/06/20

Project

Storm King
Art Center
Pond Pavilion

Seal

NOT FOR CONSTRUCTION

Drawing Title

Electrical Schedules

Date	11/06/20
Scale	12" = 1'-0"
Drawing Number	E-P-601
Sheet Size	ARCH D

- A. SHORT CIRCUIT EQUIPMENT RATINGS: ASSUME THE FOLLOWING SHORT CIRCUIT CURRENT RATINGS FOR EQUPMENT LOCATED:
 - a. 10 KAIC: FOR ALL EQUIPMENT THROUGHOUT BUILDING.
 - b. PRIMARY CONNECTED EQUIPMENT AVAILABLE FAULT CURRENT TO BE CONFIRMED BY UTILITY.

KEY NOTES

- 1 LOCATION OF UTILITY JUNCTION BOX,
- TRANSFORMER RATING TO BE CONFIRMED BY SITE SURVEY FROM
- CUSTOMER SUPPLIED AND INSTALLED PRIMARY CONDUITS AND CONDUCTORS.
- AND CONDUCTORS.

- - heneghan peng architects 14-16 Lord Edward Street Dublin, D02 YC63 +353 1 633 9000

224 Centre Street, 5th Floor New York, NY 10013 +1 (212) 219-1953

Owner

Storm King Art Center 1 Museum Road

+1 (845) 534-3115

Executive Architect

WXY Architecture + Urban Design

Design Architect

New Windsor, NY 12553

- TRANSFORMER AND METER TO BE CONFIRMED BY CIVIL.
- CIVIL. RATING ASSUMED FROM UTILITY SUPPLIED DOCUMENTS.
- CUSTOMER SECONDARY CONDUITS

Landscape Architect Gustafson Porter + Bowman 1 Cobham Mews London, MW1 9SB +44 020 7284 8950 Reed Hilderbrand LLC 33 Whitney Avenue, 3rd Floor New Haven, CT 06510 +1 (617) 923-2422 Structural & Lighting ARUP 77 Water Street New York, NY 10005 +1 (212) 896-3000 MEPF & IT BuroHappold 100 Broadway #23 New York, NY 10005 +1 (212) 616-0228 Civil VHB 100 Great Oaks Blvd., Suite 118 Albany, NY 12203 +1 (518) 389-3606 **AV & Acoustics** LSTN Consultants 76 Beaver Street, 2nd Floor New York, NY 10005

+1 (347) 788-0810

New York, NY 10002 +1 (212) 242-2220

100 E. Broadway Street, #501

Facade Front Inc.

Key Plan


Description Date 50% Design Development 02/24/20 100% Design Development 05/29/20 50% Construction Documents 11/06/20

Project Storm King Art Center

Pond Pavilion

NOT FOR CONSTRUCTION **Drawing Title** Electrical Riser

11/06/20 Date 12" = 1'-0" Drawing E-P-701 Number ARCH D Sheet Size

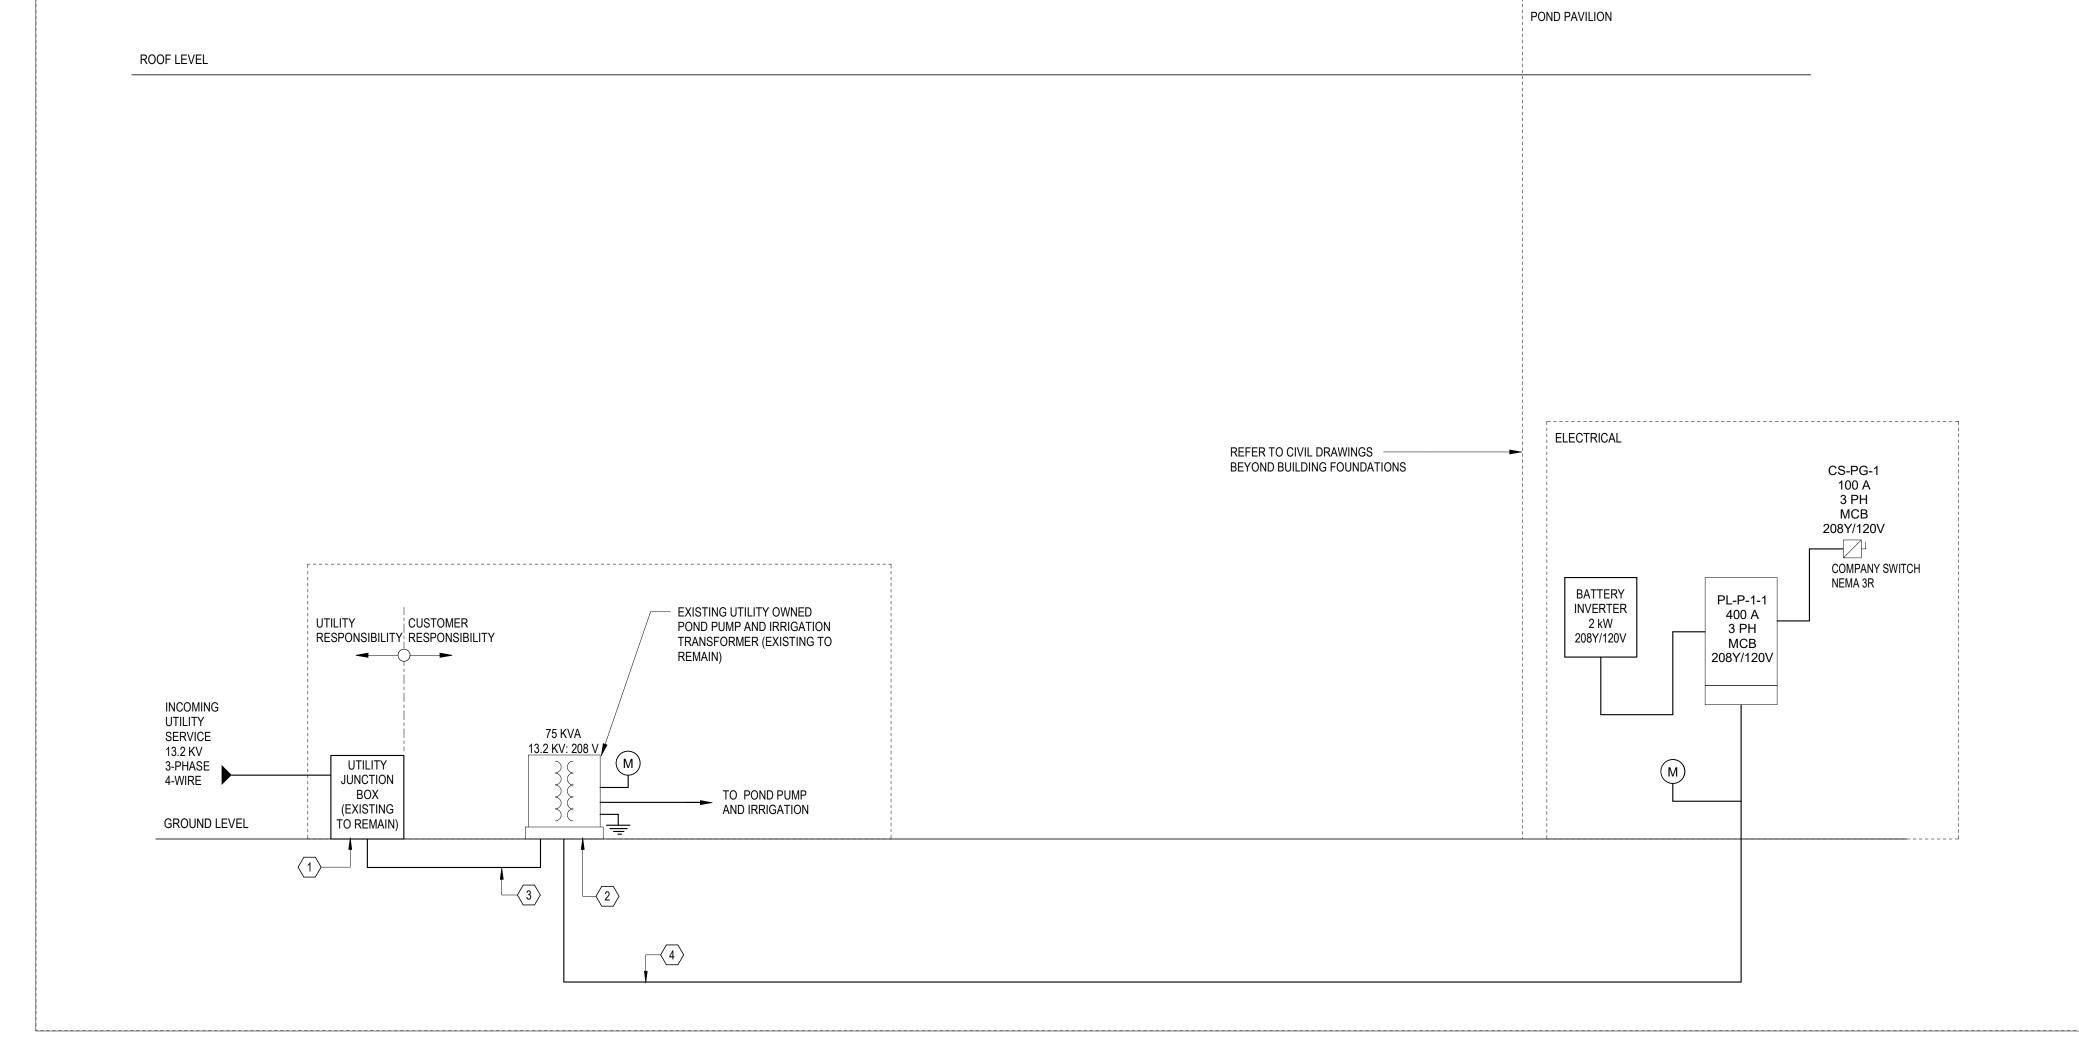



SITE CONSTRUCTION NOTES:

A. REFER TO CIVIL PLANS FOR EXACT ROUTING CONNECTIONS AND EXACT INFORMATION. THIS PLAN IS PROVIDED FOR GUIDE ONLY.

Owner Storm King Art Center 1 Museum Road New Windsor, NY 12553

+1 (845) 534-3115 Design Architect

heneghan peng architects 14-16 Lord Edward Street Dublin, D02 YC63 +353 1 633 9000

Executive Architect WXY Architecture + Urban Design 224 Centre Street, 5th Floor New York, NY 10013 +1 (212) 219-1953

Landscape Architect Gustafson Porter + Bowman 1 Cobham Mews London, MW1 9SB +44 020 7284 8950

Reed Hilderbrand LLC 33 Whitney Avenue, 3rd Floor New Haven, CT 06510

+1 (617) 923-2422 Structural & Lighting

ARUP 77 Water Street New York, NY 10005 +1 (212) 896-3000

MEPF & IT BuroHappold 100 Broadway #23 New York, NY 10005

+1 (212) 616-0228 Civil VHB

100 Great Oaks Blvd., Suite 118 Albany, NY 12203

+1 (518) 389-3606 **AV & Acoustics** LSTN Consultants

76 Beaver Street, 2nd Floor New York, NY 10005 +1 (347) 788-0810

Facade Front Inc. 100 E. Broadway Street, #501 New York, NY 10002

Key Plan

+1 (212) 242-2220



Description

50% Construction Documents

Project

Storm King Art Center **Pond Pavilion**

NOT FOR CONSTRUCTION Site Plan - Property -Electrical Power

Date	11/06/20
Scale	1" = 100'-0"
Drawing Number	E-P-900
Sheet Size	ARCH D



- PROVIDE AND INSTALL LOW VOLTAGE DIMMING WIRING FOR ALL CONTROL ZONES CONNECTED TO LIGHTING CONTROL SYSTEM INCLUDING SWITCHED-ONLY ZONES.
- FLOOR PLANS ARE DIAGRAMMATIC TO REPRESENT REQUIRED OCCUPANCY SENSORS AND SWITCHES TO ACHIEVE CONTROL INTENT. LIGHTING CONTROL PANELS, POWER PACKS, POWER SUPPLIES, WIRELESS RECEIVERS, INTERFACES, ETC. ARE NOT EXPLICITLY SHOWN ON PLOOR PLANS. PROVIDE ALL DEVICES AND ACCESSORIES FOR A COMPLETE SYSTEM TO ACHIEVE DESIGN INTENT. REFER TO LIGHTING CONTROL DETAILS FOR FURTHER INFORATION.
- WHEN NORMAL POWER IS AVAILABLE, LIGHT FIXTURES ON EMERGENCY POWER SHALL BE CONTROLLED WITH LIGHTING FIXTURES ON NORMAL POWER IN THE SAME ZONE. IN THE EVENT OF A POWER OUTAGE, EMERGENCY BYPASS RELAY SHALL OVERRIDE NORMAL CONTROL AND SWITCH FIXTURES ON EMERGENCY POWER TO FULL BRIGHTNESS. FIXTURES DESIGNATED 'EM' ON THE LIGHTING CONTROL SYSTEM SHALL BE CONNECTED TO BATTERY INVERTER. REFER TO LIGHTING CONTROL DETAILS.

Owner

Storm King Art Center 1 Museum Road New Windsor, NY 12553

+1 (845) 534-3115 **Design Architect** heneghan peng architects 14-16 Lord Edward Street

Dublin, D02 YC63 +353 1 633 9000 **Executive Architect** WXY Architecture + Urban Design

224 Centre Street, 5th Floor

New York, NY 10013 +1 (212) 219-1953 **Landscape Architect** Gustafson Porter + Bowman 1 Cobham Mews London, MW1 9SB

+44 020 7284 8950 Reed Hilderbrand LLC 33 Whitney Avenue, 3rd Floor

New Haven, CT 06510 +1 (617) 923-2422

Structural & Lighting ARUP 77 Water Street New York, NY 10005

+1 (212) 896-3000 MEPF & IT BuroHappold

100 Broadway #23 New York, NÝ 10005 +1 (212) 616-0228

Civil VHB

100 Great Oaks Blvd., Suite 118 Albany, NY 12203

+1 (518) 389-3606 **AV & Acoustics**

LSTN Consultants 76 Beaver Street, 2nd Floor New York, NY 10005

+1 (347) 788-0810 Facade Front Inc.

100 E. Broadway Street, #501 New York, NY 10002 +1 (212) 242-2220

Key Plan



50% Construction Documents

Project

Storm King Art Center **Pond Pavilion**

NOT FOR CONSTRUCTION **Drawing Title** Site Plan - Building -Lighting

Date	11/06/20
Scale	1/16" = 1'-0"
Drawing Number	E-P-911
Sheet Size	ARCH D

							CONT	ROL UNIT AN	NUNCIATION			NO	TIFICATIO	N			REQUIRED FIRE SAFETY CONTROL			
		CHINECO	CTURE P	AND SCHALL WAS LAND TO SEED THE PROPERTY OF TH	actual actual of	TUATE AUDITE COMPANIES TO THE RECTUATE AUDITE OF THE PROPERTY	JULIANOR SIGNAL WITH A STANDARD WITH A STANDARD BEEN WAT USED OF	FRANKRINI CHARLES	AND TOWATC ALADAS OF THE PROPERTY OF THE PROPE	July Collection of the Collect	SET ATOM SET	2 Martin To	ROUBLESON	ALT SUPER	Julius of the state of the stat	m Litera	OSE ALLES TO OSE ALLES	Solution of the state of the st	ORENCAS DOOR AND REMOVE SOUND ON DOOR HARDWARE SHOWN ON THE SHOWN ON DOOR HARDWARE SHOWN OF THE	LELEUN CORPONER LELEUN
SYSTEM INPUTS		В	C	D	E F	G H		KL	. M N				s	, , , , , , , , , , , , , , , , , , ,		v	w	x	Y Z	
STSTEM INPUTS	A	В	C	D	E F	G п	I J	N L	. IVI IN	0	P Q	R	5	l	U	V	VV	^	1 2	
1 MANUAL FIRE ALARM BOX	X	X				Х	Х	X				Х				Х	Х		1	
2 SMOKE DETECTORS	X	Х				X	X	X				Х				Х	Х	Х	2	
3 FIRE ALARM AC FAILURE					X X		Х				Х								3	
4 FIRE ALARM SYSTEM LOW BATTERY					X X		Х				Х								4	
5 OPEN CIRCUIT					X X		Х				Х								5	
6 GROUND FAULT					X X		Х				Х								6	
7 NOTIFICATION APPLIANCE CIRCUIT SHORT					X X		Х				Х								7	
8																			X 8	

FIRE ALA	FIRE ALARM LEGEND						
SYMBOL	DESCRIPTION						
	WALL MOUNTED FIRE ALARM STROBE LIGHT						
▼	WALL MOUNTED FIRE ALARM COMBINATION HORN/STROBE						
\Bar{\Bar{\Bar{\Bar{\Bar{\Bar{\Bar{	WALL MOUNTED FIRE ALARM HORN						
	CEILING MOUNTED FIRE ALARM HORN						
X	CEILING MOUNTED FIRE ALARM HORN/STROBE						
E	ADDRESSABLE FIRE ALARM PULL STATION						
\$	ADDRESSABLE FIRE ALARM SMOKE DETECTOR						
	ADDRESSABLE COMBINATION SMOKE AND CO DETECTOR WITH SOUNDER BASE						
(H)	ADDRESSABLE FIRE ALARM HEAT DETECTOR						
®	FIRE ALARM SMOKE DETECTOR - ELEVATOR RECALL						
MM	MONITOR MODULE						
R	RELAY MODULE						
FACP	FIRE ALARM CONTROL PANEL WITH GRAPHIC ANNUNCIATOR						
WP	WEATHER PROOF						

New Windsor, NY 12553 +1 (845) 534-3115 Design Architect heneghan peng architects 14-16 Lord Edward Street Dublin, D02 YC63 +353 1 633 9000 **Executive Architect** WXY Architecture + Urban Design 224 Centre Street, 5th Floor New York, NY 10013 +1 (212) 219-1953 Landscape Architect Gustafson Porter + Bowman 1 Cobham Mews London, MW1 9SB +44 020 7284 8950 Reed Hilderbrand LLC 33 Whitney Avenue, 3rd Floor New Haven, CT 06510 +1 (617) 923-2422 Structural & Lighting ARUP 77 Water Street New York, NY 10005 +1 (212) 896-3000 MEPF & IT BuroHappold 100 Broadway #23 New York, NY 10005 +1 (212) 616-0228 Civil VHB 100 Great Oaks Blvd., Suite 118 Albany, NY 12203 +1 (518) 389-3606 **AV & Acoustics**

> Description Date 50% Design Development 02/24/20 100% Design Development 05/29/20 50% Construction Documents 11/06/20

LSTN Consultants

Facade Front Inc.

Key Plan

New York, NY 10005 +1 (347) 788-0810

New York, NY 10002 +1 (212) 242-2220

76 Beaver Street, 2nd Floor

100 E. Broadway Street, #501


Project Storm King Art Center **Pond Pavilion**

Owner

Storm King Art Center 1 Museum Road

NOT FOR CONSTRUCTION **Drawing Title** Abbreviations, Symbols, and General Notes

Date	11/06/20
Scale	12" = 1'-0"
Drawing Number	FA-P-001
Sheet Size	ARCH D

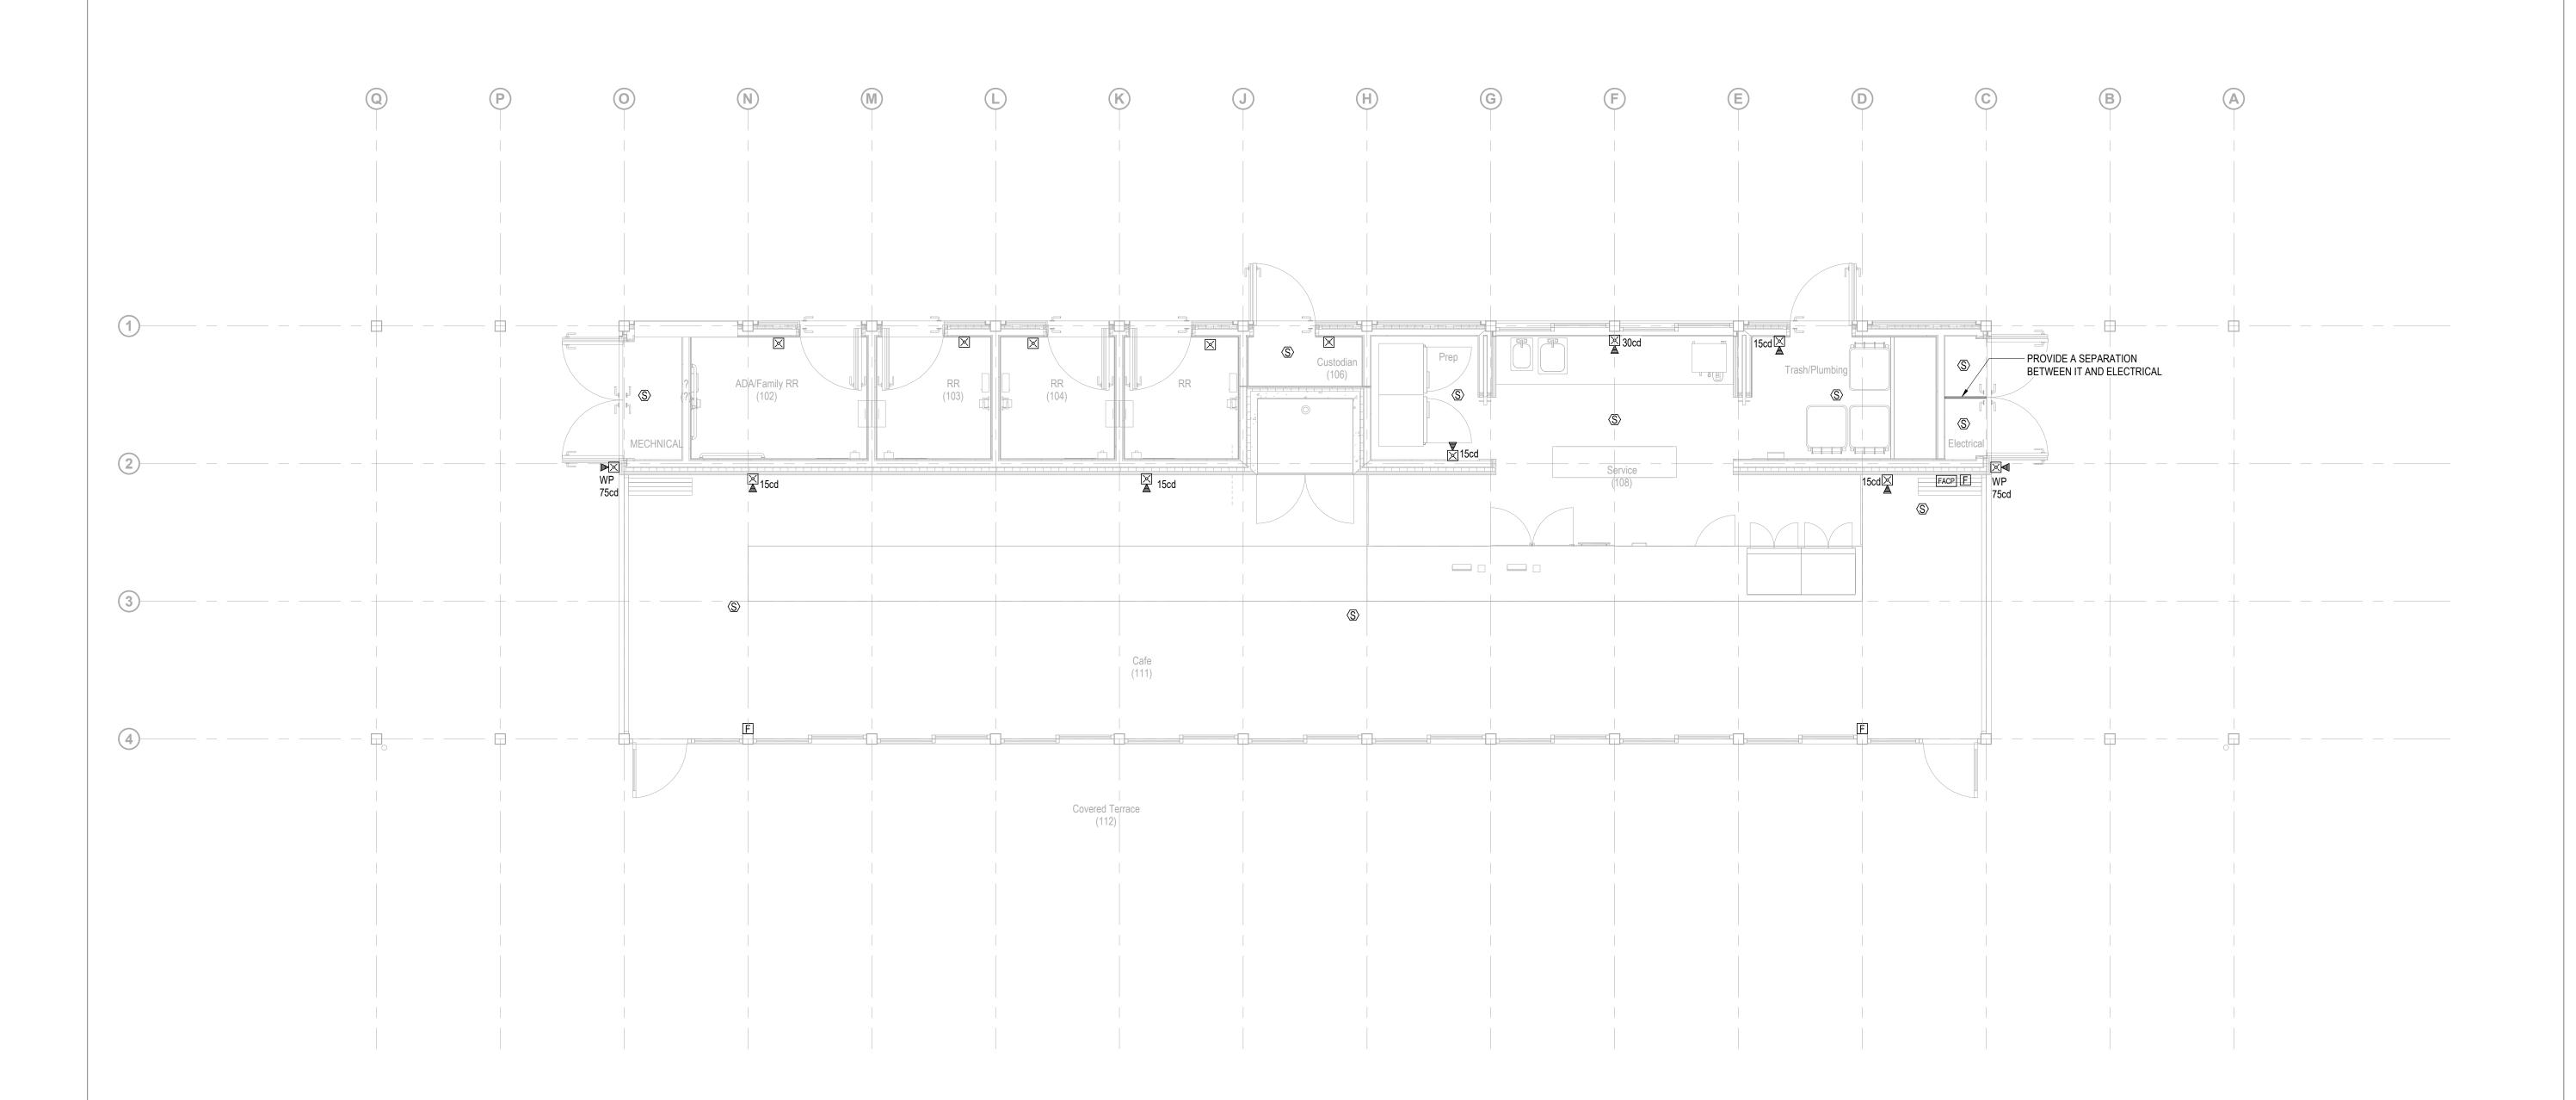

Owner
Storm King Art Center
1 Museum Road
New Windsor, NY 12553
+1 (845) 534-3115

Design Architect
heneghan peng architects
14-16 Lord Edward Street
Dublin, D02 YC63
+353 1 633 9000

Executive Architect
WXY Architecture + Urban Design
224 Centre Street, 5th Floor
New York, NY 10013
+1 (212) 219-1953

Landscape Architect
Gustafson Porter + Bowman
1 Cobham Mews
London, MW1 9SB
+44 020 7284 8950

Reed Hilderbrand LLC 33 Whitney Avenue, 3rd Floor New Haven, CT 06510

+1 (617) 923-2422
Structural & Lighting
ARUP

+1 (212) 896-3000

MEPF & IT

BuroHappold

100 Broadway #23

New York, NY 10005

100 Broadway #23 New York, NY 10005 +1 (212) 616-0228

77 Water Street

Civil VHB

100 Great Oaks Blvd., Suite 118 Albany, NY 12203

+1 (518) 389-3606 **AV & Acoustics**

LSTN Consultants
76 Beaver Street, 2nd Floor
New York, NY 10005

+1 (347) 788-0810

Facade
Front Inc.

100 E. Broadway Street, #501 New York, NY 10002 +1 (212) 242-2220

Key Plan



Description

escription

11/06/20

50% Construction Documents

Project

Storm King
Art Center
Pond Pavilion

Se

NOT FOR CONSTRUCTION

Drawing Title

Fire Alarm Plan
Ground Level

Date	11/06/20
Scale	1/4" = 1'-0"
Drawing Number	FA-P-101
Sheet Size	ARCH D

FIRE ALARM GENERAL NOTES

- 1. INSTALL FIRE ALARM EQUIPMENT, FIRE ALARM SPEAKERS AND STROBE LIGHTS (ADA TYPE) UNITS AT THE LOCATION INDICATED ON THE PLAN.
- 2. THE OPERATION OF THE FIRE ALARM INSTALLATION DOES NOT CONSTITUTE AN ACCEPTANCE OF THE WORK BY THE OWNER. FINAL ACCEPTANCE IS TO BE MADE AFTER THE CONTRACTOR HAS DEMONSTRATED THAT THE WORK FULFILLS ALL THE REQUIREMENTS OF THE PLANS AND SPECIFICATIONS AND HAS FURNISHED ALL REQUIRED CERTIFICATES OF APPROVAL FROM THE STATE AUTHORITIES, MUNICIPAL AUTHORITIES AND
- 3. INCLUDE ALL FEES FOR FILING APPROVALS AND SELF-CERTIFICATION OF THE FIRE ALARM INSTALLATION.
- 4. ALL WIRING, POWER, CONDUCTORS, CONDUITS ETC. SHALL MEET NATIONAL ELECTRICAL CODE ARTICLE 760.
- ALL WORK SHALL BE IN ACCORDANCE WITH THE 2020 NEW YORK STATE BUILDING CODE AND IN ACCORDANCE WITH APPENDIX K, 2020 NEW YORK STATE FIRE CODE FIRE ALARM RULES, AND 2016 NFPA 72.
- 6. ALL FIRE ALARM EQUIPMENT SHALL BE APPROVED 2020 NEW YORK STATE BUILDING CODE (MEA, BSA OR COA APPROVED).
- ALL FIRE ALARM CIRCUITS SHALL BE SIZED TO A MAXIMUM OF 80% OF CAPACITY.
- ALL FIRE ALARM CIRCUITS SHALL BE WIRED PER NFPA CLASS A WITH THE EXCEPTION OF THE NETWORK CIRCUIT WHICH SHALL BE NFPA STYLE 7 (CLASS A WITH ISOLATION). ALL AUDIBLE AND VISUAL CIRCUITS SHALL BE SPLIT A/B. A/B CIRCUITS SHALL BE WIRED SO THAT EVERY OTHER DEVICE IS WIRED ON AN ALTERNATE CIRCUIT.
- 9. CONDUITS MAY NOT ENTER THE TOP OF ANY FIRE ALARM EQUIPMENT CABINET.
- 10. ALL FIRE ALARM EQUIPMENT SHALL BE INSTALLED WITH AESTHETICS IN MIND. CABINETS SHALL BE SEMI FLUSH MOUNTED AND CABLE TRAYS SHALL BE HIDDEN.
- 11. ALL FIRE ALARM CABINETS AND JUNCTION BOXES SHALL BE PAINTED FIRE DEPARTMENT RED. ALL FIRE ALARM CABINETS SHALL BE CLEARLY LABELED WITH A 2020 NEW YORK STATE BUILDING CODE APPROVED
- 12. ALL FIRE ALARM WIRE SHALL BE CLEARLY LABELED IN JUNCTION BOXES AND CABINETS. ALL TERMINALS SHALL BE NUMBERED AND LABELED. ALL CONNECTIONS SHALL BE EITHER SOLDERED, APPROVED TERMINAL STRIPS OR SCOTCH LOCKS.
- 13. ALL LOW VOLTAGE FIRE ALARM CONDUCTORS SHALL BE IN RIGID METAL CONDUIT.

LAMINATE ENGRAVED LABEL.


- 14. FIRE ALARM CABLES SHALL NOT BE MIXED WITH NON FIRE ALARM CABLING. LOW VOLTAGE FIRE ALARM CABLING SHALL NOT BE MIXED OR WIRED NEAR ANY AC CIRCUIT.
- 15. ALL LOW VOLTAGE WIRING SHALL BE FPLP 150 DEGREE C CERTIFIED WIRE. ALL NOTIFICATION CIRCUITS SHALL BE A MINIMUM OF 14 AWG AND ALL OTHER LOW VOLTAGE FIRE ALARM CIRCUITS SHALL BE 16 AWG MINIMUM.
- 16. VERTICAL RISER CABLE FOR ALL SYSTEMS SHALL INCLUDE 2-HOUR PROTECTION CABLE PER THE 2017 NATIONAL ELECTRICAL CODE OR BE INSTALLED IN A 2 HOUR RATED SHAFT.
- 7. POLARITY SHALL BE OBSERVED ON ALL CIRCUITS. T-TAPPING SHALL NOT BE ALLOWED ON ANY NOTIFICATION CIRCUITS (HORN, STROBE OR SPEAKER). T-TAPPING SHALL NOT BE PERMITTED ON ADDRESSABLE CIRCUITS WITHOUT THE EXPRESS PERMISSION OF THE ENGINEER.

- . ALL WIRING SHALL BE INSPECTED TO ASSURE THERE ARE NO OPENS, SHORTS OR EARTH GROUNDS.
- 19. SHIELDED CONDUCTORS OR RUNNING IN SEPARATE RACEWAY SHALL BE AS INSTRUCTED BY THE FIRE ALARM MANUFACTURER'S DOCUMENTATION. ALL NON-POWER LIMITED WIRING, INCLUDING CIRCUITS FOR CENTRALIZED AMPLIFIERS SHALL BE RUN IN A SEPARATE RACEWAY (NOTE: CENTRALIZED AMPLIFIERS "AMP RACKS" ARE NOT PERMITTED ON NEW SYSTEMS).
- 20. FIRE ALARM EQUIPMENT SHALL BE POWERED THROUGH AN APPROVED FUSE DISCONNECT SWITCH (FDS). THE FDS SHALL BE HEAVY DUTY (200,000 RMS SHORT CIRCUIT AMPS) SAFETY SWITCH @30 AMPS MINIMUM, PAINTED RED, INCLUDE A GROUND AND NEUTRAL KIT WITH GROUNDING SCREW (TO BOND NEUTRAL), INCLUDE A PADLOCK WITH Y1 CYLINDER KEYED TO A 2020 NEW YORK STATE FIRE CODE APPROVED KEY. ALL WIRING SHALL BE #10 MINIMUM THHN OR EQUIVALENT RUN IN ¾ INCH EMT/RGS AND IN ACCORDANCE WITH 2020 NEW YORK STATE BUILDING CODE REQUIREMENTS. THE GROUND TO THE FDS SHALL BE MADE USING A 2020 NEW YORK STATE BUILDING CODE ACCEPTED METHOD (SEE 2017 NATIONAL ELECTRICAL CODE), AND THE GROUND WIRE TO THE FDS SHALL BE #10 MINIMUM (LARGER IF NECESSARY TO MEET FEED SIZE). THE EQUIPMENT GROUND LEAVING FROM THE FDS CONNECTING TO THE FIRE ALARM EQUIPMENT SHALL INCLUDE A #10 GREEN GROUND. THE FDS PANEL SHALL BEAR AN ENGRAVED WHITE-CORE PHENOLIC OR BAKELITE IDENTIFICATION NAMEPLATE STATING IN MINIMUM ONE-QUARTER INCH (1/4") HIGH WHITE LETTERS ON A RED BACKGROUND "FIRE ALARM FUSED DISCONNECT".
- 21. WHERE ADDITIONAL CIRCUITS ARE REQUIRED BY THE FIRE ALARM SYSTEM, A FUSED CUTOUT, PROPERLY SIZED SHALL BE INCLUDED, WIRED AFTER THE FDS. THE SIZE OF THE FUSES SHALL BE SIZED APPROPRIATELY BUT BE TWENTY (20) AMPERES MINIMUM AND EACH CIRCUIT SHALL ONLY FEED ONE "INDIVIDUAL" FIRE ALARM SYSTEM COMPONENT. THE FUSED CUT-OUT PANEL SHALL BEAR AN ENGRAVED WHITE-CORE PHENOLIC OR BAKELITE IDENTIFICATION NAMEPLATE STATING IN MINIMUM ONE-QUARTER INCH (1/4") HIGH WHITE LETTERS ON A RED BACKGROUND "FIRE ALARM FUSED CUT-OUT". THE NEUTRAL SHALL NOT BE BONDED IN THE FUSED CUTOUT.
- 22. A CENTRAL STATION DIALER AND TWO DEDICATED PHONE LINES SHALL BE PROVIDED. THE DIALER SHALL BE CAPABLE OF SENDING THE FOLLOWING EVENTS: ALARM, MANUAL STATION, WATERFLOW, SUPERVISORY, TROUBLE, PUMP RUNNING AND PUMP TROUBLE.
- 23. ALL AREA OR DUCT SMOKE DETECTORS SHALL BE PHOTO-ELECTRIC TYPE.
- 24. SMOKE DETECTORS MUST BE MOUNTED AT LEAST 3 FT AWAY FROM ANY AIR REGISTER.
- 25. ALL CEILING MOUNT DEVICES MUST BE SECURELY FASTENED TO BUILDING CONSTRUCTION.
- 26. DEVICE LOCATIONS MUST BE READILY ACCESSIBLE TO ALLOW FOR MAINTENANCE AND REPAIR.
- DUCT MOUNTED SMOKE DETECTORS SHALL BE MOUNTED ON THE DUCTWORK IN STRICT ACCORDANCE WITH THE MANUFACTURERS INSTRUCTIONS. ALL DUCT DETECTORS SHALL BE PROVIDED WITH A REMOTE LED.
- 28. MANUAL STATIONS SHALL BE MOUNTED 48 INCHES ABOVE THE FINISHED FLOOR TO THE HANDLE OF THE STATION AND SHALL BE PAINTED FIRE DEPARTMENT RED. ALL MANUAL STATION SHALL BE INSTALLED SO THAT THEY ARE KEPT UN-OBSTRUCTED AT ALL TIMES.
- ALL STROBE LIGHTS SHALL BE ADA AND UL-1971 APPROVED/LISTED. THE MINIMUM CANDELA IS 75 UNLESS OTHERWISE NOTED. A 15/75 STROBE MAY BE UTILIZED WHERE 15 CANDELA STROBES MEET NFPA REQUIREMENTS (CORRIDORS AND 20 X 20 SPACES). THE SAME CANDELA SETTING SHALL ALSO BE APPLIED TO THE DESIGNATED H&V APARTMENTS.

- 30. NOTIFICATION DEVICES THAT INCLUDE A STROBE SHALL BE MOUNTED 80 INCHES OFF THE FINISHED FLOOR TO THE BOTTOM OF THE STROBE, NOT NECESSARILY THE ELECTRICAL BOX.
- 31. ALL AUXILIARY RELAYS FOR FAN SHUTDOWN, DOOR RELEASE, DAMPER CONTROL, ELEVATOR CONTROL, ETC SHALL BE WIRED A MAXIMUM OF 3 FT FROM THE CONTROLLED DEVICE. THE AUXILIARY RELAY SHALL FUNCTION WITHIN THE REQUIRED VOLTAGE AND CURRENT OF THE CONTROLLED DEVICE. SLAVE OR INTERPOSING RELAYS SHALL BE INCLUDED AND POWERED BY THE FIRE ALARM CONTROL PANEL IN A FAIL-SAFE (FIRE FUNCTION) POSITION. POWER TO THE INTERPOSING RELAY SHALL BE MONITORED BY THE FIRE ALARM SYSTEM.
- 32. THE FIRE DEPARTMENT SHALL APPROVE THE PLANS PRIOR TO THE BEGINNING OF ANY WORK.
- 33. LOCATIONS OF ALL FIRE ALARM EQUIPMENT SHALL BE SUBJECT TO THE DEPARTMENT OF BUILDINGS AND FD APPROVAL. NO CHANGE OR MODIFICATION TO THE SYSTEM OR PLANS SHALL BE PERMITTED WITHOUT WRITTEN APPROVAL FROM THE ENGINEER OF RECORD. IF ANY CHANGES ARE MADE TO THE DRAWINGS PRIOR TO OR DURING INSTALLATION, AS BUILT PLANS SHALL BE PREPARED BY THE FIRE ALARM CONTRACTOR AND FILED WITH THE APPROPRIATE AGENCIES FOR FINAL ACCEPTANCE.
- 34. THE CONTRACTOR SHALL RETAIN A NEW YORK STATE PE TO SIGN AND SEAL ALL NECESSARY DOCUMENTS REQUIRED FOR INSPECTION AND TO OBTAIN A FINAL LETTER OF APPROVAL. THIS SHALL INCLUDE A SIGNED AND SEALED 11X17 AS-BUILT DRAWING, STATEMENT OF OPERATION, AN NFPA PROGRAMMING MATRIX, AND THE CONTRACTORS SIGNED AND SEALED FORMS. THESE DOCUMENTS SHALL BE SUBMITTED AS NECESSARY TO THE FIRE DEPARTMENT/ DEPARTMENT OF BUILDINGS TO OBTAIN A FIRE ALARM INSPECTION. IF A LETTER OF DEFECT IS ISSUED, THE CONTRACTOR SHALL CORRECT ALL ITEMS AND SUBMIT A SIGNED AND SEALED CERTIFICATE OF CORRECTION TO THE FIRE DEPARTMENT TO OBTAIN A FINAL LETTER OF APPROVAL AT NO ADDITIONAL COST TO THE PROJECT.
- 35. THE CONTRACTOR SHALL BE RESPONSIBLE FOR REMOVING ANY AND ALL ABANDONED FIRE ALARM CABINETS, DEVICES, AND WIRE. PAINT, PATCH AND CLEANUP SHALL ALSO BE INCLUDED.
- 36. CARBON MONOXIDE (CO) AND COMBINATION SMOKE AND CO DETECTORS SHALL BE FULLY ADDRESSABLE (EST SIGA2 SERIES OR EQUAL) AND INCLUDE A SOUNDER BASE. MANUFACTURERS THAT DO NOT OFFER AN ADDRESSABLE CO OR SMOKE/CO TYPE DEVICE SHALL INCLUDE SEPARATE CO AND SMOKE DETECTORS, EACH WITH AN INTERNAL SOUNDER, AND THE NECESSARY MONITORING DEVICES SO THAT THE FIRE ALARM SYSTEM MAY MONITOR BOTH TYPES SEPARATELY AT NO ADDITIONAL COST TO THE PROJECT. IF POWERED SEPARATELY (24VDC), POWER TO THE DEVICE SHALL ALSO BE SUPERVISED.
- 37. BATTERY BACKUP SHALL BE PROVIDED FOR A MINIMUM OF 24 HOURS STANDBY FOLLOWED BY 45 HOURS OF FULL ALARM WITH ALL CALL VOICE PAGING CAPABILITY PLUS REQUIRED SPARE CAPACITY AND TEN PERCENT DEGREDATION OF BATTERIES.
- 38. WHERE DISAGREEMENTS OR DISCREPANCIES OCCUR BETWEEN THE PLANS AND THE SPECIFICATIONS, OR WITHIN EITHER DOCUMENT ITSELF, THE ITEM OR ARRANGEMENT OF BETTER QUALITY, GREATER QUANTITY OR HIGHER COST SHALL BE INCLUDED IN THE BASE BID.
- 39. LEVEL OF SURVIVABILITY; VERTICAL RISER CABLE FOR ALL SYSTEMS THAT INCLUDE PARTIAL EVACUATION (ANYTHING OTHER THAN A GENERAL ALARM SEQUENCE SEE SEQUENCE / MATRIX) SHALL INCLUDE A LEVEL 2 PATHWAY OF SURVIVABLITY (NOT FULLY SPRINKLERED) OR LEVEL 3 (FULLY SPRINKLERED) AND A 2 HOUR RATED SHAFT OR RISER. ALL OTHERS SHALL INCLUDE A PATHWAY LEVEL 0 (UNSPRINKLERED) OR LEVEL 1 (FULLY SPRINKLERED).

ROOF LEVEL

GROUND LEVEL

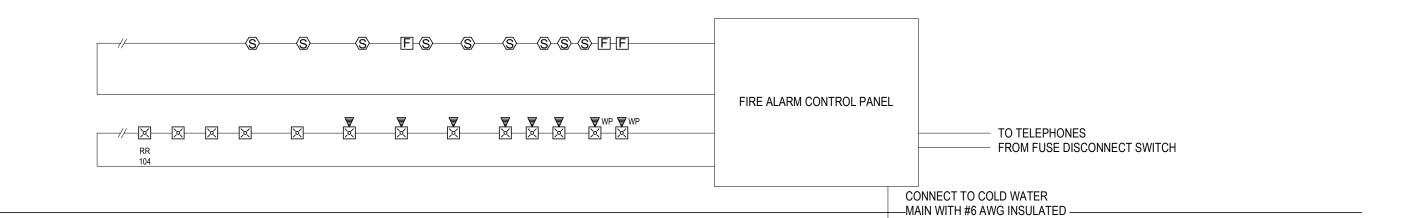

GROUND CONDUCTOR IN 3/4"C

Owner
Storm King Art Center
1 Museum Road
New Windsor, NY 12553

+1 (845) 534-3115

Design Architect

heneghan peng architects 14-16 Lord Edward Street Dublin, D02 YC63 +353 1 633 9000

Executive Architect
WXY Architecture + Urban Design
224 Centre Street, 5th Floor
New York, NY 10013
+1 (212) 219-1953

Landscape Architect
Gustafson Porter + Bowman
1 Cobham Mews
London, MW1 9SB
+44 020 7284 8950

Reed Hilderbrand LLC 33 Whitney Avenue, 3rd Floor New Haven, CT 06510 +1 (617) 923-2422

Structural & Lighting

ARUP 77 Water Street New York, NY 10005 +1 (212) 896-3000

MEPF & IT
BuroHappold
100 Broadway #23
New York, NY 10005

+1 (212) 616-0228 **Civil** VHB

100 Great Oaks Blvd., Suite 118 Albany, NY 12203

+1 (518) 389-3606

AV & Acoustics LSTN Consultants 76 Beaver Street, 2nd Floor New York, NY 10005 +1 (347) 788-0810

Facade
Front Inc.
100 E. Broadway Street, #501
New York, NY 10002
+1 (212) 242-2220

Key Plan

Description Date
50% Design Development 02/24/20
100% Design Development 05/29/20
50% Construction Documents 11/06/20

Project

Storm King
Art Center
Pond Pavilion

Seal

NOT FOR CONSTRUCTION

Drawing Title

Fire Alarm Riser

 Date
 11/06/20

 Scale
 12" = 1'-0"

 Drawing Number
 FA-P-701

 Sheet Size
 ARCH D

- 1. PROVIDE ELECTRICAL METALLIC TUBING (EMT) SLEEVES WITH INSULATED BUSHINGS ON EACH END FOR ALL CABLES PASSING THROUGH WALLS AND FLOORS. ALL PENETRATIONS SHALL BE FIRESTOPPED BY ELECTRICAL CONTRACTOR. ALL PENETRATIONS THROUGH RATED WALLS SHALL BE FIRESTOPPED. SEAL AROUND OUTSIDE OF CONDUITS AND SEAL INSIDE OF CONDUIT SLEEVES AS REGISTERED BY APPLICABLE CODES AND STANDARDS. APPLY SEALS AFTER WIRE/CABLE INSTALLATION.
- 2. DO NOT ROUTE CONDUITS CONCEALED IN ABOVE GRADE SLABS. CONDUITS SHALL BE ROUTED EXPOSED AND SECURED TO THE SLAB AND STUBBED THROUGH TO THE EQUIPMENT BEING SERVED.
- 3. CONDUIT AND BOX LABELS SHALL BE HEAVY-DUTY PRE-PRINTED LAMINATED LABELS SUITABLE FOR THE ENVIRONMENT THE LABEL WILL RESIDE WITHIN. HAND-WRITTEN LABELS SHALL NOT BE PERMITTED.
- 4. CONTRACTOR SHALL INSTALL AND MOUNT ALL EQUIPMENT CABINETS AND RACKS PER MANUFACTURERS AND SEISMIC REQUIREMENTS.
- 5. ALL EXPOSED CONDUIT, BOXES, SUPPORTING HARDWARE, ETC. LOCATED IN FINISHED AREAS SHALL BE PAINTED TO MATCH. COORDINATE FINISH WITH ARCHITECT.
- 6. PROVIDE ACCESS PANEL IN CONCEALED CEILINGS FOR ACCESS TO ELECTRICAL MATERIAL AND EQUIPMENT. COORDINATE ACCESS PANEL LOCATIONS WITH ARCHITECT AND OTHER TRADES PRIOR TO INSTALLATION.
- 7. REFER TO T-SERIES SHEETS FOR OUTLET BOX LOCATIONS. REFER TO S-SERIES DRAWINGS FOR CCTV CAMERA LOCATIONS THAT REQUIRE STRUCTURED CABLING INFRASTRUCTURE.
- 8. ALL LOW VOLTAGE OUTLETS SHALL BE COORDINATED WITH ARCHITECT.
- 9. COORDINATE CONDUIT LOCATIONS (VERTICALLY & HORIZONTALLY) OUTSIDE THE TELECOM ROOM WITH CABLE TRAY/LADDER RACK LOCATIONS INSIDE THE TELECOM ROOM.
- 10. ELECTRICAL SCOPE: CONTRACTOR SHALL FURNISH AND INSTALL CONDUITS/RISER, CABLE TRAYS, JUNCTION BOXES, AND OUTLET BOXES.
- 11. TELECOM SCOPE: CONTRACTOR SHALL FURNISH AND INSTALL STRUCTURED CABLES, JACKS, RACKS, EQUIPMENT, CABINETS, TERMINATION AND TESTING PER EIA STANDARDS. PROVIDE 20' SLACK AT WIRELESS ACCESS POINT TO RELOCATE FINAL LOCATION BASED ON SITE CONDITIONS.

CONDUIT FILL GUIDE

NUMBER OF CABLES AT 40% CONDUIT FILL BASED ON TRADE SIZE OF CONDUIT.

CABLE	TYPE	O.D.	0.75"	1"	1.25"	1.5"	2"	2.5"	3"	3.5"	4"
CAT6A	4 PAIR UTP	0.295	2	4	7	10	18	28	41	56	73
CAT6E	4 PAIR UTP	0.244	3	6	10	15	27	42	60	82	107
CAT6e	4 PAIR UTP	0.228	4	7	12	17	30	48	69	94	123
CAT6	4 PAIR F/UTP	0.255	3	6	9	14	24	38	55	75	98
CAT6	4 PAIR UTP	0.208	5	9	14	21	37	57	83	113	148
CAT5E	4 PAIR UTP	0.190	6	11	17	25	44	69	99	135	177
CAT5E	4 PAIR F/UTP	0.224	4	8	12	18	32	50	71	97	127
CAT5e	4 PAIR UTP	0.180	7	12	19	27	49	77	111	151	197
CAT5e	4 PAIR F/UTP	0.218	4	8	13	19	33	52	75	103	134
CAT5e	25 PAIR UTP	0.430	1	2	3	5	8	13	19	26	34
CAT5e	25 PAIR F/UTP	0.472	1	1	2	4	7	11	16	22	28
CAT5	4 PAIR UTP	0.180	7	12	19	27	49	77	111	151	197
CAT5	4 PAIR F/UTP	0.230	4	7	12	17	30	47	68	92	121
CAT5	25 PAIR UTP	0.430	1	2	3	5	8	13	19	26	34
CAT5	25 PAIR F/UTP	0.472	1	1	2	4	7	11	16	22	28

CABLE TRAY FILL GUIDE

CABLE TRAY HEIGHT X WIDTH	CAT 5e FIL	L RATIO AT:	CAT 6 FILL	RATIO AT:	CAT 6A FIL	L RATIO AT:
	25%	40%	25%	40%	25%	40%
2" X 4"	33	52	21	34	15	23
2" X 6"	49	79	32	50	22	35
2" X 8"	66	106	42	68	29	47
2" X 12"	99	158	63	101	44	70
2" X 16"	133	213	85	136	59	94
2" X 18"	150	239	96	153	67	106
2" X 20"	166	266	107	170	74	118
2" X 24"	200	320	128	204	89	142
4" X 4"	62	21	40	64	28	44
4" X 6"	94	150	60	96	42	67
4" X 8"	126	201	81	129	56	90
4" X 12"	188	300	120	192	84	134
4" X 16"	253	405	162	259	113	180
4" X 18"	285	456	182	292	127	202
4" X 20"	317	507	203	324	141	225
4" X 24"	381	609	244	390	169	270
6" X 8"	189	302	121	193	84	134
6" X 12"	282	451	180	288	125	200
6" X 16"	380	607	243	389	169	270
6" X 18"	427	684	274	438	190	304
6" X 20"	475	760	304	486	211	338
6" X 24"	571	913	365	584	254	406

GENERAL SYMBOLS

		SYMBOL	DESCRIPTION
		X	KEYNOTE IDENTIFIER X - KEYNOTE NUMBER
)		X	REVISION CHANGE X - DELTA NUMBER
	-	X TXXX	DETAIL/ENLARGED PLAN CALLOUT X - DETAIL/REFERENCE# TXXX - SHEET #
		X	SECTION IDENTIFIER X - SECTION # TXXX - SHEET #

COI	NDUIT AND CABLE TRAY
	CONDUIT CONCEALED IN CEILING OR WALL.

·	CONDUIT CONCEALED UNDER FLOOR OR UNDERGROUND
	CONDUIT TURNING UP
 5	CONDUIT TURNING DOWN
[CONDUIT STUB WITH CAP
CSB	CABLE SUPPORT BOX
	TELECOM CABLE TRAY REFER TO T-SERIES SHEETS FOR SIZE LION

TELECOM AND SECURITY DEVICES

PROTECTION, ELECTRICAL, AND LIGHT FIXTURES.

COORDINATE LOCATION WITH DUCTWORK, PLUMBING, FIRE

	WALL MOUNTED SINGLE TELECOM OUTLET AT 48" AFF UON. PROVIDE A 5S BACKBOX WITH SINGLE GANG MUD RING. PROVIDE (1) CAT6A IN 1-1/4" CONDUIT TO NEAREST CABLE TRAY OR RUN DIRECT TO TELECOM ROOM. PROVIDE NON-METALLIC BUSHING ON END OF
IP	CONDUIT.
INT	IP = IP PHONE
	INT = INTERCOM
	WALL MOUNTED SINGLE TELECOM OUTLET AT 18" AFF UON - REFER

BMS SM	TO TO PI BI SI

TO ELECTRICAL FOR BOX TYPE. PROVIDE (1) CAT6A IN 1-1/4" CONDUIT TO NEAREST CABLE TRAY OR RUN DIRECT TO TELECOM ROOM.


PROVIDE NON-METALLIC BUSHING ON END OF CONDUIT.

BMS = CONNECTION FOR BULDING MANAGEMENT SYSTEM SM = CONNECTION FOR SMART METER

WALL MOUNTED DUPLEX TELECOM OUTLET AT 18" AFF UON. - REFER

TO ELECTRICAL FOR BOX TYPE. PROVIDE (2) CAT6A IN 1-1/4" CONDUIT

TO NEAREST CABLE TRAY OR RUN DIRECT TO TELECOM ROOM PROVIDE NON-METALLIC BUSHING ON END OF CONDUIT.

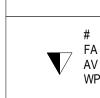

AS ABOVE, WHERE
= NUMBER OF PORTS (3, 5, ETC.)
FA = ANALOG LINE FOR FIRE ALARM
AV = OUTLET DEDICATED FOR AV
WP = WEATHERPROOF OUTLET



WIRELESS ACCESS POINT WITH 5S BACK BOX ABOVE CEILING. PROVIDE (2) CAT6A IN 1-1/4" CONDUIT TO NEAREST TELECOM ROOM.

CONTRACTOR SHALL COORDINATE MOUNTING OPTIONS WITH



MULTI-SERVICE FLOOR BOX/CAST - REFER TO ELECTRICAL AND AV PLANS FOR FLOOR BOX TYPE. PROVIDE ONE (4) DATA PORT, UNLESS OTHERWISE NOTED ON PLANS, VIA CAT6A IN 1-1/4" CONDUIT TO NEAREST TELECOM ROOM.
= NUMBER OF PORTS



JUNCTION BOX/FLOOR FEED BOX - AV AND TELECOM MAY BE COMBINED IN SAME BOX. PROVIDE METALLIC BARRIER WHEN POWER CIRCUITS ARE FED BY BOX. COORDINATE WITH ELECTRICAL AND AV.

CCTV CAMERA. TELECOM CONTRACTOR SHALL PROVIDE (1) CAT6A

CABLE IN 1-1/4" CONDUIT TO NEAREST CABLE TRAY OR RUN DIRECT

TO TELECOM ROOM. TELECOM CONTRACTOR TO TERMINATE CABLE

IN BISCUIT JACK AT CCTV CAMERA LOCATION. FINAL CONNECTION TO



AXIS F44 MAIN UNIT, TELECOM CONTRACTOR SHALL PROVIDE (1) CAT6A CABLE IN 1-1/4" CONDUIT TO NEAREST CABLE TRAY OR RUN DIRECT TO TELECOM ROOM. TELECOM CONTRACTOR TO COORDINATE FINAL

LOCATION OF AXIS F44 MAIN UNIT FOR FINAL CABLE TERMINATION.

LECTRICAL AND LOW VOLTAGE SYSTEMS DIVISION OF WORK									
SYSTEM	RISER CONDUIT	CABLE TRAYS	OUTLET BOXES	DEVICES	WIRING	STRUCTURED CABLING	RJ-45 JACKS	SPECIAL TERMINATIONS	WALL PLATES
LECTRICAL	DIV 26	NA	NA	NA	DIV 26				
IRE ALARM	DIV 26	DIV 27/IT	DIV 26	NA	DIV 26				
IT	DIV 26 *	DIV 26 *	DIV 26 *	NA	NA	DIV 27/IT	DIV 27/IT	NA	DIV 27/IT
SECURITY	DIV 26 *	DIV 26 *	DIV 26	DIV 28	DIV 28	DIV 27/IT	DIV 27/IT	DIV 28/SEC	DIV 27/IT
AV	DIV 26 ***	DIV 26 *	DIV 26 *	DIV 27/AV	DIV 27/AV	DIV 27/IT	DIV 27/IT	DIV 27/AV	DIV 27/IT
BMS	DIV 25/CONTROLS	DIV 27/IT	DIV 27/IT	DIV 25/BMS	DIV 27/IT				
	·	·	·	·		·	· · · · · · · · · · · · · · · · · · ·		·

ABBREVIATIONS

BMS

- ELECTRICAL CONTRACTOR
 INFORMATION TECHNOLOGY CONTRACTOR
 SECURITY CONTRACTOR
- SECURITY CONTRACTOR
 AUDIO VISUAL CONTRACTOR
 BUILDING MANAGEMENT CONTRACTOR
- EC REFER TO T-SERIES DRAWINGS
 TT REFER TO S-SERIES DRAWINGS
 SEC REFER TO AV-SERIES DRAWINGS

MATRIX OF RESPONSIBILITY BURO HAPPOLD DESKTOP MODELING AND LOCATION OF CONNECTION POINTS TELECOM CONTRACTOR INSTALLATION OF TELECOM CABLES, COORDINATING EXACT LOCATIONS BASED ON FIELD CONDITION CLIENT INSTALLATION OF ACTIVE EQUIPMENT

TELECOMMUNICATIONS ABBREVIATIONS

LS

LTG

MAX

MDF

MECH

MIC

MIN

MISC

MTD

NEC

NEMA

NO

OD

PB

PBX

PCU

PDU

PG

PH

PLB

PNL

PSU

PWR

RDP

RCP

RECP

REQ

RMS

SEC

SEP

SPECS

SPKLR

SPKR

STA

STD

STP

SURF

SYM

TBD

TERM

TYP

UFD

UON

UPS

UTP

VENT

W/O

NTS

LOUDSPEAKER

LIGHTING

MILLIAMPS

MAXIMUM

MICROPHONE

MISCELLANEOUS

NOT APPLICABLE

NATIONAL ELECTRICAL CODE

PRIVATE BRANCH EXCHANGE

POWER CONDITIONING UNIT

POWER DISTRIBUTION UNIT

NATIONAL ELECTRICAL MANUFACTURERS ASSOCIATION

MINIMUM

MOUNTED

NUMBER

PULL BOX

PAGING

PHASE

PANEL

POWER

RECEPTACLE

REQUIRED

SECURITY

SECURITY

SEPARATE

SPRINKLEF

SPEAKER

STATION

STANDARD

SURFACE

SYMMETRICAL

TELEPHONE

TELCO TELEPHONE COMPANY

TYPICAL

VOLTS

VOLT-AMPERES

VERIFY IN FIELD

VENTILATING

VERTICAL

WATTS

WITH

WKSTA WORKSTATION

WITHOUT

TELEVISION

UNDER FLOOR DUCT

UNLESS OTHERWISE NOTED

UNSHIELDED TWISTED PAIR

UNINTERRUPTIBLE POWER SUPPLY

TERMINATION

TO BE DETERMINED

SHIELDING TWISTED PAIR

SPECIFICATIONS

PLUMBING

POWER SUPPLY UNIT

REFLECTED CEILING PLAN

RACK MOUNTED SPACES

RESIDENTIAL DISTRIBUTION PANEL

NOT TO SCALE

OUTSIDE DIAMETER

MAIN DISTRIBUTION FRAME

MECHANICAL/ELECTRICAL/PLUMBING

ACCESS CONTROL SYSTEM USE

ALTERNATING CURRENT

ABOVE FINISHED FLOOR

ABOVE FINISHED GRADE

AMERICAN WIRE GAUGE

AIR CONDITIONING

ARCHITECTURAL

AUDIOVISUAL

AVERAGE

BLANK

BUILDING

CIRCUIT

CEILING

CLOSET

COLUMN

CONCRETE

CONDUIT

CIRCUIT MIL

COAXIAL CABLE

CONSTRUCTION

CONVENIENCE

DIRECT CURRENT

DISH SATELLITE SYSTEM

ELECTRO MECHANICAL TUBING

EMERGENCY USE DESIGNATION

ELECTRONIC INDUSTRIES ASSOCIATION

ELECTRICAL CONTRACTOR

CONTINUOUS

DIAMETER

DOWN

DETAIL

DRAWING

ELEVATION

ELECTRIC

ELEVATOR

EQUIPMENT

EXISTING

FIRE ALARM

FIBER OPTIC

FEET

GAUGE

HEIGHT

INCHES

INTERCOM

JUNCTION BOX

HORIZONTAL

FURNISH & INSTALL

GENERAL CONTRACTOR

HEATING DISTRIBUTION FRAME

INTERNET SERVICE PROVIDER

INTERCOM OVER INTERNET PROTOCOL (IP)

INTERMEDIATE DISTRIBUTION FRAME

FLOOR

EQUAL

EACH

BY OTHERS

CENTER LINE

CABLE TELEVISION

CLOSED CIRCUIT TELEVISION

AIR COND

ARCH

AVG

AWG

BLDG.

B.O.

CATV

CCTV

CKT

CLG

CLOS

COAX

CONC

COND

CONST

CONT

CONV

DC

DIA

DN

DSS

DWG

EA

E.C.

EL

ELEC

ELEV

EM

EQ

EQUIP

EXIST

FIN

F.O.

FT

GA

G.C.

GD

HGT

HOR

INT

JBOX

EIA/TIA

CM

COL

ELECTRICAL NOTES FOR TELECOM

1.	ALL ELECTRICAL RECEPTACLES, GROUND BARS, CONDUITS, FLOOR BOXES,
	RACEWAYS, STEEL STRUT, AND SLEEVES ARE TO BE FURNISHED AND INSTALLED
	BY THE ELECTRICAL CONTRACTOR AS OUTLINED BELOW.

- PULL-BOXES FOR COMMUNICATIONS SYSTEMS SHALL BE PROVIDED WHERE THE COMBINED SUM OF THE BENDS EXCEEDS 180 DEGREES.
- 3. THE BEND RADIUS FOR COMMUNICATIONS CONDUITS SHALL BE 10 TIMES THE INSIDE DIAMETER OF THE CONDUITS. FOR CONDUITS GREATER THAN 2" IN
- 4. CONDUIT RUNS FOR COMMUNICATIONS CABLING SHALL NOT EXCEED 90 FEET WITHOUT A PULL-BOX.
- 5. JUNCTION BOXES FOR COMMUNICATIONS CABLING SHALL HAVE TAMPER-PROOF SCREWS.
- INCLUDE ALL REQUIRED JUNCTION AND PULL-BOXES REGARDLESS OF QUANTITIES INDICATED ON THE DRAWINGS.
- 7. ALL EMPTY CONDUITS ARE TO BE PROVIDED WITH A MINIMUM OF (2) NYLON DRAG LINES OR PULL STRINGS, AND FITTED WITH BUSHED ENDS.
- 8. PROVIDE PULL-BOXES ON ALL VERTICAL RISER CONDUIT RUNS REGARDLESS OF THE DRAWING INTERVALS, NO GREATER THAN 50FT. PULL-BOX AND JUNCTION-BOX SIZES ARE SHOWN FOR COORDINATION PURPOSES ONLY. ELECTRICAL CONTRACTOR TO SIZE PULL-BOXES AND JUNCTION-BOXES IN ACCORDANCE WITH FIELD CONDITIONS, AND EQUIPMENT STANDARDS.
- 9. ALL CABLE TRAY, LADDER RACKS, AND STEEL STRUTS SHALL BE FURNISHED AND INSTALLED BY THE ELECTRICAL CONTRACTOR.
- 10. REGARDLESS OF THEIR REPRESENTATION ON THE FLOOR PLANS, SLEEVES (EZPATH OR EQUIV.) SHALL BE PROVIDED AT ALL LOCATIONS WHERE CABLE PASSES THROUGH FIRE-RATED WALLS OR FLOORS. EXACT LOCATIONS SHALL BE COORDINATED BETWEEN THE COMMUNICATIONS CABLING CONTRACTOR AND THE ELECTRICAL CONTRACTOR. OPENING SIZES SHALL BE NO LESS THAN 1.5 TIMES THE CABLE CROSS SECTION PASSING THROUGH THE OPENING.
- 11. ELECTRICAL CONTRACTOR TO COORDINATE CABLE TRAY, LADDER RACKS, AND/OR STEEL STRUT SUPPORT SYSTEM LOCATIONS WITH COMMUNICATIONS CABLING CONTRACTOR.
- 12. COORDINATE CONDUIT LOCATIONS (VERTICALLY & HORIZONTALLY) OUTSIDE THE TELECOM ROOM WITH CABLE TRAY/LADDER RACK LOCATIONS INSIDE THE TELECOM ROOM.
- 13. DEDICATED ELECTRICAL CIRCUITS SHALL BE PROVIDED FOR EACH COMMUNICATIONS CABINET OR RACK AS NOTED ON THE TELECOM ROOM
- 14. ALL VOICE/DATA INFORMATION OUTLET BOXES SHALL BE 4 11/16" x 4 11/16" x 2 1/8" DEEP W/ 1/2" DEEP SINGLE GANG ADJUSTABLE MUD RING AND 1-1/4" CONDUIT TO NEAREST ACCESSIBLE CEILING UNLESS OTHERWISE NOTED.
- 15. CONDUITS USED TO FEED COMMUNICATIONS WORKSTATIONS IN INACCESSIBLE CEILING AREAS SHALL BE EXTENDED TO NEAREST ACCESSIBLE CEILING AREA.
- 16. FLOOR BOXES SHALL HAVE ONE (1) 1-1/4" CONDUIT EXTENDED TO ACCESSIBLE CEILING FOR COMMUNICATIONS CABLING. ADDITIONAL CONDUITS MAY BE REQUIRED TO SUPPORT A/V OR OTHER SYSTEMS CABLING AND ARE NOTED ON THE FLOOR PLANS.
- 17. ALL EXTERNAL COMMUNICATIONS OUTLETS ARE TO BE INSTALLED IN A WEATHERPROOF ELECTRICAL BOX WITH A WEATHERPROOF-WHILE-IN-USE COVER. CONDUIT BY ELECTRICAL CONTRACTOR FOR ALL EXTERIOR LOCATIONS TO NEAREST

MDF/IDF NOTES

- ALL COORDINATION IN THE CEILING OF THE TELECOM ROOM SHALL BE THE RESPONSIBILITY OF THE GENERAL CONTRACTOR.
- 2. TELECOM ROOM SHALL BE PROVIDED WITH EXPOSED CEILINGS UNLESS OTHERWISE NOTED.
- 3. ANY EXPOSED FIREPROOFING WITHIN TELECOM ROOM SHALL BE SEALED TO REDUCE DUST FROM DISLODGED MATERIAL.
- 4 CARLE LARRED CHALL RELIGER TO CURRORT CARLES WITHIN THE TELECOM ROC
- 4. CABLE LADDER SHALL BE USED TO SUPPORT CABLES WITHIN THE TELECOM ROOM. LADDER SIZE SHALL BE AS INDICATED ON FLOOR/PART PLANS OR BASED UPON CABLING FILL REQUIREMENTS.
- 5. CABLES ROUTED ON CABLE LADDER (VERTICAL OR HORIZONTAL) SHALL BE SECURED TO TRAY OR LADDER WITH REUSABLE VELCRO-BASED CABLE WRAPS EVERY RUNG.
- 6. VERTICAL CABLE LADDER SHALL BE USED AT WALLS TO SUPPORT VERTICAL CABLE TRANSITIONS WITHIN THE TELECOM ROOM.
- 7. A MINIMUM OF 6" CLEARANCE SHALL BE MAINTAINED ABOVE AND BELOW THE HORIZONTAL CABLE LADDER. LADDER ABOVE ALL RACKS TO ALL WALLS IN MDF LOCATIONS. ELECTRICALLY BOND AS REQUIRED.
- 8. TELECOM ROOM WALLS SHALL BE CONTINUOUS FROM SLAB (FLOOR) TO SLAB (CEILING) WITH ALL THROUGH WALL PENETRATIONS SEALED.
- 9. THE GENERAL CONTRACTOR SHALL SEAL ALL OPENINGS AROUND WALL PENETRATIONS TO MAINTAIN THE INTEGRITY OF CONDITIONED SPACES. ALL WORK PERFORMED SHALL
- 10. PLYWOOD FOR WALL FIELDS SHALL BE FIRE-RATED GRADE A C WITH "A" SIDE

MAINTAIN THE PRESCRIBED FIRE RATING OF THE SPACE.

- 11. ALL FLOORING SHALL BE ANTI-STATIC VCT TILE UNLESS OTHERWISE NOTED.
- 12. WALL PHONE OUTLETS MECHANICAL AND TELECOM ROOMS SHALL BE MOUNTED AT
- 13. ALL RACKS, CABINETS AND CABLE TRAY/LADDER RACKS SHALL BE ELECTRICALLY CONNECTED, VIA #6 AWG GREEN JACKETED WIRE, TO A PRE-DRILLED AND TAPPED GROUND BAR TO BE LOCATED WITHIN THE ROOM, GROUND BAD SHALL BE
- GROUND BAR TO BE LOCATED WITHIN THE ROOM. GROUND BAD SHALL BE CADWELD CONNECTED TO BUILDING STEEL BY WAY OF THE LOCAL TELECOMMUNICATIONS GROUNDING BAR. (2) HOLE CRIMP CONNECTORS SHALL BE USED.

> N /

Storm King Art Center 1 Museum Road New Windsor, NY 12553

+1 (845) 534-3115 Design Architect

heneghan peng architects 14-16 Lord Edward Street Dublin, D02 YC63 +353 1 633 9000

Executive Architect
WXY Architecture + Urban Design
224 Centre Street, 5th Floor
New York, NY 10013
+1 (212) 219-1953

Landscape Architect
Gustafson Porter + Bowman
1 Cobham Mews
London, MW1 9SB

+44 020 7284 8950

Reed Hilderbrand LLC
33 Whitney Avenue, 3rd Floor
New Haven, CT 06510
+1 (617) 923-2422

Structural & Lighting

ARUP
77 Water Street
New York, NY 10005

+1 (212) 896-3000

MEPF & IT

BuroHappold

BuroHappold 100 Broadway #23 New York, NY 10005

- +1 (212) 616-0228 **Civil** VHB
- 100 Great Oaks Blvd., Suite 118 Albany, NY 12203 +1 (518) 389-3606
- AV & Acoustics
 LSTN Consultants
- 76 Beaver Street, 2nd Floor New York, NY 10005
- +1 (347) 788-0810 Facade

Front Inc. 100 E. Broadway S

100 E. Broadway Street, #501 New York, NY 10002 +1 (212) 242-2220

Key Plan



Description

50% Construction Documents

Date

11/06/20

Project

Storm King Art Center Pond Pavilion

Seal

NOT FOR CONSTRUCTION

Drawing Title

Abbreviations,

Symbols and

Legends

Date	11/06/20
Scale	12" = 1'-0"
Drawing Number	IT-P-001
Sheet Size	ARCH D

Q 0 M E N K J H D B A - EQUIPMENT RACK 23"W x 27"D x 67"H SLIDE OUT Custodian MECHNICAL Trash/Plumbing Service Electrical Covered Terrace ADA/Family RR AV WAP DATA Ψ DATA Covered Terrace

GENERAL NOTES:

ALL TELECOM ROUTING TO CAFE AREA TO BE VIA IN-SLAB CONDUITS.

Owner Storm King Art Center 1 Museum Road New Windsor, NY 12553 +1 (845) 534-3115

> **Design Architect** heneghan peng architects 14-16 Lord Edward Street Dublin, D02 YC63 +353 1 633 9000

Executive Architect WXY Architecture + Urban Design 224 Centre Street, 5th Floor New York, NY 10013 +1 (212) 219-1953

Landscape Architect Gustafson Porter + Bowman 1 Cobham Mews London, MW1 9SB +44 020 7284 8950

Reed Hilderbrand LLC 33 Whitney Avenue, 3rd Floor New Haven, CT 06510 +1 (617) 923-2422

Structural & Lighting ARUP

77 Water Street New York, NY 10005 +1 (212) 896-3000

MEPF & IT BuroHappold 100 Broadway #23

New York, NÝ 10005 +1 (212) 616-0228

Civil VHB

100 Great Oaks Blvd., Suite 118 Albany, NY 12203

+1 (518) 389-3606 **AV & Acoustics**

LSTN Consultants 76 Beaver Street, 2nd Floor

New York, NY 10005 +1 (347) 788-0810 Facade

Front Inc. 100 E. Broadway Street, #501 New York, NY 10002 +1 (212) 242-2220

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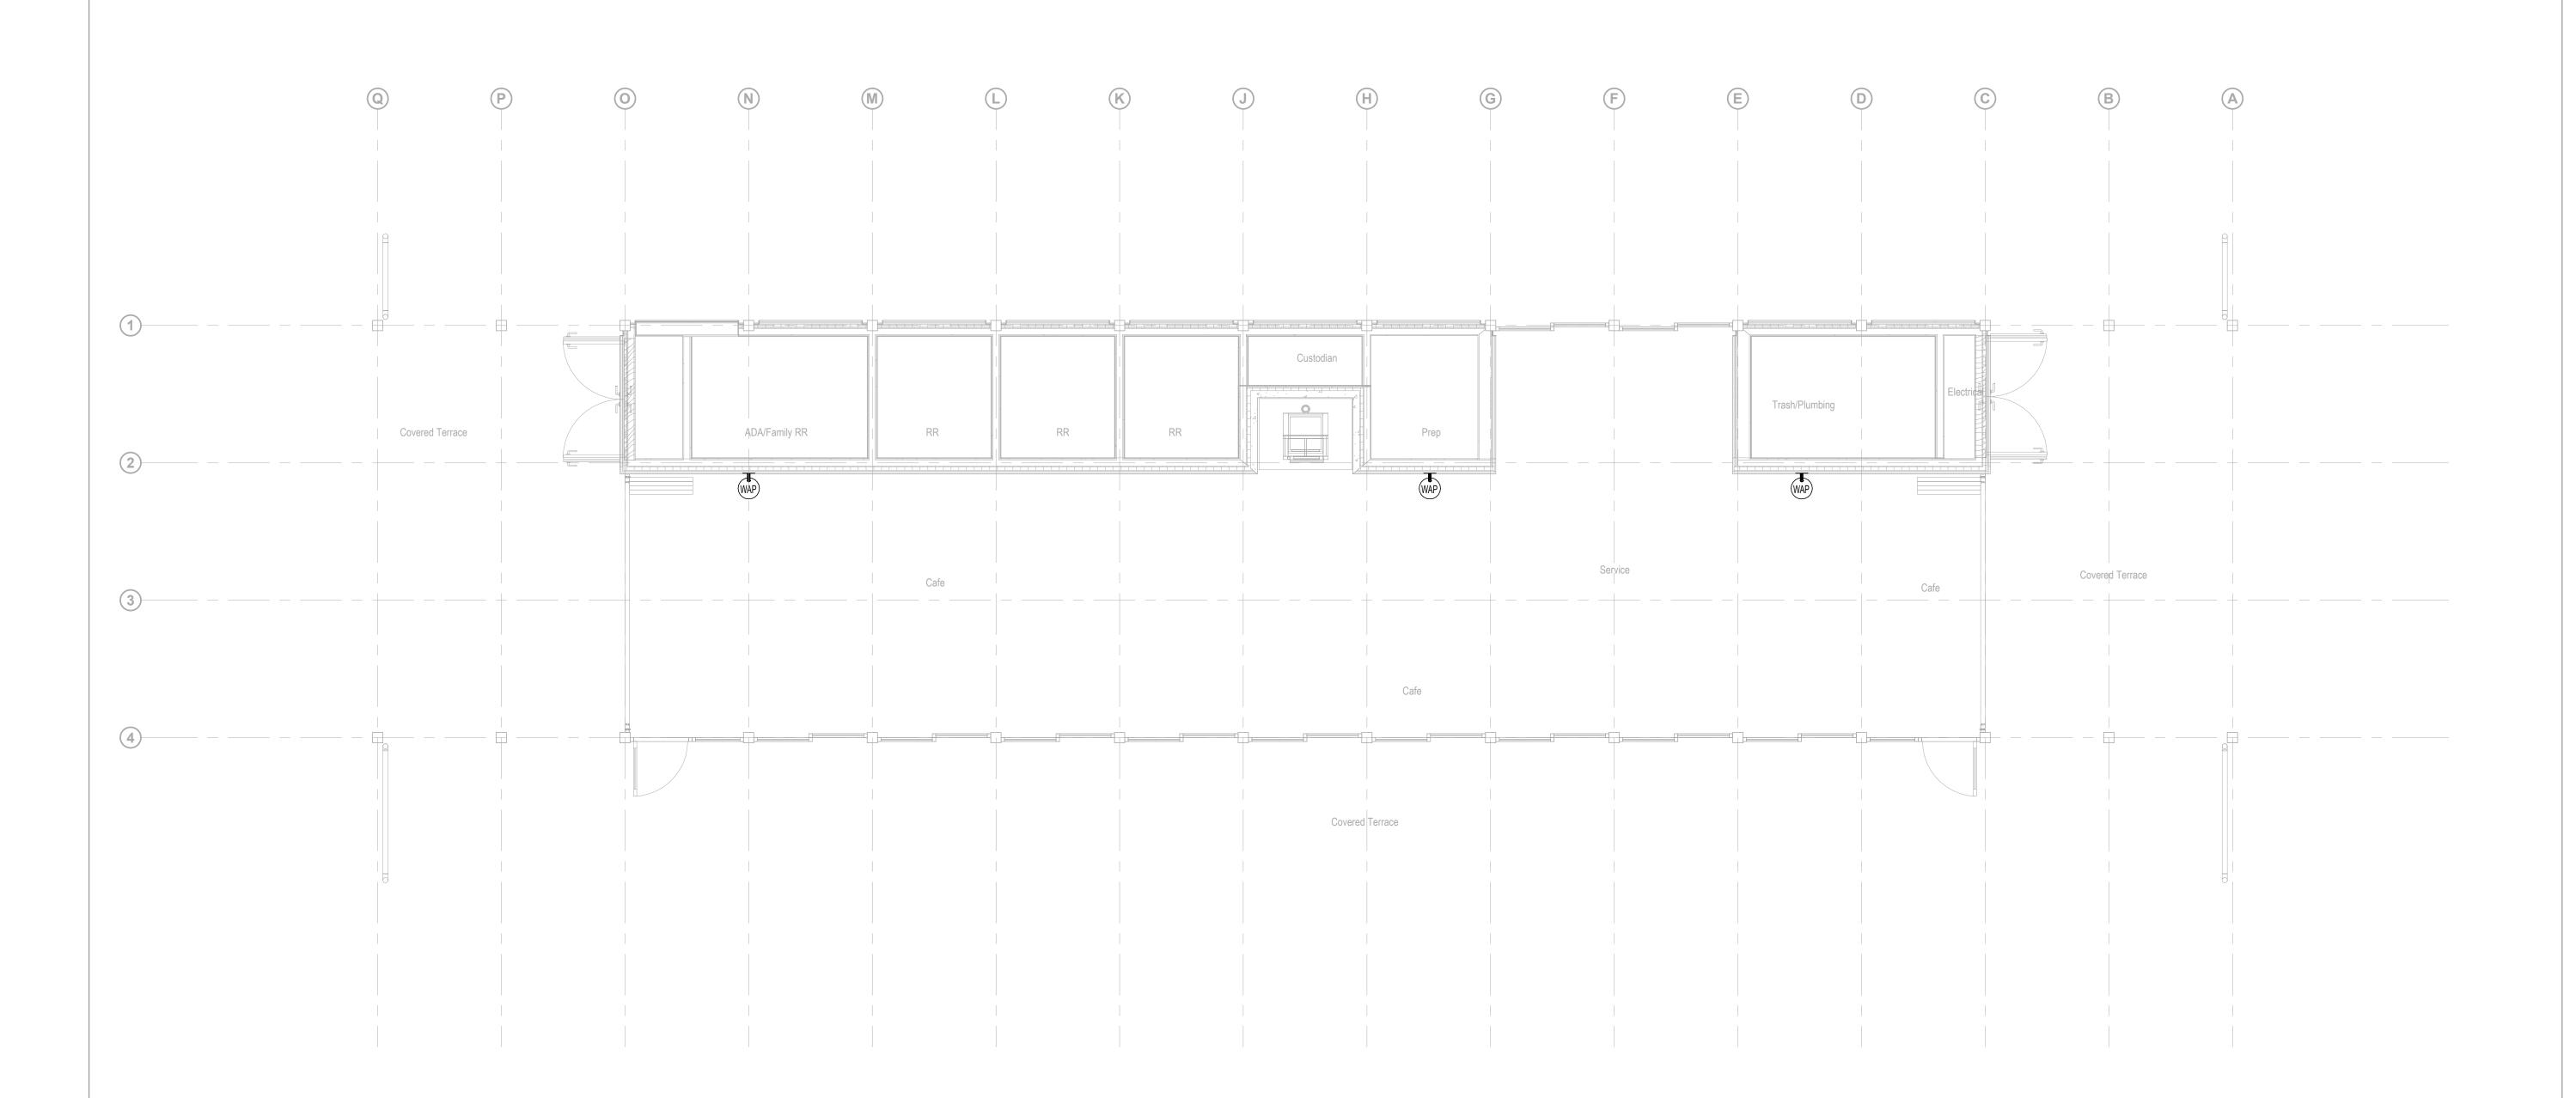
11/06/20

Project

Storm King Art Center **Pond Pavilion**

NOT FOR CONSTRUCTION **Drawing Title** Telecom Plan -**Ground Level**

11/06/20
1/4" = 1'-0"
IT-P-101
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+1 (845) 534-3115

Design Architect heneghan peng architects 14-16 Lord Edward Street Dublin, D02 YC63 +353 1 633 9000

Executive Architect WXY Architecture + Urban Design 224 Centre Street, 5th Floor New York, NY 10013 +1 (212) 219-1953

Landscape Architect Gustafson Porter + Bowman 1 Cobham Mews London, MW1 9SB +44 020 7284 8950

Reed Hilderbrand LLC 33 Whitney Avenue, 3rd Floor New Haven, CT 06510 +1 (617) 923-2422

Structural & Lighting ARUP 77 Water Street

+1 (212) 896-3000 MEPF & IT BuroHappold

New York, NY 10005

100 Broadway #23 New York, NY 10005 +1 (212) 616-0228

Civil VHB

100 Great Oaks Blvd., Suite 118 Albany, NY 12203

+1 (518) 389-3606

AV & Acoustics LSTN Consultants 76 Beaver Street, 2nd Floor New York, NY 10005

+1 (347) 788-0810 Facade Front Inc.

100 E. Broadway Street, #501 New York, NY 10002 +1 (212) 242-2220

Key Plan



Description

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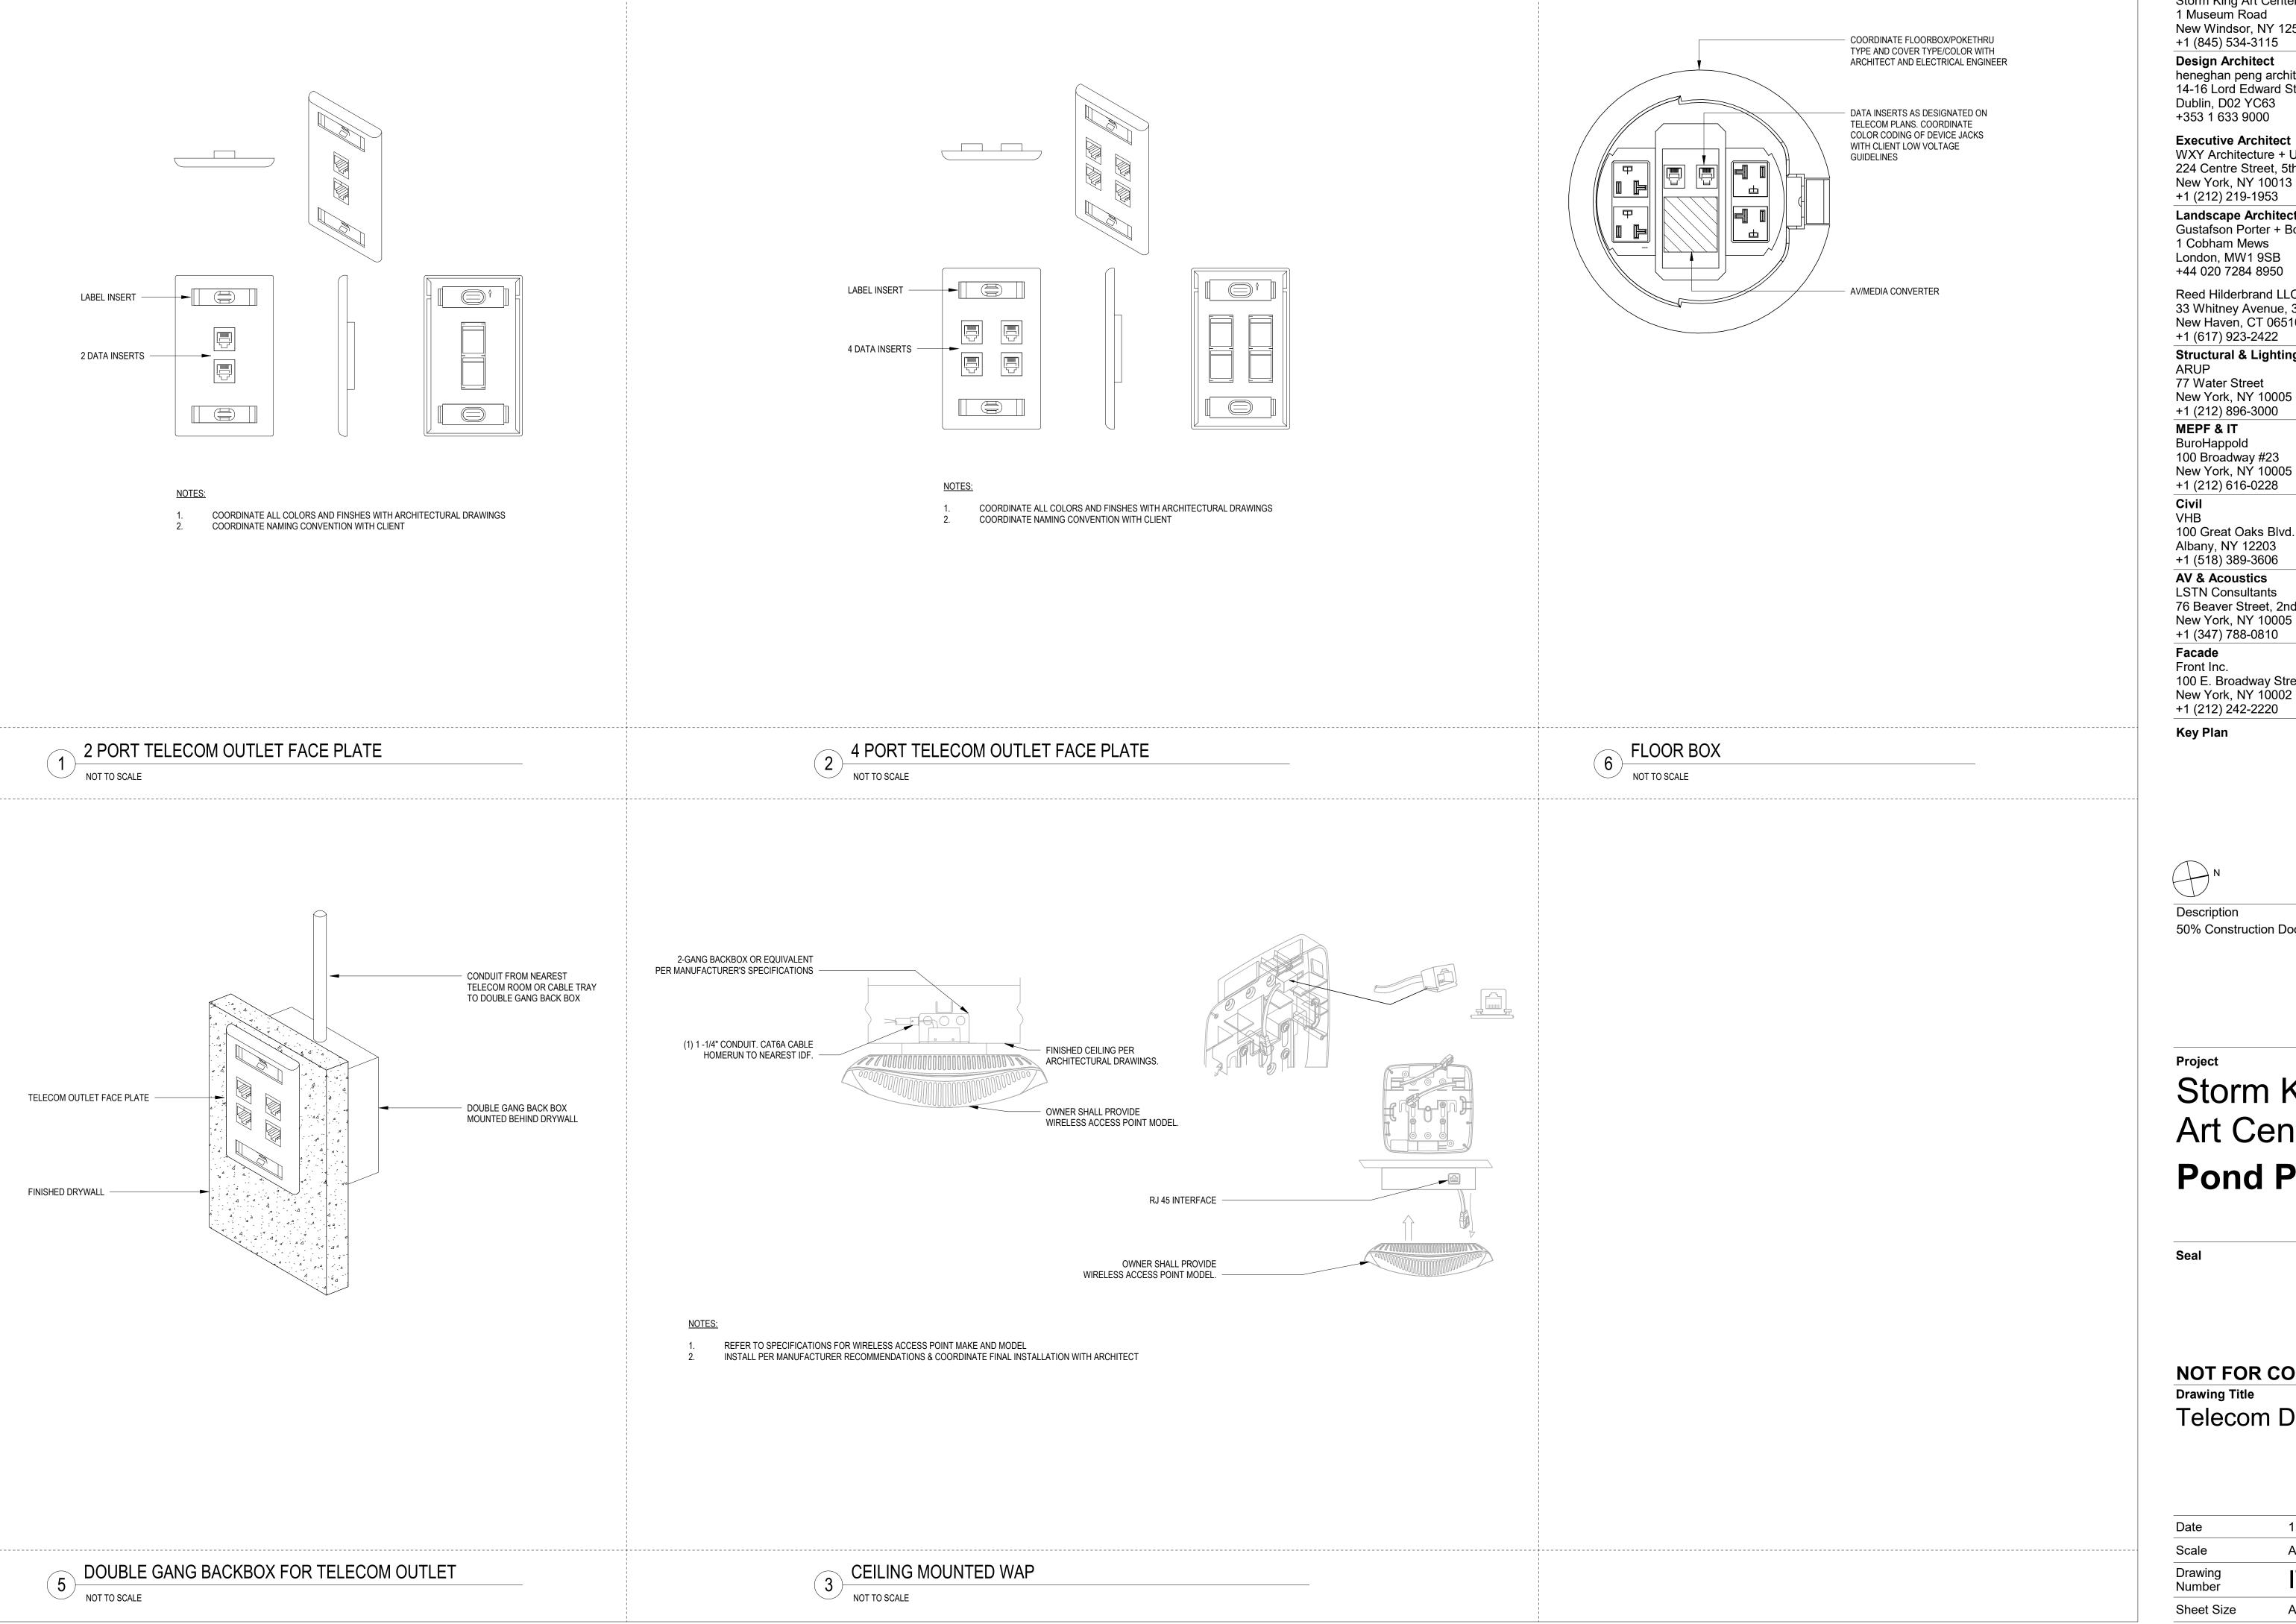
11/06/20

Project

Storm King Art Center **Pond Pavilion**

NOT FOR CONSTRUCTION **Drawing Title** Telecom RCP -**Ground Level**

Date	11/06/20
Scale	1/4" = 1'-0"
Drawing Number	IT-P-201
Sheet Size	ARCH D



> **Design Architect** heneghan peng architects 14-16 Lord Edward Street Dublin, D02 YC63 +353 1 633 9000

Executive Architect WXY Architecture + Urban Design 224 Centre Street, 5th Floor New York, NY 10013 +1 (212) 219-1953

Landscape Architect Gustafson Porter + Bowman 1 Cobham Mews London, MW1 9SB +44 020 7284 8950

Reed Hilderbrand LLC 33 Whitney Avenue, 3rd Floor New Haven, CT 06510 +1 (617) 923-2422

Structural & Lighting ARUP

New York, NY 10005 +1 (212) 896-3000 MEPF & IT

BuroHappold 100 Broadway #23 New York, NY 10005

+1 (212) 616-0228

100 Great Oaks Blvd., Suite 118 Albany, NY 12203

+1 (518) 389-3606

AV & Acoustics LSTN Consultants 76 Beaver Street, 2nd Floor New York, NY 10005

+1 (347) 788-0810 Facade Front Inc. 100 E. Broadway Street, #501

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Storm King Art Center **Pond Pavilion**

NOT FOR CONSTRUCTION **Drawing Title** Telecom Details

11/06/20 As indicated IT-P-501 Number ARCH D



Owner Storm King Art Center 1 Museum Road

New Windsor, NY 12553 +1 (845) 534-3115

Design Architect heneghan peng architects 14-16 Lord Edward Street Dublin, D02 YC63 +353 1 633 9000

Executive Architect WXY Architecture + Urban Design 224 Centre Street, 5th Floor New York, NY 10013 +1 (212) 219-1953

Landscape Architect Gustafson Porter + Bowman 1 Cobham Mews London, MW1 9SB +44 020 7284 8950

Reed Hilderbrand LLC 33 Whitney Avenue, 3rd Floor New Haven, CT 06510 +1 (617) 923-2422

Structural & Lighting ARUP

77 Water Street New York, NY 10005 +1 (212) 896-3000

MEPF & IT BuroHappold 100 Broadway #23

New York, NY 10005 +1 (212) 616-0228

Civil VHB

100 Great Oaks Blvd., Suite 118 Albany, NY 12203

+1 (518) 389-3606 AV & Acoustics

LSTN Consultants 76 Beaver Street, 2nd Floor

New York, NY 10005 +1 (347) 788-0810 Facade

Front Inc. 100 E. Broadway Street, #501 New York, NY 10002

+1 (212) 242-2220

Key Plan



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Storm King Art Center **Pond Pavilion**

NOT FOR CONSTRUCTION Site Plan - Property -Telecom

11/06/20 1" = 100'-0" IT-P-900 ARCH D