

O Number	Decembrism	Carret	Equipment	Cross Niversham	Natas	
EQ Number	Description	Count	Туре	Spec Number	Notes	
A-1	5 Ton Bridge Crane	1	N	14 22 13	ADD ALT. #4	
B-1	72,000lbs Four Post Mobile Lift	1	N	14 45 00		
B-2	18K 2 Post Lift	1	N	14 45 00		
B-3	1,800lbs Portable Mower Lift	1	N	14 45 00		
C-1	Lube Reel Bank (5 reels)	1	N	11 11 29	ADD ALT. #5	
C-2	Low Profile Waste Oil Caddy	1	N	11 11 29	ADD ALT. #5	
C-3	Waste Oil Pump Out	1	N	11 11 29	ADD ALT. #5	
C-4	Waste Oil High Level Alarm	1	N	11 11 29	ADD ALT. #5	
C-5A	Waste Oil Caddy	1	N	11 11 29	ADD ALT. #5	
C-5B	Waste Antifreeze Caddy	1	N	11 11 29	ADD ALT. #5	
C-6	Waste Anti-Freeze Pump Out	1	N	11 11 29	ADD ALT. #5	
C-7	Waste Antifreeze High Level Alarm	1	N	11 11 29	ADD ALT. #5	
C-8	Oil Filter Drain Box	1	N	11 11 29	ADD ALT. #5	
C-9	DEF Mobile Cart w/ Pump	1	ERO	N/A		
C-10	Portable Grease Caddy	1	ERO	N/A		
C-11	N/A	1	N/A	N/A		
C-12	Fluid Tank 300 Gal (100 15W-40, 100 ATF, 100 Hydraulic Fluid)	1	N	11 11 29	ADD ALT. #5	
C-13	Waste Fluid Tank (300 Waste oil, 100 Waste Anti Freeze)	1	N	11 11 29	ADD ALT. #5	
C-14	Fluid Storage Room Sump Alarm	1	N	11 11 29	ADD ALT. #5	
C-15	Wall Mounted Lube Pumps	3	N	11 11 29	ADD ALT. #5	
C-16	Oil Trolley	2	N	11 11 29	ADD ALT. #5	
D-1	Steel Work Bench (72inx36in)	2	N	12 40 00	ADD ALT. #7	
D-2	Steel Work Bench w Casters	1	N	12 40 00	ADD ALT. #7	
D-3	Electric Charging Station	1	N	12 40 00	ADD ALT. #7	
E-1	Hydraulic Hose Crimping Machine	1	N	12 40 00	TOD TELL III	
E-2	Hydraulic Hose & Fitting Storage	1	N	12 40 00		
E-3	Hydraulic Hose Reel Rack	1	N	12 40 00		
E-4	Hydraulic Hose Saw	1	N	12 40 00		
F-1	MIG Welder	1	N	12 40 00		
F-2	Torch Cart	1	N	12 40 00		
F-3	Welding Screen	2	N	12 40 00		
F-4	Plasma Cutter	1	ERO	N/A		
F-5	Oxygen Tank Storage Cage	1	N	12 40 00		
F-6	Portable Weld Fume Extractor	1	N	12 40 00		
G-1	Tire Changer	1	N	12 40 00		
G-1 G-2	Tire Balancer	1	N	12 40 00		
G-3	Tire Storage Rack	1	N	12 40 00		
H-1	Pallet Rack	1	N	12 40 00	ADD ALT. #7	
H-2	Storage Cabinet	1	N	12 40 00	ADD ALT. #7	
H-3	Bin Storage	3	N	12 40 00	ADD ALT. #7	
п-э H-4	Flammable Cabinet (45 Gallons)	1	N N	12 40 00	ADD ALT. #7	
H-5	Small Part Drawer Storage	1	N N	12 40 00	ADD ALT. #7	

	Industrial Equipr	ment Schedule			
EQ Number	Description	Count	Equipment Type	Spec Number	Notes
H-6	Parts Shelving (6' x 2')	18	N	12 40 00	ADD ALT. #7
H-7	Cantilever Rack	1	N	12 40 00	ADD ALT. #7
H-8	Cubby Storage	1	N	12 40 00	ADD ALT. #7
M-1	Anchor Pot	1	N	12 40 00	
M-2	Drill Press	1	N	12 40 00	
M-3	Heavy Duty Anvil Bench Vice	1	N	12 40 00	
M-4	Parts Washer	1	N	12 40 00	
M-5	Bench Grinder	1	N	12 40 00	
M-6	Portable Battery Charger	1	N	12 40 00	
M-7	Brake Fluid Exchanger	1	N	12 40 00	
M-8	N/A	1	N/A	N/A	
M-9	3-Ton Floor Jack	2	N	12 40 00	
M-10	5-Ton Floor Jack	1	N	12 40 00	
M-11	AC Recovery and Recharge System	1	N	12 40 00	
M-12	Shop Press	1	ERO	N/A	
M-13	Snap-On Red Toolbox	1	ERO	N/A	
M-14	Bench Vice	1	ERO	N/A	
M-15	Tool Cart	3	ERO	N/A	
M-16	Bench Mounted Chainsaw Sharpener	1	ERO	N/A	
M-17	Transmission Jack	1	ERO	N/A	
M-18	2-Ton Engine Crane	1	ERO	N/A	
M-19	KantLeak Vac-U Fill	1	ERO	N/A	
M-20	3/4 Ton Wheel Dolly	1	ERO	N/A	
M-21	Trash Can	1	ERO	N/A	
M-23	Drum Dolley	5	N	12 40 00	
M-24	Mobile Platform	1	N	12 40 00	
V-1	Vehicle wash Pressure Plant	1	N	11 11 26	
V-1A	Manual Wash Control panel	1	N	11 11 26	
V-2	Vehicle Wash - Hot Water Heater	1	N	11 11 26	
V-3	Vehicle Wash Festoon	2	N	11 11 26	
V-4	Automatic Undercarriage Pump Skid	1	N	11 11 26	
V-4A	Undercarriage Wash Control Panel	1	N	11 11 26	
V-5	Automatic Undercarriage photo Eye	2	N	11 11 26	
V-6	Undercarriage Control Panel	2	N	11 11 26	
V-7	Vehicle Wash Soap Drum	1	N	11 11 26	
V-8	Vehicle Wash Guide Rails	1	N	11 11 26	
V-9	Vehicle Wash Pre-Treatment Tank (1500gal)	1	N	11 11 26	
V-10	Vehicle Wash Mobile Platform	1	N	11 11 26	
V-11	Vehicle wash Entry Traffic Light	1	N	11 11 26	
V-12	Automatic Undercarriage Blasters	1	N	11 11 26	
V-13	Vehicle Wash Activation Light	1	N	11 11 26	
V-14	Automatic Undercarriage Wash Toggle Swtich	1	N	11 11 26	
V-15	Loop Detector	1	N	11 11 26	

GENERAL NOTES:

- EQUIPMENT LAYOUTS ARE SCHEMATIC. GENERAL CONTRACTOR IS RESPONSIBLE FOR COORDINATING EXACT LOCATIONS WITH OWNER AND MANUFACTURER REQUIREMENTS. GENERAL CONTRACTOR SHALL COORDINATE ALL UTILITY REQUIREMENTS WITH ELECTRICAL, PLUMBING, AND HVAC CONTRACTORS. FINAL EQUIPMENT LOCATIONS SHALL BE CONFIRMED BY THE OWNER PRIOR TO RUNNING UTILITIES AND INSTALLATION
- GENERAL CONTRACTOR SHALL COORDINATE UTILITY REQUIREMENTS OF EXISTING EQUIPMENT PRIOR TO INSTALLATION OF SERVICES. PRIOR TO RUNNING UTILITIES, GENERAL CONTRACTOR SHALL MARK OUT ALL EQUIPMENT LOCATIONS ON THE FLOOR USING CHALK OR ANOTHER
- ACCEPTABLE MEANS, AND SHALL REVIEW/REVISE FINAL EQUIPMENT LOCATIONS AS DIRECTED BY THE OWNER AND THE ENGINEER. B-2 SHALL BE CENTERED IN THE MAINTENANCE BAYS AS DEFINED BY THE OVERHEAD DOOR OPENING. CONFIRM INSTALLATION LAYOUT

DIMENSIONS WITH THE MANUFACTURER. ALSO SEE OWNERS MANUALS.

ELECTRICAL, MECHANICAL, AND PLUMBING CONTRACTORS SHALL PROVIDE AND CONNECT UTILITIES TO ALL EQUIPMENT AS SHOWN ON THE ELECTRICAL, MECHANICAL AND PLUMBING DRAWINGS AND SPECIFICATIONS IN ACCORDANCE WITH THE MANUFACTURERS REQUIREMENTS IN ORDER TO PROVIDED A COMPLETE AND OPERABLE SYSTEM. ALL UTILITIES FOR EQUIPMENT SHALL BE PROVIDED AS PART OF THE BASE BID HOWEVER THE COSTS ASSOCIATED WITH MAKING FINAL UTILITY CONNECTIONS FOR EQUIPMENT SHALL BE INCLUDED IN THE APPLICABLE BID

THE ELECTRICAL CONTRACTOR SHALL HAVE A NEW YORK LICENSED ELECTRICIAN CONFIRM THE VOLTS, PHASE, AMPS, AND NEMA PLUG CONFIGURATION FOR EACH PIECE OF EQUIPMENT (INCLUDING EXISTING EQUIPMENT TO BE RELOCATED) IN ADVANCE OF ORDERING MATERIALS AND INSTALLATION.

- SEE SPECIFICATION SECTION 11 11 29 FLUID DISTRIBUTION SYSTEM ALONG WITH DETAILS ON EQ102 & EQ103 FOR ADDITIONAL INFORMATION AND SCOPE DELINEATION FOR THE FLUID AND WASTE FLUID DISTRIBUTION SYSTEMS.
- 8. THE UNDERCARRIAGE WASH TRENCH DRAINS SHALL BE FURNISHED BY THE GENERAL CONTRACTOR'S VEHICLE WASH SUB CONTRACTOR AND

ABBREVIATIONS:

NEW EQUIPMENT TO BE SUPPLIED AND INSTALLED BY THE CONTRACTOR.

SHALL BE INSTALLED BY THE PLUMBING CONTRACTOR.

- EXISTING EQUIPMENT TO BE RELOCATED AND INSTALLED BY THE OWNER. UTILITIES FOR ERO EQUIPMENT TO BE PROVIDED BY GENERAL CONTRACTOR. UTILITES SHALL BE PROVIDED BY THE ELECTRICAL AND PLUMBING CONTRACTORS.
- EXISTING EQUIPMENT TO BE RELOCATED AND INSTALLED BY THE CONTRACTOR. UTILITIES FOR ERC EQUIPMENT TO BE PROVIDED BY THE GENERAL CONTRACTOR. THE ELECTRICAL AND PLUMBING CONTRACTORS.

CEILING

WALL

NEW EQUIPMENT PROVIDED AND INSTALLED BY THE OWNER (NOT IN CONTRACT), HOWEVER UTILITIES FOR THIS EQUIPMENT SHALL BE PROVIDED BY SUB-CONTRACTORS. BY THE ELECTRICAL AND PLUMBING CONTRACTORS.



VILLAGE OF ARDSLEY, NY **NEW PUBLIC WORKS**

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Consultants:







Revisions:

Rev	Date	Description
1	4/22/22	ADDENDUM NO. 1

Issued For: BID





SCALE: AS NOTED

APRIL 7, 2022

NCH Drawn By:

Reviewed By: TJC


Approved By: JFB

W&S Project No: ENG20-0501

Drawing Title:


EQUIPMENT LAYOUT PLAN

Sheet Number:

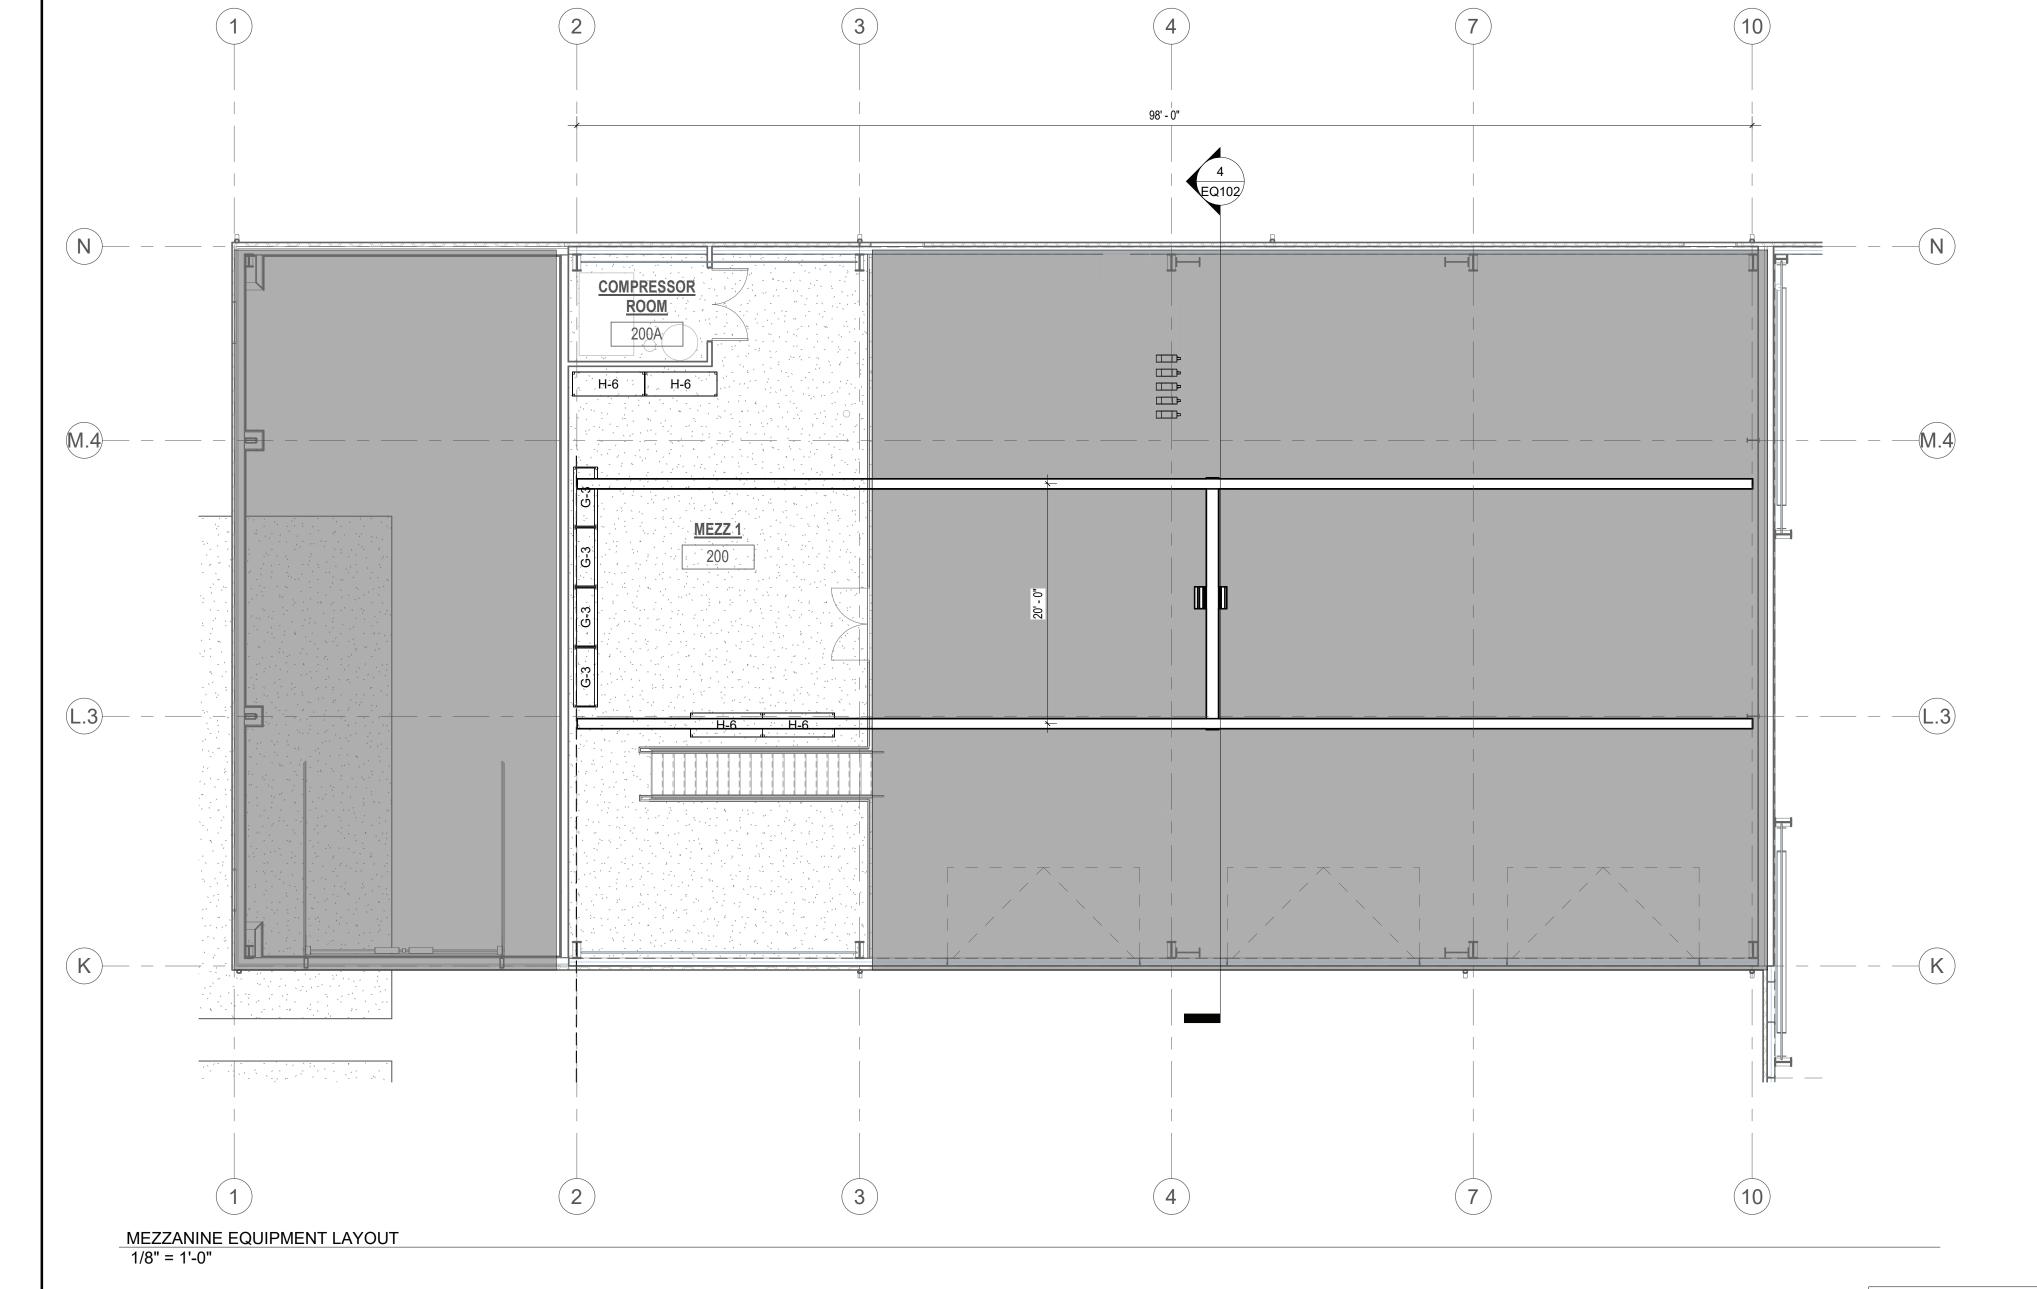

	Mezzanin	e Industrial Equip	ment Schedule		
EQ Number	Description	Count	Equipment Type	Spec Number	Notes
0.0	T: 01 B			40.40.00	455 ALT
G-3	Tire Storage Rack	4	N	12 40 00	ADD ALT.
H-6	Parts Shelving (6' x 2')	4	N	12 40 00	ADD ALT.

	D	0 1	F 1/ "			
EQ Number	Description	Count	E - Voltage	E - Phase	E - Amps	E - HP
A-1	5 Ton Bridge Crane	1	480V	3PH	14A Nom. 53A St.	
B-1	72,000lbs Four Post Mobile Lift	1	120V	1PH	1.3A	
B-2	18K 2 Post Lift	1	208V	1PH	1.0/1	4HP
C-1	Lube Reel Bank (5 reels)	1 /1	120V	1PH	25A	7111
C-4	Waste Oil High Level Alarm	1	120V	1PH	6.6A	
C-7	Waste Antifreeze High Level Alarm	1	120V	1PH	6.6A	
C-9	DEF Mobile Cart w/ Pump	1	120V	1PH	2.5A	
C-14	Fluid Storage Room Sump Alarm	1	120V	1PH	6.6A	
D-3	Electric Charging Station	1	120V	1PH	15A	
E-1	Hydraulic Hose Crimping Machine	1	120V	1PH		1.5HP
E-4	Hydraulic Hose Saw	1	208V	1PH		5HP
F-1	MIG Welder	1	208V	1PH	57A	
F-4	Plasma Cutter	1 /	2080	1PH	52A	
F-6	Portable Weld Fume Extractor	1	120V	1PH	11.9A	1HP
G-1	Tire Changer	1	208V	1PH	20A Breaker	1HP
G-2	Tire Balancer	1	208V	1PH	10A	
M-2	Drill Press	1 ^	120V	1PH		1.5HP
M-4	Parts Washer	1 /1	120V	1PH	1.4A	
M-5	Bench Grinder	1	120V	1PH	3.6A	
M-6	Portable Battery Charger	1	120V	1PH	10A	
M-11	AC Recovery and Recharge System	1	120V	1PH	10 A	
M-16	Bench Mounted Chainsaw Sharpener	1	120V	1PH	2.1A	
V-1	Vehicle wash Pressure Plant	1	480V	3 PH	25 A	7.5 HP
V-1A	Manual Wash Control panel	1	120V	1PH	20A	
V-2	Vehicle Wash - Hot Water Heater	1	120V	1PH	1A	
V-4	Automatic Undercarriage Pump Skid	1	480V	3PH	70A	40HP
V-4A	Undercarriage Wash Control Panel	1	120V	1PH	20A	

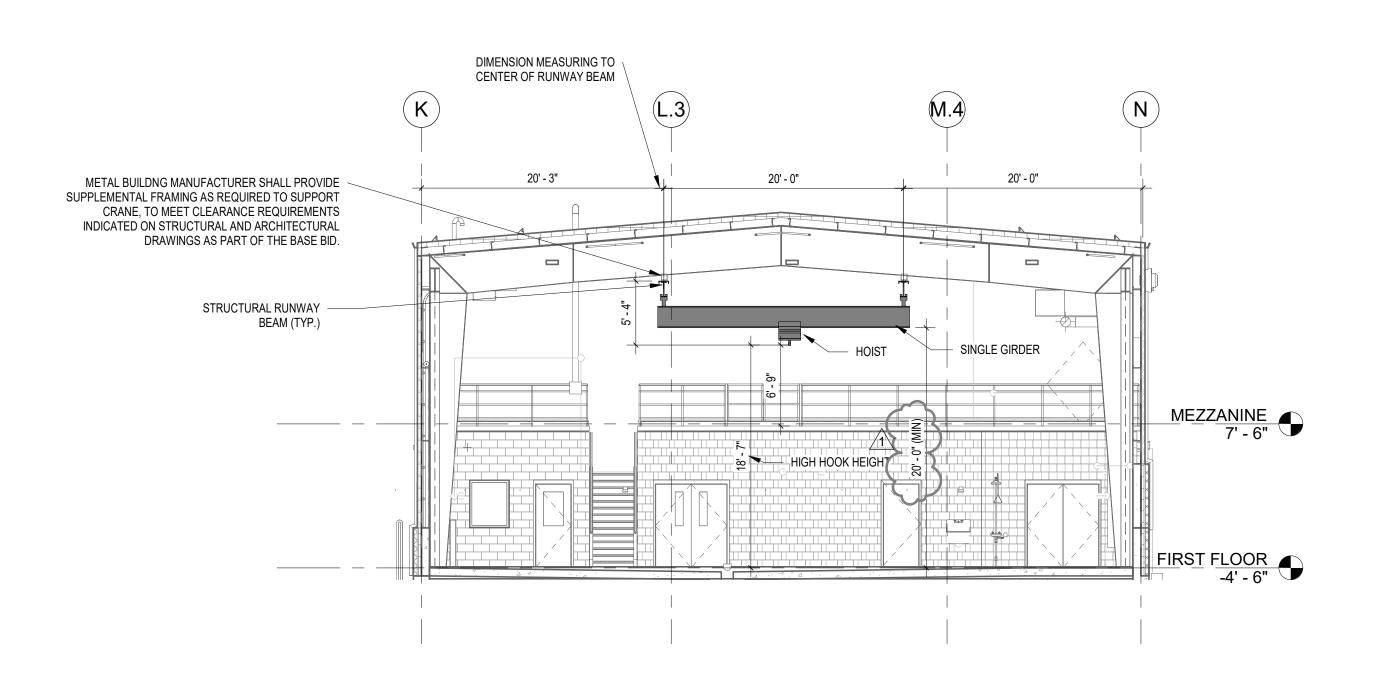

5-TON BRIDGE CRANE DETAIL (ADD ALTERNATE #4)

1/8" = 1'-0"

	Industrial Equipment Plumbing Schedule								
EQ Number	Туре	Count	P - Vent	P - Air	P - Water				
B-3	1,800lbs Portable Mower Lift	1		Shop Air (90-100 psi)					
C-3	Waste Oil Pump Out	1		Shop air (60-120PSI)					
C-6	Waste Anti-Freeze Pump Out	1		Shop air (60-120PSI)					
C-10	Portable Grease Caddy	1		Air Operated					
C-15	Wall Mounted Lube Pumps	3		6:1 pumps 7 scfm @ 40 psi. 12:1 pumps 69 scfm @ 90 psi. Diaphragm pumps 10 scfm @ 60 psi.					
G-1	Tire Changer	1		110-145 PSI					
V-1	Vehicle wash Pressure Plant	1		1/2"- 6CFM @ 90PSI	1" Water connection from V-2				
V-2	Vehicle Wash - Hot Water Heater	1	4" Vent	3/4" Gas connection (440,000btu/hr)	1" Water 10 gpm @ 60psi				
V-4	Automatic Undercarriage Pump Skid	1		1/2" 6 cfm 80-100psi air	1.5" suppy (water line connects to a 25 gallon buffer tank)				
V-9	Vehicle Wash Pre-Treatment Tank (1500gal)	1	4" vent per chamber						

NOTES:

- 1. BRIDGE CRANE SHALL BE INLCUDED IN ADD ALTERNATE #4.
- 2. METAL BUILDING MANUFACTURER SHALL PROVIDE STEEL SUPPORT/SHIMS FOR BRIDGE CRANE EQUIPMENT TO ACCOMODATE THE SLOPE OF THE STRUCTURAL STEEL IN ORDER TO PROVIDE A LEVEL BRIDGE CRANE SYSTEM AS REQUIRED FOR A COMPLETE AND OPERABLE SYSTEM.
- 3. HOOK SHALL NOT EXTEND MORE THAN 1.5 FT DOWN FROM CRANE GIRDER WHEN IN FULL UP POSITION.
- 4. SEE STRUCTURAL AND ARCHITECTURAL DRAWINGS FOR ADDITIONAL DETAILS.
- 5. COORDINATE BRIDGE CRANE HEIGHT WITH OTHER UTILITIES AS REQUIRED.
- 6. BRIDGE CRANE SHALL BE LOCATED VERTICALLY IN THE VEHICLE MAINTENANCE SHOP TO PROVIDE A MINIMUM OF 7 FT OF CLEARANCE OVER THE MEZZANINE MEASURED FROM THE MEZZANINE SURFACE TO HIGH HOOK HEIGHT.

VILLAGE OF ARDSLEY, NY NEW PUBLIC WORKS **FACILITY**

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APRIL 7, 2022

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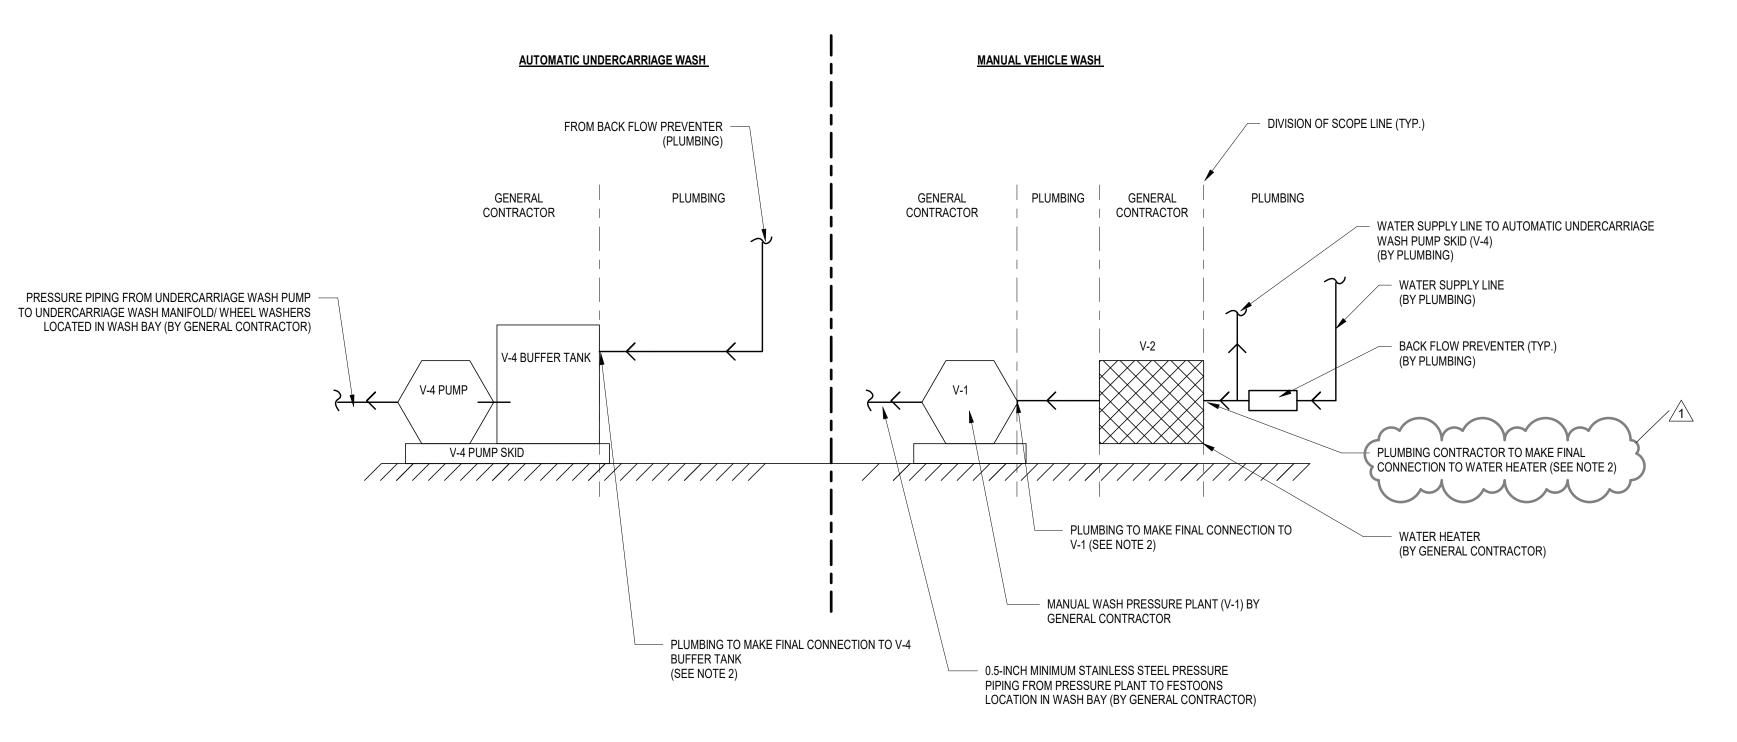
Approved By: Approver

W&S Project No: ENG20-0501

Drawing Title:

DETAILS


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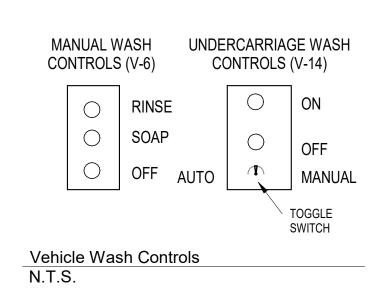



NOTE:

1. THIS DETAIL IS SCHEMATIC ONLY, AND NOT ALL COMPONENTS ARE SHOWN. THE GENERAL CONTRACTOR SHALL PROVIDE ALL VALVES, FITTINGS AND PIPING AS REQUIRED TO PROVIDE A COMPLETE AND OPERABLE SYSTEM 2. PLUMBING CONTRACTOR SHALL MAKE ALL FINAL CONNECTIONS TO PUMPS AND HOT WATER HEATER, COORDINATE FINAL CONNECTION REQUIREMENTS WITH VEHICLE WASH EQUIPMENT INSTALLER.

Vehicle Wash Equipment Room Coordination Schematic




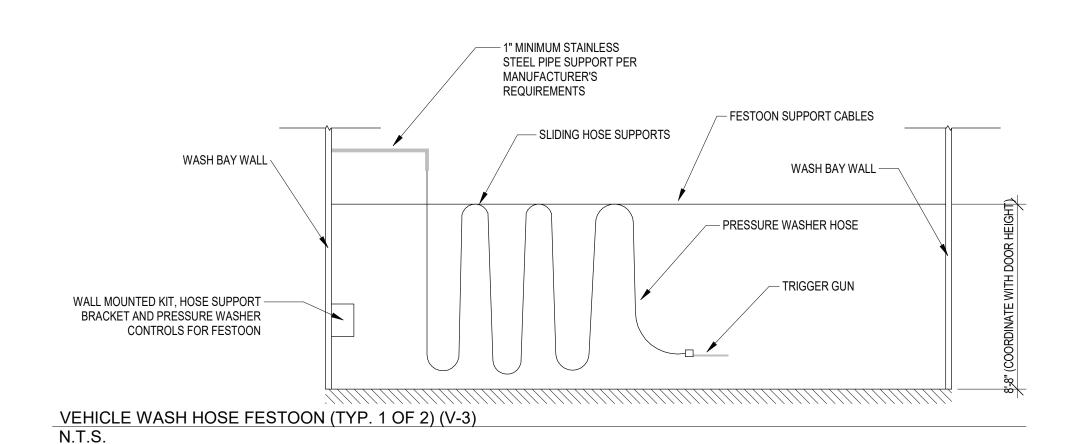

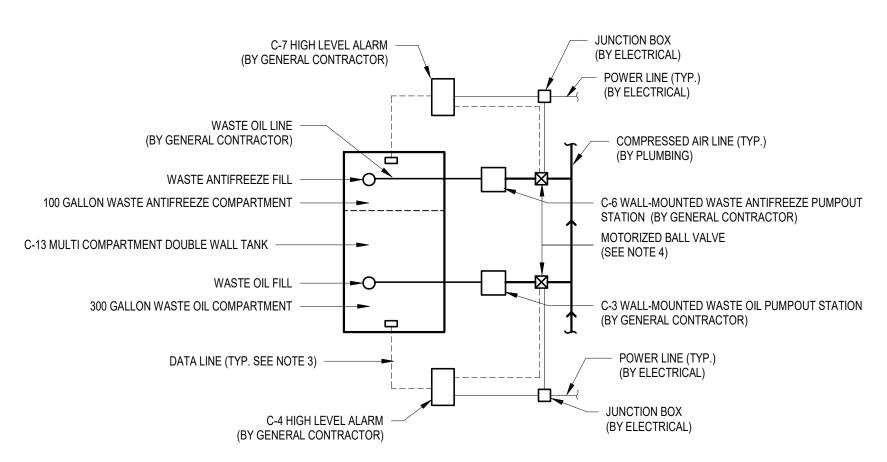


- 1. NOT ALL COMPONENTS OF PUMPING SYSTEM ARE SHOWN. CONTRACTOR SHALL PROVIDE ALL EQUIPMENT/COMPONENTS NECESSARY FOR A COMPLETE AND OPERABLE SYSTEM, PER MANUFACTURER'S REQUIREMENTS.
- 2. HIGH LEVEL ALARM SHALL ACTIVATE THE MOTORIZED BALL VALVE TO SHUT OFF AIR SUPPLY TO PUMPOUT STATION WHEN THE WASTE OIL
- TANK REACHES 90% CAPACITY.
- 3. EMPTY 1" CONDUITS WITH PULL STRING SHALL BE INSTALLED BY THE ELECTRICAL CONTRACTOR. GENERAL CONTRACTOR SHALL PULL
- 4. MOTORIZED BALL VALVE SHALL BE SUPPLIED BY THE GENERAL CONTRACTOR AND SHALL BE INSTALLED BY THE PLUMBING CONTRACTOR. POWER SHALL BE PROVIDED BY THE ELECTRICAL CONTRACTOR.

WASTE OIL TANK SCHEMATIC PIPING ARRANGEMENT (ADD ALTERNATE #5)

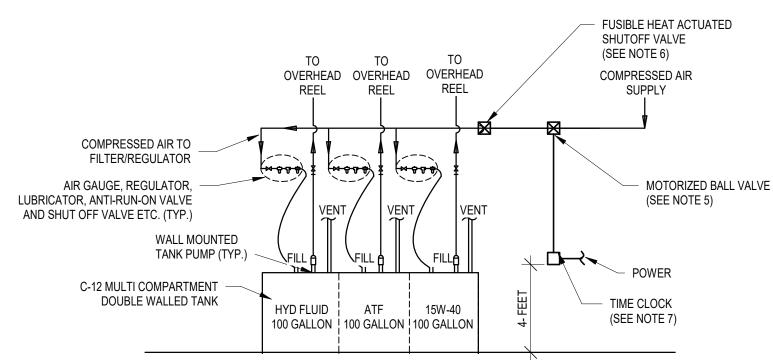

- ACCORDANCE WITH SPECIFICATIONS
- 5. MOTORIZED BALL VALVE SUPPLIED BY GENERAL CONTRACTOR AND INSTALLED BY PLUMBING.
- 6. HEAT ACTUATE SHUTOFF SUPPLIED BY GENERAL CONTRACTOR, INSTALLED BY PLUMBING.
- 7. TIME CLOCK PROVIDED BY GENERAL CONTRACTOR, INSTALLED BY ELECTRICAL. ELECTRICAL TO PROVIDE AN OVERRIDE SWITCH ADJACENT TO TIME CLOCK.
- 8. OWNER SHALL PROVIDE FLUIDS TO FILL LUBE TANKS, TO ALLOW GENERAL CONTRACTOR TO PRESSURIZE AND CALIBRATE SYSTEM.

GENERAL TANK PIPING ARRANGEMENT (ADD ALTERNATE #5)

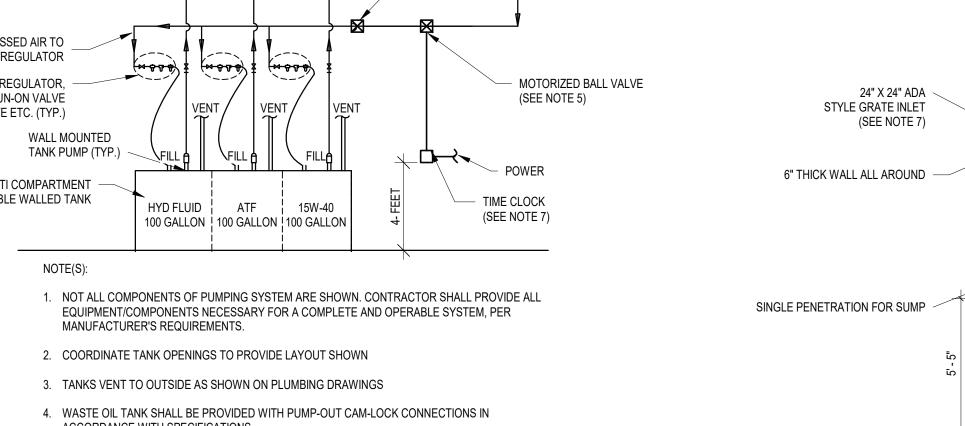

POWER PROVIDED BY ELCTRICAL.

HS-20 WATERTIGHT COVER PROVIDED AND INSTALLED BY THE GENERAL CONTRACTOR (TYP.). EXTEND TO SLAB 4' - 9" 4' - 9" FINISH FLOOR AS NEEDED. (2) 4" TANK VENTS (BY PLUMBING CONTRACTOR) INLET: 6" DRAIN LINE FROM WASH BAY SUMP (BY PLUMBING CONTRACTOR)


10' - 0"

OUTLET

1,500 GALLON H-20 TRAFFIC

GENERAL CONTRACTOR

RATED TANK (WATERTIGHT) BY

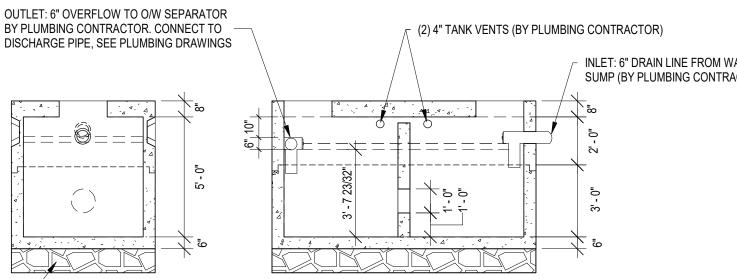


GENERAL NOTE: TANK SHALL BE SUBPPLEID AND INSTALLED BY THE G.C.

DESIGN NOTES: 1. CONCRETE 5,000 PSI @ 28 DAYS 2. HS-20-44 LOADING WITH 12" TO 60" OF COVER 3. REINFORCING ASTM A615 GRADE 60 4. CONST. JOINT TO HAVE MIN. 1" BUTYL SEALANT

VEHICLE WASH PRE-TREATMENT TANK DETAIL (V-9) (BASE BID)


1/4" = 1'-0"

12" OF GRAVEL BORROW-

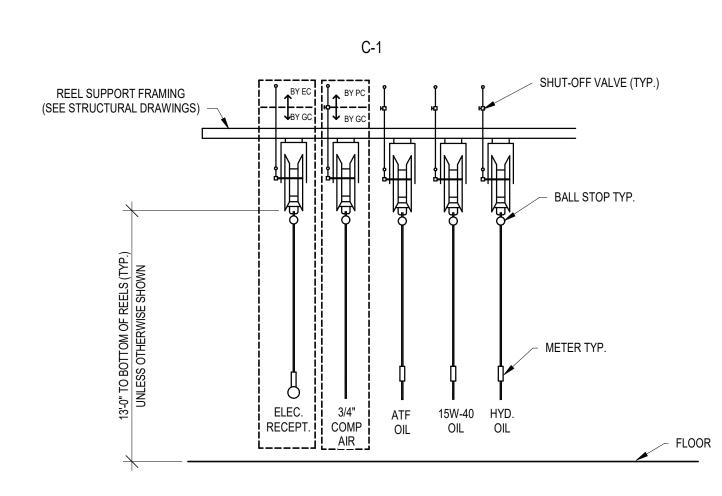

NOTE: CONTRACTOR SHALL PROVIDE SUPPLEMENTAL FRAMING/SUPPORTS AS NEEDED TO CONNECT TO REEL SUPPORT FRAMING

REEL BANK DETAIL (ADD ALTERNATE #5)

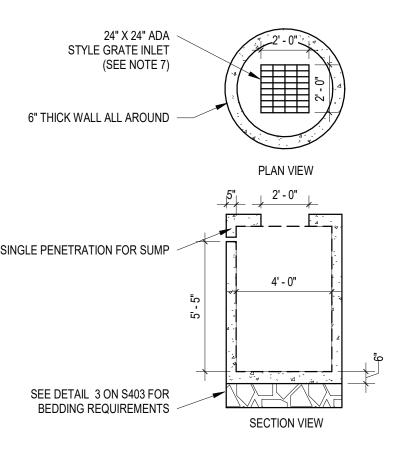

FLUID STORAGE ROOM SUMP NOTES:

- 1. TANK SHALL HAVE A MINIMUM CAPACITY OF 500 GALLONS BELOW THE SUMP SENSOR
- 2. TANK SHALL BE LOCATED BENEATH THE FLUID STORAGE ROOM TO SERVE AS SECONDARY CONTAINMENT FOR THE FLUID STORAGE TANKS, THEREFORE THE TANK SHALL NOT HAVE ANY INLET OR OUTLETS BESIDES THE DRAIN INLET AT THE TOP OF THE TANK AND THE PENETRATION FOR THE SUMP SENSOR CONDUIT WHICH SHALL BE SEALED WATER TIGHT AND LOCATED AS HIGH UP ON THE TANK AS POSSIBLE.
- 3. TANK SHALL BE INSTALLED PER DETAIL SHOWN ON THE STRUCTURAL DRAWINGS.
- 4. CONCRETE SHALL HAVE 4,000 PSI. MINIMUM CEMENT PER ASTM C-478 (6.1)
- 5. REINFORCED STEEL COMFORMS TO LATEST ASTM A 185 SPECIFICATIONS. 0.15 SQ. IN / LINEAL FT. AND 0.15 SQ. IN (BOTH WAYS) BASE BOTTOM STEEL REINFORCEMENT TO MEET OR EXCEED AASHTO HS-20 LOADING.
- 6. TANK SHALL BE SEALED INSIDE AND OUT WITH AQUA-SAFE CONCERTED SEALER AS
- MANUFACTURED BY BAY OIL COMPANY OR APPROVED EQUAL. 7. SEE DETAIL 3 ON SHEET S403 FOR ADDITIONAL FRAME AND GRATE REQUIREMENTS.
- 8. PRE-CAST CONCRETE TANK SHALL BE DESIGNED FOR H-20 WHEEL LOAD RATING AND ANTI-BUOYANCY WITH GROUNDWATER ASSUMED TO BE AT GRADE. PROVIDE ANTI-BUOYANCY CALCULATIONS STAMPED BY A NEW YORK PROFESSIONAL ENGINEER.
- 9. BUTYL RUBBER JOIN T SEALAN T PER ASTM C—990 AASHTO M —198
- 10. ONE POUR MONOLITHIC BASE
- 11. THE FLUID STORAGE ROOM SUMP SHALL BE A 5FT DIAMETER CONCRETE PRECAST CATCH BASIN WITH NO OUTLET PIPE AS MANUFACTURED BY SITUATE RAY PRECAST OR APPROVED EQUAL

FLUID STORAGE ROOM SUMP DETAIL (BASE BID) N.T.S.

MIN. SUMP VOLUME = 500 GALLONS

VILLAGE OF ARDSLEY, NY **NEW PUBLIC WORKS**

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FACILITY

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VILLAGE OF ARDSLEY,

Consultants:






Mechanical/Electrical Engineering Consultants



ARCHITECTURE

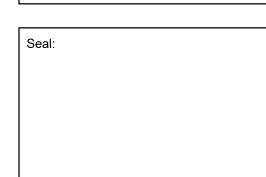

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SCALE: AS NOTED

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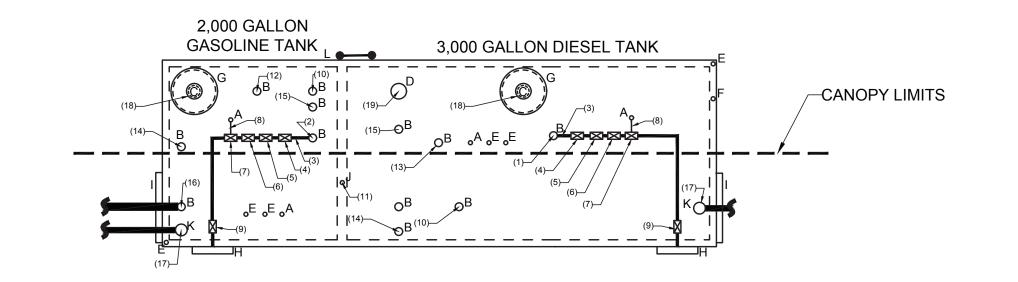
Approved By: JFB


W&S Project No: ENG20-0501

Drawing Title:

DETAILS II

Sheet Number:



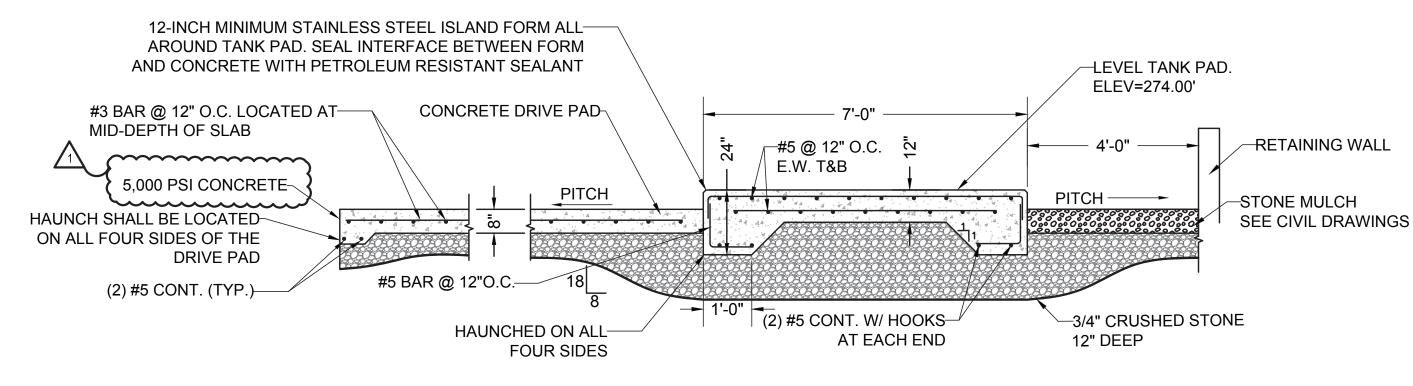

NOTES:

1. CONCRETE PADS SHALL BE 4 500 PSI AND COATED WITH SALT RESISTANT SEALANT AS SPECIFIED. SEE SECTION 03 30 00 - CAST IN PLACE CONCRETE.

CONCRETE FUELING PAD AND TANK PAD

SCALE: N.T.S.

LEGEND:

- A. 2" FEMALE FIREGUARD COUPLING
- B. 4" FEMALE FIREGUARD COUPLING
- C. 8" FFSO 150# FLANGE PRIMARY EMERGENCY VENT USE ONLY
- D. 8" FFSO 150# FLANGE THROUGH OUTER SHELL ONLY. MARK WITH SPECIAL WARNING LABEL "INTERSTITIAL EMERGENCY VENT USE ONLY"
- E. 2" FITTING THROUGH OUTER SHELL ONLY WITH CAST IRON PLUG FOR MFG **USE ONLY**
- F. 2" INTERSTITIAL MONITOR PIPE MALE NPT END
- G. 24" TIGHT BOLT MANWAY WITH "C" MOUNTED IN COVER
- H. WAYNE S1 BRACKET
- PIPING SUPPORT BRACKET
- J. 2" INTERSTITIAL MONITOR PIPE MALE NPT END BULK HEAD MONITOR USE
- K. 6" FEMALE FIREGUARD COUPLING
- L. EXTERNAL TANK LADDER FOR MAINTENANCE ACCESS


NOTES:

- 1. SEE PIPING NOTES ON EQ202 FOR ADDITIONAL INFORMATION/REQUIREMENTS.
- 2. FINAL TANK FITTING LAYOUT AND QUANTITY TO BE ADJUSTED AS NEEDED AND CONFIRMED DURING THE SUBMITTAL PROCESS TO MEET THE DESIGN LAYOUT AND TO MEET MANUFACTURER AND CODE REQUIREMENTS.
- 3. TANK TOP PIPING SUPPORT BRACKETS (NOT SHOWN) SHALL BE INCLUDED TO SUPPORT DISPENSER PIPING AS NEEDED.

PUEL SYSTEM COMPONENT SCHEDULE
SCALE: N.T.S.

SCHEDULE:

- 1. 1.5 HP RED JACKET PUMP
- 2. 3/4 HP RED JACKET PUMP
- 1.5" SCH 40 CARBON STEEL PIPE 4. 1.5" THREADED GATE VALVE
- 5. 1.5" EMERGENCY VALVE (MORRISON BROS. 346DI-0400 AV)
- 6. 1.5" SOLENOID VALVE (MORRISON BROS. 710SS-2150 1V)
- 0.5" EXPANSION RELIEF VALVE (MORRISON BROS. 078DI-0200 AV)
- 0.5" SCH 40 CARBON STEEL PIPE FROM EXP. RELIEF VALVE TO TANK
- 9. 1.5" BALL VALVE (MORRISON BROS. 691 BSS)
- 10. TANK LEVEL PROBE/HIGH LEVEL SENSOR (VEEDER ROOT 846391-399)
- 11. INTERSTITIAL SENSOR (VEEDER ROOT 794390-420)
- 12. 3" CARBON STEEL VENT PIPE WITH PV VENT CAP (HUSKY 005885, PRES.
- 2.5-6" W.C., VAC. 6"-10" W.C. AND 005041 ADAPTER) 13. 3" CARBON STEEL VENT PIPE WITH ATMOSPHERIC VENT CAP (OPW 23-0055)
- 14. CLOCK GAUGE (MORRISON BROS. 818-0400AGEVR)
- 15. GAUGE STICK PORT WITH CAP (MORRISON BROS. 305GSP2000AKEVR)
- 16. VAPOR RECOVERY ADAPTOR AND CAP 17. PRODUCT FILL
- 18. PRIMARY EMERGENCY VENT (MORRISON BROS. 2440F-0200AEVR)
- 19. SECONDARY EMERGENCY VENT (MORRISON BROS. 2440F-0100AEVR)

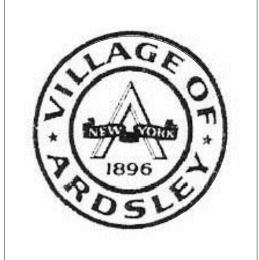

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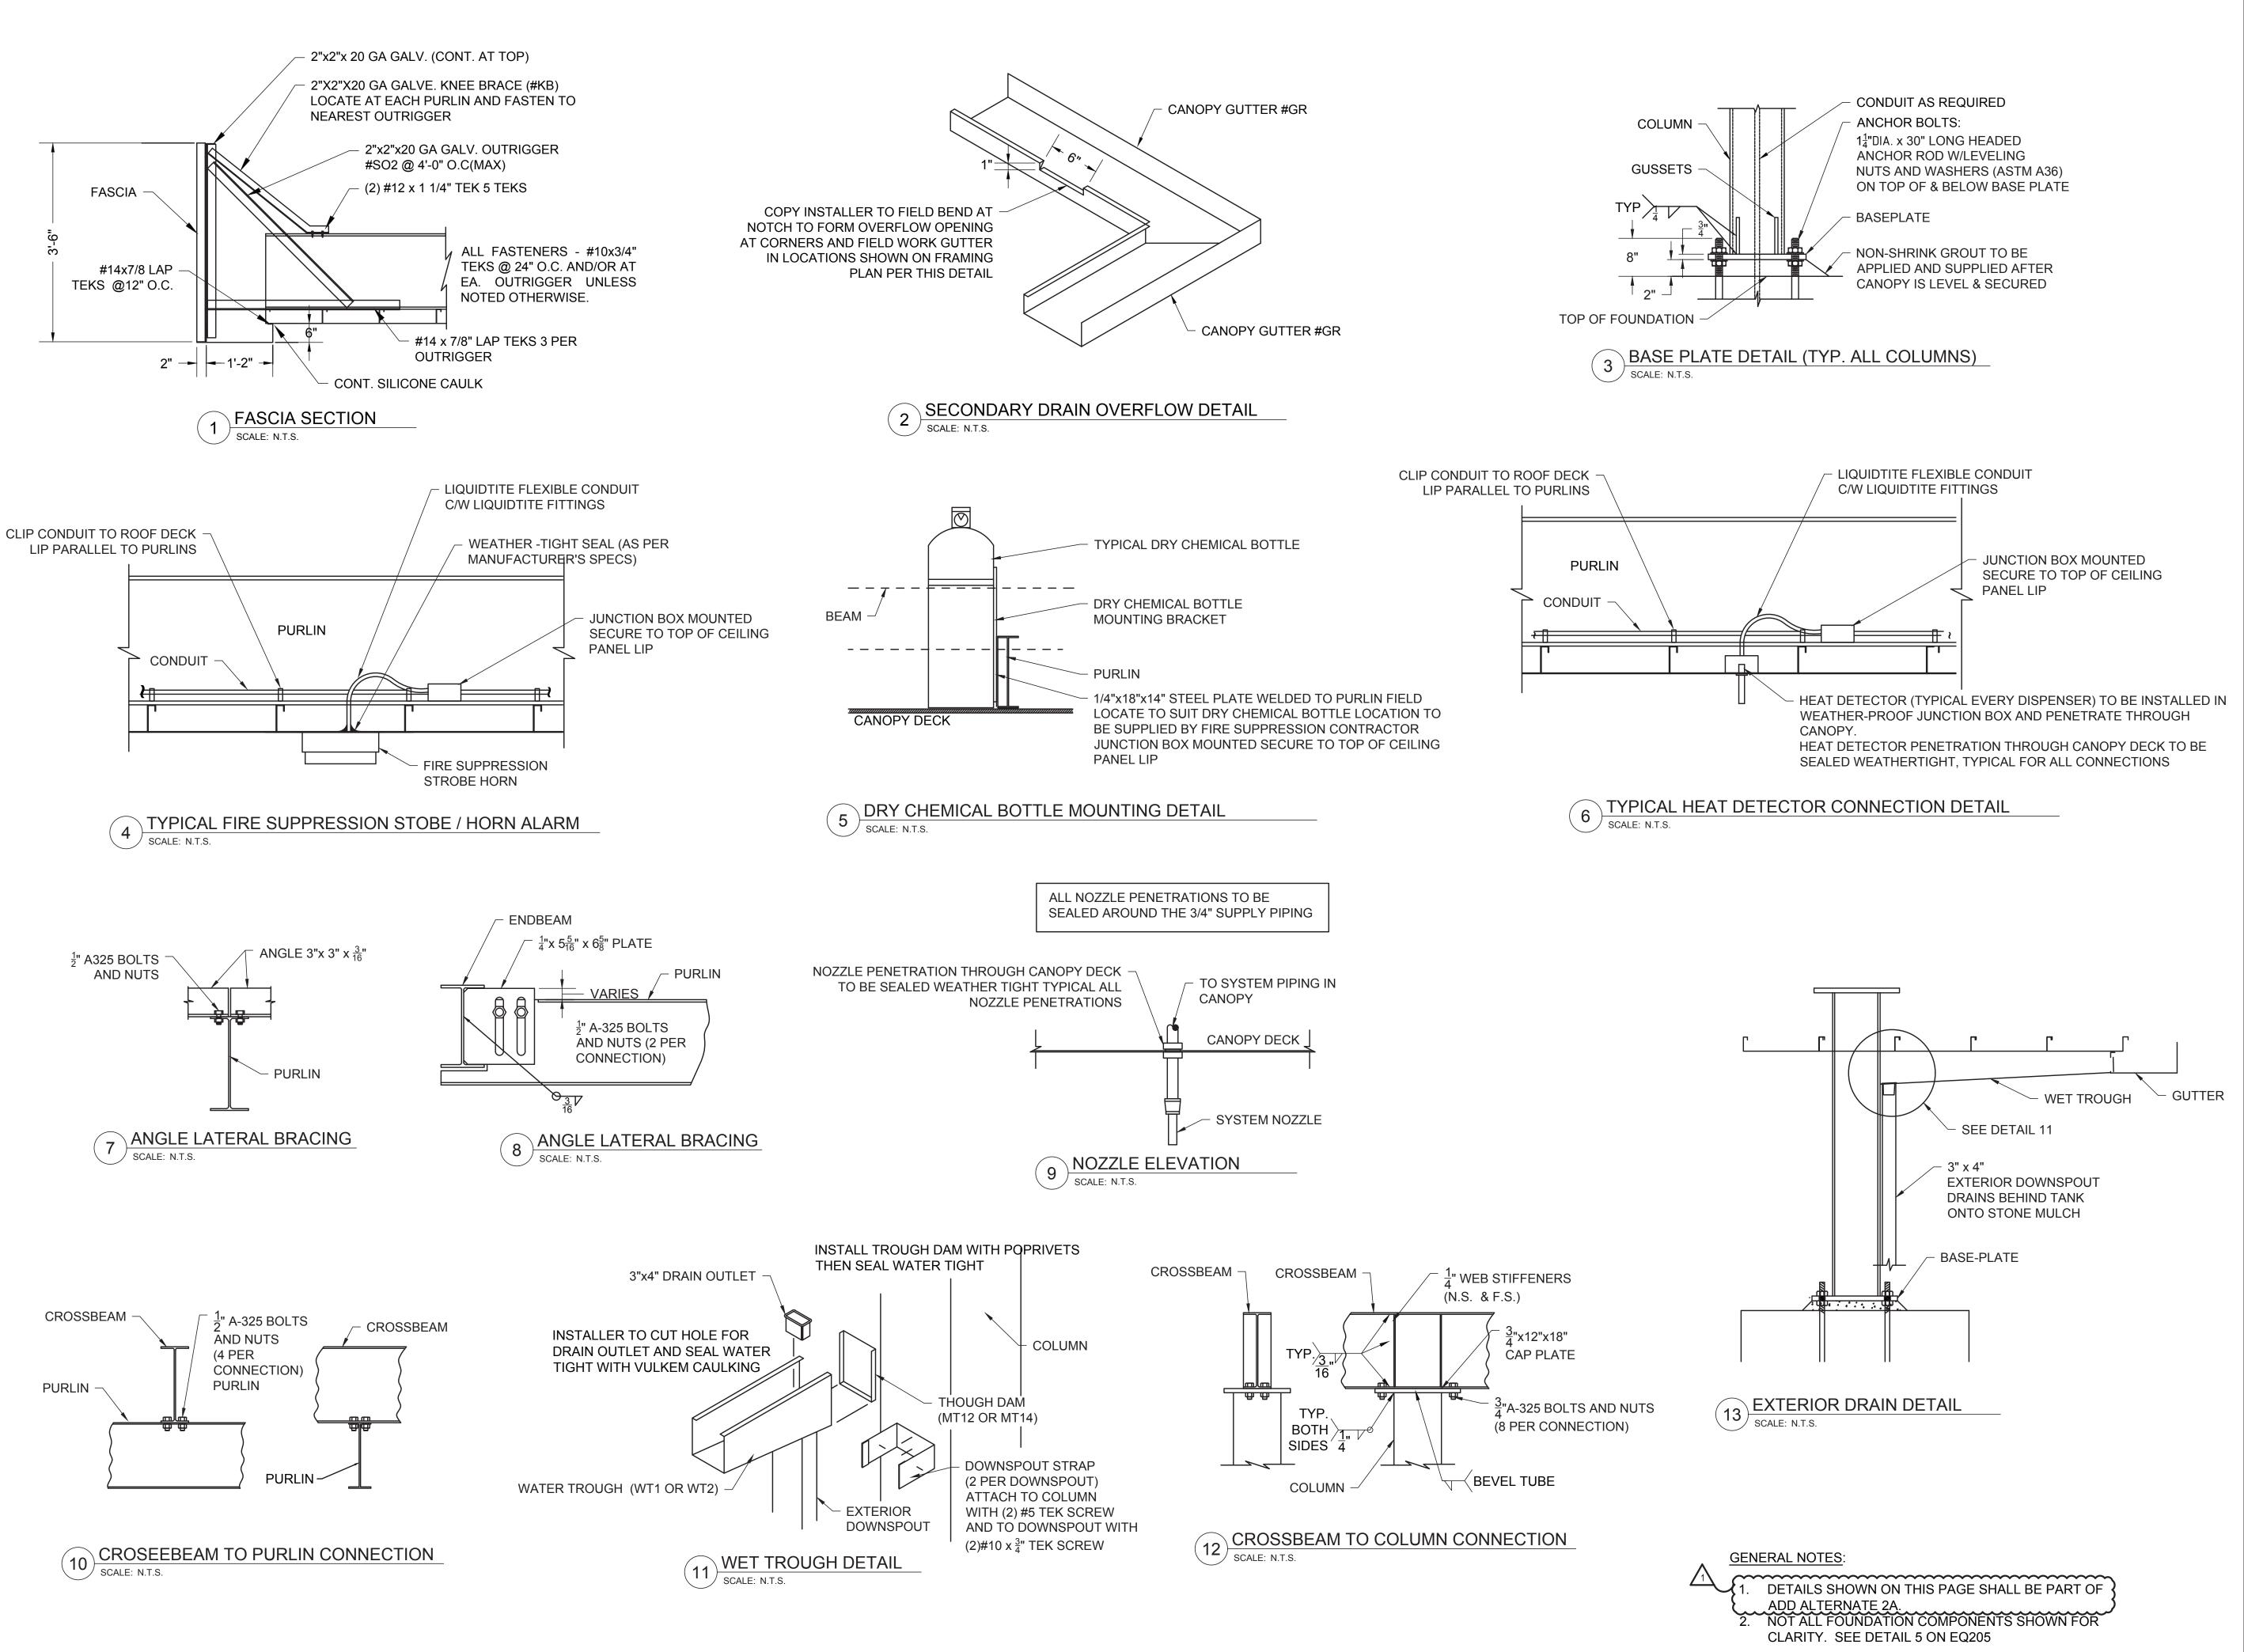
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FUEL SYSTEM DETAILS II

BID ALTERNATE 2

Sheet Number:

EQ203



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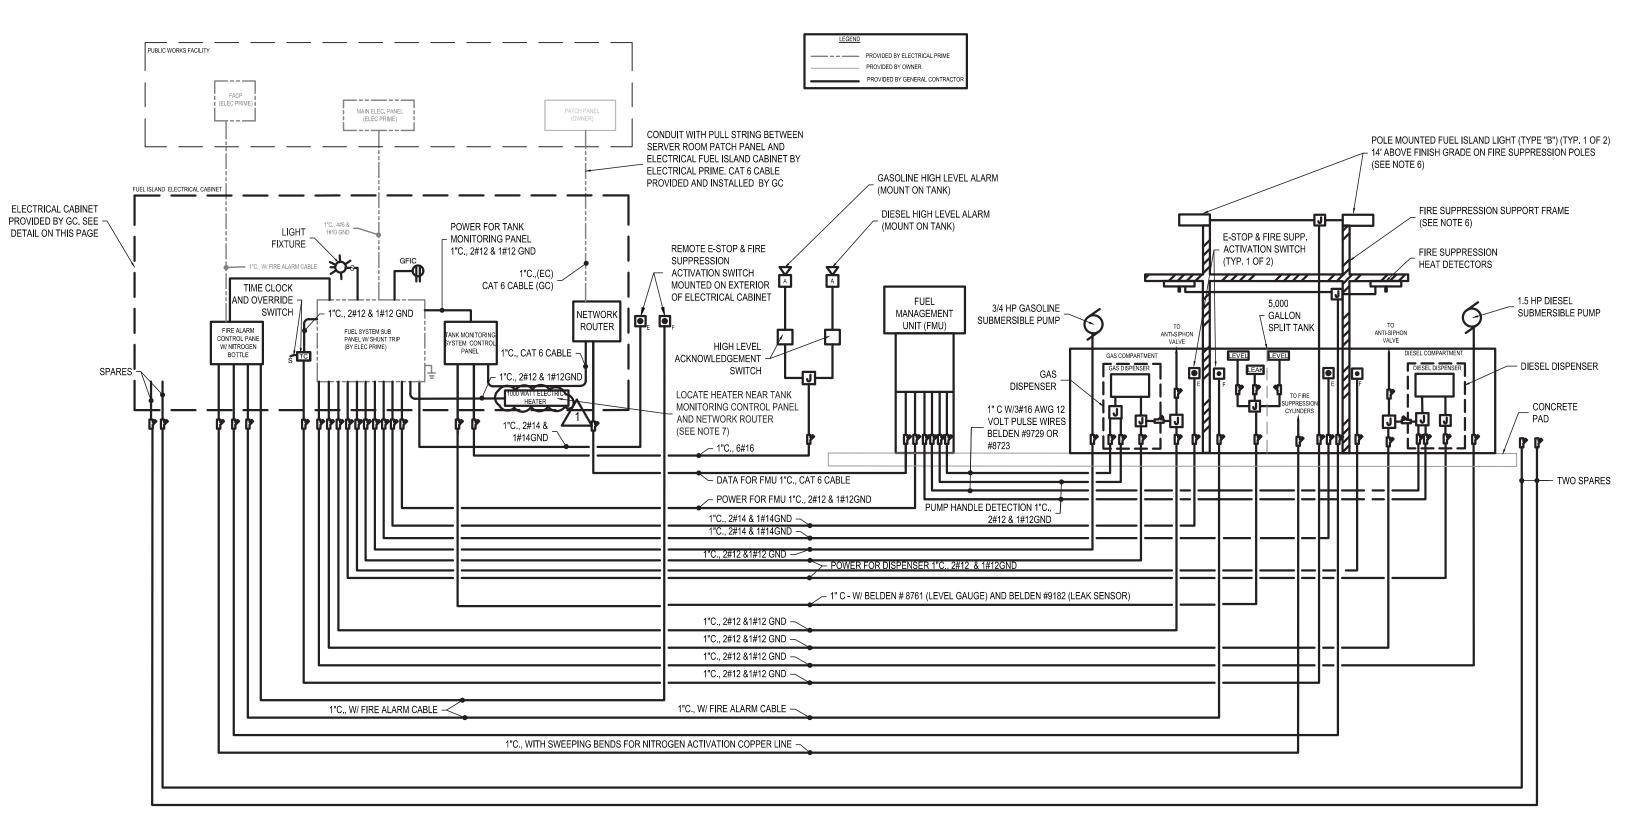
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CANOPY DETAILS I ADD ALTERNATE 2A

Sheet Number:

EQ204




FUEL ISLAND ONE LINE DETAIL (ADD ALTERNATE 2) SCALE: N.T.S.

- 1. GENERAL CONTRACTOR SHALL PROVIDE ALL EQUIPMENT CONDUITS, SEALS, AND WIRING DOWN STREAM OF THE FUEL ISLAND ELECTRICAL SUB-PANEL. SUB PANEL SHALL BE PROVIDED BY THE ELECTRICAL PRIME.
- 2. THIS DETAIL IS A SCHEMATIC AND SHOWS THE GENERAL LAYOUT OF THE FUEL SYSTEM CONDUITS ONLY. THE CONTRACTOR SHALL PROVIDE ALL EQUIPMENT, MATERIALS, LABOR, ETC. INCLUDING CONDUIT, SEALS, JUNCTION BOXES, E-STOPS, WIRING, AND ALL OTHER APPURTENANCES AS NEEDED IN ORDER TO PROVIDE A COMPLETE AND OPERABLE SYSTEM.
- 3. ALL ABOVE GRADE CONDUITS SHALL BE 1" GALVANIZED RIGID STEEL W/ 3#12 & 1#12 GND THHN / THWN STRANDED CONDUCTORS UNLESS OTHERWISE NOTED. ALL BELOW GRADE CONDUITS SHALL BE 1" SCHEDULE 80 PVC W/ 3#12 & 1#12 GND THHN / THWN STRANDED CONDUCTORS UNLESS SPECIFIED OTHERWISE.
- 4. CONTRACTOR SHALL CONFIRM EXACT CONDUIT, WIRING AND EQUIPMENT REQUIREMENTS WITH SPECIFIC EQUIPMENT MANUFACTURER'S REQUIREMENTS PRIOR TO
- INSTALLATION. 5. ALL EMERGENCY SHUTOFFS AND DISCONNECTS WITHIN 20' OF THE FUEL DISPENSING EQUIPMENT SHALL BE INTRINSICALLY SAFE.
- 6. IF ADD ALTERNATE 2A (FUEL ISLAND CANOPY) IS SELECTED, THE FIRE SUPPRESSION SUPPORT FRAME SHALL NOT BE INSTALLED AND THE FOLLOWING SHALL BE INSTEAD
- MOUNTED IN THE CANOPY: 6.1. FUEL ISLAND LIGHTS (SEE LIGHTING FIXTURE SCHEDULE NOTES BELOW)
- 6.2. FIRE SUPPRESSION HEAT DETECTORS 6.3. FIRE SUPPRESSION CYLINDERS
- 6.4. SECURITY CAMERAS (PROVIDED BY OWNER)
- THE ELECTRIC HEATER SHALL BE 1000 WATTS AND SHALL HELP MAINTAIN A STABLE ENCLOSURE TEMPERATURE DURING THE WINTER MONTH. THE HEATER SHALL HAVE THE
- FOLLOWING MINIMUM REQUIREMENTS: 7.1. STEEL HOUSING 7.2. BUILT IN THERMOSTAT (RANGE 40 F TO 100 F)
- 7.3. UNIT SHALL BE AS MANUFACTURED BY ELECTRIC KING PART NUMBER U12100 OR APPROVED EQUAL.
- 8. THE NETWORK ROUTER SHALL HAVE A MINIMUM OF 4 LAN CONNECTION PORTS. ROUTER SHALL BE AS MANUFACTURED BY D-LINK MODEL DI-604, OR APPROVED EQUAL.

	FUEL ISLAND LIGHT FIXTURE SCHEDULE								
TYPE	TYPE	MANUFACTURER	CATALOG NUMBER	MOUNTING	REMARKS				
	RECESSED CANOPY LED AREA LIGHT (ADD ALTERNATE 2A)	CREE	#CAN-304-PS-RS-04-E-UL-WH-700	RECESS CANOPY	TIME CLOCK CONTROLLED				
В	POLE MOUNTED LED AREA LIGHT (ADD ALTERNATE 2)	CREE	#QSQ-HO-A-NM-4ME- 40L-40K-UL-BK-R	POLE MOUNTED	TIME CLOCK CONTROLLED				

LIGHTS. THE SIX (6) LIGHTS SHALL BE EVENLY SPACED IN THE DECKING OF THE CANOPY. 2. IF BID ALTERNATE 2A IS NOT SELECTED THE CONTRACTOR SHALL FURNISH TWO (2) TYPE "B" POLE MOUNTED LED AREA LIGHTS. THE TWO POLE MOUNTED LIGHTS SHALL BE SUPPORTED ON THE FIRE SUPPRESSION SUPPORT POLES AS INDICATED IN THE ONE LINE DETAIL, SHOWN ABOVE ON THIS SHEET.


1. IF BID ALTERNATE 2A IS SELECTED THE CONTRACTOR SHALL FURNISH SIX (6) TYPE "A" RECESSED CANOPY LED AREA

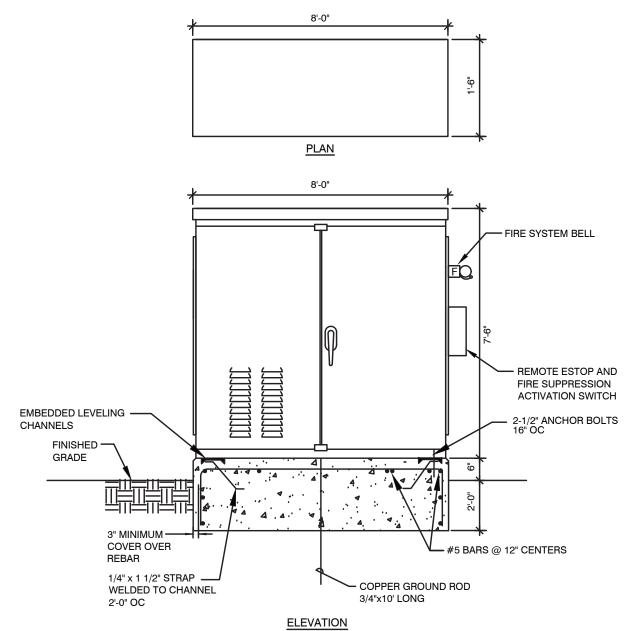

PAD MOUNTED ELECRICAL CABINET DETAIL

- 1. CONTRACTOR SHALL COORDINATE WITH THE EXACT CABINET SIZE WITH ALL MANUFACTURER EQUIPMENT SIZES PRIOR TO SUBMITTING THE CABINET FOR APPROVAL. PROVIDE A SCALED DRAWING SHOWING ALL EQUIPMENT.
- 2. FUEL ISLAND ELECTRICAL CABINET SHALL BE STAINLESS STEEL NEMA 3R RATED CABINET WITH THE FOLLOWING
- MINIMUM REQUIREMENTS: 2.1. SLOPED ROOF AND OPEN BOTTOM
- 2.2. CONTINUOUS STAINLESS STEEL HINGES
- 2.3. FILTERED LOUVERS IN LEFT HAND DOOR 2.4. STAINLESS STEEL 3-POINT PAD LOCKABLE HANDLE
- 2.5. TWO STEEL BACK PANELS PAINTED WHITE FOR MOUNTING DEVICES IN CABINET

3. CONTRACTOR SHALL INSTALL 1-INCH HARD BOARD INSULATION ALONG THE SIDE WALLS, ROOF AND DOORS USING CONSTRUCTION ADHESIVE. WHEN INSTALLING INSULATION ON DOORS, CUT AND SHAPE INSULATION BOARD AS NEEDED TO AVOID THE DOOR LOCKING HARDWARE AND LOUVER IN LEFT HAND DOOR.

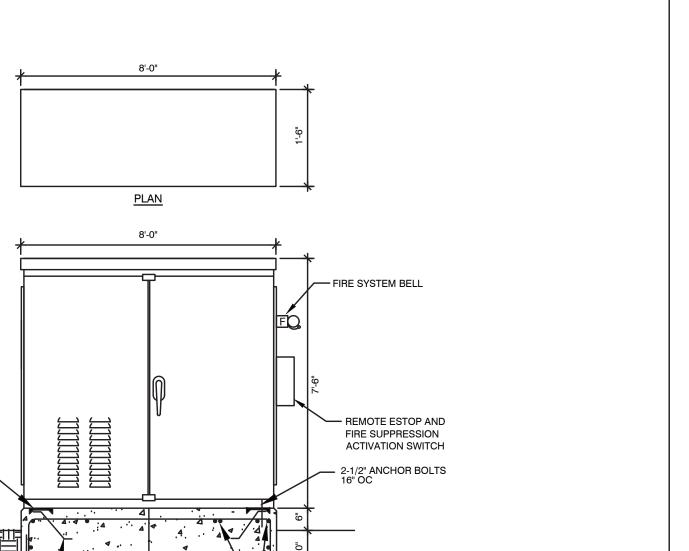



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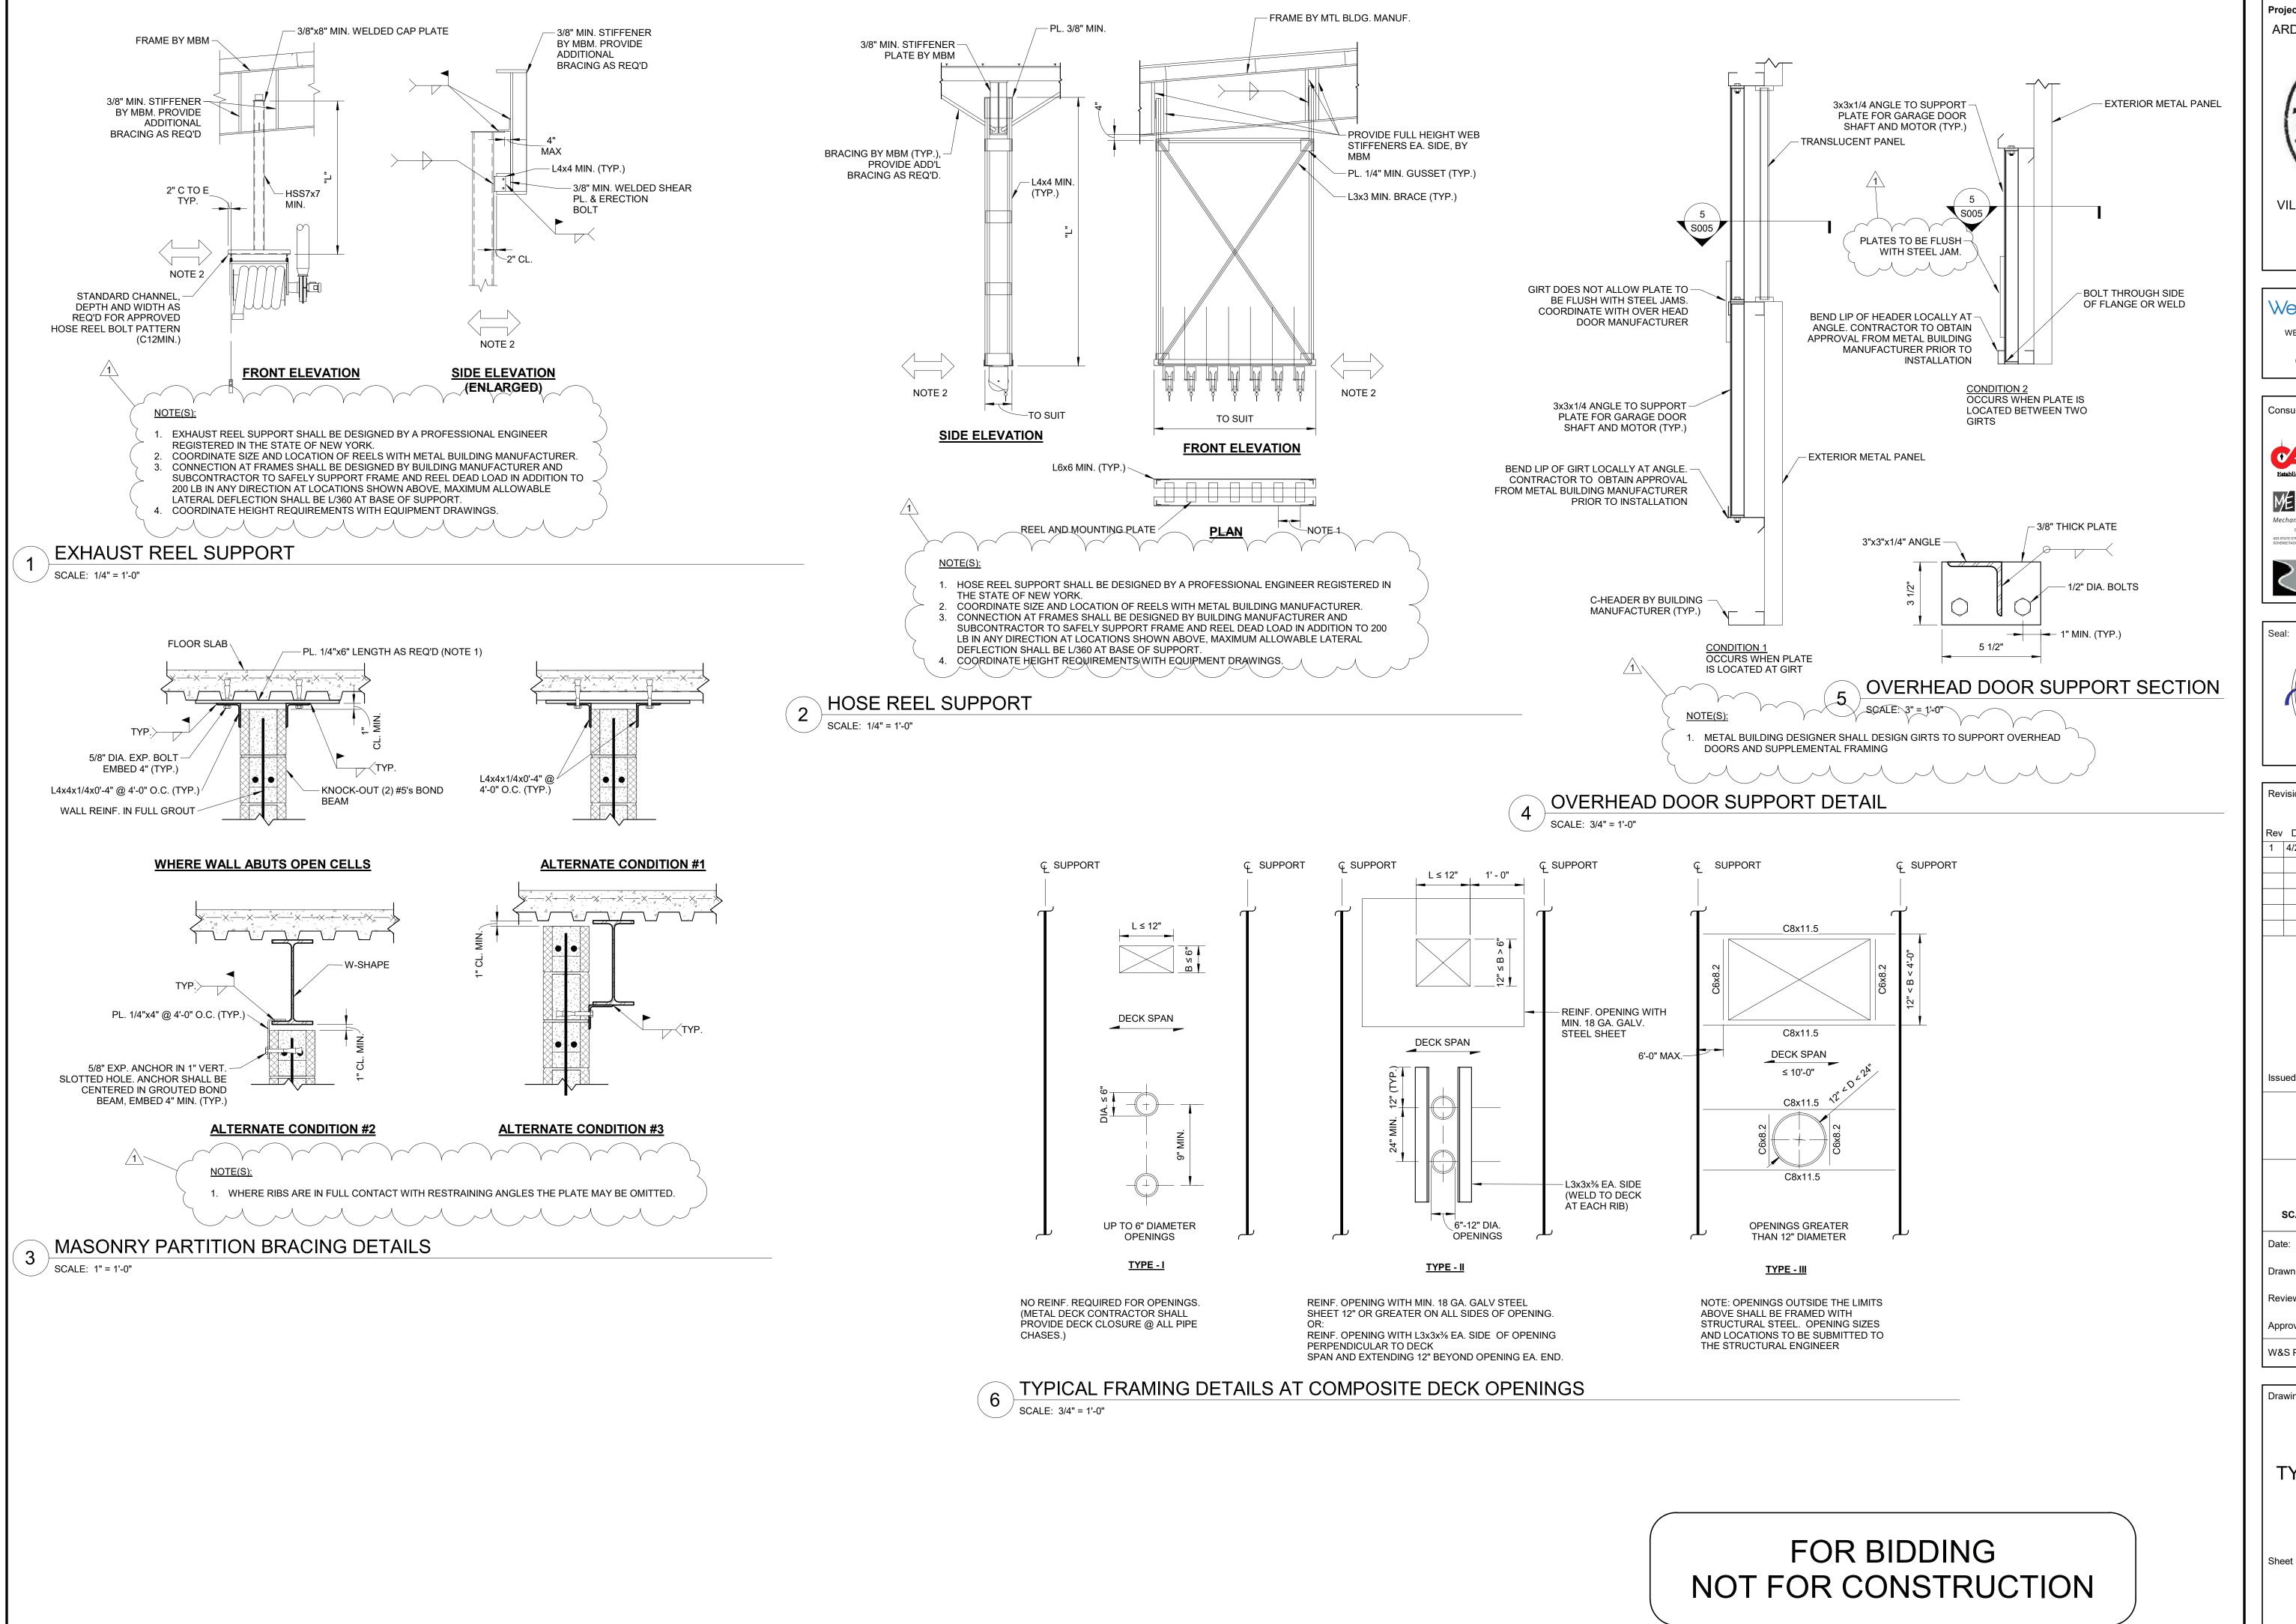
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FUEL ISLAND ONE-LINE DIAGRAM

ADD ALTERNATE 2

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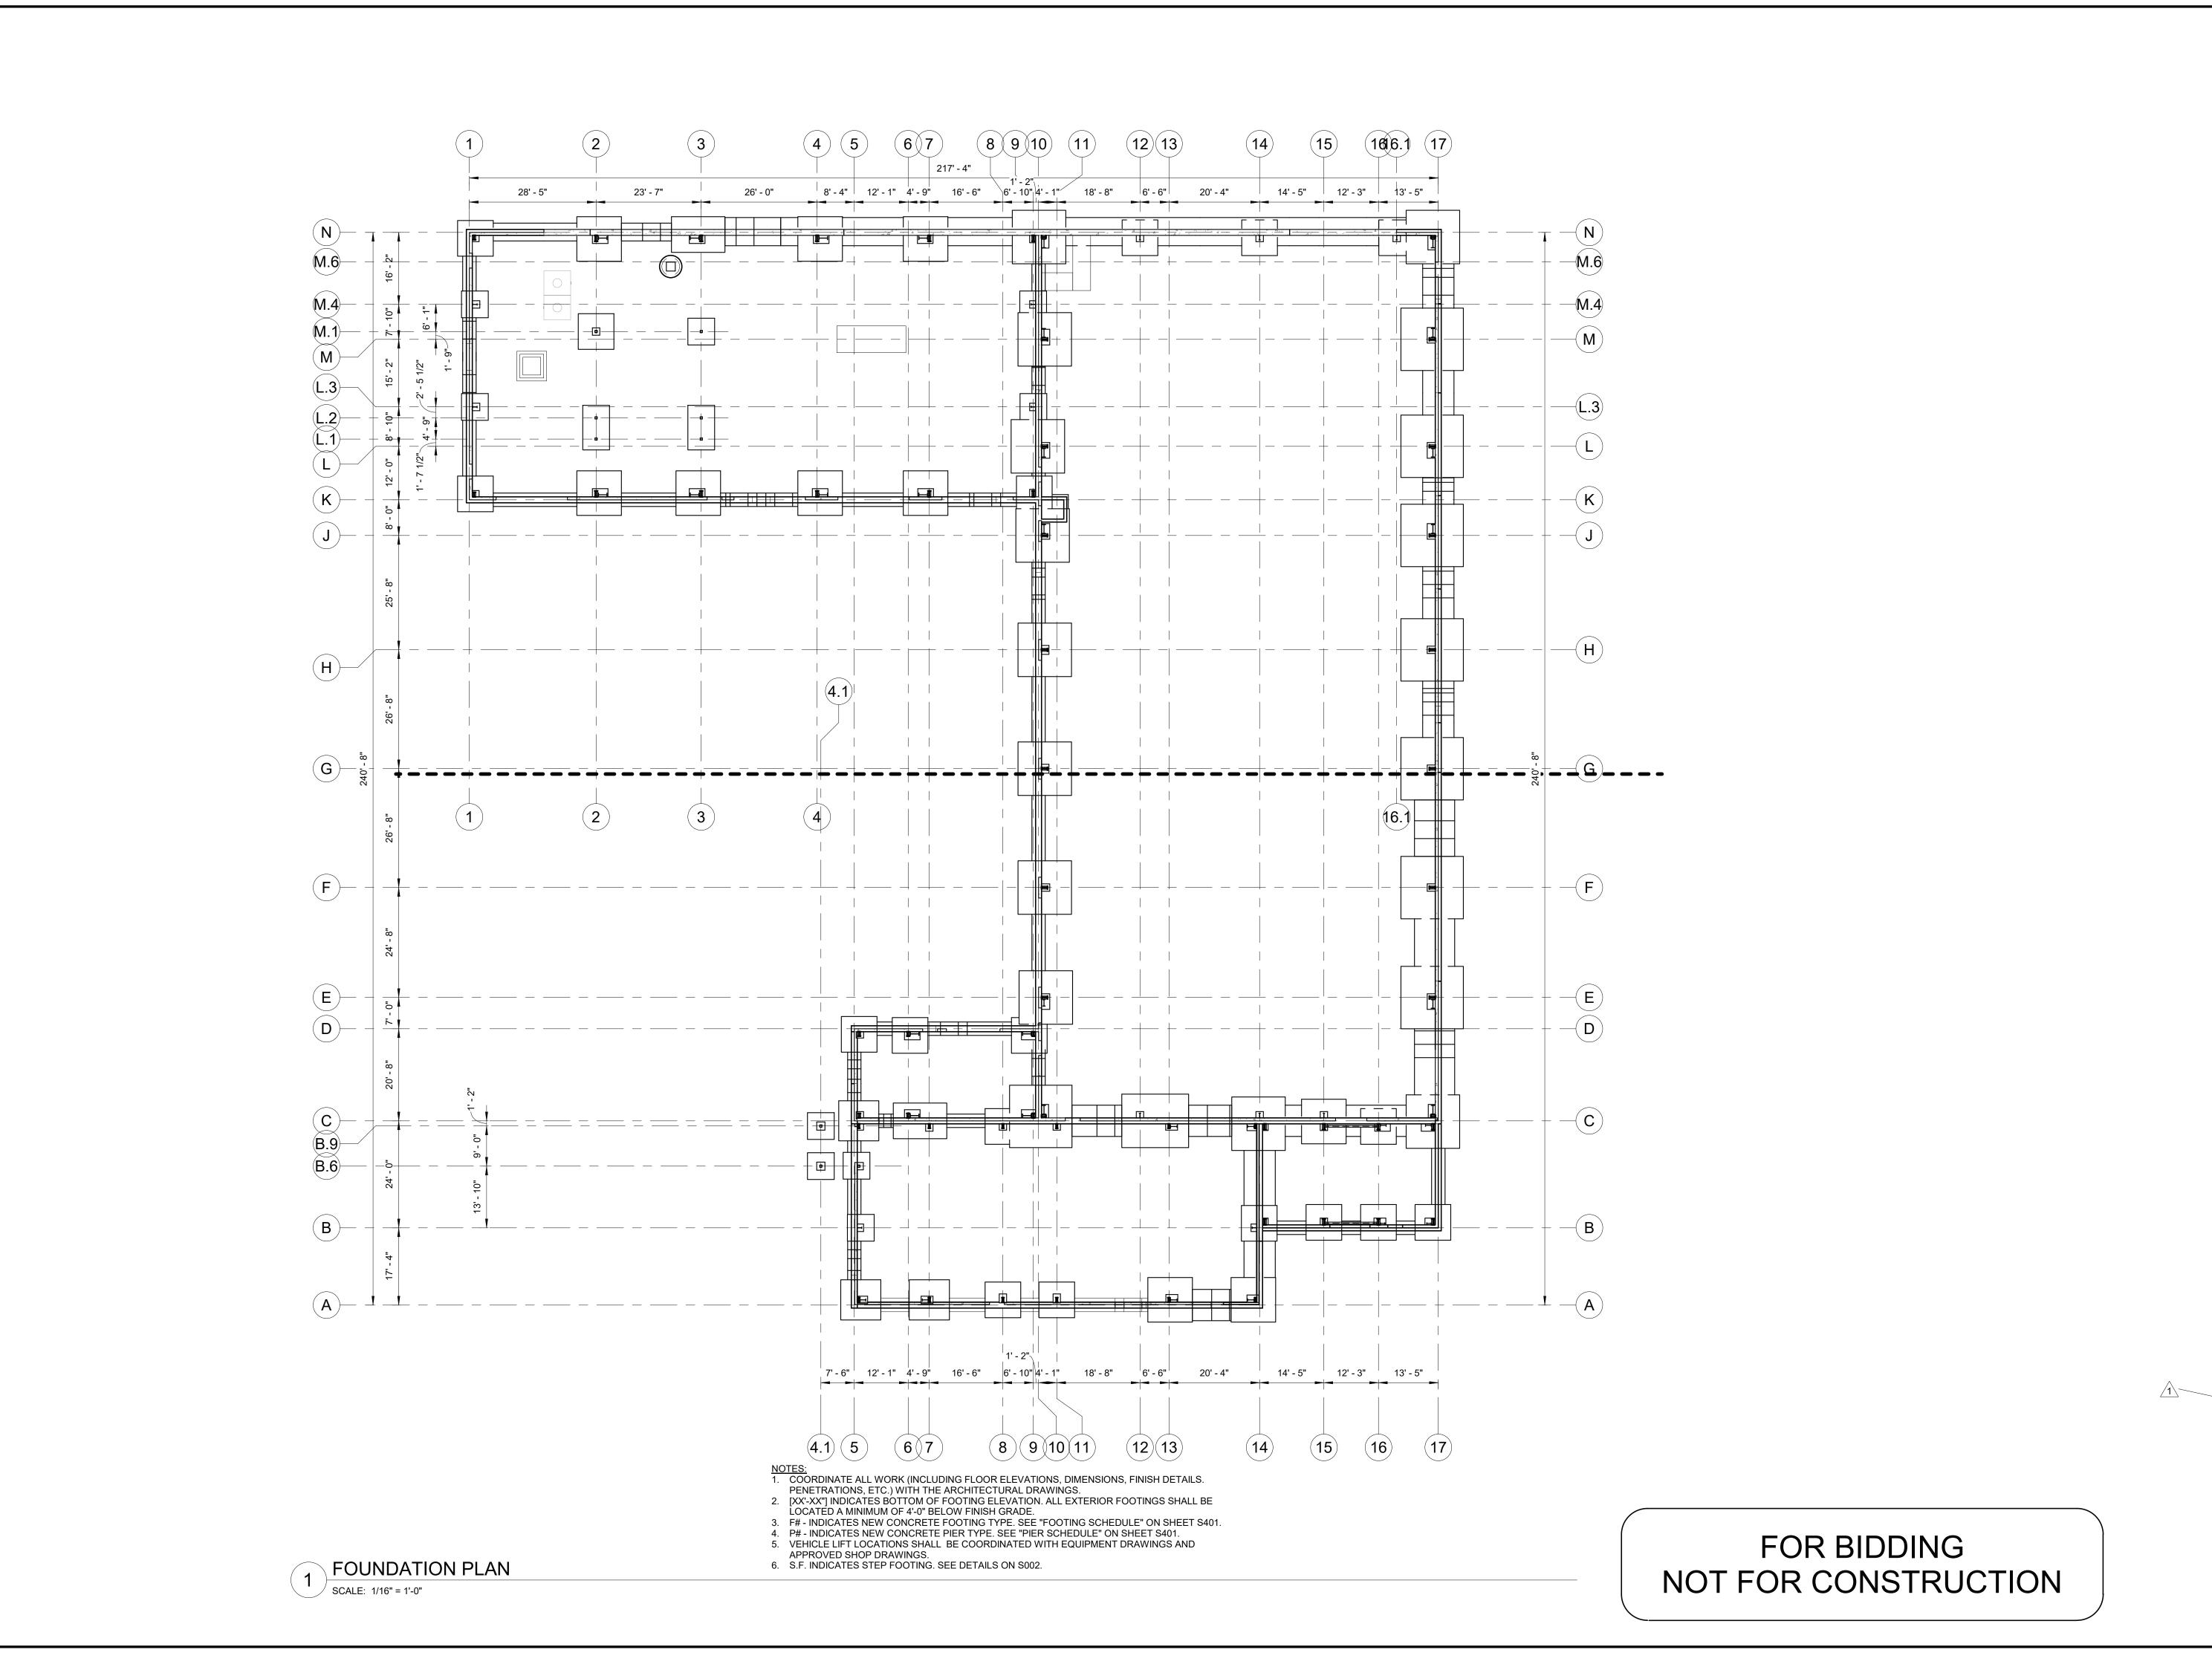
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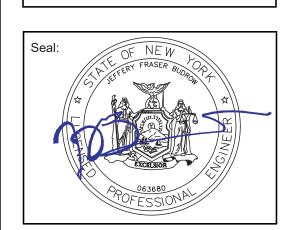
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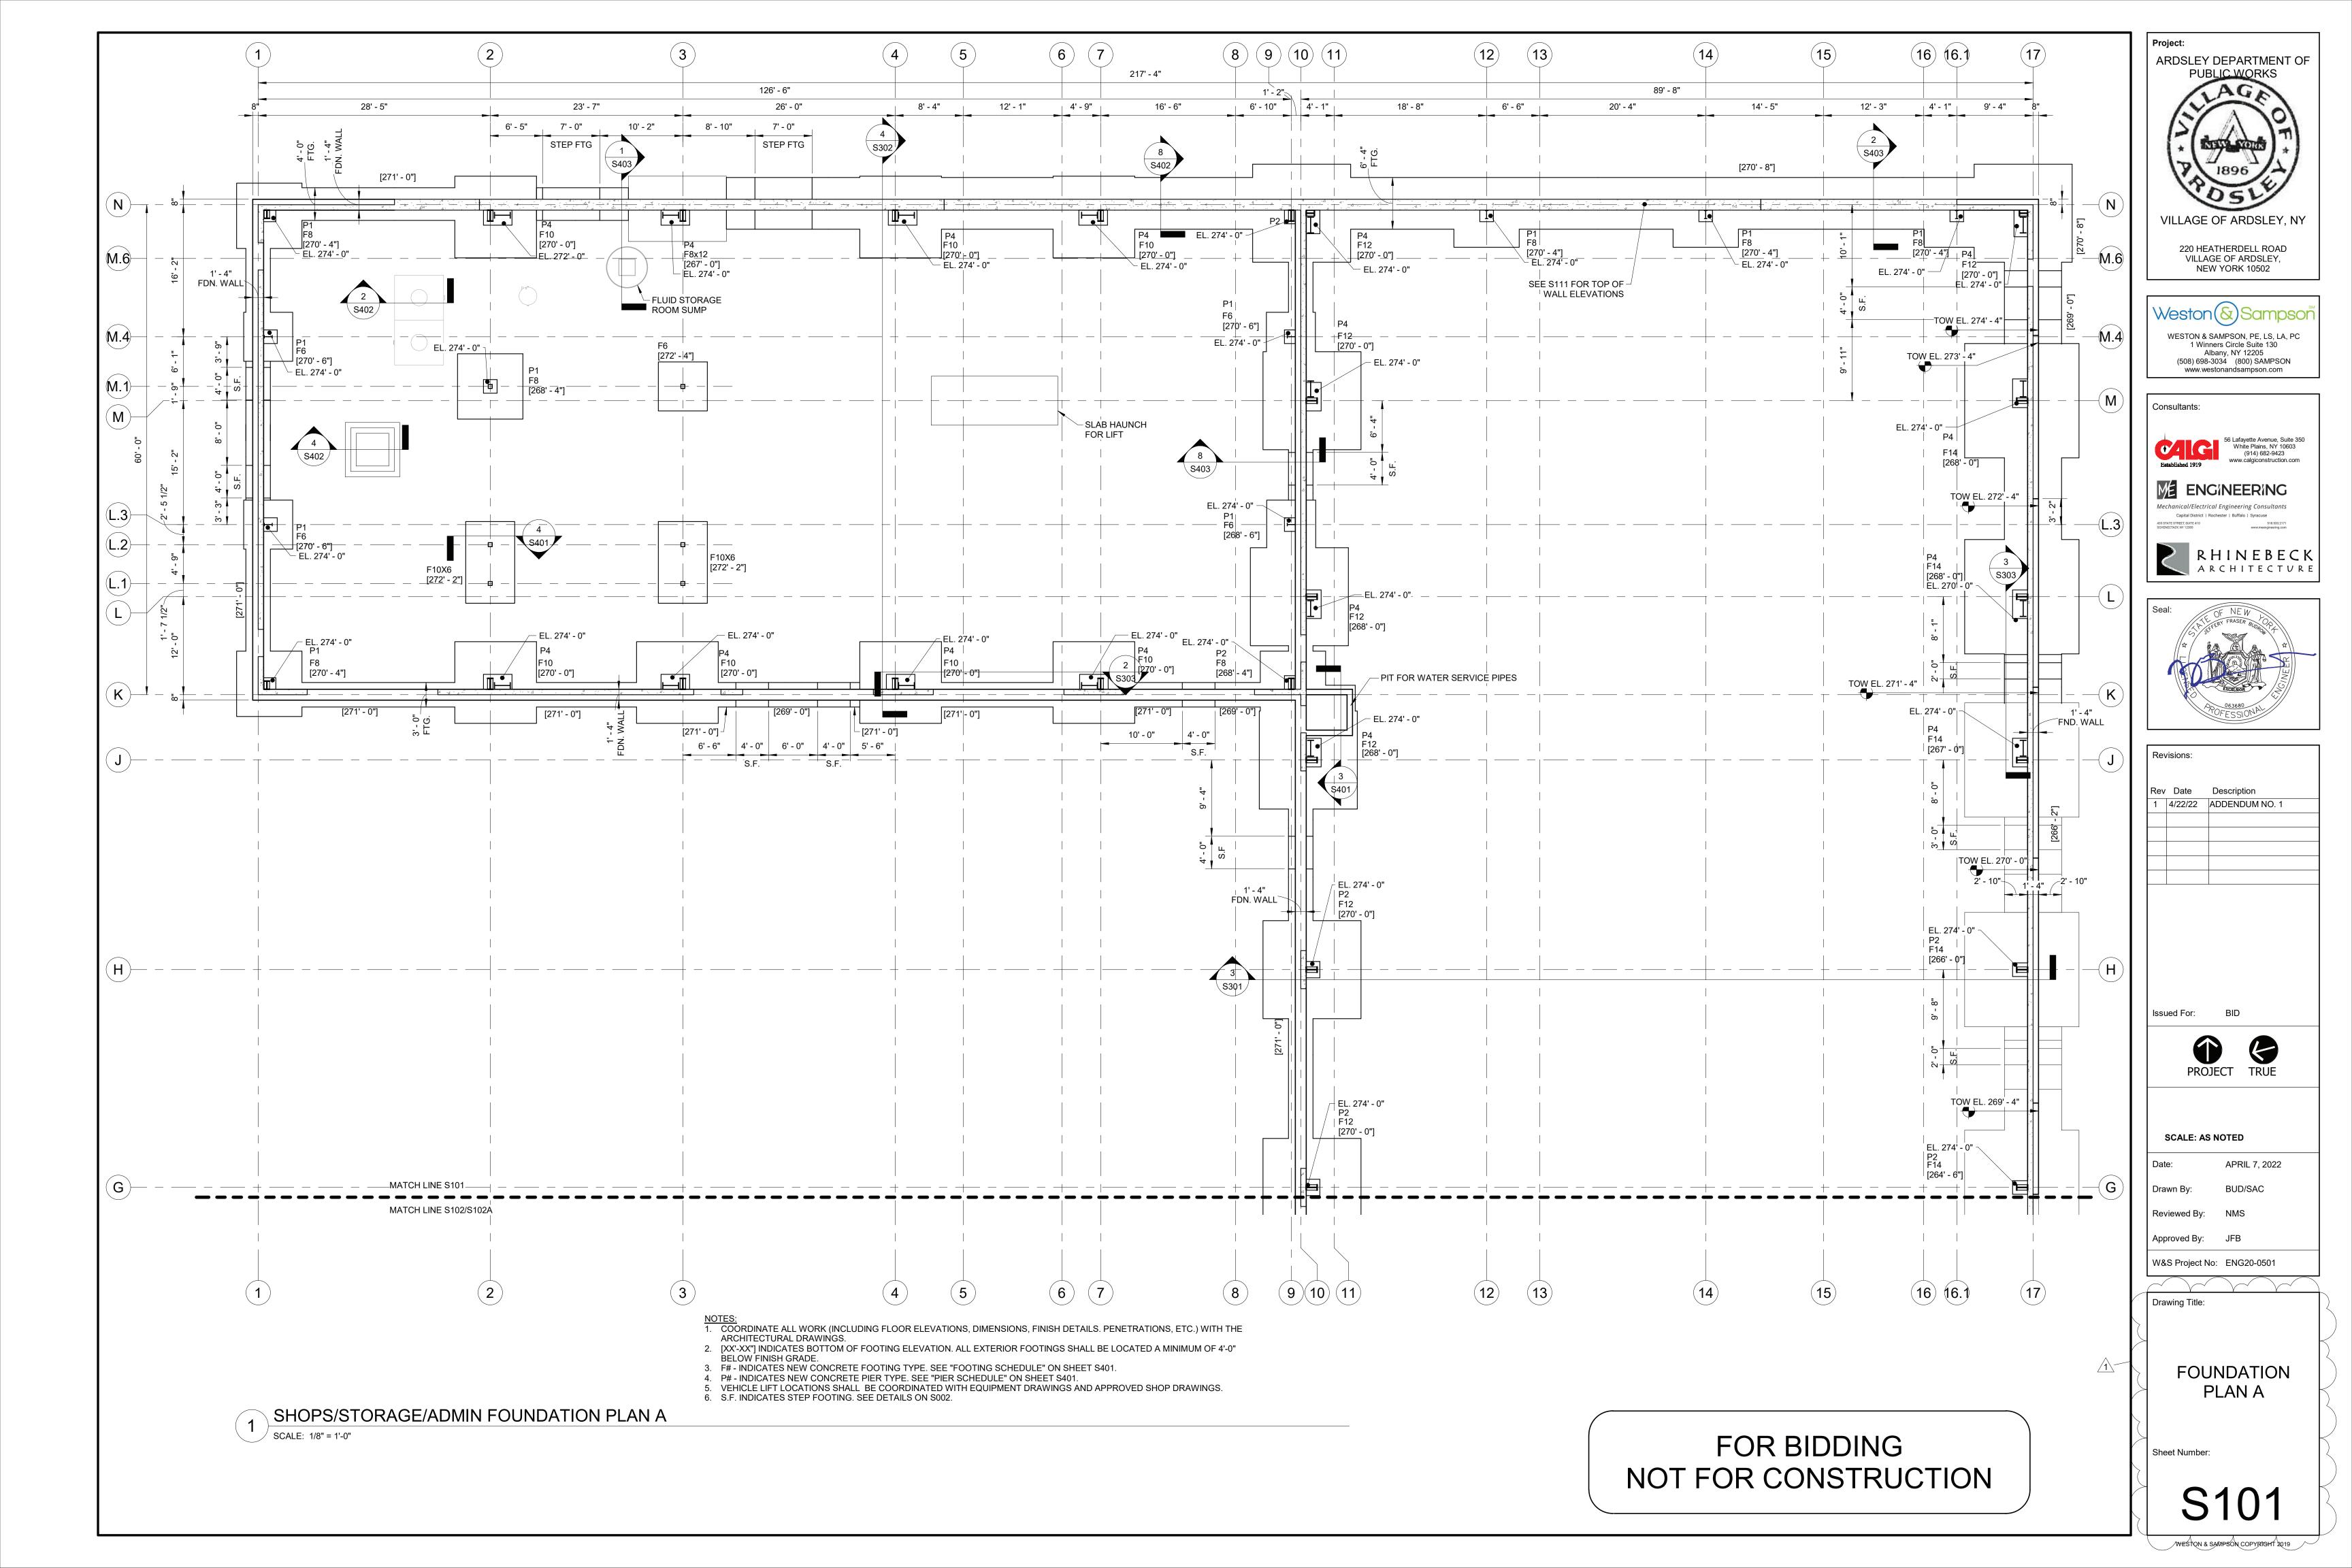
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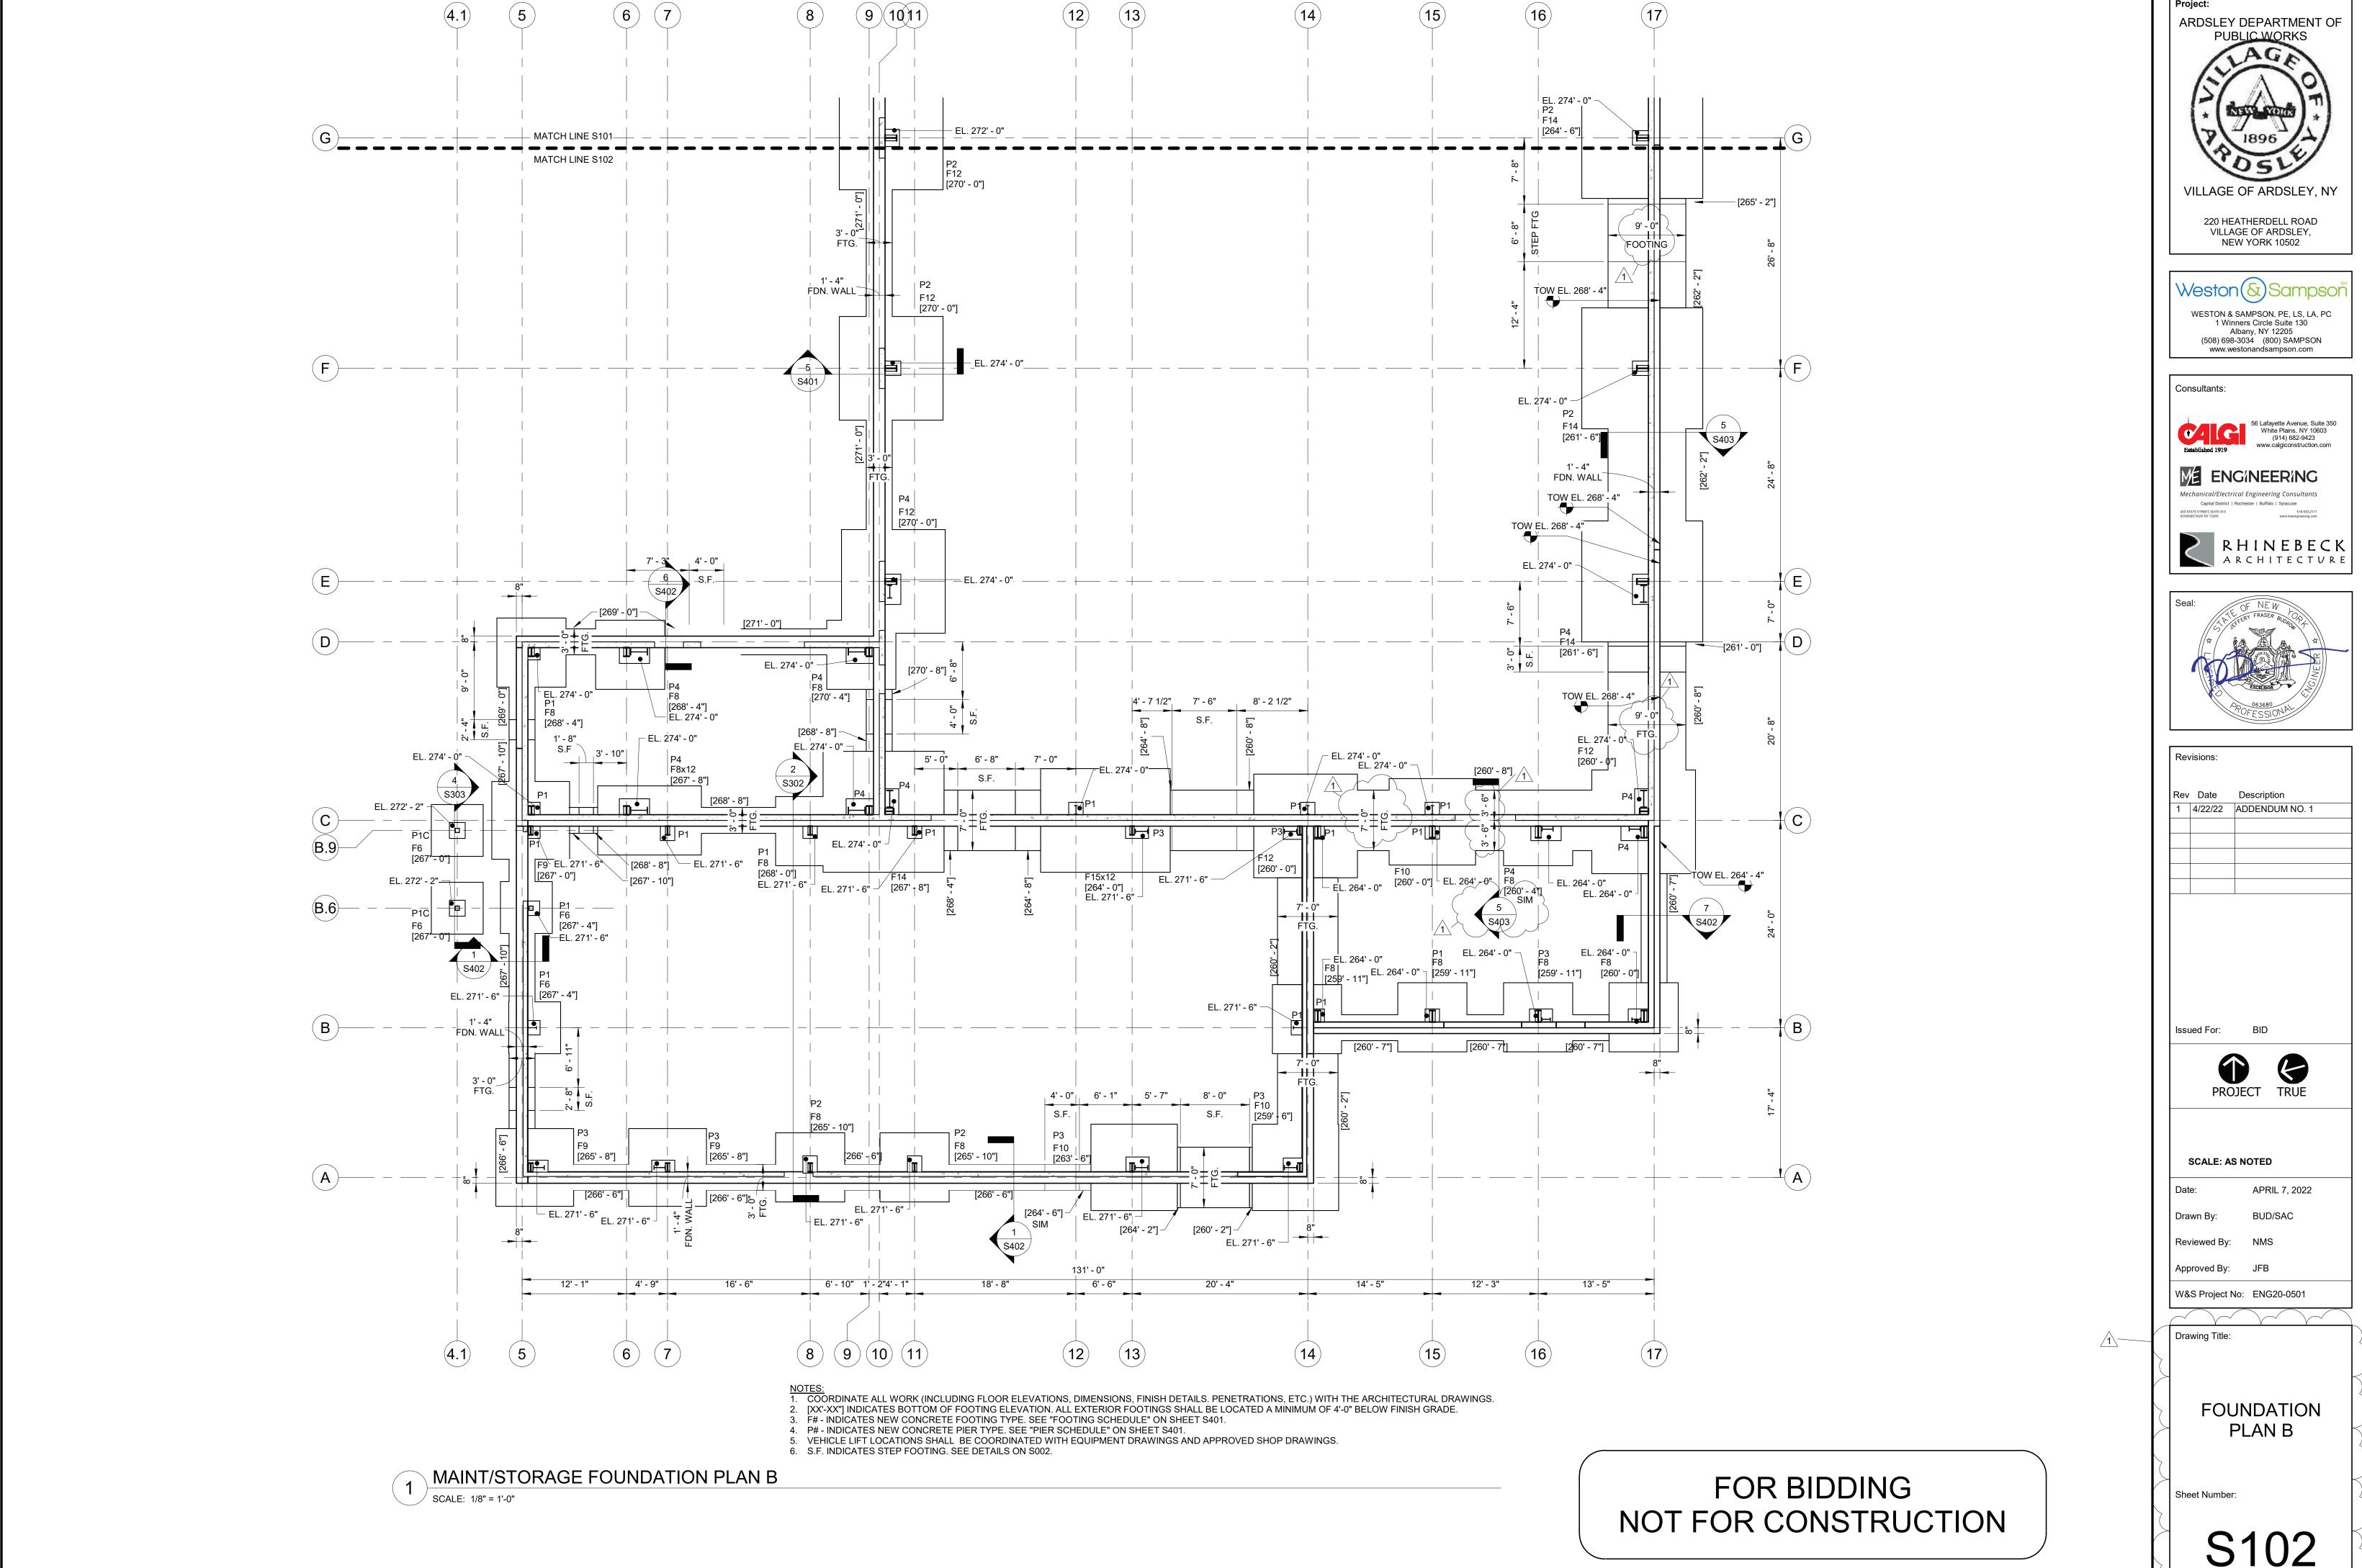
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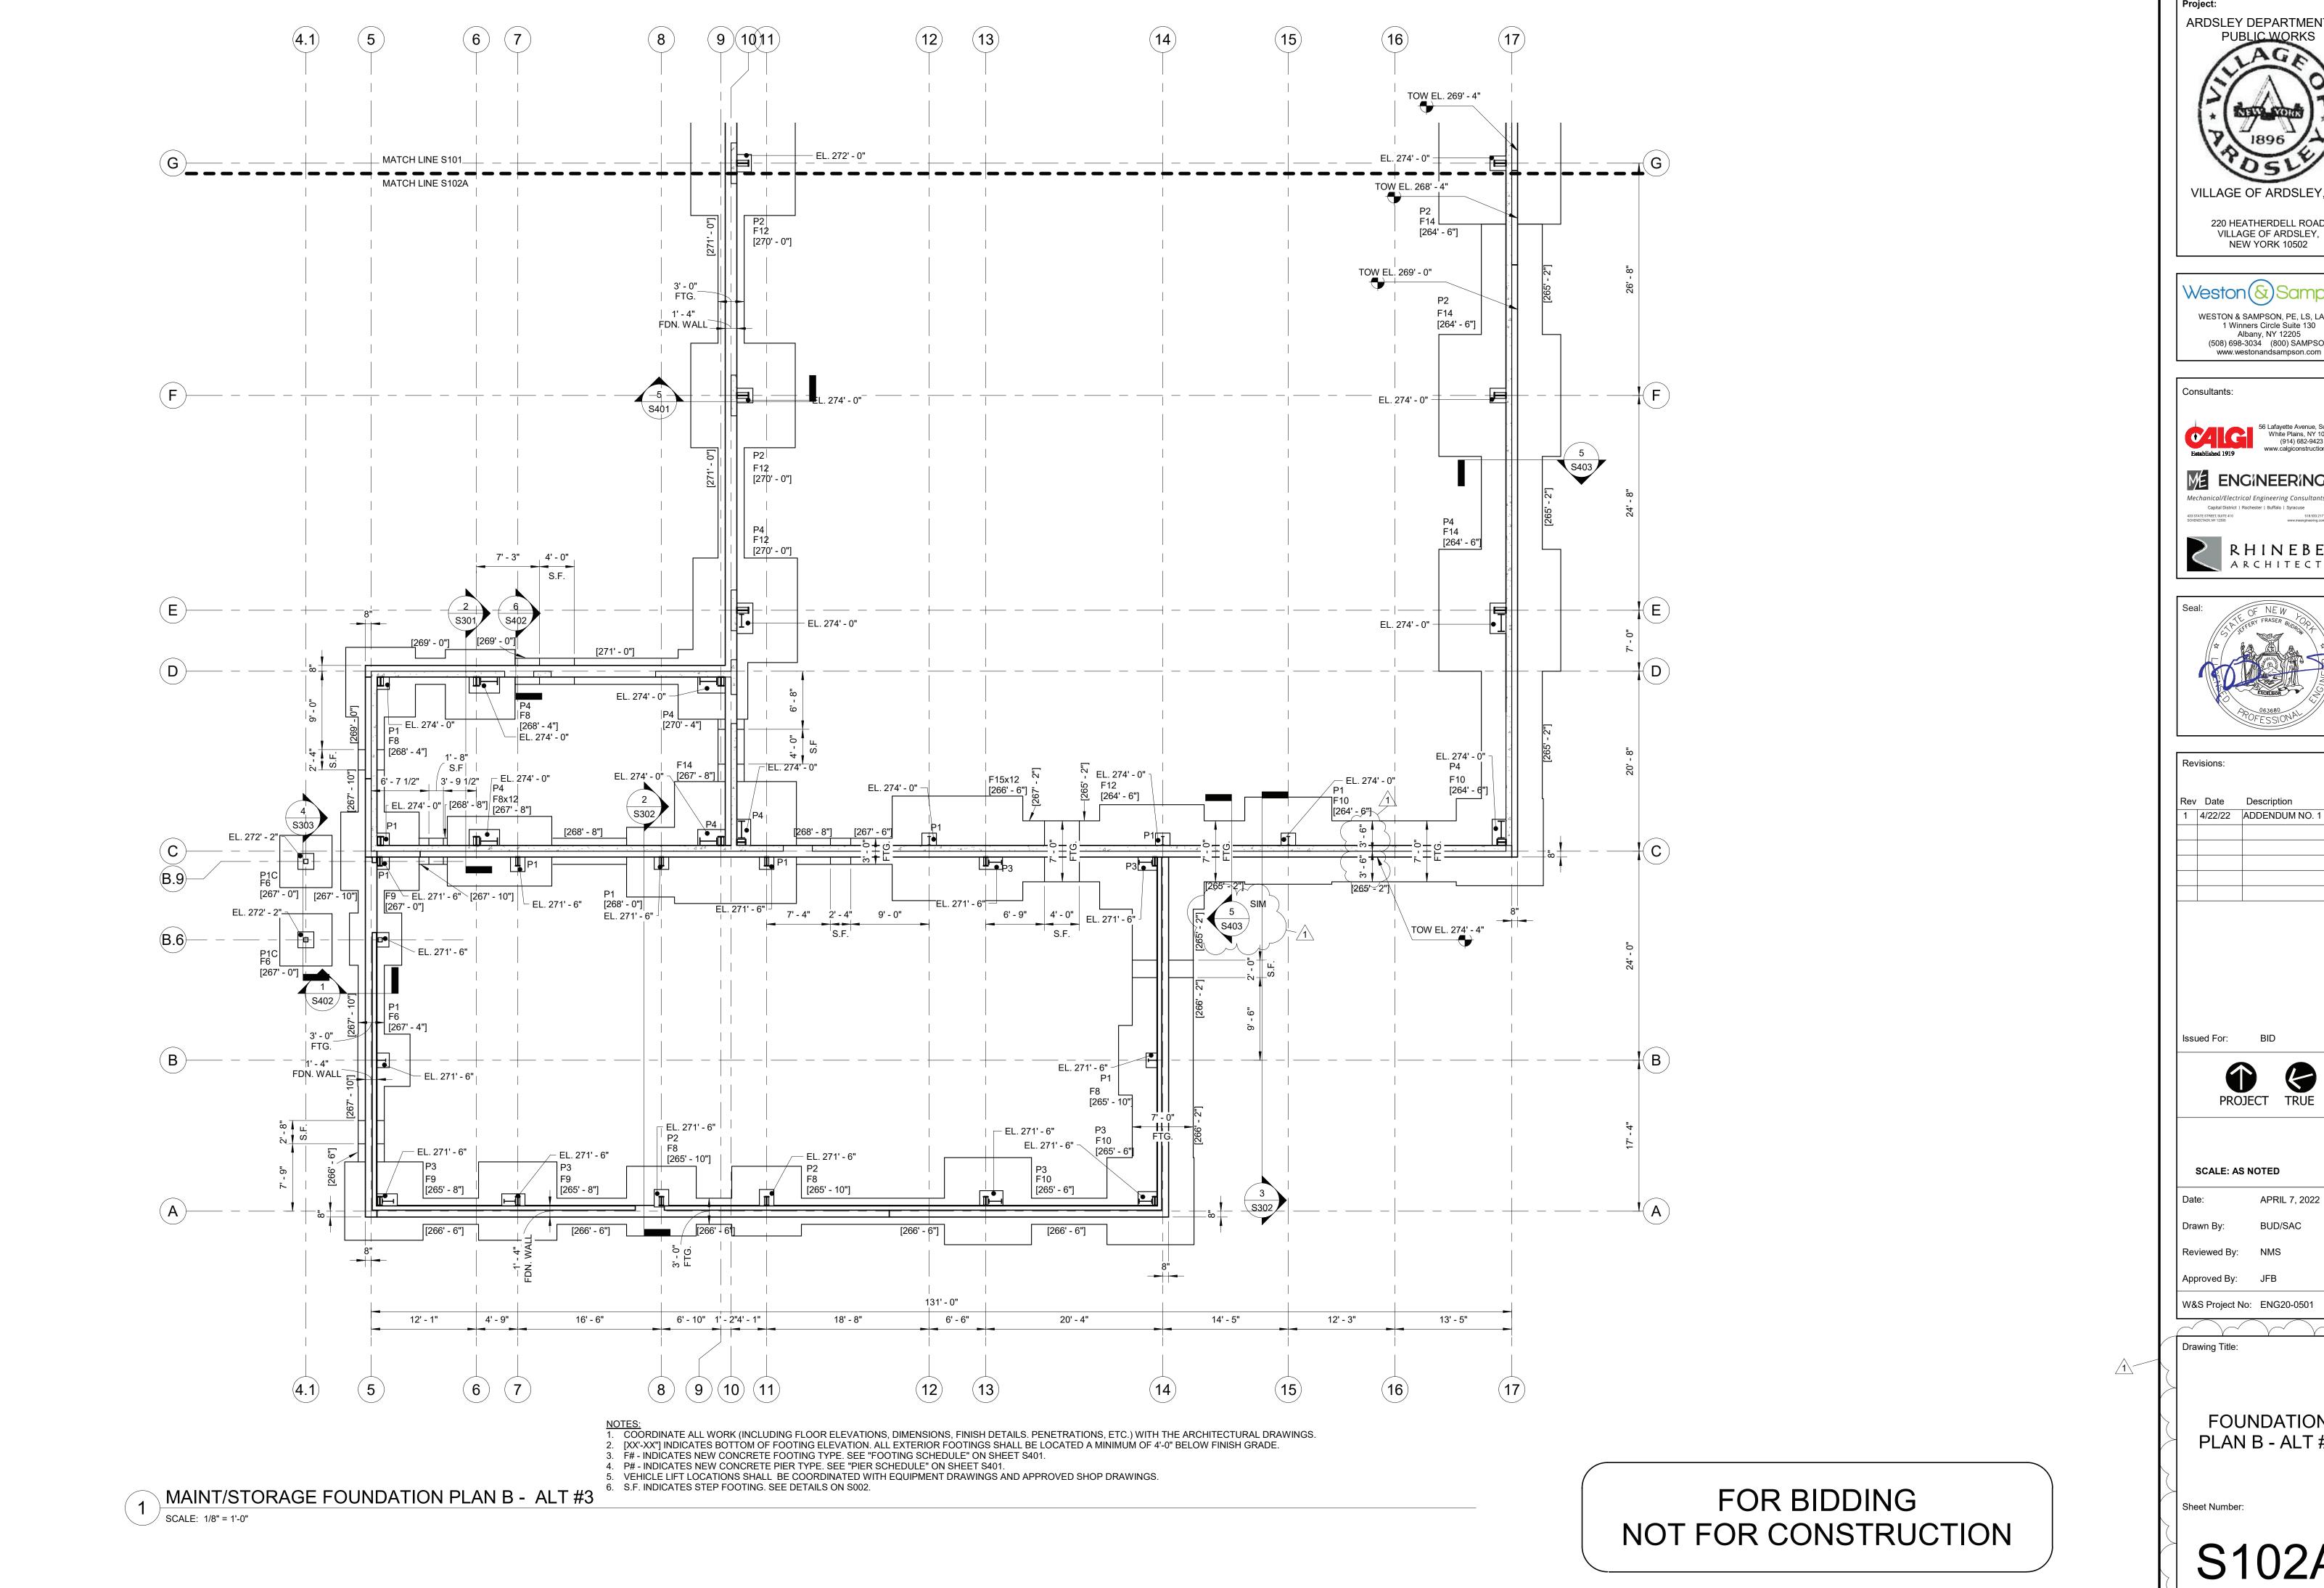
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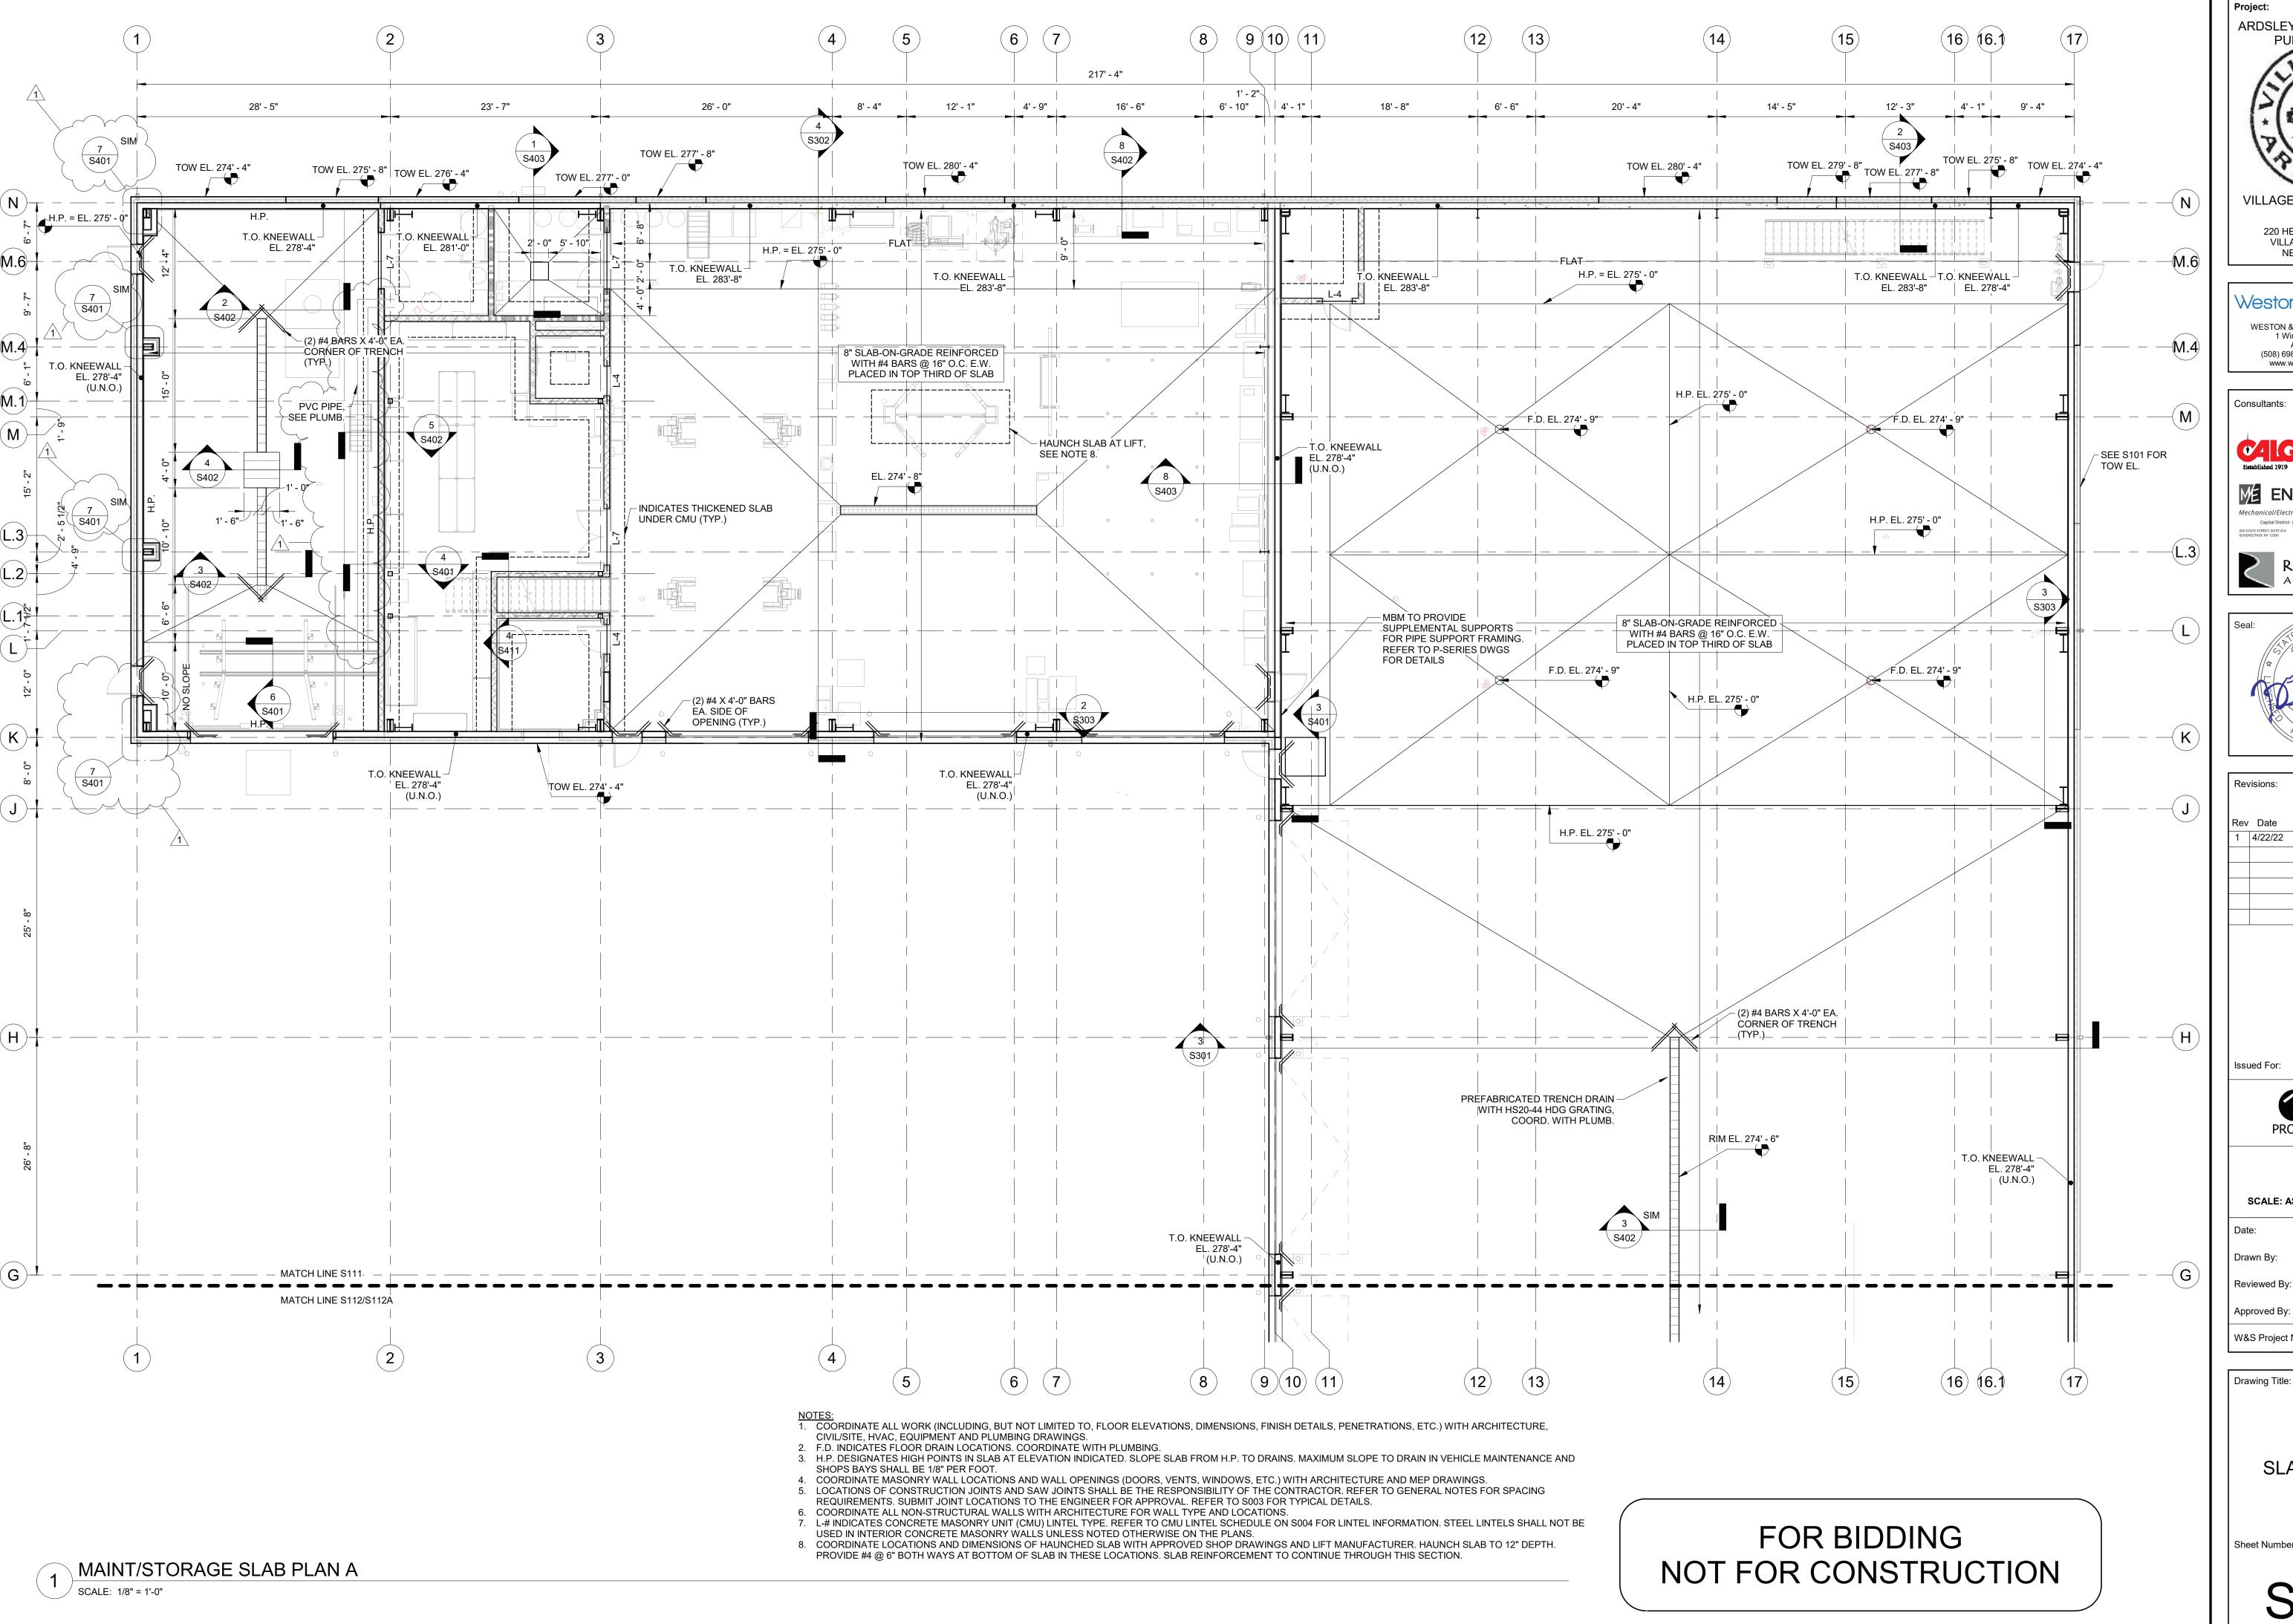
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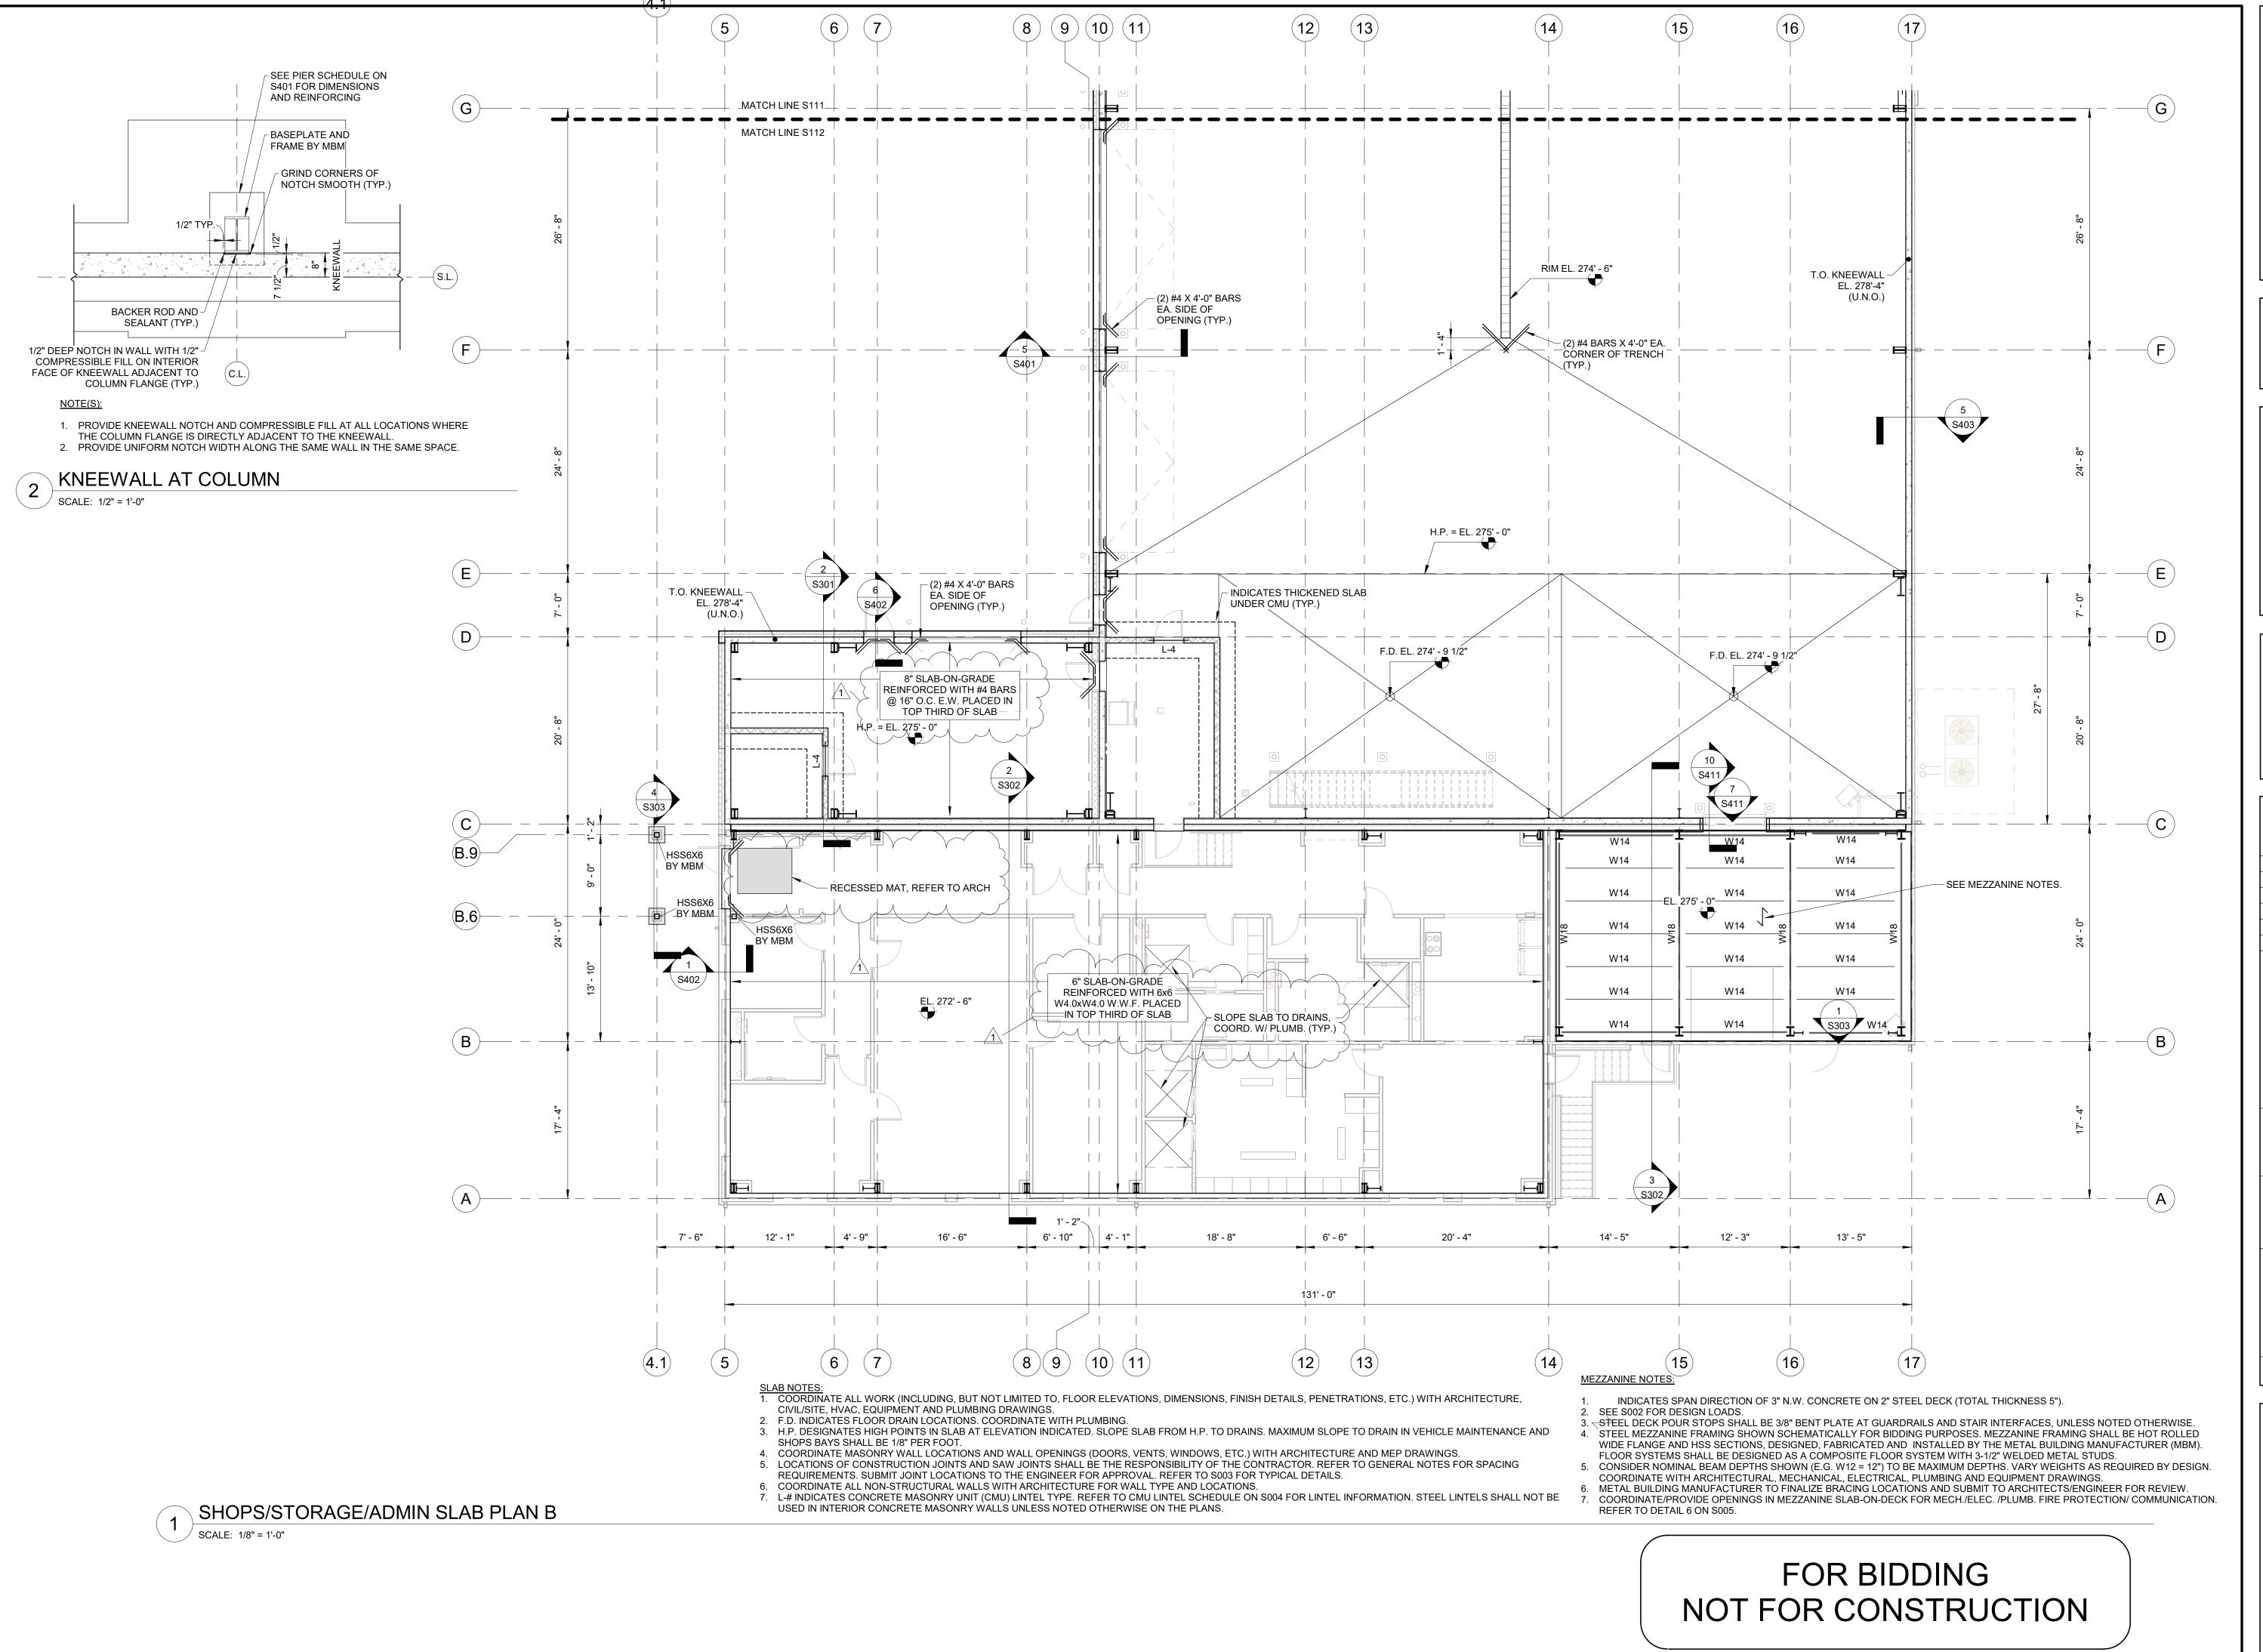
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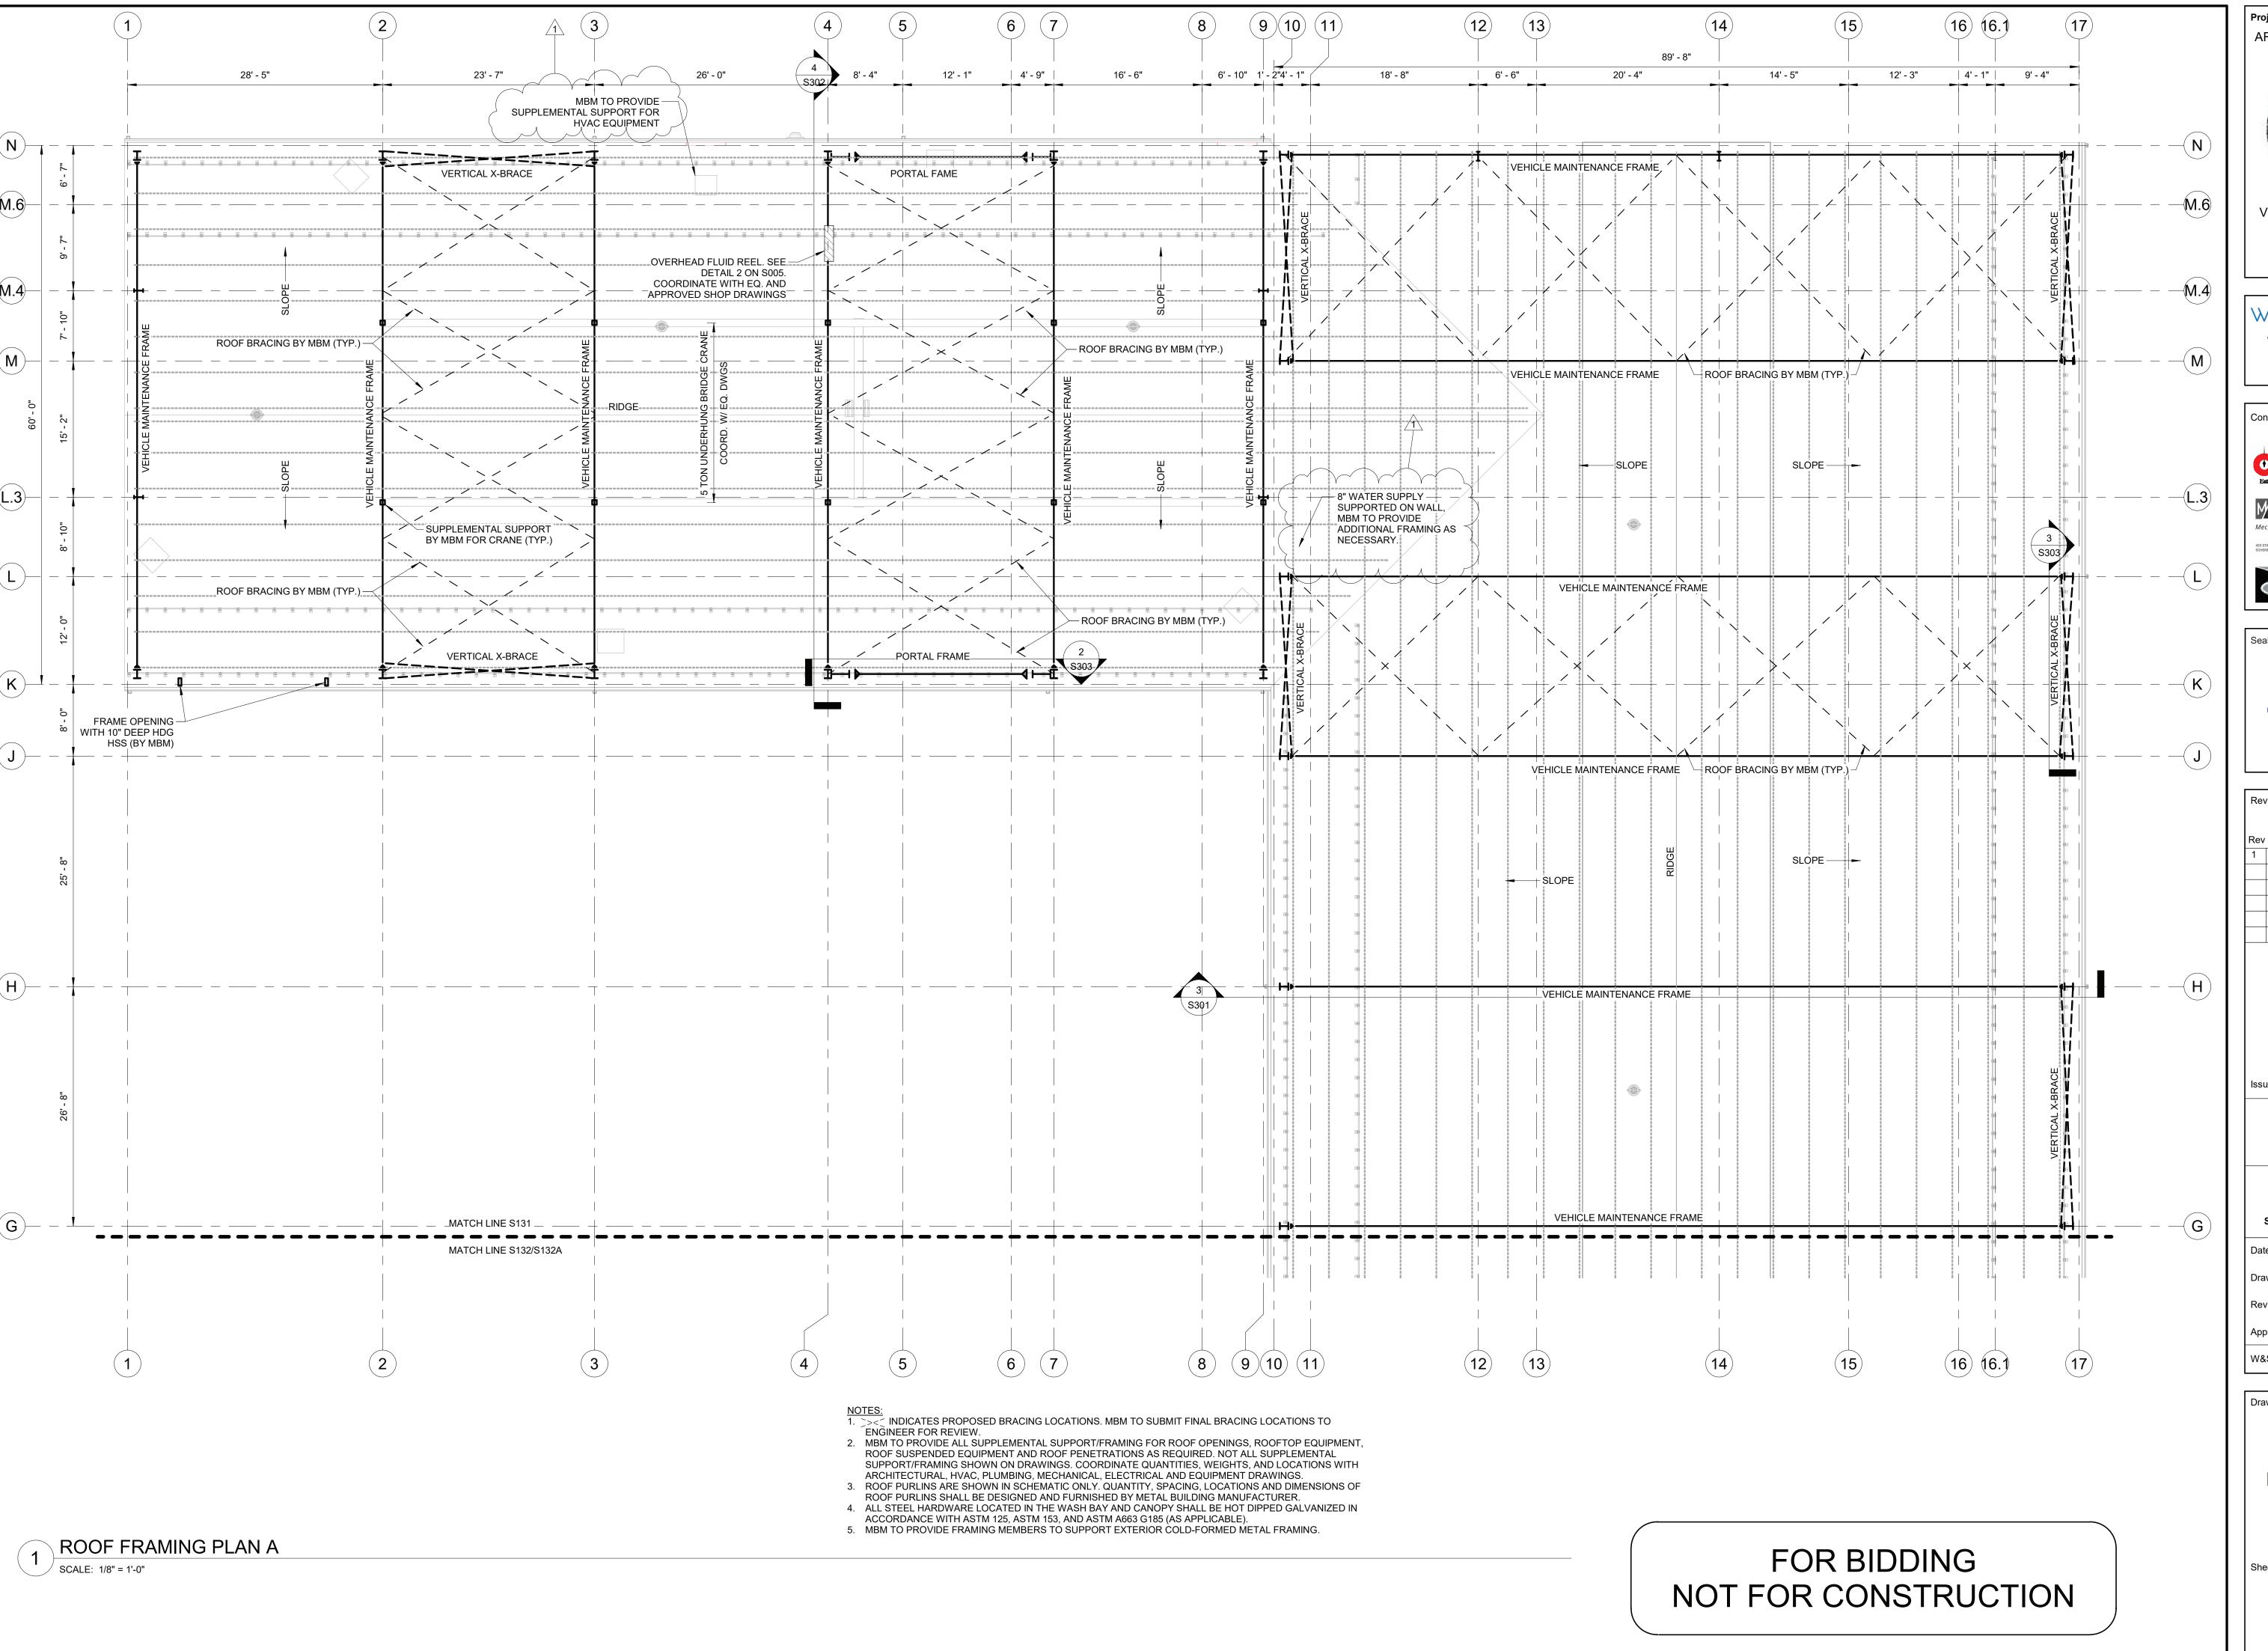
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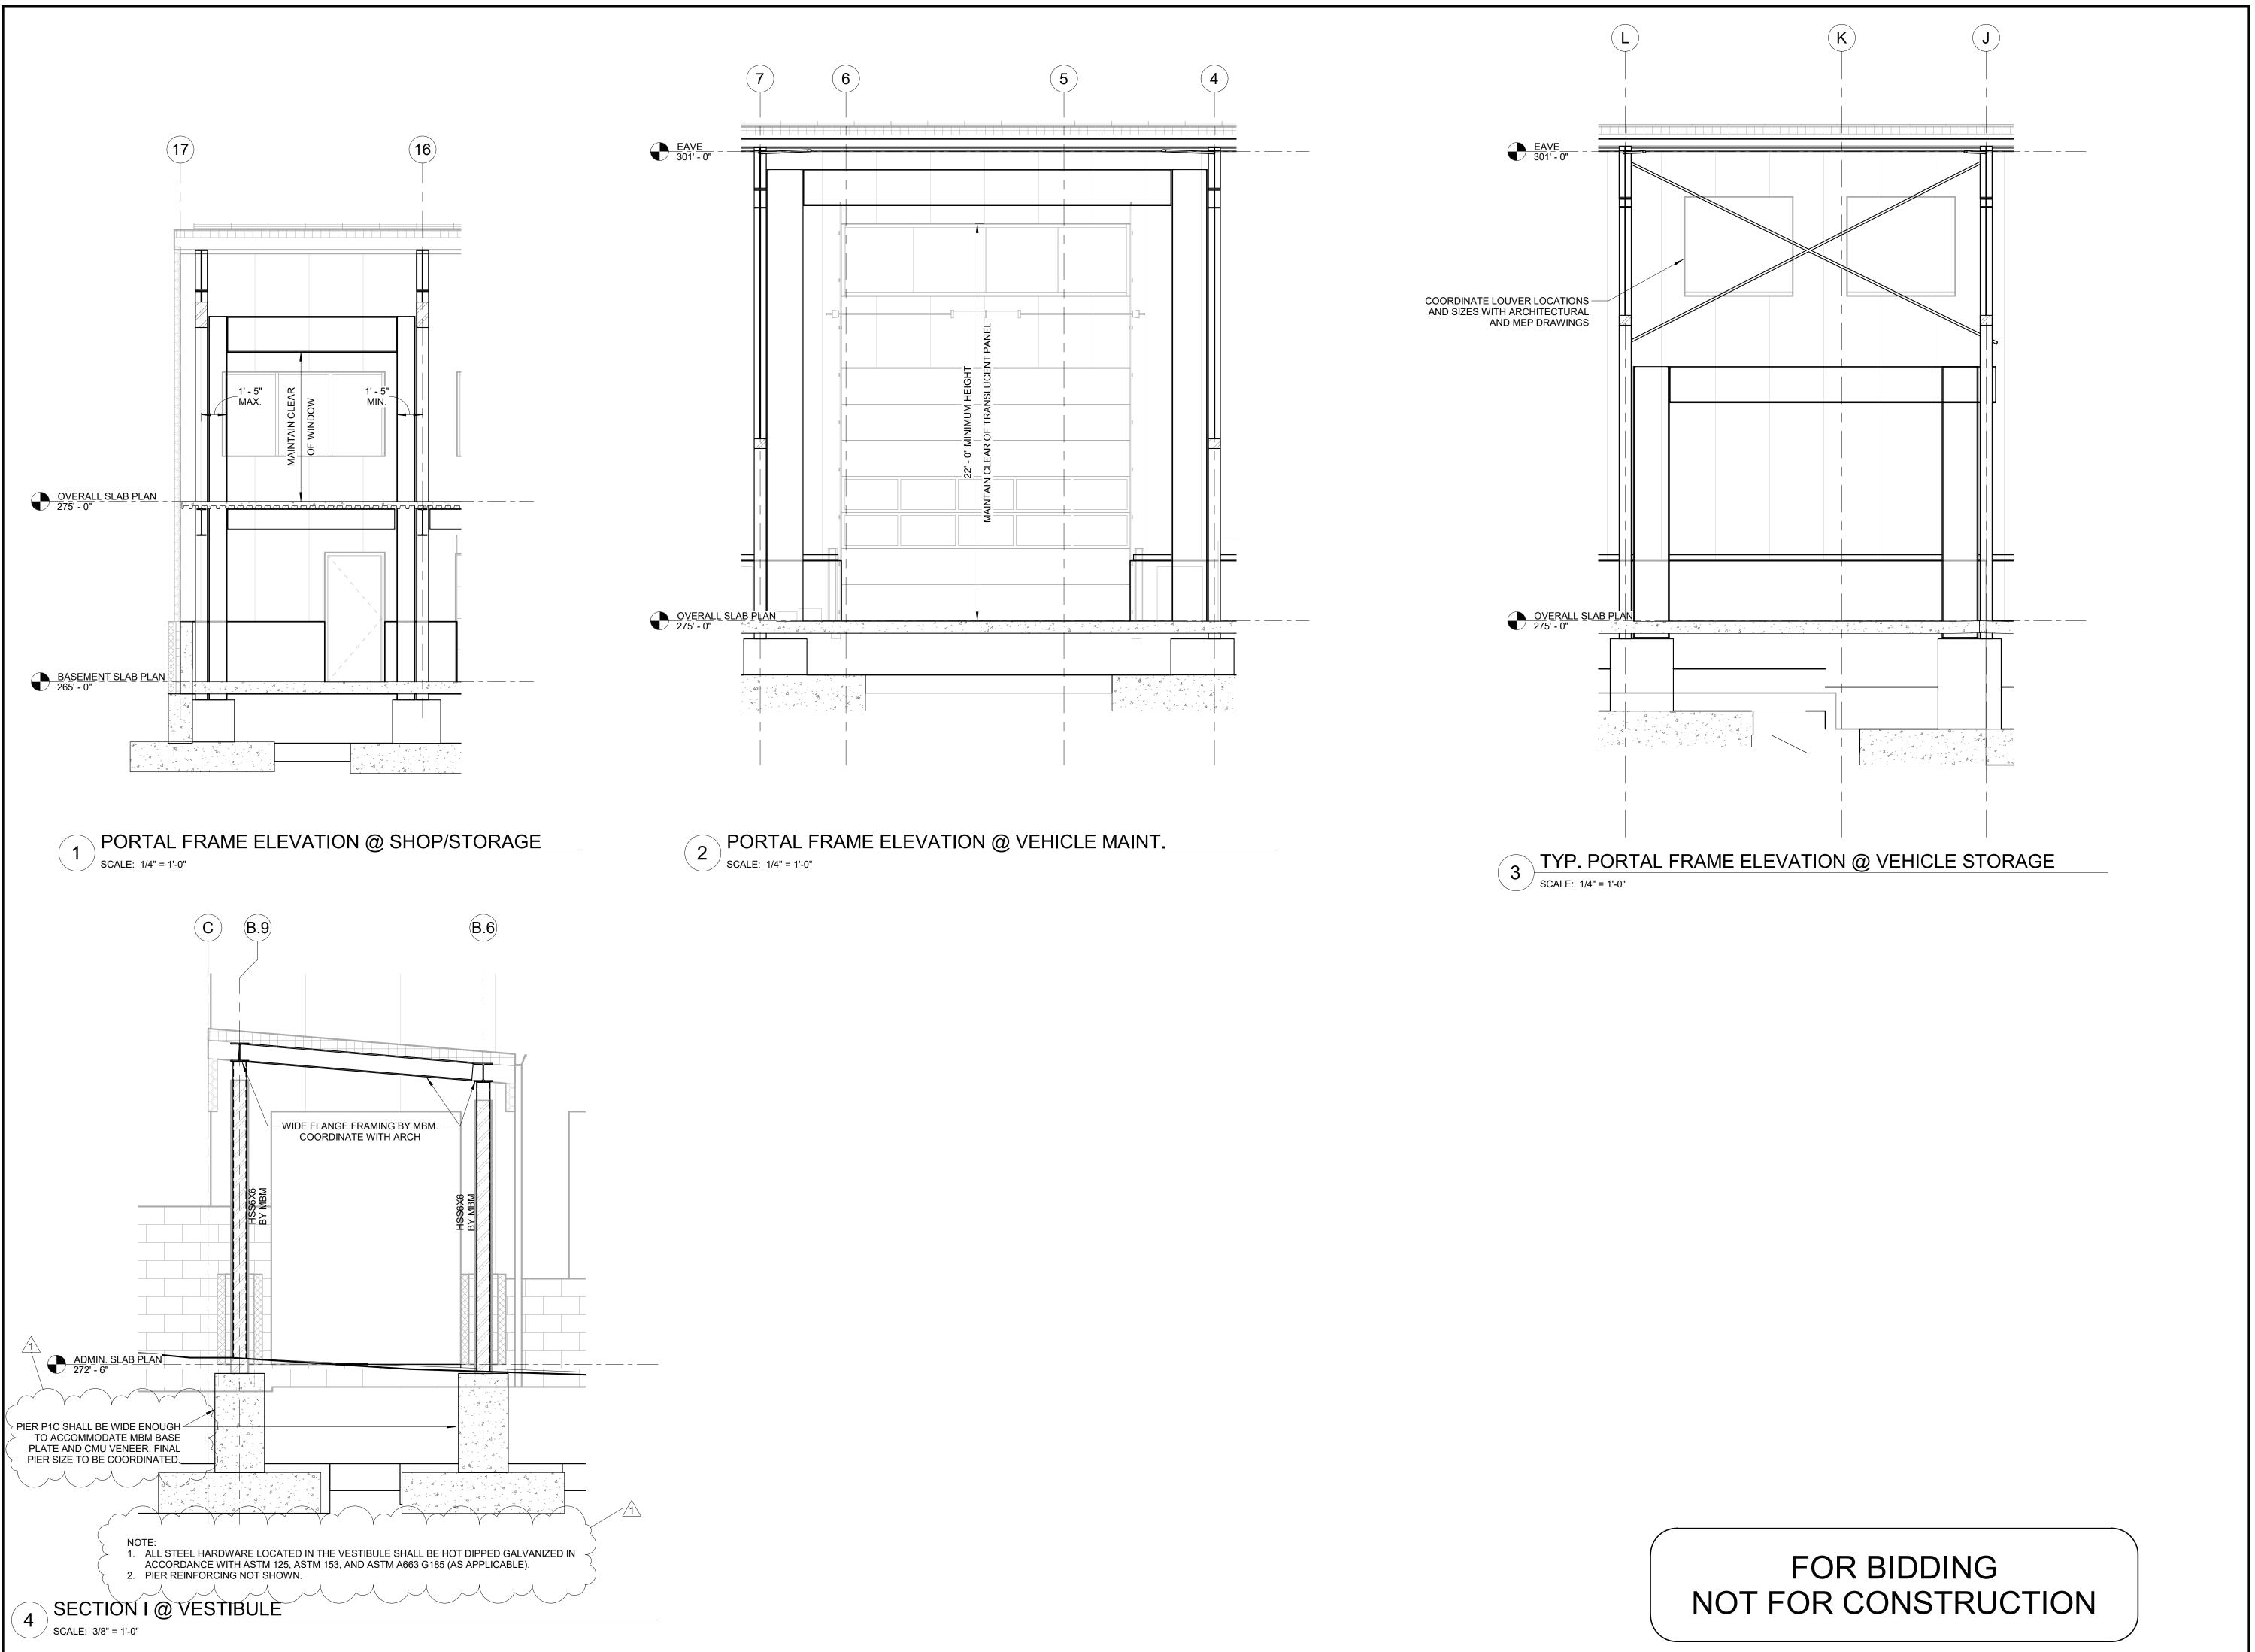
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ROOF FRAMING PLAN A

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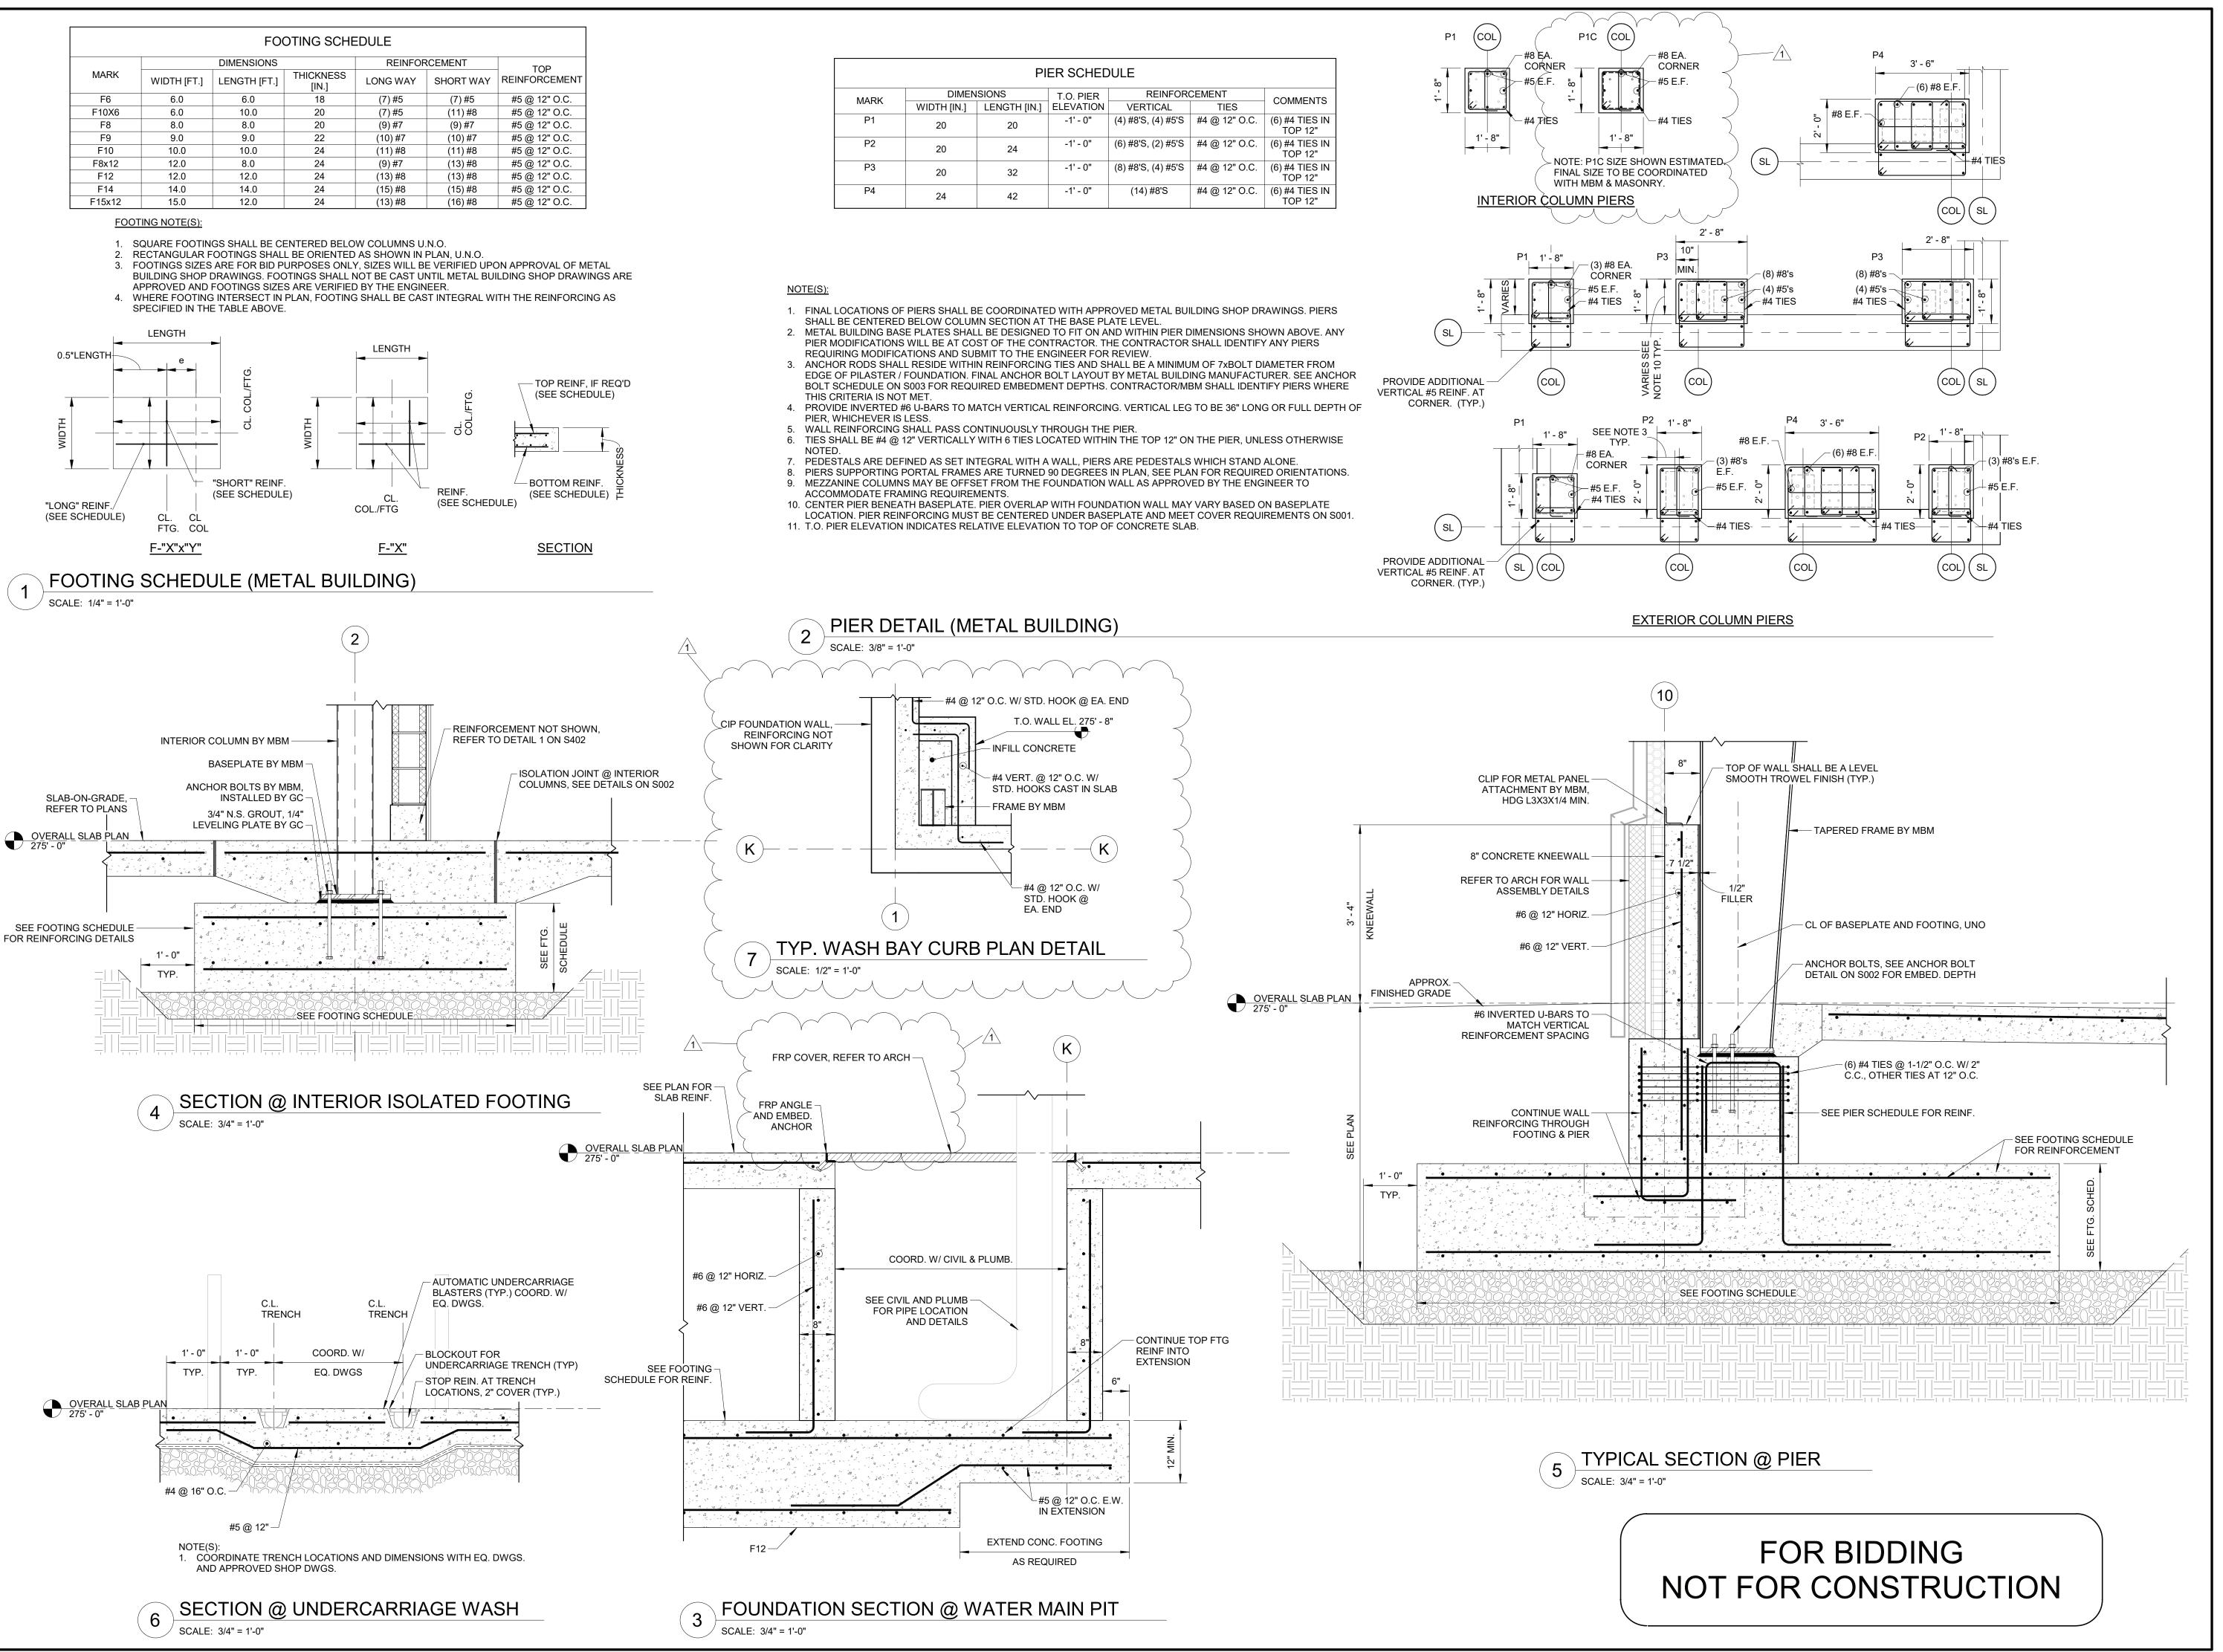
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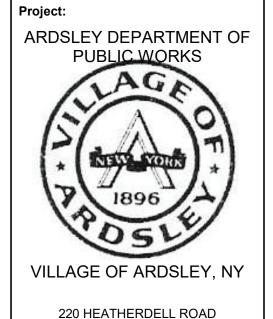
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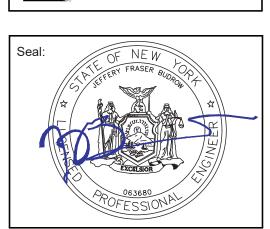
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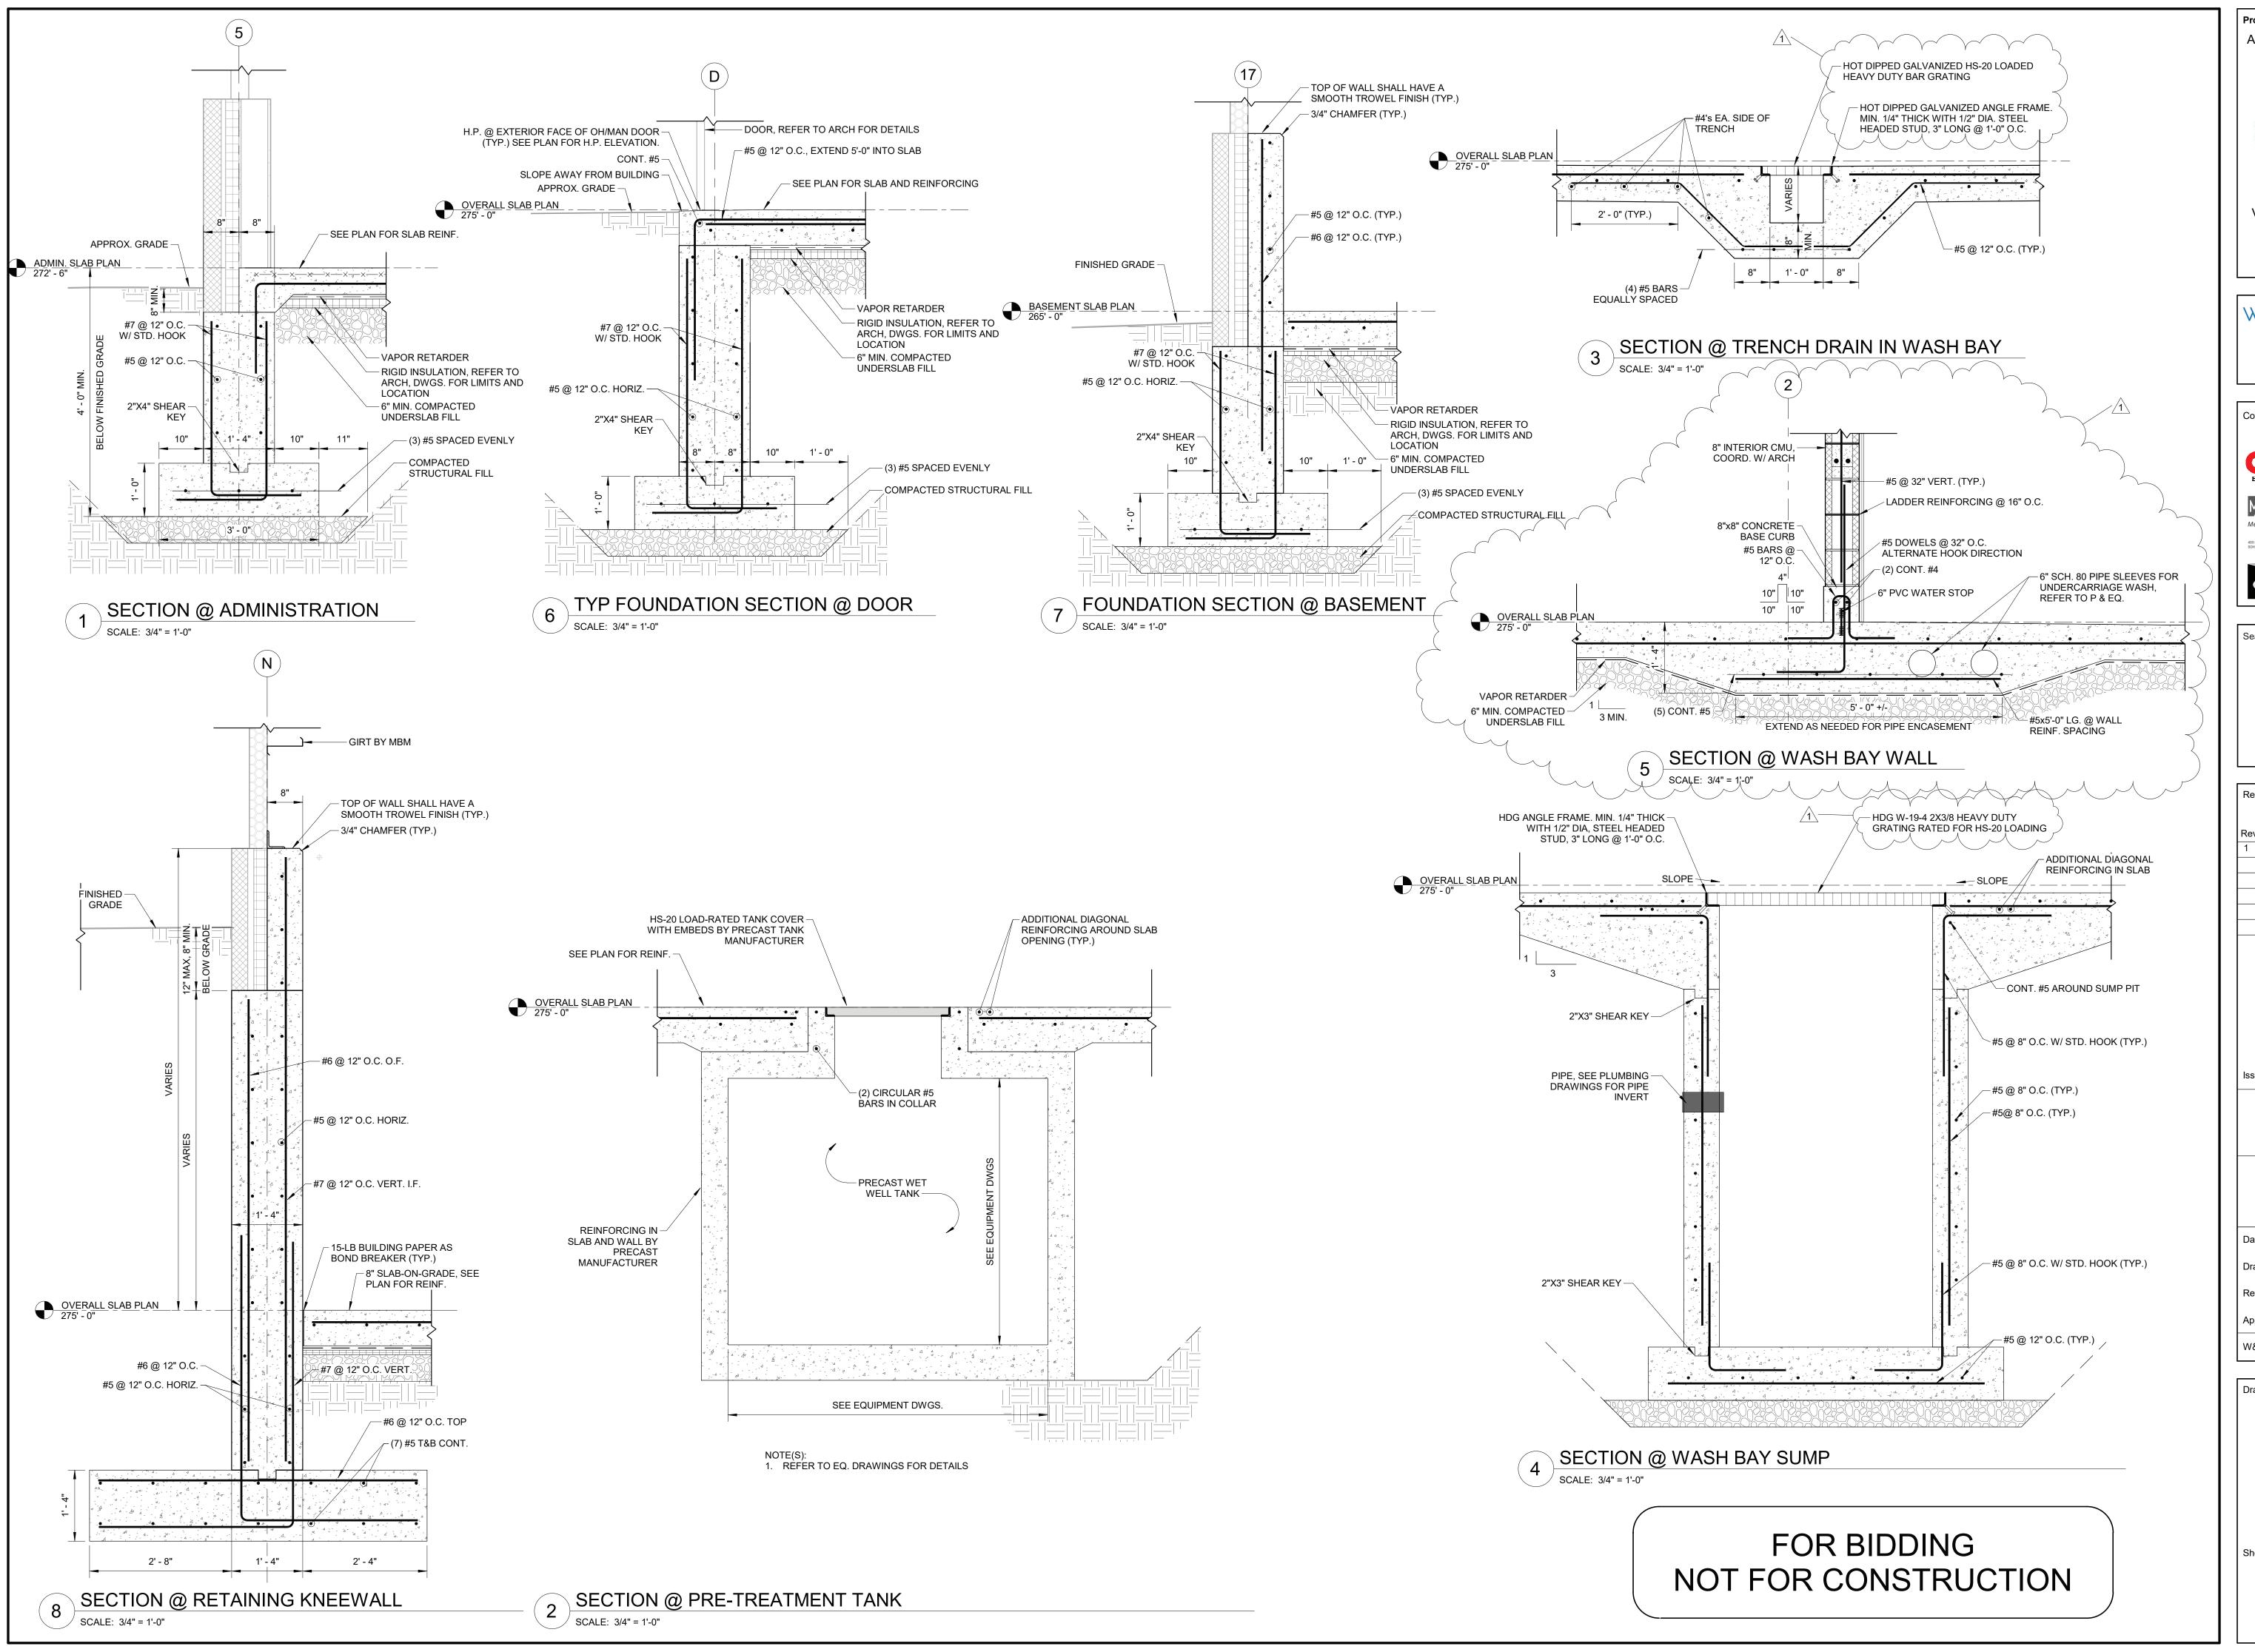
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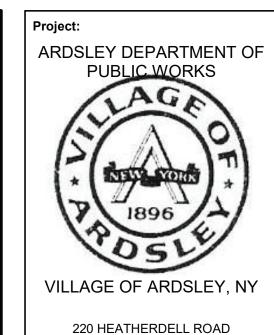
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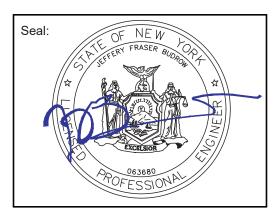
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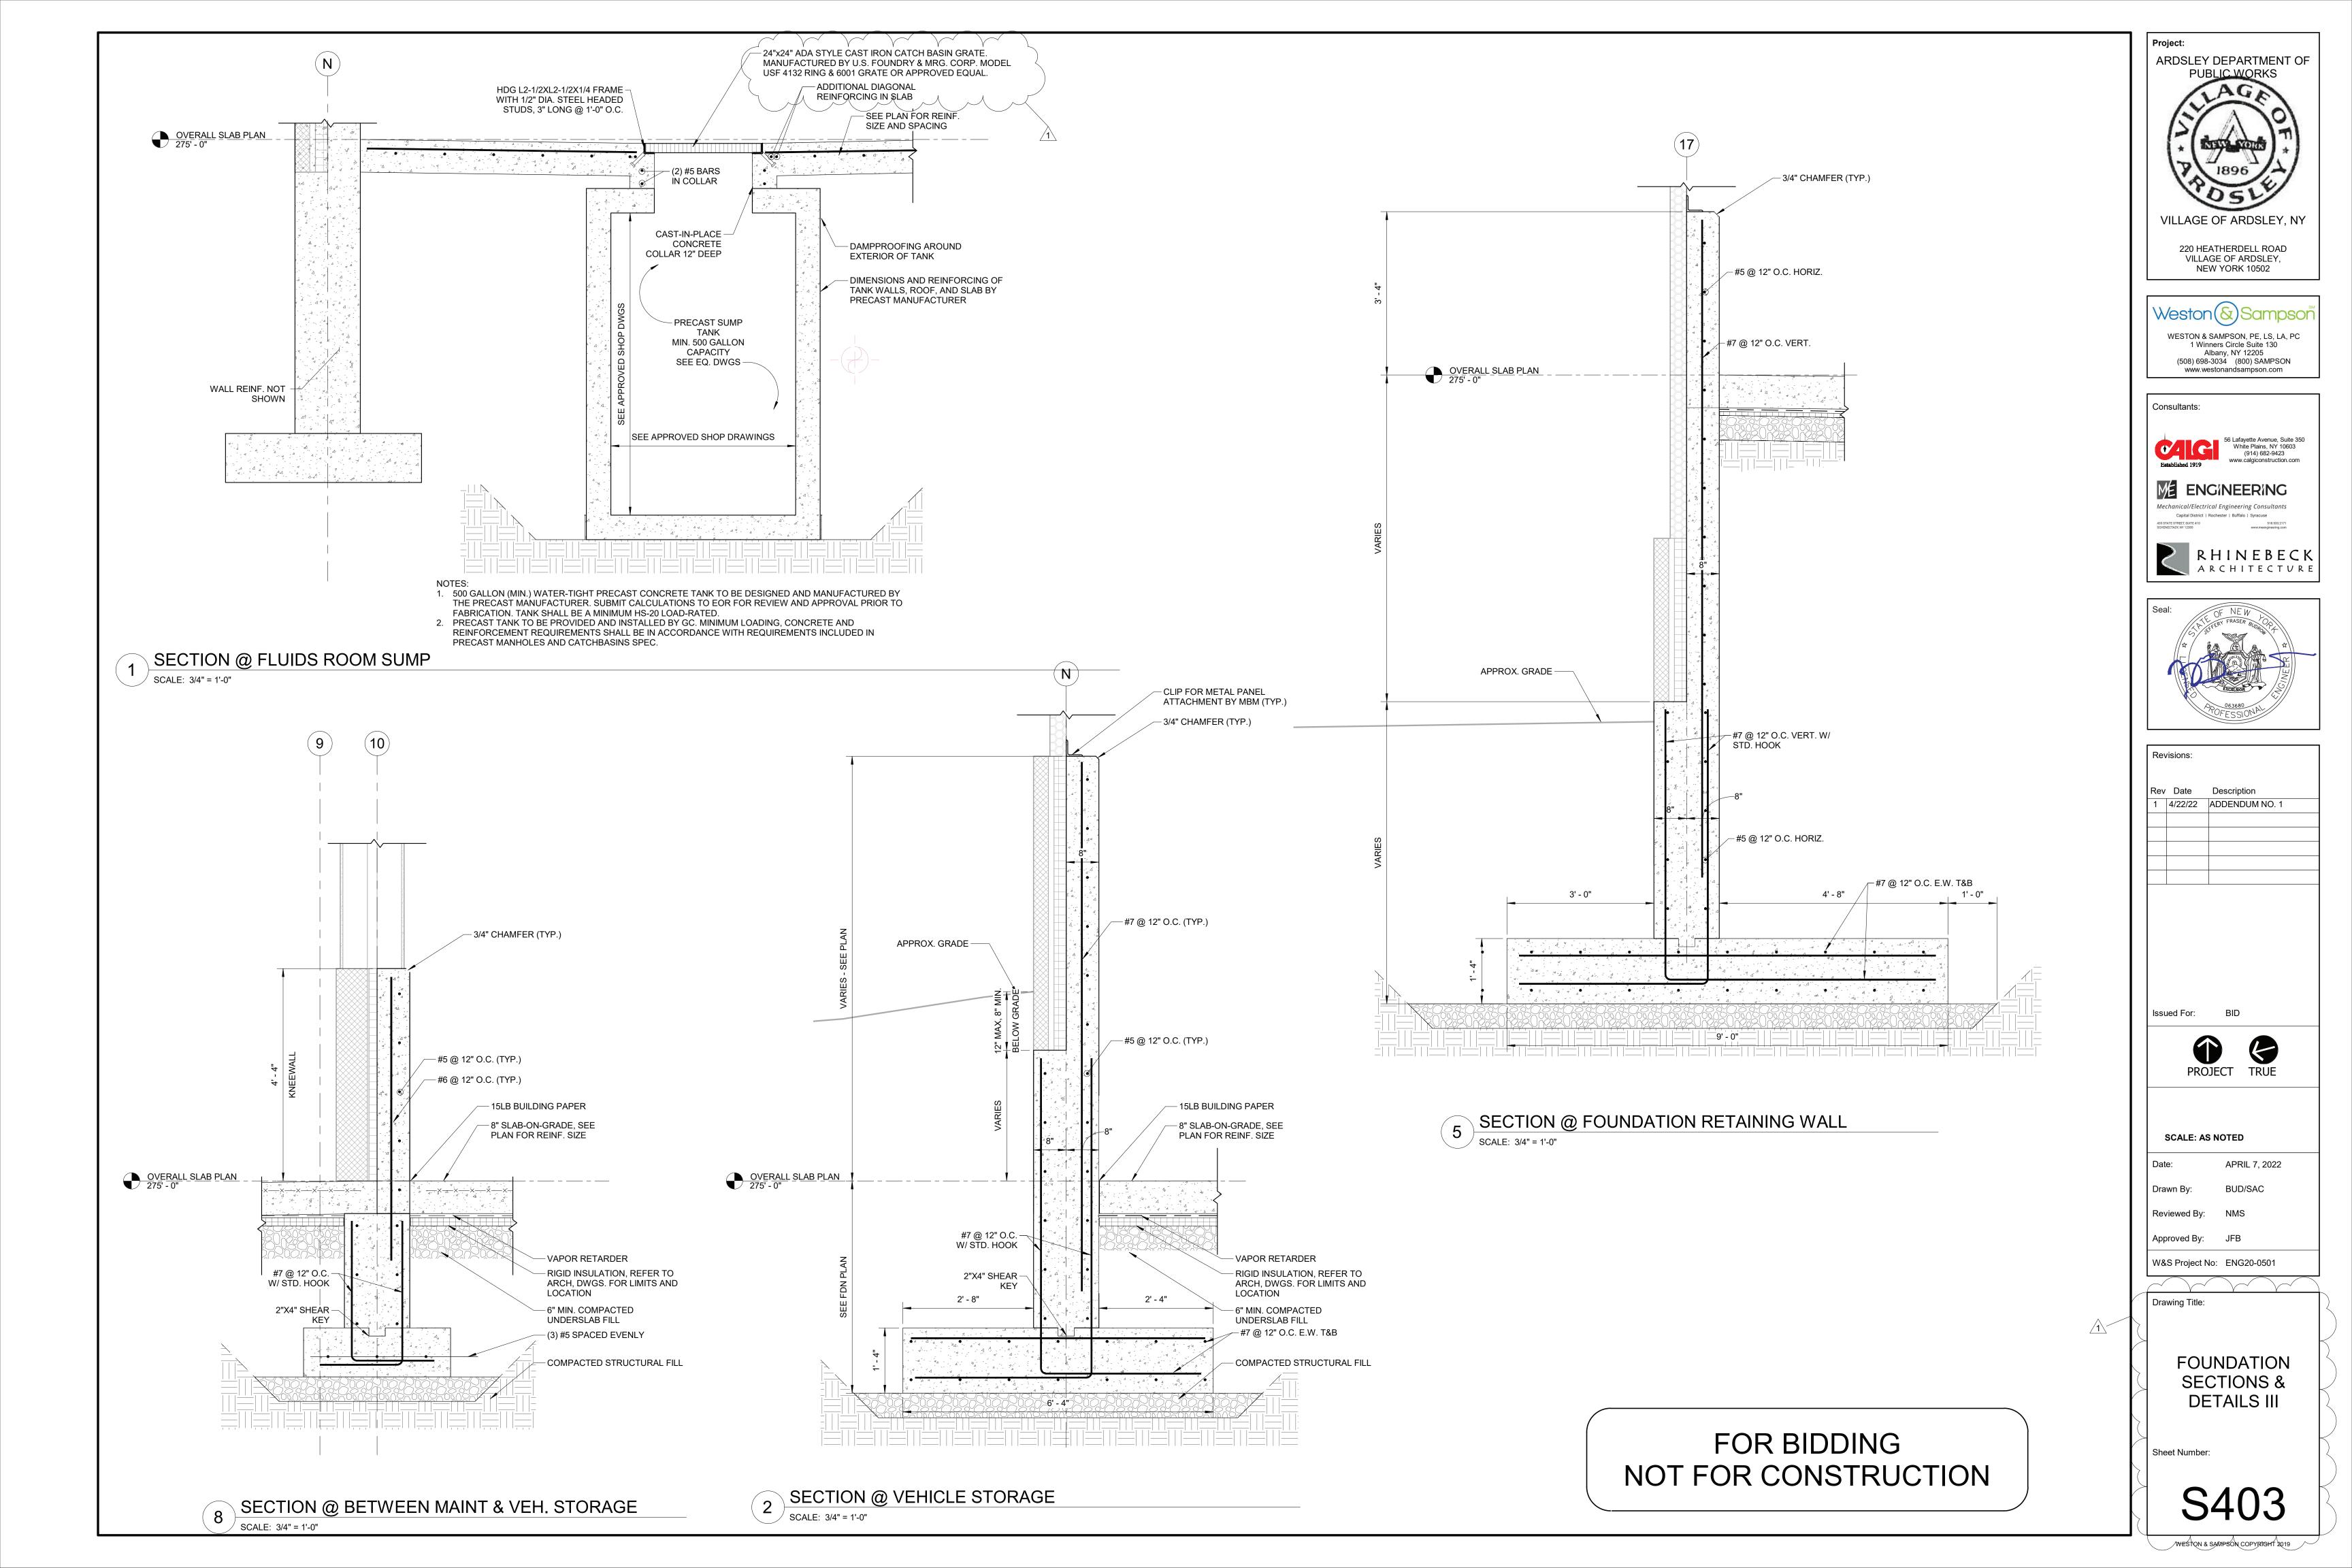
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FOUNDATION SECTIONS & DETAILS II

Sheet Number:

S402



GENERAL NOTES:

- A. ALL WORK AND MATERIALS SHALL BE IN ACCORDANCE WITH CURRENT LOCAL CODES AND PROJECT SPECIFICATIONS.
- 3. THE PLUMBING CONTRACTOR SHALL COORDINATE ALL PIPING WITH MECHANICAL, ELECTRICAL, ARCHITECTURAL, AND STRUCTURAL TRADES PRIOR TO CONSTRUCTION TO AVOID ITERFERENCE.
- C. PROVIDE ACCESS PANELS FOR ALL CONCEALED VALVES, WATER HAMMER ARRESTORS, TRAPS, ETC.
 D. PROVIDE TRAP GUARDS FOR ALL P-TRAPS FOR FLOOR DRAINS LOCATED IN MECHANICAL ROOMS, PUBLIC RESTROOMS AND OTHER
- AREAS WHERE TRAP EVAPORATION MAY OCCUR.

 E. PLUMBING CONTRACTOR SHALL CONNECT ALL ITEMS OF EQUIPMENT FURNISHED BY OTHERS AND UNDER OTHER SECTIONS OF THE
- SPECIFICATIONS. CONTRACTOR SHALL PROVIDE ALL ITEMS NECESSARY TO COMPLETE THE PLUMBING INSTALLATION.
 F. REFER TO ARCHITECTURAL DRAWING FOR ROUGHING DIMENSIONS OF PLUMBING FIXTURE MOUNTINGS HEIGHTS.
- G. PROVIDE UNIONS FOR ALL PIPING CONNECTIONS TO EQUIPMENT.
 H. ALL PLUMBING FIXTURES AND EQUIPMENT SHALL BE IN COMPLIANCE WITH CURRENT APPLICABLE ENERGY CONSERVATION CODES.
 I. ALL PIPING AND EQUIPMENT IS SHOWN DIAGRAMMATICALLY ONLY. GENERAL ORIENTATION SHOWN IN PLAN AND SECTIONAL DRAWINGS. EXACT LOCATION SHALL BE DETERMINED IN FIELD. MAINTAIN HEAD ROOM AND SPACE CONDITIONS AT ALL TIMES. ALL WORK SHALL BE COORDINATED WITH ALL TRADES BEFORE PROCEEDING WITH INSTALLATION. PRIOR TO CONSTRUCTION, CONTRACTOR SHALL NOTIFY ARCHITECT OF ANY DISCREPANCIES. PRIOR TO EQUIPMENT SUBMITTALS, CONTRACTOR SHALL VERIFY EXISTING AND PROPOSED
- CONDITIONS SUCH AS CORRIDORS, PASSAGE-WAY ROOM SIZES, ETC. TO ENSURE SPECIFIED EQUIPMENT CAN BE PROPERLY INSTALLED.

 J. FABRICATE AND INSTALL ALL PIPING IN ACCORDANCE WITH THE STATE PLUMBING CODE, LOCAL PLUMBING CODE, AND APPLICABLE SECTIONS OF THE BUILDING CODES.
- K. INSTALL PIPING CLOSE TO WALLS, PARTITIONS, CEILINGS, ETC. OFFSET ONLY WHERE NECESSARY TO FOLLOW WALLS, AS INDICATED.
- PROVIDE ALL NECESSARY FITTINGS, OFFSETS, VALVES AND OTHER DEVICES REQUIRED FOR A COMPLETE INSTALLATION.

 L. INSTALL PIPING IN A CONCEALED MANNER, STRAIGHT, PLUMB AND AS DIRECT AS POSSIBLE. FORM RIGHT ANGLES PARALLEL WITH BUILDING WALLS. LOCATE GROUPS OF PIPES PARALLEL TO EACH OTHER. PIPE SHALL BE LOCATED TO PERMIT ACCESS FOR SERVICE
- VALVES.

 M. CONCRETE PADS, PITS, AND FLASHING FOR PLUMBING EQUIPMENT SHALL BE AS INDICATED ON THE STRUCTURAL AND ARCHITECTURAL PLANS, UNLESS NOTED OTHERWISE. COORDINATE EXACT SIZES OF REQUIRED OPENINGS AND SUPPORTS FOR FURNISHED EQUIPMENT.
- N. ALL PIPING SHALL BE REAMED TO BE FREE OF BURRS. KEEP PIPING FREE FROM SCALE AND DIRT. PROTECT OPEN PIPE ENDS
 WHENEVER WORK IS SUSPENDED DURING CONSTRUCTION TO PREVENT FOREIGN MATERIAL FROM ENTERING, AND CAP ALL OPEN ENDS
 DURING CONSTRUCTION WITH APPROVED TEMPORALLY CAPS OR MATERIALS.

 O ALL GAS PIPING AND OTHER PLUMRING SYSTEMS SHALL BE SEISMICALLY BRACED IN ACCORDANCE WITH THE APPLICABLE SECTIONS OF
- O. ALL GAS PIPING AND OTHER PLUMBING SYSTEMS SHALL BE SEISMICALLY BRACED IN ACCORDANCE WITH THE APPLICABLE SECTIONS OF THE STATE BUILDING CODE AND THE NATIONAL FIRE PROTECTION ASSOCIATION (NFPA). SEAL ALL WALL AND FLOOR PENETRATIONS AROUND NEW PIPES WITH FIRE PROOF CAULKING.
- P. MAINTENANCE LABELS SHALL BE AFFIXED TO ALL PLUMBING EQUIPMENT AND MAINTENANCE AND OPERATION MANUALS SHALL BE PROVIDED TO OWNER.
- Q. INSTALL WELDED OR THREADED PIPE IN AREAS WHERE SPACE IS CRITICAL BETWEEN FINISHED CEILING AND STRUCTURAL SURFACE. INSTALL ALL VENTS THRU ROOF 10'-0" MINIMUM FROM EDGE OF ROOF AND 25'-0" FROM FRESH AIR INTAKES.
- R. SUBMIT ALL REQUIRED PLUMBING DOCUMENTS TO LOCAL PLUMBING OFFICIAL FOR APPROVAL. THE ENTIRE PLUMBING SYSTEM SHALL BE INSTALLED IN COMPLIANCE WITH ALL APPLICABLE BUILDING CODES, REGULATIONS, AND LOCAL REQUIREMENTS.
- S. SUBMIT APPROVED PRESSURE REDUCING VALVES & BACKFLOW PREVENTION DEVICES TO WATER AUTHORITY. CONTRACTOR SHALL PROVIDE ALL NECESSARY DEVICES PER WATER AUTHORITY REQUIREMENTS AND MANUFACTURER RECOMMENDATIONS.
 T. ALL WALL, CEILING AND FLOOR PENETRATIONS CONVEYING PLUMBING AND DRAINS SHALL BE FULLY SEALED AND CAULKED AROUND THE PENETRATING FEATURE TO RESTORE THE REQUIRED FIRE OR SMOKE BARRIER RATING OF THE WALL, CEILING OR FLOOR PENETRATED. AT A MINIMUM, AT ALL LOCATIONS A TWENTY (20) MINUTE FIRE/SMOKE RESISTANCE SHALL BE MAINTAINED. WHERE
- WILL MAINTAIN THE WALL, CEILING OR FLOOR RATING IN THE EVENT OF A FIRE.

 U. PLUMBING OR SPRINKLER RELATED PIPE SHALL NOT PENETRATE INTO OR PASS THROUGH STAIRWAYS UNLESS IT IS REQUIRED FOR SERVICING THE STAIRWAY OR IT IS SEGREGATED FROM THE STAIRWAY PASSAGEWAY BY AN ENCLOSURE SYSTEM RATED EQUAL TO OR GREATER THAN THE REQUIRED STAIRWAY RATING.

REQUIRED BY CODE, THE PENETRATING FEATURES SHALL ALSO BE SUPPLIED AND INSTALLED WITH A MECHANISM OR MATERIAL WHICH

- V. PROVIDE FLUSH TYPE ACCESS DOORS OR PANELS NO SMALLER THAN 12"x12" AND NO LARGER THAN 30"x30" FOR ALL VALVES OR APPARATUS LOCATED IN CHASES, WALLS, AND NON ACCESSIBLE CEILINGS, OR FLOORS.
- W. INSTALL WATER HAMMER ARRESTORS IN COMPLIANCE WITH ALL APPLICABLE CODES. SIZE OF WATER HAMMER ARRESTORS SHALL BE ACCORDING TO THE WATER HAMMER SCHEDULE AND MANUFACTURER'S RECOMMENDATIONS FOR THAT BRANCH LINE.
- X. CLEANOUTS SHALL BE PROVIDED AS INDICATED ON PLANS AND AS REQUIRED BY THE LOCAL CODES.
 Y. PRIOR TO INSTALLING ANY PIPING, VERIFY EXISTING OR NEW INVERT ELEVATIONS, LOCATIONS AND PIPE SIZES. INSTALL ALL SANITARY
- AND WASTE BEGINNING AT LOW POINT OF EACH SYSTEM AND CONTINUE WITH UNBROKEN CONTINUITY OF INVERT. LOW POINT OF EACH
 Z. SYSTEM SHALL BE COORDINATED WITH SITE UTILITIES CONTRACTOR. REFER TO SITE UTILITY PLANS FOR REFERENCE.
- AA. DRAIN VALVES SHALL BE PROVIDED ON LOWEST POINT OF ALL DOMESTIC WATER RISERS AS FOLLOWS: 1-1/2" OR LESS-PROVIDE 1/2"
 DRAIN VALVE. 2" OR LARGER-PROVIDE 3/4" DRAIN VALVE.

 BB. PROVIDE ISOLATION VALVES AT ALL FIXTURES AND EQUIPMENT.
- CC. PLUMBING CONTRACTOR SHALL INSTALL GAS VENTS FOR ALL GAS MANIFOLD/TRAIN SYSTEMS LOCATED AT BOILERS OR WATER HEATERS. PRIOR TO CONSTRUTION, CONTRACTOR SHALL REVIEW THE EXISTING CONDITIONS TO DETERMINE MOST ECONOMICAL ROUTE FOR MANIFOLD VENTS BEGINNING AT EQUIPMENT AND EXTENDING THROUGH ROOF.

	PLUMBING SYMBOL LIST
OVMBOL	
SYMBOL	DESCRIPTION
lacktriangle	POINT OF CONNECTION
NTS	NOT TO SCALE
AFF	ABOVE FINISHED FLOOR
BFF	BELOW FINISHED FLOOR
VTR	VENT THRU ROOF
GC	GENERAL CONTRACTOR
MC	MECHANICAL CONTRACTOR
PC	PLUMBING CONTRACTOR
EC	ELECTRICAL CONTRACTOR
	NEW PIPING LOCATED ABOVE FLOOR/SLAB
	NEW PIPING LOCATED BELOW FLOOR/SLAB
•	COLD WATER PIPING (CW)
••	HOT WATER PIPING (HW)
•••	HOT WATER RECIRCULATING PIPING (HWR)
——W——	WATER SERVICE - EXTERIOR
SAN	SANITARY SEWER PIPING
v	VENT PIPING (V)
——G——	NATURAL GAS PIPING (G)
OW	OIL/WATER WASTE PIPING (OW)
——CA——	COMPRESSED AIR PIPING (CA)
	ELBOW DOWN
	45°OFFSET
	ELBOW UP
	BOTTOM/TEE CONNECTION
U	TOP TEE CONNECTION
$-\!\!\!-\!\!\!\!-\!\!\!\!\infty$	"P" TRAP
	PIPE CONTINUATION
	CAP OR PLUG
——ф	DECK PLATE CLEANOUT (DPCO)
	WALL PLATE CLEANOUT (WPCO)
	CLEANOUT (CO)
	FLOOR DRAIN (FD) / FLOOR SINK (FS)
	WALL HYDRANT (WH) / HOSE BIBB (HB)
	STRAINER
M	WATER METER
	SHUT OFF VALVE
<u></u> ——⊗——	BALANCING VALVE
	CHECK VALVE
	SOLENOID VALVE
	PRESSURE REDUCING VALVE
	RELIEF VALVE
	UNION
	BACKFLOW PREVENTER (BFP)
<u> </u>	SHOWER HEAD
1~1	SHOCK ABSORBER (SA)
	RECIRCULATION PUMP
	THERMOMETER
<u>+ (3)</u>	PRESSURE GAUGE
<u>(X)</u>	DRAWING KEYNOTE

FIXTURE ANI	D EQUIPMENT CONNECTION SC	HEDULE				
DESIGNATION	DESCRIPTION	COLD WATER	HOT WATER	WASTE OR SANITARY	VENT	REMARKS
WC-A	WATER CLOSET - PUBLIC - FLUSH VALVE	1"	-	3"	2"	ADA HEIGHT, WALL HUNG, ELONGATED, 1.28 GPF: AMERICAN STANDARD AFWALL. OPEN FRONT TOILET SEAT.
UR-A	URINAL -PUBLIC - FLUSH VALVE	3/4"	-	2"	1-1/2"	WALL MOUNTED, ELONGATED FLUSHING RIM, TOP SPUD, SLOAN G2 OPTIMA PLUS SENSOR BATTERY POWERED, 0.5 GPF: AMERICAN STANDARD WASHBROOK.
LAV-A	LAVATORY - ADA	1/2"	1/2"	1-1/2"	1-1/2"	AMERICAN STANDARD LUCERNE, WALL-HUNG, LAV GUARD
LAV-B	LAVATORY - PUBLIC - ADA	1/2"	1/2"	1-1/2"	1-1/2"	AMERICAN STANDARD, LAV GUARD
SK-A	KITCHEN SINK	1/2"	1/2"	1-1/2"	1-1/2"	ELKAY LUSTERTONE, ADA, STRAINER
SH-A	SHOWER - ADA	1/2"	1/2"	1-1/2"	1-1/2"	AQUATIC ADVANTAGE 16030BFSC, CENTER BRASS DRAIN, SLIP RESISTANT TEXTURED BOTTOM, VINYL FLEXIBLE DAM, REINFORCED FOR FOLDING SEAT AND GRAB BARS, CURTAIN ROD, SOAP DISH. MOEN 8346EP15 POSI-TEMP TRIM KIT, CHROME FINISH, HAND-HELD SHOWER WITH 30" SLIDE BAR, DROP ELL, 69" METAL HOSE, CHROME FINISH, 1.5 GPM.
FD-A	FLOOR DRAIN - STANDARD	-	-	2"	1-1/2"	JAY R SMITH FIGURE 2010,7" ADJUSTABLE STRAINER, TRAP GUARD
FD-B	FLOOR DRAIN - WITH RECESS	-	-	3"	1-1/2"	JAY R SMITH FIGURE 2010, 7" ADJUSTABLE STRAINER, TRAP GUARD, WITH RECESSED, ANTI-FLOOD RIM.
FD-C	FLOOR DRAIN - HEAVY DUTY	-	-	4",6"	-	JAY R SMITH FIGURE 21243C, 12" NICKEL BRONZE HINGED GRATE, SEDIMENT BUCKET, QUAD CLOSE TRAP SEAL,
TD-A	TRENCH DRAIN SYSTEM WITH CATCH BASIN	-	-	4",6"	-	ZURN Z882-HDG, GALVANIZED PRE-SLOPED TRENCH DRAIN SYSTEM, HIGH DENSITY POLYETHYLENE, EXTRA HEAVY DUTY 12" WIDE GRATE, EN1433 CLASSIFICATION 'E', GALVANIZED CATH BASIN WITH SEDIMENT BASKET.
EWC-A	WATER COOLER - ADA	1/2"	_	1-1/2"		ELKAY EZSTL8LC, BI-LEVEL NON-FILTERING, 8 GPH.
~~MBA~~~	THE ABESIDAL THE A	~3/A"~~	~~*\\\	~~ ² \~~	1-1/2"	FURTURE TO THE PROPERTY OF THE
EM-SH	EMERGENCY SHOWER AND EYE/FACE WASH	1"	1"	- 		SPEAKMAN SE-603, FREE-STANDING, 20GPM TEPID (60-100 DEG.F.) WATER AMERICAN STANDARD AKRON
SS-A	SERVICE SINK	1/2"	1/2"	2'	1-1/2"	AMERICAN STANDARD AKRON

BACKFLO	BACKFLOW PREVENTER SCHEDULE									
NO.	AREA SERVED	USAGE	TYPE	ORIENTATION	INLET/ OUTLET SIZE (IN.)	INLET/ OUTLET SHUTOFF VALVE TYPE	MAX. WORKING PRESSURE (PSI)	FLOW AT 7.5 FPS (GPM)	PRESSURE DROP AT 7.5 FPS (PSI)	DESIGN MAKE
DCDA-1	DPW BLDG	FIRE WATER	DCDA	HORIZONTAL	6"	OSY	175	680	7.0	WATTS 709 DCDA
RPZ-1	DPW BLDG	DOMESTIC WATER	RPZ	HORIZONTAL	3"	OSY	175	170	12.0	WATTS LF909 RPZ
RPZ-2	WASHBAY	WASHBAY EQUIPMENT	RPZ	HORIZONTAL	1"	QUARTER TURN BALL	175	20	10.0	WATTS 009M2-QT-S

NO.	LOCATION	SERVICE	ACFM	MAX. PRESSURE (PSIG)	MOTOR HP	VOLTAGE	PHASE	TYPE	DESIGN MAKE
COMP-1	COMPRESSOR ROOM	TRUCK BAYS	92.4	175	15	480	3	DUPLEX RECIPROCATING	CHAMPION MODEL HR15-12

- REMARKS:

 1. INCLUDE 120 GA
- INCLUDE 120 GALLON RECEIVER
 INCLUDE REFRIGERANT DRYER
- INCLUDE 400 GALLON DRY STORAGE TANK

WATER HE	ATER SCHEDUL	.E								
NO.	SERVICE	STORAGE VOLUME (GAL.)	BTUH INPUT	GALLONS/ HOUR	TEMP RISE DEG F	FUEL TYPE	VENT IN INCHES	ELECTRIC	EFFICIENCY	DESIGN MAKE
WH-1	ADMIN	60	1200000	138	100	NAT GAS	3"	120V / 5A	95%	A.O. SMITH CYCLONE MXI BTH 120(A)
WH_2	VEHICLE MAINT	60	120000	138	100	NAT GAS	3"	120\/ / 5Δ	95%	Δ O SMITH CYCLONE MXI BTH 120(Δ)

MASTER	R MIXING VA	LVE SCHE	DULE						
TAG NO.	TAG NO. SERVICE T		DESIGN RANGE	PEAK FLOW	MAX. PRESSURE DROP AT		CONNECT	DESIGN MAKE	
TAG NO.	TAG NO. SERVICE TYPE	1111	(GPM)	(GPM)	PEAK FLOW (PSI)	HW INLET	CW INLET	MIXED OUTLET	DESIGN WARE
MMV-1	WH-1,WH-2	HIGH/LOW	0.5 - 159	60.0	10	1-1/4"	1-1/4"	1-1/2"	POWERS LFSH1434

PUMP S	CHEDULE									
				HEAD FT	MOTOR					
NO.	NO. LOCATION SERVICE	GPM	WATER	HP	VOLTAGE	PHASE	RPM	TYPE	DESIGN MAKE	
RP-1	MEZZANINE	ADMIN HWR	1.2	13.1	0.5	208	1	2225	INLINE	BELL & GOSSETT ECOCIRC XL 55-45

		VIEDII E					
EXPANSION TANK SCHEDULE							
NO.	LOCATION	SERVICE	RELIEF PRESSURE	TANK VOLUME (GALLONS)	MAX. ACCEPT FACTOR	DESIGN EQUIPMENT	
FT ₋ 1	WH_1 WH_2	DOM WATER	125 PSI	10	1.0	AMTROL ST-35-CI	

SHOCK	ABSORBE	R SCHEDU	JLE
NO.	FIXTURE UNIT RATING	SIZE IN INCHES	PDI SYMBOL
SA-A	1 - 11	1/2"	А
SA-B	12 - 32	3/4"	В
SA-C	33 - 60	1"	С
SA-D	61 - 113	1 1/4"	D
SA-E	114 - 154	1 1/2"	E
SA-F	155 - 330	2"	F

ject:

VILLAGE OF ARDSLEY, NY
1896

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PROJECT

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Drawn By: CES

Reviewed By: PJW

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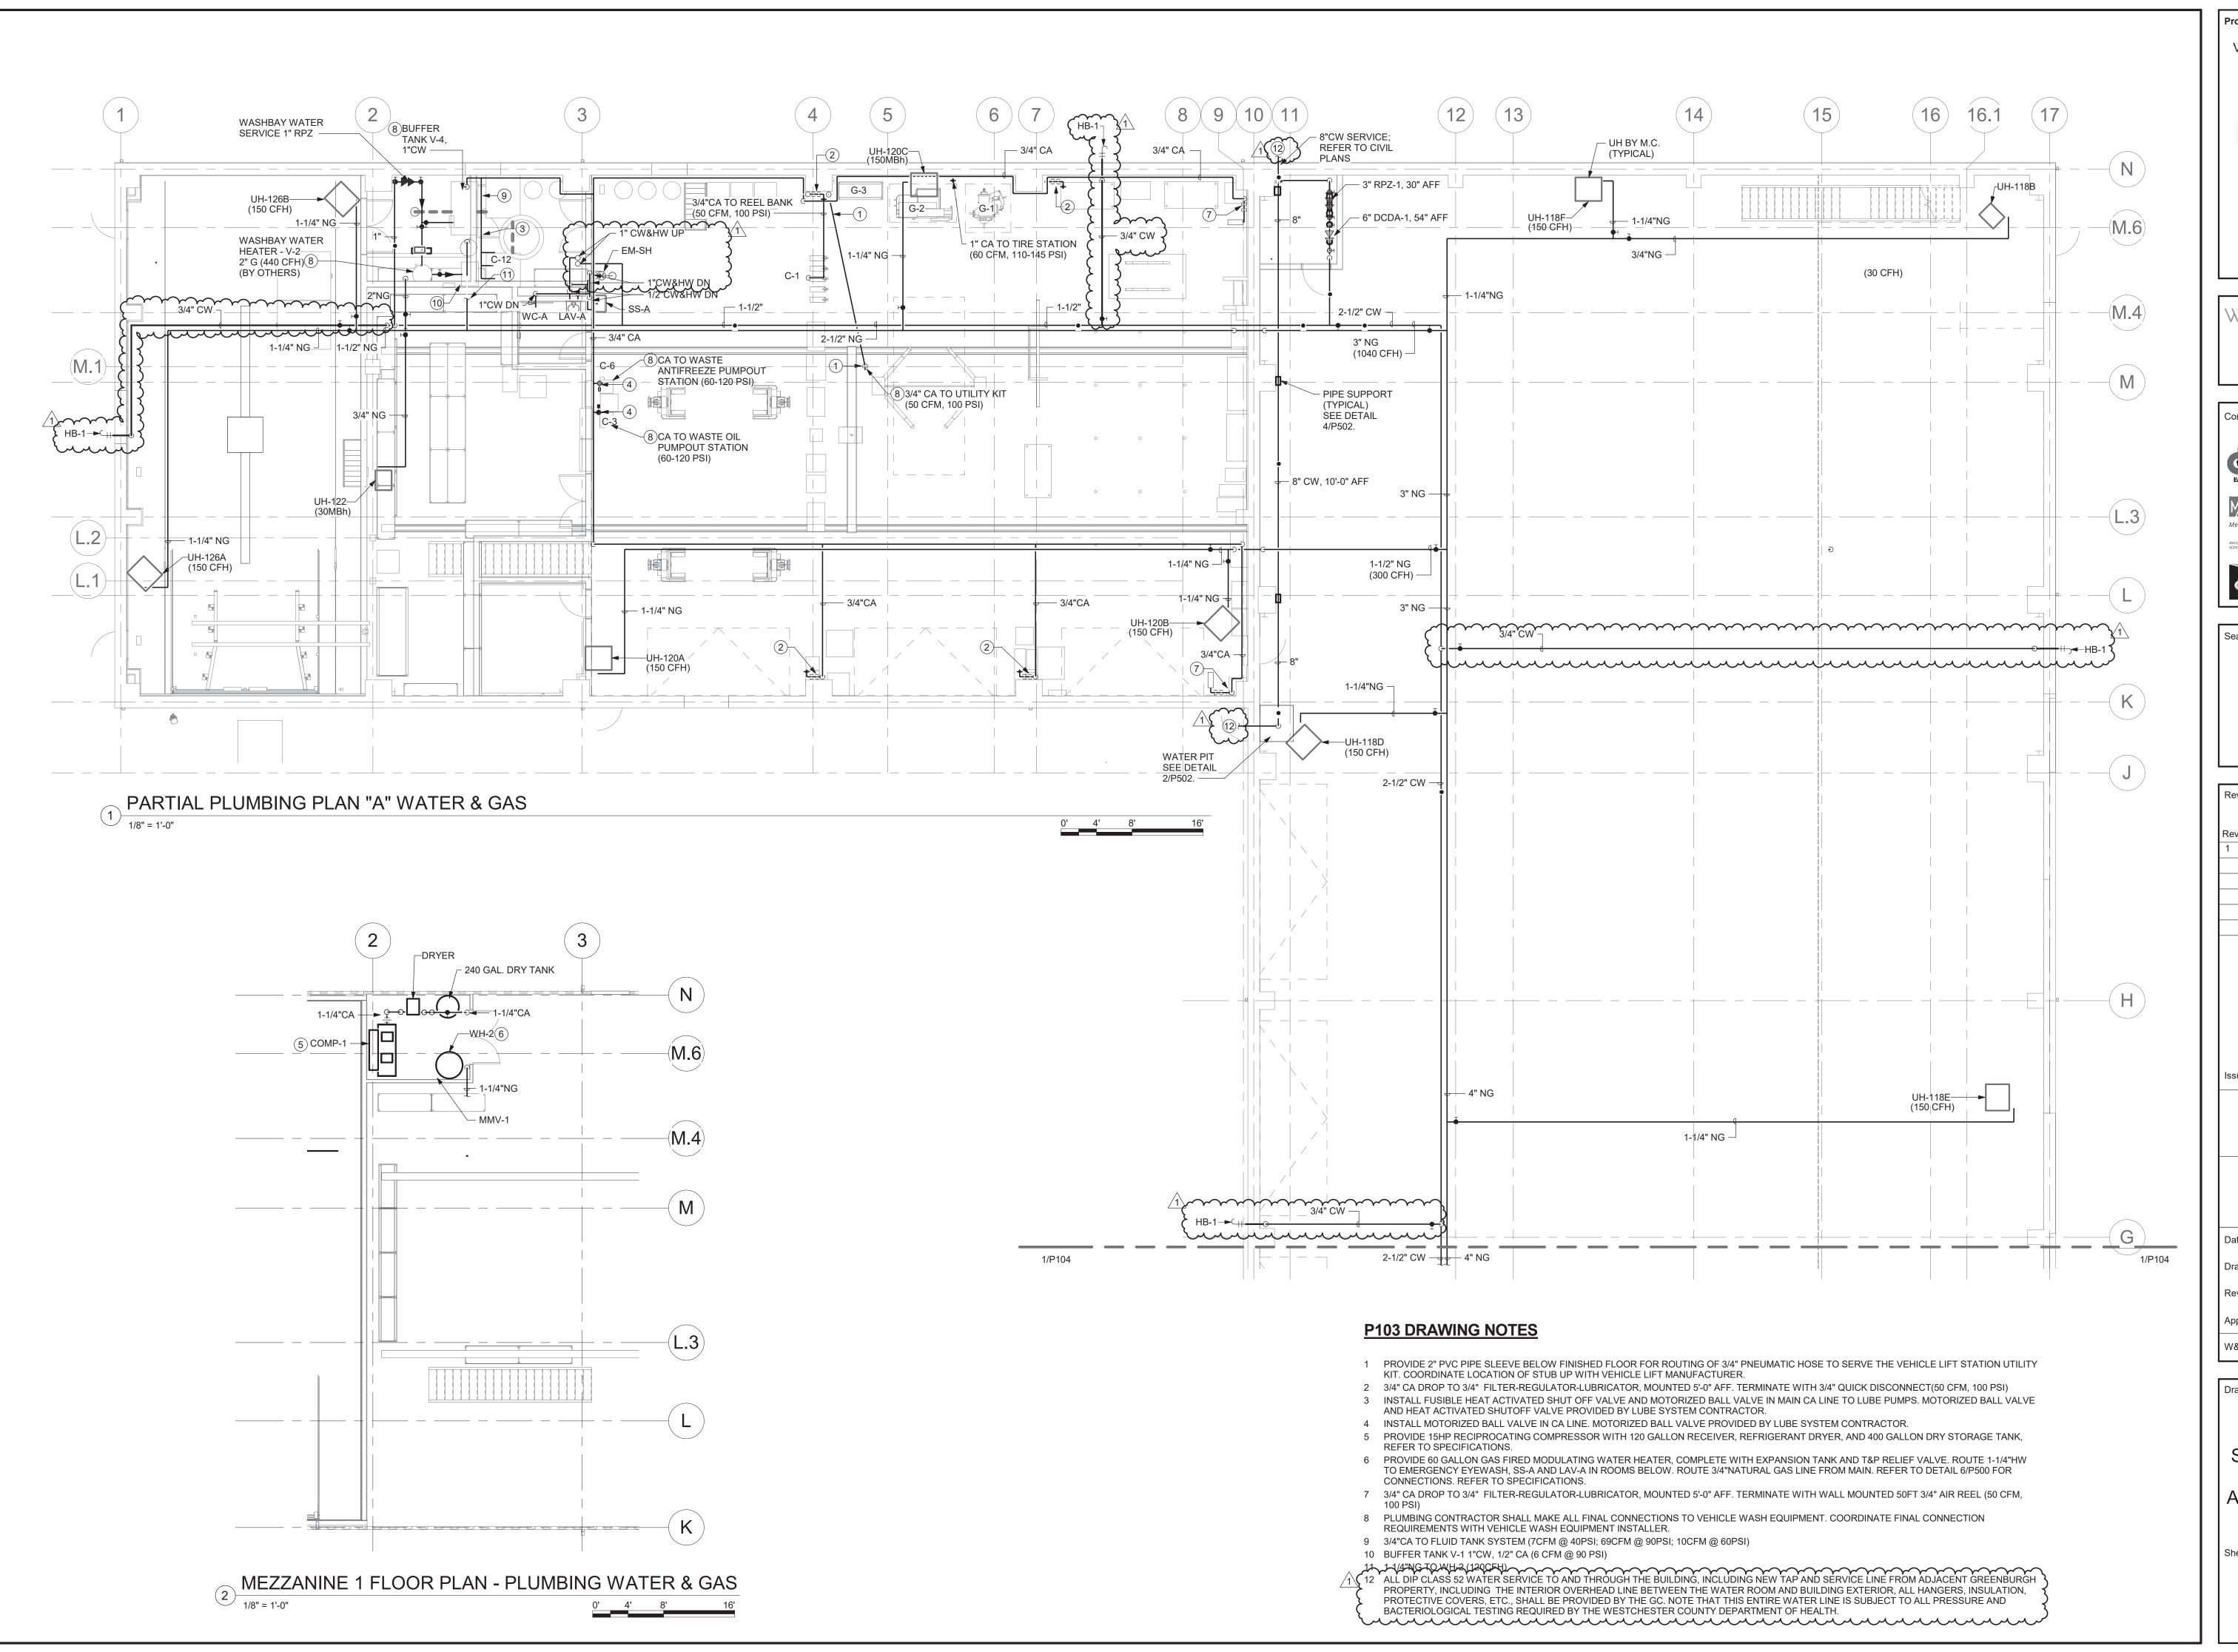
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Drawing Title:

GENERAL NOTES, SCHEDULES & SYMBOL LIST

Sheet Number:

P001



VILLAGE OF ARDSLEY, NY

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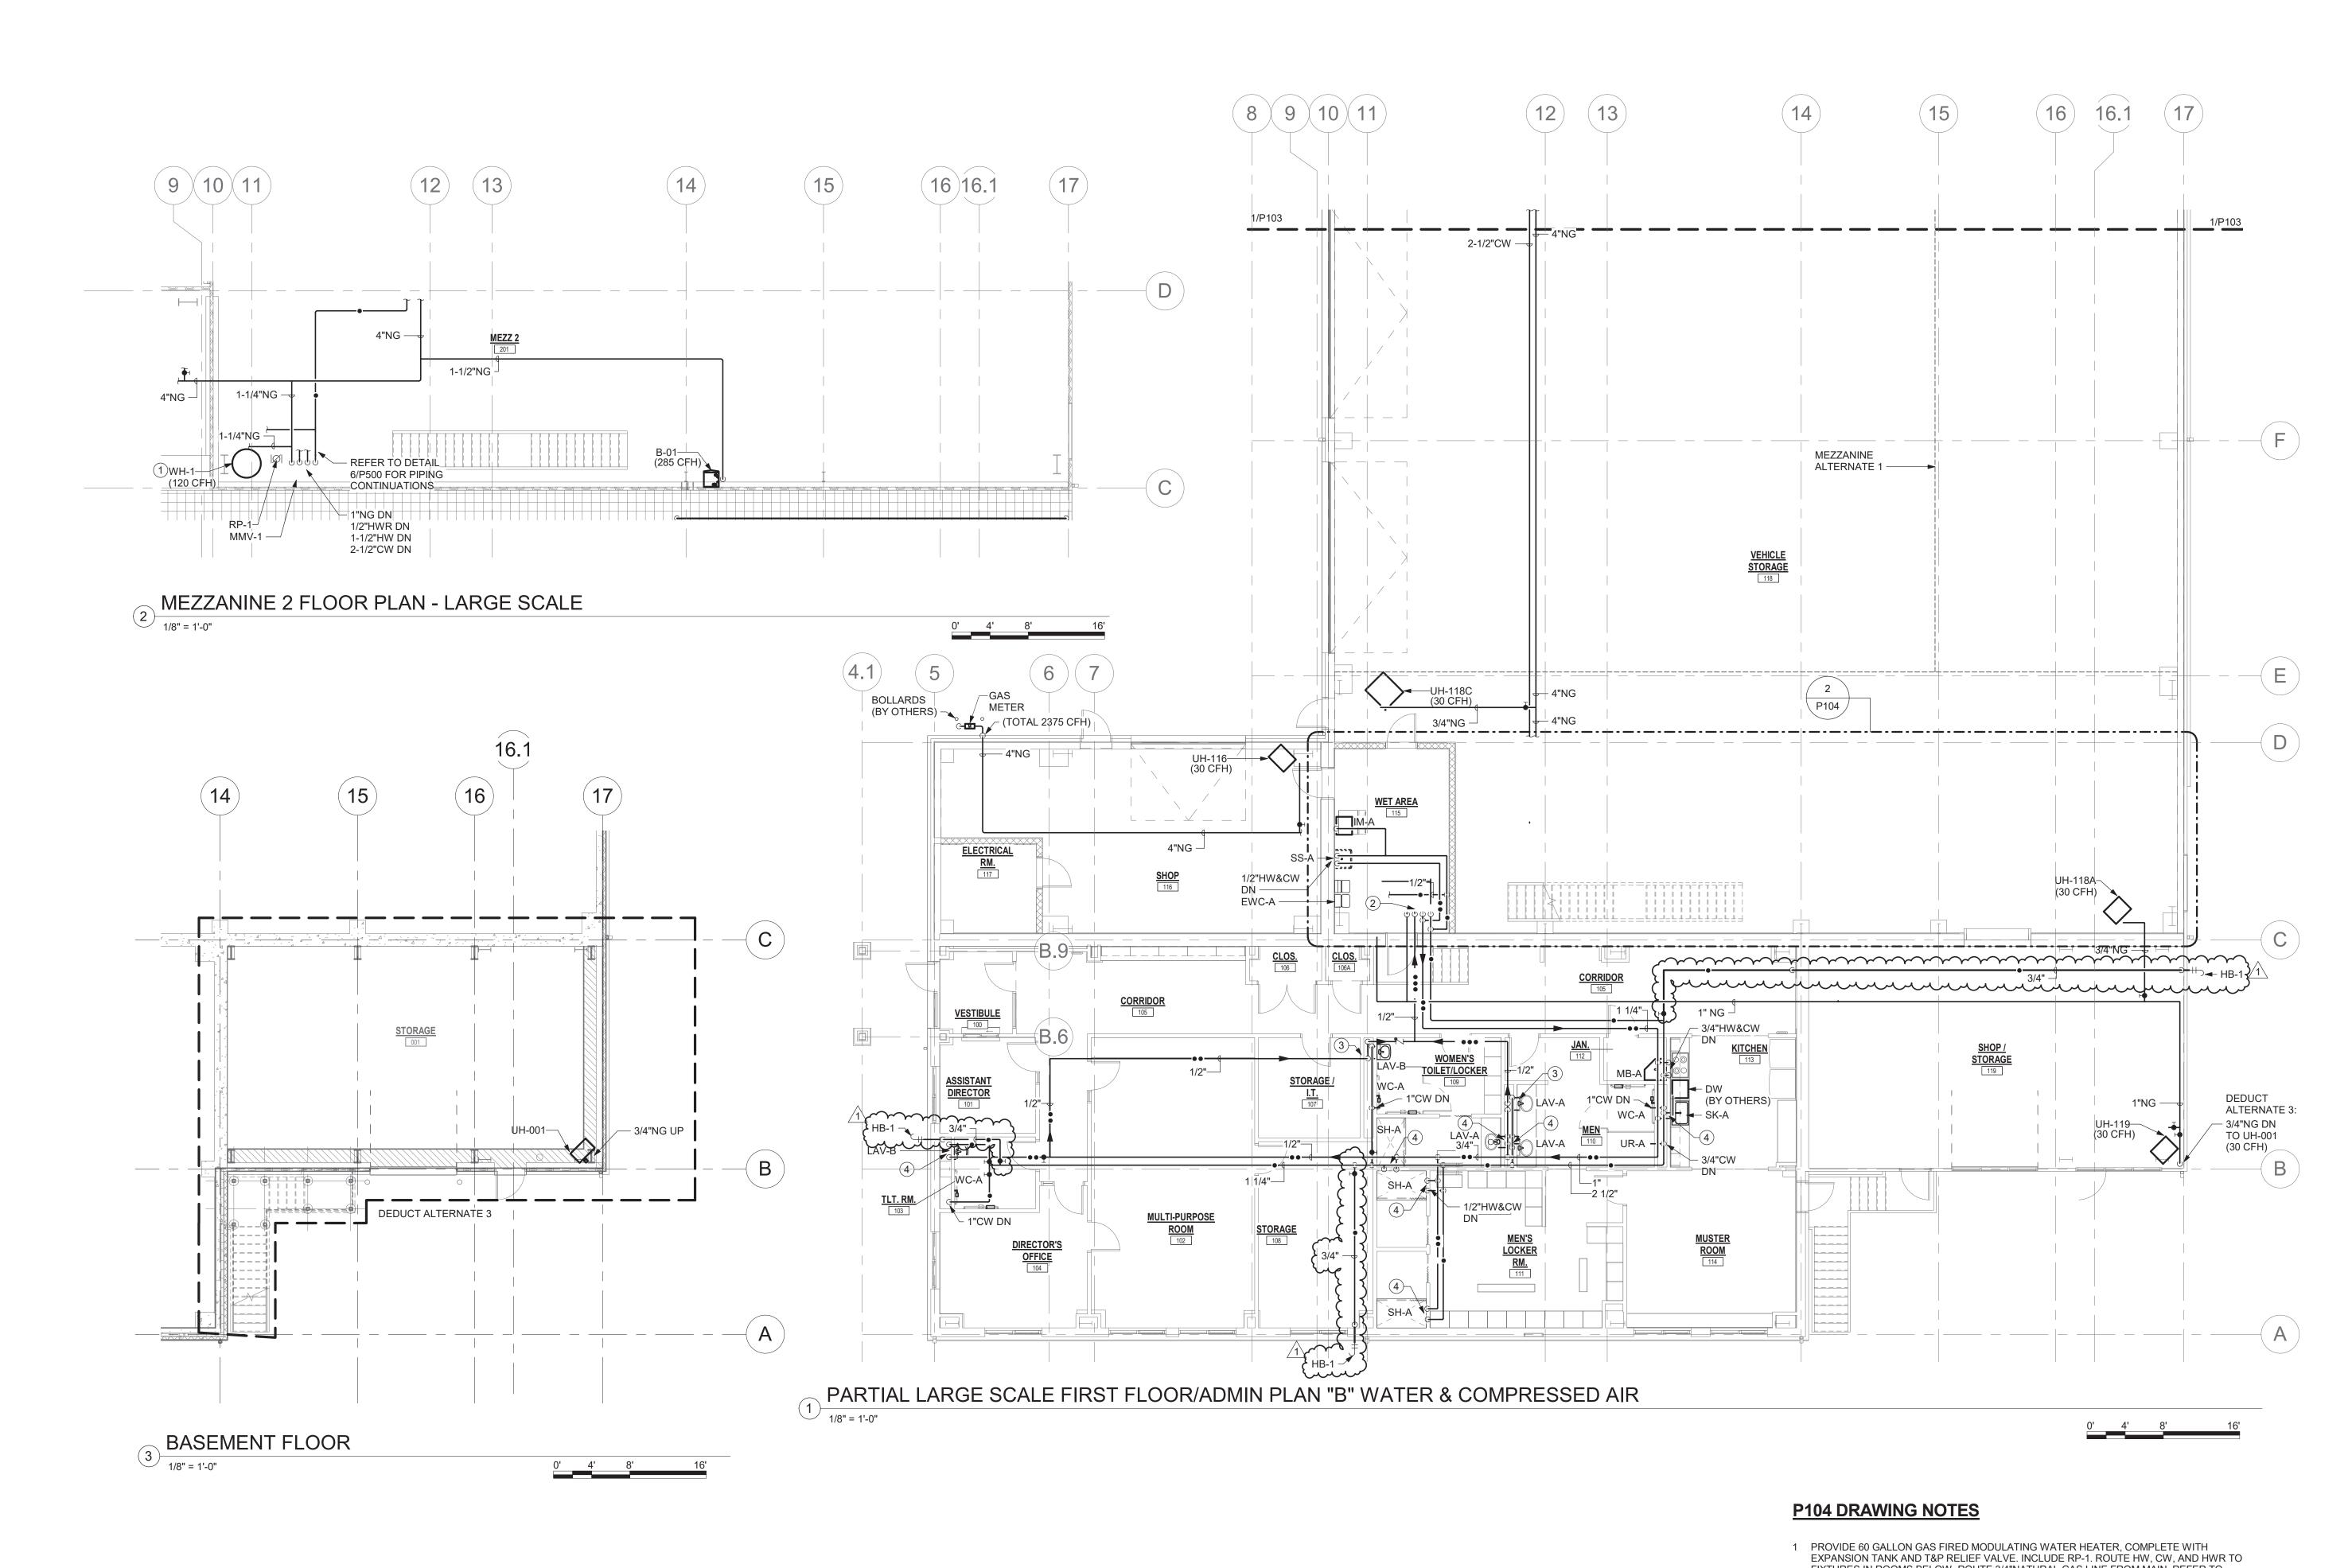
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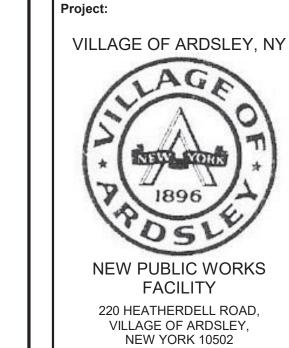
PARTIAL LARGE SCALE PLUMBING FLOOR PLANS -AREA "A" - WATER AND GAS

Sheet Number:

P103



- FIXTURES IN ROOMS BELOW. ROUTE 3/4"NATURAL GAS LINE FROM MAIN. REFER TO DETAIL 6/P500 FOR CONNECTIONS. REFER TO SPECIFICATIONS.
- 2 1"NG UP; 1/2"HWR UP; 1-1/2"HW UP; 2-1/2"CW UP
- 3 1/2"HW, CW&HWR DN
- 4 1/2"HW&CW DN



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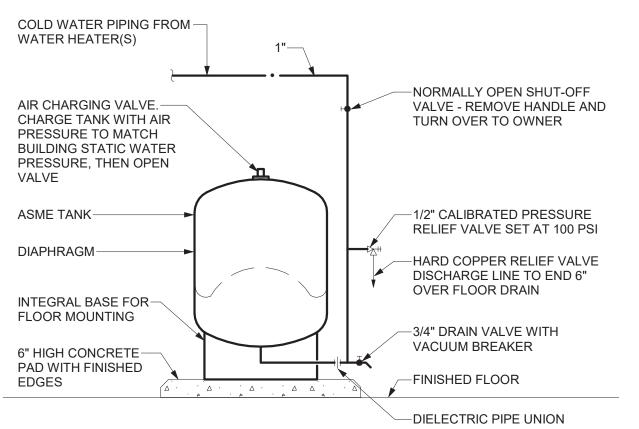
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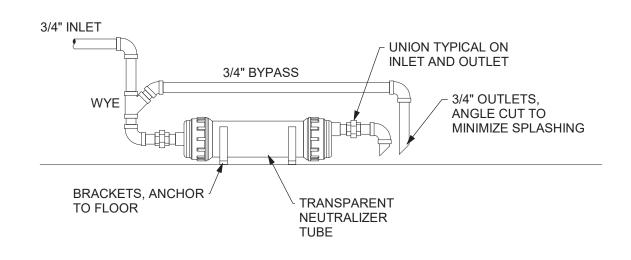
PARTIAL LARGE SCALE PLUMBING FLOOR PLANS -AREA "B" - WATER & GAS

Sheet Number:



THERMAL EXPANSION TANK DETAIL


1) NOT TO SCALE



DETAIL NOTES:

- A. NEUTRALIZER AND PIPING SHALL NOT OBSTRUCT ANY SERVICE SPACES OR ACCESS DOORS ON EQUIPMENT
- B. PIPING SIZE SHALL BE 3/4" MINIMUM, DO NOT USE 1/2" VINYL TUBE
- MOUNT NEUTRALIZER LEVEL, AND HORIZONTAL, WITH OUTLET HIGHER THAN INLET. VERTICAL MOUNTING SHALL NOT BE ACCEPTED DUE TO POSSIBLE BLOCKAGE OF INLET BY NEUTRALIZING MEDIA.
- D. ALL PIPING SHALL BE LOWER THAN APPLIANCE CONDENSATE OUTLETS
- TOTAL CONNECTED EQUIPMENT SHALL BE 300,000 BTUH OR LESS
- F. DESIGN BASIS: AXIOM NC-1


CONDENSATE NEUTRALIZER DETAIL

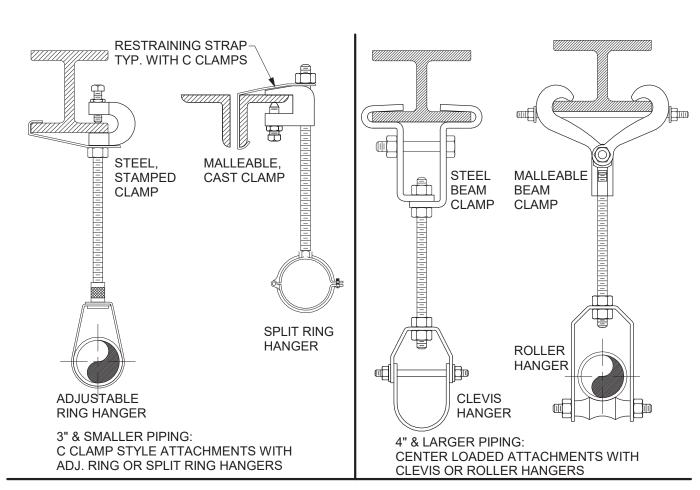

SUPPORT	SCHEDULE									
	PIPE MA	PIPE MATERIAL & SUPPORT SPACING								
PIPE SIZE	STEEL	COPPER	PLASTIC	CAST IRON	ROD SIZE					
3/4" TO 1"	8 FT.	6 FT.	3 FT.	EACH	3/8 IN.					
1 1/4" TO 2"	10 FT.	6 FT.	3 FT.	HORIZONTAL	3/8 IN.					
2 1/2" TO 4"	12 FT.	10 FT.	4 FT.	JT., 5 FT. MAXIMUM	1/2 IN.					
5" TO 6"	12 FT.	10 FT.	4 FT.	SPACING	5/8 IN.					
8"	12 FT.	10 FT.	4 FT.		3/4 IN.					
OVER 8"	TO SUIT L	TO SUIT LOADING CONDITIONS								


DETAIL NOTES:

- HORIZONTAL PIPING
- SUPPORT WITHIN 18 INCHES OF EACH COUPLING JOINT FOR 10 FT. PIPE LENGTHS
- SUPPORT AT 5 FT. INTERVALS FOR 5 FT. PIPE LENGTHS 4 INCH AND LARGER PIPE - BRACE AT CHANGES IN DIRECTION TO PREVENT
- HORIZONTAL MOVEMENT INSTALLATIONS REQUIRING MULTIPLE JOINTS WITHIN A FOUR FOOT DEVELOPED LENGTH SHALL BE SUPPORTED AT EVERY OTHER OR ALTERNATING COUPLINGS. **FINISHES**
- TYPICAL ELECTROPLATED ZINC OR CADMIUM FINISH
- COPPER PIPING, UNINSULATED COPPER PLATED OR PVC COATED EXTERIOR & WET LOCATIONS, HOT DIPPED GALVANIZED HARDWARE & HANGERS
- 8 PIPE HANGER AND SPACING DETAILS STEEL STRUCTURE
 NOT TO SCALE

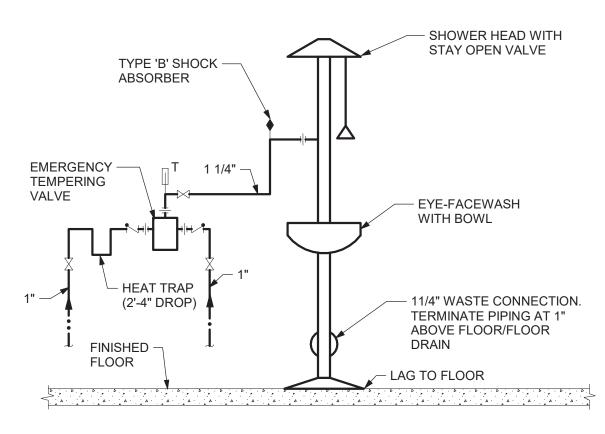

EMERGENCY SHOWER/EYEWASH DETAIL


NOT TO SCALE

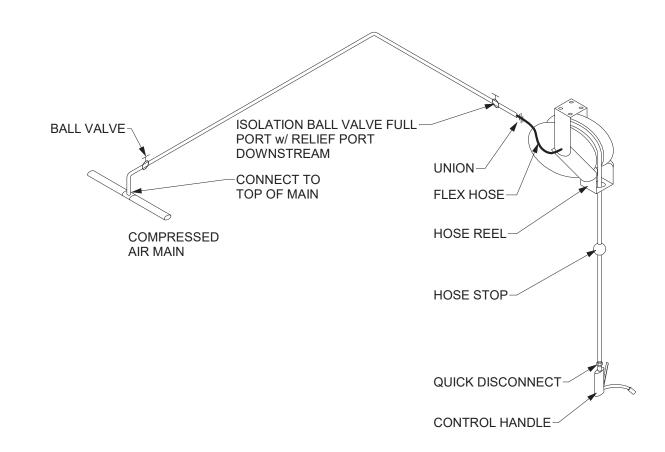

GENERAL NOTES:

- ADJUST HOSE STOPS AND REEL TENSION. CONTROL HANDLE TO HANG AT 4'-6" AFF UNLESS OTHERWISE REQUESTED BY OWNER.
- QUICK DISCONNECT TO MATCH OWNER'S MODEL FOR RENOVATIONS
- COLOR CODE EXPOSED PIPING IN SERVICE BAYS. PAINT 12" BAND ON PIPING ON 20 FOOT CENTERS WITH UNIQUE COLOR FOR EACH PIPE CONTENTS. PROVIDE CHART WITH KEY TO COLORS TO OWNER.


COMPRESSED AIR - HOSE REEL DETAIL

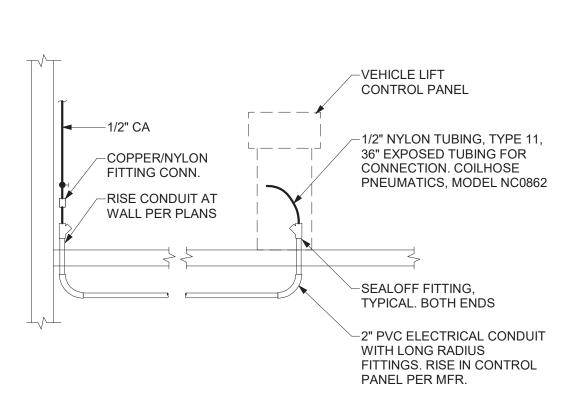

DRAWING NOTES:

- A. PROVIDE ONE DEDICATED CONDUIT PER VEHICLE LIFT CONTROL PANEL
- B. PROVIDE 1/2" COMPRESSED AIR CONNECTION TO CONDUIT RISER AT WALL
- C. PROVIDE PERMANENT LABEL AT VALVE "VEHICLE LIFT COMPRESSED AIR"
- STUB UP ABOVE FINISHED FLOOR PER LIFT MFR. COORDINATE CONDUIT ROUTE AND RISE LOCATIONS AT LIFT CONTROL CABINET WITH E.C. PROVIDE SEALOFF AT BOTH ENDS OF CONDUIT PER LIFT MANUFACTURER. PROVIDE 1/2", NYLON, TYPE 11, TUBING IN CONDUIT WITH 36" MIN. EXPOSED TUBING AT BOTH ENDS.
- VEHICLE LIFT COMPRESSED AIR DETAIL

NOT TO SCALE

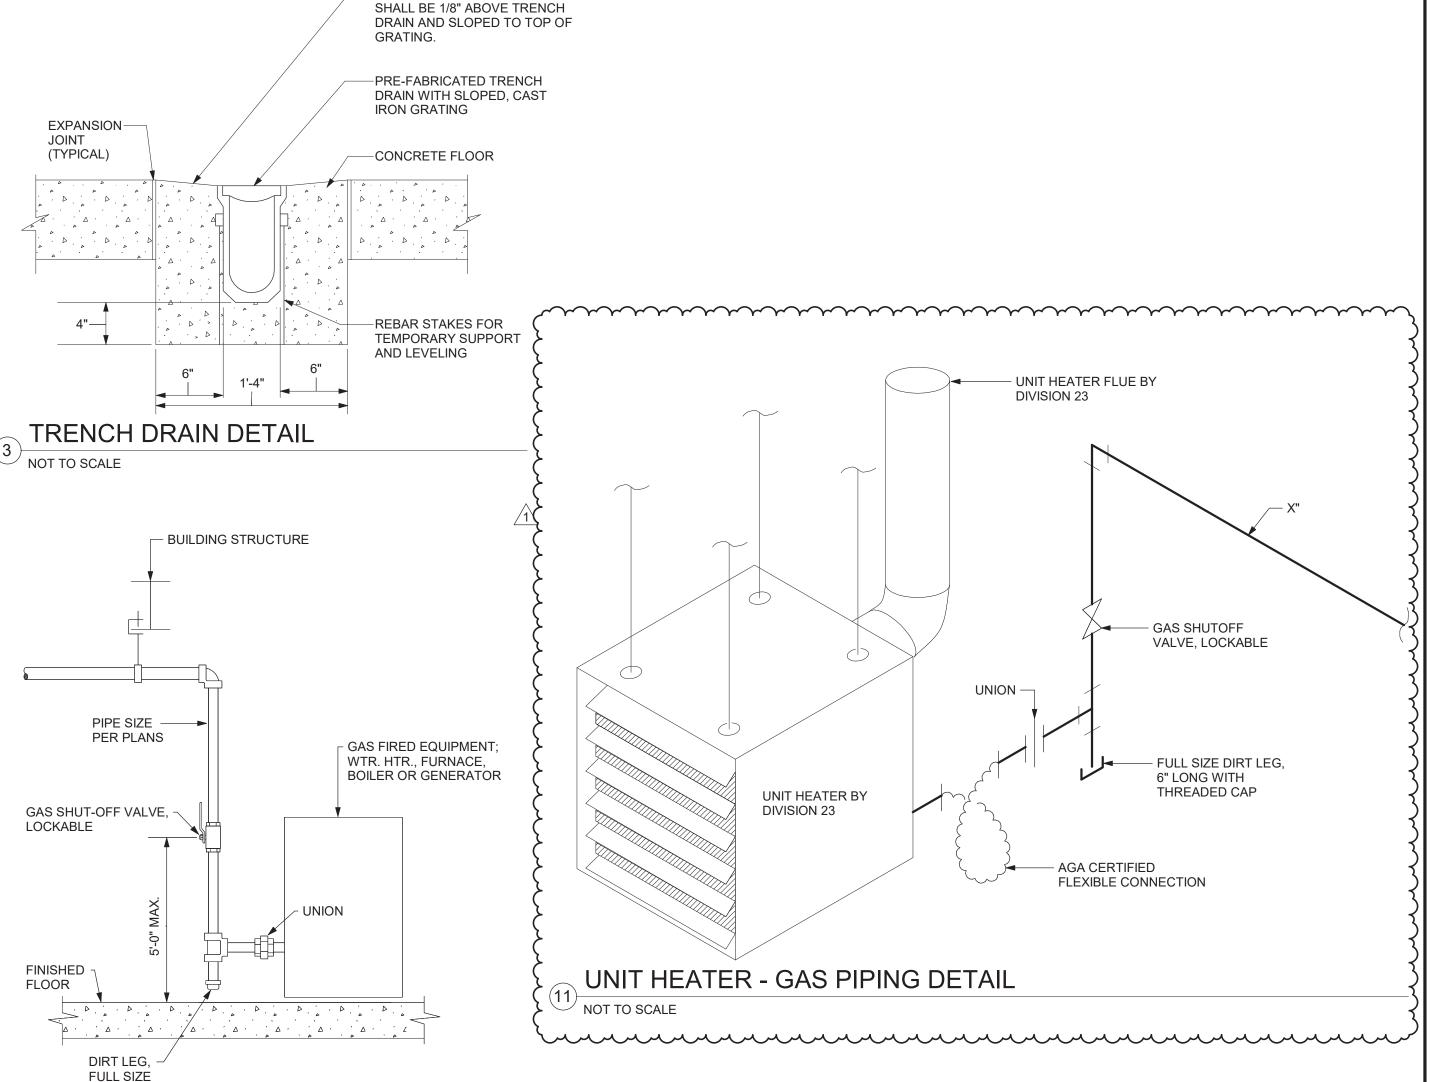

-FINISHED LEVEL OF CONCRETE


DETAIL NOTES:

WITH CAP

- A. PROVIDE SHUT-OFF VALVE, DIRT LEG AND UNION AT EACH GAS CONNECTION ON EACH PIECE OF EQUIPMENT.
- B. VERIFY CONNECTION SIZES, QUANTITIES AND LOCATIONS WITH M.C.
- PROVIDE PIPE NIPPLE THROUGH EQUIPMENT CASE. CSST & FLEX

GAS EQUIPMENT CONNECTION DETAIL

LINES SHALL NOT PENETRATE CASING PER CODE.

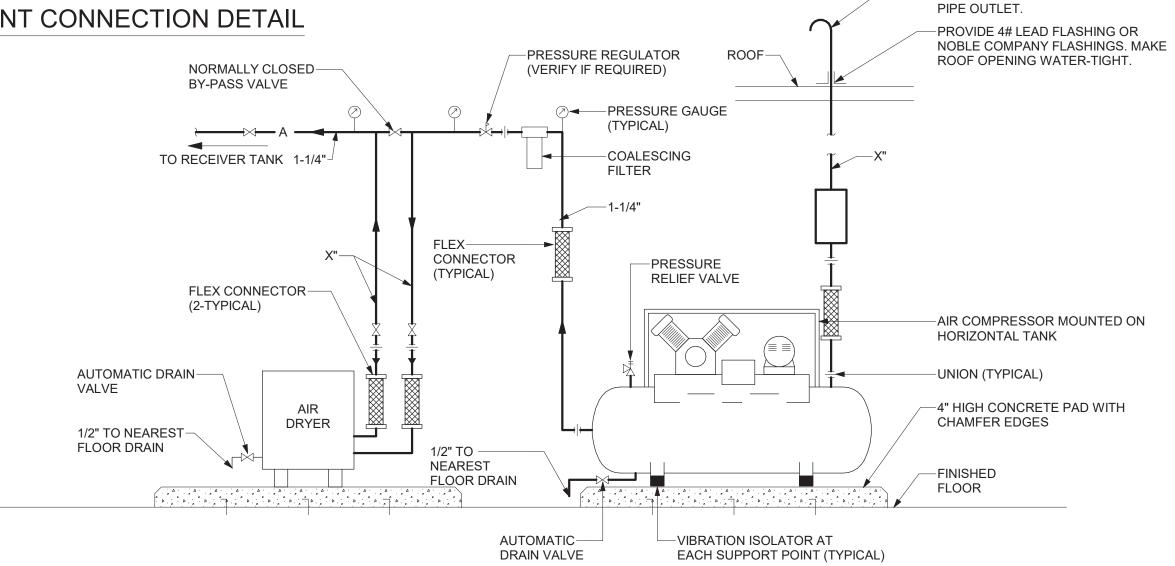

DETAIL NOTES:

- PIPE SIZES AND COMPRESSOR LOCATION AS INDICATED ON DRAWINGS.
- COORDINATE EQUIPMENT ELECTRICAL CONNECTION REQUIREMENTS WITH SECTION 16/DIVISION 26.
- ALL DRAIN PIPING SHALL TERMINATE AT 1" ABOVE NEAREST FLOOR DRAIN.
- PAINT EXPOSED PIPING ABOVE ROOF WITH ONE(1) PRIMER AND TWO(2) FINISH COATS AS SPECIFIED.

AIR COMPRESSOR DETAIL

VILLAGE OF ARDSLEY, NY **NEW PUBLIC WORKS FACILITY** 220 HEATHERDELL ROAD,

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-INSTALL AIR INTAKE AT 3' ABOVE

STAINLESS STEEL BIRDSCREEN ON

ROOF WITH GOOSENECK AND

PROJECT

SCALE: AS NOTED

APRIL 7, 2022 CES Drawn By: Reviewed By:


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W&S Project No: N2190088

Drawing Title:

DETAILS

Sheet Number:

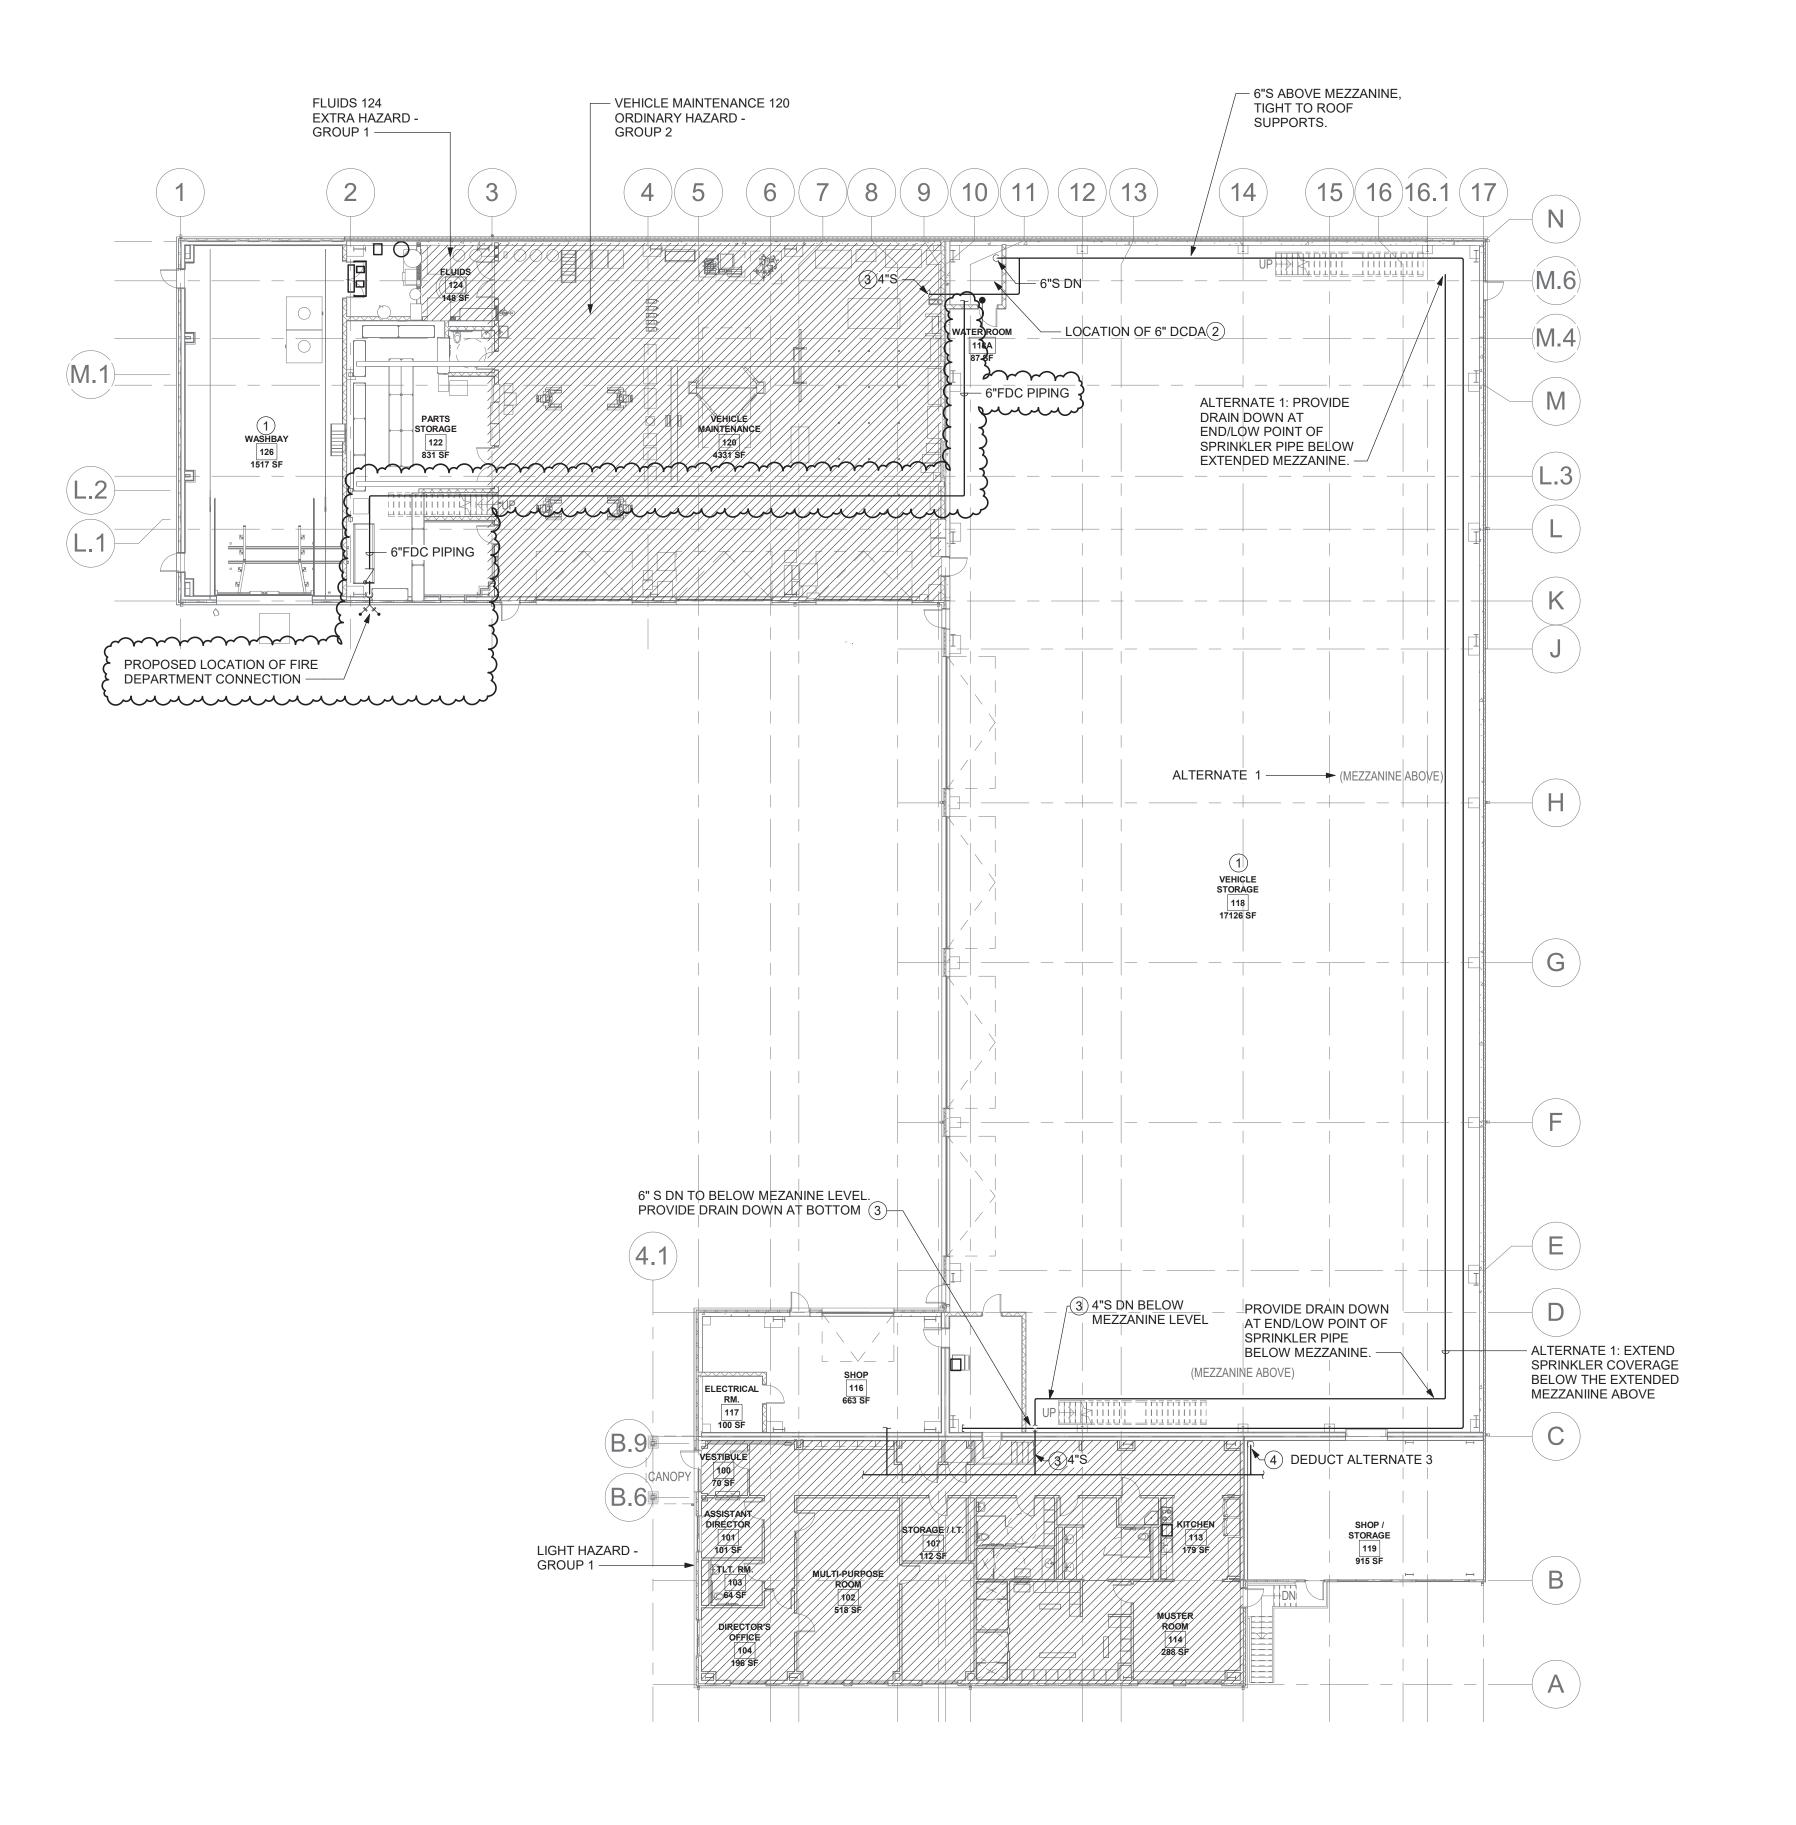

FP101 DRAWING NOTES

- 1 FIRE HAZARD CLASSIFICATION SHALL BE ORDINARY HAZARD GROUP 1 UNLESS
- 4 DEDUCT ALTERNATE No. 3: 2"S DN TO BASEMENT LEVEL. PROVIDE DRAIN DOWN AT BOTTOM.

OTHERWISE NOTED. 2 FIRE SERVICE BACK FLOW PREVENTOR PROVIDED BY THE PLUMBING CONTRACTOR. COORDINATE SIZE AND CLEARANCE REQUIRMENTS WITH THE PC BASED ON THE RESULTS OF THE HYDRAULIC CALCULATIONS. REFER TO THE PLUMBING DRAWINGS FOR ROOM LAYOUT.

3 SPRINKLER MAIN SIZES INDICATED ARE FOR SUGGESTED ROUTING REFERENCE ONLY. THIS CONTRACTOR SHALL HYDRAULICALLY CALULATE AND CONFIRM ALL MAINS AND

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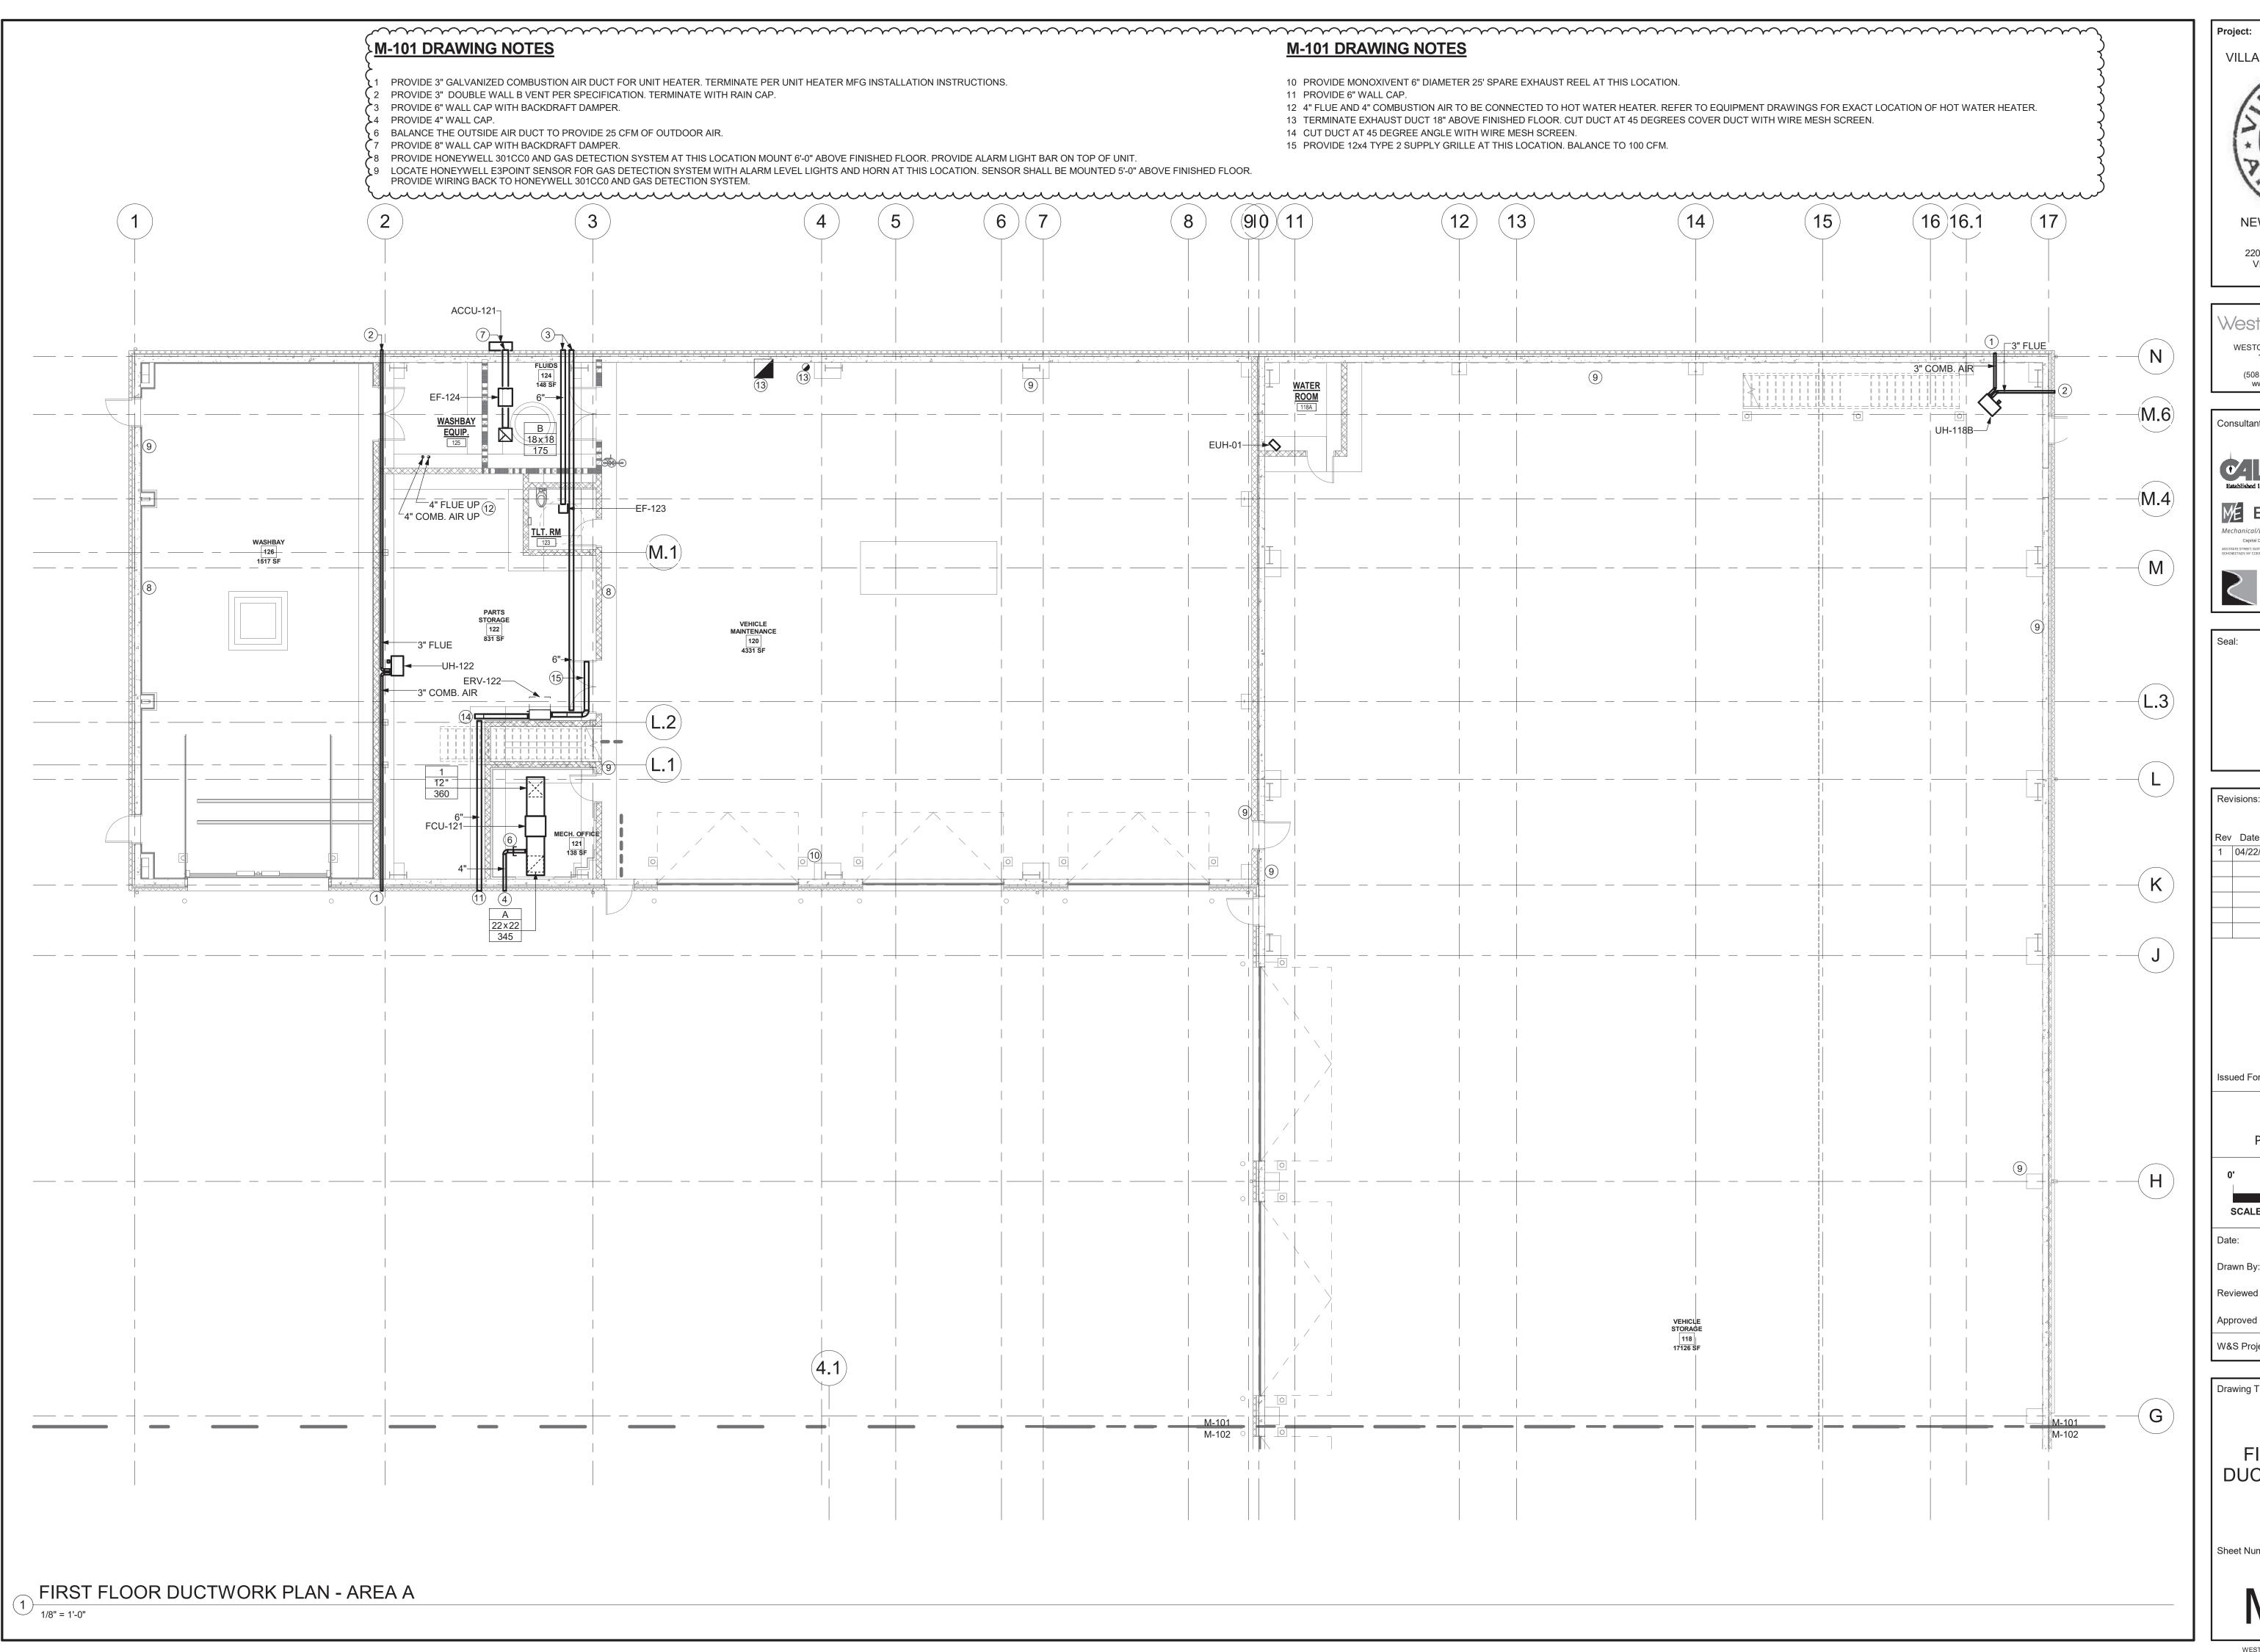
Drawing Title:

OVERALL FIRE PROTECTION FLOOR PLAN

Sheet Number:

OVERALL FIRST FLOOR FIRE PROTECTION PLAN

1/16" = 1'-0"



VILLAGE OF ARDSLEY, NY

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PROJECT TRUE

SCALE: 1/8" = 1'-0"

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Drawing Title:

FIRST FLOOR DUCTWORK PLAN - AREA A

Sheet Number:

M-103 DRAWING NOTES M-103 DRAWING NOTES 1 CUT DUCT AT 45 DEGREE ANGLE WITH WIRE MESH SCREEN. 8 PROVIDE HONEYWELL 301CC0 AND GAS DETECTION SYSTME AT THIS LOCATION MOUNT 6'-0" ABOVE FINISHED FLOOR. 2 PROVIDE 3" GALVANIZED COMBUSTION AIR DUCT FOR UNIT HEATER. TERMINATE PER UNIT HEATER MFG INSTALLATION 9 LOCATE HONEYWELL E3POINT SENSOR FOR GAS DETECTION SYSTEM WITH ALARM LEVEL LIGHTS AND HORN AT THIS INSTRUCTIONS. LOCATION. SENSOR SHALL BE MOUNTED 5'-0" ABOVE FINISHED FLOOR. 3 PROVIDE 10" WALL CAP WITH BACKDRAFT DAMPER. 10 PROVIDE MONOXIVENT SPRING OPERATED REEL MODEL 9000-W, 6" DIAMETER, 36' HOSE LENGTH. 4 PROVIDE 10" WALL CAP. 11 PROVIDE MONOXIVENT D20 FAN, 208V 3 PHASE MOTOR. SIZE 900 CFM 6" ESP. 5 PROVIDE 6" WALL CAP WITH BACKDRAFT DAMPER. 12 6" DUCT UP FROM EXHAUST REEL AND ASSOCIATED FAN. TERMINATE ABOVE ROOF WITH GOOSENECK. 6 PROVIDE 6" WALL CAP. 13 TERMINATE 4" FLUE AND 4" COMBUSTION AIR IN A CONCENTRIC VENT ABOVE ROOF. 7 PROVIDE 3" GALVANIZED COMBUSTION AIR DUCT FOR UNIT HEATER. TERMINATE PER UNIT HEATER MFG INSTALLATION 14 PROVIDE 12x4 TYPE 2 SUPPLY GRILLE AT THIS LOCATION. BALANCE TO 100 CFM. 15 PROVIDE 12x8 TYPE 2 SUPPLY GRILLE AT THIS LOCATION. BALANCE TO 250 CFM. 16 PROVIDE 12x8 TYPE 2 SUPPLY GRILLE AT THIS LOCATION. BALANCE TO 300 CFM. 17 MOUNT ERV BELOW UNIT HEATER. **NEW PUBLIC WORKS** 220 HEATHERDELL ROAD, 3 16)16.1 4" FLUE ___EF-200 WESTON & SAMPSON, PE, LS, LA, PC 4" COMB. AIR 4" COMB. AIR **□[◆]₽** 4" FLUE Consultants: UH-118F EUH-02 ----4" FLUE UP (13) <u>4" COMB. AIR UP</u> ●**→** DSF-120A DSF-118C-----4" FLUE 4" COMB. AIR LV-A UH-120A-[—]4" C<mark>OMB. AIR</mark> 4" FLUE K Issued For: -(H)4" COMB. AIR-Drawn By: DSF-118B-----MEZZANINE FLOOR DUCTWORK PLAN - AREA A 1/8" = 1'-0"

VILLAGE OF ARDSLEY, NY

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A R C H I T E C T V R I

Revisions: Rev Date Description 1 04/22/22 ADDENDUM NO. 1

PROJECT TRUE

0' 4' 8' SCALE: 1/8" = 1'-0"

APRIL 7, 2022

Reviewed By: Approved By: BAB

W&S Project No: N2190088

Drawing Title:

MEZZANINE DUCTWORK PLAN - AREA A

Sheet Number:

12) DSF-118A-----▶ E 4" FLUE $\left(\mathsf{D}\right)$ 4" COMB. AIR (C)

MEZZANINE FLOOR DUCTWORK PLAN - AREA B

1/8" = 1'-0"

M-104 DRAWING NOTES

- 1 CUT DUCT AT 45 DEGREE ANGLE WITH WIRE MESH SCREEN.
- 2 PROVIDE 3" DOUBLE WALL B VENT PER SPECIFICATION. TERMINATE WITH RAIN CAP.
- 3 PROVIDE HONEYWELL 301CC0 AND GAS DETECTION SYSTME AT THIS LOCATION MOUNT 6'-0" ABOVE FINISHED FLOOR.
- 4 LOCATE HONEYWELL E3POINT SENSOR FOR GAS DETECTION SYSTEM WITH ALARM LEVEL LIGHTS AND HORN AT THIS LOCATION. SENSOR SHALL BE MOUNTED 5'-0" ABOVE FINISHED FLOOR.
- 5 PROVIDE 3" GALVANIZED COMBUSTION AIR DUCT FOR UNIT HEATER. TERMINATE PER UNIT HEATER MFG INSTALLATION INSTRUCTIONS.
- 6 TERMINATE 3" COMBUSTION AIR AND 3" FLUE FROM B-01 IN CONCENTRIC VENT ON ROOF.
 7 PROVIDE 12x8 TYPE 2 SUPPLY GRILLE AT THIS LOCATION. BALANCE TO 300 CFM.
- 8 PROVIDE 14" WALL CAP.
- 9 PROVIDE 14" WALL CAP WITH BACKDRAFT DAMPER.

VILLAGE OF ARDSLEY, NY

P 1896

FACILITY
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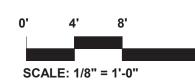
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Rev Date Description

1 04/22/22 ADDENDUM NO. 1





APRIL 7, 2022

Date:

Drawn By: JDH

Reviewed By: TES

Approved By: BAB


W&S Project No: N2190088

Drawing Title:

MEZZANINE DUCTWORK PLAN - AREA B

Sheet Number:

M104

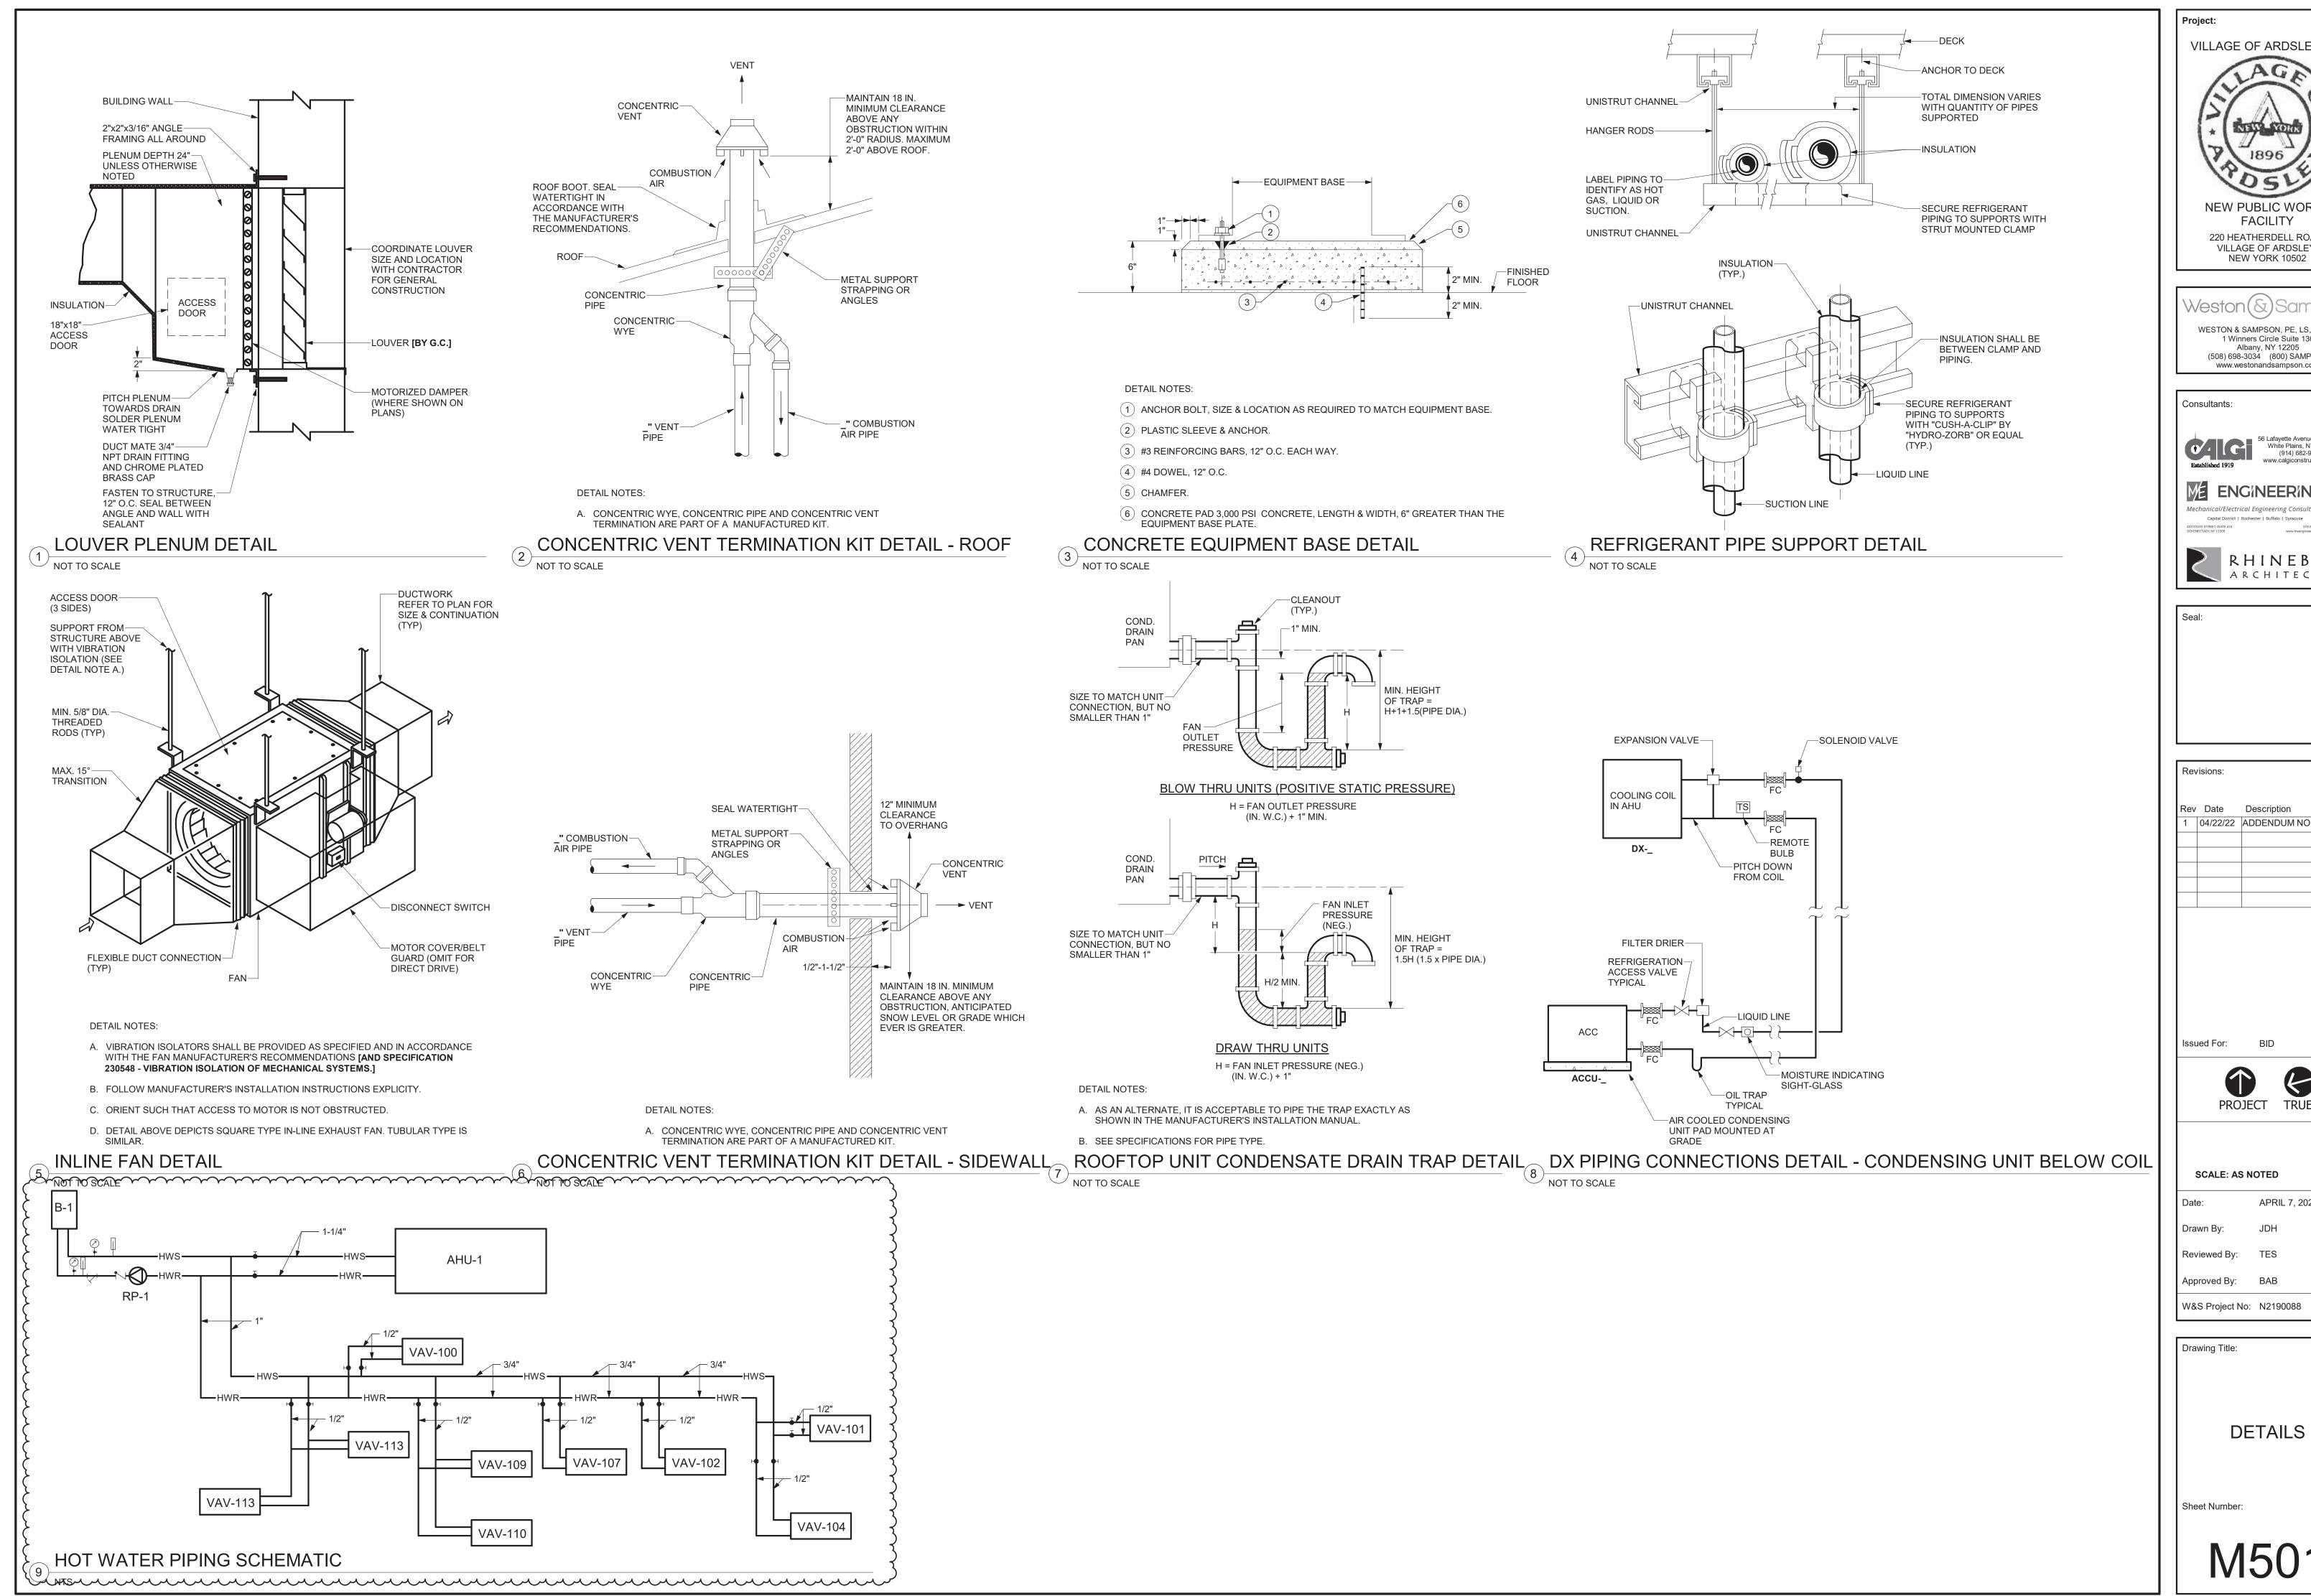

VILLAGE OF ARDSLEY, NY **NEW PUBLIC WORKS FACILITY** 220 HEATHERDELL ROAD, VILLAGE OF ARDSLEY,

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Rev Date Description 1 04/22/22 ADDENDUM NO. 1

PROJECT TRUE

SCALE: AS NOTED

APRIL 7, 2022 JDH

Approved By: BAB

W&S Project No: N2190088

DETAILS

GENERAL NOTES

(APPLY TO ALL DRAWINGS)

- A. PROVIDE ALL LABOR. MATERIALS, EQUIPMENT AND SERVICES TO PERFORM ALL OPERATIONS REQUIRED FOR THE COMPLETE INSTALLATION AND RELATED WORK AS SHOWN ON THE DRAWINGS AND AS SPECIFIED HEREIN. ELECTRIC EQUIPMENT SHALL BE INSTALLED IN A NEAT AND WORKMANLIKE MANNER.
- B. PROVIDE ALL ELECTRICAL EQUIPMENT CONNECTIONS.
- C. PROVIDE ALL REQUIRED SUPPORTS AND ACCESSORIES.
- PROVIDE ALL WORK IN COMPLIANCE WITH THE NATIONAL ELECTRICAL CODE (NEC) AND THE LATEST EDITION OF THE: 1. BUILDING CODE OF NEW YORK STATE
 - 2. ENERGY CONSERVATION CONSTRUCTION CODE OF NEW YORK STATE

PROVIDE ELECTRICAL INSPECTION CERTIFICATE FROM INSPECTION AGENCY

- 3. OSHA REQUIREMENTS 4. LOCAL MUNICIPAL ORDINANCES AND CODES
- 5. AUTHORITY HAVING JURISDICTION (AHJ)

RECOGNIZED AS ACCEPTABLE FROM THE AHJ.

- 6. SERVING UTILITY COMPANIES
- F. ALL RECEPTACLES INDICATED AS GFI TYPE MUST BE A GFI RECEPTACLE. CONNECTING NORMAL RECEPTACLES DOWNSTREAM OF ONE GFI RECEPTACLE IS NOT ACCEPTABLE PROVIDE TEMPORARY ELECTRICAL SERVICE IN SIZES TO ACCOMMODATE CONSTRUCTION WHERE REQUIRED.
- G. REPAIR OR REPLACE ALL DEFECTS IN MATERIAL OR WORKMANSHIP WITHIN ONE YEAR OF CONSTRUCTION CLOSE OUT DATE AT NO ADDITIONAL COST TO
- H. PERFORM ALL OPERATIONS REQUIRED FOR A COMPLETE SYSTEM TEST. PRIOR TO CLOSE OUT DATE SUBMIT ALL SATISFACTORY SYSTEM TEST RESULTS FOR RECORD.
- I. SUBMITTALS:
- 1. ALL ITEMS OF EQUIPMENT AND MATERIALS PROVIDED SHALL BE SUBMITTED FOR ENGINEERING REVIEW.
- 2. SUBMIT A MINIMUM OF THREE COPIES OF SHOP DRAWINGS/PRODUCT DATA INFORMATION.
- CONTRACTOR IS HERE BY CAUTIONED THAT ELECTRIC POWER CHARACTERISTICS (VOLTAGE, PHASE, HORSEPOWER, AMPERAGE, ETC.) OF EQUIPMENT IS BASED ON AVAILABLE INFORMATION AT THE TIME OF PROJECT DESIGN. CONTRACTOR MUST VERIFY CHARACTERISTICS FOR EACH PIECE OF NEW EQUIPMENT PRIOR TO ORDERING ELECTRICAL EQUIPMENT. INDICATE VERIFICATION ON SUBMITTALS.
- K. LOCATIONS INDICATED FOR LIGHTING FIXTURES ARE APPROXIMATE. LOCATE FIXTURES AS REQUIRED TO AVOID INTERFERENCE WITH BUILDING STEEL. PIPING, DUCTWORK, CONDUIT, DIFFUSERS, GRILLES, SPEAKERS, SMOKE DETECTORS, ETC. FIELD COORDINATE EXACT LOCATIONS AS NEAR AS POSSIBLE TO THE LOCATION INDICATED. VERIFY COMPLIANCE WITH NEC ARTICLE 410.16 FOR INSTALLATION OF LIGHT FIXTURES IN CLOTHES CLOSETS, PRIOR TO ROUGH-IN. REFER TO ARCHITECTURAL REFLECTED CEILING PLANS.
- L. EXACT LOCATIONS OF CEILING MOUNTED SMOKE DETECTORS, EXIT SIGNS, ETC. SHALL BE COORDINATED WITH OTHER CEILING MOUNTED EQUIPMENT TO AVOID CONFLICT. LOCATE DEVICES AS NEAR AS POSSIBLE TO THE LOCATION INDICATED. FIRE ALARM SMOKE AND HEAT DETECTORS SHALL BE LOCATED 3'-0 MINIMUM FROM HVAC DIFFUSERS, REGISTERS, GRILLES, ETC. SMOKE DETECTORS AT SMOKE DOORS MUST BE INSTALLED WITHIN 5'-0 OF THE DOORS (REFER TO NFPA 72).
- M. ALL NEW CIRCUITING SHALL BE CONCEALED (EXCEPT IN UNFINISHED SPACES). PROVIDE ALL CUTTING AND PATCHING AS REQUIRED.
- N. CONTRACTOR SHALL REVIEW ALL TRADES' CONTRACT DOCUMENTS TO DETERMINE SPECIFIC MOUNTING LOCATIONS FOR ELECTRICAL EQUIPMENT. COORDINATE EXACT MOUNTING LOCATIONS WITH THE ARCHITECT AND OTHER CONTRACTORS. REFER TO ARCHITECTURAL PLANS FOR CASEWORK LAYOUT, ELEVATIONS, ETC. COORDINATE WITH LOCATIONS OF ELECTRICAL DEVICES
- O. EXACT LOCATION OF MECHANICAL AND PLUMBING EQUIPMENT THAT REQUIRE ELECTRICAL CONNECTIONS ARE SHOWN ON THE MECHANICAL AND PLUMBING
- P. PROVIDE CONDUIT/WIRING (CIRCUITING) AND REQUIRED CONNECTIONS TO ALL DEVICES/ EQUIPMENT. CONNECT TO CIRCUIT(S) AS INDICATED.
- Q. COORDINATE ALL WORK WITH OTHER TRADES; REFER TO ARCHITECTURAL DRAWINGS FOR COORDINATING LOCATIONS.
- R. RE-INSTALL REMOVED SYSTEM DEVICES REMOVED AS A RESULT IN WALL. PARTITION OR CEILING REPLACEMENT WORK. PROVIDE POWER AND COMMUNICATION WALL AND PARTITION MOUNTED DEVICES AND RECONNECT TO EXISTING SYSTEMS. CLEAN EXISTING CEILING MOUNTED DEVICES. EXTEND EXISTING SYSTEM CIRCUITS AS REQUIRED FOR REINSTALLATION. COORDINATE WITH EXISTING SYSTEM MANUFACTURER.
- S. SLEEVE AND SEAL ALL WALL AND FLOOR PENETRATIONS. PROVIDE APPROPRIATE FIRE STOPPING FOR ALL PENETRATIONS.
- SHARED NEUTRAL SHALL NOT BE ALLOWED ON ANY BRANCH CIRCUITS. MAINTAIN SERVICE CLEARANCES OF ALL EQUIPMENT. ADVISE OTHER TRADES OF SERVICE CLEARANCES AND ENSURE NO SERVICES OR TRADES RUN THROUGH SERVICE AREA.
- U. ALL WIRING INDICATED ON PLANS IS TO BE COPPER WIRING UNLESS OTHERWISE NOTED.
- V. REFER TO ONE-LINE DIAGRAM. RATINGS TO MATCH THE RATING OF THE WALL/CEILING. UTILIZE FIRE RATED PUDDY PADS IN THESE LOCATIONS.
- W. REFER TO ARCHITECTURAL DRAWINGS FOR MOUNTING OF RECEPTACLES IN AND NEAR ALL MILLWORK AND CABINETRY.
- X. THE CONTRACTOR MUST FOLLOW FEDERAL AND STATE ELECTRICAL SAFETY PRACTICE INCLUDING LOCK OUT TAG OUT (LOTO). THE CONTRACTOR MUST AFFIX THEIR COMPANY'S INDIVIDUAL LOTO LOCKS AND TAGS TO CONTROL HAZARDOUS ENERGIES AND TO PREVENT INJURIES

COORDINATION NOTES

(APPLY TO ALL DRAWINGS)

- A. VERTICAL CLEARANCES BY SPACE: a. VEHICLE STORAGE 19'-8"
- b. MAINTENANCE 23'-0" c. WASH BAY 23'-0"
- d. MEZZANINE 7'-6" e. SHOPS 19'-0"
- f. CANOPY 21'-8"

	ABBREVIATIONS	
BREV.	DESCRIPTION	
A AIC AFF AFG	AMPERE AMPERE INTERRUPTING CURRENT ABOVE FINISHED FLOOR ABOVE FINISHED GRADE	SYMBO
AL ASD ATS	ALUMINUM ADJUSTABLE SPEED DRIVE AUTOMATIC TRANSFER SWITCH AUTOMATIC	PP-XX
AV AWG	AUDIOVISUAL AMERICAN WIRE GAUGE CONDUIT	PP-XX
CB CLG CM	CIRCUIT BREAKER CEILING CONSTRUCTION MANAGER	
CU DN EA	COPPER DOWN EACH	
EC EG ELEC	ELECTRICAL CONTRACTOR EQUIPMENT GROUND ELECTRIC	
EM EMT FA	EMERGENCY ELECTRICAL METALLIC TUBING FIRE ALARM	ASD
FACP GC GEN GFI	FIRE ALARM CONTROL PANEL GENERAL CONTRACTOR GENERATOR GROUND FAULT CIRCUIT INTERRUPTER	(M)
/GND HH	GROUND HAND HOLE	ACCU-
HOA HP IVAC JB	HAND-OFF-AUTO HORSEPOWER HEATING, VENTILATING AND AIR CONDITIONING JUNCTION BOX	⊕ S _M
KV KVA KW	KILOVOLT KILOVOLT AMPERE KILOWATT	SPD
KWH LED LTG	KILOWATT HOUR LIGHT EMITTING DIODE LIGHTING	X
MC MCB MH	METAL CLAD CABLE MAIN CIRCUIT BREAKER MAN HOLE	ВАЗ
MLO NA NEC	MAIN LUG ONLY NOT APPLICABLE NATIONAL ELECTRICAL CODE	TVPS

NOT IN CONTRACT

NON-METALLIC TUBING

RIGID METAL CONDUIT

SPECIFICATION

SWITCHBOARD

WIRE OR WATT

WEATHERPROOF

EXPLOSION PROOF

TELEVISION

SURGE PROTECTIVE DEVICE

UNDERWRITER'S LABORATORY

SHIELDED TWISTED PAIR

NON-METALLIC SHEATHED CABLE

PLUMBING CONTRACTOR OR PHOTO CELL

NIGHT LIGHT

NOT TO SCALE

OVERHEAD

PHASE

SPACE

SWITCH

VOLT

NTS

ОН

RMC

SPD

SWBD

TV

INDICATES ITEM ON SCHEDULE. SIC MATERIALS AND METHODS **DESCRIPTION**

MANUAL MOTOR STARTER

SURGE PROTECTIVE DEVICE

POWER DISTRIBUTION

AND CONTROL

DESCRIPTION

AND TRANSFORMER SCHEDULE FOR SIZE AND TYPE

MOTOR STARTER. REFER TO ELECTRIC EQUIPMENT AND CONTROL SCHEDULE FOR SIZE AND TYPE.

DISCONNECT SWITCH AMP RATING AS INDICATED

COMBINATION DISCONNECT SWITCH AND MAGNETIC

STARTER REFER TO ELECTRIC EQUIPMENT AND

ELECTRICAL CONNECTION. REFER TO ELECTRIC

DESCRIPTION. LETTERS AND NUMBERS REFER TO

ELECTRICAL CONNECTION. REFER TO ELECTRIC

DESCRIPTION. LETTERS AND NUMBERS REFER TO

EQUIPMENT CONNECTION, REFER TO EQUIPMENT

SCHEDULE FOR WIRING REQUIREMENTS NUMBER

EQUIPMENT AND CONTROL SCHEDULE FOR

EQUIPMENT AND CONTROL SCHEDULE FOR

SINGLE POINT CONNECTION TO EQUIPMENT

"ITEM DESIGNATION" ON THE SCHEDULE.

"ITEM DESIGNATION" ON THE SCHEDULE.

FUSED DISCONNECT SWITCH AMP RATING AS

TRANSFORMER, REFER TO ONE LINE DIAGRAM

208/120 VOLT RECESSED PANELBOARD

480/277 VOLT RECESSED PANELBOARD

208/120 VOLT PANELBOARD

480/277 VOLT PANELBOARD

DISTRIBUTION PANELBOARD.

CONTROL SCHEDULE

ADJUSTABLE SPEED DRIVE

TVP SP	GANGED DEVICES
E — — — 🗵	TWO PIECE PREWIRED SURFACE RACEWAY
	DIVIDABLE SURFACE RACEWAY WITH DEVICES AS INDICATED.
	SPECIAL PURPOSE RECEPTACLE. PROVIDE PROPER VOLTAGE, CLASS, CURRENT RATING AND NEMA CONFIGURATION AS REQUIRED BY BRANCH CIRCUIT AND/OR MATCH CAP ON EQUIPMENT BEING FURNISHED BY OTHERS. PROVIDE CORD AND CAP. SUBSCRIPT INDICATES TYPE:

- NEMA TYPE D - DRYER RECEPTACLE R - RANGE RECEPTACLE T - TWISTLOCK X - MATCH EQUIPMENT CAP

JUNCTION BOX

PUSH BUTTON

EMERGENCY SHUTDOWN PUSH BUTTON.

SUBSCRIPT INDICATE TYPE:

TYPICAL	
MOUNTED UNDER COUNTER HEIGHT OR UNDERGROUND COMMUNICATION	
UNDERGROUND ELECTRICAL	
UNDERGROUND	
LINDEDIA/DITEDIO LABORATORY	

	B - BOILER G - GENERATOR P - POWER
φ	DUPLEX RECEPTACLE, SUBSCRIPTS INDICATE TYPE:
	G - GROUND FAULT CIRCUIT INTERRUPTER AC - ABOVE COUNTER

	WP - WEATHERPROOF
Φ	DUPLEX RECEPTACLE, CEILING MOUNTED
#	TWO DUPLEX RECEPTACLE, SINGLE COVER
TC	TIME CLOCK

HD	ELECTRIC HAND DRYER
	UNDERGROUND HANDHOLE
МН	MANHOLE
	

	EXISTING WIRING OR EQUIPMENT, SOLID LIGHT LINE WEIGHT IS EXISTING.
—— •	HEAVY SOLID LINE WEIGHT IS NEW

REFERENCE TO DRAWING NOTE

ONE LINE DIAGRAM SYMBOL DESCRIPTION NON-FUSED DISCONNECT SWITCH THERMAL MAGNETIC MOLDED CASE CIRCUIT ___ BREAKER CIRCUIT BREAKER SOLID STATE TRIP CHARACTERISTICS INDICATED BY SUBSCRIPTS AT - TRIP COIL AMPERE RATING AF - FRAME SIZE AMPERE RATING L - LONG TIME TRIP S - SHORT TIME TRIP - INSTANTANEOUS TRIP G - GROUND FAULT TRIP CURRENT TRANSFORMER UTILITY METER POWER METER GRAP GENERATOR REMOTE ANNUNCIATION PANEL TRANSFORMER, REFER TO SCHEDULE OR ONE-LIN **GENERATOR SET** TRANSFER SWITCH, RATING AS INDICATED. ATS = AUTOMATIC

LIGHTING CONTROL SYMBOL **DESCRIPTION**

PANELBOARD

GROUND CONNECTION

			น	,
		1		
S 3 _{a,b}	TOGGLE SWITCH, VOLTAGE AS INDICATED ON FIXTURE SCHEDULE, SUBSCRIPTS INDICATE TYPE:		CLO	SED CIRCUIT TELEVISION
	3 - THREE WAY SWITCH 4 - FOUR WAY SWITCH		SYMBOL	DESCRIPTION
	LV - LOW VOLTAGE WP - WEATHER PROOF EP - EXPLOSION PROOF OS - OCCUPANCY SENSOR VS - VACANCY SENSOR			SECURITY CAMERA. PROVIDE SINGLE GANG JUNCTION BOX AND 1" CONDUIT WITH PULL STRING TO ABOVE ACCESSIBLE CEILING. (CAMERA AND CABLING BY OTHERS)
	a,b,c - SWITCHING DESIGNATIONS NUMBER OF LETTERS EQUALS NO. OF GANGED SWITCHES			COMMUNICATIONS
\bigcirc 3 a,b,c	DIMMER SWITCH, SUBSCRIPTS INDICATE TYPE:		SYMBOL	DESCRIPTION
V a,b,c	LV - LOW VOLTAGE OS - OCCUPANCY SENSOR VS - VACANCY SENSOR a,b,c - SWITCHING DESIGNATIONS NUMBER OF LETTERS EQUALS NO. OF GANGED SWITCHES		□ ^{2P}	COMBINATION POWER AND TELE/DATA OUTLET; "#P" INDICATES QUANTITY OF DUPLEX RECEPTACLES REQUIRED. PROVIDE SEPERATE SINGLE-GANG BOX AND 1" CONDUIT TO ABOVE ACCESSIBLE CEILING SPACE FOR TELE/DATA OUTLET.
PC	PHOTOELECTRIC CONTROL			EXAMPLE SYMBOL SHOWN INDICATES: (2) DUPLEX RECEPTACLES AND (1) SINGLE-GANG TELE/DATA

CEILING MOUNTED OCCUPANCY SENSOR

a,b,c - INDICATES CONTROL ZONES

a,b,c - INDICATES CONTROL ZONES

CEILING MOUNTED VACANCY SENSOR

DRAWING SYMBOLS		
E-XXX	—SECTION DETAIL NUMBER —VIEW REFERENCE SHEET NUMBER	
E-XXX	— DETAIL/ENLARGED PLAN NUMBER — VIEW REFERENCE SHEET NUMBER	
1-	ELEVATION DETAIL NUMBER	

		FIRE ALARM
	SYMBOL	DESCRIPTION
	F	MANUAL PULL STATION
	S	SMOKE DETECTOR
	Н	COMBINATION SET TEMPERATURE AND RATE OF RISE HEAT DETECTOR
	CO	CARBON MONOXIDE DETECTOR
	DSD	DUCT SMOKE DETECTOR
	15 F € H	NOTIFICATION APPLIANCE, AUDIBLE AND VISUAL # INDICATES STROBE CANDELA IF OTHER THAN 75. C - INDICATES CEILING
	F.H	NOTIFICATION APPLIANCE, VISUAL # INDICATES STROBE CANDELA IF OTHER THAN 75. C - INDICATES CEILING
-	15 CO	CARBON MONOXIDE NOTIFICATION APPLIANCE, AUDIBLE AND VISUAL; # INDICATES STROBE CANDELA IF OTHER THAN 75
	TS	TAMPER SWITCH
	WF	SPRINKLER WATERFLOW SWITCH (PADDLE OR PRESSURE SWITCH TYPE)
	FACP	FIRE ALARM CONTROL PANEL
	FAAP	FIRE ALARM ANNUNCIATION PANEL

WIRING BY OTHERS CARD READER. PROVIDE DOUBLE GANG JUNCTION BOX AND 1" CONDUIT WITH PULL STRING TO ABOVE ACCESSIBLE CEILING SPACE. (HARDWARE AND

WIRING BY OTHERS)

ACCESS CONTROL

DESCRIPTION

JUNCTION BOX AND 1" CONDUIT WITH PULL STRING TO

ABOVE ACCESSIBLE CEILING SPACE. (HARDWARE AND

DOOR CONTACT SWITCH. PROVIDE SINGLE GANG

SYMBOL

CLOSED CIRCUIT TELEVISION	
SYMBOL	DESCRIPTION
Ū	SECURITY CAMERA. PROVIDE SINGLE GANG JUNCTION BOX AND 1" CONDUIT WITH PULL STRING TO ABOVE ACCESSIBLE CEILING. (CAMERA AND CABLING BY OTHERS)

	COMMUNICATIONS	
SYMBOL	DESCRIPTION	
□ ^{2P}	COMBINATION POWER AND TELE/DATA OUTLET; "#P" INDICATES QUANTITY OF DUPLEX RECEPTACLES REQUIRED. PROVIDE SEPERATE SINGLE-GANG BOX AND 1" CONDUIT TO ABOVE ACCESSIBLE CEILING SPACE FOR TELE/DATA OUTLET. EXAMPLE SYMBOL SHOWN INDICATES: (2) DUPLEX RECEPTACLES AND (1) SINGLE-GANG TELE/DATA WALL BOX.	
WAP	WIRELESS ACCESS POINT (ALL WORK BY OTHERS)	
VP	VIDEO PROJECTOR MOUNT	

LUMINAIRES		
YMBOL	DESCRIPTION	
	LUMINAIRE. UPPER CASE LETTERS INDICATE FIXTURE TYPE ON SCHEDULE, LOWER CASE LETTER INDICATES CONTROL DESIGNATION.	
	WALL MOUNTED LUMINAIRE. UPPER CASE	

	LETTERS INDICATE FIXTURE TYPE ON SCHEDULE, LOWER CASE LETTER INDICATES CONTROL DESIGNATION.
NL	LUMINAIRE CONNECTED TO NIGHT LIGHT CIRCUIT, UNSWITCHED
EM	LUMINAIRE WITH INTEGRAL EMERGENCY BATTERY BACKUP
INV	LUMINAIRE CONNECTED TO EMERGENCY LIGHTING INVERTER
	LUMINAIRE STRIP


WALL MOUNTED EMERGENCY LUMINAIRE WITH

WALL MOUNTED EXIT LUMINAIRE

BATTERY PACK **CEILING MOUNTED EXIT LUMINAIRE**

> **ELECTRICAL** LEGEND & **ABBREVIATIONS**

Sheet Number:

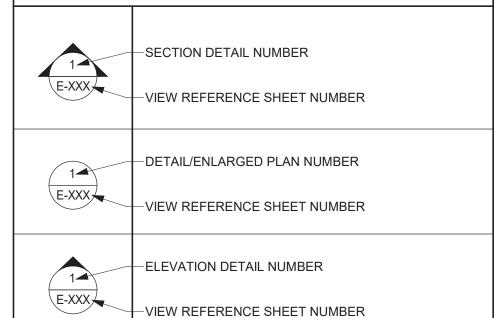


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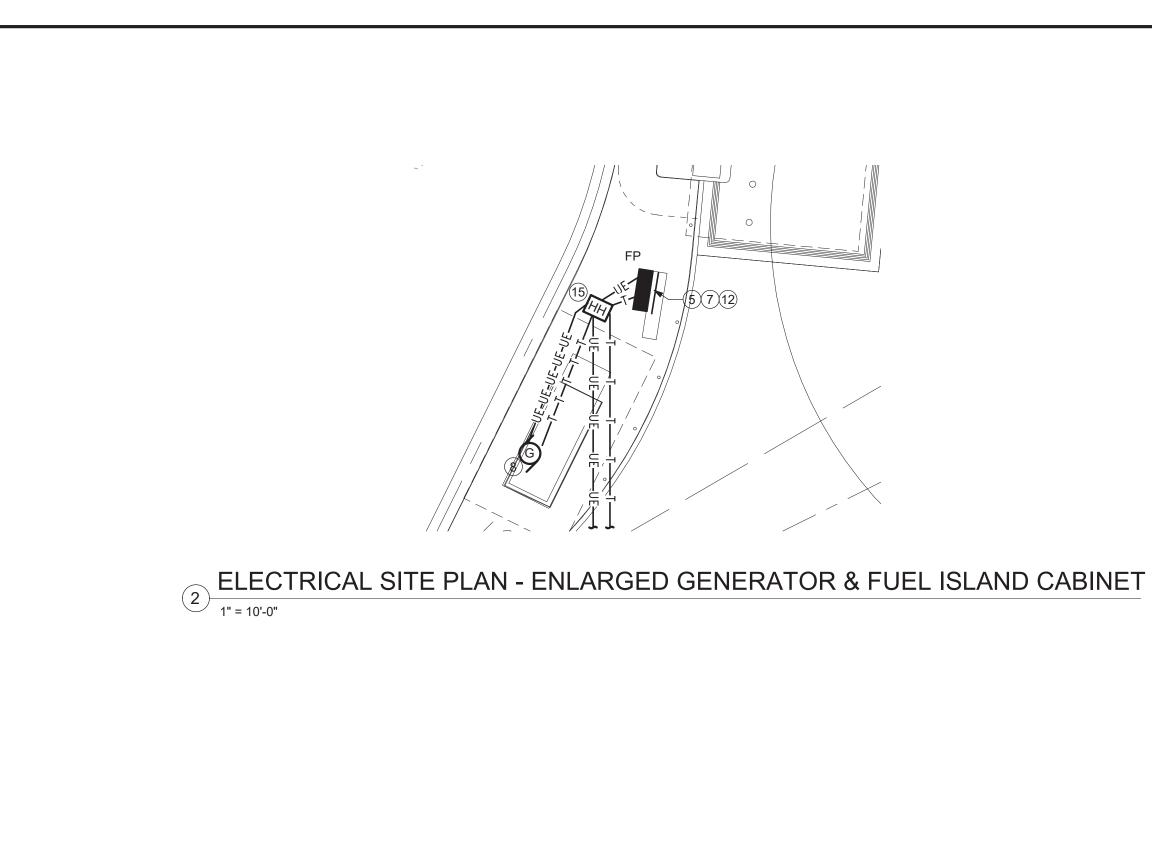



SCALE: AS NOTED APRIL 7, 2022

KML Drawn By: Reviewed By: SZE Approved By: BAB

W&S Project No: N2190088

Drawing Title:

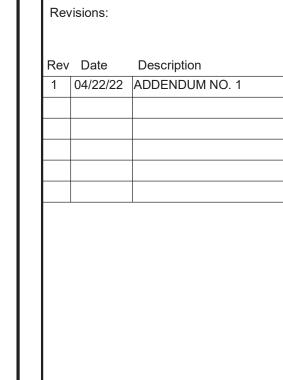

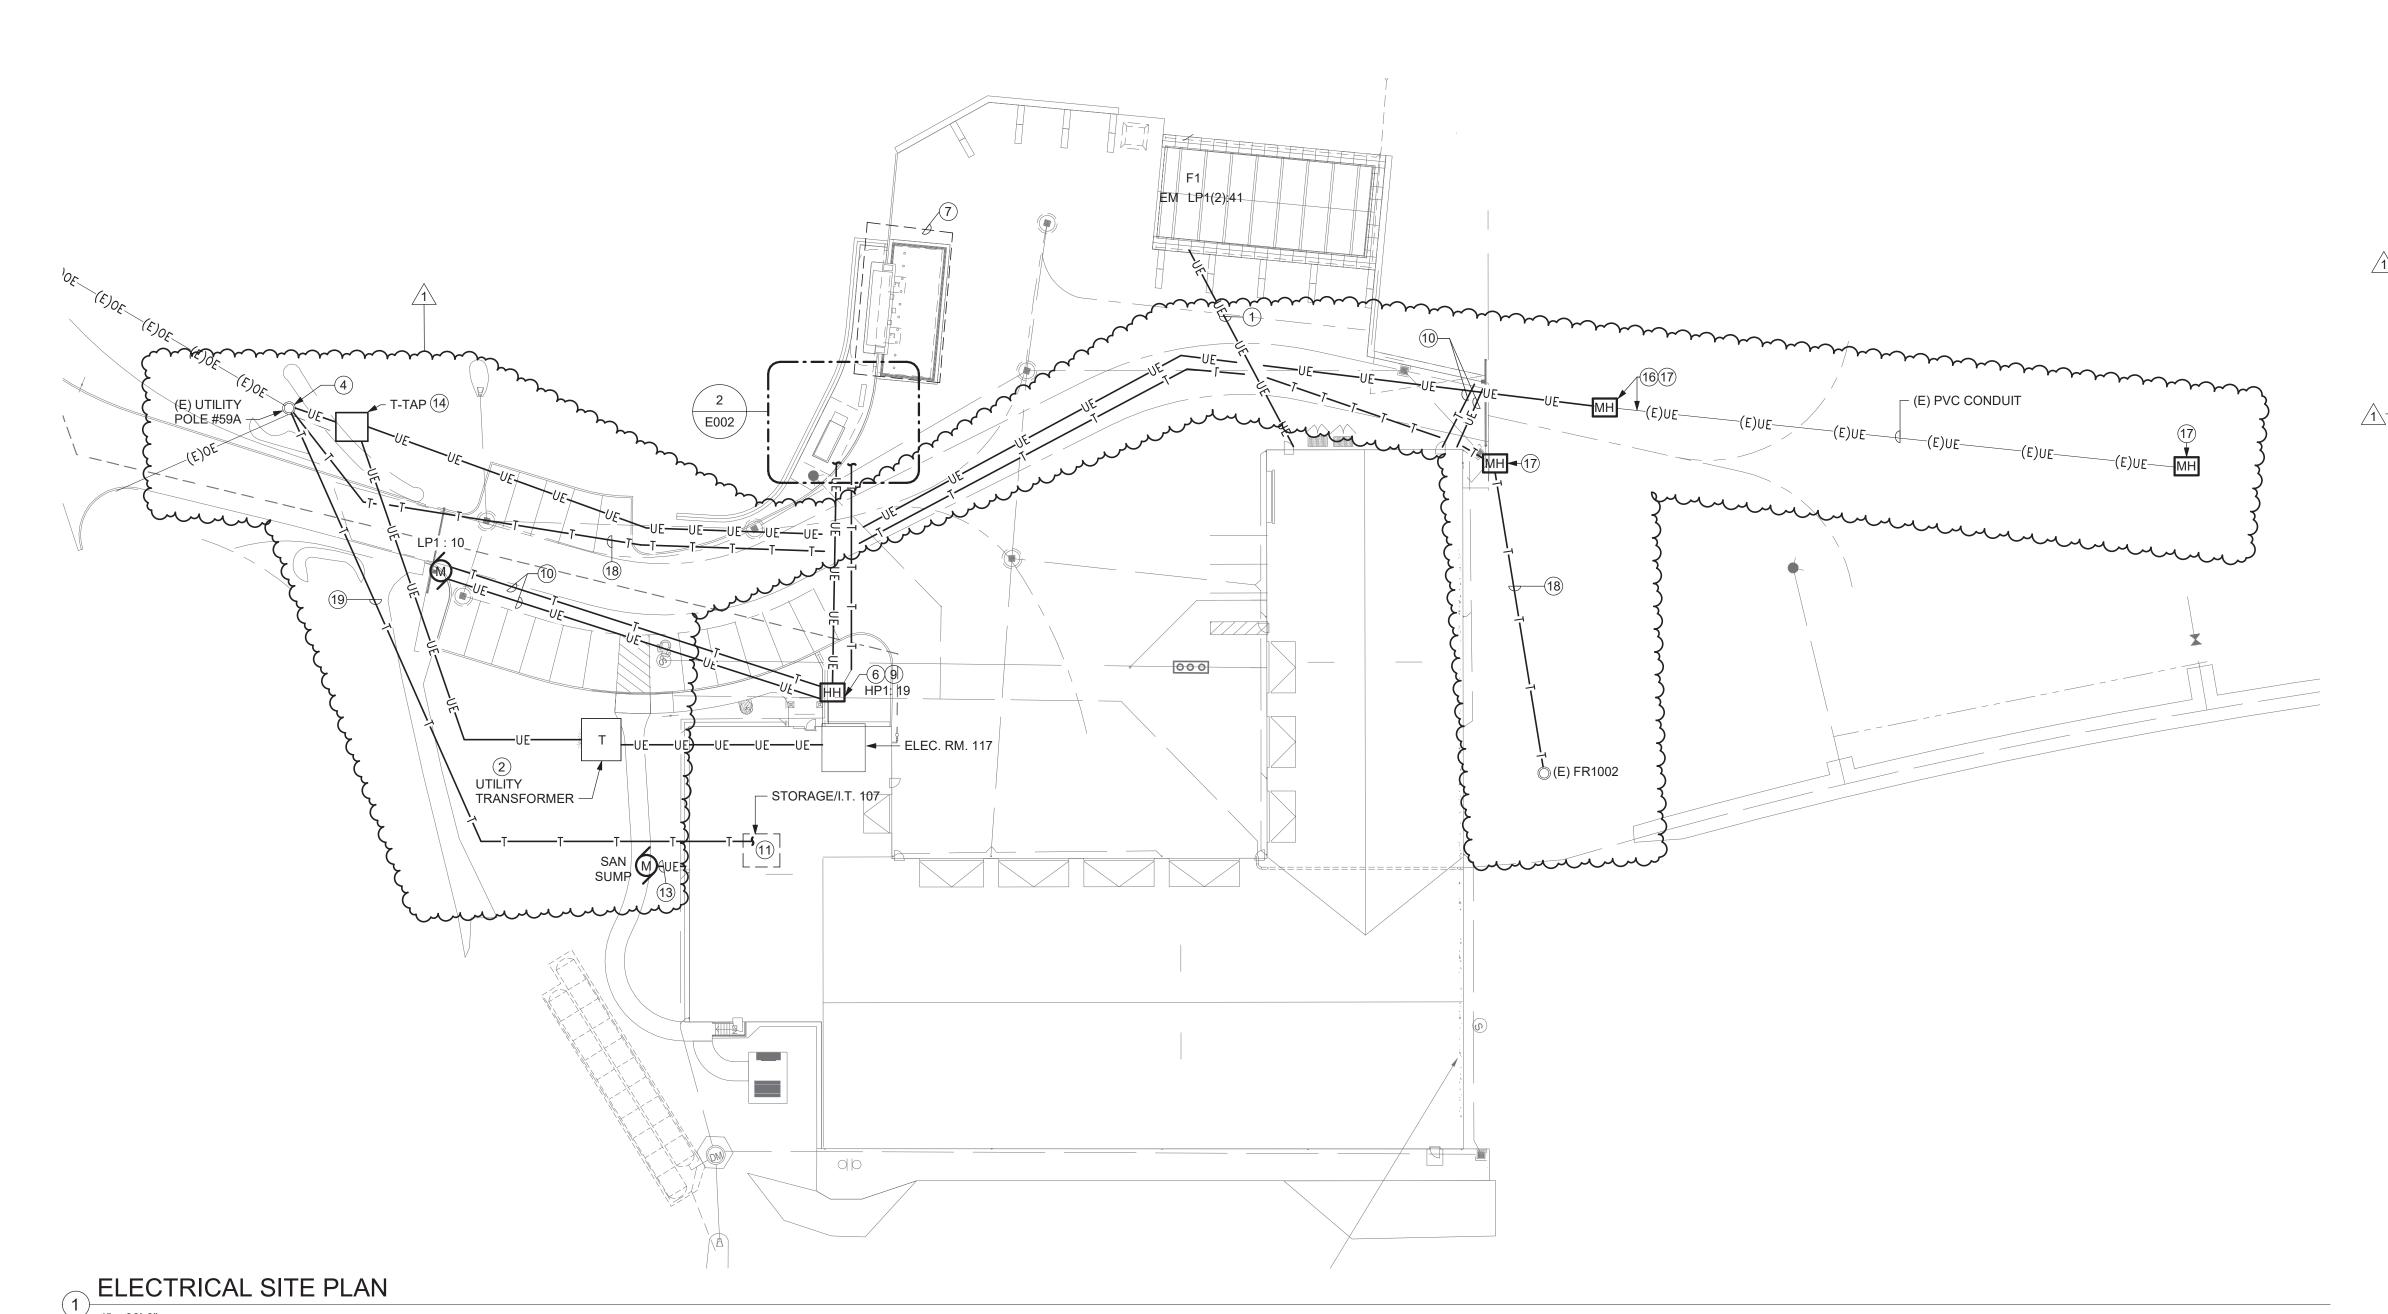

GENERAL NOTES:

- A. REFER TO ONE-LINE DIAGRAM, SCHEDULES AND DETAILS FOR ADDITIONAL INFORMATION AND REQUIREMENTS.
- B. ALL CONDUITS BENEATH AREAS OF VEHICULAR TRAFFIC SHALL BE RIGID METAL CONDUIT (RMC). RMC SHALL EXTEND A MINIMUM OF 24" BEYOND THE AREA OF VEHICULAR TRAFFIC. REFER TO TYPICAL DUCTBANK SECTION DETAIL.
- C. ALL CONDUITS NOT BENEATH AREAS OF VEHICULAR TRAFFIC SHALL BE SCHEDULE 80 RIGID NONMETALLIC CONDUIT (DIRECT BURIED). REFER TO TYPICAL DIRECT BURIED CONDUIT DETAIL.
- D. PROVIDE FIRESTOPPING AND WATERPROOF SEALS AS REQUIRED WHERE PENETRATING
- EXTERIOR WALLS. E. THE EC SHALL BE RESPONSIBLE FOR CONDUIT WIRE, TRENCHING, BACKFILLING, AND SITE REPAIRATIONS.

- 1. PROVIDE (1) 1" CONDUIT FOR SHED ELECTRICAL LOADS.
- 2. PROVIDE UTILITY TRANSFORMER PAD. REFER TO UTILITY TRANSFORMER PAD DETAIL FOR
- \cdots PROVIDE (1) 4"C FROM T-TAP TO WITHIN 2' OF SERVICE CONDUCTORS INSTALLED BY THE MARK AT END OF CONDUIT RUN. SEE UTILITY POLE CONDUIT RISER DETAIL AND ONE-LINE FOR ADDIONAL INFORMATION AND REQUIREMENTS.
- 5. PROVIDE FUEL ISLAND PANEL "FP" IN WEATHERPROOF ENCLOSURE. ENCLOSURE PROVIDED BY OTHERS. PROVIDE 2" COMMUNICATIONS CONDUIT FROM ENCLOSURE TO HANDHOLE.
- THE BUILDING.
- 9. PROVIDE (1)277V, 20A BRANCH CIRCUIT FOR SITE LIGHTING BY OTHERS. TIE INTO TIMECLOCK.
- 10. PROVIDE UNDERGROUND POWER AND 1" SPARE DATA CONDUIT FOR MOTORIZED VEHICLE GATE.
- 11. PROVIDE 2" SPARE COMMUNICATIONS UNDERGROUND CONDUIT TO UTILITY POLE INDICATED BY DRAWING NOTE 4.
- 12. PROVIDE MONITOR MODULE AND FIRE ALARM CIRCUIT FOR CONNECTION TO FUEL ISLAND FIRE SUPPRESSION SYSTEM. ROUTE FIRE ALARM CIRCUIT IN SPARE FUEL ISLAND COMMUNICATIONS CONDUIT.
- 14. PROVIDE S&C 15KV PME-9 PAD MOUNTED T-TAP SWITCH IN ACCORDANCE WITH THE UTILITY COMPANY, WITHIN 10' OF THE UTILITY POLE. COORDINATE REQUIREMENTS WITH THE UTILITY COMPANY. PROVIDE CONCREATE PAD PER CONCRETE PAD DETAIL.
- 16. PROVIDE OLD CASTLE DB-9 MANHOLE. REFER TO MANHOLE DETAIL FOR ADDITIONAL INFORMATIN AND REQUIREMENTS.
- 17. PROVIDE MANHOLE TO TIE INTO EXISTING UNDERGROUND PVC CONDUIT. EXTEND WIRING THROUGH EXISTING CONDUIT AND TERMINATE INSIDE NEXT MANHOLE DOWNSTREAM OF THIS LOCATION. EXISTING UNDERGROUND CONDUIT IS ROUGHLY 175' IN LENGTH. CONTRACTOR TO VERIFY EXACT LENGTH IN THE FIELD.
- SERVICE PROVIDERS THROUGH ENTIRETY OF CONDUIT IS SHOWN: (2) 4"C FOR VERIZON, (1) 4"C FOR CROWN CASTLE, (1) 4"C FOR ALTICE. COORDINATE WITH SERVICE PROVIDERS. PROVIDE CONDUIT RISERS AT EACH END, FOR EACH CONDUIT.
- EXISTING UTILITY POLE FOR INCOMING TELECOM. SERVICE PROVIDED BY OTHERS.

E002 DRAWING NOTES:

- REQUIREMENTS.
- 3. PROVIDE GENERATOR AND CONCRETE PAD. REFER TO ONE-LINE DIAGRAM AND DETAILS FOR ADDITIONAL INFORMATION AND REQUIREMENTS. THE EXISTING UTILITY POLE FOR NEW PRIMARY UTILITY COMPANY. PROVIDE WITH REFERENCE
- 6. PROVIDE (2) POWER HANDHOLES AND 1 DATA HANDHOLE FOR CONDUITS COMING INTO/OUT OF THE BUILDING. REQUIRED CONDUIT INCLUDE BUT ARE NOT LIMITED TO GENERATOR FEEDER (ADD ALTERNATE 6), MOTORIZED GATE, SITE LIGHTING CIRCUIT, FUEL ISLAND FEEDER, AND TELE/DATA SERVICE. REFER TO ONE LINE DIAGRAM AND ELECTRICAL SHCEDULES AND FLOOR PLANS FOR INDIVIDUAL CIRCUIT REQUIREMENTS. PROVIDE (1) SPARE 2" CONDUIT TO EACH HANDHOLE FROM INSIDE OF
- 7. FUEL ISLAND IS PART OF ALTERNATE 2.
- 8. GENERATOR IS PART OF ALTERNATE 6. PROVIDE PAD MOUNTED GENERATOR, REFER TO DRAWING E503.
- REFER TO EQUIPMENT CONTROL SCHEDULE FOR GATE POWER REQUIREMENTS.

- 13. EMPTY CONDUIT WITH PULL STRING FOR ROUTING OF PUMP CABLE PROVIDED BY OTHERS, SEE DRAWING E102 FOR DETAILS ON CONDUIT.
- 15. PROVIDE (2) HANDHOLES, (1) FOR POWER AND (1) FOR COMMUNICATIONS.

- 18. PROVIDE THE FOLLOWING CONDUITS FOR SITE WHERE UNDERGROUND COMMUNICATIONS
- 19. PROVIDE 4" UNDERGROUND CONDUIT FROM

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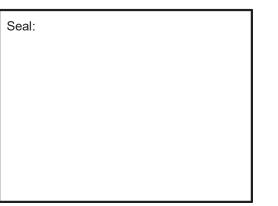
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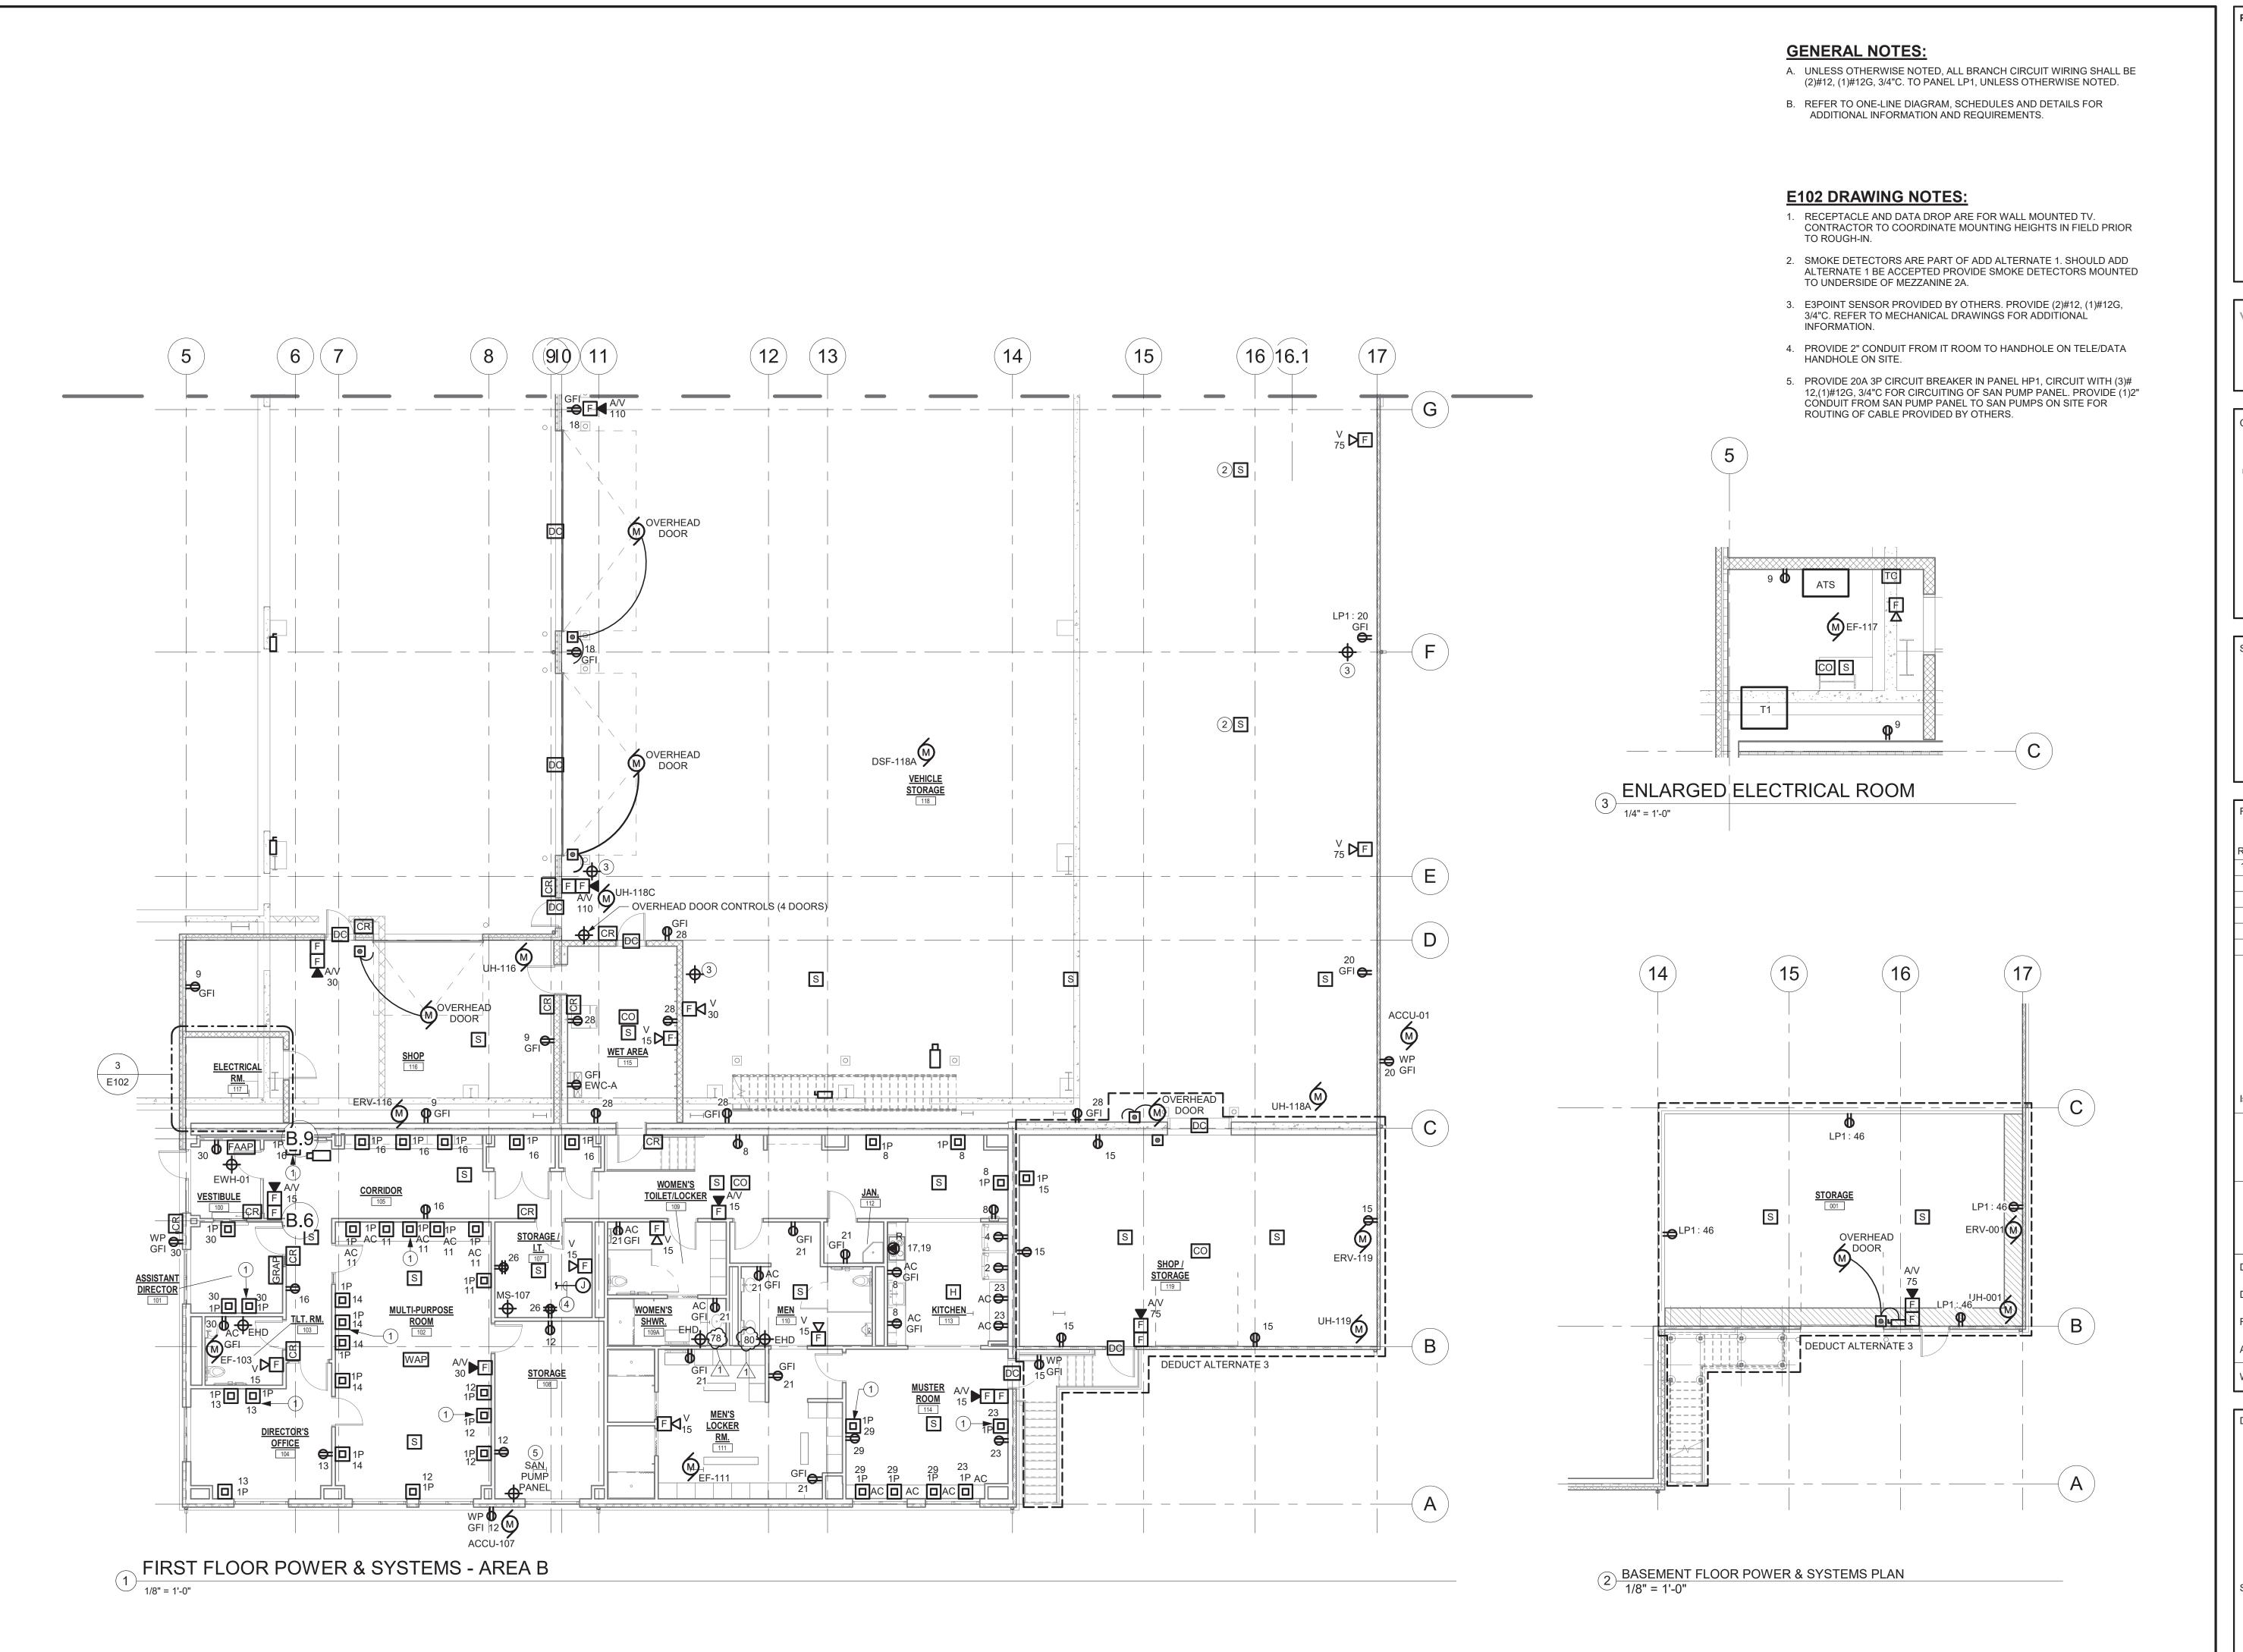
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Drawing Title:

SITE PLAN

Sheet Number:



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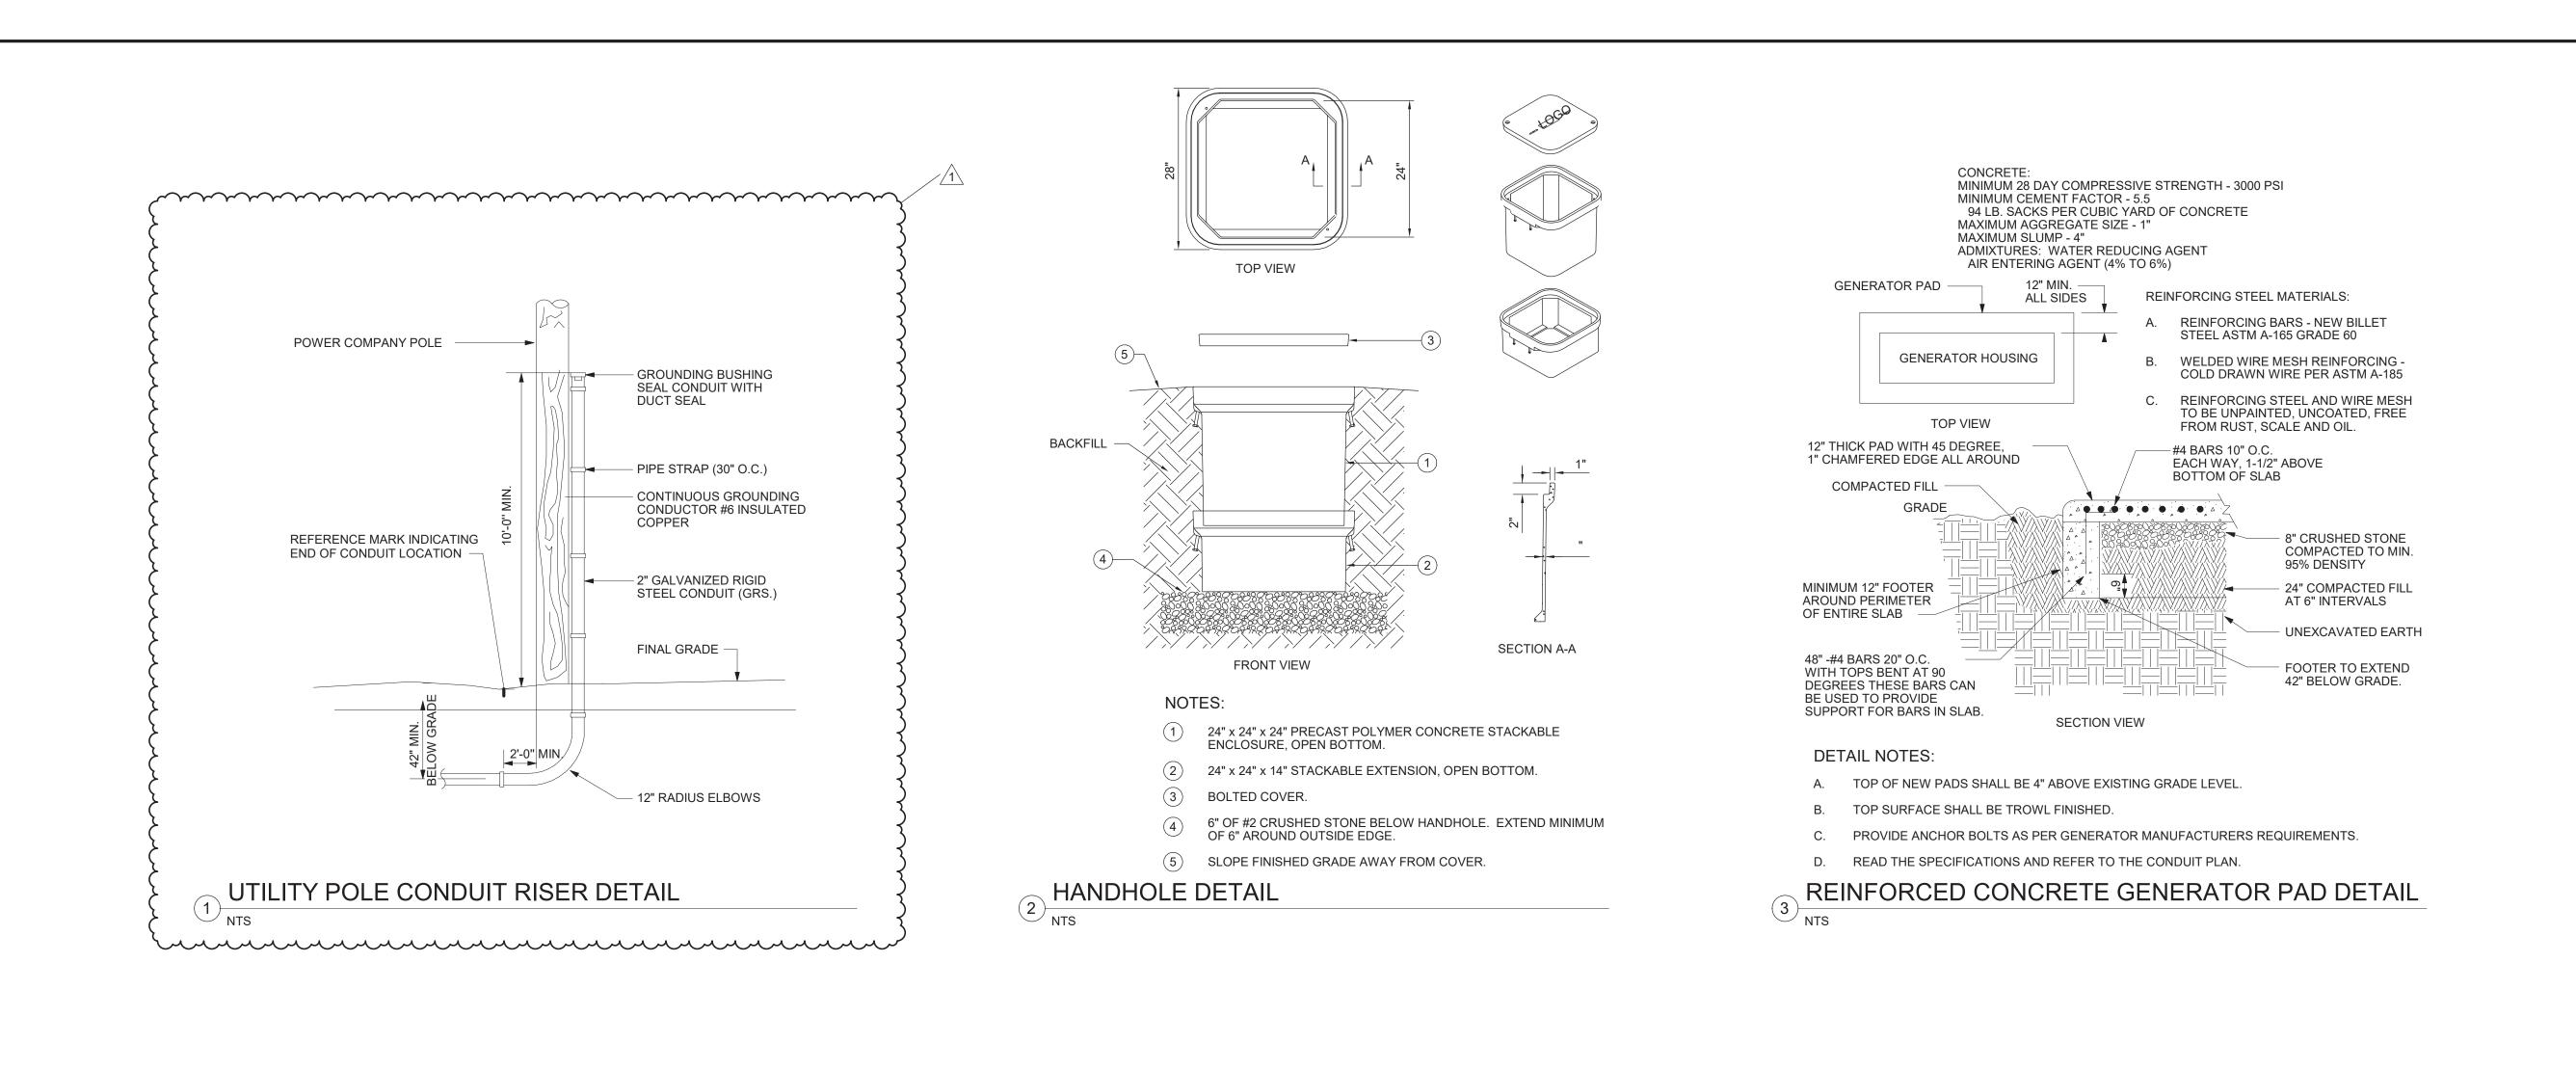
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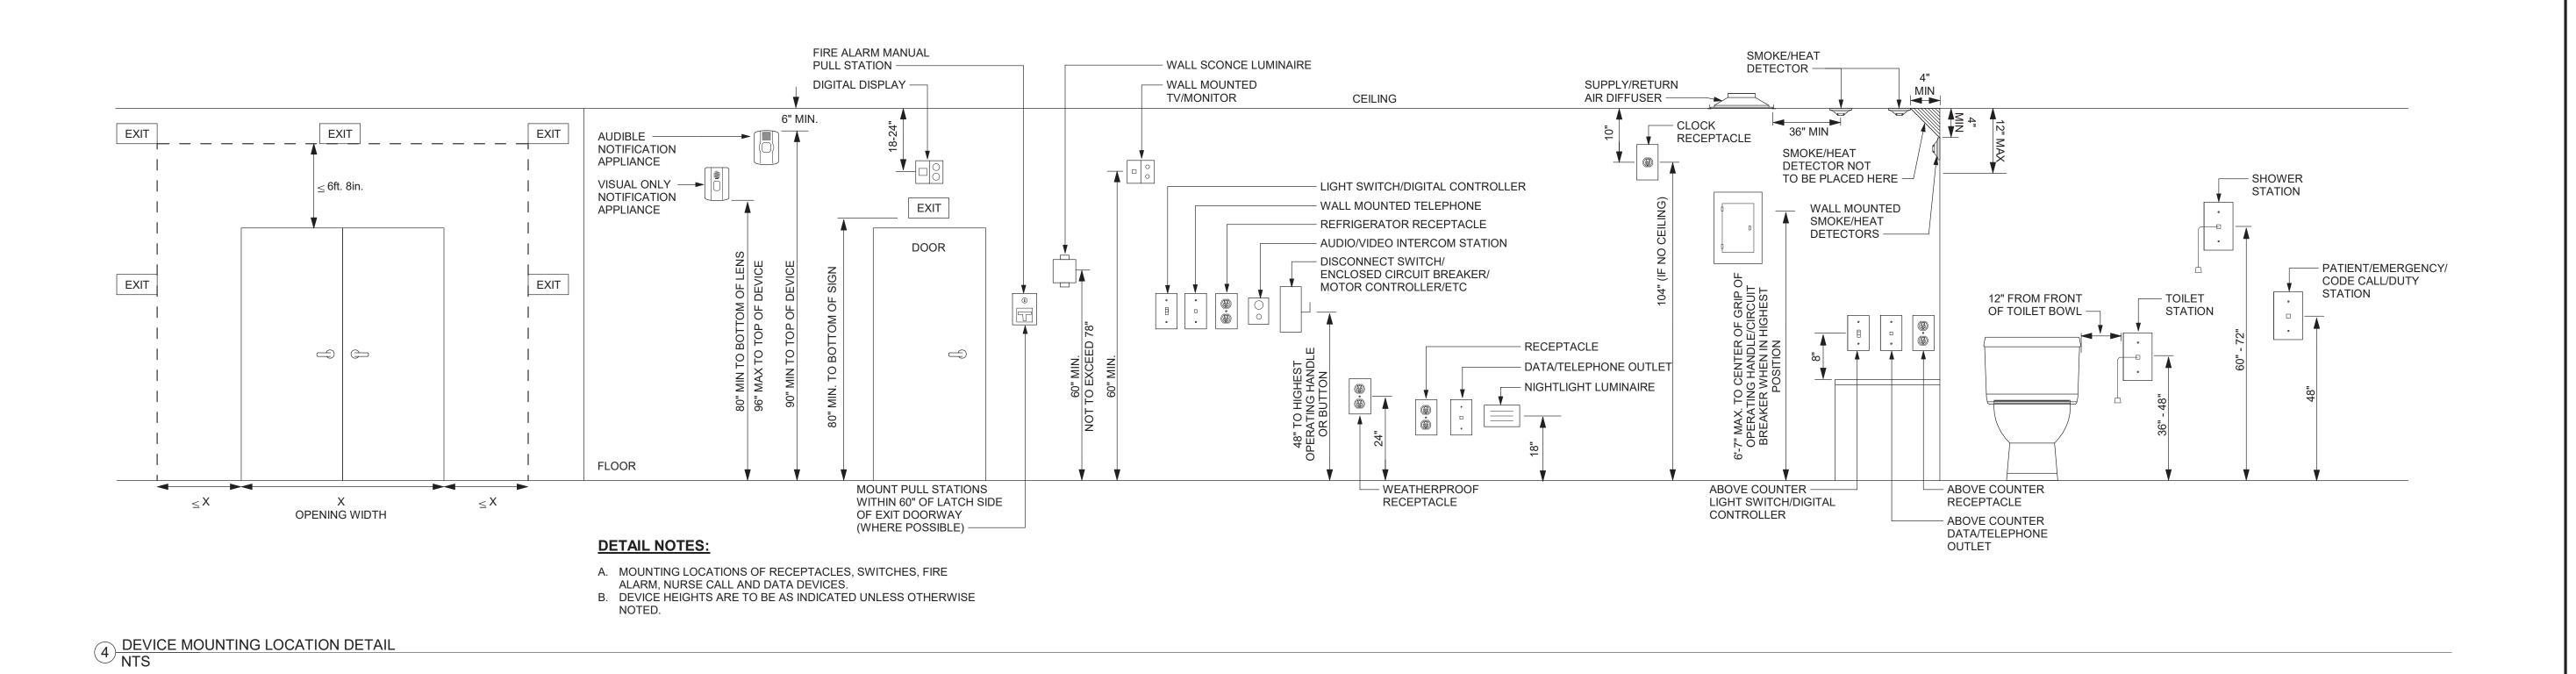
Drawing Title:

FIRST FLOOR
AREA B AND
BASEMENT
POWER &
SYSTEMS PLAN

Sheet Number:

E102





Project:

VILLAGE OF ARDSLEY, NY

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FACILITY

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Figure 1919

Figure 2019

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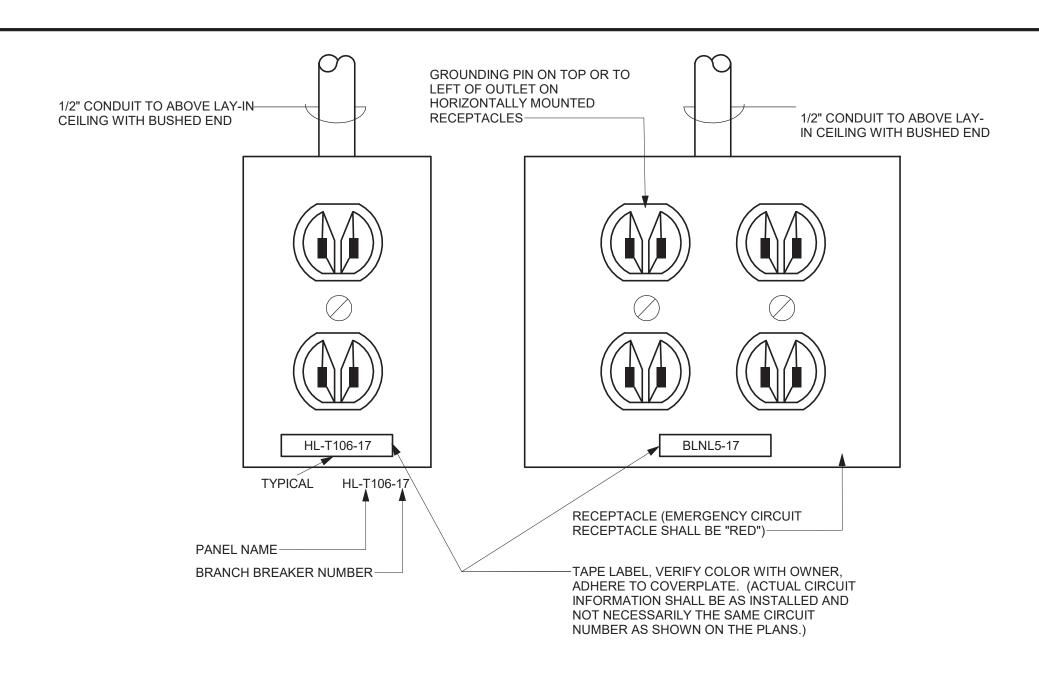
ELECTRICAL DETAILS

APRIL 7, 2022

KML

Sheet Number:


E501




GENERAL DETAIL NOTES:

- A. PROVIDE GREEN GROUND WIRE IN ALL RECEPTACLE CIRCUITS.
- CONNECT TO GROUND BUS IN PANEL.
- B. DO NOT INSTALL RECEPTACLES, COMPUTER OR TELEPHONE OUTLETS BACK TO BACK. INSTALL IN ADJACENT STUD CAVITIES, TO REDUCE SOUND TRANSMISSION.

1 TYPICAL RECEPTACLE IDENTIFICATION REQUIREMENTS NTS

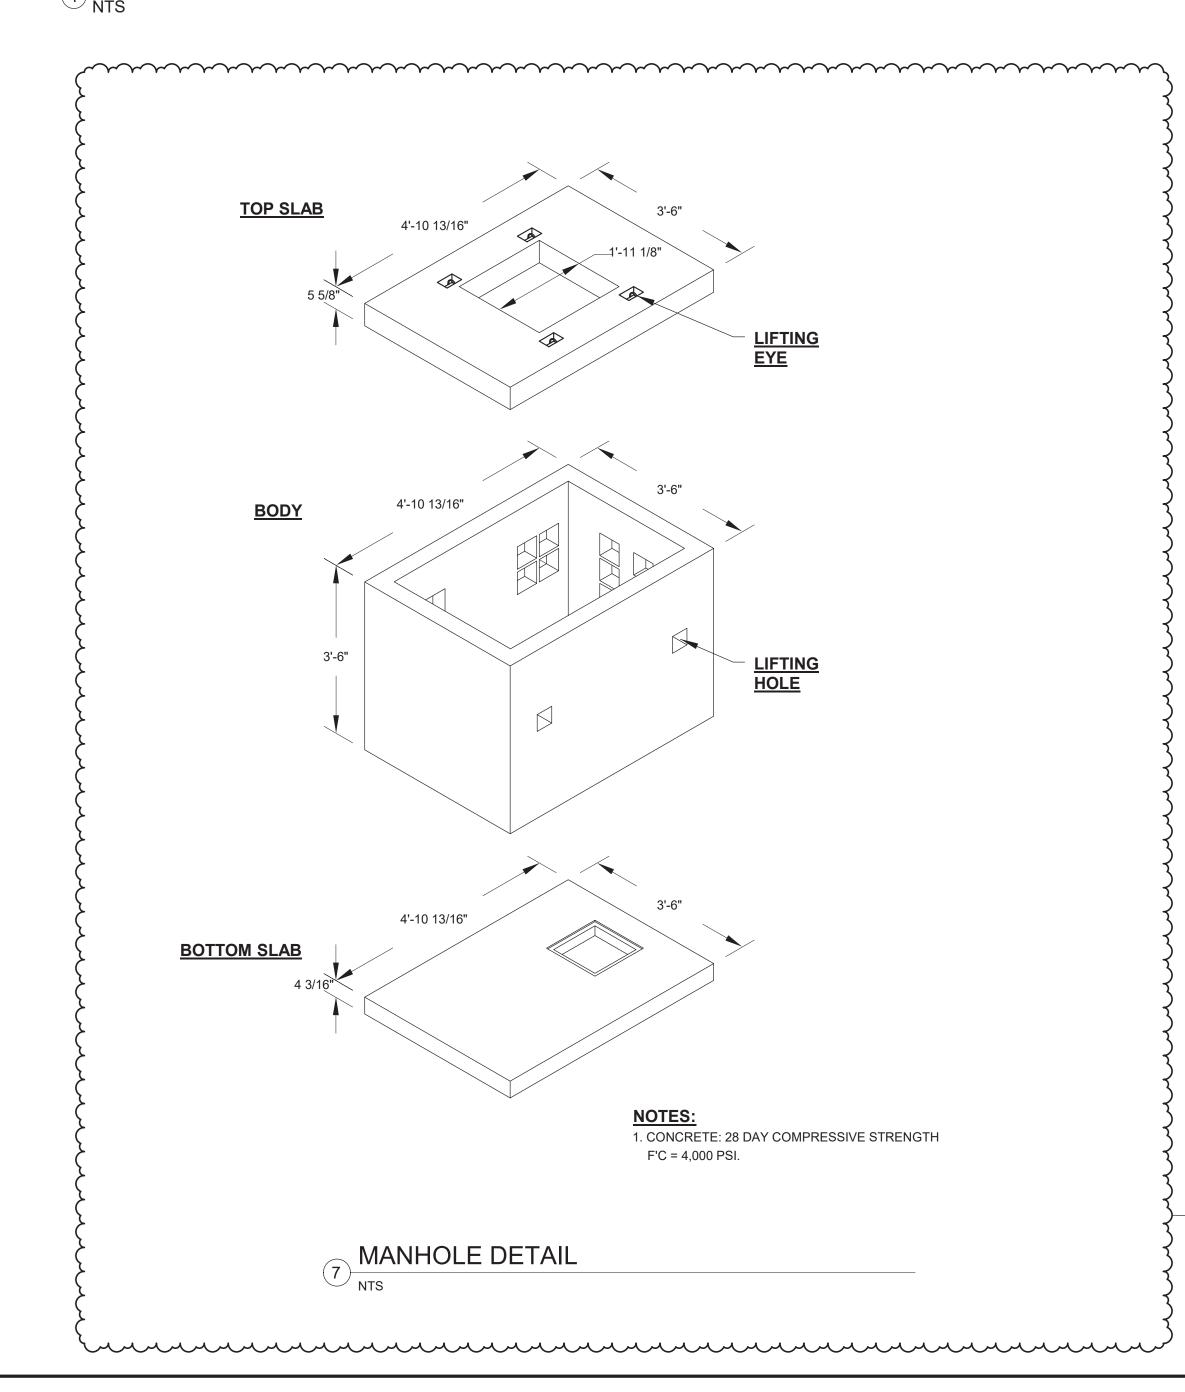


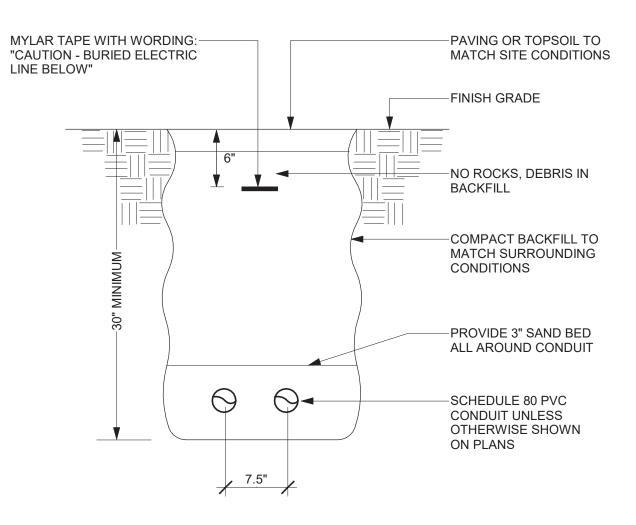

DETAIL NOTES:

- A. READ THE SPECIFICATIONS.
- B. REPAIR ALL SETTLEMENT.
- C. MINIMUM TOP SOIL 6".
- D. WHERE ADDITIONAL CONDUITS ARE REQUIRED, INCREASE TRENCH WIDTH AND INSTALL CONDUITS WITH 3" MINIMUM SPACING.

2 TYPICAL DIRECT BURIED CONDUIT DETAIL NTS

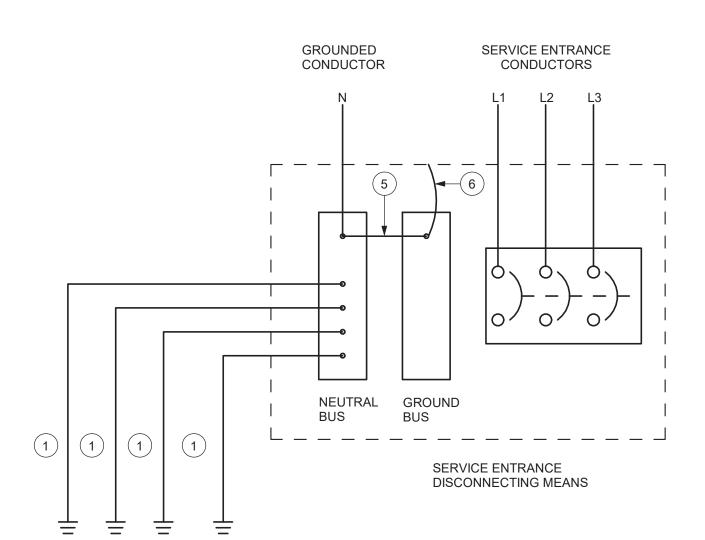


DETAIL NOTES:


3

- (1) GROUNDING ELECTRODE CONDUCTOR. PROVIDE INSULATED COPPER CONDUCTOR PER SPECIFICATIONS. IF NO SIZE IS SPECIFIED, PROVIDE INSULATED COPPER CONDUCTOR SIZED PER N.E.C., TABLE 250-66. INSTALL IN RIGID, SCHEDULE 40, PVC RACEWAY.
- 2 METAL UNDERGROUND WATER PIPE IN DIRECT CONTACT WITH EARTH FOR 10 FEET OR MORE. SHALL BE SUPPLEMENTED BY ITEMS 3 & 4.
- BUILDING STRUCTURAL STEEL.
- 4 MADE GROUNDING ELECTRODE. REFER TO MADE GROUNDING ELECTRODE-GROUND GRID" DETAIL & SPECIFICATIONS.
- MAIN BONDING JUMPER. PROVIDE INSULATED COPPER CONDUCTOR
- PER N.E.C. ARTICLE 250-28.
- BOND GROUND BUS TO EQUIPMENT ENCLOSURE WITH BARE COPPER BONDING JUMPER PER N.E.C ARTICLE 250-28.


5 SERVICE ENTRANCE GROUNDING NTS

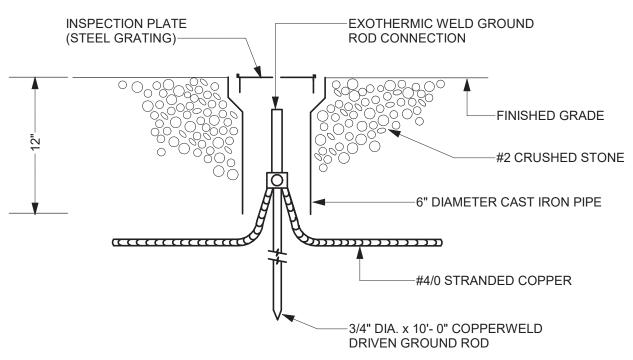


3 TYPICAL GROUND ROD DETAIL 1/8" = 1'-0"

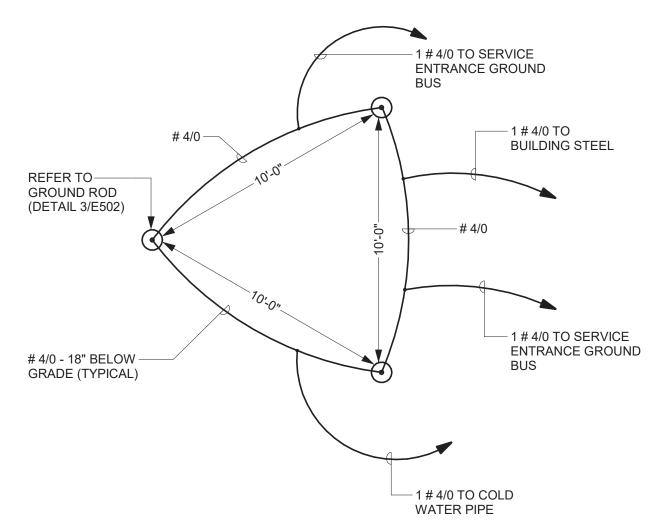


4 GROUNDING SYSTEM DETAIL NTS

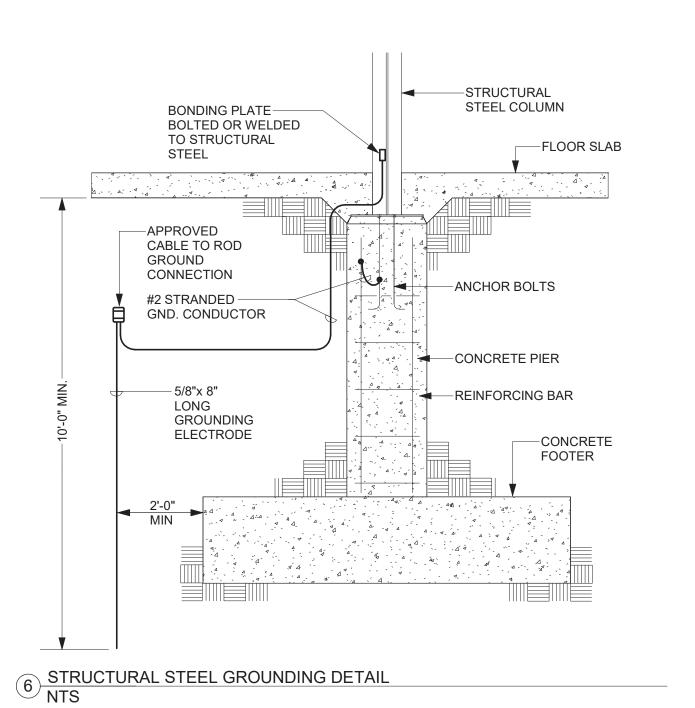


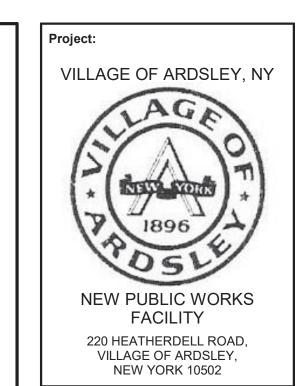

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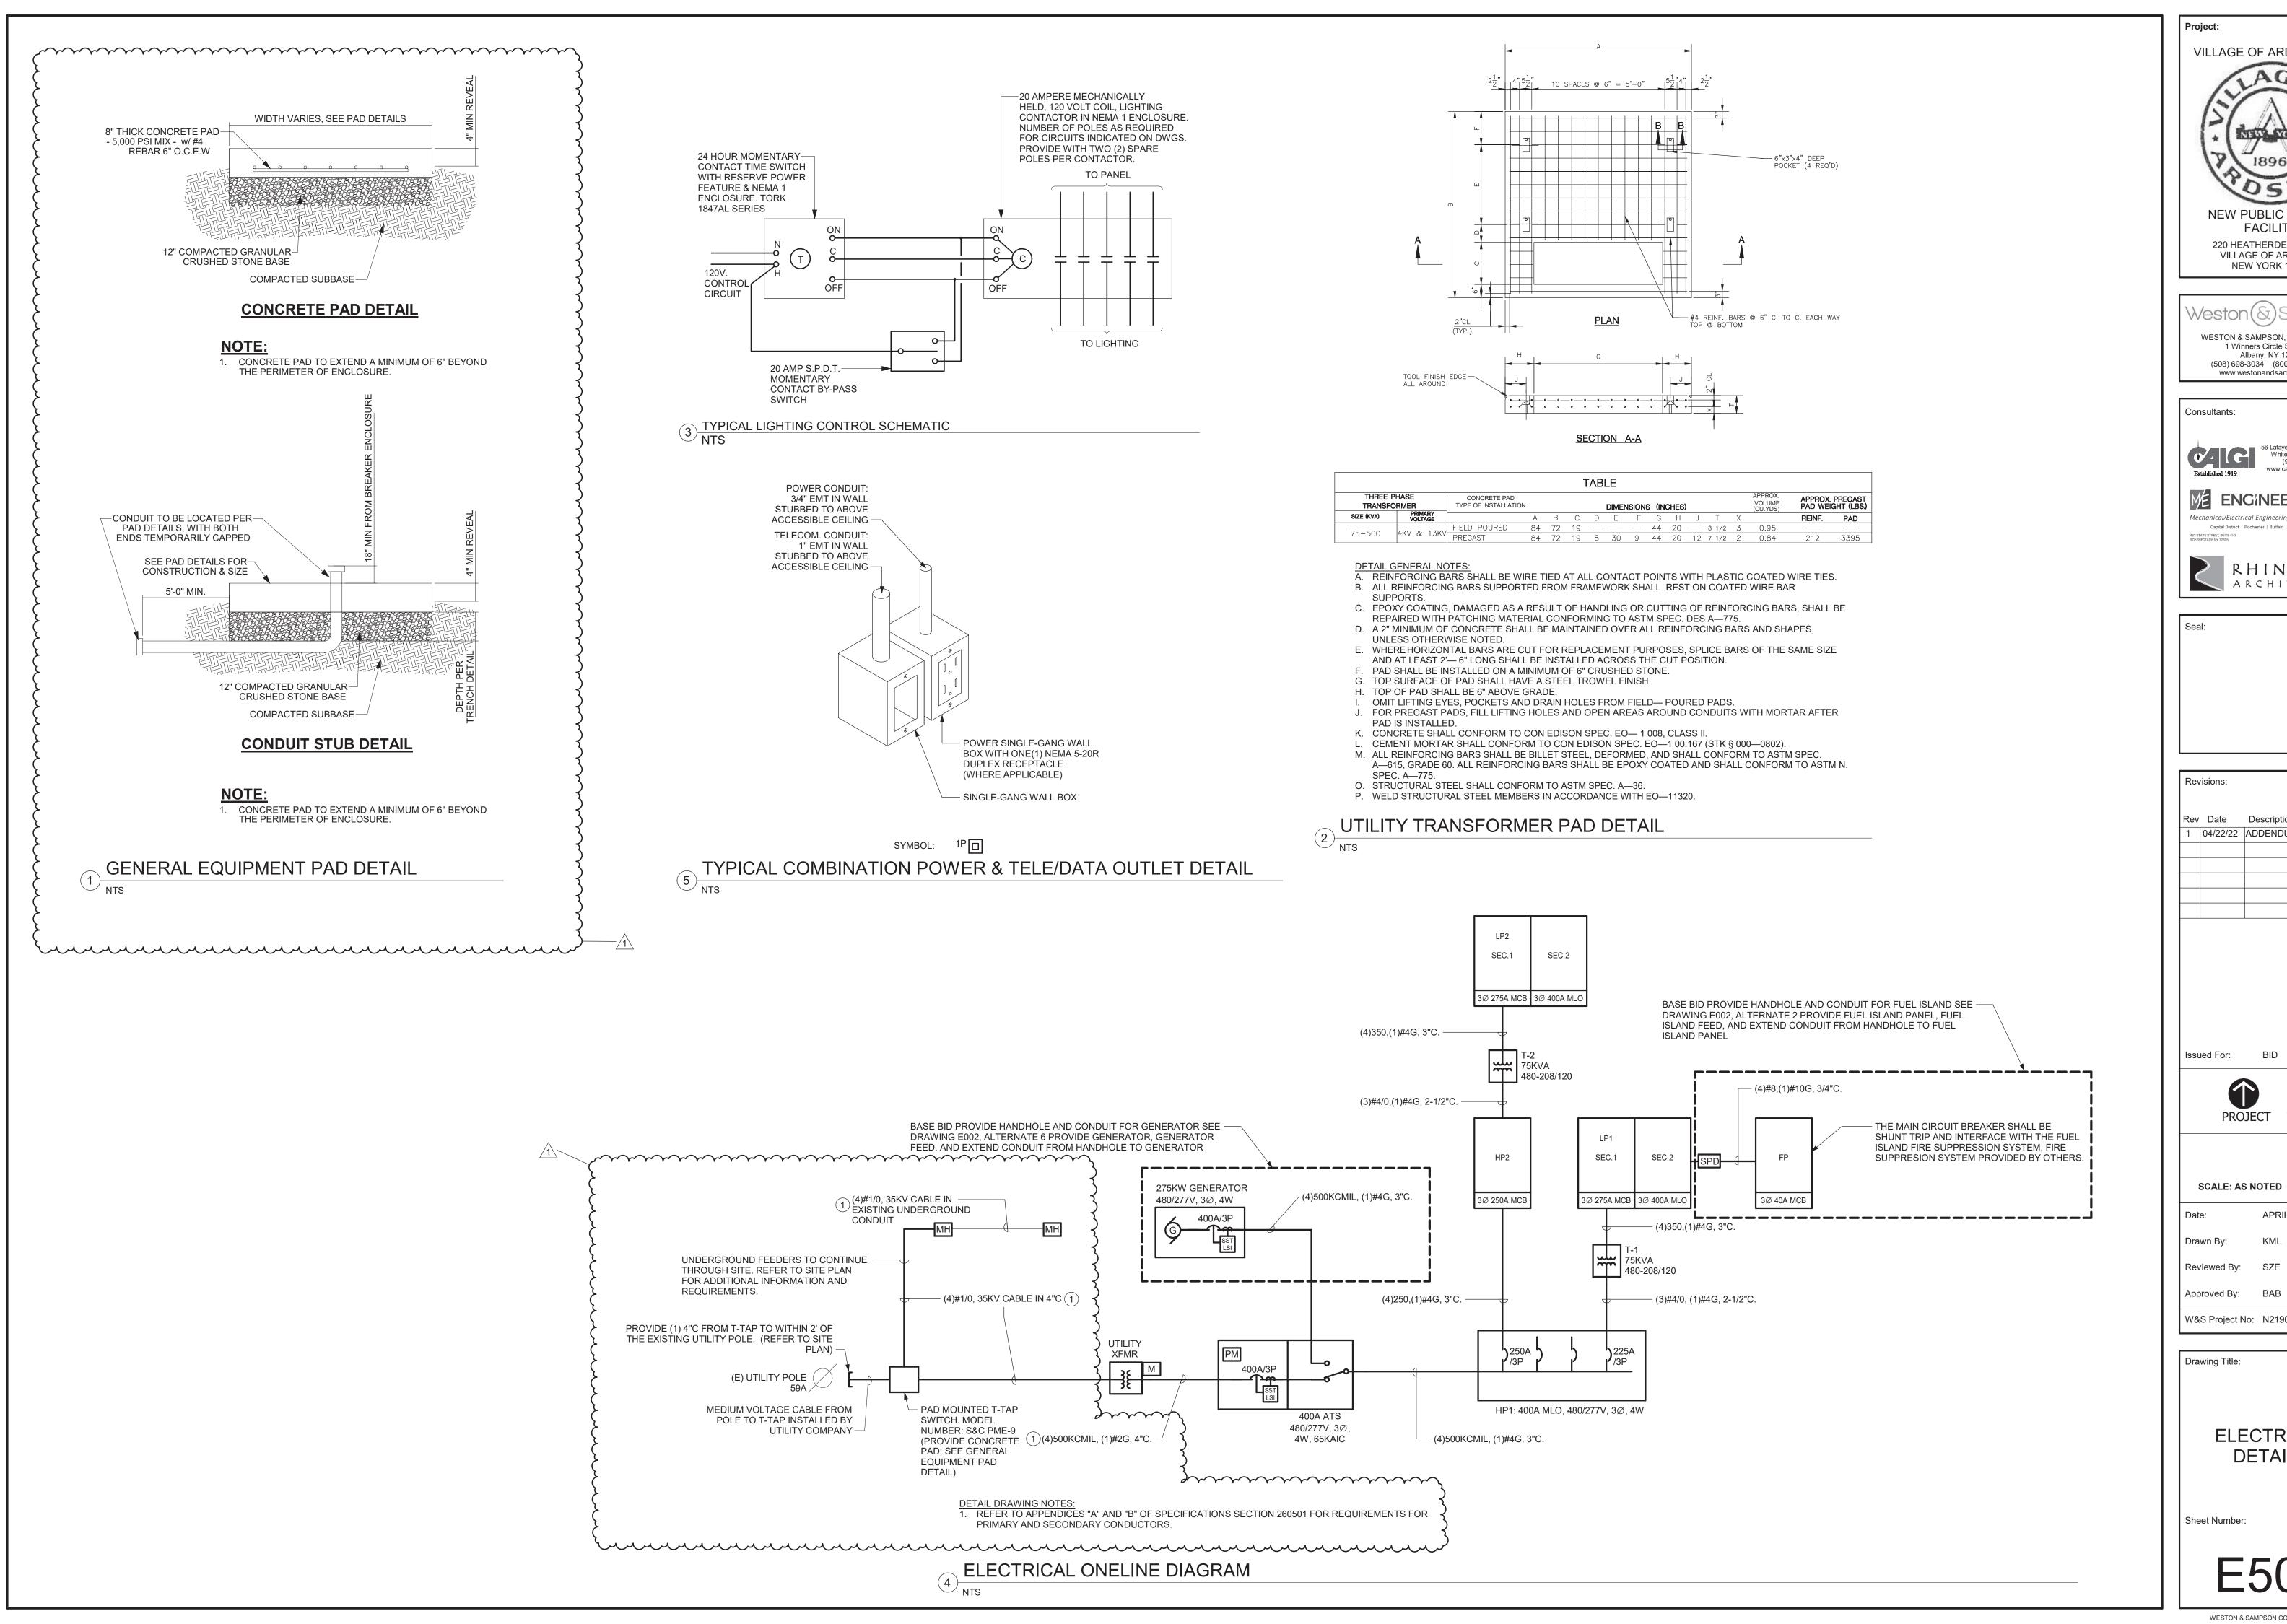
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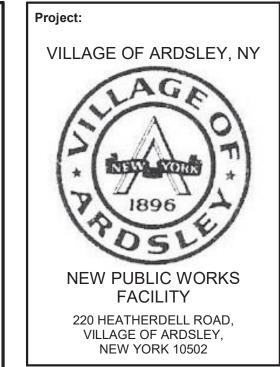
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ELECTRICAL DETAILS

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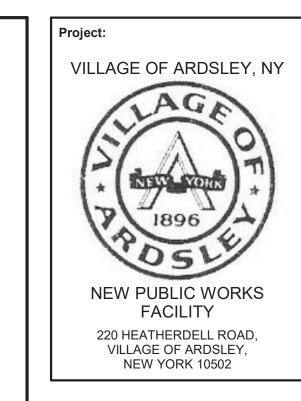
ELECTRICAL DETAILS

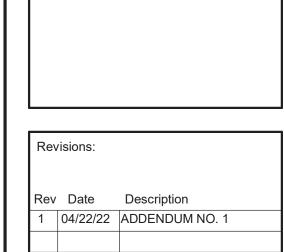Sheet Number:

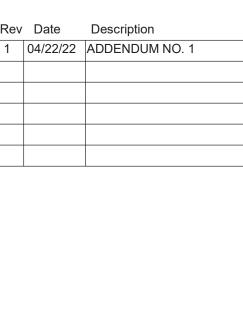					F	PANELE	BOAF	RD DIRE	ECTOF	RY				
		M/E PROJECT: NEW PUBLIC V	WORKS	FACILIT	Υ								TYPE: BRANCH	
		PROJECT NO.: 203050				PANEL NA	AME:		HP1			MOUN	NTING: Wall Mounted	
		FACILITY:				VO	LTAGE:	480/277 Wye	L-L F	PHASE: 3	3	OCP	TYPE: MLO	
		LOCATION:					AIC:	65	k	WIRE: 4			ATING: 400 A	
						S	DURCE:		i			MCB RA	ATING:	
CKT NO.		CIRCUIT DESCRIPTION	TRIP	POLE		Α		В		С	POLE	TRIP	CIRCUIT DESCRIPTION	CKT NO.
1					3394.8	9422.4								2
3	AHU-01		20 A	3			3394.	8 9422.4			3	20 A	ACCU-01	4
5									3394.8	9422.4	1			6
7					2909.8	23051.7								8
9	OVERH	EAD DOORS	20 A	3			2909.	8 21603.9			3	225 A	T1 (FEEDING LP1)	10
11									2909.8	24744.7	1			12
13					61719.1	191.1					1	15 A	DSF-118A,B,C	14
15	HP2		250 A	3			62376	.7 3214			1	20 A	VEHICLE STORAGE LIGHTS	16
17									53000.2	4968	1	30 A	VEHICLE STORAGE LIGHTS	18
19	EXTERI	OR LIGHTING	20 A	1	559.9	0					1	20 A	EXIT SIGNS	20
21	MEZZAN	NINE LIGHTS	20 A	1			2185	1108.5						22
23	ADMIN I	LIGHTS	20 A	1					2957.4	1108.5	3	20 A	SAN PUMP PANEL	24
25	SPACE				0	1108.5					1			26
27	SPACE						0	0					SPACE	28
29	SPACE								0	0			SPACE	30
31	SPACE				0	0							SPACE	32
33	SPACE						0	0					SPACE	34
35	SPACE								0	0			SPACE	36
37	SPACE				0	0							SPACE	38
39	SPACE						0	0					SPACE	40
41	SPACE								0	0			SPACE	42

				P.	ANELE	BOAR	D DIRE	ECTOF	RY						
		M/E PROJECT: NEW PUBLIC WORKS FACILITY PANEL NAME: PANEL NAME: LP1 TYPE: BRANCH MOUNTING SUPPLIES													
	PROJECT NO.: 203050											ITING: SURFACE			
	FACILITY:				VO		20/208 Wye		HASE: 3		OCP TYPE: MLO				
	LOCATION:				SC	AIC: DURCE: LF		k	WIRE: 4		MCB RA	ATING: 400 A			
CKT NO.	CIRCUIT DESCRIPTION	TRIP	POLE	I	A		В	(C	POLE		CIRCUIT DESCRIPTION	CK ⁻ NO		
43	INVERTER	20 A	1	0	16.8					1	15 A	EF-103	44		
45	EWC-A	20 A	1			180	720			1	20 A	REC RM 001 STORAGE	46		
47	B-01	15 A	1					216	468	1	20 A	ERV-001, ERV-116, ERV-119	48		
49	1111 004	45.0		124.8	600					1	15 A	WH-1	50		
51	UH-001	15 A	2			124.8	800.8				20. 4	EDV 440	52		
53								2900.4	8.008	2	20 A	ERV-118	54		
55	FP	60 A	3	3336	660					1	20 A	DRYER	56		
57						2640	2038.4				00.4	10011407	58		
59	1111.440	45.0						124.8	2038.4	2	30 A	ACCU-107	60		
61	UH-116	15 A	2	124.8	998.4						45 4	EMILO	62		
63	1111.440	45.0				124.8	998.4			2	15 A	EWH-01	64		
65	UH-119	15 A	2					124.8	124.8		45.4	1111 4404	66		
67	LIII 440D	45.0		124.8	124.8					2	15 A	UH-118A	68		
69	UH-118B	15 A	2			124.8	260				45.4	LUL 440E	70		
71	III. 440F	15.0						260	260	2	15 A	UH-118E	72		
73	UH-118F	15 A	2	260	260						15 ^	1111 1400	74		
75	FF 444	45.4			~~~	~~268~	260~	~~~	~~~	2~		UH-118C	76		
77	EF-111	15 A	2	(260	1740	1	20 A	EHD	78		
79	LIII 440D	45.4		260 🤇	1740					1	20 A	EHD	80		
81	UH-118D	15 A	2		www	~200	The same	ww	ww	س	m	8PACE	1/82		
83	SPACE							0	0			SPACE	84		

						F	PANELBOARD DIRECTORY									
	M/E PROJECT N		NEW PUBLIC 203050	WORKS	FACILIT	Υ	PANEL N	IAME:		LP1				TYPE: BRANCH NTING: SURFACE		
	FACILI	TY:					V	OLTAGE:	120/208 Wye	L-L	PHASE:	3	OCP	TYPE: MCB		
	LOCATIO	ON:						AIC:	10	k	WIRE:			ATING: 400 A		
							5	OURCE:	T1				MCB RA	ATING: 275 A		
CKT NO.	CIRCUIT DES	SCRI	IPTION	TRIP	POLE		Α		В		С	POLE	TRIP	CIRCUIT DESCRIPTION	CKT NO.	
1	EF-117			15 A	1	16.8	180					1	20 A	REFRIGERATOR	2	
3	EF-123			15 A	1			16.8	180			1	20 A	REFRIGERATOR	4	
5	FACP			20 A	1					50	540	1	20 A	REC MEZZ 2	6	
7	REC WATER RM, VEI	HICL	E STOR	20 A	1	540	1295					1	20 A	REC CORR & KIT, UC LIGHTS	8	
9	REC ELEC RM & SHO)P 1	16	20 A	1			900	1176			1	20 A	FRONT GATE	10	
11	REC MULTI PURPOS	E RI	M	20 A	1					1080	1260	1	20 A	REC MULTI PURPOSE & STOR RM	12	
13	REC DIRECTOR'S OF	FIC	E	20 A	1	720	900					1	20 A	REC MULTI PURPOSE RM	14	
15	REC EXT & SHOP/ST	OR		20 A	1			1260	1440			1	20 A	REC CORR	16	
17	KITOLIEN DANGE									4160	720	1	20 A	REC VEHICLE STOR	18	
19	KITCHEN RANGE			50 A	2	4160	1080					1	20 A	REC VEHICLE STOR	20	
21	REC JAN, MEN, WOM	1EN'	S	20 A	1			1440	509.6				45.4	EDV 400	22	
23	REC MUSTER & KITC	HEN	V	20 A	1					900	509.6	2	15 A	ERV-120	24	
25	DD 4			45.0		582.4	720					1	20 A	REC IT	26	
27	RP-1			15 A	2			582.4	1080			1	20 A	REC WET AREA & VEHICLE STOR	28	
29	REC MUSTER			20 A	1					900	1080	1	20 A	REC VEST, AST DIR, TLT RM	30	
31						2113.6	2113.6								32	
33	EF-118A			25 A	3			2113.	6 2113.6			3	25 A	EF-118B	34	
35	1						2113.6	2113.6				36				
37	SPACE					0	0					1	20 A	SPARE	38	
39	SPACE							0	0			1	20 A	SPARE	40	
41	SPACE									0	0	1	20 A	SPARE	42	



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ELECTRICAL SCHEDULES

Sheet Number:

F703