





WESTCHESTER COUNTY, NEW YORK DEPARTMENT OF PUBLIC WORKS AND TRANSPORTATION DIVISION OF ENGINEERING

CONTRACT No. 21-528 STEAM SYSTEM UPGRADES, PHASE II MICHAELIAN OFFICE BUILDING 148 MARTINE AVE, WHITE PLAINS, NY

SHEET NO.	SHEET TITLE	DPW FILE NO.
T-1	TITLE SHEET	52-02-T-1320
G-1	CONSTRUCTION NOTES & PHASING PLAN	52-02-G-1321
A-1	5TH FLOOR PLAN - ITEM E	52-02-A-1322
A-2	7TH FLOOR PLAN, PART PLANS AND DETAILS - ITEM E	52-02-A-1323
A-3	PART PLANS AT PIPE EXPANSION JOINT CHASE - ITEM E	52-02-A-1324
A-4	EXPANSION JOINT CHASE WALL DETAILS - ITEM E	52-02-A-1325
AS-1	ASBESTOS ABATEMENT-5TH FLOOR- ITEM D	52-02-AS-1326
AS-2	ASBESTOS ABATEMENT-7TH FLOOR- ITEM D	52-02-AS-1327
H-1	GENERAL NOTES AND DETAILS	52-02-H-1328
H-2	MOB 5TH FLOOR MECHANICAL PLAN	52-02-H-1329
H-3	MOB 7TH FLOOR MECHANICAL PLAN	52-02-H-1330
H-4	MOB STEAM RISER DIAGRAM (5TH & 7TH FLOORS)	52-02-H-1331

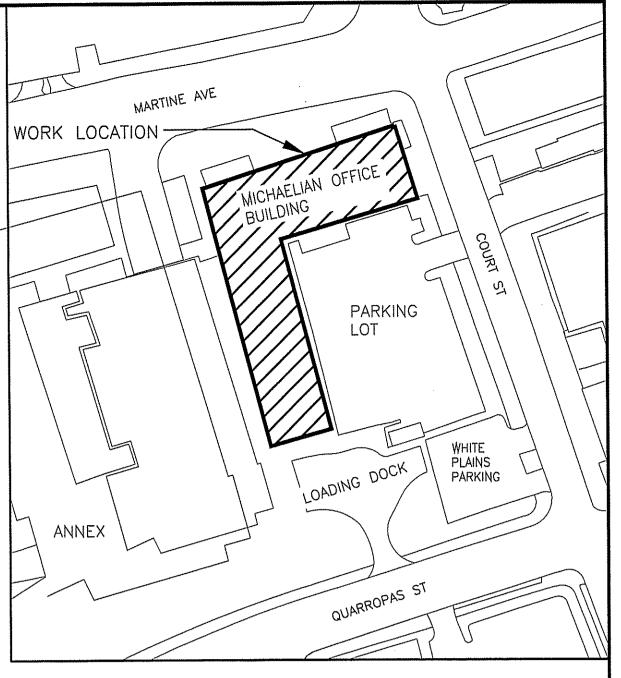

LOCATION MAP

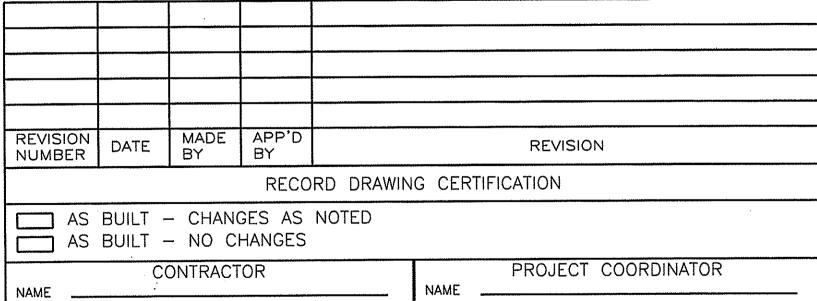

SIGNATURE

SCALE: AS SHOWN

DATE: 12/3/2021

52-02-T-1320

DPW FILE NO.

NUMBER DEPARTMENT OF PUBLIC WORKS AND TRANSPORTATION DIVISION OF ENGINEERING SHEET NO. 1 OF 12

STEAM SYSTEM UPGRADES, PHASE II MICHAELIAN OFFICE BUILDING 148 MARTINE AVE, WHITE PLAINS, NEW YORK TITLE SHEET

RECOMMENDED FOR DESIGN JAI PUNNOOSE, P.E. ASSOCIATE ENGINEER

AND TRANSPORTATION

DEPARTMENT OF PUBLIC WORKS


RECOMMENDED FOR CONSTRUCTION GAYLE M. KATZMAN, P.E. FIRST DEPUTY COMMISSIONER DEPARTMENT OF PUBLIC WORKS AND TRANSPORTATION

HUGH J. GREECHAN JR., P.E. COMMISSIONER DEPARTMENT OF PUBLIC WORKS AND TRANSPORTATION

APPROVED FOR CONSTRUCTION

11.19-7.24

IN CHARGE OF JAI PUNNOOSE, P.E. VINCENT LEONE, P.E. VINCENT LEONE, P.E.

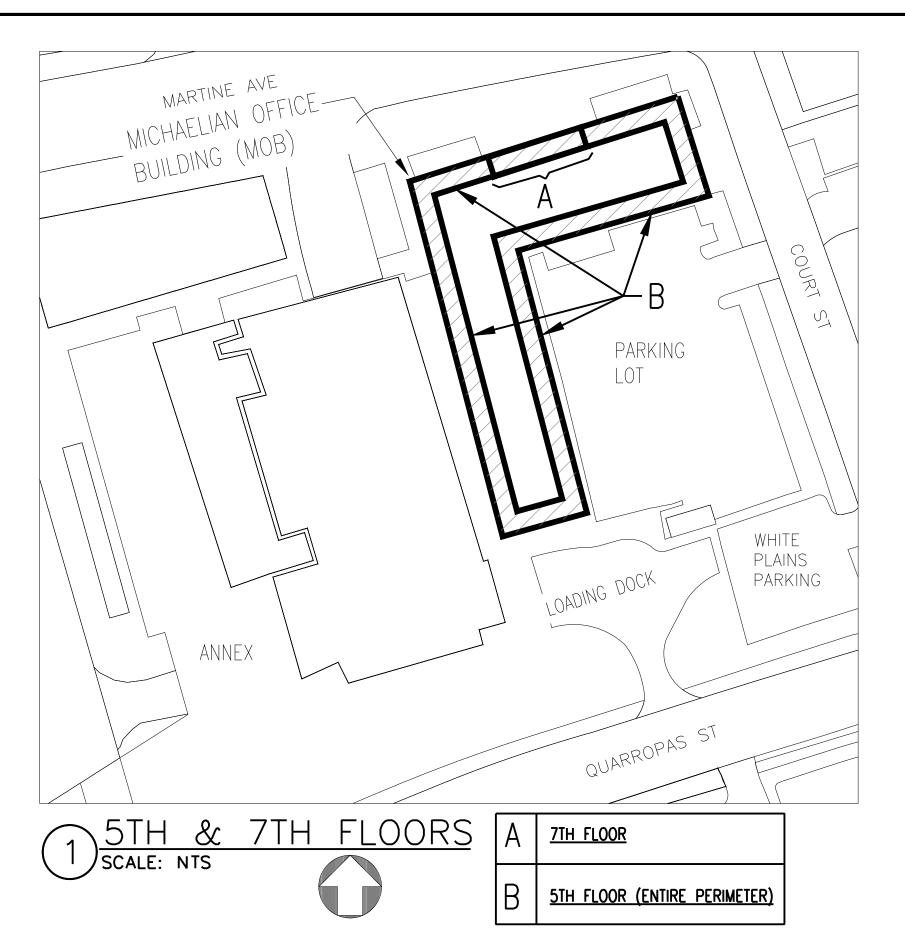

JAI PUNNOOSE, P.E.

VINCENT LEONE, P.E.

<u>JAI PU</u>NNOOSE, P.E

IN CHARGE OF

BIT ITEM DESCRIPTION ITEM A DEMOLISH EXISTING AND PROVIDE NEW EXPANSION JOINTS, INSULATE AND TEST. ITEM B DEMOLISH EXISTING AND PROVIDE NEW RADIATOR VALVES/TRAPS AND TEST ITEM C | DISASSEMBLY, MOVING & REASSEMBLY OF ALL FURNITURE/PARTITIONS AS REQUIRED TO PERFORM ALL WORK ITEMS. ITEM D ALL ABATEMENT INCLUDING SELECTIVE DEMO OF ENCLOSURES AND ACCESS PANELS CONTAINING LEAD PAINT ITEM E | ALL ARCHITECTURAL RESTORATION

			TYPICAL PHASE				
	SUBPHASE	а	b	С			
6AM-6PM	FRIDAY						
6PM-6AM	IMDAT		Move/Demo/Abate (ITEM C; ITEM D)				
	SATURDAY						
	SUNDAY						
		E.J., Danfoss & Steam Trap Removals					
6AM-6PM	MONDAY	and Provisions (ITEM A; ITEM B)					
	MONDAT	Test provisions with Live Steam (AFTER					
6PM-6AM		7PM) (ITEM A; ITEM B)					
			E.J., Danfoss & Steam Trap Removals				
6AM-6PM	TUESDAY	Start Architectural Restoration (ITEM E)	and Provisions (ITEM A; ITEM B)				
	TUESDAT		Test provisions with Live Steam (AFTER				
6PM-6AM			7PM) (ITEM A; ITEM B)				
				E.J., Danfoss & Steam Trap Removals			
6AM-6PM	WEDNESDAY	Finish Restoration (ITEM E)	Start Architectural Restoration (ITEM E)	and Provisions (ITEM A; ITEM B)			
	VVEDINESDAT			Test provisions with Live Steam (AFTER			
6PM-6AM				7PM) (ITEM A; ITEM B)			
6AM-6PM	THURSDAY		Finish Restoration (ITEM E)	Start Architectural Restoration (ITEM E)			
6PM-6AM							
6AM-6PM	EDID AV			Finish Restoration (ITEM E)			
6PM-6AM	FRIDAY	Move Everything Back / Cleanup Finish Phase & Move/Demo/Abate for Next Phase (Repeat Above)					

2,3


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8.9

4

5,6,7

- 1. ABOVE SCHEDULE IS A SUGGESTED SCHEDULE. ACTUAL SCHEDULE, MEANS & METHODS WILL BE UP TO THE CONTRACTOR AND SHALL BE COORDINATED IN THE FIELD. TIMING LIMITS IN PLACE TO LIMIT OCCUPANT DISTRACTION, HAZARD AND/OR DISCOMFORT SHALL NOT BE VIOLATED.
- 2. CONTRACTOR SHALL COMPLETE THE SCOPE OF WORK FOR AT LEAST ONE ZONE IDENTIFIED IN THE CONTRACT DOCUMENTS WITHIN THE ALLOCATED TIME PERIOD (ONE WEEK) AND TURN OVER TO COUNTY FOR NORMAL BUSINESS.
- 3. TO LIMIT OCCUPANT DISTRACTION, DEMOLITION OF EXPANSION JOINTS SHALL BE DONE MONDAY FRIDAY (BEFORE 8AM OR AFTER 6PM) OR
- 4. FINAL AIR CLEARANCE (AFTER ABATEMENT) OBTAINED BY MONDAY 7 AM FOR EACH ZONE.
- FOR OCCUPANT SAFETY, WELDING SHALL BE DONE UNDER NEGATIVE PRESSURIZATION (SIMILAR PRECAUTION AS ASBESTOS)
- 5. FOR OCCUPANT COMFORT, ALL STEAM TESTING SHALL REQUIRE LIVE STEAM AND SHALL BE CONDUCTED MONDAY FRIDAY (7PM 12AM).
- 7. CONTRACTOR WILL BE REQUIRED TO DEMONSTRATE WORK SPEED (PROGRESSION) DURING EARLY STAGES AND PROVIDE WRITTEN REQUEST PRIOR

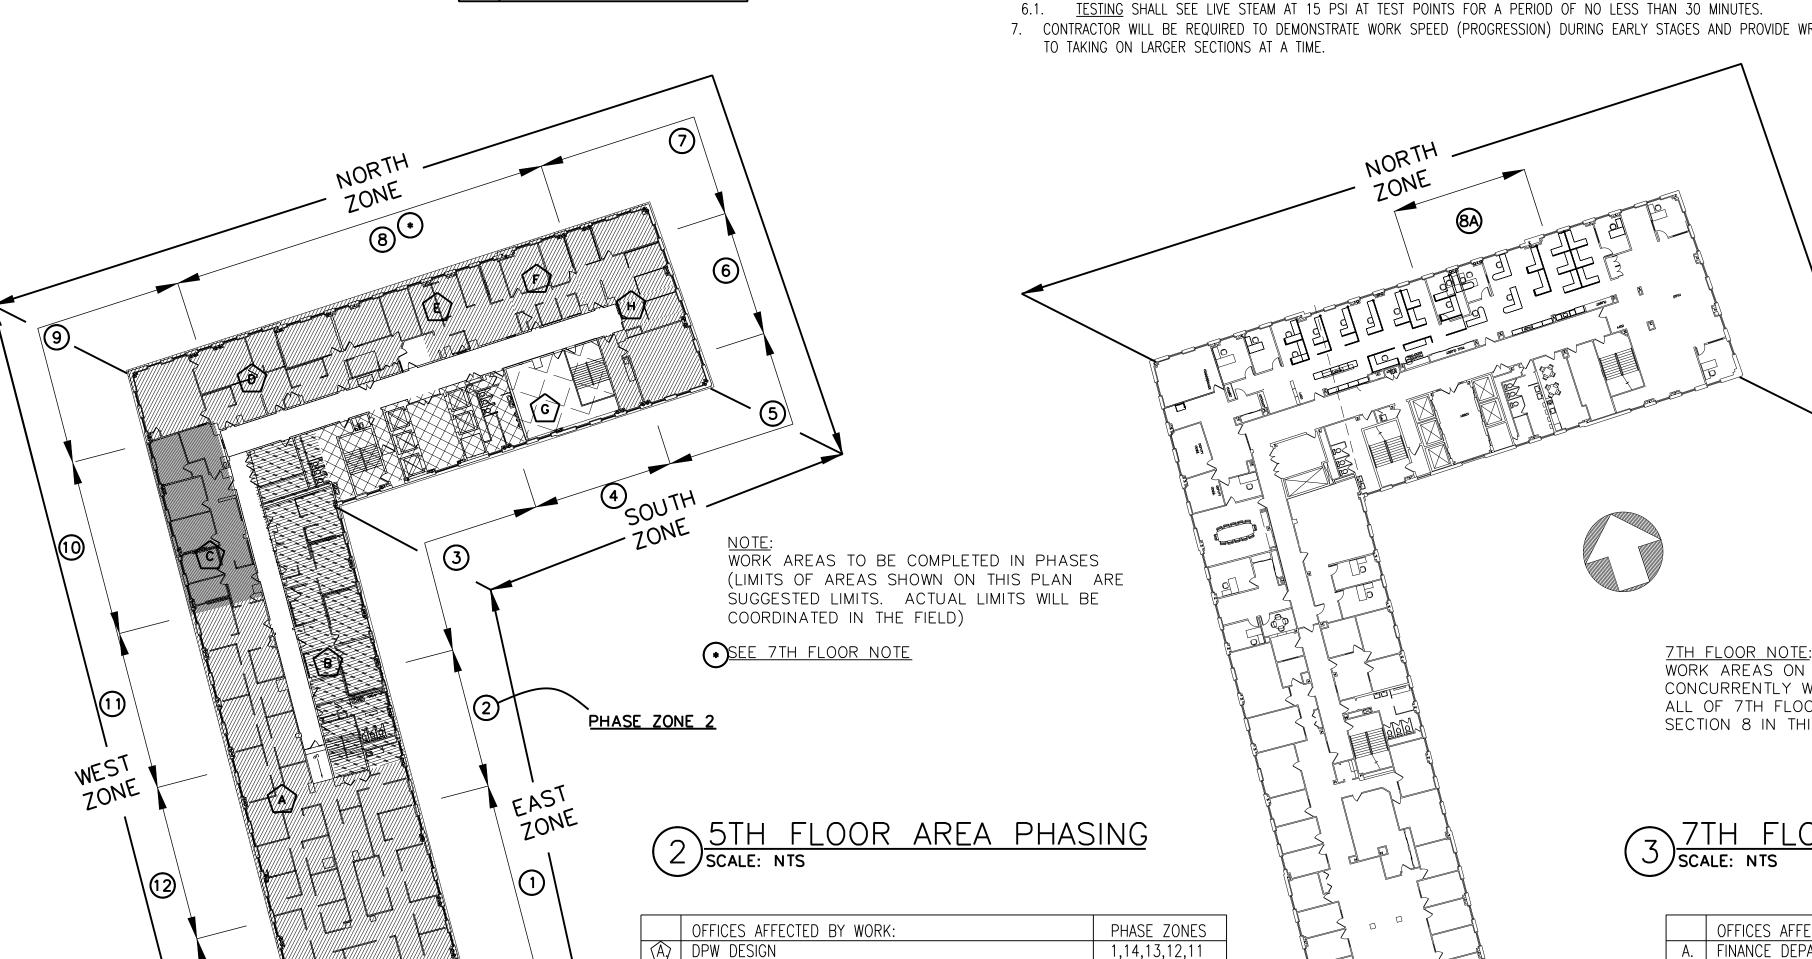

OFFICE OF ADMINISTRATION SERVICES

(D) COMMISSIONERS OFFICE

TRANSPORTATION DIVISION

(A) ACQUISITION AND CONTRACT

OFFICE OF PROJECT MANAGEMENT DIRECTORS

(E) OFFICE OF CONTRACT ADMINISTRATION AND PERMITS (F.) | AIRPORT DIVISION & TRANSPORTATION DIVISION

WORK AREAS ON THE 7TH FLOOR CAN BE DONE CONCURRENTLY WITH WORK ON 5TH FLOOR. ALL OF 7TH FLOOR WORK TAKES PLACE ABOVE SECTION 8 IN THIS PHASE MAP.

3 TH FLOOR AREA PHASING SCALE: NTS

	OFFICES AFFECTE	ED BY WORK:	PHASE Z	ONES
Α.	FINANCE DEPART	MENT	8A	

FURNITURE OBSTRUCTING WORK AREAS: ITEM C

- A. THE CONTRACTOR IS RESPONSIBLE FOR MOVING DESKS, CABINETS CHAIRS, MOVABLE FURNISHINGS (REFERRED TO AS "FURNITURE") AND PARTITIONS AS NEEDED TO PEFRORM WORK SO AS NOT TO DAMAGE ANYTHING. THE FURNITURE SHALL THEN BE RESET AT THE COMPLETION OF WORK. IN GENERAL, THE OFFICE LAYOUT IS OPEN STYLE. CONTRACTOR MAY HAVE TO BREAK DOWN OFFICE PARTITIONS AND ASSOCIATED WORK AS REQUIRED TO COMPLETE THE WORK AT CERTAIN AREAS. THIS MAY INCLUDE DISCONNECTION AND RECONNECTION OF POWER AND DATA CIRCUITS.
- B. <u>FURNITURE</u> <u>DISASSEMBLY</u>/<u>REASSEMBLY</u>: THE CONTRACTOR SHALL HAVE OFFICE FURNITURE, FURNISHINGS, OR RELATED EQUIPMENT REQUIRED TO COMPLETE THE WORK OF THIS CONTRACT TEMPORARILY DISASSEMBLED AND REASSEMBLED BY QUALIFIED SYSTEMS INSTALLERS.
- C. OFFICE PERSONELL RESPONSIBILITY: OFFICE PERSONNEL WILL REMOVE LOOSE PAPERWORK, BOOKS, AND SIMILAR FILES FROM THE TOP OF FURNITURE THAT NEEDS TO BE MOVED FOR ACCESS TO THE WORK AREAS.
- D. <u>ALL COSTS ASSOCIATED</u>: CONTRACTOR SHALL INCLUDE ALL COSTS ASSOCIATED WITH MOVING FURNITURE AND FURNISHING IN THEIR BID AMOUNT, NO ADDITIONAL PAYMENT WILL BE MADE FOR FURNITURE RELOCATION.
- E. AT THE COMPLETION OF A PHASE THE WORK AREA SHALL BE RETURNED BACK TO ITS ORIGINAL STATE. ALL WORK SURFACES SHALL BE WIPED CLEAN OF ANY DUST AND DEBRIS AND SANITIZED. FLOOR SHALL BE VACUUMED TO THE SATISFACTION OF THE CONSTRUCTION MANAGER.

TEMPORARY PARTITIONS AND DUST/SMOKE PROTECTION: **ITEM D**

- A. THE CONTRACTOR SHALL PROVIDE <u>DUST PROTECTION</u> MEASURES TO PREVENT THE SPREAD OF DUST, SMOKE AND RELATED DEBRIS TO OTHER PARTS OF THE OFFICE SPACE(S). WITHIN A DESIGNATED WORK AREA THE CONTRACTOR SHALL ALSO PROVIDE DUST/DEBRIS PROTECTION OVER DESKS, FURNITURE, FURNISHINGS, AND RELATED EQUIPMENT. PROTECT WALL, CEILINGS, FLOORS AND OTHER FINISHED WORK FROM DAMAGE DURING THE COURSE OF THE WORK.
- B. PROVIDE <u>TEMPORARY</u> <u>BARRICADES</u> AND OTHER PROTECTION REQUIRED TO PREVENT INJURY TO PEOPLE AND DAMAGE TO ADJACENT OFFICE SPACES AND FACILITIES TO REMAIN. ENSURE SAFE PASSAGE OF PEOPLE AROUND WORK AREA BUILDING OCCUPANTS. IF WORK IS INCOMPLETE IN THE WORK AREA IT SHALL BE CAPPED OR SEALED BETWEEN SHIFTS. PLASTIC SHEETING TARPS SHALL BE INSTALLED. ALL UNFINISHED WORK SHALL BE SECURE SO THAT THE ADJOINING OFFICE SPACE CAN BE USED. EXISTING CEILING LIGHTING SHALL NOT BE BLOCKED OR REMOVED.
- C. FLOOR/WALL PROTECTION: THE CONTRACTOR SHALL TAKE ALL NECESSARY MEASURES TO PREVENT FLOORS AND WALLS FROM GETTING DIRTY. EVERY AREA TREADED BY CONTRACTOR AND SUBCONTRACTOR EMPLOYEES SHALL BE LAIDEN WITH CLEAN ABSORBENT TARP AND PLASTIC WHERE BUILDING OCCUPANTS RELY ON THE SAME WALKWAY, FLOOR PROTECTION SHALL BE INSTALLED TAUGHT TO THE GROUND TO PREVENT SLIPPING AND TRIPPING.

COMMON TO ALL WORK ITEMS

- 1. DO NOT SCALE THE DRAWINGS,. USE WRITTEN DIMENSIONS ONLY.
- 2. THE CONTRACTOR IS RESPONSIBLE FOR FIELD VERIFYING ALL CONDITIONS AND DIMENSIONS PRIOR TO COMMENCING ANY WORK
- 3. ALL WORK WILL FOLLOW ALL APPLICABLE LOCAL STATE AND NATIONAL CODES AND REQUIREMENTS.
- 4. ALL QUESTIONS AND/OR DISCREPANCIES SHALL BE BROUGHT TO THE ATTENTION OF THE CONSTRUCTION MANAGER IMMEDIATELY

<u>SCHEDULING</u>

- A. ALL WORK SHALL BE COMPLETED, TESTED AND PUT BACK INTO SERVICE PRIOR TO OCTOBER 15, 2022.
- B. ALL WORK SHALL BE COMPLETED BETWEEN THE HOURS OF 7AM AND 5PM MONDAY THRU FRIDAY UNLESS STATED OTHERWISE.
- C. MICHAELIAN OFFICE BUILDING WILL BE OCCUPIED WITH OFFICE PERSONNEL DURING REGULAR DAYTIME HOURS 7:30 AM 6:00 PM, THE CONTRACTOR'S WORK THAT IS DESIGNATED AS AFTER-HOURS, MUST TAKE PLACE OUTSIDE OF THESE HOURS.
- D. ALL WORK SHALL BE COORDINATED WITH THE CONSTRUCTION MANAGER.
- E. ALL WELDING ON 5TH AND 7TH FLOORS AREAS SHALL BE DONE AFTER-HOURS UNLESS APPROVED CONTAINMENT IS
- F. WORK ON 5TH AND 7TH FLOORS SHALL BE SPLIT INTO PHASES. EACH PHASE MUST BE COMPLETED BEFORE THE NEXT PHASE BEGINS. EACH PHASE SHALL LAST NO LONGER THAN 1 WEEK. THE PHASE WILL BE PERMITTED TO START AFTER HOURS ON A FRIDAY 6PM AND ALL OF THE WORK SPACE SHALL BE MOVE-IN READY BY THE START OF THE WORKDAY OF THE SECOND MONDAY 6AM (10 DAYS LATER). CONTRACTOR SHALL REVIEW AND COORDINATE THE AMOUNT OF WORK THEY WILL COMMIT TO COMPLETING IN THAT 1 WEEK. ONCE A CONTRACTOR COMMITS TO COMPLETING THAT PHASE, IT SHALL BE THE RESPONSIBILITY OF THE CONTRACTOR TO ENSURE THAT ALL OF THE WORK IS COMPLETED AND SPACES RESTORED ON TIME. SUGGESTED PHASE BOUNDARIES ARE INCLUDED ON THIS SHEET. RULES FOR ACTUAL PHASE BOUNDARIES ARE AS
 - PHASE BOUNDARIES NUMBERED FROM 1-14 IN THE PHASING PLAN ON THIS SHEET MAY BE GROUPED TOGETHER BUT MAY NOT BE SPLIT INTO SEPARATE PHASES.

PARKING:

A. PARKING FOR THE CONTRACTORS' EMPLOYEES IS AVAILABLE AT PUBLIC PARKING LOTS. THE COST FOR ALL PARKING IS THE RESPONSIBILITY OF THE CONTRACTOR. UNDER NO CIRCUMSTANCES ARE CONTRACTOR'S VEHICLES TO BE PARKED AT THE WORK SITE EXCEPT FOR DELIVERIES.


DELIVERIES:

- A. CONTRACTORS' DELIVERIES TO THE WORK SITES WILL REQUIRE 48 HOUR ADVANCE NOTICE TO THE COUNTY. DELIVERIES TO THE MICHAELIAN OFFICE BUILDING WORK SITE WILL UTILIZE THE MARTINE AVENUE DRIVEWAY OR THE LOADING DOCK. ACCESS THROUGH THE MICHAELIAN OFFICE BUILDING, WORK SITES WILL BE BY PERMISSION OF THE COUNTY.
- B. 24 HOUR ADVANCE NOTICE WILL BE REQUIRED FOR THE MOVEMENT OF ALL MATERIALS AND/OR DEBRIS THROUGH THE WORK SITES. THE CONTRACTORS ARE RESPONSIBLE TO PROVIDE ADEQUATE PROTECTION FOR ALL EXISTING BUILDING FINISHES AT EACH WORK LOCATION. ALL PROTECTIVE MEASURES MUST BE APPROVED BY THE COUNTY IN ADVANCE.

SECURITY:

A. THE CONTRACTORS ARE HEREBY NOTIFIED THAT THE MICHAELIAN OFFICE BUILDING, IS TO BE CONSIDERED AS "OPEN TO THE PUBLIC" ON A 24 HOUR BASIS. ALL CONTRACTORS ARE RESPONSIBLE TO PROVIDE FOR THE SAFETY OF THE WORKERS, THE COUNTY'S EMPLOYEES, AND THE PUBLIC AS PER ALL LOCAL, STATE, AND NATIONAL CODES AND REGULATIONS.

REVISION NUMBER	DATE	MADE BY	APP'D BY			REVISION			
			RECO	RD DRAWIN	G CERTIF	ICATION			
AS BUILT — CHANGES AS NOTED AS BUILT — NO CHANGES									
CONTRACTOR NAME NAM					NAME	PROJECT C	COORDINATOR	?	
SIGNATURE TITLE	SIGNATURE DATE TITLE					DATE		_	
WESTCHESTER COUNTY, NEW DEPARTMENT OF PUBLIC WORKS AND TRANSF						CONTRACT NUMBER 21-528	SHEET NUMBER G-1		
DIVISION OF ENGINEERING						SHEET NO. 2	OF 12	2	
STEAM SYSTEM UPGRADES, PHASE II MICHAELIAN OFFICE BUILDING						SCALE: AS STATE: 12/STATE: DPW FILE NO.	3/2021	RFV	
148 MARTINE AVE, WHITE PLAINS, NEW YORK CONSTRUCTION NOTES & PHASING PLAN					RK	52-02-G-		REV. NO. O	

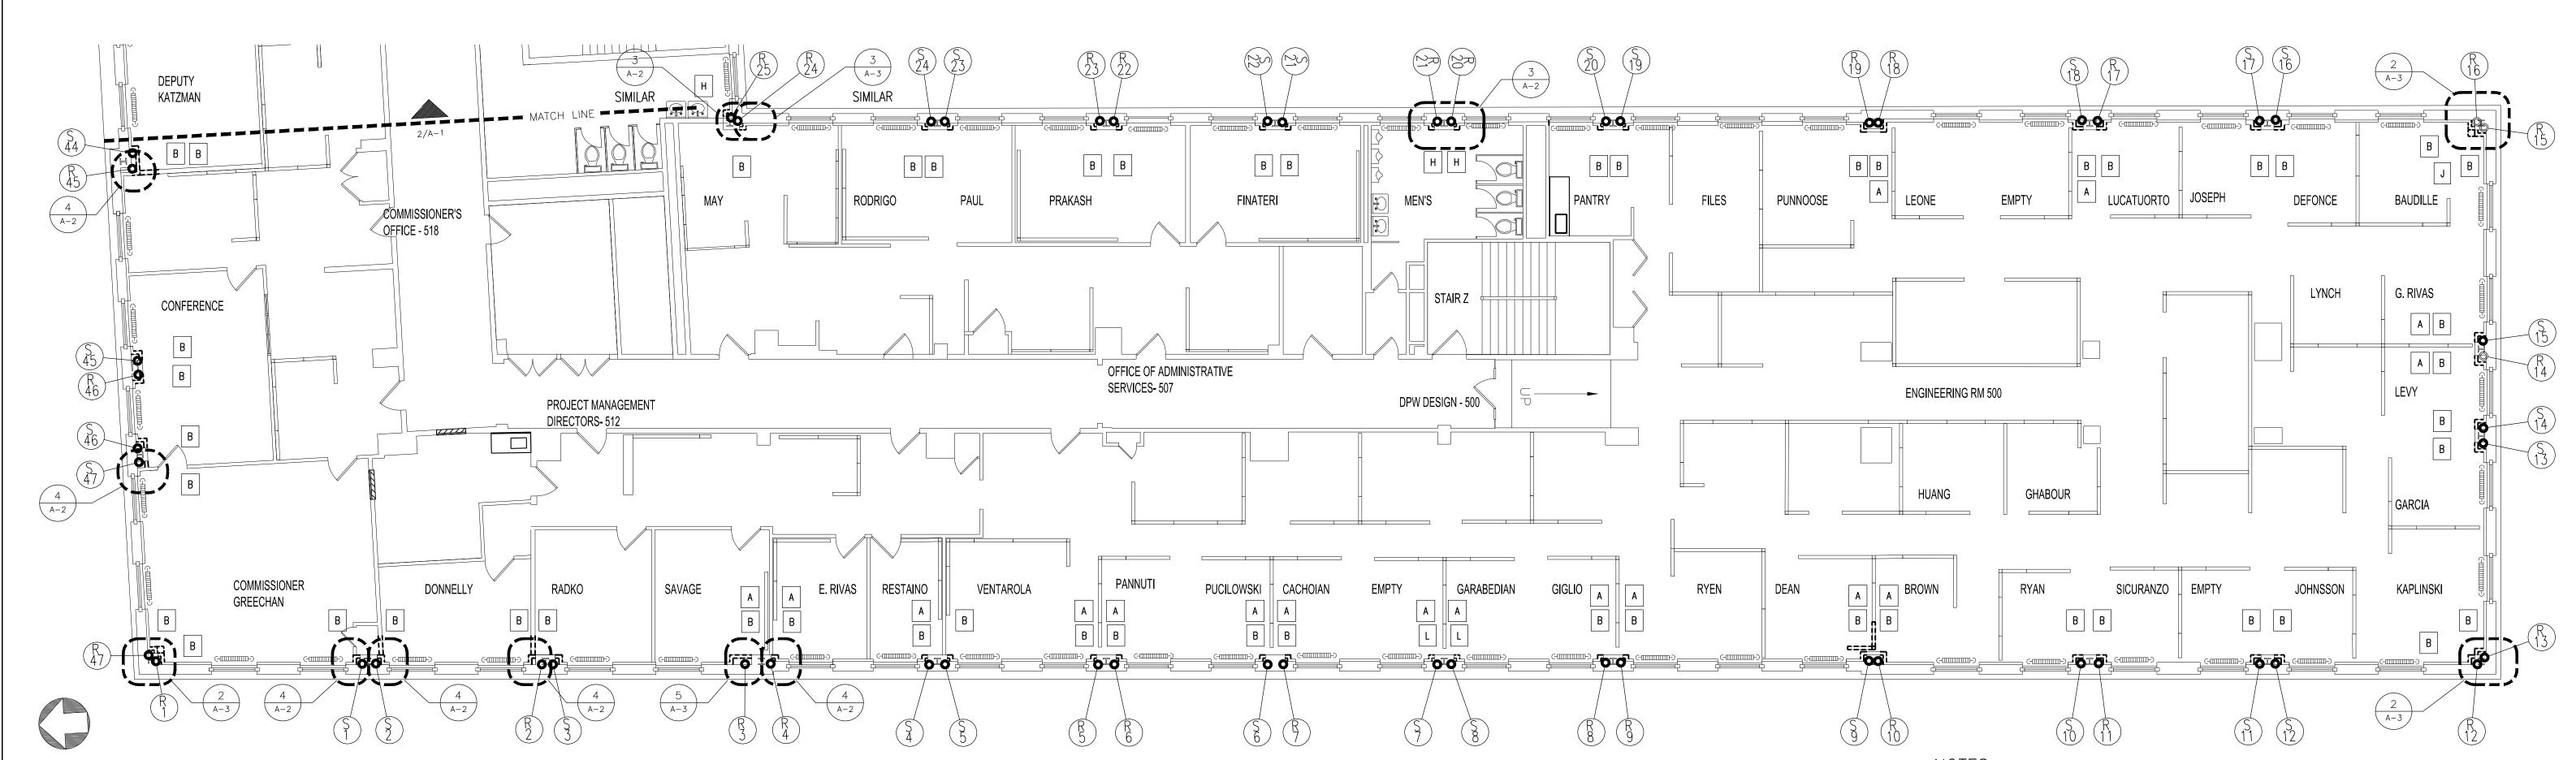

KEY NOTES

- REMOVE AND REINSTALL PORTIONS OF SYSTEM FURNITURE FOR ACCESS TO HEAT PIPE PLUMBING CHASE
- PARTIAL DEMOLITION OF PAINTED PLASTER THROUGH ACCESS


 CHASE WALL, RESTORE CHASE WALL, INSTALL NEW ACCESS PARTIAL DEMOLITION OF PAINTED PLASTER FINISHED MASONRY
- PARTIALLY DEMOLISH AND REBUILD DRYWALL INTERIOR PARTITION AS REQUIRED TO PROVIDE ACCESS FOR STEAM PIPE EXPANSION JOINT WORK.
- D INSTALL NEW ACCESS DOOR
- E MOVE OFFICE FURNITURE AND CASEWORK FOR WORK IN STEAM PIPE CHASE WALL
- F REMOVE AND REINSTALL STONE WAINSCOT PANELS IN ELEVATOR LOBBY FOR WORK IN STEAM PIPE CHASE WALL
- G REMOVE AND REINSTALL EXPOSED BRICK MASONRY TO ACCESS EXPANSION JOINT WORK @ STAIR Y AND BALCONY RISERS # S25 AND S27, AND UNUSED SPACE CONNECTING TO AIR VENTILATION SHAFT RISER # S29
- PARTIALLY DEMOLISH AND REBUILD EXISTING RESTROOM PARTITION INSTALL NEW ACCESS DOORS
- J EXISTING DRYWALL CORNER ENCLOSURE, CREATE OPENING TO ACCESS STEAM PIPE CHASE WALL, INSTALL 12 IN. HOR. X 30 IN. VERT. ACCESS DOOR. PERFORM WORK ON MASONRY AND PLASTER CHASE WALL EQUAL TO OTHER LOCATIONS. CENTER ACCESS DOOR IN DRYWALL PARTITION WITH ACCESS DOOR IN MASONRY AND PLASTER PARTITION.
- PARTIALLY DEMOLISH PAINTED PLASTER FINISHED MASONRY PARTITION AND RESTORE ORIGINAL CONDITIONS AFTER EXPANSION JOINT REPLACEMENT WORK
- L FLOOR TO CLNG. 16 GAUGE 2-1/2" MTL. STUD FRAMING (2 LA.) TYPE X GYP. BD. FLOOR PAINT FINISH NEW ACCESS DOORS @ EA. RISER
- M CUT OPENING IN DRYWALL PARTITION TO ACCESS STEAM PIPE MASONRY CHASE WALL. INSTALL NEW ACCESS DOOR IN MASONRY CHASE WALL AFTER EXPANSION JOINT REPLACEMENT WORK. PATCH DRYWALL PARTITION AND INSTALL NEW ACCESS
- N EXISTING 1 HR. FIRE RATED DRYWALL CHASE WALL FLOOR TO CEILING INSTALL NEW ACCESS DOOR

IN CHARGE OF ADAM KAPLINSKI, R.A. CHECKED BY <u>ADAM KAPLINSKI,</u> RA. MADE BY _____ALEXIS GARCIA

<u>5TH FLOOR PLAN - SOUTHWEST WING</u> SCALE: 1/8" = 1'-0"

LEAD ABATEMENT


PERFORM LEAD ABATEMENT OF PAINTED PLASTER FINISHED PIPE CHASE WALLS AT ALL RISERS LABELED ON 5TH FLOOR PLANS ON DWG. A-1 AND 7TH FLOOR PLAN ON DWG. A-2 IN ACCORDANCE WITH EPA, STATE AND LOCAL CODES AND REGULATIONS.

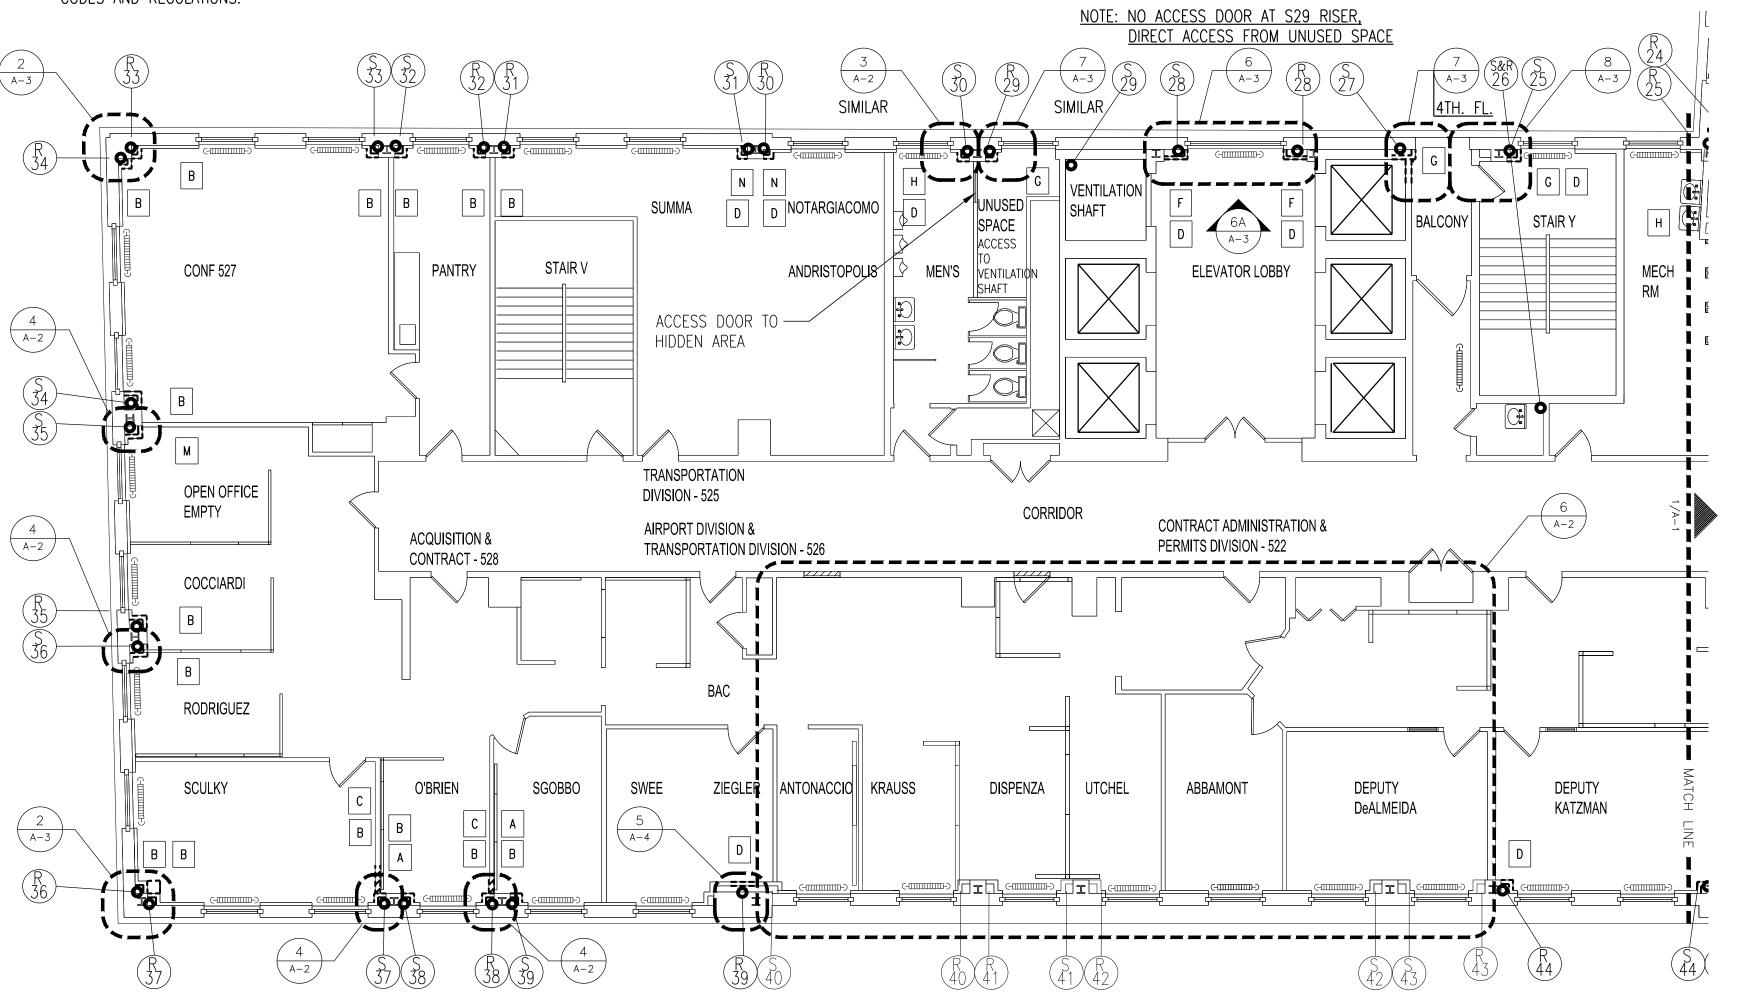

2 SCALE: 1/8" = 1'-0"

NOTES


- ALL RISERS THAT ARE LABELED ON PLAN SHALL BE FITTED WITH ACCESS DOORS U.N.O.
- FOR TYPICAL DETAILS ON CHASE WALL WORK REFER TO SHEET A-4. REFER TO PART PLANS FOR FOR ADDITIONAL CONDITIONS
- FOR WORK ON CHASES FOR RISERS # S40 THROUGH R43 SEE 7TH. FLR. PLAN DWG. 6/A-2

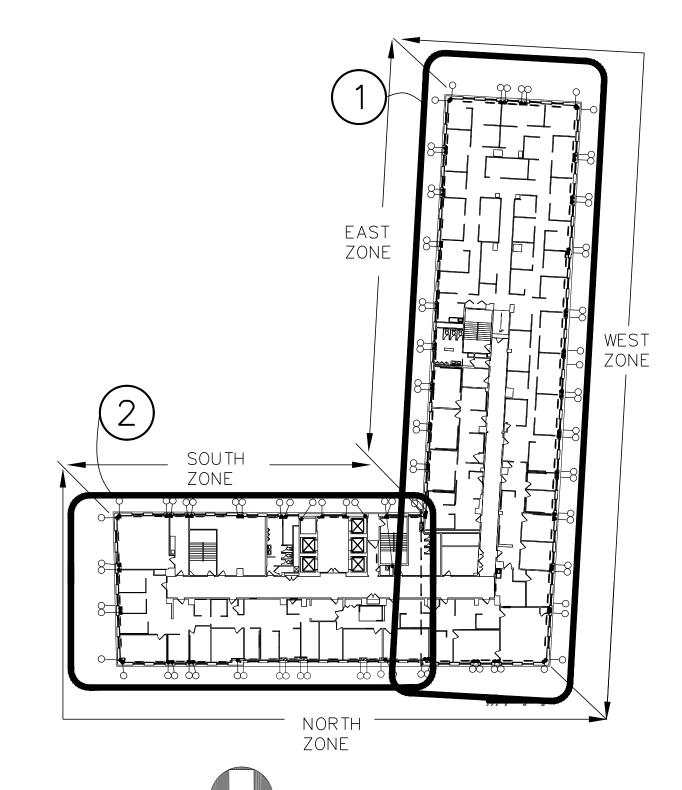





LED TO BE ABATED UNDER ITEM B

WESTCHESTER COUNTY, NEW YORK DEPARTMENT OF PUBLIC WORKS AND TRANSPORTATION	CONTRACT NUMBER 21-528	SHEET NUMBER A-1	
DIVISION OF ENGINEERING	SHEET NO. 3	OF 12	2
STEAM SYSTEM UPGRADES — PHASE II MICHAELIAN OFFICE BUILDING	SCALE: AS S DATE: 12/0	SHOWN 03/2021	1
148 MARTINE AVE, WHITE PLAINS, NEW YORK	DPW FILE NO.	I	REV. NO.
5TH FLOOR PLAN - ITEM E	52-02-A-	-1322	0

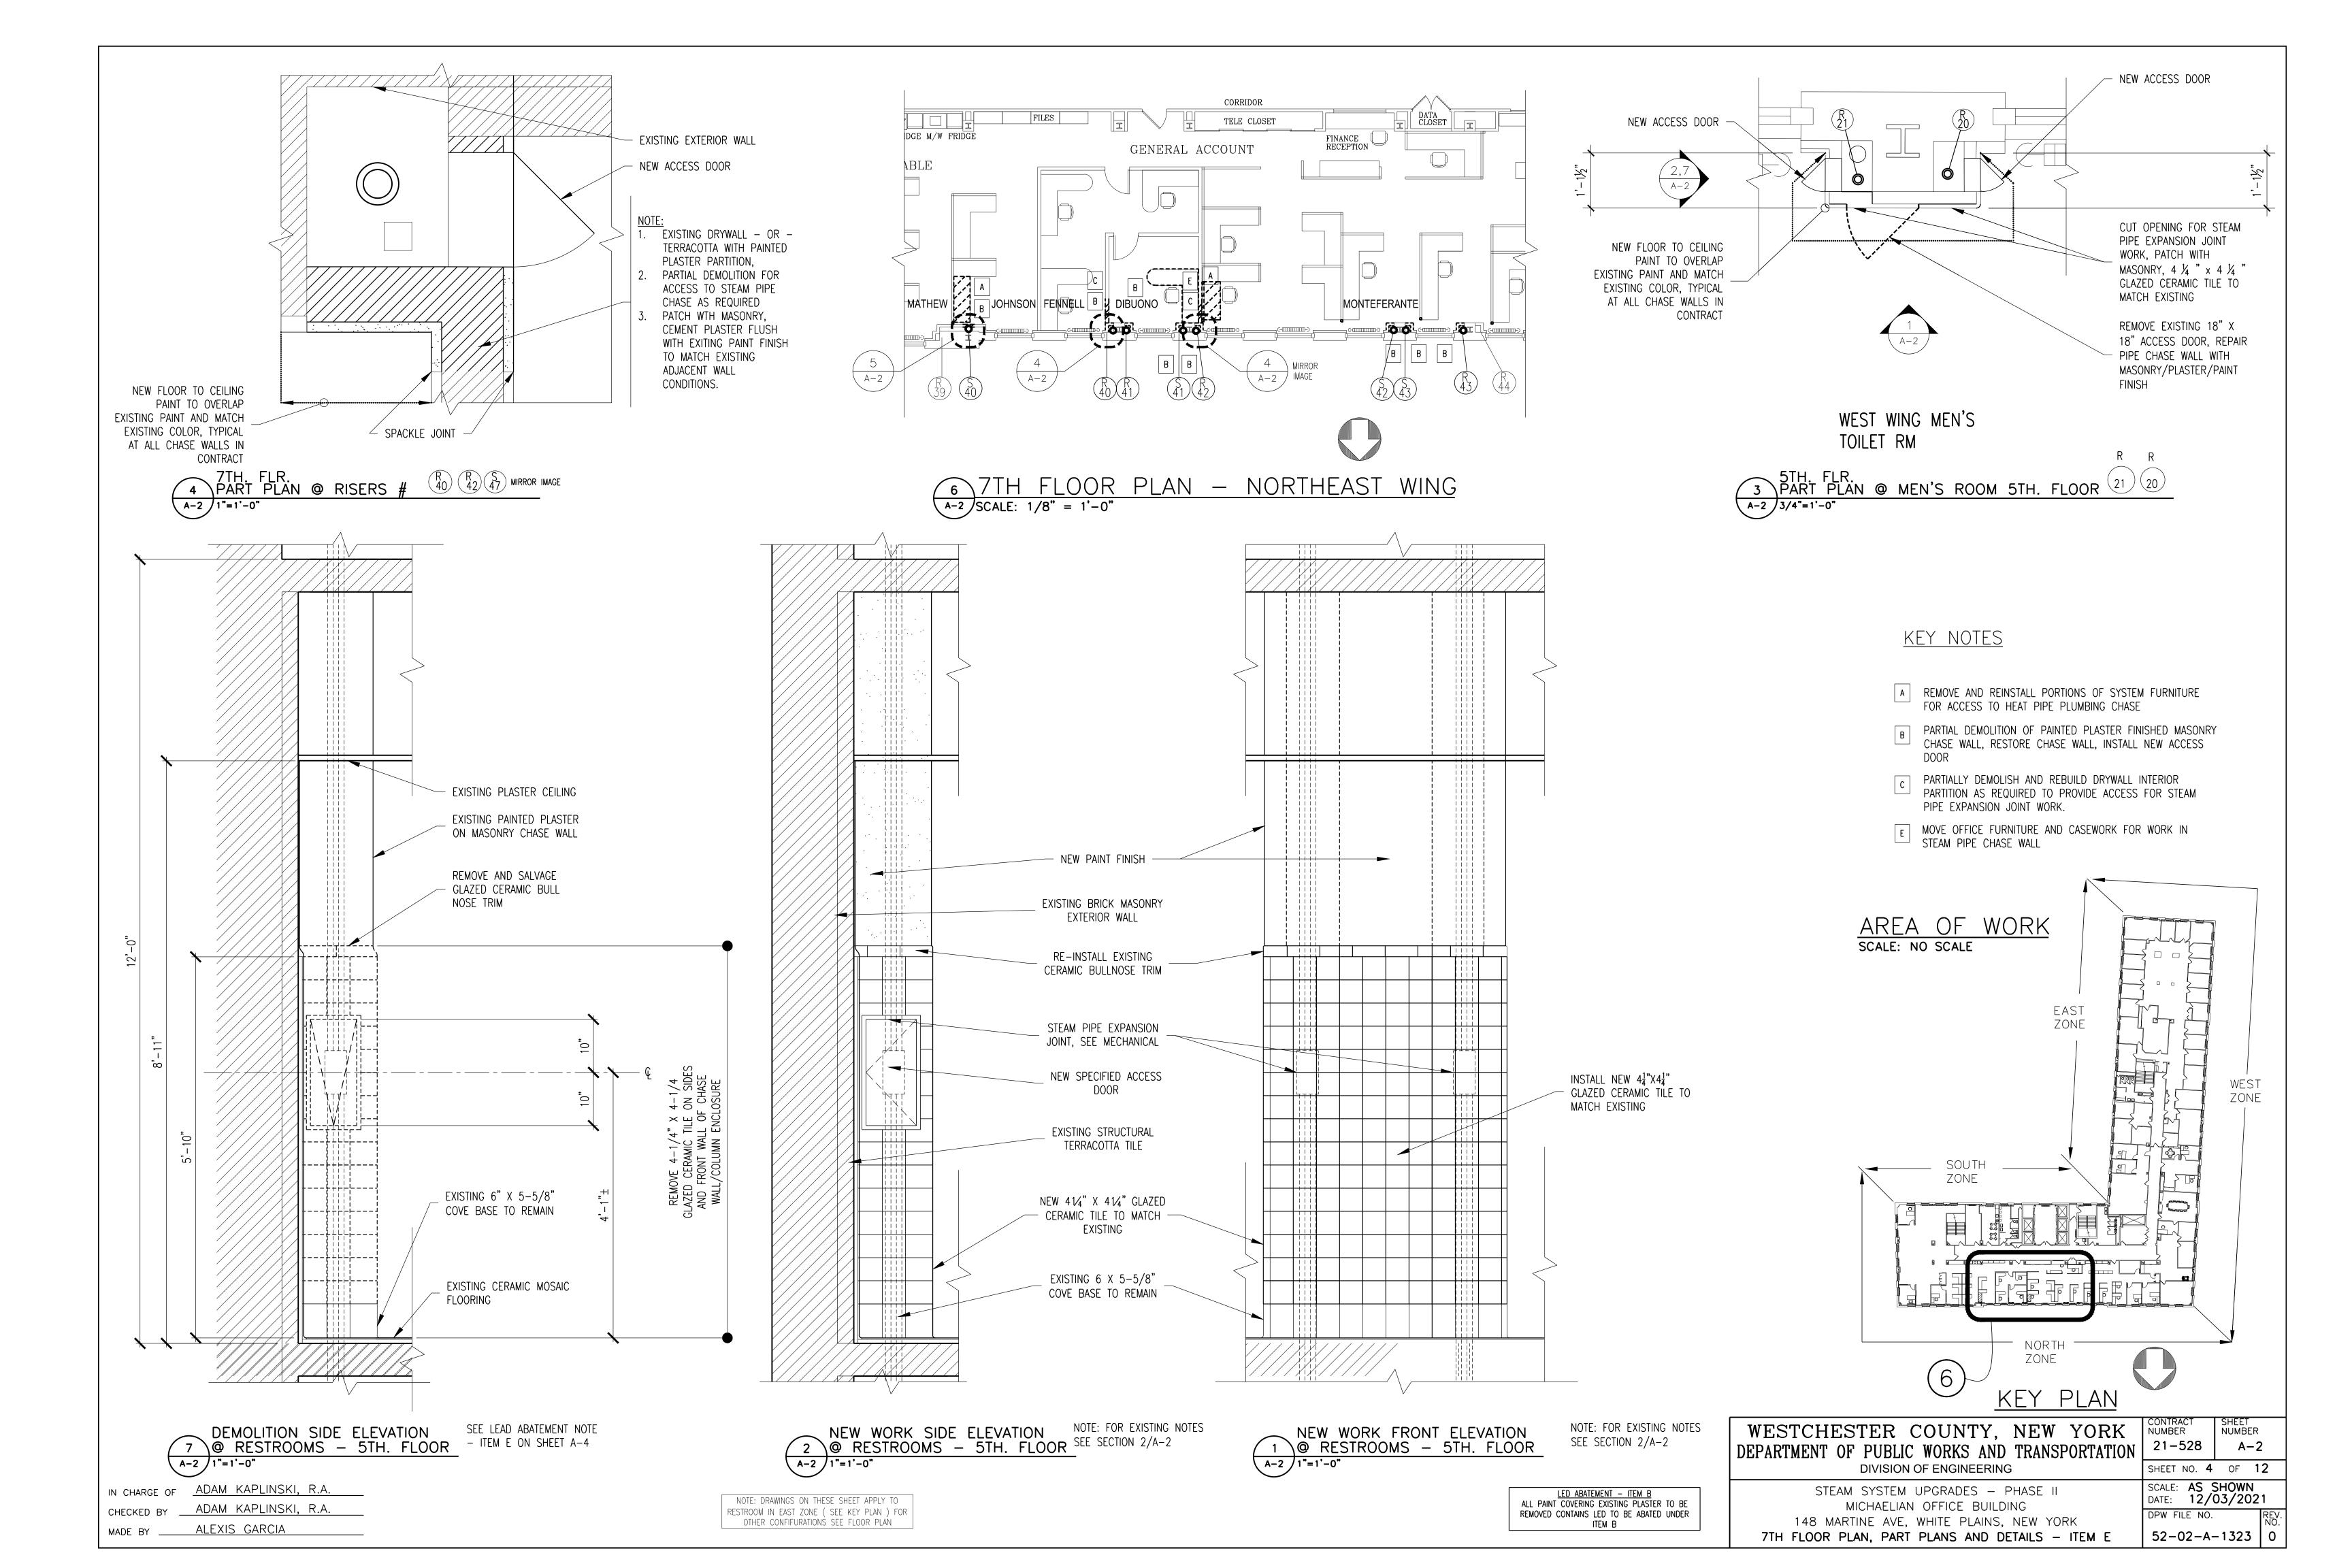

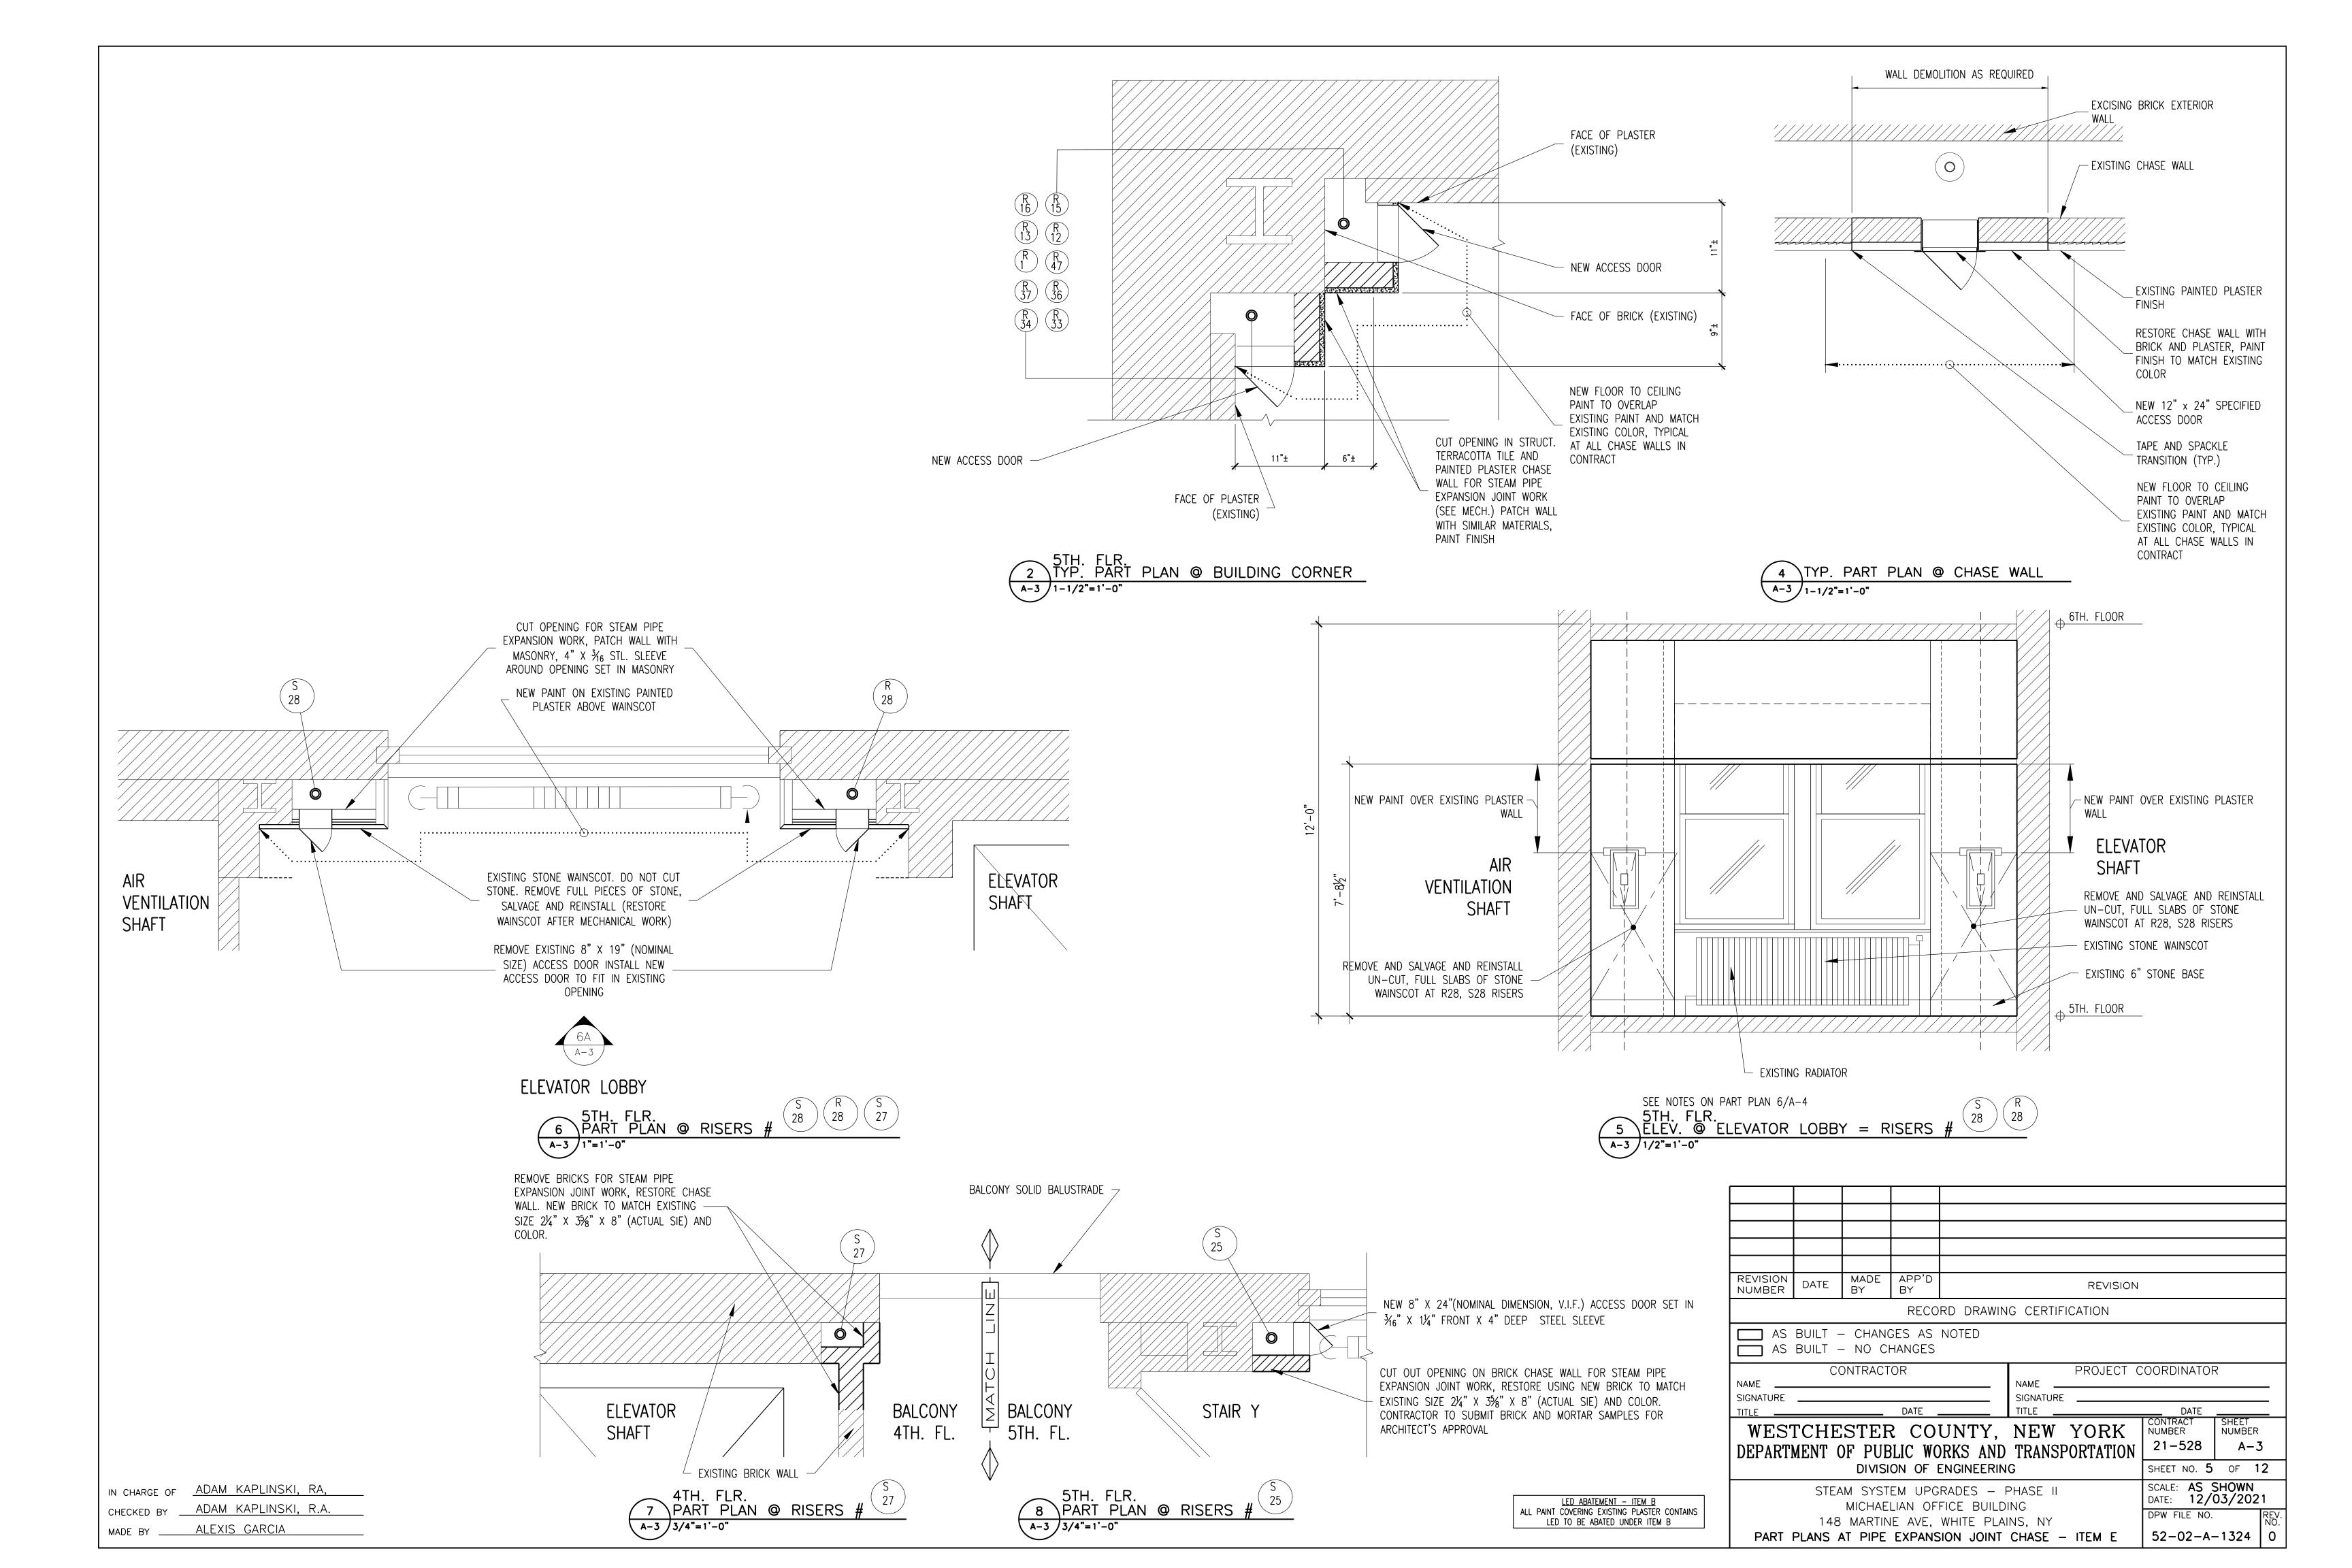

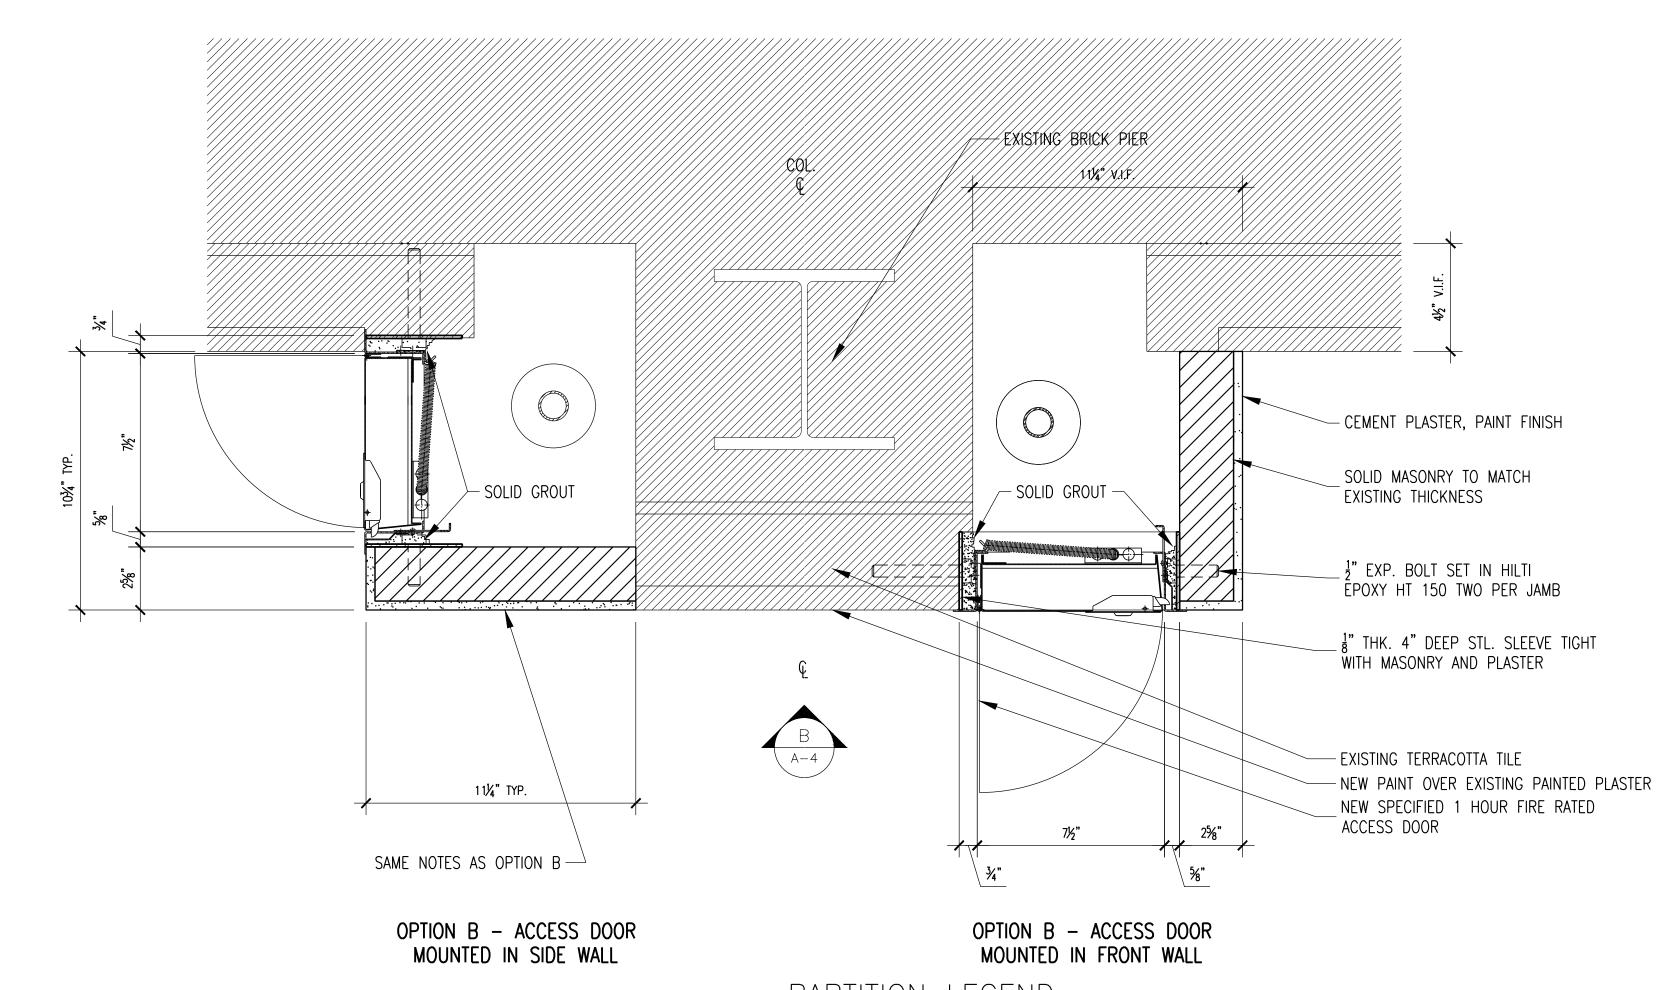

PARTITION LEGEND

4-1/4" GLAZED CERAMIC TILE WAINSCOT.

CHASE WALL AT PIPE EXPANSION JOINTS - EXISTING 1) 3" THK. 12" X 12" HOLLOW TERRACOTTA BLOCKS; 2) METAL LATH, 1" PLASTER, PAINT FINISH

CHASE WALL AT EXTERIOR WALL (RESTROOM) - EXISTING 1) 3" THK. 12" X 12" HOLLOW TERRACOTTA BLOCKS 2) METAL LATH, 1" PLASTER. 3) PAINT FINISH. 4) 6" X 5\%" GLAZED CERAMIC BASE, 4-1/4" X

BRICK WALLS @ STAIR Y AND BALCONY, UNUSED SPACE ACCESS TO VENTILATION SHAFT (S25, S27, S29): REMOVE EXISTING AND INSTALL NEW BRICK. BRICK SIZE STANDARD NOT NOMINAL 8" \times 2-1/4" \times 3-5/8". INSTALL 3 \times 3 \times 0.25" LINTEL ABOVE

ALL NEW ACCESS DOORS WITH 4" BEARING BOTH SIDES

INTERIOR WALLS - EXISTING: 1) STRUCTURAL TERRACOTTA TILE; 2.) PLASTER BOTH SIDES OF WALL; 3.) PAINT FINISH

INTERIOR WALLS - EXISTING: (RESTORE WHERE MARKED 'C' ON FLOOR PLANS A-1 AND A-2)

1) LIGHT METAL FRAMING TO MATCH EXISTING; 2) THERMAFIBER FIRE AND SOUND GUARD INSULATION; 3) TYPE X GYPSUM BOARD; 4) PAINT FINISH. SEE SPEC. NO. 092900 GYPSUM BOARD ASSEMBLIES, 099100 PAINT.

- 1. HR. FIRE RATED ACCESS DOOR AS SPECIFIED
- DIMENSIONS.
- LENGTH RESTRICTIONS. HEIGHT OF NEW DOOR SHALL BE 2'-0" UNLESSS OTHERWISE NOTED. FIELD CONDITIONS SHALL BE VERIFIED BY CONTRACTOR TO DETERMINE ACTUAL DOOR SIZE.
- 5. INSTALL 12"X 24" ACCESS DOOR WHERE IT CAN BE ACCOMMODATED.

1. PERFORM LEAD ABATEMENT FOR PAINT ON PLASTER TO BE


- 3. SEE SPECIFICATIONS.
- FOLLOW ALL STATE AND LOCAL REGULATIONS AND ORDINANCES

GENERAL NOTE:

DIMENSIONS ARE GIVEN FOR BIDDING PURPOSES AND REFLECT EXISTING CONDITIONS THAT SHALL BE VERIFIED BY CONTRACTOR

RESPONSIBLE FOR MEASURING EACH PIPE CHASE

<u>LED ABATEMENT - ITEM B</u>
ALL PAINT COVERING EXISTING PLASTER TO BE PART PLANS ARE SHOWN FOR GUIDANCE AND BIDDING PURPOSES. CONTRACTOR IS REMOVED CONTAINS LED TO BE ABATED UNDER ITEM B

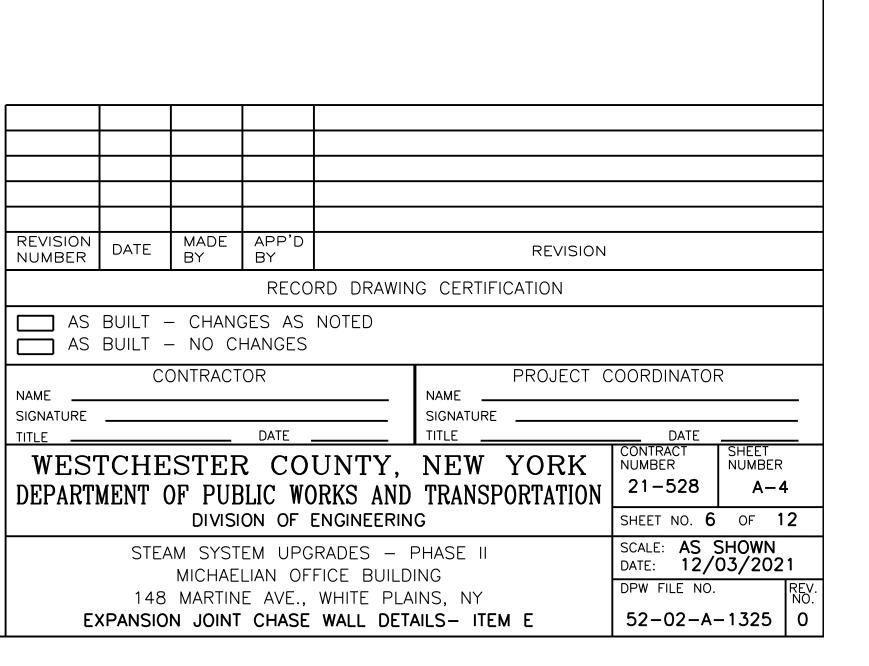

- 1jjl [†]

B FRONT ELEVATION - OPTIONS B

A-4 / 1"=1'-0"

— INSULATED PIPE


- NEW ACCESS DOOR

— EXPANSION JOINT


FLOOR FINISH

OPTIONS B, C


- EXISTING COLUMN ENCLOSURE

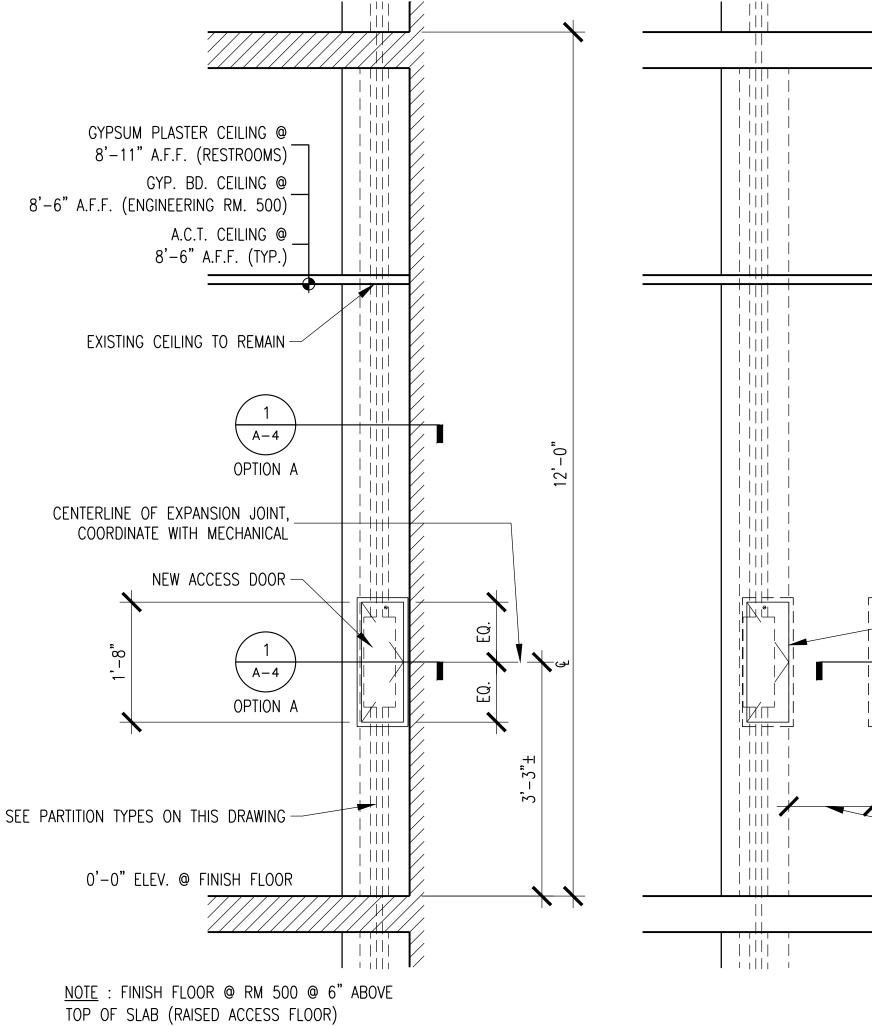

SIDE ELEVATION. - OPTION A A-4 / 1"=1'-0"

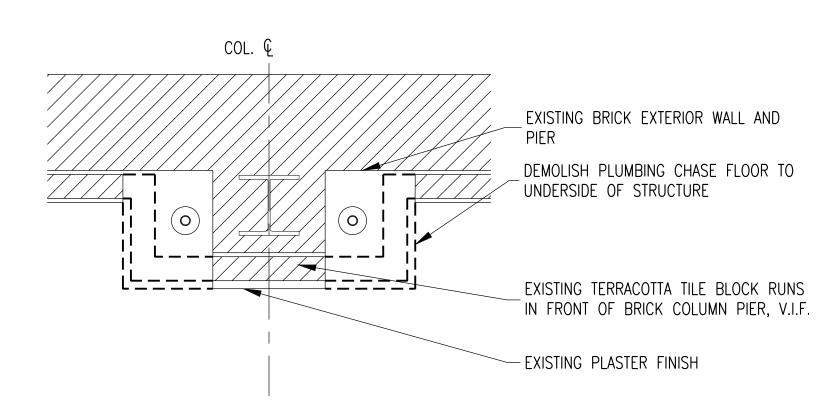

TYPE A

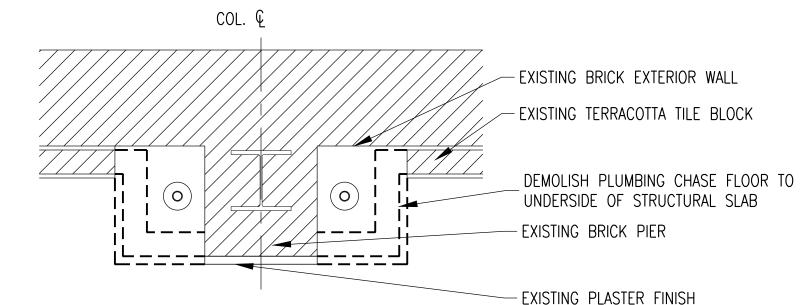

TYPE B

NOTE: TYPICAL PLUMBING CHASE DEMOLITION PLANS AT BUILDING PERIMETER

TYPICAL DEMOLITION PLANS 1" = 1'-0"


IN CHARGE OF ADAM KAPLINSKI, R.A. CHECKED BY ADAM KAPLINSKI, R.A. MADE BY _____ALEXIS GARCIA


ACCESS DOOR NOTES:


- 2. CONCEALED FLANGE, TAPE AND SPACKLE THROUGHOUT U.N.O.
- 3. ACCESS DOOR SIZE DETERMINED BY EXISTING CHASE WALL
- 4. TYPICALLY EXISTING ACCESS DOORS ARE 8" WIDE DUE TO WALL

LEAD ABATEMENT NOTE - ITEM B: REMOVED.

2. EXISTING PAINT ON PLASTER TO BE REMOVED CONTAINS LEAD. PERFORM LEAD ABATEMENT IN THE QUANTITY OF 30 S.F.

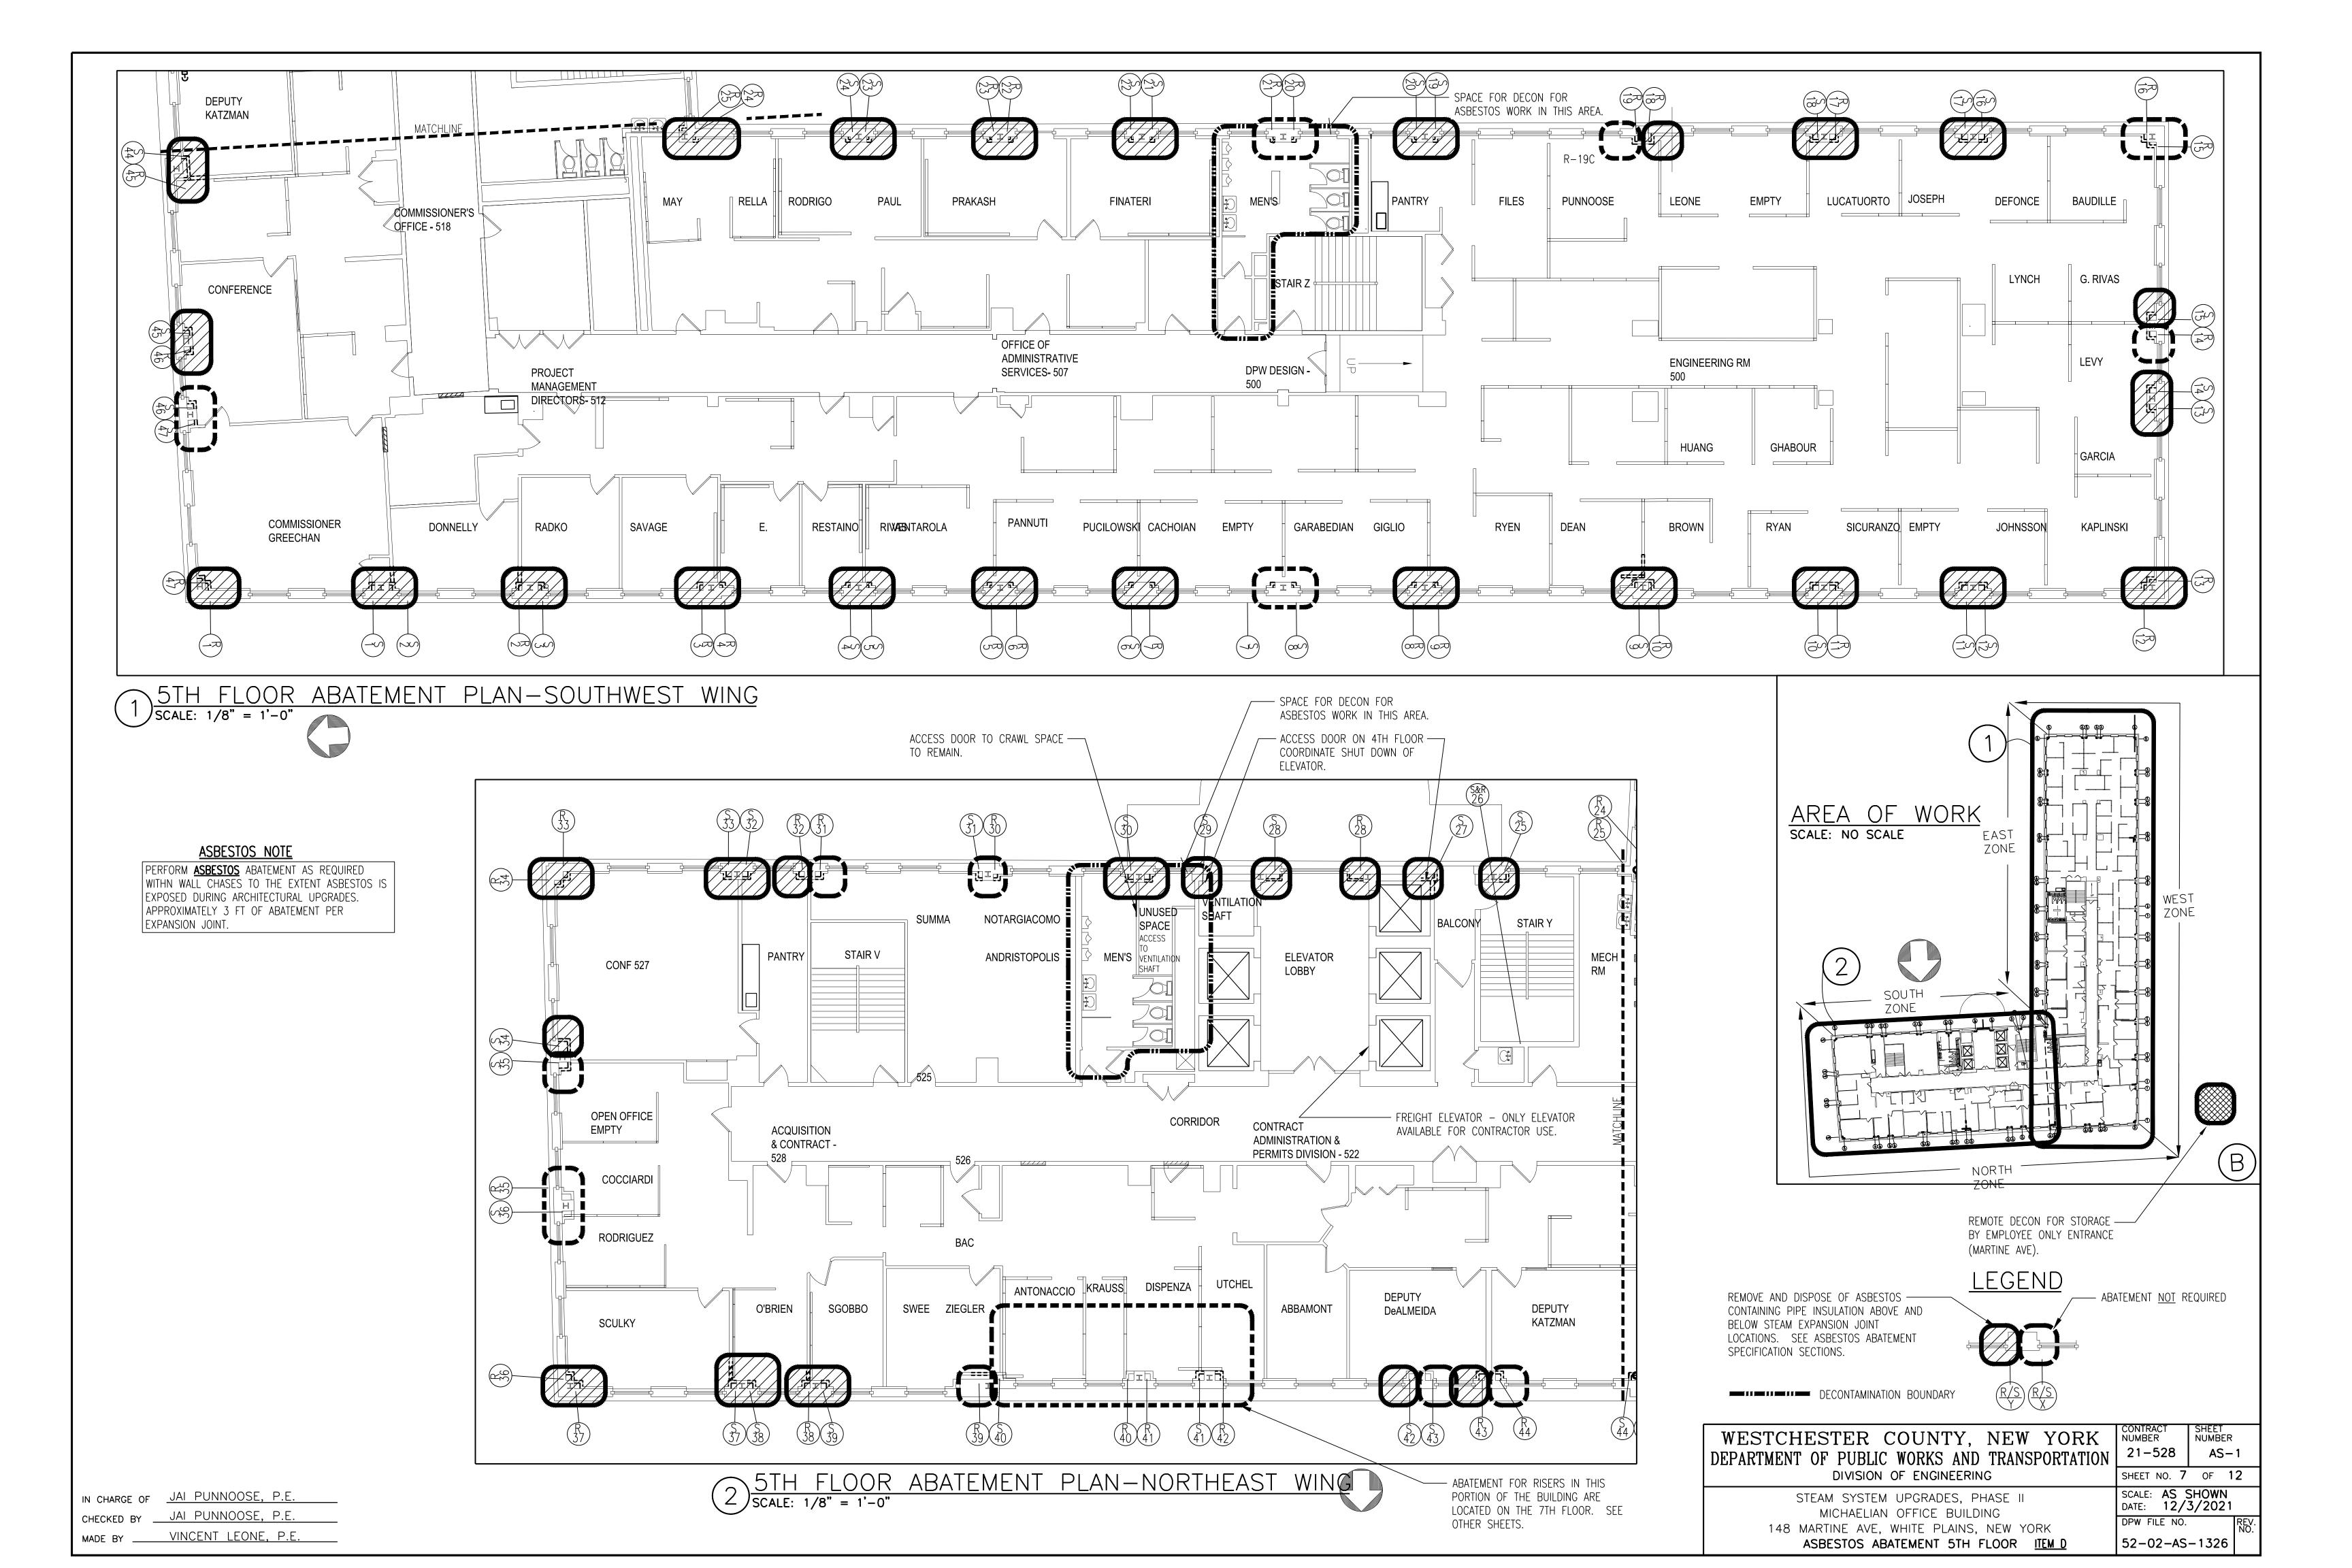

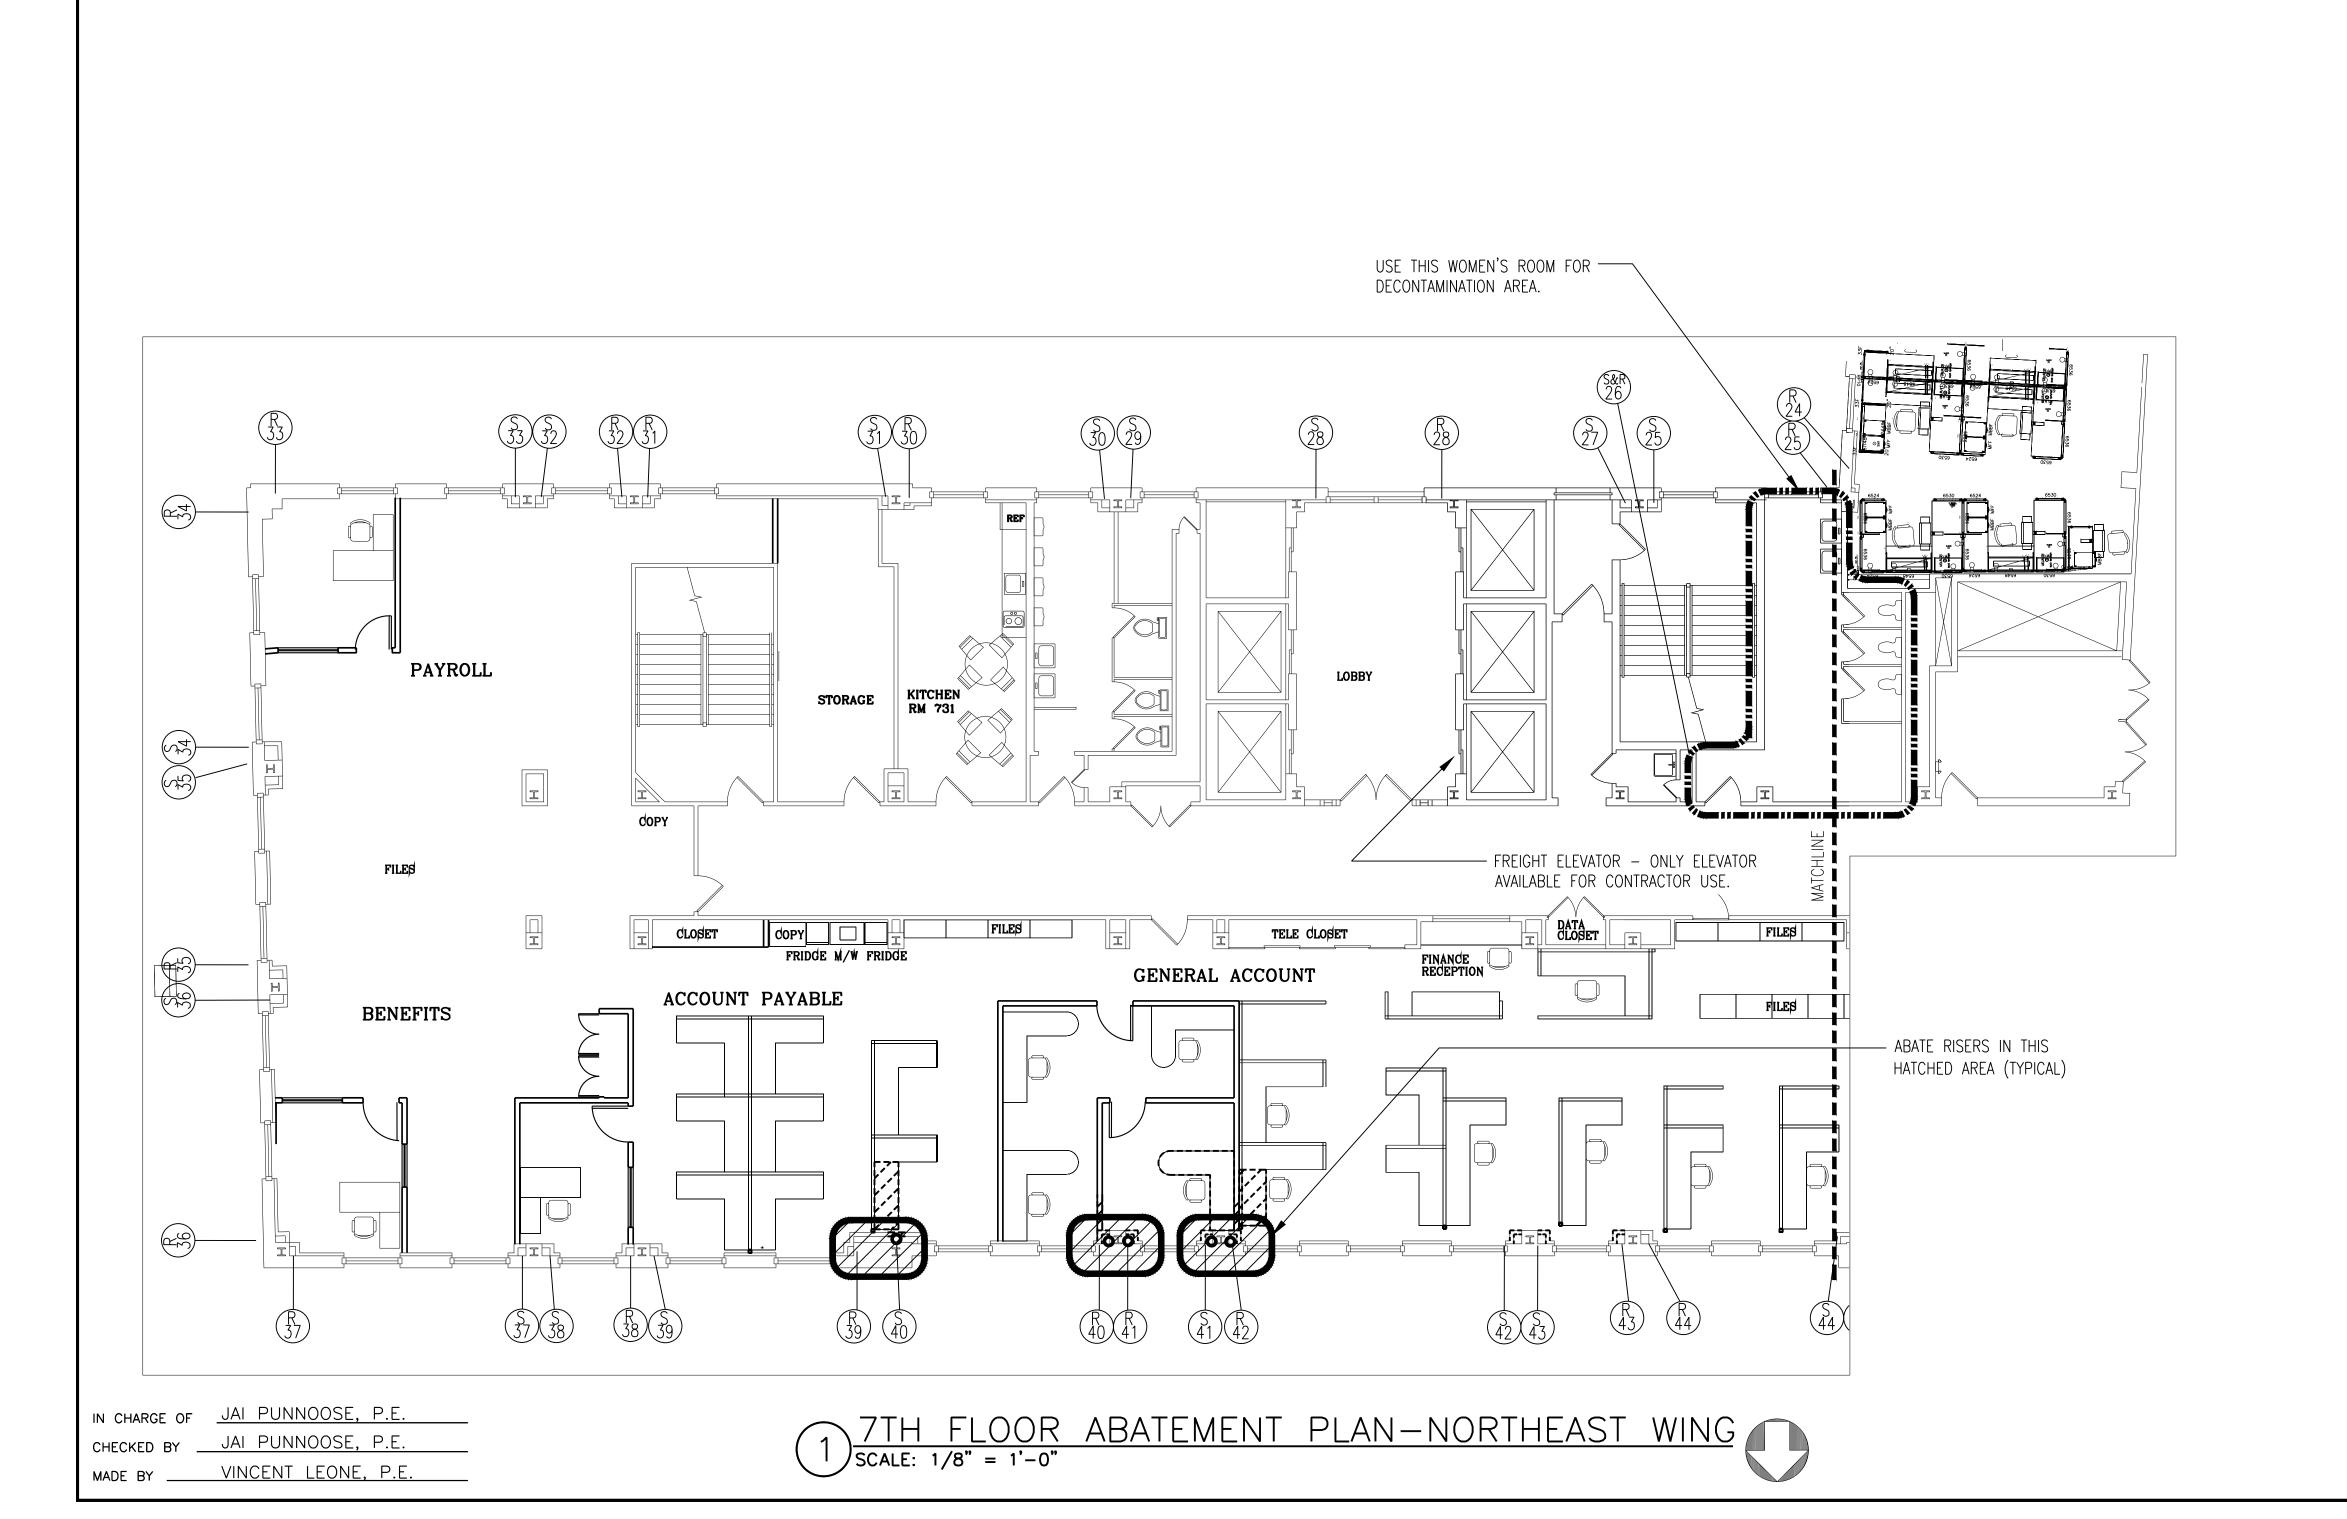


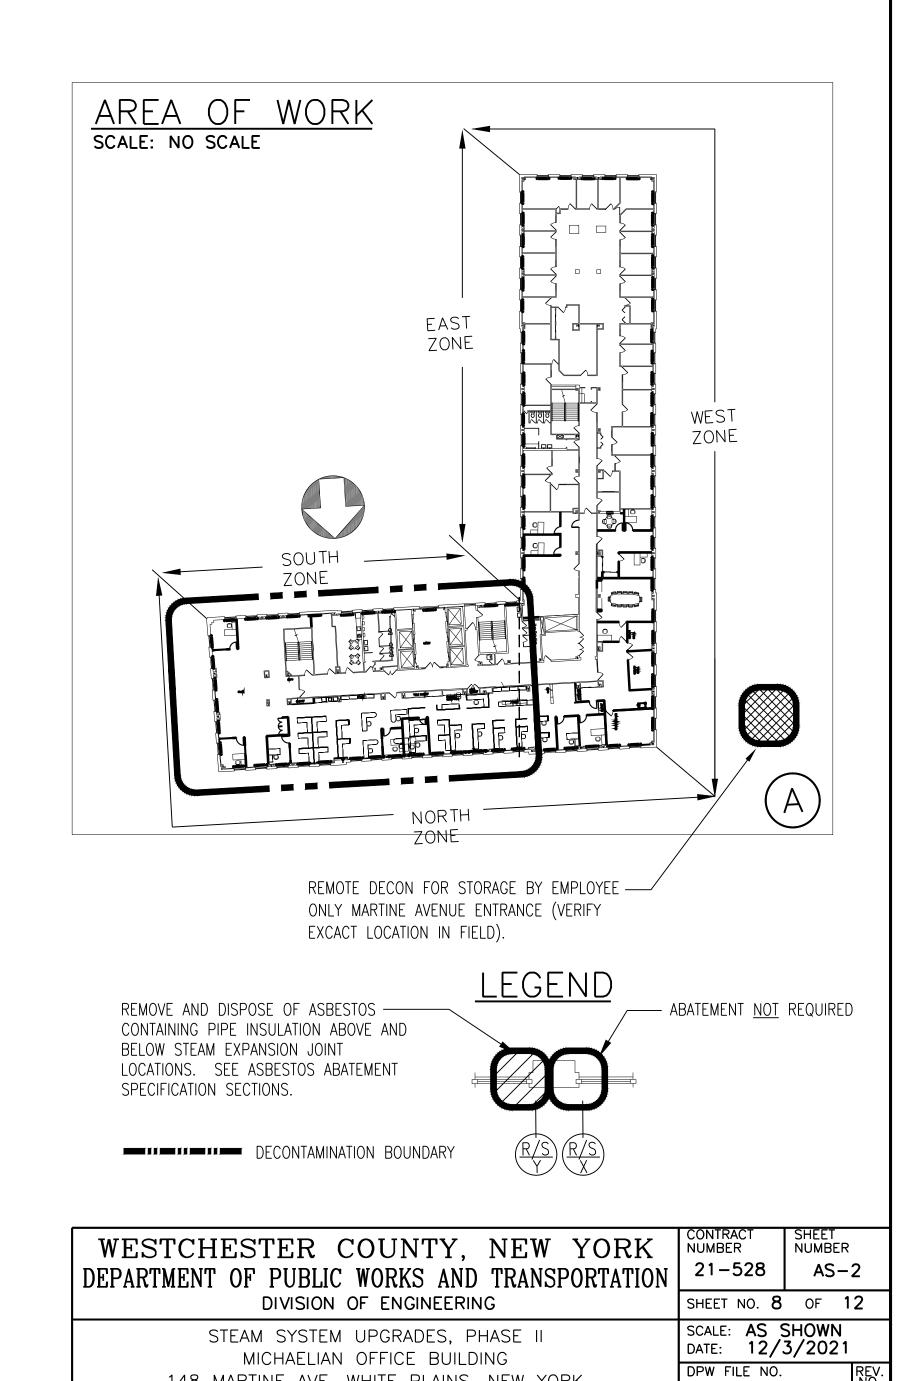

148 MARTINE AVE, WHITE PLAINS, NEW YORK

ASBESTOS ABATEMENT 7TH FLOOR ITEM D

52-02-AS-1327

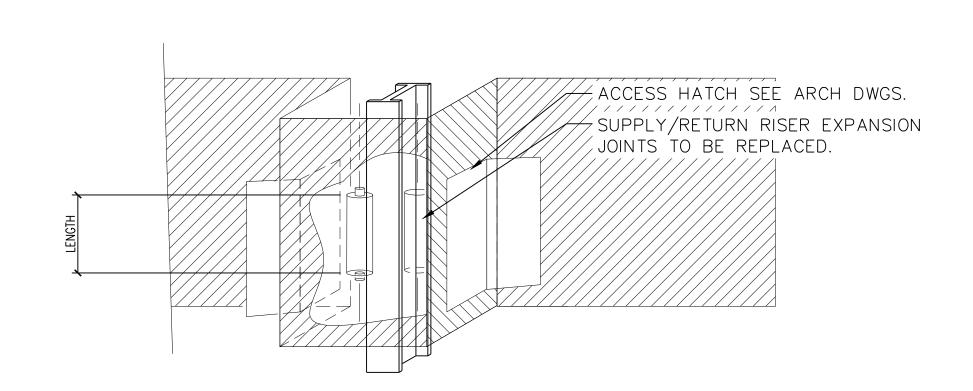

1) EXPANSION JOINT DETAIL SCALE: NONE

EXPANSION JOINT REPLACEMENT NOTES:

- 1. RELOCATE OFFICE FURNITURE AS REQUIRED TO PERFORM REPLACEMENT WORK.
- 2. REFER TO ARCHITECTURAL DWGS FOR WALL MODIFICATIONS REQUIRED TO REMOVE EXISTING AND INSTALL NEW EXPANSION JOINTS.
- 3. REMOVE EXISTING EXPANSION JOINTS IN WALL CHASE. TEMPORARILY SUPPORT PIPE AS NEEDED.
- 4. PREPARE EXISTING PIPING TO RECEIVE NEW EXPANSION JOINT. INSTALL EXPANSION JOINTS WITH UNIONS ON EITHER SIDE FOR SIZES 2" AND SMALLER. EXPANSION JOINTS 2\frac{1}{2}" AND LARGER SHALL BE FLANGED TYPE.
- 5. ALL STEAM SUPPLY PIPING SHALL BE SCHEDULE 40 BLACK STEEL. ALL CONDENSATE RETURN & STEAM DRIP RETURN PIPING SHALL BE SCHEDULE 80 BLACK STEEL.
- 6. FURNISH AND INSTALL ACCESS DOORS AND PAINT. INSTALL ACCESS DOOR WITH FRAME AND PATCH WALL AROUND ACCESS DOOR AS REQUIRED.
- 7. EXPANSION JOINT SHALL BE WRAPPED IN BLANKET INSULATION (MINIMUM R-6). BLANKET INSULATION SHALL BE SECURED IN PLACE LOOSELY WITH REMOVABLE FASTENERS SUCH THAT INSULATION CAN BE OPENED TO MONITOR CONDITION OF EXPANSION JOINT AND RE-WRAPPED FROM NEW ACCESS PANEL.


FOR LOCATIONS WHERE EXPANSION JOINTS HAVE ALREADY BEEN REPLACED, PROVIDE NEW ACCESS PANELS.

EXPANSION JOINTS BASED ON HYSPAN				
NOM. PIPE	LENGTH (IN.)	MODEL		
2-1/2 "	16.000	8505/FLG-235-2		
2 "	14.375	8503/THD-231-2		
1-1/2 "	14.375	8503/THD-227-2		
1 "	13.125	8503/THD-219-2		
3/4 "	13.125	8503/THD-214-2		

EXPANSION JOINT ABATEMENT NOTES:

- ABATED PIPING SECTION SHALL BE CLEANED OF ALL ACM.
 THE OPEN ENDS OF PIPES CONTAINING ACM SHALL BE SCALED WITH WET WRAP OR ANOTHER APPROPRIATE ENCAPSULATION MATERIAL.
- 3. ALL ENCLOSED/WRAPPED SURFACES SHALL BE WET PIPED AND HEPA VACUUMED.

ITEM D

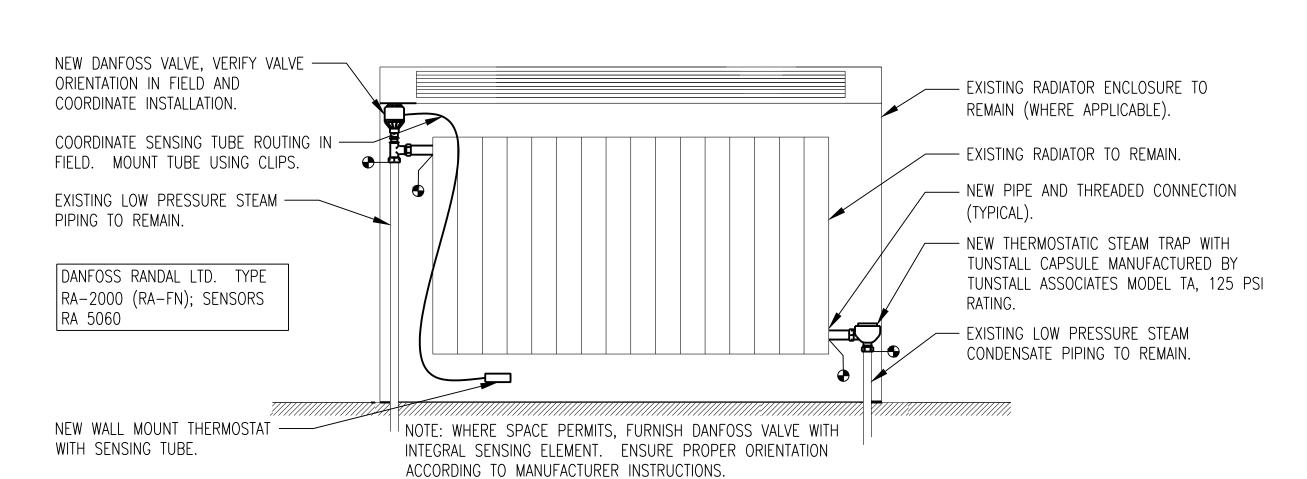

2 RADIATOR WORK DETAIL SCALE: NONE

RADIATOR VALVE AND STEAM TRAP NOTES:

1. PREPARE EACH AREA FOR VALVE REPLACEMENT. MOVE FURNITURE, RADIATOR COVER ETC. AS REQUIRED.

- 2. REPLACE ALL RADIATOR VALVES WITH NEW TAMPER RESISTANT THERMOSTATIC VALVE AND REMOTE MOUNTED SENSOR WHERE REQUIRED (SEE NOTE BELOW). NEW VALVE SHALL BE SIZED TO MATCH EXISTING PIPING. VALVES SHALL BE SUITABLE FOR ANGLE, STRAIGHT OR VERTICAL TYPE INSTALLATION. COORDINATE EXACT TYPE IN FIELD (TYPICAL FOR ALL VALVES ON 5TH FLOOR AND WHERE SHOWN ON RISER DIAGRAM FOR 7TH FLOOR).
- 3. FOR RADIATORS WITH ENCLOSURES, OR WHERE SPACE DOES NOT ALLOW FOR SIDE MOUNT ORIENTATION WHERE AN INTEGRAL SENSOR WOULD BE INSUFFICIENT TO MONITOR ROOM AIR TEMPERATURE, INSTALL NEW THERMOSTATIC SENSOR NEXT TO RADIATOR ON WALL. COORDINATE SENSING TUBE ROUTING IN FIELD. MOUNT TUBE USING CLIPS (TYPICAL).
- 4. REPLACE EXISTING STEAM TRAP WITH NEW THERMOSTATIC TRAP. NEW TRAP SHALL BE SIZED TO MATCH EXISTING. TRAPS SHALL BE SUITABLE FOR ANGLE TYPE INSTALLATION. COORDINATE EXACT TYPE IN FIELD (TYPICAL FOR ALL RADIATOR TRAPS ON 5TH FLOOR AND WHERE SHOWN ON RISER DIAGRAM FOR 7TH FLOOR).
- 5. PROVIDE ALL REQUIRED PIPE NIPPLES, UNIONS, FITTINGS ETC. FOR A COMPLETE INSTALLATION.
- 6. RETURN FURNITURE/RADIATOR COVER TO ITS ORIGINAL LOCATION (TYPICAL).


IN CHARGE OF JAI PUNNOOSE, P.E.

CHECKED BY VINCENT LEONE, P.E.

MADE BY VINCENT LEONE, P.E.


ITEM B


ITEM A

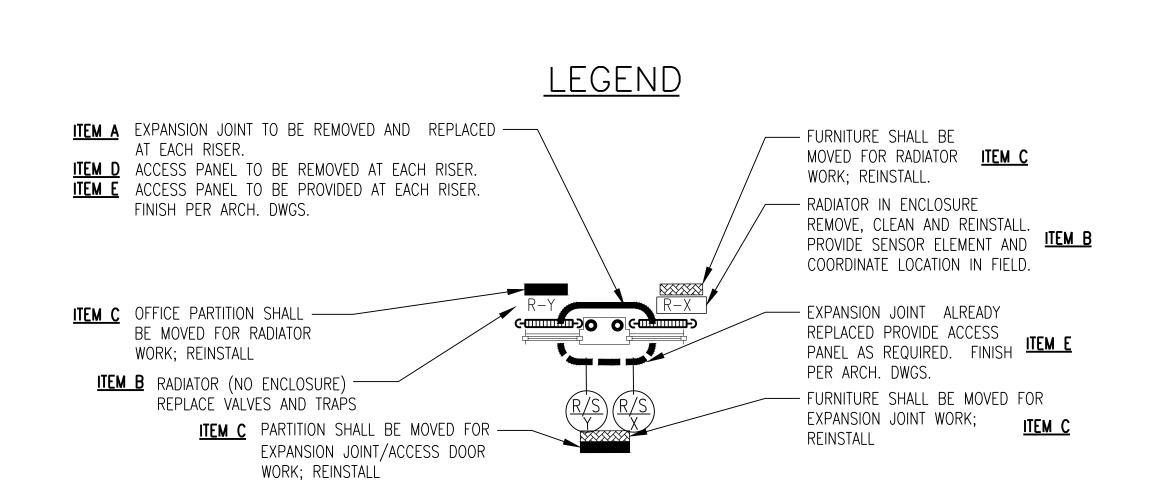

		ABBREVIATIONS
•		POINT OF DISCONNECTION
		CONDENSATE PIPES
		STEAM SUPPLY PIPES
——⋈——		GATE VALVE
─		BALL VALVE
C		CAP
——II——		UNION
* * * * *		REMOVE PIPE
0		PIPE TURNED UP
•		NEW TO EXISTING CONNECTION
—— 		FLOAT & THERMOSTATIC TRAP
C		PIPE TURNED DOWN
×		STUB UP TO RADIATOR
8		SUPPLY RISER 9 (DOWNFEED)
Rg		C.R. RISER 9
	BMS	BUILDING MANAGEMENT SYSTEM
	C.R.	CONDENSATE
	S.D.	STEAM DRIP
	LPR	LOW PRESSURE RETURN
	LPS	LOW PRESSURE STEAM
	EDR	EQUIVALENT DIRECT RADIATION
	RF	RETURN FAN
	EF	EXHAUST FAN
	AHU	AIR HANDLING UNIT
	SCH.	SCHEDULE
	FLRS.	FLOORS
	DWGS.	DRAWINGS
	GC	GENERAL CONTRACTING
	PRV	PRESSURE REDUCING VALVE
	RTD	RESISTANCE TEMPERATURE DETECTO
	NPT	NATIONAL PIPE THREAD (TAPERED)
	DPW	DEPARTMENT OF PUBLIC WORKS
	TYP,	TYPICAL
	ETR	EXISTING TO REMAIN
	PD	PUMPED DISCHARGE
	PWM	PULSE WIDTH MODULATION


	·
CONTRACT NUMBER 21-528	SHEET NUMBER H – 1
SHEET NO. 9	OF 12
SCALE: AS S	SHOWN 3/2021
DPW FILE NO.	REV NO.
52-02- H-	-1328
	21-528 SHEET NO. 9 SCALE: AS STATE: 12/2 DPW FILE NO.

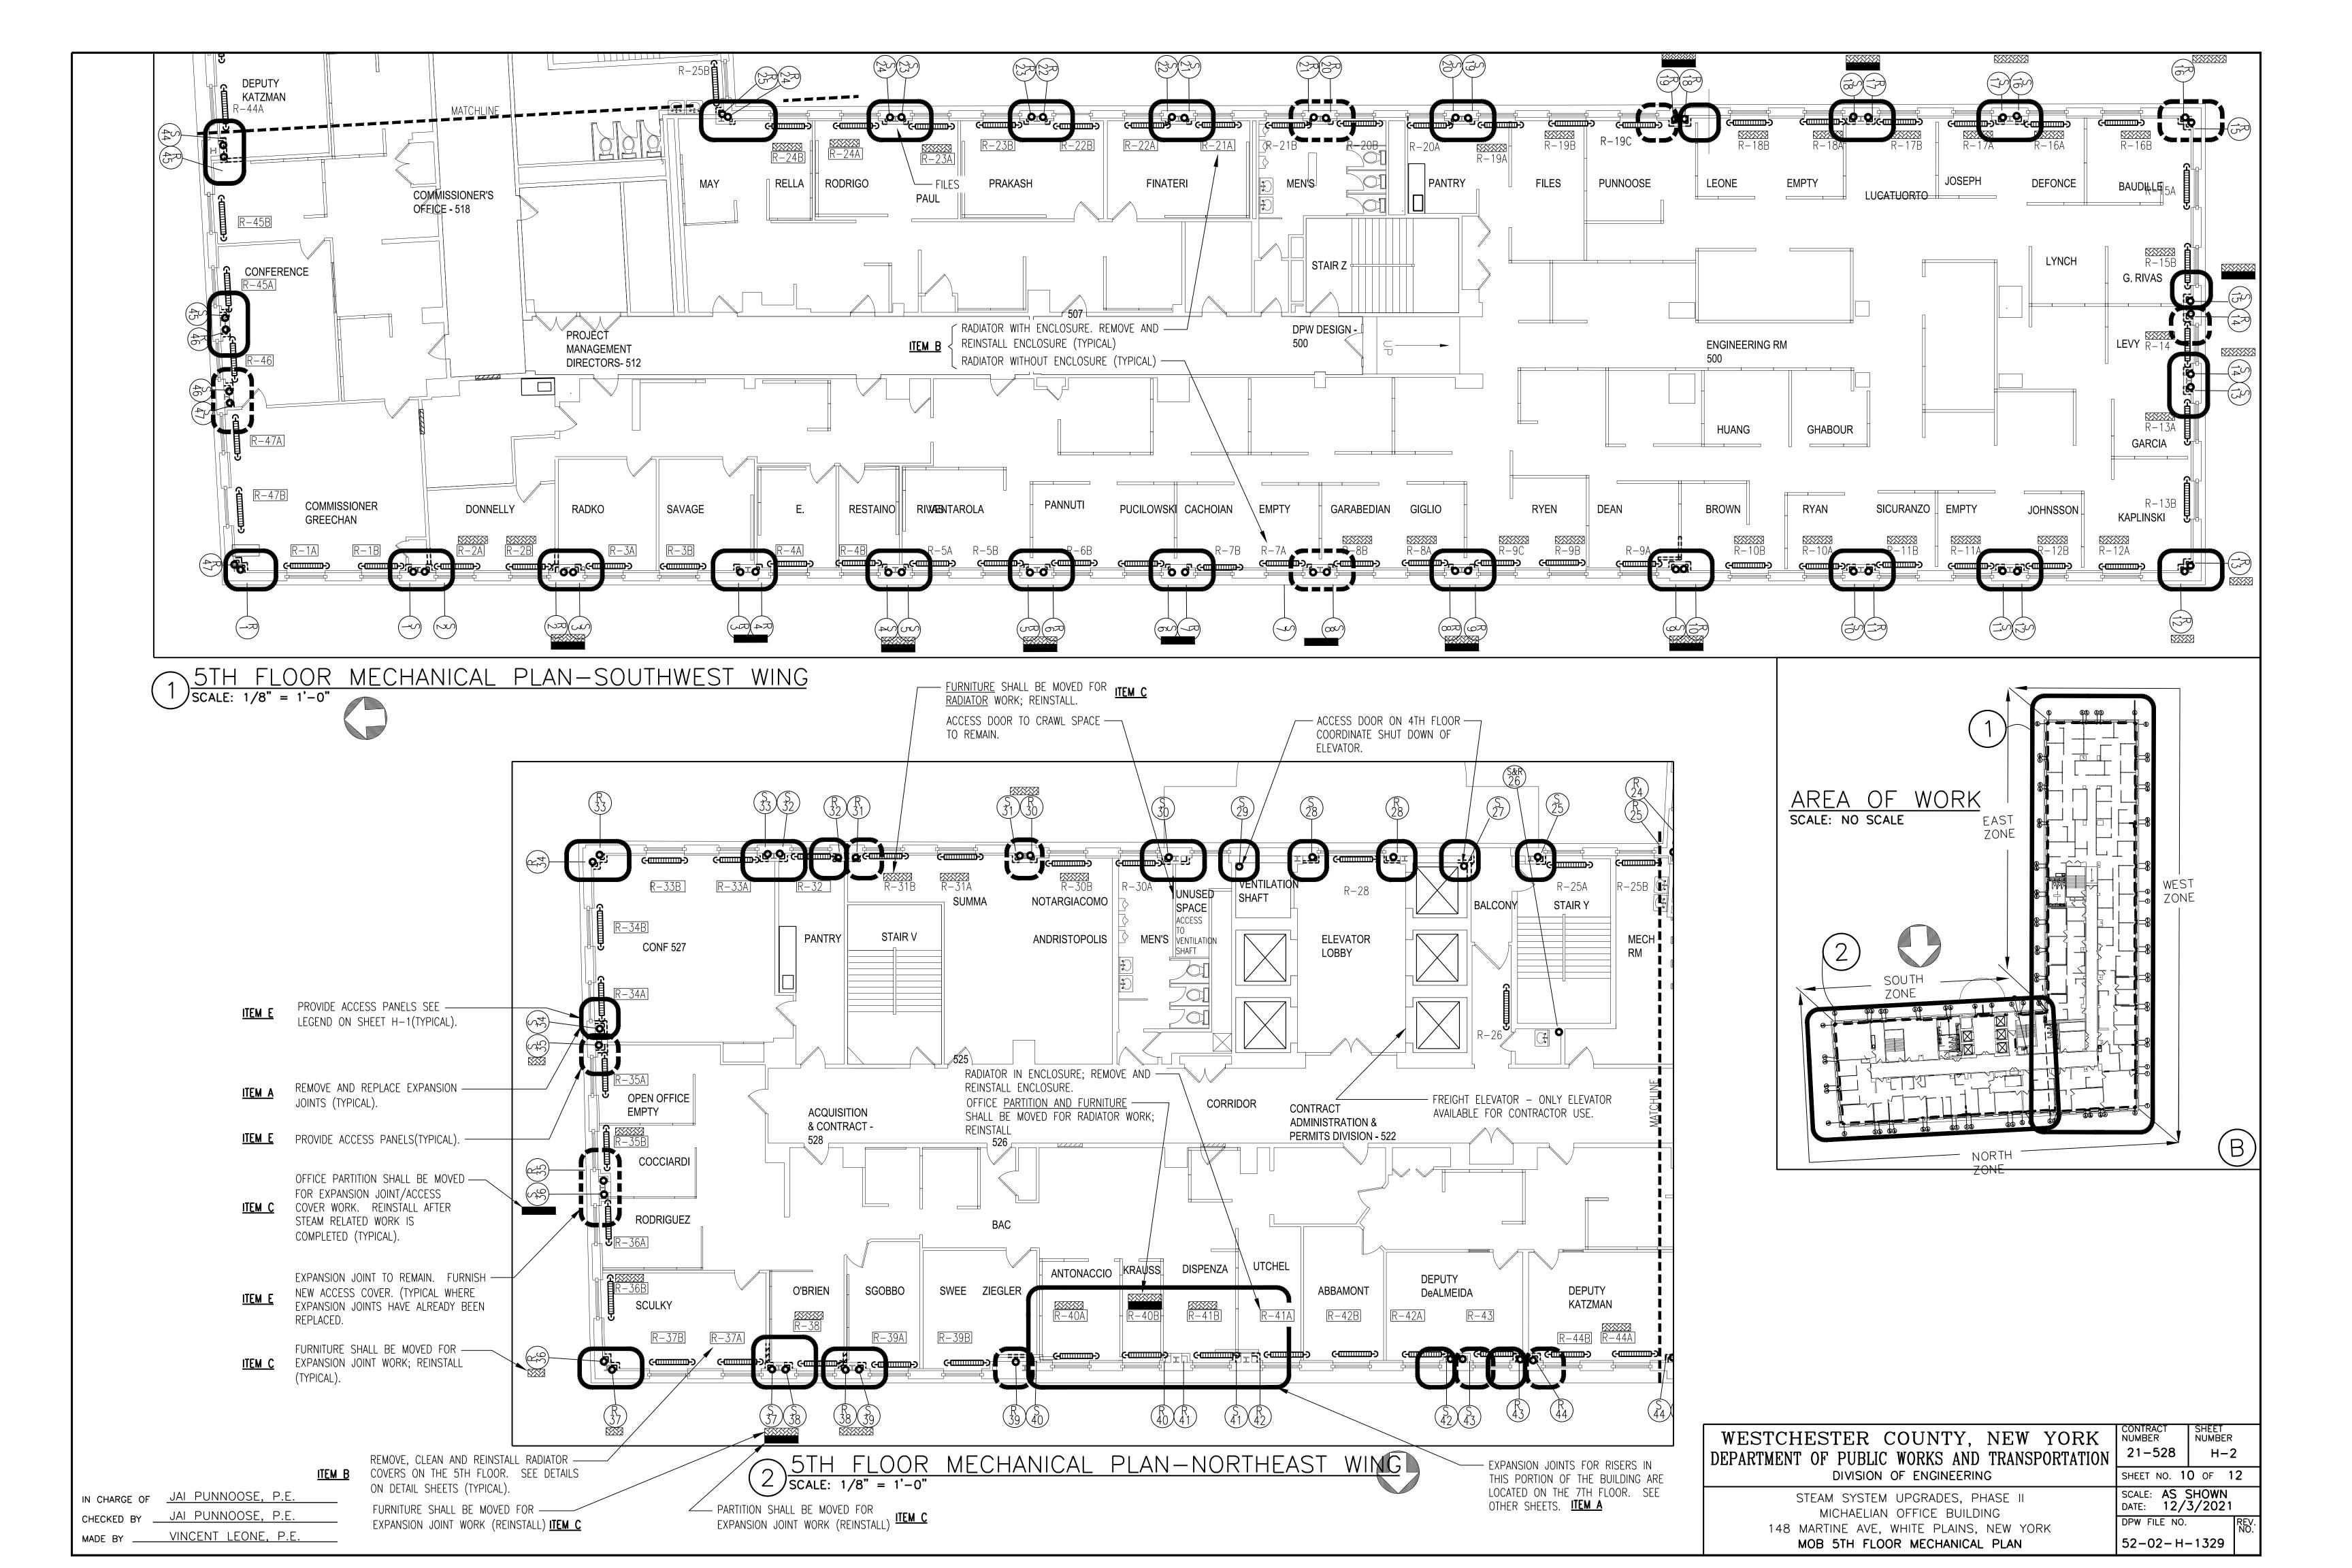

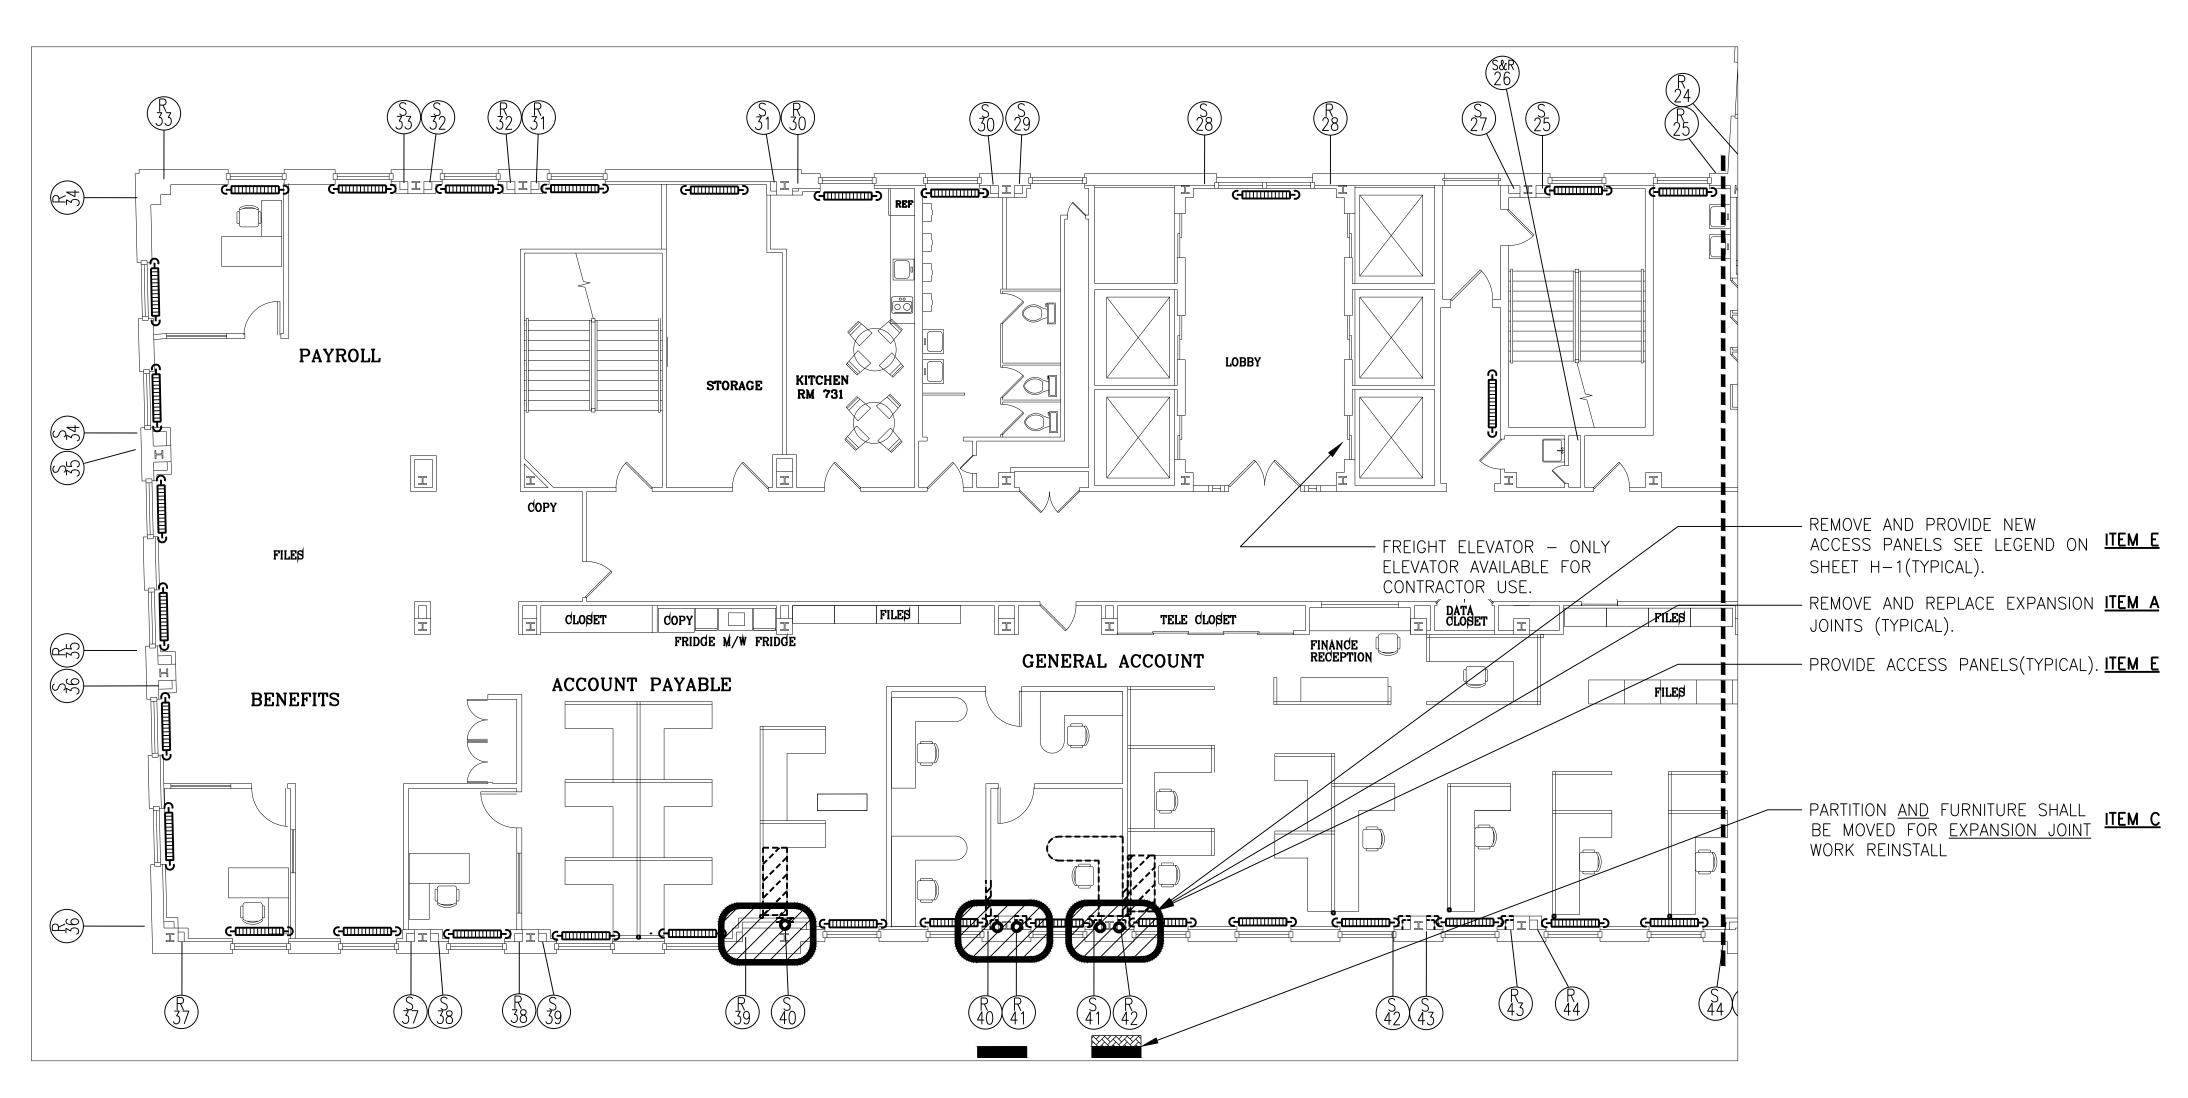

7TH FLOOR MECHANICAL PLAN-NORTHEAST WING SCALE: 1/8" = 1'-0"



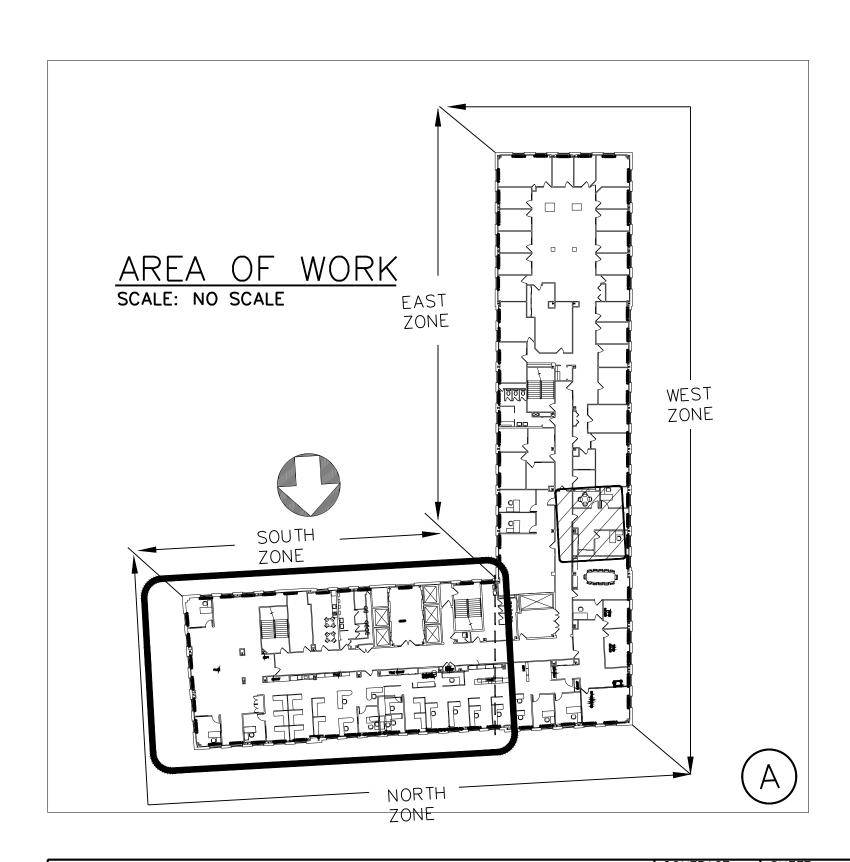

WESTCHESTER COUNTY, NEW YORK DEPARTMENT OF PUBLIC WORKS AND TRANSPORTATION DIVISION OF ENGINEERING

STEAM SYSTEM UPGRADES, PHASE II
MICHAELIAN OFFICE BUILDING

148 MARTINE AVE, WHITE PLAINS, NEW YORK
MOB 7TH FLOOR MECHANICAL PLAN

CONTRACT NUMBER

21-528 H-3

SHEET NO. 11 OF 12

SCALE: AS SHOWN
DATE: 12/3/2021

52-02-H-1330

DPW FILE NO.

IN CHARGE OF JAI PUNNOOSE, P.E.

CHECKED BY JAI PUNNOOSE, P.E.

MADE BY VINCENT LEONE, P.E.

