


BUILDING LOCATION (TOP) | CAMPUS LOCATION (BOTTOM)

PROJECT LOCATION D1 A001 1" = 40'-0"

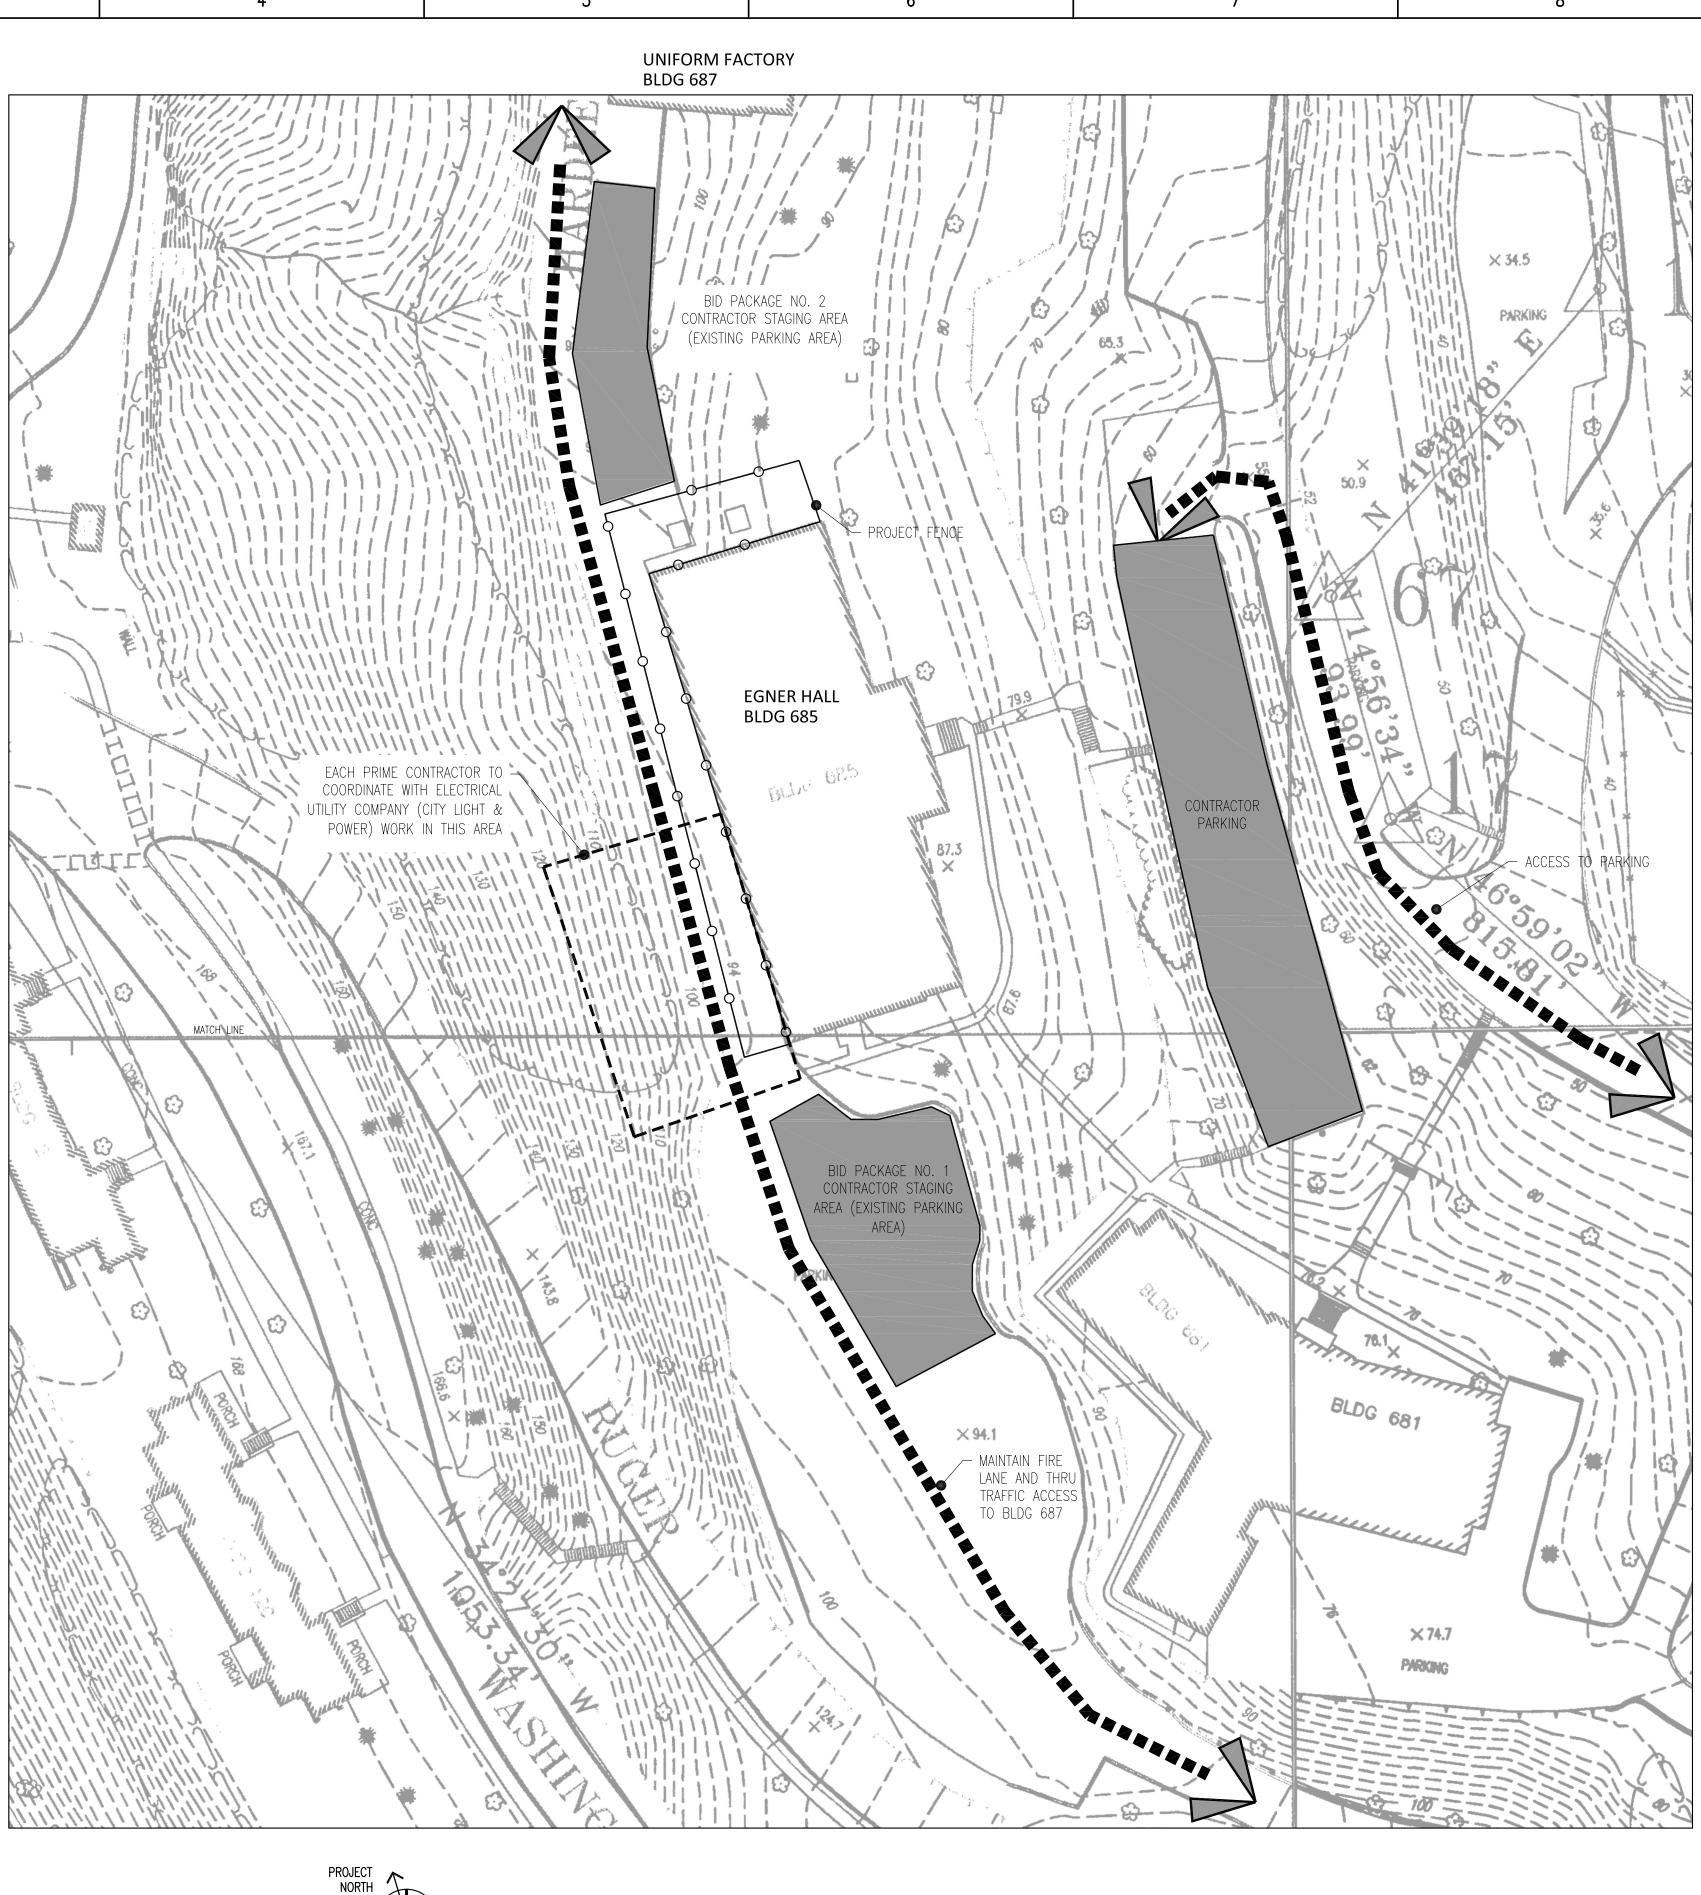

0 15 30 60 Feet

SITE USE PLAN F3 A001 1" = 40'-0"

SITE USE NOTES

DURING THE EXECUTION OF THE PROPOSED UNDERTAKING THE FOLLOWING PROVISIONS SHALL BE ADHERED TO:

N THE EVENT TRAFFIC WILL BE DISRUPTED FOR MORE THAN TWO HOURS, THE CONTRACTOR WILL PREPARE A TRAFFIC MANAGEMENT PLAN, TO BE VETTED THROUGH THE USAG WP DPW OPERATIONS OFFICE. THE PLAN WILL SHOW HOW THE SITE WILL BE ASSESSED EAC DAY. HOW LONG ACCESS WILL BE REQUIRED AND WHAT (IF ANY) PARKING SPACES WILL BE IMPACTED.

THE CONTRACTOR SHALL KEEP ALL MATERIALS, EQUIPMENT, TRAILERS C. WITHIN THE BOUNDARIES OF THEIR ASSIGNED STAGING AREA. TH ONTRACTOR SHALL NOT PARK VEHICLES OR EQUIPMENT IN A WAY HAT IMPEDES TRAFFIC.

EGNER HALL IS A TIER 2 (OFFICES AND CLASSROOMS) NOISE ZONE. NOISE PRODUCING ACTIVITIES ARE RESTRICTED TO 7AM-7PM MON-FRI 10AM-4PM SATURDAY, UNLESS PRIOR APPROVAL IS GRANTED BY THE PROJECT MANAGER (PM). ACCEPTABLE NOISE LEVELS MUST BE MAINTAINED LESS THAN 84DB FOR REOCCURRING NOISE (I.E. EQUIPMENT USE). IMPULSIVE SOUNDS WHICH OCCUR ABRUPTLY FOR A SHORT DURATION, SUCH AS DETONATIONS, ARE FURTHER RESTRICTED, AND SHALL BE SCHEDULED WITH THE PM. BLDG 685 IS ADJACENT THE WEST POINT CEMETERY. THE CONTRACTOR WILL CURTAIL ANY OUTDOOR NOISE-MAKING ACTIVITIES WHICH MAY IMPACT INTERMENTS OTHER CEREMONIES AT OCCURRING AT THE CEMETERY. THE CONTRACTOR SHALL DEVELOP A NOISE MITIGATION PLAN AND HAVE IT APPROVED BY THE PM PRIOR TO THE START OF WORK. THE NOISE MITIGATION PLAN MUST BE ON THE CONSTRUCTION SITE AND AVAILABL FOR INSPECTION ON DEMAND. IF NOISE COMPLAINTS ARE RECEIVED,

THE PM AND CONTRACTOR QC SHALL ENSURE THAT THE PLAN IS BEING FOLLOWED, AND DEVELOP FURTHER MITIGATIONS, IF NEEDED I ACCORDANCE WITH THE PROCEDURE PRESENTED IN CHAPTER 3.7.1 THE USAG WP OPERATIONAL NOISE MANAGEMENT PLAN (USAPHC 2013 THE CONTRACTOR SHALL PREPARE A CONSTRUCTION & DEMOLITION

(C&D) PLAN IN ACCORDANCE WITH THE LATEST VERSION OF USGS 01 4 19 DESCRIBING HOW C&D FOR THIS PROJECT WILL BE MANAGED. THE CONTRACTOR MUST DIVERT AT LEAST 60% OF C&D WASTE FROM LANDFILL DISPOSAL AND REPORT TO THE CONTRACTING OFFICER REPRESENTATIVE HOW MUCH PROJECT DERIVED C&D WASTE WAS RECYCLED AND HOW MUCH WENT TO AN OFF-SITE LANDFILL OR OTH DISPOSAL SITE. THE CONTRACTOR SHALL MAINTAIN RECORDS TO DOCUMENT THE QUANTITY OF WASTE GENERATED; QUANTITY DIVERTED THROUGH SALE, REUSE OR RECYCLING: AND THE QUANTITY OF WASTE DISPOSED BY LANDFILL OR INCINERATION. THE RECORDS SHALL BE PROVIDED TO THE ENVIRONMENTAL DIVISION AT THE END OF THE

JSE ALL EXCAVATION SPOILS ON SITE TO THE GREATEST EXTENT DSSIBLE. IF THE PROJECT WILL GENERATE EXCESS FILL, INCLUDE TH DLLOWING REQUIREMENTS IN THE SPECIFICATIONS: WEST POINT DOES NOT HAVE A LANDFILL ON SITE SUITABLE FOR DISPOSAL OF EXCESS SOIL/FILL MATERIAL. ALL EXCESS SOIL/FIL MATERIAL GENERATED BY THE PROJECT MUST BE ANALYZED PRIOR TO BEING SHIPPED OFF SITE FOR REUSE OR DISPOSAL. SOIL/FILL MATERIAL SHALL NOT BE SHIPPED OFF SITE WITHOUT WRITTEN APPROVAL FROM THE WEST POINT ENVIRONMENTAL MANAGEMENT

EXCESS SOIL/FILL MATERIAL MAY BE STOCKPILED UNTIL THE ND OF THE PROJECT, THEN REUSED ON SITE AS MUCH AS POSSIBL PRIOR TO SAMPLING AND ANALYSIS FOR RESIDUAL SOIL TO BE DISPOSED. STORE IN A MANNER THAT PREVENTS RAIN FROM INFILTRATING THE SOIL MATRIX AND PREVENTING RUNOFF INTO THE SURROUNDING SOIL OR PAVEMENT (FOR EXAMPLE, STORE THE SOIL TOP OF PLASTIC SHEETS AND COVERED WITH PLASTIC SHEETS OR STORE IN LINED, COVERED DUMPSTERS). IF THE SOIL IS GOING TO E RELOCATED OR DISPOSED OUTSIDE THE CONSTRUCTION SITE, SAMPLING AND ANALYSIS IS REQUIRED. IF SOIL/FILL MATERIAL IS TO BE REUSED ON THE

CONSTRUCTION SITE, SAMPLING IS NOT REQUIRED UNLESS ONTAMINATION IS SUSPECTED OR OTHERWISE DIRECTED. SAMPLING ND ANALYSIS WILL BE REQUIRED IF THERE IS VISUAL EVIDENCE OF SPILL, ODORS, FIELD INSTRUMENT READINGS, DEBRIS OR OTHER INDICATIONS THAT THE SOIL IS CONTAMINATED.

THE CONTRACTOR SHALL NOT MOVE EXCESS SOIL/FILL MATERI F-SITE WITHOUT WRITTEN PERMISSION FROM THE WEST POINT VIRONMENTAL MANAGEMENT DIVISION. THIS REQUIREMENT IS IN ECT EVEN IF THE CONTRACTOR DOES NOT BELIEVE THE SOIL IS ONTAMINATED EXCESS SOIL FOR DISPOSAL SHALL BE ANALYZED I ACCORDANCE WITH 6 NYCRR 371 AND 6 NYCRR 360.13. SAMPLING FREQUENCY SHALL BE AS REQUIRED BY THE DISPOSAL FACILITY BUT AT A MINIMUM SHALL BE IN ACCORDANCE WITH 6 NYCRR 360.13. T NALYSIS REPORT SHALL INCLUDE A DESCRIPTION OF THE SOIL STOCKPILE, ESTIMATED QUANTITY OF SOIL BEING CHARACTERIZED, AI A SKETCH SHOWING WHERE THE SAMPLES WERE COLLECTED. THE PORT SHALL IDENTIFY ALL EXCEEDANCES OF UNR SOIL CLEANUP OBJECTIVES AT 6NYCRR 375-6.8. THE CONTRACTOR SHALL SUBMIT THE ANALYSIS REPORT AND DOCUMENTATION THAT TH RECEIVING FACILITY IS PROPERLY PERMITTED AND CAN ACCEPT THE SOIL, TO THE WEST POINT ENVIRONMENTAL MANAGEMENT DIVISION FOR WRITTEN APPROVAL TO SHIP THE SOIL TO THE DISPOSAL FACILITY. AFTER THE SOIL/FILL MATERIAL HAS BEEN SHIPPED OFF SITE, THE CONTRACTOR SHALL SUBMIT DOCUMENTATION SUCH AS SHIPPING MANIFESTS, WEIGHT TICKETS, AND INVOICES DOCUMENTING THE QUANTITIES AND LOCATIONS THE EXCESS SOIL WAS SHIPPED.

THE CONTRACTOR SHALL KEEP STAGING AREAS NEAT AND CLEAN. ALL WASTE AND RECYCLABLES SHALL BE PROPERLY STORED IN DUMPSTERS OR OTHER TRASH RECEPTACLES. WASTE SHALL NOT BE STORED EXPOSED TO THE WEATHER OR IN A MANNER THAT COULD CONTAMINATE THE ENVIRONMENT. STAGING AREAS SHALL NOT BE USEI FOR LONG TERM STORAGE OR DISPOSAL OF SOLID WASTE. AT CONCLUSION OF THE CONTRACT ALL SOLID WASTE SHALL BE REMOVED FROM THE SITE.

PORTIONS OF THE BUILDING THAT WILL BE DISTURBED BY THIS PROJECT MUST BE SURVEYED BY EPA CERTIFIED INSPECTORS FOR HAZARDOUS MATERIALS INCLUDING, BUT NOT LIMITED TO, LEAD BASED PAINT, PCB'S, UNIVERSAL WASTES, AND EXIT SIGNS. ANY ACTIVITIES THAT WILL DISTURB LBP MUST BE CONDUCTED IN ACCORDANCE WITH OSHA (29 CFR 1926.62) AND ARMY (AR 420-1) REGULATIONS. IF ASBESTOS IS PRESENT IT MUST BE HANDLED IN ACCORDANCE WITH EPA (40 CFR 61.145), AND OSHA (29 CFR 1926.1101) REGULATIONS. ACCUMULATION AND DISPOSAL OF HAZARDOUS WASTE MUST BE IN ACCORDANCE WITH EPA, NYSDEC, AND USAG POLICY 26. COLLECT PAINT CHIPS, DUST, DIRT, AND RUBBLE IN PLASTIC BAGS FOR DISPOSAL. LARGER ARCHITECTURAL DEBRIS SHOULD BE STORED IN DUMPSTERS OR OTHER CONTAINERS. WASTE SOLVENTS AND SLUDGE'S FROM DE-LEADING SHOULD BE STORED IN SEALED CONTAINERS IN GOOD CONDITION. CONTAINERS SHOULD BE STORED IN A SECURE LOCATION THAT PROVIDES SECONDARY CONTAINMENT AND PROTECTION FROM THE WEATHER. DEPARTMENT OF TRANSPORTATION (DOT) REQUIREMENTS STILL APPLY. ANY WASTES CONSIDERED HAZARDOUS MATERIALS MUST BE SHIPPED IN ACCORDANCE WITH DOT REQUIREMENTS.

WEST POINT IS A LARGE QUANTITY GENERATOR OF HAZARDOUS WAS ALL HAZARDOUS WASTE GENERATED DURING THIS CONTRACT SHALL MANAGED IN ACCORDANCE WITH APPLICABLE NYSDEC HAZARDOUS WASTE REGULATIONS AND USAG POLICY 26.COORDINATE ALL HAZARDOUS WASTE MANIFESTS WITH THE DPW ENVIRONMENTAL MANAGEMENT DIVISION. ONLY AUTHORIZED WEST POINT PERSONNEL

SHALL SIGN HAZARDOUS WASTE MANIFESTS AS THE GENERATOR. THE PROPOSED ACTION WILL NOT IMPACT CHARACTER-DEFINING

FEATURES OF THE BUILDING AND WILL NOT ADVERSELY AFFECT THE JSMA NHLD. SHPO CONSULTATION WILL BE INITIATED IAW THE 2016 PA OR OM&D

STORAGE OF PETROLEUM FOR CONTRACTOR USE MUST BE ADDRESSED IN A SPCCP APPROPRIATE TO THE AMOUNT OF PETROLEUM THAT WILL BE STORED.

ENSURE THAT THE WATER SUPPLY CONNECTION(S) ARE PROTECTED BY A BACK-FLOW DEVICE, PLACED TO FACILITATE INSPECTION AS REQUIRED BY REGULATION.

9

ALL PROJECTS ENGAGED IN EXCAVATION REQUIRE AN APPROVED SOIL EROSION AND SEDIMENT CONTROL PLAN.

ANY PROJECT WITH CONCRETE OR CEMENT WORK REQUIRES A DESIGNATED CONCRETE WASH OUT ON SITE.

Mark B. Thompson Associates Architecture 502 South 24th Street Philadelphia, PA 19146 215.985.1000 www.mbtarchitects.com Keast & Hood Company of New York, PC Structural Engineering

400 Market Street, Suite 1250 Philadelphia, PA 19106 215.625.0099 www.keasthood.com Dimitri J. Ververelli, Inc. Mechanical, Electrical, Plumbing, Fire Protection Engineering

211 North 13th Street Philadelphia, PA 19107 215.496.0000 www.djvinc.com Langan

Civil Engineering 21 Penn Plaza, 360 West 31st Street, 8th Floor New York, NY 10001 212.479.5400 www.langan.com

Theatre Proiects Acoustical Design 47 Water Street South Norwalk, CT 06854

203.299.0830 www.theatreprojects.com

It is a violation of New York State Law for any person, unless he is acting under the direction of a licensed Professional Engineer or Land Surveyor, to alter an item in any way. If an item bearing the seal of an Engineer or Land Surveyor is altered, the altering Engineer or Land Surveyor shall affix to the item his seal and the notation "altered by" followed by his signature and the date of such alteration, and a specific description of the alteration.

General Notes

- 1. All dimensions and existing conditions shall be checked and verified by contractor at the site prior to proceeding with the work. 2. Contractor shall inform Architect/ Engineer of
- any discrepancies on drawings before construction begins. 3. No existing service may be cut without Architect/Engineers's consent. Any existing
- service severed or damaged shall be replaced at no cost to owner. . Contractor must notify Architect/ Engineer at
- once if hidden existing conditions encountered require design modifications.

Date

07-06-2022

Issue Issued For

Key Plan

Bid & Permit

PRELIMINARY Not For Construction


EGNER HALL BUILDING 685

U.S. MILITARY ACADEMY West Point, New York

Project No.: 11300 Date: July 06, 2022

Drawing Title: Project Location & Site Use Plans

A 0 0 1

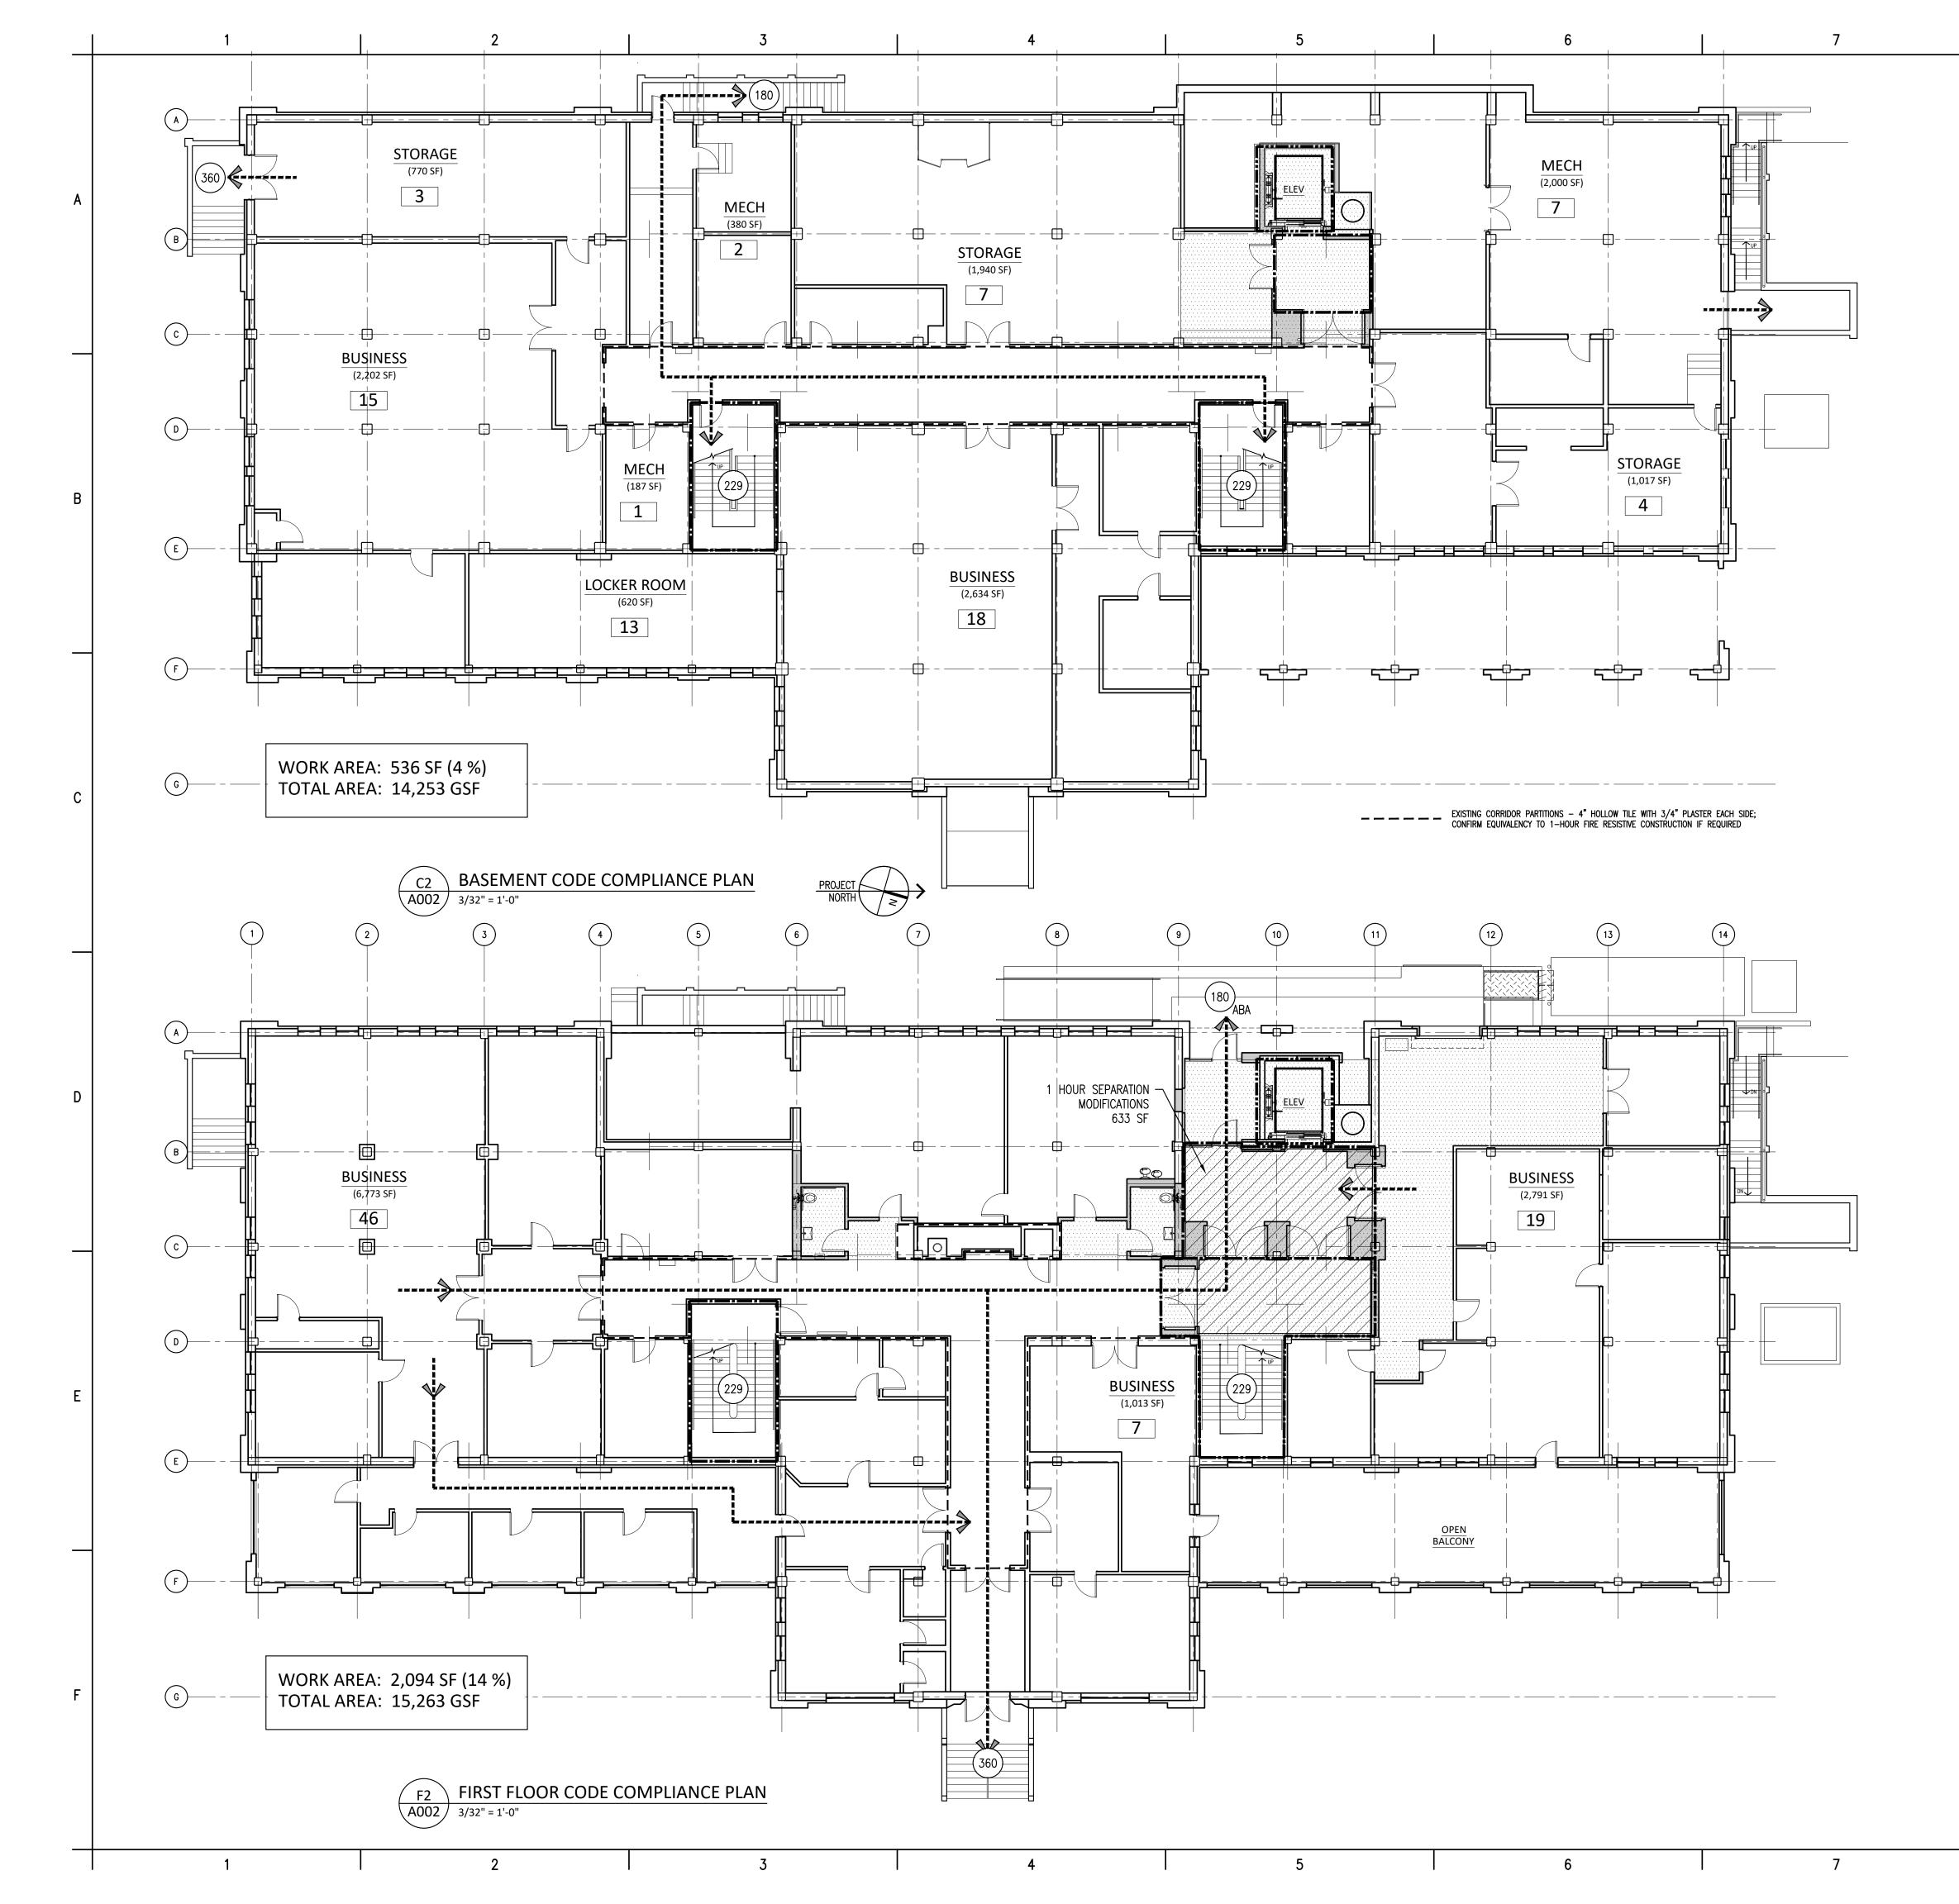

SEPARATE BID PACKAGES - GENERAL:

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- ARE IDENTIFIED ON THE DRAWING INDEX. 3) THE DOCUMENT SET INCLUDES THE COMBINED SCOPE OF WORK FOR BOTH CONTRACTS. EACH CONTRACTOR SHALL BE RESPONSIBLE TO REVIEW THE DRAWINGS TO DETERMINE ALL DRAWING REFERENCES, ANNOTATIONS, AND SPECIFICATIONS THAT ARE RELEVANT, OR SHALL REQUEST CLARIFICATION DURING THE BID PHASE. 4) BUILDING, LIFE SAFETY AND ACCESSIBILITY CODE REVIEW IS BASED ON ALL WORK CONSTRUCTED SIMULTANEOUSLY OR IN SEQUENCE
- BUILDING, LIFE SAFETY AND ACCESSIBILITY CODE REVIEW UNIFIED FACILITIES CRITERIA UFC 1-200-01 GENERAL

BUILDING REQUIREMENTS (8 OCTOBER 2019)

2) IN ADDITION TO IBC, COMPLY WITH THE FOLLOWING: UFC 3-101-01 FOR ARCHITECTURAL DESIGN UFC 3-110-03 FOR ROOFING CRITERIA UFC 3-120-10 FOR INTERIOR DESIGN OTHER UFC'S AS APPLICABLE

UNIFIED FACILITIES CRITERIA FIRE PROTECTION ENGINEERING 3-600-01 (8 AUGUST 2016)

- 1) UFC 3-600-01 SUPPLEMENTS THE REQUIREMENTS OF UFC 1-200-01. 2) UFC 3-600-01 SUPERSEDES NFPA AND OTHER INDUSTRY STANDARDS, EXCEPT WHERE NOT SPECIFICALLY ADDRESSED BY THIS UFC. 3) WHERE THE IBC REFERENCES THE INTERNATIONAL
- FIRE CODE (IFC), THE IFC MUST BE REPLACED WITH NFPA 1, EXCEPT WHERE SUPERSEDED BY THIS UFC EXCEPT AS INDICATED, USE: IBC NFPA 101

CLASSIFICATION OF WORK IN EXISTING BUILDINGS WORK AREA COMPLIANCE METHOD (IEBC 301.3.2) COMPLY WITH IEBC CHAPTERS 6 THROUGH 12

ALTERATION LEVEL 2 - COMPLY WITH: IEBC CHAPTER 7 FOR LEVEL 1 ALTERATIONS IEBC CHAPTER 8 FOR LEVEL 2 ALTERATIONS

UFC 3-600-01 COMPLY WITH EXISTING FACILITIES (CHAPTER 34)

- MINOR MODIFICATIONS (DEFINITIONS 2-1.20): - WORK CONSISTS OF LESS THAN 50% OF THE TOTAL FLOOR AREA OF AN EXISTING FACILITY. WORK TO AN AREA LESS THAN 5,000 SF OF FLOOR AREA THAT INVOLVES EXISTING OR NEW FIRE BARRIERS OR FIRE-RATED CONSTRUCTION; LIFE
- SAFETY SYSTEMS; FIRE ALARM OR DETECTION SYSTEM WORK AREA TO AN EXISTING HVAC SYSTEM THAT REMOVES OR INSTALLS DUCT WORK PASSING THROUGH FIRE-RATED OR SMOKE PARTITIONS/BARRIERS OR INTERCONNECTED PLENUM AREAS SERVING AN AREA GREATER THAN
- 5,000 SF OR FLOOR AREA. HISTORIC MINIMUM REQUIREMENTS: FACILITIES, AS THEY EXIST, MUST MEET THE
- REQUIREMENTS OF NFPA 101, FOR EXISTING OCCUPANCIES.
- NFPA 101 CATEGORY OF REHABILITATION WORK: MODIFICATIONS / HISTORIC BUILDINGS
- USE AND OCCUPANCY USE IBC CHAPTER 3 EXCEPT AS MODIFIED BY UFC 3-600-01 CHANGE 3. IF THERE IS A CONFLICT, UFC SHALL TAKE PRECEDENCE.

USE GROUP: BUSINESS GROUP B

- SPECIAL DETAILED REQUIREMENTS BASED ON USE AND OCCUPANCY USE UFC 3-600-01 CHANGE 3. USE IBC CHAPTER 4 ONLY AS
- SPECIFICALLY REFERENCED BY UFC 3-600-01. GENERAL BUILDING HEIGHTS AND AREAS
- USE IBC CHAPTER 5 AS MODIFIED IN UFC 1-200-01 AND BY UFC 3-600-01.

BUILDING HEIGHT LIMITATIONS USE IBC CHAPTER 5

- TABLE 504.3 ALLOWABLE HEIGHT BUSINESS B
- UNADJUSTED ALLOWABLE HEIGHT: 55 FT, 3 STORIES MODIFICATION FOR SPRINKLER: ADD 20 FT; ADD 1 STORY
- NOT SPRINKLERED TOTAL ALLOWABLE HEIGHT: 55 FT; 3 STORIES
- EXISTING BUILDING HEIGHT ~56' FT TO AVERAGE HEIGHT HIGHEST ROOF SURFACE EXISTING BUILDING CONSTRUCTION TYPE: PRESUMED IIB, NOT SPRINKLERED

BUILDING AREA LIMITATIONS

USE IBC CHAPTER 5

- ALLOWABLE AREA UNADJUSTED ALLOWABLE AREA: 23,000 SF (B OCCUPANCY, TYPE IIB, NOT SPRINKLERED)
- TOTAL ALLOWABLE AREA: 112,815 SF (B OCCUPANCY, TYPE IIB, NOT SPRINKLERED)

AREA OF EXISTING BUILDING:

FLOOR 0:	14,253 SF
FLOOR 1:	15,263 SF
FLOOR 2:	15,263 SF
FLOOR 3:	12,852 SF
TOTAL	57.631 SF

FULLY SPRINKLERED BUILDING EXISTING BUILDING: NO

CLASSIFICATION OF WORK

USE IEBC CHAPTER 6

WORK AREA:	
FLOOR 0:	536 SF (04%)
FLOOR 1:	2,094 SF (14%)
FLOOR 2:	7,605 SF (50%)
FLOOR 3:	4,887 SF (38%)
TOTAL	15,122 SF (26%)

WORK AREA DOES NOT EXCEED 50% OF THE BUILDING AREA, THEREFORE CLASSIFICATION OF WORK IS ALTERATION LEVEL 2 (IEBC) OR MINOR MODIFICATION (UFC 3-600-01)

TYPES OF CONSTRUCTION USE IBC CHAPTER 6 EXCEPT AS MODIFIED UFC 3-600-01.

WHERE IBC CHAPTER 6 REFERENCES IBC CHAPTER 7,

USE IBC CHAPTER 7 REFERENCE. EXISTING TYPE OF CONSTRUCTION: TYPE IIB

- BUILDING MATERIALS ARE NONCOMBUSTIBLE EXCEPT WHERE PERMITTED IN SECTION 603 AND ELSEWHERE IN THE CODE.
- FIRE-RESISTANCE RATING FOR BUILDING ELEMENTS: 0 HOURS
- FIRE RESISTANCE RATING FOR EXTERIOR WALLS > 30' FIRE SEPARATION DISTANCE: 0 HOURS
- EXISTING FIRE SEPARATION DISTANCE: > 30 FT PROPOSED: > 30 FT
- FIRE DEPARTMENT ACCESS: 12 FEET CLEARANCE ON WEST SIDE OF BUILDING
- FIRE-RESISTANCE-RATED CONSTRUCTION USE IBC CHAPTER 7 EXCEPT AS MODIFIED UFC 3-600-01.
- INTERIOR FINISHES USE UFC 3-600-01 AND UFC 3-120-10 IN LIEU OF IBC

FIRE PROTECTION SYSTEMS USE UFC 3-600-01 IN LIEU OF IBC CHAPTER 9.

- UFC 3-600-01 CHAPTER 34 EXISTING FACILITIES
- USE UFC 3-600-01, SECTION 9-7 SPRINKLER PROTECTION IS NOT REQUIRED FOR MINOR MODIFICATIONS WHEN APPROVED BY THE CFPE (COMPONENT FIRE PROTECTION ENGINEER)

MEANS OF EGRESS

CHAPTER 8.

- USE UFC 3-600-01 IN LIEU OF IBC CHAPTER 10.
- USE IBC CHAPTER 10, WHEN SPECIFICALLY REFERENCED BY US ACCESS BOARD, ARCHITECTURAL BARRIERS ACT (ABA) STANDARDS AND AS REFERENCED BY UFC 3-600-01. WHERE THE ABA STANDARDS REFERENCE THE PREVIOUS VERSIONS OF THE IBC, THE APPLICABLE REQUIREMENTS OF THE 2018 IBC ARE ACCEPTABLE
- UFC 3-600-01 REFERS TO NFPA 101

COMPLY WITH NFPA 101 FOR ALL COMPONENTS AND FEATURES RELATED TO MEANS OF EGRESS. IBC MUST NOT

BE USED FOR ANY MEANS OF EGRESS FEATURES, EXCEPT AS SPECIFICALLY NOTED BELOW.

OCCUPANT LOAD

CALCULATED OCCUPANT LOAD (EXISTING BUILDING): FLOOR O:

72

218

180

540

FLOOR 1:	
FLOOR 2:	
FLOOR 3:	
TOTAL	

TOTAL	
ACCESSIBILITY	

IN LIEU OF IBC CHAPTER 11 USE THE ABA STANDARDS AND THE SPECIAL PROVISIONS OF THE DEPARTMENT OF DEFENSE DEPUTY SECRETARY OF DEFENSE MEMORANDUM SUBJECT: ACCESS FOR PEOPLE WITH DISABILITIES, OCTOBER 31, 2008.

INTERIOR ENVIRONMENT USE IBC CHAPTER 12, EXCEPT AS MODIFIED BY UFC 1-200-01

ENERGY EFFICIENCY

USE UFC 1-200-02

EXTERIOR WALLS USE IBC CHAPTER 14 EXCEPT AS MODIFIED BY UFC 1-200-01.

ROOF ASSEMBLIES AND ROOFTOP STRUCTURES USE IBC CHAPTER 15 EXCEPT AS MODIFIED BY UFC 3-110-03 AND UFC 3-600-01.

STRUCTURAL DESIGN USE IBC CHAPTER 16 EXCEPT AS MODIFIED BY UFC 1-200-01 AND BY UFC 3-301-01 AND UFC 3-310-04.


GLASS AND GLAZING USE IBC CHAPTER 24 EXCEPT AS MODIFIED BY UFC 4-010-01 (AT /FP)

PLUMBING SYSTEMS


USE IBC CHAPTER 29 AS MODIFIED BY UFC 3-420-01. MINIMUM PLUMBING FACILITIES FOR B BUSINESS:

Fixture	Occupants	IBC Table 2902.1	Requir
WC male	50	1 per 25	2
	223	1 per 50	5
WC female	50	1 per 25	2
	223	1 per 50	5
Lavatories	80	1 per 40	2
	465	1 per 80	6
Drinking Fountain	545	1 per 100	6
Service Sink	N/A	1 service sink	1

TOTAL PLUMBING FIXTURES REQUIRED / PROVIDED:

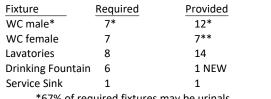

*67% of required fixtures may be urinals ** 2 of the provided fixtures are gender neutral

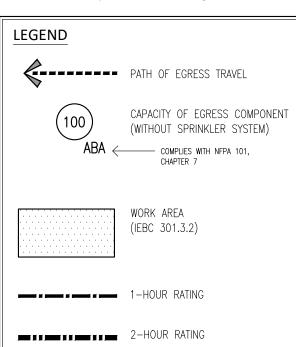

1 CALCULATED OCCUPANCY

02 South 24th S hiladelphia, PA 15.985.1000		cts.com
tructural Engine 00 Market Stree hiladelphia, PA	et, Suite 1250	
ngineering 11 North 13th S hiladelphia, PA	trical, Plumbing, F treet	Fire Protection
lew York, NY 10	50 West 31st Stre 1001 www.langan.com	
heatre Projects coustical Design 7 Water Street outh Norwalk, C 03.299.0830	า	ects.com
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`		-
-		-
is a violation of N	/ Vew York State Law	for any person.
nless he is acting rofessional Engine any way. If an ite and Surveyor is al urveyor shall affi» altered by" follow	under the direction eer or Land Surveyd em bearing the sea tered, the altering < to the item his sea yed by his signature d a specific descrip	n of a licensed or, to alter an iter I of an Engineer o Engineer or Land al and the notatio and the date of
checked and v prior to proce . Contractor sh	s and existing cor verified by contra eding with the we all inform Archite icies on drawings	ctor at the site ork. ct/ Engineer of

Mark B. Thompson Associates

- construction begins. 3. No existing service may be cut without Architect/Engineers's consent. Any existing service severed or damaged shall be replaced at
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Date

07-06-2022

Issue Issued For

Bid & Permit

PRELIMINARY Not For Construction

Key Plan


EGNER HALL BUILDING 685

U.S. MILITARY ACADEMY West Point, New York

Project No.: 11300 Date: July 06, 2022

Drawing Title: Code Compliance Plans

A 0 0 2

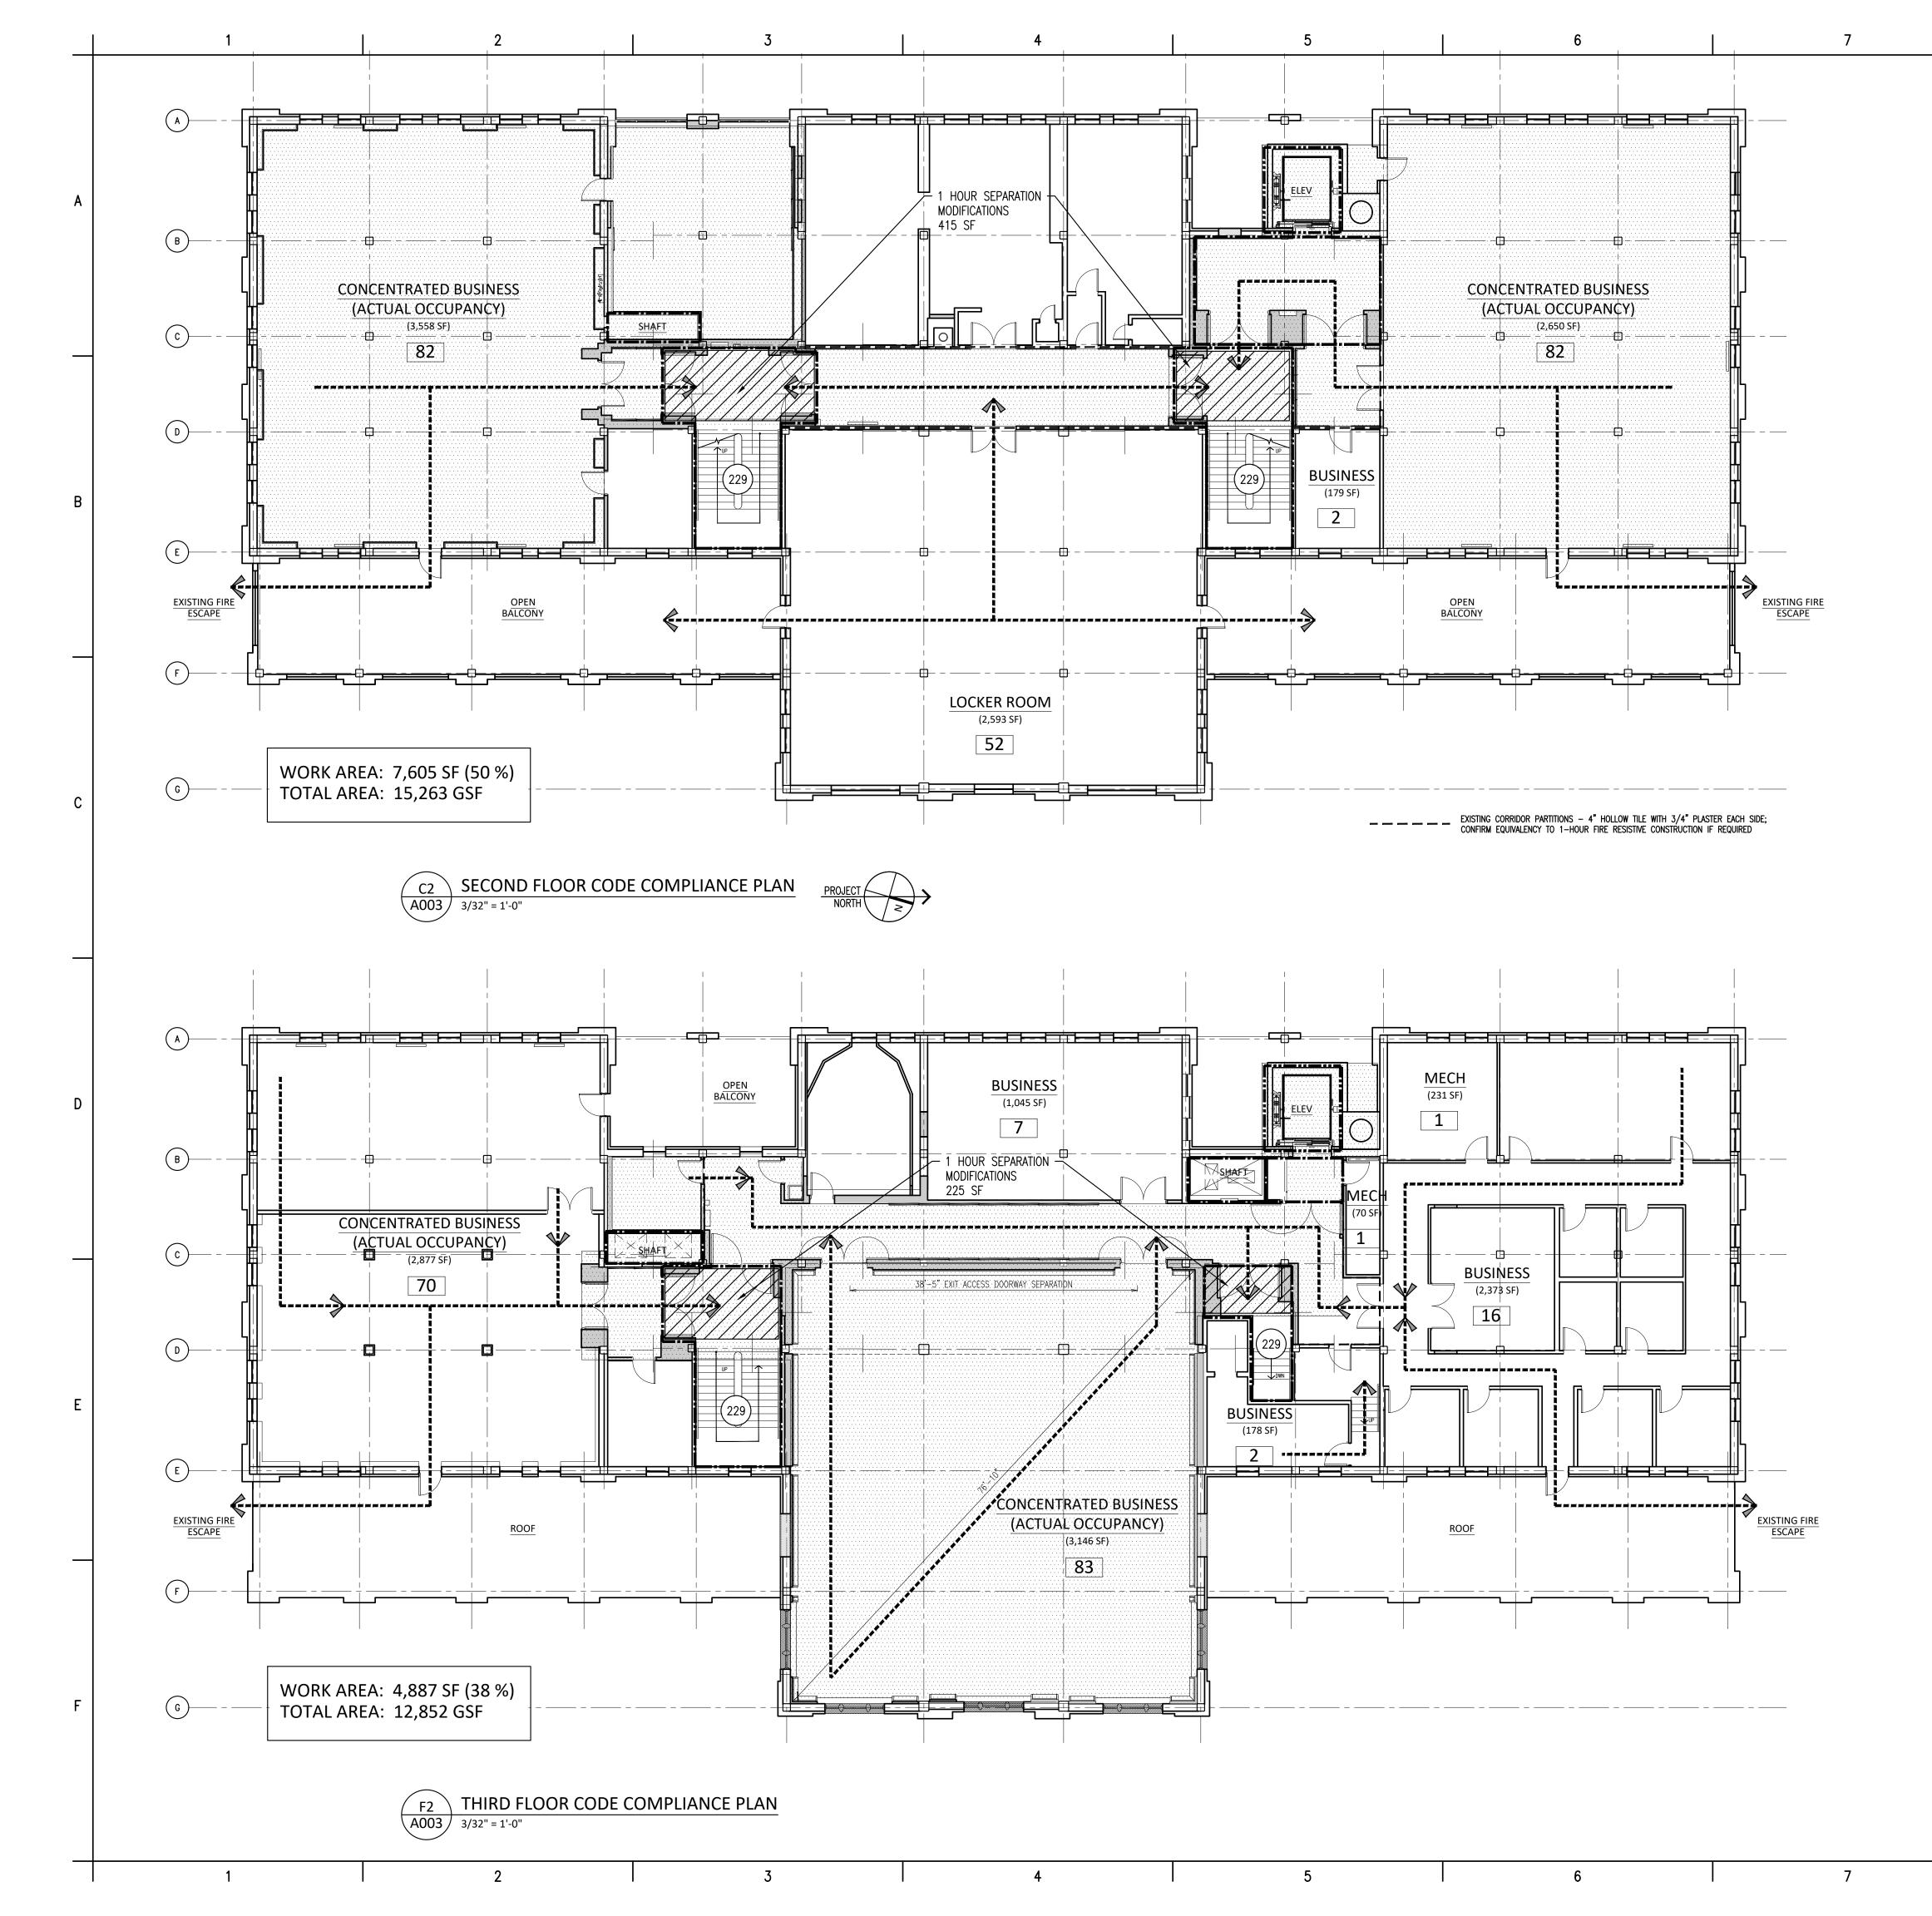

1) EXCEPT AS INDICATED, USE 2018 IBC AND 2018 IEBC

SEPARATE BID PACKAGES - GENERAL

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BUILDING REQUIREMENTS (8 OCTOBER 2019)

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- USE AND OCCUPANCY USE IBC CHAPTER 3 EXCEPT AS MODIFIED BY UFC 3-600-01 CHANGE 3. IF THERE IS A CONFLICT, UFC SHALL TAKE PRECEDENCE.

USE GROUP: BUSINESS GROUP B

- SPECIAL DETAILED REQUIREMENTS BASED ON USE AND OCCUPANCY USE UFC 3-600-01 CHANGE 3. USE IBC CHAPTER 4 ONLY AS
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BUILDING HEIGHT LIMITATIONS USE IBC CHAPTER 5

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FLOOR 3:	4,887 SF (38%)
TOTAL	15,122 SF (26%)

WORK AREA DOES NOT EXCEED 50% OF THE BUILDING AREA, THEREFORE CLASSIFICATION OF WORK IS ALTERATION LEVEL 2 (IEBC) OR MINOR MODIFICATION (UFC 3-600-01)

TYPES OF CONSTRUCTION USE IBC CHAPTER 6 EXCEPT AS MODIFIED UFC 3-600-01.

WHERE IBC CHAPTER 6 REFERENCES IBC CHAPTER 7,

USE IBC CHAPTER 7 REFERENCE. EXISTING TYPE OF CONSTRUCTION: TYPE IIB

- BUILDING MATERIALS ARE NONCOMBUSTIBLE EXCEPT WHERE PERMITTED IN SECTION 603 AND ELSEWHERE IN THE CODE.
- FIRE-RESISTANCE RATING FOR BUILDING ELEMENTS: 0 HOURS
- FIRE RESISTANCE RATING FOR EXTERIOR WALLS > 30' FIRE SEPARATION DISTANCE: 0 HOURS
- EXISTING FIRE SEPARATION DISTANCE: > 30 FT PROPOSED: > 30 FT
- FIRE DEPARTMENT ACCESS: 12 FEET CLEARANCE ON WEST
- SIDE OF BUILDING FIRE-RESISTANCE-RATED CONSTRUCTION

USE IBC CHAPTER 7 EXCEPT AS MODIFIED UFC 3-600-01.

INTERIOR FINISHES USE UFC 3-600-01 AND UFC 3-120-10 IN LIEU OF IBC CHAPTER 8.

FIRE PROTECTION SYSTEMS

- USE UFC 3-600-01 IN LIEU OF IBC CHAPTER 9.
- UFC 3-600-01 CHAPTER 34 EXISTING FACILITIES
- USE UFC 3-600-01, SECTION 9-7 SPRINKLER PROTECTION IS NOT REQUIRED FOR MINOR MODIFICATIONS WHEN APPROVED BY THE CFPE (COMPONENT FIRE PROTECTION ENGINEER)

MEANS OF EGRESS

- USE UFC 3-600-01 IN LIEU OF IBC CHAPTER 10. USE IBC CHAPTER 10, WHEN SPECIFICALLY
- REFERENCED BY US ACCESS BOARD, ARCHITECTURAL BARRIERS ACT (ABA) STANDARDS AND AS REFERENCED BY UFC 3-600-01. WHERE THE ABA STANDARDS REFERENCE THE PREVIOUS VERSIONS OF THE IBC, THE APPLICABLE REQUIREMENTS OF THE 2018 IBC ARE ACCEPTABLE
- UFC 3-600-01 REFERS TO NFPA 101

COMPLY WITH NFPA 101 FOR ALL COMPONENTS AND FEATURES RELATED TO MEANS OF EGRESS. IBC MUST NOT

BE USED FOR ANY MEANS OF EGRESS FEATURES, EXCEPT AS SPECIFICALLY NOTED BELOW.

OCCUPANT LOAD

CALCULATED OCCUPANT LOAD (EXISTING BUILDING): FLOOR O: 70

72

218

FLOOR 1: FLOOR 2: FLOOR 3:

TOTAL ACCESSIBILITY

IN LIEU OF IBC CHAPTER 11 USE THE ABA STANDARDS AND THE SPECIAL PROVISIONS OF THE DEPARTMENT OF DEFENSE DEPUTY SECRETARY OF DEFENSE MEMORANDUM SUBJECT: ACCESS FOR PEOPLE WITH DISABILITIES, OCTOBER 31, 2008.

INTERIOR ENVIRONMENT USE IBC CHAPTER 12, EXCEPT AS MODIFIED BY UFC

1-200-01

ENERGY EFFICIENCY USE UFC 1-200-02

EXTERIOR WALLS USE IBC CHAPTER 14 EXCEPT AS MODIFIED BY UFC 1-200-01.

ROOF ASSEMBLIES AND ROOFTOP STRUCTURES USE IBC CHAPTER 15 EXCEPT AS MODIFIED BY UFC 3-110-03 AND UFC 3-600-01.

STRUCTURAL DESIGN USE IBC CHAPTER 16 EXCEPT AS MODIFIED BY UFC 1-200-01 AND BY UFC 3-301-01 AND UFC 3-310-04.

GLASS AND GLAZING USE IBC CHAPTER 24 EXCEPT AS MODIFIED BY UFC 4-010-01 (AT /FP)

PLUMBING SYSTEMS

USE IBC CHAPTER 29 AS MODIFIED BY UFC 3-420-01. MINIMUM PLUMBING FACILITIES FOR B BUSINESS:


WINNING WIT EDWIDING TACIETTES FOR D DOSINESS.				
	Fixture	Occupants	IBC Table 2902.1	Required

i integri e	occupanto	100 10010 200212	
WC male	50	1 per 25	2
	223	1 per 50	5
WC female	50	1 per 25	2
	223	1 per 50	5
Lavatories	80	1 per 40	2
	465	1 per 80	6
Drinking Fountain	545	1 per 100	6
Service Sink	N/A	1 service sink	1


TOTAL PLUMBING FIXTURES REQUIRED / PROVIDED:

Fixture	Required	Provided	
WC male*	7*	12*	
WC female	7	7**	
Lavatories	8	14	
Drinking Fountain	6	1 NEW	
Service Sink	1	1	
*67% of required fixtures may be urinals			

*67% of required fixtures may be urinals ** 2 of the provided fixtures are gender neutral

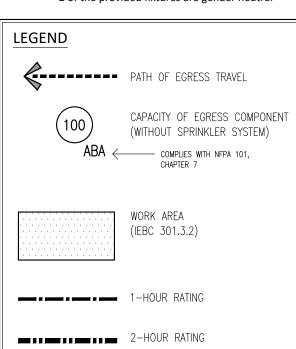

1 CALCULATED OCCUPANCY

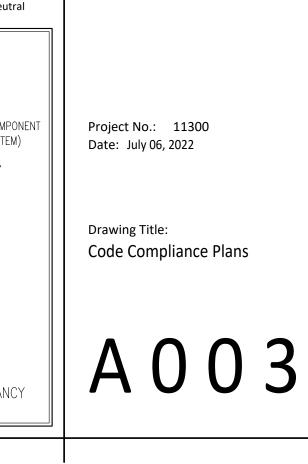

Mark B. Thompson Associates Architecture 502 South 24th Street Philadelphia, PA 19146 215.985.1000 www.mbtarchitects.com

Keast & Hood Company of New York, PC Structural Engineering 400 Market Street, Suite 1250 Philadelphia, PA 19106

215.625.0099 www.keasthood.com

Dimitri J. Ververelli, Inc. Mechanical, Electrical, Plumbing, Fire Protection Engineering 211 North 13th Street Philadelphia, PA 19107 215.496.0000 www.djvinc.com

Langan Civil Engineering 21 Penn Plaza, 360 West 31st Street, 8th Floor New York, NY 10001 212.479.5400 www.langan.com

Theatre Projects Acoustical Design 47 Water Street South Norwalk, CT 06854 203.299.0830 www.theatreprojects.com

It is a violation of New York State Law for any person, unless he is acting under the direction of a licensed Professional Engineer or Land Surveyor, to alter an item in any way. If an item bearing the seal of an Engineer or Land Surveyor is altered, the altering Engineer or Land Surveyor shall affix to the item his seal and the notation "altered by" followed by his signature and the date of such alteration, and a specific description of the alteration.

General Notes

- 1. All dimensions and existing conditions shall be checked and verified by contractor at the site prior to proceeding with the work. 2. Contractor shall inform Architect/ Engineer of
- any discrepancies on drawings before construction begins. 3. No existing service may be cut without
- Architect/Engineers's consent. Any existing service severed or damaged shall be replaced at no cost to owner.
- 4. Contractor must notify Architect/ Engineer at once if hidden existing conditions encountered require design modifications.

Date

07-06-2022

Issue Issued For

Key Plan

Bid & Permit


PRELIMINARY Not For Construction

EGNER HALL

BUILDING 685

U.S. MILITARY ACADEMY

West Point, New York

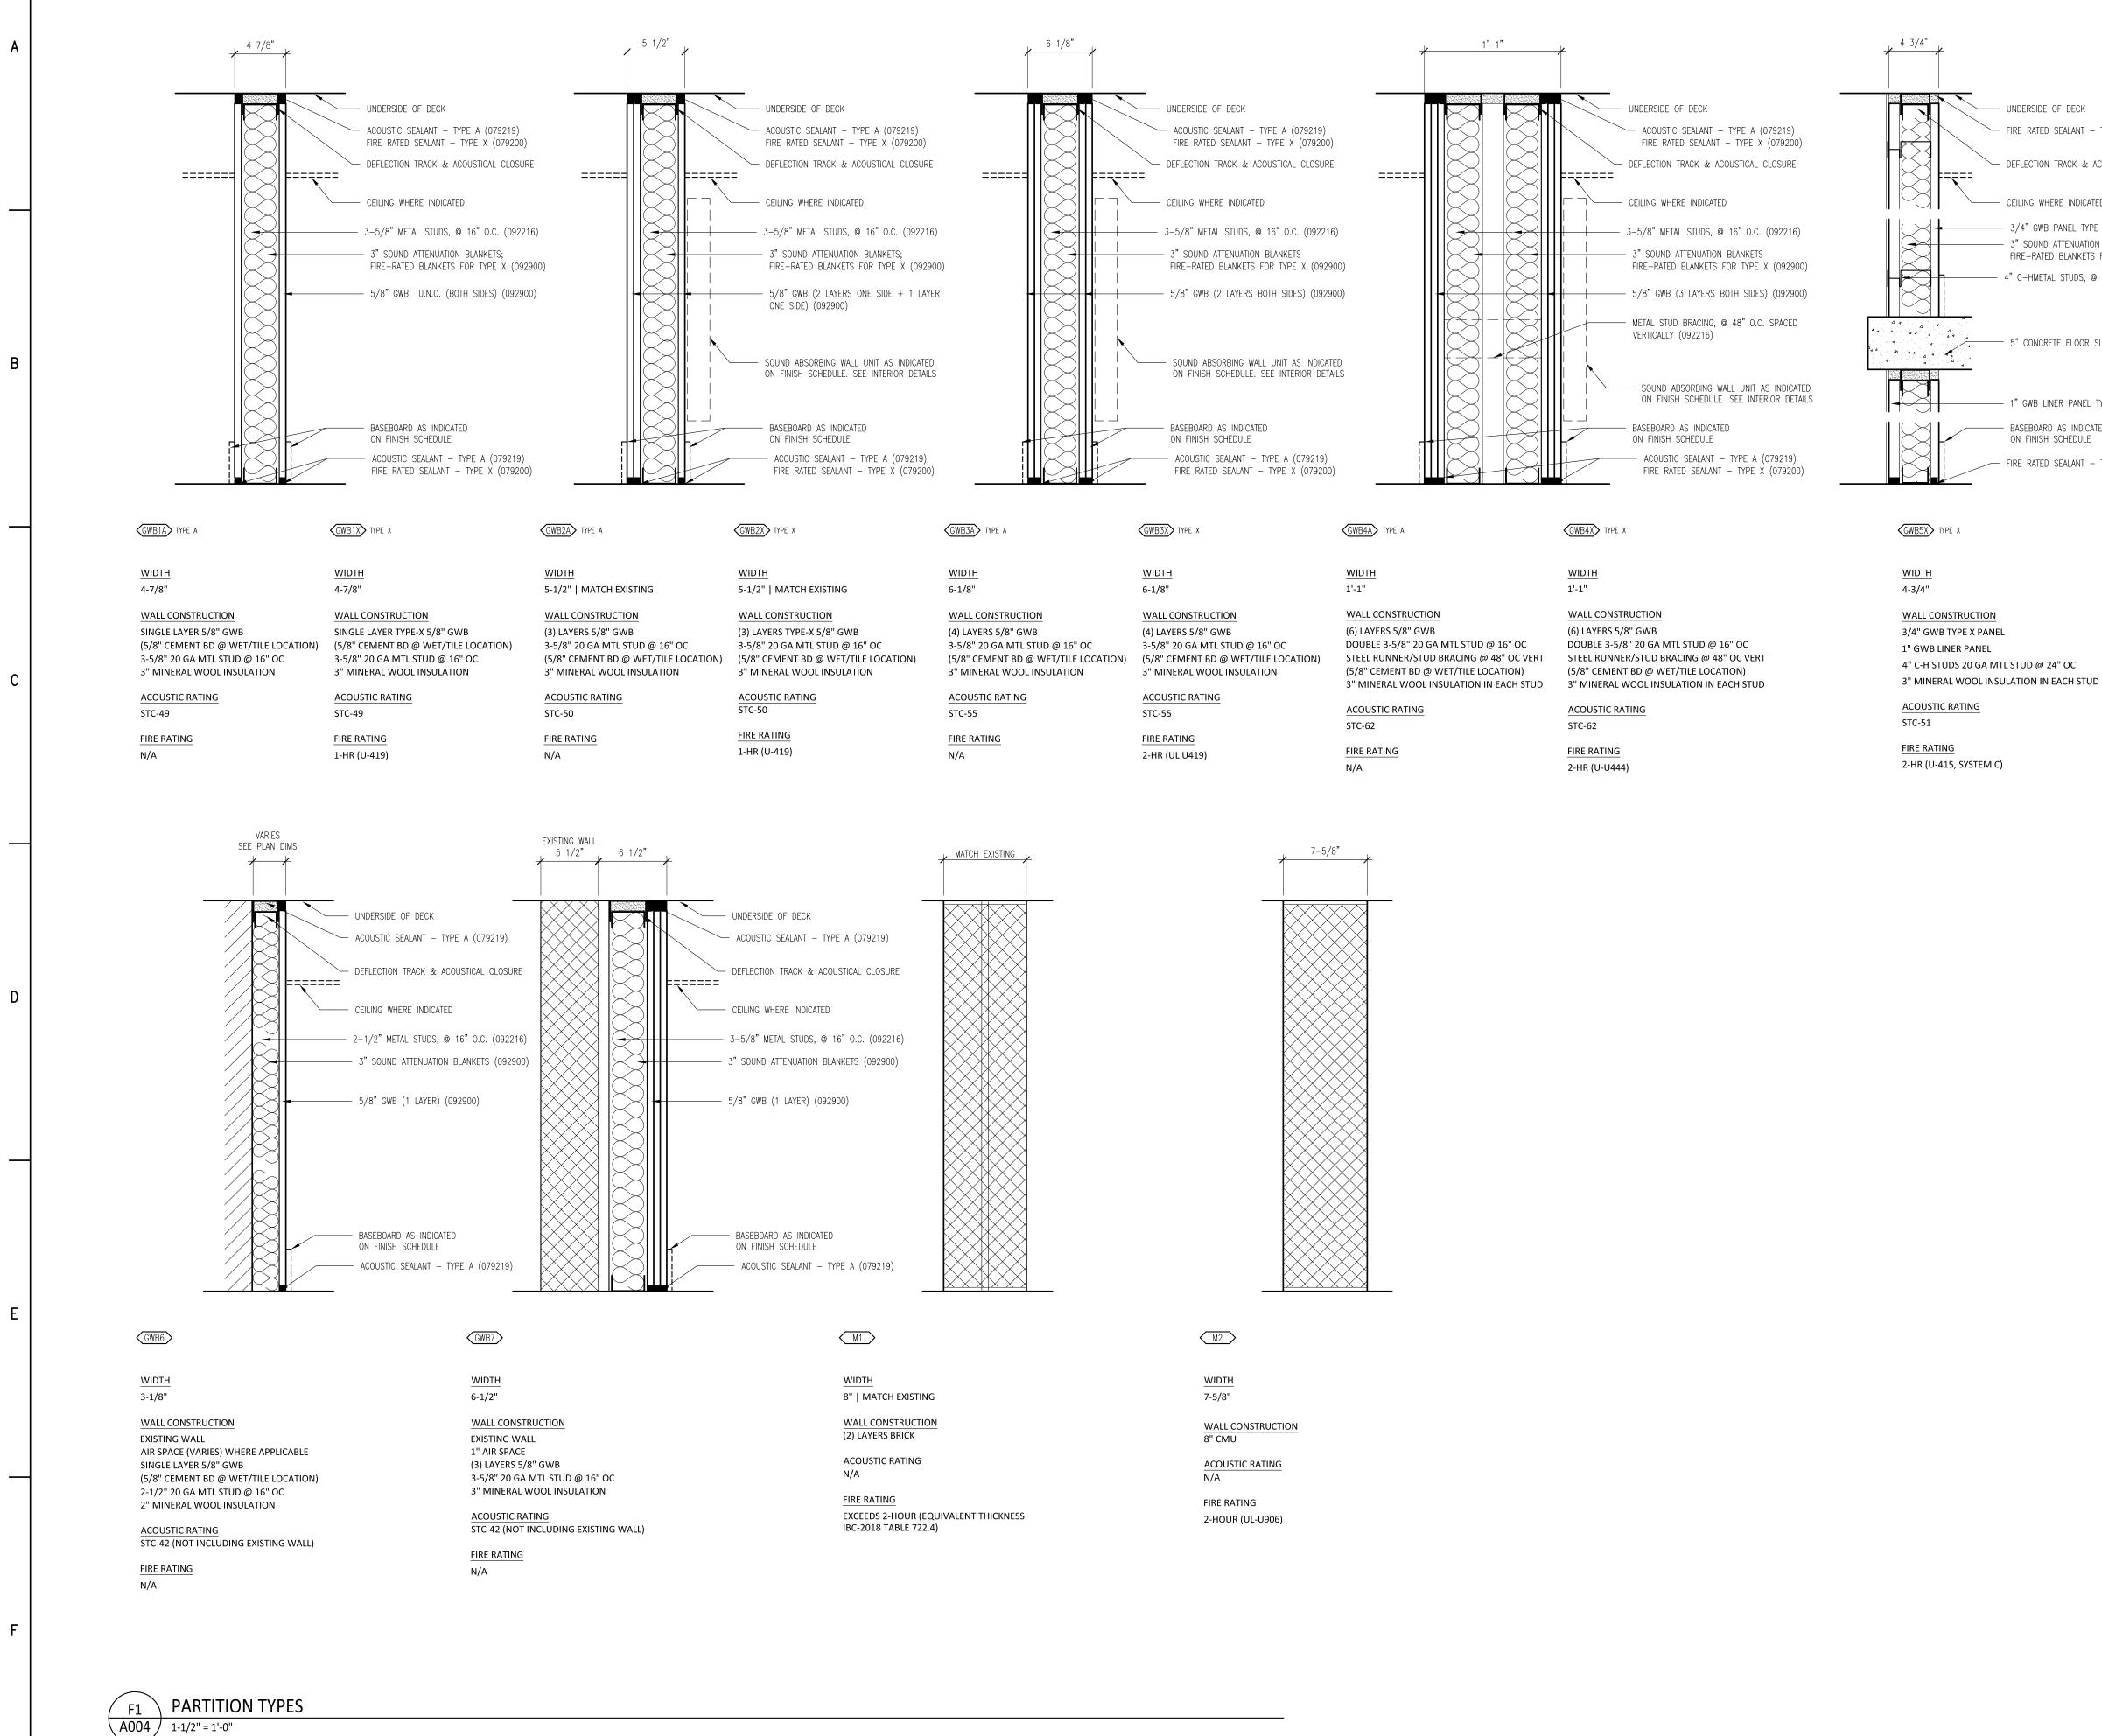

2

5

7

- UNDERSIDE OF DECK — FIRE RATED SEALANT – TYPE X (079200)

└── DEFLECTION TRACK & ACOUSTICAL CLOSURE

- CEILING WHERE INDICATED

3/4" GWB PANEL TYPE X (092116.23) 3" SOUND ATTENUATION BLANKETS FIRE-RATED BLANKETS FOR TYPE X (092900) — 4"C-HMETAL STUDS, @ 24"O.C. (092116.23)

— 5" CONCRETE FLOOR SLAB

— 1" GWB LINER PANEL TYPE X (092116.23) BASEBOARD AS INDICATED

FIRE RATED SEALANT – TYPE X (079200)

GENERAL PARTITION NOTES:

PROVIDE FLAT STRAP AND BACKING PLATE, BLOCKING, OR SUPPLEMENTARY FRAMING WITH METAL STUD FRAMING TO SUPPORT FIXTURES, EQUIPMENT, ACCESSORIES, ETC. WHERE REQUIRED (092216). AT EXTERNAL CORNERS IN HALLS AND CORRIDORS PROVIDE

CORNER GUARD PROTECTION. BASIS OF DESIGN: FLEXIBLE VINYL CORNER GUARDS, 1–1/2" RETURNS, 1/8" THICK, TAPERED ENDS, BY ROPPE (#166) OR TARKETT (VBG-XX-A). Mark B. Thompson Associates Architecture 502 South 24th Street Philadelphia, PA 19146 215.985.1000 www.mbtarchitects.com

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Date

07-06-2022

Issue Issued For

Bid & Permit

PRELIMINARY Not For Construction

Key Plan

EGNER HALL BUILDING 685

U.S. MILITARY ACADEMY West Point, New York

Project No.: 11300 Date: July 06, 2022

Drawing Title: Partition Types

9

A 0 0 4

NUMBER FIRST FLOO 104:1 109:1 110:1	ROOM NAME	(W x H)	ш Ш	RIAL		IESS S)		AL		ETAIL	DETAIL	ARE	TING (S	ICAL	
104:1 109:1)R		ТҮРЕ	MATERIAL	FINISH	THICKNESS (INCHES)	ТҮРЕ	MATERIAL	FINISH	HEAD DETAIL	JAMB D	HARDWARE SET	FIRE RATING (HOURS)	ACOUSTICAL	
104:1 109:1)R			1		•	BI	D PAC		NO. 1				<u></u>	·
104:1 109:1															
	RESOURCE MANAGEMENT SUPPLY	3'-0" x 7'-0"	F	WD	TR	1-3/4"	HM	ΗM	PT	B5/A005	B5/A005	02	-	-	
110:1	LOADING/UNLOADING	(2) 3'-0" x 7'-0"	F	ΗМ	РТ	1-3/4"	НМ	ΗM	PT	B5/A005	B5/A005	01	-	-	
,	LOADING/UNLOADING	8'-0" x 9'-8"	-	ST	FF	-	НМ	ST	FF	D7/A601	E7/A601	во	-	-	
111:1	OFFICE	3'-0 x 7'-0''	F	WD	TR	1-3/4"	НМ	HM	PT	B5/A005	B5/A005	03	-	-	
112:1	LOBBY	(2) 4'-0" x 8'-11"	F	НM	FF	1-3/4"	НМ	ΗM	FF	A8/A901	B4/A901	BO	1	-	
112:2	LOBBY	(2) 4'-0" x 8'-11"	F	НM	FF	1-3/4"	HМ	ΗM	FF	A8/A901	B4/A901	BO	1	-	
112:3	LOBBY	(2) 3'-6" x 8'-11"	F	ΗM	FF	1-3/4"	HМ	ΗM	FF	A8/A901	B4/A901	BO	1	-	
113:1	HALL	(2) 4'-0" x 8'-11"	F	НM	FF	1-3/4"	НM	ΗM	FF	A8/A901	B4/A901	BO	1	-	
114:1	RESTROOM	3'-0" x 7'-0"	F	WD	TR	1-3/4"	HМ	ΗM	PT	B5/A005	B5/A005	04	1/3		
116:1	BREAK ROOM	3'-0" x 7'-0"	HG	WD	TR	1-3/4"	нм	HM	PT	B5/A005	B5/A005	02A	1/3	-	Ļ
117:1	RESTROOM	3'-0" x 7'-0"	F	WD	TR	1-3/4"	НМ	HM	PT	B5/A005	B5/A005	04	1/3	-	╞
118:1	JANITORS CLOSET	3'-0" x 7'-0"	EX	WD	TR	-	EX	WD	TR	-	-	EX 01		-	Ļ
120:1	STORAGE	3'-0" x 7'-0"	HG	WD	TR	1-3/4"	нм	HM	РТ	B5/A005	B5/A005	05	1/3	-	Ļ
145:1	VESTIBULE	-	EX	-	-	-	EX	-	-	-	-	<u> </u>	<u> </u>		
SECOND FL			Г				1			1	1				
202:1 203:1	GLEE CLUB OFFICE GLEE CLUB	3'-0" x 7'-0" (2) 3'-0" x 7'-6"	VL PNL	WD WD	TR TR	1-3/4" 1-3/4"	HM HM	HM HM	PT PT	B6:1/A005 D6/A005	B6:2/A005 D7/A005	08 06	- 1/3	Y Y	-
203:2	GLEE CLUB	3'-0 x 7'-0"	EX	WD	TR	EX	EX	WD	TR	-	-	EX 01	-	-	
204:1	STAIR	(2) 4'-0" x 7'-11"	F	HM	FF	1-3/4"	НМ	HM	FF	A8/A901	D4 & D6/A901	BO	1		Ľ
204:2	STAIR	(2) 4'-0" x 7'-11"	F	HМ	FF	1-3/4"	НМ	ΗM	FF	A8/A901	B4 & D6/A901	BO	1	-	
205:1	GLEE CLUB SECTIONALS	3'-0" x 7'-0"	VL	WD	TR	1-3/4"	нм	НМ	PT	B6:1/A001	B6:2/A005	08A	-	Y	
213:1	STAIR	(2) 4'-0" x 7'-11"	F	НМ	FF	1-3/4"	нм	НМ	FF	A8/A901	B4/A901	BO	1	<u> </u>	╞
213.1	STAIN		•	11101		1-3/4								+	†
214:1	SPIRIT BAND	(2) 3'-0" x 7'-6"	PNL	WD	TR	1-3/4"	НМ	ΗM	РТ	D6/A005	D7/A005	06	1/3	Y	
215:1	LOBBY	(2) 4'-0" x 7'-11"	F	НМ	FF	1-3/4"	нм	НМ	FF	A8/A901	B4/A901	ВО	1	<u>+ -</u>	t-
215:2	LOBBY	(2) 4'-0" x 7'-11"		HM	FF	<u> </u>	НМ	HM	FF	A8/A901	B4 & D4/A901	BO	1	_	†
THIRD FLOC			1			, ·				, -	, .			<u> </u>	<u> </u>
300:1	CONCERT BAND	(2) 3'-0" x 8'-0"	F	WD	TR	1-3/4"	HM	HM	PT	D6/A005	D7/A005	06A	1/3	Y	
300:2	CONCERT BAND	(2) 3'-0" x 8'-0"	F	WD	TR	1-3/4"	НM	HM	РТ	D6/A005	D7/A005	06A	1/3	Y	
301:1	BAND LIBRARY	(2) 3'-0" x 8'-0"	F	WD	TR	1-3/4"	HM	НM	PT	D6/A005	D7/A005	07	1/3	Y	
302:1	OFFICE	3'-0" x 7'-0"	F	WD	TR	1-3/4"	HM	НM	РТ	B5/A005	B5/A005	03A	1/3	-	
303:1	JAZZ KNIGHTS	(2) 3'-0" x 7'-0"	F	WD	TR	1-3/4"	НМ	ΗМ	PT	D6/A005	D7/A005	06	1/3	Y	
304:1	IT/AV EQUIPMENT ROOM	3'-0" x 7'-0"	F	WD	TR	1-3/4"	ΗМ	НM	РТ	D6/A005	D7/A005	05A	1/3	Y	
305:1	JANITORS CLOSET	3'-0" x 7'-0"	F	WD	TR	1-3/4"	HM	НM	PT	B5/A005	B5/A005	02B	1/3	-	
306:1	CONTROL ROOM	3'-0" x 7'-0"	VL	WD	TR	1-3/4"	HM	НM	РТ	B7:1/A005	B7:2/A005	08	1/3	Y	
309:1	PRACTICE	(2) 3'-0" x 7'-0"	F	WD	РТ	1-3/4"	НМ	HM	PT	D6/A005	D7/A005	07	1/3	Y	
311:1	STAIR	(2) 4'-0" x 8'-5"	F	ΗМ	FF	1-3/4"	НМ	НM	FF	B8/A901	B6/A901	BO	1	-	Ē
313:1	STAIR	(2) 4'-0" x 8'-5"	F	НM	FF	1-3/4"	НМ	ΗM	FF	A8/A901	B4/A901	BO	1	_	Ľ
316:1	CLOSET	3'-0" x 7'-0"	F	ΗM	РТ	1-3/4"	НМ	ΗM	РТ	B5/A005	B5/A005	05	1		
319:1	HALL	(2) 3'-0" x 7'-0"	F	WD	TR	1-3/4"	НМ	HM	РТ	D6/A005	D7/A005	06	1/3	Y	Ĺ
323:1	VESTIBULE	(2) 4'-0" x 8'-5"	F	ΗM	FF	1-3/4"	НМ	ΗM	FF	A8/A901	D4 & D6/A901	BO	1	-	Ļ
324:1	ELEVATOR LOBBY	(2) 4'-0" x 8'-5"	F	НM	FF	1-3/4"	ΗМ	НM	FF	A8/A901	E4/A901	BO	1		
_			_	_	_	_				NO. 1		_	_	_	-
						ALTE	RNATI	E 1.1:	<u>CADE</u>	<u>T SPIRIT BA</u>	AND				
SECOND FL	OOR						1			1	1				,
214:2	SPIRIT BAND	3'-0" x 7'-0"	EX	WD	TR	-	EX	WD	TR	-	-	EX 02	-	-	╞
214:3	SPIRIT BAND	3'-0" x 7'-0"	EX	WD	TR	-	EX	WD	TR	-	-	EX 01	-	-	
							BI	D PAC	KAGE	NO. 2					_
FIRST FLOO	אנ די														Γ
115:1	VESTIBULE	3'-4" x 7'-0"	SF	AL	FF	1-3/4"	SF	AL	FF	C2/A601	E1/601	AL 01	-	-	
115:2	VESTIBULE	3'-4" x 7'-0"	SF	AL	FF	1-3/4"	SF	AL	FF	C5/A601	E4/A601	AL 02	-	-	-
				_						NO. 2	, .			<u> </u>	<u> </u>
						A				ASEMENT					
BASEMENT										, 					
B-9:1	LOBBY	(2) 3'-0" x 7'-0"	F	НМ	РТ	1-3/4"	НМ	НМ	PT	B5/A005	B5/A005	01	1	-	Γ
B-9:2	LOBBY	(2) 4'-0" x 6'-8"	F	НМ	FF	1-3/4"	НМ	HM	FF	A8/A901	B4/A901	BO	1	-	T

LEGEND:

MATERIALS:

EX: EXISTING | HM: HOLLOW METAL | WD: WOOD | ST: STEEL

FINISHES: PT: PAINT | TR: TRANSPARENT FINISH | FF: FACTORY FINISH

1

NOTES:


1. SEE DIVISION 8 SPECIFICATION SECTIONS FOR INTEGRATED METAL DOOR

OPENING ASSEMBLIES INCLUDING HARDWARE 2. SEE DIVISION 13 SPECIFICATION SECTIONS FOR STC RATED DOORS


INCLUDING HARDWARE

3. SEE HARDWARE SCHEDULE FOR OTHER DOORS IDENTIFIED AS ACOUSTICAL

2

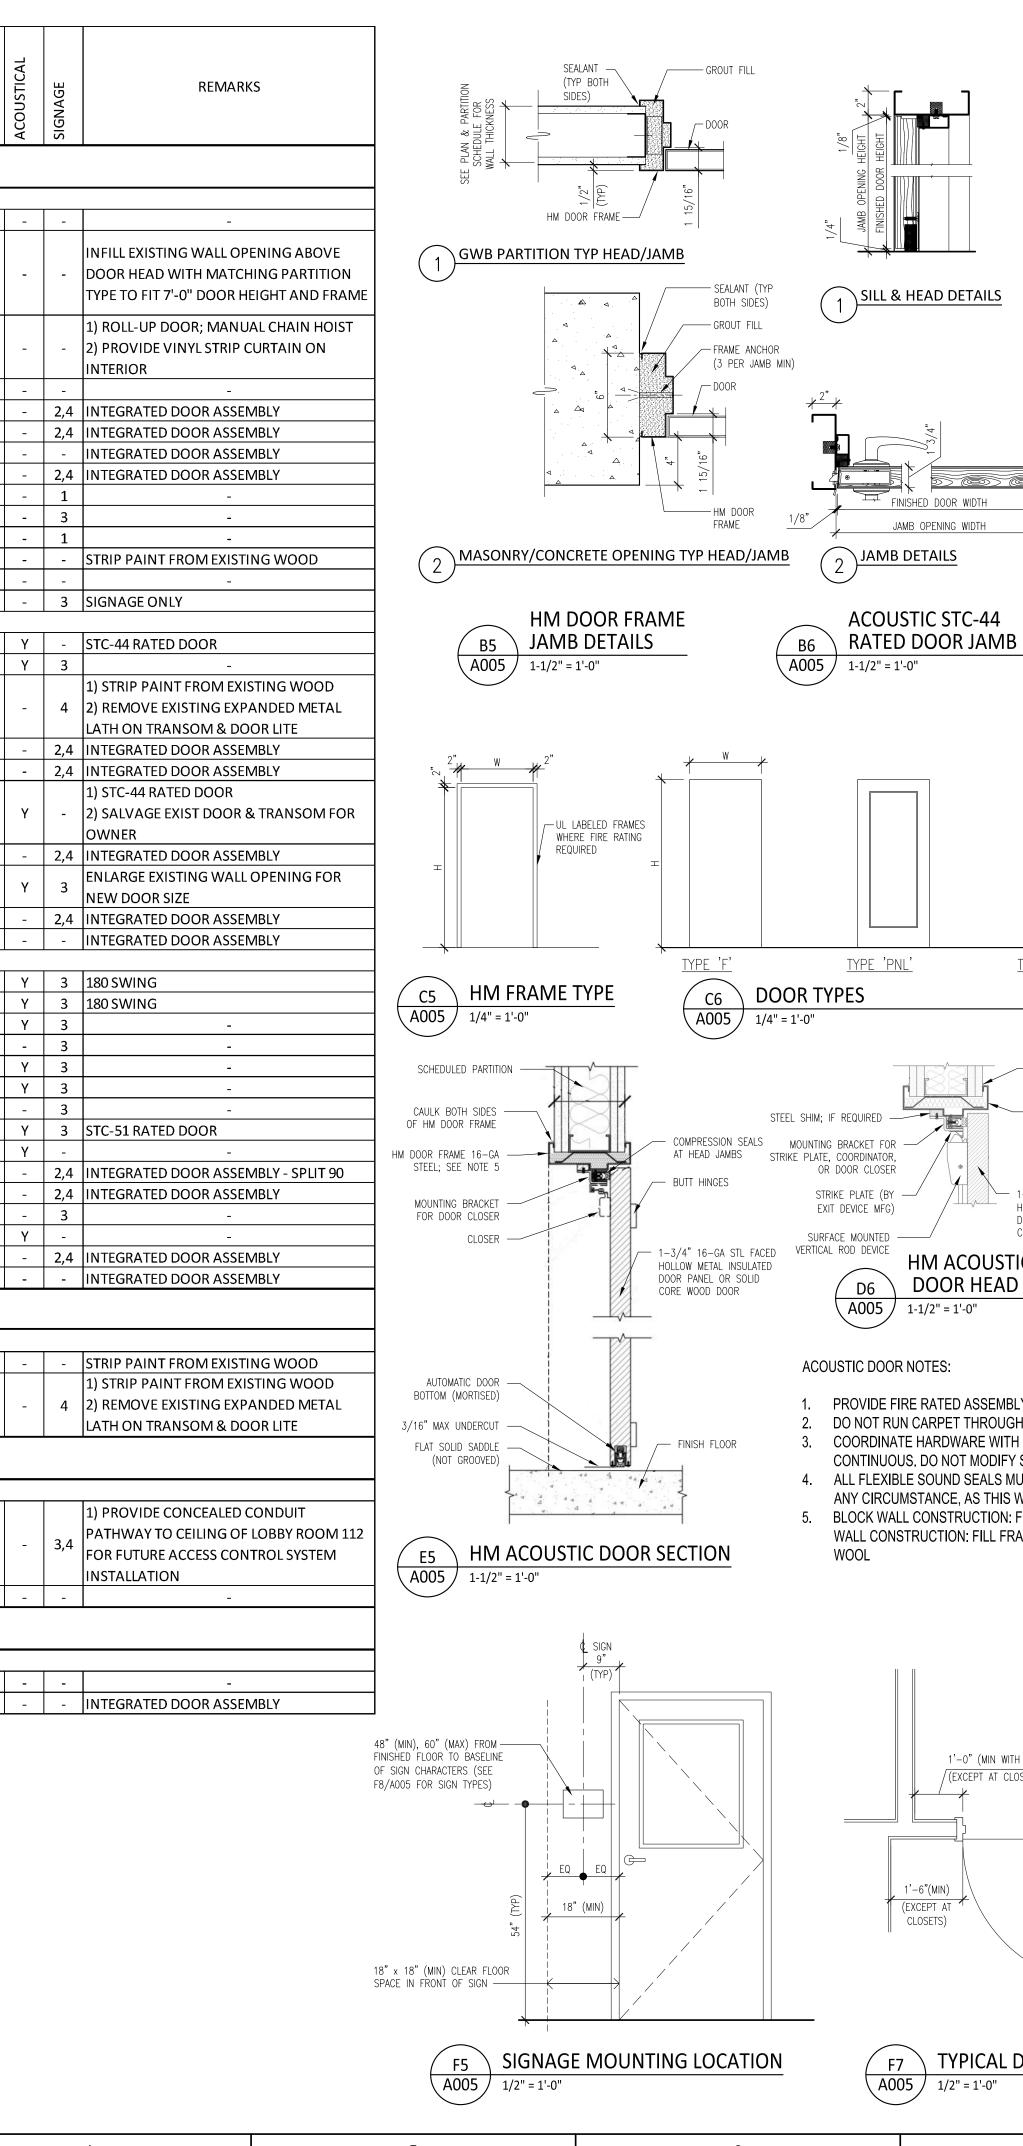

5

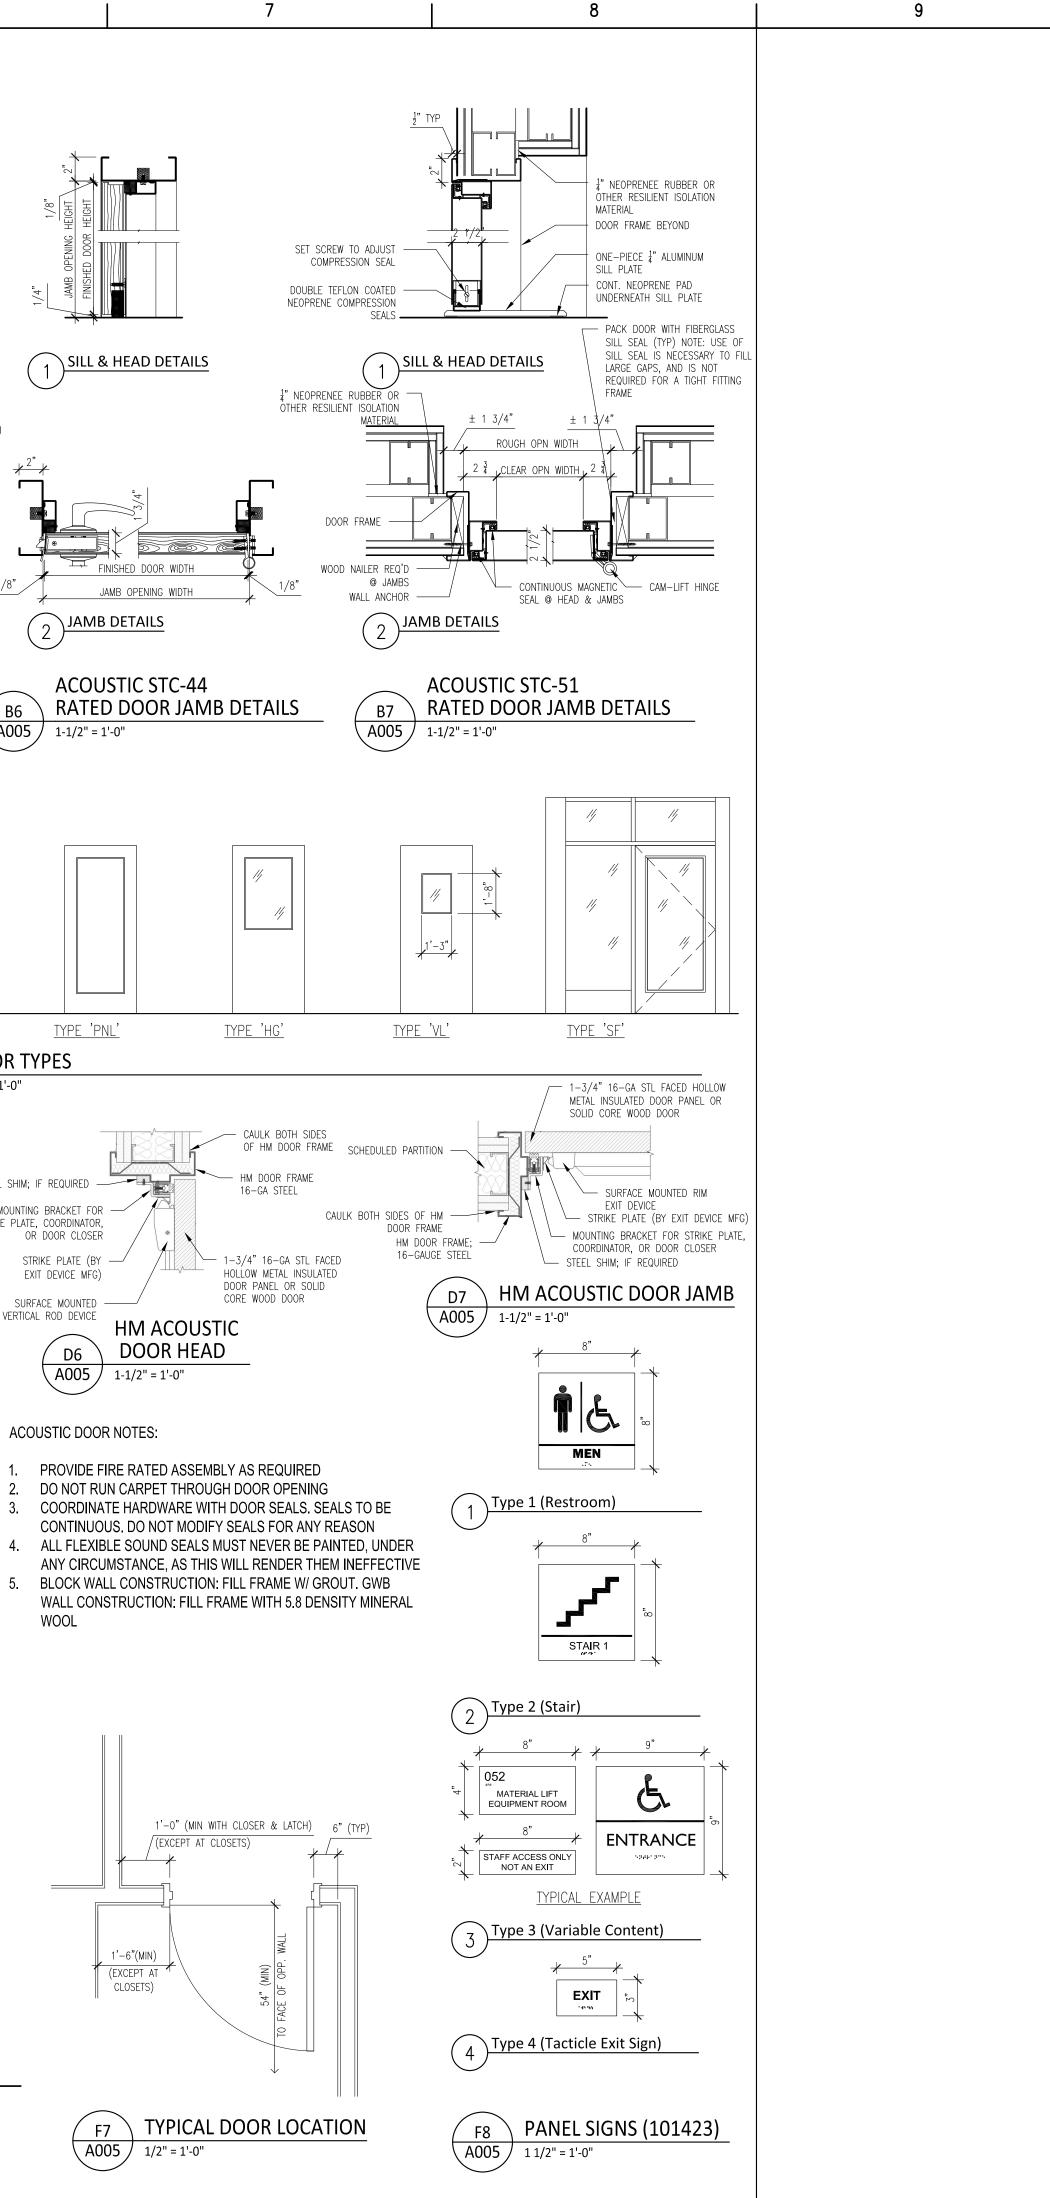

Architecture 502 South 24th Street Philadelphia, PA 19146 215.985.1000 www.mbtarchitects.com	
Keast & Hood Company of New York, PCStructural Engineering400 Market Street, Suite 1250Philadelphia, PA 19106215.625.0099www.keasthood.com	
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FINISH SCHEDULE

2

ROOM	ΝΑΝΑΓ	NORTH	DACE	EAST	DACE	SOUTH	DACE	WEST	DACE	FLOOR	CEILING	NOTES
NUMBER	NAME	WALL	BASE	WALL	BASE	WALL	BASE	WALL	BASE			
						BID P	PACKAGE N	10.1				
FIRST FLOOR	1		1					1				
109	LOADING/UNLOADING	EX / PT	EX	EX / PT	EX	EX / PT	EX	EX / PT	EX	EX	OSA / PT	-
110	LOADING/UNLOADING	EX / PT	EX	EX / GWB / PT		EX / GWB / PT	EX/TB1	EX / PT	EX	EX	OSA / PT	-
113	HALL	GWB / PT	TB1	EX / PT	EX	EX / PT	EX	EX / GWB / PT	TB1	EX	GWB / PT	-
112	LOBBY	GWB / PT	TB1	GWB / PT	TB1	GWB / PT	TB1	GWB / PT	TB1	VCT1	APC1	-
114	RESTROOM	CT1	CT2	GWB / PT	CT2	GWB / PT	CT2	CT1	CT2	CT2	APC1	-
116	BREAK ROOM	EX / PT	EX	EX / PT	RB1	EX / PT	EX	EX / PT	EX	EX	EX*	* REPAIR / EXTEND EX FINISHES TO NEW EAST WALL
117	RESTROOM	GWB / PT	CT2	GWB / PT	CT2	CT1	CT2	CT1	CT2	CT2	APC1	-
118	JANITOR	EX	EX	EX	EX	EX	EX	EX	EX	EX	EX	
146/B-13**	STAIR	EX / PT	EX	EX / PT	EX	EX / PT	EX	-	-	EX*	OSA / PT	*CLEAN/REPAIR EXISTING TERRAZZO BELOW REMOVED I **CONTINUE FINISHES TO BASEMENT STAIR LANDING
149/B-20**	STAIR	EX / PT	EX	EX / PT	EX	EX / PT	EX	-	-	EX*	OSA / PT	*CLEAN/REPAIR EXISTING TERRAZZO BELOW REMOVED F **CONTINUE FINISHES TO BASEMENT STAIR LANDING
SECOND FLOO)R		L		1						- I · ·	
200	HALL	GWB / PT	TB1	EX / PT	EX	GWB / PT	TB1	EX / PT	EX	EX	APC1	-
202	GLEE CLUB OFFICE	EX / PT	EX	EX / PT	EX	GWB / PT	TB1	GWB / PT	TB1	EX	APC1	-
203	GLEE CLUB		EX/TB1	EX / PT / FWC1	EX/TB1	EX / PT / FWC1	EX/TB1	EX / PT / FWC1	EX/TB1	EX	SACF1 / PT	PT FOR CEILING APPLIES TO EXPOSED STRUCTURE
204	STAIR	EX / GWB / PT	EX/TB1	EX / PT	-	EX / GWB / PT	EX/TB1	GWB / PT	TB1	EX	GWB / OSA / PT	PT FOR CEILING APPLIES TO EXPOSED STRUCTURE
205	GLEE CLUB SECTIONALS	EX / GWB / PT / SAWU1		GWB / PT		EX / GWB / PT / SAWU1	TB1	GWB / PT	TB1	VCT1	GWB / SACF1 / PT	PT FOR CEILING APPLIES TO EXPOSED STRUCTURE
208	VESTIBULE	EX/PT	EX	EX / PT	EX	GWB / PT / SAWU1	TB1	GWB / PT	TB1	CPT1	APC1	-
213	STAIR	EX / GWB / PT	EX/TB1	EX / PT	EX	EX / GWB / PT	EX/TB1	GWB / PT	TB1	EX	GWB / OSA / PT	PT FOR CEILING APPLIES TO EXPOSED STRUCTURE
215	LOBBY	EX / GWB / PT	EX	GWB / PT	TB1	GWB / PT	TB1	EX / PT	EX	EX	APC1	-
216	VESTIBULE		TB1	GWB / PT / SAWU1	TB1	GWB / PT	TB1	GWB / PT / SAWU1	TB1	CPT1	APC1	-
THIRD FLOOR												
300	CONCERT BAND ROOM	GWB / PT / SAWU2	WB1	GWB / PT / SAWU2	WB1	GWB / PT / SAWU2	WB1	GWB / PT / SAWU2	WB1	WF1	SACP1 / SACF1 / PT	PT FOR CEILING APPLIES TO EXPOSED STRUCTURE
301	BAND LIBRARY	EX/PT	EX	GWB / PT	TB1	EX / GWB / PT	EX/TB1	EX / PT	EX	VCT1	APC1 / GWB / PT	-
302	OFFICE		EX	EX / PT	EX	EX / PT	EX	GWB / PT	TB1	EX	APC1	-
304	AV EQUIP ROOM	EX / PT	EX	GWB / PT	RB1	GWB / PT	RB1	EX / PT	EX	VCT1	APC1	-
305	JANITOR	EX / GWB / PT	RB1	GWB / PT	RB1	GWB / PT	RB1	EX / PT	EX	EX	OSA	-
306	CONTROL ROOM	EX* / PT	EX*	GWB / PT	EX*	EX* / PT	EX*	EX	EX	EX*	EX* / PT	* REPAIR / EXTEND EX FINISHES TO NEW EAST WALL; REI ON EAST WALL
309	PRACTICE	EX / PT	EX	EX / PT	EX	EX / PT	EX	EX / PT	EX	VCT1	APC1	-
311	STAIR	EX / GWB / PT	EX/TB1	EX / PT	EX	EX / GWB / PT	EX/TB1	GWB / PT	TB1	EX*	GWB / OSA / PT	*CLEAN/REPAIR EXISTING TERRAZZO BELOW REMOVED F
313	STAIR	EX / GWB / PT	EX/TB1	EX / PT	EX	EX / GWB / PT	EX/TB1	GWB / PT	TB1	EX*	GWB / OSA / PT	*CLEAN/REPAIR EXISTING TERRAZZO BELOW REMOVED F
316	CLOSET	EX / PT	EX	GWB / PT	RB1	GWB / PT	, RB1	EX / PT	EX	EX*	OSA / PT	*CLEAN/REPAIR EXISTING TERRAZZO BELOW REMOVED F
322	HALL	GWB / PT	TB1	GWB / PT / SAWU1	TB1	EX / GWB / PT	EX/TB1	GWB / PT / SAWU1	TB1	VCT1	APC1	-
323	VESTIBULE	GWB / PT	TB1	GWB / PT	TB1	GWB / PT	TB1	GWB / PT / SAWU1	TB1	CPT1	APC1	-
324	ELEV VESTIBULE	GWB / PT	TB1	GWB / PT	TB1	GWB / PT	TB1	GWB / PT	TB1	VCT1	APC1	-
							PACKAGE N					
SECOND FLOO)B					ALTERNATE 1	LI: CADET	SPIKII BAND				
214	CADET SPIRIT BAND	EX / PT	EX	EX / PT	EX	EX / PT	EX	EX / PT	EX	EX	SACF1 / PT	PT FOR CEILING APPLIES TO EXPOSED STRUCTURE
			1-11		12/2		PACKAGE N			1		
						י עוס	AUNAUE N	0.2				
FIRST FLOOR												
115	VESTIBULE	EX / PT	-	SEE DOORS	-	EX / GWB / PT	-	SEE DOORS	-	VCT1	GWB / PT	-
-		· · · ·	1		1		PACKAGE N		I	· -	1 /	1
						ALTERNA	TE 2.1: BA	SEMENT				
BASEMENT B-9	HALL	GWB / PT	RB1	GWB / PT	RB1	GWB / PT	RB1	GWB / PT	RB1	VCT1	APC1	_
	···· 	,	+									
B-10	STORAGE	GWB / PT	RB1	EX	EX	EX	EX	GWB / PT	RB1	EX / CONC (PT)	EX	

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FINISH SCHEDULE MATERIALS

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TAG	MATERIAL	SPEC SECTION(S)	BASIS OF DESIGN MANUFACTURER	BASIS OF DESIGN PRODUCT	NOTES/COLOR/SIZE
APC1	ACOUSTICAL PANEL CEILING	095113	ARMSTRONG	CALLA HEALTH ZONE AIR ASSURE 9/16" SQUARE TEGULAR WITH 9/16" SUPRAFINE XL EXPOSED SUSPENSION SYSTEM	24" X 24" TILE / 9/16" SUSPENSION SYSTEM
CPT1	CARPET TILE	096813	MOHAWK	STATEMENT STONE TILE QB390	COLOR TBD / 24" X 24"
CT1	CERAMIC TILING	093013	CROSSVILLE	COLOR BLOX 2.0 PORCELAIN STONE	COLOR TBD/ 3" X 3" MOSAIC
CT2	CERAMIC TILING	093013	CROSSVILLE	COLOR BLOX 2.0 PORCELAIN STONE	COLOR TBD / 12" X 12" WITH 6" X 12" COVE BASE TRIM
FWC1	FABRIC WALL COVERING	097200	GUILFORD OF MAINE	FR701 STYLE 2100	COLOR TBD / WIDTH 66" STRETCHED ON FRAMING MEMBERS WITH VERTICAL PANEL JOINTS AT 5 FT OC
RB1	RESILIENT BASE	-	ROPPE	RUBBER COVE BASE	4" COVE BASE WITH LONG TOE / COLOR TBD
SACP1	SOUND ABSORBING CEILING PANEL	-	N/A	PLYWOOD PANEL SOUND REFLECTING CLOUDS	48" X 48" / STAIN COLOR TBD
SACF1	SOUND ABSORBING CEILING FINISH	072129	INTERNATIONAL CELLULOSE CORPORATION	K-13 SPRAY-APPLIED ACOUSTICAL INSULATION	COLOR TBD 4" THICK
SAWU1	SOUND ABSORBING WALL UNIT	098433	KINETICS NOISE CONTROL	HARDSIDE ACOUSTICAL WALL PANEL	COLOR TBD / 2-1/8" THICK, SEE DRAWINGS FOR SIZES, 4 WIDE X 8 FT HIGH TYP MAX
SAWU2	SOUND ABSPORBING WALL UNIT	098433	KINETICS NOISE CONTROL	HARDSIDE ACOUSTICAL WALL PANEL	COLOR TBD / 1-1/8" THICK, SEE DRAWINGS FOR SIZES, 4 WIDE X 8 FT HIGH TYP MAX
TB1	TERRAZZO BASE	096623	WAUSAU TILE	STANDARD EPOXY TERRAZZO COVE BASE TO MATCH EXISTING	REINSTALL SALVAGED MATERIAL WHERE POSSIBLE / NE COLOR MATCH TBD / 3/8" THICK X 6" HIGH
VCT1	VINYL COMPOSITION TILE	096519	ARMSTRONG	PREMIUM EXCELON CROWN TEXTURE	FIELD AND BORDER COLORS TBD / 12" X 12"
WB1	WOOD BASE	062023	N/A	WOOD BASE TRIM	SEE DRAWINGS FOR PROFILE & DIMENSIONS / STAIN COLOR TBD
WF1	WOOD FLOORING	-	N/A	EXISTING WOOD FLOORING	REFINISH / STAIN COLOR TBD

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Keast & Hood Company of New York, PC Structural Engineering 400 Market Street, Suite 1250 Philadelphia, PA 19106 215.625.0099 www.keasthood.com

Dimitri J. Ververelli, Inc. Mechanical, Electrical, Plumbing, Fire Protection Engineering 211 North 13th Street Philadelphia, PA 19107 215.496.0000 www.djvinc.com

Langan Civil Engineering 21 Penn Plaza, 360 West 31st Street, 8th Floor New York, NY 10001 212.479.5400 www.langan.com

Theatre Projects Acoustical Design 47 Water Street South Norwalk, CT 06854 203.299.0830 www.theatreprojects.com

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It is a violation of New York State Law for any person, unless he is acting under the direction of a licensed Professional Engineer or Land Surveyor, to alter an item in any way. If an item bearing the seal of an Engineer or Land Surveyor is altered, the altering Engineer or Land Surveyor shall affix to the item his seal and the notation "altered by" followed by his signature and the date of such alteration, and a specific description of the alteration.

General Notes

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- any discrepancies on drawings before construction begins. 3. No existing service may be cut without Architect/Engineers's consent. Any existing service severed or damaged shall be replaced at
- no cost to owner. 4. Contractor must notify Architect/ Engineer at
- once if hidden existing conditions encountered require design modifications. Date

07-06-2022

Issue Issued For Bid & Permit

PRELIMINARY Not For Construction

Key Plan

EGNER HALL **BUILDING 685**


U.S. MILITARY ACADEMY West Point, New York

Project No.: 11300 Date: July 06, 2022

Drawing Title: Finish Schedules

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A006

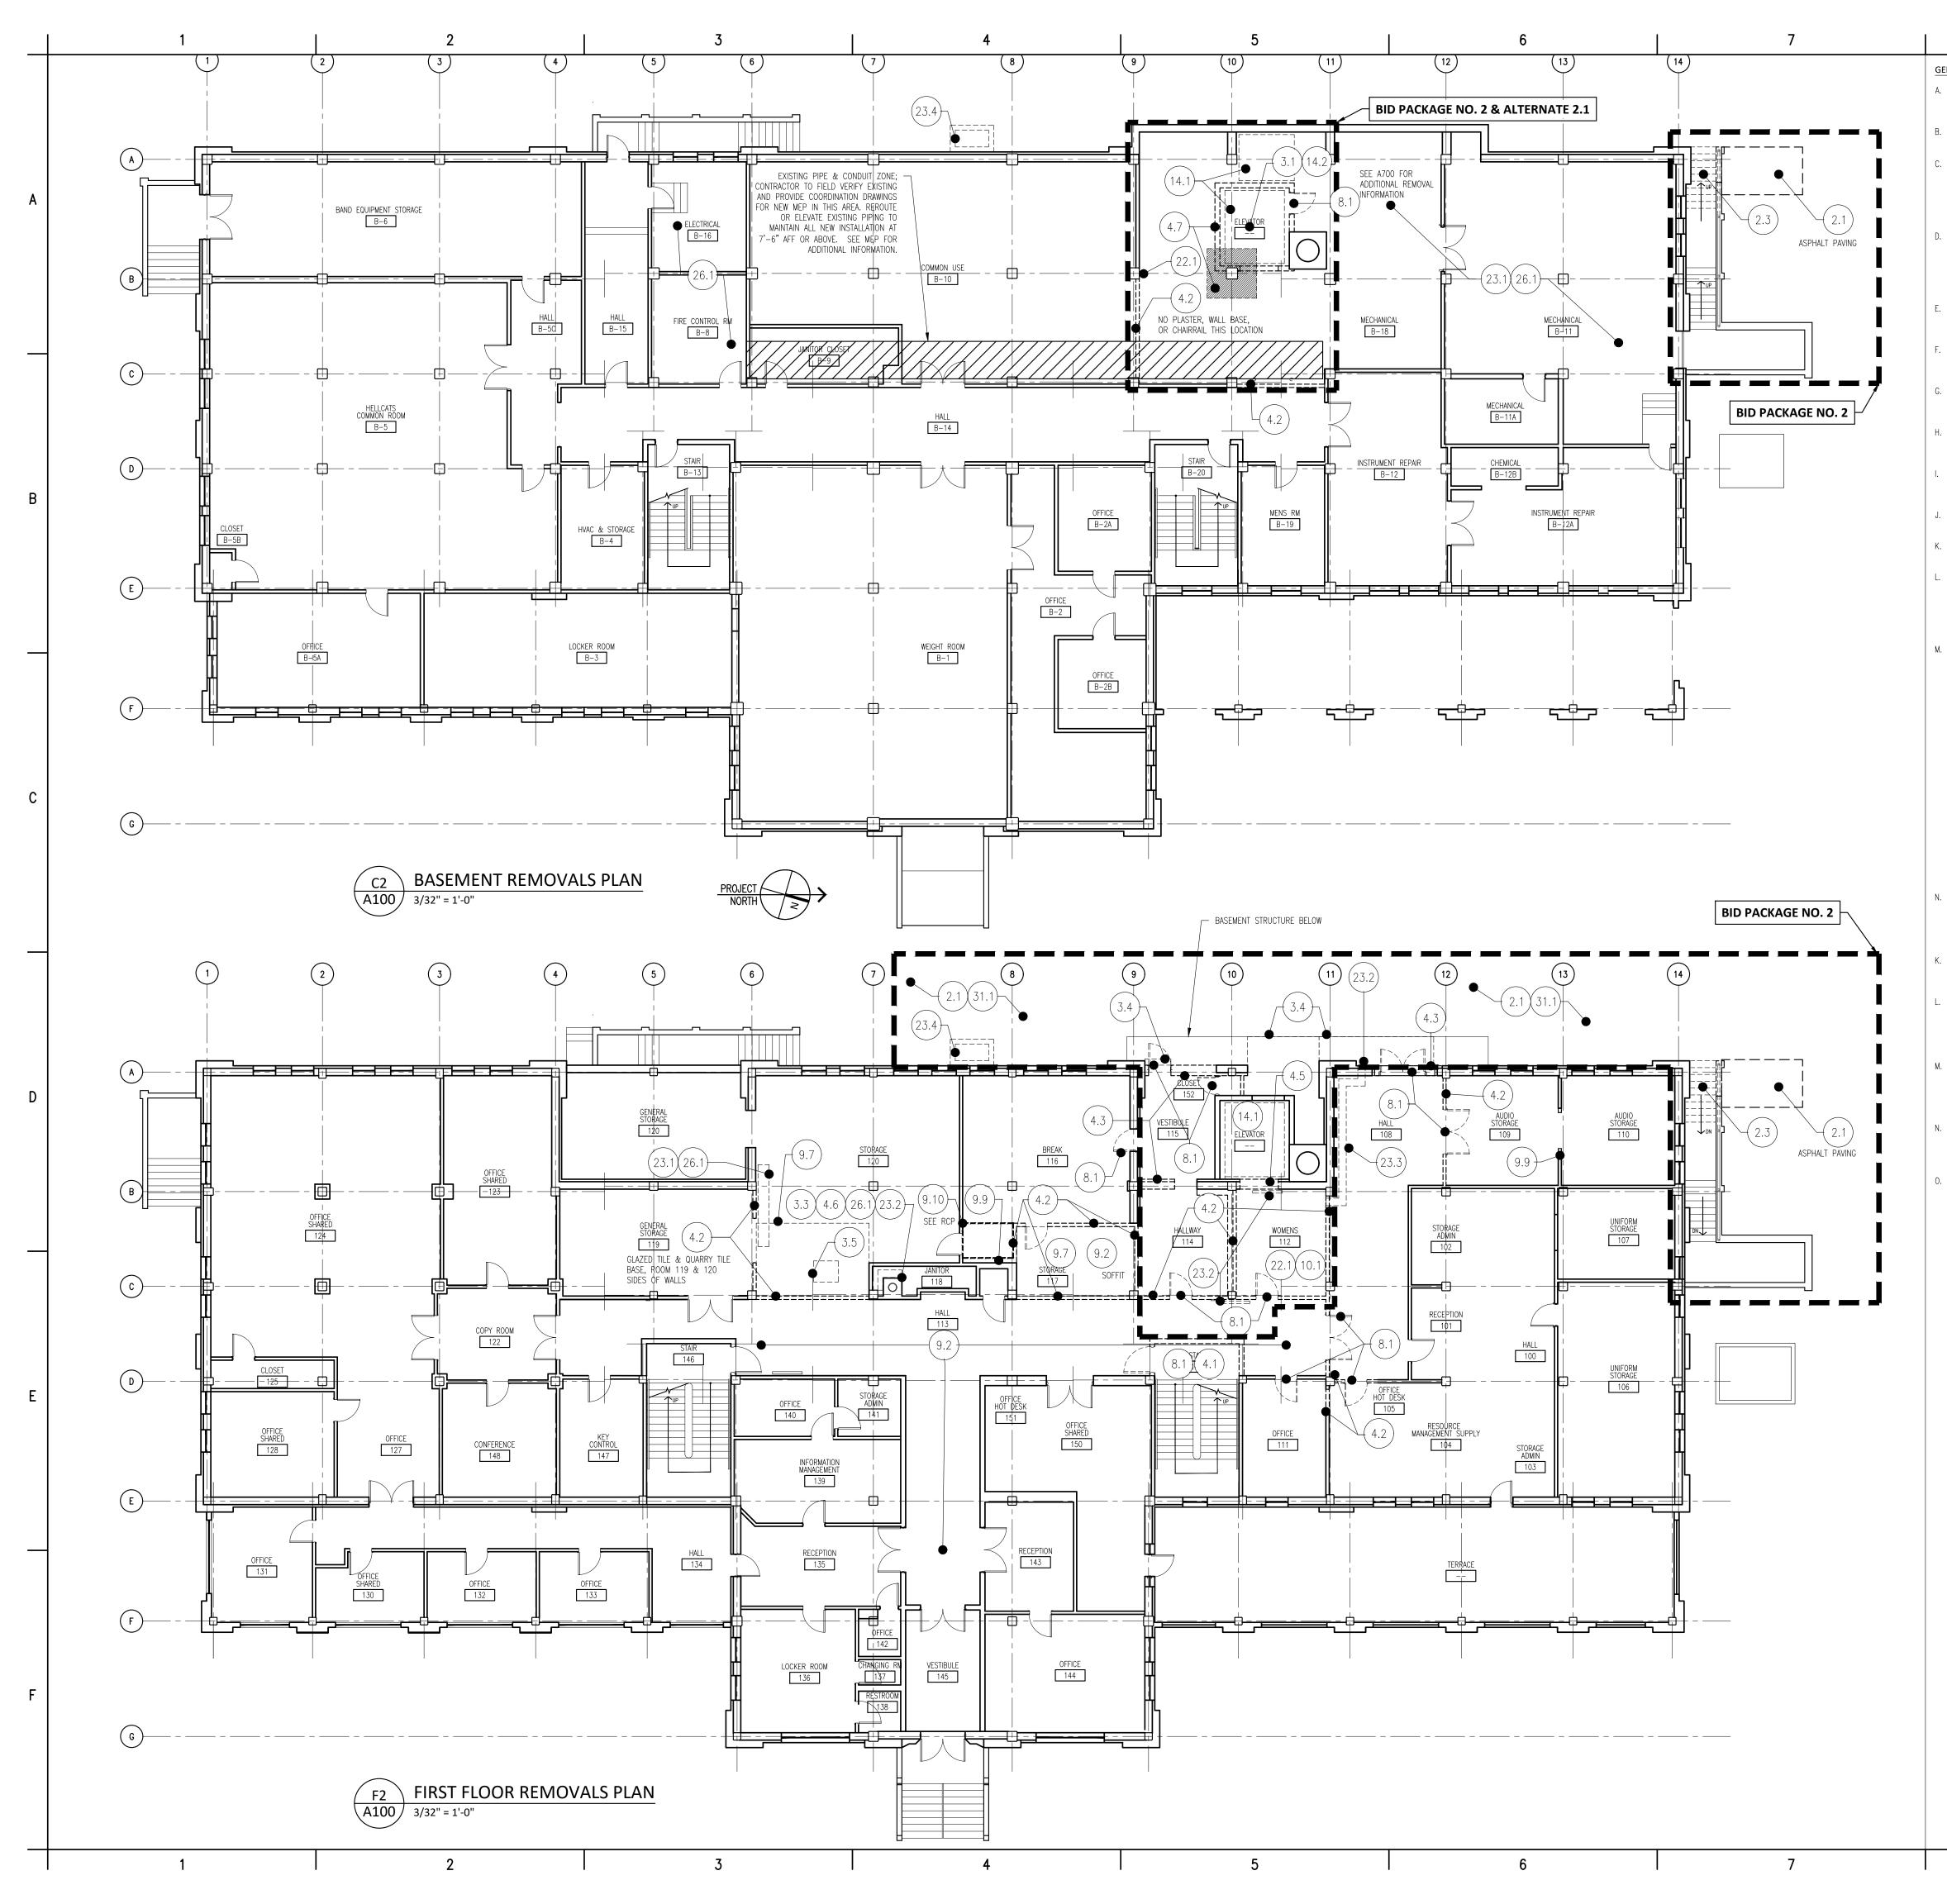

GENERAL REMOVALS NOTES: A. PROTECT ALL EXISTING AND HISTORIC FABRIC TO REMAIN DURING DISMANTLING, REMOVALS, AND CONSTRUCTION ACTIVITIES.

PHOTOGRAPH, SURVEY, AND RECORD LOCATIONS, DIMENSIONS, AND ELEVATIONS PRIOR TO REMOVAL OF ANY STRUCTURE.

ASBESTOS CONTAINING MATERIALS (ACM), LEAD PAINT, AND OTHER HAZARDOUS MATERIALS ARE PRESENT IN THE BUILDING. A REPORT ON THE PRESENCE OF HAZARDOUS MATERIALS IS ON FILE FOR REVIEW AND USE BY THE CONTRACTOR. SEE SEPARATE DOCUMENTS FOR REMOVAL OF HAZARDOUS MATERIALS.

. GC TO COORDINATE SAFE REMOVAL OF ALL ITEMS SCHEDULED TO BE DISMANTLED AND REINSTALLED. AND STORE IN WEATHERPROOF AREA TO BE PROVIDED BY GC. ALL OTHER MATERIALS, TRASH, DEBRIS, FURNISHINGS, ETC. NOT SCHEDULED FOR REINSTALLATION SHALL BE REMOVED AND DISPOSED OF BY GC.

ALL MATERIALS REMOVED AND SCHEDULED FOR REINSTALLATION SHALL BE LABELED FOR REINSTALLATION IN ORIGINAL LOCATION, U.N.O.

COORDINATE DEMOLITION WORK WITH ARCHITECTURAL, CIVIL, STRUCTURAL, MECHANICAL, ELECTRICAL, PLUMBING, AND FIRE PROTECTION, HAZARDOUS MATERIALS, AND AV DRAWINGS.

PROVIDE TEMPORARY SHORING AS REQUIRED TO SAFELY PERFORM THE WORK. SEE STRUCTURAL DRAWINGS FOR SHORING REQUIREMENTS.

PROVIDE TEMPORARY WEATHER PROTECTION FOR ENTIRE STRUCTURE DURING DEMOLITION & CONSTRUCTION ACTIVITIES. SEE DIVISION 1 REQUIREMENTS.

REMOVAL OF PAINT WILL INCLUDE COATINGS CONTAINING LEAD–BASED PAINT. PREPARE WOOD AND METAL SUBSTRATES FOR REPAIRS, PRIMING, & NEW FINISHES AS SCHEDULED. . SEE SCHEDULE SHEETS FOR NEW AND EXISTING DOORS AND FINISHES.

. REMOVE ALL MISCELLANEOUS DEBRIS FROM SURFACES AND FROM WITHIN CONCEALED CEILING, FLOOR, AND WALL CAVITIES.

THE GC SHALL COORDINATE AND MANAGE ALL DISCONNECTIONS, CAPPINGS, REMOVALS, AND RELOCATIONS OF ACTIVE SERVICES WITH THE APPROPRIATE TRADE CONTRACTOR TO ENSURE THAT SERVICE AND RELOCATIONS MEET REQUIREMENTS FOR NEW SERVICES AND SYSTEMS INDICATED ON THE DRAWINGS.

M. THE GC SHALL COORDINATE AND MANAGE CUTTING WORK TO BE PROVIDED BY EACH TRADE CONTRACTOR. GC WILL PROVIDE PATCHING FOLLOWING CUTTING AND INSTALLATION WORK OF THE TRADE CONTRACTORS. WHERE CUTTING AND PATCHING OF MATERIALS PROVIDED UNDER THIS CONTRACT IS REQUIRED, EMPLOY THE ORIGINAL INSTALLER OR FABRICATOR TO PERFORM CUTTING AND PATCHING OF: STRUCTURAL STEEL AND CONCRETE; WEATHER-EXPOSED ELEMENTS; MOISTURE AND CORROSION-RESISTANT ELEMENTS; FIRE-RESISTANT ELEMENTS; AND SIGHT-EXPOSED FINISHED SURFACES.

NOT ALL REQUIRED OPENINGS AND PENETRATIONS ARE SHOWN ON DRAWINGS. EACH TRADE CONTRACTOR SHALL IDENTIFY THE NUMBER, EXACT LOCATION, AND DIMENSION OF ALL CUTTING AND PATCHING LOCATIONS AND SUBMIT A PROPOSED

SCHEDULE AND WORK PLAN PRIOR TO PROCEEDING. EACH TRADE CONTRACTOR SHALL IDENTIFY FULL SIZE LOCATIONS USING COLORED MASKING TAPE ON SURFACES PROPOSED TO BE CUT. THE WORK PLAN SHALL BE USED TO COORDINATE WITH ALL TRADE CONTRACTORS TO MINIMIZE NUMBER OF PENETRATIONS REQUIRED. ALL LOCATIONS MUST BE APPROVED BY THE ARCHITECT AND ENGINEERS PRIOR TO PROCEEDING WITH CUTTING WORK.

. UNLESS NOTED OTHERWISE, REMOVE EXISTING PROJECTIONS, HANGERS, BOLTS, NAILS, BRACKETS, VALANCES, ETC. FROM EXISTING WALLS, COLUMNS, ARCH OPENINGS, ETC. PATCH ALL HOLES TO MATCH ADJACENT SURFACES AND/OR PROVIDE NEW SCHEDULED FINISHES.

UNLESS NOTED OTHERWISE. REMOVE ALL EXTERIOR ELECTRICAL FIXTURES, CONDUIT, HANGERS, ATTACHMENTS, ETC. WITHIN THE WORK AREAS; SEE ELECTRICAL DRAWINGS.

UNLESS NOTED OTHERWISE, REMOVE ALL ELECTRICAL DEVICES INCLUDING LIGHTS, SWITCHES, RECEPTACLES, AND FIRE & SECURITY SYSTEM COMPONENTS; SEE ELECTRICAL DRAWINGS. REVIEW W/ARCHITECT PRIOR TO PROCEEDING. COORDINATE REUSE W/OWNER & ARCHITECT.

REMOVE ALL EXISTING PIPING & RELATED ANCHORAGES EXCEPT AS NOTED TO REMAIN FOR CONNECTION TO NEW SYSTEMS. SEE MECHANICAL, PLUMBING, AND ELECTRICAL DRAWINGS FOR ADDITIONAL INFORMATION AND FOR REUSE OF EXISTING RADIATORS.

WHERE EXISTING CONSTRUCTION TO REMAIN IS DISTURBED DUE TO MECHANICAL, PLUMBING, ELECTRICAL OR OTHER REQUIRED DEMOLITION, REPAIR TO MATCH EXISTING ADJACENT AND/OR SIMILAR SURFACES AND MATERIALS U.N.O.

PROTECT ALL ORIGINAL AND EXISTING FABRIC THAT IS SCHEDULED TO REMAIN DURING DEMOLITION AND

CONSTRUCTION.

2.0 SITE CONSTRUCTION & HARDSCAPING

- 2.1 REMOVE HARDSCAPE, PAVING, LIGHT FIXTURES, ETC. SEE CIVIL DRAWINGS FOR SITE REMOVALS AND UTILITIES RELOCATIONS
- REMOVE PORTION OF CONCRETE STEPS AND METAL RAILING; SEE CIVIL DRAWINGS AND DETAIL PLANS, A700 SERIES

3.0 CONCRETE

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REMOVALS KEYNOTES:

- .1 REMOVE CONCRETE SLAB ON GRADE 3.2 REMOVE CONCRETE SLAB FOR NEW HVAC; SEE STRUCTURAL
- CORE CONCRETE SLAB FOR NEW MEP; SEE STRUCTURAL & 3.3 MEP DRAWINGS
- REMOVE CONCRETE TOPPING SLABS AND STEPS OVERBUILT ON BASEMENT ROOF SLAB; SEE CIVIL DRAWINGS 3.5 REMOVE CONCRETE HOUSEKEEPING PAD

4.0 MASONRY

- 4.1 REMOVE CMU WALL REMOVE HOLLOW TILE NON-BEARING PARTITIONS WITH 4.2 PLASTER FINISH. SALVAGE TERRAZZO WALL BASE AND WOOD CHAIRRAIL TRIM FOR REUSE (SIZE VARIES, 4" AND 6" HOLLOW THE) 4.3 REMOVE EXTERIOR BRICK MASONRY WALL IN ITS ENTIRETY;
- BRICK VENEER AND HOLLOW TILE BACK UP. FOR REMOVAL AT COLUMN LINE 'A' REMOVE BRICK TO BELOW LEVEL OF NEW SLAB (APPROX. 10"). REMOVE MASONRY INFILL AT ORIGINAL WINDOW OPENINGS; SEE ELEVATION DIAGRAM
- REMOVE BRICK MASONRY FOR NEW HOISTWAY DOOR OPENING; SEE STRUCTURAL FOR NEW LINTEL 4.6 REMOVED ABANDONED TERRA COTTA EXHAUST FLUES; EXCEPT FOR PATHWAY FOR NEW UTILITIES, CAP AT
- UNDERSIDE OF ROOF DECK REMOVE BASEMENT LEVEL BRICK MASONRY HOISTWAY BEARING WALLS & FOOTINGS AND COLUMN FOOTING @ GRID B-10 FOR ELEVATOR PIT; SEE STRUCTURAL
- DRAWINGS FOR SHORING REQUIREMENTS REMOVE HOLLOW TILE FOR NEW DUCT OR UTILITY OPENING; REMOVE TO UNDERSIDE OF BEAM OR DECK OR PROVIDE LINTEL. COORDINATE SIZE & BOTTOM OF OPENING WITH DUCT SIZE AND BOTTOM OF DUCT
- REMOVE AND SALVAGE GLAZED BLOCK AND TERRAZZO WALL BASE FOR REINSTALLATION IN EXISTING LOCATION REMOVE BRICK MASONRY CHIMNEY AND 12" DIA TERRA 4.10
- COTTA FLUE ABOVE 3RD FLOOR SLAB TO APPROX. 20" ABOVE ROOF SLAB (LEAVE ONE COURSE ABOVE EXISTING FLASHING)

METALS

5.1 REMOVE METAL RAILINGS

6.0 WOOD AND PLASTICS

- 7.0 THERMAL & MOISTURE PROTECTION
- REMOVE ROOFING AS REQUIRED AROUND NEW MECHANICAL OPENINGS AND ELEVATOR HOISTWAY; SEE MECHANICAL AND ROOFING DETAILS

DOORS AND WINDOWS 8.0

- REMOVE DOOR, FRAME, AND ATTACHMENTS; AT LOCATIONS WITH TRANSOM, REMOVE TRANSOM FRAME & PANEL REMOVE WINDOW OR LOUVER, FRAME, AND ATTACHMENTS
- REMOVE EXISTING DOOR, TRANSOM, FRAME, & HARDWARE. LABEL & STORE FOR OWNER WHERE DIRECTED ON SITE. 9.0 INTERIOR FINISHES

- 9.1 REMOVE INTERIOR DRYWALL PARTITIONS, WALL BASE, AND REMOVE CEILING SYSTEM IN ITS ENTIRETY, CEILING FINISHES AND LIGHTING
- REMOVE COLUMN COVERS 9.4 REMOVE ACOUSTIC WALL CONSTRUCTION IN ITS ENTIRFTY 9.5 REMOVE VINYL FLOORING, RESILIENT WALL BASE, AND
 - MASTIC REMOVE SURFACE-MOUNTED ACOUSTICAL PANELS FROM
 - WALLS AND CEILING REMOVE QUARRY TILE FLOORING, WALL BASE, AND SETTING
- REMOVE WOOD FLOORING AND UNDERLAYMENTS REMOVE DRYWALL CONSTRUCTION, WALL BASE, AND
- RELATED FRAMING, ATTACHMENTS, FINISHES, ETC. 9.10 REMOVE PORTION OF CEILING AS REQUIRED FOR MEP INSTALLATION; SEE RCP AND MEP DRAWINGS

10.0 SPECIALTIES

10.1 REMOVE TOILET PARTITIONS AND TOILET ROOM ACCESSORIES

11.0 EQUIPMENT

11.1 EXISTING SEATING-PLATFORM RISERS TO BE INSTALLED IN NEW CONFIGURATION WITHOUT 4TH/TOP RISER; SEE PLANS AND ELEVATIONS. DELIVER UNUSED SECTIONS TO OWNER

12.0 FURNISHINGS

12.1 REMOVE HIGH-DENSITY LIBRARY STORAGE SHELVING UNITS FOR REINSTALLATION 12.2 REMOVE ACOUSTIC DIFFUSION CABINET FOR REINSTALLATION

13.0 SPECIAL CONSTRUCTION

- 14.0 CONVEYING SYSTEMS
- 14.1 REMOVE ELEVATOR SYSTEM IN ITS ENTIRETY INCLUDING CAB, HOISTWAY DOORS & JAMBS, LIFT EQUIPMENT, MOTOR, PLUNGER, GRATING PLATFORM AND SUPPORTS, HYDRAULICS, ETC. HOISTWAY WALLS TO REMAIN BELOW ROOF; SEE DRAWINGS FOR REMOVALS RELATED TO ALTERNATE NO. 2.1
- 14.2 EXCAVATE FOR NEW ELEVATOR PIT REMOVE ROOFING, ROOF DECK, ROOF FRAMING, AND MASONRY HOISTWAY WALLS DOWN TO EXISTING CONCRETE ROOF DECK
- 22.0 PLUMBING SEE PLUMBING DRAWINGS
- 22.1 REMOVE PLUMBING FIXTURES
- 23.0 MECHANICAL SEE MECHANICAL DRAWINGS
- 23.1 SEE MECHANICAL AND PLUMBING FOR EQUIPMENT TO BE MAINTAINED IN SERVICE OR RELOCATED
- 23.2 REMOVE MECHANICAL EQUIPMENT
- 23.3 REMOVE DUCTWORK 23.4 REMOVE GREASE INTERCEPTOR STRUCTURE, ACCESS DOORS, AND PIPING. CUT AND CAP AT BUILDING INTERIOR
- OR REMOVE DRAIN AND RELATED PIPING IN ITS ENTIRETY; SEE CIVIL DRAWINGS 23.5 REMOVE MECHANICAL ROOF PENTHOUSE AND SHAFT FLOOR
- INFILL CONSTRUCTION 26.0 ELECTRICAL – SEE ELECTRICAL DRAWINGS
- 26.1 SEE ELECTRICAL FOR EQUIPMENT TO BE MAINTAINED IN SERVICE OR RELOCATED, AND EQUIPMENT TO BE REMOVED
- 31.0 UTILITIES SEE CIVIL DRAWINGS
- 31.1 SEE CIVIL FOR UTILITIES RELOCATION

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Date

07-06-2022

Issue Issued For

Bid & Permit

PRELIMINARY Not For Construction

Key Plan


EGNER HALL BUILDING 685

U.S. MILITARY ACADEMY West Point, New York

Project No.: 11300 Date: July 06, 2022

Drawing Title: Removals Plans Basement & First Floor

A100

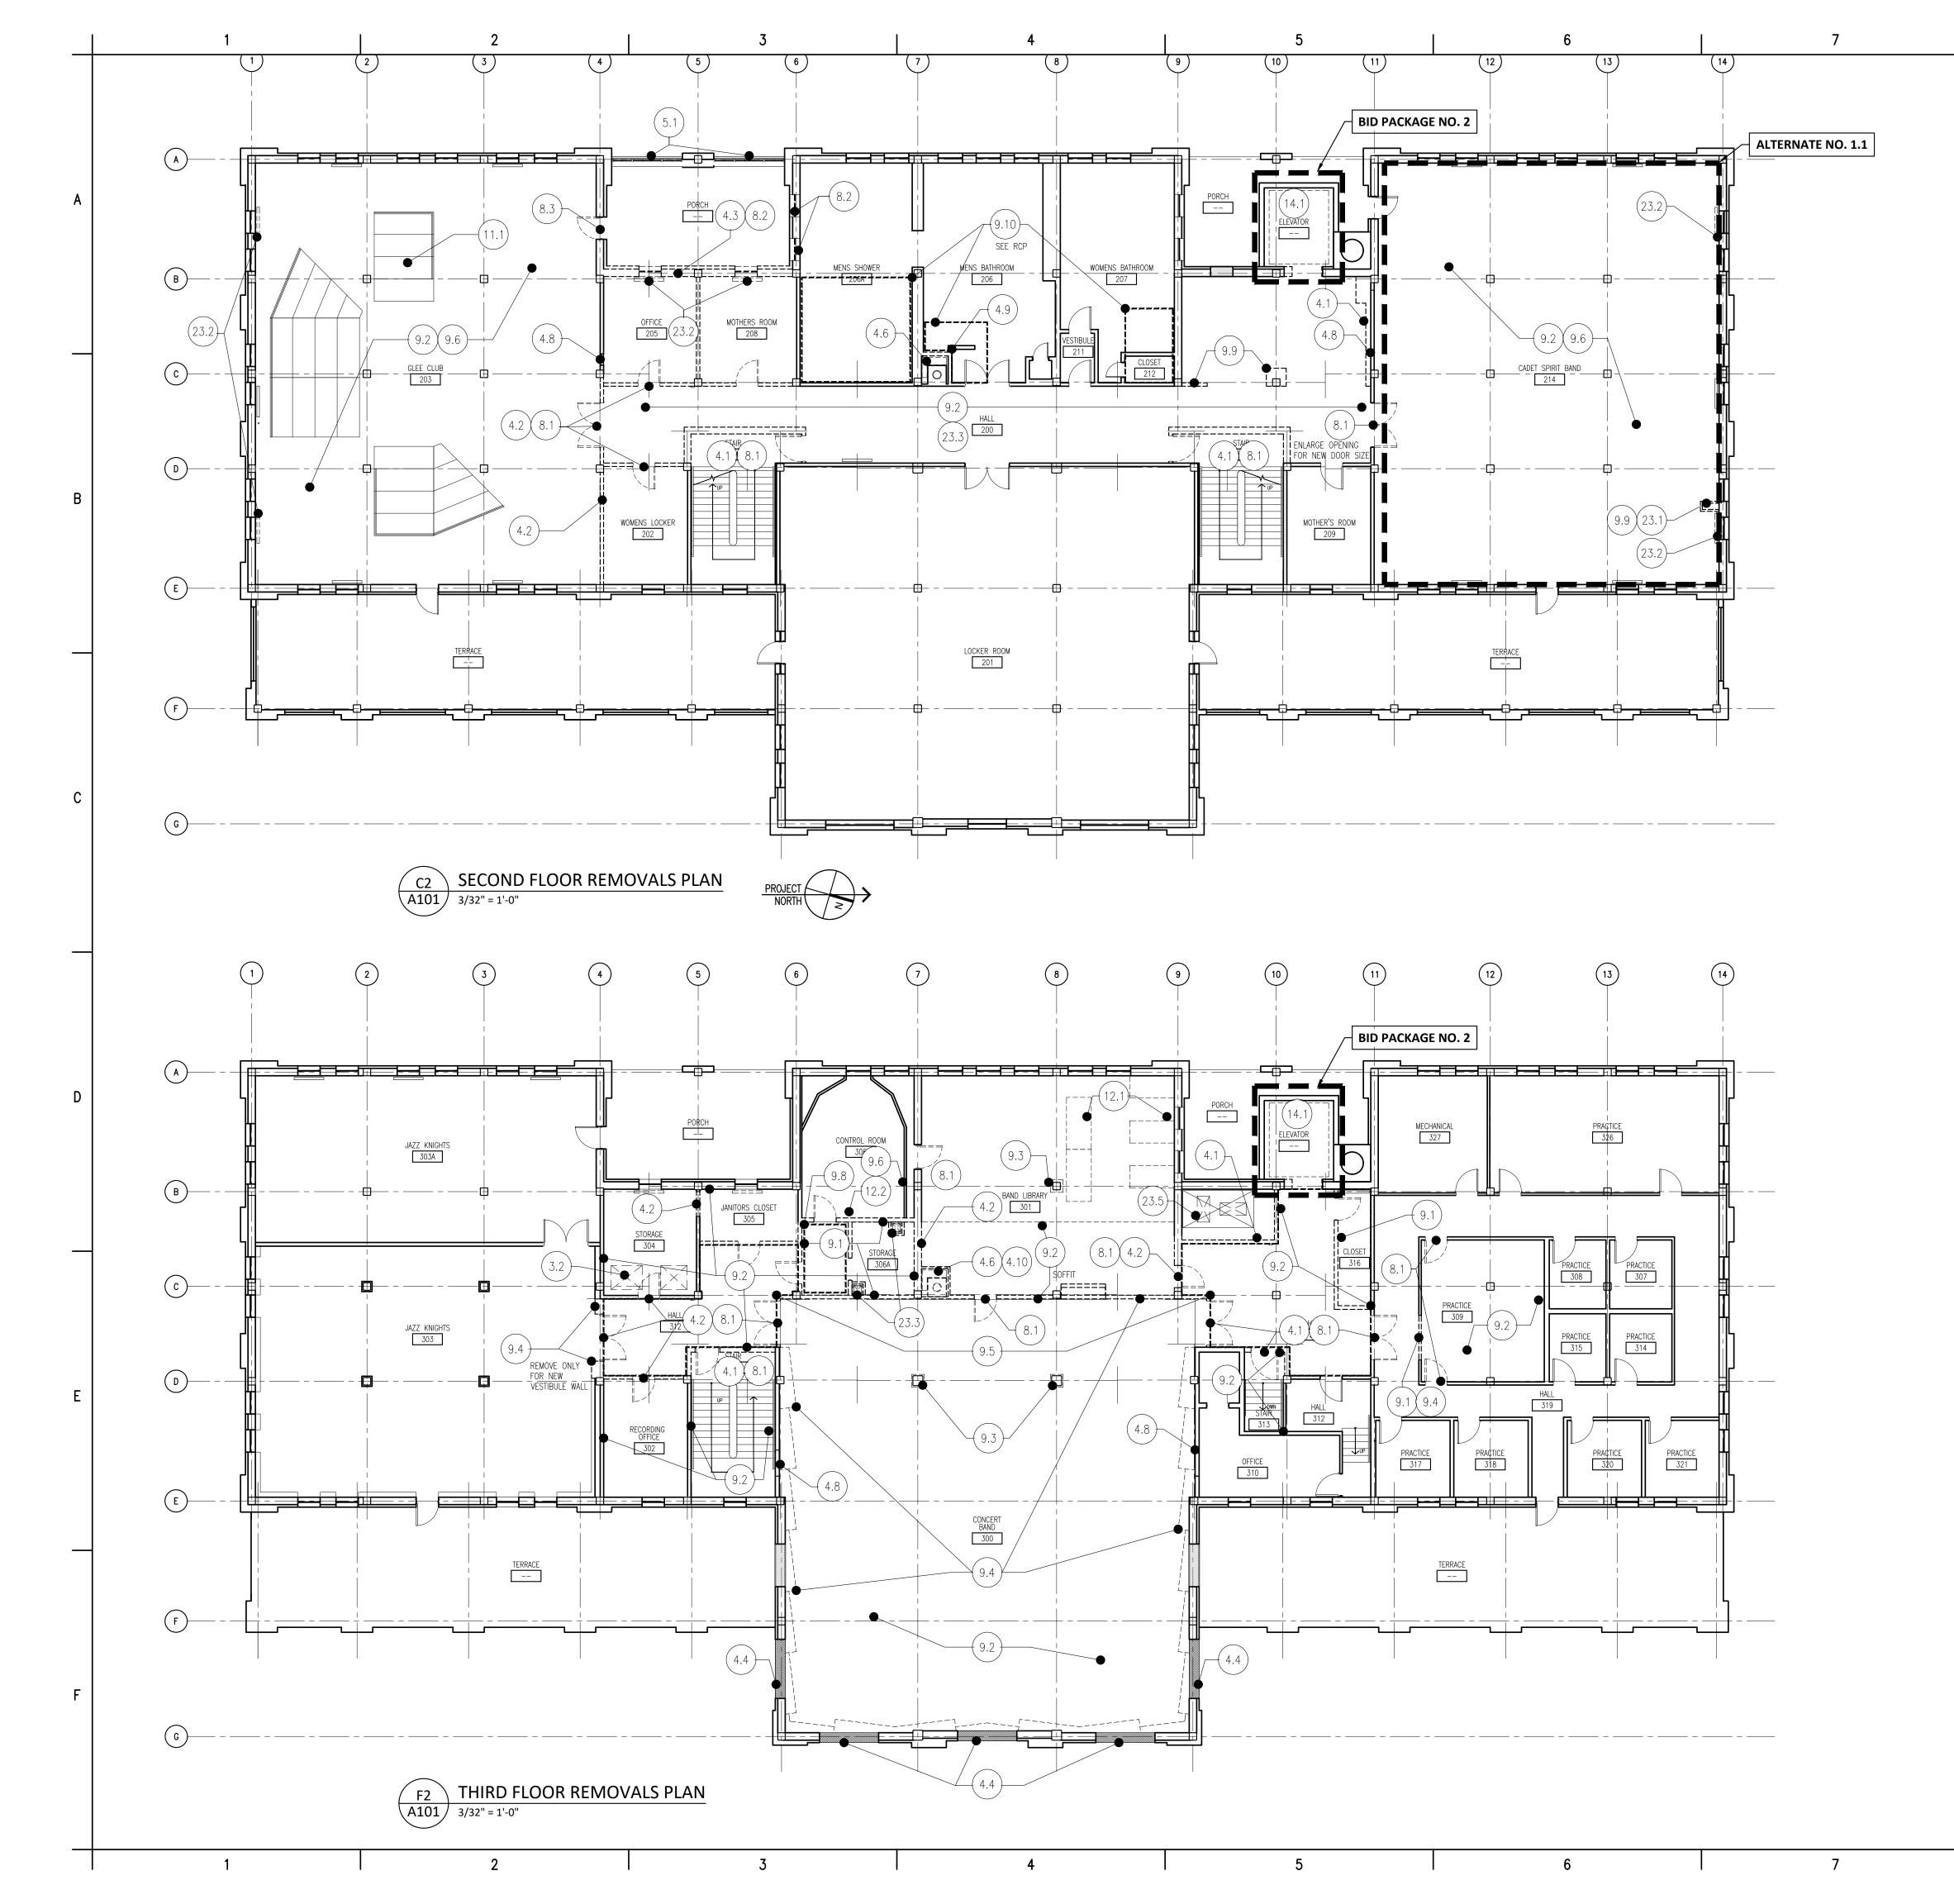

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- REMOVE CONCRETE TOPPING SLABS AND STEPS OVERBUILT 3.4 ON BASEMENT ROOF SLAB; SEE CIVIL DRAWINGS 3.5 REMOVE CONCRETE HOUSEKEEPING PAD

4.0 MASONRY

- 4.1 REMOVE CMU WALL REMOVE HOLLOW TILE NON-BEARING PARTITIONS WITH 4.2 PLASTER FINISH. SALVAGE TERRAZZO WALL BASE AND WOOD CHAIRRAIL TRIM FOR REUSE (SIZE VARIES, 4" AND 6" HOLLOW THE) 4.3 REMOVE EXTERIOR BRICK MASONRY WALL IN ITS ENTIRETY;
- BRICK VENEER AND HOLLOW TILE BACK UP. FOR REMOVAL AT COLUMN LINE 'A' REMOVE BRICK TO BELOW LEVEL OF NEW SLAB (APPROX. 10"). REMOVE MASONRY INFILL AT ORIGINAL WINDOW OPENINGS; SEE ELEVATION DIAGRAM
- REMOVE BRICK MASONRY FOR NEW HOISTWAY DOOR 4.5 OPENING; SEE STRUCTURAL FOR NEW LINTEL 4.6 REMOVED ABANDONED TERRA COTTA EXHAUST FLUES; EXCEPT FOR PATHWAY FOR NEW UTILITIES, CAP AT
- UNDERSIDE OF ROOF DECK REMOVE BASEMENT LEVEL BRICK MASONRY HOISTWAY BEARING WALLS & FOOTINGS AND COLUMN FOOTING @ GRID B-10 FOR ELEVATOR PIT; SEE STRUCTURAL
- DRAWINGS FOR SHORING REQUIREMENTS 4.8 REMOVE HOLLOW TILE FOR NEW DUCT OR UTILITY OPENING; REMOVE TO UNDERSIDE OF BEAM OR DECK OR PROVIDE LINTEL. COORDINATE SIZE & BOTTOM OF
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- COTTA FLUE ABOVE 3RD FLOOR SLAB TO APPROX. 20" ABOVE ROOF SLAB (LEAVE ONE COURSE ABOVE EXISTING FLASHING)

METALS

5.1 REMOVE METAL RAILINGS

6.0 WOOD AND PLASTICS

- 7.0 THERMAL & MOISTURE PROTECTION
- REMOVE ROOFING AS REQUIRED AROUND NEW MECHANICAL OPENINGS AND ELEVATOR HOISTWAY; SEE MECHANICAL AND ROOFING DETAILS

DOORS AND WINDOWS

- REMOVE DOOR, FRAME, AND ATTACHMENTS; AT LOCATIONS WITH TRANSOM, REMOVE TRANSOM FRAME & PANEL REMOVE WINDOW OR LOUVER, FRAME, AND ATTACHMENTS
- REMOVE EXISTING DOOR, TRANSOM, FRAME, & HARDWARE. LABEL & STORE FOR OWNER WHERE DIRECTED ON SITE. 9.0 INTERIOR FINISHES

- 9.1 REMOVE INTERIOR DRYWALL PARTITIONS, WALL BASE, AND REMOVE CEILING SYSTEM IN ITS ENTIRETY, CEILING FINISHES AND LIGHTING
- REMOVE COLUMN COVERS 9.4 REMOVE ACOUSTIC WALL CONSTRUCTION IN ITS ENTIRFTY 9.5 REMOVE VINYL FLOORING, RESILIENT WALL BASE, AND
 - MASTIC REMOVE SURFACE-MOUNTED ACOUSTICAL PANELS FROM
 - WALLS AND CEILING REMOVE QUARRY TILE FLOORING, WALL BASE, AND SETTING
- REMOVE WOOD FLOORING AND UNDERLAYMENTS REMOVE DRYWALL CONSTRUCTION, WALL BASE, AND
- RELATED FRAMING, ATTACHMENTS, FINISHES, ETC. 9.10 REMOVE PORTION OF CEILING AS REQUIRED FOR MEP INSTALLATION; SEE RCP AND MEP DRAWINGS

10.0 SPECIALTIES

10.1 REMOVE TOILET PARTITIONS AND TOILET ROOM ACCESSORIES

11.0 EQUIPMENT

11.1 EXISTING SEATING-PLATFORM RISERS TO BE INSTALLED IN NEW CONFIGURATION WITHOUT 4TH/TOP RISER; SEE PLANS AND ELEVATIONS. DELIVER UNUSED SECTIONS TO OWNER

12.0 FURNISHINGS

12.1 REMOVE HIGH-DENSITY LIBRARY STORAGE SHELVING UNITS FOR REINSTALLATION 12.2 REMOVE ACOUSTIC DIFFUSION CABINET FOR REINSTALLATION

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- 14.0 CONVEYING SYSTEMS
- 14.1 REMOVE ELEVATOR SYSTEM IN ITS ENTIRETY INCLUDING CAB, HOISTWAY DOORS & JAMBS, LIFT EQUIPMENT, MOTOR, PLUNGER, GRATING PLATFORM AND SUPPORTS, HYDRAULICS, ETC. HOISTWAY WALLS TO REMAIN BELOW ROOF; SEE DRAWINGS FOR REMOVALS RELATED TO ALTERNATE NO. 2.1
- 14.2 EXCAVATE FOR NEW ELEVATOR PIT REMOVE ROOFING, ROOF DECK, ROOF FRAMING, AND MASONRY HOISTWAY WALLS DOWN TO EXISTING CONCRETE ROOF DECK
- 22.0 PLUMBING SEE PLUMBING DRAWINGS
- 22.1 REMOVE PLUMBING FIXTURES
- 23.0 MECHANICAL SEE MECHANICAL DRAWINGS
- 23.1 SEE MECHANICAL AND PLUMBING FOR EQUIPMENT TO BE MAINTAINED IN SERVICE OR RELOCATED
- 23.2 REMOVE MECHANICAL EQUIPMENT 23.3 REMOVE DUCTWORK
- 23.4 REMOVE GREASE INTERCEPTOR STRUCTURE, ACCESS
- DOORS, AND PIPING. CUT AND CAP AT BUILDING INTERIOR OR REMOVE DRAIN AND RELATED PIPING IN ITS ENTIRETY; SEE CIVIL DRAWINGS 23.5 REMOVE MECHANICAL ROOF PENTHOUSE AND SHAFT FLOOR
- INFILL CONSTRUCTION 26.0 ELECTRICAL – SEE ELECTRICAL DRAWINGS
- 26.1 SEE ELECTRICAL FOR EQUIPMENT TO BE MAINTAINED IN SERVICE OR RELOCATED, AND EQUIPMENT TO BE REMOVED

9

- 31.0 UTILITIES SEE CIVIL DRAWINGS
- 31.1 SEE CIVIL FOR UTILITIES RELOCATION

Mark B. Thompson Associates Architecture 502 South 24th Street Philadelphia, PA 19146

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General Notes

alteration.

- 1. All dimensions and existing conditions shall be checked and verified by contractor at the site prior to proceeding with the work. 2. Contractor shall inform Architect/ Engineer of
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Date

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Issue Issued For Bid & Permit

PRELIMINARY Not For Construction

Key Plan


EGNER HALL BUILDING 685

U.S. MILITARY ACADEMY West Point, New York

Project No.: 11300 Date: July 06, 2022

Drawing Title: Removals Plans Second & Third Floors

A 1 0 1

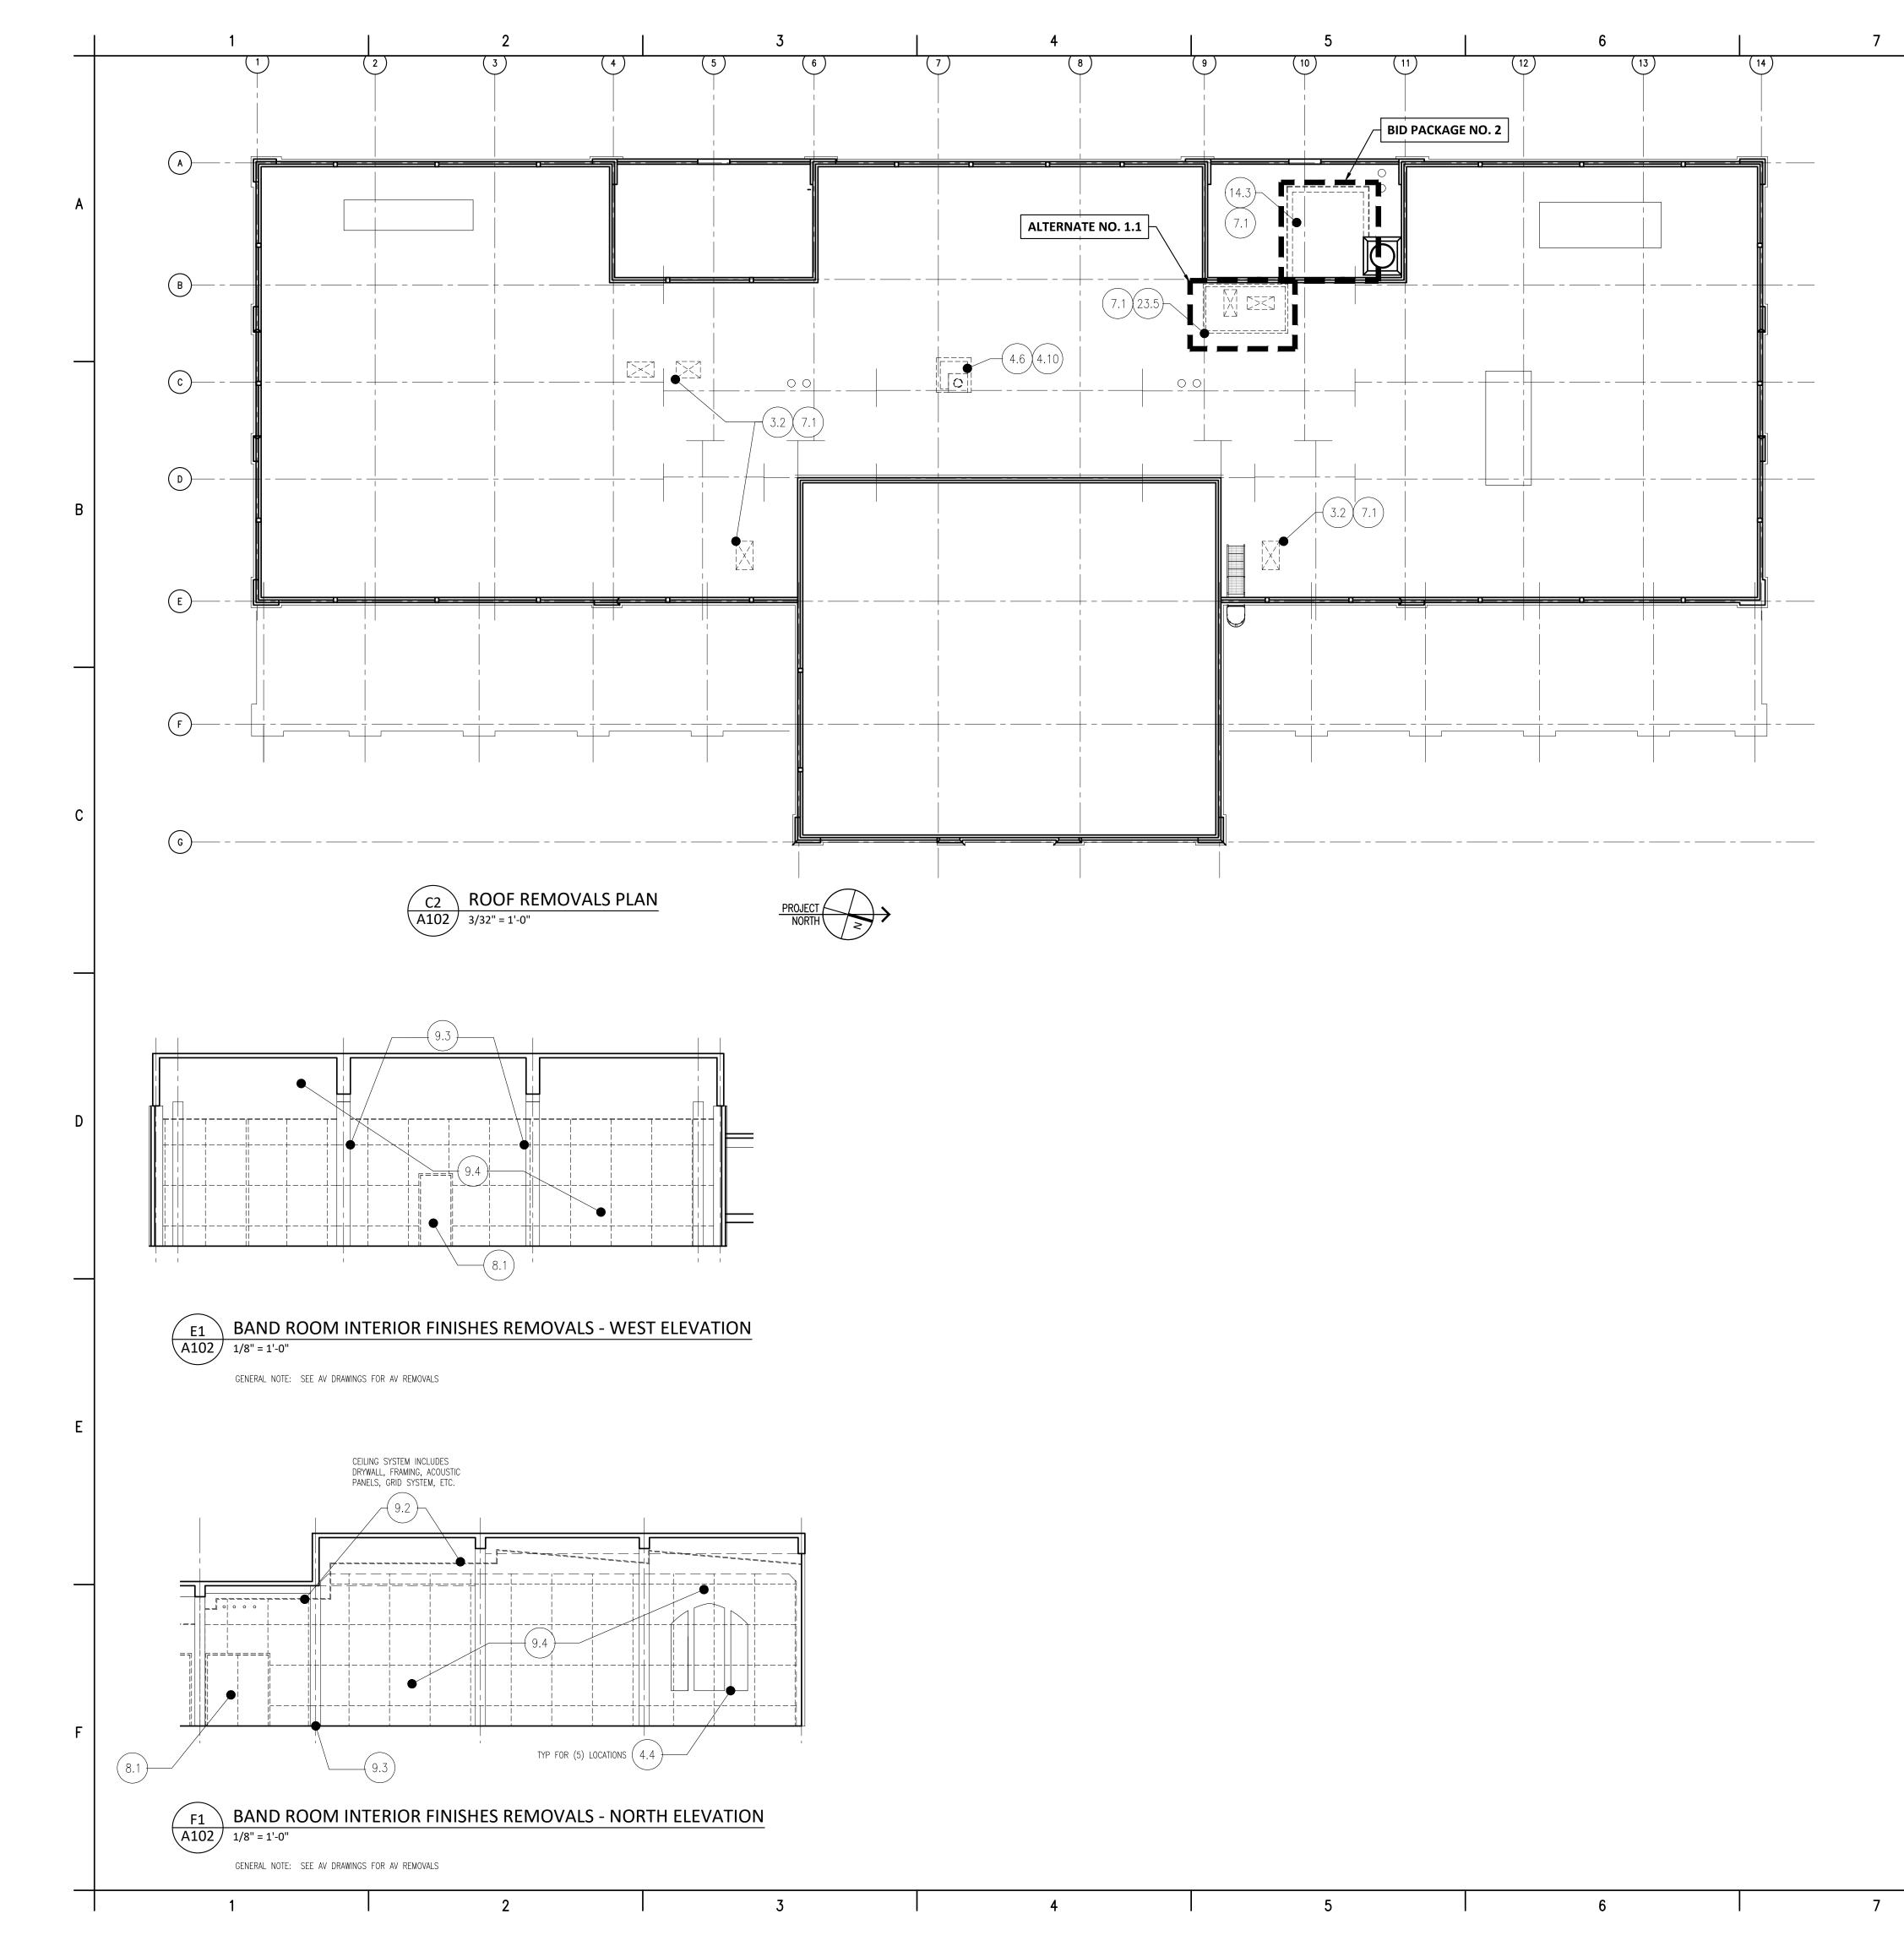

GENERAL REMOVALS NOTES: A. PROTECT ALL EXISTING AND HISTORIC FABRIC TO REMAIN DURING DISMANTLING, REMOVALS, AND CONSTRUCTION ACTIVITIES

B. PHOTOGRAPH, SURVEY, AND RECORD LOCATIONS, DIMENSIONS, AND ELEVATIONS PRIOR TO REMOVAL OF ANY STRUCTURE.

ASBESTOS CONTAINING MATERIALS (ACM), LEAD PAINT, AND OTHER HAZARDOUS MATERIALS ARE PRESENT IN THE BUILDING. A REPORT ON THE PRESENCE OF HAZARDOUS MATERIALS IS ON FILE FOR REVIEW AND USE BY THE CONTRACTOR. SEE SEPARATE DOCUMENTS FOR REMOVAL OF HAZARDOUS MATERIALS.

. GC TO COORDINATE SAFE REMOVAL OF ALL ITEMS SCHEDULED TO BE DISMANTLED AND REINSTALLED. AND STORE IN WEATHERPROOF AREA TO BE PROVIDED BY GC. ALL OTHER MATERIALS, TRASH, DEBRIS, FURNISHINGS, ETC. NOT SCHEDULED FOR REINSTALLATION SHALL BE REMOVED AND DISPOSED OF BY GC.

ALL MATERIALS REMOVED AND SCHEDULED FOR REINSTALLATION SHALL BE LABELED FOR REINSTALLATION IN ORIGINAL LOCATION, U.N.O.

COORDINATE DEMOLITION WORK WITH ARCHITECTURAL, CIVIL, STRUCTURAL, MECHANICAL, ELECTRICAL, PLUMBING, AND FIRE PROTECTION, HAZARDOUS MATERIALS, AND AV DRAWINGS.

PROVIDE TEMPORARY SHORING AS REQUIRED TO SAFELY PERFORM THE WORK. SEE STRUCTURAL DRAWINGS FOR SHORING REQUIREMENTS.

. PROVIDE TEMPORARY WEATHER PROTECTION FOR ENTIRE STRUCTURE DURING DEMOLITION & CONSTRUCTION ACTIVITIES. SEE DIVISION 1 REQUIREMENTS.

REMOVAL OF PAINT WILL INCLUDE COATINGS CONTAINING LEAD–BASED PAINT. PREPARE WOOD AND METAL SUBSTRATES FOR REPAIRS, PRIMING, & NEW FINISHES AS SCHEDULED. . SEE SCHEDULE SHEETS FOR NEW AND EXISTING DOORS AND FINISHES.

. REMOVE ALL MISCELLANEOUS DEBRIS FROM SURFACES AND FROM WITHIN CONCEALED CEILING, FLOOR, AND WALL CAVITIES. THE GC SHALL COORDINATE AND MANAGE ALL

DISCONNECTIONS, CAPPINGS, REMOVALS, AND RELOCATIONS OF ACTIVE SERVICES WITH THE APPROPRIATE TRADE CONTRACTOR TO ENSURE THAT SERVICE AND RELOCATIONS MEET REQUIREMENTS FOR NEW SERVICES AND SYSTEMS INDICATED ON THE DRAWINGS.

M. THE GC SHALL COORDINATE AND MANAGE CUTTING WORK TO BE PROVIDED BY EACH TRADE CONTRACTOR. GC WILL PROVIDE PATCHING FOLLOWING CUTTING AND INSTALLATION WORK OF THE TRADE CONTRACTORS. WHERE CUTTING AND PATCHING OF MATERIALS PROVIDED UNDER THIS CONTRACT IS REQUIRED, EMPLOY THE ORIGINAL INSTALLER OR FABRICATOR TO PERFORM CUTTING AND PATCHING OF: STRUCTURAL STEEL AND CONCRETE; WEATHER-EXPOSED ELEMENTS; MOISTURE AND CORROSION-RESISTANT ELEMENTS; FIRE-RESISTANT ELEMENTS; AND SIGHT-EXPOSED FINISHED SURFACES.

NOT ALL REQUIRED OPENINGS AND PENETRATIONS ARE SHOWN ON DRAWINGS. EACH TRADE CONTRACTOR SHALL IDENTIFY THE NUMBER, EXACT LOCATION, AND DIMENSION OF ALL CUTTING AND PATCHING LOCATIONS AND SUBMIT A PROPOSED

SCHEDULE AND WORK PLAN PRIOR TO PROCEEDING. EACH TRADE CONTRACTOR SHALL IDENTIFY FULL SIZE LOCATIONS USING COLORED MASKING TAPE ON SURFACES PROPOSED TO BE CUT. THE WORK PLAN SHALL BE USED TO COORDINATE WITH ALL TRADE CONTRACTORS TO MINIMIZE NUMBER OF PENETRATIONS REQUIRED. ALL LOCATIONS MUST BE APPROVED BY THE ARCHITECT AND ENGINEERS PRIOR TO PROCEEDING WITH CUTTING WORK.

I. UNLESS NOTED OTHERWISE, REMOVE EXISTING PROJECTIONS, HANGERS, BOLTS, NAILS, BRACKETS, VALANCES, ETC. FROM EXISTING WALLS, COLUMNS, ARCH OPENINGS, ETC. PATCH ALL HOLES TO MATCH ADJACENT SURFACES AND/OR PROVIDE NEW SCHEDULED FINISHES.

UNLESS NOTED OTHERWISE. REMOVE ALL EXTERIOR ELECTRICAL FIXTURES, CONDUIT, HANGERS, ATTACHMENTS, ETC. WITHIN THE WORK AREAS; SEE ELECTRICAL DRAWINGS.

UNLESS NOTED OTHERWISE, REMOVE ALL ELECTRICAL DEVICES INCLUDING LIGHTS, SWITCHES, RECEPTACLES, AND FIRE & SECURITY SYSTEM COMPONENTS; SEE ELECTRICAL DRAWINGS. REVIEW W/ARCHITECT PRIOR TO PROCEEDING. COORDINATE REUSE W/OWNER & ARCHITECT.

M. REMOVE ALL EXISTING PIPING & RELATED ANCHORAGES EXCEPT AS NOTED TO REMAIN FOR CONNECTION TO NEW SYSTEMS. SEE MECHANICAL, PLUMBING, AND ELECTRICAL DRAWINGS FOR ADDITIONAL INFORMATION AND FOR REUSE OF EXISTING RADIATORS.

. WHERE EXISTING CONSTRUCTION TO REMAIN IS DISTURBED DUE TO MECHANICAL, PLUMBING, ELECTRICAL OR OTHER REQUIRED DEMOLITION, REPAIR TO MATCH EXISTING ADJACENT AND/OR SIMILAR SURFACES AND MATERIALS U.N.O.

PROTECT ALL ORIGINAL AND EXISTING FABRIC THAT IS SCHEDULED TO REMAIN DURING DEMOLITION AND

CONSTRUCTION.

2.0 SITE CONSTRUCTION & HARDSCAPING

- 2.1 REMOVE HARDSCAPE, PAVING, LIGHT FIXTURES, ETC. SEE CIVIL DRAWINGS FOR SITE REMOVALS AND UTILITIES RELOCATIONS NOT USED
- REMOVE PORTION OF CONCRETE STEPS AND METAL RAILING; SEE CIVIL DRAWINGS AND DETAIL PLANS, A700 SERIES

3.0 CONCRETE

REMOVALS KEYNOTES:

- 3.1 REMOVE CONCRETE SLAB ON GRADE 3.2 REMOVE CONCRETE SLAB FOR NEW HVAC; SEE STRUCTURAL
- 3.3 CORE CONCRETE SLAB FOR NEW MEP; SEE STRUCTURAL & MEP DRAWINGS
- REMOVE CONCRETE TOPPING SLABS AND STEPS OVERBUILT 3.4 ON BASEMENT ROOF SLAB; SEE CIVIL DRAWINGS 3.5 REMOVE CONCRETE HOUSEKEEPING PAD

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- 9.6 WALLS AND CEILING REMOVE QUARRY TILE FLOORING, WALL BASE, AND SETTING
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10.0 SPECIALTIES

9.7

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9.9

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- 26.0 ELECTRICAL SEE ELECTRICAL DRAWINGS
- 26.1 SEE ELECTRICAL FOR EQUIPMENT TO BE MAINTAINED IN SERVICE OR RELOCATED, AND EQUIPMENT TO BE REMOVED
- 31.0 UTILITIES SEE CIVIL DRAWINGS
- 31.1 SEE CIVIL FOR UTILITIES RELOCATION

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Date

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Key Plan


BUILDING 685 U.S. MILITARY ACADEMY West Point, New York


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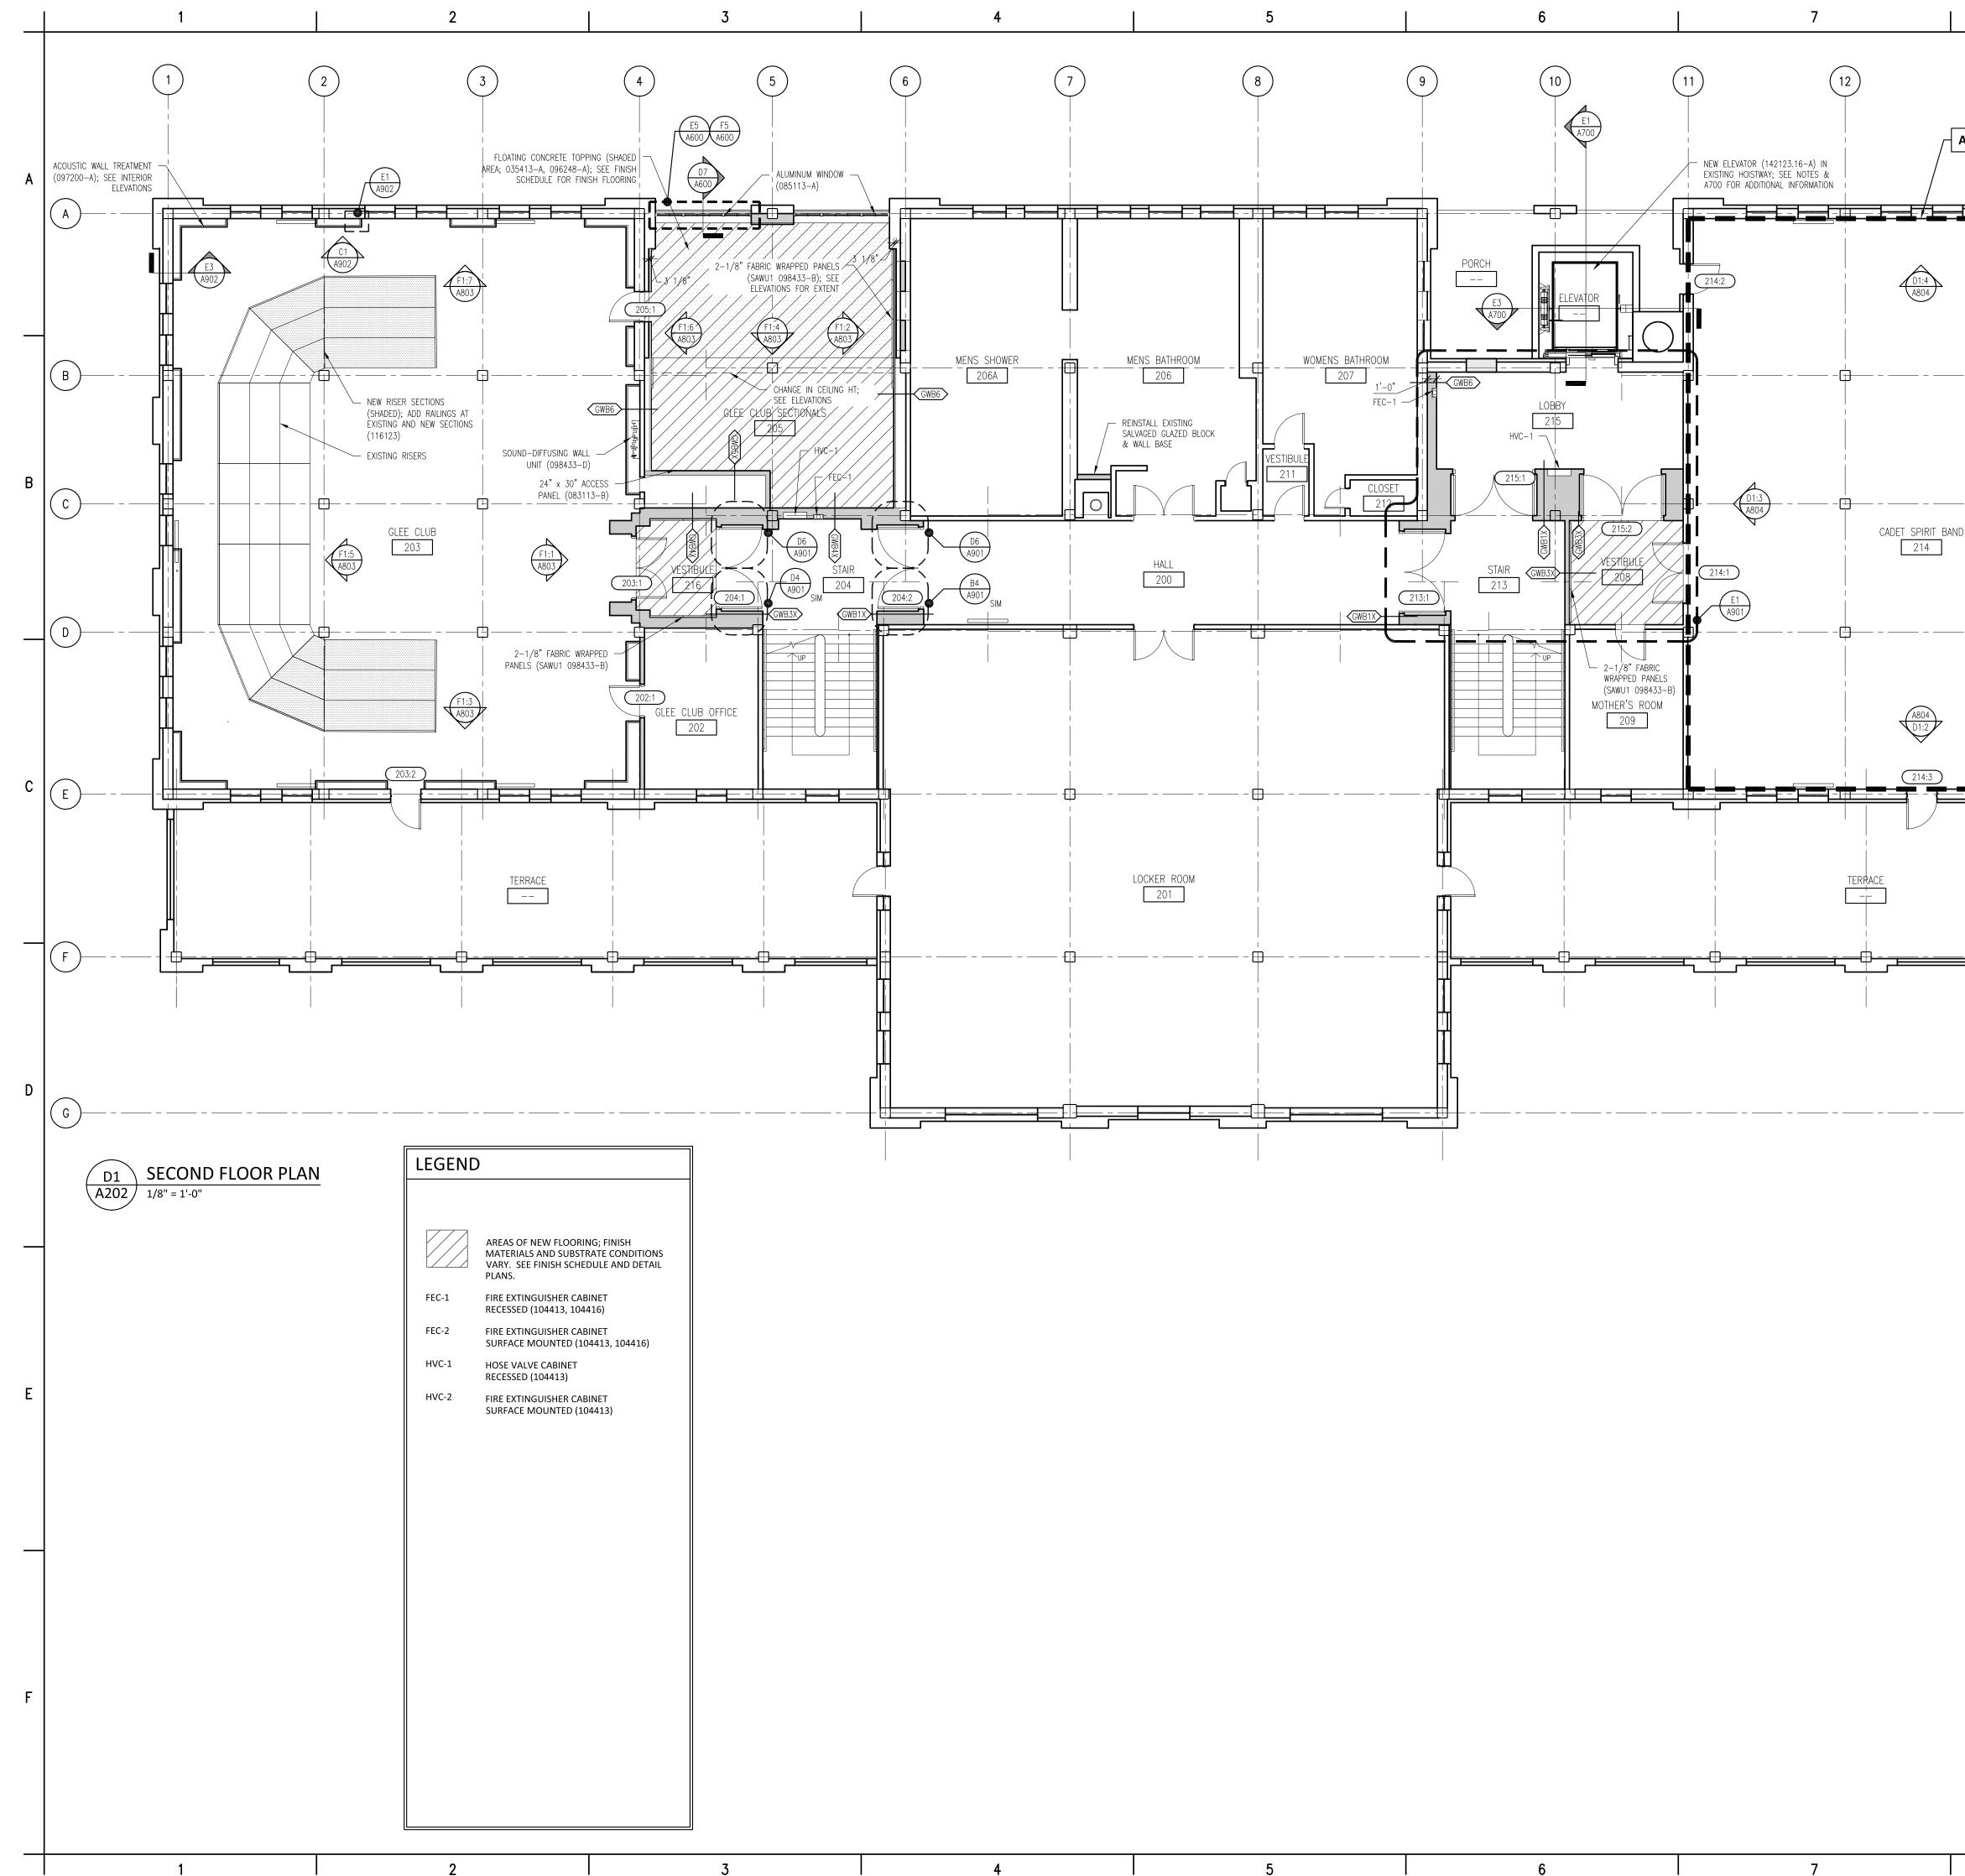
Project No.: 11300 Date: July 06, 2022

Drawing Title: Removals Plans Roof & Band Room Int Finishes


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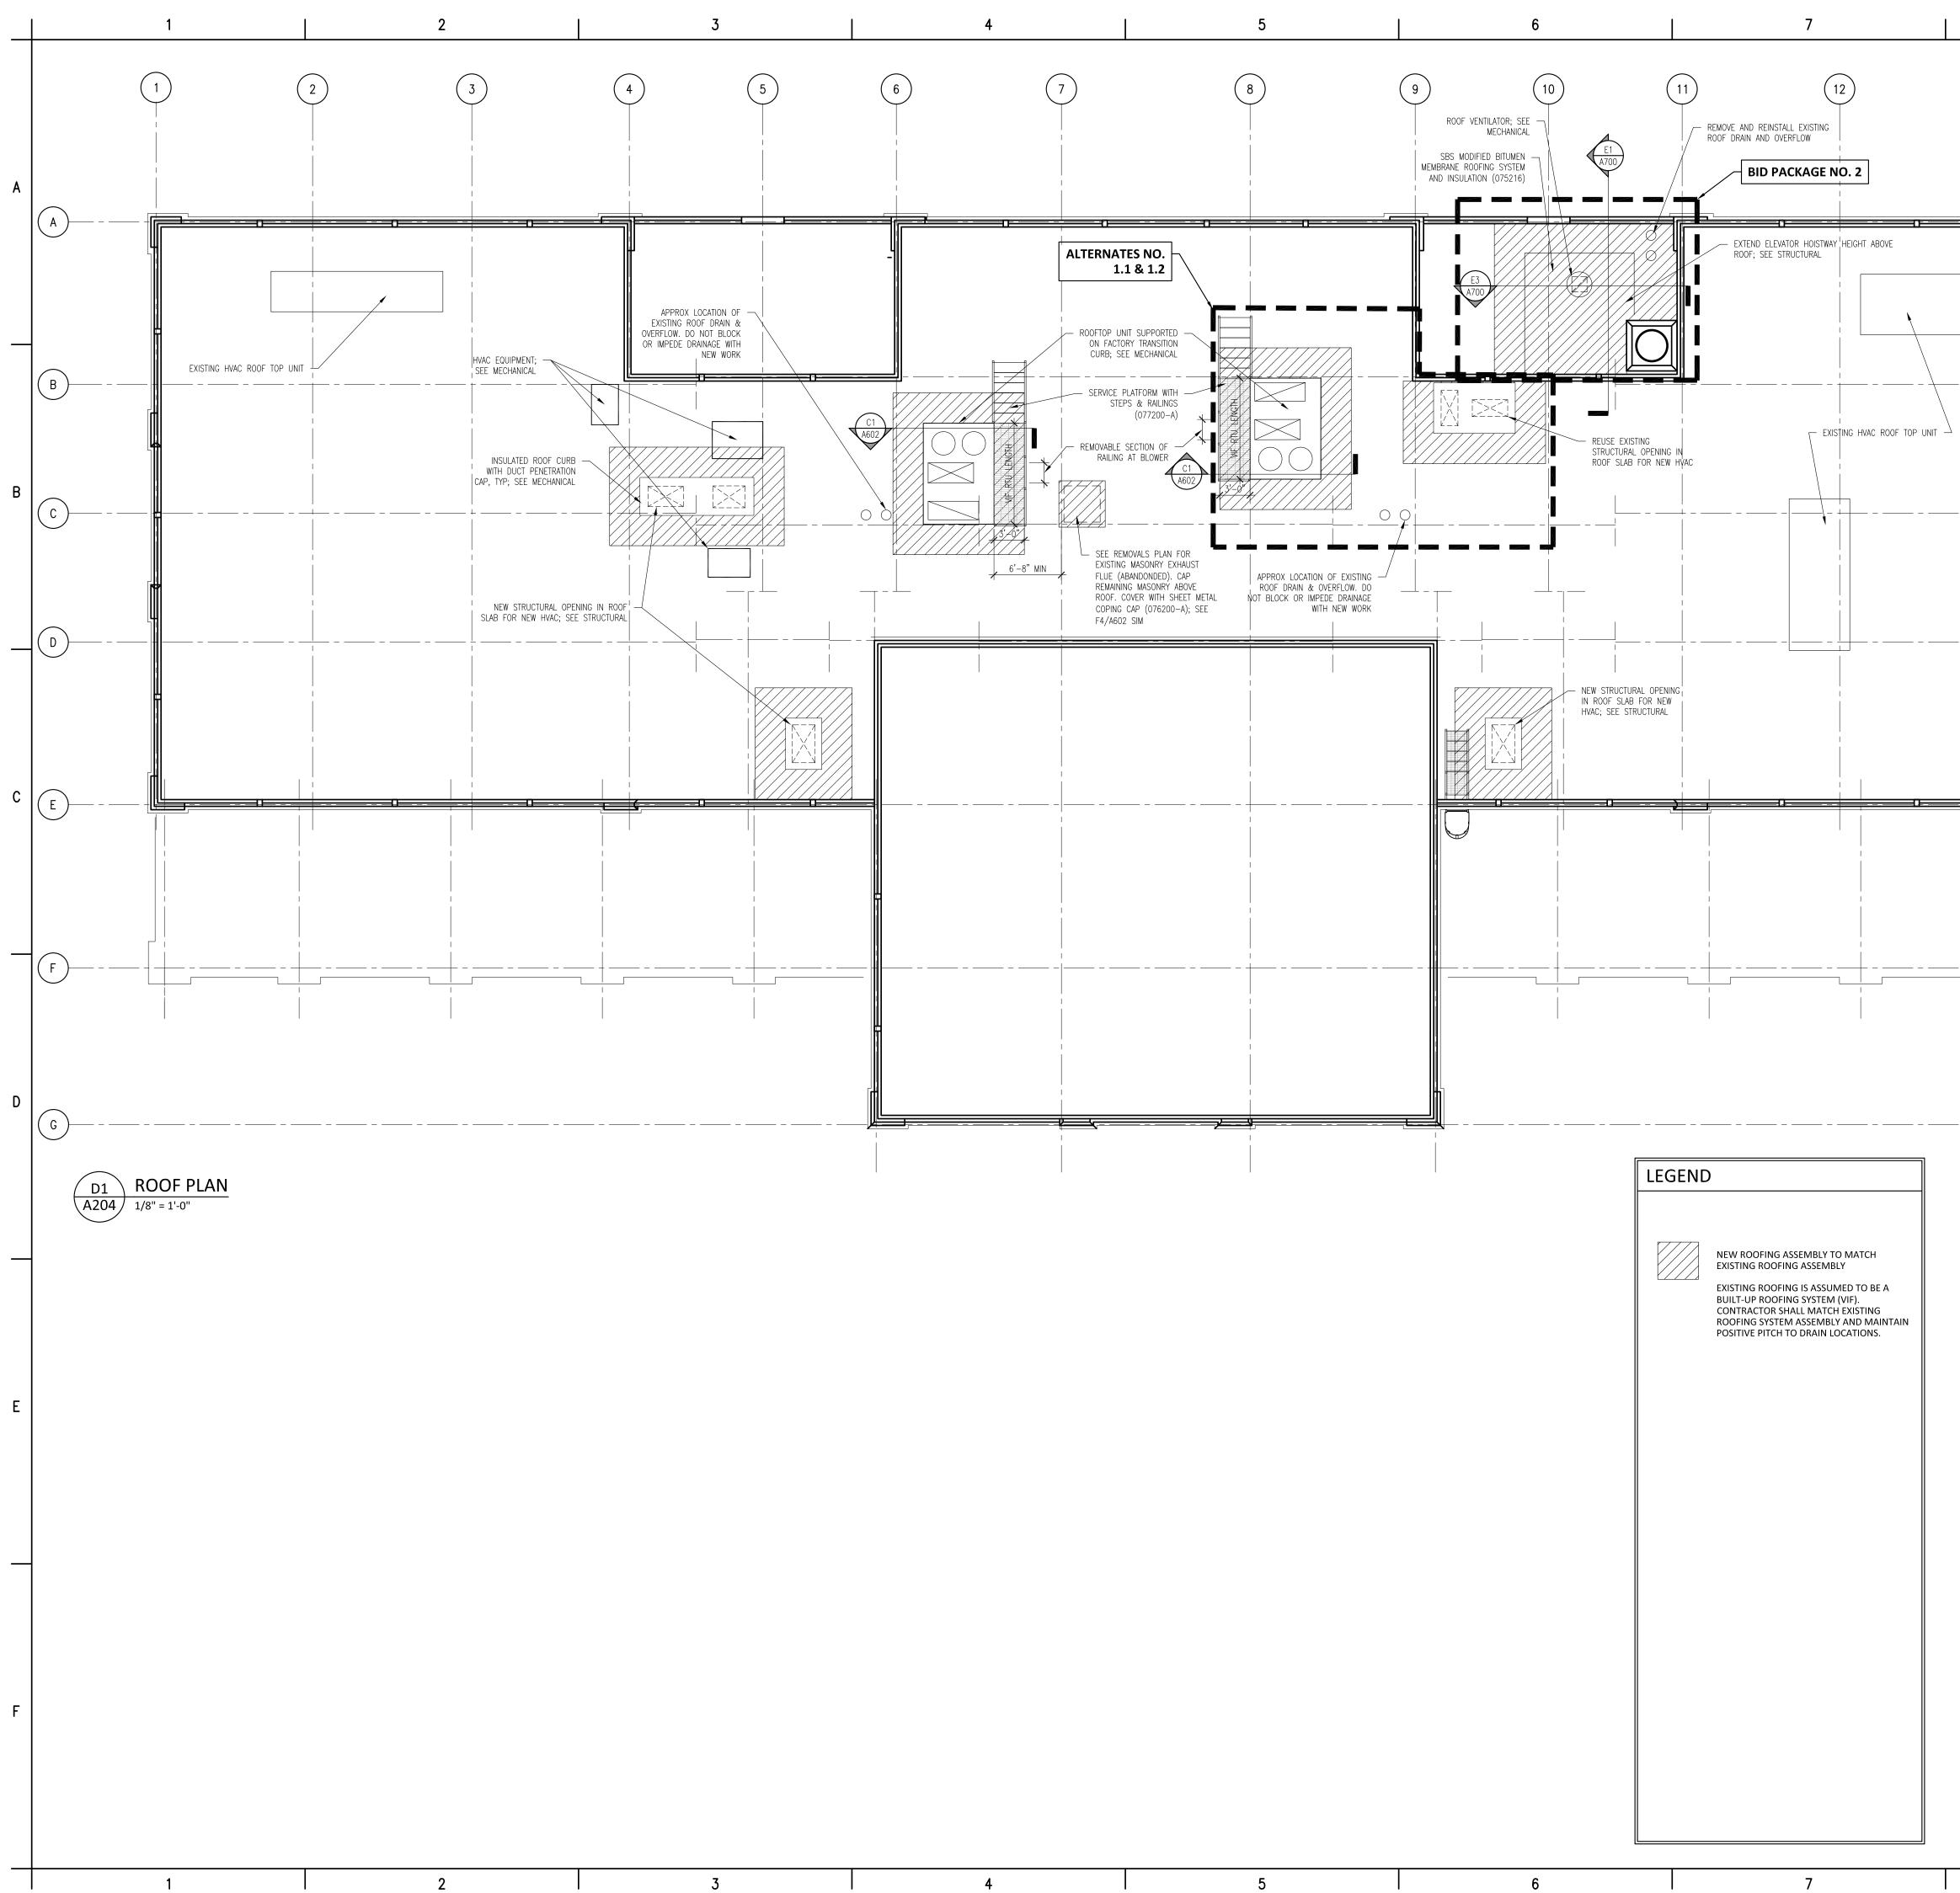




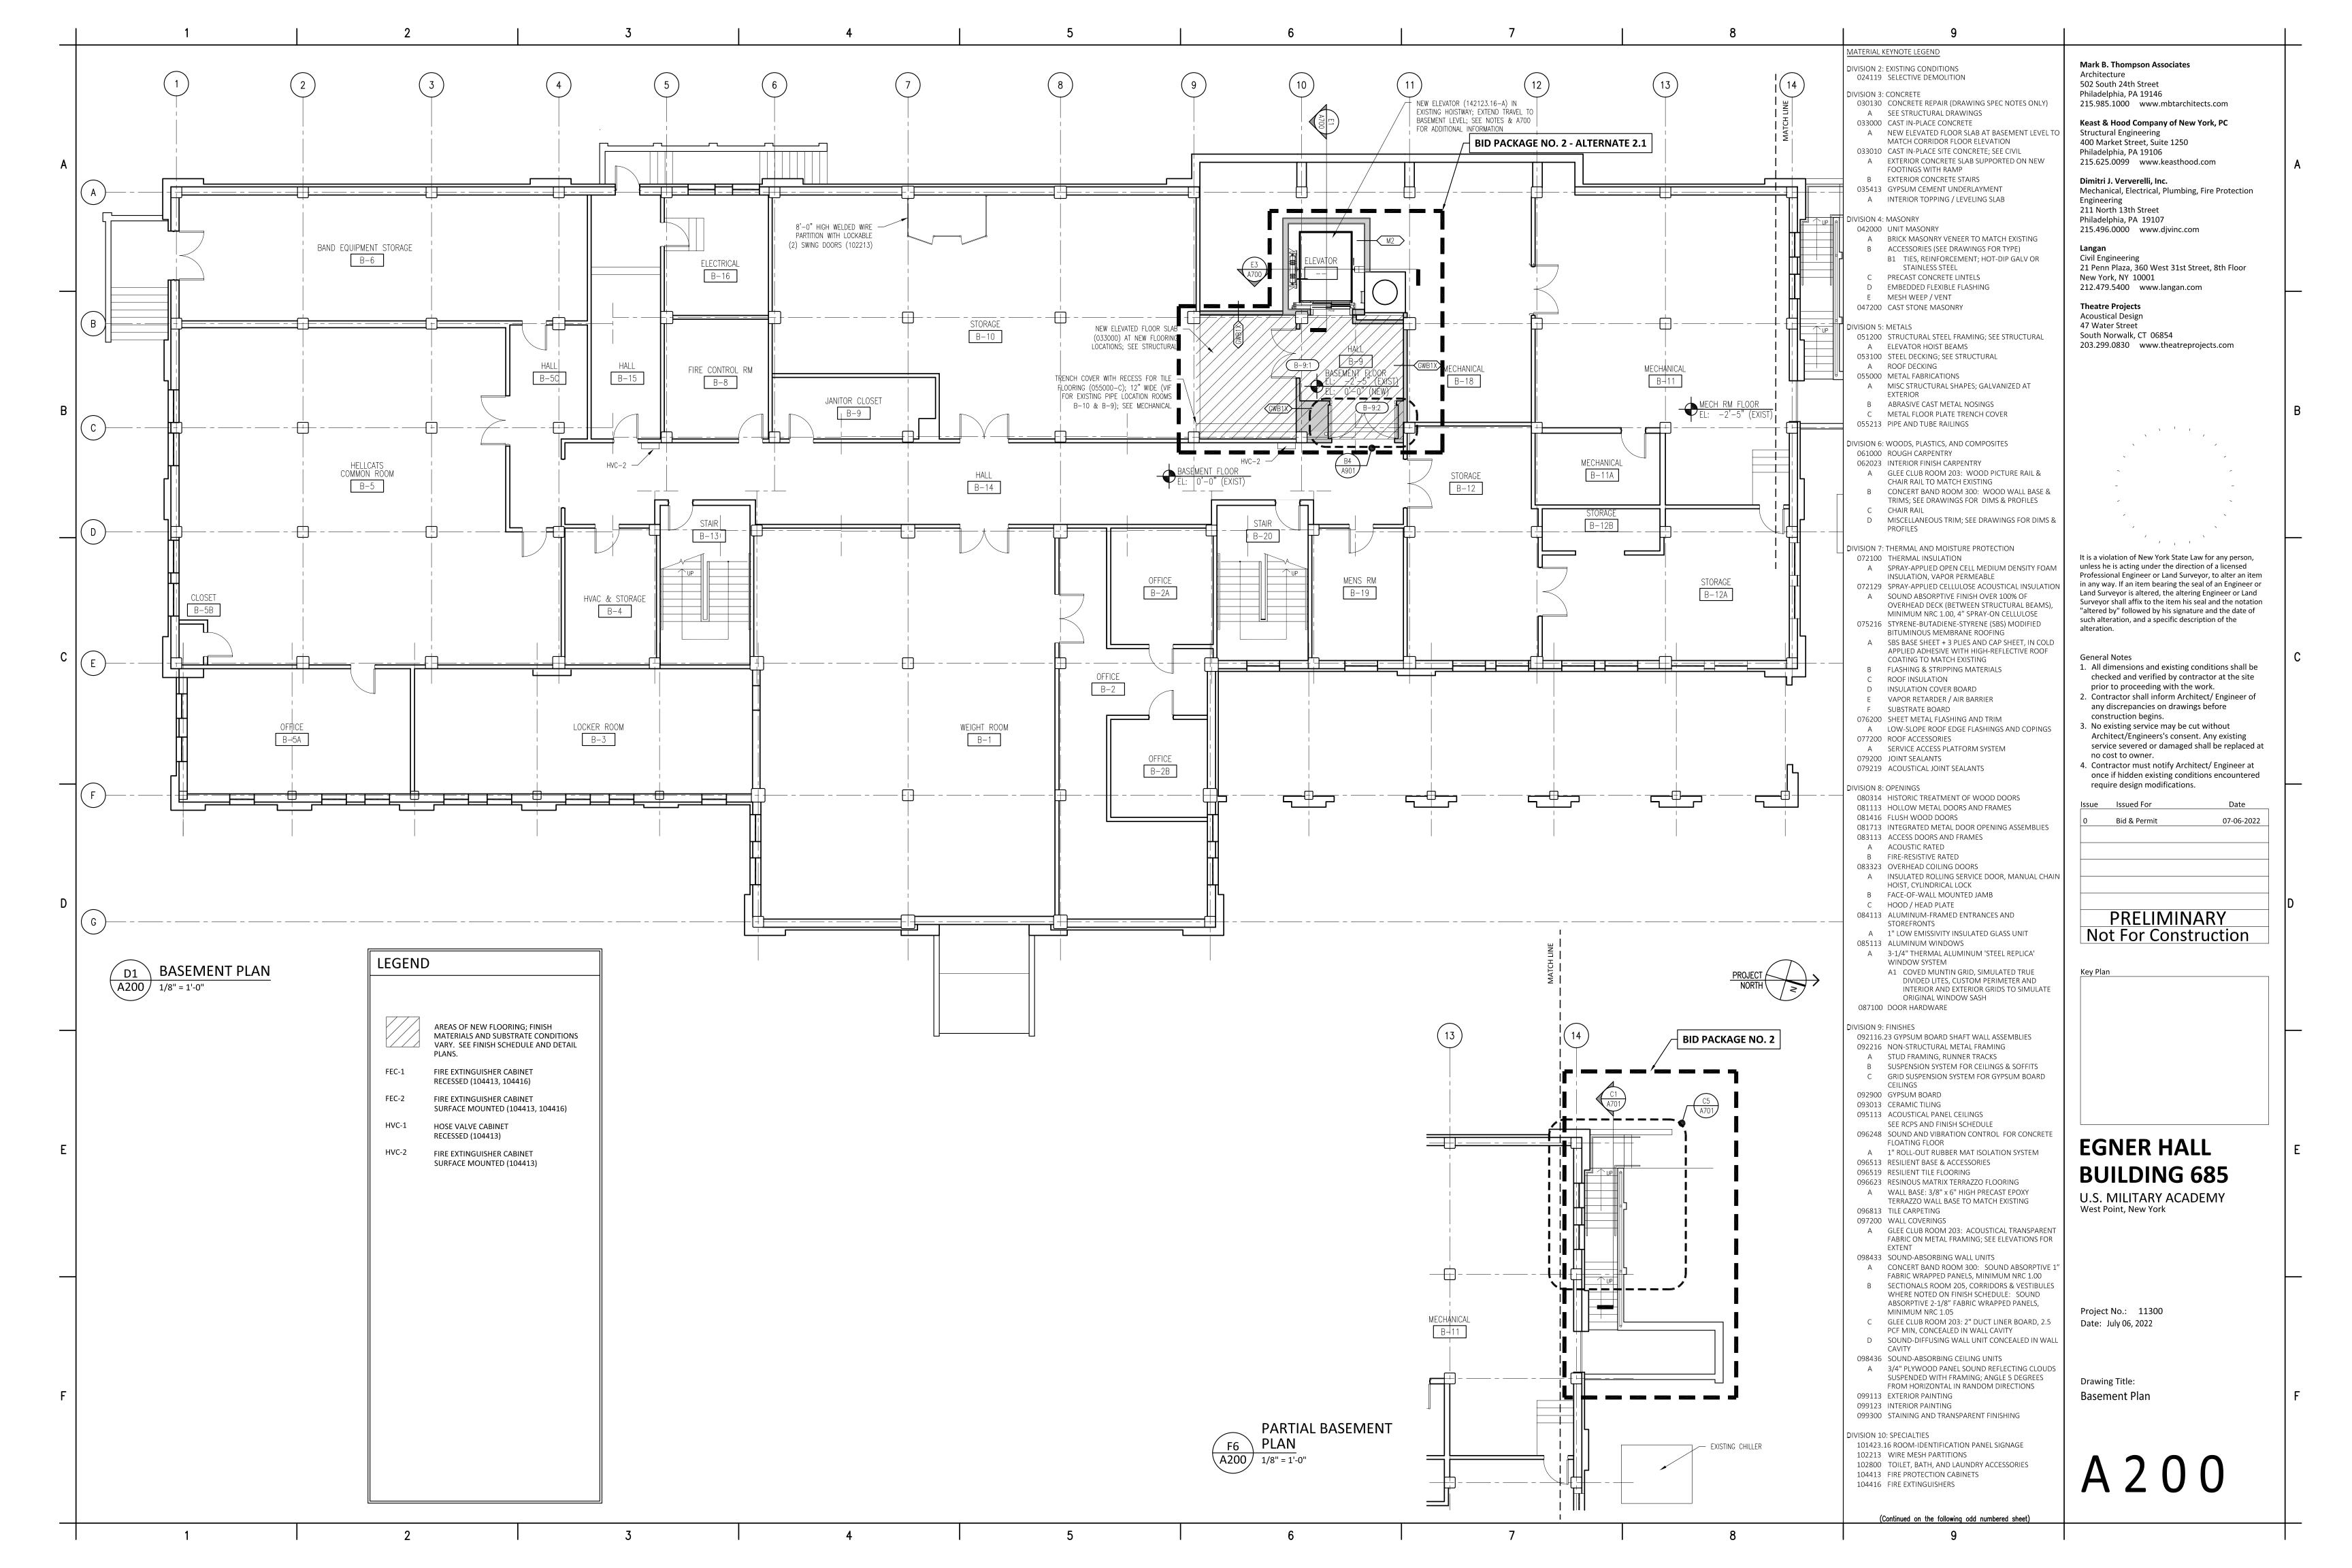

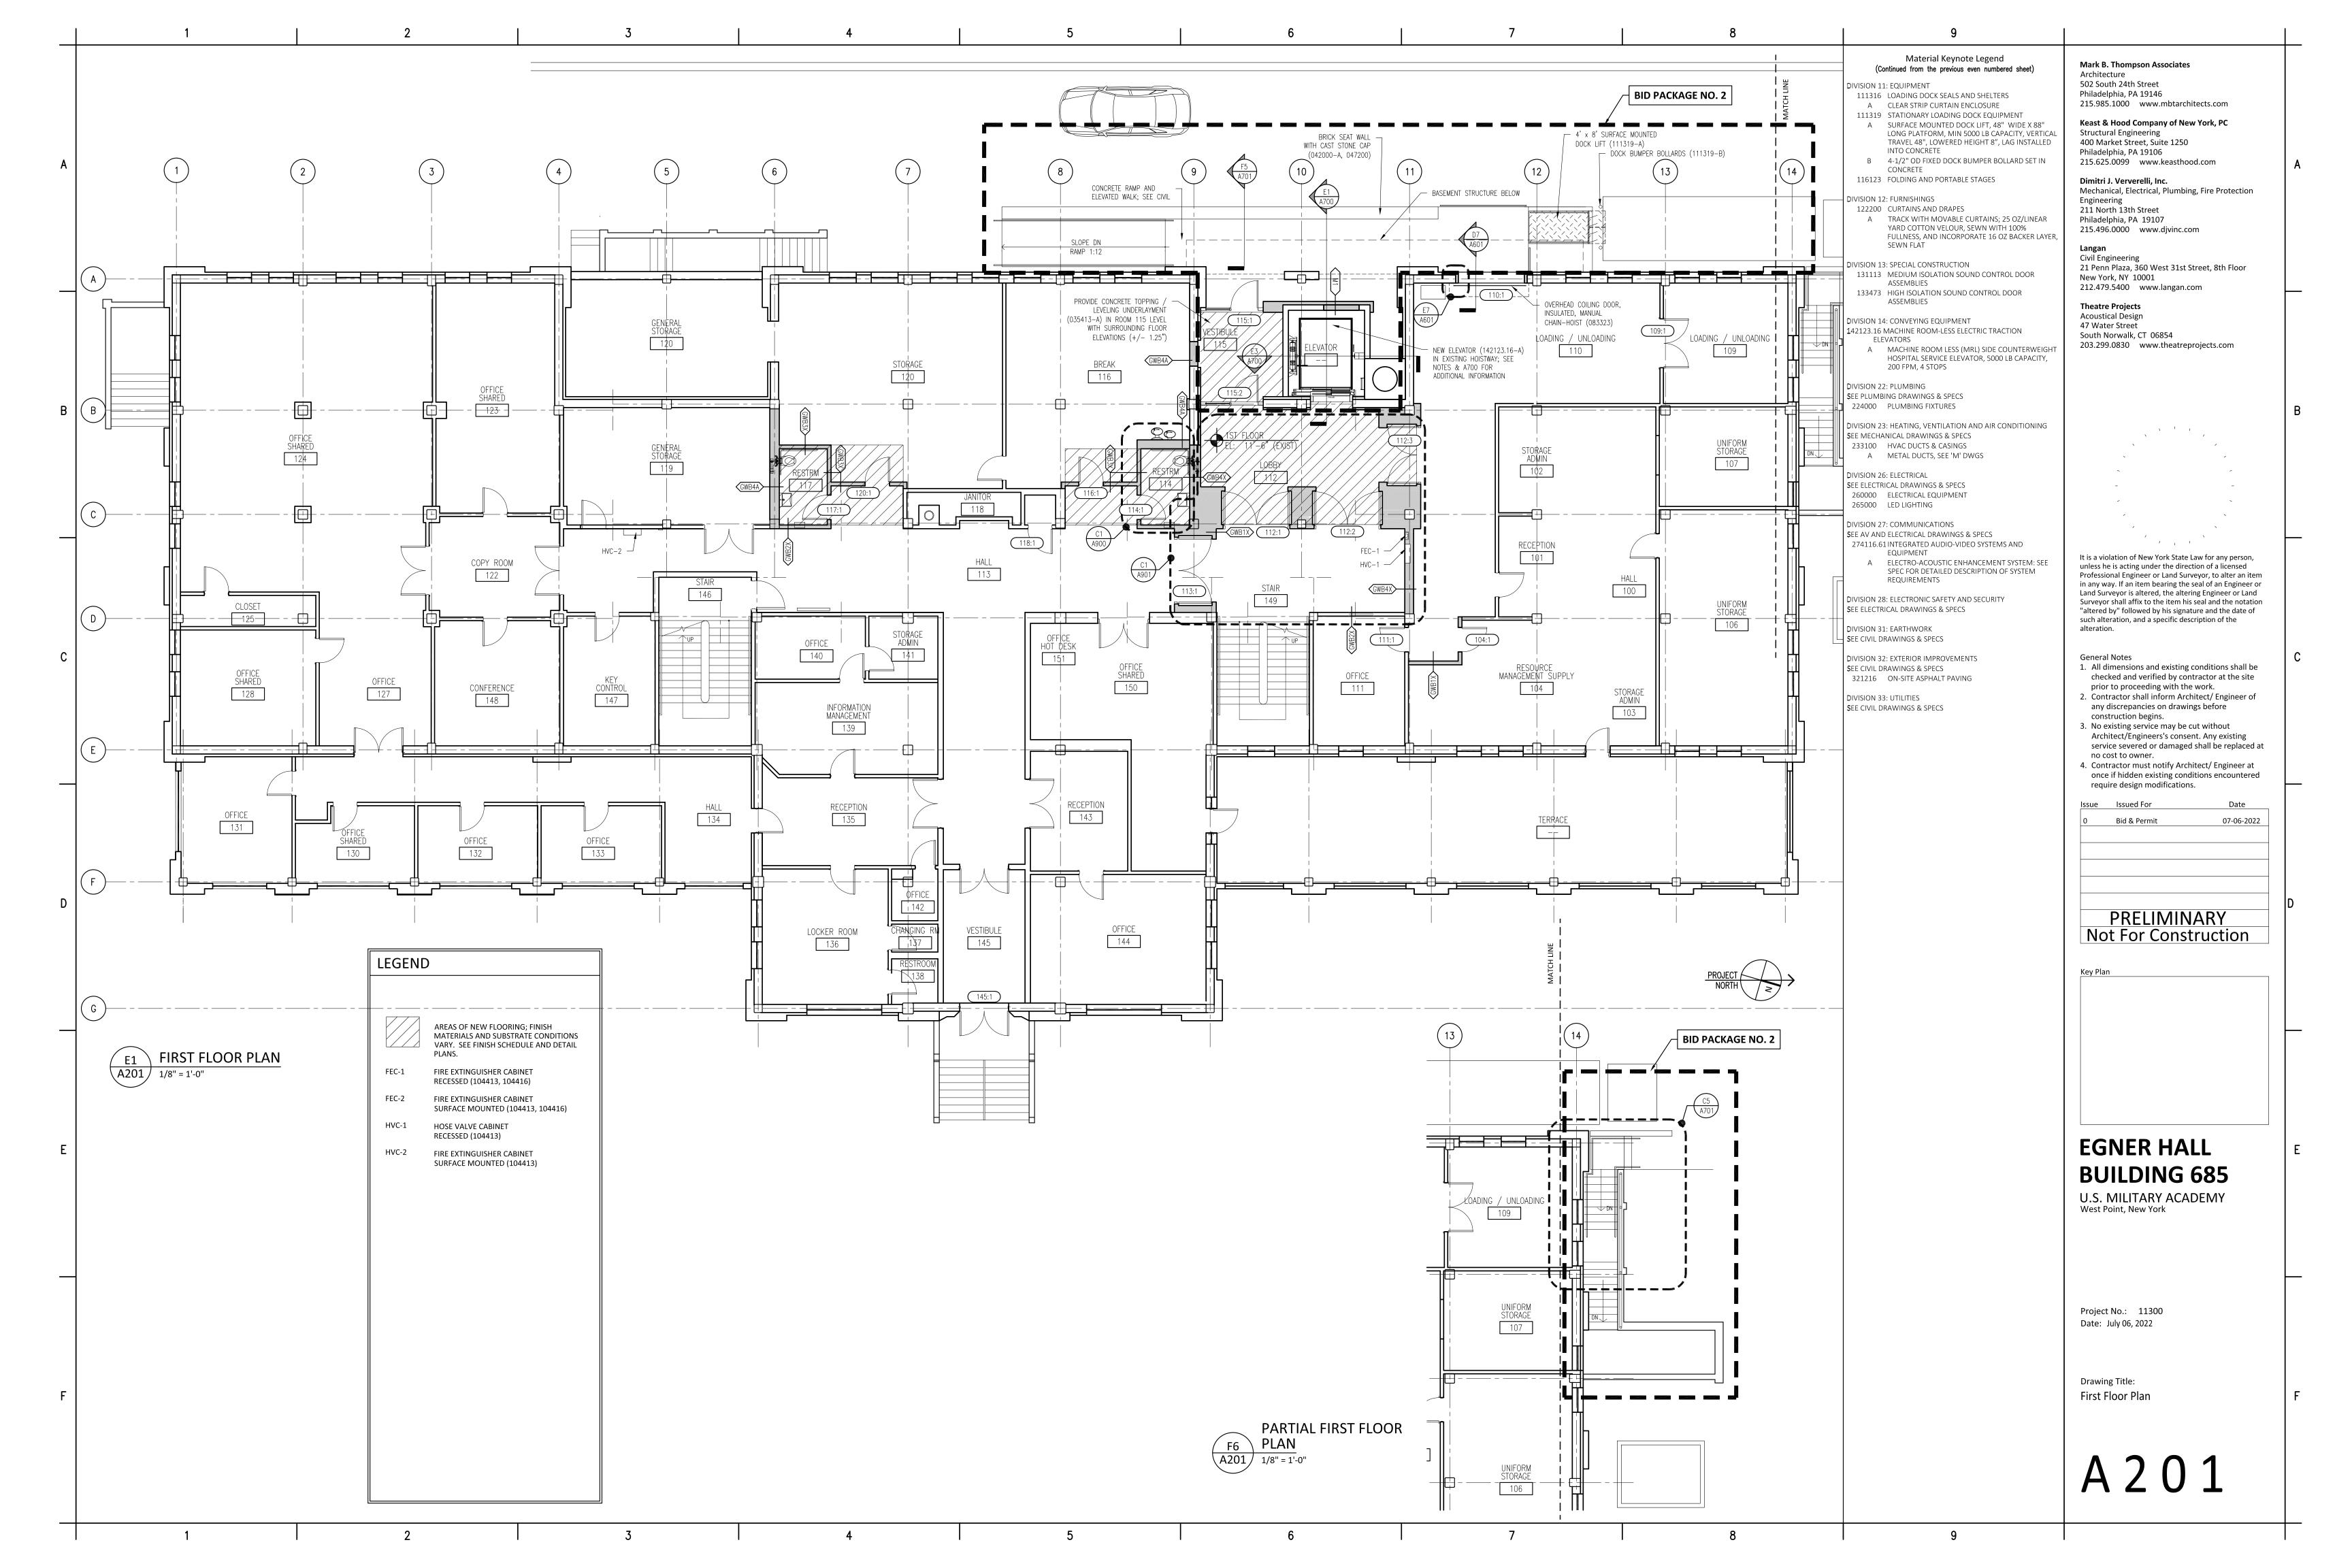
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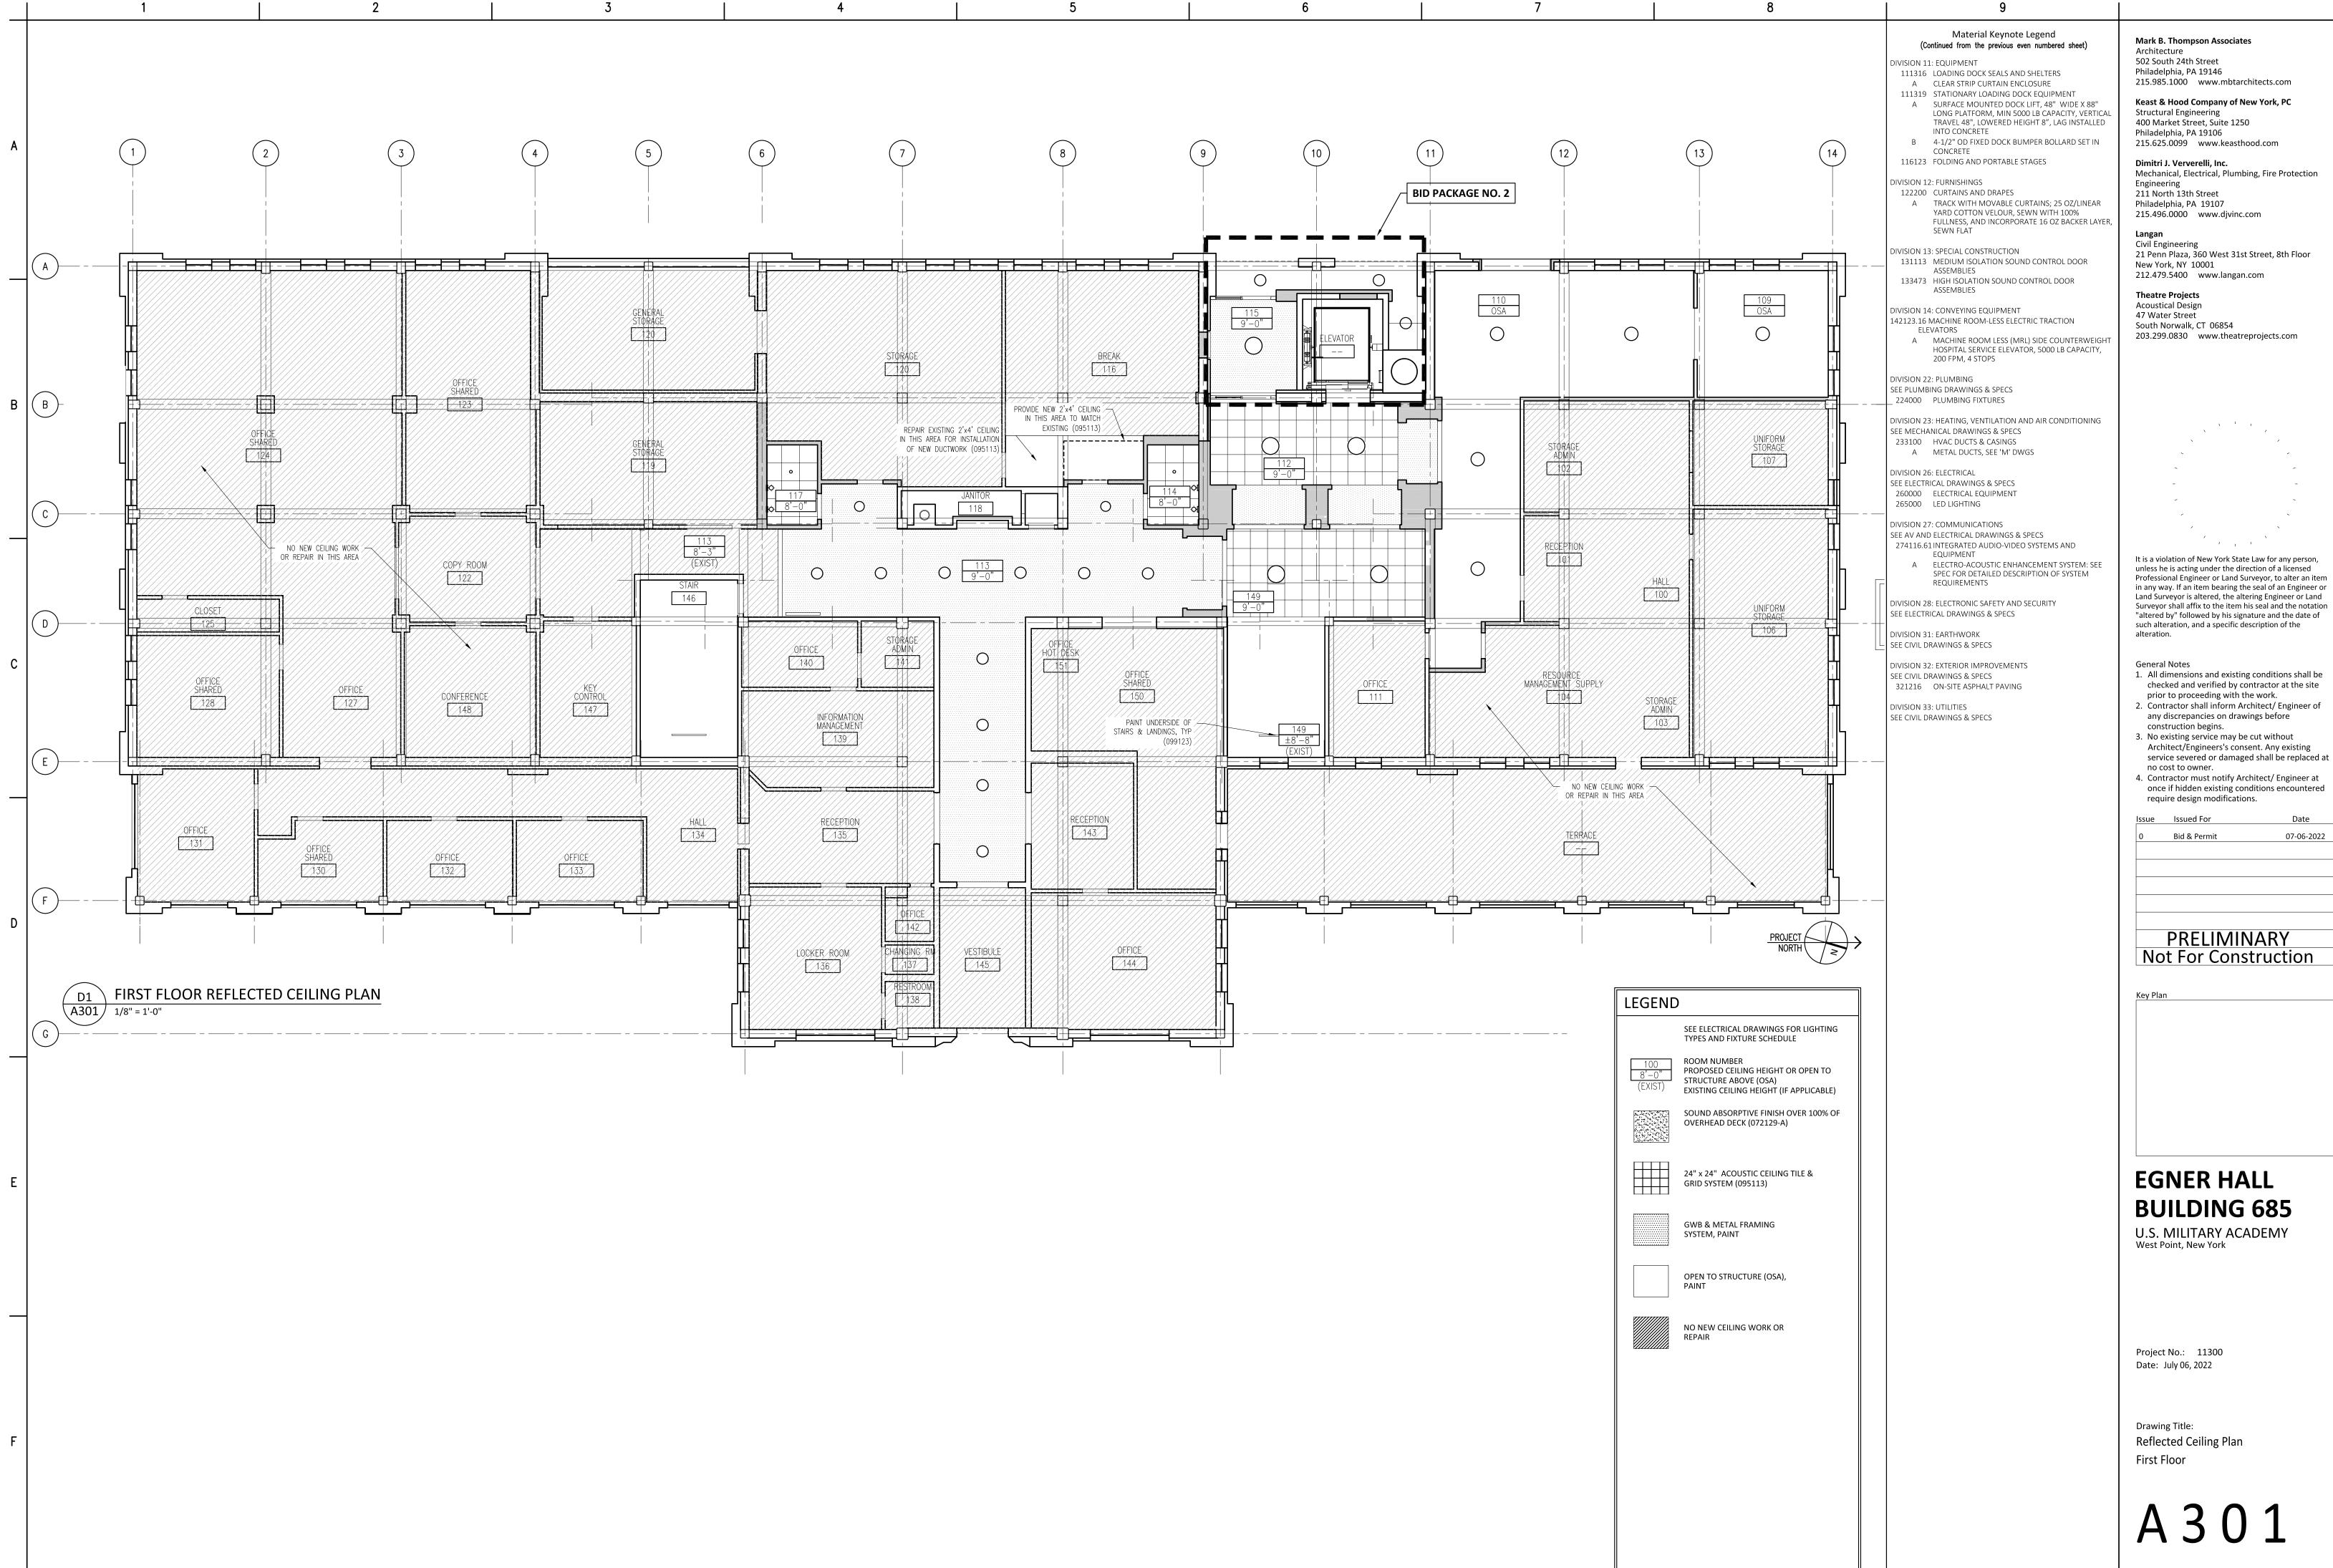
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	(13) (14)	MATERIAL KEYNOTE LEGEND DIVISION 2: EXISTING CONDITIONS 024119 SELECTIVE DEMOLITION	Mark B. Thompson Associates Architecture 502 South 24th Street
		DIVISION 3: CONCRETE 030130 CONCRETE REPAIR (DRAWING SPEC NOTES ONLY) A SEE STRUCTURAL DRAWINGS 033000 CAST IN-PLACE CONCRETE	Philadelphia, PA 19146 215.985.1000 www.mbtarchitects.com Keast & Hood Company of New York, PC
ATE 2.1		 A NEW ELEVATED FLOOR SLAB AT BASEMENT LEVEL TO MATCH CORRIDOR FLOOR ELEVATION 033010 CAST IN-PLACE SITE CONCRETE; SEE CIVIL 	Structural Engineering 400 Market Street, Suite 1250 Philadelphia, PA 19106
		A EXTERIOR CONCRETE SLAB SUPPORTED ON NEW FOOTINGS WITH RAMP B EXTERIOR CONCRETE STAIRS 035413 GYPSUM CEMENT UNDERLAYMENT	215.625.0099 www.keasthood.com Dimitri J. Ververelli, Inc. Mechanical, Electrical, Plumbing, Fire Protection
		A INTERIOR TOPPING / LEVELING SLAB	Engineering 211 North 13th Street Philadelphia, PA 19107
		042000 UNIT MASONRY A BRICK MASONRY VENEER TO MATCH EXISTING B ACCESSORIES (SEE DRAWINGS FOR TYPE)	215.496.0000 www.djvinc.com Langan Civil Engineering
		B1 TIES, REINFORCEMENT; HOT-DIP GALV OR STAINLESS STEEL C PRECAST CONCRETE LINTELS D EMBEDDED FLEXIBLE FLASHING	21 Penn Plaza, 360 West 31st Street, 8th Floor New York, NY 10001 212.479.5400 www.langan.com
		E MESH WEEP / VENT 047200 CAST STONE MASONRY	Theatre Projects Acoustical Design 47 Water Street
		DIVISION 5: METALS 051200 STRUCTURAL STEEL FRAMING; SEE STRUCTURAL A ELEVATOR HOIST BEAMS 053100 STEEL DECKING; SEE STRUCTURAL	South Norwalk, CT 06854 203.299.0830 www.theatreprojects.com
WORK OR REF		A ROOF DECKING 055000 METAL FABRICATIONS A MISC STRUCTURAL SHAPES; GALVANIZED AT EXTERIOR	
		B ABRASIVE CAST METAL NOSINGS C METAL FLOOR PLATE TRENCH COVER 055213 PIPE AND TUBE RAILINGS	
MNICAL		DIVISION 6: WOODS, PLASTICS, AND COMPOSITES 061000 ROUGH CARPENTRY 062023 INTERIOR EINISH CARPENTRY	
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		TRIMS; SEE DRAWINGS FOR DIMS & PROFILES C CHAIR RAIL D MISCELLANEOUS TRIM; SEE DRAWINGS FOR DIMS & PROFILES	
AGE 28		DIVISION 7: THERMAL AND MOISTURE PROTECTION 072100 THERMAL INSULATION	It is a violation of New York State Law for any person,
	STORAGE	A SPRAY-APPLIED OPEN CELL MEDIUM DENSITY FOAM INSULATION, VAPOR PERMEABLE 072129 SPRAY-APPLIED CELLULOSE ACOUSTICAL INSULATION A SOUND ABSORPTIVE FINISH OVER 100% OF	unless he is acting under the direction of a licensed Professional Engineer or Land Surveyor, to alter an item in any way. If an item bearing the seal of an Engineer or Land Surveyor is altered, the altering Engineer or Land
		OVERHEAD DECK (BETWEEN STRUCTURAL BEAMS), MINIMUM NRC 1.00, 4" SPRAY-ON CELLULOSE 075216 STYRENE-BUTADIENE-STYRENE (SBS) MODIFIED BITUMINOUS MEMBRANE ROOFING	Surveyor shall affix to the item his seal and the notation "altered by" followed by his signature and the date of such alteration, and a specific description of the alteration.
		A SBS BASE SHEET + 3 PLIES AND CAP SHEET, IN COLD APPLIED ADHESIVE WITH HIGH-REFLECTIVE ROOF COATING TO MATCH EXISTING	General Notes 1. All dimensions and existing conditions shall be
		 B FLASHING & STRIPPING MATERIALS C ROOF INSULATION D INSULATION COVER BOARD E VAPOR RETARDER / AIR BARRIER 	 All dimensions and existing conditions shall be checked and verified by contractor at the site prior to proceeding with the work. Contractor shall inform Architect/ Engineer of
		FSUBSTRATE BOARD076200SHEET METAL FLASHING AND TRIMALOW-SLOPE ROOF EDGE FLASHINGS AND COPINGS	any discrepancies on drawings before construction begins.3. No existing service may be cut without Architect (Engineers), concent, Any existing
		077200 ROOF ACCESSORIES A SERVICE ACCESS PLATFORM SYSTEM 079200 JOINT SEALANTS 079219 ACOUSTICAL JOINT SEALANTS	Architect/Engineers's consent. Any existing service severed or damaged shall be replaced at no cost to owner. 4. Contractor must notify Architect/ Engineer at
	╶ <u>┎</u> ╼┇╼ <u>╼</u> ╴╴──╶┎━─┇┼──╴	DIVISION 8: OPENINGS 080314 HISTORIC TREATMENT OF WOOD DOORS	once if hidden existing conditions encountered require design modifications.
		081113 HOLLOW METAL DOORS AND FRAMES 081416 FLUSH WOOD DOORS 081713 INTEGRATED METAL DOOR OPENING ASSEMBLIES 083113 ACCESS DOORS AND FRAMES	Issue Issued For Date 0 Bid & Permit 07-06-2022
		A ACOUSTIC RATED B FIRE-RESISTIVE RATED 083323 OVERHEAD COILING DOORS	
	PROJECT	 A INSULATED ROLLING SERVICE DOOR, MANUAL CHAIN HOIST, CYLINDRICAL LOCK B FACE-OF-WALL MOUNTED JAMB C HOOD / HEAD PLATE 	
		O84113 ALUMINUM-FRAMED ENTRANCES AND STOREFRONTS A 1" LOW EMISSIVITY INSULATED GLASS UNIT	PRELIMINARY Not For Construction
		085113 ALUMINUM WINDOWS A 3-1/4" THERMAL ALUMINUM 'STEEL REPLICA' WINDOW SYSTEM A1 COVED MUNTIN GRID, SIMULATED TRUE	Key Plan
EGEND	SEE ELECTRICAL DRAWINGS FOR LIGHTING	DIVIDED LITES, CUSTOM PERIMETER AND INTERIOR AND EXTERIOR GRIDS TO SIMULATE ORIGINAL WINDOW SASH 087100 DOOR HARDWARE	
100	TYPES AND FIXTURE SCHEDULE ROOM NUMBER PROPOSED CEILING HEIGHT OR OPEN TO	DIVISION 9: FINISHES 092116.23 GYPSUM BOARD SHAFT WALL ASSEMBLIES	
8'-0" (EXIST)	STRUCTURE ABOVE (OSA) EXISTING CEILING HEIGHT (IF APPLICABLE)	092216 NON-STRUCTURAL METAL FRAMING A STUD FRAMING, RUNNER TRACKS B SUSPENSION SYSTEM FOR CEILINGS & SOFFITS C GRID SUSPENSION SYSTEM FOR GYPSUM BOARD	
	SOUND ABSORPTIVE FINISH OVER 100% OF OVERHEAD DECK (072129-A)	CEILINGS 092900 GYPSUM BOARD 093013 CERAMIC TILING	
	24" x 24" ACOUSTIC CEILING TILE &	095113 ACOUSTICAL PANEL CEILINGS SEE RCPS AND FINISH SCHEDULE 096248 SOUND AND VIBRATION CONTROL FOR CONCRETE FLOATING FLOOR	EGNER HALL
	GRID SYSTEM (095113)	A 1" ROLL-OUT RUBBER MAT ISOLATION SYSTEM 096513 RESILIENT BASE & ACCESSORIES 096519 RESILIENT TILE FLOORING 096623 RESINOUS MATRIX TERRAZZO FLOORING	BUILDING 685
	GWB & METAL FRAMING SYSTEM, PAINT	A WALL BASE: 3/8" x 6" HIGH PRECAST EPOXY TERRAZZO WALL BASE TO MATCH EXISTING 096813 TILE CARPETING	U.S. MILITARY ACADEMY West Point, New York
	OPEN TO STRUCTURE (OSA), PAINT	097200 WALL COVERINGS A GLEE CLUB ROOM 203: ACOUSTICAL TRANSPARENT FABRIC ON METAL FRAMING; SEE ELEVATIONS FOR EXTENT	
		098433 SOUND-ABSORBING WALL UNITS A CONCERT BAND ROOM 300: SOUND ABSORPTIVE 1" FABRIC WRAPPED PANELS, MINIMUM NRC 1.00	
	NO NEW CEILING WORK OR REPAIR	B SECTIONALS ROOM 205, CORRIDORS & VESTIBULES WHERE NOTED ON FINISH SCHEDULE: SOUND ABSORPTIVE 2-1/8" FABRIC WRAPPED PANELS, MINIMUM NRC 1.05	Project No.: 11300
		C GLEE CLUB ROOM 203: 2" DUCT LINER BOARD, 2.5 PCF MIN, CONCEALED IN WALL CAVITY D SOUND-DIFFUSING WALL UNIT CONCEALED IN WALL CAVITY	Date: July 06, 2022
		098436 SOUND-ABSORBING CEILING UNITS A 3/4" PLYWOOD PANEL SOUND REFLECTING CLOUDS SUSPENDED WITH FRAMING; ANGLE 5 DEGREES FROM HORIZONTAL IN RANDOM DIRECTIONS	Drawing Title:
		099113 EXTERIOR PAINTING 099123 INTERIOR PAINTING 099300 STAINING AND TRANSPARENT FINISHING	Reflected Ceiling Plan Basement
		DIVISION 10: SPECIALTIES 101423.16 ROOM-IDENTIFICATION PANEL SIGNAGE 102213 WIRE MESH PARTITIONS	
		102213 WIRE MESH PARTITIONS 102800 TOILET, BATH, AND LAUNDRY ACCESSORIES 104413 FIRE PROTECTION CABINETS 104416 FIRE EXTINGUISHERS	A 3 0 0
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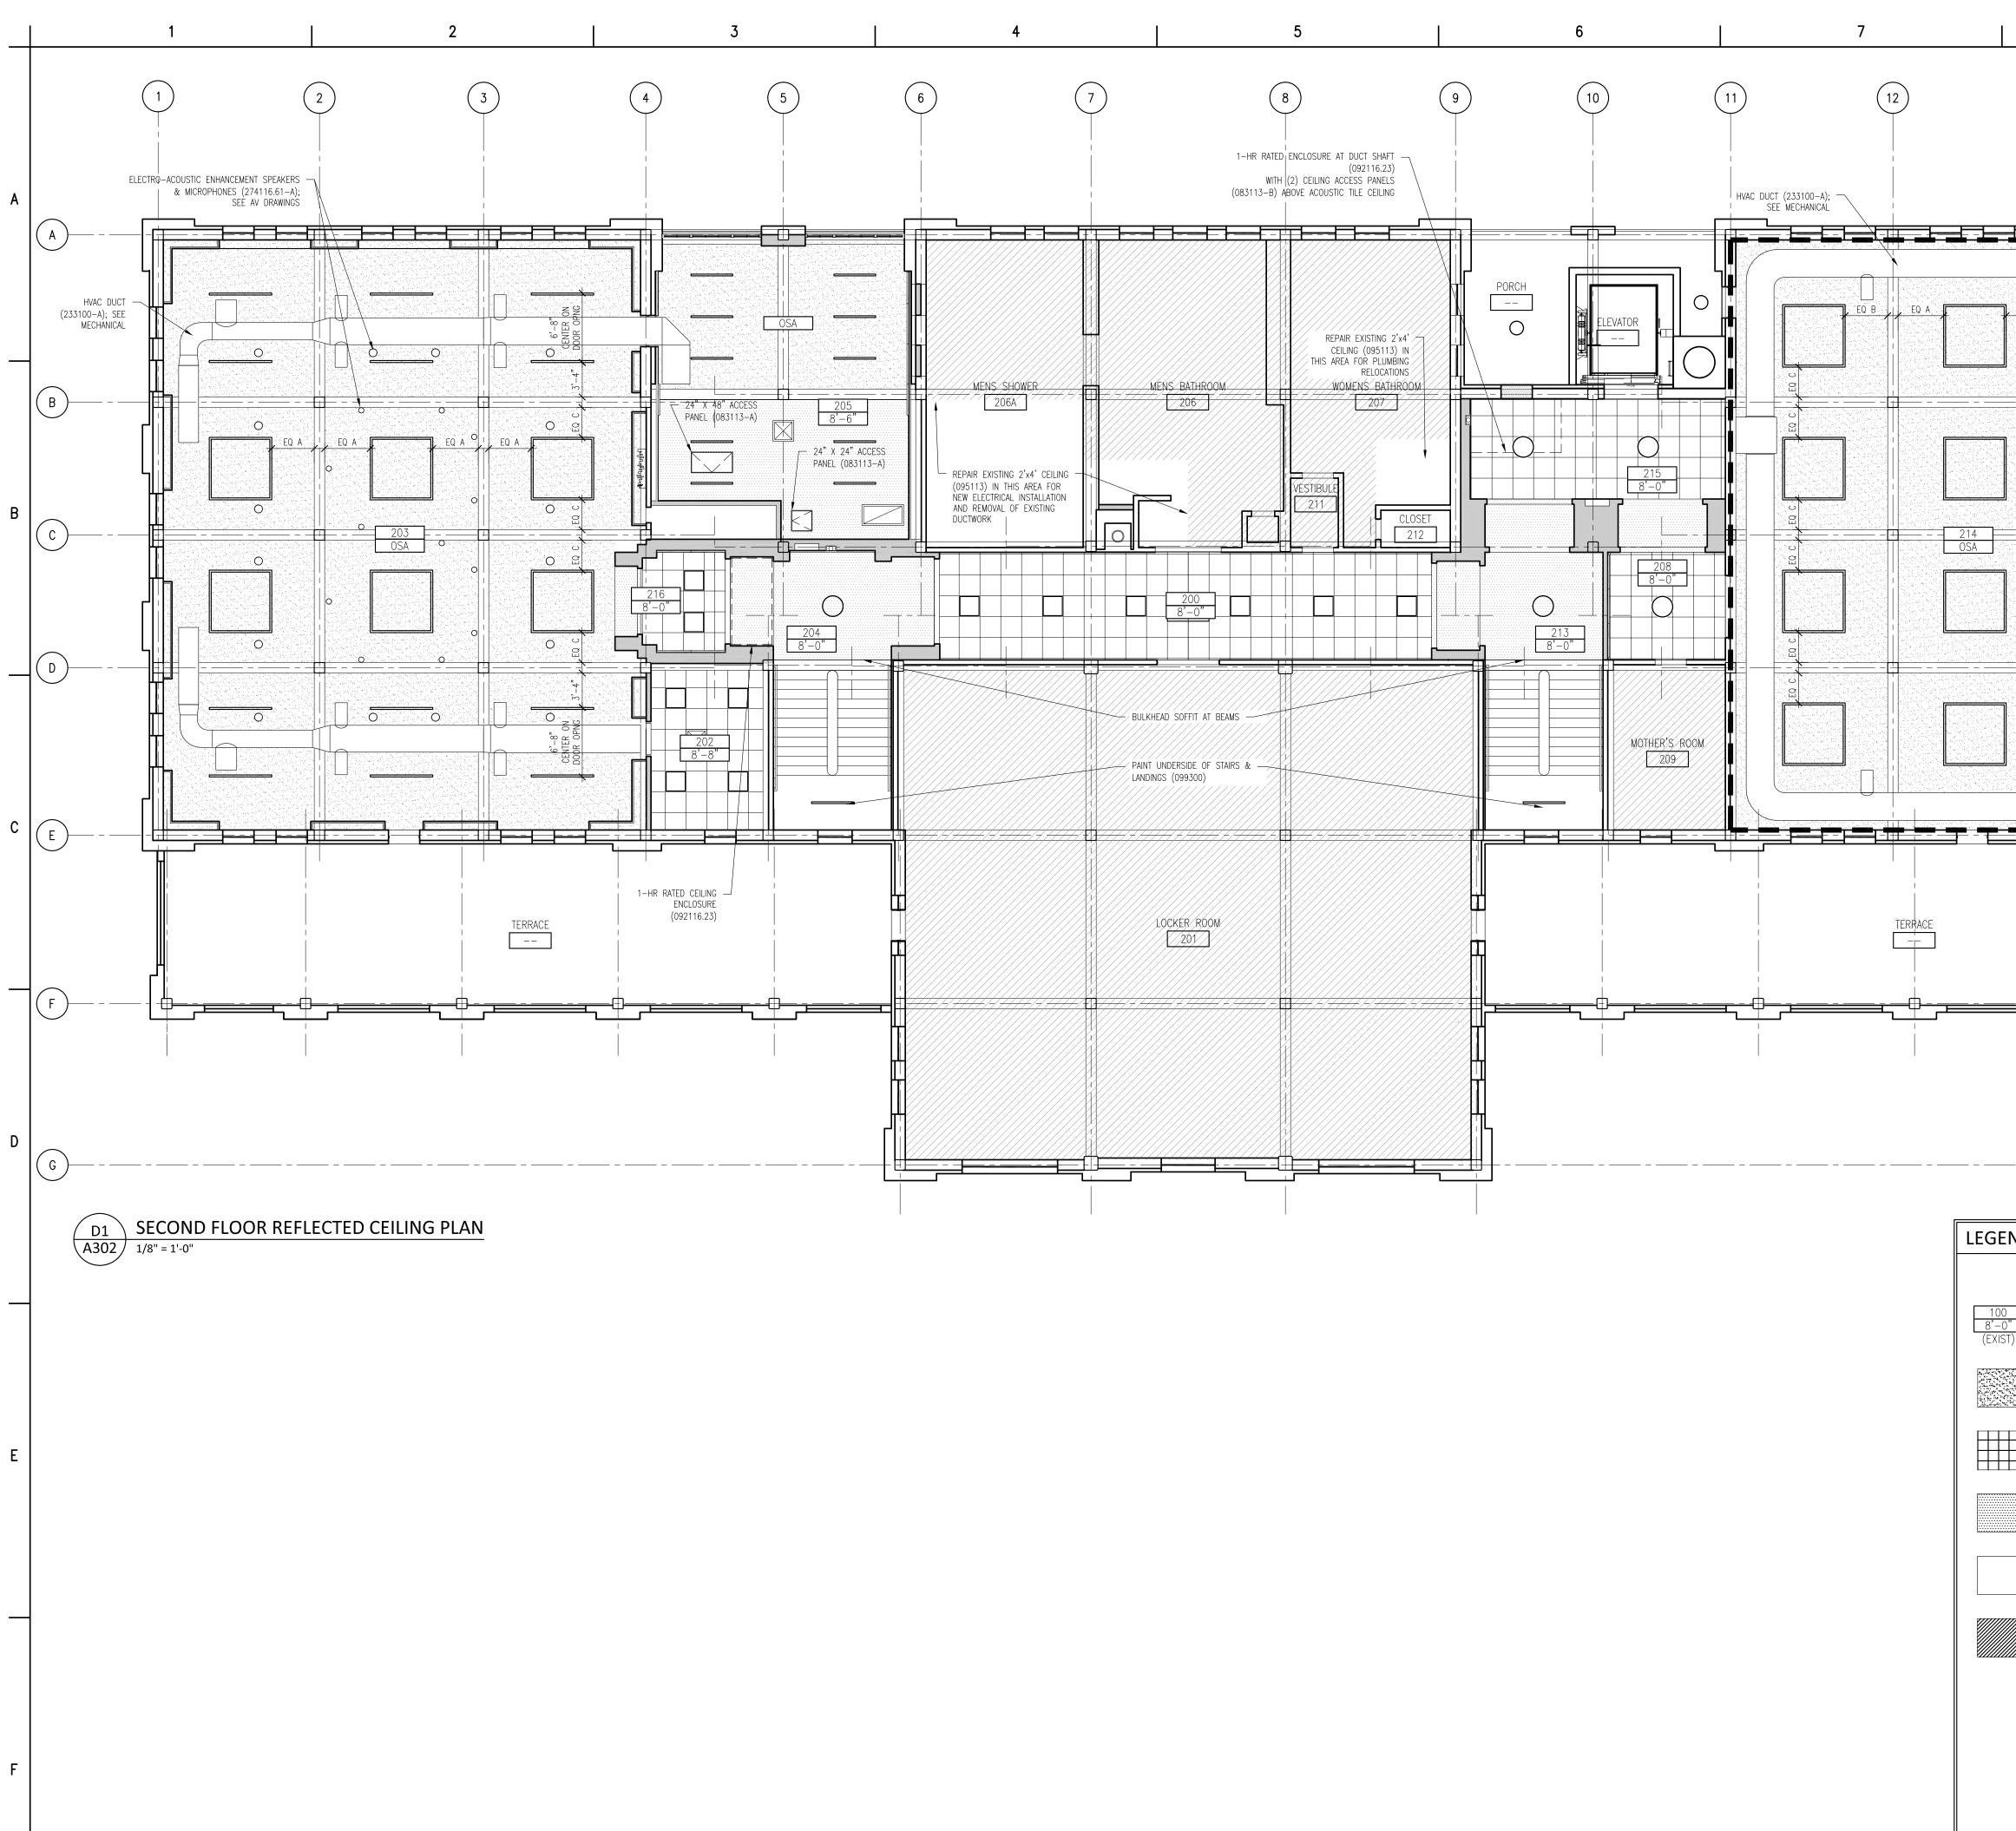
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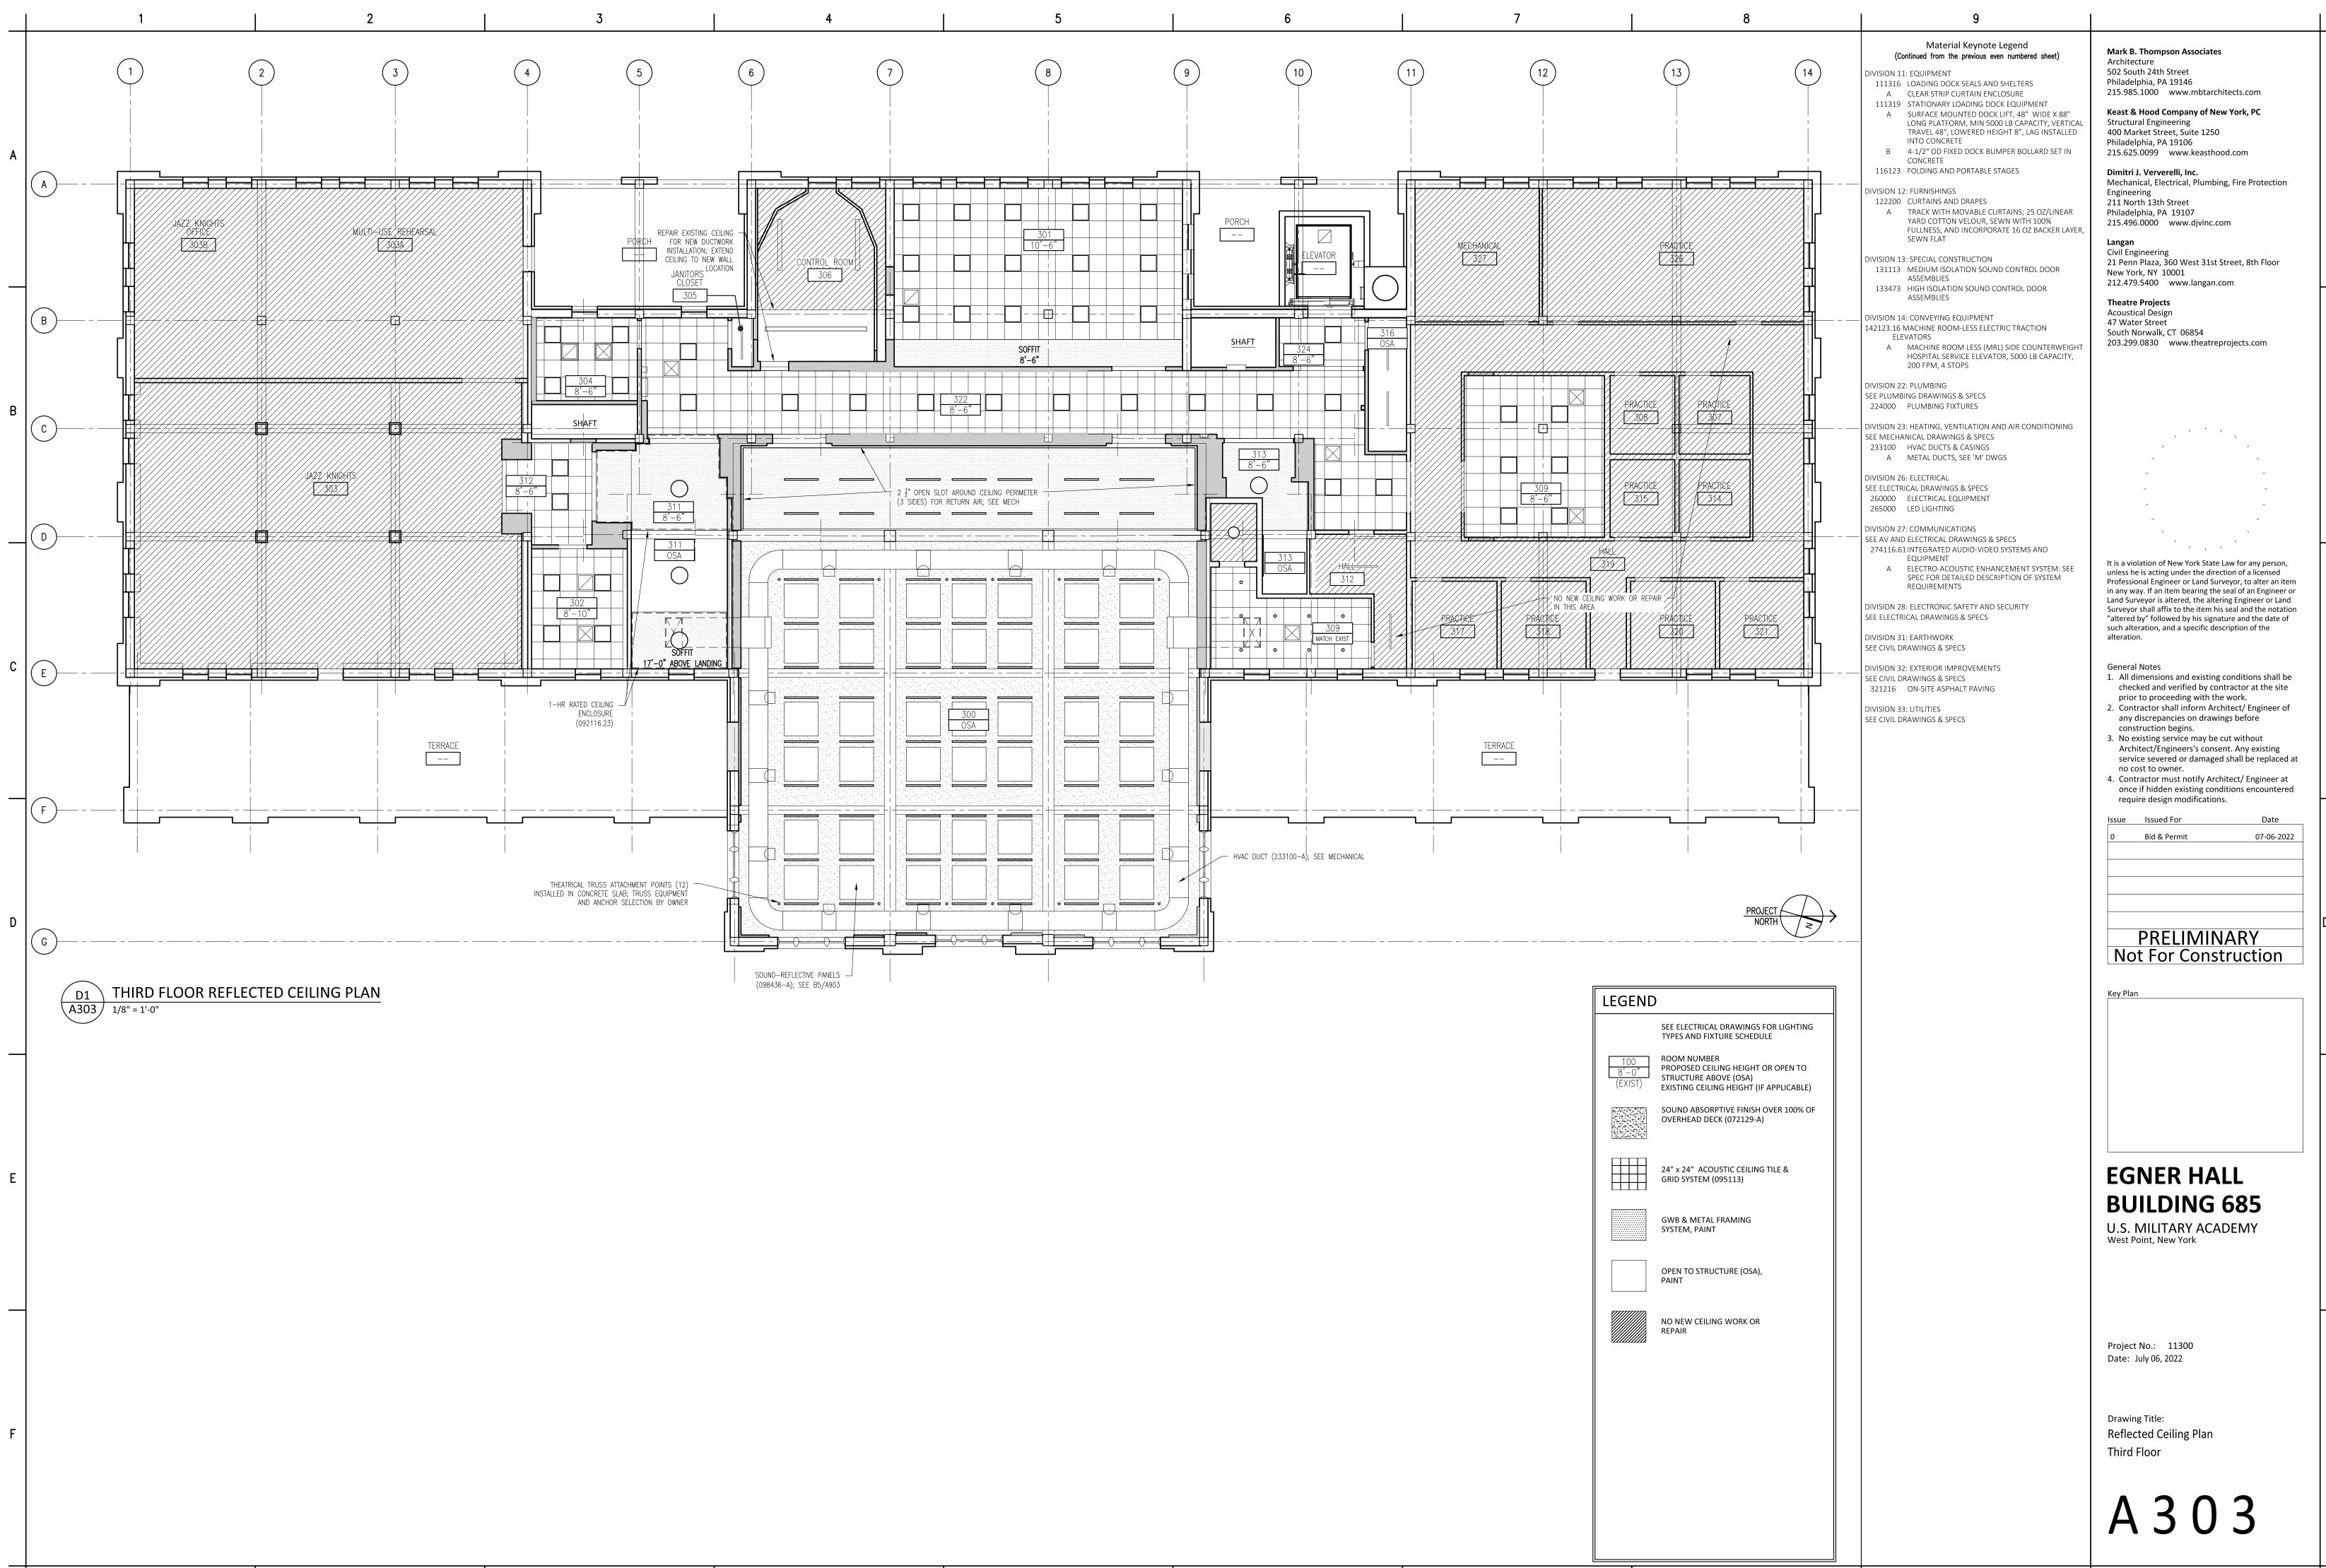
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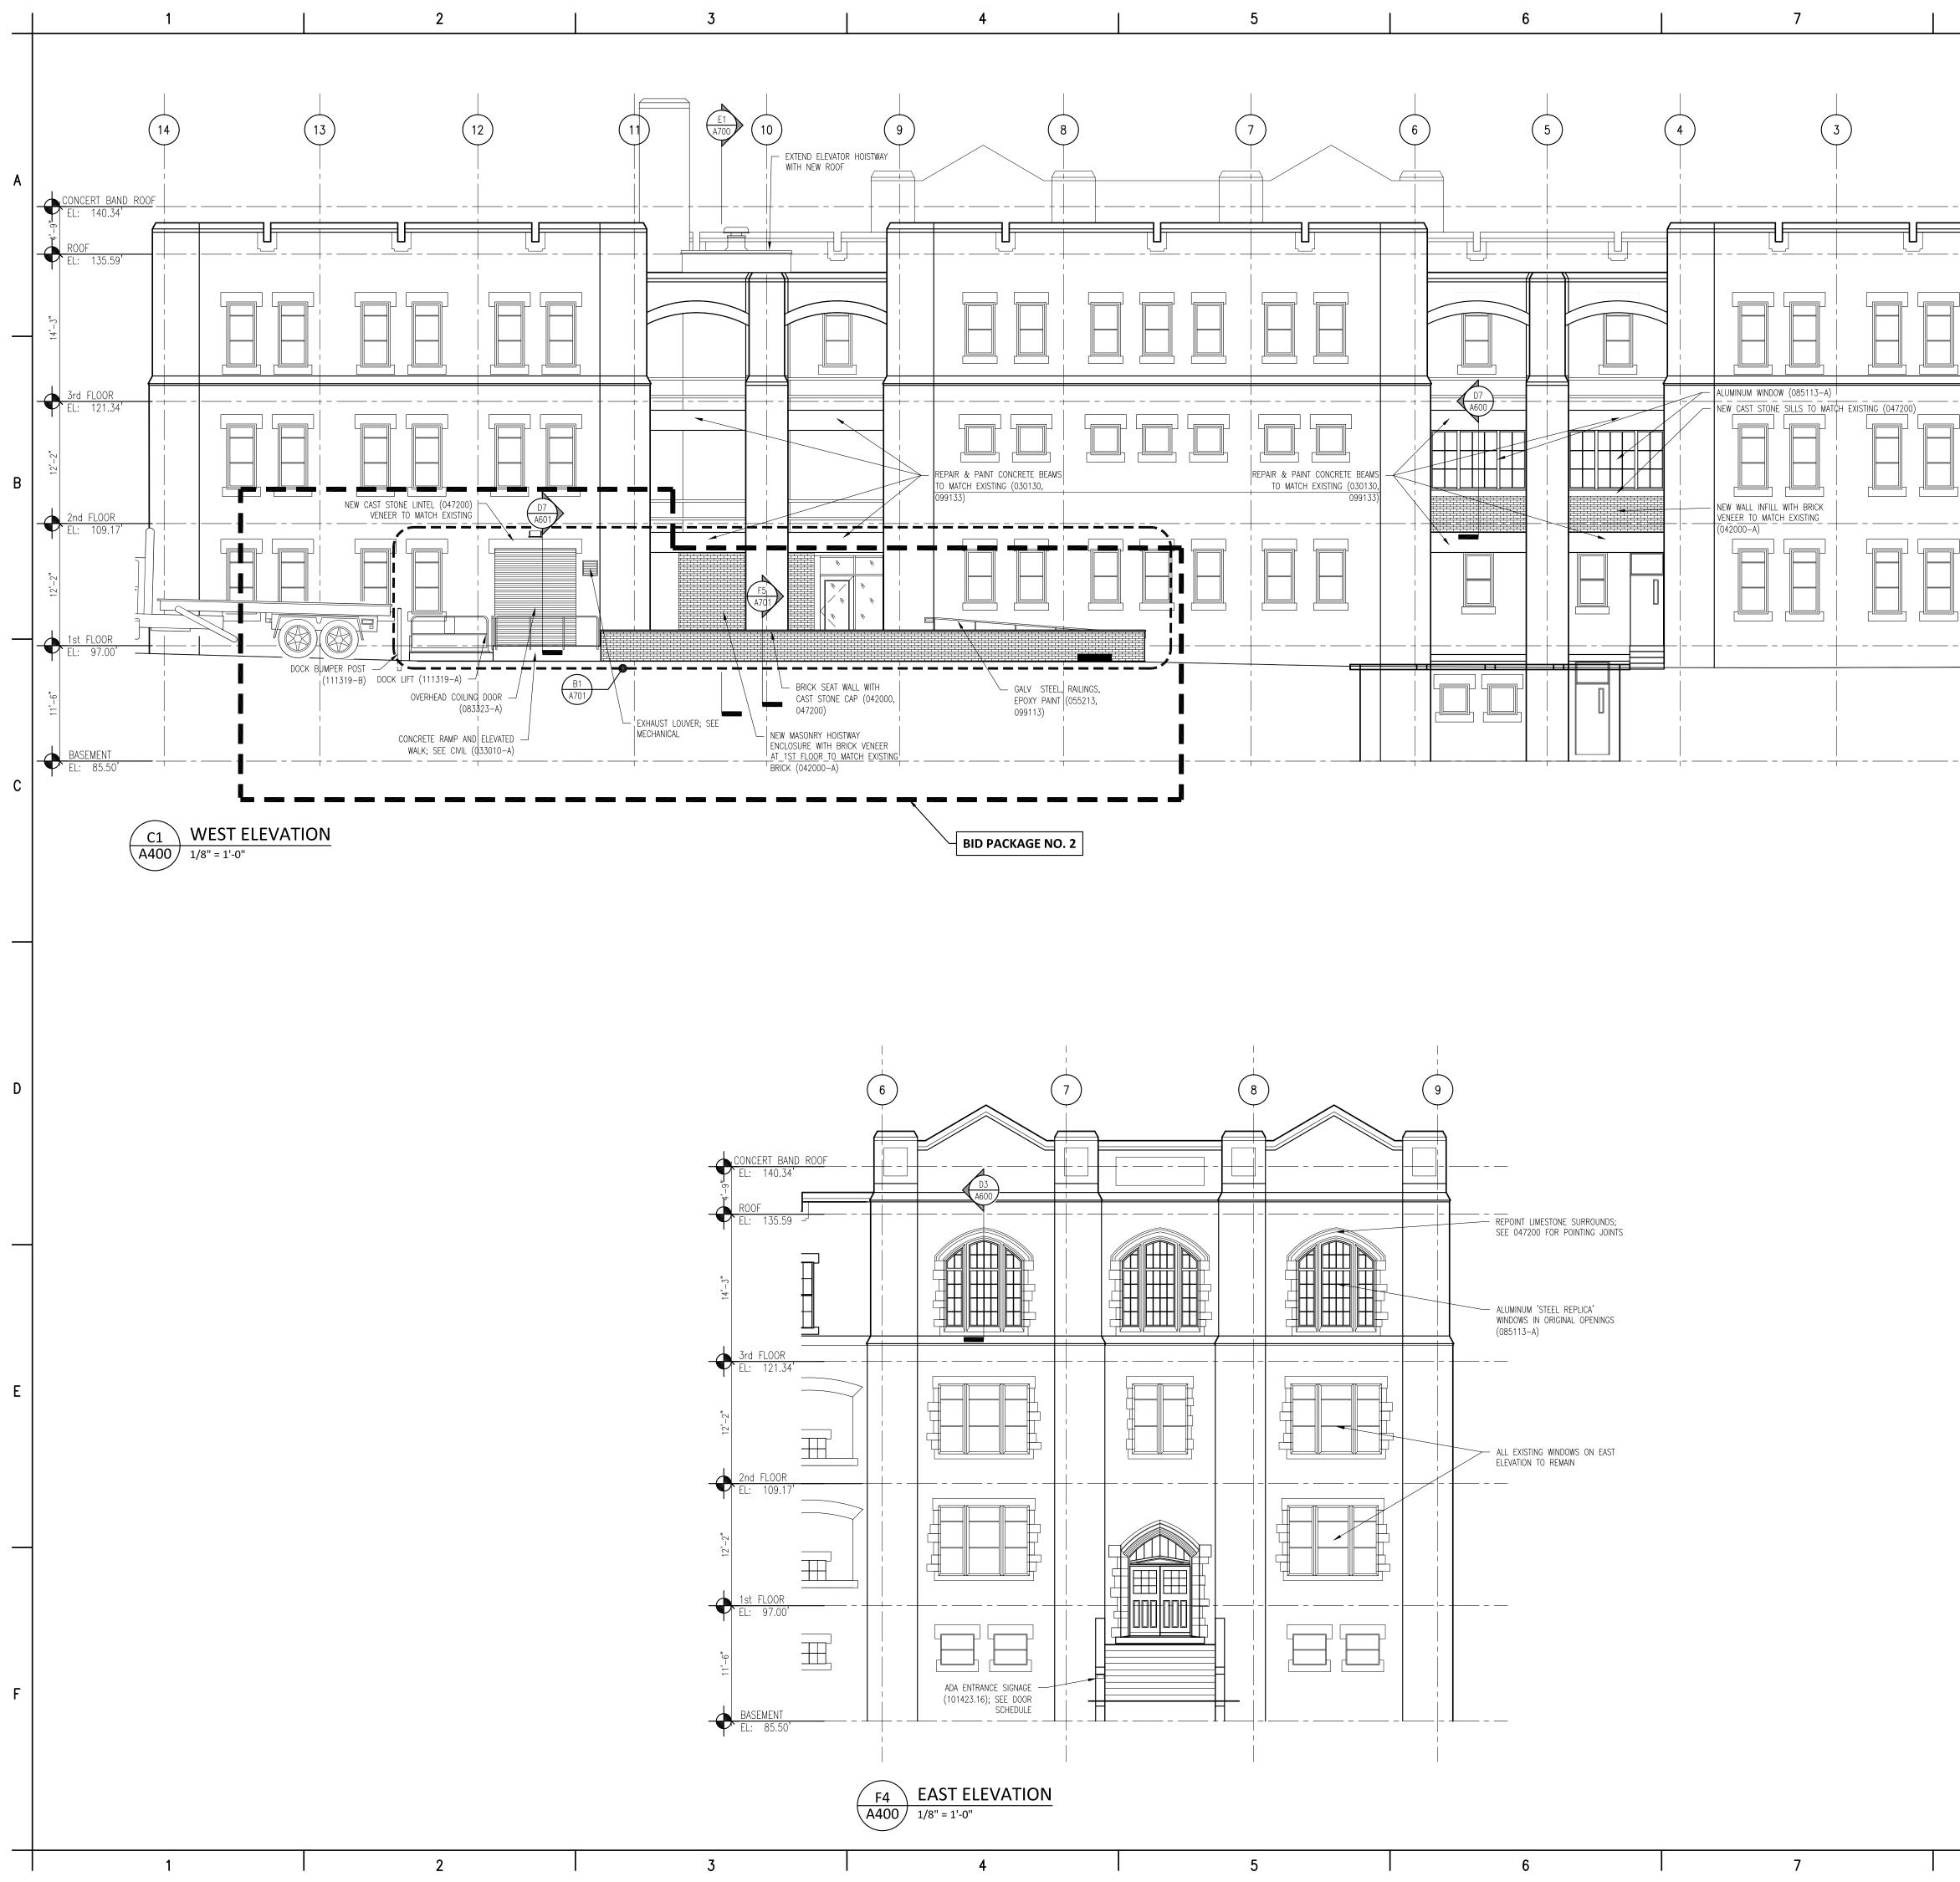
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	MATERIAL KEYNOTE LEGEND DIVISION 2: EXISTING CONDITIONS 024119 SELECTIVE DEMOLITION DIVISION 3: CONCRETE 030130 CONCRETE REPAIR (DRAWING SPEC NOTES ONLY) A SEE STRUCTURAL DRAWINGS	Mark B. Thompson Associates Architecture 502 South 24th Street Philadelphia, PA 19146 215.985.1000 www.mbtarchitects.com
ALTERNATE NO. 1.1	 033000 CAST IN-PLACE CONCRETE A NEW ELEVATED FLOOR SLAB AT BASEMENT LEVEL TO MATCH CORRIDOR FLOOR ELEVATION 033010 CAST IN-PLACE SITE CONCRETE; SEE CIVIL A EXTERIOR CONCRETE SLAB SUPPORTED ON NEW FOOTINGS WITH RAMP B EXTERIOR CONCRETE STAIRS 	Keast & Hood Company of New York, PC Structural Engineering 400 Market Street, Suite 1250 Philadelphia, PA 19106 215.625.0099 www.keasthood.com Dimitri J. Ververelli, Inc.
	035413 GYPSUM CEMENT UNDERLAYMENT A INTERIOR TOPPING / LEVELING SLAB DIVISION 4: MASONRY 042000 UNIT MASONRY A BRICK MASONRY VENEER TO MATCH EXISTING B ACCESSORIES (SEE DRAWINGS FOR TYPE)	Mechanical, Electrical, Plumbing, Fire Protection Engineering 211 North 13th Street Philadelphia, PA 19107 215.496.0000 www.djvinc.com Langan
	B1 TIES, REINFORCEMENT; HOT-DIP GALV OR STAINLESS STEEL C PRECAST CONCRETE LINTELS D EMBEDDED FLEXIBLE FLASHING E MESH WEEP / VENT 047200 CAST STONE MASONRY	Civil Engineering 21 Penn Plaza, 360 West 31st Street, 8th Floor New York, NY 10001 212.479.5400 www.langan.com Theatre Projects Acoustical Design
	 DIVISION 5: METALS 051200 STRUCTURAL STEEL FRAMING; SEE STRUCTURAL A ELEVATOR HOIST BEAMS 053100 STEEL DECKING; SEE STRUCTURAL A ROOF DECKING 055000 METAL FABRICATIONS A MISC STRUCTURAL SHAPES; GALVANIZED AT EXTERIOR B ABRASIVE CAST METAL NOSINGS C METAL FLOOR PLATE TRENCH COVER 055213 PIPE AND TUBE RAILINGS 	47 Water Street South Norwalk, CT 06854 203.299.0830 www.theatreprojects.com
	DIVISION 6: WOODS, PLASTICS, AND COMPOSITES 061000 ROUGH CARPENTRY 062023 INTERIOR FINISH CARPENTRY A GLEE CLUB ROOM 203: WOOD PICTURE RAIL & CHAIR RAIL TO MATCH EXISTING B CONCERT BAND ROOM 300: WOOD WALL BASE &	
	TRIMS; SEE DRAWINGS FOR DIMS & PROFILES C CHAIR RAIL D MISCELLANEOUS TRIM; SEE DRAWINGS FOR DIMS & PROFILES DIVISION 7: THERMAL AND MOISTURE PROTECTION 072100 THERMAL INSULATION	It is a violation of New York State Law for any person,
	 A SPRAY-APPLIED OPEN CELL MEDIUM DENSITY FOAM INSULATION, VAPOR PERMEABLE 072129 SPRAY-APPLIED CELLULOSE ACOUSTICAL INSULATION A SOUND ABSORPTIVE FINISH OVER 100% OF OVERHEAD DECK (BETWEEN STRUCTURAL BEAMS), MINIMUM NRC 1.00, 4" SPRAY-ON CELLULOSE 075216 STYRENE-BUTADIENE-STYRENE (SBS) MODIFIED BITUMINOUS MEMBRANE ROOFING A SBS BASE SHEET + 3 PLIES AND CAP SHEET, IN COLD APPLIED ADHESIVE WITH HIGH-REFLECTIVE ROOF 	unless he is acting under the direction of a licensed Professional Engineer or Land Surveyor, to alter an item in any way. If an item bearing the seal of an Engineer or Land Surveyor is altered, the altering Engineer or Land Surveyor shall affix to the item his seal and the notation "altered by" followed by his signature and the date of such alteration, and a specific description of the alteration.
	COATING TO MATCH EXISTING B FLASHING & STRIPPING MATERIALS C ROOF INSULATION D INSULATION COVER BOARD E VAPOR RETARDER / AIR BARRIER F SUBSTRATE BOARD 076200 SHEET METAL FLASHING AND TRIM A LOW-SLOPE ROOF EDGE FLASHINGS AND COPINGS	 General Notes All dimensions and existing conditions shall be checked and verified by contractor at the site prior to proceeding with the work. Contractor shall inform Architect/ Engineer of any discrepancies on drawings before construction begins. No existing service may be cut without
	077200 ROOF ACCESSORIES A SERVICE ACCESS PLATFORM SYSTEM 079200 JOINT SEALANTS 079219 ACOUSTICAL JOINT SEALANTS DIVISION 8: OPENINGS 080314 HISTORIC TREATMENT OF WOOD DOORS	 Architect/Engineers's consent. Any existing service severed or damaged shall be replaced at no cost to owner. 4. Contractor must notify Architect/ Engineer at once if hidden existing conditions encountered require design modifications.
	081113 HOLLOW METAL DOORS AND FRAMES 081113 HOLLOW METAL DOORS AND FRAMES 081416 FLUSH WOOD DOORS 081713 INTEGRATED METAL DOOR OPENING ASSEMBLIES 083113 ACCESS DOORS AND FRAMES A ACOUSTIC RATED B FIRE-RESISTIVE RATED 083323 OVERHEAD COILING DOORS	Issue Issued For Date 0 Bid & Permit 07-06-2022
PROJECT NORTH	A INSULATED ROLLING SERVICE DOOR, MANUAL CHAIN HOIST, CYLINDRICAL LOCK B FACE-OF-WALL MOUNTED JAMB C HOOD / HEAD PLATE 084113 ALUMINUM-FRAMED ENTRANCES AND STOREFRONTS A 1" LOW EMISSIVITY INSULATED GLASS UNIT 085113 ALUMINUM WINDOWS	PRELIMINARY Not For Construction
LEGEND SEE ELECTRICAL DRAWINGS FOR LIGHTING TYPES AND FIXTURE SCHEDULE	A 3-1/4" THERMAL ALUMINUM 'STEEL REPLICA' WINDOW SYSTEM A1 COVED MUNTIN GRID, SIMULATED TRUE DIVIDED LITES, CUSTOM PERIMETER AND INTERIOR AND EXTERIOR GRIDS TO SIMULATE ORIGINAL WINDOW SASH 087100 DOOR HARDWARE	Key Plan
100 8'-0"ROOM NUMBER PROPOSED CEILING HEIGHT OR OPEN TO STRUCTURE ABOVE (OSA) EXISTING CEILING HEIGHT (IF APPLICABLE)SOUND ABSORPTIVE FINISH OVER 100% OF OVERHEAD DECK (072129-A)	DIVISION 9: FINISHES 092116.23 GYPSUM BOARD SHAFT WALL ASSEMBLIES 092216 NON-STRUCTURAL METAL FRAMING A STUD FRAMING, RUNNER TRACKS B SUSPENSION SYSTEM FOR CEILINGS & SOFFITS C GRID SUSPENSION SYSTEM FOR GYPSUM BOARD CEILINGS 092900 GYPSUM BOARD 093013 CERAMIC TILING	
24" x 24" ACOUSTIC CEILING TILE & GRID SYSTEM (095113)	095113 ACOUSTICAL PANEL CEILINGS SEE RCPS AND FINISH SCHEDULE 096248 SOUND AND VIBRATION CONTROL FOR CONCRETE FLOATING FLOOR A 1" ROLL-OUT RUBBER MAT ISOLATION SYSTEM 096513 RESILIENT BASE & ACCESSORIES 096519 RESILIENT TILE FLOORING	EGNER HALL BUILDING 685
GWB & METAL FRAMING SYSTEM, PAINT OPEN TO STRUCTURE (OSA),	096623RESINOUS MATRIX TERRAZZO FLOORINGAWALL BASE: 3/8" x 6" HIGH PRECAST EPOXY TERRAZZO WALL BASE TO MATCH EXISTING096813TILE CARPETING097200WALL COVERINGSAGLEE CLUB ROOM 203: ACOUSTICAL TRANSPARENT FABRIC ON METAL FRAMING; SEE ELEVATIONS FOR	U.S. MILITARY ACADEMY West Point, New York
PAINT NO NEW CEILING WORK OR REPAIR	EXTENT 098433 SOUND-ABSORBING WALL UNITS A CONCERT BAND ROOM 300: SOUND ABSORPTIVE 1" FABRIC WRAPPED PANELS, MINIMUM NRC 1.00 B SECTIONALS ROOM 205, CORRIDORS & VESTIBULES WHERE NOTED ON FINISH SCHEDULE: SOUND ABSORPTIVE 2-1/8" FABRIC WRAPPED PANELS, MINIMUM NRC 1.05	Project No.: 11300
	 C GLEE CLUB ROOM 203: 2" DUCT LINER BOARD, 2.5 PCF MIN, CONCEALED IN WALL CAVITY D SOUND-DIFFUSING WALL UNIT CONCEALED IN WALL CAVITY 098436 SOUND-ABSORBING CEILING UNITS A 3/4" PLYWOOD PANEL SOUND REFLECTING CLOUDS SUSPENDED WITH FRAMING; ANGLE 5 DEGREES 	Date: July 06, 2022 Drawing Title:
	FROM HORIZONTAL IN RANDOM DIRECTIONS 099113 EXTERIOR PAINTING 099123 INTERIOR PAINTING 099300 STAINING AND TRANSPARENT FINISHING DIVISION 10: SPECIALTIES 101423.16 ROOM-IDENTIFICATION PANEL SIGNAGE	Reflected Ceiling Plan Second Floor
	102213 WIRE MESH PARTITIONS 102800 TOILET, BATH, AND LAUNDRY ACCESSORIES 104413 FIRE PROTECTION CABINETS 104416 FIRE EXTINGUISHERS (Continued on the following odd numbered sheet)	A 3 0 2
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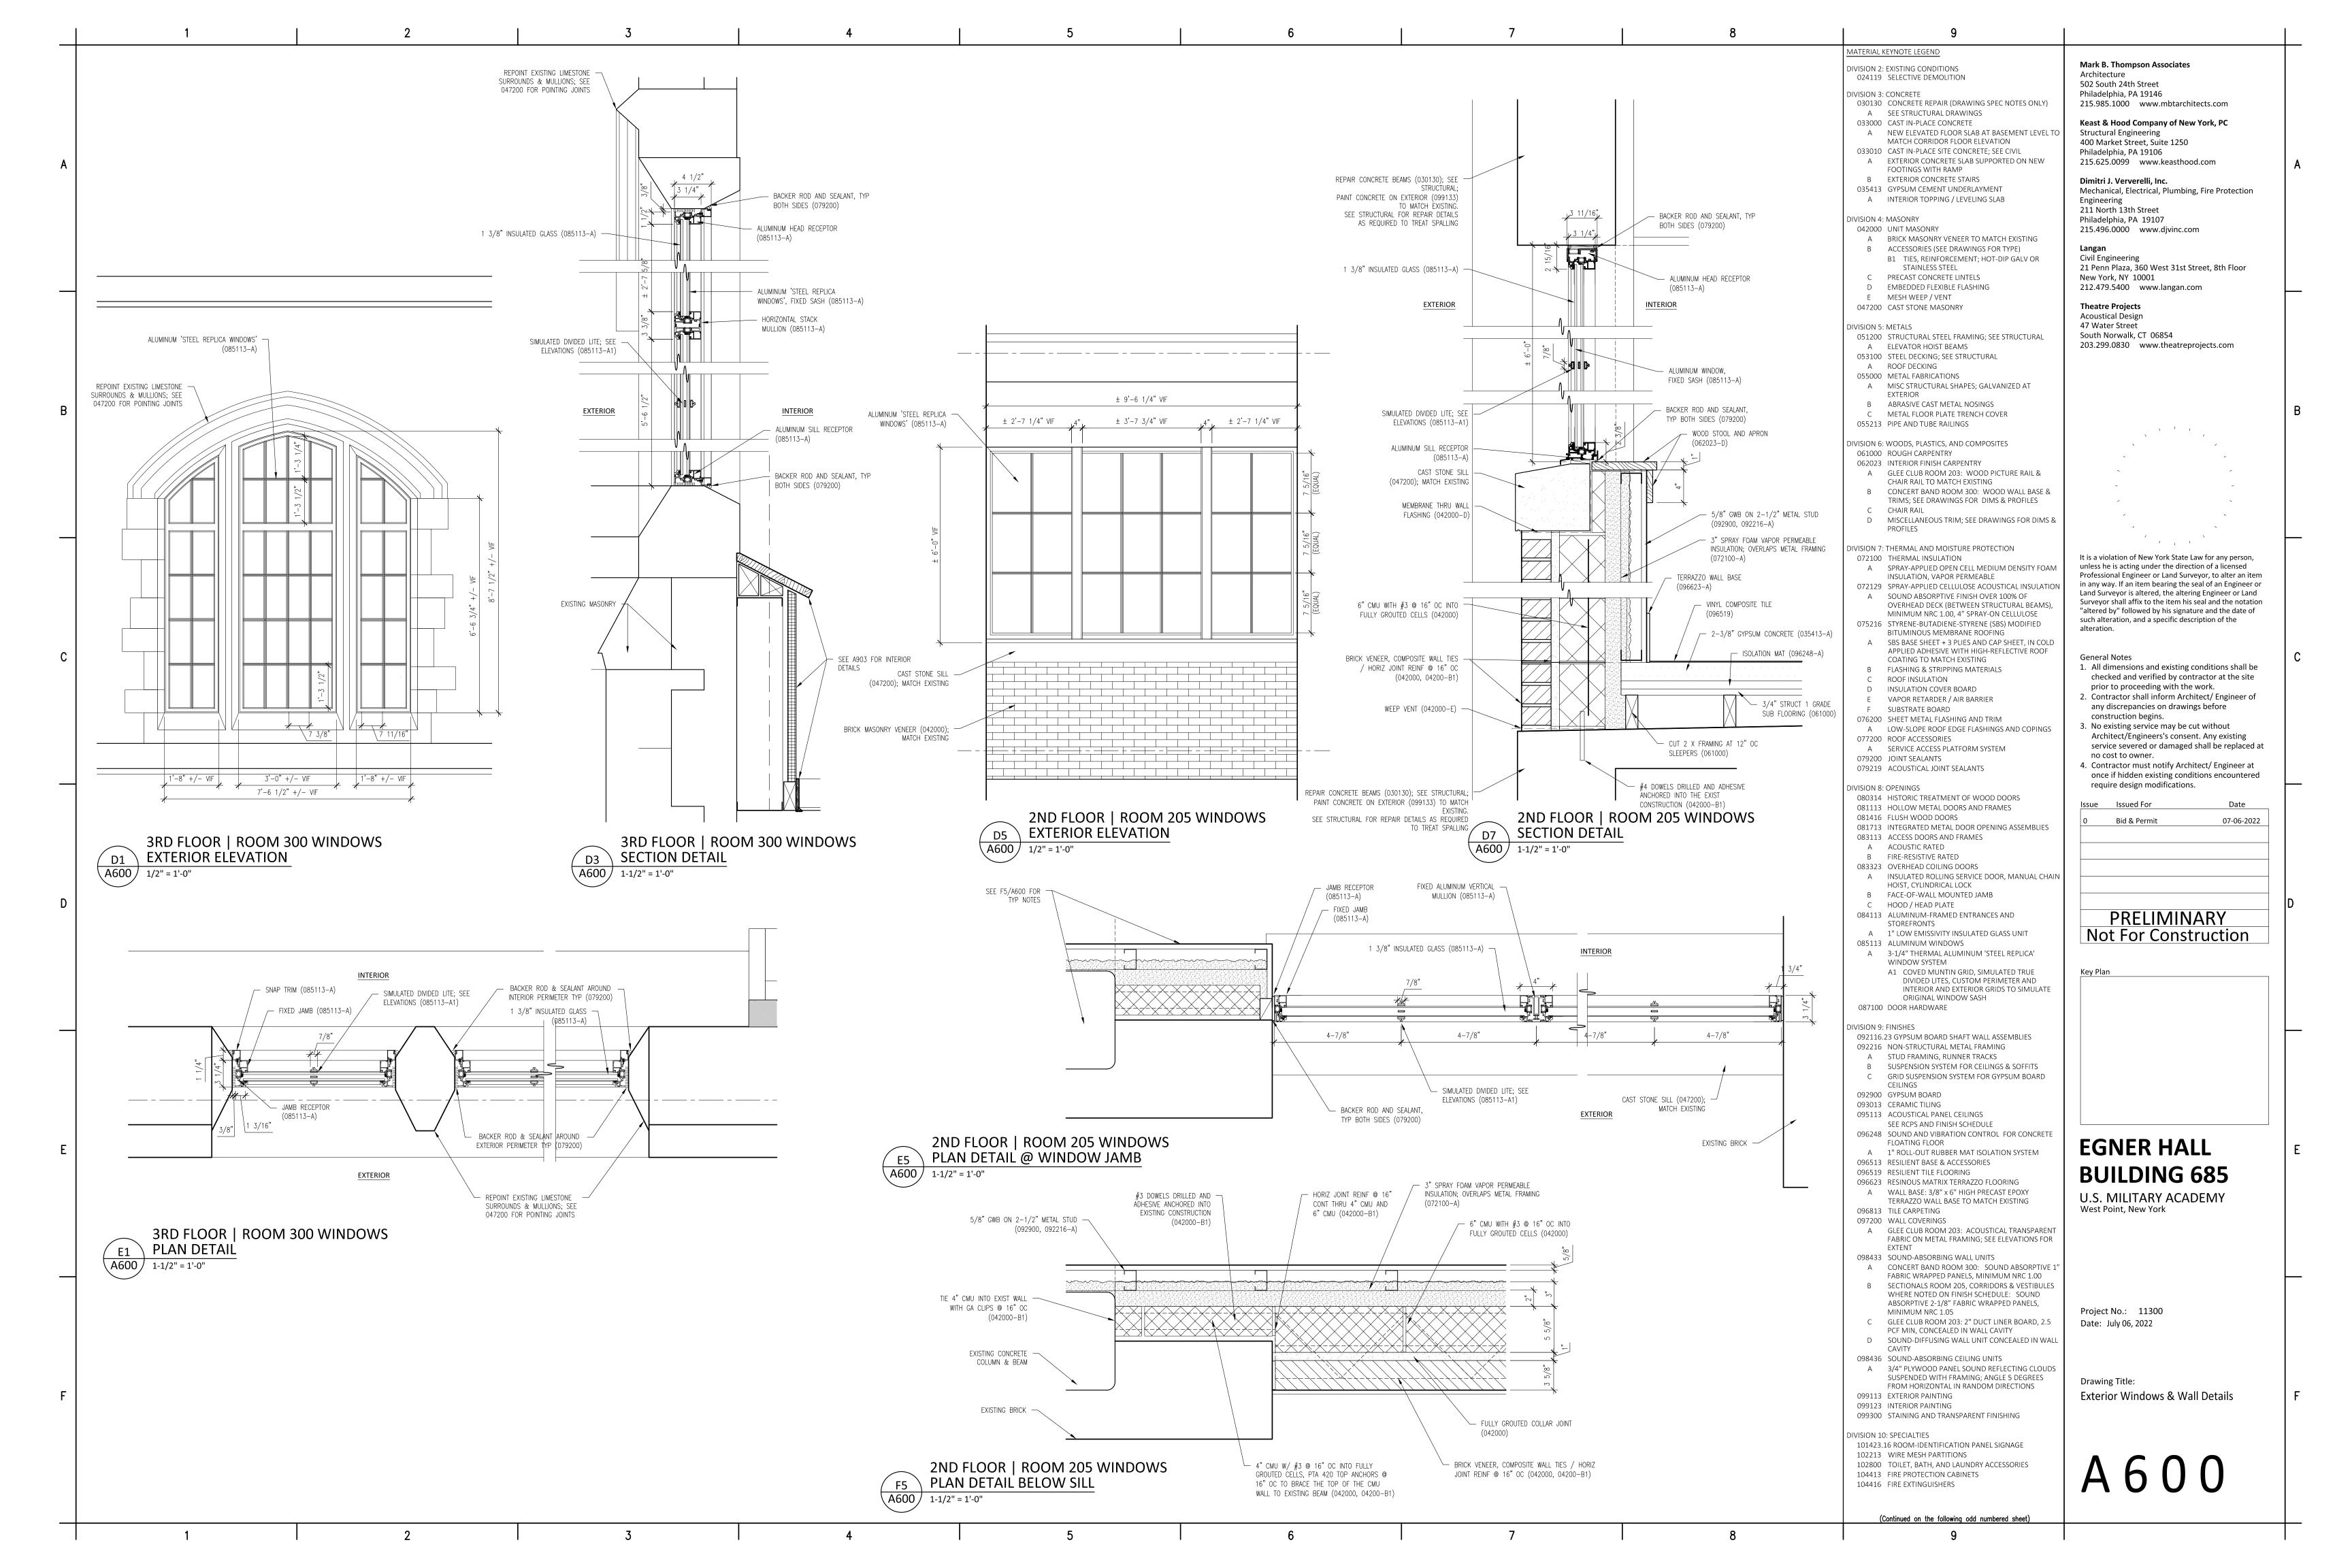



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	MATERIAL KEYNOTE LEGEND DIVISION 2: EXISTING CONDITIONS 024119 SELECTIVE DEMOLITION DIVISION 3: CONCRETE E 030300 CAST IN-PLACE CONCRETE A NEW LEVATED FLOOR SLAB AST BASEMENT LEVEL TO MATCH CORRIDOR FLOOR FLOOR SLAB AST BASEMENT LEVEL TO MATCH CORRIDOR FLOOR FLOOR SLAB AST BASEMENT LEVEL TO MATCH CORRIGOR TO PHILD AND MATCH EXISTING B EXTERIOR CONCRETE STARS 035410 STRUCTURAL STEEL C PRECAST CONCRETE LINTELS D ENBEDDED FLEXIBLE FLASHING E MESH WEEP / VENT 047200 CAST STORE MASONRY DIVISION 5: METALS 05100 STRUCTURAL STEEL FRAMING; SEE STRUCTURAL A ELEVATOR MOIST BEAMS 053100 STRUCTURAL STEEL FRAMING; SEE STRUCTURAL A ELEVATOR MOIST BEAMS 053100 STRUCTURAL STEEL FRAMING; SEE STRUCTURAL A ELEVATOR MOIST BEAMS 053100 STRUCTURAL STEEL FRAMING; SEE STRUCTURAL A ELEVATOR MOIST BEAMS 053100 STRUCTURAL STEEL FRAMING; SEE STRUCTURAL A ELEVATOR MOIST BEAMS 053100 STRUCTURAL STEEL FRAMING; SEE STRUCTURAL A ELEVATOR MOIST BEAMS 053100 STRUCTURAL STEEL FRAMING; SEE STRUCTURAL A ELEVATOR MOIST BEAMS 053100 STRUCTURAL STRUCTURAL SEA SALIVANIZED AT EXTENDR B ARASIVE CAST METAL NOSINGS C METAL FABRICATIONS A MISC STRUCTURAL STRUCTURAL SEA SALIVANIZED AT EXTENDR B ARASIVE CAST METAL NOSINGS C METAL FLOOR PLATE TRENCH COVER 055213 PIPE AND TUBE RALINGS DIVISION THERIOR FINISH CARPENTRY A GLEQUES NOVED PLATER FROM SOLID PLATER FALL SALIVANIZED AT C MOOD, PLATER, SEE ORAWINGS FOR DIMS & PROFILES DIVISION THERMAL INDUMINES AND CONDENTY FOAM A NISCELLANEDUS TRIM; SEE DRAWINGS FOR DIMS & PROFILES DIVISION THERMAL AND MOISTURE PROTECTION A SUBDER FOR CONG PREVERABL	Mark 8. Thompson Associates Architecture SO2 South 24th Street Philadelphia, PA 19146 215.985.1000 Www.keasthood.com Cast & Hood Company of New York, PC Structural Engineering 400 Market Street, Suite 1250 Philadelphia, PA 19106 215.625.0099 211 Vorth 13th Street Philadelphia, PA 19107 211. North 13th Street Philadelphia, PA 19107 215.496.0000 211 Penn Plaza, 360 West 31st Street, 8th Floor New York, NY 10001 212.479.5400 Yater Street South Norwalk, CT 06854 203.299.0830 Yoww.theatreprojects.com
	083323 OVERHEAD COILING DOORS A INSULATED ROLLING SERVICE DOOR, MANUAL CHAIN HOIST, CYLINDRICAL LOCK B FACE-OF-WALL MOUNTED JAMB C HOOD / HEAD PLATE	PRELIMINARY Not For Construction

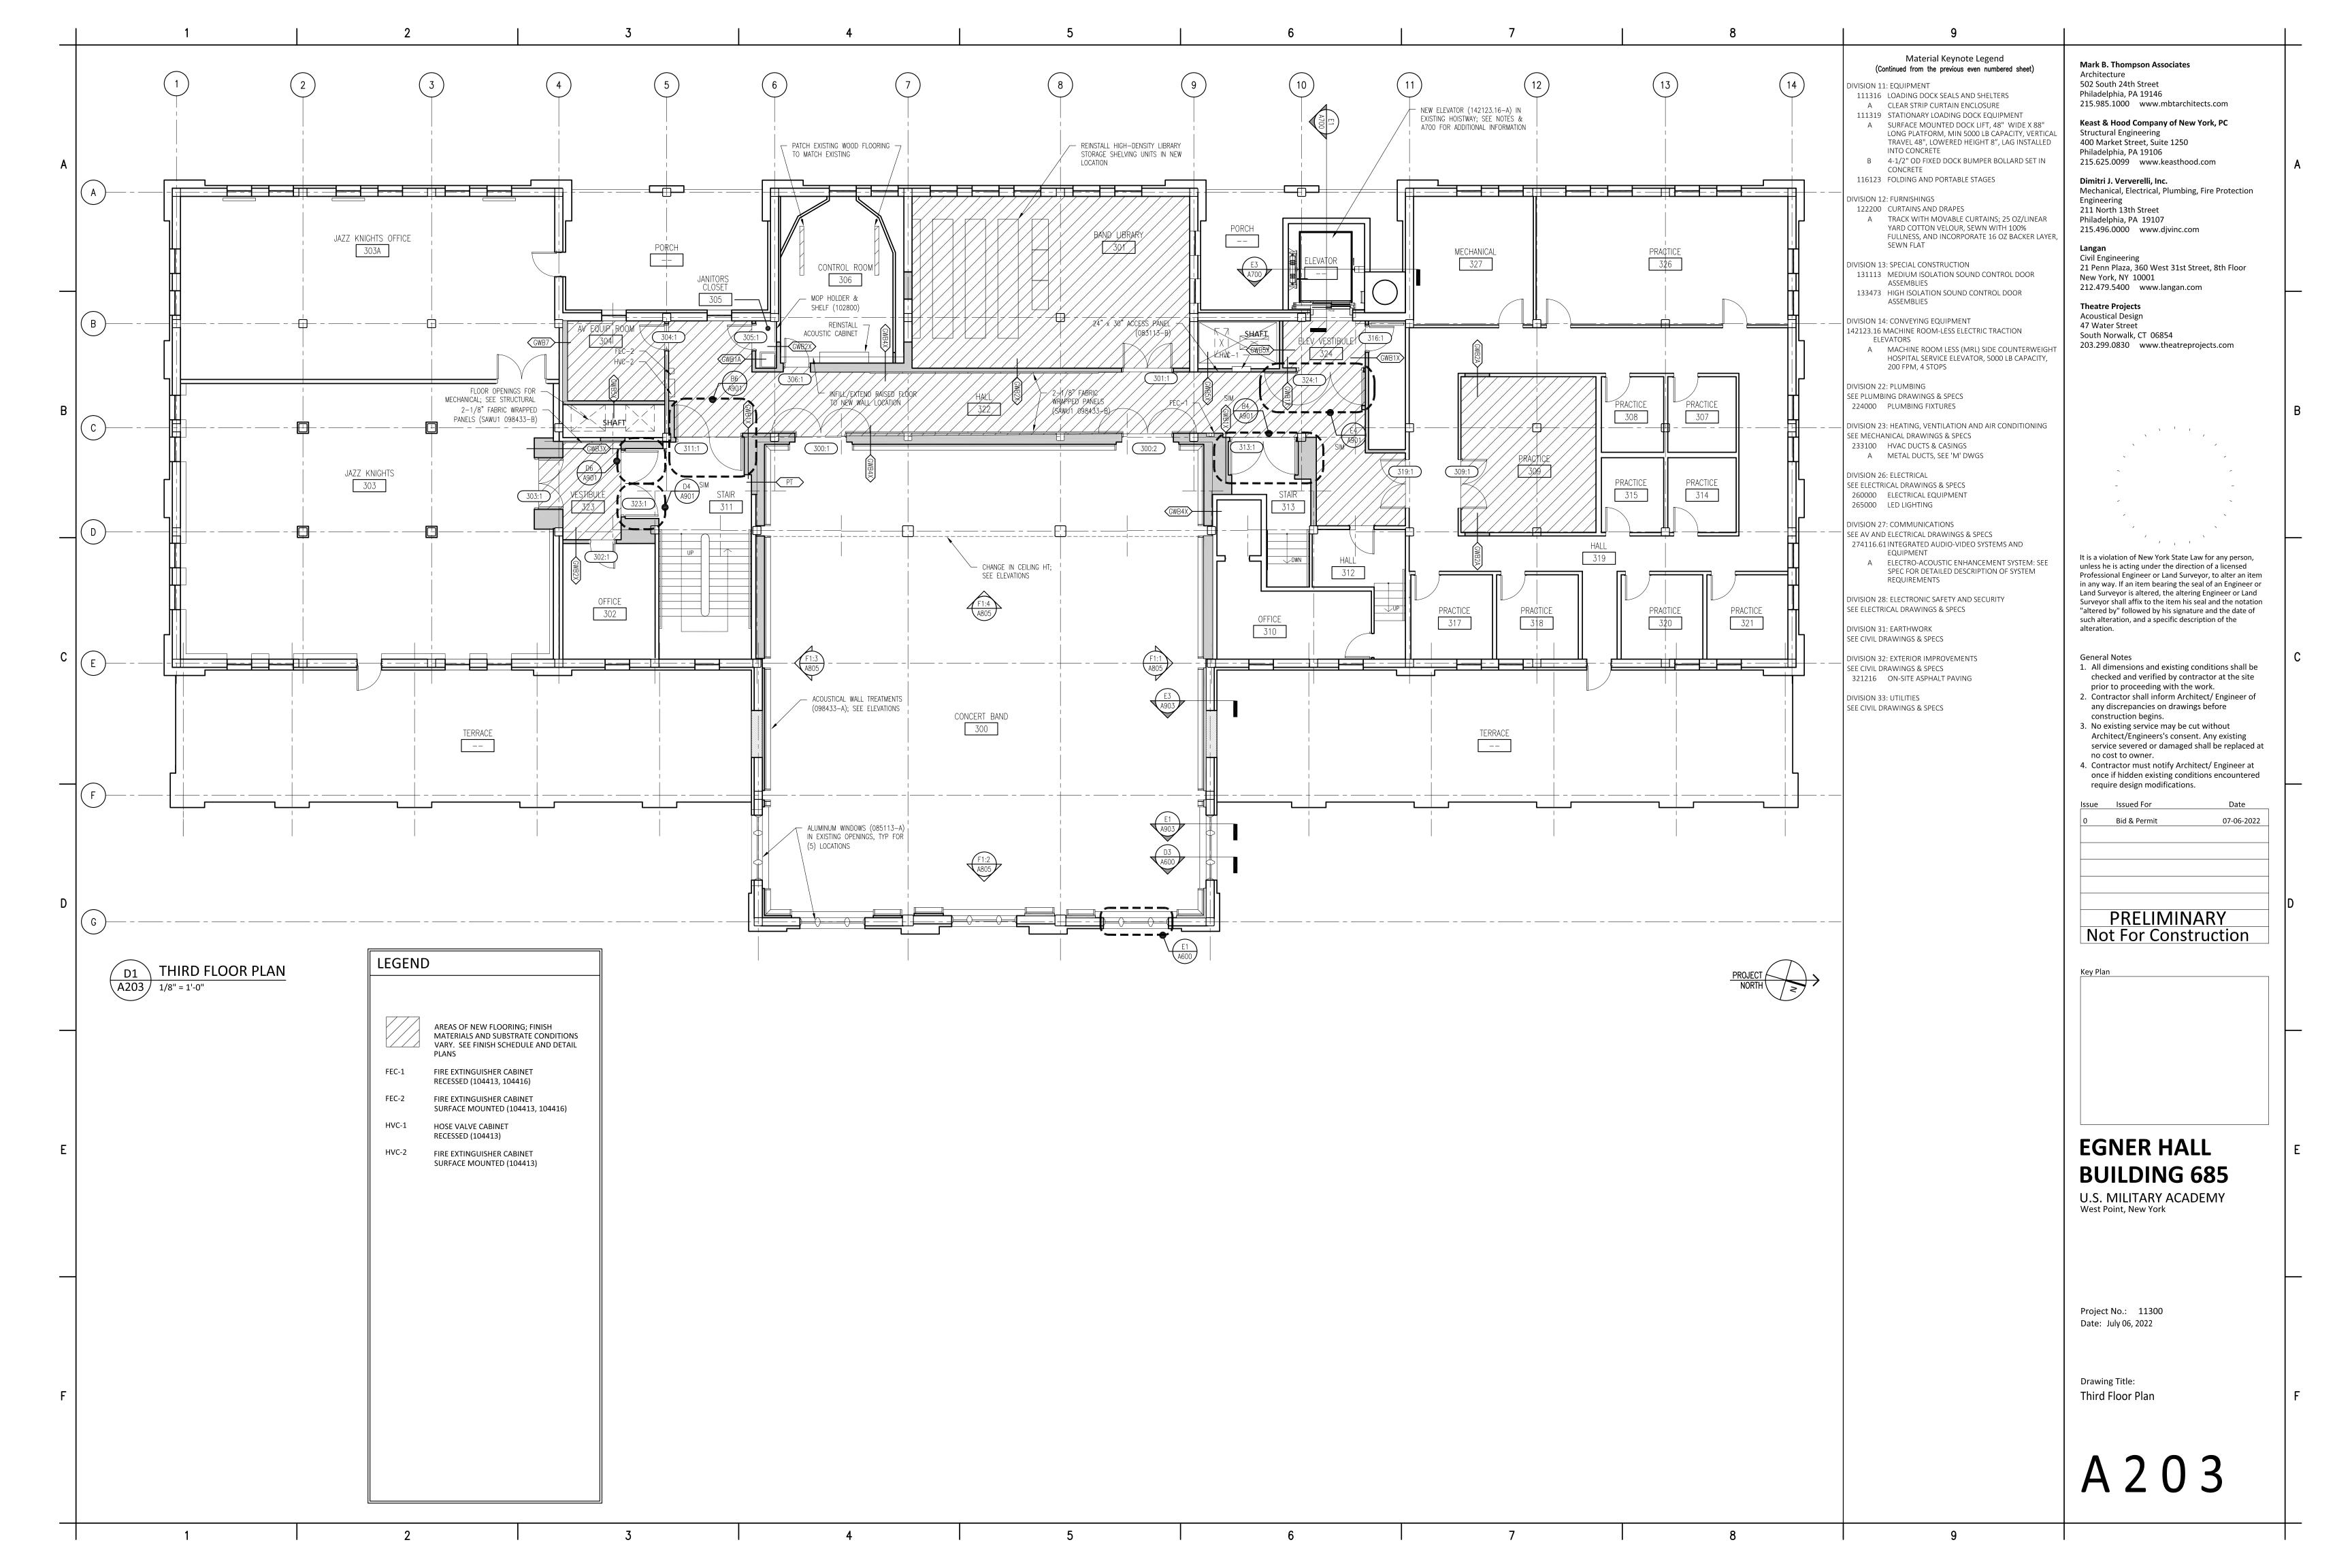
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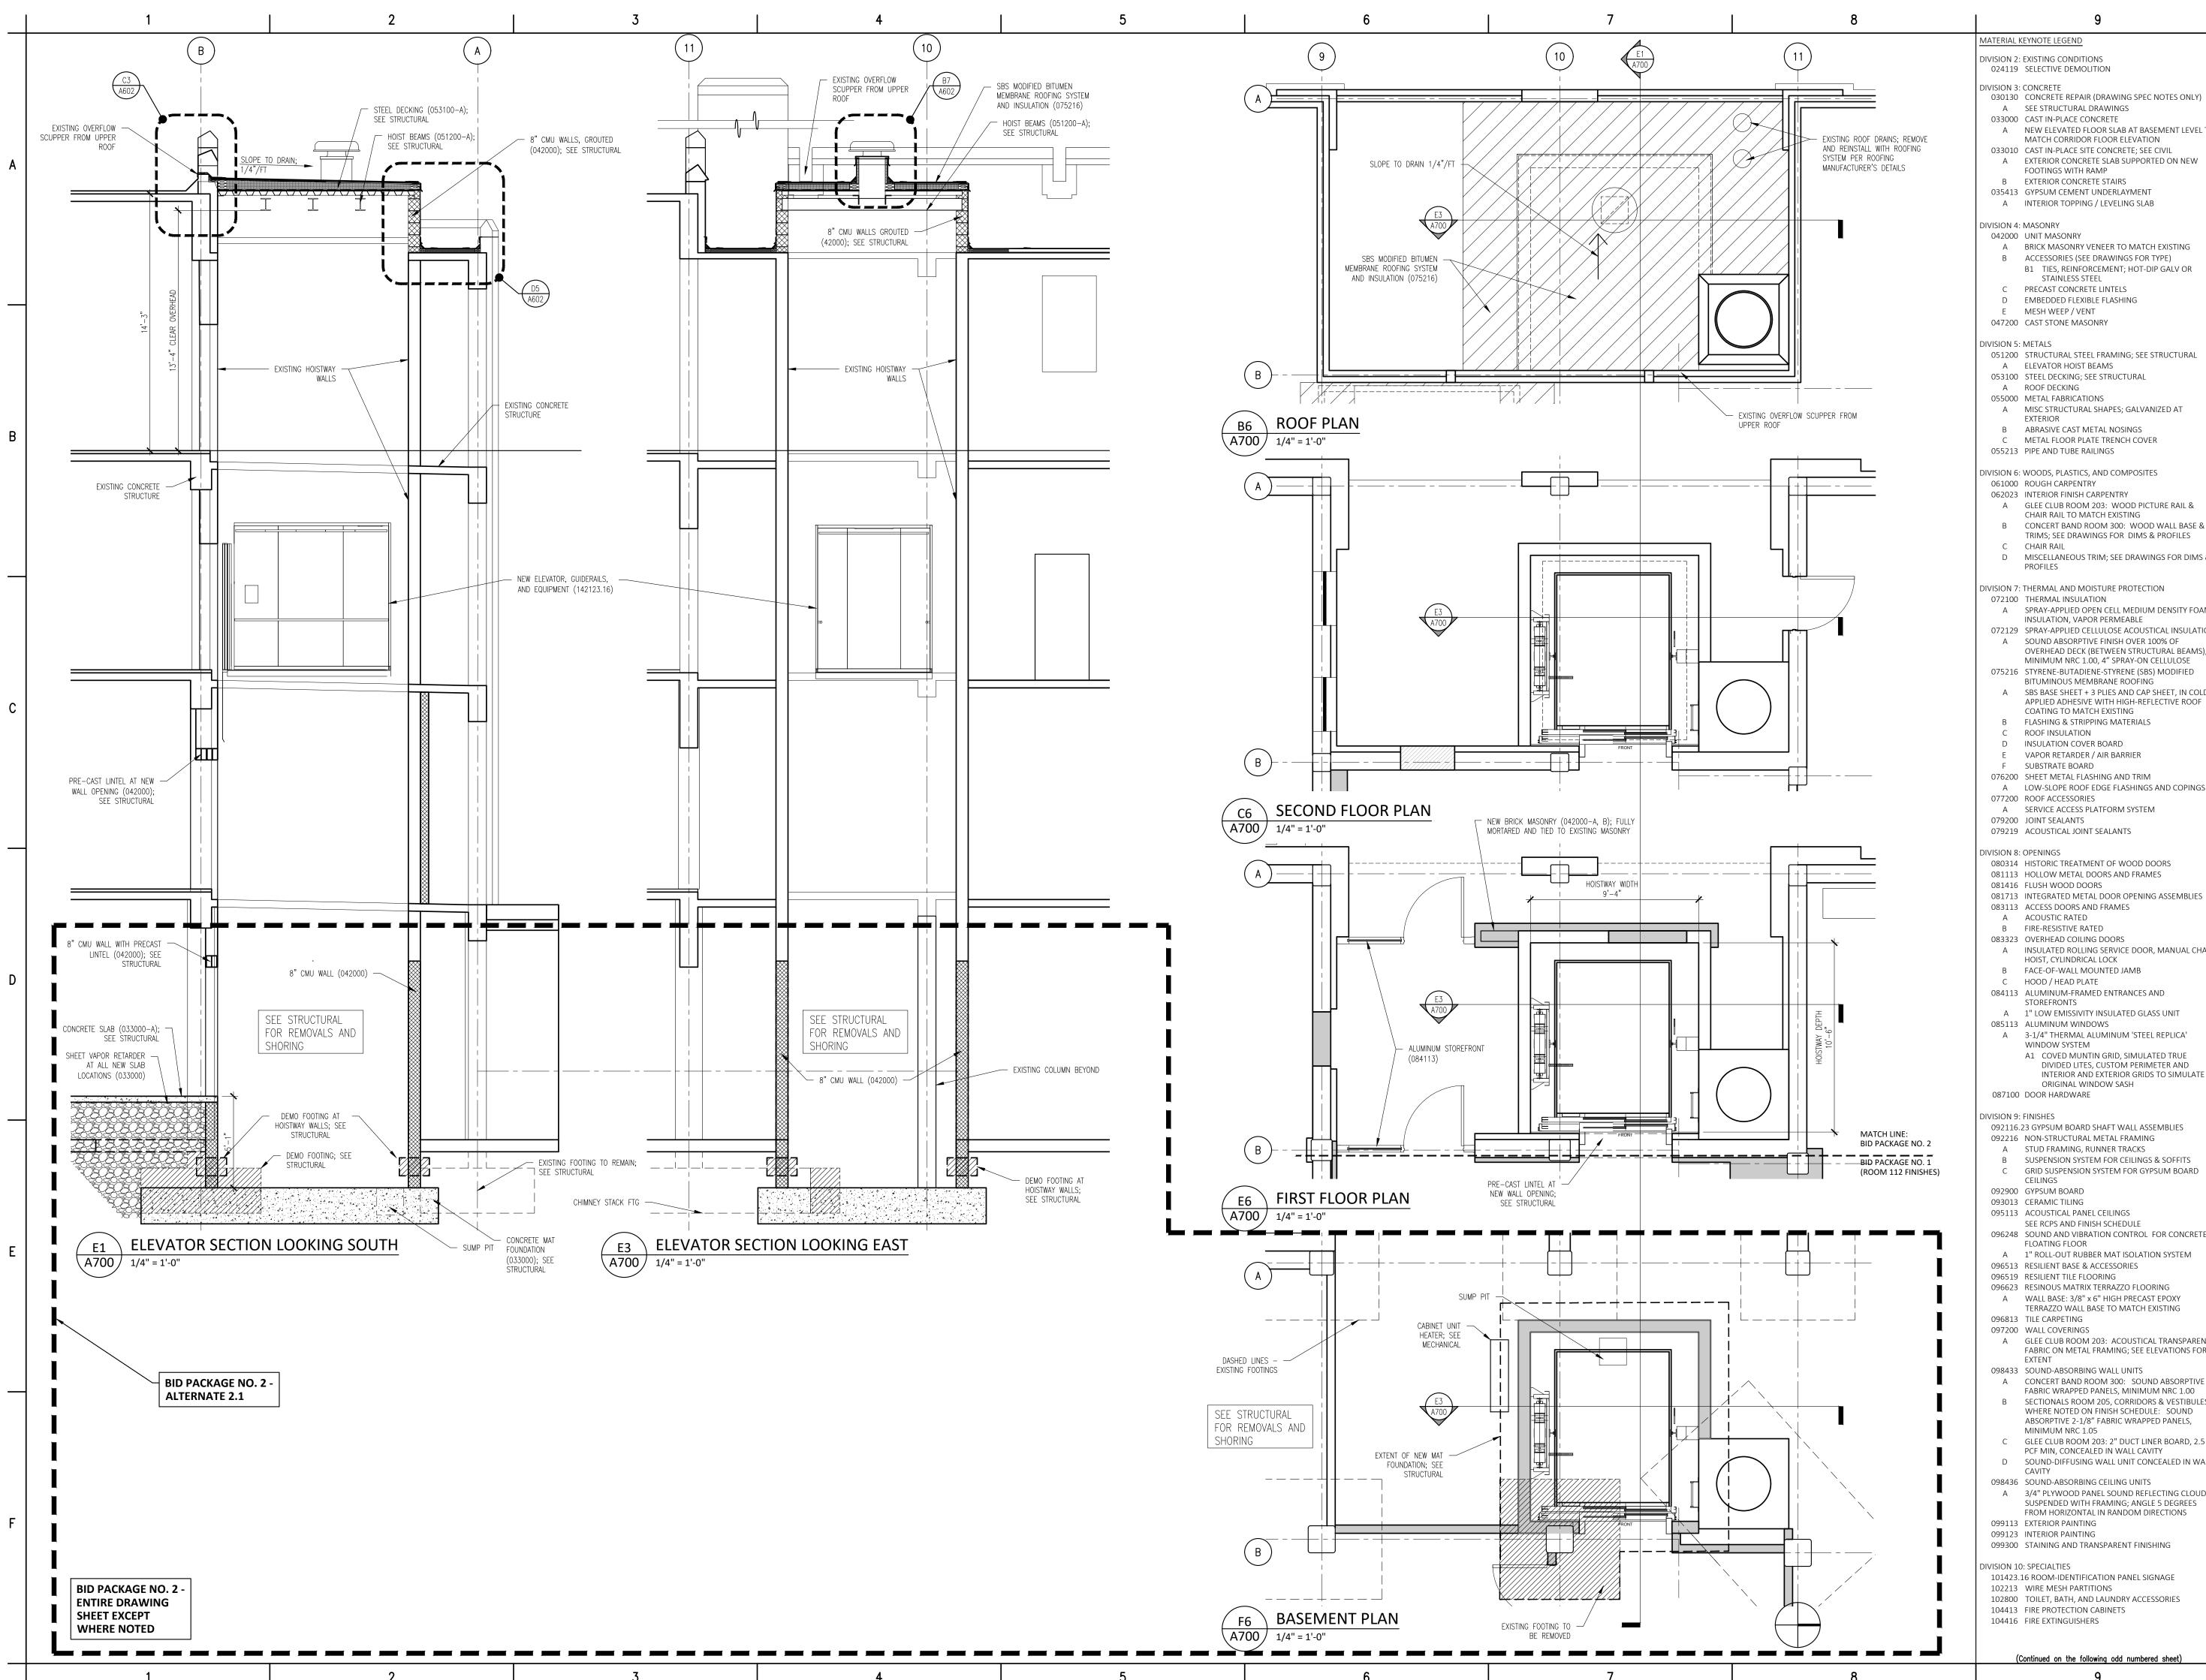
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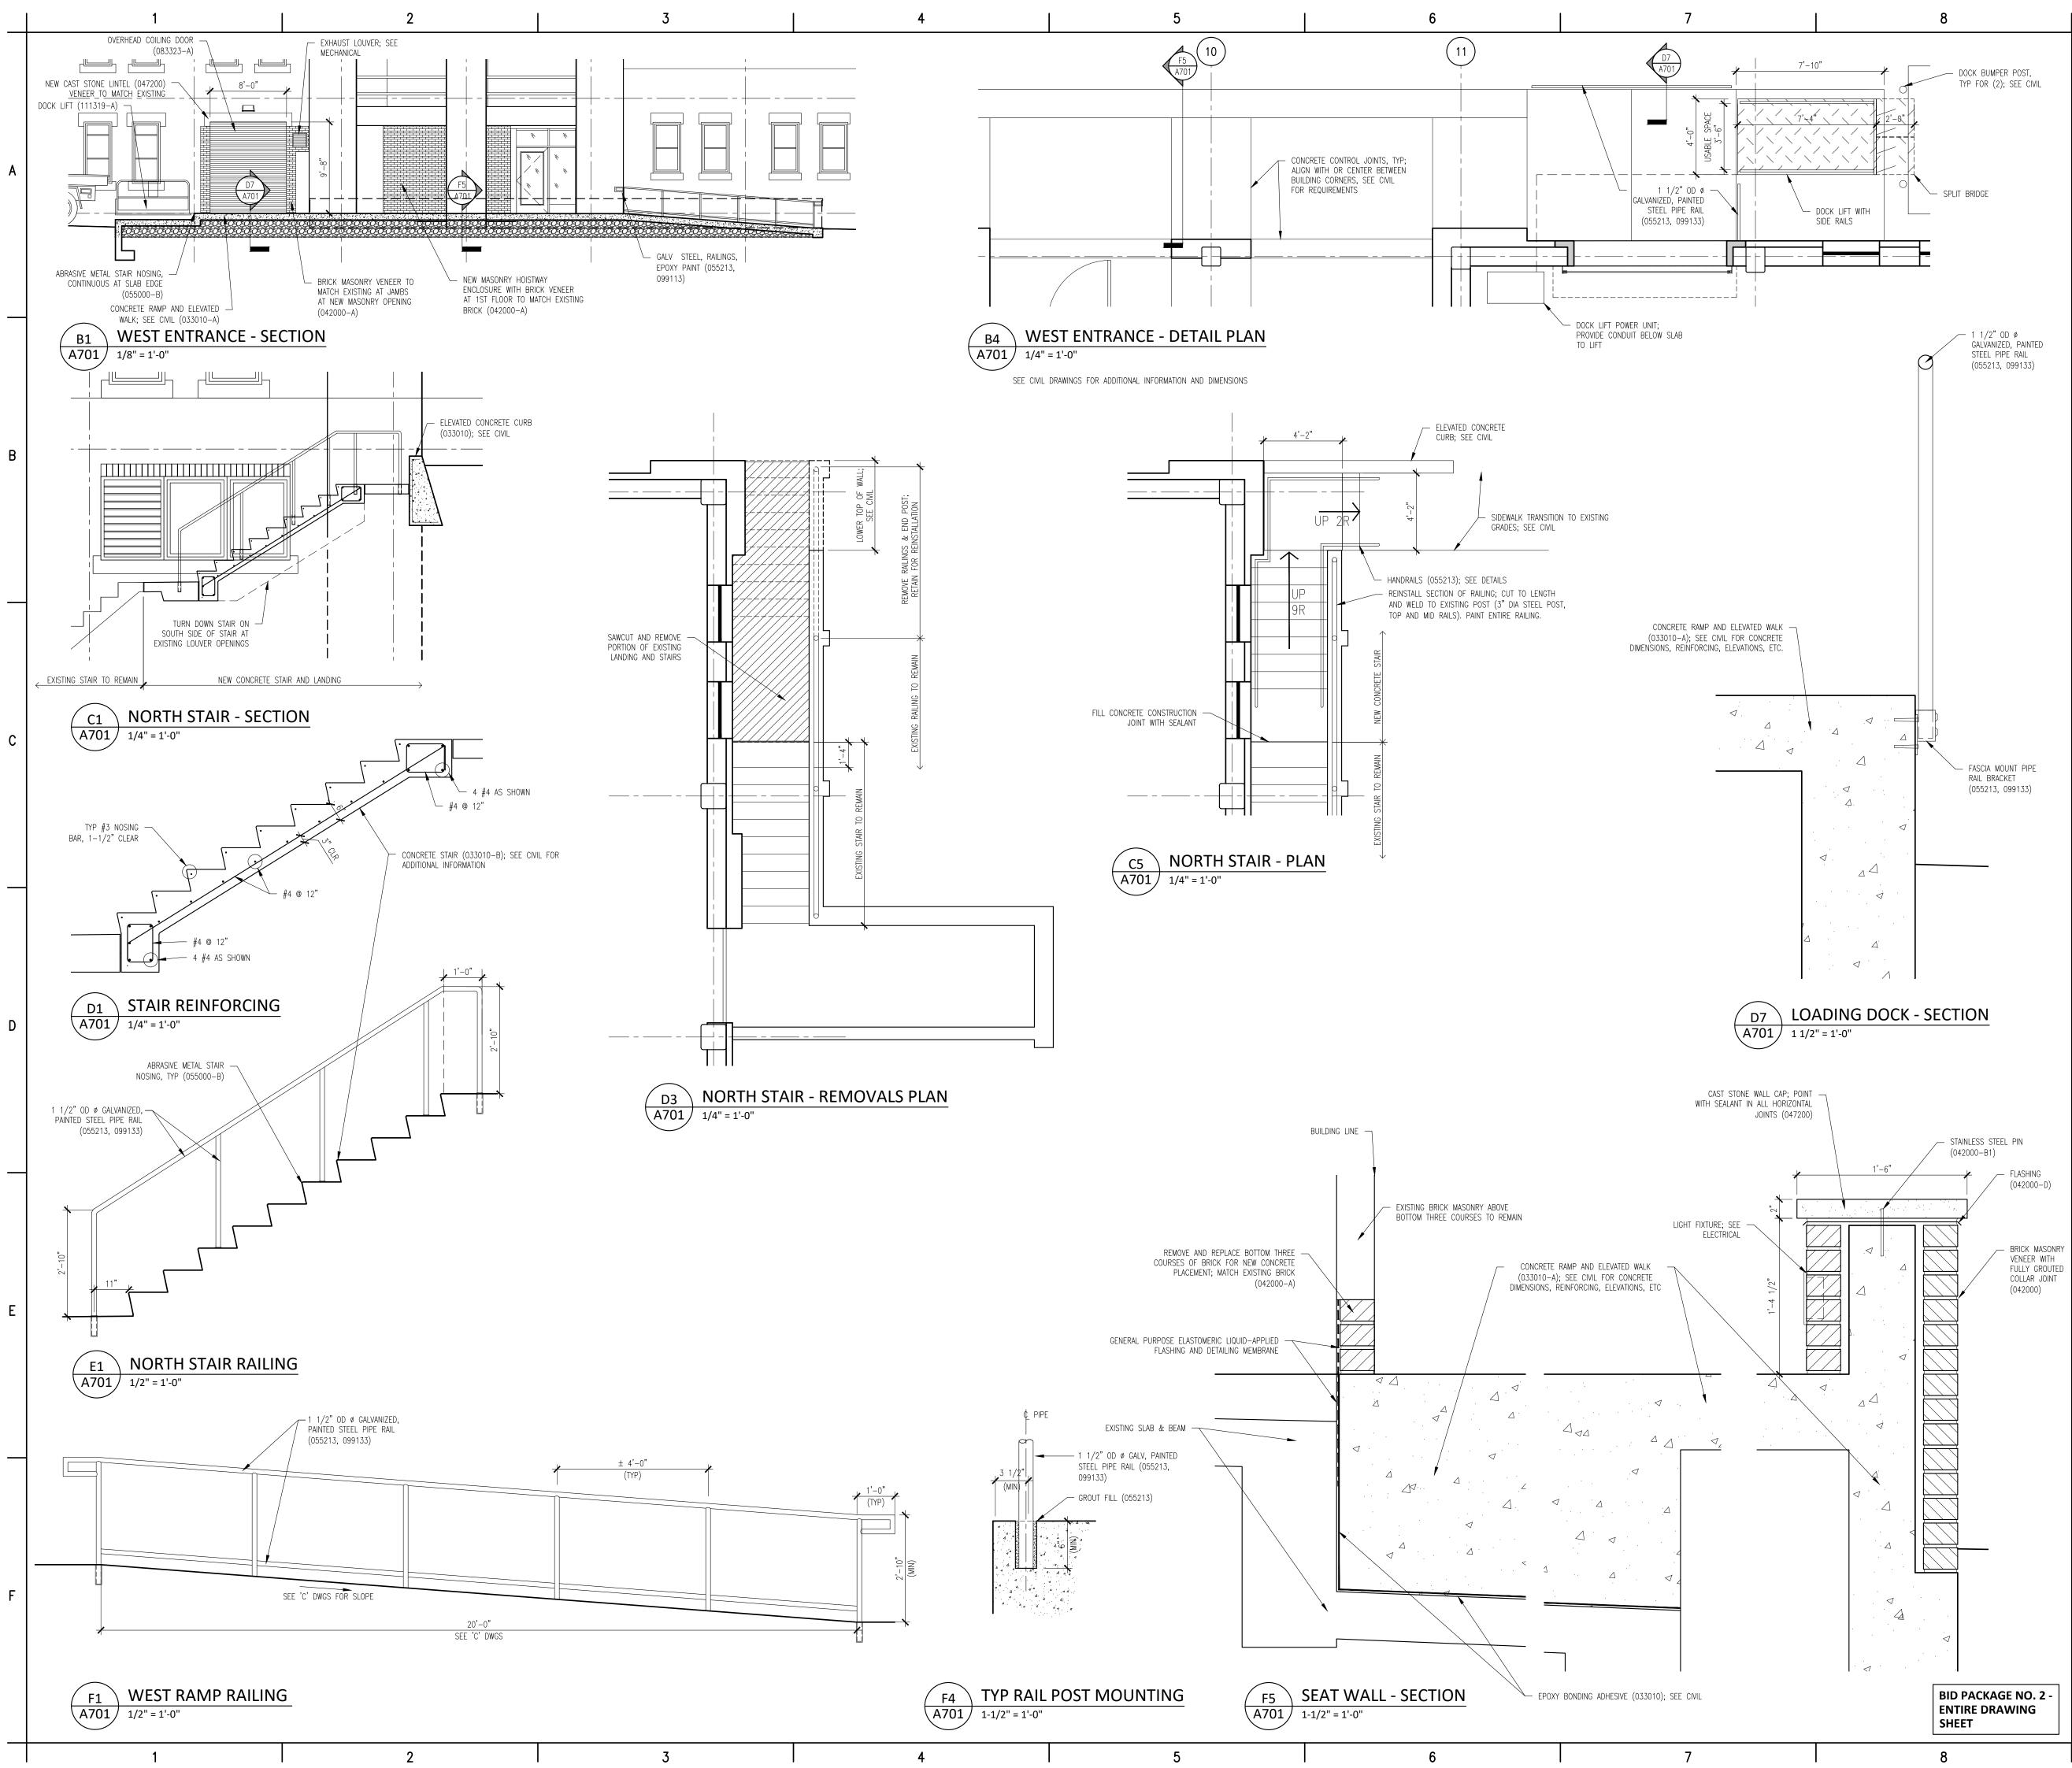


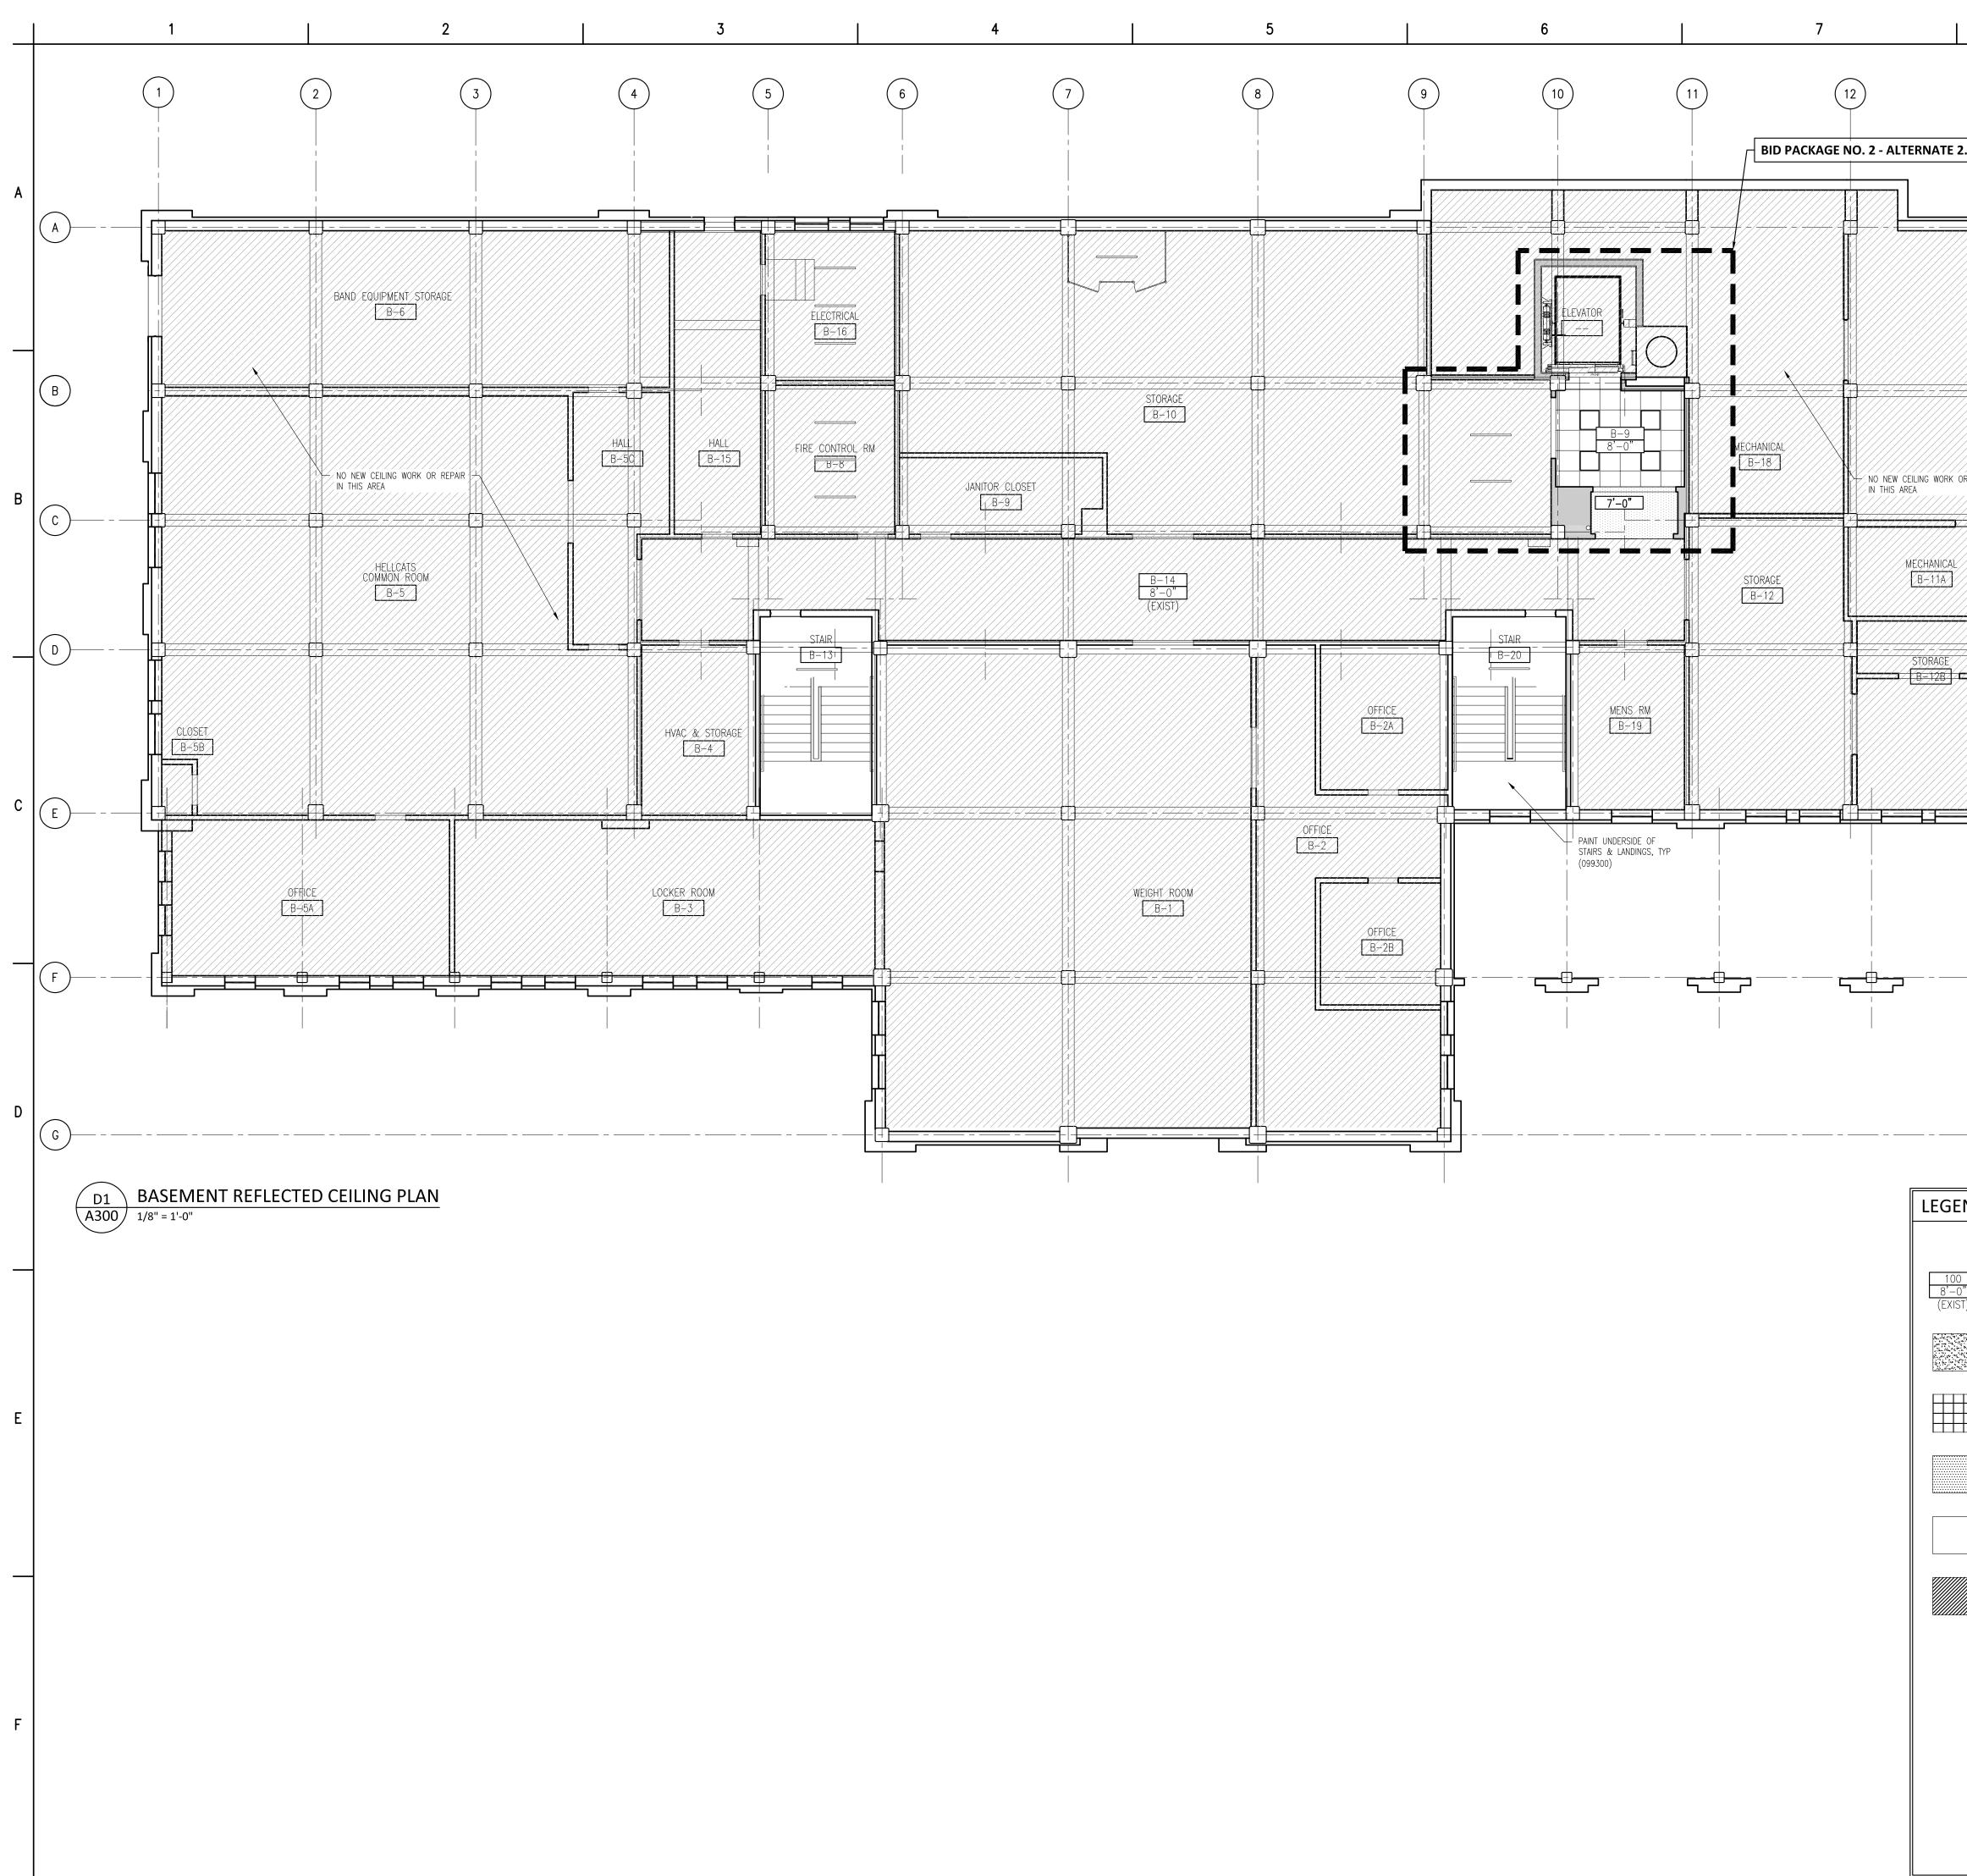


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. VENTILATOR WITH INSULATED MECHANICAL DRAWINGS	MATERIAL KEYNOTE LEGEND DIVISION 2: EXISTING CONDITIONS 024119 SELECTIVE DEMOLITION DIVISION 3: CONCRETE	Mark B. Thompson Associates Architecture 502 South 24th Street Philadelphia, PA 19146 215 205 1020
	 030130 CONCRETE REPAIR (DRAWING SPEC NOTES ONLY) A SEE STRUCTURAL DRAWINGS 033000 CAST IN-PLACE CONCRETE A NEW ELEVATED FLOOR SLAB AT BASEMENT LEVEL TO MATCH CORRIDOR FLOOR ELEVATION 033010 CAST IN-PLACE SITE CONCRETE; SEE CIVIL A EXTERIOR CONCRETE SLAB SUPPORTED ON NEW FOOTINGS WITH RAMP B EXTERIOR CONCRETE STAIRS 035413 GYPSUM CEMENT UNDERLAYMENT 	215.985.1000 www.mbtarchitects.com Keast & Hood Company of New York, PC Structural Engineering 400 Market Street, Suite 1250 Philadelphia, PA 19106 215.625.0099 www.keasthood.com Dimitri J. Ververelli, Inc.
METAL FLASHING AT EQUIPMENT CURB (076200–A) FLASHING CAP SHEET (075216–B)	A INTERIOR TOPPING / LEVELING SLAB DIVISION 4: MASONRY 042000 UNIT MASONRY A BRICK MASONRY VENEER TO MATCH EXISTING B ACCESSORIES (SEE DRAWINGS FOR TYPE) B1 TIES, REINFORCEMENT; HOT-DIP GALV OR	Mechanical, Electrical, Plumbing, Fire Protection Engineering 211 North 13th Street Philadelphia, PA 19107 215.496.0000 www.djvinc.com Langan Civil Engineering
FLEXIBLE MEMBRANE STRIPPING (075216-B)	STAINLESS STEEL C PRECAST CONCRETE LINTELS D EMBEDDED FLEXIBLE FLASHING E MESH WEEP / VENT 047200 CAST STONE MASONRY DIVISION 5: METALS	21 Penn Plaza, 360 West 31st Street, 8th Floor New York, NY 10001 212.479.5400 www.langan.com Theatre Projects Acoustical Design 47 Water Street
6" MIN SEE E1/A602 FOR TYPICAL ROOFING ASSEMBLY	051200 STRUCTURAL STEEL FRAMING; SEE STRUCTURAL A ELEVATOR HOIST BEAMS 053100 STEEL DECKING; SEE STRUCTURAL A ROOF DECKING 055000 METAL FABRICATIONS A MISC STRUCTURAL SHAPES; GALVANIZED AT EXTERIOR B ABRASIVE CAST METAL NOSINGS C METAL FLOOR PLATE TRENCH COVER 055213 PIPE AND TUBE RAILINGS	South Norwalk, CT 06854 203.299.0830 www.theatreprojects.com
SEE STRUCTURAL DRAWINGS FOR VENT OPENING SUPPORT DETAIL	DIVISION 6: WOODS, PLASTICS, AND COMPOSITES 061000 ROUGH CARPENTRY 062023 INTERIOR FINISH CARPENTRY A GLEE CLUB ROOM 203: WOOD PICTURE RAIL & CHAIR RAIL TO MATCH EXISTING B CONCERT BAND ROOM 300: WOOD WALL BASE & TRIMS; SEE DRAWINGS FOR DIMS & PROFILES C CHAIR RAIL D MISCELLANEOUS TRIM; SEE DRAWINGS FOR DIMS & PROFILES	
ATOR HOISTWAY VENTILATOR 1'-0" AL DRAWINGS FOR ADDITIONAL INFORMATION L EQUIPMENT CURB DETAILS	 DIVISION 7: THERMAL AND MOISTURE PROTECTION 072100 THERMAL INSULATION A SPRAY-APPLIED OPEN CELL MEDIUM DENSITY FOAM INSULATION, VAPOR PERMEABLE 072129 SPRAY-APPLIED CELLULOSE ACOUSTICAL INSULATION A SOUND ABSORPTIVE FINISH OVER 100% OF OVERHEAD DECK (BETWEEN STRUCTURAL BEAMS), MINIMUM NRC 1.00, 4" SPRAY-ON CELLULOSE 075216 STYRENE-BUTADIENE-STYRENE (SBS) MODIFIED BITUMINOUS MEMBRANE ROOFING A SBS BASE SHEET + 3 PLIES AND CAP SHEET, IN COLD APPLIED ADHESIVE WITH HIGH-REFLECTIVE ROOF 	It is a violation of New York State Law for any person, unless he is acting under the direction of a licensed Professional Engineer or Land Surveyor, to alter an item in any way. If an item bearing the seal of an Engineer or Land Surveyor is altered, the altering Engineer or Land Surveyor shall affix to the item his seal and the notation "altered by" followed by his signature and the date of such alteration, and a specific description of the alteration. General Notes
FOR VN AND DF IE IN EM	COATING TO MATCH EXISTING B FLASHING & STRIPPING MATERIALS C ROOF INSULATION D INSULATION COVER BOARD E VAPOR RETARDER / AIR BARRIER F SUBSTRATE BOARD 076200 SHEET METAL FLASHING AND TRIM A LOW-SLOPE ROOF EDGE FLASHINGS AND COPINGS 077200 ROOF ACCESSORIES A SERVICE ACCESS PLATFORM SYSTEM 079200 JOINT SEALANTS 079219 ACOUSTICAL JOINT SEALANTS	 All dimensions and existing conditions shall be checked and verified by contractor at the site prior to proceeding with the work. Contractor shall inform Architect/ Engineer of any discrepancies on drawings before construction begins. No existing service may be cut without Architect/Engineers's consent. Any existing service severed or damaged shall be replaced at no cost to owner. Contractor must notify Architect/ Engineer at
	DIVISION 8: OPENINGS 080314 HISTORIC TREATMENT OF WOOD DOORS 081113 HOLLOW METAL DOORS AND FRAMES 081416 FLUSH WOOD DOORS 081713 INTEGRATED METAL DOOR OPENING ASSEMBLIES 083113 ACCESS DOORS AND FRAMES A ACOUSTIC RATED B FIRE-RESISTIVE RATED 083323 OVERHEAD COILING DOORS	once if hidden existing conditions encountered require design modifications. Issue Issued For Date 0 Bid & Permit 07-06-2022
BID PACKAGE NO. 2 - ALTERNATE 2.1	 A INSULATED ROLLING SERVICE DOOR, MANUAL CHAIN HOIST, CYLINDRICAL LOCK B FACE-OF-WALL MOUNTED JAMB C HOOD / HEAD PLATE 084113 ALUMINUM-FRAMED ENTRANCES AND STOREFRONTS A 1" LOW EMISSIVITY INSULATED GLASS UNIT 085113 ALUMINUM WINDOWS A 3-1/4" THERMAL ALUMINUM 'STEEL REPLICA' WINDOW SYSTEM A1 COVED MUNTIN GRID, SIMULATED TRUE 	PRELIMINARY Not For Construction
SYSTEM; JFACTURER T	DIVIDED LITES, CUSTOM PERIMETER AND INTERIOR AND EXTERIOR GRIDS TO SIMULATE ORIGINAL WINDOW SASH 087100 DOOR HARDWARE DIVISION 9: FINISHES 092116.23 GYPSUM BOARD SHAFT WALL ASSEMBLIES 092216 NON-STRUCTURAL METAL FRAMING A STUD FRAMING, RUNNER TRACKS B SUSPENSION SYSTEM FOR CEILINGS & SOFFITS C GRID SUSPENSION SYSTEM FOR GYPSUM BOARD CEILINGS 092900 GYPSUM BOARD 093013 CERAMIC TILING 095113 ACOUSTICAL PANEL CEILINGS SEE RCPS AND FINISH SCHEDULE 096248 SOUND AND VIBRATION CONTROL FOR CONCRETE FLOATING FLOOR A 1" ROLL-OUT RUBBER MAT ISOLATION SYSTEM 096513 RESILIENT BASE & ACCESSORIES 096623 RESINOUS MATRIX TERRAZZO FLOORING	EGNER HALL BUILDING 685
	 A WALL BASE: 3/8" x 6" HIGH PRECAST EPOXY TERRAZZO WALL BASE TO MATCH EXISTING 096813 TILE CARPETING 097200 WALL COVERINGS A GLEE CLUB ROOM 203: ACOUSTICAL TRANSPARENT FABRIC ON METAL FRAMING; SEE ELEVATIONS FOR EXTENT 098433 SOUND-ABSORBING WALL UNITS A CONCERT BAND ROOM 300: SOUND ABSORPTIVE 1" FABRIC WRAPPED PANELS, MINIMUM NRC 1.00 B SECTIONALS ROOM 205, CORRIDORS & VESTIBULES WHERE NOTED ON FINISH SCHEDULE: SOUND ABSORPTIVE 2-1/8" FABRIC WRAPPED PANELS, MINIMUM NRC 1.05 C GLEE CLUB ROOM 203: 2" DUCT LINER BOARD, 2.5 PCF MIN, CONCEALED IN WALL CAVITY 	U.S. MILITARY ACADEMY West Point, New York Project No.: 11300 Date: July 06, 2022
	 D SOUND-DIFFUSING WALL UNIT CONCEALED IN WALL CAVITY 098436 SOUND-ABSORBING CEILING UNITS A 3/4" PLYWOOD PANEL SOUND REFLECTING CLOUDS SUSPENDED WITH FRAMING; ANGLE 5 DEGREES FROM HORIZONTAL IN RANDOM DIRECTIONS 099113 EXTERIOR PAINTING 099123 INTERIOR PAINTING 099300 STAINING AND TRANSPARENT FINISHING 	Drawing Title: Roof Details
	DIVISION 10: SPECIALTIES 101423.16 ROOM-IDENTIFICATION PANEL SIGNAGE 102213 WIRE MESH PARTITIONS 102800 TOILET, BATH, AND LAUNDRY ACCESSORIES 104413 FIRE PROTECTION CABINETS 104416 FIRE EXTINGUISHERS	A 6 0 2
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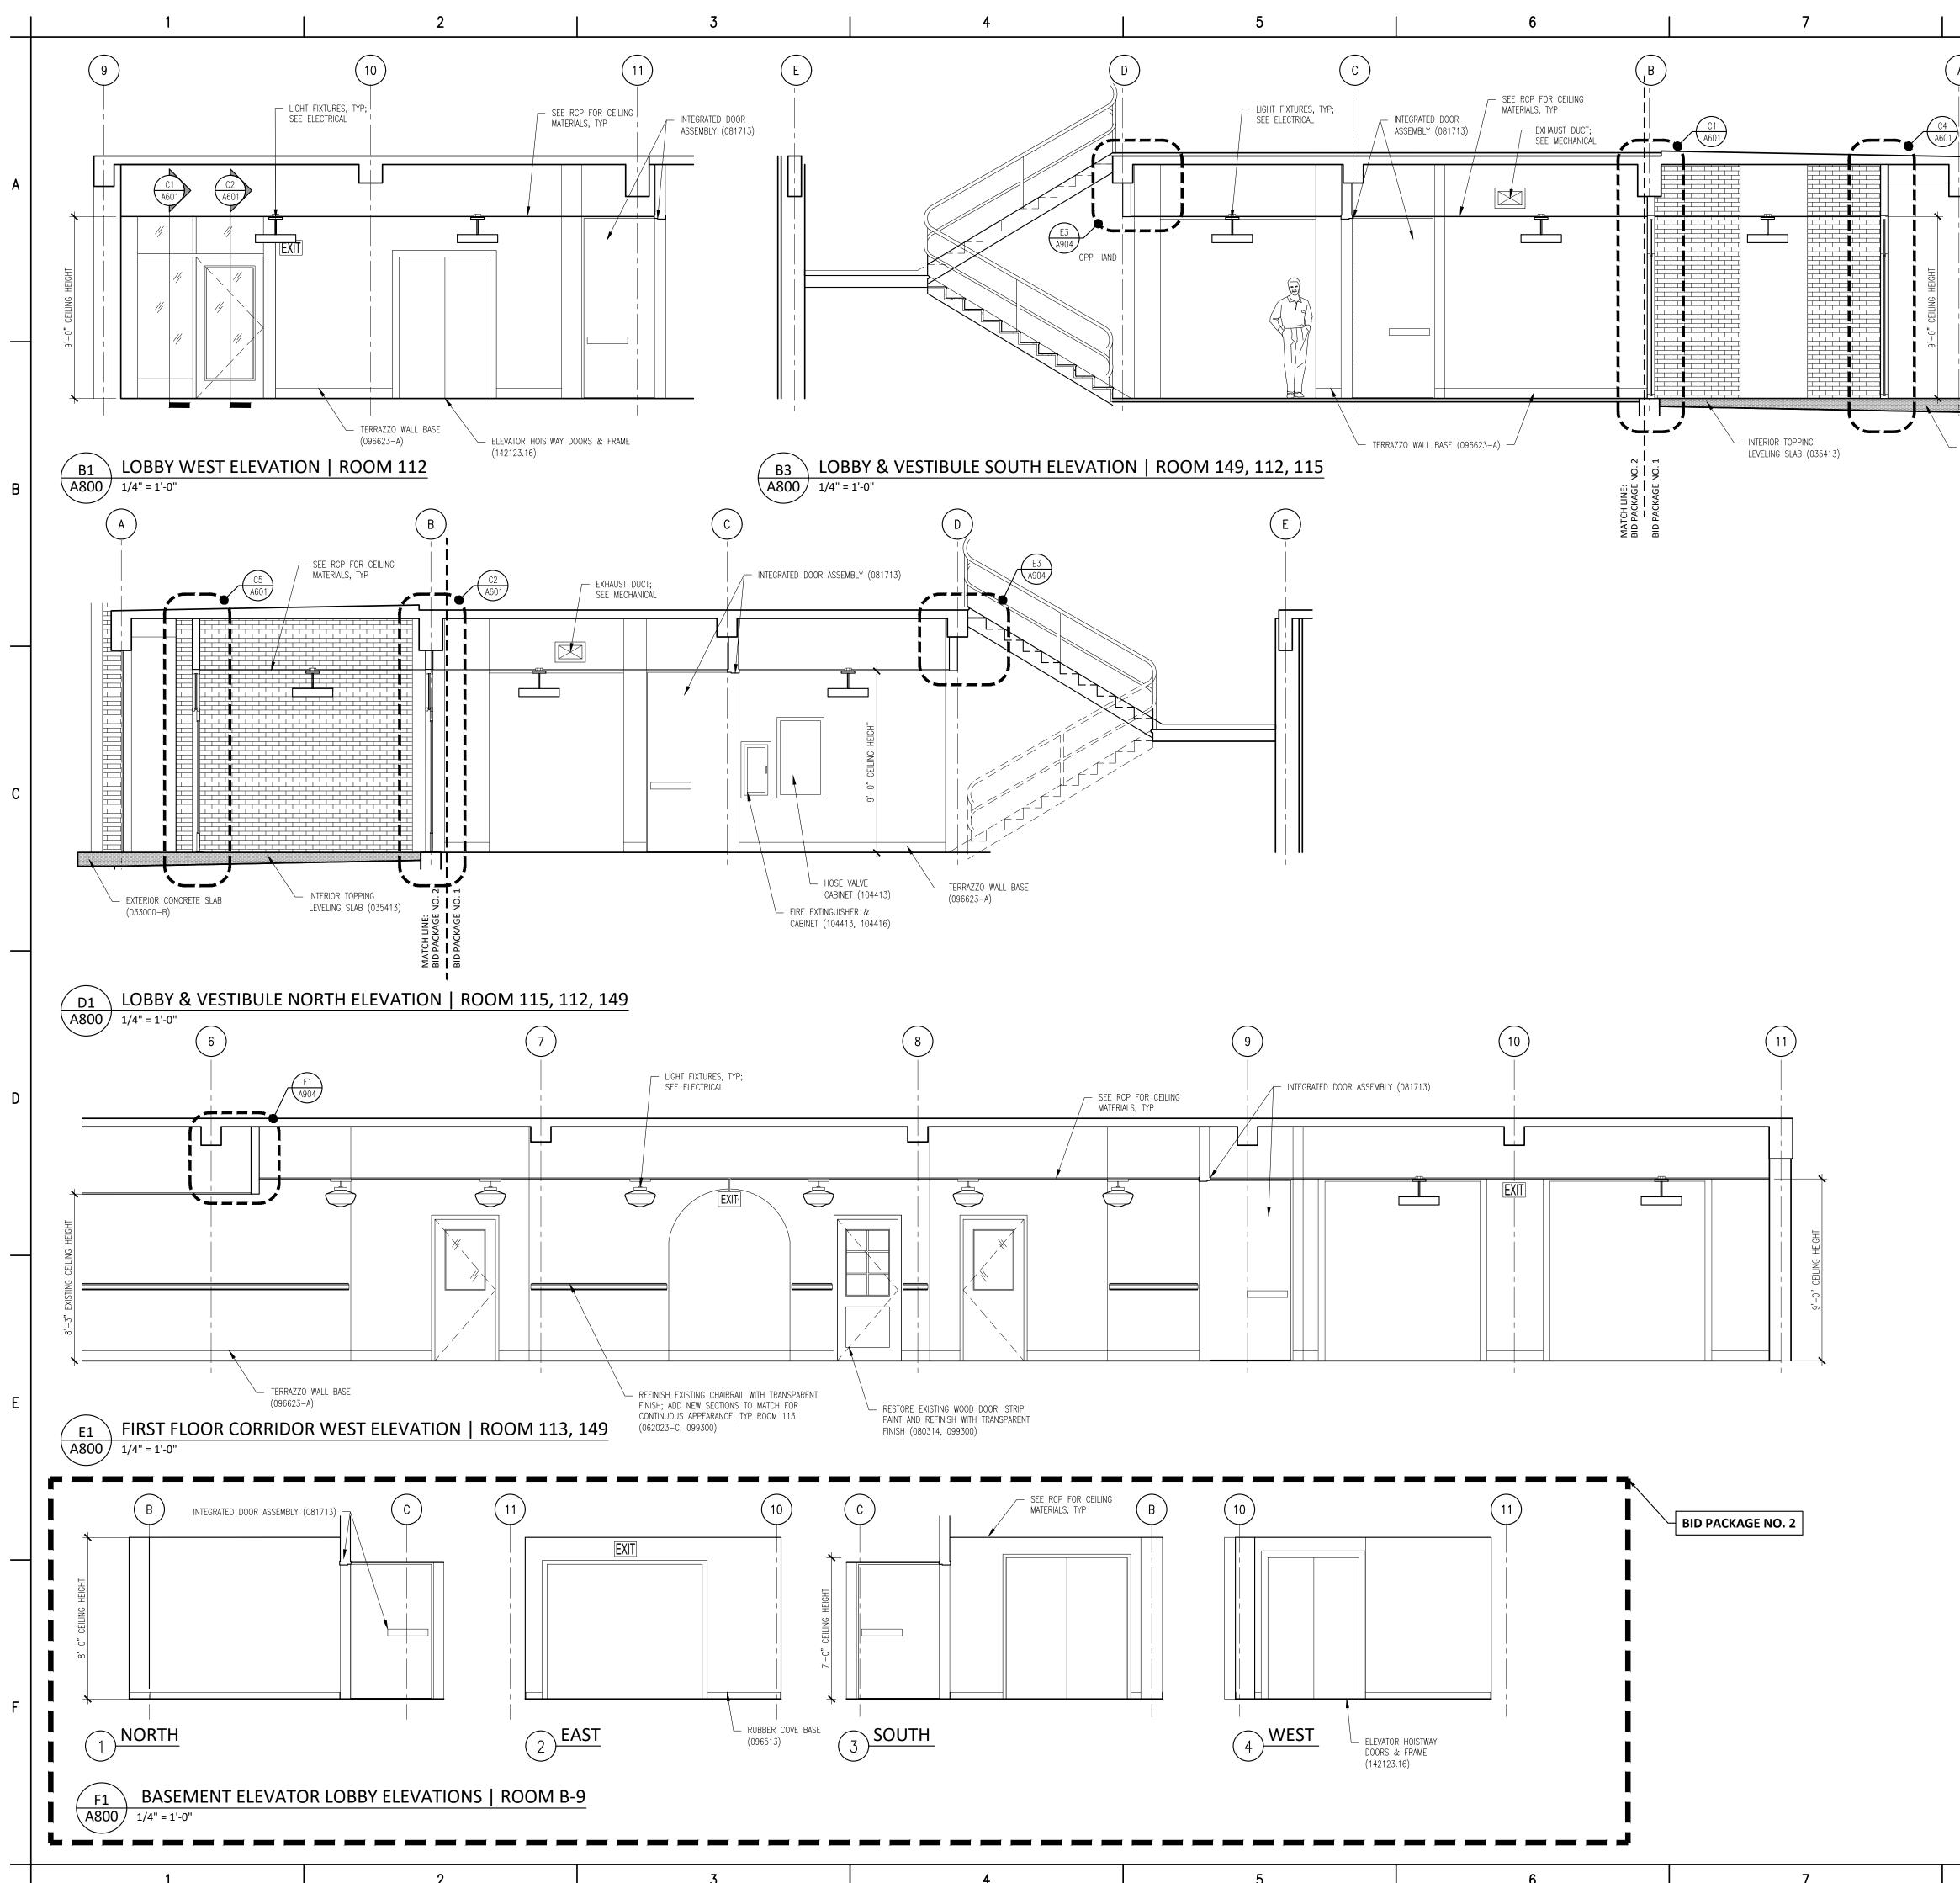


	Mark B. Thompson Associates Architecture 502 South 24th Street	
	Philadelphia, PA 19146 215.985.1000 www.mbtarchitects.com	
	Keast & Hood Company of New York, PC Structural Engineering	
	400 Market Street, Suite 1250 Philadelphia, PA 19106	
	215.625.0099 www.keasthood.com Dimitri J. Ververelli, Inc.	
	Mechanical, Electrical, Plumbing, Fire Protection Engineering 211 North 12th Street	
	211 North 13th Street Philadelphia, PA 19107 215.496.0000 www.djvinc.com	
	Langan	
	Civil Engineering 21 Penn Plaza, 360 West 31st Street, 8th Floor New York, NY 10001	
	212.479.5400 www.langan.com	-
	Theatre Projects Acoustical Design 47 Water Street	
	South Norwalk, CT 06854 203.299.0830 www.theatreprojects.com	
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	It is a violation of New York State Law for any person, unless he is acting under the direction of a licensed	
1	Professional Engineer or Land Surveyor, to alter an item in any way. If an item bearing the seal of an Engineer or Land Surveyor is altered, the altering Engineer or Land	
	Surveyor shall affix to the item his seal and the notation "altered by" followed by his signature and the date of	
	such alteration, and a specific description of the alteration.	
	General Notes	
	 All dimensions and existing conditions shall be checked and verified by contractor at the site prior to proceeding with the work. 	
	 Contractor shall inform Architect/ Engineer of any discrepancies on drawings before 	
	construction begins. 3. No existing service may be cut without	
	Architect/Engineers's consent. Any existing service severed or damaged shall be replaced at no cost to owner.	
	 Contractor must notify Architect/ Engineer at once if hidden existing conditions encountered require closing and difference. 	
	require design modifications.	
	Issue Issued For Date	
	Issue Issued For Date O Bid & Permit 07-06-2022	
	0 Bid & Permit 07-06-2022	D
	0 Bid & Permit 07-06-2022	D
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	0 Bid & Permit 07-06-2022	D
	0 Bid & Permit 07-06-2022 PRELIMINARY Not For Construction Key Plan	D
	0 Bid & Permit 07-06-2022 PRELIMINARY Not For Construction Key Plan	
	0 Bid & Permit 07-06-2022	
	0 Bid & Permit 07-06-2022 PRELIMINARY Not For Construction Key Plan EGNER HALL BUILDING 685 U.S. MILITARY ACADEMY	
	0 Bid & Permit 07-06-2022 PRELIMINARY Not For Construction Key Plan EGNER HALL BUILDING 685 U.S. MILITARY ACADEMY	
	0 Bid & Permit 07-06-2022 PRELIMINARY Not For Construction Key Plan EGNER HALL BUILDING 685 U.S. MILITARY ACADEMY	
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	0 Bid & Permit 07-06-2022 PRELIMINARY PRELIMINARY Not For Construction Key Plan EGRER HALL BUILDING 685 U.S. MILITARY ACADEMY West Point, New York Project No:: 11300	
	0 Bid & Permit 07-06-2022 PRELIMINARY PRELIMINARY Not For Construction Key Plan EGNER HALL BUILDING 685 U.S. MILITARY ACADEMY West Point, New York	
	0 Bid & Permit 07-06-2022 PRELIMINARY PRELIMINARY Not For Construction	
	0 Bid & Permit 07-06-2022 PRELIMINARY Not For Construction Regner Hall Key Plan EGNER HALL BUILDING 685 U.S. MILITARY ACADEMY West Point, New York Project No.: 11300 Drawing Title:	E
	0 Bid & Permit 07-06-2022 PRELIMINARY PRELIMINARY Not For Construction Key Plan EGNER HALL BUILDING 685 U.S. MILITARY ACADEMY West Point, New York Project No.: 11300 Date: July 06, 2022 Drawing Title:	D F
	0 Bid & Permit 07-06-2022 PRELIMINARY PRELIMINARY Not For Construction Key Plan EGNER HALL BUILDING 685 U.S. MILITARY ACADEMY West Point, New York Project No:: 11300	E
	0 Bid & Permit 07-06-2022 PRELIMINARY PRELIMINARY Not For Construction Key Plan EGNER HALL BUILDING 6855 U.S. MILITARY ACADEMY West Point, New York Project No.: 11300 Date: July 06, 2022 Drawing Title: Elevator Details Plans & Sections	E
	0 Bid & Permit 07-06-2022 PRELIMINARY PRELIMINARY Not For Construction Key Plan EGNER HALL BUILDING 685 U.S. MILITARY ACADEMY West Point, New York Project No.: 11300 Date: July 06, 2022 Drawing Title:	

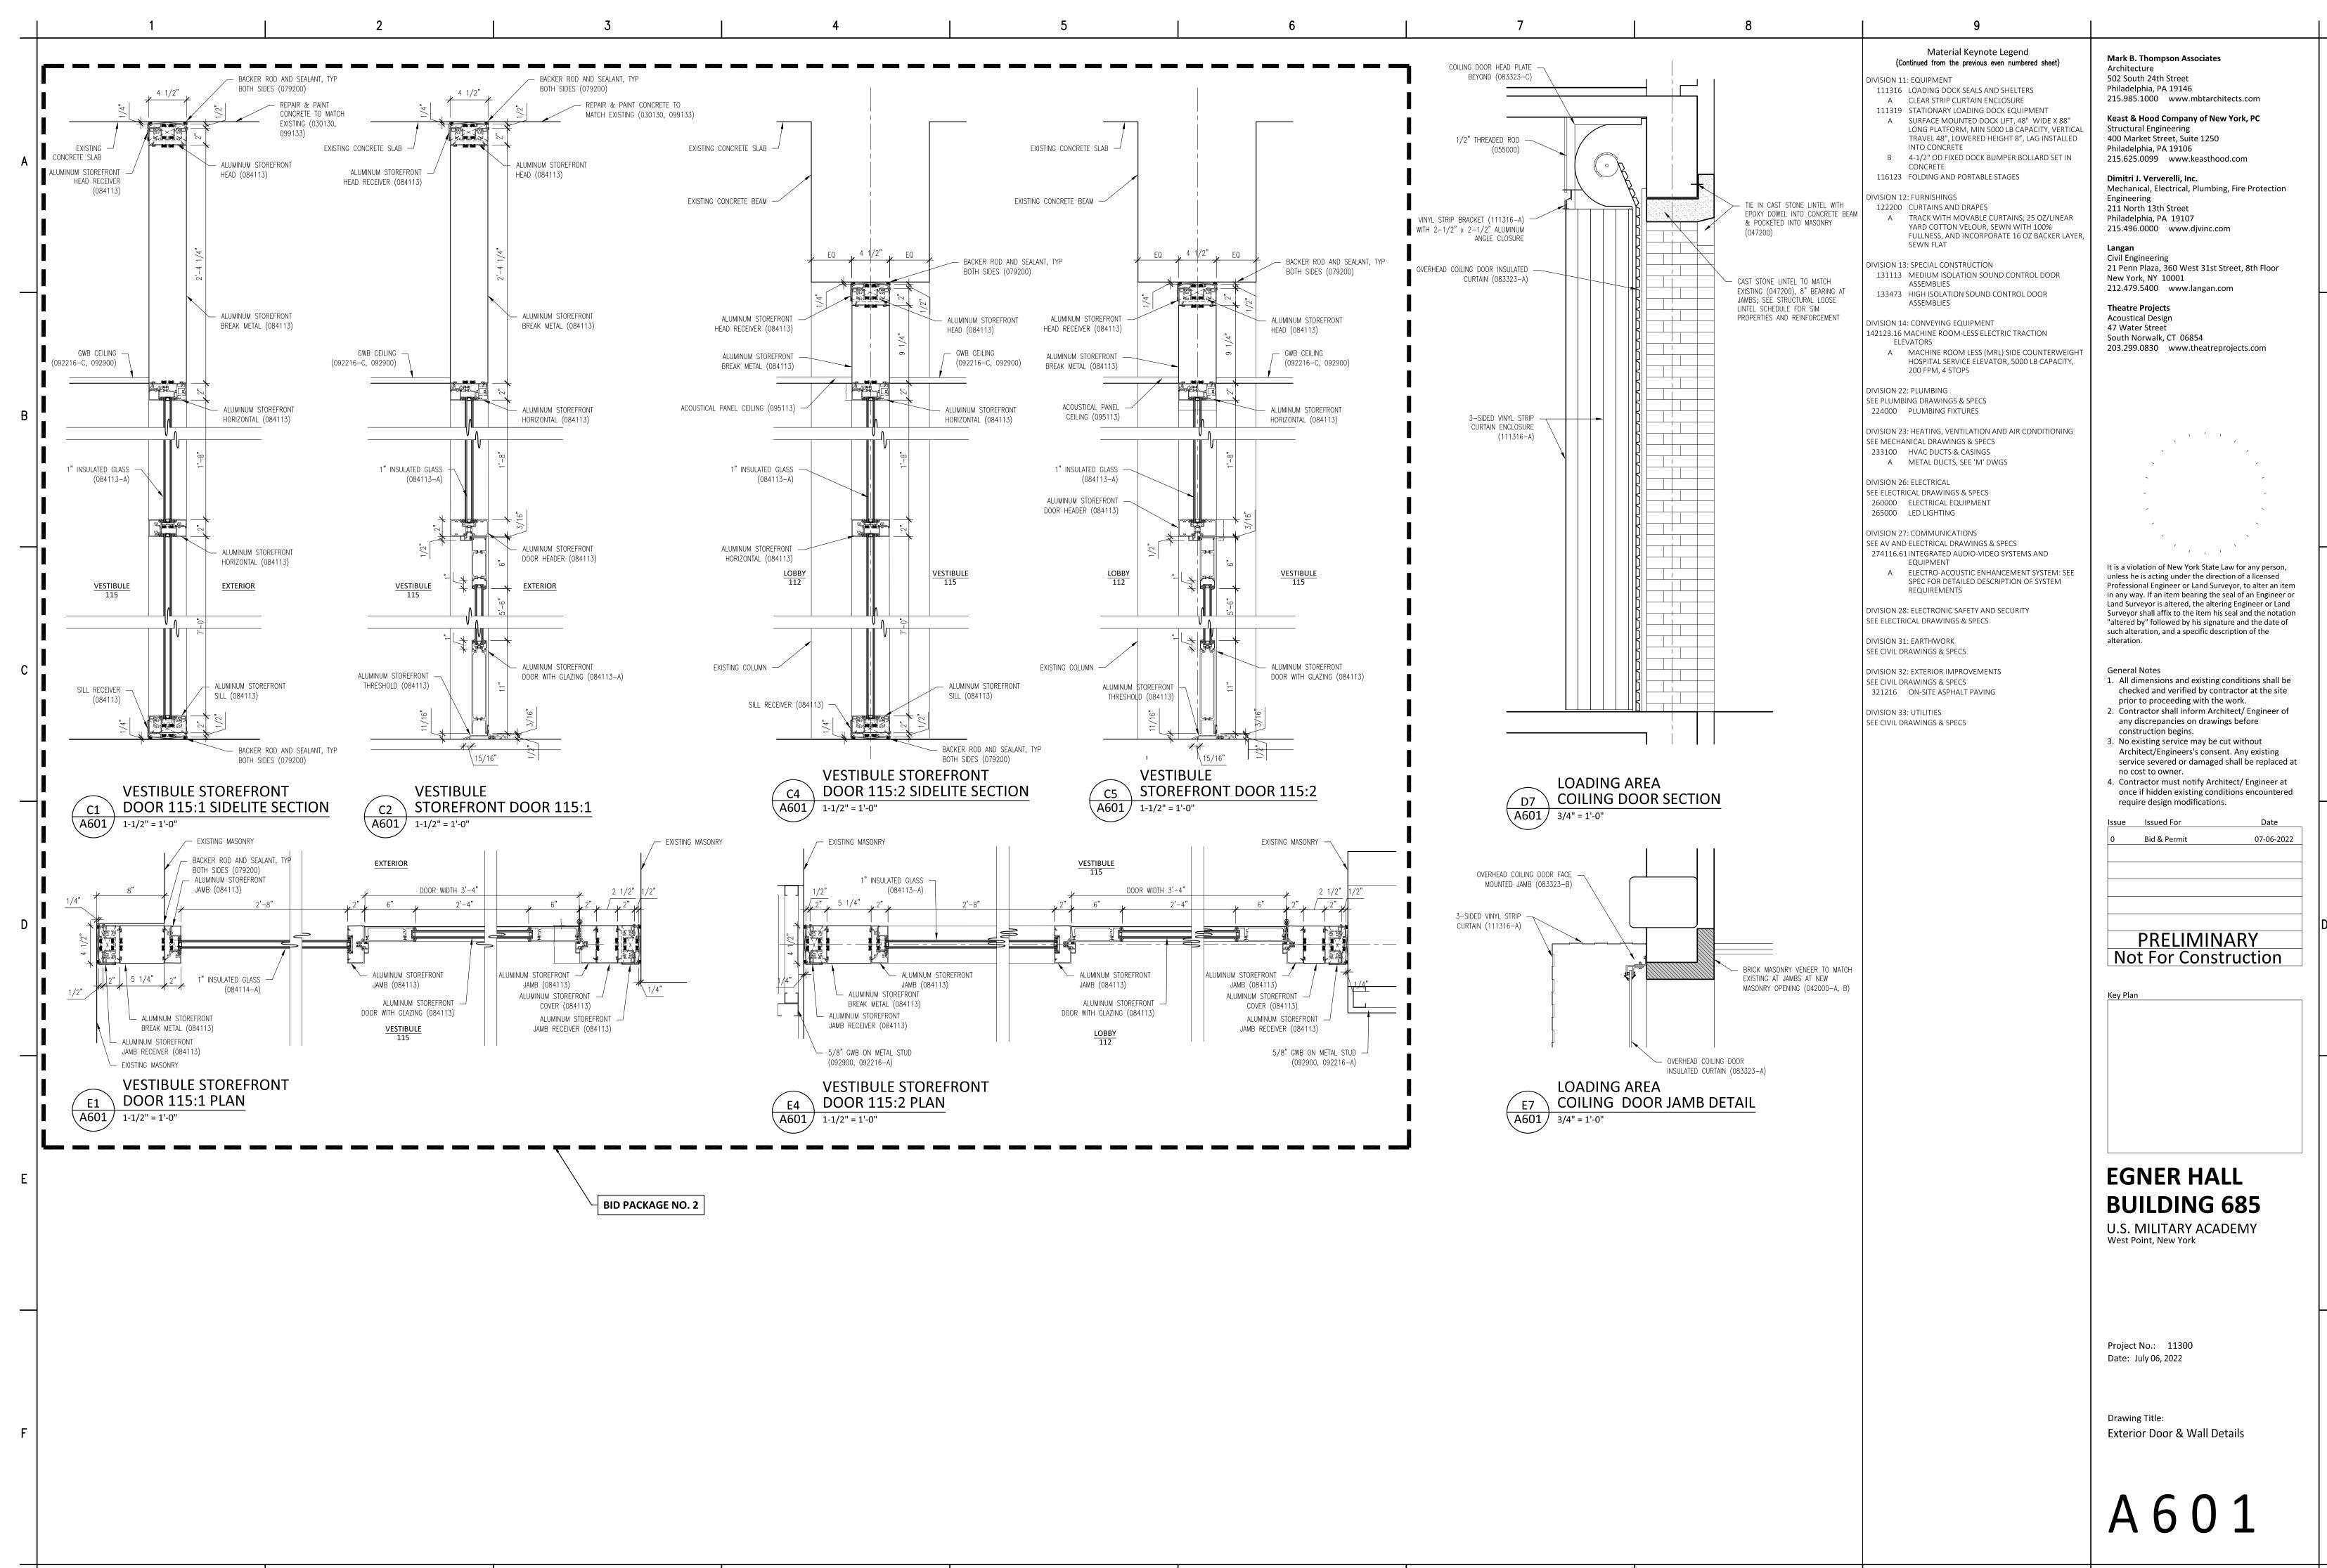

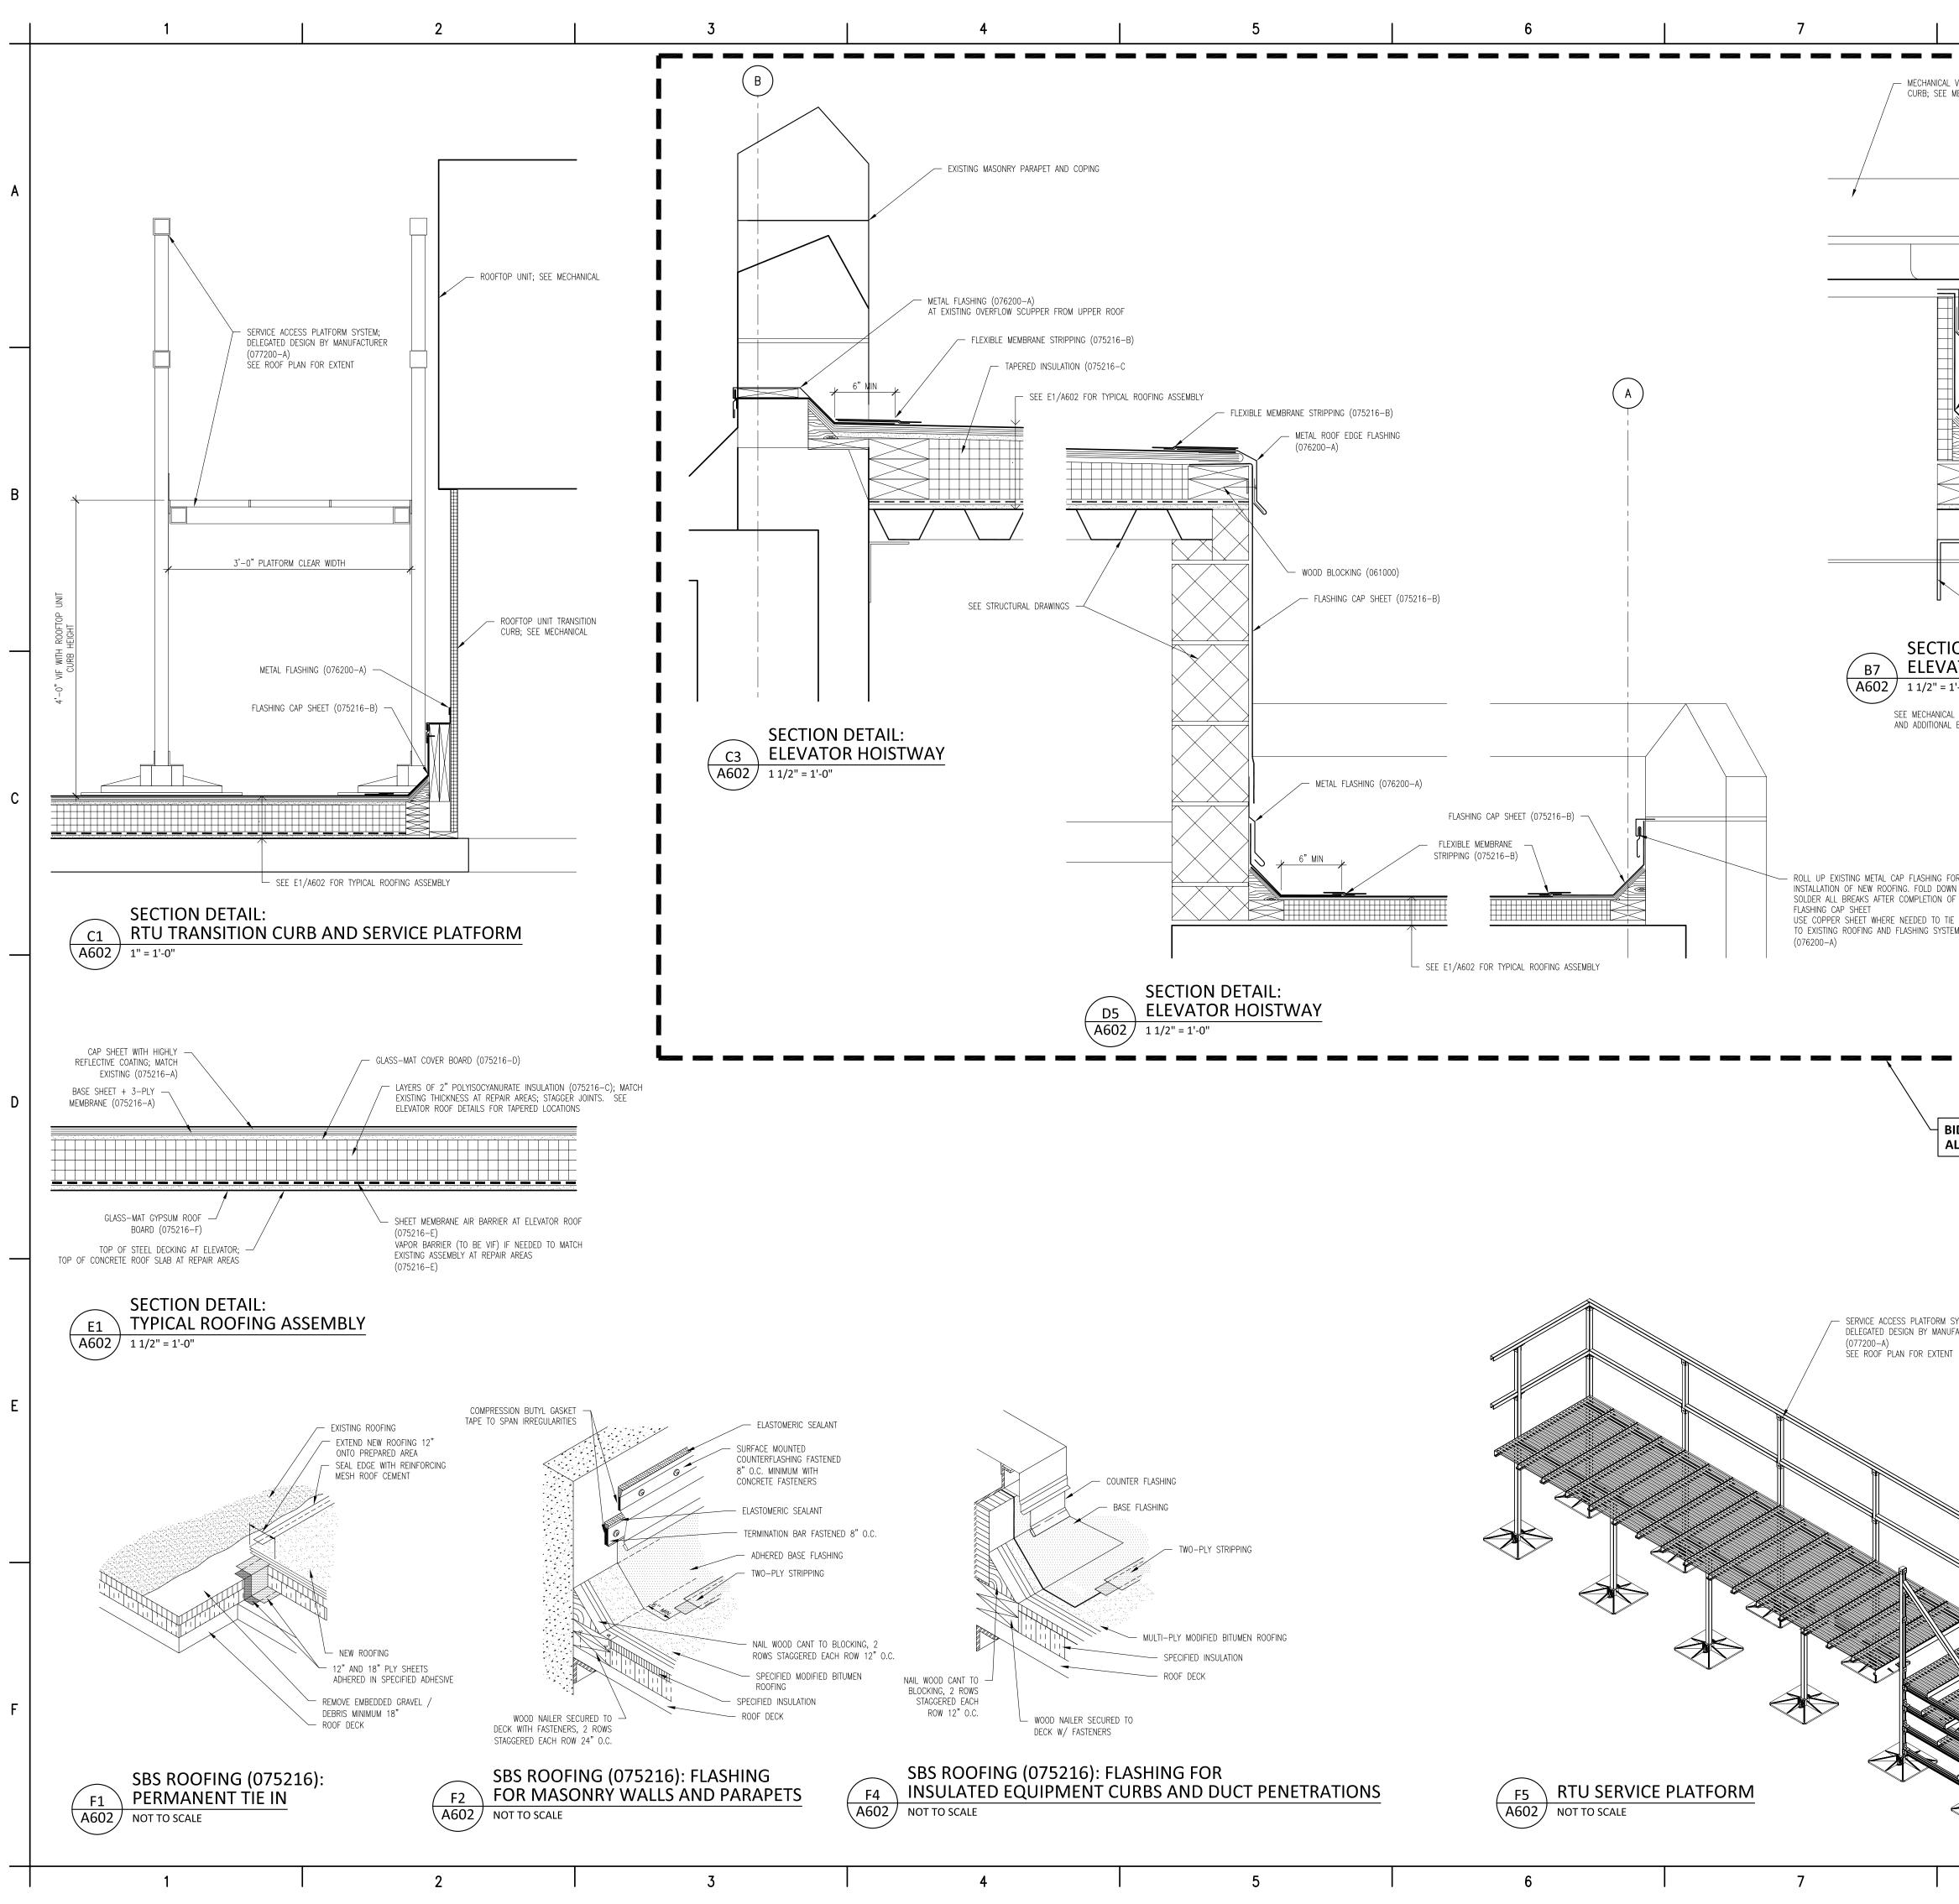Material Keynote Legend	
(Continued from the previous even number	
DIVISION 11: EQUIPMENT 111316 LOADING DOCK SEALS AND SHELTEF A CLEAR STRIP CURTAIN ENCLOSURE 111319 STATIONARY LOADING DOCK EQUIP A SURFACE MOUNTED DOCK LIFT, 48" LONG PLATFORM, MIN 5000 LB CAP TRAVEL 48", LOWERED HEIGHT 8", I INTO CONCRETE B 4-1/2" OD FIXED DOCK BUMPER BO CONCRETE 116123 FOLDING AND PORTABLE STAGES	MENT ' WIDE X 88" 'ACITY, VERTICA LAG INSTALLED
DIVISION 12: FURNISHINGS 122200 CURTAINS AND DRAPES A TRACK WITH MOVABLE CURTAINS; 2 YARD COTTON VELOUR, SEWN WITH FULLNESS, AND INCORPORATE 16 O SEWN FLAT	H 100%
DIVISION 13: SPECIAL CONSTRUCTION 131113 MEDIUM ISOLATION SOUND CONTR ASSEMBLIES 133473 HIGH ISOLATION SOUND CONTROL I ASSEMBLIES	
DIVISION 14: CONVEYING EQUIPMENT 142123.16 MACHINE ROOM-LESS ELECTRIC TRAC ELEVATORS A MACHINE ROOM LESS (MRL) SIDE CO HOSPITAL SERVICE ELEVATOR, 5000 200 FPM, 4 STOPS	OUNTERWEIGH
DIVISION 22: PLUMBING SEE PLUMBING DRAWINGS & SPECS 224000 PLUMBING FIXTURES	
DIVISION 23: HEATING, VENTILATION AND AIR CO SEE MECHANICAL DRAWINGS & SPECS 233100 HVAC DUCTS & CASINGS A METAL DUCTS, SEE 'M' DWGS	ONDITIONING
DIVISION 26: ELECTRICAL SEE ELECTRICAL DRAWINGS & SPECS 260000 ELECTRICAL EQUIPMENT 265000 LED LIGHTING	
DIVISION 27: COMMUNICATIONS SEE AV AND ELECTRICAL DRAWINGS & SPECS 274116.61 INTEGRATED AUDIO-VIDEO SYSTEM EQUIPMENT A ELECTRO-ACOUSTIC ENHANCEMENT SPEC FOR DETAILED DESCRIPTION C	T SYSTEM: SEE
REQUIREMENTS DIVISION 28: ELECTRONIC SAFETY AND SECURITY SEE ELECTRICAL DRAWINGS & SPECS	<i>,</i>
DIVISION 31: EARTHWORK SEE CIVIL DRAWINGS & SPECS	
DIVISION 32: EXTERIOR IMPROVEMENTS SEE CIVIL DRAWINGS & SPECS 321216 ON-SITE ASPHALT PAVING	
DIVISION 33: UTILITIES SEE CIVIL DRAWINGS & SPECS	
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2014)	



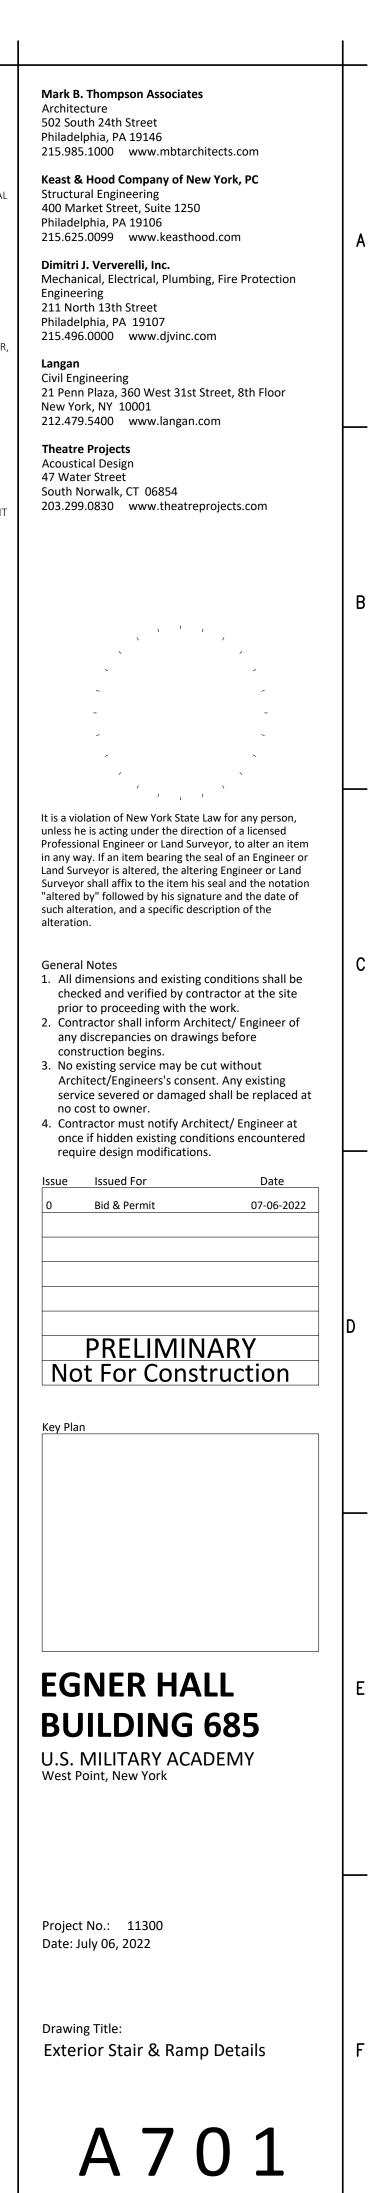


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- EXTERIOR CONCRETE SLAB (033000-B)

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MATERIAL KEYNOTE LEGEND DIVISION 2: EXISTING CONDITIONS 024119 SELECTIVE DEMOLITION	Mark B. Thompson Associates Architecture 502 South 24th Street Bhiladelabia, BA 10146
DIVISION 3: CONCRETE 030130 CONCRETE REPAIR (DRAWING SPEC NOTES ONLY) A SEE STRUCTURAL DRAWINGS	Philadelphia, PA 19146 215.985.1000 www.mbtarchitects.com
033000 CAST IN-PLACE CONCRETE A NEW ELEVATED FLOOR SLAB AT BASEMENT LEVEL T MATCH CORRIDOR FLOOR ELEVATION	 Keast & Hood Company of New York, PC Structural Engineering 400 Market Street, Suite 1250
033010 CAST IN-PLACE SITE CONCRETE; SEE CIVIL A EXTERIOR CONCRETE SLAB SUPPORTED ON NEW FOOTINGS WITH RAMP B EXTERIOR CONCRETE STAIRS	Philadelphia, PA 19106 215.625.0099 www.keasthood.com Dimitri J. Ververelli, Inc.
035413 GYPSUM CEMENT UNDERLAYMENT A INTERIOR TOPPING / LEVELING SLAB DIVISION 4: MASONRY	Mechanical, Electrical, Plumbing, Fire Protection Engineering 211 North 13th Street Philadelphia, PA 19107
042000 UNIT MASONRY A BRICK MASONRY VENEER TO MATCH EXISTING B ACCESSORIES (SEE DRAWINGS FOR TYPE) B1 TIES, REINFORCEMENT; HOT-DIP GALV OR	215.496.0000 www.djvinc.com Langan Civil Engineering
STAINLESS STEEL C PRECAST CONCRETE LINTELS D EMBEDDED FLEXIBLE FLASHING E MESH WEEP / VENT	21 Penn Plaza, 360 West 31st Street, 8th Floor New York, NY 10001 212.479.5400 www.langan.com
047200 CAST STONE MASONRY DIVISION 5: METALS	Theatre Projects Acoustical Design 47 Water Street
051200 STRUCTURAL STEEL FRAMING; SEE STRUCTURAL A ELEVATOR HOIST BEAMS 053100 STEEL DECKING; SEE STRUCTURAL A ROOF DECKING	South Norwalk, CT 06854 203.299.0830 www.theatreprojects.com
055000 METAL FABRICATIONS A MISC STRUCTURAL SHAPES; GALVANIZED AT EXTERIOR B ABRASIVE CAST METAL NOSINGS	
C METAL FLOOR PLATE TRENCH COVER 055213 PIPE AND TUBE RAILINGS	
DIVISION 6: WOODS, PLASTICS, AND COMPOSITES 061000 ROUGH CARPENTRY	
062023 INTERIOR FINISH CARPENTRY A GLEE CLUB ROOM 203: WOOD PICTURE RAIL & CHAIR RAIL TO MATCH EXISTING	
B CONCERT BAND ROOM 300: WOOD WALL BASE & TRIMS; SEE DRAWINGS FOR DIMS & PROFILES C CHAIR RAIL	
D MISCELLANEOUS TRIM; SEE DRAWINGS FOR DIMS 8 PROFILES	
DIVISION 7: THERMAL AND MOISTURE PROTECTION 072100 THERMAL INSULATION	It is a violation of New York State Law for any person,
A SPRAY-APPLIED OPEN CELL MEDIUM DENSITY FOAN INSULATION, VAPOR PERMEABLE 072129 SPRAY-APPLIED CELLULOSE ACOUSTICAL INSULATIO	Professional Engineer or Land Surveyor, to alter an item
A SOUND ABSORPTIVE FINISH OVER 100% OF OVERHEAD DECK (BETWEEN STRUCTURAL BEAMS),	Land Surveyor is altered, the altering Engineer or Land Surveyor shall affix to the item his seal and the notation "altered by" followed by his signature and the date of
MINIMUM NRC 1.00, 4" SPRAY-ON CELLULOSE 075216 STYRENE-BUTADIENE-STYRENE (SBS) MODIFIED BITUMINOUS MEMBRANE ROOFING	such alteration, and a specific description of the alteration.
A SBS BASE SHEET + 3 PLIES AND CAP SHEET, IN COLD APPLIED ADHESIVE WITH HIGH-REFLECTIVE ROOF COATING TO MATCH EXISTING	General Notes
B FLASHING & STRIPPING MATERIALS C ROOF INSULATION	 All dimensions and existing conditions shall be checked and verified by contractor at the site
D INSULATION COVER BOARD E VAPOR RETARDER / AIR BARRIER F SUBSTRATE BOARD	prior to proceeding with the work.2. Contractor shall inform Architect/ Engineer of any discrepancies on drawings before
076200 SHEET METAL FLASHING AND TRIM A LOW-SLOPE ROOF EDGE FLASHINGS AND COPINGS	construction begins. 3. No existing service may be cut without
077200 ROOF ACCESSORIES A SERVICE ACCESS PLATFORM SYSTEM 079200 JOINT SEALANTS	Architect/Engineers's consent. Any existing service severed or damaged shall be replaced at no cost to owner.
079219 ACOUSTICAL JOINT SEALANTS	 Contractor must notify Architect/ Engineer at once if hidden existing conditions encountered require design modifications.
DIVISION 8: OPENINGS 080314 HISTORIC TREATMENT OF WOOD DOORS 081113 HOLLOW METAL DOORS AND FRAMES	Issue Issued For Date
081416 FLUSH WOOD DOORS 081713 INTEGRATED METAL DOOR OPENING ASSEMBLIES 083113 ACCESS DOORS AND FRAMES	0 Bid & Permit 07-06-2022
A ACOUSTIC RATED B FIRE-RESISTIVE RATED 083323 OVERHEAD COILING DOORS	
A INSULATED ROLLING SERVICE DOOR, MANUAL CHAI HOIST, CYLINDRICAL LOCK B FACE-OF-WALL MOUNTED JAMB	N
C HOOD / HEAD PLATE 084113 ALUMINUM-FRAMED ENTRANCES AND STOREFRONTS	PRELIMINARY
A 1" LOW EMISSIVITY INSULATED GLASS UNIT 085113 ALUMINUM WINDOWS	Not For Construction
A 3-1/4" THERMAL ALUMINUM 'STEEL REPLICA' WINDOW SYSTEM A1 COVED MUNTIN GRID, SIMULATED TRUE	Key Plan
DIVIDED LITES, CUSTOM PERIMETER AND INTERIOR AND EXTERIOR GRIDS TO SIMULATE ORIGINAL WINDOW SASH	
087100 DOOR HARDWARE	
DIVISION 9: FINISHES 092116.23 GYPSUM BOARD SHAFT WALL ASSEMBLIES 092216 NON-STRUCTURAL METAL FRAMING	
 A STUD FRAMING, RUNNER TRACKS B SUSPENSION SYSTEM FOR CEILINGS & SOFFITS C GRID SUSPENSION SYSTEM FOR GYPSUM BOARD CEILINGS 	
092900 GYPSUM BOARD 093013 CERAMIC TILING 095113 ACOUSTICAL PANEL CEILINGS	
SEE RCPS AND FINISH SCHEDULE 096248 SOUND AND VIBRATION CONTROL FOR CONCRETE	
FLOATING FLOOR A 1" ROLL-OUT RUBBER MAT ISOLATION SYSTEM 096513 RESILIENT BASE & ACCESSORIES	EGNER HALL
096519 RESILIENT TILE FLOORING 096623 RESINOUS MATRIX TERRAZZO FLOORING A WALL BASE: 3/8" x 6" HIGH PRECAST EPOXY TERRAZZO WALL BASE TO MATCH EXISTING	BUILDING 685 U.S. MILITARY ACADEMY
096813 TILE CARPETING 097200 WALL COVERINGS	West Point, New York
A GLEE CLUB ROOM 203: ACOUSTICAL TRANSPARENT FABRIC ON METAL FRAMING; SEE ELEVATIONS FOR EXTENT	
098433 SOUND-ABSORBING WALL UNITS A CONCERT BAND ROOM 300: SOUND ABSORPTIVE 1 FABRIC WRAPPED PANELS, MINIMUM NRC 1.00	<i>"</i>
B SECTIONALS ROOM 205, CORRIDORS & VESTIBULES WHERE NOTED ON FINISH SCHEDULE: SOUND ABSORPTIVE 2-1/8" FABRIC WRAPPED PANELS,	
MINIMUM NRC 1.05 C GLEE CLUB ROOM 203: 2" DUCT LINER BOARD, 2.5 PCF MIN, CONCEALED IN WALL CAVITY	Project No.: 11300 Date: July 06, 2022
D SOUND-DIFFUSING WALL UNIT CONCEALED IN WAL CAVITY	
098436 SOUND-ABSORBING CEILING UNITS A 3/4" PLYWOOD PANEL SOUND REFLECTING CLOUDS SUSPENDED WITH FRAMING; ANGLE 5 DEGREES	Drawing Title:
FROM HORIZONTAL IN RANDOM DIRECTIONS 099113 EXTERIOR PAINTING 099123 INTERIOR PAINTING 099300 STAINING AND TRANSPARENT FINISHING	Interior Elevations - Basement & First Floor Corridors
DIVISION 10: SPECIALTIES	
101423.16 ROOM-IDENTIFICATION PANEL SIGNAGE 102213 WIRE MESH PARTITIONS 102800 TOILET, BATH, AND LAUNDRY ACCESSORIES	
104413 FIRE PROTECTION CABINETS 104416 FIRE EXTINGUISHERS	A 8 0 0
(Continued on the following odd numbered sheet)	

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	Material Keynote Legend (Continued from the previous even numbered sheet)
	DIVISION 11: EQUIPMENT 111316 LOADING DOCK SEALS AND SHELTERS A CLEAR STRIP CURTAIN ENCLOSURE 111319 STATIONARY LOADING DOCK EQUIPMENT A SURFACE MOUNTED DOCK LIFT, 48" WIDE X 88" LONG PLATFORM, MIN 5000 LB CAPACITY, VERTICAL TRAVEL 48", LOWERED HEIGHT 8", LAG INSTALLED INTO CONCRETE
	 B 4-1/2" OD FIXED DOCK BUMPER BOLLARD SET IN CONCRETE 116123 FOLDING AND PORTABLE STAGES
	DIVISION 12: FURNISHINGS 122200 CURTAINS AND DRAPES A TRACK WITH MOVABLE CURTAINS; 25 OZ/LINEAR YARD COTTON VELOUR, SEWN WITH 100% FULLNESS, AND INCORPORATE 16 OZ BACKER LAYER, SEWN FLAT
	DIVISION 13: SPECIAL CONSTRUCTION 131113 MEDIUM ISOLATION SOUND CONTROL DOOR ASSEMBLIES
	133473 HIGH ISOLATION SOUND CONTROL DOOR ASSEMBLIES
	DIVISION 14: CONVEYING EQUIPMENT 142123.16 MACHINE ROOM-LESS ELECTRIC TRACTION ELEVATORS
	A MACHINE ROOM LESS (MRL) SIDE COUNTERWEIGHT HOSPITAL SERVICE ELEVATOR, 5000 LB CAPACITY, 200 FPM, 4 STOPS
	DIVISION 22: PLUMBING SEE PLUMBING DRAWINGS & SPECS 224000 PLUMBING FIXTURES
	DIVISION 23: HEATING, VENTILATION AND AIR CONDITIONING SEE MECHANICAL DRAWINGS & SPECS 233100 HVAC DUCTS & CASINGS A METAL DUCTS, SEE 'M' DWGS
	DIVISION 26: ELECTRICAL SEE ELECTRICAL DRAWINGS & SPECS 260000 ELECTRICAL EQUIPMENT 265000 LED LIGHTING
	DIVISION 27: COMMUNICATIONS SEE AV AND ELECTRICAL DRAWINGS & SPECS 274116.61 INTEGRATED AUDIO-VIDEO SYSTEMS AND EQUIPMENT A ELECTRO-ACOUSTIC ENHANCEMENT SYSTEM: SEE SPEC FOR DETAILED DESCRIPTION OF SYSTEM REQUIREMENTS
	DIVISION 28: ELECTRONIC SAFETY AND SECURITY SEE ELECTRICAL DRAWINGS & SPECS
	DIVISION 31: EARTHWORK SEE CIVIL DRAWINGS & SPECS
	DIVISION 32: EXTERIOR IMPROVEMENTS SEE CIVIL DRAWINGS & SPECS 321216 ON-SITE ASPHALT PAVING
	DIVISION 33: UTILITIES SEE CIVIL DRAWINGS & SPECS
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Mark B. Thompson Associates Architecture 502 South 24th Street Philadelphia, PA 19146 215.985.1000 www.mbtarchitects.com

Keast & Hood Company of New York, PC Structural Engineering 400 Market Street, Suite 1250 Philadelphia, PA 19106 215.625.0099 www.keasthood.com

Dimitri J. Ververelli, Inc. Mechanical, Electrical, Plumbing, Fire Protection Engineering 211 North 13th Street Philadelphia, PA 19107 215.496.0000 www.djvinc.com

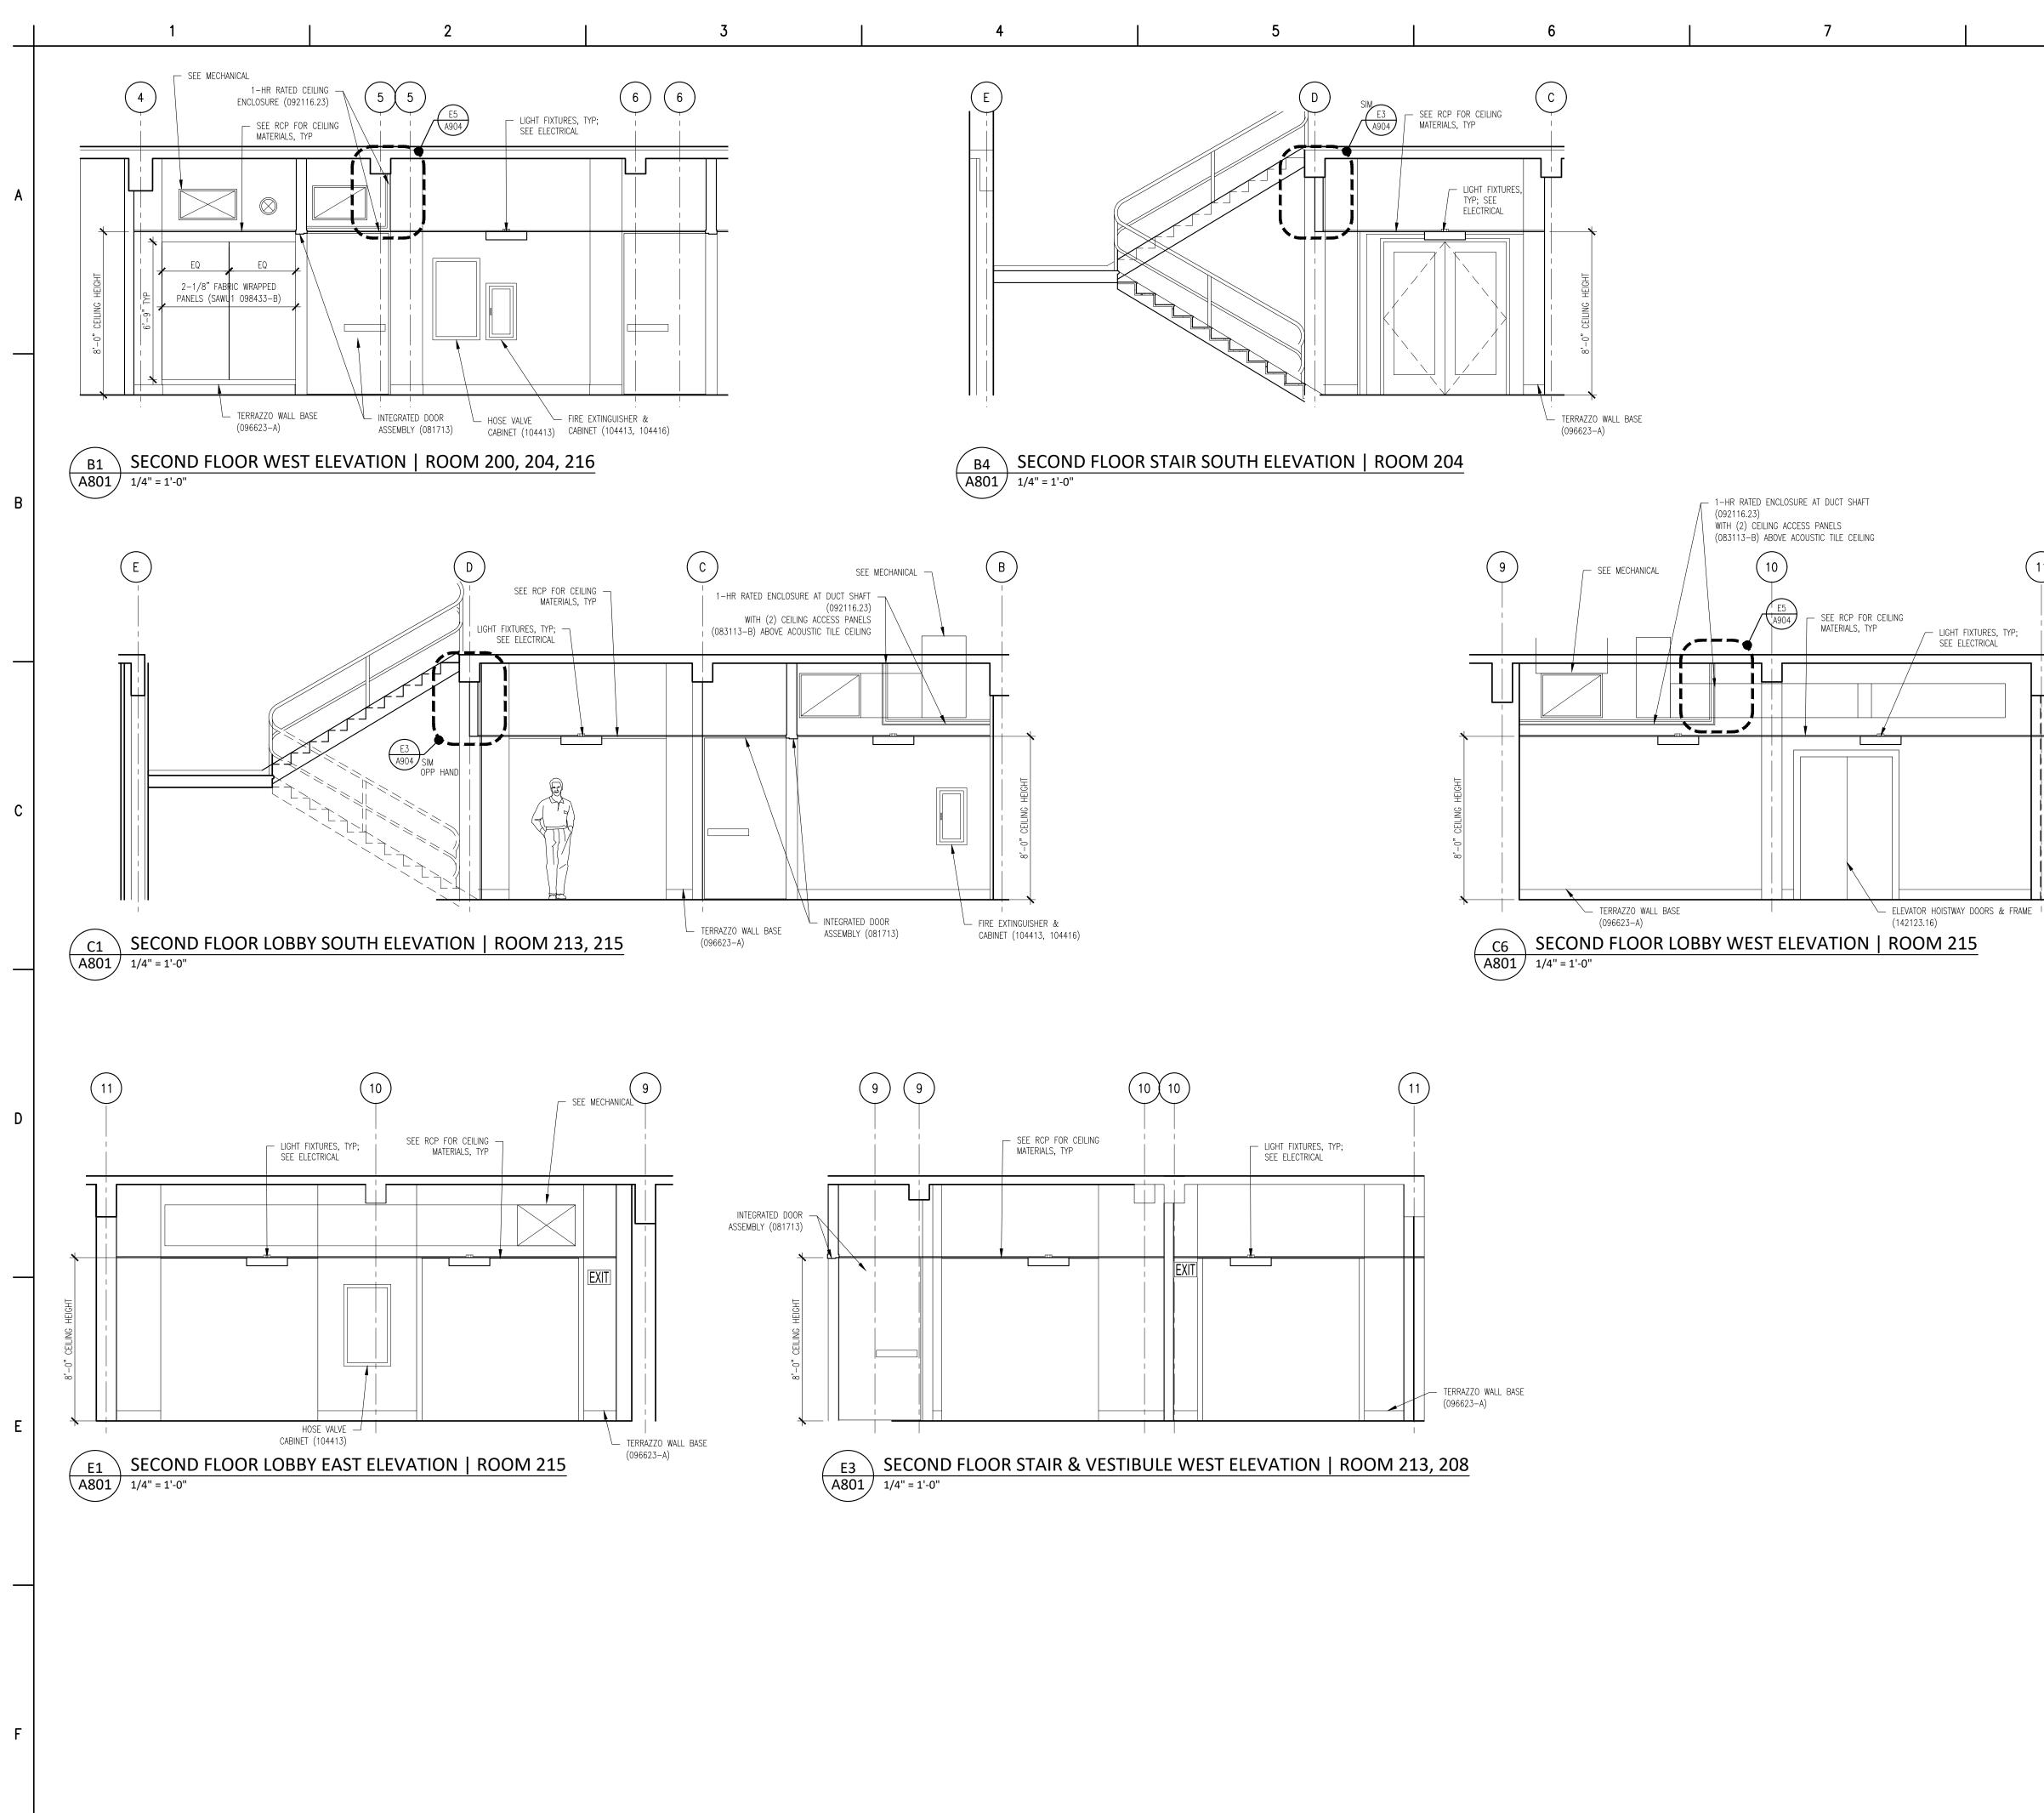Langan Civil Engineering 21 Penn Plaza, 360 West 31st Street, 8th Floor New York, NY 10001 212.479.5400 www.langan.com

Theatre Projects Acoustical Design 47 Water Street South Norwalk, CT 06854 203.299.0830 www.theatreprojects.com

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General Notes

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- any discrepancies on drawings before construction begins. 3. No existing service may be cut without Architect/Engineers's consent. Any existing service severed or damaged shall be replaced at
- no cost to owner. 4. Contractor must notify Architect/ Engineer at once if hidden existing conditions encountered

Date

07-06-2022

require design modifications.

Issue Issued For Bid & Permit

PRELIMINARY Not For Construction

Key Plan

EGNER HALL **BUILDING 685**

U.S. MILITARY ACADEMY West Point, New York


Project No.: 11300 Date: July 06, 2022

Drawing Title: Interior Elevations -Second Floor Corridors

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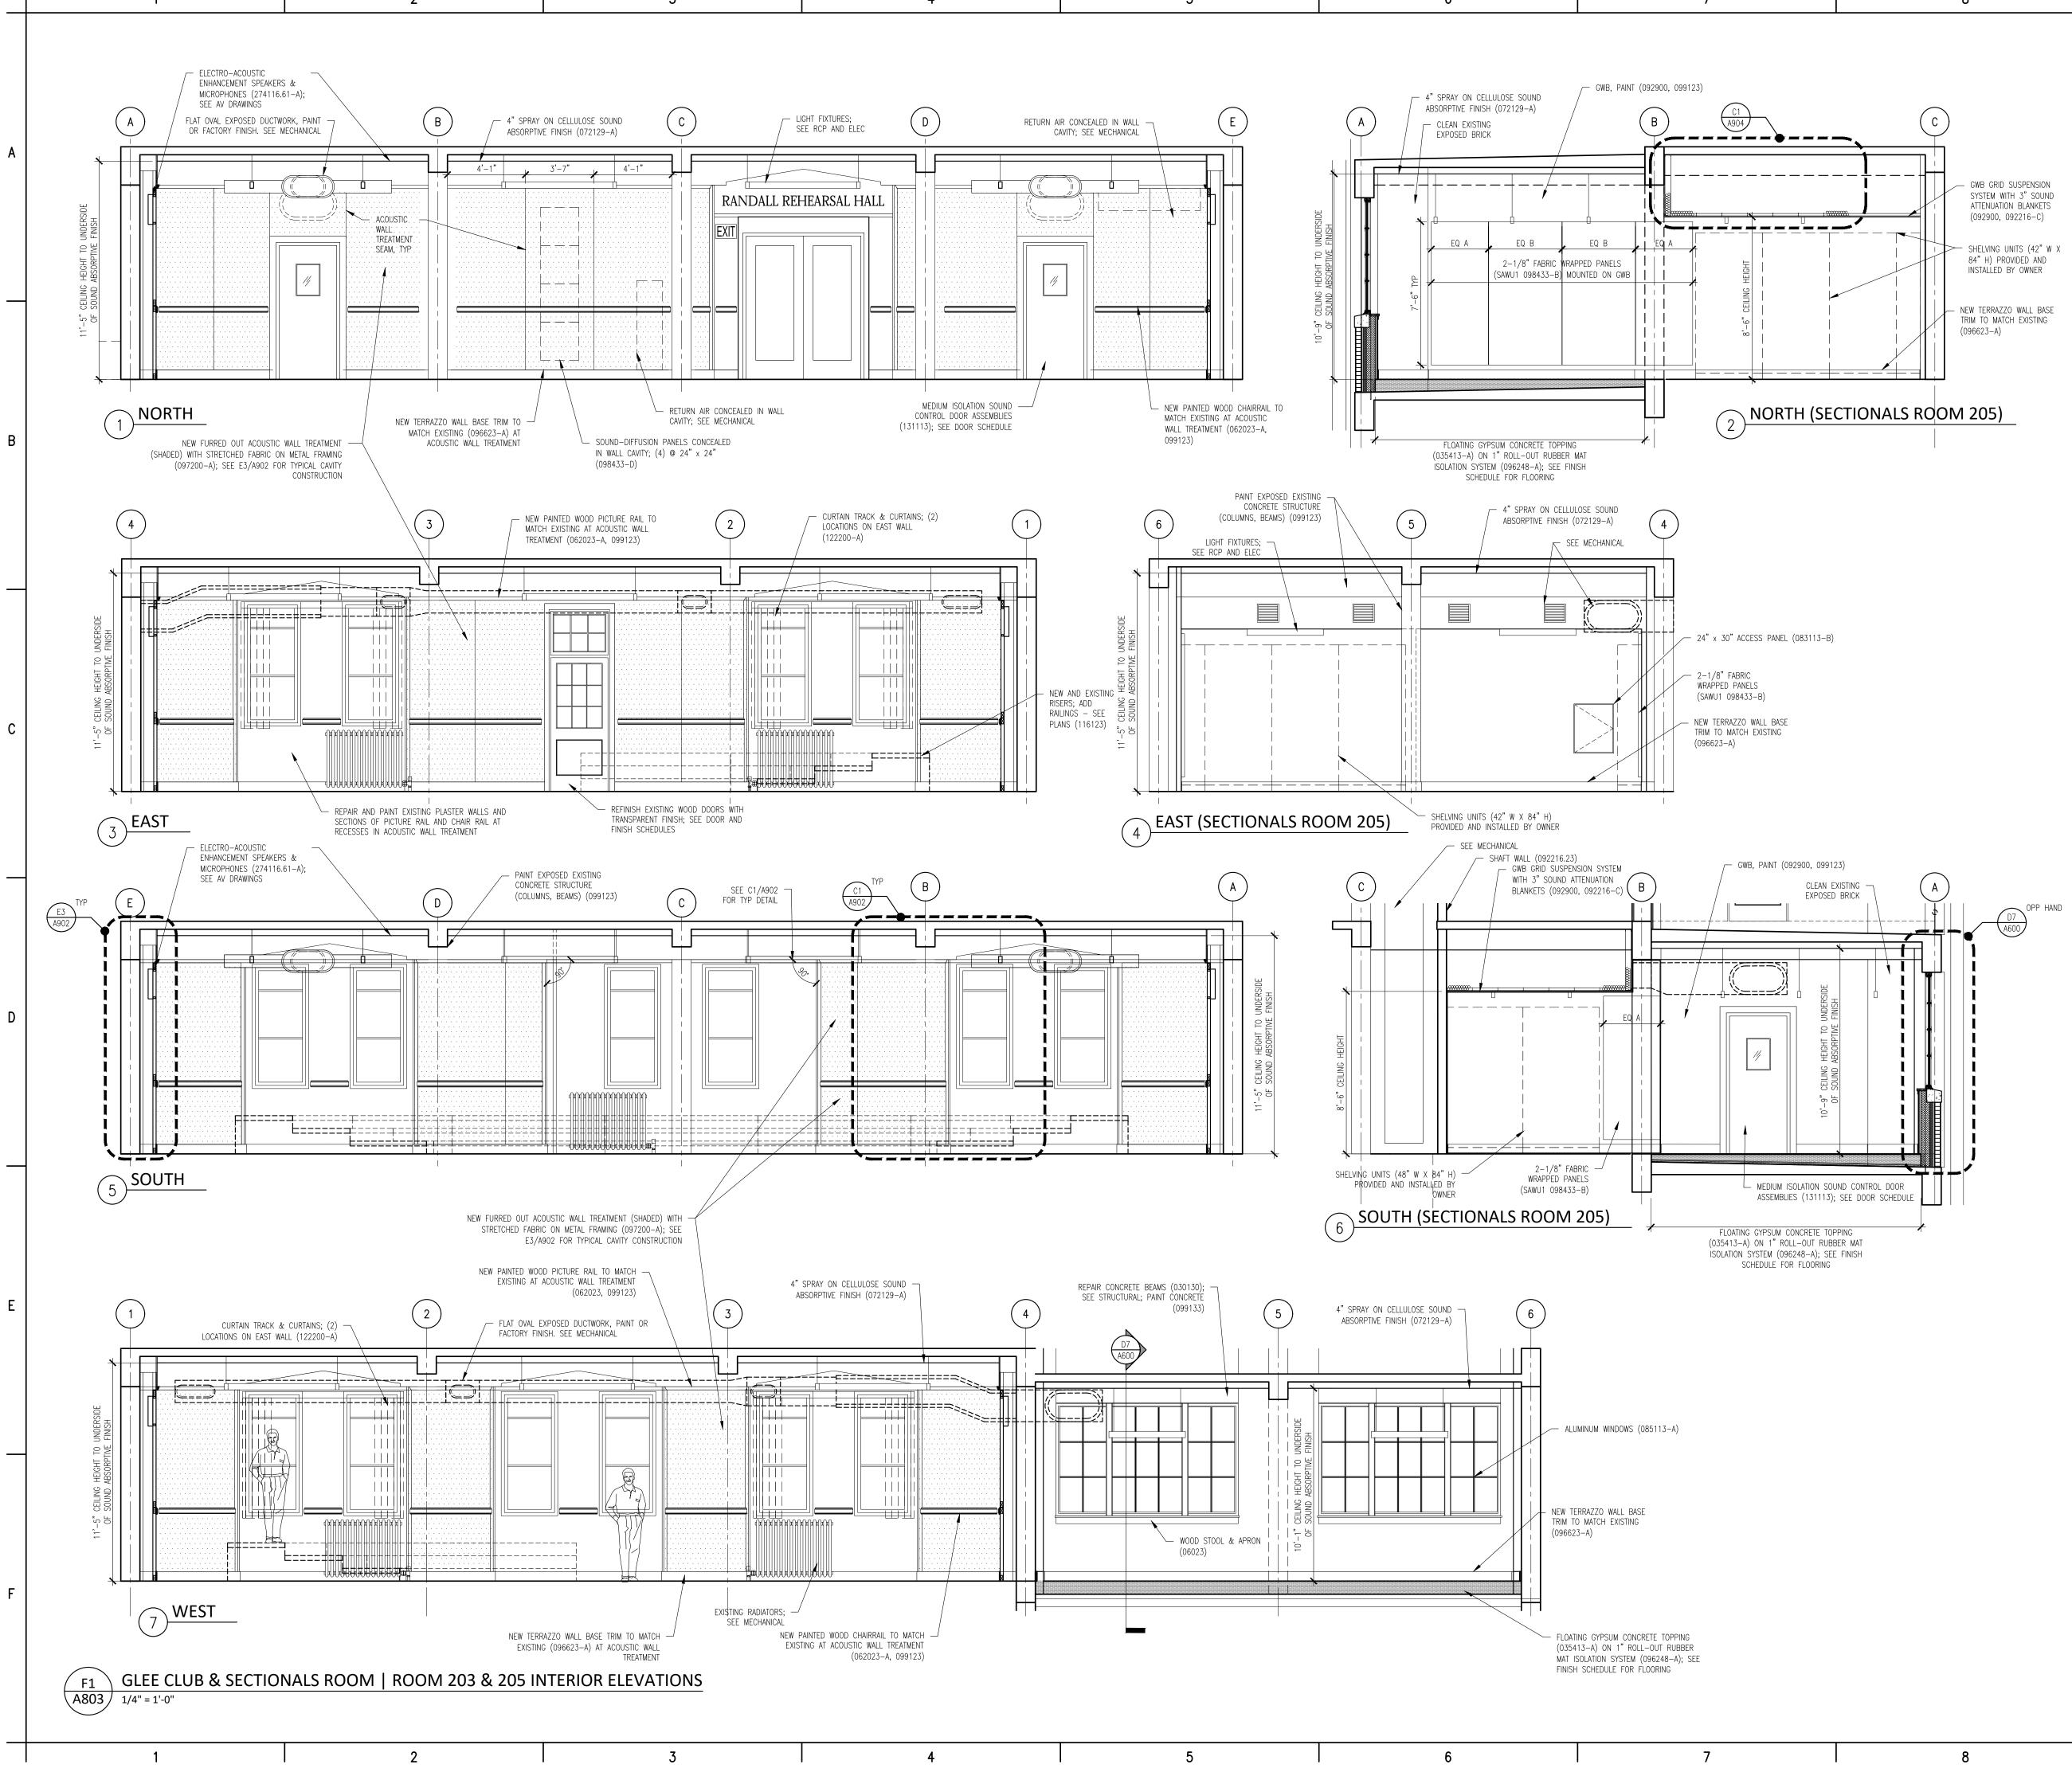
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IVISION 2:	EYNOTE LEGEND EXISTING CONDITIONS	Mark B. Thompson Associates Architecture
IVISION 3:	SELECTIVE DEMOLITION CONCRETE	502 South 24th Street Philadelphia, PA 19146
А	CONCRETE REPAIR (DRAWING SPEC NOTES ONLY) SEE STRUCTURAL DRAWINGS CAST IN-PLACE CONCRETE	215.985.1000 www.mbtarchitects.com Keast & Hood Company of New York, PC
A	NEW ELEVATED FLOOR SLAB AT BASEMENT LEVEL TO MATCH CORRIDOR FLOOR ELEVATION	Structural Engineering 400 Market Street, Suite 1250
033010 A	CAST IN-PLACE SITE CONCRETE; SEE CIVIL EXTERIOR CONCRETE SLAB SUPPORTED ON NEW FOOTINGS WITH RAMP	Philadelphia, PA 19106 215.625.0099 www.keasthood.com
B 035413 A	EXTERIOR CONCRETE STAIRS GYPSUM CEMENT UNDERLAYMENT INTERIOR TOPPING / LEVELING SLAB	Dimitri J. Ververelli, Inc. Mechanical, Electrical, Plumbing, Fire Protection Engineering
	MASONRY	211 North 13th Street Philadelphia, PA 19107
042000 A B	UNIT MASONRY BRICK MASONRY VENEER TO MATCH EXISTING ACCESSORIES (SEE DRAWINGS FOR TYPE)	215.496.0000 www.djvinc.com Langan
	B1 TIES, REINFORCEMENT; HOT-DIP GALV OR STAINLESS STEEL	Civil Engineering 21 Penn Plaza, 360 West 31st Street, 8th Floor
C D E	PRECAST CONCRETE LINTELS EMBEDDED FLEXIBLE FLASHING MESH WEEP / VENT	New York, NY 10001 212.479.5400 www.langan.com
	CAST STONE MASONRY	Theatre Projects Acoustical Design 47 Water Street
IVISION 5: 051200 A	STRUCTURAL STEEL FRAMING; SEE STRUCTURAL ELEVATOR HOIST BEAMS	South Norwalk, CT 06854 203.299.0830 www.theatreprojects.com
А	STEEL DECKING; SEE STRUCTURAL ROOF DECKING METAL FABRICATIONS	
A	MISC STRUCTURAL SHAPES; GALVANIZED AT EXTERIOR	
B C 055213	ABRASIVE CAST METAL NOSINGS METAL FLOOR PLATE TRENCH COVER PIPE AND TUBE RAILINGS	
	WOODS, PLASTICS, AND COMPOSITES ROUGH CARPENTRY	
	INTERIOR FINISH CARPENTRY GLEE CLUB ROOM 203: WOOD PICTURE RAIL &	
В	CHAIR RAIL TO MATCH EXISTING CONCERT BAND ROOM 300: WOOD WALL BASE & TRIMS; SEE DRAWINGS FOR DIMS & PROFILES	
C D	CHAIR RAIL MISCELLANEOUS TRIM; SEE DRAWINGS FOR DIMS & PROFILES	
	THERMAL AND MOISTURE PROTECTION	
072100 A	THERMAL INSULATION SPRAY-APPLIED OPEN CELL MEDIUM DENSITY FOAM INSULATION, VAPOR PERMEABLE	It is a violation of New York State Law for any person, unless he is acting under the direction of a licensed Professional Engineer or Land Surveyor, to alter an item
072129 A	SPRAY-APPLIED CELLULOSE ACOUSTICAL INSULATION SOUND ABSORPTIVE FINISH OVER 100% OF OVERHEAD DECK (BETWEEN STRUCTURAL BEAMS),	in any way. If an item bearing the seal of an Engineer or Land Surveyor is altered, the altering Engineer or Land Surveyor shall affix to the item his seal and the notation
075216	MINIMUM NRC 1.00, 4" SPRAY-ON CELLULOSE STYRENE-BUTADIENE-STYRENE (SBS) MODIFIED	"altered by" followed by his signature and the date of such alteration, and a specific description of the alteration.
А	BITUMINOUS MEMBRANE ROOFING SBS BASE SHEET + 3 PLIES AND CAP SHEET, IN COLD APPLIED ADHESIVE WITH HIGH-REFLECTIVE ROOF	
B C	COATING TO MATCH EXISTING FLASHING & STRIPPING MATERIALS ROOF INSULATION	General Notes All dimensions and existing conditions shall be checked and verified by contractor at the site
D E	INSULATION COVER BOARD VAPOR RETARDER / AIR BARRIER	prior to proceeding with the work. 2. Contractor shall inform Architect/ Engineer of any discrepancies on drawings before
F 076200 A	SUBSTRATE BOARD SHEET METAL FLASHING AND TRIM LOW-SLOPE ROOF EDGE FLASHINGS AND COPINGS	construction begins. 3. No existing service may be cut without
А	ROOF ACCESSORIES SERVICE ACCESS PLATFORM SYSTEM JOINT SEALANTS	Architect/Engineers's consent. Any existing service severed or damaged shall be replaced at no cost to owner.
	ACOUSTICAL JOINT SEALANTS	 Contractor must notify Architect/ Engineer at once if hidden existing conditions encountered require design modifications.
080314	OPENINGS HISTORIC TREATMENT OF WOOD DOORS HOLLOW METAL DOORS AND FRAMES	require design modifications. Issue Issued For Date
081416 081713	FLUSH WOOD DOORS INTEGRATED METAL DOOR OPENING ASSEMBLIES	0 Bid & Permit 07-06-2022
083113 A B	ACCESS DOORS AND FRAMES ACOUSTIC RATED FIRE-RESISTIVE RATED	
083323 A	OVERHEAD COILING DOORS INSULATED ROLLING SERVICE DOOR, MANUAL CHAIN HOIST, CYLINDRICAL LOCK	
B C	FACE-OF-WALL MOUNTED JAMB HOOD / HEAD PLATE	
084113 A	ALUMINUM-FRAMED ENTRANCES AND STOREFRONTS 1" LOW EMISSIVITY INSULATED GLASS UNIT	PRELIMINARY Not For Construction
085113 A	ALUMINUM WINDOWS 3-1/4" THERMAL ALUMINUM 'STEEL REPLICA'	
	WINDOW SYSTEM	
	WINDOW SYSTEM A1 COVED MUNTIN GRID, SIMULATED TRUE DIVIDED LITES, CUSTOM PERIMETER AND INTERIOR AND EXTERIOR GRIDS TO SIMULATE	Key Plan
087100	A1 COVED MUNTIN GRID, SIMULATED TRUE DIVIDED LITES, CUSTOM PERIMETER AND	Key Plan
IVISION 9: 092116.2	 A1 COVED MUNTIN GRID, SIMULATED TRUE DIVIDED LITES, CUSTOM PERIMETER AND INTERIOR AND EXTERIOR GRIDS TO SIMULATE ORIGINAL WINDOW SASH DOOR HARDWARE FINISHES 23 GYPSUM BOARD SHAFT WALL ASSEMBLIES 	Key Plan
IVISION 9: 092116.2	A1 COVED MUNTIN GRID, SIMULATED TRUE DIVIDED LITES, CUSTOM PERIMETER AND INTERIOR AND EXTERIOR GRIDS TO SIMULATE ORIGINAL WINDOW SASH DOOR HARDWARE FINISHES	Key Plan
IVISION 9: 092116. 092216 A B C	A1 COVED MUNTIN GRID, SIMULATED TRUE DIVIDED LITES, CUSTOM PERIMETER AND INTERIOR AND EXTERIOR GRIDS TO SIMULATE ORIGINAL WINDOW SASH DOOR HARDWARE FINISHES 23 GYPSUM BOARD SHAFT WALL ASSEMBLIES NON-STRUCTURAL METAL FRAMING STUD FRAMING, RUNNER TRACKS SUSPENSION SYSTEM FOR CEILINGS & SOFFITS GRID SUSPENSION SYSTEM FOR GYPSUM BOARD CEILINGS	Key Plan
IVISION 9: 092116.3 092216 A B C 092900 093013	A1 COVED MUNTIN GRID, SIMULATED TRUE DIVIDED LITES, CUSTOM PERIMETER AND INTERIOR AND EXTERIOR GRIDS TO SIMULATE ORIGINAL WINDOW SASH DOOR HARDWARE FINISHES 23 GYPSUM BOARD SHAFT WALL ASSEMBLIES NON-STRUCTURAL METAL FRAMING STUD FRAMING, RUNNER TRACKS SUSPENSION SYSTEM FOR CEILINGS & SOFFITS GRID SUSPENSION SYSTEM FOR GYPSUM BOARD CEILINGS GYPSUM BOARD CERAMIC TILING ACOUSTICAL PANEL CEILINGS	Key Plan
IVISION 9: 092116.3 092216 A B C 092900 093013 095113	A1 COVED MUNTIN GRID, SIMULATED TRUE DIVIDED LITES, CUSTOM PERIMETER AND INTERIOR AND EXTERIOR GRIDS TO SIMULATE ORIGINAL WINDOW SASH DOOR HARDWARE FINISHES 23 GYPSUM BOARD SHAFT WALL ASSEMBLIES NON-STRUCTURAL METAL FRAMING STUD FRAMING, RUNNER TRACKS SUSPENSION SYSTEM FOR CEILINGS & SOFFITS GRID SUSPENSION SYSTEM FOR GYPSUM BOARD CEILINGS GYPSUM BOARD CERAMIC TILING	
IVISION 9: 092116.3 092216 A B C 092900 093013 095113 096248 A 096513	 A1 COVED MUNTIN GRID, SIMULATED TRUE DIVIDED LITES, CUSTOM PERIMETER AND INTERIOR AND EXTERIOR GRIDS TO SIMULATE ORIGINAL WINDOW SASH DOOR HARDWARE FINISHES 23 GYPSUM BOARD SHAFT WALL ASSEMBLIES NON-STRUCTURAL METAL FRAMING STUD FRAMING, RUNNER TRACKS SUSPENSION SYSTEM FOR CEILINGS & SOFFITS GRID SUSPENSION SYSTEM FOR GYPSUM BOARD CEILINGS GYPSUM BOARD CERAMIC TILING ACOUSTICAL PANEL CEILINGS SEE RCPS AND FINISH SCHEDULE SOUND AND VIBRATION CONTROL FOR CONCRETE FLOATING FLOOR 1" ROLL-OUT RUBBER MAT ISOLATION SYSTEM RESILIENT BASE & ACCESSORIES 	EGNER HALL
IVISION 9: 092116.3 092216 A B C 092900 093013 095113 096248 A 096513 096513 096519	A1 COVED MUNTIN GRID, SIMULATED TRUE DIVIDED LITES, CUSTOM PERIMETER AND INTERIOR AND EXTERIOR GRIDS TO SIMULATE ORIGINAL WINDOW SASH DOOR HARDWARE FINISHES 23 GYPSUM BOARD SHAFT WALL ASSEMBLIES NON-STRUCTURAL METAL FRAMING STUD FRAMING, RUNNER TRACKS SUSPENSION SYSTEM FOR CEILINGS & SOFFITS GRID SUSPENSION SYSTEM FOR GYPSUM BOARD CEILINGS GYPSUM BOARD CERAMIC TILING ACOUSTICAL PANEL CEILINGS SEE RCPS AND FINISH SCHEDULE SOUND AND VIBRATION CONTROL FOR CONCRETE FLOATING FLOOR 1" ROLL-OUT RUBBER MAT ISOLATION SYSTEM RESILIENT BASE & ACCESSORIES RESILIENT TILE FLOORING RESINOUS MATRIX TERRAZZO FLOORING WALL BASE: 3/8" x 6" HIGH PRECAST EPOXY	EGNER HALL BUILDING 685
IVISION 9: 092116.3 092216 A B C 092900 093013 095113 096248 A 096513 096513 096623 A 096613	 A1 COVED MUNTIN GRID, SIMULATED TRUE DIVIDED LITES, CUSTOM PERIMETER AND INTERIOR AND EXTERIOR GRIDS TO SIMULATE ORIGINAL WINDOW SASH DOOR HARDWARE FINISHES 23 GYPSUM BOARD SHAFT WALL ASSEMBLIES NON-STRUCTURAL METAL FRAMING STUD FRAMING, RUNNER TRACKS SUSPENSION SYSTEM FOR CEILINGS & SOFFITS GRID SUSPENSION SYSTEM FOR GYPSUM BOARD CEILINGS GYPSUM BOARD CERAMIC TILING ACOUSTICAL PANEL CEILINGS SEE RCPS AND FINISH SCHEDULE SOUND AND VIBRATION CONTROL FOR CONCRETE FLOATING FLOOR 1" ROLL-OUT RUBBER MAT ISOLATION SYSTEM RESILIENT TILE FLOORING RESINOUS MATRIX TERRAZZO FLOORING 	EGNER HALL
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IVISION 9: 092116.3 092216 A B C 092900 093013 095113 096248 A 096513 096513 096519 096623 A 096813 097200 A 098433 A B	A1 COVED MUNTIN GRID, SIMULATED TRUE DIVIDED LITES, CUSTOM PERIMETER AND INTERIOR AND EXTERIOR GRIDS TO SIMULATE ORIGINAL WINDOW SASH DOOR HARDWARE FINISHES 23 GYPSUM BOARD SHAFT WALL ASSEMBLIES NON-STRUCTURAL METAL FRAMING STUD FRAMING, RUNNER TRACKS SUSPENSION SYSTEM FOR CEILINGS & SOFFITS GRID SUSPENSION SYSTEM FOR GYPSUM BOARD CEILINGS GYPSUM BOARD CERAMIC TILING ACOUSTICAL PANEL CEILINGS SEE RCPS AND FINISH SCHEDULE SOUND AND VIBRATION CONTROL FOR CONCRETE FLOATING FLOOR 1" ROLL-OUT RUBBER MAT ISOLATION SYSTEM RESILIENT BASE & ACCESSORIES RESILIENT TILE FLOORING RESINOUS MATRIX TERRAZZO FLOORING WALL BASE: 3/8" x 6" HIGH PRECAST EPOXY TERRAZZO WALL BASE TO MATCH EXISTING TILE CARPETING WALL COVERINGS GLEE CLUB ROOM 203: ACOUSTICAL TRANSPARENT FABRIC ON METAL FRAMING; SEE ELEVATIONS FOR EXTENT SOUND-ABSORBING WALL UNITS CONCERT BAND ROOM 300: SOUND ABSORPTIVE 1" FABRIC WRAPPED PANELS, MINIMUM NRC 1.00 SECTIONALS ROOM 205, CORRIDORS & VESTIBULES WHERE NOTED ON FINISH SCHEDULE: SOUND ABSORPTIVE 2-1/8" FABRIC WRAPPED PANELS, MINIMUM NRC 1.05	EGRER HALL BUILDING 6855 U.S. MILITARY ACADEMY West Point, New York
IVISION 9: 092116.3 092216 A B C 092900 093013 095113 096248 A 096513 096519 096623 A 096813 097200 A 098433 A B C C D	A1 COVED MUNTIN GRID, SIMULATED TRUE DIVIDED LITES, CUSTOM PERIMETER AND INTERIOR AND EXTERIOR GRIDS TO SIMULATE ORIGINAL WINDOW SASH DOOR HARDWARE FINISHES 23 GYPSUM BOARD SHAFT WALL ASSEMBLIES NON-STRUCTURAL METAL FRAMING STUD FRAMING, RUNNER TRACKS SUSPENSION SYSTEM FOR CEILINGS & SOFFITS GRID SUSPENSION SYSTEM FOR GYPSUM BOARD CEILINGS GYPSUM BOARD CERAMIC TILING ACOUSTICAL PANEL CEILINGS SEE RCPS AND FINISH SCHEDULE SOUND AND VIBRATION CONTROL FOR CONCRETE FLOATING FLOOR 1" ROLL-OUT RUBBER MAT ISOLATION SYSTEM RESILIENT BASE & ACCESSORIES RESINOUS MATRIX TERRAZZO FLOORING WALL BASE: 3/8" × 6" HIGH PRECAST EPOXY TERRAZZO WALL BASE TO MATCH EXISTING TILE CARPETING WALL COVERINGS GLEE CLUB ROOM 203: ACOUSTICAL TRANSPARENT FABRIC ON METAL FRAMING; SEE ELEVATIONS FOR EXTENT SOUND-ABSORBING WALL UNITS CONCERT BAND ROOM 300: SOUND ABSORPTIVE 1" FABRIC WRAPPED PANELS, MINIMUM NRC 1.00 SECTIONALS ROOM 205, CORRIDORS & VESTIBULES WHERE NOTED ON FINISH SCHEDULE: SOUND ABSORPTIVE 2-1/8" FABRIC WRAPPED PANELS, MINIMUM NRC 1.05 GLEE CLUB ROOM 205 2" DUCT LINER BOARD, 2.5 PCF MIN, CONCEALED IN WALL CAVITY SOUND-ABSORBING WALL UNIT CONCEALED IN WALL CAVITY SOUND-ABSORBING CEILING UNITS 3/4" PLYWOOD PANEL SOUND REFLECTING CLOUDS	EGRNER HALL BUDLDING 6855 US. MILITARY ACADEMY West Point, New York Project No.: 11300 Date: July 06, 2022
IVISION 9: 092116.3 092216 A B C 092900 093013 095113 096248 A 096513 096519 096623 A 096813 097200 A 098433 A B C D 098436 A	A1 COVED MUNTIN GRID, SIMULATED TRUE DIVIDED LITES, CUSTOM PERIMETER AND INTERIOR AND EXTERIOR GRIDS TO SIMULATE ORIGINAL WINDOW SASH DOOR HARDWARE FINISHES 23 GYPSUM BOARD SHAFT WALL ASSEMBLIES NON-STRUCTURAL METAL FRAMING STUD FRAMING, RUNNER TRACKS SUSPENSION SYSTEM FOR CEILINGS & SOFFITS GRID SUSPENSION SYSTEM FOR GYPSUM BOARD CEILINGS GYPSUM BOARD CERAMIC TILING ACOUSTICAL PANEL CEILINGS SEE RCPS AND FINISH SCHEDULE SOUND AND VIBRATION CONTROL FOR CONCRETE FLOATING FLOOR 1" ROLL-OUT RUBBER MAT ISOLATION SYSTEM RESILIENT BASE & ACCESSORIES RESINOUS MATRIX TERRAZZO FLOORING WALL BASE: 3/8" × 6" HIGH PRECAST EPOXY TERRAZZO WALL BASE TO MATCH EXISTING TILE CARPETING WALL COVERINGS GLEE CLUB ROOM 203: ACOUSTICAL TRANSPARENT FABRIC ON METAL FRAMING; SEE ELEVATIONS FOR EXTENT SOUND-ABSORBING WALL UNITS CONCERT BAND ROOM 300: SOUND ABSORPTIVE 1" FABRIC WRAPPED PANELS, MINIMUM NRC 1.00 SECTIONALS ROOM 203: COUND ABSORPTIVE 1" FABRIC WRAPPED PANELS, MINIMUM NRC 1.00 SECTIONALS ROOM 203: 2" DUCT LINER BOARD, 2.5 PCF MIN, CONCEALED IN WALL CAVITY SOUND-ABSORBING WALL UNITS CONCERT BAND ROOM 203: 2" DUCT LINER BOARD, 2.5 PCF MIN, CONCEALED IN WALL CAVITY SOUND-DIFFUSING WALL UNIT CONCEALED IN WALL CAVITY SOUND-ABSORBING CEILING UNITS	EGRORER HALL BULLDING 6885 U.S. MILITARY ACADEMY West Point, New York
IVISION 9: 092116.3 092216 A B C 092900 093013 095113 096248 A 096513 096519 096623 A 096813 097200 A 098433 A B C D 098436 A 099113 099123	A1 COVED MUNTIN GRID, SIMULATED TRUE DIVIDED LITES, CUSTOM PERIMETER AND INTERIOR AND EXTERIOR GRIDS TO SIMULATE ORIGINAL WINDOW SASH DOOR HARDWARE FINISHES 23 GYPSUM BOARD SHAFT WALL ASSEMBLIES NON-STRUCTURAL METAL FRAMING STUD FRAMING, RUNNER TRACKS SUSPENSION SYSTEM FOR CEILINGS & SOFFITS GRID SUSPENSION SYSTEM FOR GYPSUM BOARD CEILINGS GYPSUM BOARD CERAMIC TILING ACOUSTICAL PANEL CEILINGS SEE RCPS AND FINISH SCHEDULE SOUND AND VIBRATION CONTROL FOR CONCRETE FLOATING FLOOR 1" ROLL-OUT RUBBER MAT ISOLATION SYSTEM RESILIENT BASE & ACCESSORIES RESILIENT TILE FLOORING RESINOUS MATRIX TERRAZZO FLOORING WALL BASE: 3/8" x 6" HIGH PRECAST EPOXY TERRAZZO WALL BASE TO MATCH EXISTING TILE CARPETING WALL COVERINGS GLEE CLUB ROOM 203: ACOUSTICAL TRANSPARENT FABRIC ON METAL FRAMING; SEE ELEVATIONS FOR EXTENT SOUND-ABSORBING WALL UNITS CONCERT BAND ROOM 300: SOUND ABSORPTIVE 1" FABRIC ON METAL FRAMING; SEE LEVATIONS FOR EXTENT SOUND-ABSORBING WALL UNITS CONCERT BAND ROOM 205, CORRIDORS & VESTIBULES WHERE NOTED ON FINISH SCHEDULE: SOUND ABSORPTIVE 2-1/8" FABRIC WRAPPED PANELS, MINIMUM NRC 1.05 GLEE CLUB ROOM 203: 2" DUCT LINER BOARD, 2.5 PCF MIN, CONCEALED IN WALL CAVITY SOUND-ABSORBING CEILING UNITS 3/4" PLYWOOD PANEL SOUND REFLECTING CLOUDS SUSPENDED WITH FRAMING; ANGLE 5 DEGREES FROM HORIZONTAL IN RANDOM DIRECTIONS	EGROER HALL BEGNER HALL BULLDING 6855 U.S. MILITARY ACADEMY West Point, New York Project No.: 11300 Date: July 06, 2022
IVISION 9: 092116.3 092216 A B C 092900 093013 095113 096248 A 096513 096519 096623 A 096813 097200 A 098433 A B C D 098436 A 099113 099123 099300	A1 COVED MUNTIN GRID, SIMULATED TRUE DIVIDED LITES, CUSTOM PERIMETER AND INTERIOR AND EXTERIOR GRIDS TO SIMULATE ORIGINAL WINDOW SASH DOOR HARDWARE FINISHES 23 GYPSUM BOARD SHAFT WALL ASSEMBLIES NON-STRUCTURAL METAL FRAMING STUD FRAMING, RUNNER TRACKS SUSPENSION SYSTEM FOR CEILINGS & SOFFITS GRID SUSPENSION SYSTEM FOR GYPSUM BOARD CEILINGS GYPSUM BOARD CERAMIC TILING ACOUSTICAL PANEL CEILINGS SEE RCPS AND FINISH SCHEDULE SOUND AND VIBRATION CONTROL FOR CONCRETE FLOATING FLOOR 1" ROLL-OUT RUBBER MAT ISOLATION SYSTEM RESILIENT TILE FLOORING RESINOUS MATRIX TERRAZZO FLOORING WALL BASE: 3/8" x 6" HIGH PRECAST EPOXY TERRAZZO WALL BASE TO MATCH EXISTING TILE CARPETING WALL COVERINGS GLEE CLUB ROOM 203: ACOUSTICAL TRANSPARENT FABRIC ON METAL FRAMING; SEE ELEVATIONS FOR EXTENT SOUND-ABSORBING WALL UNITS CONCERT BAND ROOM 300: SOUND ABSORPTIVE 1" FABRIC WRAPPED PANELS, MINIMUM NRC 1.00 SECTIONALS ROOM 205, CORRIDORS & VESTIBULES WHER NOTED ON FINISH SCHEDULE: SOUND ABSORPTIVE 2-1/8" FABRIC WRAPPED PANELS, MINIMUM NRC 1.05 GLEE CLUB ROOM 203: 2" DUCT LINER BOARD, 2.5 PCF MIN, CONCEALED IN WALL CAVITY SOUND-ABSORBING WALL UNITS CONCERT BAND ROOM 300: SOUND ABSORPTIVE 1" FABRIC WRAPPED PANELS, MINIMUM NRC 1.00 SECTIONALS ROOM 203; 2" DUCT LINER BOARD, 2.5 PCF MIN, CONCEALED IN WALL CAVITY SOUND-ABSORBING CEILING UNITS 3/4" PLYWOOD PANEL SOUND REFLECTING CLOUDS SUSPENDED WITH FRAMING; ANGLE 5 DEGREES FROM HORIZONTAL IN RANDOM DIRECTIONS EXTERIOR PAINTING INTERIOR PAINTING INTERIOR PAINTING STAINING AND TRANSPARENT FINISHING	EGRNER HALL BUILDING 6855 U.S. MILITARY ACADEMY West Point, New York Project No.: 11300 Date: July 06, 2022 Drawing Title: Interior Elevations -
IVISION 9: 092116.3 092216 A B C 092900 093013 095113 096248 A 096513 096519 096623 A 096813 097200 A 098433 A B C D 098436 A 099113 099123 099300 IVISION 10 101423.3 102203	A1 COVED MUNTIN GRID, SIMULATED TRUE DIVIDED LITES, CUSTOM PERIMETER AND INTERIOR AND EXTERIOR GRIDS TO SIMULATE ORIGINAL WINDOW SASH DOOR HARDWARE FINISHES 23 GYPSUM BOARD SHAFT WALL ASSEMBLIES NON-STRUCTURAL METAL FRAMING STUD FRAMING, RUNNER TRACKS SUSPENSION SYSTEM FOR CEILINGS & SOFFITS GRID SUSPENSION SYSTEM FOR GYPSUM BOARD CELLINGS GYPSUM BOARD CERAMIC TILING ACOUSTICAL PANEL CEILINGS SEE RCPS AND FINISH SCHEDULE SOUND AND VIBRATION CONTROL FOR CONCRETE FLOATING FLOOR 1" ROLL-OUT RUBBER MAT ISOLATION SYSTEM RESILIENT BASE & ACCESSORIES RESILIENT TILE FLOORING RESINOUS MATRIX TERRAZZO FLOORING WALL BASE: 3/8" x 6" HIGH PRECAST EPOXY TERRAZZO WALL BASE TO MATCH EXISTING TILE CARPETING WALL COVERINGS GLEE CLUB ROOM 203: ACOUSTICAL TRANSPARENT FABRIC ON METAL FRAMING; SEE ELEVATIONS FOR EXTENT SOUND-ABSORBING WALL UNITS CONCERT BAND ROOM 300: SOUND ABSORPTIVE 1" FABRIC ON METAL FRAMING; SEE ELEVATIONS FOR EXTENT SOUND-ABSORBING WALL UNITS CONCERT BAND ROOM 300: SOUND ABSORPTIVE 1" FABRIC ON METAL FRAMING; SEE ELEVATIONS FOR EXTENT SOUND-ABSORBING WALL UNITS CONCERT BAND ROOM 300: SOUND ABSORPTIVE 1" FABRIC ON METAL FRAMING; SEE ELEVATIONS FOR EXTENT SOUND-ABSORBING WALL UNITS CONCERT BAND ROOM 203: ACOUSTICAL TRANSPARENT FABRIC ON METAL FRAMING; SEE ELEVATIONS FOR EXTENT SOUND-ABSORBING WALL UNITS CONCERT BAND ROOM 300: SOUND ABSORPTIVE 1" FABRIC ON METAL FRAMING; SEE ELEVATIONS FOR EXTENT SOUND-ABSORBING WALL UNITS CONCERT BAND ROOM 203: ACOUSTICAL TRANSPARENT FABRIC ON METAL FRAMING; SEE ELEVATIONS FOR EXTENT SOUND-ABSORBING CEILING UNITS 3/4" PLYWOOD PANELS OND REFLECTING CLOUDS SUSPENDED WITH FRAMING; ANGLE 5 DEGREES FROM HORIZONTAL IN RANDOM DIRECTIONS EXTERIOR PAINTING STAINING AND TRANSPARENT FINISHING STAINING AND TRANSPARENT FINISHING	EGRNER HALL BUILDING 6855 U.S. MILITARY ACADEMY West Point, New York Project No.: 11300 Date: July 06, 2022 Drawing Title: Interior Elevations -


(Continued on the following odd numbered sheet)

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Material Keynote Legend (Continued from the previous even numbered sheet)			
DIVISION 11	L: EQUIPMENT		
111316	LOADING DOCK SEALS AND SHELTERS		
А	CLEAR STRIP CURTAIN ENCLOSURE		
111319	STATIONARY LOADING DOCK EQUIPMENT		
А	SURFACE MOUNTED DOCK LIFT, 48" WIDE X 88"		
	LONG PLATFORM, MIN 5000 LB CAPACITY, VERTICAL TRAVEL 48", LOWERED HEIGHT 8", LAG INSTALLED		
	INTO CONCRETE		
В	4-1/2" OD FIXED DOCK BUMPER BOLLARD SET IN		
	CONCRETE		
116123	FOLDING AND PORTABLE STAGES		
DIVISION 12	2: FURNISHINGS		
122200	CURTAINS AND DRAPES		
A	TRACK WITH MOVABLE CURTAINS; 25 OZ/LINEAR		
	YARD COTTON VELOUR, SEWN WITH 100% FULLNESS, AND INCORPORATE 16 OZ BACKER LAYER,		
	SEWN FLAT		
DIVISION 13	3: SPECIAL CONSTRUCTION		
131113	MEDIUM ISOLATION SOUND CONTROL DOOR ASSEMBLIES		
133473	HIGH ISOLATION SOUND CONTROL DOOR ASSEMBLIES		
	: CONVEYING EQUIPMENT		
	MACHINE ROOM-LESS ELECTRIC TRACTION		
	VATORS		
A	MACHINE ROOM LESS (MRL) SIDE COUNTERWEIGHT		
	HOSPITAL SERVICE ELEVATOR, 5000 LB CAPACITY, 200 FPM, 4 STOPS		
DIVISION 22	2: PLUMBING		

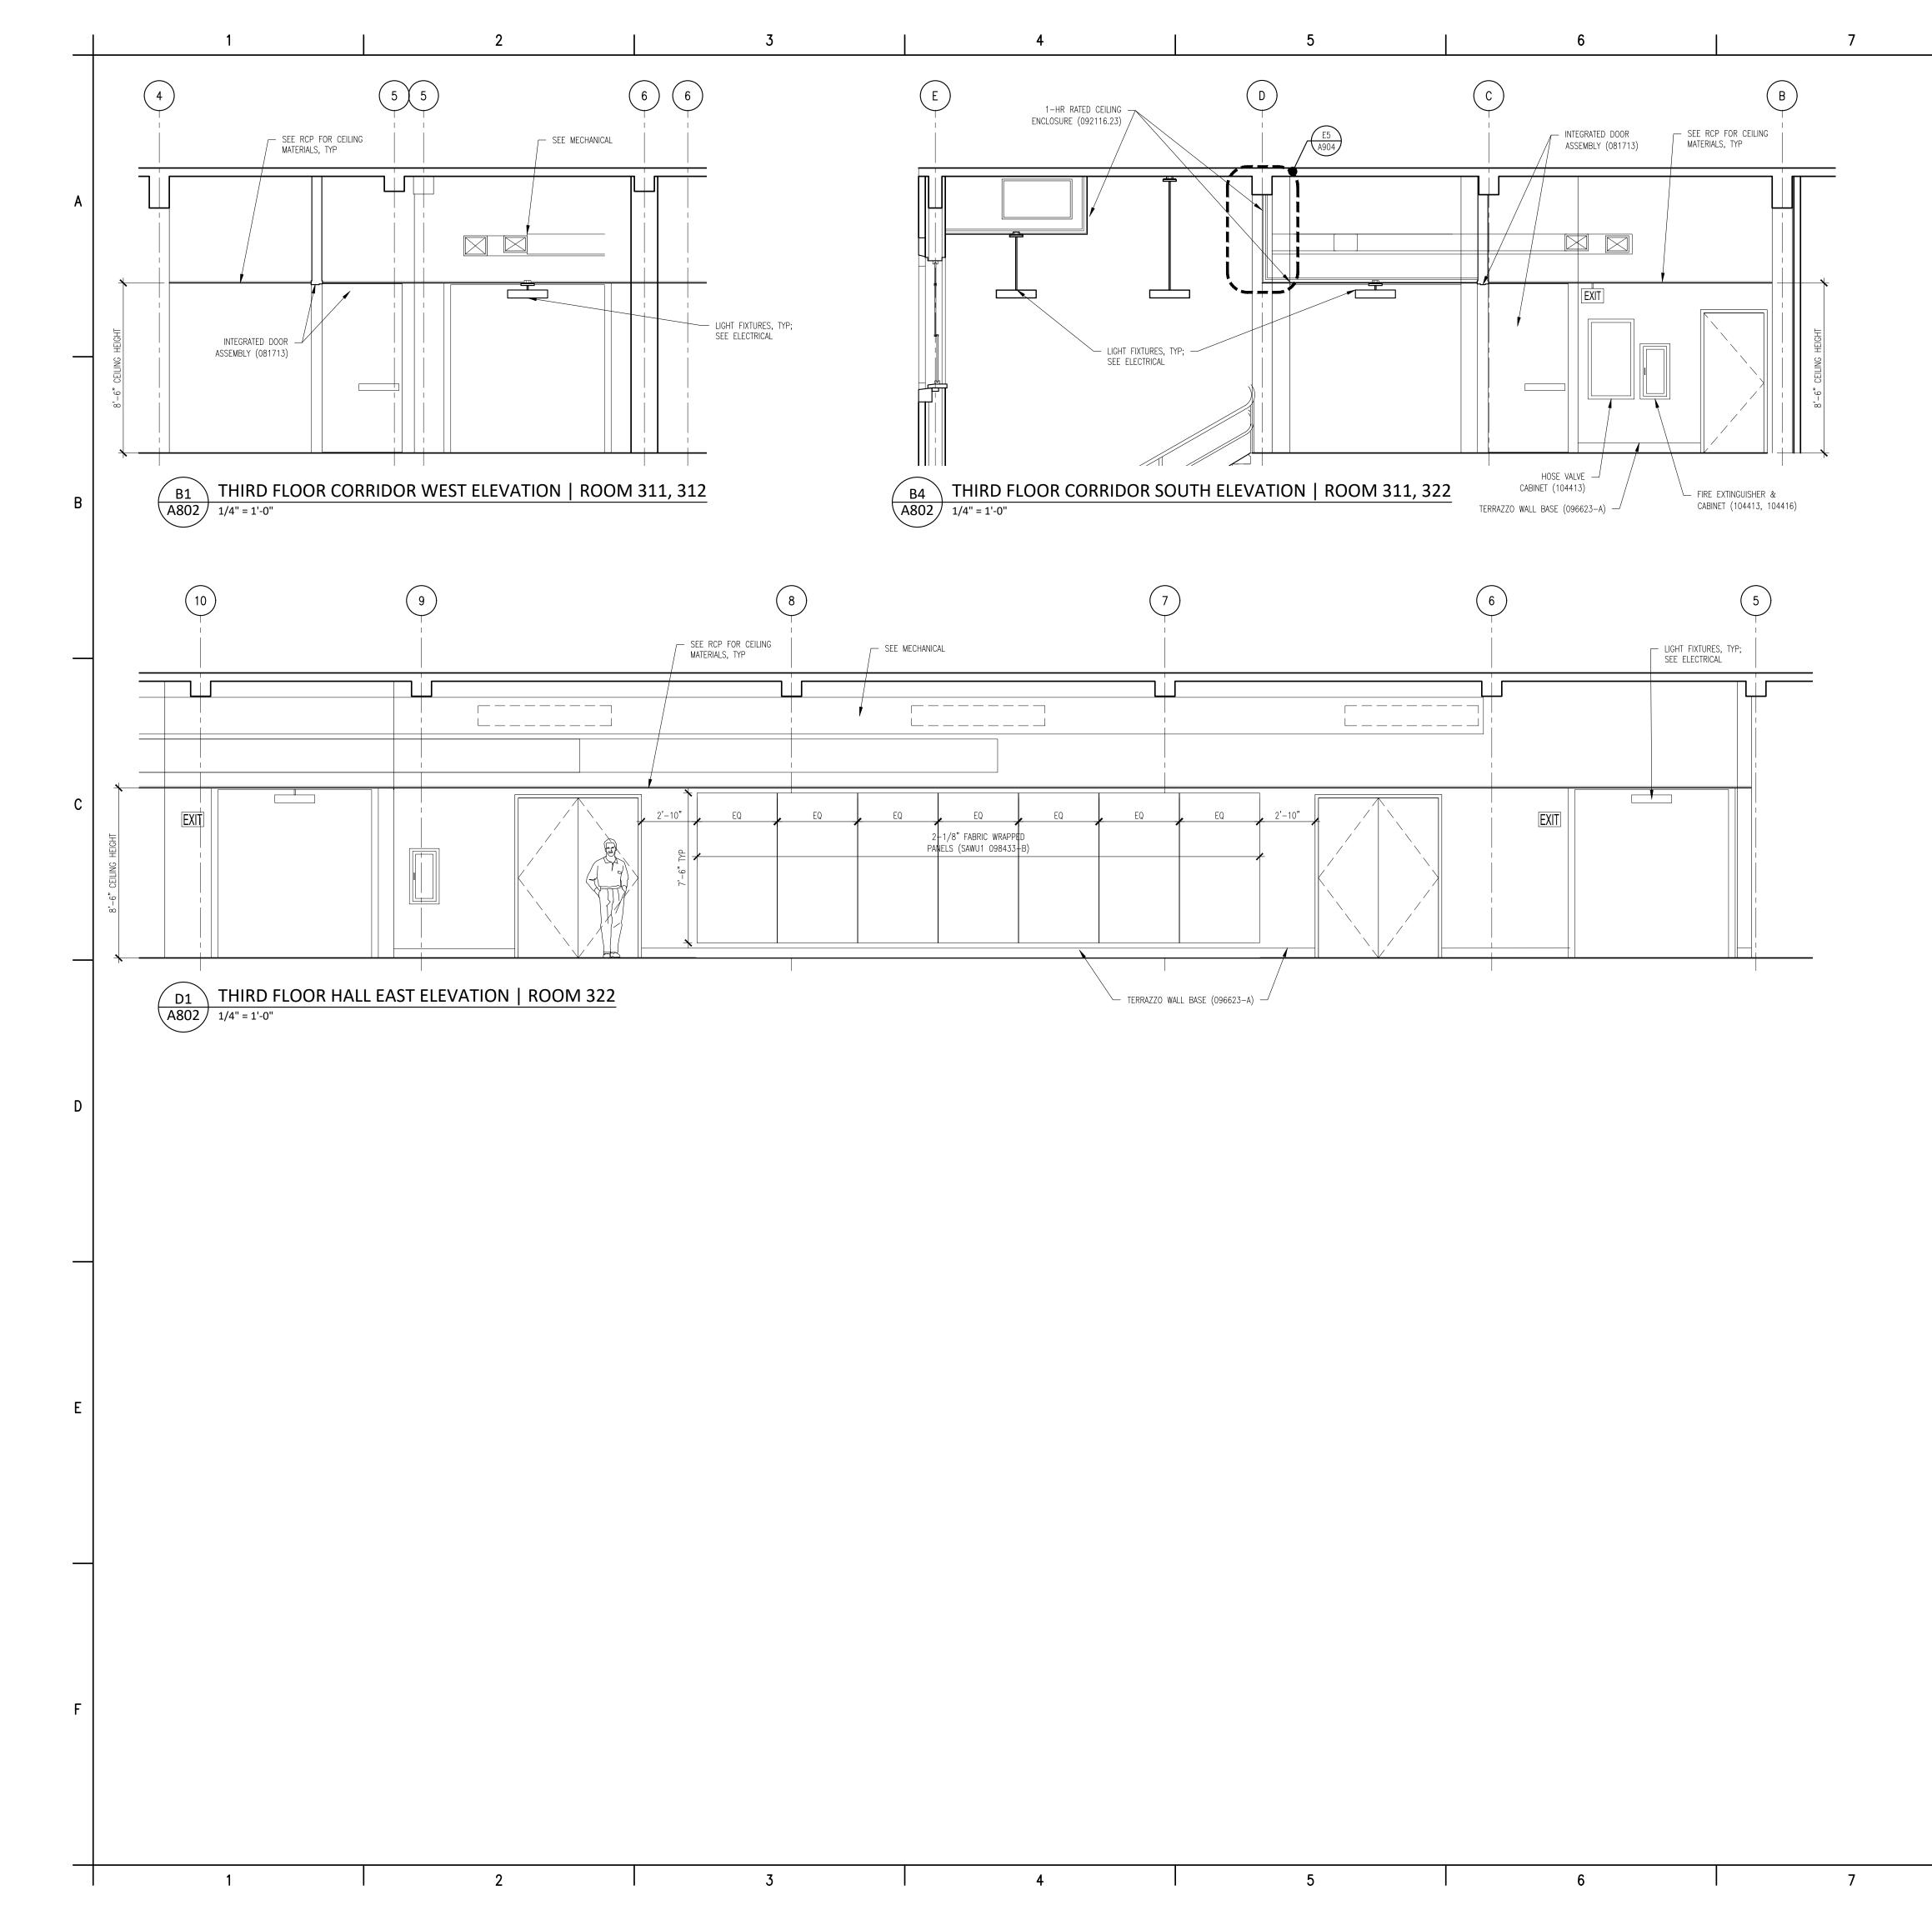SEE PLUMBING DRAWINGS & SPECS 224000 PLUMBING FIXTURES DIVISION 23: HEATING, VENTILATION AND AIR CONDITIONING

SEE MECHANICAL DRAWINGS & SPECS 233100 HVAC DUCTS & CASINGS A METAL DUCTS, SEE 'M' DWGS

DIVISION 26: ELECTRICAL SEE ELECTRICAL DRAWINGS & SPECS 260000 ELECTRICAL EQUIPMENT 265000 LED LIGHTING

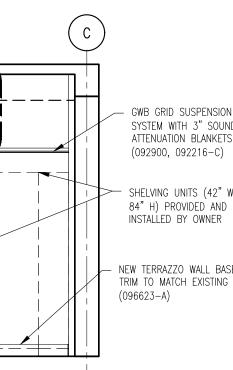DIVISION 27: COMMUNICATIONS

SEE AV AND ELECTRICAL DRAWINGS & SPECS 274116.61 INTEGRATED AUDIO-VIDEO SYSTEMS AND EQUIPMENT

A ELECTRO-ACOUSTIC ENHANCEMENT SYSTEM: SEE SPEC FOR DETAILED DESCRIPTION OF SYSTEM REQUIREMENTS

DIVISION 28: ELECTRONIC SAFETY AND SECURITY SEE ELECTRICAL DRAWINGS & SPECS

DIVISION 31: EARTHWORK SEE CIVIL DRAWINGS & SPECS

DIVISION 32: EXTERIOR IMPROVEMENTS SEE CIVIL DRAWINGS & SPECS 321216 ON-SITE ASPHALT PAVING

DIVISION 33: UTILITIES SEE CIVIL DRAWINGS & SPECS

502 South 24th Street Philadelphia, PA 19146 215.985.1000 www.mbtarchitects.com Keast & Hood Company of New York, PC Structural Engineering 400 Market Street, Suite 1250 Philadelphia, PA 19106 215.625.0099 www.keasthood.com Dimitri J. Ververelli, Inc.

Mark B. Thompson Associates

Architecture

Mechanical, Electrical, Plumbing, Fire Protection Engineering 211 North 13th Street Philadelphia, PA 19107 215.496.0000 www.djvinc.com

Langan Civil Engineering 21 Penn Plaza, 360 West 31st Street, 8th Floor New York, NY 10001 212.479.5400 www.langan.com

Theatre Projects Acoustical Design 47 Water Street South Norwalk, CT 06854 203.299.0830 www.theatreprojects.com

~ It is a violation of New York State Law for any person,

unless he is acting under the direction of a licensed Professional Engineer or Land Surveyor, to alter an item in any way. If an item bearing the seal of an Engineer or Land Surveyor is altered, the altering Engineer or Land Surveyor shall affix to the item his seal and the notation "altered by" followed by his signature and the date of such alteration, and a specific description of the alteration.

General Notes

- 1. All dimensions and existing conditions shall be checked and verified by contractor at the site prior to proceeding with the work. 2. Contractor shall inform Architect/ Engineer of
- any discrepancies on drawings before construction begins. 3. No existing service may be cut without Architect/Engineers's consent. Any existing service severed or damaged shall be replaced at
- no cost to owner. 4. Contractor must notify Architect/ Engineer at once if hidden existing conditions encountered

Date

07-06-2022

require design modifications.

Issue Issued For Bid & Permit

PRELIMINARY Not For Construction

Key Plan


EGNER HALL BUILDING 685

U.S. MILITARY ACADEMY West Point, New York

Project No.: 11300 Date: July 06, 2022

Drawing Title: Interior Elevations -Glee Club & Sectionals Rooms

A 8 0 3

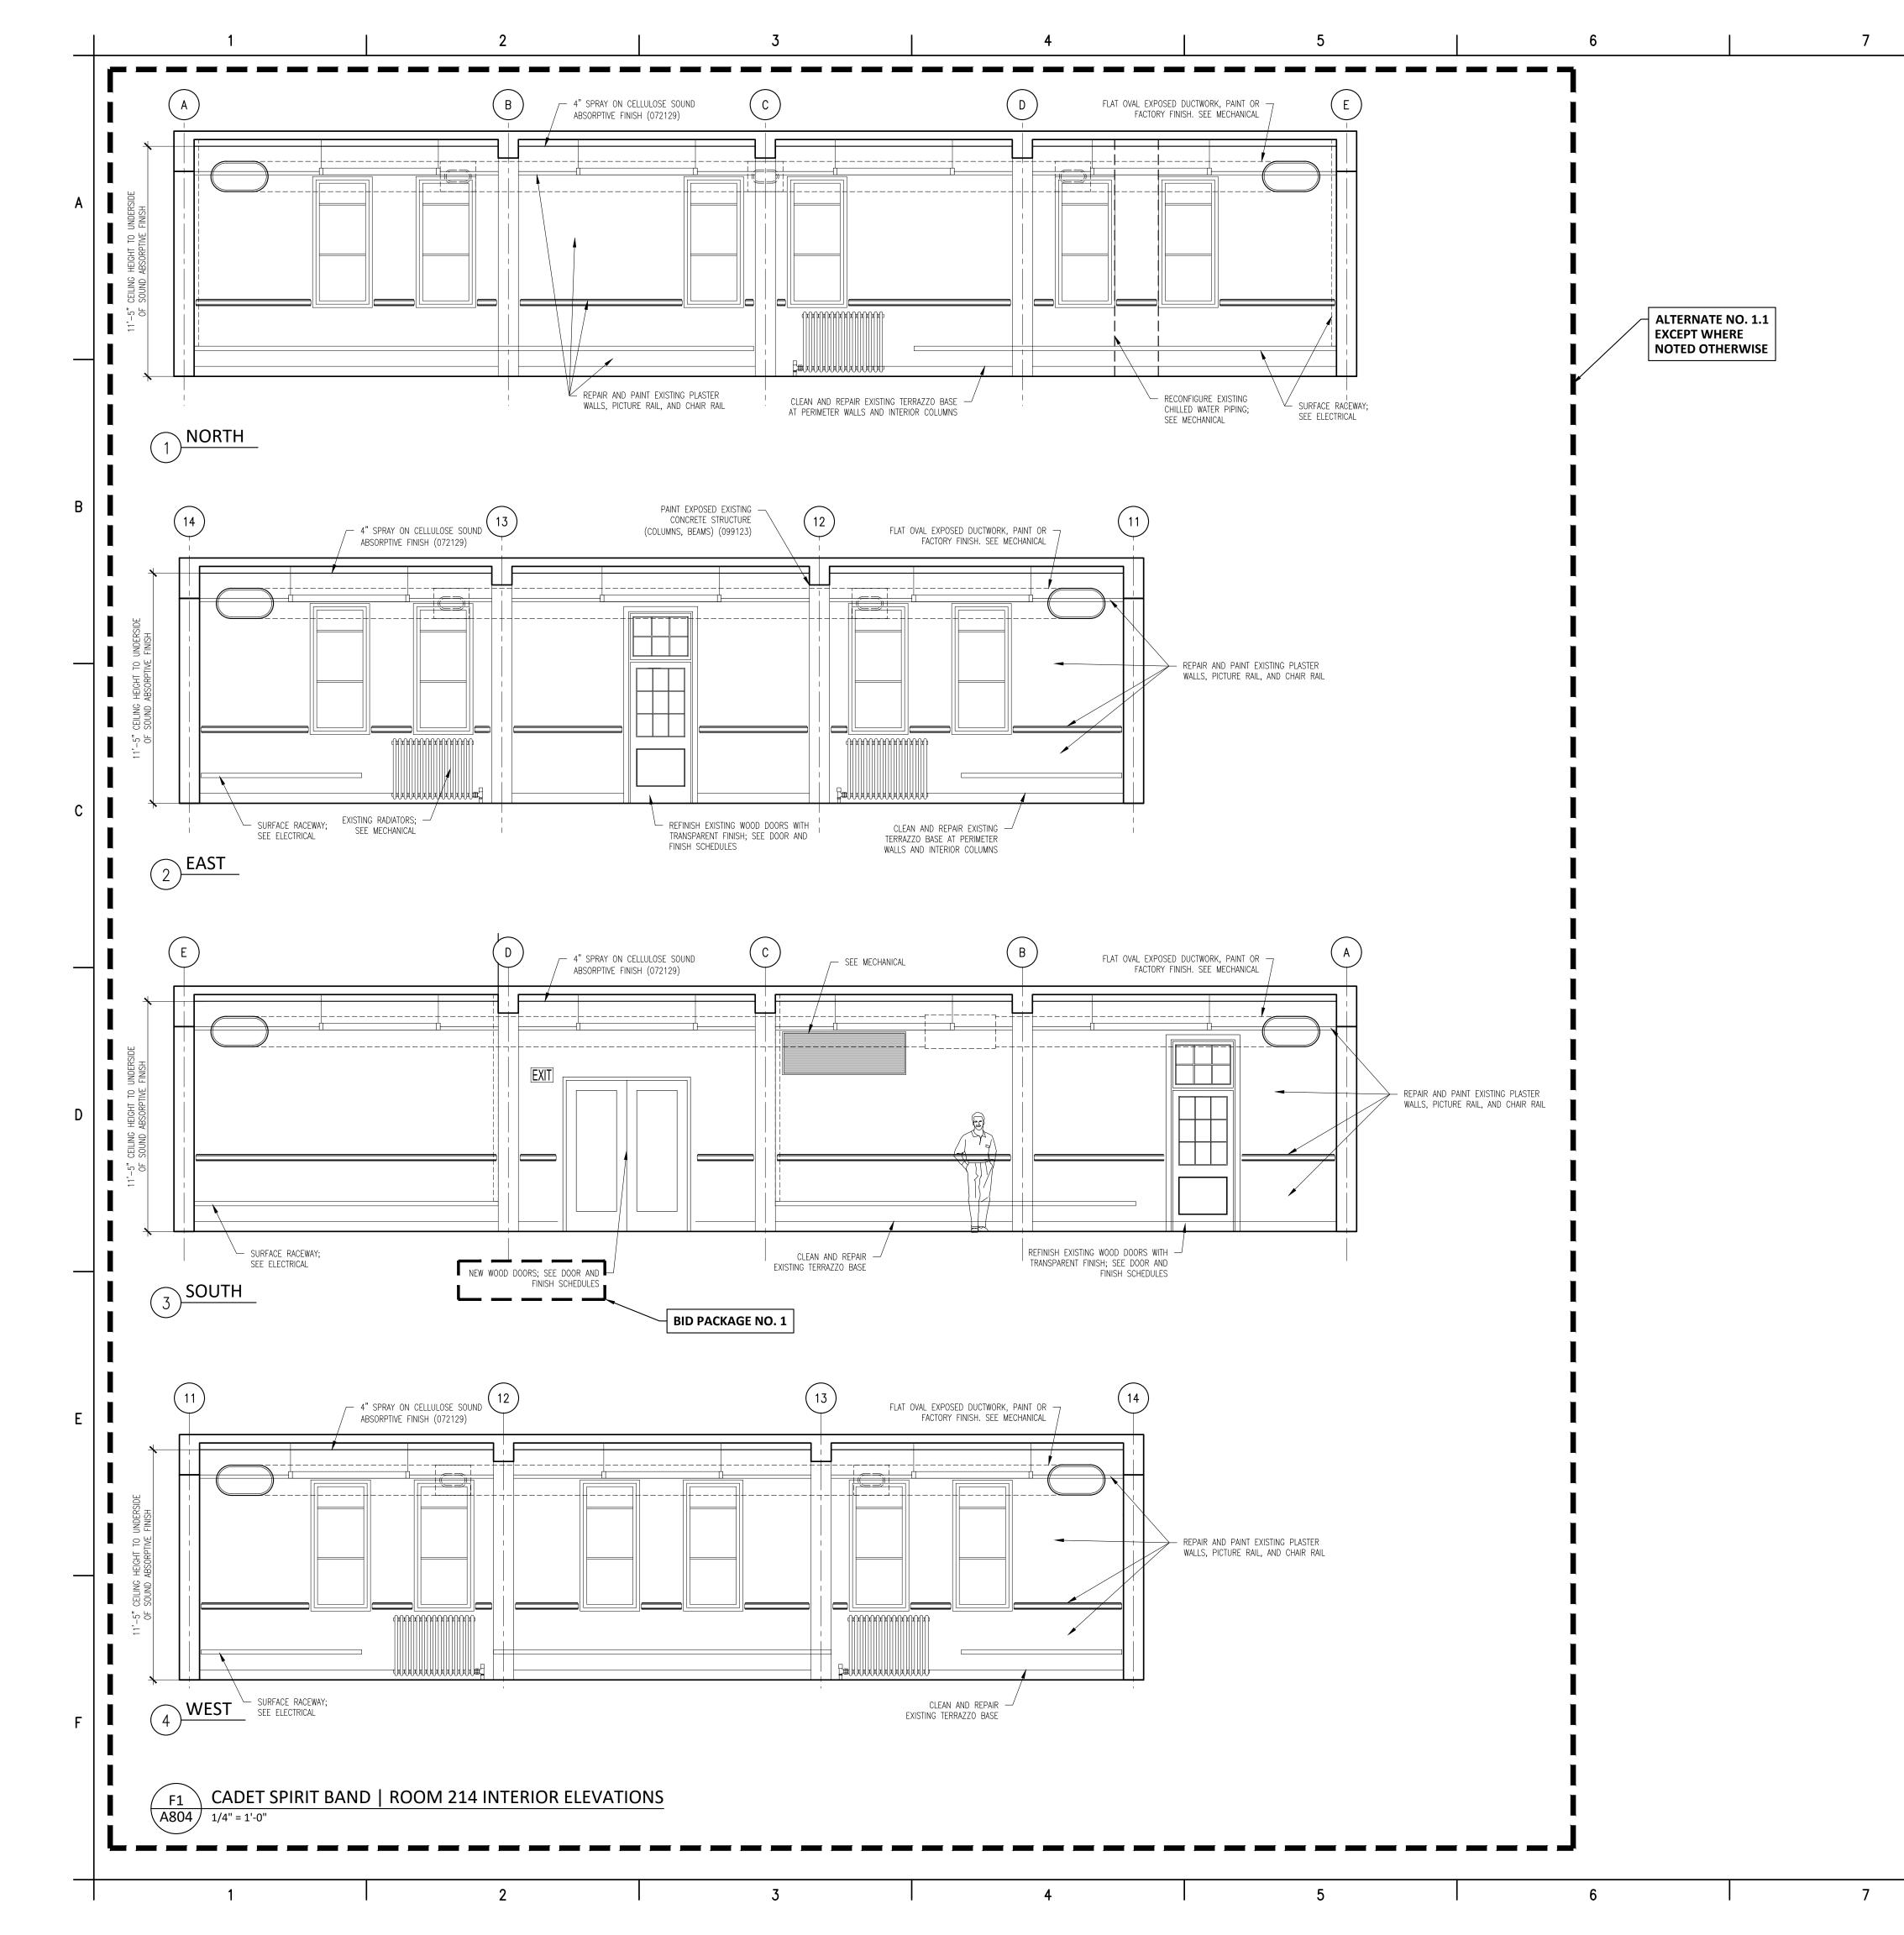


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VIVISION 2:	EXISTING CONDITIONS	Mark B. Thompson Associates Architecture
	SELECTIVE DEMOLITION CONCRETE	502 South 24th Street Philadelphia, PA 19146
А	CONCRETE REPAIR (DRAWING SPEC NOTES ONLY) SEE STRUCTURAL DRAWINGS CAST IN-PLACE CONCRETE	215.985.1000 www.mbtarchitects.com Keast & Hood Company of New York, PC
A	NEW ELEVATED FLOOR SLAB AT BASEMENT LEVEL TO MATCH CORRIDOR FLOOR ELEVATION	Structural Engineering 400 Market Street, Suite 1250
033010 A	CAST IN-PLACE SITE CONCRETE; SEE CIVIL EXTERIOR CONCRETE SLAB SUPPORTED ON NEW FOOTINGS WITH RAMP	Philadelphia, PA 19106 215.625.0099 www.keasthood.com
B 035413	EXTERIOR CONCRETE STAIRS GYPSUM CEMENT UNDERLAYMENT	Dimitri J. Ververelli, Inc. Mechanical, Electrical, Plumbing, Fire Protection
	INTERIOR TOPPING / LEVELING SLAB	Engineering 211 North 13th Street Philadelphia, PA 19107
	UNIT MASONRY BRICK MASONRY VENEER TO MATCH EXISTING	215.496.0000 www.djvinc.com
В	ACCESSORIES (SEE DRAWINGS FOR TYPE) B1 TIES, REINFORCEMENT; HOT-DIP GALV OR STAINLESS STEEL	Langan Civil Engineering 21 Penn Plaza, 360 West 31st Street, 8th Floor
C D	PRECAST CONCRETE LINTELS EMBEDDED FLEXIBLE FLASHING	New York, NY 10001 212.479.5400 www.langan.com
E 047200	MESH WEEP / VENT CAST STONE MASONRY	Theatre Projects Acoustical Design
VISION 5: 051200	METALS STRUCTURAL STEEL FRAMING; SEE STRUCTURAL	47 Water Street South Norwalk, CT 06854
A 053100 A	ELEVATOR HOIST BEAMS STEEL DECKING; SEE STRUCTURAL ROOF DECKING	203.299.0830 www.theatreprojects.com
	METAL FABRICATIONS MISC STRUCTURAL SHAPES; GALVANIZED AT	
B C	EXTERIOR ABRASIVE CAST METAL NOSINGS METAL FLOOR PLATE TRENCH COVER	
055213	PIPE AND TUBE RAILINGS	
061000	WOODS, PLASTICS, AND COMPOSITES ROUGH CARPENTRY INTERIOR FINISH CARPENTRY	
А	GLEE CLUB ROOM 203: WOOD PICTURE RAIL & CHAIR RAIL TO MATCH EXISTING	
B C	CONCERT BAND ROOM 300: WOOD WALL BASE & TRIMS; SEE DRAWINGS FOR DIMS & PROFILES CHAIR RAIL	
D	MISCELLANEOUS TRIM; SEE DRAWINGS FOR DIMS & PROFILES	
	THERMAL AND MOISTURE PROTECTION THERMAL INSULATION	It is a violation of New York State Law for any person,
A 072129	SPRAY-APPLIED OPEN CELL MEDIUM DENSITY FOAM INSULATION, VAPOR PERMEABLE SPRAY-APPLIED CELLULOSE ACOUSTICAL INSULATION	unless he is acting under the direction of a licensed Professional Engineer or Land Surveyor, to alter an item in any way. If an item bearing the seal of an Engineer or
A	SOUND ABSORPTIVE FINISH OVER 100% OF OVERHEAD DECK (BETWEEN STRUCTURAL BEAMS),	Land Surveyor is altered, the altering Engineer or Land Surveyor shall affix to the item his seal and the notation "altered by" followed by his signature and the date of
075216	MINIMUM NRC 1.00, 4" SPRAY-ON CELLULOSE STYRENE-BUTADIENE-STYRENE (SBS) MODIFIED BITUMINOUS MEMBRANE ROOFING	such alteration, and a specific description of the alteration.
A	SBS BASE SHEET + 3 PLIES AND CAP SHEET, IN COLD APPLIED ADHESIVE WITH HIGH-REFLECTIVE ROOF COATING TO MATCH EXISTING	General Notes
B C	FLASHING & STRIPPING MATERIALS ROOF INSULATION	 All dimensions and existing conditions shall be checked and verified by contractor at the site prior to proceeding with the work.
D E F	INSULATION COVER BOARD VAPOR RETARDER / AIR BARRIER SUBSTRATE BOARD	 Contractor shall inform Architect/ Engineer of any discrepancies on drawings before
076200 A		construction begins. 3. No existing service may be cut without
А	ROOF ACCESSORIES SERVICE ACCESS PLATFORM SYSTEM JOINT SEALANTS	Architect/Engineers's consent. Any existing service severed or damaged shall be replaced at no cost to owner.
	ACOUSTICAL JOINT SEALANTS	 Contractor must notify Architect/ Engineer at once if hidden existing conditions encountered require design modifications
080314	OPENINGS HISTORIC TREATMENT OF WOOD DOORS HOLLOW METAL DOORS AND FRAMES	require design modifications. Issue Issued For Date
081416	FLUSH WOOD DOORS INTEGRATED METAL DOOR OPENING ASSEMBLIES	0 Bid & Permit 07-06-2022
083113 A B	ACCESS DOORS AND FRAMES ACOUSTIC RATED FIRE-RESISTIVE RATED	
-	OVERHEAD COILING DOORS INSULATED ROLLING SERVICE DOOR, MANUAL CHAIN	
B C	HOIST, CYLINDRICAL LOCK FACE-OF-WALL MOUNTED JAMB HOOD / HEAD PLATE	
084113	ALUMINUM-FRAMED ENTRANCES AND STOREFRONTS	PRELIMINARY
A 085113 A	1" LOW EMISSIVITY INSULATED GLASS UNIT ALUMINUM WINDOWS 3-1/4" THERMAL ALUMINUM 'STEEL REPLICA'	Not For Construction
	A1 COVED MUNTIN GRID, SIMULATED TRUE DIVIDED LITES, CUSTOM PERIMETER AND	Key Plan
	INTERIOR AND EXTERIOR GRIDS TO SIMULATE ORIGINAL WINDOW SASH	
087100 011/01/01/01/01/01/01/01/01/01/01/01/01/	DOOR HARDWARE FINISHES	
092216	23 GYPSUM BOARD SHAFT WALL ASSEMBLIES NON-STRUCTURAL METAL FRAMING	
A B C	STUD FRAMING, RUNNER TRACKS SUSPENSION SYSTEM FOR CEILINGS & SOFFITS GRID SUSPENSION SYSTEM FOR GYPSUM BOARD	
	CEILINGS GYPSUM BOARD CERAMIC TILING	
	ACOUSTICAL PANEL CEILINGS SEE RCPS AND FINISH SCHEDULE	
096248 A	SOUND AND VIBRATION CONTROL FOR CONCRETE FLOATING FLOOR 1" ROLL-OUT RUBBER MAT ISOLATION SYSTEM	EGNER HALL
096519	RESILIENT BASE & ACCESSORIES RESILIENT TILE FLOORING	BUILDING 685
096623 A	RESINOUS MATRIX TERRAZZO FLOORING WALL BASE: 3/8" x 6" HIGH PRECAST EPOXY TERRAZZO WALL BASE TO MATCH EXISTING	U.S. MILITARY ACADEMY
097200	TILE CARPETING WALL COVERINGS	West Point, New York
A	GLEE CLUB ROOM 203: ACOUSTICAL TRANSPARENT FABRIC ON METAL FRAMING; SEE ELEVATIONS FOR EXTENT	
098433 A	SOUND-ABSORBING WALL UNITS CONCERT BAND ROOM 300: SOUND ABSORPTIVE 1" FABRIC WRAPPED PANELS, MINIMUM NRC 1.00	
В	SECTIONALS ROOM 205, CORRIDORS & VESTIBULES WHERE NOTED ON FINISH SCHEDULE: SOUND	
С	ABSORPTIVE 2-1/8" FABRIC WRAPPED PANELS, MINIMUM NRC 1.05 GLEE CLUB ROOM 203: 2" DUCT LINER BOARD, 2.5	Project No.: 11300 Date: July 06, 2022
D	PCF MIN, CONCEALED IN WALL CAVITY SOUND-DIFFUSING WALL UNIT CONCEALED IN WALL CAVITY	
098436 A	SOUND-ABSORBING CEILING UNITS 3/4" PLYWOOD PANEL SOUND REFLECTING CLOUDS	
099113	SUSPENDED WITH FRAMING; ANGLE 5 DEGREES FROM HORIZONTAL IN RANDOM DIRECTIONS EXTERIOR PAINTING	Drawing Title: Interior Elevations -
099123	INTERIOR PAINTING INTERIOR PAINTING STAINING AND TRANSPARENT FINISHING	Cadet Spirit Band Room
	: SPECIALTIES L6 ROOM-IDENTIFICATION PANEL SIGNAGE	
102213 102800	WIRE MESH PARTITIONS TOILET, BATH, AND LAUNDRY ACCESSORIES	
	FIRE PROTECTION CABINETS FIRE EXTINGUISHERS	A 8 0 4

(Continued on the following odd numbered sheet)

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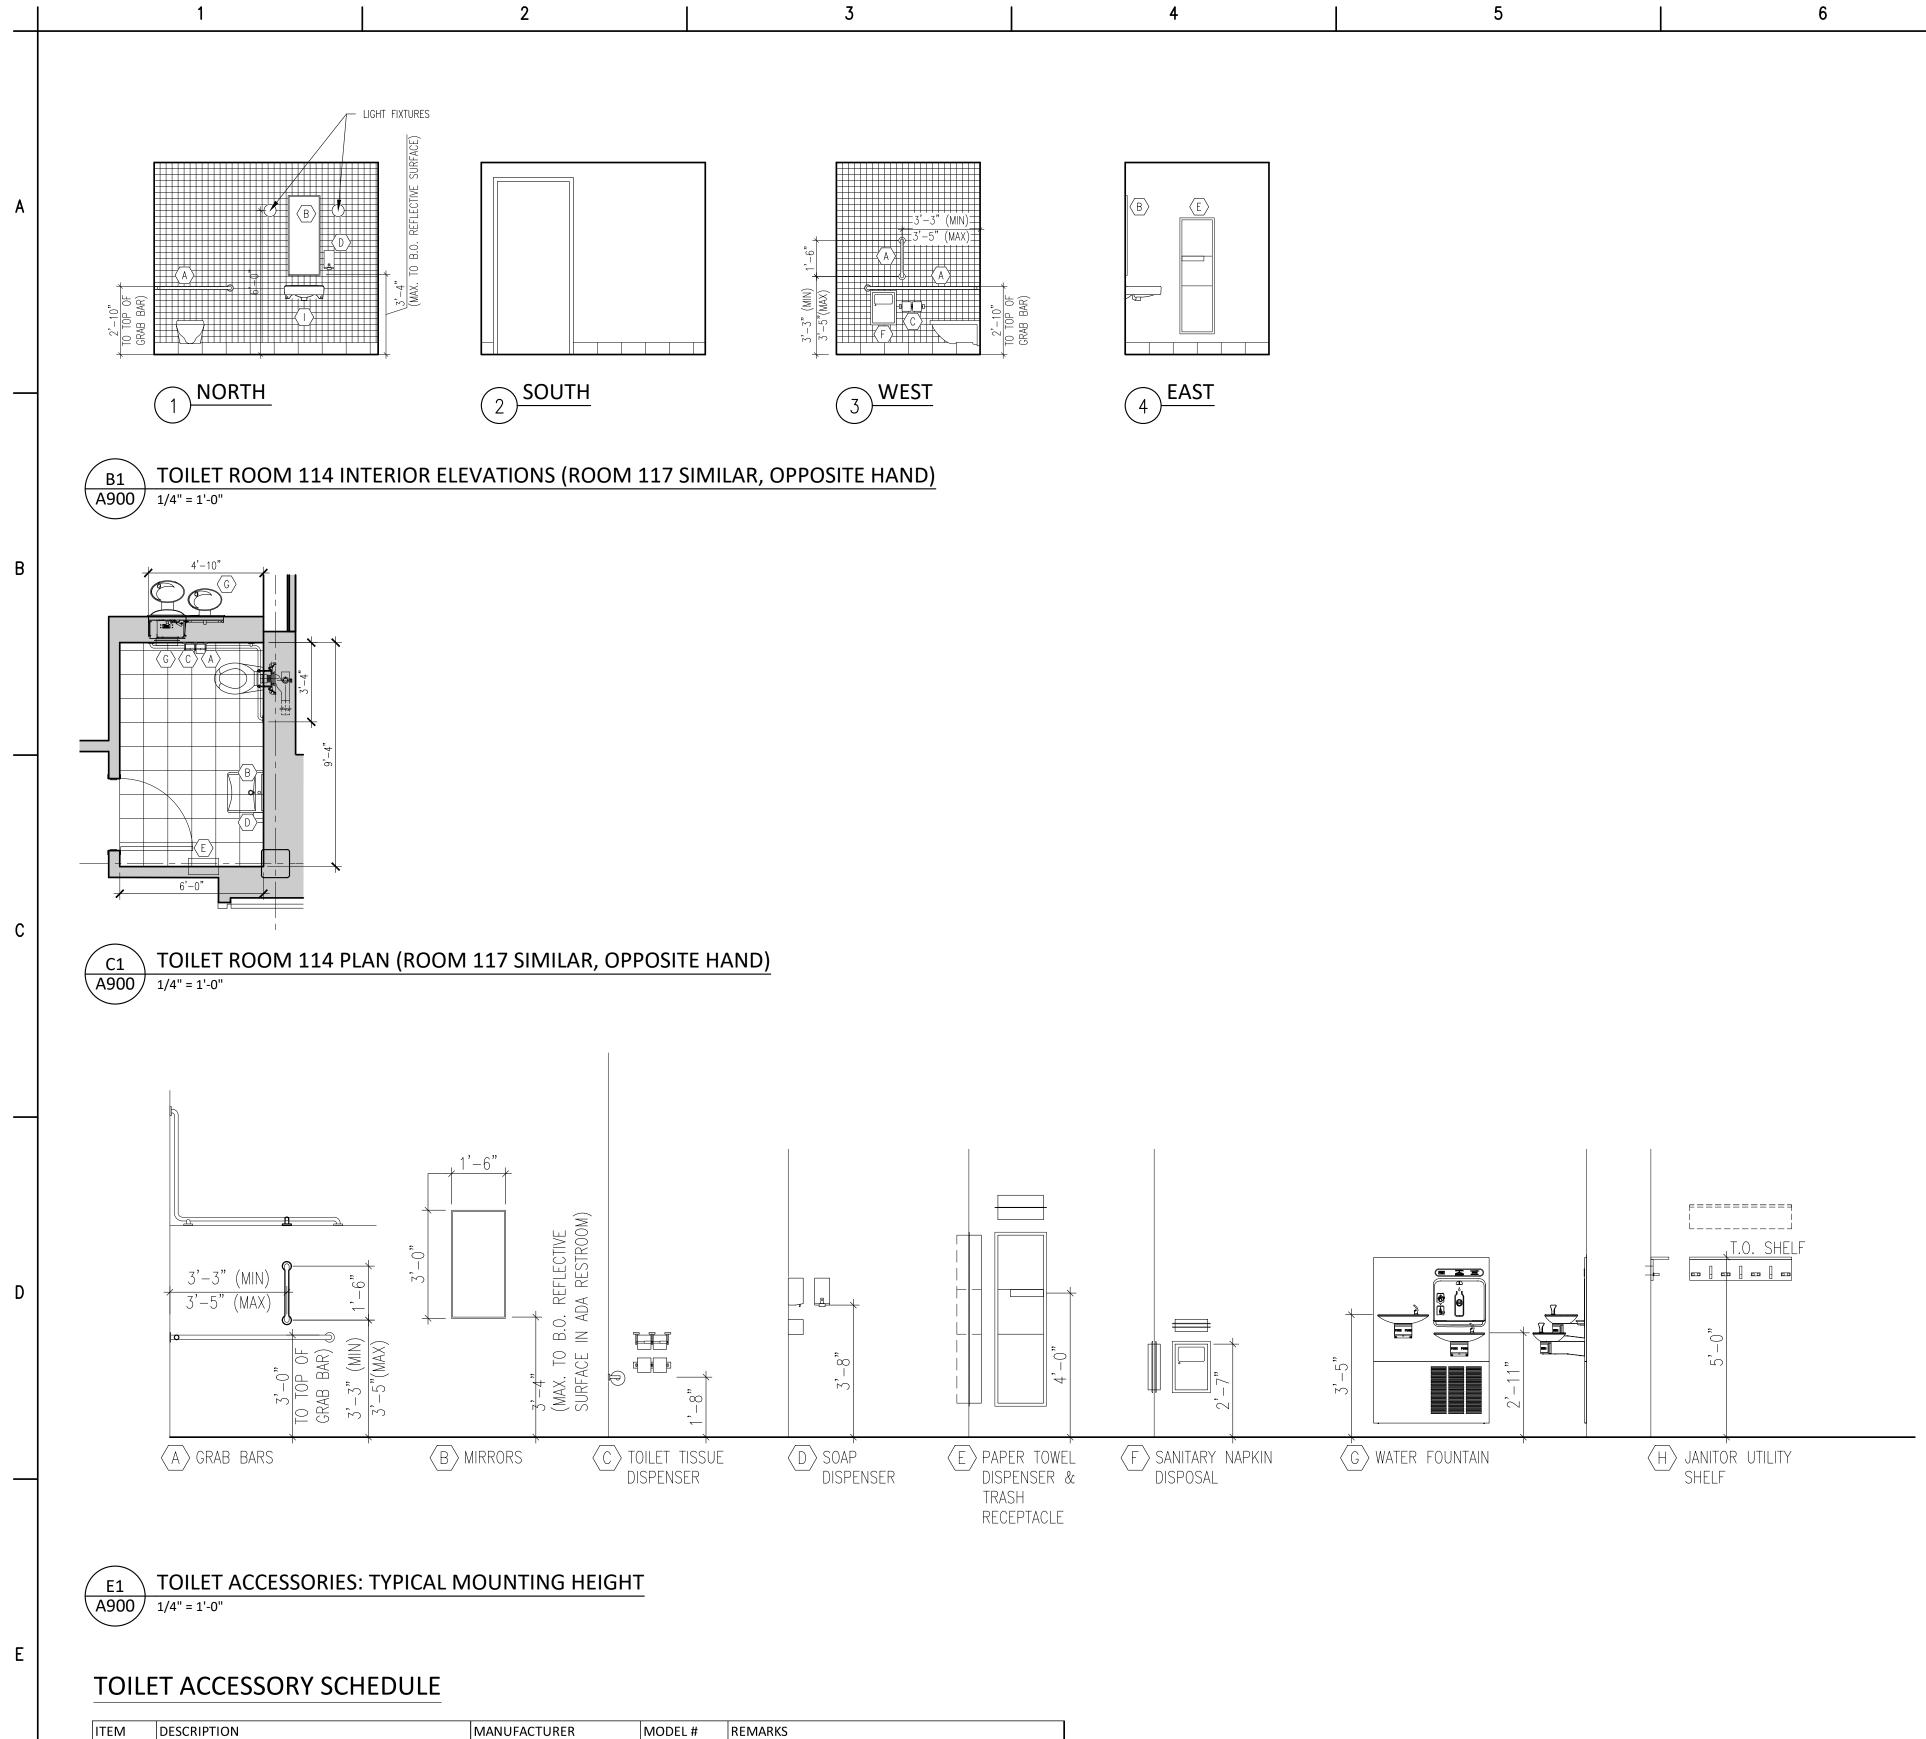
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Material Keynote Legend (Continued from the previous even numbered sheet) DIVISION 11: EQUIPMENT 111316 LOADING DOCK SEALS AND SHELTERS A CLEAR STRIP CURTAIN ENCLOSURE 111319 STATIONARY LOADING DOCK EQUIPMENT A SURFACE MOUNTED DOCK LIFT, 48" WIDE X 88" LONG PLATFORM, MIN 5000 LB CAPACITY, VERTICAL TRAVEL 48", LOWERED HEIGHT 8", LAG INSTALLED INTO CONCRETE B 4-1/2" OD FIXED DOCK BUMPER BOLLARD SET IN CONCRETE 116123 FOLDING AND PORTABLE STAGES DIVISION 12: FURNISHINGS 122200 CURTAINS AND DRAPES A TRACK WITH MOVABLE CURTAINS; 25 OZ/LINEAR YARD COTTON VELOUR, SEWN WITH 100% FULLNESS, AND INCORPORATE 16 OZ BACKER LAYER, SEWN FLAT DIVISION 13: SPECIAL CONSTRUCTION 131113 MEDIUM ISOLATION SOUND CONTROL DOOR ASSEMBLIES 133473 HIGH ISOLATION SOUND CONTROL DOOR ASSEMBLIES DIVISION 14: CONVEYING EQUIPMENT 142123.16 MACHINE ROOM-LESS ELECTRIC TRACTION ELEVATORS A MACHINE ROOM LESS (MRL) SIDE COUNTERWEIGHT HOSPITAL SERVICE ELEVATOR, 5000 LB CAPACITY, 200 FPM, 4 STOPS	Mark B. Thompson Associates Architecture 502 South 24th Street Philadelphia, PA 19146 215.985.1000 www.mbtarchitects.com Keast & Hood Company of New York, PC Structural Engineering 400 Market Street, Suite 1250 Philadelphia, PA 19106 215.625.0099 www.keasthood.com Dimitri J. Ververelli, Inc. Mechanical, Electrical, Plumbing, Fire Protection Engineering 211 North 13th Street Philadelphia, PA 19107 215.496.0000 www.djvinc.com Langan Civil Engineering 21 Penn Plaza, 360 West 31st Street, 8th Floor New York, NY 10001 212.479.5400 www.langan.com Theatre Projects Acoustical Design 47 Water Street South Norwalk, CT 06854 203.299.0830 www.theatreprojects.com
SEE PLUMBING DRAWINGS & SPECS 224000 PLUMBING FIXTURES DIVISION 23: HEATING, VENTILATION AND AIR CONDITIONING SEE MECHANICAL DRAWINGS & SPECS	
233100 HVAC DUCTS & CASINGS A METAL DUCTS, SEE 'M' DWGS DIVISION 26: ELECTRICAL SEE ELECTRICAL DRAWINGS & SPECS 260000 ELECTRICAL PAWINGS & SPECS 2741166 JINTEGRATED AUDIO-VIDEO SYSTEMS AND EQUIPMENT A ELECTRO-ACOUSTIC ENHANCEMENT SYSTEM: SEE SPEC FOR DETAILED DESCRIPTION OF SYSTEM REQUIREMENTS DIVISION 23: ELECTRONIC SAFETY AND SECURITY SEE ELECTRICAL DRAWINGS & SPECS DIVISION 32: EXTERIOR IMPROVEMENTS SEE CIVIL DRAWINGS & SPECS 321216 ON-SITE ASPHALT PAVING DIVISION 33: UTILITIES SEE CIVIL DRAWINGS & SPECS	It is a violation of New York State Law for any person, unless he is acting under the direction of a licensed Professional Engineer or Land Surveyor, to alter an item in any way. If an item bearing the seal of an Engineer or land Surveyor is altered, the altering Engineer or Land Surveyor shall affix to the item his seal and the notation "altered by" followed by his signature and the date of such alteration, and a specific description of the alteration. Seneral Notes 1. All dimensions and existing conditions shall be checked and verified by contractor at the site prior to proceeding with the work. Contractor shall inform Architect/ Engineer of any discrepancies on drawings before construction begins. No existing service may be cut without Architect/Engineers's consent. Any existing service severed or damaged shall be replaced at no cost to owner. Contractor must notify Architect/ Engineer at once if hidden existing conditions encountered require design modifications. Issue Issued For Date 0 Bid & Permit 07-06-2022 PRELIMINARRY Not For Construction
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IIEM	DESCRIPTION	MANUFACIURER	MODEL #	REMARKS		
А	HORIZONTAL GRAB BARS	BOBRICK	B-5837	-		
А	VERTICAL GRAB BARS	BOBRICK	B-5806 x18	-		
В	MIRROR	BOBRICK	B-290	-		
С	TOILET TISSUE DISPENSER	BOBRICK	B-76867	SURFACE MOUNTED		
D	SOAP DISPENSER	BOBRICK	B-2012	SURFACE MOUNTED		
E	PAPER TOWEL DISPENSER & TRASH RECEPTACLE	BOBRICK	B-3944	SEMI-RECESSED		
F	SANITARY NAPKIN DISPOSAL	BOBRICK	B-353	RECESSED		
G	WATER FOUNTAIN	HALSEY TAYLOR	-	SEE PLUMBING DRAWINGS		
Н	JANITOR UTILITY SHELF	BOBRICK	B-239	-		
I	UNDERLAVATORY GUARD	TRUE-BRO	LAV GUARD 2	-		
GENERAL NOTES:						
1) EACH INDIVIDUAL COMPONENT IS NOT TAGGED. TAGGED ITEMS DO NOT QUANTIFY ALL ITEMS IN THE SCOPE OF WORK						
2) PROVID	E FLAT STRAP AND BACKING PLATE, BLOCKING, OR SUPP	LEMENTARY FRAMING WITH N	ETAL STUD FRAM	MING TO SUPPORT FIXTURES, EQUIPMENT, ACCESSORIES,		
ETC. (092216)						

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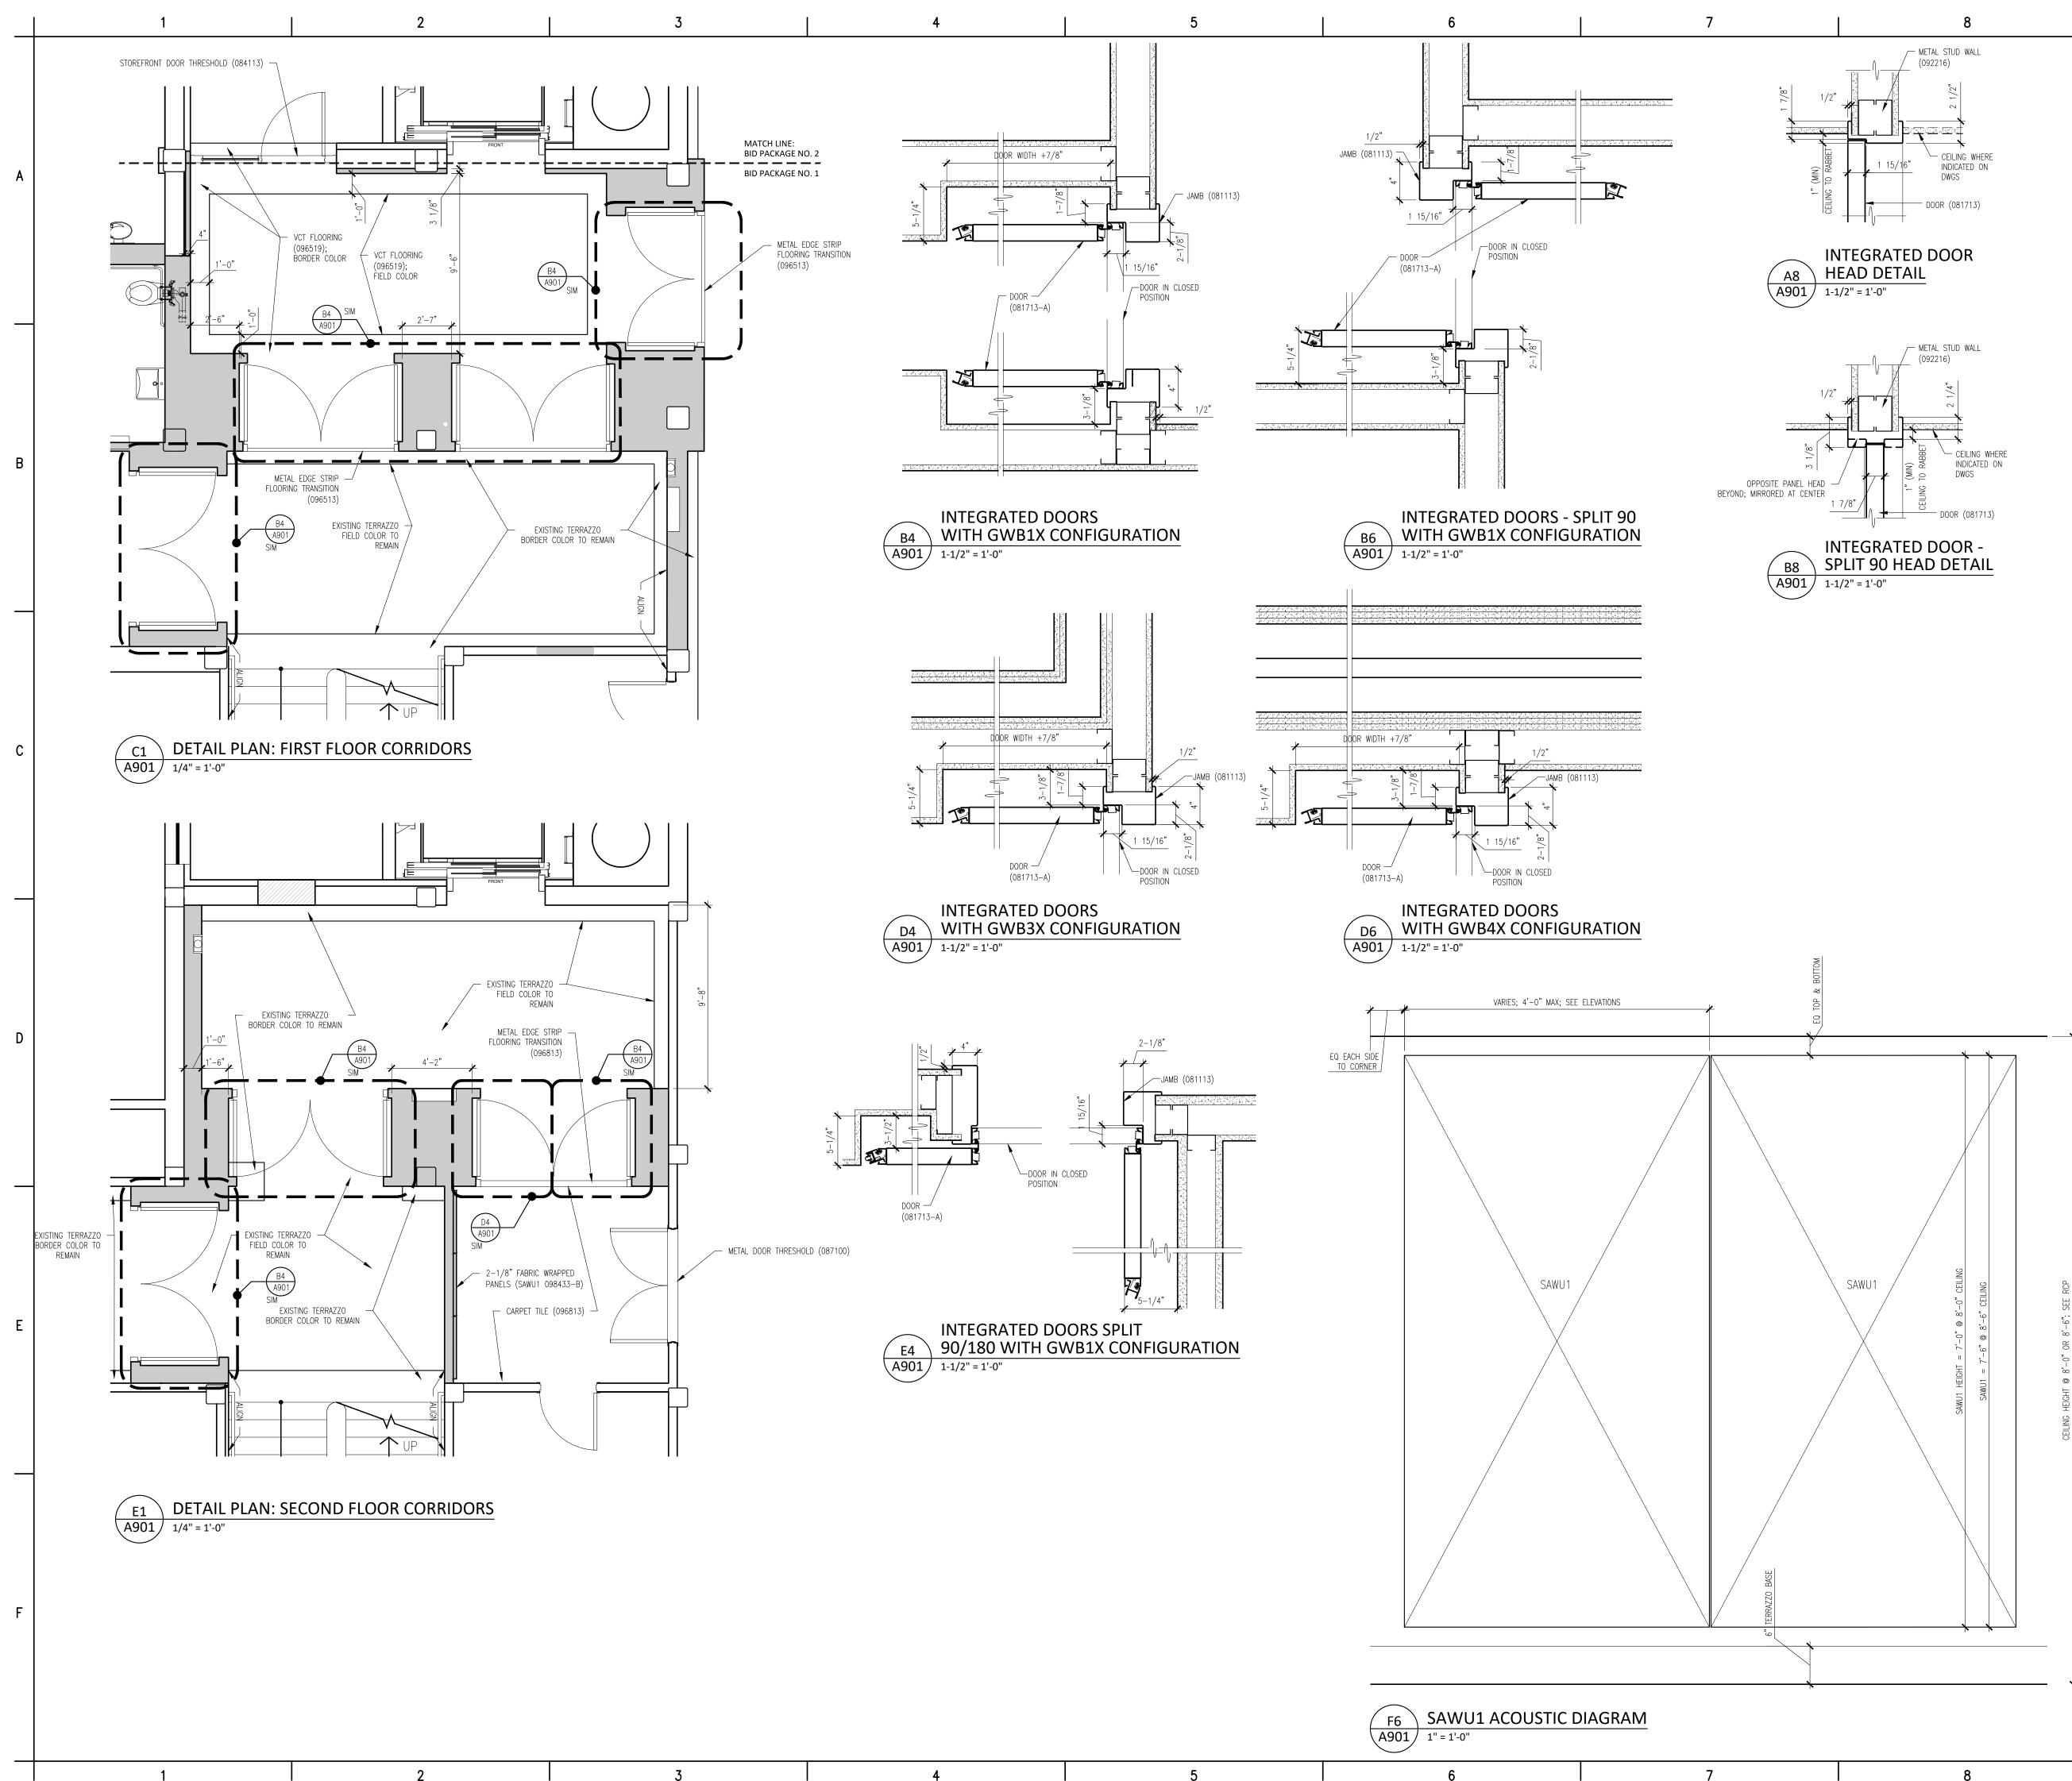
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	EYNOTE LEGEND EXISTING CONDITIONS	Mark B. Thompson Associates
	SELECTIVE DEMOLITION	Architecture 502 South 24th Street
	CONCRETE CONCRETE REPAIR (DRAWING SPEC NOTES ONLY) SEE STRUCTURAL DRAWINGS	Philadelphia, PA 19146 215.985.1000 www.mbtarchitects.com
	CAST IN-PLACE CONCRETE NEW ELEVATED FLOOR SLAB AT BASEMENT LEVEL TO	Keast & Hood Company of New York, PC Structural Engineering
	MATCH CORRIDOR FLOOR ELEVATION CAST IN-PLACE SITE CONCRETE; SEE CIVIL	400 Market Street, Suite 1250 Philadelphia, PA 19106
A B	EXTERIOR CONCRETE SLAB SUPPORTED ON NEW FOOTINGS WITH RAMP EXTERIOR CONCRETE STAIRS	215.625.0099 www.keasthood.com
	GYPSUM CEMENT UNDERLAYMENT INTERIOR TOPPING / LEVELING SLAB	Dimitri J. Ververelli, Inc. Mechanical, Electrical, Plumbing, Fire Protection Engineering
IVISION 4:	MASONRY	211 North 13th Street Philadelphia, PA 19107
А	UNIT MASONRY BRICK MASONRY VENEER TO MATCH EXISTING	215.496.0000 www.djvinc.com
В	ACCESSORIES (SEE DRAWINGS FOR TYPE) B1 TIES, REINFORCEMENT; HOT-DIP GALV OR STAINLESS STEEL	Langan Civil Engineering 21 Penn Plaza, 360 West 31st Street, 8th Floor
C D	PRECAST CONCRETE LINTELS EMBEDDED FLEXIBLE FLASHING	New York, NY 10001 212.479.5400 www.langan.com
E 047200	MESH WEEP / VENT CAST STONE MASONRY	Theatre Projects
IVISION 5:	METALS STRUCTURAL STEEL FRAMING; SEE STRUCTURAL	Acoustical Design 47 Water Street South Norwalk, CT 06854
А	ELEVATOR HOIST BEAMS STEEL DECKING; SEE STRUCTURAL	203.299.0830 www.theatreprojects.com
A 055000	ROOF DECKING METAL FABRICATIONS	
A B	MISC STRUCTURAL SHAPES; GALVANIZED AT EXTERIOR ABRASIVE CAST METAL NOSINGS	
С	METAL FLOOR PLATE TRENCH COVER PIPE AND TUBE RAILINGS	
	WOODS, PLASTICS, AND COMPOSITES	
	ROUGH CARPENTRY INTERIOR FINISH CARPENTRY GLEE CLUB ROOM 203: WOOD PICTURE RAIL &	
B	CHAIR RAIL TO MATCH EXISTING CONCERT BAND ROOM 300: WOOD WALL BASE &	
С	TRIMS; SEE DRAWINGS FOR DIMS & PROFILES CHAIR RAIL	
D	MISCELLANEOUS TRIM; SEE DRAWINGS FOR DIMS & PROFILES	
	THERMAL AND MOISTURE PROTECTION THERMAL INSULATION	It is a violation of New York State Law for any person,
A	SPRAY-APPLIED OPEN CELL MEDIUM DENSITY FOAM INSULATION, VAPOR PERMEABLE	unless he is acting under the direction of a licensed Professional Engineer or Land Surveyor, to alter an item in any way. If an item bearing the seal of an Engineer or
072129 A	SPRAY-APPLIED CELLULOSE ACOUSTICAL INSULATION SOUND ABSORPTIVE FINISH OVER 100% OF OVERHEAD DECK (BETWEEN STRUCTURAL BEAMS),	Land Surveyor is altered, the altering Engineer or Land Surveyor shall affix to the item his seal and the notation
075216	MINIMUM NRC 1.00, 4" SPRAY-ON CELLULOSE STYRENE-BUTADIENE-STYRENE (SBS) MODIFIED	"altered by" followed by his signature and the date of such alteration, and a specific description of the alteration.
А	BITUMINOUS MEMBRANE ROOFING SBS BASE SHEET + 3 PLIES AND CAP SHEET, IN COLD APPLIED ADHESIVE WITH HIGH-REFLECTIVE ROOF	
В	COATING TO MATCH EXISTING FLASHING & STRIPPING MATERIALS	General Notes All dimensions and existing conditions shall be
C D	ROOF INSULATION INSULATION COVER BOARD	checked and verified by contractor at the site prior to proceeding with the work. 2. Contractor shall inform Architect/ Engineer of
E F 076200	VAPOR RETARDER / AIR BARRIER SUBSTRATE BOARD SHEET METAL FLASHING AND TRIM	any discrepancies on drawings before construction begins.
А	LOW-SLOPE ROOF EDGE FLASHINGS AND COPINGS ROOF ACCESSORIES	3. No existing service may be cut without Architect/Engineers's consent. Any existing
	SERVICE ACCESS PLATFORM SYSTEM JOINT SEALANTS	service severed or damaged shall be replaced at no cost to owner. 4. Contractor must notify Architect/ Engineer at
	ACOUSTICAL JOINT SEALANTS OPENINGS	once if hidden existing conditions encountered require design modifications.
080314	HISTORIC TREATMENT OF WOOD DOORS HOLLOW METAL DOORS AND FRAMES	Issue Issued For Date
081713	FLUSH WOOD DOORS INTEGRATED METAL DOOR OPENING ASSEMBLIES	0 Bid & Permit 07-06-2022
083113 A B	ACCESS DOORS AND FRAMES ACOUSTIC RATED FIRE-RESISTIVE RATED	
-	OVERHEAD COILING DOORS INSULATED ROLLING SERVICE DOOR, MANUAL CHAIN	
В	HOIST, CYLINDRICAL LOCK FACE-OF-WALL MOUNTED JAMB	
C 084113	HOOD / HEAD PLATE ALUMINUM-FRAMED ENTRANCES AND STOREFRONTS	PRELIMINARY
A 085113	1" LOW EMISSIVITY INSULATED GLASS UNIT ALUMINUM WINDOWS	Not For Construction
A	3-1/4" THERMAL ALUMINUM 'STEEL REPLICA' WINDOW SYSTEM A1 COVED MUNTIN GRID, SIMULATED TRUE	Key Plan
	DIVIDED LITES, CUSTOM PERIMETER AND INTERIOR AND EXTERIOR GRIDS TO SIMULATE	
087100	ORIGINAL WINDOW SASH DOOR HARDWARE	
IVISION 9: 092116.2	FINISHES 23 GYPSUM BOARD SHAFT WALL ASSEMBLIES	
А	NON-STRUCTURAL METAL FRAMING STUD FRAMING, RUNNER TRACKS	
B C	SUSPENSION SYSTEM FOR CEILINGS & SOFFITS GRID SUSPENSION SYSTEM FOR GYPSUM BOARD CEILINGS	
093013	GYPSUM BOARD CERAMIC TILING	
	ACOUSTICAL PANEL CEILINGS SEE RCPS AND FINISH SCHEDULE	
096248 A	SOUND AND VIBRATION CONTROL FOR CONCRETE FLOATING FLOOR 1" ROLL-OUT RUBBER MAT ISOLATION SYSTEM	EGNER HALL
096519	RESILIENT BASE & ACCESSORIES RESILIENT TILE FLOORING	BUILDING 685
096623 A	RESINOUS MATRIX TERRAZZO FLOORING WALL BASE: 3/8" x 6" HIGH PRECAST EPOXY TERRAZZO WALL BASE TO MATCH EXISTING	U.S. MILITARY ACADEMY
	TILE CARPETING WALL COVERINGS	West Point, New York
А	GLEE CLUB ROOM 203: ACOUSTICAL TRANSPARENT FABRIC ON METAL FRAMING; SEE ELEVATIONS FOR	
098433 A	EXTENT SOUND-ABSORBING WALL UNITS CONCERT BAND ROOM 300: SOUND ABSORPTIVE 1"	
В	FABRIC WRAPPED PANELS, MINIMUM NRC 1.00 SECTIONALS ROOM 205, CORRIDORS & VESTIBULES	
	WHERE NOTED ON FINISH SCHEDULE: SOUND ABSORPTIVE 2-1/8" FABRIC WRAPPED PANELS, MINIMUM NRC 1.05	Project No.: 11300
С	GLEE CLUB ROOM 203: 2" DUCT LINER BOARD, 2.5 PCF MIN, CONCEALED IN WALL CAVITY	Date: July 06, 2022
D 098436	SOUND-DIFFUSING WALL UNIT CONCEALED IN WALL CAVITY SOUND-ABSORBING CEILING UNITS	
098436 A	3/4" PLYWOOD PANEL SOUND REFLECTING CLOUDS SUSPENDED WITH FRAMING; ANGLE 5 DEGREES	Drawing Title:
	FROM HORIZONTAL IN RANDOM DIRECTIONS EXTERIOR PAINTING	Toilet Room Details
	INTERIOR PAINTING STAINING AND TRANSPARENT FINISHING	
101423.1	: SPECIALTIES L6 ROOM-IDENTIFICATION PANEL SIGNAGE	
102800	WIRE MESH PARTITIONS TOILET, BATH, AND LAUNDRY ACCESSORIES FIRE PROTECTION CABINETS	ΛΟΛΛ
	FIRE PROTECTION CABINETS FIRE EXTINGUISHERS	A900

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Material Keynote Legend (Continued from the previous even numbered sheet)					
/ISION 11: EQUIPMENT					
111316	LOADING DOCK SEALS AND SHELTERS				
А	CLEAR STRIP CURTAIN ENCLOSURE				
111319	STATIONARY LOADING DOCK EQUIPMENT				
A	SURFACE MOUNTED DOCK LIFT, 48" WIDE X 88" LONG PLATFORM, MIN 5000 LB CAPACITY, VERTICAL TRAVEL 48", LOWERED HEIGHT 8", LAG INSTALLED INTO CONCRETE				
В	4-1/2" OD FIXED DOCK BUMPER BOLLARD SET IN CONCRETE				
116123	FOLDING AND PORTABLE STAGES				
VISION 12	: FURNISHINGS				
122200	CURTAINS AND DRAPES				
А	TRACK WITH MOVABLE CURTAINS; 25 OZ/LINEAR YARD COTTON VELOUR, SEWN WITH 100%				

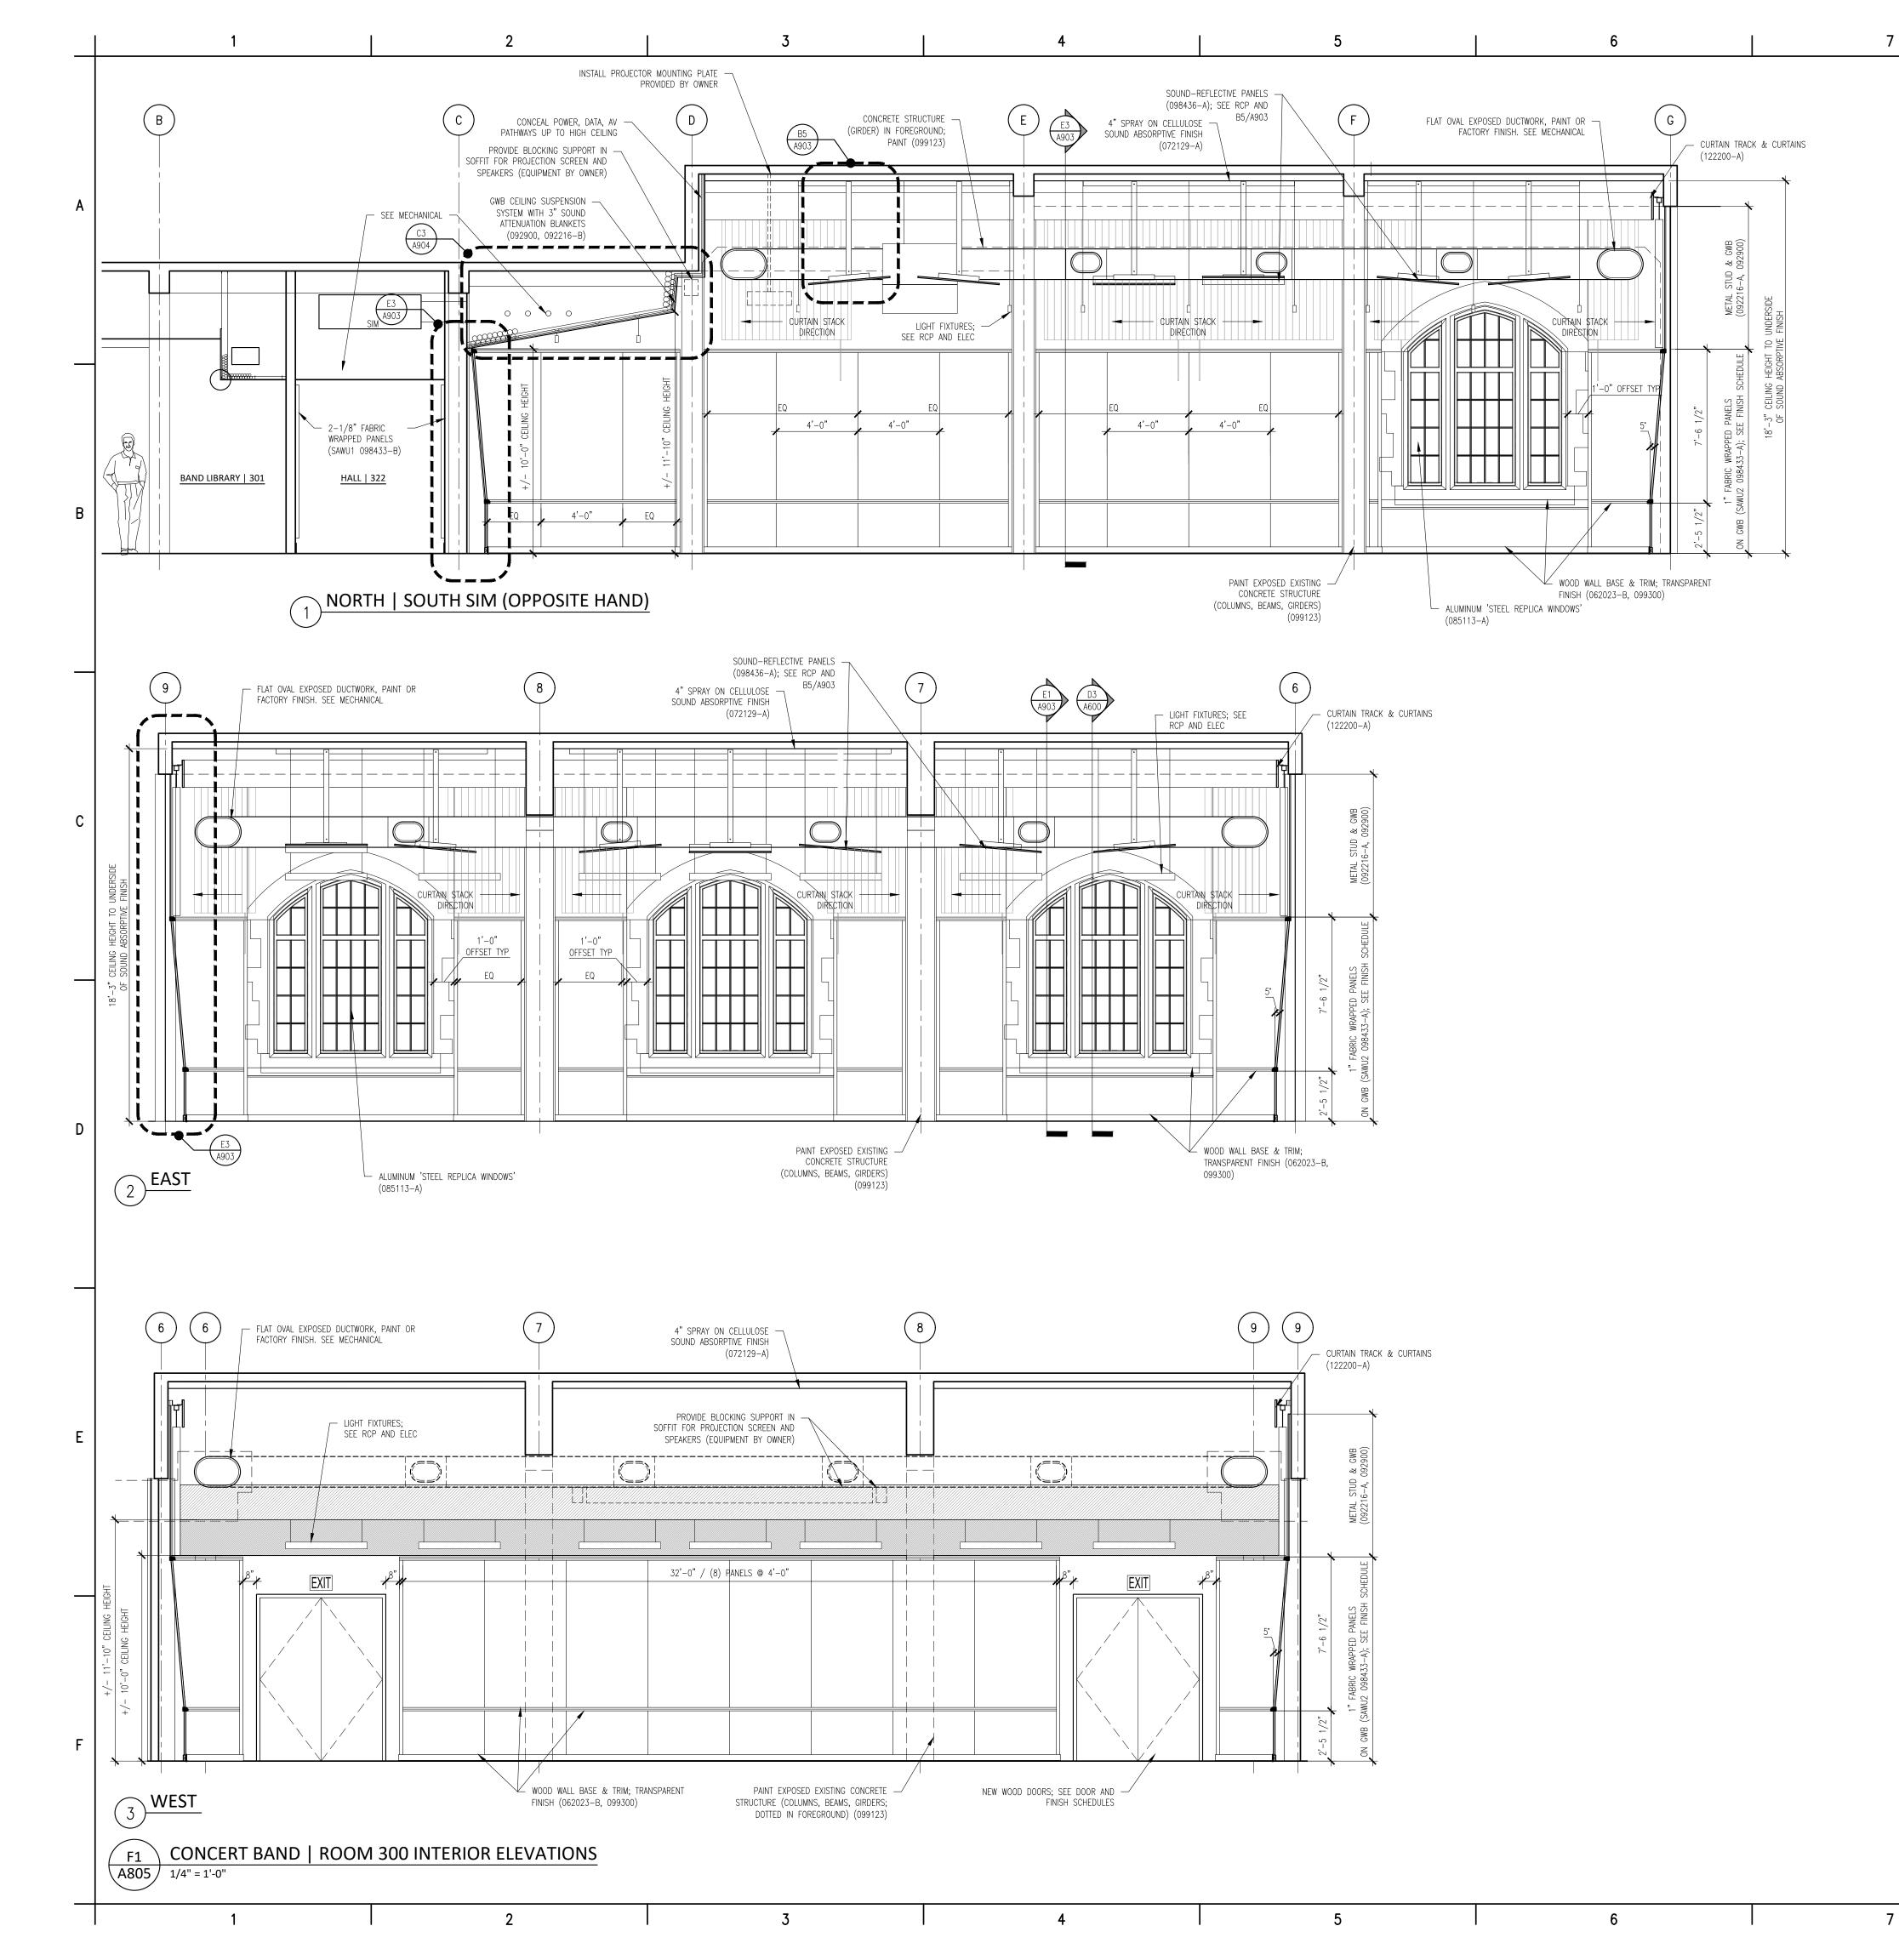FULLNESS, AND INCORPORATE 16 OZ BACKER LAYER, SEWN FLAT DIVISION 13: SPECIAL CONSTRUCTION 131113 MEDIUM ISOLATION SOUND CONTROL DOOR ASSEMBLIES

133473 HIGH ISOLATION SOUND CONTROL DOOR ASSEMBLIES DIVISION 14: CONVEYING EQUIPMENT 142123.16 MACHINE ROOM-LESS ELECTRIC TRACTION

ELEVATORS A MACHINE ROOM LESS (MRL) SIDE COUNTERWEIGHT HOSPITAL SERVICE ELEVATOR, 5000 LB CAPACITY, 200 FPM, 4 STOPS

DIVISION 22: PLUMBING SEE PLUMBING DRAWINGS & SPECS 224000 PLUMBING FIXTURES

DIVISION 23: HEATING, VENTILATION AND AIR CONDITIONING SEE MECHANICAL DRAWINGS & SPECS 233100 HVAC DUCTS & CASINGS A METAL DUCTS. SEE 'M' DWGS

DIVISION 26: ELECTRICAL SEE ELECTRICAL DRAWINGS & SPECS 260000 ELECTRICAL EQUIPMENT 265000 LED LIGHTING

DIVISION 27: COMMUNICATIONS SEE AV AND ELECTRICAL DRAWINGS & SPECS

274116.61 INTEGRATED AUDIO-VIDEO SYSTEMS AND EQUIPMENT A ELECTRO-ACOUSTIC ENHANCEMENT SYSTEM: SEE SPEC FOR DETAILED DESCRIPTION OF SYSTEM REQUIREMENTS

DIVISION 28: ELECTRONIC SAFETY AND SECURITY SEE ELECTRICAL DRAWINGS & SPECS

DIVISION 31: EARTHWORK SEE CIVIL DRAWINGS & SPECS

DIVISION 32: EXTERIOR IMPROVEMENTS SEE CIVIL DRAWINGS & SPECS 321216 ON-SITE ASPHALT PAVING

DIVISION 33: UTILITIES SEE CIVIL DRAWINGS & SPECS

It is a violation of New York State Law for any person, unless he is acting under the direction of a licensed Professional Engineer or Land Surveyor, to alter an item in any way. If an item bearing the seal of an Engineer or Land Surveyor is altered, the altering Engineer or Land Surveyor shall affix to the item his seal and the notation "altered by" followed by his signature and the date of such alteration, and a specific description of the alteration. General Notes 1. All dimensions and existing conditions shall be checked and verified by contractor at the site prior to proceeding with the work. 2. Contractor shall inform Architect/ Engineer of any discrepancies on drawings before construction begins. 3. No existing service may be cut without Architect/Engineers's consent. Any existing service severed or damaged shall be replaced at no cost to owner. 4. Contractor must notify Architect/ Engineer at once if hidden existing conditions encountered require design modifications. Date Issue Issued For Bid & Permit 07-06-2022

Mark B. Thompson Associates

Structural Engineering 400 Market Street, Suite 1250

Philadelphia, PA 19106

Dimitri J. Ververelli, Inc.

211 North 13th Street

Civil Engineering

Theatre Projects

Acoustical Design

South Norwalk, CT 06854

47 Water Street

New York, NY 10001

Philadelphia, PA 19107

215.496.0000 www.djvinc.com

212.479.5400 www.langan.com

Engineering

Langan

215.985.1000 www.mbtarchitects.com

Keast & Hood Company of New York, PC

215.625.0099 www.keasthood.com

Mechanical, Electrical, Plumbing, Fire Protection

21 Penn Plaza, 360 West 31st Street, 8th Floor

203.299.0830 www.theatreprojects.com

Architecture

502 South 24th Street Philadelphia, PA 19146

PRELIMINARY Not For Construction

Key Plan

EGNER HALL **BUILDING 685**

U.S. MILITARY ACADEMY West Point, New York

Project No.: 11300 Date: July 06, 2022


Drawing Title: Corridor Interior Details

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ACOUSTIC WALL TREATMENT SOFFIT ABOVE WINDOWS

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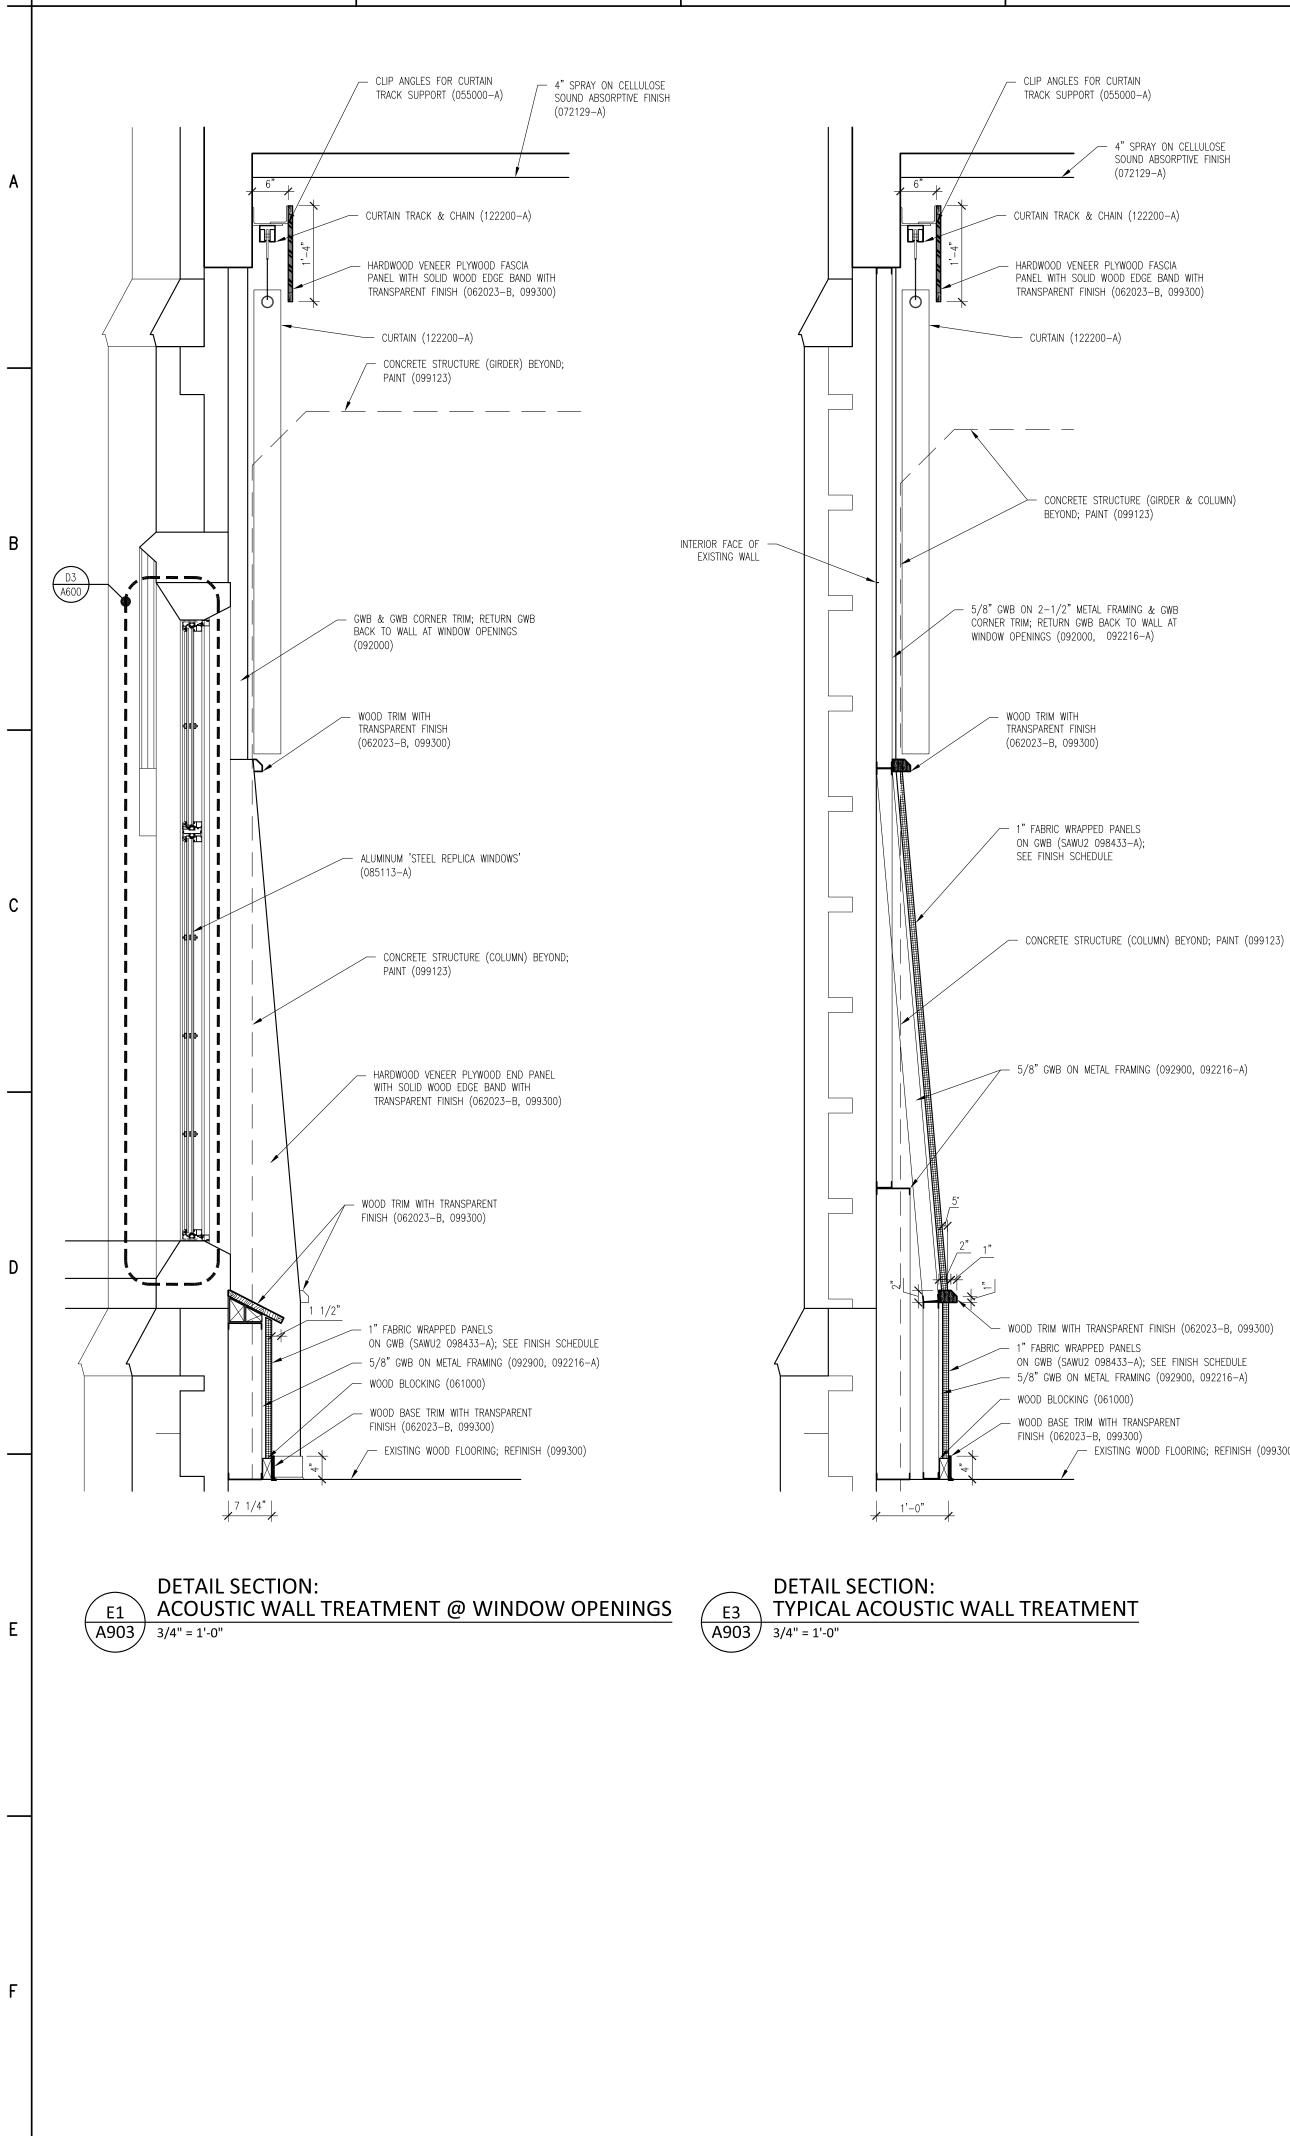
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	EYNOTE LEGEND EXISTING CONDITIONS	Mark B. Thompson Associates
024119	SELECTIVE DEMOLITION	Architecture 502 South 24th Street Philadelphia, PA 19146
	CONCRETE CONCRETE REPAIR (DRAWING SPEC NOTES ONLY) SEE STRUCTURAL DRAWINGS	215.985.1000 www.mbtarchitects.com
033000 A	CAST IN-PLACE CONCRETE NEW ELEVATED FLOOR SLAB AT BASEMENT LEVEL TO	Keast & Hood Company of New York, PC Structural Engineering
	MATCH CORRIDOR FLOOR ELEVATION CAST IN-PLACE SITE CONCRETE; SEE CIVIL	400 Market Street, Suite 1250 Philadelphia, PA 19106
A B	EXTERIOR CONCRETE SLAB SUPPORTED ON NEW FOOTINGS WITH RAMP EXTERIOR CONCRETE STAIRS	215.625.0099 www.keasthood.com Dimitri J. Ververelli, Inc.
	GYPSUM CEMENT UNDERLAYMENT INTERIOR TOPPING / LEVELING SLAB	Mechanical, Electrical, Plumbing, Fire Protection Engineering
VISION 4:		211 North 13th Street Philadelphia, PA 19107
А	UNIT MASONRY BRICK MASONRY VENEER TO MATCH EXISTING	215.496.0000 www.djvinc.com
В	ACCESSORIES (SEE DRAWINGS FOR TYPE) B1 TIES, REINFORCEMENT; HOT-DIP GALV OR STAINLESS STEEL	Langan Civil Engineering 21 Penn Plaza, 360 West 31st Street, 8th Floor
C D	PRECAST CONCRETE LINTELS EMBEDDED FLEXIBLE FLASHING	New York, NY 10001 212.479.5400 www.langan.com
E 047200	MESH WEEP / VENT CAST STONE MASONRY	Theatre Projects
IVISION 5:		Acoustical Design 47 Water Street South Norwalk, CT 06854
А	STRUCTURAL STEEL FRAMING; SEE STRUCTURAL ELEVATOR HOIST BEAMS STEEL DECKING; SEE STRUCTURAL	203.299.0830 www.theatreprojects.com
А	ROOF DECKING METAL FABRICATIONS	
A	MISC STRUCTURAL SHAPES; GALVANIZED AT EXTERIOR	
B C 055213	ABRASIVE CAST METAL NOSINGS METAL FLOOR PLATE TRENCH COVER PIPE AND TUBE RAILINGS	
	WOODS, PLASTICS, AND COMPOSITES	
061000	ROUGH CARPENTRY INTERIOR FINISH CARPENTRY	
A B	GLEE CLUB ROOM 203: WOOD PICTURE RAIL & CHAIR RAIL TO MATCH EXISTING CONCERT BAND ROOM 300: WOOD WALL BASE &	
C	TRIMS; SEE DRAWINGS FOR DIMS & PROFILES CHAIR RAIL	
D	MISCELLANEOUS TRIM; SEE DRAWINGS FOR DIMS & PROFILES	
	THERMAL AND MOISTURE PROTECTION	/ / · · ·
072100 A	THERMAL INSULATION SPRAY-APPLIED OPEN CELL MEDIUM DENSITY FOAM INSULATION, VAPOR PERMEABLE	It is a violation of New York State Law for any person, unless he is acting under the direction of a licensed Professional Engineer or Land Surveyor, to alter an item
072129 A	SPRAY-APPLIED CELLULOSE ACOUSTICAL INSULATION SOUND ABSORPTIVE FINISH OVER 100% OF	in any way. If an item bearing the seal of an Engineer or Land Surveyor is altered, the altering Engineer or Land
	OVERHEAD DECK (BETWEEN STRUCTURAL BEAMS), MINIMUM NRC 1.00, 4" SPRAY-ON CELLULOSE	Surveyor shall affix to the item his seal and the notation "altered by" followed by his signature and the date of such alteration, and a specific description of the
075216 A	STYRENE-BUTADIENE-STYRENE (SBS) MODIFIED BITUMINOUS MEMBRANE ROOFING SBS BASE SHEET + 3 PLIES AND CAP SHEET, IN COLD	alteration.
	APPLIED ADHESIVE WITH HIGH-REFLECTIVE ROOF COATING TO MATCH EXISTING	General Notes
B C	FLASHING & STRIPPING MATERIALS ROOF INSULATION	 All dimensions and existing conditions shall be checked and verified by contractor at the site prior to proceeding with the work.
D E F	INSULATION COVER BOARD VAPOR RETARDER / AIR BARRIER SUBSTRATE BOARD	 Contractor shall inform Architect/ Engineer of any discrepancies on drawings before
076200 A		construction begins. 3. No existing service may be cut without
077200 A	ROOF ACCESSORIES SERVICE ACCESS PLATFORM SYSTEM	Architect/Engineers's consent. Any existing service severed or damaged shall be replaced at no cost to owner.
	JOINT SEALANTS ACOUSTICAL JOINT SEALANTS	 Contractor must notify Architect/ Engineer at once if hidden existing conditions encountered
	OPENINGS HISTORIC TREATMENT OF WOOD DOORS	require design modifications.
081113	HOLLOW METAL DOORS AND FRAMES FLUSH WOOD DOORS	Issue Issued For Date 0 Bid & Permit 07-06-2022
	INTEGRATED METAL DOOR OPENING ASSEMBLIES ACCESS DOORS AND FRAMES	
A B	ACOUSTIC RATED FIRE-RESISTIVE RATED	
083323 A	OVERHEAD COILING DOORS INSULATED ROLLING SERVICE DOOR, MANUAL CHAIN HOIST, CYLINDRICAL LOCK	
B C	FACE-OF-WALL MOUNTED JAMB HOOD / HEAD PLATE	
	ALUMINUM-FRAMED ENTRANCES AND STOREFRONTS	PRELIMINARY
A 085113 A	1" LOW EMISSIVITY INSULATED GLASS UNIT ALUMINUM WINDOWS 3-1/4" THERMAL ALUMINUM 'STEEL REPLICA'	Not For Construction
	WINDOW SYSTEM A1 COVED MUNTIN GRID, SIMULATED TRUE	Key Plan
	DIVIDED LITES, CUSTOM PERIMETER AND INTERIOR AND EXTERIOR GRIDS TO SIMULATE ORIGINAL WINDOW SASH	
087100	DOOR HARDWARE	
	23 GYPSUM BOARD SHAFT WALL ASSEMBLIES	
А	NON-STRUCTURAL METAL FRAMING STUD FRAMING, RUNNER TRACKS	
B C	SUSPENSION SYSTEM FOR CEILINGS & SOLETTS	
	SUSPENSION SYSTEM FOR CEILINGS & SOFFITS GRID SUSPENSION SYSTEM FOR GYPSUM BOARD CEILINGS	
093013	GRID SUSPENSION SYSTEM FOR GYPSUM BOARD CEILINGS GYPSUM BOARD CERAMIC TILING	
093013 095113	GRID SUSPENSION SYSTEM FOR GYPSUM BOARD CEILINGS GYPSUM BOARD CERAMIC TILING ACOUSTICAL PANEL CEILINGS SEE RCPS AND FINISH SCHEDULE	
093013 095113	GRID SUSPENSION SYSTEM FOR GYPSUM BOARD CEILINGS GYPSUM BOARD CERAMIC TILING ACOUSTICAL PANEL CEILINGS	EGNER HALL
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093013 095113 096248 A 096513 096519 096623 A 096813 097200 A	GRID SUSPENSION SYSTEM FOR GYPSUM BOARD CEILINGS GYPSUM BOARD CERAMIC TILING ACOUSTICAL PANEL CEILINGS SEE RCPS AND FINISH SCHEDULE SOUND AND VIBRATION CONTROL FOR CONCRETE FLOATING FLOOR 1" ROLL-OUT RUBBER MAT ISOLATION SYSTEM RESILIENT BASE & ACCESSORIES RESILIENT TILE FLOORING RESINOUS MATRIX TERRAZZO FLOORING WALL BASE: 3/8" x 6" HIGH PRECAST EPOXY TERRAZZO WALL BASE TO MATCH EXISTING TILE CARPETING WALL COVERINGS GLEE CLUB ROOM 203: ACOUSTICAL TRANSPARENT FABRIC ON METAL FRAMING; SEE ELEVATIONS FOR EXTENT SOUND-ABSORBING WALL UNITS	BUILDING 685 U.S. MILITARY ACADEMY
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093013 095113 096248 A 096513 096623 A 096813 097200 A 098433 A B C D 098436 A	GRID SUSPENSION SYSTEM FOR GYPSUM BOARD CEILINGS GYPSUM BOARD CERAMIC TILING ACOUSTICAL PANEL CEILINGS SEE RCPS AND FINISH SCHEDULE SOUND AND VIBRATION CONTROL FOR CONCRETE FLOATING FLOOR 1" ROLL-OUT RUBBER MAT ISOLATION SYSTEM RESILIENT BASE & ACCESSORIES RESILIENT TILE FLOORING RESINOUS MATRIX TERRAZZO FLOORING WALL BASE: 3/8" x 6" HIGH PRECAST EPOXY TERRAZO WALL BASE TO MATCH EXISTING TILE CARPETING WALL COVERINGS GLEE CLUB ROOM 203: ACOUSTICAL TRANSPARENT FABRIC ON METAL FRAMING; SEE ELEVATIONS FOR EXTENT SOUND-ABSORBING WALL UNITS CONCERT BAND ROOM 300: SOUND ABSORPTIVE 1" FABRIC WRAPPED PANELS, MINIMUM NRC 1.00 SECTIONALS ROOM 205, CORRIDORS & VESTIBULES WHERE NOTED ON FINISH SCHEDULE: SOUND ABSORPTIVE 2-1/8" FABRIC WRAPPED PANELS, MINIMUM NRC 1.05 GLEE CLUB ROOM 203: 2" DUCT LINER BOARD, 2.5 PCF MIN, CONCEALED IN WALL CAVITY SOUND-DIFFUSING WALL UNIT CONCEALED IN WALL CAVITY	BUILDING 685U.S. MILITARY ACADEMY West Point, New YorkProject No.: 11300 Date: July 06, 2022Drawing Title:
093013 095113 096248 A 096513 096519 096623 A 096813 097200 A 098433 A B C D 098436 A 099113 099123	GRID SUSPENSION SYSTEM FOR GYPSUM BOARD CEILINGS GYPSUM BOARD CERAMIC TILING ACOUSTICAL PANEL CEILINGS SEE RCPS AND FINISH SCHEDULE SOUND AND VIBRATION CONTROL FOR CONCRETE FLOATING FLOOR 1" ROLL-OUT RUBBER MAT ISOLATION SYSTEM RESILIENT BASE & ACCESSORIES RESILIENT TILE FLOORING RESINOUS MATRIX TERRAZZO FLOORING WALL BASE: 3/8" x 6" HIGH PRECAST EPOXY TERRAZO WALL BASE TO MATCH EXISTING TILE CARPETING WALL COVERINGS GLEE CLUB ROOM 203: ACOUSTICAL TRANSPARENT FABRIC ON METAL FRAMING; SEE ELEVATIONS FOR EXTENT SOUND-ABSORBING WALL UNITS CONCERT BAND ROOM 300: SOUND ABSORPTIVE 1" FABRIC WRAPPED PANELS, MINIMUM NRC 1.00 SECTIONALS ROOM 203: 2" DUCT LINER BOARD, 2.5 PCF MIN, CONCEALED IN WALL CAVITY SOUND-DIFFUSING WALL UNIT CONCEALED IN WALL CAVITY SOUND-ABSORBING CEILING UNITS 3/4" PLYWOOD PANEL SOUND REFLECTING CLOUDS SUSPENDED WITH FRAMING; ANGLE 5 DEGREES FROM HORIZONTAL IN RANDOM DIRECTIONS	BUILDING 685U.S. MILITARY ACADEMY West Point, New YorkProject No.: 11300Date: July 06, 2022
093013 095113 096248 A 096513 096519 096623 A 096813 097200 A 098433 A B C D 098436 A 099113 099123 099300	GRID SUSPENSION SYSTEM FOR GYPSUM BOARD CEILINGS GYPSUM BOARD CERAMIC TILING ACOUSTICAL PANEL CEILINGS SEE RCPS AND FINISH SCHEDULE SOUND AND VIBRATION CONTROL FOR CONCRETE FLOATING FLOOR 1" ROLL-OUT RUBBER MAT ISOLATION SYSTEM RESILIENT BASE & ACCESSORIES RESILIENT TILE FLOORING RESINOUS MATRIX TERRAZZO FLOORING WALL BASE: 3/8" x 6" HIGH PRECAST EPOXY TERRAZZO WALL BASE TO MATCH EXISTING TILE CARPETING WALL COVERINGS GLEE CLUB ROOM 203: ACOUSTICAL TRANSPARENT FABRIC ON METAL FRAMING; SEE ELEVATIONS FOR EXTENT SOUND-ABSORBING WALL UNITS CONCERT BAND ROOM 300: SOUND ABSORPTIVE 1" FABRIC WRAPPED PANELS, MINIMUM NRC 1.00 SECTIONALS ROOM 205, CORRIDORS & VESTIBULES WHERE NOTED ON FINISH SCHEDULE: SOUND ABSORPTIVE 2-1/8" FABRIC WRAPPED PANELS, MINIMUM NRC 1.05 GLEE CLUB ROOM 203: 2" DUCT LINER BOARD, 2.5 PCF MIN, CONCEALED IN WALL CAVITY SOUND-ABSORBING CEILING UNITS 3/4" PLYWOOD PANEL SOUND REFLECTING CLOUDS SUSPENDED WITH FRAMING; ANGLE 5 DEGREES FROM HORIZONTAL IN RANDOM DIRECTIONS EXTERIOR PAINTING INTERIOR PAINTING STAINING AND TRANSPARENT FINISHING	BUILDING 685U.S. MILITARY ACADEMY West Point, New YorkProject No.: 11300 Date: July 06, 2022Drawing Title:
093013 095113 096248 A 096513 096519 096623 A 096813 097200 A 098433 A B C D 098436 A 099113 099123 099300	GRID SUSPENSION SYSTEM FOR GYPSUM BOARD CEILINGS GYPSUM BOARD CERAMIC TILING ACOUSTICAL PANEL CEILINGS SEE RCPS AND FINISH SCHEDULE SOUND AND VIBRATION CONTROL FOR CONCRETE FLOATING FLOOR 1" ROLL-OUT RUBBER MAT ISOLATION SYSTEM RESILIENT BASE & ACCESSORIES RESILIENT TILE FLOORING RESINOUS MATRIX TERRAZZO FLOORING WALL BASE: 3/8" × 6" HIGH PRECAST EPOXY TERRAZZO WALL BASE TO MATCH EXISTING TILE CARPETING WALL COVERINGS GLEE CLUB ROOM 203: ACOUSTICAL TRANSPARENT FABRIC ON METAL FRAMING; SEE ELEVATIONS FOR EXTENT SOUND-ABSORBING WALL UNITS CONCERT BAND ROOM 300: SOUND ABSORPTIVE 1" FABRIC WRAPPED PANELS, MINIMUM NRC 1.00 SECTIONALS ROOM 205, CORRIDORS & VESTIBULES WHERE NOTED ON FINISH SCHEDULE: SOUND ABSORPTIVE 2-1/8" FABRIC WRAPPED PANELS, MINIMUM NRC 1.05 GLEE CLUB ROOM 203: 2" DUCT LINER BOARD, 2.5 PCF MIN, CONCEALED IN WALL CAVITY SOUND-DIFFUSING WALL UNITS OUND-ABSORBING CEILING UNITS 3/4" PLYWOOD PANEL SOUND REFLECTING CLOUDS SUSPENDED WITH FRAMING; ANGLE 5 DEGREES FROM HORIZONTAL IN RANDOM DIRECTIONS EXTERIOR PAINTING STAINING AND TRANSPARENT FINISHING : SPECIALTIES 6 ROOM-IDENTIFICATION PANEL SIGNAGE WIRE MESH PARTITIONS	<section-header><text><text><text><text><text><text></text></text></text></text></text></text></section-header>
093013 095113 096248 A 096513 096519 096623 A 096813 097200 A 098433 A B C D 098436 A 099113 099123 099300 0V/ISION 10 101423.2 102213 102800 104413	GRID SUSPENSION SYSTEM FOR GYPSUM BOARD CEILINGS GYPSUM BOARD CERAMIC TILING ACOUSTICAL PANEL CEILINGS SEE RCPS AND FINISH SCHEDULE SOUND AND VIBRATION CONTROL FOR CONCRETE FLOATING FLOOR 1" ROLL-OUT RUBBER MAT ISOLATION SYSTEM RESILIENT BASE & ACCESSORIES RESILIENT TILE FLOORING RESINOUS MATRIX TERRAZZO FLOORING WALL BASE: 3/8" × 6" HIGH PRECAST EPOXY TERRAZZO WALL BASE TO MATCH EXISTING TILE CARPETING WALL COVERINGS GLEE CLUB ROOM 203: ACOUSTICAL TRANSPARENT FABRIC ON METAL FRAMING; SEE ELEVATIONS FOR EXTENT SOUND-ABSORBING WALL UNITS CONCERT BAND ROOM 300: SOUND ABSORPTIVE 1" FABRIC WRAPPED PANELS, MINIMUM NRC 1.00 SECTIONALS ROOM 205, CORRIDORS & VESTIBULES WHERE NOTED ON FINISH SCHEDULE: SOUND ABSORPTIVE 2-1/8" FABRIC WRAPPED PANELS, MINIMUM NRC 1.05 GLEE CLUB ROOM 203: 2" DUCT LINER BOARD, 2.5 PCF MIN, CONCEALED IN WALL CAVITY SOUND-ABSORBING CEILING UNITS JA" PLYWOOD PANEL SOUND REFLECTING CLOUDS SUSPENDED WITH FRAMING; ANGLE 5 DEGREES FROM HORIZONTAL IN RANDOM DIRECTIONS EXTERIOR PAINTING STAINING AND TRANSPARENT FINISHING : SPECIALTIES 6 ROOM-IDENTIFICATION PANEL SIGNAGE	BUILDING 685U.S. MILITARY ACADEMY West Point, New YorkProject No.: 11300 Date: July 06, 2022Drawing Title:

(Continued on the following odd numbered sheet)

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← 4" SPRAY ON CELLULOSE SOUND ABSORPTIVE FINISH (072129-A) UNDERSIDE OF CONCRETE ROOF SLAB 4" SPRAY ON CELLULOSE -----SOUND ABSORPTIVE FINISH - PANEL SUSPENSION SYSTEM; (072129-A) SLOTTED CHANNEL CARRYING CHANNEL AND DOWN POST (098436) (4) SPLAY WIRES — (098436) 24" LONG SLOTTED CHANNEL -– (4) TORSION CONTROL DIAGONAL THRU-BOLTED TO PLYWOOD SPLAY WIRES (098436) (098436) ____ _____ - CONCRETE STRUCTURE (GIRDER & COLUMN) - ¾" HARDWOOD VENEER PLYWOOD WITH SOLID WOOD EDGE BAND ROUND HEAD STAINLESS STEEL (062023, 098436) CARRIAGE BOLTS SOUND REFLECTIVE PANEL DETAIL B5 A903 / 3/4" = 1'-0"

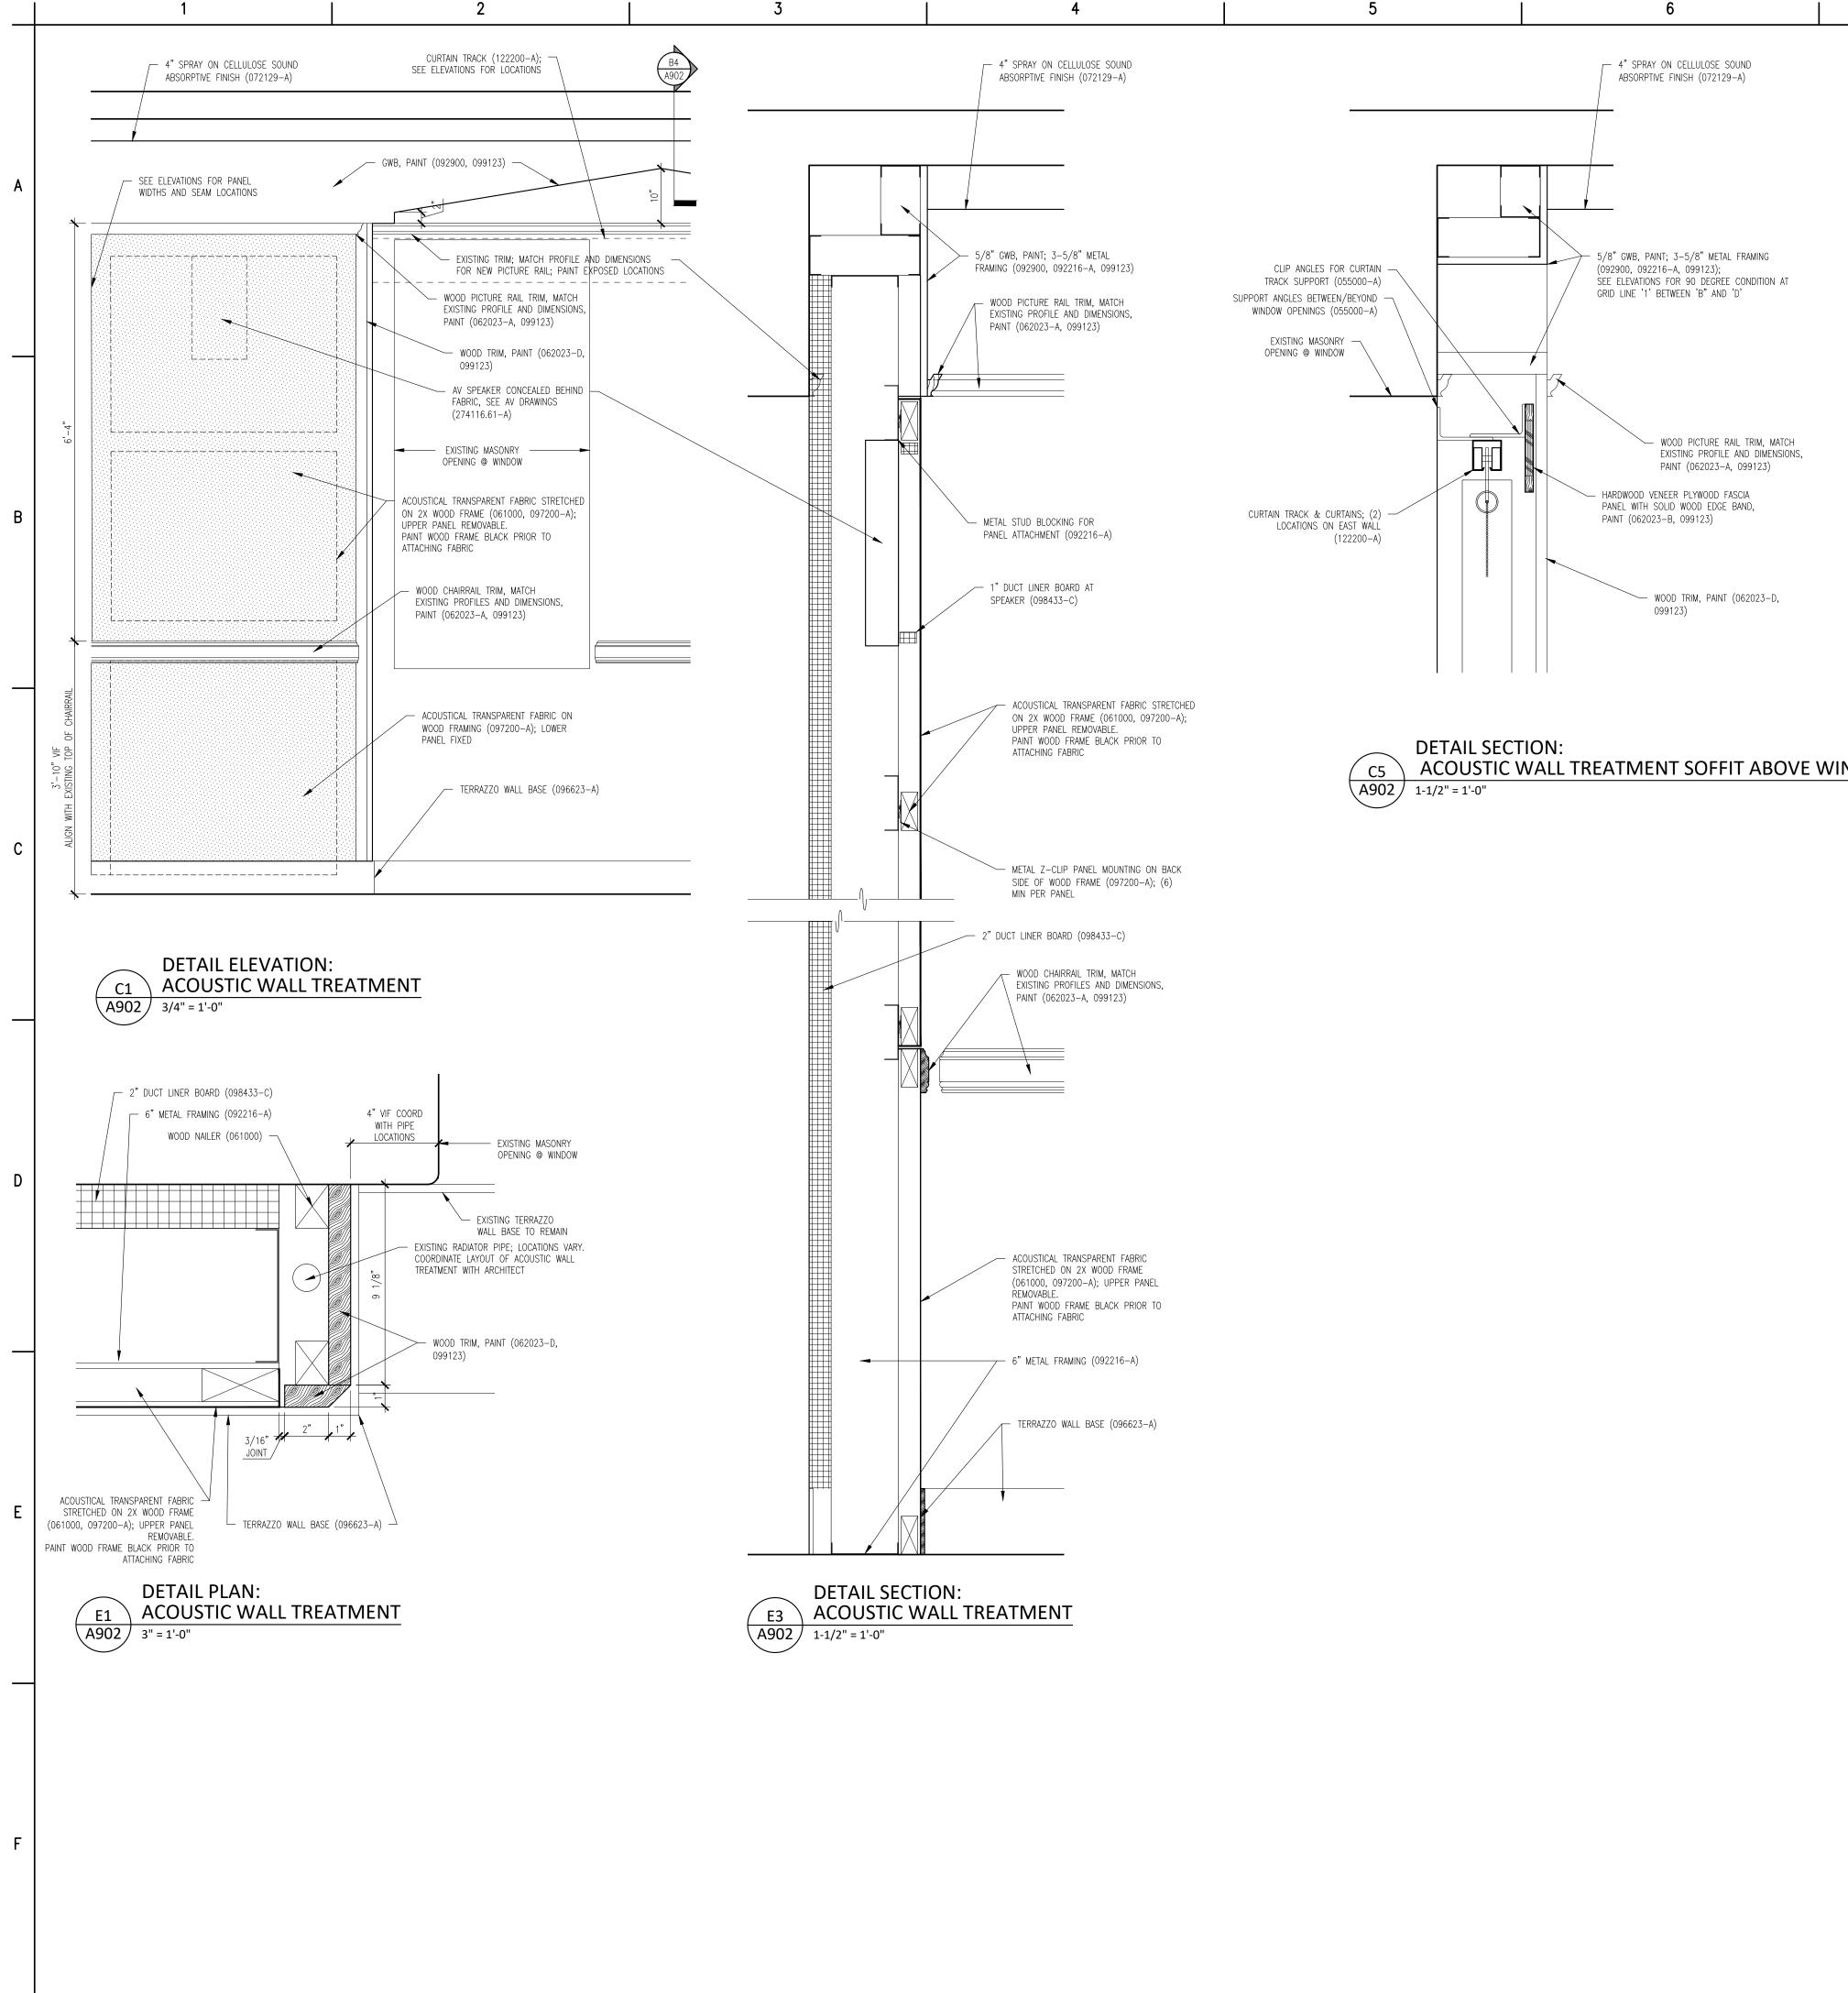
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WOOD TRIM WITH TRANSPARENT FINISH (062023-B, 099300)

ON GWB (SAWU2 098433-A); SEE FINISH SCHEDULE

/ EXISTING WOOD FLOORING; REFINISH (099300)



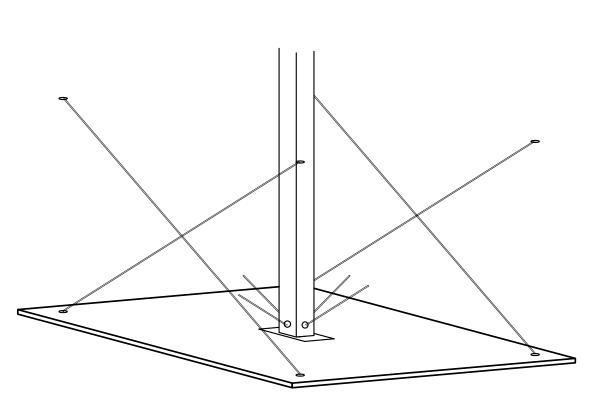

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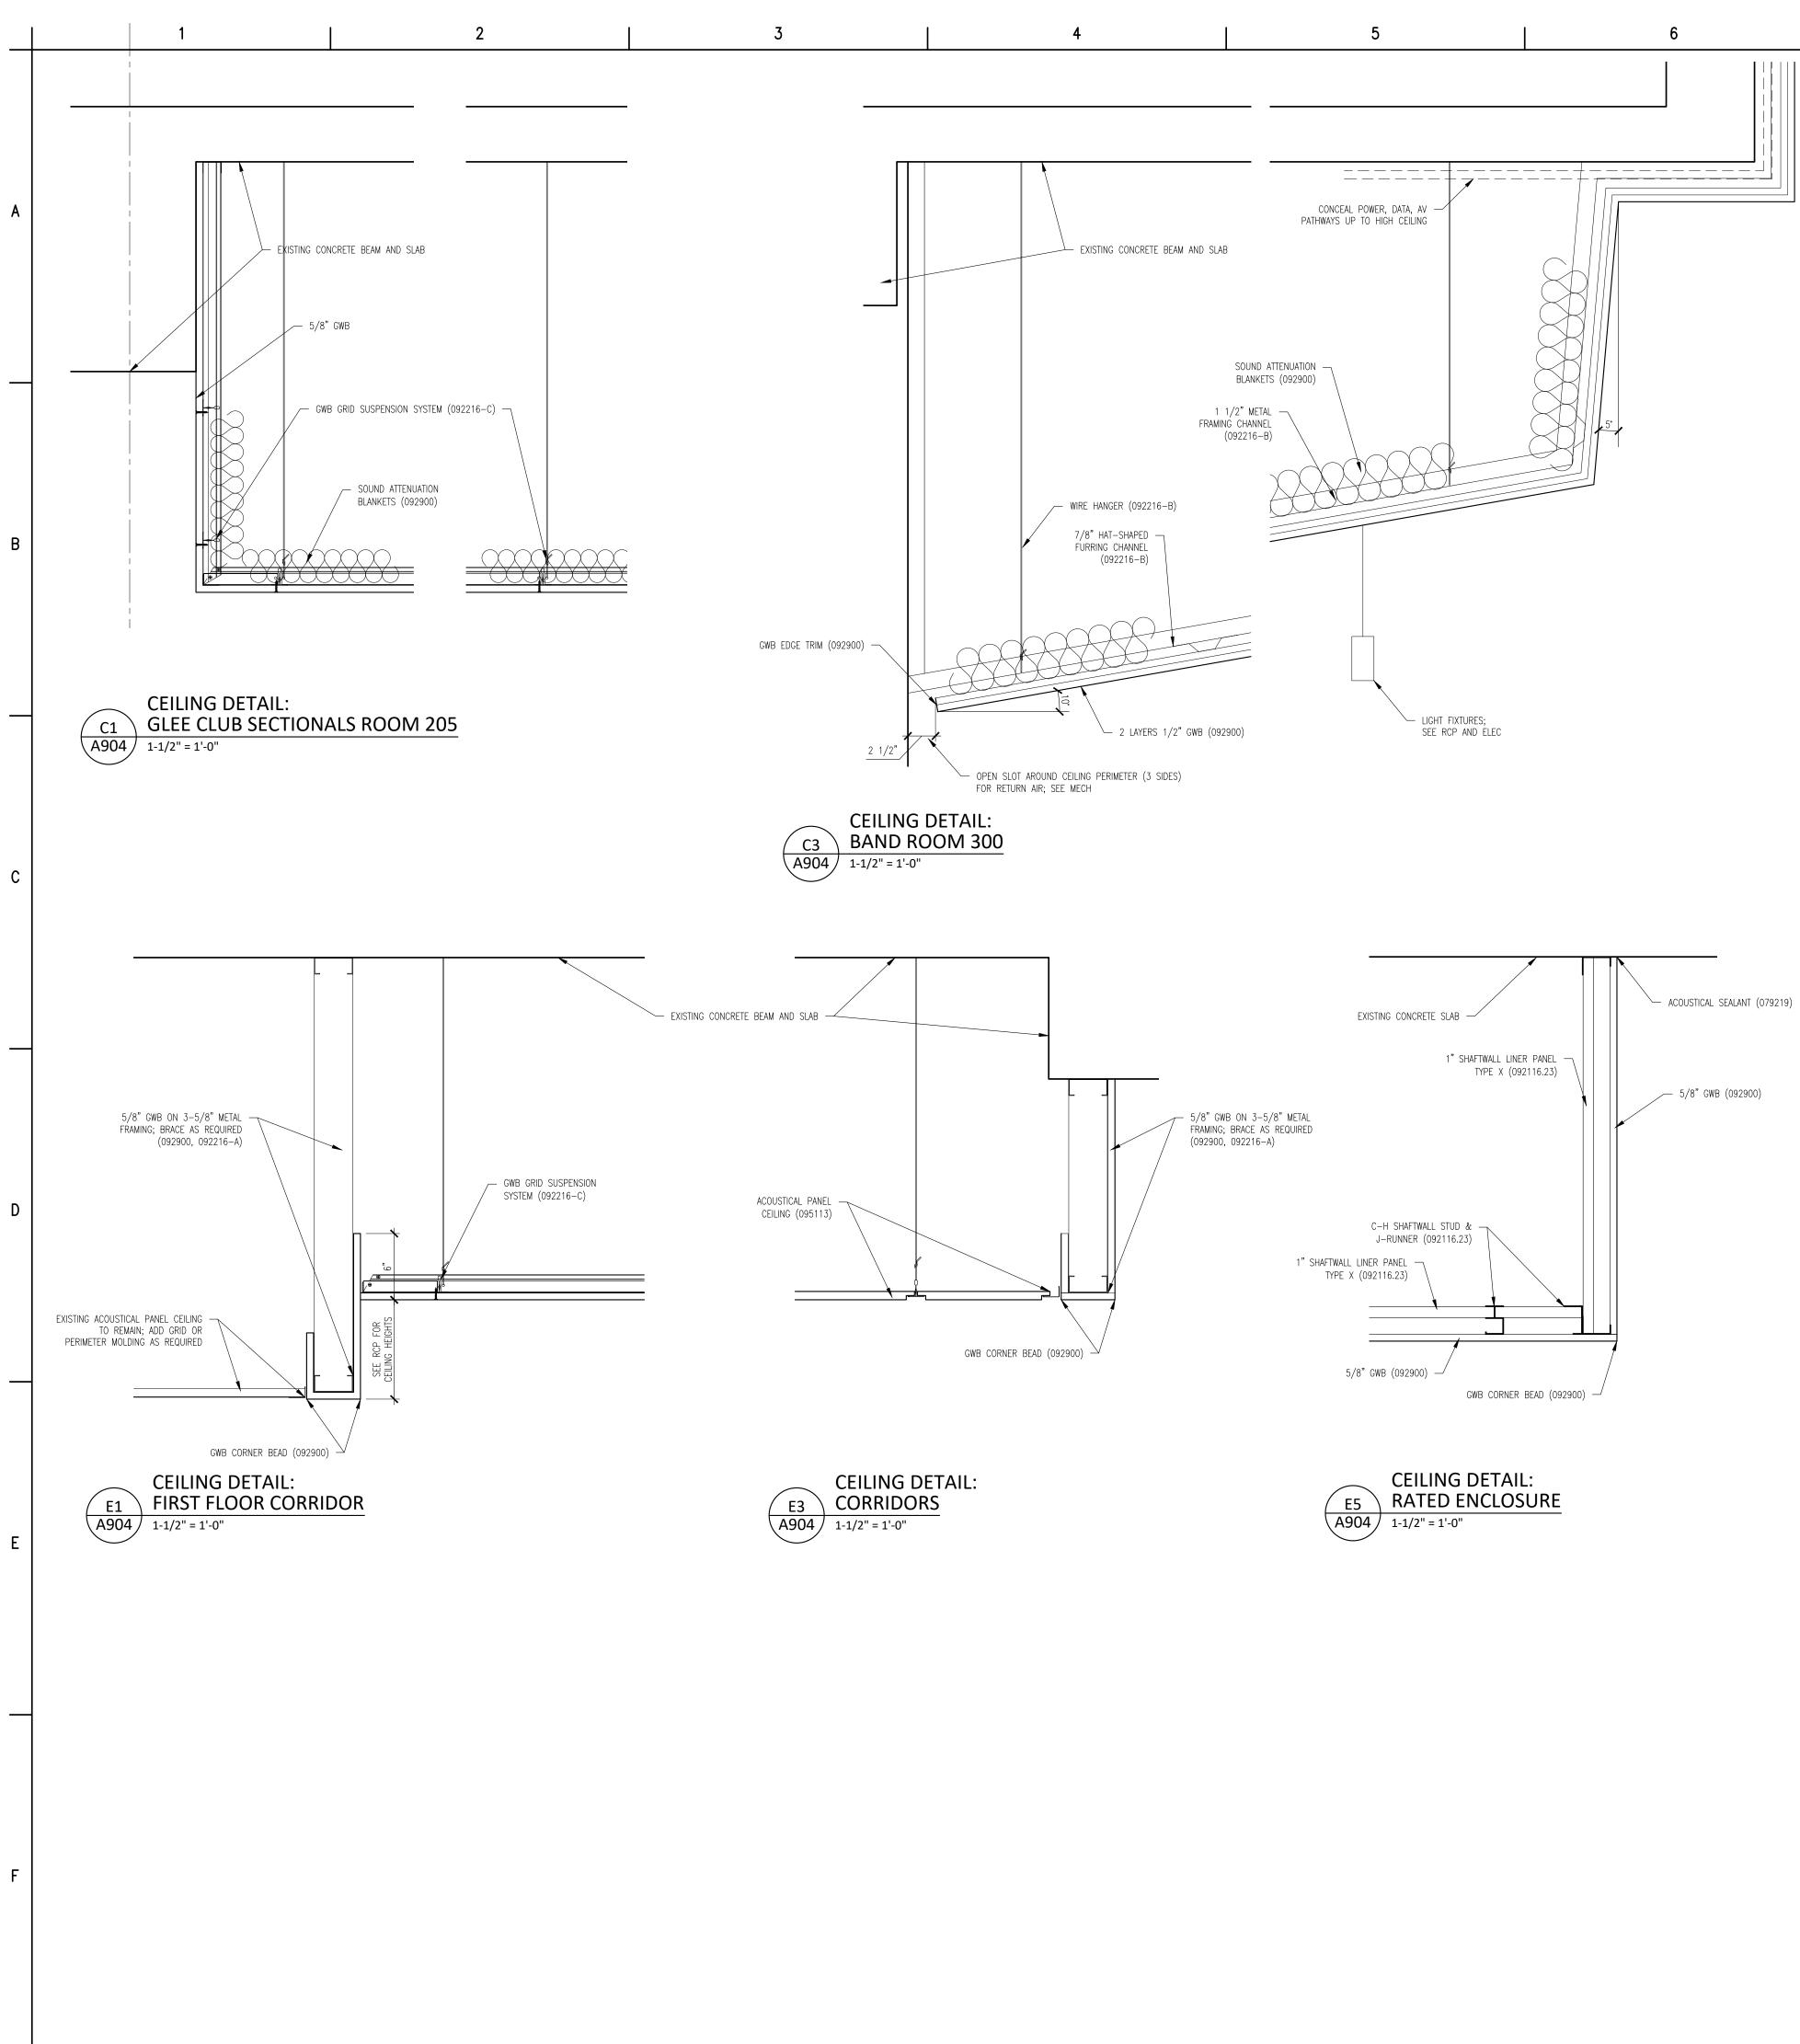
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Material Keynote Legend (Continued from the previous even numbered sheet) DIVISION 11: EQUIPMENT 111316 LOADING DOCK SEALS AND SHELTERS A CLEAR STRIP CURTAIN ENCLOSURE 111319 STATIONARY LOADING DOCK LEQUIPMENT A SURFACE MOUNTED DOCK LIFT, 48" WIDE X 88" LONG PLATFORM, MIN 5000 LB CAPACITY, VERTICAL TRAVEL 48", LOWERED HEIGHT 8", LAG INSTALLED INTO CONCRETE B 4-1/2" OD FIXED DOCK BUMPER BOLLARD SET IN CONCRETE 116123 FOLDING AND PORTABLE STAGES DIVISION 12: FURNISHINGS 122200 122200 CURTAINS AND DRAPES A TRACK WITH MOVABLE CURTAINS; 25 OZ/LINEAR YARD COTTON VELOUR, SEWN WITH 100% FULLNESS, AND INCORPORATE 16 OZ BACKER LAYER, SEWN FLAT DIVISION 13: SPECIAL CONSTRUCTION 131113 MEDIUM ISOLATION SOUND CONTROL DOOR ASSEMBLIES 133473 HIGH ISOLATION SOUND CONTROL DOOR ASSEMBLIES DIVISION 14: CONVEYING EQUIPMENT 142123.16 MACHINE ROOM-LESS ELECTRIC TRACTION ELEVATORS A MACHINE ROOM LESS (MRL) SIDE COUNTERWEIGHT HOSPITAL SERVICE ELEVATOR, 5000 LB CAPACITY, 200 FPM, 4 STOPS	Mark B. Thompson Associates Architecture 502 South 24th Street Philadelphia, PA 19146 215.985.1000 www.mbtarchitects.com Keast & Hood Company of New York, PC Structural Engineering 400 Market Street, Suite 1250 Philadelphia, PA 19106 215.625.0099 www.keasthood.com Dimitri J. Ververelli, Inc. Mechanical, Electrical, Plumbing, Fire Protection Engineering 211 North 13th Street Philadelphia, PA 19107 215.496.0000 www.djvinc.com Langan Civil Engineering 21 Penn Plaza, 360 West 31st Street, 8th Floor New York, NY 10001 212.479.5400 www.langan.com Theatre Projects Acoustical Design 47 Water Street South Norwalk, CT 06854 203.299.0830 www.theatreprojects.com
DIVISION 22: PLUMBING SEE PLUMBING DRAWINGS & SPECS 224000 PLUMBING FIXTURES DIVISION 23: HEATING, VENTILATION AND AIR CONDITIONING SEE MECHANICAL DRAWINGS & SPECS 233100 HVAC DUCTS & CASINGS A METAL DUCTS, SEE 'M' DWGS DIVISION 26: ELECTRICAL SEE ELECTRICAL DRAWINGS & SPECS 260000 ELECTRICAL EQUIPMENT	
265000 LED LIGHTING 265000 LED LIGHTING DIVISION 27: COMMUNICATIONS SEE AV AND ELECTRICAL DRAWINGS & SPECS 274116.61 INTEGRATED AUDIO-VIDEO SYSTEMS AND EQUIPMENT A ELECTRO-ACOUSTIC ENHANCEMENT SYSTEM: SEE SPEC FOR DETAILED DESCRIPTION OF SYSTEM REQUIREMENTS DIVISION 28: ELECTRONIC SAFETY AND SECURITY SEE ELECTRICAL DRAWINGS & SPECS DIVISION 31: EARTHWORK SEE CIVIL DRAWINGS & SPECS DIVISION 32: EXTERIOR IMPROVEMENTS SEE CIVIL DRAWINGS & SPECS 321216 ON-SITE ASPHALT PAVING DIVISION 33: UTILITIES SEE CIVIL DRAWINGS & SPECS	Arrive of the second structure of the second st
	Key Plan Egnation and the set of

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	EYNOTE LEGEND EXISTING CONDITIONS	Mark B. Thompson Associates
024119	SELECTIVE DEMOLITION	Architecture 502 South 24th Street
	CONCRETE CONCRETE REPAIR (DRAWING SPEC NOTES ONLY) SEE STRUCTURAL DRAWINGS	Philadelphia, PA 19146 215.985.1000 www.mbtarchitects.com
	CAST IN-PLACE CONCRETE NEW ELEVATED FLOOR SLAB AT BASEMENT LEVEL TO	Keast & Hood Company of New York, PC Structural Engineering
	MATCH CORRIDOR FLOOR ELEVATION CAST IN-PLACE SITE CONCRETE; SEE CIVIL	400 Market Street, Suite 1250 Philadelphia, PA 19106
А	EXTERIOR CONCRETE SLAB SUPPORTED ON NEW FOOTINGS WITH RAMP	215.625.0099 www.keasthood.com
	EXTERIOR CONCRETE STAIRS GYPSUM CEMENT UNDERLAYMENT	Dimitri J. Ververelli, Inc. Mechanical, Electrical, Plumbing, Fire Protection
	INTERIOR TOPPING / LEVELING SLAB	Engineering 211 North 13th Street
	MASONRY UNIT MASONRY BRICK MASONRY VENEER TO MATCH EXISTING	Philadelphia, PA 19107 215.496.0000 www.djvinc.com
В	ACCESSORIES (SEE DRAWINGS FOR TYPE) B1 TIES, REINFORCEMENT; HOT-DIP GALV OR	Langan Civil Engineering
С	STAINLESS STEEL PRECAST CONCRETE LINTELS	21 Penn Plaza, 360 West 31st Street, 8th Floor New York, NY 10001
D E	EMBEDDED FLEXIBLE FLASHING MESH WEEP / VENT	212.479.5400 www.langan.com
	CAST STONE MASONRY	Theatre Projects Acoustical Design 47 Water Street
IVISION 5: 051200 A	STRUCTURAL STEEL FRAMING; SEE STRUCTURAL ELEVATOR HOIST BEAMS	South Norwalk, CT 06854 203.299.0830 www.theatreprojects.com
	STEEL DECKING; SEE STRUCTURAL ROOF DECKING	
055000 A	METAL FABRICATIONS MISC STRUCTURAL SHAPES; GALVANIZED AT	
В	EXTERIOR ABRASIVE CAST METAL NOSINGS	
C 055213	METAL FLOOR PLATE TRENCH COVER PIPE AND TUBE RAILINGS	х ¹ г
	WOODS, PLASTICS, AND COMPOSITES ROUGH CARPENTRY	
	INTERIOR FINISH CARPENTRY GLEE CLUB ROOM 203: WOOD PICTURE RAIL &	
В	CHAIR RAIL TO MATCH EXISTING CONCERT BAND ROOM 300: WOOD WALL BASE &	
C D	TRIMS; SEE DRAWINGS FOR DIMS & PROFILES CHAIR RAIL MISCELLANEOUS TRIM; SEE DRAWINGS FOR DIMS &	
D	PROFILES	
	THERMAL AND MOISTURE PROTECTION THERMAL INSULATION	It is a violation of New York State Law for any person,
А	SPRAY-APPLIED OPEN CELL MEDIUM DENSITY FOAM INSULATION, VAPOR PERMEABLE	unless he is acting under the direction of a licensed Professional Engineer or Land Surveyor, to alter an item in any way. If an item bearing the seal of an Engineer or
072129 A	SPRAY-APPLIED CELLULOSE ACOUSTICAL INSULATION SOUND ABSORPTIVE FINISH OVER 100% OF OVERHEAD DECK (BETWEEN STRUCTURAL BEAMS),	Land Surveyor is altered, the altering Engineer or Land Surveyor shall affix to the item his seal and the notation
075216	MINIMUM NRC 1.00, 4" SPRAY-ON CELLULOSE STYRENE-BUTADIENE-STYRENE (SBS) MODIFIED	"altered by" followed by his signature and the date of such alteration, and a specific description of the
А	BITUMINOUS MEMBRANE ROOFING SBS BASE SHEET + 3 PLIES AND CAP SHEET, IN COLD	alteration.
В	APPLIED ADHESIVE WITH HIGH-REFLECTIVE ROOF COATING TO MATCH EXISTING FLASHING & STRIPPING MATERIALS	General Notes 1. All dimensions and existing conditions shall be
C D	ROOF INSULATION INSULATION COVER BOARD	checked and verified by contractor at the site prior to proceeding with the work.
E F	VAPOR RETARDER / AIR BARRIER SUBSTRATE BOARD	Contractor shall inform Architect/ Engineer of any discrepancies on drawings before
076200 A	SHEET METAL FLASHING AND TRIM LOW-SLOPE ROOF EDGE FLASHINGS AND COPINGS	construction begins. 3. No existing service may be cut without
А	ROOF ACCESSORIES SERVICE ACCESS PLATFORM SYSTEM	Architect/Engineers's consent. Any existing service severed or damaged shall be replaced at no cost to owner.
	JOINT SEALANTS ACOUSTICAL JOINT SEALANTS	 Contractor must notify Architect/ Engineer at once if hidden existing conditions encountered
	OPENINGS HISTORIC TREATMENT OF WOOD DOORS	require design modifications.
081113	HOLLOW METAL DOORS AND FRAMES FLUSH WOOD DOORS	Issue Issued For Date O Bid & Permit 07-06-2022
	INTEGRATED METAL DOOR OPENING ASSEMBLIES ACCESS DOORS AND FRAMES	
A B	ACOUSTIC RATED FIRE-RESISTIVE RATED	
083323 A	OVERHEAD COILING DOORS INSULATED ROLLING SERVICE DOOR, MANUAL CHAIN HOIST, CYLINDRICAL LOCK	
B C	FACE-OF-WALL MOUNTED JAMB HOOD / HEAD PLATE	
084113	ALUMINUM-FRAMED ENTRANCES AND STOREFRONTS	PRELIMINARY
	1" LOW EMISSIVITY INSULATED GLASS UNIT ALUMINUM WINDOWS	Not For Construction
A	3-1/4" THERMAL ALUMINUM 'STEEL REPLICA' WINDOW SYSTEM A1 COVED MUNTIN GRID, SIMULATED TRUE	Key Plan
	DIVIDED LITES, CUSTOM PERIMETER AND INTERIOR AND EXTERIOR GRIDS TO SIMULATE	
087100	ORIGINAL WINDOW SASH DOOR HARDWARE	
IVISION 9: 092116.2	FINISHES 23 GYPSUM BOARD SHAFT WALL ASSEMBLIES	
092216 A	NON-STRUCTURAL METAL FRAMING STUD FRAMING, RUNNER TRACKS	
B C	SUSPENSION SYSTEM FOR CEILINGS & SOFFITS GRID SUSPENSION SYSTEM FOR GYPSUM BOARD	
	CEILINGS GYPSUM BOARD CERAMIC TILING	
	ACOUSTICAL PANEL CEILINGS SEE RCPS AND FINISH SCHEDULE	
096248	SOUND AND VIBRATION CONTROL FOR CONCRETE FLOATING FLOOR	EGNER HALL
	1" ROLL-OUT RUBBER MAT ISOLATION SYSTEM RESILIENT BASE & ACCESSORIES	
	RESILIENT TILE FLOORING RESINOUS MATRIX TERRAZZO FLOORING WALL BASE: 3/8" x 6" HIGH PRECAST EPOXY	BUILDING 685
	TERRAZZO WALL BASE TO MATCH EXISTING TILE CARPETING	U.S. MILITARY ACADEMY West Point, New York
097200 A	WALL COVERINGS GLEE CLUB ROOM 203: ACOUSTICAL TRANSPARENT	
008422	FABRIC ON METAL FRAMING; SEE ELEVATIONS FOR EXTENT SOUND-ABSORBING WALL UNITS	
098433 A	CONCERT BAND ROOM 300: SOUND ABSORPTIVE 1" FABRIC WRAPPED PANELS, MINIMUM NRC 1.00	
В	SECTIONALS ROOM 205, CORRIDORS & VESTIBULES WHERE NOTED ON FINISH SCHEDULE: SOUND	
С	ABSORPTIVE 2-1/8" FABRIC WRAPPED PANELS, MINIMUM NRC 1.05 GLEE CLUB ROOM 203: 2" DLICT LINER BOARD, 2,5	Project No.: 11300
D	GLEE CLUB ROOM 203: 2" DUCT LINER BOARD, 2.5 PCF MIN, CONCEALED IN WALL CAVITY SOUND-DIFFUSING WALL UNIT CONCEALED IN WALL	Date: July 06, 2022
098436	CAVITY SOUND-ABSORBING CEILING UNITS	
A	3/4" PLYWOOD PANEL SOUND REFLECTING CLOUDS SUSPENDED WITH FRAMING; ANGLE 5 DEGREES FROM HORIZONTAL IN RANDOM DIRECTIONS	Drawing Title:
	EXTERIOR PAINTING INTERIOR PAINTING	Ceiling Details
	STAINING AND TRANSPARENT FINISHING	
101423.1	: SPECIALTIES 16 ROOM-IDENTIFICATION PANEL SIGNAGE WIDE MESH DAPTITIONS	
102800	WIRE MESH PARTITIONS TOILET, BATH, AND LAUNDRY ACCESSORIES FIRE PROTECTION CABINETS	A904
	FIRE EXTINGUISHERS	インしょ

(Continued on the following odd numbered sheet)

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