

WESTCHESTER COUNTY LOCATION MAP

Westchester Sterester Westchester Westchester

WESTCHESTER COUNTY, NEW YORK DEPARTMENT OF PUBLIC WORKS AND TRANSPORTATION DIVISION OF ENGINEERING

CONTRACT No. 19-515 PARKING GARAGE REHABILITATION - PHASE 1 MICHAELIAN OFFICE BUILDING 148 MARTINE AVENUE WHITE PLAINS, NEW YORK



LOCATION PLAN

383 Westchesteter Avenue

32 OLD SLIP, 0TH FLOOR NEW YORK, NEW YORK 10005

JEFFRY R. CARLSON, P.E. S.E. 601 WEST GOLF ROAD, SECOND FLOOR MOUNT PROSPECT, ILLINOIS 60056

914-741-1115

MICHAEL SCHULLER

917-647-9350

White Plains, New York 10604

ATKINSON-NOLAND AND ASSOCIATES

FORENSIC INVESTIGATION

STRUCTURAL ENGINEER

MEP ENGINEERS

INDEX OF DRAWINGS

| ARCHITECTU | IRAL DRAWINGS | | | STRUCTURAL | DRAWINGS | | | FIRE PROTEC | TION, PLUMBING AND ELECTRICAL DRAWINGS | | |
|------------|---|----------------|-------------|----------------|--|---------------|----------------------|--------------|--|--------------------------------|----------------------|
| SHEET NO. | SHEET TITLE | DPW FILE NO. | SHEET OF 97 | SHEET NO. | SHEET TITLE | DPW FILE NO. | SHEET OF 97 | SHEET NO. | SHEET TITLE | DPW FILE NO. | SHEET OF 9 |
| | | | | | | | | FIRE PROTEC | TION | | |
| 000 | TITLE SHEET | 52-01-T-348-0 | 1 OF 97 | S040 | NOTES | 52-01-S-367-0 | 20 OF 97 | FP100 | SPECIFICATIONS, LEGEND AND NOTES | 52-01-FP-416-0 | 69 OF 97 |
| 000.1 | CODE COMPLIANCE SHEET | 52-01-A-349-0 | 2 OF 97 | S060 | BENT REINFORCING BAR DETAILS | 52-01-S-368-0 | 21 OF 97 | FP101(B3) | LOCATION PART PLAN PARKING LEVEL B3 | 52-01-FP-417-0 | 70 OF 97 |
| 001 | 3D RAMP LOCATION DIAGRAM | 52-01-A-350-0 | 3 OF 97 | S100 | LEVEL B3 COLUMN REPAIRS & SHORING | 52-01-S-369-0 | 22 OF 97 | FP102(B2) | LOCATION PART PLAN PARKING LEVEL B2 | 52-01-FP-418-0 | 71 OF 97 |
| 002 | RAMP CONSTRUCTION PHASING PLAN 1 | 52-01-A-351-0 | 4 OF 97 | S102 | LEVEL B2 (B) COLUMN REPAIRS & SHORING | 52-01-S-370-0 | 23 OF 97 | FP201(B3) | PARKING LEVEL B3 PART PLANS AND NOTES | 52-01-FP-419-0 | 72 OF 97 |
| 003 | RAMP CONSTRUCTION PHASING PLAN 2 | 52-01-A-352-0 | 5 OF 97 | S103 | LEVEL B1 & 1 COLUMN REPAIRS & SHORING | 52-01-S-371-0 | 24 OF 97 | FP202(B2) | PARKING LEVEL B2 PART PLANS AND NOTES | 52-01-FP-420-0 | 73 OF 97 |
| 004 | TEMPORARY TRAFFIC PATTERN PLAN | 52-01-A-353-0 | 6 OF 97 | S104 | LEVEL 2 & 3 COLUMN REPAIRS & SHORING | 52-01-S-372-0 | 25 OF 97 | FP203(B2) | PARKING LEVEL B2 PART PLANS AND NOTES | 52-01-FP-421-0 | 74 OF 97 |
| 010 | PLAZA LEVEL EXPANSION JOINT LOCATION PLAN AND DETAILS - ALTERNATE 1 | 52-01-A-354-0 | 7 OF 97 | S107 | LEVEL 8 COLUMN REPAIRS - ALTERNATE 2 | 52-01-S-373-0 | 26 OF 97 | | | | |
| 030 | LEVEL 8 COLUMN REPAIR PLAN - ALTERNATE 2 | 52-01-A-355-0 | 8 OF 97 | S122 | EXPANSION JOINT REPAIR AREA GROUND FLOOR - ALTERNATE 1 | 52-01-S-374-0 | 27 OF 97 | PLUMBING | | | |
| 111 | CONSTRUCTION KEY PLANS | 52-01-A-356-0 | 9 OF 97 | S128 | LEVEL 9 & 10 FLOOR DELAMINATION | 52-01-S-375-0 | 28 OF 97 | P100 | ABBREVIATION LIST, GENERAL NOTES AND LEGEND | 52-01-P-422-0 | 75 OF 97 |
| 112 | LEVEL B3 ENLARGED CONSTRUCTION AND STRIPING PLANS | 52-01-A-357-0 | 10 OF 97 | S161 | SOUTH RAMP EXISTING PLAN & SECTION (Y-Z) | 52-01-S-376-0 | 29 OF 97 | P101(B3) | LOCATION PART PLAN PARKING LEVEL B3 | 52-01-P-422-0 52-01-P-423-0 | 76 OF 97 |
| 113 | LEVEL B2 ENLARGED CONSTRUCTION AND STRIPING PLANS | 52-01-A-358-0 | 11 OF 97 | S161A | SOUTH RAMP REPAIRED PLAN & SECTION (Y-Z) | 52-01-S-377-0 | 30 OF 97 | P102(B2) | LOCATION PART PLAN PARKING LEVEL B3 LOCATION PART PLAN PARKING LEVEL B2 | 52-01-P-424-0 | 77 OF 97 |
| 114 | LEVELS 9 & 10 CONSTRUCTION PLAN | 52-01-A-359-0 | 12 OF 97 | S162 | SOUTH RAMP EXISTING PLAN & SECTION (Y-Z) | 52-01-S-378-0 | 31 OF 97 | P103(B1) | LOCATION PART PLAN PARKING LEVEL B2 LOCATION PLAN LEVELS B1 AND 1 AND CONSTRUCTION PART PLAN | 52-01-P-425-0 52-01-P-425-0 | 77 OF 97 78 OF 97 |
| 115 | LEVELS 9 & 10 STRIPING PLAN | 52-01-A-360-0 | 13 OF 97 | S162A | SOUTH RAMP REPAIRED PLAN & SECTION (Y-Z) | 52-01-S-379-0 | 32 OF 97 | P104(L6, L7) | | 52-01-P-426-0 | 79 OF 97 |
| 116 | ENLARGED RAMP PLANS | 52-01-A-361-0 | 14 OF 97 | S163 | SOUTH RAMP PLANS (Y-Z) | 52-01-S-380-0 | 33 OF 97 | P105(L8, L9) | LOCATION PLAN LEVELS 6 AND 7 AND CONSTRUCTION PART PLAN LOCATION PLAN LEVELS 8 AND 9 AND CONSTRUCTION PART PLAN | 52-01-P-420-0 52-01-P-427-0 | 80 OF 97 |
| 117 | ENLARGED RAMP PLANS | 52-01-A-362-0 | 15 OF 97 | S164 | SOUTH RAMP PLANS (W-X) | 52-01-S-381-0 | 34 OF 97 | P201(B3) | | | |
| 00 | DETAILS | 52-01-A-363-0 | 16 OF 97 | S165 | NORTH RAMP PLANS (S-T) | S2-01-S-382-0 | 35 OF 97 | P202(B2) | PARKING LEVEL B3 PART PLANS AND NOTES | 52-01-P-428-0 | 81 OF 97 |
| 00 | B3 ENLARGED PLANS, ELEVATIONS AND DETAILS | 52-01-A-364-0 | 17 OF 97 | S166 | NORTH RAMP PLANS (S-T) | 52-01-S-383-0 | 36 OF 97 | F202(B2) | PARKING LEVEL B2 PART PLANS AND NOTES | 52-01-P-429-0 | 82 OF 97 |
| 01 | B2 ENLARGED PLANS, ELEVATIONS AND DETAILS | 52-01-A-365-0 | 18 OF 97 | S169 | SOUTH RAMP SECTIONS (EXISTING CONDITION) | 52-01-S-384-0 | 37 OF 97 | | | | |
| 300 | DOOR SCHEDULE AND DETAILS | 52-01-A-366-0 | 19 OF 97 | S169A | SOUTH RAMP SECTIONS (REPAIRED CONDITION) | 52-01-S-385-0 | 38 OF 97 | | | | |
| | | 02 01 77 000 0 | 15 61 57 | S170 | NORTH RAMP SECTION (EXISTING CONDITION) | 52-01-S-386-0 | 39 OF 97 | ELECTRICAL | | | |
| | | | | S170A | NORTH RAMP SECTION (REPAIRED CONDITION) | 52-01-S-387-0 | 40 OF 97 | E001 | ELECTRICAL SYMBOLS LIST AND PARKING STRUCTURE RAMP RISER DIAGRAM | 52-01-E-430-0 | 83 OF 97 |
| | | | | S175 | SOUTH RAMP ELEVATION AT LINE 'Y' LOOKING NORTH (EXISTING CONDITION) | 52-01-S-388-0 | 40 OF 97 41 OF 97 | E101 | ELECTRICAL PLAN, PARKING LEVEL B3 | 52-01-E-431-0 | 84 OF 97 |
| | | | | S175A | SOUTH RAMP ELEVATION AT LINE 'Y' LOOKING NORTH (REPAIRED CONDITION) | 52-01-S-389-0 | 41 OF 97 42 OF 97 | E102 | PARKING STRUCTURE LEVEL B2 ELECTRICAL PLAN, PART PLAN AND KEYED NOTES | 52-01-E-432-0 | 85 OF 97 |
| | | | | S175B | SOUTH RAMP ELEVATION AT LINE 'Y' LOOKING SOUTH (EXISTING CONDITION) | 52-01-S-390-0 | 42 OF 97 43 OF 97 | E103 | ELECTRICAL PART PLAN, PARKING STRUCTURE LEVEL B1 AND LEVEL 1 | 52-01-E-433-0 | 86 OF 97 |
| | | | | S175C | SOUTH RAMP ELEVATION AT LINE 'Y' LOOKING SOUTH (REPAIRED CONDITION) | 52-01-S-391-0 | | E104 | ELECTRICAL PLAN, PARKING STRUCTURE LEVELS 6 AND 7 | 52-01-E-434-0 | 87 OF 97 |
| | | | | S175C S175D | SOUTH RAMP ELEVATION AT LINE 'Z' LOOKING SOUTH (EXISTING CONDITION) | | 44 OF 97 | E201 | ELECTRICAL PART PLANS, PARKING STRUCTURE LEVEL B3 | 52-01-E-435-0 | 88 OF 97 |
| | | | | S175E | SOUTH RAMP ELEVATION AT LINE 'Z' LOOKING SOUTH (EXISTING CONDITION) | 52-01-S-392-0 | 45 OF 97 | E202 | ELECTRICAL PART PLANS, RAMP #3 PARKING STRUCTURE LEVEL B3 (LIGHTING) | 52-01-E-436-0 | 89 OF 97 |
| | | | | | NORTH RAMP ELEVATION AT LINE 'S' LOOKING NORTH (EXISTING AND REPAIRED CONDITION) | 52-01-S-393-0 | 46 OF 97 | E203 | ELECTRICAL PART PLANS, RAMP #3 PARKING STRUCTURE LEVEL B3 | 52-01-E-437-0 | 90 OF 97 |
| | | | | S176 | NORTH RAMP ELEVATION AT LINE 'T' LOOKING NORTH (EXISTING AND REPAIRED CONDITION) | 52-01-S-394-0 | 47 OF 97 | E204 | ELECTRICAL PART PLANS, RAMP #3 PARKING STRUCTURE LEVEL B3 (TEMPORARY POWER AND LIGHTING) | 52-01-E-438-0 | 91 OF 97 |
| | | | | S176A | NORTH RAMP ELEVATION AT LINE 'T' LOOKING NORTH (EXISTING AND REPAIRED CONDITION) | 52-01-S-395-0 | 48 OF 97 | E205 | ELECTRICAL PART PLANS, RAMP #4 PARKING STRUCTURE LEVEL B2 | 52-01-E-439-0 | 92 OF 97 |
| | | | | S176B | NORTH AND SOUTH RAMP ELEVATIONS AT LINE "W" (EXISTING AND REPAIRED CONDITION) | 52-01-S-396-0 | 49 OF 97 | E206 | ELECTRICAL PART PLANS, RAMP #4 PARKING STRUCTURE LEVEL B2 | 52-01-E-440-0 | 93 OF 97 |
| | | | | S177 | | 52-01-S-397-0 | 50 OF 97 | E207 | ELECTRICAL PART PLANS, PARKING STRUCTURE LEVEL B2 AREA UNDER RAMP #7 | 52-01-E-441-0 | 94 OF 97 |
| | | | | S177A | NORTH AND SOUTH RAMP ELEVATIONS AT LINE 'X' (EXISTING AND REPAIRED CONDITION) | 52-01-S-398-0 | 51 OF 97 | E208 | ELECTRICAL PART PLANS, PARKING STRUCTURE LEVEL 1 - RAMPS #6 AND #5 AREA | 52-01-E-442-0 | 95 OF 97 |
| | | | | S180 | RAMP DETAILS & SECTIONS | 52-01-S-399-0 | 52 OF 97 | E209 | ELECTRICAL PART PLANS, PARKING STRUCTURE LEVELS 6 TO 7 - RAMP #14 | 52-01-E-443-0 | 96 OF 97 |
| | | | | S181 | RAMP DETAILS & SECTIONS | 52-01-S-400-0 | 53 OF 97 | E210 | ELECTRICAL PART PLANS, PARKING STRUCTURE LEVELS 7 TO 8 - RAMP #13 | 52-01-E-444-0 | 97 OF 97 |
| | | | | S300 | TYPICAL COLUMN ENCASEMENT REPAIR DETAILS | 52-01-S-401-0 | 54 OF 97 | | ==== // Let / E / Let / E / Let / Le | 02 01 2 444 0 | 0, 0, 0, |
| | | | | S301 | EXISTING SLAB DETERIORATION PLAN - LEVEL B3 | 52-01-S-402-0 | 55 OF 97 | | | | |
| | | | | S301A | SLAB REPAIR PLAN - LEVEL B3 | 52-01-S-403-0 | 56 OF 97 | | | | |
| | | | | S301B | EXISTING SLAB DETERIORATION AND EXPANSION JOINT PLAN - LEVEL B2 | 52-01-S-404-0 | 57 OF 97 | | | | SED AD |
| | | | | S301C | SLAB AND EXPANSION JOINT REPAIR PLAN - LEVEL B2 | 52-01-S-405-0 | 58 OF 97 | | | (E) | THE SALCE |
| | | | | S302 | COLUMN E11 (L11) ENCASEMENT REPAIR DETAILS | 52-01-S-406-0 | 59 OF 97 | | | 1/3/3 | A. GABY |
| | | | | S303 | COLUMN E11 (L11) ENCASEMENT REPAIR DETAILS LEVEL B2 COLUMN & SLAB REPAIR DETAILS | 52-01-S-407-0 | 60 OF 97 | | | 1/3/3 | 2/2 |
| | | | | S304 | LEVEL B2 & B3 SLAB AND EXPANSION JOINT - REPAIR PLAN AND DETAILS | 52-01-S-408-0 | 61 OF 97 | | | 1 2 2 V | AGAE |
| | | | | S307 | ADDITIONAL COLUMN ENCASEMENT REPAIR DETAILS | 52-01-S-409-0 | 62 OF 97 | | | | 和歌唱 日 |
| | | | | S308 | ADDITIONAL COLUMN ENCASEMENT REPAIR DETAILS | 52-01-S-410-0 | 63 OF 97 | | | | Mose H. |
| | · | | | 0050 | CENEDAL DEDAID DETAILS | 52 01 C 111 C | 64 OF 97 | 1 | | MALE | Tomas I Want |

S350

S351

S352

S353 S354

GENERAL REPAIR DETAILS

RECOMMENDED FOR CONSTRUCTION ROBERT S. DONNELLY, P.E. DIRECTOR OF DESIGN COORDINATION

FIRST DEPUTY COMMISSIONER DEPARTMENT OF PUBLIC WORKS DEPARTMENT OF PUBLIC WORKS AND TRANSPORTATION AND TRANSPORTATION

64 OF 97

65 OF 97

66 OF 97

67 OF 97

68 OF 97

52-01-S-411-0

52-01-S-412-0

52-01-S-413-0

52-01-S-414-0

52-01-S-415-0

1.24.202 RECOMMENDED FOR CONSTRUCTION DATE GAYLE M. KATZMAN, P.E.

COMMISSIONER

CBK ENGINEERING, PC 44-46 FOSTER ROAD HOPEWELL JUNCTION, NY 12533 914-509-8161 (O) REVISION RECORD DRAWING CERTIFICATION AS BUILT - CHANGES AS NOTED AS BUILT - NO CHANGES CONTRACTOR PROJECT COORDINATOR SIGNATURE __ SIGNATURE ____ APPROVED FOR CONSTRUCTION DATE WESTCHESTER COUNTY, NEW YORK DEPARTMENT OF PUBLIC WORKS HUGH J. GREECHAN, JR., P.E. 19-515 A000 AND TRANSPORTATION SHEET NO. 1 OF 97 PARKING GARAGE REHABILITATION - PHASE 1 SCALE: AS NOTED DEPARTMENT OF PUBLIC WORKS MICHAELIAN OFFICE BUILDING DATE: 7-23-2020 148 MARTINE AVENUE, WHITE PLAINS, NEW YORK DPW FILE NO. AND TRANSPORTATION

BOB GABALSKI IN CHARGE OF MICHAEL BERTA CHECKED BY BRETT HUTTMAN MADE BY

COUNTY BUILDING INSPECTOR

CODE ANALYSIS PROJECT: Westchester County Parking Garage ADDRESS: 148 Martine Ave White Plains, NY PREPARED BY: Lothrop Associates LLP Project No.: 2058-01 July 16, 2020 International Property Maintenance Code Analysis - IPMC 2020 THESE PLANS ARE IN CONFORMANCE WITH THE FOLLOWING CODES TO THE EXTENT THAT THEY APPLY TO THE EXISTING BUILDING WHERE THE SCOPE OF WORK IS A REPAIR IN ACCORDANCE WITH CHAPTER 4 OF THE EXISTING BUILDING CODE OF NEW YORK STATE: 2020 International Building Code 2020 International Existing Building Code 2020 International Fire Code 2020 International Plumbing Code 2020 International Mechanical Code 2020 International Fuel Gas Code 2020 International Property Maintenance Code 2020 International Energy Conservation Code 2016 ASHRAE 90.1 CHAPTER 1 - SCOPE AND ADMINISTRATION CHAPTER 2 - DEFINITIONS CHAPTER 3 - GENERAL REQUIREMENTS 301 GENERAL - APPLIES 302 EXTERIOR PROPERTY AREAS - APPLIES 303 SWIMMING POOLS, SPAS AND HOT TOPS - N/A 304 EXTERIOR STRUCTURE - APPLIES 305 INTERIOR STRUCTURE - APPLIES 306 COMPONENT SERVICEABILITY - APPLIES 307 HANDRAILS AND GUARDRAILS - APPLIES 308 RUBBISH AND GARBAGE - APPLIES 309 PEST ELIMINATION - APPLIES 310 LIVE FIRE TRAINING FACILITIES - N/A CHAPTER 4 - LIGHT, VENTILATION AND OCCUPANCY LIMITATIONS 401 GENERAL - APPLIES 402 LIGHT - APPLIES 403 VENTILATION - APPLIES 404 OCCUPANCY LIMITATIONS - APPLIES CHAPTER 5 - PLUMBING FACILITIES AND FIXTURE REQUIREMENTS 501 GENERAL - APPLIES 502 REQUIRED FACILITIES - N/A 503 TOILET ROOMS - N/A 504 PLUMBING SYSTEMS AND FIXTURES - N/A 505 WATER SYSTEM - N/A 506 SANITARY DRAINAGE SYSTEM - N/A 507 STORM DRAINAGE - APPLIES CHAPTER 6 - MECHANICAL AND ELECTRICAL REQUIREMENTS 601 GENERAL - APPLIES 602 HEATING FACILITIES - N/A 603 MECHANICAL EQUIPMENT - N/A 604 ELECTRICAL FACILITIES - APPLIES 605 ELECTRICAL EQUIPMENT - APPLIES 606 ELEVATORS, ESCALATORS AND DUMBWAITERS - APPLIES 607 DUCT SYSTEMS - APPLIES 608 ASSISTIVE LISTENING SYSTEMS - N/A CHAPTER 7 - FIRE SAFETY REQUIREMENTS 701 GENERAL - APPLIES 702 MEANS OF EGRESS - APPLIES

703 FIRE-RESISTANCE RATINGS - APPLIES

704 FIRE PROTECTION SYSTEMS - APPLIES

BOB GABALSKI

MICHAEL BERTA

BRETT HUTTMAN

IN CHARGE OF

CHECKED BY

MADE BY

705 CARBON MONOXIDE ALARMS AND DETECTION - N/A

Project No.: 2058-01 International Existing Building Code Analysis - IEBC 2020 2016 ASHRAE 90.1 **401 GENERAL** 405 STRUCTURAL

CODE ANALYSIS PROJECT: Westchester County Parking Garage ADDRESS: 148 Martine Ave White Plains, NY PREPARED BY: Lothrop Associates LLP July 16, 2020

THESE PLANS ARE IN CONFORMANCE WITH THE FOLLOWING CODES TO THE EXTENT THAT THEY APPLY TO THE EXISTING BUILDING WHERE THE SCOPE OF WORK IS A REPAIR IN ACCORDANCE WITH CHAPTER 4 OF THE EXISTING BUILDING CODE OF NEW YORK STATE:

2020 International Building Code 2020 International Existing Building Code 2020 International Fire Code 2020 International Plumbing Code 2020 International Mechanical Code 2020 International Fuel Gas Code

2020 International Property Maintenance Code 2020 International Energy Conservation Code

USE AND OCCUPANCY CLASSIFICATION EXISTING OCCUPANCY: PARKING GARAGE LOW HAZARD STORAGE, S2 PROPOSED OCCUPANCY: PARKING GARAGE LOW HAZARD STORAGE, S2

CONSTRUCTION CLASSIFICATION CONSTRUCTION CLASSIFICATION IS TYPE 1A - NONCOMBUSTIBLE, CONCRETE STRUCTURE

(3) STORIES BELOW GRADE, (9) STORIES ABOVE GRADE

BUILDING IS PARTIALLY SPRINKLERED - BELOW GRADE ONLY

BUILDING IS PROTECTED WITH A FIRE ALARM SYSTEM

CHAPTER 4 - REPAIRS

401.1 REPAIRS SHALL COMPLY WITH THE REQUIREMENTS OF THIS CHAPTER

401.2 THE WORK SHALL NOT MAKE THE BUILDING LESS COMPLYING THAN IT WAS BEFORE THE REPAIR WAS UNDERTAKEN

402 BUILDING ELEMENTS AND MATERIALS

402.1 REPLACEMENT GLAZING IN HAZARDOUS LOCATIONS SHALL COMPLY WITH THE SAFETY GLAZING REQUIREMENTS OF THE BUILDING CODE OF NEW

EXCEPTION: GLASS BLOCK WALLS, LOUVERED WINDOWS AND JALOUSIES REPAIRED WITH LIKE MATERIALS

403.1 REPAIRS SHALL BE DONE IN A MANNER THAT MAINTAINS THE LEVEL OF FIRE PROTECTION PROVIDED

404 MEANS OF EGRESS

404.1 REPAIRS SHALL BE DONE IN A MANNER THAT MAINTAINS THE LEVEL OF PROTECTION PROVIDED FOR THE MEANS OF EGRESS

405.1 STRUCTURAL REPAIRS SHALL BE IN COMPLIANCE WITH THIS SECTION AND SECTION 401.2

405.2 REPAIRS TO DAMAGED BUILDINGS SHALL COMPLY WITH THIS SECTION

405.2.1 UNLESS OTHERWISED REQUIRED BY THIS SECTION, FOR DAMAGE LESS THAN SUBSTANTIAL STRUCTURAL DAMAGE, THE DAMAGED ELEMENTS SHALL BE PERMITTED TO BE RESTORED TO THEIR PREDAMAGED CONDITION

405.2.1.1 STRUCTURAL COMPONENTS WHOSE DAMAGE WAS CAUSED BY OR RELATED TO SNOW LOAD EFFECTS SHALL BE REPAIRED, REPLACED OR ALTERED TO SATISFY THE REQUIREMENTS OF SECTION 1608 OF THE BUILDING CODE OF NEW YORK STATE

405.2.2 A BUILDING ASSIGNED TO SEISMIC DESIGN CATEGORY D, E, OR F THAT HAS SUSTAINED DISPROPORTIONATE EARTHQUAKE DAMAGE SHALL BE SUBJECT TO THE REQUIREMENTS FOR BUILDINGS WITH SUBSTANTIAL STRUCTURAL DAMAGE TO VERTICAL ELEMENTS OF THE LATERAL FORCE SYSTEM

405.2.3 A BUILDING THAT HAS SUSTAINED SUBSTANTIAL STRUCTURAL DAMAGE TO THE VERTICAL ELEMENTS OF ITS LATERAL FORCE-RESISTING SYSTEM SHALL BE EVALUATED IN ACCORDANCE WITH SECTION 405.2.3.1, AND EITHER REPAIRED IN ACCORDANCE WITH SECTION 405.2.3.2 OR REPAIRED AND

RETROFITTED IN ACCORDANCE WITH SECTION 405.2.3.3, DEPENDING ON THE RESULTS OF THE EVALUATION.

1. BUILDINGS ASSIGNED TO SEISMIC DESIGN CATEGORY A, B OR C WHOSE SUBSTANTIAL STRUCTURAL DAMAGE WAS NOT CAUSED BY EARTHQUAKE NEED NOT BE EVALUATED OR RETROFITTED FOR LOAD COMBINATIONS THAT INCLUDE EARTHQUAKE EFFECTS

2. ONE-AND TWO-FAMILY DWELLINGS NEED NOT BE EVALUATED OR RETROFITTED FOR LOAD COMBINATIONS THAT INCLUDE EARTHQUAKE EFFECTS

405.2.3.1 THE BUILDING SHALL BE EVALUATED BY A REGISTERED DESIGN PROFESSIONAL, AND THE EVALUTION FINDINGS SHALL BE SUBMITTED TO THE BUILDING OFFICIAL. THE EVALUATION SHALL ESTABLISH WHETHER THE DAMAGED BUILDING, IF REPAIRED TO ITS PREDAMAGED STATE, WOULD COMPLY WITH THE PROVISIONS OF THE BUILDING CODE OF NEW YORK STATE FOR LOAD COMBINATIONS THAT INCLUDE WIND OR EARTHQUAKE EFFECTS, EXCEPT THAT THE SEISMIC FORCES SHALL BE THE REDUCED SEISMIC FORCES.

405.2.3.2 IF THE EVALUATION ESTABLISHES THAT THE BUILDING IN ITS PREDAMAGED CONDITION COMPLIES WITH THE PROVISIONS OF SECTION 405.2.3.1, THEN THE DAMAGED ELEMENTS SHALL BE PERMITTED TO BE RESTORED TO THEIR PREDAMAGED CONDITION.

405.2.3.3 IF THE EVALUATION DOES NOT ESTABLISH THAT THE BUILDING IN ITS PREDAMAGED CONDITION COMPLIES WITH THE PROVISIONS OF SECTION 405.2.3.1, THEN THE BUILDING SHALL BE RETROFITTED TO COMPLY WITH THE PROVISIONS OF THIS SECTION. THE WIND LOADS FOR THE REPAIR AND RETROFIT SHALL BE THOSE REQUIRED BY THE BUILDING CODE IN EFFECT AT THE TIME OF ORIGINAL CONSTRUCTION, UNLESS THE DAMAGE WAS CAUSED BY WIND, IN WHICH CASE THE WIND LOADS SHALL BE IN ACCORDANCE WITH THE BUILDING CODE OF NEW YORK STATE. THE SEISMIC LOADS FOR THIS RETORFIT DESIGN SHALL BE THOSE REQUIRED BY THE BUILDING CODE IN EFFECT AT THE TIME OF THE ORIGINAL CONSTRUCTION, BUT NOT LESS THAN THE REDUCED SEISMIC FORCES.

405.2.4 GRAVITY LOAD-CARRYING COMPONENTS THAT HAVE SUSTAINED SUBSTANTIAL STRUCTURAL DAMAGE SHALL BE REHABILITATED TO COMPLY WITH THE APPLICABLE PROVISIONS FOR DEAD AND LIVE LOADS IN THE BUILDING CODE OF NEW YORK STATE. SNOW LOADS SHALL BE CONSIDERED IF THE SUBSTANTIAL STRUCTURAL DAMAGE WAS CAUSED BY OR RELATED TO SNOW LOAD EFFECTS. UNDAMAGED GRAVITY LOAD-CARRYING COMPONENTS SHALL ALSO BE REHABILITATED IF REQUIRED TO COMPLY WITH THE DESIGN LOADS OF THE REHABILITATION DESIGN.

405.2.4.1 REGARDLESS OF THE LEVEL OF DAMAGE TO VERTICAL ELEMENTS OF THE LATERAL FORCE-RESISTING SYSTEM, IF SUBSTANTIAL STRUCTURAL DAMAGE TO GRAVITY LOAD-CARRYING COMPONENTS WAS CAUSED PRIMARILY BY WIND OR SEISMIC EFFECTS, THEN THE BUILDING SHALL BE EVALUATED IN ACCORDANCE WITH SECTION 405.2.3.1 AND, IF NONCOMPLIANT, RETROFITTED IN ACCORDANCE WITH SECTION 405.2.3.3.

EXCEPTIONS:

BUILDING ASSIGNED TO SEISMIC DESIGN CATEGORY A, B OR C WHOSE SUBSTANTIAL STRUCTURAL DAMAGE WAS NOT CAUSED BY EARTHQUAKE NEED NOT BE EVALUATED OR RETROFITTED FOR LOAD COMBINATIONS THAT INCLUDE EARTHQUAKE EFFECTS

ONE-AND TWO-FAMILY DWELLINGS NEED NOT BE EVALUATED OR RETROFITTED FOR LOAD COMBINATIONS THAT INCLUDE EARTHQUAKE EFFECTS

405.2.5 IN FLOOD HAZARD AREAS, BUILDINGS THAT HAVE SUSTAINED SUBSTANTIAL DAMAGE SHALL BE BROUGHT INTO COMPLIANCE WITH SECTION 1612 OF THE BUILDING CODE OF NEW YORK STATE, OR SECTION R322 OF THE RESIDENTIAL CODE OF NEW YORK STATE, AS APPLICABLE.

406 ELECTRICAL

406.1 EXISTING ELECTRICAL WIRING AND EQUIPMENT UNDERGOING REPAIR SHALL BE ALLOWED TO BE REPAIRED OR REPLACED WITH LIKE MATERIAL

406.1.1 REPLACEMENT OF ELECTRICAL RECEPTACLES SHALL COMPLY WITH THE APPLICABLE REQUIREMENTS OF SECTION 406.4(D) OF NFPA 70

406.1.2 PLUG FUSES OF THE EDISON-BASE TYPE SHALL BE USED FOR REPLACEMENTS ONLY WHERE THERE IS NO EVIDENCE OF OVER FUSING OR TAMPERING PER APPLICABLE REQUIREMENTS OF SECTION 240.51(B) OF NFPA 70.

406.1.3 FOR REPLACEMENT OF NONGROUNDING-TYPE RECEPTACLES WITH GROUNDING-TYPE RECEPTACLES AND FOR BRANCH CIRCUITS THAT DO NOT HAVE AN EQUIPMENT GROUNDING CONDUCTOR IN THE BRANCH CIRCUITRY, THE GROUNDING CONDUCTOR OF A GROUNDING-TYPE RECEPTACLE OUTLET SHALL BE PERMITTED TO BE GROUNDED TO ANY ACCESSIBLE POINT ON THE GROUNDING ELECTRODE SYSTEM OR TO ANY ACCESSIBLE POINT ON THE GROUNDING ELECTRODE CONDUCTOR IN ACCORDANCE WITH SECTION 250.130(C) OF NFPA 70.

406.1.4 GROUP I-2 RECEPTACLES - N/A

406.1.5 GROUNDING OF APPLIANCES - N/A

407.1 EXISTING MECHANICAL SYSTEMS UNDERGOING REPAIR SHALL NOT MAKE THE BUILDING LESS COMPLYING THAN IT WAS BEFORE THE DAMAGE

407.2 MECHANICAL DRAFT SYSTEMS FOR MANUALLY FIRED APPLIANCES AND FIREPLACES - N/A


408 PLUMBING

408.1 PLUMBING MATERIALS AND SUPPLIES SHALL NOT BE USED FOR REPAIRS THAT ARE PROHIBITED IN THE PLUMBING CODE OF NEW YORK STATE


408.2 WHEN ANY WATER CLOSET IS REPLACED, THE REPLACEMENT WATER CLOSET SHALL COMPLY WITH SECTION 604.4 OF THE PLUMBING CODE OF NEW

EXCEPTION: BLOWOUT-DESIGN WATER CLOSETS [3.5 GALLONS (1.3 L) PER FLUSHING CYCLE]



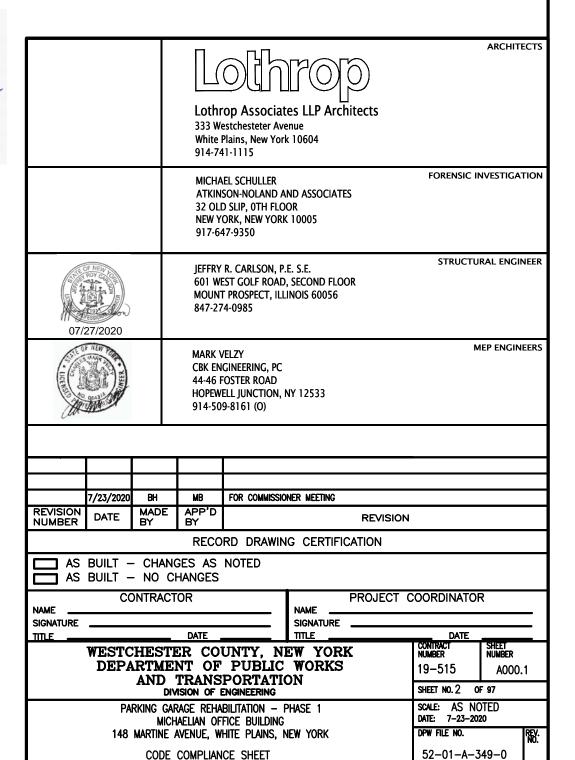

NOTE: THIS DRAWING SHOULD BE PRINTED IN COLOR FOR MAXIMUM READABILITY

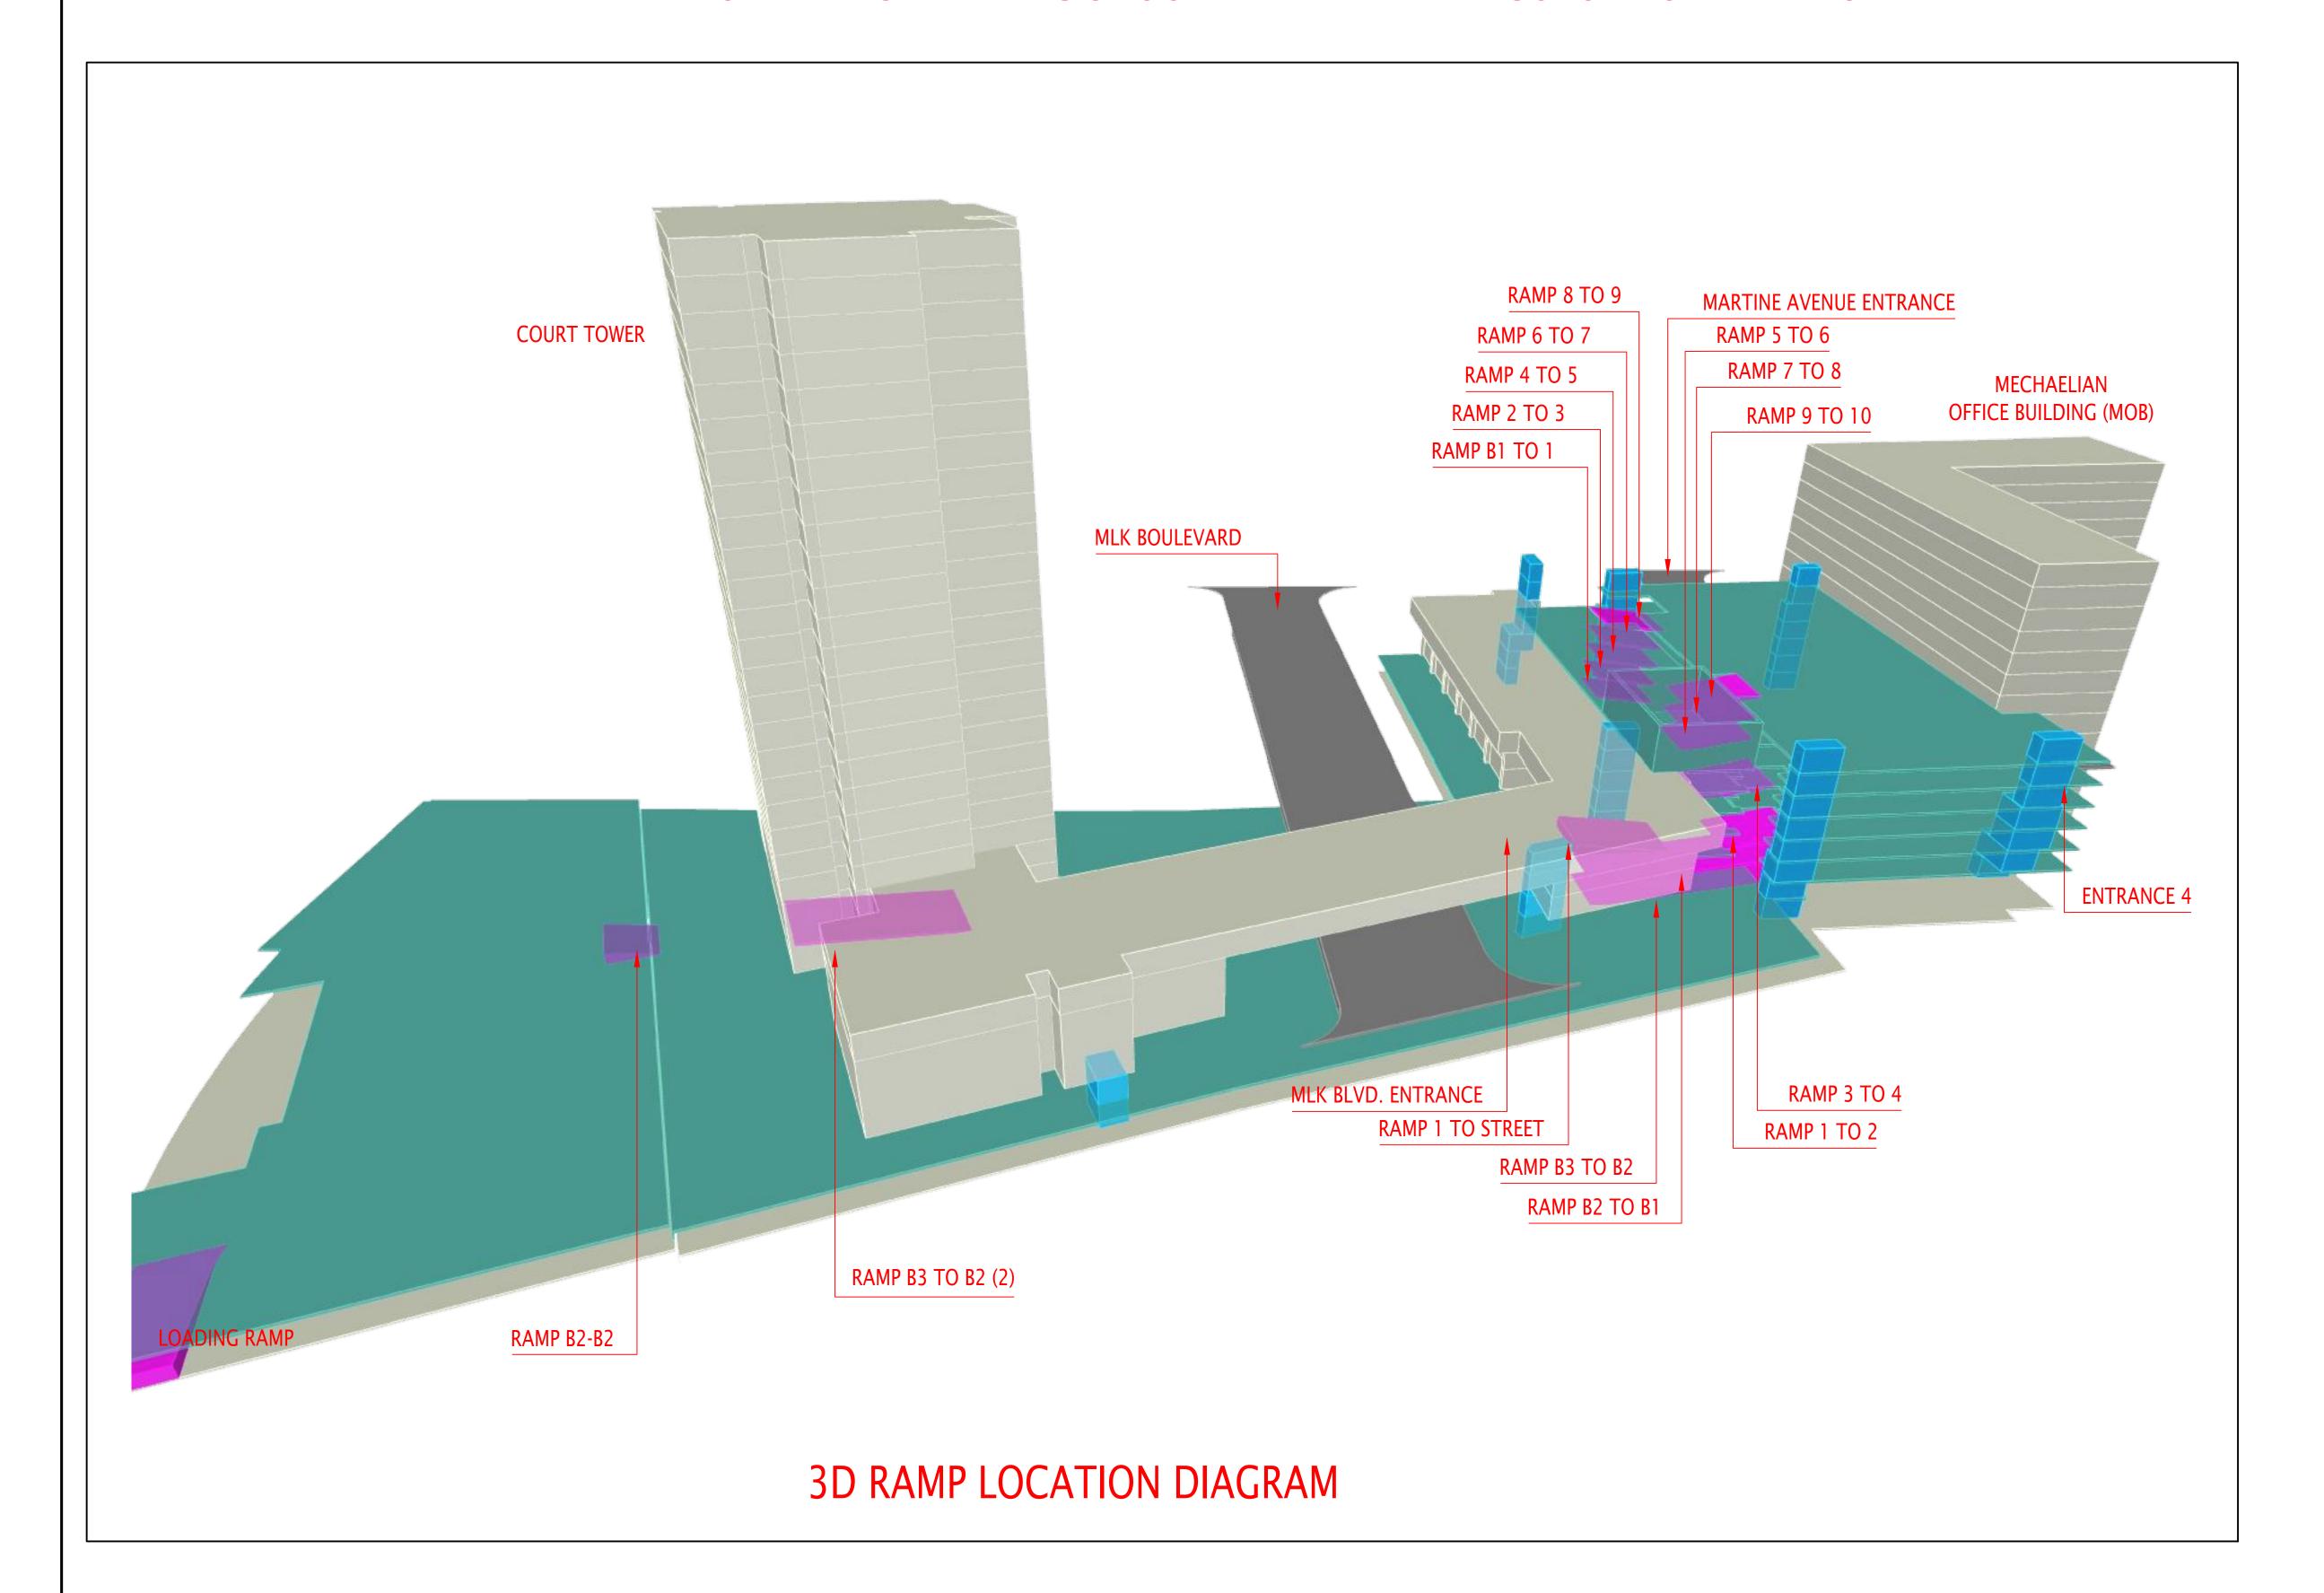


| | l |
|---|---------------------|
| DESCRIPTION OF WORK | DURATION |
| RAMP FROM MARTIN LUTHER BLVD. TO LEVEL 1 TO LEVEL 2 | 75 DAYS TO COMPLETE |
| NOTE: | |
| CONTRACTOR TO BE RESPONSIBLE TO PROVIDE SECURITY SERVICES AT WARTINE AVENUE ENTRANCE DURING REPAIRS TO RAMP AT MARTIN | |
| LUTHER BLVD. TO LEVEL 2 UNTIL COMPLETED. REFER TO SECTIONS | |
| 015000 OF THE SPECIFICATION MANUAL FOR ADDITIONAL INFORMATION. | |
| RAMP FROM LEVEL B2 TO LEVEL B1 | 60 DAYS TO COMPLETE |
| | |
| RAMP FROM LEVEL 8 TO LEVEL 9 | 45 DAYS TO COMPLETE |
| RAMP FROM LEVEL 9 TO LEVEL 10 | 45 DAYS TO COMPLETE |
| LEVEL 9 (INCLUDING ALL REPAIRS, WATERPROOFING, STRIPING AND | 45 DAYS TO COMPLETE |
| LEVEL 8 TO LEVEL 9 RAMP) | |
| LEVEL 10 (INCLUDING ALL REPAIRS, WATERPROOFING, STRIPING AND | 60 DAYS TO COMPLETE |
| LEVEL 9 TO LEVEL 10 RAMP) | |
| | |
| NOTE: | |
| THE FOLLOWING WORK CAN BE DONE CONCURRENT WITH OTHER | |
| WORK: | |
| RAMP LEVEL B1 TO LEVEL 1 — MAY BE REPLACED AT THE SAME TIME | 45 DAYS TO COMPLETE |
| THE RAMP FROM MARTIN LUTHER BLVD. TO LEVEL 1 TO LEVEL 2 IS BEING REPLACED | |
| SEINO NEI BIOLD | |
| LEVEL B3 — ALL WORK AS SHOWN AROUND COLUMN LINE E-11 | 50 DAYS TO COMPLETE |
| (INCLUDING EXPANSION JOINT REPLACEMENT, CONCRETE SLAB REPAIR, | |
| STRIPING, LOBBY REPAIRS AND WATERPROOFING SEALER) | |
| LEVEL B2 - ALL WORK AS SHOWN AROUND COLUMN LINE E-11 | 50 DAYS TO COMPLETE |
| (INCLUDING EXPANSION JOINT REPLACEMENT, CONCRETE SLAB REPAIR, | |
| STRIPING, LOBBY REPAIRS AND WATERPROOFING SEALER) | |
| PLAZA AT COURTHOUSE - REPLACE EXPANSION JOINT, REMOVE AND | 30 DAYS TO COMPLETE |
| REPLACE CONCRETE SIDEWALK (MATCH EXISTING PATTERN) | ······ 2 |
| | |
| ALTERNATE NO. 1 - REPLACE EXISTING EXPANSION JOINT AS SHOWN | 85 DAYS TO COMPLETE |
| ON PLANS, INSTALL ALL DRAINAGE, REMOVE AND REPLACE CONCRETE SIDEWALK (MATCH EXISTING PATTERN) | |
| SIDEM EN (MINIOT ENGINE PATIENT) | |
| ALTERNATE NO. 2 - LEVEL 8 COLUMN REPAIRS (STRUCTURAL AND | 60 DAYS TO COMPLETE |
| MISCELLANEOUS REPAIRS) | |





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| | | | ATKIN 32 OLI NEW Y | AEL SCHULLER SON-NOLAND A D SLIP, 0TH FLO ORK, NEW YORI 47-9350 | | FORENSIC INVESTIGATION |
| | | | 601 WI | R. CARLSON, P EST GOLF ROAD T PROSPECT, ILL 74-0985 | , SECOND FLOOR | STRUCTURAL ENGINE |
| | | | 44-46 F HOPEW | /ELZY IGINEERING, PC FOSTER ROAD ELL JUNCTION, 9-8161 (O) | NY 12533 | MEP ENGINEE |
| | 7/31/2020 | ВН | МВ | RELEASE FOR I | BID | |
| | 7/23/2020 | ВН | МВ | FOR COMMISSION | ONER MEETING | |
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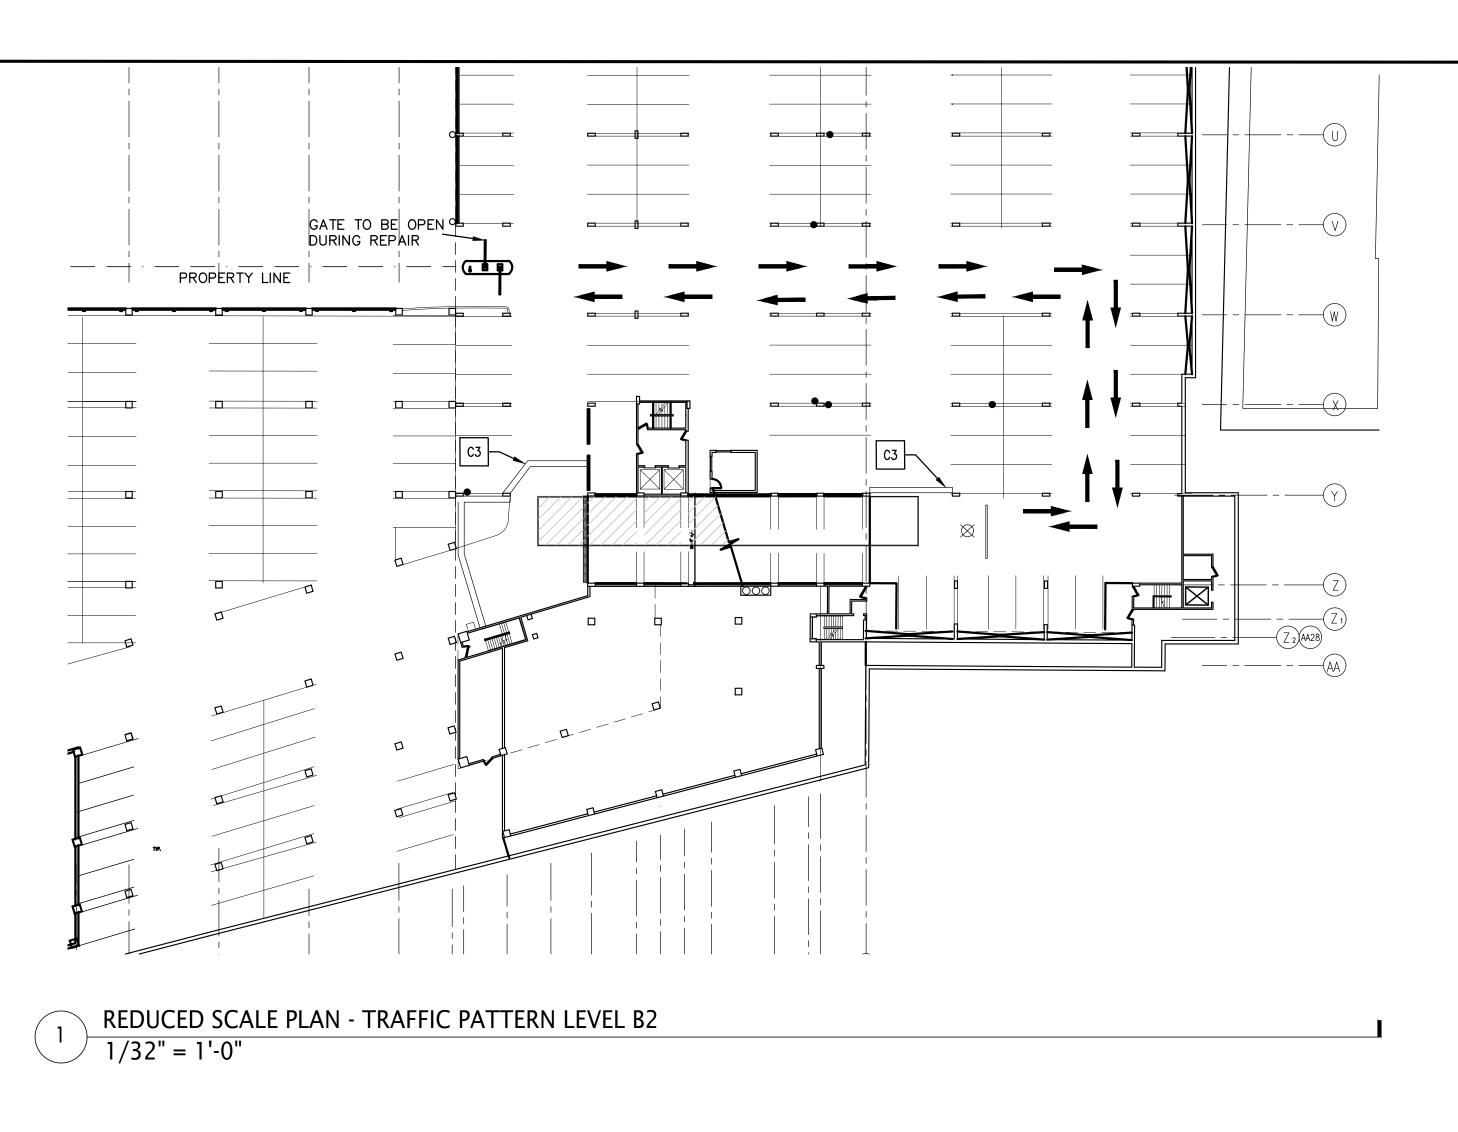
MICHAELIAN OFFICE BUILDING 148 MARTINE AVENUE, WHITE PLAINS, NEW YORK SHEET NO. 3 OF 97

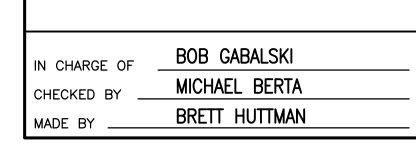


NOTE: THIS DRAWING SHOULD BE PRINTED IN COLOR FOR MAXIMUM READABILITY




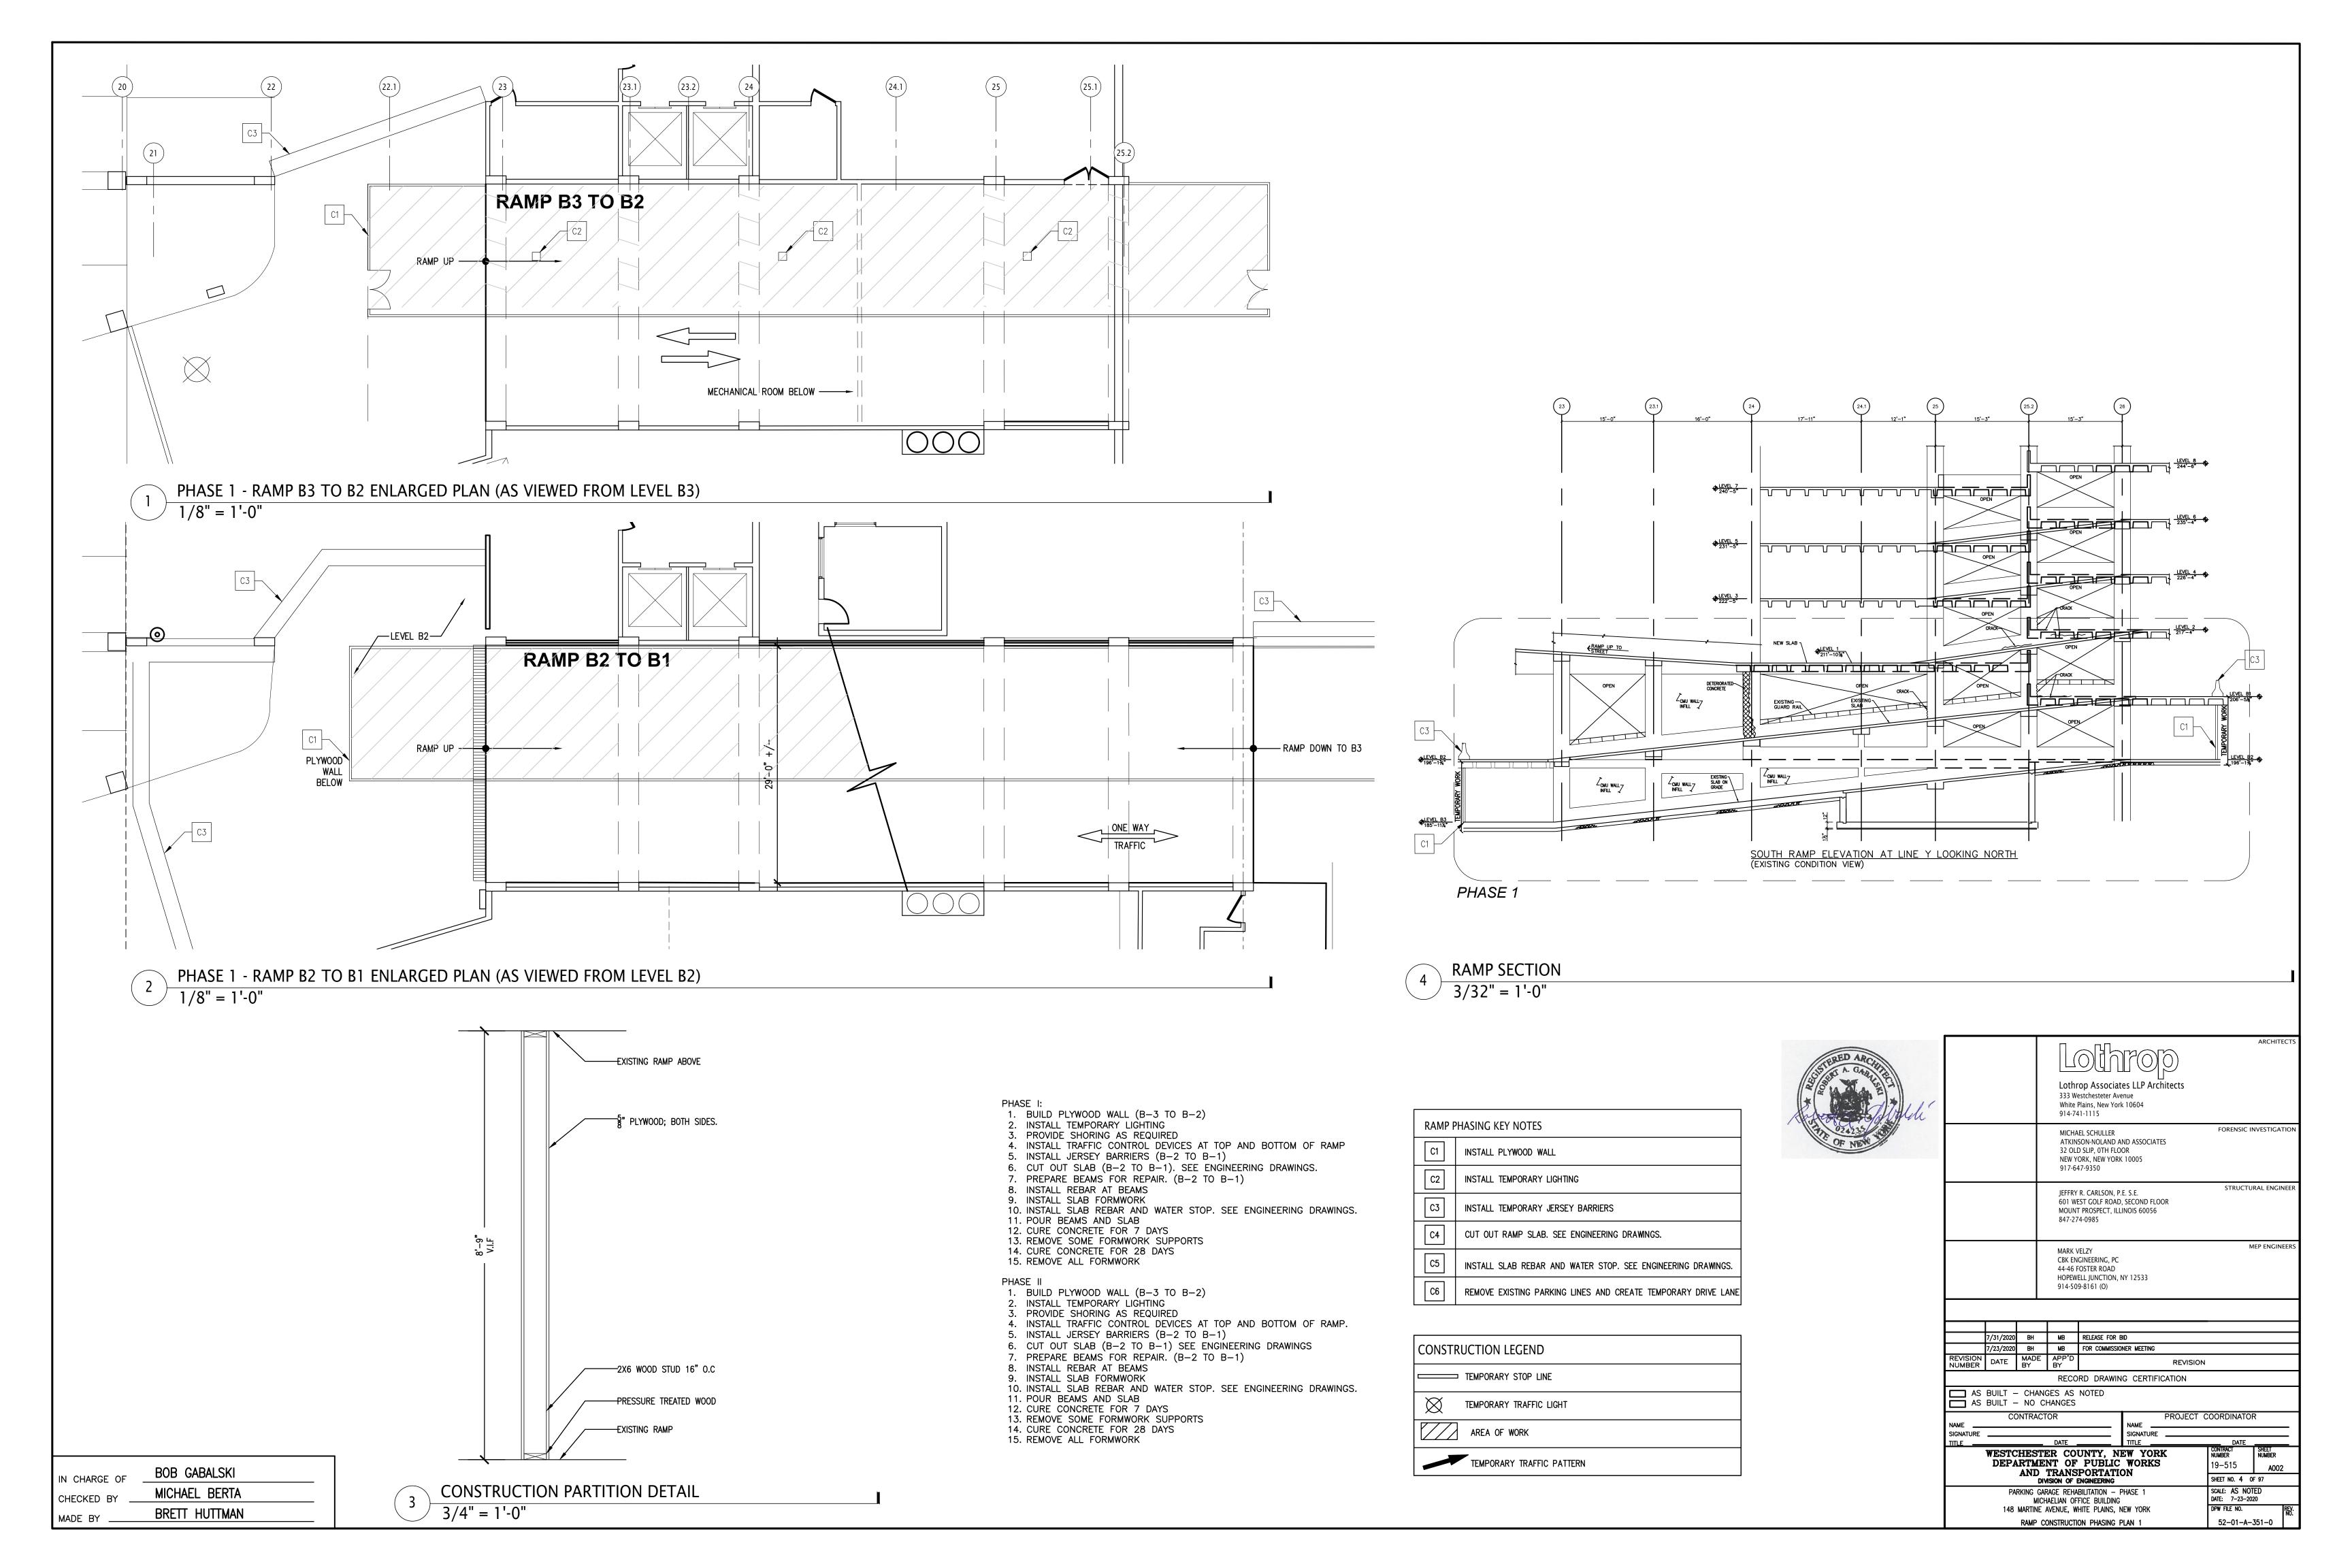

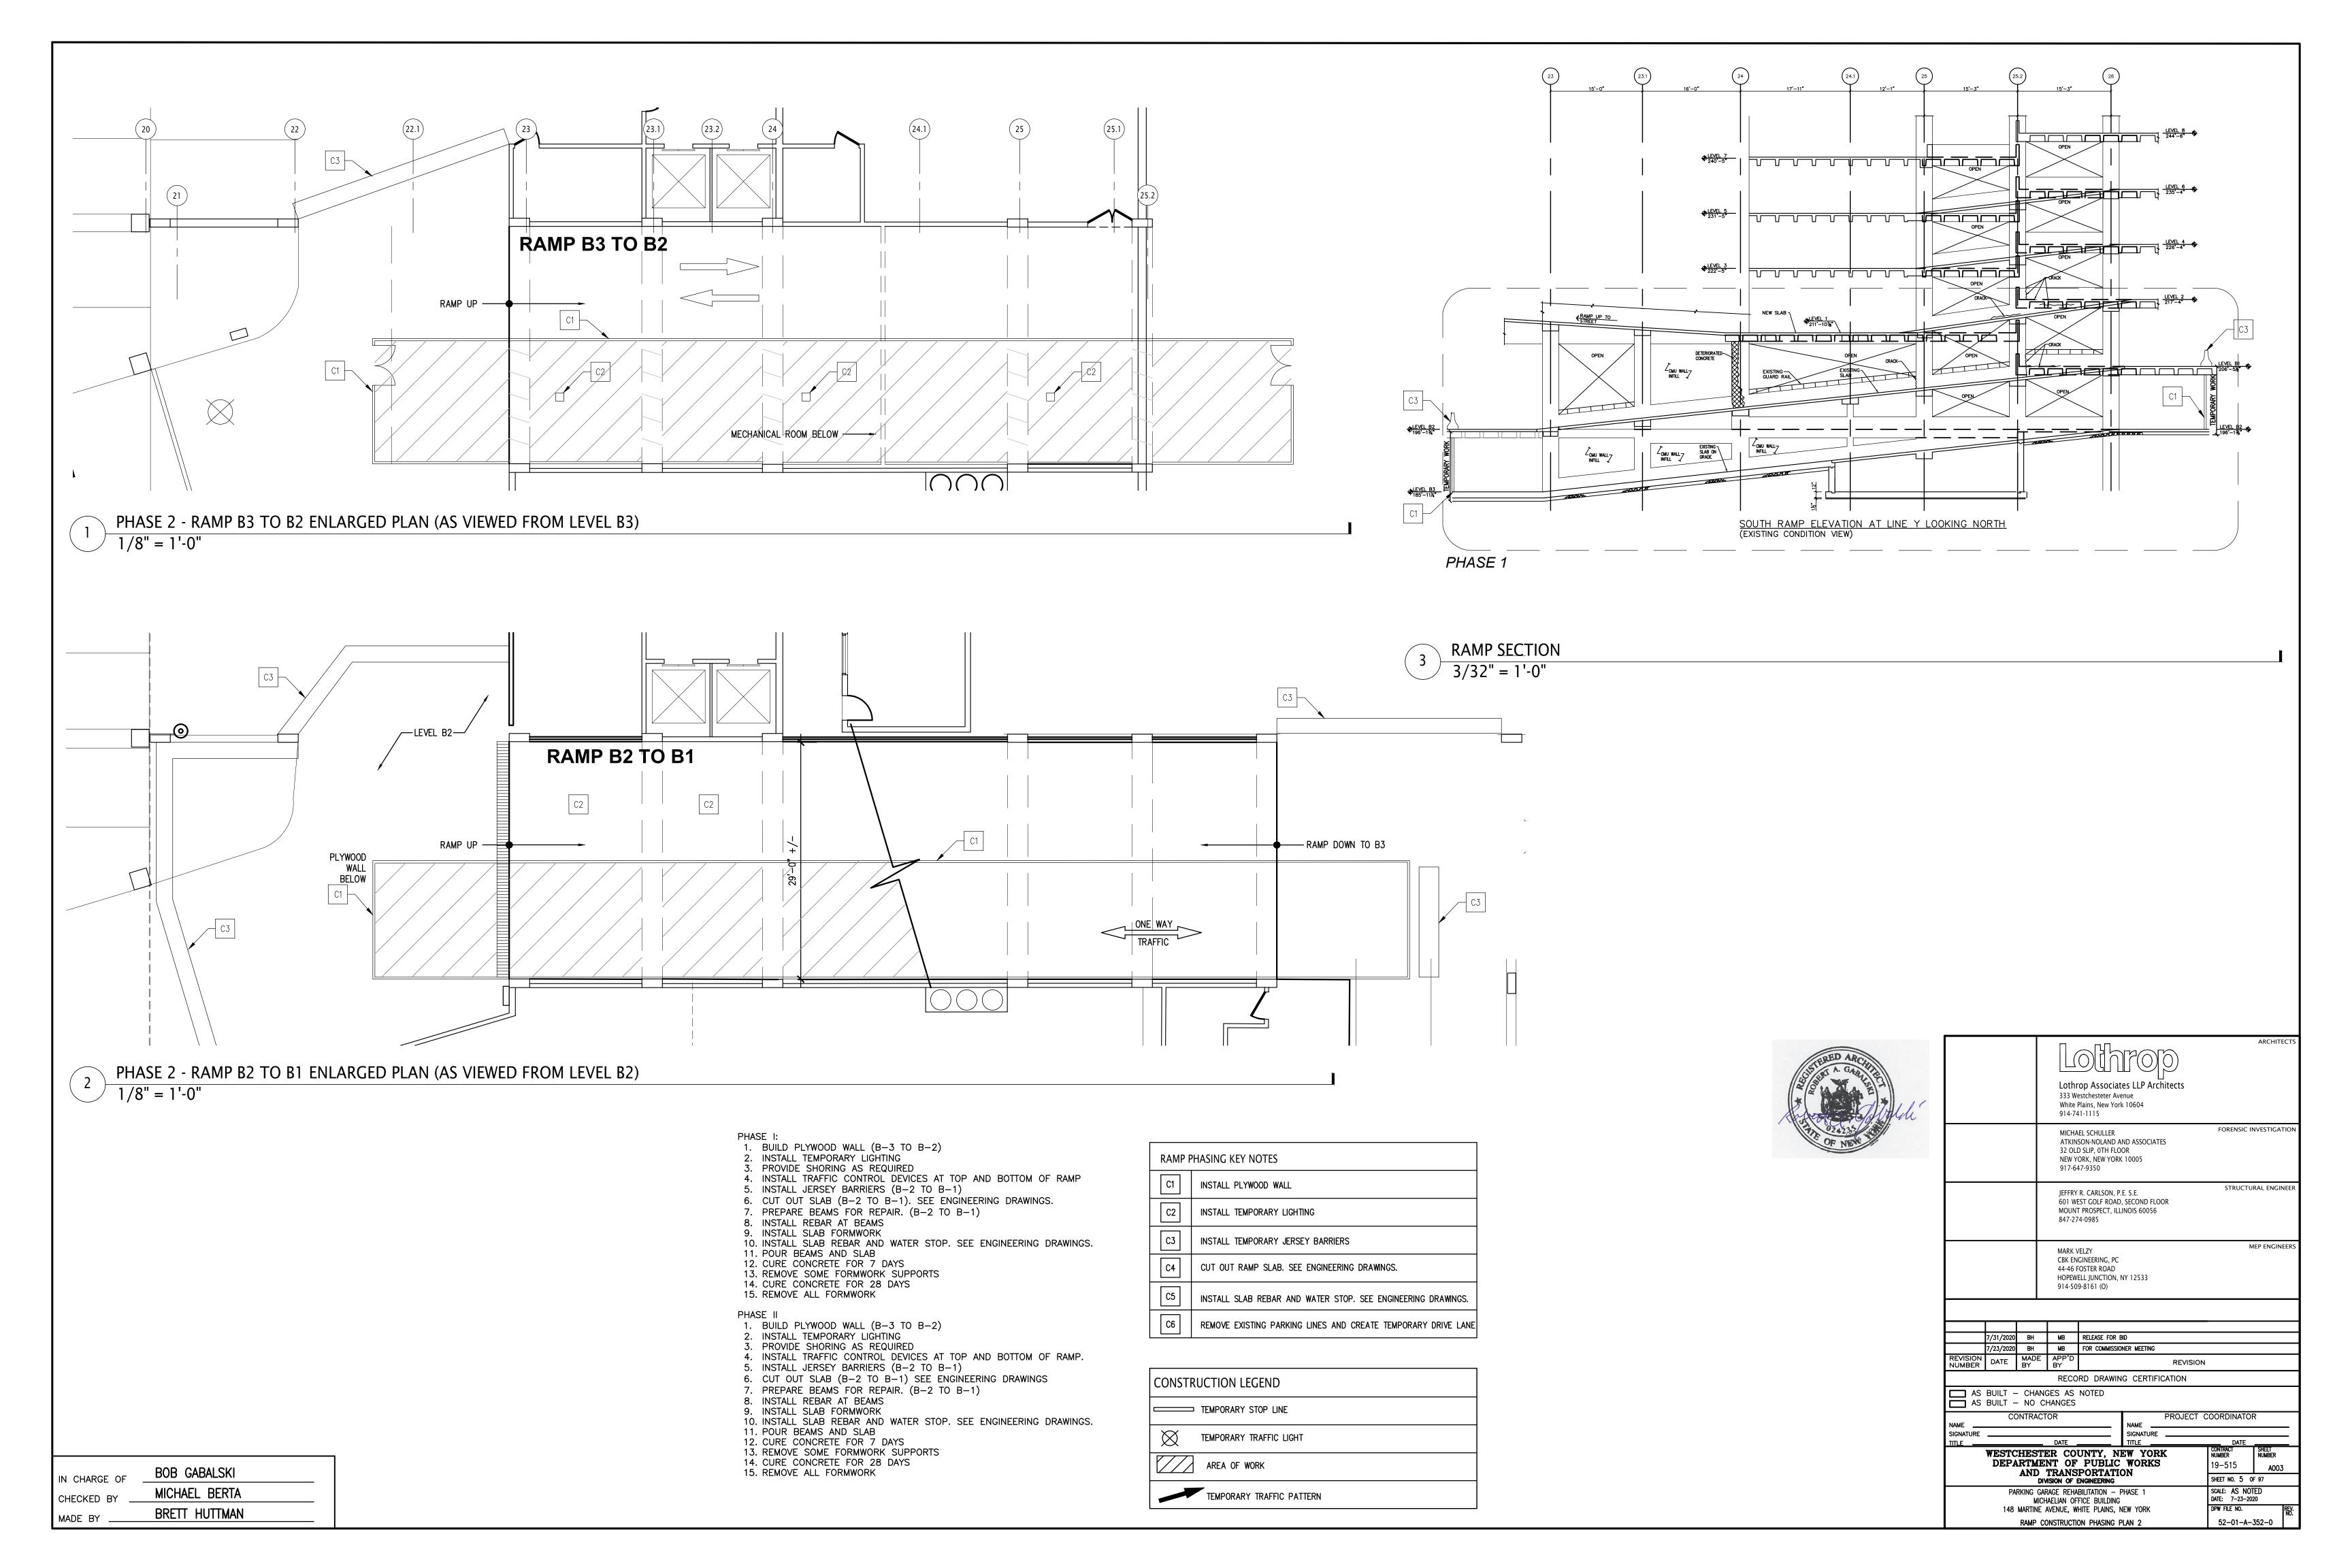

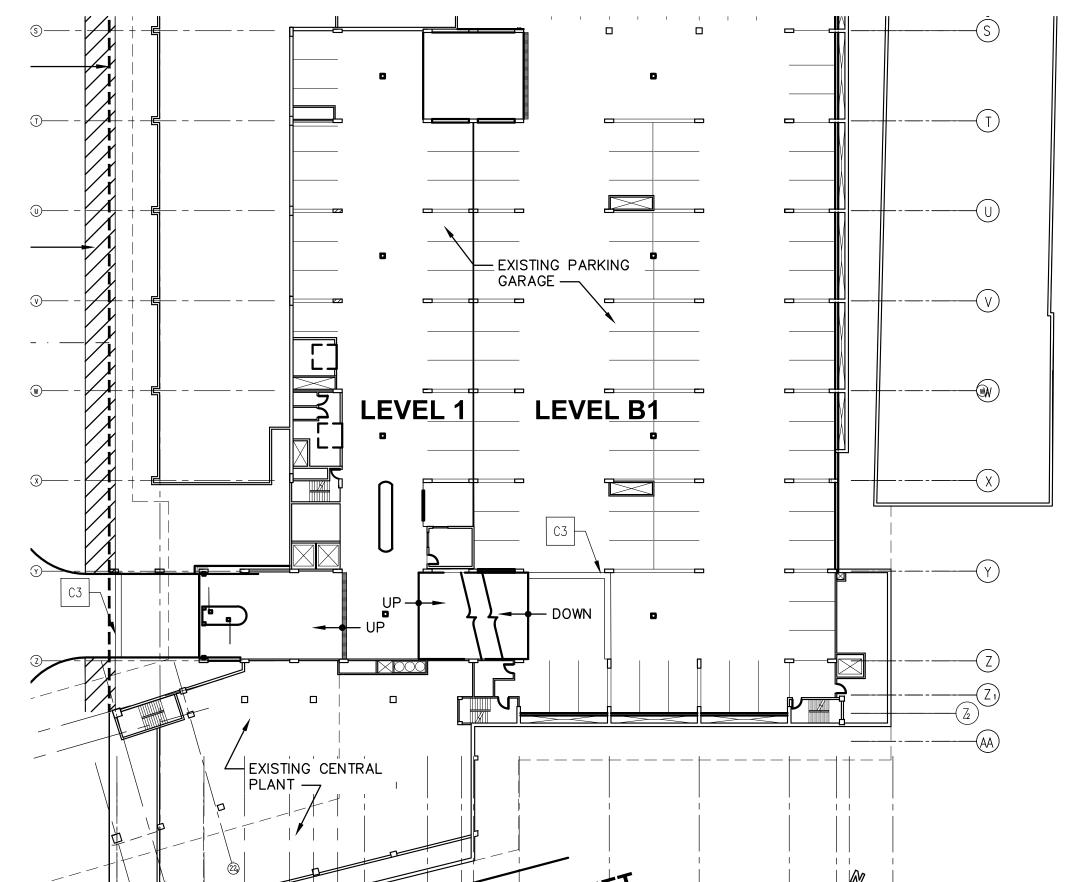

REDUCED SCALE PLAN - TRAFFIC PATTERN LEVEL B1

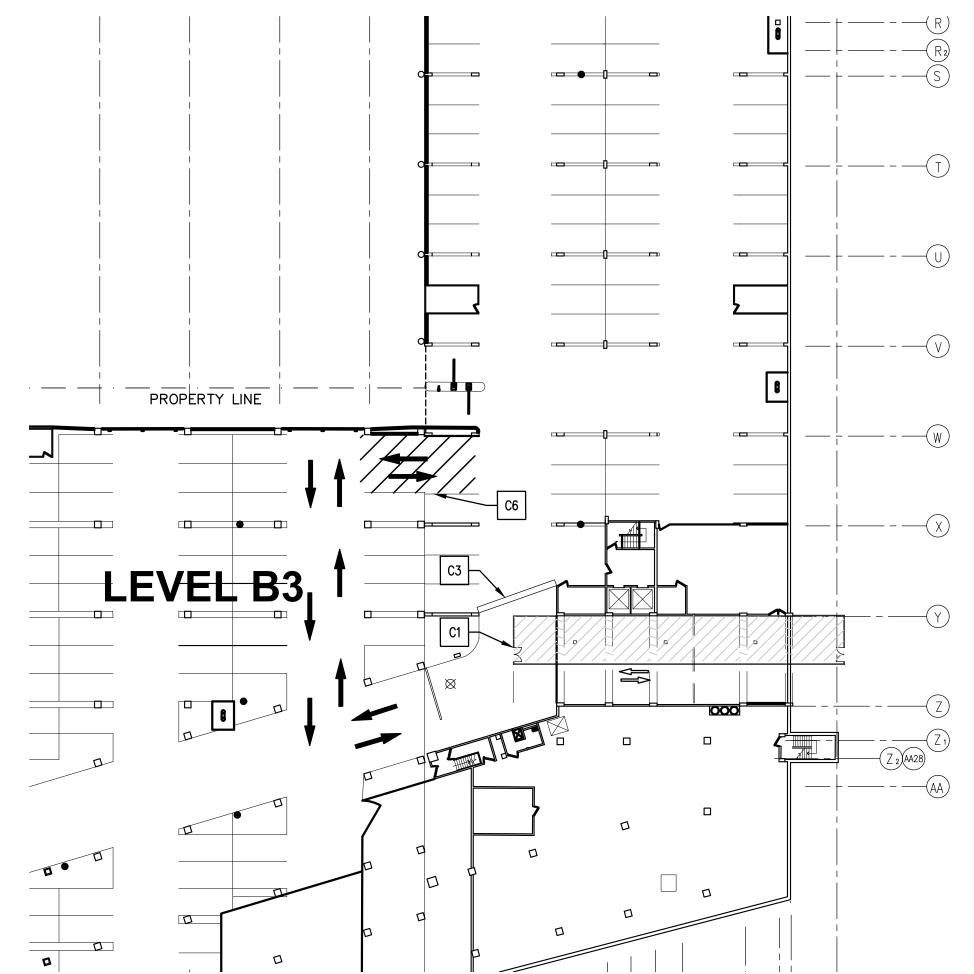

REDUCED SCALE PLAN - TRAFFIC PATTERN LEVEL B3

BOB GABALSKI

MICHAEL BERTA

BRETT HUTTMAN

IN CHARGE OF

CHECKED BY

MADE BY

1. BUILD PLYWOOD WALL (B-3 TO B-2)
2. INSTALL TEMPORARY LIGHTING
3. PROVIDE SHORING AS REQUIRED
4. INSTALL TRAFFIC CONTROL DEVICES AT TOP AND BOTTOM OF RAMP 5. INSTALL JERSEY BARRIERS (B-2 TO B-1)

6. CUT OUT SLAB (B-2 TO B-1). SEE ENGINEERING DRAWINGS. 7. PREPARE BEAMS FOR REPAIR. (B-2 TO B-1)

8. INSTALL REBAR AT BEAMS

9. INSTALL SLAB FORMWORK
10. INSTALL SLAB REBAR AND WATER STOP. SEE ENGINEERING DRAWINGS.
11. POUR BEAMS AND SLAB

12. CURE CONCRETE FOR 7 DAYS

13. REMOVE SOME FORMWORK SUPPORTS
14. CURE CONCRETE FOR 28 DAYS
15. REMOVE ALL FORMWORK

1. BUILD PLYWOOD WALL (B-3 TO B-2)
2. INSTALL TEMPORARY LIGHTING
3. PROVIDE SHORING AS REQUIRED
4. INSTALL TRAFFIC CONTROL DEVICES AT TOP AND BOTTOM OF RAMP.

5. INSTALL JERSEY BARRIERS (B-2 TO B-1) 6. CUT OUT SLAB (B-2 TO B-1) SEE ENGINEERING DRAWINGS 7. PREPARE BEAMS FOR REPAIR. (B-2 TO B-1)

8. INSTALL REBAR AT BEAMS
9. INSTALL SLAB FORMWORK
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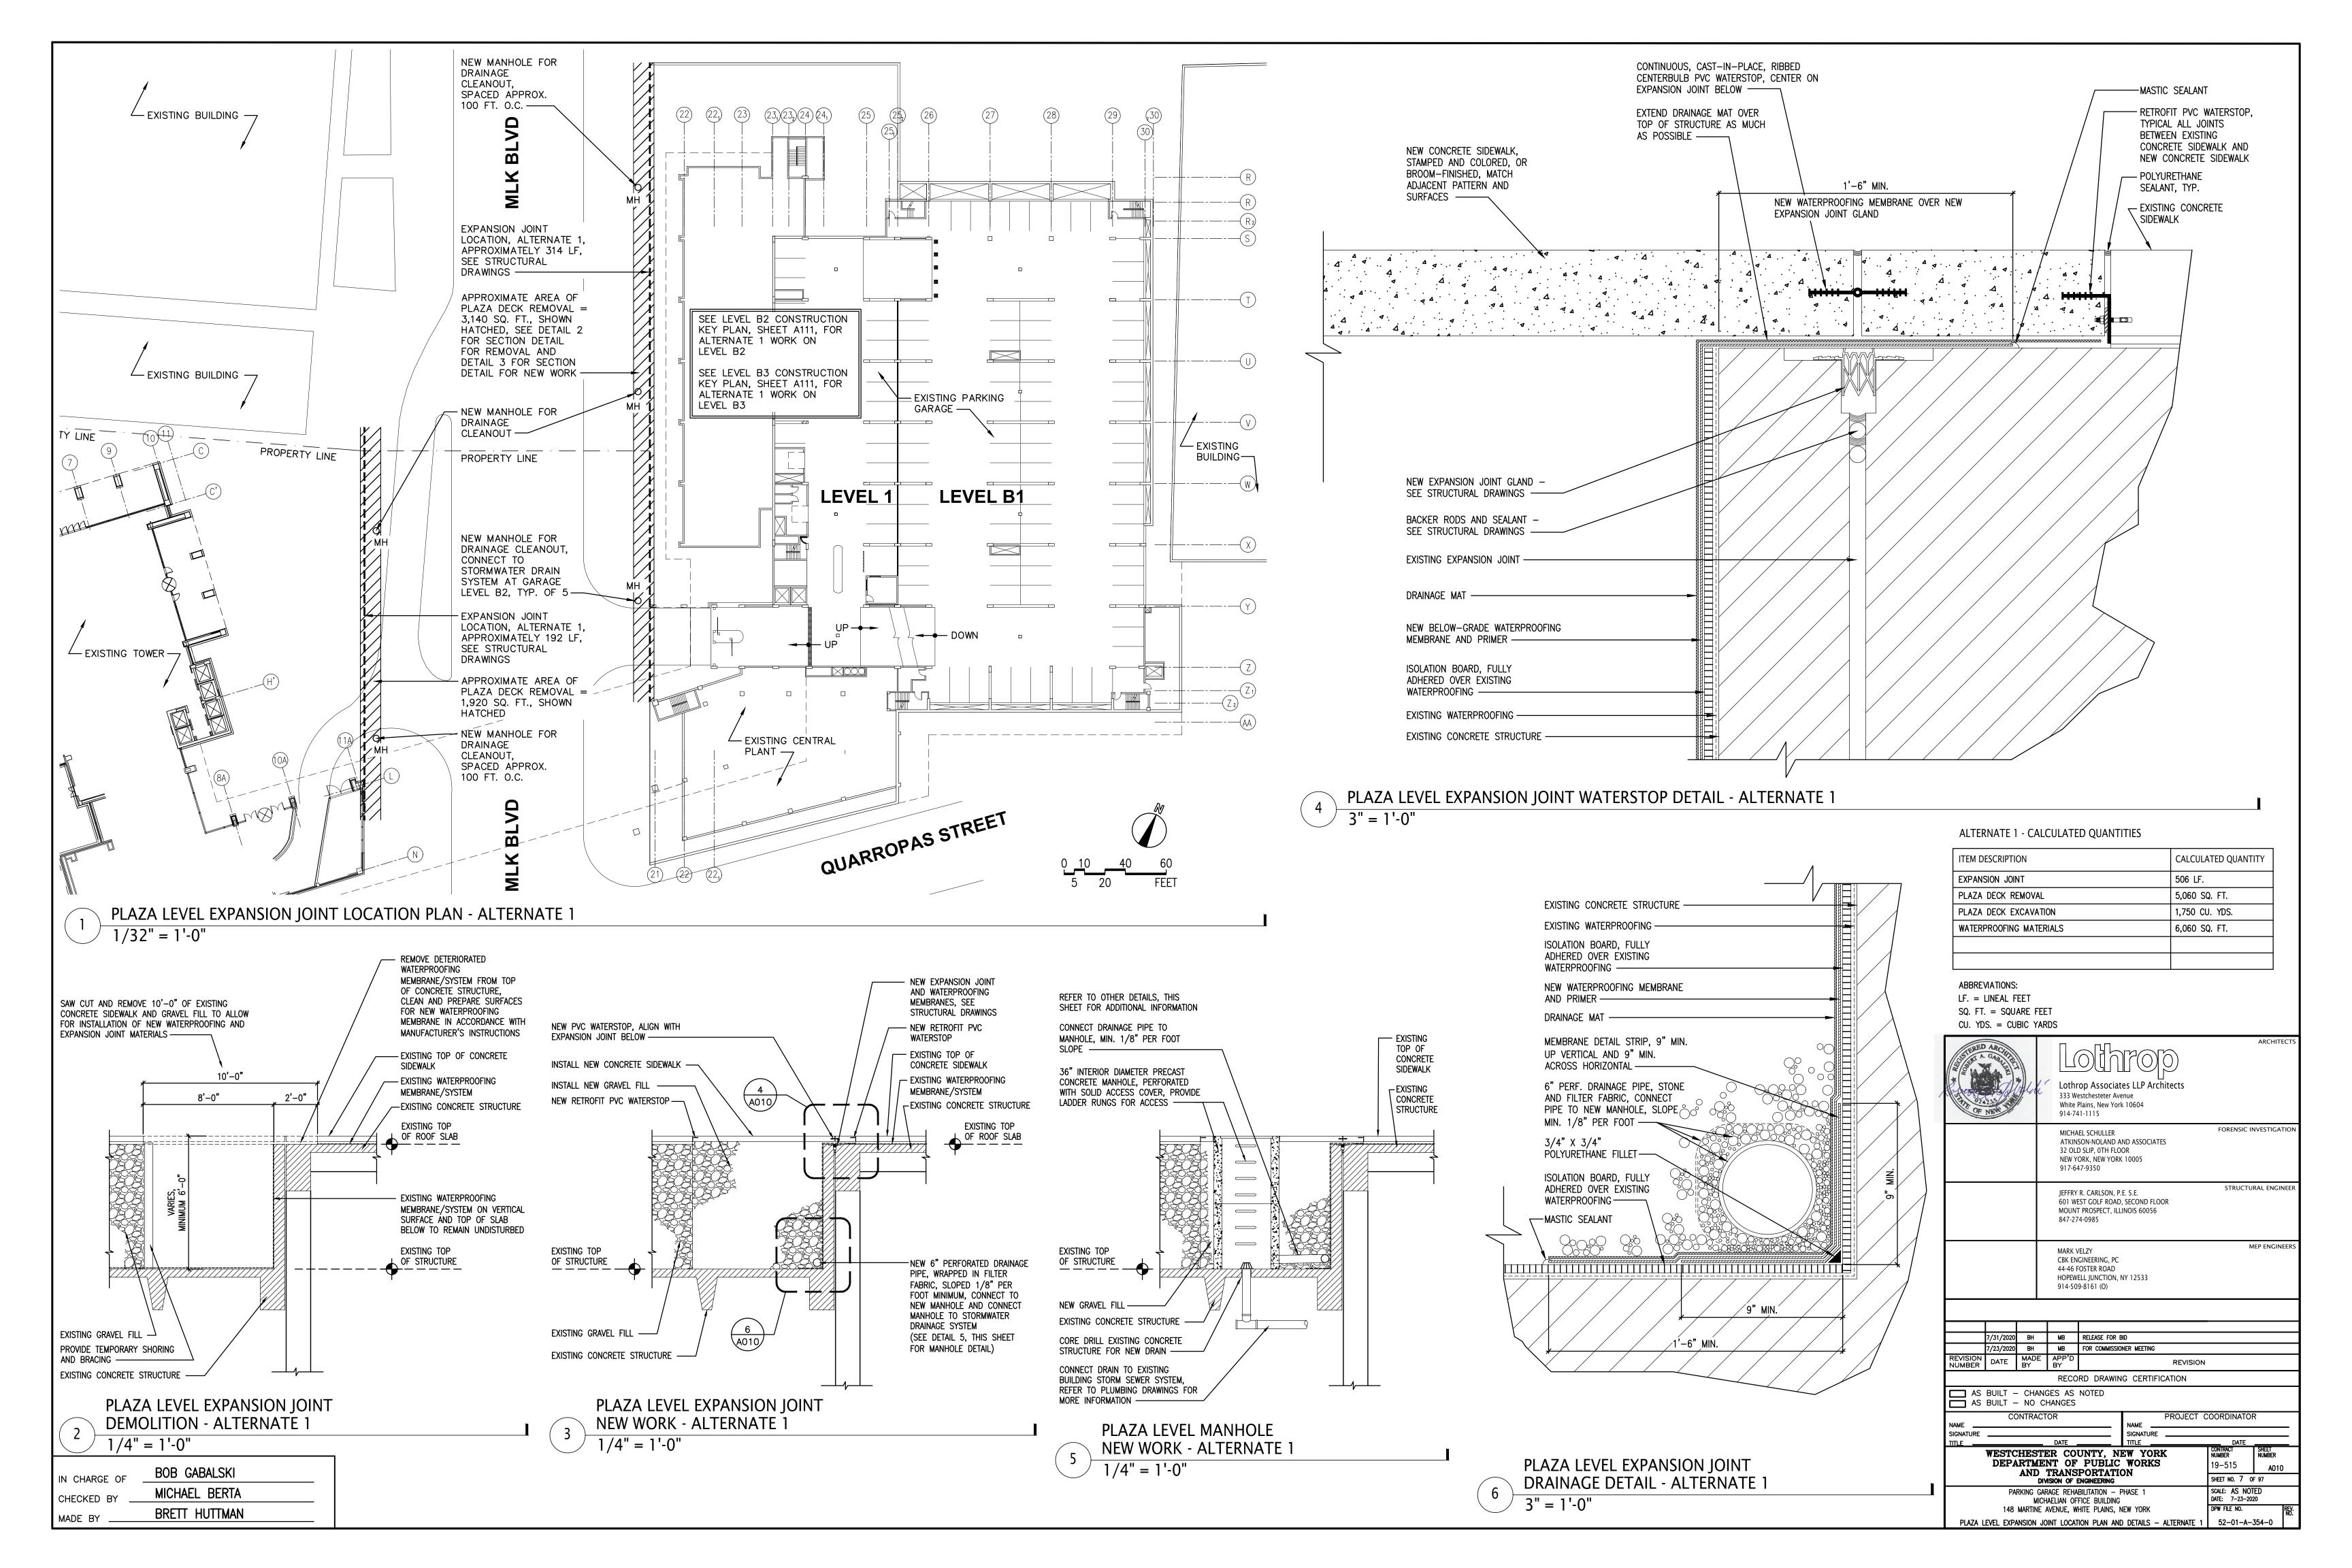
11. POUR BEAMS AND SLAB
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14. CURE CONCRETE FOR 28 DAYS
15. REMOVE ALL FORMWORK


| RAMP F | PHASING KEY NOTES |
|--------|---|
| C1 | INSTALL PLYWOOD WALL |
| C2 | INSTALL TEMPORARY LIGHTING |
| C3 | INSTALL TEMPORARY JERSEY BARRIERS |
| C4 | CUT OUT RAMP SLAB. SEE ENGINEERING DRAWINGS. |
| C5 | INSTALL SLAB REBAR AND WATER STOP. SEE ENGINEERING DRAWINGS. |
| C6 | REMOVE EXISTING PARKING LINES AND CREATE TEMPORARY DRIVE LANE |

| CONSTRUCTION LEGEND |
|---------------------------|
| TEMPORARY STOP LINE |
| TEMPORARY TRAFFIC LIGHT |
| AREA OF WORK |
| TEMPORARY TRAFFIC PATTERN |



| | | | | | 17010 |) | | ARCHIT | IEC I |
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| | | | 601 W MOUN | / R. CARLSON, P /EST GOLF ROAD T PROSPECT, ILI 74-0985 |), SECOND FLOOR | | STRUCT | URAL ENG | INEEF |
| | | | MARK Y | VELZY NGINEERING, PC | | | | MEP ENGI | NEERS |
| | | | 44-46 HOPEW | FOSTER ROAD /ELL JUNCTION, 09-8161 (O) | | | | | |
| | | | 44-46 HOPEW | FOSTER ROAD /ELL JUNCTION, | | | | | |
| | 7/31/2020 | ВН | 44-46 HOPEW | FOSTER ROAD /ELL JUNCTION, | NY 12533 | | | | |
| | 7/23/2020 | BH | 44-46 HOPEW 914-50 | FOSTER ROAD /ELL JUNCTION, 09-8161 (O) | NY 12533 BID | | | | |
| | 7/23/2020 | | 44-46 HOPEW 914-50 | FOSTER ROAD /ELL JUNCTION, 09-8161 (O) | NY 12533 BID DNER MEETING | EVISION | | | |
| | 7/23/2020 | BH MADE | 44-46 HOPEW 914-50 MB MB APP'D BY | FOSTER ROAD /ELL JUNCTION, 09-8161 (O) RELEASE FOR FOR COMMISSIO | NY 12533 BID DNER MEETING | | | | |
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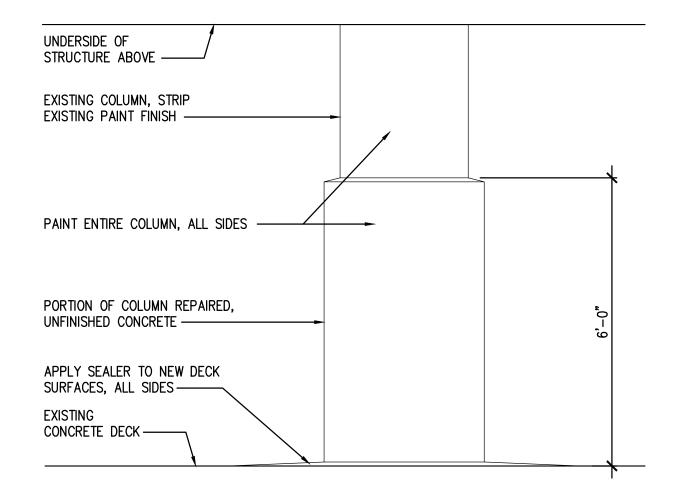


MICHAEL BERTA

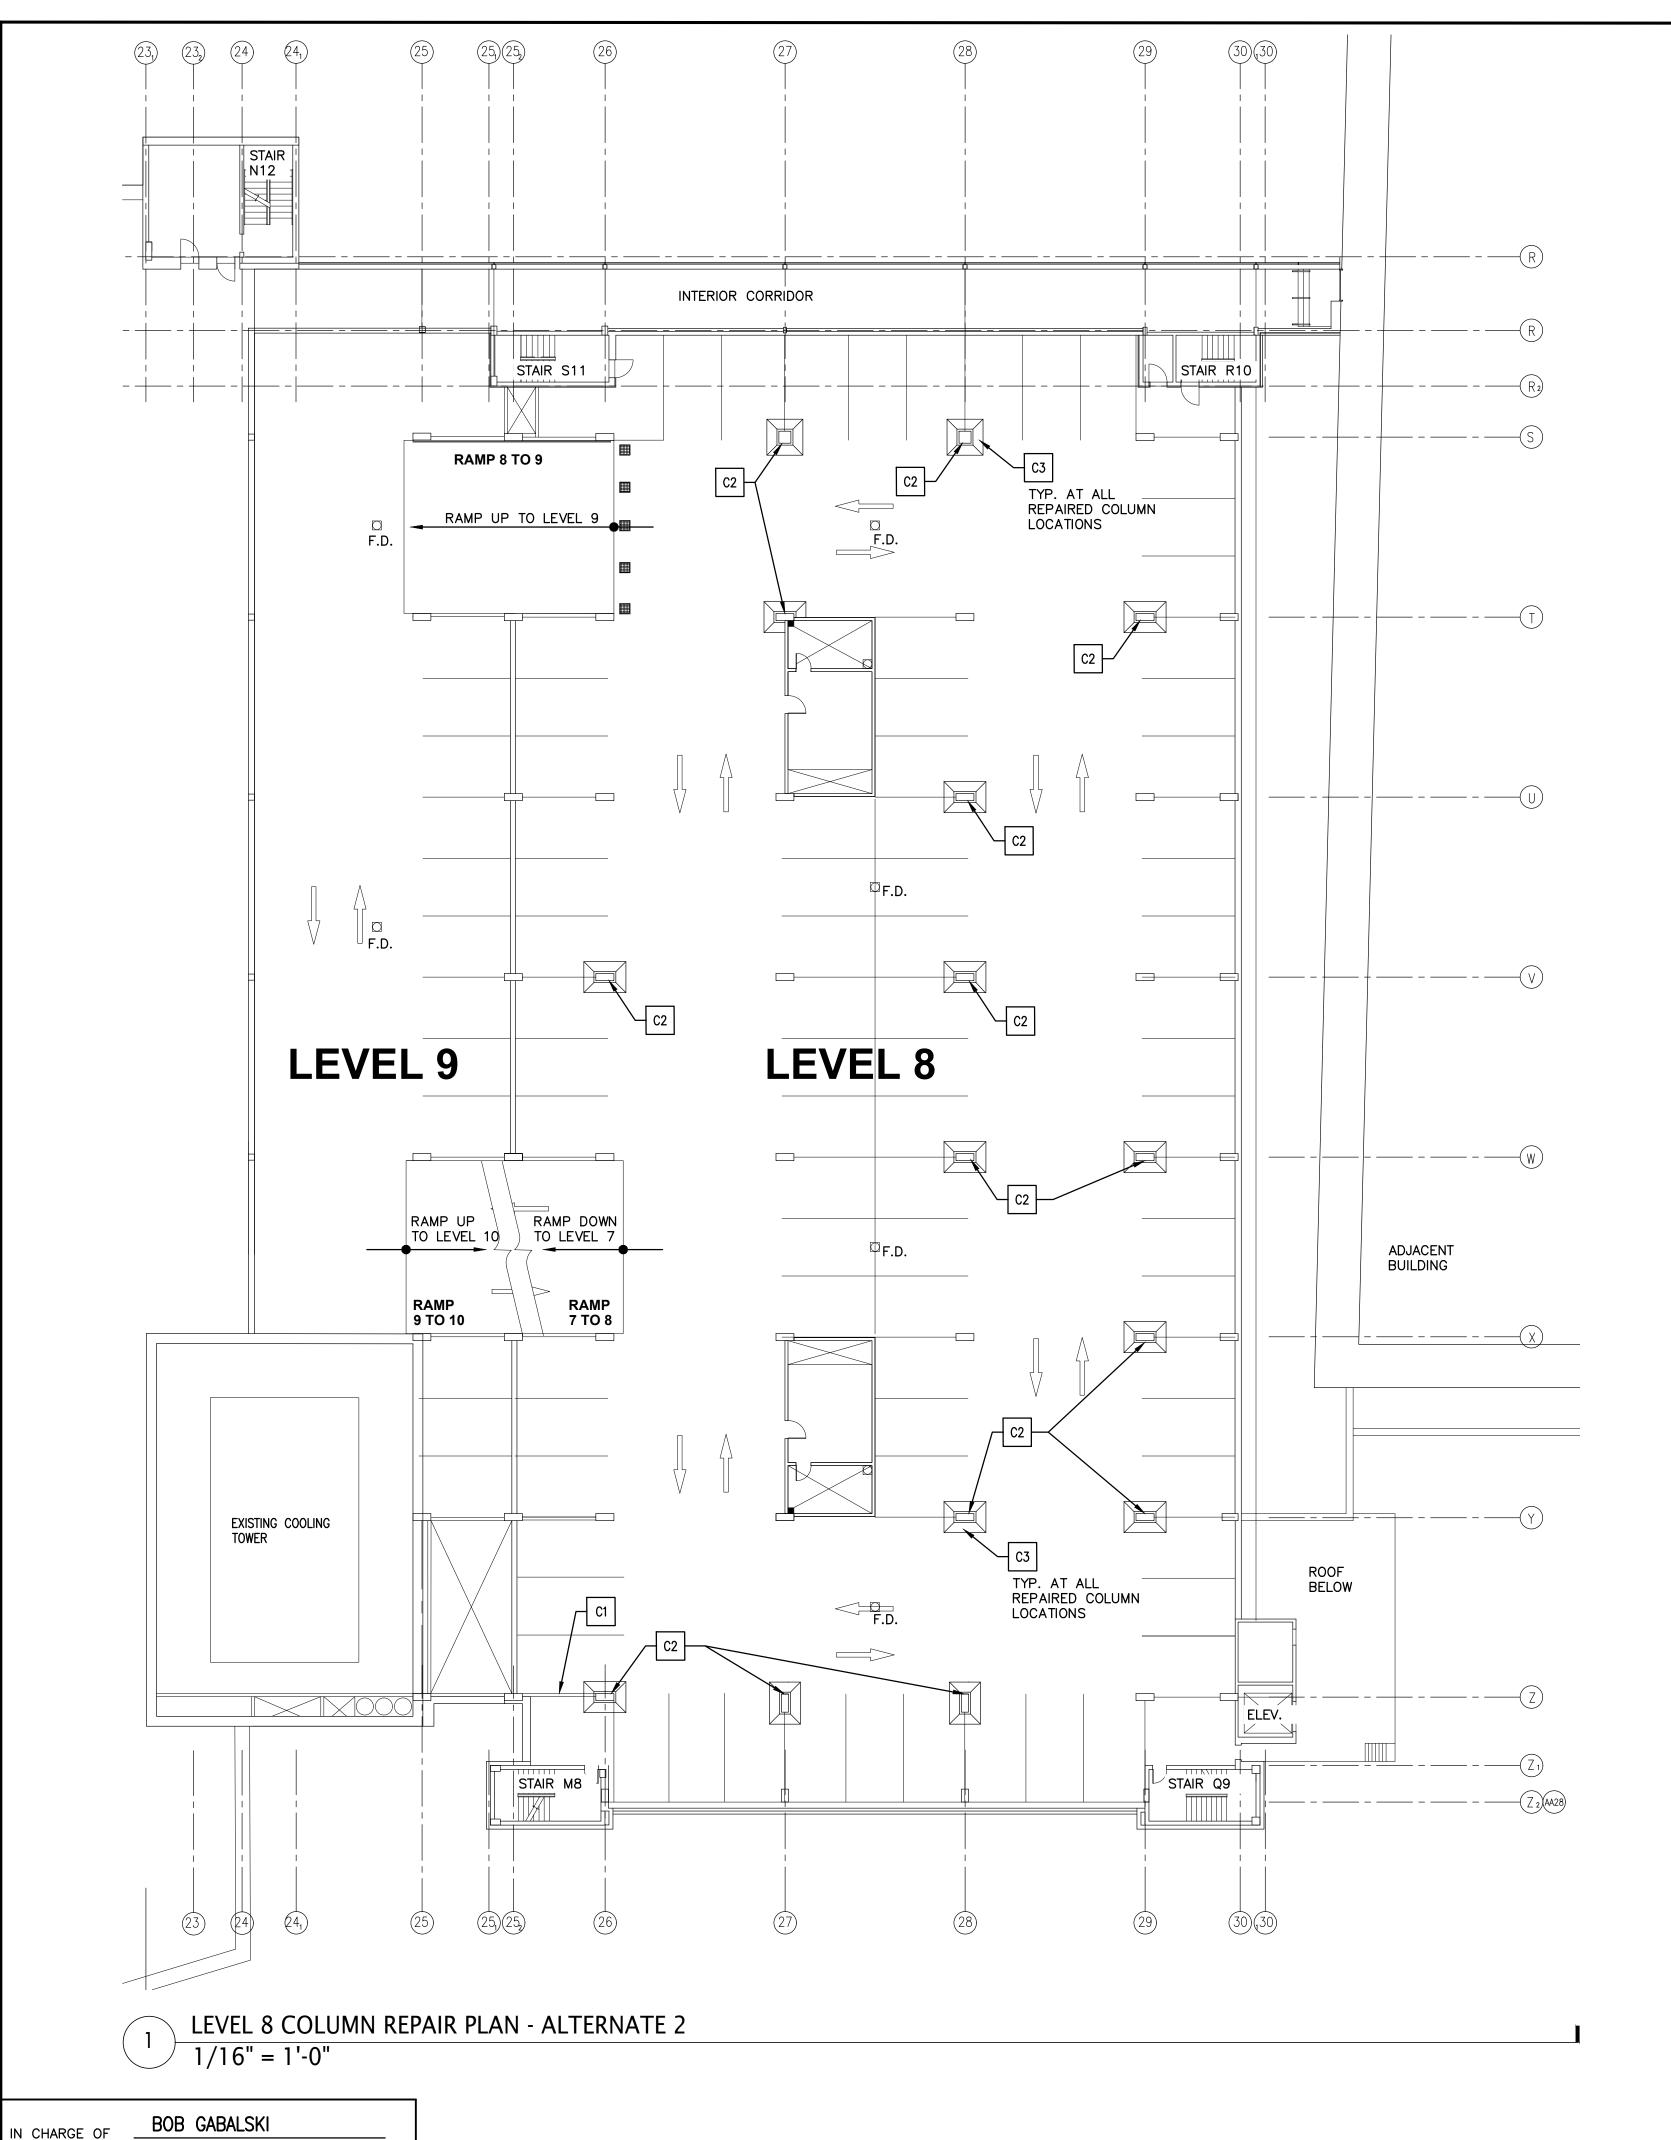BRETT HUTTMAN


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REPAIRED COLUMN ELEVATION

1/2" = 1'-0"



REPAIRED COLUMN PLAN SECTION

ALTERNATE CONSTRUCTION KEY NOTES

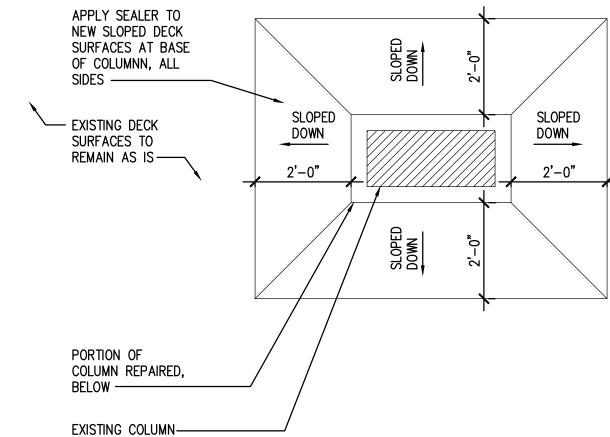TEMPORARILY REMOVE EXISTING GUARDRAIL OR OTHER ITEMS AS NECESSARY FOR NEW WORK, RE-INSTALL FOLLOWING COMPLETION OF REPAIRS

STRIP EXISTING PAINT FINISH FROM COLUMN AND PREPARE ALL SURFACES FOR NEW PAINT AS PER MANUFACTURERS INSTRUCTIONS. PAINT ENTIRE REPAIRED COLUMN FROM DECK TO STRUCTURE ABOVE, SEE DETAIL 2 FOR MORE INFORMATION

PREPARE SURFACE FOR APPLICATION OF SILANE SEALER IN ACCORDANCE WITH

GENERAL NOTES

1. TEMPORARILY REMOVE ALL EXISTING ITEMS, DEVICES, SIGNAGE, ETC. FROM COLUMNS INDICATED FOR REPAIR, WHERE NECESSARY, TO ACCOMMODATE THE REPAIR WORK. RE—INSTALL ALL ITEMS PREVIOUSLY REMOVED, FOLLOWING COMPLETION OF PAINTING. ALLOW SUFFICIENT TIME FOR PAINT TO CURE BEFORE RE—INSTALLATION.

MANUFACTURER'S WRITTEN INSTRUCTIONS. APPLY SILANE SEALER TO NEW CONCRETE DECK

- 2. ALL NEWLY INSTALLED OR REPAIRED ITEMS ARE TO BE FINISHED TO MATCH ADJACENT EXISTING ITEMS UNLESS OTHERWISE INDICATED. SUCH ITEMS MAY INCLUDE HANDRAILS, GUARDRAILS, DOORS, DOOR FRAMES, GFRC WALL PANELS, ETC.
- 3. INSTALL NEW "KEEP RIGHT" SIGNS AT EACH RAMP APPROACH AT EACH LEVEL. APPROXIMATE LOCATION AS SHOWN ON DRAWINGS.
- 4. PRIOR TO ANY WORK, TEST EXISTING PAINTED SURFACES THAT WILL BE DISTURBED OR REMOVED FOR LEAD PAINT CONTENT. IF FOUND, ABATE LEAD—BASED PAINT MATERIALS WITH APPROVED DUMOND PEEL AWAY PAINT REMOVER SYSTEM.

WATERPROOFING DEMOLITION AND PREPARATION NOTES

SURFACES, SEE DETAIL 3 FOR MORE INFORMATION

- 1. REMOVE ALL EXISTING JOINTING MATERIALS, INCLUDING BACKER AND SEALANT, WITHIN ALL AREAS OF WORK IDENTIFIED TO RECEIVE NEW WATERPROOFING OR DECK SEALING MATERIAL.
- 2. SHOT-BLAST ALL CONCRETE SURFACES TO RECEIVE NEW WATERPROOFING OR DECK SEALING MATERIAL.
- 3. CLEAN ALL SURFACES TO RECEIVE NEW WATERPROOFING OR DECK SEALING MATERIAL AS PER MANUFACTURER'S RECOMMENDATIONS OR WRITTEN INSTRUCTIONS.

WATERPROOFING INSTALLATION NOTES

- 1. INSTALL WATERPROOFING AND SEALER MATERIALS IN STRICT ACCORDANCE WITH MANUFACTURER'S WRITTEN INSTRUCTIONS.
- 2. INSTALL NEW JOINTING MATERIALS, INCLUDING BACKER AND SEALANT, AS INDICATED AND IN ACCORDANCE WITH MANUFACTURER'S WRITTEN INSTRUCTIONS.

PAINTING NOTES

1. SEE PAINTING SCHEDULE ON SHEET A111 FOR COLORS

ALTERNATE 2 - CALCULATED QUANTITIES

| ITEM DESCRIPTION | CALCULATED QUANTITY |
|------------------------------------|---------------------|
| COLUMNS REQUIRING REPAIR AND PAINT | 15 |
| PARKING DECK SEALING | 600 SQ. FT. |
| | |
| | |
| | |
| | |


ABBREVIATIONS:
LIN. FT. = LINEAR FEET
SQ. FT. = SQUARE FEET
CU. YDS. = CUBIC YARDS



| | | | | |)) | | ARCHIT | ECTS |
|---------------|--------------|---------------------------|--|----------------|----------|---|----------------------------------|----------|
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| | | 44-46 F HOPEWI | CELZY GINEERING, PC OSTER ROAD ELL JUNCTION, 9-8161 (O) | NY 12533 | | ۸ | MEP ENGIN | IEERS |
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| 7/31/2 | 020 BH | MB | RELEASE FOR I | RID. | | | | |
| 7/23/20 | _ | MB | FOR COMMISSION | | | | | |
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| | | | RD DRAWIN | IG CERTIFICA | TION | | | |
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| 1 | М | ICHAELIAN OF | BILITATION – FICE BUILDING HITE PLAINS, I | | | SCALE: AS NO DATE: 7-23-20 DPW FILE NO. | | REV. |

LEVEL 8 COLUMN REPAIR PLAN - ALTERNATE 2

52-01-A-355-0

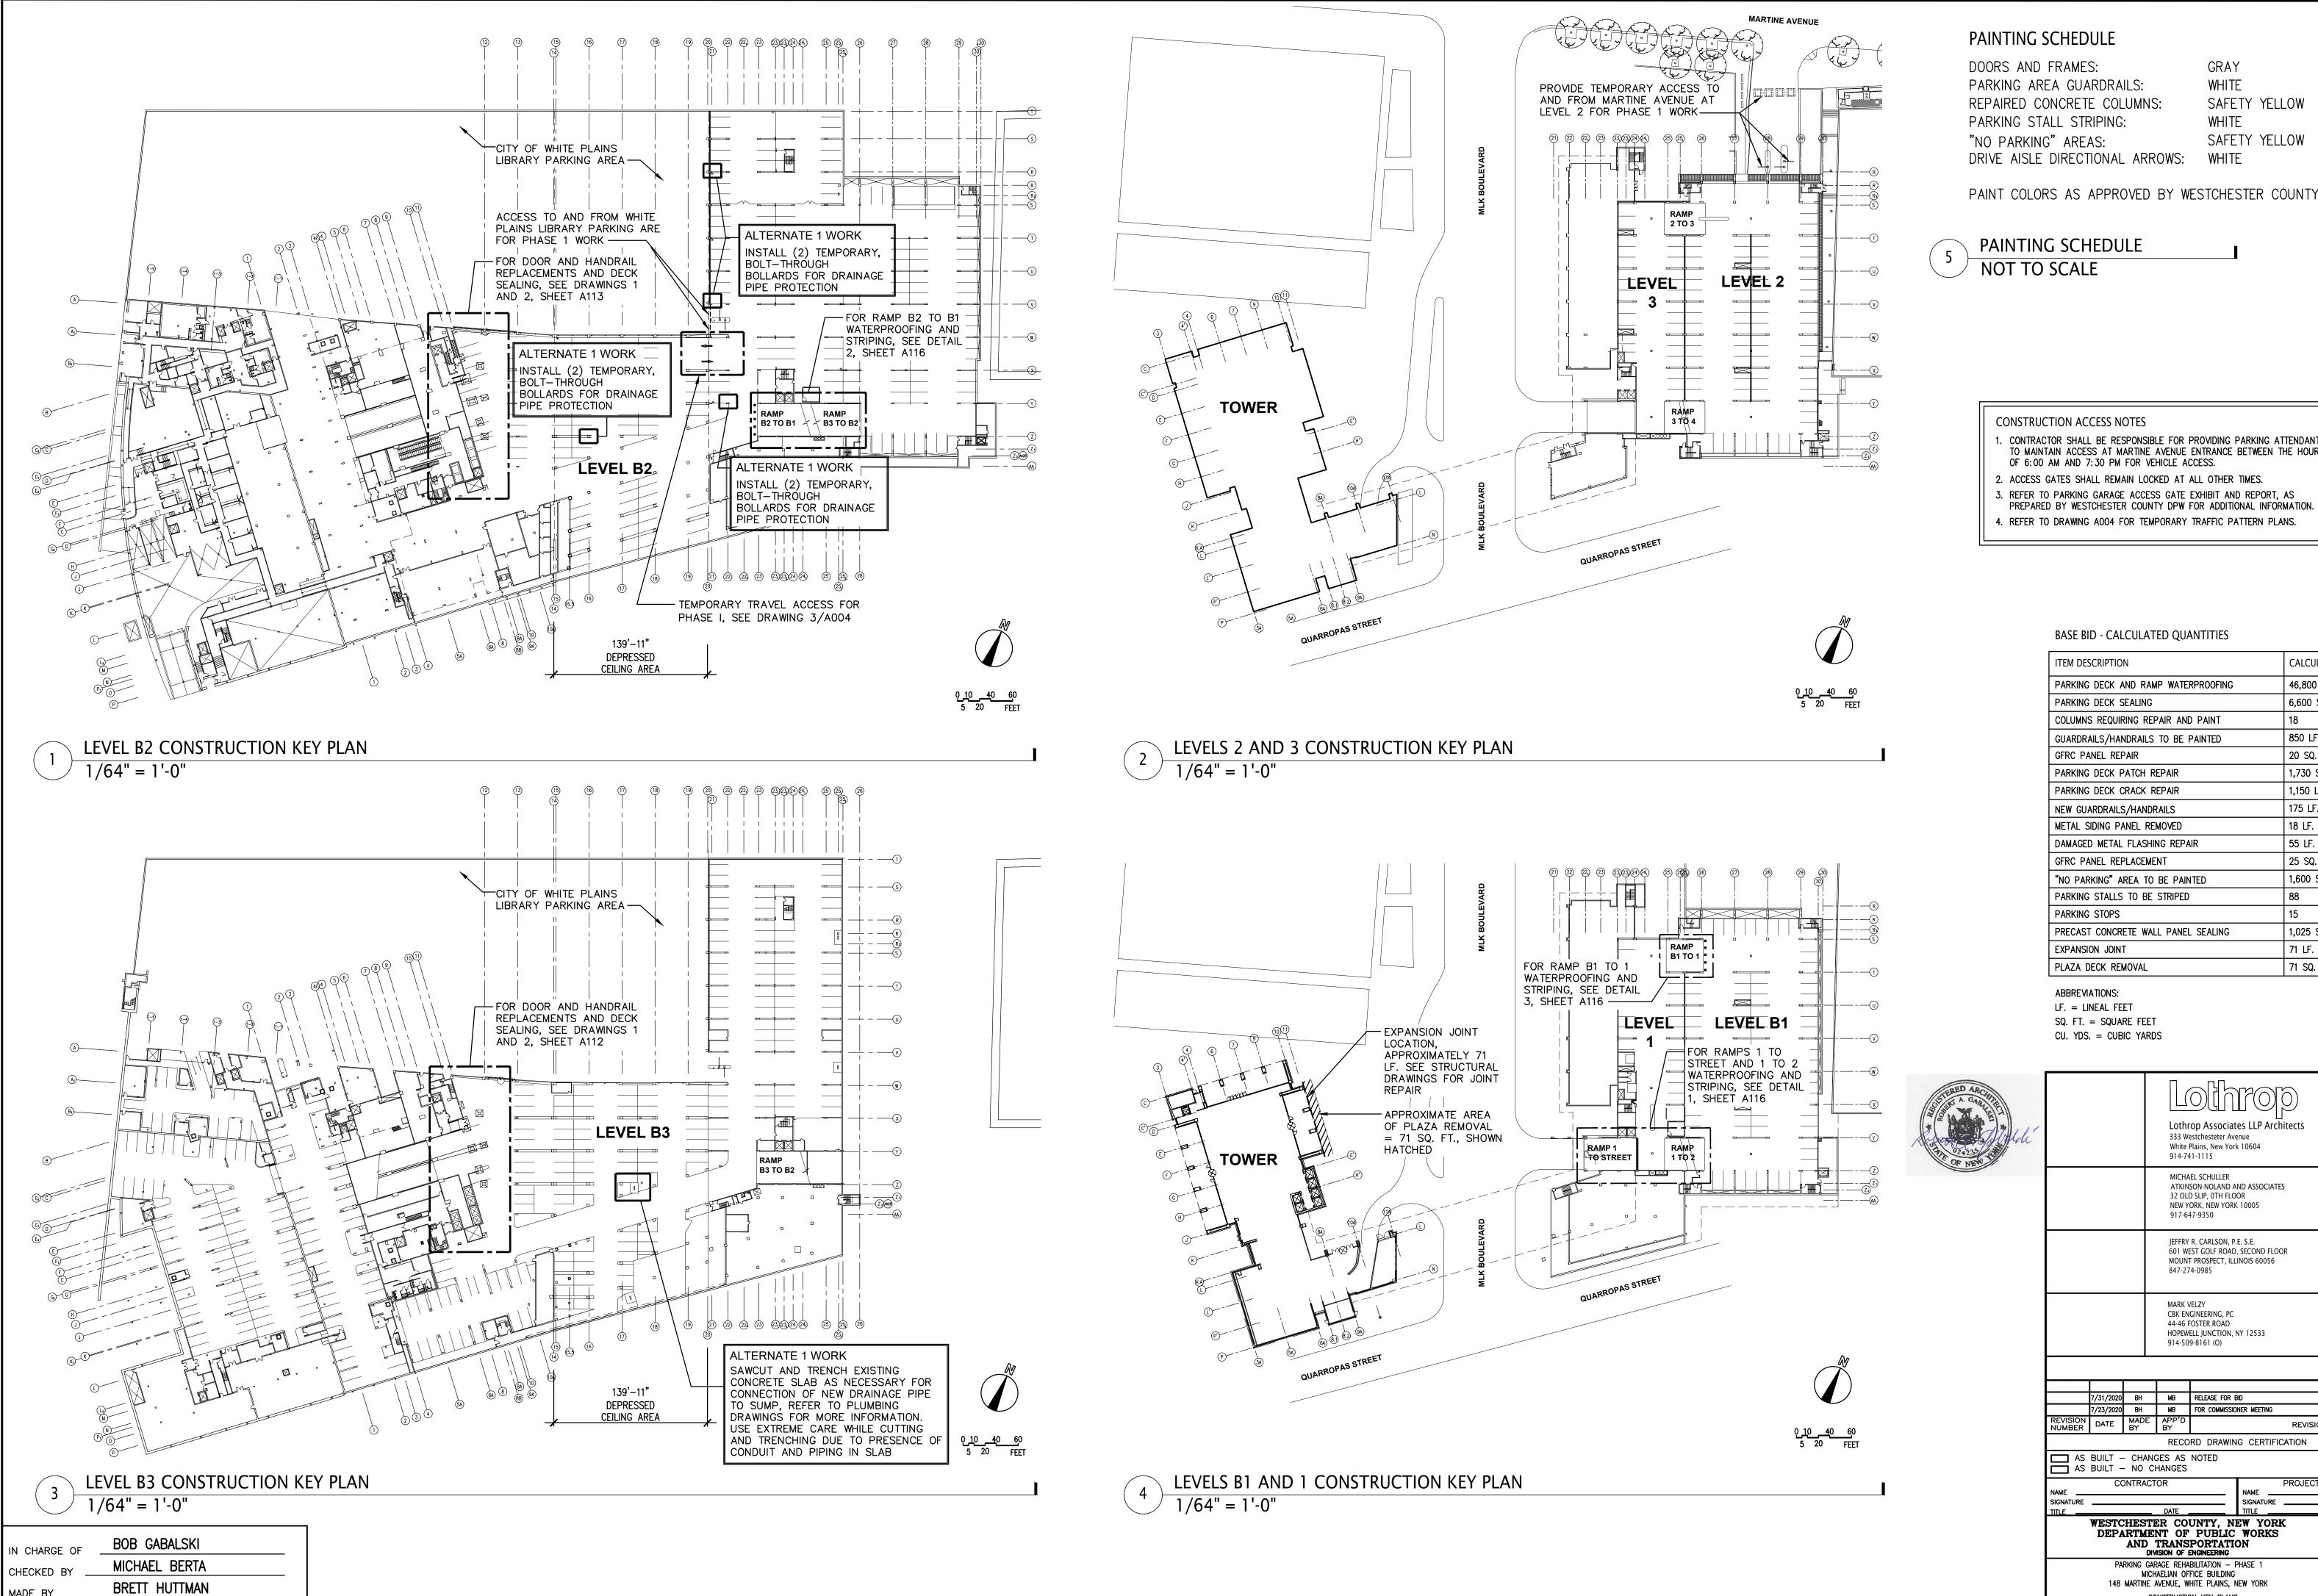

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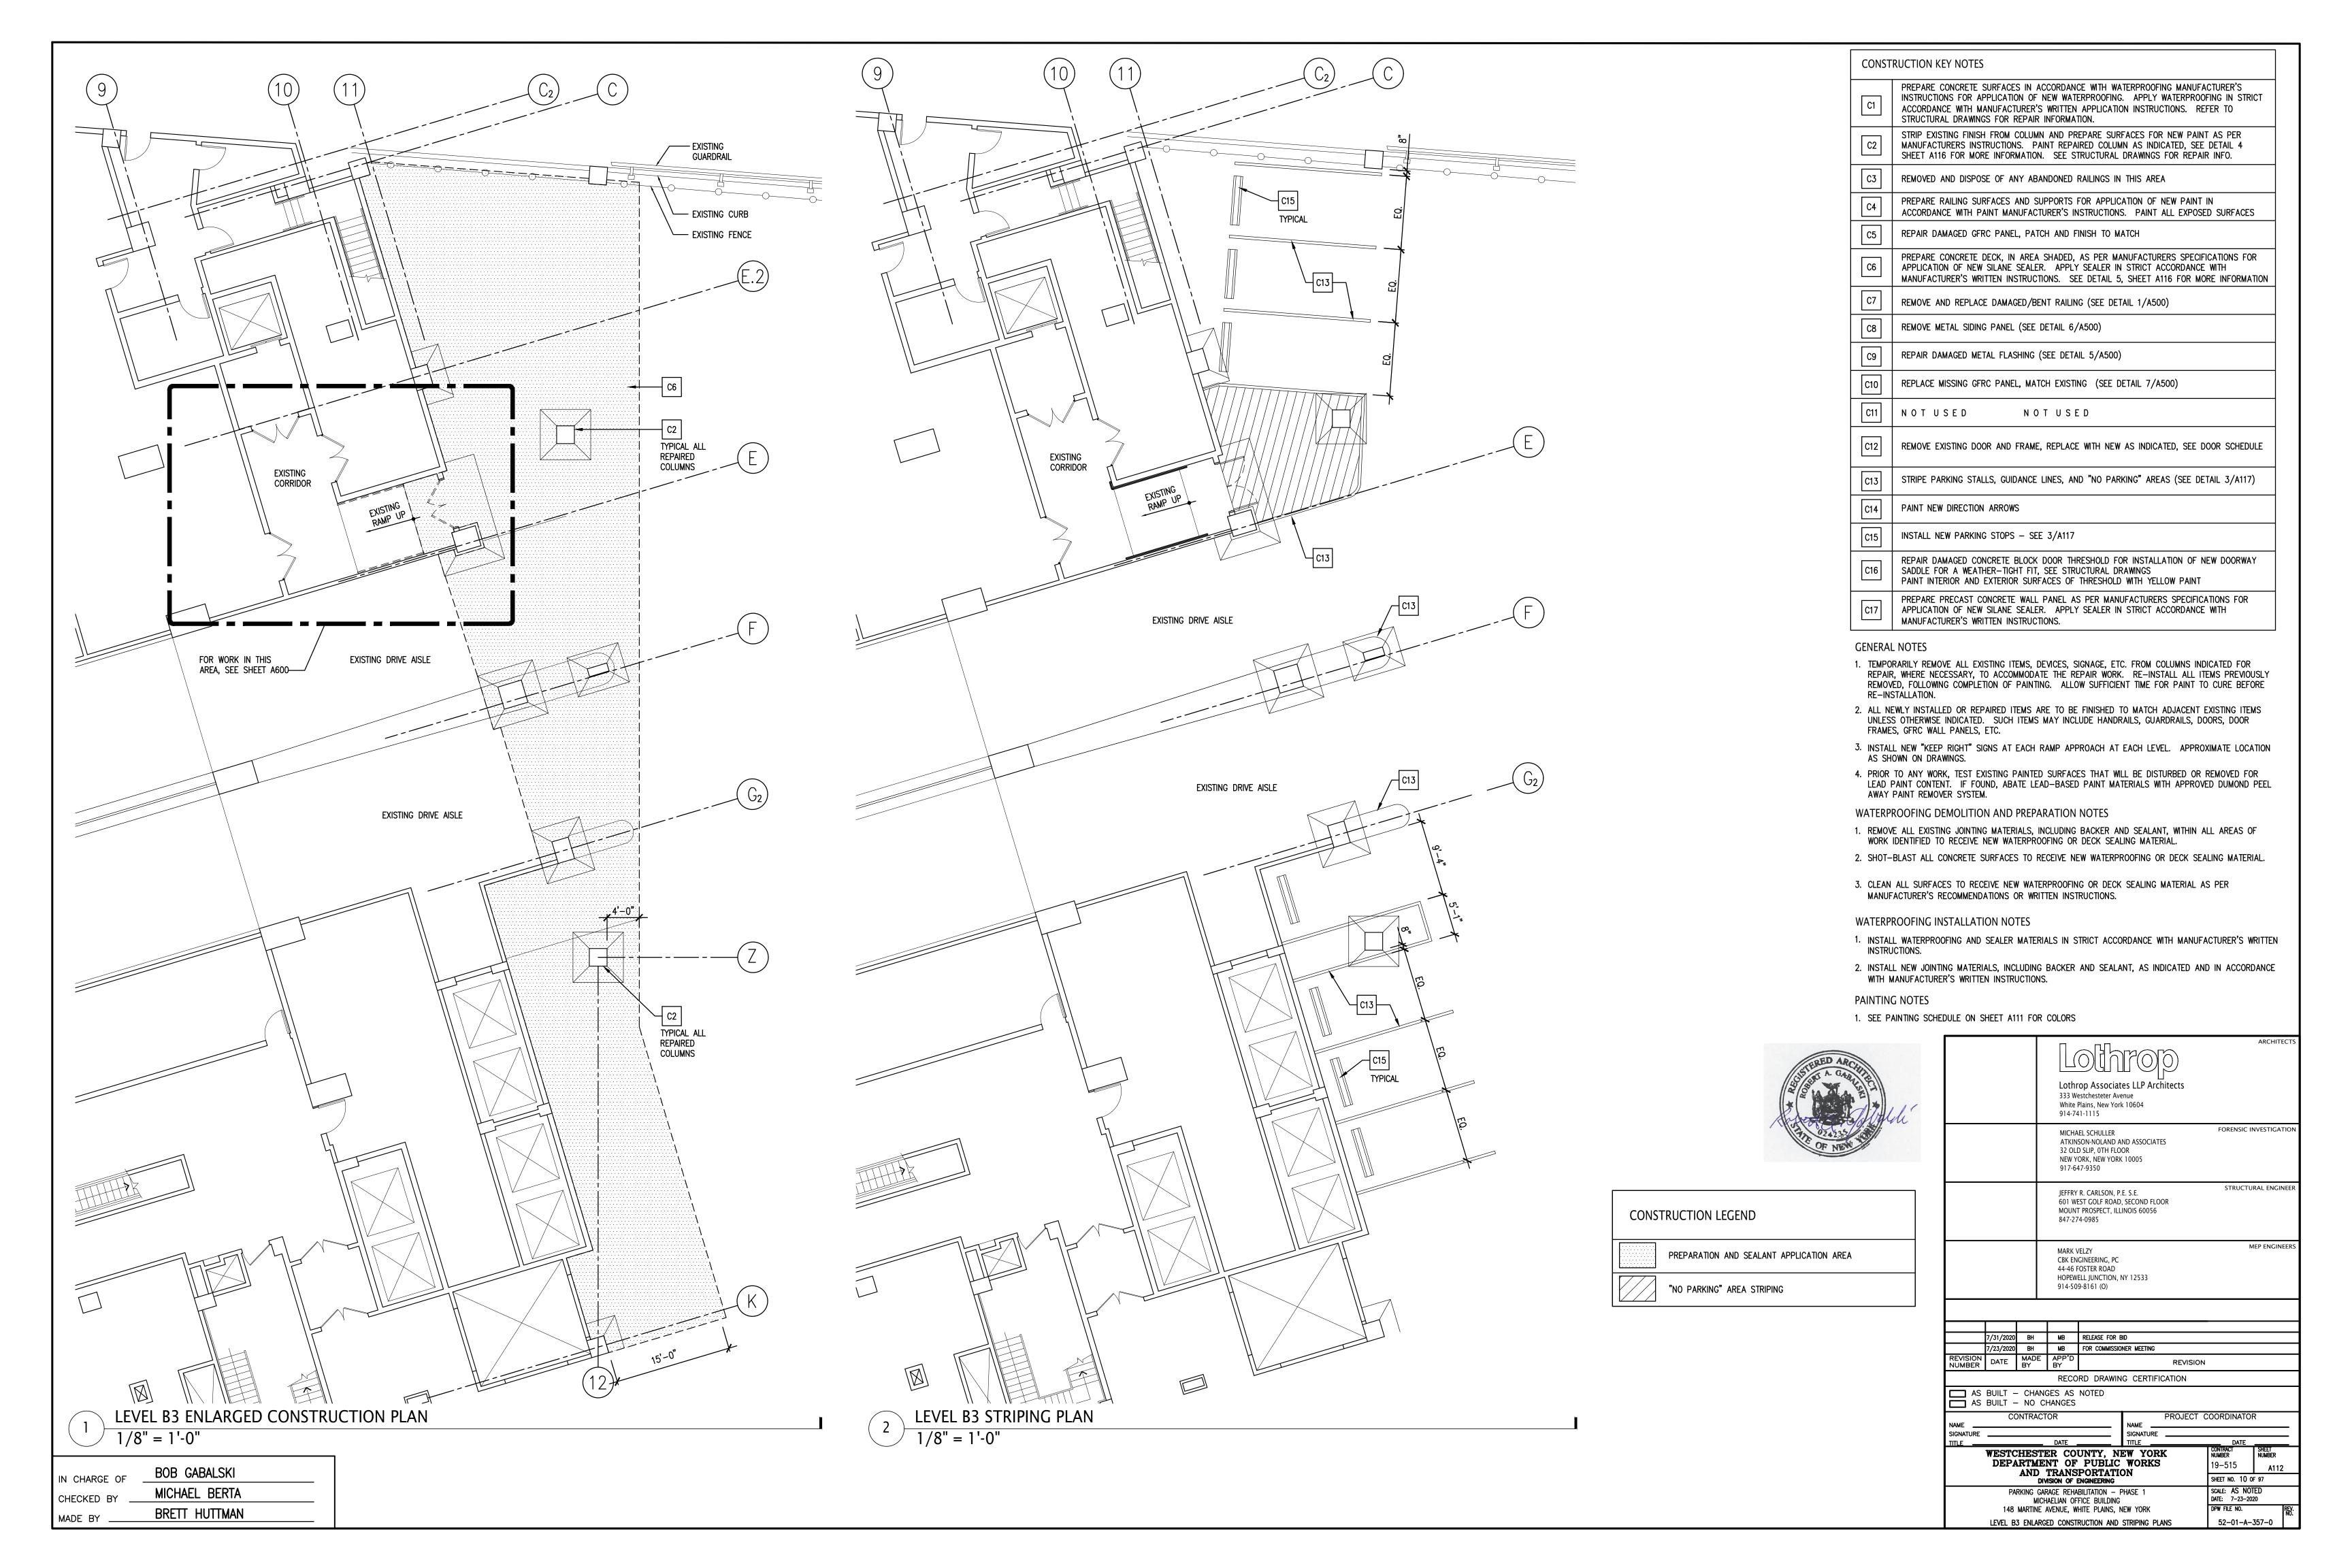
GRAY WHITE SAFETY YELLOW WHITE SAFETY YELLOW


PAINT COLORS AS APPROVED BY WESTCHESTER COUNTY


- . CONTRACTOR SHALL BE RESPONSIBLE FOR PROVIDING PARKING ATTENDANTS TO MAINTAIN ACCESS AT MARTINE AVENUE ENTRANCE BETWEEN THE HOURS
- 3. REFER TO PARKING GARAGE ACCESS GATE EXHIBIT AND REPORT, AS
- 4. REFER TO DRAWING A004 FOR TEMPORARY TRAFFIC PATTERN PLANS.


| ITEM DESCRIPTION | CALCULATED QUANTITY |
|-------------------------------------|---------------------|
| PARKING DECK AND RAMP WATERPROOFING | 46,800 SQ. FT. |
| PARKING DECK SEALING | 6,600 SQ. FT. |
| COLUMNS REQUIRING REPAIR AND PAINT | 18 |
| GUARDRAILS/HANDRAILS TO BE PAINTED | 850 LF. |
| GFRC PANEL REPAIR | 20 SQ. FT. |
| PARKING DECK PATCH REPAIR | 1,730 SQ. FT. |
| PARKING DECK CRACK REPAIR | 1,150 LF. |
| NEW GUARDRAILS/HANDRAILS | 175 LF. |
| METAL SIDING PANEL REMOVED | 18 LF. |
| DAMAGED METAL FLASHING REPAIR | 55 LF. |
| GFRC PANEL REPLACEMENT | 25 SQ. FT. |
| "NO PARKING" AREA TO BE PAINTED | 1,600 SQ. FT. |
| PARKING STALLS TO BE STRIPED | 88 |
| PARKING STOPS | 15 |
| PRECAST CONCRETE WALL PANEL SEALING | 1,025 SQ. FT. |
| EXPANSION JOINT | 71 LF. |
| PLAZA DECK REMOVAL | 71 SQ. FT. |

| Lothrop Associates LLP Architects 333 Westchester Avenue White Plains, New York 10604 914-741-1115 MICHAEL SCHULLER ATKINSON-NOLAND AND ASSOCIATES 32 OLD SUP, 0TH FLOOR NEW YORK, NEW YORK 10005 917-647-9350 JEFFRY R. CARLSON, P.E. S.E. 601 WEST GOLF ROAD, SECOND FLOOR MOUNT PROSPECT, ILLINOIS 60056 847-274-0985 MARK VELZY CBK ENGINEERING, PC 44-65 FOSTER ROAD HOPEWELL JUNCTION, NY 12533 914-509-8161 (0) AS BUILT — CHANGES AS NOTED AS BUILT — CHANGES AS NOTED AS BUILT — NO CHANGES CONTRACTOR NAME SIGNATURE TITLE WESTCHESTER COUNTY, NEW YORK DEPARTMENT OF PUBLIC WORKS AND TRANSPORTATION PRACKING CARAGE REHABILITATION SEET NO. 9 or 97 SOLE AS NOTED PARKING CARAGE REHABILITATION SEET NO. 9 or 97 PRECINC. 90 OF 97 PREC | | | | | | | | | |
|--|-----------|--------------|--|--|---|------------------|---------------|---------------------------------------|-----------------|
| ### Wisterlains, New York 10604 914-741-1115 MICHAEL SCHULLER | | | | | | rop |) | | ARCHITECTS |
| MICHAEL SCHULLER ATKINSON-NOLAND AND ASSOCIATES 32 OLD SLIP, OTH FLOOR NEW YORK, NEW YORK 10005 917-647-9350 JEFFRY R. CARLSON, P.E. S.E. 601 WEST COLF ROAD, SECOND FLOOR MOUNT PROSPECT, ILLINOIS 60056 847-274-0985 MARK VELZY CBK ENGINEERING, PC 44-46 FOSTER ROAD HOPEWELL JUNCTION, NY 12533 914-509-8161 (O) 7/31/2020 BH MB FOR COMMISSIONER MEETING REVISION NUMBER 7/23/2020 BH MB FOR COMMISSIONER MEETING REVISION NUMBER DATE RECORD DRAWING CERTIFICATION AS BUILT — CHANGES AS NOTED AS BUILT — NO CHANGES CONTRACTOR NAME SIGNATURE TITLE DATE WESTCHESTER COUNTY, NEW YORK DEPARTMENT OF PUBLIC WORKS AND TRANSPORTATION DIVISION OF ENGINEERING PARKING GARAGE REHABILITATION — PHASE 1 MICHAELIAN OFFICE BUILDING 148 MARTINE AVENUE, WHITE PLAINS, NEW YORK DPW FILE NO. REVISION CONTRACTOR NAME SIGNATURE TITLE DATE OTHER SIGNATURE TITLE DATE PROJECT COORDINATOR NUMBER N | | | | 333 W White | estchesteter Av Plains, New Yo | /enue | ts | | |
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| MARK VELZY CBK ENGINEERING, PC 44-46 FOSTER ROAD HOPEWELL JUNCTION, NY 12533 914-509-8161 (0) 7/31/2020 BH MB RELEASE FOR BID 7/23/2020 BH MB FOR COMMISSIONER MEETING REVISION NUMBER DATE BY BY REVISION RECORD DRAWING CERTIFICATION AS BUILT — CHANGES AS NOTED AS BUILT — NO CHANGES CONTRACTOR PROJECT COORDINATOR NAME SIGNATURE TITLE DATE TITLE DATE WESTCHESTER COUNTY, NEW YORK DEPARTMENT OF PUBLIC WORKS AND TRANSPORTATION DIMISION OF ENGINEERING PARKING GARAGE REHABILITATION — PHASE 1 MICHAELIAN OFFICE BUILDING 148 MARTINE AVENUE, WHITE PLAINS, NEW YORK DPW FILE NO. SCALE: AS NOTED DATE: 7-23-2020 DPW FILE NO. PPW FILE NO. PPW FILE NO. RECORD DRAWING CERTIFICATION SHEET NO. 9 OF 97 SCALE: AS NOTED DATE: 7-23-2020 DPW FILE NO. PPW FILE NO. RECORD DRAWING CERTIFICATION SHEET NO. 9 OF 97 SCALE: AS NOTED DATE: 7-23-2020 DPW FILE NO. RECORD DRAWING CERTIFICATION SHEET NO. 9 OF 97 SCALE: AS NOTED DATE: 7-23-2020 DPW FILE NO. RECORD DRAWING CERTIFICATION DIVISION OF ENGINEERING SCALE: AS NOTED DATE: 7-23-2020 DPW FILE NO. RECORD DRAWING CERTIFICATION DIVISION OF ENGINEERING DATE: 7-23-2020 DPW FILE NO. RECORD DRAWING CERTIFICATION DIVISION OF ENGINEERING DATE: 7-23-2020 DPW FILE NO. RECORD DRAWING CERTIFICATION DIVISION OF ENGINEERING DATE: 7-23-2020 DPW FILE NO. RECORD DRAWING CERTIFICATION DIVISION OF ENGINEERING DATE: 7-23-2020 DPW FILE NO. RECORD DRAWING CERTIFICATION DIVISION OF ENGINEERING DATE: 7-23-2020 DPW FILE NO. | | | | 601 WEST GOLF ROAD, SECOND FLOOR MOUNT PROSPECT, ILLINOIS 60056 | | | | STRUCT | URAL ENGINEER |
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| CONSTRUCTION KEY PLANS 52-01-A-356-0 | TITLE | DEP A | ARTME AND DI RKING GA MICI | TRANS WISION OF I RAGE REHA HAELIAN OF | SPORTATI ENGINEERING ABILITATION — FICE BUILDING | PHASE 1 | | SHEET NO. 9 SCALE: AS NO DATE: 7-23-2 | OF 97 OTED |



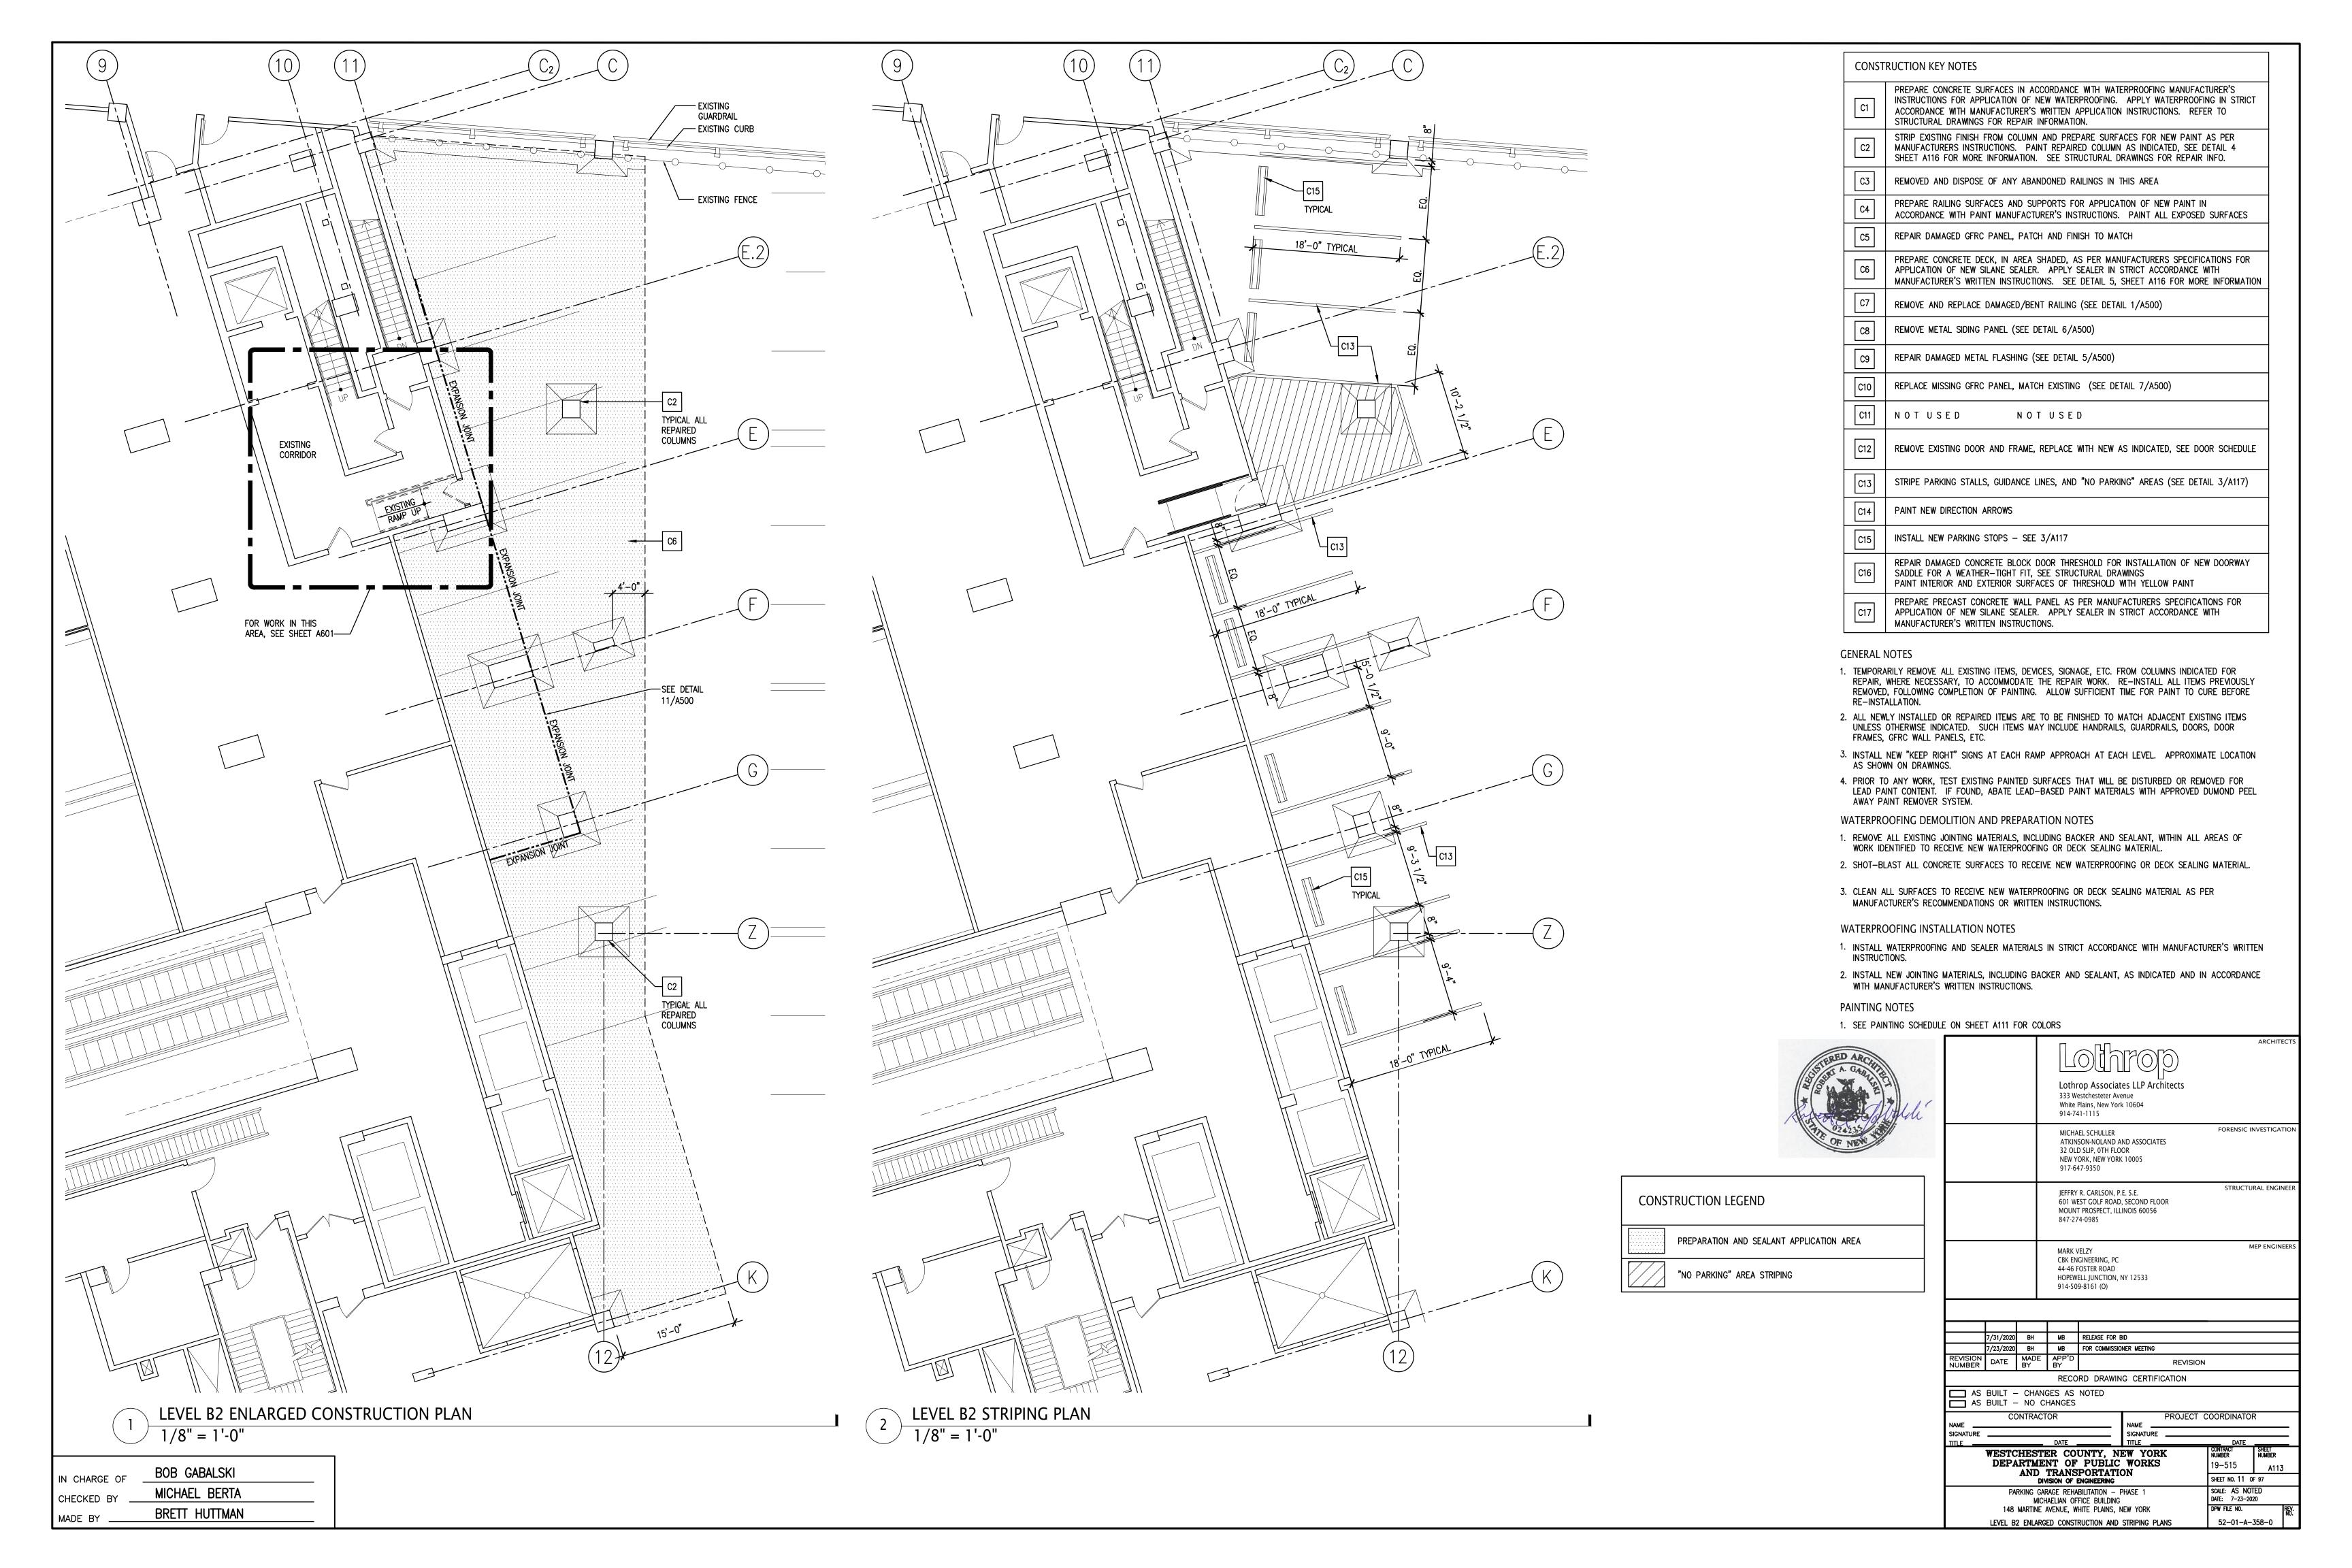

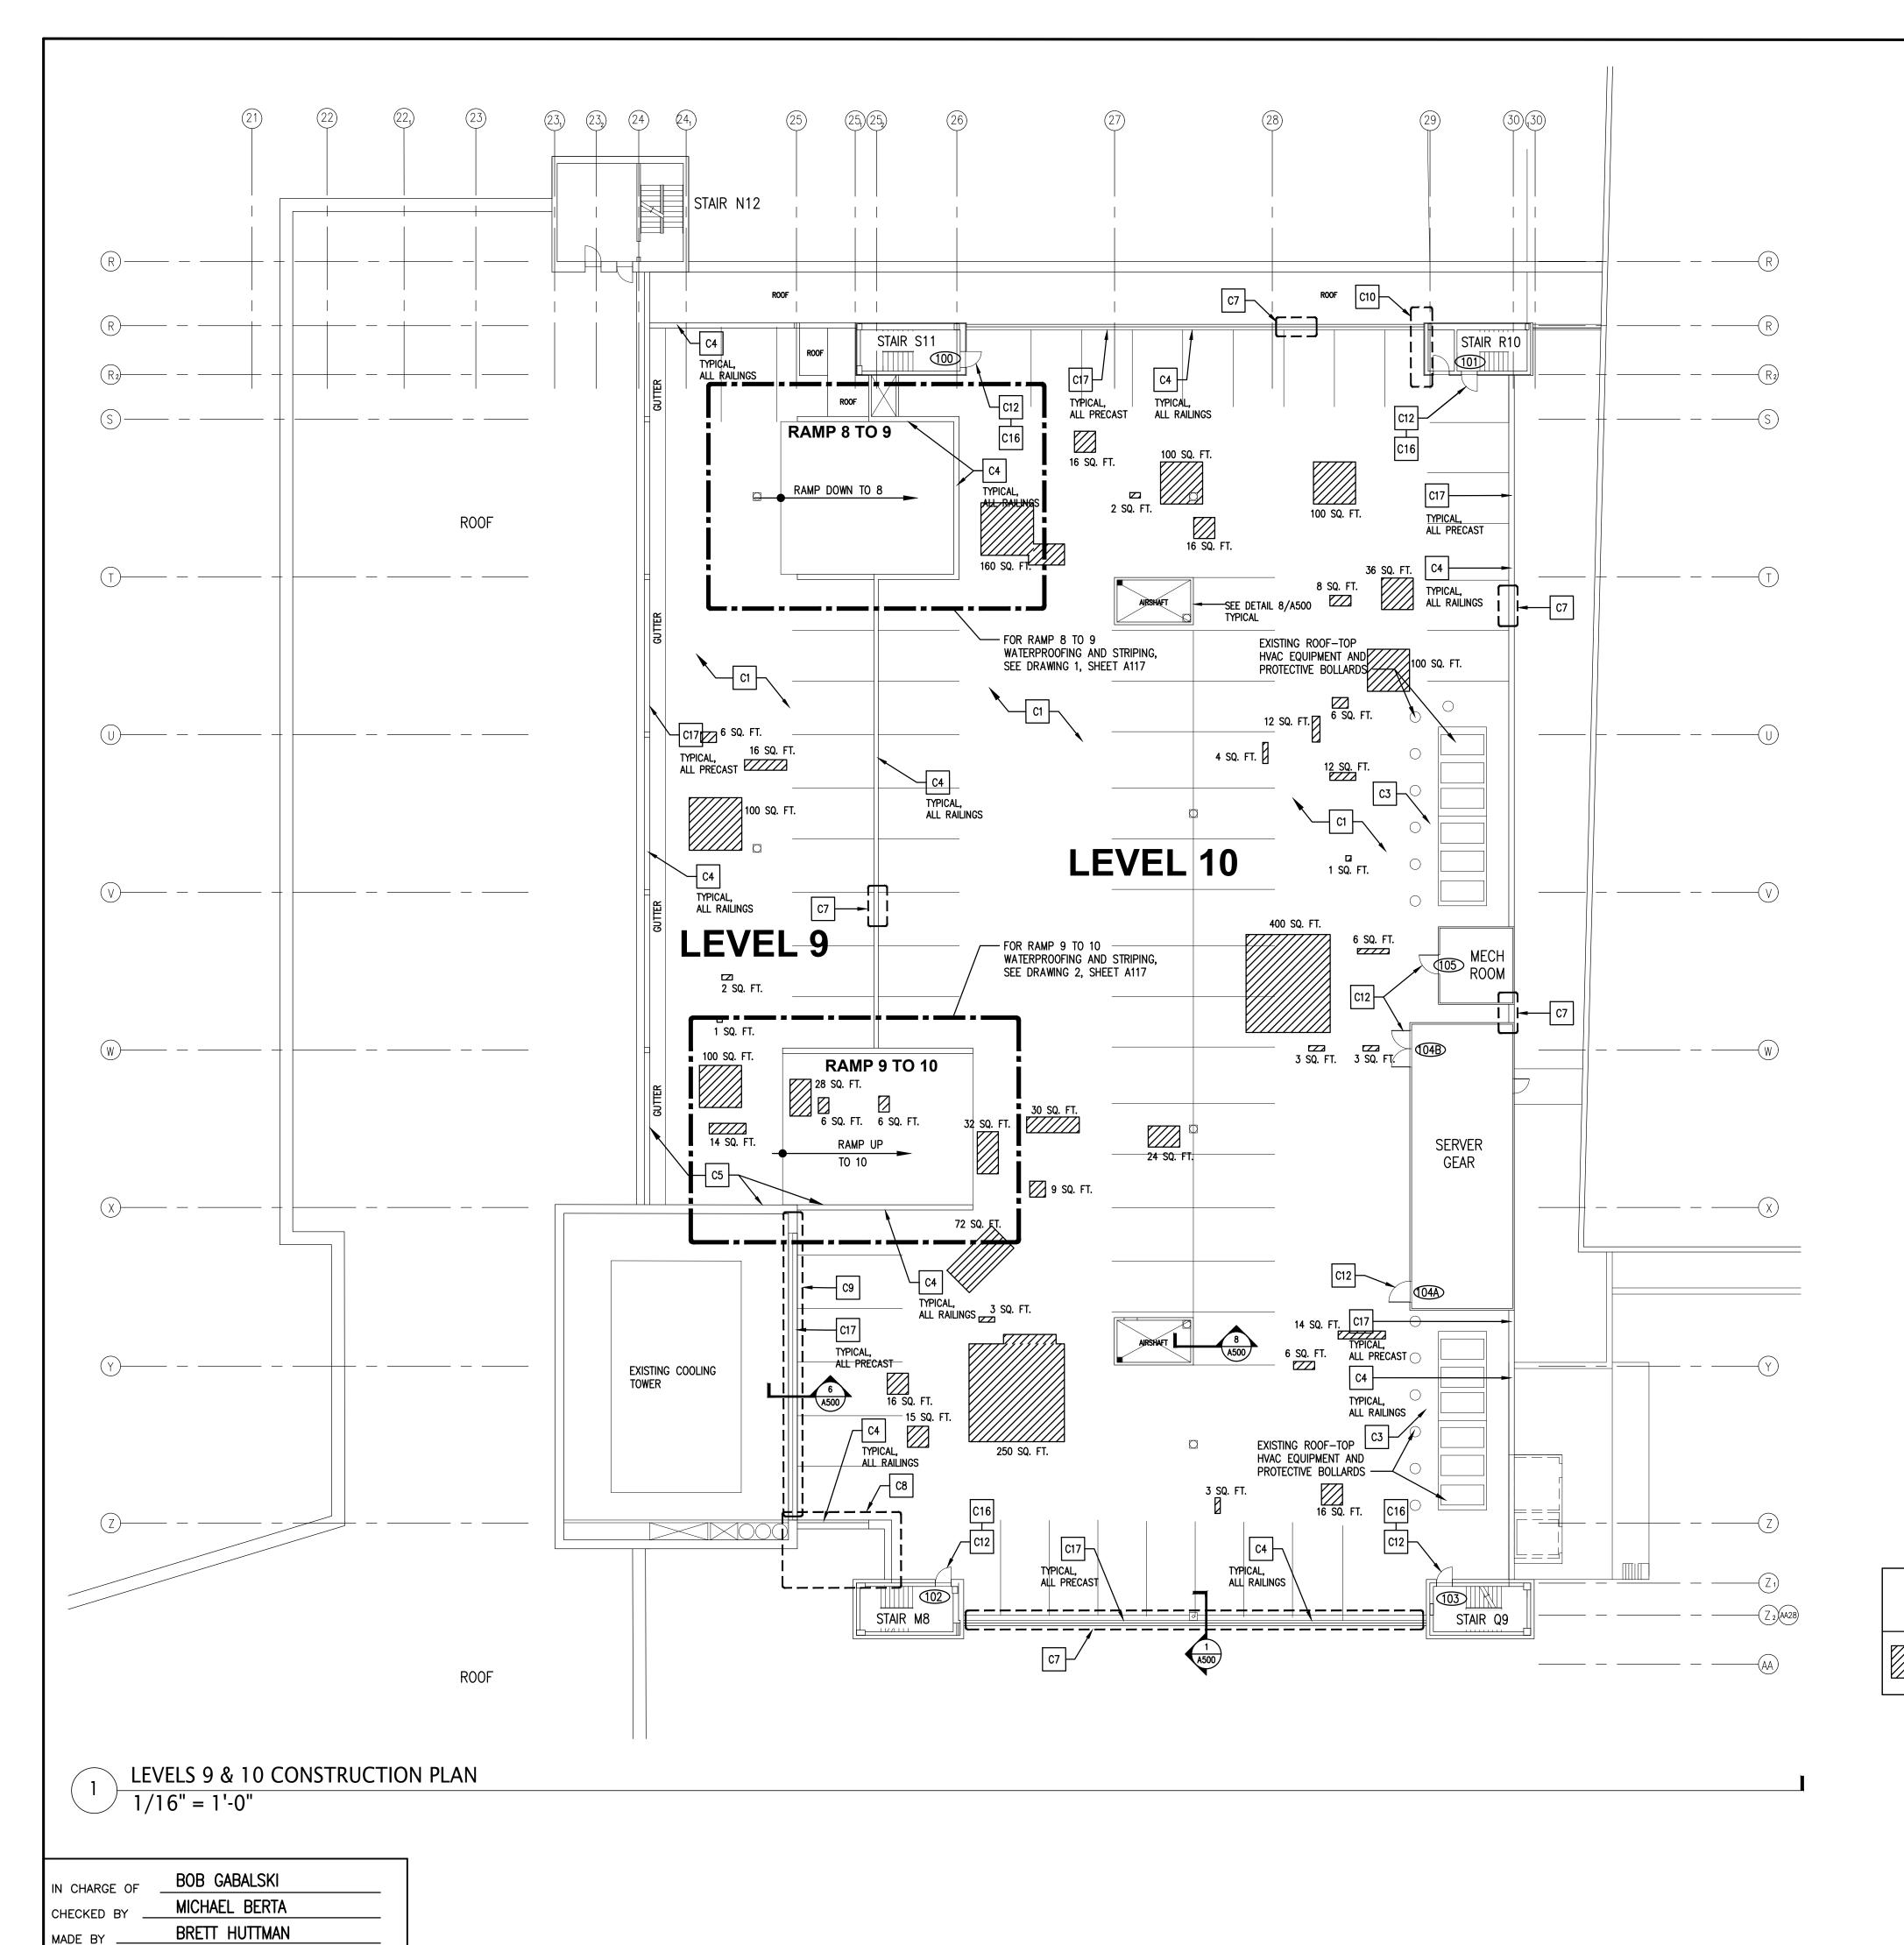

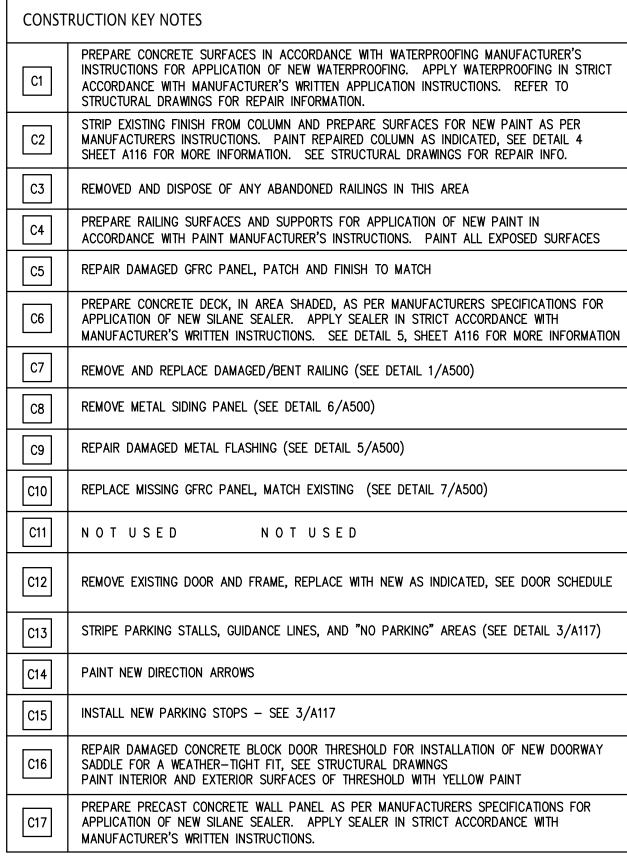

GENERAL NOTES

- 1. TEMPORARILY REMOVE ALL EXISTING ITEMS, DEVICES, SIGNAGE, ETC. FROM COLUMNS INDICATED FOR REPAIR, WHERE NECESSARY, TO ACCOMMODATE THE REPAIR WORK. RE—INSTALL ALL ITEMS PREVIOUSLY REMOVED, FOLLOWING COMPLETION OF PAINTING. ALLOW SUFFICIENT TIME FOR PAINT TO CURE BEFORE RE—INSTALLATION.
- 2. ALL NEWLY INSTALLED OR REPAIRED ITEMS ARE TO BE FINISHED TO MATCH ADJACENT EXISTING ITEMS UNLESS OTHERWISE INDICATED. SUCH ITEMS MAY INCLUDE HANDRAILS, GUARDRAILS, DOORS, DOOR FRAMES, GFRC WALL PANELS, ETC.
- 3. INSTALL NEW "KEEP RIGHT" SIGNS AT EACH RAMP APPROACH AT EACH LEVEL. APPROXIMATE LOCATION AS SHOWN ON DRAWINGS.
- 4. PRIOR TO ANY WORK, TEST EXISTING PAINTED SURFACES THAT WILL BE DISTURBED OR REMOVED FOR LEAD PAINT CONTENT. IF FOUND, ABATE LEAD-BASED PAINT MATERIALS WITH APPROVED DUMOND PEEL AWAY PAINT REMOVER SYSTEM.

WATERPROOFING DEMOLITION AND PREPARATION NOTES

- 1. REMOVE ALL EXISTING JOINTING MATERIALS, INCLUDING BACKER AND SEALANT, WITHIN ALL AREAS OF WORK IDENTIFIED TO RECEIVE NEW WATERPROOFING OR DECK SEALING MATERIAL.
- 2. SHOT-BLAST ALL CONCRETE SURFACES TO RECEIVE NEW WATERPROOFING OR DECK SEALING MATERIAL.
- 3. CLEAN ALL SURFACES TO RECEIVE NEW WATERPROOFING OR DECK SEALING MATERIAL AS PER MANUFACTURER'S RECOMMENDATIONS OR WRITTEN INSTRUCTIONS.


WATERPROOFING INSTALLATION NOTES

- INSTALL WATERPROOFING AND SEALER MATERIALS IN STRICT ACCORDANCE WITH MANUFACTURER'S WRITTEN INSTRUCTIONS.
- 2. INSTALL NEW JOINTING MATERIALS, INCLUDING BACKER AND SEALANT, AS INDICATED AND IN ACCORDANCE WITH MANUFACTURER'S WRITTEN INSTRUCTIONS.

PAINTING NOTES

1. SEE PAINTING SCHEDULE ON SHEET A111 FOR COLORS



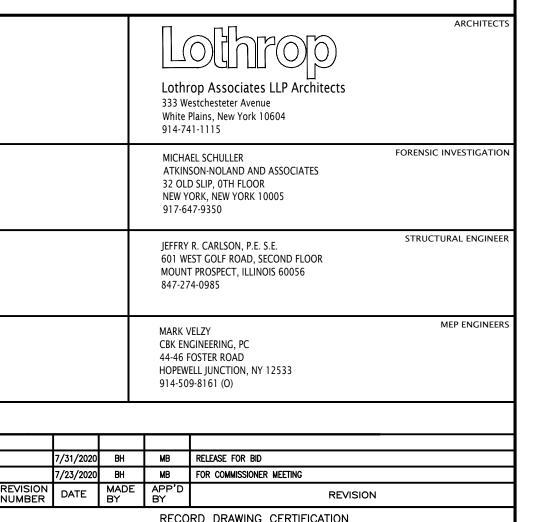



CONSTRUCTION LEGEND


AREA OF DAMAGED CONCRETE SLAB FOR PATCH AND REPAIR TOTALING
APPROXIMATELY 1,730 SQ. FT. — REFER TO STRUCTURAL DRAWINGS FOR REPAIR
INFORMATION, INCLUDING APPROXIMATELY 1,150 LIN. FT. OF CRACK REPAIR NOT
SHOWN ON THIS PLAN

LEVELS 9 AND 10
LEVEL 9 = APPROXIMATELY 6,016 SF
LEVEL 10 = APPROXIMATELY 29,184 SF
TOTAL AREA = APPROXIMATELY 35,200 SF


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| | | RTME | NT OF | UNTY, NI PUBLIC PORTATION | WORKS | ζ | CONTRACT NUMBER 19-515 | SHEET NUMBER A114 | | |
| | | | | ENGINEERING | <i>7</i> 11 | | SHEET NO. 12 0 | F 97 | | |
| | PA | | | BILITATION — F FICE BUILDING | PHASE 1 | | SCALE: AS NOTED DATE: 7–23–2020 | | | |
| | 148 | | • | HITE PLAINS, N | | | | | SKA SKA | |
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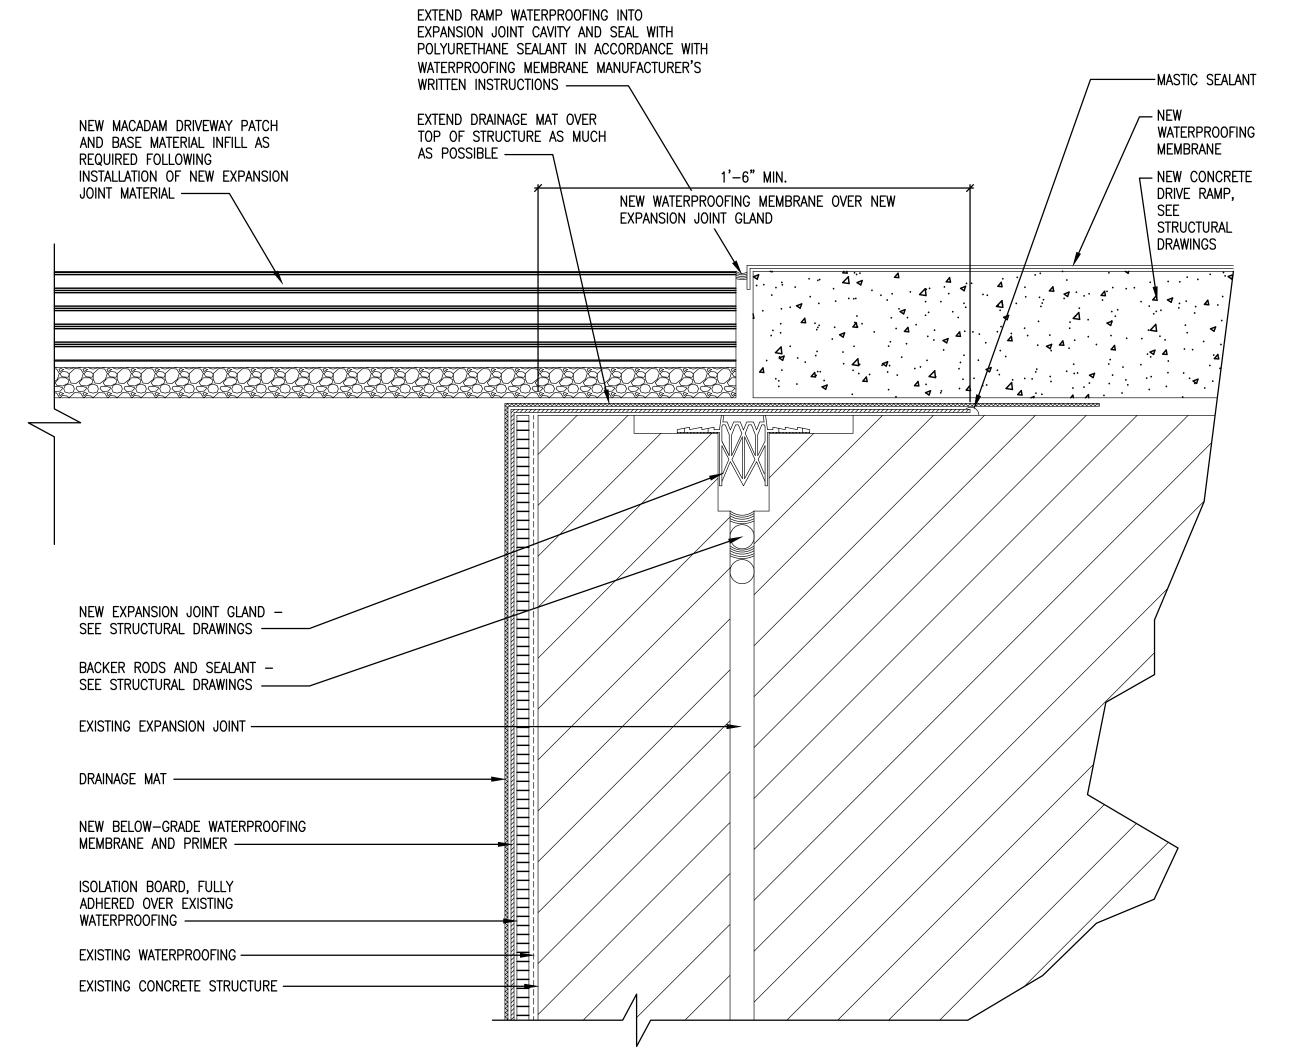


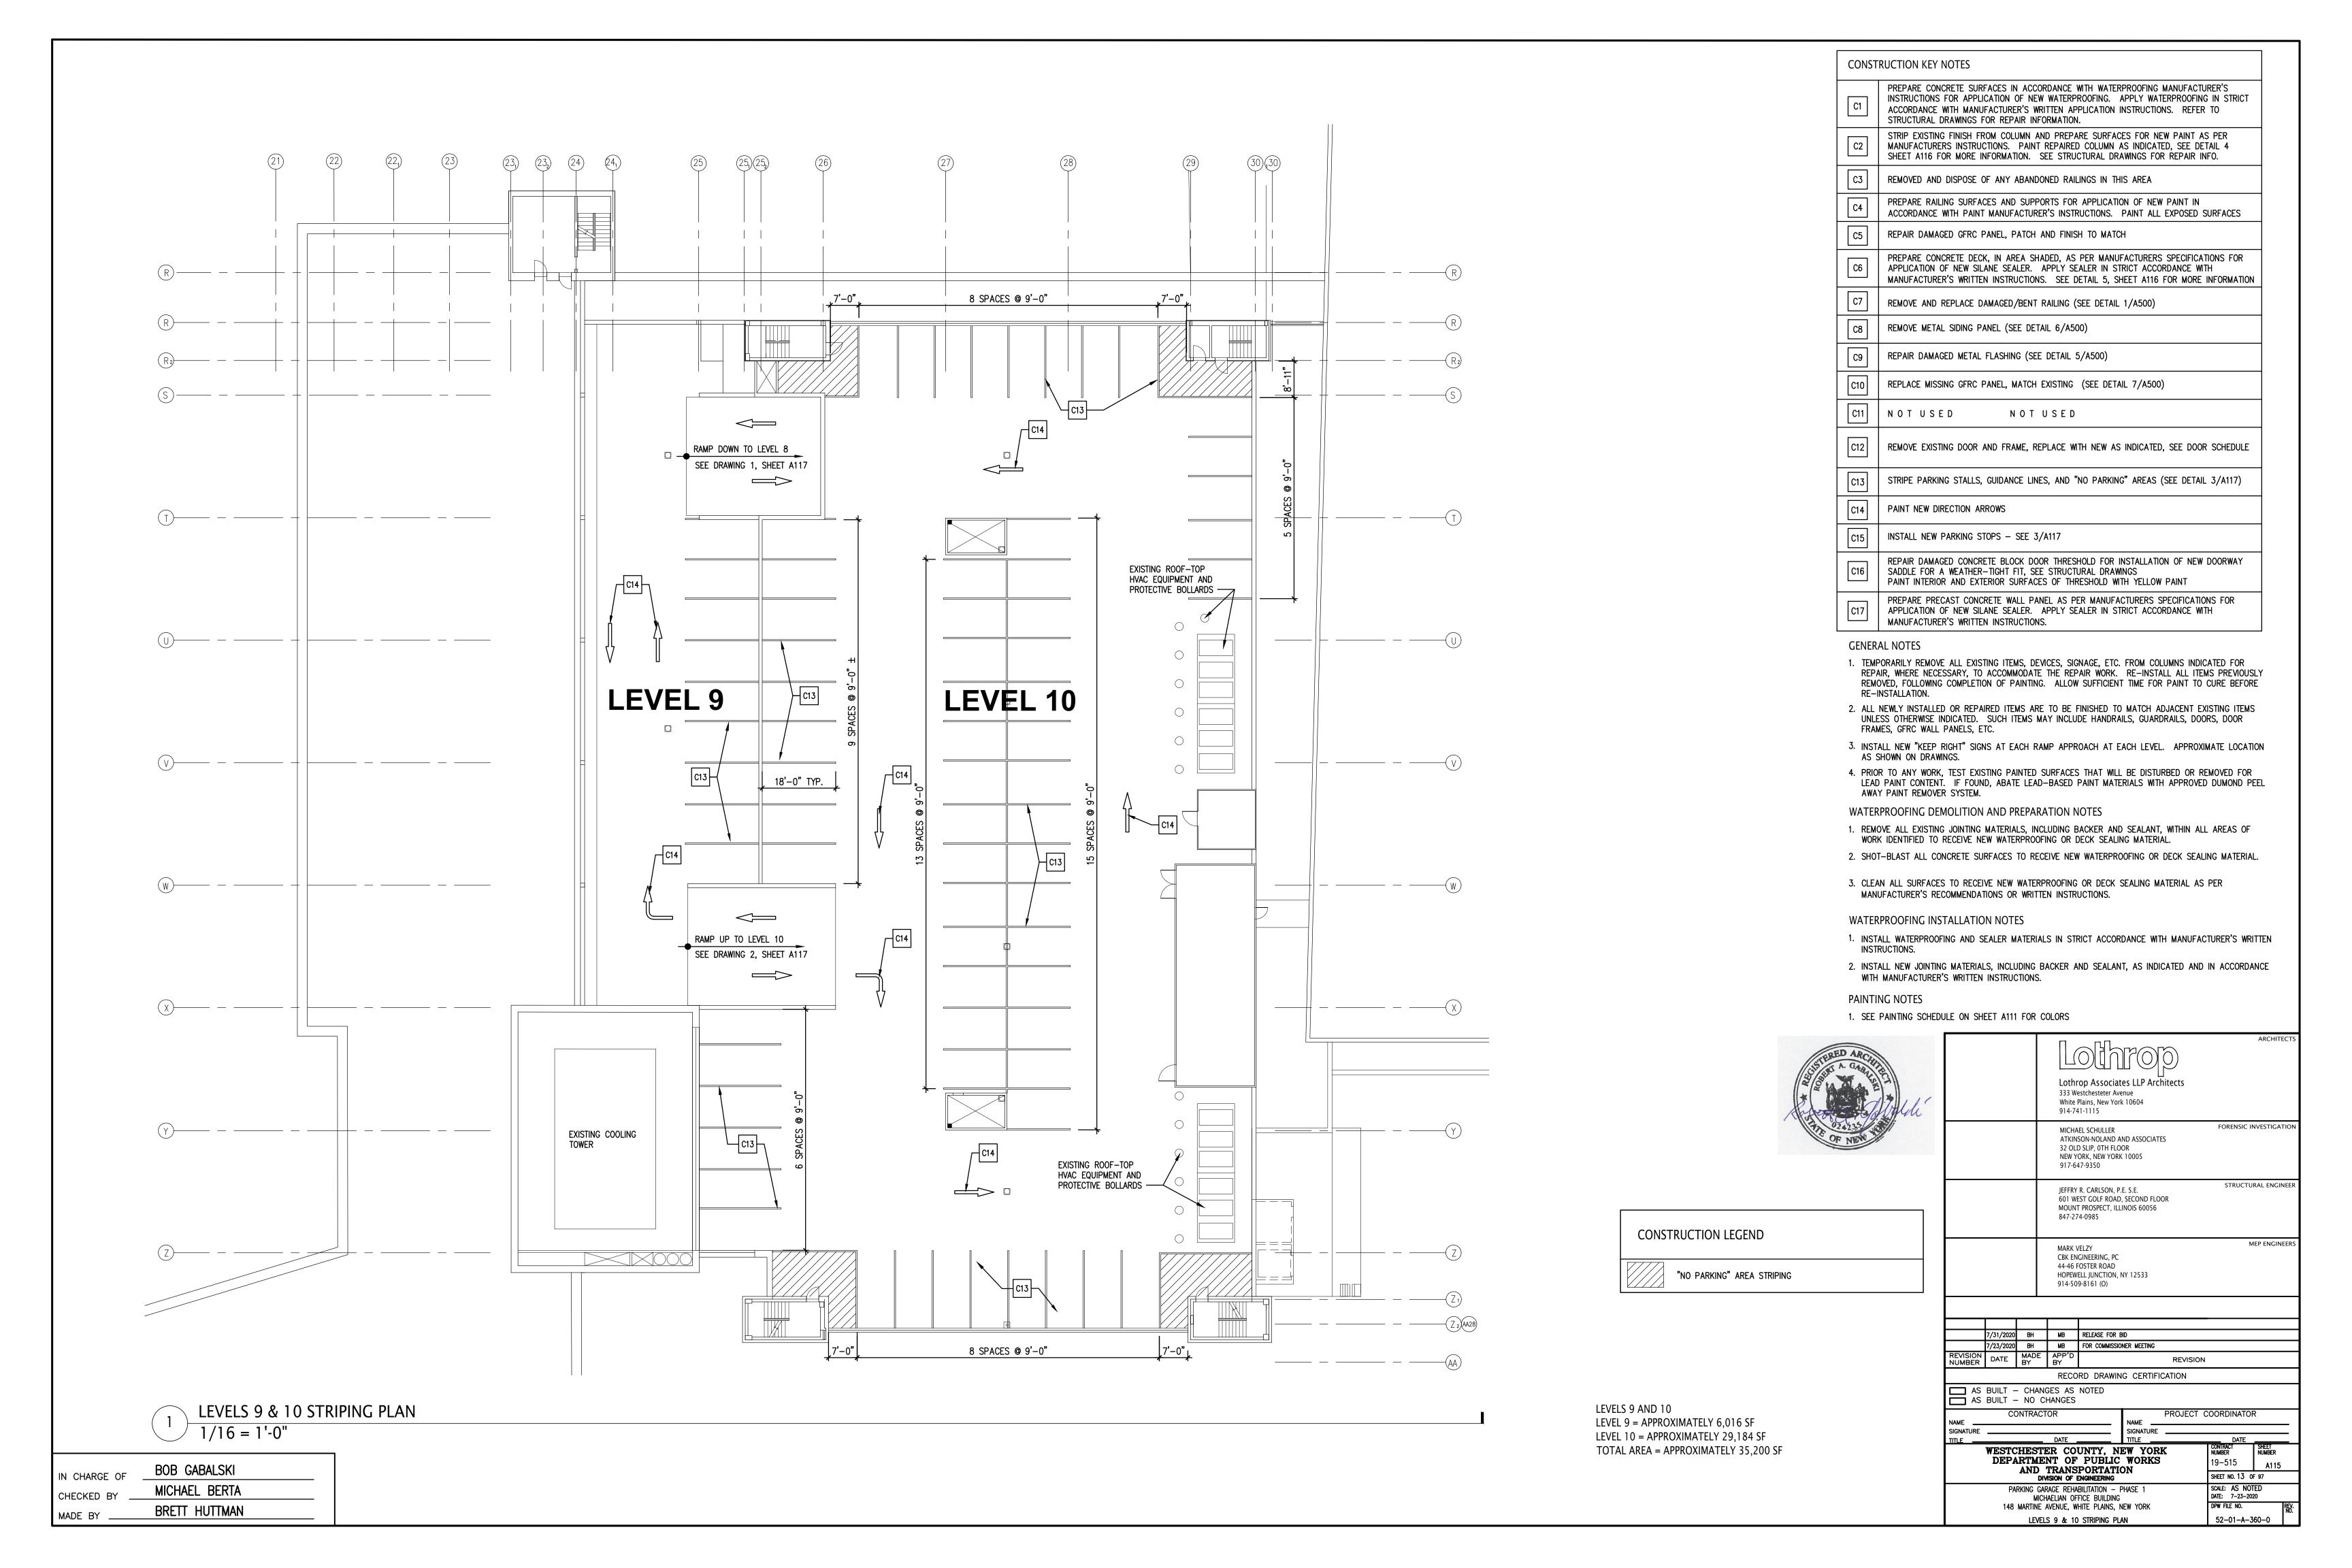

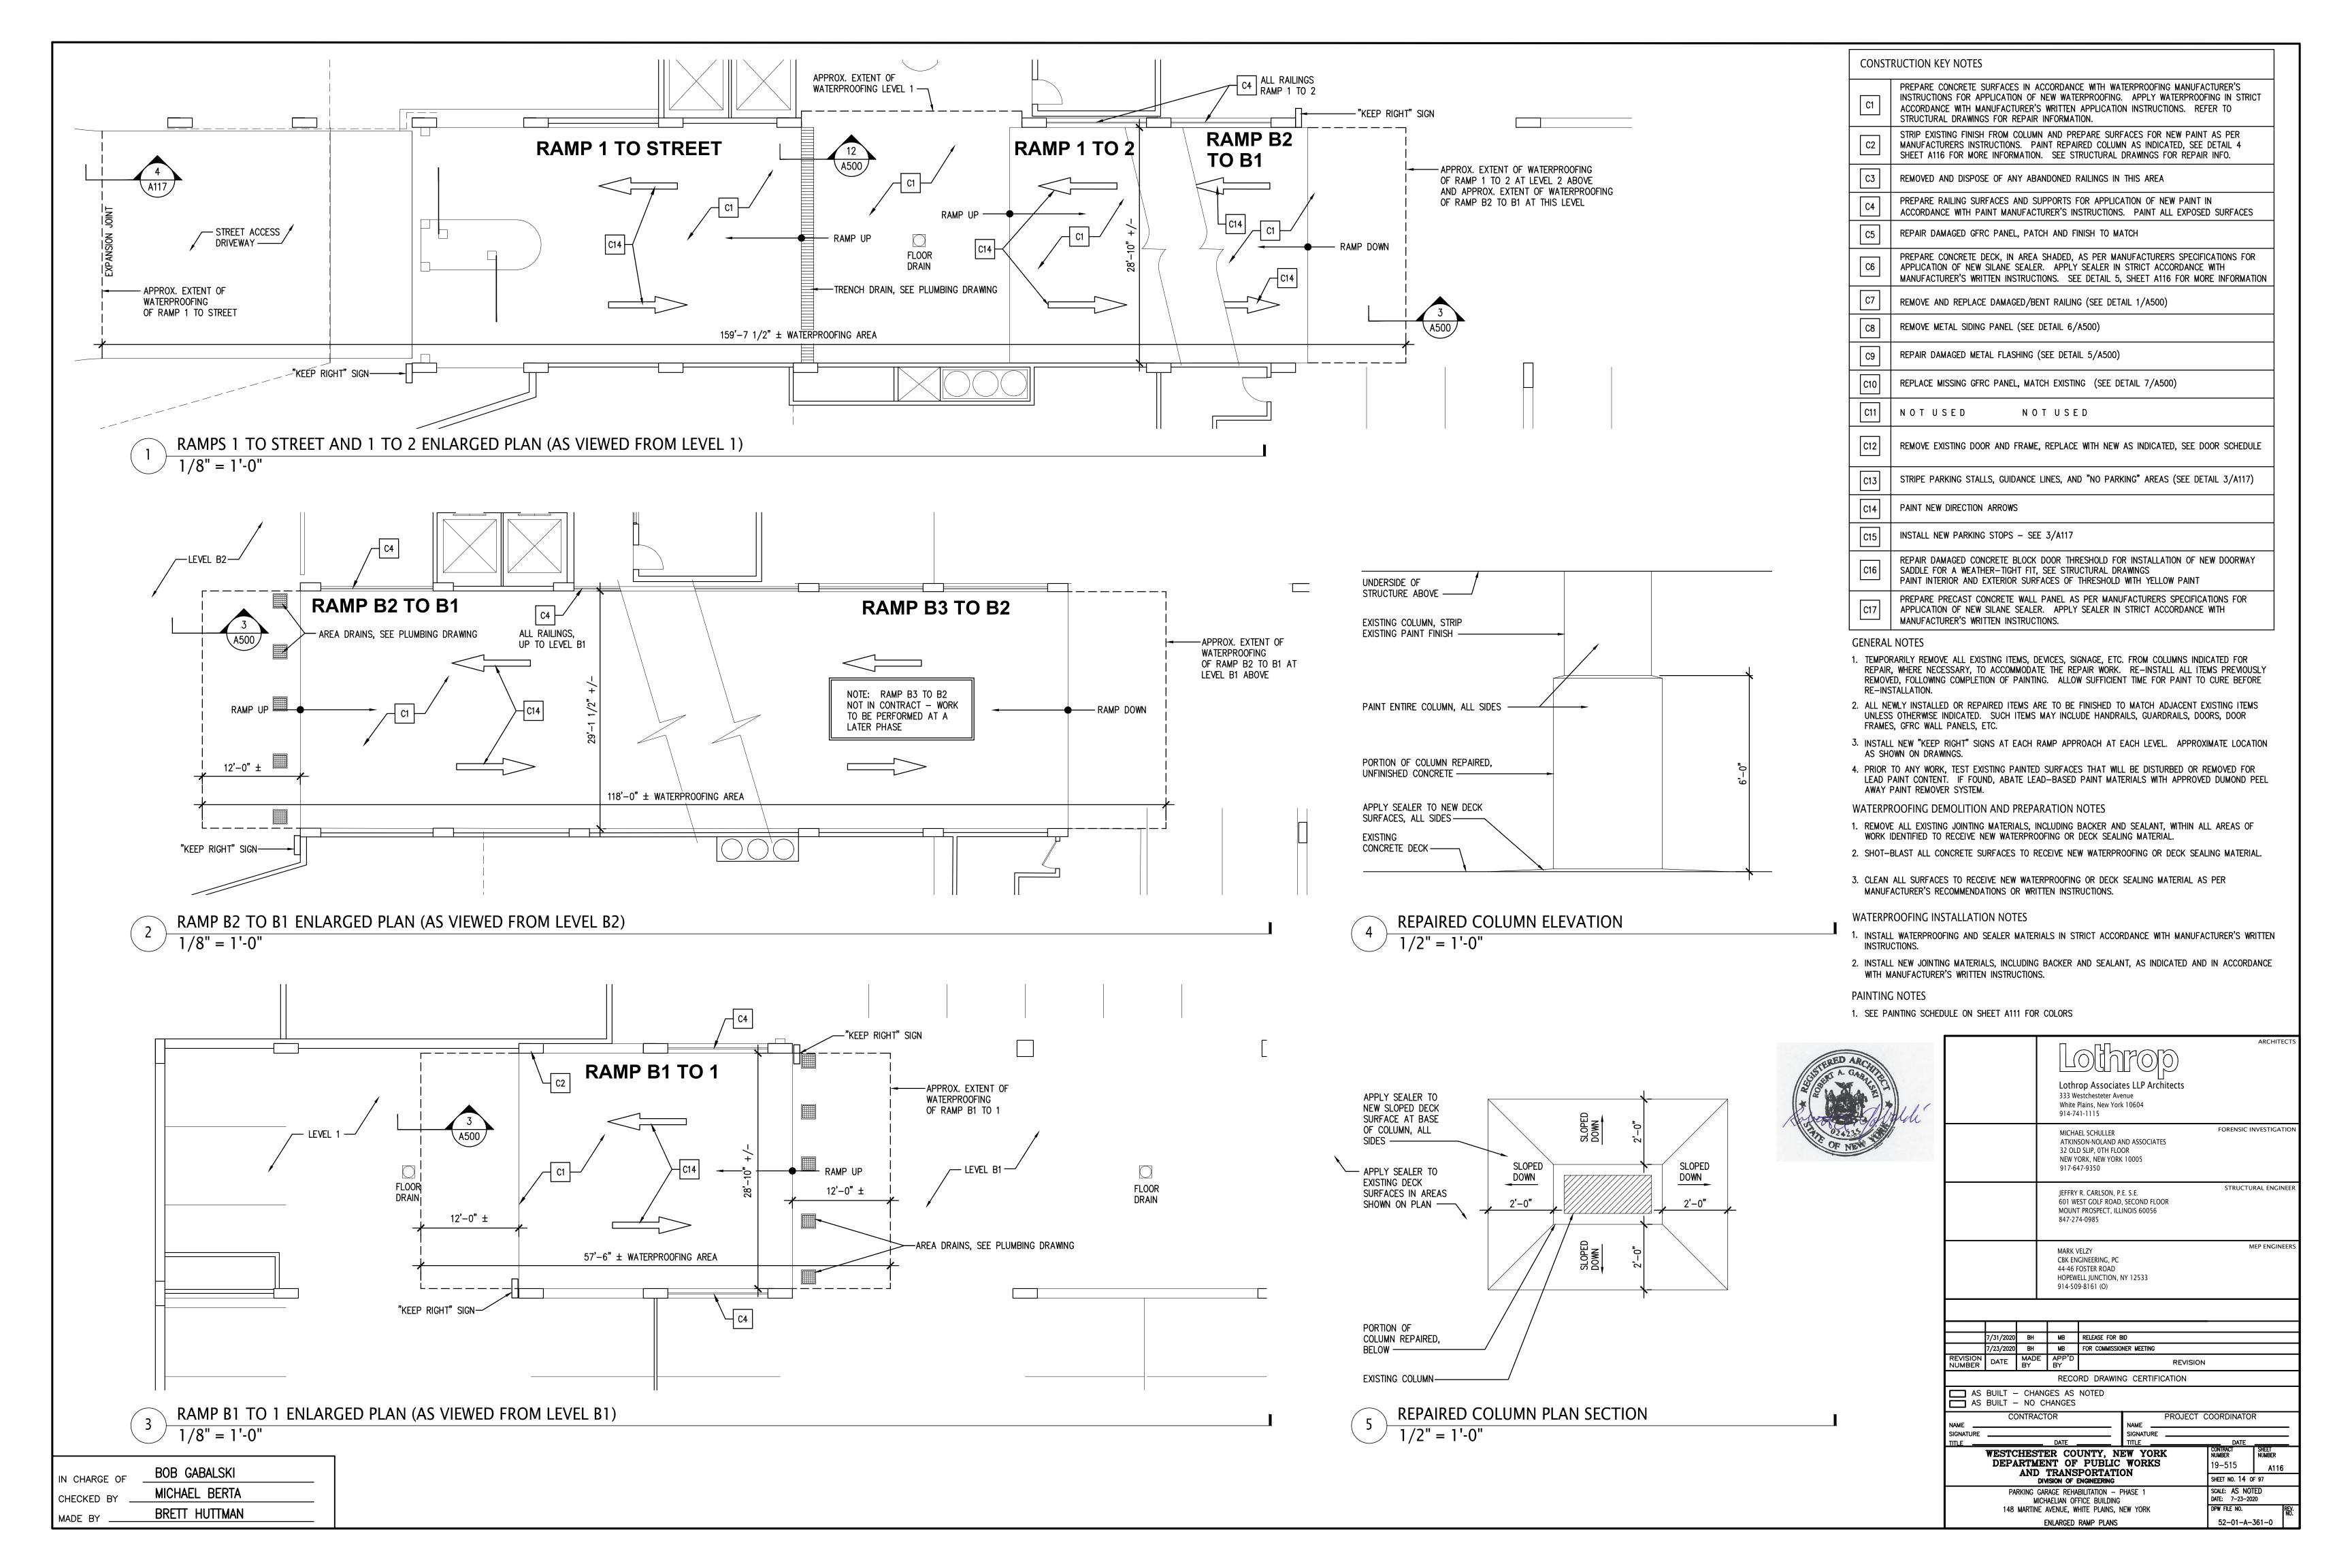EXPANSION JOINT AND RAMP WATERPROOFING DETAIL - RAMP 1 TO STREET

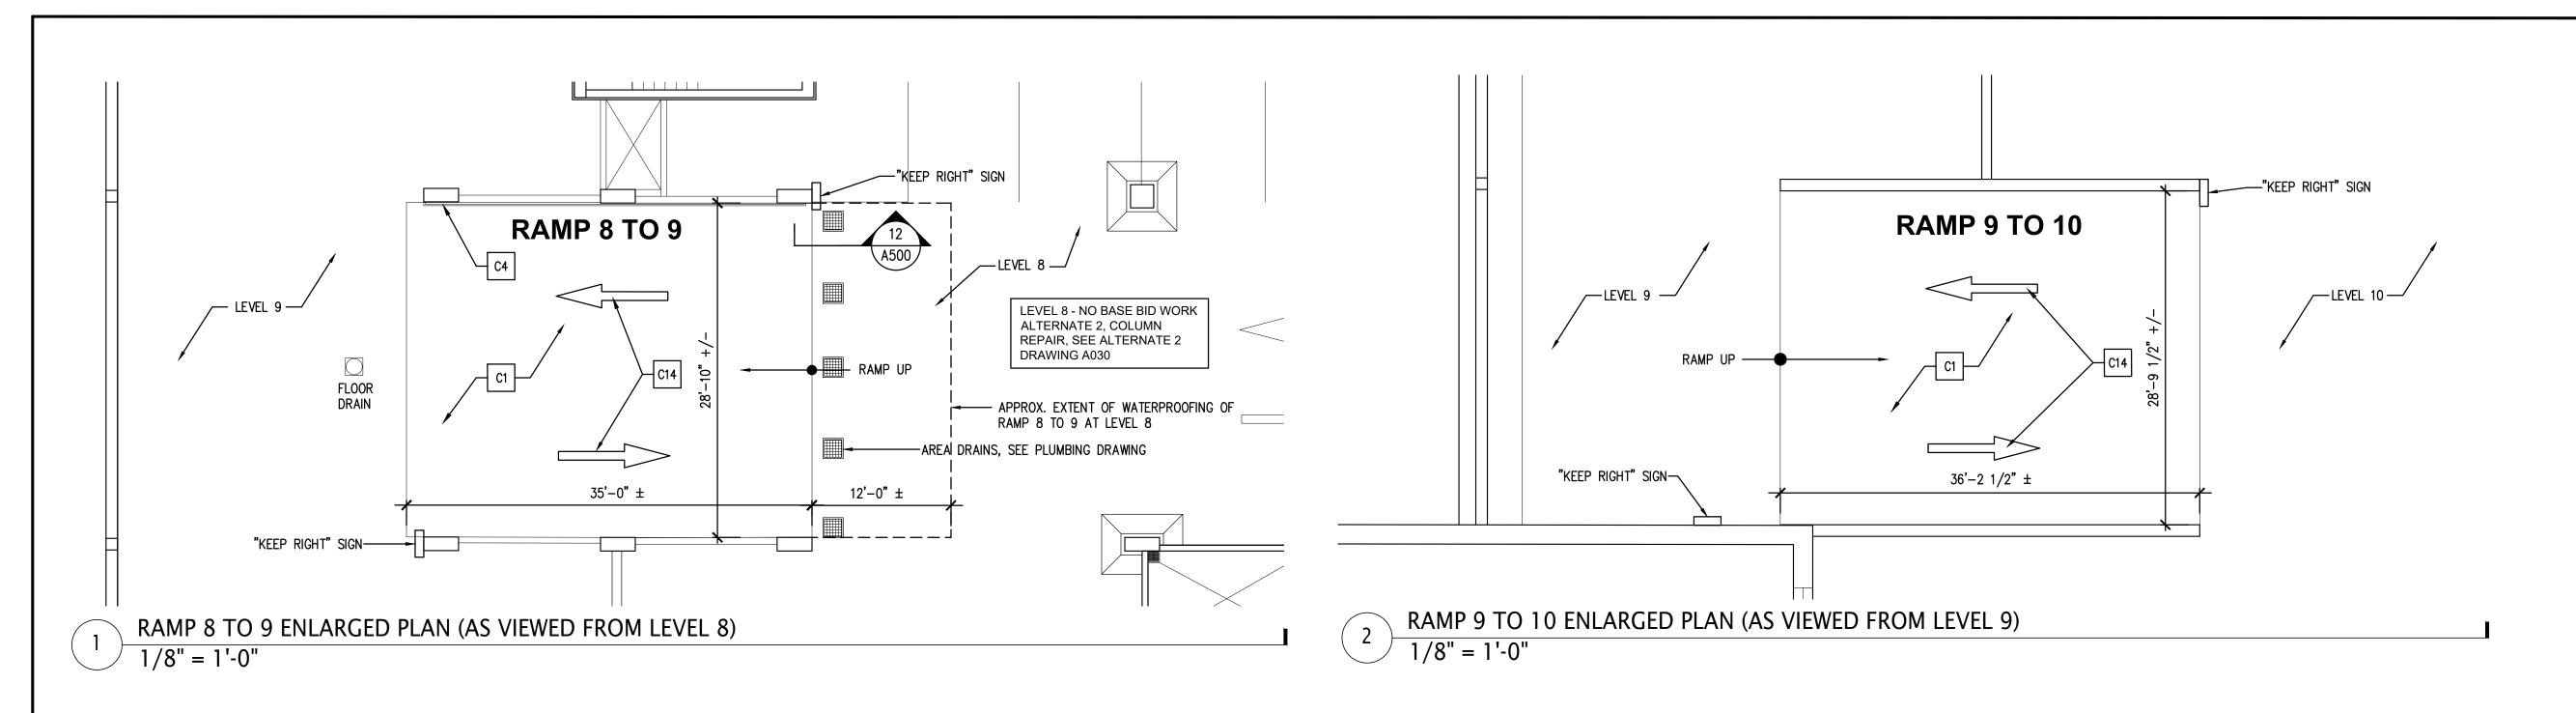



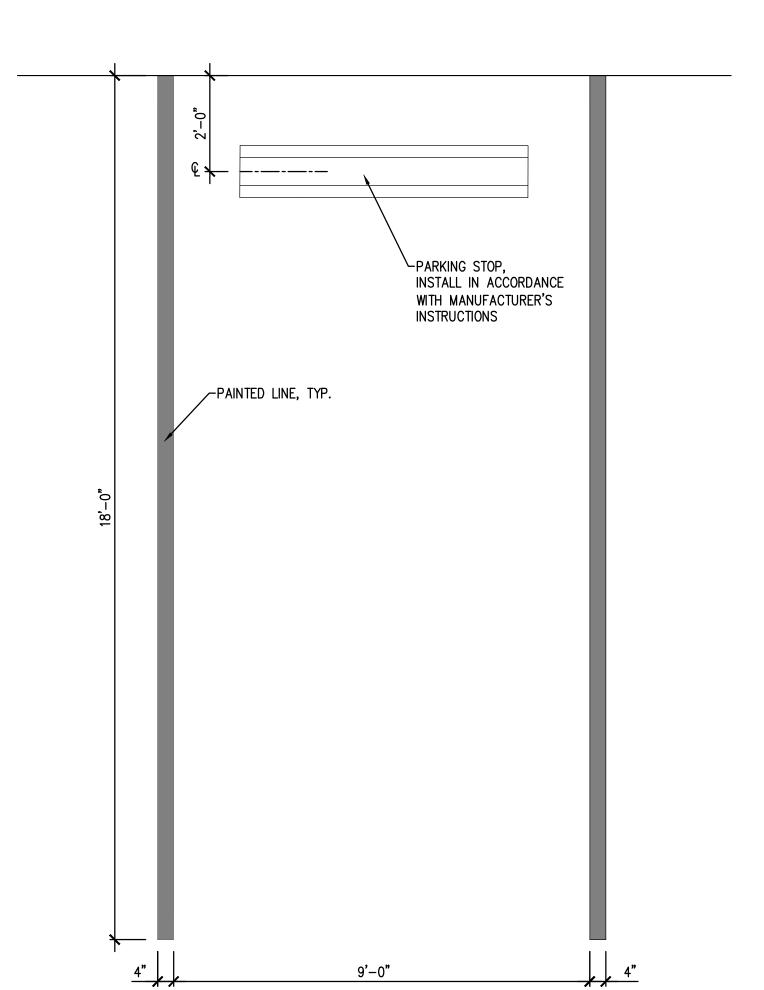

INSTRUCTIONS FOR APPLICATION OF NEW WATERPROOFING. APPLY WATERPROOFING IN STRICT ACCORDANCE WITH MANUFACTURER'S WRITTEN APPLICATION INSTRUCTIONS. REFER TO STRUCTURAL DRAWINGS FOR REPAIR INFORMATION. STRIP EXISTING FINISH FROM COLUMN AND PREPARE SURFACES FOR NEW PAINT AS PER MANUFACTURERS INSTRUCTIONS. PAINT REPAIRED COLUMN AS INDICATED, SEE DETAIL 4 SHEET A116 FOR MORE INFORMATION. SEE STRUCTURAL DRAWINGS FOR REPAIR INFO. REMOVED AND DISPOSE OF ANY ABANDONED RAILINGS IN THIS AREA PREPARE RAILING SURFACES AND SUPPORTS FOR APPLICATION OF NEW PAINT IN ACCORDANCE WITH PAINT MANUFACTURER'S INSTRUCTIONS. PAINT ALL EXPOSED SURFACES REPAIR DAMAGED GFRC PANEL, PATCH AND FINISH TO MATCH PREPARE CONCRETE DECK, IN AREA SHADED, AS PER MANUFACTURERS SPECIFICATIONS FOR APPLICATION OF NEW SILANE SEALER. APPLY SEALER IN STRICT ACCORDANCE WITH MANUFACTURER'S WRITTEN INSTRUCTIONS. SEE DETAIL 5, SHEET A116 FOR MORE INFORMATION REMOVE AND REPLACE DAMAGED/BENT RAILING (SEE DETAIL 1/A500) REMOVE METAL SIDING PANEL (SEE DETAIL 6/A500) REPAIR DAMAGED METAL FLASHING (SEE DETAIL 5/A500) REPLACE MISSING GFRC PANEL, MATCH EXISTING (SEE DETAIL 7/A500) NOT USED NOT USED REMOVE EXISTING DOOR AND FRAME, REPLACE WITH NEW AS INDICATED, SEE DOOR SCHEDULE STRIPE PARKING STALLS, GUIDANCE LINES, AND "NO PARKING" AREAS (SEE DETAIL 3/A117) PAINT NEW DIRECTION ARROWS INSTALL NEW PARKING STOPS - SEE 3/A117 REPAIR DAMAGED CONCRETE BLOCK DOOR THRESHOLD FOR INSTALLATION OF NEW DOORWAY SADDLE FOR A WEATHER-TIGHT FIT, SEE STRUCTURAL DRAWINGS PAINT INTERIOR AND EXTERIOR SURFACES OF THRESHOLD WITH YELLOW PAINT PREPARE PRECAST CONCRETE WALL PANEL AS PER MANUFACTURERS SPECIFICATIONS FOR APPLICATION OF NEW SILANE SEALER. APPLY SEALER IN STRICT ACCORDANCE WITH

PREPARE CONCRETE SURFACES IN ACCORDANCE WITH WATERPROOFING MANUFACTURER'S

GENERAL NOTES

CONSTRUCTION KEY NOTES

- 1. TEMPORARILY REMOVE ALL EXISTING ITEMS, DEVICES, SIGNAGE, ETC. FROM COLUMNS INDICATED FOR REPAIR, WHERE NECESSARY, TO ACCOMMODATE THE REPAIR WORK. RE—INSTALL ALL ITEMS PREVIOUSLY REMOVED, FOLLOWING COMPLETION OF PAINTING. ALLOW SUFFICIENT TIME FOR PAINT TO CURE BEFORE RE—INSTALLATION.
- 2. ALL NEWLY INSTALLED OR REPAIRED ITEMS ARE TO BE FINISHED TO MATCH ADJACENT EXISTING ITEMS UNLESS OTHERWISE INDICATED. SUCH ITEMS MAY INCLUDE HANDRAILS, GUARDRAILS, DOORS, DOOR FRAMES, GFRC WALL PANELS, ETC.
- 3. INSTALL NEW "KEEP RIGHT" SIGNS AT EACH RAMP APPROACH AT EACH LEVEL. APPROXIMATE LOCATION AS SHOWN ON DRAWINGS.
- 4. PRIOR TO ANY WORK, TEST EXISTING PAINTED SURFACES THAT WILL BE DISTURBED OR REMOVED FOR LEAD PAINT CONTENT. IF FOUND, ABATE LEAD—BASED PAINT MATERIALS WITH APPROVED DUMOND PEEL AWAY PAINT REMOVER SYSTEM.

WATERPROOFING DEMOLITION AND PREPARATION NOTES

MANUFACTURER'S WRITTEN INSTRUCTIONS.

- REMOVE ALL EXISTING JOINTING MATERIALS, INCLUDING BACKER AND SEALANT, WITHIN ALL AREAS OF WORK IDENTIFIED TO RECEIVE NEW WATERPROOFING OR DECK SEALING MATERIAL.
- 2. SHOT-BLAST ALL CONCRETE SURFACES TO RECEIVE NEW WATERPROOFING OR DECK SEALING MATERIAL.
- 3. CLEAN ALL SURFACES TO RECEIVE NEW WATERPROOFING OR DECK SEALING MATERIAL AS PER MANUFACTURER'S RECOMMENDATIONS OR WRITTEN INSTRUCTIONS.

WATERPROOFING INSTALLATION NOTES

- 1. INSTALL WATERPROOFING AND SEALER MATERIALS IN STRICT ACCORDANCE WITH MANUFACTURER'S WRITTEN INSTRUCTIONS.
- 2. INSTALL NEW JOINTING MATERIALS, INCLUDING BACKER AND SEALANT, AS INDICATED AND IN ACCORDANCE WITH MANUFACTURER'S WRITTEN INSTRUCTIONS.


PAINTING NOTES

1. SEE PAINTING SCHEDULE ON SHEET A111 FOR COLORS



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| | JEFFRY R. CARLSON, P.E. S.E. 601 WEST GOLF ROAD, SECOND FLOOR MOUNT PROSPECT, ILLINOIS 60056 847-274-0985 | | | | | | | STRUCTUI | RAL ENGI | NEER |
| | | | | MARK VELZY CBK ENGINEERING, PC 44-46 FOSTER ROAD HOPEWELL JUNCTION, NY 12533 914-509-8161 (O) | | | | | EP ENGIN | EERS |
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| | | | M | ICHAELIAN OF | ABILITATION — FICE BUILDING | | | SCALE: AS NOT DATE: 7-23-202 DPW FILE NO. | | loc. |
| | | 140 | MILTININ | • | /HITE PLAINS, RAMP PLANS | NEW TURK | | 52-01-A-3 | 362-0 | REV. No. |
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IN CHARGE OF BOB GABALSKI
CHECKED BY MICHAEL BERTA
MADE BY BRETT HUTTMAN

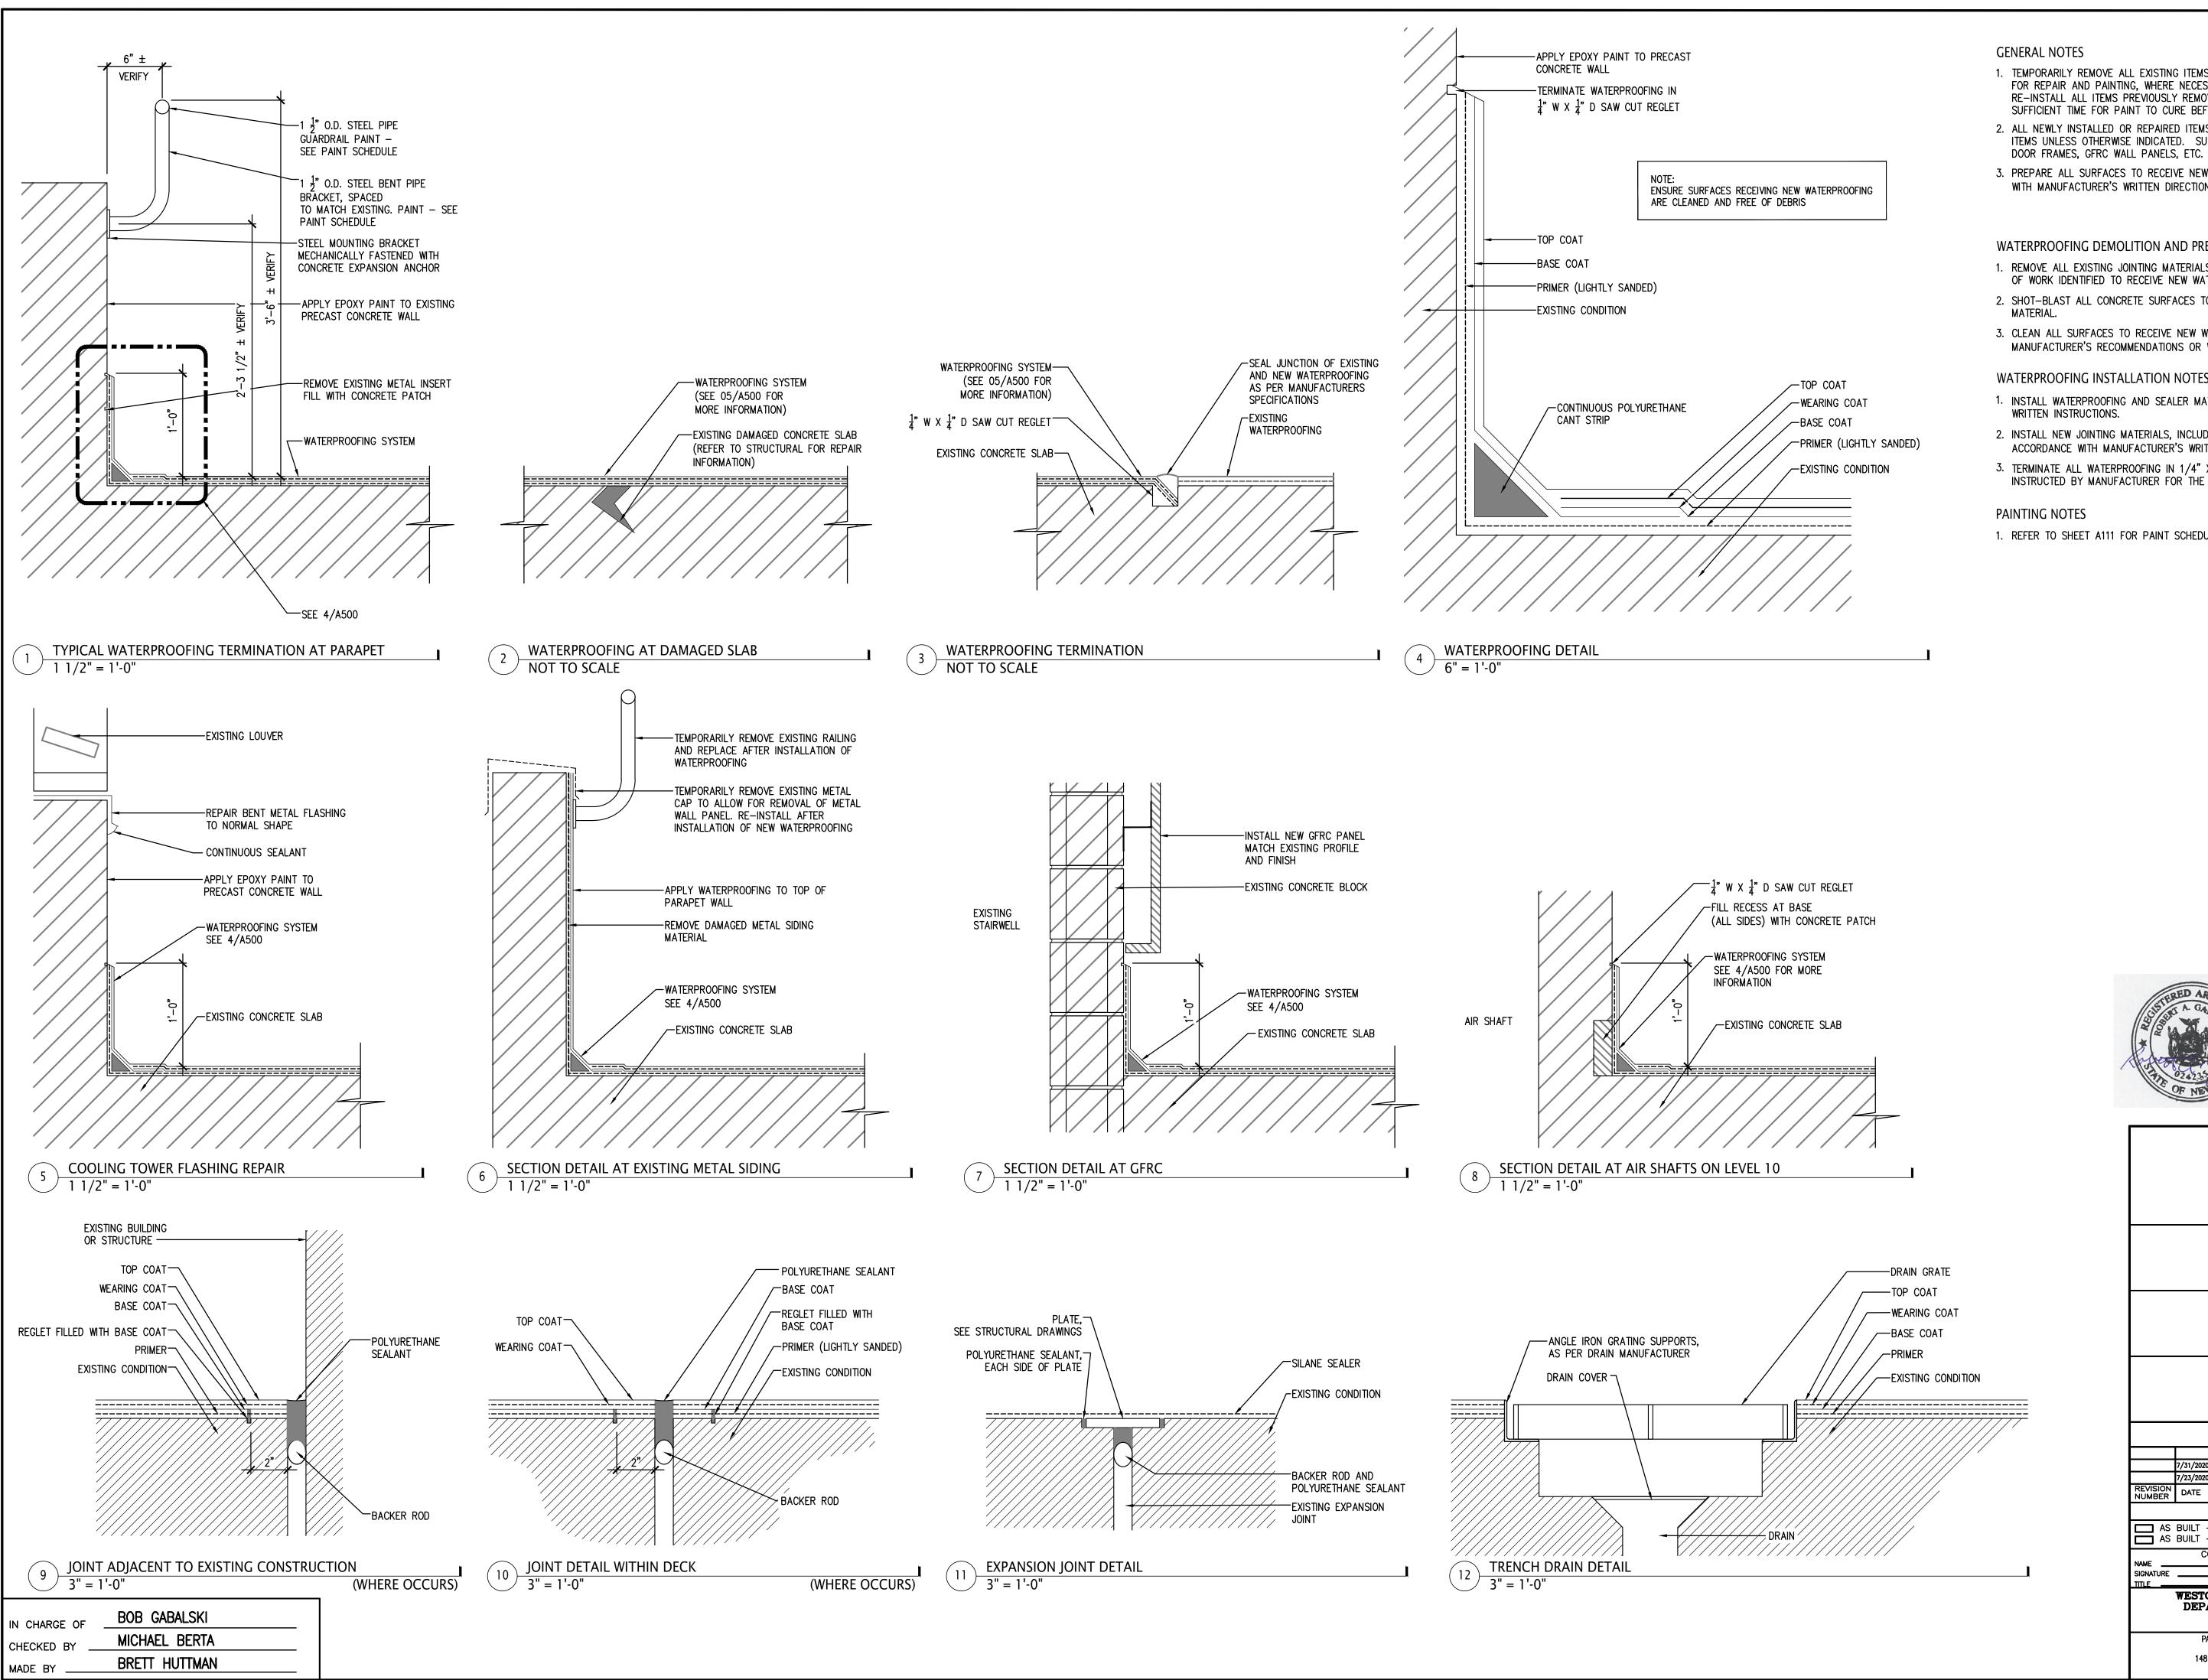

- 1. TEMPORARILY REMOVE ALL EXISTING ITEMS, DEVICES, SIGNAGE, ETC. FROM SURFACES INDICATED FOR REPAIR AND PAINTING, WHERE NECESSARY, TO ACCOMMODATE THE REPAIR OR PAINTING WORK. RE-INSTALL ALL ITEMS PREVIOUSLY REMOVED, FOLLOWING COMPLETION OF PAINTING. ALLOW SUFFICIENT TIME FOR PAINT TO CURE BEFORE RE-INSTALLATION.
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- 3. PREPARE ALL SURFACES TO RECEIVE NEW PAINT OR WATERPROOFING MATERIALS IN ACCORDANCE WITH MANUFACTURER'S WRITTEN DIRECTIONS.

WATERPROOFING DEMOLITION AND PREPARATION NOTES

- 1. REMOVE ALL EXISTING JOINTING MATERIALS, INCLUDING BACKER AND SEALANT, WITHIN ALL AREAS OF WORK IDENTIFIED TO RECEIVE NEW WATERPROOFING OR DECK SEALING MATERIAL.
- 2. SHOT-BLAST ALL CONCRETE SURFACES TO RECEIVE NEW WATERPROOFING OR DECK SEALING
- 3. CLEAN ALL SURFACES TO RECEIVE NEW WATERPROOFING OR DECK SEALING MATERIAL AS PER MANUFACTURER'S RECOMMENDATIONS OR WRITTEN INSTRUCTIONS.


WATERPROOFING INSTALLATION NOTES


- 1. INSTALL WATERPROOFING AND SEALER MATERIALS IN STRICT ACCORDANCE WITH MANUFACTURER'S
- 2. INSTALL NEW JOINTING MATERIALS, INCLUDING BACKER AND SEALANT, AS INDICATED AND IN ACCORDANCE WITH MANUFACTURER'S WRITTEN INSTRUCTIONS.
- 3. TERMINATE ALL WATERPROOFING IN 1/4" X 1/4" SAWCUT REGLET, UNLESS OTHERWISE NOTED OR INSTRUCTED BY MANUFACTURER FOR THE CONDITION ENCOUNTERED.

1. REFER TO SHEET A111 FOR PAINT SCHEDULE




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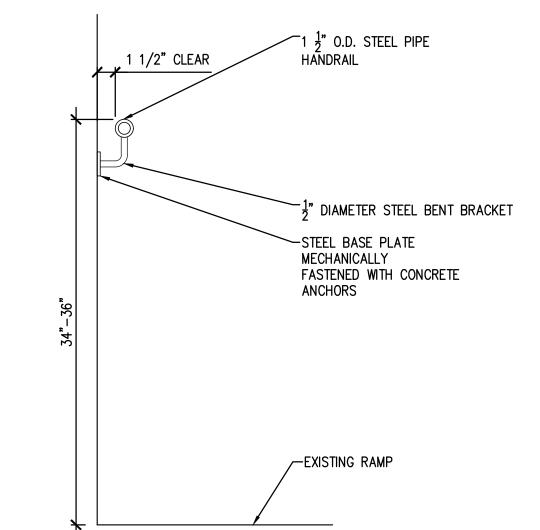


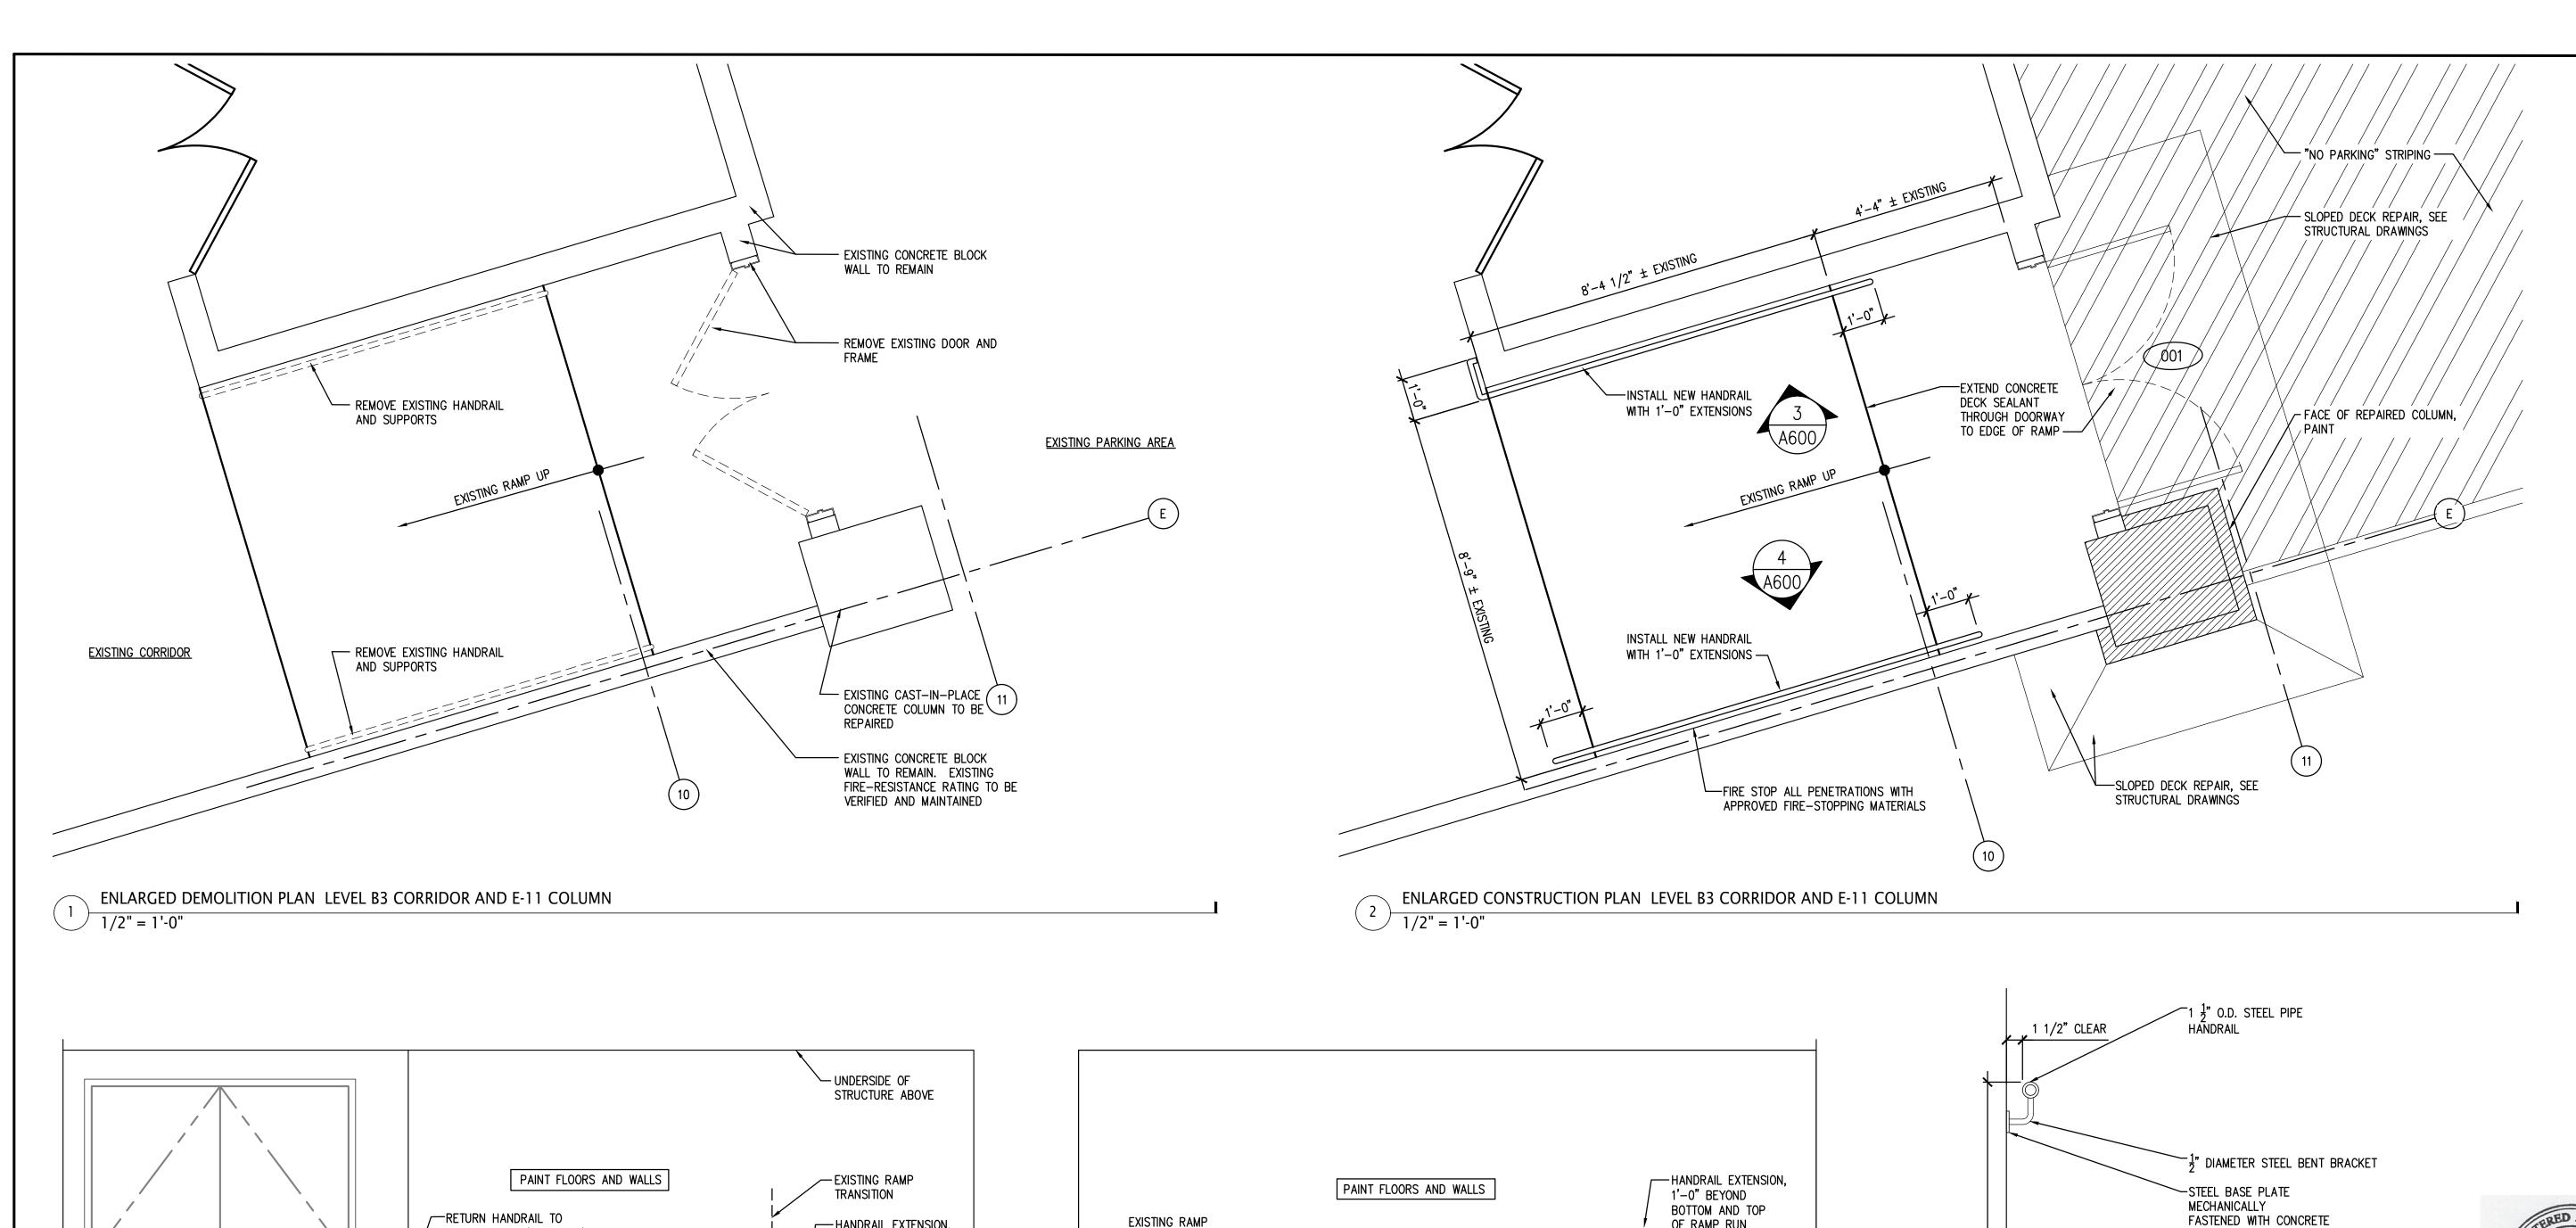

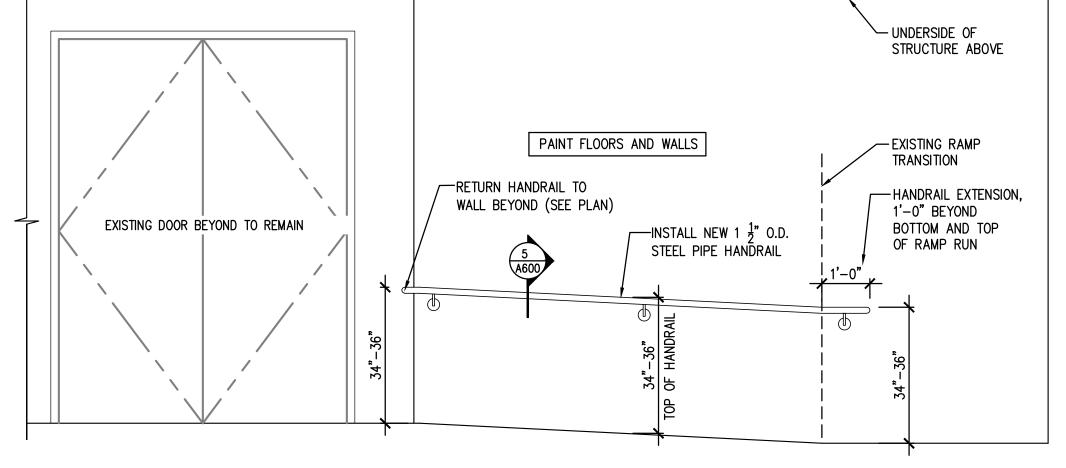



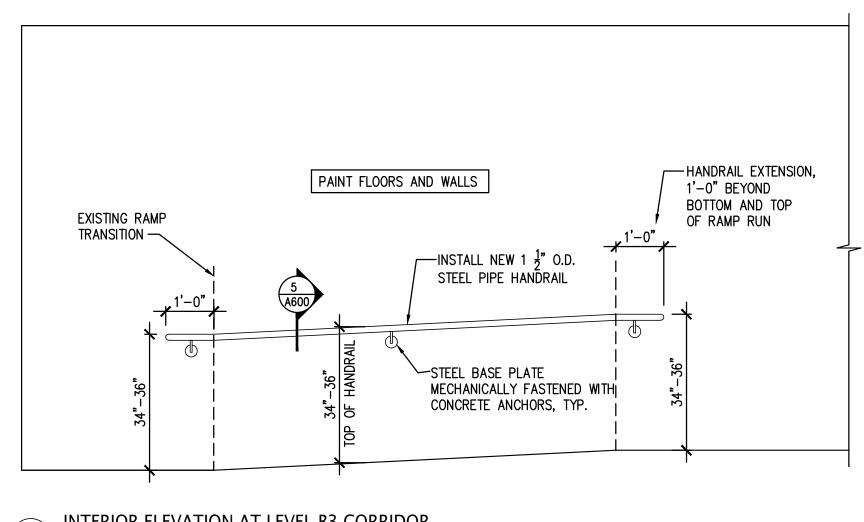





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| IN CHARGE OF | BOB GABALSKI |
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| CHECKED BY | MICHAEL BERTA |
| MADE BY | BRETT HUTTMAN |





MICHAELIAN OFFICE BUILDING

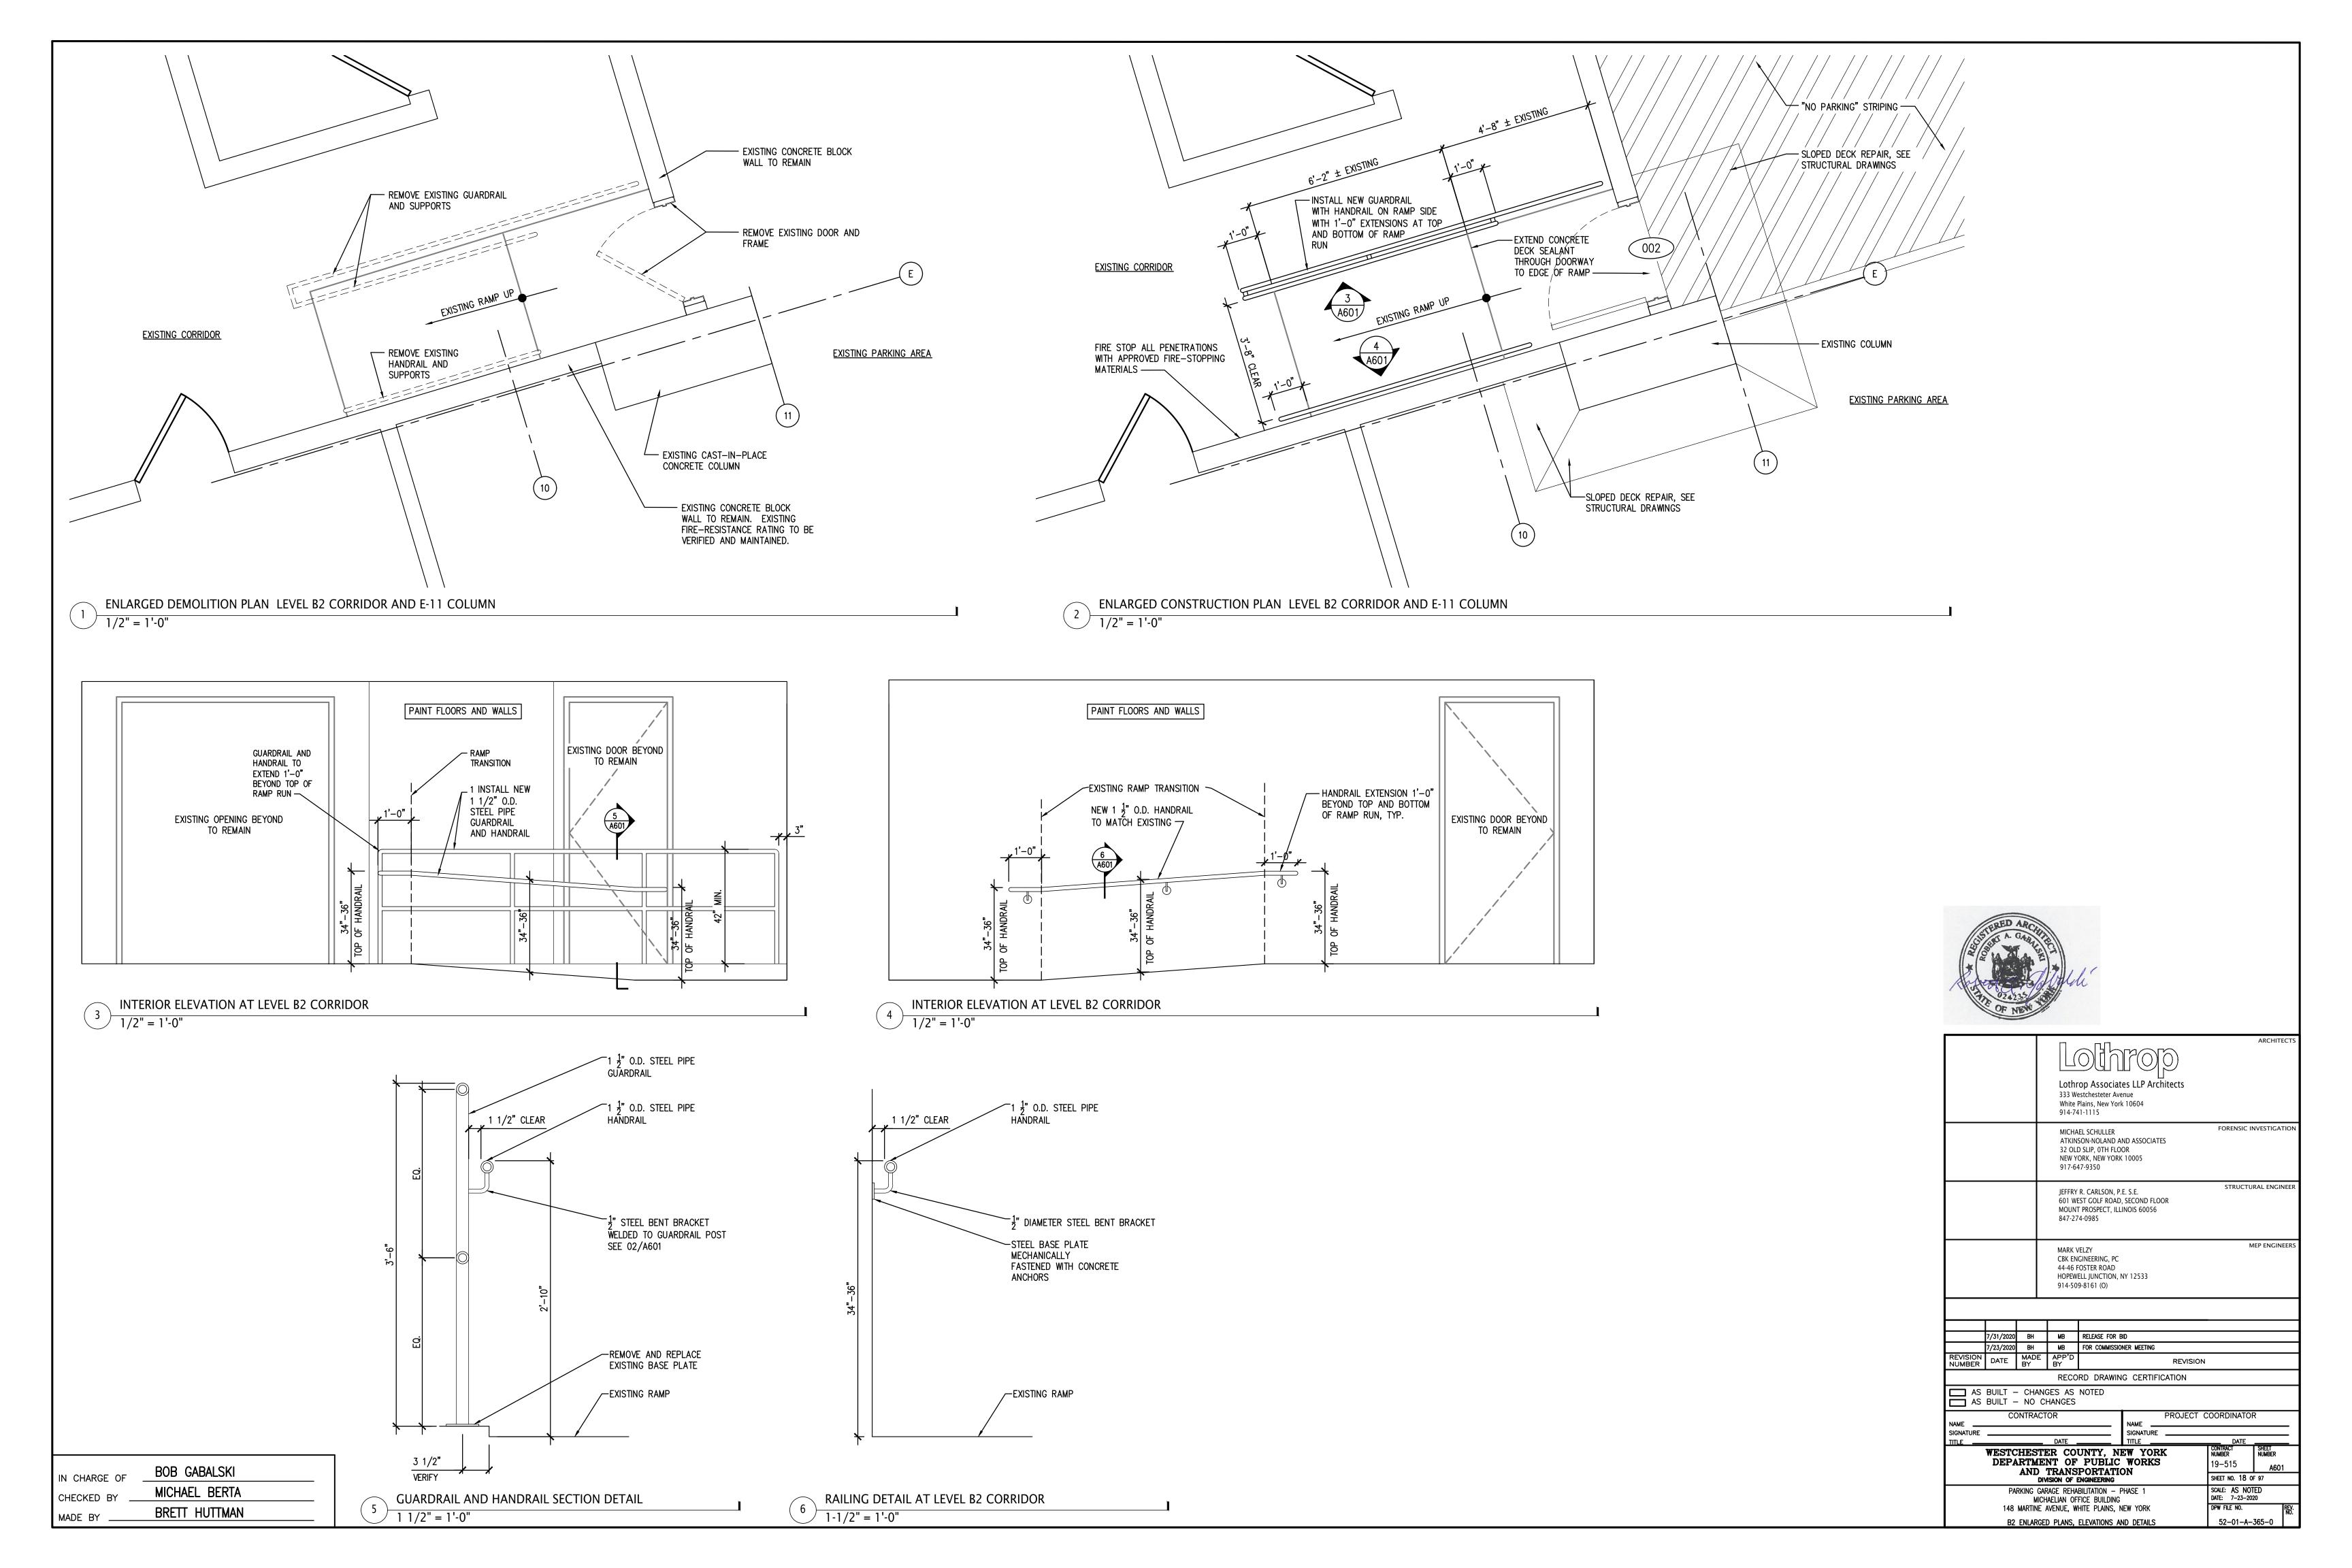148 MARTINE AVENUE, WHITE PLAINS, NEW YORK

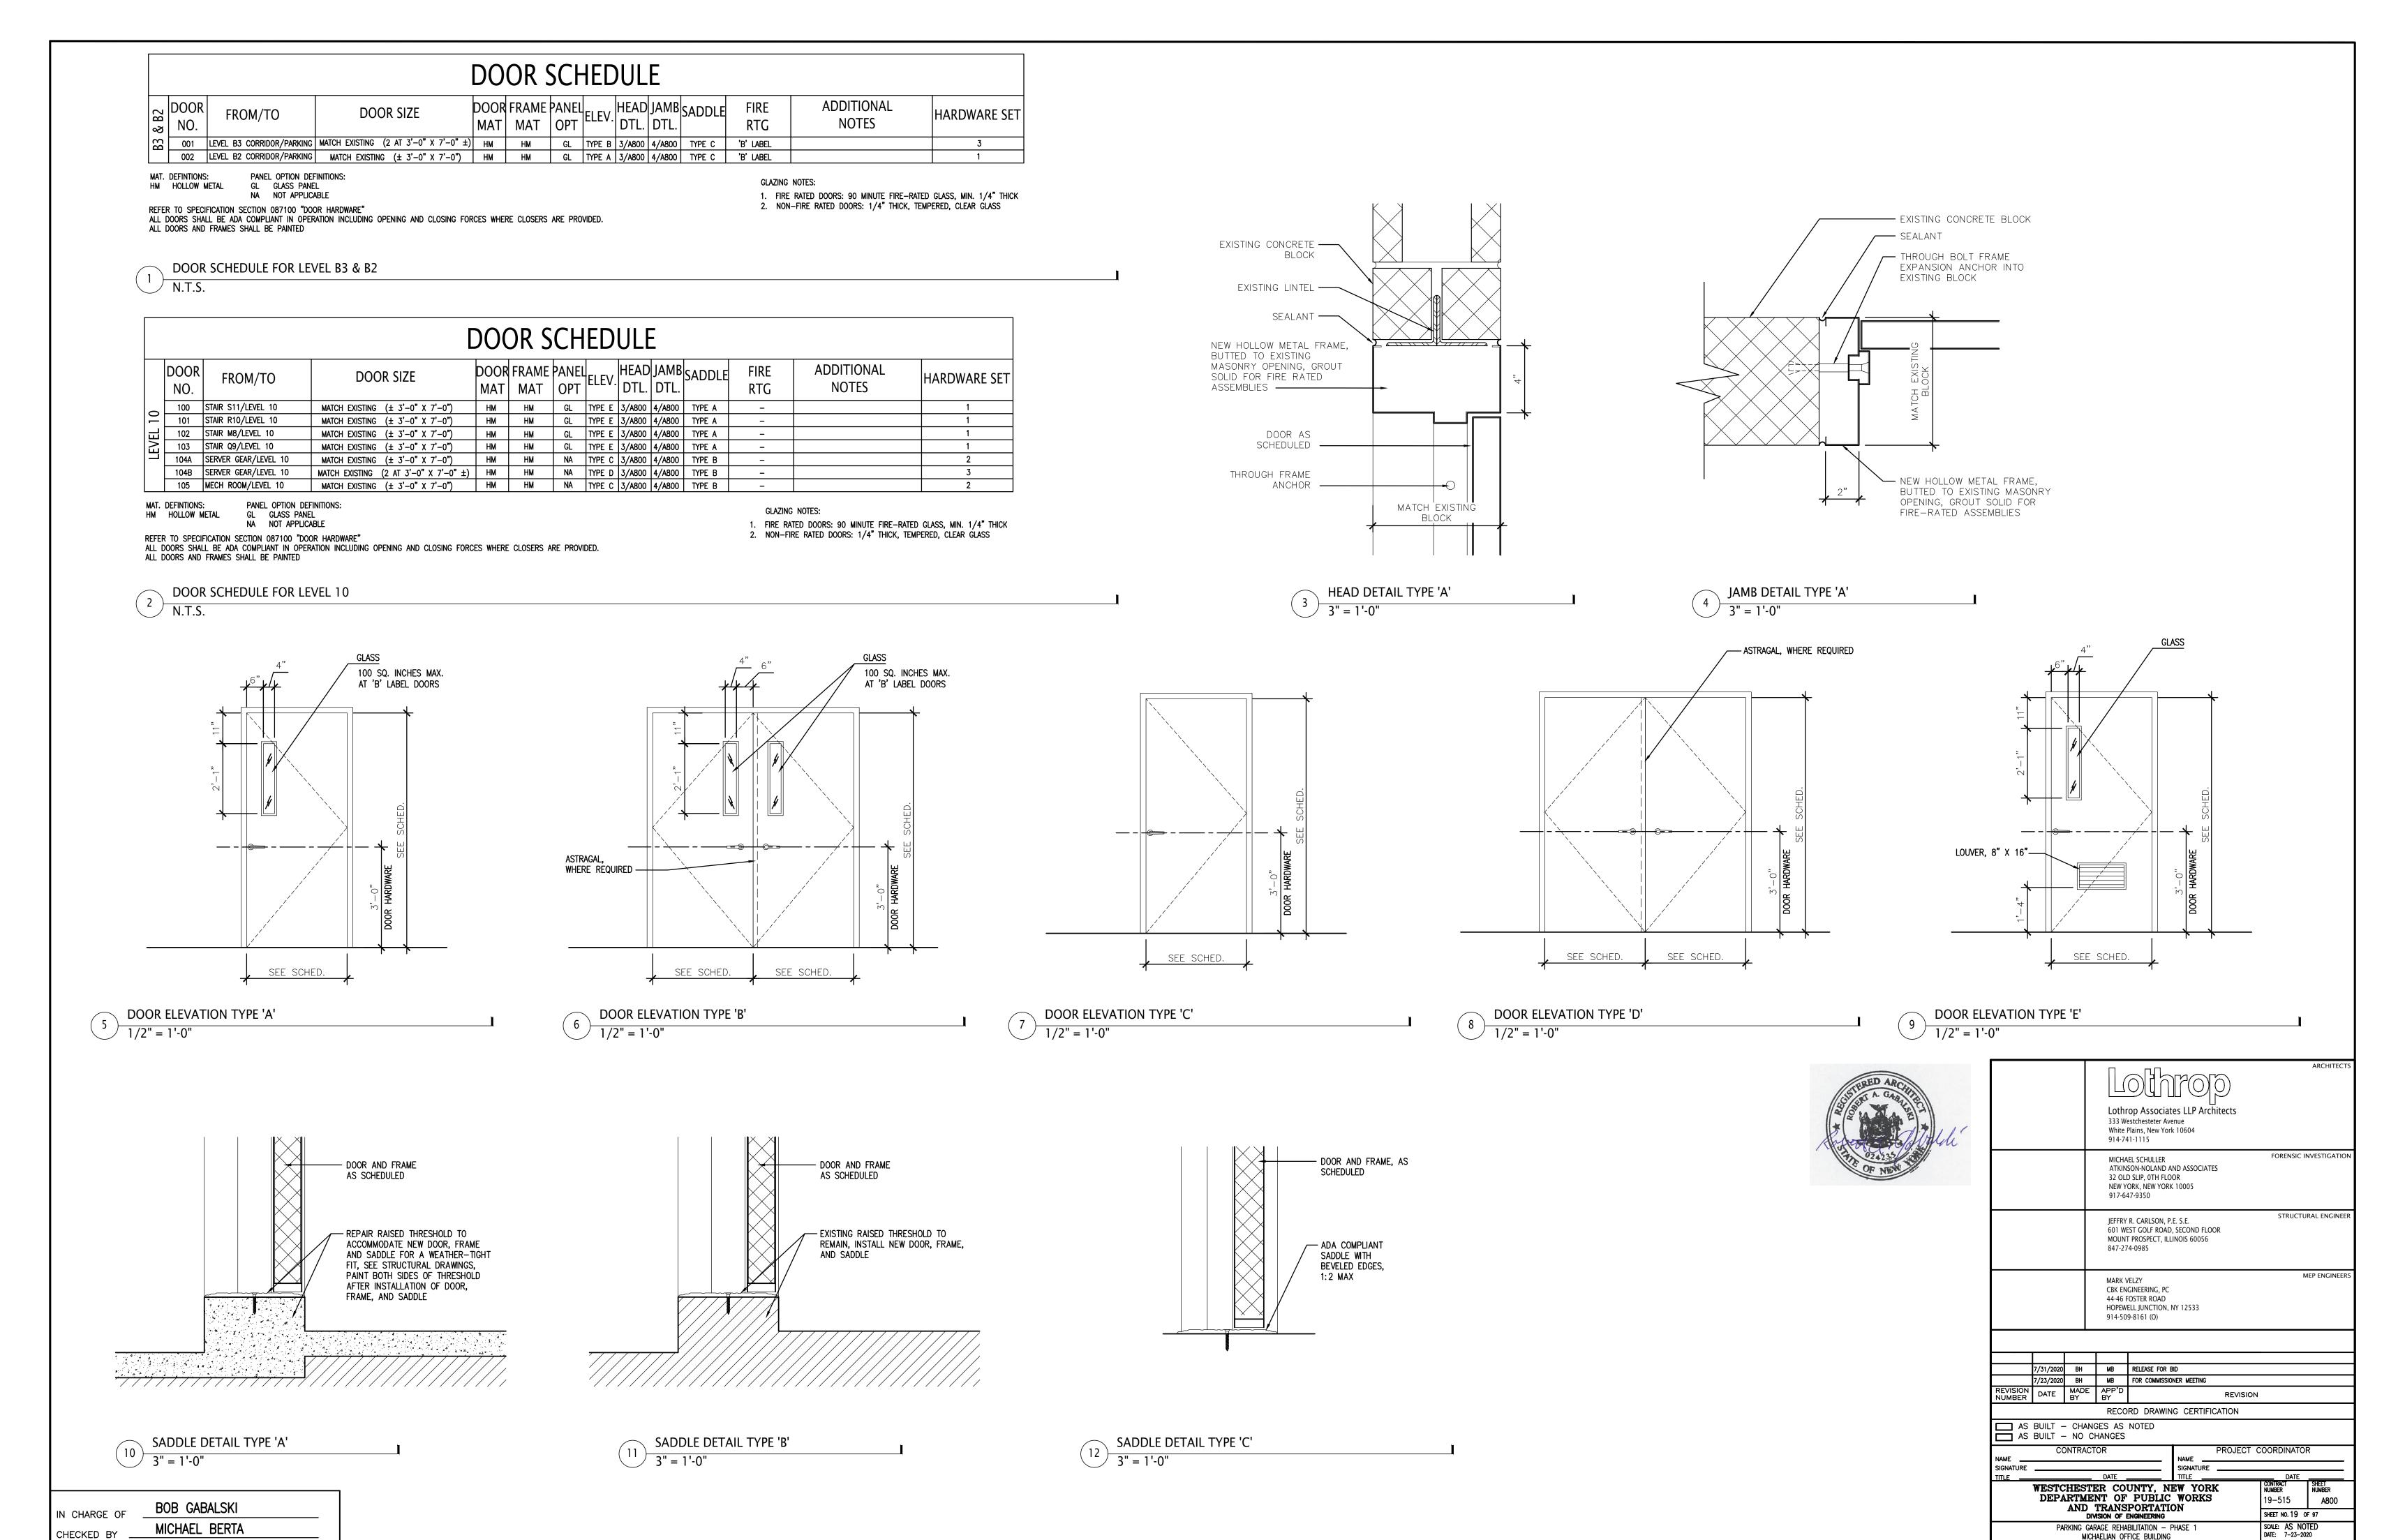DOOR SCHEDULE AND DETAILS

DPW FILE NO.

52-01-A-366-0

CHECKED BY

MADE BY

BRETT HUTTMAN