

# HVAC DRAWINGS FOR: LINCOLN EQUITIES BUILDING B SOUTHEAST, NY

DESIGNER / BUILDER

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**ADBI** | DESIGN  
SERVICES

PROJECT TITLE

**LINCOLN  
EQUITIES -  
NY-312 -  
BLDG B**  
NY-312 & PUGSLEY RD,  
SOUTHEAST, NY 10509

ARCHITECT

ADBI | DESIGN SERVICES LLC  
44 SOUTH BROADWAY, SUITE 1003  
WHITE PLAINS, NY 10601

CIVIL ENGINEER

LANGAN ENGINEERING  
300 KIMBALL DRIVE  
PARSONS, NY 10754

STRUCTURAL ENGINEER

SMITH ROBERTS AND ASSOCIATES, INC.  
6501 BLUFF RD.  
INDIANAPOLIS, INDIANA 46217

MECHANICAL ENGINEER

NATIONAL DESIGN/BUILD SERVICES  
11840 BORMAN DRIVE  
ST. LOUIS, MO 63146

ELECTRICAL ENGINEER

FBX ENGINEERING  
5 CHRISTY DRIVE, SUITE 307  
CHADDS FORD, PA 19317

PLUMBING ENGINEER

MCCARTHY ENGINEERING ASSOCIATES,  
INC.  
315 EAST SECOND STREET  
BOYERTOWN, PA 19512



FIRE PROTECTION ENGINEER

S A COMMUNALE CO. INC.  
2900 NEWPARK DRIVE  
BARTERTON, OH 44203

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KEY PLAN



SUBMITTALS

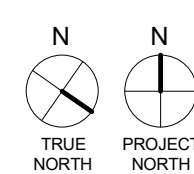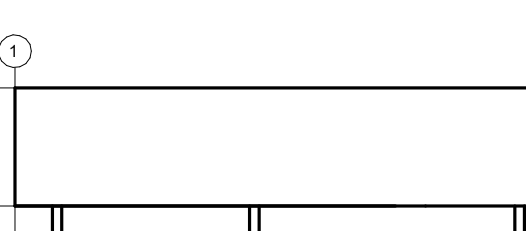NO.	DATE	DESCRIPTION
A	02/04/2022	QA/QC SET
B	03/29/2022	QA/QC SET
C	05/20/2022	QA/QC SET

PROJECT NO.

J22006

SHEET TITLE


COVER SHEET

SHEET NO.

M000

## SYMBOLS

## ABBREVIATIONS

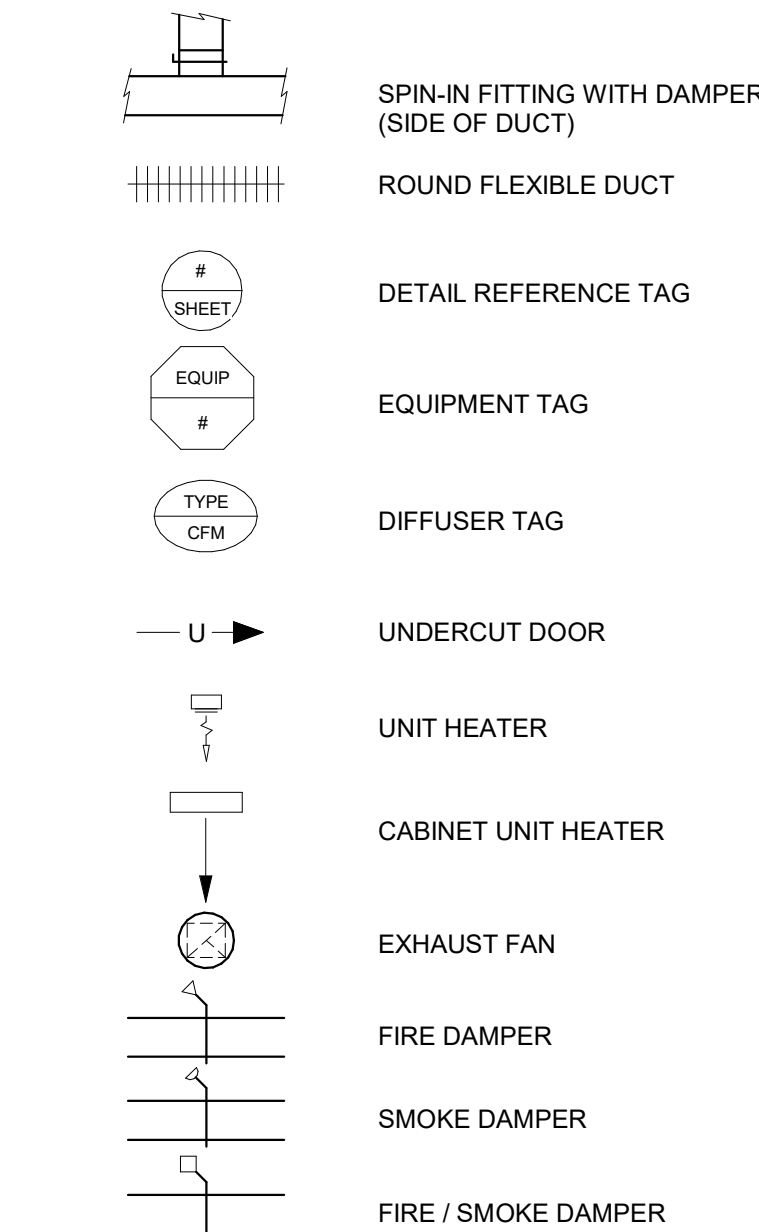


## PIPING LINE TYPES

CWS	CHILLED WATER SUPPLY
CWR	CHILLED WATER RETURN
CA	COMPRESSED AIR
CD	CONDENSATE DRAIN PIPING
CS	CONDENSER WATER SUPPLY
CR	CONDENSER WATER RETURN
FO	FUEL OIL
G	GAS PIPING
HWS	HEATING WATER SUPPLY
HWR	HEATING WATER RETURN
HG	REFRIGERANT HOT GAS
LPS	LOW PRESSURE STEAM
LPC	LOW PRESSURE CONDENSATE
MPS	MEDIUM PRESSURE STEAM
MPC	MEDIUM PRESSURE CONDENSATE
HPS	HIGH PRESSURE STEAM
HPC	HIGH PRESSURE CONDENSATE
RL	REFRIGERANT LIQUID
RS	REFRIGERANT SUCTION

\* NOTE: NOT ALL PIPING LINE TYPES, SYMBOLS, OR ABBREVIATIONS ARE UTILIZED ON EVERY PROJECT.

## SITE LOCATION MAP

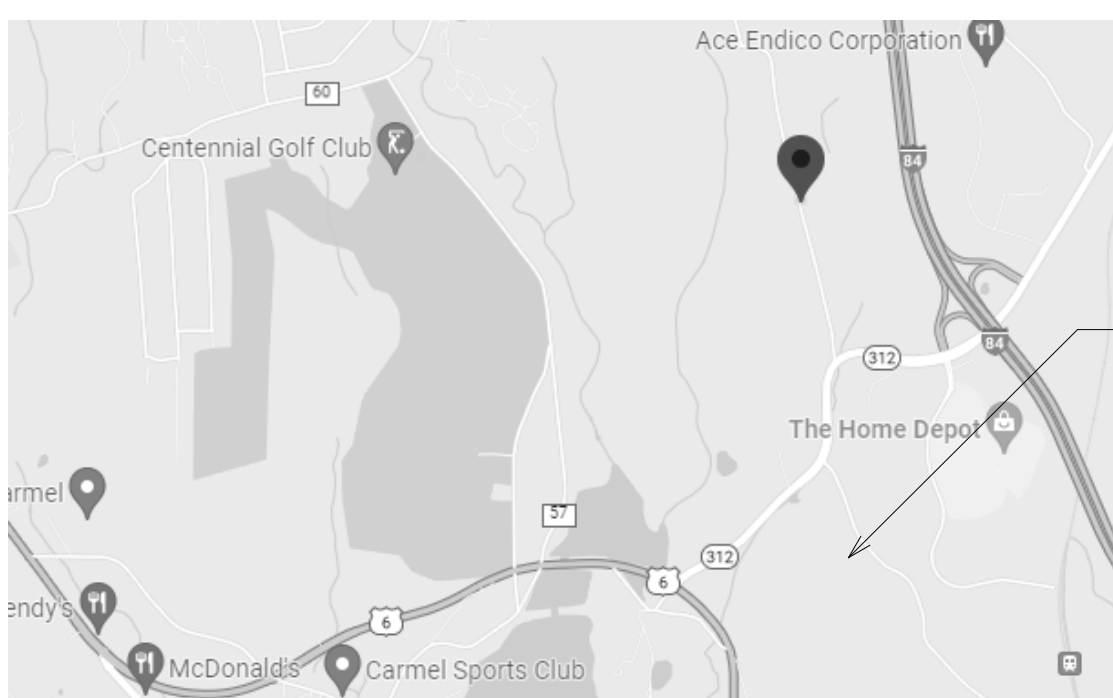

PROJECT SITE

## HVAC SHEET LIST

SHEET NUMBER	SHEET NAME	CURRENT REVISION	DESCRIPTION
M000	COVER SHEET	05/20/2022	QA/QC SET
M100	OVERALL FLOOR PLAN	05/20/2022	QA/QC SET
M101	OVERALL ROOF PLAN	05/20/2022	QA/QC SET
M400	SCHEDULES	05/20/2022	QA/QC SET
M500	DETAILS	05/20/2022	QA/QC SET

## SPECIFICATIONS:

### SECTION 1 - HVAC CRITERIA

#### 1.0 GENERAL

- THESE DOCUMENTS ARE INTENDED TO PROVIDE ALL DRAWINGS, NOTATIONS, DETAILS, AND SCHEDULES NECESSARY FOR THE INSTALLATION OF A COMPLETE HVAC SYSTEM. THESE DOCUMENTS ARE PREPARED TO EXCLUDE ALL WORK NOT SPECIFICALLY INCLUDED IN THE SET.
- THIS CONTRACTOR SHALL FURNISH AND INSTALL ALL NECESSARY LABOR AND MATERIALS FOR A COMPLETE SYSTEM TO MEET THE INTENT OF THE DESIGN AND AS INDICATED IN THE DESIGN DOCUMENTS. ANY ACCESSORIES OR MATERIALS OBVIOUSLY A PART OF THE SYSTEM AND INTEGRAL IN ITS OPERATION, ALTHOUGH NOT SPECIFICALLY MENTIONED HEREIN, SHALL BE FURNISHED AND INSTALLED AS IF CALLED FOR IN DETAIL.
- THIS CONTRACTOR IS RESPONSIBLE FOR CONSTRUCTING COMPLETE AND OPERATING SYSTEMS. THIS CONTRACTOR ACKNOWLEDGES AND UNDERSTANDS THAT THE CONTRACT DOCUMENTS ARE A TWO-DIMENSIONAL REPRESENTATION OF A THREE-DIMENSIONAL OBJECT, SUBJECT TO HUMAN INTERPRETATION. THIS REPRESENTATION MAY INCLUDE IMPERFECT DATA, INTERPRETED CODES, UTILITY GUIDELINES, THREE-DIMENSIONAL CONFLICTS, AND REQUIRED FIELD COORDINATION ITEMS. SUCH DEFICIENCIES CAN BE CORRECTED WHEN IDENTIFIED PRIOR TO ORDERING MATERIAL AND STARTING INSTALLATION. THIS CONTRACTOR AGREES TO CAREFULLY STUDY AND COMPARE THE INDIVIDUAL CONTRACT DOCUMENTS AND REPORT AT ONCE IN WRITING TO THE DESIGN TEAM ANY DEFICIENCIES THIS CONTRACTOR MAY DISCOVER. THIS CONTRACTOR FURTHER AGREES TO REQUIRE EACH SUBCONTRACTOR TO LIKEWISE STUDY THE DOCUMENTS AND REPORT AT ONCE ANY DEFICIENCIES DISCOVERED.
- ALL MATERIAL AND EQUIPMENT USED SHALL BE NEW AND FREE FROM DEFECTS.
- THIS CONTRACTOR SHALL PERFORM WORK IN A SAFE MANNER. COMPLY WITH ALL APPLICABLE OSHA SAFETY GUIDELINES IN ACCORDANCE WITH 29 CFR 1926 OSHA CONSTRUCTION INDUSTRY REGULATIONS DURING THE COURSE OF COMPLETING THE WORK DESCRIBED IN THESE DOCUMENTS.
- THIS CONTRACTOR SHALL KEEP AND MAINTAIN ON SITE A COPY OF ALL SAFETY DATA SHEETS FOR ALL PRODUCTS AND MATERIALS ON SITE WHICH COMPLY WITH THE GLOBALLY HARMONIZED SYSTEM OF CLASSIFICATION AND LABELING OF CHEMICALS. THIS INCLUDES:
  - MAINTAINING A HAZARD COMMUNICATION PROGRAM DETAILING THE PLANS IN PLACE FOR THE SAFE HANDLING OF CHEMICALS
  - MAINTAINING A WRITTEN CHEMICAL INVENTORY OF EVERY HAZARD CHEMICAL IN THE FACILITY TO WHICH EMPLOYEES ARE EXPOSED
  - MAINTAINING PROPER LABELS AND WARNING SIGNS ASSOCIATED WITH SAID CHEMICALS
  - TRAINING EMPLOYEES ON CHEMICAL HAZARDS AND NECESSARY PRECAUTIONS
- NO CHEMICALS MAY BE STORED IN ANY CONTAINERS OTHER THAN THE ORIGINAL MANUFACTURER'S CONTAINERS.
  - INSTALL ALL ITEMS PER THE MANUFACTURER'S INSTRUCTIONS AND PROVIDE PROPER ELECTRICAL AND MAINTENANCE CLEARANCES.

#### 1.1 COORDINATION

- COORDINATE THE ROUTING OF ALL MECHANICAL SYSTEMS WITH THE OTHER TRADES TO AVOID CONFLICTS WITH DUCTS, PIPES, ETC. ITEMS REQUIRING PITCH MUST BE CONSIDERED FOR THEIR RIGHT-OF-WAY.
- GENERAL CONTRACTOR (G.C.) SHALL PROVIDE AND INSTALL ALL PRIMARY STRUCTURAL SUPPORT, UNIFORM LEVEL, FOR ALL FLOOR, CEILING, OR ROOF MOUNTED EQUIPMENT OR COMPONENTS AS DESIGNED BY ARCHITECT OR STRUCTURAL ENGINEER AND APPROVED BY THE JURISDICTION OF AUTHORITY.
- THIS CONTRACTOR SHALL FIELD VERIFY LOCATION AND ELEVATION OF ALL EXISTING UTILITIES. ANY DISCREPANCIES SHALL BE RELAYED TO NDBS FOR COMMENT AND CORRECTIVE ACTION AS NEEDED.
- ALL LINTELS, FRAMING, FURRING, PATCHING, AND PAINTING REQUIRED WILL BE PROVIDED BY THE G.C.
- ALL GAS PIPING EXPOSED TO WEATHER SHALL BE PAINTED BY THE G.C.
- THE G.C. SHALL PROVIDE ALL PADS AS REQUIRED FOR THE INSTALLATION OF THE HVAC EQUIPMENT. PADS SHALL BE PROVIDED IN ACCORDANCE WITH THE STRUCTURAL ENGINEER'S DESIGN FOR SITE CONDITIONS, WEIGHT, SEISMIC AND WIND CONSIDERATIONS. HEIGHT OF THE PAD SHALL (FOR GRAVITY DRAIN EQUIPMENT) SHALL BE FIELD ADJUSTED BY G.C. BASED ON APPROVED EQUIPMENT SUBMITTALS.
  - E. C. SHALL MOUNT AND WIRE/CONNECT ALL 480 VOLT AND 120 VOLT COMPONENTS (RELAYS, FAN WIRING, HIGH LIMITS, SOLENOIDS, CONTROLLERS, ETC...) AND OTHER ELECTRICAL COMPONENTS FURNISHED BY THIS CONTRACTOR. THIS CONTRACTOR IS RESPONSIBLE FOR ALL 24 VOLT THERMOSTAT WIRING.
- EQUIPMENT IS NOT INTENDED FOR TEMPORARY CONDITIONING UNLESS COORDINATED WITH NDBS AHEAD OF TIME. SHOULD NDBS APPROVE OF TEMPORARY USE, RETURN AIR OPENINGS SHALL BE PROTECTED WITH FILTER MEDIA (MINIMUM MERV 8) WHILE EQUIPMENT IS OPERATED DURING CONSTRUCTION.

#### 1.2 CONSTRUCTION

- ALL EQUIPMENT, PIPING SUPPORTS, AND DUCTWORK SUPPORTS SUSPENDED FROM ROOF JOISTS SHALL BE SUSPENDED FROM THE TOP CHORD OF THE JOIST UNLESS PRIOR APPROVAL FROM G.C. OR STRUCTURAL ENGINEER.
- PROVIDE DUCT, PIPING AND HANGER PENETRATIONS THROUGH NON-RATED ENCLOSURES WITH DRAFT STOPPING OR SMOKE BARRIER SEALANT SYSTEMS. INSTALL PENETRATION SEALANT SYSTEMS IN STRICT ACCORDANCE TO MANUFACTURER'S APPLICATION DETAILS AND INSTRUCTIONS. PROVIDE DRAFT STOPPING OR SMOKE BARRIER SEALANTS TO MEET APPROVAL OF AHJ.
- PROVIDE SCHEDULE 40 STEEL SLEEVES AT ALL PIPING PENETRATIONS THROUGH CONCRETE FOOTINGS, FLOORS OR WALL CONSTRUCTION. SLEEVE SHALL PROVIDE MINIMUM 2" CLEARANCE BETWEEN SLEEVE AND PIPE. PROVIDE A LINK SEAL THROUGH ALL FOUNDATION WALL PENETRATIONS.
- PROTECT ALL EQUIPMENT, PIPING AND DUCTWORK OPENINGS DURING CONSTRUCTION WITH PLASTIC OR OTHER NON-POROUS MATERIAL TO LIMIT CONTAMINATION FROM DUST AND OTHER CONSTRUCTION DEBRIS. MATERIAL AND EQUIPMENT SHALL BE ELEVATED OFF FLOOR AND PROTECTED WHEN STORED ON SITE.

#### 1.4 ACTION SUBMITTALS

- PRODUCT DATA:
  - FOR ALL EQUIPMENT FURNISHED BY THIS CONTRACTOR (1) SHOP DRAWINGS INCLUDING AT A MINIMUM: CAPACITIES, DIMENSIONS, WEIGHTS, ELECTRICAL REQUIREMENTS, FAN AND PUMP CURVES
- METAL DUCTS
  - (1) LINERS AND ADHESIVES
  - (2) SEALANTS AND GASKETS
- PIPING
  - (1) PIPING SPECIALTIES
  - (2) VALVES
  - (3) PRESSURE REGULATORS
  - (4) PIPING SPECIALTIES ITEMS

#### 1.5 INFORMATIONAL SUBMITTALS

- BRAZING AND WELDING CERTIFICATES
- FIELD QUALITY-CONTROL REPORTS

### SECTION 2 - FIELD QUALITY CONTROL


#### 2.0 GENERAL

- REFER TO PIPE SCHEDULE FOR PIPE TESTING REQUIREMENTS.
- EQUIPMENT THAT IS NOT INTENDED TO BE SUBJECT TO THE TEST PRESSURE SHALL BE ISOLATED FROM THE PIPING. IF A VALVE IS USED TO ISOLATE THE EQUIPMENT, ITS CLOSURE SHALL BE CAPABLE OF SEALING AGAINST THE TEST PRESSURE WITHOUT DAMAGE TO THE VALVE. FLANGED JOINTS AT WHICH BLINDS ARE INSERTED TO ISOLATE EQUIPMENT NEED NOT BE TESTED.
- PIPE PRESSURE TEST REPORTS ARE REQUIRED AS PART OF THE PROJECT CLOSE OUT DOCUMENTS AND ARE TO INCLUDE WITNESS SIGNATURES. A WRITTEN FIELD PRESSURE TEST DECLARATION SHALL BE PREPARED DOCUMENTING THE FIELD TEST PROCEDURE AS REQUIRED BY APPLICABLE CODE AND PROVIDE TO NDBS AND THE BUILDING INSPECTOR PRIOR TO FINAL APPROVAL.
- DURING PRESSURE TESTING, VERIFY THAT STRESS DUE TO PRESSURE AT BOTTOM OF VERTICAL RISERS DOES NOT EXCEED 90% OF SPECIFIED MINIMUM YIELD STRENGTH OR 1.7 TIMES "SE" VALUE AS LISTED IN ASME B31.9.

### SECTION 3 - EQUIPMENT TESTING AND START-UP

#### 3.0 GENERAL

- PRIOR TO START-UP PROCEDURES, SUBMITTAL DOCUMENTATION SHALL BE VERIFIED FOR COMPLETENESS AND CORRECTNESS AS IT APPLIES TO ALL INSTALLED EQUIPMENT BASED ON THE CURRENT CONTRACT DOCUMENTS.
- SUBMITTALS SHALL BE COMPARED TO ALL INSTALLED EQUIPMENT AND VERIFICATION MADE THAT EACH DOCUMENT MATCHES THE FINAL INSTALLATION. THE FOLLOWING ITEMS SHALL BE SPECIFICALLY VERIFIED:
  - TAGGING OF EQUIPMENT AND MODEL NUMBER IS CONSISTENT WITH DOCUMENTS, SUBMITTALS AND NAMEPLATE DATA.
  - PHYSICAL DIMENSIONS COINCIDE WITH INSTALLATION INCLUDING SERVICE CLEARANCES.
  - SHIPPED LOOSE ACCESSORIES ARE PROPERLY INSTALLED.
- THIS CONTRACTOR SHALL FILL OUT ALL MANUFACTURER START-UP SHEETS AS A CLOSE OUT DOCUMENT

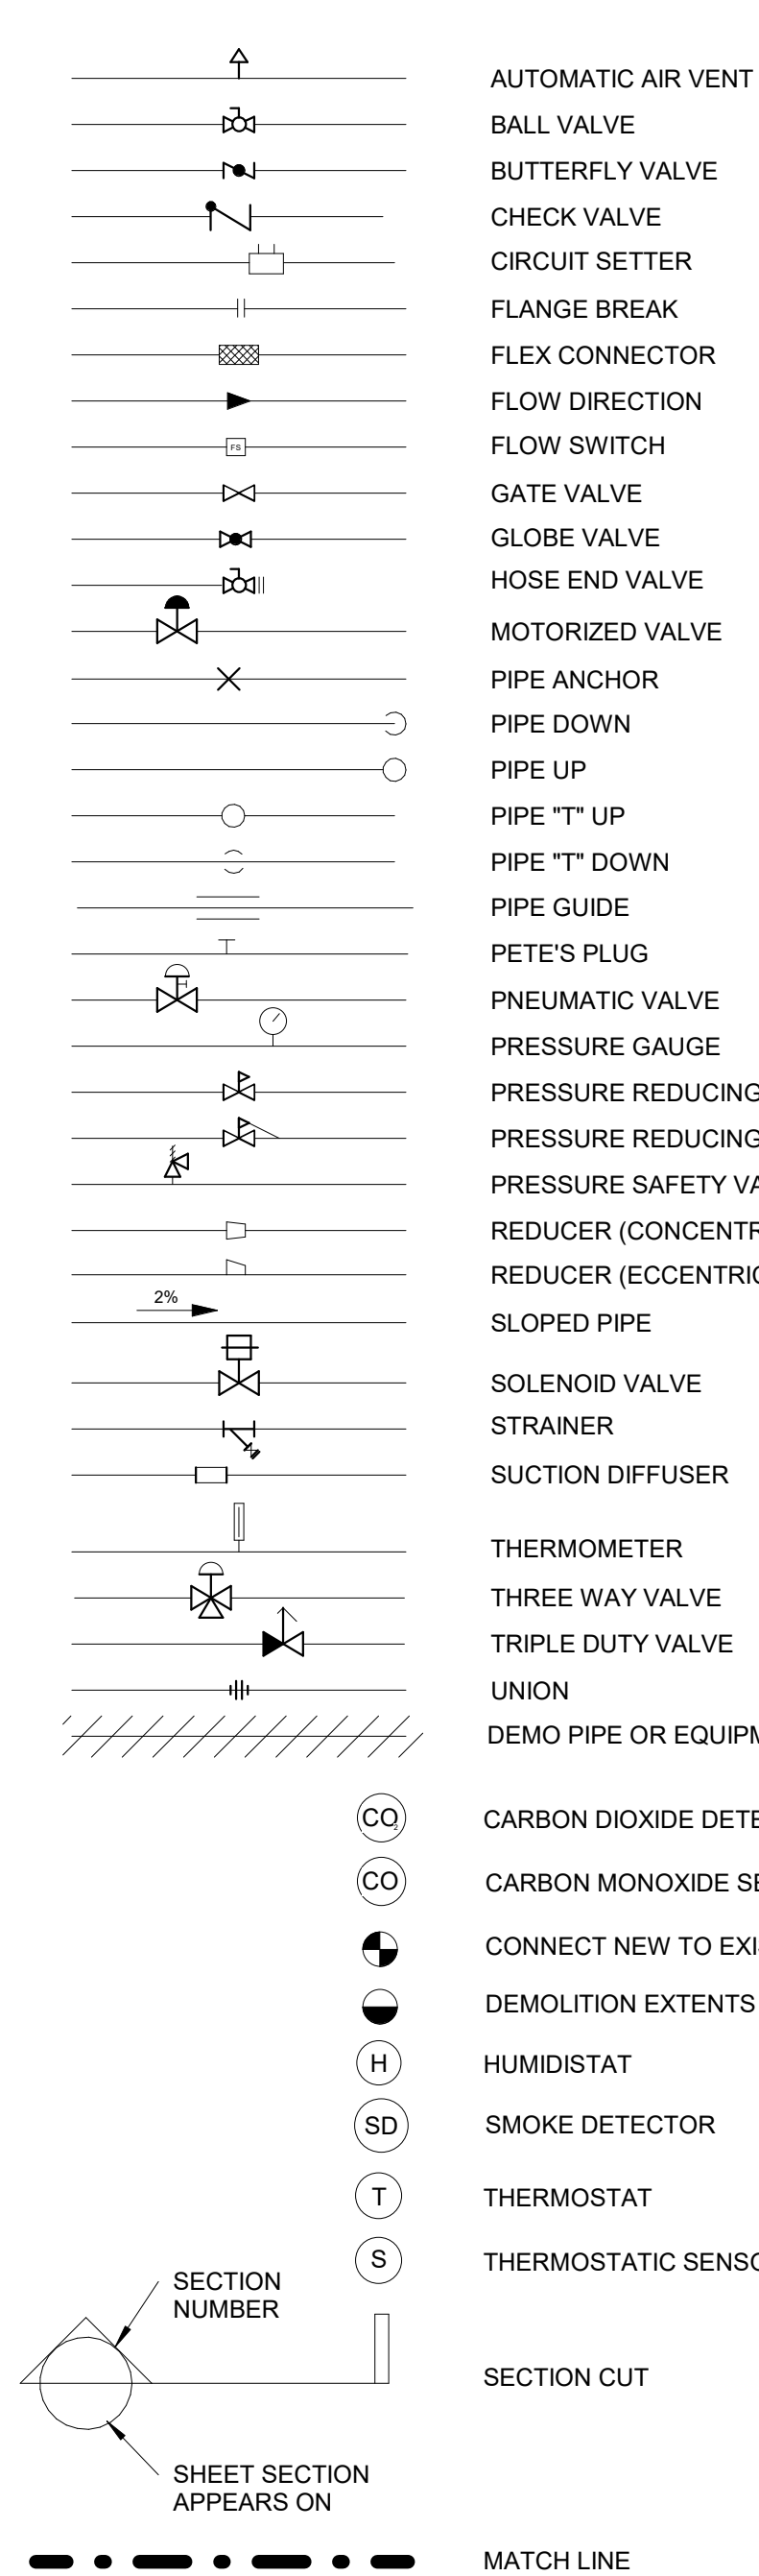

AUTOMATIC AIR VENT

BALL VALVE

BUTTERFLY VALVE

CHECK VALVE

CIRCUIT SETTER

FLANGE BREAK

FLEX CONNECTOR

FLOW DIRECTION

FLOW SWITCH

GATE VALVE

GLOBE VALVE

HOSE END VALVE

MOTORIZED VALVE

PIPE ANCHOR

PIPE DOWN

PIPE "T" UP

PIPE "T" DOWN

PIPE GUIDE

PETE'S PLUG

PNEUMATIC VALVE

PRESSURE GAUGE

PRESSURE REDUCING VALVE

PRESSURE REDUCING VALVE w/ SENSING PORT

PRESSURE SAFETY VALVE

REDUCER (CONCENTRIC)

REDUCER (ECCENTRIC)

SLOPED PIPE

SOLENOID VALVE

STRAINER

SUCTION DIFFUSER

THERMOMETER

THREE WAY VALVE

TRIPLE DUTY VALVE

UNION

DEMO PIPE OR EQUIPMENT

CARBON DIOXIDE DETECTOR

CARBON MONOXIDE SENSOR

CONNECT NEW TO EXISTING

DEMOLITION EXTENTS

HUMIDISTAT

SMOKE DETECTOR

THERMOSTAT

THERMOSTATIC SENSOR

SECTION CUT

MATCH LINE

## PROJECT DESIGN CONDITIONS

OUTDOOR DESIGN CONDITIONS	LOCATION		ZONE	SUMMER 1% (F DB / F WB)	WINTER 99% (F DB)	SEISMIC		WIND (MPH)		
	SOUTHEAST, NY		5A	90.2 / 72.9	9.5	DESIGN CAT	SITE CLASS	D	115	
	AREA	LOW WALL R-VALUE	UPPER WALL R-VALUE	ROOF R-VALUE	GLASS U-VALUE	GLASS SC	PARTITION U-VALUE			
ENVELOPE CONDITIONS	WAREHOUSE	1.5	14 (SEE NOTE 1)	20	0.35	N/A	N/A			
APPLICABLE CODES	2020 NY STATE BUILDING CODE									
	2020 NY STATE MECHANICAL CODE									
	2020 NY STATE ENERGY CONSERVATION CODE									
LOAD ASSUMPTIONS										
ROOM DESIGN PARAMETERS	SPACE TYPE	COOLING	HEATING	PEOPLE		LIGHTING		MISC	OUTDOOR AIR	
		F / MAX RH	F / MIN RH	SQFT / PERSON	SENS. GAIN / PERSON (BTUH)	LATENT GAIN / PERSON (BTUH)	W / SQFT	W / SQFT	CFM / PERSON	CFM / SQFT
		WAREHOUSE	N/A	55	N/A	N/A	N/A	N/A	N/A	5
NOTES:										
1. WALL INSULATION PROVIDED FROM 4'-0" AFF. TO DECK ON NON-DOCK WALLS AND 13'-0" AFF. TO DECK ON DOCK WALLS.										



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GENERAL NOTES:

1. GAS PIPING TO BE HUNG FROM TOP CHORD OF BAR JOISTS. GAS PIPING SHALL BE INSTALLED ABOVE BOTTOM CHORD OF JOISTS, BETWEEN JOIST WEBBING, AND NOT WITHIN 1'-0" OF ANY SPRINKLER HEAD. GAS PIPING SHALL PENETRATE THE ROOF NEAR THE GAS CONNECTION AT EACH GAS-FIRED UNIT.

KEYED NOTES:

- 1 EC TO INSTALL MAU CONTROL PANEL 4'-0" AFF. ON COLUMN FACING DOCK WALL PER WIRING DIAGRAM DETAIL 7 ON SHEET M500 - EC TO PROVIDE CONTROL WIRING
- 2 MC TO INSTALL GAS PIPING DOWN WALL ON INSIDE OF BUILDING AND CONNECT TO METER PER DETAIL 5 ON SHEET M500
- 3 MC TO INSTALL INLINE FAN AND FIRE DAMPER PER DETAIL 8 ON SHEET M500 12'-0" AFF. TO BOTTOM OF FAN - DAMPER OPENING TO BE 14'X14"
- 4 MC TO INSTALL FIRE DAMPER PER DETAIL 9 ON SHEET M500 12'-0" AFF. TO BOTTOM OF 14'X14" OPENING
- 5 EC TO MOUNT AND WIRE AWH 2'-0" AFF TO BOTTOM OF HEATER
- 6 EC TO MOUNT COOLING ONLY THERMOSTAT 4'-0" AFF. AND WIRE TO EXHAUST FAN - MC TO PROVIDE THERMOSTAT - DAYTON 1UHH4
- 7 MC TO INSTALL 3-WAY DIFFUSER 35'-0" AFF TO BOTTOM OF DIFFUSER

DESIGNER / BUILDER

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**ADBI** / **DESIGN SERVICES**

PROJECT TITLE

**LINCOLN  
EQUITIES -  
NY-312 -  
BLDG B**  
**NY-312 & PUGSLEY RD,  
SOUTHEAST, NY 10509**

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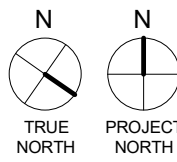
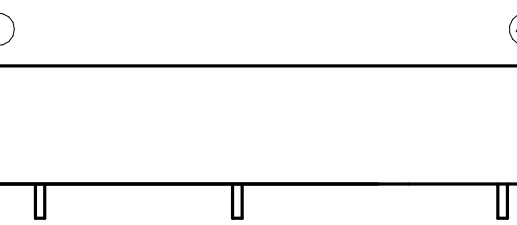
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KEY PLAN



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DRAWN BY


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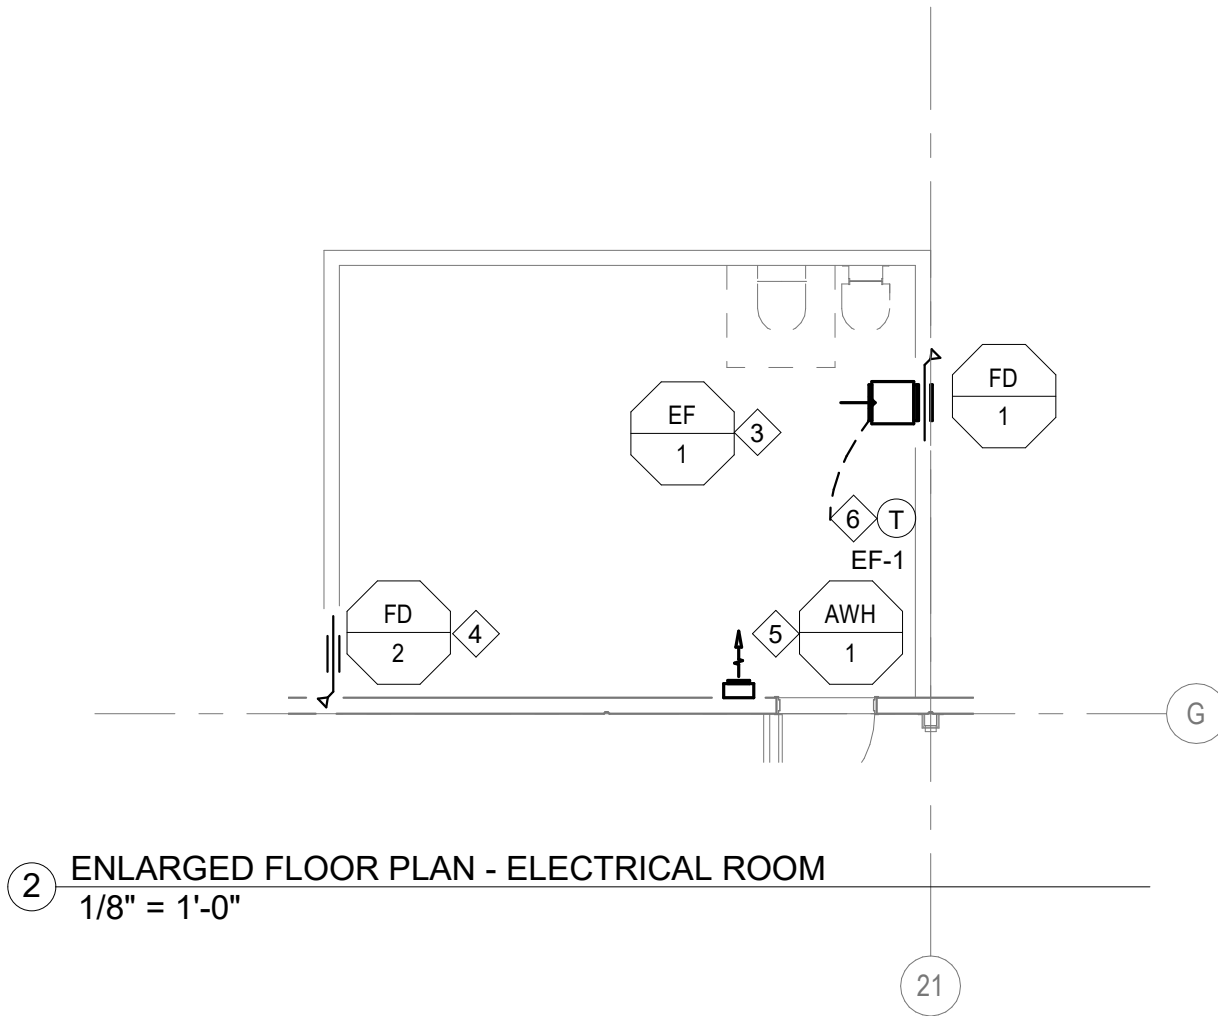
**OVERALL  
FLOOR PLAN**

SHEET NO.

**M100**



1 OVERALL FLOOR PLAN  
1" = 60'-0"

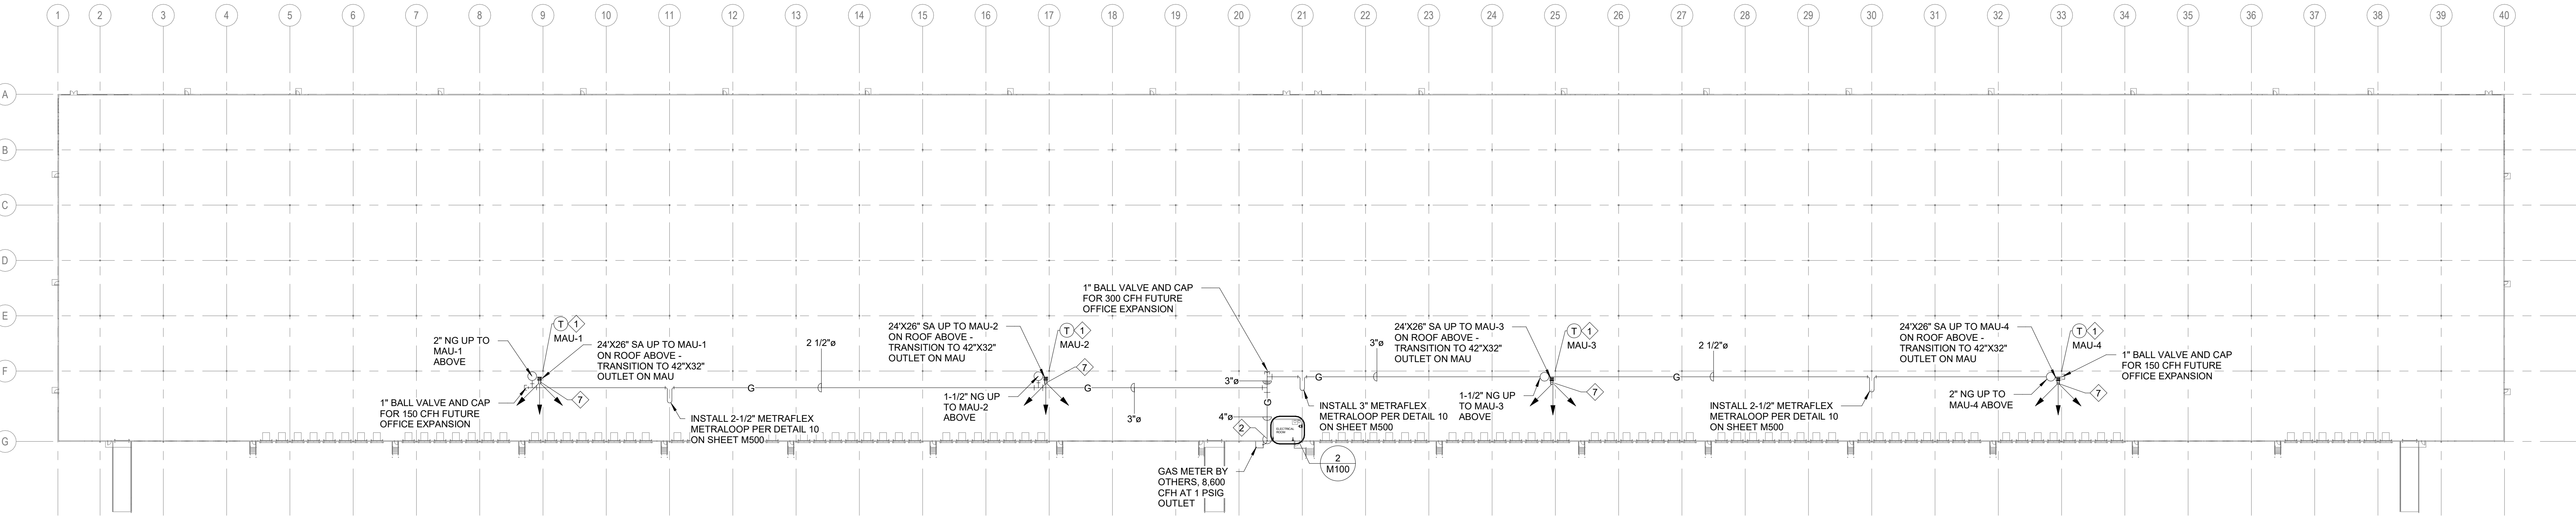

2 ENLARGED FLOOR PLAN - ELECTRICAL ROOM  
1/8" = 1'-0"

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GENERAL NOTES:

1. ALL SUPPLEMENTAL STEEL SUPPORTING MECHANICAL ROOF MOUNTED EQUIPMENT TO BE A MINIMUM OF 4" WIDE ANGLE.

KEYED NOTES:

1. INSTALL GAS TRAIN TO MAU PER DETAIL 4 ON SHEET M500 - SIZE PER SHEET M100

DESIGNER / BUILDER

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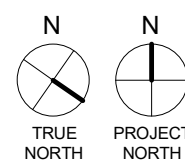
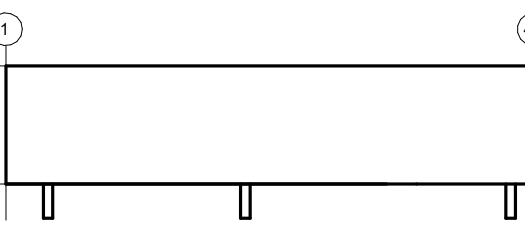
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PROJECT NO.

J22006

DRAWN BY

MT

SHEET TITLE

**OVERALL ROOF  
PLAN**

SHEET NO.

M101

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GAS PIPING SPECIFICATION:

SECTION 1 - PIPING SYSTEMS

1.0 GENERAL

- A. PROVIDE ISOLATION VALVES AT MAIN BRANCH CONNECTIONS, EQUIPMENT, AND AT BOTTOM OF RISERS WHERE THEY ORIGINATE FROM A CONTINUOUS MAIN AND RISE TO A FLOOR OR FLOORS ABOVE.
- B. SIZE REDUCTIONS SHALL BE MADE BY ECCENTRIC REDUCERS WITH FLAT SIDE ON TOP WHERE SPECIFIED. NO BUSHINGS FOR PIPE REDUCTIONS PERMITTED.
- C. PROVIDE DIELECTRIC UNION AT ALL CONNECTIONS OF DISSIMILAR METALS.
- D. PROPERLY SEAL ALL PIPE PENETRATIONS THROUGH WALLS, ROOFS, FLOORS, OR CEILINGS.
- E. ELBOWS ARE TO BE LONG RADIUS; FIELD FABRICATED FITTINGS ARE NOT ACCEPTABLE.
- F. BRANCH CONNECTIONS TO MAIN MAY BE SADDLE-TYPE; FORGED STEEL WELDED FITTING.
- G. ALL PIPING TAKE-OFFS FOR NATURAL GAS SHALL BE MADE FROM THE SIDE OR TOP OF PIPING. "BULLHEAD" TEE ARE PROHIBITED.
- H. VISUALLY INSPECT ALL PIPING, VALVES AND JOINTS PRIOR TO INSULATING, ENCLOSING, BURYING, OR OTHERWISE CONCEALING.

1.1 PIPE HANGERS AND SUPPORTS

- A. PIPE SHALL BE SUPPORTED BY SPLIT RING ADJUSTABLE TYPE, CLEVIS HANGER, TRAPEZE (MULTIPIPE RACK) OR OTHER APPROVED HANGERS, OR ROOF SUPPORTS.
- B. BRACKETS OR CLAMPS MAY BE USED WHERE PIPE RUNS ALONG WALLS, COLUMNS OR CEILINGS, BUT MUST ALLOW FOR EXPANSION AND CONTRACTION.
- C. RADIAL SUPPORTS SHALL BE RIGID TYPE. IF WALL BRACKETS OR LONGITUDINAL SUPPORTS ARE USED ON STRAIGHT LENGTHS OVER 20 FEET LONG, THEY SHALL BE OF THE FLEXIBLE TYPE TO PROVIDE FOR THERMAL EXPANSION AND CONTRACTION.
- D. HANGERS AND SUPPORTS SHALL BE PLACED WITHIN 1 FOOT FROM EACH CHANGE IN DIRECTION AND WITHIN 3 FEET OF THE END OF EACH RUNOUT OR AS DEFINED BY PIPE STRESS ANALYSIS OR PIPE EXPANSION ANALYSIS AS PART OF A DELEGATED DESIGN.
- E. PIPING AT ALL EQUIPMENT AND CONTROL VALVES SHALL BE SUPPORTED TO PREVENT STRAINS OR DISTORTIONS IN THE CONNECTED EQUIPMENT AND CONTROL VALVES.
- F. MAXIMUM ALLOWABLE HANGER ROD LOADING AND SPACING FOR PIPING SYSTEMS ARE SHOWN BELOW. CHECK LOCAL CODES TO DETERMINE IF A DIFFERENT SPACING IS REQUIRED. CLOSER HANGER SPACING MAY BE REQUIRED DUE TO ADDITIONAL VALVES AND FITTINGS

1.2 NATURAL GAS SYSTEM

- A. NATURAL GAS PIPING SHALL COMPLY WITH THE INTERNATIONAL FUEL GAS CODE AND NFPA-54 AND LOCAL CODE/AMENDMENTS.
- B. VALVES, UNIONS AND CLOSE NIPPLES SHALL NOT BE INSTALLED IN ANY CONCEALED SPACE.

MAXIMUM ALLOWABLE HANGER ROD LOADING								
ROD DIA. (IN)	3/8	1/2	5/8	3/4	7/8	1	1-1/8	1-1/4
MAX. LOAD	610	1130	1810	2710	3770	4960	6230	8000

MAXIMUM ALLOWABLE HANGER SPACING - NATURAL GAS PIPE		
NOMINAL TUBING SIZE	ROD DIAMETER (IN)	MAXIMUM SPACING (FT)
1/2"	3/8"	6'-0"
3/4" - 1"	3/8"	8'-0"
1-1/4" - 2"	3/8"	10'-0"
2-1/2" - 3"	1/2"	10'-0"
4"	5/8"	10'-0"
6"	3/4"	10'-0"
8"-12"	7/8"	10'-0"

PIPE AND PIPE INSULATION SCHEDULE

SYSTEM ABBREV	SYSTEM	LOCATION	OPERATING TEMP [°F]	OPERATING PRESS. [PSIG]	PIPE				INSULATION			PRESSURE TEST PROCEDURE	NOTES
					SIZE	TYPE/SCHED	MATERIAL	JOINING METHOD	TYPE	JACKET	THICKNESS [IN]	TEST TYPE	
G	NATURAL GAS	ABOVE GRADE	50-70	1	1/2" THRU 2"	SCH. 40	CARBON STEEL	150# MALLEABLE IRON NPT	-	-	-	P.2	1
		ABOVE GRADE	50-70	1	1/2" THRU 4"	SCH 10	CARBON STEEL	COLD PRESS MECHANICAL	-	-	-	P.2	
		ABOVE GRADE	50-70	1	2-1/2" AND UP	SCH 40	CARBON STEEL	BUTT WELDED	-	-	-	P.2	

PIPE PRESSURE TEST:

- P.1 HYDROSTATICALLY TEST PER ASME B31.1 & B31.3
- P.2 PNEUMATICALLY TEST PER ASME B31.1 & B31.3. TEST PRESSURE TO BE 60 PSI MINIMUM
- P.3 PNEUMATICALLY TEST WITH DRY NITROGEN PER ASME B31.5

NOTES:

1. FITTINGS EQUAL TO VIEGA MEGAPRESS/PROPPRESS

GENERAL REMARKS APPLICABLE TO ALL PIPE SYSTEMS:

1. PROVIDE IDENTIFICATION LABELS ON ALL ABOVE FLOOR AND ABOVE GRADE PIPING.
2. WHERE REQUIRED, PAINTING OF PIPE SYSTEMS SHALL BE BY GC/OTHERS.
3. ALL PIPES, INSULATION, AND MATERIALS IN PLENUMS MUST MEET ASTM E84 FLAME/SMOKE RATING OF 25/50.

DUCTWORK AND DUCT INSULATION SCHEDULE

SYSTEM	DUCT						LINER		EXTERNAL DUCT INSULATION			NOTES
	FUNCTION	LOCATION	SHAPE	PRESS. CLASS [IN WG]	OPERATING PRESS. [IN WG]	MATERIAL	TYPE	R-VALUE	TYPE	FINISH	MINIMUM R-VALUE	
MAU-1,2,3,4	SA	WAREHOUSE	RECT	2"	1"	GALVANIZED G-90	-	-	-	-	-	

NOTES:

1. SNAP-LOCK WILL BE ALLOWED ON LOW PRESSURE DUCT LESS THAN 14"ø
2. DUCTWORK FLEXIBLE INSULATION JOINTS TO OVERLAP MINIMUM 2"
3. EXPOSED DUCTWORK TO BE GASKETED SPIRAL OR TDC, SUITABLE FOR PAINTING. PAINTING BY OTHERS
4. DUCTWORK AND EXHAUST SYSTEMS SERVING TYPE I OR TYPE II KITCHEN HOODS SHALL BE CONSTRUCTED PER NFPA REQUIREMENTS.

GENERAL REMARKS APPLICABLE TO ALL DUCT SYSTEMS:

1. ALL DUCTWORK SHALL BE HUNG WITH GALVANIZED STRAP, GRIPPLE OR TRAPEZED.
2. DUCT SIZES INDICATED ON DRAWINGS ARE SHEET METAL SIZE AND INCLUDE LINER SPECIFIED.
3. ALL DUCTWORK, INSULATION, AND MATERIALS IN PLENUMS MUST MEET ASTM E84 FLAME/SMOKE RATING OF 25/50.
4. ALL DUCTWORK SHALL BE SEALED TO CLASS A REQUIREMENTS.
5. DUCT GAUGE SHALL BE PER SMACNA STANDARD FOR PRESSURE CLASS INDICATED, UNLESS NOTED OTHERWISE, AND SHALL BE NO LESS THAN 26 GAUGE

EXHAUST FAN SCHEDULE

PLAN MARK	MANUFACTURER	MODEL	LOCATION	TYPE	OCCUPIED		UNOCCUPIED		ESP [IN WC]	TSP [IN WC]	HP	BHP	DRIVE TYPE	CONTROL / SWITCH BY	SONES	ELECTRICAL		WEIGHT [LBS]	NOTES
					AIRFLOW [CFM]	FAN RPM	AIRFLOW [CFM]	FAN RPM								VOLTS/PH	FLA		
EF-01			ELECTRICAL ROOM	INLINE	1,000	1255	-	-	0.1	0.1	1/4	0.09	DIRECT	T-STAT	7.6	115/1	5.8	100	1, 2, 3

- GENERAL REMARKS:
1. CURB LEVELING AND BLOCKING, BY GENERAL CONTRACTOR

- NOTES:
1. FACTORY INSTALLED AND WIRED NON FUSED DISCONNECT
2. FIELD INSTALL FACTORY PROVIDED MOUNTING BRACKET WITH VIBRATION HANGERS
3. FURNISH WITH SPEED CONTROLLER. INSTALLED AND WIRED BY E.C.

DIRECT FIRED MAKE-UP AIR UNIT SCHEDULE

PLAN MARK	MANUFACTURER	MODEL	LOCATION	SUPPLY FAN					OUTDOOR AIRFLOW [CFM]	NATURAL GAS HEATING					ELECTRICAL			WEIGHT [LBS]	NOTES
				AIRFLOW [CFM]	ESP [IN WC]	HP	BHP	QTY		EDB [°F]	LDB [°F]	INPUT [MBH]	OUTPUT [MBH]	MIN PRESS. [IN WC]	VOLTS/PH	MCA	MOCP		
MAU-1			WAREHOUSE	13,575	0.05	7.5	7.1	1	13,575	0	125.5	2,000	1,840	14	460/3	14.6	25	1,600	1, 2, 3, 4, 5, 6, 7, 8
MAU-2			WAREHOUSE	13,575	0.05	7.5	7.1	1	13,575	0	125.5	2,000	1,840	14	460/3	14.6	25	1,600	1, 2, 3, 4, 5, 6, 7, 8
MAU-3			WAREHOUSE	13,575	0.05	7.5	7.1	1	13,575	0	125.5	2,000	1,840	14	460/3	14.6	25	1,600	1, 2, 3, 4, 5, 6, 7, 8
MAU-4			WAREHOUSE	13,575	0.05	7.5	7.1	1	13,575	0	125.5	2,000	1,840	14	460/3	14.6	25	1,600	1, 2, 3, 4, 5, 6, 7, 8

- GENERAL REMARKS:
1. EXTERNAL STATIC PRESSURE INCLUDES LOSSES DUE TO DUCTWORK, AIR DEVICES, DAMPERS AND DUCT MOUNTED COILS
2. MAINTAIN MINIMUM ELECTRICAL CLEARANCE AS REQUIRED BY NEC
3. MAU SHALL NOT BE STARTED OR OPERATED WITHOUT THE REQUIRED FILTERS INSTALLED

- NOTES:
1. FURNISHED WITH 24" TALL, FLAT, UNINSULATED ROOF CURB
2. FACTORY INSTALLED AND WIRED NON-FUSED DISCONNECT SWITCH
3. FACTORY INSTALLED AND WIRED GFCI SERVICE OUTLET
4. FURNISHED WITH MAU CONTROL PANEL - EC TO INSTALL AND WIRE
5. FURNISHED WITH 3-WAY DIFFUSER
6. VFD FACTORY MOUNTED AND WIRED
7. FACTORY INSTALLED INTAKE WEATHERHOOD WITH ALUMINUM MESH FILTERS
8. FREEZE PROTECTION

ARCHITECTURAL WALL HEATER SCHEDULE

PLAN MARK	MANUFACTURER	MODEL	LOCATION	FAN DATA		ELECTRIC HEAT COIL		ELECTRICAL		NOTES	
				AIRFLOW [CFM]	POWER [W]	LAT [°F]	CAPACITY [MBH]	KW	VOLTS/PH		MCA
AWH-01			ELECTRICAL ROOM	175	-	128.0	13.8	4	277/1	14.4	1.2

- GENERAL REMARKS:
1. INLET TEMPERATURE = 55 °F, UNLESS NOTED
2. AWH MOUNTED, INSTALLED, AND WIRED BY EC

- NOTES:
1. FACORY INSTALLED THERMOSTAT AND DISCONNECT
2. FURNISHED WITH SURFACE MOUNTING SLEEVE.

FIRE DAMPER SCHEDULE

PLAN MARK	MANUFACTURER	MODEL	LOCATION	SERVICE (SAR/A/E/A)	APPLICATION (STATIC/DYNAMIC)	DAMPER SIZE			RATING [HRS]	STYLE	MOUNTING (HORIZ/VERT)	NOTES
						WIDTH [IN]	HEIGHT [IN]	OVERALL HEIGHT [IN]				
FD-01			ELECTRICAL ROOM	EA	DYNAMIC	14	14	14	1.5	A	VERT	1
FD-02			ELECTRICAL ROOM	EA	DYNAMIC	14	14	14	1.5	A	VERT	1

- GENERAL REMARKS:
1. FUSIBLE LINK = 165°F
2. PROVIDE SLEEVE AND COORDINATE SIZE AND LENGTH WITH APPLICATION AND MOUNTING LOCATION
3. PROVIDE RETAINING CLIPS AND SEAL OPENING PER UL 555 AND LOCAL REQUIREMENTS
4. COORDINATE FINAL OPENING SIZE WHEN MULTIPLE DAMPERS ARE REQUIRED

- STYLE:
- A- BLADES IN AIRSTREAM
- B- BLADES OUT OF AIRSTREAM
- C- BLADES OUT OF AIRSTREAM
- G- BLADES OUT OF WALL

- NOTES:
1. FACTORY PROVIDED GRILL MOUNTING TABS

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**ARCO**  
DESIGN/BUILD INDUSTRIAL

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PROJECT TITLE

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NY-312 -  
BLDG B  
NY-312 & PUGSLEY RD,  
SOUTHEAST, NY 10509**

ARCHITECT

ADBI / DESIGN SERVICES LLC  
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PLUMBING ENGINEER

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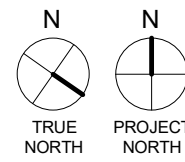
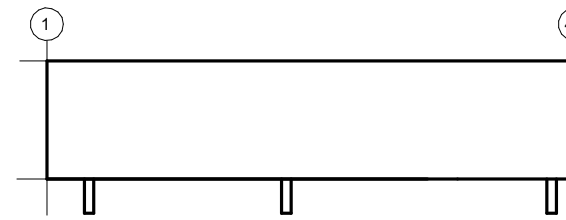
FIRE PROTECTION ENGINEER

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KEY PLAN



SUBMITTALS

NO.	DATE	DESCRIPTION
A	02/04/2022	QA/QC SET
B	03/29/2022	QA/QC SET
C	05/20/2022	QA/QC SET

PROJECT NO.

J22006

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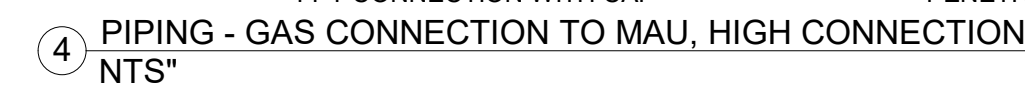
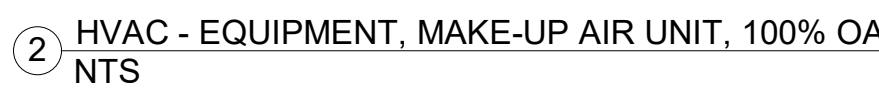
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