


OWTS KEY MAP
SCALE: 1" = 1,500'

LEGEND	
	EXISTING/PROPOSED PROPERTY LINE
	PROPOSED SUBDIVISION LINE
	ADJACENT PROPERTY LINE
	EXISTING WETLAND LINE AND DELINEATION
	EXISTING NYSDEC WETLAND BUFFER
	EXISTING TOWN WETLAND BUFFER
	EXISTING WETLAND LIMITING DISTANCE
	EXISTING STONE WALL
	PROPOSED BUILDING LINE
	PROPOSED EDGE OF PAVEMENT/CURB LINE
	PROPOSED SANITARY SEWER MANHOLE
	PROPOSED STORM DRAIN MANHOLE
	FUTURE SANITARY SEWER FORCE MAIN CLEANOUT IN MANHOLE
	PROPOSED SANITARY SEWER FORCE MAIN CLEANOUT IN MANHOLE
	PROPOSED TYPE B DRAIN INLET
	PROPOSED END SECTION
	PROPOSED HYDRANT
	PROPOSED STORM DRAIN LINE & SIZE
	PROPOSED SANITARY SEWER LINE
	FUTURE 100% EXPANSION SANITARY SEWER LINE
	PRIMARY ABSORPTION FIELD
	100% EXPANSION ABSORPTION FIELD
	PROPOSED WATER LINE
	PROPOSED WATER VALVE
	PROPOSED RETAINING WALL (DESIGN BY OWNER)
	PROPOSED UTILITY POLE
	LOCATION OF DEEP HOLE TESTING
	LOCATION OF INFILTRATION HOLE TESTING
	7' DEEP, 4" SOLID CURTAIN DRAIN PIPE
	7' DEEP, 4" PERFORATED CURTAIN DRAIN PIPE

- NOTES**
- EXISTING CONDITIONS DEPICTED ON THIS PLAN HAVE BEEN TAKEN FROM SURVEYS PREPARED BY BADEY & WATSON, SURVEYING AND ENGINEERING, P.C.
 - GEOTECHNICAL BORING/TEST PIT LOCATIONS DEPICTED ON THIS PLAN WERE TAKEN FROM THE GEOTECHNICAL REPORT ENTITLED, "PRELIMINARY SURFACE INVESTIGATION," DATED 05/13/2021, PREPARED BY SES CONSULTING ENGINEERS.
 - PAVEMENT CORE, STORMWATER TEST, SANITARY TEST LOCATIONS DEPICTED ON THIS PLAN WERE TAKEN FROM THE GEOTECHNICAL REPORT ENTITLED, "GEOTECHNICAL INVESTIGATION REPORT FOR PROPOSED NORTHEAST INTERSTATE LOGISTICS CENTER ROUTE 312 AND FUSLEY ROAD," REVISED 06/26/2020, PREPARED BY SES CONSULTING ENGINEERS.
 - PIPE FOR STORM DRAINS IDENTIFIED AS HDPE HEREON SHALL BE HIGH DENSITY POLYETHYLENE PIPE (HDPE) WITH A SMOOTH INTERIOR AND ANNUAL EXTERIOR CORRUGATIONS IN ACCORDANCE WITH ASTM F-2648. JOINTS SHALL BE WATER TIGHT IN ACCORDANCE WITH ASTM C-3212.

- CONTRACTOR SHALL INSTALL CURTAIN DRAINS AND MONITORING TRENCH AND MONITOR THE GROUNDWATER ELEVATION AS OUTLINED IN PCDOH REGULATIONS FROM MARCH 15 TO JUNE 30. THE RESULTS OF THE MONITORING SHALL BE PROVIDED TO THE PCDOH, NYDEP AND DESIGN ENGINEER PRIOR TO THE INSTALLATION OF ABSORPTION FIELDS.
- THE FILL MATERIAL MUST BE STABILIZED PRIOR TO SEPTIC FIELD INSTALLATIONS IN ACCORDANCE WITH SECTION E1.3 OF DEC'S DESIGN MANUAL.
 - THE FILL MATERIAL SHALL HAVE A PERCOLATION RATE OF 5-30 MINUTES PER INCH.
 - PERCOLATION TEST IN THE FILL MATERIAL MUST BE CONDUCTED AT THE BORROW PIT AND AFTER PLACEMENT AND SETTLING AT THE SITE. DEP MUST MINUTE THE LATTER.

30 0 15 30
SCALE IN FEET

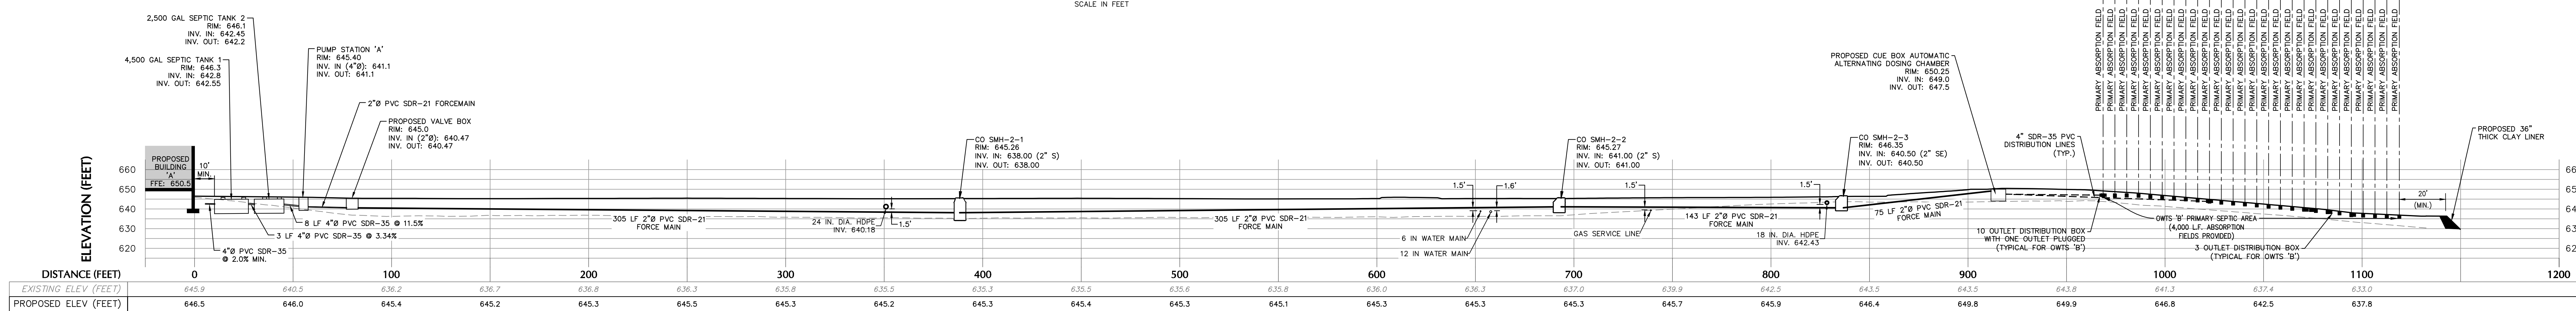

OWTS B PROFILE
VERTICAL SCALE: 1" = 30'
HORIZONTAL SCALE: 1" = 30'

PROFILES
VERTICAL SCALE: 1" = 30'
HORIZONTAL SCALE: 1" = 30'
SCALE IN FEET

- PUTNAM COUNTY HEALTH DEPARTMENT NOTES:**
- SSIS AREA TO BE FIELD STAKED AND CORRODED OFF TO PREVENT THE OPERATIONS OF TRUCKS AND/OR MACHINERY OR STORAGE OF HEAVY EQUIPMENT, OR EXCAVATED EARTH IN THIS AREA.
 - SSIS SYSTEM TO BE INSPECTED BY THE DESIGN PROFESSIONAL AND PUTNAM COUNTY HEALTH DEPARTMENT AFTER INSTALLATION AND PRIOR TO BACKFILL.
 - PUTNAM COUNTY HEALTH DEPARTMENT APPROVAL IS BASED ON THE LOCATION OF THE SEWAGE SYSTEM, WELL, BUILDINGS, SETBACKS, ROADS AND DRAINAGES, AS WELL AS BUILDING SIZE AND USE AS SHOWN ON THE APPROVED DRAWINGS. ANY MODIFICATIONS OR REVISIONS ARE TO HAVE FROM PUTNAM COUNTY HEALTH DEPARTMENT APPROVAL.
 - UNAUTHORIZED MODIFICATIONS MADE TO THE DRAWINGS AFTER THE DATE OF THE PUTNAM COUNTY DEPARTMENT OF HEALTH APPROVAL, VOID AND APPROVAL.
 - PUTNAM COUNTY DEPARTMENT OF HEALTH APPROVAL IS BASED ON A MAXIMUM FLOW OF 4,500 GPD FOR BUILDING A AND 7,800 GPD FOR BUILDING B. AN INCREASE IN THE FLOW WILL REQUIRE PRIOR APPROVAL FROM THE DEPARTMENT.
 - WATER METERS SHALL BE INSTALLED AT EACH BUILDING AND DAILY READINGS FURNISHED TO THE PUTNAM COUNTY HEALTH DEPARTMENT EACH MONTH.
 - THE SSIS IS TO RECEIVE SANITARY WASTES ONLY. THE DISCHARGE OF INDUSTRIAL WASTES, CONTAMINATED COOLING WATER, OR OTHER DANGEROUS SUBSTANCES INTO OR ONTO THE SURFACE OF THE GROUND IS PROHIBITED. THE PUTNAM COUNTY HEALTH DEPARTMENT RESERVES THE RIGHT OF INSPECTION OF THE PREMISES TO INSURE COMPLIANCE WITH THESE REQUIREMENTS.
 - PUTNAM COUNTY HEALTH DEPARTMENT SHALL BE PROMPTLY NOTIFIED IN THE EVENT THAT ANY WASTE OTHER THAN STRICTLY DOMESTIC SANITARY WASTES ARE PRODUCED AT THIS FACILITY.
 - OCCUPANCY OF THE BUILDINGS WILL NOT BE PERMITTED UNTIL THE CONSTRUCTION COMPLIANCE APPLICATION HAS BEEN RECEIVED AND APPROVED BY THE PUTNAM COUNTY HEALTH DEPARTMENT AND FORWARDED TO THE BUILDING INSPECTOR OF THE RESPECTIVE MUNICIPALITY AS PART OF THE CERTIFICATE OF OCCUPANCY APPLICATION.
 - AFTER BACKFILLING THE SYSTEM, THE SSIS AREA SHALL BE COVERED WITH A MINIMUM OF 6 INCHES OF TOP SOIL, SEED AND MULCHED.
 - REMOVE ALL TREES WITHIN 10 FEET OF THE ABSORPTION SYSTEM.
 - ALL EXISTING AND/OR PROPOSED SUBSURFACE SEWAGE TREATMENT SYSTEMS AND WELLS ON NEIGHBORING PROPERTIES WITHIN 300 FEET OF THE PROPOSED SSIS AND WELL ARE SHOWN ON THE PLANS.
 - CUT OR FILL IS NOT PERMITTED IN THE SEWAGE TREATMENT AREAS, EXCEPT AS SPECIFIED ON THE PLANS.
 - ALL STONE WALLS IN AND WITHIN 10 FEET OF THE SSIS AREA SHALL BE REMOVED TO THEIR ENTIRE DEPTH AND THE RESULTING VOID REPLACED WITH SIMILAR ON SITE SOIL.
 - IF ANY PRECAST CONCRETE TANK IS DELIVERED TO THE SITE IN SECTION, IT SHALL BE DEMONSTRATED TO THE DEPARTMENT AND/OR CERTIFYING DESIGN PROFESSIONAL THAT THE TANK IS SEALED, WATER TIGHT AND ACCEPTABLE FOR USE. THIS SHALL REQUIRE AS A MINIMUM, THE FILLING OF THE TANK WITH WATER AND OBSERVING THE WATER LEVEL AFTER A 24-HOUR PERIOD TO DEMONSTRATE IF IT IS IN FACT SEALED, WATER TIGHT AND ACCEPTABLE FOR USE.
 - ALL EROSION CONTROL MEASURES FOR THE BUILDINGS, WELLS AND SSIS'S ARE TO BE INSTALLED PRIOR TO ANY CONSTRUCTION.
 - THE CONDITIONS NOTED ON THE PUTNAM COUNTY DEPARTMENT OF HEALTH LETTER OF APPROVAL ARE AN INTEGRAL PART OF THIS APPROVAL AND COMPLIANCE IS REQUIRED.
 - THIS PLAN IS APPROVED FOR SEWAGE TREATMENT AND/OR WATER SUPPLY ONLY, AND ALL OTHER PERMITS AND/OR APPROVALS ARE THE RESPONSIBILITY OF THE FURNISHER.
 - THE PUTNAM COUNTY HEALTH DEPARTMENT APPROVAL EXPRESSES TWO (2) YEARS FROM THE DATE OF THE APPROVAL. STAMP AND IS REQUIRED TO BE RENEWED ON OR BEFORE THE EXPIRATION DATE. THE APPROVAL IS REVOCABLE FOR CAUSE OR MAY BE AMENDED OR MODIFIED WHEN CONSIDERED NECESSARY BY THE DEPARTMENT.

Date	Description	No.	Date	Description	No.
04/19/2023	REV. PER RFI 29	9	12/16/2022	REV. PER WATERSHED INSPECTOR GENERAL COMMENTS	5
Revisions			Revisions		

WARNING: IT IS A VIOLATION OF THE NYS EDUCATION LAW ARTICLE 149 FOR ANY PERSON, UNLESS HE IS ACTING UNDER THE DIRECTION OF A LICENSED PROFESSIONAL ENGINEER AND SURVEYOR OR GEOLOGIST, TO ALTER THIS ITEM IN ANY WAY.

STATE OF NEW YORK
MICHAEL J. JONES
Professional Engineer
No. 081473
05/03/2023
Date

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Project
**LINCOLN LOGISTICS
BREWSTER**
TOWN OF SOUTHEAST
PUTNAM COUNTY
NEW YORK

Drawing Title
OWTS PLAN 'B'

Project No.
190065201
Date
12/28/2022
Drawn By
JMSK
Checked By
CZMF
Drawing No.
C-324
Sheet 43 of 96