



Reconstruction To:
JV Forrestal Elementary School
Sargent Elementary School
South Ave Elementary School
Rombout Middle School
Beacon High School
Bus Maintenance Facility
Addition and Alteration to:
Glenham Elementary School
Beacon City School District
Beacon, New York

SED Control No. 13-02-00-01-0-002-021
SED Control No. 13-02-00-01-0-008-020
SED Control No. 13-02-00-01-0-003-016
SED Control No. 13-02-00-01-0-004-023
SED Control No. 13-02-00-01-0-020-012
SED Control No. 13-02-00-01-5-018-006

SED Control No. 13-02-00-01-0-006-022

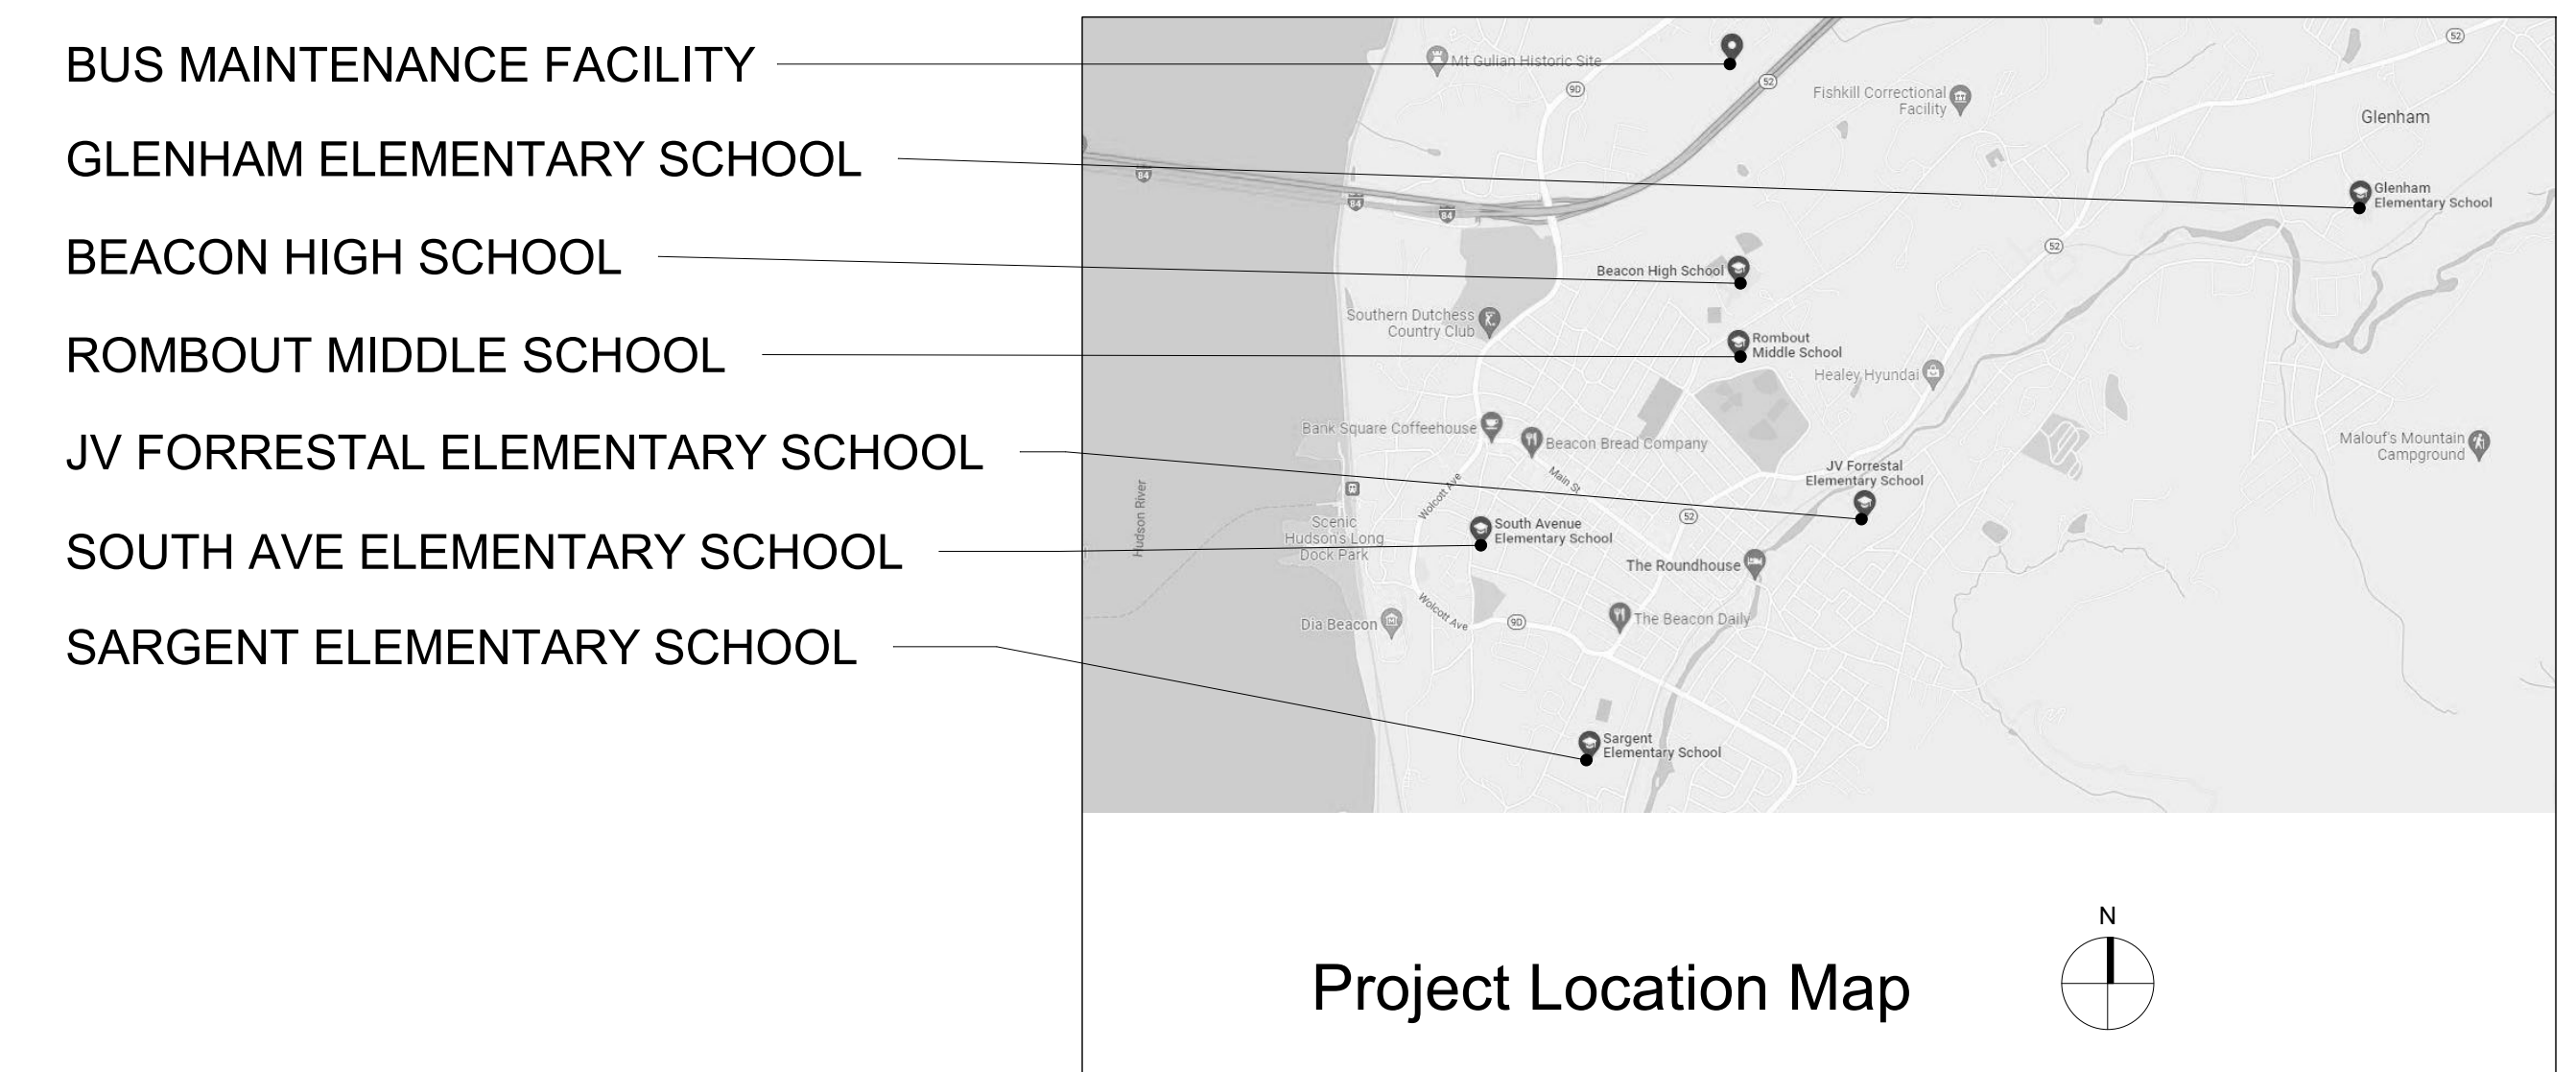

Drawing List		Glenham Elementary School		Glenham Elementary School		South Ave Elementary School	
GENERAL G001 Title Sheet G100 Symbols and Abbreviations		CODE COMPLIANCE BG350 Code Compliance Review and Key Plan		PLUMBING BP130 First Floor Plan - Area C, Details and Schedule		CODE COMPLIANCE DG350 Code Compliance Review DG351 Code Compliance Ground, First, and Second Floor Key Plans	
JV Forrestal Elementary School		HAZARDOUS MATERIALS BH100 Asbestos Abatement		HAZARDOUS MATERIALS DH100 Asbestos Abatement		HAZARDOUS MATERIALS DH100 Asbestos Abatement	
CODE COMPLIANCE AG350 Code Compliance Review and Vintage Key Plan AG351 Code Compliance Ground and First Floor Key Plans		ARCHITECTURAL BA100 First Floor Demolition Plan - Area A and C BA101 First Floor Demolition Plan - Area B BA102 First Floor Demolition Plan - Area D BA130 First Floor Plan - Area A and C BA131 First Floor Plan - Area B BA132 First Floor Plan - Area D BA160 First Floor Reflected Ceiling Plan - Area C BA161 First Floor Reflected Ceiling Plan - Area B BA400 Enlarged Vestibule Plans / Elevations / Sections BA401 Enlarged Toilet Room Plans / Interior Elevations BA500 Details BA600 Door Schedule, Door and Window Types, and Details BA900 Misc. Details		Sargent Elementary School		ARCHITECTURAL DA100 Ground Floor Demolition Plans - Area A and B DA101 First Floor Demolition Plan - Area A and B DA102 Second Floor Demolition Plan - Area A and B DA130 Ground Floor Plan - Area A, Door Schedule, Door and Frame Types and Details DA131 First Floor Plan - Area A DA160 Reflected Ceiling Plans	
HAZARDOUS MATERIALS AH100 Asbestos Abatement Ground Floor Plan AH101 Asbestos Abatement First Floor Plan		STRUCTURAL BS130 Partial Foundation and Framing Plan - Area B BS500 Typical Details BS600 Notes and Schedules		CODE COMPLIANCE CG350 Code Compliance Review and Vintage Plan CG351 Code Compliance Basement, First and Second Floor Key Plans		MECHANICAL DM050 Ground Floor Floor Key, Demolition and Floor Plans DM500 Details, Schedules and Controls	
ARCHITECTURAL AA100 Ground Floor Demolition Plans - Area A and B AA101 Ground Floor Demolition Plan - Area C AA102 First Floor Demolition Plan AA130 Ground Floor Plans - Area A and B AA131 Ground Floor Plan - Area C and Ground Floor Reflected Ceiling Plan - Partial Area C AA132 First Floor Plan AA940 Details		MECHANICAL BM051 First Floor Key Plan BM100 First Floor Demolition Plans - Partial Area A and Area B BM101 First Floor Demolition Plans - Area C and Partial Area D BM130 First Floor Plans - Partial Area A and Area B BM131 First Floor Plan - Area C and Partial Area D BM500 Details and Controls BM600 Schedules, Details and Controls		ARCHITECTURAL CA100 Basement Demolition Plan - Area A CA101 First Floor Demolition Plan - Area A CA130 Basement Plan - Area A CA131 First Floor Plan - Area A CA132 Second Floor Plan CA161 First Floor Reflected Ceiling Plan - Area A CA400 Enlarged Plans / Interior Elevations CA401 Enlarged Stair Plans, Sections, and Details CA600 Door Schedule, Door and Window Types, and Details CA750 Miscellaneous Details CA900 Details		ELECTRICAL DE001 Electrical Site Plan DE100 Ground Floor Demolition Plan - Areas A and B DE101 First Floor Demolition Plan - Areas A and B DE102 Second Floor Demolition Plan DE130 Ground Floor Floor Lighting Plan - Areas A and B DE131 First Floor Lighting Plan - Area A DE132 Second Floor Lighting Plan DE500 Details	
MECHANICAL AM050 Key Plans AM100 Ground Floor Plans - Area A AM101 Ground Floor Plans - Area B AM102 Ground Floor Plans - Area C AM103 First Floor Demolition Plan - Area A AM104 First Floor Plan - Area A AM500 Details and Controls AM600 Schedules		ELECTRICAL BE100 First Floor Demolition Plan - Areas A and C BE101 First Floor Demolition Plan - Area B BE102 First Floor Demolition Plan - Area D BE130 First Floor Lighting and Power Plan - Areas A and C BE131 First Floor Lighting and Power Plan - Area B BE132 First Floor Lighting and Power Plan - Area D BE500 Details BE501 Details		MECHANICAL CM050 Key Plans CM100 Partial Plans CM500 Details, Schedules and Controls		PLUMBING DP130 First Floor Plan - Area A, Details and Schedule	
ELECTRICAL AE100 Ground Floor Plans - Area A AE101 Ground Floor Plans - Area B AE102 Ground Floor Plans - Area C AE103 First Floor Demolition Plan - Area A AE104 First Floor Power Plan - Area A		ELECTRICAL CE050 Key Plans CE100 Partial Plans CE500 Details CE501 Details		PLUMBING CP130 Basement Floor Plan - Area A, Details and Schedule CP131 First Floor Plan - Area A and Schedule			
PLUMBING AP130 First Floor Plan - Area A, Details, and Schedule							

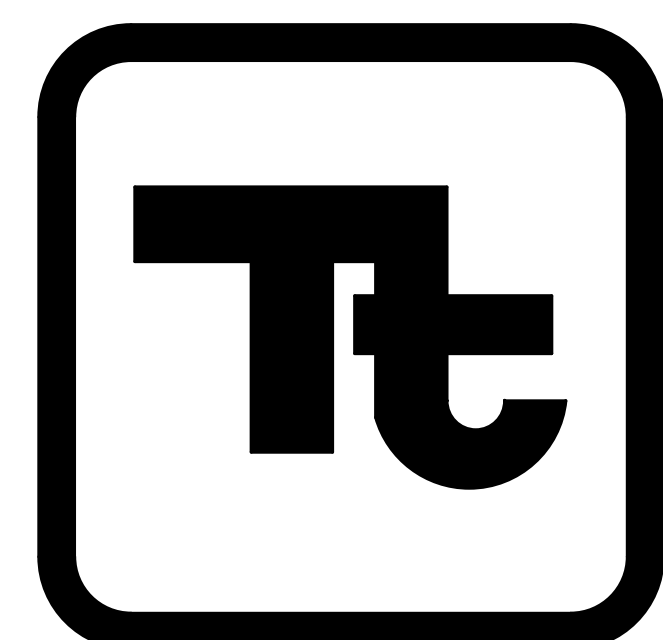

TETRA TECH
ARCHITECTS & ENGINEERS

Architecture Engineering Planning for High Performance Facilities

Tetra Tech Engineers, Architects & Landscape Architects, P.C.

Volume 1 of 2


Set No.

279180-22004
10/28/2022

ing Number:

G001

BID SET PRINTED AUGUST 8, 2023

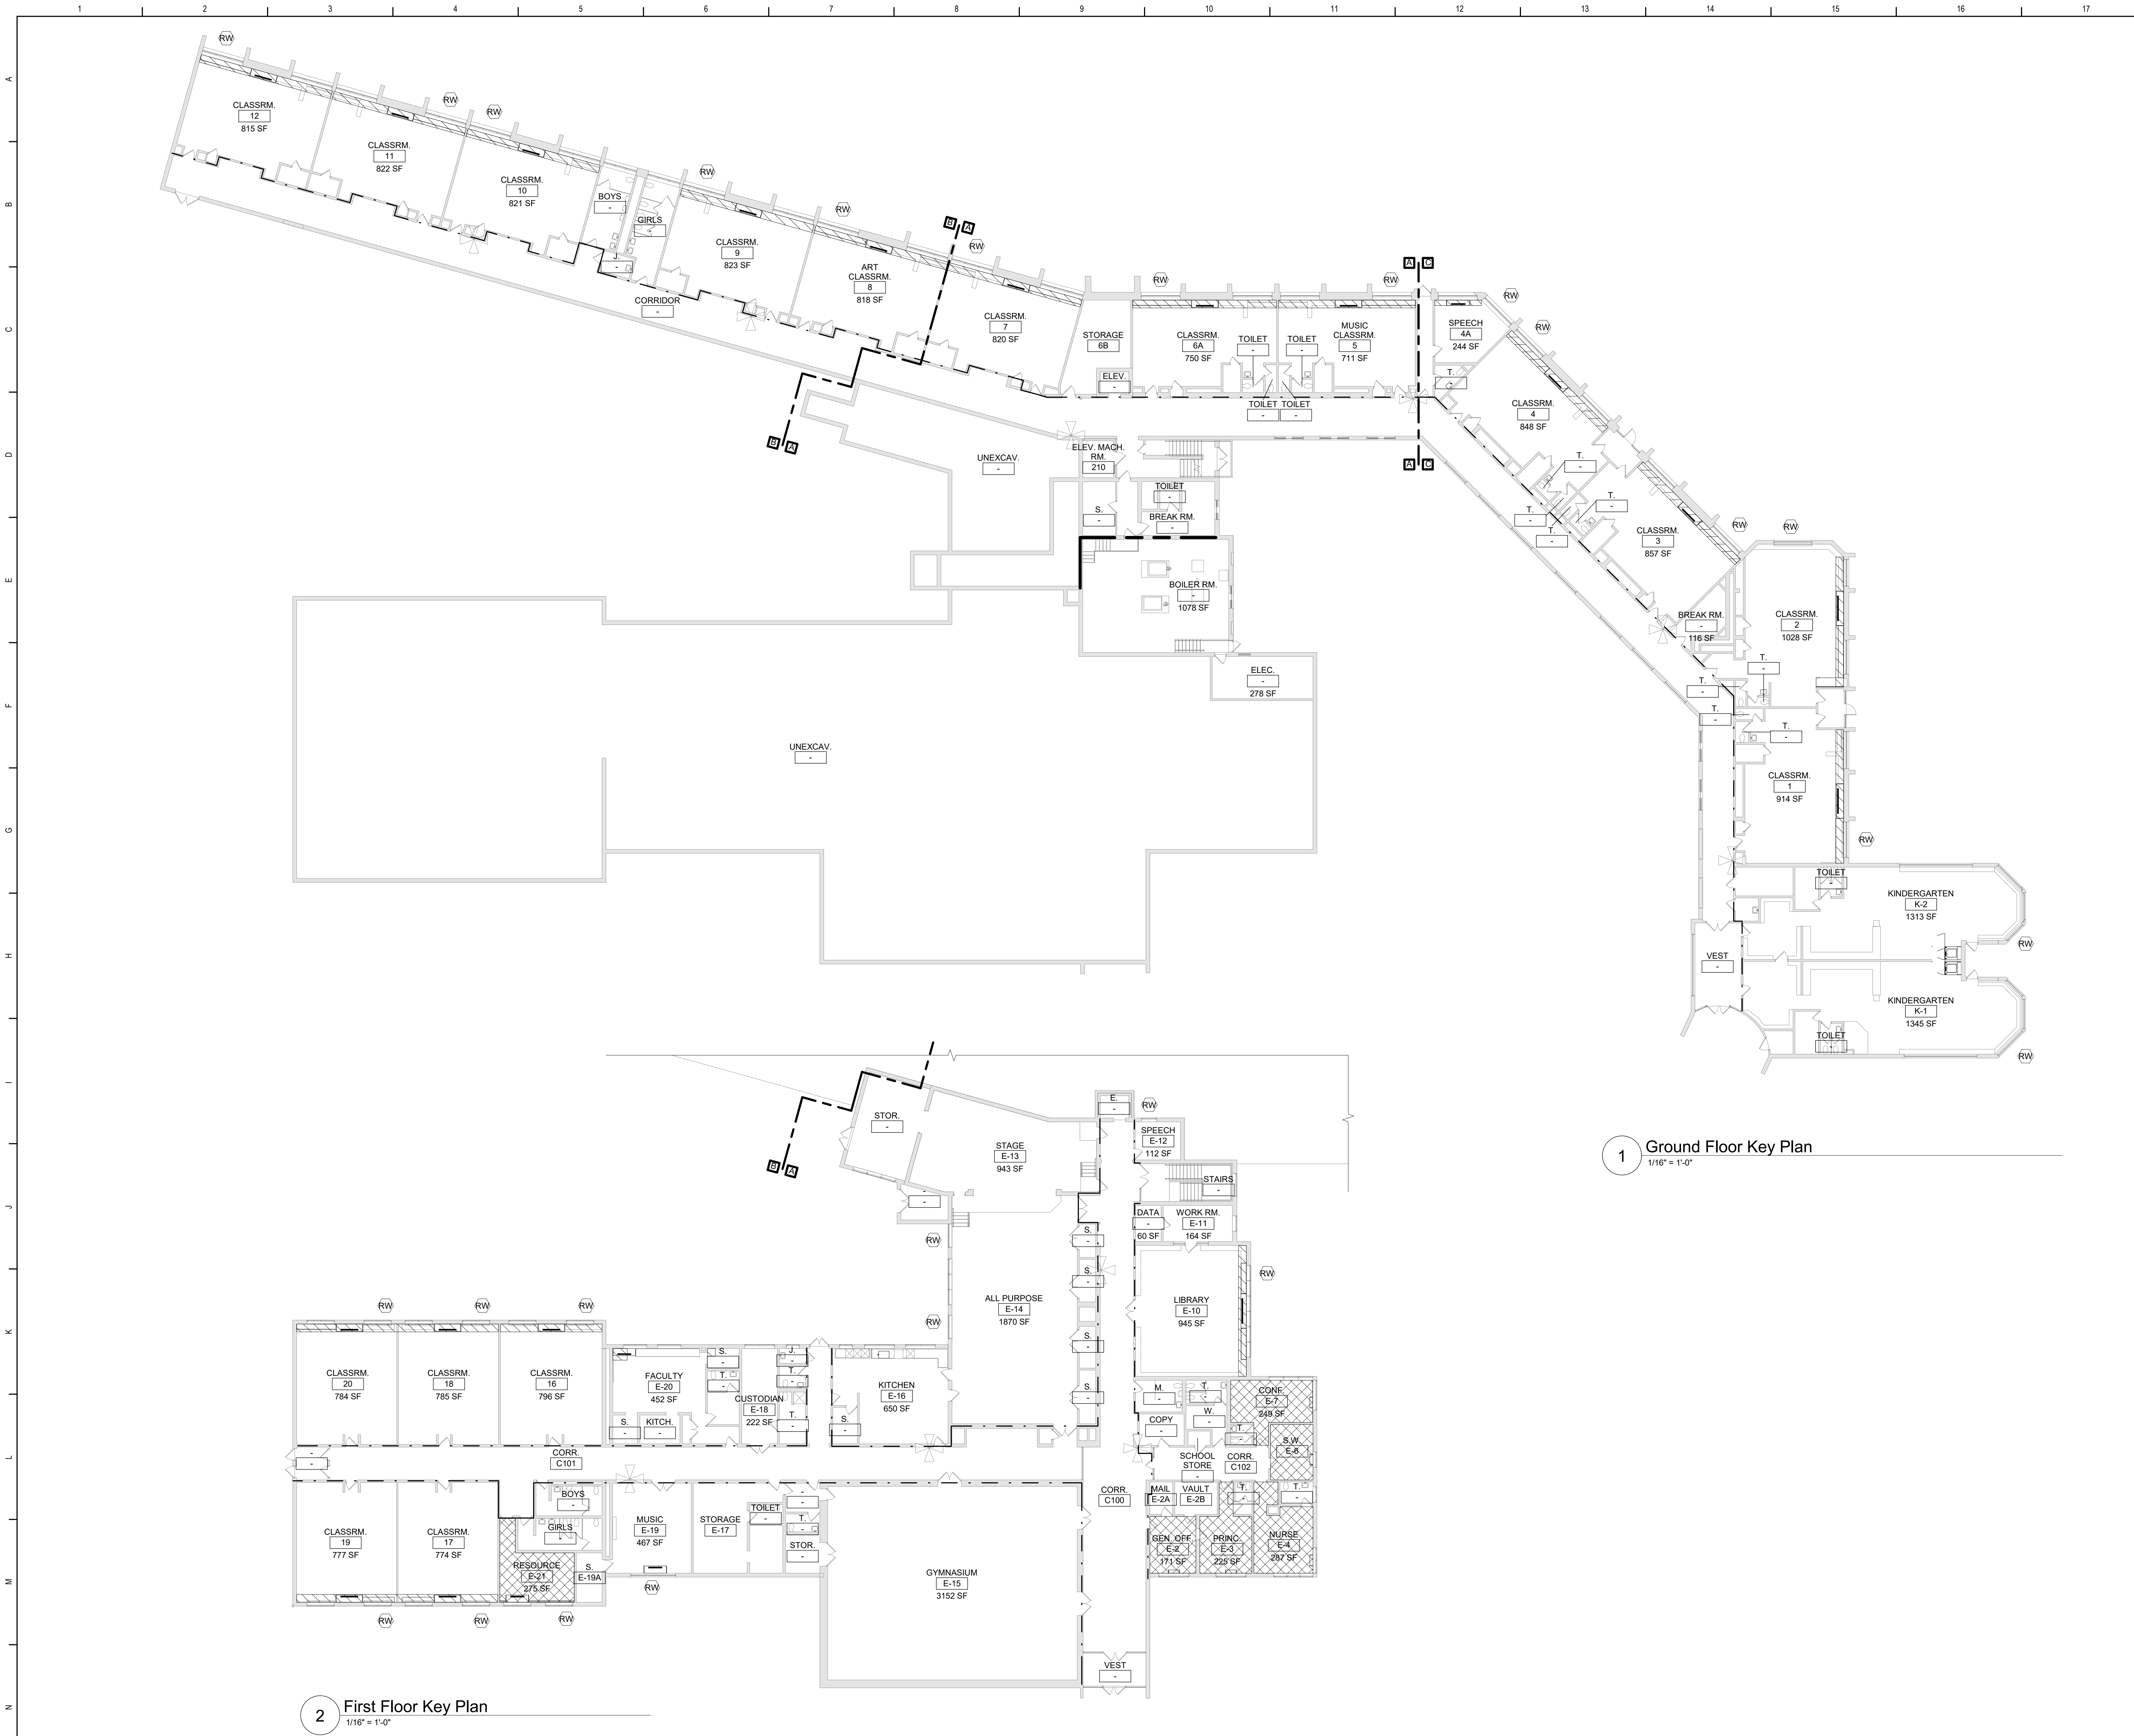

General Code Notes

A. REFER TO CODE COMPLIANCE DRAWINGS FOR ADDITIONAL CODE COMPLIANCE INFORMATION.

B. AT AREAS OF PROJECT WORK, COMPLETELY SEAL ALL NEW PENETRATIONS REQUIRED TO COMPLY WITH FIRE RESISTANCE RATINGS IDENTIFIED ON THE CODE DRAWINGS, REGARDLESS IF WALL IS NEW OR EXISTING, TYPICAL UNLESS NOTED OTHERWISE.

Legend

ALL WALLS, INCLUDING CORRIDOR WALLS, EXTEND TO THE ROOF DECK OR FLOOR DECK ABOVE UNLESS NOTED OTHERWISE.

--- 1-HOUR FIRE PARTITION

--- 2-HOUR FIRE BARRIER

✱ EXISTING FIRE EXTINGUISHER LOCATION

ALTERATION LEVEL 1 WORK AREA

ALTERATION LEVEL 2 WORK AREA

Key Plan

N.T.S.

S.E.D. Control No. 13-02-00-01-0-002-021

Rev. No.	Date	Description

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BID SET


TETRA TECH
ARCHITECTS & ENGINEERS

Beacon City School District
Beacon, New York

Reconstruction to:
JV Forrestal Elementary School

Code Compliance Ground and First
Floor Key Plans

Drawn By: TLG	Date: 10/28/2022	Drawing Number: AG351
Project No.: 279180-22004		

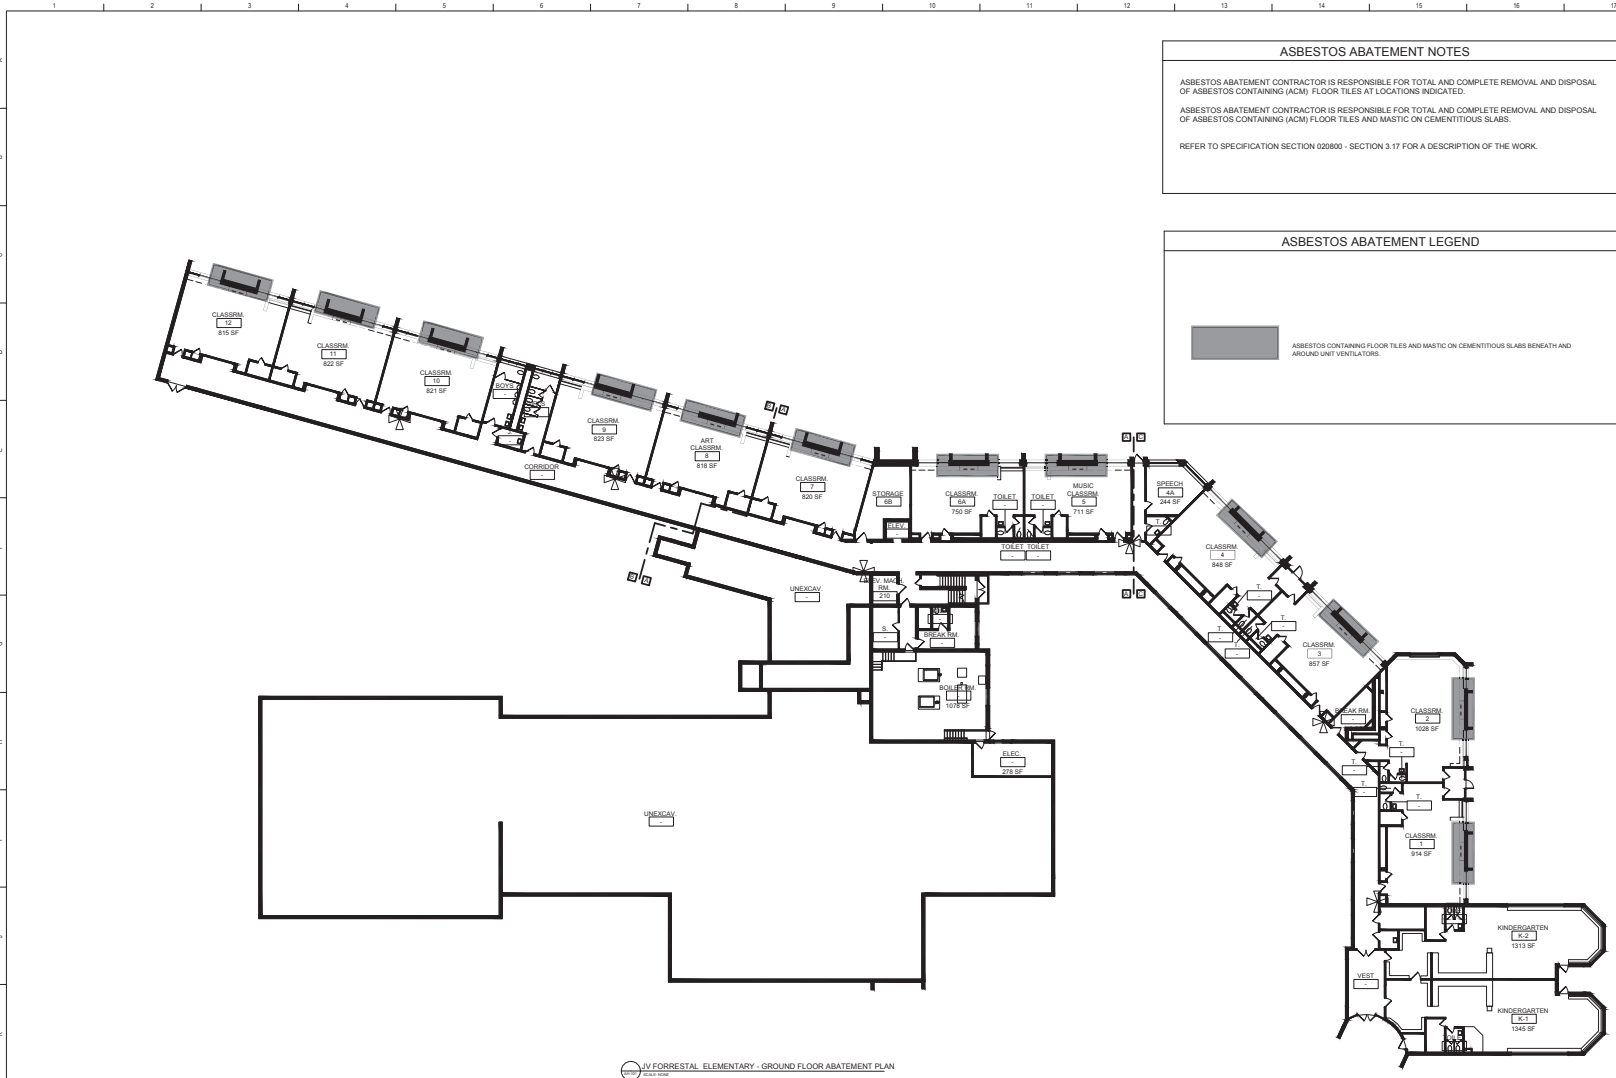

JV FORRESTER ELEMENTARY - GROUND FLOOR ABATEMENT PLAN

ASBESTOS ABATEMENT NOTES

ASBESTOS ABATEMENT CONTRACTOR IS RESPONSIBLE FOR TOTAL AND COMPLETE REMOVAL AND DISPOSAL OF ASBESTOS CONTAINING (ACM) FLOOR TILES AT LOCATIONS INDICATED.


ASBESTOS ABATEMENT CONTRACTOR IS RESPONSIBLE FOR TOTAL AND COMPLETE REMOVAL AND DISPOSAL OF ASBESTOS CONTAINING (ACM) FLOOR TILES AND MASTIC ON CEMENTITIOUS SLABS.


REFER TO SPECIFICATION SECTION 020800 - SECTION 3.17 FOR A DESCRIPTION OF THE WORK.

ASBESTOS ABATEMENT LEGEND


ASBESTOS CONTAINING FLOOR TILES AND MASTIC ON CEMENTITIOUS SLAB BENEATH AND AROUND UNIT VENTILATORS

QUALITY ENVIRONMENTAL SOLUTIONS & TECHNOLOGIES, INC.
1376 NYS ROUTE 9
WAPPINGERS FALLS, NY 12590
TEL.: (845) 298-6031



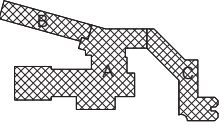



Key Plan
N.T.S.



S.E.D. Control No. 13-02-00-01-0-002-021

Rev. No.	Date	Description
1	4-13-22	100% SED Submit




Beacon City School District
Beacon, New York

Reconstruction to:
JV Forrester Elementary School

Asbestos Abatement - Ground Floor Plan

Drawn By: TTAE	Date: 10/08/2022	Drawing Number: AH100
Project No.: 279180-22004		

QUALITY ENVIRONMENTAL SOLUTIONS
& TECHNOLOGIES, INC.
1376 NYS ROUTE 9
WAPPINGERS FALLS, NY 12590
TEL.: (845) 298-6031

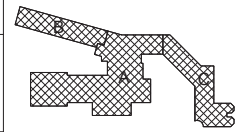

S.E.D. Control No. 13-02-00-01-0-002-021

Rev. No.	Date	Description
1	4/13/22	100% SED Submittal



Beacon City School District
Beacon, New York

Reconstruction to:
JV Forrestal Elementary School

Asbestos Abatement First Floor Plan

Drawn By: TTAE	Date: 10/28/2022	Drawing Number: AH101
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Project No.: 279180-22004


ASBESTOS ABATEMENT NOTES

ASBESTOS ABATEMENT CONTRACTOR IS RESPONSIBLE FOR TOTAL AND COMPLETE REMOVAL AND DISPOSAL OF ASBESTOS CONTAINING (ACM) FLOOR TILES AT LOCATIONS INDICATED.
ASBESTOS ABATEMENT CONTRACTOR IS RESPONSIBLE FOR TOTAL AND COMPLETE REMOVAL AND DISPOSAL OF ASBESTOS CONTAINING (ACM) FLOOR TILES AND MASTIC ON CEMENTITIOUS SLABS.
REFER TO SPECIFICATION SECTION 020800 - SECTION 3.17 FOR A DESCRIPTION OF THE WORK.


ASBESTOS ABATEMENT LEGEND



ASBESTOS CONTAINING FLOOR TILES AND MASTIC ON CEMENTITIOUS SLABS BENEATH AND AROUND UNIT VENTILATORS.

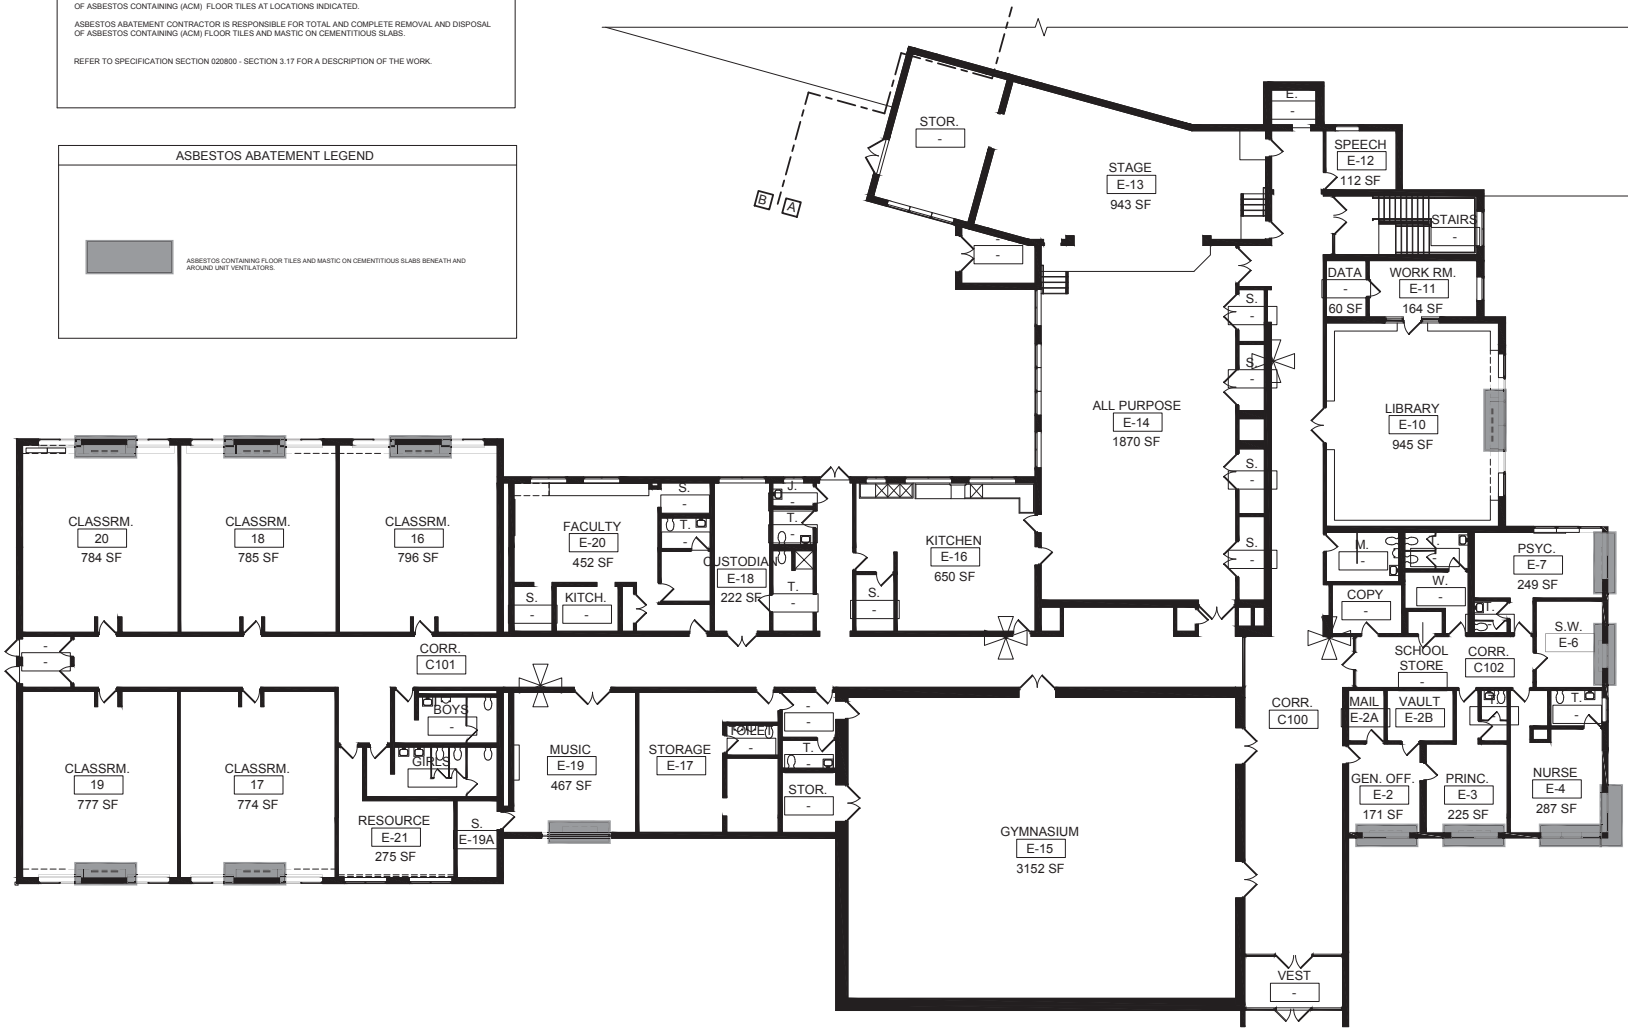

JV FORRESTAL ELEMENTARY - GROUND FLOOR ABATEMENT PLAN

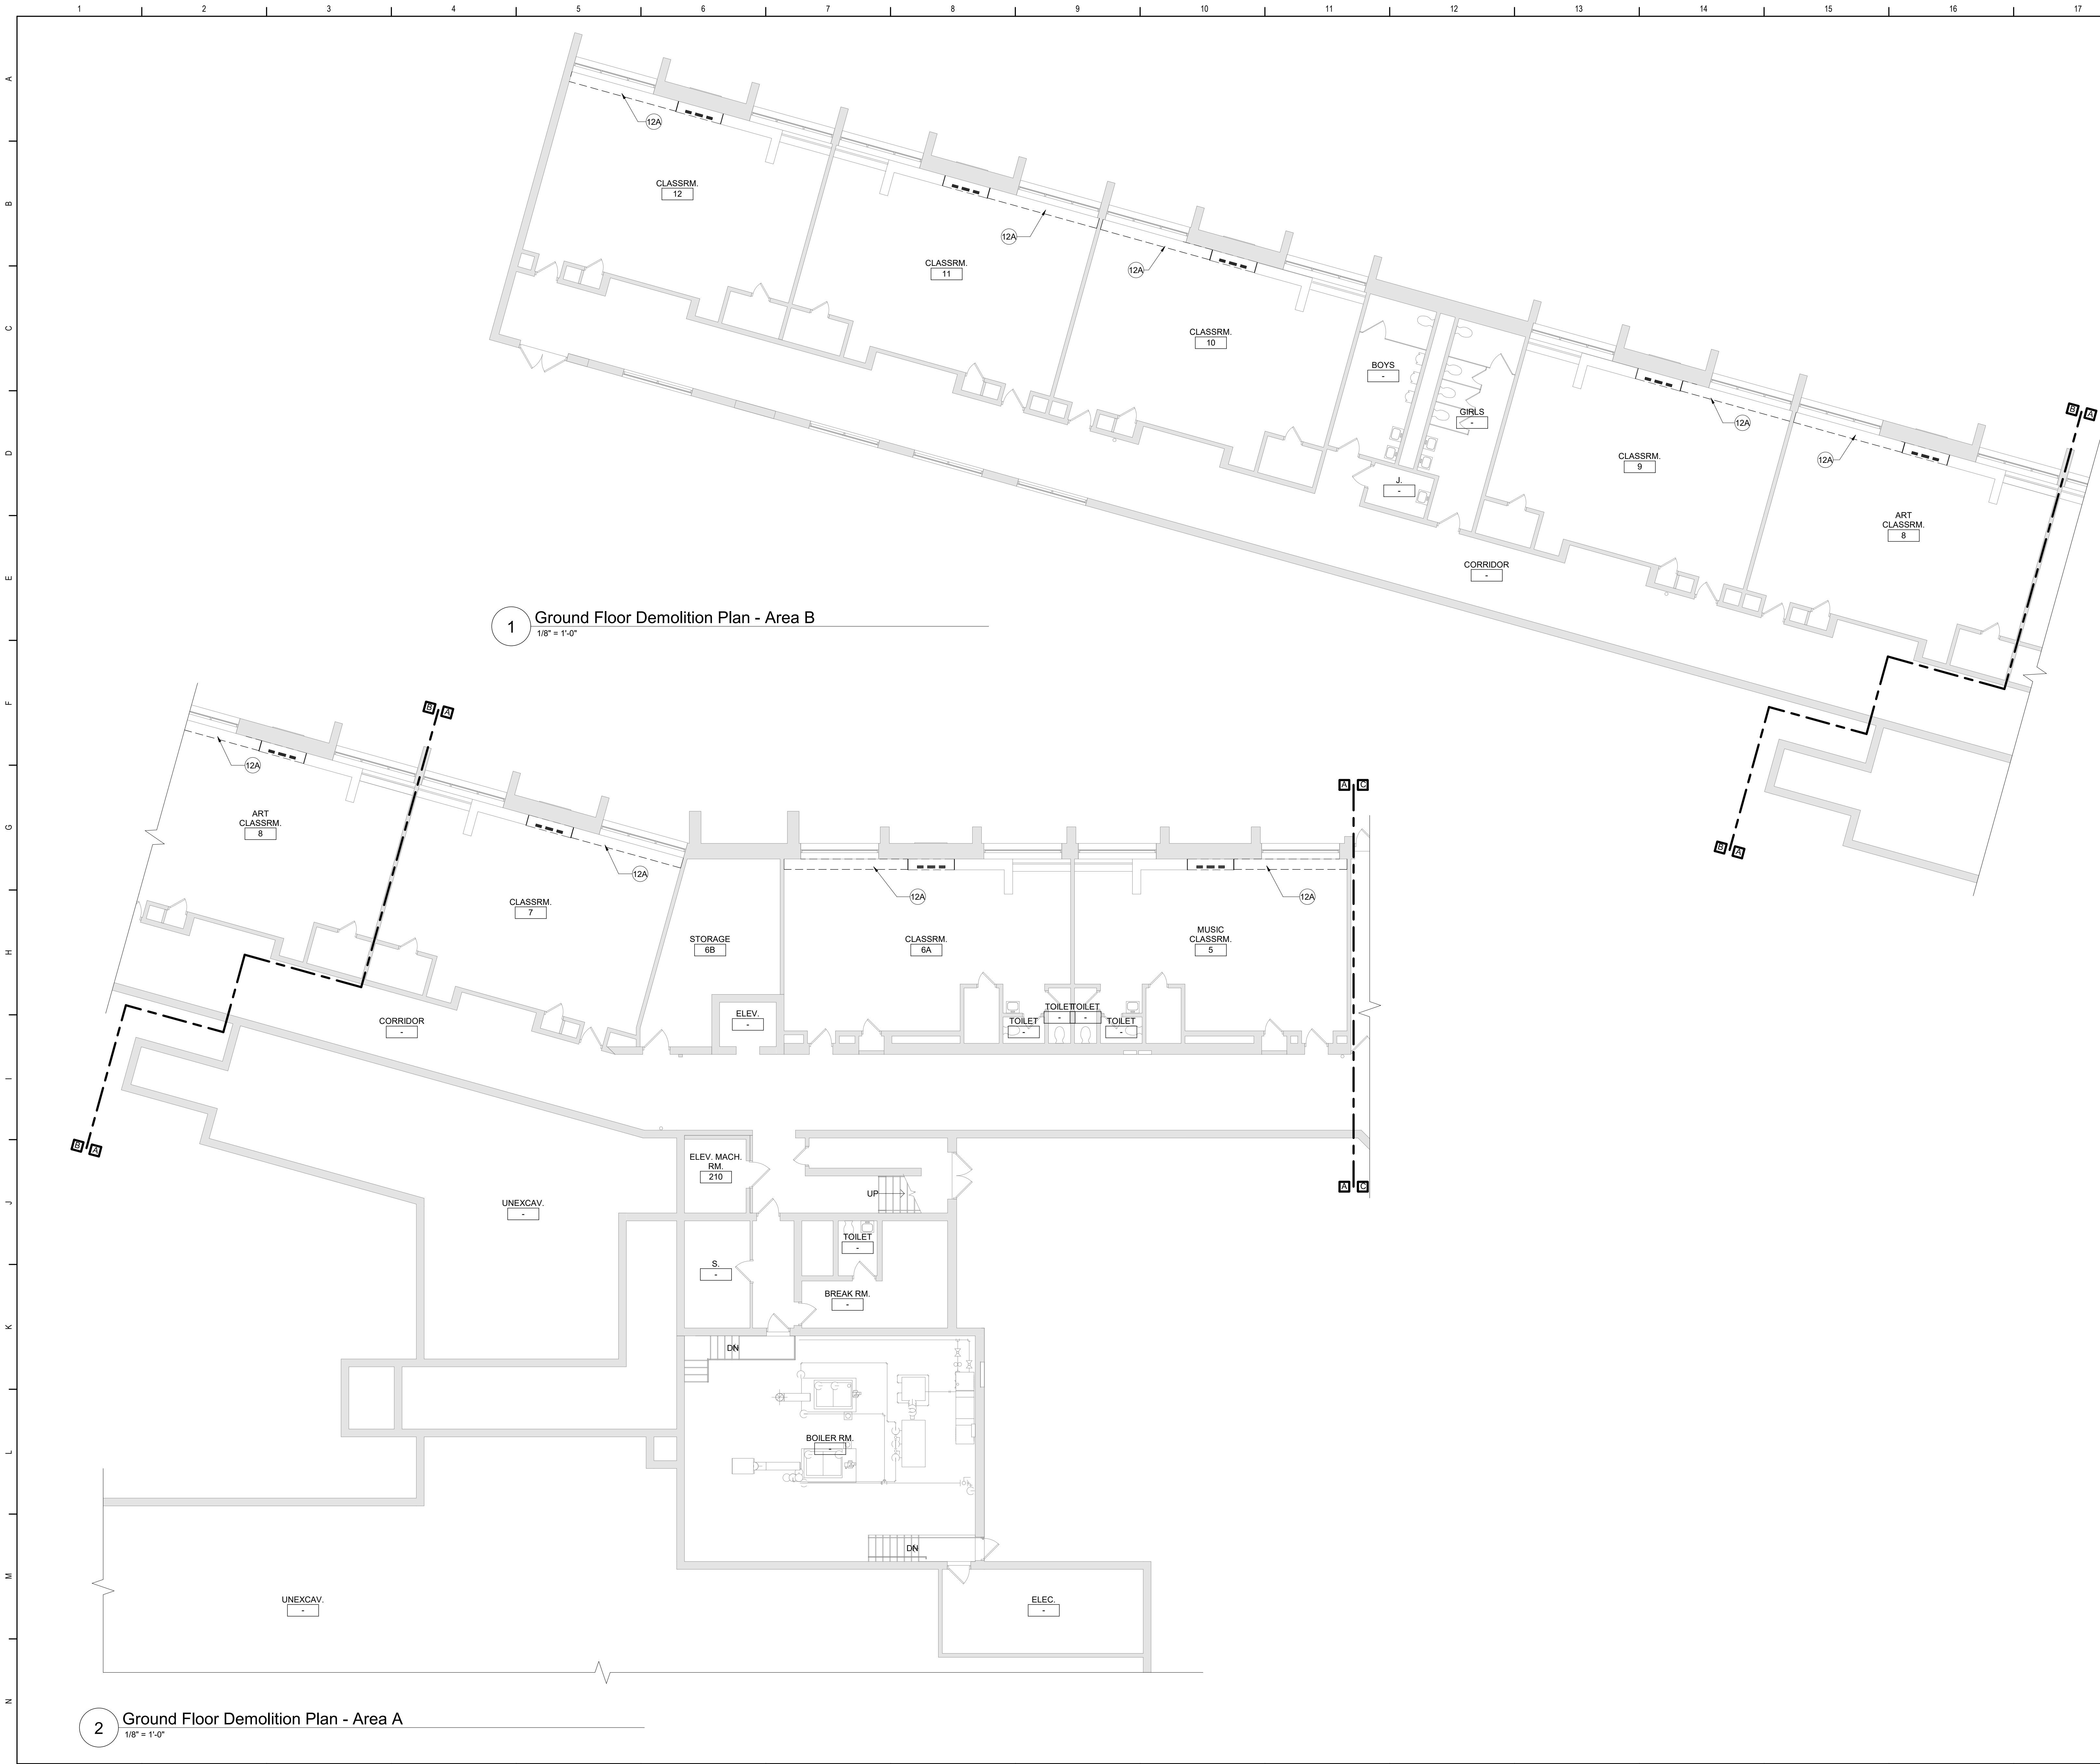

General Demolition Notes

A. - - - - REMOVE ITEMS INDICATED BY DASHED LINE.

B. KEYED DEMOLITION TAGS REFER TO SPECIFIC LOCATIONS AS FOLLOWS:

- DEMOLITION TAGS LOCATED WITHIN THE MIDDLE OF A SPACE REFER TO DEMOLITION OF ALL ITEMS OF THAT SAME TYPE WITHIN THAT ENTIRE SPACE.
- DEMOLITION TAGS PLACED IMMEDIATELY ON OR ADJACENT TO A DASHED LINE INDICATING ITEM REMOVAL OR THAT HAVE A LEADER POINTING TO SPECIFIC ITEM(S) REFER TO DEMOLITION OF THAT SPECIFIC ITEM ONLY OF THAT TYPE WITHIN THAT SPACE.
- DEMOLITION TAGS IN SERIES REFER TO DEMOLITION OF ALL THOSE ITEMS EITHER WITHIN THAT ENTIRE SPACE OR TO THE SPACE IDENTIFIED BY THAT LEADER.

C. WHEN AN ITEM IS INDICATED TO BE DEMOLISHED REMOVE ALL ASSOCIATED COMPONENTS AS PART OF THAT WORK.

D. ALL ARTWORK NOT PERMANENTLY AFFIXED TO EXISTING CONSTRUCTION SHALL BE REMOVED AND STORED BY OWNER PRIOR TO BEGINNING DEMOLITION WORK. CONTACT OWNER'S AGENT(S) IF ANY ARTWORK IS ENCOUNTERED PRIOR TO START OF DEMOLITION WORK.

E. COORDINATE WITH ABATEMENT DRAWINGS PRIOR TO DEMOLITION.

Demolition Key Notes

(1H) PROVIDE NEW OR ENLARGE EXISTING OPENING IN WALL TO EXTENT REQUIRED TO PERFORM SCHEDULED WORK. PROVIDE LINTEL PER LINTEL SCHEDULE. PATCH EXPOSED SURFACES TO MATCH ADJACENT FINISHES / SURFACES. COORDINATE WITH SCHEDULED WORK ON MECHANICAL DRAWINGS.

(8A) REMOVE EXISTING WINDOW AND ALL ASSOCIATED COMPONENTS. COORDINATE WITH HVAC DWGS AND ELEVATIONS.

(9A) REMOVE FLOOR FINISH, MASTIC AND WALL BASE TO EXTENT REQUIRED TO PERFORM SCHEDULED WORK. AT ALL AREAS OF FLOOR REMOVAL, LEVEL SLAB WITH ADJACENT SLABS AT LOCATIONS SCHEDULED TO RECEIVE FLOOR FINISH. INCLUDE CONCRETE FLOOR PATCHING AND LEVELING MATERIALS TO MAKE SURFACE LEVEL. PREPARE FOR FINISH. PATCH AREAS OF WALLS TO REMAIN THAT WERE DAMAGED BY REMOVAL OF WALL BASE.

SUFFIX KEY (FLOOR FINISH IDENTIFICATIONS):

- A. VANTIC
- B. CERAMIC FLOOR TILE
- C. CARPET
- D. VINYL SHEET
- E. LINOLEUM, SHEET OR TILE

(9E) REMOVE WALL BASE AND ASSOCIATED MASTIC ONLY. EXISTING FLOOR FINISH TO REMAIN. PATCH AREAS OF WALLS TO REMAIN THAT WERE DAMAGED BY REMOVAL OF WALL BASE.

(12A) REMOVE CASEWORK, SHELVING AND ASSOCIATED COMPONENTS TO THE EXTENT REQUIRED TO PERFORM SCHEDULED WORK. COORDINATE WITH CASEWORK AND MECHANICAL DRAWINGS. PATCH FLOOR FINISH TO MATCH ADJACENT SURFACES.


(12B) REMOVE COUNTERTOP, CASEWORK AND ASSOCIATED COMPONENTS. SALVAGE CASEWORK TO BE REINSTALLED. COORDINATE WITH CASEWORK AND MECHANICAL DRAWINGS. PATCH FLOOR FINISH TO MATCH ADJACENT SURFACES.

Key Plan

N.T.S.

S.E.D. Control No. 13-02-00-01-0-002-021

Rev. No.	Date	Description



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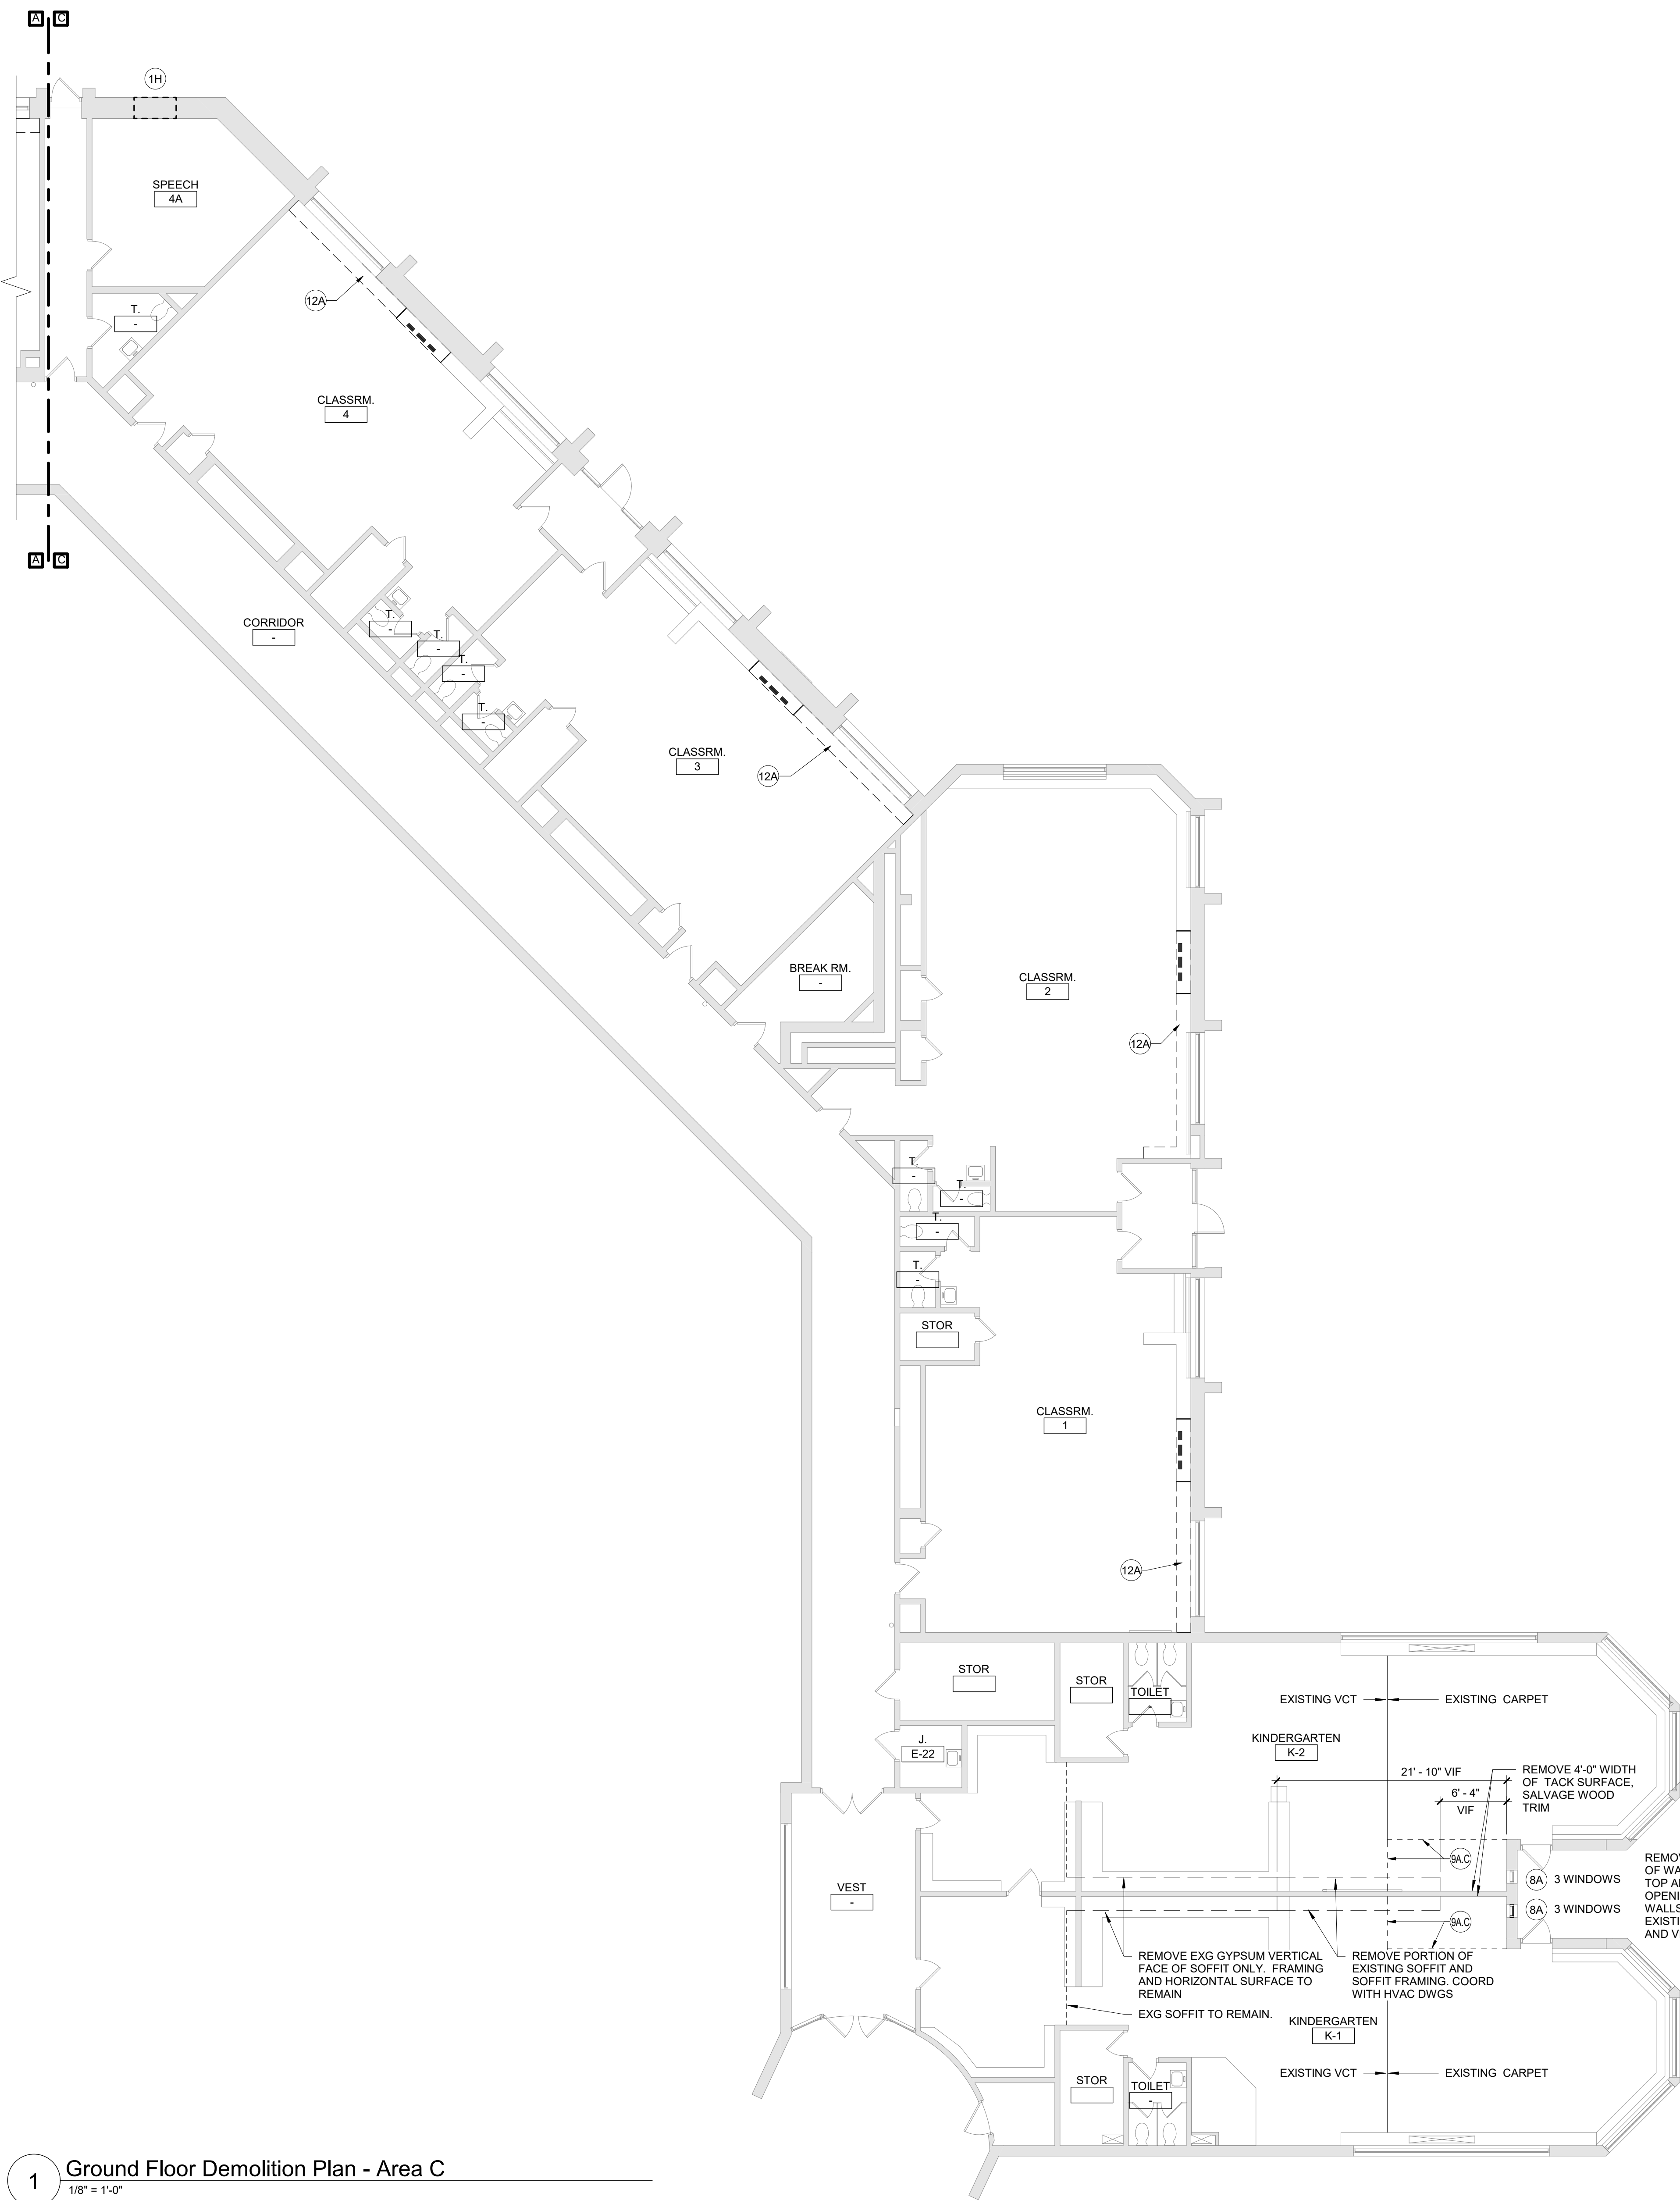
TETRA TECH
ARCHITECTS & ENGINEERS

Beacon City School District
Beacon, New York

Reconstruction to:
JV Forrester Elementary School

Ground Floor Demolition Plans - Area A and B

Drawn By: GCK/1lg	Date: 10/28/2022	Drawing Number: AA100
Project No.: 279180-22004		




1 Ground Floor Demolition Plan - Area C
1/8" = 1'-0"

General Demolition Notes

- A. - - - - REMOVE ITEMS INDICATED BY DASHED LINE.
- B. KEYED DEMOLITION TAGS REFER TO SPECIFIC LOCATIONS AS FOLLOWS:
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- C. WHEN AN ITEM IS INDICATED TO BE DEMOLISHED REMOVE ALL ASSOCIATED COMPONENTS AS PART OF THAT WORK.
- D. ALL ARTWORK NOT PERMANENTLY AFFIXED TO EXISTING CONSTRUCTION SHALL BE REMOVED AND STORED BY OWNER PRIOR TO BEGINNING DEMOLITION WORK. CONTACT OWNER'S AGENT(S) IF ANY ARTWORK IS ENCOUNTERED PRIOR TO START OF DEMOLITION WORK.
- E. COORDINATE WITH ABATEMENT DRAWINGS PRIOR TO DEMOLITION.


Demolition Key Notes

- (1H) PROVIDE NEW OR ENLARGE EXISTING OPENING IN WALL TO EXTENT REQUIRED TO PERFORM SCHEDULED WORK. PROVIDE LINTEL PER LINTEL SCHEDULE. PATCH EXPOSED SURFACES TO MATCH ADJACENT FINISHES / SURFACES. COORDINATE WITH SCHEDULED WORK ON MECHANICAL DRAWINGS.
- (8A) REMOVE EXISTING WINDOW AND ALL ASSOCIATED COMPONENTS. COORDINATE WITH HVAC DWGS AND ELEVATIONS.
- (8A) REMOVE FLOOR FINISH, MASTIC AND WALL BASE TO EXTENT REQUIRED TO PERFORM SCHEDULED WORK. AT ALL AREAS OF FLOOR REMOVAL, LEVEL SLAB WITH ADJACENT SLABS AT LOCATIONS SCHEDULED TO RECEIVE FLOOR FINISH. INCLUDE CONCRETE FLOOR PATCHING AND LEVELING MATERIALS TO MAKE SURFACE LEVEL. PREPARE FOR FINISH. PATCH AREAS OF WALLS TO REMAIN THAT WERE DAMAGED BY REMOVAL OF WALL BASE.
- SUFFIX KEY (FLOOR FINISH IDENTIFICATIONS):
- A. VAT/VCT.
 - B. CERAMIC FLOOR TILE.
 - C. CARPET
 - D. VINYL SHEET
 - E. LINOLEUM, SHEET OR TILE.
- (9E) REMOVE WALL BASE AND ASSOCIATED MASTIC ONLY. EXISTING FLOOR FINISH TO REMAIN. PATCH AREAS OF WALLS TO REMAIN THAT WERE DAMAGED BY REMOVAL OF WALL BASE.
- (12A) REMOVE CASEWORK, SHELVING AND ASSOCIATED COMPONENTS TO THE EXTENT REQUIRED TO PERFORM SCHEDULED WORK. COORDINATE WITH CASEWORK AND MECHANICAL DRAWINGS. PATCH FLOOR FINISH TO MATCH ADJACENT SURFACES.
- (12B) REMOVE COUNTERTOP, CASEWORK AND ASSOCIATED COMPONENTS. SALVAGE CASEWORK TO BE REINSTALLED. COORDINATE WITH CASEWORK AND MECHANICAL DRAWINGS. PATCH FLOOR FINISH TO MATCH ADJACENT SURFACES.

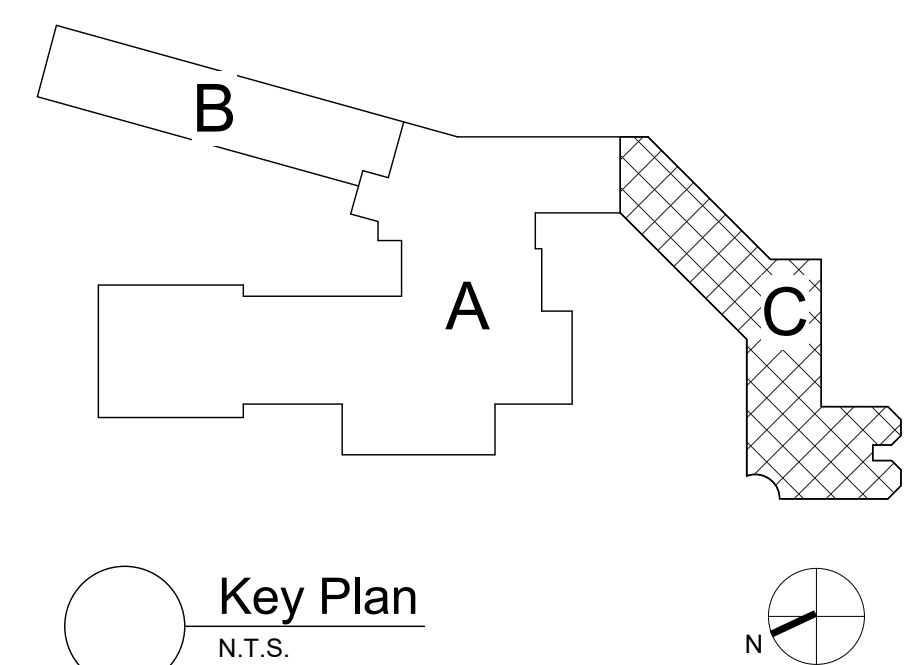

S.E.D. Control No. 13-02-00-01-0-002-021

Rev. No.	Date	Description

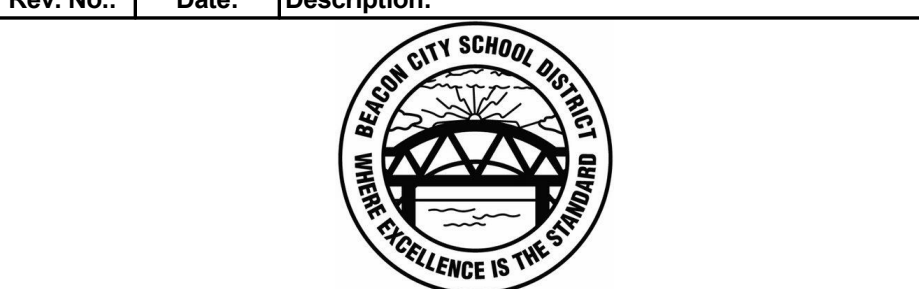

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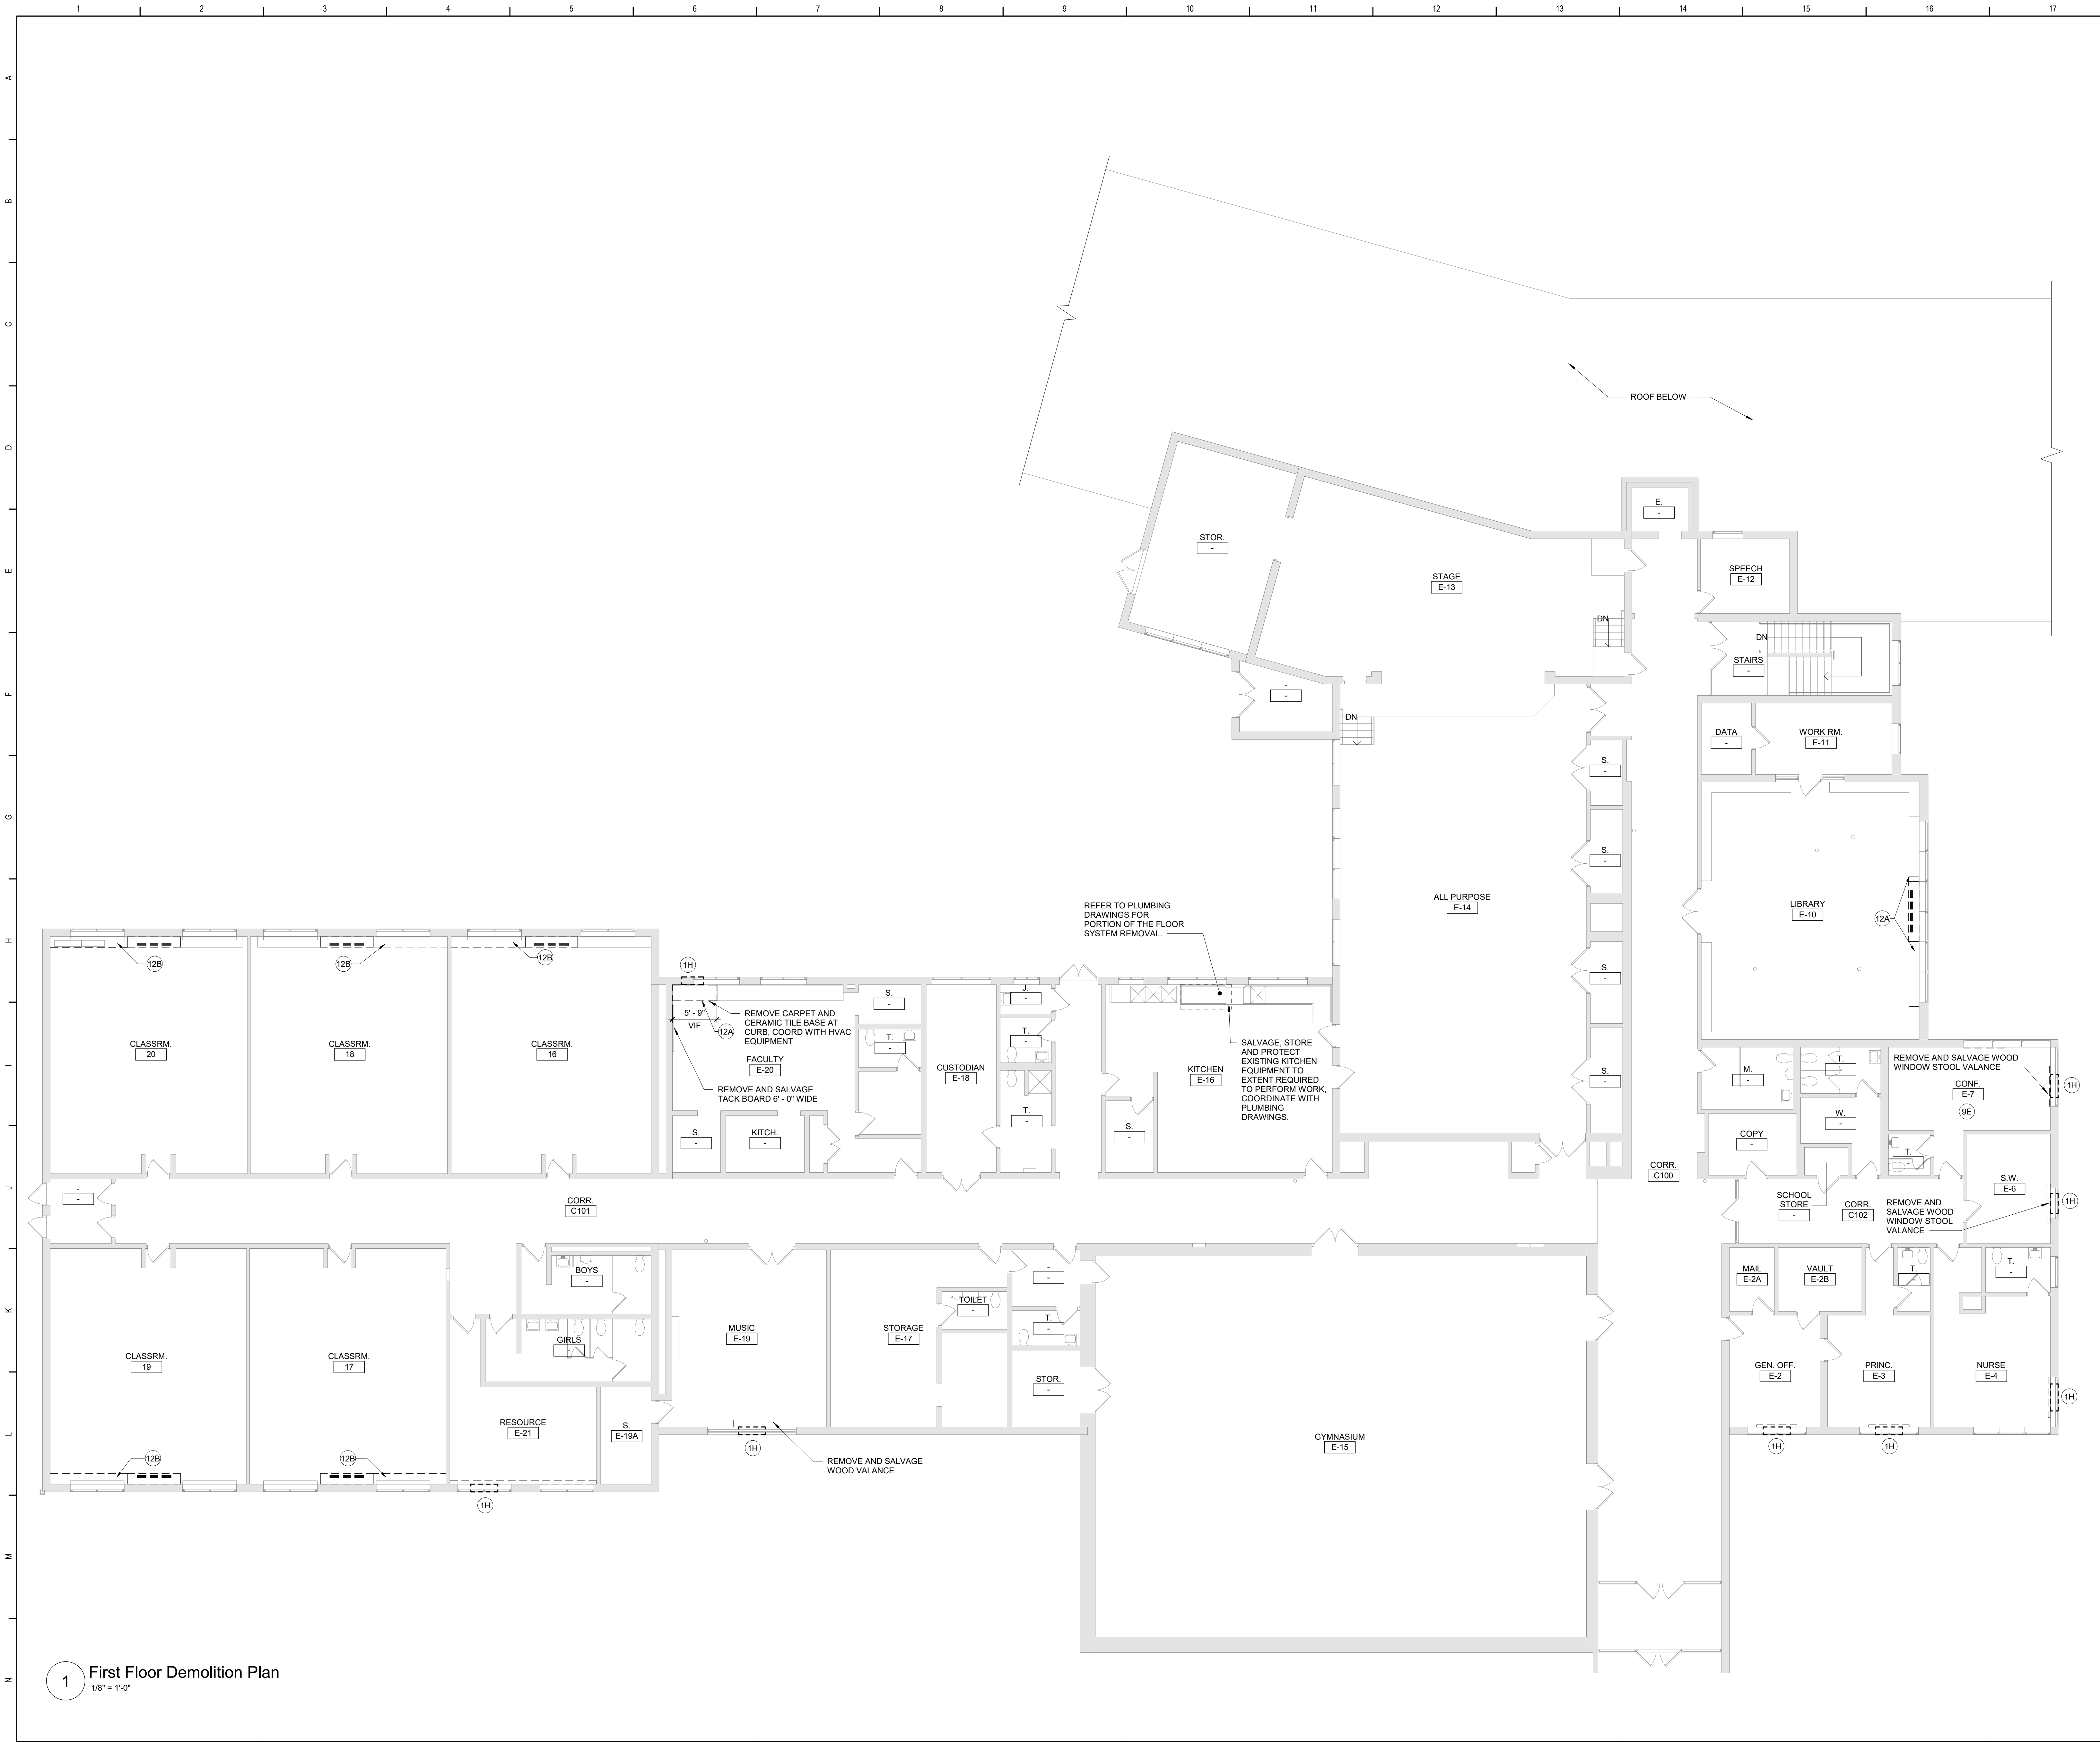


Beacon City School District
Beacon, New York

Reconstruction to:
JV Forrestal Elementary School

Ground Floor Demolition Plan - Area C

Drawn By: GCK/lig	Date: 10/28/2022	Drawing Number:
Project No.: 279180-22004	AA101	




General Demolition Notes

- A. - - - - - REMOVE ITEMS INDICATED BY DASHED LINE.
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- DEMOLITION TAGS LOCATED WITHIN THE MIDDLE OF A SPACE REFER TO DEMOLITION OF ALL ITEMS OF THAT SAME TYPE WITHIN THAT ENTIRE SPACE.
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- E. COORDINATE WITH ABATEMENT DRAWINGS PRIOR TO DEMOLITION.

Demolition Key Notes

- (1H) PROVIDE NEW OR ENLARGE EXISTING OPENING IN WALL TO EXTENT REQUIRED TO PERFORM SCHEDULED WORK. PROVIDE LINTEL PER LINTEL SCHEDULE. PATCH EXPOSED SURFACES TO MATCH ADJACENT FINISHES / SURFACES. COORDINATE WITH SCHEDULED WORK ON MECHANICAL DRAWINGS.
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- (9AX) REMOVE FLOOR FINISH, MASTIC AND WALL BASE TO EXTENT REQUIRED TO PERFORM SCHEDULED WORK. AT ALL AREAS OF FLOOR REMOVAL, LEVEL SLAB WITH ADJACENT SLABS AT LOCATIONS SCHEDULED TO RECEIVE FLOOR FINISH. INCLUDE CONCRETE FLOOR PATCHING AND LEVELING MATERIALS TO MAKE SURFACE LEVEL. PREPARE FOR FINISH. PATCH AREAS OF WALLS TO REMAIN THAT WERE DAMAGED BY REMOVAL OF WALL BASE.
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- (12B) REMOVE COUNTERTOP, CASEWORK AND ASSOCIATED COMPONENTS. SALVAGE CASEWORK TO BE REINSTALLED. COORDINATE WITH CASEWORK AND MECHANICAL DRAWINGS. PATCH FLOOR FINISH TO MATCH ADJACENT SURFACES.

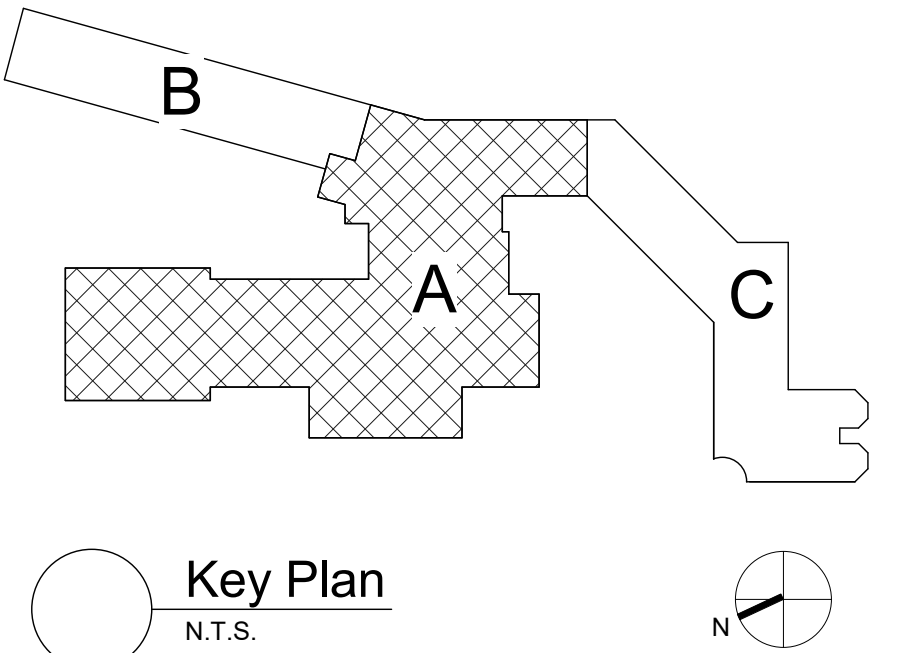

S.E.D. Control No. 13-02-00-01-0-002-021

Rev. No.:	Date:	Description:



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Tetra Tech Engineers, Architects & Landscape Architects, P.C.

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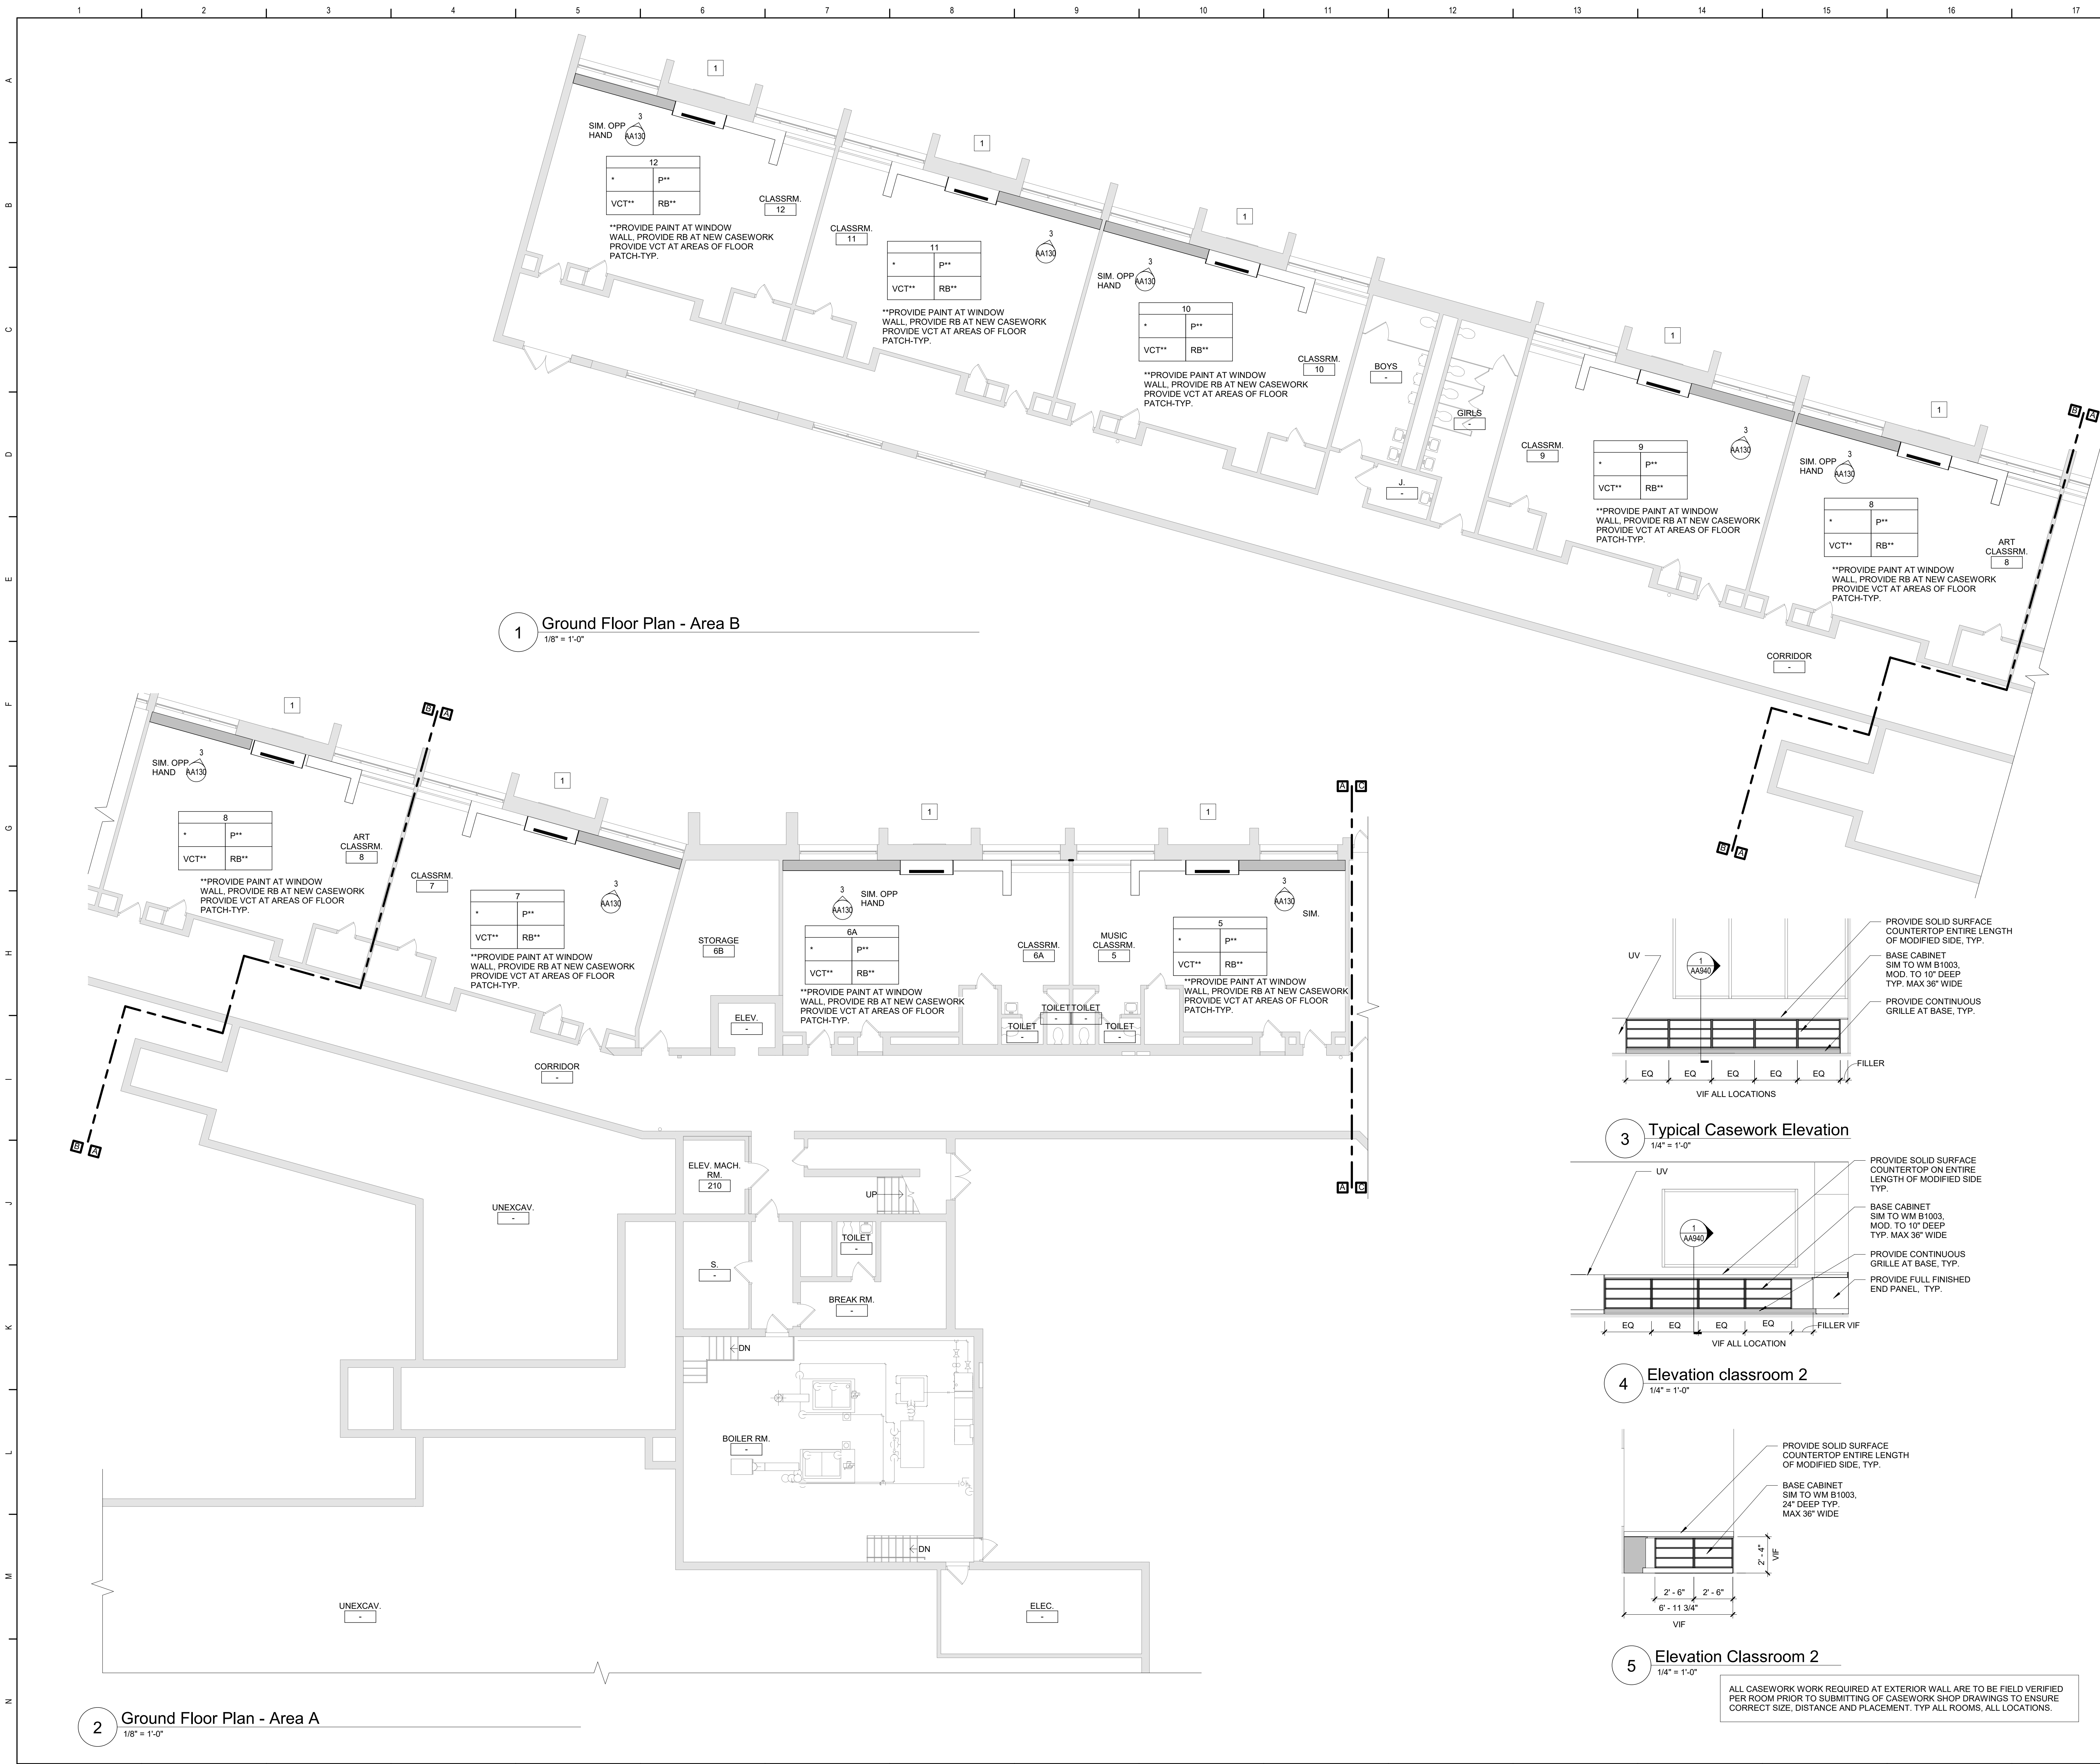


Beacon City School District
Beacon, New York

Reconstruction to:
JV Forrestal Elementary School

First Floor Demolition Plan

Drawn By: GCK/lig	Date: 10/28/2022	Drawing Number:
Project No.: 279180-22004	AA102	



General Notes

A. DO NOT SCALE DRAWINGS TO OBTAIN DIMENSIONS.

B. TAKE FIELD MEASUREMENTS TO FIT THE WORK PROPERLY. VERIFY ALL EXISTING CONDITIONS AND DIMENSIONS IN THE FIELD.

C. REFER INCONSISTENCIES TO ARCHITECT PRIOR TO COMMENCING THE WORK IN AFFECTED AREA.

D. ITEMS ARE SHOWN DIAGRAMMATICALLY ON DRAWINGS. VERIFY SPACE REQUIREMENTS AND DIMENSIONS TO FIT THE WORK PROPERLY.

E. NOTES SHOWN ON ONE DRAWING APPLY TO ALL SIMILAR DRAWINGS.

F. DO NOT DISTURB CONSTRUCTION SUSPECTED OF CONTAINING HAZARDOUS MATERIAL. IF ENCOUNTERED, IMMEDIATELY NOTIFY ARCHITECT, CONSTRUCTION MANAGER, AND OWNER.

General Plan Notes

A. WHERE EXISTING CONSTRUCTION IS DAMAGED OR DISTURBED, PATCH IS REQUIRED TO RESTORE SURFACES TO THEIR ORIGINAL CONDITION.

Keyed Plan Notes

1. INSTALL LOUVER FURNISHED BY OTHERS AT EXISTING OPENING. COORDINATE WITH MECHANICAL DRAWINGS.

2. PROVIDE INFILL AT MECH REMOVAL WITH P16.3 OR SIMILAR CONSTRUCTION. MATCH EXISTING ADJACENT SURFACE. PREPARE FOR SCHEDULED FINISH. VIF. COORD WITH HVAC DWGS FOR LOCATIONS OF NEW MECH EQUIPMENT FOR NEW R.O.

3. COPE SALVAGED WOOD WINDOW STOOL VALANCE TO MECHANICAL EQUIPMENT. REINSTALL.

4. PATCH EXG FLOOR AT MECHANICAL REMOVAL. INFILL ALL PENETRATIONS WITH SIMILAR MATERIALS. VIF

5. INSTALL LOUVER FURNISHED BY OTHERS AT NEW OPENING. COORDINATE WITH MECHANICAL DRAWINGS.

REFER TO DRAWING AA940 FOR ALL GENERAL FINISH NOTES
REFER TO DRAWING AA940 FOR ALL CASEWORK NOTES

Room Finish Key

N	NO WORK REQUIRED
P	PAINT SURFACE(S) INCLUDING SOFFITS
RB	RUBBER BASE
QT	QUARRY TILE
VCT	VINYL COMPOSITION TILE - TYPE 1
*	SEE REFLECTED CEILING PLAN
+	INDICATED CHANGE IN FLOOR FINISH

NOTE: ALL FINISHES LISTED MAY NOT BE REQUIRED FOR THIS PROJECT

RM#	
CLG*	WALL
FLR	BASE

FINISHES SHOWN IN ROOM FINISH BOX ARE FOR ALL WALLS AND ENTIRE FLOOR AND CEILING. REFER TO EACH ROOM FOR MORE INFORMATION.

Key Plan

N.T.S.

S.E.D. Control No. 13-02-00-01-0-002-021

Rev. No.	Date	Description

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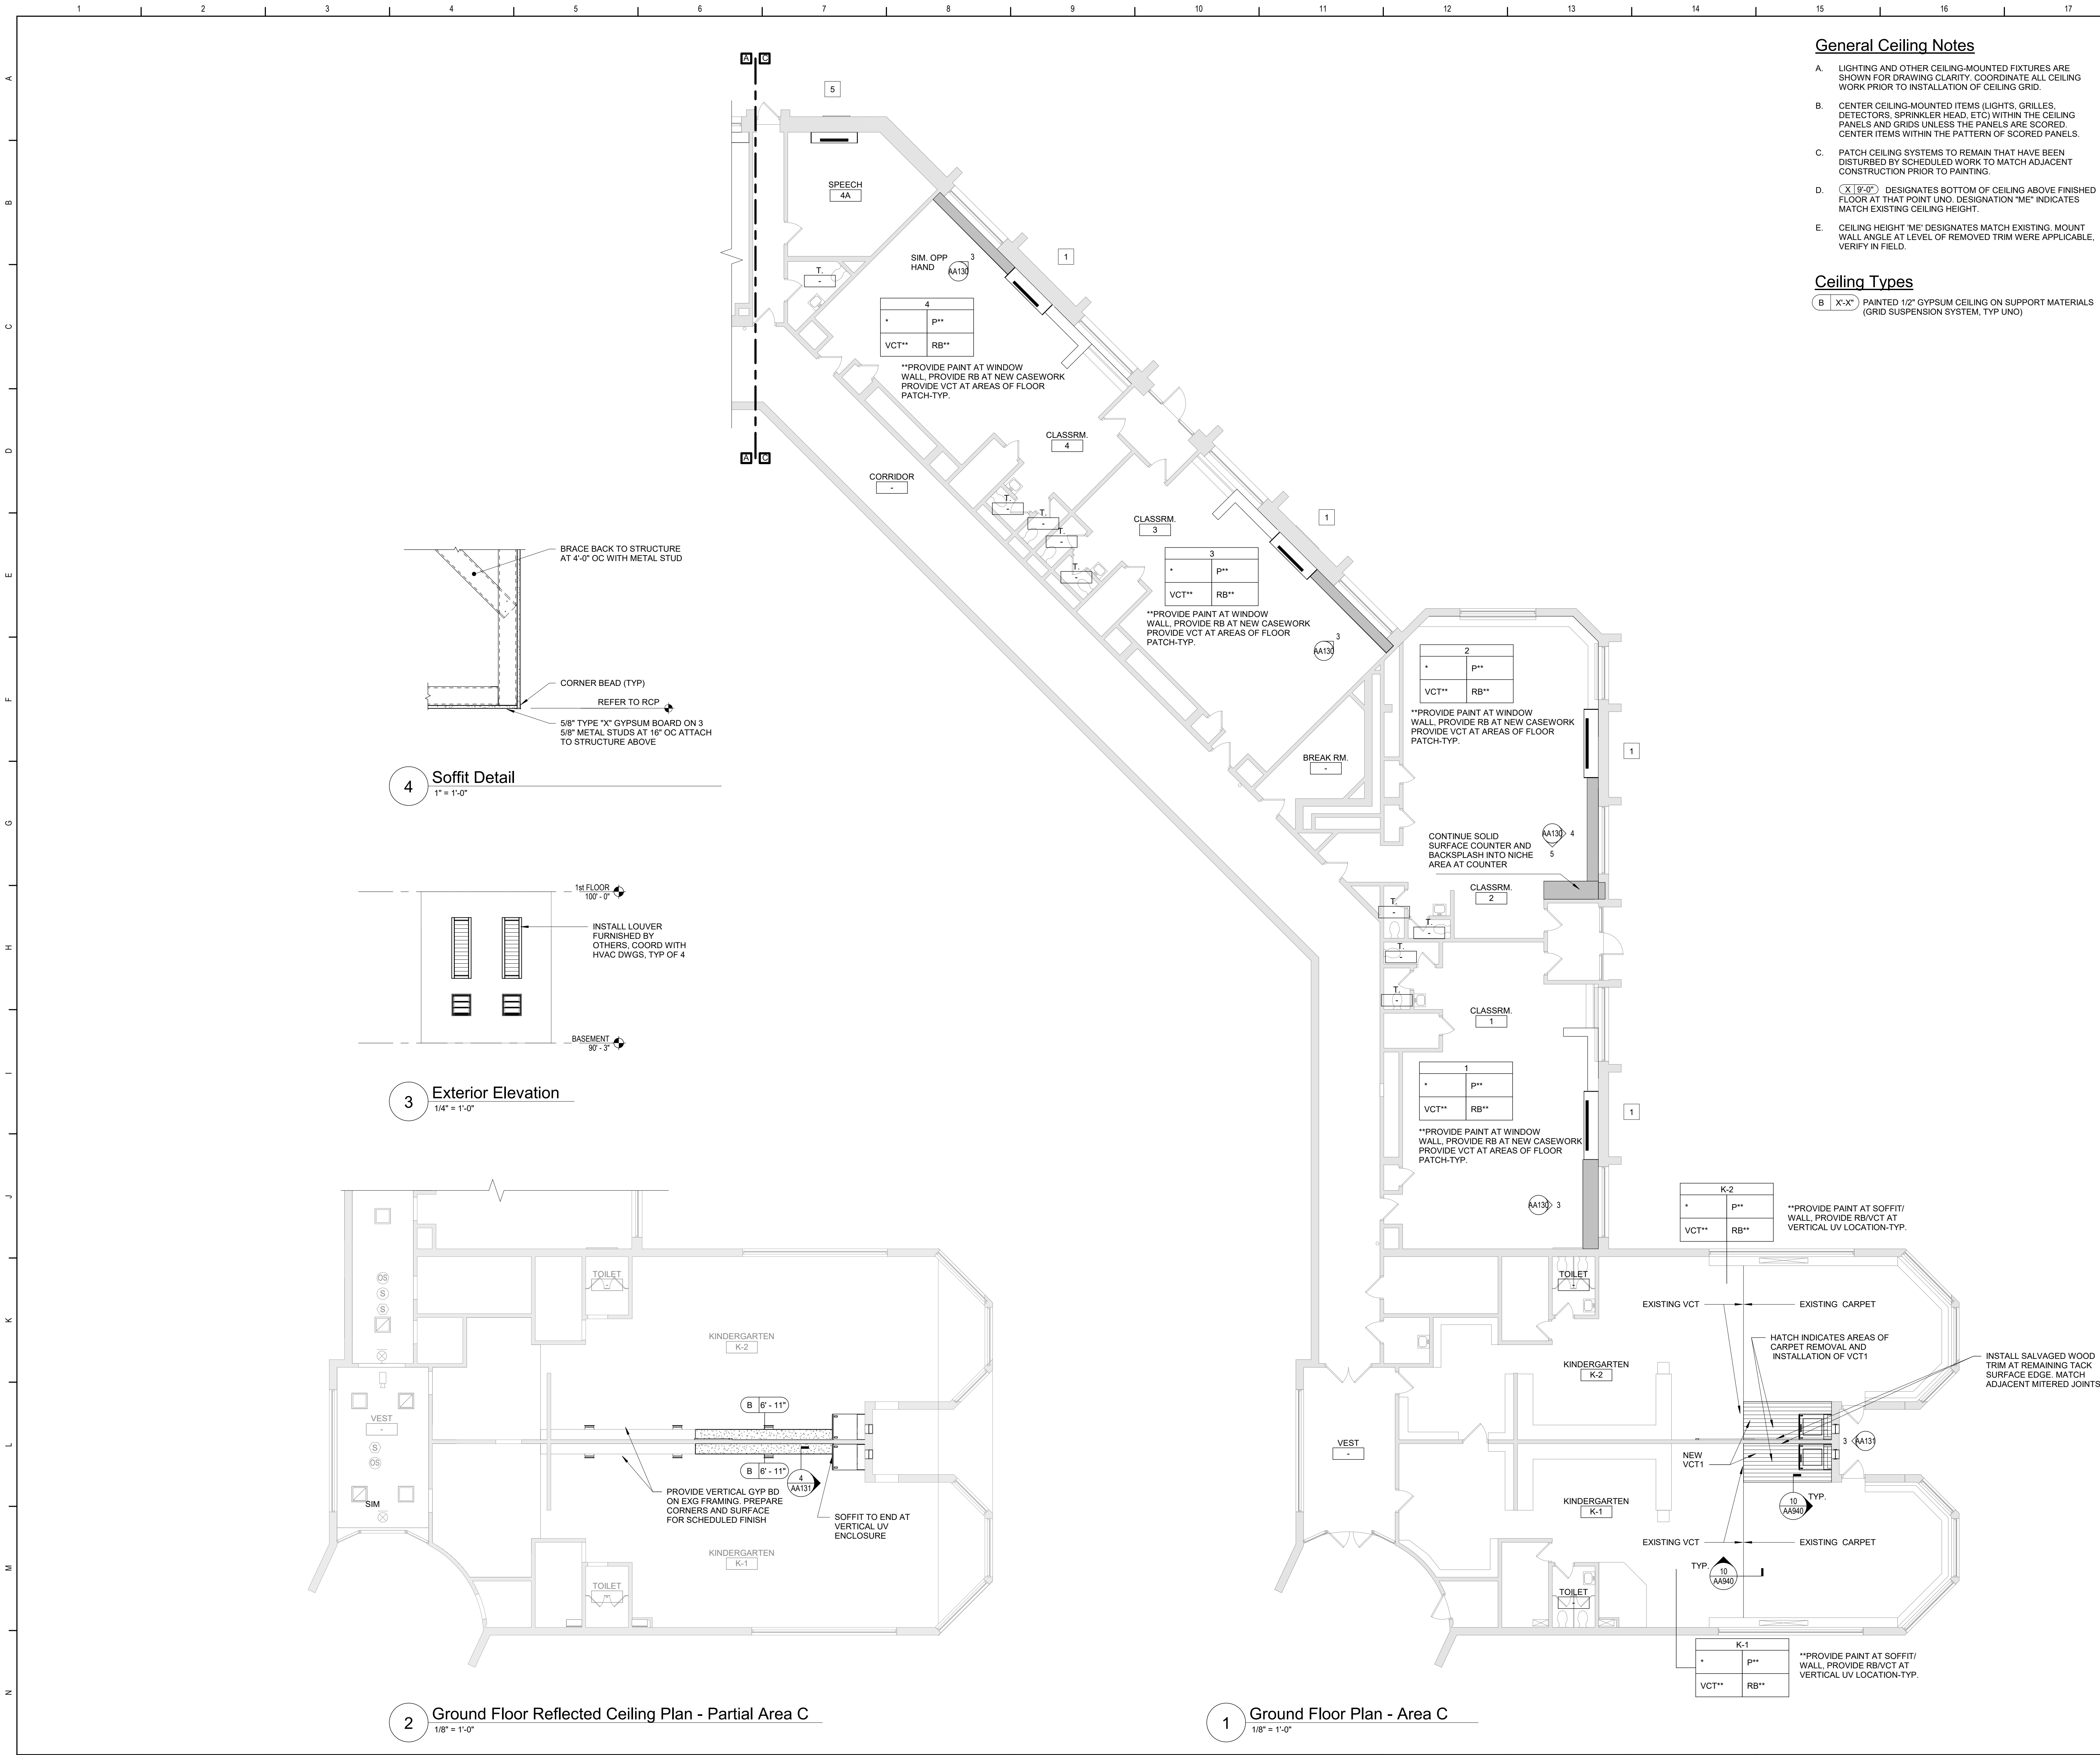
TETRA TECH
ARCHITECTS & ENGINEERS

Beacon City School District
Beacon, New York

Reconstruction to:
JV Forrester Elementary School

Ground Floor Plans - Area A and B

Drawn By: GCK/lig	Date: 10/28/2022	Drawing Number:
Project No.: 279180-22004		AA130



- General Ceiling Notes
- A.

LIGHTING AND OTHER CEILING-MOUNTED FIXTURES ARE SHOWN FOR DRAWING CLARITY. COORDINATE ALL CEILING WORK PRIOR TO INSTALLATION OF CEILING GRID.
- B.

CENTER CEILING-MOUNTED ITEMS (LIGHTS, GRILLES, DETECTORS, SPRINKLER HEAD, ETC) WITHIN THE CEILING PANELS AND GRIDS UNLESS THE PANELS ARE SCORED. CENTER ITEMS WITHIN THE PATTERN OF SCORED PANELS.
- C.

PATCH CEILING SYSTEMS TO REMAIN THAT HAVE BEEN DISTURBED BY SCHEDULED WORK TO MATCH ADJACENT CONSTRUCTION PRIOR TO PAINTING.
- D.

(X | 9'-0") DESIGNATES BOTTOM OF CEILING ABOVE FINISHED FLOOR AT THAT POINT UNO. DESIGNATION "ME" INDICATES MATCH EXISTING CEILING HEIGHT.
- E.

CEILING HEIGHT "ME" DESIGNATES MATCH EXISTING. MOUNT WALL ANGLE AT LEVEL OF REMOVED TRIM WERE APPLICABLE. VERIFY IN FIELD.
- Ceiling Types
- B

X-X"

PAINTED 1/2" GYPSUM CEILING ON SUPPORT MATERIALS (GRID SUSPENSION SYSTEM, TYP UNO)

- General Plan Notes
- A.

WHERE EXISTING CONSTRUCTION IS DAMAGED OR DISTURBED, PATCH AS REQUIRED TO RESTORE SURFACES TO THEIR ORIGINAL CONDITION.
- General Notes
- A.

DO NOT SCALE DRAWINGS TO OBTAIN DIMENSIONS.
- B.

TAKE FIELD MEASUREMENTS TO FIT THE WORK PROPERLY. VERIFY ALL EXISTING CONDITIONS AND DIMENSIONS IN THE FIELD.
- C.

REFER INCONSISTENCIES TO ARCHITECT PRIOR TO COMMENCING THE WORK IN AFFECTED AREA.
- D.

ITEMS ARE SHOWN DIAGMATICALLY ON DRAWINGS. VERIFY SPACE REQUIREMENTS AND DIMENSIONS TO FIT THE WORK PROPERLY.
- E.

NOTES SHOWN ON ONE DRAWING APPLY TO ALL SIMILAR DRAWINGS.
- F.

DO NOT DISTURB CONSTRUCTION SUSPECTED OF CONTAINING HAZARDOUS MATERIAL. IF ENCOUNTERED, IMMEDIATELY NOTIFY ARCHITECT, CONSTRUCTION MANAGER AND OWNER.
- Keyed Plan Notes
- 1

INSTALL LOUVER FURNISHED BY OTHERS AT EXISTING OPENING. COORDINATE WITH MECHANICAL DRAWINGS.
- 2

PROVIDE INFILL AT MECH REMOVAL WITH P16.3 OR SIMILAR CONSTRUCTION. MATCH EXISTING ADJACENT SURFACE. PREPARE FOR SCHEDULED FINISH, VIF. COORD WITH HVAC DWGS FOR LOCATIONS OF NEW MECH EQUIPMENT FOR NEW R.O.
- 3

COPE SALVAGED WOOD WINDOW STOOL VALANCE TO MECHANICAL EQUIPMENT, REINSTALL.
- 4

PATCH EXG FLOOR AT MECHANICAL REMOVAL. INFILL ALL PENETRATIONS WITH SIMILAR MATERIALS, VIF.
- 5


INSTALL LOUVER FURNISHED BY OTHERS AT NEW OPENING. COORDINATE WITH MECHANICAL DRAWINGS.
- REFER TO DRAWING AA940 FOR ALL GENERAL FINISH NOTES
REFER TO DRAWING AA940 FOR ALL CASEWORK NOTES

Room Finish Key

N	NO WORK REQUIRED
P	PAINT SURFACE(S) INCLUDING SOFFITS
RB	RUBBER BASE
QT	QUARRY TILE
VCT	VINYL COMPOSITION TILE - TYPE 1
*	SEE REFLECTED CEILING PLAN
+	INDICATED CHANGE IN FLOOR FINISH


NOTE: ALL FINISHES LISTED MAY NOT BE REQUIRED FOR THIS PROJECT

FINISHES SHOWN IN ROOM FINISH BOX ARE FOR ALL WALLS AND ENTIRE FLOOR AND CEILING. REFER TO EACH ROOM FOR MORE INFORMATION.		RM#
CLG*	WALL	
FLR	BASE	

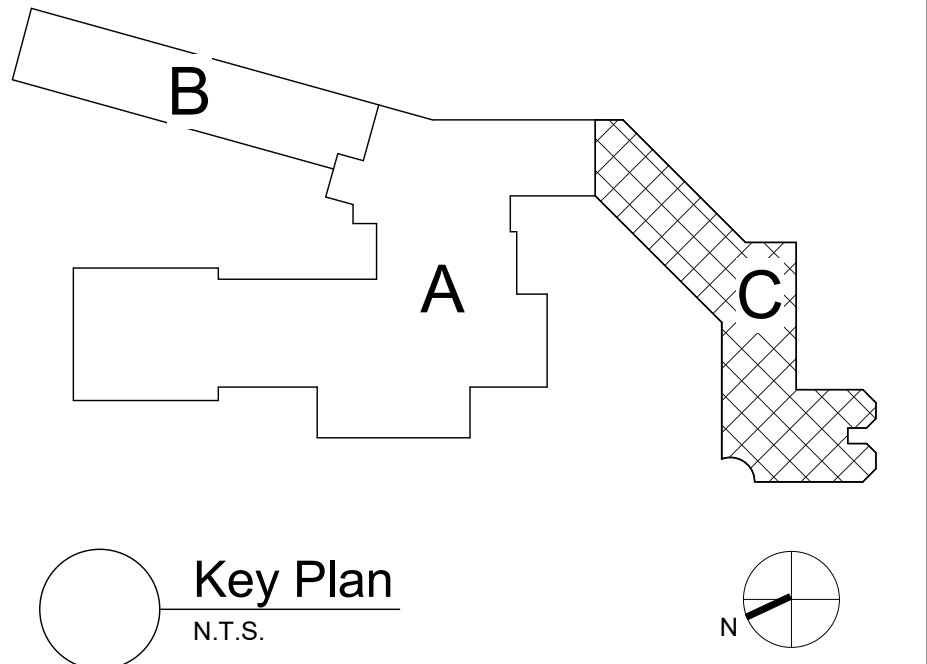

S.E.D. Control No. 13-02-00-01-0-002-021


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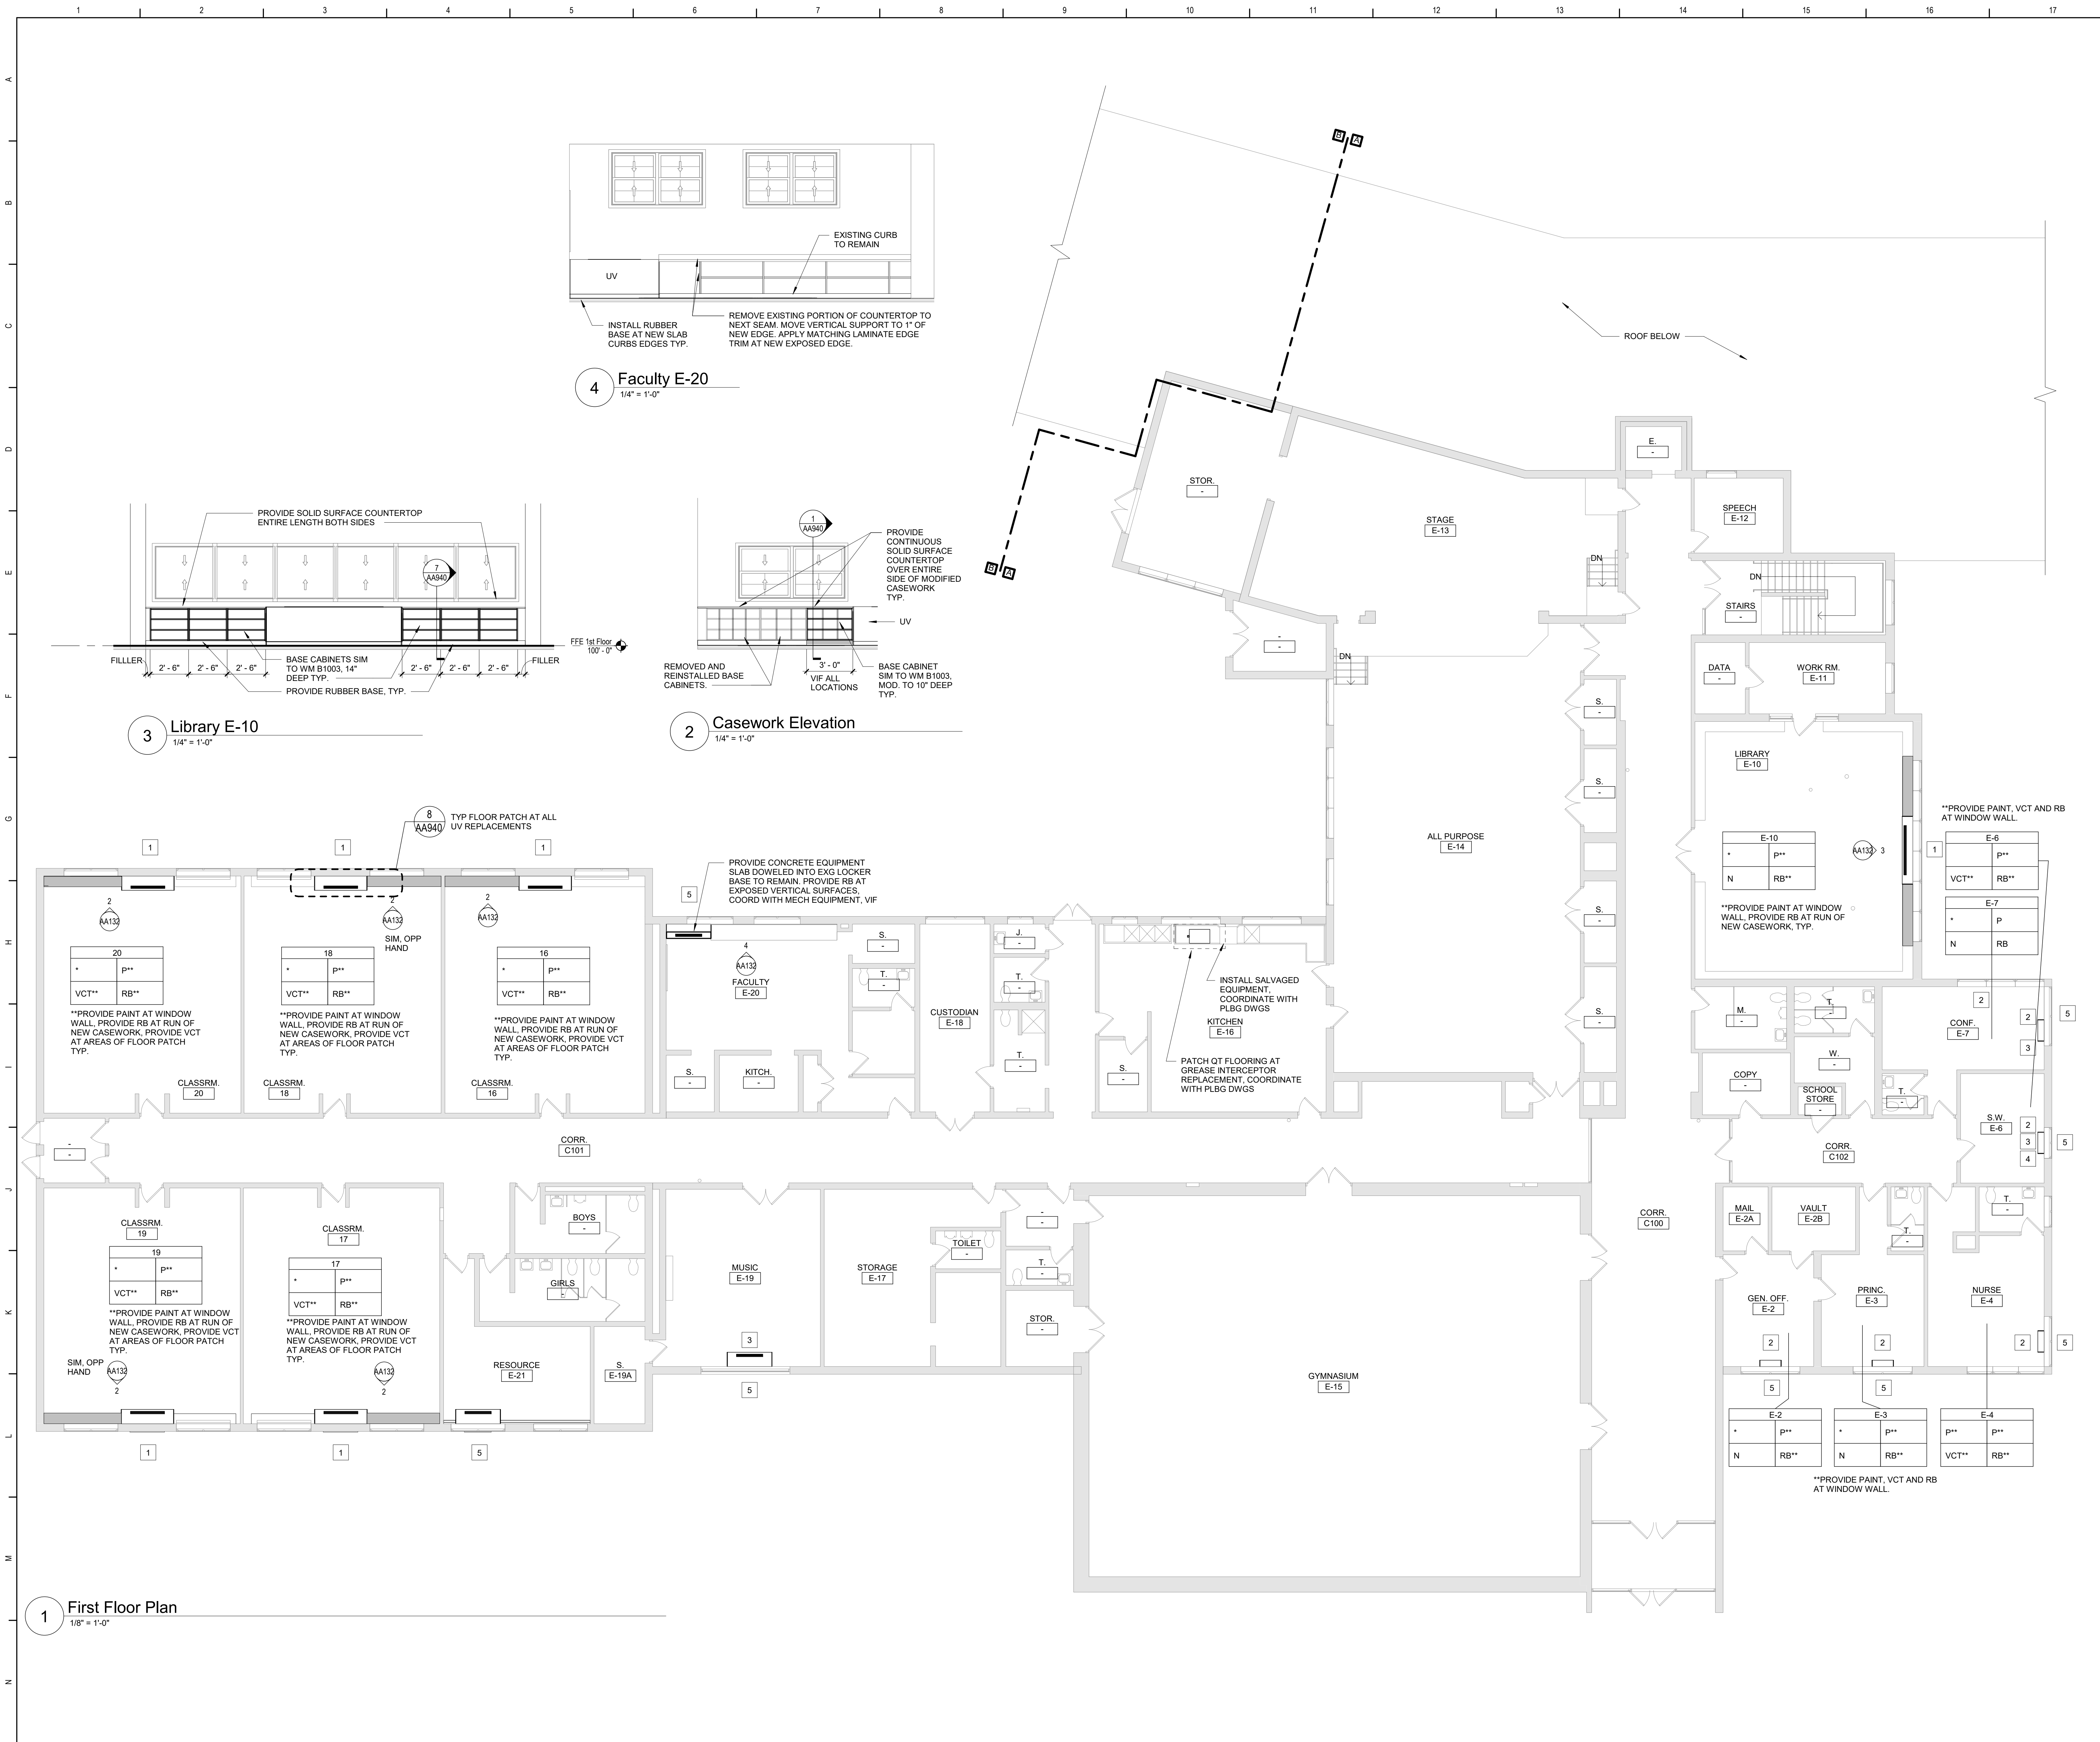


Beacon City School District
Beacon, New York

Reconstruction to:
JV Forrestral Elementary School

Ground Floor Plan - Area C and
Ground Floor Reflected Ceiling Plan -
Partial Area C

Drawn By: GCK/lig	Date: 10/28/2022	Drawing Number:
Project No.:		AA131
279180-22004		



General Plan Notes

A. WHERE EXISTING CONSTRUCTION IS DAMAGED OR DISTURBED, PATCH AS REQUIRED TO RESTORE SURFACES TO THEIR ORIGINAL CONDITION.

General Notes

A. DO NOT SCALE DRAWINGS TO OBTAIN DIMENSIONS.

B. TAKE FIELD MEASUREMENTS TO FIT THE WORK PROPERLY. VERIFY ALL EXISTING CONDITIONS AND DIMENSIONS IN THE FIELD.

C. REFER INCONSISTENCIES TO ARCHITECT PRIOR TO COMMENCING THE WORK IN AFFECTED AREA.

D. ITEMS ARE SHOWN DIAGRAMMATICALLY ON DRAWINGS. VERIFY SPACE REQUIREMENTS AND DIMENSIONS TO FIT THE WORK PROPERLY.

E. NOTES SHOWN ON ONE DRAWING APPLY TO ALL SIMILAR DRAWINGS.

F. DO NOT DISTURB CONSTRUCTION SUSPECTED OF CONTAINING HAZARDOUS MATERIAL. IF ENCOUNTERED, IMMEDIATELY NOTIFY ARCHITECT, CONSTRUCTION MANAGER AND OWNER.

Keyed Plan Notes

1. INSTALL LOUVER FURNISHED BY OTHERS AT EXISTING OPENING. COORDINATE WITH MECHANICAL DRAWINGS.

2. PROVIDE INFILL AT MECH REMOVAL WITH P16.3 OR SIMILAR CONSTRUCTION. MATCH EXISTING ADJACENT SURFACE. PREPARE FOR SCHEDULED FINISH. VIF. COORD WITH HVAC DWGS FOR LOCATIONS OF NEW MECH EQUIPMENT FOR NEW R.O.

3. COPE SALVAGED WOOD WINDOW STOOL VALANCE TO MECHANICAL EQUIPMENT, REINSTALL.

4. PATCH EXG FLOOR AT MECHANICAL REMOVAL. INFILL ALL PENETRATIONS WITH SIMILAR MATERIALS. VIF.

5. INSTALL LOUVER FURNISHED BY OTHERS AT NEW OPENING. COORDINATE WITH MECHANICAL DRAWINGS.

REFER TO DRAWING AA940 FOR ALL GENERAL FINISH NOTES
REFER TO DRAWING AA940 FOR ALL CASEWORK NOTES

Room Finish Key

N	NO WORK REQUIRED
P	PAINT SURFACE(S) INCLUDING SOFFITS
RB	RUBBER BASE
QT	QUARRY TILE
VCT	VINYL COMPOSITION TILE - TYPE 1
*	SEE REFLECTED CEILING PLAN
+	INDICATED CHANGE IN FLOOR FINISH

NOTE: ALL FINISHES LISTED MAY NOT BE REQUIRED FOR THIS PROJECT

RM#	
CLG*	WALL
FLR	BASE

Key Plan

N.T.S.

S.E.D. Control No. 13-02-00-01-0-002-021

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Beacon City School District
Beacon, New York

Reconstruction to:
JV Forrester Elementary School

First Floor Plan

Drawn By: GCK/lig	Date: 10/28/2022	Drawing Number:
Project No.: 279180-22004		AA132

General Finish Notes


ALL FINISH PRODUCTS ARE TO BE INSTALLED IN ACCORDANCE WITH CONTRACT SPECIFICATION AND MANUFACTURES INSTRUCTIONS. REFER TO SPECIFICATIONS AND FINISH DETAILS FOR ADDITIONAL INFORMATION ON INSTALLATION OF SPECIFIED MATERIALS.

- A. ALL PAINTS FOR INTERIOR AND EXTERIOR ARE TO BE APPLIED IN ACCORDANCE WITH SPECIFICATION SECTION 09 91 00 AND 09 96 00.
- B. ALL EXPOSED STRUCTURES, INCLUDING BUT NOT LIMITED TO PIPING AND FIREPROOFING, CONDUIT, AND ALL ASSOCIATED EQUIPMENT ARE TO BE PAINTED.
- C. APPLY PAINT TO BOTH NEW AND EXISTING ITEMS IN ALL AREAS INDICATED WITH A FINISH BOX AND/OR NOTES. THESE ITEMS ARE INCLUDING BUT ARE NOT LIMITED TO:
- FEC 'S, LADDERS, BEAMS, DOOR/FRAMES - BOTH SIDES
 - GLAZING FRAMES IN DOOR/WALLS- BOTH SIDES, ALL ITEMS ARE TO BE ACCENT COLORS.
- D. PATTERNS FOR FLOORS AND WALLS ARE ISSUED DURING THE CONSTRUCTION PHASE, INCLUDING ALL ACCENT LOCATIONS. SUBMIT SHOP DRAWINGS SHOWING DETAILED LAYOUTS OF EACH AREA, INCLUDING EDGES AND TRANSITIONS; ALL LAYOUTS ARE TO BE CENTERED IN EACH ROOM. UNO - TYP ALL DRAWINGS. ABOVE REQUIREMENTS ARE TO INCLUDE BUT NOT LIMITED TO:
- VCT
 - RUBBER
- E. FIELD AND ACCENT PAINT ARE ISSUED DURING THE CONSTRUCTION PHASE. CONTRACTOR IS TO ASSUME ALL FIELD AND ACCENT COLORS ARE DIFFERENT ROOM TO ROOM. AS WELL AS WITHIN EACH ROOM, REQUIREMENTS ARE TO INCLUDE BUT ARE NOT LIMITED TO:
- WALL, FIELD COLOR
 - WALL, ACCENT COLOR
 - CEILING CLOUDS, ACCENT COLOR
 - SOFFITS, ACCENT COLOR
 - DOOR AND WINDOW FRAMES, ACCENT COLOR
 - EXPOSED COLUMNS, ACCENT COLOR
 - EXPOSED DECKS, ACCENT COLOR
 - EXPOSED JOISTS, ACCENT COLOR
 - EXPOSED DUCTWORK, ACCENT COLOR
- F. PROVIDE PAINT AT ALL NEW SOFFITS, REFER TO REFLECTIVE CEILING PLANS FOR ADDITIONAL LOCATIONS.
- G. ALL EXPOSED BRICK, GROUND FACE BLOCK IS TO REMAIN UNPAINTED, UNO.
- H. CONFIRM WITH OWNER AND ARCHITECT PRIOR TO PAINTING OVER MURALS ON EXISTING SURFACES.
- I. PROVIDE PAINT AND RUBBER BASE AT ALL NEW CHASES, REFER TO NEW WORK PLANS FOR ADDITIONAL LOCATIONS.
- J. FOR ALL RENOVATED AREAS REQUIRING FINISH WORK REMOVE, PROTECT AND REINSTALL MOVABLE EQUIPMENT INCLUDING BUT NOT LIMITED TO: BOARD UNITS, LOCKERS GYM EQUIPMENT, SHADES/BLINDS, BOOKCASES ETC. REINSTALL IN ORIGINAL LOCATION, OR AS NOTED ON DRAWINGS. COORDINATE WITH OWNER. REFER TO SPEC SECTION 01 23 00 ALTERATION PROJECT PROCEDURES FOR MORE INFORMATION.
- K. PROVIDE ALL FINISHES AS INDICATED BY ROOM FINISH BOX AND/OR AS NOTED ON DRAWINGS.

General Wood Casework Notes


FOR ALL CONTRACTOR RESPONSIBILITIES REFER TO SPECIFICATION SECTION 01 10 0001 12 00.

- A. THE CASEWORK SHOWN ON THE DRAWINGS IS BASED ON WOOD METAL. WOOD CASEWORK REFER TO THE PROJECT MANUAL, SECTION 12 32 13 FOR DETAILED SPECIFICATIONS.
- B. ALL STANDARD CASEWORK DIMENSIONS TO BE MODIFIED TO CORRESPOND WITH THE DIMENSIONS NOTED ON THE DRAWINGS. FIELD VERIFY ALL DIMENSIONS PRIOR TO FABRICATION OF CABINETS.
- C. MODEL NUMBERS LISTED ON DRAWINGS APPLY TO ELEVATIONS SHOWN. PROVIDE OPPOSITE HAND MODELS WHERE SHOWN.
- D. PROVIDE FULL DEPTH SHELVES AT BASE, WALL AND TALL CABINETS, UNLESS NOTED OTHERWISE.
- E. BASE AND TALL CABINETS ARE 24 INCHES DEEP. UNO, WALL CABINETS ARE 14 INCHES DEEP. UNO BASE CABINET DEPTH DOES NOT INCLUDE 1" COUNTERTOP OVERHANG, TYP.
- F. PROVIDE FINISHED ENDS, BACK EXTENSIONS, SCRIBES AND FINISHED FILLER PANELS ON ALL CABINETS. FILLER PANELS ARE NOT TO EXCEED 3" WIDE, UNLESS NOTED OTHERWISE. PROVIDE TOP AND BOTTOM FILLER PANELS AT ALL BASE & WALL UNITS. SUBMIT SHOP DRAWINGS SHOWING DETAILS OF THESE CONDITIONS.
- G. ALL COUNTERTOPS TO BE SOLID SURFACE UNLESS NOTED OTHERWISE, TYP.
- H. RADIUS COUNTERTOPS AT COUNTERTOPS ENDS MEETING TALL SHELVING UNITS WITH A DEPTH LESS THAN COUNTERTOP DEPTH. RADIUS TO BE 1-1/2" UNLESS NOTED OTHERWISE. REFER TO DETAIL 6/AA940.
- I. PROVIDE CUTS AT ALL CONDITIONS THAT INTERFERE WITH COUNTERTOPS/CABINETS. SCRIBE TO FIT.
- J. PROVIDE AT ALL UV SHELVING LOCATIONS-REMOVABLE BACKS IN CABINETS AT PLUMBING AND FIN TUBE VALVE LOCATIONS. VERIFY POSITIONS OF VALVES PRIOR TO SHOP. FABRICATION OF ALL CABINETS.
- K. PROVIDE SHOP DRAWINGS SHOWING LOCATIONS AND DETAILS FOR ALL GRILLES, LOUVERS, REMOVABLE PANELS, VALVE LOCATIONS ECT. ASSOCIATED WITH CASEWORK COORDINATE WITH ALL REQUIRED CONTRACTORS.
- L. PROVIDE CABINETS WITH FINISHED SIDES, INCLUDING BUT NOT LIMITED TO, LOCATIONS OF ADJACENT CABINETS OR EQUIPMENT WITH A DEPTH LESS THAN CABINET OR EQUIPMENT.
- M. PROVIDE ALL STANDARD FEATURES OF CASEWORK UNITS AS INDICATED BY MODEL NUMBER OR AS SHOWN ON PLANS. DETAILS AND ELEVATIONS, INCLUDED BUT NOT LIMITED TO: OUTLETS, SWITCHES, LIGHTS ETC.
- N. PROVIDE BLOCKING AT NEW AND EXISTING GYPSUM BOARD WALLS PER MANUFACTURER RECOMMENDATIONS FOR SUPPORT OF WALL TALL MOUNTED UNITS. REFER TO SPECIFICATION SECTION 06 10 00 FOR WOOD BLOCKING RESPONSIBILITIES.
- O. PROVIDE LOCKS AT ALL CASEWORK DOORS/DRAWERS AND FILE UNITS TYP.
- P. PROVIDE ALL CUTOUTS AS SHOWN ON CASEWORK PLANS AND ELEVATIONS OR AS REQUIRED. CUTOUTS ARE TO INCLUDE BUT NOT LIMITED TO, ALL ELEC BOXES, OUTLETS, AND ASSOCIATED WIRING AND FINAL HOOK-UP.
- Q. REFER TO BOTH 1/8" AND 1/4" PLANS FOR LAYOUTS.

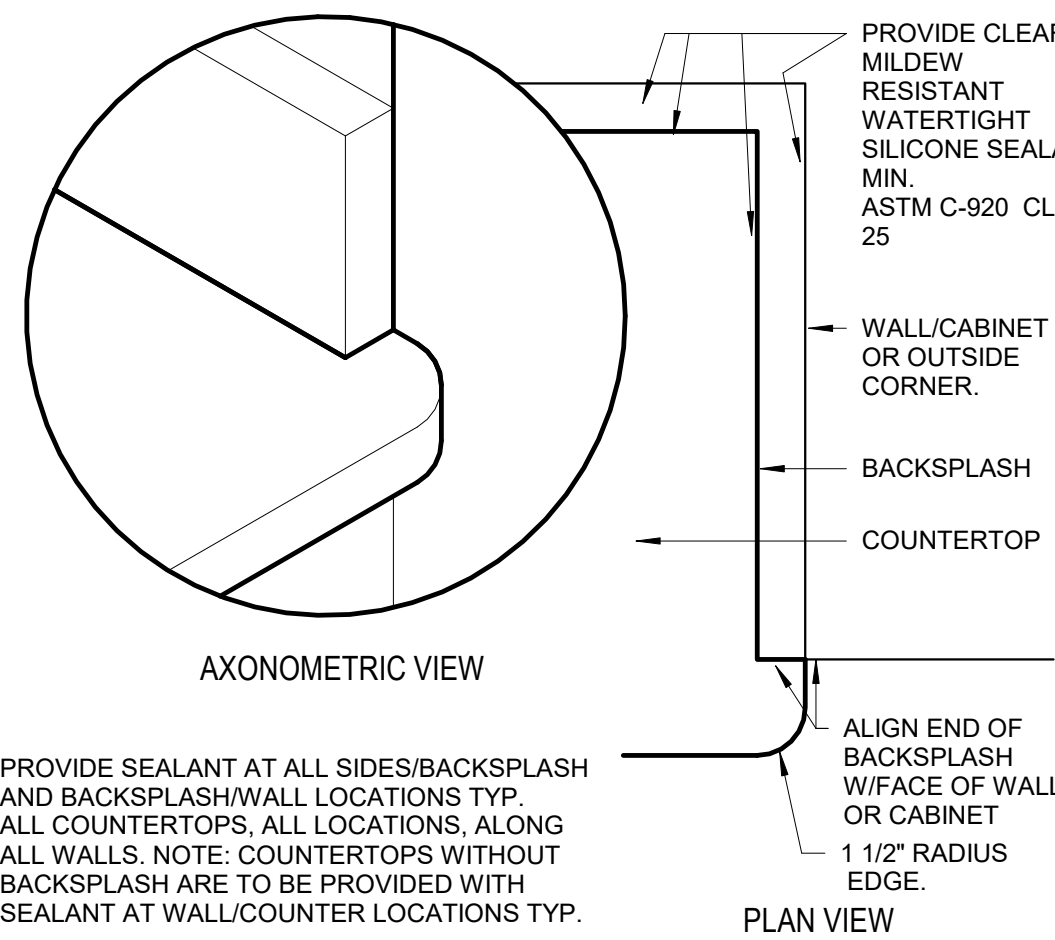


6 Solid Surface Countertop Edge

3" = 1'-0"

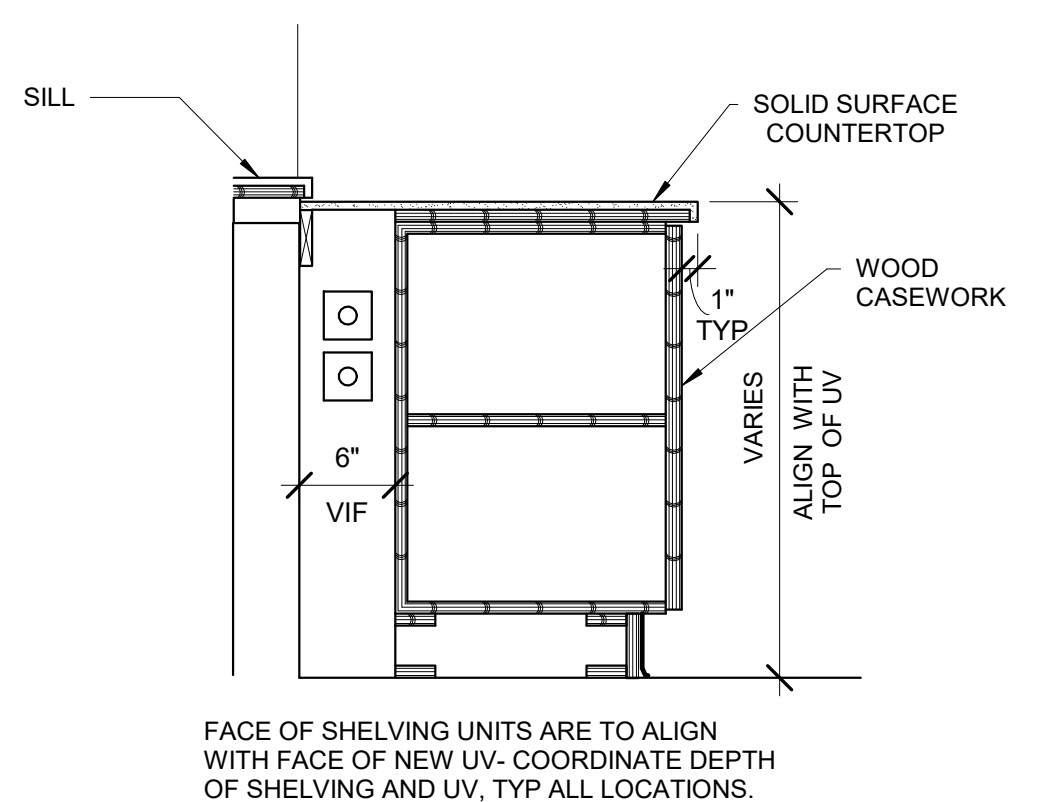

7 Typical Casework Section at Library

1" = 1'-0"

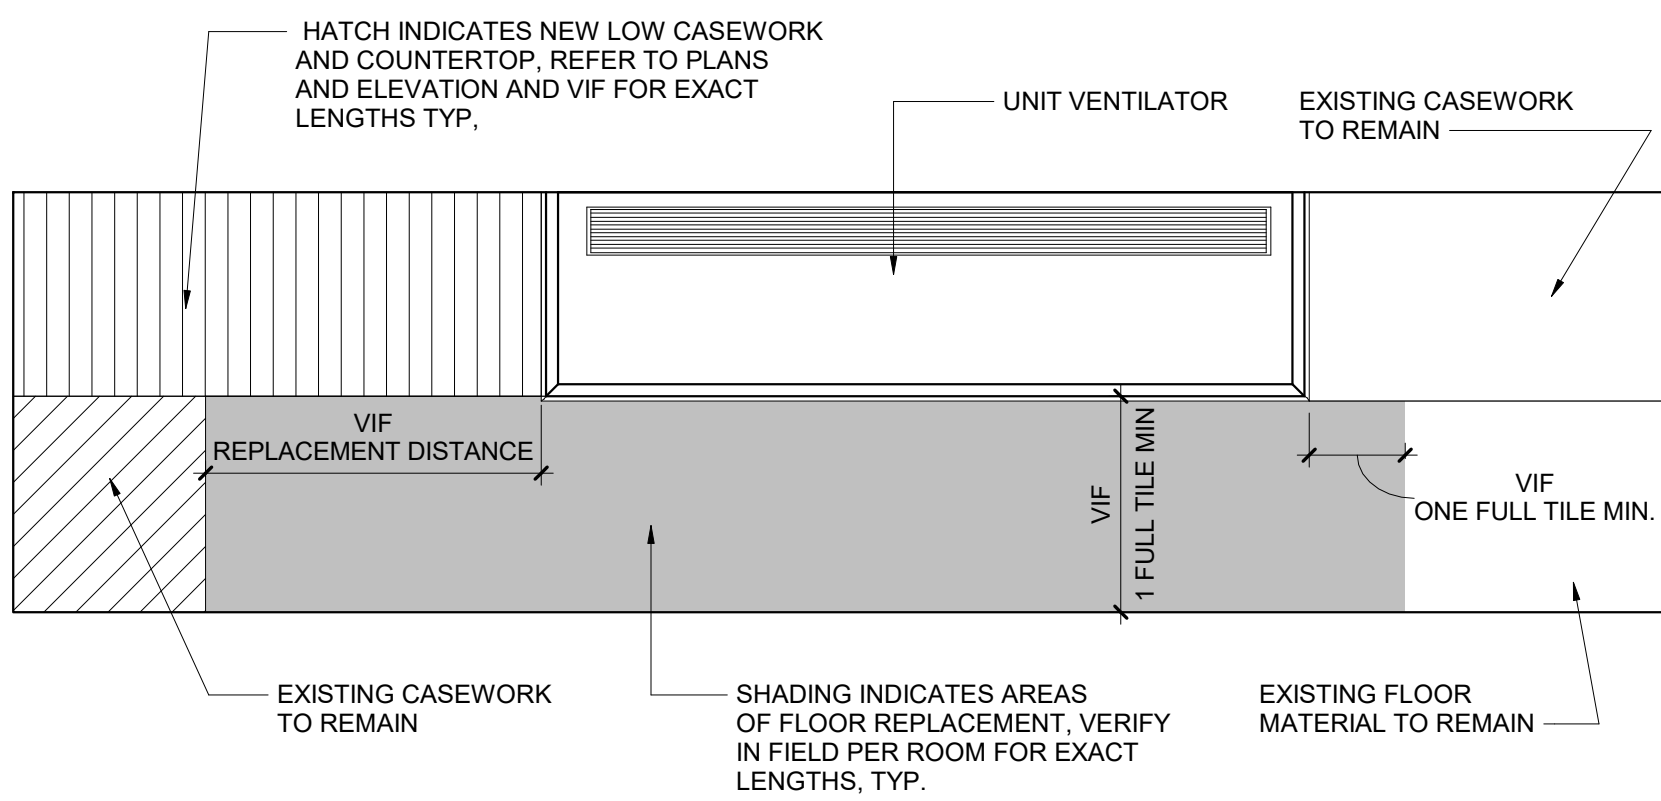

8 TYP Floor Patch at UV Replacement Detail

3" = 1'-0"

OPP. HAND IN SOME ROOMS, REFER TO PLANS

1. FOR 4" THICK WALLS

MASONRY OPENING UP TO 6'-4"	LINTEL ANGLE MT 6X5.9
-----------------------------	-----------------------

2. FOR 6" THICK WALLS

MASONRY OPENING (S)	LINTEL ANGLE
5'-0"	2- L2 1/2X2 1/2X5/16
6'-0"	2- L3X2 1/2X5/16 LLV
7'-0"	2- L3 1/2X2 1/2X5/16 LLV
8'-0"	2- L3 1/2X2 1/2X5/16 LLV

3. FOR 8", 12", AND 16" THICK WALLS FOR EACH 4" THICKNESS OF WALL


MASONRY OPENING (S)	LINTEL ANGLE
5'-0"	L3 1/2X3 1/2X5/16
6'-0"	L4X3 1/2X 5/16 LLV
7'-0"	L5X3 1/2X5/16 LLV
8'-0"	L6X3 1/2X5/16 LLV
9'-0"	L6X3 1/2X5/16 LLV
10'-0"	L6X3 1/2X5/16 LLV

LINTEL NOTES

- ALL OPENINGS 1'-0" AND OVER REQUIRE LINTELS.
- STEEL TO BE A36.
- THIS SCHEDULE IS TYPICAL FOR ALL MASONRY OPENINGS IN NON-LOAD BEARING WALLS UNLESS OTHERWISE NOTED.
- ALL LINTELS TO HAVE MINIMUM 8" BEARING BOTH ENDS.
- BACK TO BACK ANGLES ARE TO BE STITCH WELDED TOGETHER BEFORE PLACEMENT.
- ALL LINTELS ARE TO HAVE BOTH ENDS BEAR ON SOLID MASONRY OR SOLIDLY GROUTED HOLLOW MASONRY.
- WHERE MINIMUM 8" BEARING LENGTH CANNOT BE PROVIDED DUE TO COLUMN INTERFERENCE, PROVIDE CONNECTION OF LINTEL TO COLUMN.
- THIS LINTEL SCHEDULE IS APPLICABLE FOR USE IN EXISTING BUILDING. SHORE EXISTING STRUCTURE AND WALL AS REQD FOR INSTALLATION OF NEW MAS AND LINTEL. SEE ARCHITECTURAL AND MECHANICAL DRAWINGS FOR SIZE AND LOCATION OF OPENINGS.


9 Lintel Schedule

12" = 1'-0"

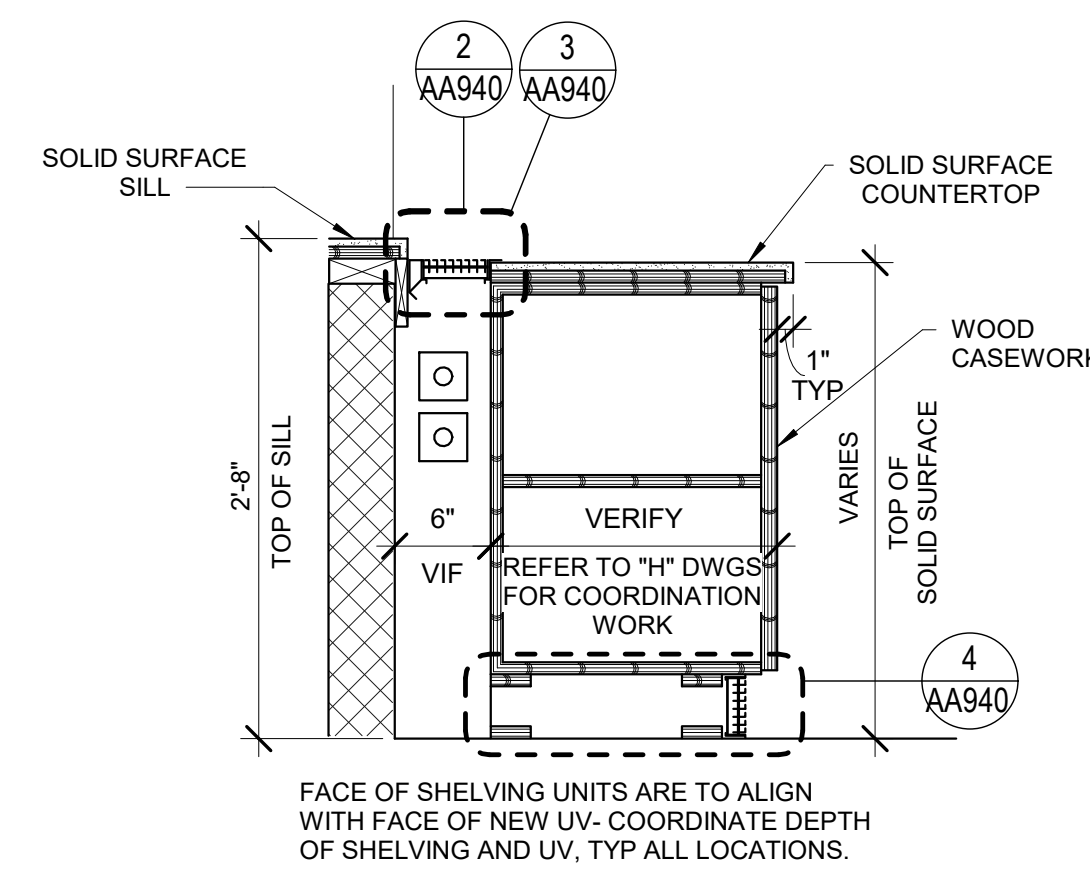


1 Typical Casework Section at UV Wall

1" = 1'-0"

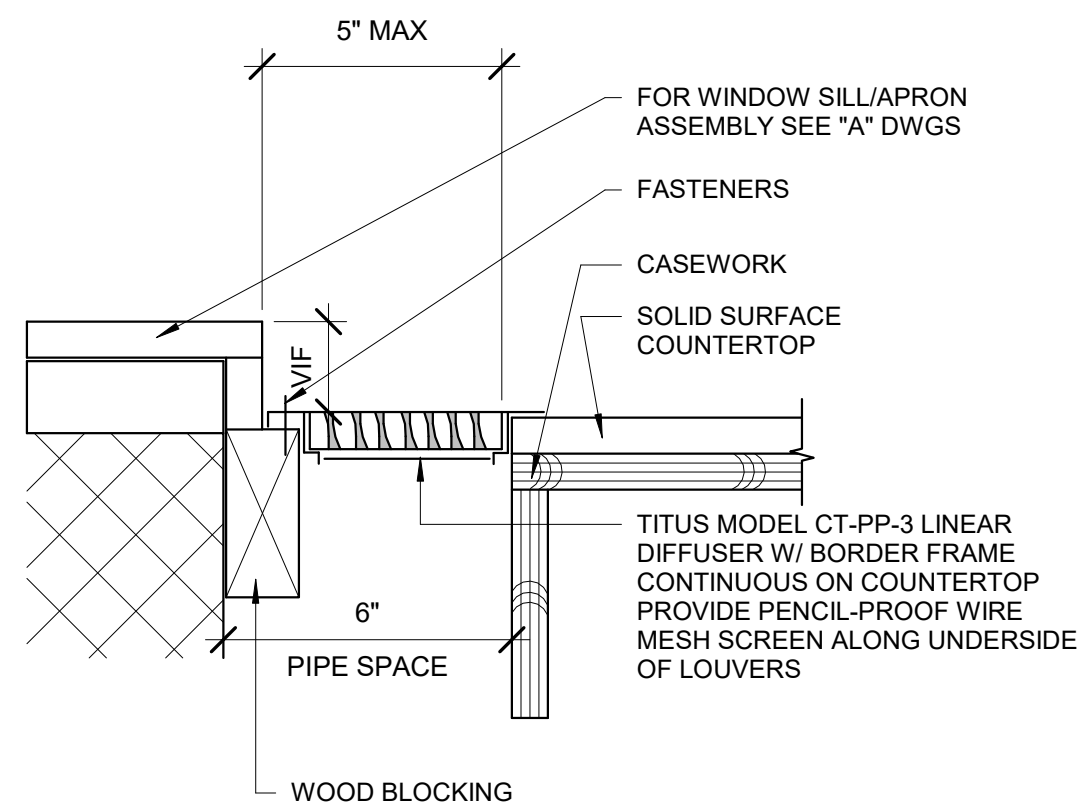


2 Top Louver Detail

3" = 1'-0"

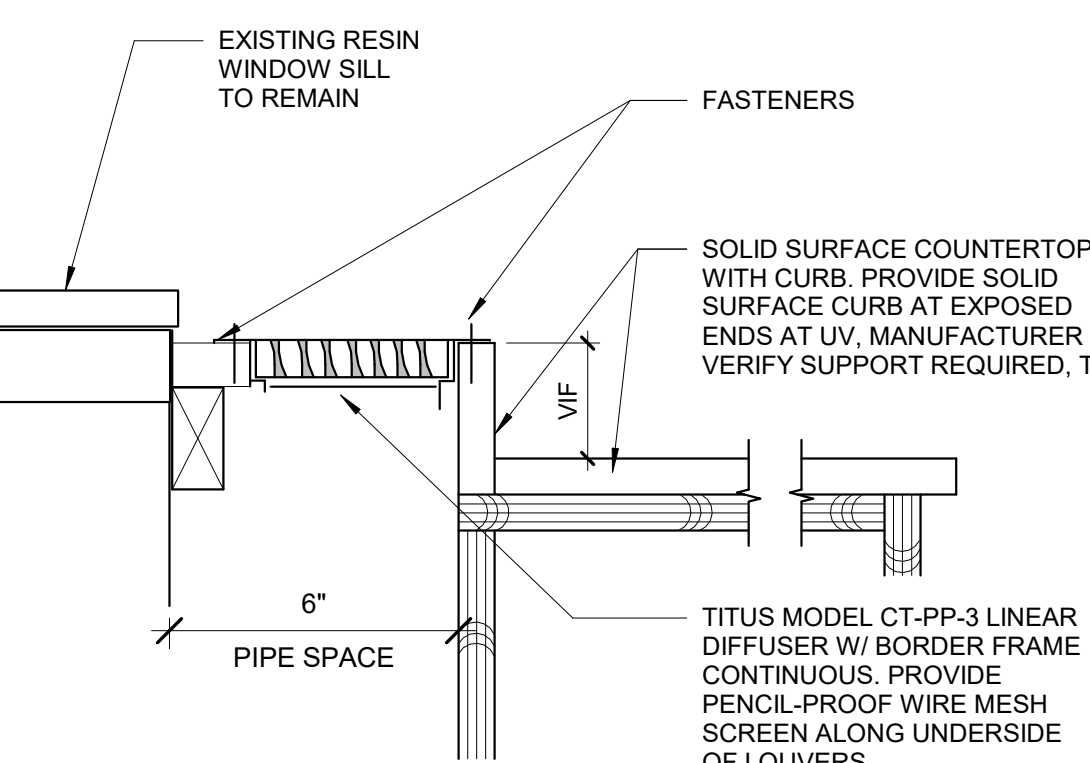


3 Top Louver with Curb Detail

3" = 1'-0"

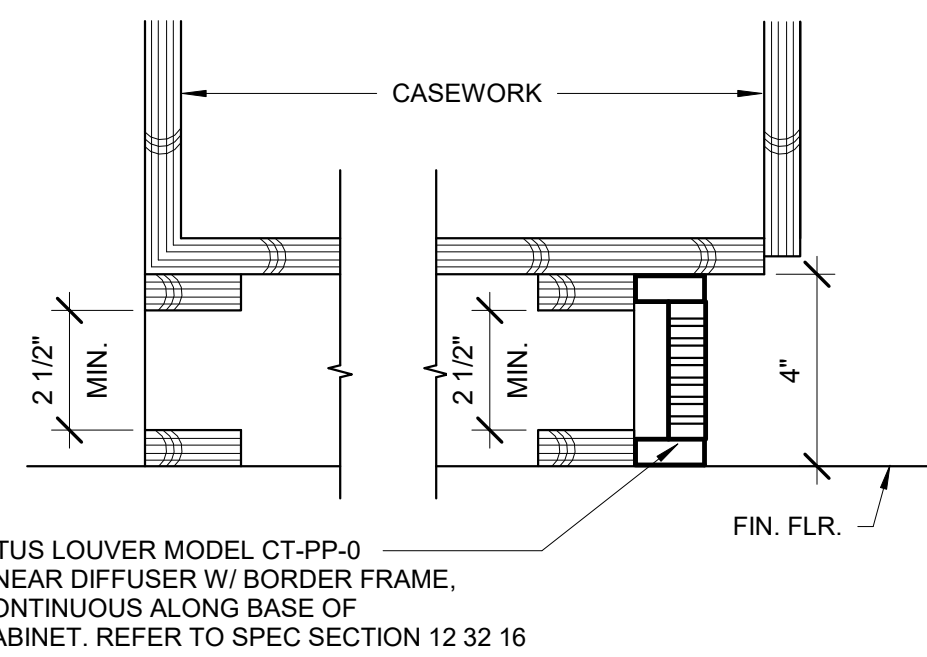


4 Continuous Grill Base Section

3" = 1'-0"

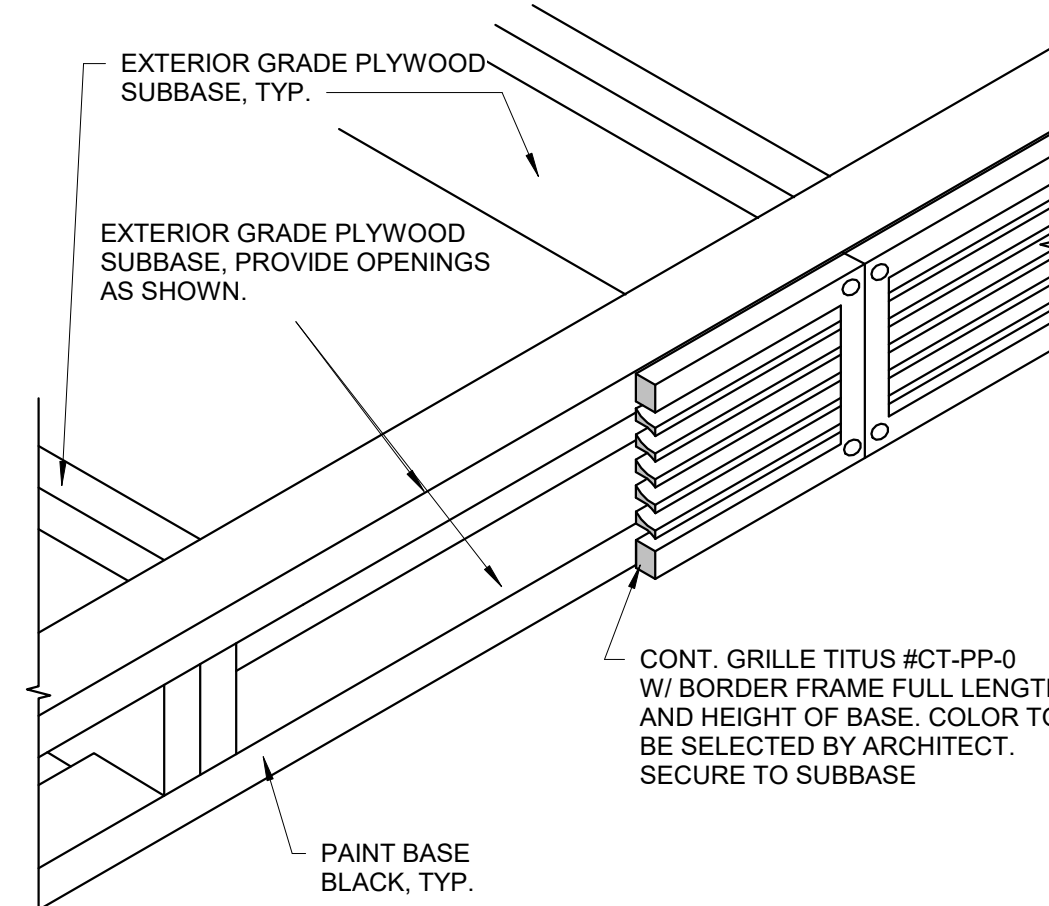

5 Continous Grille Base Detail

3" = 1'-0"

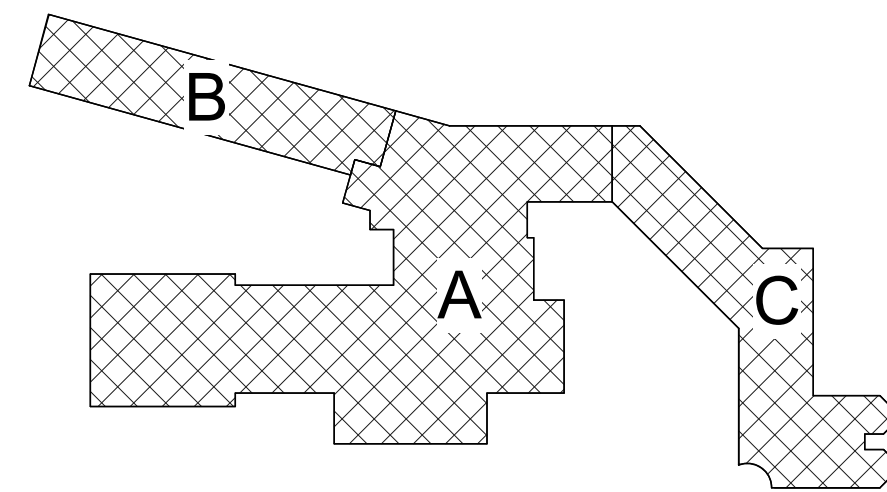

Key Plan
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Beacon City School District
Beacon, New York

Reconstruction to:
JV Forrestal Elementary School

Details


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MHH

Date:
10/28/2022

Project No.:
279180-22004

Drawing Number:

AA940

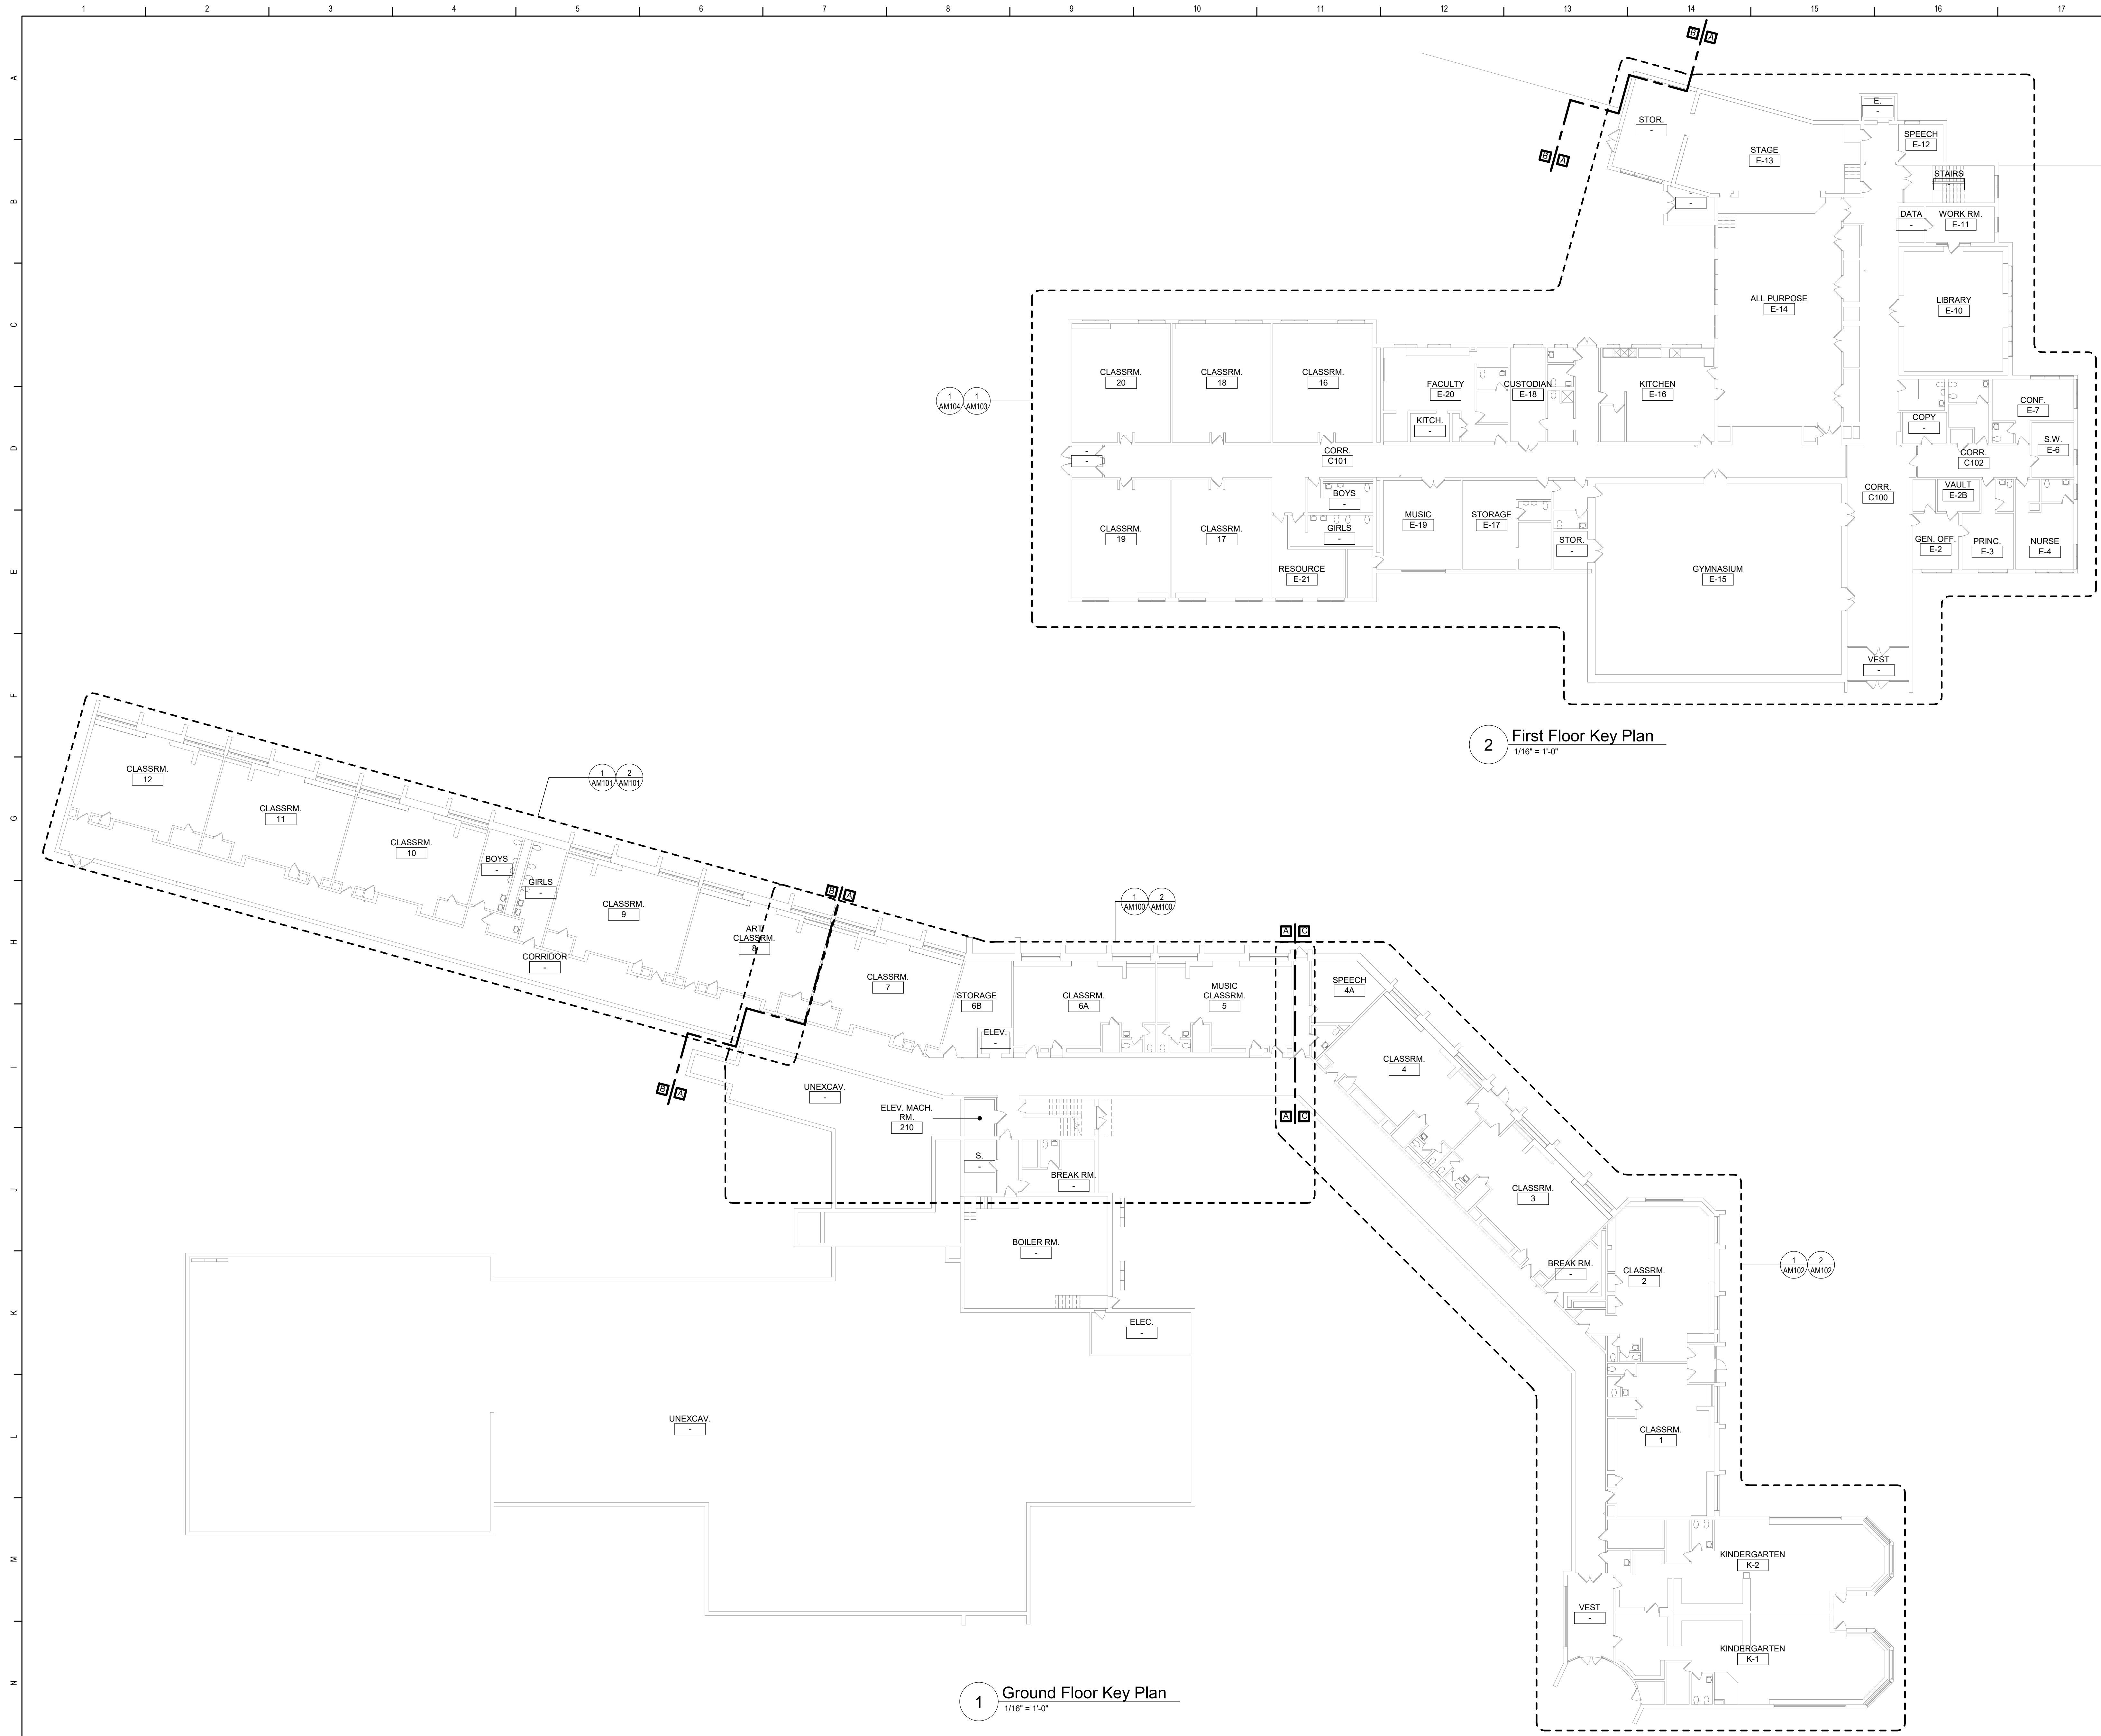


2 First Floor Key Plan
1/16" = 1'-0"

1 Ground Floor Key Plan
1/16" = 1'-0"

General Notes


- A. THE FOLLOWING GENERAL NOTES APPLY TO ALL "AM" SERIES DRAWINGS.
- B. REFER TO ALL CONTRACT DOCUMENTS, DRAWINGS AND SPECIFICATIONS, FOR DETAILED STANDARDS AND REQUIREMENTS.
- C. REPORT UNSAFE OR UNSATISFACTORY CONDITIONS IN WRITING TO ARCHITECT AND RESOLVE ISSUES BEFORE PROCEEDING.
- D. WORK INCLUDES ALL LABOR AND MATERIALS REQUIRED TO PROVIDE COMPLETE WORKING SYSTEMS.
- E. COORDINATE PHASING REQUIREMENTS AT JOB MEETINGS AND ON WORK SCHEDULES.
- F. DO NOT SCALE DRAWINGS. PIPING AND DUCTWORK ARE SHOWN DIAGRAMMATICALLY. IT IS NOT POSSIBLE TO SHOW EVERY TRANSITION, FITTING, ASPECT RATIO CHANGE, ETC.; PROVIDE AS REQUIRED TO FIT WITHIN STRUCTURAL CONSTRAINTS. EXAMINE CONDITIONS UNDER WHICH THE WORK IS TO BE PERFORMED AND VERIFY ALL ACCESS, LOCATIONS, DIMENSIONS, ARRANGEMENTS, ELECTRICAL CHARACTERISTICS AND INTERFERENCE IN THE FIELD PRIOR TO BID.
- G. VERIFY EXTENT OF CEILING WORK SHOWN ELSEWHERE IN THE CONTRACT DOCUMENTS. PROVIDE FOR ADDITIONAL CEILING SYSTEM REMOVAL, PROTECTION, AND REINSTALLATION AS REQUIRED FOR CONTRACT WORK.
- H. DEMOLITION DRAWINGS SHOW THE GENERAL SCOPE OF ITEMS AND SYSTEMS TO BE REMOVED. IT IS NOT THE INTENT TO SHOW ALL ITEMS TO BE REMOVED. FIELD VERIFY AND REMOVE ALL ASSOCIATED ITEMS BACK TO POINT OF CONTINUED SERVICE, UNLESS OTHERWISE NOTED. VERIFY WHAT ALL EQUIPMENT SERVES PRIOR TO REMOVAL.
- I. GIVE ALL REMOVED EQUIPMENT TO THE OWNER. DELIVER ON SITE WHERE DESIGNATED BY THE OWNER. PROMPTLY REMOVE FROM THE SITE AND LEGALLY DISPOSE OF ANY SUCH ITEMS DECLINED BY OWNER.
- J. IF UNANTICIPATED MECHANICAL, ELECTRICAL, OR STRUCTURAL CONFLICTS ARE ENCOUNTERED, INVESTIGATE AND REPORT BOTH NATURE AND EXTENT OF THE CONFLICT. RE-ROUTE WORK AS REQUIRED.
- K. CUT, DRILL, OR OTHERWISE CREATE OPENINGS AS NEATLY AS POSSIBLE, AS REQUIRED FOR THE INDICATED CONTRACT WORK. PROVIDE SUPPORT AS REQUIRED FOR AND USE METHODS LEAST LIKELY TO DAMAGE ELEMENTS TO REMAIN. PRIOR TO WORK, VERIFY LOCATIONS OF ALL STRUCTURAL MEMBERS INCLUDING CROSS BRACING, ELECTRICAL WIRING, PLUMBING, ETC. PROMPTLY NOTIFY ARCHITECT OF ANY CONFLICTS. DO NOT CUT ANY STRUCTURAL MEMBERS OR OTHER SERVICES UNTIL SPECIFICALLY DIRECTED TO DO SO. PENDING RECEIPT OF DIRECTIVE, REARRANGE SCHEDULE AS NECESSARY TO CONTINUE OVERALL JOB PROGRESS WITHOUT DELAY.
- L. PATCH ALL DISTURBANCES RESULTING FROM DEMOLITION OR NEW WORK TO MATCH SURROUNDING SURFACES. PATCH FOLLOWING DEMOLITION, AND AGAIN FOLLOWING WORK, WHERE HOLES REMAIN FROM REMOVALS, INFILL AND PATCH TO MATCH UNLESS HOLE IS TO BE REUSED.
- M. PROTECT ALL CONTRACT EQUIPMENT, ELEMENTS TO REMAIN, OWNER'S BELONGINGS, AND EQUIPMENT TO BE REUSED OR RETAINED BY OWNER DURING ALL CONTRACT WORK. AT NO ADDITIONAL COST TO OWNER, REPAIR OR REPLACE ITEMS WHICH ARE DAMAGED.
- N. THOROUGHLY CLEAN FOLLOWING DEMOLITION AND BEFORE BEGINNING CONTRACT INSTALLATIONS. THOROUGHLY CLEAN AGAIN DURING AND FOLLOWING CONTRACT WORK AS REQUIRED. LEAVE ALL WORK AREAS CLEANER THAN FOUND. LEGALLY DISPOSE OF ALL CONSTRUCTION DEBRIS.
- O. PROVIDE TEMPORARY PIPING, DUCT, HEAT, WEATHERPROOFING, ETC. TO SERVICES TO REMAIN UNTIL PERMANENT INSTALLATIONS CAN BE MADE.
- P. ALL EXCESS MATERIALS AND SCRAPS ARE CONTRACTOR'S PROPERTY. PROMPTLY REMOVE FROM SITE UNLESS SPECIFICALLY DIRECTED OTHERWISE.
- Q. EXISTING HVAC COMPONENTS IN THIS BUILDING MAY CONTAIN, BE IN PROXIMITY TO, OR, WORK ON THEM MAY CAUSE DISTURBANCE OF, ASBESTOS CONTAINING OR OTHER HAZARDOUS MATERIALS. REFER TO ABATEMENT SERIES DRAWINGS AND SPECIFICATIONS COMPLETE FOR ADDITIONAL INFORMATION.
- R. SEAL ALL FLOOR, WALL, AND CEILING PENETRATIONS PER FIRE-RESISTANCE RATINGS NOTED ON AG-SERIES DRAWINGS, BUT NOT LESS THAN 1-HOUR, AND IN ACCORDANCE WITH SECTION 07 84 13 - PENETRATION FIRESTOPPING. THIS INCLUDES ALL NEW PENETRATIONS AND EXISTING UNFIRESSTOPPED PENETRATIONS CREATED BY REMOVALS, AS REQUIRED TO PERFORM THE WORK.

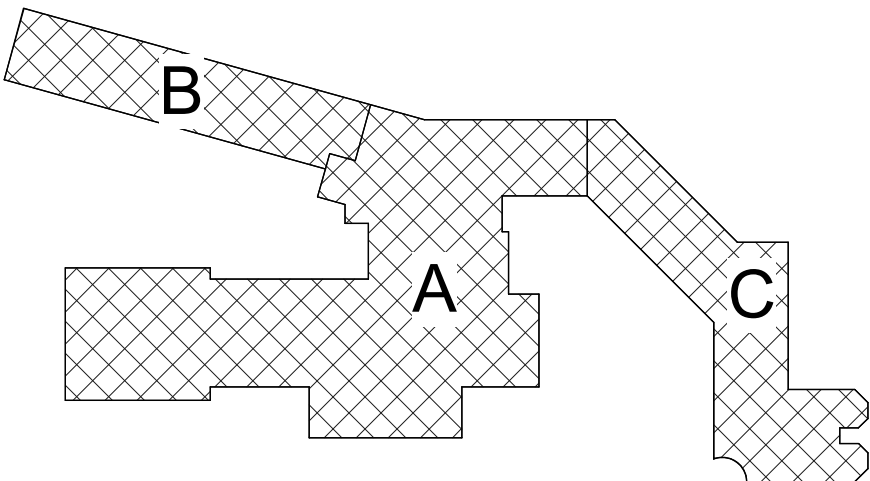

Key Plan
N.T.S.

S.E.D. Control No. 13-02-00-01-0-002-021

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CLEAR SOLUTIONS

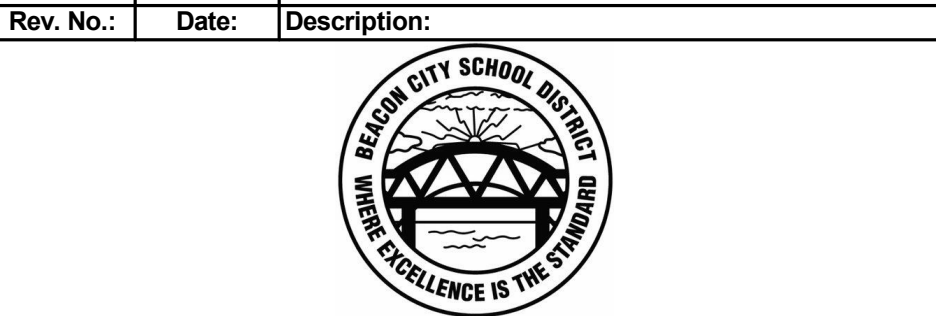Tetra Tech Engineers, Architects & Landscape Architects, P.C.

BID SET




Beacon City School District
Beacon, New York


Reconstruction to:
JV Forrestal Elementary School

Key Plans

Drawn By: JPF/ljgm	Date: 10/28/2022	Drawing Number:
Project No.: 279180-22004		AM050

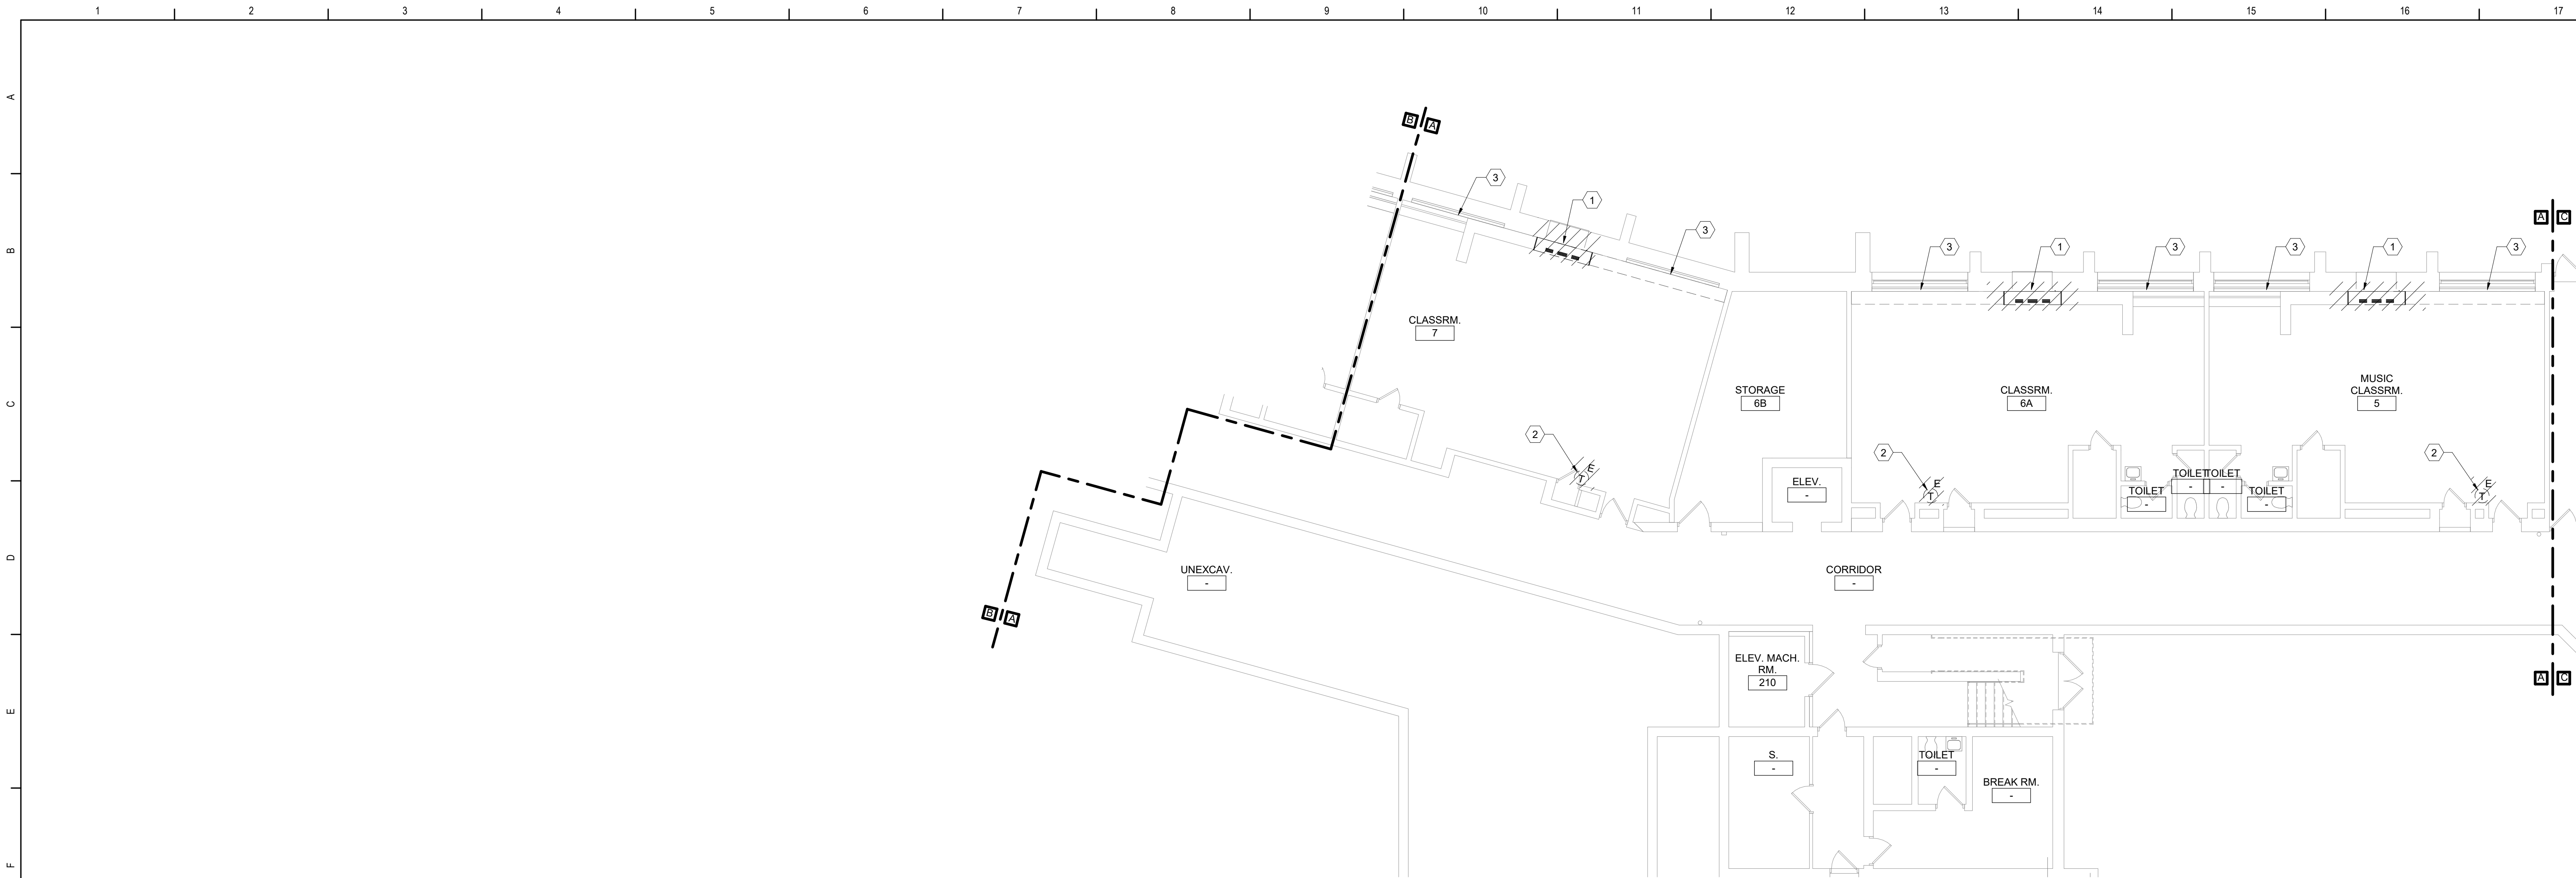

1 Ground Floor Demolition Plan - Area A
1/8" = 1'-0"

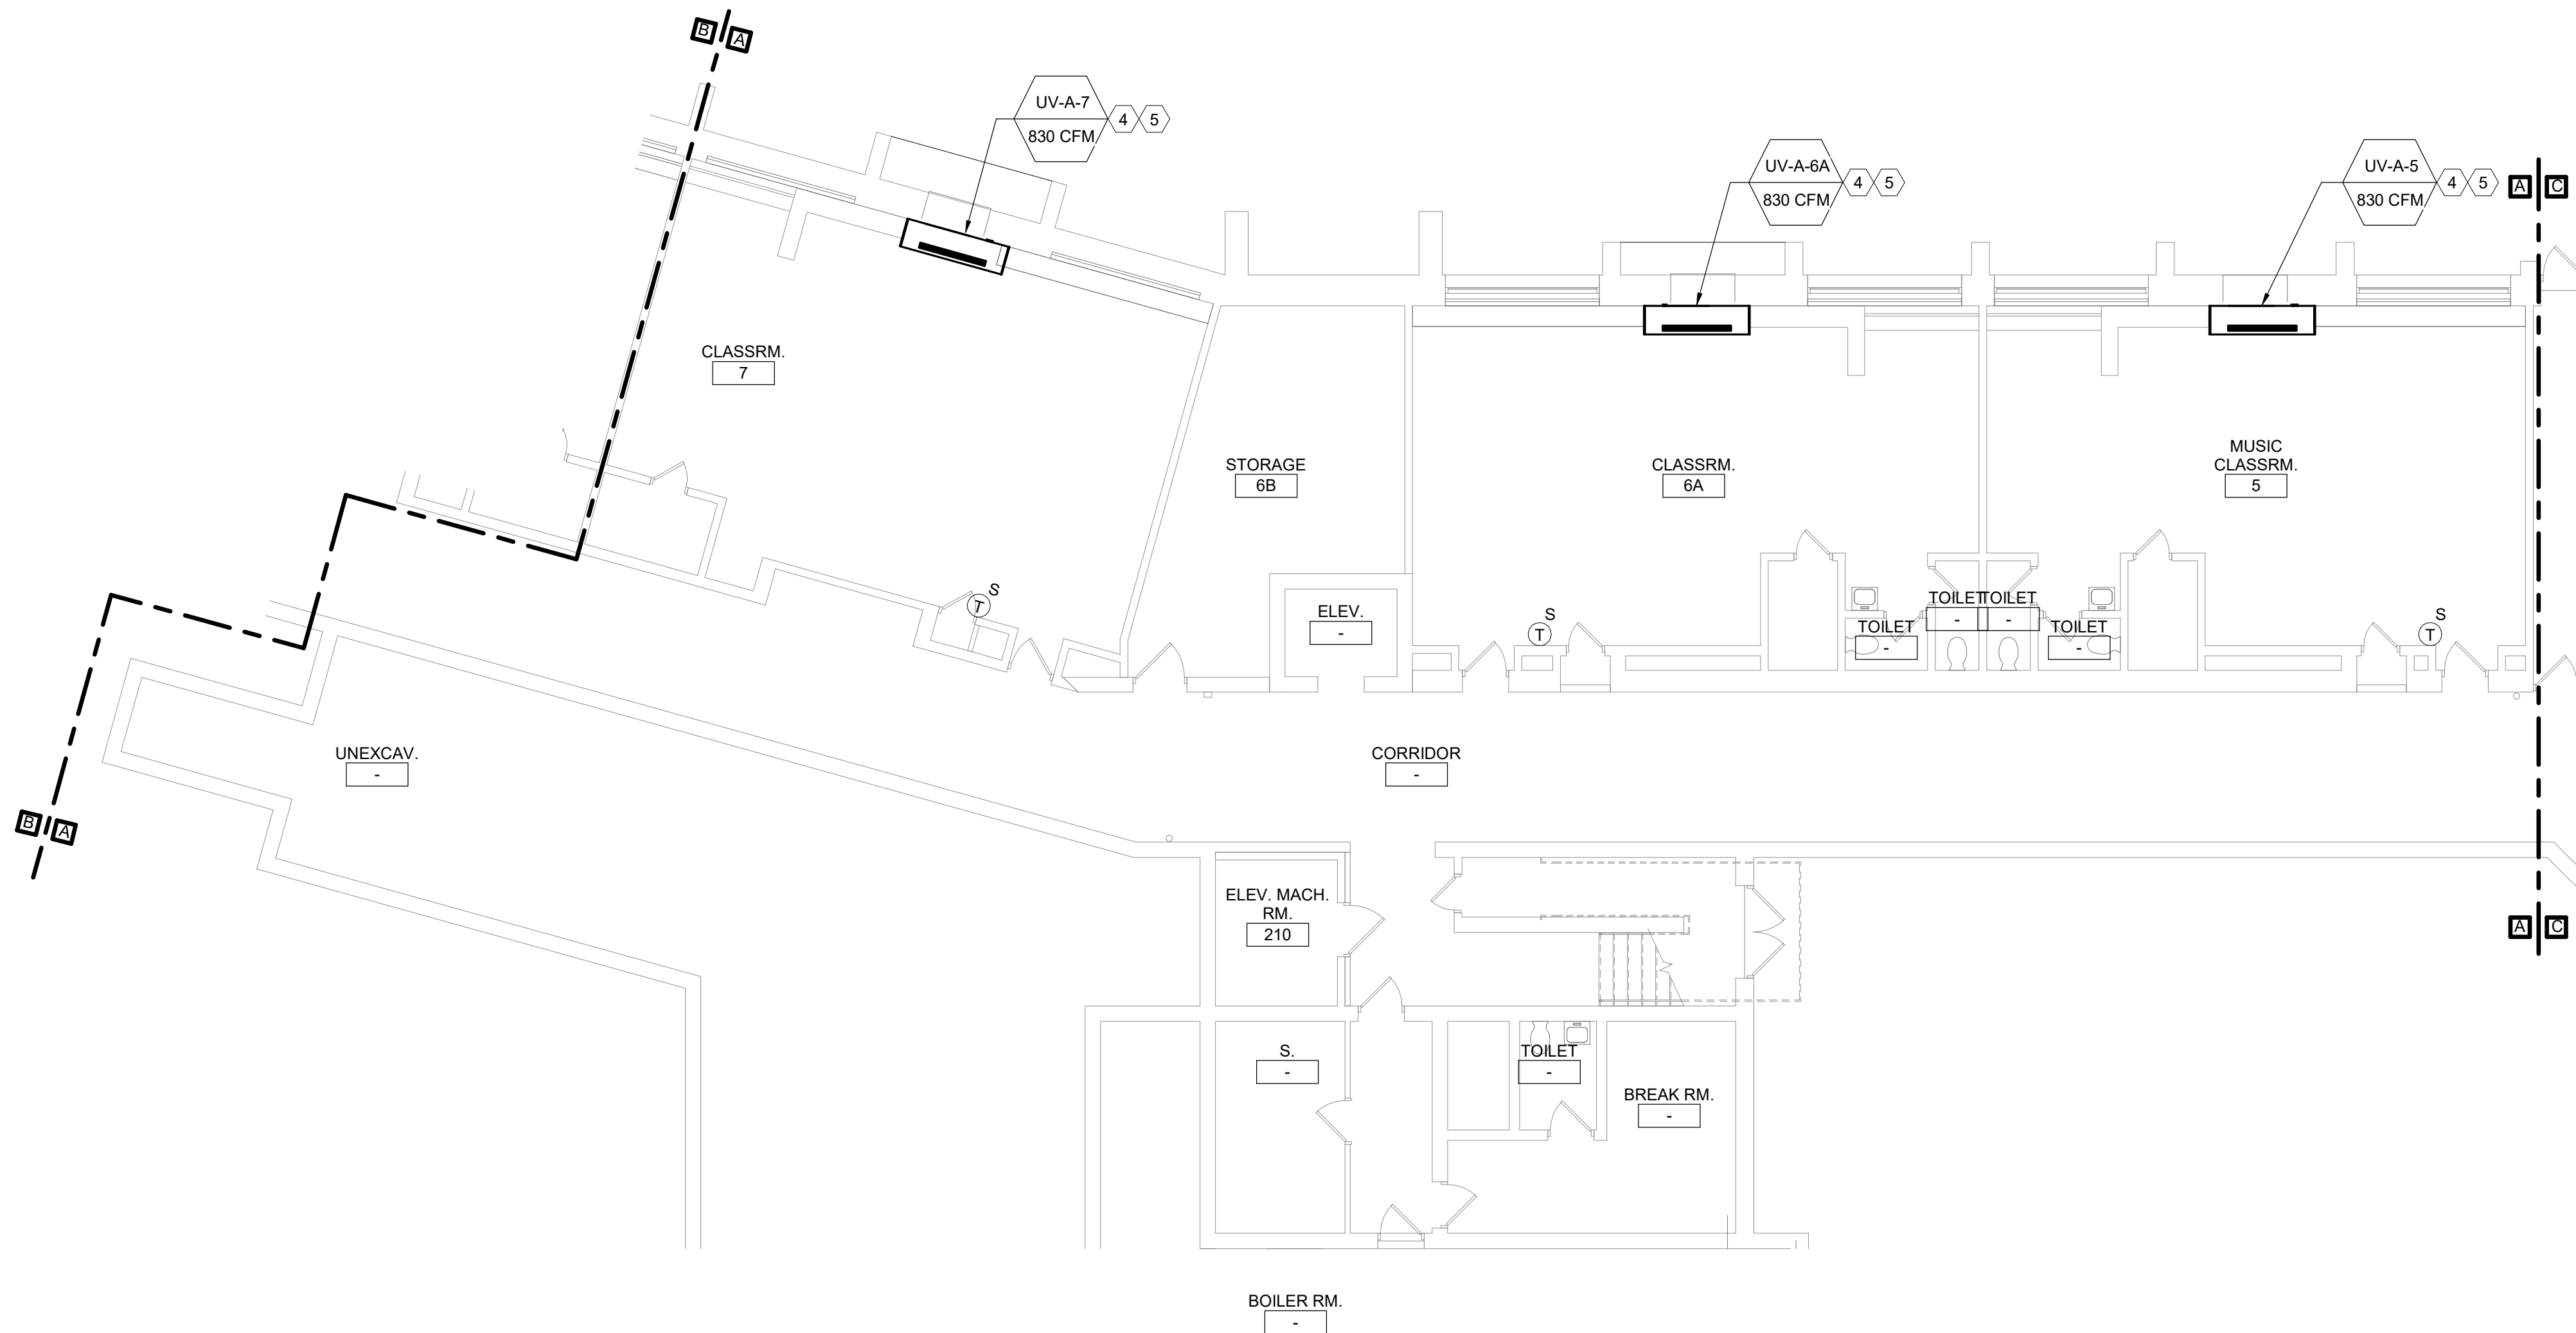

2 Ground Floor Plan - Area A
1/8" = 1'-0"

General Notes


- A. REFER TO AM050 FOR GENERAL NOTES.

KEYED DEMOLITION NOTES:

- 1 REMOVE UNIT VENTILATOR, LOUVER, OUTDOOR AIR INTAKE SLEEVE AND ALL ASSOCIATED ACCESSORIES COMPLETE. REMOVE LPS/LPG PIPING AS REQUIRED FOR UV REMOVAL.
2 REMOVE THERMOSTAT AND ASSOCIATED ACCESSORIES.
3 FINNED TUBE RADIATION TO REMAIN.


KEYED NOTES:

- 4 EXTEND LPS/LPG PIPING AS REQUIRED TO MAKE CONNECTION AND PIPE PER DETAIL.
5 PROVIDE OUTDOOR AIR LOUVER SIZED TO MATCH EXISTING OPENING. PROVIDE OA INTAKE SLEEVE AND SECURE TO LOUVER PER DETAIL. REFER TO ARCHITECTURAL DRAWINGS FOR LOUVER INSTALLATION.

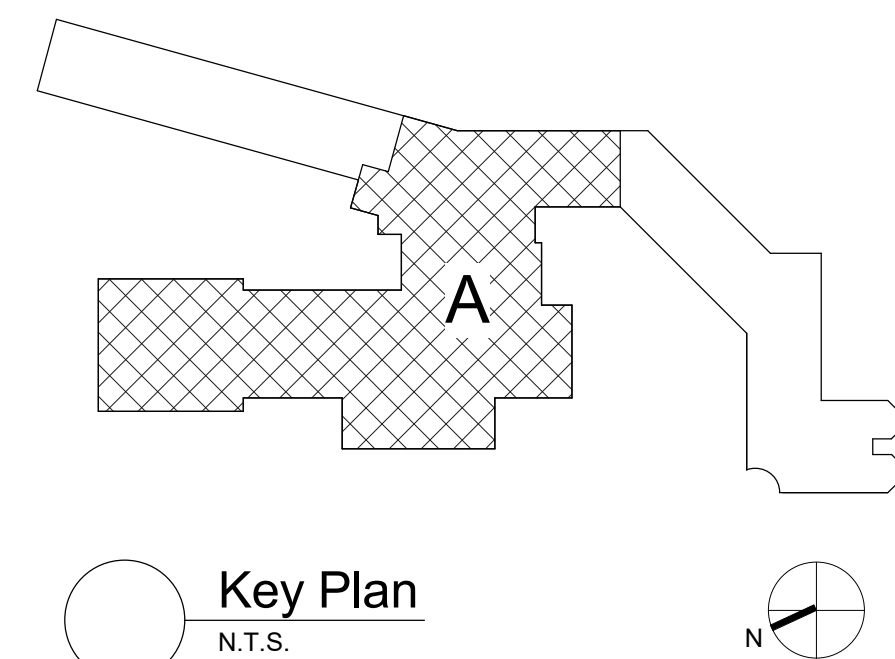

S.E.D. Control No. 13-02-00-01-0-002-021

Rev. No.:	Date:	Description:

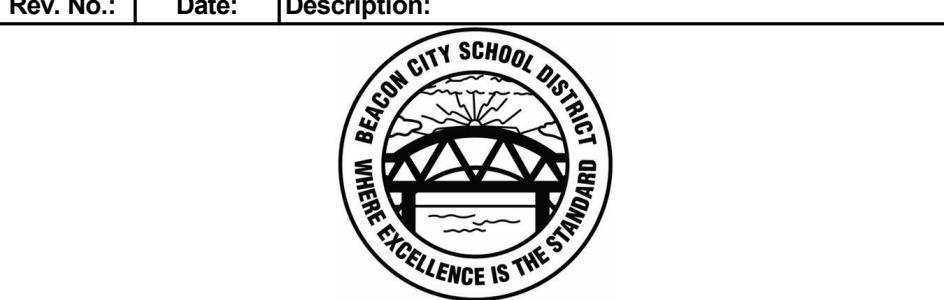

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BID SET




Beacon City School District
Beacon, New York

Reconstruction to:
JV Forrestal Elementary School

Ground Floor Plans - Area A

Drawn By: JPF/1/pgm	Date: 10/28/2022	Drawing Number: AM100
Project No.: 279180-22004		

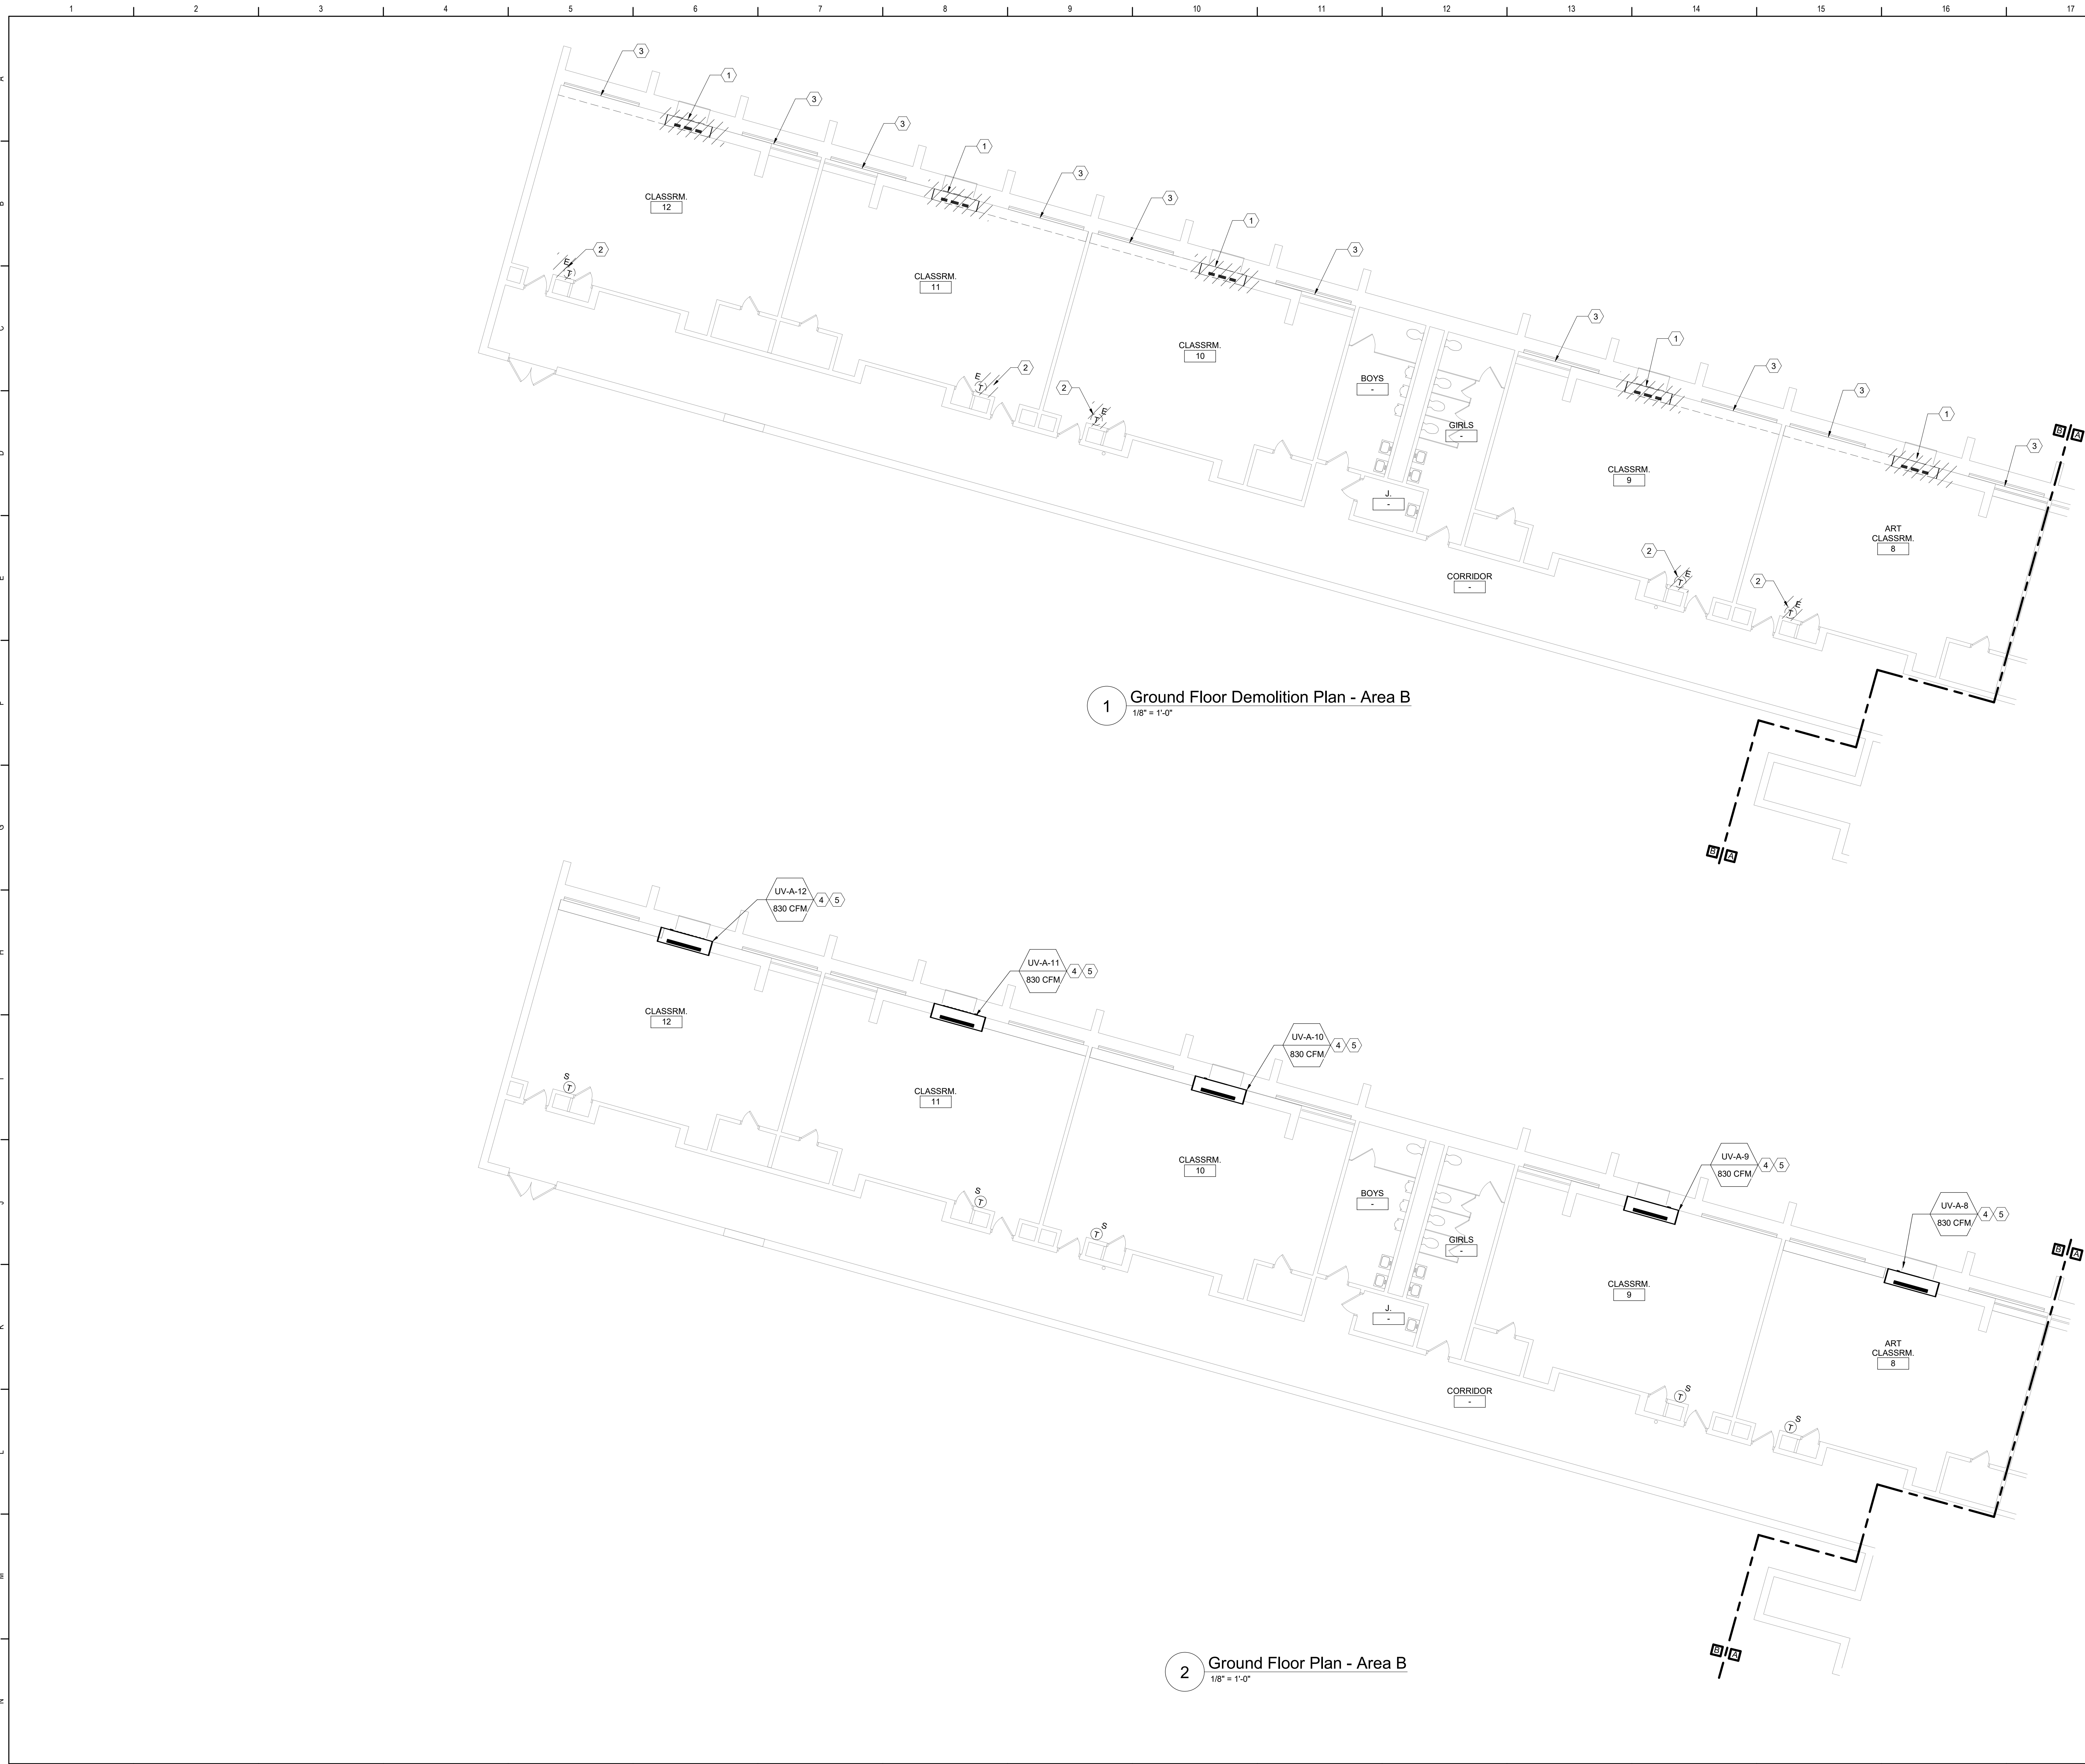


- General Notes**
- A. REFER TO AM050 FOR GENERAL NOTES.
- KEYED DEMOLITION NOTES:**
- 1 REMOVE UNIT VENTILATOR, LOUVER, OUTDOOR AIR INTAKE SLEEVE AND ALL ASSOCIATED ACCESSORIES COMPLETE. REMOVE LPS/LPC PIPING AS REQUIRED FOR UV REMOVAL.
 - 2 REMOVE THERMOSTAT AND ASSOCIATED ACCESSORIES.
 - 3 FINNED TUBE RADIATION TO REMAIN.
- KEYED NOTES:**
- 4 EXTEND LPS/LPC PIPING AS REQUIRED TO MAKE CONNECTION AND PIPE PER DETAIL.
 - 5 PROVIDE OUTDOOR AIR LOUVER SIZED TO MATCH EXISTING OPENING. PROVIDE OA INTAKE SLEEVE AND SECURE TO LOUVER PER DETAIL. REFER TO ARCHITECTURAL DRAWINGS FOR LOUVER INSTALLATION.

Key Plan
N.T.S.

S.E.D. Control No. 13-02-00-01-0-002-021


Rev. No.:	Date:	Description:


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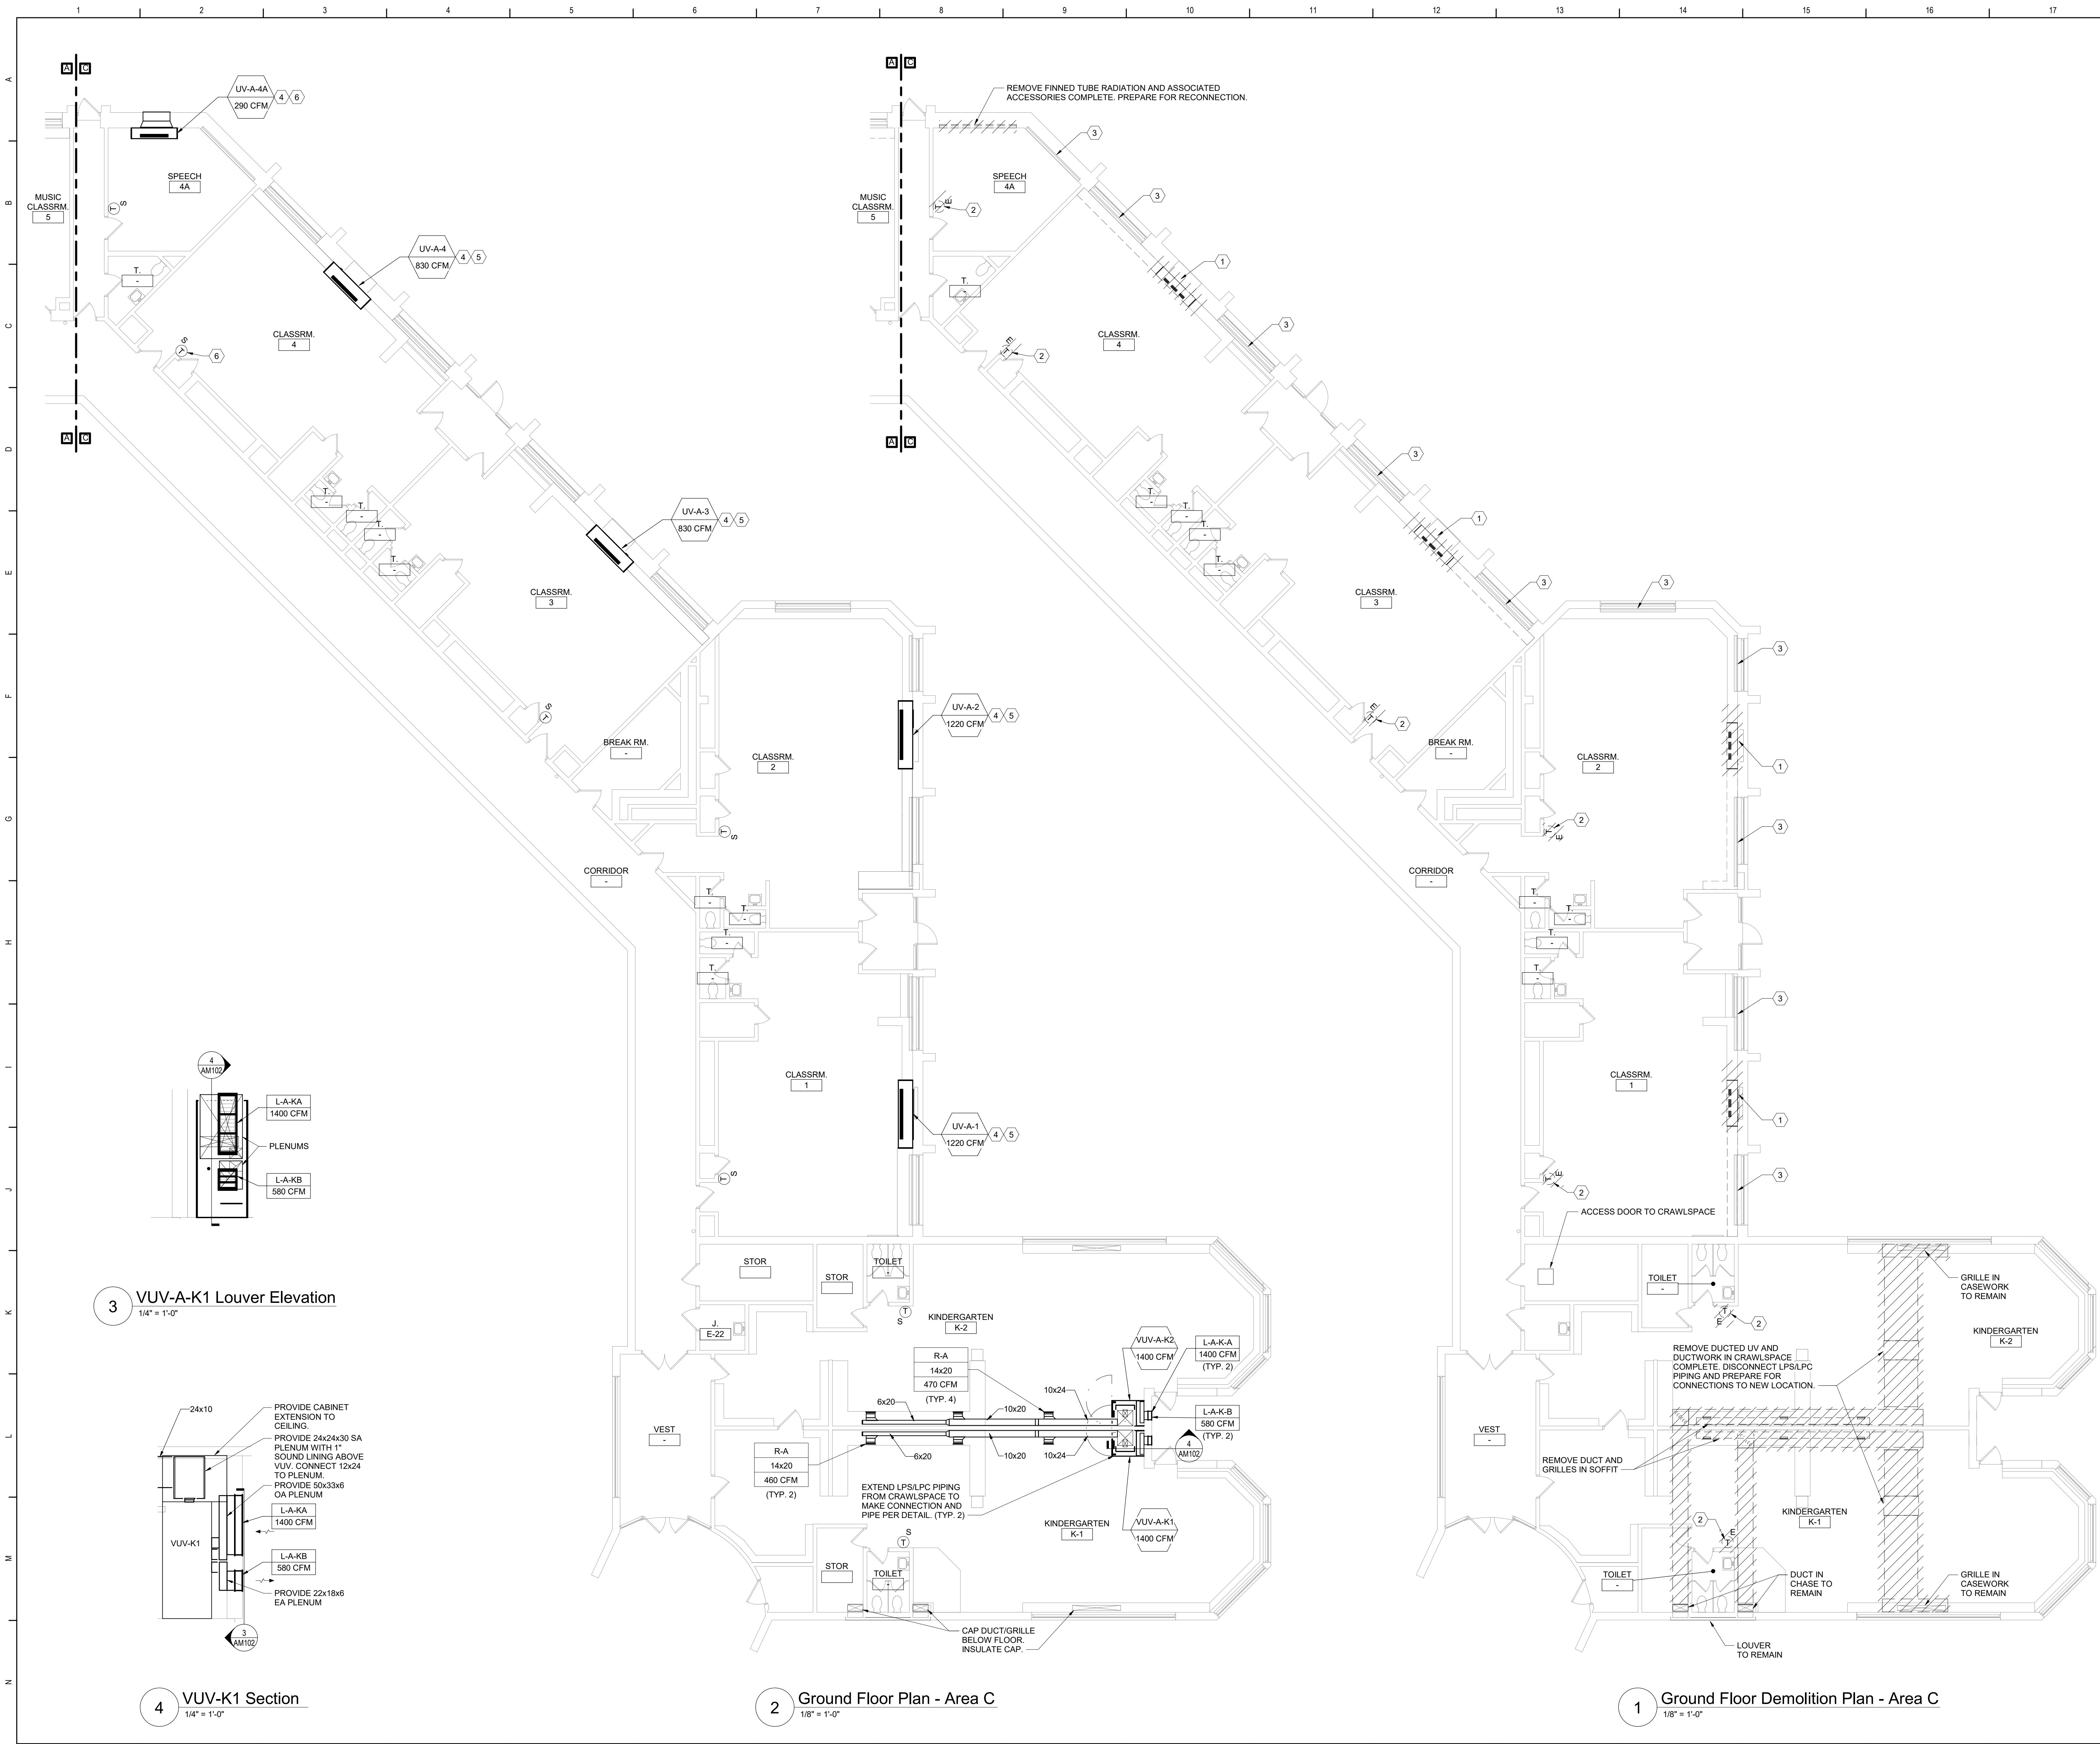
 **TETRA TECH**
ARCHITECTS & ENGINEERS

Beacon City School District
Beacon, New York

Reconstruction to:
JV Forrestal Elementary School

Ground Floor Plans - Area B

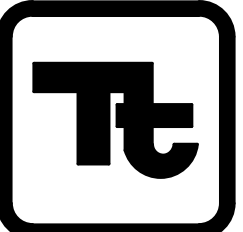Drawn By: JPF/l/pgm	Date: 10/28/2022	Drawing Number:
Project No.: 279180-22004		AM101



General Notes

A. REFER TO AM050 FOR GENERAL NOTES.

KEYED DEMOLITION NOTES:

1

REMOVE UNIT VENTILATOR, LOUVER, OUTDOOR AIR INTAKE SLEEVE AND ALL ASSOCIATED ACCESSORIES COMPLETE. REMOVE LPS/LPC PIPING AS REQUIRED FOR UV REMOVAL.

2

REMOVE THERMOSTAT AND ASSOCIATED ACCESSORIES.

3

FINNED TUBE RADIATION TO REMAIN.

KEYED NOTES:

4

EXTEND LPS/LPC PIPING AS REQUIRED TO MAKE CONNECTION AND PIPE PER DETAIL.

5

PROVIDE LOUVER SIZED TO MATCH EXISTING OPENING. PROVIDE OA INTAKE SLEEVE AND SECURE TO LOUVER PER DETAIL. REFER TO ARCHITECTURAL DRAWINGS FOR LOUVER INSTALLATION.

6

PROVIDE LOUVER AND OA INTAKE SLEEVE AND SECURE PER DETAIL. REFER TO ARCHITECTURAL DRAWINGS FOR WALL OPENING AND LOUVER INSTALLATION.

Key Plan

N.T.S.

S.E.D. Control No. 13-02-00-01-0-002-021

Rev. No.	Date	Description

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ARCHITECTS & ENGINEERS

Beacon City School District
Beacon, New York


Reconstruction to:
JV Forrestal Elementary School

Ground Floor Plans - Area C

Drawn By:
JPF/1/pgm

Date:
10/28/2022

Drawing Number:
AM102

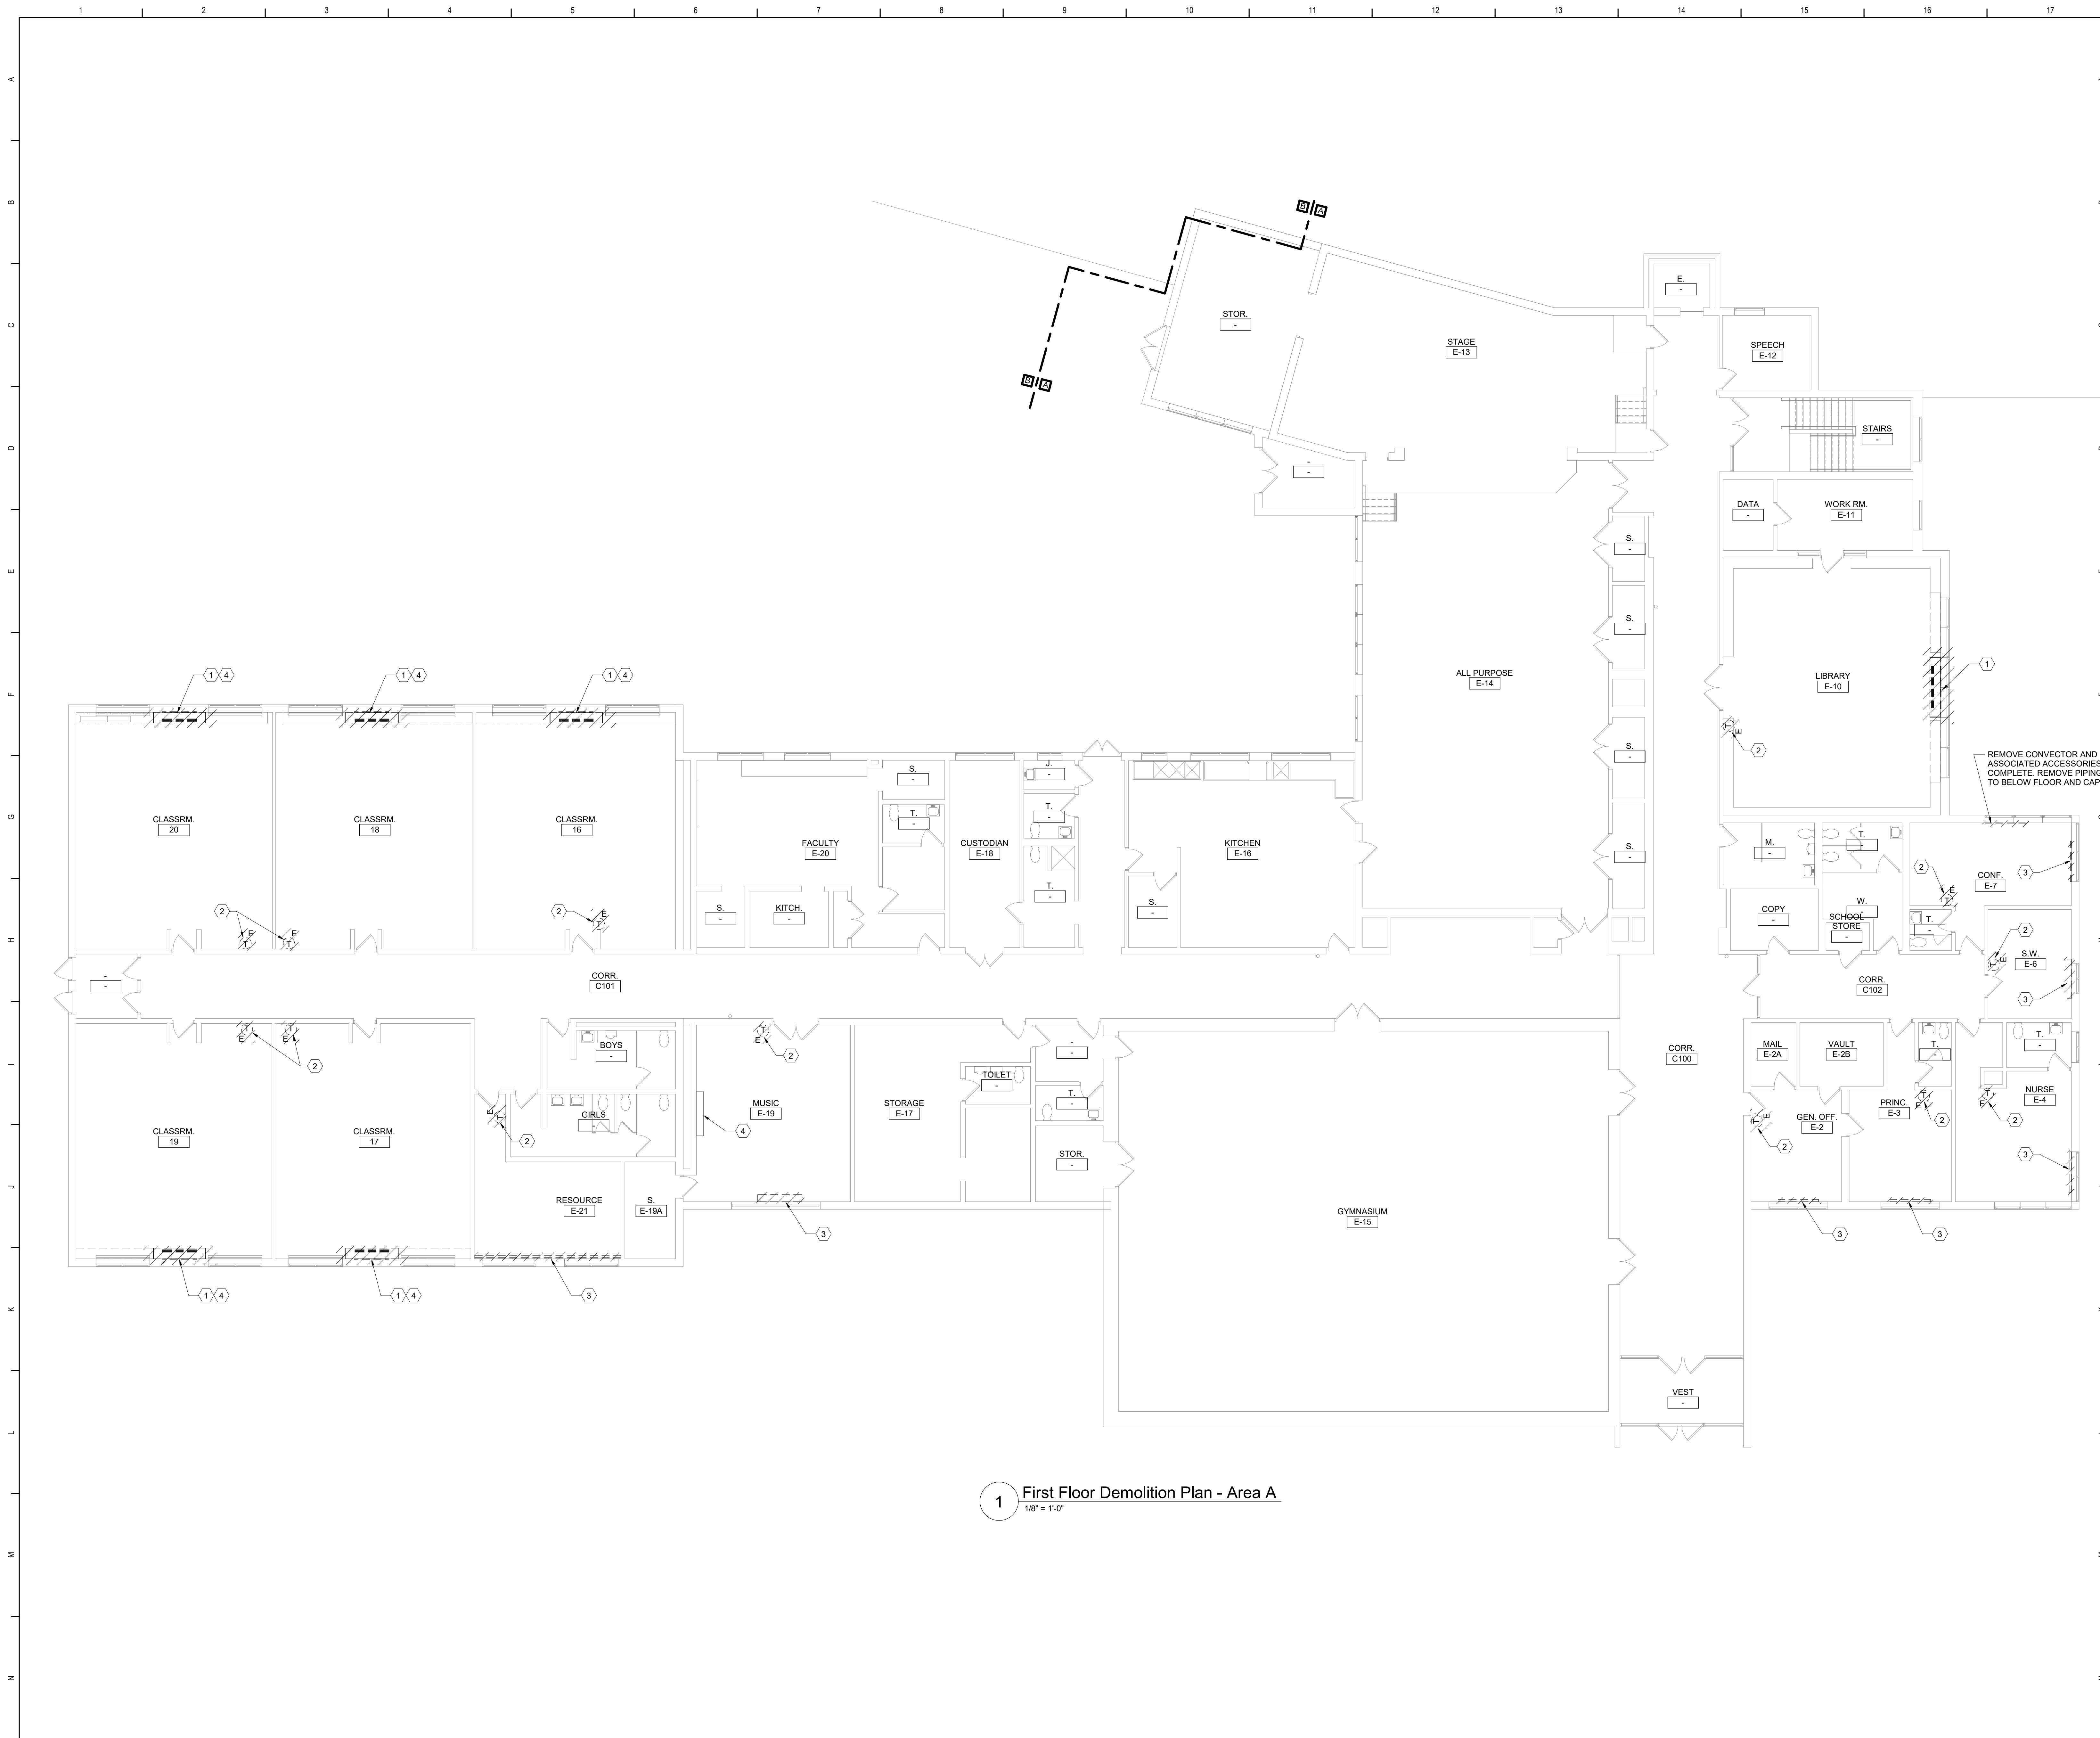

1 First Floor Demolition Plan - Area A
1/8" = 1'-0"

General Notes

A. REFER TO AM050 FOR GENERAL NOTES.

KEYED DEMOLITION NOTES:

- 1 REMOVE UNIT VENTILATOR, LOUVER, OUTDOOR AIR INTAKE SLEEVE AND ALL ASSOCIATED ACCESSORIES COMPLETE. REMOVE LPS/LPG PIPING AS REQUIRED FOR UV REMOVAL.
- 2 REMOVE THERMOSTAT AND ASSOCIATED ACCESSORIES.
- 3 REMOVE FINNED TUBE RADIATION OR CONVECTOR AND ASSOCIATED ACCESSORIES COMPLETE. PREPARE FOR RECONNECTION.
- 4 FINNED TUBE RADIATION OR CONVECTOR TO REMAIN.

Key Plan
N.T.S.

S.E.D. Control No. 13-02-00-01-0-002-021

Rev. No.	Date	Description

Beacon City School District
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BID SET


TETRA TECH
ARCHITECTS & ENGINEERS

Beacon City School District
Beacon, New York

Reconstruction to:
JV Forrestal Elementary School

First Floor Demolition Plan - Area A

Drawn By: JPF/l/pgm	Date: 10/28/2022	Drawing Number: AM103
Project No.: 279180-22004		

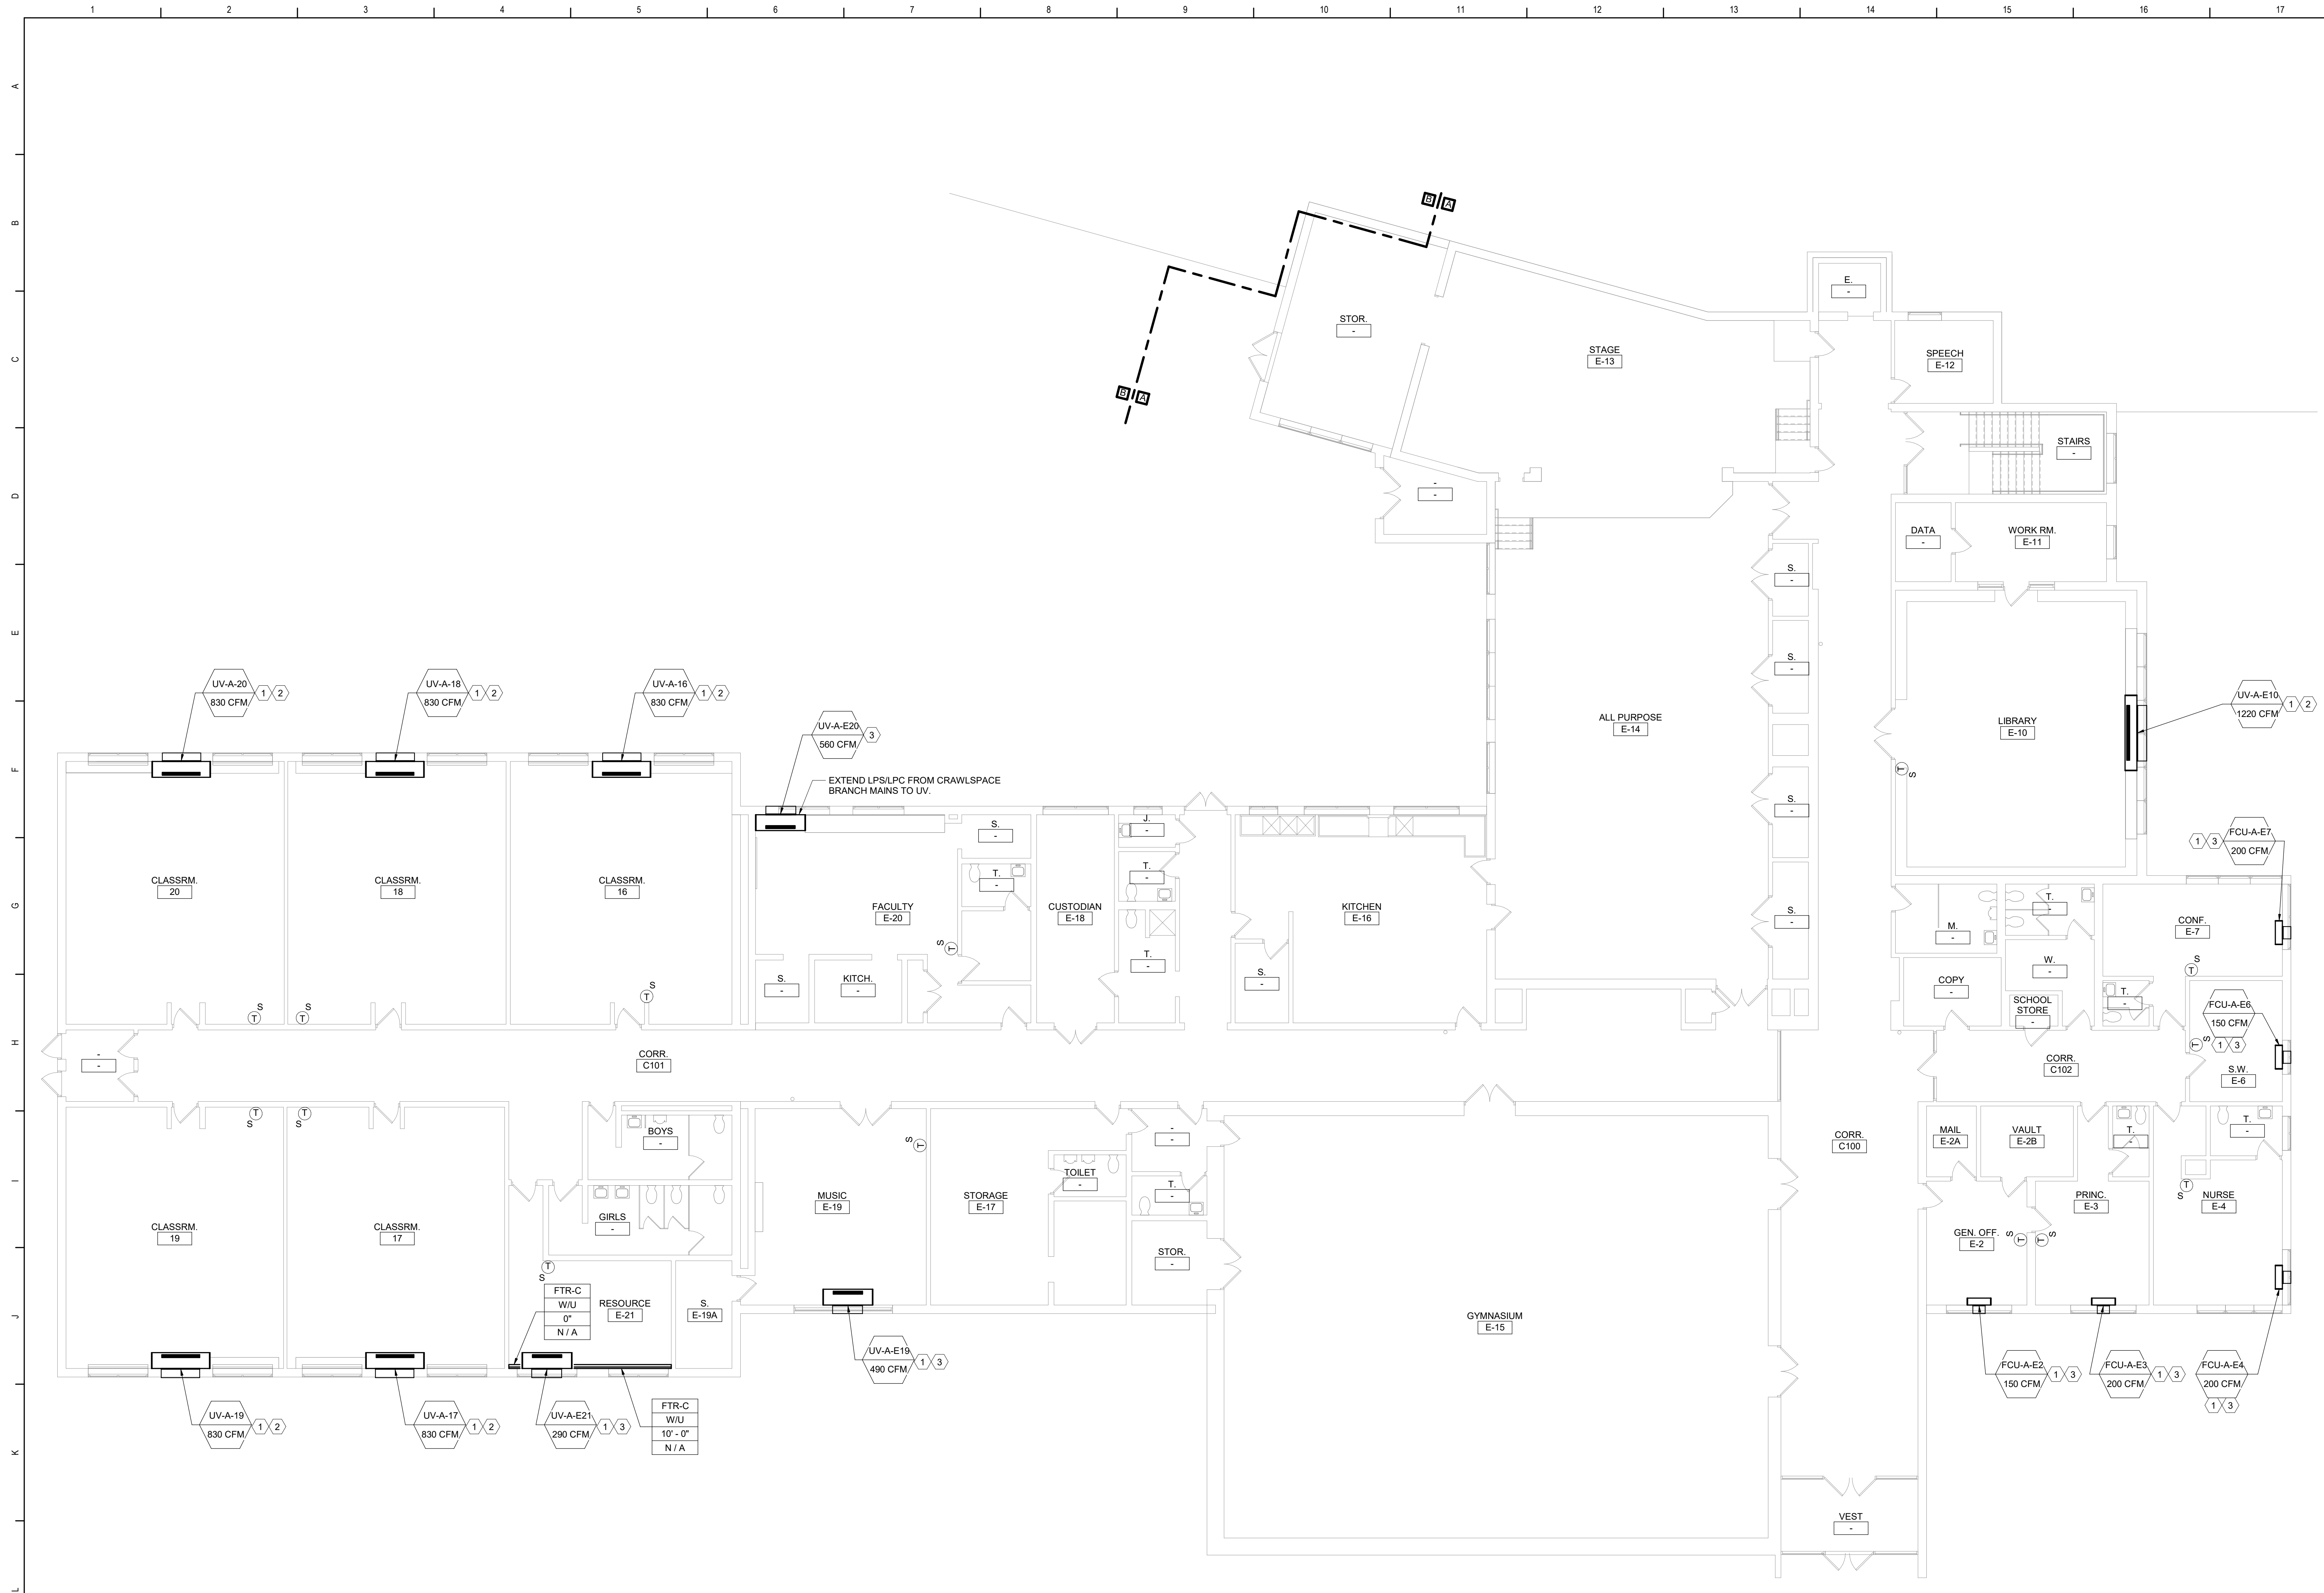


1 First Floor Plan - Area A
1/8" = 1'-0"

General Notes

A. REFER TO AM050 FOR GENERAL NOTES.

KEYED NOTES:

- 1 EXTEND LPS/LPC PIPING AS REQUIRED TO MAKE CONNECTION AND PIPE PER DETAIL.
- 2 PROVIDE LOUVER SIZED TO MATCH EXISTING OPENING. PROVIDE OA INTAKE SLEEVE AND SECURE TO LOUVER PER DETAIL. REFER TO ARCHITECTURAL DRAWINGS FOR LOUVER INSTALLATION.
- 3 PROVIDE LOUVER AND OA INTAKE SLEEVE AND SECURE PER DETAIL. REFER TO ARCHITECTURAL DRAWINGS FOR WALL OPENING AND LOUVER INSTALLATION.

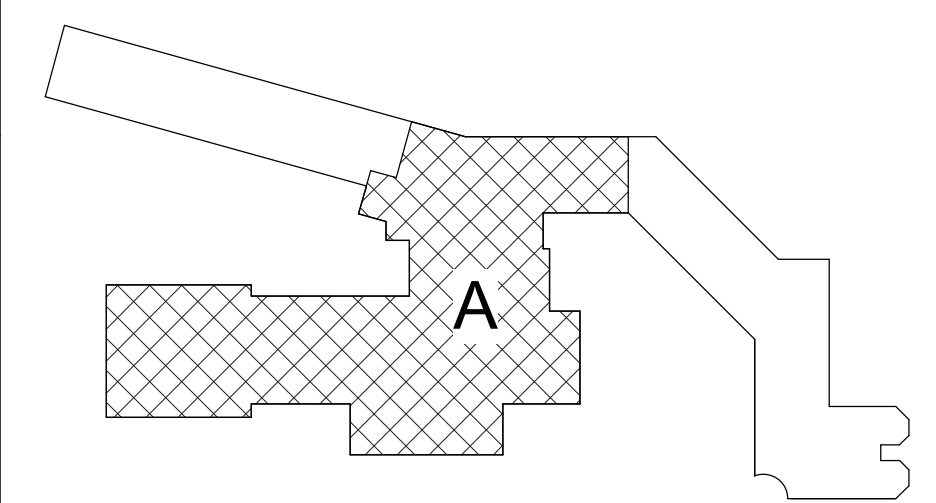

Key Plan
N.T.S.

S.E.D. Control No. 13-02-00-01-0-002-021

Rev. No.: Date: Description:

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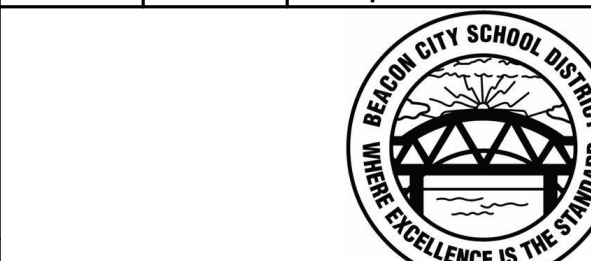
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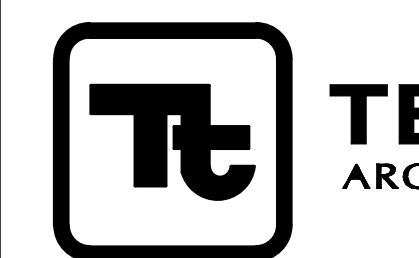
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Beacon City School District
Beacon, New York

Reconstruction to:
JV Forrestal Elementary School

First Floor Plan - Area A

Drawn By:

JPF1/pgm

Date:

10/28/2022


Project No.:

279180-22004

Drawing Number:

AM104

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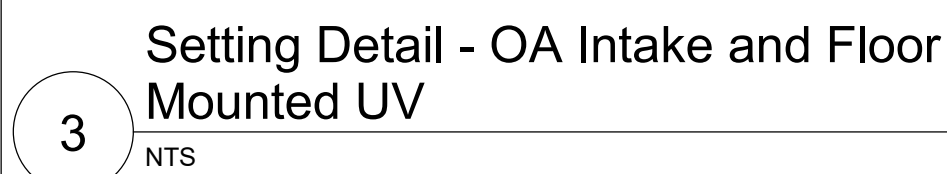
- 7 VUV w/Energy Recovery - Steam - Valve Control
NTS

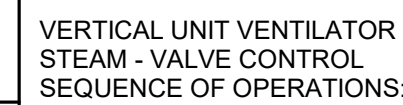

- 5 UV - Steam Control
NTS




- FCU - Steam Control
-
- NTS



- _____

AI	ANALOG IN
AO	ANALOG OUT
COM	COMMUNICATIONS PORT
CS	AIRBORNE CONTAMINANT SENSOR
DI	DIGITAL IN
I	DAMPER MOTOR
DO	DIGITAL OUT
EMCS	ENERGY MANAGEMENT CONTROL SYSTEM
F	FLOW (WATER/AIR)
FM	FLOW METER
FS	AIR FLOW SENSOR
FZ	FREEZE STAT
H	HUMIDITY SENSOR
HL	HIGH LIMIT
KWH	KILOWATT HOUR METER
LL	LOW LIMIT
M/S	MANUAL SWITCH STOP / START
P	PRESSURE SENSOR
ΔP	DIFFERENTIAL PRESSURE
PS	POSITION SENSOR
S/S	STOP / START
SD	SMOKE DETECTOR
ST	STATUS
START	STARTER
T	ADJUSTABLE THERMOSTAT
TS	TEMPERATURE SENSOR
VFD	VARIABLE FREQUENCY DRIVE
WS	WATER SENSOR
%	PERCENT
ES	END SWITCH
BS	BOILER SWITCH

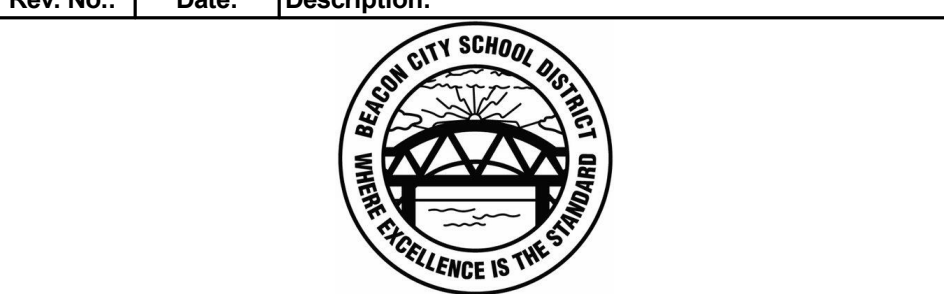

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Beacon City School District
Beacon, New York

Reconstruction to:
JV Forrestal Elementary School

Details and Controls

Drawn By: JPF1/pgm	Date: 10/28/2022	Drawing Number:
Project No.: 279180-22004		AM

BID SET

UNIT VENTILATOR (UV) SCHEDULE																	
DWG LABEL	LOCATION	MODEL NO.	SA CFM	MIN. O/A	HEATING DATA				ESP (IN. WG.)	RPM	ELECTRICAL					NOTES	
					NO. ROW	EAT (°F)	LAT (°F)	CAP. (MBH)			MOTOR QTY	MOTOR SIZE (HP)	V/PH	FLA	MCA		MOP
UV-A-1	CLASSROOM 1	VUVE150	1220	430	1	44.0	110.0	111.1	0.00	1120	2	0.25	120V/1ø	7.0	9.0	15	1-7
UV-A-2	CLASSROOM 2	VUVE150	1220	490	1	44.0	110.0	111.1	0.00	1120	2	0.25	120V/1ø	7.0	9.0	15	1-7
UV-A-3	CLASSROOM 3	VUVE100	830	410	1	38.5	110.0	75.4	0.00	1110	1	0.25	120V/1ø	3.5	4.5	15	1-7
UV-A-4	CLASSROOM 4	VUVE100	830	410	1	38.5	110.0	75.4	0.00	1110	1	0.25	120V/1ø	3.5	4.5	15	1-7
UV-A-4A	SPEECH 4A	VUVE075	290	130	1	40.8	110.0	55.2	0.00	670	1	0.25	120V/1ø	3.5	4.5	15	1-7
UV-A-5	MUSIC CLASSROOM 5	VUVE100	830	340	1	38.5	110.0	75.4	0.00	1110	1	0.25	120V/1ø	3.5	4.5	15	1-7
UV-A-6A	CLASSROOM 6 A	VUVE100	830	370	1	38.5	110.0	75.4	0.00	1110	1	0.25	120V/1ø	3.5	4.5	15	1-7
UV-A-7	CLASSROOM 7	VUVE100	830	400	1	38.5	110.0	75.4	0.00	1110	1	0.25	120V/1ø	3.5	4.5	15	1-7
UV-A-8	ART CLASSROOM 8	VUVE100	830	390	1	38.5	110.0	75.4	0.00	1110	1	0.25	120V/1ø	3.5	4.5	15	1-7
UV-A-9	CLASSROOM 9	VUVE100	830	390	1	38.5	110.0	75.4	0.00	1110	1	0.25	120V/1ø	3.5	4.5	15	1-7
UV-A-10	CLASSROOM 10	VUVE100	830	390	1	38.5	110.0	75.4	0.00	1110	1	0.25	120V/1ø	3.5	4.5	15	1-7
UV-A-11	CLASSROOM 11	VUVE100	830	390	1	38.5	110.0	75.4	0.00	1110	1	0.25	120V/1ø	3.5	4.5	15	1-7
UV-A-12	CLASSROOM 12	VUVE100	830	390	1	38.5	110.0	75.4	0.00	1110	1	0.25	120V/1ø	3.5	4.5	15	1-7
UV-A-16	CLASSROOM 16	VUVE100	830	380	1	38.5	110.0	75.4	0.00	1105	1	0.25	120V/1ø	3.5	4.5	15	1-7
UV-A-17	CLASSROOM 17	VUVE100	830	380	1	38.5	110.0	75.4	0.00	1105	1	0.25	120V/1ø	3.5	4.5	15	1-7
UV-A-18	CLASSROOM 18	VUVE100	830	380	1	38.5	110.0	75.4	0.00	1105	1	0.25	120V/1ø	3.5	4.5	15	1-7
UV-A-19	CLASSROOM 19	VUVE100	830	380	1	38.5	110.0	75.4	0.00	1105	1	0.25	120V/1ø	3.5	4.5	15	1-7
UV-A-20	CLASSROOM 20	VUVE100	830	380	1	38.5	110.0	75.4	0.00	1105	1	0.25	120V/1ø	3.5	4.5	15	1-7
UV-A-E10	LIBRARY E-10	VUVE150	1220	490	1	44.0	110.0	111.1	0.00	1120	2	0.25	120V/1ø	7.0	9.0	15	1-7
UV-A-E19	MUSIC E-19	VUVE075	490	220	1	40.4	110.0	55.1	0.00	730	1	0.25	120V/1ø	3.5	4.5	15	1-7
UV-A-E20	FACULTY E-20	VUVE075	560	260	1	40.6	110.0	55.1	0.00	1110	1	0.25	120V/1ø	3.5	4.5	15	1-7
UV-A-E21	RESOURCE E-21	VUVE075	290	130	1	40.8	110.0	55.2	0.00	670	1	0.25	120V/1ø	3.5	4.5	15	1-7
NOTES: 1. DESIGN BASIS: TRANE 2. FLOOR MOUNTED UNIT 3. PROVIDE 1" MERV13 FILTER. 4. STEAM COIL CONDITIONS: STEAM TEMP=222°F, PRESSURE=3 PSIG 5. VERIFY PIPE AND ELECTRICAL LEFT/RIGHT HAND CONNECTIONS PRIOR TO ORDERING. 6. PROVIDE LOUVER AND WALL SLEEVE TO MATCH EXISTING OR NEW WALL OPENING. 7. UNIT 21-1/4" DEEP W/CLOSED PIPE TUNNEL. NEMA 1 DISCONNECT SWITCH.																	

FAN COIL UNIT (FCU) SCHEDULE																
EQUIP NO.	LOCATION	MODEL NO.	SA CFM	MIN. OA	HEATING DATA				SUPPLY FAN		ELECTRICAL				NOTES	
					NO. ROW	EAT (°F)	LAT (°F)	CAP. (MBH)	ESP (IN. WG.)	RPM	MOTOR SIZE (HP)	V/PH	FLA	MCA		MOP
FCU-A-E2	GEN. OFF. E-2	FCDB020	150	20	1	60.1	110.0	13.2	0.00	700	0.02	120V/1ø	2.2	2.8	15	1-7
FCU-A-E3	PRINC. E-3	FCDB020	200	30	1	59.2	110.0	15.5	0.00	870	0.02	120V/1ø	2.2	2.8	15	1-7
FCU-A-E4	NURSE E-4	FCDB020	200	30	1	59.2	110.0	15.5	0.00	870	0.02	120V/1ø	2.2	2.8	15	1-7
FCU-A-E6	S.W. E-6	FCDB020	150	20	1	60.1	110.0	13.2	0.00	700	0.02	120V/1ø	2.2	2.8	15	1-7
FCU-A-E7	CONF. E-7	FCDB020	200	30	1	59.2	110.0	15.5	0.00	870	0.02	120V/1ø	2.2	2.8	15	1-7
NOTES:																
1. DESIGN BASIS: TRANE.					4. STEAM COIL CONDITIONS: STEAM TEMP=222°F, PRESSURE=3 PSIG					7. PROVIDE NEMA 1 DISCONNECT SWITCH.						
2. VERTICAL CABINET UNIT					5. VERIFY PIPE AND ELECTRICAL LEFT/RIGHT HAND CONNECTIONS PRIOR TO ORDERING.											
3. PROVIDE 1" MERV13 FILTER.					6. PROVIDE RETURN AIR BOTTOM INLET TOP GRILLE OUTLET AND OUTSIDE AIR WALL BOX.											

VERTICAL UNIT VENTILATOR (VUV) SCHEDULE																	
EQUIP NO.	LOCATION	MODEL NO.	SA (CFM)	MIN. OA AND EA (CFM)	HEATING DATA				STEAM COIL		ELECTRICAL					NOTES	
					NO. ROW	EAT (°F)	LAT (°F)	TC (MBH)	INLET (PSI)	SUPPLY ESP (IN. WG.)	SUPPLY FAN (HP)	RELIEF FAN (HP)	WHEEL (W)	V/PH	MCA		MOP
VUV-A-K1	KINDERGARTEN K-1	VER 1800D	1400	630	1	61.6	133.0	108.9	3.0	0.20	0.5	0.33	76	120 V/1ø	22.0	25	1-8
VUV-A-K2	KINDERGARTEN K-2	VER 1800D	1400	630	1	61.6	133.0	108.9	3.0	0.20	0.5	0.33	76	120 V/1ø	22.0	25	1-8
NOTES:																	
1.	DESIGN BASIS: TEMPSPEC		4.		STEAM COIL CONDITIONS: STEAM TEMP=222°F, PRESSURE=3 PSIG				7.	PROVIDE ENERGY RECOVERY WHEEL (70% MIN. EFFICIENCY)							
2.	VERTICAL CABINET UNIT		5.		PROVIDE NEMA1 1 DISCONNECT SWITCH				8.	A. WINTER (73%); OA EDB: 8.4; EWB: 6.6; RETURN AIR EDB: 65; EWB: 45							
3.	PROVIDE 2" MERV13 FILTER.		6.		PROVIDE RELIEF FAN CAPABLE OF 580 CFM.				PROVIDE 12" BACK CABINET EXTENSION AND 24" SHEET METAL VERTICAL EXTENSION.								

LOUVER (L) SCHEDULE											
DWG LABEL	SERVES	MODEL NO.	TYPE	LENGTH (IN)	HEIGHT (IN)	DEPTH (IN)	FREE AREA (S.F.)	AIRFLOW (CFM)	VELOCITY (FPM)	MAX APD (IN WG)	NOTES
L-A-KA	VUV-A-K1 AND VUV-A-K2	ESD-635HP	INTAKE	13	46	6	2.20	1400	640	0.07	1-5
L-A-KB	VUV-A-K1 AND VUV-A-K2	ESD-635HP	EXHAUST	13	15	6	0.50	580	1160	0.2	1-5
NOTES: 1. DESIGN BASIS: GREENHECK 2. PROVIDE WITH KYNAR FINISH. 3. COLOR TO BE SELECTED BY ARCHITECT. 4. PROVIDE WITH EXTENDED SILL. 5. PROVIDE WITH ALUMINUM BIRDSCREEN IN REMOVABLE FRAME.											

JV FORRESTAL BUILDING/EQUIPMENT VENTILATION CALCULATIONS														
EQUIPMENT NUMBER	ZONE ID				MINIMUM VENTILATION RATES									
	ROOM NUMBER	ROOM NAME	OCCUPANCY CLASSIFICATION	Az - AREA (SF)	Pz - ZONE OCCU. #/1000 FT	ZONE OCCU.	Rp (CFM/ Person)	RpP	Ra (CFM/SF)	RaA	Vbz (CFM)	EZ	Voz (CFM)	
VUV-A-K1	K-1	KINDERGARTEN	Classrooms (ages 5-8)	1350	25	34	10	340	0.12	162	502	0.8	630	
VUV-A-K2	K-2	KINDERGARTEN	CLASSROOMS (AGES 5-8)	1313	25	33	10	330	0.12	158	488	0.8	610	
UV-A-1	1	CLASSRM.	CLASSROOMS (AGE 9 PLUS)	914	35	32	10	320	0.12	110	430	0.9	480	
UV-A-2	2	CLASSRM.	CLASSROOMS (AGE 9 PLUS)	1028	35	36	10	360	0.12	123	483	0.9	540	
UV-A-3	3	CLASSRM.	CLASSROOMS (AGE 9 PLUS)	857	35	30	10	300	0.12	103	403	0.9	450	
UV-A-4	4	CLASSRM.	CLASSROOMS (AGE 9 PLUS)	848	35	30	10	300	0.12	102	402	0.9	450	
UV-A-5	5	MUSIC CLASSRM.	CLASSROOMS (AGE 9 PLUS)	711	35	25	10	250	0.12	85	335	0.9	380	
UV-A-6A	6A	CLASSRM.	CLASSROOMS (AGE 9 PLUS)	756	35	27	10	270	0.12	91	361	0.9	410	
UV-A-7	7	CLASSRM.	CLASSROOMS (AGE 9 PLUS)	831	35	30	10	300	0.12	100	400	0.9	450	
UV-A-8	8	ART CLASSRM.	CLASSROOMS (AGE 9 PLUS)	819	35	29	10	290	0.12	98	388	0.9	440	
UV-A-9	9	CLASSRM.	CLASSROOMS (AGE 9 PLUS)	824	35	29	10	290	0.12	99	389	0.9	440	
UV-A-10	10	CLASSRM.	CLASSROOMS (AGE 9 PLUS)	822	35	29	10	290	0.12	99	389	0.9	440	
UV-A-11	11	CLASSRM.	CLASSROOMS (AGE 9 PLUS)	823	35	29	10	290	0.12	99	389	0.9	440	
UV-A-12	12	CLASSRM.	CLASSROOMS (AGE 9 PLUS)	816	35	29	10	290	0.12	98	388	0.9	440	
UV-A-16	16	CLASSRM.	CLASSROOMS (AGE 9 PLUS)	796	35	28	10	280	0.12	96	376	0.9	420	
UV-A-17	17	CLASSRM.	CLASSROOMS (AGE 9 PLUS)	774	35	28	10	280	0.12	93	373	0.9	420	
UV-A-18	18	CLASSRM.	CLASSROOMS (AGE 9 PLUS)	785	35	28	10	280	0.12	94	374	0.9	420	
UV-A-19	19	CLASSRM.	CLASSROOMS (AGE 9 PLUS)	792	35	28	10	280	0.12	95	375	0.9	420	
UV-A-20	20	CLASSRM.	CLASSROOMS (AGE 9 PLUS)	797	35	28	10	280	0.12	96	376	0.9	420	
UV-A-E10	E-10	LIBRARY	CLASSROOMS (AGE 9 PLUS)	945	35	34	10	340	0.12	113	453	0.9	510	
UV-A-4A	4A	SPEECH	CLASSROOMS (AGE 9 PLUS)	244	35	9	10	90	0.12	29	119	0.9	140	
FCU-A-E2	E-2	GEN. OFF.	OFFICE SPACE	171	5	1	5	5	0.06	10	15	0.9	20	
FCU-A-E3	E-3	PRINC.	OFFICE SPACE	225	5	2	5	10	0.06	14	24	0.9	30	
FCU-A-E4	E-4	NURSE	OFFICE SPACE	287	5	2	5	10	0.06	17	27	0.9	40	
FCU-A-E6	E-6	S.W.	OFFICE SPACE	154	5	1	5	5	0.06	9	14	0.9	20	
FCU-A-E7	E-7	PSYC.	OFFICE SPACE	249	5	2	5	10	0.06	15	25	0.9	30	
UV-A-E19	E-19	MUSIC	CLASSROOMS (AGE 9 PLUS)	467	35	17	10	170	0.12	56	226	0.9	260	
UV-A-E20	E-20	FACULTY	BREAKROOMS	687	50	35	5	175	0.12	82	257	0.9	290	
UV-A-E21	E-21	RESOURCE	CLASSROOMS (AGE 9 PLUS)	275	35	10	10	100	0.12	33	133	0.9	150	
NOTES: UV EZ = AIR DISTRIBUTION CONFIGURATION, Voz = ZONE OUTDOOR AIRFLOW														

S.E.D. Control No. 13-02-00-01-0-002-021

Rev. No.: Date: Description:



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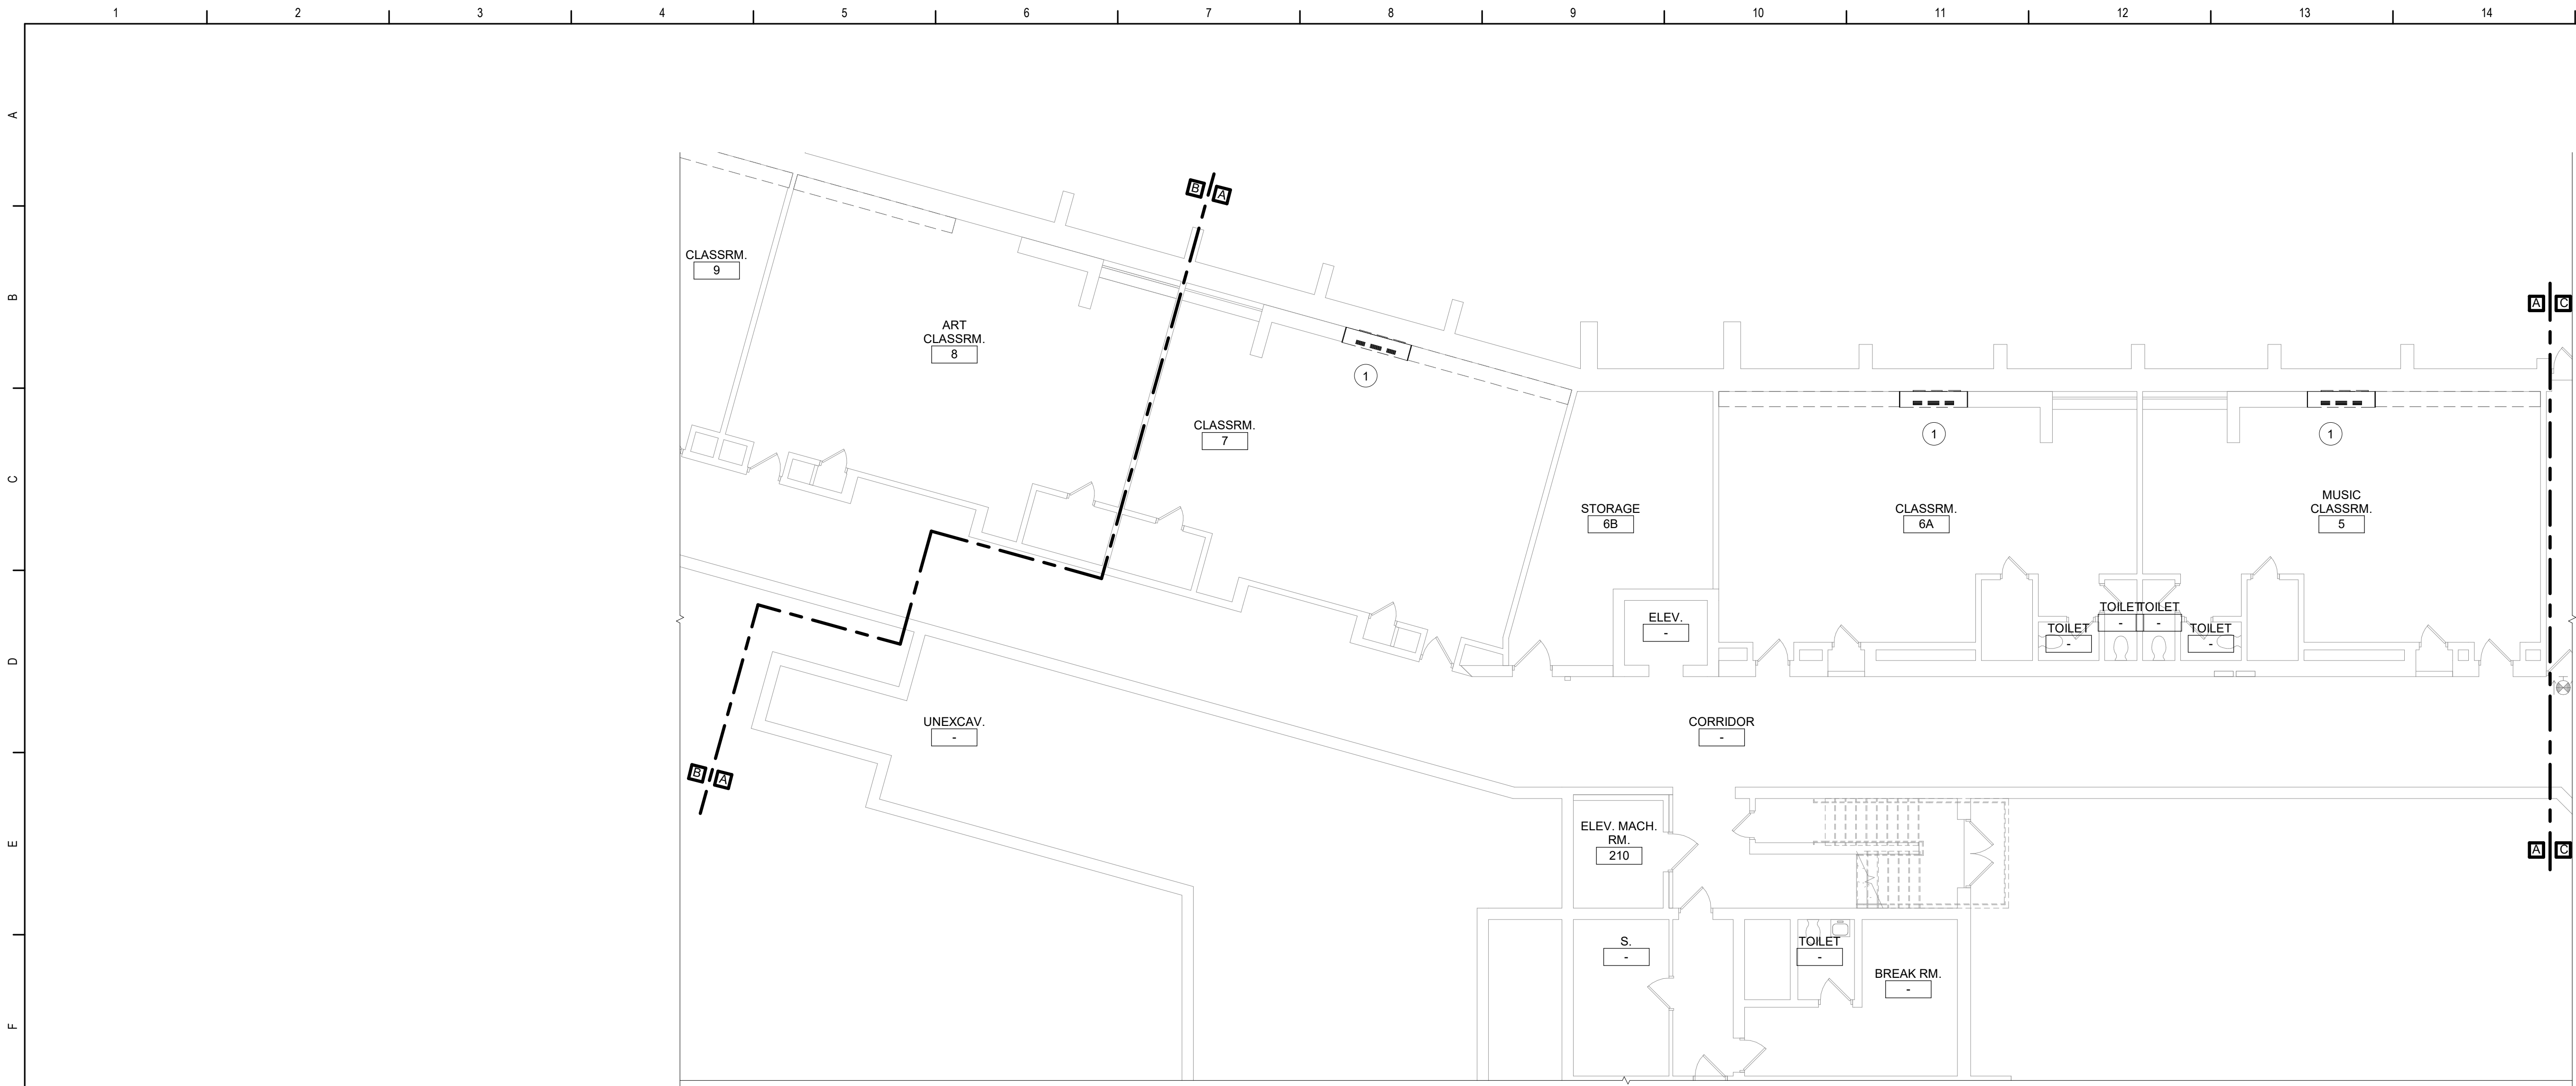


Beacon City School District
Beacon, New York


Reconstruction to:
JV Forrestal Elementary School

Schedules

Drawn By: JPF1/pgm	Date: 10/28/2022</
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1 Ground Floor Demolition Plan - Area A
1/8" = 1'-0"



2 Ground Floor Power Plan - Area A
1/8" = 1'-0"

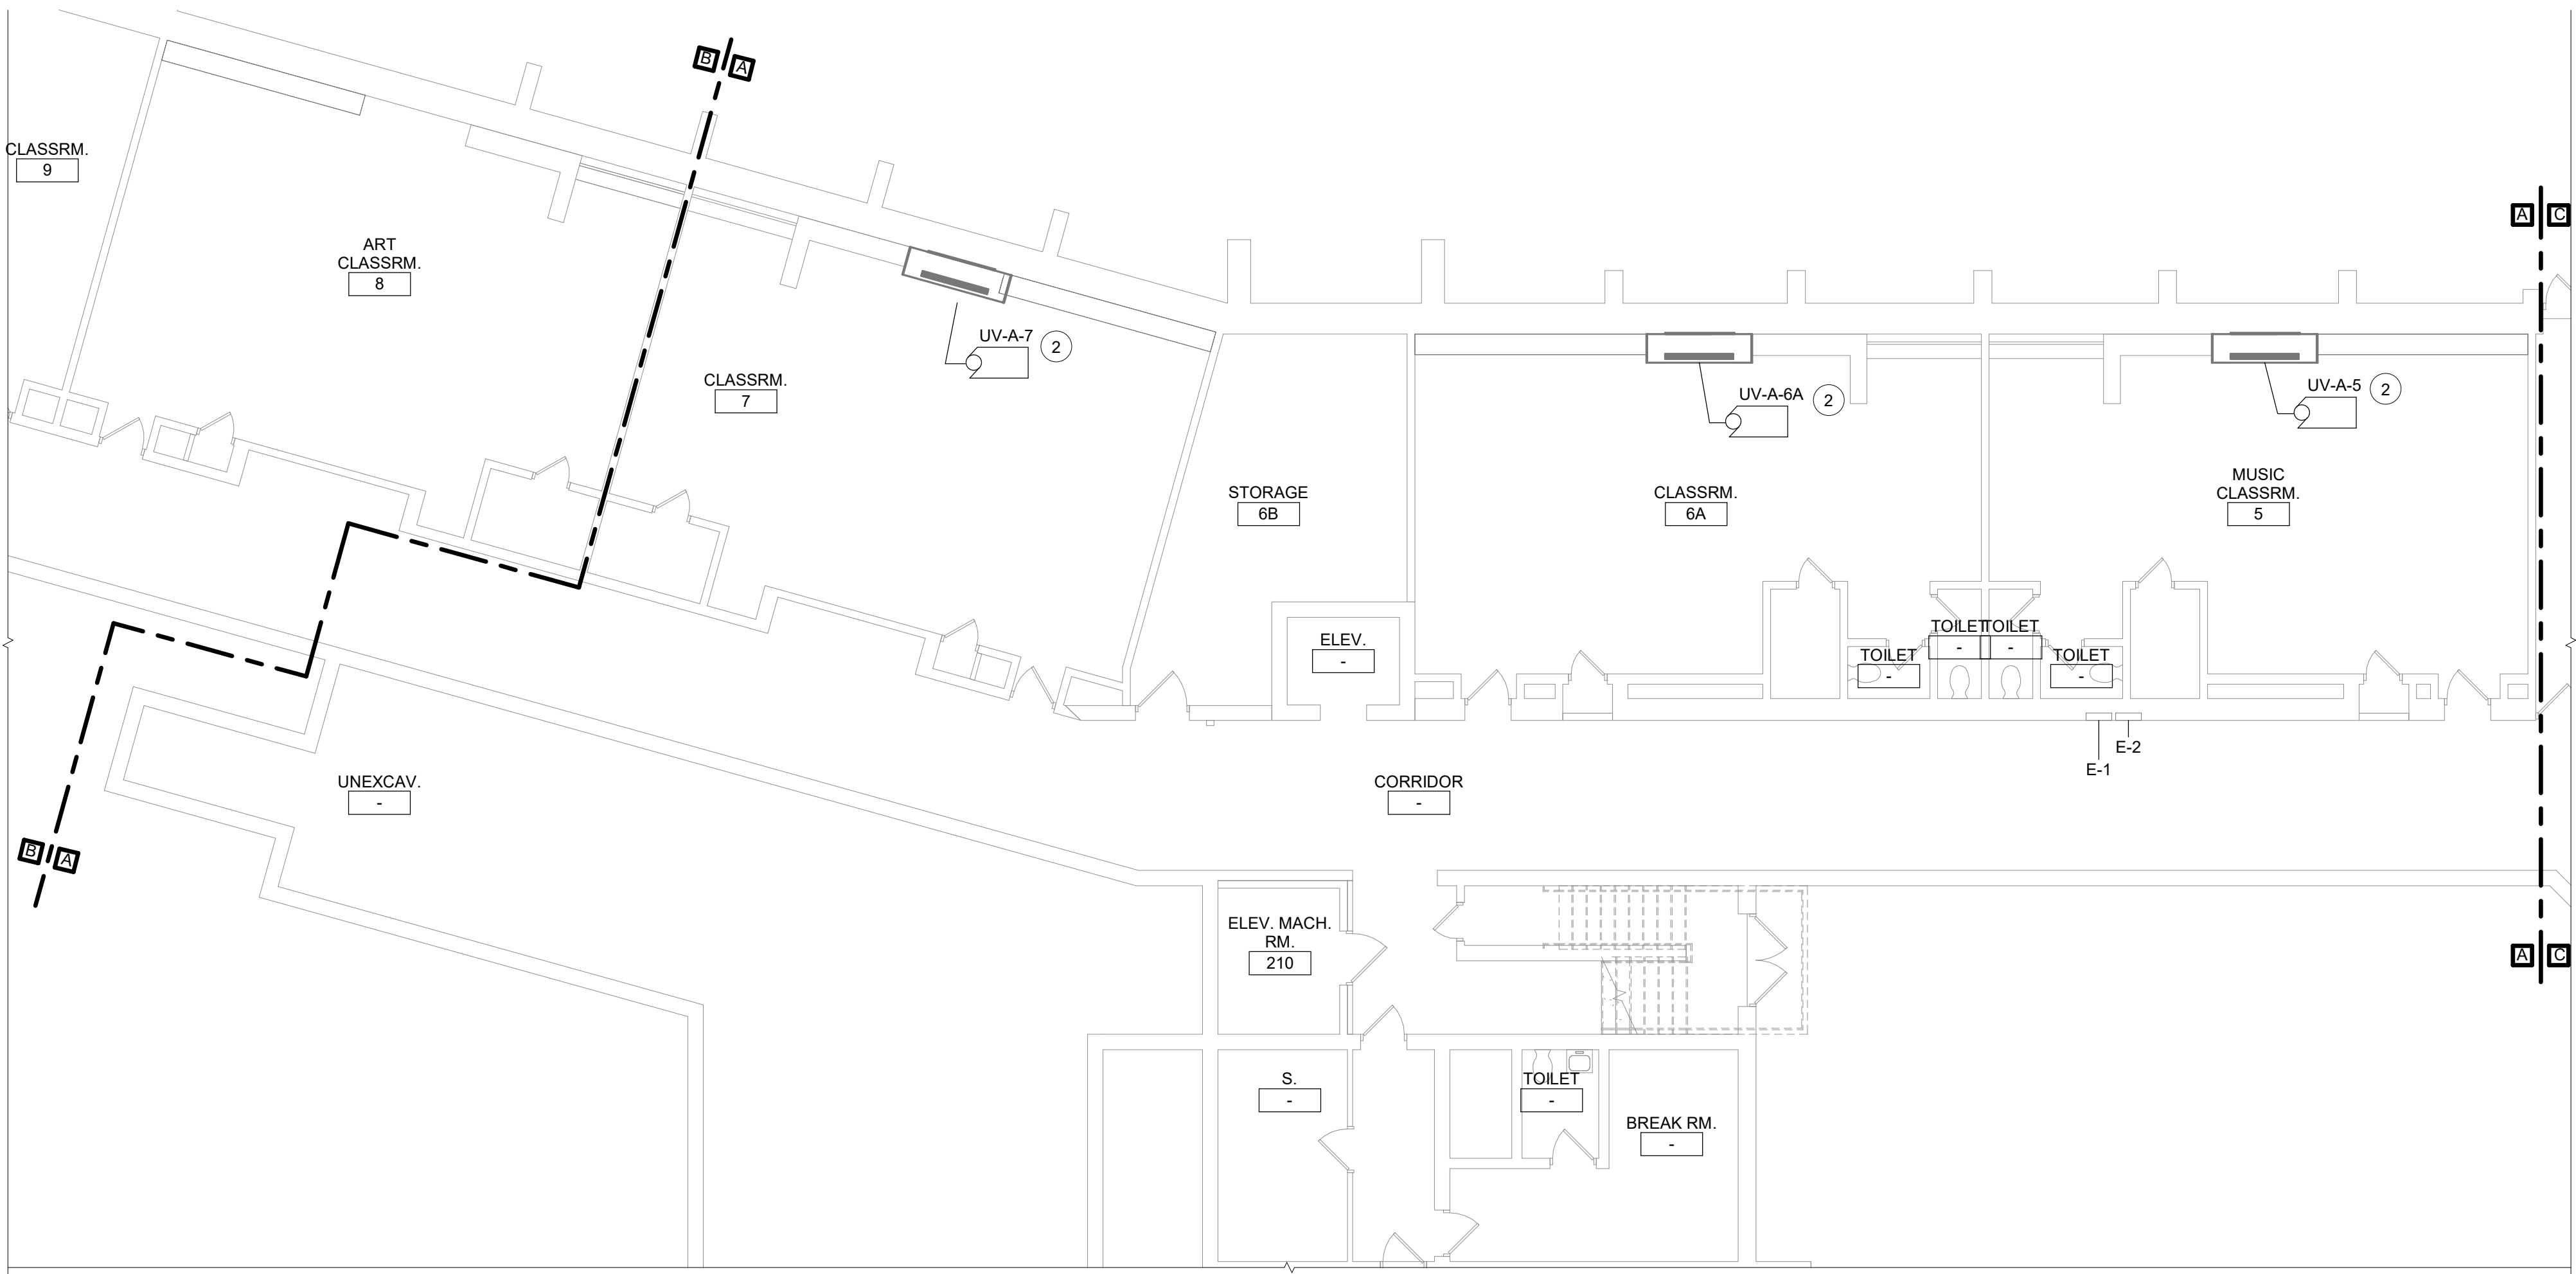Demolition General Notes


- A. ALL ELECTRICAL DEVICES INTERFERING WITH DEMOLITION WORK SHALL BE DISCONNECTED AND REMOVED, UNLESS OTHERWISE NOTED. EXISTING CIRCUIT WIRING SHALL BE REMOVED BACK TO SOURCE AND PANEL DIRECTORIES MODIFIED ACCORDINGLY.
- B. ANY DEVICE INTERFERING WITH DEMOLITION WORK NOT SHOWN ON THESE DRAWINGS SHALL NOT BE REMOVED WITHOUT WRITTEN AUTHORIZATION FROM THE OWNER'S REPRESENTATIVE OR THE ENGINEER.
- C. ALL ELECTRICAL DEMOLITION WORK SHALL BE PROPERLY COORDINATED WITH ALL OTHER TRADES.

Keyed Notes:


- 1 DISCONNECT POWER CIRCUITRY TO HVAC EQUIPMENT AND TAG FOR RE-USE.
- 2 RECONNECT TAGGED POWER CIRCUITRY TO HVAC EQUIPMENT. MODIFY/EXTEND CIRCUITRY AS NECESSARY.

General Notes

- A. COORDINATE ALL ELECTRICAL WORK AND POWER OUTAGES WITH OWNER AND OTHER TRADES PRIOR TO THE START OF CONSTRUCTION. NO POWER OUTAGES SHALL OCCUR WITHOUT OWNER'S PRIOR KNOWLEDGE AND CONSENT.
 - B. REFER TO DRAWING G100 FOR STANDARD SYMBOLS AND ABBREVIATIONS.
 - C. PROPERLY IDENTIFY ALL CIRCUITS AT PANELS AND J-BOXES AND IN ACCORDANCE WITH PROJECT SPECIFICATIONS.
 - D. PROVIDE ALL ADAPTERS, COUPLINGS AND ASSOCIATED FITTINGS REQUIRED FOR COMPLETE OPERATIONAL SYSTEM.
 - E. WHEN INSTALLING NEW DEVICES IN EXISTING LOCATIONS, REUSE EXISTING CONDUIT/RACEWAY AND BACK BOXES IF IN GOOD CONDITION. EXTEND/INSTALL NEW CONDUIT/RACEWAY AS REQUIRED FOR PROPER MOUNTING OF DEVICE. CONCEAL ABOVE CEILINGS OR WITHIN WALLS WHERE POSSIBLE. REFER TO SPECIFICATION SECTION 26 05 33.
 - F. COORDINATE ALL ELECTRICAL WORK WITH OTHER TRADES.
 - G. TESTS OF ALL ELECTRICAL WORK SHALL BE PERFORMED IN THE PRESENCE OF THE ENGINEER OR ARCHITECT, AS EQUIPMENT IS INSTALLED AND AS SYSTEMS ARE COMPLETED. IN ADDITION AN ELECTRIC APPROVED CERTIFICATE SHALL BE ISSUED BY AN ELECTRICAL INSPECTION AGENCY.
 - H. UNLESS NOTED ELSEWHERE ON THE CONTRACT DOCUMENTS, THE FOLLOWING LIST REPRESENTS THE TYPICAL MOUNTING HEIGHTS FOR THE DEVICES SHOWN:
 - 1. SWITCHES AND PANIC STATIONS.....48" (TO TOP)
 - 2. RECEPTACLES.....16"
 - 3. COMPUTER RECEPTACLES.....48" (TO TOP)
 - 4. WALL (W) TELEPHONE AND CALL SWITCHES.....48" (TO TOP)
 - 5. TELEPHONE OUTLETS (UNLABELED).....16"
 - 6. VOLUME CONTROLS.....48" (TO TOP)
 - 7. TELEVISION OUTLETS.....16"
 - 8. FIRE ALARM PULL STATIONS.....48" (TO TOP)
 - 9. FIRE ALARM AUDIO/VISUAL UNITS.....88" * (OR 6" BELOW CEILING, WHICHEVER IS LOWER)
 - 10. POWER PANELS.....72" (TO TOP)
 - 11. DISCONNECT SWITCHES.....60" (TO TOP)
 - 12. MOTOR STARTERS.....60" (TO TOP)
- THE HEIGHTS INDICATED SHALL BE NOMINAL TO THE BOTTOM OF THE BOX UNLESS NOTED OTHERWISE. MAINTAIN HEIGHT CONSISTENCY BETWEEN NEW AND EXISTING DEVICES.

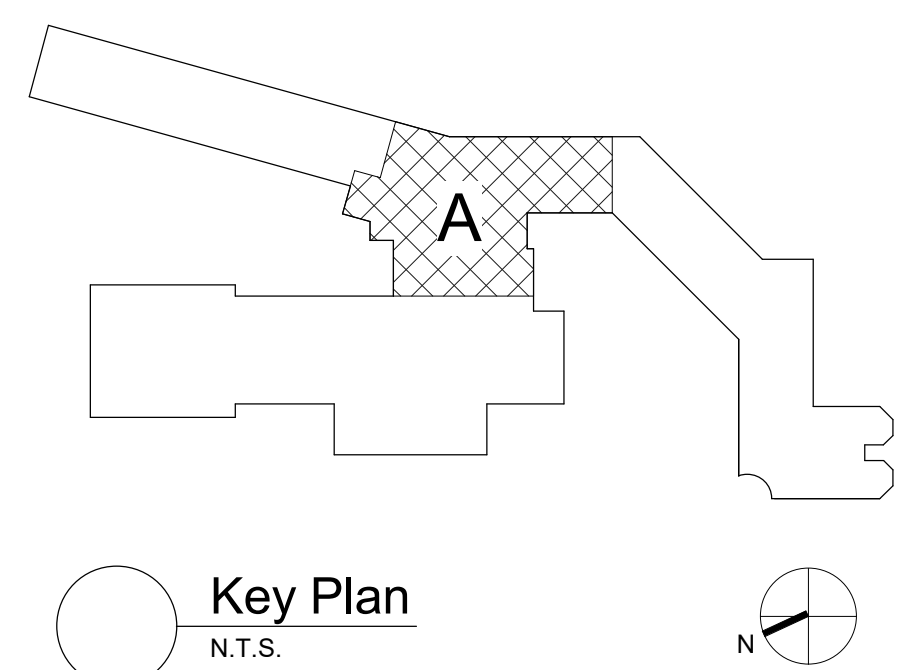

S.E.D. Control No. 13-02-00-01-0-002-021

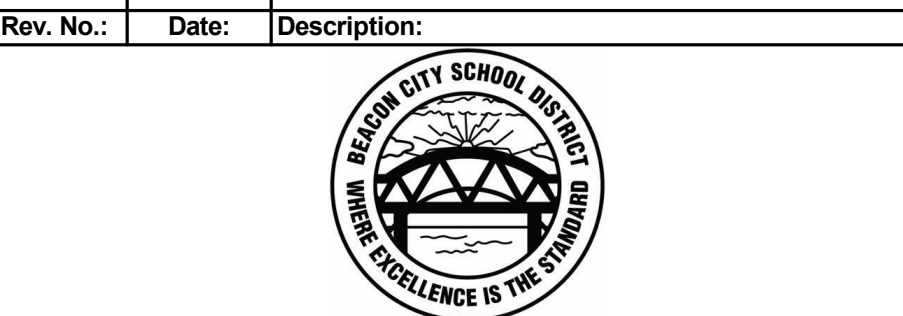

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BID SET



Beacon City School District
Beacon, New York

Reconstruction to:
JV Forrestral Elementary School

Ground Floor Plans - Area A

Drawn By: SAS
Date: 10/28/2022
Project No.: 279180-22004
Drawing Number: AE100




Keyed Notes:

- 1 DISCONNECT POWER CIRCUITRY TO HVAC EQUIPMENT AND TAG FOR RE-USE.
- 2 RECONNECT TAGGED POWER CIRCUITRY TO HVAC EQUIPMENT. MODIFY/EXTEND CIRCUITRY AS NECESSARY.


General Notes:

- A. REFER TO DRAWING AE100 FOR GENERAL NOTES

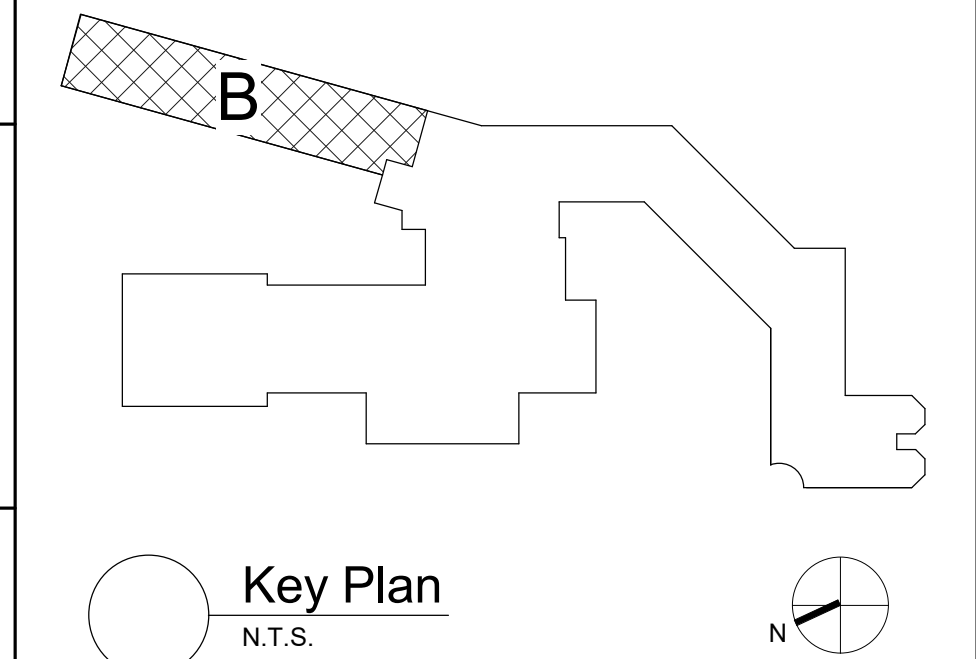

S.E.D. Control No. 13-02-00-01-0-002-021

Rev. No.:	Date:	Description:

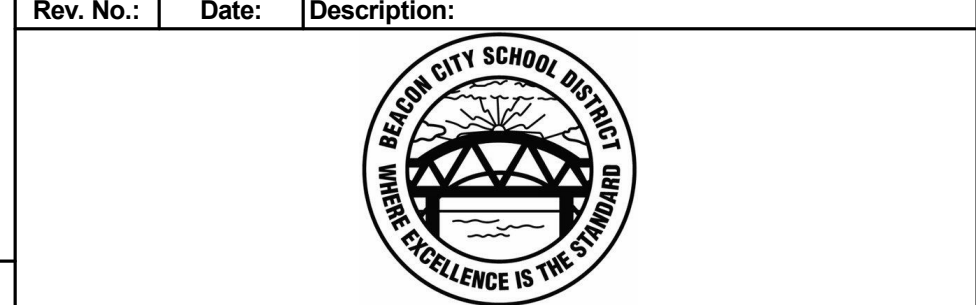

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BID SET




Beacon City School District
Beacon, New York

Reconstruction to:
JV Forrestal Elementary School

Ground Floor Plans - Area B

Drawn By: SAS	Date: 10/28/2022	Drawing Number:
Project No.: 279180-22004	AE101	

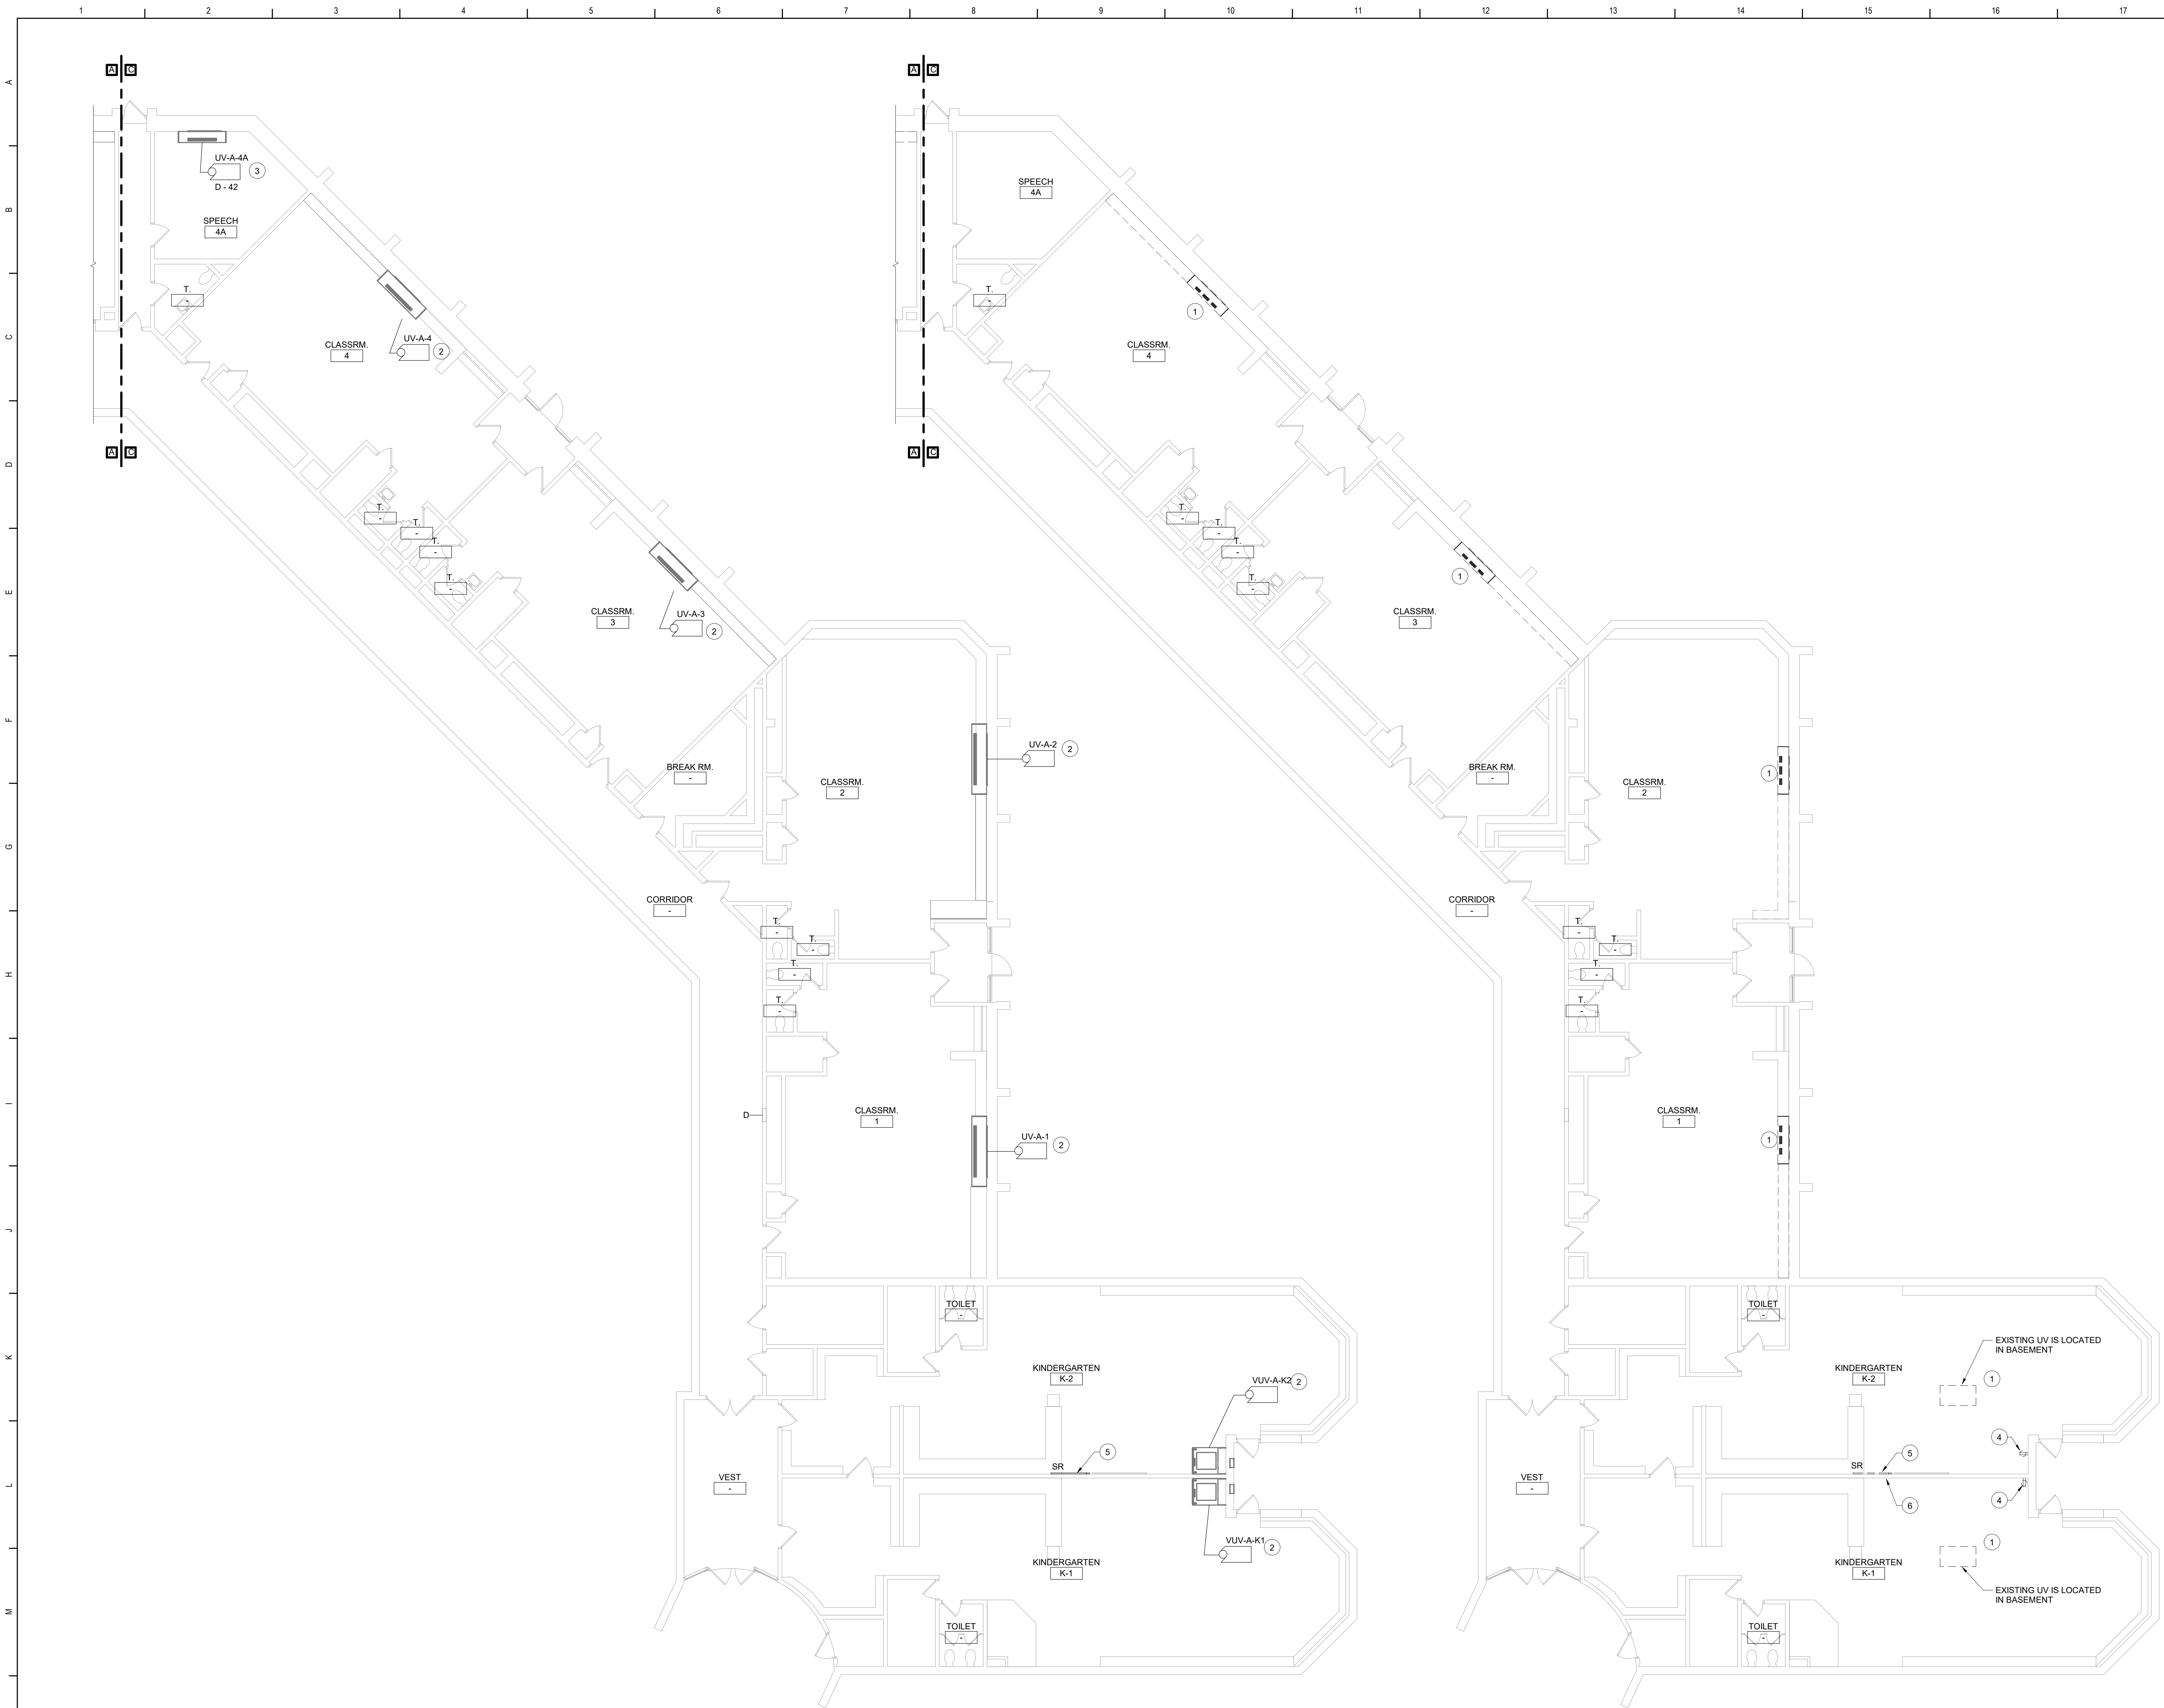


2 Ground Floor Power Plan - Area C
1/8" = 1'-0"

1 Ground Floor Demolition Plan - Area C
1/8" = 1'-0"


- Keyed Notes:**
- 1 DISCONNECT POWER CIRCUITRY TO HVAC EQUIPMENT AND TAG FOR RE-USE.
 - 2 RECONNECT TAGGED POWER CIRCUITRY TO HVAC EQUIPMENT. MODIFY/EXTEND CIRCUITRY AS NECESSARY.
 - 3 CONNECT TO SPARE 20A1P BREAKER IN EXISTING PANEL D USING (2)#12, (1)#12 G. IN 1/2" CONDUIT. AMEND PANEL DIRECTORY.
 - 4 REMOVE RECEPTACLE AND WIREMOLD COMPLETE BACK TO SOURCE.
 - 5 RELOCATE SURFACE RACEWAY, RECEPTACLE(S), DATA OUTLET(S) AND CIRCUITRY TO BE BELOW SOFFIT. MODIFY/EXTEND CIRCUITRY AS NECESSARY. REPLACE DATA CABLING IF THERE IS NOT SUFFICIENT SLACK TO REACH THE RELOCATED DATA OUTLET.
 - 6 RELOCATE WIREMOLD INTERFERING WITH SOFFIT CONSTRUCTION. MODIFY/EXTEND CIRCUITRY AS NECESSARY.

- General Notes:**
- A. REFER TO DRAWING AE100 FOR GENERAL NOTES

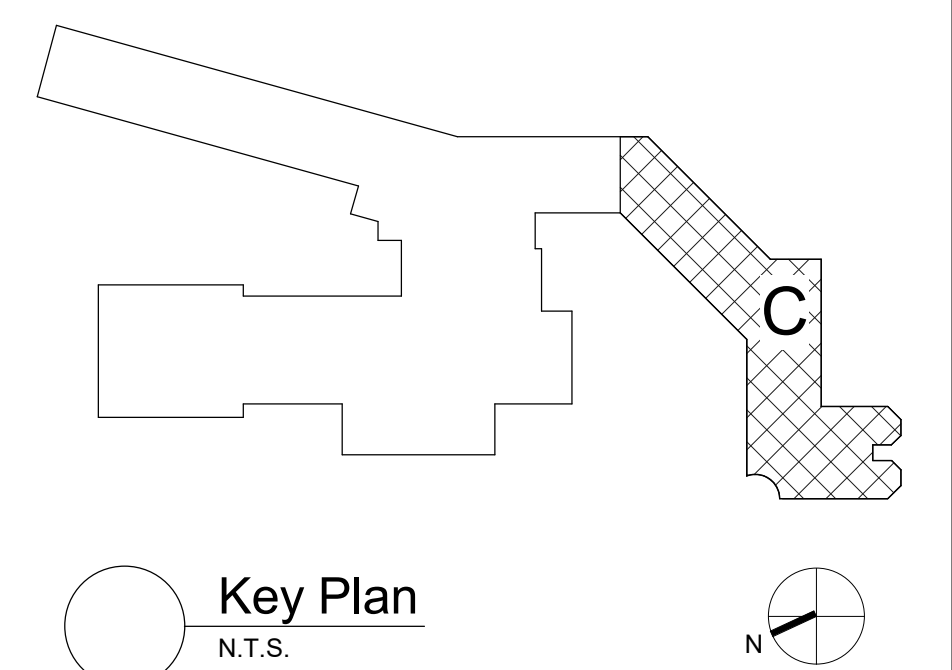

S.E.D. Control No. 13-02-00-01-0-002-021

Rev. No.:	Date:	Description:

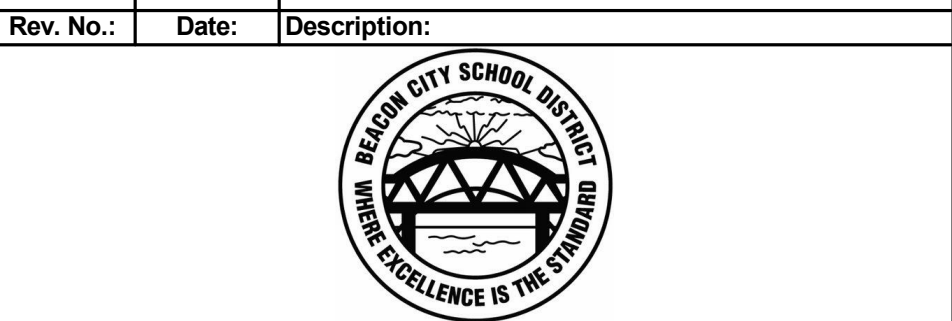

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BID SET




Beacon City School District
Beacon, New York

Reconstruction to:
JV Forrestal Elementary School

Ground Floor Plans - Area C

Drawn By: SAS	Date: 10/28/2022	Drawing Number:
Project No.: 279180-22004	AE102	

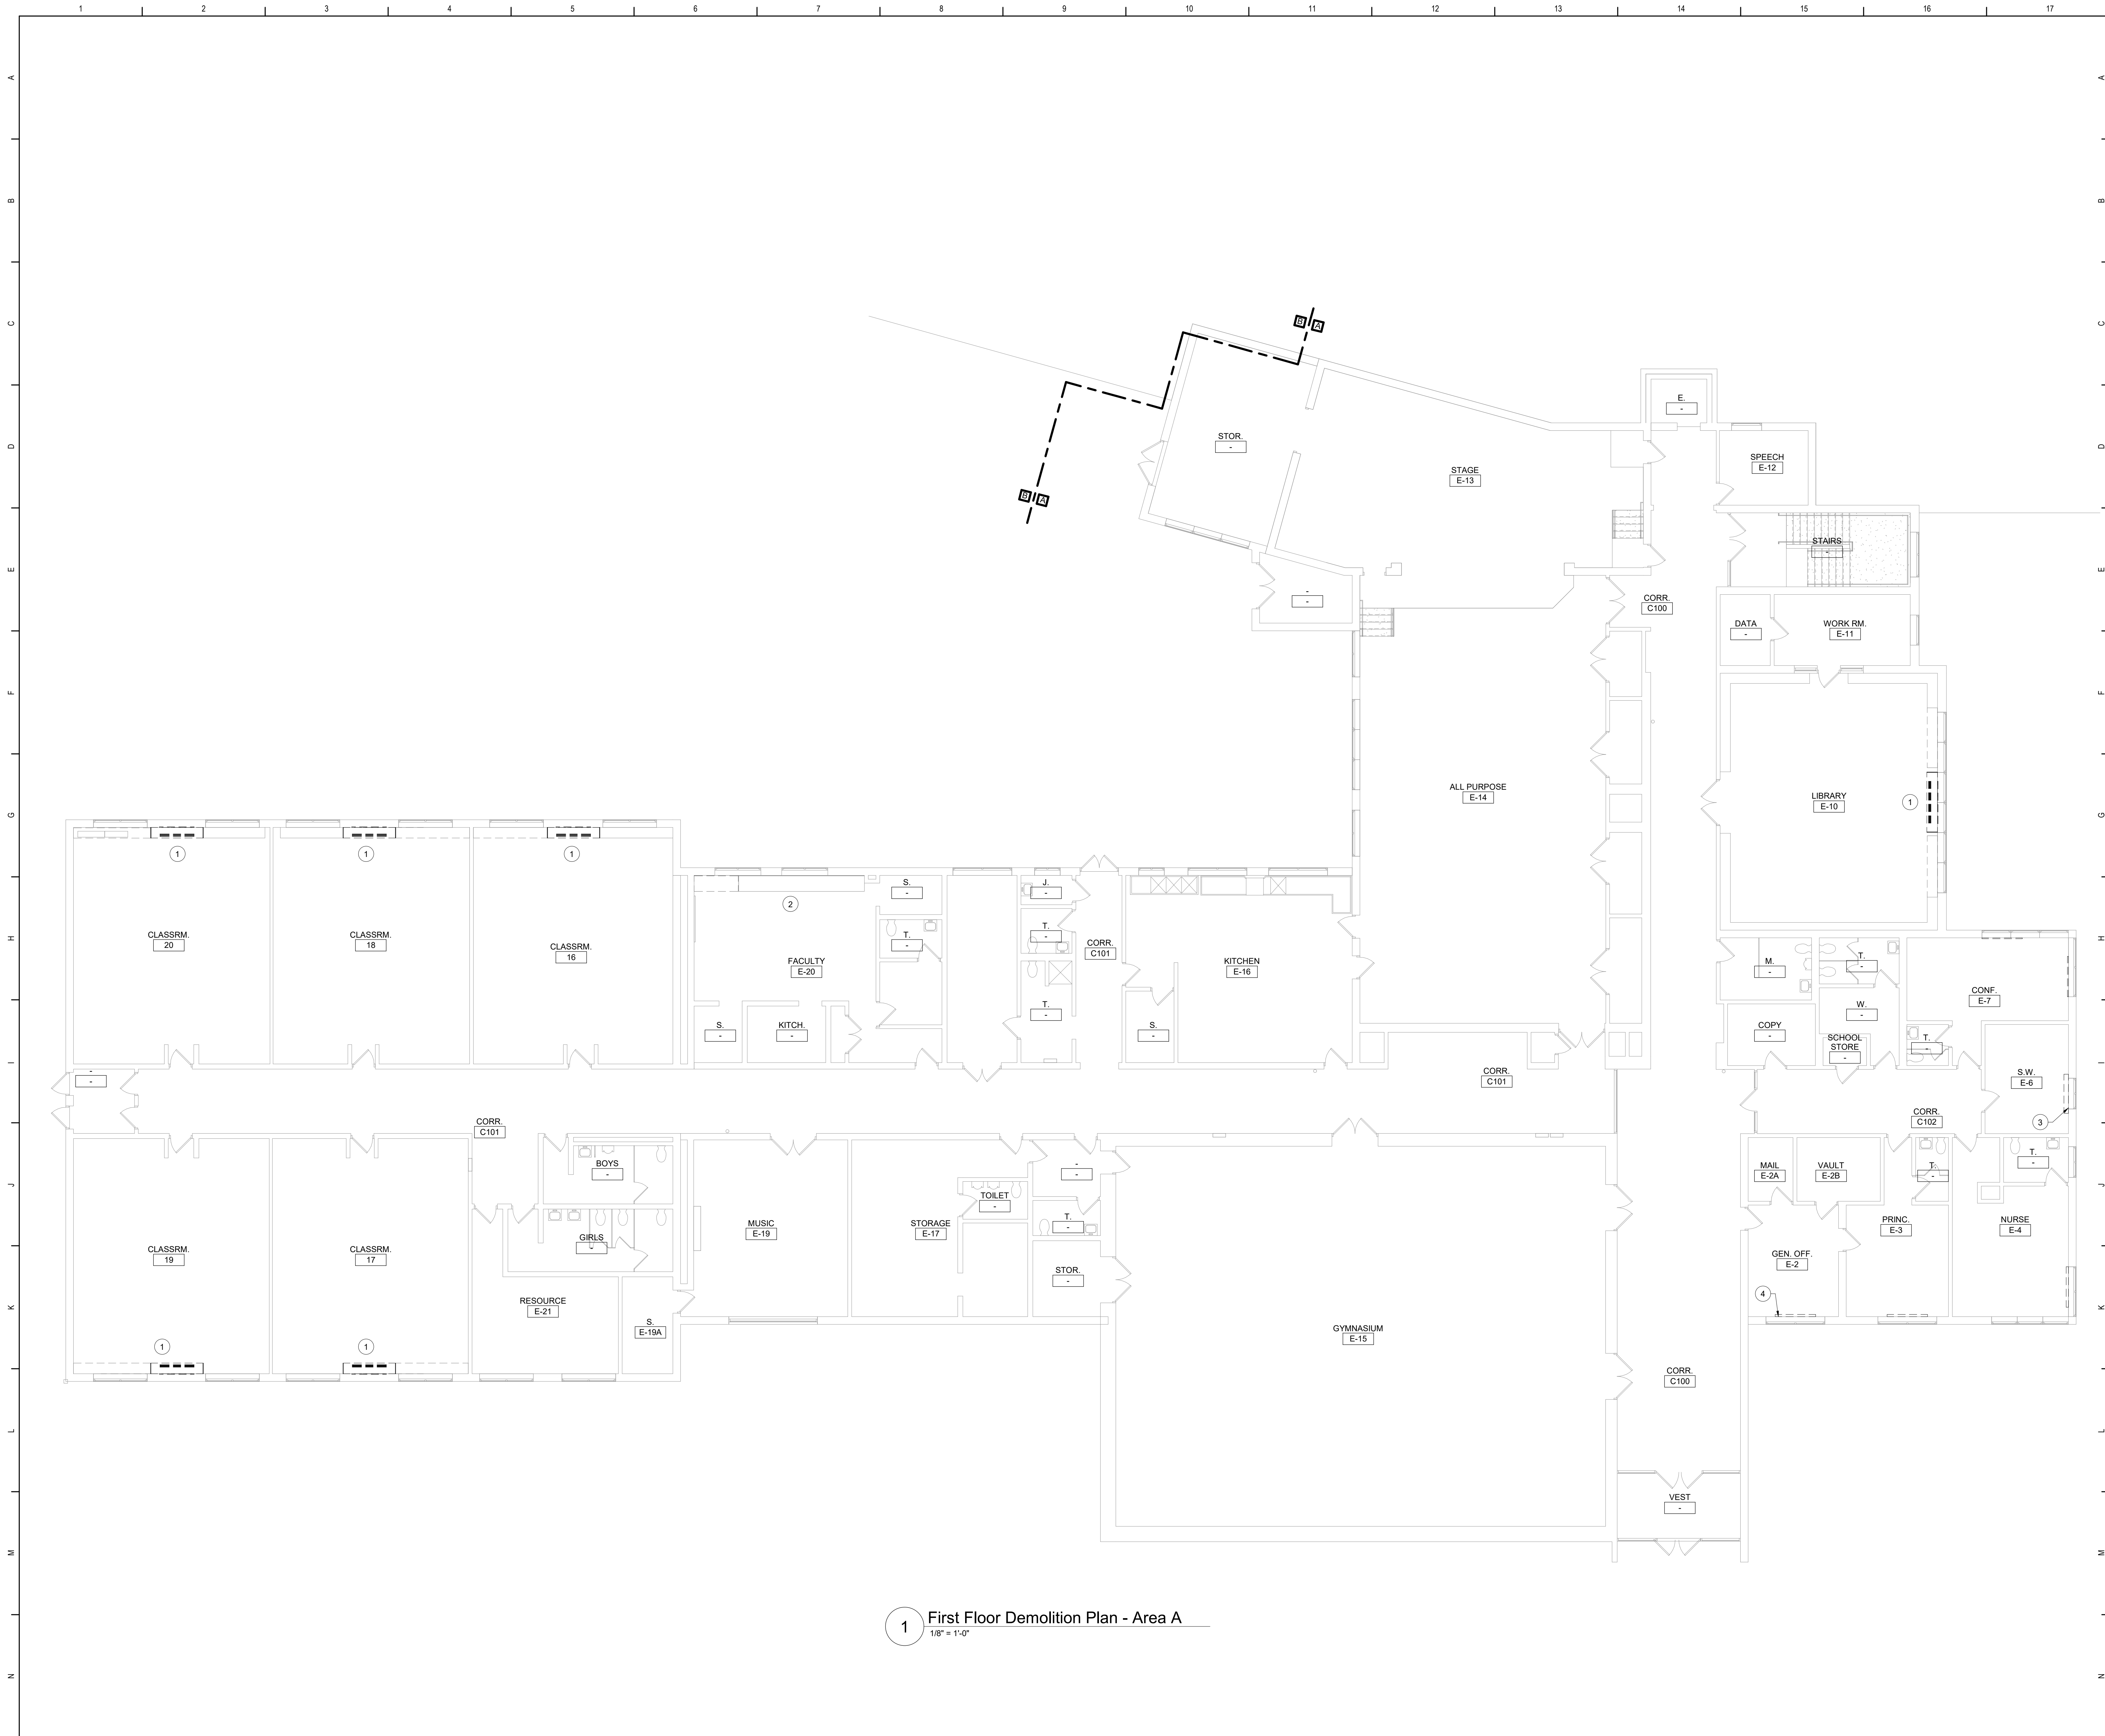


1 First Floor Demolition Plan - Area A
1/8" = 1'-0"

Keyed Notes:

- 1 DISCONNECT POWER CIRCUITRY TO HVAC EQUIPMENT AND TAG FOR RE-USE.
- 2 REMOVE RECEPTACLES AND WIREMOLD UNDER COUNTER IN FACULTY E-20 AND PREPARE FOR RE-INSTALLATION.
- 3 REMOVE RECEPTACLE AND WIREMOLD UNDER WINDOW IN S.W. E-6 AND PREPARE FOR RE-INSTALLATION.
- 4 REMOVE RECEPTACLES, WIREMOLD AND SURFACE RACEWAY UNDER WINDOW IN GEN. OFF. E-2 AND PREPARE FOR RE-INSTALLATION.

General Notes:

- A. REFER TO DRAWING AE100 FOR GENERAL NOTES

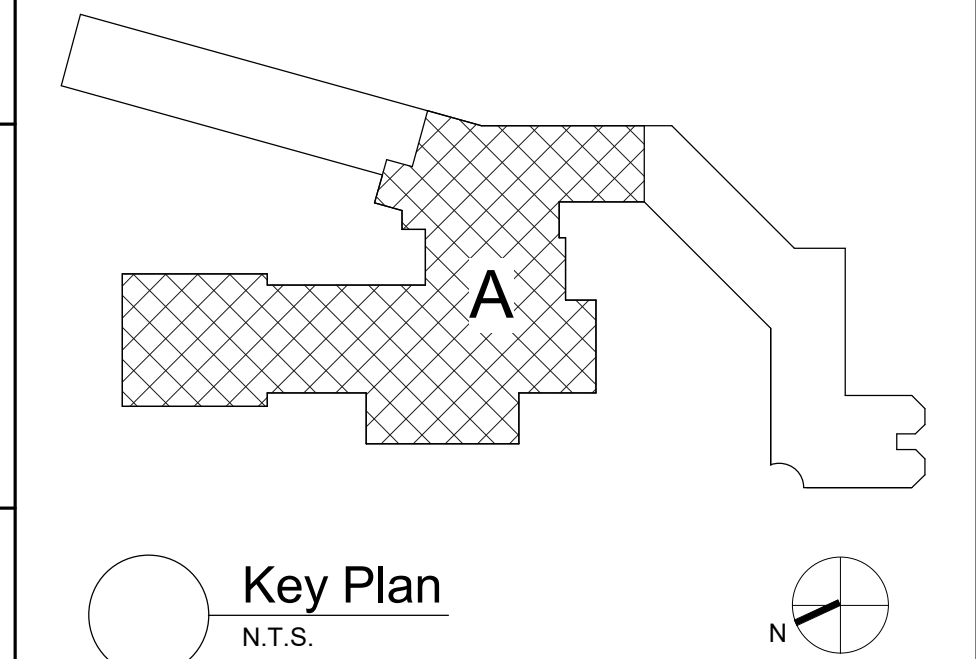

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Rev. No.	Date	Description



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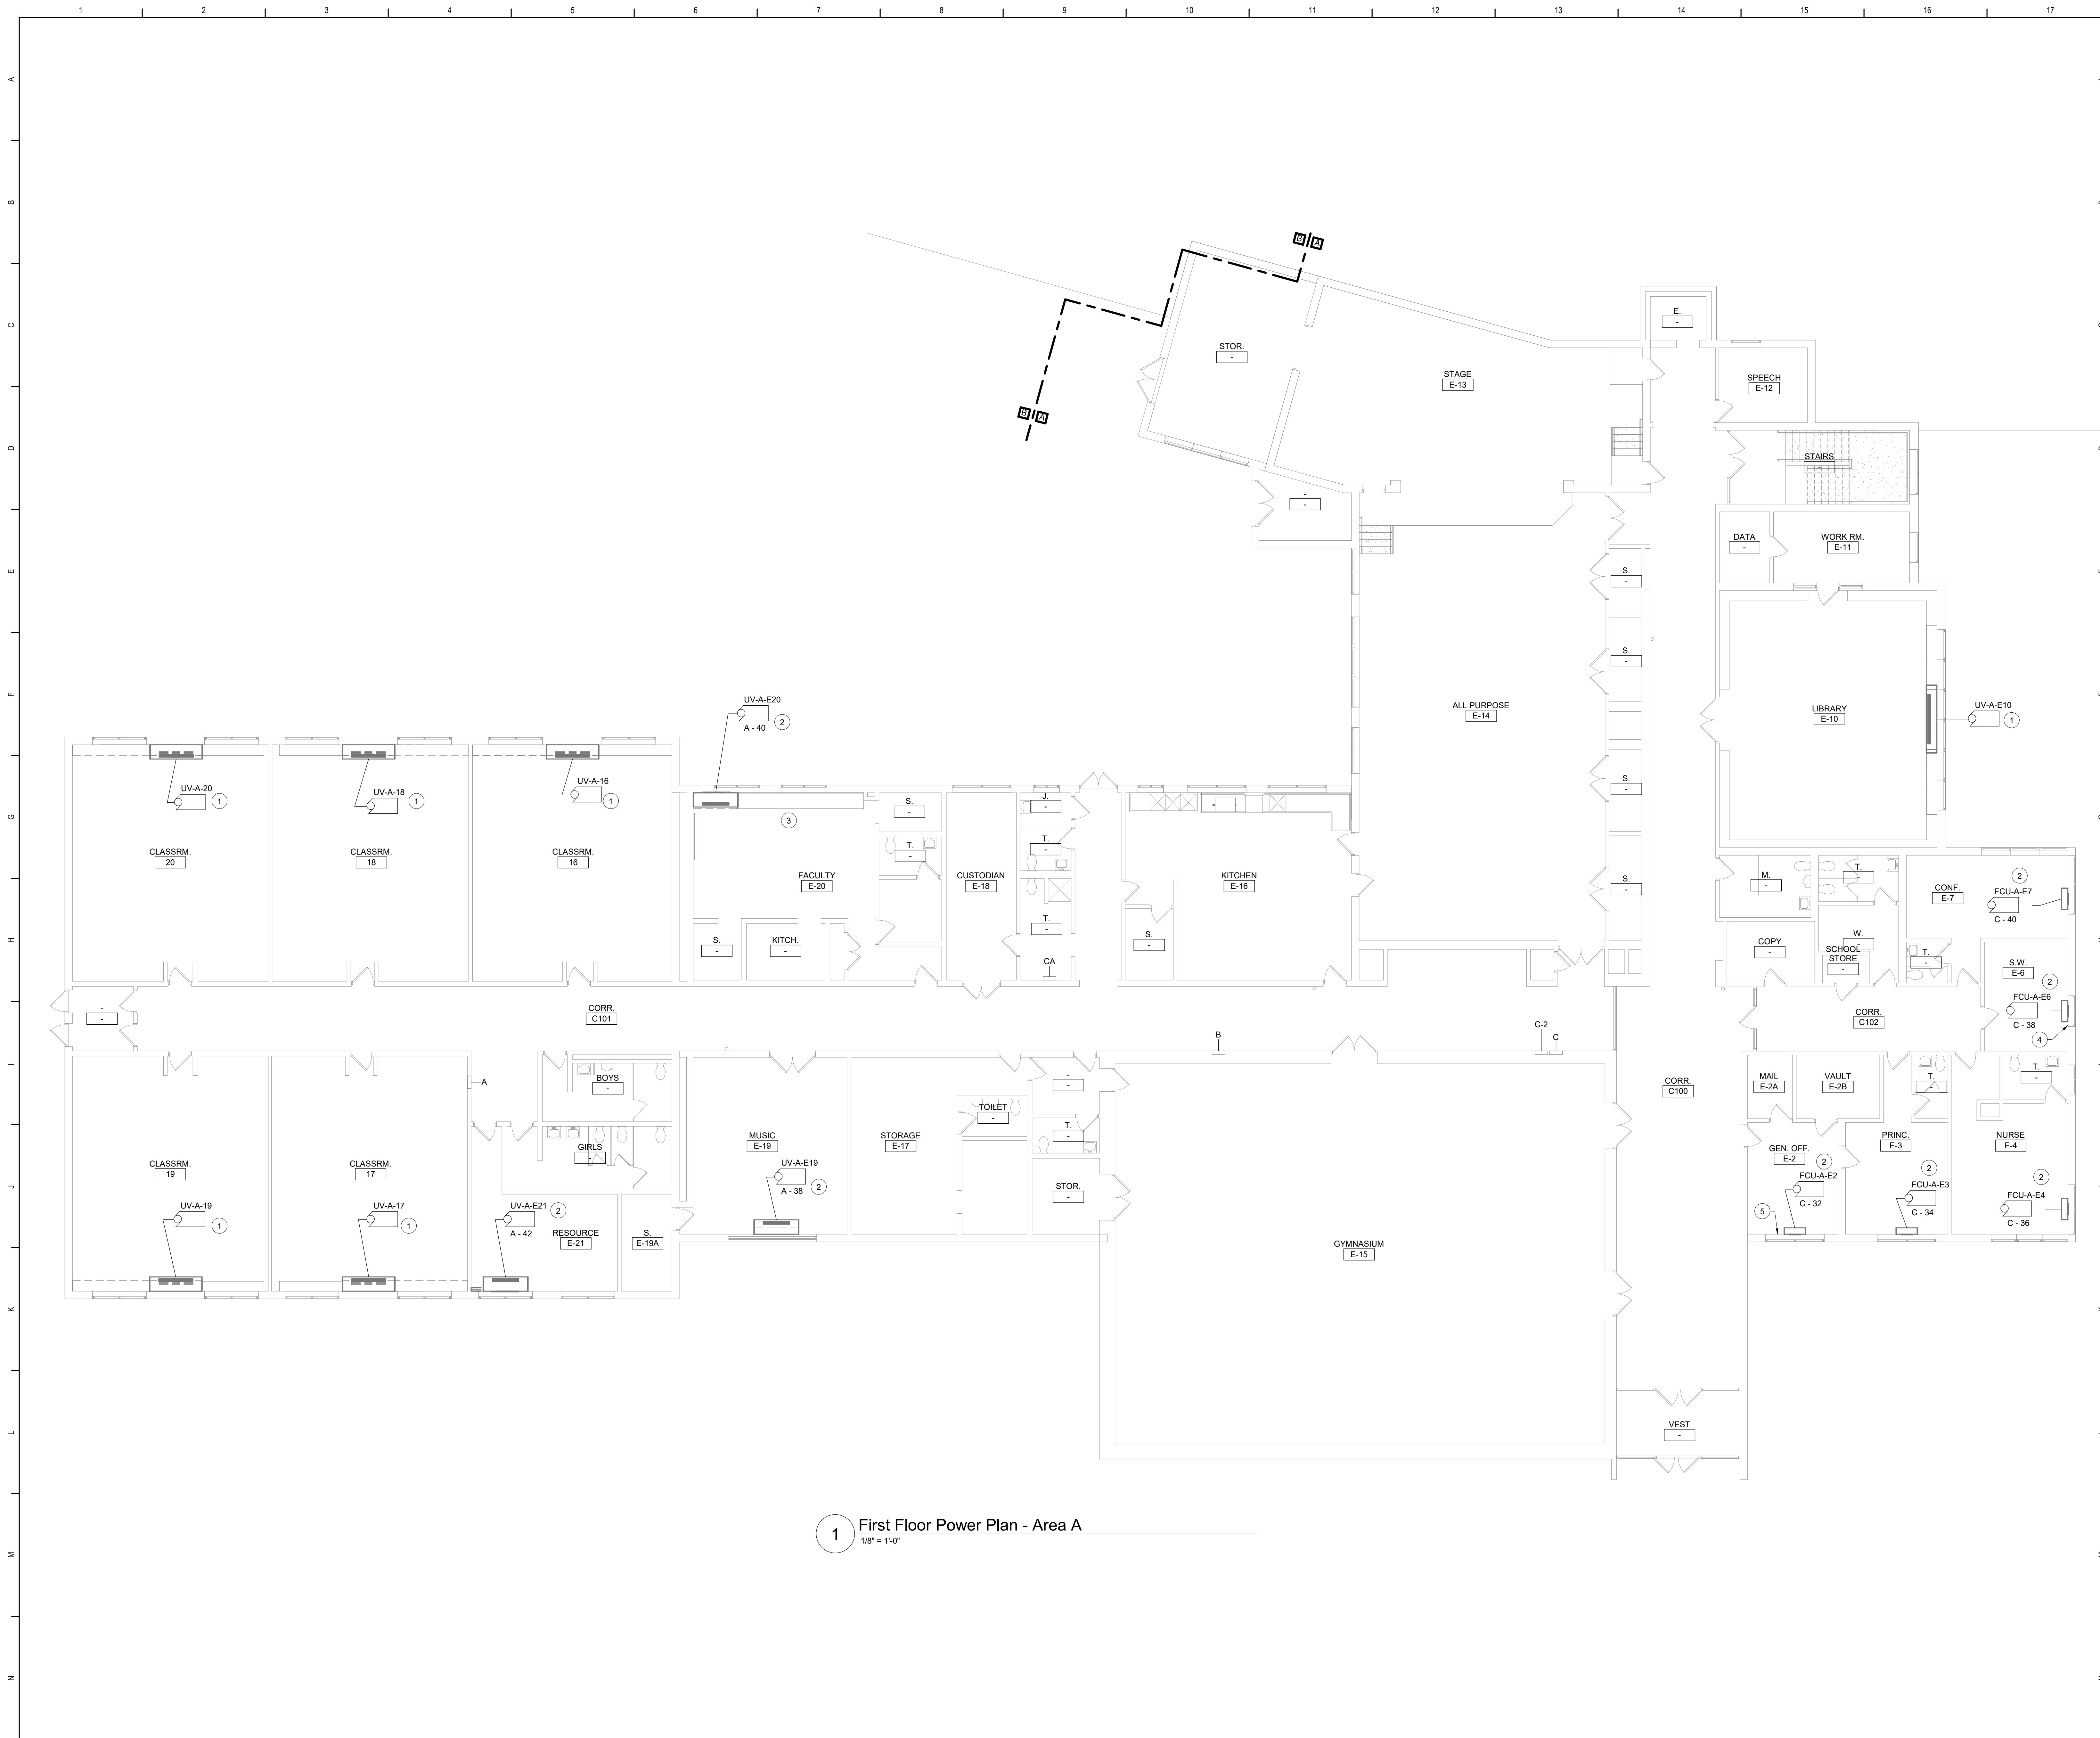


Beacon City School District
Beacon, New York

Reconstruction to:
JV Forrestal Elementary School

First Floor Demolition Plan - Area A

Drawn By: SAS	Date: 10/28/2022	Drawing Number:
Project No.: 279180-22004	AE103	




1 First Floor Power Plan - Area A
1/8" = 1'-0"

Keyed Notes:

- 1 RECONNECT TAGGED POWER CIRCUITRY TO HVAC EQUIPMENT. MODIFY/EXTEND CIRCUITRY AS NECESSARY.
- 2 CONNECT TO SPARE 20A1P BREAKER IN EXISTING PANEL INDICATED USING (2)#12, (1)#12 G. IN 1/2" CONDUIT. AMEND PANEL DIRECTORY.
- 3 RE-INSTALL RECEPTACLES AND WIREMOLD ABOVE COUNTER IN FACULTY E-20. MODIFY/EXTEND CIRCUITRY AS NECESSARY.
- 4 RE-INSTALL RECEPTACLE AND WIREMOLD IN S.W. E-6 AFTER FCU-A-E6 IS INSTALLED. MODIFY/EXTEND CIRCUITRY AS NECESSARY.
- 5 RE-INSTALL RECEPTACLES, WIREMOLD AND SURFACE RACEWAY IN GEN. OFF. E-2 AFTER FCU-A-E2 IS INSTALLED. MODIFY/EXTEND CIRCUITRY AS NECESSARY.


General Notes:

- A. REFER TO DRAWING AE100 FOR GENERAL NOTES

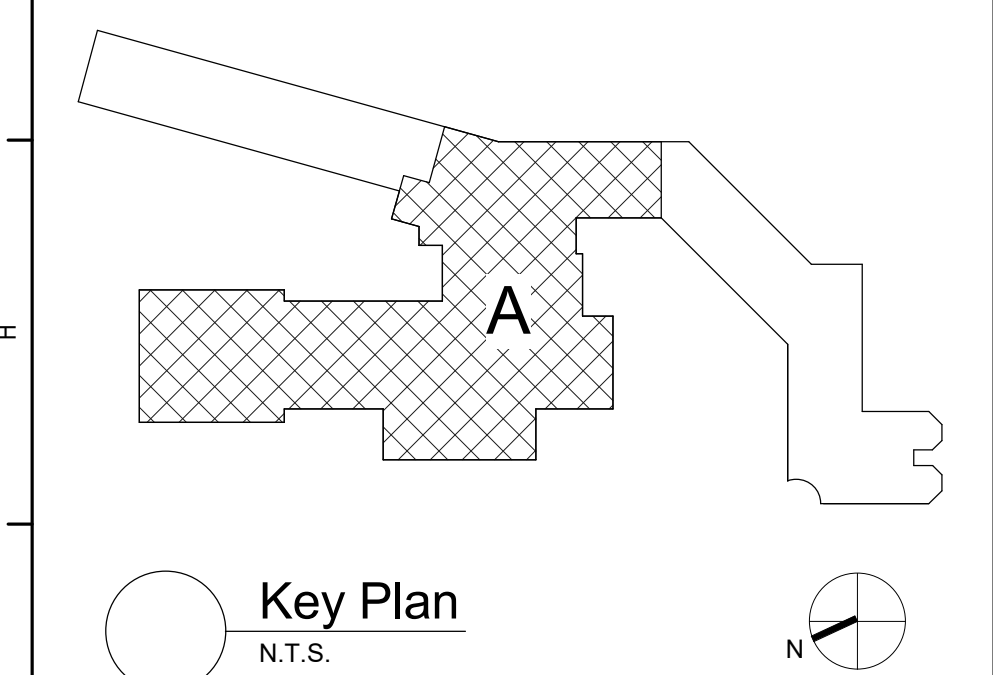

S.E.D. Control No. 13-02-00-01-0-002-021

Rev. No.	Date	Description

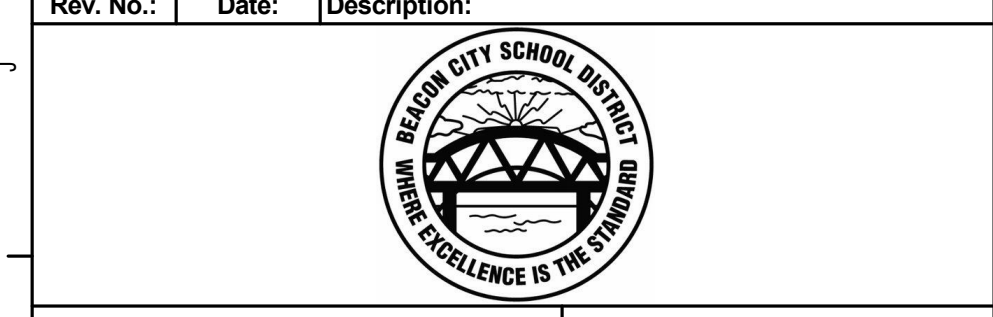

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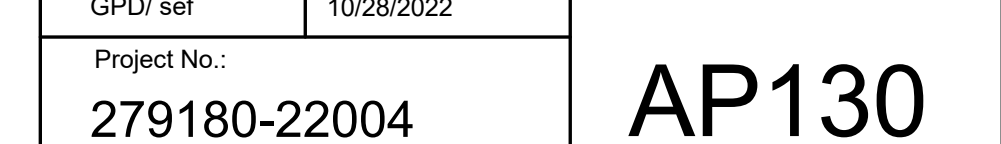
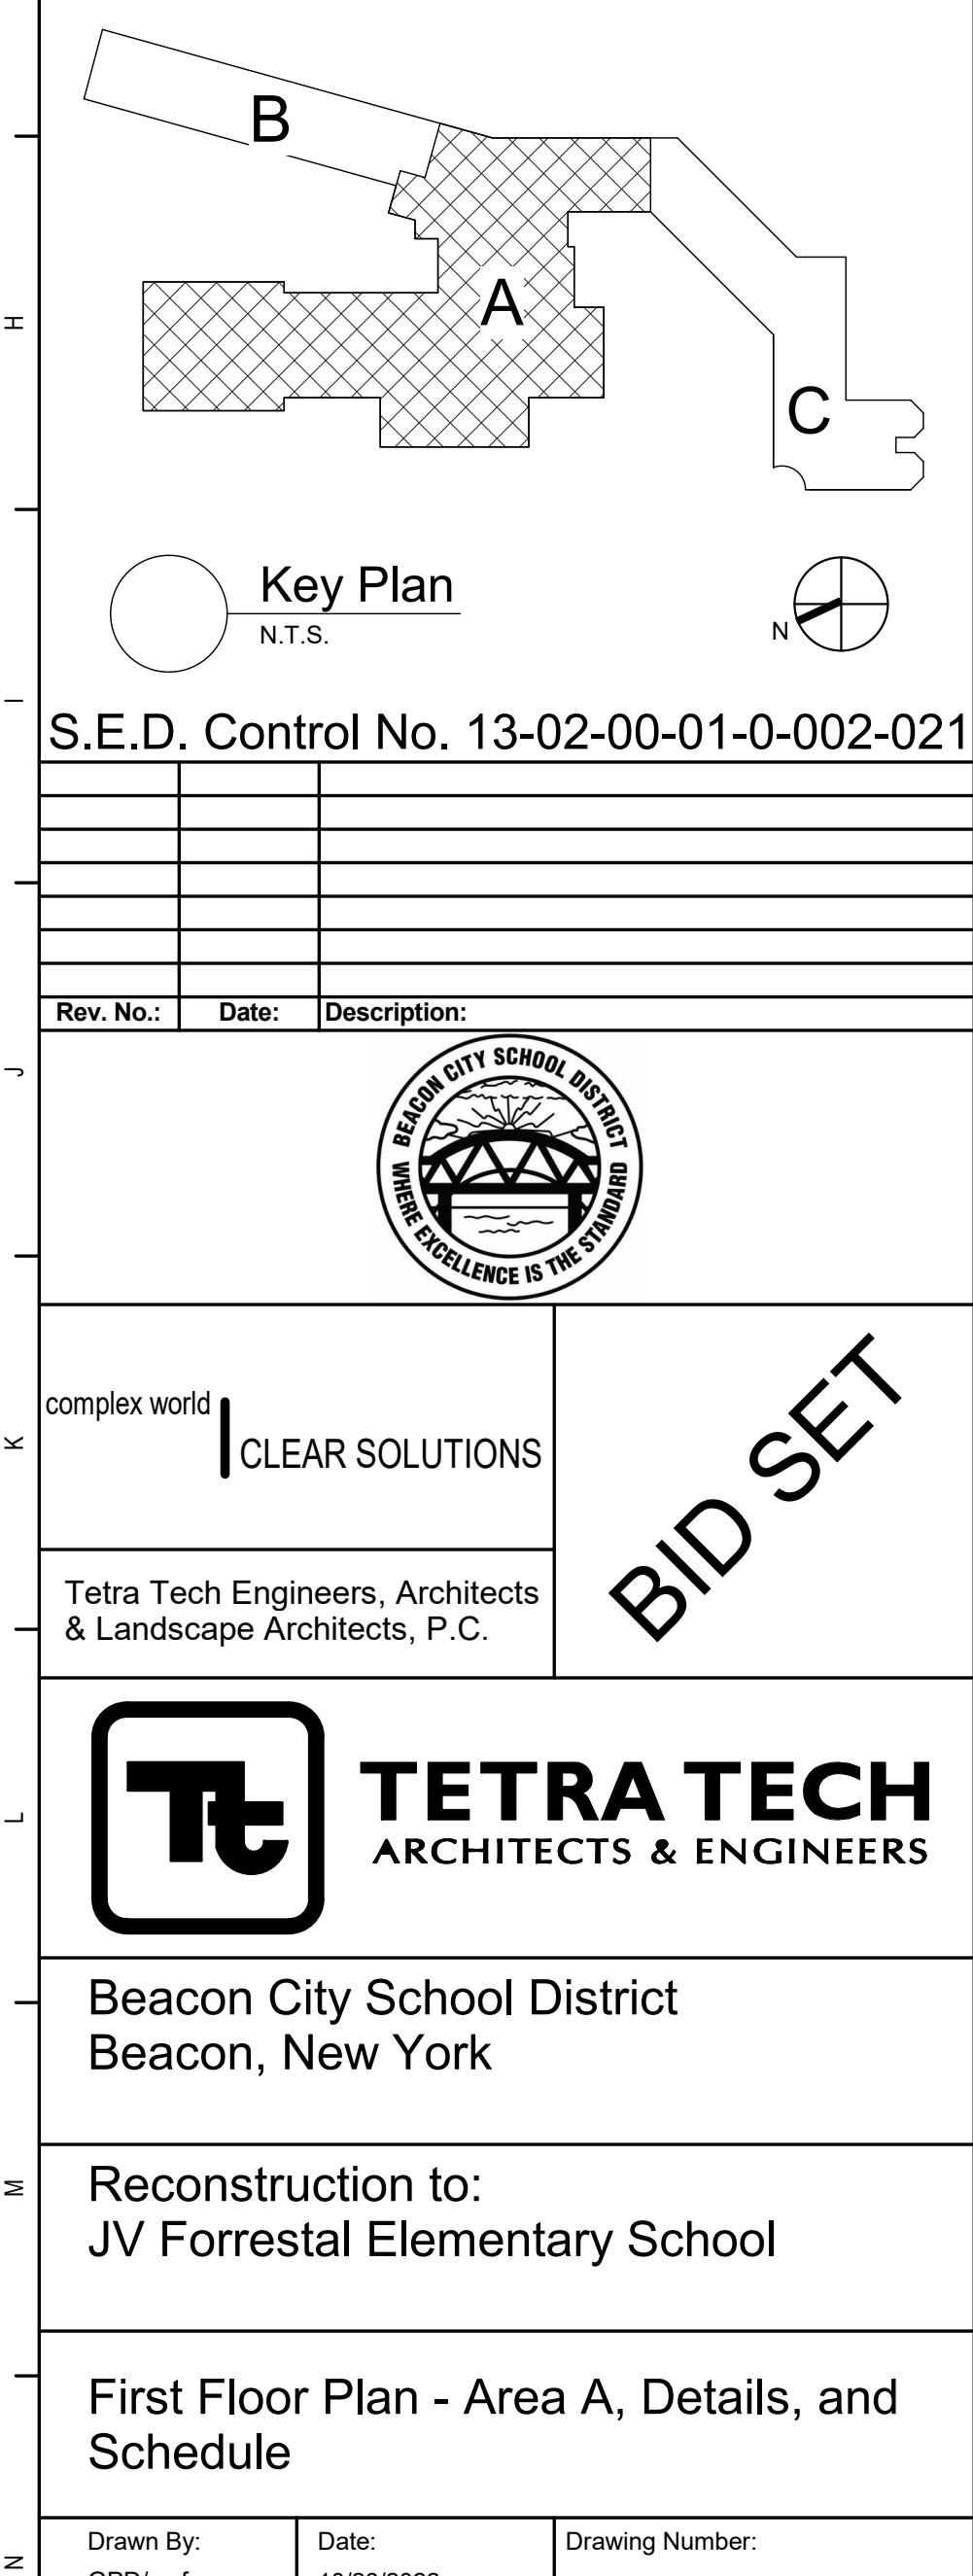
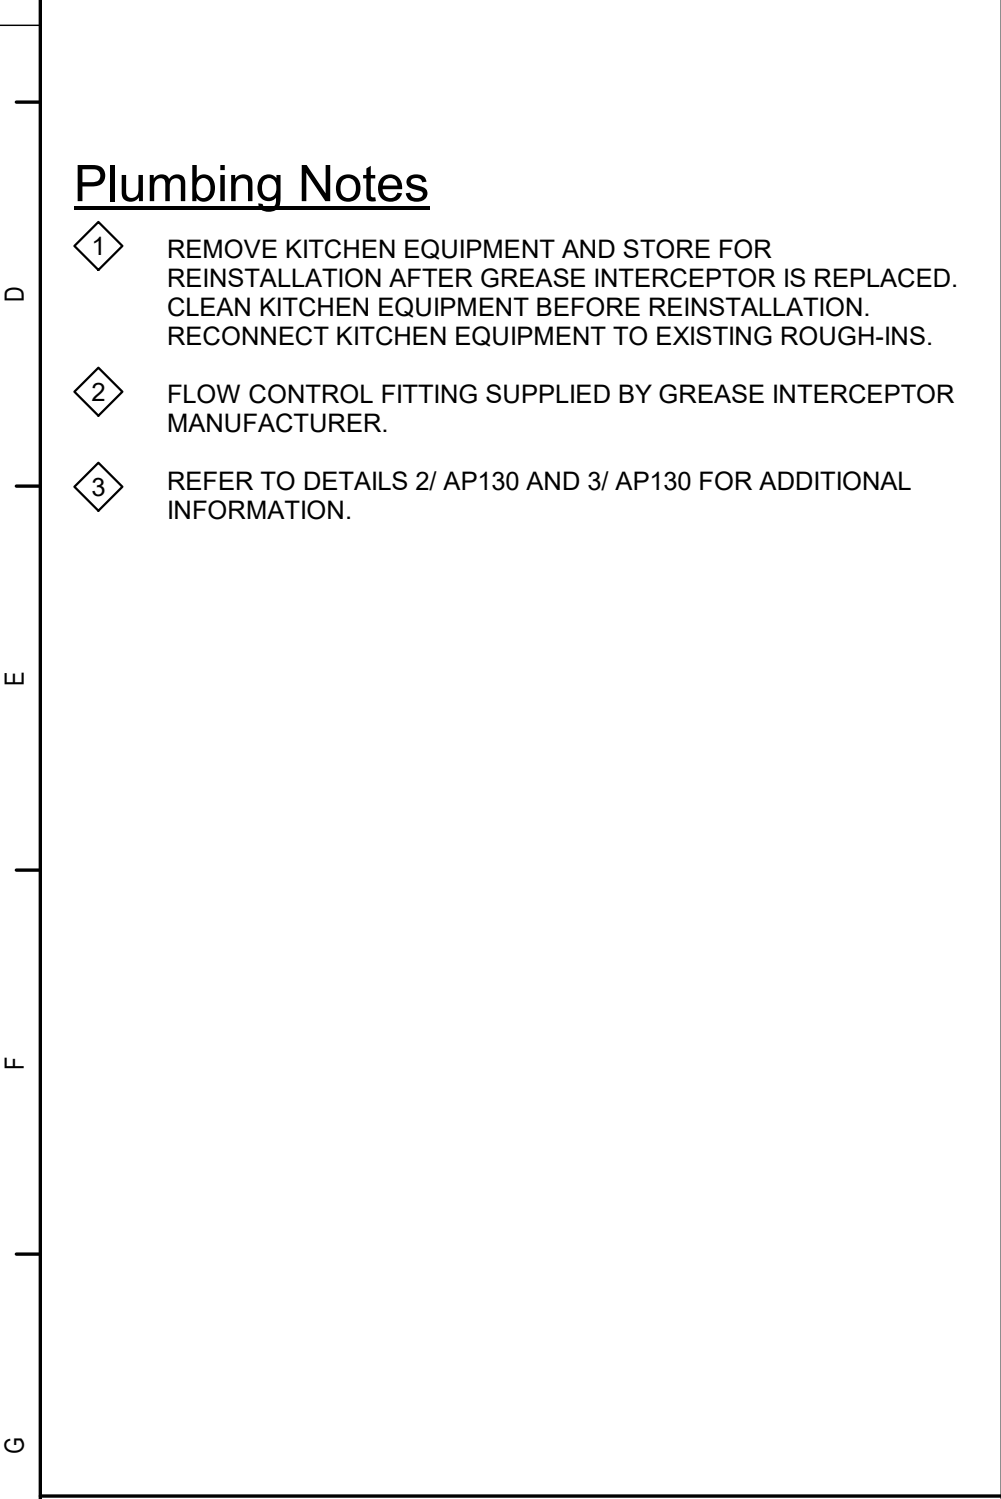
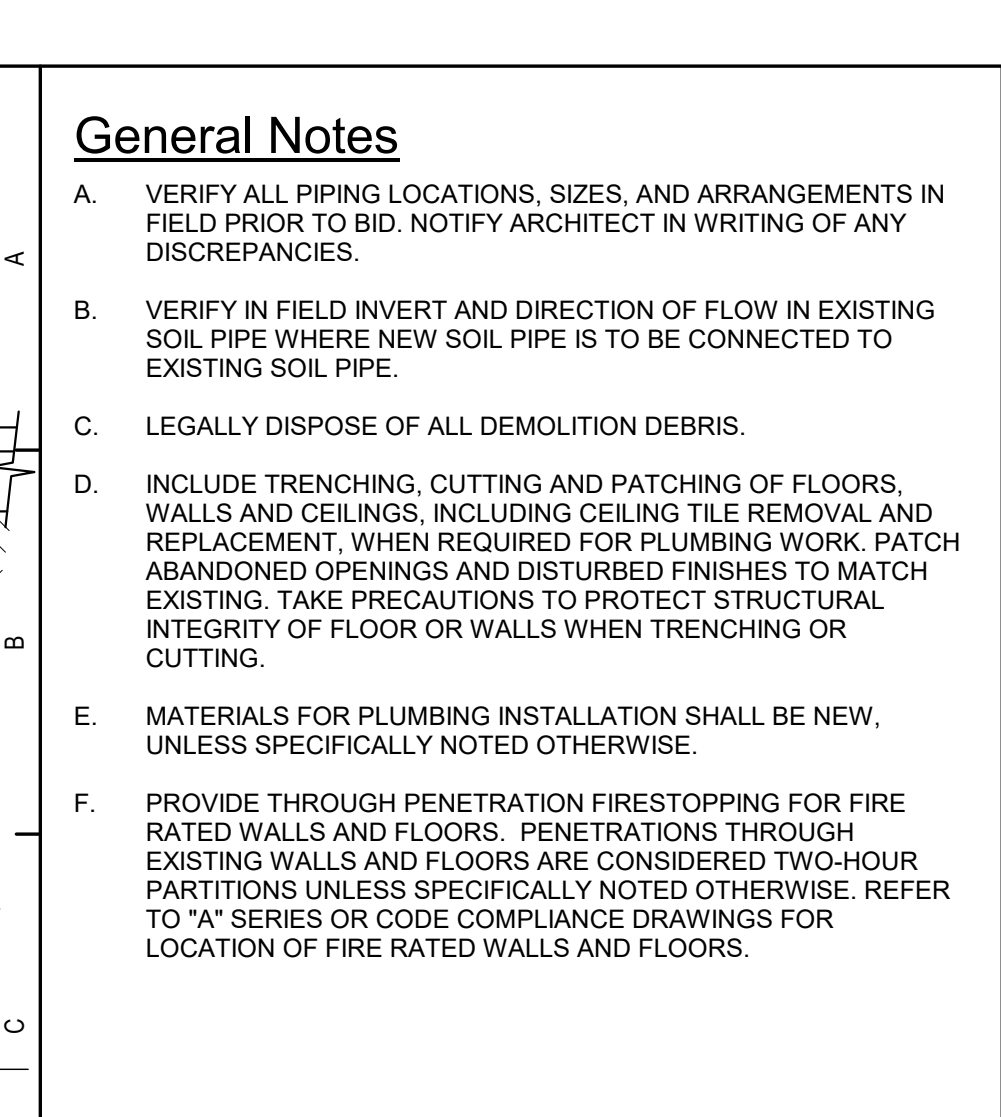


Beacon City School District
Beacon, New York

Reconstruction to:
JV Forrester Elementary School

First Floor Power Plan - Area A

Drawn By: SAS	Date: 10/28/2022	Drawing Number:
Project No.: 279180-22004	AE104	





APPLICABLE CODES AND STANDARDS:

BASED ON THE NEW YORK STATE UNIFORM FIRE PREVENTION AND BUILDING CODE INCLUDING APPLICABLE 2018 ICC CODES AND 2020 BUILDING CODES OF NYS, AND ICC A117.1-2017 STANDARD FOR ACCESSIBLE AND UNIVERSAL BUILDINGS AND FACILITIES.

REFER TO PROJECT MANUAL FOR REQUIREMENTS STATED IN "NYCRR 155 REGULATIONS OF THE COMMISSIONER OF EDUCATION".

BUILDING DATA:

BUILDING:	GLENHAM ELEMENTARY SCHOOL	
	20 CHASE DR	
	FISHKILL, NY 12524	
DESCRIPTION:	ONE STORY MASONRY BUILDING	
YEAR BUILT:	1956	
ADDITIONS:	1975, 1986, 1987 AND 1998	
BUILDING AREA: 1ST FLOOR	40,590 SQFT	
NEW BUILDING AREA:	481 SQFT	
TOTAL GROSS AREA=	41,071 SQFT	

A.	REFER TO CODE COMPLIANCE DRAWINGS FOR ADDITIONAL CODE COMPLIANCE INFORMATION.
B.	COORDINATE WITH FLOOR PLANS, WALL SECTIONS AND PARTITION TYPES FOR RATED WALL TYPES AND LOCATIONS. IMMEDIATELY NOTIFY ARCHITECT OF ANY WALL RATING DISCREPANCIES BETWEEN CODE DRAWINGS AND FLOOR PLANS.
D.	AT AREAS OF PROJECT WORK, COMPLETELY SEAL ALL PENETRATIONS REQUIRED TO COMPLY WITH FIRE RESISTANCE RATINGS IDENTIFIED ON THE CODE DRAWINGS. REGARDLESS IF WALL IS NEW OR EXISTING, TYPICAL UNLESS NOTED OTHERWISE.

ALL WALLS, INCLUDING CORRIDOR WALLS, EXTEND TO THE ROOF DECK OR FLOOR DECK ABOVE UNLESS NOTED OTHERWISE.

General Notes

- A. DO NOT SCALE DRAWINGS TO OBTAIN DIMENSIONS.
- B. TAKE FIELD MEASUREMENTS TO FIT THE WORK PROPERLY. VERIFY ALL EXISTING CONDITIONS AND DIMENSIONS IN THE FIELD.
- C. REFER INCONSISTENCIES TO ARCHITECT PRIOR TO COMMENCING THE WORK IN AFFECTED AREA.
- D. ITEMS ARE SHOWN DIAGRAMMATICALLY ON DRAWINGS. VERIFY SPACE REQUIREMENTS AND DIMENSIONS TO FIT THE WORK PROPERLY.
- E. NOTES SHOWN ON ONE DRAWING APPLY TO ALL SIMILAR DRAWINGS.
- F. ELEVATION 100'-0" ON ARCHITECTURAL DRAWINGS CORRESPONDS TO ELEVATION 232.64' ON THE SURVEY DRAWINGS.
- G. DO NOT DISTURB CONSTRUCTION SUSPECTED OF CONTAINING UNIDENTIFIED MATERIAL IF ENCOUNTERED, IMMEDIATELY NOTIFY ARCHITECT AND OWNER.



S.E.D. Control No. 13-02-00-01-0-006-022

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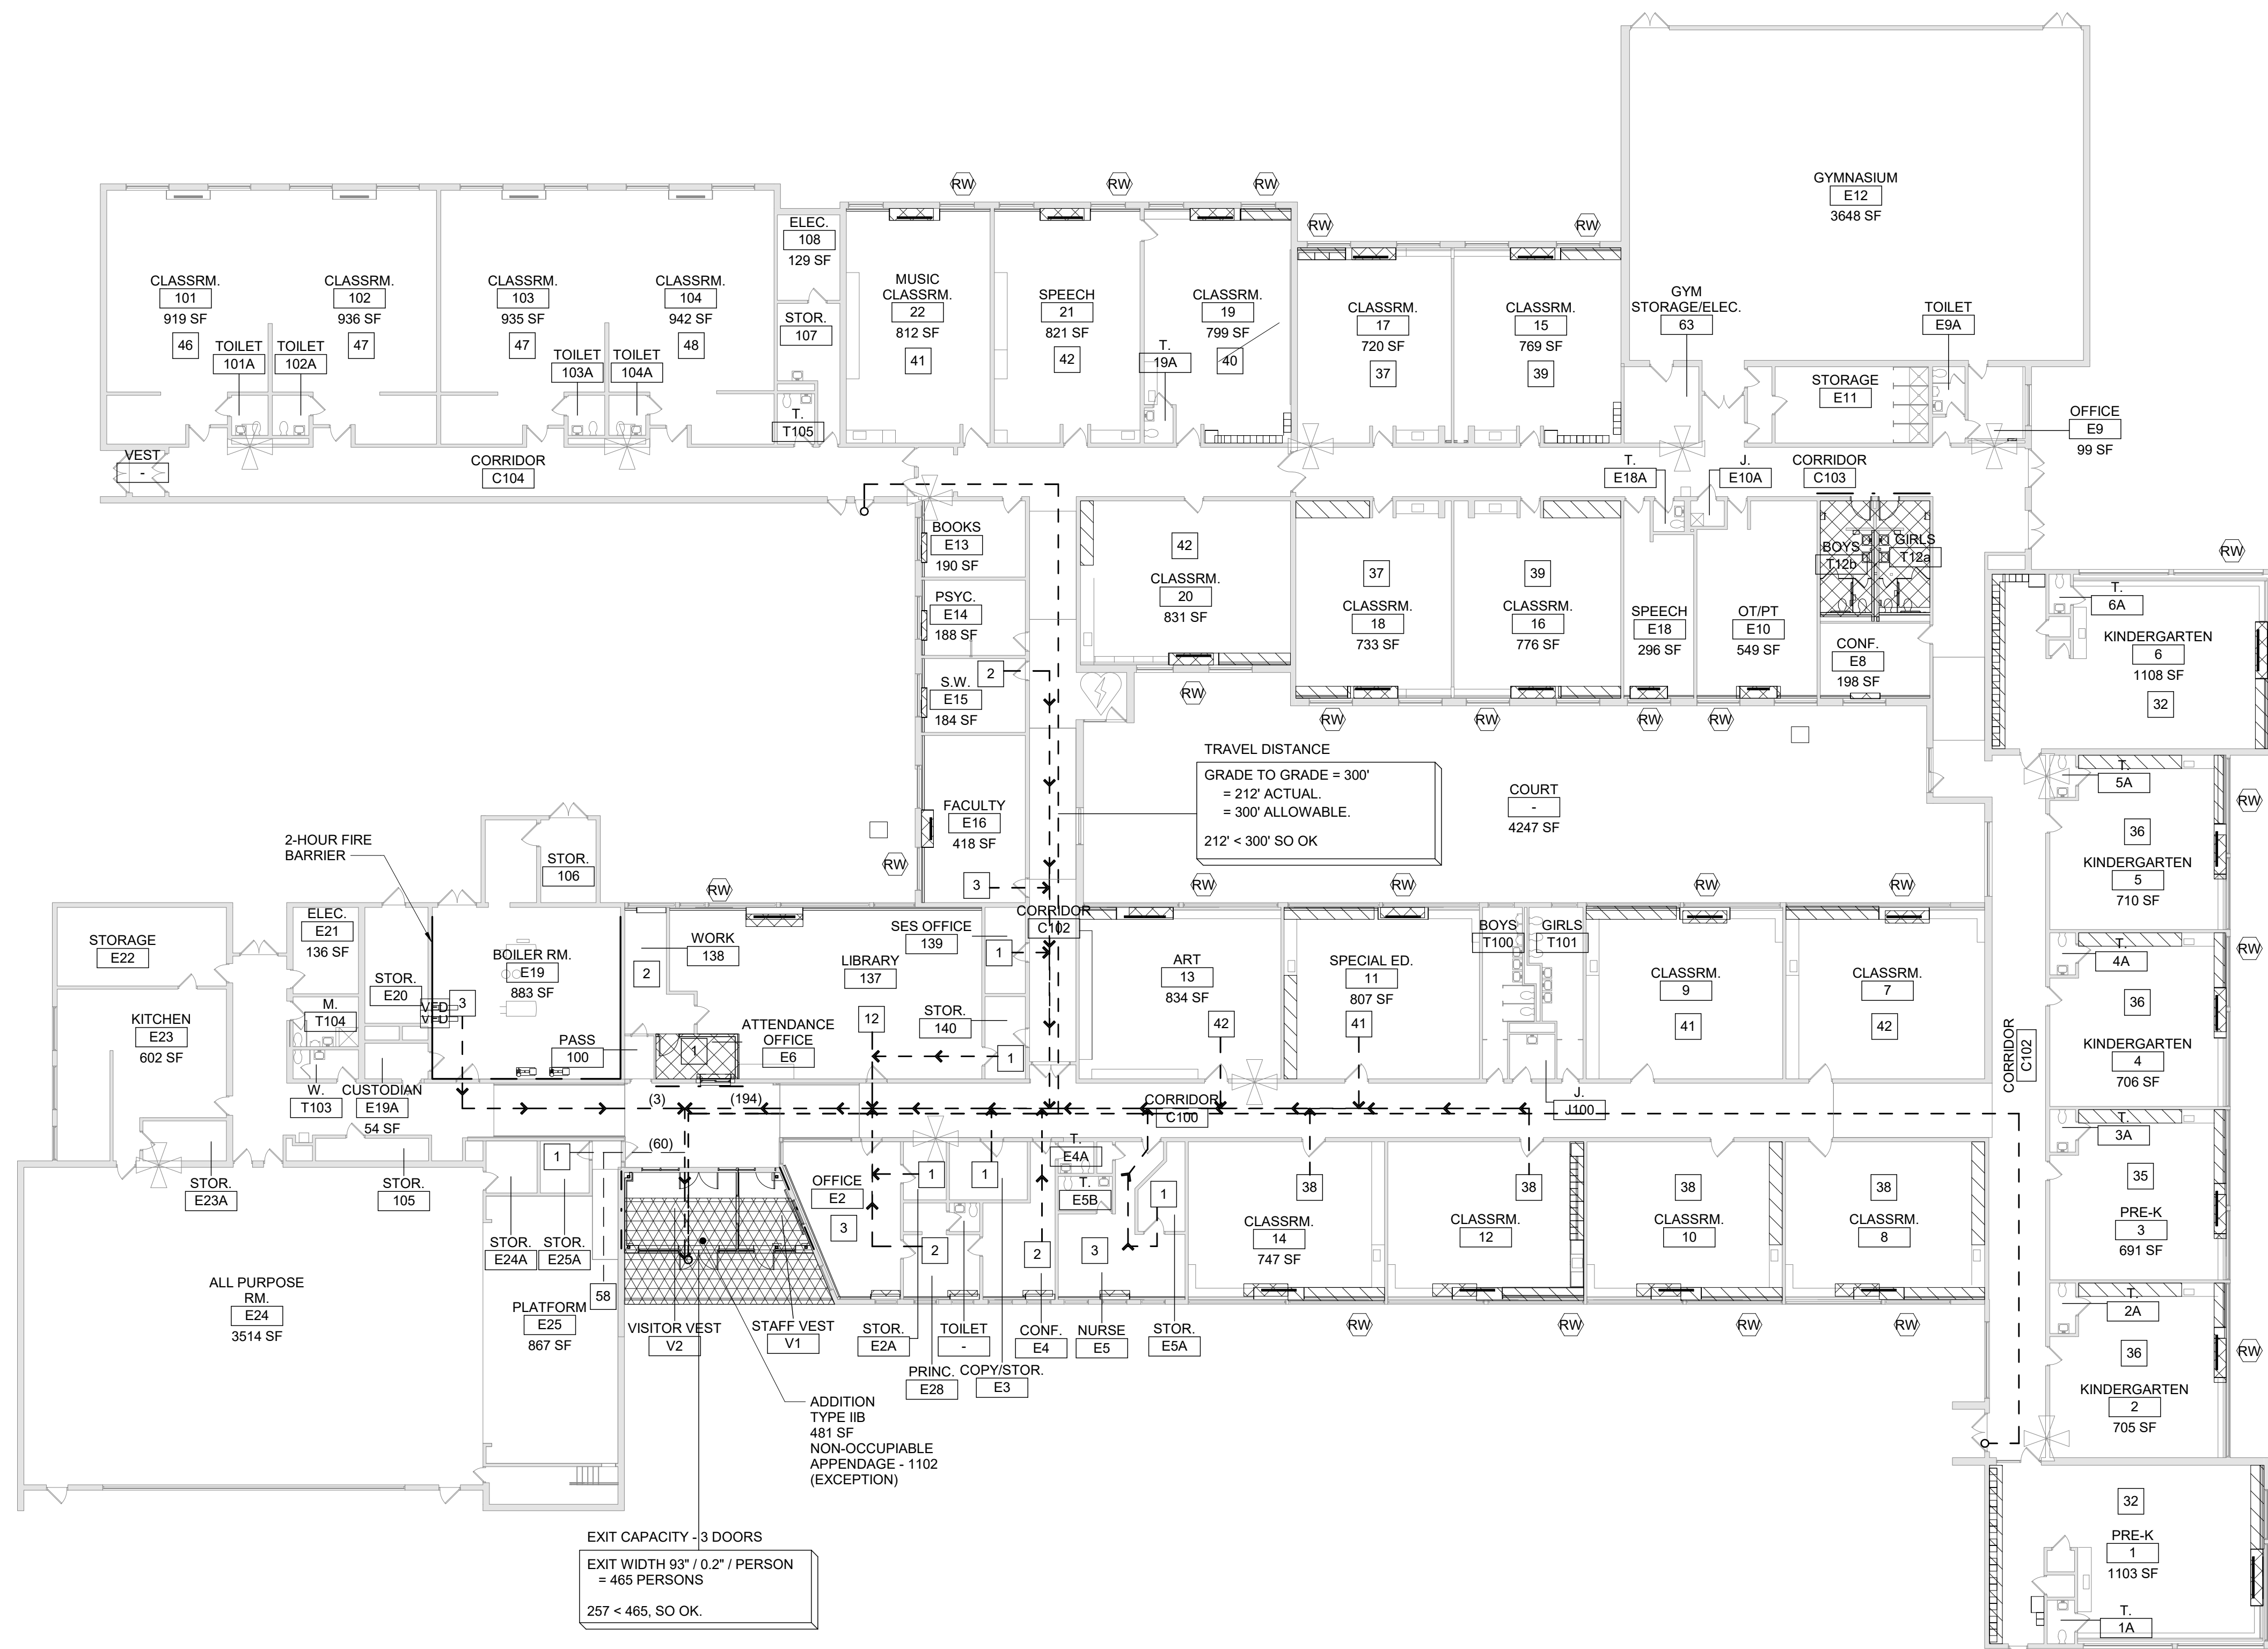


Beacon City School District
Beacon, New York

	<p>Additions and Alterations to: Glenham Elementary School</p>
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Code Compliance Review and Key Plan

Drawn By: TLG	Date: 10/28/2022	Drawing Number: BG350
Project No.: 279180-22004		



2 First Floor Key Plan

$$1/16'' = 1'-0''$$



GLENHAM ELEMENTARY - FIRST FLOOR ABATEMENT PLAN

ASBESTOS ABATEMENT NOTES


ASBESTOS ABATEMENT CONTRACTOR IS RESPONSIBLE FOR TOTAL AND COMPLETE REMOVAL AND DISPOSAL OF ASBESTOS CONTAINING (ACM) MORTAR AT LOUVER / UNIT VENTILATORS WHERE INDICATED.
REFER TO SPECIFICATION SECTION 020800 - SECTION 3.17 FOR A DESCRIPTION OF THE WORK.

ASBESTOS ABATEMENT LEGEND



REMOVE AND DISPOSE OF EXTERIOR ASBESTOS CONTAINING FRABLE (ACM/MORTAR AROUND LOUVER PENETRATION (BRICK TO METAL) AT UNIT VENTILATORS.

QUALITY ENVIRONMENTAL SOLUTIONS & TECHNOLOGIES, INC.
1376 NYS ROUTE 9
WAPPINGERS FALLS, NY 12590
TEL.: (845) 298-6031

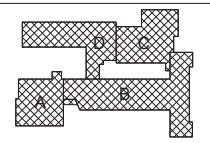

S.E.D. Control No. 13-02-00-01-0-006-022
N.Y.S.

Rev. No.	Date	Description
1	4/13/22	100% SED Submittal




Beacon City School District
Beacon, New York

Additions and Alterations to:
Glenham Elementary School


Asbestos Abatement

Client By: TIAE
Project No.: 279180-22004
Date: 10/08/2022
Drawing Number:

BH100

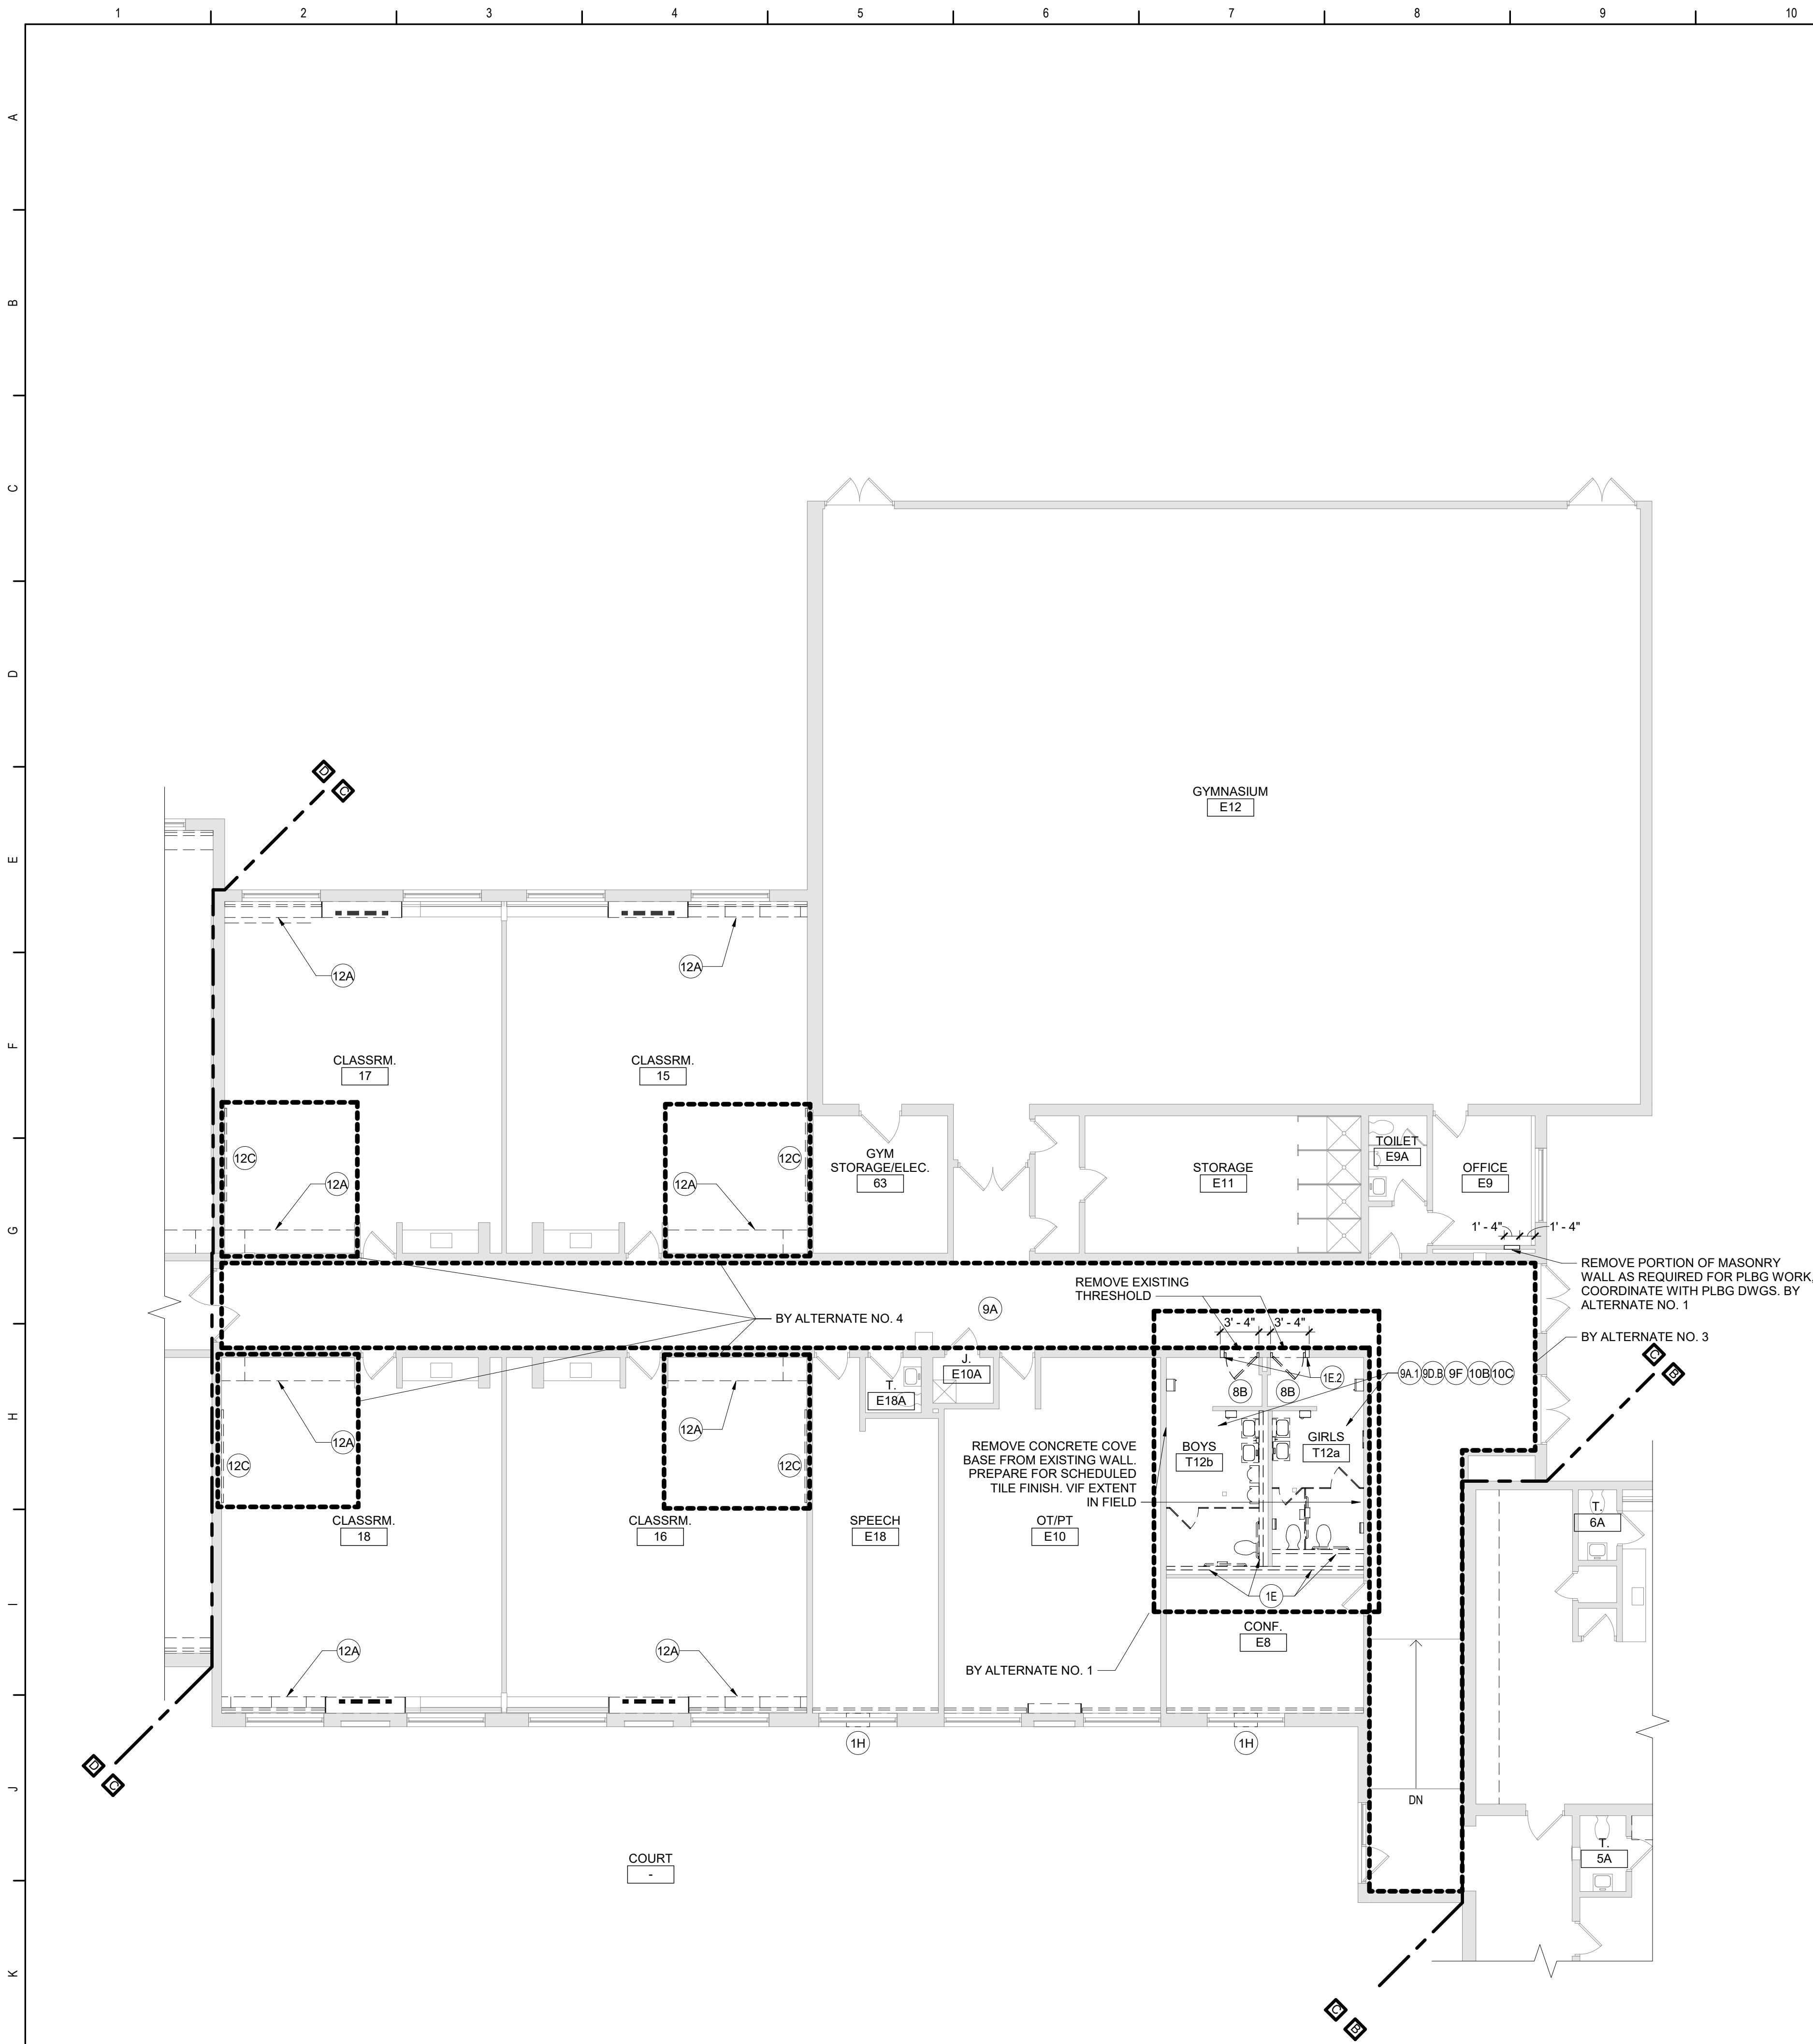

2 First Floor Demolition Plan - Area C
1/8" = 1'-0"

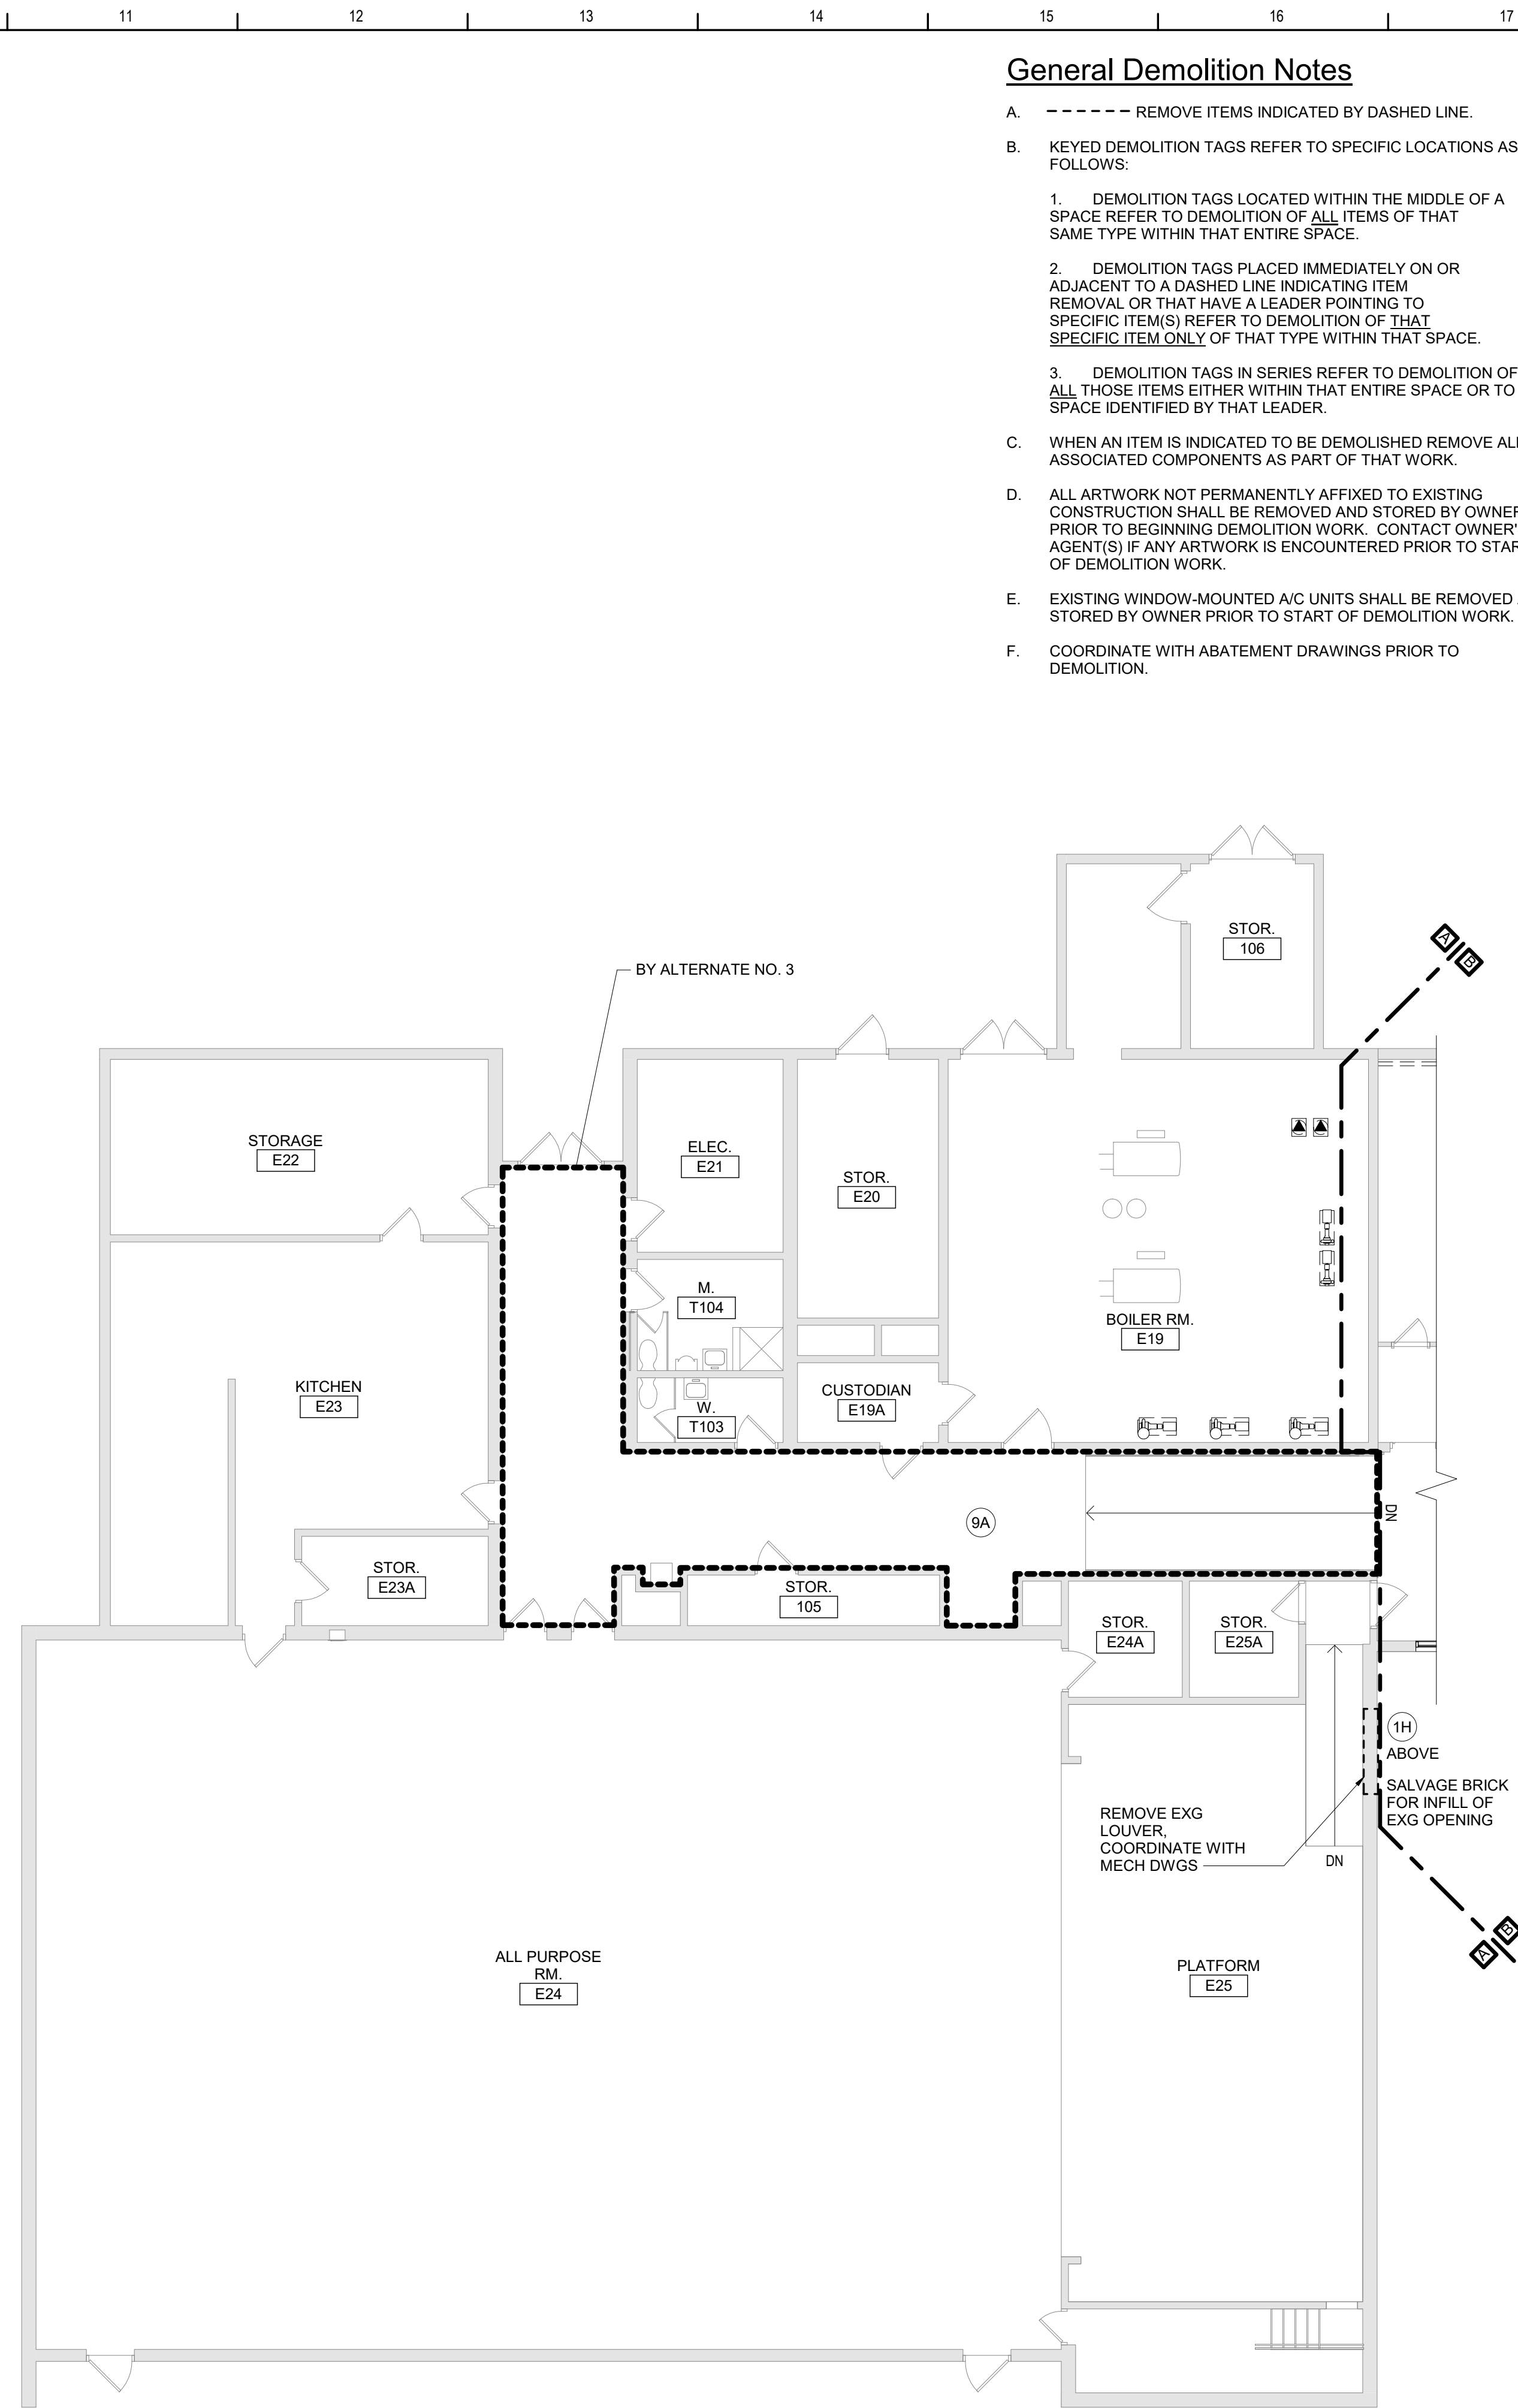


1 First Floor Demolition Plan - Area A
1/8" = 1'-0"

General Demolition Notes


- A. - - - - - REMOVE ITEMS INDICATED BY DASHED LINE.
- B. KEYED DEMOLITION TAGS REFER TO SPECIFIC LOCATIONS AS FOLLOWS:
- DEMOLITION TAGS LOCATED WITHIN THE MIDDLE OF A SPACE REFER TO DEMOLITION OF ALL ITEMS OF THAT SAME TYPE WITHIN THAT ENTIRE SPACE.
 - DEMOLITION TAGS PLACED IMMEDIATELY ON OR ADJACENT TO A DASHED LINE INDICATING ITEM REMOVAL OR THAT HAVE A LEADER POINTING TO SPECIFIC ITEM(S) REFER TO DEMOLITION OF THAT SPECIFIC ITEM ONLY OF THAT TYPE WITHIN THAT SPACE.
 - DEMOLITION TAGS IN SERIES REFER TO DEMOLITION OF ALL THOSE ITEMS EITHER WITHIN THAT ENTIRE SPACE OR TO THE SPACE IDENTIFIED BY THAT LEADER.
- C. WHEN AN ITEM IS INDICATED TO BE DEMOLISHED REMOVE ALL ASSOCIATED COMPONENTS AS PART OF THAT WORK.
- D. ALL ARTWORK NOT PERMANENTLY AFFIXED TO EXISTING CONSTRUCTION SHALL BE REMOVED AND STORED BY OWNER PRIOR TO BEGINNING DEMOLITION WORK. CONTACT OWNER'S AGENT(S) IF ANY ARTWORK IS ENCOUNTERED PRIOR TO START OF DEMOLITION WORK.
- E. EXISTING WINDOW-MOUNTED A/C UNITS SHALL BE REMOVED AND STORED BY OWNER PRIOR TO START OF DEMOLITION WORK.
- F. COORDINATE WITH ABATEMENT DRAWINGS PRIOR TO DEMOLITION.

Demolition Key Notes

- 1E REMOVE WALL FULL HEIGHT AND ALL ASSOCIATED COMPONENTS. PATCH EXPOSED SURFACE TO MATCH EXISTING ADJACENT SURFACES.
- 1E2 REMOVE PORTION OF WALL AS INDICATED AND ALL ASSOCIATED COMPONENTS. PATCH EXPOSED SURFACES TO MATCH EXISTING ADJACENT SURFACES.
- 1H PROVIDE NEW OR ENLARGE EXISTING OPENING IN WALL TO EXTENT REQUIRED TO PERFORM SCHEDULED WORK. PROVIDE LINTEL PER LINTEL SCHEDULE. SEE STRU DRAWINGS. PATCH EXPOSED SURFACES TO MATCH ADJACENT FINISHES / SURFACES. COORDINATE WITH SCHEDULED WORK ON MECHANICAL DRAWINGS. SEE ABATEMENT DRAWINGS.
- 1P REMOVE PORTION OF STOREFRONT INSULATED PANEL TO ACCOMMODATE SCHEDULED WORK. COORDINATE WITH MECHANICAL DRAWINGS.
- 8A REMOVE WINDOW AND STOREFRONT SYSTEM COMPLETELY. PREPARE OPENING TO EXTENT REQUIRED TO PERFORM SCHEDULED WORK. PATCH EXPOSED SURFACES TO MATCH ADJACENT FINISHES / SURFACES.
- 8B REMOVE DOOR AND FRAME COMPLETELY. PATCH EXPOSED SURFACES TO MATCH ADJACENT FINISHES / SURFACES.
- 9A REMOVE PORTION OF CEILING SYSTEM AND/OR SOFFIT SYSTEM, TO EXTENT REQUIRED TO PERFORM NEW WORK. CLEAN, SALVAGE AND PROTECT FOR RE-INSTALLATION.
- 9A1 REMOVE CEILING SYSTEM AND/OR SOFFIT SYSTEM IN ITS ENTIRETY.
- 9B REMOVE PORTION OF CEILING SYSTEM AND/OR SOFFIT SYSTEM, TO EXTENT REQUIRED TO PERFORM NEW WORK. CAREFULLY TRIM CEILING GRID TO REMAIN.
- 9C REMOVE CEILING- OR WALL-MOUNTED ACOUSTICAL TREATMENTS IN THEIR ENTIRETY.
- 9D REMOVE FLOOR FINISH, MASTIC AND WALL BASE TO EXTENT REQUIRED TO PERFORM SCHEDULED WORK. AT ALL AREAS OF FLOOR REMOVAL, LEVEL SLAB WITH ADJACENT SLABS AT LOCATIONS SCHEDULED TO RECEIVE FLOOR FINISH. INCLUDE CONCRETE FLOOR PATCHING AND LEVELING MATERIALS TO MAKE SURFACE LEVEL. PREPARE FOR FINISH. PATCH AREAS OF WALLS TO REMAIN THAT WERE DAMAGED BY REMOVAL OF WALL BASE.
- SUFFIX KEY (FLOOR FINISH IDENTIFICATIONS):
- A. CARPET
- B. CERAMIC FLOOR TILE
- C. VAT/VCT
- 9E REMOVE WALL BASE AND ASSOCIATED MASTIC ONLY. EXISTING FLOOR FINISH TO REMAIN. PATCH AREAS OF WALLS TO REMAIN THAT WERE DAMAGED BY REMOVAL OF WALL BASE.
- 9F REMOVE WALL TILE IN ITS ENTIRETY. PATCH EXPOSED SURFACES TO MATCH ADJACENT FINISHES / SURFACES TO EXTENT REQUIRED TO PERFORM SCHEDULED WORK.
- 10B REMOVE TOILET COMPARTMENTS IN THEIR ENTIRETY.
- 10C REMOVE TOILET AND BATH ACCESSORIES. PATCH EXPOSED SURFACES TO MATCH ADJACENT FINISHES / SURFACES TO EXTENT REQUIRED TO PERFORM SCHEDULED WORK.
- 12A REMOVE CASEWORK, SHELVING AND ASSOCIATED COMPONENTS TO THE EXTENT REQUIRED TO PERFORM SCHEDULED WORK. PATCH EXPOSED SURFACES TO MATCH ADJACENT FINISHES / SURFACES. COORDINATE WITH CASEWORK AND MECHANICAL DRAWINGS.
- 12C REMOVE TEACHING SURFACES INCLUDING MARKER BOARDS, TACK BOARDS AND CHALK BOARDS. TURN OVER TO OWNER. PATCH EXPOSED SURFACES TO MATCH ADJACENT FINISHES AND SURFACES.

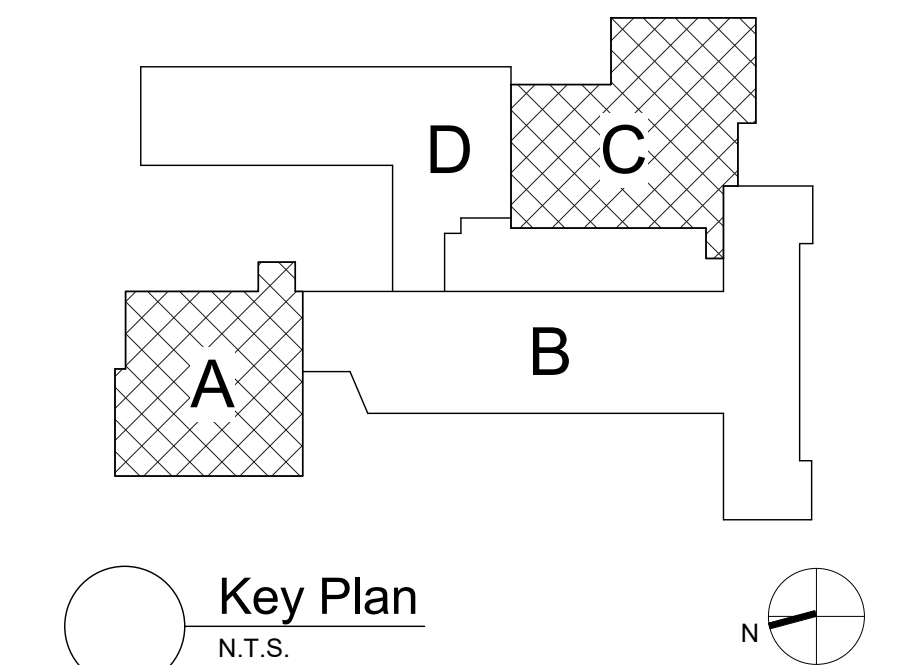

S.E.D. Control No. 13-02-00-01-0-006-022

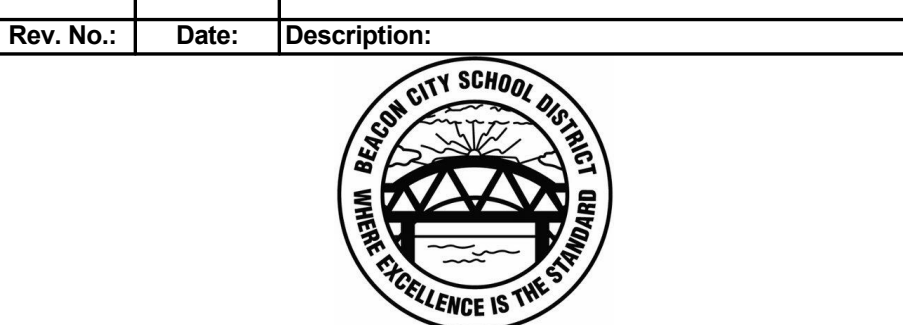

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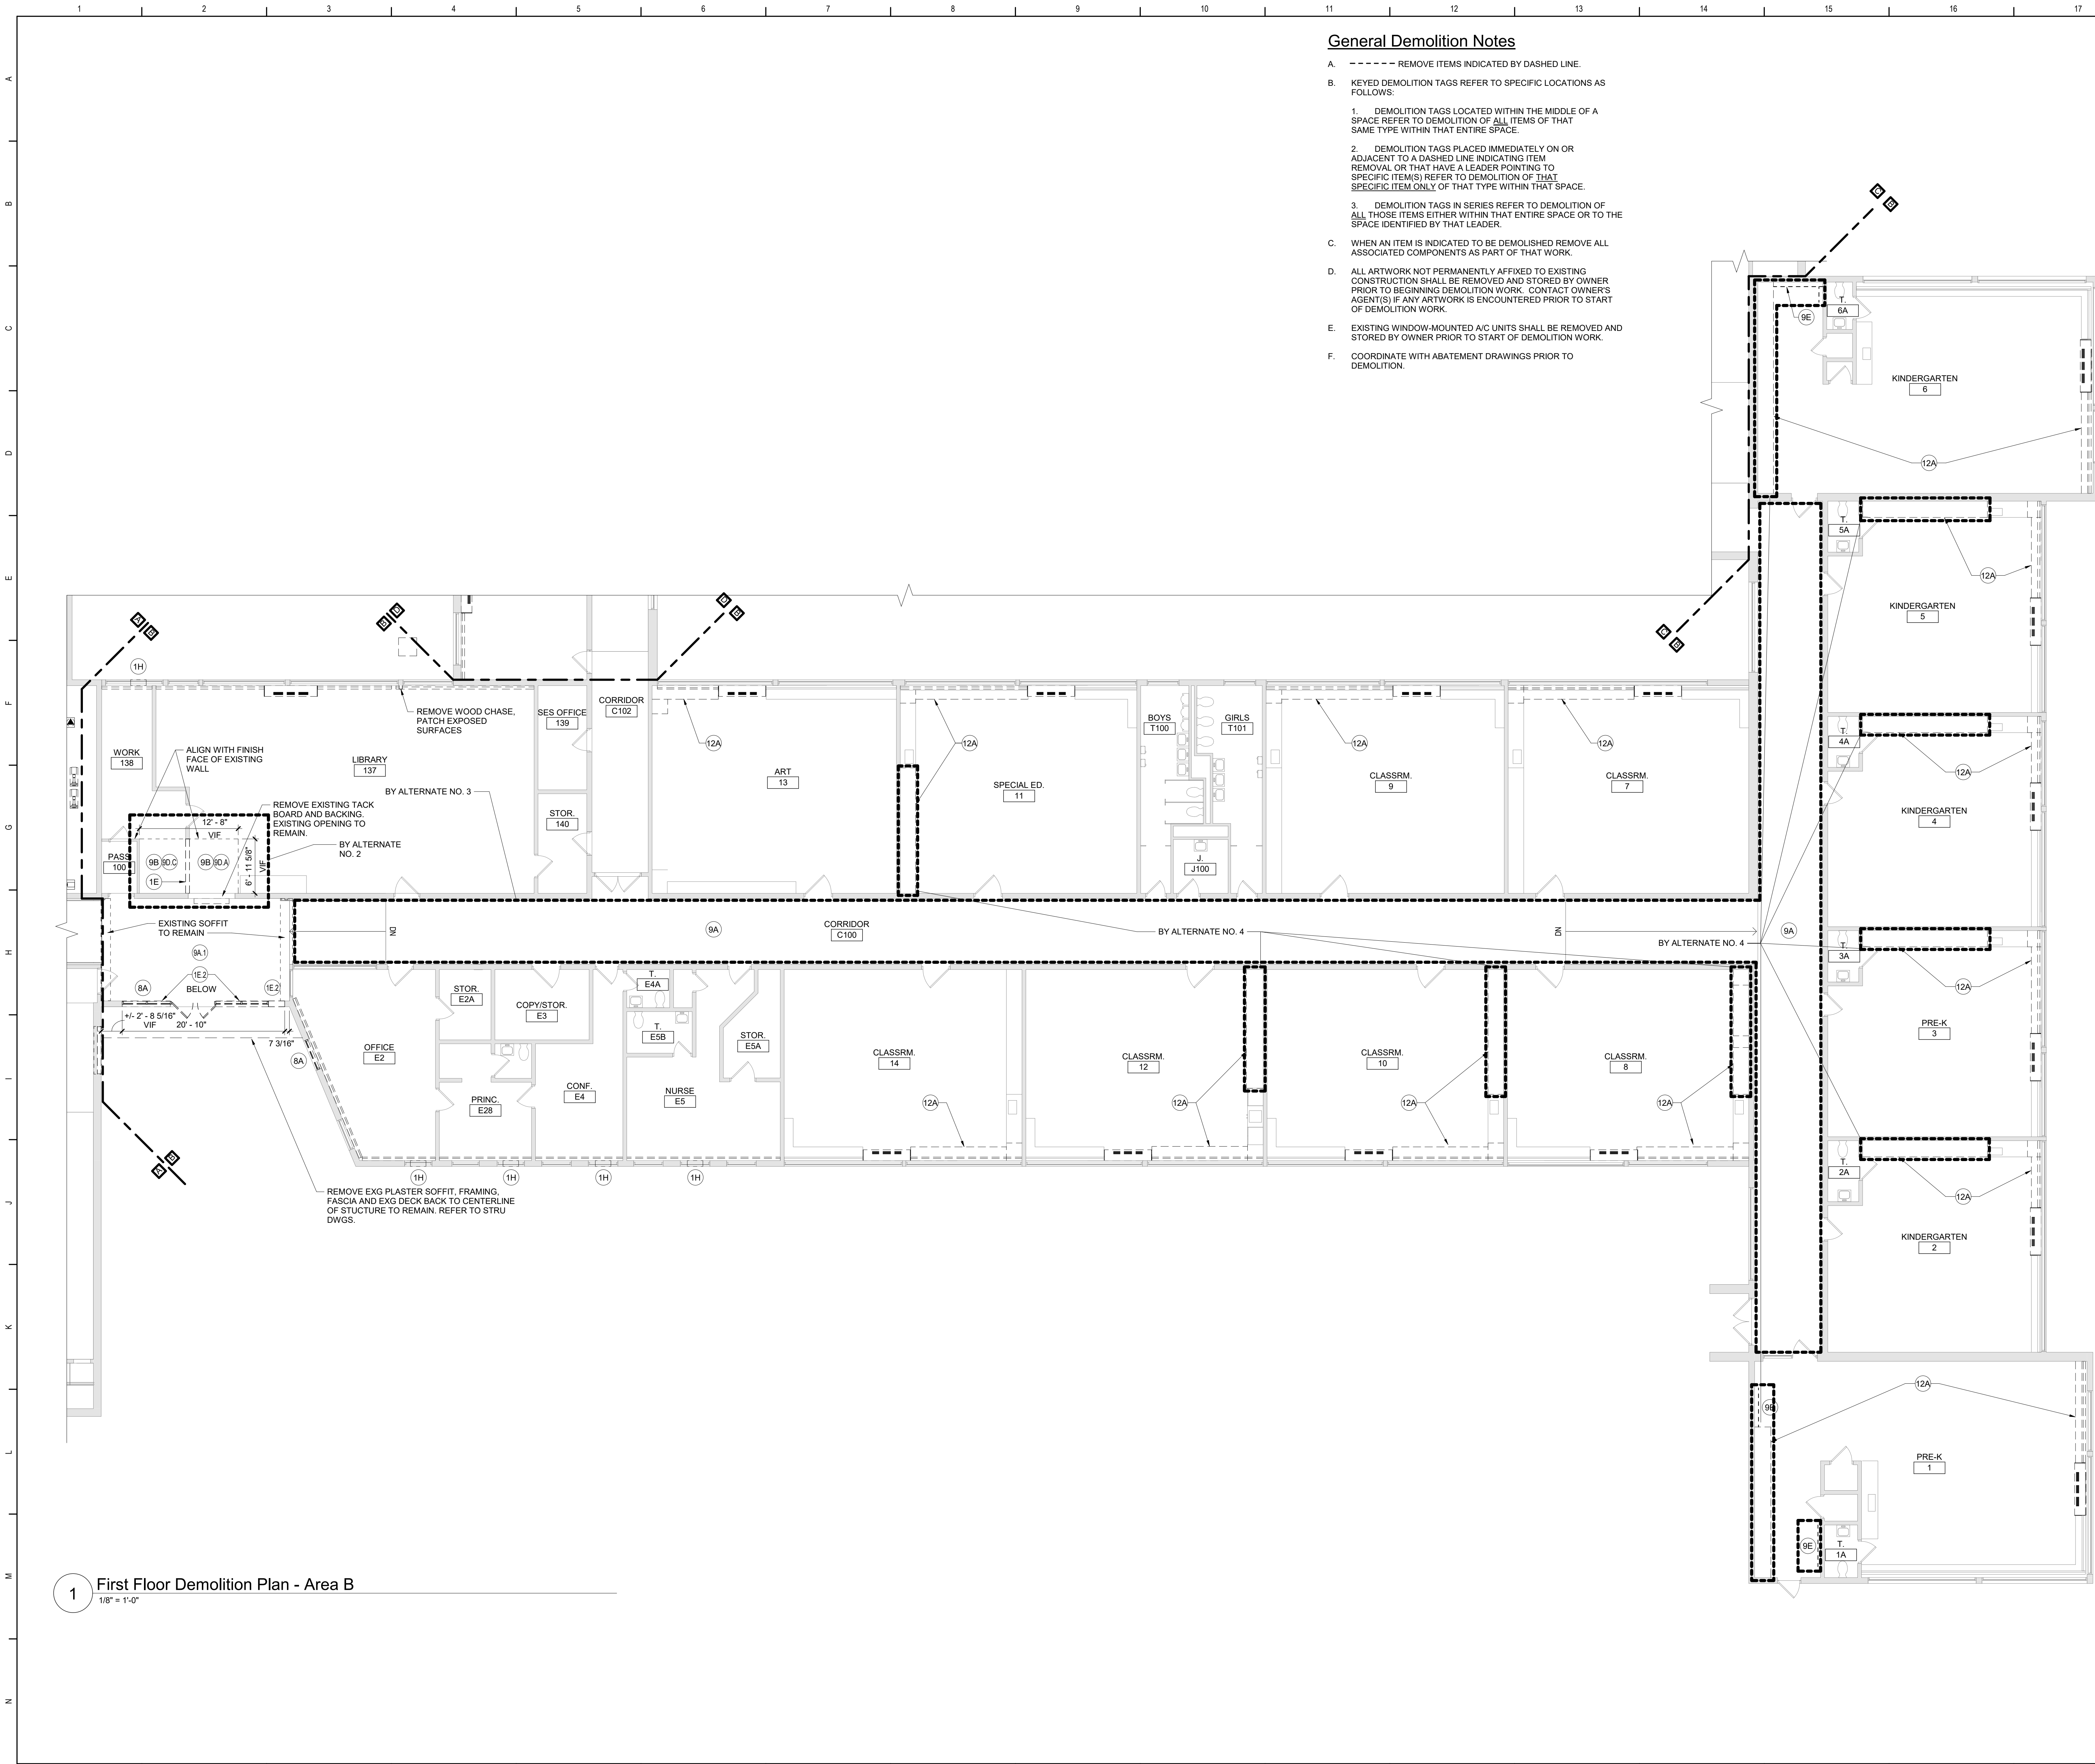


Beacon City School District
Beacon, New York

Additions and Alterations to:
Glenham Elementary School

First Floor Demolition Plan - Area A
and C

Drawn By: GCK/llg Date: 10/28/2022 Drawing Number: 279180-22004 BA100




General Demolition Notes

- A. - - - - - REMOVE ITEMS INDICATED BY DASHED LINE.
- B. KEYED DEMOLITION TAGS REFER TO SPECIFIC LOCATIONS AS FOLLOWS:
- DEMOLITION TAGS LOCATED WITHIN THE MIDDLE OF A SPACE REFER TO DEMOLITION OF ALL ITEMS OF THAT SAME TYPE WITHIN THAT ENTIRE SPACE.
 - DEMOLITION TAGS PLACED IMMEDIATELY ON OR ADJACENT TO A DASHED LINE INDICATING ITEM REMOVAL OR THAT HAVE A LEADER POINTING TO SPECIFIC ITEM(S) REFER TO DEMOLITION OF THAT SPECIFIC ITEM ONLY OF THAT TYPE WITHIN THAT SPACE.
 - DEMOLITION TAGS IN SERIES REFER TO DEMOLITION OF ALL THOSE ITEMS EITHER WITHIN THAT ENTIRE SPACE OR TO THE SPACE IDENTIFIED BY THAT LEADER.
- C. WHEN AN ITEM IS INDICATED TO BE DEMOLISHED REMOVE ALL ASSOCIATED COMPONENTS AS PART OF THAT WORK.
- D. ALL ARTWORK NOT PERMANENTLY AFFIXED TO EXISTING CONSTRUCTION SHALL BE REMOVED AND STORED BY OWNER PRIOR TO BEGINNING DEMOLITION WORK. CONTACT OWNER'S AGENT(S) IF ANY ARTWORK IS ENCOUNTERED PRIOR TO START OF DEMOLITION WORK.
- E. EXISTING WINDOW-MOUNTED A/C UNITS SHALL BE REMOVED AND STORED BY OWNER PRIOR TO START OF DEMOLITION WORK.
- F. COORDINATE WITH ABATEMENT DRAWINGS PRIOR TO DEMOLITION.

Demolition Key Notes

- 1E) REMOVE WALL FULL HEIGHT AND ALL ASSOCIATED COMPONENTS. PATCH EXPOSED SURFACE TO MATCH EXISTING ADJACENT SURFACES.
- 1E2) REMOVE PORTION OF WALL AS INDICATED AND ALL ASSOCIATED COMPONENTS. PATCH EXPOSED SURFACES TO MATCH EXISTING ADJACENT SURFACES.
- 1H) PROVIDE NEW OR ENLARGE EXISTING OPENING IN WALL TO EXTENT REQUIRED TO PERFORM SCHEDULED WORK. PROVIDE LINTEL PER LINTEL SCHEDULE. SEE STRU DRAWINGS. PATCH EXPOSED SURFACES TO MATCH ADJACENT FINISHES / SURFACES. COORDINATE WITH SCHEDULED WORK ON MECHANICAL DRAWINGS. SEE ABATEMENT DRAWINGS.
- 1P) REMOVE PORTION OF STOREFRONT INSULATED PANEL TO ACCOMMODATE SCHEDULED WORK. COORDINATE WITH MECHANICAL DRAWINGS.
- 8A) REMOVE WINDOW AND STOREFRONT SYSTEM COMPLETELY. PREPARE OPENING TO EXTENT REQUIRED TO PERFORM SCHEDULED WORK. PATCH EXPOSED SURFACES TO MATCH ADJACENT FINISHES / SURFACES.
- 8B) REMOVE DOOR AND FRAME COMPLETELY. PATCH EXPOSED SURFACES TO MATCH ADJACENT FINISHES/SURFACES.
- 9A) REMOVE PORTION OF CEILING SYSTEM AND/OR SOFFIT SYSTEM, TO EXTENT REQUIRED TO PERFORM NEW WORK. CLEAN, SALVAGE AND PROTECT FOR RE-INSTALLATION.
- 9A1) REMOVE CEILING SYSTEM AND/OR SOFFIT SYSTEM IN ITS ENTIRETY.
- 9B) REMOVE PORTION OF CEILING SYSTEM AND/OR SOFFIT SYSTEM, TO EXTENT REQUIRED TO PERFORM NEW WORK. CAREFULLY TRIM CEILING GRID TO REMAIN.
- 9C) REMOVE CEILING- OR WALL-MOUNTED ACOUSTICAL TREATMENTS IN THEIR ENTIRETY.
- 9D) REMOVE FLOOR FINISH, MASTIC AND WALL BASE TO EXTENT REQUIRED TO PERFORM SCHEDULED WORK. AT ALL AREAS OF FLOOR REMOVAL, LEVEL SLAB WITH ADJACENT SLABS AT LOCATIONS SCHEDULED TO RECEIVE FLOOR FINISH. INCLUDE CONCRETE FLOOR PATCHING AND LEVELING MATERIALS TO MAKE SURFACE LEVEL. PREPARE FOR FINISH. PATCH AREAS OF WALLS TO REMAIN THAT WERE DAMAGED BY REMOVAL OF WALL BASE.
- SUFFIX KEY (FLOOR FINISH IDENTIFICATIONS):
- A. CARPET.
- B. CERAMIC FLOOR TILE.
- C. VAT/VCT.
- 9E) REMOVE WALL BASE AND ASSOCIATED MASTIC ONLY. EXISTING FLOOR FINISH TO REMAIN. PATCH AREAS OF WALLS TO REMAIN THAT WERE DAMAGED BY REMOVAL OF WALL BASE.
- 9F) REMOVE WALL TILE IN ITS ENTIRETY. PATCH EXPOSED SURFACES TO MATCH ADJACENT FINISHES / SURFACES TO EXTENT REQUIRED TO PERFORM SCHEDULED WORK.
- 10B) REMOVE TOILET COMPARTMENTS IN THEIR ENTIRETY.
- 10C) REMOVE TOILET AND BATH ACCESSORIES. PATCH EXPOSED SURFACES TO MATCH ADJACENT FINISHES / SURFACES TO EXTENT REQUIRED TO PERFORM SCHEDULED WORK.
- 12A) REMOVE CASEWORK, SHELVING AND ASSOCIATED COMPONENTS TO THE EXTENT REQUIRED TO PERFORM SCHEDULED WORK. PATCH EXPOSED SURFACES TO MATCH ADJACENT FINISHES / SURFACES. COORDINATE WITH CASEWORK AND MECHANICAL DRAWINGS.
- 12C) REMOVE TEACHING SURFACES INCLUDING MARKER BOARDS, TACK BOARDS AND CHALK BOARDS. TURN OVER TO OWNER. PATCH EXPOSED SURFACES TO MATCH ADJACENT FINISHES AND SURFACES.

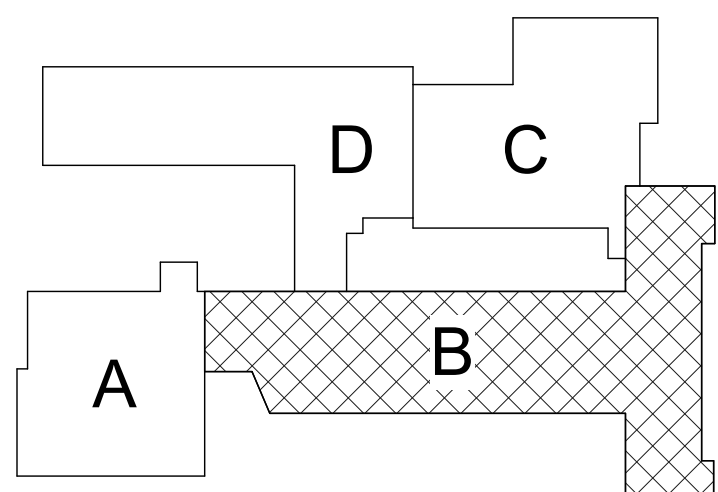

Key Plan
N.T.S.

S.E.D. Control No. 13-02-00-01-0-006-022

Rev. No.	Date	Description
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BID SET



Beacon City School District
Beacon, New York

Additions and Alterations to:
Glenham Elementary School


First Floor Demolition Plan - Area B

Drawn By: GCK/1lg	Date: 10/28/2022	Drawing Number:
Project No.: 279180-22004	BA101	



- A. ----- REMOVE ITEMS INDICATED BY DASHED LINE.
- B. KEYED DEMOLITION TAGS REFER TO SPECIFIC LOCATIONS AS FOLLOWS:
 1. DEMOLITION TAGS LOCATED WITHIN THE MIDDLE OF A SPACE REFER TO DEMOLITION OF ALL ITEMS OF THAT SAME TYPE WITHIN THAT ENTIRE SPACE.
 2. DEMOLITION TAGS PLACED IMMEDIATELY ON OR ADJACENT TO A DASHED LINE INDICATING ITEM REMOVAL OR THAT HAVE A LEADER POINTING TO SPECIFIC ITEM(S) REFER TO DEMOLITION OF THAT SPECIFIC ITEM ONLY OF THAT TYPE WITHIN THAT SPACE.
 3. DEMOLITION TAGS IN SERIES REFER TO DEMOLITION OF ALL ITEMS EITHER WITHIN THAT ENTIRE SPACE OR TO THE SPACE IDENTIFIED BY THAT LEADER.
- C. WHEN AN ITEM IS INDICATED TO BE DEMOLISHED REMOVE ALL ASSOCIATED COMPONENTS AS PART OF THAT WORK.
- D. ALL ARTWORK NOT PERMANENTLY AFFIXED TO EXISTING CONSTRUCTION SHALL BE REMOVED AND STORED BY OWNER PRIOR TO BEGINNING DEMOLITION WORK. CONTACT OWNER'S AGENT IF ANY ARTWORK IS ENCOUNTERED PRIOR TO START OF DEMOLITION WORK.
- E. EXISTING WINDOW-MOUNTED AC UNIT SHALL BE REMOVED AND STORED BY OWNER PRIOR TO START OF DEMOLITION WORK.
- F. COORDINATE WITH ABATEMENT DRAWINGS PRIOR TO DEMOLITION.

1E	REMOVE WALL FULL HEIGHT AND ALL ASSOCIATED COMPONENTS. PATCH EXPOSED SURFACES TO MATCH EXISTING ADJACENT SURFACES.
1Ea	REMOVE PORTION OF WALL AS INDICATED AND ALL ASSOCIATED COMPONENTS. PATCH EXPOSED SURFACES TO MATCH EXISTING ADJACENT SURFACES.
1H	PROVIDE NEW OR ENLARGE EXISTING OPENING IN WALL TO EXTENT REQUIRED TO PERFORM SCHEDULED WORK. PROVIDE LINTEL PER LINTEL SCHEDULE. SEE STRU DRAWINGS. PATCH EXPOSED SURFACES TO MATCH ADJACENT FINISHES / SURFACES. COORDINATE WITH SCHEDULED WORK ON MECHANICAL DRAWINGS. SEE ABATEMENT DRAWINGS.
1P	REMOVE PORTION OF STOREFRONT INSULATED PANEL TO ACCOMMODATE SCHEDULED WORK. COORDINATE WITH MECHANICAL DRAWINGS.
8A	REMOVE WINDOW AND STOREFRONT SYSTEM COMPLETELY. PREPARE OPENING TO EXTENT REQUIRED TO PERFORM SCHEDULED WORK. PATCH EXPOSED SURFACES TO MATCH ADJACENT FINISHES / SURFACES.
8B	REMOVE DOOR AND FRAME COMPLETELY. PATCH EXPOSED SURFACES TO MATCH ADJACENT FINISHES/SURFACES.
9A	REMOVE PORTION OF CEILING SYSTEM AND/OR SOFFIT SYSTEM TO EXTENT REQUIRED TO PERFORM SCHEDULED WORK. CLEAN, SALVAGE AND PROTECT FOR RE-INSTALLATION.
9A1	REMOVE CEILING SYSTEM AND/OR SOFFIT SYSTEM IN ITS ENTIRETY.
9B	REMOVE PORTION OF CEILING SYSTEM AND/OR SOFFIT SYSTEM, TO EXTENT REQUIRED TO PERFORM NEW WORK. CAREFULLY TRIM CEILING GRID TO REMAIN.
9C	REMOVE CEILING-OR WALL-MOUNTED ACOUSTICAL TREATMENTS IN THEIR ENTIRETY.
9Cv	REMOVE FLOOR FINISH, MASTIC AND WALL BASE TO EXTENT REQUIRED TO PERFORM SCHEDULED WORK - AT ALL AREAS OF FLOOR, WALL, AND CEILING. PATCH ADJACENT SLABS AT LOCATIONS SCHEDULED TO RECEIVE FLOOR FINISH. INCLUDE CONCRETE FLOOR PATCHING AND LEVELING MATERIALS TO MATCH EXISTING LEVEL. PATCH ADJACENT PATCH AREAS OF WALLS TO REMAIN THAT WERE DAMAGED BY REMOVAL OF WALL BASE.
<u>SUFFIX KEY (FLOOR FINISH IDENTIFICATIONS):</u>	
A. CARPET	
B. CERAMIC FLOOR TILE	
C. VAT/CUT.	
9E	REMOVE WALL BASE AND ASSOCIATED MASTIC ONLY - EXISTING FLOOR FINISH TO REMAIN. PATCH AREAS OF WALLS TO REMAIN THAT WERE DAMAGED BY REMOVAL OF WALL BASE.
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10B	REMOVE TOILET COMPONENTS IN THEIR ENTIRETY.
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12C	REMOVE TEACHING SURFACES INCLUDING MARKER BOARDS, TASK BOARDS AND CHALK BOARDS. TURN OVER TO OWNER PATCH EXPOSED SURFACES TO MATCH ADJACENT FINISHES AND SURFACES.

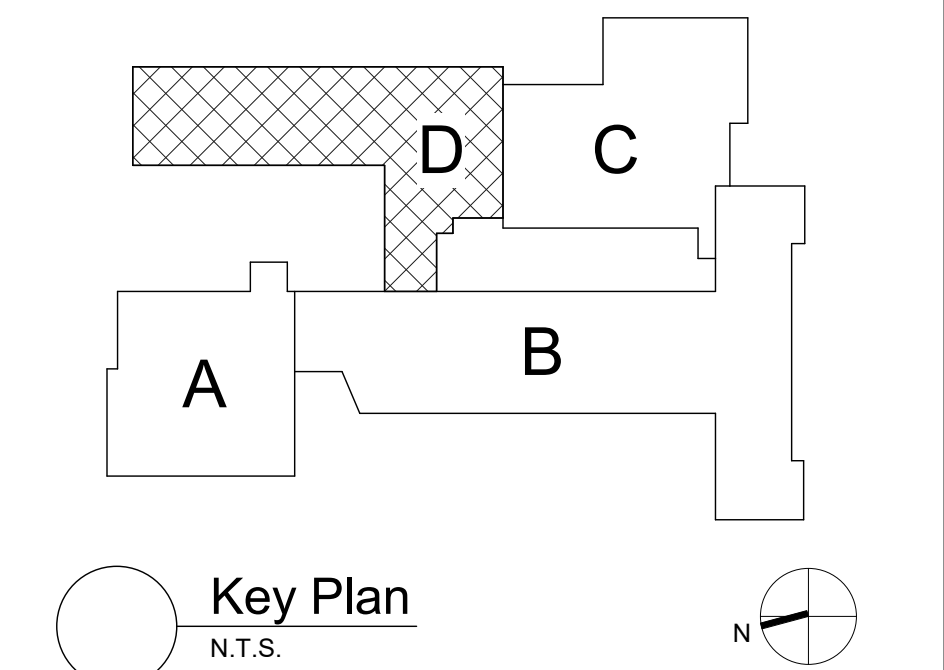


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TETRA TECH
ARCHITECTS & ENGINEERS

Beacon City School District
Beacon, New York

Additions and Alterations to: Glenham Elementary School


First Floor Demolition Plan - Area D

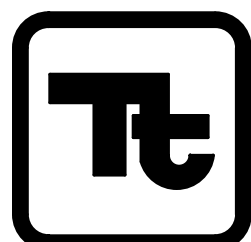Drawn By: GCK/tlg	Date: 10/28/2022
Project No.: 279180-22004	


BA102

2 First Floor Plan - Area C
1/8" = 1'-0"

1 First Floor Plan - Area A
1/8" = 1'-0"

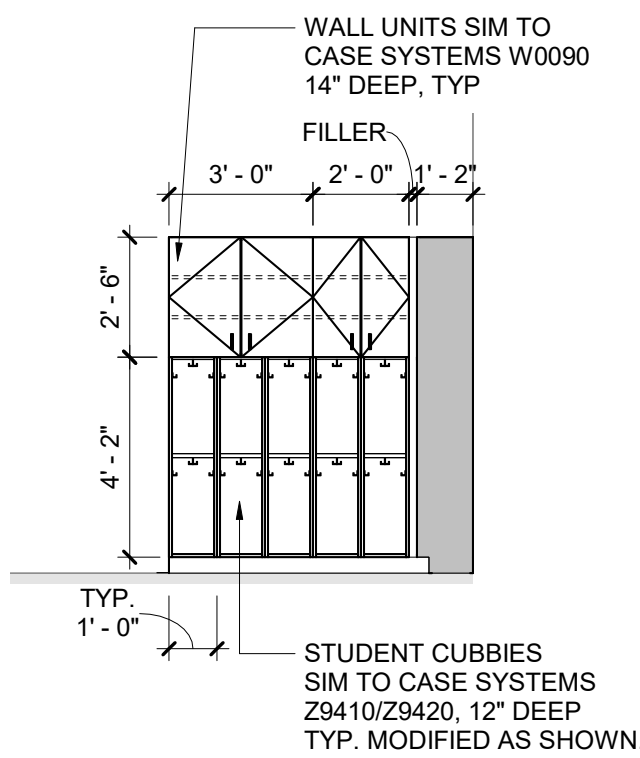

4 Classroom 15, 16-18, sim. - By Alternate No. 4
1/4" = 1'-0"

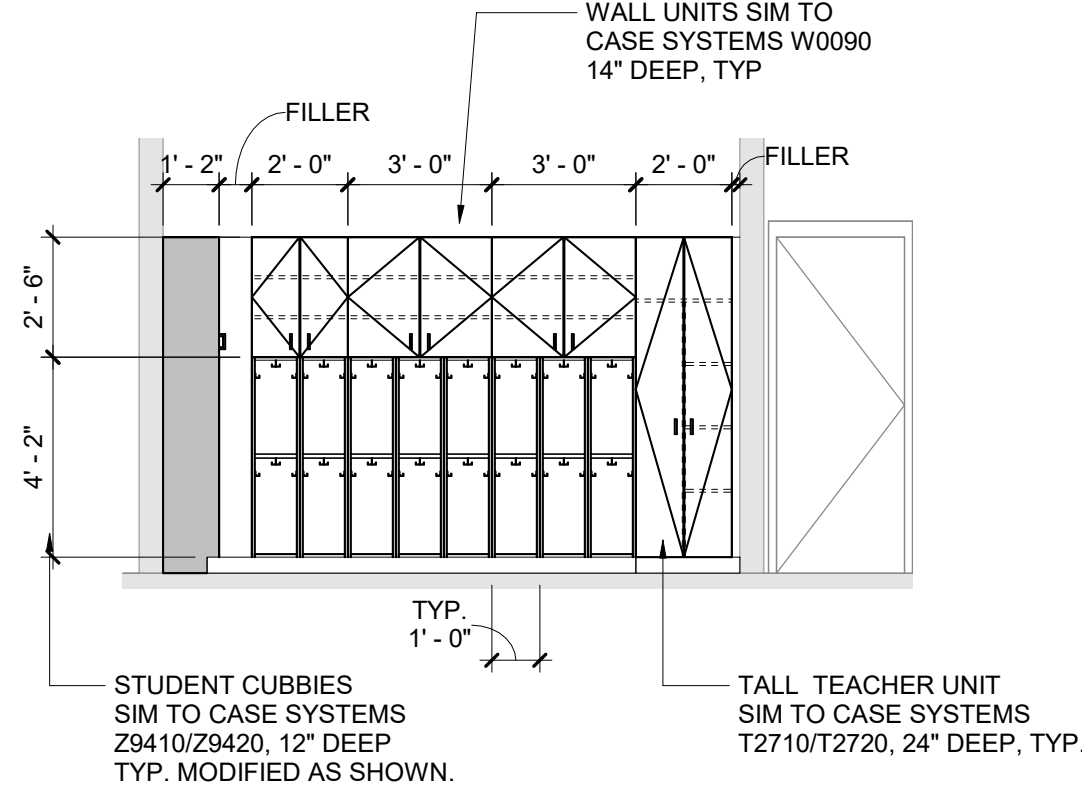

3 Classroom 15, 16-18, sim. - By Alternate No. 4
1/4" = 1'-0"

General Plan Notes

- A. WHERE EXISTING CONSTRUCTION IS DAMAGED OR DISTURBED, PATCH AS REQUIRED TO RESTORE SURFACES TO THEIR ORIGINAL CONDITION.
- B. PARTITION TYPE TAGS APPLY TO ENTIRE LENGTH OF WALL INDICATED BY THAT TAG, REGARDLESS OF OPENINGS WITHIN THAT WALL, TYPICAL UNLESS NOTED OTHERWISE.
- ALL EXTERIOR WALLS SHALL BE WALL/PARTITION TYPE EW1, TYPICAL UNLESS NOTED OTHERWISE.
 - ALL INTERIOR WALLS SHALL BE WALL/PARTITION TYPE P12.3, TYPICAL UNLESS NOTED OTHERWISE.
- C. PROVIDE BRACING WITHIN CHASES AS FOLLOWS:
- MASONRY WALLS: FULL-HEIGHT 4" CMU BRACES AT MAXIMUM SPACING OF 11'-0" OC.
 - GYPSUM BOARD/TILE BACKING PANELS ON METAL FRAMING: FULL-HEIGHT 6" METAL STUD BRACES AT MAXIMUM SPACING OF 11'-0" OC.

Keyed Plan Notes


- REINSTALL EXISTING CEILING PANELS AND GRID.
- INSTALL LOUVER IN EXG INSULATED PANEL, COORD WITH HVAC DRAWINGS
- INSTALL LOUVER FURNISHED BY OTHERS AT EXISTING OPENING. COORDINATE WITH MECHANICAL DRAWINGS.
- INSTALL LOUVER FURNISHED BY OTHERS AT NEW OPENING. COORDINATE WITH MECHANICAL DRAWINGS.

Room Finish Key

- C1 CARPET - TYPE 1
C2 CARPET - TYPE 2
CFT1 CERAMIC FLOOR TILE - TYPE 1
CT CERAMIC TILE COVE BASE
CWT1 CERAMIC WALL TILE - TYPE 1
LVT LUXURY VINYL TILE
MCS MOISTURE CONTROL SYSTEM
N NO WORK REQUIRED
P PAINT SURFACE(S) INCLUDING SOFFITS
RB RUBBER BASE
VCT1 VINYL COMPOSITION TILE - TYPE 1
- * SEE REFLECTED CEILING PLAN
+ INDICATED CHANGE IN FLOOR FINISH
- NOTE: ALL FINISHES LISTED MAY NOT BE REQUIRED FOR THIS PROJECT

RM#	
CLG*	WALL
FLR	BASE

REFER TO DRAWING BA900 FOR GENERAL FINISH NOTES
REFER TO DRAWING BA900 FOR CASEWORK NOTES

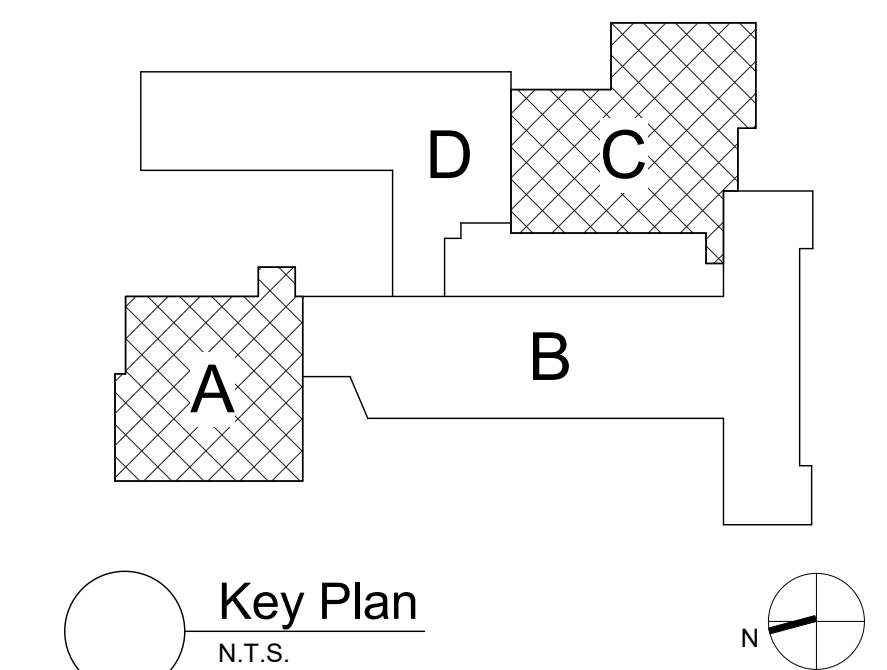

S.E.D. Control No. 13-02-00-01-0-006-022

Rev. No.: Date: Description:



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Beacon City School District
Beacon, New York


Additions and Alterations to:
Glenham Elementary School

First Floor Plan - Area A and C

Drawn By: GCK/ig Date: 10/28/2022 Drawing Number:

Project No.: 279180-22004

BA130

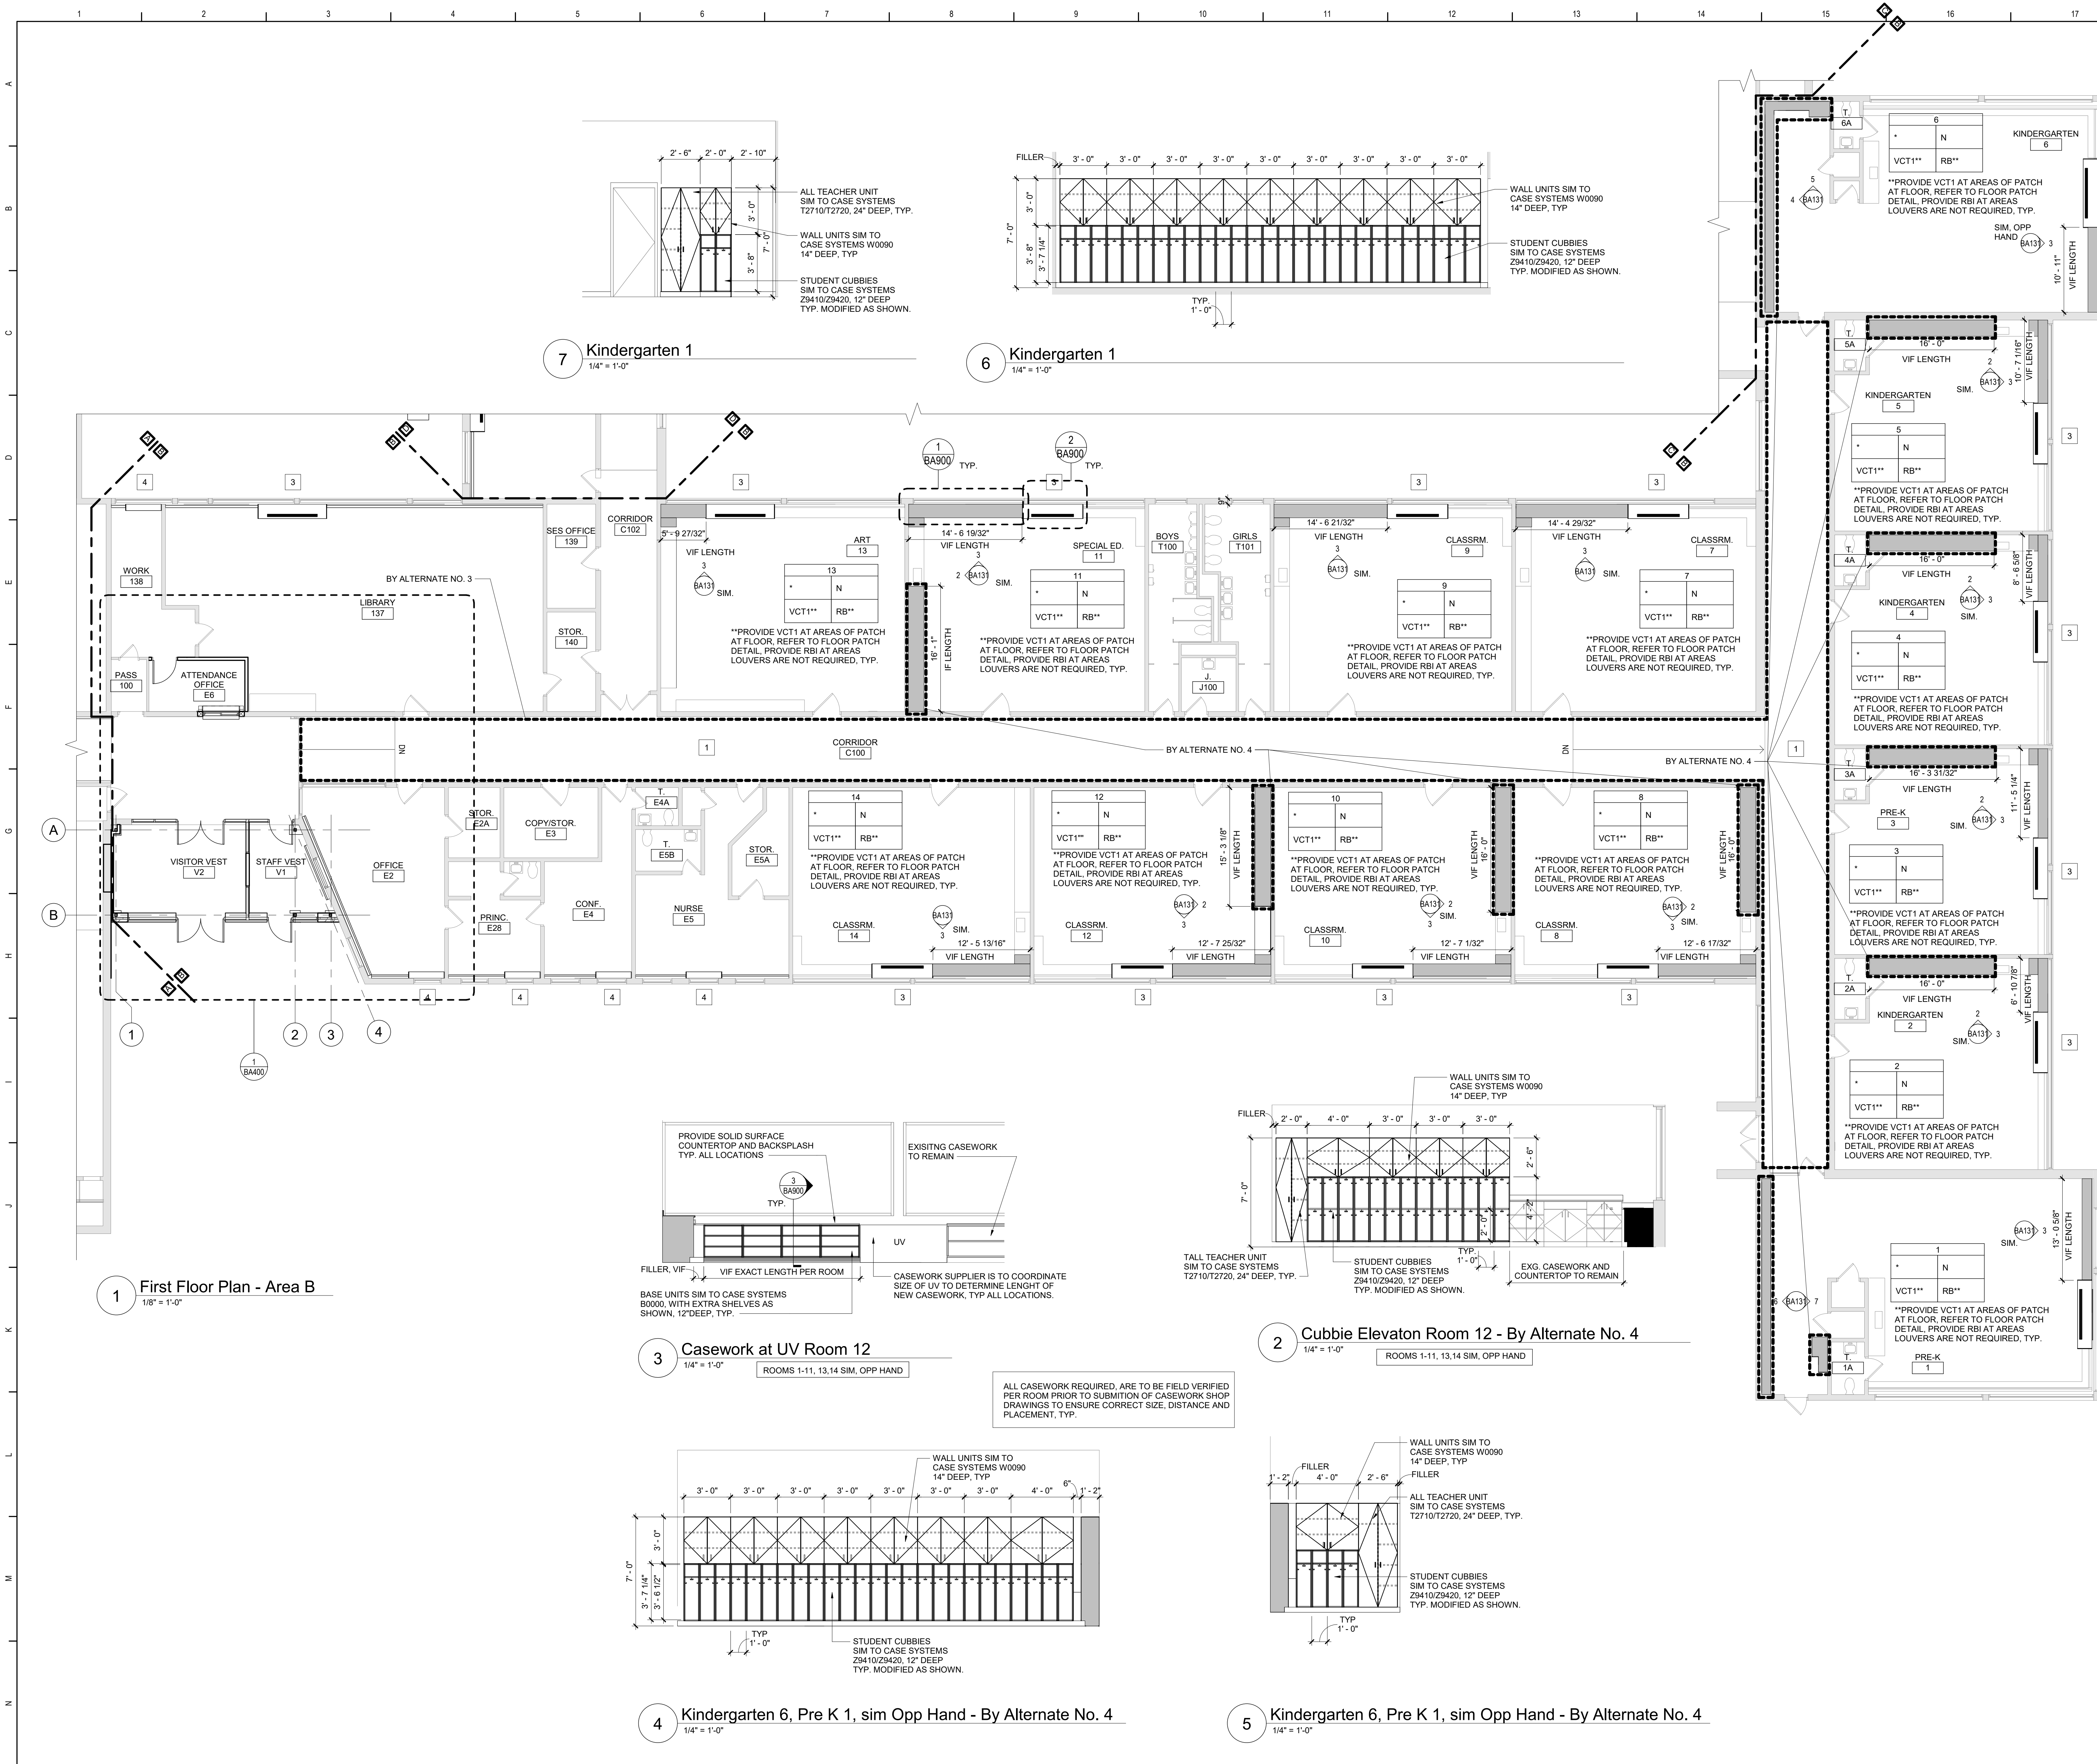

General Plan Notes

- WHERE EXISTING CONSTRUCTION IS DAMAGED OR DISTURBED, PATCH AS REQUIRED TO RESTORE SURFACES TO THEIR ORIGINAL CONDITION.
- PARTITION TYPE TAGS APPLY TO ENTIRE LENGTH OF WALL INDICATED BY THAT TAG, REGARDLESS OF OPENINGS WITHIN THAT WALL, TYPICAL UNLESS NOTED OTHERWISE.
 - ALL EXTERIOR WALLS SHALL BE WALL/PARTITION TYPE EW1, TYPICAL UNLESS NOTED OTHERWISE.
 - ALL INTERIOR WALLS SHALL BE WALL/PARTITION TYPE PI2.3, TYPICAL UNLESS NOTED OTHERWISE.
- PROVIDE BRACING WITHIN CHASES AS FOLLOWS:
 - MASONRY WALLS: FULL-HEIGHT 4" CMU BRACES AT MAXIMUM SPACING OF 11'-0" OC.
 - GYPSON BOARD/TILE BACKING PANELS ON METAL FRAMING: FULL-HEIGHT 6" METAL STUD BRACES AT MAXIMUM SPACING OF 11'-0" OC.

Keyed Plan Notes

- REINSTALL EXISTING CEILING PANELS AND GRID.
- INSTALL LOUVER IN EXG INSULATED PANEL, COORD WITH HVAC DRAWINGS
- INSTALL LOUVER FURNISHED BY OTHERS AT EXISTING OPENING. COORDINATE WITH MECHANICAL DRAWINGS.
- INSTALL LOUVER FURNISHED BY OTHERS AT NEW OPENING. COORDINATE WITH MECHANICAL DRAWINGS.


Room Finish Key

- | | |
|------|------------------------------------|
| C1 | CARPET - TYPE 1 |
| C2 | CARPET - TYPE 2 |
| CT | CERAMIC TILE COVE BASE |
| CWT1 | CERAMIC WALL TILE - TYPE 1 |
| LVT | LUXURY VINYL TILE |
| MCS | MOISTURE CONTROL SYSTEM |
| N | NO WORK REQUIRED |
| PC | PAINT SURFACE(S) INCLUDING SOFFITS |
| RB | RUBBER BASE |
| VCT1 | VINYL COMPOSITION TILE - TYPE 1 |

- SEE REFLECTED CEILING PLAN
- INDICATED CHANGE IN FLOOR FINISH
- NOTE: ALL FINISHES LISTED MAY NOT BE REQUIRED FOR THIS PROJECT

FINISHES SHOWN IN ROOM FINISH BOX ARE FOR ALL WALLS AND ENTIRE FLOOR AND CEILING. REFER TO EACH ROOM FOR MORE INFORMATION.	RM#
CLG*	WALL
FLR	BASE

REFER TO DRAWING BA900 FOR GENERAL FINISH NOTES
REFER TO DRAWING BA900 FOR CASEWORK NOTES

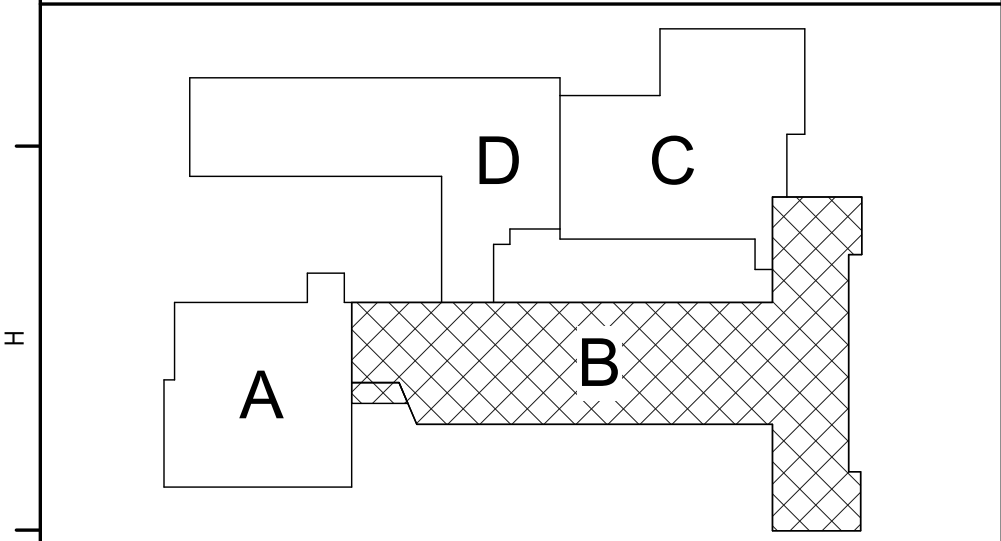

Key Plan
N.T.S.

S.E.D. Control No. 13-02-00-01-0-006-022

Rev. No.: Date: Description:



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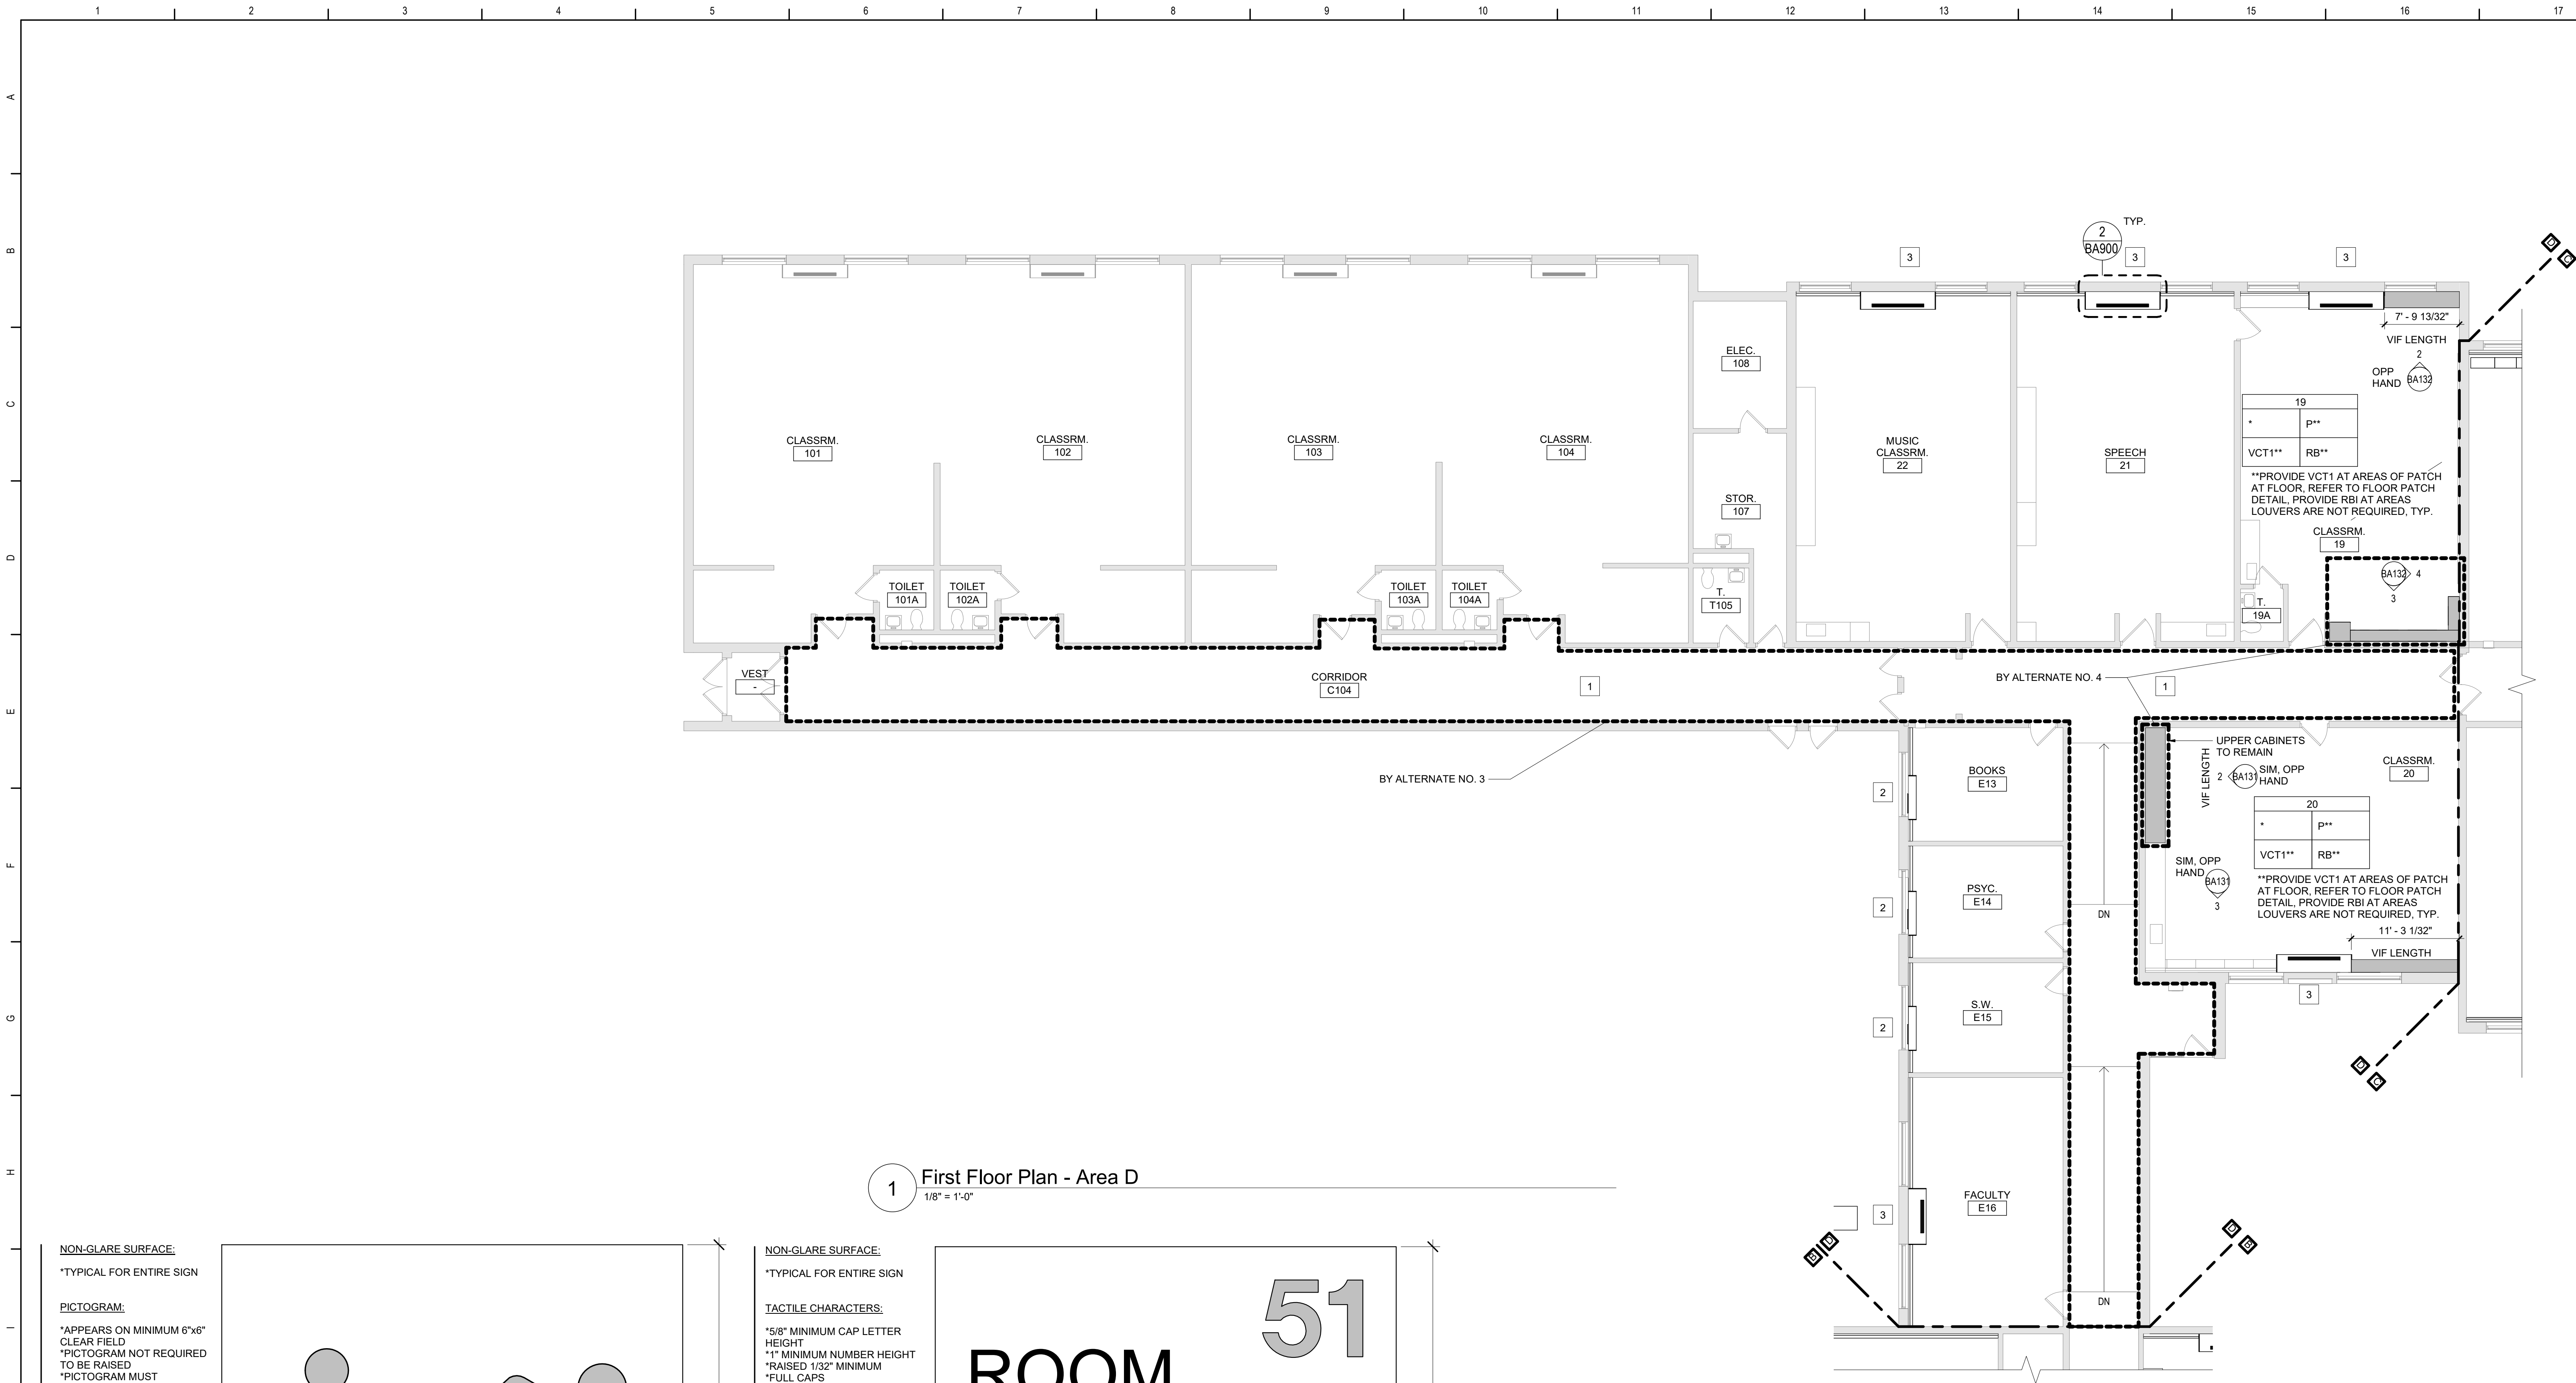


Beacon City School District
Beacon, New York

Additions and Alterations to:
Glenham Elementary School

First Floor Plan - Area B

Drawn By: GCK/lig	Date: 10/28/2022	Drawing Number:
Project No.: 279180-22004	BA131	



General Plan Notes

- A. WHERE EXISTING CONSTRUCTION IS DAMAGED OR DISTURBED, PATCH AS REQUIRED TO RESTORE SURFACES TO THEIR ORIGINAL CONDITION.
- B. PARTITION TYPE TAGS APPLY TO ENTIRE LENGTH OF WALL INDICATED BY THAT TAG, REGARDLESS OF OPENINGS WITHIN THAT WALL, TYPICAL UNLESS NOTED OTHERWISE.
1. ALL EXTERIOR WALLS SHALL BE WALL/PARTITION TYPE EW1, TYPICAL UNLESS NOTED OTHERWISE.
2. ALL INTERIOR WALLS SHALL BE WALL/PARTITION TYPE P12.3, TYPICAL UNLESS NOTED OTHERWISE.
- C. PROVIDE BRACING WITHIN CHASES AS FOLLOWS:
1. MASONRY WALLS: FULL-HEIGHT 4" CMU BRACES AT MAXIMUM SPACING OF 11'-0" OC.
2. GYPSUM BOARD/TILE BACKING PANELS ON METAL FRAMING: FULL-HEIGHT 6" METAL STUD BRACES AT MAXIMUM SPACING OF 11'-0" OC.

Keyed Plan Notes

1. REINSTALL EXISTING CEILING PANELS AND GRID.
2. INSTALL LOUVER IN EXG INSULATED PANEL, COORD WITH HVAC DRAWINGS.
3. INSTALL LOUVER FURNISHED BY OTHERS AT EXISTING OPENING. COORDINATE WITH MECHANICAL DRAWINGS.
4. INSTALL LOUVER FURNISHED BY OTHERS AT NEW OPENING. COORDINATE WITH MECHANICAL DRAWINGS.

Room Finish Key


C1	CARPET - TYPE 1
C2	CARPET - TYPE 2
CT1	CERAMIC FLOOR TILE - TYPE 1
CT	CERAMIC TILE COVE BASE
CWT1	CERAMIC WALL TILE - TYPE 1
LVT	LUXURY VINYL TILE
MCS	MOISTURE CONTROL SYSTEM
N	NO WORK REQUIRED
P	PAINT SURFACE(S) INCLUDING SOFFITS
RB	RUBBER BASE
VCT1	VINYL COMPOSITION TILE - TYPE 1

- * SEE REFLECTED CEILING PLAN
- INDICATED CHANGE IN FLOOR FINISH

NOTE: ALL FINISHES LISTED MAY NOT BE REQUIRED FOR THIS PROJECT

RM#	CLG*	WALL
FLR	FLR	BASE

REFER TO DRAWING BA900 FOR GENERAL FINISH NOTES
REFER TO DRAWING BA900 FOR CASEWORK NOTES

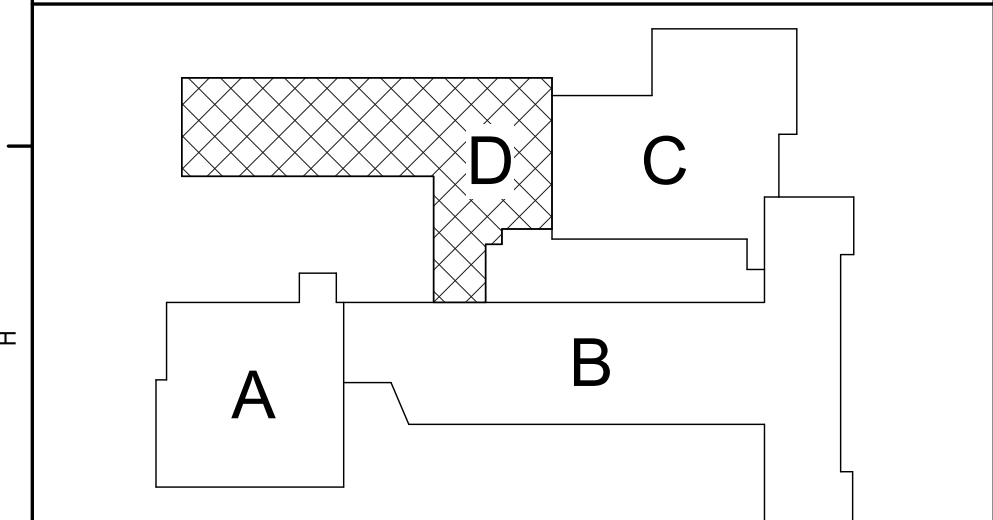

Key Plan
N.T.S.

S.E.D. Control No. 13-02-00-01-0-006-022

Rev. No.	Date	Description



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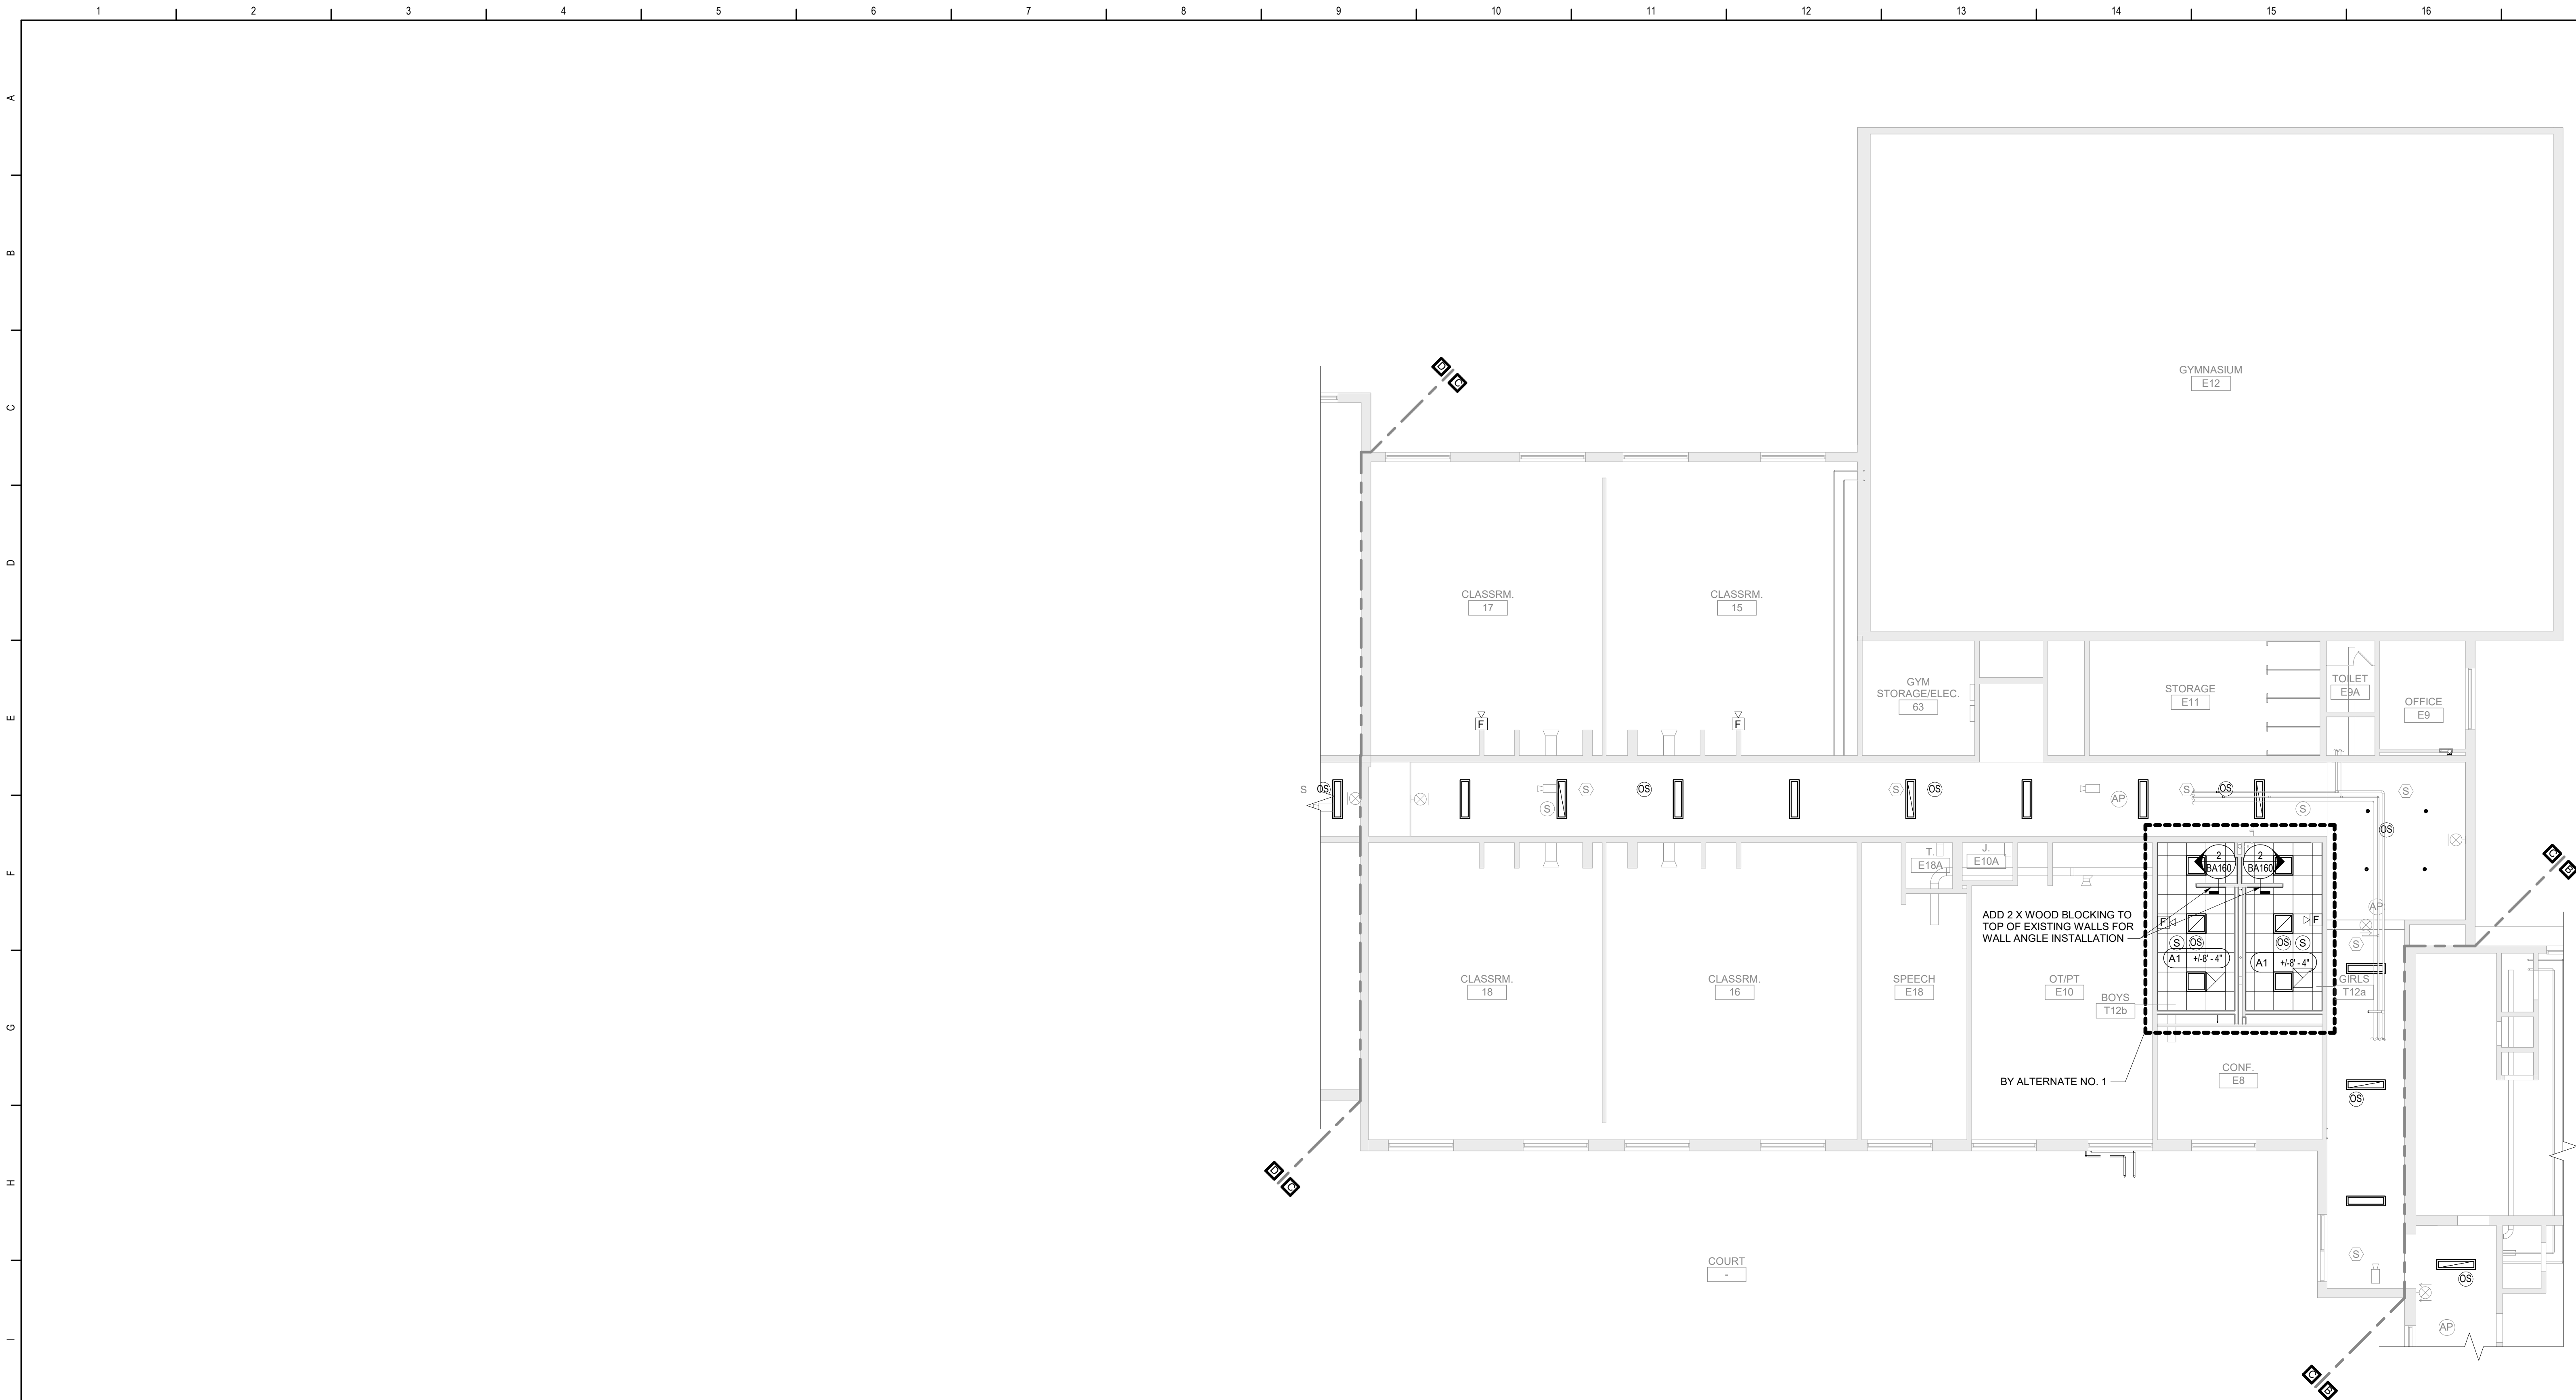


Beacon City School District
Beacon, New York


Additions and Alterations to:
Glenham Elementary School

First Floor Plan - Area D

Drawn By: GCK/lig	Date: 10/28/2022	Drawing Number:
Project No.: 279180-22004	BA132	



1 First Floor Reflected Ceiling Plan - Area C
1/8" = 1'-0"

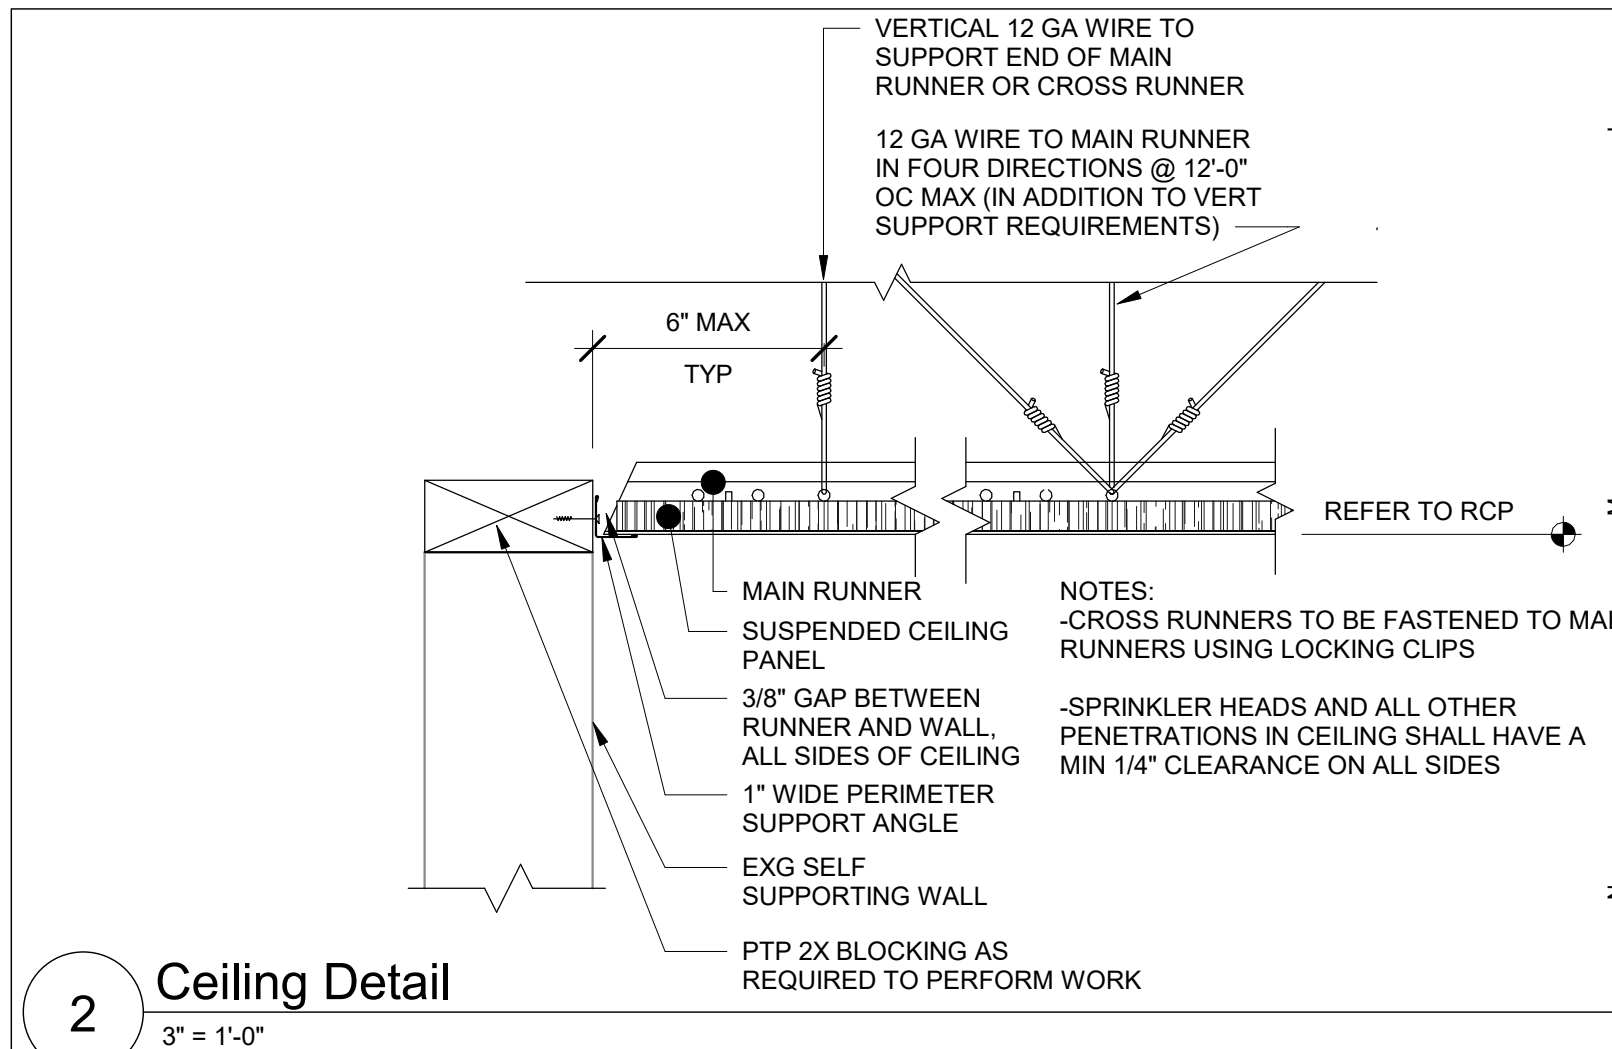

2 Ceiling Detail
3" = 1'-0"

General Ceiling Notes


- LIGHTING AND OTHER CEILING-MOUNTED FIXTURES ARE SHOWN FOR DRAWING CLARITY. COORDINATE ALL CEILING WORK PRIOR TO INSTALLATION OF CEILING GRID.
- CEILING HEIGHT IS 9'-0" ABOVE FINISHED FLOOR (UNO).
- CENTER CEILING-MOUNTED ITEMS (LIGHTS, GRILLES, DETECTORS, SPRINKLER HEAD, ETC) WITHIN THE CEILING PANELS AND GRIDS UNLESS THE PANELS ARE SCORED. CENTER ITEMS WITHIN THE PATTERN OF SCORED PANELS.
- PROVIDE EXPANSION JOINT (EJ) COVERS IN CEILINGS AND SOFFITS AT EJ LOCATIONS.
- PROVIDE CONTROL JOINTS IN GYPSUM BOARD CEILINGS AND SOFFITS AS DETAILED ON DRAWINGS (MAXIMUM 20'-0" OC, EVENLY SPACED, TYP UNO).
- PATCH CEILING SYSTEMS TO REMAIN THAT HAVE BEEN DISTURBED BY SCHEDULED WORK TO MATCH ADJACENT CONSTRUCTION PRIOR TO PAINTING.
- X 9'-0" DESIGNATES BOTTOM OF CEILING ABOVE FINISHED FLOOR AT THAT POINT UNO. DESIGNATION "ME" INDICATES MATCH EXISTING CEILING HEIGHT.
- AT ALL LOCATIONS OF GYPSUM CEILINGS - PROVIDE 24" X 24" CONCEALED FLANGE ACCESS DOOR REGARDLESS OF LOCATION OR REQUIREMENT FOR ACCESS TO EQUIPMENT.

Ceiling Types

- (A1) X-X" ACOUSTIC PANEL CEILING
- (A2) X-X" ACOUSTIC PANEL CEILING
- (B1) X-X" PAINTED 1/2" EXTERIOR GRADE GYPSUM CEILING ON SUPPORT MATERIALS (GRID SUSPENSION SYSTEM, TYP UNO)


NOTE: AT AREAS WITH "4/4", THE INTENT IS TO MATCH EXISTING. VERIFY IN FIELD.

REFER TO BA130 SERIES DWGS FOR REINSTALLATION OF SALVAGED CEILING AREAS.

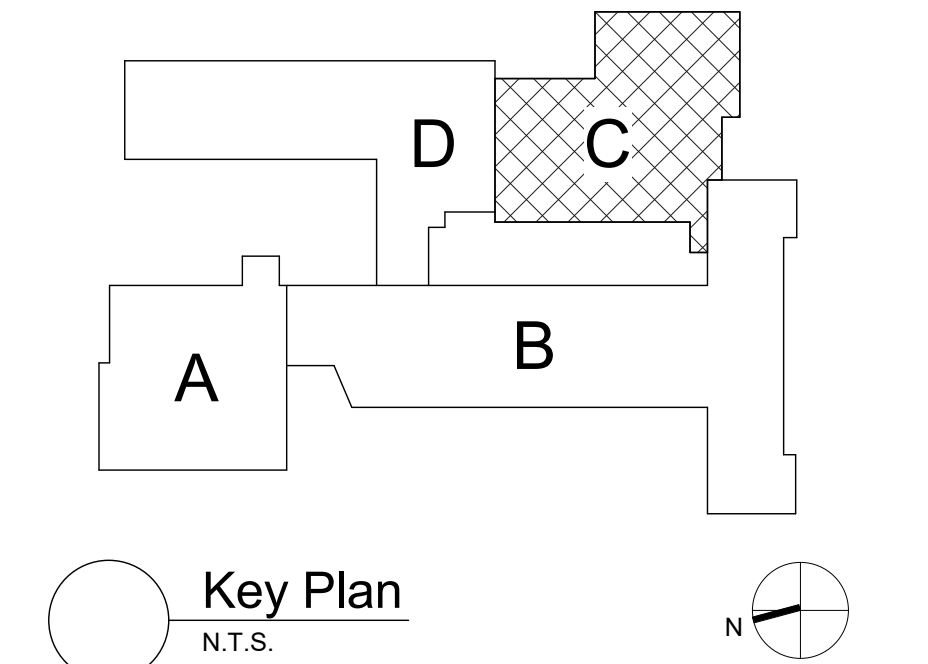

S.E.D. Control No. 13-02-00-01-0-006-022

Rev. No.	Date	Description

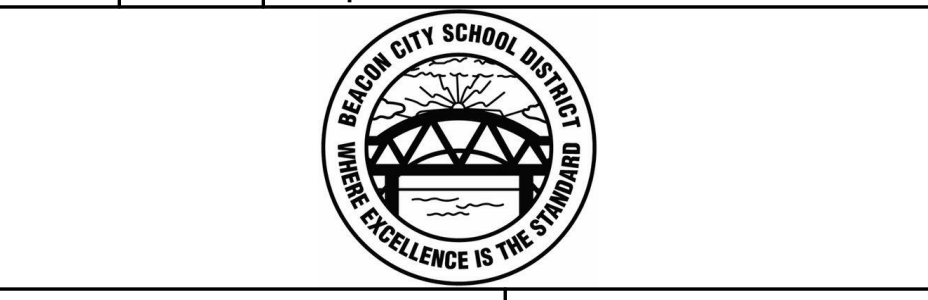

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BID SET




Beacon City School District
Beacon, New York

Additions and Alterations to:
Glenham Elementary School

First Floor Reflected Ceiling Plan -
Area C

Drawn By: GCK/tlg	Date: 10/28/2022	Drawing Number: BA160
Project No.: 279180-22004		

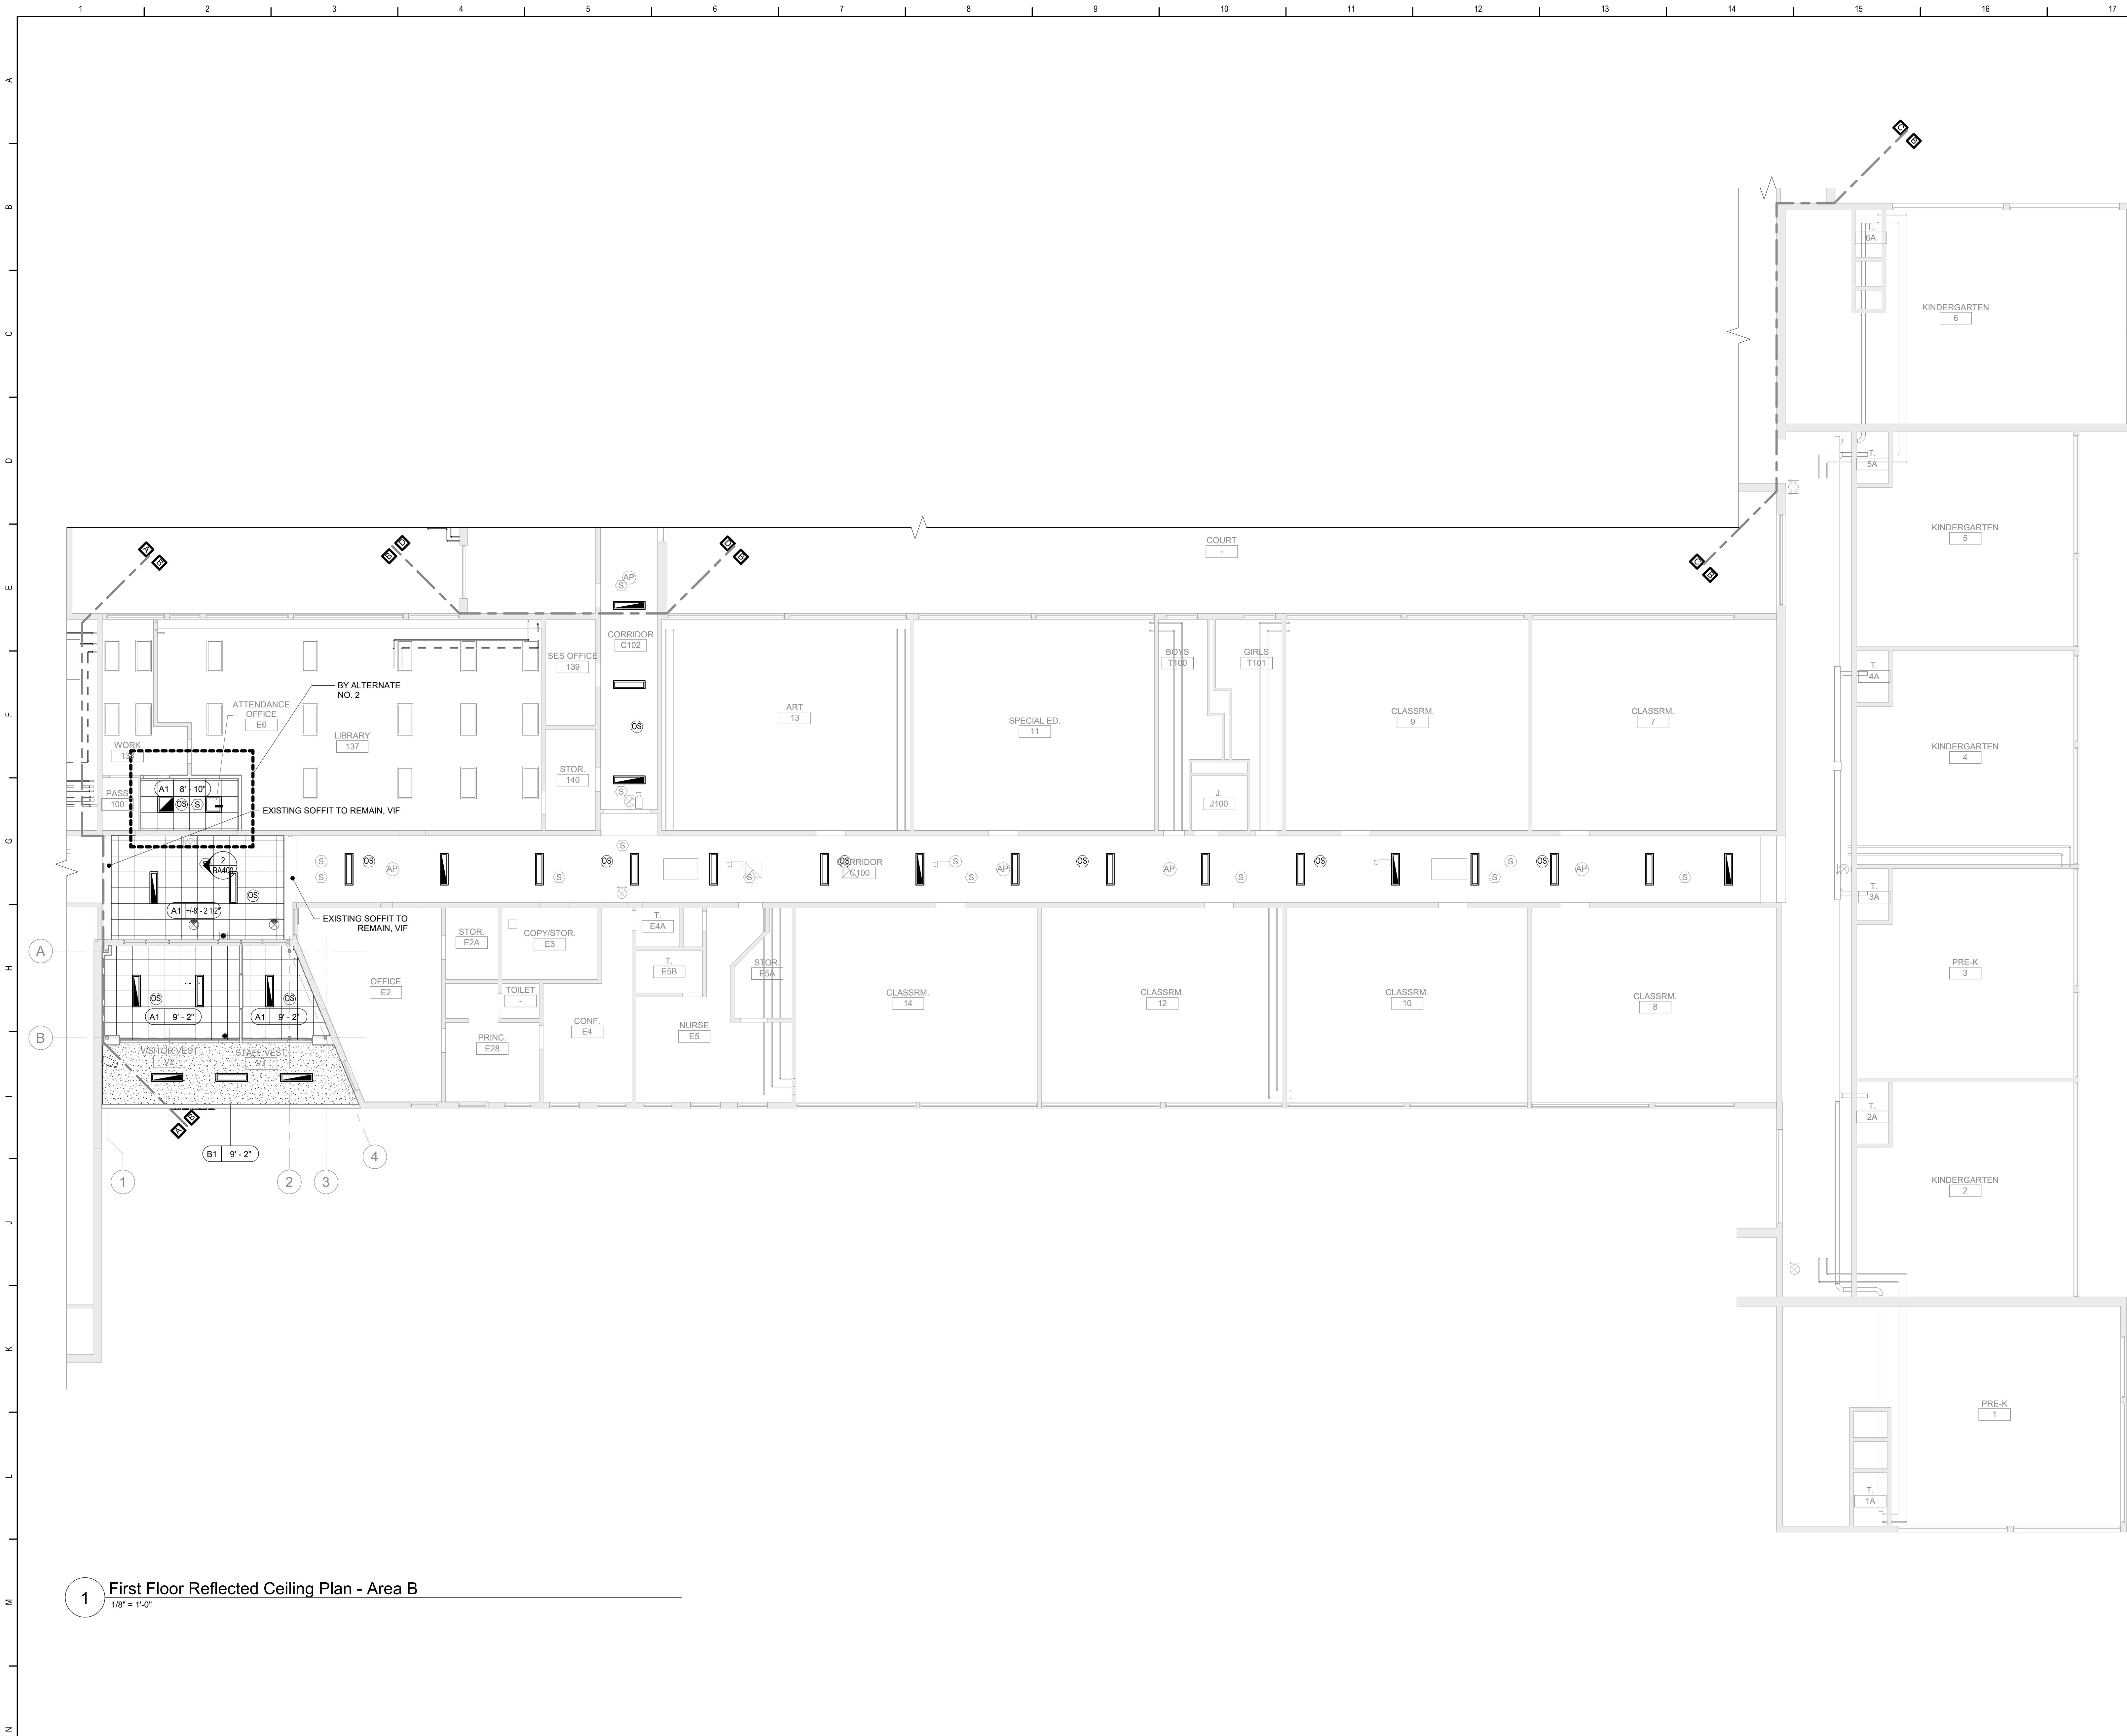

1 First Floor Reflected Ceiling Plan - Area B
1/8" = 1'-0"


General Ceiling Notes

- A. LIGHTING AND OTHER CEILING-MOUNTED FIXTURES ARE SHOWN FOR DRAWING CLARITY. COORDINATE ALL CEILING WORK PRIOR TO INSTALLATION OF CEILING GRID.
- B. CEILING HEIGHT IS 9'-0" ABOVE FINISHED FLOOR (UNO).
- C. CENTER CEILING-MOUNTED ITEMS (LIGHTS, GRILLES, DETECTORS, SPRINKLER HEAD, ETC) WITHIN THE CEILING PANELS AND GRIDS UNLESS THE PANELS ARE SCORED. CENTER ITEMS WITHIN THE PATTERN OF SCORED PANELS.
- D. PROVIDE EXPANSION JOINT (EJ) COVERS IN CEILINGS AND SOFFITS AT EJ LOCATIONS.
- E. PROVIDE CONTROL JOINTS IN GYPSUM BOARD CEILINGS AND SOFFITS AS DETAILED ON DRAWINGS (MAXIMUM 20'-0" OC, EVENLY SPACED, TYP UNO).
- F. PATCH CEILING SYSTEMS TO REMAIN THAT HAVE BEEN DISTURBED BY SCHEDULED WORK TO MATCH ADJACENT CONSTRUCTION PRIOR TO PAINTING.
- G. (X) 9'-0" DESIGNATES BOTTOM OF CEILING ABOVE FINISHED FLOOR AT THAT POINT UNO. DESIGNATION "ME" INDICATES MATCH EXISTING CEILING HEIGHT.
- H. AT ALL LOCATIONS OF GYPSUM CEILINGS - PROVIDE 24" X 24" CONCEALED FLANGE ACCESS DOOR REGARDLESS OF LOCATION OR REQUIREMENT FOR ACCESS TO EQUIPMENT.

Ceiling Types


- A1 (X-X") ACOUSTIC PANEL CEILING
- A2 (X-X") ACOUSTIC PANEL CEILING
- B1 (X-X") PAINTED 1/2" EXTERIOR GRADE GYPSUM CEILING ON SUPPORT MATERIALS (GRID SUSPENSION SYSTEM, TYP UNO)

NOTE: AT AREAS WITH "+/-", THE INTENT IS TO MATCH EXISTING. VERIFY IN FIELD.
REFER TO BA130 SERIES DWGS FOR REINSTALLATION OF SALVAGED CEILING AREAS.

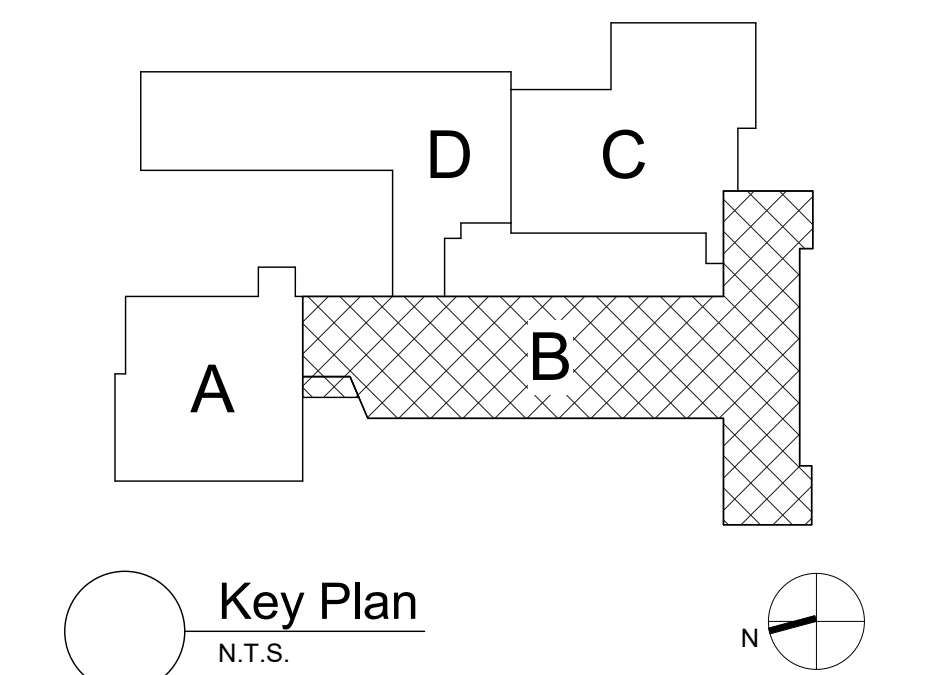

S.E.D. Control No. 13-02-00-01-0-006-022

Rev. No.:	Date:	Description:

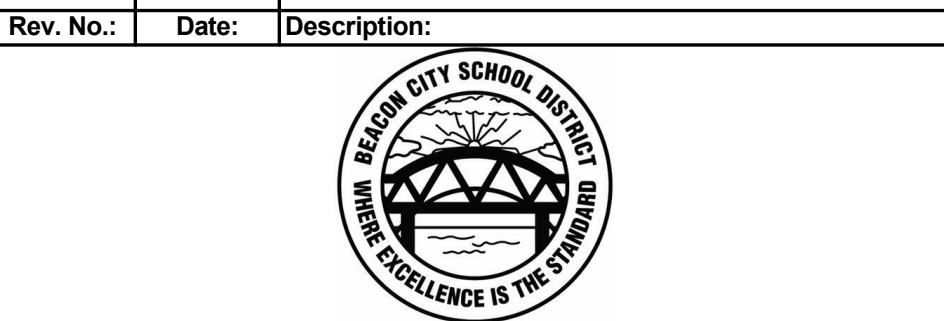

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BID SET




Beacon City School District
Beacon, New York


Additions and Alterations to:
Glenham Elementary School

First Floor Reflected Ceiling Plan -
Area B


Drawn By: GCK/lig	Date: 10/28/2022	Drawing Number:
Project No.:	279180-22004	BA161

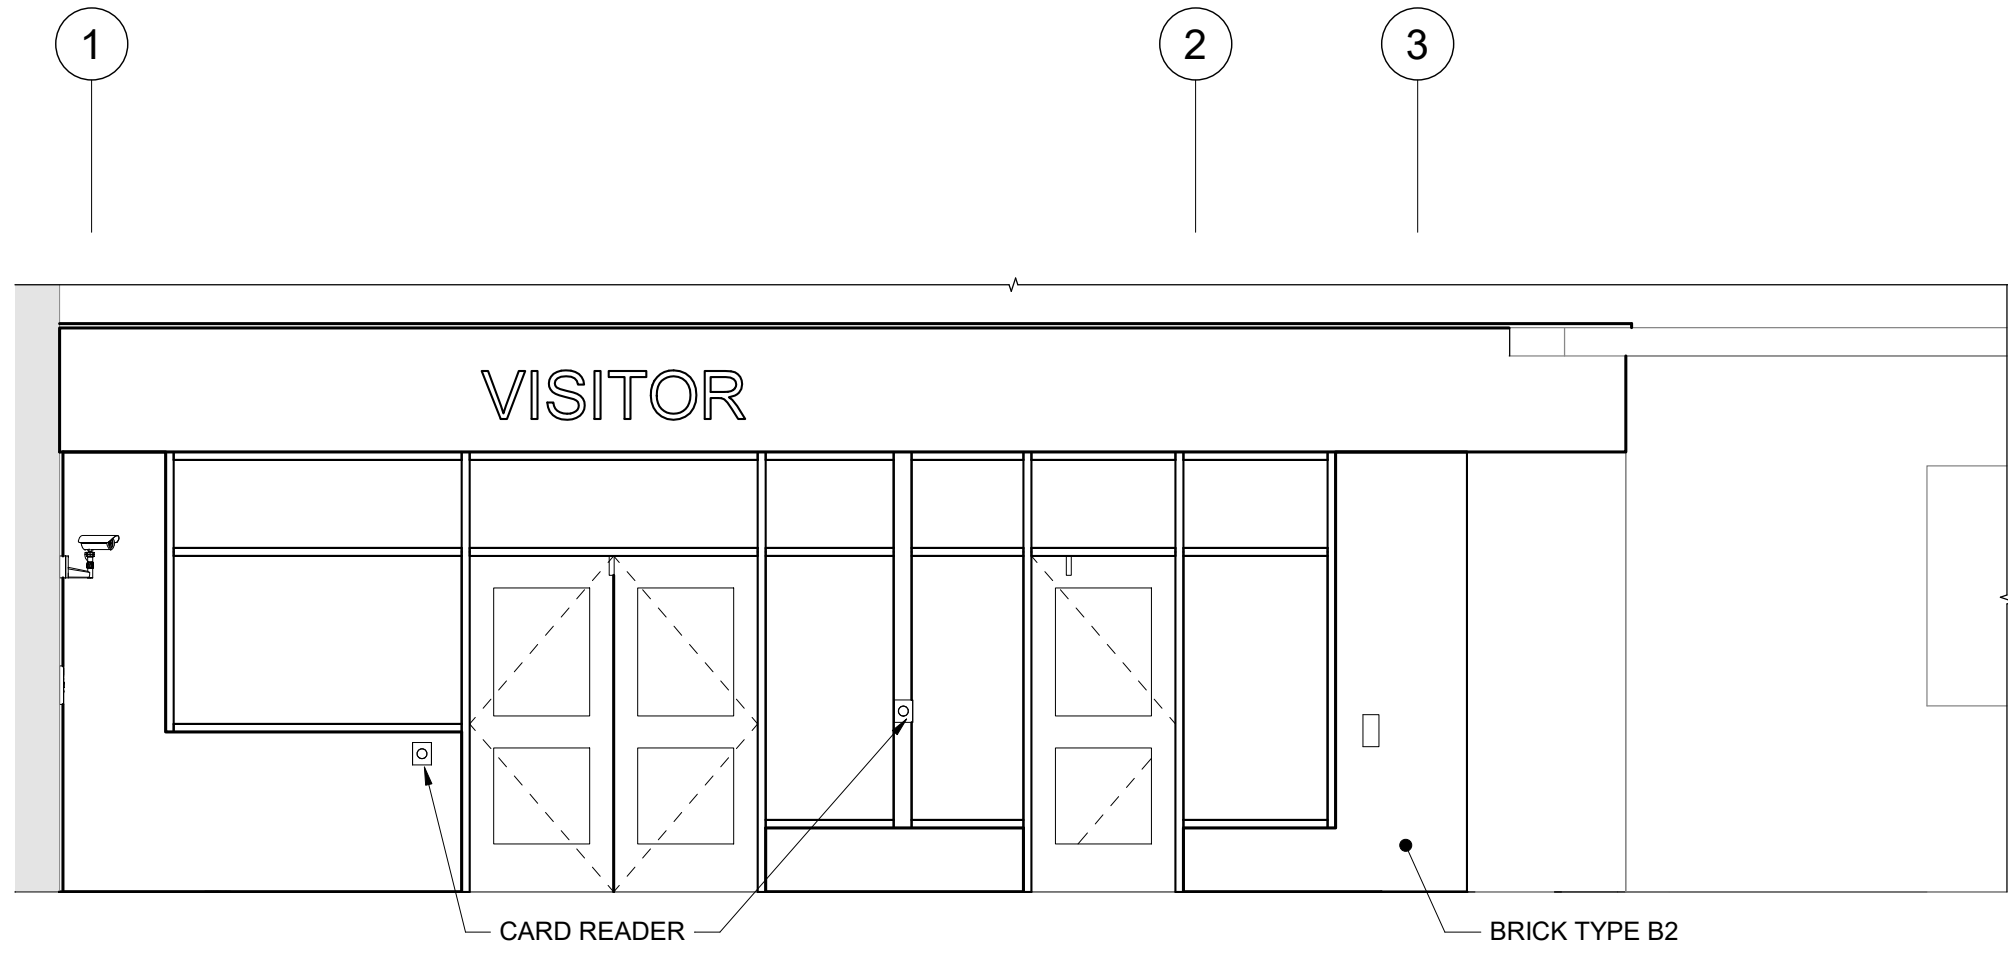


4 Main Entry Elevation
1/4" = 1'-0"

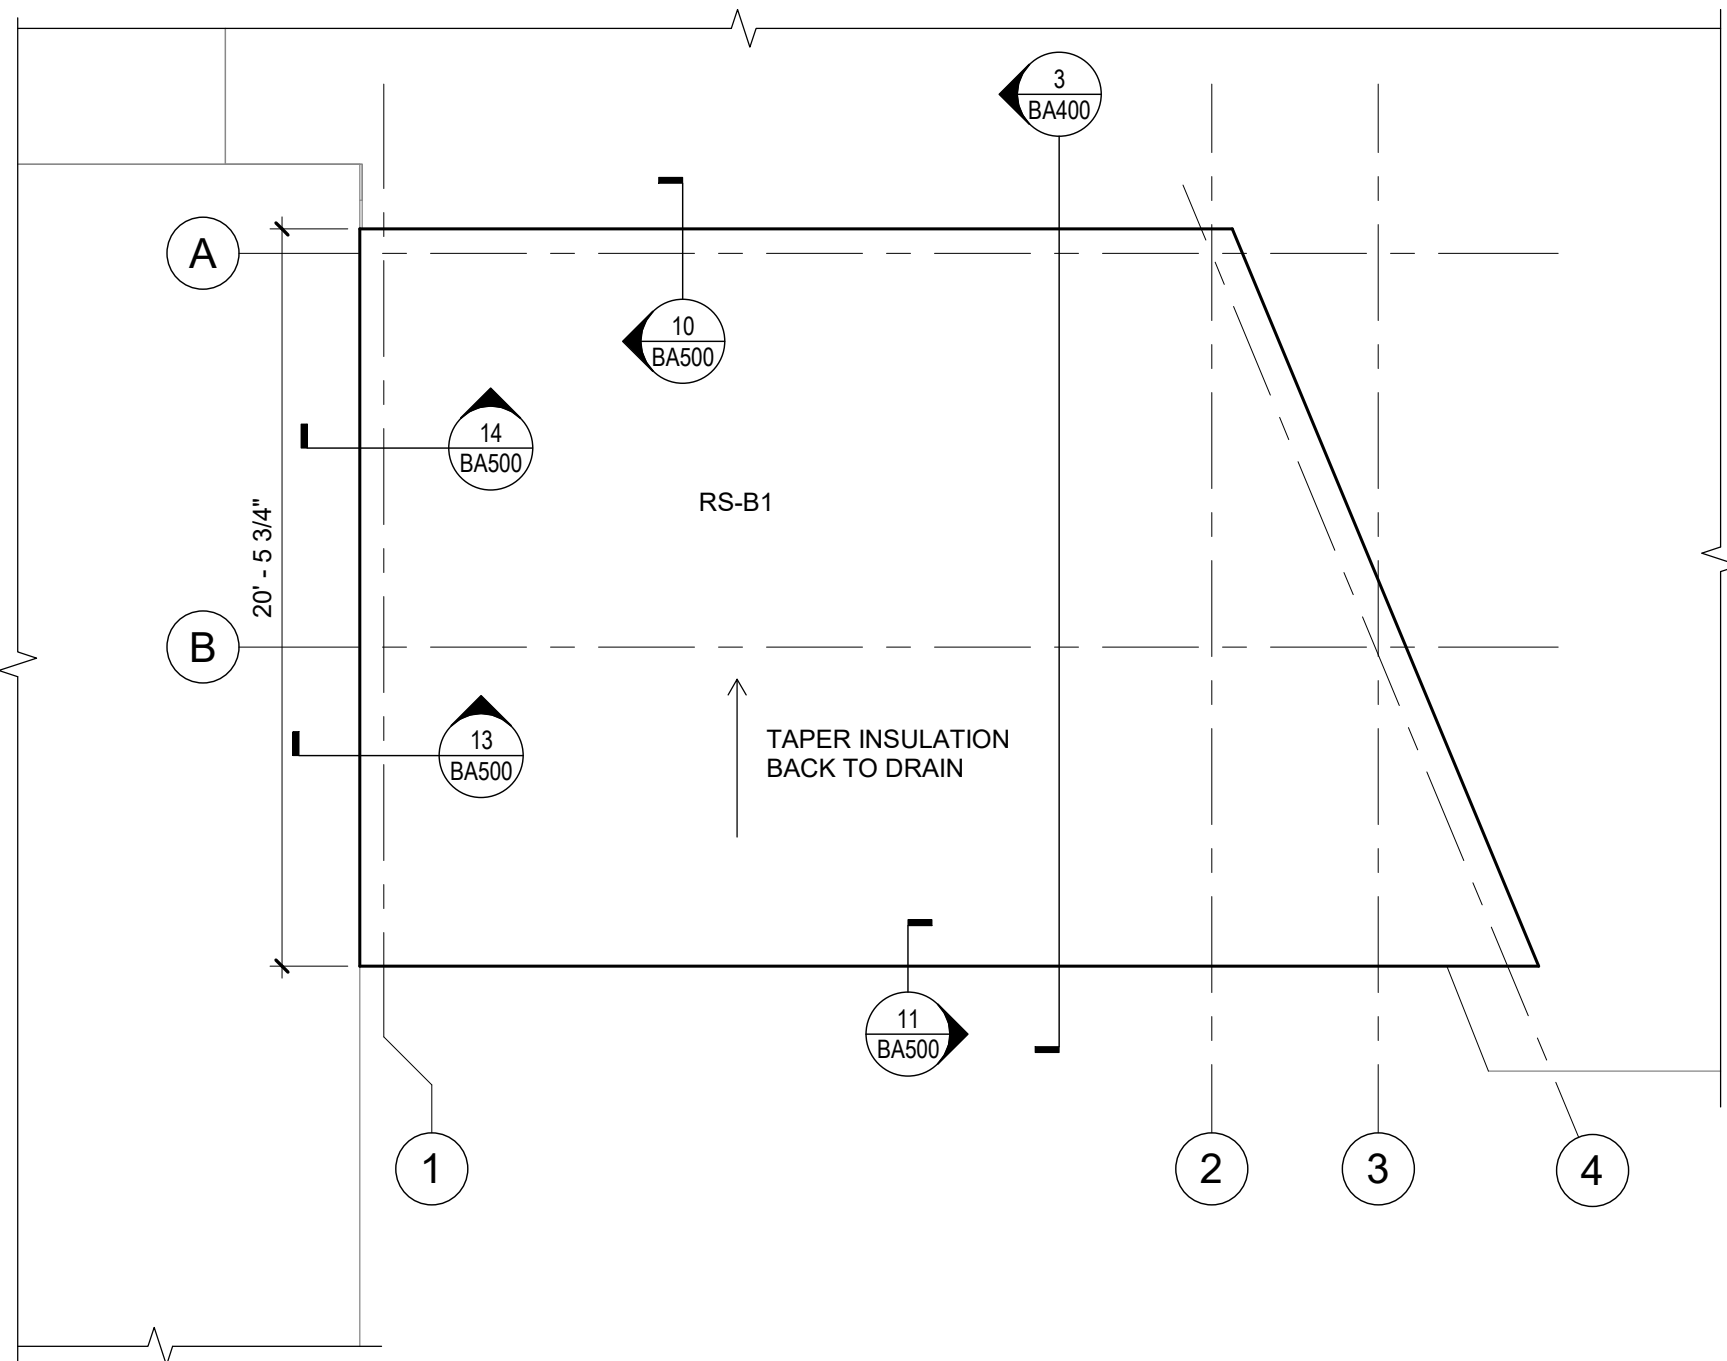


5 Roof Plan
3/16" = 1'-0"

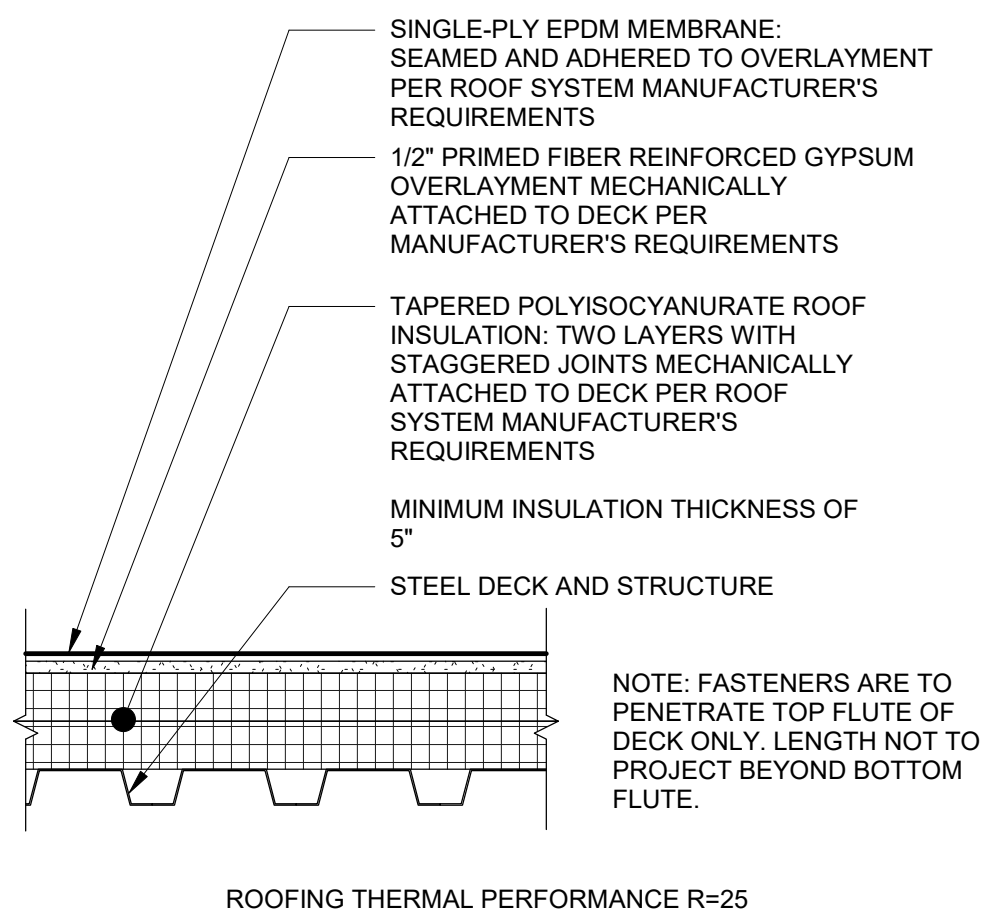


6 Roof System RS-B1
1 1/2" = 1'-0"

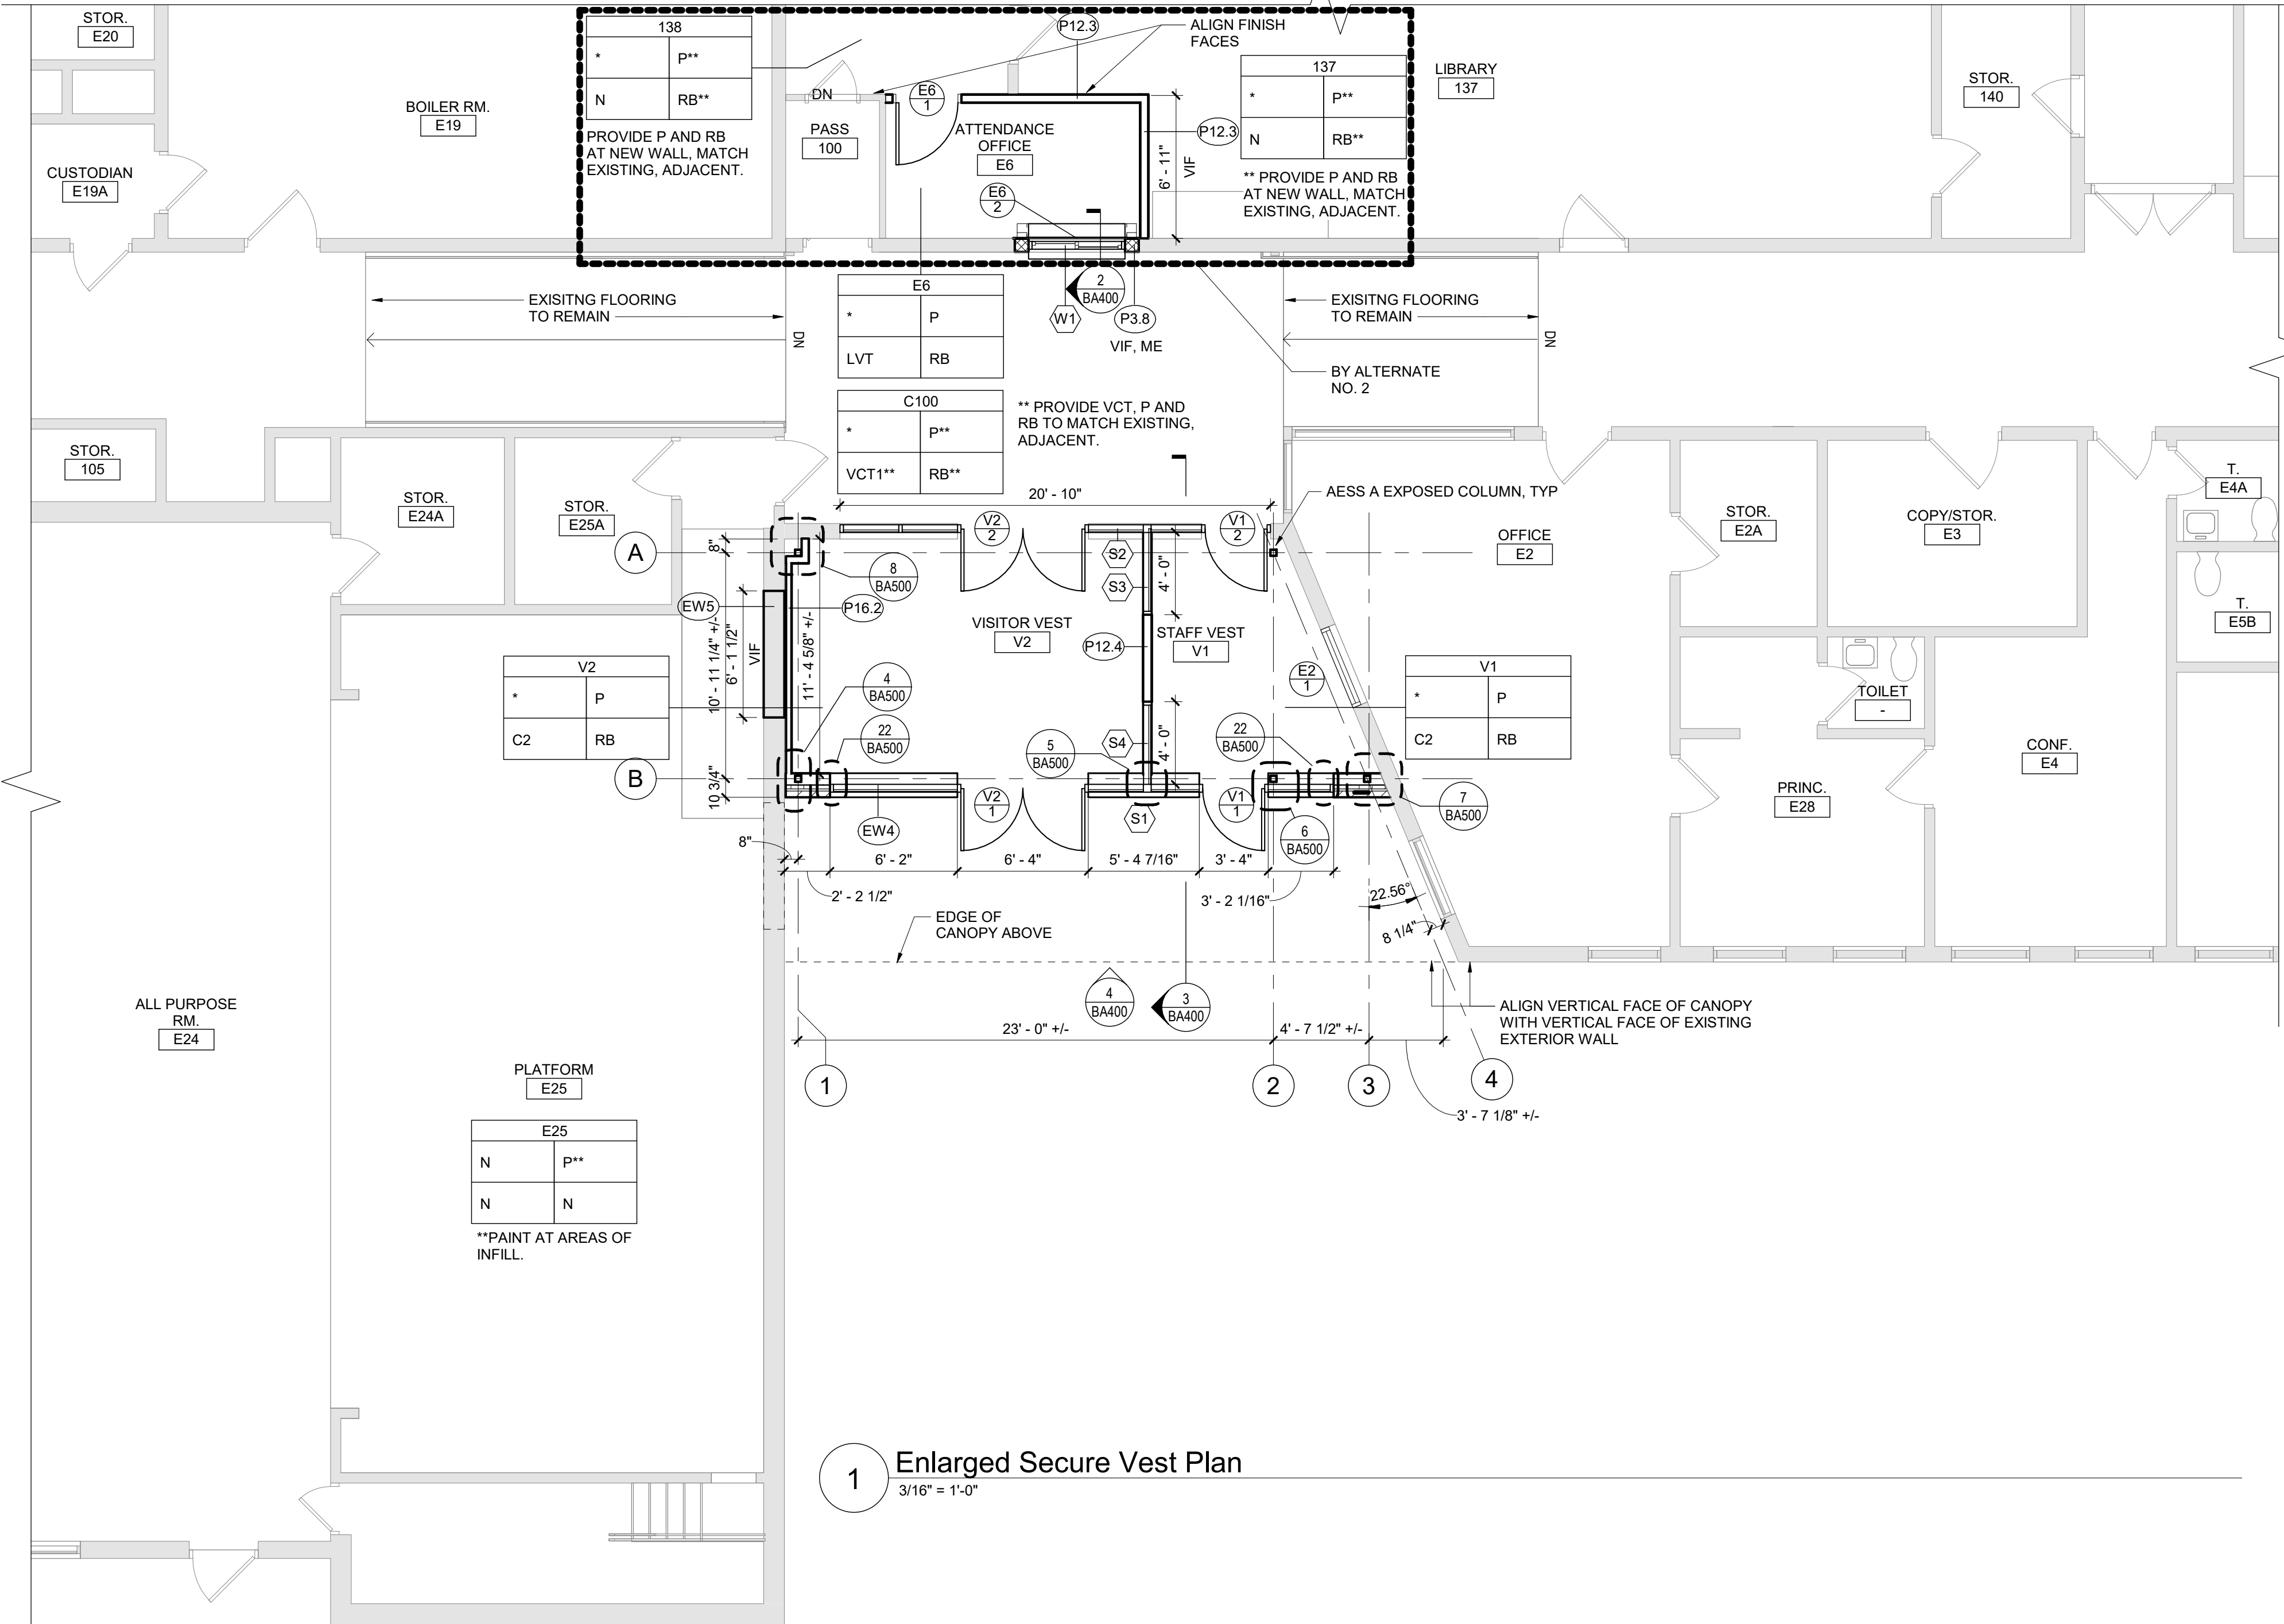

1 Enlarged Secure Vest Plan
3/16" = 1'-0"

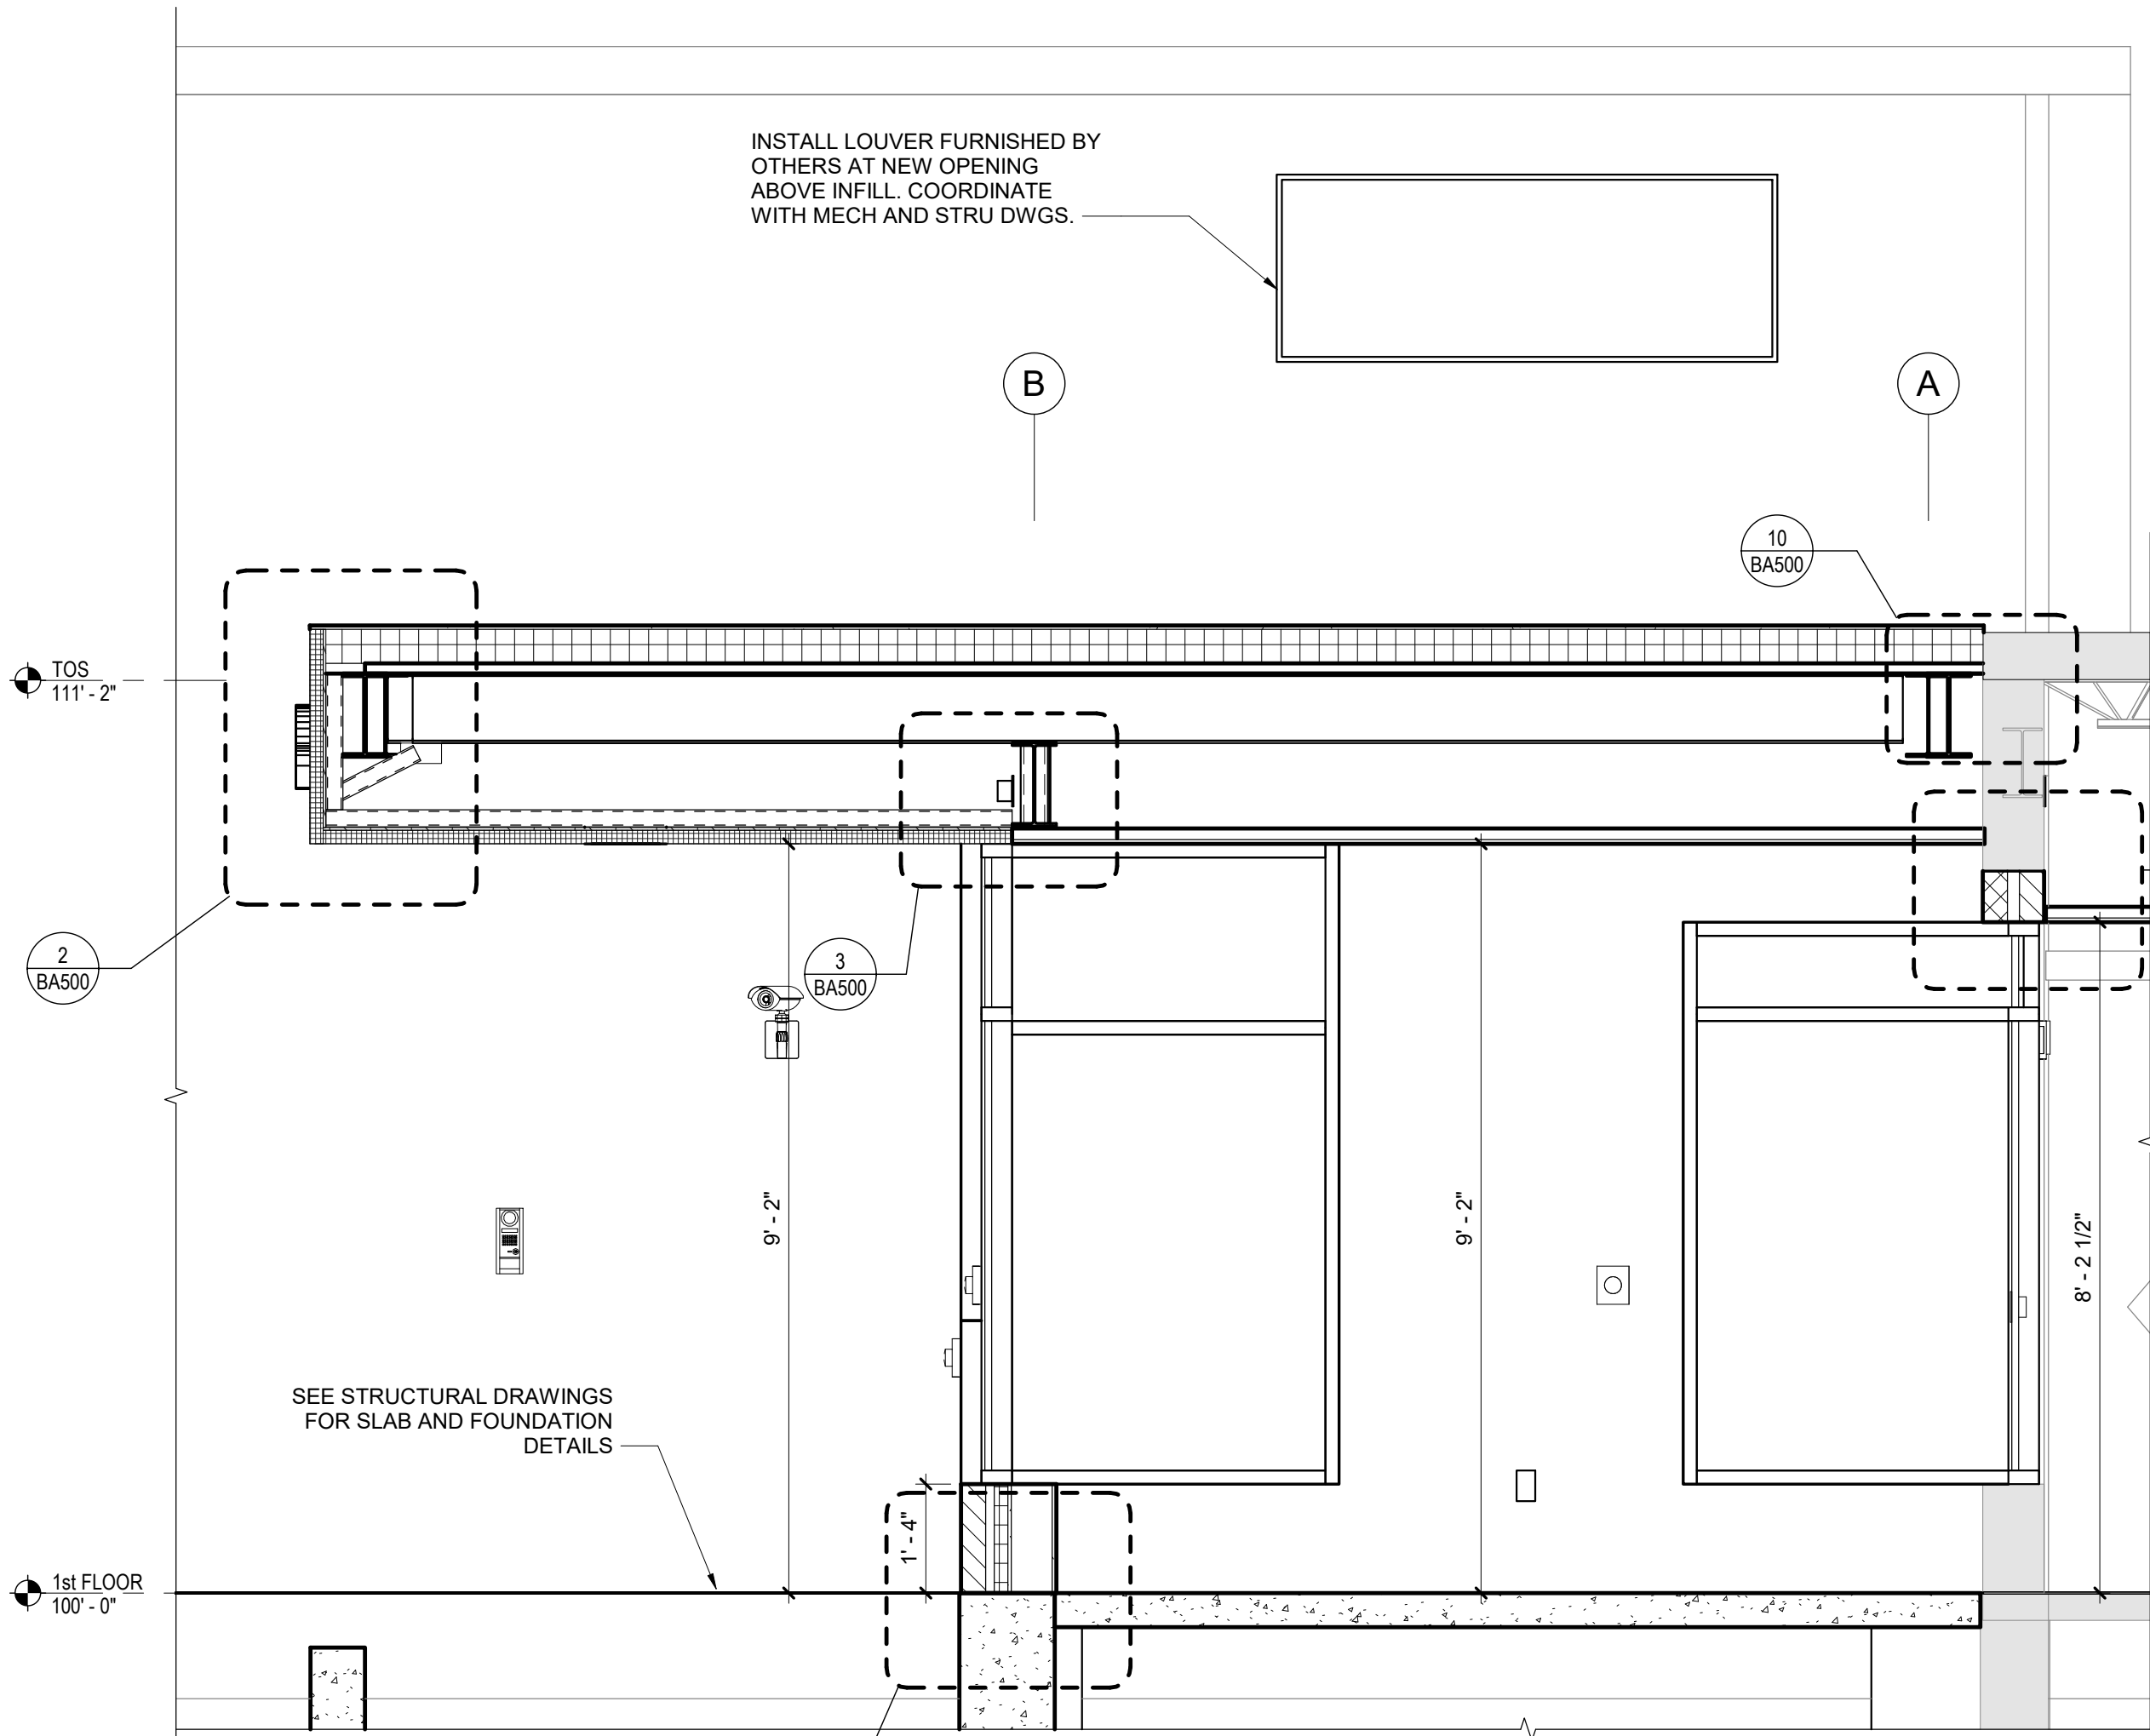

3 Section
1/2" = 1'-0"

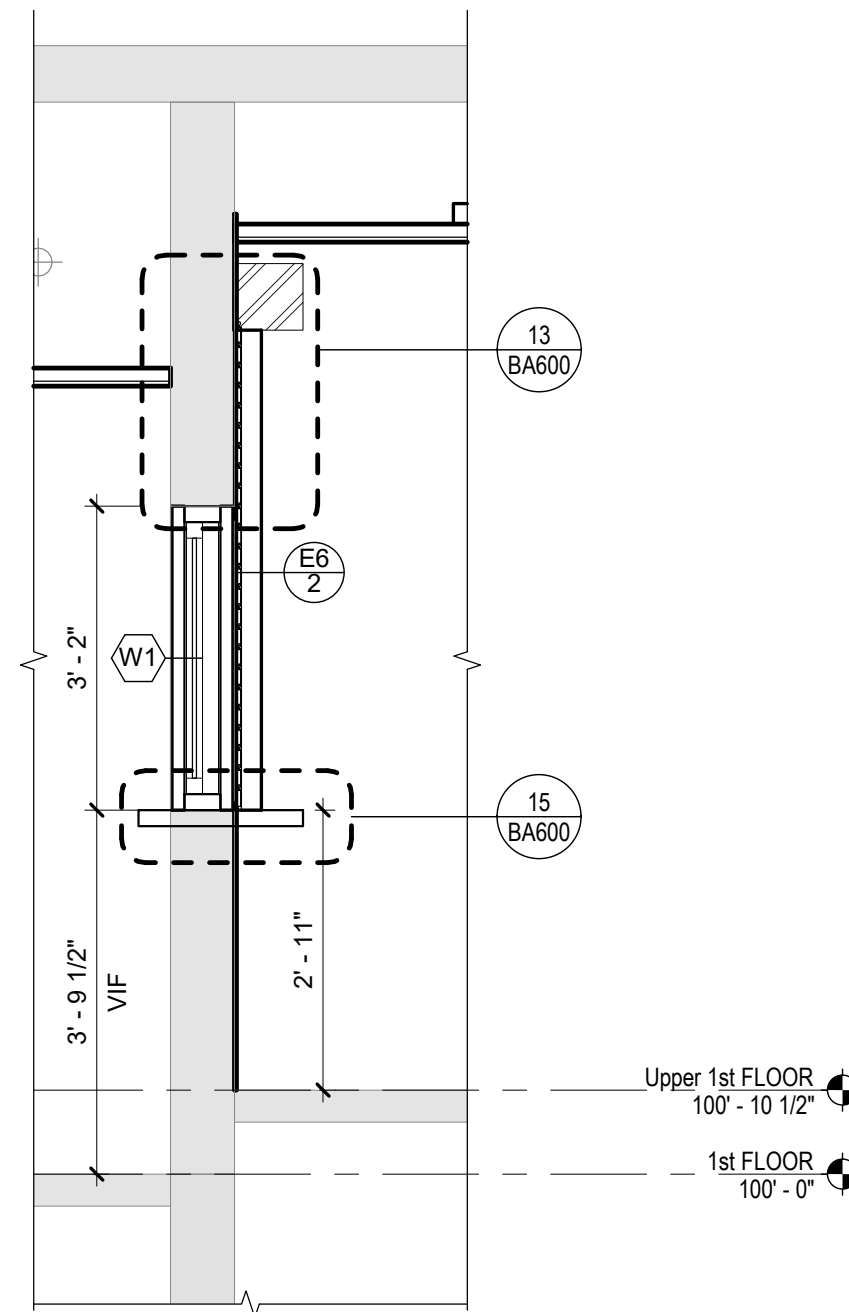

2 Storefront 1 Section
1/2" = 1'-0"

Room Finish Key

C1	CARPET - TYPE 1
C2	CARPET - TYPE 2
CT1	CERAMIC FLOOR TILE - TYPE 1
CT	CERAMIC TILE COVE BASE
CWT1	CERAMIC WALL TILE - TYPE 1
LVT	LUXURY VINYL TILE
MCS	MOISTURE CONTROL SYSTEM
N	NO WORK REQUIRED
P	PAINT SURFACE(S) INCLUDING SOFFITS
RB	RUBBER BASE
VCT1	VINYL COMPOSITION TILE - TYPE 1


* SEE REFLECTED CEILING PLAN
INDICATED CHANGE IN FLOOR FINISH

NOTE: ALL FINISHES LISTED MAY NOT BE REQUIRED FOR THIS PROJECT

FINISHES SHOWN IN ROOM FINISH BOX ARE FOR ALL WALLS AND ENTIRE FLOOR AND CEILING. REFER TO EACH ROOM FOR MORE INFORMATION.

RM#	CLG*	WALL
	FLR	BASE

REFER TO DRAWING BA900 FOR GENERAL FINISH NOTES
REFER TO DRAWING BA900 FOR CASEWORK NOTES

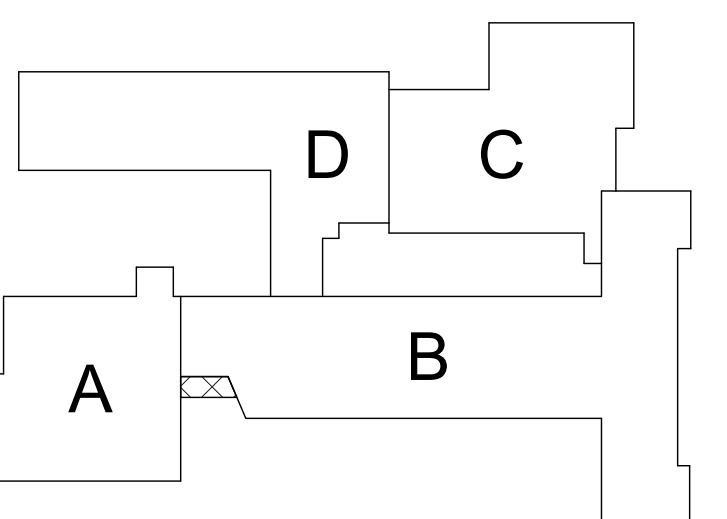

Key Plan
N.T.S.

S.E.D. Control No. 13-02-00-01-0-006-022

Rev. No.: Date: Description:



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Beacon City School District
Beacon, New York

Additions and Alterations to:
Glenham Elementary School

Enlarged Vestibule Plans / Elevations /
Sections


Drawn By:
GCK/lig
Project No.:
279180-22004

Date:
10/28/2022


Drawing Number:

BA400

BID SET

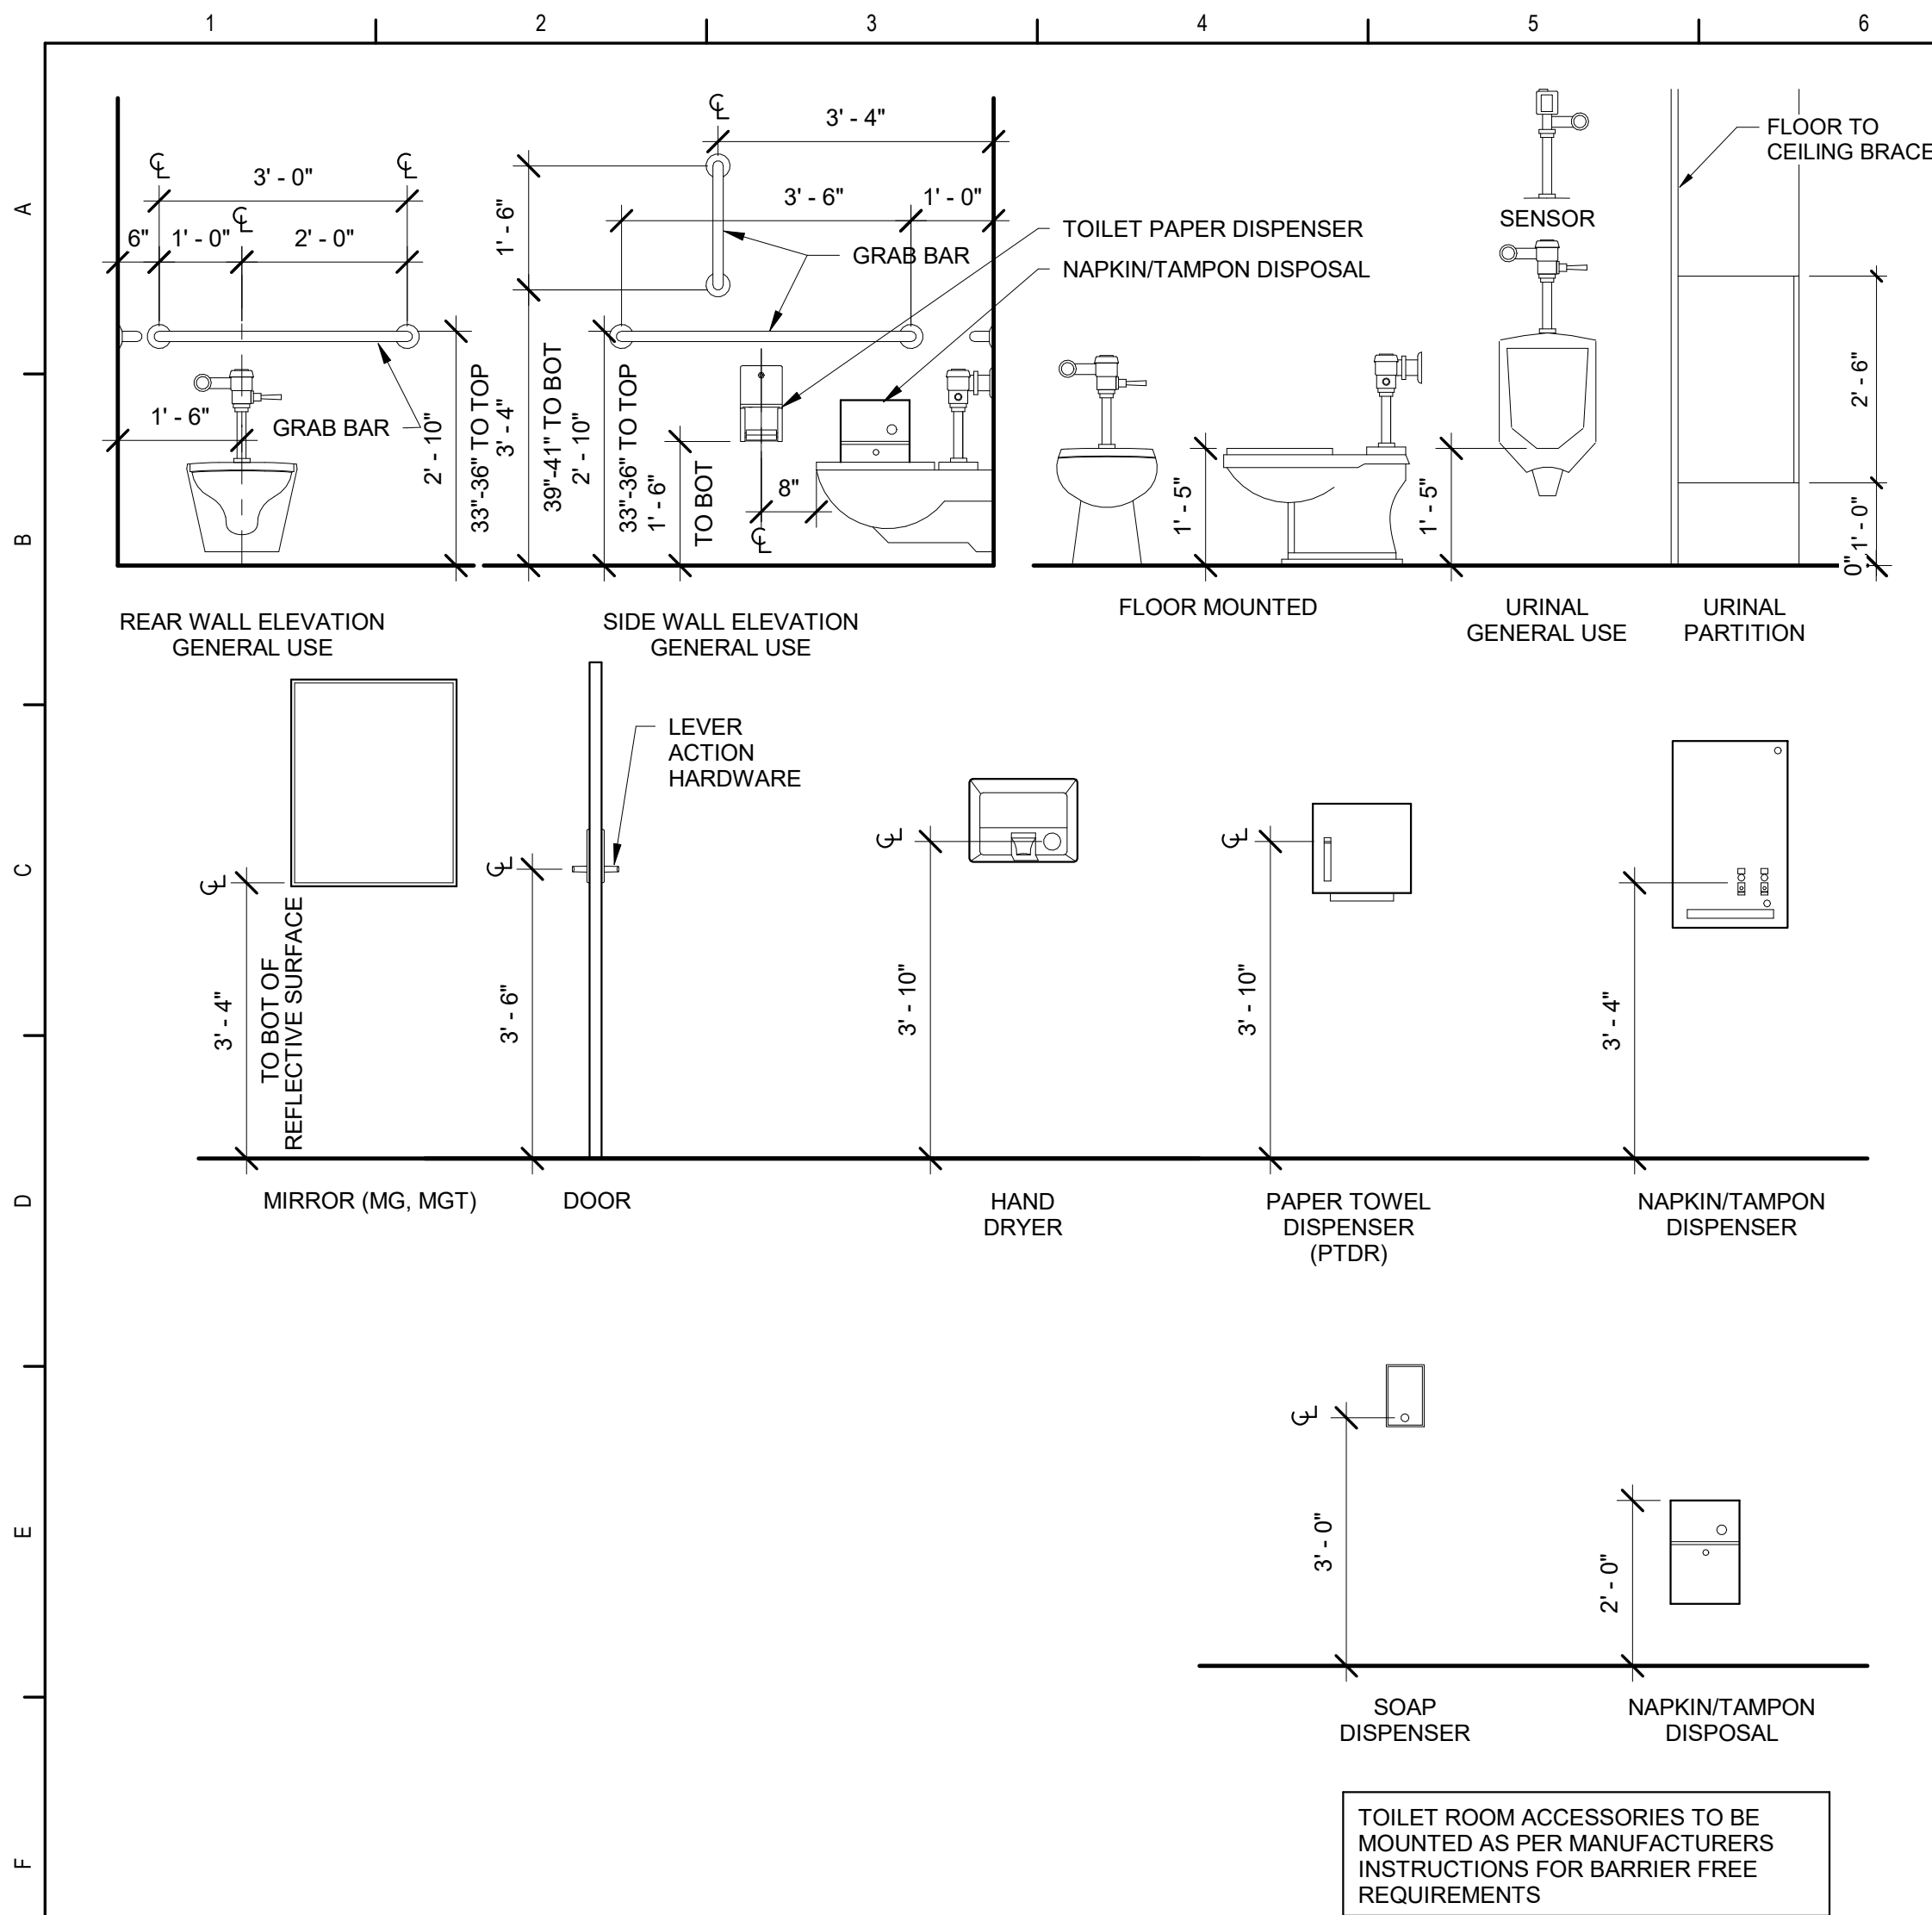


10 Toilet Accessories - Mounting Heights 7th Gr - Adult
1/2" = 1'-0"

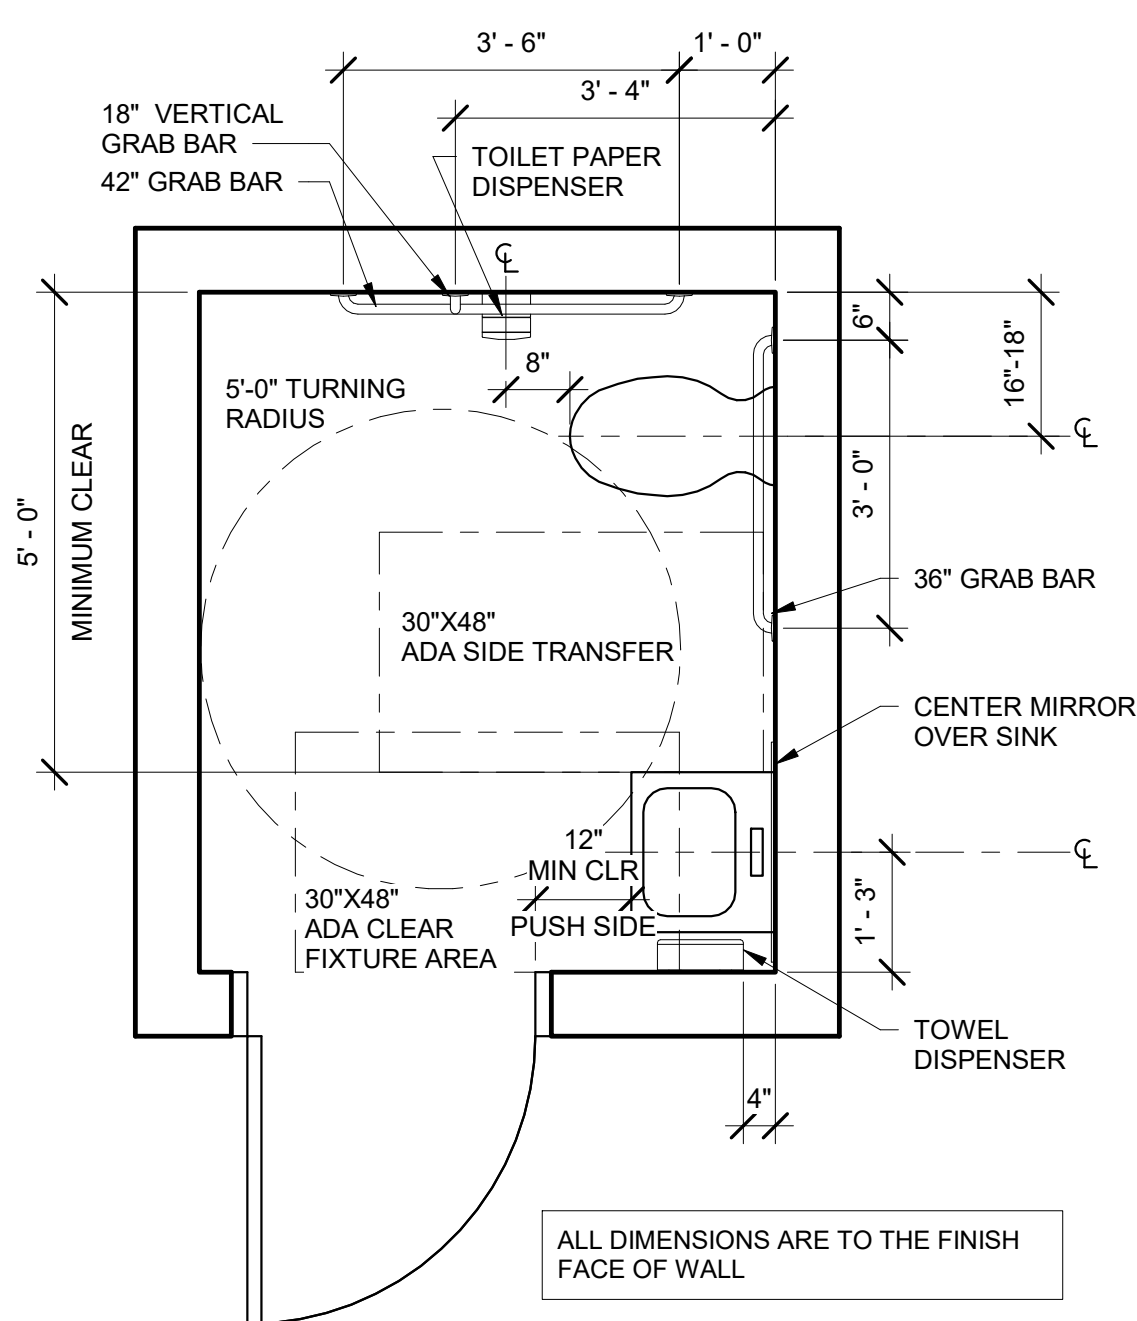


11 Typical ADA Clearances
1/2" = 1'-0"


6 Interior Elevation - Boys
1/4" = 1'-0"

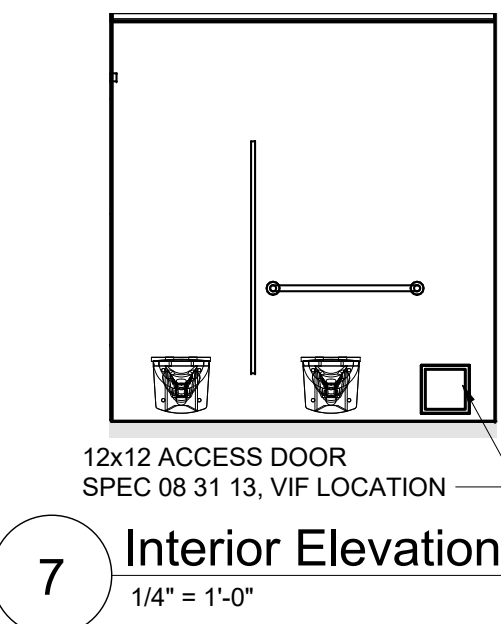


8 Interior Elevation - Boys
1/4" = 1'-0"

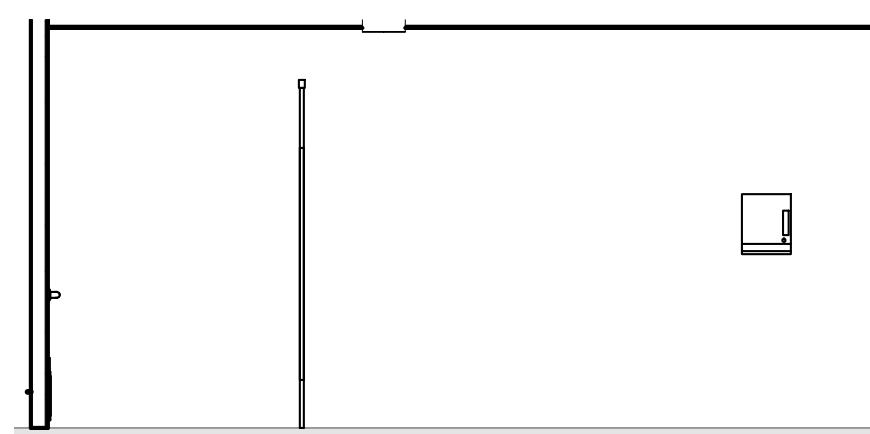


9 Interior Elevation - Boys
1/4" = 1'-0"

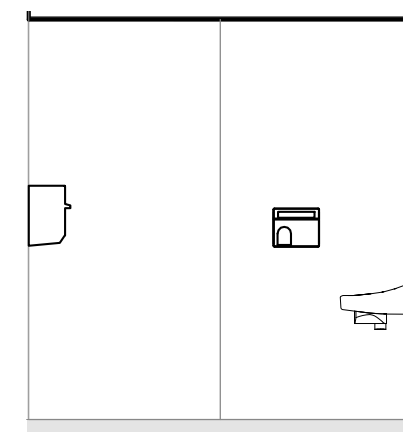


2 Interior Elevation - Girls
1/4" = 1'-0"

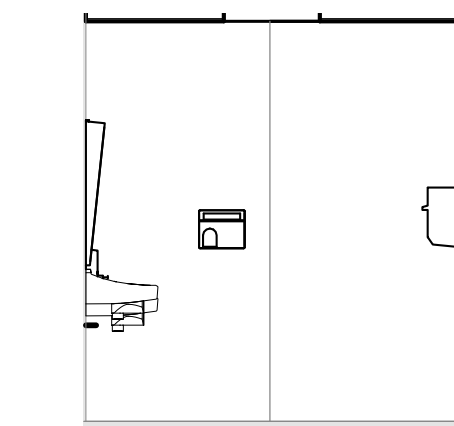

3 Interior Elevation - Girls
1/4" = 1'-0"

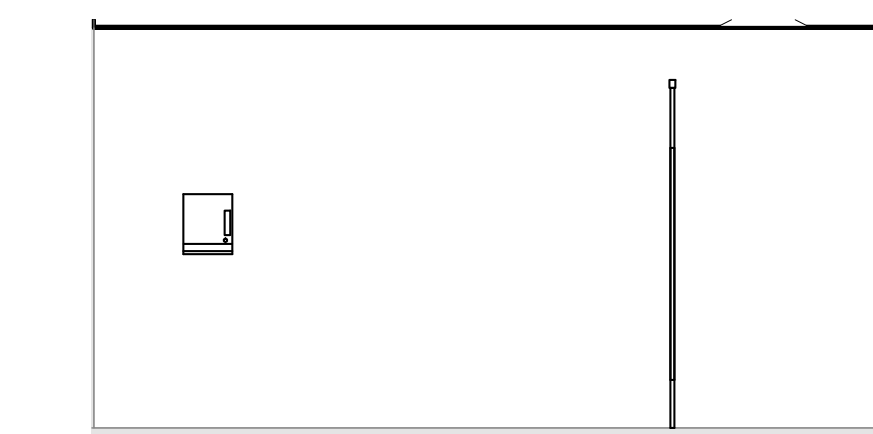


4 Interior Elevation - Girls
1/4" = 1'-0"

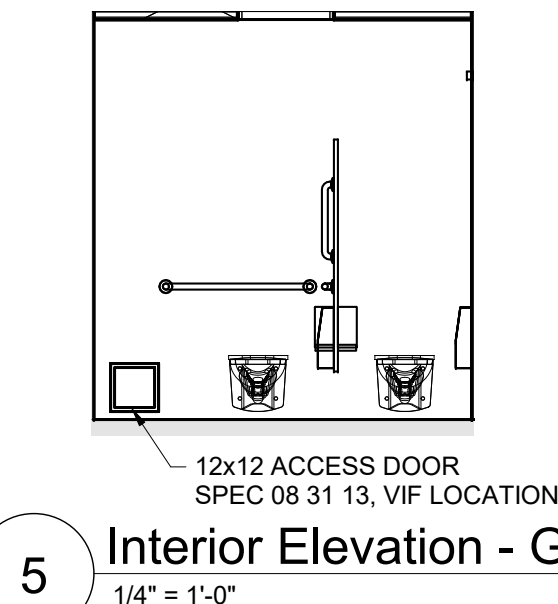


5 Interior Elevation - Girls
1/4" = 1'-0"

1 Enlarged ADA Bathrooms Plan - By Alternate No. 1
3/8" = 1'-0"

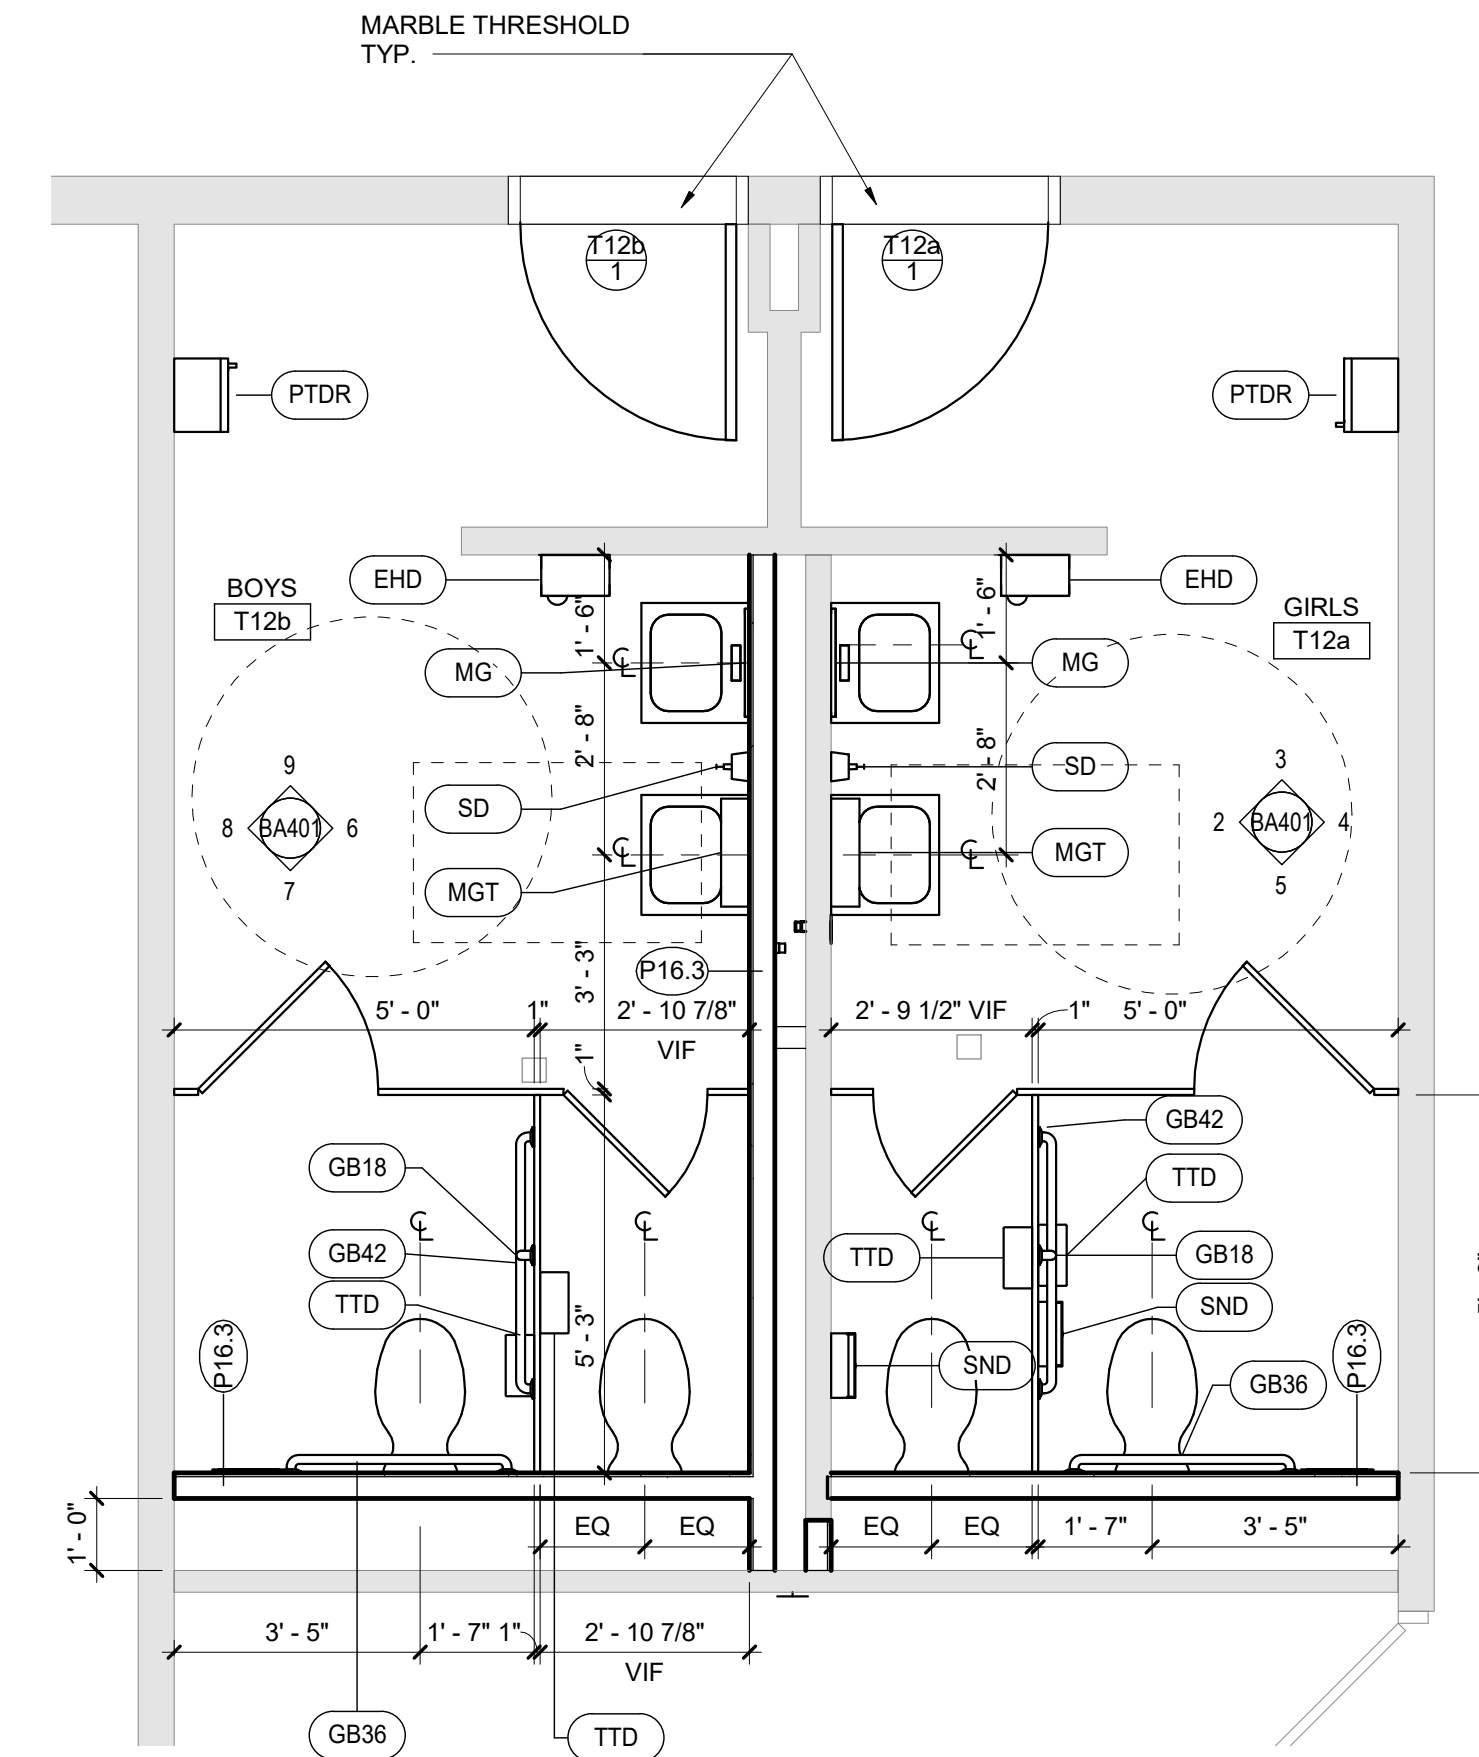

Toilet Room Accessory Schedule		
ITEM	DESCRIPTION	COMMENTS
GB18	18" GRAB BAR - VERTICAL	
GB36	36" GRAB BAR - HORIZONTAL	
GB42	42" GRAB BAR - HORIZONTAL	
EHD	ELECTRIC HAND DRYER - STANDARD	
MG	MIRROR	1'-6" x 3'-0"
MGT	MIRROR - TILT	1'-6" x 3'-0"
PTDR	PAPER TOWEL DISPENSER - ROLL	OWNER FURNISHED, CONTRACTOR INSTALLED
SND	SANITARY NAPKIN DISPOSAL	OWNER FURNISHED, CONTRACTOR INSTALLED
SD	SOAP DISPENSER - VERTICAL	OWNER FURNISHED, CONTRACTOR INSTALLED
TTD	TOILET TISSUE DISPENSER - JUMBO	OWNER FURNISHED, CONTRACTOR INSTALLED

REFER TO DRAWING BA900 FOR GENERAL FINISH NOTES
REFER TO DRAWING BA900 FOR CASEWORK NOTES

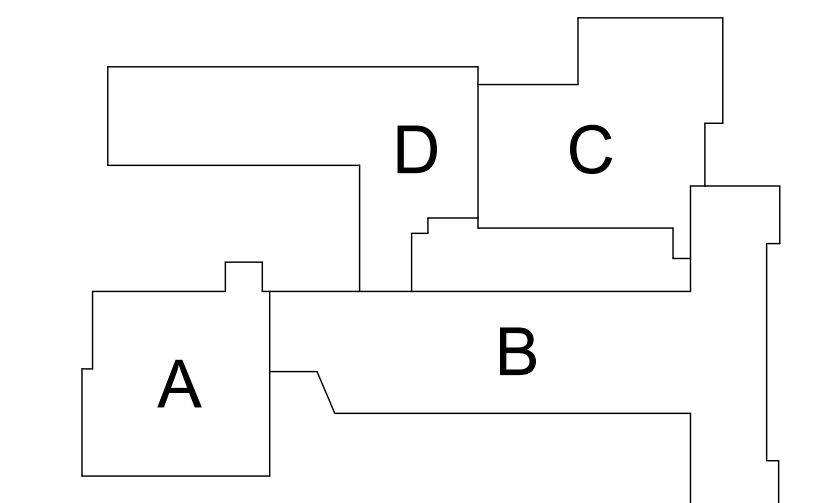

Key Plan
N.T.S.

S.E.D. Control No. 13-02-00-01-0-006-022

Rev. No.: Date: Description:



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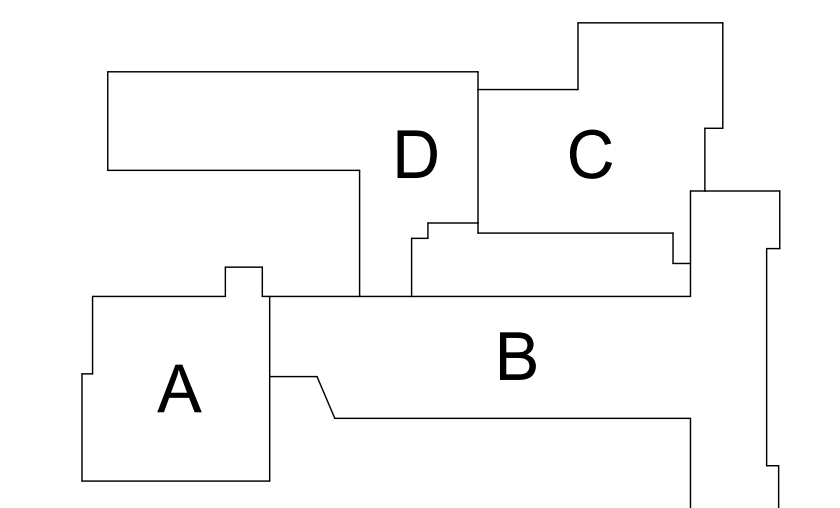
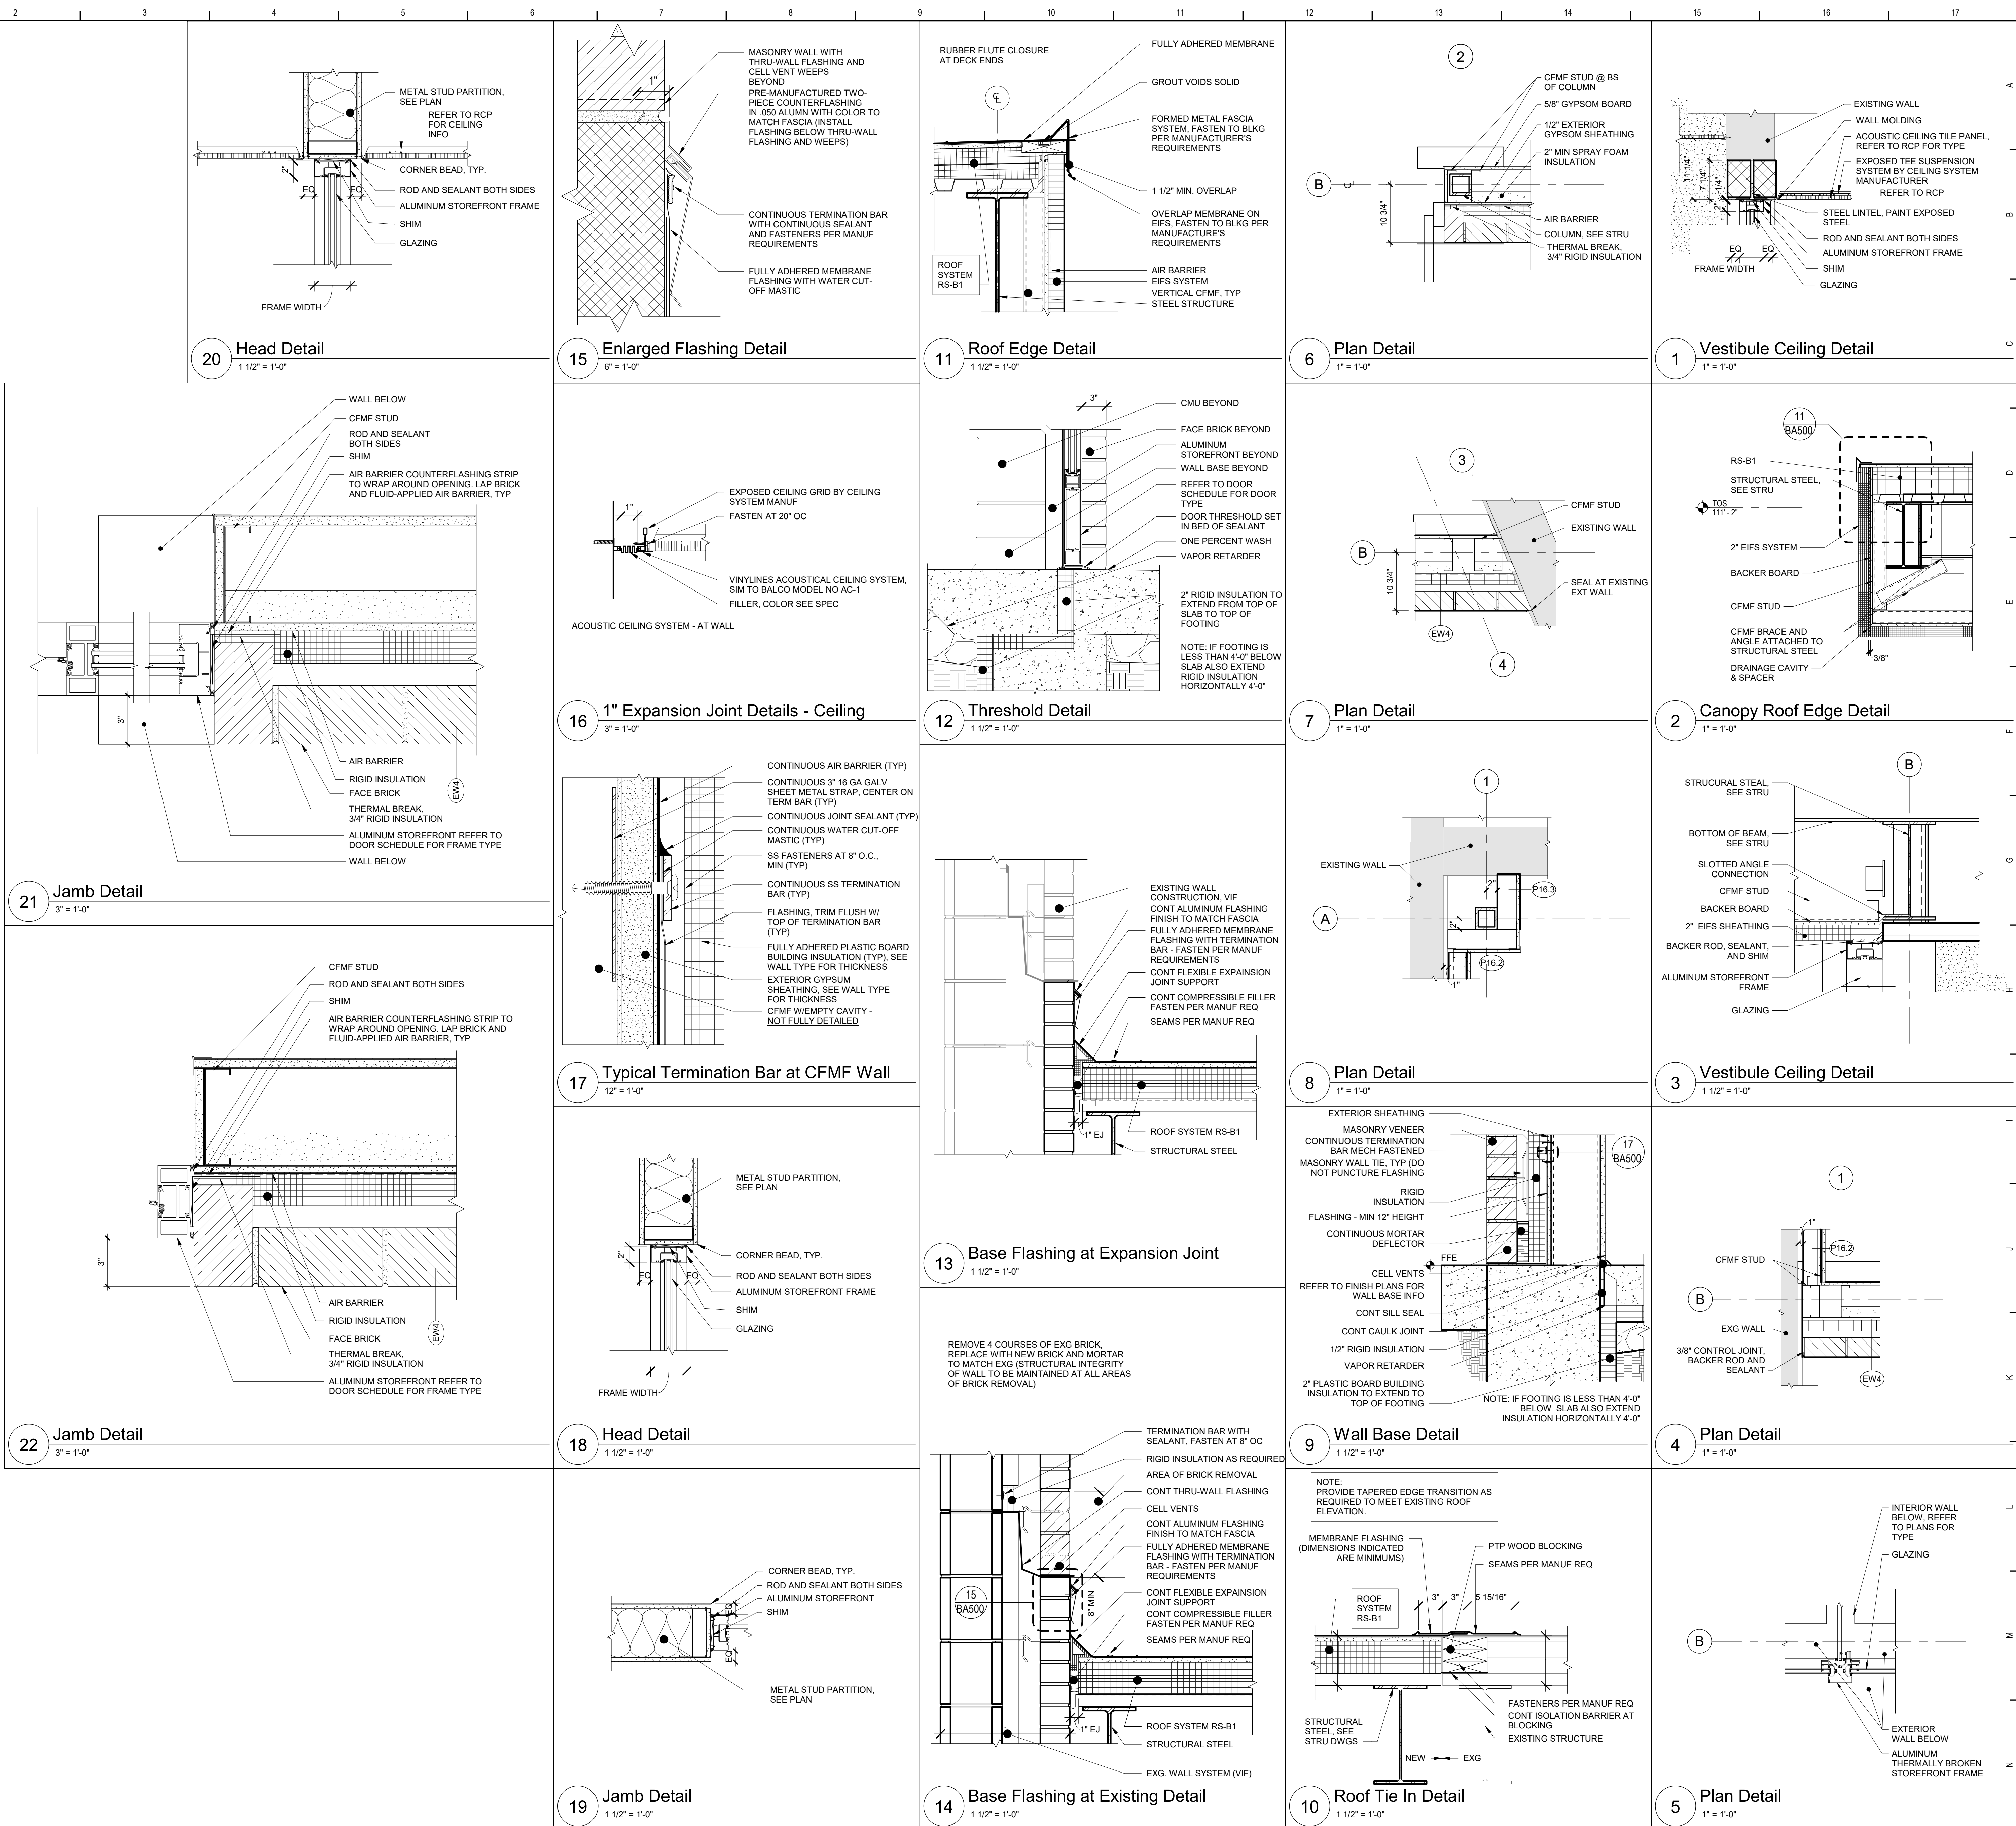
Beacon City School District
Beacon, New York

Additions and Alterations to:
Glenham Elementary School

Enlarged Toilet Room Plans / Interior
Elevations

Drawn By: GCK/lig Date: 10/28/2022 Drawing Number:
Project No.: 279180-22004

BID SET
BA401



Key Plan
N.T.S.

S.E.D. Control No. 13-02-00-01-0-006-022

Rev. No.: Date: Description:



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Beacon City School District
Beacon, New York

Additions and Alterations to:
Glenham Elementary School

Details

Drawn By: GCK/ltg Date: 10/28/2022 Drawing Number:
Project No.: 279180-22004
BA500


BID SET

Door Schedule																			
ROOM NUMBER	DOOR NUMBER	TYPE	MATERIAL	WIDTH	HEIGHT	RATING	GLAZING	TYPE	MATERIAL	WIDTH	HEIGHT	RATING	GLAZING	HEAD	JAMB	SILL	HDW SET	REMARKS	
E2	1	-	-	4'-0"	7'-0"	-	-	F22	HM	4'-0"	7'-0"	20 MIN	FRI	J-6	J-6	J-6, SIM	12		
E6	1	N	WD	3'-0"	7'-0"	-	FC	F2	HM	3'-4"	7'-2"	-	-	H-13	J-13	-	03		
E6	2	CD1	HM	4'-10"	5'-0"	60 MIN	-	-	STL	5'-9 1/4"	5'-0"	60 MIN	-	13/BA600	14/BA600	15/BA600	13		
T12a	1	F	WD	3'-0"	7'-0"	-	-	F2	HM	3'-4"	7'-2"	-	-	H-4	J-4	-	14	NOTE 1	
T12b	1	F	WD	3'-0"	7'-0"	-	-	F2	HM	3'-4"	7'-2"	-	-	H-4	J-4	-	14	NOTE 2	
V1	1	G2	AL	3'-0"	7'-0"	-	FCE/SCL	S1	AL	0"	0"	-	FCE/SCL	3/BA500	6/BA500 and 22/BA500	12/BA500	E17		
V1	2	G2	AL	3'-0"	7'-0"	-	FCE/SCL	S2	AL	0"	0"	-	FCE/SCL	1/BA500	22/BA500	-	E18	NOTE 3	
V2	1	G2-PR	AL	3'-0"	7'-0"	-	FCE/SCL	S1	AL	0"	0"	-	FCE/SCL	3/BA500	22/BA500	12/BA500	E19	NOTE 2	
V2	2	G2-PR	AL	3'-0"	7'-0"	-	FCE/SCL	S2	AL	0"	0"	-	FCE/SCL	1/BA500	22/BA500	-	E20 5'-9 1/4"	NOTE 3	


GENERAL NOTES:
VERIFY ALL DIMENSIONS IN THE FIELD

SPECIFIC NOTES:
- NOT APPLICABLE


- PROVIDE 10" HIGH BY 20" WIDE LOUVER IN DOOR. VERIFY OPENING DIMENSIONS IN FIELD.
- PROVIDE CARD READER AND ELECTRONIC HARDWARE, COORD WITH ELEC DWGS AND SECURITY CONTRACTOR
- PROVIDE CARD READER, ELECTRONIC HARDWARE AND REMOTE RELEASE, COORDINATE WITH ELEC DWGS AND SECURITY CONTRACTOR

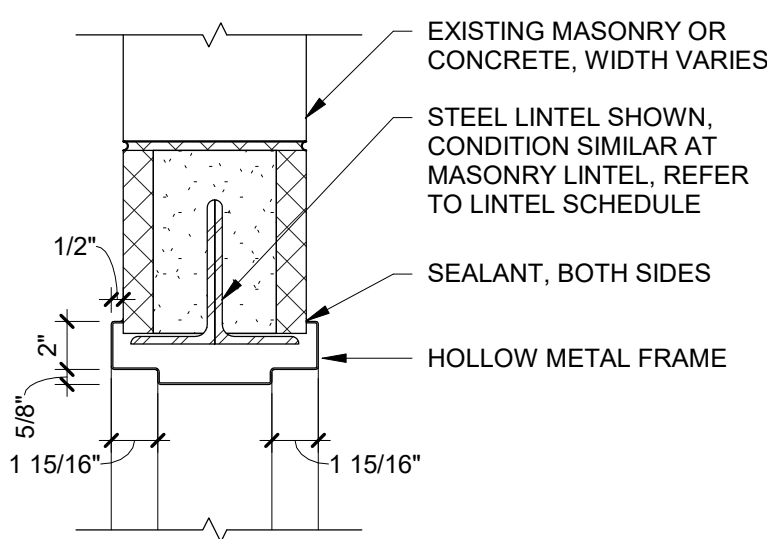


H-4

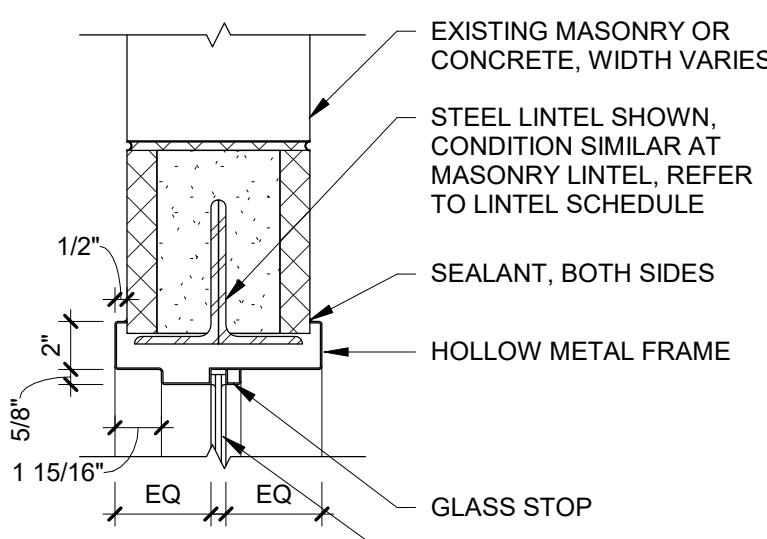


H-6

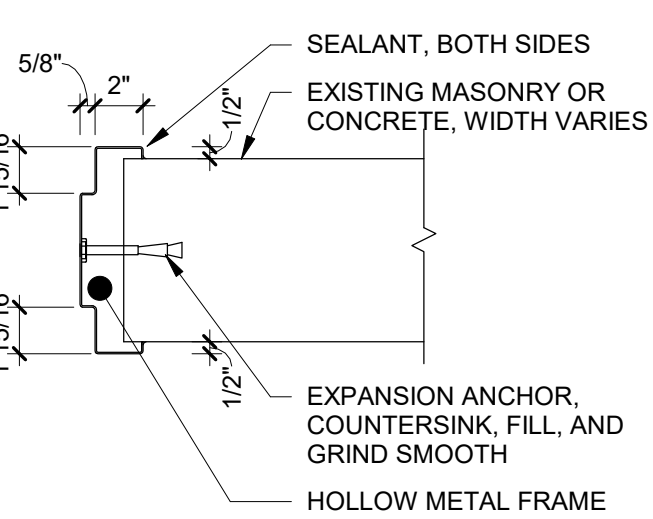


J-4

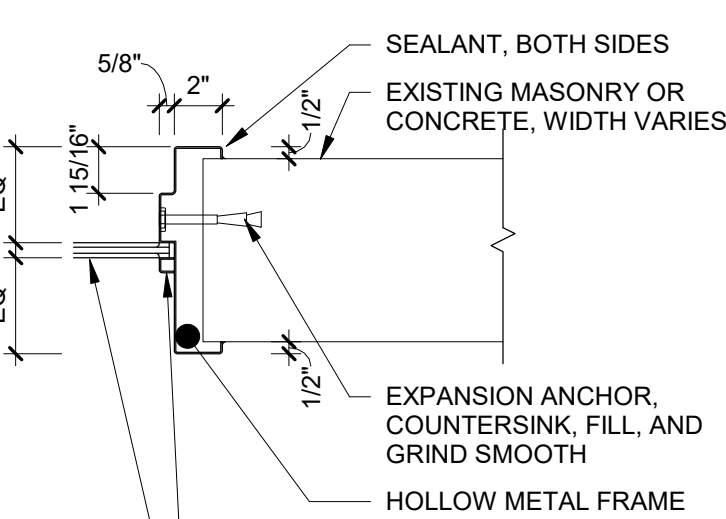


J-6

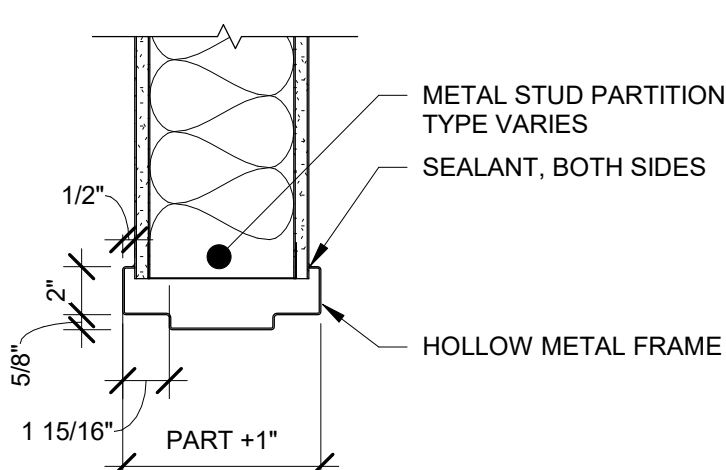

H-13

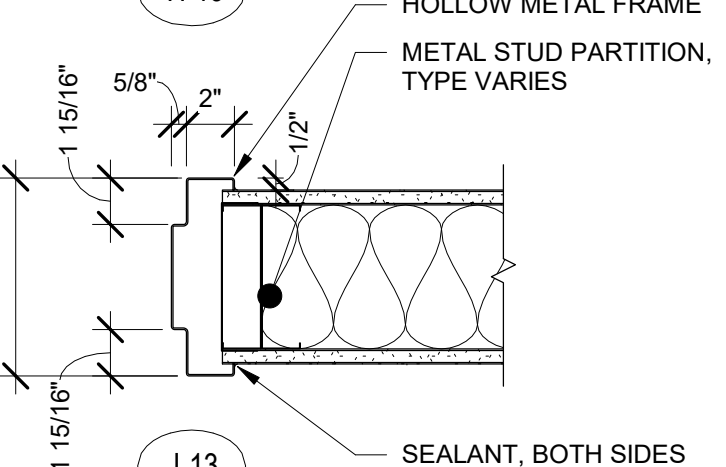


J-13

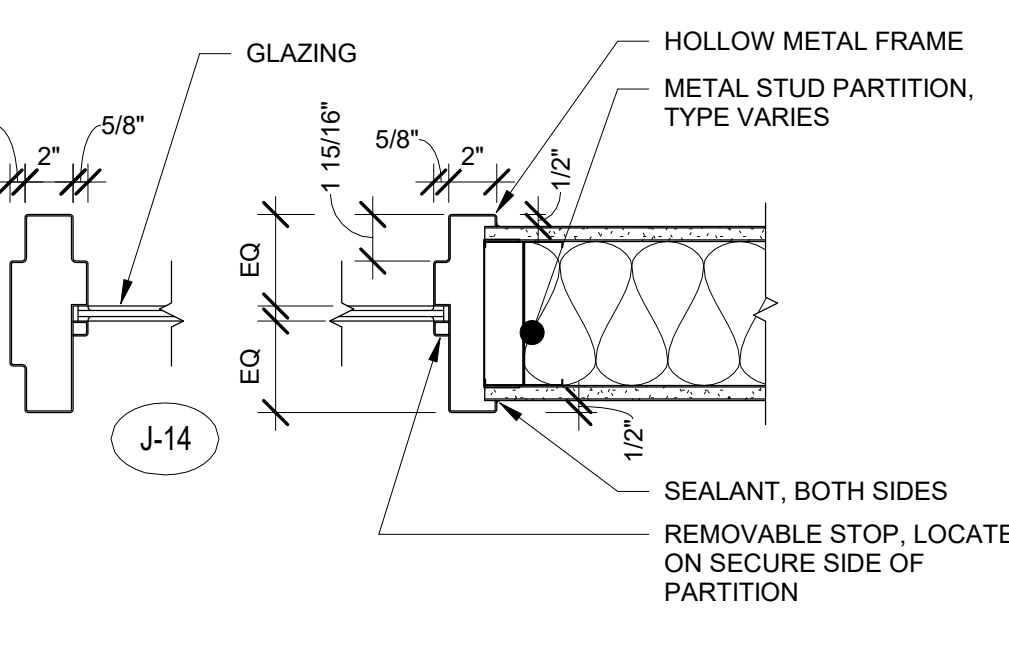

J-14


12 Hollow Metal Frame Details

1 1/2" = 1'-0"

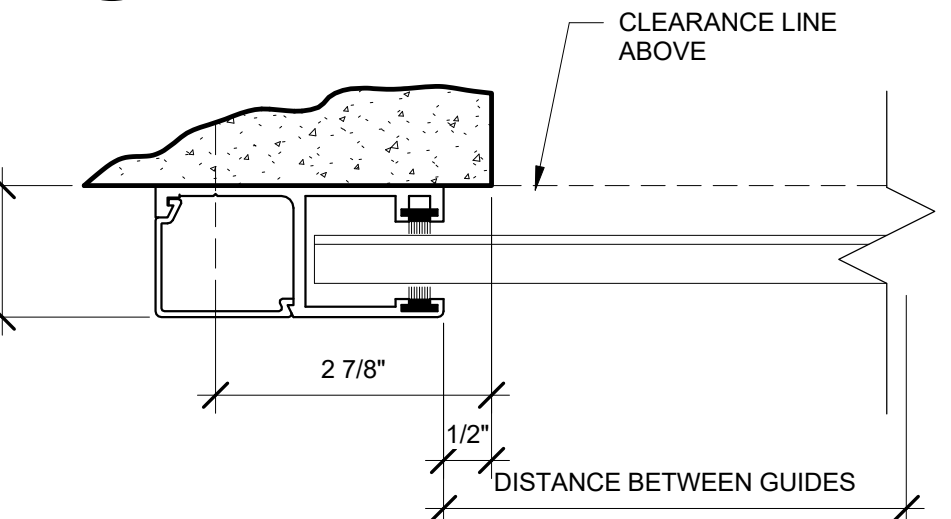


16 Jamb Detail

6" = 1'-0"

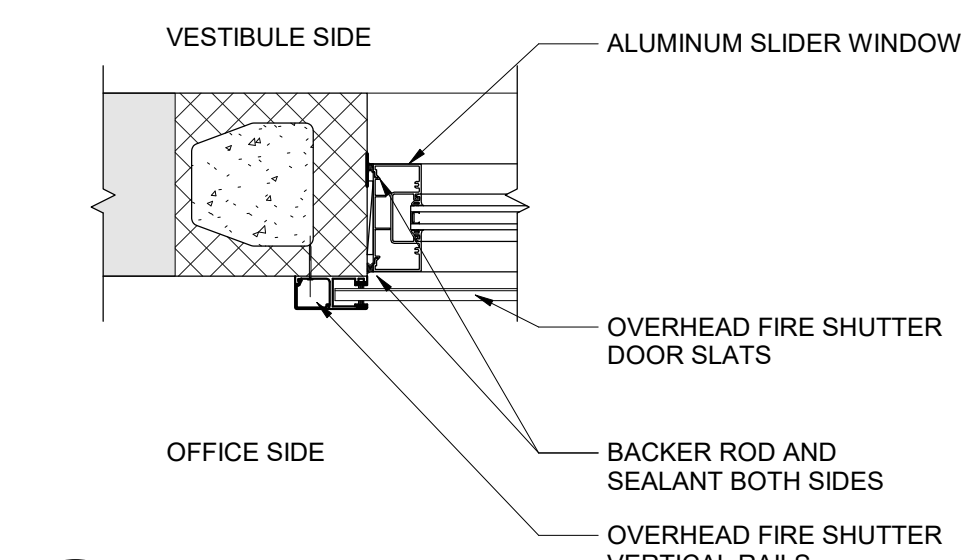


14 Head Detail

1 1/2" = 1'-0"

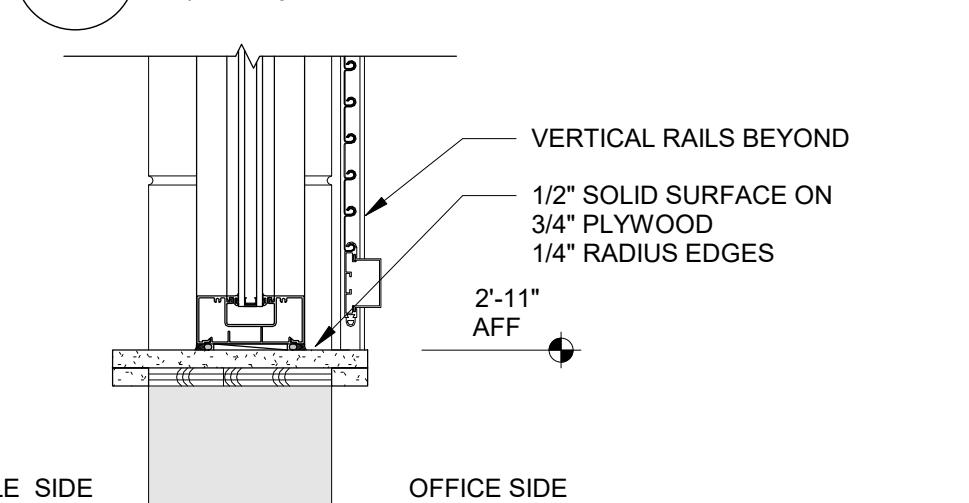


15 Sill Detail

1 1/2" = 1'-0"

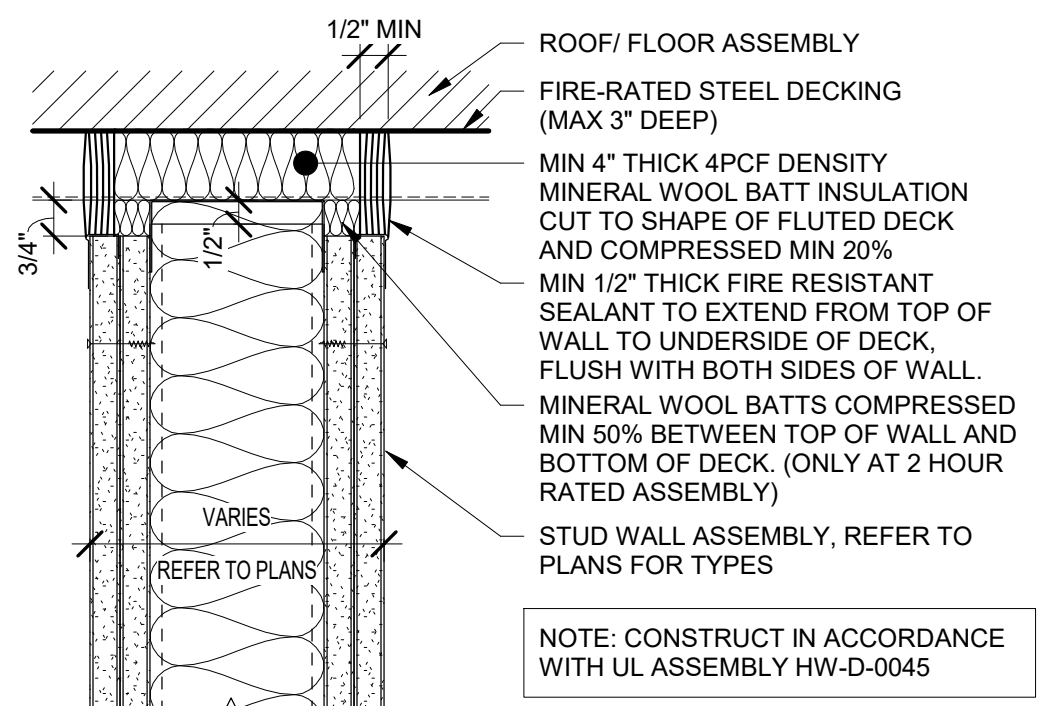


9 Typical Top of Wall Assembly (Rated)

3\"/>

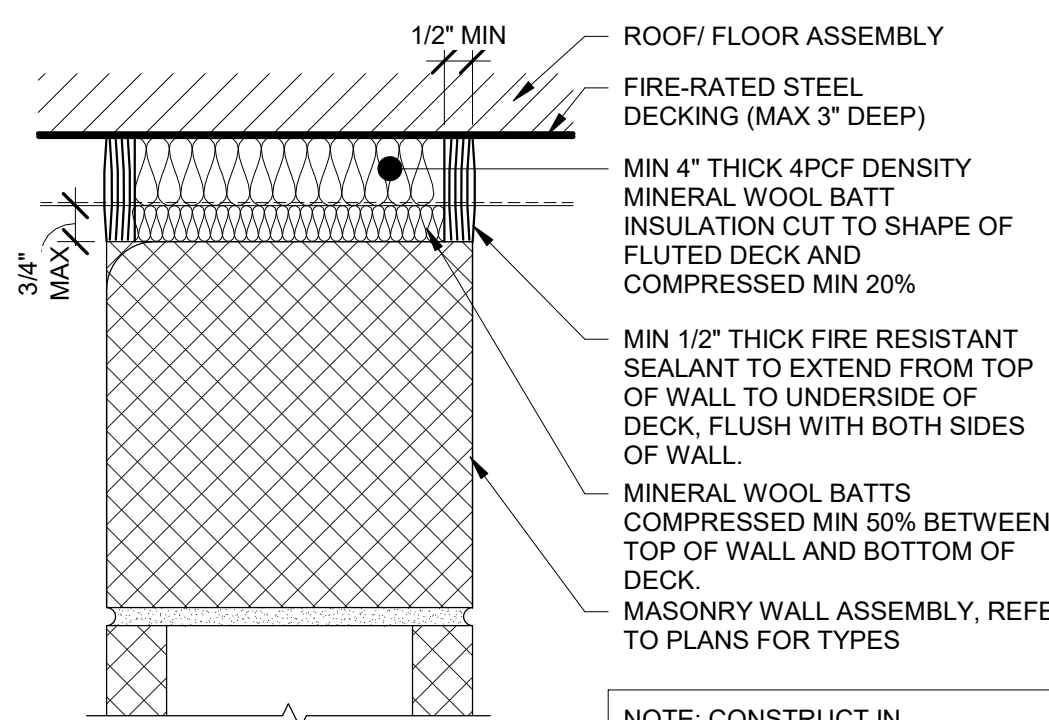


10 Typical Rated Top of Wall Assembly

3\"/>

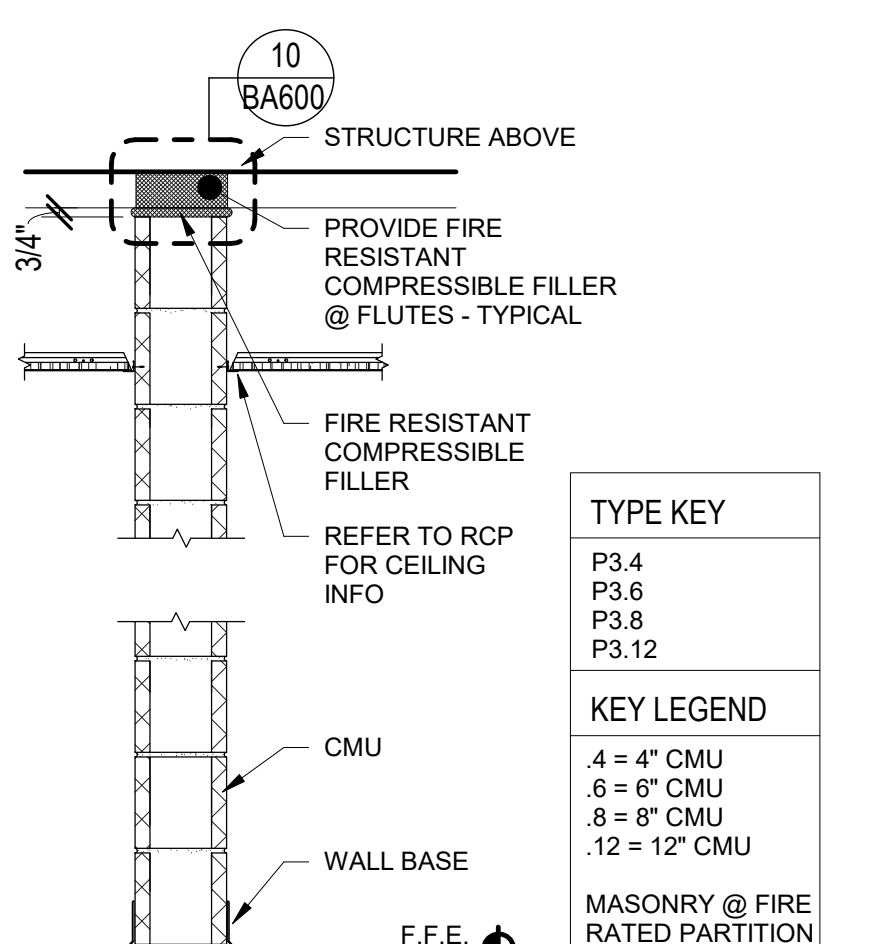


11 Partition Type P3

3/4\"/>

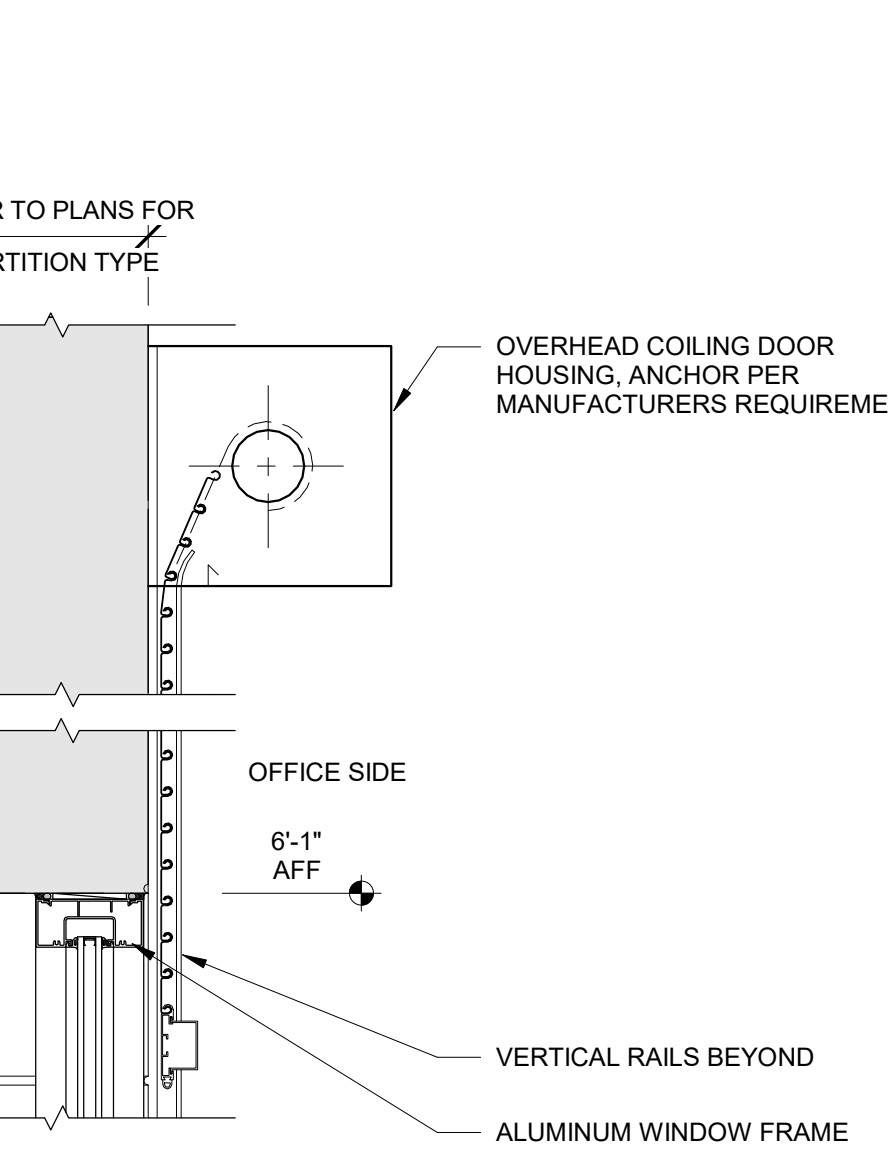


13 Head Detail


1 1/2\"/>

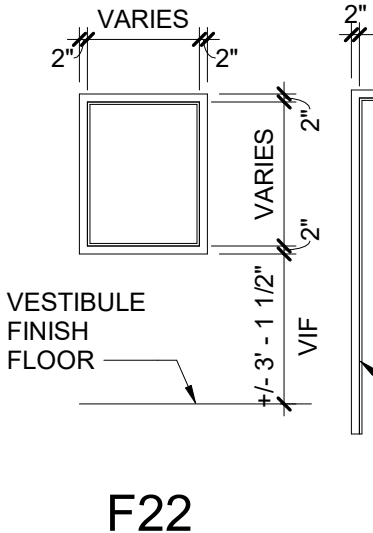


FRAME TYPES

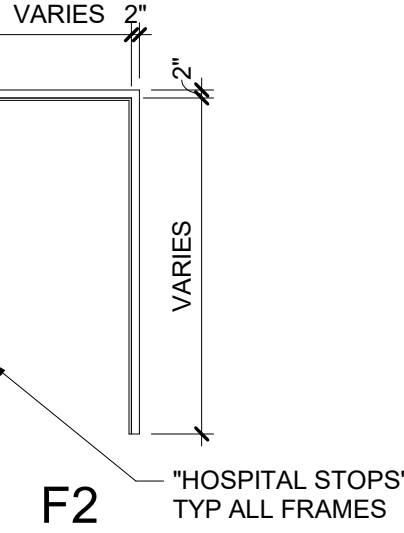


DOOR TYPES

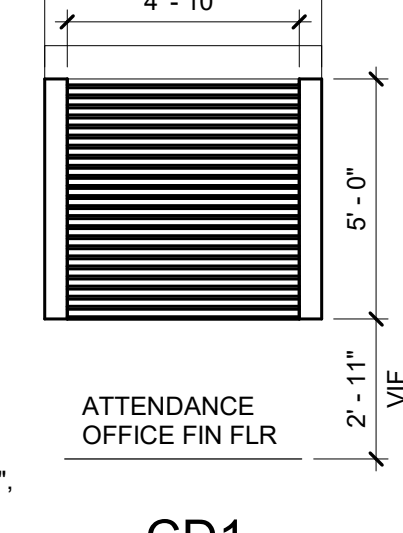


DOOR TYPES

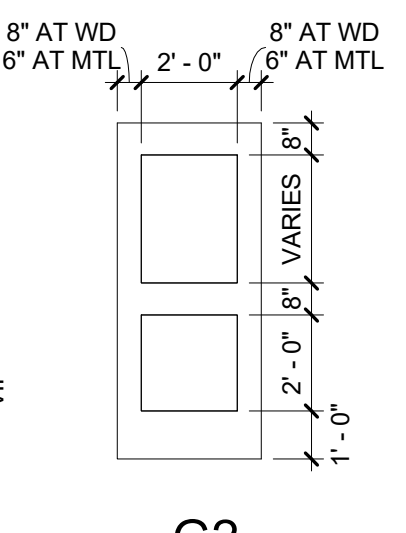


DOOR TYPES

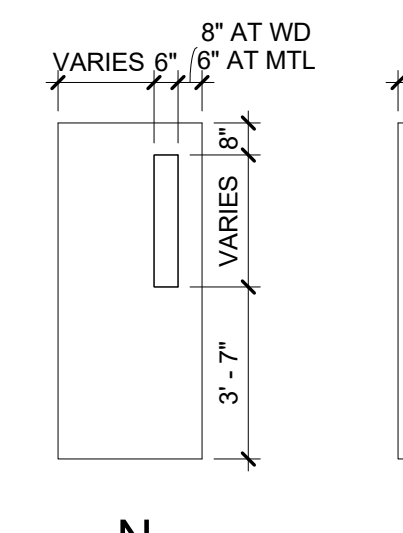


DOOR TYPES

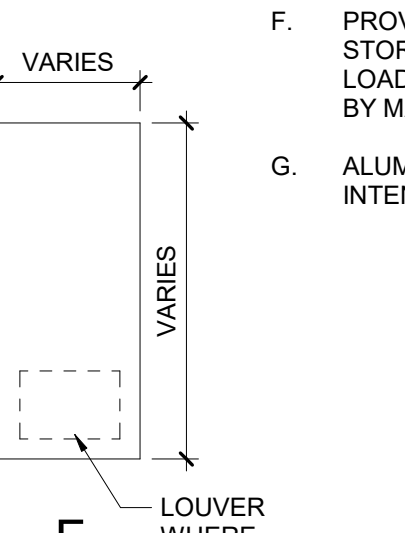


DOOR TYPES

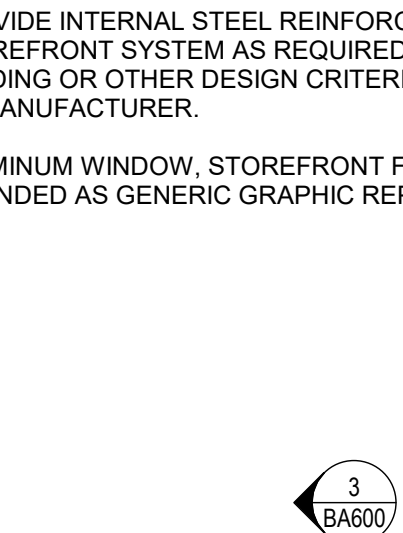


DOOR TYPES

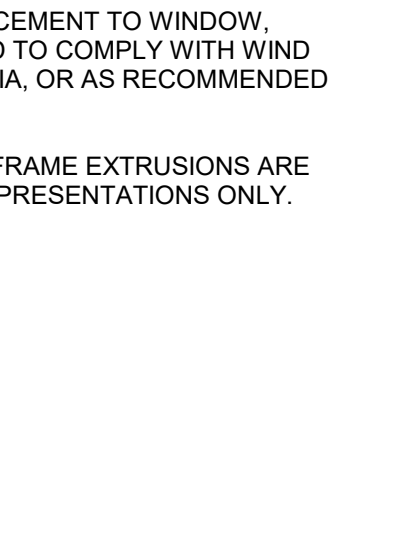

DOOR TYPES

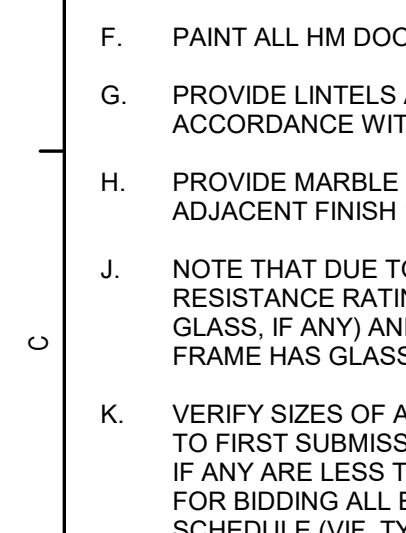

DOOR TYPES

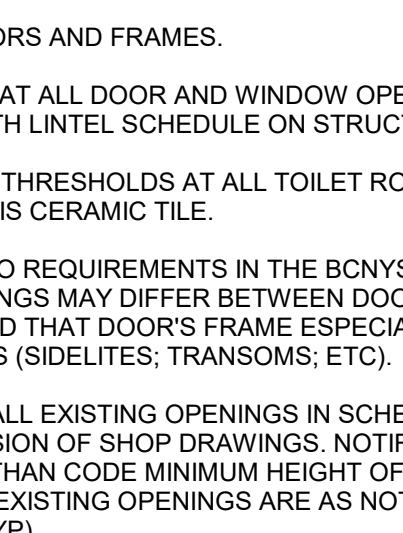

DOOR TYPES

General Window Notes

- INSULATING GLASS UNITS SHALL BE TYPE FCE/SCL, TYP UNO.
- RESCUE WINDOWS ARE INDICATED BY THE DESIGNATION "RW" ON CODE DRAWINGS.
- PROVIDE ALL ALUMINUM FLASHINGS, RECEIVERS, TRIM AND SILLS REQUIRED FOR A COMPLETE AND FINISHED INSTALLATION REGARDLESS OF IF SHOWN ON DRAWINGS.
- REFER TO WINDOW TREATMENTS AS SHOWN ON DRAWINGS.
- GLAZING SYSTEMS FRAME TYPE KEY:
F HOLLOW METAL
S ALUMINUM STOREFRONT
W ALUMINUM WINDOWS
- PROVIDE INTERNAL STEEL REINFORCEMENT TO WINDOW. STOREFRONT SYSTEM AS REQUIRED TO COMPLY WITH WIND LOADING OR OTHER DESIGN CRITERIA, OR AS RECOMMENDED BY MANUFACTURER.
- ALUMINUM WINDOW, STOREFRONT FRAME EXTRUSIONS ARE INTENDED AS GENERIC GRAPHIC REPRESENTATIONS ONLY.


General Door Notes

- SEE DWGS BA601 FOR ADDITIONAL INFORMATION AND DETAILS.
- HARDWARE ON DOORS FROM SPACES OF PUPIL OCCUPANCY SHALL BE A TYPE WHICH WILL ALWAYS PERMIT THE DOOR TO BE OPENED FROM THE INSIDE WITHOUT DIRECT MANIPULATION OF ANY TYPE LOCKING DEVICE.
- METAL VISION PANEL TRIM SHALL BE PAINTED SAME COLOR AS DOOR FRAMES.
- ALL DOORS WITH ELECTRO-MAGNETIC HOLD OPEN DEVICES SHALL SWING TOWARDS ADJACENT WALLS. COORDINATE ALL INSTANCES WITH CONTRACTOR RESPONSIBLE FOR ELECTRICAL WORK, AND SEE ELECTRICAL DWGS.
- APPLY CONTINUOUS JOINT SEALANT TO ALL JOINTS BETWEEN FRAMES AND WALLS, TYP ALL.
- PAINT ALL HM DOORS AND FRAMES.
- PROVIDE LINTELS AT ALL DOOR AND WINDOW OPENINGS IN ACCORDANCE WITH LINTEL SCHEDULE ON STRUCTURAL DWGS.
- PROVIDE MARBLE THRESHOLDS AT ALL TOILET ROOMS WHERE ADJACENT FINISH IS CERAMIC TILE.
- NOTE THAT DUE TO REQUIREMENTS IN THE BONYS, SOME FIRE RESISTANCE RATINGS MAY DIFFER BETWEEN DOORS (AND ITS GLASS, IF ANY) AND THAT DOORS FRAME ESPECIALLY IF THAT FRAME HAS GLASS (SIDELITES, TRANSOMS, ETC).
- VERIFY SIZES OF ALL EXISTING OPENINGS IN SCHEDULE PRIOR TO FIRST SUBMISSION OF SHOP DRAWINGS. NOTIFY ARCHITECT IF ANY ARE LESS THAN CODE MINIMUM HEIGHT OF 6'-8\"/>

- MATERIAL DESIGNATION KEY:
FRP FIBERGLASS REINFORCED PLASTIC
HM HOLLOW METAL
WD WOOD
AL ALUMINUM
STL STEEL
EXO EXISTING
- ADDITIONAL DOOR SCHEDULE DESIGNATIONS:
EXISTING TO REMAIN
- NOT APPLICABLE
NOT APPLICABLE OR TO BE COORDINATED WITH STOREFRONT TYPE


1 Storefront S1

1/4\"/>

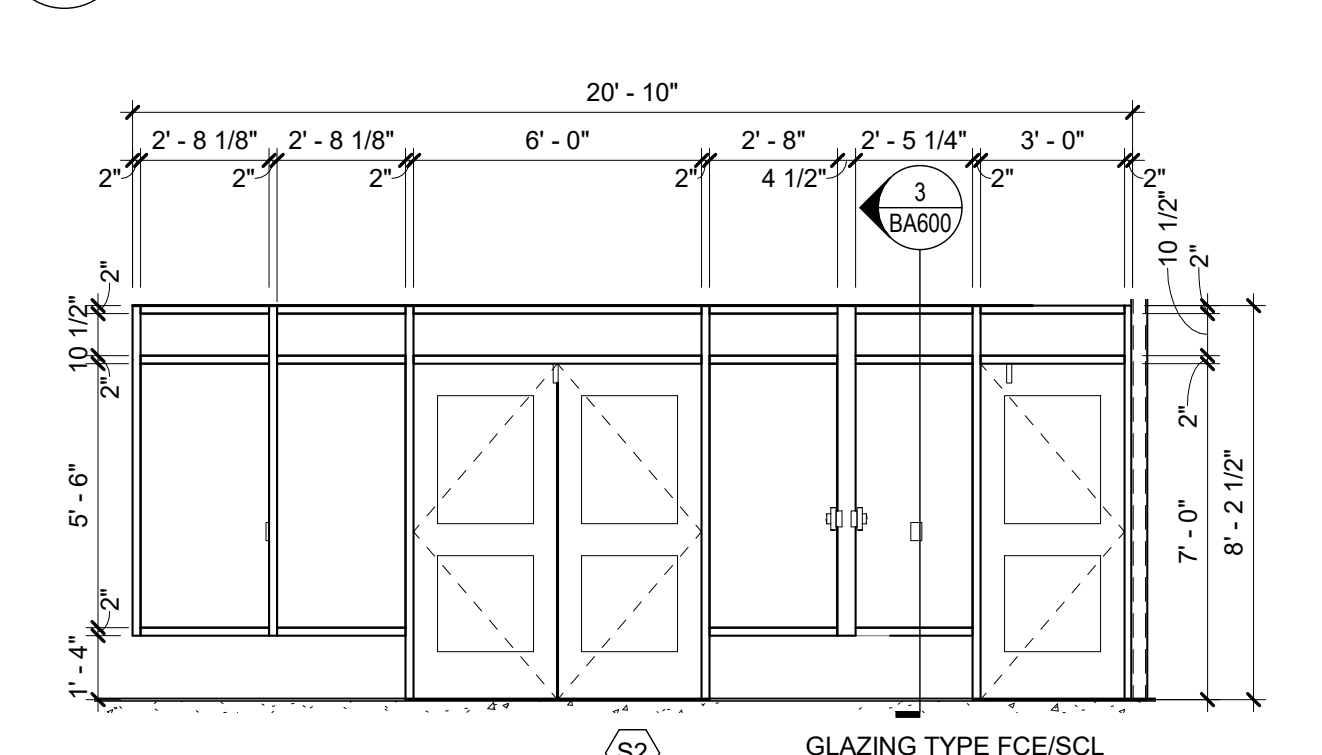


2 Storefront S2

1/4\"/>

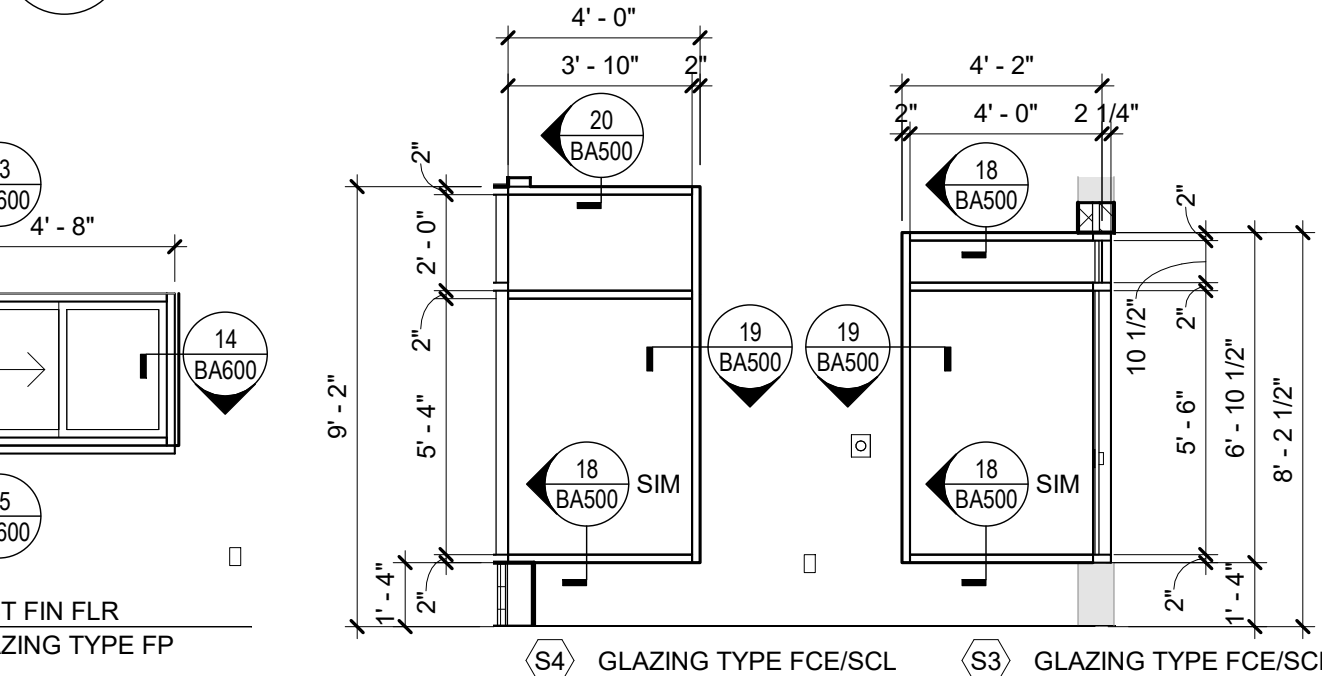


3 Storefront S3 and S4

1/4\"/>

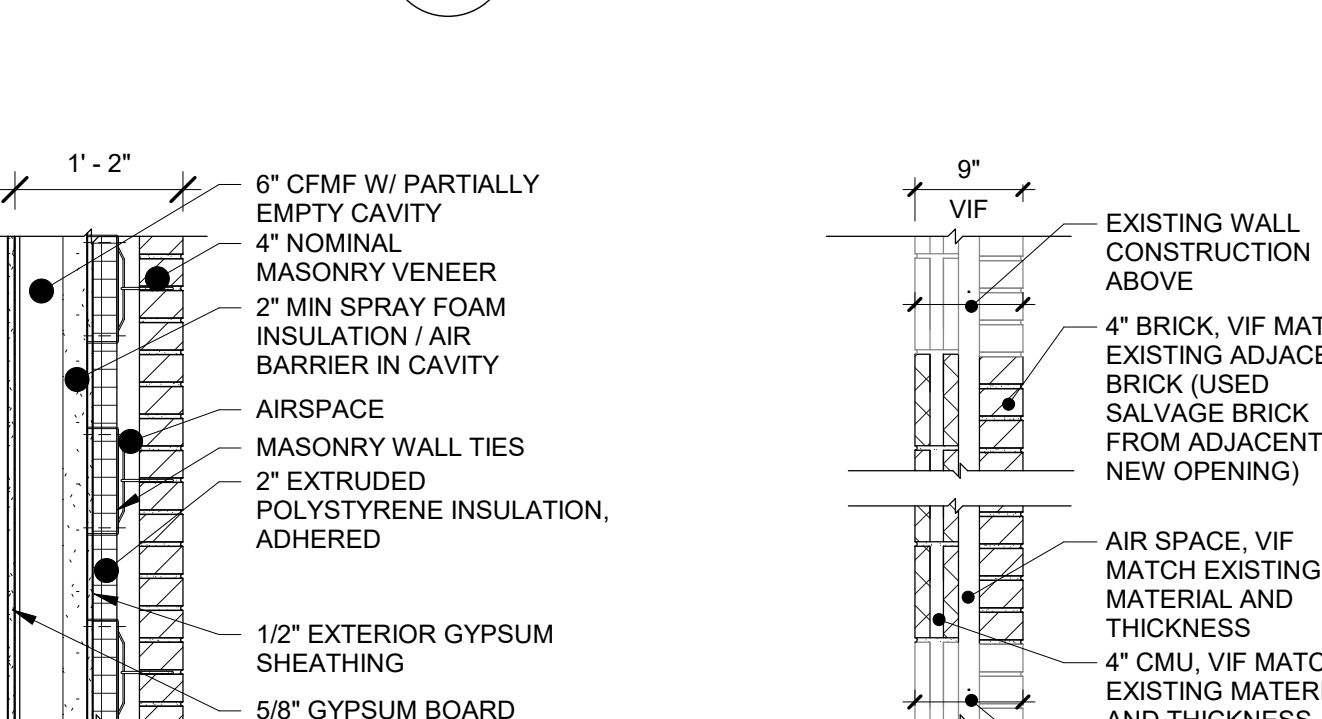


4 W1

1/4\"/>

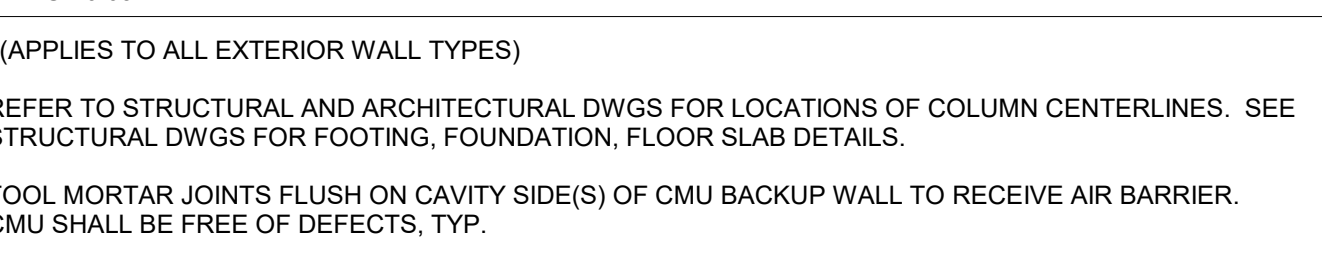

5 Typical Exterior Wall Types


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Key Plan
N.T.S.

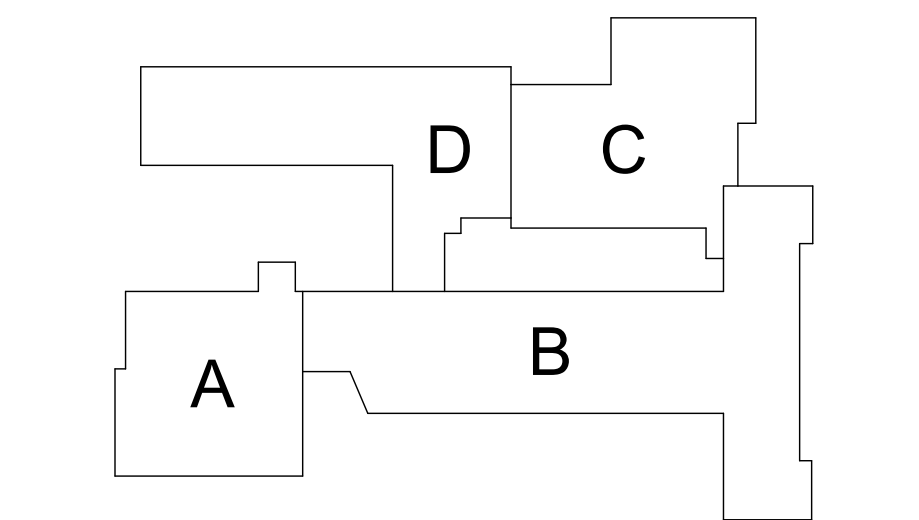S.E.D. Control No. 13-02-00-01-0-006-022

Rev. No.	Date	Description



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ARCHITECTS & ENGINEERS

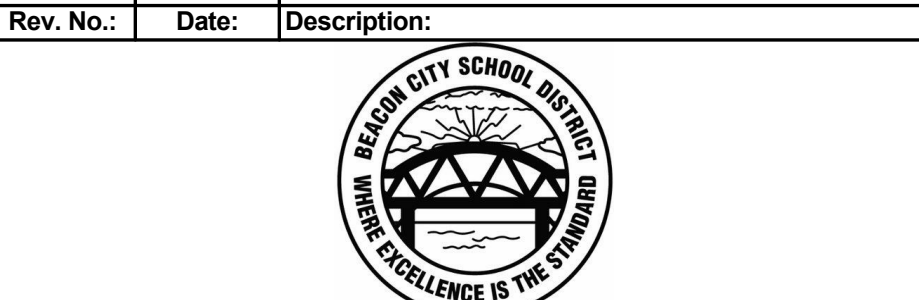Beacon City School District
Beacon, New York

Additions and Alterations to:
Glenham Elementary School

Door Schedule, Door and Window
Types, and Details

Drawn By: GCK/lig Date: 10/28/2022 Drawing Number: 279180-22004

BA600

15 Existing Drain Section
3" = 1'-0"

General Finish Notes

ALL FINISH PRODUCTS ARE TO BE INSTALLED IN ACCORDANCE WITH CONTRACT SPECIFICATION AND MANUFACTURERS INSTRUCTIONS. REFER TO SPECIFICATIONS AND FINISH DETAILS FOR ADDITIONAL INFORMATION ON INSTALLATION OF SPECIFIED MATERIALS.

A. ALL PAINTS FOR INTERIOR AND EXTERIOR ARE TO BE APPLIED IN ACCORDANCE WITH SPECIFICATION SECTION 09 91 00 AND 09 96 00.

B. ALL EXPOSED STRUCTURES, INCLUDING BUT NOT LIMITED TO PIPING AND FIREPROOFING, CONDUIT, AND ALL ASSOCIATED EQUIPMENT ARE TO BE PAINTED.

C. APPLY PAINT TO BOTH NEW AND EXISTING ITEMS IN ALL AREAS INDICATED WITH A FINISH BOX AND/OR NOTES - THESE ITEMS ARE INCLUDING BUT ARE NOT LIMITED TO:
- FEC 'S, LADDERS, BEAMS, DOOR/FRAMES - BOTH SIDES GLAZING FRAMES IN DOOR/WALLS - BOTH SIDES, ALL ITEMS ARE TO BE ACCENT COLORS

D. PATTERNS FOR FLOORS AND WALLS ARE ISSUED DURING THE CONSTRUCTION PHASE DRAWINGS INCLUDING ALL ACCENT LOCATIONS. SUBMIT SHOP DRAWINGS SHOWING DETAILED LAYOUTS OF EACH AREA, INCLUDING EDGES AND TRANSITIONS. ALL LAYOUTS ARE TO BE CENTERED IN EACH ROOM. UNO - TYP ALL DRAWINGS, ABOVE REQUIREMENTS ARE TO INCLUDE BUT NOT LIMITED TO:

- CERAMIC TILE, BOTH WALL AND FLOOR.
- TERRAZZO AND BASE
- CARPET
- VCT
- LVT
- RUBBER

E. FIELD AND ACCENT PAINT ARE ISSUED DURING THE CONSTRUCTION PHASE-CONTRACTOR IS TO ASSUME ALL FIELD AND ACCENT COLORS ARE DIFFERENT ROOM TO ROOM. AS WELL AS WITHIN EACH ROOM, REQUIREMENTS ARE TO INCLUDE BUT ARE NOT LIMITED TO:

- WALL, FIELD COLOR
- WALL, ACCENT COLOR
- SOFFITS, ACCENT COLOR
- DOOR AND WINDOW FRAMES, ACCENT COLOR
- EXPOSED COLUMNS, ACCENT COLOR
- EXPOSED DECKS, ACCENT COLOR
- EXPOSED JOISTS, ACCENT COLOR
- EXPOSED DUCTWORK, ACCENT COLOR

F. PROVIDE PAINT AT ALL NEW SOFFITS. REFER TO REFLECTIVE CEILING PLANS FOR ADDITIONAL LOCATIONS.

G. ALL EXPOSED BRICK, GROUND FACE BLOCK IS TO REMAIN UNPAINTED, UNO.

H. CONFIRM WITH OWNER AND ARCHITECT PRIOR TO PAINTING OVER MURALS ON EXISTING SURFACES.

I. CERAMIC WALL TILE IS TO RUN FLOOR TO 6" ABOVE CEILING UNO.

J. PROVIDE PAINT AND RUBBER BASE AT ALL NEW CHASES. REFER TO NEW WORK PLANS FOR ADDITIONAL LOCATIONS.

K. REFER TO STRUCTURAL DRAWINGS FOR LOCATIONS OF SLAB DEPRESSIONS. REFER TO FINISH MATERIAL SPECIFICATION SECTIONS FOR SLAB DEPRESSION DEPTH REQUIREMENTS.


L. FOR ALL RENOVATED AREAS REQUIRING FINISH WORK REMOVE, PROTECT AND REINSTALL MOVABLE EQUIPMENT INCLUDING BUT NOT LIMITED TO: BOARD UNITS, LOCKERS OYM EQUIPMENT, SHADES/BLINDS, BOOKCASES ETC. REINSTALL IN ORIGINAL LOCATION, OR AS NOTED ON DRAWINGS. COORDINATE WITH OWNER. REFER TO SPEC SECTION 01 23 00 ALTERATION PROJECT PROCEDURES FOR MORE INFORMATION.

M. FIELD VERIFY ALL CONTROL JOINTS LOCATIONS IN CONCRETE SLAB. LOCATE CONTROL JOINTS IN EXISTING FLOOR FINISH MATERIAL DIRECTLY ABOVE SLAB JOINTS OR AS RECOMMENDED BY FLOORING MATERIAL MANUFACTURER.
- AT NEW SLABS REFER TO STRUCTURAL DRAWINGS FOR SLAB CONTROL JOINT LOCATIONS.
- AT EXISTING SLABS, FIELD VERIFY LOCATIONS OF EXISTING SLAB CONTROL JOINTS.


- REFER TO FINISH DRAWINGS AND SPECIFICATIONS FOR NEW FLOOR MATERIALS
COORDINATE FLOOR PATTERNS WITH CONTROL JOINT PRIOR TO SUBMISSION OF REQUIRED FLOOR PATTERN DRAWINGS.

N. INSTALLER IS TO FIELD VERIFY ALL EXG AND NEW FLOOR DRAIN LOCATIONS IN ALL EXG AND NEW SLABS AS PART OF THIS PROJECT.
* REFER TO ARCHITECTURAL DRAWINGS FOR FLOOR DEMO AREAS AND REQUIREMENTS
* REFER TO PLUMBING DRAWINGS FOR EXG AND NEW FLOOR DRAIN LOCATIONS.
* REFER TO STRUCTURAL DRAWINGS FOR LOCATIONS OF SLAB DEPRESSIONS
* REFER TO FINISH DRAWINGS FOR LOCATIONS OF NEW FLOOR FINISH MATERIALS AND FLOORING SLOPE.
* REFER TO FINISH MATERIAL SPECIFICATION SECTIONS FOR SLAB DEPRESSION DEPTH REQUIREMENTS.


O. PROVIDE ALL FINISHES AS INDICATED BY ROOM FINISH BOX AND/OR AS NOTED ON DRAWINGS.

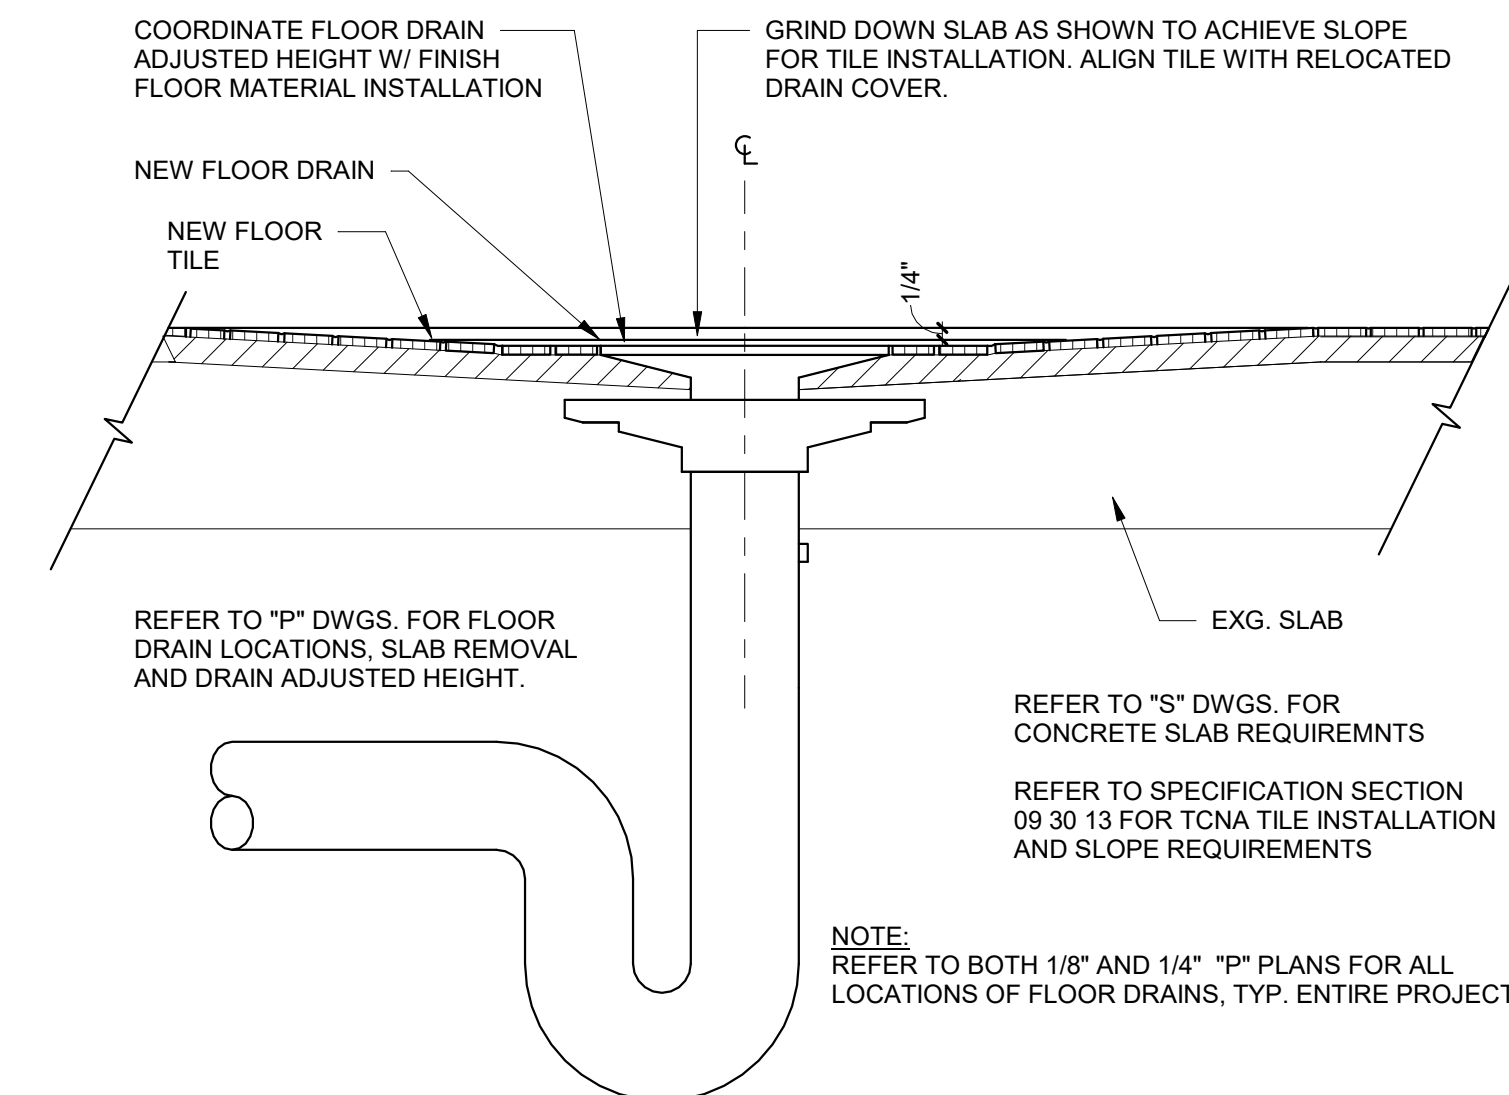


10 Ceramic Tile Base at Ceramic Floor With Wall Tile
3" = 1'-0"

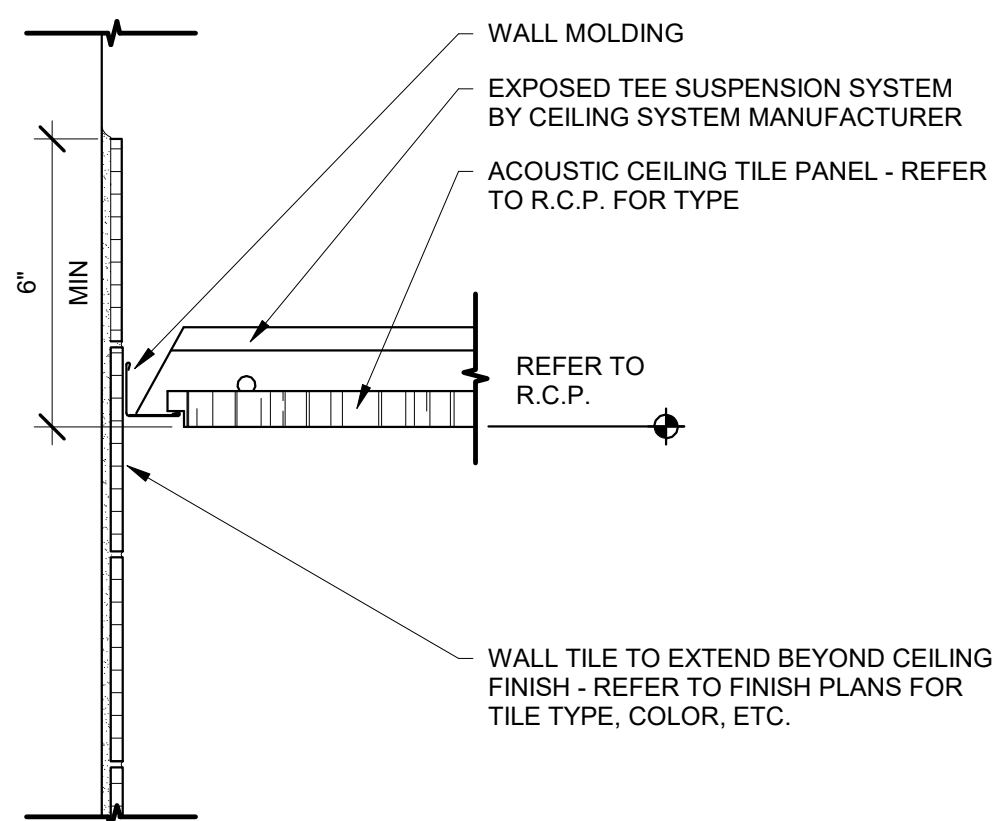


11 Ceramic Wall Tile at Acoustic Ceiling
3" = 1'-0"

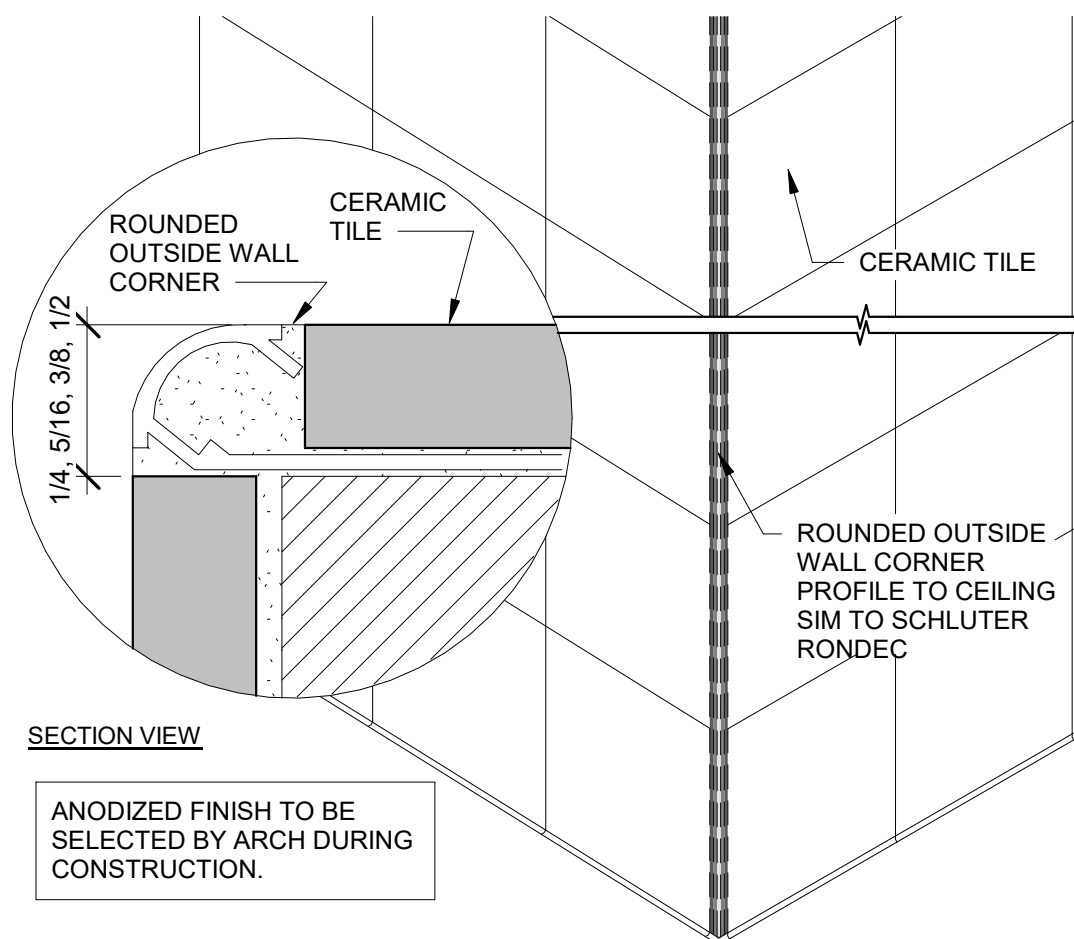


12 Outside Corner/ Rounded Profile
3" = 1'-0"

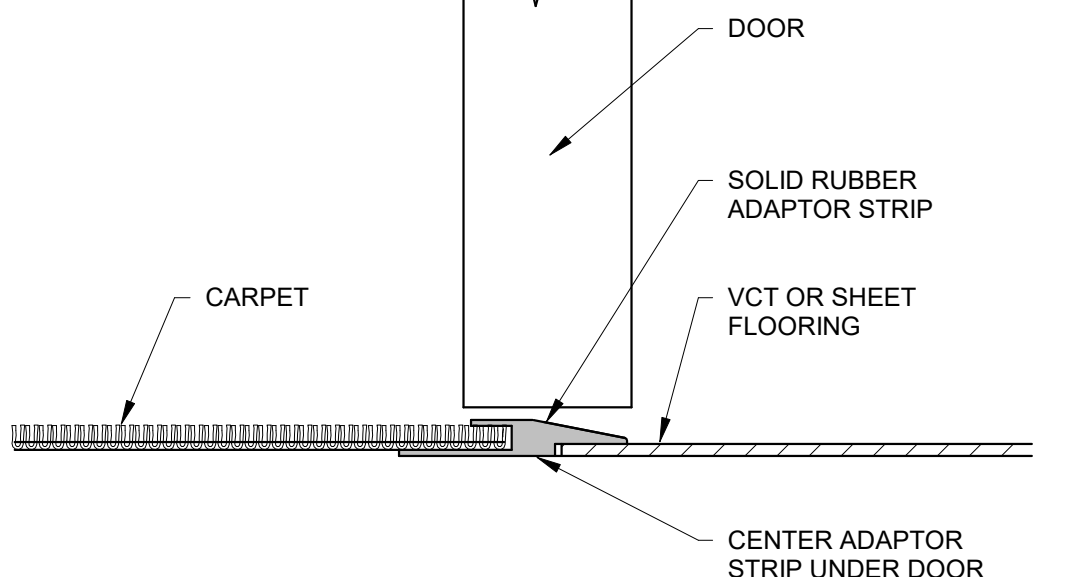


14 Threshold Detail
6" = 1'-0"

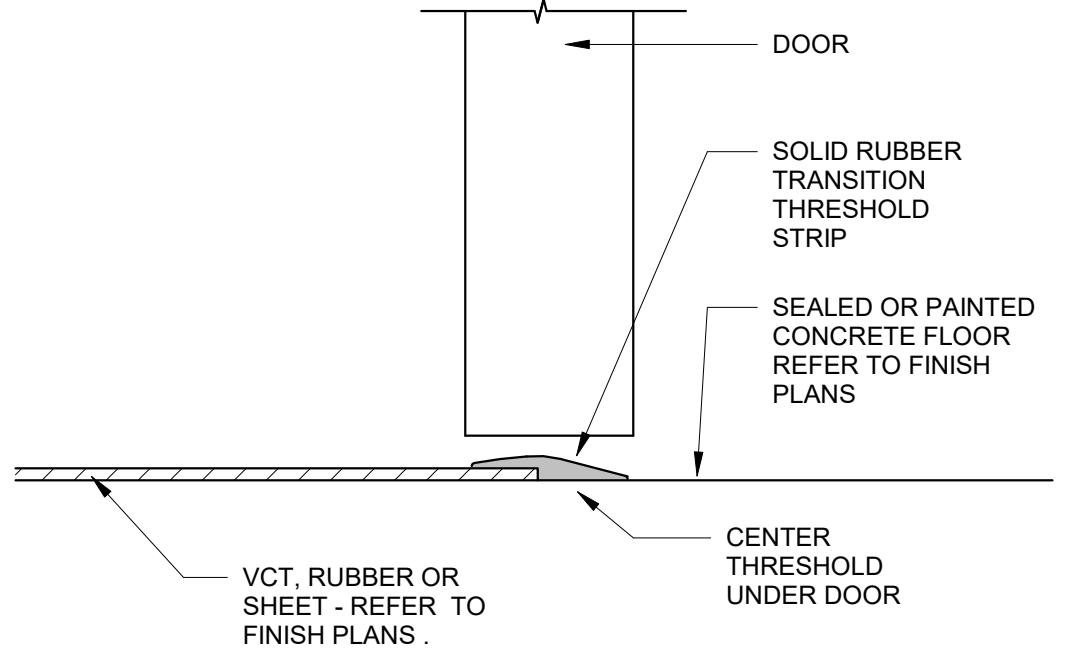


13 Threshold Detail
6" = 1'-0"

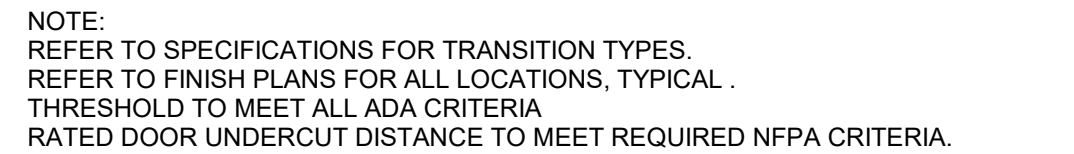


6 Base/ Grille Detail
3" = 1'-0"

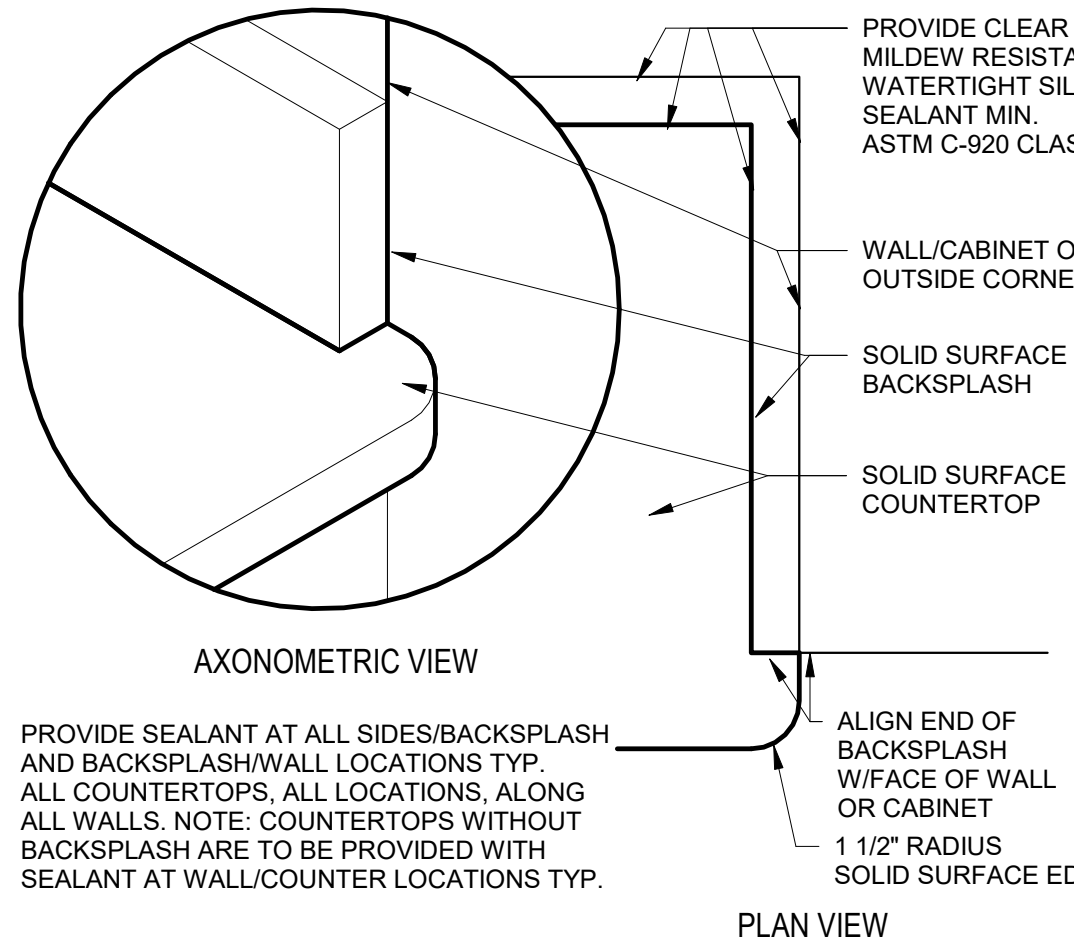

7 Solid Surface Countertop Edge Detail
3" = 1'-0"

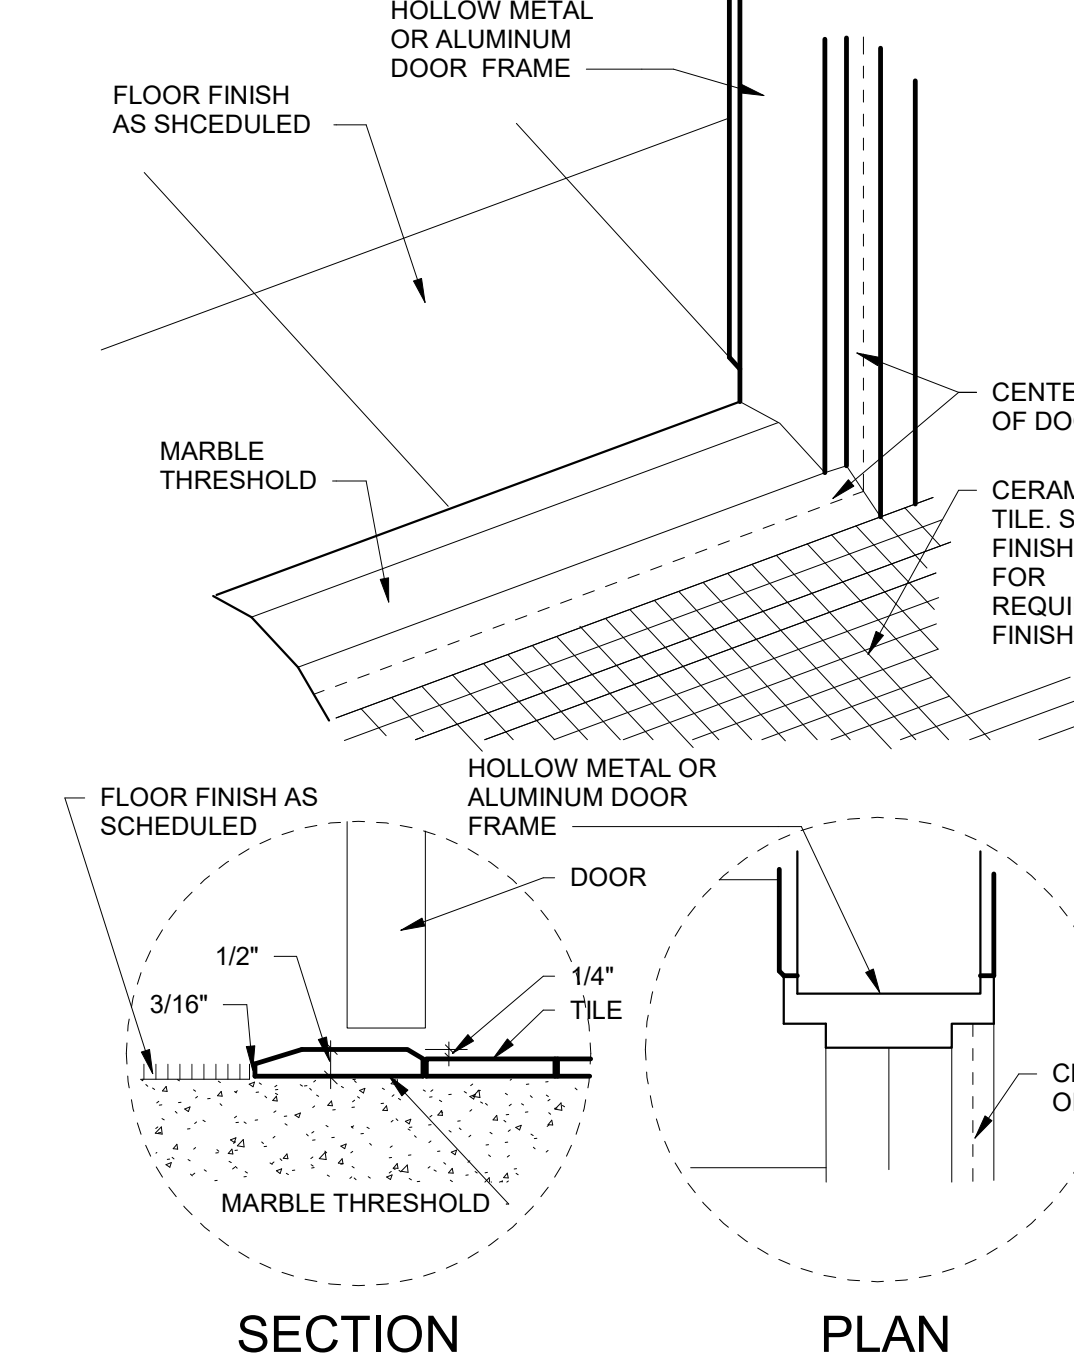


8 ADA Marble Threshold Detail
1 1/2" = 1'-0"

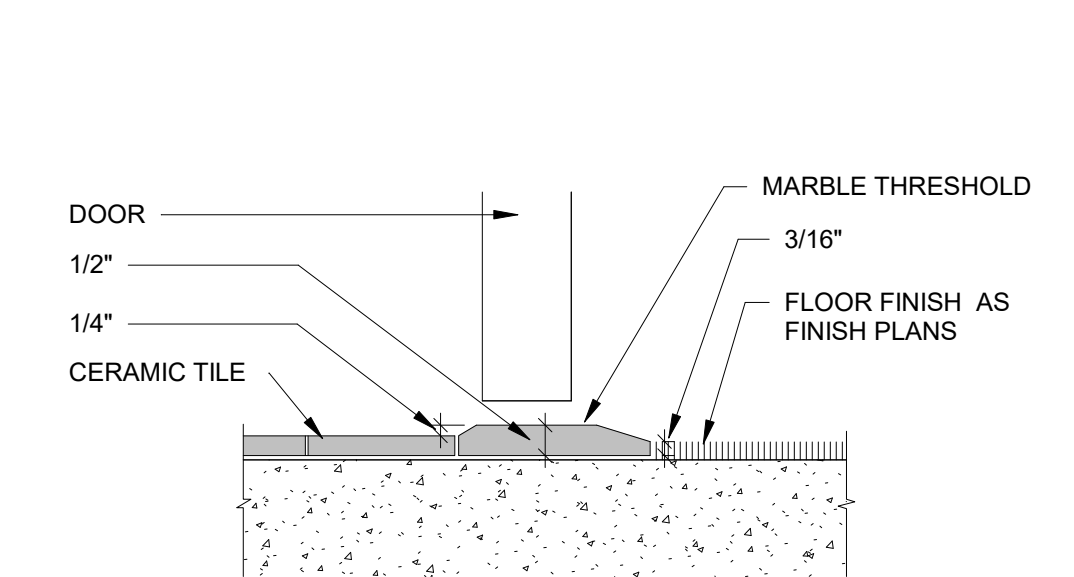


9 ADA Marble Threshold Detail
12" = 1'-0"




1 TYP. Corner Filler @ UV Casework Detail
3/4" = 1'-0"

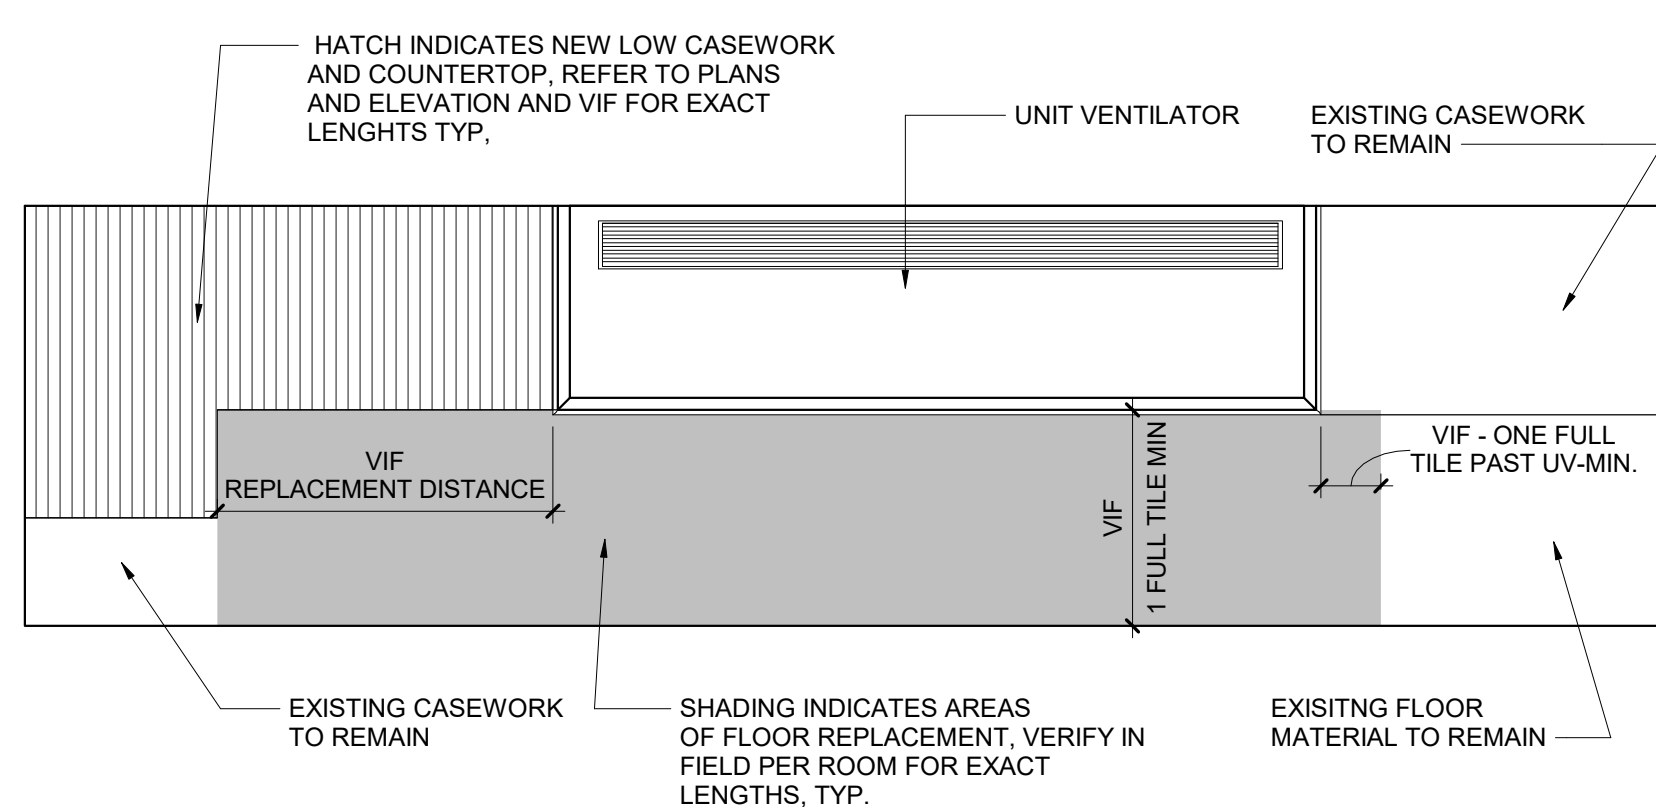


2 TYP. Floor Patch at UV Replacement Detail
3" = 1'-0"

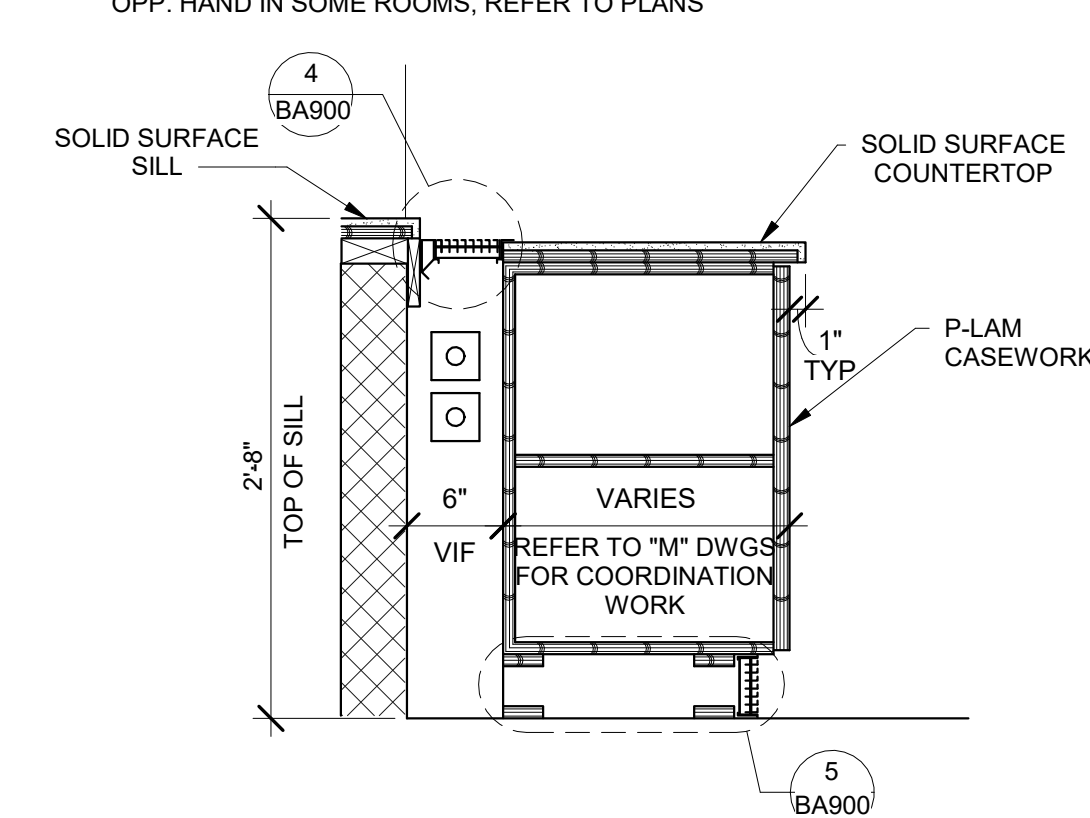


3 Casework/ Fin Tube Sections
1" = 1'-0"

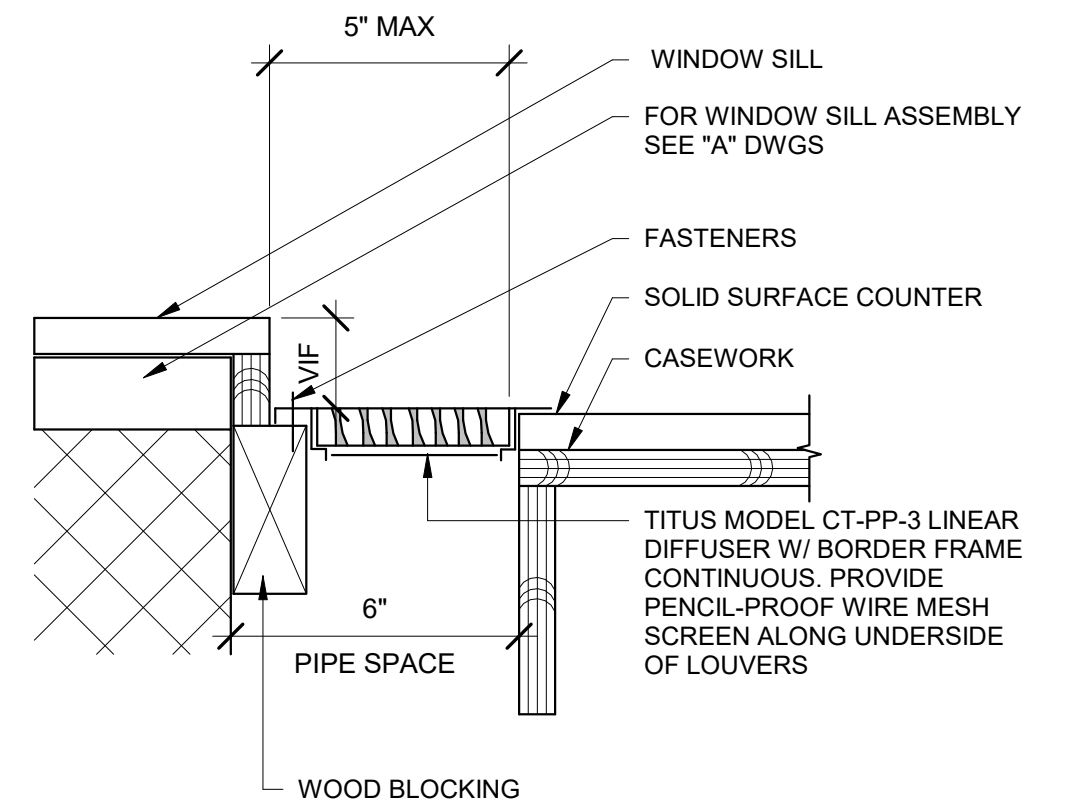

4 Grille Detail
3" = 1'-0"

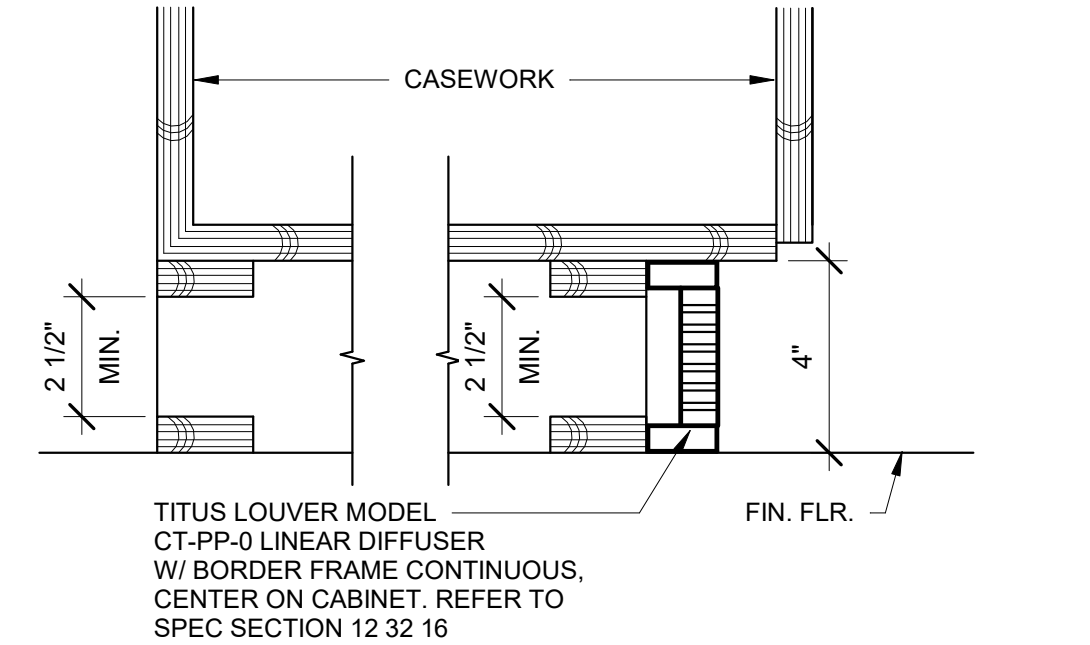


5 Base Detail
3" = 1'-0"

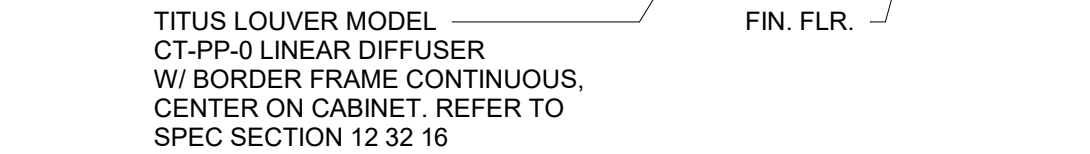


General P-Lam Casework Notes

- FOR ALL CONTRACTOR RESPONSIBILITIES REFER TO SPECIFICATION SECTION 01 10 0001 12 00.
- THE CASEWORK SHOWN ON THE DRAWINGS IS BASED ON CASE SYSTEMS DESIGN CORPORATION.
 - ALL STANDARD CASEWORK DIMENSIONS ARE TO BE MODIFIED TO CORRESPOND WITH THE DIMENSIONS NOTED ON THE DRAWINGS. FIELD VERIFY ALL DIMENSIONS PRIOR TO FABRICATION OF CABINETS.
 - MODEL NUMBERS LISTED ON DRAWINGS APPLY TO ELEVATIONS SHOWN. PROVIDE OPPOSITE HAND MODELS WHERE NECESSARY.
 - PROVIDE FULL DEPTH SHELVES AT BASE, WALL AND TALL CABINETS TYP UNLESS NOTED OTHERWISE.
 - BASE AND TALL CABINETS ARE 24 INCHES DEEP, UNO WALL CABINETS ARE 14 INCHES DEEP, UNO BASE CABINET DEPTH DOES NOT INCLUDE 1" COUNTERTOP OVERHANGS, TYP.
 - PROVIDE FINISHED ENDS, BACK EXTENSIONS, SCRIBES, AND FINISHED FILLER PANELS ON ALL CABINETS. FILLER PANELS ARE NOT TO EXCEED 3" WIDE, UNLESS NOTED OTHERWISE. PROVIDE OP AND BOTTOM FILLER PANELS AT ALL BASE, WALL @ TALL NITS. SUBMIT SHOP DRAWINGS SHOWING DETAILS OF THESE CONDITIONS.
 - ALL COUNTERTOPS TO BE 1-1/4" SOLID SURFACE WITH 4" HIGH BACKSPASH, TYP.
 - PROVIDE AT ALL P-LAM UV SHELVING LOCATIONS-REMOVABLE BACKS IN CABINETS AT PLUMBING AND FIN TUBE VALVE LOCATIONS. VERIFY POSITIONS OF VALVES PRIOR TO SHOP FABRICATION OF ALL CABINETS.
 - PROVIDE SHOP DRAWINGS SHOWING LOCATIONS AND DETAILS FOR ALL GRILLES, LOUVERS, REMOVABLE PANELS, VALVE LOCATIONS, ETC ASSOCIATED WITH CASEWORK. COORDINATE WITH ALL REQUIRED CONTRACTORS.
 - PROVIDE CABINETS WITH FINISHED SIDES, INCLUDING BUT NOT LIMITED TO, LOCATIONS OF ADJACENT CABINETS OR EQUIPMENT WITH A DEPTH LESS THAN CABINET OR EQUIPMENT.
 - PROVIDE REMOVABLE BACK PANELS AT ALL SINK BASE CABINETS.
 - COUNTERTOP EDGES AT OPEN ENDS AND AT ENDS MEETING TALL SHELVING UNITS WITH A DEPTH LESS THAN COUNTERTOP DEPTH TO BE AS SHOWN, REFER TO DETAIL.
 - PROVIDE CUTS AT ALL CONDITIONS THAT INTERFERE WITH COUNTERTOPS/CABINETS - SCRIBE TO FIT.
 - PROVIDE ALL CUTOUPS AS SHOWN ON CASEWORK PLANS AND ELEVATIONS OR AS REQUIRED. CUTOUPS ARE TO INCLUDE BUT NOT LIMITED TO, ALL ELEC BOXES, OUTLETS, AND ASSOCIATED WIRING AND FINAL HOOK-UP.
 - PROVIDE BLOCKING AT NEW AND EXISTING GYPSUM BOARD WALLS PER MANUFACTURER RECOMMENDATIONS FOR SUPPORT OF WALL /TALL MOUNTED UNITS.
 - PROVIDE LOOKS AT ALL NEW CASEWORK DOORS/DRAWERS AND FILE UNITS.
 - REFER TO BOTH 1/8" AND 1/4" PLANS FOR LAYOUTS.
 - PROVIDE ALL STANDARD FEATURES OF CASEWORK UNITS AS INDICATED BY MODEL NUMBER OR AS SHOWN ON PLANS, DETAILS AND ELEVATIONS, INCLUDING BUT NOT LIMITED TO: OUTLETS, SWITCHES, LIGHTS ETC.

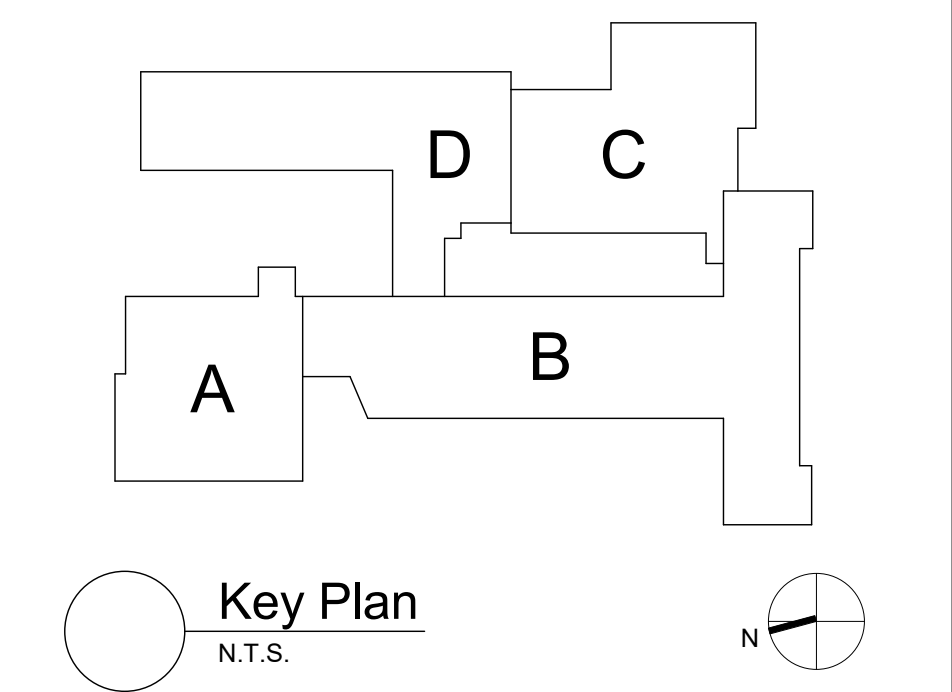

S.E.D. Control No. 13-02-00-01-0-006-022

Rev. No.:	Date:	Description:

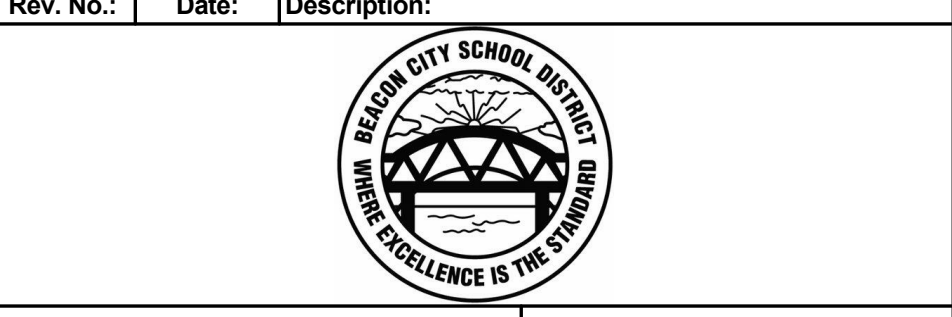

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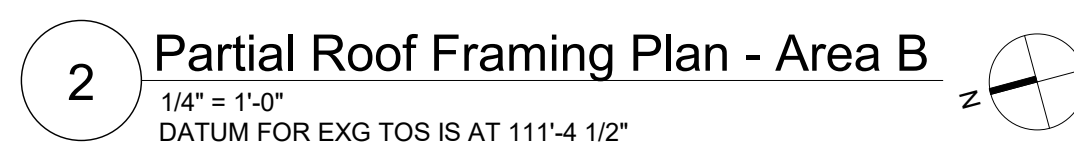
TETRA TECH
ARCHITECTS & ENGINEERS

Beacon City School District
Beacon, New York

Additions and Alterations to:
Glenham Elementary School

Misc. Details

Drawn By: MHH	Date: 10/28/2022	Drawing Number: BA900
Project No.: 279180-22004		



- Key Plan**
N.T.S.

S.E.D. Control No. 13-02-00-01-0-006-022

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Tetra Tech Engineers, Architects
& Landscape Architects, P.C.











Beacon City School District
Beacon, New York

Additions and Alterations to:
Glenham Elementary School






Partial Foundation and Framing Plan -
Area B

Drawn By: DMB/kjr	Date: 10/28/2022	Drawing Number: BS130
Project No.: 279180-22004		

BID SET

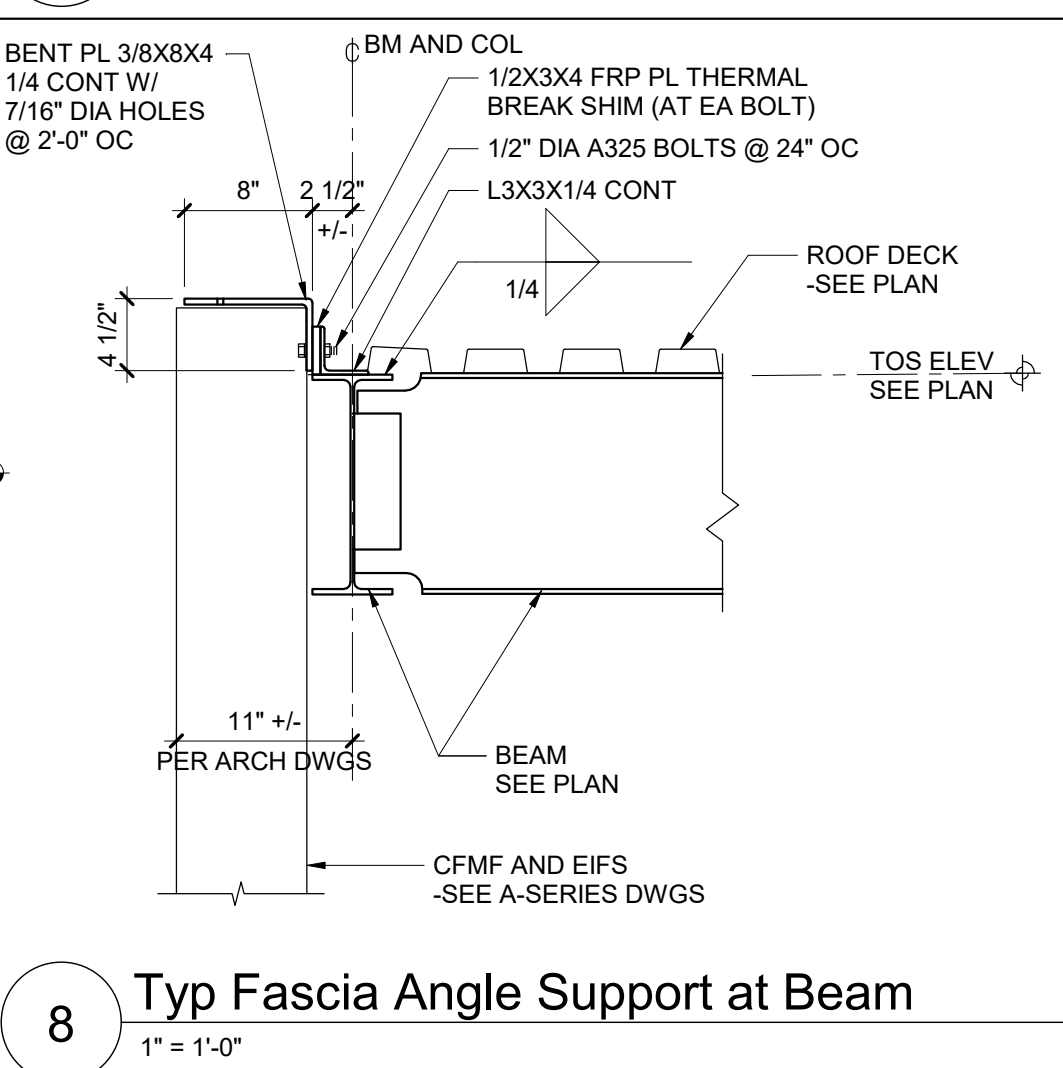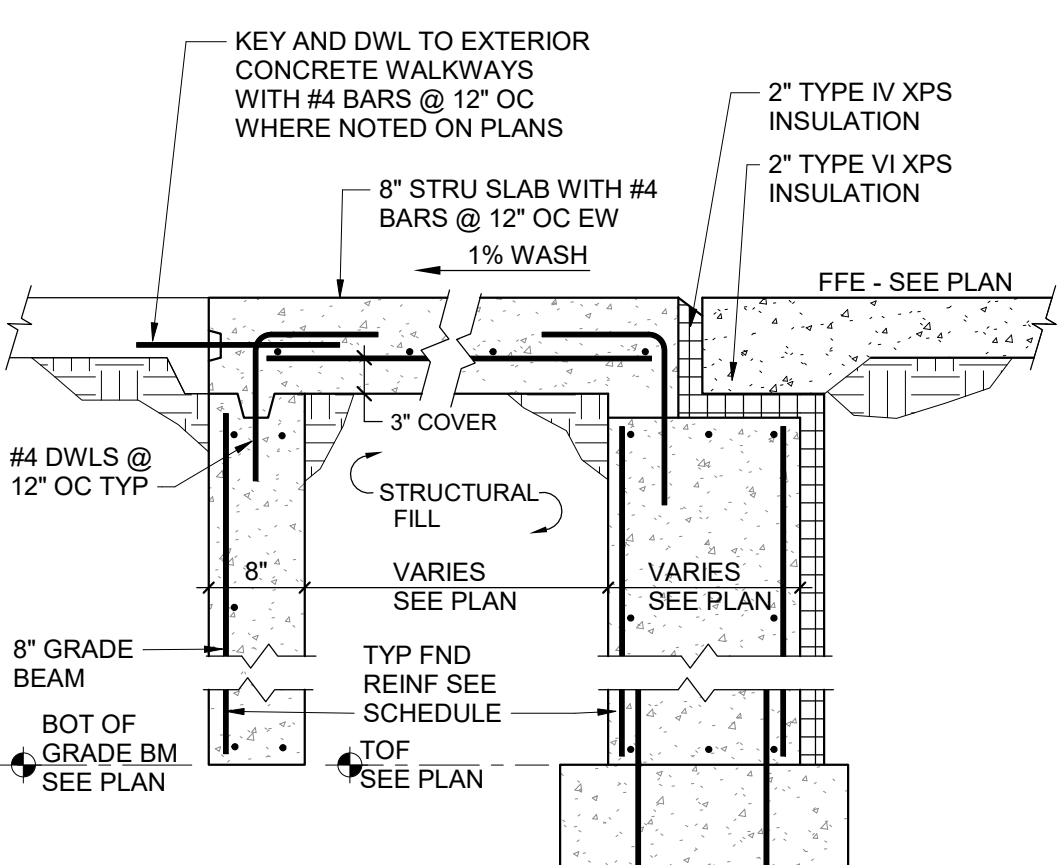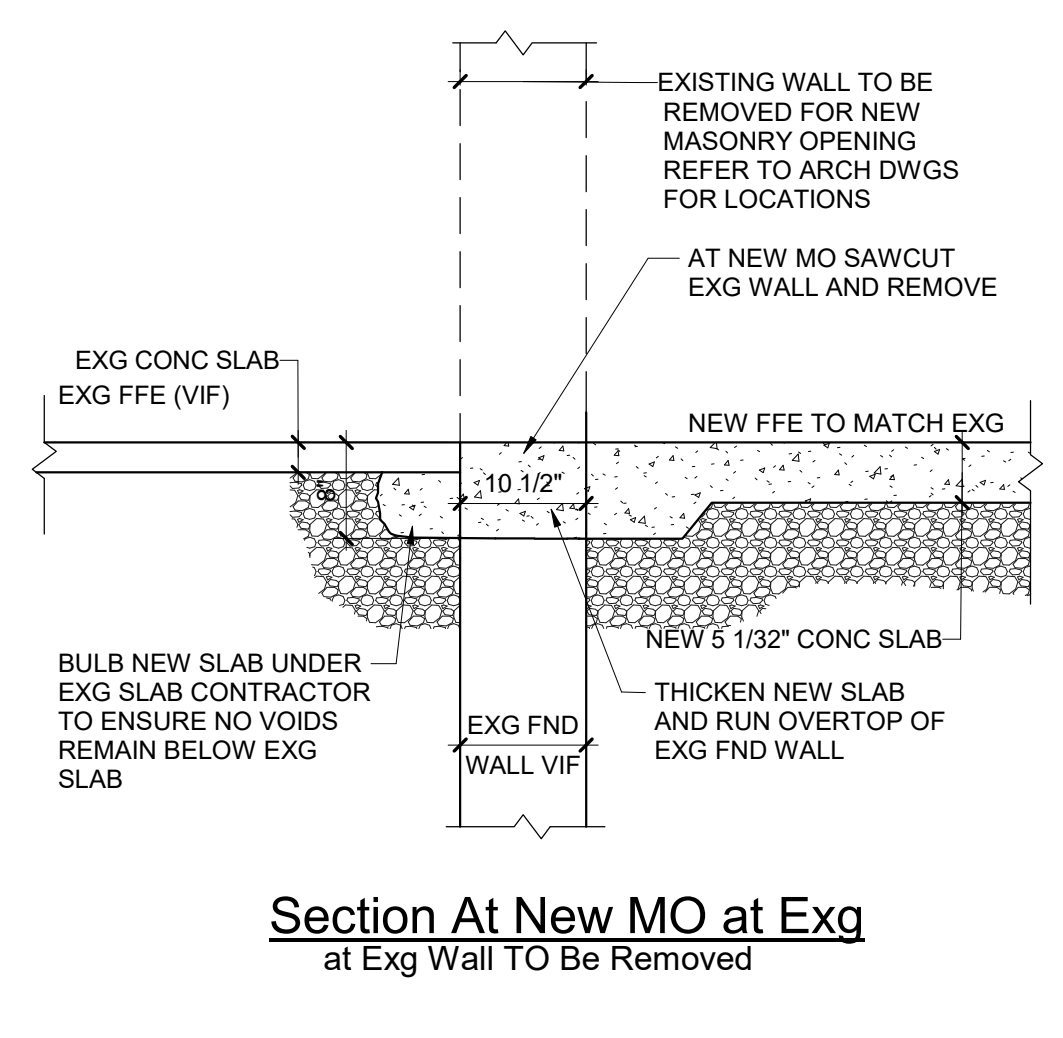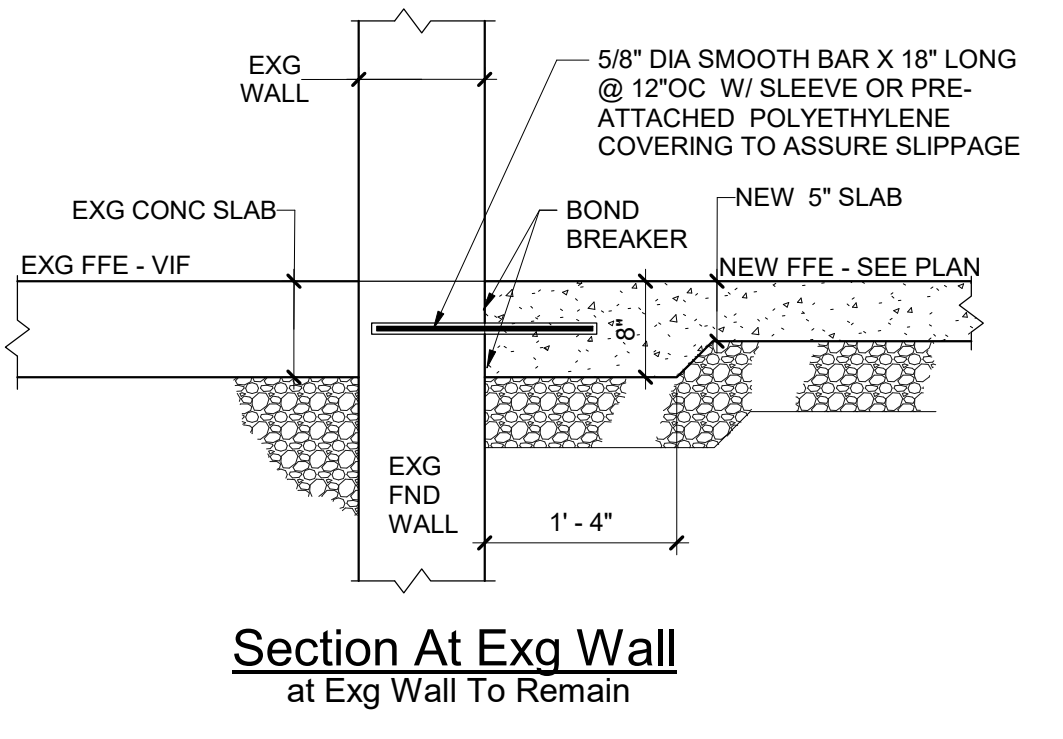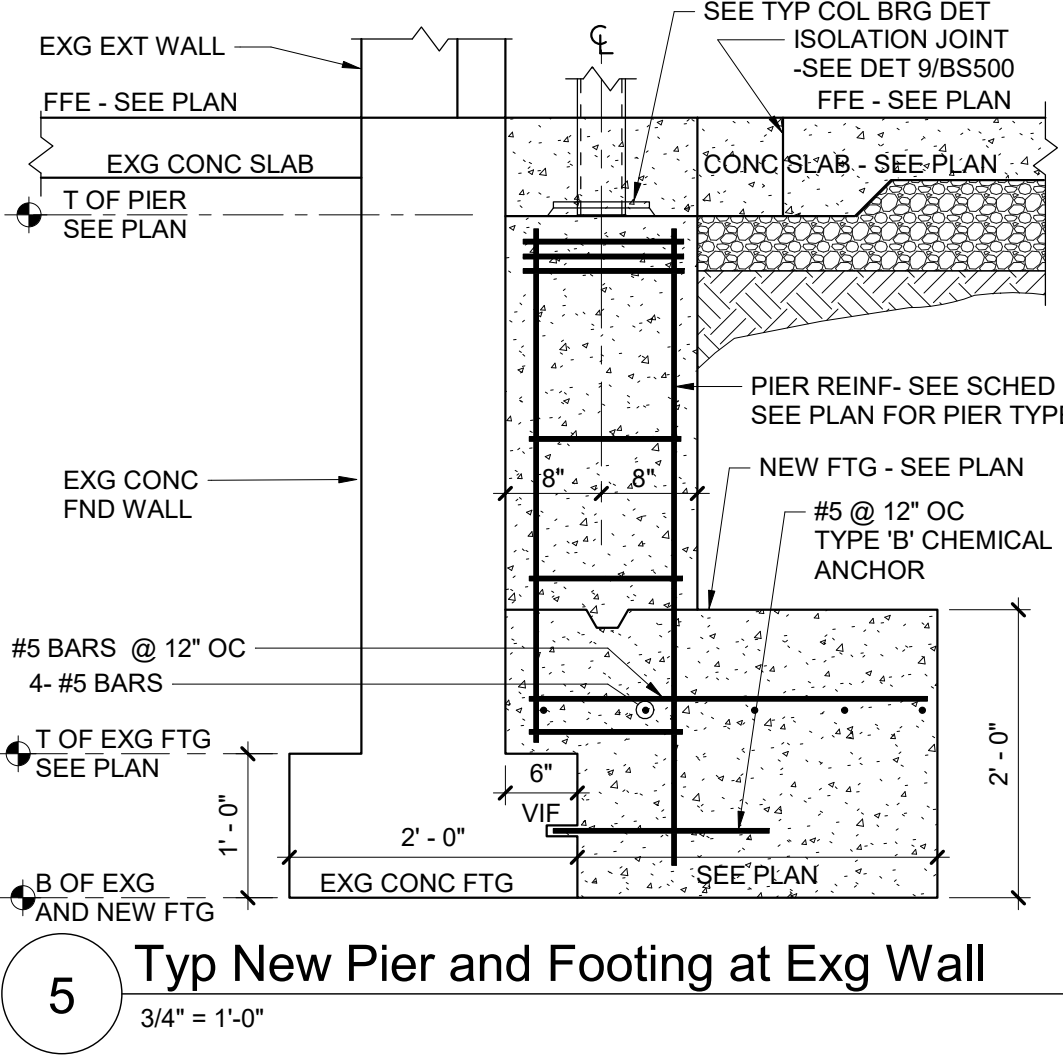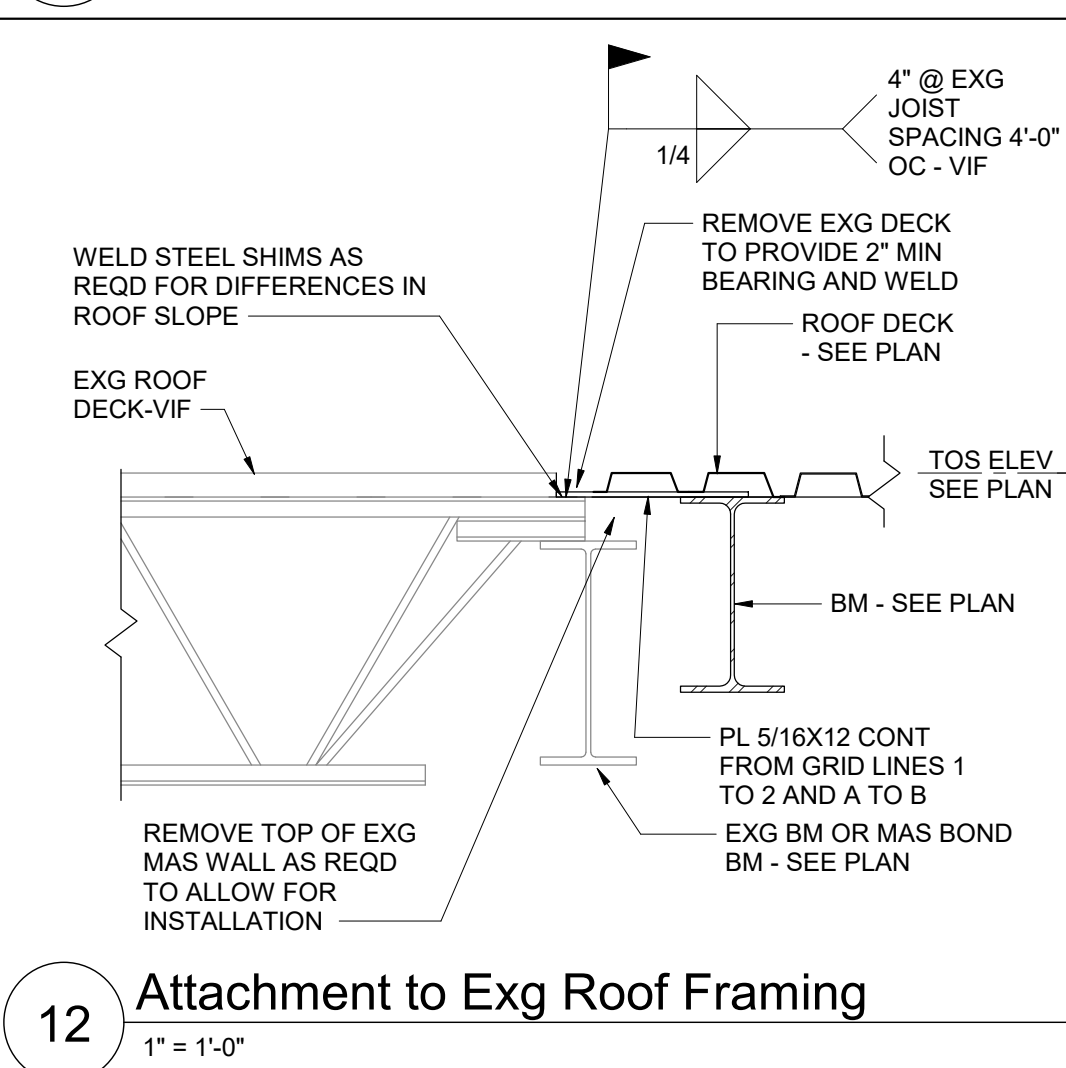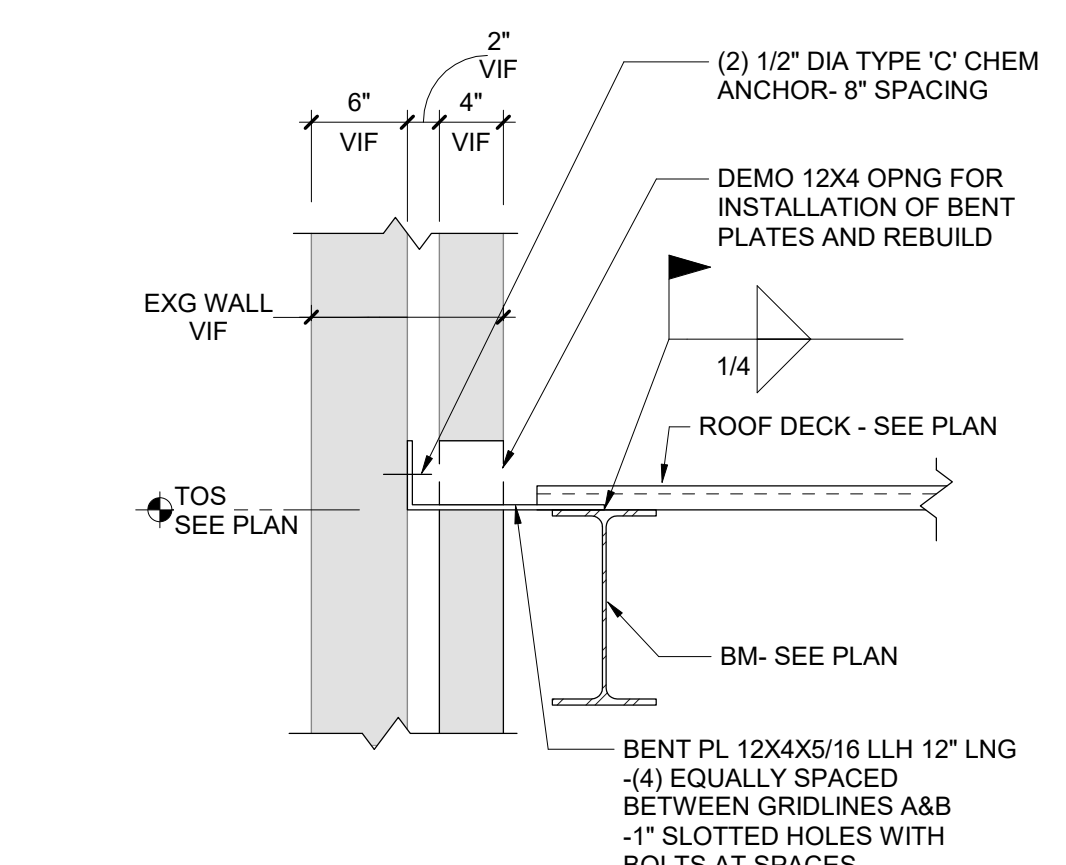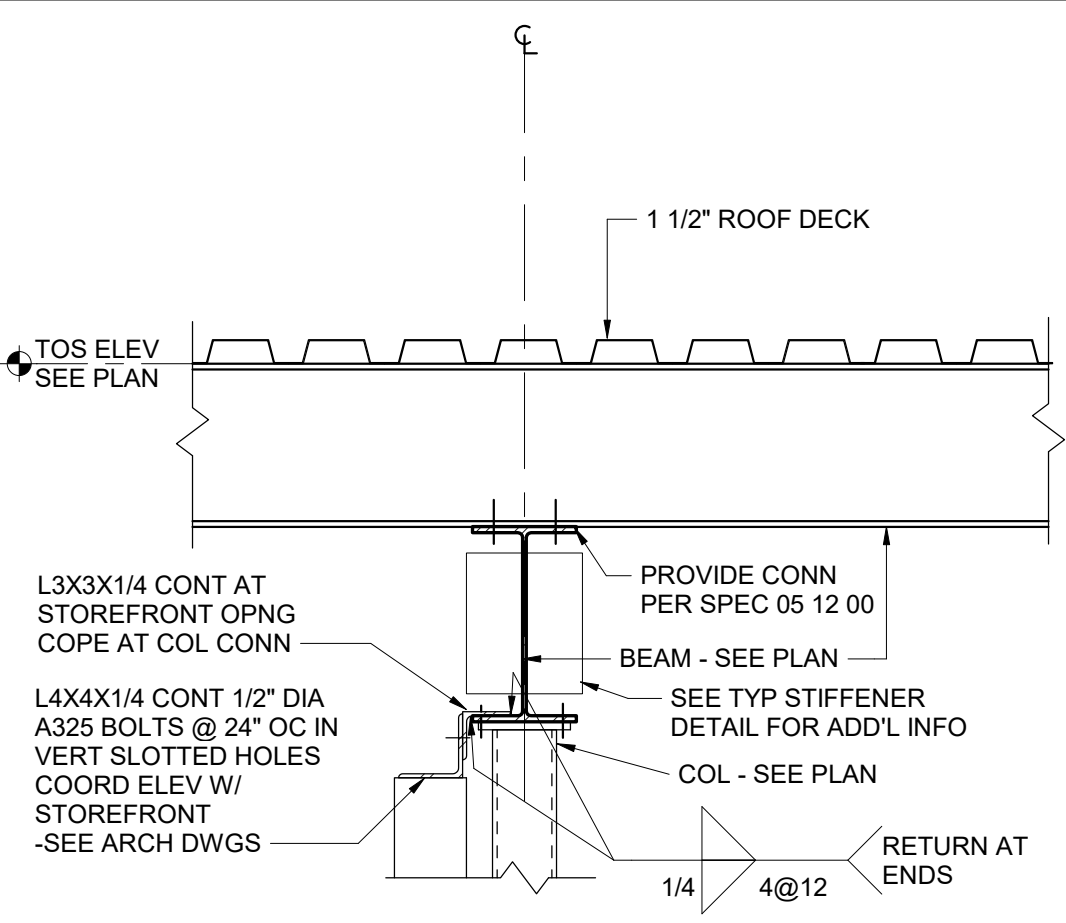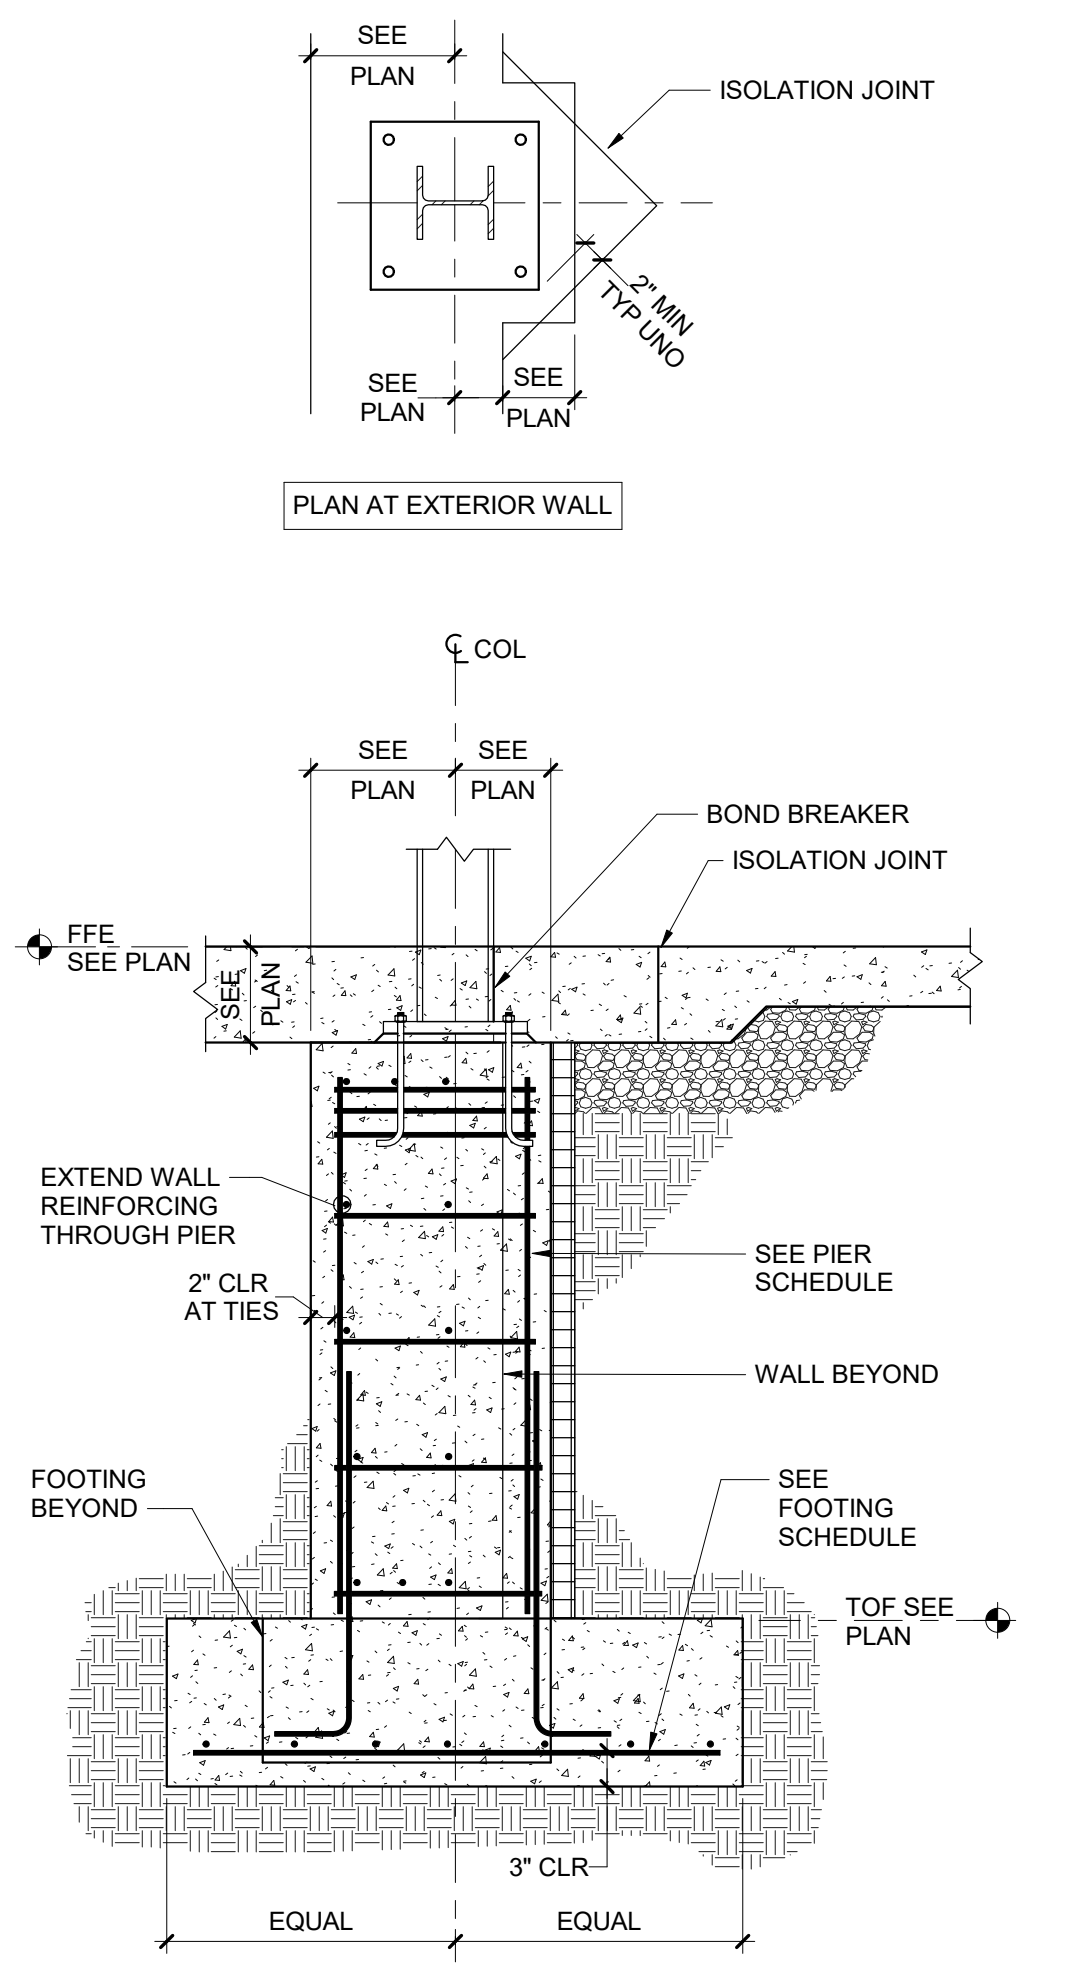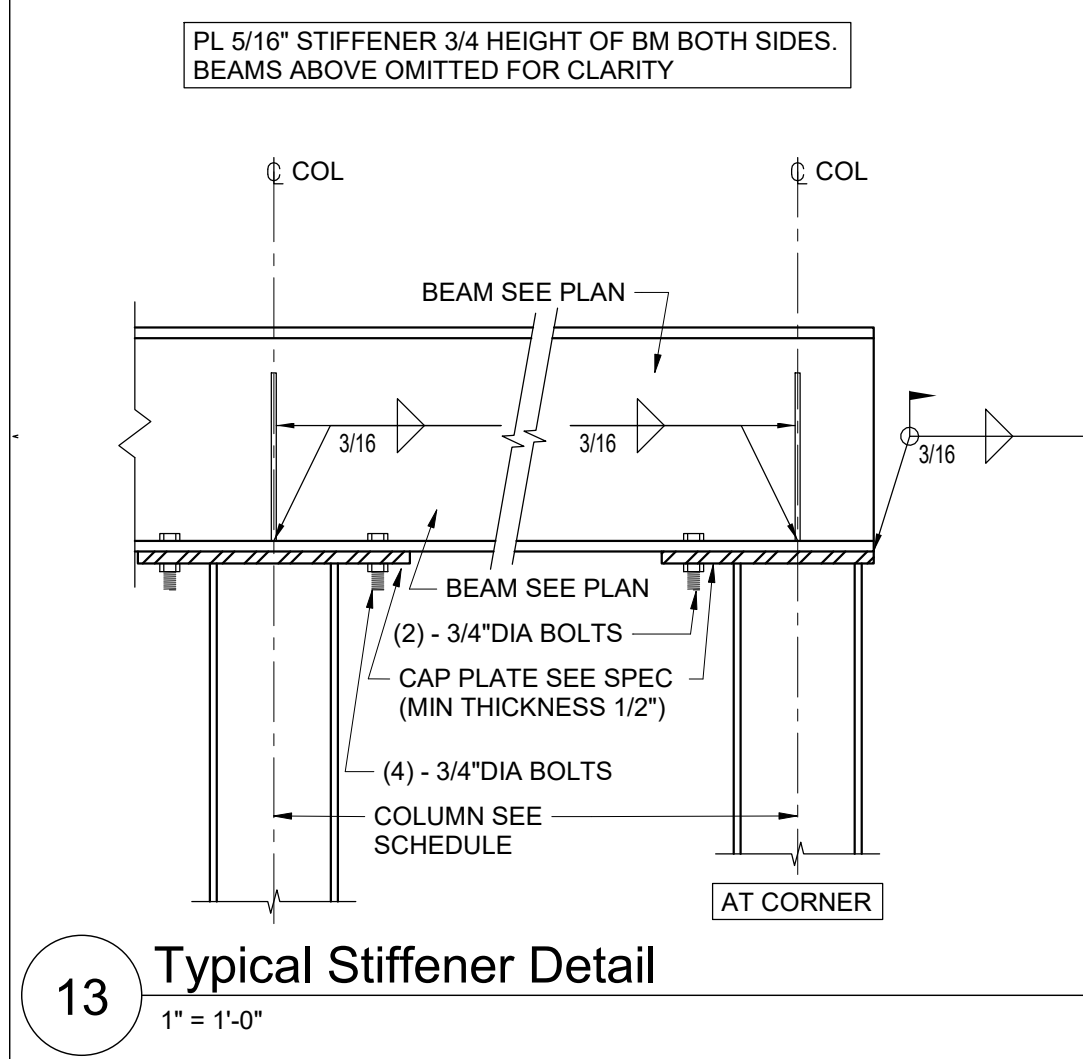

WALL THICKNESS	HORIZONTAL BARS	TOP AND BOTTOM BARS
8"	#4 @ 12" OF	2-#6
10"	#4 @ 12" EF	3-#6
1'-0"	#4 @ 12" EF	3-#6
1'-2"	#4 @ 12" EF	3-#6
1'-4"	#4 @ 12" EF	3-#6
1'-6"	#4 @ 11" EF	3-#6
1'-8"	#5 @ 15" EF	3-#6
1'-10"	#5 @ 14" EF	3-#6
2'-0"	#5 @ 13" EF	3-#6
2'-2"	#5 @ 12" EF	3-#6
2'-4"	#5 @ 11" EF	3-#6

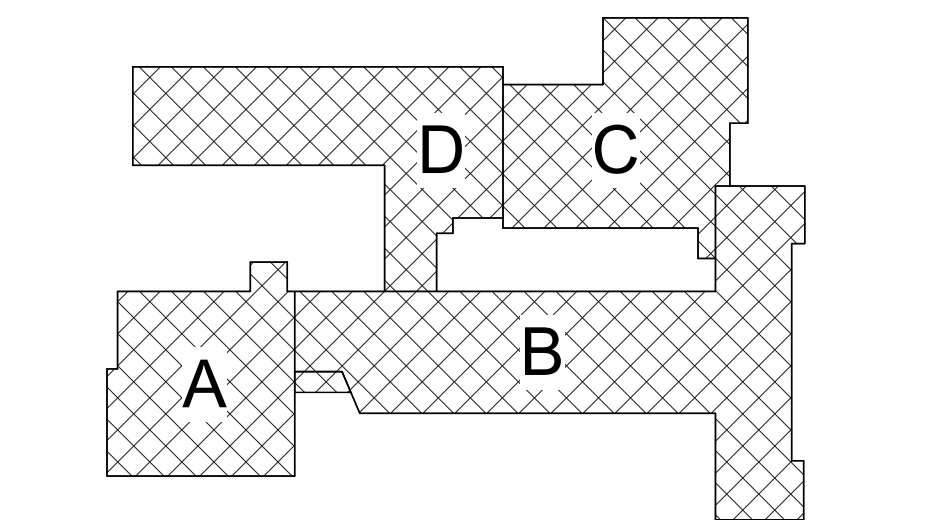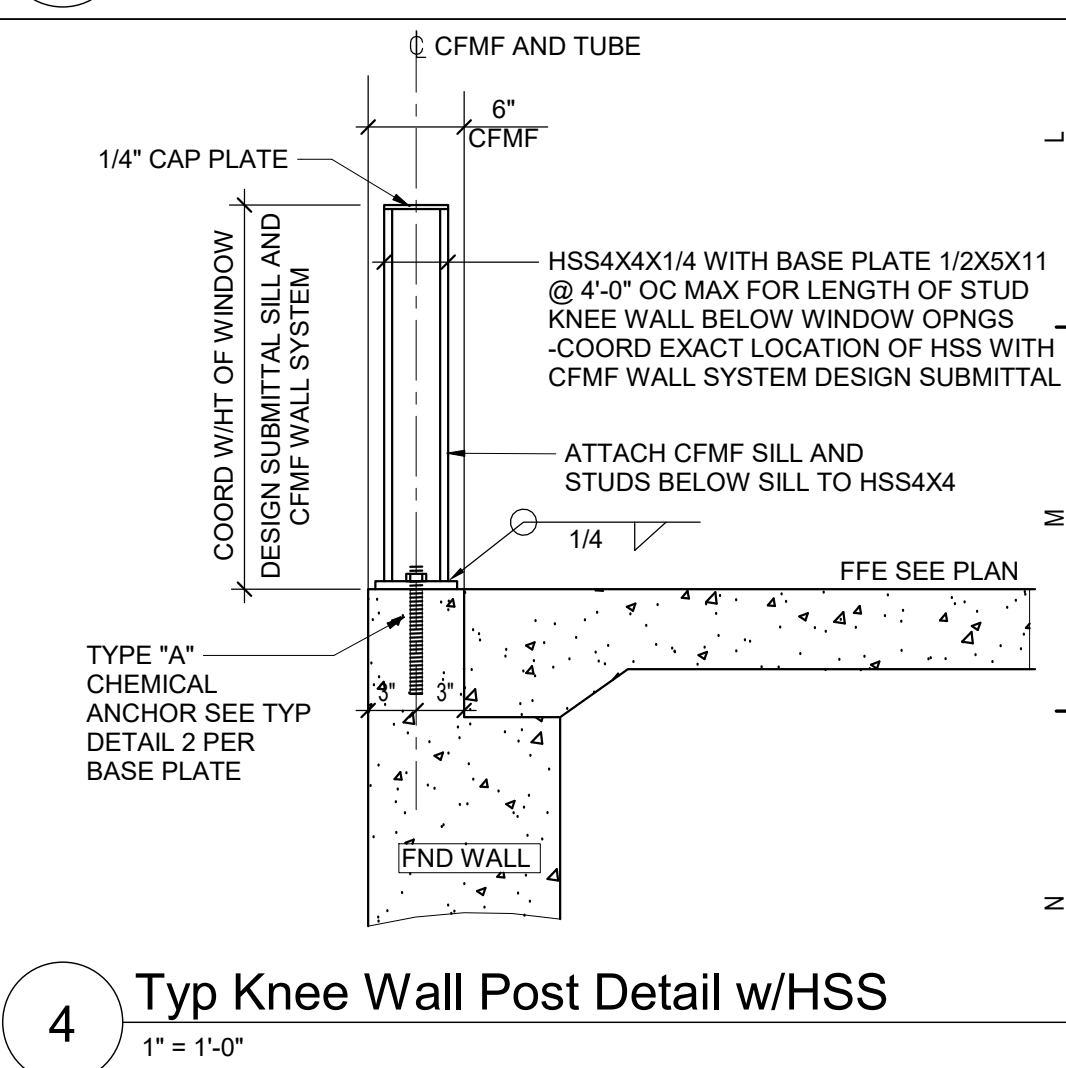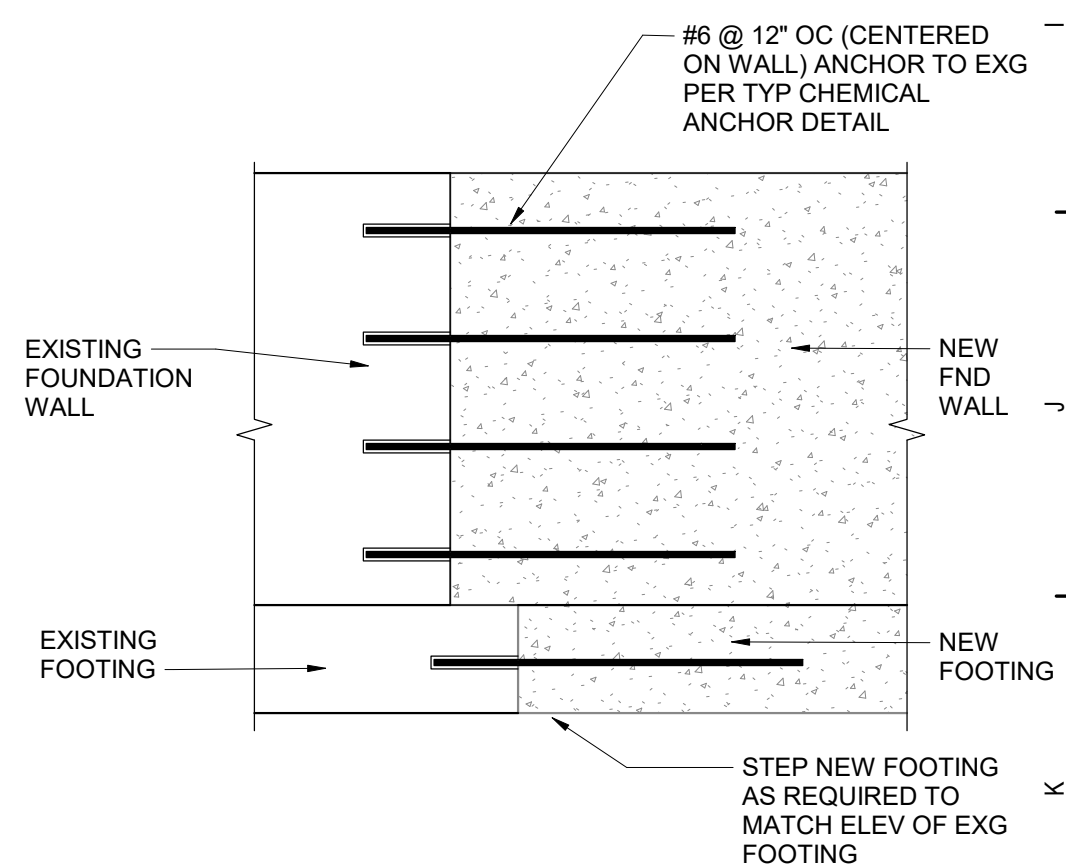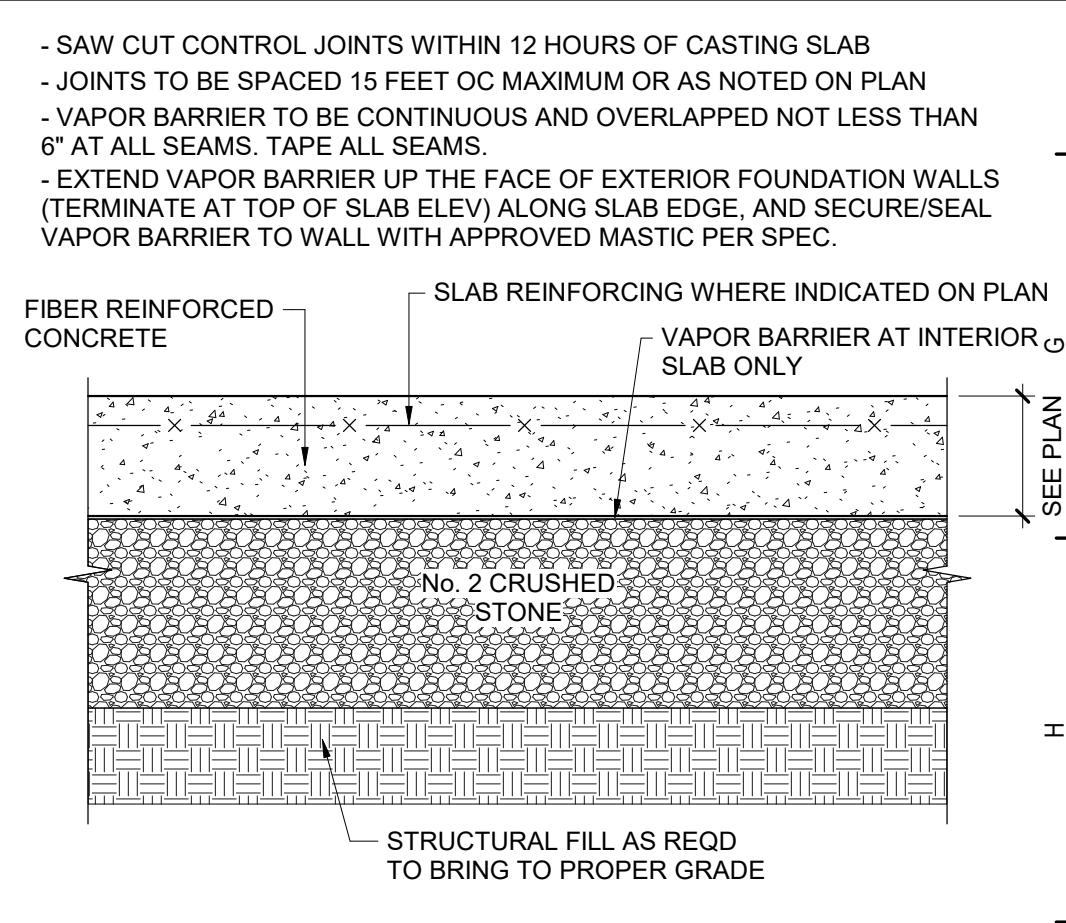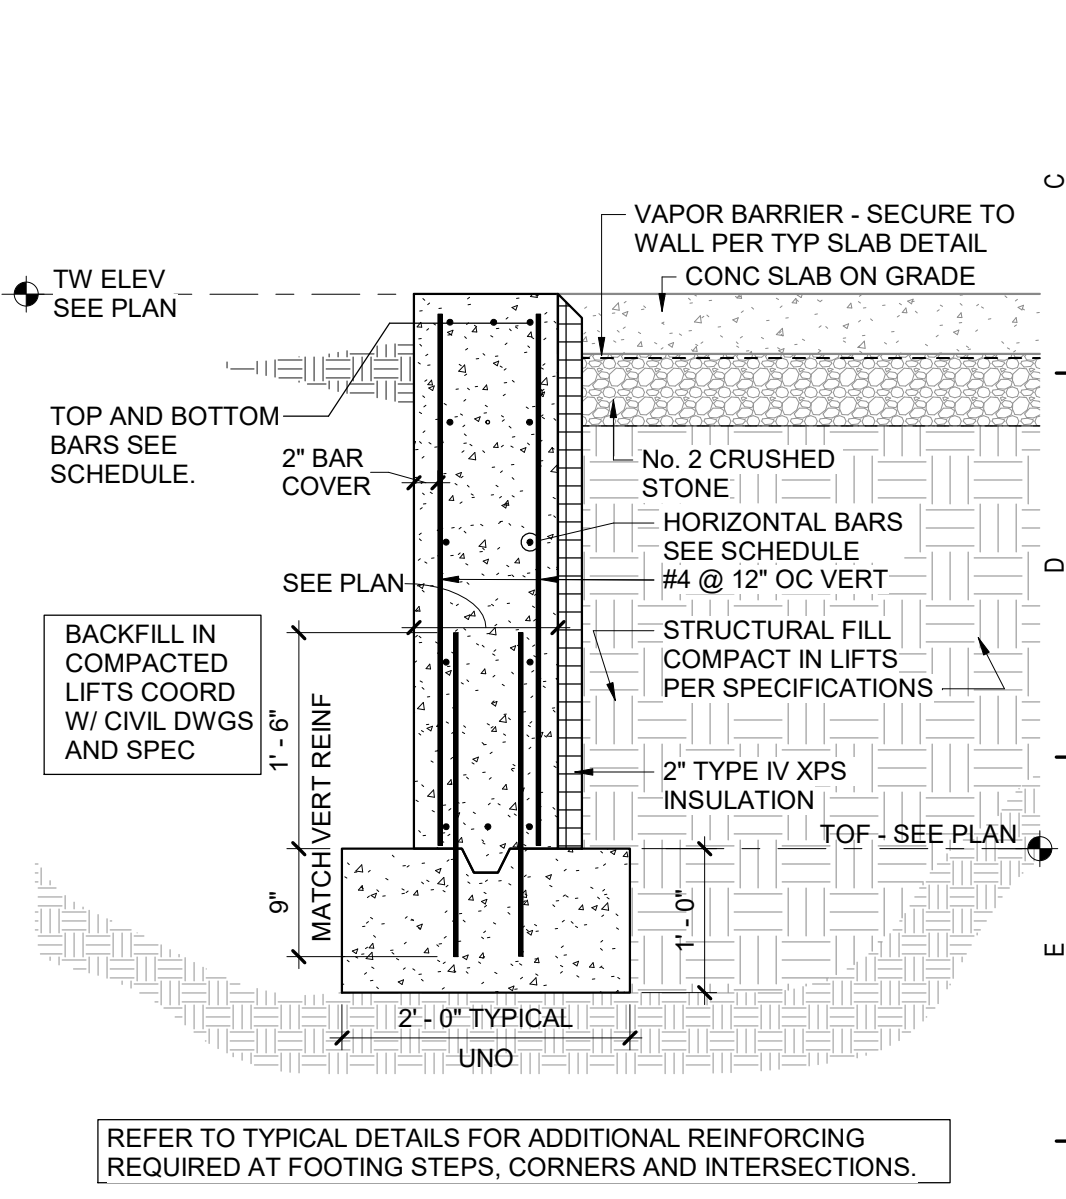

Key Plan
N.T.S.

S.E.D. Control No. 13-02-00-01-0-006-022

Rev. No.	Date	Description



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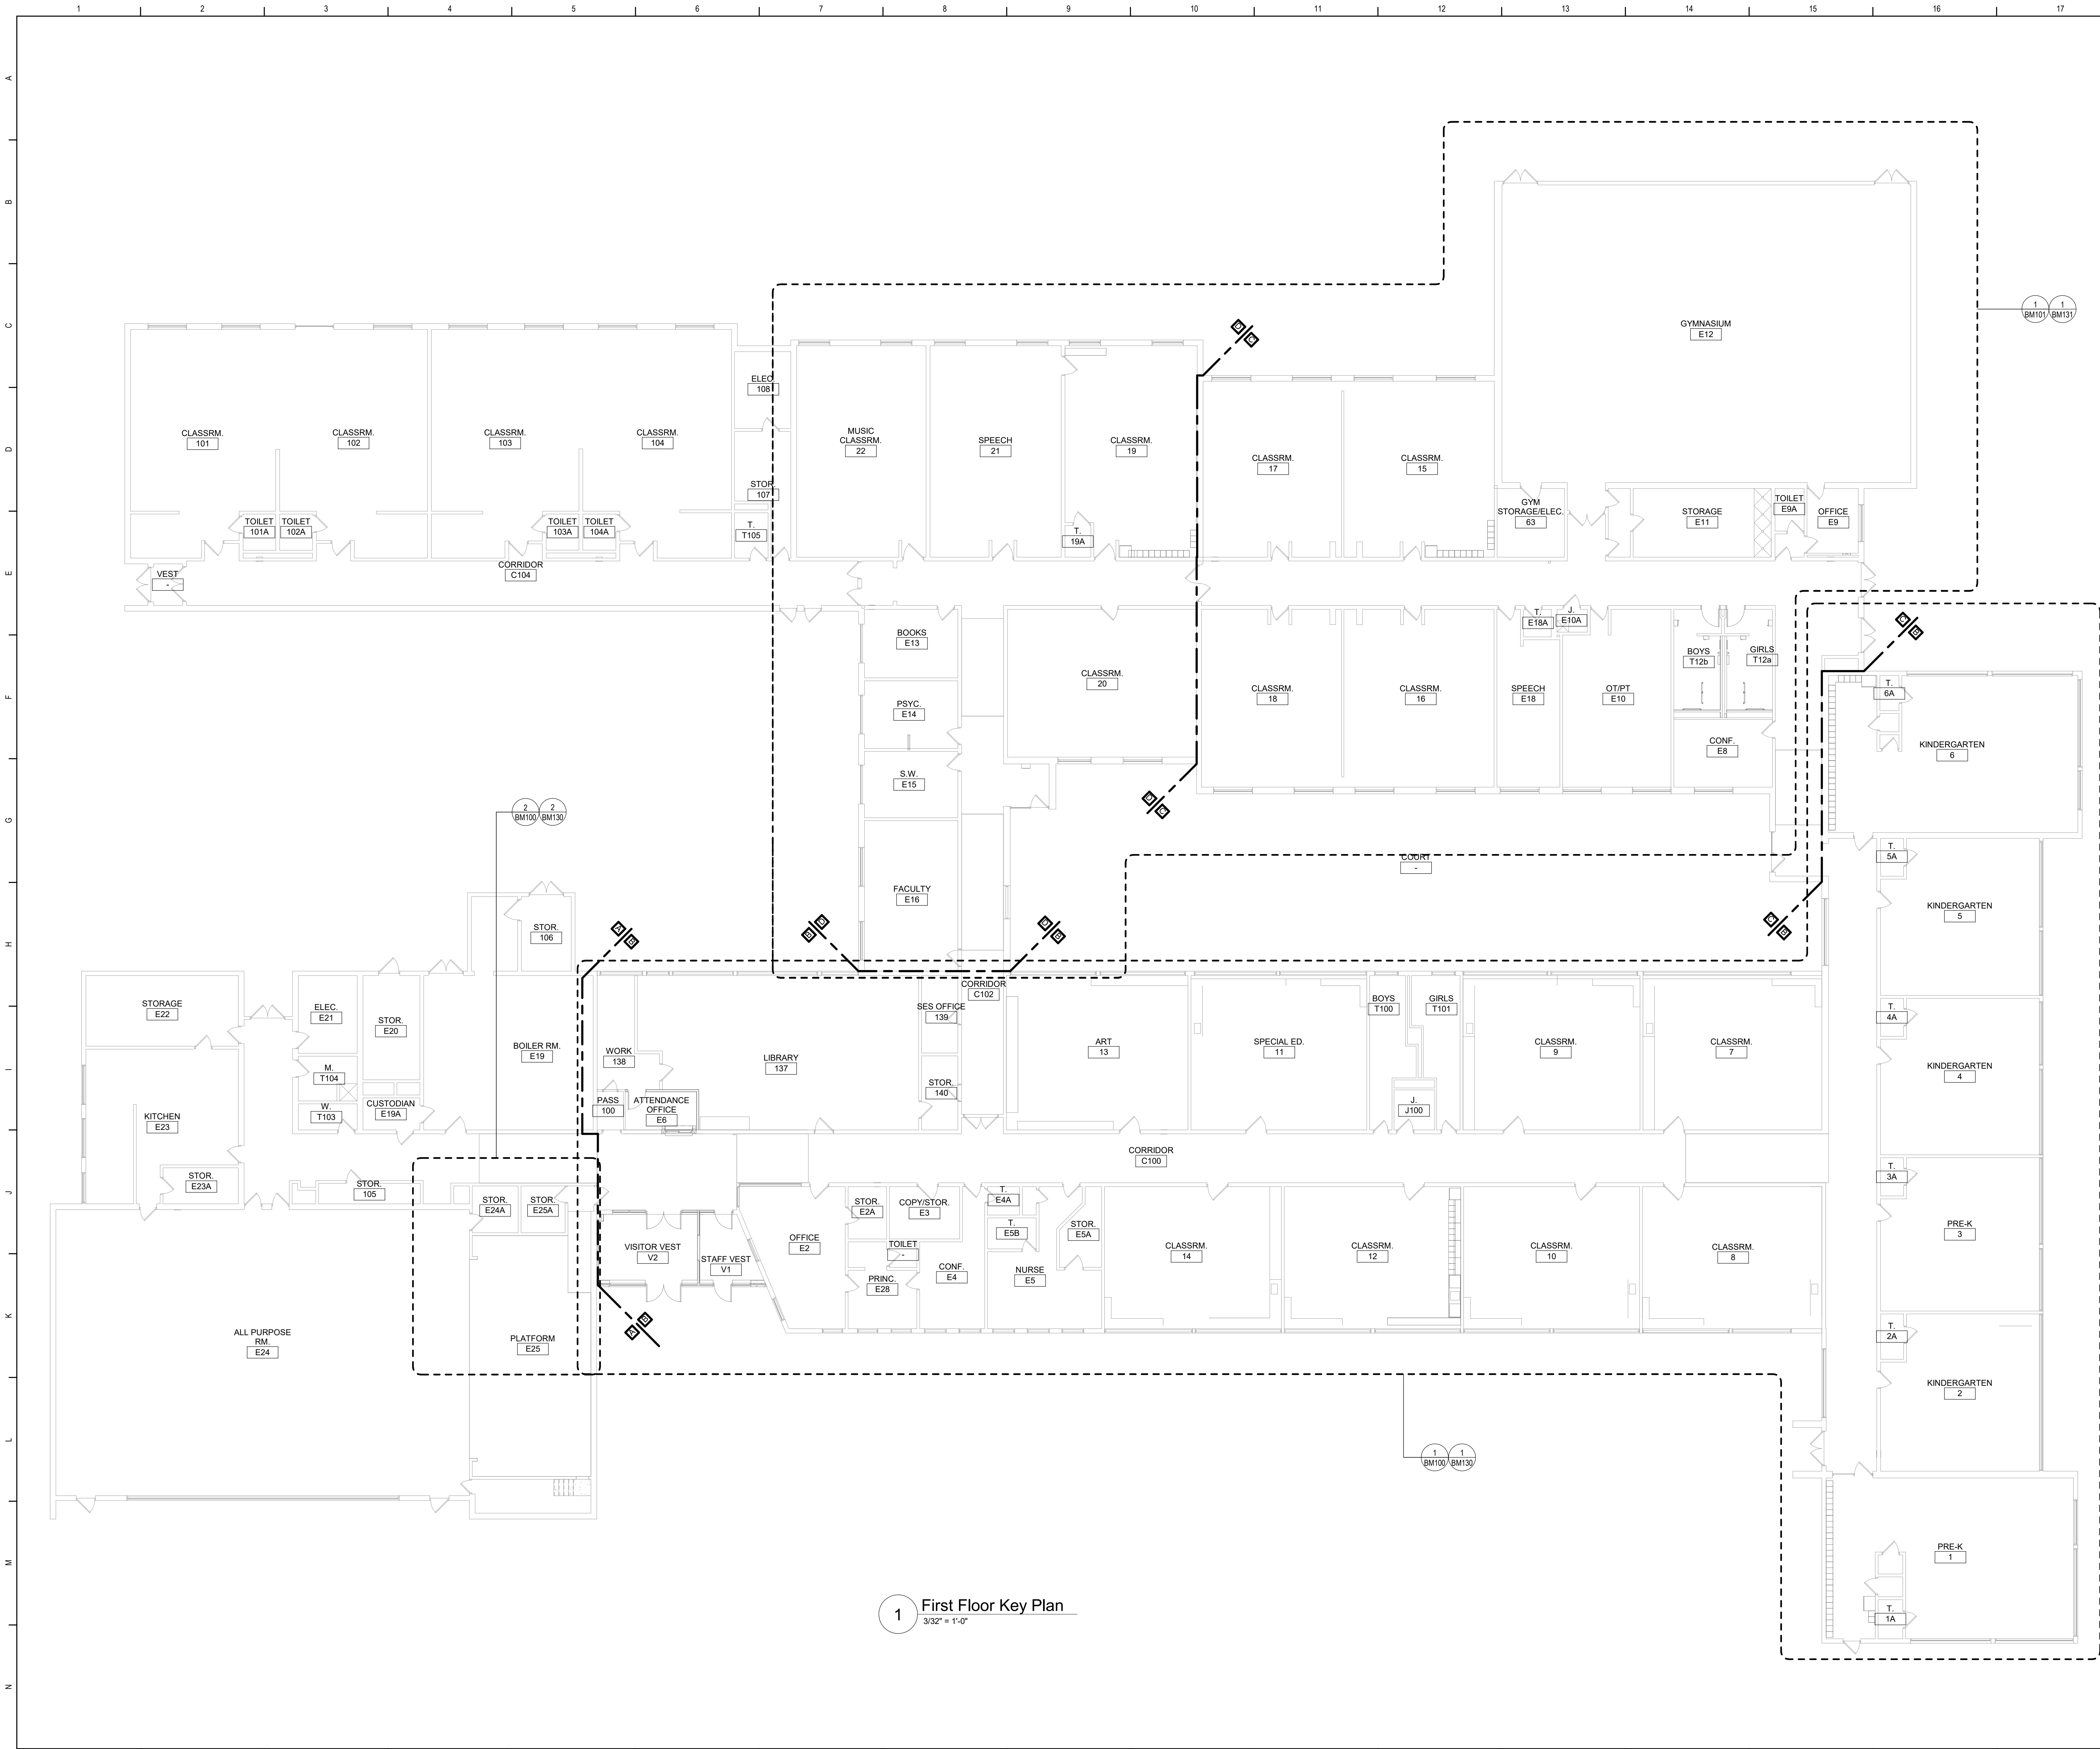
Beacon City School District
Beacon, New York

Additions and Alterations to:
Glenham Elementary School

Typical Details


Drawn By: DMB/kjr Date: 10/28/2022 Drawing Number: 279180-22004

BS500



1 First Floor Key Plan
3/32" = 1'-0"

- General Notes**
- A. THE FOLLOWING GENERAL NOTES APPLY TO ALL "BM" SERIES DRAWINGS.
 - B. REFER TO ALL CONTRACT DOCUMENTS, DRAWINGS AND SPECIFICATIONS, FOR DETAILED STANDARDS AND REQUIREMENTS.
 - C. REPORT UNSAFE OR UNSATISFACTORY CONDITIONS IN WRITING TO ARCHITECT AND RESOLVE ISSUES BEFORE PROCEEDING.
 - D. WORK INCLUDES ALL LABOR AND MATERIALS REQUIRED TO PROVIDE COMPLETE WORKING SYSTEMS.
 - E. COORDINATE PHASING REQUIREMENTS AT JOB MEETINGS AND ON WORK SCHEDULES.
 - F. DO NOT SCALE DRAWINGS. PIPING AND DUCTWORK ARE SHOWN DIAGRAMMATICALLY. IT IS NOT POSSIBLE TO SHOW EVERY TRANSITION, FITTING, ASPECT RATIO CHANGE, ETC.; PROVIDE AS REQUIRED TO FIT WITHIN STRUCTURAL CONSTRAINTS. EXAMINE CONDITIONS UNDER WHICH THE WORK IS TO BE PERFORMED AND VERIFY ALL ACCESS, LOCATIONS, DIMENSIONS, ARRANGEMENTS, ELECTRICAL CHARACTERISTICS AND INTERFERENCE IN THE FIELD PRIOR TO BID.
 - G. VERIFY EXTENT OF CEILING WORK SHOWN ELSEWHERE IN THE CONTRACT DOCUMENTS. PROVIDE FOR ADDITIONAL CEILING SYSTEM REMOVAL, PROTECTION, AND REINSTALLATION AS REQUIRED FOR CONTRACT WORK.
 - H. DEMOLITION DRAWINGS SHOW THE GENERAL SCOPE OF ITEMS AND SYSTEMS TO BE REMOVED. IT IS NOT THE INTENT TO SHOW ALL ITEMS TO BE REMOVED. FIELD VERIFY AND REMOVE ALL ASSOCIATED ITEMS BACK TO POINT OF CONTINUED SERVICE, UNLESS OTHERWISE NOTED. VERIFY WHAT ALL EQUIPMENT SERVES PRIOR TO REMOVAL.
 - I. GIVE ALL REMOVED EQUIPMENT TO THE OWNER. DELIVER ON SITE WHERE DESIGNATED BY THE OWNER. PROMPTLY REMOVE FROM THE SITE AND LEGALLY DISPOSE OF ANY SUCH ITEMS DECLINED BY OWNER.
 - J. IF UNANTICIPATED MECHANICAL, ELECTRICAL, OR STRUCTURAL CONFLICTS ARE ENCOUNTERED, INVESTIGATE AND REPORT BOTH NATURE AND EXTENT OF THE CONFLICT. RE-ROUTE WORK AS REQUIRED.
 - K. CUT, DRILL, OR OTHERWISE CREATE OPENINGS AS NEATLY AS POSSIBLE. AS REQUIRED FOR THE INDICATED CONTRACT WORK, PROVIDE SUPPORT AS REQUIRED FOR AND USE METHODS LEAST LIKELY TO DAMAGE ELEMENTS TO REMAIN. PRIOR TO WORK, VERIFY LOCATIONS OF ALL STRUCTURAL MEMBERS INCLUDING CROSS BRACING, ELECTRICAL WIRING, PLUMBING, ETC. PROMPTLY NOTIFY ARCHITECT OF ANY CONFLICTS. DO NOT CUT ANY STRUCTURAL MEMBERS OR OTHER SERVICES UNTIL SPECIFICALLY DIRECTED TO DO SO. PENDING RECEIPT OF DIRECTIVE, REARRANGE SCHEDULE AS NECESSARY TO CONTINUE OVERALL JOB PROGRESS WITHOUT DELAY.
 - L. PATCH ALL DISTURBANCES RESULTING FROM DEMOLITION OR NEW WORK TO MATCH SURROUNDING SURFACES. PATCH FOLLOWING DEMOLITION, AND AGAIN FOLLOWING WORK, WHERE HOLES REMAIN FROM REMOVALS, INFILL AND PATCH TO MATCH UNLESS HOLE IS TO BE REUSED.
 - M. PROTECT ALL CONTRACT EQUIPMENT, ELEMENTS TO REMAIN, OWNER'S BELONGINGS, AND EQUIPMENT TO BE REUSED OR RETAINED BY OWNER DURING ALL CONTRACT WORK. AT NO ADDITIONAL COST TO OWNER, REPAIR OR REPLACE ITEMS WHICH ARE DAMAGED.
 - N. THOROUGHLY CLEAN FOLLOWING DEMOLITION AND BEFORE BEGINNING CONTRACT INSTALLATIONS. THOROUGHLY CLEAN AGAIN DURING AND FOLLOWING CONTRACT WORK AS REQUIRED. LEAVE ALL WORK AREAS CLEANER THAN FOUND. LEGALLY DISPOSE OF ALL CONSTRUCTION DEBRIS.
 - O. PROVIDE TEMPORARY PIPING, DUCT, HEAT, WEATHERPROOFING, ETC. TO SERVICES TO REMAIN UNTIL PERMANENT INSTALLATIONS CAN BE MADE.
 - P. ALL EXCESS MATERIALS AND SCRAPS ARE CONTRACTOR'S PROPERTY. PROMPTLY REMOVE FROM SITE UNLESS SPECIFICALLY DIRECTED OTHERWISE.
 - Q. EXISTING HVAC COMPONENTS IN THIS BUILDING MAY CONTAIN, BE IN PROXIMITY TO, OR, WORK ON THEM MAY CAUSE DISTURBANCE OF, ASBESTOS CONTAINING OR OTHER HAZARDOUS MATERIALS. REFER TO ABATEMENT SERIES DRAWINGS AND SPECIFICATIONS COMPLETE FOR ADDITIONAL INFORMATION.
 - R. SEAL ALL FLOOR, WALL, AND CEILING PENETRATIONS PER FIRE-RESISTANCE RATINGS NOTED ON AG-SERIES DRAWINGS, BUT NOT LESS THAN 1-HOUR, AND IN ACCORDANCE WITH SECTION 07 84 13 - PENETRATION FIRESTOPPING. THIS INCLUDES ALL NEW PENETRATIONS AND EXISTING UNFIRESSTOPPED PENETRATIONS CREATED BY REMOVALS, AS REQUIRED TO PERFORM THE WORK.

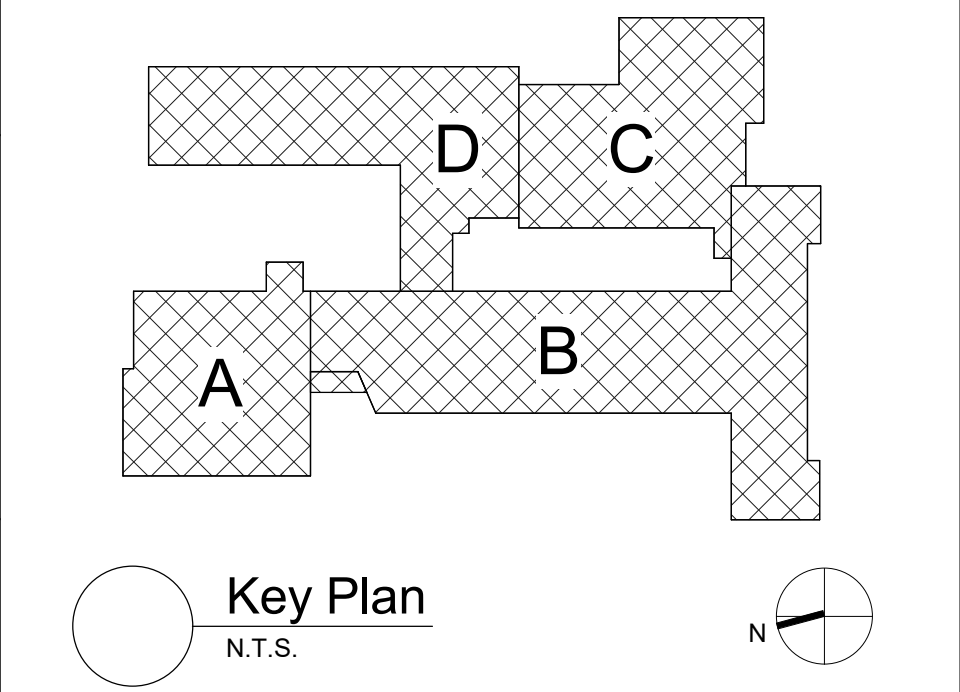

Key Plan
N.T.S.

S.E.D. Control No. 13-02-00-01-0-006-022

Rev. No.	Date	Description



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BID SET




Beacon City School District
Beacon, New York

Additions and Alterations to:
Glenham Elementary School

First Floor Key Plan

Drawn By: JPF/1/pgm	Date: 10/28/2022	Drawing Number: BM051
Project No.: 279180-22004		

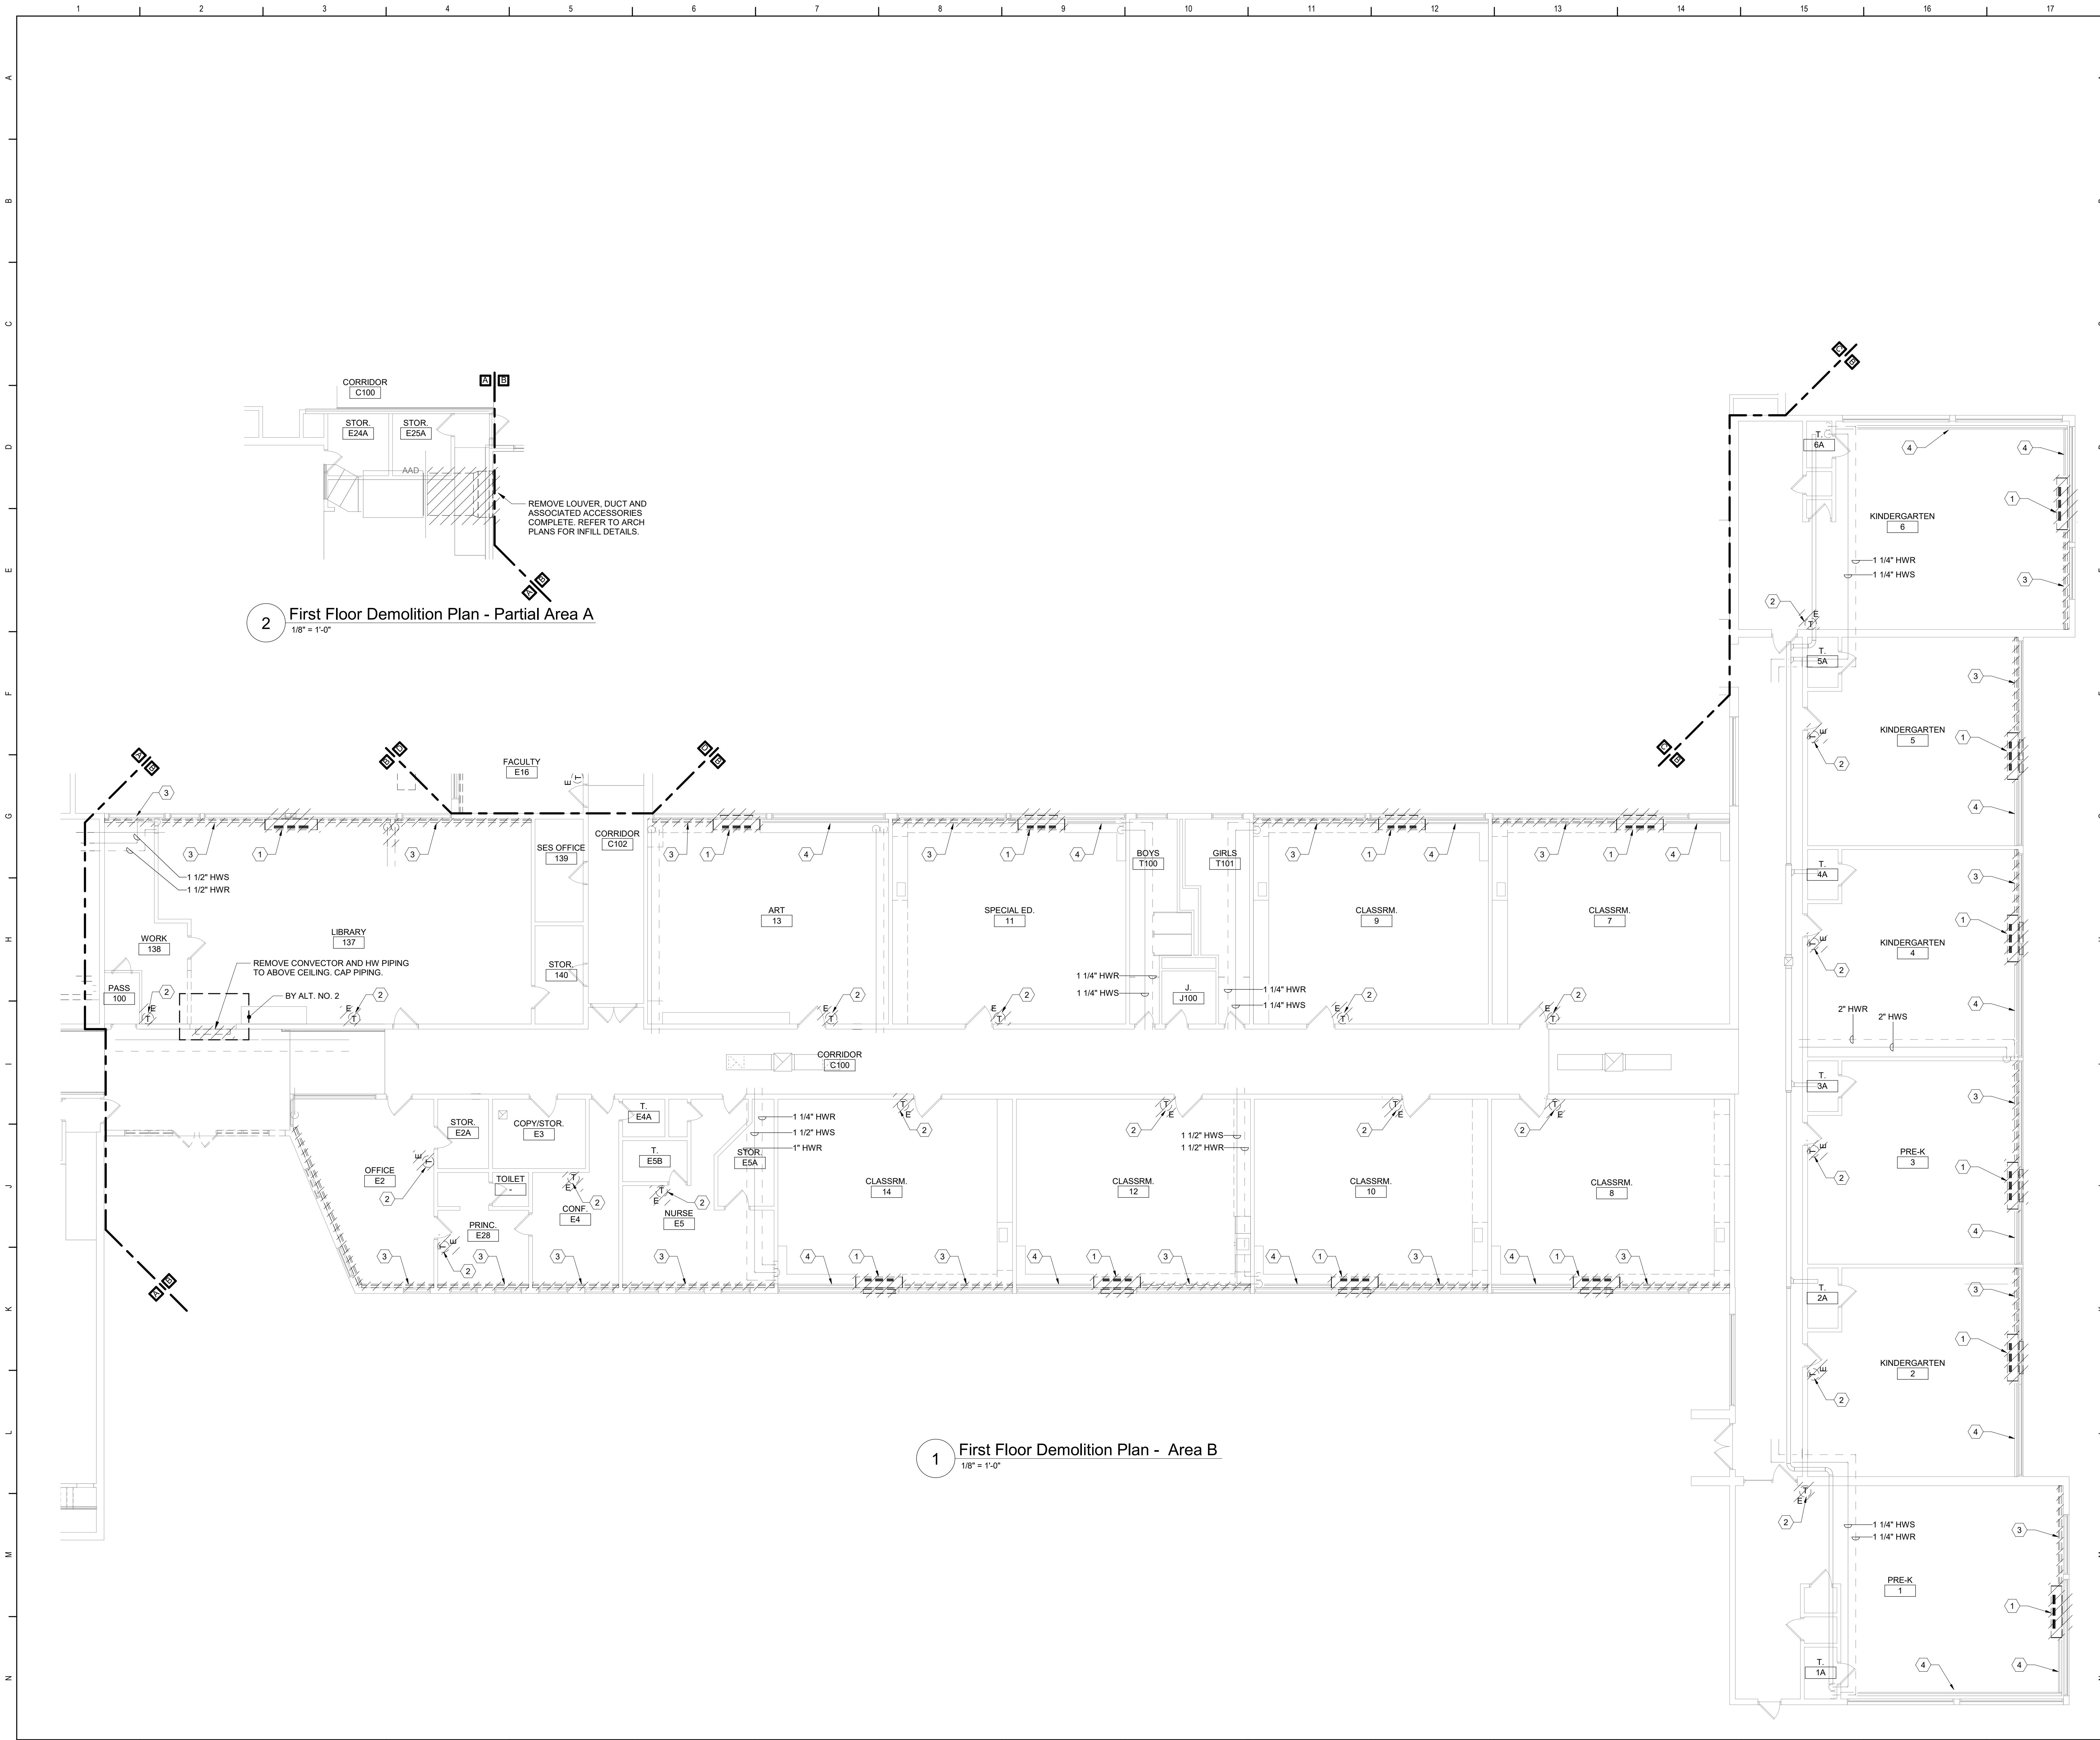

2 First Floor Demolition Plan - Partial Area A
1/8" = 1'-0"

1 First Floor Demolition Plan - Area B
1/8" = 1'-0"

General Notes

A. REFER TO BM051 FOR GENERAL NOTES.

KEYED DEMOLITION NOTES:

1

REMOVE UNIT VENTILATOR, OUTDOOR AIR INTAKE SLEEVE AND ALL ASSOCIATED ACCESSORIES COMPLETE. REMOVE HWS/R PIPING AS REQUIRED FOR UV REMOVAL. REFER TO OTHER TRADES FOR LOUVER REMOVAL.

2

REMOVE THERMOSTAT AND ASSOCIATED ACCESSORIES.

3

REMOVE FINNED TUBE RADIATION AND ASSOCIATED ACCESSORIES COMPLETE. PREPARE FOR RECONNECTION.

4

FINNED TUBE RADIATION AND ASSOCIATED ACCESSORIES TO REMAIN.

Key Plan

N.T.S.

S.E.D. Control No. 13-02-00-01-0-006-022

Rev. No.:	Date:	Description:

BEACON CITY SCHOOL DISTRICT

EXCELLENCE IS THE WAY

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CLEAR SOLUTIONS

Tetra Tech Engineers, Architects & Landscape Architects, P.C.

TETRA TECH

ARCHITECTS & ENGINEERS

Beacon City School District

Beacon, New York

Additions and Alterations to:

Glenham Elementary School

First Floor Demolition Plans - Partial Area A and Area B

Drawn By: JPF1/pgm

Date: 10/28/2022

Project No.: 279180-22004

Drawing Number: BM100

BID SET



A. REFER TO BM051 FOR GENERAL NOTES

B	1	REMOVE UNIT VENTILATOR, LOUVER, OUTDOOR AIR INTAKE SLEEVE AND ALL ASSOCIATED ACCESSORIES COMPLETE. REMOVE HWSR PIPING AS REQUIRED FOR U/I REMOVAL.
	2	REMOVE THERMOSTAT AND ASSOCIATED ACCESSORIES.
	3	REMOVE FINNED TUBE RADIATION AND ASSOCIATED ACCESSORIES COMPLETE. PREPARE FOR RECONNECTION.
	4	REMOVE CONDENSING UNIT, REFRIGERANT PIPING AND CONCRETE PAD.
	5	REMOVE PACKAGED HEAT PUMP, 6" DIAMETER DUCTS TO COMPRESSOR AND LOUVER COMPLETE.
	6	REMOVE ABANDONED CONDENSING UNIT AND CONCRETE PAD.
	7	REMOVE EXHAUST GRILLE AND ASSOCIATED ACCESSORIES COMPLETE. PREPARE FOR RECONNECTION.
C	FINNED TUBE RADIATION AND ASSOCIATED ACCESSORIES TO REMAIN.	



S.E.D. Control No. 13-02-00-01-0-006-022

Rev. No.:	Date:	Description:
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Tetra Tech Engineers, Architects
& Landscape Architects, P.C.




Beacon City School District
Beacon, New York

M	Additions and Alterations to: Glenham Elementary School
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First Floor Demolition Plans - Area C
and Partial Area D

N	Drawn By: JPF1/pgm	Date: 10/28/2022	Drawing Number:
	Project No.: 279180-22004		BM101

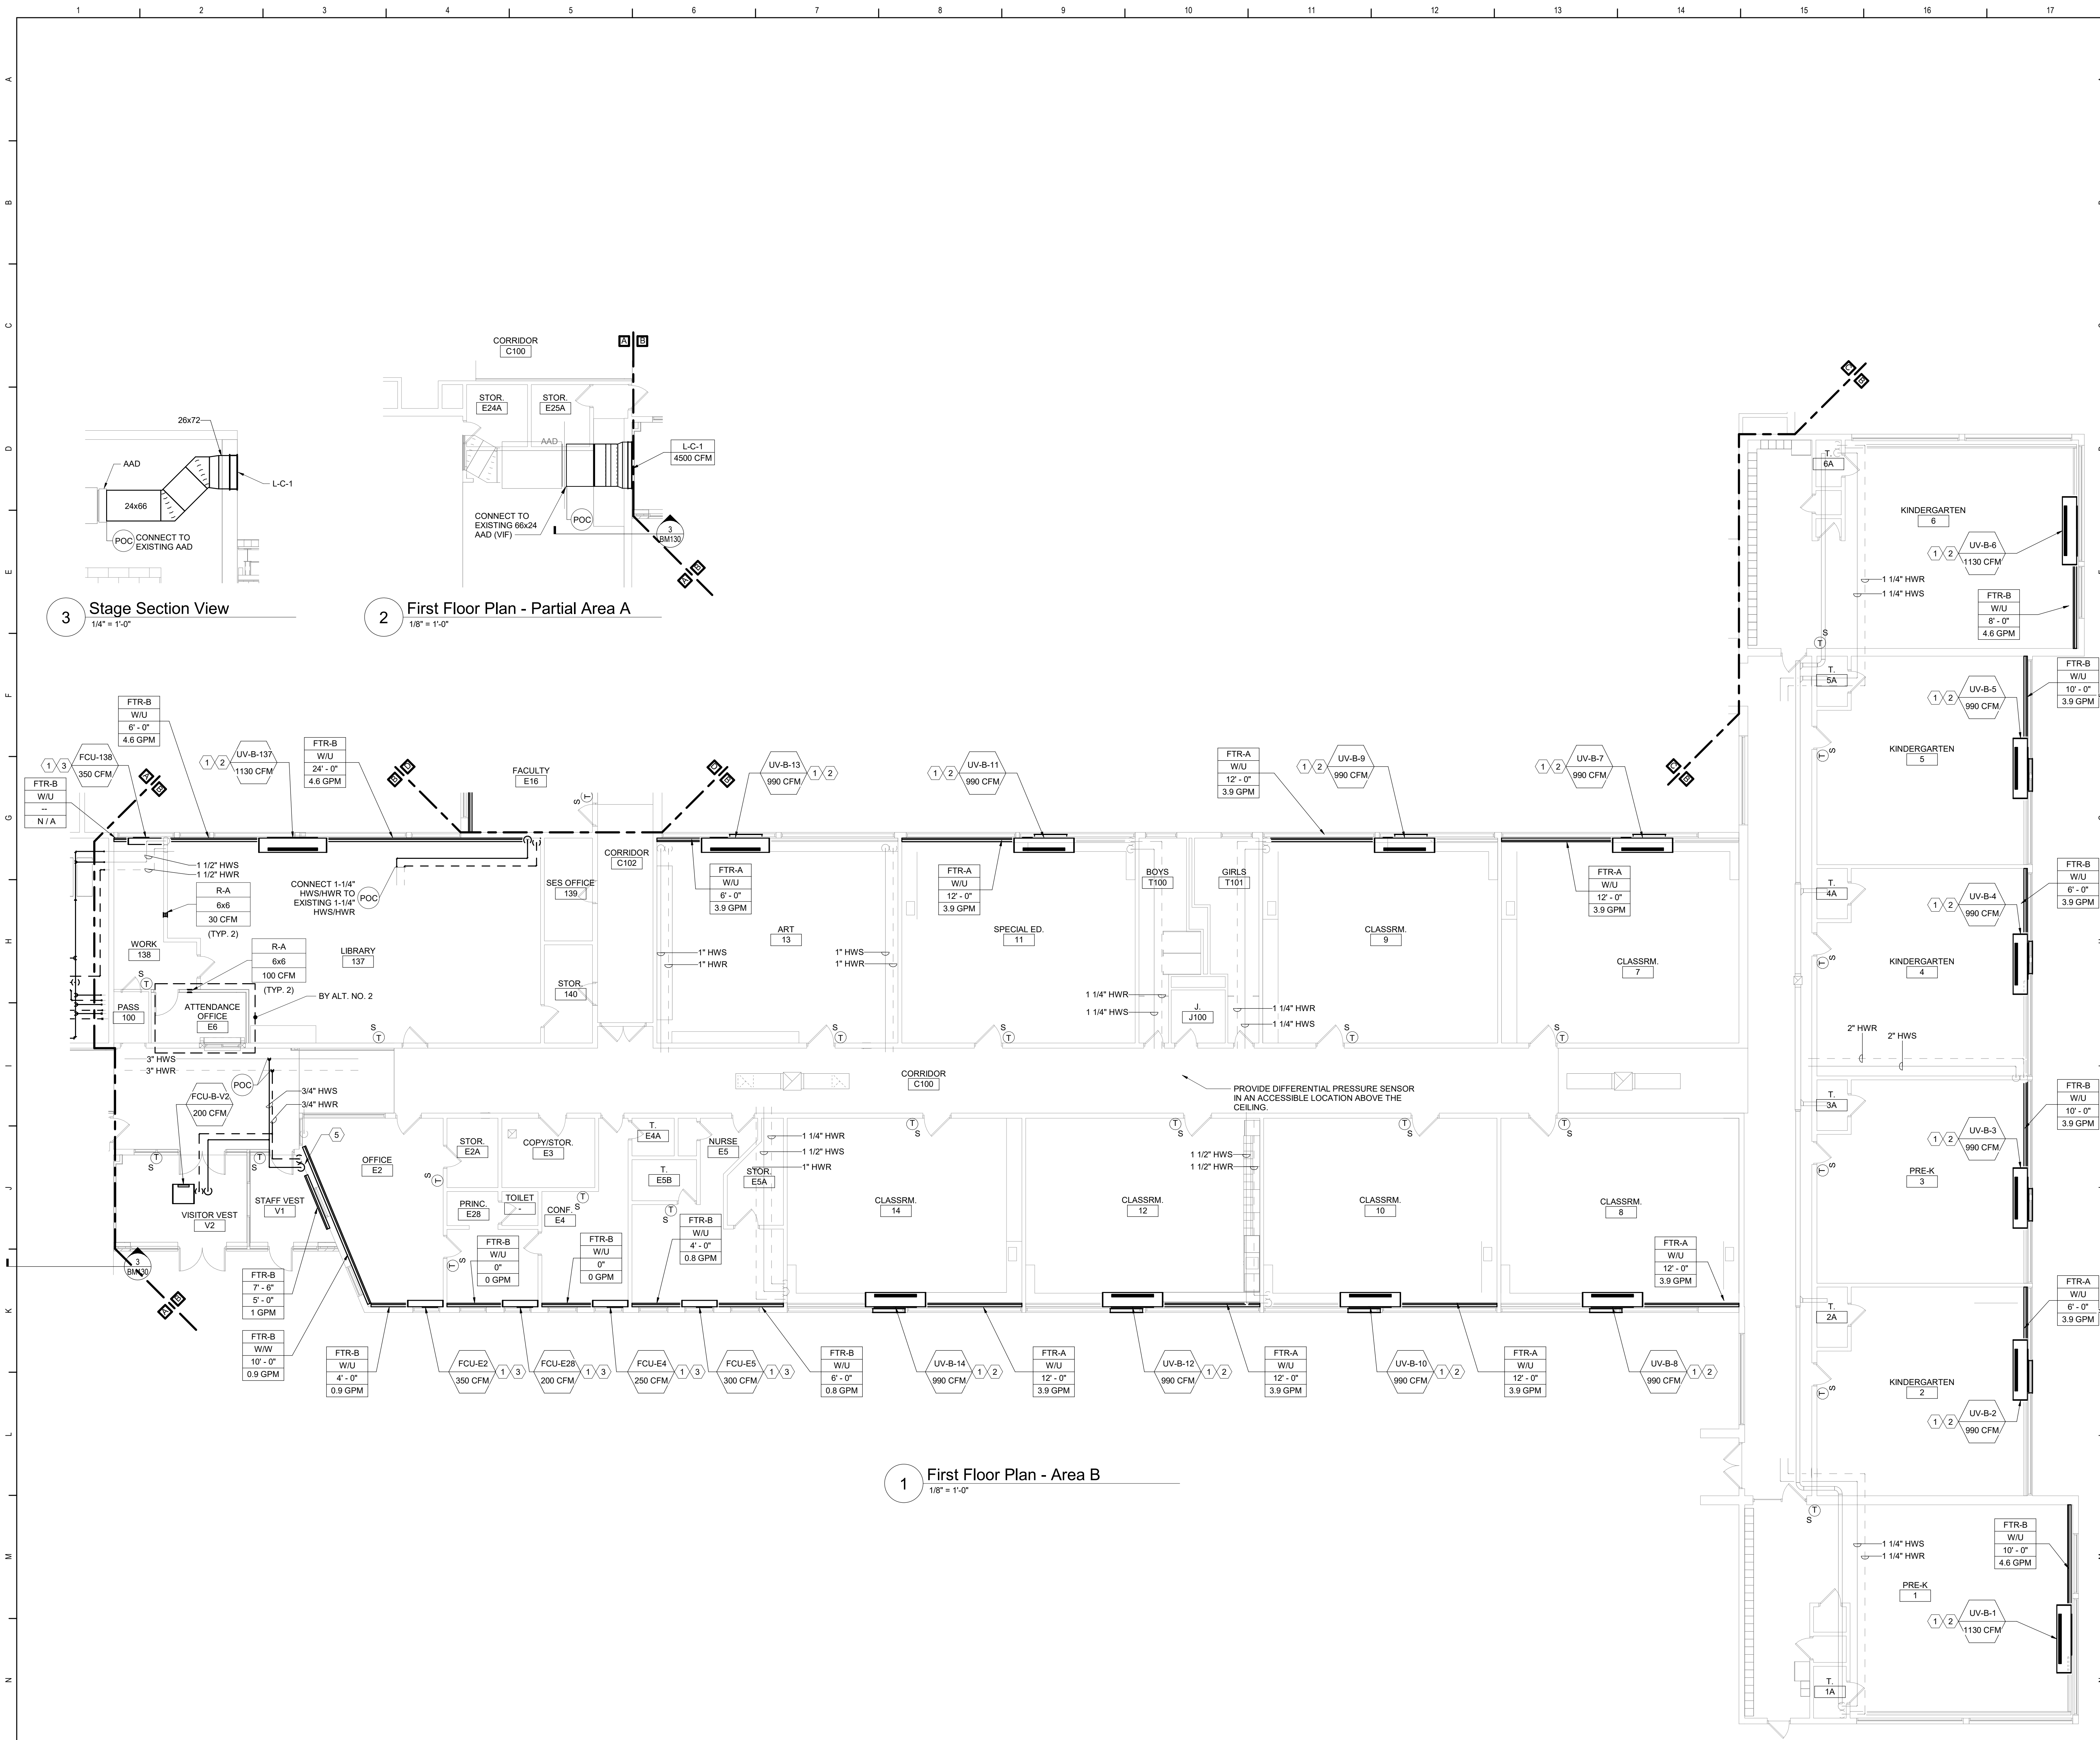

General Notes

A. REFER TO BM051 FOR GENERAL NOTES.

KEYED NOTES:

- EXTEND HWS/R PIPING AS REQUIRED TO MAKE CONNECTION AND PIPE PER DETAIL.
- PROVIDE LOUVER SIZED TO MATCH EXISTING OPENING. PROVIDE OA INTAKE SLEEVE AND SECURE TO LOUVER PER DETAIL. REFER TO ARCHITECTURAL DRAWINGS FOR LOUVER INSTALLATION.
- PROVIDE LOUVER AND OA INTAKE SLEEVE AND SECURE PER DETAIL. REFER TO ARCHITECTURAL DRAWINGS FOR WALL OPENING AND LOUVER INSTALLATION.
- EXTEND 1" HWS PIPING AS REQUIRED AND CONNECT INTO EXISTING 1" EXPANSION TANK PIPING.
- PROVIDE SHEET METAL PIPE ENCLOSURE.

Key Plan
N.T.S.

S.E.D. Control No. 13-02-00-01-0-006-022

Rev. No.	Date	Description

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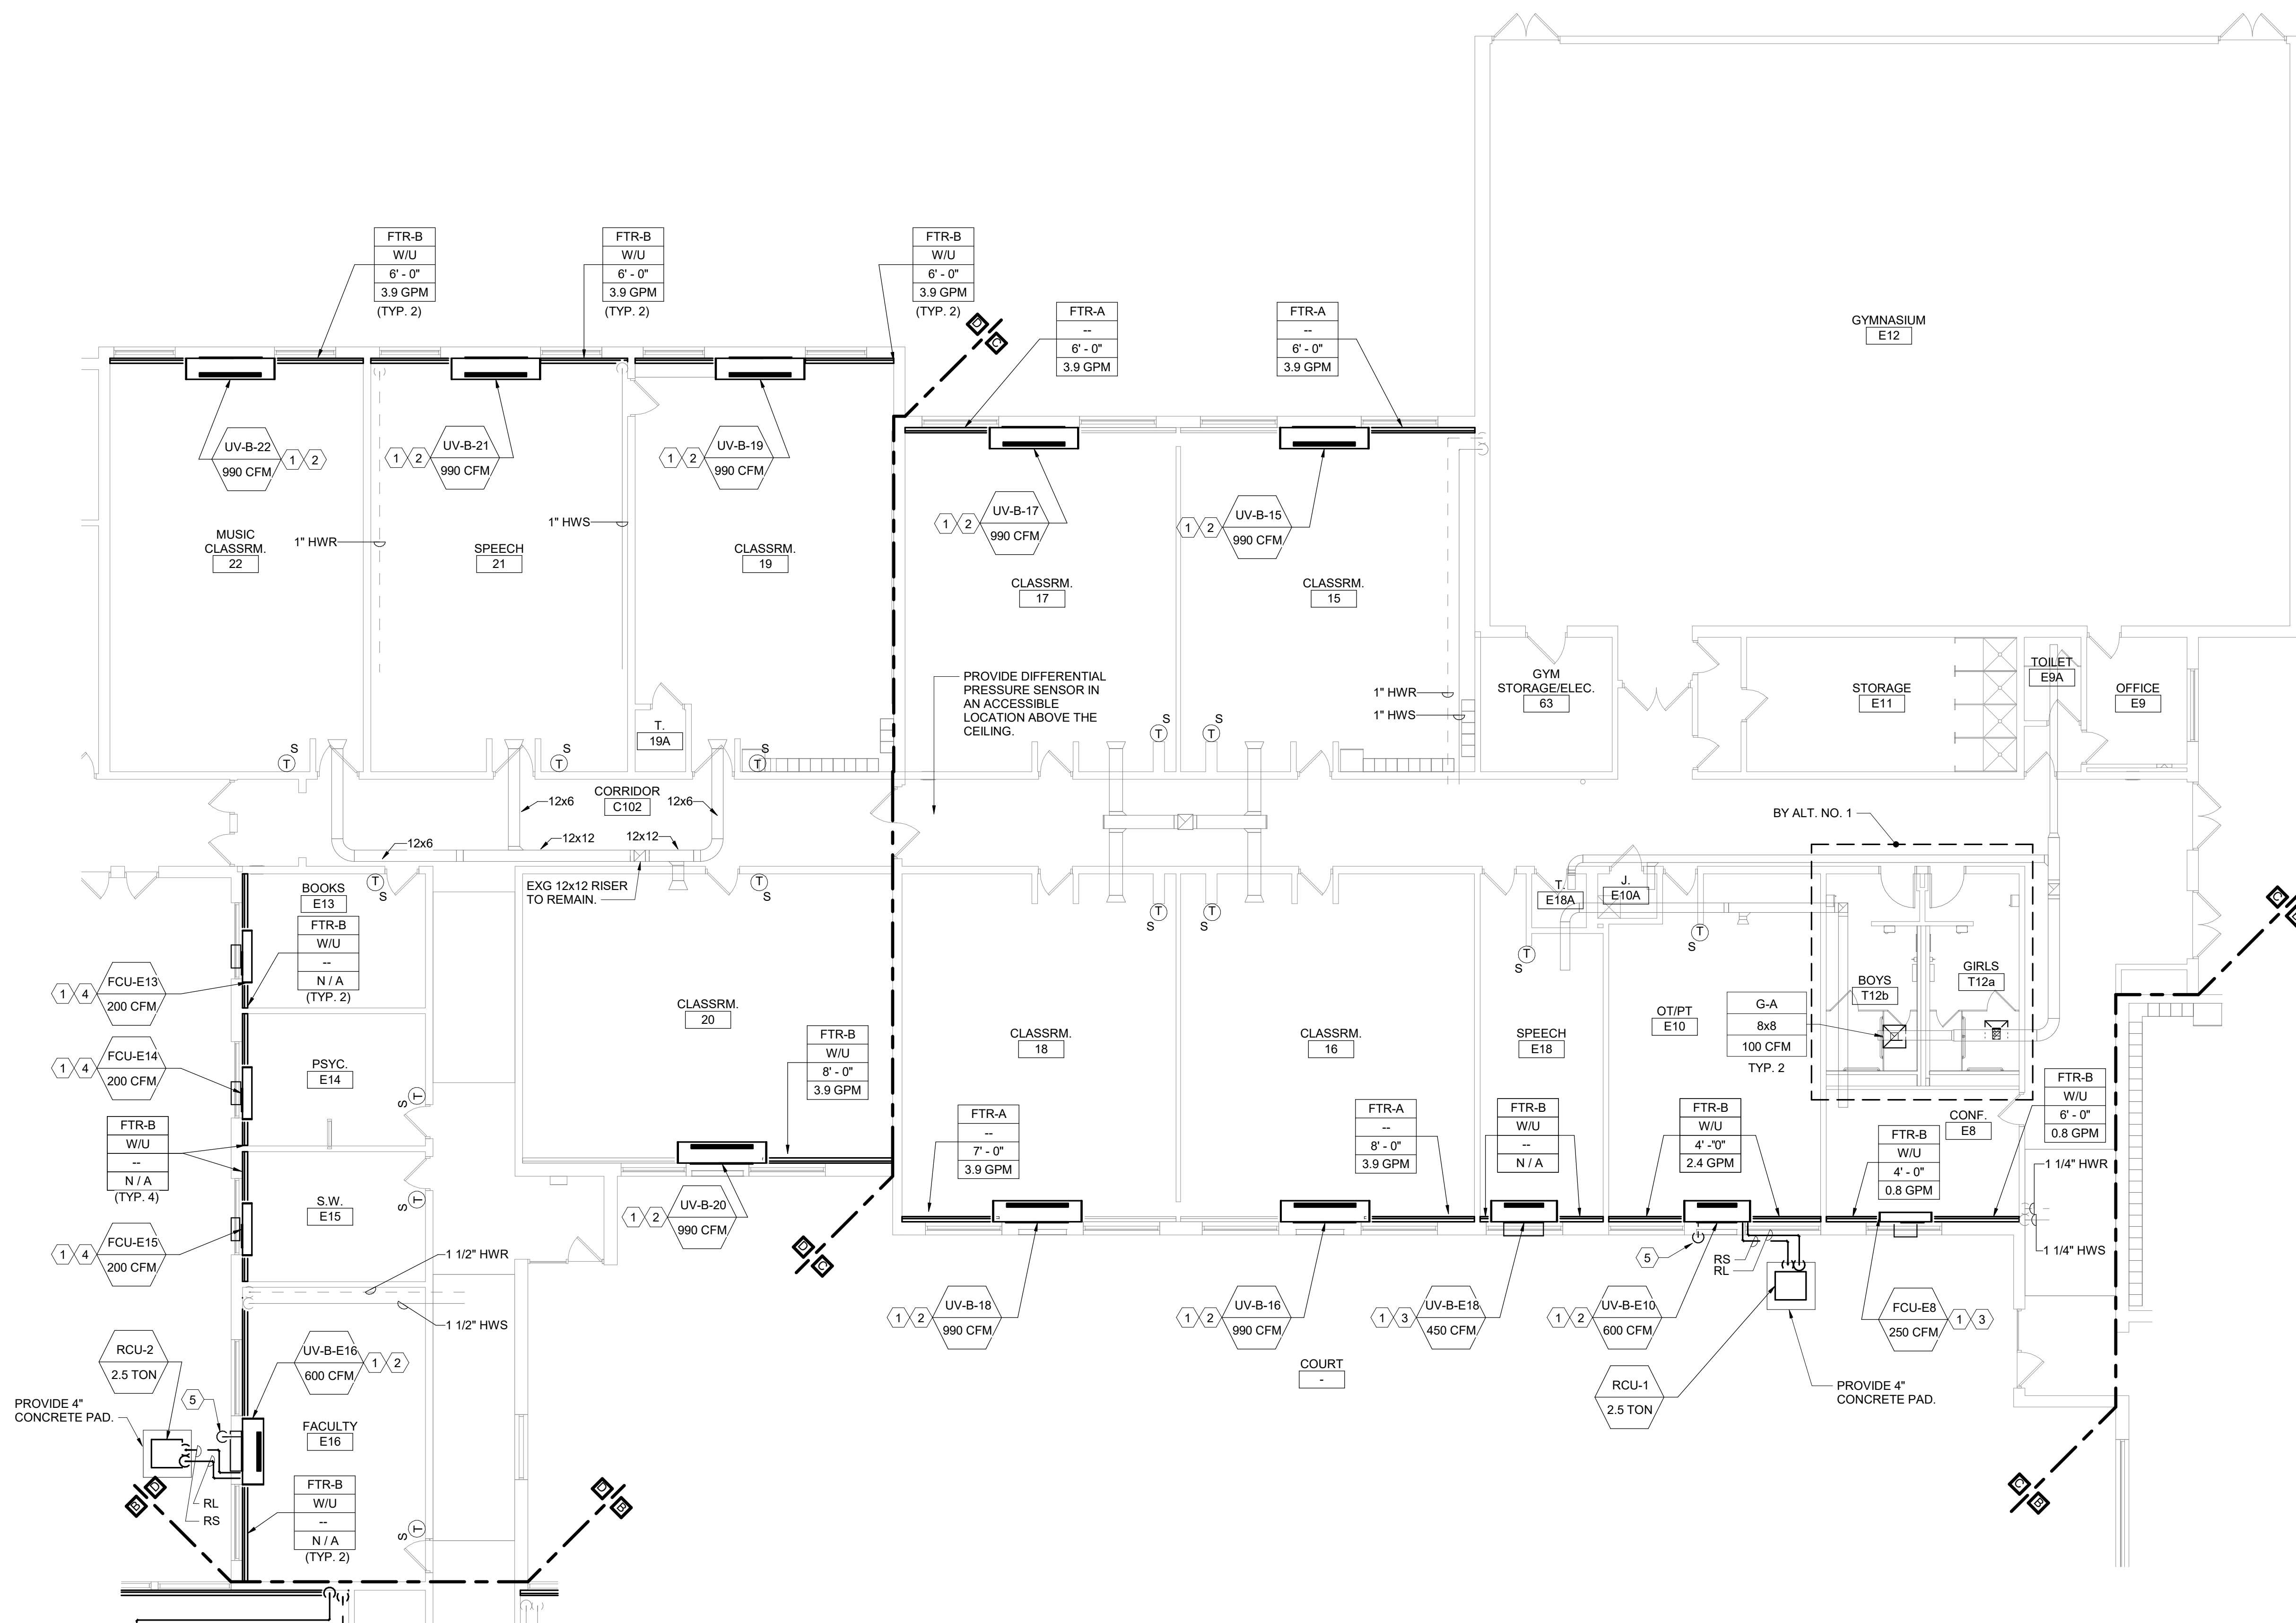
TETRA TECH
ARCHITECTS & ENGINEERS

Beacon City School District
Beacon, New York

Additions and Alterations to:
Glenham Elementary School

First Floor Plans - Partial Area A and Area B

Drawn By: JPF/1/pgm	Date: 10/28/2022	Drawing Number:
Project No.: 279180-22004		BM130




1 First Floor Plan - Area C and Parital Area D
1/8" = 1'-0"

General Notes

- A. REFER TO BM051 FOR GENERAL NOTES.

KEYED NOTES:

- 1 EXTEND HWS/R PIPING AS REQUIRED TO MAKE CONNECTION AND PIPE PER DETAIL.
- 2 PROVIDE LOUVER SIZED TO MATCH EXISTING OPENING. PROVIDE OA INTAKE SLEEVE AND SECURE TO LOUVER PER DETAIL. REFER TO ARCHITECTURAL DRAWINGS FOR LOUVER INSTALLATION.
- 3 PROVIDE LOUVER AND OA INTAKE SLEEVE AND SECURE PER DETAIL. REFER TO ARCHITECTURAL DRAWINGS FOR WALL OPENING AND LOUVER INSTALLATION.
- 4 PROVIDE LOUVER AND OA INTAKE SLEEVE. FIELD FABRICATE POWDER COATED SHEETMETAL PLENUM AND SECURE TO LOUVER.
- 5 PROVIDE 1" CONDENSATE DRAIN. REFER TO BM500.

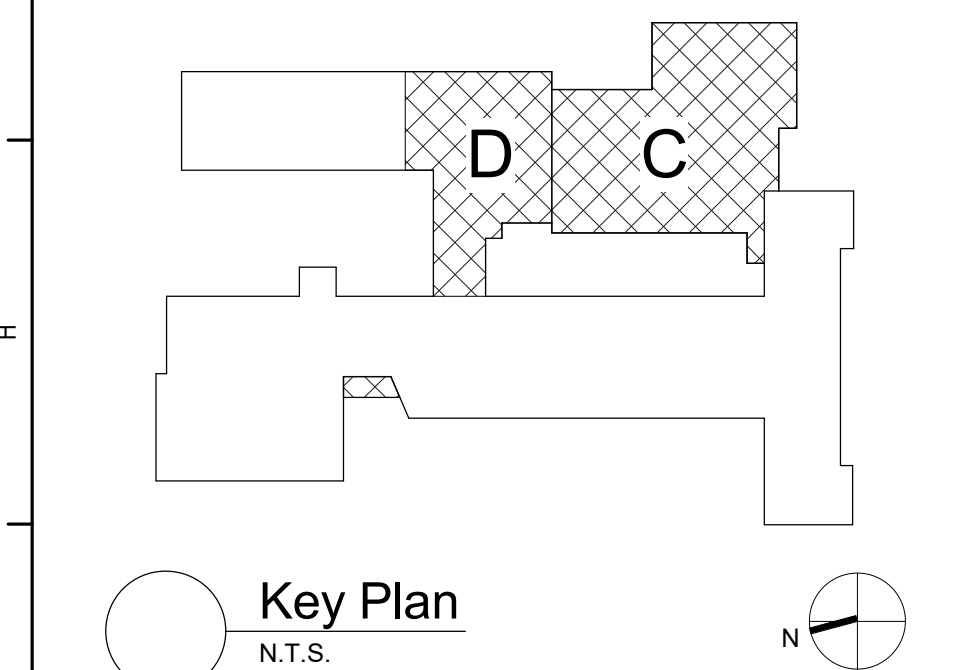

S.E.D. Control No. 13-02-00-01-0-006-022

Rev. No.: Date: Description:



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& Landscape Architects, P.C.



Beacon City School District
Beacon, New York

Additions and Alterations to:
Glenham Elementary School

First Floor Plan - Area C and Partial
Area D

Drawn By:
JPF1/pgm
Project No.:
279180-22004

Date:
10/28/2022

Drawing Number:

BM131

UNIT VENTILATOR (UV) SCHEDULE																														
DWG LABEL	LOCATION	MODEL NO.	SA CFM	MIN. OA	HEATING DATA					HW COIL					COOLING DATA										ELECTRICAL					NOTES
					NO. ROW	EAT (°F)	LAT (°F)	CAP. (MBH)	GPM	WPD (°F/HD)	NO. ROWS	EDB (°F)	EWB (°F)	LDB (°F)	LWB (°F)	YC (MBH)	SC (MBH)	ESP (IN WG)	RPM	MOTOR QTY	MOTOR SIZE (HP)	V/PH	FLA	MCA	MOP					
UV-B-1	PRE-K 1	VUVE150	1130	510	2	40.9	110.0	91.4	4.6	4.0	0	0.0	0.0	0.0	0.0	0.0	0.0	0.0	1120	2	0.25	120V/1ø	7.0	9.0	15	1,2,4,6-11				
UV-B-2	KINDERGARTEN 2	VUVE125	990	330	2	40.0	110.0	77.1	3.9	2.3	0	0.0	0.0	0.0	0.0	0.0	0.0	0.0	1120	2	0.25	120V/1ø	7.0	9.0	15	1,2,4,6-11				
UV-B-3	PRE-K 3	VUVE125	990	330	2	40.0	110.0	77.1	3.9	2.3	0	0.0	0.0	0.0	0.0	0.0	0.0	0.0	1120	2	0.25	120V/1ø	7.0	9.0	15	1,2,4,6-11				
UV-B-4	KINDERGARTEN 4	VUVE125	990	330	2	40.0	110.0	77.1	3.9	2.3	0	0.0	0.0	0.0	0.0	0.0	0.0	0.0	1120	2	0.25	120V/1ø	7.0	9.0	15	1,2,4,6-11				
UV-B-5	KINDERGARTEN 5	VUVE125	990	340	2	40.0	110.0	77.1	3.9	2.3	0	0.0	0.0	0.0	0.0	0.0	0.0	0.0	1120	2	0.25	120V/1ø	7.0	9.0	15	1,2,4,6-11				
UV-B-6	KINDERGARTEN 6	VUVE150	1130	510	2	40.9	110.0	91.4	4.6	4.0	0	0.0	0.0	0.0	0.0	0.0	0.0	0.0	1120	2	0.25	120V/1ø	7.0	9.0	15	1,2,4,6-11				
UV-B-7	CLASSRM. 7	VUVE125	990	380	2	40.0	110.0	77.1	3.9	2.3	0	0.0	0.0	0.0	0.0	0.0	0.0	0.0	1120	2	0.25	120V/1ø	7.0	9.0	15	1,2,4,6-11				
UV-B-8	CLASSRM. 8	VUVE125	990	350	2	40.0	110.0	77.1	3.9	2.3	0	0.0	0.0	0.0	0.0	0.0	0.0	0.0	1120	2	0.25	120V/1ø	7.0	9.0	15	1,2,4,6-11				
UV-B-9	CLASSRM. 9	VUVE125	990	380	2	40.0	110.0	77.1	3.9	2.3	0	0.0	0.0	0.0	0.0	0.0	0.0	0.0	1120	2	0.25	120V/1ø	7.0	9.0	15	1,2,4,6-11				
UV-B-10	CLASSRM. 10	VUVE125	990	350	2	40.0	110.0	77.1	3.9	2.3	0	0.0	0.0	0.0	0.0	0.0	0.0	0.0	1120	2	0.25	120V/1ø	7.0	9.0	15	1,2,4,6-11				
UV-B-11	SPECIAL ED. 11	VUVE125	990	390	2	40.0	110.0	77.1	3.9	2.3	0	0.0	0.0	0.0	0.0	0.0	0.0	0.0	1120	2	0.25	120V/1ø	7.0	9.0	15	1,2,4,6-11				
UV-B-12	CLASSRM. 12	VUVE125	990	350	2	40.0	110.0	77.1	3.9	2.3	0	0.0	0.0	0.0	0.0	0.0	0.0	0.0	1120	2	0.25	120V/1ø	7.0	9.0	15	1,2,4,6-11				
UV-B-13	ART 13	VUVE150	990	400	2	40.0	110.0	77.1	3.9	2.3	0	0.0	0.0	0.0	0.0	0.0	0.0	0.0	1120	2	0.25	120V/1ø	7.0	9.0	15	1,2,4,6-11				
UV-B-14	CLASSRM. 14	VUVE125	990	350	2	40.0	110.0	77.1	3.9	2.3	0	0.0	0.0	0.0	0.0	0.0	0.0	0.0	1120	2	0.25	120V/1ø	7.0	9.0	15	1,2,4,6-11				
UV-B-15	CLASSRM. 15	VUVE125	990	360	2	40.0	110.0	77.1	3.9	2.3	0	0.0	0.0	0.0	0.0	0.0	0.0	0.0	1120	2	0.25	120V/1ø	7.0	9.0	15	1,2,4,6-11				
UV-B-16	CLASSRM. 16	VUVE125	990	370	2	40.0	110.0	77.1	3.9	2.3	0	0.0	0.0	0.0	0.0	0.0	0.0	0.0	1120	2	0.25	120V/1ø	7.0	9.0	15	1,2,4,6-11				
UV-B-17	CLASSRM. 17	VUVE125	990	350	2	40.0	110.0	77.1	3.9	2.3	0	0.0	0.0	0.0	0.0	0.0	0.0	0.0	1120	2	0.25	120V/1ø	7.0	9.0	15	1,2,4,6-11				
UV-B-18	CLASSRM. 18	VUVE125	990	360	2	40.0	110.0	77.1	3.9	2.3	0	0.0	0.0	0.0	0.0	0.0	0.0	0.0	1120	2	0.25	120V/1ø	7.0	9.0	15	1,2,4,6-11				
UV-B-19	CLASSRM. 19	VUVE125	990	380	2	40.0	110.0	77.1	3.9	2.3	0	0.0	0.0	0.0	0.0	0.0	0.0	0.0	1120	2	0.25	120V/1ø	7.0	9.0	15	1,2,4,6-11				
UV-B-20	CLASSRM. 20	VUVE125	990	390	2	40.0	110.0	77.1	3.9	2.3	0	0.0	0.0	0.0	0.0	0.0	0.0	0.0	1120	2	0.25	120V/1ø	7.0	9.0	15	1,2,4,6-11				
UV-B-21	SPEECH 21	VUVE125	990	390	2	40.0	110.0	77.1	3.9	2.3	0	0.0	0.0	0.0	0.0	0.0	0.0	0.0	1120	2	0.25	120V/1ø	7.0	9.0	15	1,2,4,6-11				
UV-B-22	MUSIC CLASSRM. 22	VUVE125	990	380	2	40.0	110.0	77.1	3.9	2.3	0	0.0	0.0	0.0	0.0	0.0	0.0	0.0	1120	2	0.25	120V/1ø	7.0	9.0	15	1,2,4,6-11				
UV-B-137	LIBRARY 137	VUVE150	1130	520	2	40.9	110.0	91.4	4.6	4.0	0	0.0	0.0	0.0	0.0	0.0	0.0	0.0	1120	2	0.25	120V/1ø	7.0	9.0	15	1,2,4,6-11				
OTV-E10	OTV E10	VUVE075	600	270	2	40.0	110.0	48.2	2.4	1.1	3	80.0	67.0	53.8	51.3	28.1	17.2	0.00	1110	1	0.25	120V/1ø	3.5	4.5	15	1-8,11				
UV-B-E16	FACULTY E16	VUVE075	600	160	2	51.2	110.0	43.7	2.2	1.0	3	80.0	67.0	53.8	51.3	28.1	17.2	0.00	1110	1	0.25	120V/1ø	3.5	4.5	15	1-8,11				
UV-B-E18	SPEECH E18	VUVE075	450	140	2	43.5	110.0	39.8	2.0	0.9	0	0.0	0.0	0.0	0.0	0.0	0.0	0.0	730	1	0.25	120V/1ø	3.5	4.5	15	1,2,4,6-11				
NOTES: 1. DESIGN BASIS: TRANE 2. FLOOR MOUNTED UNIT 3. PROVIDE 1" MERV8 FILTERS. 4. HOT WATER COIL CONDITIONS: EWT=160°F, LWT=120°F 5. DX COIL CONDITIONS: SUCTION TEMP=45°F, LIQUID TEMP=110°F 6. VERIFY PIPE AND ELECTRICAL LEFT/HAND HAND CONNECTIONS PRIOR TO ORDERING. 7. UNIT 21-114" DEEP W/ CLOSED PIPE TUNNEL. 8. NEMA 1 DISCONNECT SWITCH. 9. PROVIDE 1" MERV13 FILTER. 10. PROVIDE LOUVER AND WALL SLEEVE TO MATCH EXISTING WALL OPENING. 11. ADJUST UV FAN SPEED TO PROVIDE SCHEDULED SUPPLY AIR QUANTITY.																														

REMOTE CONDENSING UNIT (RCU) SCHEDULE																			ELECTRICAL		NET WEIGHT (LBS)		NOTES
DWG LABEL	LOCATION	SERVES	MODEL NO.	REFRIG.	SUCTION (°F)	LIQUID (°F)	SUCTION SIZE	LIQUID SIZE	NOMINAL CAPACITY	COOLING CAPACITY	COMPRESSOR QTY & TYPE	FAN CONDENSER QTY & DRIVE TYPE	EER	MCA	MOP	V/PH							
RCU-1	GROUND	UV-B-E10	4TTR4030	R-410A	45	110	3/8"	3/4"	2.5 TONS	30000 Btu/h	1 SCROLL	1 DIRECT	12.2	17.0	25	208 V/2ø	160	1-9					
RCU-2	GROUND	UV-B-E16	4TTR4030	R-410A	45	110	3/8"	3/4"	2.5 TONS	30000 Btu/h	1 SCROLL	1 DIRECT	12.2	17.0	25	208 V/1ø	160	1-9					
NOTES:																							
1. DESIGN BASIS: TRANE				3. PROVIDE DEFROST CONTROLS.				6. PROVIDE BRAZED TUBING REFRIGERANT LINE SETS AND COUPLINGS.				9. PROVIDE 4" CONCRETE PAD.											
2. PROVIDE MOTOR STARTER AND NEMA 3R DISCONNECT.				4. PROVIDE LOW AMBIENT OPERATION BELOW 60°F.				7. FIELD CHARGE REFRIGERANT FOR SUPPLY LINE, CONDENSER AND COILS.															
				5. PROVIDE INTERNAL THERMAL PROTECTION.				8. VERIFY LINE SIZES WITH MANUFACTURER.															

FAN COIL UNIT (FCU) SCHEDULE																					
DWG LABEL	LOCATION	MODEL NO.	SA CFM	MIN.	HEATING DATA					HW COIL		SUPPLY FAN			ELECTRICAL						NOTES
					NO. ROW	EAT (°F)	LAT (°F)	CAP (MBH)	GPM	WPD (FT HD)	ESP (IN WG)	RPM	MOTOR SIZE (HP)	V/PH	FLA	MCA	MOP				
FCU-138	WORK 138	FCDB020	350	30	2	63.0	108.6	17.3	0.9	0.9	0.00	1280	0.13	120V/1ø	2.2	2.8	15	1-7			
FCU-B-V2	VISITOR VEST V2	FCDB020	200	0	2	60.0	111.8	11.2	0.6	0.4	0.00	800	0.13	120V/1ø	2.2	2.8	15	1-3,8			
FCU-E2	OFFICE E2	FCDB020	350	30	2	63.0	108.6	17.3	0.9	0.9	0.00	1280	0.13	120V/1ø	2.2	2.8	15	1-7			
FCU-E4	CONFERENCE E4	FCDB020	250	70	2	51.5	109.7	15.8	0.8	0.7	0.00	960	0.13	120V/1ø	2.2	2.8	15	1-7			
FCU-E5	NURSE E5	FCDB020	300	30	2	62.1	110.4	15.7	0.8	0.7	0.00	1120	0.13	120V/1ø	2.2	2.8	15	1-7			
FCU-E8	CONF E8	FCDB020	250	70	2	51.5	109.7	15.8	0.8	0.7	0.00	960	0.13	120V/1ø	2.2	2.8	15	1-7			
FCU-E13	BOOKS E13	FCDB020	200	20	2	62.1	113.9	11.2	0.6	0.4	0.00	800	0.13	120V/1ø	2.2	2.8	15	1-7			
FCU-E14	PSYC. E14	FCDB020	200	20	2	62.1	113.9	11.2	0.6	0.4	0.00	800	0.13	120V/1ø	2.2	2.8	15	1-7			
FCU-E15	S.W. E15	FCDB020	200	20	2	62.1	113.9	11.2	0.6	0.4	0.00	800	0.13	120V/1ø	2.2	2.8	15	1-7			
FCU-E28	PRINC. E28	FCDB020	200	50	2	53.3	105.1	11.2	0.6	0.4	0.00	800	0.13	120V/1ø	2.2	2.8	15	1-7			
NOTES:																					
1. DESIGN BASIS: TRANE					3. HOT WATER COIL CONDITIONS: EWT=160°F, LWT=120°F					5. VERIFY PIPE AND ELECTRICAL LEFT/RIGHT HAND CONNECTIONS PRIOR TO ORDERING.					7. PROVIDE NEMA 1						
2. VERTICAL CABINET UNIT					4. PROVIDE 1" MERV13 FILTER.					6. PROVIDE RETURN AIR BOTTOM INLET TOP GRILLE OUTLET AND OUTSIDE AIR WALL BOX.					8. DISCONNECT SWITCH, CEILING CABINET UNIT.						

Keyed Notes:


- 1 REMOVE LUMINAIRE(S) AND CIRCUITRY COMPLETE BACK TO SOURCE.
- 2 REMOVE WALL MOUNTED EMERGENCY LIGHT. REMOVE EXISTING CIRCUITRY BACK TO NEAREST JUNCTION BOX OR DEVICE OUTSIDE OF DEMOLITION AREA. MODIFY EXISTING SYSTEM CIRCUITRY TO ALLOW FOR PROPER OPERATION OF REMAINING DEVICES ON CIRCUIT.
- 3 REMOVE LIGHT SWITCH(ES) CONTROLLING CORRIDOR LUMINAIRES. REMOVE EXISTING CIRCUITRY BACK TO NEAREST JUNCTION BOX OR DEVICE OUTSIDE OF DEMOLITION AREA. MODIFY EXISTING SYSTEM CIRCUITRY TO ALLOW FOR PROPER OPERATION OF REMAINING DEVICES ON CIRCUIT. PROVIDE BLANK COVER PLATE.
- 4 REMOVE, CLEAN AND STORE FIRE ALARM STROBE.
- 5 REMOVE JUNCTION BOX.
- 6 REMOVE, CLEAN AND STORE SPEAKER.
- 7 DISCONNECT POWER CIRCUITRY TO HAND DRYER, TAG FOR RE-USE.
- 8 DISCONNECT POWER CIRCUITRY TO HVAC EQUIPMENT AND TAG FOR RE-USE.
- 9 REMOVE POWER CIRCUITRY TO HVAC EQUIPMENT COMPLETE BACK TO SOURCE. LABEL ANY UNUSED CIRCUIT BREAKERS AS "SPARE". AMEND PANEL DIRECTORY AS NECESSARY.
- 10 REMOVE RECEPTACLE COMPLETE BACK TO SOURCE.
- 11 REMOVE FIRE ALARM HORN STROBE AND TELEPHONE LINE. PREPARE FOR RE-INSTALLATION.

Demolition General Notes


- A. ALL ELECTRICAL DEVICES INTERFERING WITH DEMOLITION WORK SHALL BE DISCONNECTED AND REMOVED, UNLESS OTHERWISE NOTED. EXISTING CIRCUIT WIRING SHALL BE REMOVED BACK TO SOURCE AND PANEL DIRECTORIES MODIFIED ACCORDINGLY.
- B. ANY DEVICE INTERFERING WITH DEMOLITION WORK NOT SHOWN ON THESE DRAWINGS SHALL NOT BE REMOVED WITHOUT WRITTEN AUTHORIZATION FROM THE OWNER'S REPRESENTATIVE OR THE ENGINEER.
- C. ALL ELECTRICAL DEMOLITION WORK SHALL BE PROPERLY COORDINATED WITH ALL OTHER TRADES.
- D. EC IS SOLELY RESPONSIBLE FOR THE SAFE HANDLING AND DISPOSAL OF ALL REMOVED LUMINAIRES AND BALLASTS THAT MAY CONTAIN PCBs (POLYCHLORINATED BIPHENYLS), IN ACCORDANCE WITH ALL APPLICABLE EPA, OSHA, FEDERAL, STATE, AND LOCAL CODES AND LAWS.
- E. EC IS SOLELY RESPONSIBLE FOR THE SAFE HANDLING AND DISPOSAL OF ALL REMOVED FLUORESCENT LIGHT TUBES THAT MAY CONTAIN MERCURY, IN ACCORDANCE WITH ALL APPLICABLE EPA, OSHA, FEDERAL, STATE, AND LOCAL CODES AND LAWS.
- F. AT ALL CORRIDORS WHERE NEW CEILINGS ARE BEING INSTALLED, DISCONNECT AND REMOVE DEVICES AS INDICATED, TAG EXISTING WIRING FOR REUSE.
- G. ALL DEVICES THAT ARE SCHEDULED TO BE REMOVED, CLEANED, STORED AND RE-INSTALLED SHALL BE TESTED PRIOR TO REMOVAL. IF ANY DEVICES IS NOT IN WORKING ORDER, NOTIFY ENGINEER AND OWNER'S REPRESENTATIVE PRIOR TO REMOVAL.

General Notes


- A. COORDINATE ALL ELECTRICAL WORK AND POWER OUTAGES WITH OWNER AND OTHER TRADES PRIOR TO THE START OF CONSTRUCTION. NO POWER OUTAGES SHALL OCCUR WITHOUT OWNER'S PRIOR KNOWLEDGE AND CONSENT.
 - B. REFER TO DRAWING G100 FOR STANDARD SYMBOLS AND ABBREVIATIONS.
 - C. CIRCUIT WIRING FOR ALL LIGHTING CIRCUITS SHALL BE IN 1/2" EMT CONDUIT (MIN) OR TYPE MC CABLE CONCEALED ABOVE CEILINGS AND IN WALLS (REFER TO SPECIFICATION SECTION 26 05 33 FOR LOCATIONS WHERE MC CABLE IS ACCEPTABLE). ALL CIRCUIT CONDUCTORS SHALL BE #12AWG COPPER (MIN) 90°C THHN THERMOPLASTIC INSULATION.
 - D. CIRCUIT EXIT AND EMERGENCY LUMINAIRES TO UNSWITCHED HOT LEG OF LIGHTING CIRCUIT OF THE AREA BEING SERVED BY OR ADJACENT TO THE LUMINAIRE. REFER TO PLANS AND DETAILS FOR MINATURE INVERTER INFORMATION.
 - E. PROPERLY IDENTIFY ALL CIRCUITS AT PANELS AND J-BOXES AND IN ACCORDANCE WITH PROJECT SPECIFICATIONS.
 - F. PROVIDE ALL ADAPTERS, COUPLINGS AND ASSOCIATED FITTINGS REQUIRED FOR COMPLETE OPERATIONAL SYSTEM.
 - G. WHEN INSTALLING NEW DEVICES IN EXISTING LOCATIONS, REUSE EXISTING CONDUIT/TRACEWAY AND BACK BOXES IF IN GOOD CONDITION. EXTEND/INSTALL NEW CONDUIT/TRACEWAY AS REQUIRED FOR PROPER MOUNTING OF DEVICE. CONCEAL ABOVE CEILINGS OR WITHIN WALLS WHERE POSSIBLE. REFER TO SPECIFICATION SECTION 26 05 33.
 - H. COORDINATE ALL ELECTRICAL WORK WITH OTHER TRADES.
 - I. TESTS OF ALL ELECTRICAL WORK SHALL BE PERFORMED IN THE PRESENCE OF THE ENGINEER OR ARCHITECT. AS EQUIPMENT IS INSTALLED AND AS SYSTEMS ARE COMPLETED. IN ADDITION AN ELECTRIC APPROVED CERTIFICATE SHALL BE ISSUED BY AN ELECTRICAL INSPECTION AGENCY.
 - J. UNLESS NOTED ELSEWHERE ON THE CONTRACT DOCUMENTS, THE FOLLOWING LIST REPRESENTS THE TYPICAL MOUNTING HEIGHTS FOR THE DEVICES SHOWN:
 1. SWITCHES AND PANIC STATIONS.....48" (TO TOP)
 2. RECEPTACLES.....16"
 3. COMPUTER RECEPTACLES.....48" (TO TOP)
 4. WALL (W) TELEPHONE AND CALL SWITCHES.....48" (TO TOP)
 5. TELEPHONE OUTLETS (UNLABELED).....16"
 6. VOLUME CONTROLS.....48" (TO TOP)
 7. TELEVISION OUTLETS.....16"
 8. FIRE ALARM PULL STATIONS.....48" (TO TOP)
 9. FIRE ALARM AUDIO/VISUAL UNITS.....88"
* (OR 6' BELOW CEILING, WHICHEVER IS LOWER)
 10. POWER PANELS.....72" (TO TOP)
 11. DISCONNECT SWITCHES.....60" (TO TOP)
 12. MOTOR STARTERS.....60" (TO TOP)
- THE HEIGHTS INDICATED SHALL BE NOMINAL TO THE BOTTOM OF THE BOX UNLESS NOTED OTHERWISE. MAINTAIN HEIGHT CONSISTENCY BETWEEN NEW AND EXISTING DEVICES.

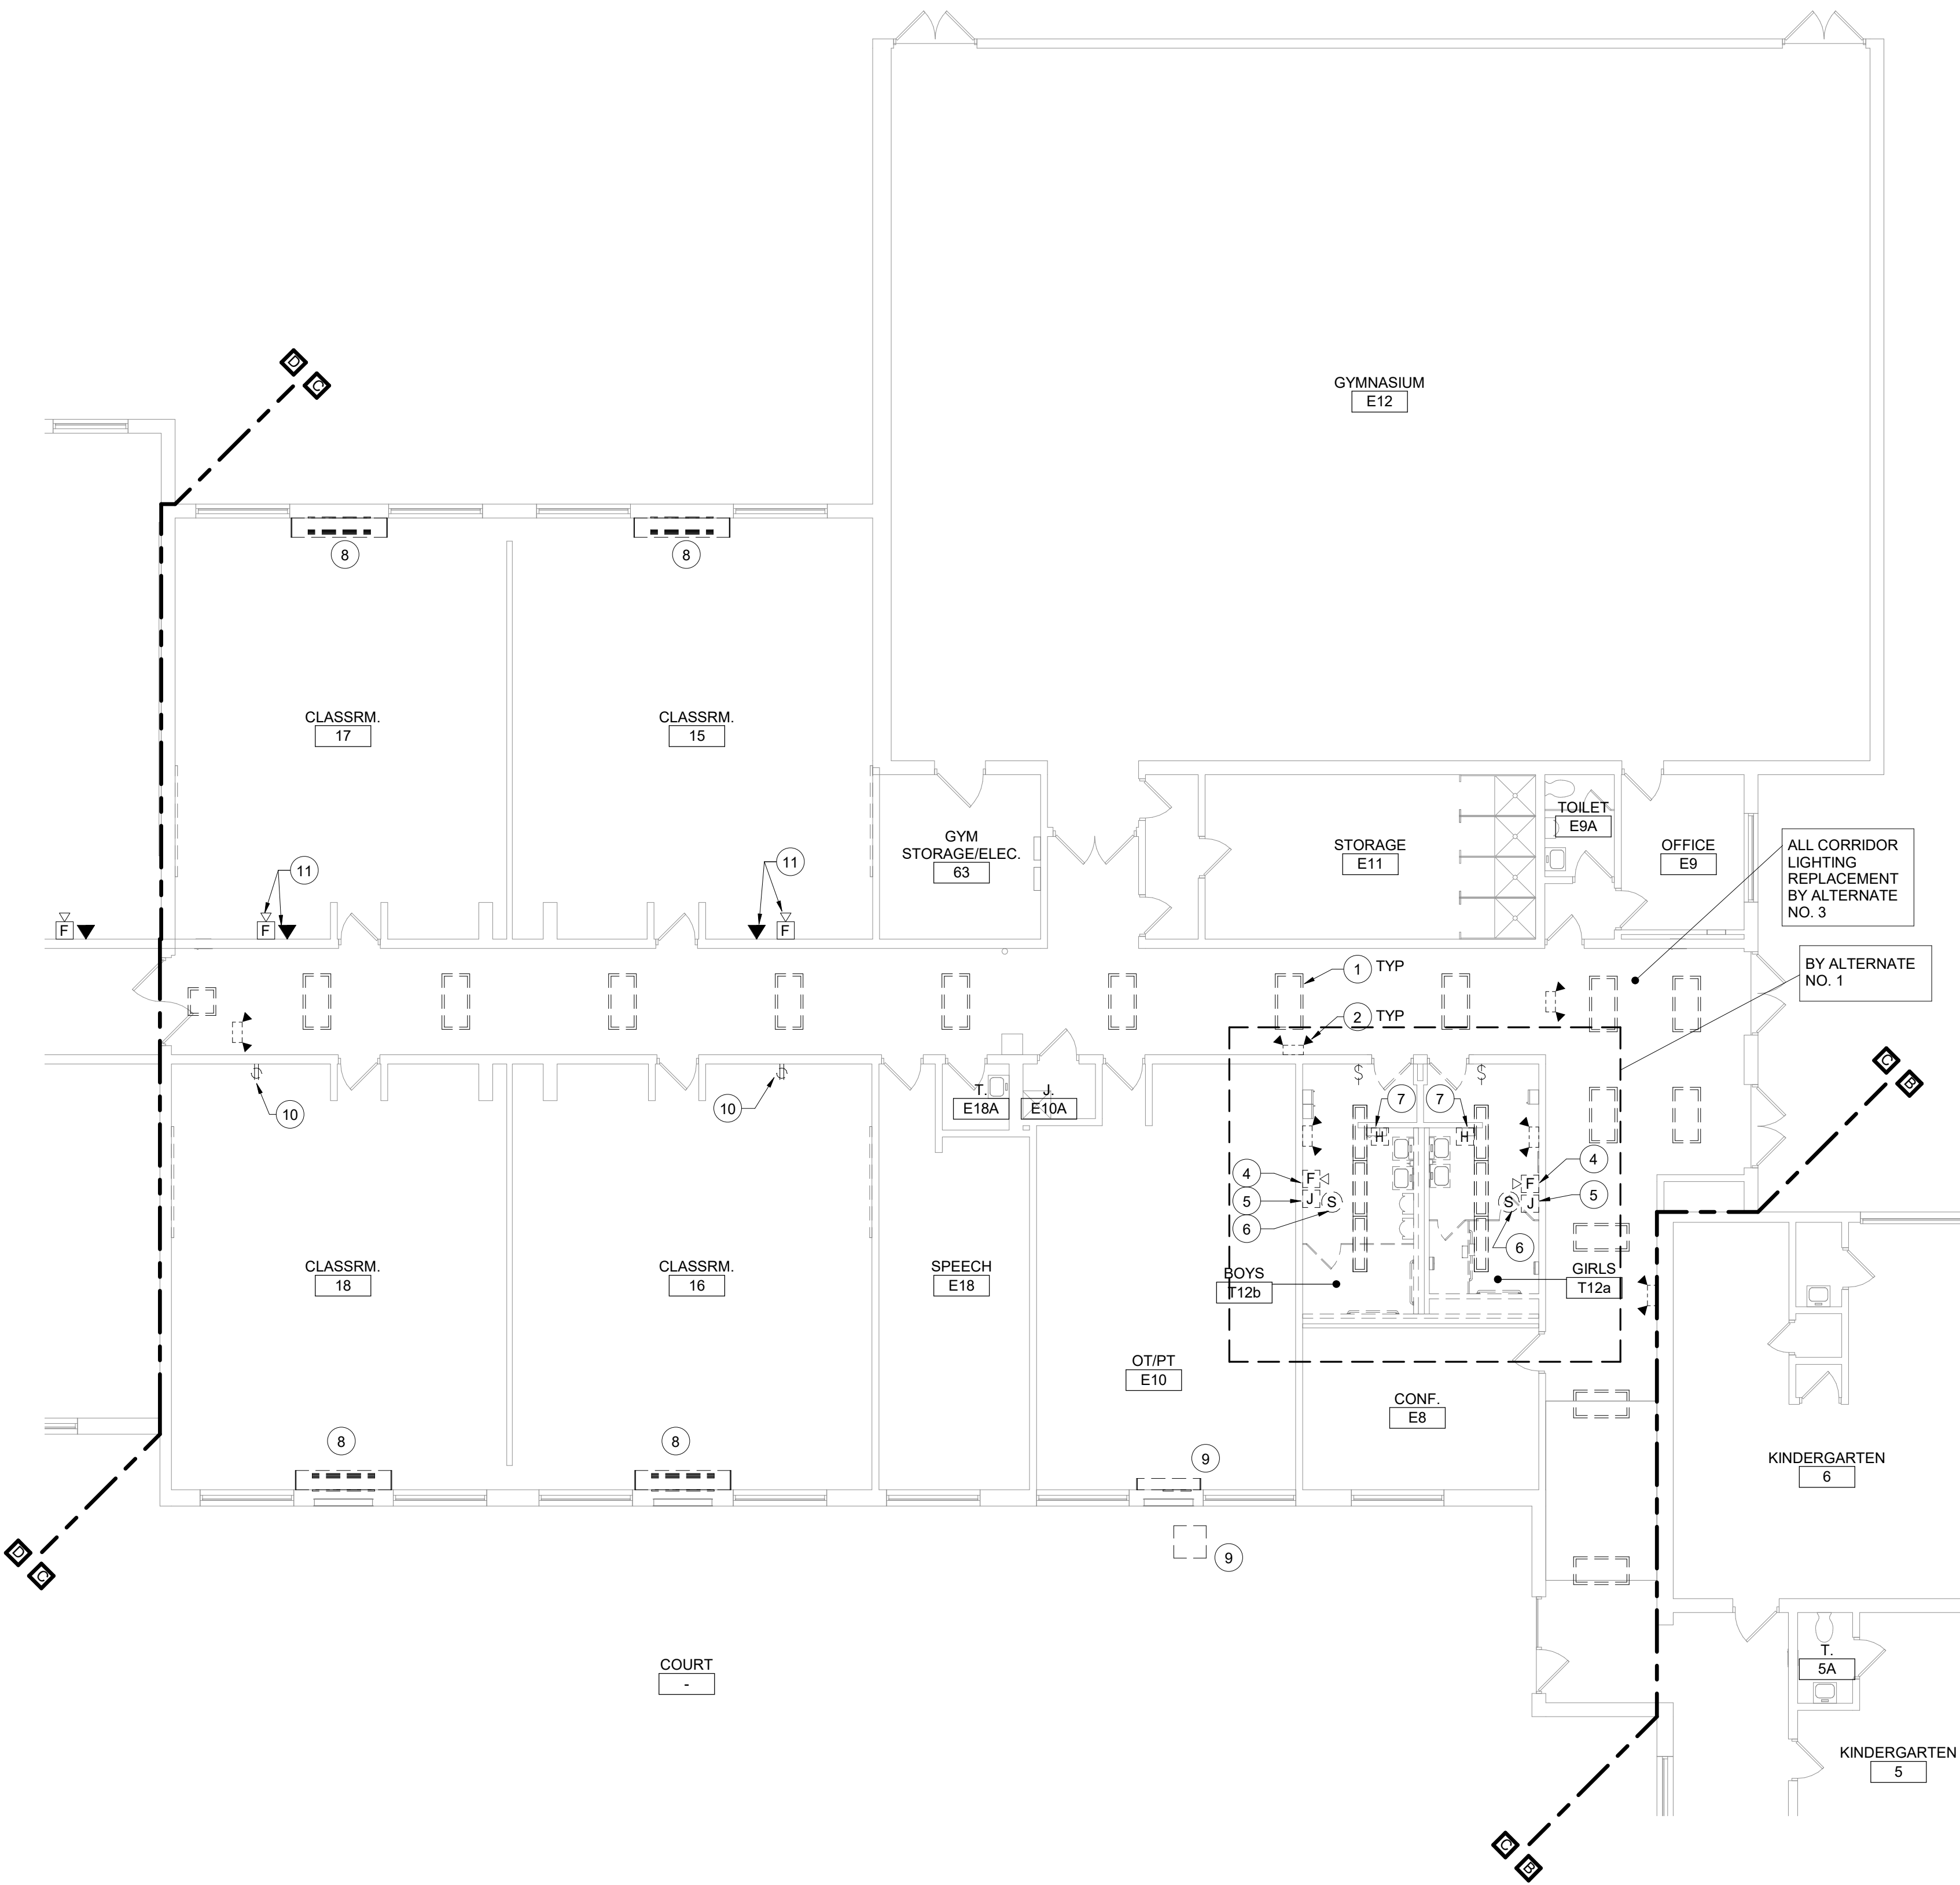

2 First Floor Demolition Plan - Area C
1/8" = 1'-0"

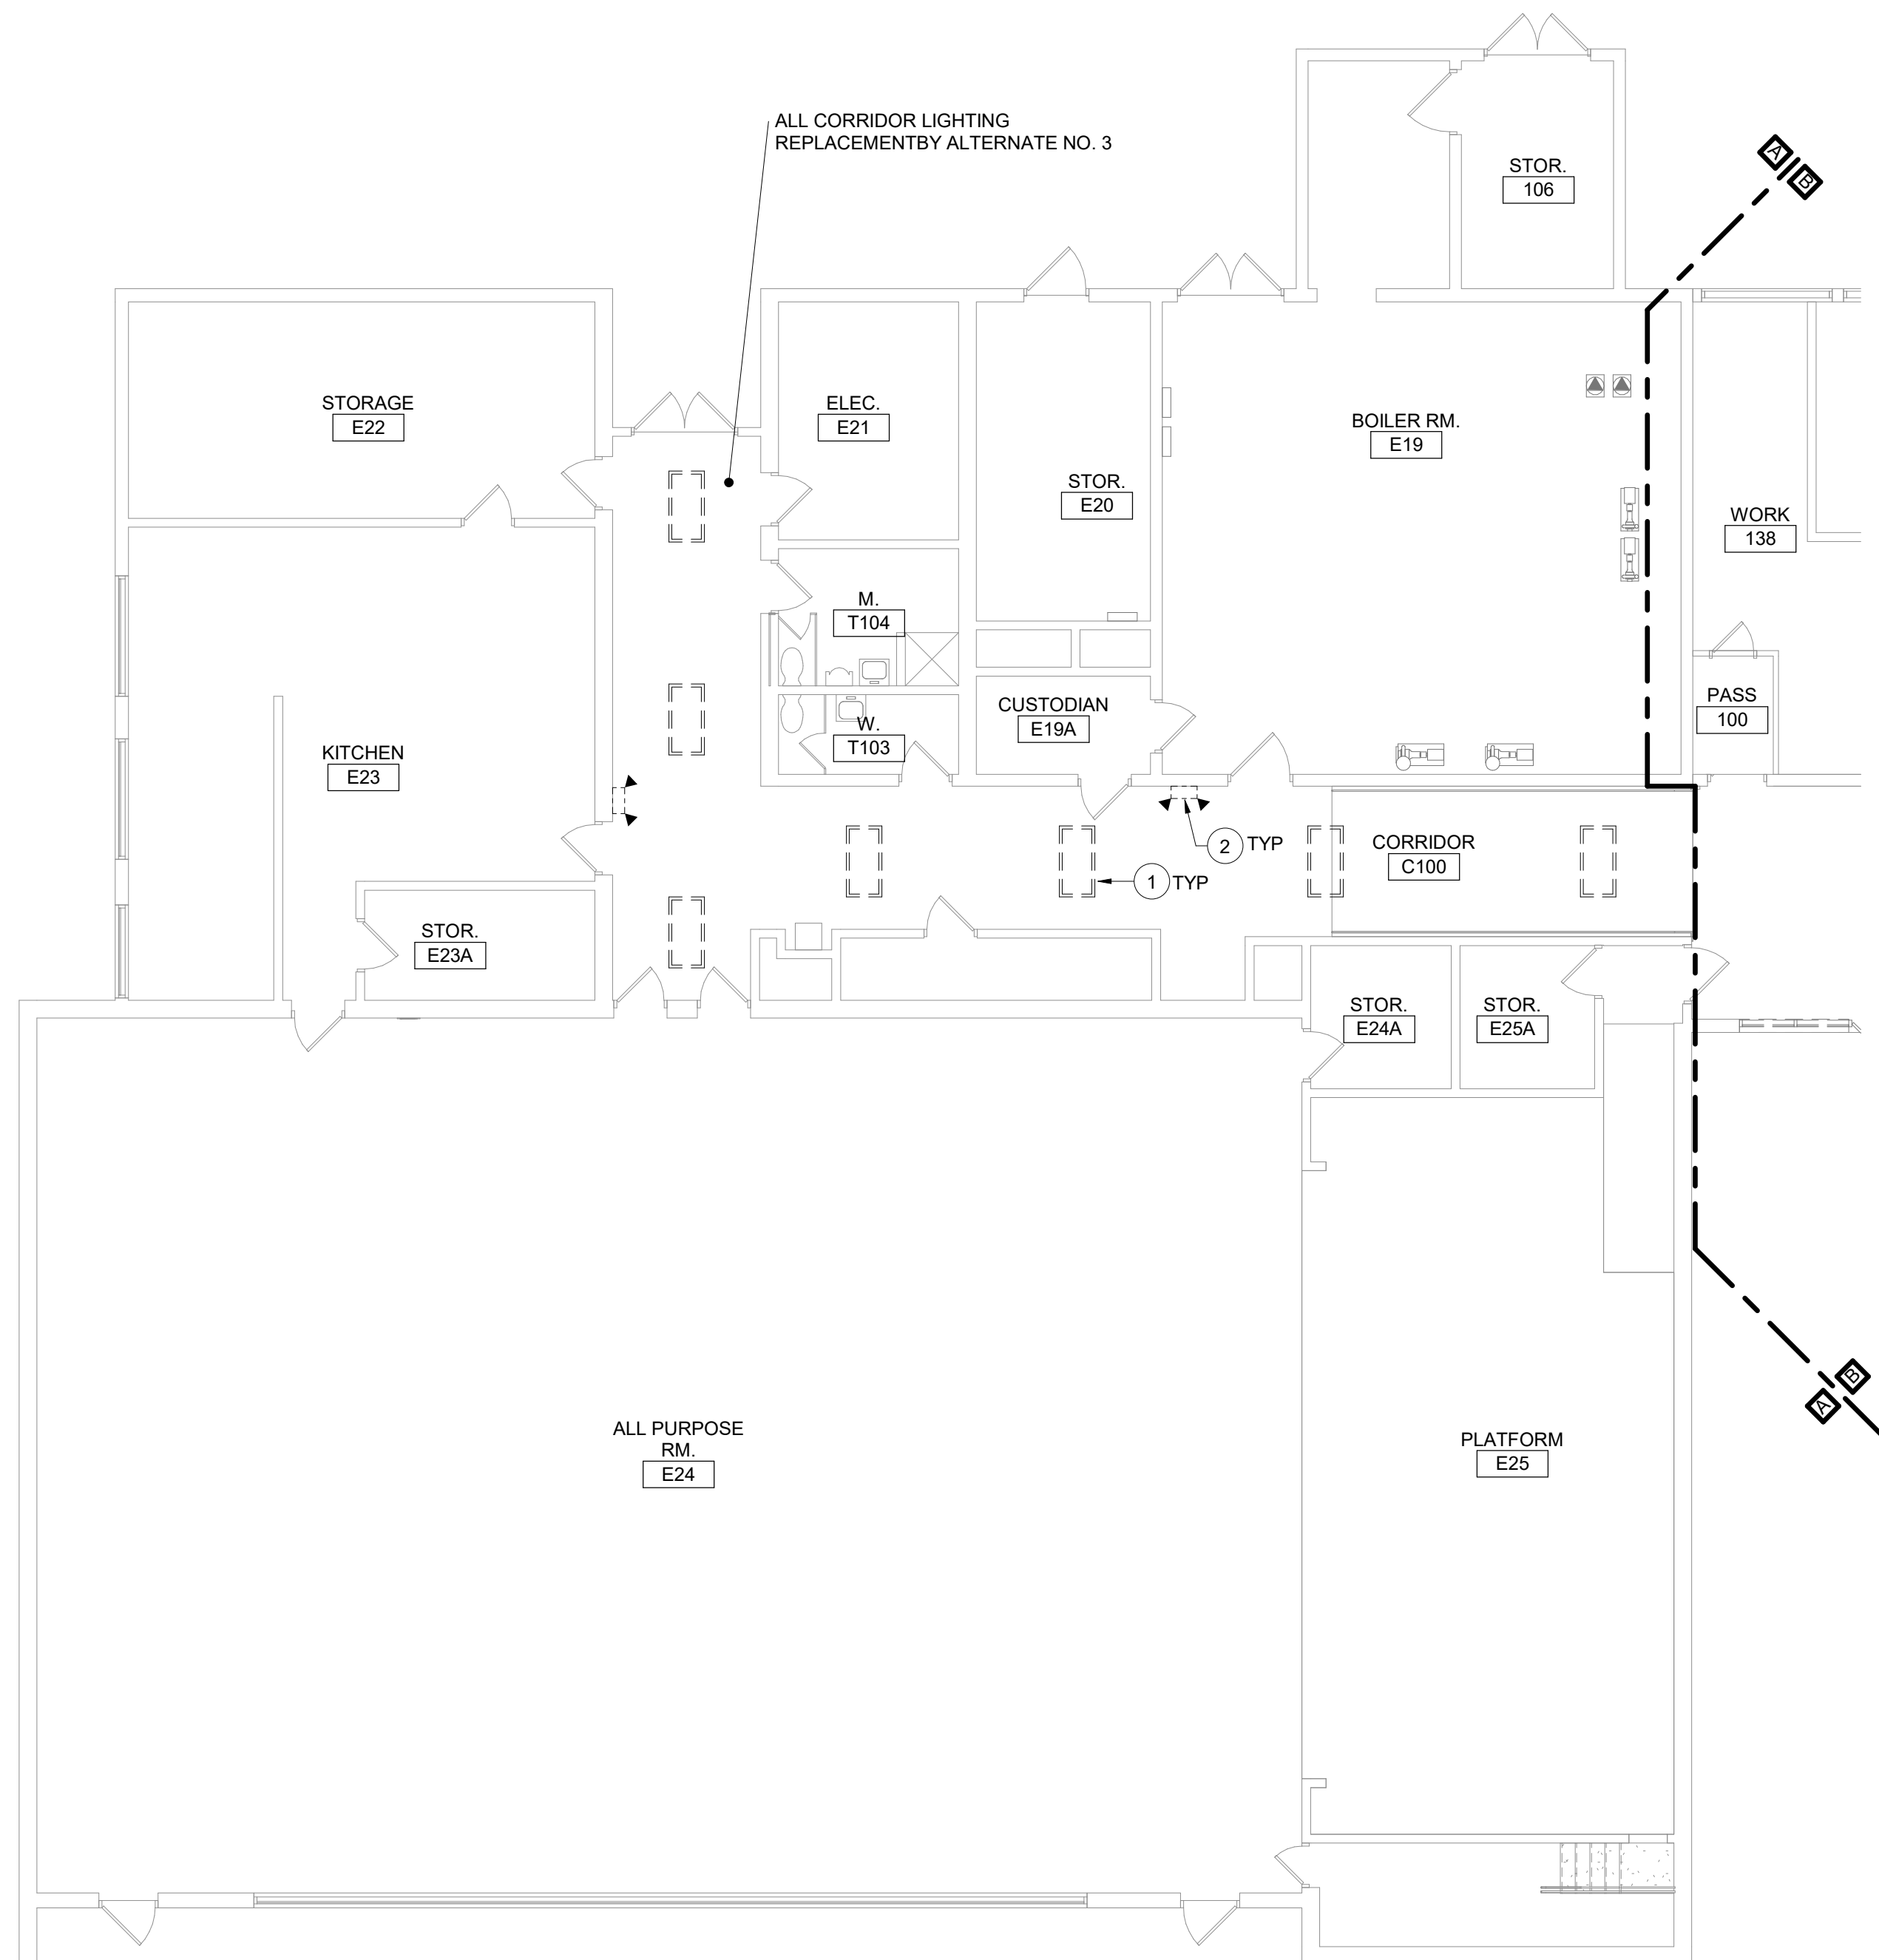

1 First Floor Demolition Plan - Area A
1/8" = 1'-0"

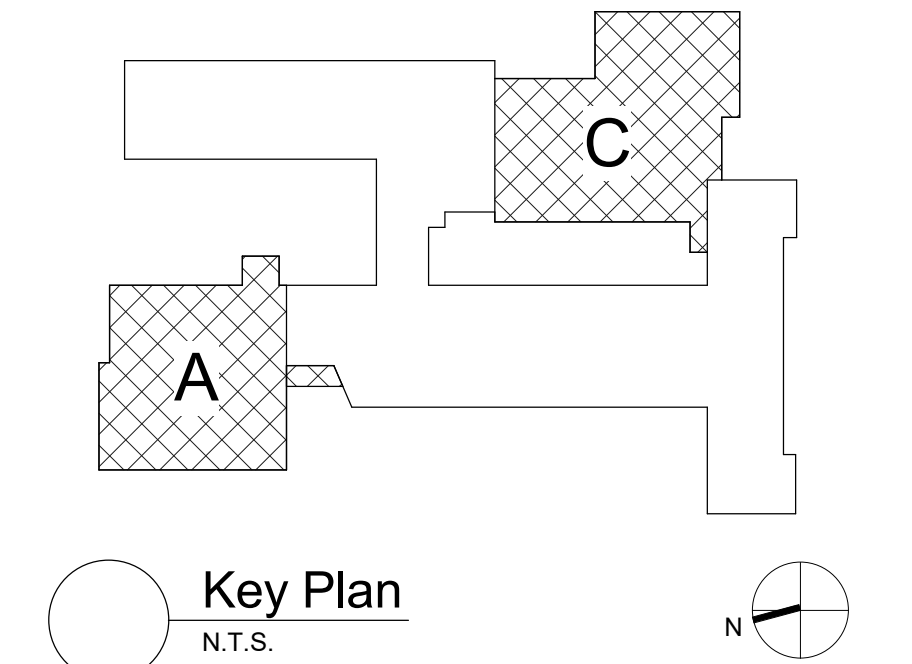

S.E.D. Control No. 13-02-00-01-0-006-022

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Beacon, New York

Additions and Alterations to:
Glenham Elementary School


First Floor Demolition Plan - Areas A
and C

Drawn By:
SAS
Project No.:
279180-22004

Date:
10/28/2022

Drawing Number:

BE100

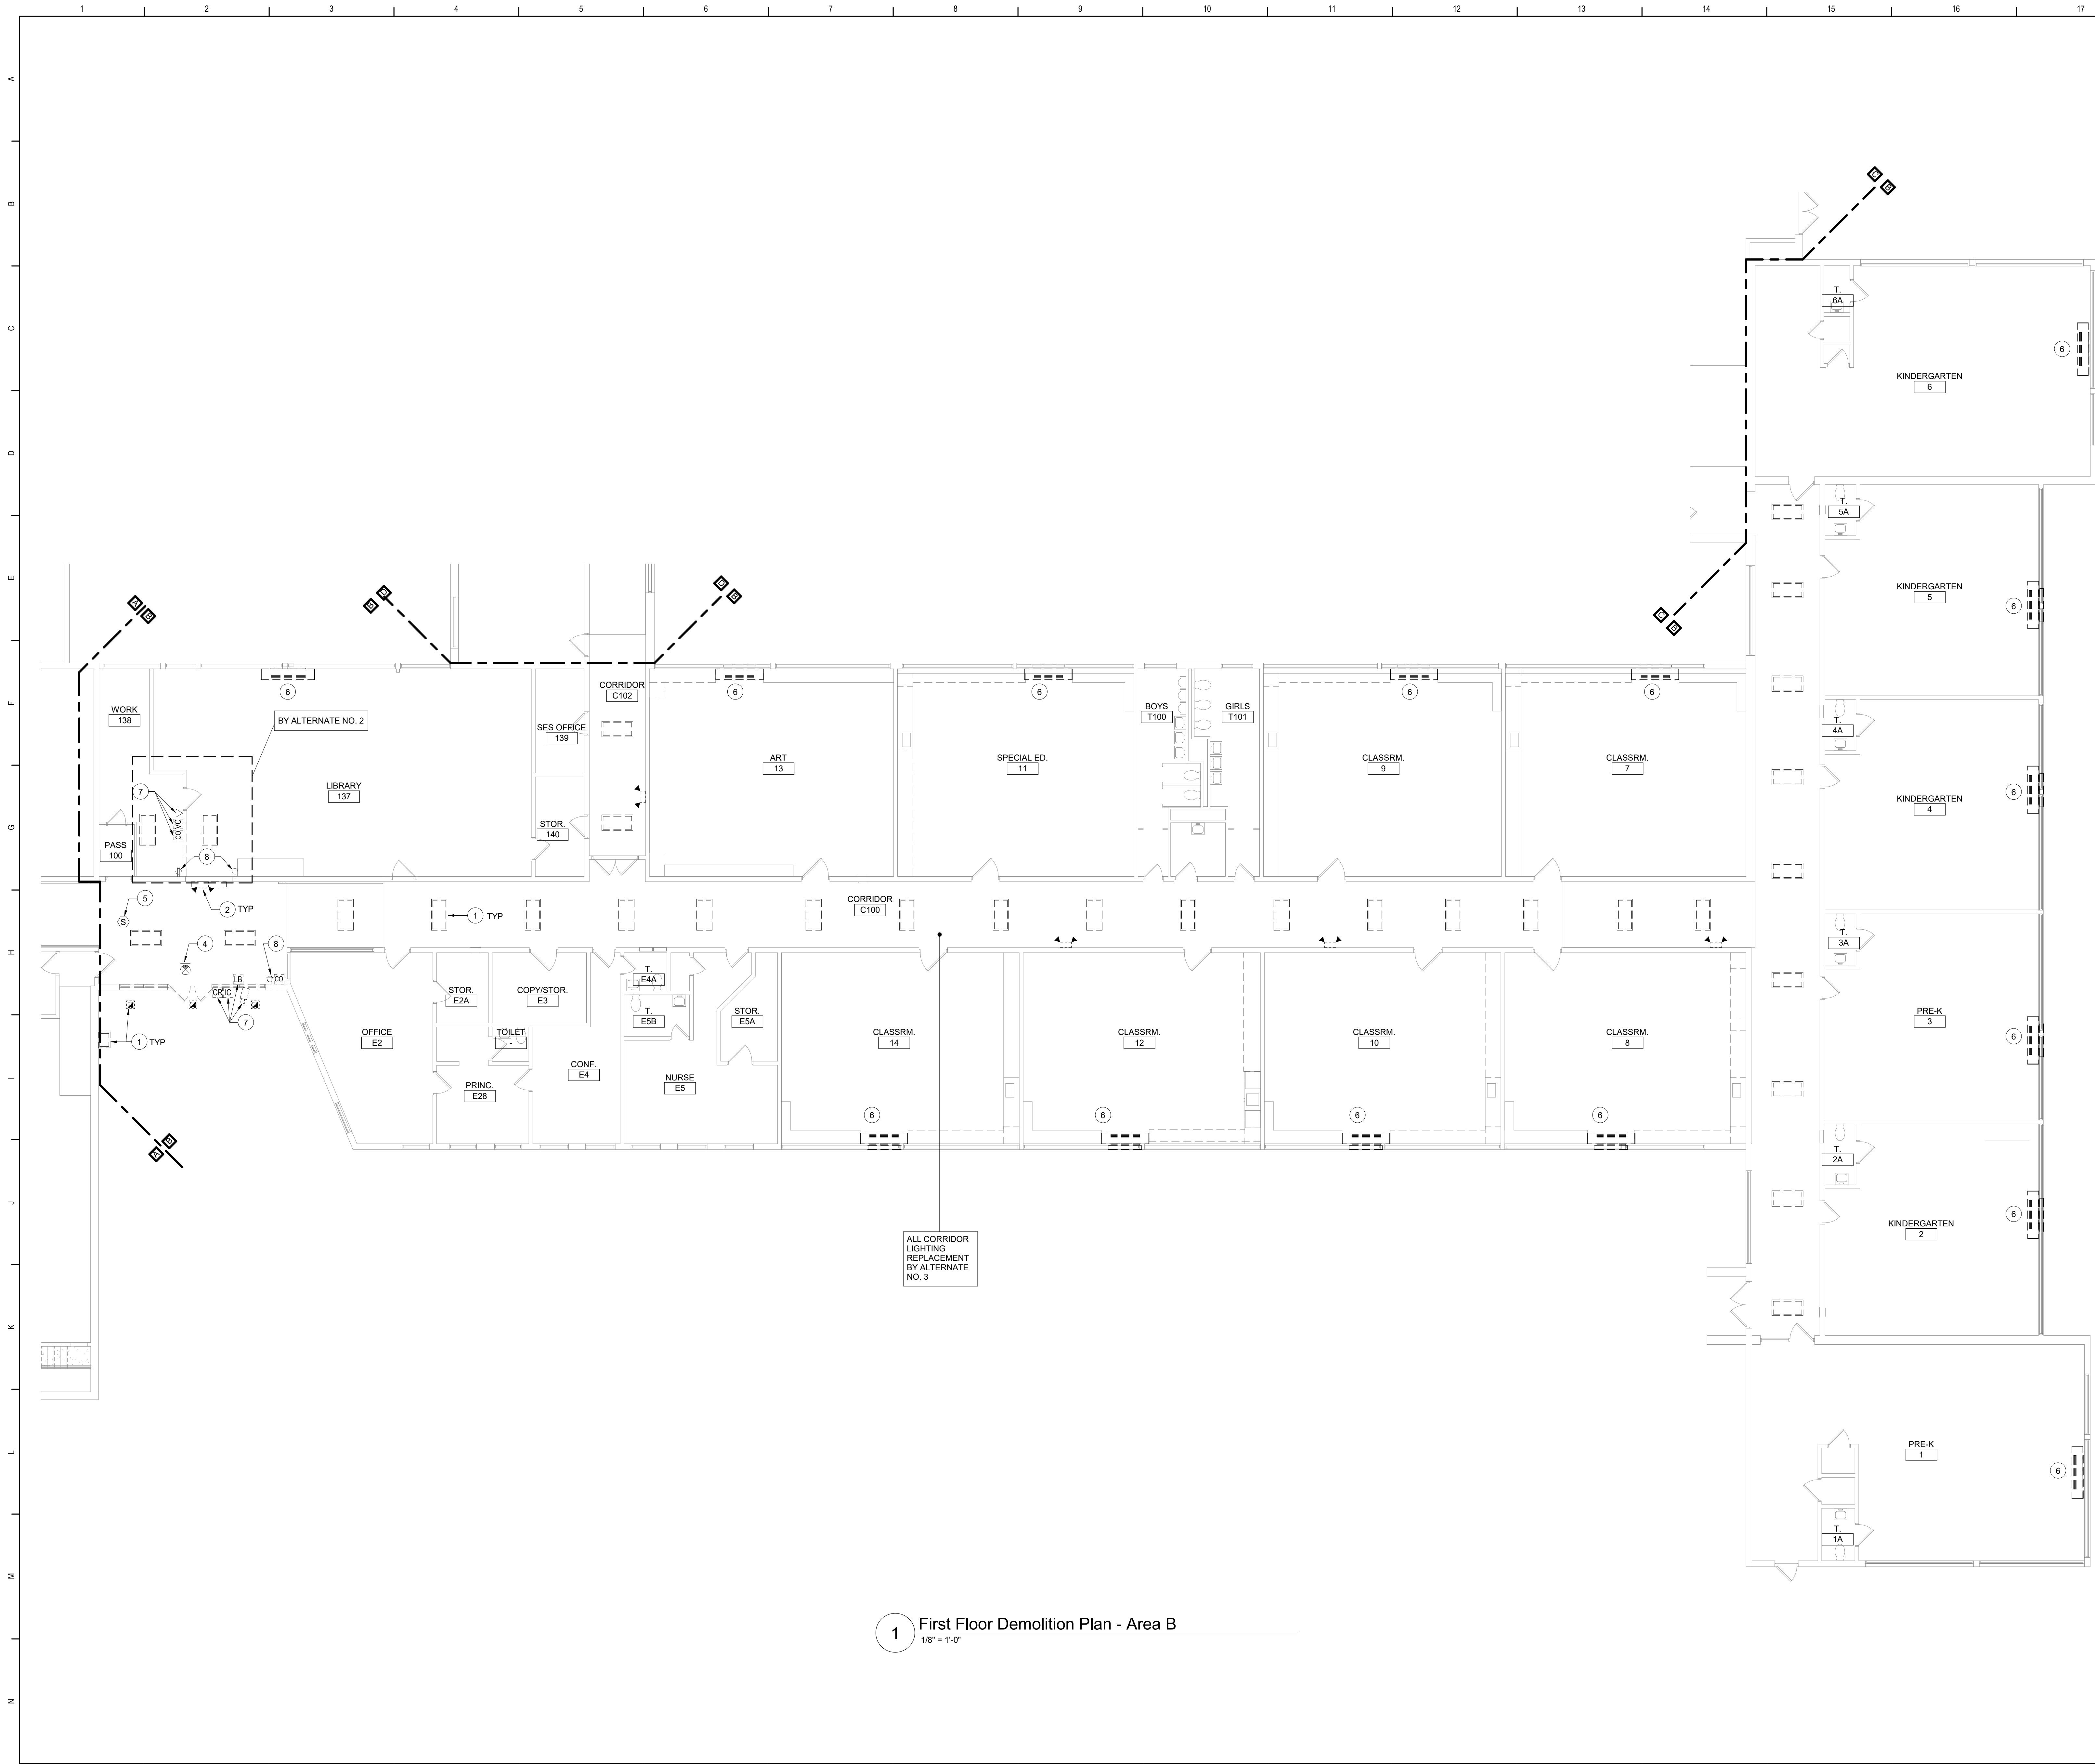

1 First Floor Demolition Plan - Area B
1/8" = 1'-0"


- Keyed Notes:**
- 1 REMOVE LUMINAIRE(S) AND CIRCUITRY COMPLETE BACK TO SOURCE.
 - 2 REMOVE WALL MOUNTED EMERGENCY LIGHT. REMOVE EXISTING CIRCUITRY BACK TO NEAREST JUNCTION BOX OR DEVICE OUTSIDE OF DEMOLITION AREA. MODIFY EXISTING SYSTEM CIRCUITRY TO ALLOW FOR PROPER OPERATION OF REMAINING DEVICES ON CIRCUIT.
 - 3 REMOVE LIGHT SWITCH(IES) CONTROLLING CORRIDOR LUMINAIRES. REMOVE EXISTING CIRCUITRY BACK TO NEAREST JUNCTION BOX OR DEVICE OUTSIDE OF DEMOLITION AREA. MODIFY EXISTING SYSTEM CIRCUITRY TO ALLOW FOR PROPER OPERATION OF REMAINING DEVICES ON CIRCUIT. PROVIDE BLANK COVER PLATE.
 - 4 REMOVE EXIT LIGHT.
 - 5 REMOVE SMOKE DETECTOR.
 - 6 DISCONNECT POWER CIRCUITRY TO HVAC EQUIPMENT AND TAG FOR RE-USE.
 - 7 REMOVE DEVICES SHOWN, CLEAN AND STORE FOR RE-INSTALLATION.
 - 8 REMOVE RECEPTACLE. REMOVE EXISTING CIRCUITRY BACK TO NEAREST JUNCTION BOX OR DEVICE OUTSIDE OF DEMOLITION AREA. MODIFY EXISTING SYSTEM CIRCUITRY TO ALLOW FOR PROPER OPERATION OF REMAINING DEVICES ON CIRCUIT.

- General Notes:**
- A. REFER TO DRAWING BE100 FOR GENERAL NOTES

Key Plan
N.T.S.

S.E.D. Control No. 13-02-00-01-0-006-022

Rev. No.:	Date:	Description:


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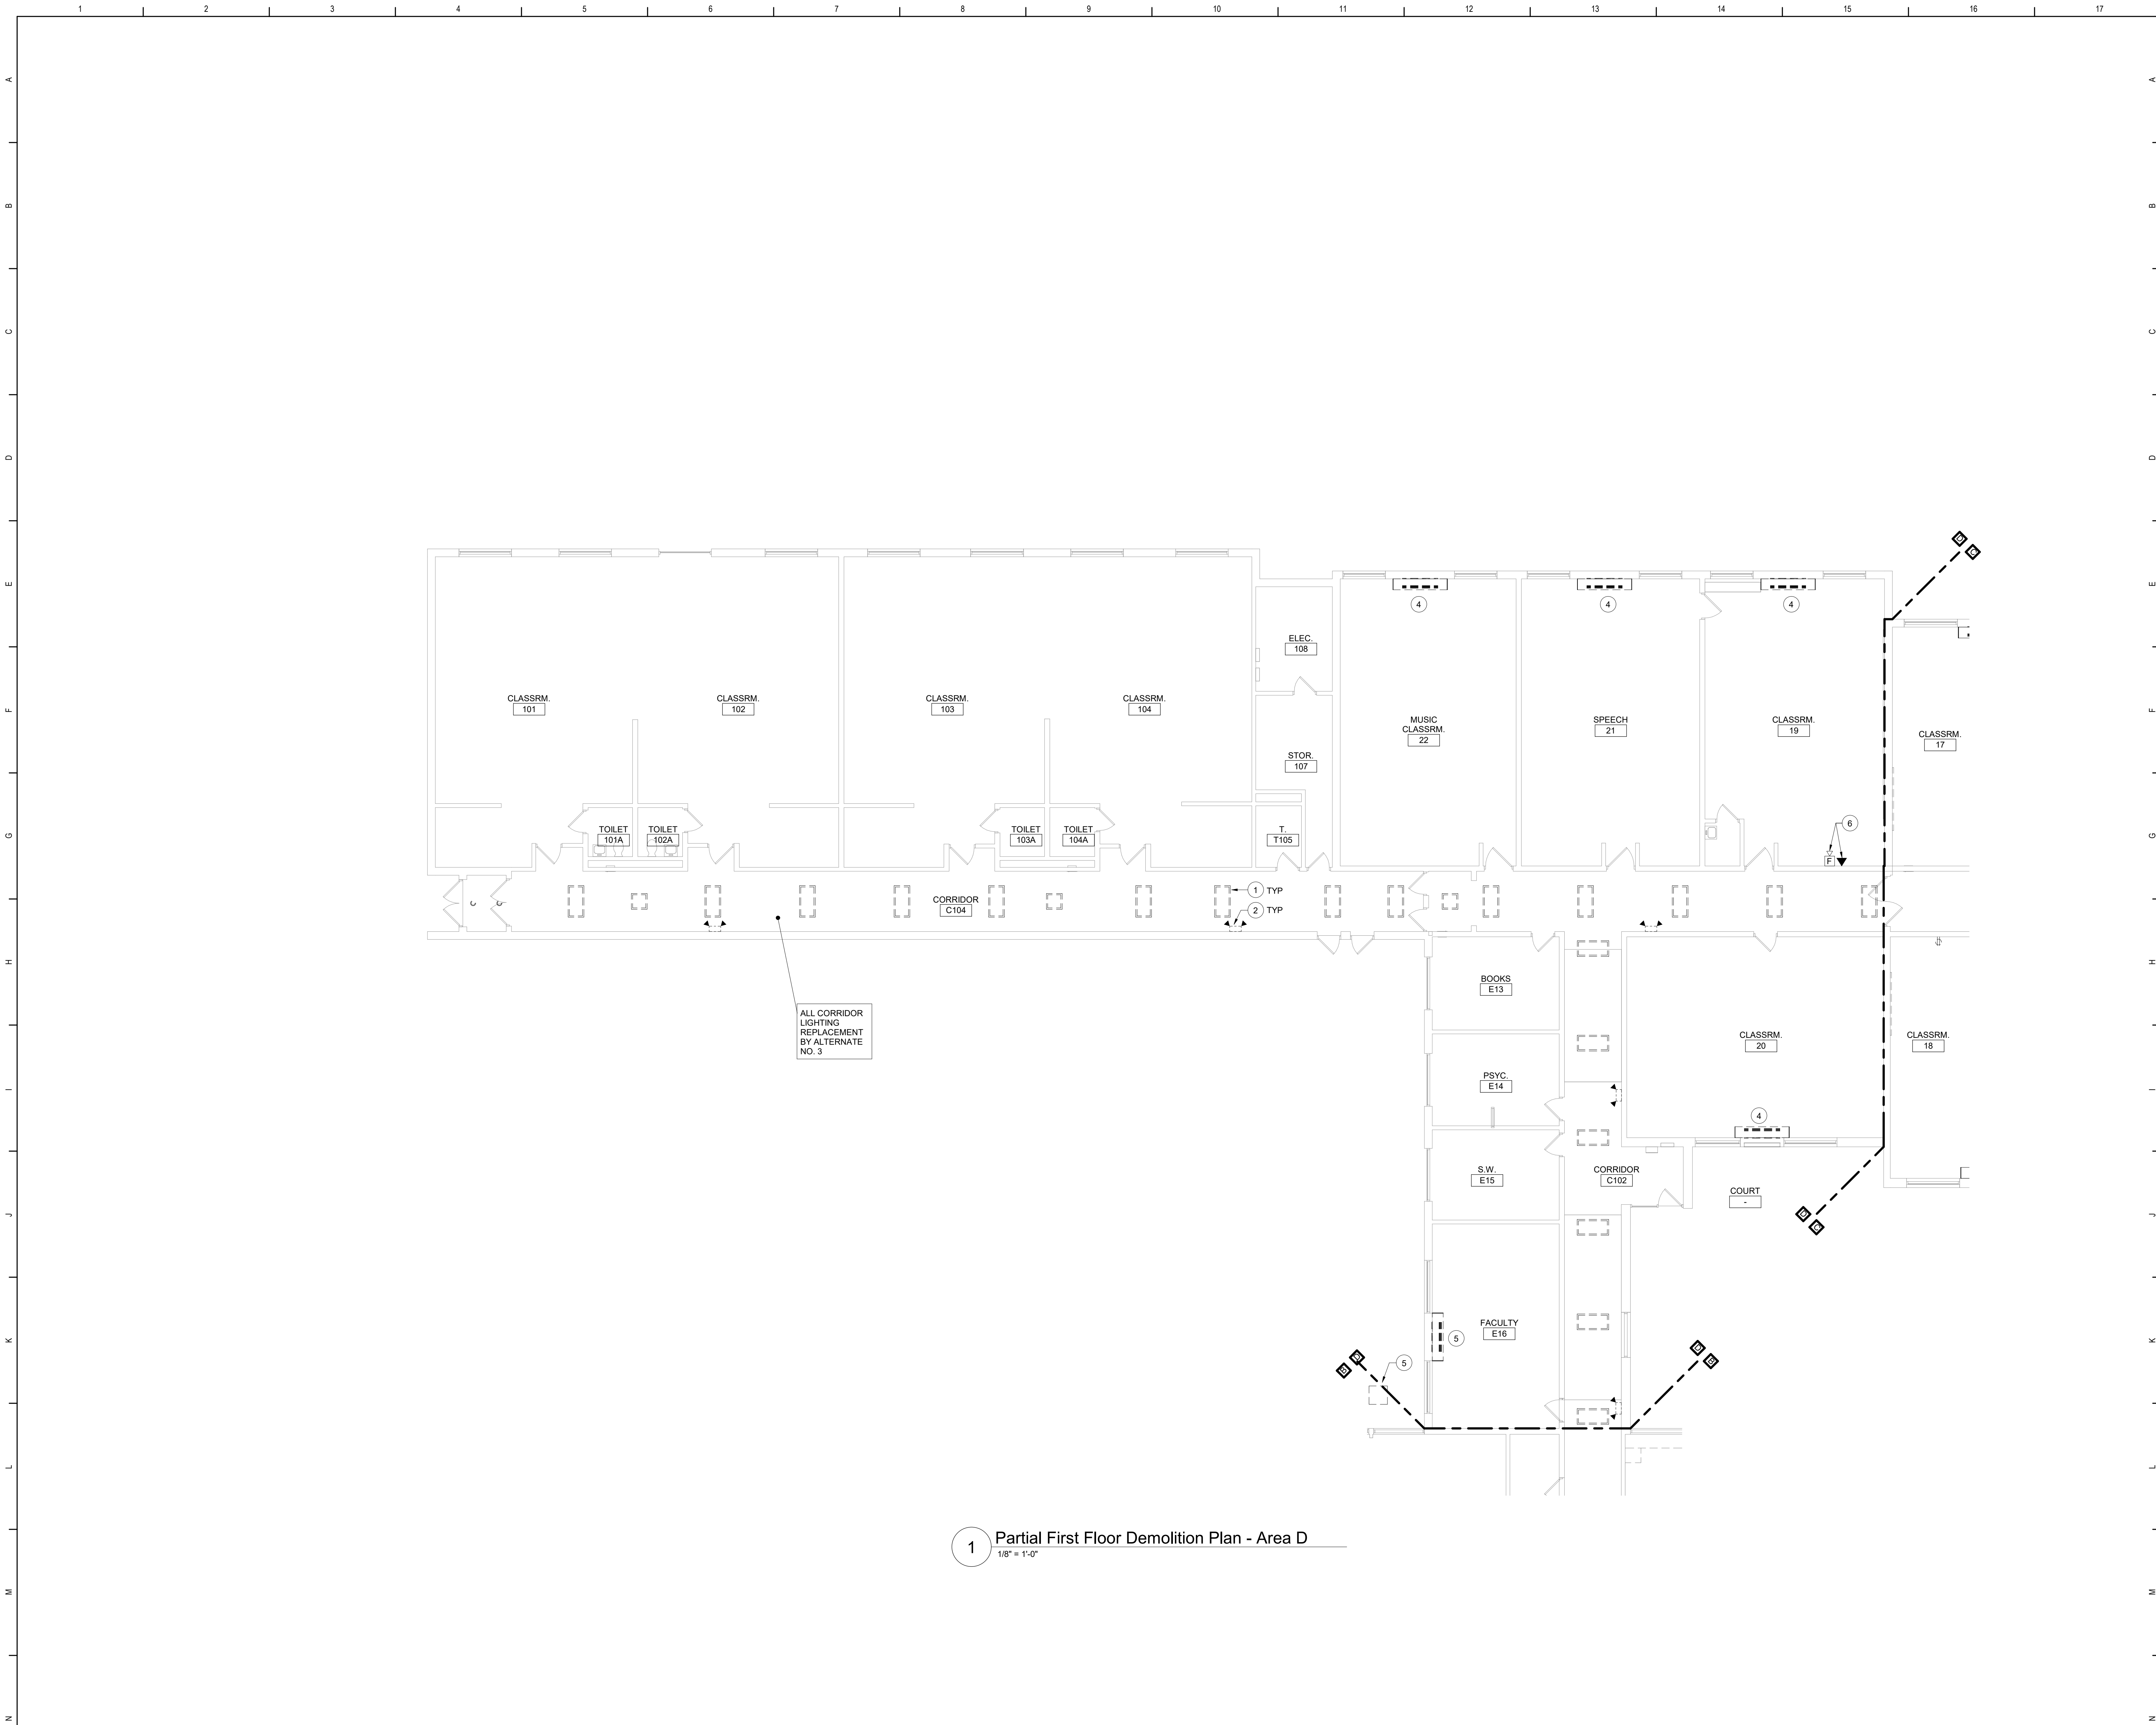
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Beacon, New York

Additions and Alterations to:
Glenham Elementary School

First Floor Demolition Plan - Area B

Drawn By:	Date:	Drawing Number:
Author	10/28/2022	
Project No.:	279180-22004	BE101




1 Partial First Floor Demolition Plan - Area D
1/8" = 1'-0"

Keyed Notes:

- 1 REMOVE LUMINAIRE(S) AND CIRCUITRY COMPLETE BACK TO SOURCE.
- 2 REMOVE WALL MOUNTED EMERGENCY LIGHT. REMOVE EXISTING CIRCUITRY BACK TO NEAREST JUNCTION BOX OR DEVICE OUTSIDE OF DEMOLITION AREA. MODIFY EXISTING SYSTEM CIRCUITRY TO ALLOW FOR PROPER OPERATION OF REMAINING DEVICES ON CIRCUIT.
- 3 REMOVE LIGHT SWITCH CONTROLLING CORRIDOR LUMINAIRES. REMOVE EXISTING CIRCUITRY BACK TO NEAREST JUNCTION BOX OR DEVICE OUTSIDE OF DEMOLITION AREA. MODIFY EXISTING SYSTEM CIRCUITRY TO ALLOW FOR PROPER OPERATION OF REMAINING DEVICES ON CIRCUIT. PROVIDE BLANK COVER PLATE.
- 4 DISCONNECT POWER CIRCUITRY TO HVAC EQUIPMENT AND TAG FOR RE-USE.
- 5 REMOVE POWER CIRCUITRY TO HVAC EQUIPMENT COMPLETE BACK TO SOURCE. LABEL ANY UNUSED CIRCUIT BREAKERS AS "SPARE". AMEND PANEL DIRECTORY AS NECESSARY.
- 6 REMOVE FIRE ALARM HORN STROBE AND TELEPHONE LINE. PREPARE FOR RE-INSTALLATION.


General Notes:

- A. REFER TO DRAWING BE100 FOR GENERAL NOTES

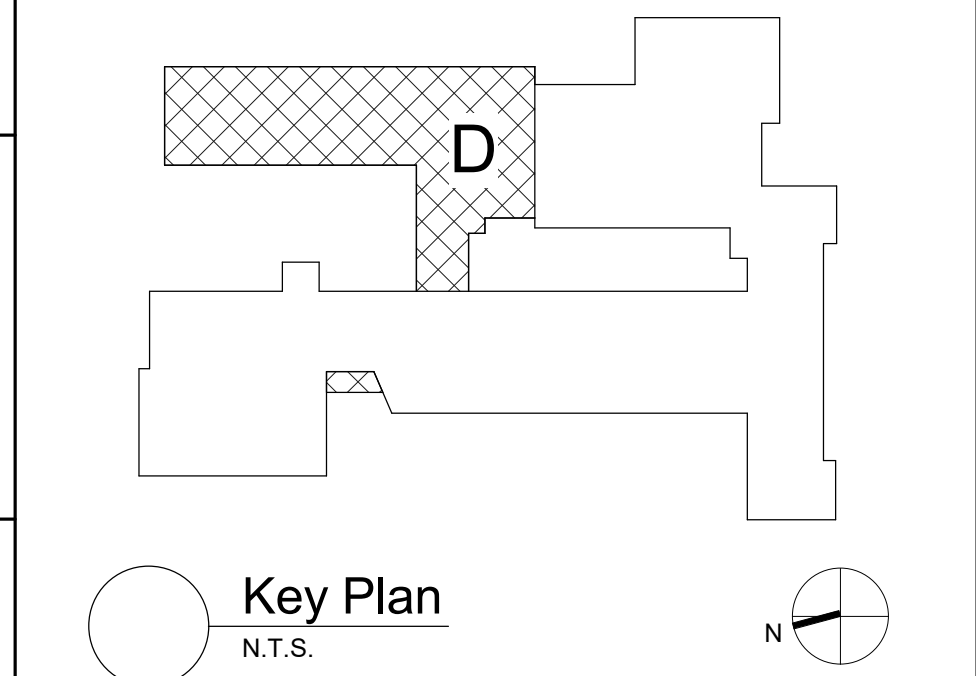

S.E.D. Control No. 13-02-00-01-0-006-022

Rev. No.:	Date:	Description:

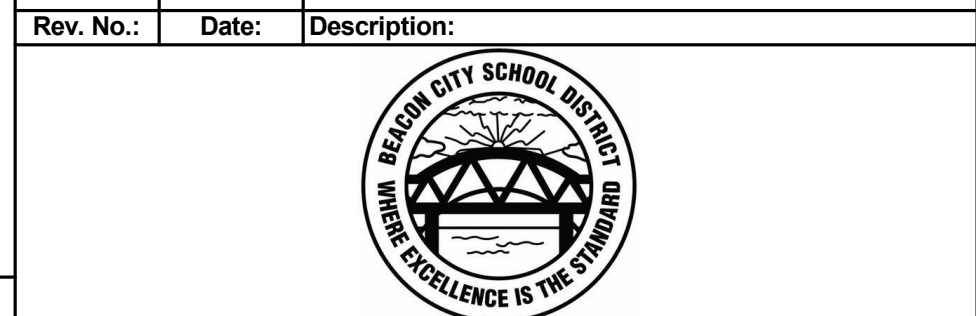

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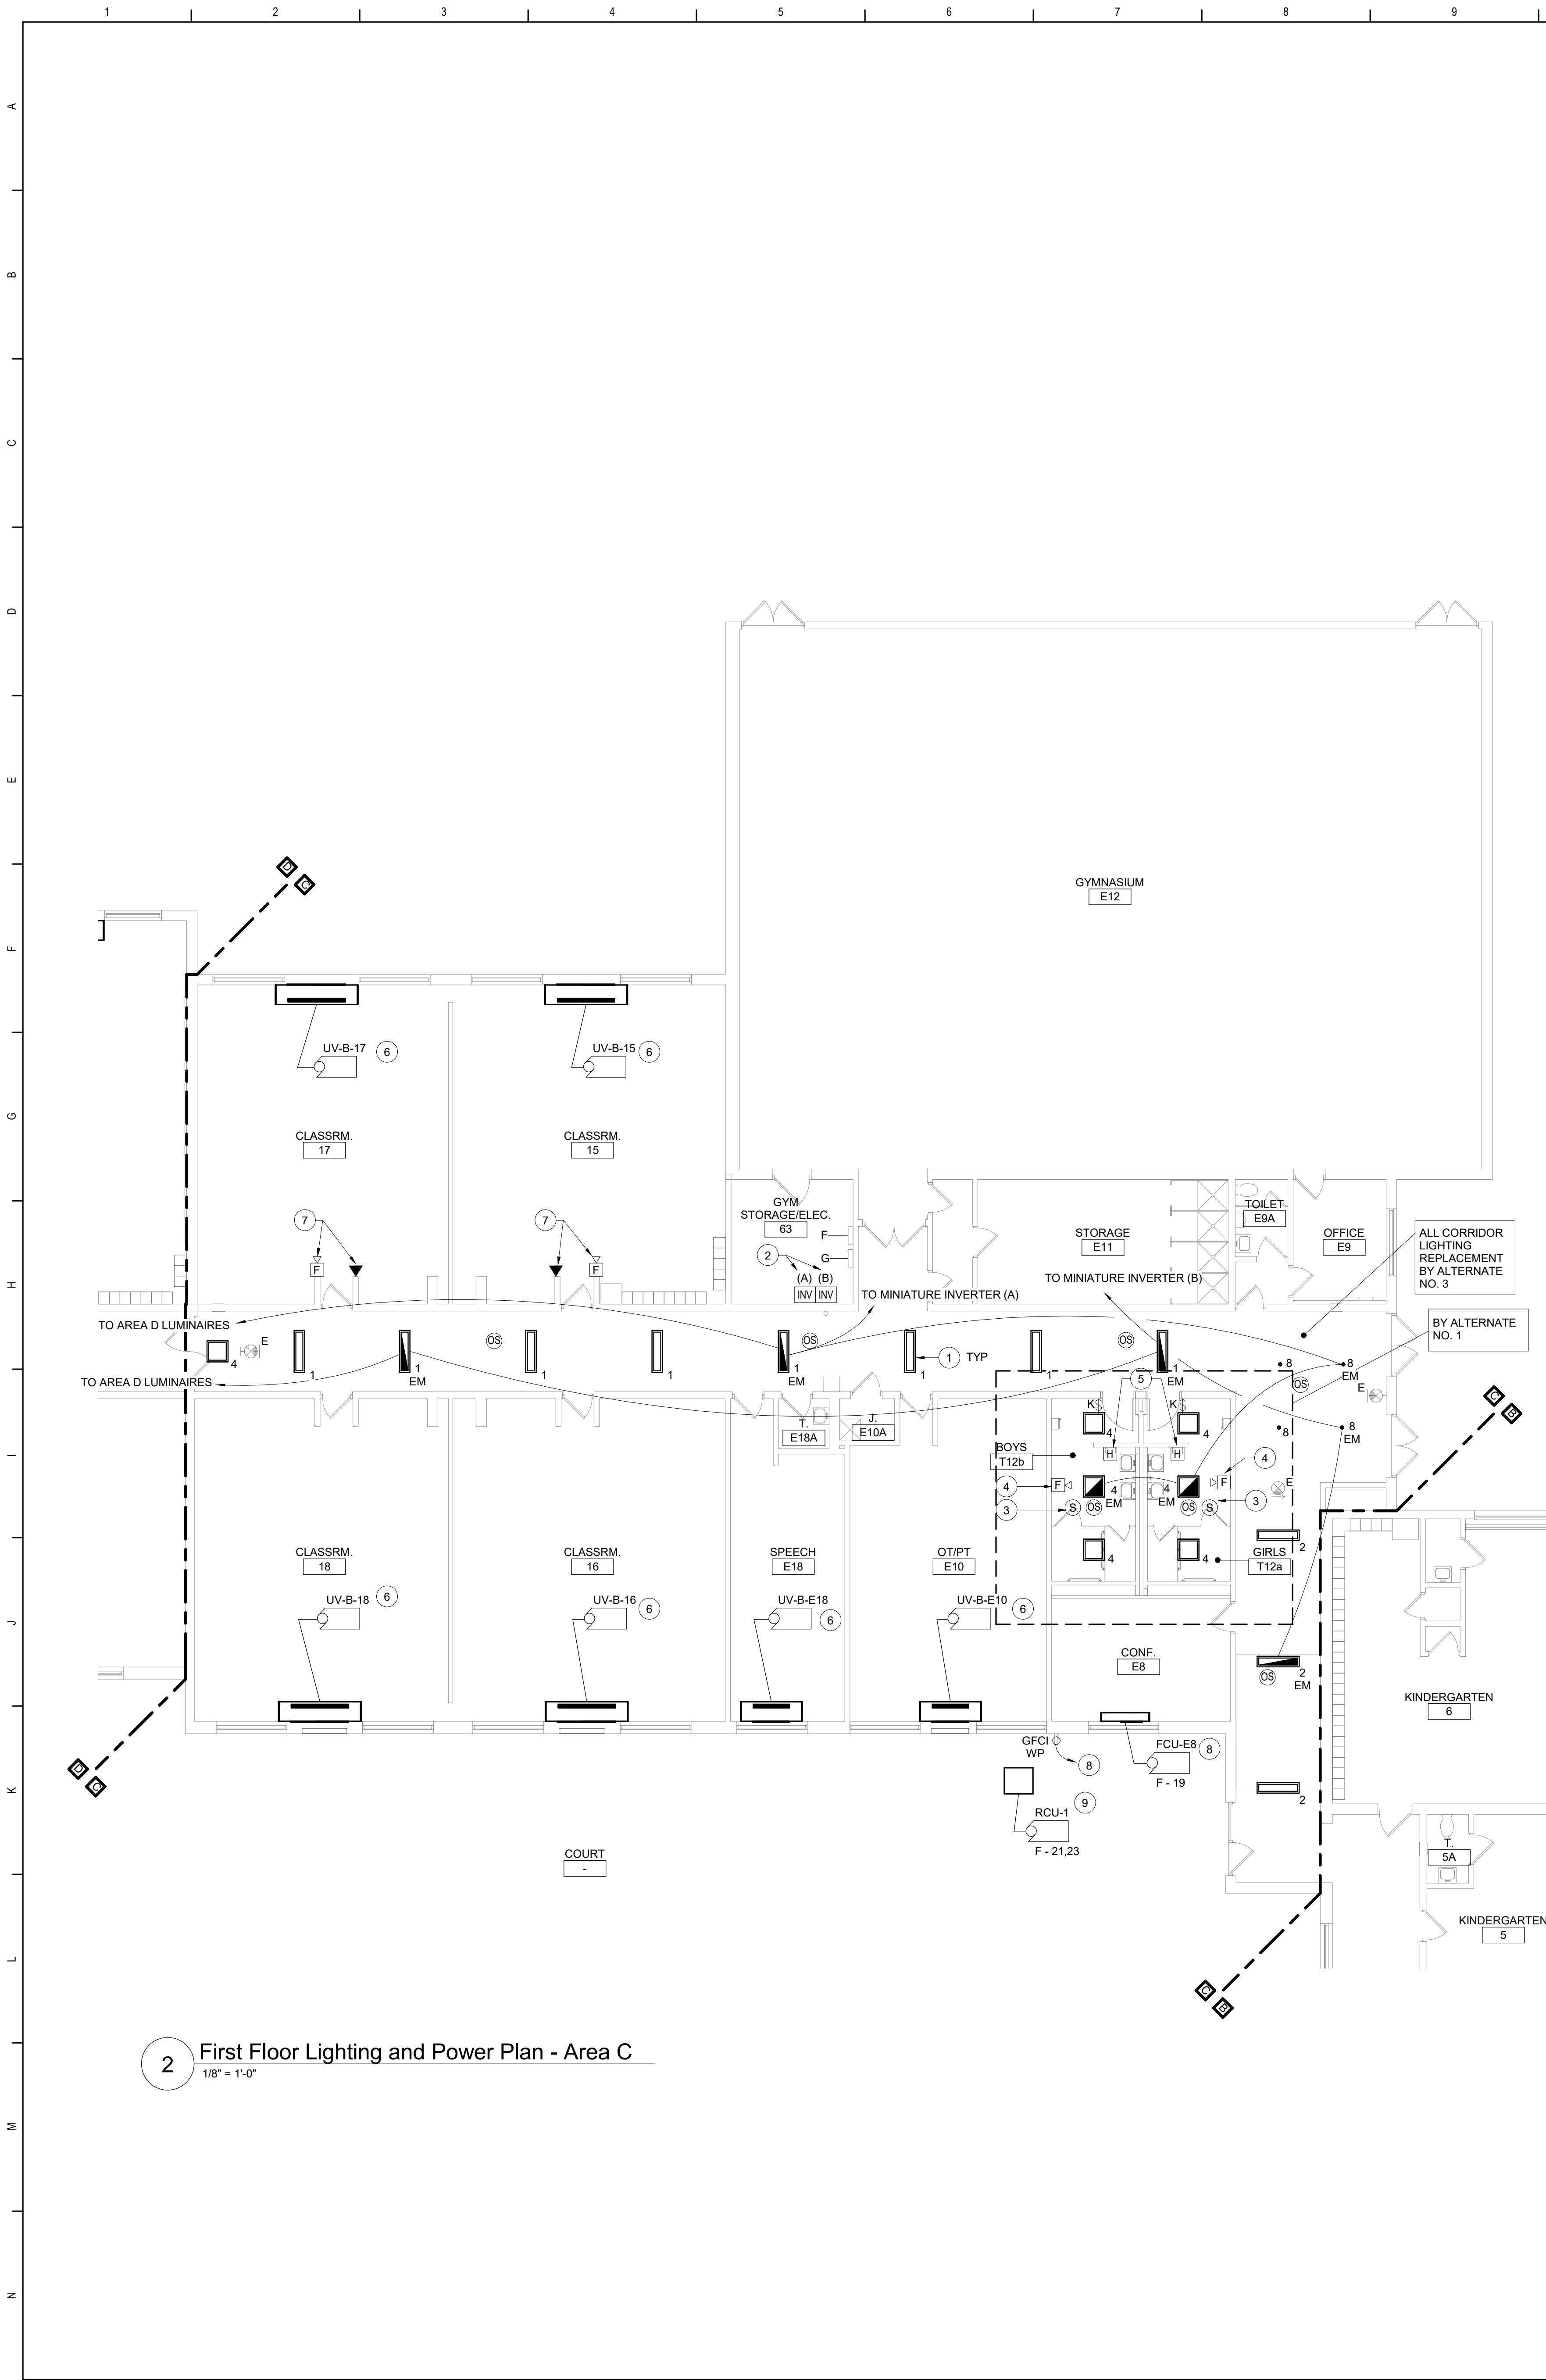


Beacon City School District
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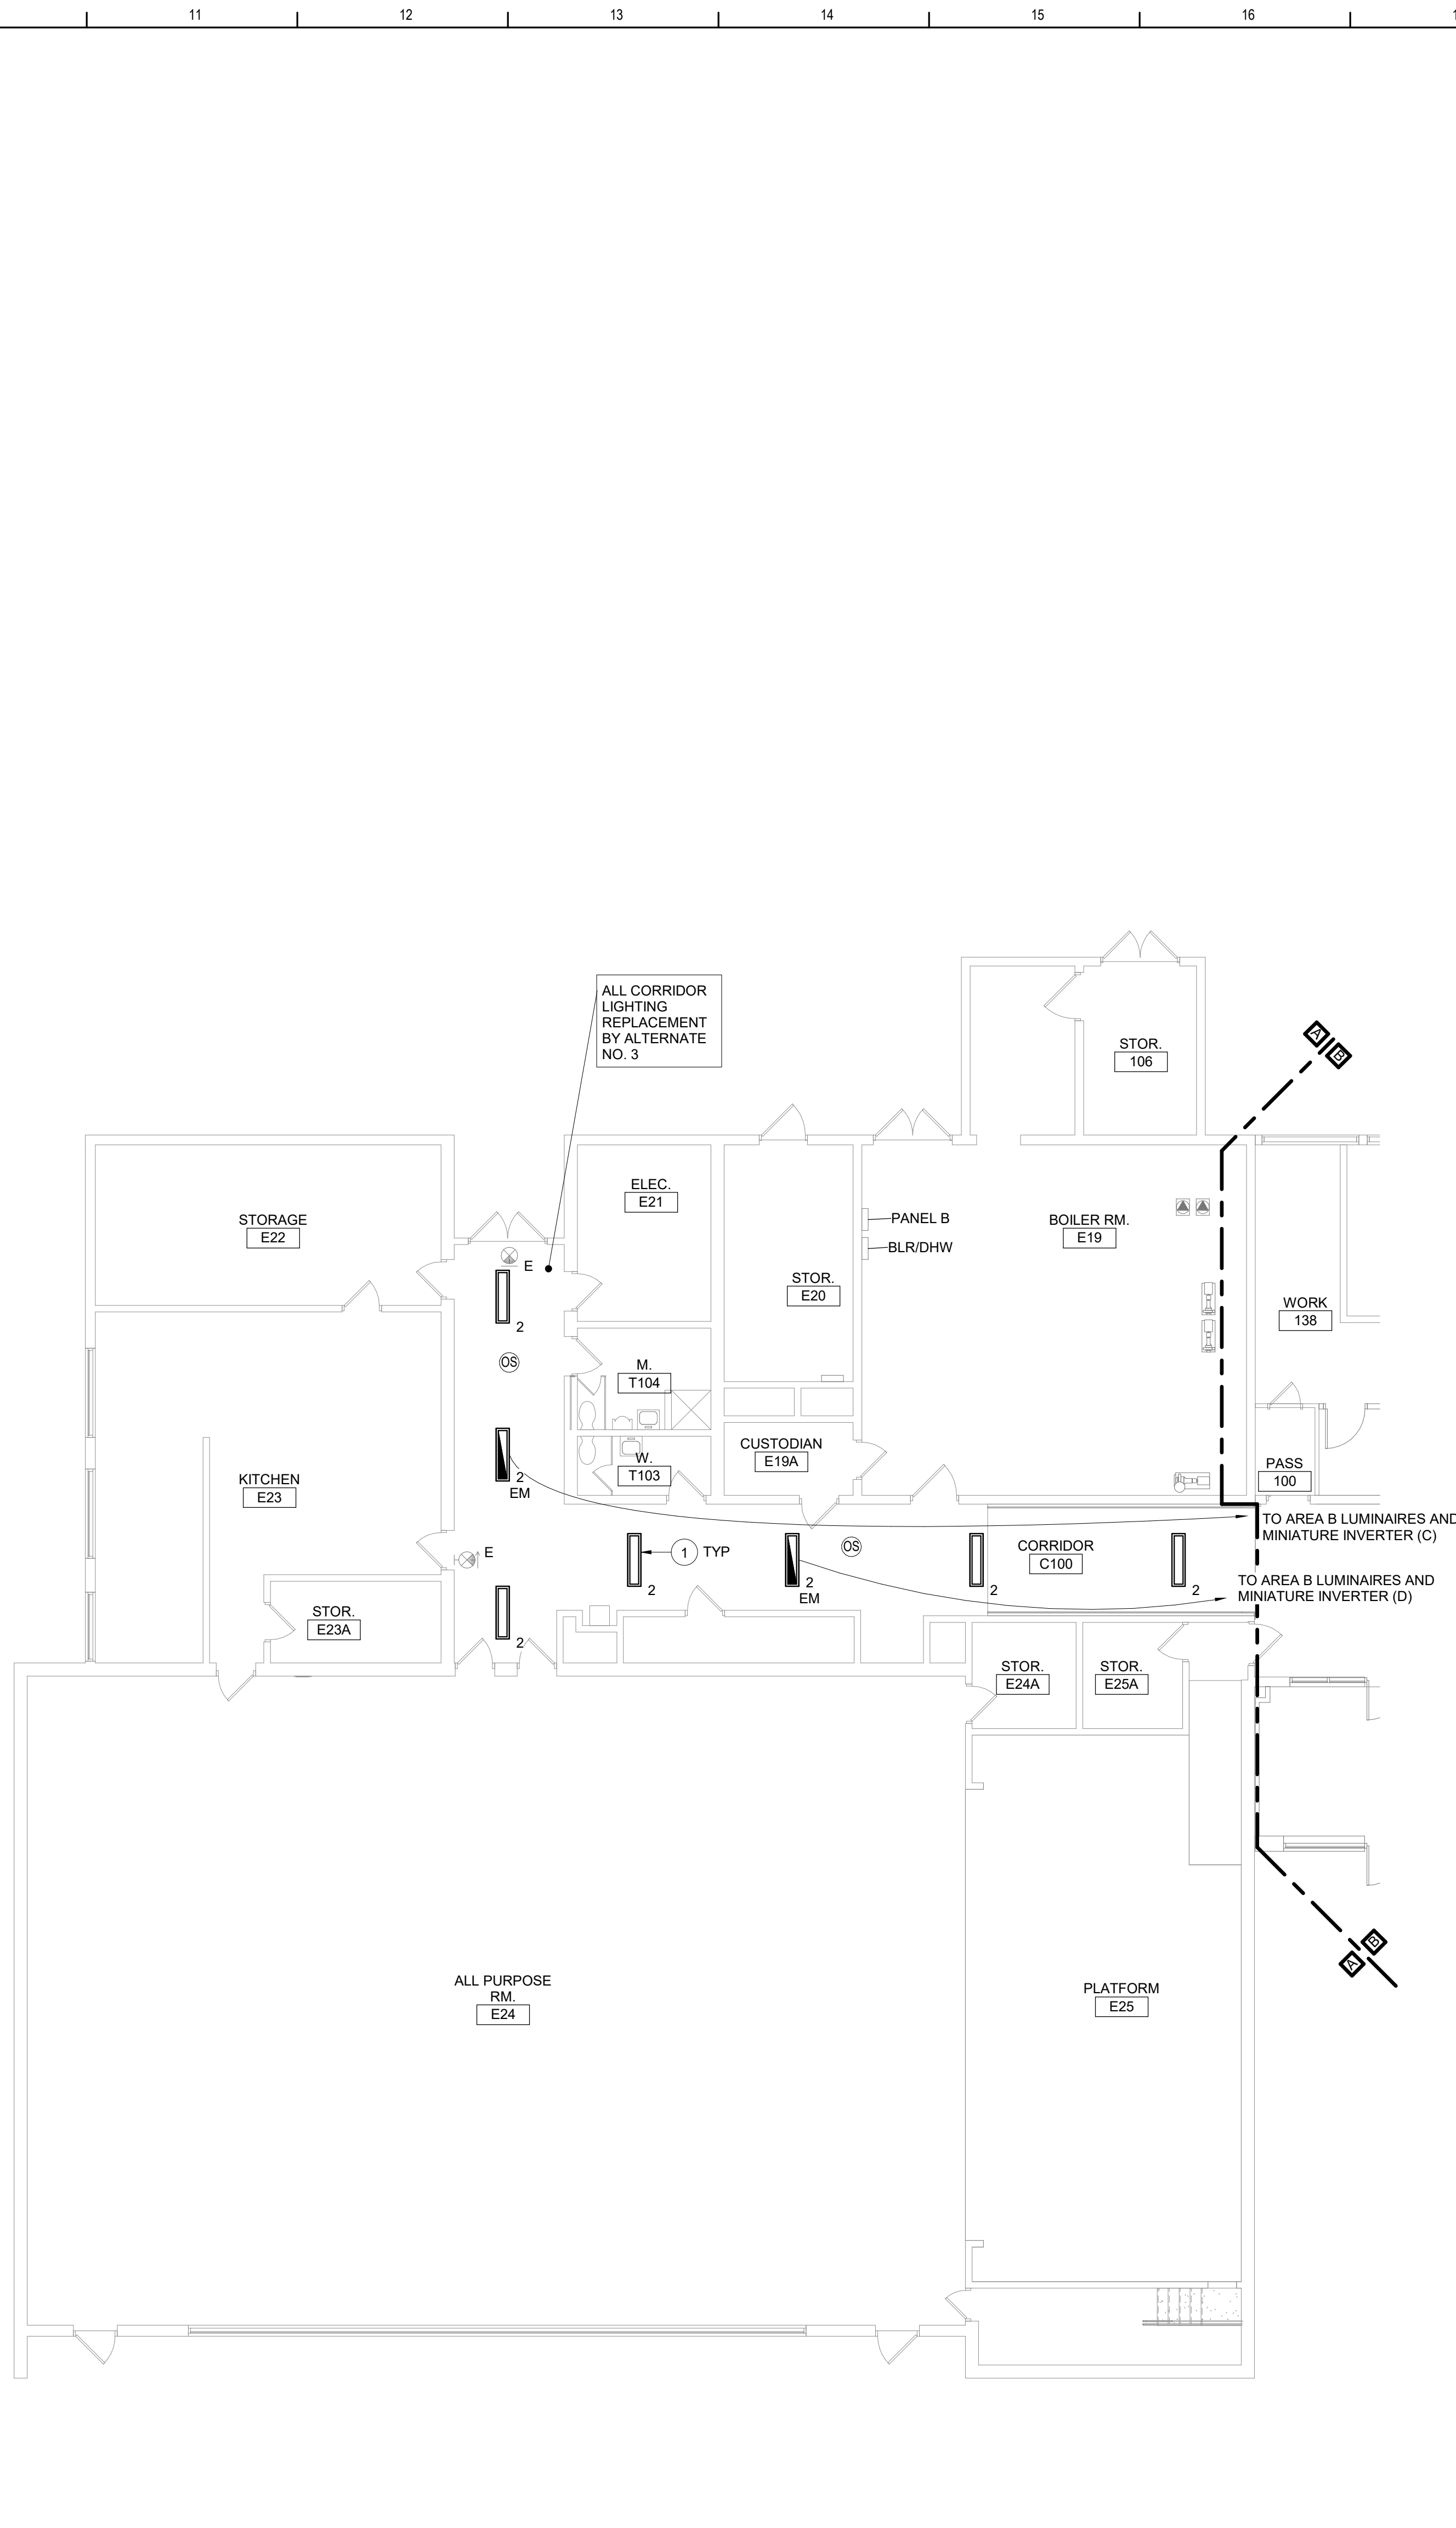
Additions and Alterations to:
Glenham Elementary School

First Floor Demolition Plan - Area D

Drawn By: Author	Date: 10/28/2022	Drawing Number:
Project No.: 279180-22004		BE102



2 First Floor Lighting and Power Plan - Area C
1/8" = 1'-0"



1 First Floor Lighting and Power Plan - Area A
1/8" = 1'-0"

- Keyed Notes:**
- CONNECT LUMINAIRES TO EXISTING CIRCUIT BREAKER PREVIOUSLY SERVING THE AREA USING (2) #12, (1) #12 G. IN 1/2" CONDUIT. LUMINAIRES TO BE CONTROLLED BY OCCUPANCY SENSORS AND DIRECT DIGITAL CONTROL SYSTEM.
 - PROVIDE WALL MOUNTED MINATURE INVERTER BASED ON MODEL VESTA MAX MODEL VST-MAX-375W-UNV-4-OK. MOUNT AT 72" AFF. COORDINATE FINAL LOCATION WITH OWNER. CONNECT EVERY OTHER EMERGENCY LUMINAIRE PER CORRIDOR TO ADJACENT INVERTER TO AVOID TOTAL OUTAGE UPON BATTERY FAILURE. REFER TO WIRING DIAGRAM ON DRAWING BES00.
 - RE-INSTALL STORED SPEAKER TO LOCATION SHOWN. MODIFY/EXTEND CIRCUITRY AS NECESSARY.
 - RE-INSTALL STORED FIRE ALARM STROBE TO LOCATION SHOWN. MODIFY/EXTEND CIRCUITRY AS NECESSARY.
 - RE-CONNECT TAGGED POWER CIRCUITRY TO HAND DRYER. MODIFY/EXTEND CIRCUITRY AS NECESSARY.
 - RE-CONNECT TAGGED POWER CIRCUITRY TO HVAC EQUIPMENT. MODIFY/EXTEND CIRCUITRY AS NECESSARY.
 - RE-INSTALL FIRE ALARM HORN STROBE AND TELEPHONE LINE AT LOCATION SHOWN. MODIFY/EXTEND CIRCUITRY AS NECESSARY.
 - PROVIDE 20A1P BREAKER IN AVAILABLE SPACE IN PANEL F IN GYM STORAGE/ELEC 63. CONNECT USING (2) #12, (1) #12 G. IN 1/2" CONDUIT. NEW BREAKER TO BE UL LISTED FOR USE IN PANEL AND MEET OR EXCEED AIC RATING OF EXISTING PANEL. AMEND PANEL DIRECTORY ACCORDINGLY.
 - PROVIDE 30A2P BREAKER IN AVAILABLE SPACE IN PANEL F IN GYM STORAGE/ELEC 63. CONNECT USING (2) #10, (1) #10 G. IN 1/2" CONDUIT. NEW BREAKER TO BE UL LISTED FOR USE IN PANEL AND MEET OR EXCEED AIC RATING OF EXISTING PANEL. AMEND PANEL DIRECTORY ACCORDINGLY.
- General Notes:**
- REFER TO DRAWING BE100 FOR GENERAL NOTES.
 - REFER TO DRAWING BES00 FOR LUMINAIRE SCHEDULE.
 - SECURE ALL EXISTING UNSUPPORTED CABLES ABOVE DISTURBED CEILINGS IN CORRIDORS USING J HOOKS OR CABLETRAYS.
 - PATCH/REPLACE CEILING SYSTEMS TO REMAIN THAT HAVE BEEN DISTURBED BY SCHEDULED WORK.
 - INVERTER SYSTEM EMERGENCY OUTPUT CIRCUITS SHALL BE INSTALLED IN DEDICATED CONDUIT SYSTEMS AND NOT SHARED WITH OTHER ELECTRICAL CIRCUITS AS DESCRIBED IN NEC 700-9(B).
 - LIGHTING CONTROL SEQUENCE:
TOILETS:
PERSON ENTERS THE ROOM AND LUMINAIRES TURN ON TO 100% OUTPUT BY OCCUPANCY SENSOR. WHEN PERSON EXITS THE ROOM THE OCCUPANCY SENSOR WILL TURN OFF THE LUMINAIRES AFTER 15 MINUTES. MANUAL CONTROL BY LINE VOLTAGE KEYED SWITCH.
LOBBY/VESTIBULES/CORRIDORS:
PERSON ENTERS THE AREA. LUMINAIRES TURN ON TO 100% OUTPUT AUTOMATICALLY BY OCCUPANCY SENSOR. PERSON EXITS THE AREA. LUMINAIRES DIM TO 50% OUTPUT (MAINTAINING EGRESS LEVEL ILLUMINATION). MANUAL CONTROL BY BUILDING MANAGEMENT SYSTEM.

Key Plan
N.T.S.

S.E.D. Control No. 13-02-00-01-0-006-022

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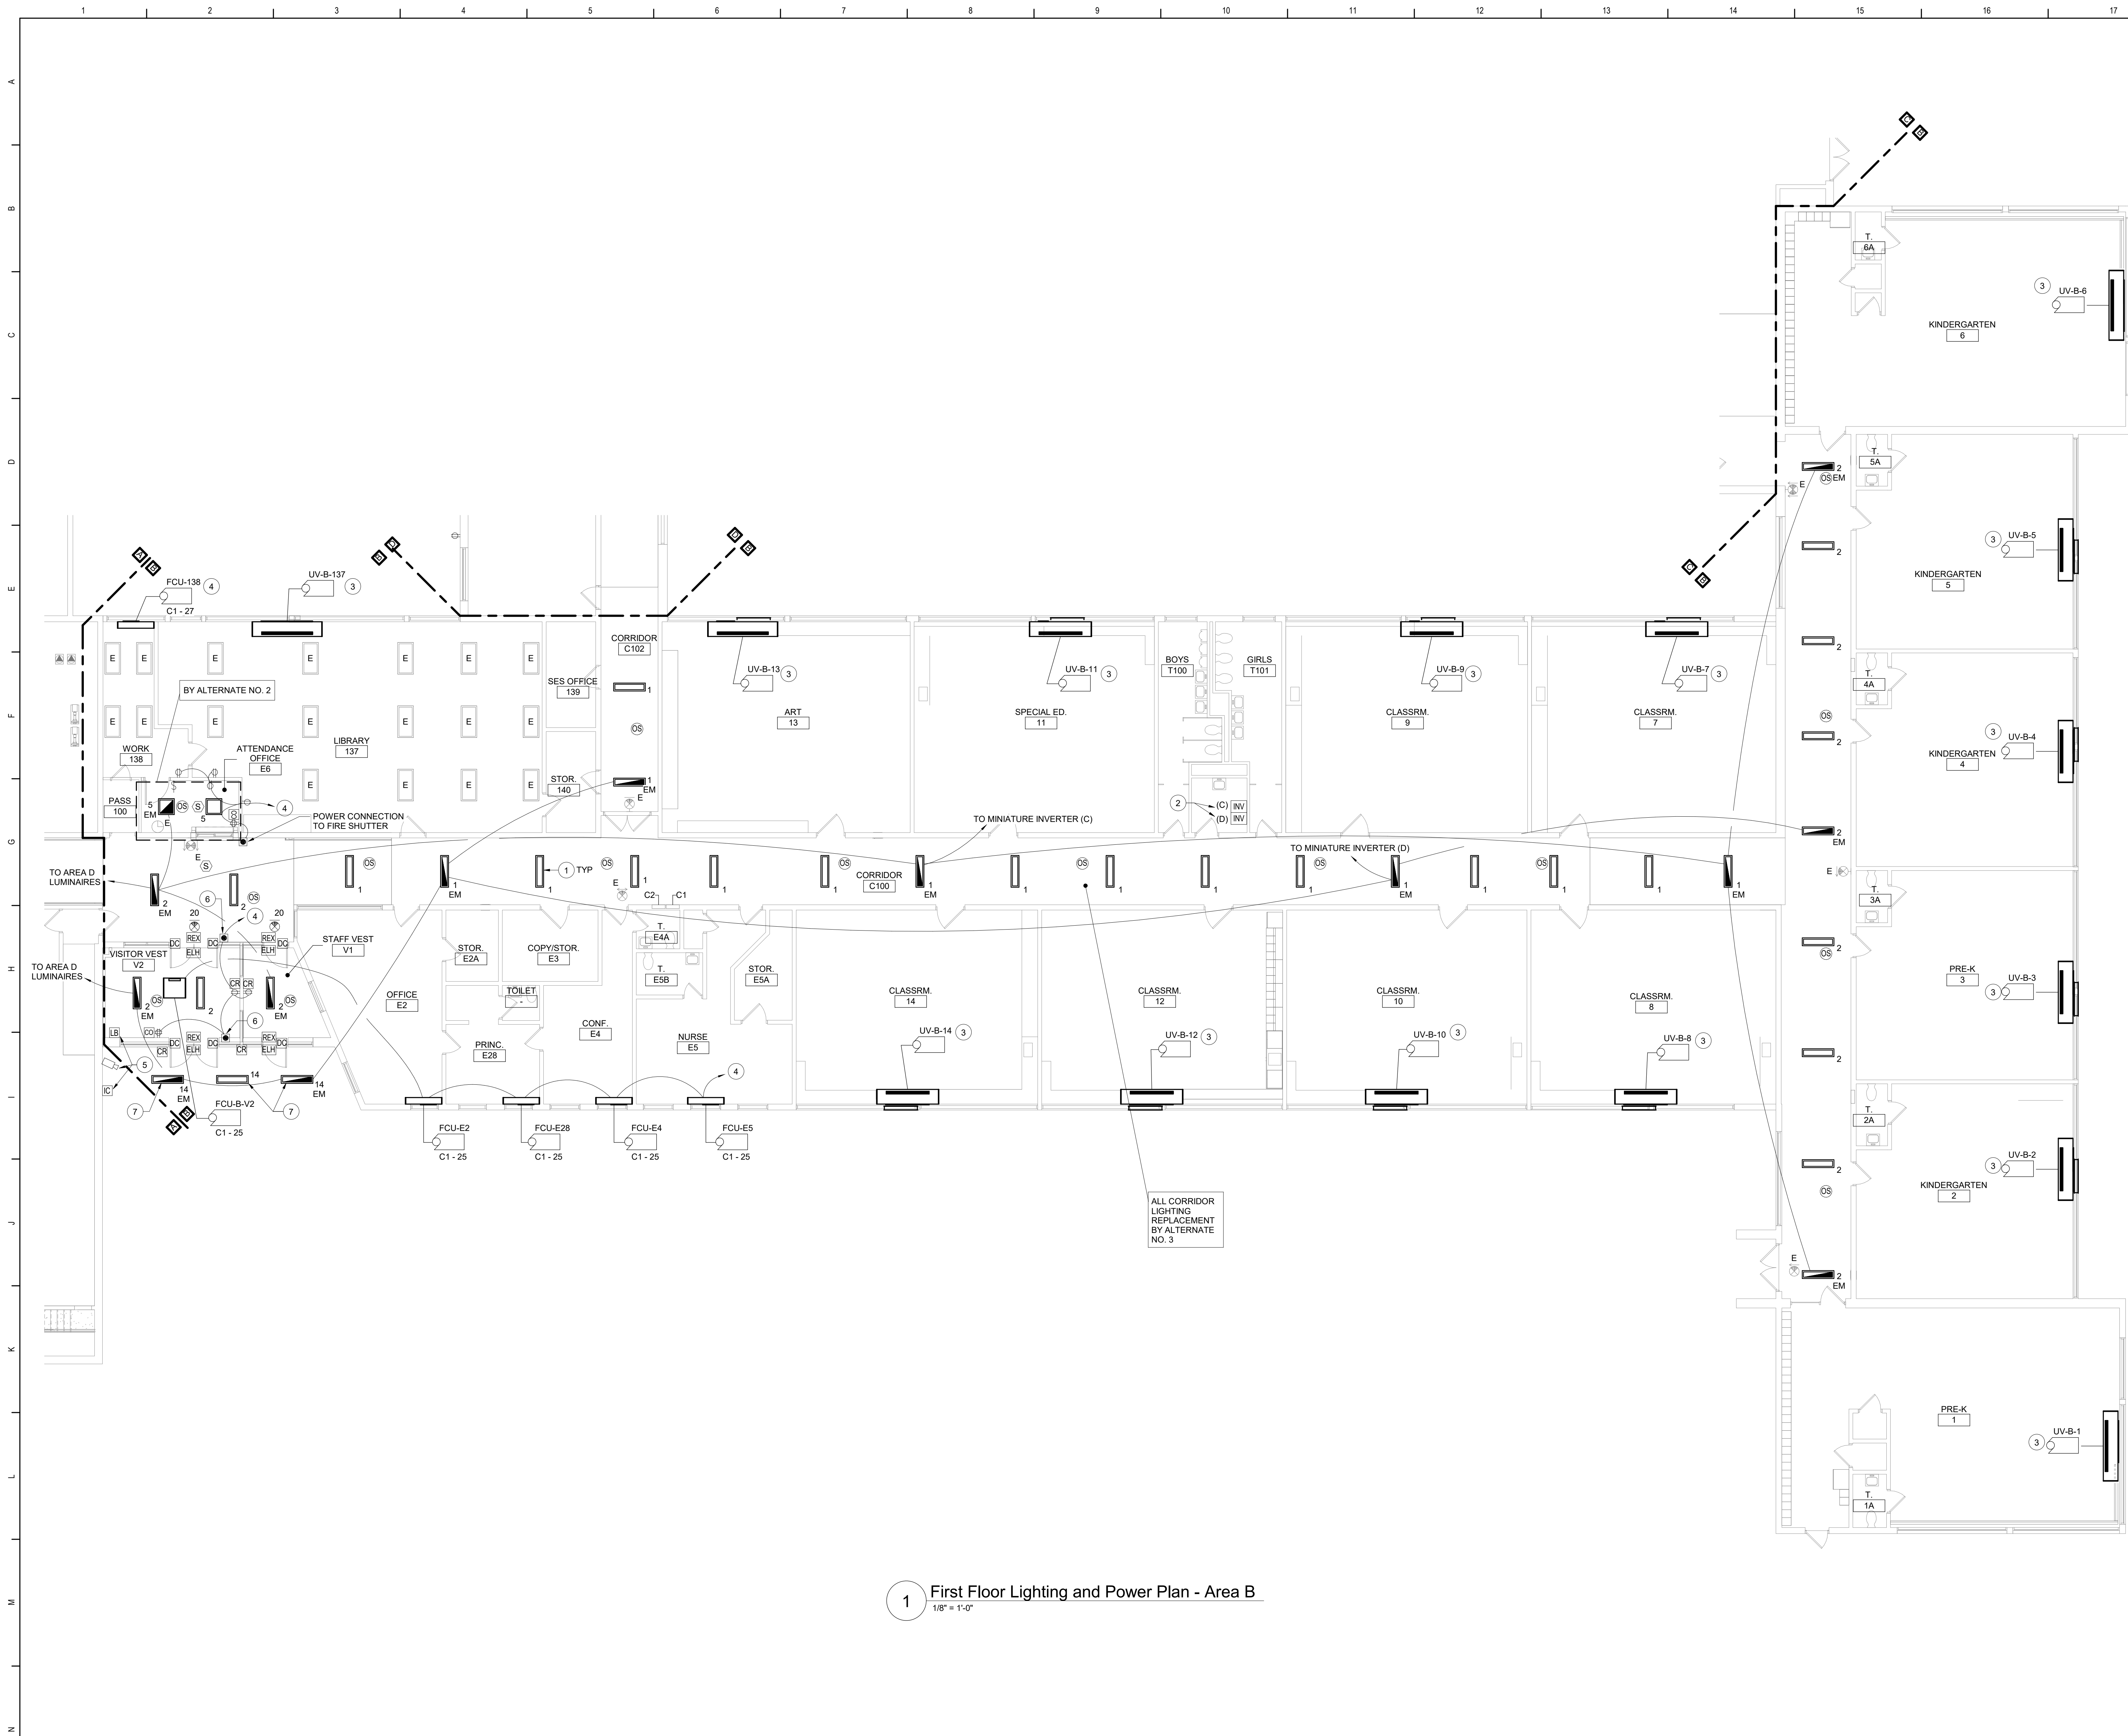
TETRA TECH
ARCHITECTS & ENGINEERS

Beacon City School District
Beacon, New York

Additions and Alterations to:
Glenham Elementary School

First Floor Lighting and Power Plan -
Areas A and C

Drawn By: CR	Date: 10/28/2022	Drawing Number:
Project No.: 279180-22004		BE130




1 First Floor Lighting and Power Plan - Area B
1/8" = 1'-0"

Keyed Notes:

- 1 CONNECT LUMINAIRES TO EXISTING CIRCUIT BREAKER PREVIOUSLY SERVING THE AREA USING (2) #12, (1) #12 G. IN 1/2" CONDUIT. LUMINAIRES TO BE CONTROLLED BY OCCUPANCY SENSORS AND DIRECT DIGITAL CONTROL SYSTEM.
- 2 PROVIDE WALL MOUNTED MINATURE INVERTER BASED ON MODEL VESTA MAX MODEL VST-MAX-375W-UNV-4-OK. MOUNT AT 72" AFF. COORDINATE FINAL LOCATION WITH OWNER. CONNECT EVERY OTHER EMERGENCY LUMINAIRE PER CORRIDOR TO ADJACENT INVERTER TO AVOID TOTAL OUTAGE UPON BATTERY FAILURE. REFER TO WIRING DIAGRAM ON DRAWING BES00.
- 3 RE-CONNECT TAGGED POWER CIRCUITRY TO HVAC EQUIPMENT. MODIFY/EXTEND CIRCUITRY AS NECESSARY.
- 4 CIRCUIT TO SPARE 20A 1P BREAKER IN PANEL C1 IN CORRIDOR C100. CONNECT USING (2) #12, (1) #12 G. IN 1/2" CONDUIT. AMEND PANEL DIRECTORY ACCORDINGLY.
- 5 RELOCATE DEVICES TO LOCATION SHOWN. MODIFY/EXTEND CIRCUITRY AS NECESSARY.
- 6 PROVIDE POWER CONNECTION TO POWER SUPPLY FOR DOOR HARDWARE.
- 7 CONNECT EXTERIOR LUMINAIRES TO EXISTING CIRCUITRY PREVIOUSLY SERVING THE AREA. CONNECT LUMINAIRES TO EXISTING EXTERIOR LIGHTING CONTROLS.

General Notes:

- A. REFER TO DRAWING BE100 FOR GENERAL NOTES.
B. REFER TO DRAWING BE500 FOR LUMINAIRE SCHEDULE.
C. SECURE ALL EXISTING UNSUPPORTED CABLES ABOVE DISTURBED CEILINGS IN CORRIDORS USING J HOOKS OR CABLETRAYS.
D. PATCH/REPLACE CEILING SYSTEMS TO REMAIN THAT HAVE BEEN DISTURBED BY SCHEDULED WORK.
E. INVERTER SYSTEM EMERGENCY OUTPUT CIRCUITS SHALL BE INSTALLED IN DEDICATED CONDUIT SYSTEMS AND NOT SHARED WITH OTHER ELECTRICAL CIRCUITS AS DESCRIBED IN NEC 700.9(B).
F. LIGHTING CONTROL SEQUENCES:
LOBBY/VESTIBULES/CORRIDORS:
PERSON ENTERS THE AREA, LUMINAIRES TURN ON TO 100% OUTPUT AUTOMATICALLY BY OCCUPANCY SENSOR. PERSON EXITS THE AREA, LUMINAIRES DIM TO 50% OUTPUT (MAINTAINING EGRESS LEVEL ILLUMINATION) - MANUAL CONTROL BY BUILDING MANAGEMENT SYSTEM.
OFFICES:
PERSON ENTERS THE ROOM AND LUMINAIRES TURN ON TO 50% OUTPUT BY OCCUPANCY SENSOR. WHEN PERSON EXITS THE ROOM THE OCCUPANCY SENSOR WILL TURN OFF THE LUMINAIRES AFTER 15 MINUTES. LOW VOLTAGE LIGHTING CONTROL. BUTTON CAPABLE OF ON/OFF, 50% AND 100% MAYBE BE MANUALLY ADJUSTED BY BUTTON.

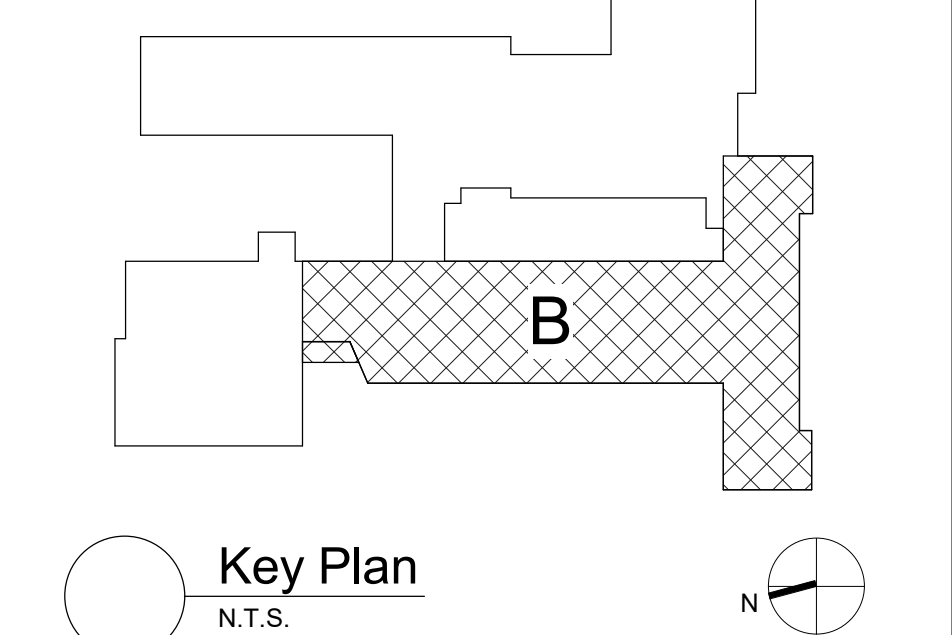

S.E.D. Control No. 13-02-00-01-0-006-022

Rev. No.: Date: Description:



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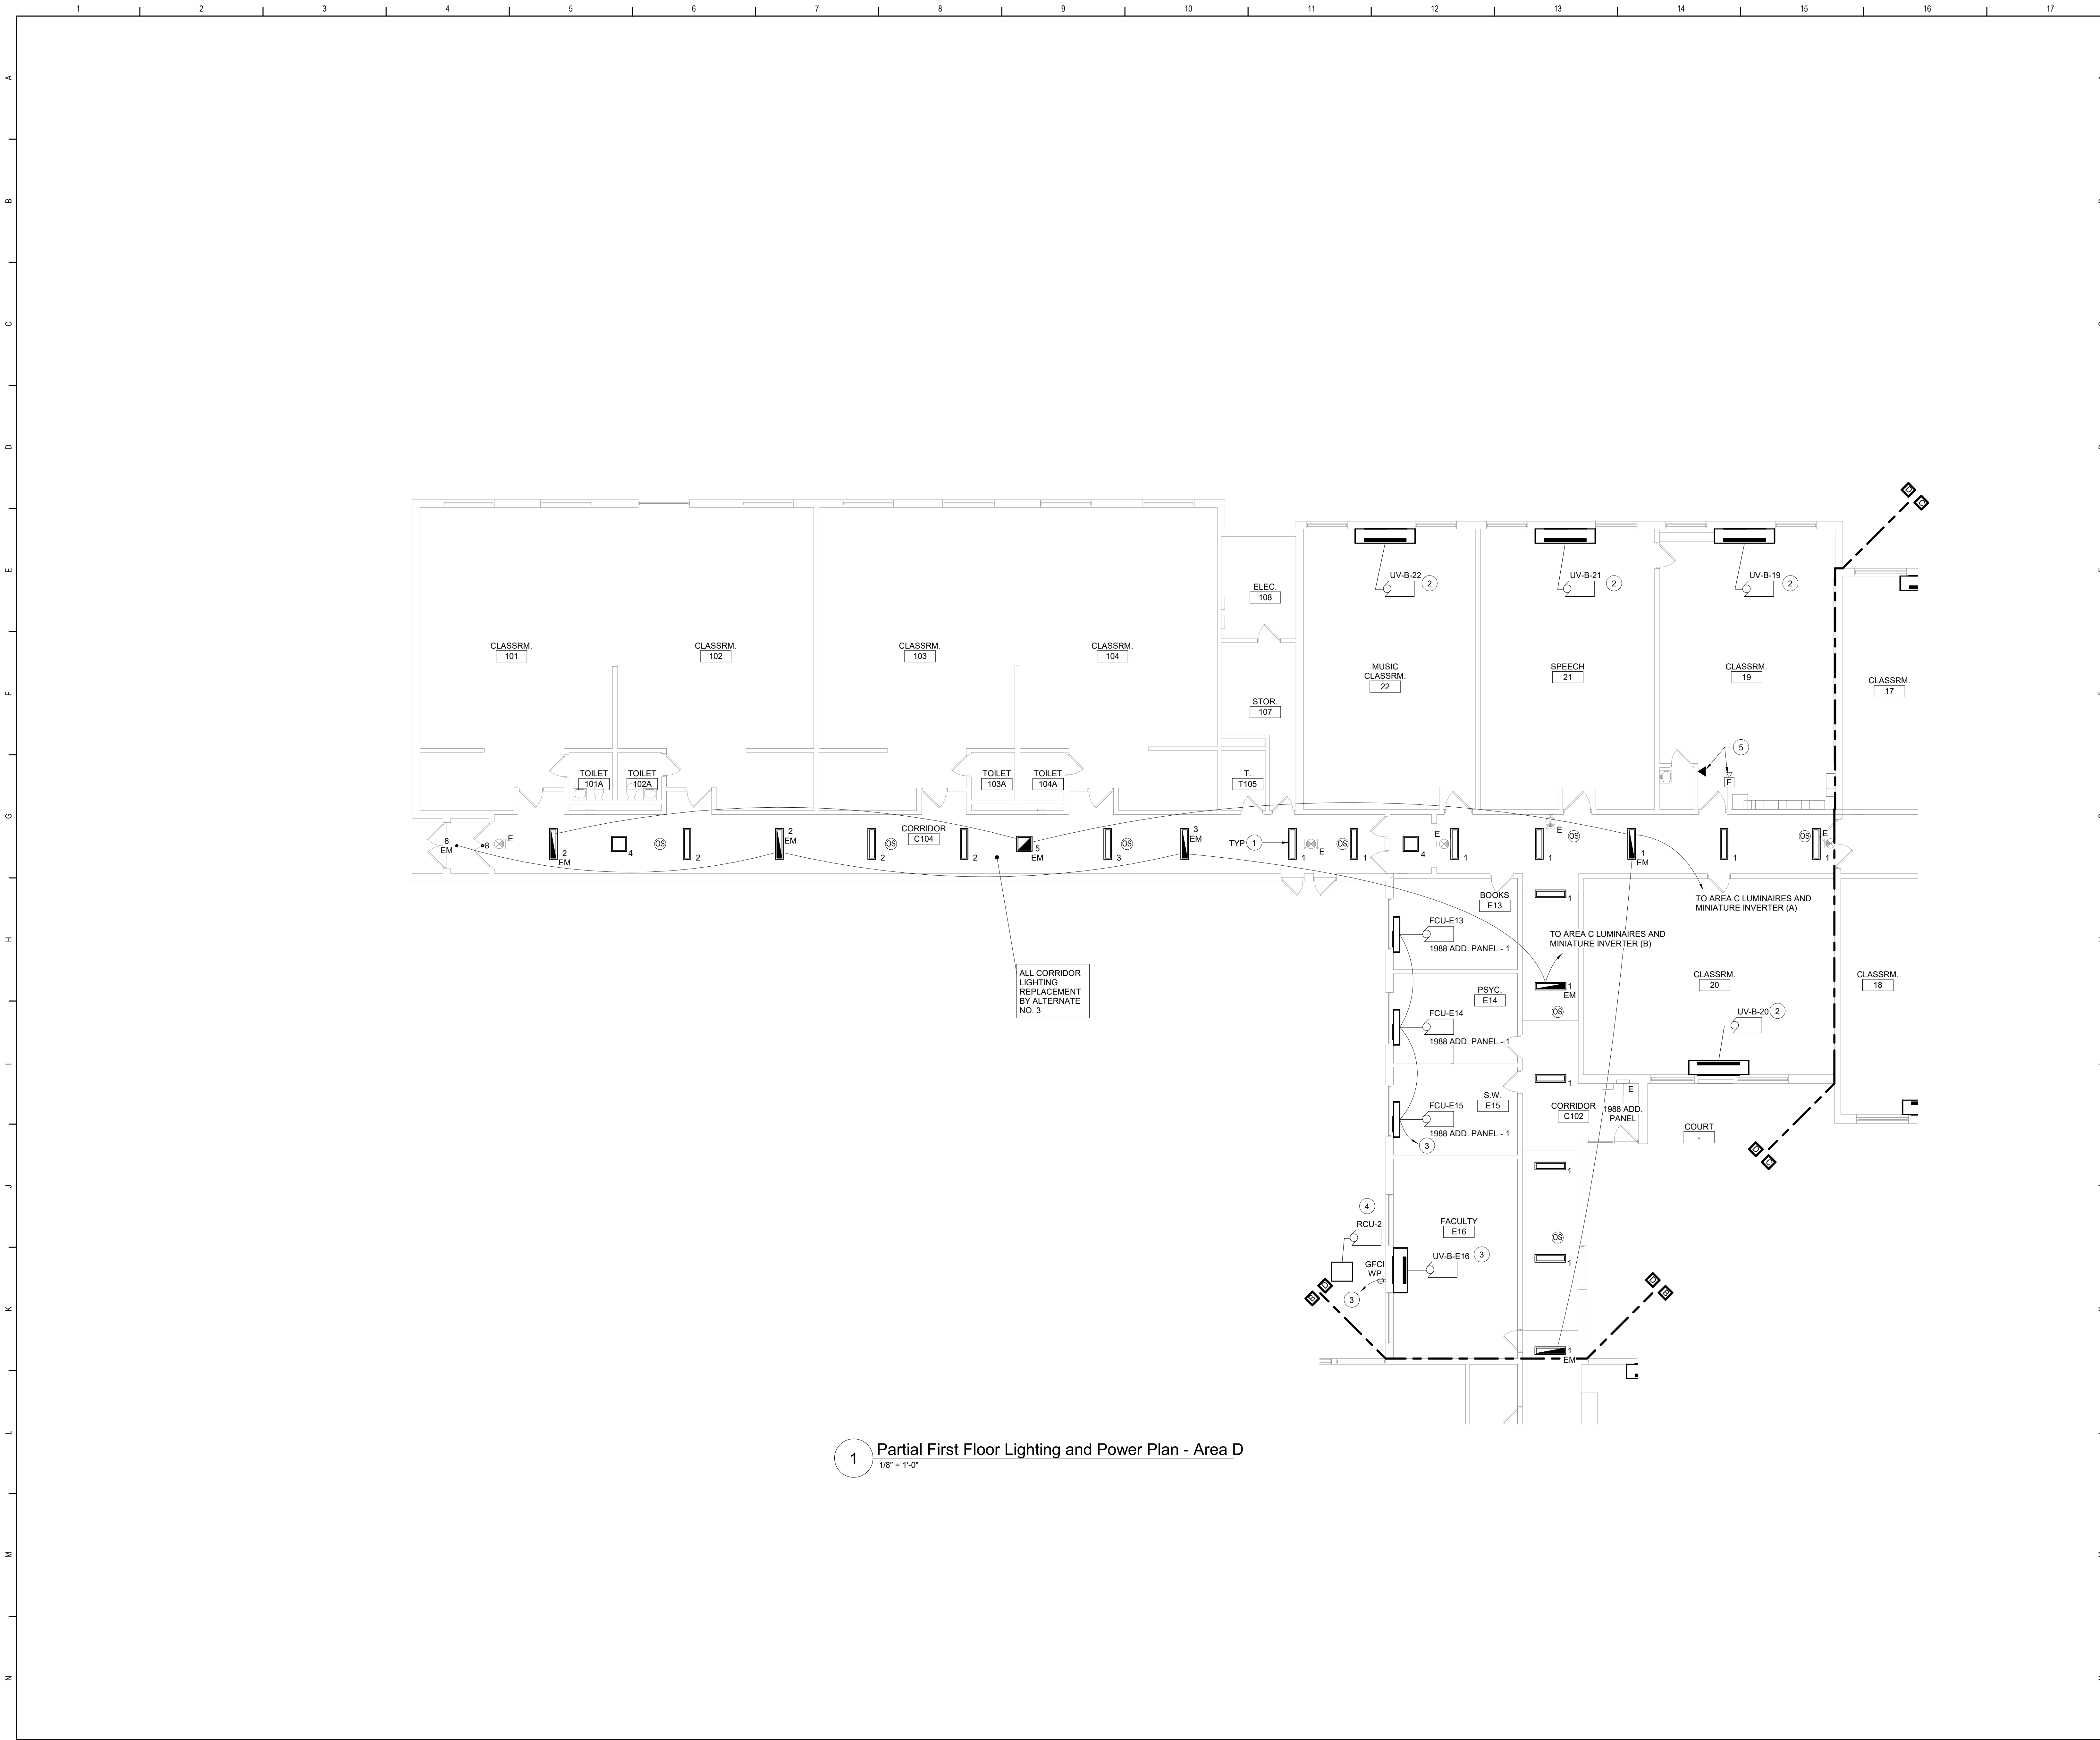


Beacon City School District
Beacon, New York

Additions and Alterations to:
Glenham Elementary School

First Floor Lighting and Power Plan -
Area B

Drawn By: CR Date: 10/28/2022 Drawing Number:
Project No.: 279180-22004 BE131




1 Partial First Floor Lighting and Power Plan - Area D
1/8" = 1'-0"

- Keyed Notes:**
- 1 CONNECT LUMINAIRES TO EXISTING CIRCUIT BREAKER PREVIOUSLY SERVING THE AREA USING (2)#12, (1)#12 G. IN 1/2" CONDUIT. LUMINAIRES TO BE CONTROLLED BY OCCUPANCY SENSORS AND DIRECT DIGITAL CONTROL SYSTEM.
 - 2 RE-CONNECT TAGGED POWER CIRCUITRY TO HVAC EQUIPMENT. MODIFY/EXTEND CIRCUITRY AS NECESSARY.
 - 3 CIRCUIT TO SPARE 20A1P BREAKER IN PANEL 1988 ADD. PANEL IN CORR C102. CONNECT USING (2)#12, (1)#12 G. IN 1/2" CONDUIT. AMEND PANEL DIRECTORY ACCORDINGLY.
 - 4 PROVIDE 30A2P BREAKER IN AVAILABLE SPACE IN PANEL 1988 ADD. PANEL IN CORR C102. CONNECT USING (2)#10, (1)#10 G. IN 1/2" CONDUIT. REMOVE EXISTING SPARE BREAKER(S) IF NECESSARY TO PROVIDE ROOM IN PANEL. NEW BREAKER TO BE UL LISTED FOR USE IN PANEL AND MEET OR EXCEED AIC RATING OF EXISTING PANEL. AMEND PANEL DIRECTORY ACCORDINGLY.
 - 5 RE-INSTALL FIRE ALARM HORN STROBE AND TELEPHONE LINE AT LOCATION SHOWN. MODIFY/EXTEND CIRCUITRY AS NECESSARY.
- General Notes:**
- A. REFER TO DRAWING BE100 FOR GENERAL NOTES.
B. REFER TO DRAWING BE500 FOR LUMINAIRE SCHEDULE.
C. SECURE ALL EXISTING UNSUPPORTED CABLES ABOVE DISTURBED CEILINGS IN CORRIDORS USING J HOOKS OR CABLETRAYS.
D. PATCH/REPLACE CEILING SYSTEMS TO REMAIN THAT HAVE BEEN DISTURBED BY SCHEDULED WORK.
E. INVERTER SYSTEM EMERGENCY OUTPUT CIRCUITS SHALL BE INSTALLED IN DEDICATED CONDUIT SYSTEMS AND NOT SHARED WITH OTHER ELECTRICAL CIRCUITS AS DESCRIBED IN NEC 700-9(B).
F. LIGHTING CONTROL SEQUENCES:
LOBBY/VESTIBULES/CORRIDORS:
PERSON ENTERS THE AREA, LUMINAIRES TURN ON TO 100% OUTPUT AUTOMATICALLY BY OCCUPANCY SENSOR.
PERSON EXITS THE AREA, LUMINAIRES DIM TO 50% OUTPUT (MAINTAINING EGRESS LEVEL ILLUMINATION). MANUAL CONTROL BY BUILDING MANAGEMENT SYSTEM.

Key Plan
N.T.S.


S.E.D. Control No. 13-02-00-01-0-006-022

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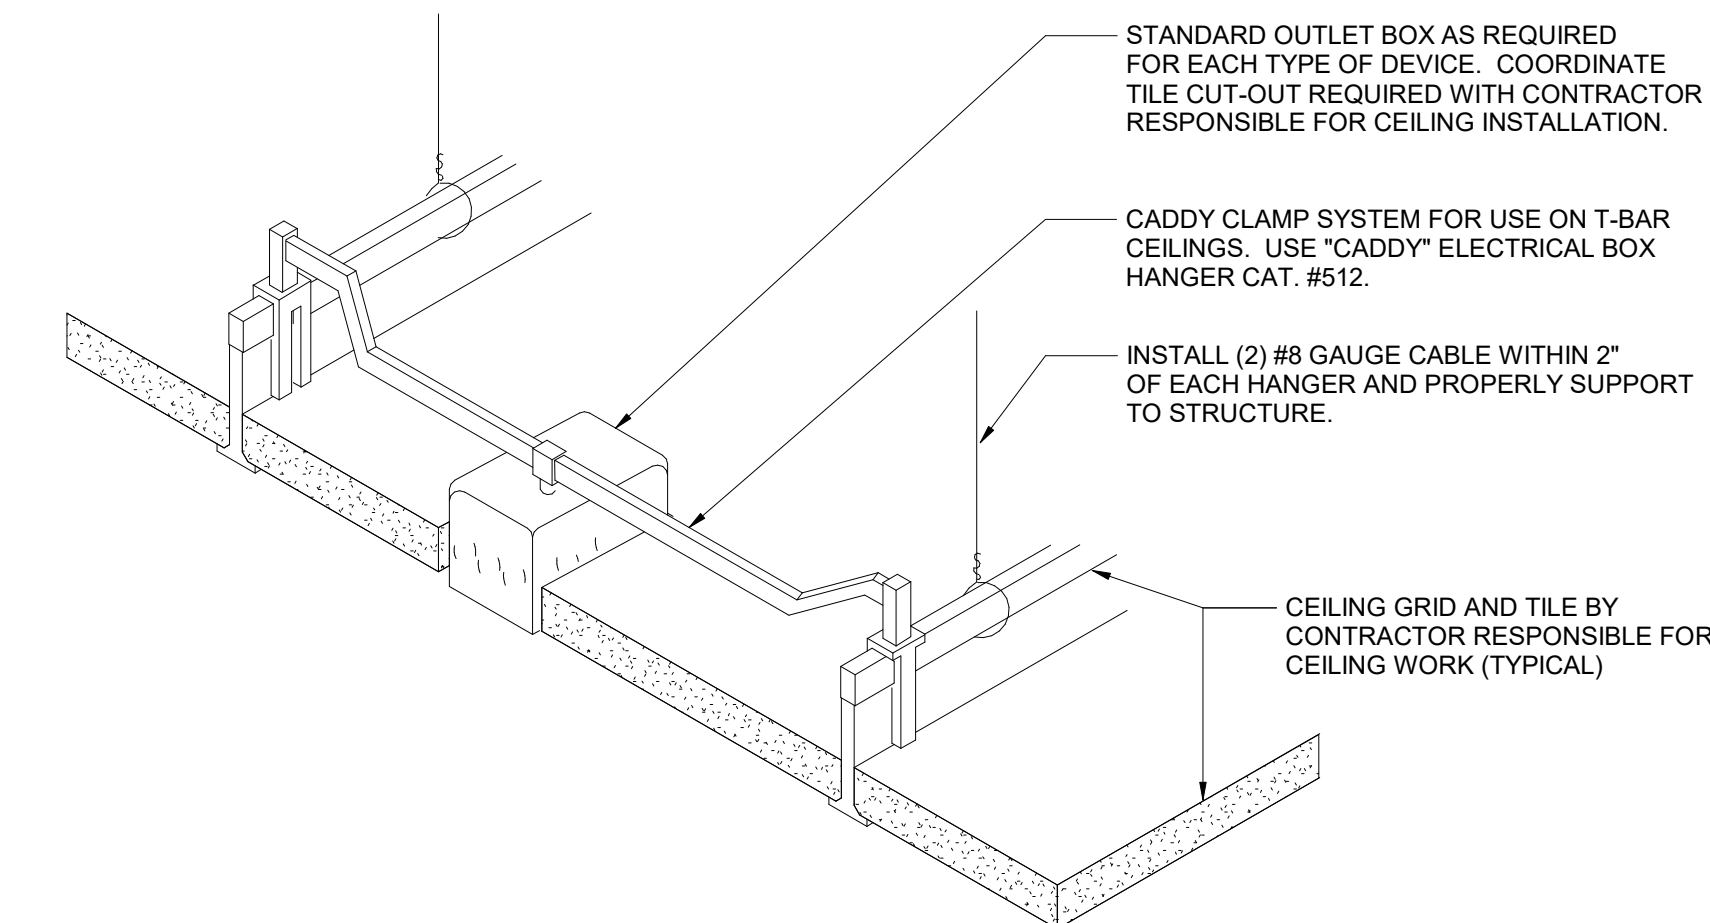
Additions and Alterations to:
Glenham Elementary School

First Floor Lighting and Power Plan - Area D

Drawn By: CR	Date: 10/28/2022	Drawing Number:
Project No.: 279180-22004		BE132


LUMINAIRE SCHEDULE							
TYPE	SYMBOL	DESCRIPTION	LAMPS			MANUFACTURERS (OR EQUAL)	
			WATTAGE	LUMENS	TYPE	NAME	MODEL OR SERIES
1		1' x 4' TROFFER (RECESSED IN GRID)	12.2	1482	LED	SIGNIFY (DAY-BRITE)	1FP215L835-4-DS-UNV-DIM
1 EM		SAME AS TYPE 1 - CONNECTED TO EMERGENCY MINIATURE INVERTER	12.2	1482	LED	SIGNIFY (DAY-BRITE)	1FP215L835-4-DS-UNV-DIM
2		1' x 4' TROFFER (RECESSED IN GRID)	24.6	2972	LED	SIGNIFY (DAY-BRITE)	1FP230L835-4-DS-UNV-DIM
2 EM		SAME AS TYPE 2 - CONNECTED TO EMERGENCY MINIATURE INVERTER	24.6	2972	LED	SIGNIFY (DAY-BRITE)	1FP230L835-4-DS-UNV-DIM
3		1' x 4' TROFFER (RECESSED IN GRID)	31.3	3775	LED	SIGNIFY (DAY-BRITE)	1FP238L835-4-DS-UNV-DIM
3 EM		SAME AS TYPE 3 - CONNECTED TO EMERGENCY MINIATURE INVERTER	31.3	3775	LED	SIGNIFY (DAY-BRITE)	1FP238L835-4-DS-UNV-DIM
4		2' x 2' TROFFER (RECESSED IN GRID)	15.7	1918	LED	SIGNIFY (DAY-BRITE)	2FP220L835-2-DS-UNV-DIM
4 EM		SAME AS TYPE 4 - CONNECTED TO EMERGENCY MINIATURE INVERTER	15.7	1918	LED	SIGNIFY (DAY-BRITE)	2FP220L835-2-DS-UNV-DIM
5		2' x 2' TROFFER (RECESSED IN GRID)	23.4	2911	LED	SIGNIFY (DAY-BRITE)	2FP230L835-2-DS-UNV-DIM
5 EM		SAME AS TYPE 5 - CONNECTED TO EMERGENCY MINIATURE INVERTER	23.4	2911	LED	SIGNIFY (DAY-BRITE)	2FP230L835-2-DS-UNV-DIM
6 **		2' x 2' TROFFER (RECESSED IN GRID)	29.8	3856	LED	SIGNIFY (DAY-BRITE)	2FP238L835-2-DS-UNV-DIM
6 ** EM		SAME AS TYPE 6 - CONNECTED TO EMERGENCY MINIATURE INVERTER	29.8	3856	LED	SIGNIFY (DAY-BRITE)	2FP238L835-2-DS-UNV-DIM
7 **		2' x 2' TROFFER (RECESSED IN GRID)	35.7	4403	LED	SIGNIFY (DAY-BRITE)	2FP245L835-2-DS-UNV-DIM
7 ** EM		SAME AS TYPE 7 - CONNECTED TO EMERGENCY MINIATURE INVERTER	35.7	4403	LED	SIGNIFY (DAY-BRITE)	2FP245L835-2-DS-UNV-DIM
8							
8 EM							
9 **							
9 ** EM							
10 **							
10 ** EM							
11 **							
11 ** EM							
12 **							
12 ** EM							
13 **		WALL MOUNT LINEAR	33.1	3361	LED	SIGNIFY (LEDALITE)	7408LBEQN047DEW
13 ** EM		SAME AS TYPE 13 - CONNECTED TO EMERGENCY MINIATURE INVERTER	33.1	3361	LED	SIGNIFY (LEDALITE)	7408LBEQN047DEW
14							
14 EM							
20		EXIT SIGN (SINGLE FACE) WALL AND CEILING MOUNT. SEE PLANS FOR DIRECTIONAL INDICATORS	2.5		LED	SIGNIFY (CHLORIDE)	ER46L-2-W-R
** LUMINAIRE TYPE NOT USED IN THIS BUILDING			NOTE: ALL LUMINAIRES ARE 120 VOLTS			* MANUFACTURER AND MODEL NUMBER ARE PROVIDED TO SHOW BASIS OF DESIGN ONLY.	

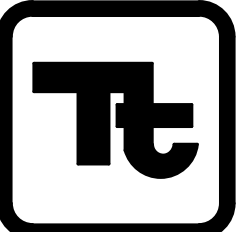5 Luminaire Schedule




DETAIL NOTES:
A. IN AREAS RECEIVING NEW CEILINGS ALL CEILING MOUNTED ITEMS (DETECTORS, SPEAKERS, ETC) ARE TO BE CENTERED WITHIN THE PATTERN OF THE CEILING PANEL. A 2'x4' PANEL SCORED TO A 2'x2' PATTERN SHALL HAVE ITEMS CENTERED IN THE 2'x2' PORTION.
B. PROVIDE ADDITIONAL SUPPORT FOR EXIT SIGNS, WHERE REQUIRED.

1 Ceiling Mounting Device Detail

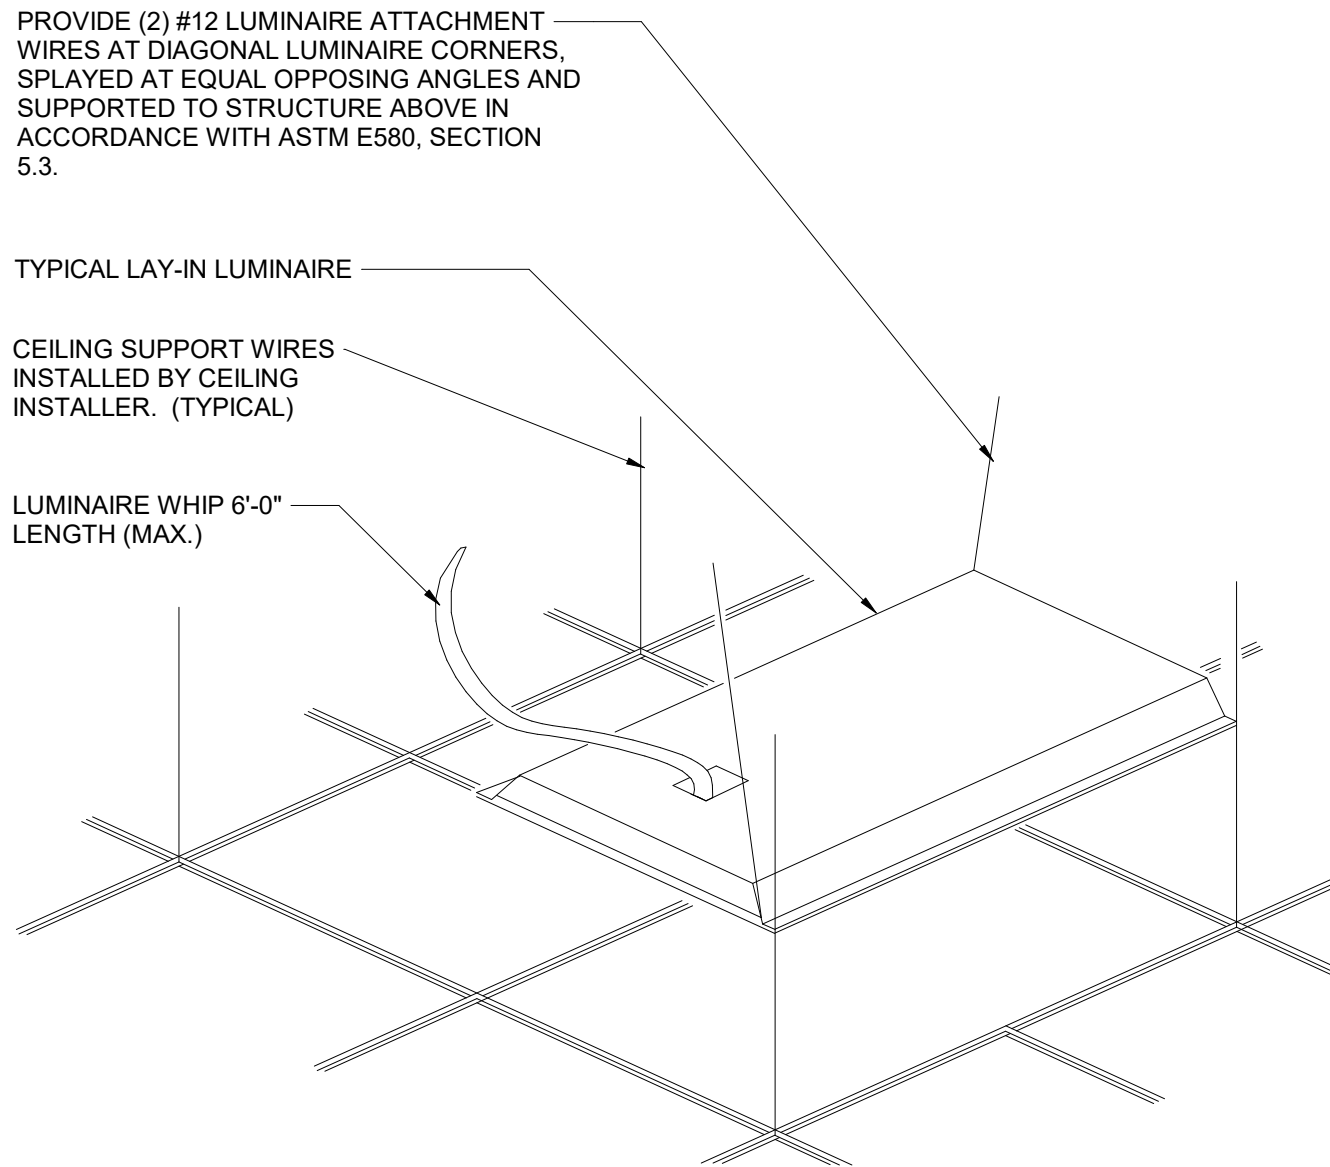


2 Typical Troffer Mounting Detail

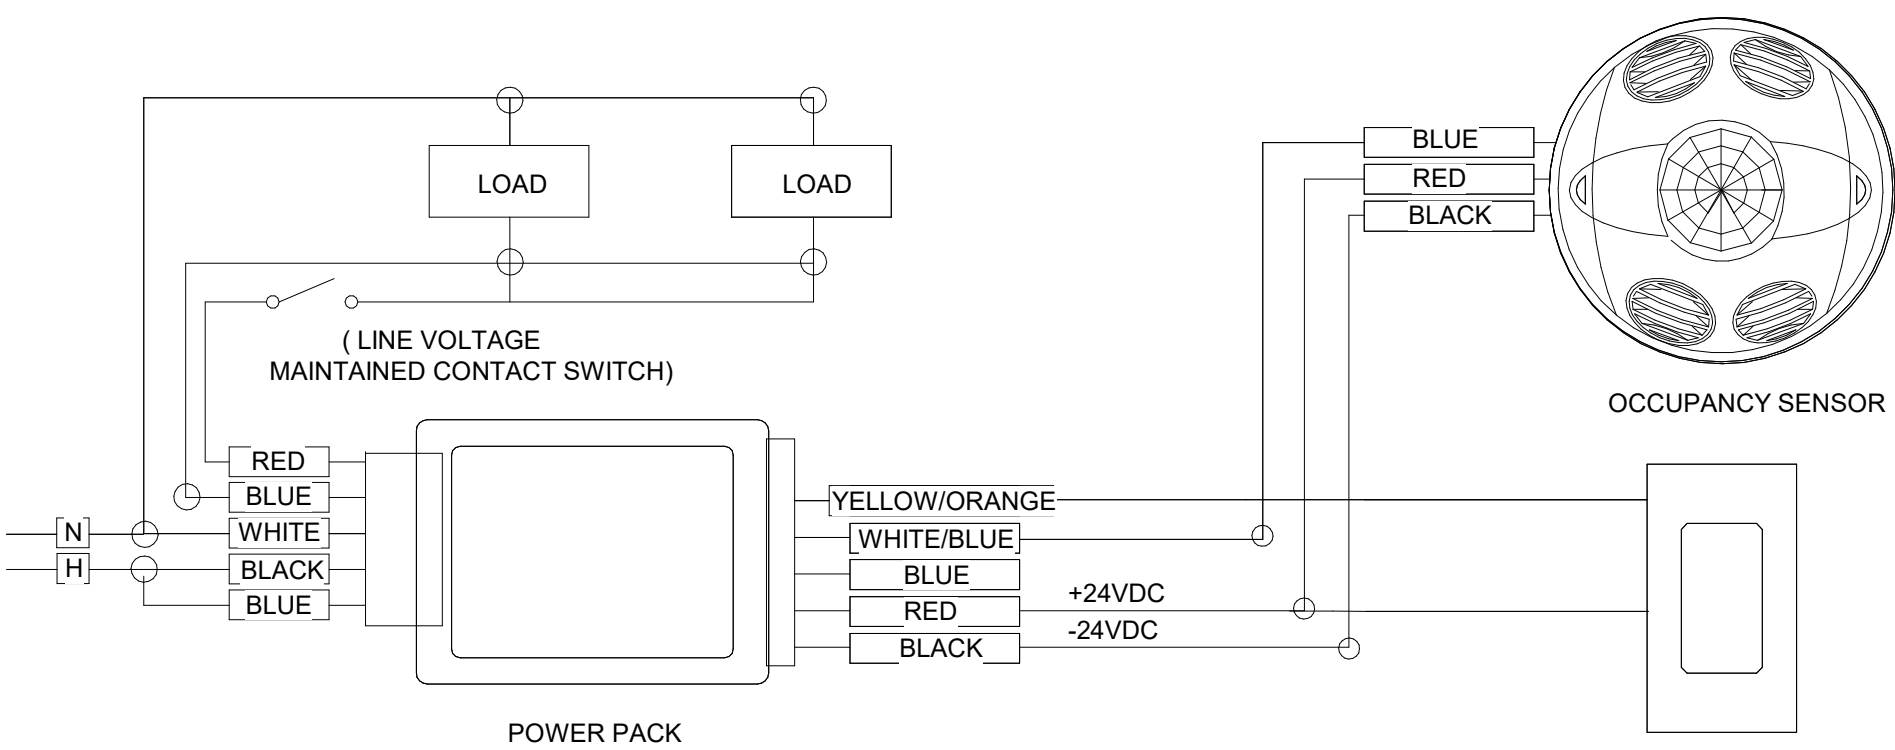


NOTES:
A. PAINT ALL SURFACE RACEWAY AND BOXES TO MATCH EXISTING SURFACES. (WHERE APPLICABLE).
B. PROVIDE RELAYS WHERE TWO OR MORE CIRCUITS FEED LIGHTING IN SAME ROOM.
C. ADJUST SENSITIVITY OF EACH OCCUPANCY SENSOR TO DETECT HUMAN MOVEMENT BUT NOT HVAC EQUIPMENT. ADJUST TIME DELAY FOR OPTIMUM PERFORMANCE. APPLY MASKING SEGMENTS TO DETECTION HEAD WHERE REQUIRED.
D. POWER PACK AND THE LOAD SWITCHED BY THE POWER PACK MUST BE FED FROM THE SAME PHASE.
E. REFER TO LIGHTING PLANS FOR LIGHTING SEQUENCES

3 Occupancy Sensor Wiring Diagram

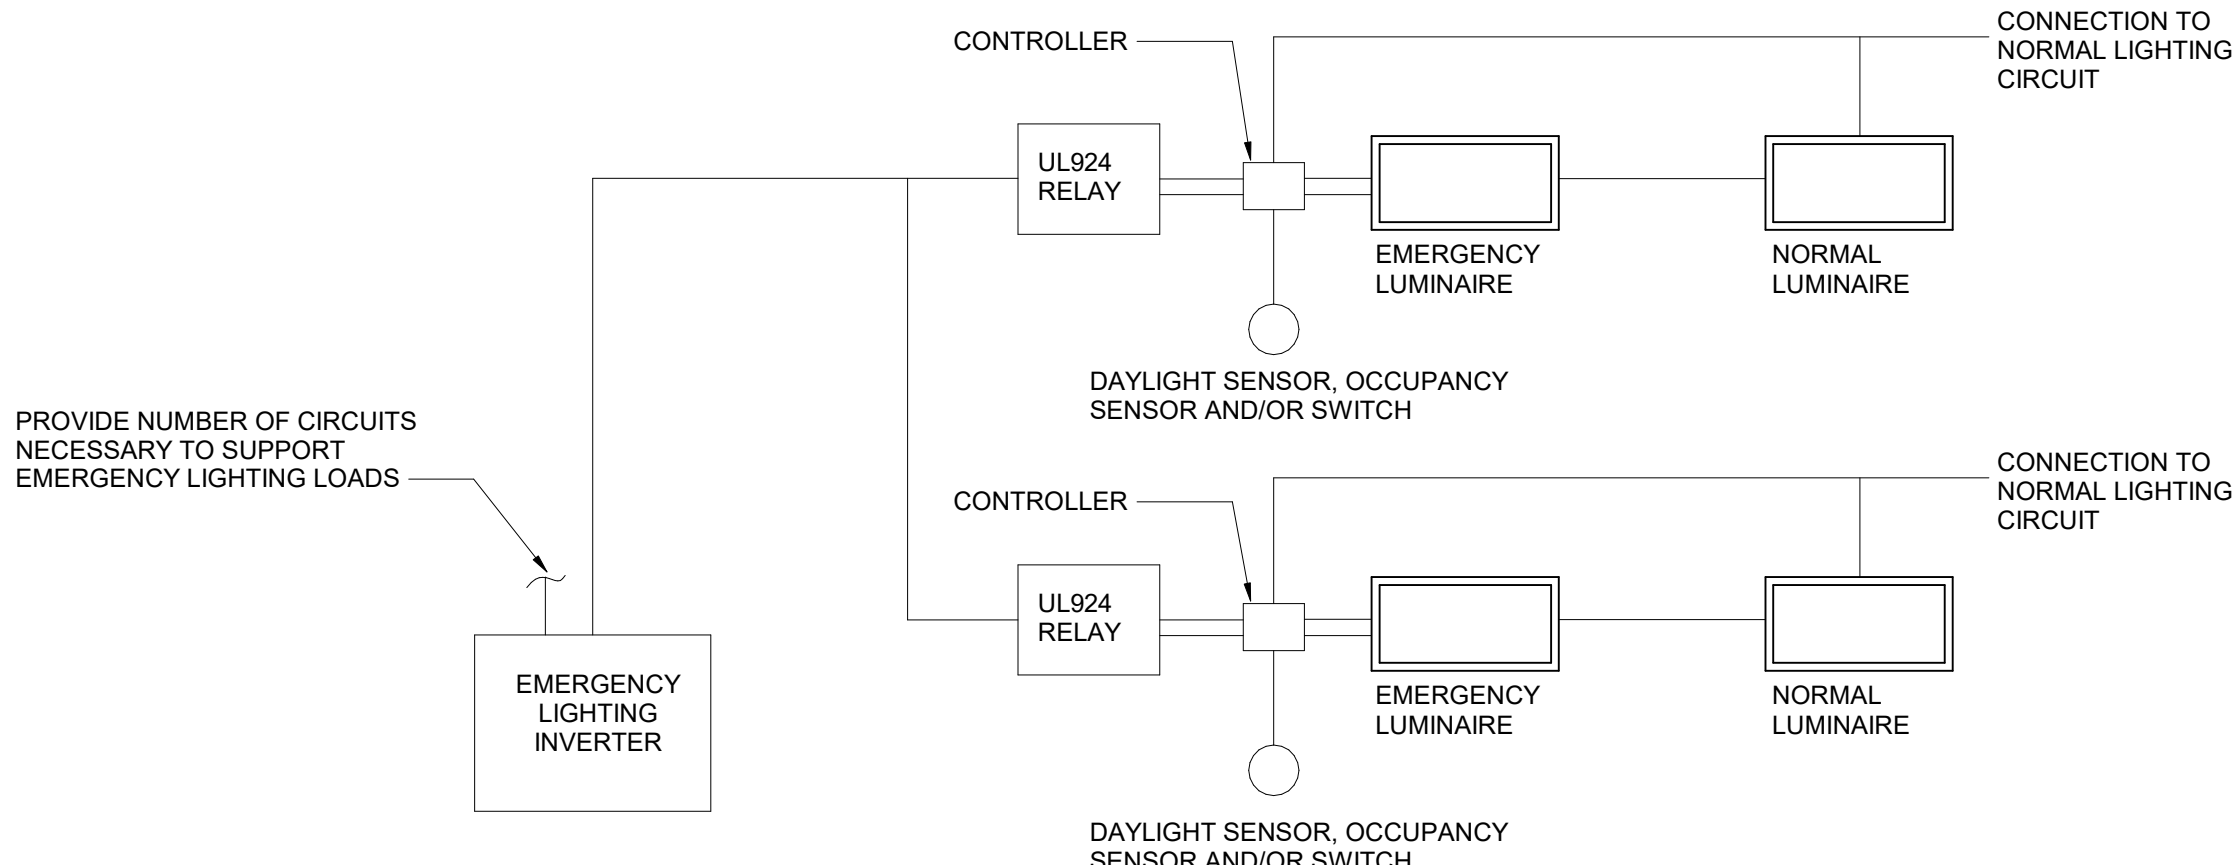


4 Emergency Miniature Inverter Wiring Diagram

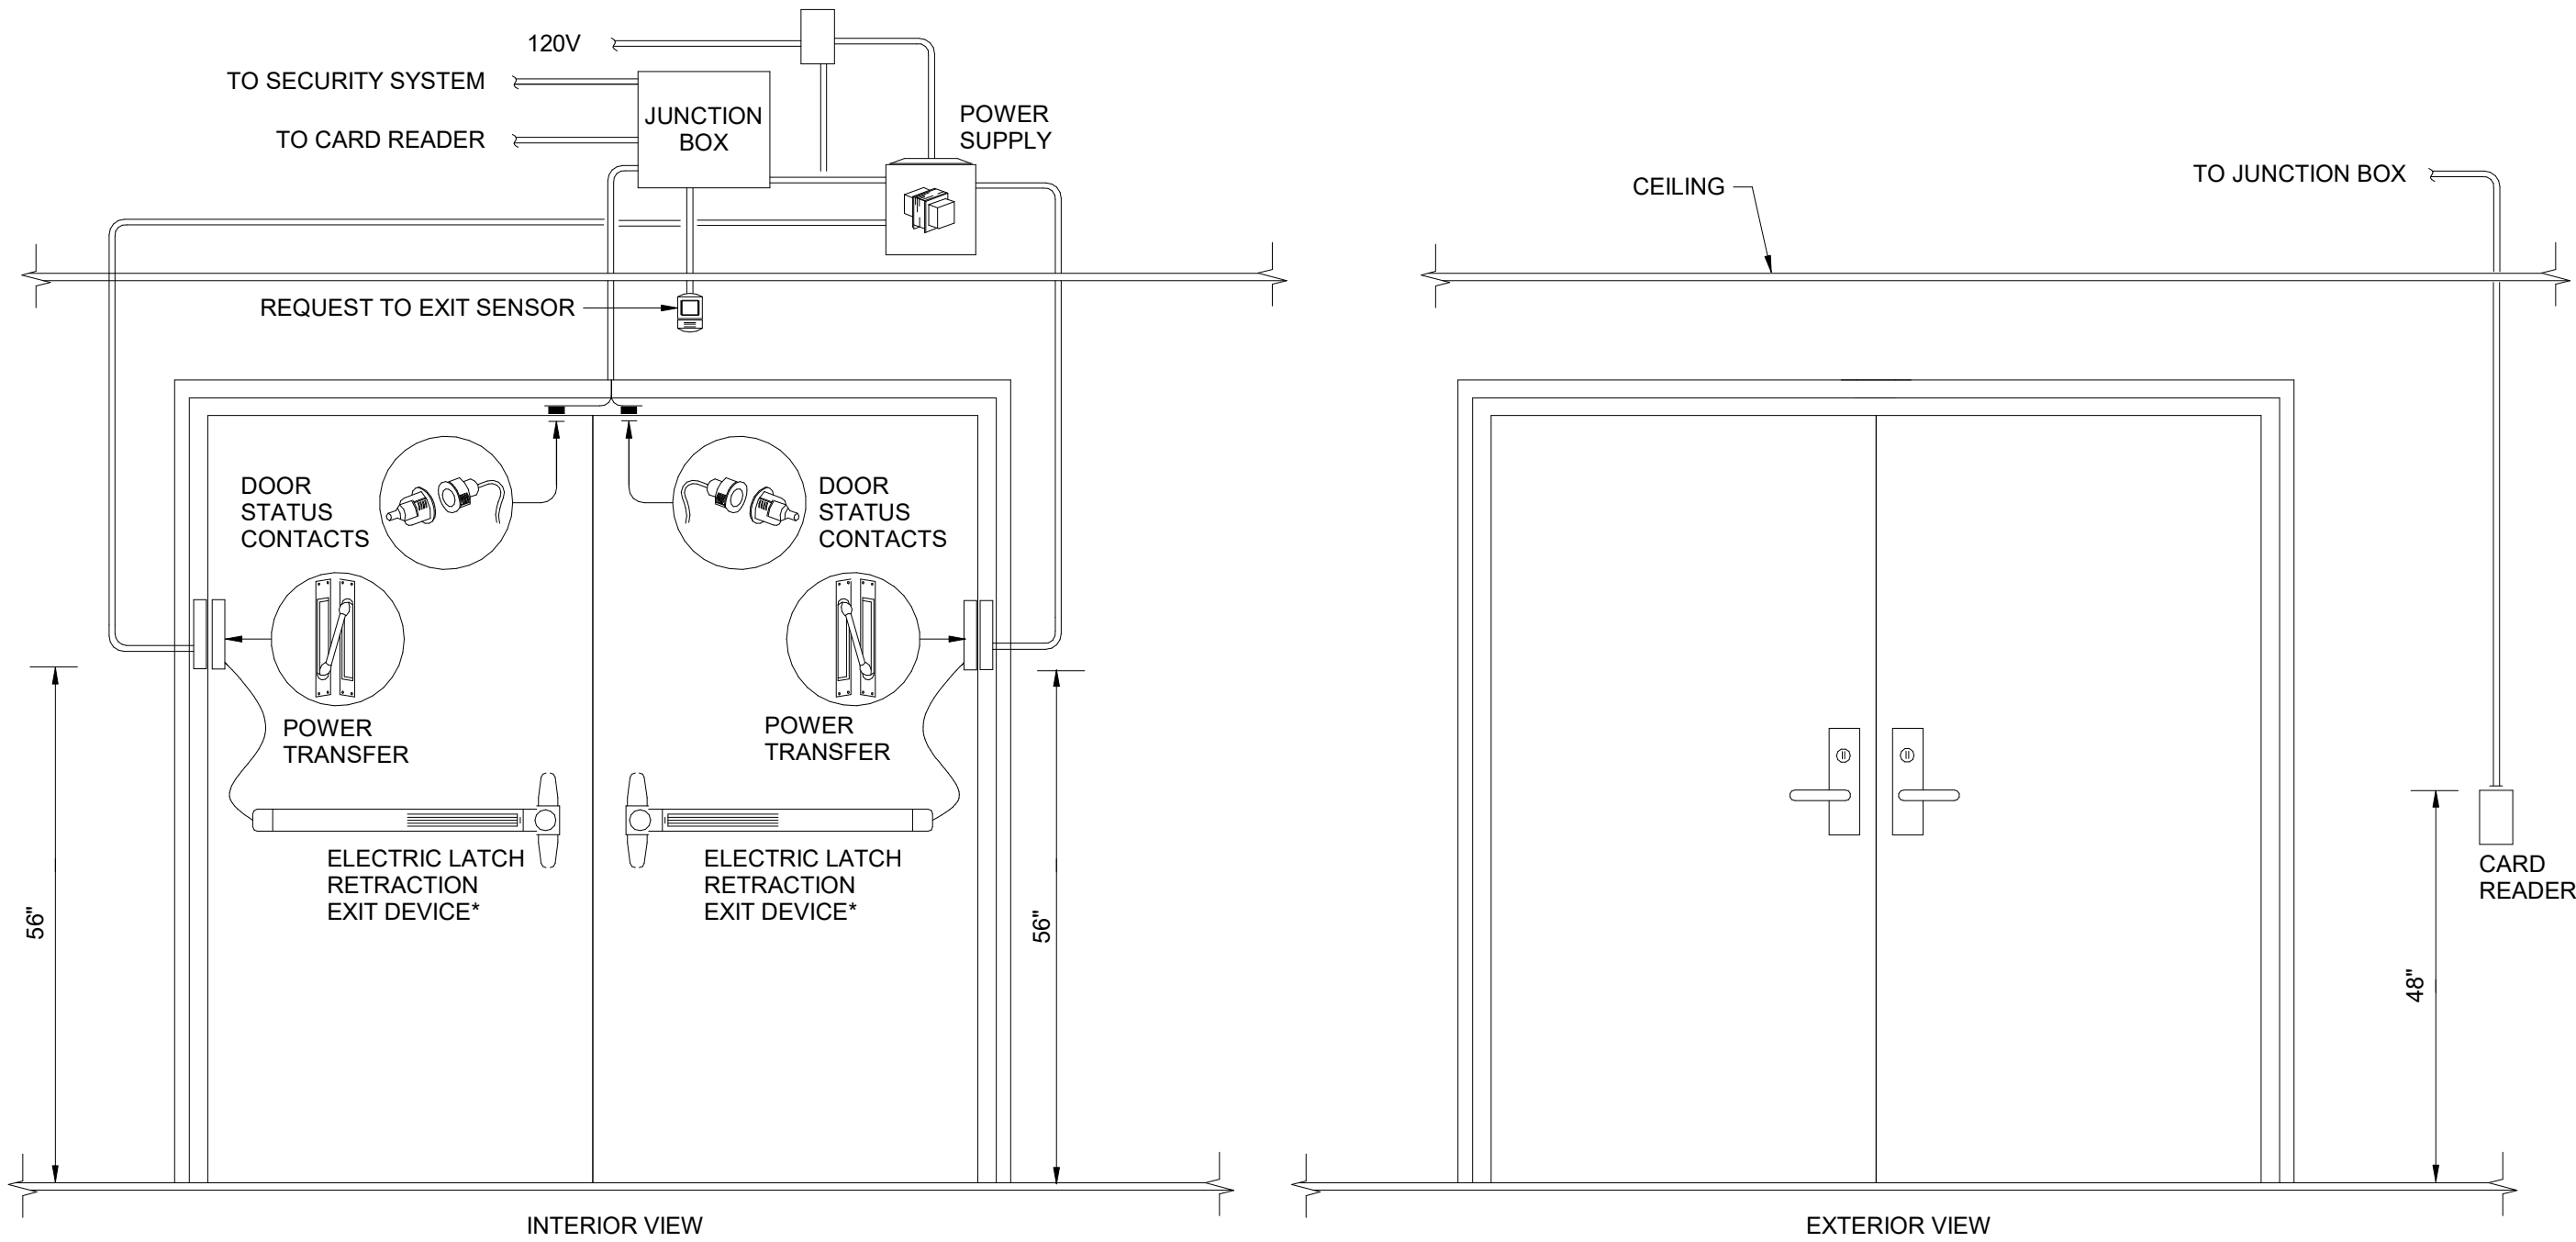


- *NOTES:
1. PANIC HARDWARE SHALL ALWAYS REMAIN FULLY OPERATIONAL MANUALLY, NO MATTER WHAT THE STATUS OF ELECTRIC LATCH. SEE SPECIFICATION SECTION 087100 FOR FURTHER INFORMATION.
 2. VIEW MAY BE MIRRORED

1 Door Configurations

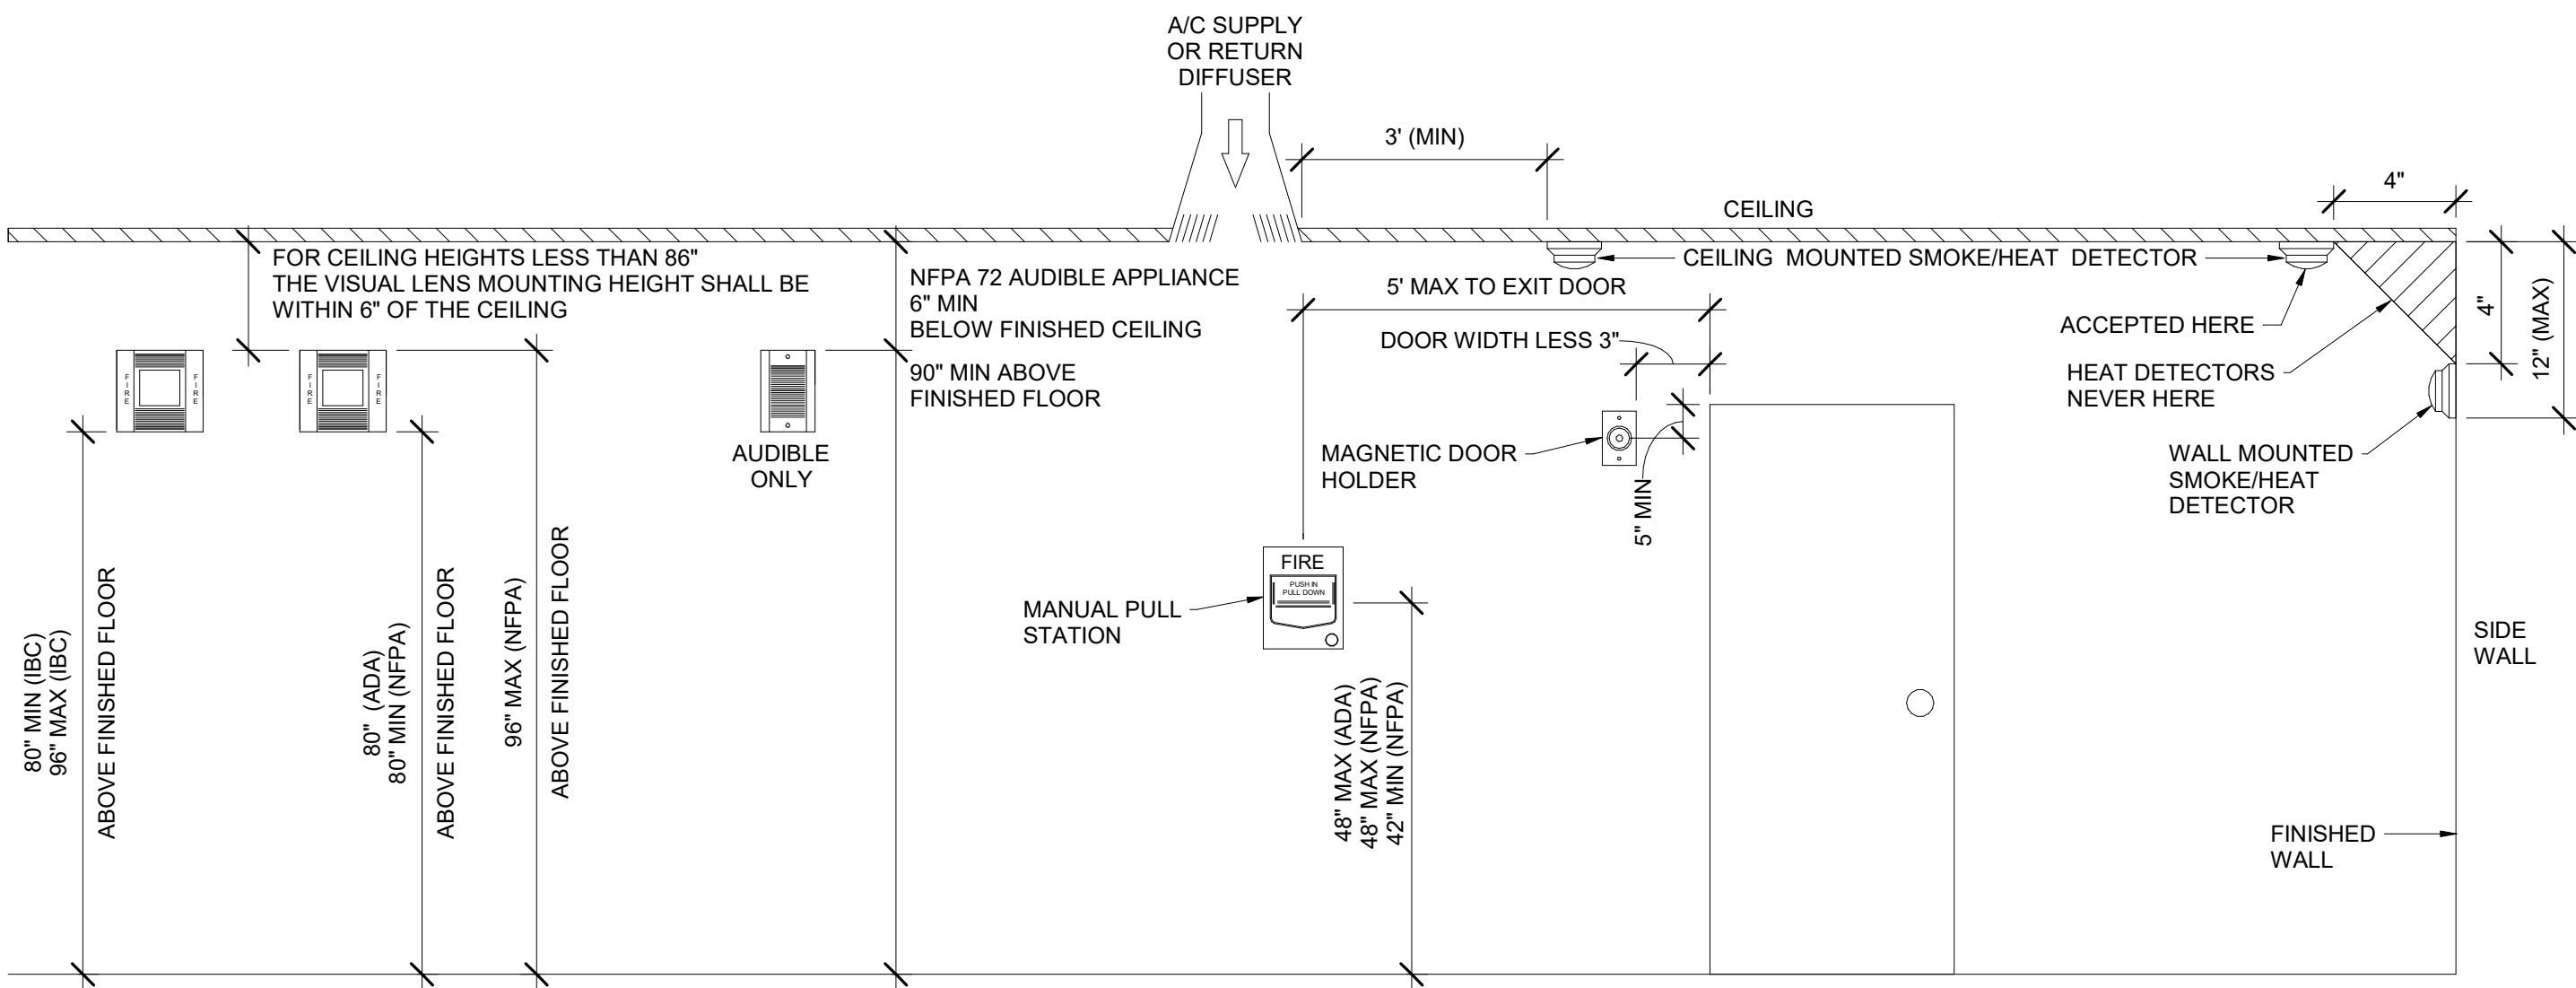

6 Typical Mounting Heights

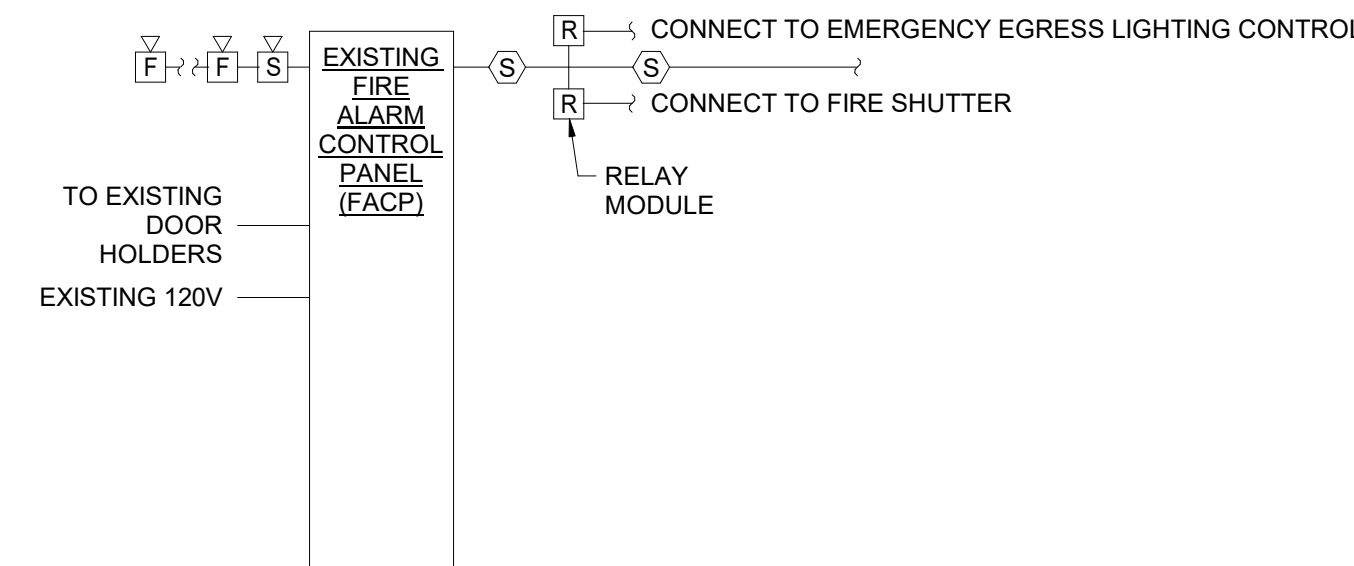


FIRE ALARM SEQUENCE OF OPERATION

- UPON ACTIVATION OF MANUAL PULL STATIONS, HEAT DETECTORS, SMOKE DETECTORS, DUCT DETECTORS, THE FIRE ALARM PANEL WILL GO INTO ALARM AND SHOULD SOUND THE A/V DEVICES, SHUT DOWN THE FANS, RELEASE THE MAGNETIC DOOR HOLDERS, CONTACT THE LOCAL FIRE DEPARTMENT AND INDICATE WHICH ALARM ZONE THE ALARM IS IN VIA THE REMOTE ANNUNCIATORS.
- UPON ACTIVATION OF A TROUBLE CONDITION THE FIRE ALARM PANEL SHALL GO INTO "TROUBLE" MODE INDICATING WHICH ZONE IS IN TROUBLE BY A LIGHT IN THE REMOTE ANNUNCIATOR AND AT THE FIRE ALARM PANEL.

NOTE:
FIRE ALARM RISER IS INTENDED TO BE SCHEMATIC ONLY.
ALL DEVICES INDICATED ON PLANS AND DETAILS ARE TO
BE INSTALLED AND CONNECTED FOR PROPER OPERATION
OF SYSTEM.


4 Fire Alarm System Wiring Diagram

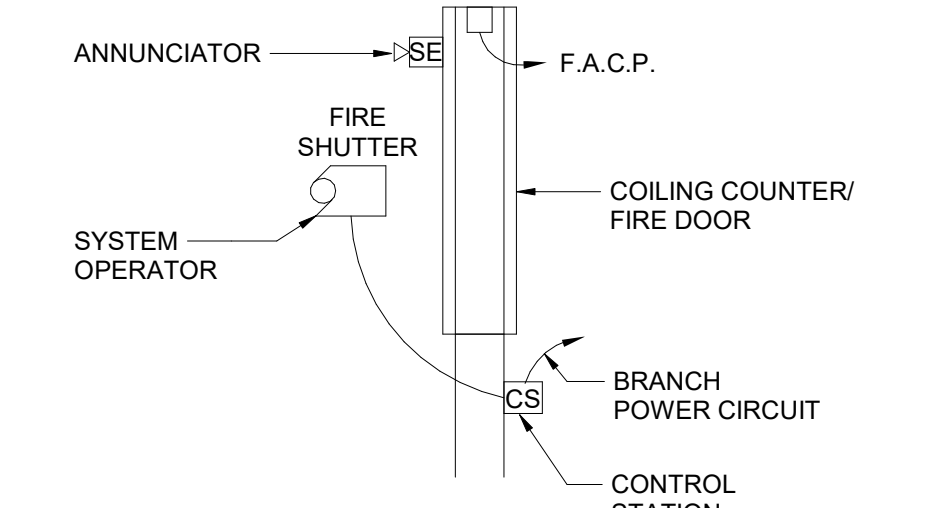


NOTES:

1. INSTALL THE FOLLOWING EQUIPMENT, FURNISHED BY OTHERS:
 - CONTROL STATION(S)
 - ANNUNCIATOR(S)
2. PROVIDE A BRANCH CIRCUIT (INDICATED ON PLAN) TO SYSTEM OPERATOR VIA THE CONTROL STATION.
3. PROVIDE A 24 VDC CONNECTION FROM THE F.A.C.P. TO THE RELEASE DEVICE(S).
4. PROPERLY PROGRAM F.A.C.P. TO SIGNAL RELEASE DEVICE TO OPERATE WHEN A FIRE DETECTION APPLIANCE IN THE ADJOINING SPACES SERVED BY ROLLING FIRE DOOR(S) ARE INITIATED.


2 Typical Coiling Door Wiring Schematic

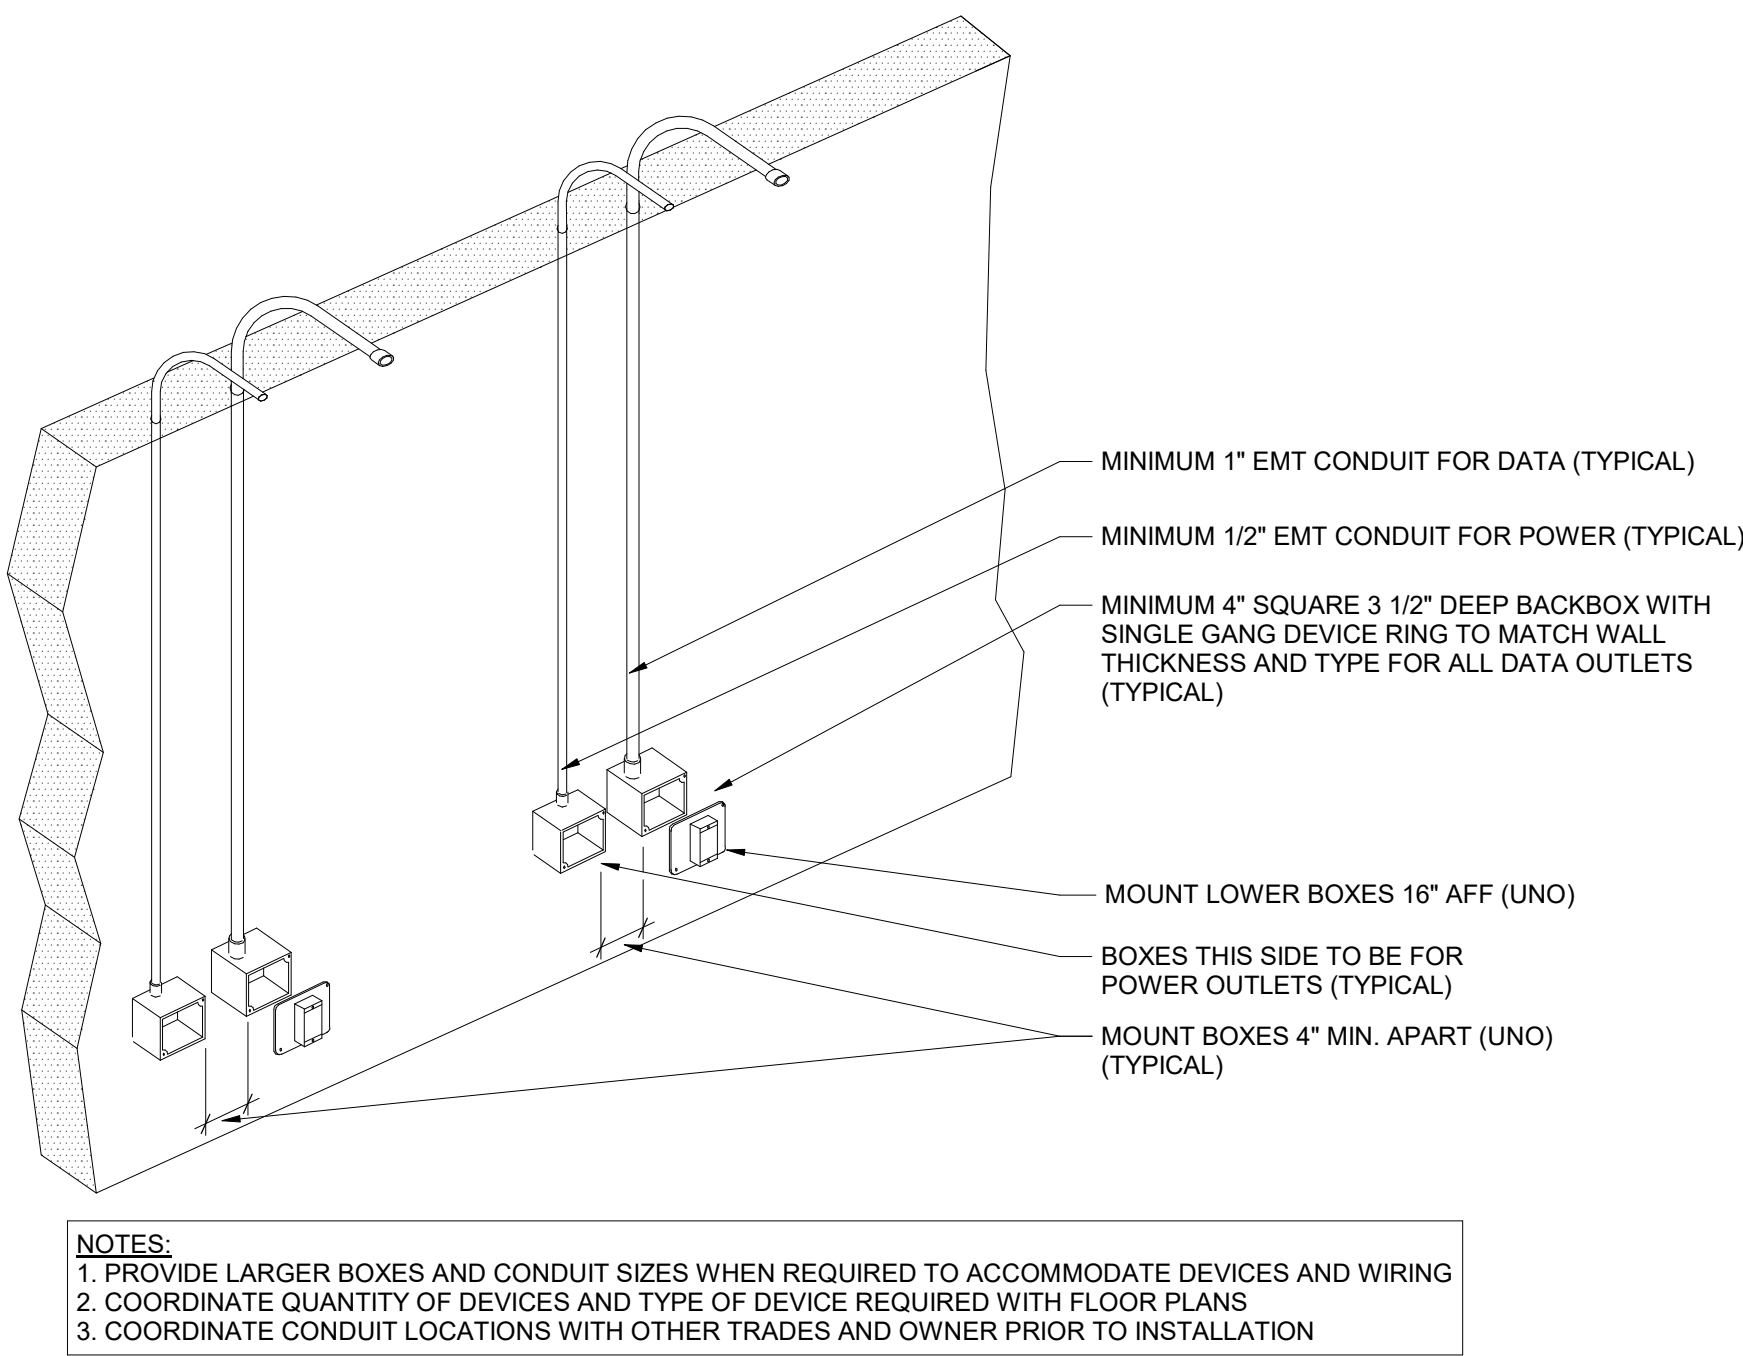

7 Conduit/Backbox Installation Detail

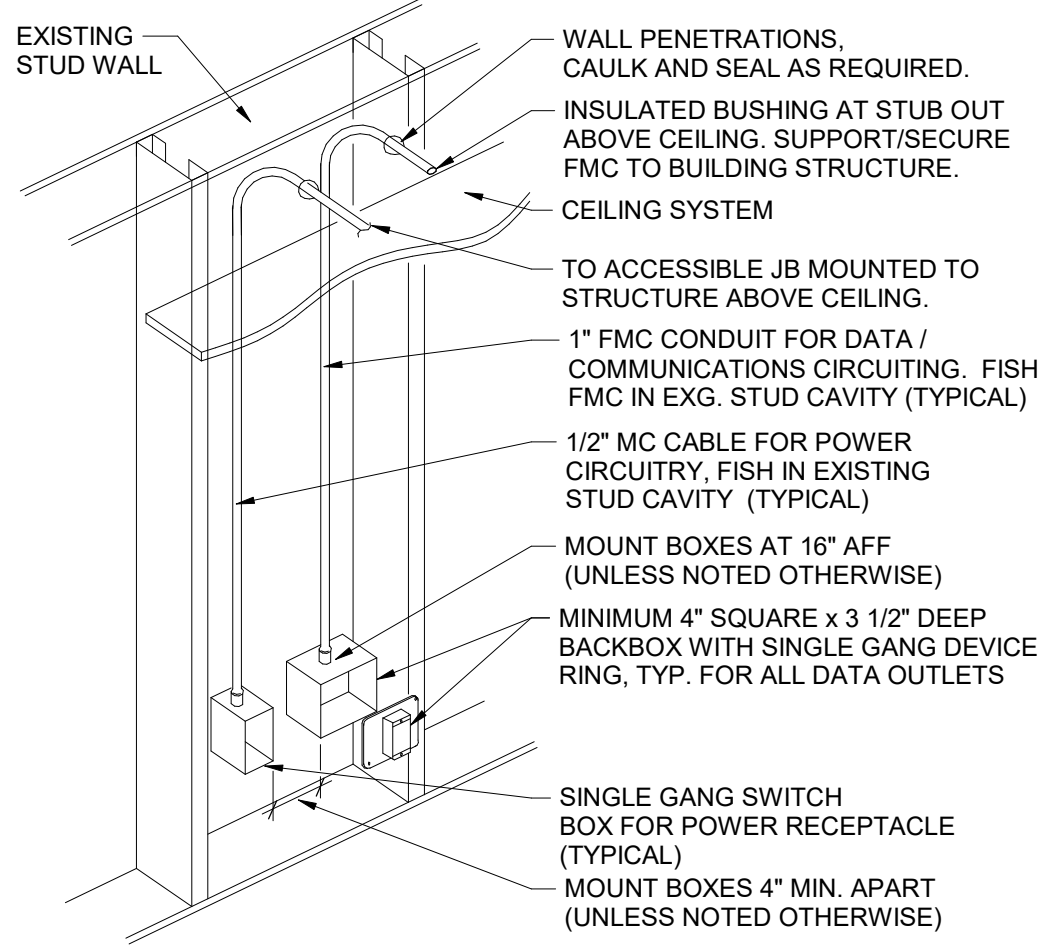

5 Conduit/Backbox Installation Detail (in Existing Stud Wall)

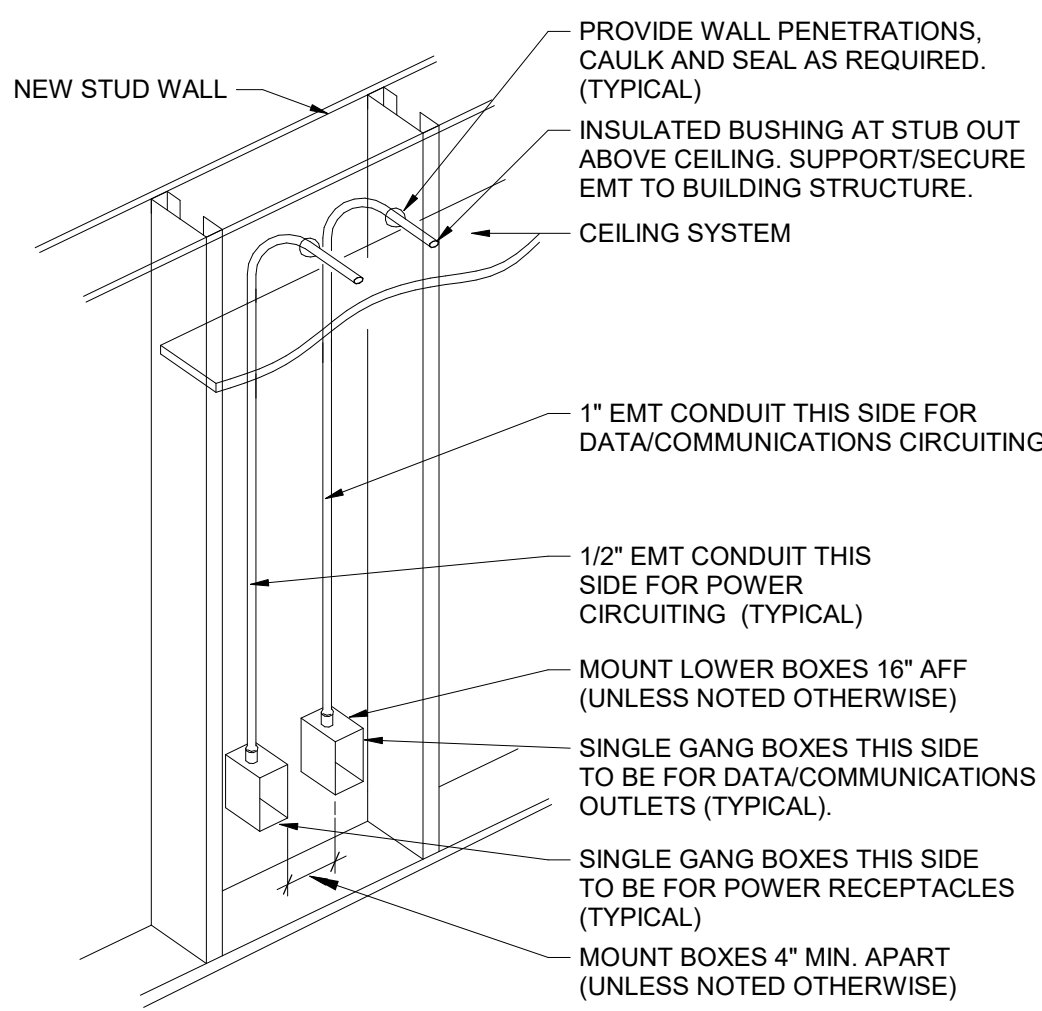

3 Conduit/Backbox Installation Detail

S.E.D. Control No. 13-02-00-01-0-006-022

Rev. No.: Date: Description:



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Beacon City School District
Beacon, New York

Additions and Alterations to:
Glenham Elementary School

Details

Drawn By: SAS
Project No.: 279180-22004

Date: 10/28/2022


Drawing Number: BE501

Plumbing Fixture Schedule


DWG LABEL	ROUGH-IN CONNECTION SIZE (INCHES)				BARRIER FREE	AGE GROUP	RIM HEIGHT	DESCRIPTION	NOTES
	SAN	VENT	CW	HW					
WC "A"	4	2	1	-	NO	ADULT	15"	VITREOUS CHINA, WALL MOUNTED WITH SUPPORT, TOP SPUD, MANUAL DUAL FLUSH VALVE AND SEAT.	1, 2
WC "B"	4	2	1	-	YES	ADULT	18"	ACCESSIBLE, VITREOUS CHINA, WALL MOUNTED WITH SUPPORT, TOP SPUD, MANUAL DUAL FLUSH VALVE AND SEAT.	1, 2
LAV "A"	1 1/2	1 1/2	1/2	1/2	NO	ADULT	31"	VITREOUS CHINA, WALL MOUNTED WITH MANUAL, HARD WIRED SENSOR FAUCET, SUPPLIES, TAILPIECE AND TRAP.	1, 2
LAV "B"	1 1/2	1 1/2	1/2	1/2	YES	ADULT	34"	ACCESSIBLE, VITREOUS CHINA, WALL MOUNTED WITH MANUAL, HARD WIRED SENSOR FAUCET, SUPPLIES, OFFSET TAILPIECE, TRAP, AND INSULATION KIT.	1, 2, 3
INT WH	-	-	3/4	-	-	-	-	CONCEALED OUTLET, SELF DRAINING MODERATE CLIMATE WALL HYDRANT.	

NOTES:

- REFER TO TOILET ROOM PLANS ON ARCHITECTURE DRAWINGS FOR FIXTURE CENTERLINE DIMENSIONS.
- SIZES INDICATED ARE MINIMUM. LARGER SIZES SPECIFICALLY INDICATED ON DRAWINGS SUPERCEDE MINIMUM SIZES INDICATED IN THIS SCHEDULE.
- REFER TO DETAIL 8/ BP130 FOR ADDITIONAL INFORMATION.

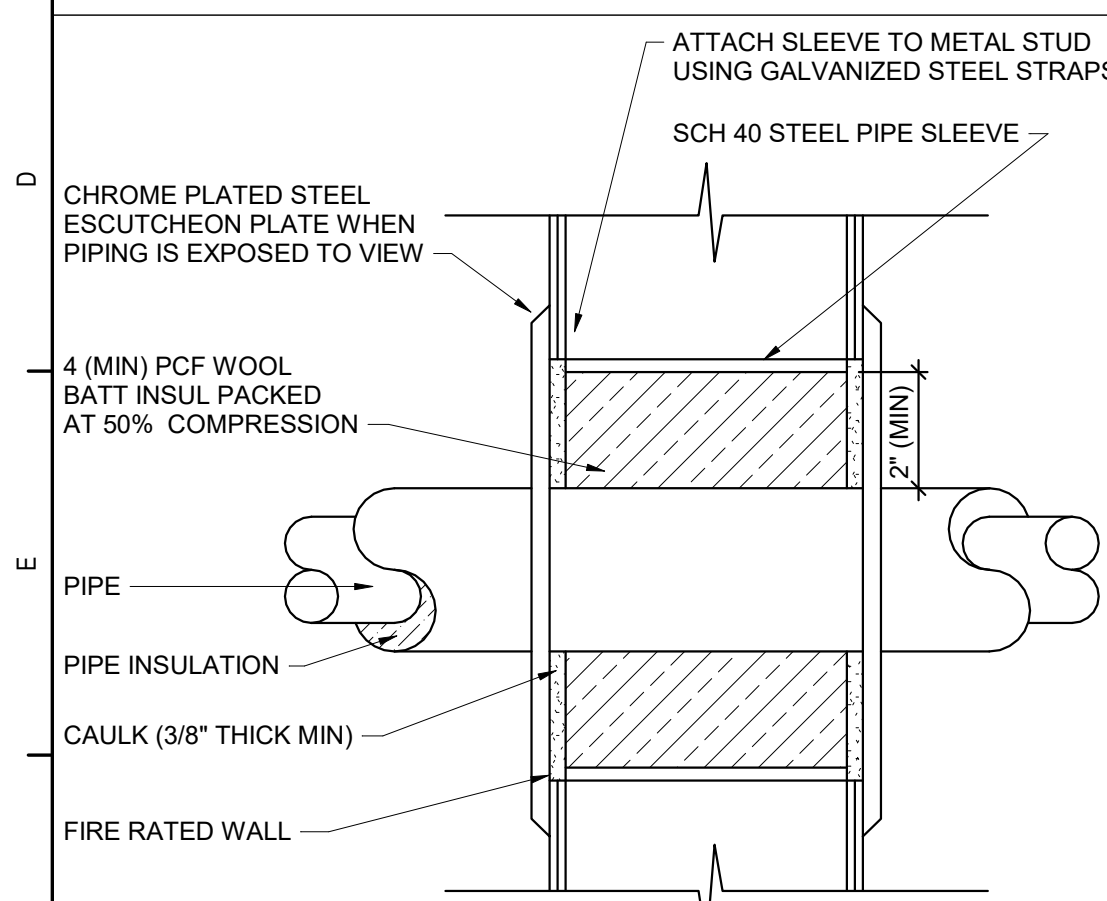


6 Fire Rated Metal Stud Wall Sleeve Detail
NTS

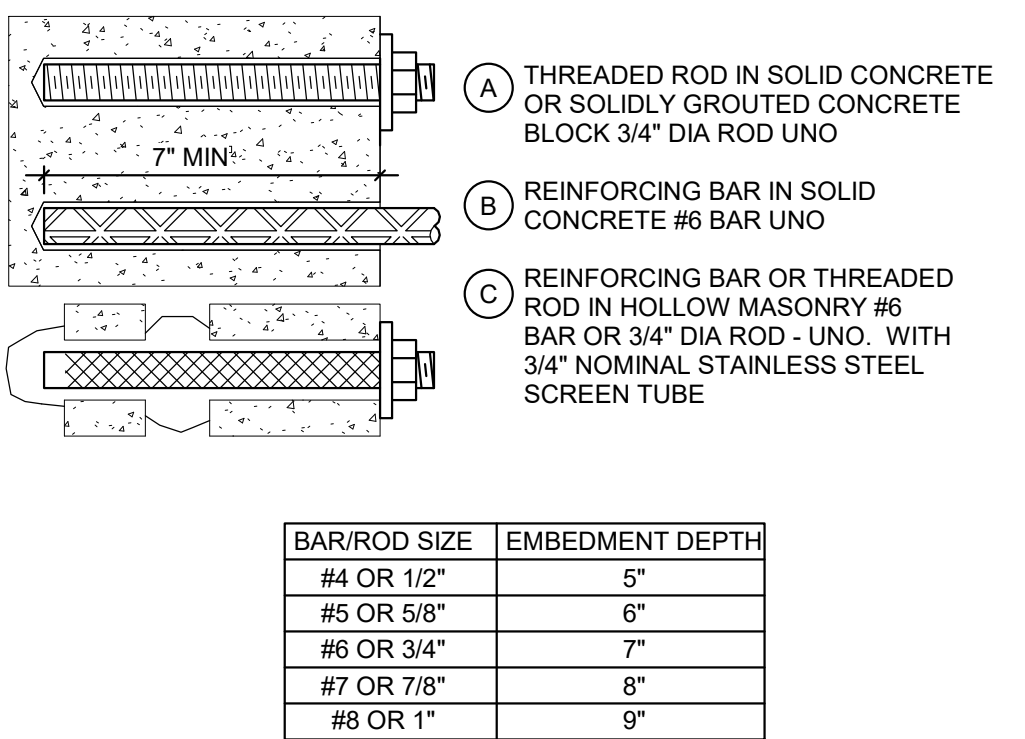


4 Insulation Shield Detail
NTS

7 Typical Chemical Anchors
NTS

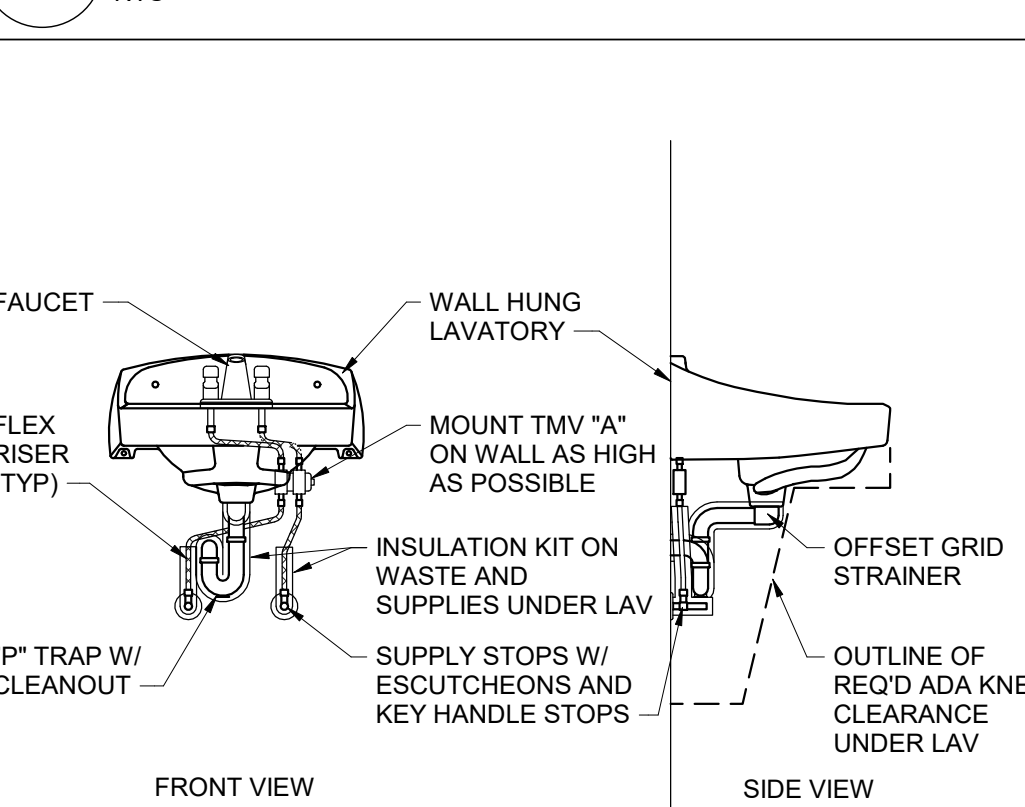


8 ADA Lavatory Rough-in Detail
NTS


5 Trenching Below Existing Slab Detail
NTS

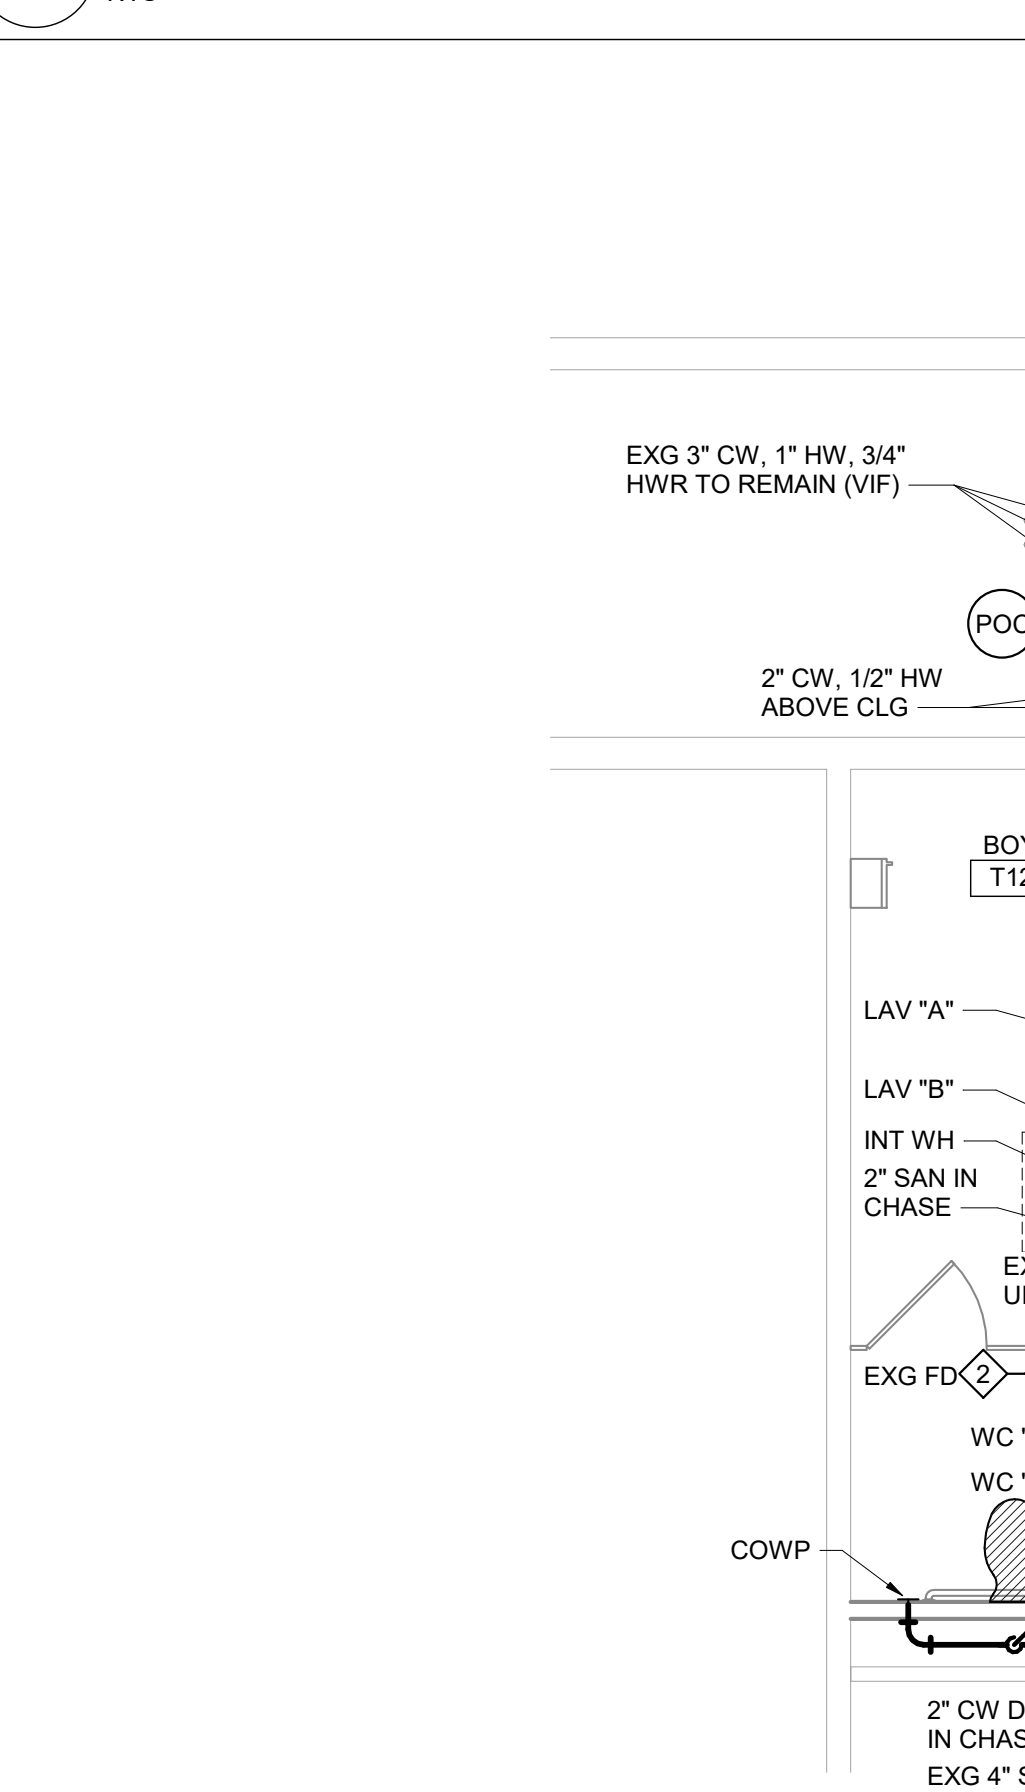

3 Toilet Rooms T12a and T12b Plan
1/4\"/>

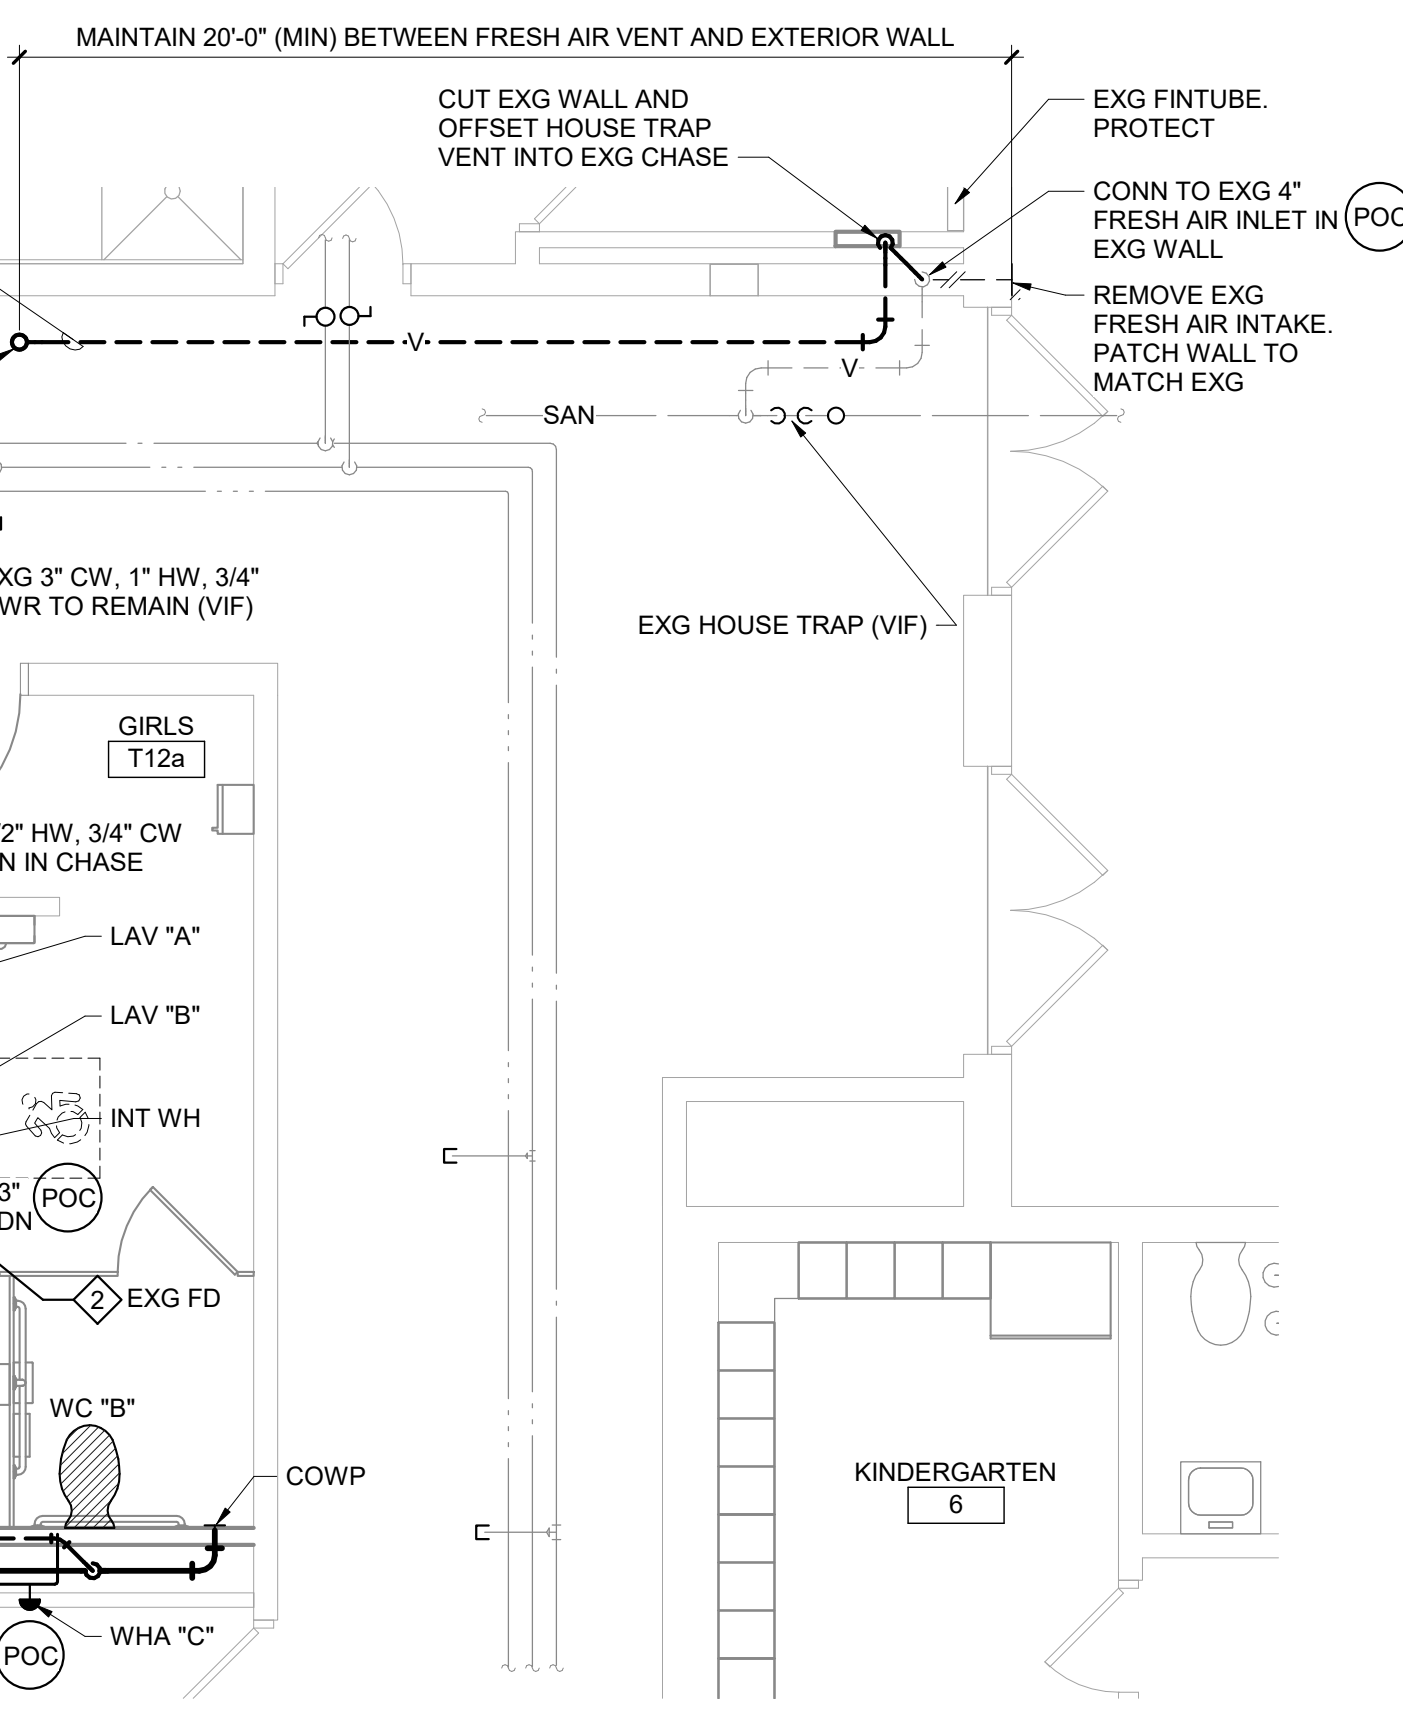

2 Toilet Rooms T12a and T12b Demolition Plan
1/4\"/>

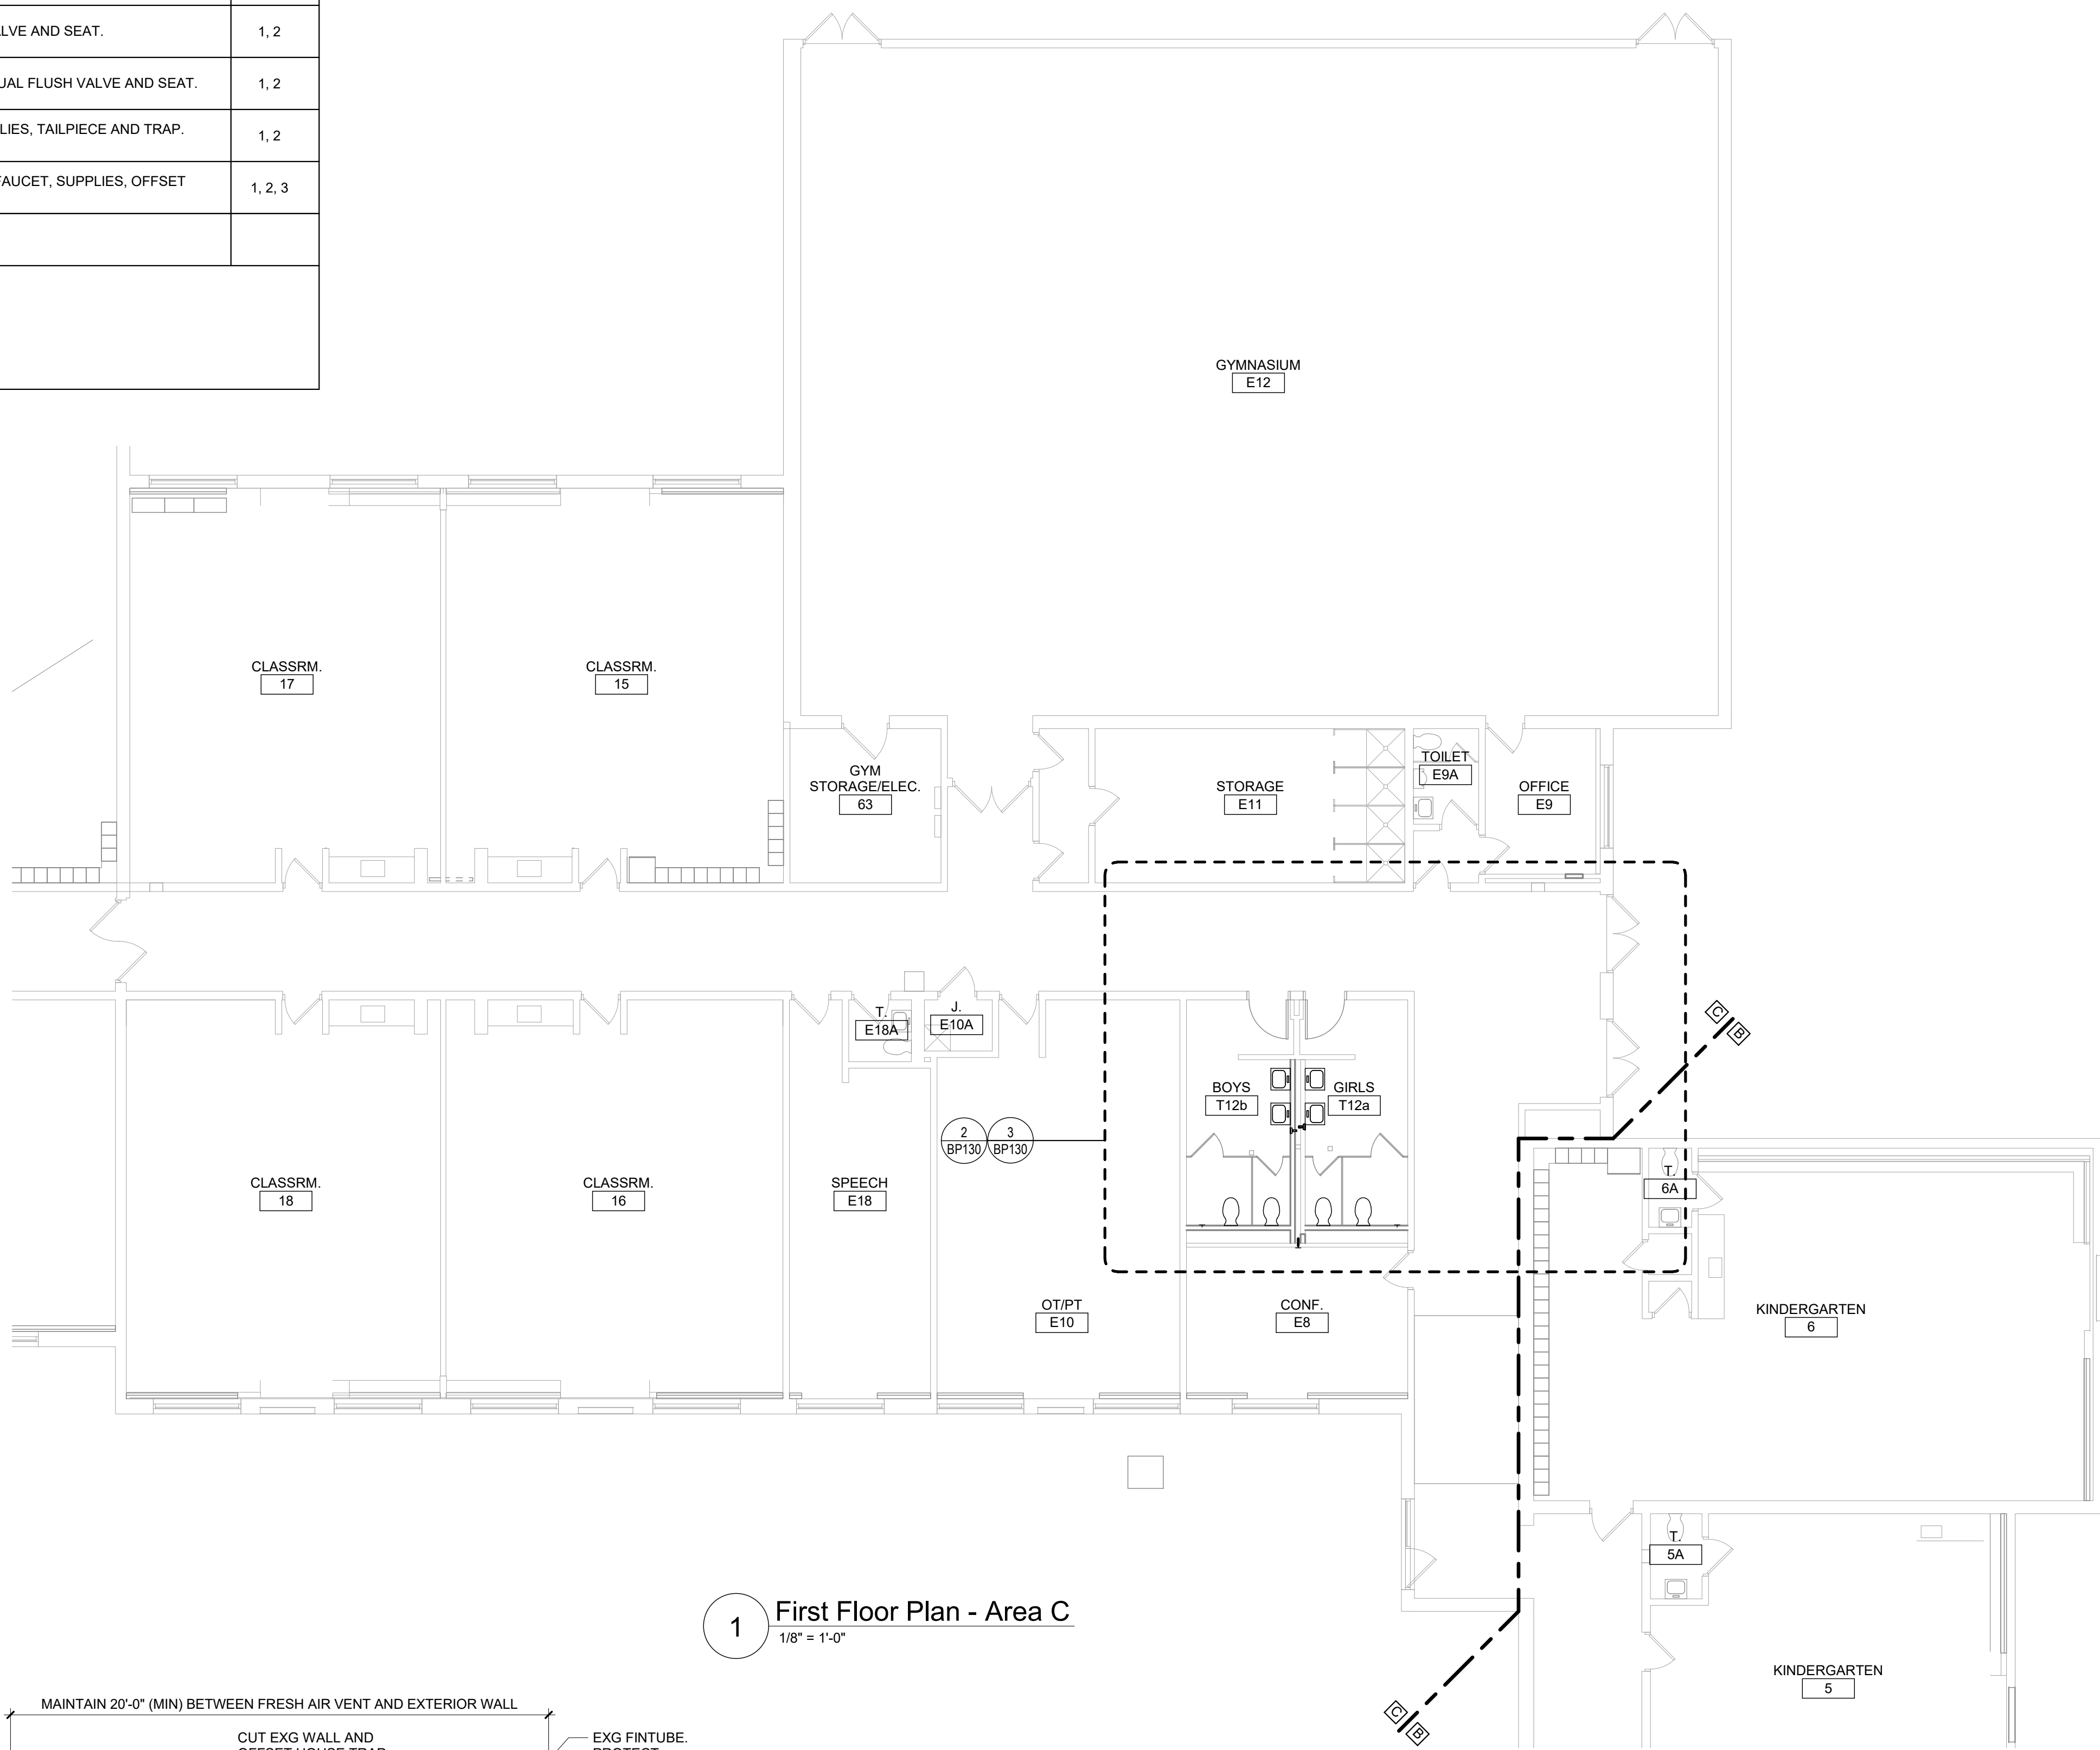


1 First Floor Plan - Area C
1/8\"/>

General Notes

- VERIFY ALL PIPING LOCATIONS, SIZES, AND ARRANGEMENTS IN FIELD PRIOR TO BID. NOTIFY ARCHITECT IN WRITING OF ANY DISCREPANCIES.
- VERIFY IN FIELD INVERT AND DIRECTION OF FLOW IN EXISTING SOIL PIPE WHERE NEW SOIL PIPE IS TO BE CONNECTED TO EXISTING SOIL PIPE.
- LEGALLY DISPOSE OF ALL DEMOLITION DEBRIS.
- INCLUDE TRENCHING, CUTTING AND PATCHING OF FLOORS, WALLS AND CEILINGS, INCLUDING CEILING TILE REMOVAL AND REPLACEMENT, WHEN REQUIRED FOR PLUMBING WORK. PATCH ABANDONED OPENINGS AND DISTURBED FINISHES TO MATCH EXISTING. TAKE PRECAUTIONS TO PROTECT STRUCTURAL INTEGRITY OF FLOOR OR WALLS WHEN TRENCHING OR CUTTING.
- MATERIALS FOR PLUMBING INSTALLATION SHALL BE NEW, UNLESS SPECIFICALLY NOTED OTHERWISE.
- PROVIDE THROUGH PENETRATION FIRESTOPPING FOR FIRE RATED WALLS AND FLOORS. PENETRATIONS THROUGH EXISTING WALLS AND FLOORS ARE CONSIDERED TWO-HOUR PARTITIONS UNLESS SPECIFICALLY NOTED OTHERWISE. REFER TO \"A\" SERIES OR CODE COMPLIANCE DRAWINGS FOR LOCATION OF FIRE RATED WALLS AND FLOORS.
- REMOVE PLUMBING FIXTURES INDICATED, INCLUDING ASSOCIATED PIPING, FASTENERS, SUPPORTS, ETC. BACK TO POINTS OF CONCEALMENT WITHIN OR BEHIND REMAINING WALLS, BELOW FLOORS OR ABOVE CEILINGS.
- REPLACE OR RELOCATE PLUMBING FIXTURE INDICATED. MODIFY AND EXTEND EXISTING PIPING AS REQUIRED TO MEET FIXTURE MFR'S ROUGH-IN RECOMMENDATIONS AND TO MAKE CONNECTIONS. CONCEAL PIPING WITHIN OR BEHIND WALLS, BELOW FLOORS OR ABOVE CEILINGS. PATCH DISTURBED FINISHES TO MATCH EXISTING UNLESS SPECIFICALLY NOTED OTHERWISE. REFER TO \"A\" SERIES DWGS FOR EXACT LOCATION AND RIM ELEVATION OF NEW OR RELOCATED FIXTURES.
- REMOVE ABANDONED ACCESSIBLE PIPING TO MAIN BRANCHES, STACKS OR RISERS AS REQUIRED TO ELIMINATE EXPOSED PIPING AND DEAD END PIPING RUNS LONGER THAN 1'-0\"/>

Plumbing Notes

- WORK IS PART OF ALTERNATE NO. 1.
- REPLACE STRAINER ON EXISTING FLOOR DRAIN.

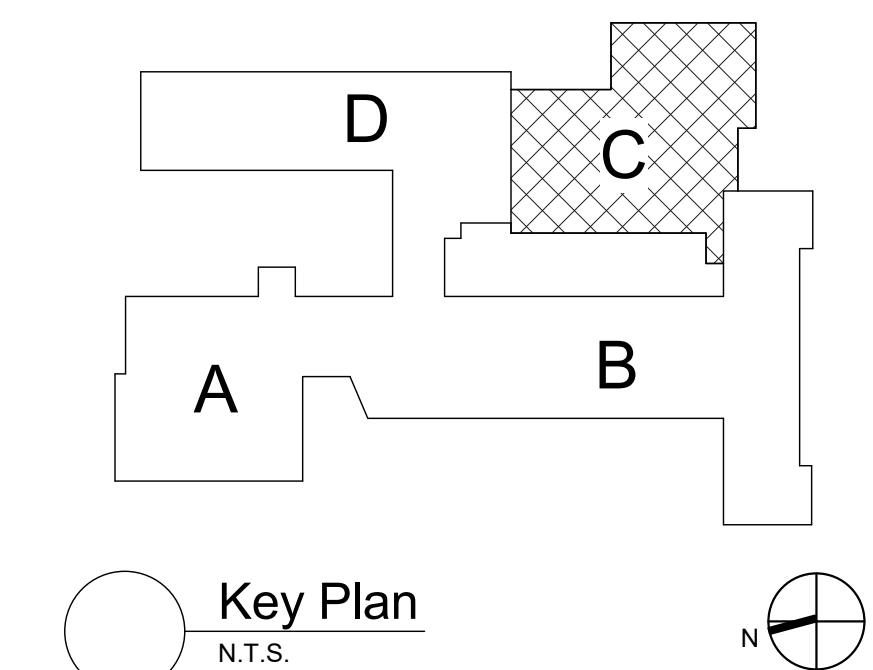

S.E.D. Control No. 13-02-00-01-0-006-022

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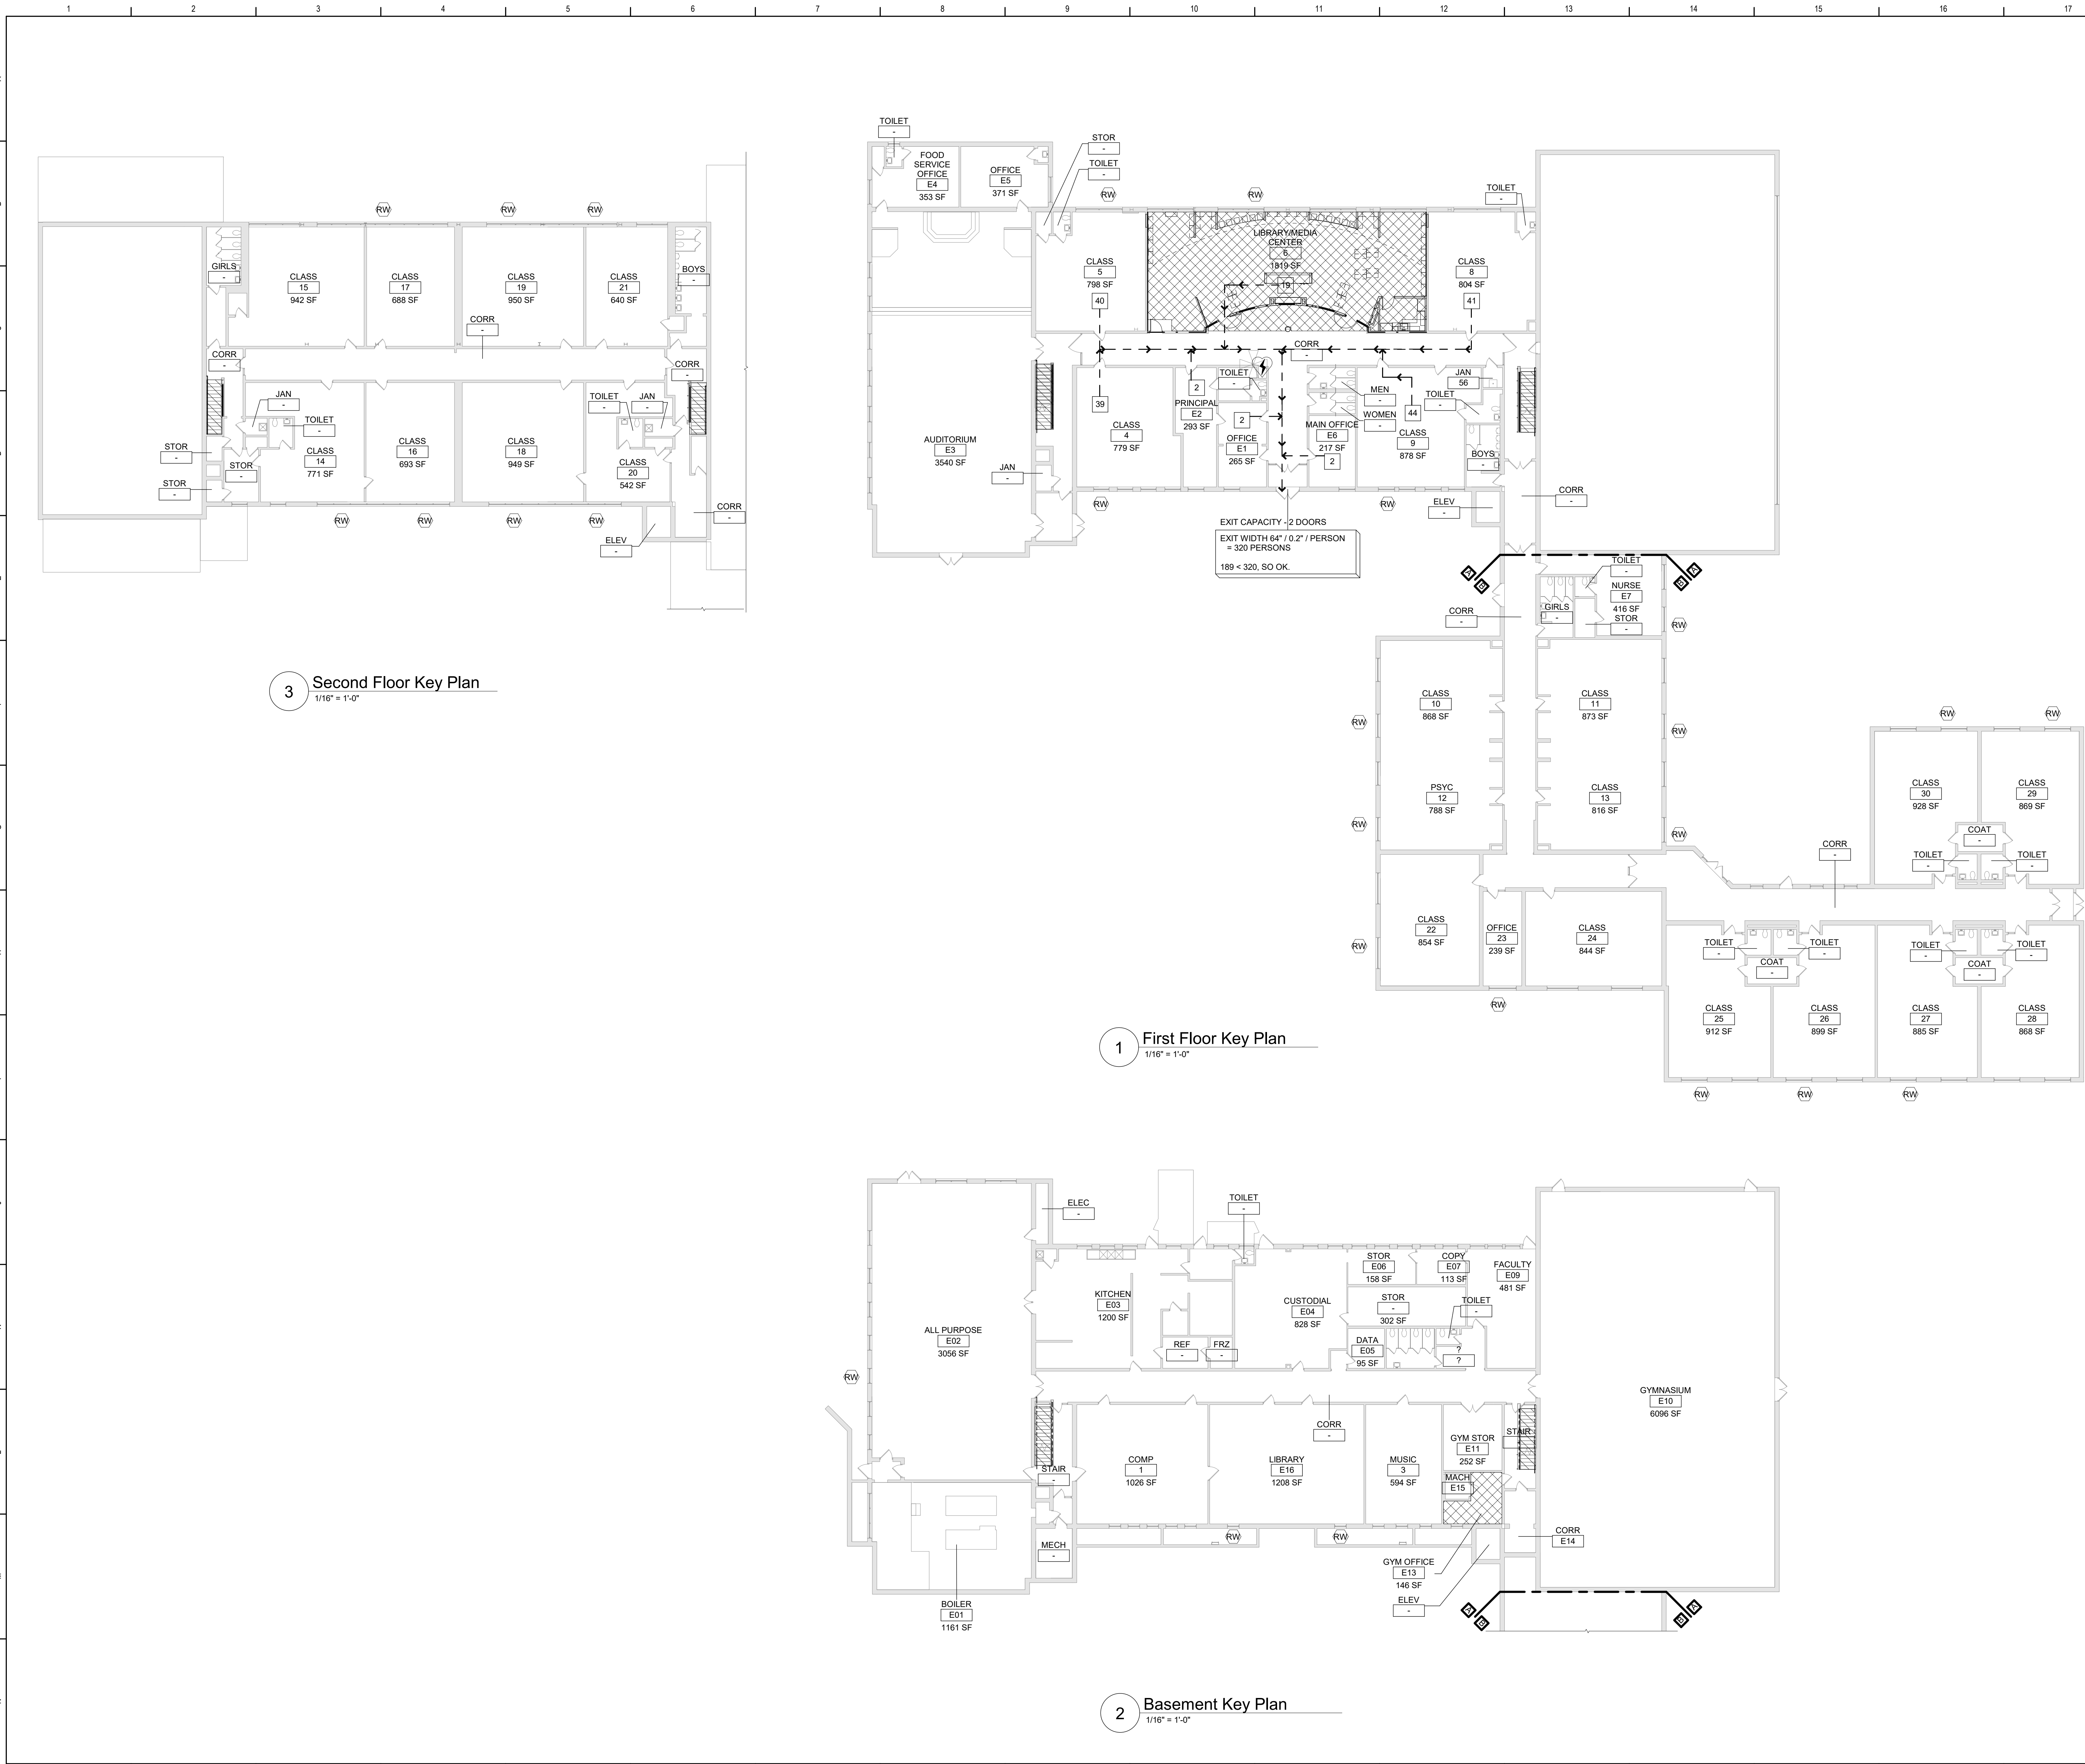
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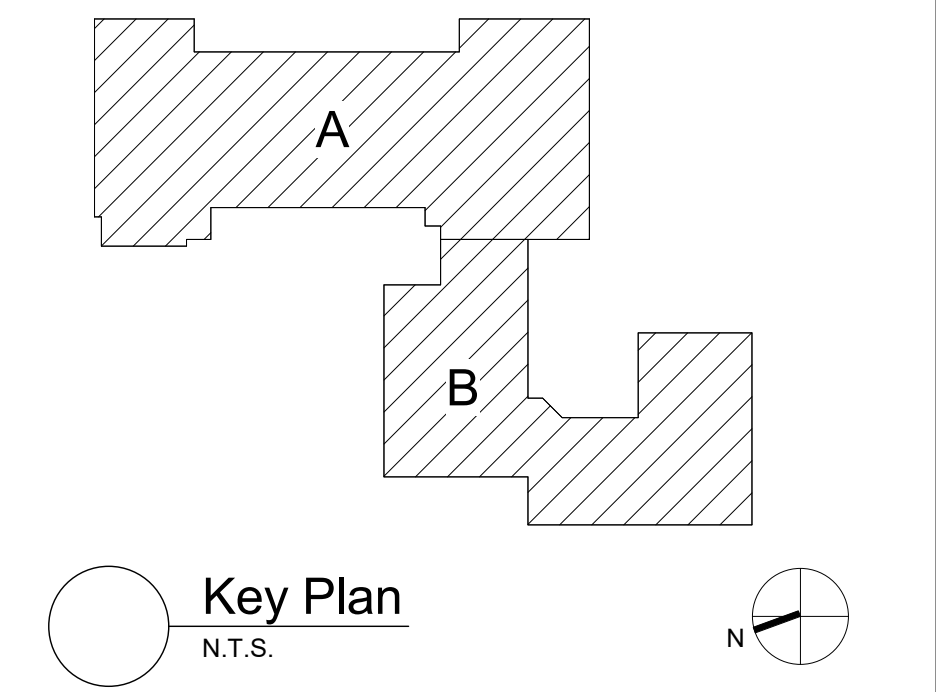


BUILDING ADDITION 1998




- General Code Notes**
- A. REFER TO CODE COMPLIANCE DRAWINGS FOR ADDITIONAL CODE COMPLIANCE INFORMATION.
 - B. COORDINATE WITH FLOOR PLANS, WALL SECTIONS AND PARTITION TYPES FOR RATED WALL TYPES AND LOCATIONS. IMMEDIATELY NOTIFY ARCHITECT OF ANY WALL RATING DISCREPANCIES BETWEEN CG351 DRAWINGS AND FLOOR PLANS.
 - C. ALL WALLS, INCLUDING AT CORRIDORS, SHALL EXTEND COMPLETELY TO THE UNDERSIDE OF DECKING, SUPPORTING STRUCTURE OR ROOF ABOVE, TYPICAL UNLESS NOTED OTHERWISE.
 - D. AT AREAS OF PROJECT WORK, COMPLETELY SEAL ALL PENETRATIONS REQUIRED TO COMPLY WITH FIRE RESISTANCE RATINGS IDENTIFIED ON THE CG351 DRAWINGS. REGARDLESS IF WALL IS NEW OR EXISTING, TYPICAL UNLESS NOTED OTHERWISE.
 - E. PROVIDE APPLIED FIREPROOFING TO ALL BEAMS, JOISTS AND STRUCTURAL STEEL ELEMENTS AT ALL FIRE BARRIERS, FIRE PARTITIONS, AND OTHER RATED WALLS WHERE INDICATED ON DRAWINGS, AND THAT ARE NOT COMPLETELY PROTECTED WITHIN THE RATED CONSTRUCTION. PROTECTION OF SUCH ELEMENTS SHALL MATCH THE RATING OF THE WALL THAT THE ELEMENTS ARE CONTAINED WITHIN.
 - F. ALL CMU CONSTRUCTION SHALL MEET FIRE RESISTANCE REQUIREMENTS INDICATED. PROVIDED BLOCK TYPE AS REQUIRED TO COMPLY WITH UL DESIGN NUMBERS AND WALL RATINGS INDICATED, REGARDLESS IF NOTED AS SUCH ON PLAN DETAILS.

- Legend**
- 1-HOUR FIRE PARTITION
 - - - - - COMMON EGRESS PATH
 - XX NUMBER OF OCCUPANTS IN EACH SPACE. UNO
 - EXISTING FIRE EXTINGUISHER LOCATION
 - RW RESCUE WINDOW
 - ALTERATION LEVEL 1 WORK AREA
 - ALTERATION LEVEL 2 WORK AREA



S.E.D. Control No. 13-02-00-01-0-008-020

Rev. No.:	Date:	Description:

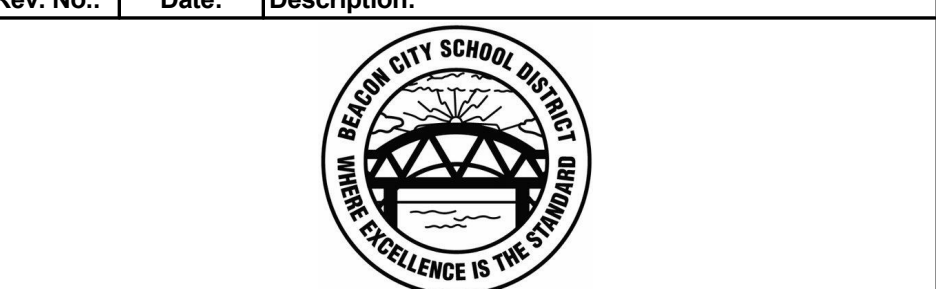

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BID SET




Beacon City School District
Beacon, New York

Reconstruction to:
Sargent Elementary School

Code Compliance Basement, First and Second Floor Key Plans

Drawn By: TLG	Date: 10/28/2022	Drawing Number:
Project No.: 279180-22004	CG351	

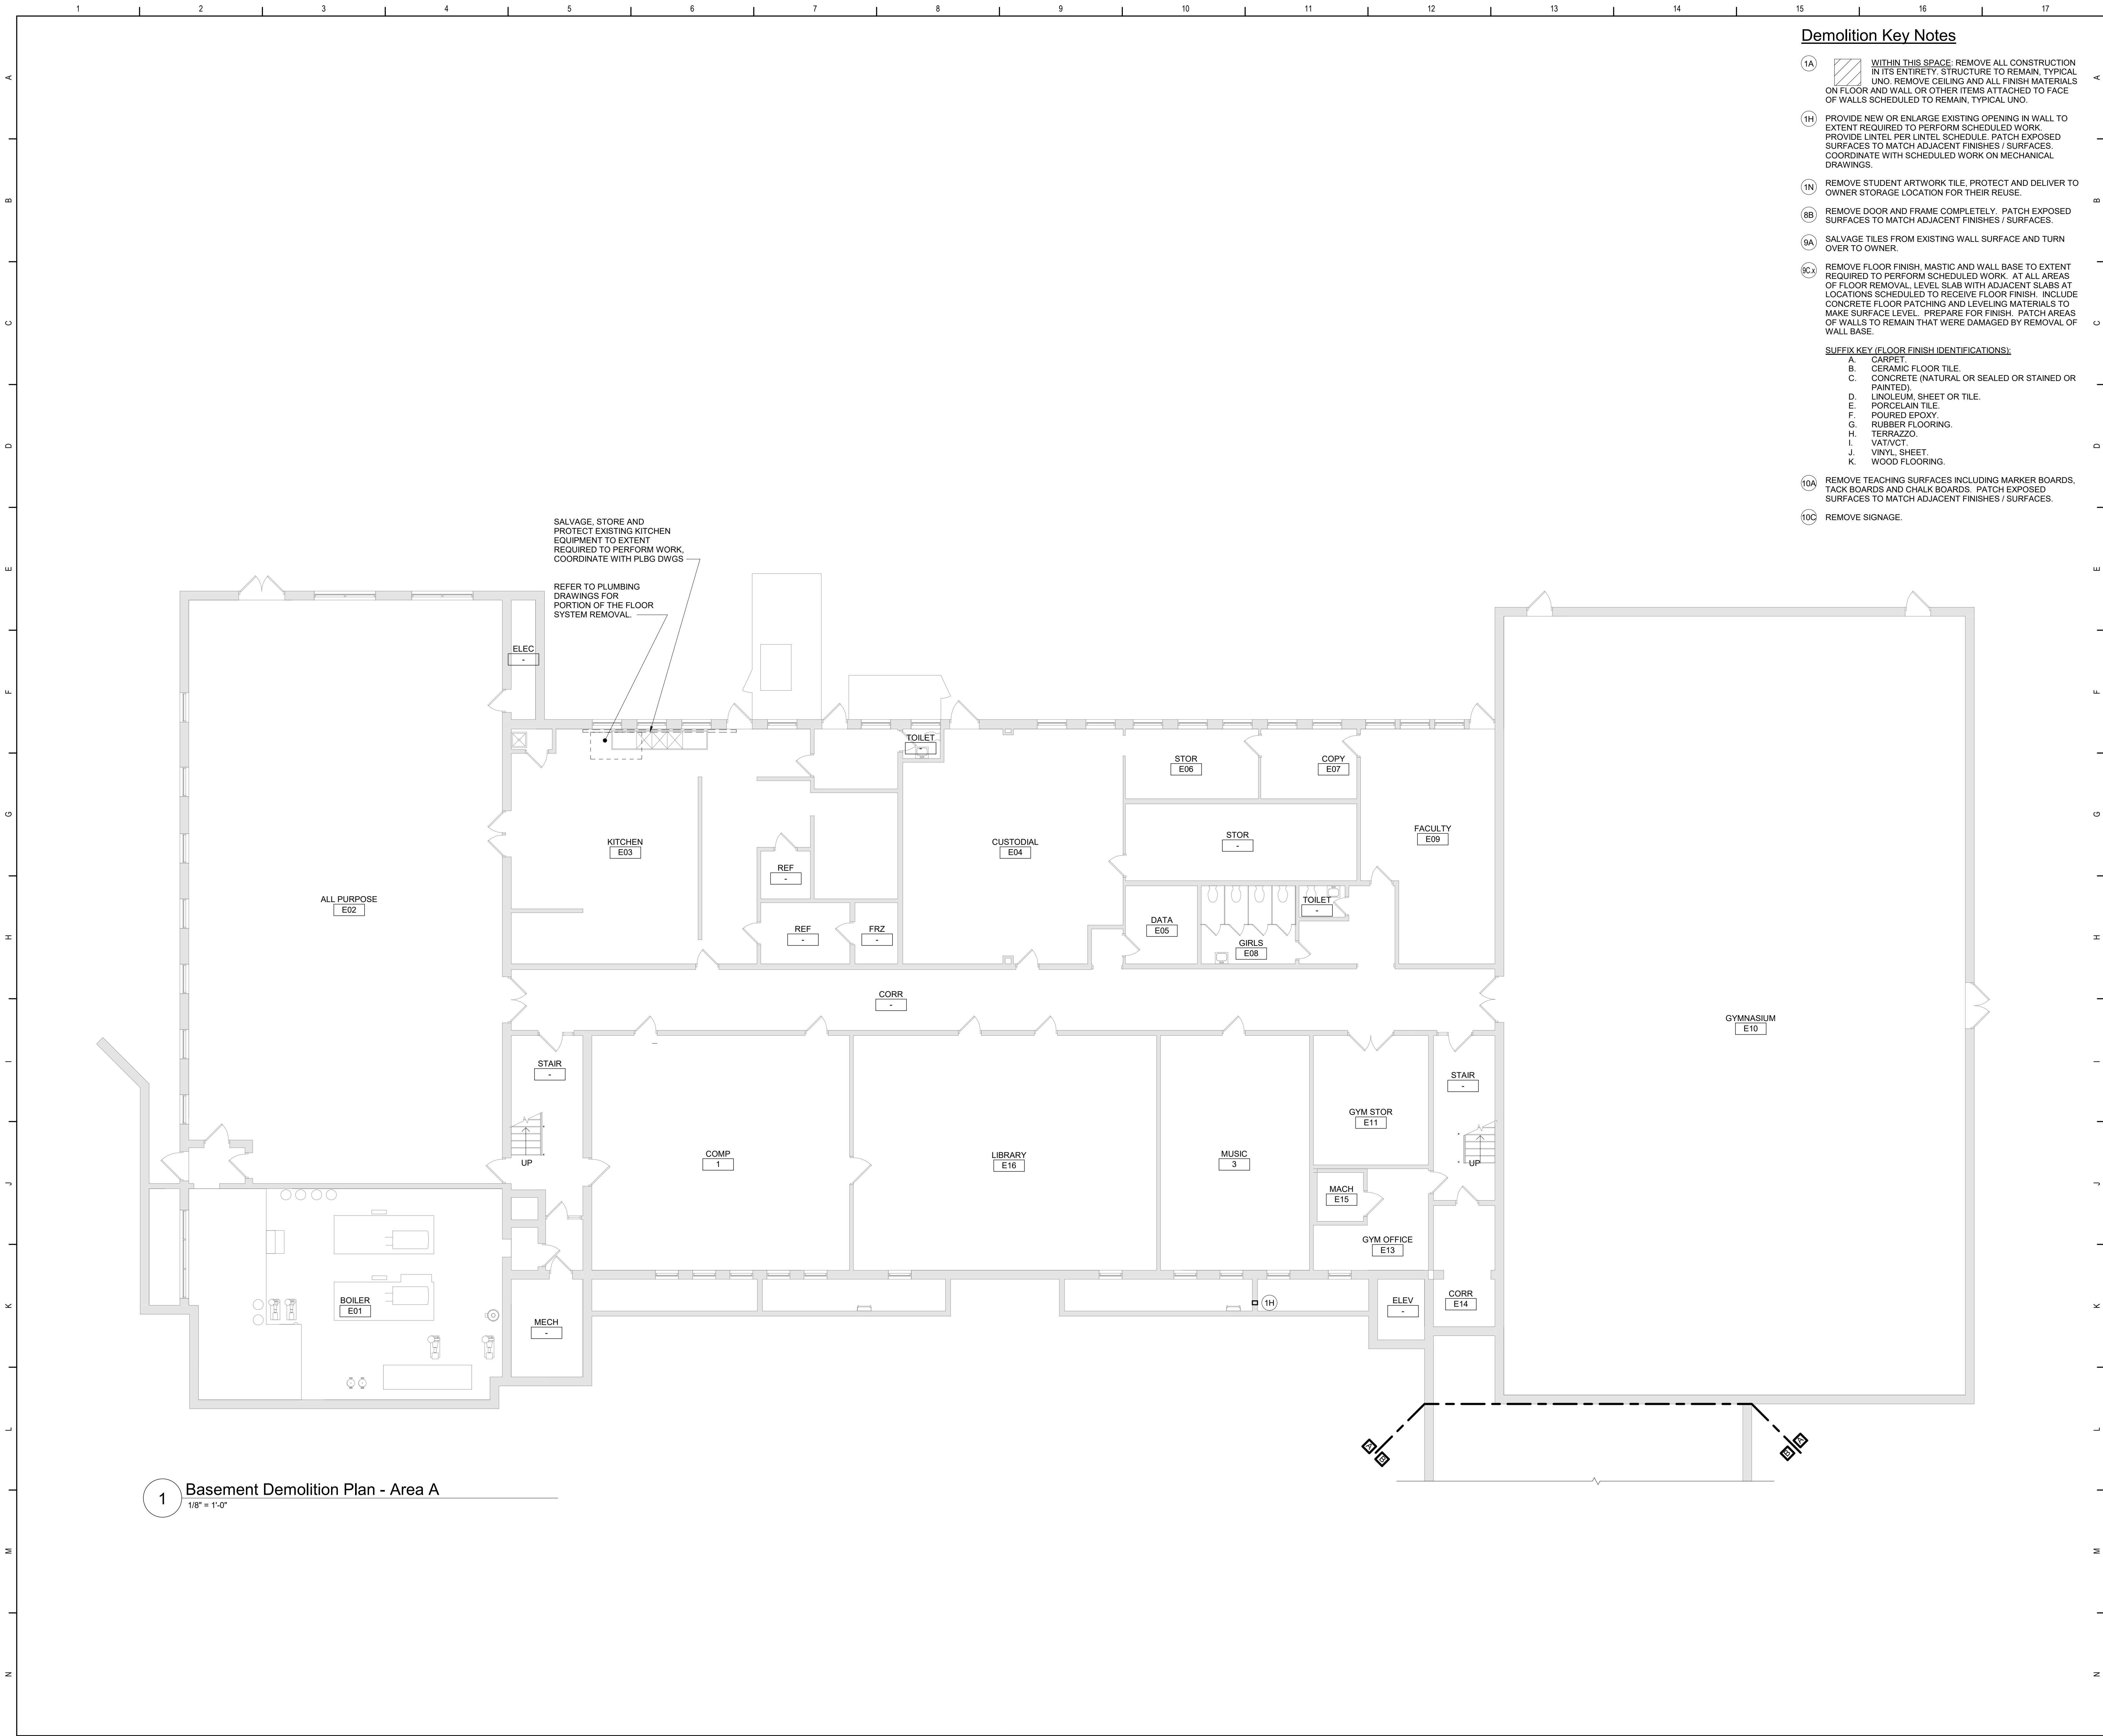


Demolition Key Notes

- (1A) WITHIN THIS SPACE, REMOVE ALL CONSTRUCTION IN ITS ENTIRETY. STRUCTURE TO REMAIN, TYPICAL UNO. REMOVE CEILING AND ALL FINISH MATERIALS ON FLOOR AND WALL OR OTHER ITEMS ATTACHED TO FACE OF WALLS SCHEDULED TO REMAIN, TYPICAL UNO.
- (1H) PROVIDE NEW OR ENLARGE EXISTING OPENING IN WALL TO EXTENT REQUIRED TO PERFORM SCHEDULED WORK. PROVIDE LINTEL PER LINTEL SCHEDULE. PATCH EXPOSED SURFACES TO MATCH ADJACENT FINISHES / SURFACES. COORDINATE WITH SCHEDULED WORK ON MECHANICAL DRAWINGS.
- (1N) REMOVE STUDENT ARTWORK TILE. PROTECT AND DELIVER TO OWNER STORAGE LOCATION FOR THEIR REUSE.
- (8B) REMOVE DOOR AND FRAME COMPLETELY. PATCH EXPOSED SURFACES TO MATCH ADJACENT FINISHES / SURFACES.
- (9A) SALVAGE TILES FROM EXISTING WALL SURFACE AND TURN OVER TO OWNER.
- (9C) REMOVE FLOOR FINISH, MASTIC AND WALL BASE TO EXTENT REQUIRED TO PERFORM SCHEDULED WORK. AT ALL AREAS OF FLOOR REMOVAL, LEVEL SLAB WITH ADJACENT SLABS AT LOCATIONS SCHEDULED TO RECEIVE FLOOR FINISH. INCLUDE CONCRETE FLOOR PATCHING AND LEVELING MATERIALS TO MAKE SURFACE LEVEL. PREPARE FOR FINISH. PATCH AREAS OF WALLS TO REMAIN THAT WERE DAMAGED BY REMOVAL OF WALL BASE.
- SUFFIX KEY (FLOOR FINISH IDENTIFICATIONS):**
- A. CARPET
 - B. CERAMIC FLOOR TILE
 - C. CONCRETE (NATURAL OR SEALED OR STAINED OR PAINTED)
 - D. LINOLEUM, SHEET OR TILE
 - E. PORCELAIN TILE
 - F. POURED EPOXY
 - G. RUBBER FLOORING
 - H. TERRAZZO
 - I. VAT/VT
 - J. VINYL SHEET
 - K. WOOD FLOORING
- (10A) REMOVE TEACHING SURFACES INCLUDING MARKER BOARDS, TACK BOARDS AND CHALK BOARDS. PATCH EXPOSED SURFACES TO MATCH ADJACENT FINISHES / SURFACES.
- (10C) REMOVE SIGNAGE.

General Demolition Notes

- A. "-----" REMOVE ITEMS INDICATED BY DASHED LINE.
- B. KEYED DEMOLITION TAGS REFER TO SPECIFIC LOCATIONS AS FOLLOWS:
- DEMOLITION TAGS LOCATED WITHIN THE MIDDLE OF A SPACE REFER TO DEMOLITION OF ALL ITEMS OF THAT SAME TYPE WITHIN THAT ENTIRE SPACE.
 - DEMOLITION TAGS PLACED IMMEDIATELY ON OR ADJACENT TO A DASHED LINE INDICATING ITEM REMOVAL OR THAT HAVE A LEADER POINTING TO SPECIFIC ITEM(S) REFER TO DEMOLITION OF THAT SPECIFIC ITEM ONLY OF THAT TYPE WITHIN THAT SPACE.
 - DEMOLITION TAGS IN SERIES REFER TO DEMOLITION OF ALL THOSE ITEMS EITHER WITHIN THAT ENTIRE SPACE OR TO THE SPACE IDENTIFIED BY THAT LEADER.
- C. WHEN AN ITEM IS INDICATED TO BE DEMOLISHED REMOVE ALL ASSOCIATED COMPONENTS AS PART OF THAT WORK.
- D. ALL ARTWORK NOT PERMANENTLY AFFIXED TO EXISTING CONSTRUCTION SHALL BE REMOVED AND STORED BY OWNER PRIOR TO BEGINNING DEMOLITION WORK. CONTACT OWNERS AGENT(S) IF ANY ARTWORK IS ENCOUNTERED PRIOR TO START OF DEMOLITION WORK.

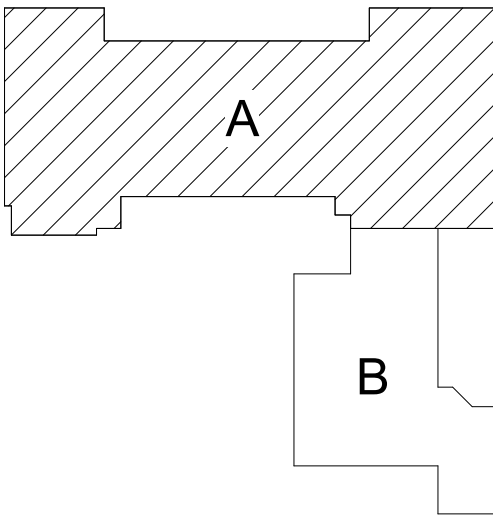

Key Plan
N.T.S.

S.E.D. Control No. 13-02-00-01-0-008-020

Rev. No.: Date: Description:



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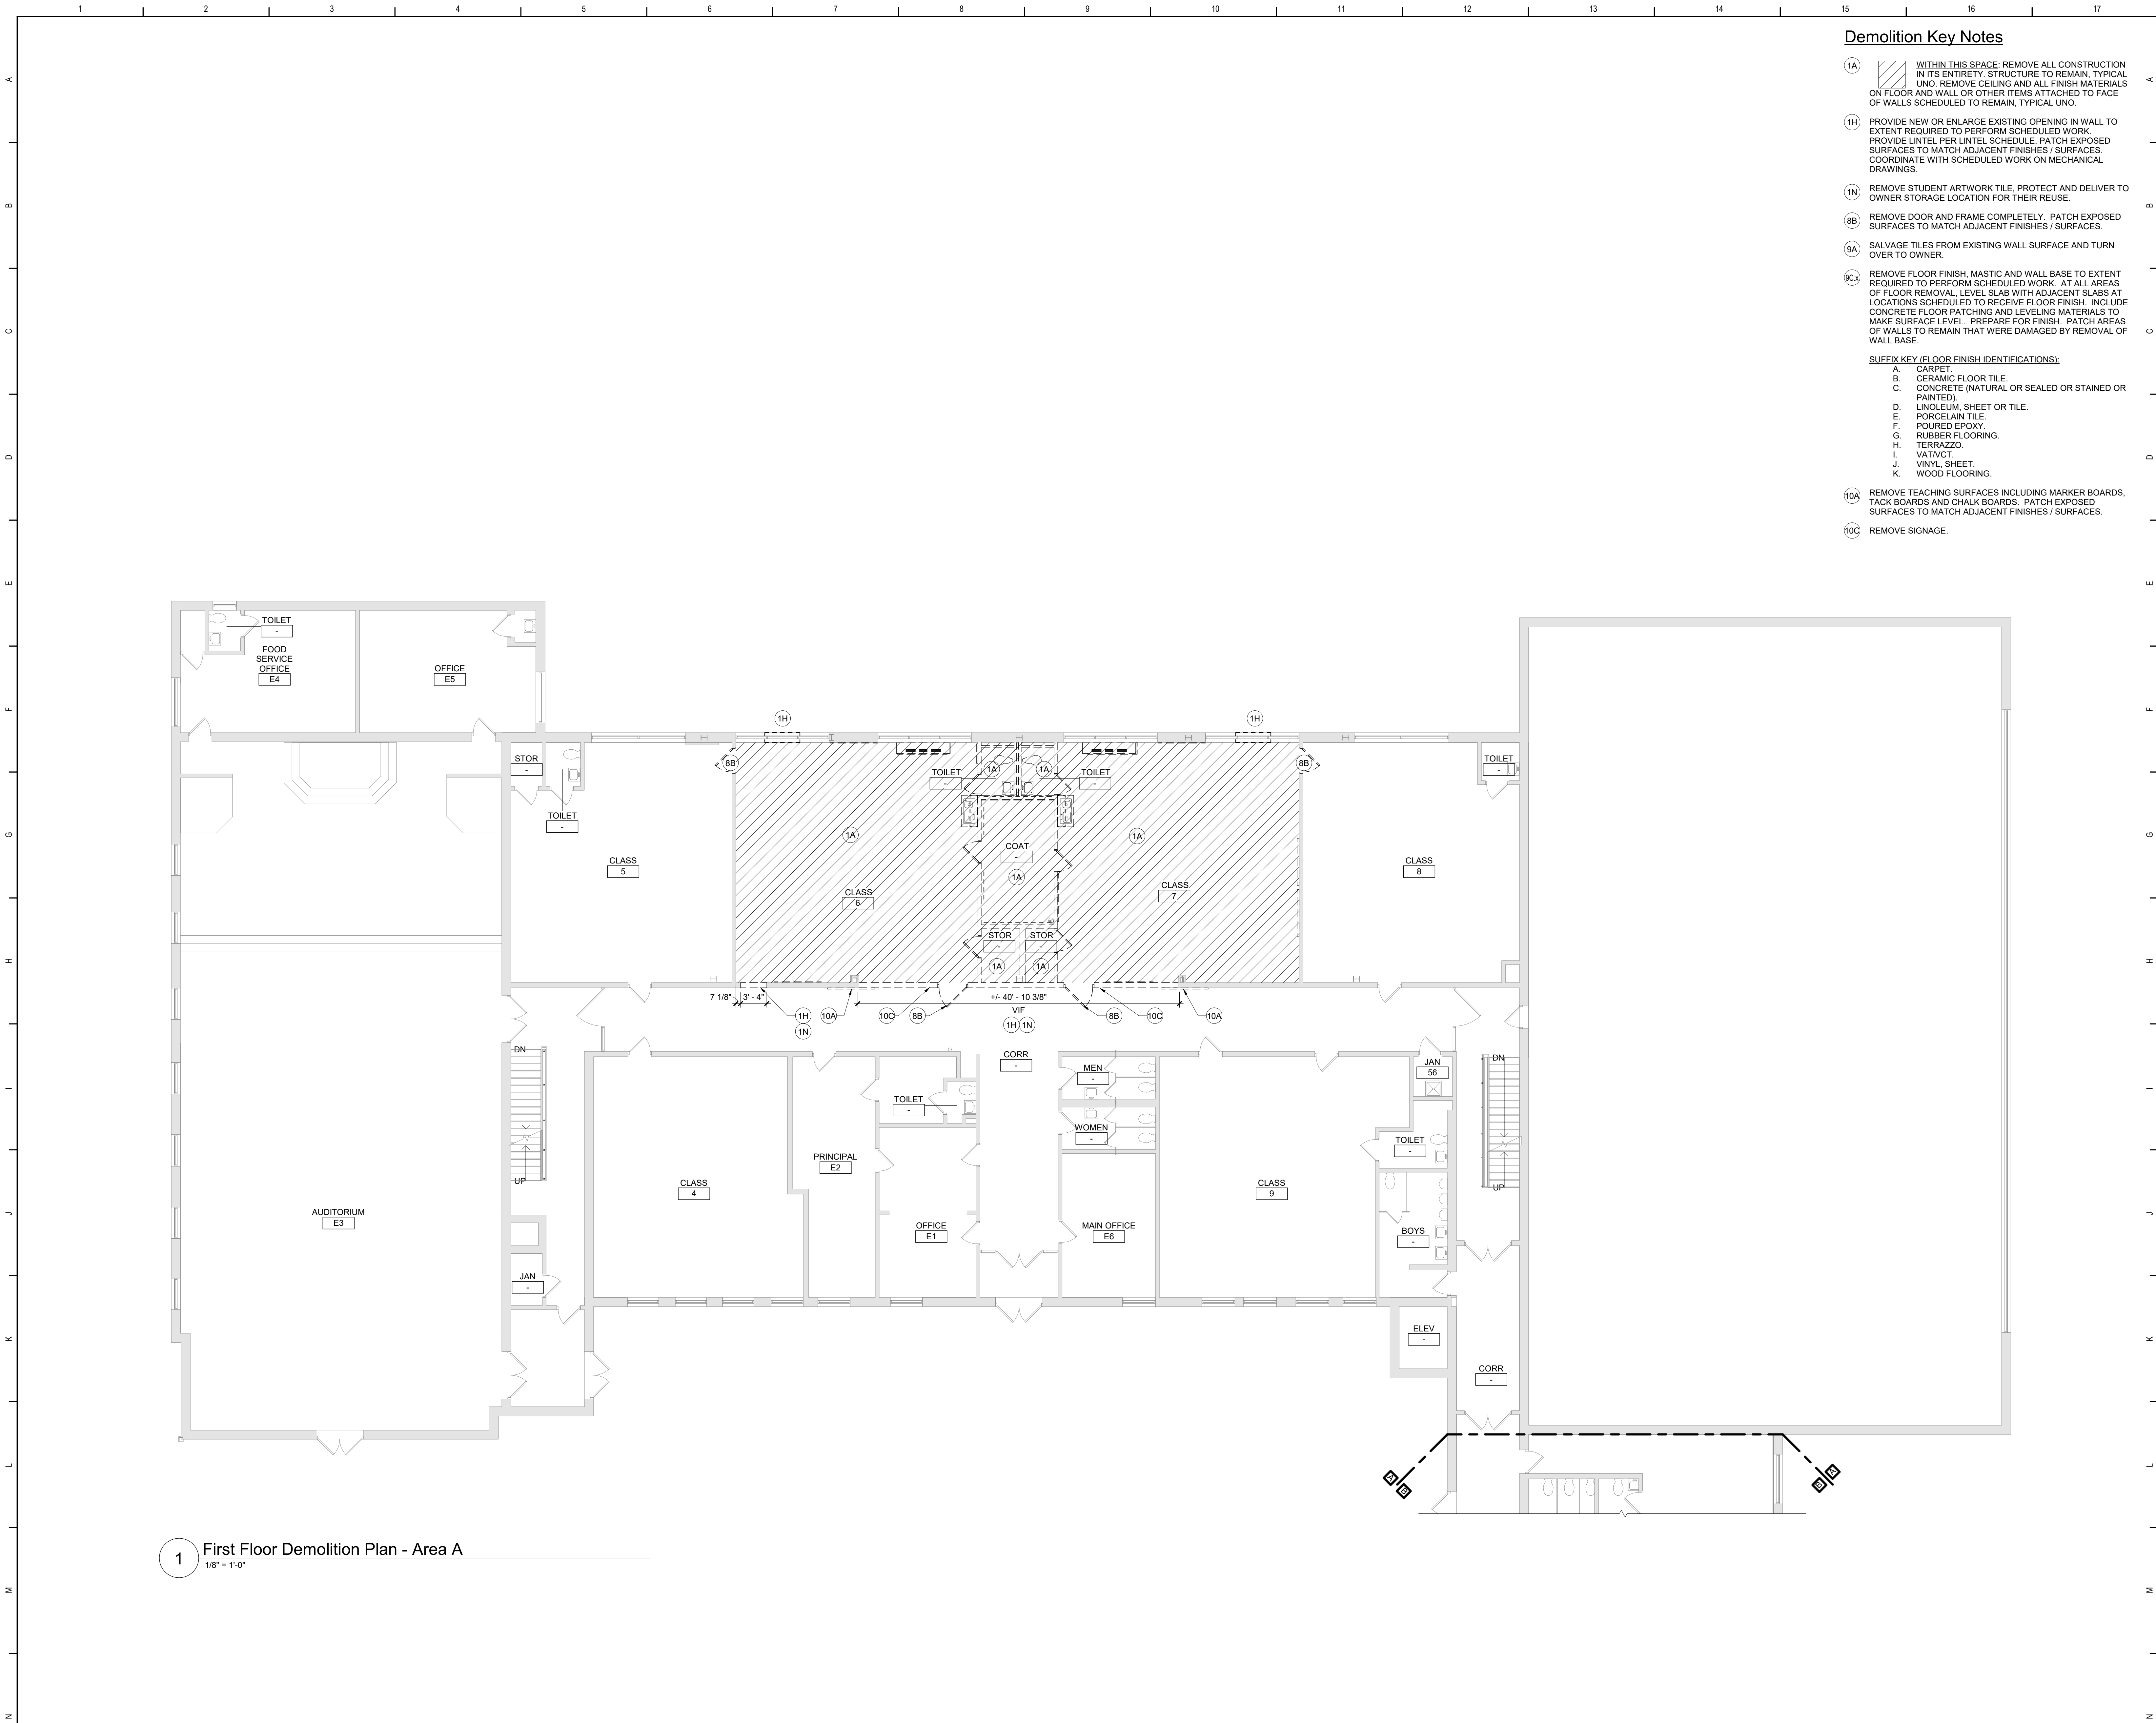


Beacon City School District
Beacon, New York

Reconstruction to:
Sargent Elementary School

Basement Demolition Plan - Area A

Drawn By: TLG	Date: 10/28/2022	Drawing Number: CA100
Project No.: 279180-22004		




1 First Floor Demolition Plan - Area A
1/8" = 1'-0"

Demolition Key Notes

- (1A) WITHIN THIS SPACE, REMOVE ALL CONSTRUCTION IN ITS ENTIRETY. STRUCTURE TO REMAIN, TYPICAL UNO. REMOVE CEILING AND ALL FINISH MATERIALS ON FLOOR AND WALL OR OTHER ITEMS ATTACHED TO FACE OF WALLS SCHEDULED TO REMAIN, TYPICAL UNO.
 - (1H) PROVIDE NEW OR ENLARGE EXISTING OPENING IN WALL TO EXTENT REQUIRED TO PERFORM SCHEDULED WORK. PROVIDE UNTEL PER UNTEL. SCHEDULE. PATCH EXPOSED SURFACES TO MATCH ADJACENT FINISHES / SURFACES. COORDINATE WITH SCHEDULED WORK ON MECHANICAL DRAWINGS.
 - (1N) REMOVE STUDENT ARTWORK TILE. PROTECT AND DELIVER TO OWNER STORAGE LOCATION FOR THEIR REUSE.
 - (8B) REMOVE DOOR AND FRAME COMPLETELY. PATCH EXPOSED SURFACES TO MATCH ADJACENT FINISHES / SURFACES.
 - (9A) SALVAGE TILES FROM EXISTING WALL SURFACE AND TURN OVER TO OWNER.
 - (9C) REMOVE FLOOR FINISH, MASTIC AND WALL BASE TO EXTENT REQUIRED TO PERFORM SCHEDULED WORK. AT ALL AREAS OF FLOOR REMOVAL, LEVEL SLAB WITH ADJACENT SLABS AT LOCATIONS SCHEDULED TO RECEIVE FLOOR FINISH. INCLUDE CONCRETE FLOOR PATCHING AND LEVELING MATERIALS TO MAKE SURFACE LEVEL. PREPARE FOR FINISH. PATCH AREAS OF WALLS TO REMAIN THAT WERE DAMAGED BY REMOVAL OF WALL BASE.
- SUFFIX KEY (FLOOR FINISH IDENTIFICATIONS):
- A. CARPET
 - B. CERAMIC FLOOR TILE
 - C. CONCRETE (NATURAL OR SEALED OR STAINED OR PAINTED)
 - D. LINOLEUM, SHEET OR TILE
 - E. PORCELAIN TILE
 - F. POURED EPOXY
 - G. RUBBER FLOORING
 - H. TERRAZZO
 - I. VAT/VCT
 - J. VINYL, SHEET
 - K. WOOD FLOORING
- (10A) REMOVE TEACHING SURFACES INCLUDING MARKER BOARDS, TACK BOARDS AND CHALK BOARDS. PATCH EXPOSED SURFACES TO MATCH ADJACENT FINISHES / SURFACES.
 - (10C) REMOVE SIGNAGE.

General Demolition Notes

- A. "-----" REMOVE ITEMS INDICATED BY DASHED LINE.
- B. KEYED DEMOLITION TAGS REFER TO SPECIFIC LOCATIONS AS FOLLOWS:
 - 1. DEMOLITION TAGS LOCATED WITHIN THE MIDDLE OF A SPACE REFER TO DEMOLITION OF ALL ITEMS OF THAT SAME TYPE WITHIN THAT ENTIRE SPACE.
 - 2. DEMOLITION TAGS PLACED IMMEDIATELY ON OR ADJACENT TO A DASHED LINE INDICATING ITEM REMOVAL OR THAT HAVE A LEADER POINTING TO SPECIFIC ITEM(S) REFER TO DEMOLITION OF THAT SPECIFIC ITEM ONLY OF THAT TYPE WITHIN THAT SPACE.
 - 3. DEMOLITION TAGS IN SERIES REFER TO DEMOLITION OF ALL THOSE ITEMS EITHER WITHIN THAT ENTIRE SPACE OR TO THE SPACE IDENTIFIED BY THAT LEADER.
- C. WHEN AN ITEM IS INDICATED TO BE DEMOLISHED REMOVE ALL ASSOCIATED COMPONENTS AS PART OF THAT WORK.
- D. ALL ARTWORK NOT PERMANENTLY AFFIXED TO EXISTING CONSTRUCTION SHALL BE REMOVED AND STORED BY OWNER PRIOR TO BEGINNING DEMOLITION WORK. CONTACT OWNERS AGENT(S) IF ANY ARTWORK IS ENCOUNTERED PRIOR TO START OF DEMOLITION WORK.

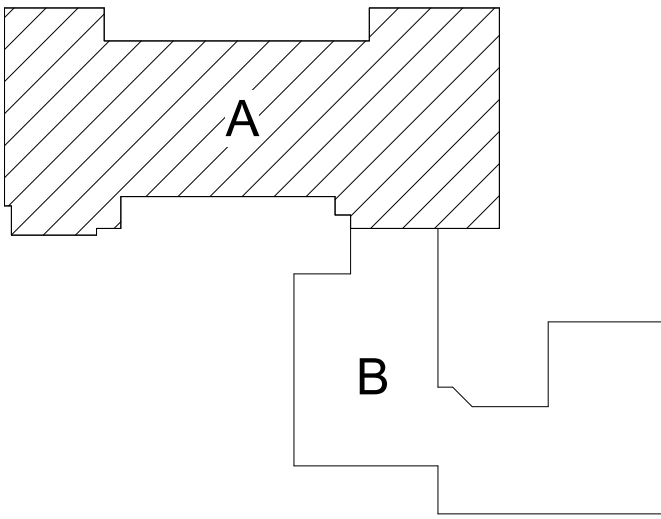

Key Plan
N.T.S.

S.E.D. Control No. 13-02-00-01-0-008-020

Rev. No.: Date: Description:



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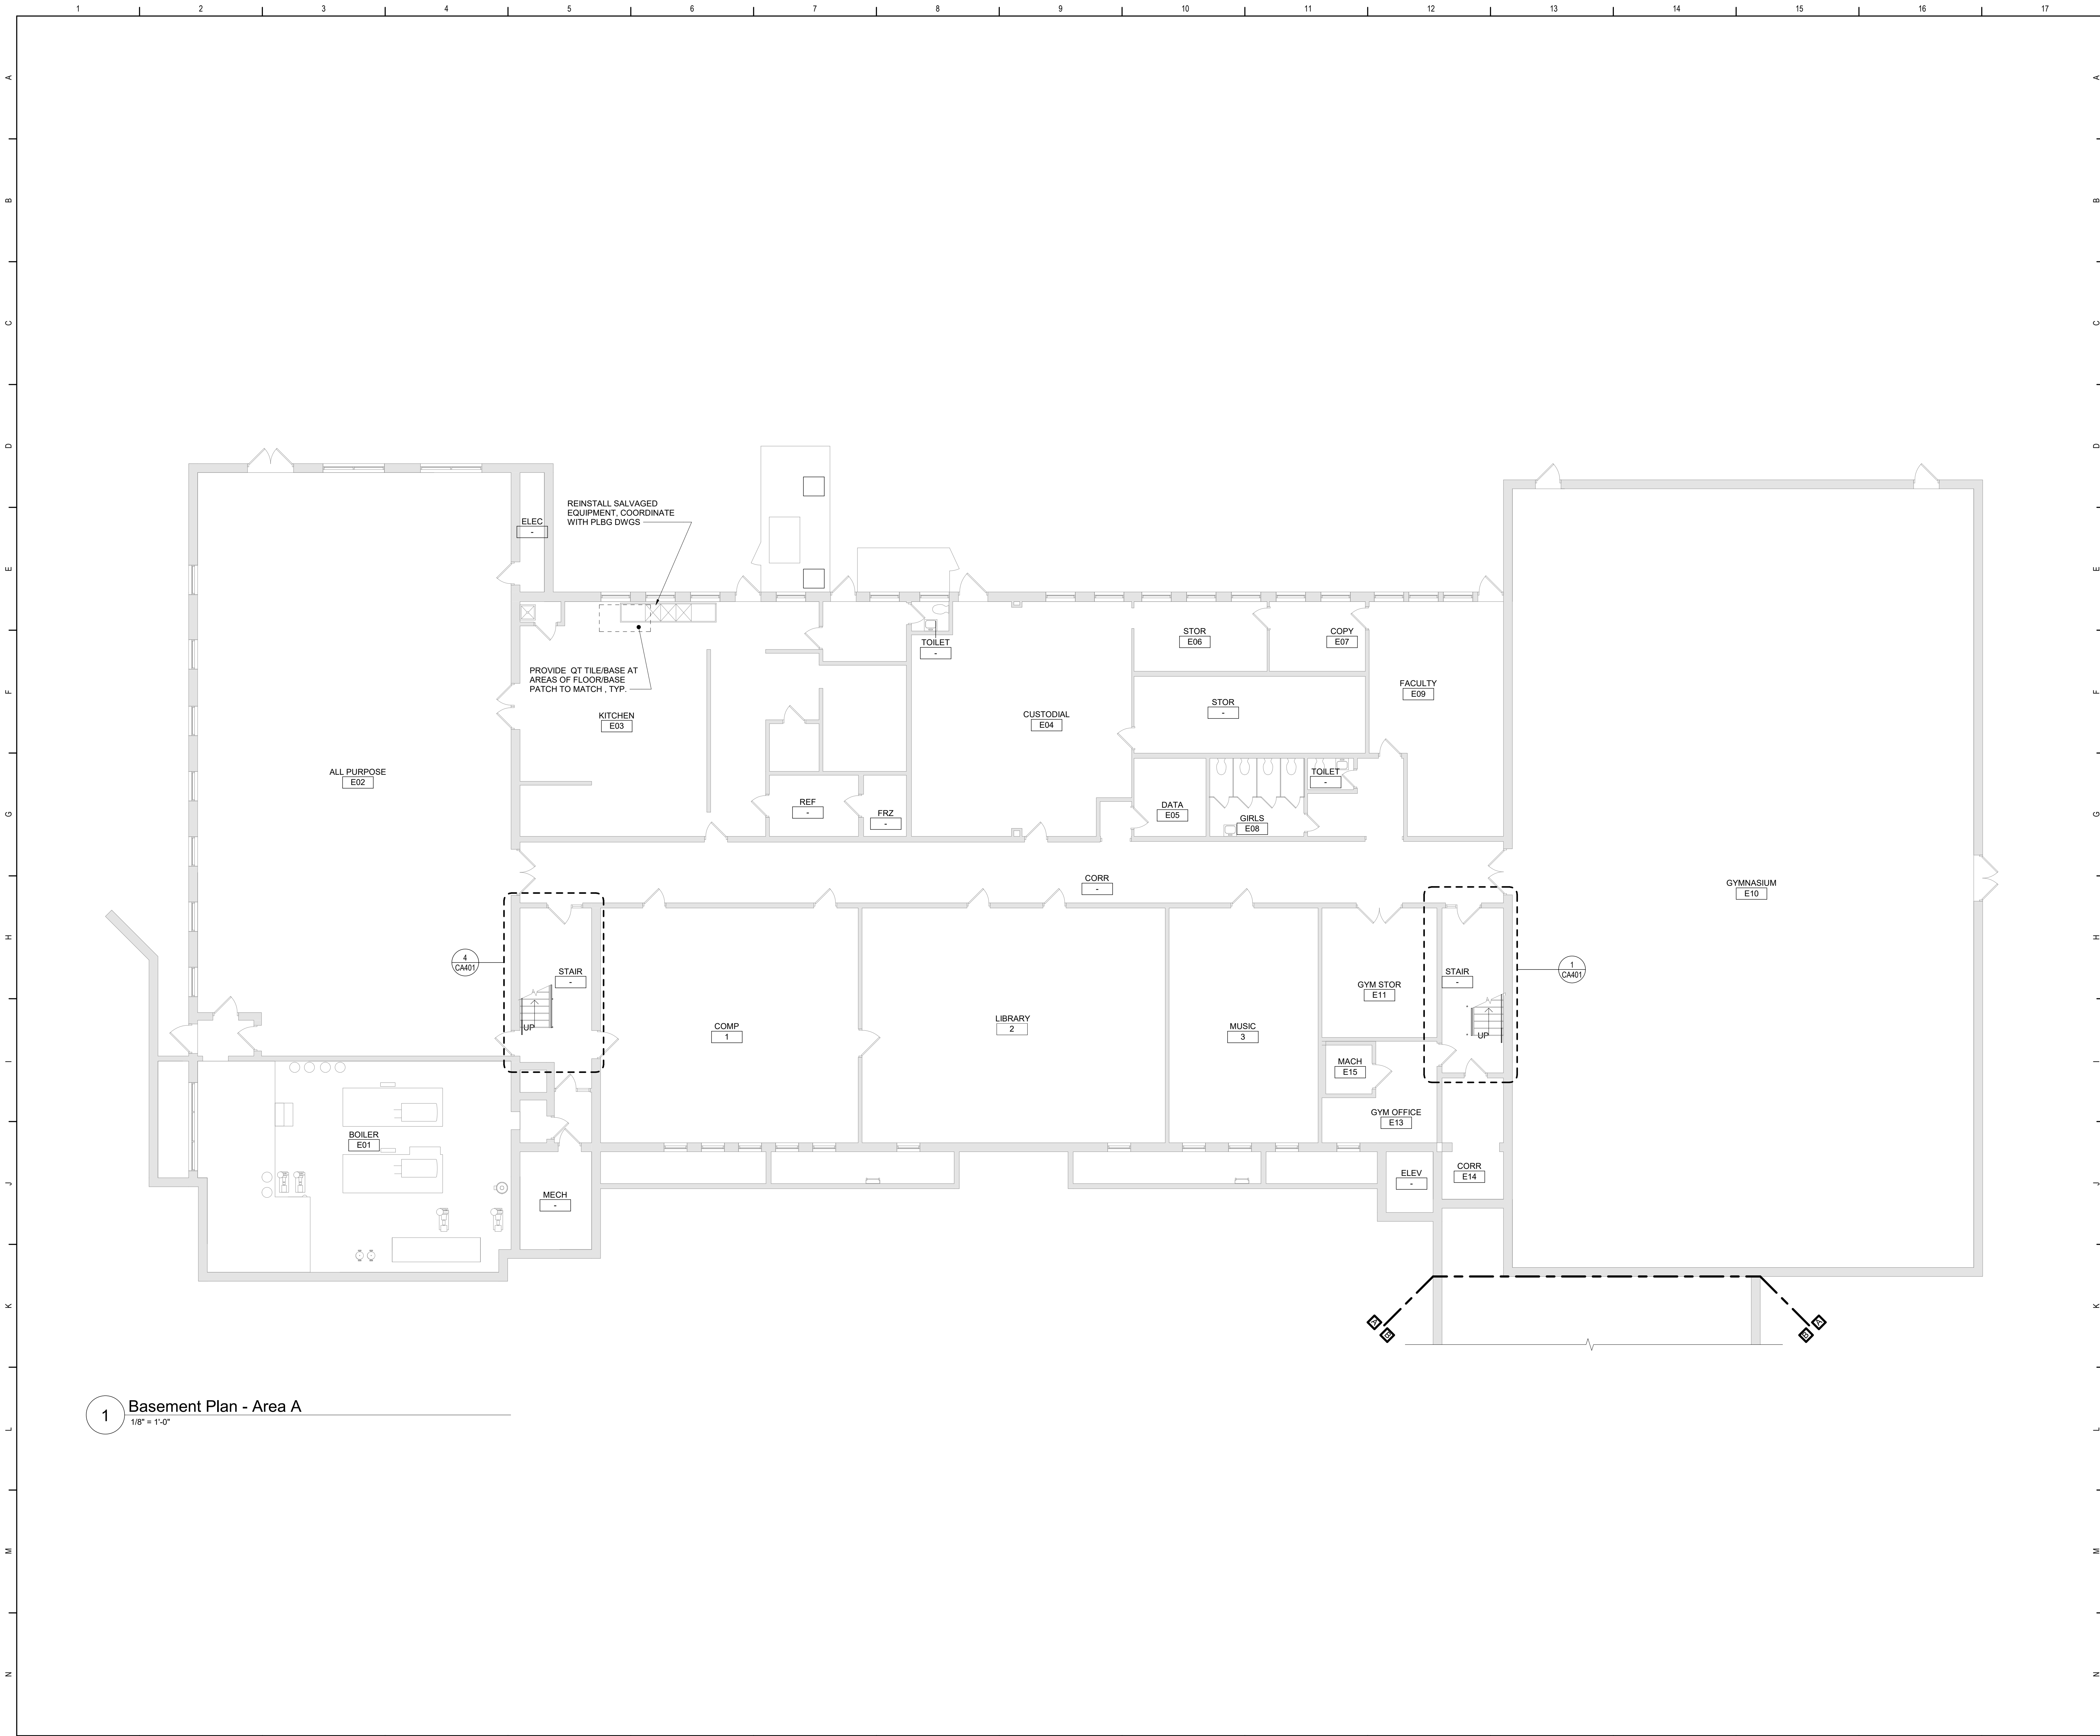


Beacon City School District
Beacon, New York

Reconstruction to:
Sargent Elementary School

First Floor Demolition Plan - Area A

Drawn By: TLG Date: 10/28/2022 Drawing Number: CA101
Project No.: 279180-22004



1 Basement Plan - Area A
1/8" = 1'-0"

General Plan Notes

A. WHERE EXISTING CONSTRUCTION IS DAMAGED OR DISTURBED, PATCH AS REQUIRED TO RESTORE SURFACES TO THEIR ORIGINAL CONDITION.

B. PARTITION TYPE TAGS APPLY TO ENTIRE LENGTH OF WALL INDICATED BY THAT TAG, REGARDLESS OF OPENINGS WITHIN THAT WALL, TYPICAL UNLESS NOTED OTHERWISE.

1. ALL INTERIOR WALLS SHALL BE WALL/PARTITION TYPE P12.3, TYPICAL UNLESS NOTED OTHERWISE.

C. INFILL AREAS OF RECESSED FLOOR MAT AND/OR FINISH REMOVALS WITH REPAIR MATERIAL PROVIDE SUBSTRATE LEVEL AS REQUIRED SO SCHEDULED FINISHED FLOOR WILL MATCH THAT OF EXISTING ADJACENT AREAS.

D. PROVIDE BRACING WITHIN CHASES AS FOLLOWS:

1. MASONRY WALLS: FULL-HEIGHT 4" CMU BRACES AT MAXIMUM SPACING OF 11'-0" OC.

2. GYPSUM BOARD/TILE BACKING PANELS ON METAL FRAMING: FULL-HEIGHT 6" METAL STUD BRACES AT MAXIMUM SPACING OF 11'-0" OC.

Key Plan
N.T.S.

S.E.D. Control No. 13-02-00-01-0-008-020

Rev. No.	Date	Description

BEACON CITY SCHOOL DISTRICT
EXCELLENCE IS THE STANDARD

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Tetra Tech Engineers, Architects & Landscape Architects, P.C.


TETRA TECH
ARCHITECTS & ENGINEERS

Beacon City School District
Beacon, New York

Reconstruction to:
Sargent Elementary School

Basement Plan - Area A

Drawn By: TLG	Date: 10/28/2022	Drawing Number:
Project No.: 279180-22004		CA130

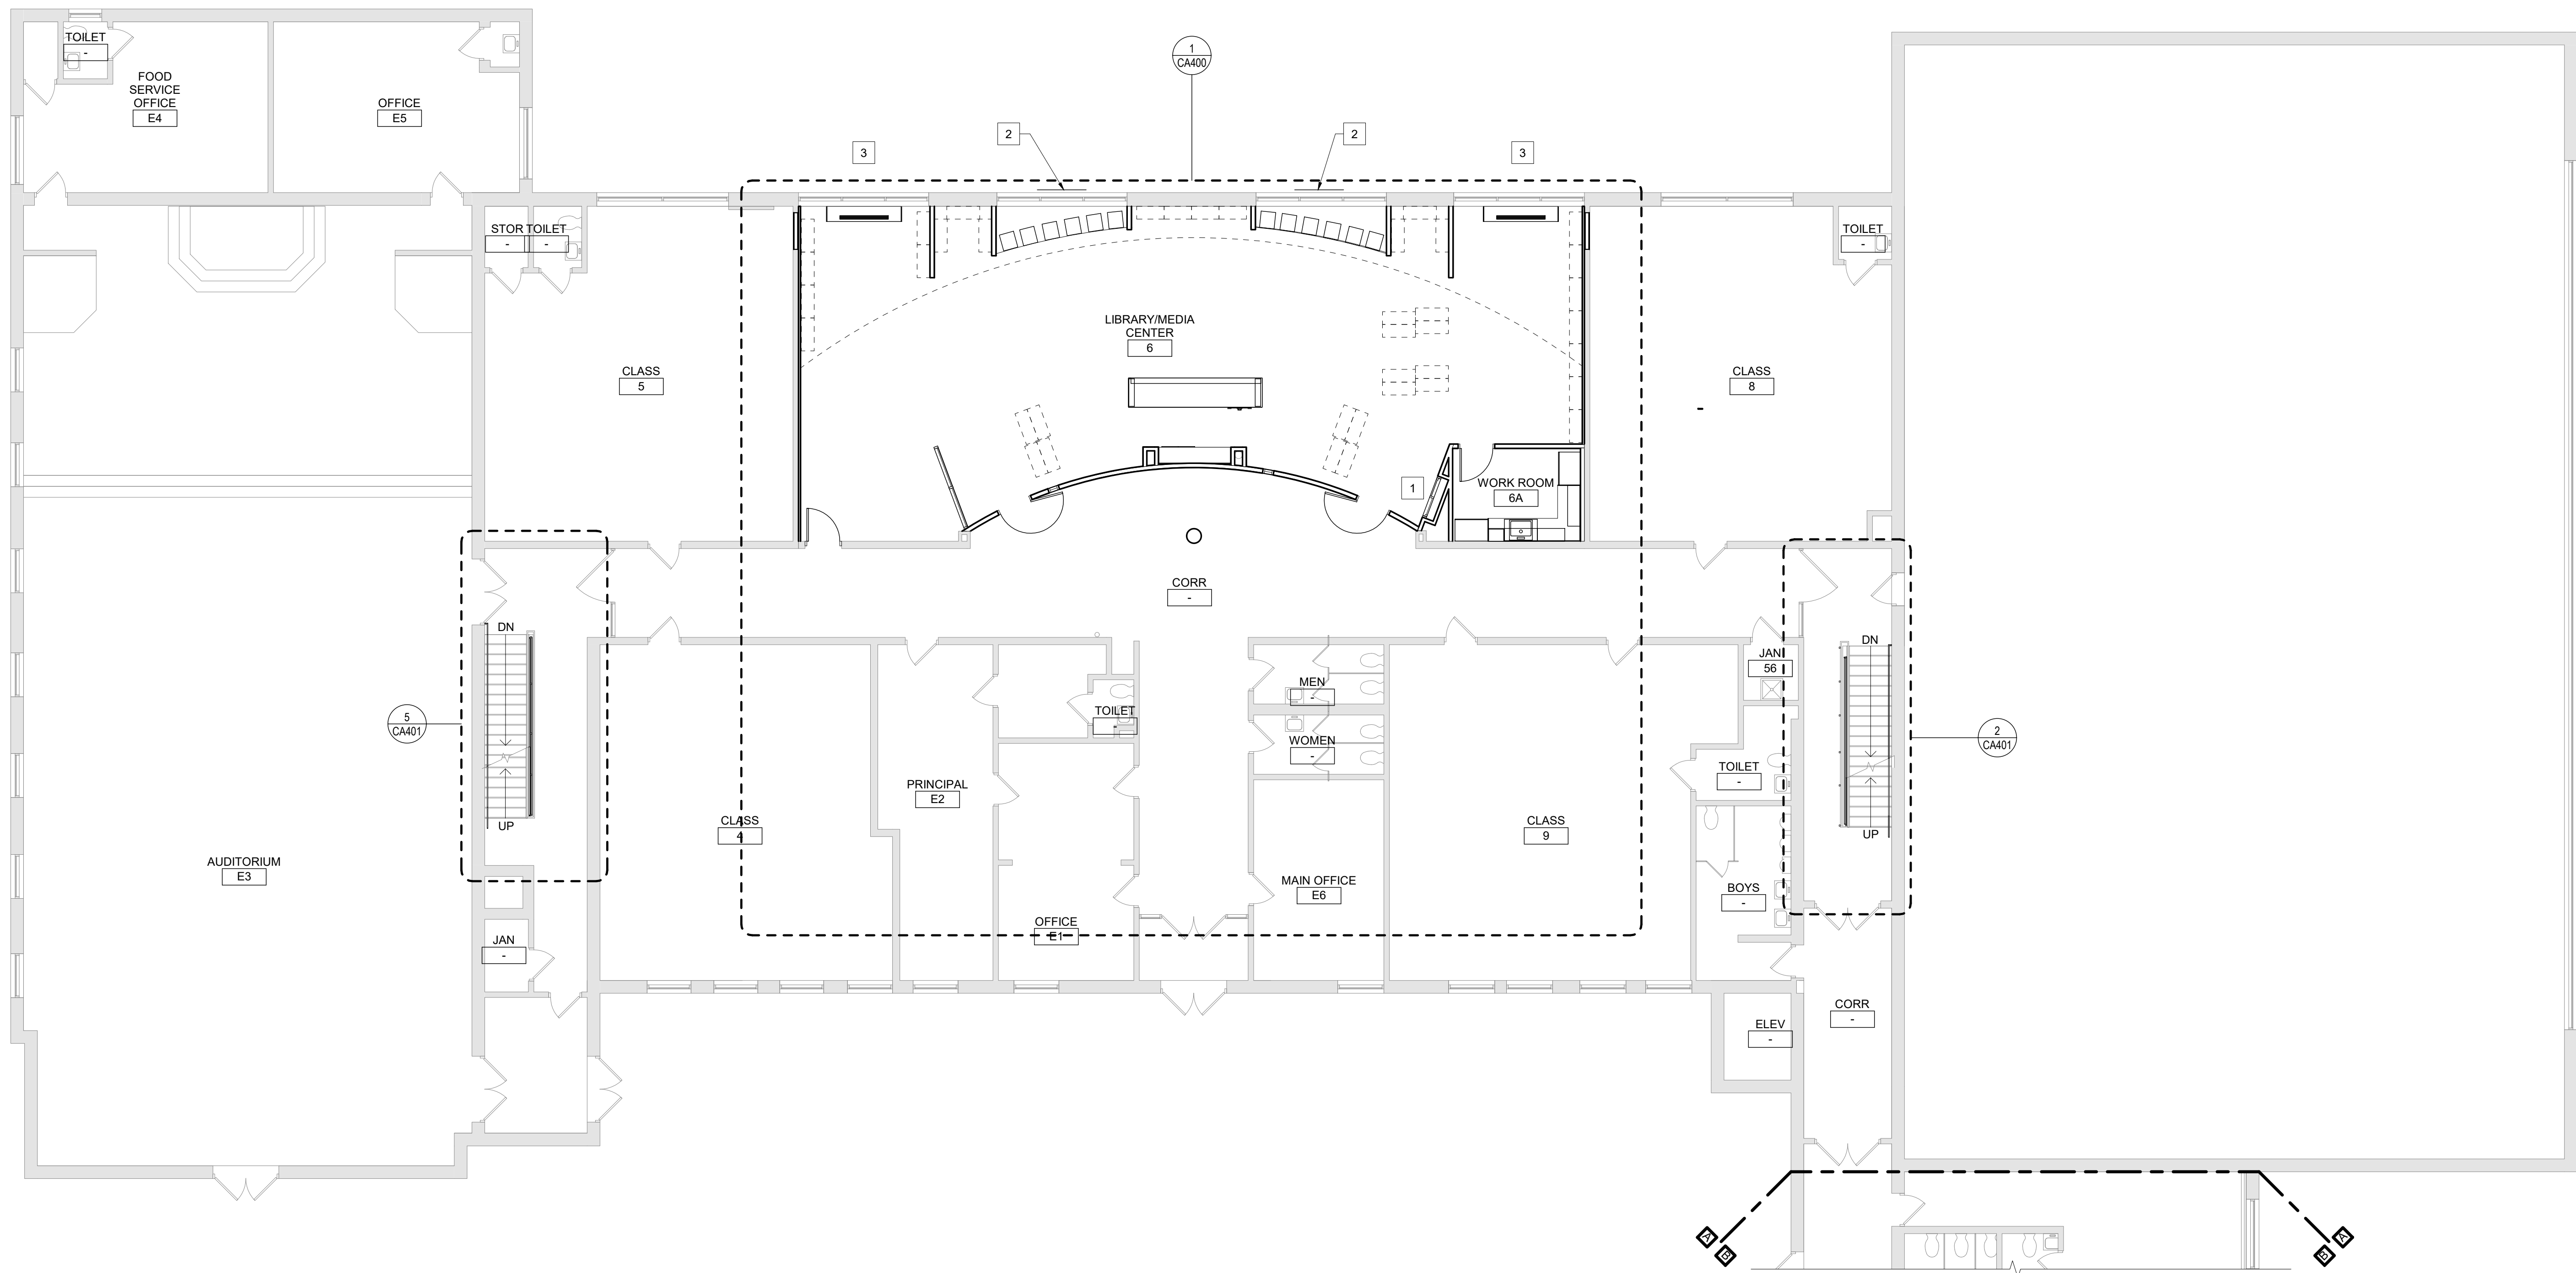


1 First Floor Plan - Area A
1/8" = 1'-0"

General Plan Notes


- A. WHERE EXISTING CONSTRUCTION IS DAMAGED OR DISTURBED, PATCH AS REQUIRED TO RESTORE SURFACES TO THEIR ORIGINAL CONDITION.
- B. PARTITION TYPE TAGS APPLY TO ENTIRE LENGTH OF WALL INDICATED BY THAT TAG, REGARDLESS OF OPENINGS WITHIN THAT WALL. TYPICAL UNLESS NOTED OTHERWISE.
1. ALL INTERIOR WALLS SHALL BE WALL/PARTITION TYPE P12.3, TYPICAL UNLESS NOTED OTHERWISE.
- C. INFILL AREAS OF RECESSED FLOOR MAT AND/OR FINISH REMOVALS WITH REPAIR MATERIAL. PROVIDE SUBSTRATE LEVEL AS REQUIRED SO SCHEDULED FINISHED FLOOR WILL MATCH THAT OF EXISTING ADJACENT AREAS.
- D. PROVIDE BRACING WITHIN CHASES AS FOLLOWS:
1. MASONRY WALLS: FULL-HEIGHT 4" CMU BRACES AT MAXIMUM SPACING OF 11'-0" OC.
2. GYPSUM BOARD/TILE BACKING PANELS ON METAL FRAMING: FULL-HEIGHT 6" METAL STUD BRACES AT MAXIMUM SPACING OF 11'-0" OC.

Keyed Plan Notes

- 1 DISPLAY CASE, REFER TO DETAIL 8/CA750.
- 2 PROVIDE EXTERIOR WALL INFILL AT EXISTING OPENING. MATCH ADJACENT CONSTRUCTION MATERIALS AND THICKNESS, V.I.F.
- 3 INSTALL LOUVER FURNISHED BY OTHERS AT NEW OPENING. COORDINATE WITH MECHANICAL DRAWINGS.

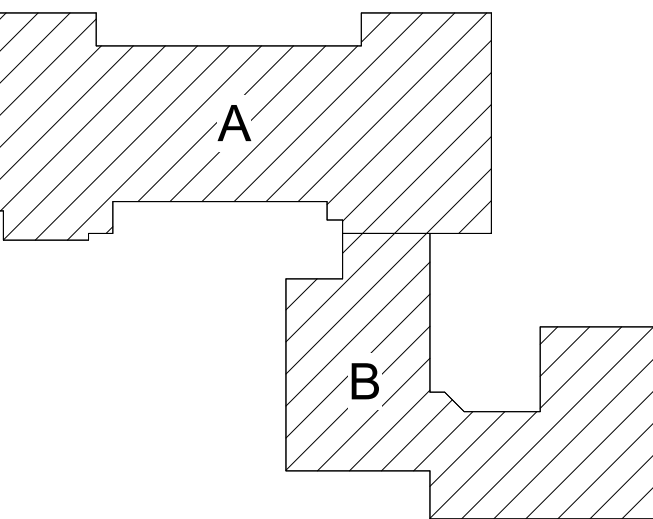

Key Plan
N.T.S.

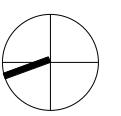

S.E.D. Control No. 13-02-00-01-0-008-020

Rev. No.: Date: Description:



complex world
CLEAR SOLUTIONS

Tetra Tech Engineers, Architects
& Landscape Architects, P.C.

BID SET




Beacon City School District
Beacon, New York

Reconstruction to:
Sargent Elementary School

First Floor Plan - Area A


Drawn By: GK	Date: 10/28/2022	Drawing Number:
Project No.: 279180-22004		CA131

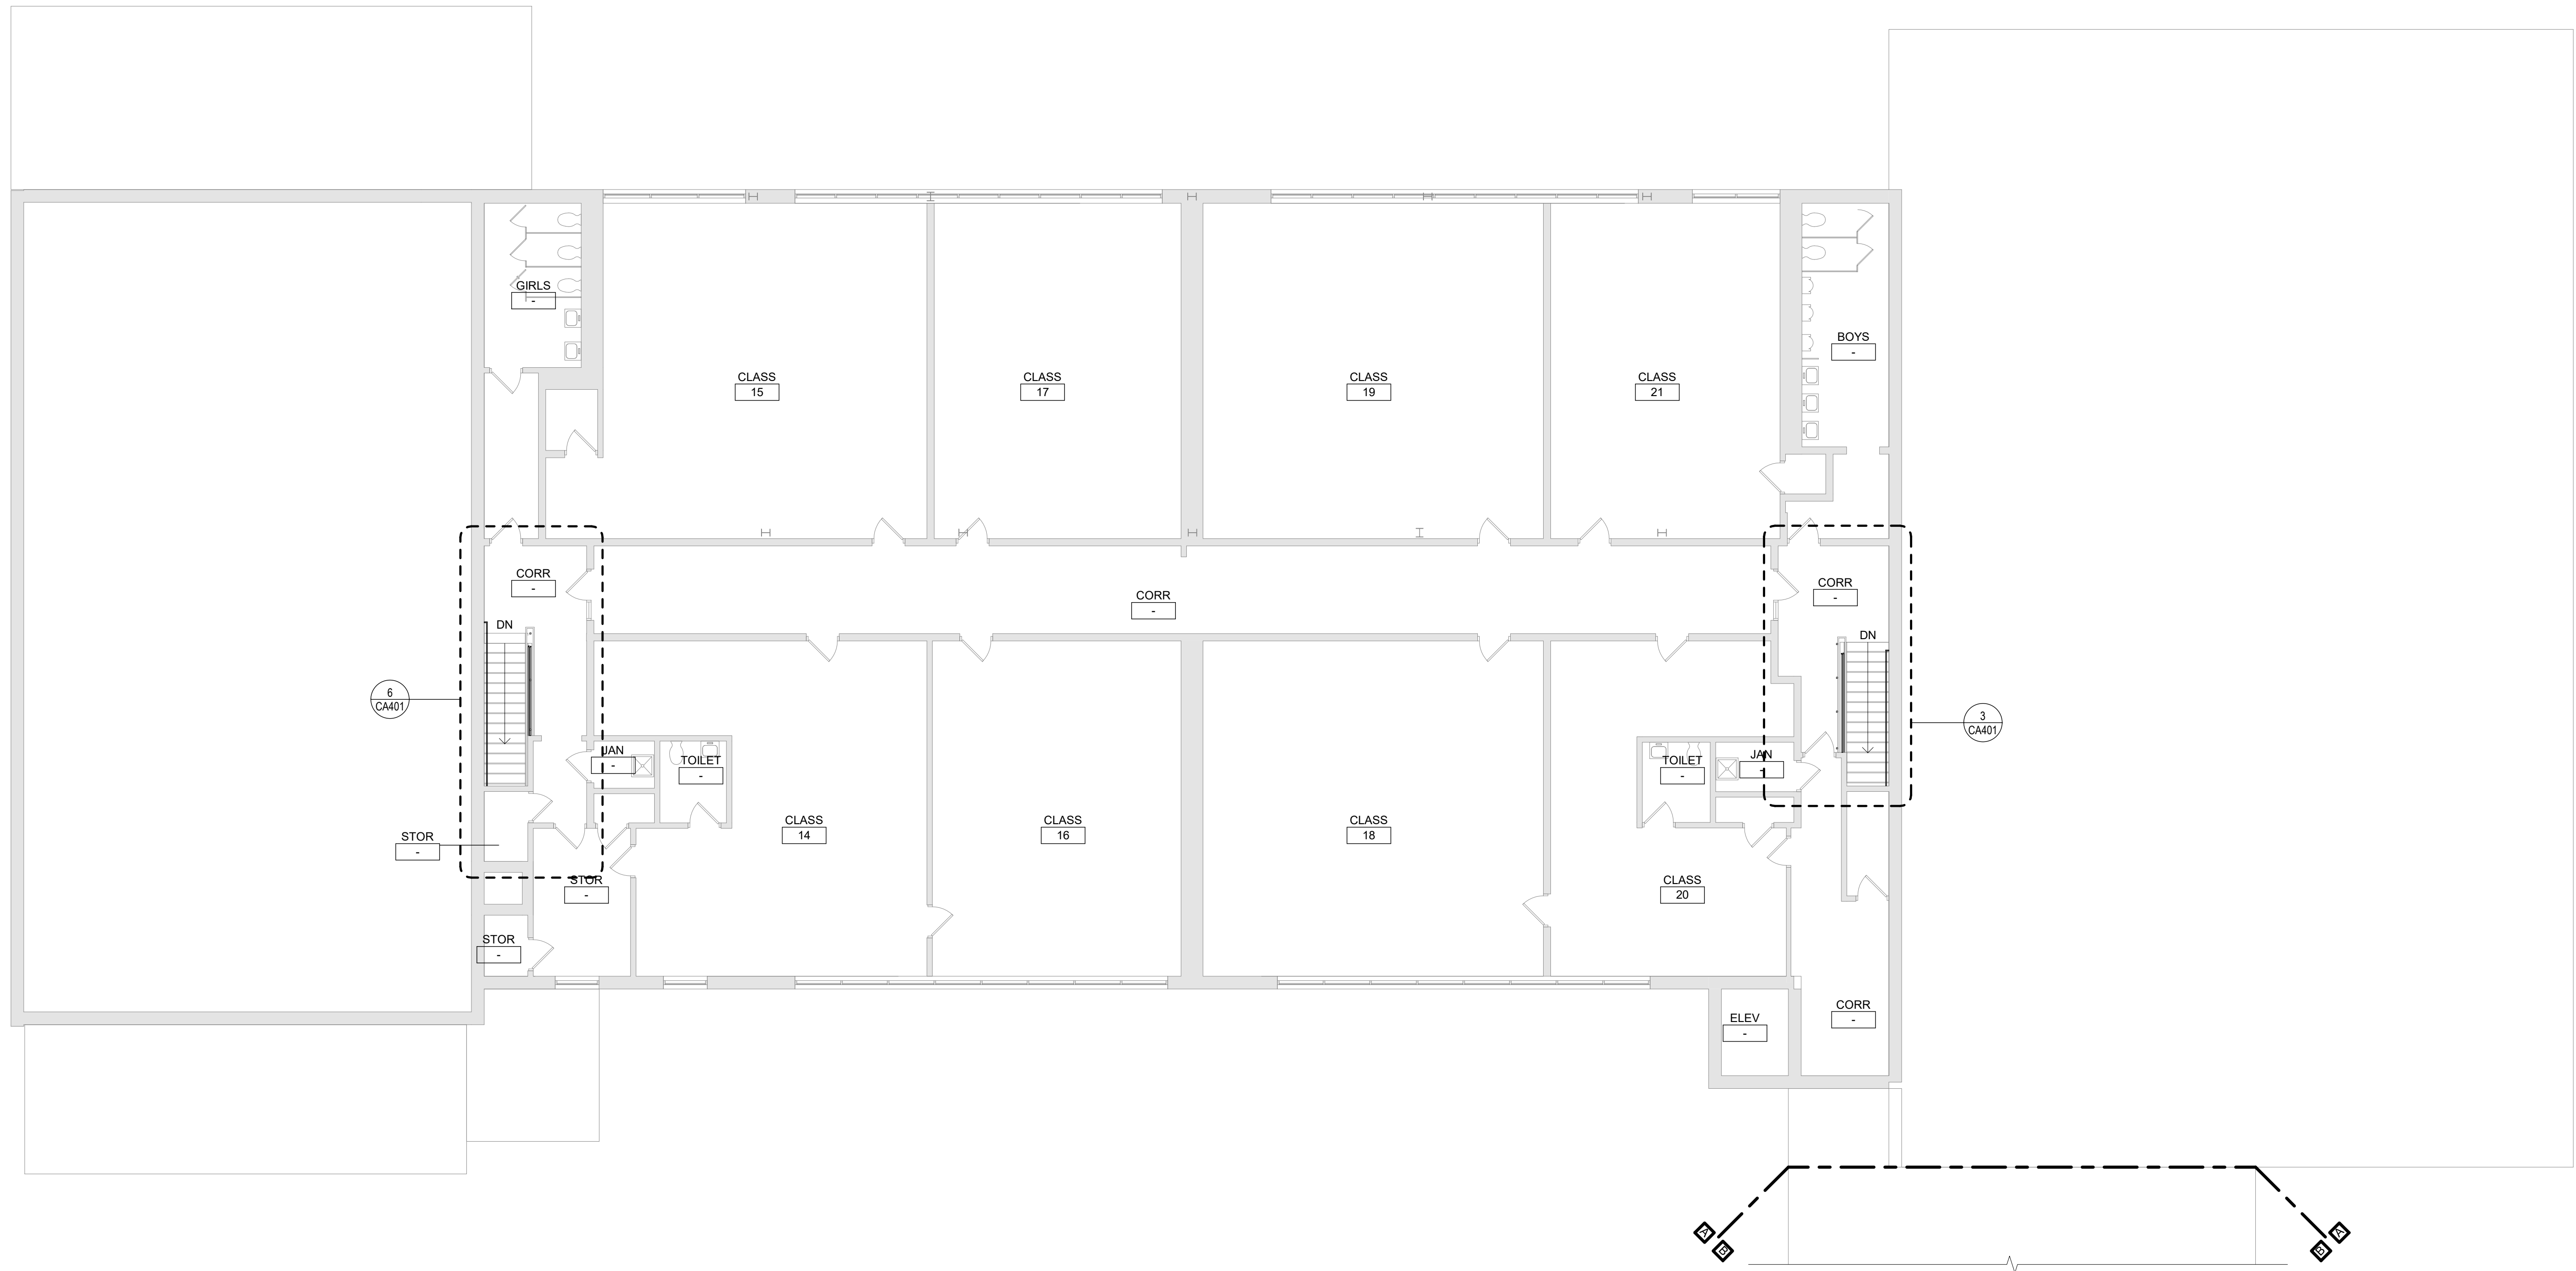

1 Second Floor Plan
1/8" = 1'-0"

General Plan Notes

- A. WHERE EXISTING CONSTRUCTION IS DAMAGED OR DISTURBED, PATCH AS REQUIRED TO RESTORE SURFACES TO THEIR ORIGINAL CONDITION.
- B. PARTITION TYPE TAGS APPLY TO ENTIRE LENGTH OF WALL INDICATED BY THAT TAG, REGARDLESS OF OPENINGS WITHIN THAT WALL, TYPICAL UNLESS NOTED OTHERWISE.
1. ALL INTERIOR WALLS SHALL BE WALL/PARTITION TYPE P12.3, TYPICAL UNLESS NOTED OTHERWISE.
- C. INFILL AREAS OF RECESSED FLOOR MAT AND/OR FINISH REMOVALS WITH REPAIR MATERIAL PROVIDE SUBSTRATE LEVEL AS REQUIRED SO SCHEDULED FINISHED FLOOR WILL MATCH THAT OF EXISTING ADJACENT AREAS.
- D. PROVIDE BRACING WITHIN CHASES AS FOLLOWS:
1. MASONRY WALLS: FULL-HEIGHT 4" CMU BRACES AT MAXIMUM SPACING OF 11'-0" OC.
2. GYPSUM BOARD/TILE BACKING PANELS ON METAL FRAMING: FULL-HEIGHT 6" METAL STUD BRACES AT MAXIMUM SPACING OF 11'-0" OC.

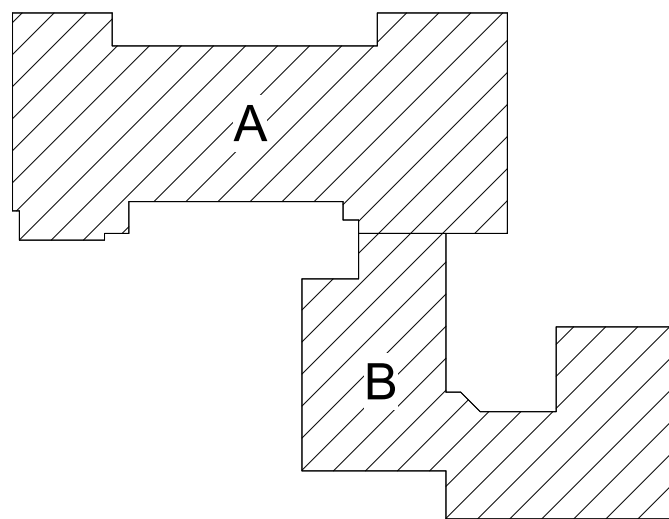

Key Plan
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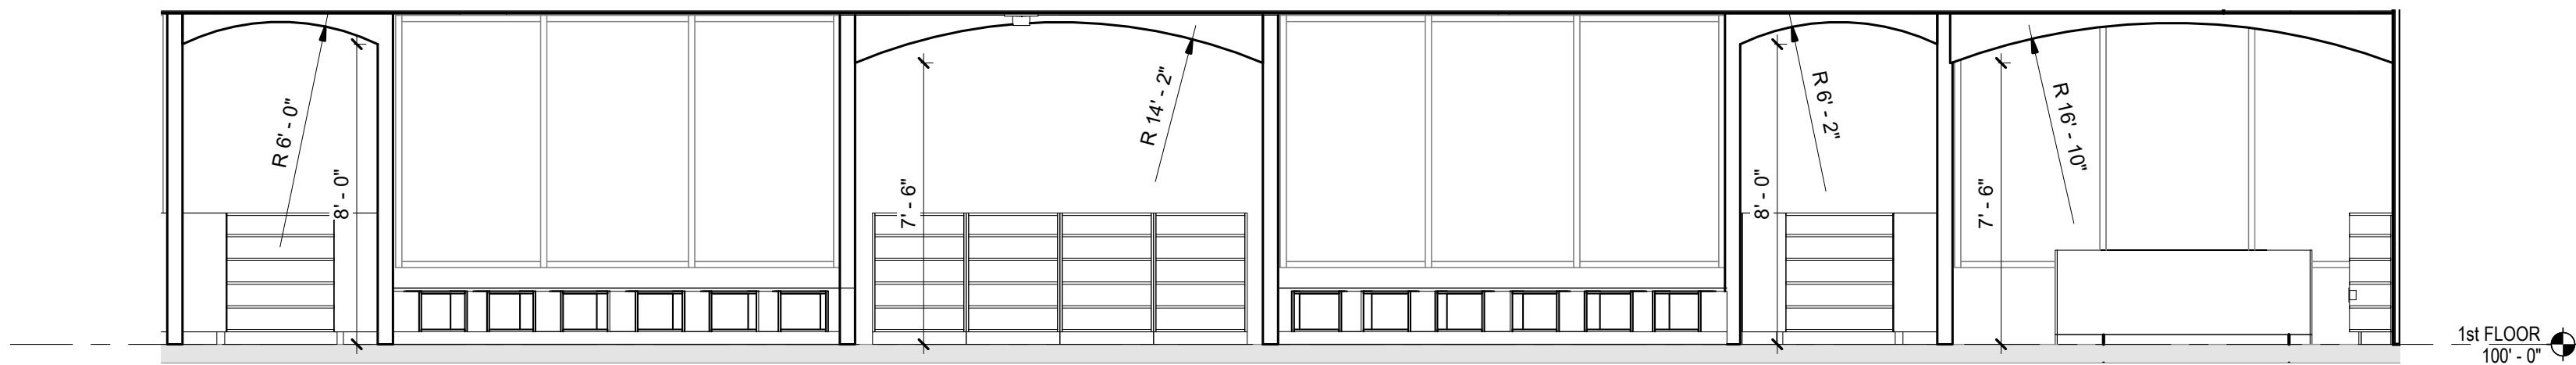


Beacon City School District
Beacon, New York


Reconstruction to:
Sargent Elementary School

Second Floor Plan


Drawn By: TLG	Date: 10/28/2022	Drawing Number: CA132
Project No.: 279180-22004		




6 Interior Elevation
1/4" = 1'-0"

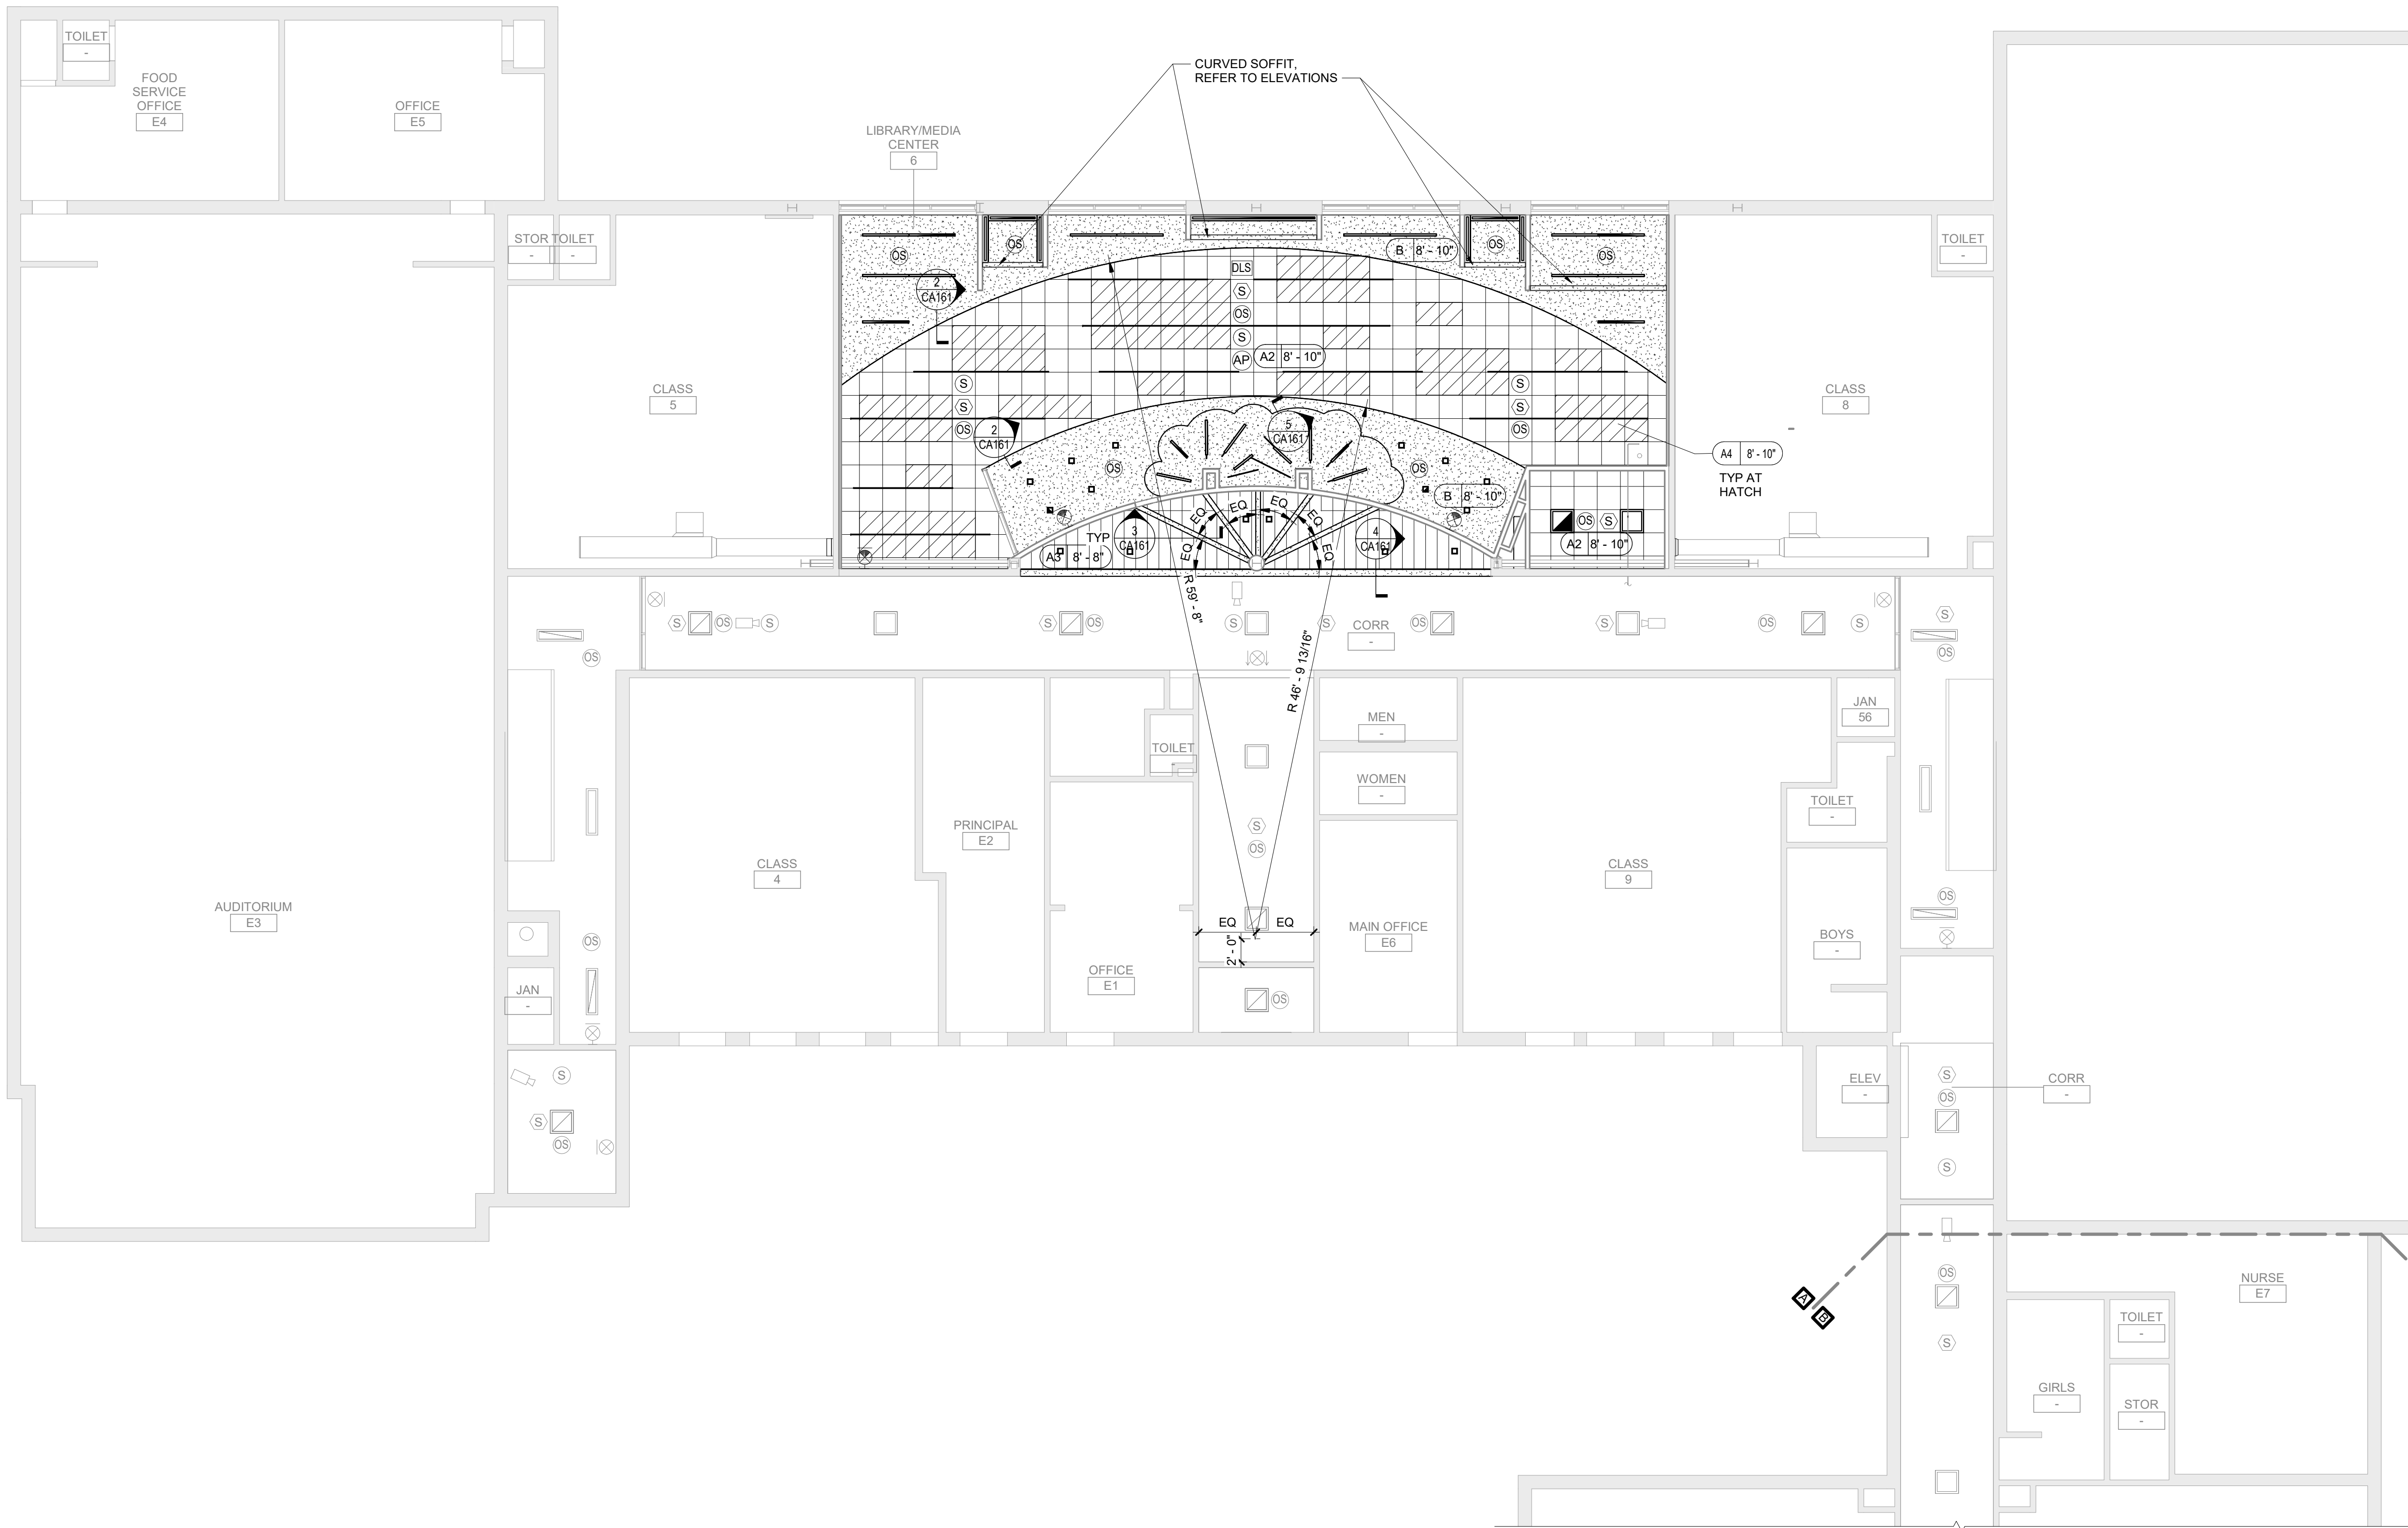


1 First Floor Reflected Ceiling Plan Area A
1/8" = 1'-0"

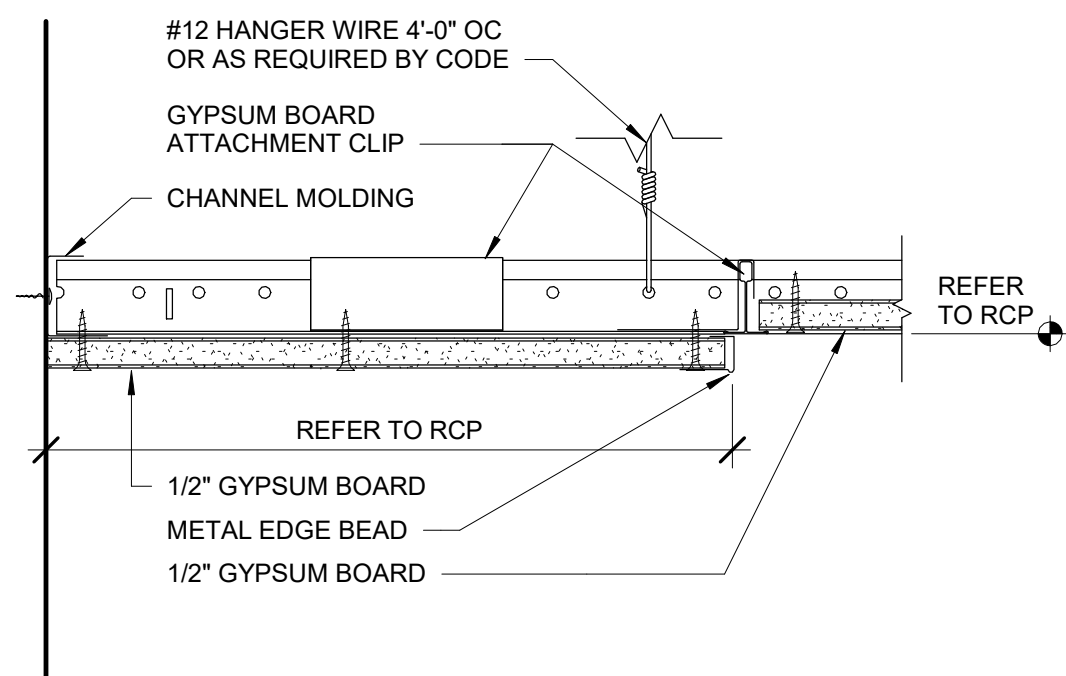


5 Ceiling Detail
3" = 1'-0"

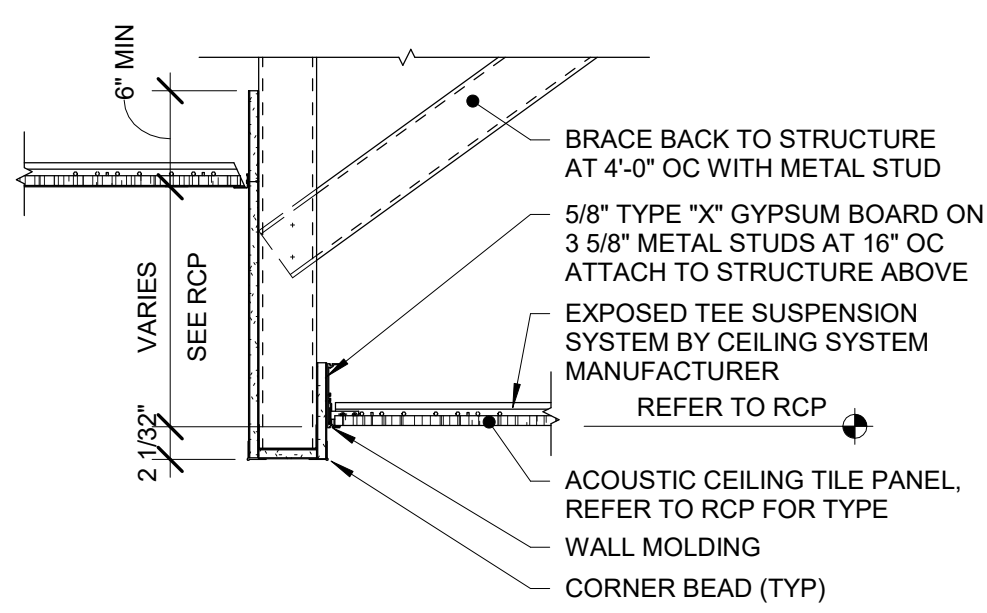

4 Soffit Detail
1" = 1'-0"

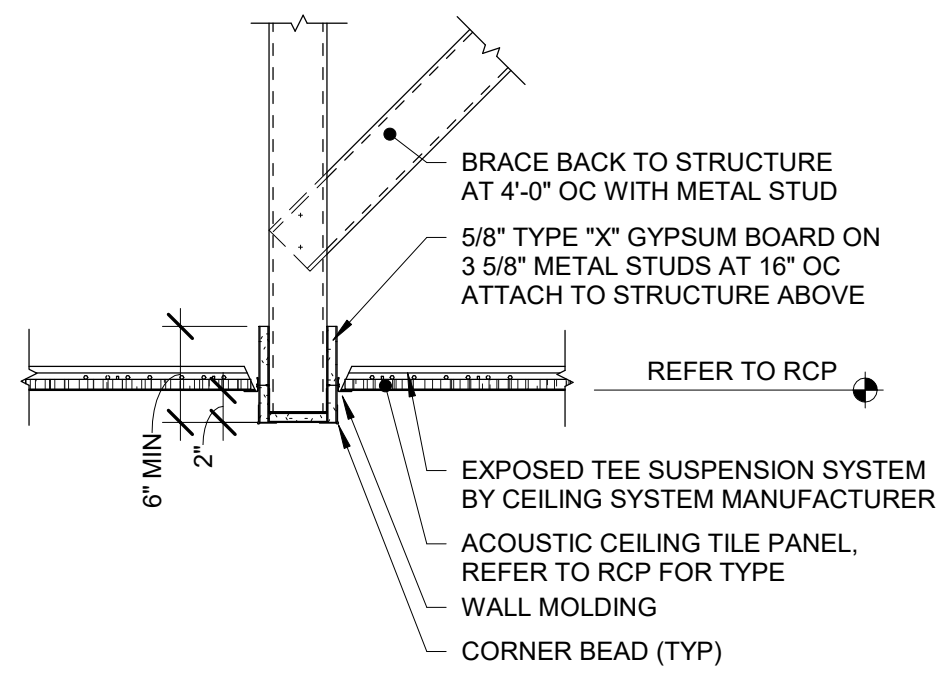

3 Soffit Detail
1" = 1'-0"

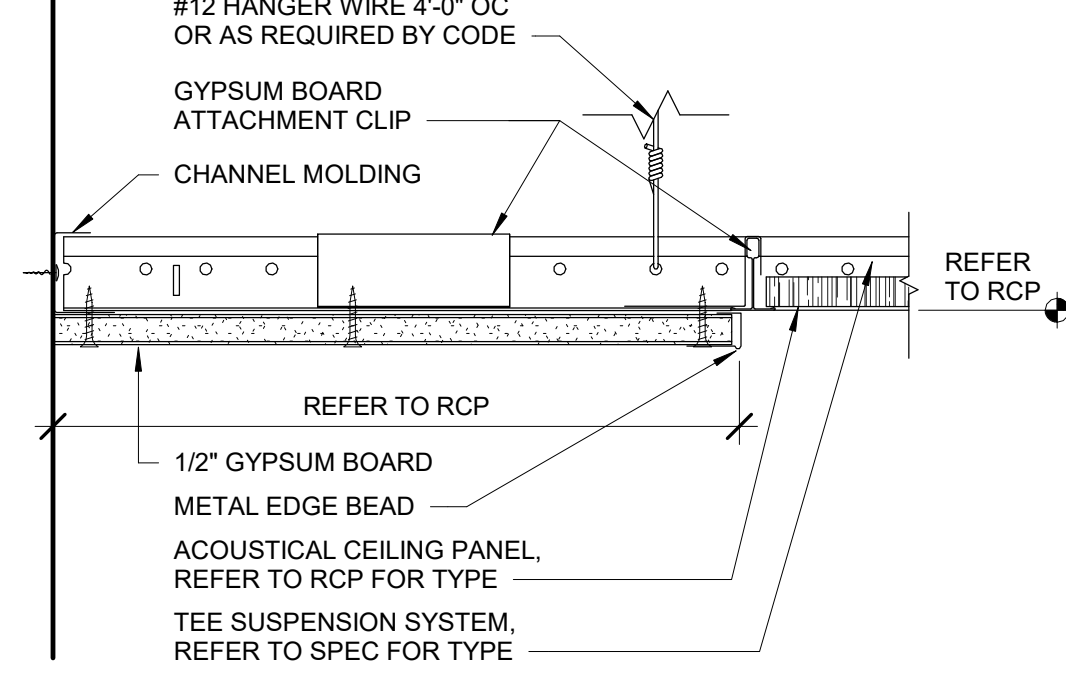

2 Ceiling Detail
3" = 1'-0"

General Finish Notes

- ALL FINISH PRODUCTS ARE TO BE INSTALLED IN ACCORDANCE WITH CONTRACT SPECIFICATION AND MANUFACTURES INSTRUCTIONS. REFER TO SPECIFICATIONS AND FINISH DETAILS FOR ADDITIONAL INFORMATION ON INSTALLATION OF SPECIFIED MATERIALS.
- A. ALL PAINTS FOR INTERIOR AND EXTERIOR ARE TO BE APPLIED IN ACCORDANCE WITH SPECIFICATION SECTION 09 91 00 AND 09 96 00.
- B. ALL EXPOSED STRUCTURES, INCLUDING BUT NOT LIMITED TO PIPING AND FIREPROOFING, CONDUIT, AND ALL ASSOCIATED EQUIPMENT ARE TO BE PAINTED.
- C. APPLY PAINT TO BOTH NEW AND EXISTING ITEMS IN ALL AREAS INDICATED WITH A FINISH BOX AND/OR NOTES - THESE ITEMS ARE INCLUDING BUT ARE NOT LIMITED TO:
- F.E.C.'S, LADDERS, BEAMS, DOORFRAMES - BOTH SIDES
- GLAZING FRAMES IN DOORWALLS - BOTH SIDES
- ALL EXPOSED STAIR PARTS INCLUDING RAILINGS, HAND AND GUARD RAILS, STRINGERS AND UNDERSIDES OF STAIRS. ALL ITEMS ARE TO BE ACCENT COLORS.
- D. PATTERNS FOR FLOORS ARE AS SHOWN. SUBMIT SHOP DRAWINGS SHOWING DETAILED LAYOUTS OF EACH AREA, INCLUDING EDGES AND TRANSITIONS. ALL LAYOUTS ARE TO BE CENTERED IN EACH ROOM UNO - TYP ALL DRAWINGS. ABOVE REQUIREMENTS ARE TO INCLUDE BUT NOT LIMITED TO:
- TERRAZZO AND BASE
- VCT
- LVT
- RUBBER
- E. FIELD AND ACCENT PAINT ARE ISSUED DURING THE CONSTRUCT ON PHASE. CONTRACTOR IS TO ASSUME ALL FIELD AND ACCENT COLORS ARE DIFFERENT ROOM TO ROOM. AS WELL AS WITHIN EACH ROOM. REQUIREMENTS ARE TO INCLUDE BUT ARE NOT LIMITED TO:
- WALL FIELD COLOR
- WALL ACCENT COLOR
- CEILING CLOUDS, ACCENT COLOR
- SOFFITS, ACCENT COLOR
- DOOR AND WINDOW FRAMES, ACCENT COLOR
- EXPOSED COLUMNS, ACCENT COLOR
- GUARDRAILS, ACCENT COLOR
- HANDRAILS, ACCENT COLOR
- EXPOSED DECKS, ACCENT COLOR
- EXPOSED JOISTS, ACCENT COLOR
- EXPOSED DUCTWORK, ACCENT COLOR
- F. PROVIDE PAINT AT ALL NEW SOFFITS. REFER TO REFLECTIVE CEILING PLANS FOR ADDITIONAL LOCATIONS.
- G. ALL EXPOSED BRICK, GROUND FACE BLOCK IS TO REMAIN UNPAINTED, UNO.
- H. CONFIRM WITH OWNER AND ARCHITECT PRIOR TO PAINTING OVER MURALS ON EXISTING SURFACES.
- I. PROVIDE PAINT AND RUBBER BASE AT ALL NEW CHASES. REFER TO NEW WORK PLANS FOR ADDITIONAL LOCATIONS.
- J. CARPET IS TO RUN WALL TO WALL, UNDER ALL FURNITURE, MOVEABLE EQUIPMENT AND LIBRARY SHELVING UNITS, INCLUDING ALL UNITS AT THE PERIMETER WALLS.
- K. FOR ALL RENOVATED AREAS REQUIRING FINISH WORK REMOVE, PROTECT AND REINSTALL MOVEABLE EQUIPMENT INCLUDING BUT NOT LIMITED TO: BOARD UNITS, LOCKERS GYM EQUIPMENT, SHADES/BLINDS, BOOKCASES ETC. REINSTALL IN ORIGINAL LOCATION, OR AS NOTED ON DRAWINGS. COORDINATE WITH OWNER. REFER TO SPEC SECTION 01 23 00 ALTERATION PROJECT PROCEDURES FOR MORE INFORMATION.
- L. PROVIDE ALL FINISHES AS INDICATED BY ROOM FINISH BOX AND/OR AS NOTED ON DRAWINGS.

General Ceiling Notes

- A. LIGHTING AND OTHER CEILING-MOUNTED FIXTURES ARE SHOWN FOR DRAWING CLARITY. COORDINATE ALL CEILING WORK PRIOR TO INSTALLATION OF CEILING GRID.
- B. CENTER CEILING-MOUNTED ITEMS (LIGHTS, GRILLES, DETECTORS, SPRINKLER HEAD, ETC) WITHIN THE CEILING PANELS AND GRIDS UNLESS THE PANELS ARE SCORED. CENTER ITEMS WITHIN THE PATTERN OF SCORED PANELS.
- C. PATCH CEILING SYSTEMS TO REMAIN THAT HAVE BEEN DISTURBED BY SCHEDULED WORK TO MATCH ADJACENT CONSTRUCTION PRIOR TO PAINTING.
- D. (X) 1/2" GYPSUM DESIGNATES BOTTOM OF CEILING ABOVE FINISHED FLOOR AT THAT POINT UNO. DESIGNATION "ME" INDICATES MATCH EXISTING CEILING HEIGHT.
- E. AT ALL LOCATIONS OF GYPSUM CEILINGS - PROVIDE 24" X 24" CONCEALED FLANGE ACCESS DOOR REGARDLESS OF LOCATION OR REQUIREMENT FOR ACCESS TO EQUIPMENT.

Ceiling Types


- A2 X-X" ACOUSTIC PANEL CEILING
A3 X-X" ACOUSTIC PANEL CEILING
A4 X-X" ACOUSTIC PANEL CEILING
B X-X" PAINTED 1/2" GYPSUM CEILING ON SUPPORT MATERIALS (GRID SUSPENSION SYSTEM, TYP UNO)

Ceiling Tile Legend

- TIDE FELT PANEL (A4)

General Notes

- A. DO NOT SCALE DRAWINGS TO OBTAIN DIMENSIONS.
- B. TAKE FIELD MEASUREMENTS TO FIT THE WORK PROPERLY. VERIFY ALL EXISTING CONDITIONS AND DIMENSIONS IN THE FIELD.
- C. REFER INCONSISTENCIES TO ARCHITECT PRIOR TO COMMENCING THE WORK IN AFFECTED AREA.
- D. ITEMS ARE SHOWN DIAGRAMMATICALLY ON DRAWINGS. VERIFY SPACE REQUIREMENTS AND DIMENSIONS TO FIT THE WORK PROPERLY.
- E. NOTES SHOWN ON ONE DRAWING APPLY TO ALL SIMILAR DRAWINGS.
- F. DO NOT DISTURB CONSTRUCTION SUSPECTED OF CONTAINING HAZARDOUS MATERIAL. IF ENCOUNTERED, IMMEDIATELY NOTIFY ARCHITECT, CONSTRUCTION MANAGER AND OWNER.

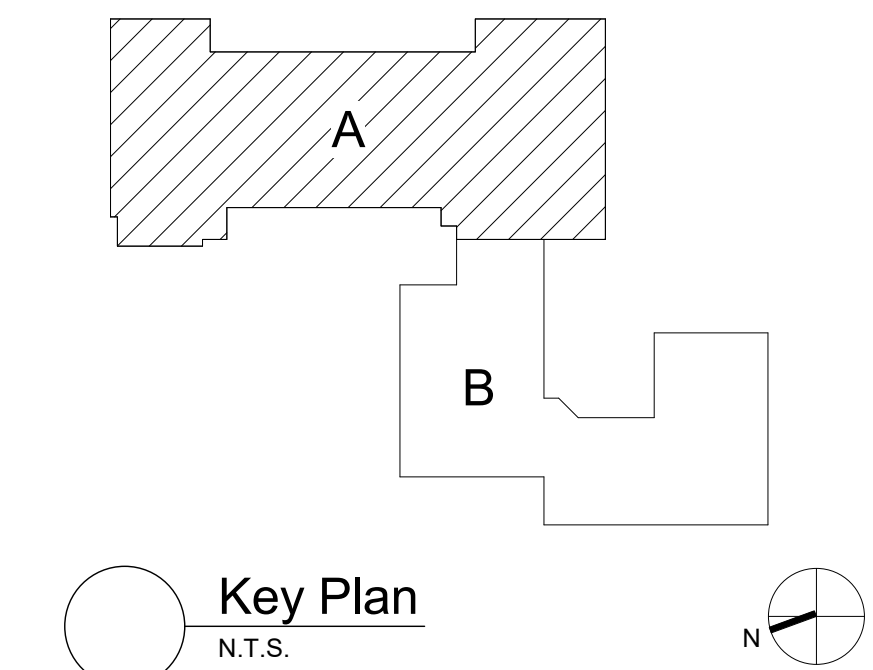

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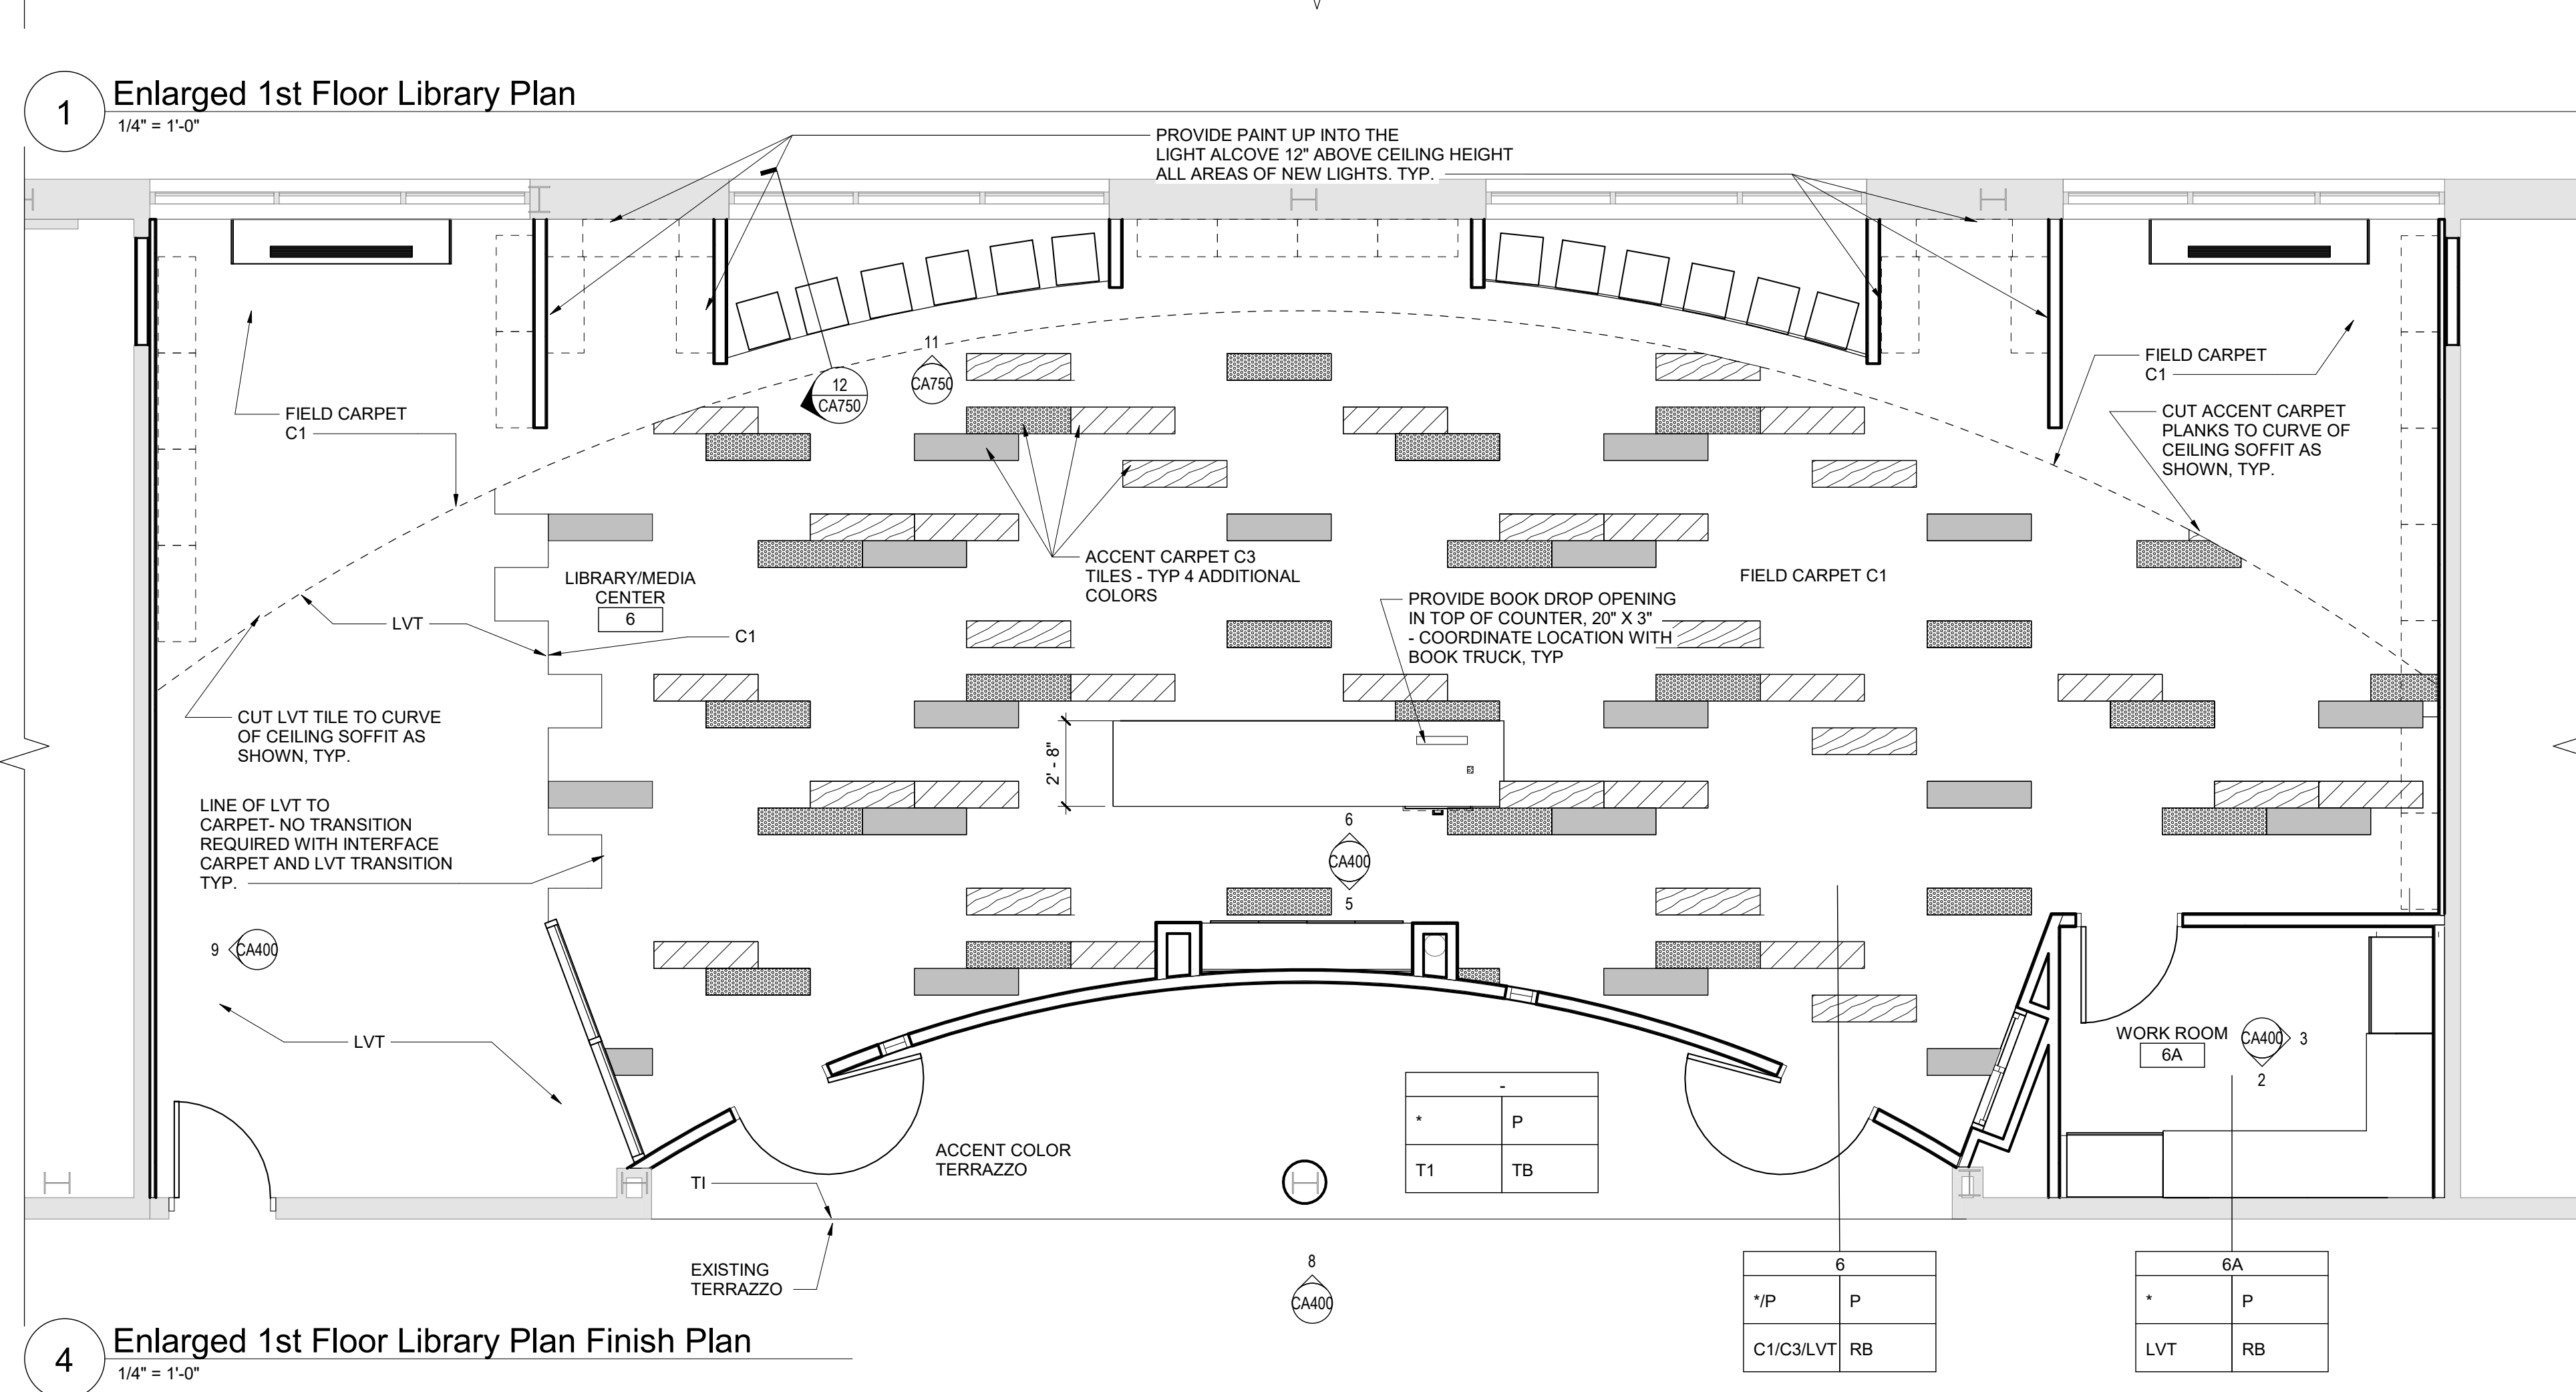
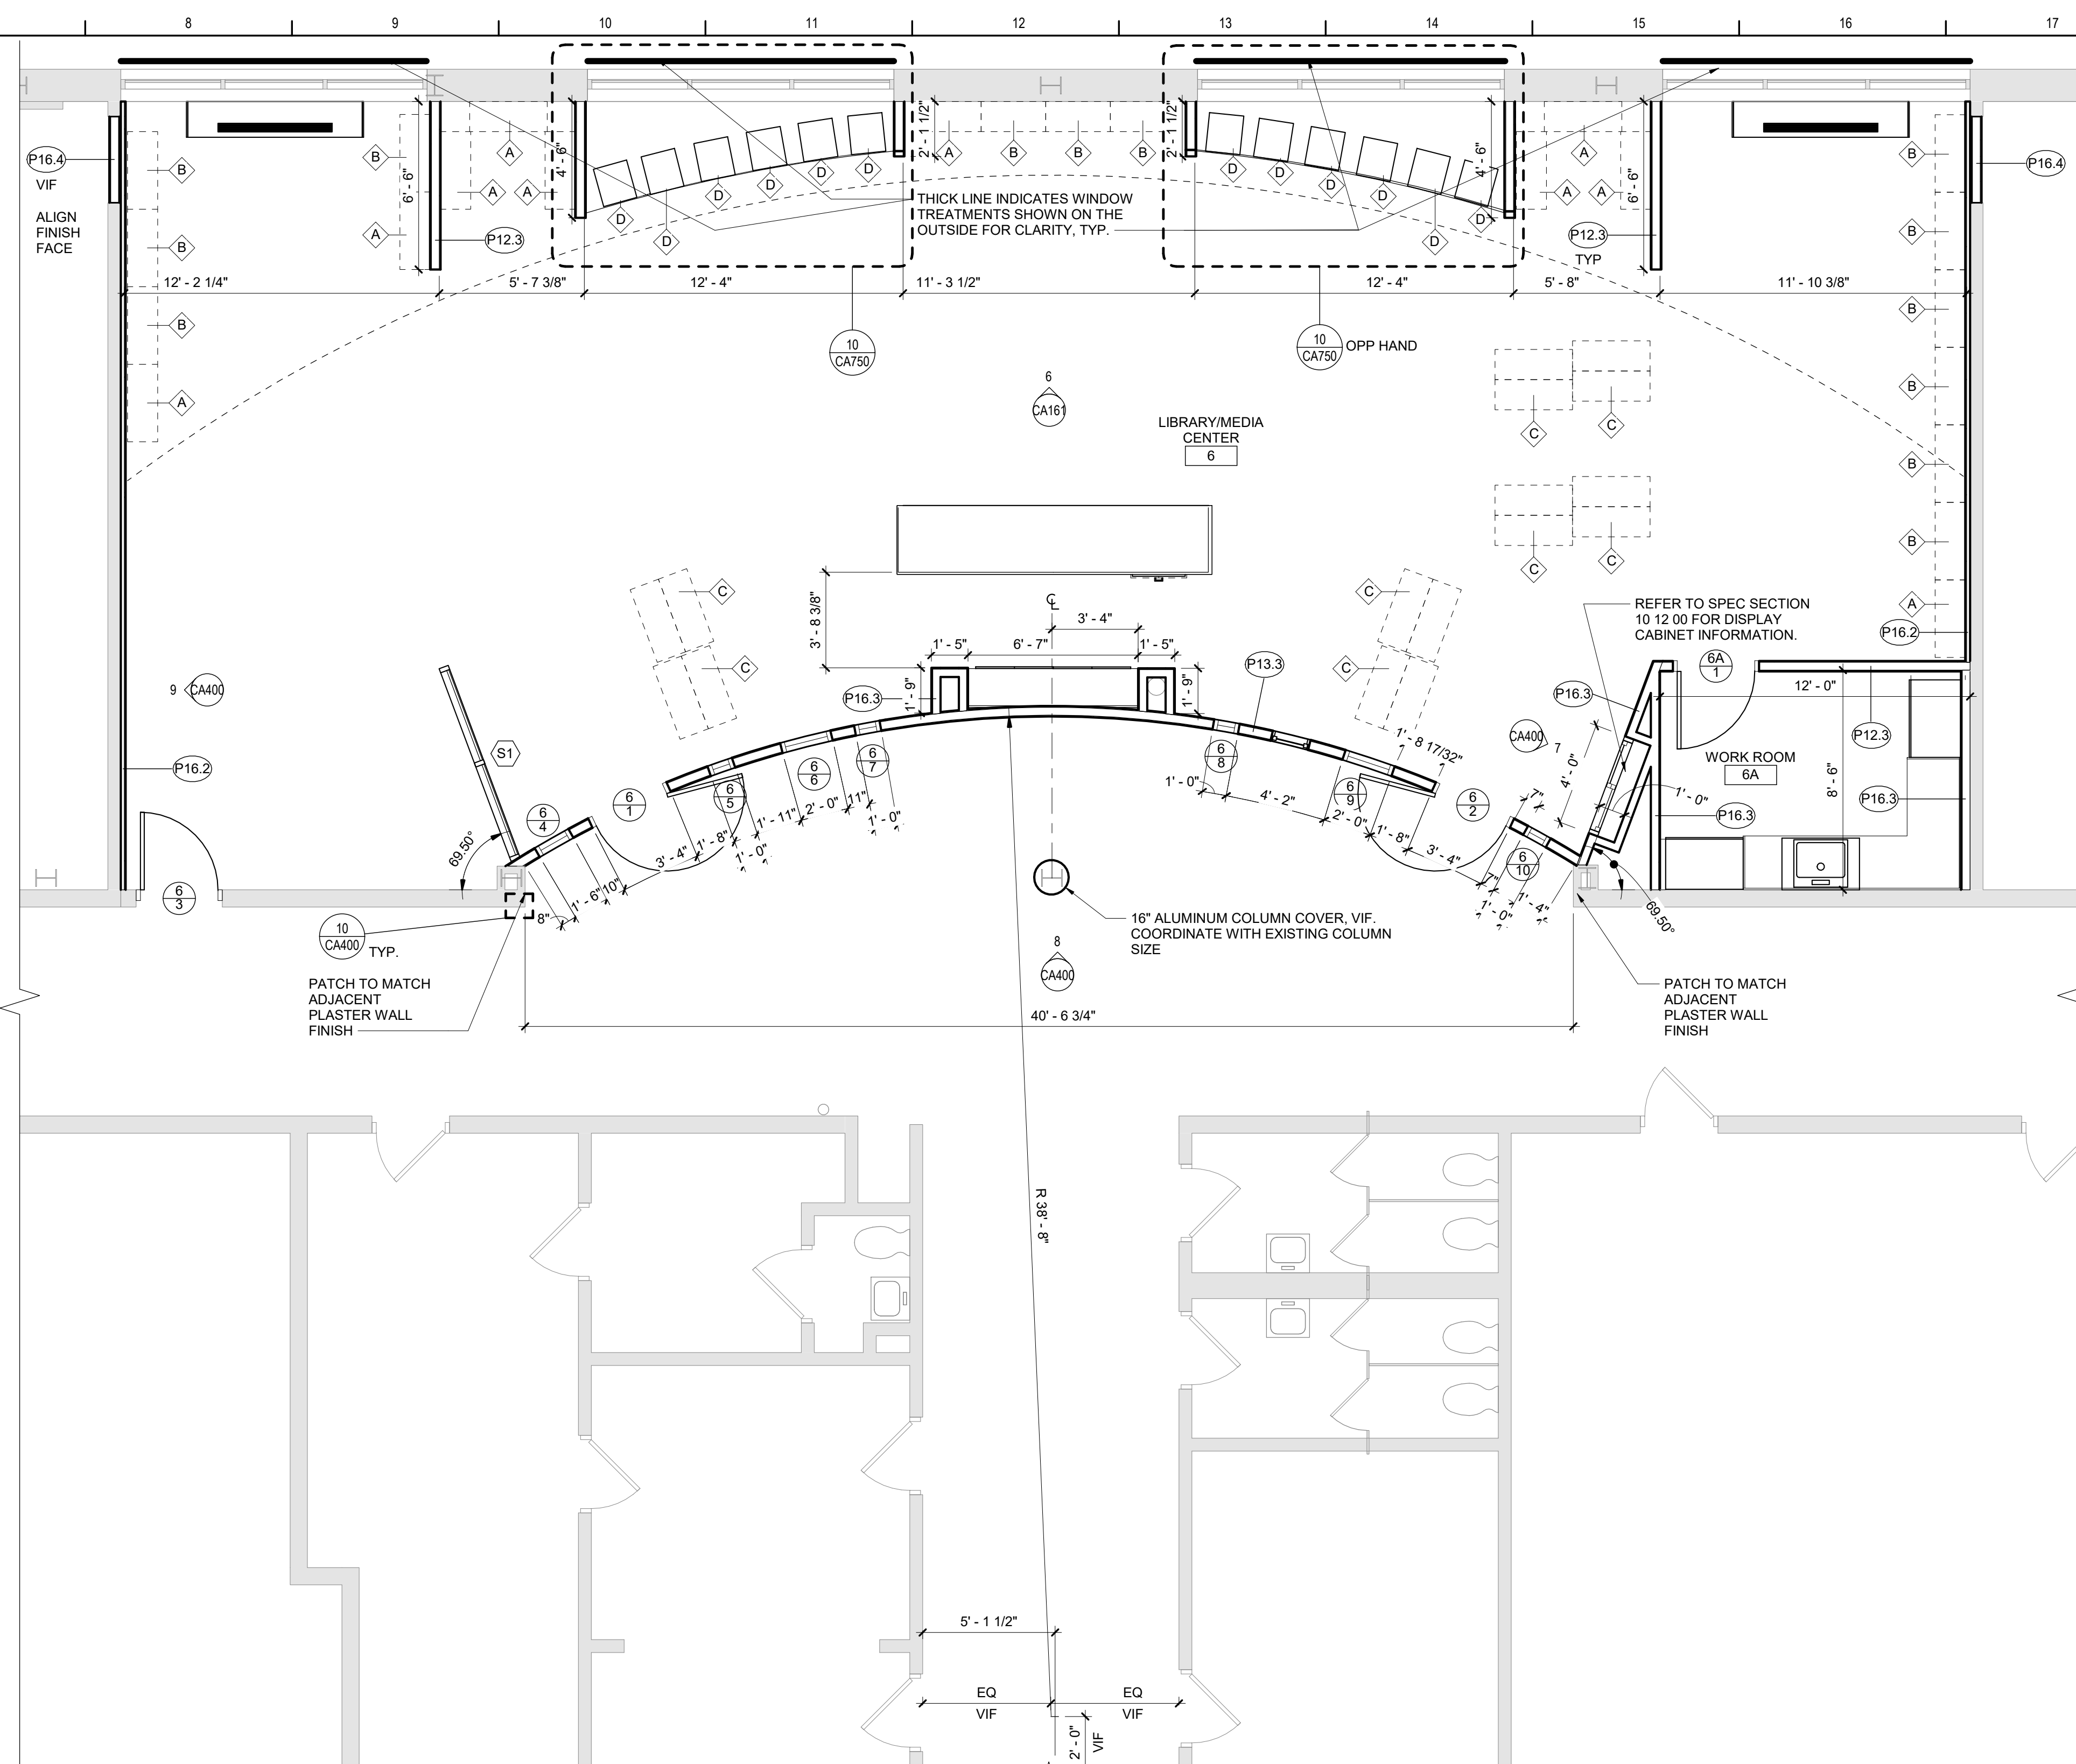
TETRA TECH
ARCHITECTS & ENGINEERS


Beacon City School District
Beacon, New York

Reconstruction to:
Sargent Elementary School


First Floor Reflected Ceiling Plan -
Area A

Drawn By: GK	Date: 10/28/2022	Drawing Number:
Project No.: 279180-22004		CA161




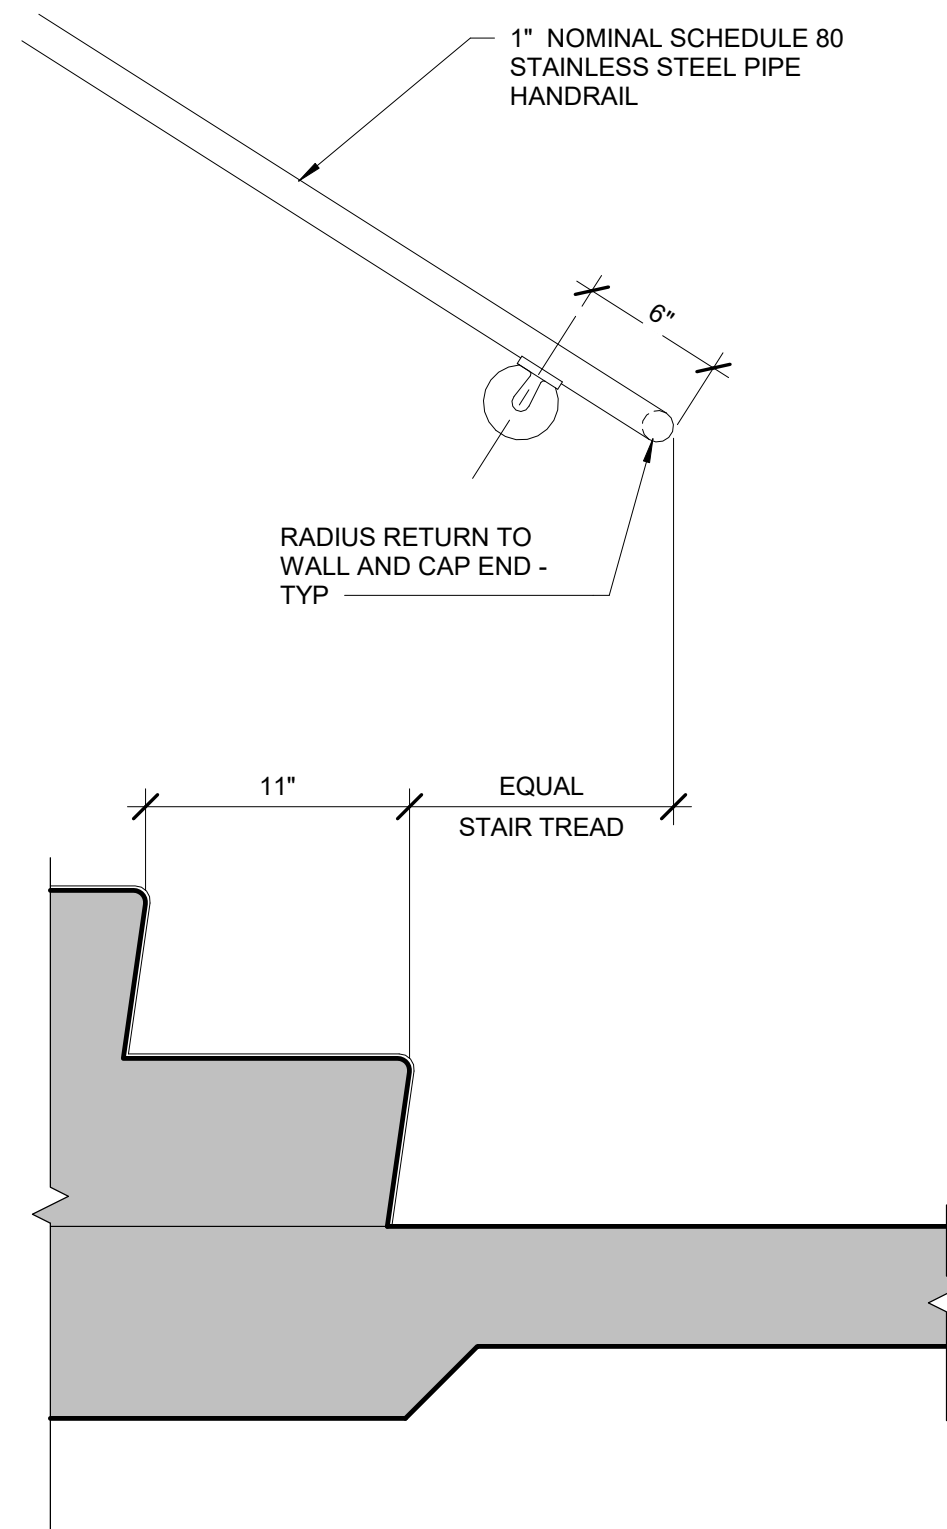


11 Typical Stair Base Section
1 1/2" = 1'-0"

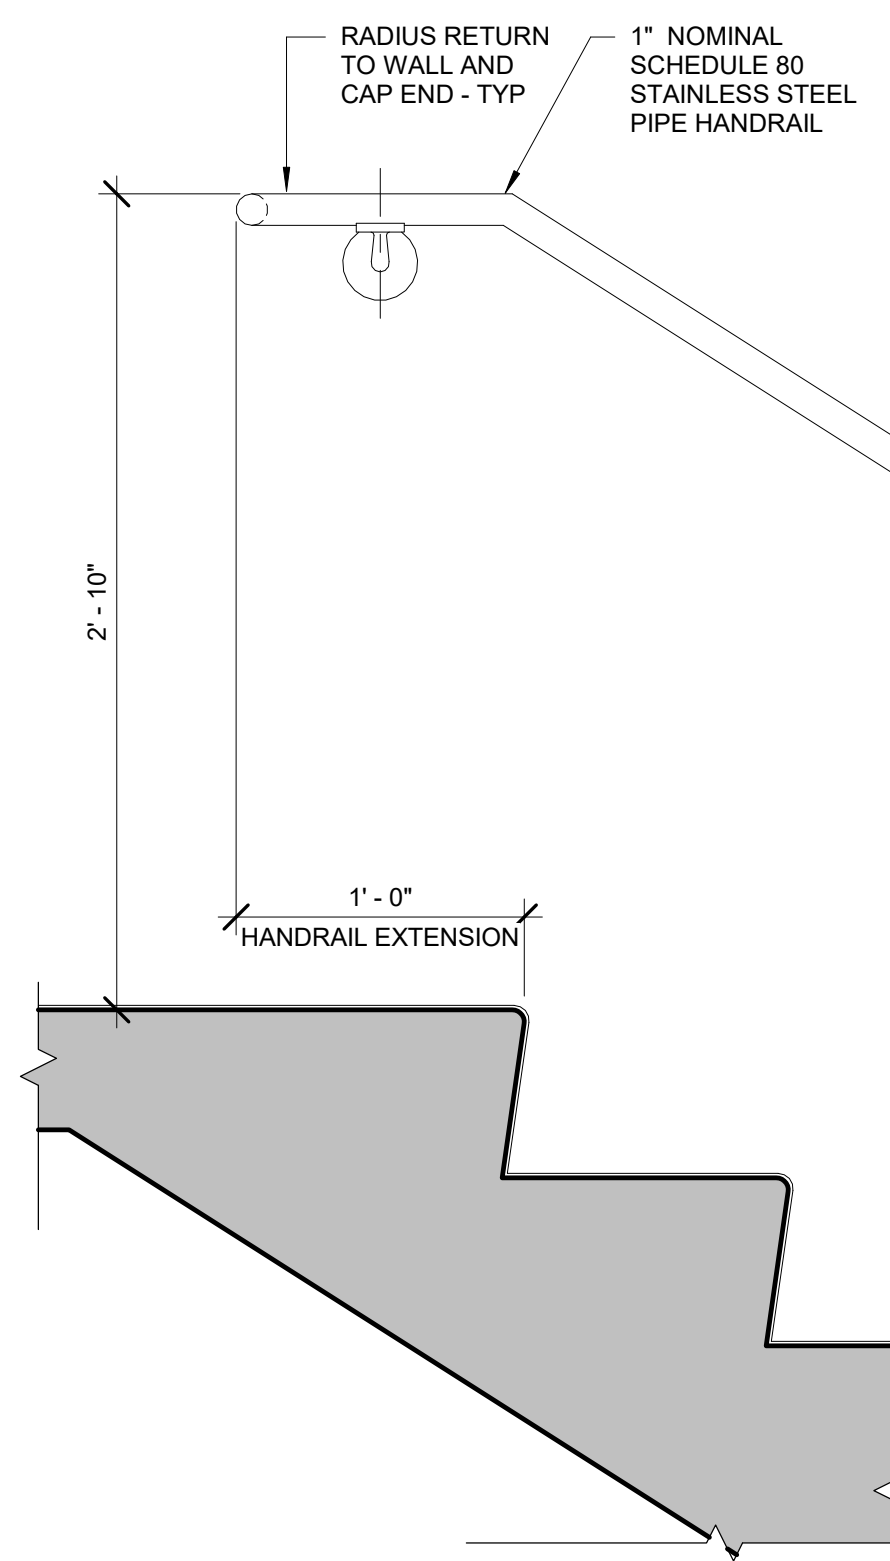


12 Typical Stair Head Section
1 1/2" = 1'-0"

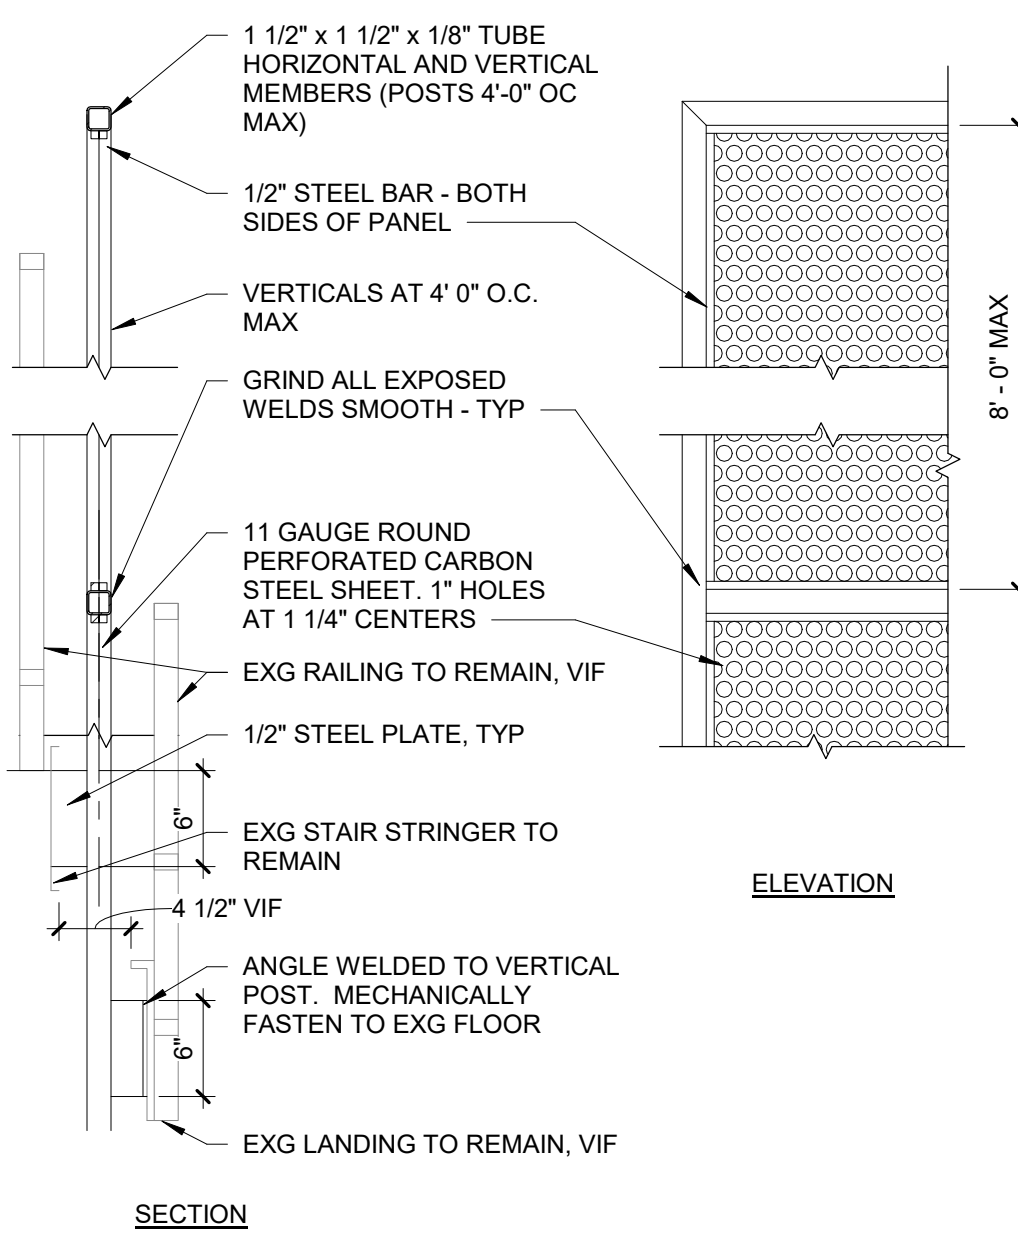


13 Guardrail Section Detail
1" = 1'-0"

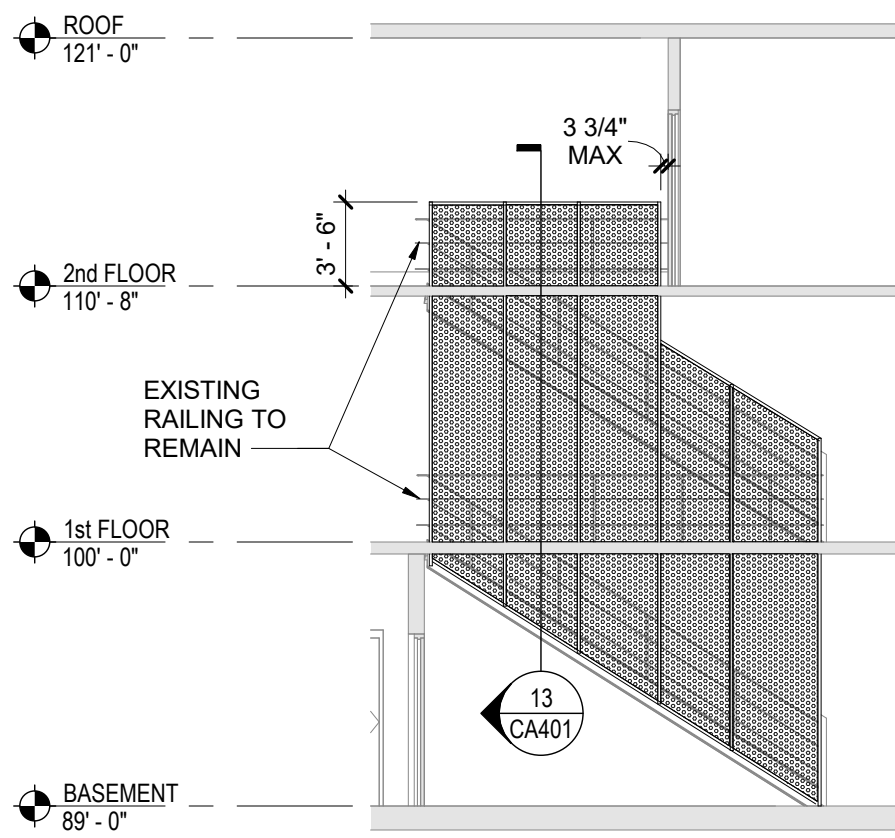


7 South Stair Section
1/8" = 1'-0"

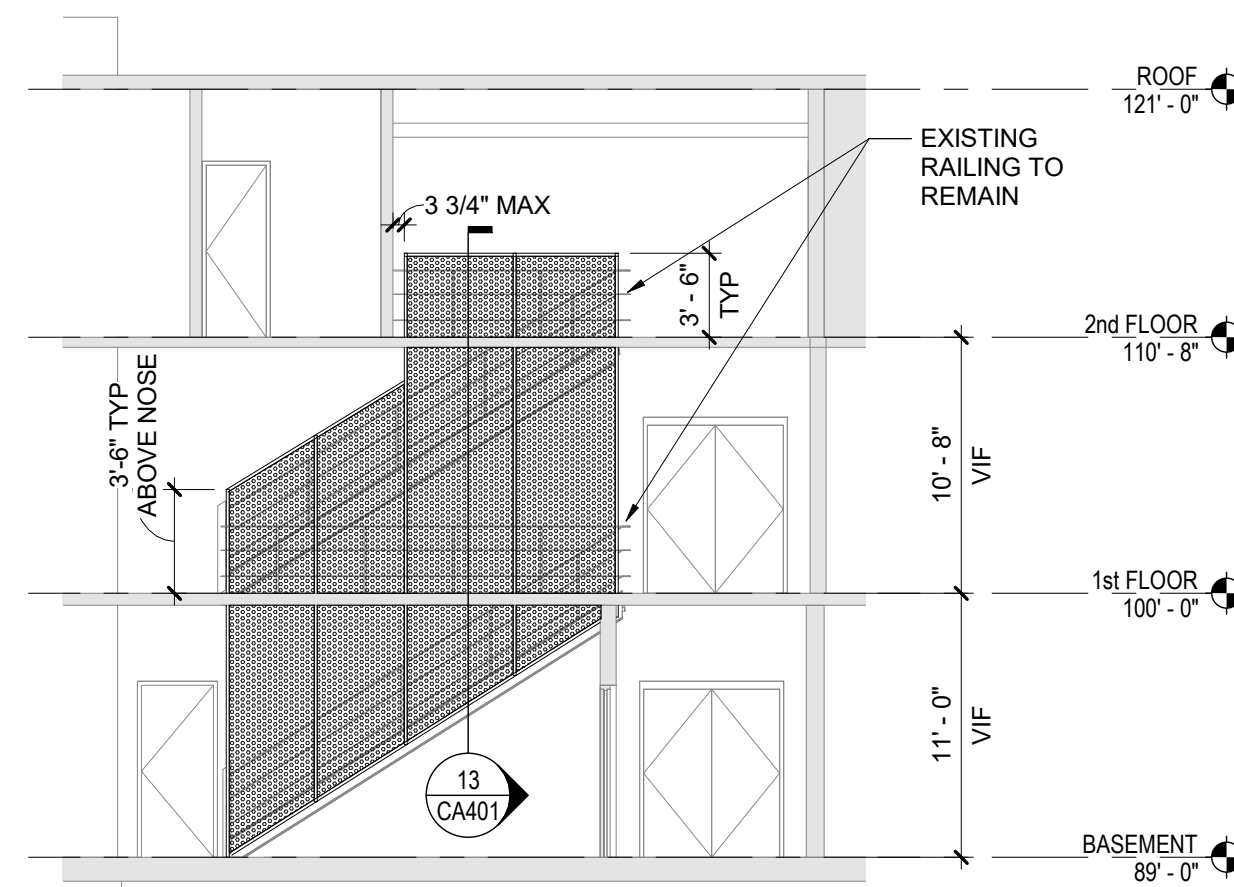


8 North Stair Section
1/8" = 1'-0"

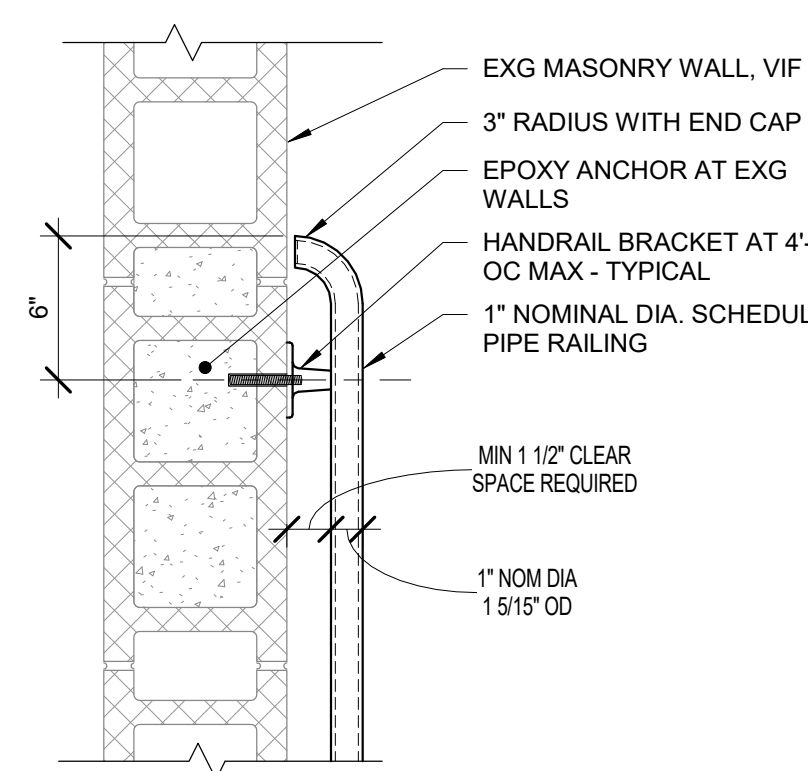


9 Railing Termination Detail
1 1/2" = 1'-0"

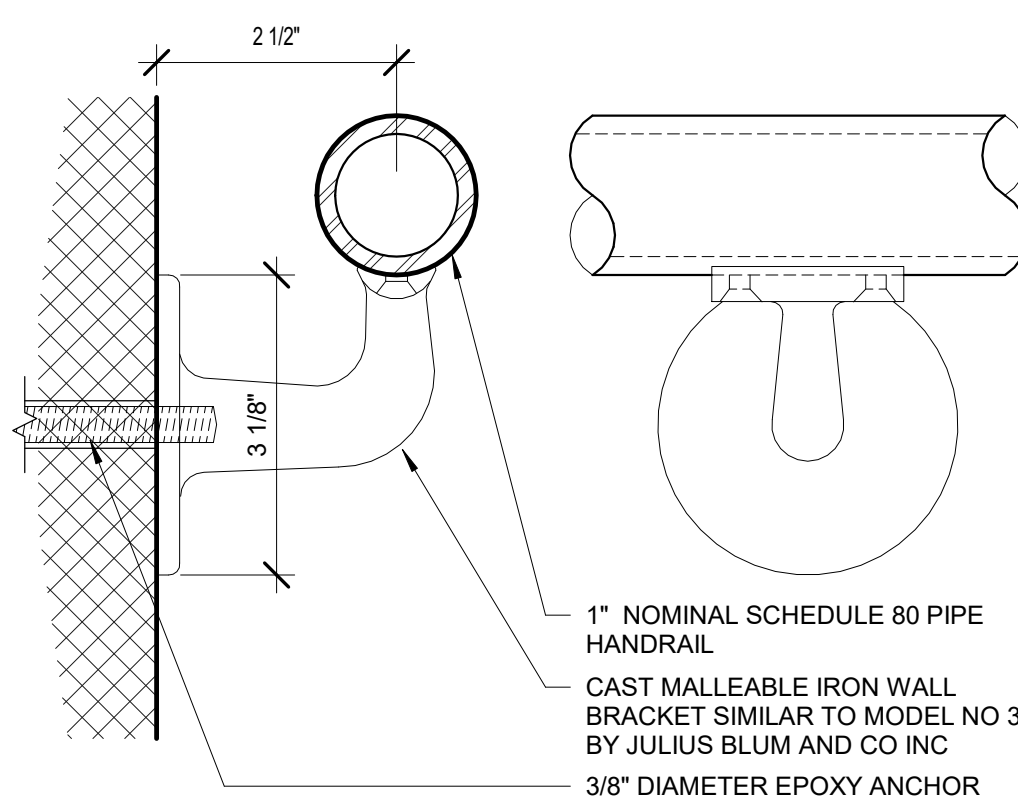


10 Wall Mounted Rail Support Detail
6" = 1'-0"

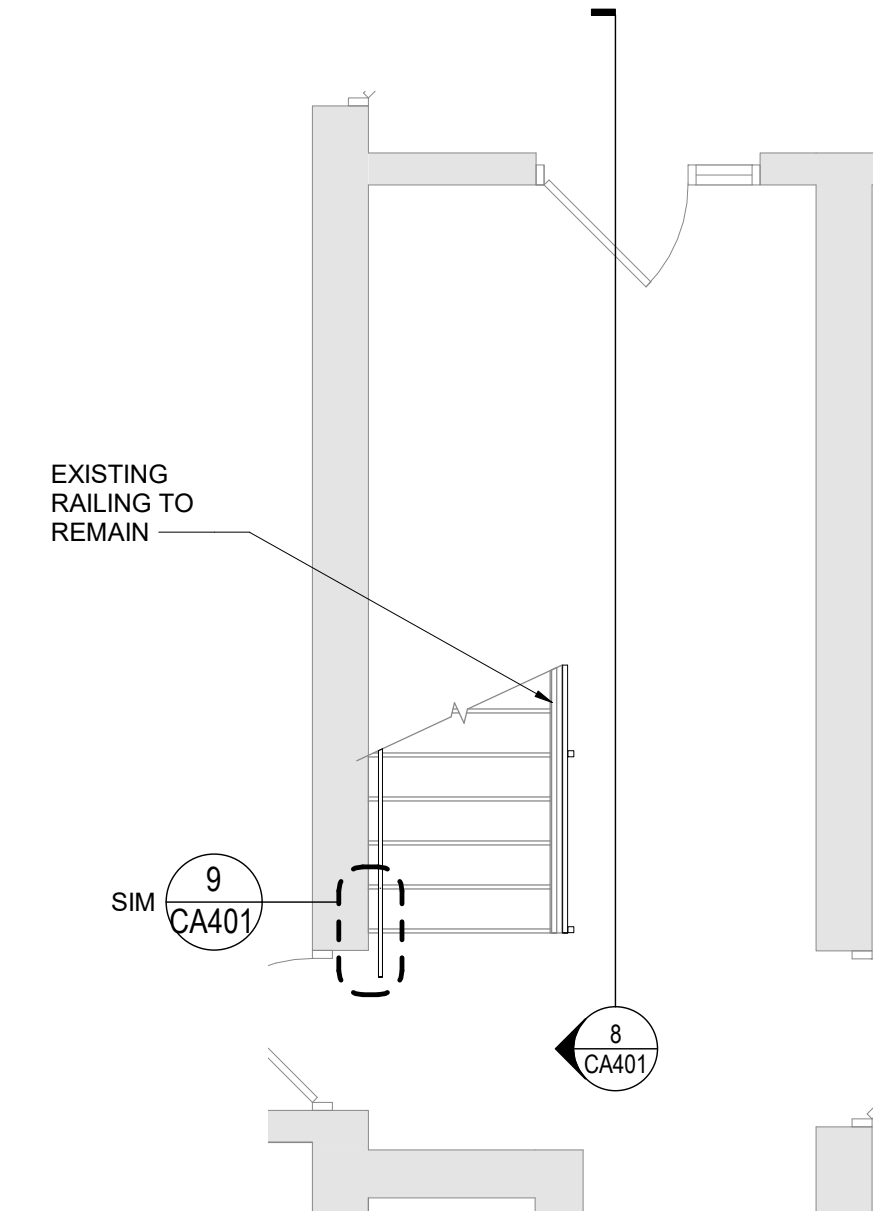


4 North Stair Enlarged Basement Plan
1/4" = 1'-0"

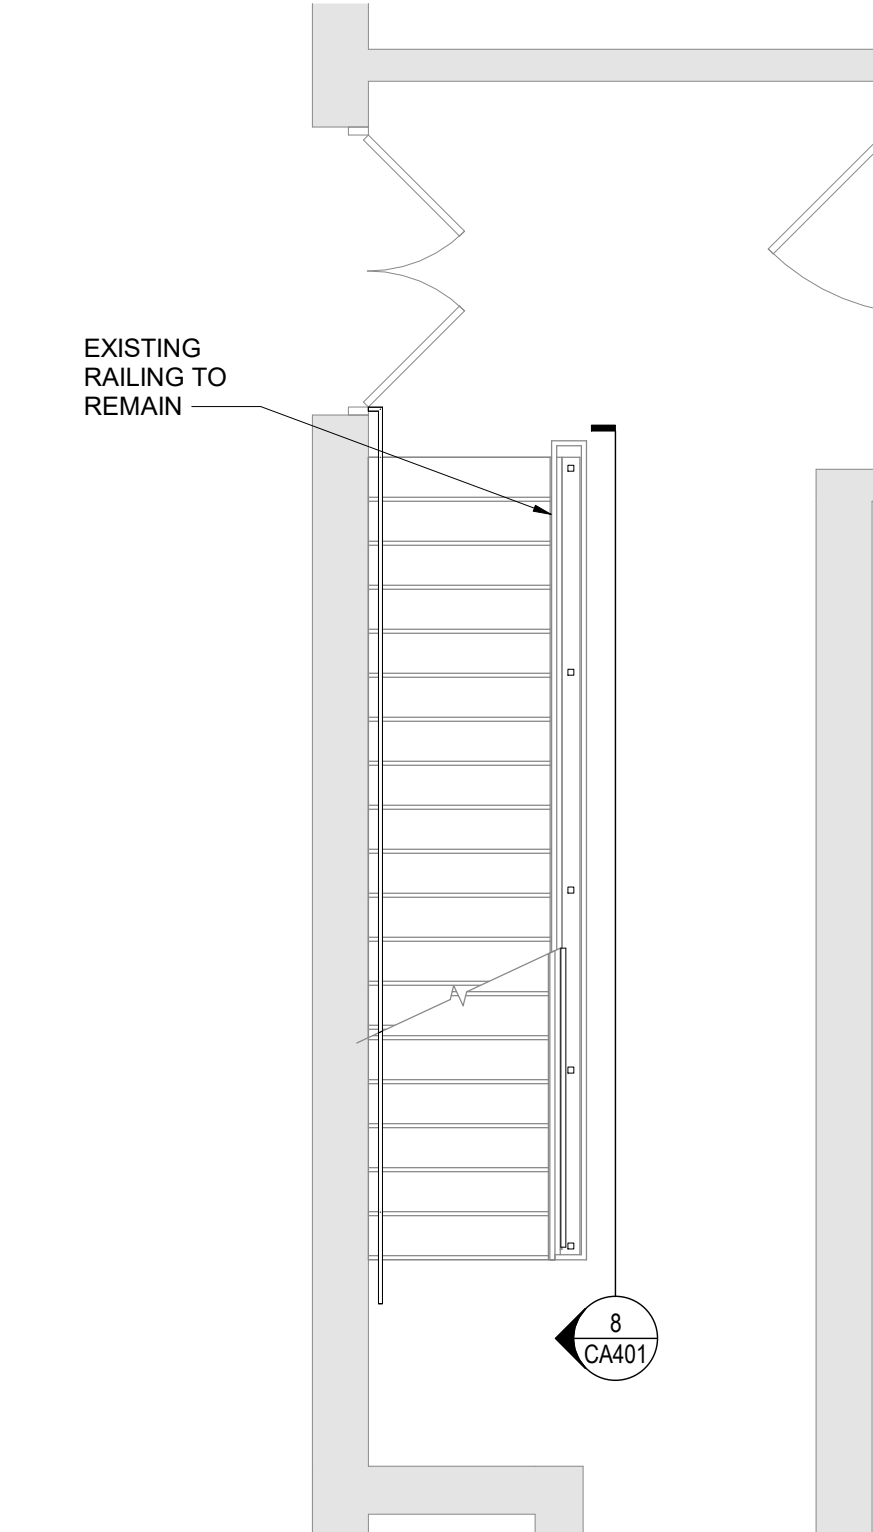


5 North Stair Enlarged First Floor Plan
1/4" = 1'-0"

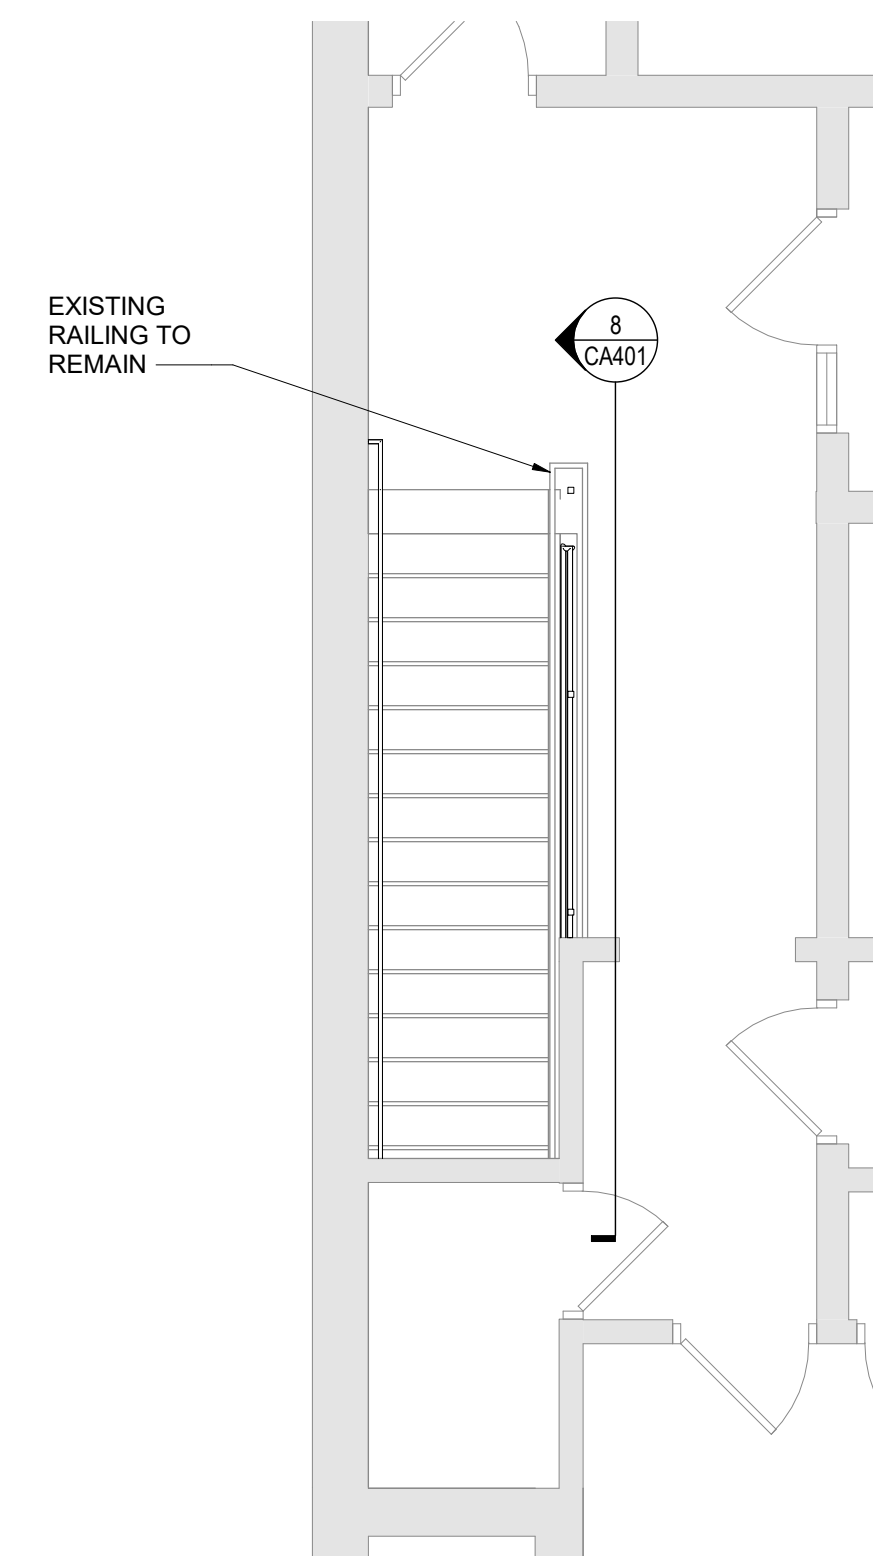


6 North Stair Enlarged Second Floor Plan
1/4" = 1'-0"

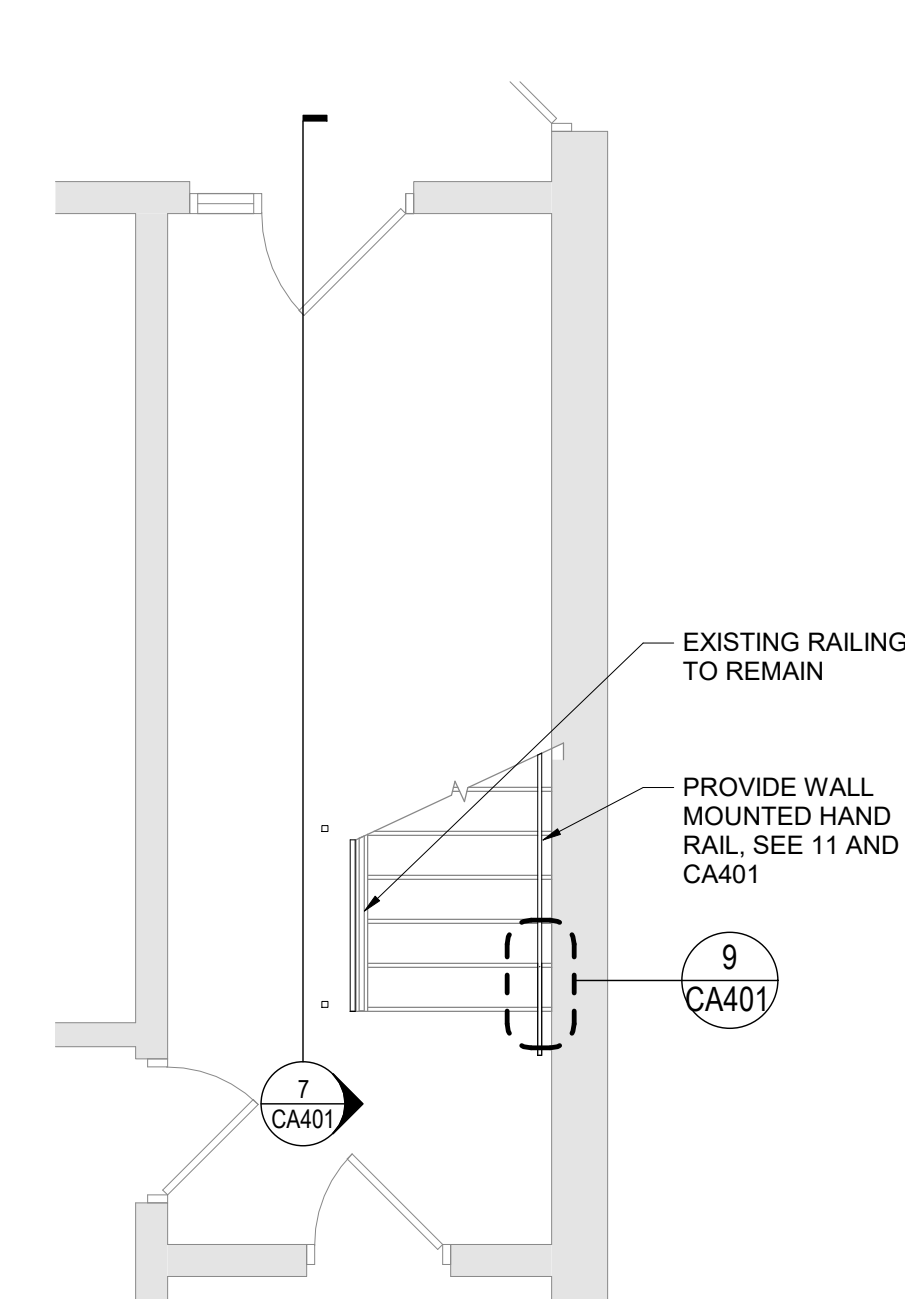


1 South Stair Enlarged Basement Plan
1/4" = 1'-0"

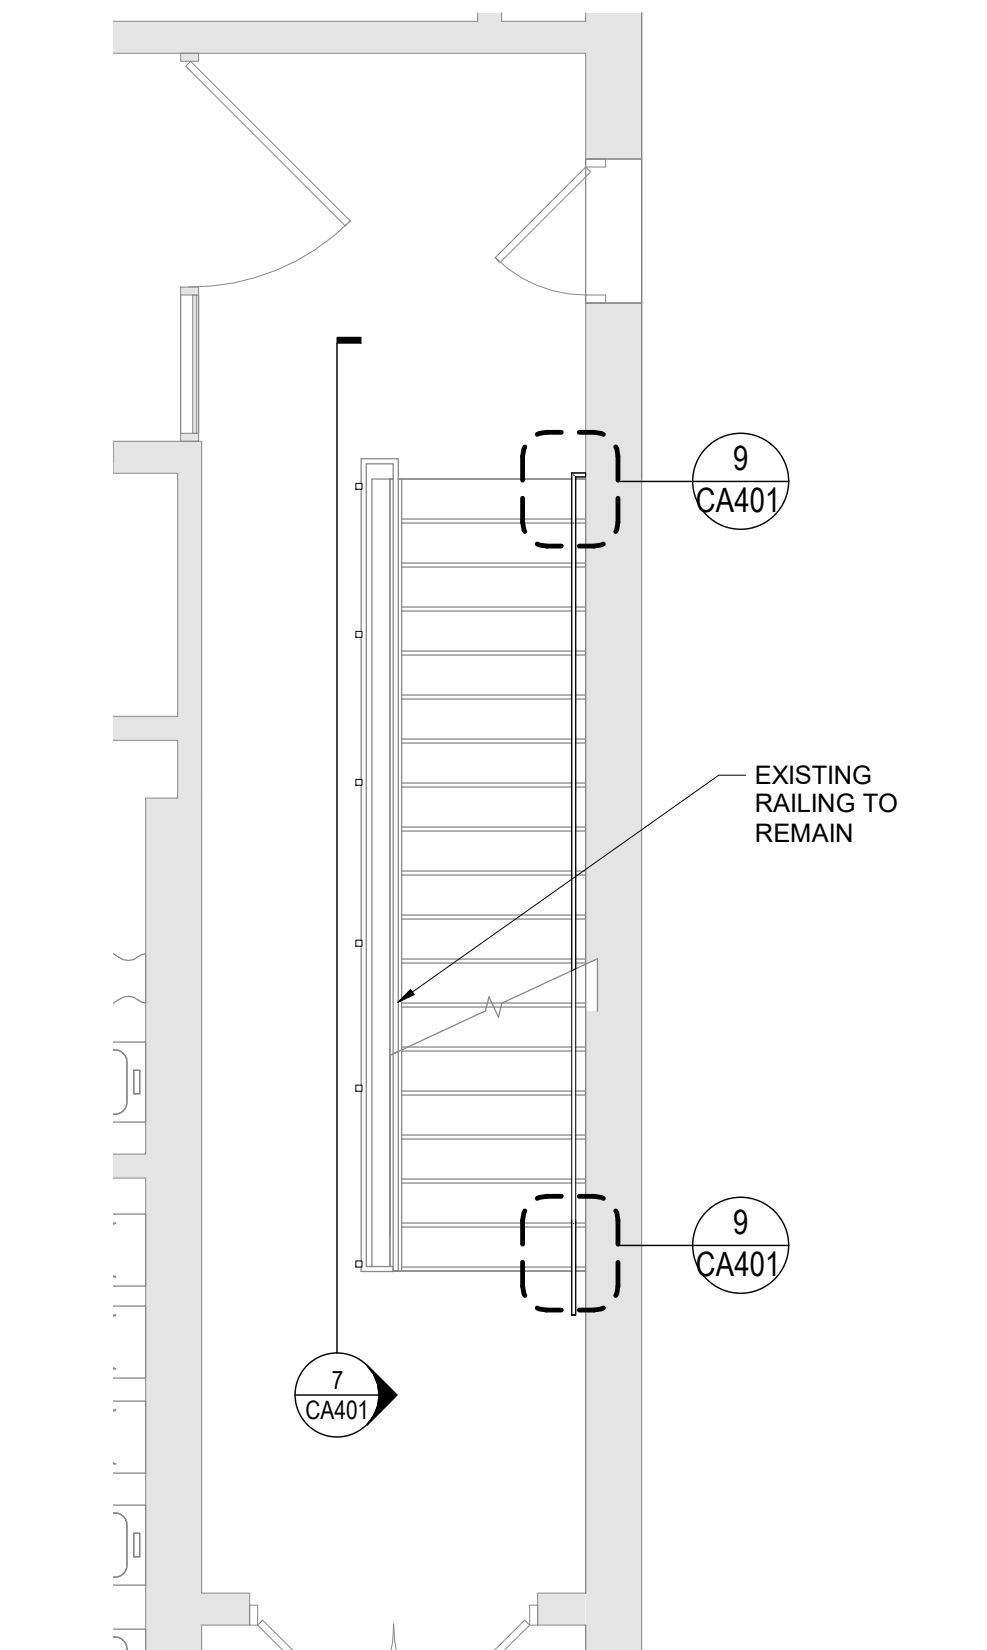

2 South Stair Enlarged First Floor Plan
1/4" = 1'-0"

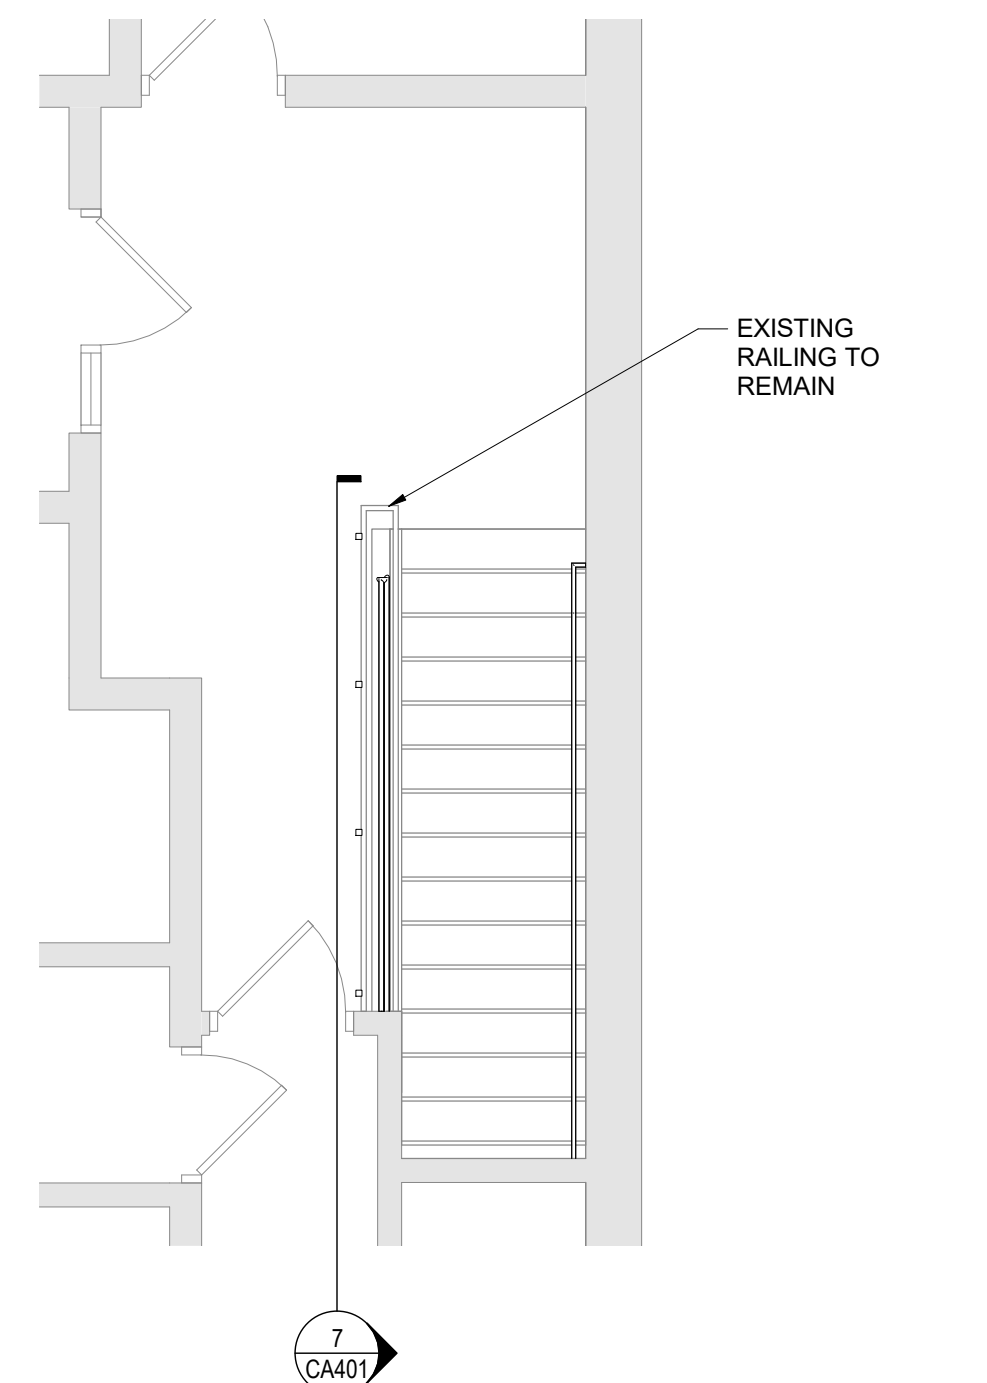


3 South Stair Enlarged Second Floor Plan
1/4" = 1'-0"

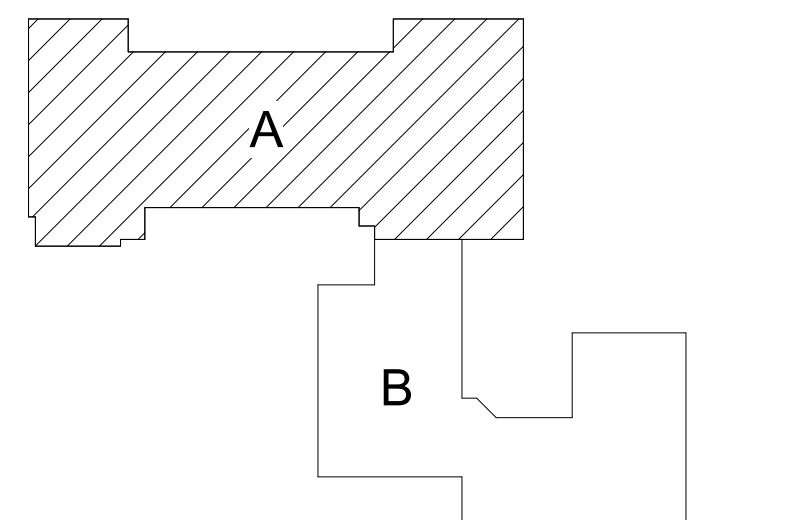

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Beacon City School District
Beacon, New York

Reconstruction to:
Sargent Elementary School


Enlarged Stair Plans, Sections, and
Details

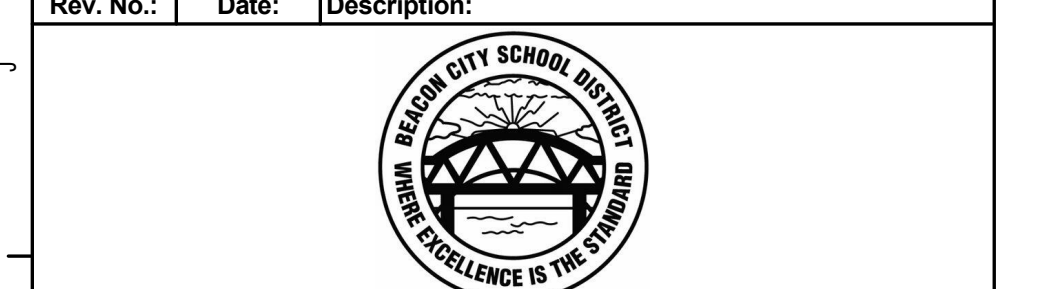Drawn By: GK	Date: 10/28/2022	Drawing Number:
Project No.: 279180-22004		CA401


Door Schedule																			
ROOM NUMBER	DOOR NUMBER	DOOR							FRAME							HDW SET	REMARKS		
		TYPE	MATERIAL	WIDTH	HEIGHT	RATING	GLAZING	TYPE	MATERIAL	WIDTH	HEIGHT	RATING	GLAZING	HEAD	JAMB			SILL	
1st FLOOR																			
6	1	N3	WD	3'-0"	7'-2"	20 MIN	FP	F2	HM	3'-4"	7'-4"	20 MIN	-	H-13	J-13	-	01	NOTE 1	
6	2	N3	WD	3'-0"	7'-2"	20 MIN	FP	F2	HM	3'-4"	7'-4"	20 MIN	-	H-13	J-13	-	01	NOTE 1	
6	3	N3	WD	3'-0"	7'-2"	20 MIN	FP	F2	HM	3'-4"	7'-4"	20 MIN	-	H-2	J-2	-	02	NOTE 1	
6	4	-	-	0'-0"	0'-0"	20 MIN	-	F22	HM	1'-6"	1'-6"	45 MIN	FPC	J-14 SIM	J-14	-		NOTE 1, SILL HEIGHT 6'-0" AFF	
6	5	-	-	0'-0"	0'-0"	20 MIN	-	F22	HM	1'-0"	3'-0"	45 MIN	FPC	J-14 SIM	J-14	-		NOTE 1, SILL HEIGHT 3'-0" AFF	
6	6	-	-	0'-0"	0'-0"	20 MIN	-	F22	HM	2'-0"	2'-0"	45 MIN	FPC	J-14 SIM	J-14	-		NOTE 1, SILL HEIGHT 6'-0" AFF	
6	7	-	-	0'-0"	0'-0"	20 MIN	-	F22	HM	1'-0"	2'-0"	45 MIN	FPC	J-14 SIM	J-14	-		NOTE 1, SILL HEIGHT 4'-0" AFF	
6	8	-	-	0'-0"	0'-0"	20 MIN	-	F22	HM	1'-0"	3'-0"	45 MIN	FPC	J-14 SIM	J-14	-		NOTE 1, SILL HEIGHT 3'-0" AFF	
6	9	-	-	0'-0"	0'-0"	20 MIN	-	F22	HM	2'-0"	2'-0"	45 MIN	FPC	J-14 SIM	J-14	-		NOTE 1, SILL HEIGHT 4'-0" AFF	
6	10	-	-	0'-0"	0'-0"	20 MIN	-	F22	HM	1'-0"	2'-0"	45 MIN	FPC	J-14 SIM	J-14	-		NOTE 1, SILL HEIGHT 5'-0" AFF	
6A	1	F	WD	3'-0"	7'-2"	-	-	F2	HM	3'-4"	7'-4"	-	-	H-13	J-13	-	03	PROVIDE LOUVER 10" HIGH X 20" WIDE	

GENERAL NOTES:
VERIFY ALL DIMENSIONS IN THE FIELD


SPECIFIC NOTES
- NOT APPLICABLE
1. COORDINATE WITH CURVED WALL RADIUS, SEE PLAN

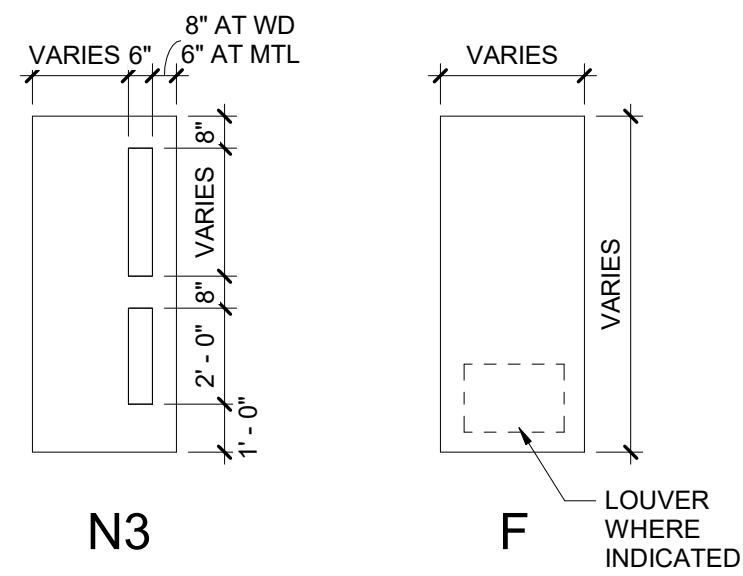


DOOR TYPES

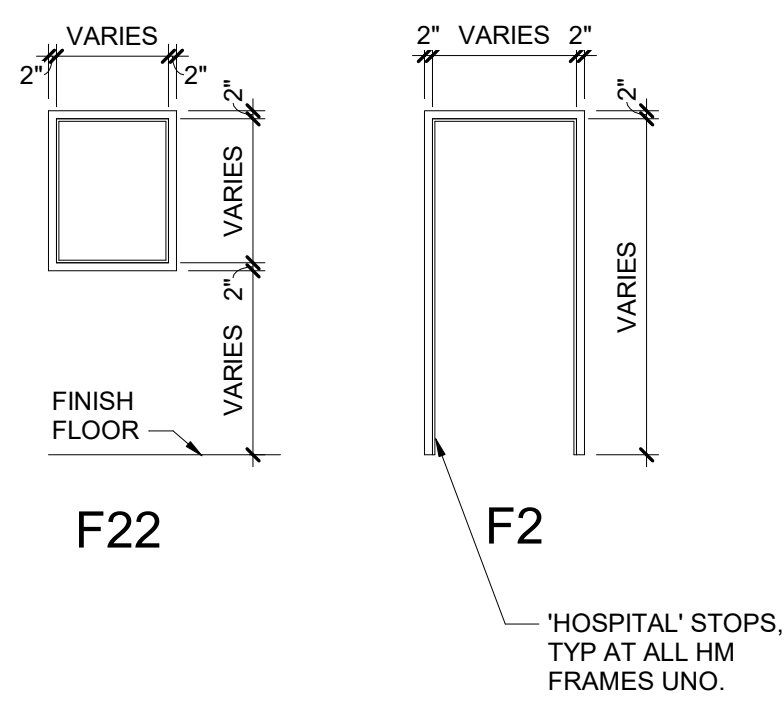


FRAME TYPES

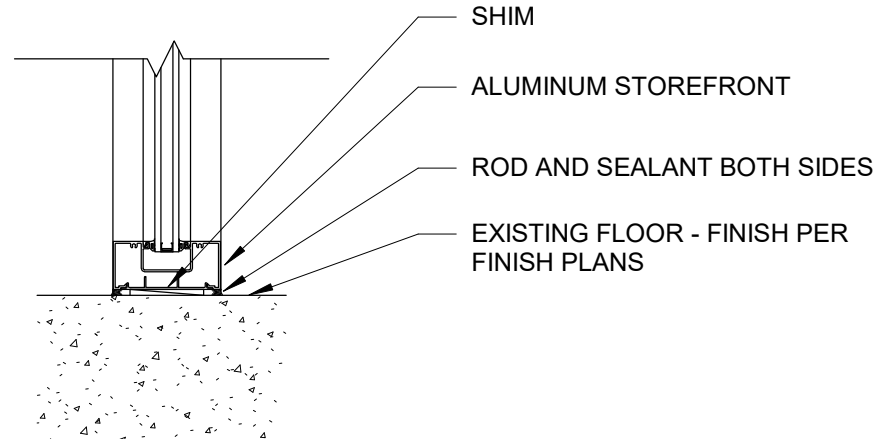


6 Sill Detail
1 1/2" = 1'-0"

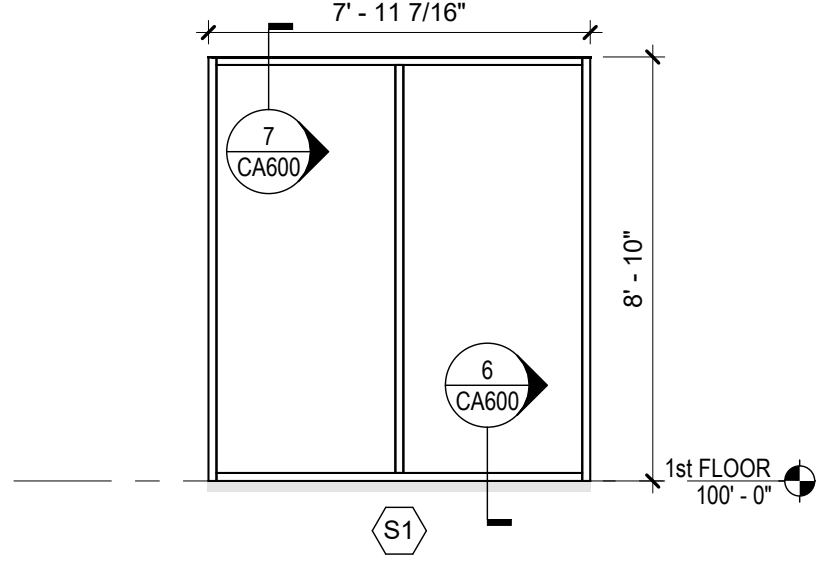


4 Storefront S1
1/4" = 1'-0"

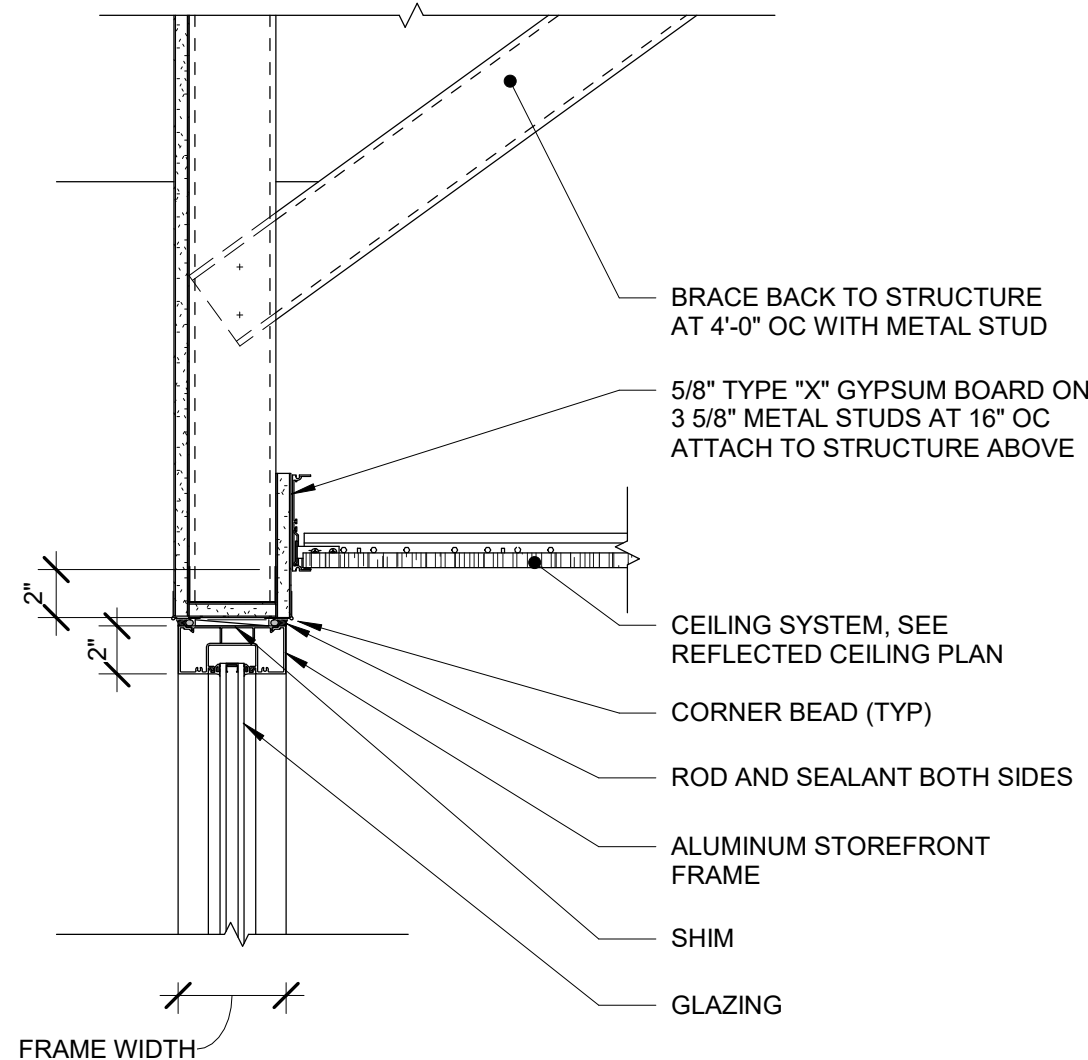


7 Head Detail
1 1/2" = 1'-0"

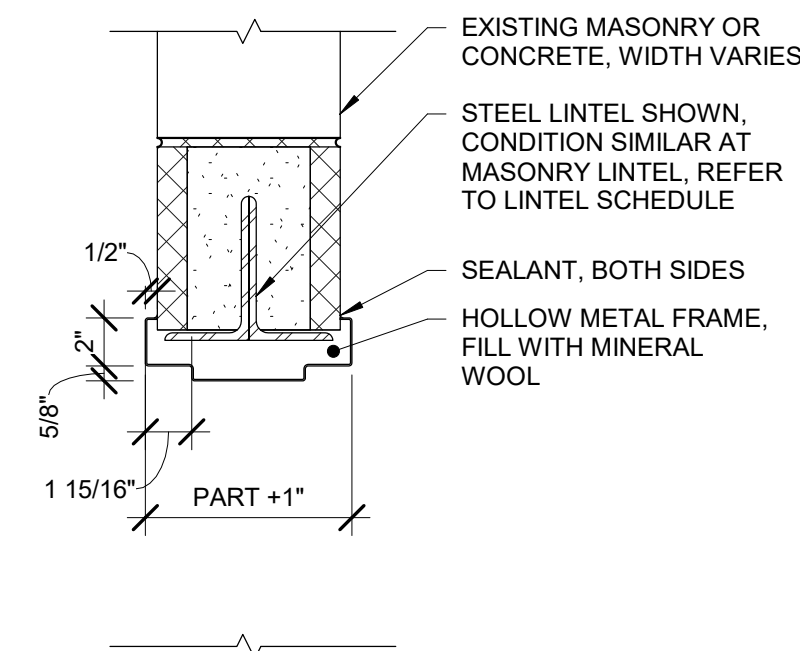


H-2

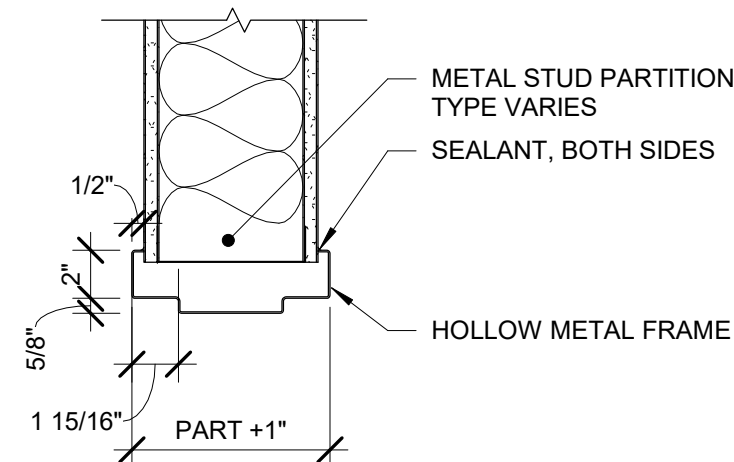


H-13

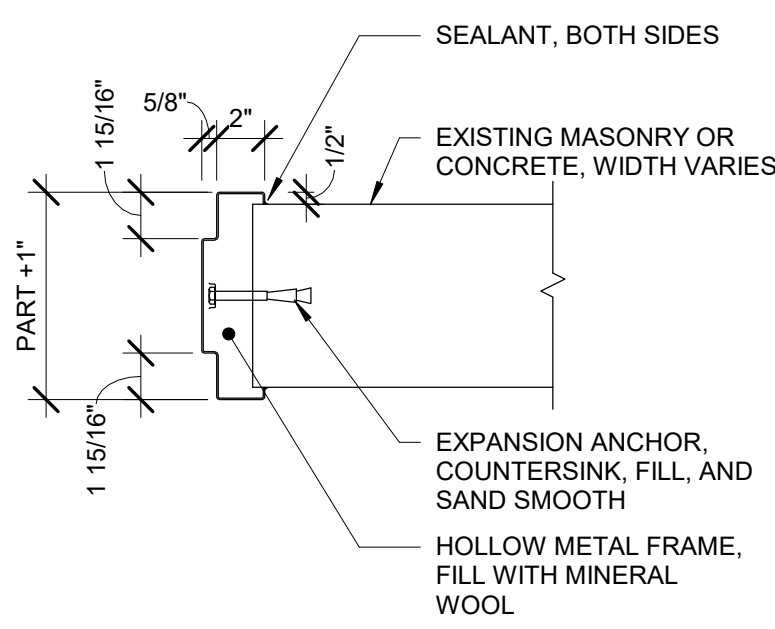

J-2

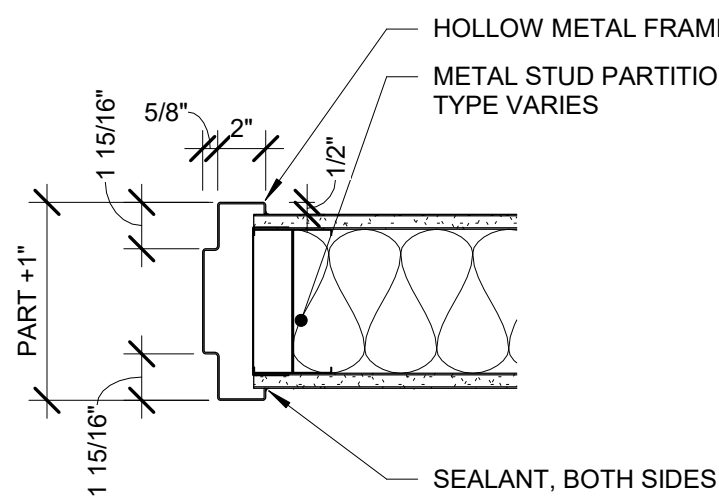


J-13

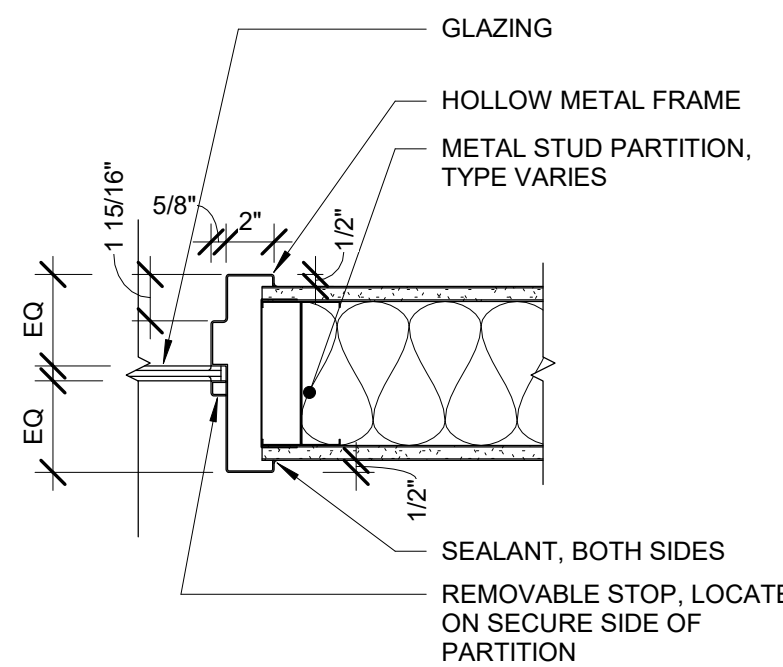


J-14

5 Typical Hollow Metal Frame Details
1 1/2" = 1'-0"

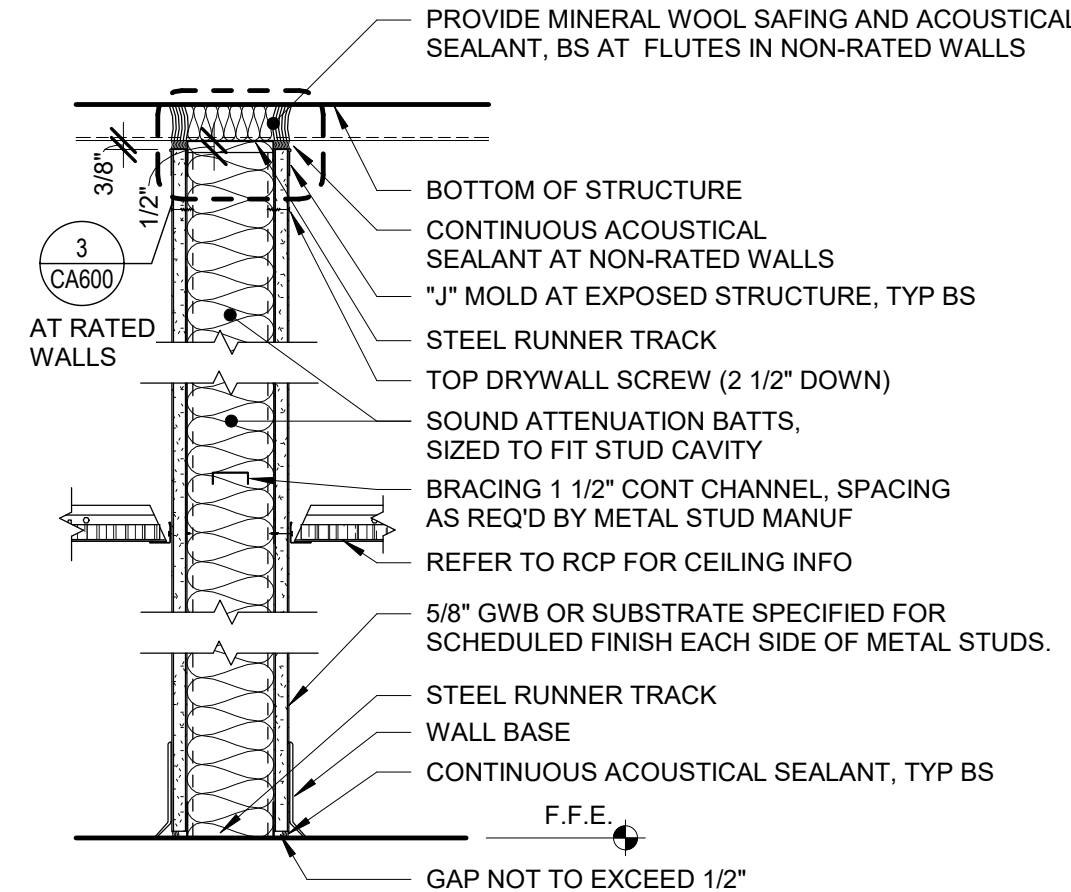


TYPE KEY	KEY LEGEND
P12.3, P12.4, AND P12.6 (NO RATING)	3 = 3-5/8" MTL STUDS
P13.3 UL DESIGN #U465 (1 HOUR)	4 = 4" MTL STUDS
P13.4 UL DESIGN #U465 (1 HOUR)	5 = 5" MTL STUDS
P13.6 UL DESIGN #U465 (1 HOUR)	6 = 6" MTL STUDS

1 Metal Stud Partition Type P12 and P13
1 1/2" = 1'-0"

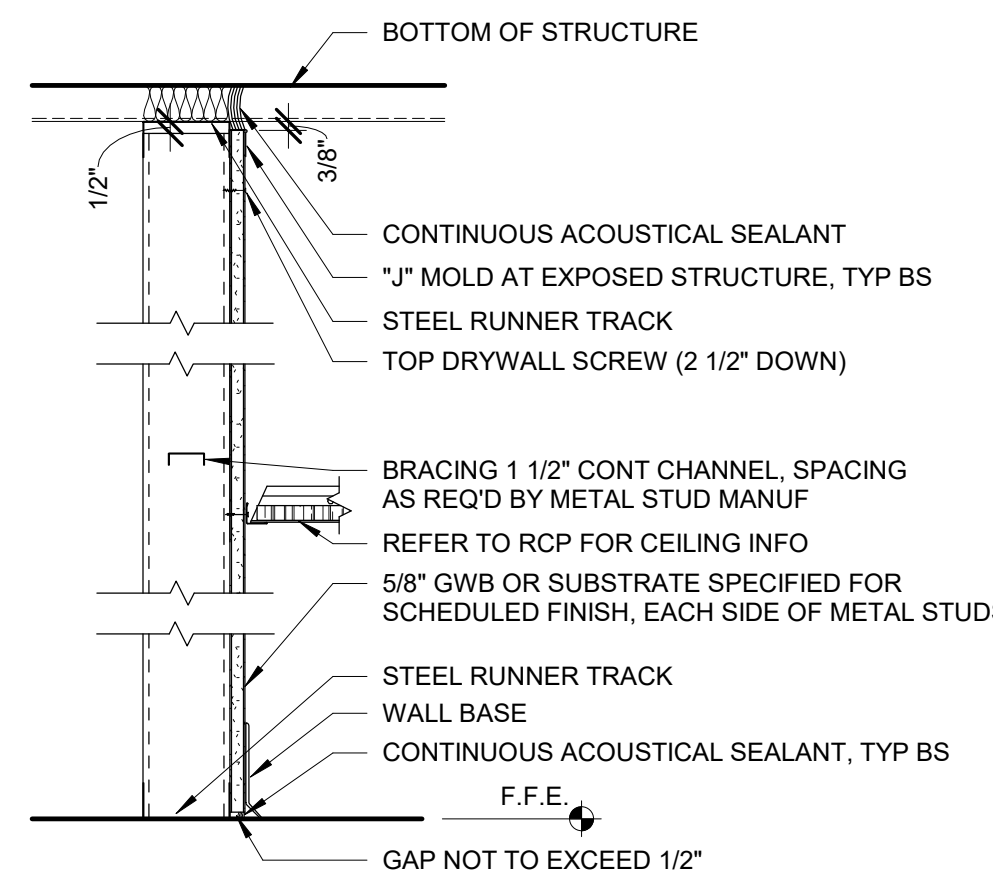

TYPE KEY	KEY LEGEND
P16.2	2 = 2-5/8" MTL STUDS
P16.3	3 = 3-5/8" MTL STUDS
P16.4	4 = 4" MTL STUDS
P16.6	6 = 6" MTL STUDS

2 Metal Stud Partition Type P16
1 1/2" = 1'-0"

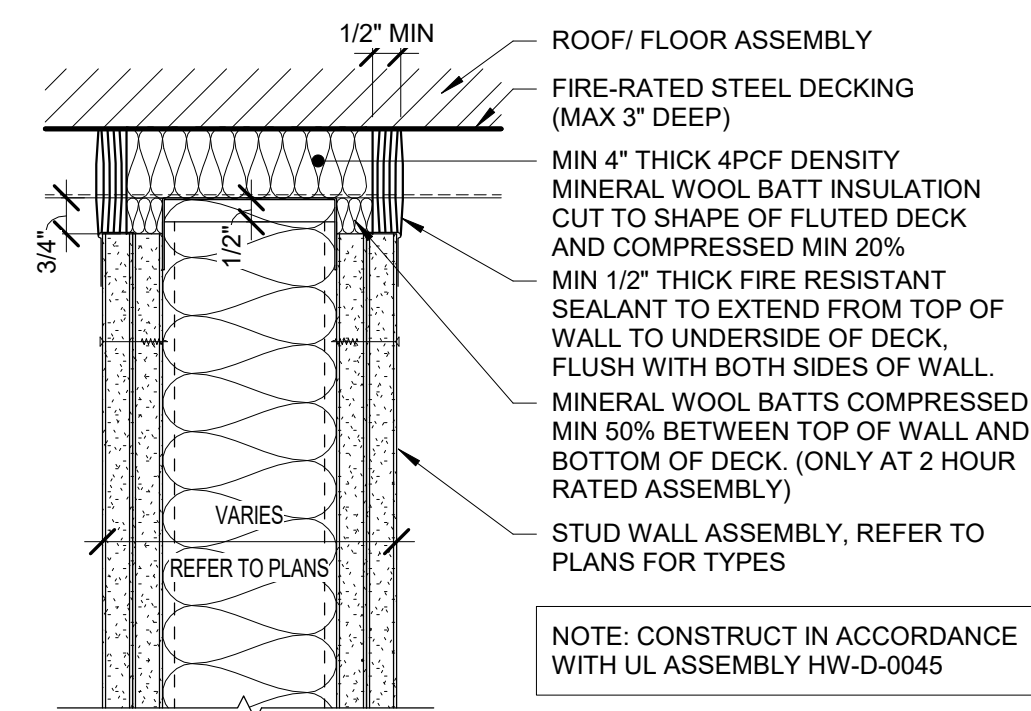


3 Typical Top of Wall Assembly (Rated)
3" = 1'-0"

General Door Notes

- HARDWARE ON DOORS FROM SPACES OF PUPIL OCCUPANCY SHALL BE A TYPE WHICH WILL ALWAYS PERMIT THE DOOR TO BE OPENED FROM THE INSIDE WITHOUT DIRECT MANIPULATION OF ANY TYPE LOCKING DEVICE.
- METAL VISION PANEL TRIM SHALL BE PAINTED SAME COLOR AS DOOR FRAMES.
- APPLY CONTINUOUS JOINT SEALANT TO ALL JOINTS BETWEEN FRAMES AND WALLS, TYP ALL.
- PAINT ALL HM DOORS AND FRAMES.
- PROVIDE LINTELS AT ALL DOOR AND WINDOW OPENINGS IN ACCORDANCE WITH LINTEL SCHEDULE ON STRUCTURAL DWGS.
- NOTE THAT DUE TO REQUIREMENTS IN THE BCNYS, SOME FIRE RESISTANCE RATINGS MAY DIFFER BETWEEN DOORS (AND ITS GLASS, IF ANY) AND THAT DOORS FRAME ESPECIALLY IF THAT FRAME HAS GLASS (SIDELITES, TRANSOMS, ETC).
- VERIFY SIZES OF ALL EXISTING OPENINGS IN SCHEDULE PRIOR TO FIRST SUBMISSION OF SHOP DRAWINGS. NOTIFY ARCHITECT IF ANY ARE LESS THAN CODE MINIMUM HEIGHT OF 6'-8". ASSUME FOR BIDDING ALL EXISTING OPENINGS ARE AS NOTED IN THE SCHEDULE (VF, TYP).
- MATERIAL DESIGNATION KEY:
 - FRP FIBERGLASS REINFORCED PLASTIC
 - HM HOLLOW METAL
 - WD WOOD
 - AL ALUMINUM
 - STL STEEL
 - EXG EXISTING
- ADDITIONAL DOOR SCHEDULE DESIGNATIONS:
 - EXISTING TO REMAIN
 - NOT APPLICABLE
 - NOT APPLICABLE OR TO BE COORDINATED WITH STOREFRONT TYPE.

General Window Notes


- REFER TO WINDOW TREATMENTS AS SHOWN ON DRAWINGS.
- GLAZING SYSTEMS FRAME TYPE KEY:
 - HM HOLLOW METAL
 - S ALUMINUM STOREFRONT

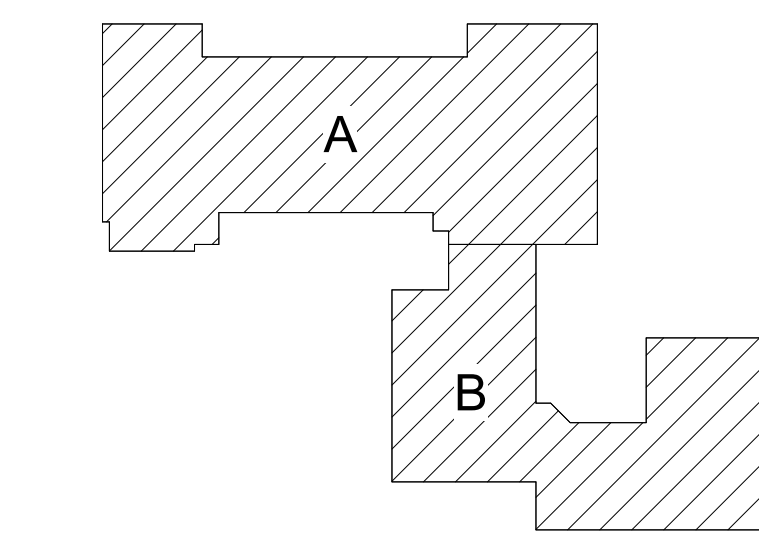

Key Plan
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S.E.D. Control No. 13-02-00-01-0-008-020

Rev. No.:	Date:	Description:

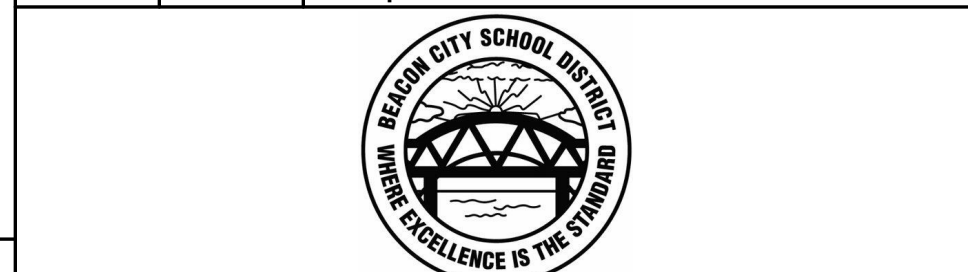

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CLEAR SOLUTIONS

Tetra Tech Engineers, Architects & Landscape Architects, P.C.

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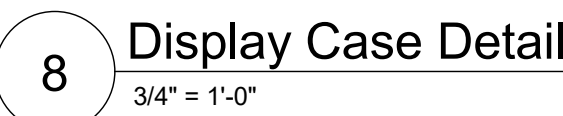
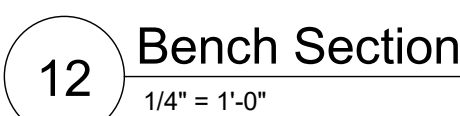
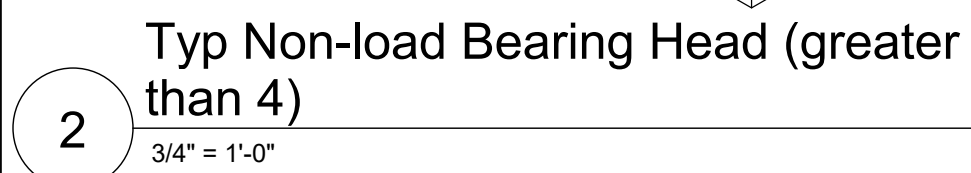
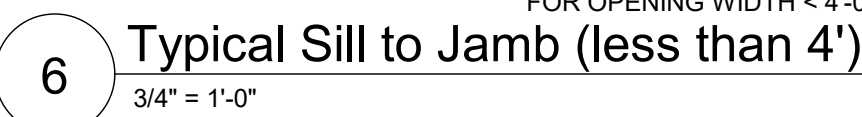
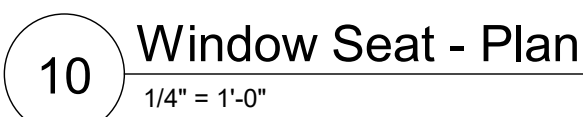


Beacon City School District
Beacon, New York

Reconstruction to:
Sargent Elementary School

Door Schedule, Door and Window
Types, and Details

Drawn By: GK	Date: 10/28/2022	Drawing Number:
Project No.:	279180-22004	CA600



Rev. No.:	Date:	Description
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Tetra Tech Engineers, Architects
& Landscape Architects, P.C.

BID SET

Beacon City School District Beacon, New York

W	Reconstruction to: Sargent Elementary School
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Miscellaneous Details

Drawn By: GK/MHH/TLG	Date: 10/28/2022	Drawing Number: CA7
Project No.: 279180-22004		

CA750

- A. THE CASEWORK SHOWN ON THE DRAWINGS IS BASED ON WOOD METAL. WOOD CASEWORK. REFER TO THE PROJECT MANUAL, SECTION 12 32 13 FOR DETAILED SPECIFICATIONS.
- B. ALL STANDARD CASEWORK DIMENSIONS TO BE MODIFIED TO CORRESPOND WITH THE DIMENSIONS NOTED ON THE DRAWING. FIELD VENEER DIMENSIONS PRIOR TO FABRICATION OF CABINETS
- C. MODEL NUMBERS LISTED ON DRAWINGS APPLY TO ELEVATION SHOWN. PROVIDE OPPOSITE HAND MODELS WHERE SHOWN.
- D. PROVIDE FULL DEPTH SHELVES AT BASE, WALL AND TALL CABINETS, UNLESS NOTED OTHERWISE.
- E. BASE AND TALL CABINETS ARE 24 INCHES DEEP. U.N.O. WALL CABINETS ARE 14 INCHES DEEP. UNO BASE CABINET DEPTH DOES NOT INCLUDE 1" COUNTERTOP OVERHANG, TYP.
- F. PROVIDE FINISHED ENDS, BACK EXTENSIONS, SCRIBES AND FINISHED FILLER PANELS ON ALL CABINETS. FILLER PANELS ARE 3/4" THICK 3" WIDE UNLESS NOTED OTHERWISE. PROVIDE TOP AND BOTTOM FILLER PANELS AT ALL BASE & WALL UNITS. SUBMIT SHOP DRAWINGS SHOWING DETAILS OF THESE
- G. ALL COUNTERTOPS TO SOLID SURFACE UNLESS NOTED OTHERWISE, BACKSLASHES TO BE 4" HIGH, TYP.
- H. RADIUS COUNTERTOPS AT EDGE OF SOLID SURFACE. COUNTERTOPS ENDS MEETING TALL SHELVING UNITS WITH A DEPTH LESS THAN COUNTERTOP DEPTH. RADIUS TO BE 1-1/2" UNLESS NOTED OTHERWISE. REFER TO DETAIL.
- I. PROVIDE CUTS AT ALL CONDITIONS THAT INTERFERE WITH COUNTERTOP/CABINETS. SCRIBE TO FIT.
- J. PROVIDE SHOP DRAWINGS SHOWING LOCATIONS AND DETAILS FOR TRIPLES, LOUVERS, REMOVABLE PANELS, VALVE LOCATIONS ETC. ASSOCIATED WITH CASEWORK COORDINATE WITH ALL REQUIRED CONTRACTORS.
- K. PROVIDE CABINETS WITH FINISHED SIDES, INCLUDING BUT NOT LIMITED TO, LOCATIONS OF ADJACENT CABINETS OR EQUIPMENT WITH A DEPTH LESS THAN CABINET OR EQUIPMENT.
- L. PROVIDE ALL STANDARD FEATURES OF CASEWORK UNITS AS NOTED BY MODEL NUMBER. PROVIDE SHOP DRAWINGS FOR DETAILS AND ELEVATIONS, INCLUDED BUT NOT LIMITED TO: OUTLETS, SWITCHES, LIGHTS ETC.
- M. PROVIDE BLOCKING AT NEW AND EXISTING GYPSUM BOARD WALLS PER MANUFACTURER RECOMMENDATIONS FOR SUPPORT OF WALL MOUNTING. PROVIDE SHOP DRAWINGS PER SPECIFICATION SECTION 06 10 00 FOR WOOD BLOCKING REQUIREMENTS.
- N. PROVIDE LOCKS AT ALL CASEWORK DOORS/DRAWERS AND FILE UNITS FOR TRIPLES.
- O. PROVIDE AS NOTED ON DRAWINGS AND DETAILS: 3" GROMMETS AT OPEN BASE CABINETS 30/30" OC, WIRE MANAGER, KEY BOARD TRAYS AND CABLE TRAYS.
- P. PROVIDE ALL CUTOUTS AS SHOWN ON CASEWORK PLANS AND DETAILS. PROVIDE SHOP DRAWINGS FOR DETAILS TO INCLUDE BUT NOT LIMITED TO: ALL ELEC BOXES, OUTLETS, AND ASSOCIATED WIRING AND FINAL HOOKUP.
- Q. REFER TO BOTH 18" AND 14" PLANS FOR LAYOUTS.

ALL FINISH PRODUCTS ARE TO BE INSTALLED IN ACCORDANCE WITH CONTRACT SPECIFICATION AND MANUFACTURERS INSTRUCTIONS. REFER TO SPECIFICATIONS AND FINISH DETAILS FOR ADDITIONAL INFORMATION ON INSTALLATION OF SPECIFIED MATERIALS.

A. ALL PAINTS FOR INTERIOR AND EXTERIOR ARE TO BE APPLIED IN ACCORDANCE WITH SPECIFICATION SECTION 09 91 01 AND 09 96 00

B. ALL EXPOSED STRUCTURES, INCLUDING BUT NOT LIMITED TO PIPING, FIREPROOFING, CONDUIT, AND ALL ASSOCIATED EQUIPMENT ARE TO BE PAINTED.

C. APPLY PAINT TO BOTH NEW AND EXISTING ITEMS IN ALL AREAS INDICATED WITH A FINISH BOX AND/OR NOTES - THESE ITEMS ARE INDICATED BUT ARE NOT LIMITED TO:
- DOORS, BENCHES, BUILT-IN CABINETS - BOTH SIDES
- GLAZING FRAMES IN DOORWAYS- BOTH SIDES, ALL EXPOSED STAIR PARTS INCLUDING RAILINGS, HAND AND GUARD RAILS, STRINGERS AND UNDERSIDES OF STAIRS. ALL ITEMS ARE TO BE ACENT COLORS.

D. PATTERNS FOR FLOORS ARE AS SHOWN, SUBMIT SHOP DRAWINGS SHOWING DETAILED LAYOUTS OF EACH AREA, INCLUDING EDGES AND TRANSITIONS. ALL LAYOUTS ARE TO BE SHOWN IN EACH ROOM. UNO - TYPE ALL DRAWINGS. ABOVE REQUIREMENTS ARE TO INCLUDE BUT NOT LIMITED TO:
- TERRAZZO AND BASE
- CARPET
- VCT
- LVT
- RUBBER

E. FIELD AND ACENT PAINT ARE ISSUED DURING THE CONSTRUCTION PHASE. CONTRACTOR IS TO ASSUME ALL FIELD AND ACENT COLORS ARE DIFFERENT ROOM TO ROOM. AS WELL AS WITHIN EACH ROOM. REQUIREMENTS ARE TO INCLUDE BUT ARE NOT LIMITED TO:
- WALL - FIELD COLOR
- WALL - ACENT COLOR
- CEILING CLOUDS, ACENT COLOR
- SOFFITS, ACENT COLOR
- CEILING AND WINDOW CASINGS, ACENT COLOR
- EXPOSED COLUMNS, ACENT COLOR
- GUARDRAILS, ACENT COLOR
- HANDRAILS, ACENT COLOR
- EXPOSED DECKS, ACENT COLOR
- EXPOSED JOISTS, ACENT COLOR
- EXPOSED DUCTWORK, ACENT COLOR

F. PROVIDE PAINT AT ALL NEW SPOOTS, REFER TO REFLECTIVE CEILING PLANS FOR ADDITIONAL LOCATIONS.

G. ALL EXPOSED BRICK, GROUND FACE BLOCK IS TO REMAIN UNPAINTED, UNO.

H. CONFIRM WITH OWNER AND ARCHITECT PRIOR TO PAINTING OVER MURALS ON EXISTING SURFACES.

I. PROVIDE PAINT AND RUBBER BASE AT ALL NEW CHASES, REFER TO NEW WORK PLANS FOR ADDITIONAL LOCATIONS.

J. CARPET IS TO RUN WALL TO WALL, UNDER ALL FURNITURE, EXISTING EQUIPMENT AND ALL NEW FURNITURE, INCLUDING ALL UNITS AT THE PERIMETER WALLS.

K. FOR ALL RENOVATED AREAS REQUIRING FINISH WORK REMOVE, PROTECT AND REINSTALL MOVABLE EQUIPMENT INCLUDING BUT NOT LIMITED TO: BOARD UNITS, LOCKERS GYM EQUIPMENT, SHOWER BOOTHS, ETC. REINSTALL IN ORIGINAL LOCATION, OR AS NOTED ON DRAWINGS. COORDINATE WITH OWNER, REFER TO SPEC SECTION 01 23 00 ALTERATION PROJECT PROCEDURES FOR ADDITIONAL INFORMATION.

L. PROVIDE ALL FINISHES AS INDICATED BY ROOM FINISH BOX AND/OR AS NOTED ON DRAWINGS.

12" = 1'-0"

ALUMINUM EXTRUDED
TACK COVERING J TRIM
APPLIED AT ALL CORNERS
NITRE ALL CORNERS,
TYP.

MARKER WALL
COVERING

ADHESIVE

PANEL TRIM TO RUN HORIZONTAL
AND VERTICAL AROUND ALL SIDES
OF WALL PANELS - MITER ALL
CORNERS FOR SMOOTH FINISH.

- A. THE LIBRARY EQUIPMENT SHOWN ARE BASED ON WORDEN REFER TO THE PROJECT MANUAL, SECTION 12.56.01 FOR DETAILED SPECIFICATIONS. CHAIRS ARE BASED ON COMMUNITY SEATING - SEE SPEC AND SCHEDULE.
- B. ALL SHELVING UNITS, BOTH SINGLE AND DOUBLE ARE TO BE PROVIDED WITH WOOD END PANELS.
- C. ALL LIBRARY SHELVING IS TO BE PROVIDED WITH CANOPY TOPS AS LISTED BELOW:
 - ALL 30", 42" HIGH SHELVING UNITS ARE TO BE PROVIDED WITH A CONTINUOUS SOLID SURFACE TOP
 - ALL SINGLE FACED SHELVING UNITS ARE TO BE FURNISHED AND INSTALLED WITH BACKS AS PER SPECIFICATIONS. SECURE ALL SINGLE FACED SHELVING TO WALLS.
- D. PROVIDE SOLID HARDBOARD BACKS FOR ALL SHELVING UNITS UNLESS OTHERWISE NOTED. PROVIDE FINISHED BACK PANELS FOR DOUBLE FACE SHELVING UNITS UNO.
- E. PROVIDE FINISHED FILLER PANELS BOTH VERTICAL AND HORIZONTAL ALL FILLER SIZE ARE TO VERIFIED IN FIELD.
- F. ALL SHELVING UNITS ARE TO BE FIELD VERIFIED PRIOR TO FABRICATION, MODIFY UNITS AS REQUIRED, SEE DETAILS.
- G. PROVIDE SHOP DRAWINGS SHOWING LAYOUTS OF ALL SHELVING, DETAILS AND CHASES.
- H. REFER TO SPEC SECTION 01 23 00 FOR ADDITIONAL INFORMATION REGARDING CASEWORK ALTERNATES.

3" = 1'-0"

COORDINATE ALL SINK SIZES
WITH CONTRACTOR RESPONSIBLE
FOR SINK AND INSTALLATION.

BACKSPLASH

TYP ADA 5 1/2" DEEP SINK

PROVIDE
REMOVABLE
ACCESS PANEL

RESILIENT
BASE

SOLID SURFACE
COUNTERTOPS

SOLID SURFACE
FACE PANEL - VERIFY
LENGTH IN FIELD

WOOD PIPE PANEL
RUN FULL LENGTH
OF OPENING 1/2"
AFT SECURE TO
UNIT PER
MANUFACTURER

6 1/32"

1"

27"

34"

9"

MIN

6 1/16"

1/2"

MAX

VARIABLES

Diagram illustrating the ADA compliant door threshold detail. The diagram shows a cross-section of a door opening. The door is labeled "DOOR". The threshold is labeled "CENTER ADAPTOR STRIP UNDER DOOR". The floor on the left is labeled "CARPET" and the floor on the right is labeled "LVT FLOORING". A "SOLID RUBBER ADAPTOR STRIP" is shown on the right side of the threshold. A dimension line indicates a width of 3/4" = 1'-0".

NOTE:
REFER TO SPECIFICATIONS FOR TRANSITION AND TYPES
REFER TO FINISH PLANS FOR ALL LOCATIONS, TYPICAL
THRESHOLD TO MEET ALL ADA CRITERIA
RATED DOOR UNDERCUT DISTANCE TO MEET REQUIRED NFPA CRITERIA

6" = 1'-0"

Diagram illustrating a cross-section of a door threshold assembly. The assembly includes a door, a solid rubber edge guard, a carpet (refer to finish plan), a terrazzo floor finish (refer to finish plans for color pattern), and a center metal divider under the door.

3" = 1'-0"

PROVIDE CUTOUT AT TOPS AS NEEDED FOR CHASES VIF ALL SIZES AND LOCATIONS

TALL SHELVING UNITS

FILLER PANELS

PROVIDE FULL FINISHED TOP AND SIDE FILLER PANELS TO MATCH LIBRARY SHELVING UNITS AT ALL INTERSECTIONS, TYP FOR BOTH TALL AND LOW SHELVING UNITS

LOW SHELVING UNITS

ALL SHELVING UNITS ARE TO BE MODIFIED AS NEEDED TO PROVIDE CLEAR CORNERS W/ NO OVERLAP OF SHELVING UNITS. TYP

3/4" = 1'-0"

PROVIDE CUTOOUT AT TOPS
AS NEEDED FOR CHASES.
VIF ALL SIZES AND LOCATIONS

PROVIDE FULL FINISHED TOP
AND SIDE FILLER PANELS TO
MATCH LIBRARY SHELVING UNITS
AT ALL CORNERS TYP FOR
BOTH TALL AND LOW SHELVING
UNITS

SHELVING UNITS

ALL SHELVING UNITS ARE TO BE
MODIFIED AS NEEDED TO PROVIDE
CLEAR CORNERS W/ NO OVERLAP
OF SHELVING UNITS. TYP

3/4" = 1'-0"

ALL 30", 42" AND 63" HIGH SHELVING UNITS ARE TO BE PROVIDED WITH A CONTINUOUS WOOD TOP, TOPS LONGER THAN 108" TO BE JOINED WITH TIGHT JOINT FASTENERS

WOOD DROP EDGE STYLE AS SPECIFIED ALL SIDES

SECURE TOP TO SHELVING UNIT FROM UNDERSIDE, TYP

WOOD

WALL

12" DEEP SINGLE FACE CONTINUOUS TOP SHELVING

WOOD


WOOD DROP EDGE STYLE AS SPECIFIED ALL SIDES

12" DEEP DOUBLE FACE CONTINUOUS TOP SHELVING

Diagram illustrating the installation of a full-height panel, showing components and labels:

- SOLID SURFACE COUNTERTOP
- GROMMET
- TRAY™ CM-201 TO RUN ENTIRE
- PROVIDE CUTOFF FOR ELEC/COMPUTER BOX
- INTERMEDIATE SUPPORT BRACKET SIM. TO A & M.
- REMOVABLE FULL LENGTH, FULL HEIGHT PANEL, TYP.
- RESILIENT BASE
- CLIENT BASE
- WORK

5 $3/4" = 1'-0"$

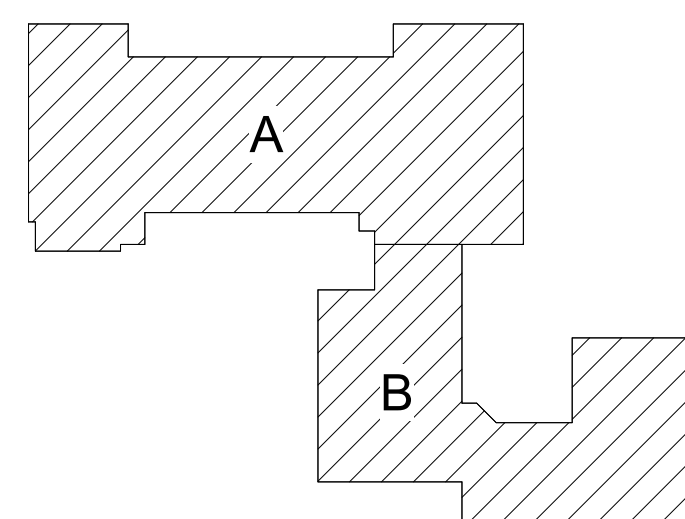

Key Plan
N.T.S.

S.E.D. Control No. 13-02-00-01-0-008-020


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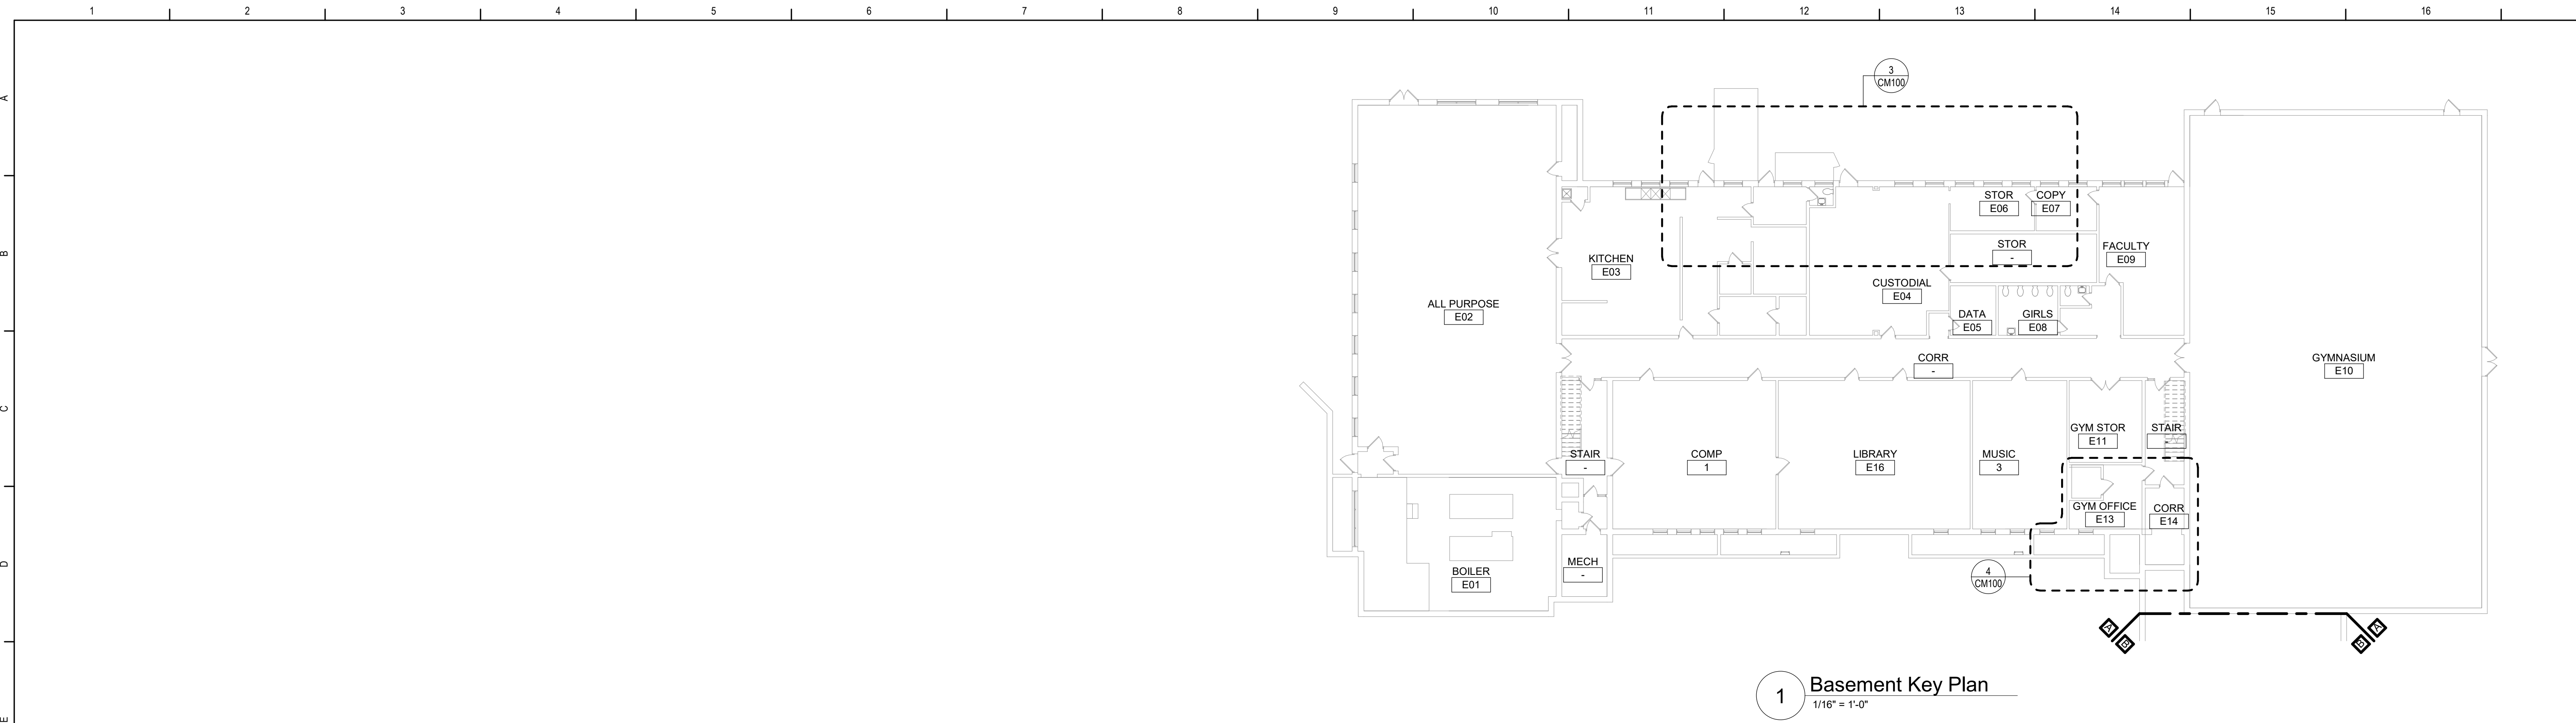
TETRA TECH
ARCHITECTS & ENGINEERS

Beacon City School District
Beacon, New York

Reconstruction to: Sargent Elementary School

Details

Drawn By: MHH	Date: 10/28/2022	Drawing Number:
Project No.: 279180-22004		CA900

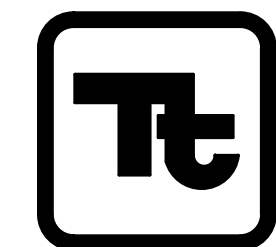


1
1/16" = 1'-0"




2
1/16" = 1'-0"

- General Notes**
- A. THE FOLLOWING GENERAL NOTES APPLY TO ALL "CM" SERIES DRAWINGS.
 - B. REFER TO ALL CONTRACT DOCUMENTS, DRAWINGS AND SPECIFICATIONS, FOR DETAILED STANDARDS AND REQUIREMENTS.
 - C. REPORT UNSAFE OR UNSATISFACTORY CONDITIONS IN WRITING TO ARCHITECT AND RESOLVE ISSUES BEFORE PROCEEDING.
 - D. WORK INCLUDES ALL LABOR AND MATERIALS REQUIRED TO PROVIDE COMPLETE WORKING SYSTEMS.
 - E. COORDINATE PHASING REQUIREMENTS AT JOB MEETINGS AND ON WORK SCHEDULES.
 - F. DO NOT SCALE DRAWINGS. PIPING AND DUCTWORK ARE SHOWN DIAGRAMMATICALLY. IT IS NOT POSSIBLE TO SHOW EVERY TRANSITION, FITTING, ASPECT RATIO CHANGE, ETC., PROVIDE AS REQUIRED TO FIT WITHIN STRUCTURAL CONSTRAINTS. EXAMINE CONDITIONS UNDER WHICH THE WORK IS TO BE PERFORMED AND VERIFY ALL ACCESS, LOCATIONS, DIMENSIONS, ARRANGEMENTS, ELECTRICAL CHARACTERISTICS AND INTERFERENCE IN THE FIELD PRIOR TO BID.
 - G. VERIFY EXTENT OF CEILING WORK SHOWN ELSEWHERE IN THE CONTRACT DOCUMENTS. PROVIDE FOR ADDITIONAL CEILING SYSTEM REMOVAL, PROTECTION, AND REINSTALLATION AS REQUIRED FOR CONTRACT WORK.
 - H. DEMOLITION DRAWINGS SHOW THE GENERAL SCOPE OF ITEMS AND SYSTEMS TO BE REMOVED. IT IS NOT THE INTENT TO SHOW ALL ITEMS TO BE REMOVED. FIELD VERIFY AND REMOVE ALL ASSOCIATED ITEMS BACK TO POINT OF CONTINUED SERVICE, UNLESS OTHERWISE NOTED. VERIFY WHAT ALL EQUIPMENT SERVES PRIOR TO REMOVAL.
 - I. GIVE ALL REMOVED EQUIPMENT TO THE OWNER. DELIVER ON SITE WHERE DESIGNATED BY THE OWNER. PROMPTLY REMOVE FROM THE SITE AND LEGALLY DISPOSE OF ANY SUCH ITEMS DECLINED BY OWNER.
 - J. IF UNANTICIPATED MECHANICAL, ELECTRICAL, OR STRUCTURAL CONFLICTS ARE ENCOUNTERED, INVESTIGATE AND REPORT BOTH NATURE AND EXTENT OF THE CONFLICT. RE-ROUTE WORK AS REQUIRED.
 - K. CUT, DRILL, OR OTHERWISE CREATE OPENINGS AS NEATLY AS POSSIBLE. AS REQUIRED FOR THE INDICATED CONTRACT WORK, PROVIDE SUPPORT AS REQUIRED FOR AND USE METHODS LEAST LIKELY TO DAMAGE ELEMENTS TO REMAIN. PRIOR TO WORK, VERIFY LOCATIONS OF ALL STRUCTURAL MEMBERS INCLUDING CROSS BRACING, ELECTRICAL WIRING, PLUMBING, ETC. PROMPTLY NOTIFY ARCHITECT OF ANY CONFLICTS. DO NOT CUT ANY STRUCTURAL MEMBERS OR OTHER SERVICES UNTIL SPECIFICALLY DIRECTED TO DO SO. PENDING RECEIPT OF DIRECTIVE, REARRANGE SCHEDULE AS NECESSARY TO CONTINUE OVERALL JOB PROGRESS WITHOUT DELAY.
 - L. PATCH ALL DISTURBANCES RESULTING FROM DEMOLITION OR NEW WORK TO MATCH SURROUNDING SURFACES. PATCH FOLLOWING DEMOLITION, AND AGAIN FOLLOWING WORK, WHERE HOLES REMAIN FROM REMOVALS, INFILL AND PATCH TO MATCH UNLESS HOLE IS TO BE REUSED.
 - M. PROTECT ALL CONTRACT EQUIPMENT, ELEMENTS TO REMAIN, OWNER'S BELONGINGS, AND EQUIPMENT TO BE REUSED OR RETAINED BY OWNER DURING ALL CONTRACT WORK. AT NO ADDITIONAL COST TO OWNER, REPAIR OR REPLACE ITEMS WHICH ARE DAMAGED.
 - N. THOROUGHLY CLEAN FOLLOWING DEMOLITION AND BEFORE BEGINNING CONTRACT INSTALLATIONS. THOROUGHLY CLEAN AGAIN DURING AND FOLLOWING CONTRACT WORK AS REQUIRED. LEAVE ALL WORK AREAS CLEANER THAN FOUND. LEGALLY DISPOSE OF ALL CONSTRUCTION DEBRIS.
 - O. PROVIDE TEMPORARY PIPING, DUCT, HEAT, WEATHERPROOFING, ETC. TO SERVICES TO REMAIN UNTIL PERMANENT INSTALLATIONS CAN BE MADE.
 - P. ALL EXCESS MATERIALS AND SCRAPS ARE CONTRACTOR'S PROPERTY. PROMPTLY REMOVE FROM SITE UNLESS SPECIFICALLY DIRECTED OTHERWISE.
 - Q. EXISTING HVAC COMPONENTS IN THIS BUILDING MAY CONTAIN, BE IN PROXIMITY TO, OR, WORK ON THEM MAY CAUSE DISTURBANCE OF, ASBESTOS CONTAINING OR OTHER HAZARDOUS MATERIALS. REFER TO ABATEMENT SERIES DRAWINGS AND SPECIFICATIONS COMPLETE FOR ADDITIONAL INFORMATION.
 - R. SEAL ALL FLOOR, WALL AND CEILING PENETRATIONS PER FIRE-RESISTANCE RATINGS NOTED ON AG-SERIES DRAWINGS, BUT NOT LESS THAN 1-HOUR, AND IN ACCORDANCE WITH SECTION 07 84 13 - PENETRATION FIRESTOPPING. THIS INCLUDES ALL NEW PENETRATIONS AND EXISTING UNFIRED STOPPED PENETRATIONS CREATED BY REMOVALS, AS REQUIRED TO PERFORM THE WORK.

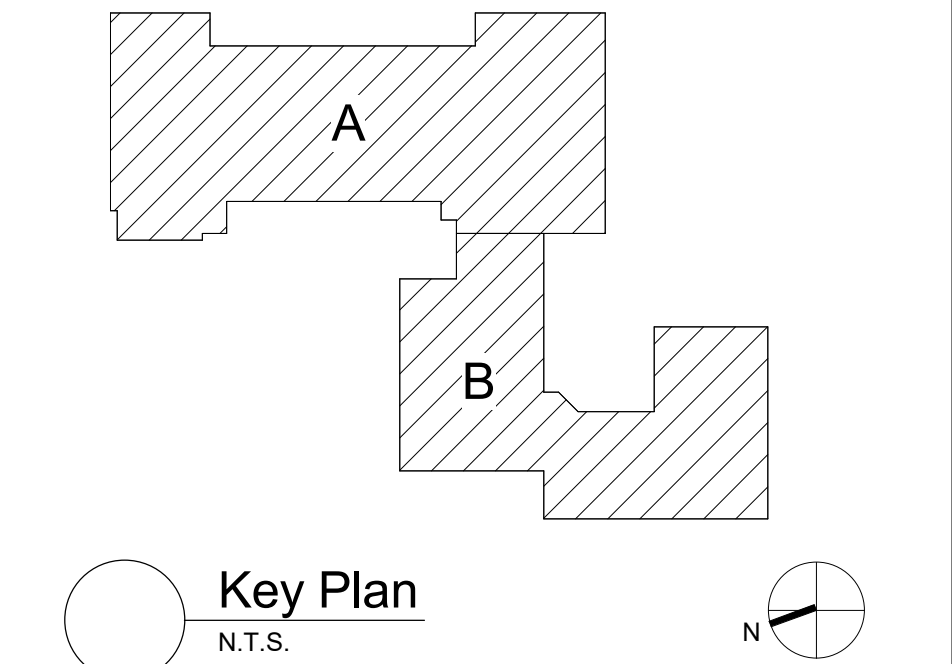

S.E.D. Control No. 13-02-00-01-0-008-020

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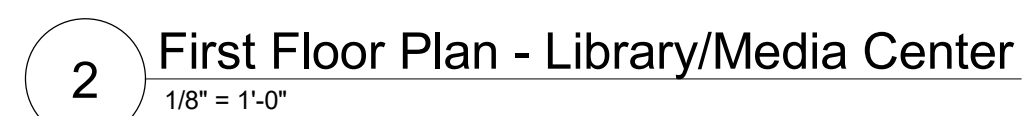


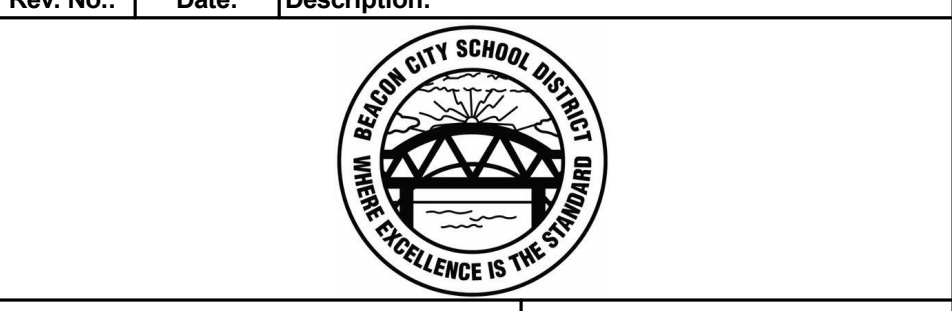Beacon City School District
Beacon, New York

Reconstruction to:
Sargent Elementary School

Key Plans

Drawn By: JPF1/pgm	Date: 10/28/2022	Drawing Number:
Project No.: 279180-22004		CM050




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	Project No.: 279180-22004		CM100



REMOTE CONDENSING UNIT (RCU) SCHEDULE																		
DWG LABEL	LOCATION	SERVES	MODEL NO.	REFRIG.	SUCTION (°F)	LIQUID (°F)	SUCTION SIZE	LIQUID SIZE	NOMINAL CAPACITY	COOLING CAPACITY	COMPRESSOR QTY & TYPE	FAN CONDENSER QTY & DRIVE TYPE	EER	MCA	MOP	VPH	NET WEIGHT (LBS)	NOTES
RCU-C-1	MECH YARD	EXISTING UV	4TTR4030	R-410A	45.0	110	3/8"	3/4"	2.5 TONS	30000 Btu/h	1 SCROLL	1 DIRECT	12.2	17.0	25	208/2ø	160	1-9
RCU-C-2	MECH YARD	EXISTING UV	4TTR4030	R-410A	45.0	110	3/8"	3/4"	2.5 TONS	30000 Btu/h	1 SCROLL	1 DIRECT	12.2	17.0	25	208/2ø	160	1-9
NOTES:																		
1. DESIGN BASIS: TRANE			3. PROVIDE DEFROST CONTROLS.						6. PROVIDE BRAZED TUBING REFRIGERANT LINE SETS AND COUPLINGS.						9. PROVIDE 4" CONCRETE PAD.			
2. PROVIDE MOTOR STARTER AND NEMA 3R DISCONNECT.			4. PROVIDE LOW AMBIENT OPERATION BELOW 60°F.						7. FIELD CHARGE REFRIGERANT FOR SUPPLY LINE, CONDENSER AND COILS.									
			5. PROVIDE INTERNAL THERMAL PROTECTION.						8. VERIFY LINE SIZES WITH MANUFACTURER.									


FAN COIL UNIT (FCU) SCHEDULE																		
EQUIP NO.	LOCATION	MODEL NO.	SA CFM	HEATING DATA					SUPPLY FAN		ELECTRICAL					NOTES		
				MIN. OA	NO. ROW	EAT (°F)	LAT (°F)	CAP. (MBH)	GPM	WPD (FT HD)	ESP (IN. WG.)	RPM	MOTOR SIZE (HP)	V/PH	FLA		MCA	MOP
FCU-C-E13	GYM OFFICE E13	FCBB040	190	20	2	60.1	116.6	9.2	0.5	1.2	0.00	740	0.01	120v/1ph	2.2	2.8	15	1-7
NOTES:																		
1. DESIGN BASIS: TRANE			4. HOT WATER COIL CONDITIONS: EWT=180°F, LWT=120°F					6. VERIFY PIPE AND ELECTRICAL LEFT/RIGHT HAND CONNECTIONS PRIOR TO ORDERING.										
2. CEILING CABINET UNIT			5. PROVIDE NEMA 1 DISCONNECT SWITCH.					7. PROVIDE RETURN AIR BOTTOM INLET, FRONT GRILLE OUTLET AND BACK FRESH AIR DUCT COLLAR.										
3. PROVIDE 1" MERV13 FILTER.																		

SARGENT BUILDING/EQUIPMENT VENTILATION CALCULATIONS											
EQUIPMENT NUMBER	ZONE ID			MINIMUM VENTILATION RATES							
	ROOM NUMBER	ROOM NAME	OCCUPANCY CLASSIFICATION	Az - AREA (SF)	Pz - ZONE OCCU. #/1000 FT	ZONE OCCU.	Rp (CFM/ Person)	RpP	Ra (CFM/SF)	RaA	Vbz (CFM)
EXG UVs	8	LIBRARY/MEDIA CENTER	Media center	1821	25	48	10	480	0.12	219	679
EXG UVs	8A	WORK ROOM	Office Space	98	5	1	5	5	0.08	6	11
FCU-C-E13	E13	GYM OFFICE	Office Space	146	5	1	5	4	0.08	9	12
NOTES:											
Rp = PEOPLE OUTDOOR AIR RATE, Ra = AREA OUTDOOR AIR RATE, Vbz = BREATHING ZONE OUTDOOR AIRFLOW, Ez = AIR DISTRIBUTION CONFIGURATION, Voz = ZONE OUTDOOR AIRFLOW											

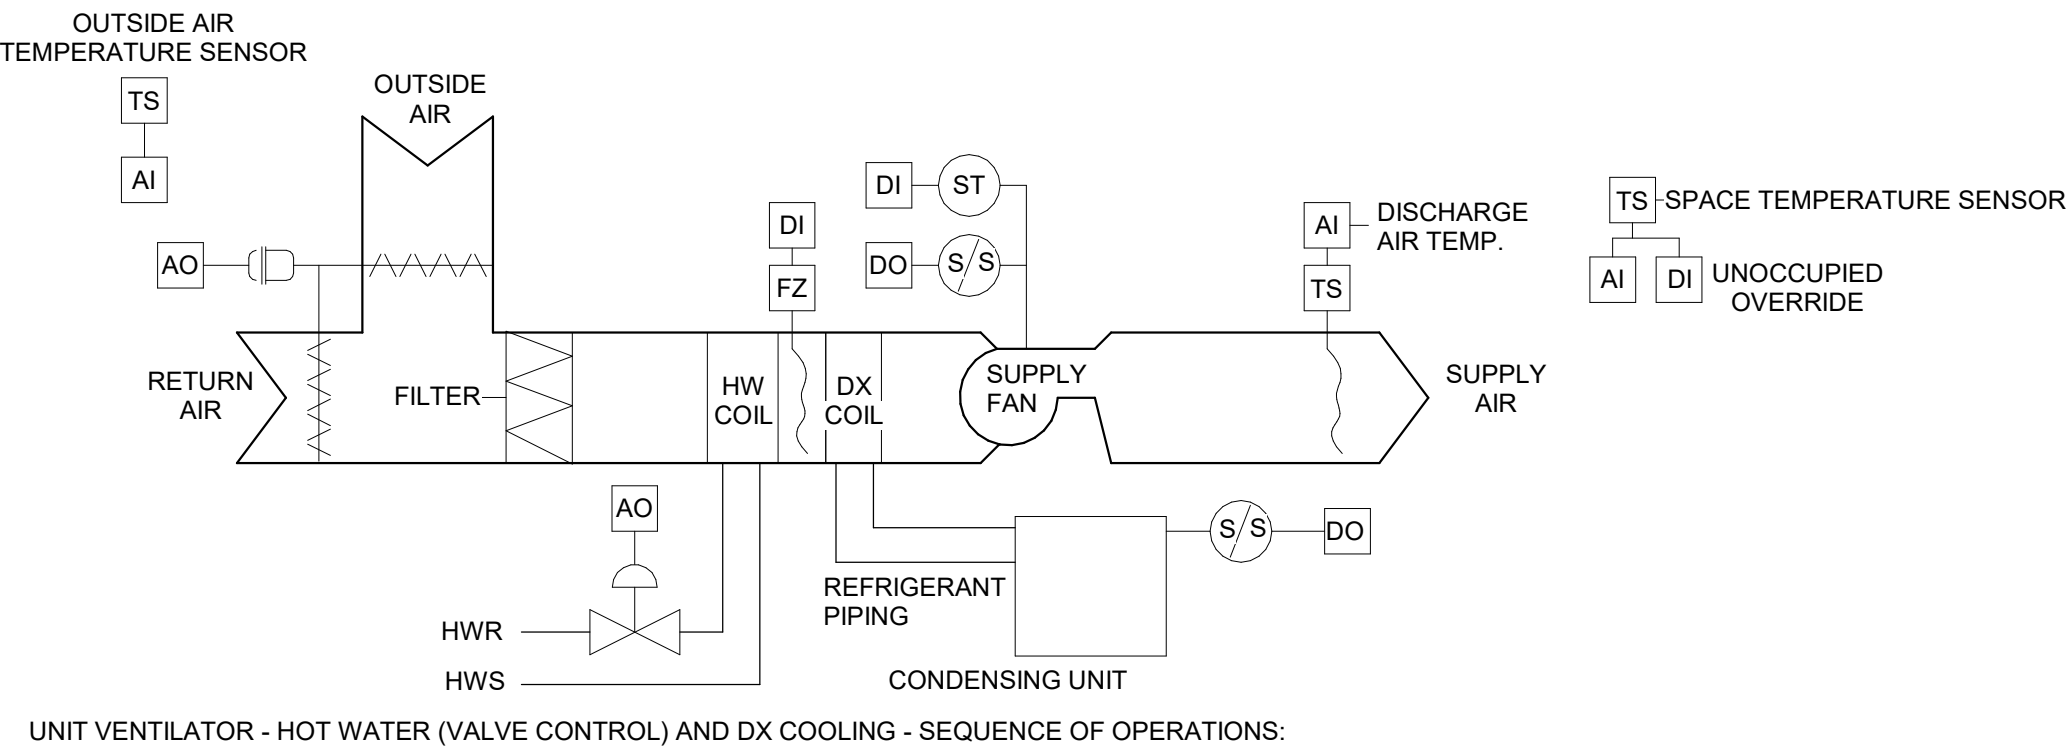


- UNIT VENTILATOR - HOT WATER (VALVE CONTROL) AND DX COOLING - SEQUENCE OF OPERATIONS:
- OCCUPIED MODE:
 - SUPPLY FAN AND ASSOCIATED EXHAUST FAN SHALL RUN CONTINUOUSLY.
 - THE OUTSIDE AIR DAMPER SHALL OPEN TO THE POSITION REQUIRED TO MAINTAIN THE MINIMUM OUTSIDE AIR QUANTITY INDICATED. OUTSIDE AIR DAMPER SHALL NEVER BE POSITIONED BELOW THIS MINIMUM POSITION EXCEPT IN CASE OF ALARM.
 - WHEN THE SPACE TEMPERATURE IS AT OR BELOW THE HEATING SETPOINT, THE 2-WAY CONTROL VALVE SHALL MODULATE TO MAINTAIN SPACE HEATING SETPOINT SUBJECT TO DISCHARGE HIGH LIMIT OF 110 DEG. F (ADJUSTABLE) AND DISCHARGE LOW LIMIT OF 70 DEG. F (ADJUSTABLE).
 - WHEN THE SPACE TEMPERATURE RISES 3 DEG. F (ADJUSTABLE) ABOVE THE SPACE HEATING SETPOINT, AND THE OUTSIDE AIR TEMPERATURE IS LOWER THAN THE SPACE TEMPERATURE, THE OUTSIDE AIR DAMPER SHALL MODULATE OPEN AND THE ASSOCIATED RELIEF HOOD DAMPER SHALL OPEN TO MAINTAIN THE OCCUPIED SETPOINT. THIS SHALL BE DONE SUBJECT TO DISCHARGE LOW LIMIT OF 55 DEG. F (ADJUSTABLE), AND WITH THE HEATING VALVE FULLY CLOSED.
 - WHEN THE SPACE TEMPERATURE IS 3 DEG. F (ADJUSTABLE) ABOVE THE COOLING SETPOINT, AND THE OUTSIDE AIR CANNOT COOL THE SPACE, THE RESPECTIVE CONDENSING UNIT SHALL BE CYCLED TO MAINTAIN SPACE TEMPERATURE WITH THE HEATING VALVE FULLY CLOSED. USE 5 DEG. F (ADJUSTABLE) DEADBAND BETWEEN HEATING AND COOLING SETPOINTS.
 - UNOCCUPIED MODE:
 - SUPPLY FAN AND ASSOCIATED EXHAUST FAN SHALL BE OFF.
 - THE OUTSIDE AIR DAMPER AND ASSOCIATED RELIEF HOOD DAMPER SHALL BE FULLY CLOSED.
 - WHERE SPACE HAS FINNED TUBE RADIATION, RADIATION SHALL PROVIDE FIRST STAGE UNOCCUPIED HEATING.
 - ON DROP IN SPACE TEMPERATURE BELOW THE UNOCCUPIED SETPOINT, CYCLE THE FAN ON AND COIL CONTROL VALVE FULL OPEN AS REQUIRED TO MAINTAIN REDUCED SPACE TEMPERATURE. USE 5 DEG. F (ADJUSTABLE) DEADBAND AS REQUIRED TO MINIMIZE SHORT CYCLING.
 - A TIMED LOCAL OVERRIDE CONTROL SHALL ALLOW AN OCCUPANT TO OVERRIDE THE SCHEDULE AND PLACE THE UNIT INTO OCCUPIED MODE FOR 1 HOUR (ADJUSTABLE). AT EXPIRATION OF THIS TIME, CONTROL OF THE UNIT SHALL AUTOMATICALLY RETURN TO THE SCHEDULE.
 - WARM-UP MODE:
 - THE UNIT SHALL START PER AN OPTIMUM START PROGRAM.
 - THE OUTSIDE AIR DAMPER AND ASSOCIATED RELIEF HOOD DAMPER SHALL BE FULLY CLOSED, AND THE ASSOCIATED EXHAUST FAN SHALL BE OFF.
 - THE SUPPLY FAN SHALL RUN AND THE CONTROL VALVE SHALL MODULATE TO MAINTAIN OCCUPIED SETPOINT.
 - PURGE VENTILATION MODE:
 - PROVIDE GLOBAL INITIATION OF PURGE VENTILATION MODE AT THE OPERATOR'S WORKSTATION SUCH THAT ONE INITIATION STARTS OR STOPS PURGE VENTILATION MODE FOR ALL EQUIPMENT SO PROGRAMMED. PROVIDE FOR GLOBAL ADJUSTMENT OF THE BELOW DESCRIBED SCHEDULING AND PERCENTAGE VENTILATION CHANGES, AND ALSO FOR LOCAL ADJUSTMENT AWAY FROM GLOBAL SETPOINTS. IF GLOBAL SETPOINTS ARE SUBSEQUENTLY RE-ADJUSTED, PROVIDE WARNING WITH A LIST OF UNITS WITH LOCAL OVERRIDES, BUT DO NOT RE-ADJUST LOCAL OVER-RIDE SETPOINTS GLOBALLY.
 - PROVIDE A PURGE VENTILATION MODE WITH INCREASED VENTILATION AS POSSIBLE WITHIN THE LIMITS OF THE EQUIPMENT. OPERATE WITH ALL THREE MODES DESCRIBED ABOVE WITH THE FOLLOWING MODIFICATIONS TO THE OCCUPIED PERIOD.
 - START OCCUPIED VENTILATION MODE 1 HOUR (ADJ) EARLIER AND END IT 4 HOURS (ADJ) LATER.
 - INCREASE VENTILATION AS POSSIBLE BY 100% (ADJ) WHERE 0% INCREASE IS THE MINIMUM VENTILATION DESCRIBED ABOVE AND 100% IS 100% OUTSIDE AIR WITH NO RETURN AIR.
 - MAINTAIN OCCUPIED SPACE TEMPERATURE AND INCREASED VENTILATION AS POSSIBLE WITHIN HEATING CAPACITY CONSTRAINTS OF LOCAL AND PLANT HEATING CAPACITY. IF SPACE TEMPERATURE DROPS MORE THAN 2 DEG. F (ADJ) BELOW SPACE HEATING SETPOINT WITH THE HEATING VALVE 100% OPEN, MODULATE VENTILATION RATE BACK TO MINIMUM SPECIFIED VENTILATION RATE DESCRIBED ABOVE WITH HEATING VALVE AT 100% OPEN.
 - SAFETIES:
 - A SEPARATE LOW LIMIT FREEZE STAT WITH AUTOMATIC RESET SHALL BE INSTALLED WITH SENSING ELEMENT SERPENTINED ACROSS THE FACE OF THE COIL. WHENEVER COIL FREEZE-UP CONDITIONS ARISE (36 DEG. F ADJUSTABLE) THE SUPPLY FAN SHALL STOP, THE OUTSIDE AIR DAMPER SHALL CLOSE 100%, AND CONTROL VALVE SHALL OPEN 100%. AN ALARM SHALL ALSO BE ACTIVATED.
 - UPON FAILURE OF THE FAN, AS SENSED BY THE CURRENT SENSING STATUS SWITCH, ACTIVATE AN ALARM.

4 UV - Hot Water - Valve Control and DX Cooling

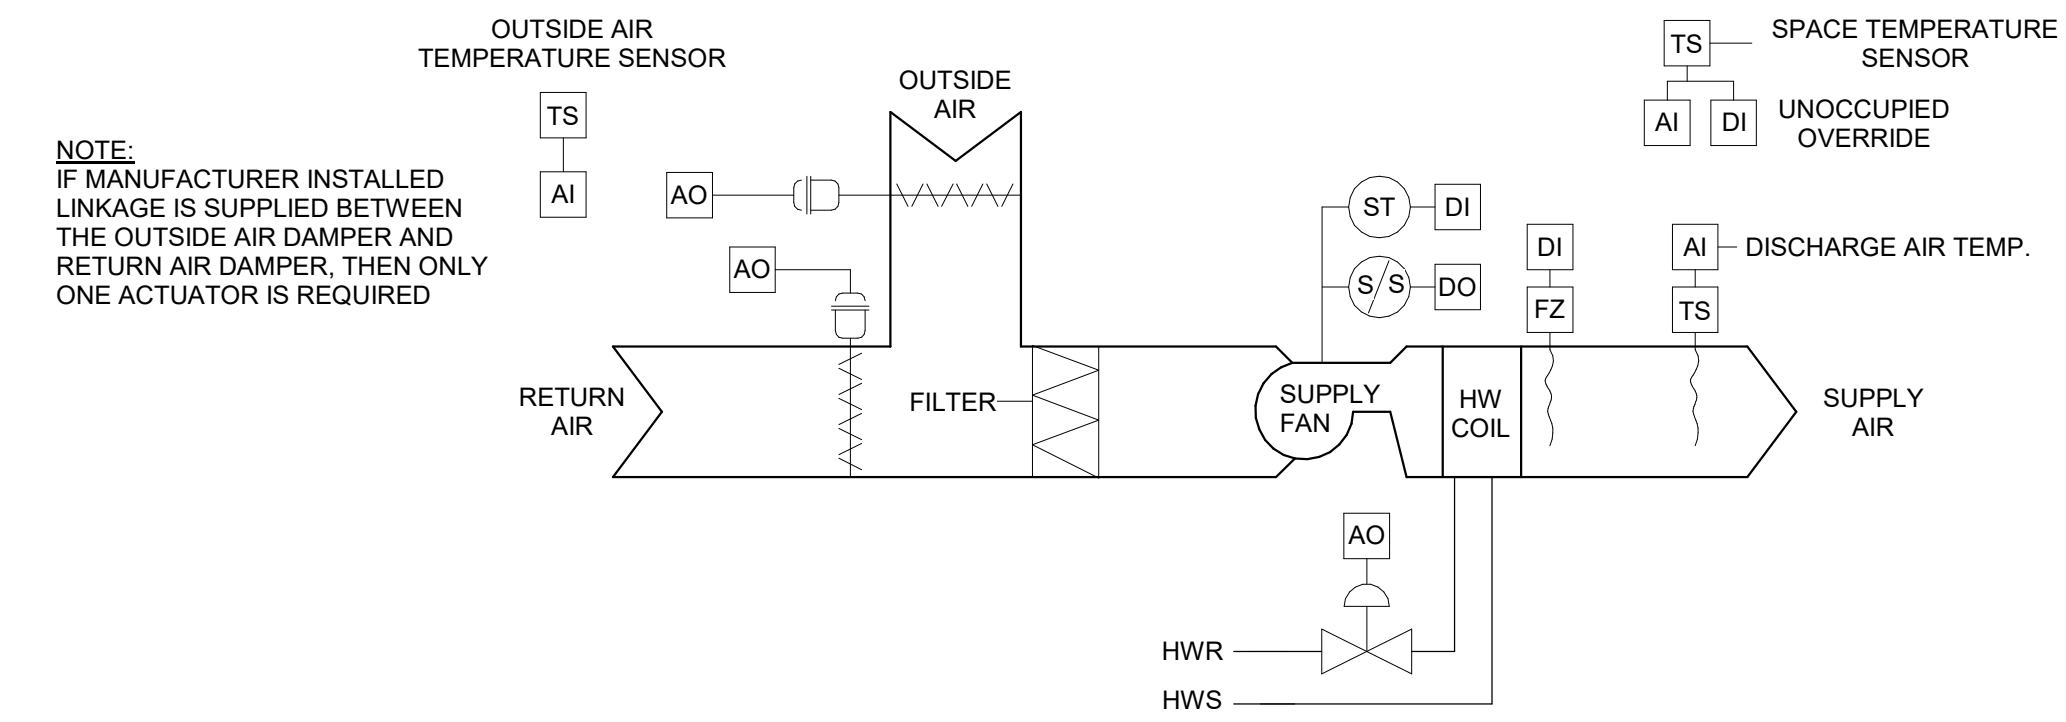


- FAN COIL UNIT - HOT WATER - VALVE CONTROL - SEQUENCE OF OPERATIONS:
- OCCUPIED MODE:
 - SUPPLY FAN AND ASSOCIATED EXHAUST FAN SHALL RUN CONTINUOUSLY.
 - THE OUTSIDE AIR DAMPER SHALL OPEN TO THE POSITION REQUIRED TO MAINTAIN THE MINIMUM OUTSIDE AIR QUANTITY AS INDICATED.
 - WHEN THE SPACE TEMPERATURE IS AT OR BELOW THE HEATING SETPOINT, THE 2-WAY CONTROL VALVE SHALL MODULATE TO MAINTAIN SPACE HEATING SETPOINT SUBJECT TO DISCHARGE HIGH LIMIT OF 110 DEG. F (ADJUSTABLE) AND DISCHARGE LOW LIMIT OF 70 DEG. F (ADJUSTABLE).
 - WHEN THE SPACE TEMPERATURE RISES 3 DEG. F (ADJUSTABLE) ABOVE THE SPACE HEATING SETPOINT, AND THE OUTSIDE AIR TEMPERATURE IS LOWER THAN THE SPACE TEMPERATURE, THE OUTSIDE AIR DAMPER SHALL MODULATE OPEN AND THE ASSOCIATED RELIEF HOOD DAMPER SHALL OPEN TO MAINTAIN THE OCCUPIED SETPOINT. THIS SHALL BE DONE SUBJECT TO DISCHARGE LOW LIMIT OF 55 DEG. F (ADJUSTABLE), AND WITH THE HEATING VALVE FULLY CLOSED.
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 - WARM-UP MODE:
 - THE UNIT SHALL START PER AN OPTIMUM START PROGRAM.
 - THE OUTSIDE AIR DAMPER AND THE ASSOCIATED RELIEF HOOD DAMPER SHALL BE FULLY CLOSED AND THE ASSOCIATED EXHAUST FAN SHALL BE OFF.
 - THE SUPPLY FAN SHALL RUN AND THE CONTROL VALVE SHALL MODULATE TO MAINTAIN OCCUPIED SETPOINT.
 - PURGE VENTILATION MODE:
 - PROVIDE GLOBAL INITIATION OF PURGE VENTILATION MODE AT THE OPERATOR'S WORKSTATION SUCH THAT ONE INITIATION STARTS OR STOPS PURGE VENTILATION MODE FOR ALL EQUIPMENT SO PROGRAMMED. PROVIDE FOR GLOBAL ADJUSTMENT OF THE BELOW DESCRIBED SCHEDULING AND PERCENTAGE VENTILATION CHANGES, AND ALSO FOR LOCAL ADJUSTMENT AWAY FROM GLOBAL SETPOINTS. IF GLOBAL SETPOINTS ARE SUBSEQUENTLY RE-ADJUSTED, PROVIDE WARNING WITH A LIST OF UNITS WITH LOCAL OVERRIDES, BUT DO NOT RE-ADJUST LOCAL OVER-RIDE SETPOINTS GLOBALLY.
 - PROVIDE A PURGE VENTILATION MODE WITH INCREASED VENTILATION AS POSSIBLE WITHIN THE LIMITS OF THE EQUIPMENT. OPERATE WITH ALL THREE MODES DESCRIBED ABOVE WITH THE FOLLOWING MODIFICATIONS TO THE OCCUPIED PERIOD.
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 - SAFETIES:
 - A SEPARATE LOW LIMIT FREEZE STAT WITH AUTOMATIC RESET SHALL BE INSTALLED WITH SENSING ELEMENT SERPENTINED ACROSS THE FACE OF THE COIL. WHENEVER COIL FREEZE-UP CONDITIONS ARISE (36 DEG. F ADJUSTABLE) THE SUPPLY FAN SHALL STOP, THE OUTSIDE AIR DAMPER SHALL CLOSE 100%, AND THE CONTROL VALVE SHALL OPEN 100%. AN ALARM SHALL ALSO BE ACTIVATED.
 - UPON FAILURE OF THE FAN, AS SENSED BY THE CURRENT SENSING STATUS SWITCH, ACTIVATE AN ALARM.


5 FCU - Hot Water - Valve Control - With Outside Air

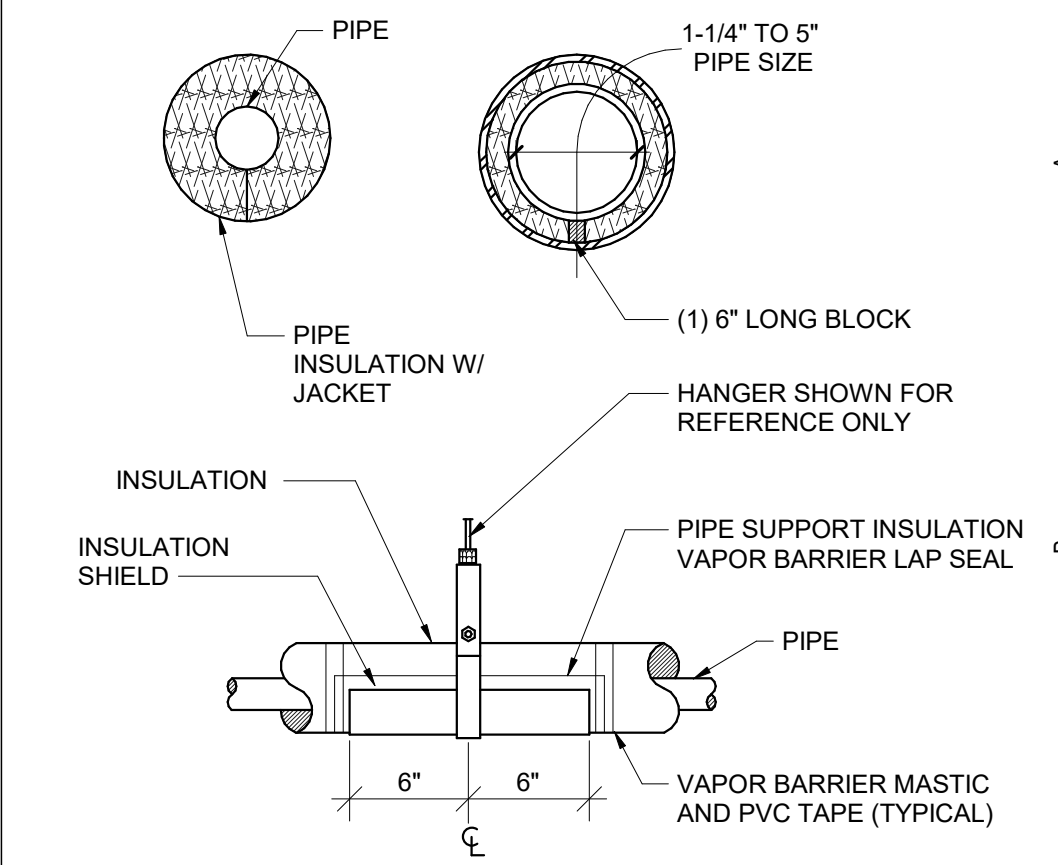

1 Pipe Insulation

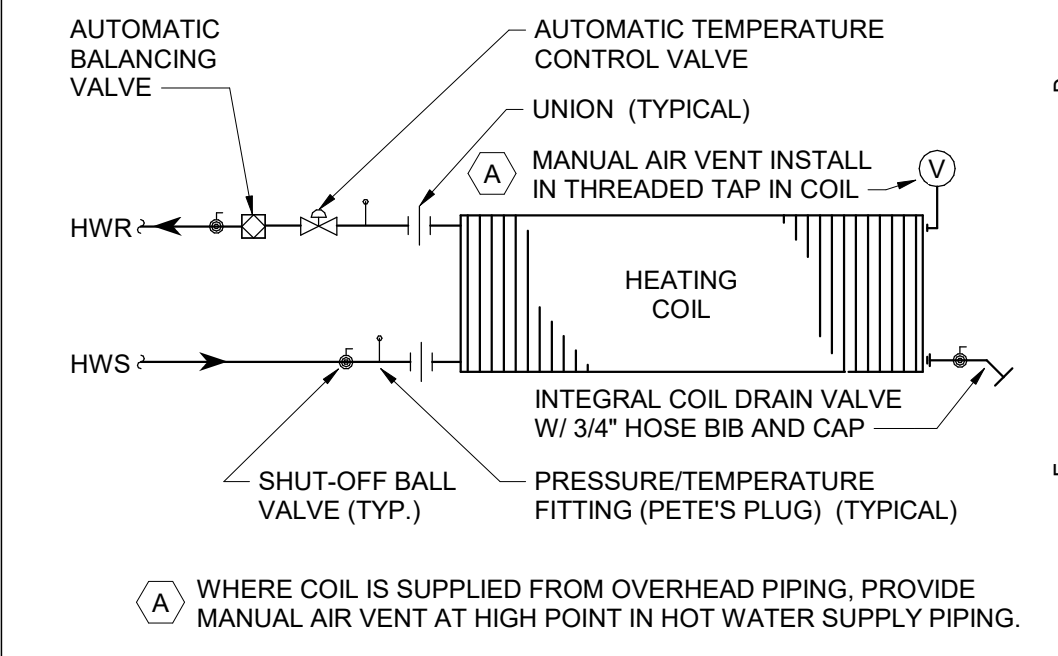

2 FCU/UV Hot Water Piping Schematic

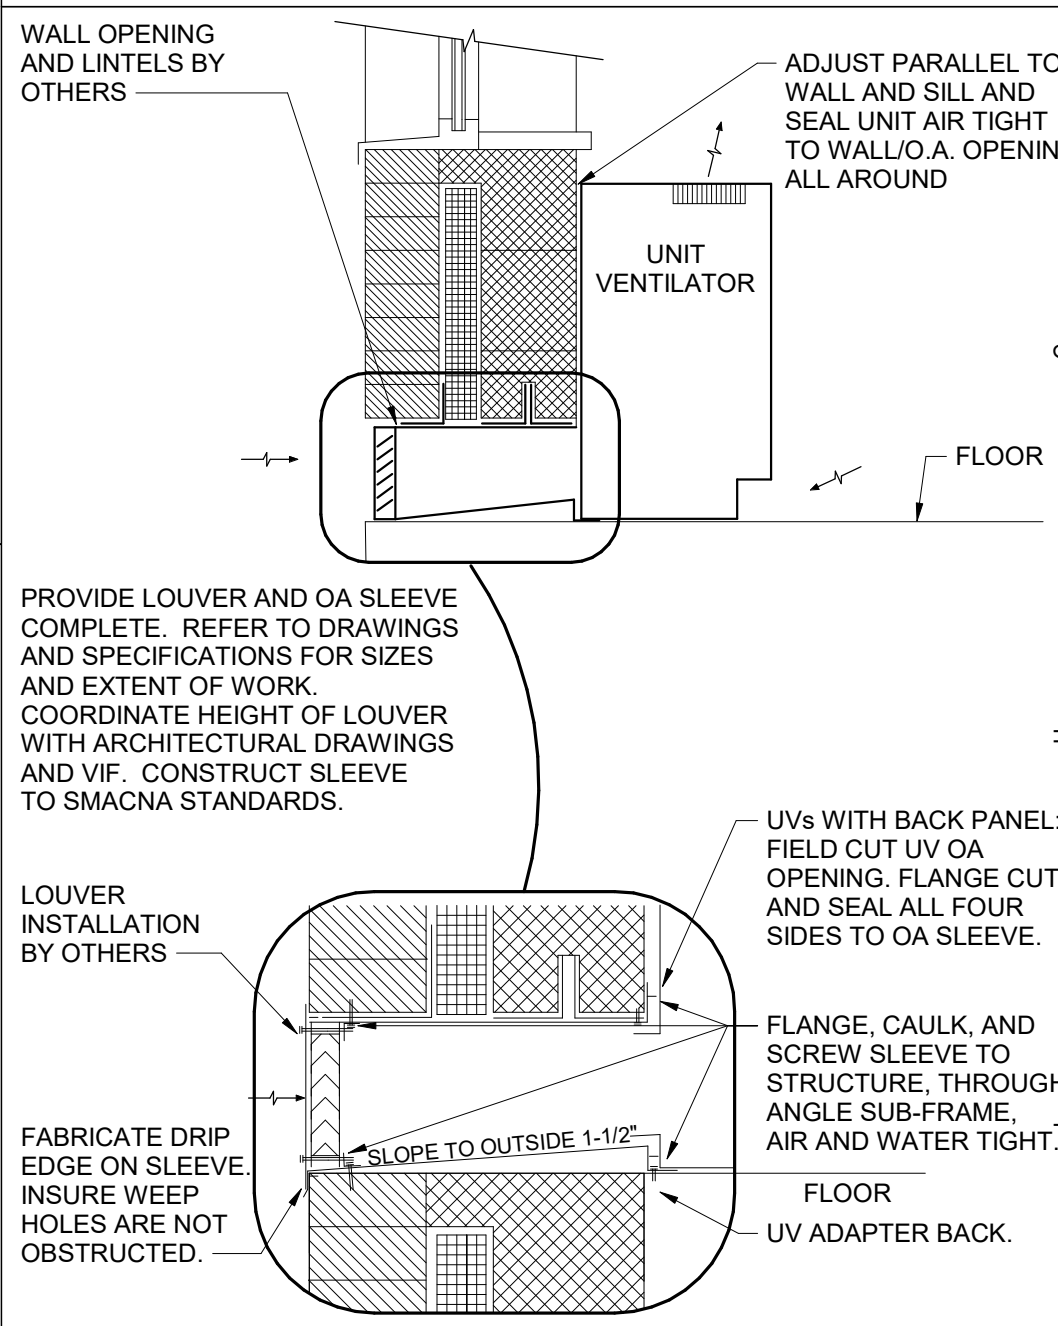

3 Floor Mounted UV OA Intake Detail

TEMPERATURE CONTROLS SYMBOLS LIST	
AI	ANALOG IN
AO	ANALOG OUT
COM	COMMUNICATIONS PORT
CS	AIRBORNE CONTAMINANT SENSOR
DI	DIGITAL IN
DM	DAMPER MOTOR
DO	DIGITAL OUT
EMCS	ENERGY MANAGEMENT CONTROL SYSTEM
F	FLOW (WATER/AIR)
FM	FLOW METER
FS	AIR FLOW SENSOR
FZ	FREEZE STAT
H	HUMIDITY SENSOR
HL	HIGH LIMIT
KWh	KILOWATT HOUR METER
LL	LOW LIMIT
M/S	MANUAL SWITCH STOP / START
P	PRESSURE SENSOR
DP	DIFFERENTIAL PRESSURE
PS	POSITION SENSOR
S/S	STOP / START
SD	SMOKE DETECTOR
ST	STATUS
START	STARTER
T	ADJUSTABLE THERMOSTAT
TS	TEMPERATURE SENSOR
VFD	VARIABLE FREQUENCY DRIVE
WS	WATER SENSOR
%	PERCENT
ES	END SWITCH
BS	BOILER SWITCH

S.E.D. Control No. 13-02-00-01-0-008-020

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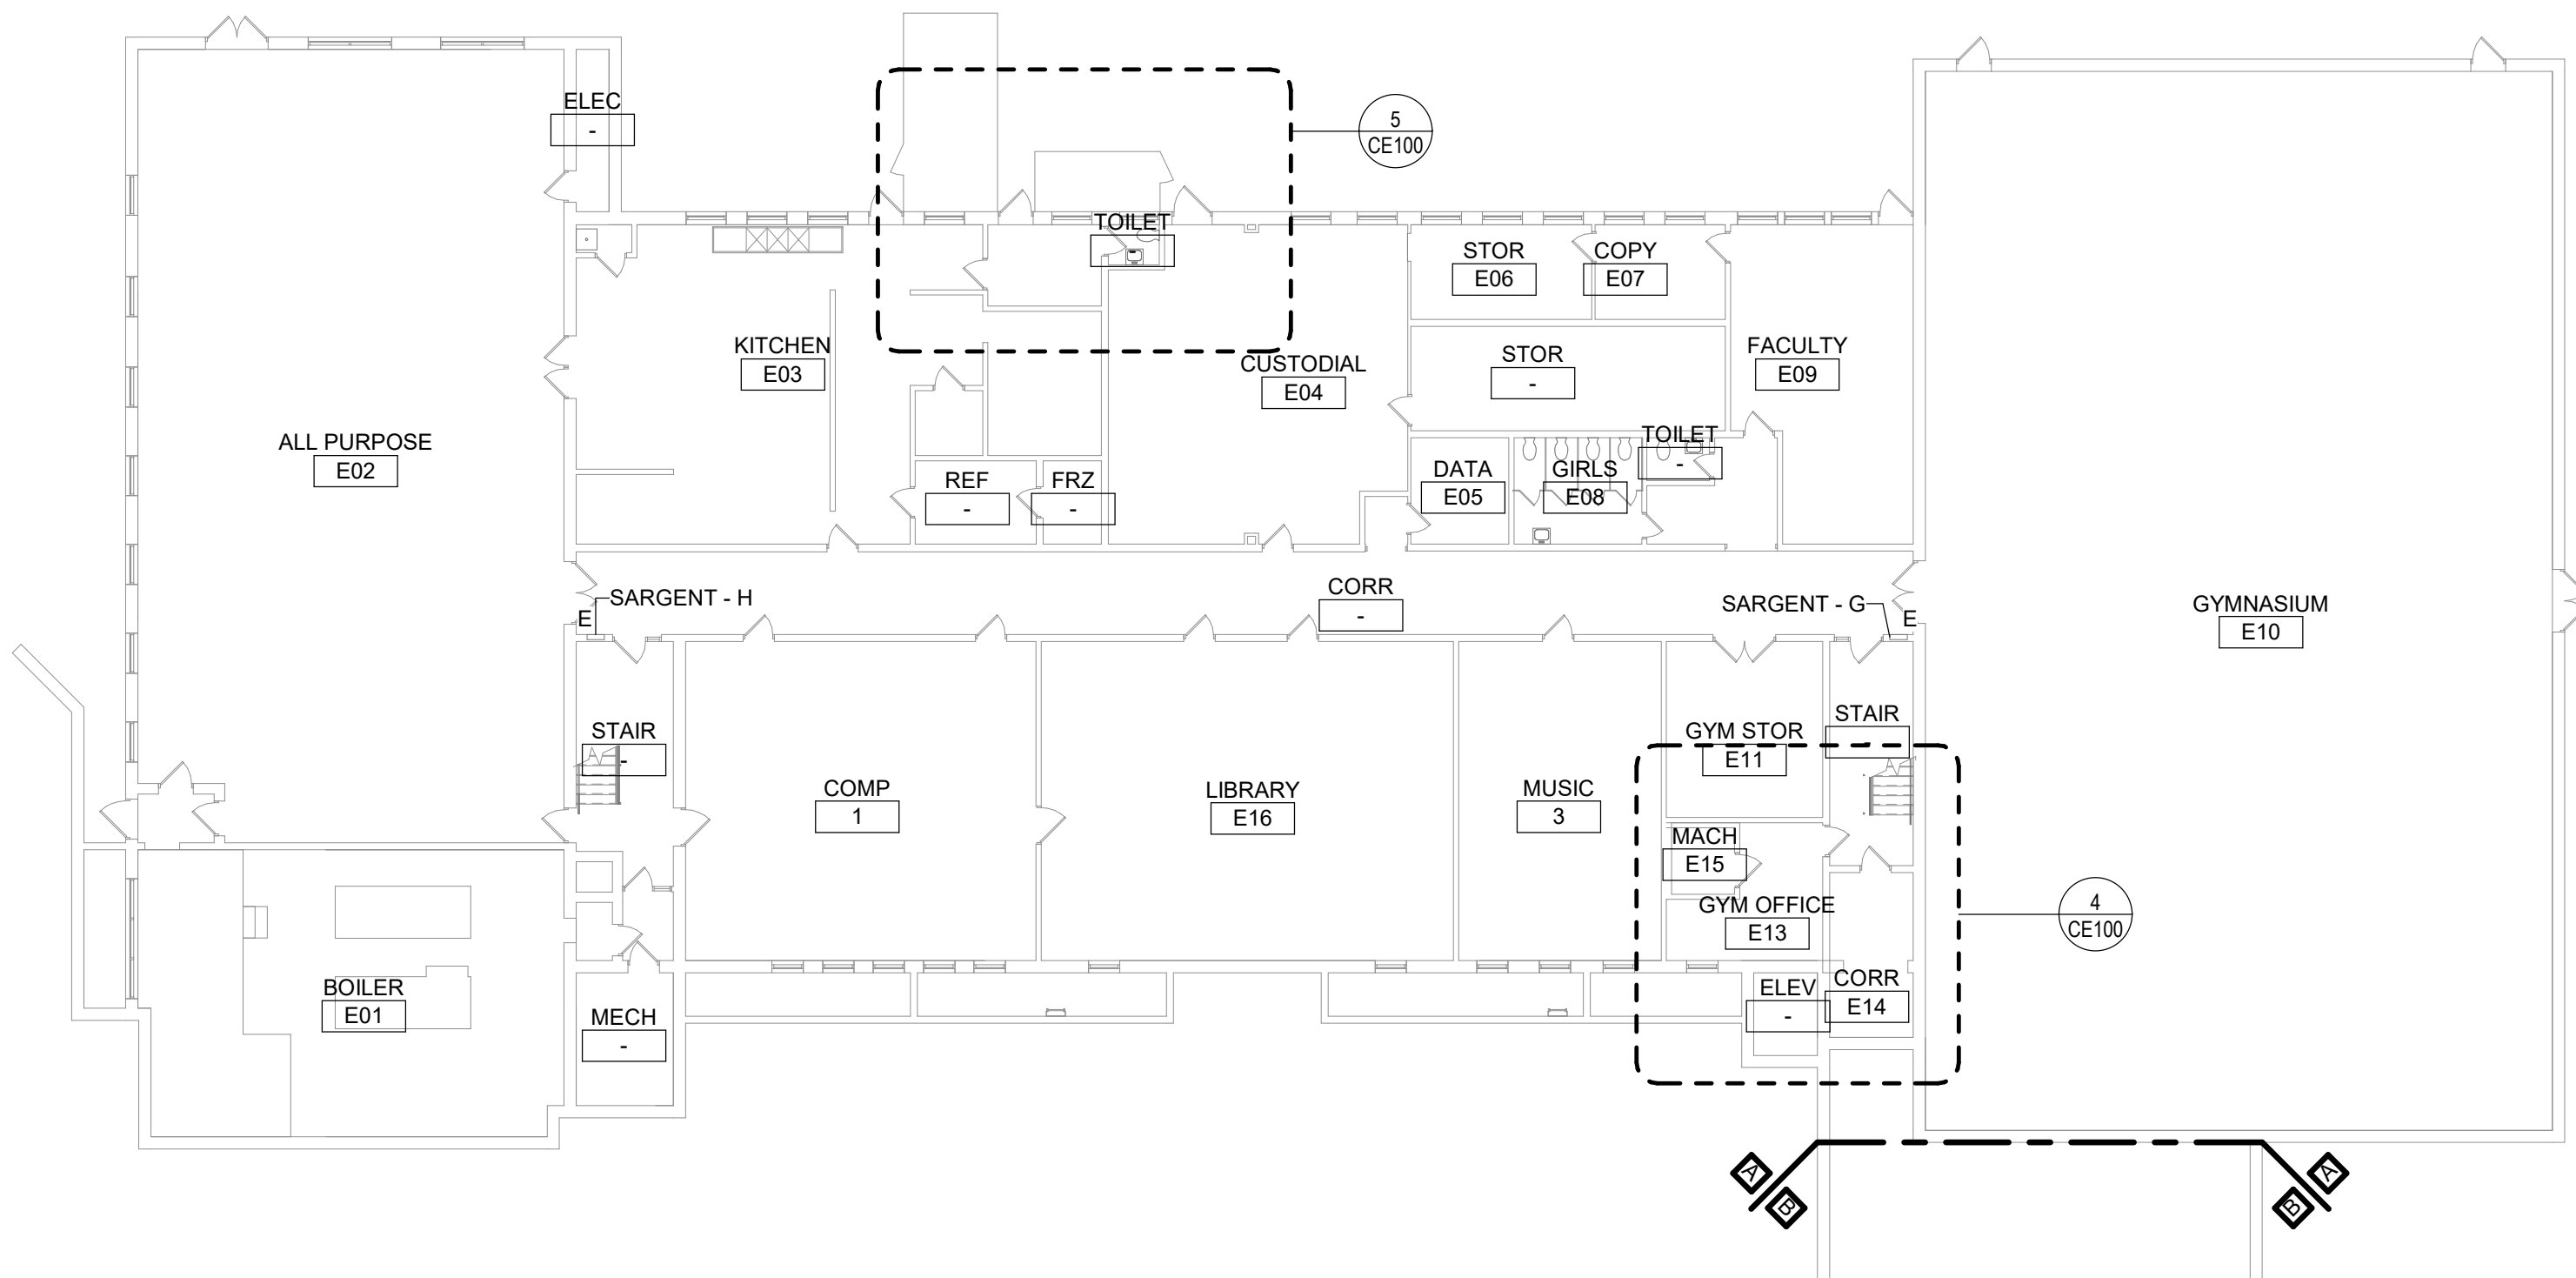
Beacon City School District
Beacon, New York

Reconstruction to:
Sargent Elementary School


Details, Schedules and Controls

Drawn By: JPF1/pgm Date: 10/28/2022 Drawing Number: 279180-22004


CM500



1 Basement - Key Plan
1/16" = 1'-0"

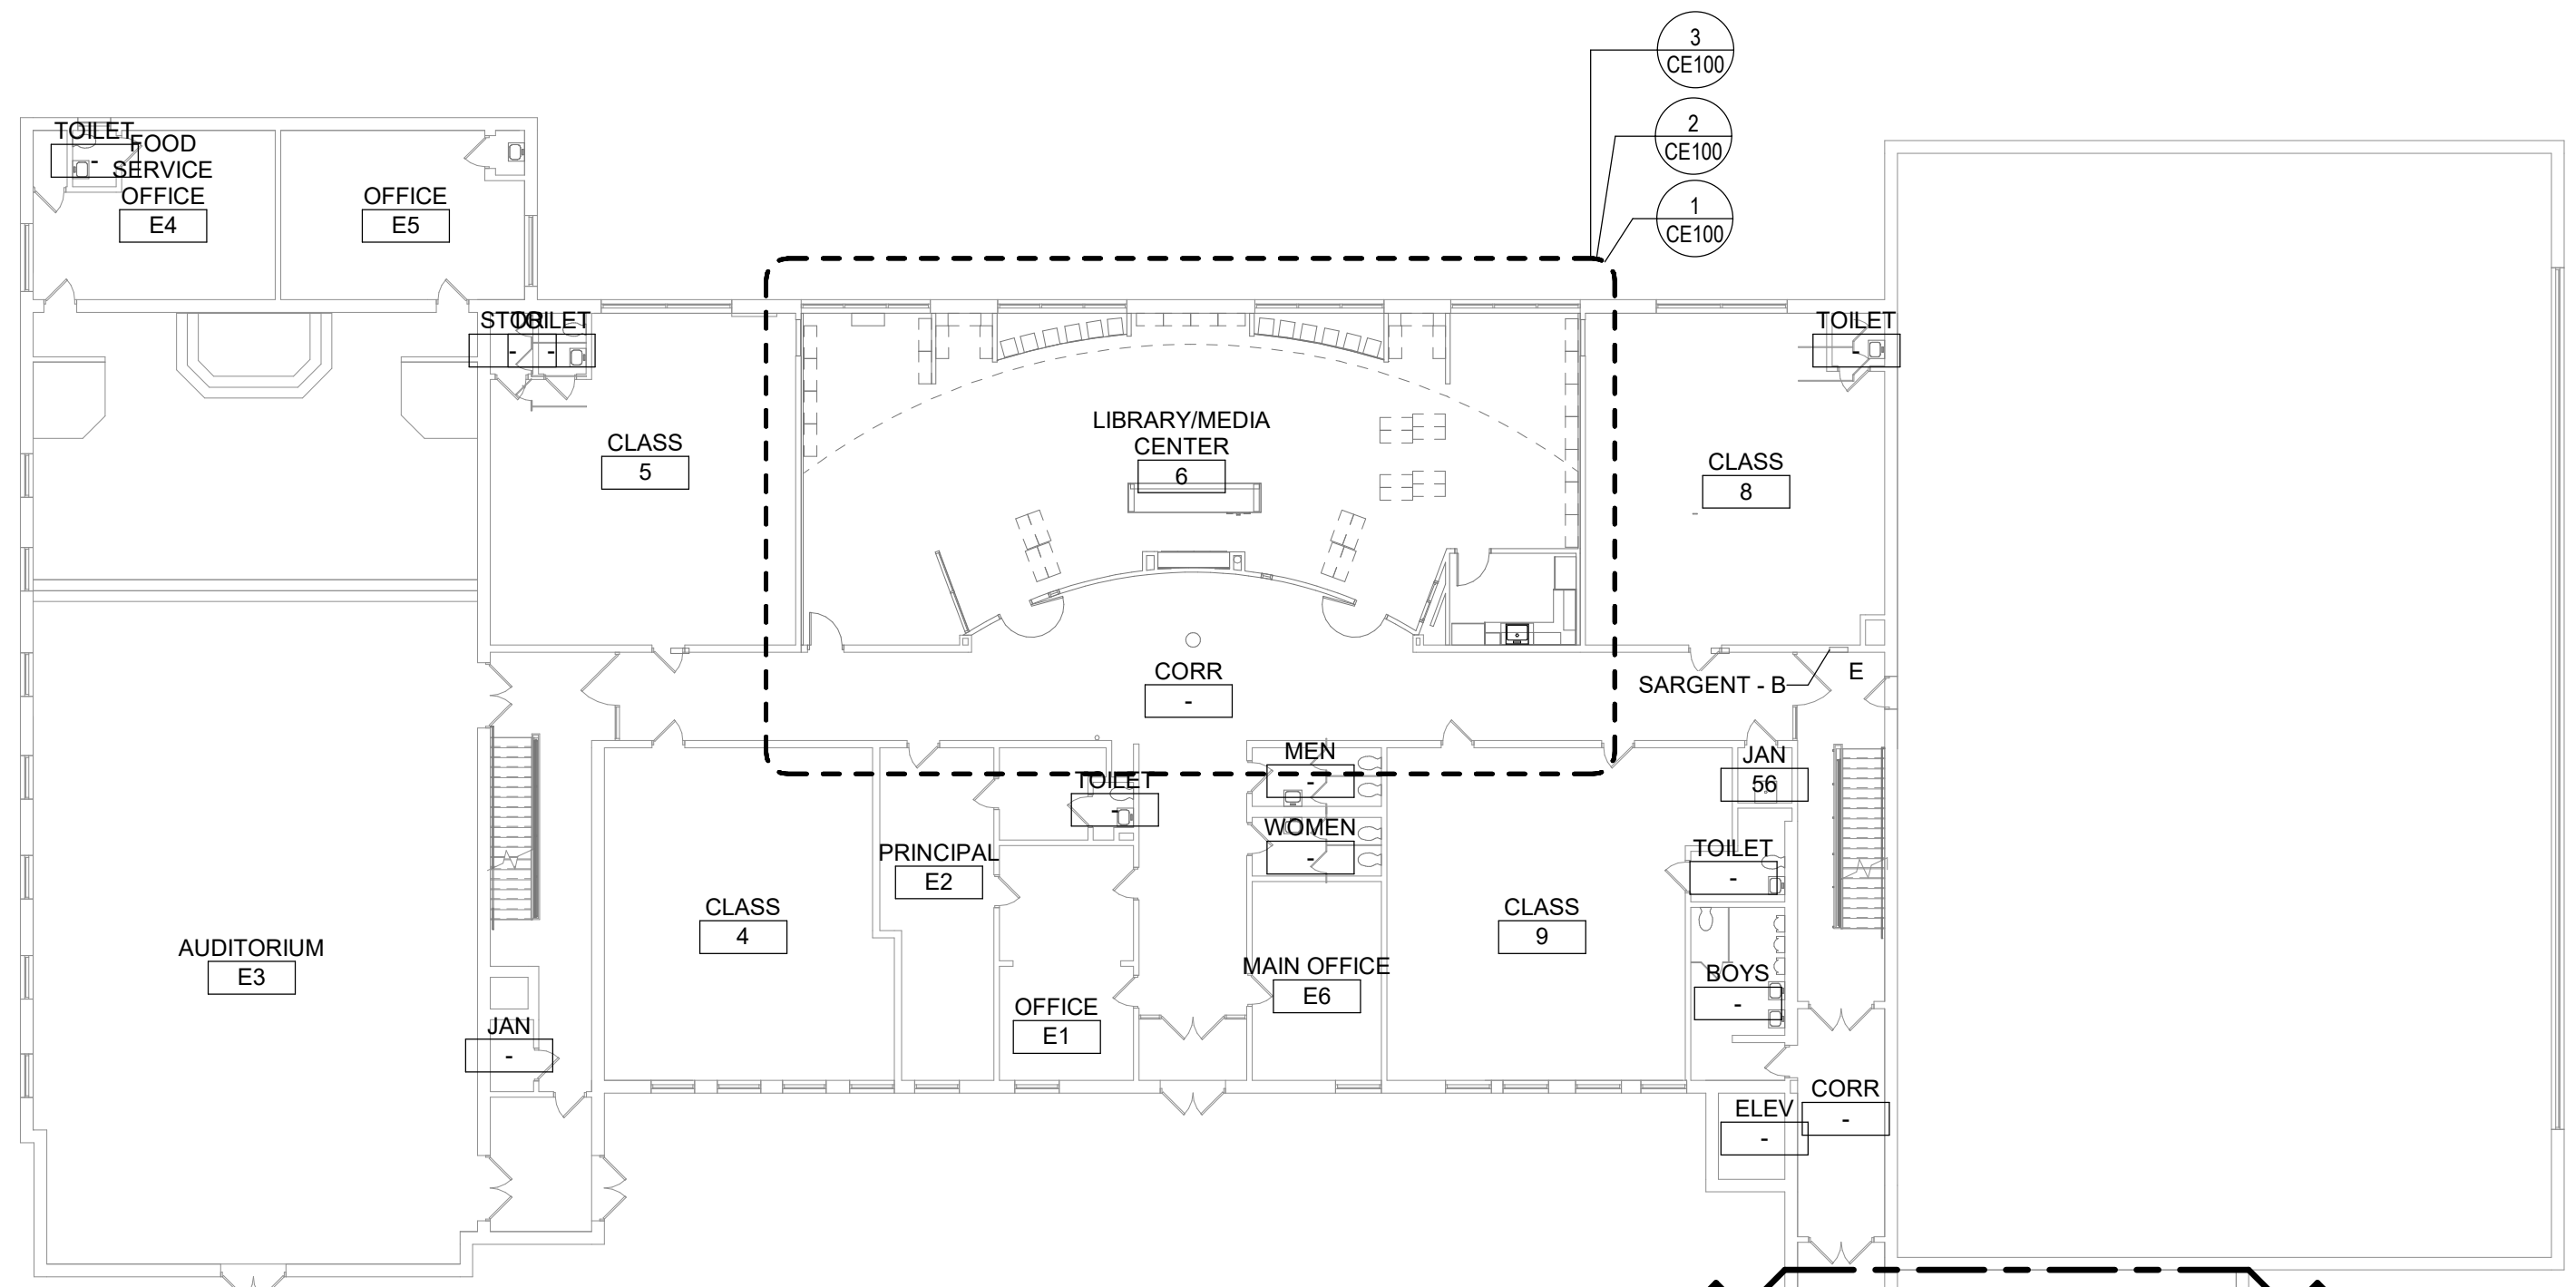

2 First Floor - Key Plan
1/16" = 1'-0"

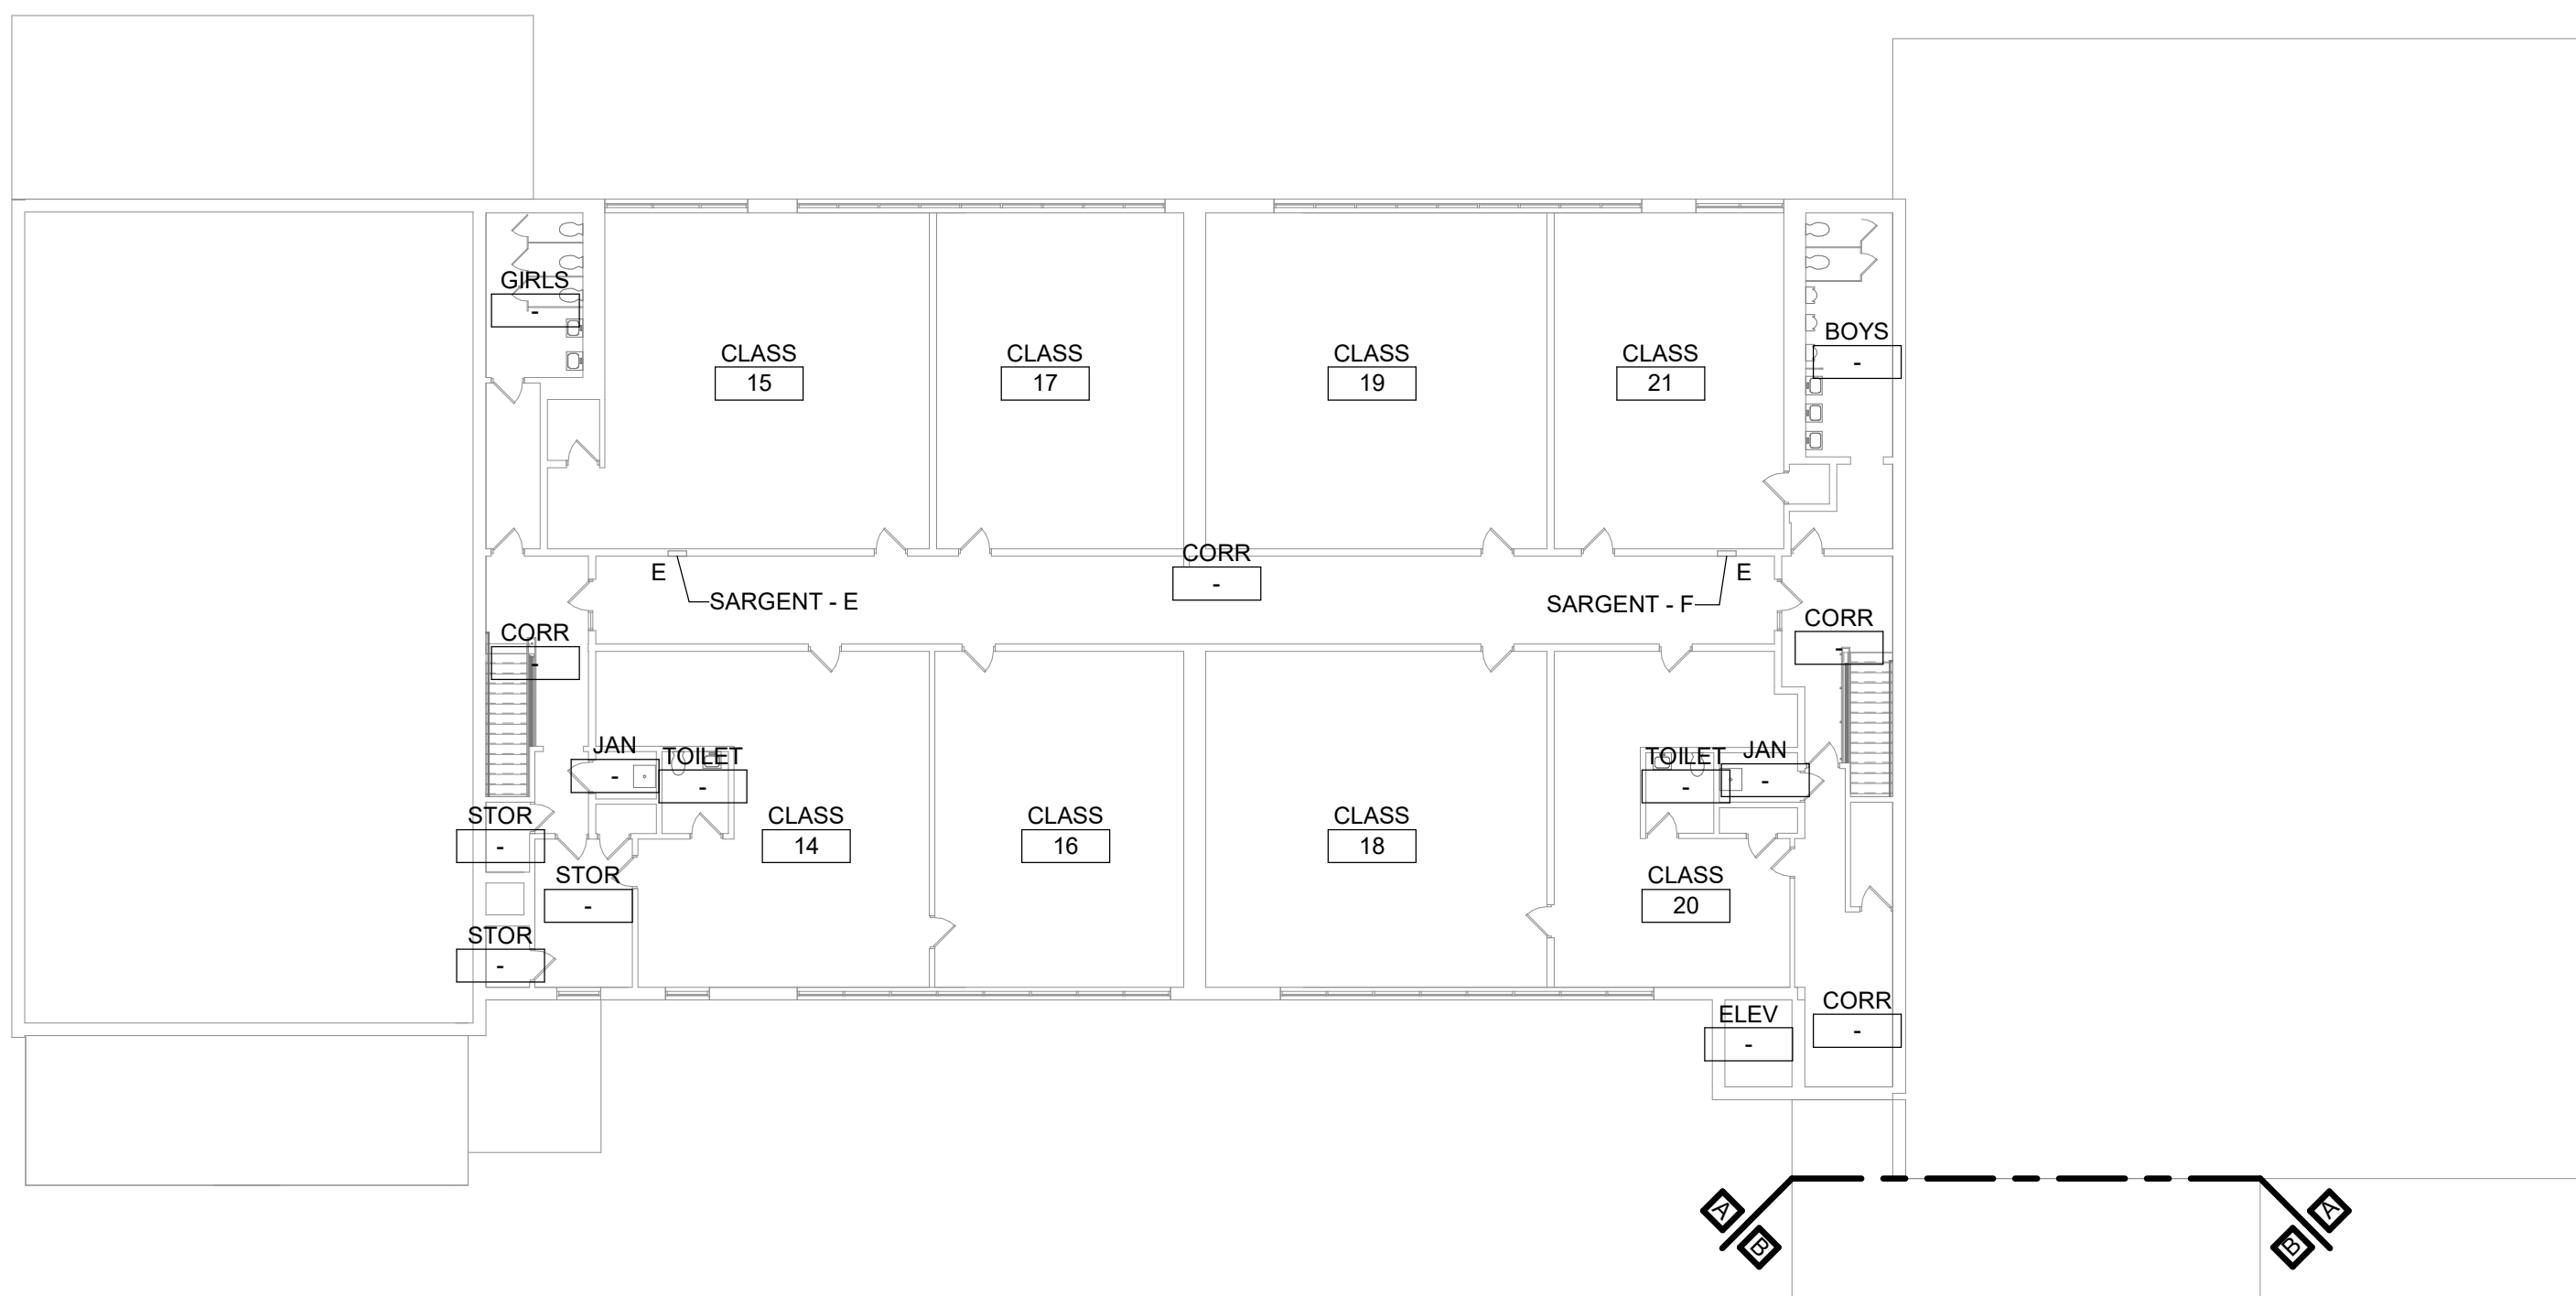


3 Second Floor - Key Plan
1/16" = 1'-0"

Demolition General Notes

- ALL ELECTRICAL DEVICES INTERFERING WITH DEMOLITION WORK SHALL BE DISCONNECTED AND REMOVED, UNLESS OTHERWISE NOTED. EXISTING CIRCUIT WIRING SHALL BE REMOVED BACK TO SOURCE AND PANEL DIRECTORIES MODIFIED ACCORDINGLY.
- ANY DEVICE INTERFERING WITH DEMOLITION WORK NOT SHOWN ON THESE DRAWINGS SHALL NOT BE REMOVED WITHOUT WRITTEN AUTHORIZATION FROM THE OWNER'S REPRESENTATIVE OR THE ENGINEER.
- ALL ELECTRICAL DEMOLITION WORK SHALL BE PROPERLY COORDINATED WITH ALL OTHER TRADES.
- EC IS SOLELY RESPONSIBLE FOR THE SAFE HANDLING AND DISPOSAL OF ALL REMOVED LUMINAIRES AND BALLASTS THAT MAY CONTAIN PCBs (POLYCHLORINATED BIPHENYLS), IN ACCORDANCE WITH ALL APPLICABLE EPA, OSHA, FEDERAL, STATE, AND LOCAL CODES AND LAWS.
- EC IS SOLELY RESPONSIBLE FOR THE SAFE HANDLING AND DISPOSAL OF ALL REMOVED FLUORESCENT LIGHT TUBES THAT MAY CONTAIN MERCURY, IN ACCORDANCE WITH ALL APPLICABLE EPA, OSHA, FEDERAL, STATE, AND LOCAL CODES AND LAWS.
- AT ALL CORRIDORS WHERE NEW CEILINGS ARE BEING INSTALLED, DISCONNECT AND REMOVE DEVICES AS INDICATED, TAG EXISTING WIRING FOR REUSE.

General Notes

- COORDINATE ALL ELECTRICAL WORK AND POWER OUTAGES WITH OWNER AND OTHER TRADES PRIOR TO THE START OF CONSTRUCTION. NO POWER OUTAGES SHALL OCCUR WITHOUT OWNER'S PRIOR KNOWLEDGE AND CONSENT.
 - REFER TO DRAWING G100 FOR STANDARD SYMBOLS AND ABBREVIATIONS.
 - CIRCUIT WIRING FOR ALL LIGHTING CIRCUITS SHALL BE IN 1/2" EMT CONDUIT (MIN) OR TYPE MC CABLE CONCEALED ABOVE CEILINGS AND IN WALLS (REFER TO SPECIFICATION SECTION 26 05 33 FOR LOCATIONS WHERE MC CABLE IS ACCEPTABLE). ALL CIRCUIT CONDUCTORS SHALL BE #12AWG COPPER (MIN) 90°C THHN THERMOPLASTIC INSULATION.
 - CIRCUIT EXIT AND EMERGENCY LUMINAIRES TO UNSWITCHED HOT LEG OF LIGHTING CIRCUIT OF THE AREA BEING SERVED BY OR ADJACENT TO THE LUMINAIRE. REFER TO PLANS AND DETAILS FOR MINATURE INVERTER INFORMATION.
 - PROPERLY IDENTIFY ALL CIRCUITS AT PANELS AND J-BOXES AND IN ACCORDANCE WITH PROJECT SPECIFICATIONS.
 - PROVIDE ALL ADAPTERS, COUPLINGS AND ASSOCIATED FITTINGS REQUIRED FOR COMPLETE OPERATIONAL SYSTEM.
 - WHEN INSTALLING NEW DEVICES IN EXISTING LOCATIONS, REUSE EXISTING CONDUIT/TRACEWAY AND BACK BOXES IF IN GOOD CONDITION. EXTENDING/INSTALL NEW CONDUIT/TRACEWAY AS REQUIRED FOR PROPER MOUNTING OF DEVICE. CONCEAL ABOVE CEILINGS OR WITHIN WALLS WHERE POSSIBLE. REFER TO SPECIFICATION SECTION 26 05 33.
 - COORDINATE ALL ELECTRICAL WORK WITH OTHER TRADES.
 - TESTS OF ALL ELECTRICAL WORK SHALL BE PERFORMED IN THE PRESENCE OF THE ENGINEER OR ARCHITECT, AS EQUIPMENT IS INSTALLED AND AS SYSTEMS ARE COMPLETED. IN ADDITION AN ELECTRIC APPROVED CERTIFICATE SHALL BE ISSUED BY AN ELECTRICAL INSPECTION AGENCY.
 - UNLESS NOTED ELSEWHERE ON THE CONTRACT DOCUMENTS, THE FOLLOWING LIST REPRESENTS THE TYPICAL MOUNTING HEIGHTS FOR THE DEVICES SHOWN:
 - SWITCHES AND PANIC STATIONS.....48" (TO TOP)
 - RECEPTACLES.....16"
 - COMPUTER RECEPTACLES.....48" (TO TOP)
 - WALL (W) TELEPHONE AND CALL SWITCHES.....48" (TO TOP)
 - TELEPHONE OUTLETS (UNLABELED).....16"
 - VOLUME CONTROLS.....48" (TO TOP)
 - TELEVISION OUTLETS.....16"
 - FIRE ALARM PULL STATIONS.....48" (TO TOP)
 - FIRE ALARM AUDIOVISUAL UNITS.....88" * (OR 6" BELOW CEILING, WHICHEVER IS LOWER)
 - POWER PANELS.....72" (TO TOP)
 - DISCONNECT SWITCHES.....60" (TO TOP)
 - MOTOR STARTERS.....60" (TO TOP)
- THE HEIGHTS INDICATED SHALL BE NOMINAL TO THE BOTTOM OF THE BOX UNLESS NOTED OTHERWISE. MAINTAIN HEIGHT CONSISTENCY BETWEEN NEW AND EXISTING DEVICES.

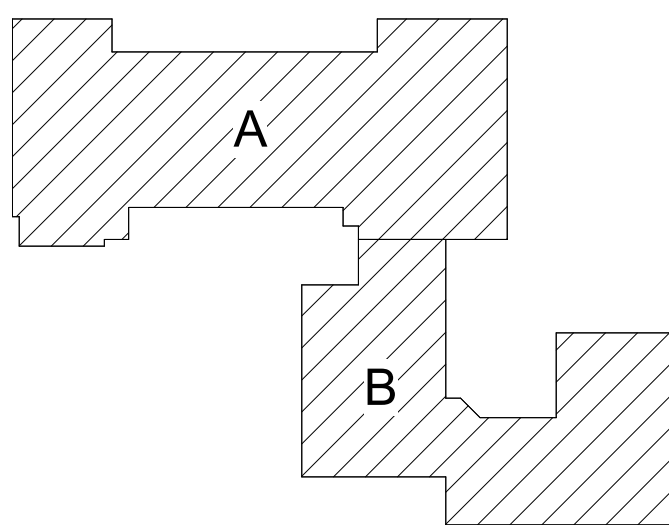

Key Plan
N.T.S.

S.E.D. Control No. 13-02-00-01-0-008-020

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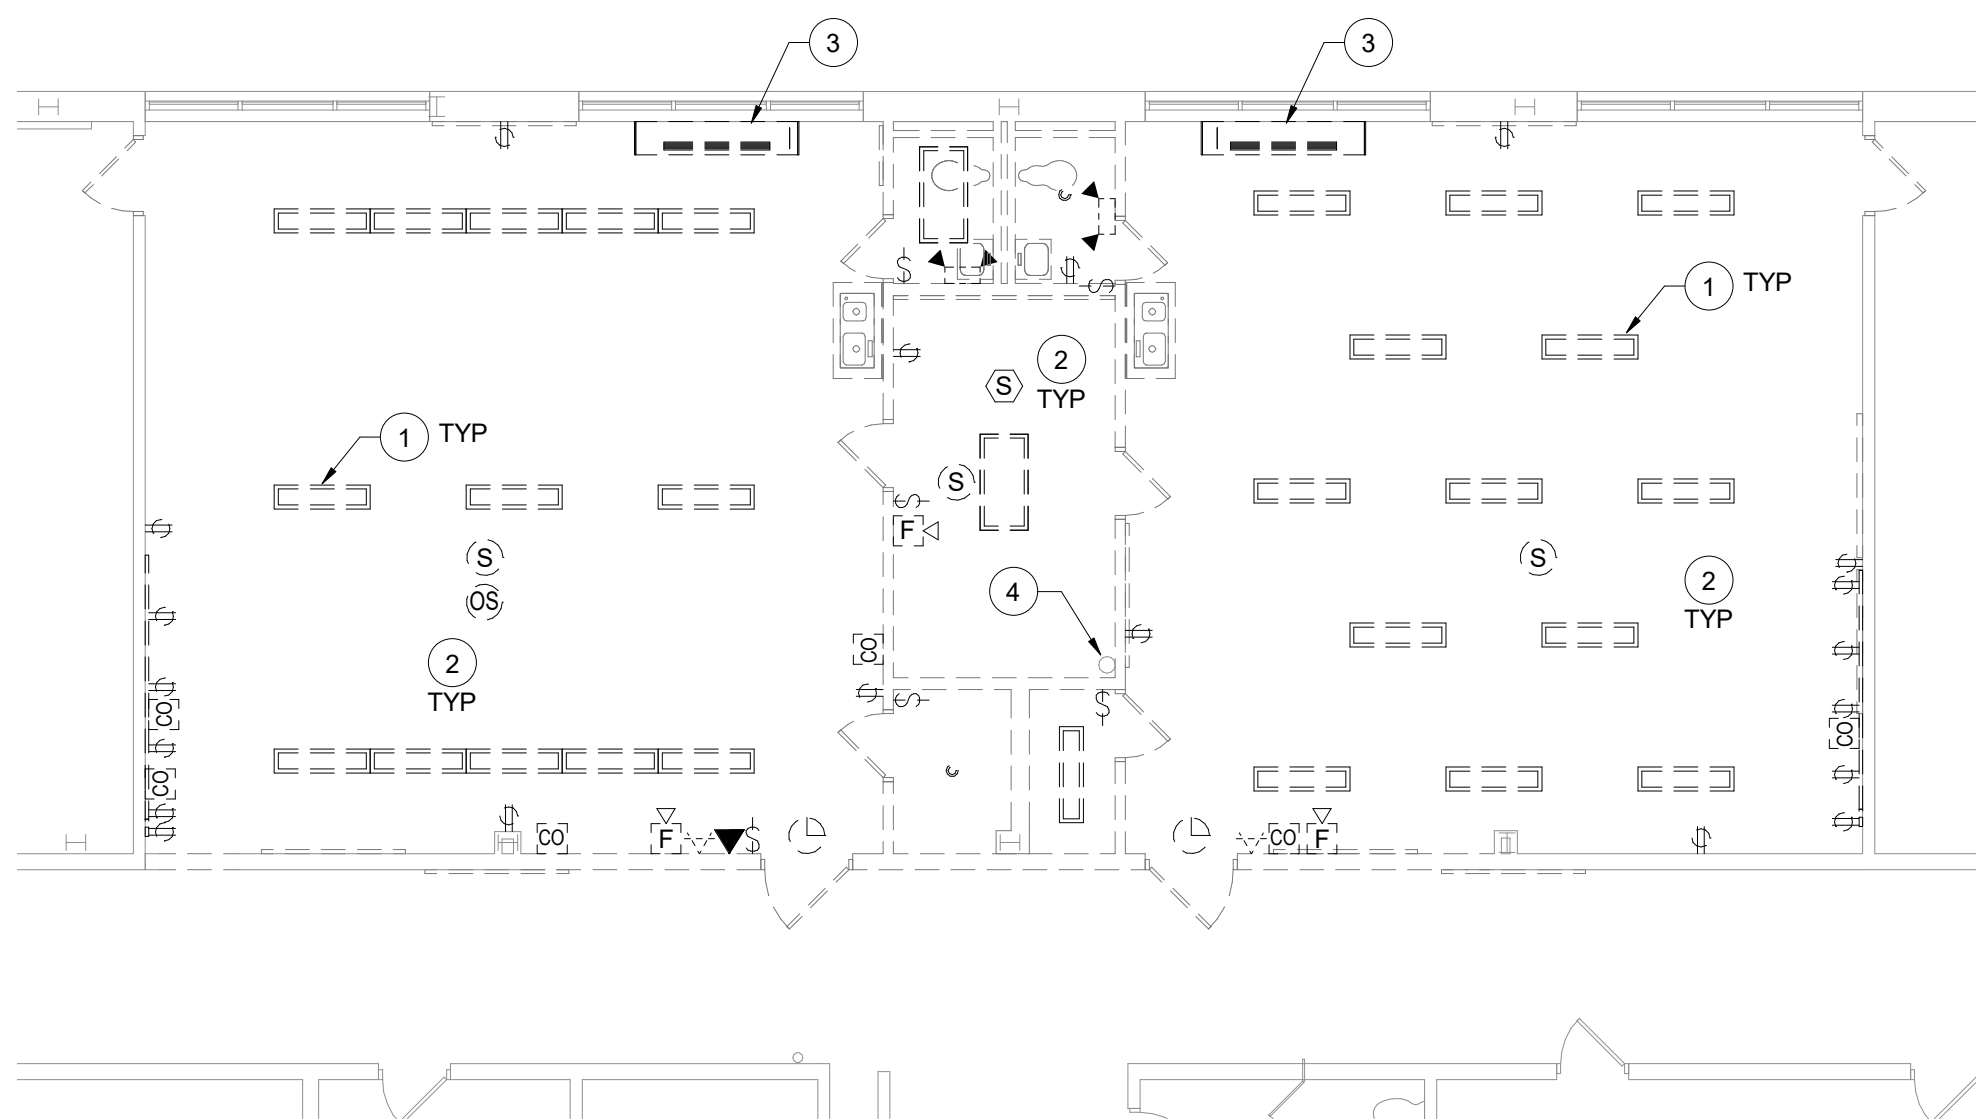


Beacon City School District
Beacon, New York


Reconstruction to:
Sargent Elementary School

Key Plans


Drawn By: SAS	Date: 10/28/2022	Drawing Number:
Project No.: 279180-22004	CE050	




1 Partial First Floor Demolition Plan - Area A
1/8" = 1'-0"

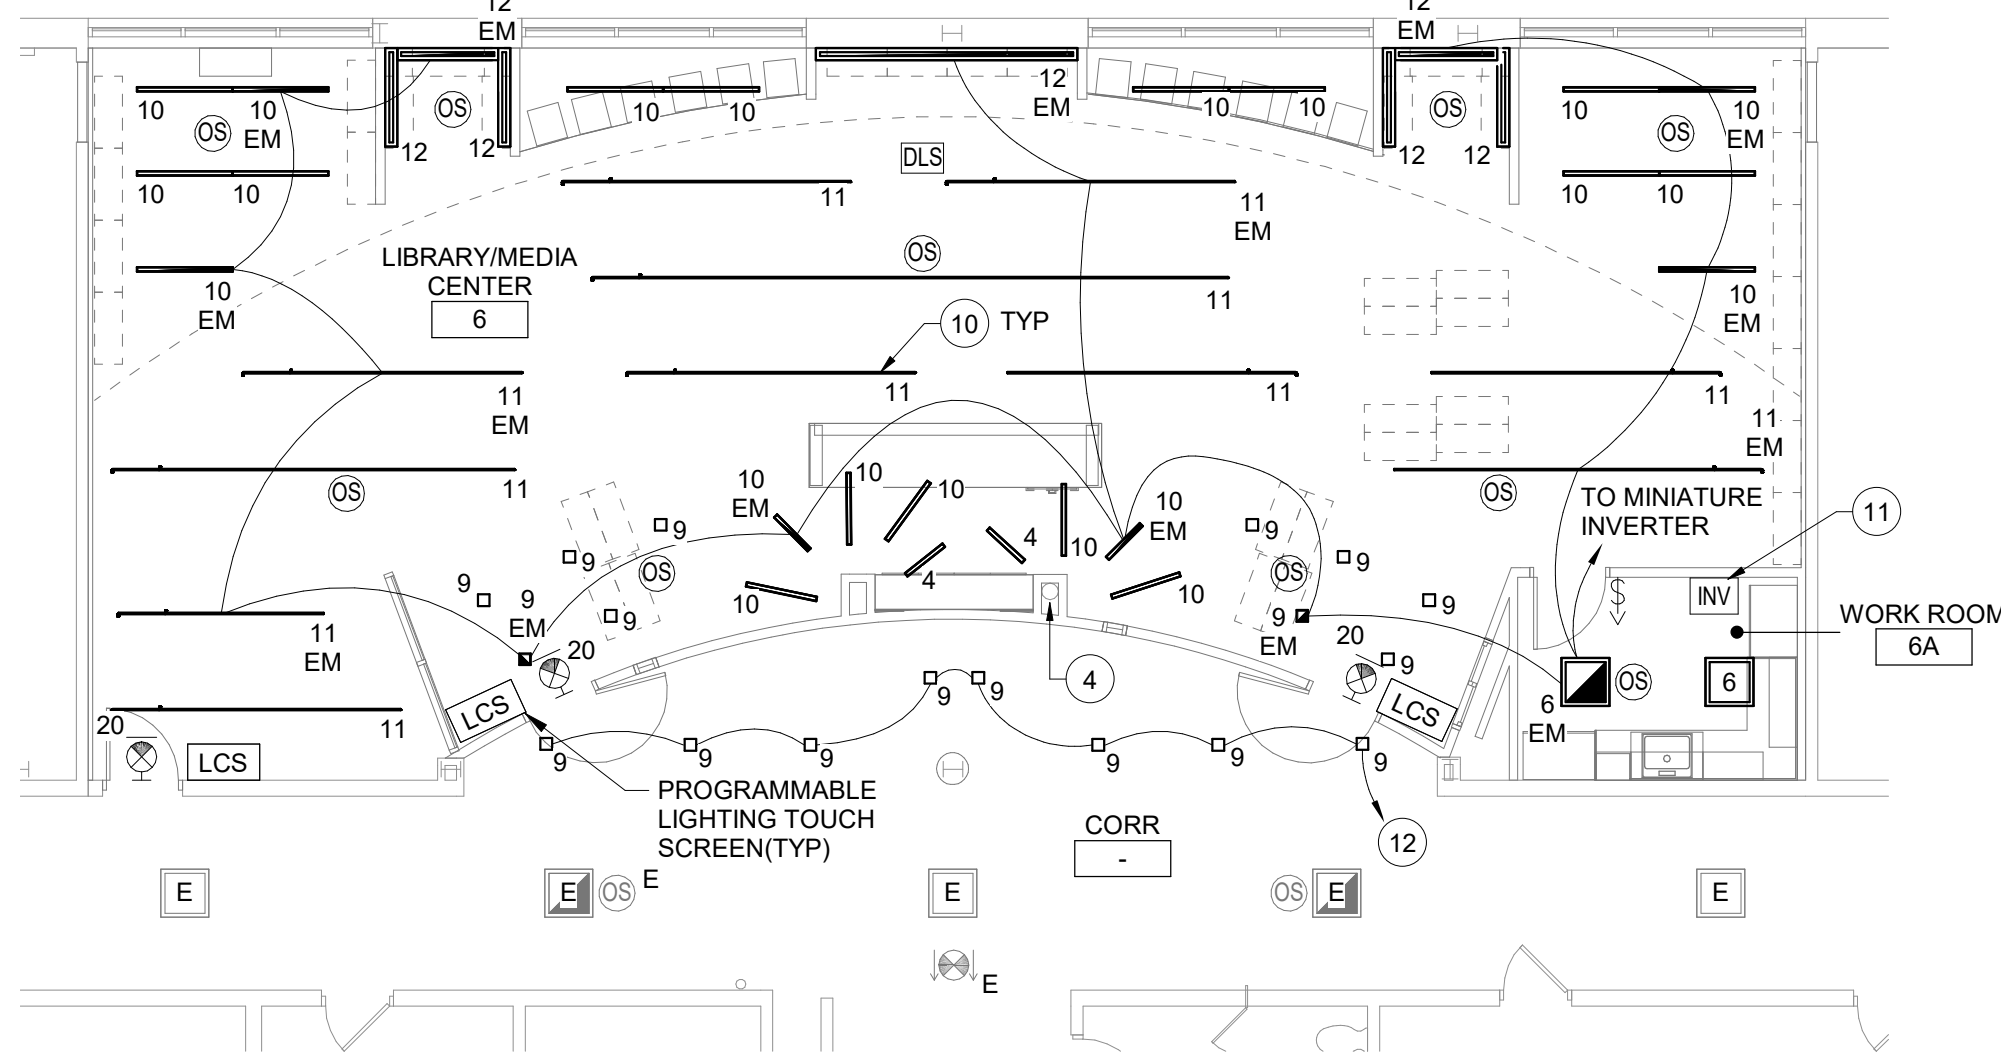


2 Partial First Floor Lighting Plan - Area A
1/8" = 1'-0"

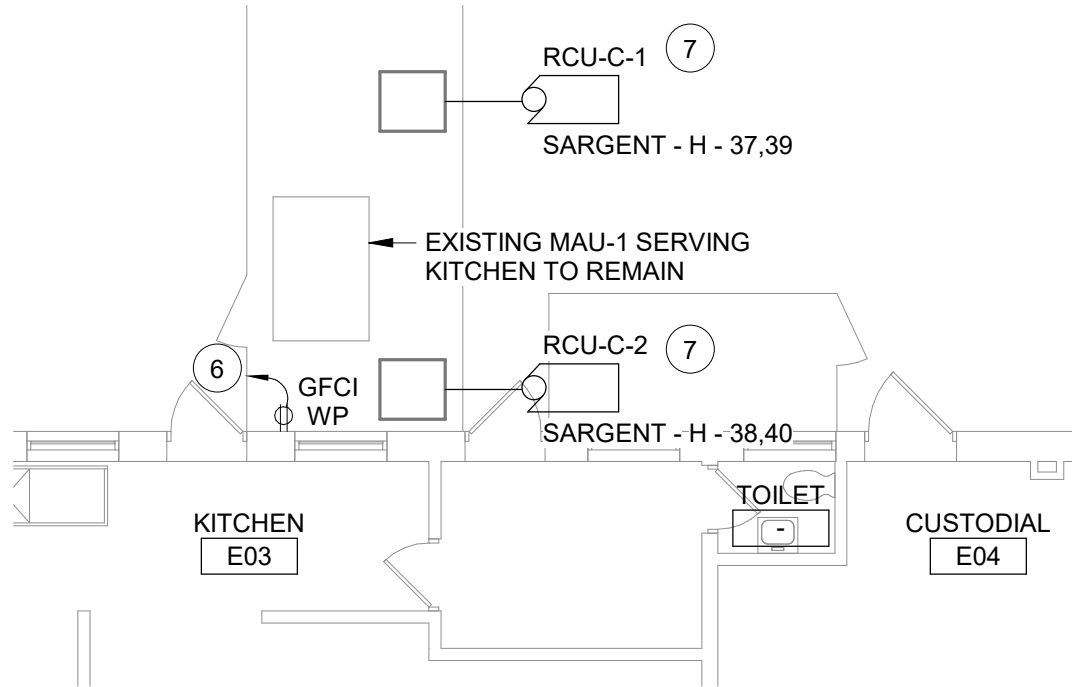

5 Partial Basement Power & Communications Plan - Area A
1/8" = 1'-0"

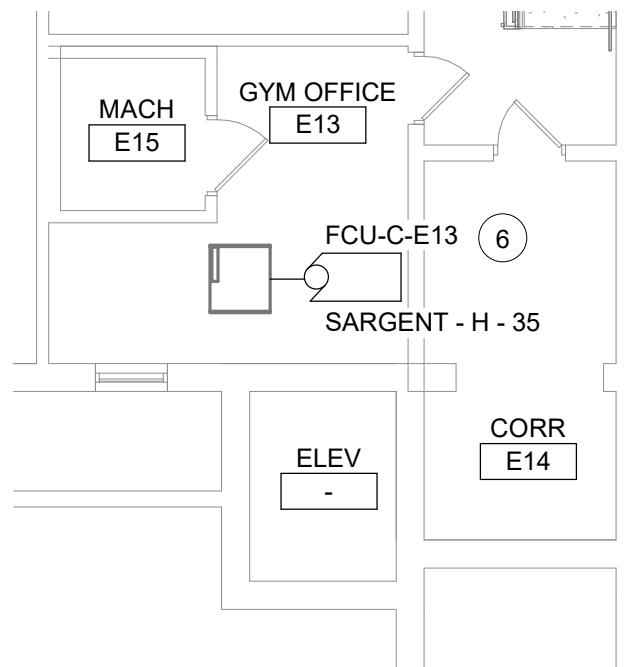

4 Partial Basement Power & Communications Plan - Area A
1/8" = 1'-0"

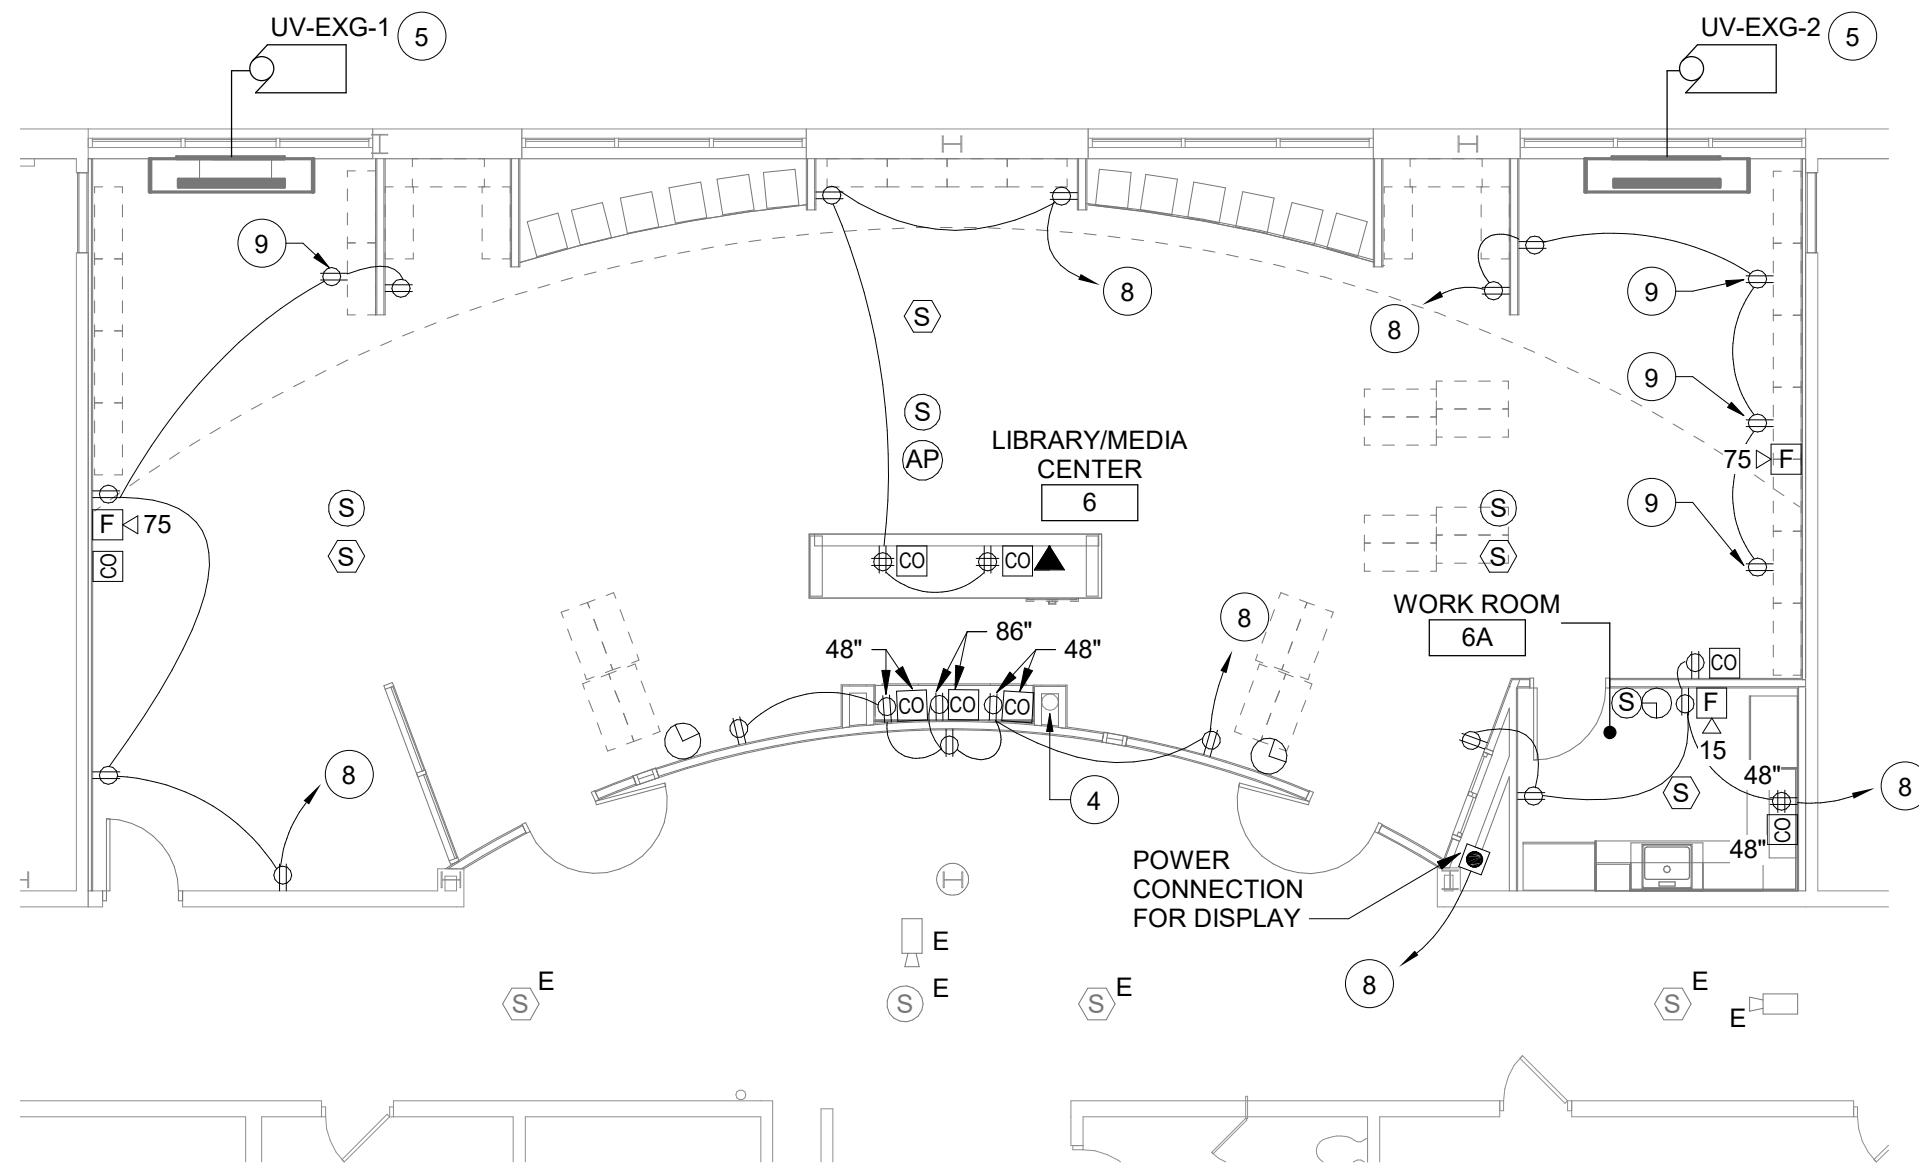


3 Partial First Floor Power & Communications Plan - Area A
1/8" = 1'-0"

Keyed Notes:

- 1 REMOVE LUMINAIRE(S). TAG CIRCUITRY FOR RE-USE.
- 2 REMOVE ELECTRICAL DEVICES SHOWN. REMOVE EXISTING CIRCUITRY BACK TO NEAREST JUNCTION BOX, DEVICE OR SWITCH OUTSIDE OF DEMOLITION AREA. MODIFY EXISTING SYSTEM CIRCUITRY TO ALLOW FOR PROPER OPERATION OF REMAINING DEVICES ON CIRCUIT.
- 3 DISCONNECT POWER CIRCUITRY SERVING HVAC EQUIPMENT. TAG CIRCUITRY FOR RE-USE.
- 4 PROTECT AND SECURE EXISTING DATA CABLES AND CONDUITS.
- 5 RE-CONNECT POWER CIRCUITRY TO RELOCATED HVAC EQUIPMENT. MODIFY/EXTEND CIRCUITRY AS NECESSARY.
- 6 CIRCUIT TO SPARE 20A1P BREAKER IN PANEL SARGENT - H. CONNECT USING (2) #12, (1) #12 G. IN 1/2" CONDUIT. AMEND PANEL DIRECTORY ACCORDINGLY.
- 7 PROVIDE 30A2P CIRCUIT BREAKER IN AVAILABLE SPACE IN PANEL SARGENT - H. CONNECT USING (2) #12, (1) #12 G. IN 3/4" CONDUIT. NEW BREAKER TO BE UL LISTED FOR USE IN PANEL AND MEET OR EXCEED AIC RATING OF EXISTING PANEL. AMEND PANEL DIRECTORY ACCORDINGLY.
- 8 CIRCUIT TO SPARE 20A1P BREAKER IN PANEL SARGENT - B. CONNECT USING (2) #12, (1) #12 G. IN 1/2" CONDUIT. AMEND PANEL DIRECTORY ACCORDINGLY.
- 9 PROVIDE RECEPTACLE IN TOE KICK OF CASEWORK. REFER TO DETAIL 1 ON SHEET CA900 FOR MORE INFORMATION.
- 10 CONNECT LUMINAIRES TO EXISTING CIRCUITRY PREVIOUSLY SERVING THE AREA.
- 11 PROVIDE WALL MOUNTED MINIATURE INVERTER BASED ON MODEL VESTA MAX MODEL VST-MAX-375W-UNV-4CK. MOUNT AT 72" AFF. COORDINATE FINAL LOCATION WITH OWNER. REFER TO WIRING DIAGRAM ON DRAWING CE500.
- 12 CONNECT LUMINAIRES TO EXISTING CIRCUITRY SERVING THE CORRIDOR LUMINAIRES. CONNECT LUMINAIRES TO EXISTING LIGHTING CONTROLS IN THE CORRIDOR.


General Notes:

- A. REFER TO DRAWING CE100 FOR GENERAL NOTES.
- B. REFER TO DRAWING CE500 FOR LUMINAIRE SCHEDULE.
- C. SECURE ALL EXISTING UNSUPPORTED CABLES ABOVE CEILINGS USING J HOOKS OR CABLETRAYS.
- D. FIRE ALARM DEVICES ARE TO BE WIRED TO EXISTING NOTIFICATION CIRCUITS.
- E. INVERTER SYSTEM EMERGENCY OUTPUT CIRCUITS SHALL BE INSTALLED IN DEDICATED CONDUIT SYSTEMS AND NOT SHARED WITH OTHER ELECTRICAL CIRCUITS AS DESCRIBED IN NEC 700-9(B).
- F. SPEAKERS ARE TO BE COMPATIBLE AND WIRED TO EXISTING PA SYSTEM.
- G. CLOCKS ARE TO BE COMPATIBLE WITH EXISTING CLOCK SYSTEM.
- H. LIGHTING CONTROL SEQUENCE:
LIBRARY:
MULTI-ZONES PER OWNER. OPERATED WITH PROGRAMMABLE TOUCH SCREEN CONTROL.

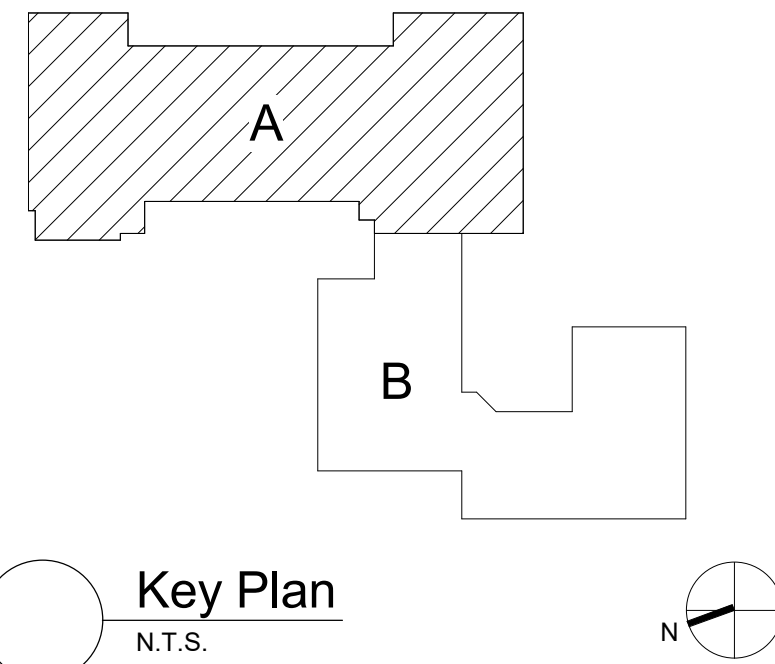

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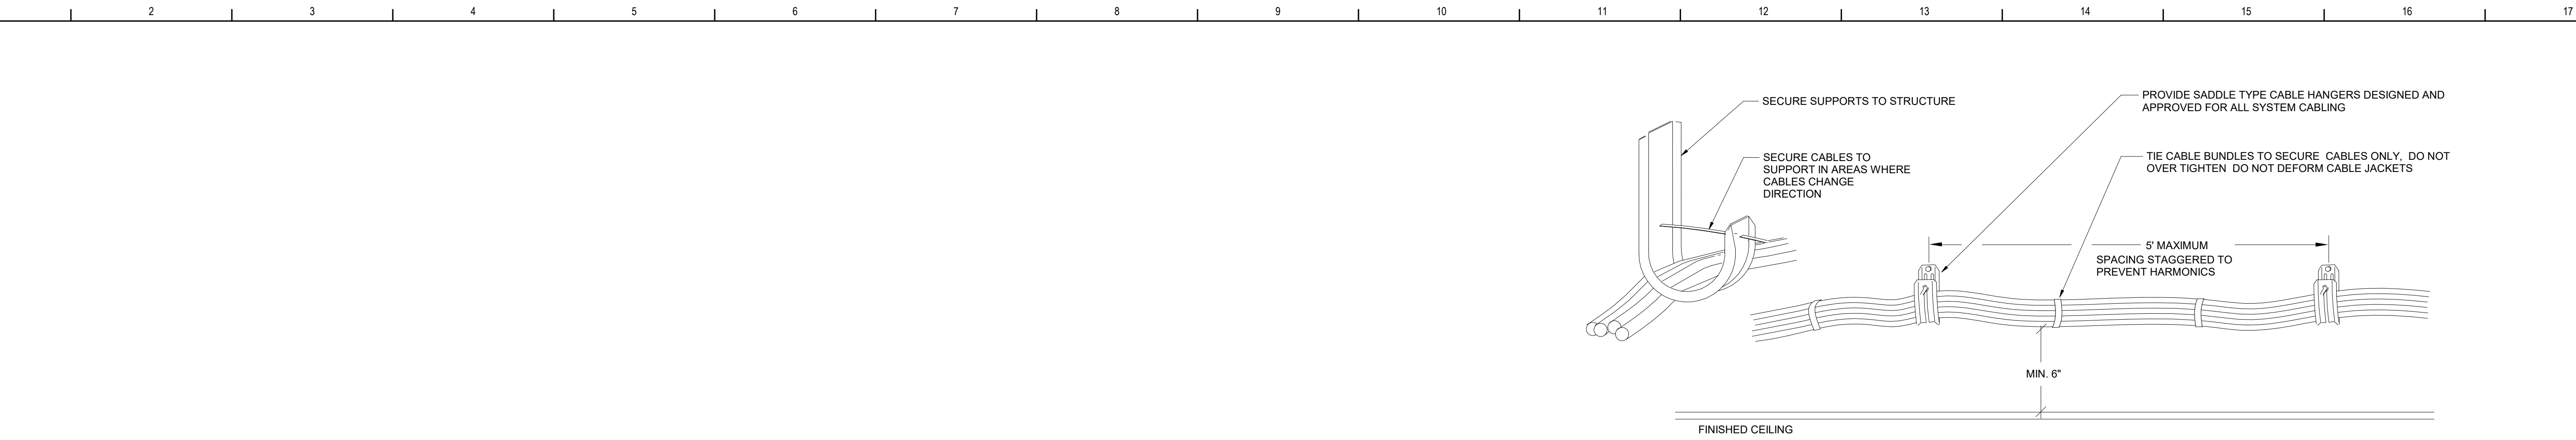


Beacon City School District
Beacon, New York

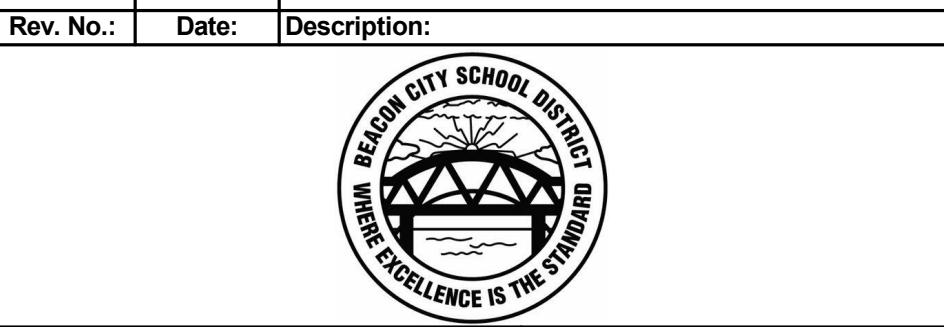Reconstruction to:
Sargent Elementary School


Partial Plans

Drawn By: SAS/CR	Date: 10/28/2022	Drawing Number:
Project No.: 279180-22004		CE100




- INSTALLATION NOTES:**
- LOCATE CABLE BUNDLES A MINIMUM OF 6" ABOVE REMOVABLE CEILINGS TO MAINTAIN CLEARANCE (ALONG WALLS WHERE POSSIBLE). LOCATE IN AREAS THAT ARE ACCESSIBLE.
 - USE 2 OR MORE CABLE HANGERS AT ALL TURNS TO MAINTAIN MANUFACTURER'S BEND RADIUS REQUIREMENTS.
 - THIS SUPPORT SYSTEM TO BE USED WHEREVER CABLE TRAY IS NOT INDICATED ON PLANS.

1 Typical Installation with Cable Hangars
NTS

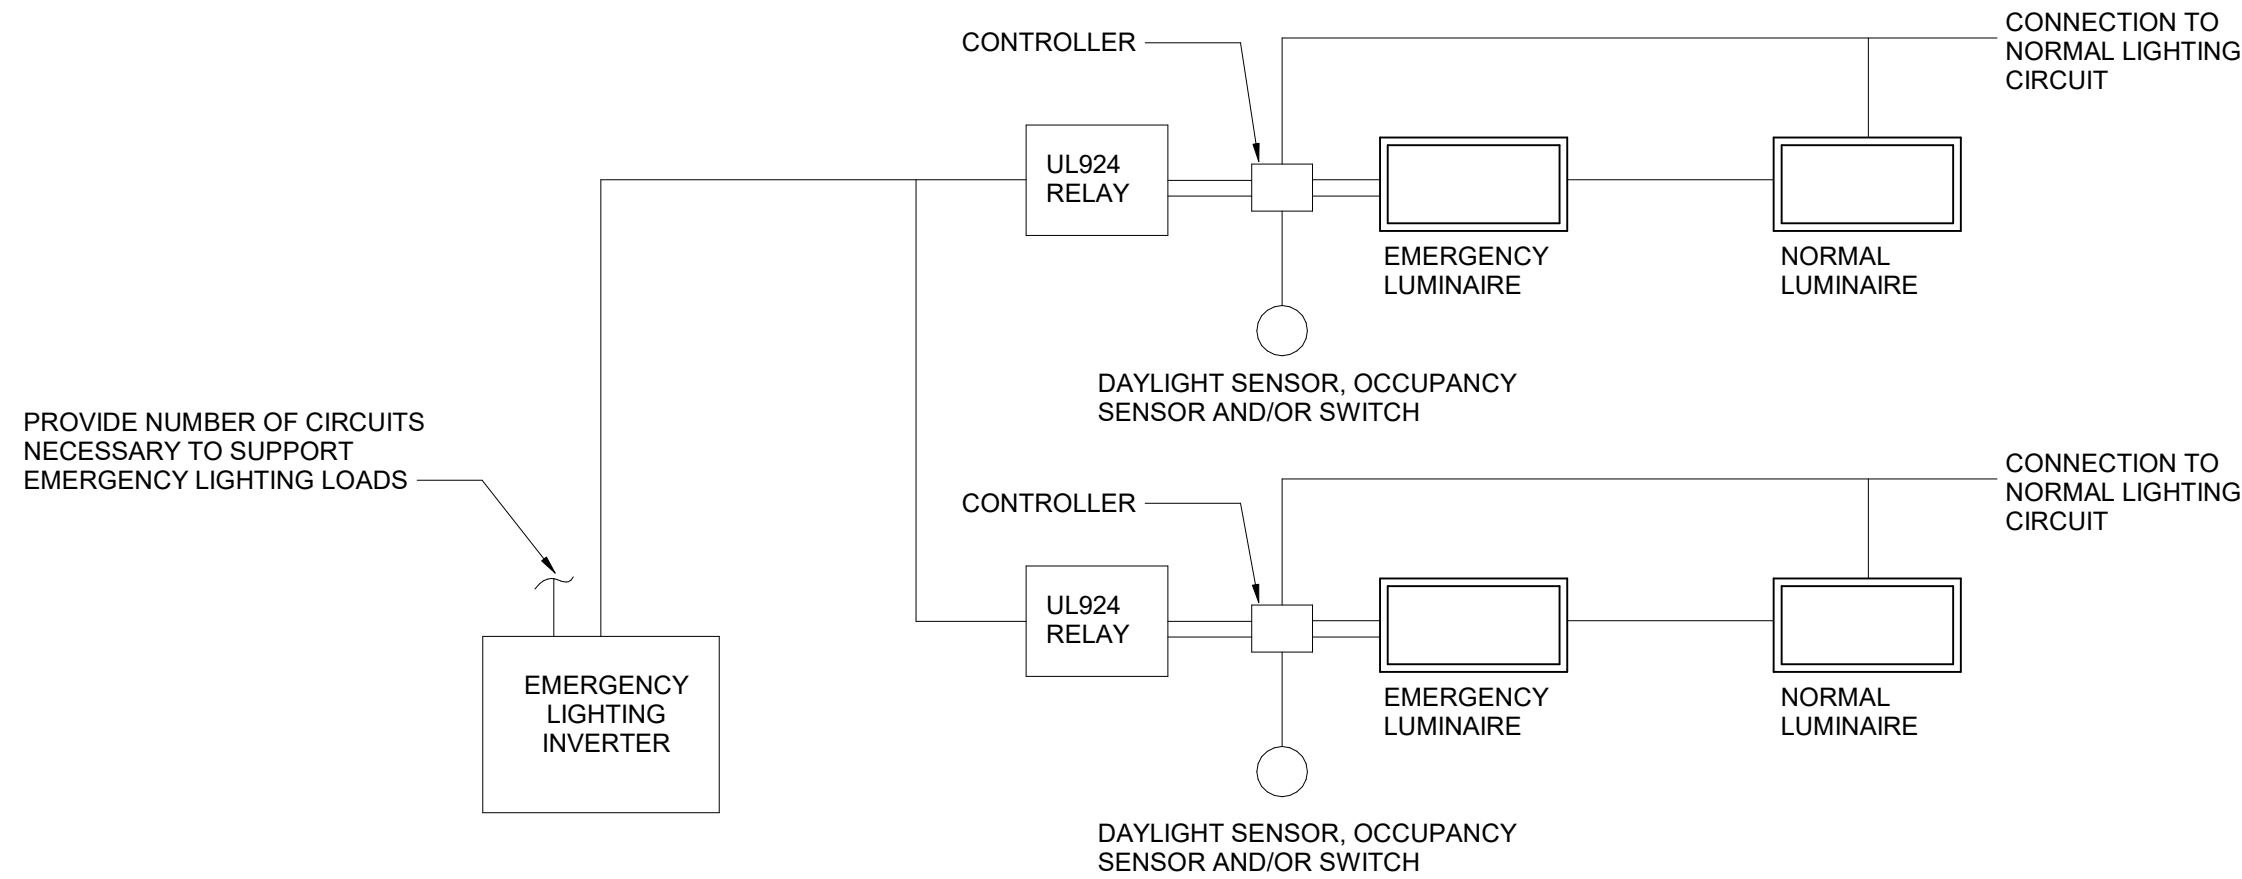

3 Emergency Miniature Inverter Wiring Diagram
1/4" = 1'-0"

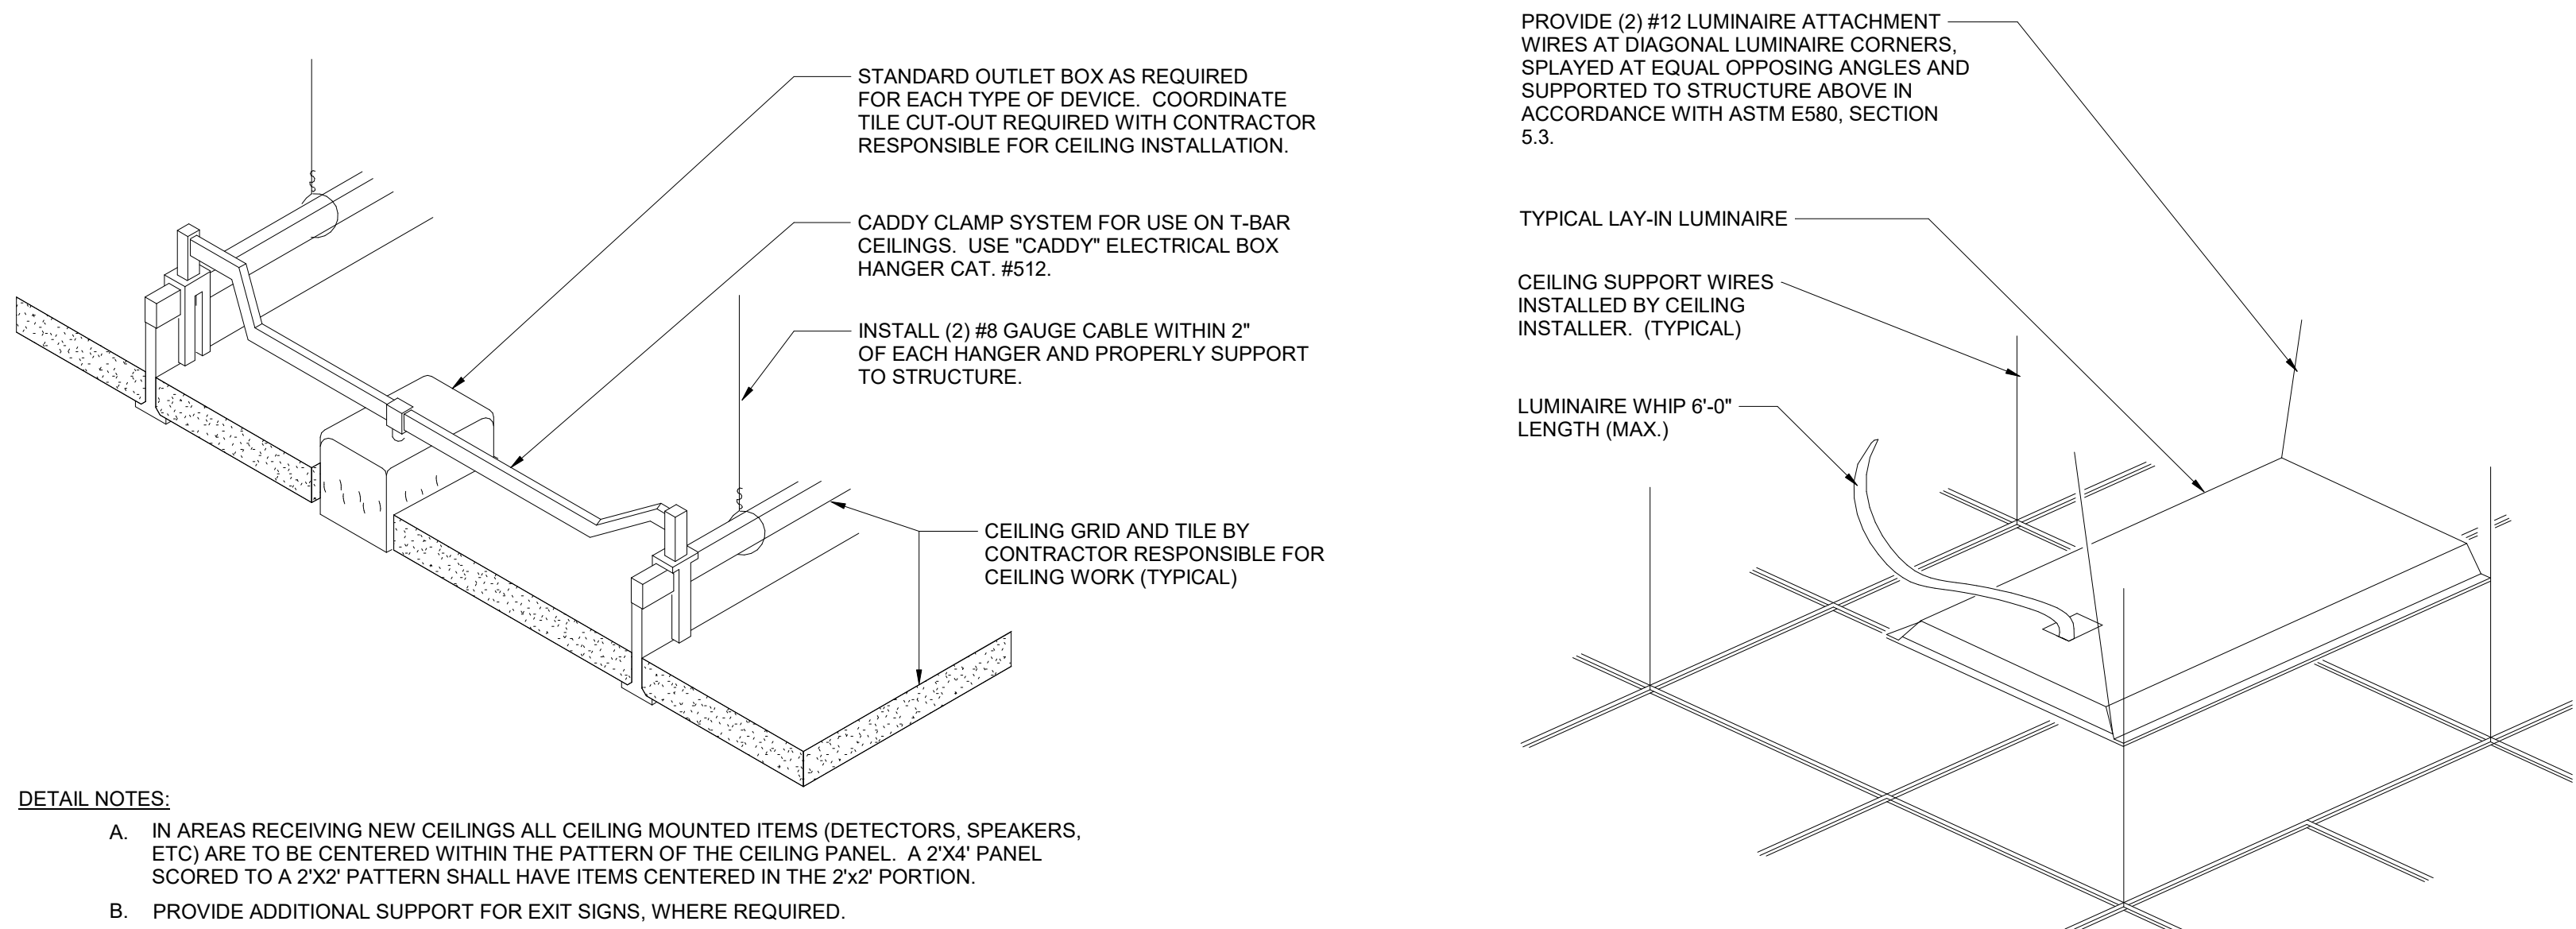

- DETAIL NOTES:**
- IN AREAS RECEIVING NEW CEILINGS ALL CEILING MOUNTED ITEMS (DETECTORS, SPEAKERS, ETC) ARE TO BE CENTERED WITHIN THE PATTERN OF THE CEILING PANEL. A 2'x4' PANEL SCORED TO A 2'x2' PATTERN SHALL HAVE ITEMS CENTERED IN THE 2'x2' PORTION.
 - PROVIDE ADDITIONAL SUPPORT FOR EXIT SIGNS, WHERE REQUIRED.

5 Ceiling Mounting Device Detail
NTS

4 Typical Troffer Mounting Detail
NTS

LUMINAIRE SCHEDULE							
TYPE	SYMBOL	DESCRIPTION	LAMPS			MANUFACTURERS (OR EQUAL)	
			WATTAGE	LUMENS	TYPE	NAME	MODEL OR SERIES
1 **		1' x 4' TROFFER (RECESSED IN GRID)	12.2	1482	LED	SIGNIFY (DAY-BRITE)	1FPZ15L835-4-DS-UNV-DIM
1 .. EM		SAME AS TYPE 1 - CONNECTED TO EMERGENCY MINIATURE INVERTER	12.2	1482	LED	SIGNIFY (DAY-BRITE)	1FPZ15L835-4-DS-UNV-DIM
2 **		1' x 4' TROFFER (RECESSED IN GRID)	24.6	2972	LED	SIGNIFY (DAY-BRITE)	1FPZ30L835-4-DS-UNV-DIM
2 .. EM		SAME AS TYPE 2 - CONNECTED TO EMERGENCY MINIATURE INVERTER	24.6	2972	LED	SIGNIFY (DAY-BRITE)	1FPZ30L835-4-DS-UNV-DIM
3 **		1' x 4' TROFFER (RECESSED IN GRID)	31.3	3775	LED	SIGNIFY (DAY-BRITE)	1FPZ38L835-4-DS-UNV-DIM
3 .. EM		SAME AS TYPE 3 - CONNECTED TO EMERGENCY MINIATURE INVERTER	31.3	3775	LED	SIGNIFY (DAY-BRITE)	1FPZ38L835-4-DS-UNV-DIM
4 **		2' x 2' TROFFER (RECESSED IN GRID)	15.7	1918	LED	SIGNIFY (DAY-BRITE)	2FPZ20L835-2-DS-UNV-DIM
4 .. EM		SAME AS TYPE 4 - CONNECTED TO EMERGENCY MINIATURE INVERTER	15.7	1918	LED	SIGNIFY (DAY-BRITE)	2FPZ20L835-2-DS-UNV-DIM
5 **		2' x 2' TROFFER (RECESSED IN GRID)	23.4	2911	LED	SIGNIFY (DAY-BRITE)	2FPZ30L835-2-DS-UNV-DIM
5 .. EM		SAME AS TYPE 5 - CONNECTED TO EMERGENCY MINIATURE INVERTER	23.4	2911	LED	SIGNIFY (DAY-BRITE)	2FPZ30L835-2-DS-UNV-DIM
6		2' x 2' TROFFER (RECESSED IN GRID)	29.8	3856	LED	SIGNIFY (DAY-BRITE)	2FPZ38L835-2-DS-UNV-DIM
6 EM		SAME AS TYPE 6 - CONNECTED TO EMERGENCY MINIATURE INVERTER	29.8	3856	LED	SIGNIFY (DAY-BRITE)	2FPZ38L835-2-DS-UNV-DIM
7 **		2' x 2' TROFFER (RECESSED IN GRID)	35.7	4403	LED	SIGNIFY (DAY-BRITE)	2FPZ45L835-2-DS-UNV-DIM
7 .. EM		SAME AS TYPE 7 - CONNECTED TO EMERGENCY MINIATURE INVERTER	35.7	4403	LED	SIGNIFY (DAY-BRITE)	2FPZ45L835-2-DS-UNV-DIM
8 **		4" ROUND DOWNLIGHT	8.8	868	LED	SIGNIFY (LEDALITE)	L4R10935VB / L4RDW
8 .. EM		SAME AS TYPE 8 - CONNECTED TO EMERGENCY MINIATURE INVERTER	8.8	868	LED	SIGNIFY (LEDALITE)	L4R10935VB / L4RDW
9		4" SQUARE DOWNLIGHT	8.8	868	LED	SIGNIFY (LEDALITE)	L4R10935VB / L4RDW
9 EM		SAME AS TYPE 9 - CONNECTED TO EMERGENCY MINIATURE INVERTER	8.8	868	LED	SIGNIFY (LEDALITE)	L4R10935VB / L4RDW
10		2" RECESSED LINEAR. LENGTH VARIES. SEE PLANS FOR SPECIFIC LENGTHS.	14.5	1345	LED	FINELITE	HP-2-R-D-XFT-S-835
10 EM		SAME AS TYPE 10 - CONNECTED TO EMERGENCY MINIATURE INVERTER	14.5	1345	LED	FINELITE	HP-2-R-D-XFT-S-835
11		15 1/16" T-BAR LED	39	2854	LED	JLC TECH	TBSL-MW-5-24-B2-X-W
11 EM		SAME AS TYPE 11 - CONNECTED TO EMERGENCY MINIATURE INVERTER	39	2854	LED	JLC TECH	TBSL-MW-5-24-B2-X-W
12		2" RECESSED PERIMETER	27.6	2999	LED	PINNACLE ARCHITECTURAL LIGHTING	EV2DPM-A-835HO-4
12 EM		SAME AS TYPE 12 - CONNECTED TO EMERGENCY MINIATURE INVERTER	27.6	2999	LED	PINNACLE ARCHITECTURAL LIGHTING	EV2DPM-A-835HO-4
13 **		WALL MOUNT LINEAR	33.1	3361	LED	SIGNIFY (LEDALITE)	7408LBEQ047DEW
13 .. EM		SAME AS TYPE 13 - CONNECTED TO EMERGENCY MINIATURE INVERTER	33.1	3361	LED	SIGNIFY (LEDALITE)	7408LBEQ047DEW
14 .. EM		4' SURFACE MOUNTED LINEAR - CONNECTED TO EMERGENCY MINIATURE INVERTER	18.8	1780	LED	PINNACLE ARCHITECTURAL LIGHTING	EX3-WET-N-835-4-S-U-QL2-1-0-W
20		EXIT SIGN (SINGLE FACE) WALL AND CEILING MOUNT. SEE PLANS FOR DIRECTIONAL INDICATORS	2.5		LED	SIGNIFY (CHLORIDE)	ER46L-2-W-R
** LUMINAIRE TYPE NOT USED IN THIS BUILDING						* MANUFACTURER AND MODEL NUMBER ARE PROVIDED TO SHOW BASIS OF DESIGN ONLY.	

2 Luminaire Schedule
NTS

S.E.D. Control No. 13-02-00-01-0-008-020

Rev. No.: Date: Description:



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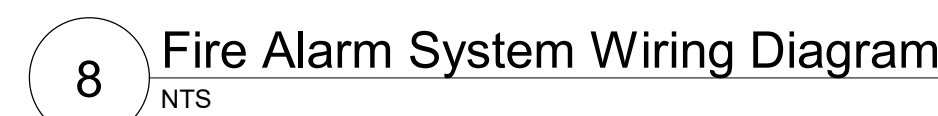
Beacon City School District
Beacon, New York

Reconstruction to:
Sargent Elementary School

Details

Drawn By: SAS Date: 10/28/2022 Drawing Number:


Project No.: 279180-22004 CE500



N	Drawn By: SAS	Date: 10/28/2022	Drawing Number:
	Project No.: 279180-22004		CE50

BID SET

CE501

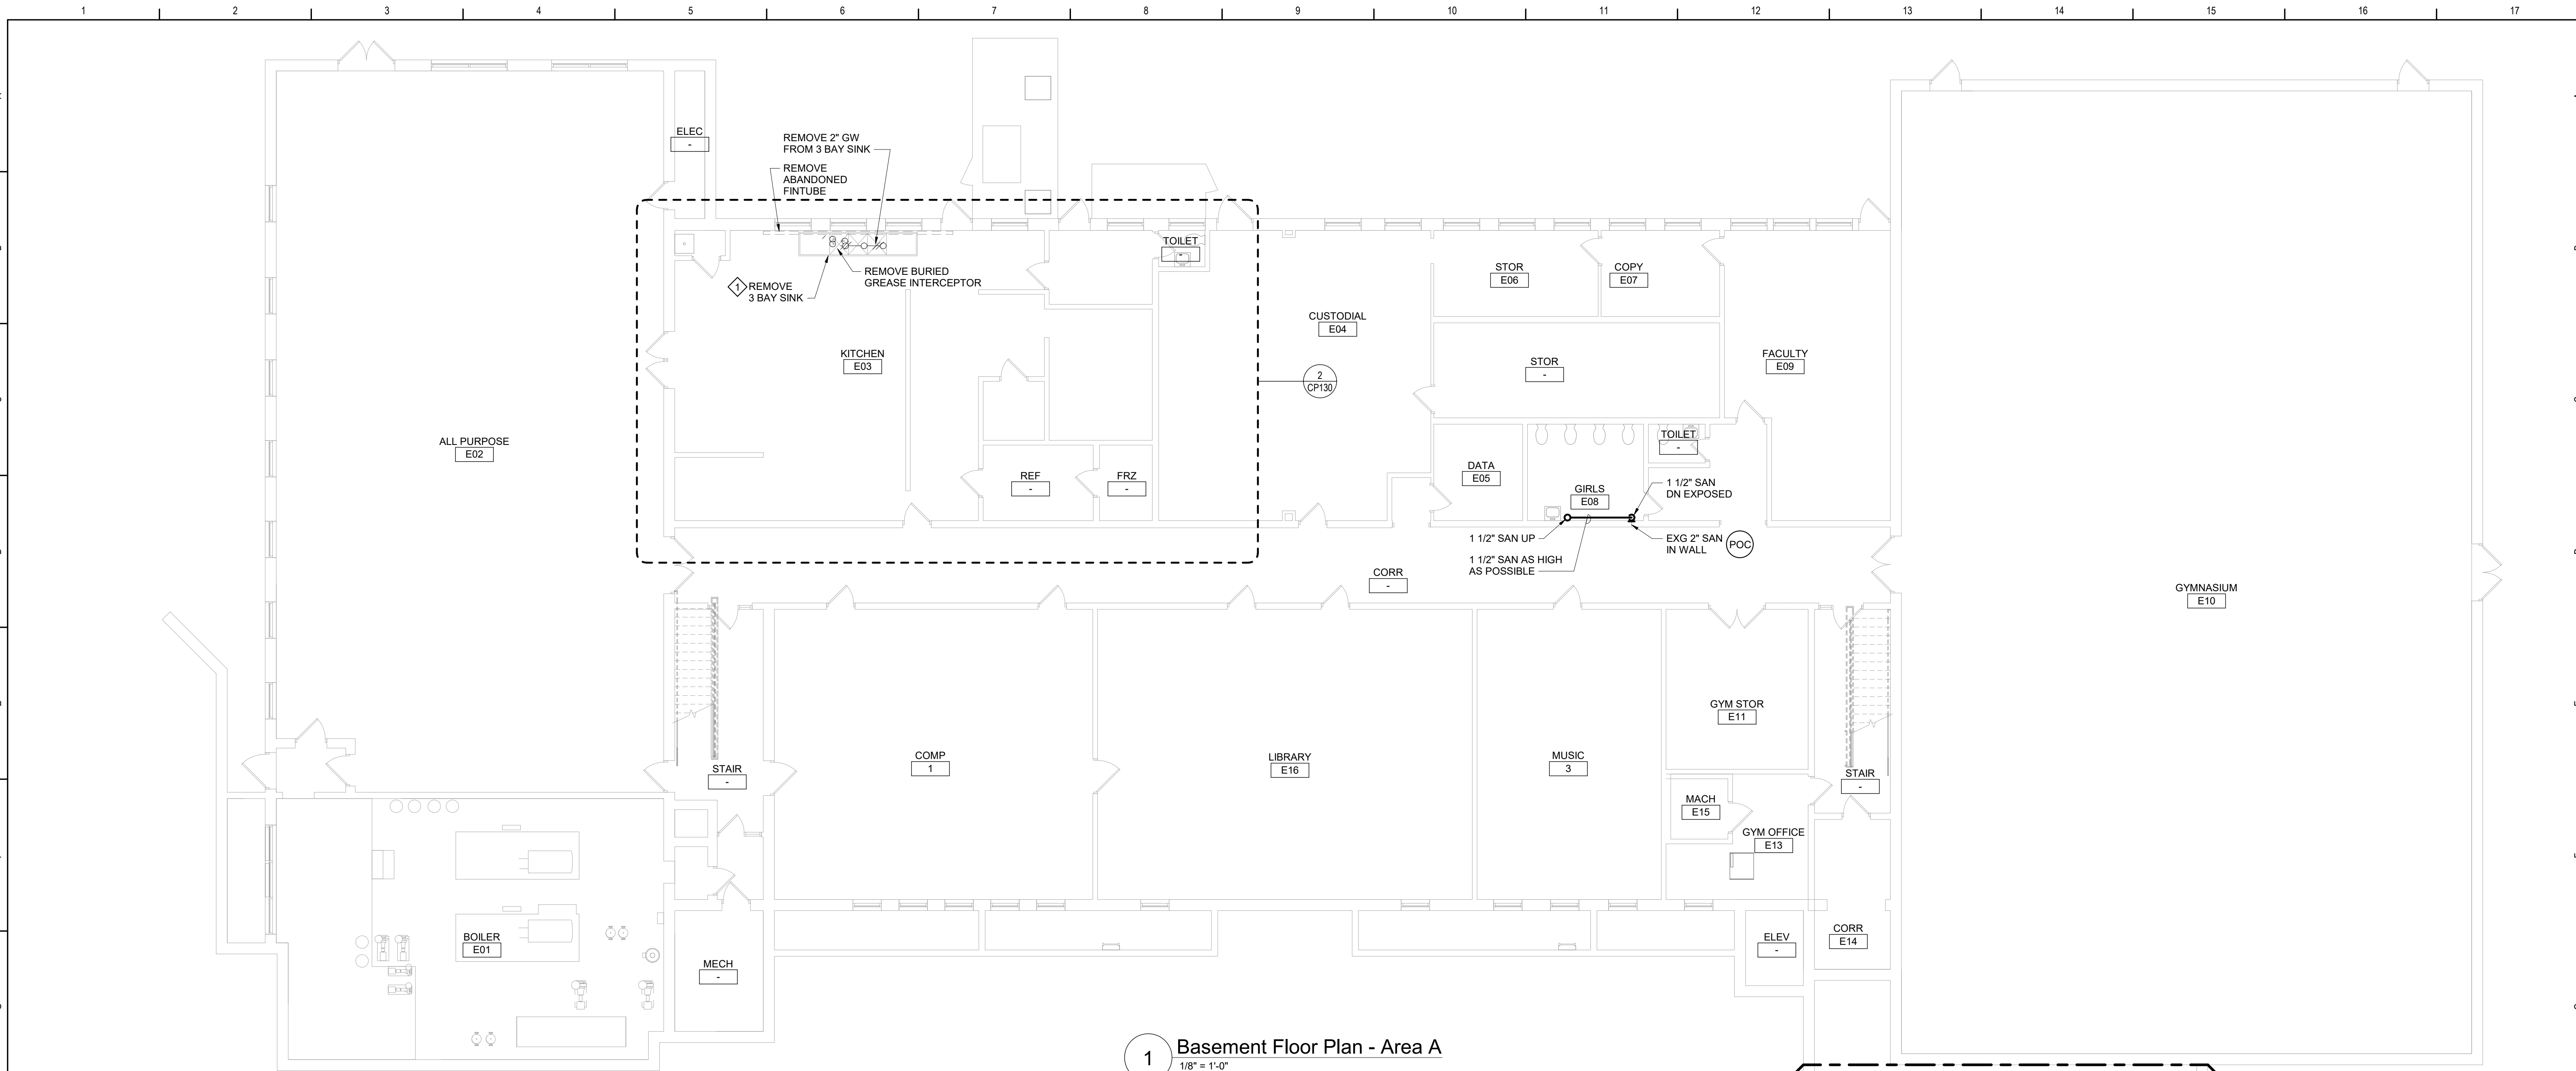


1 Basement Floor Plan - Area A
1/8" = 1'-0"

Grease Interceptor Schedule


DWG LABEL	LOCATION	DESIGN MAKE AND MODEL	GREASE RETENTION CAPACITY (POUNDS)	PDI RATED FLOW RATE (GPM)	INSTALLATION	INLET / OUTLET SIZE (NPS)	CENTERLINE OF INLET / OUTLET TO BOTTOM (INCHES)	CENTERLINE OF INLET / OUTLET TO TOP (INCHES)	EXTENSION HEIGHT (INCHES)	LENGTH (INCHES)	WIDTH (INCHES)	HEIGHT (INCHES)	VENT SIZE (NPS)	NOTES
GI-C-1	KITCHEN E03	JR SMITH 8050	100	50	BURIED	3	17-1/2	6-3/4	FIELD VERIFY	35-1/2	20-3/4	24-1/4	2	1, 2

NOTES:

- PROVIDE EXTERNAL FLOW CONTROL FITTING SUPPLIED BY SAME MANUFACTURER AS GREASE INTERCEPTOR.
- SET UNIT COVER/EXTENSION FLUSH WITH FINISHED FLOOR.

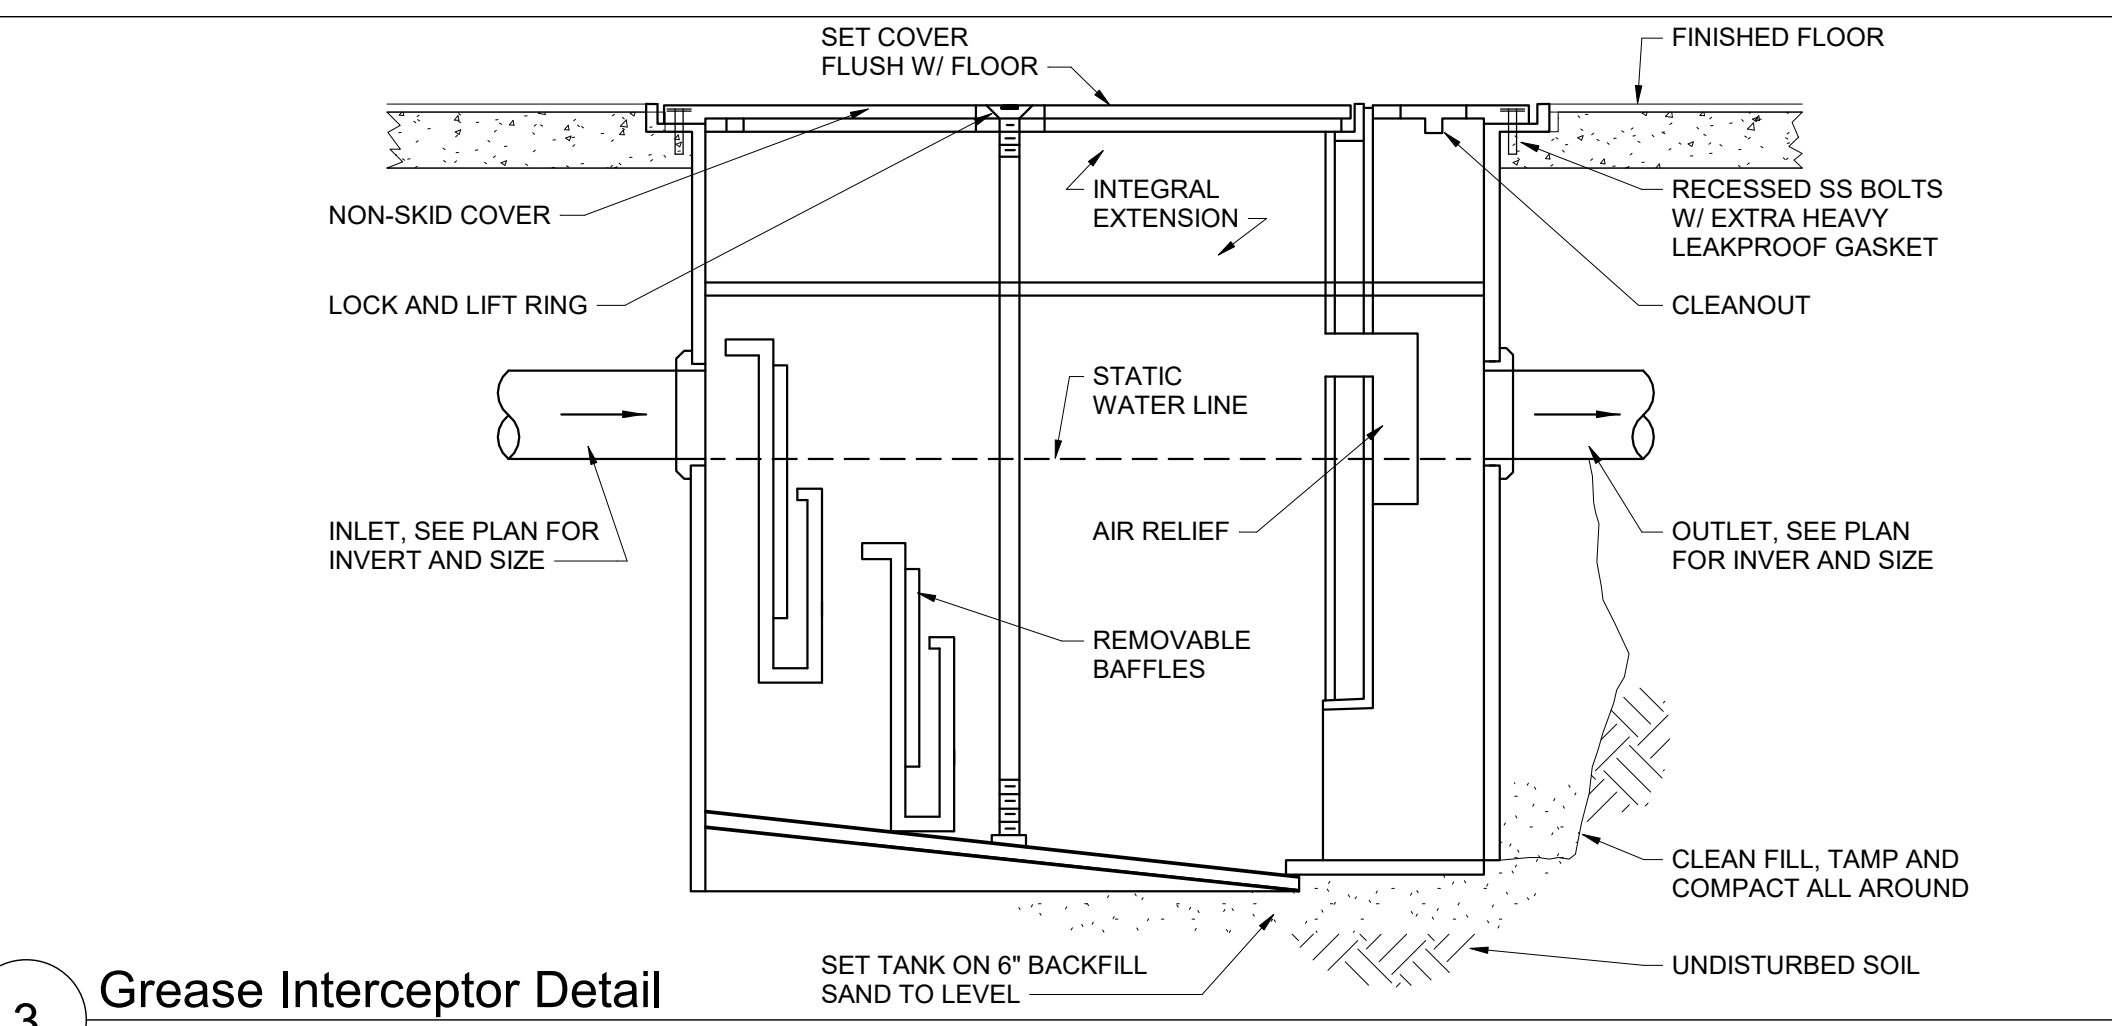


3 Grease Interceptor Detail
NTS

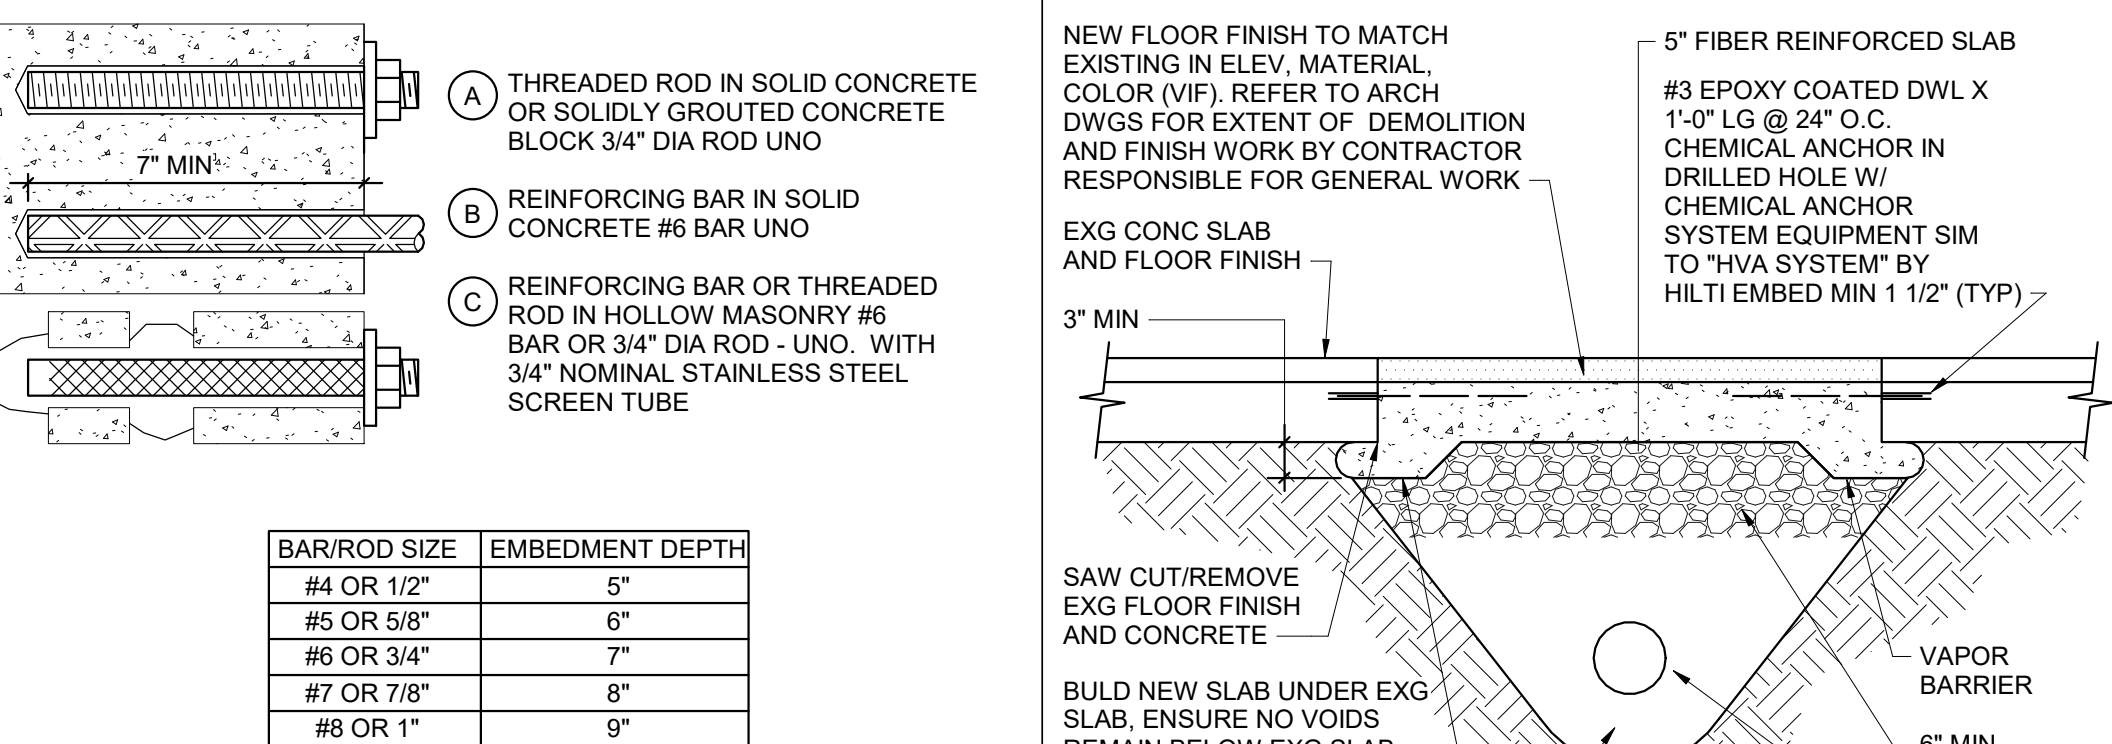

- GENERAL NOTES:
- FOR ACCEPTABLE ADHESIVE PRODUCTS REFER TO SPECIFICATIONS.
 - COMPLY WITH MANUFACTURERS REQUIREMENTS FOR INSTALLATION.

5 Typical Chemical Anchors
NTS

4 Trenching Below Existing Slab Detail
NTS

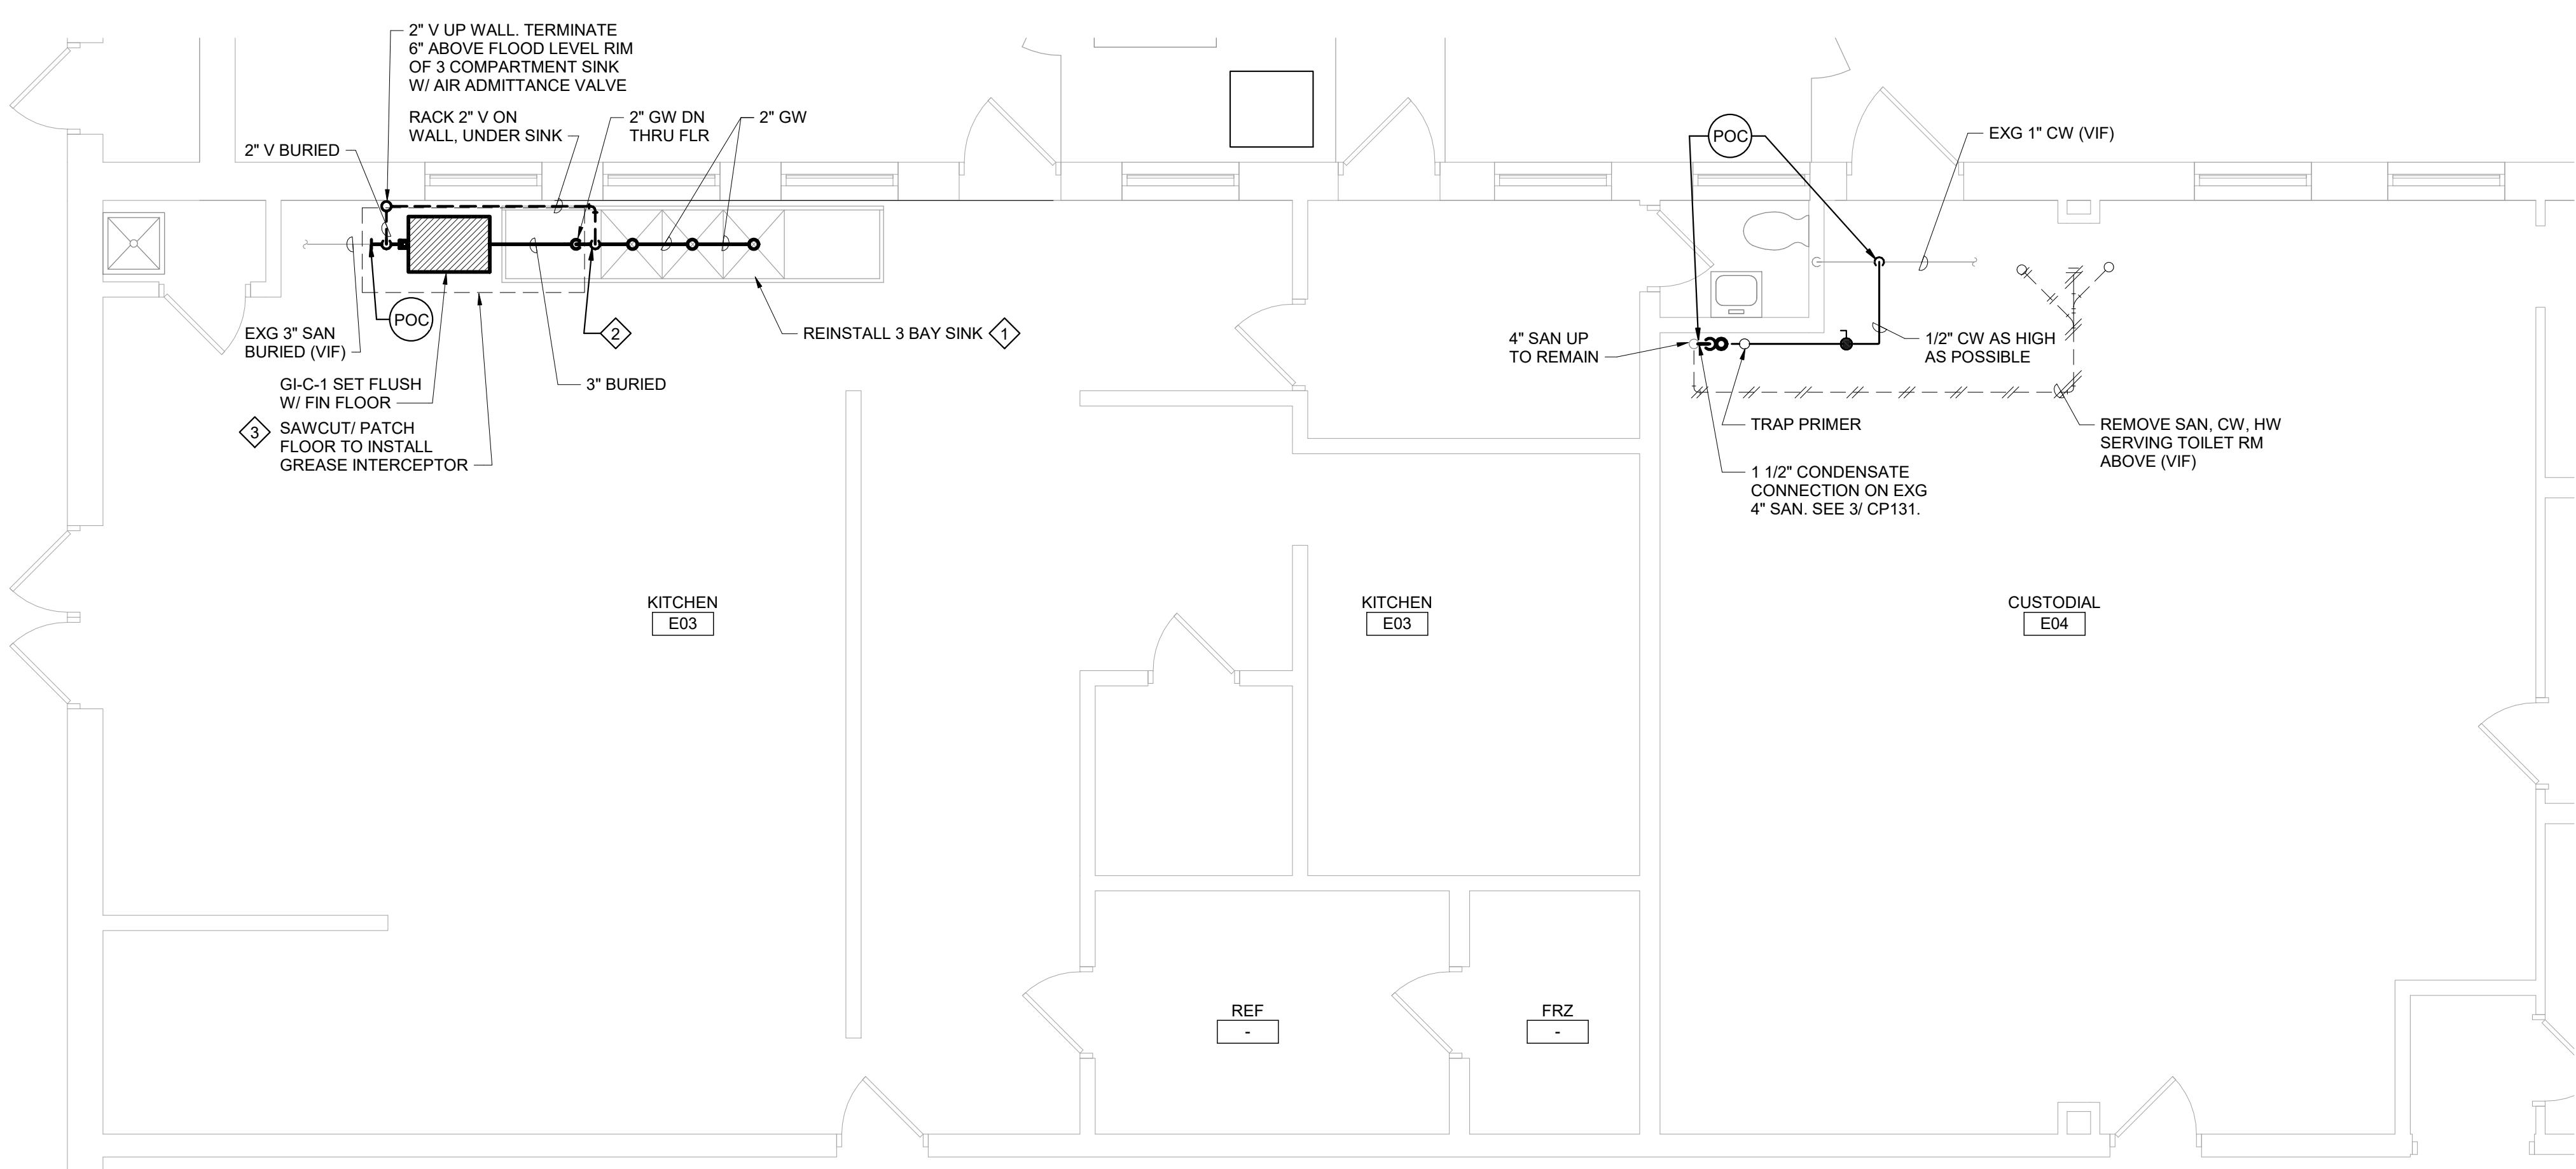


2 Kitchen E03 Plan
1/4" = 1'-0"

General Notes

- VERIFY ALL PIPING LOCATIONS, SIZES, AND ARRANGEMENTS IN FIELD PRIOR TO BID. NOTIFY ARCHITECT IN WRITING OF ANY DISCREPANCIES.
- VERIFY IN FIELD INVERT AND DIRECTION OF FLOW IN EXISTING SOIL PIPE WHERE NEW SOIL PIPE IS TO BE CONNECTED TO EXISTING SOIL PIPE.
- LEGALLY DISPOSE OF ALL DEMOLITION DEBRIS.
- INCLUDE TRENCHING, CUTTING AND PATCHING OF FLOORS, WALLS AND CEILINGS, INCLUDING CEILING TILE REMOVAL AND REPLACEMENT, WHEN REQUIRED FOR PLUMBING WORK. PATCH ABANDONED OPENINGS AND DISTURBED FINISHES TO MATCH EXISTING. TAKE PRECAUTIONS TO PROTECT STRUCTURAL INTEGRITY OF FLOOR OR WALLS WHEN TRENCHING OR CUTTING.
- MATERIALS FOR PLUMBING INSTALLATION SHALL BE NEW, UNLESS SPECIFICALLY NOTED OTHERWISE.
- REPLACE PLUMBING EQUIPMENT INDICATED. MODIFY AND EXTEND EXISTING PIPING AS REQUIRED TO MEET FIXTURE MFR'S ROUGH-IN RECOMMENDATIONS AND TO MAKE CONNECTIONS. CONCEAL PIPING WITHIN OR BEHIND WALLS, BELOW FLOORS OR ABOVE CEILINGS. PATCH DISTURBED FINISHES TO MATCH EXISTING UNLESS SPECIFICALLY NOTED OTHERWISE.

Plumbing Notes


- REMOVE 3 BAY SINK AND STORE FOR REINSTALLATION AFTER GREASE INTERCEPTOR IS REPLACED. CLEAN TABLE BEFORE REINSTALLATION.
- FLOW CONTROL FITTING SUPPLIED BY GREASE INTERCEPTOR MANUFACTURER.
- REFER TO DETAILS 4/CP130 AND 5/CP130 FOR ADDITIONAL INFORMATION.

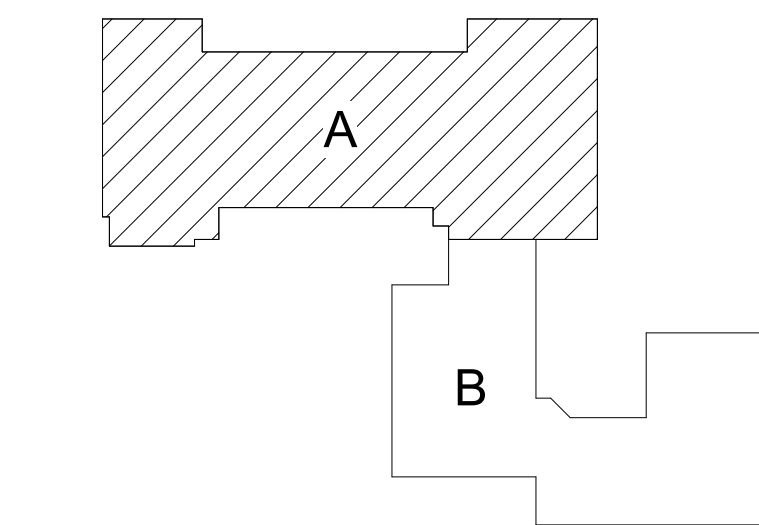

Key Plan
N.T.S.

S.E.D. Control No. 13-02-00-01-0-008-020

Rev. No.	Date	Description

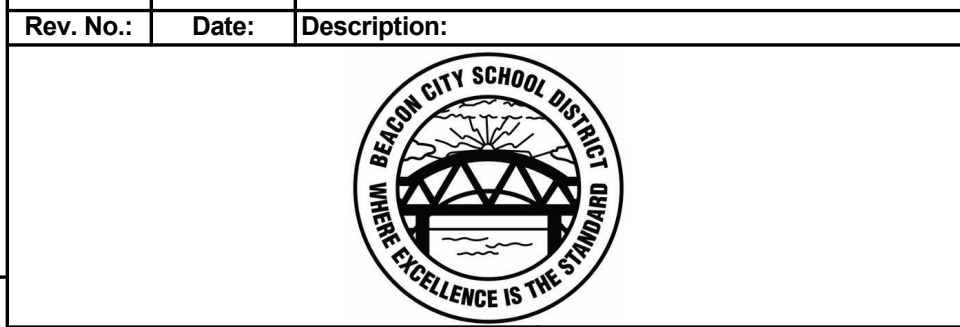

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ARCHITECTS & ENGINEERS




Beacon City School District
Beacon, New York



Reconstruction to:
Sargent Elementary School


Basement Floor Plan - Area A, Details
and Schedule

Drawn By: GPD / sef	Date: 10/28/2022	Drawing Number: CP130
Project No.: 279180-22004		

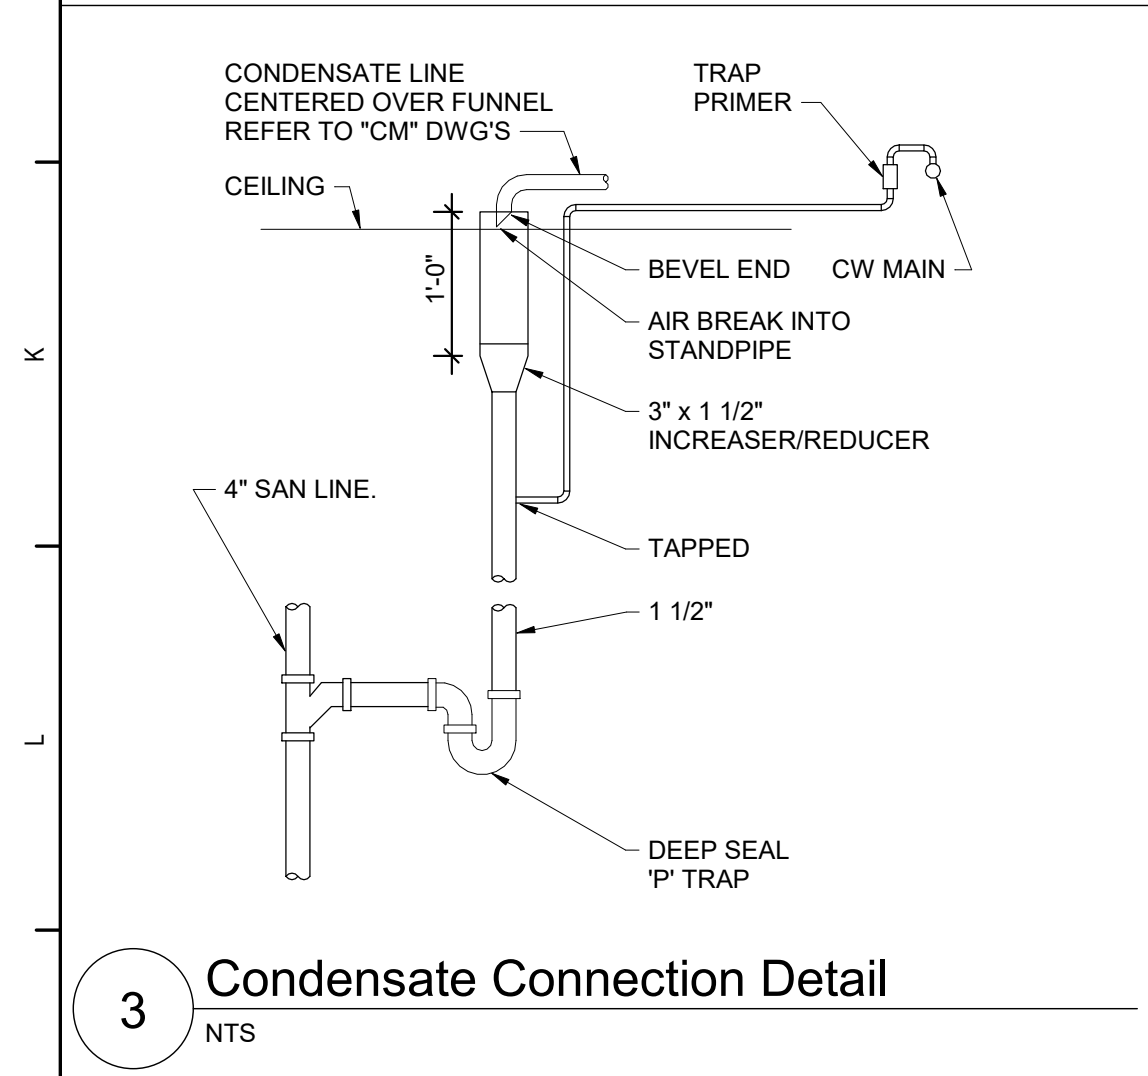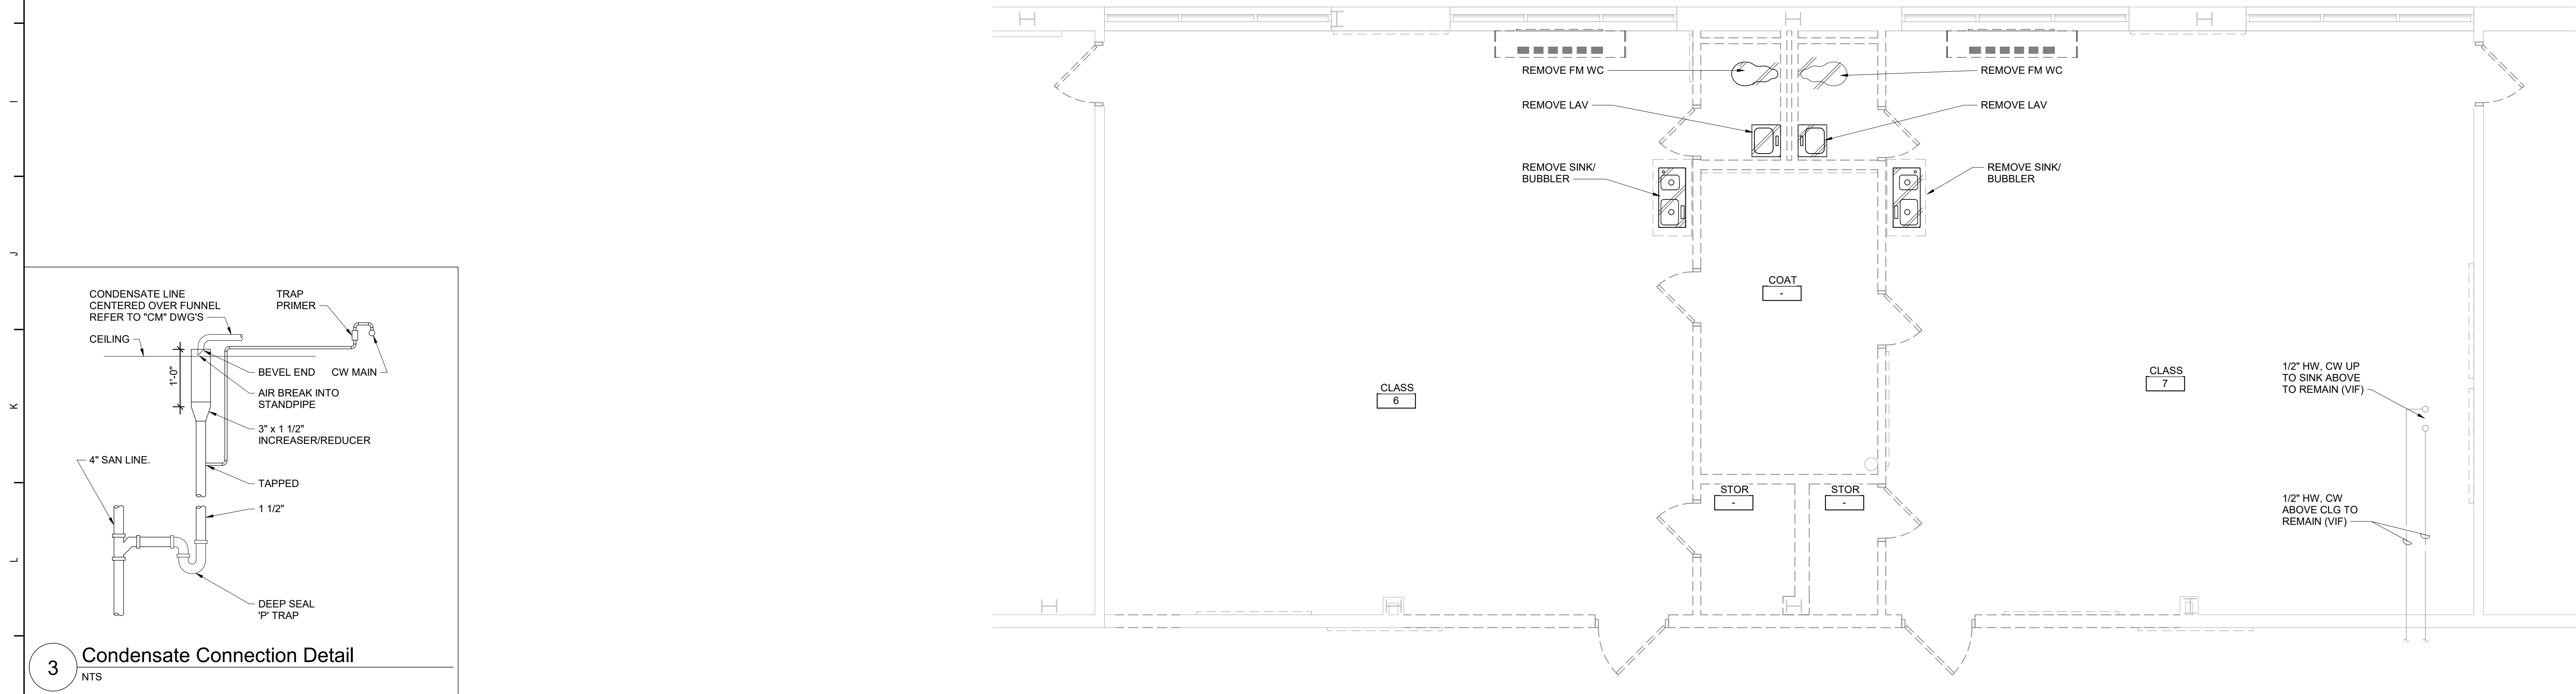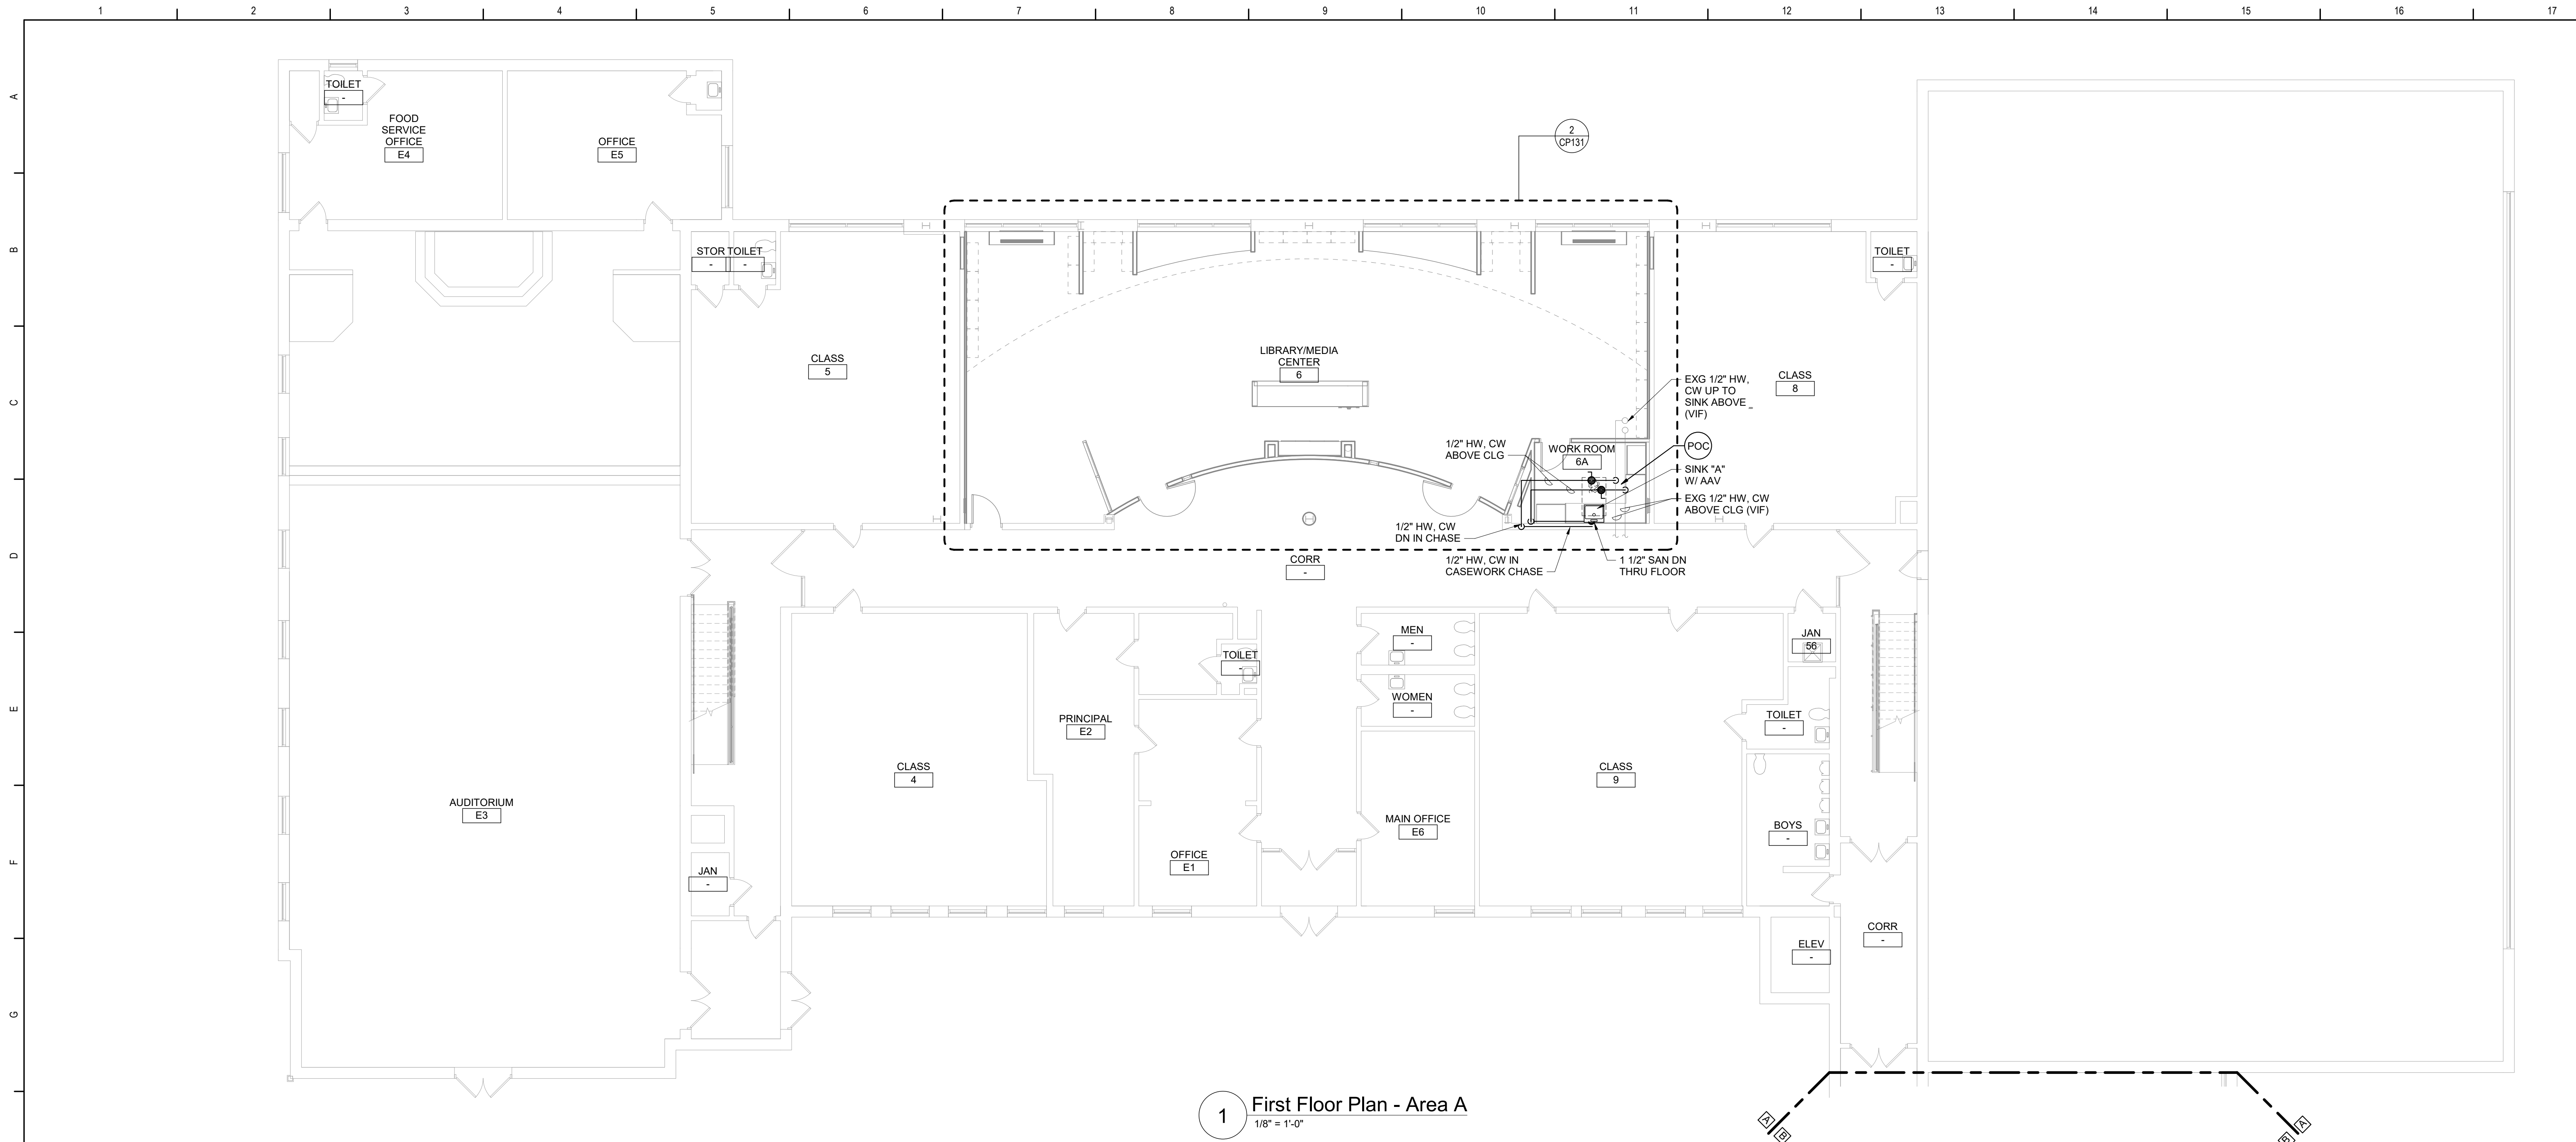


Plumbing Fixture Schedule									
DWG LABEL	ROUGH-IN CONNECTION SIZE (INCHES)				BARRIER FREE	AGE GROUP	RIM HEIGHT	DESCRIPTION	NOTES
	SAN	VENT	CW	HW					
SINK "A"	1 1/2	1 1/2	1/2	1/2	YES	ADULT	-	ACCESSIBLE, STAINLESS STEEL, COUNTER MOUNTED SINK W/ MANUAL, SINGLE CONTROL MIXING FAUCET W/ SWING SPOUT, SUPPLIES, OFFSET DRAIN FITTING AND TRAP.	1, 2, 3
NOTES: 1. SIZES INDICATED ARE MINIMUM. LARGER SIZES SPECIFICALLY INDICATED ON DRAWINGS SUPERCEDE MINIMUM SIZES INDICATED IN THIS SCHEDULE. 2. TERMINATION STYLE AND SIZE FOR FIXTURE CONNECTIONS SHALL BE AS INDICATED BY FIXTURE MANUFACTURER. 3. DRAIN AND TRAP CONCEALED BEHIND ADA CASEWORK PANEL. REFER TO DETAILS ON "A" SERIES DRAWINGS.									

- Plan Notes**
- A. REFER TO DRAWING NO. CP130 FOR GENERAL NOTES.
- B. REMOVE PLUMBING FIXTURES INDICATED, INCLUDING ASSOCIATED PIPING, FASTENERS, SUPPORTS, ETC., BACK TO POINTS OF CONCEALMENT WITHIN OR BEHIND REMAINING WALLS, BELOW FLOORS OR ABOVE CEILINGS.
- C. REMOVE ABANDONED ACCESSIBLE PIPING TO MAIN BRANCHES, STACKS OR RISERS AS REQUIRED TO ELIMINATE EXPOSED PIPING AND DEAD END PIPING RUNS LONGER THAN 1'-0". COORDINATE CONCEALMENT OF PIPING WITH FINAL CONSTRUCTION OF WALLS, FLOORS AND CEILINGS.

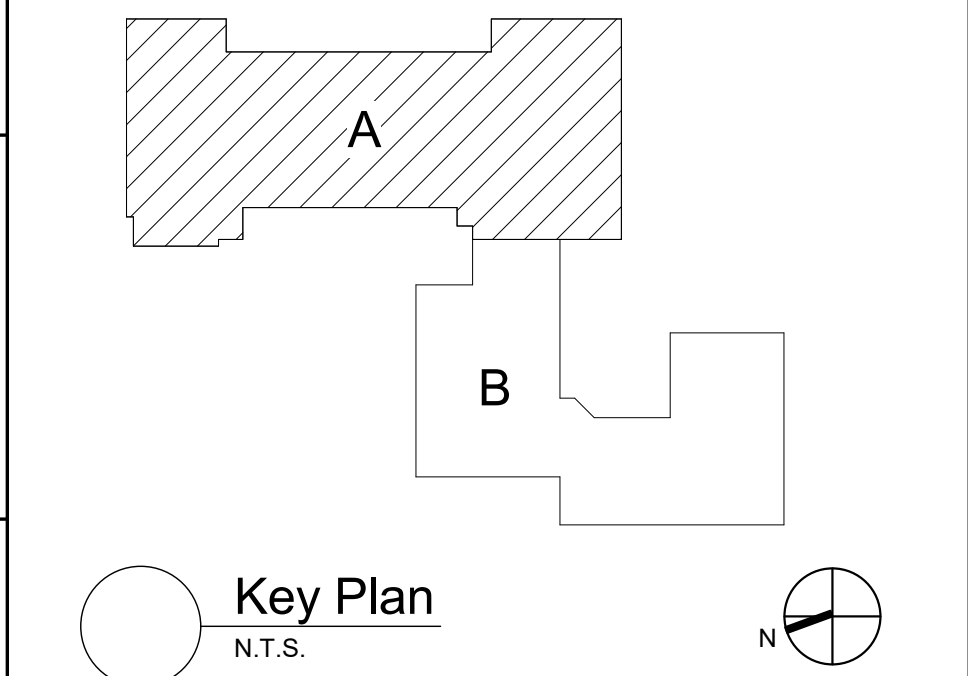

S.E.D. Control No. 13-02-00-01-0-008-020

Rev. No.	Date	Description

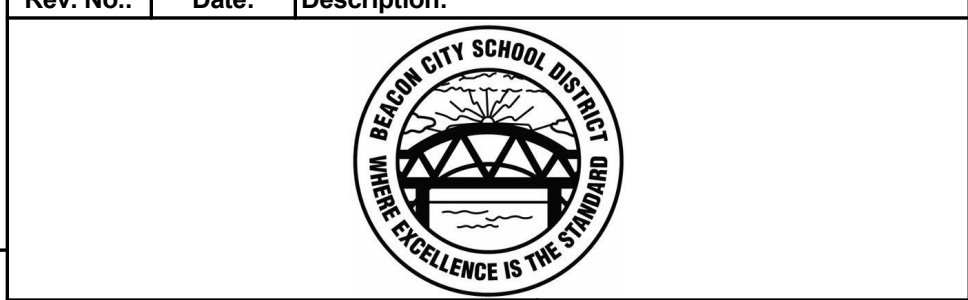

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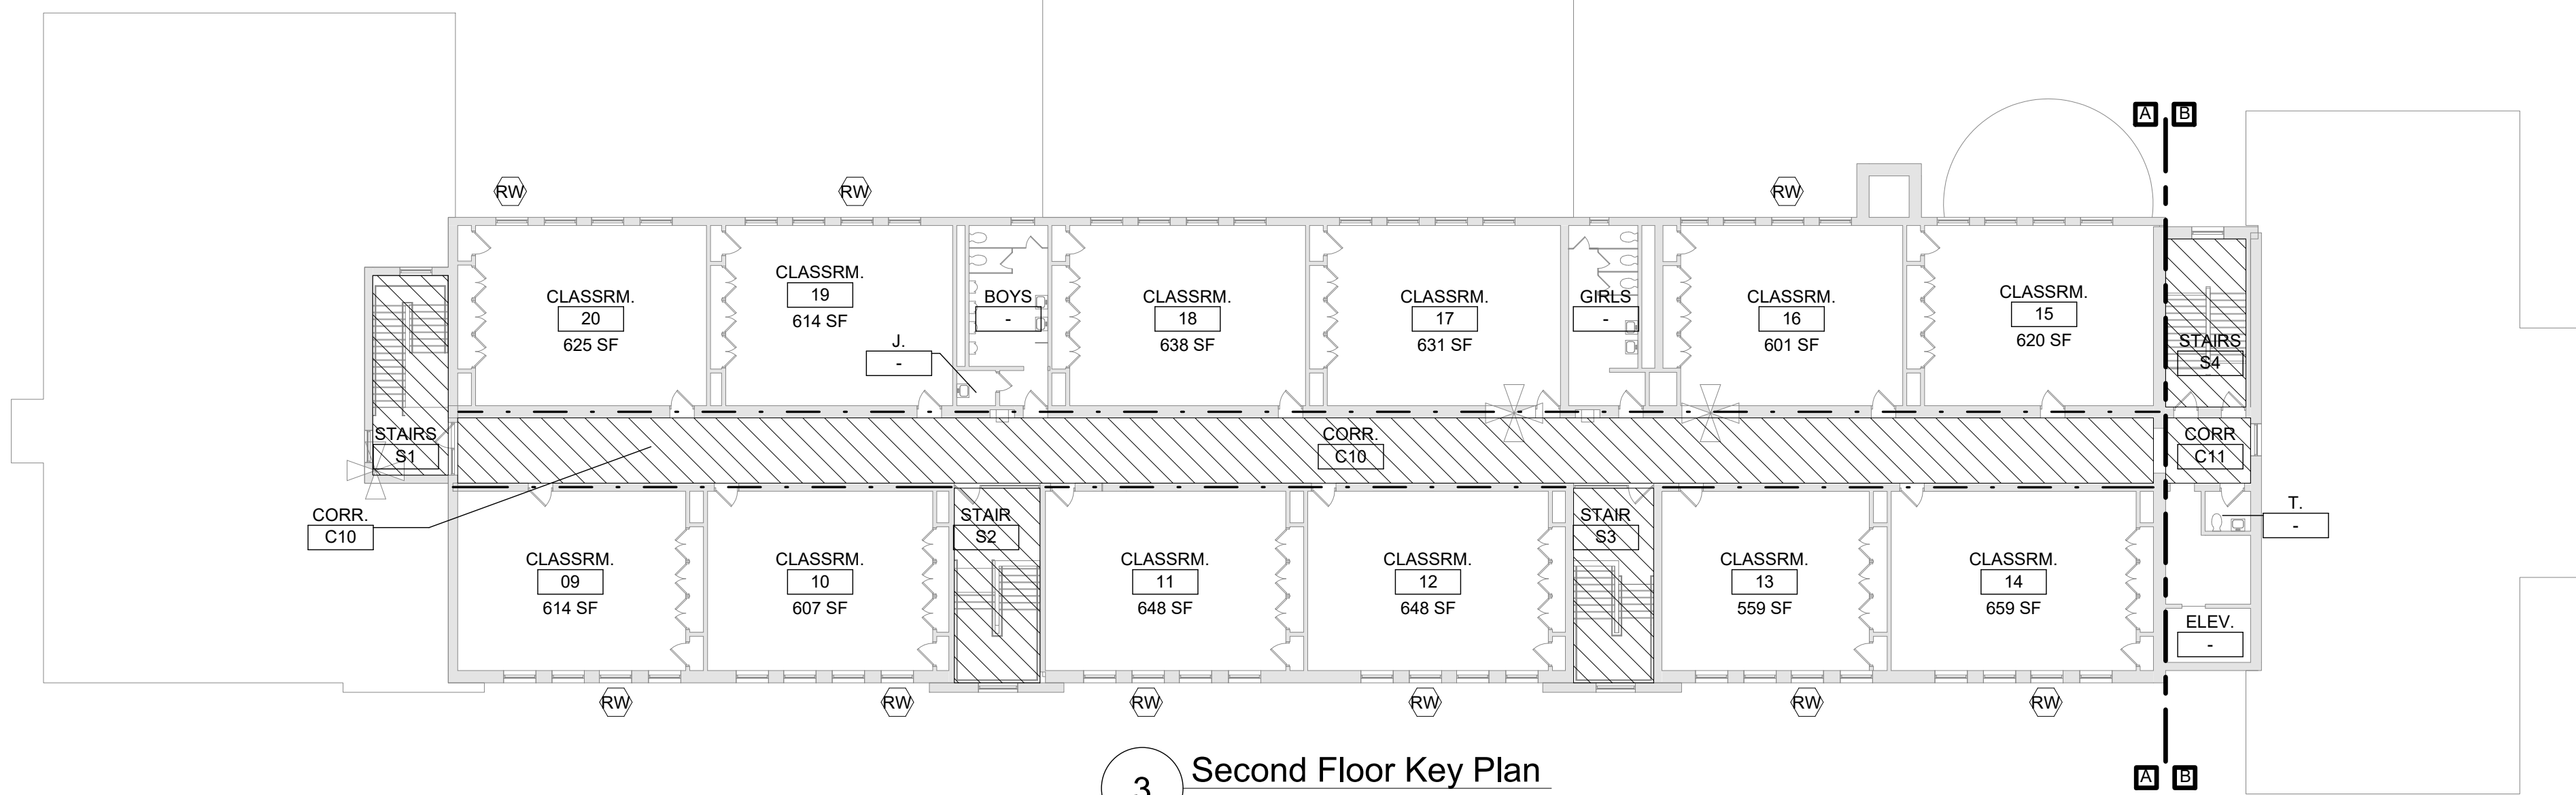


Beacon City School District
Beacon, New York


Reconstruction to:
Sargent Elementary School

First Floor Plan - Area A and Schedule


Drawn By: GPD / sef	Date: 10/28/2022	Drawing Number:
Project No.: 279180-22004	CP131	



3 Second Floor Key Plan
1/16" = 1'-0"

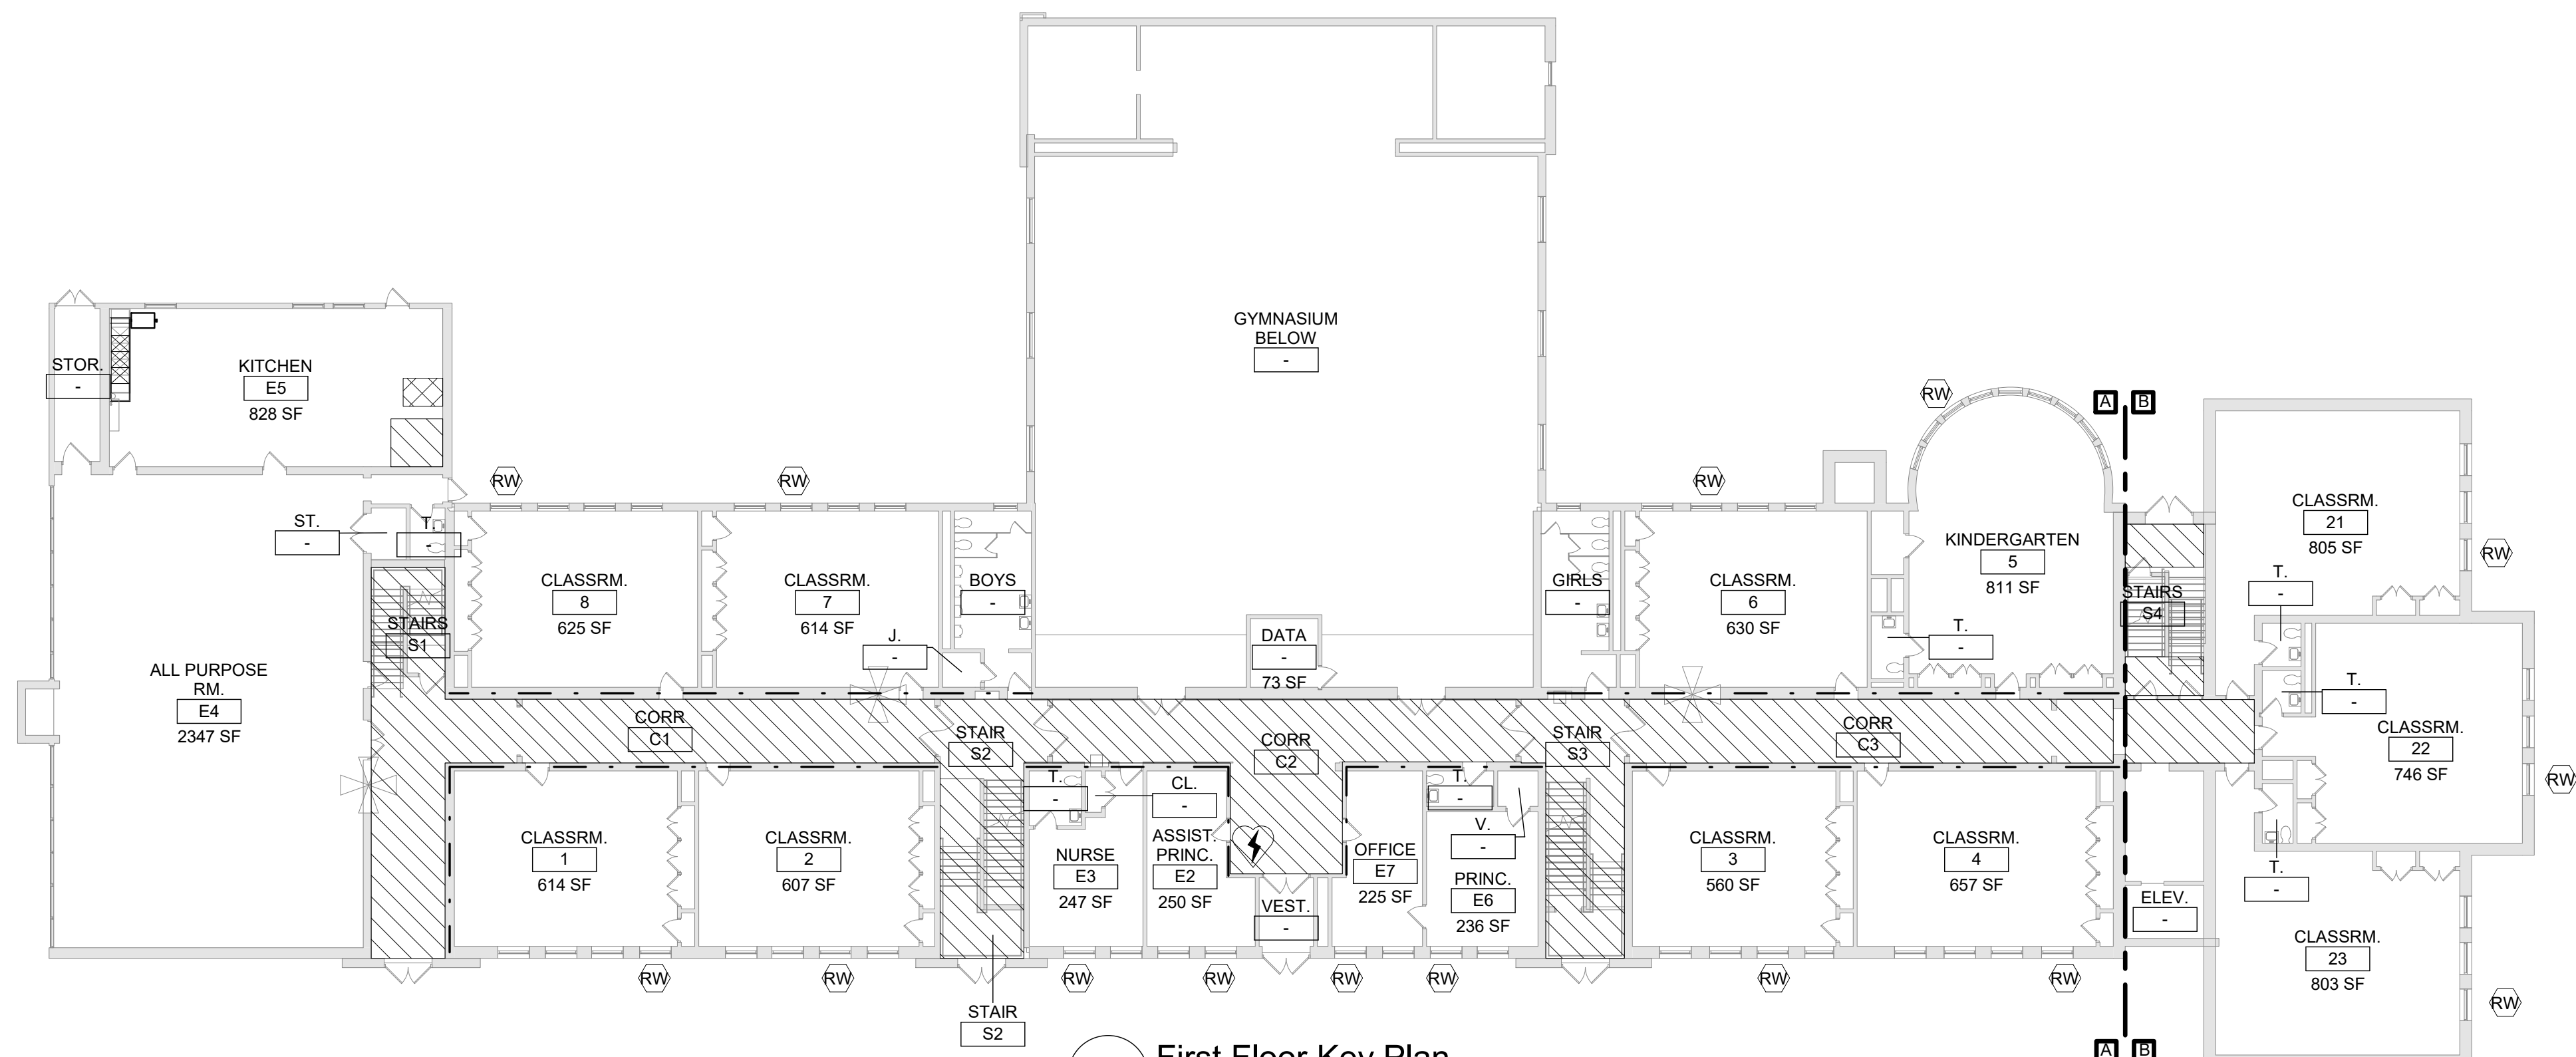

2 First Floor Key Plan
1/16" = 1'-0"

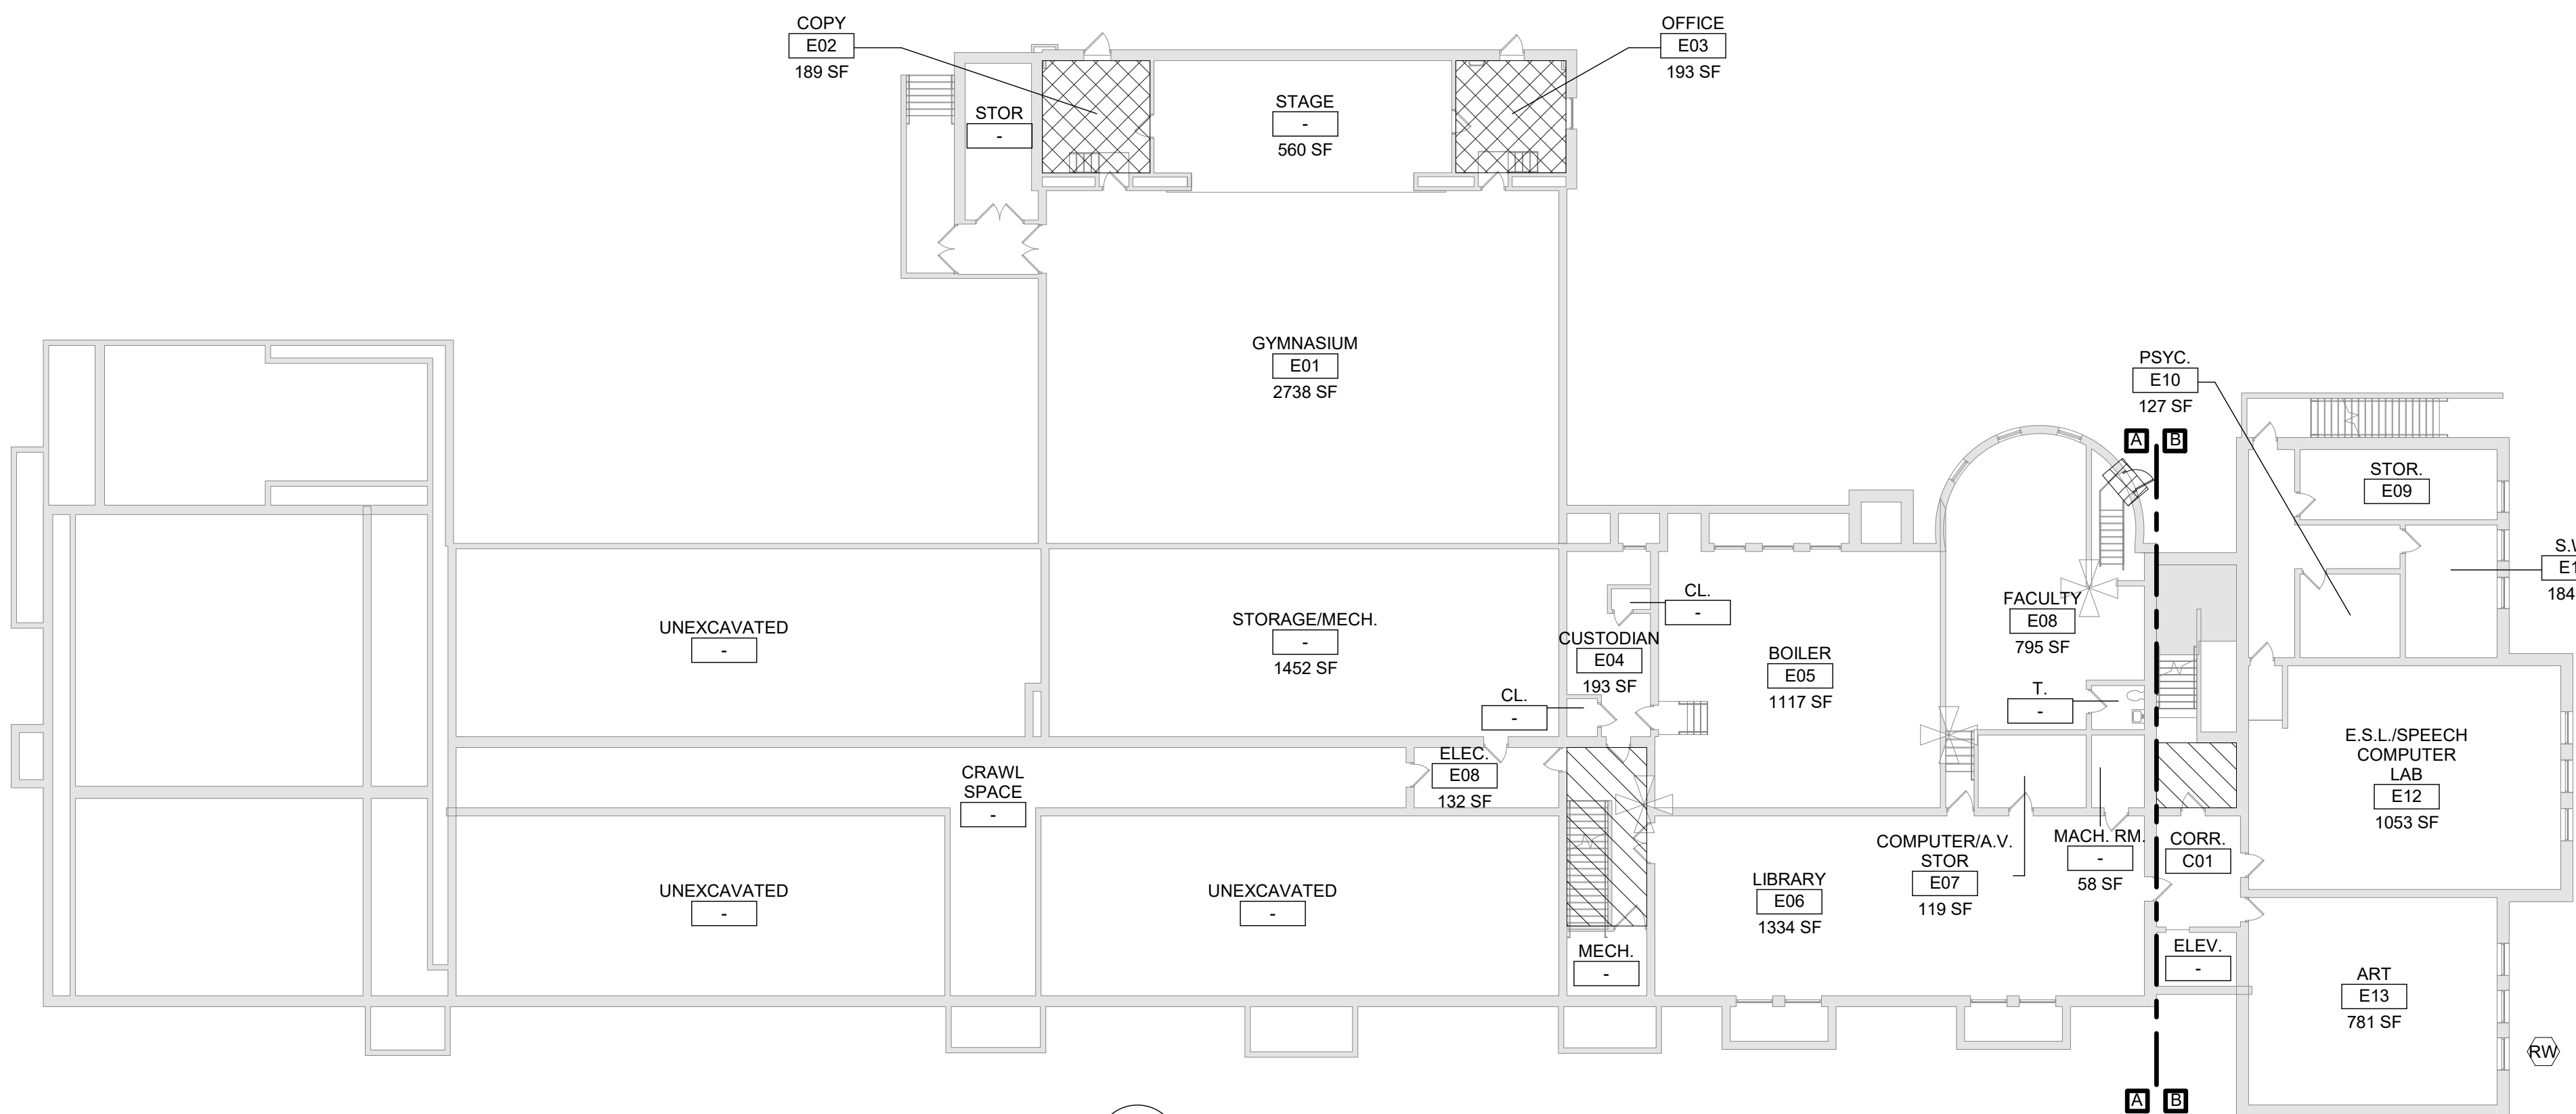

1 Ground Floor Key Plan
1/16" = 1'-0"

General Notes

- A. DO NOT SCALE DRAWINGS TO OBTAIN DIMENSIONS.
- B. TAKE FIELD MEASUREMENTS TO FIT THE WORK PROPERLY. VERIFY ALL EXISTING CONDITIONS AND DIMENSIONS IN THE FIELD.
- C. REFER INCONSISTENCIES TO ARCHITECT PRIOR TO COMMENCING THE WORK IN AFFECTED AREA.
- D. ITEMS ARE SHOWN DIAGRAMMATICALLY ON DRAWINGS. VERIFY SPACE REQUIREMENTS AND DIMENSIONS TO FIT THE WORK PROPERLY.
- E. NOTES SHOWN ON ONE DRAWING APPLY TO ALL SIMILAR DRAWINGS.
- F. DO NOT DISTURB CONSTRUCTION SUSPECTED OF CONTAINING HAZARDOUS MATERIAL IF ENCOUNTERED, IMMEDIATELY NOTIFY ARCHITECT, CONSTRUCTION MANAGER AND OWNER.


General Code Notes

- A. REFER TO CODE COMPLIANCE DRAWINGS FOR ADDITIONAL CODE COMPLIANCE INFORMATION.
- B. COORDINATE WITH FLOOR PLANS, WALL SECTIONS AND PARTITION TYPES FOR RATED WALL TYPES AND LOCATIONS. IMMEDIATELY NOTIFY ARCHITECT OF ANY WALL RATING DISCREPANCIES BETWEEN CODE DRAWINGS AND FLOOR PLANS.
- C. ALL WALLS, INCLUDING AT CORRIDORS, SHALL EXTEND COMPLETELY TO THE UNDERSIDE OF DECKING, SUPPORTING STRUCTURE OR ROOF ABOVE, TYPICAL UNLESS NOTED OTHERWISE.
- D. AT AREAS OF PROJECT WORK, COMPLETELY SEAL ALL PENETRATIONS REQUIRED TO COMPLY WITH FIRE RESISTANCE RATINGS IDENTIFIED ON THE CODE DRAWINGS, REGARDLESS IF WALL IS NEW OR EXISTING, TYPICAL UNLESS NOTED OTHERWISE.
- E. PROVIDE APPLIED FIREPROOFING TO ALL BEAMS, JOISTS AND STRUCTURAL STEEL ELEMENTS AT ALL FIRE BARRIERS, FIRE PARTITIONS, AND OTHER RATED WALLS WHERE INDICATED ON DRAWINGS, AND THAT ARE NOT COMPLETELY PROTECTED WITHIN THE RATED CONSTRUCTION. PROTECTION OF SUCH ELEMENTS SHALL MATCH THE RATING OF THE WALL THAT THE ELEMENTS ARE CONTAINED WITHIN.
- F. ALL CMU CONSTRUCTION SHALL MEET FIRE RESISTANCE REQUIREMENTS INDICATED. PROVIDED BLOCK TYPE AS REQUIRED TO COMPLY WITH UL DESIGN NUMBERS AND WALL RATINGS INDICATED, REGARDLESS IF NOTED AS SUCH ON PLAN DETAILS.

Legend


ALL WALLS, INCLUDING CORRIDOR WALLS, EXTEND TO THE ROOF DECK OR FLOOR DECK ABOVE UNLESS NOTED OTHERWISE.

- 2-HOUR FIRE BARRIER
- 1-HOUR FIRE BARRIER
- 1-HOUR FIRE PARTITION
- SMOKE PARTITION
- COMMON EGRESS PATH
- EXISTING FIRE EXTINGUISHER LOCATION
- AREA OF REFUGE
- AUTOMATED EXTERNAL DEFIBRILLATOR (AED)
- RESCUE WINDOW
- ALTERATION LEVEL 1 WORK AREA
- ALTERATION LEVEL 2 WORK AREA

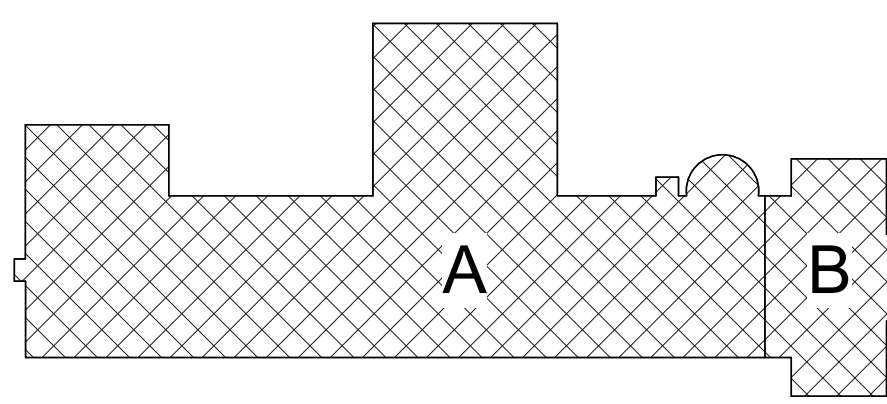

Key Plan
N.T.S.

S.E.D. Control No. 13-02-00-01-0-003-016

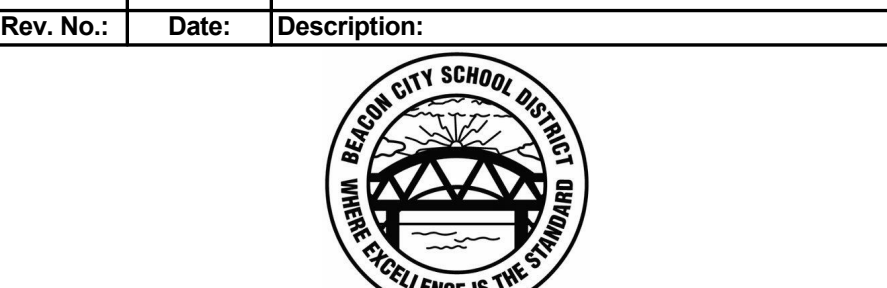

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Tetra Tech Engineers, Architects & Landscape Architects, P.C.




Beacon City School District
Beacon, New York

Reconstruction to:
South Ave Elementary School

Code Compliance Ground, First, and
Second Floor Key Plans

Drawn By: TLG Date: 10/28/2022 Drawing Number:
Project No.: 279180-22004 DG351

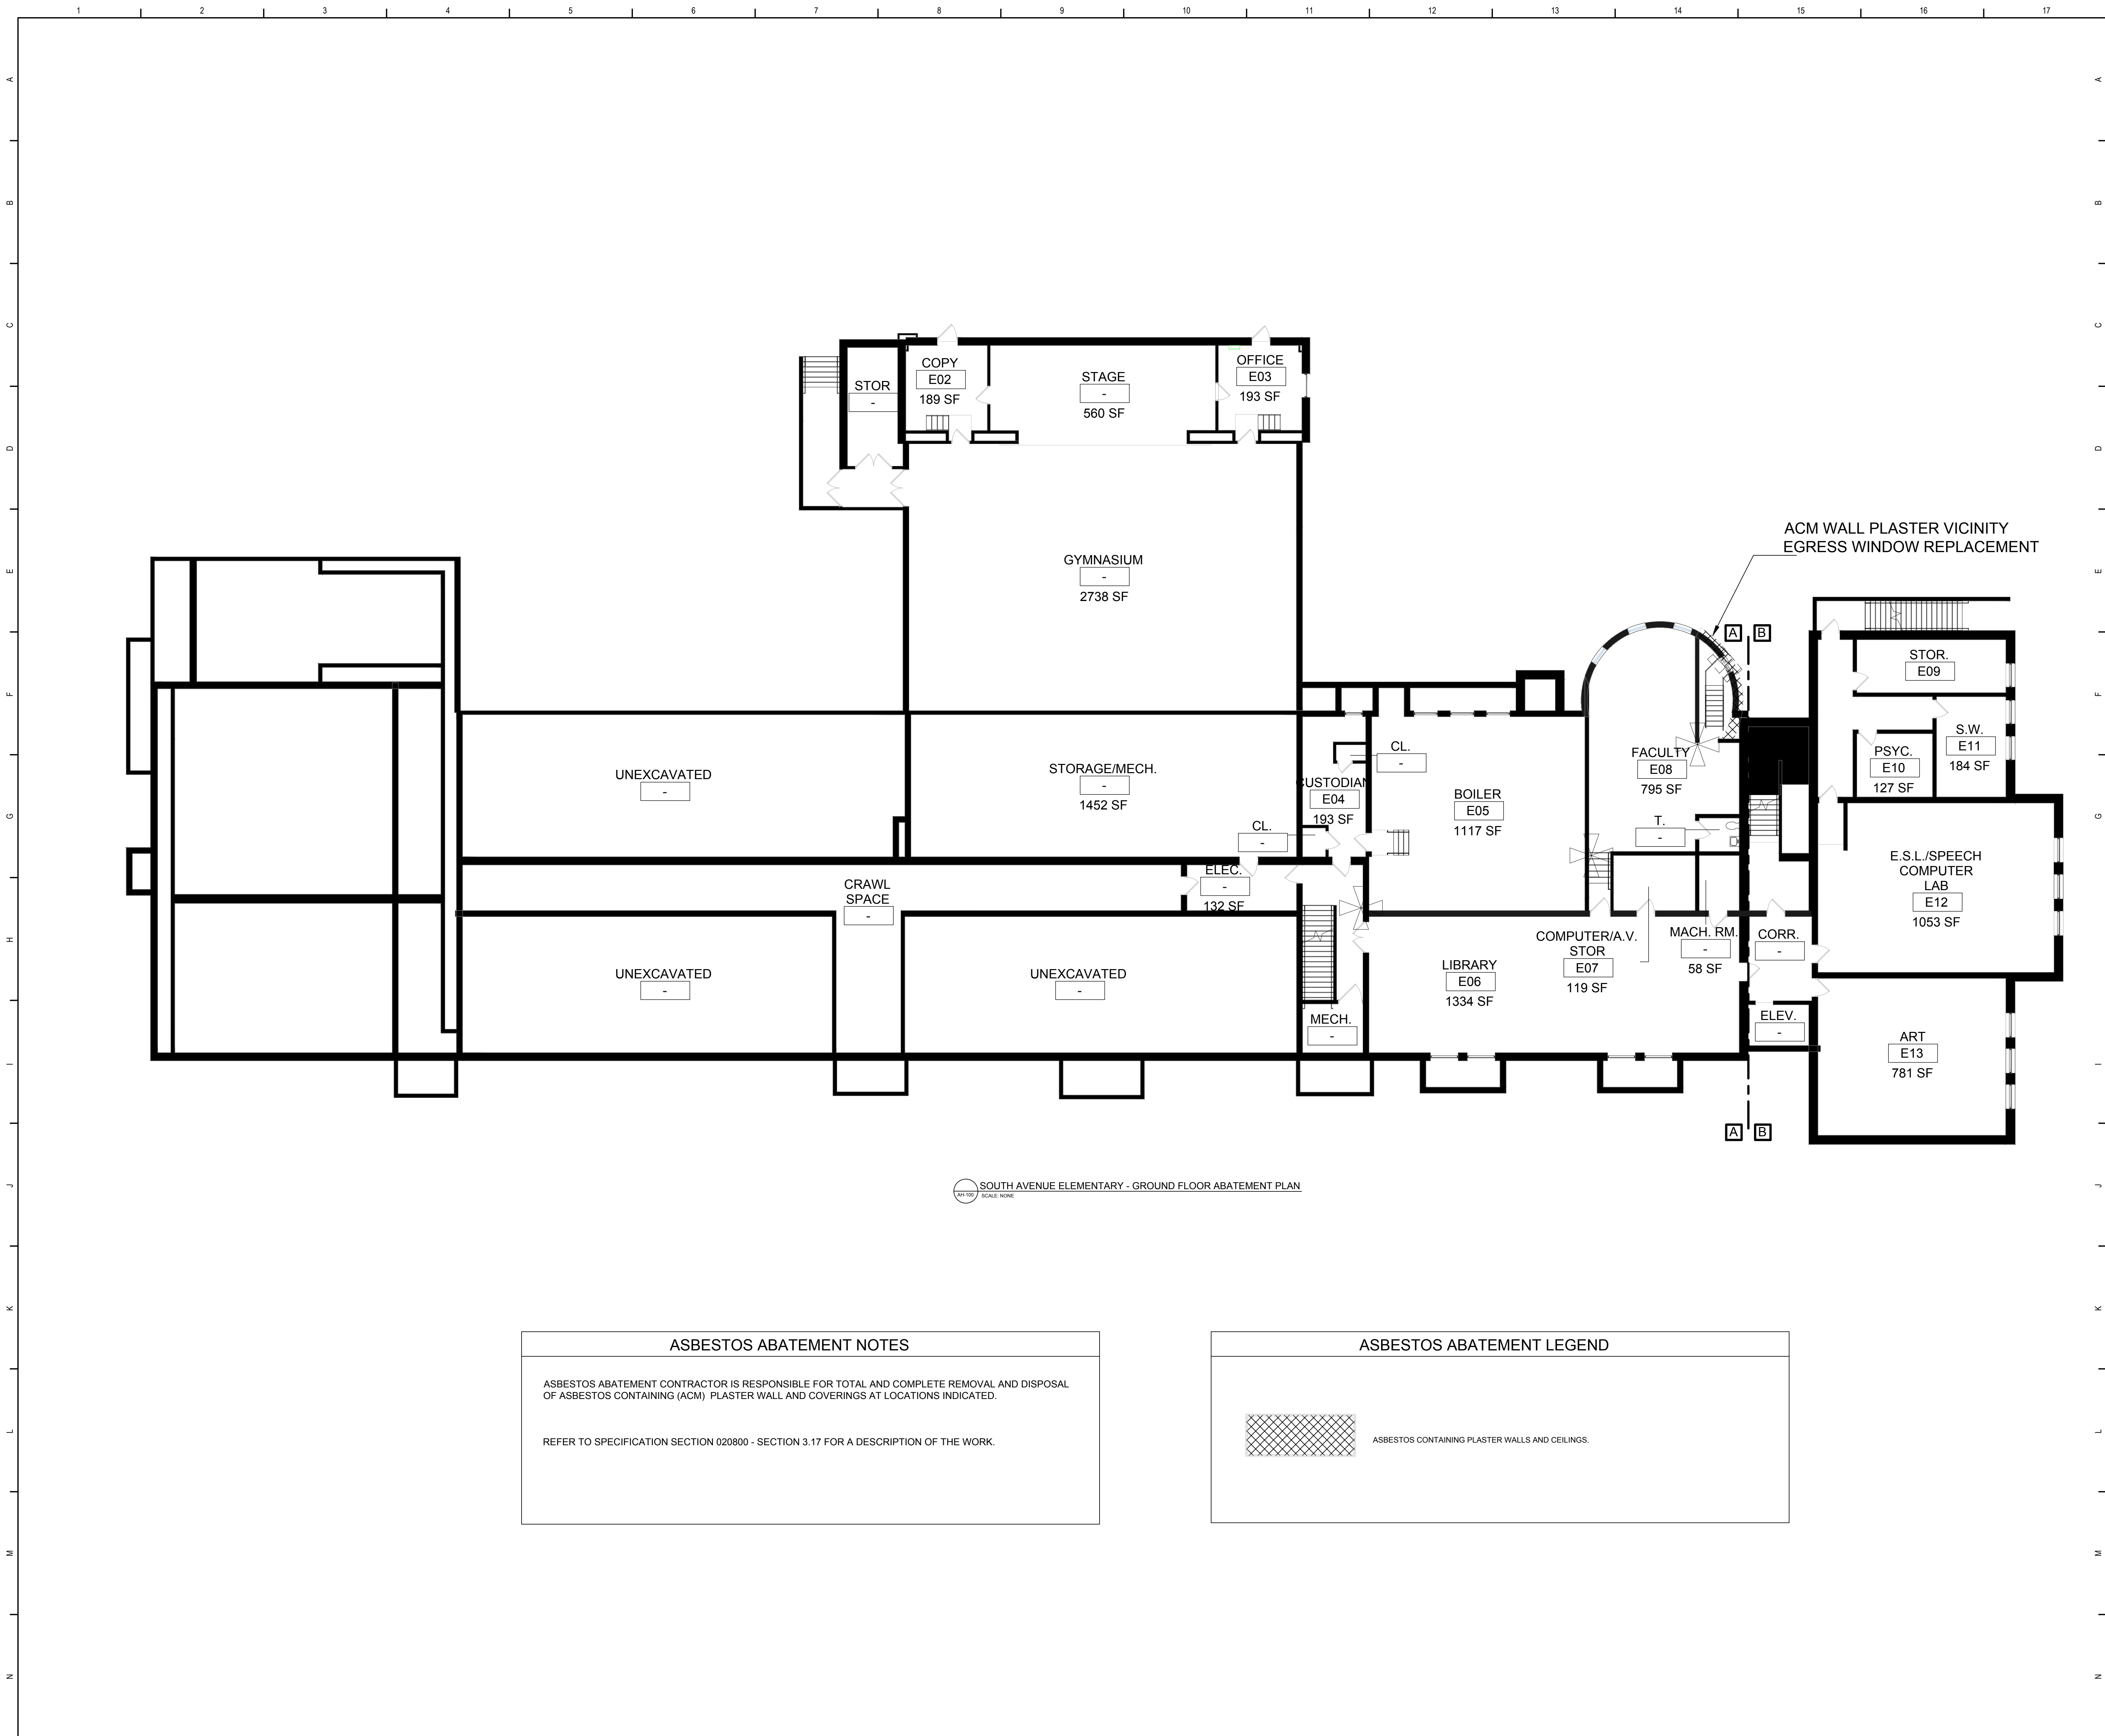


ASBESTOS ABATEMENT NOTES

ASBESTOS ABATEMENT CONTRACTOR IS RESPONSIBLE FOR TOTAL AND COMPLETE REMOVAL AND DISPOSAL OF ASBESTOS CONTAINING (ACM) PLASTER WALL AND COVERINGS AT LOCATIONS INDICATED.


REFER TO SPECIFICATION SECTION 020800 - SECTION 3.17 FOR A DESCRIPTION OF THE WORK.

ASBESTOS ABATEMENT LEGEND

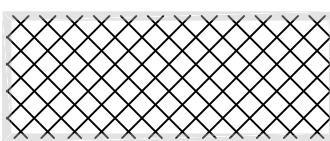 ASBESTOS CONTAINING PLASTER WALLS AND CEILINGS.

QUALITY ENVIRONMENTAL SOLUTIONS & TECHNOLOGIES, INC.


1376 NYS ROUTE 9
WAPPINGERS FALLS, NY 12590
TEL. : (845) 298-6031




Key Plan
N.T.S.

S.E.D. Control No. 13-02-00-01-0-003-016

Rev. No.:	Date:	Description:
1	9-13-22	100% SED Submittal






Beacon City School District
Beacon, New York

Reconstruction to:
South Avenue Elementary School

Asbestos Abatement

Drawn By: AM/GD	Date: 10/28/2022	Drawing Number:
Project No.: 279180-22004		DH100

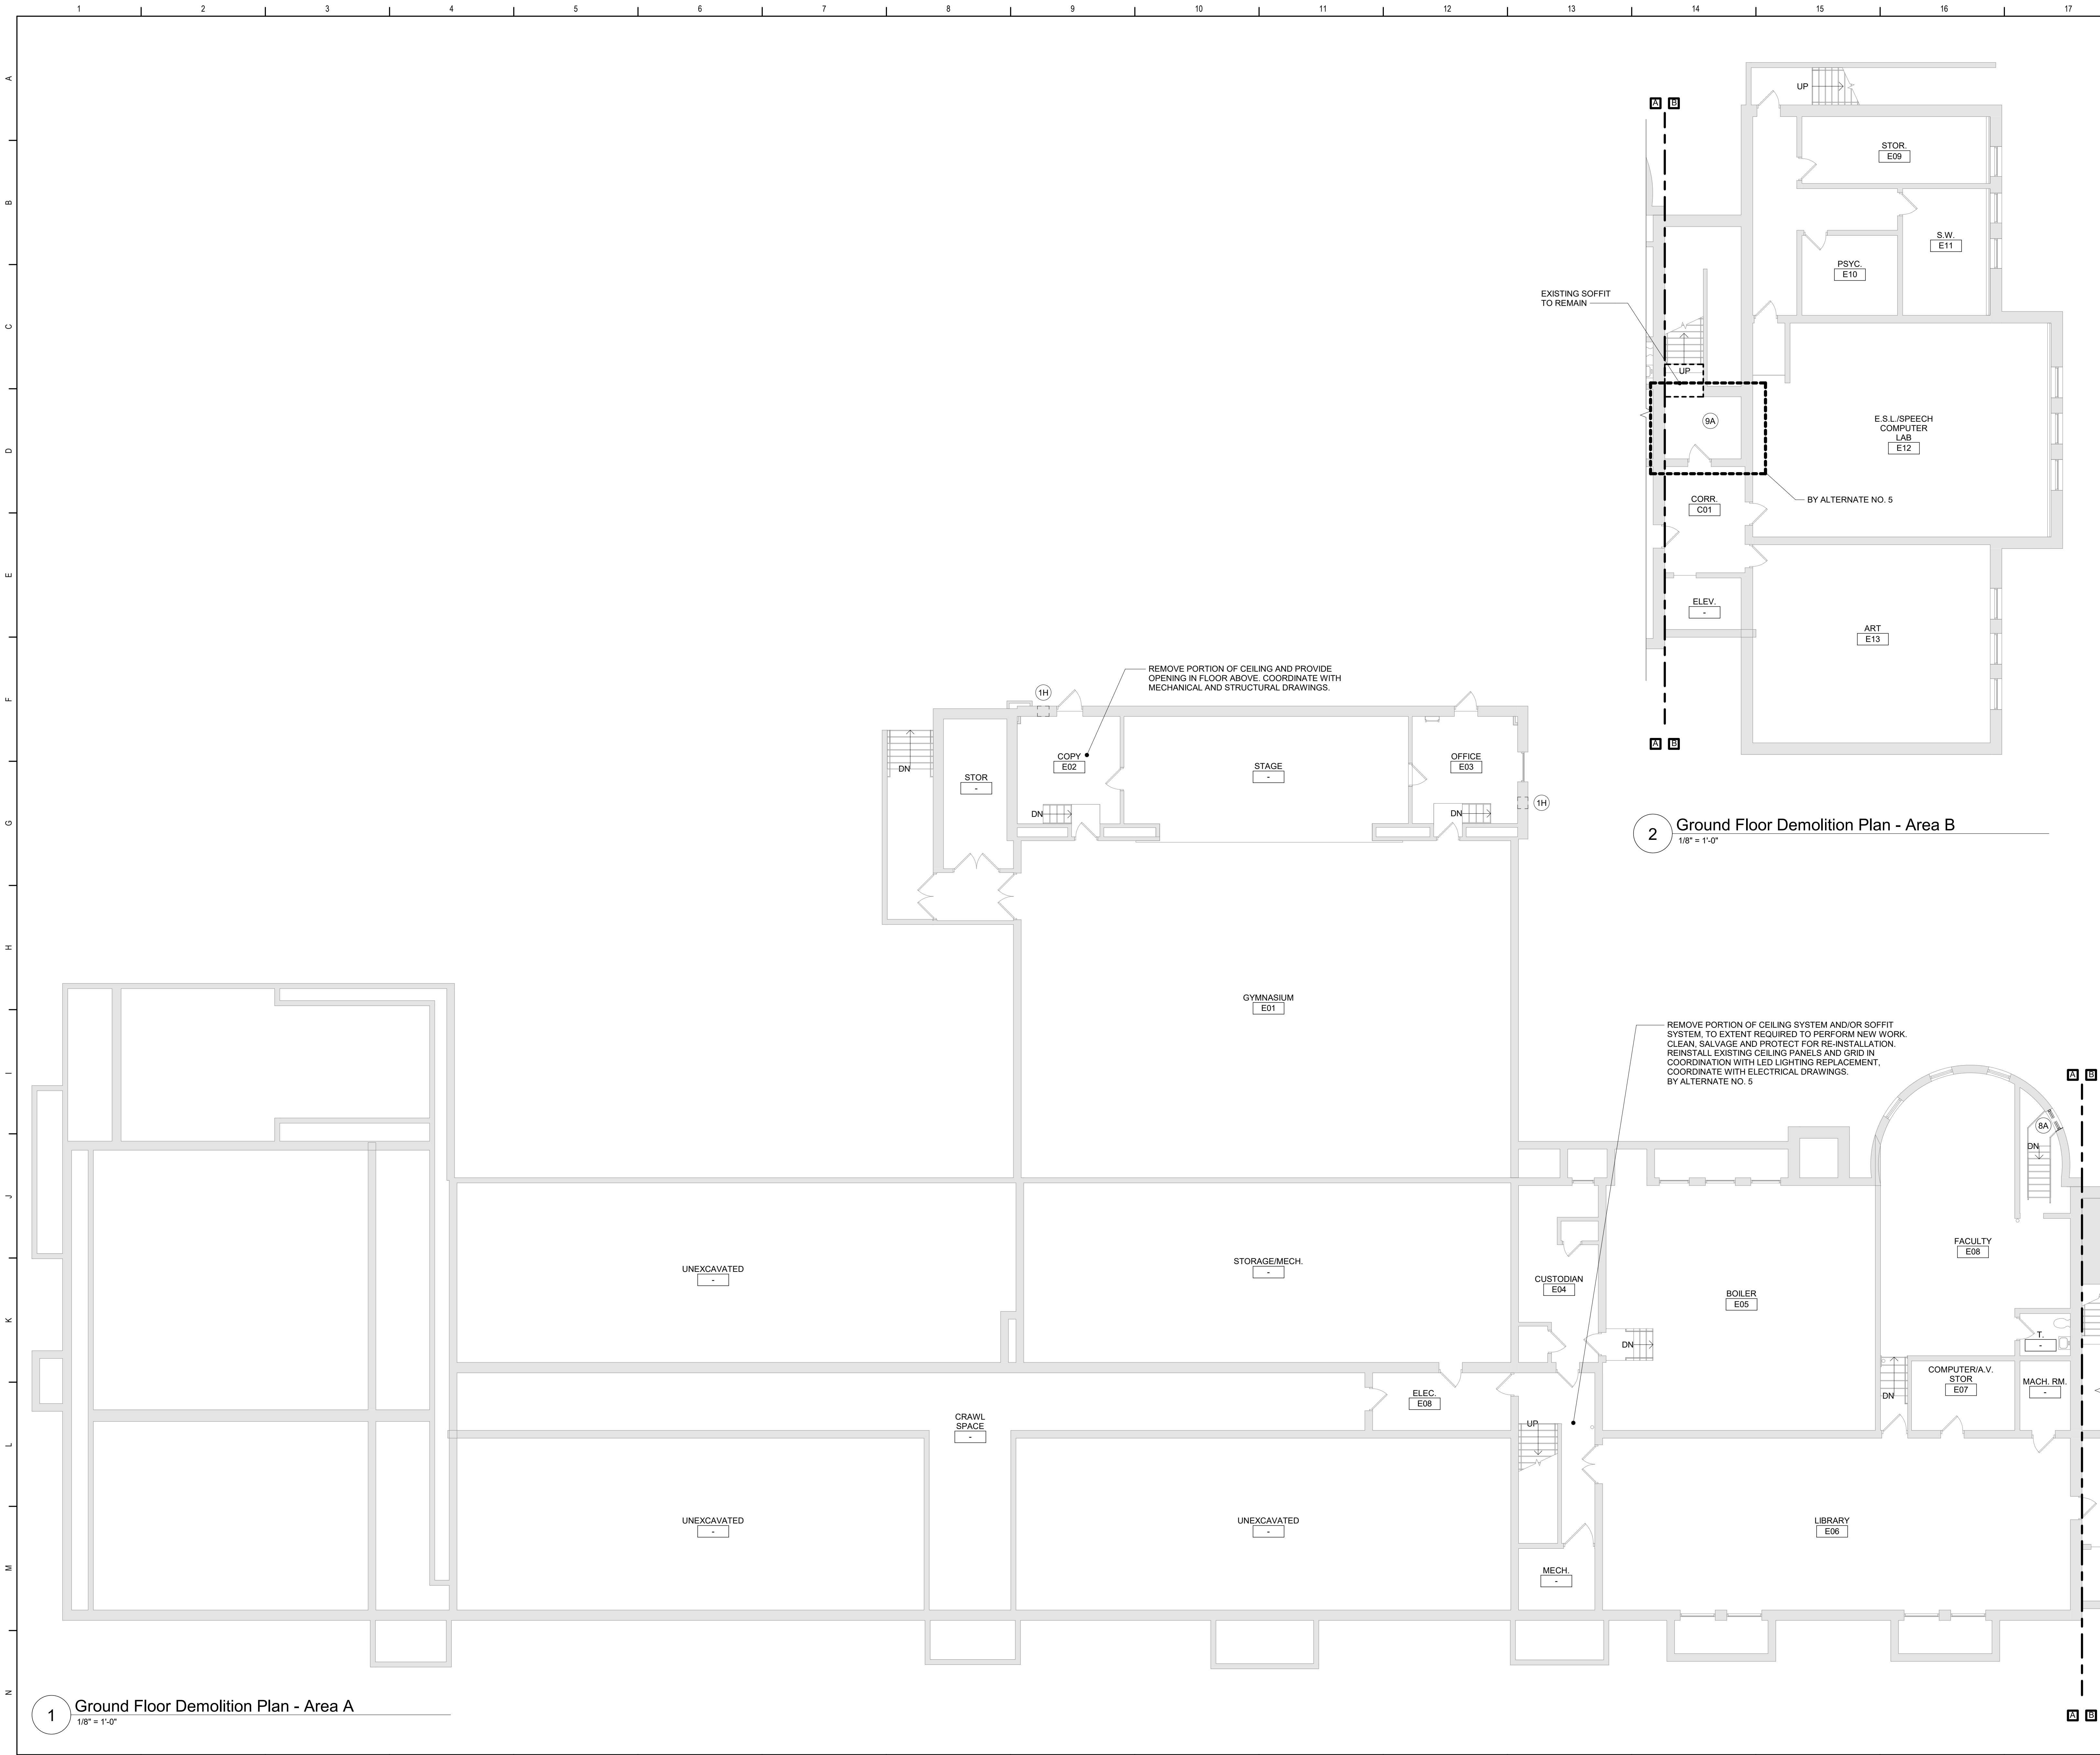

General Demolition Notes

A. - - - - REMOVE ITEMS INDICATED BY DASHED LINE.

B. KEYED DEMOLITION TAGS REFER TO SPECIFIC LOCATIONS AS FOLLOWS:

- DEMOLITION TAGS LOCATED WITHIN THE MIDDLE OF A SPACE REFER TO DEMOLITION OF ALL ITEMS OF THAT SAME TYPE WITHIN THAT ENTIRE SPACE.
- DEMOLITION TAGS PLACED IMMEDIATELY ON OR ADJACENT TO A DASHED LINE INDICATING ITEM REMOVAL OR THAT HAVE A LEADER POINTING TO SPECIFIC ITEM(S) REFER TO DEMOLITION OF THAT SPECIFIC ITEM ONLY OF THAT TYPE WITHIN THAT SPACE.
- DEMOLITION TAGS IN SERIES REFER TO DEMOLITION OF ALL THOSE ITEMS EITHER WITHIN THAT ENTIRE SPACE OR TO THE SPACE IDENTIFIED BY THAT LEADER.

C. WHEN AN ITEM IS INDICATED TO BE DEMOLISHED REMOVE ALL ASSOCIATED COMPONENTS AS PART OF THAT WORK.

D. ALL ARTWORK NOT PERMANENTLY AFFIXED TO EXISTING CONSTRUCTION SHALL BE REMOVED AND STORED BY OWNER PRIOR TO BEGINNING DEMOLITION WORK. CONTACT OWNERS AGENT(S) IF ANY ARTWORK IS ENCOUNTERED PRIOR TO START OF DEMOLITION WORK.

E. COORDINATE WITH ABATEMENT DRAWINGS PRIOR TO DEMOLITION.

Demolition Key Notes

(1H) PROVIDE NEW OR ENLARGE EXISTING OPENING IN WALL TO EXTENT REQUIRED TO PERFORM SCHEDULED WORK. PROVIDE LINTEL PER LINTEL SCHEDULE. SEE STRU DRAWINGS. PATCH EXPOSED SURFACES TO MATCH ADJACENT FINISHES / SURFACES. COORDINATE WITH SCHEDULED WORK ON MECHANICAL DRAWINGS.

(8A) REMOVE WINDOW COMPLETELY. PREPARE OPENING TO EXTENT REQUIRED TO PERFORM SCHEDULED WORK. PATCH EXPOSED SURFACES TO MATCH ADJACENT FINISHES / SURFACES. SEE ABATEMENT DRAWINGS.

(9A) REMOVE CEILING SYSTEM AND/OR SOFFIT SYSTEM IN ITS ENTIRETY.

(9B) REMOVE FLOOR FINISH, MASTIC AND WALL BASE TO EXTENT REQUIRED TO PERFORM SCHEDULED WORK. AT ALL AREAS OF FLOOR REMOVAL, LEVEL SLAB WITH ADJACENT SLABS AT LOCATIONS SCHEDULED TO RECEIVE FLOOR FINISH. INCLUDE CONCRETE FLOOR PATCHING AND LEVELING MATERIALS TO MAKE SURFACE LEVEL. PREPARE FOR FINISH. PATCH AREAS OF WALLS TO REMAIN THAT WERE DAMAGED BY REMOVAL OF WALL BASE.

SUFFIX KEY (FLOOR FINISH IDENTIFICATIONS):


A. CERAMIC FLOOR TILE.

Key Plan

N.T.S.

S.E.D. Control No. 13-02-00-01-0-003-016

Rev. No.	Date	Description



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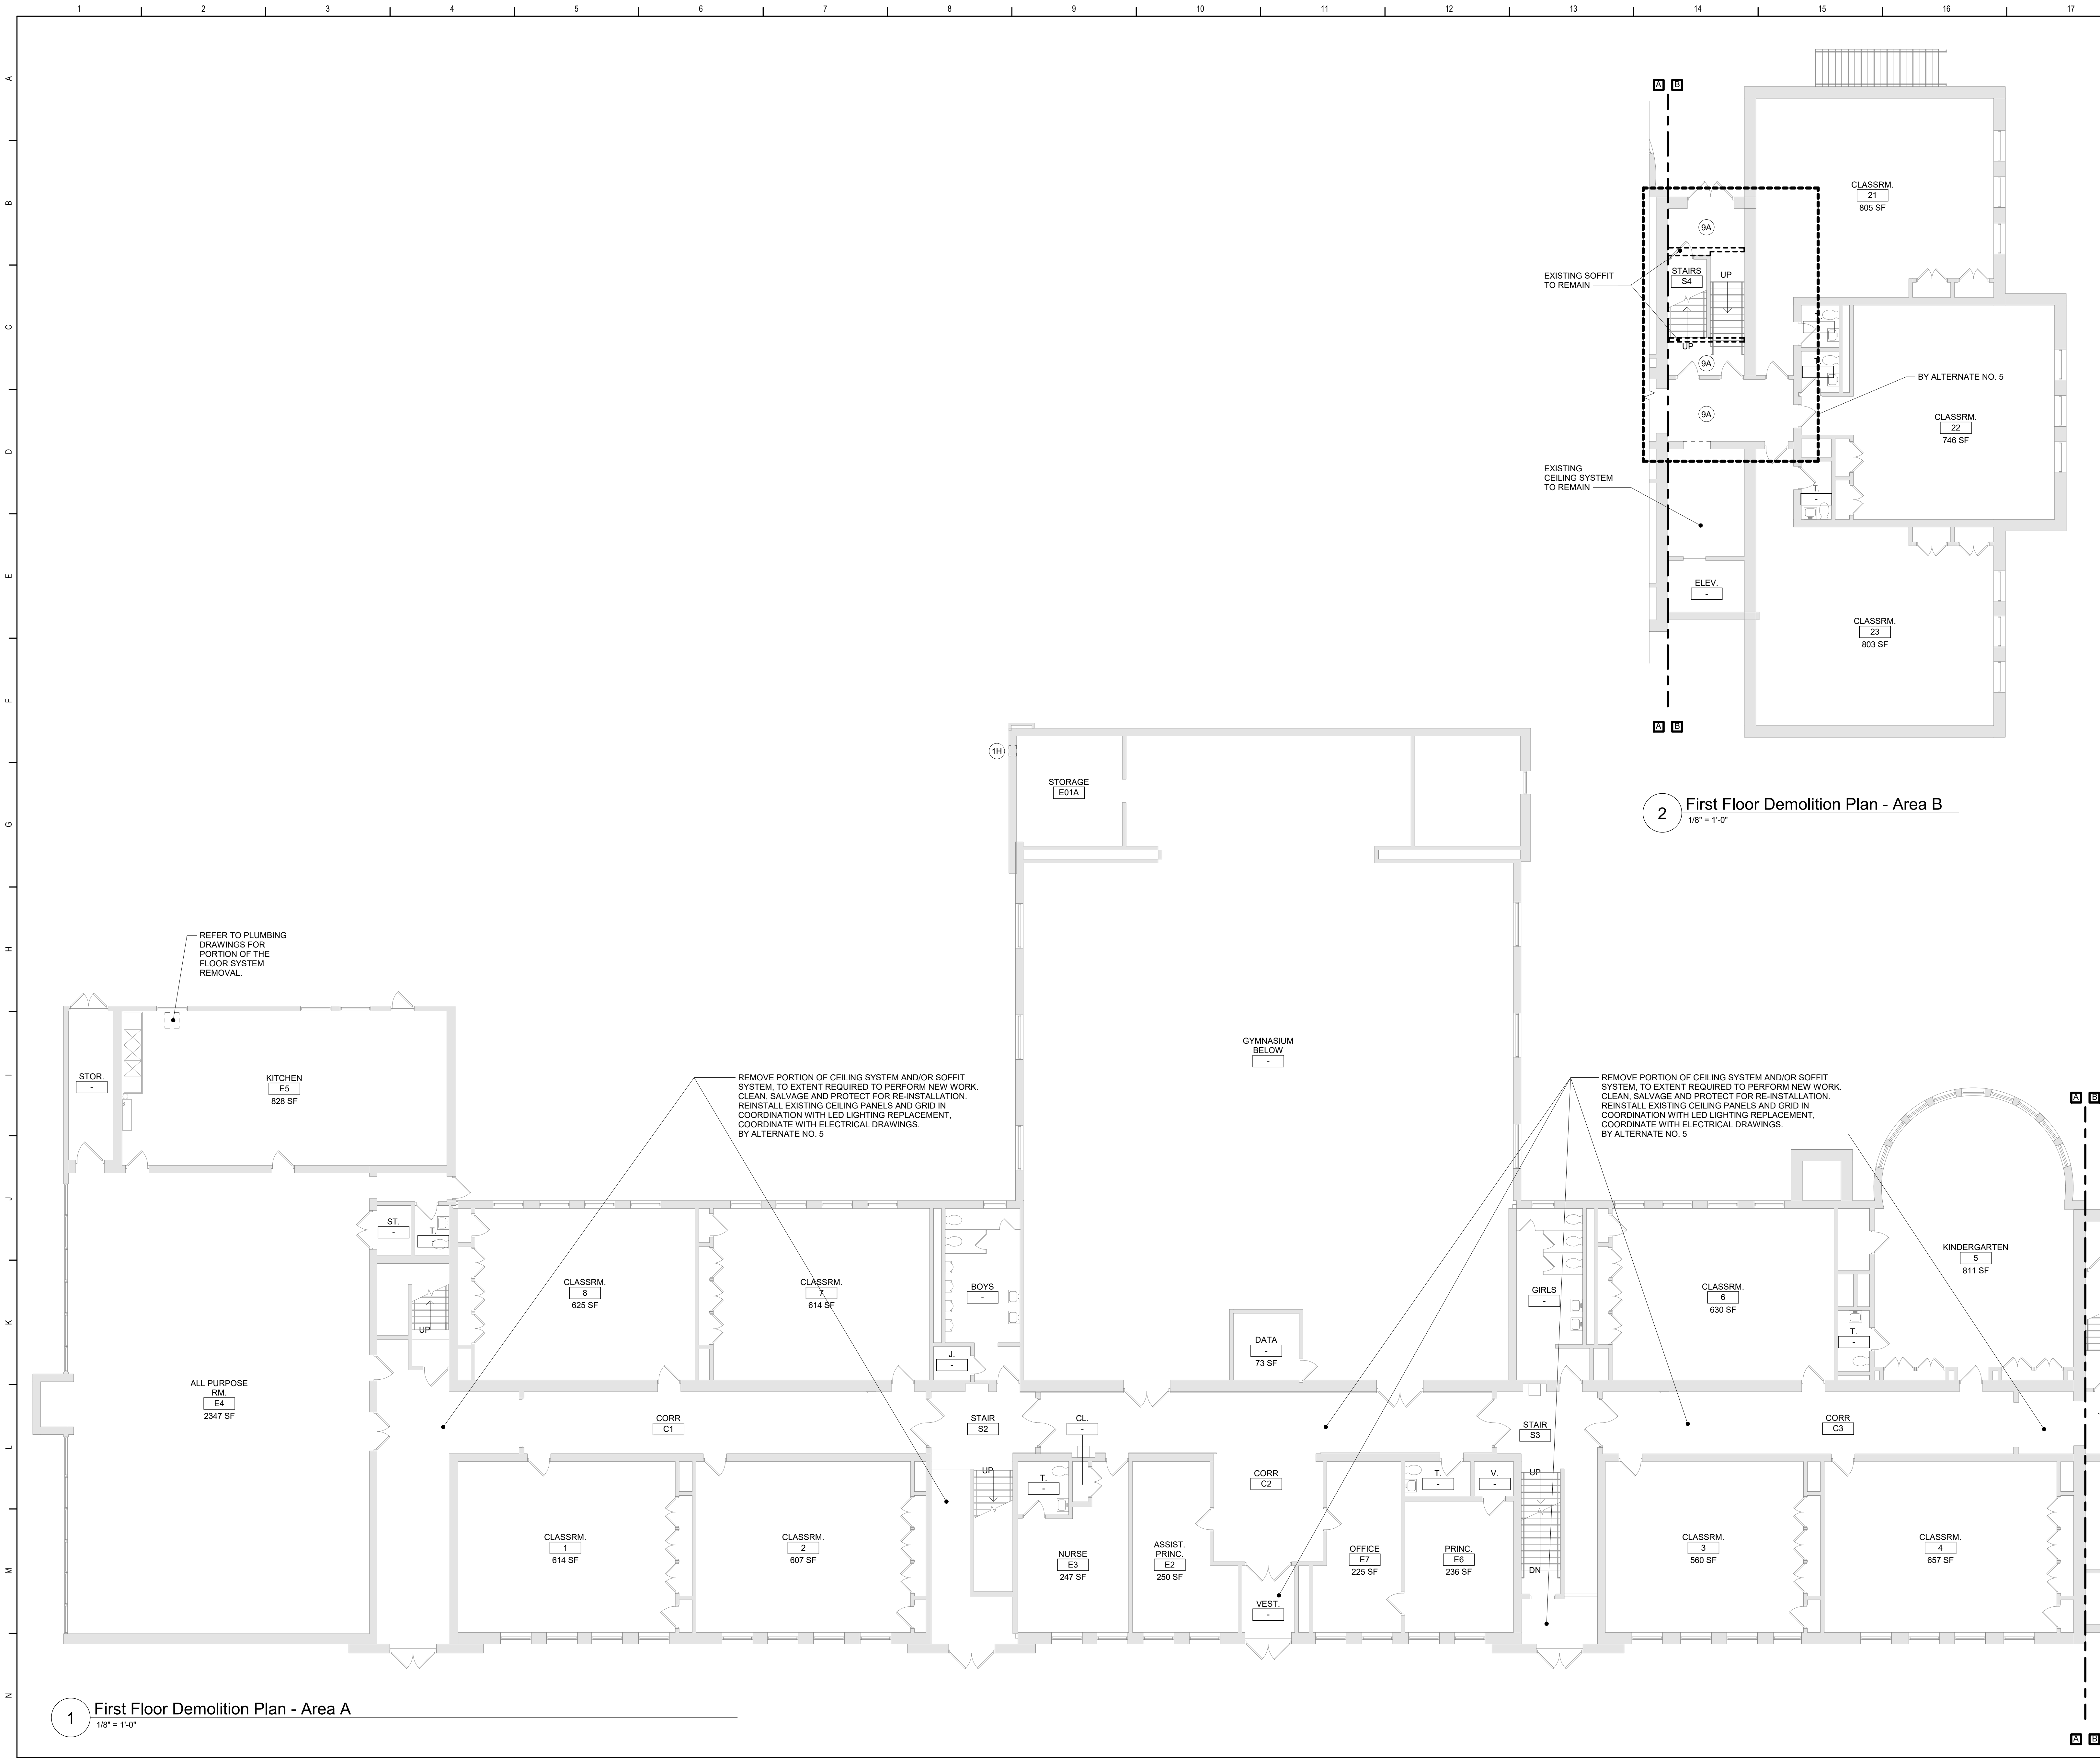
TETRA TECH
ARCHITECTS & ENGINEERS

Beacon City School District
Beacon, New York

Reconstruction to:
South Ave Elementary School

Ground Floor Demolition Plans - Area A and B

Drawn By: TLG	Date: 10/28/2022	Drawing Number: DA100
Project No.: 279180-22004		



General Demolition Notes

A. - - - - REMOVE ITEMS INDICATED BY DASHED LINE.

B. KEYED DEMOLITION TAGS REFER TO SPECIFIC LOCATIONS AS FOLLOWS:

- DEMOLITION TAGS LOCATED WITHIN THE MIDDLE OF A SPACE REFER TO DEMOLITION OF ALL ITEMS OF THAT SAME TYPE WITHIN THAT ENTIRE SPACE.
- DEMOLITION TAGS PLACED IMMEDIATELY ON OR ADJACENT TO A DASHED LINE INDICATING ITEM REMOVAL OR THAT HAVE A LEADER POINTING TO SPECIFIC ITEM(S) REFER TO DEMOLITION OF THAT SPECIFIC ITEM ONLY OF THAT TYPE WITHIN THAT SPACE.
- DEMOLITION TAGS IN SERIES REFER TO DEMOLITION OF ALL THOSE ITEMS EITHER WITHIN THAT ENTIRE SPACE OR TO THE SPACE IDENTIFIED BY THAT LEADER.

C. WHEN AN ITEM IS INDICATED TO BE DEMOLISHED REMOVE ALL ASSOCIATED COMPONENTS AS PART OF THAT WORK.

D. ALL ARTWORK NOT PERMANENTLY AFFIXED TO EXISTING CONSTRUCTION SHALL BE REMOVED AND STORED BY OWNER PRIOR TO BEGINNING DEMOLITION WORK. CONTACT OWNERS AGENT(S) IF ANY ARTWORK IS ENCOUNTERED PRIOR TO START OF DEMOLITION WORK.

E. COORDINATE WITH ABATEMENT DRAWINGS PRIOR TO DEMOLITION.

Demolition Key Notes

(1H) PROVIDE NEW OR ENLARGE EXISTING OPENING IN WALL TO EXTENT REQUIRED TO PERFORM SCHEDULED WORK. PROVIDE LINTEL PER LINTEL SCHEDULE. SEE STRU DRAWINGS. PATCH EXPOSED SURFACES TO MATCH ADJACENT FINISHES / SURFACES. COORDINATE WITH SCHEDULED WORK ON MECHANICAL DRAWINGS.

(8A) REMOVE WINDOW COMPLETELY. PREPARE OPENING TO EXTENT REQUIRED TO PERFORM SCHEDULED WORK. PATCH EXPOSED SURFACES TO MATCH ADJACENT FINISHES / SURFACES. SEE ABATEMENT DRAWINGS.

(9A) REMOVE CEILING SYSTEM AND/OR SOFFIT SYSTEM IN ITS ENTIRETY.

(9B) REMOVE FLOOR FINISH, MASTIC AND WALL BASE TO EXTENT REQUIRED TO PERFORM SCHEDULED WORK. AT ALL AREAS OF FLOOR REMOVAL, LEVEL SLAB WITH ADJACENT SLABS AT LOCATIONS SCHEDULED TO RECEIVE FLOOR FINISH. INCLUDE CONCRETE FLOOR PATCHING AND LEVELING MATERIALS TO MAKE SURFACE LEVEL. PREPARE FOR FINISH. PATCH AREAS OF WALLS TO REMAIN THAT WERE DAMAGED BY REMOVAL OF WALL BASE.

SUFFIX KEY (FLOOR FINISH IDENTIFICATIONS):
A. CERAMIC FLOOR TILE.

Key Plan

N.T.S.

S.E.D. Control No. 13-02-00-01-0-003-016

Rev. No.	Date	Description

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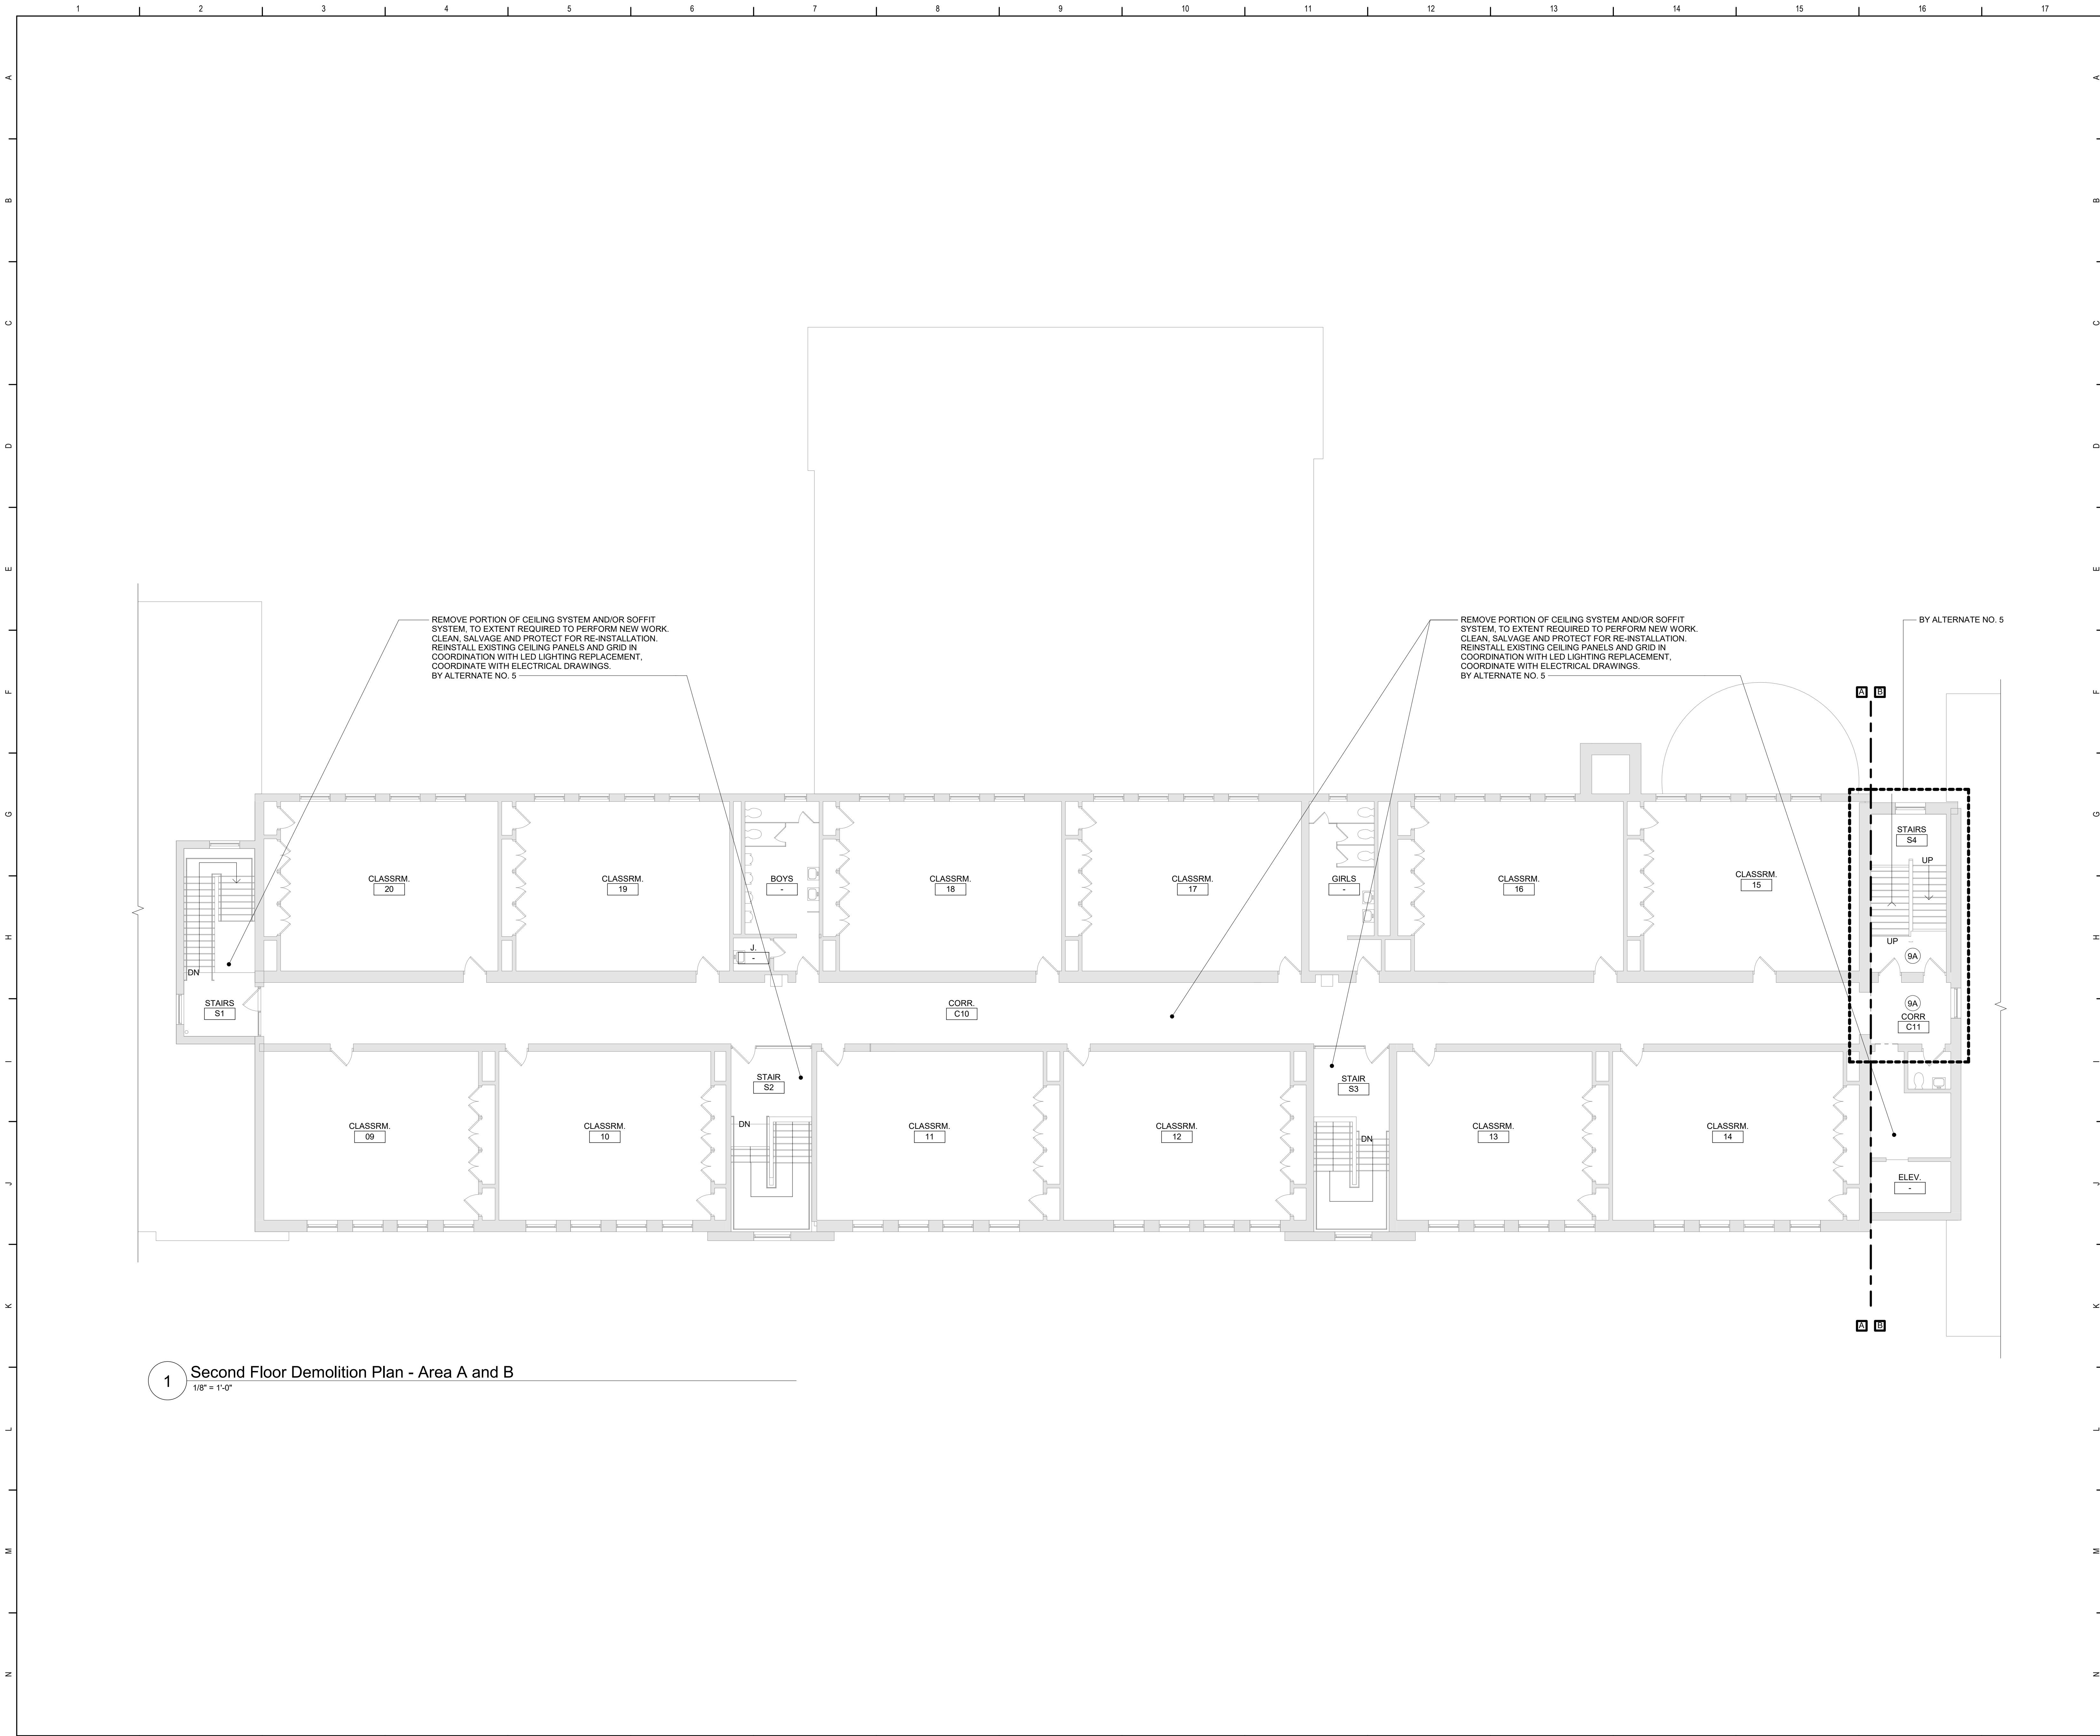
TETRA TECH
ARCHITECTS & ENGINEERS

Beacon City School District
Beacon, New York

Reconstruction to:
South Ave Elementary School

First Floor Demolition Plan - Area A and B

Drawn By: TLG	Date: 10/28/2022	Drawing Number:
Project No.: 279180-22004		DA101



1 Second Floor Demolition Plan - Area A and B
1/8" = 1'-0"


General Demolition Notes

- A. - - - - - REMOVE ITEMS INDICATED BY DASHED LINE.
- B. KEYED DEMOLITION TAGS REFER TO SPECIFIC LOCATIONS AS FOLLOWS:
1. DEMOLITION TAGS LOCATED WITHIN THE MIDDLE OF A SPACE REFER TO DEMOLITION OF ALL ITEMS OF THAT SAME TYPE WITHIN THAT ENTIRE SPACE.
 2. DEMOLITION TAGS PLACED IMMEDIATELY ON OR ADJACENT TO A DASHED LINE INDICATING ITEM REMOVAL OR THAT HAVE A LEADER POINTING TO SPECIFIC ITEM(S) REFER TO DEMOLITION OF THAT SPECIFIC ITEM ONLY OF THAT TYPE WITHIN THAT SPACE.
 3. DEMOLITION TAGS IN SERIES REFER TO DEMOLITION OF ALL THOSE ITEMS EITHER WITHIN THAT ENTIRE SPACE OR TO THE SPACE IDENTIFIED BY THAT LEADER.
- C. WHEN AN ITEM IS INDICATED TO BE DEMOLISHED REMOVE ALL ASSOCIATED COMPONENTS AS PART OF THAT WORK.
- D. ALL ARTWORK NOT PERMANENTLY AFFIXED TO EXISTING CONSTRUCTION SHALL BE REMOVED AND STORED BY OWNER PRIOR TO BEGINNING DEMOLITION WORK. CONTACT OWNERS AGENT(S) IF ANY ARTWORK IS ENCOUNTERED PRIOR TO START OF DEMOLITION WORK.
- E. COORDINATE WITH ABATEMENT DRAWINGS PRIOR TO DEMOLITION.

Demolition Key Notes

- (1H) PROVIDE NEW OR ENLARGE EXISTING OPENING IN WALL TO EXTENT REQUIRED TO PERFORM SCHEDULED WORK. PROVIDE LINTEL PER LINTEL SCHEDULE. SEE STRU DRAWINGS. PATCH EXPOSED SURFACES TO MATCH ADJACENT FINISHES / SURFACES. COORDINATE WITH SCHEDULED WORK ON MECHANICAL DRAWINGS.
- (8A) REMOVE WINDOW COMPLETELY. PREPARE OPENING TO EXTENT REQUIRED TO PERFORM SCHEDULED WORK. PATCH EXPOSED SURFACES TO MATCH ADJACENT FINISHES / SURFACES. SEE ABATEMENT DRAWINGS.
- (9A) REMOVE CEILING SYSTEM AND/OR SOFFIT SYSTEM IN ITS ENTIRETY.
- (9B) REMOVE FLOOR FINISH, MASTIC AND WALL BASE TO EXTENT REQUIRED TO PERFORM SCHEDULED WORK. AT ALL AREAS OF FLOOR REMOVAL, LEVEL SLAB WITH ADJACENT SLABS AT LOCATIONS SCHEDULED TO RECEIVE FLOOR FINISH. INCLUDE CONCRETE FLOOR PATCHING AND LEVELING MATERIALS TO MAKE SURFACE LEVEL. PREPARE FOR FINISH. PATCH AREAS OF WALLS TO REMAIN THAT WERE DAMAGED BY REMOVAL OF WALL BASE.

SUFFIX KEY (FLOOR FINISH IDENTIFICATIONS):
A. CERAMIC FLOOR TILE

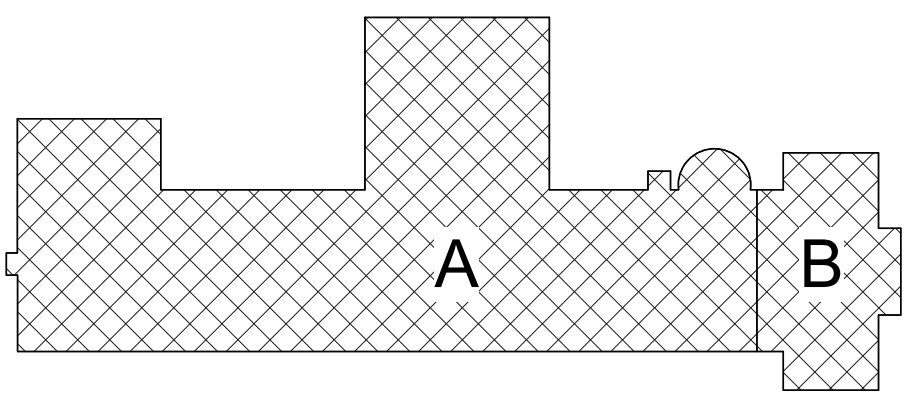

Key Plan
N.T.S.

S.E.D. Control No. 13-02-00-01-0-003-016

Rev. No.: Date: Description:



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Beacon City School District
Beacon, New York

Reconstruction to:
South Ave Elementary School





Second Floor Demolition Plan - Area A
and B

Drawn By: TLG Date: 10/28/2022 Drawing Number:
Project No.: 279180-22004 DA102




GENERAL NOTES:
VERIFY ALL DIMENSIONS IN THE FIELD

SPECIFIC NOTES:
- NOT APPLICABLE
1. THRESHOLD 2'-1" ABOVE INTERIOR LANDING, LEVEL WITH EXTERIOR GRADE, VIF.
2. MATCH FRAME TO EXISTING OPENING HEIGHT AND WIDTH, VIF.
3. PROVIDE 1" HIGH BUMPER SEAL THRESHOLD. FULL WIDTH OF WALL, VIF

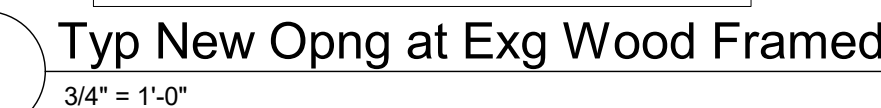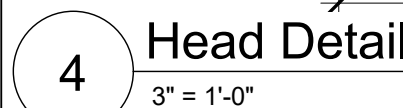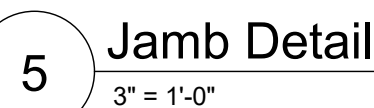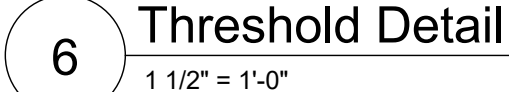

2 Lintel Schedule

N	Drawn By: TLG	Date: 10/28/2022	Drawing Number: DA130
	Project No.: 279180-22004		

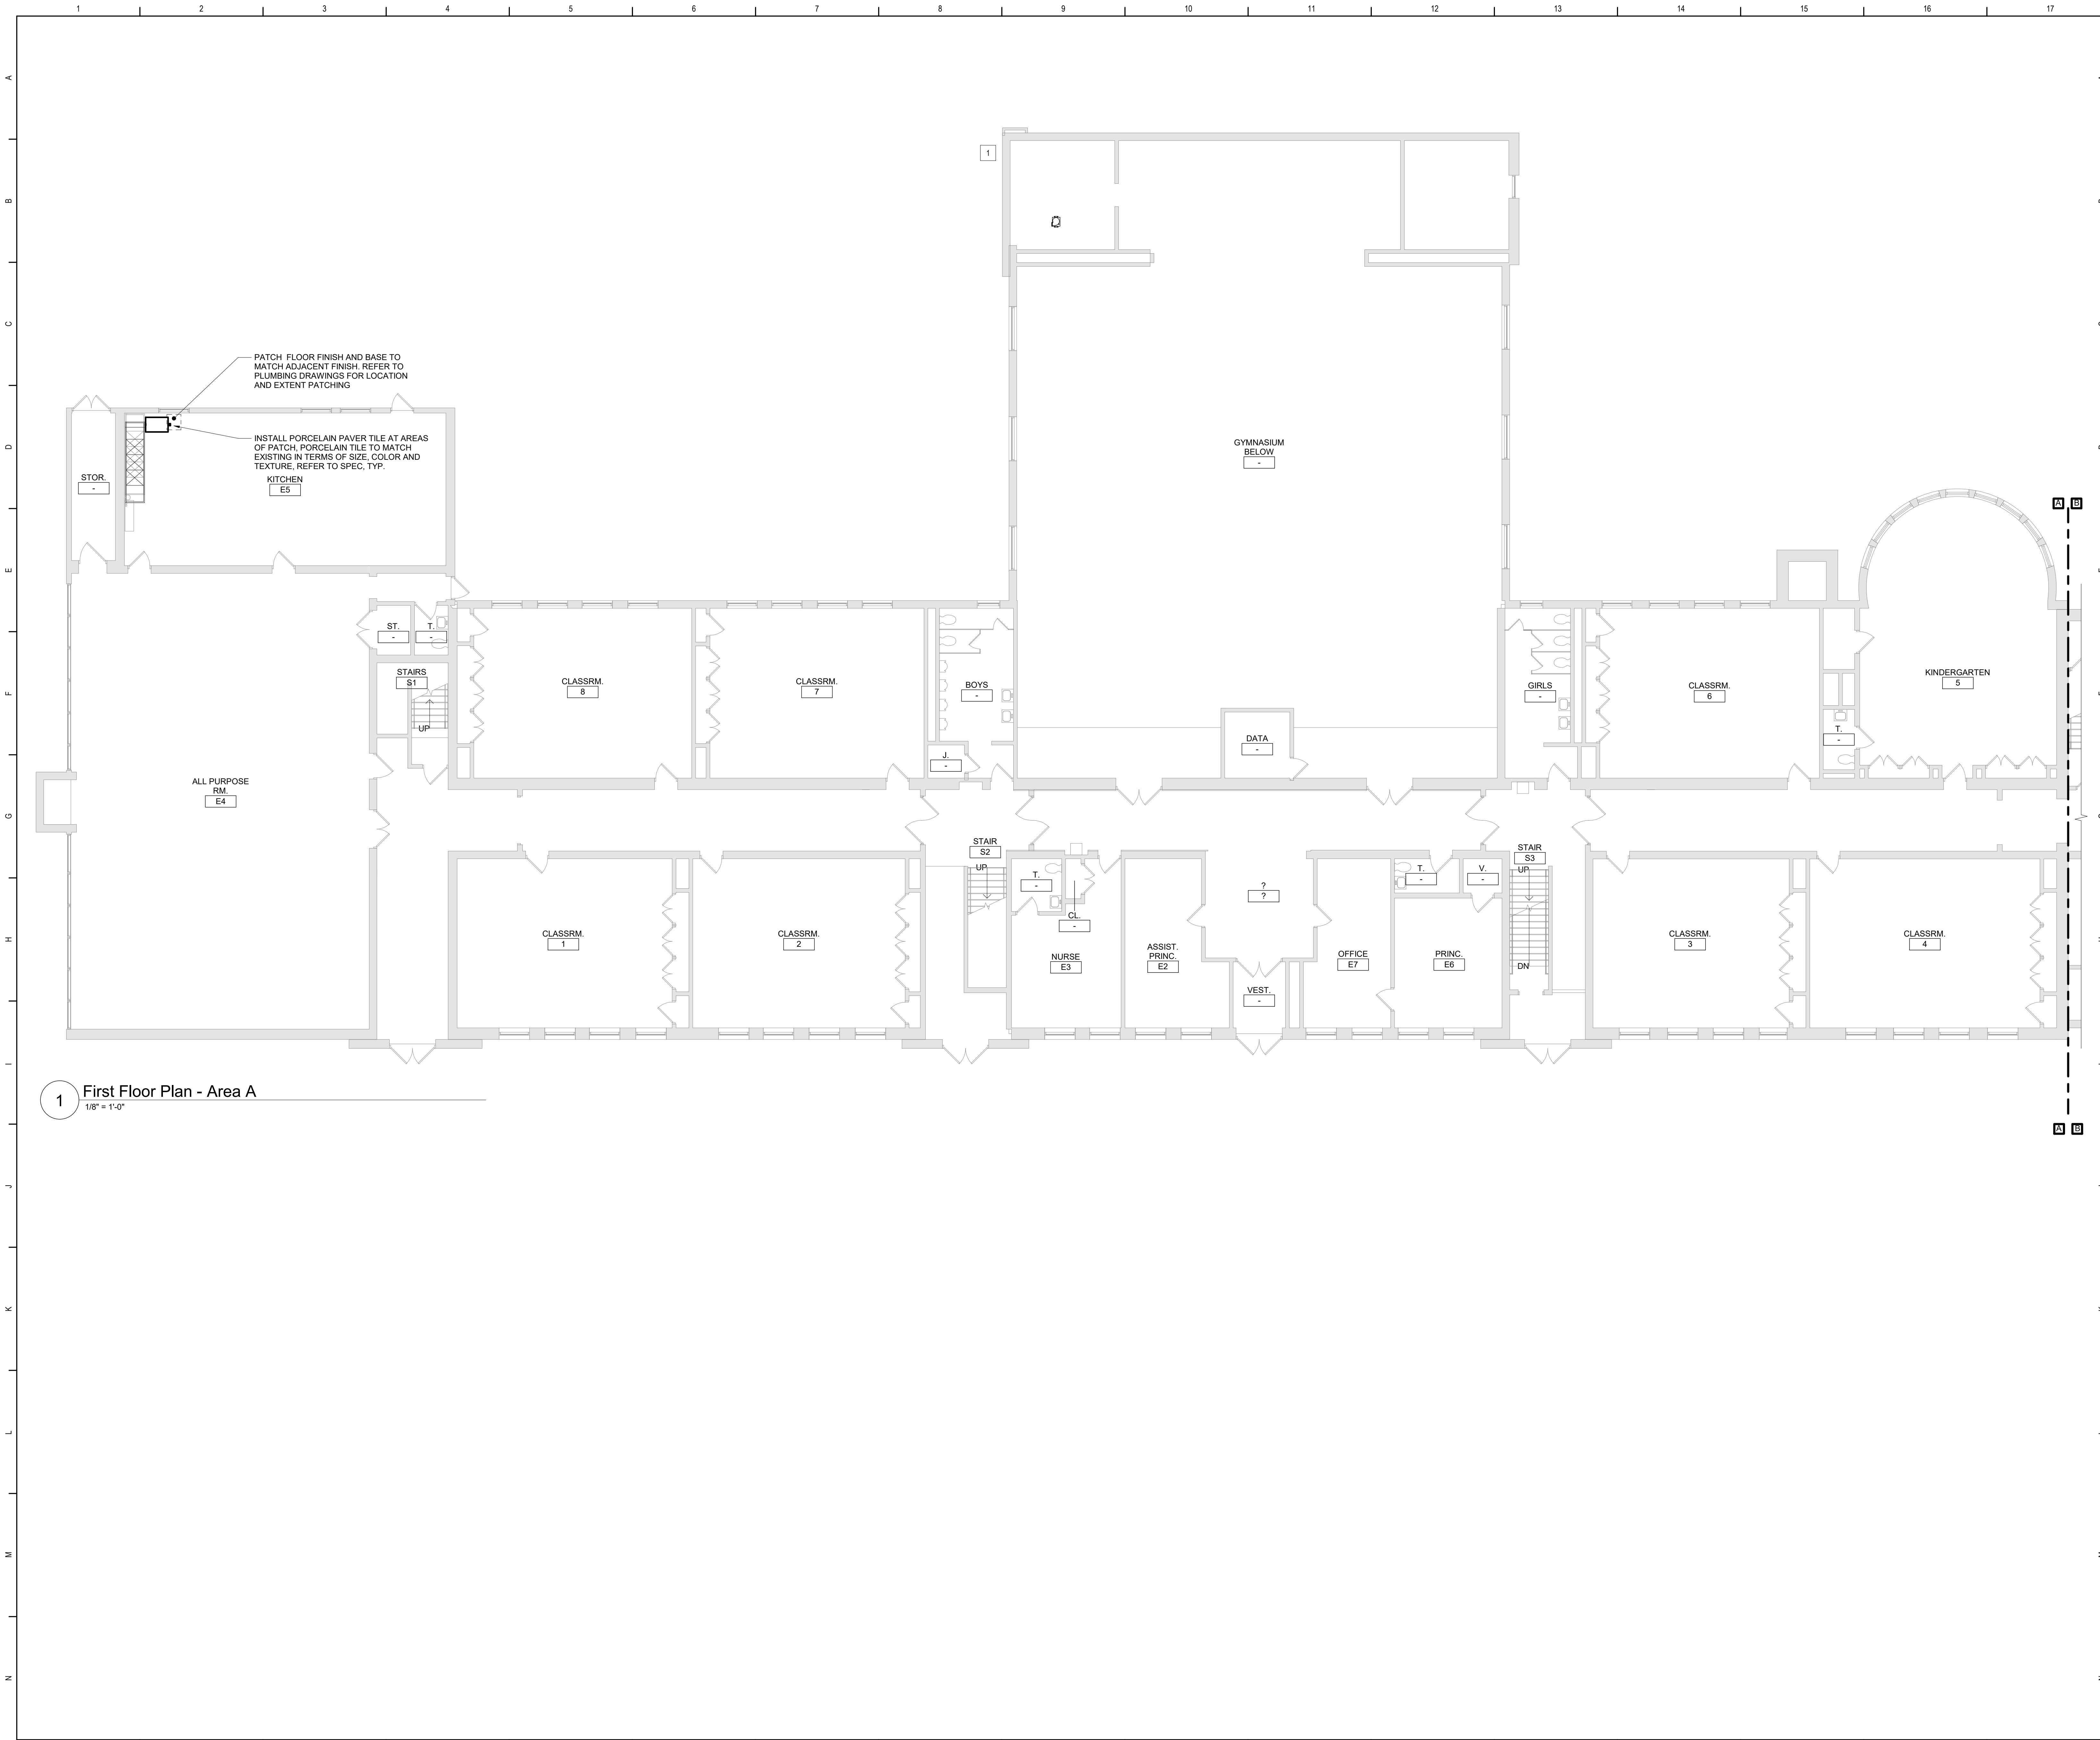


1 First Floor Plan - Area A
1/8" = 1'-0"

General Plan Notes

A. WHERE EXISTING CONSTRUCTION IS DAMAGED OR DISTURBED, PATCH AS REQUIRED TO RESTORE SURFACES TO THEIR ORIGINAL CONDITION.


Keyed Plan Notes

1. INSTALL LOUVER FURNISHED BY OTHERS AT NEW OPENING. COORDINATE WITH MECHANICAL DRAWINGS.

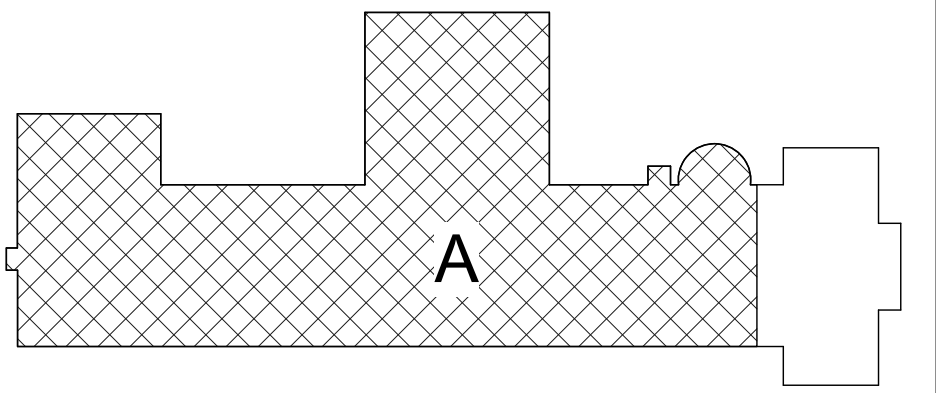

Key Plan
N.T.S.

S.E.D. Control No. 13-02-00-01-0-003-016

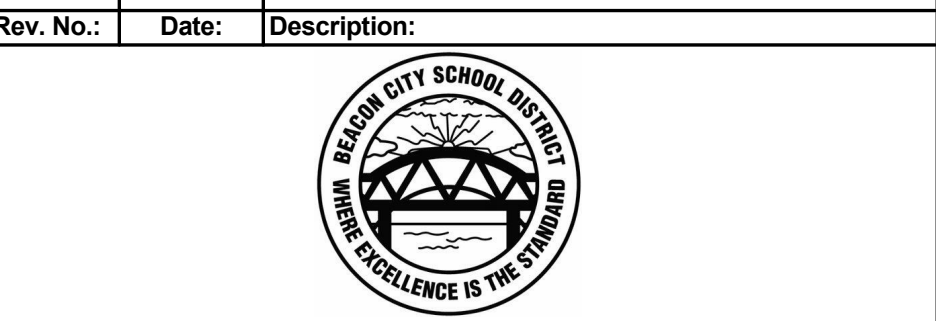

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Beacon City School District
Beacon, New York

Reconstruction to:
South Ave Elementary School



First Floor Plan - Area A

Drawn By: TLG	Date: 10/28/2022	Drawing Number: DA131
Project No.: 279180-22004		

3 Second Floor - Reflected Ceiling Plan - Area B
1/8" = 1'-0"

2 First Floor - Reflected Ceiling Plan - Area B
1/8" = 1'-0"

1 Ground Floor - Reflected Ceiling Plan - Area B
1/8" = 1'-0"

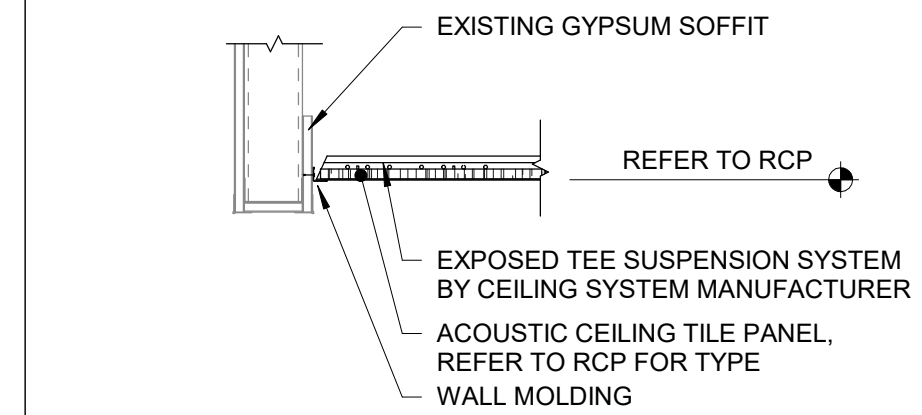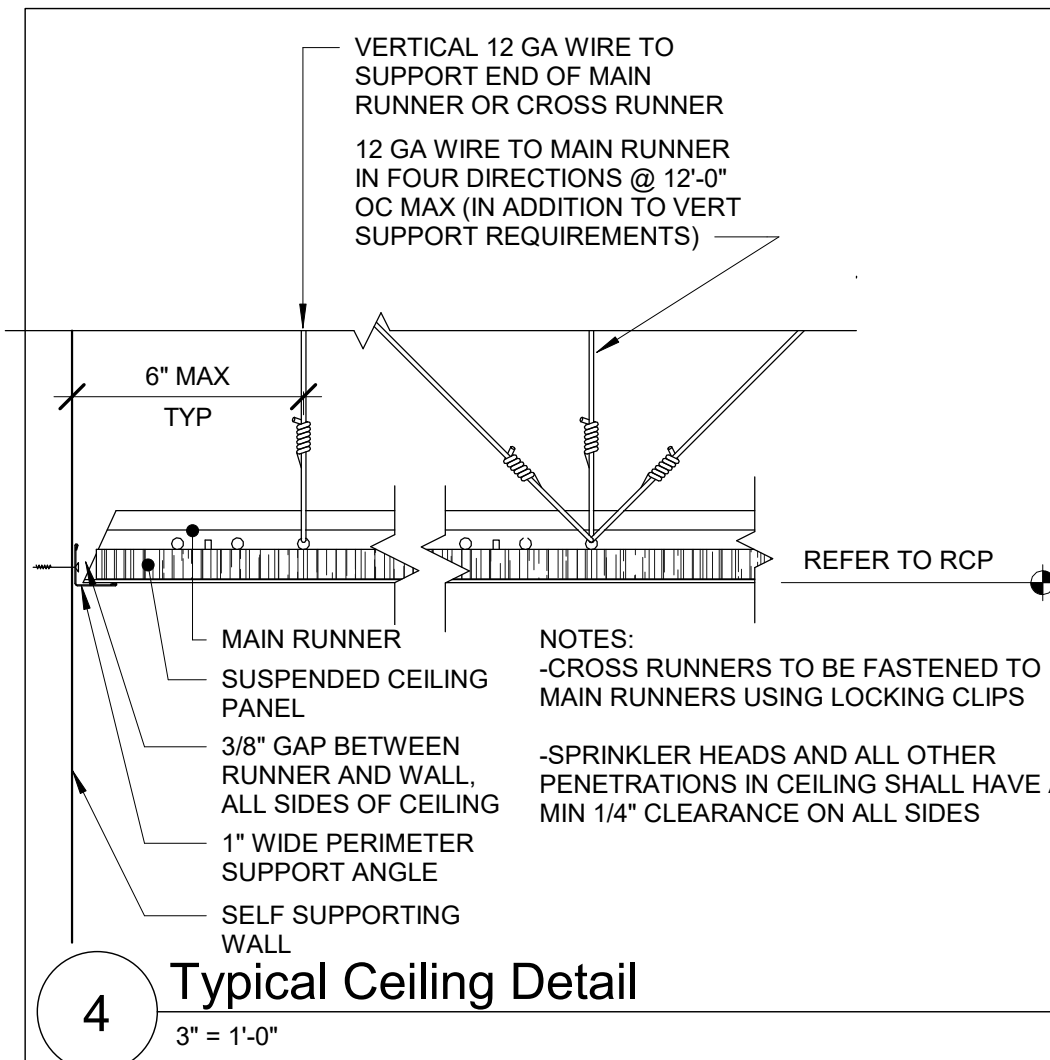


General Ceiling Notes

- LIGHTING AND OTHER CEILING-MOUNTED FIXTURES ARE SHOWN FOR DRAWING CLARITY. COORDINATE ALL CEILING WORK PRIOR TO INSTALLATION OF CEILING GRID.
- CEILING HEIGHT IS 9'-0" ABOVE FINISHED FLOOR (UNO).
- CENTER CEILING-MOUNTED ITEMS (LIGHTS, GRILLES, DETECTORS, SPRINKLER HEAD, ETC) WITHIN THE CEILING PANELS AND GRIDS UNLESS THE PANELS ARE SCORED. CENTER ITEMS WITHIN THE PATTERN OF SCORED PANELS.
- PROVIDE EXPANSION JOINT (EJ) COVERS IN CEILINGS AND SOFFITS AT EJ LOCATIONS.
- PROVIDE CONTROL JOINTS IN GYPSUM BOARD CEILINGS AND SOFFITS AS DETAILED ON DRAWINGS (MAXIMUM 20'-0" OC, EVENLY SPACED, TYP UNO).
- PATCH CEILING SYSTEMS TO REMAIN THAT HAVE BEEN DISTURBED BY SCHEDULED WORK TO MATCH ADJACENT CONSTRUCTION PRIOR TO PAINTING.
- (X) 9'-0" DESIGNATES BOTTOM OF CEILING ABOVE FINISHED FLOOR AT THAT POINT UNO. DESIGNATION "ME" INDICATES MATCH EXISTING CEILING HEIGHT.
- AT ALL LOCATIONS OF GYPSUM CEILINGS - PROVIDE 24" X 24" CONCEALED FLANGE ACCESS DOOR REGARDLESS OF LOCATION OR REQUIREMENT FOR ACCESS TO EQUIPMENT.

Ceiling Types

A1 X-X" ACOUSTIC PANEL CEILING

NOTE: AT AREAS WITH "H", THE INTENT IS TO MATCH EXISTING, VERIFY IN FIELD.

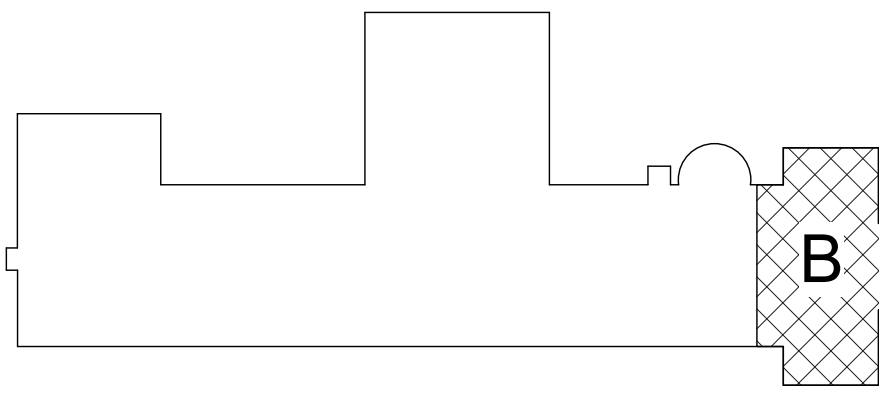

Key Plan
N.T.S.

S.E.D. Control No. 13-02-00-01-0-003-016

Rev. No.: Date: Description:



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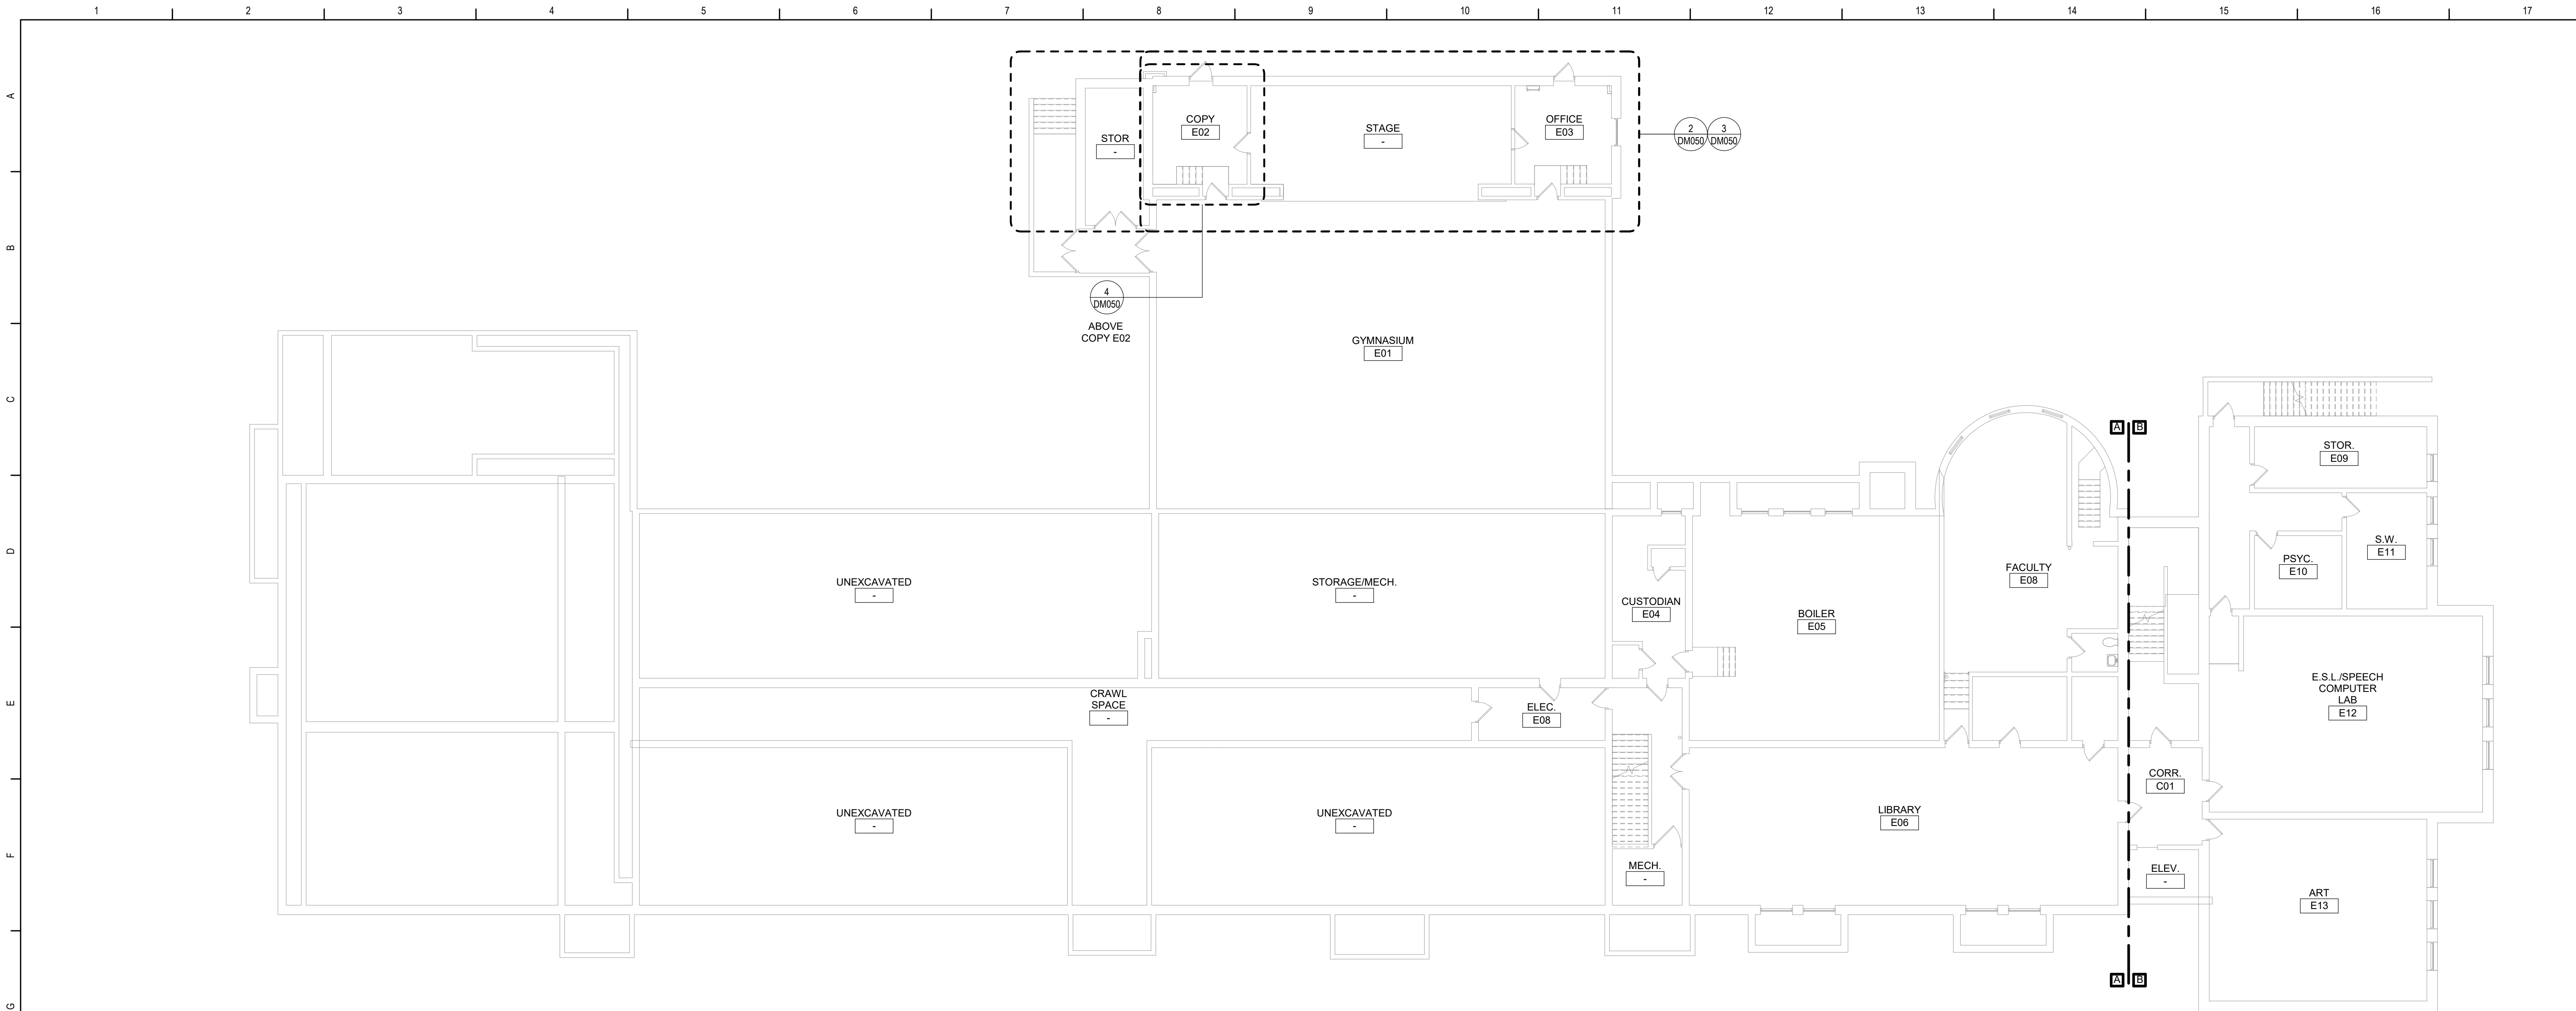


Beacon City School District
Beacon, New York


Reconstruction to:
South Ave Elementary School

Reflected Ceiling Plans


Drawn By: TLG Date: 10/28/2022 Drawing Number:
Project No.: 279180-22004
DA160



1 Ground Floor Key Plan
3/32" = 1'-0"

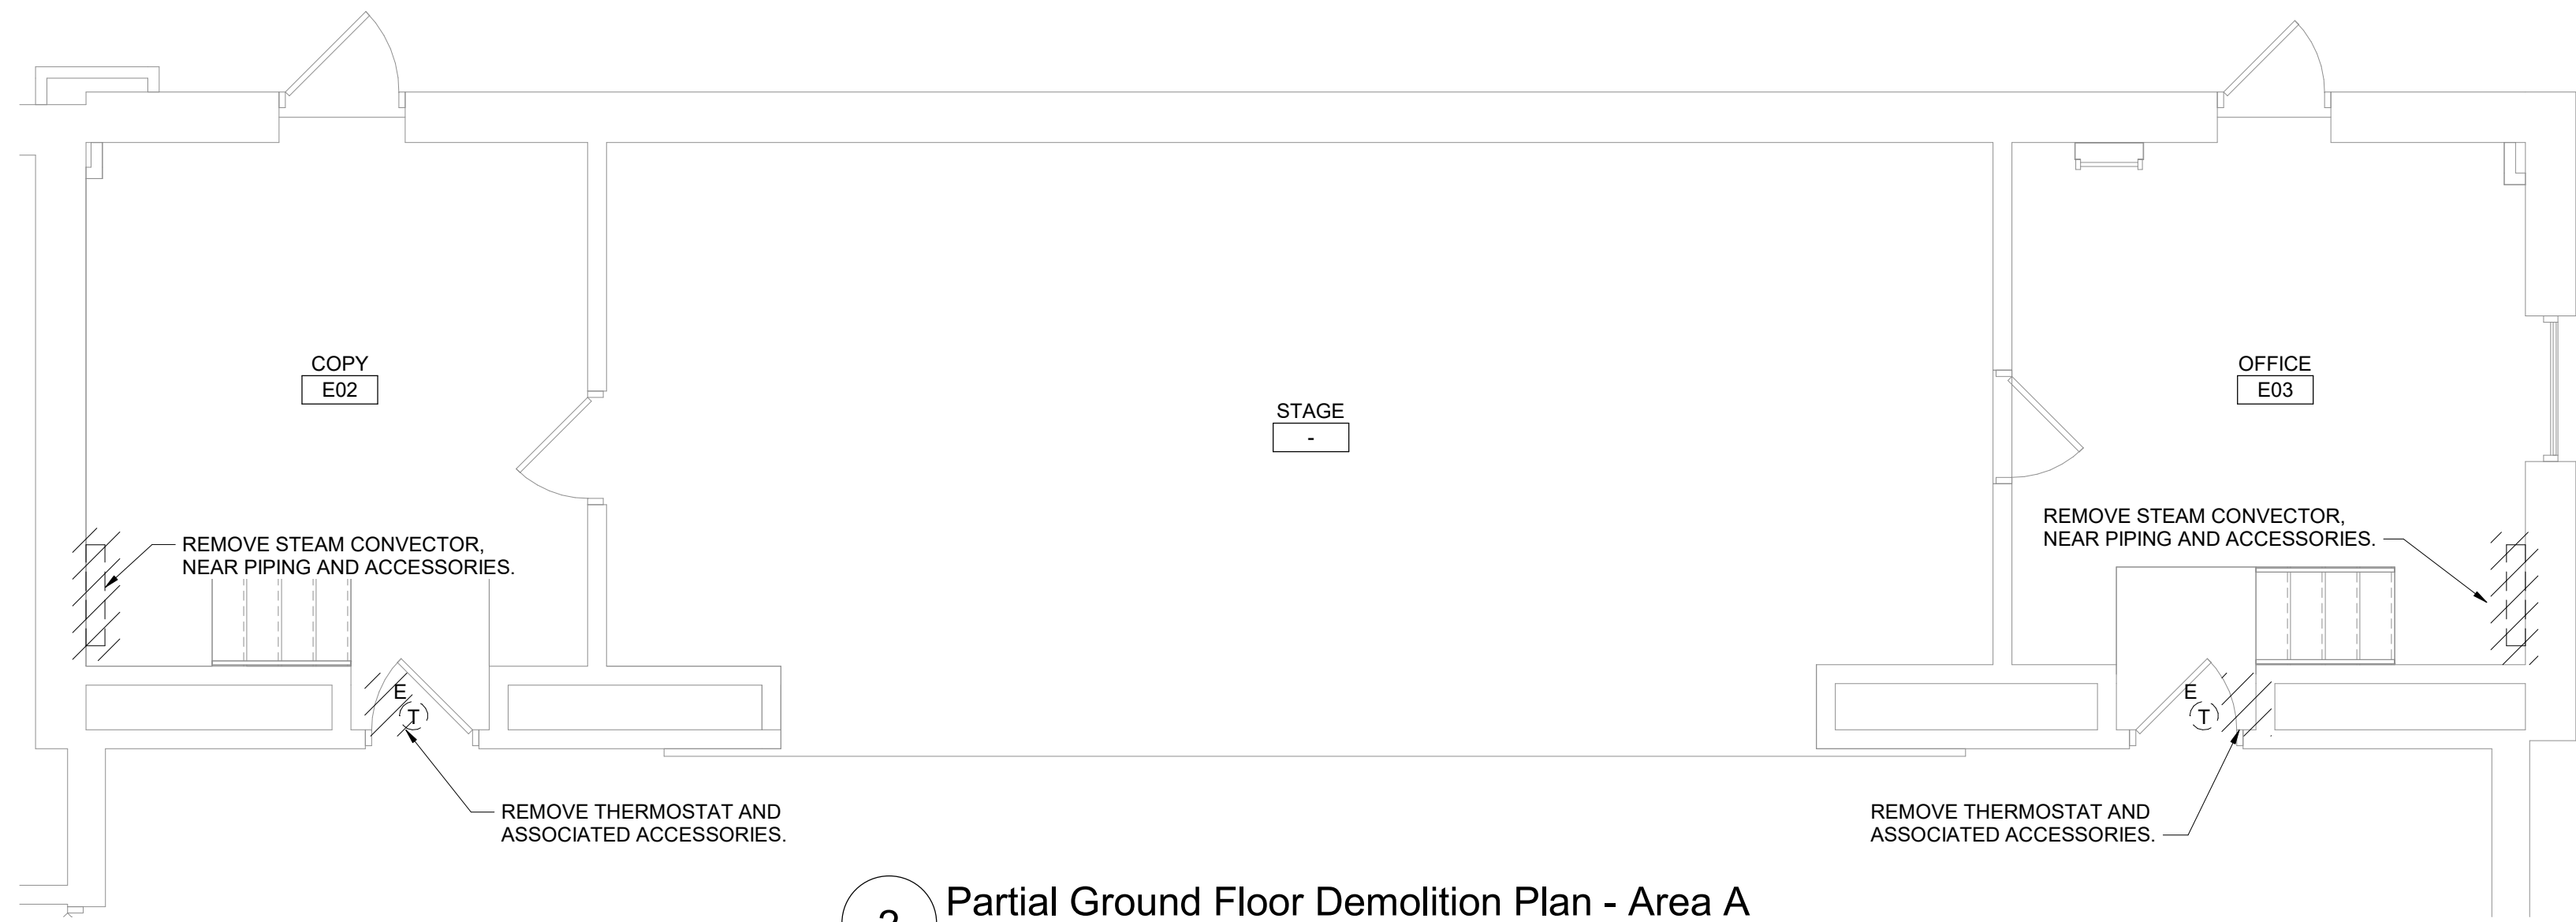


2 Partial Ground Floor Demolition Plan - Area A
1/4" = 1'-0"

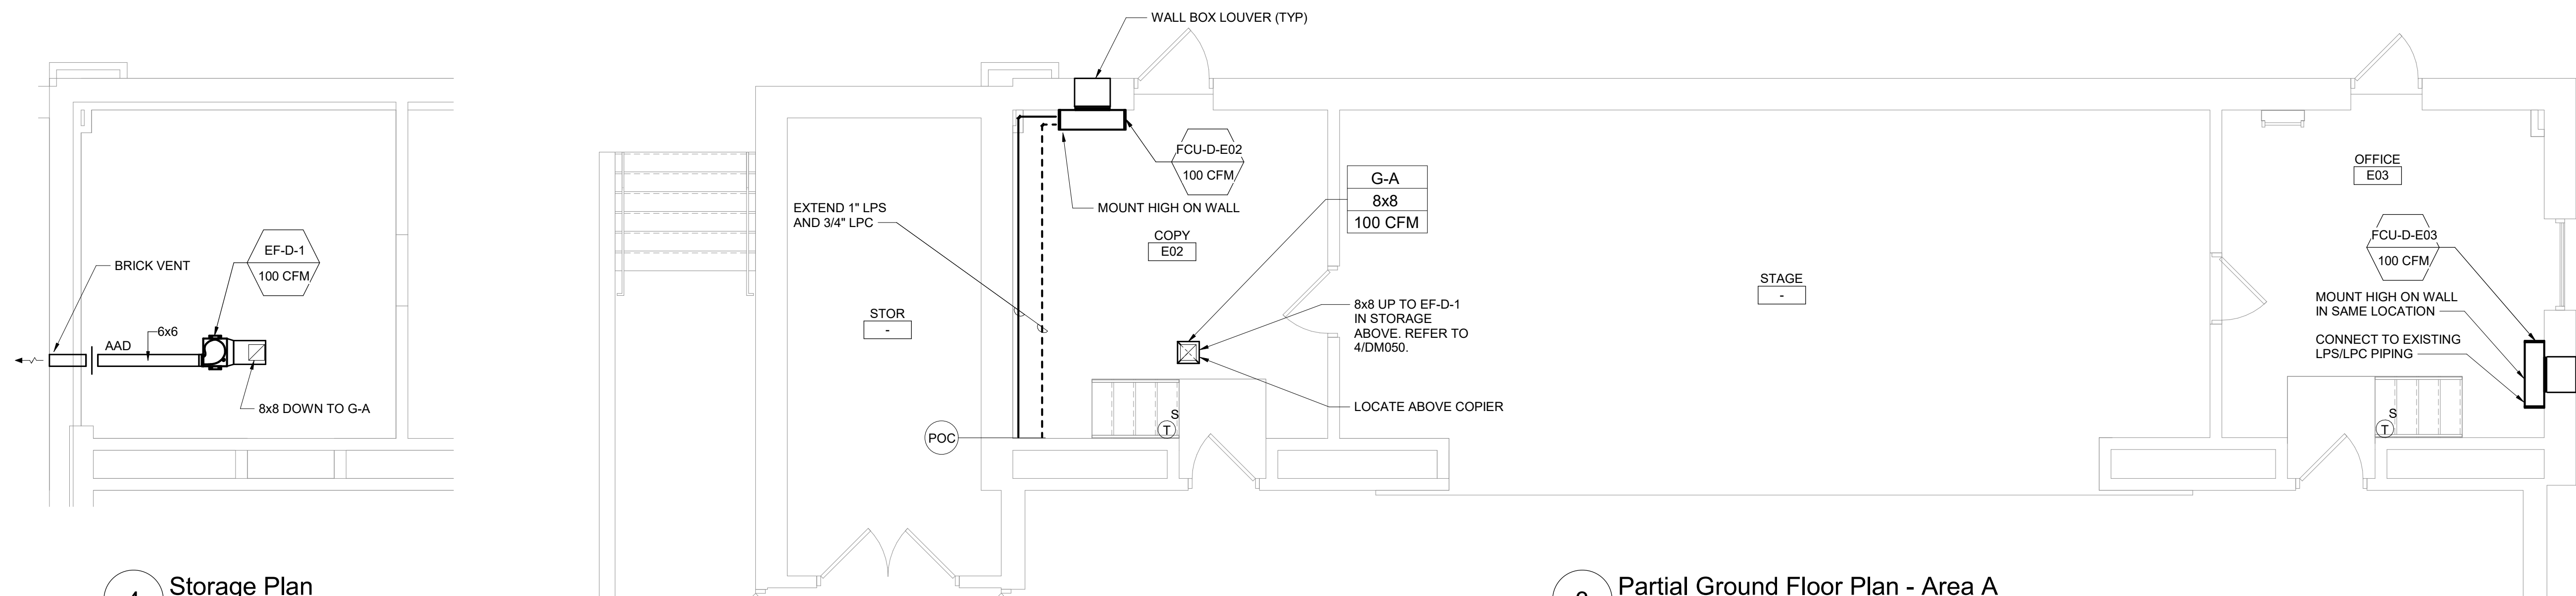

3 Partial Ground Floor Plan - Area A
1/4" = 1'-0"

4 Storage Plan
1/4" = 1'-0"

- General Notes**
- THE FOLLOWING GENERAL NOTES APPLY TO ALL "DM" SERIES DRAWINGS.
 - REFER TO ALL CONTRACT DOCUMENTS, DRAWINGS AND SPECIFICATIONS, FOR DETAILED STANDARDS AND REQUIREMENTS.
 - REPORT UNSAFE OR UNSATISFACTORY CONDITIONS IN WRITING TO ARCHITECT AND RESOLVE ISSUES BEFORE PROCEEDING.
 - WORK INCLUDES ALL LABOR AND MATERIALS REQUIRED TO PROVIDE COMPLETE WORKING SYSTEMS.
 - COORDINATE PHASING REQUIREMENTS AT JOB MEETINGS AND ON WORK SCHEDULES.
 - DO NOT SCALE DRAWINGS. PIPING AND DUCTWORK ARE SHOWN DIAGRAMMATICALLY. IT IS NOT POSSIBLE TO SHOW EVERY TRANSITION, FITTING, ASPECT RATIO CHANGE, ETC.; PROVIDE AS REQUIRED TO FIT WITHIN STRUCTURAL CONSTRAINTS. EXAMINE CONDITIONS UNDER WHICH THE WORK IS TO BE PERFORMED AND VERIFY ALL ACCESS, LOCATIONS, DIMENSIONS, ARRANGEMENTS, ELECTRICAL CHARACTERISTICS AND INTERFERENCE IN THE FIELD PRIOR TO BID.
 - VERIFY EXTENT OF CEILING WORK SHOWN ELSEWHERE IN THE CONTRACT DOCUMENTS. PROVIDE FOR ADDITIONAL CEILING SYSTEM REMOVAL, PROTECTION, AND REINSTALLATION AS REQUIRED FOR CONTRACT WORK.
 - DEMOLITION DRAWINGS SHOW THE GENERAL SCOPE OF ITEMS AND SYSTEMS TO BE REMOVED. IT IS NOT THE INTENT TO SHOW ALL ITEMS TO BE REMOVED. FIELD VERIFY AND REMOVE ALL ASSOCIATED ITEMS BACK TO POINT OF CONTINUED SERVICE, UNLESS OTHERWISE NOTED. VERIFY WHAT ALL EQUIPMENT SERVES PRIOR TO REMOVAL.
 - GIVE ALL REMOVED EQUIPMENT TO THE OWNER. DELIVER ON SITE WHERE DESIGNATED BY THE OWNER. PROMPTLY REMOVE FROM THE SITE AND LEGALLY DISPOSE OF ANY SUCH ITEMS DECLINED BY OWNER.
 - IF UNANTICIPATED MECHANICAL, ELECTRICAL, OR STRUCTURAL CONFLICTS ARE ENCOUNTERED, INVESTIGATE AND REPORT BOTH NATURE AND EXTENT OF THE CONFLICT. RE-ROUTE WORK AS REQUIRED.
 - CUT, DRILL, OR OTHERWISE CREATE OPENINGS AS NEATLY AS POSSIBLE, AS REQUIRED FOR THE INDICATED CONTRACT WORK. PROVIDE SUPPORT AS REQUIRED FOR AND USE METHODS LEAST LIKELY TO DAMAGE ELEMENTS TO REMAIN. PRIOR TO WORK, VERIFY LOCATIONS OF ALL STRUCTURAL MEMBERS INCLUDING CROSS BRACING, ELECTRICAL WIRING, PLUMBING, ETC. PROMPTLY NOTIFY ARCHITECT OF ANY CONFLICTS. DO NOT CUT ANY STRUCTURAL MEMBERS OR OTHER SERVICES UNTIL SPECIFICALLY DIRECTED TO DO SO. FURNISH RECEIPT OF DIRECTIVE.
 - REARRANGE SCHEDULE AS NECESSARY TO CONTINUE OVERALL JOB PROGRESS WITHOUT DELAY.
 - PATCH ALL DISTURBANCES RESULTING FROM DEMOLITION OR NEW WORK TO MATCH SURROUNDING SURFACES. PATCH FOLLOWING DEMOLITION, AND AGAIN FOLLOWING WORK, WHERE HOLES REMAIN FROM REMOVALS, INFILL AND PATCH TO MATCH UNLESS HOLE IS TO BE REUSED.
 - PROTECT ALL CONTRACT EQUIPMENT. ELEMENTS TO REMAIN, OWNER'S BELONGINGS, AND EQUIPMENT TO BE REUSED OR RETAINED BY OWNER DURING ALL CONTRACT WORK. AT NO ADDITIONAL COST TO OWNER, REPAIR OR REPLACE ITEMS WHICH ARE DAMAGED.
 - THOROUGHLY CLEAN FOLLOWING DEMOLITION AND BEFORE BEGINNING CONTRACT INSTALLATIONS. THOROUGHLY CLEAN AGAIN DURING AND FOLLOWING CONTRACT WORK AS REQUIRED. LEAVE ALL WORK AREAS CLEANER THAN FOUND. LEGALLY DISPOSE OF ALL CONSTRUCTION DEBRIS.
 - PROVIDE TEMPORARY PIPING, DUCT, HEAT, WEATHERPROOFING, ETC. TO SERVICES TO REMAIN UNTIL PERMANENT INSTALLATIONS CAN BE MADE.
 - ALL EXCESS MATERIALS AND SCRAPS ARE CONTRACTOR'S PROPERTY. PROMPTLY REMOVE FROM SITE UNLESS SPECIFICALLY DIRECTED OTHERWISE.
 - EXISTING HVAC COMPONENTS IN THIS BUILDING MAY CONTAIN, BE IN PROXIMITY TO, OR, WORK ON THEM MAY CAUSE DISTURBANCE OF, ASBESTOS CONTAINING OR OTHER HAZARDOUS MATERIALS. REFER TO ABATEMENT SERIES DRAWINGS AND SPECIFICATIONS COMPLETE FOR ADDITIONAL INFORMATION.
 - SEAL ALL FLOOR, WALL AND CEILING PENETRATIONS PER FIRE-RESISTANCE RATINGS NOTED ON AG-SERIES DRAWINGS, BUT NOT LESS THAN 1-HOUR, AND IN ACCORDANCE WITH SECTION 07 84 13 - PENETRATION FIRESTOPPING. THIS INCLUDES ALL NEW PENETRATIONS AND EXISTING UNFIRESTOPPED PENETRATIONS CREATED BY REMOVALS, AS REQUIRED TO PERFORM THE WORK.

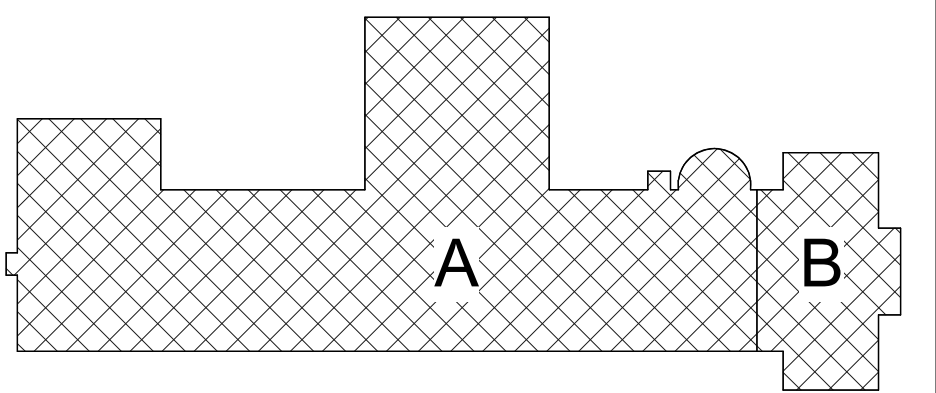

Key Plan
N.T.S.

S.E.D. Control No. 13-02-00-01-0-003-016

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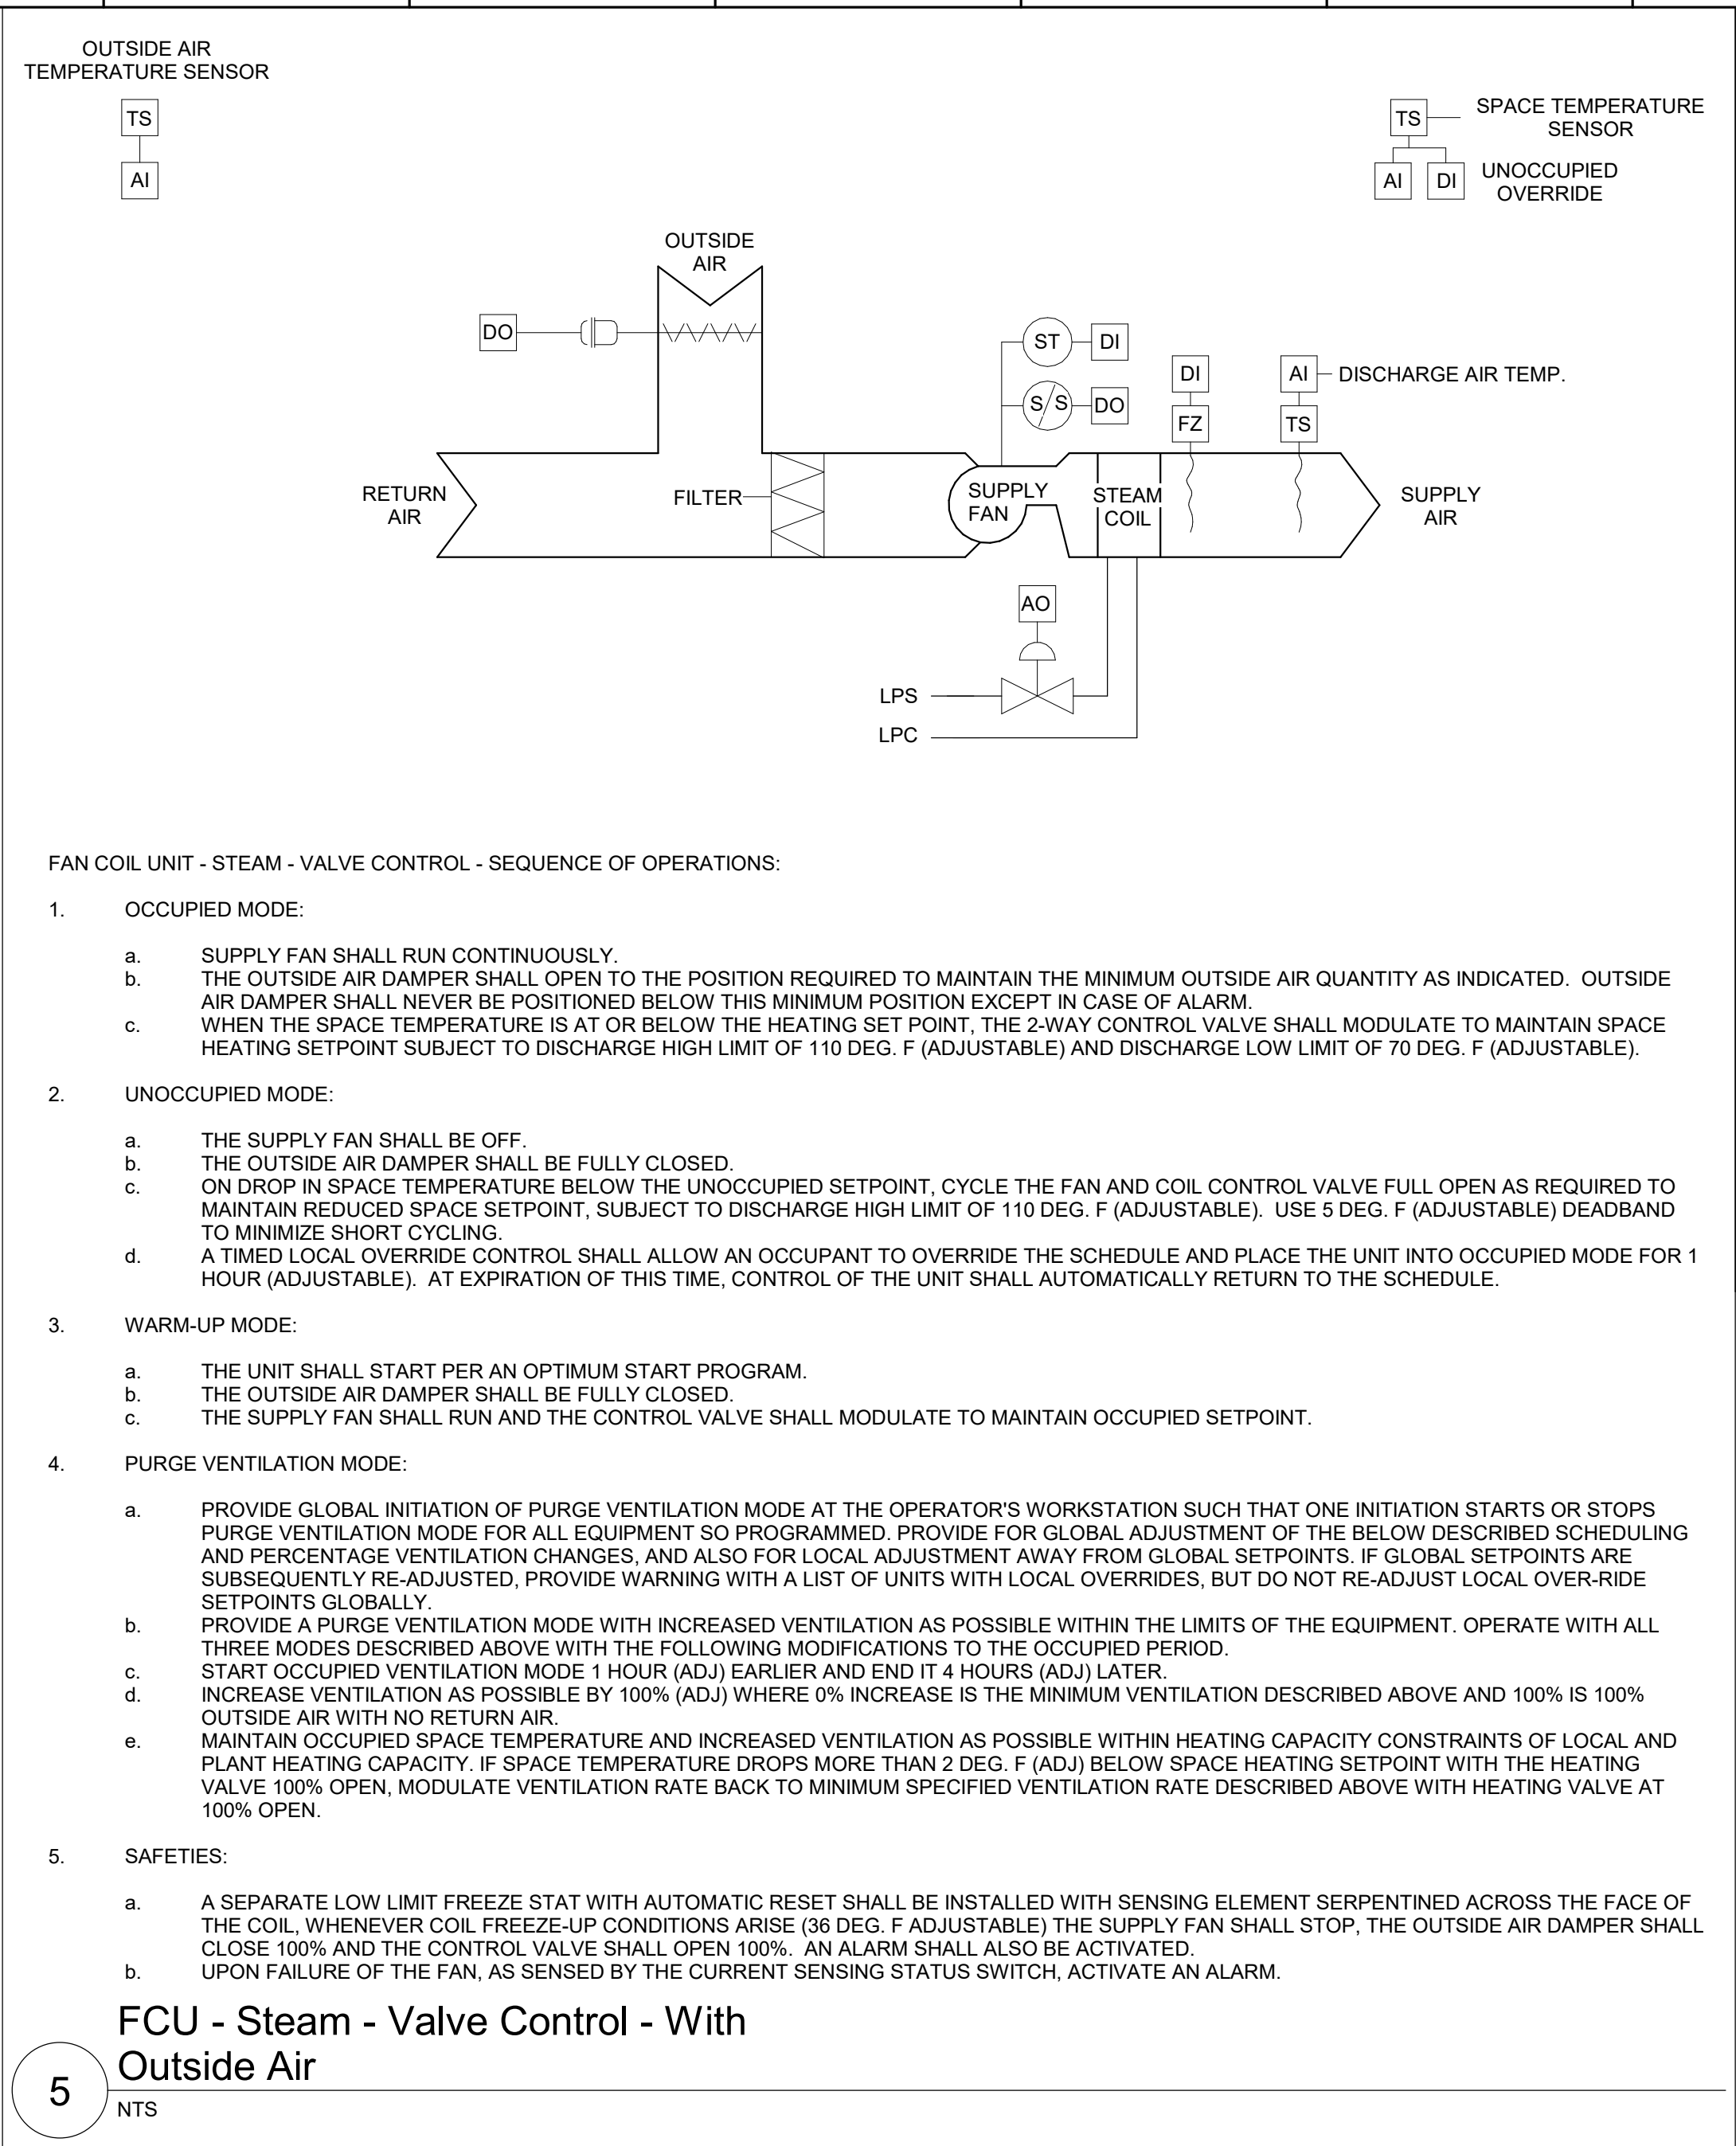


Beacon City School District
Beacon, New York

Reconstruction to:
South Ave Elementary School

Ground Floor Floor Key, Demolition
and Floor Plans

Drawn By: JPF/1/pgm Date: 10/28/2022 Drawing Number:
Project No.: 279180-22004
DM050




4 Fan Coil Unit Detail
NTS

SOUTH AVE BUILDING/EQUIPMENT VENTILATION CALCULATIONS												
EQUIPMENT NUMBER	ZONE ID				MINIMUM VENTILATION RATES							
	ROOM NUMBER	ROOM NAME	OCCUPANCY CLASSIFICATION	Az - AREA (SF)	Pz - ZONE OCCU #/1000 FT	ZONE OCCU	Rp (CFM/Person)	RpP	Ra (CFM/SF)	RaA	Vbz (CFM)	Voz (CFM)
FCU-D-E02	E02	COPY	Office Space	189	5	1	5	5	0.06	11	18	1 20
FCU-D-E03	E03	OFFICE	Office Space	194	5	1	5	5	0.06	12	17	1 20
NOTES: Rp = PEOPLE OUTDOOR AIR RATE, Ra = AREA OUTDOOR AIR RATE, Vbz = BREATHING ZONE OUTDOOR AIRFLOW, Ez = AIR DISTRIBUTION CONFIGURATION, Voz = ZONE OUTDOOR AIRFLOW												


FAN COIL UNIT (FCU) SCHEDULE																	
DWG LABEL	LOCATION	MODEL NO.	SA CFM	MIN. OA	HEATING DATA				SUPPLY FAN		ELECTRICAL				NOTES		
					NO. ROW	EAT (°F)	LAT (°F)	CAP. (MBH)	STEAM PRESS. (PSI)	ESP. (IN. WG.)	RPM	MOTOR SIZE (HP)	V/PH	FLA		MCA	MOP
FCU-D-E02	COPY E-02	FFF8020	100	20	1	56.2	153.3	10.5	2	0.00	0.03	120V/1ø	2.2	2.8	15	1-6	
FCU-D-E03	OFFICE E-03	FFF8020	100	20	1	56.2	153.3	10.5	2	0.00	730	0.03	120V/1ø	2.2	2.8	15	1-6
NOTES:																	
1. DESIGN BASIS: TRANE				3.	PROVIDE 1" MERV13 FILTER.				5.	VERIFY PIPE AND ELECTRICAL LEFT/RIGHT HAND CONNECTIONS PRIOR TO ORDERING.							
2. VERTICAL WALL HUNG CABINET UNIT				4.	PROVIDE NEMA 1 DISCONNECT SWITCH.				6.	PROVIDE FRONT BOTTOM INLET, FRONT TOP OUTLET AND BACK FRESH AIR INTAKE WITH WALL BOX LOUVER.							

FAN (EF) SCHEDULE												
DWG LABEL	SERVES	TYPE	MODEL NO.	FAN DATA				ELECTRICAL				
				CFM	SP (IN WG)	SONES	RPM	TIP SPEED (FPM)	DRIVE	BHP	HP	NOTES
EF-D-1	COPY E02	IN-LINE CENTRIFUGAL	GN-148	100	0.40	2.0	980	1960	DIRECT	41W	1/8	1-4
NOTES: 1. DESIGN BASIS: LOREN COOK 2. PROVIDE 4" WALL BRICK VENT. 3. PROVIDE NEMA 1 DISCONNECT 4. SONES, TIP SPEED AND BHP ARE MAXIMUM ALLOWABLE. CFM, SP AND OPENING ARE MINIMUM ALLOWABLE.												

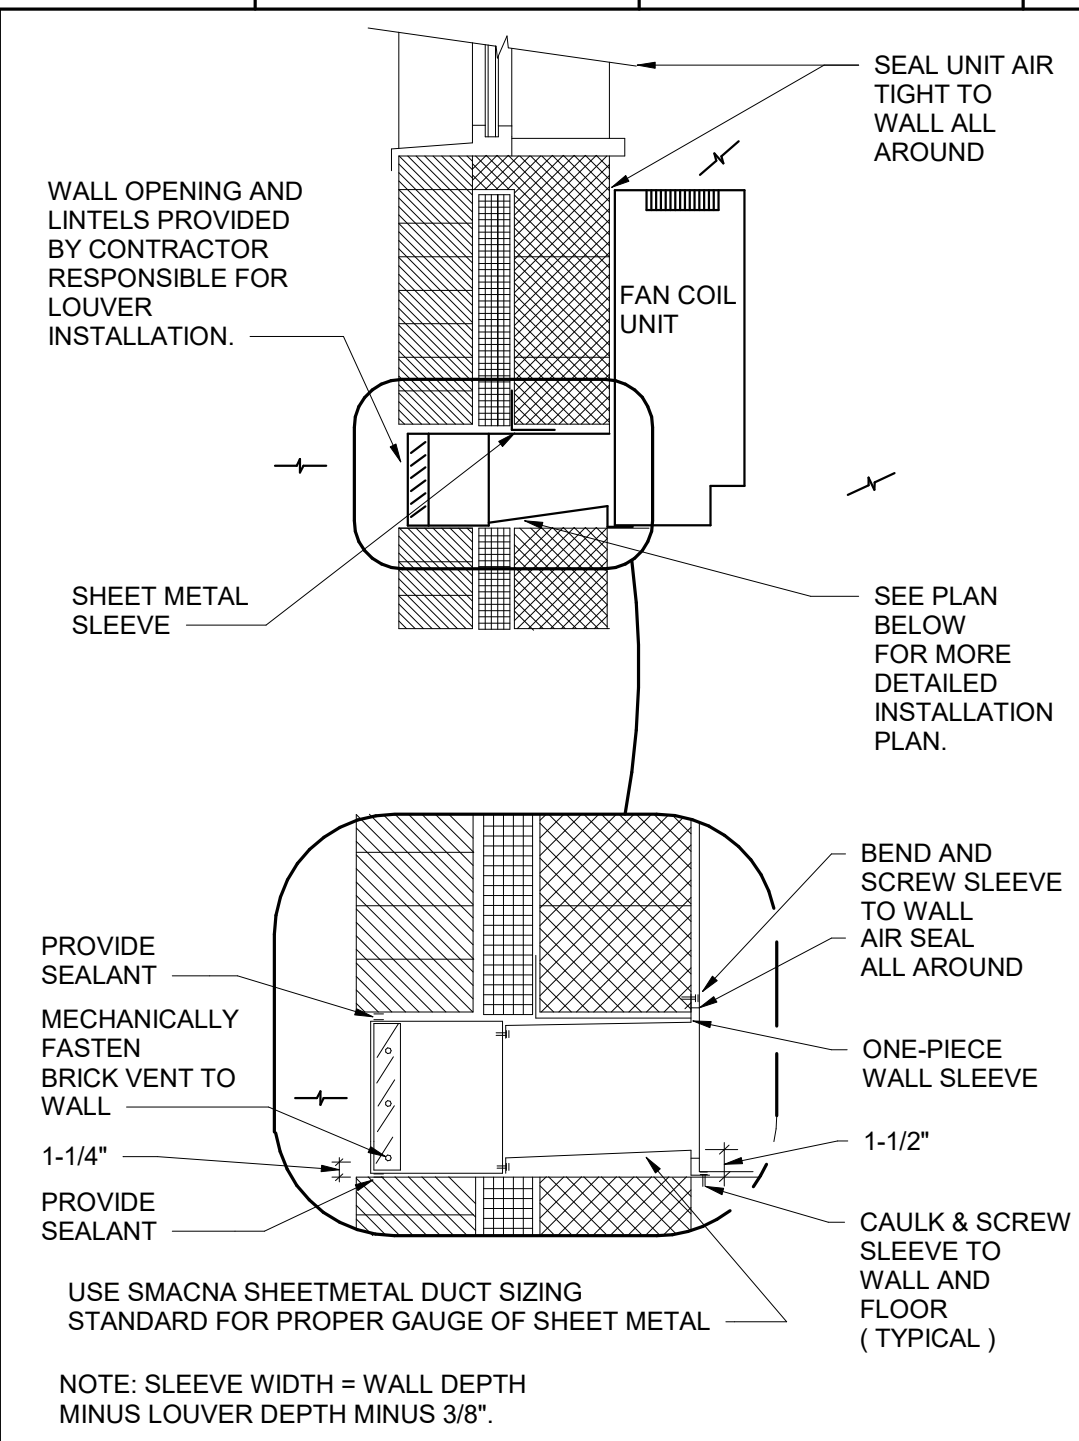


4 Fan Coil Unit Detail
NTS

1 Pipe Insulation
NTS

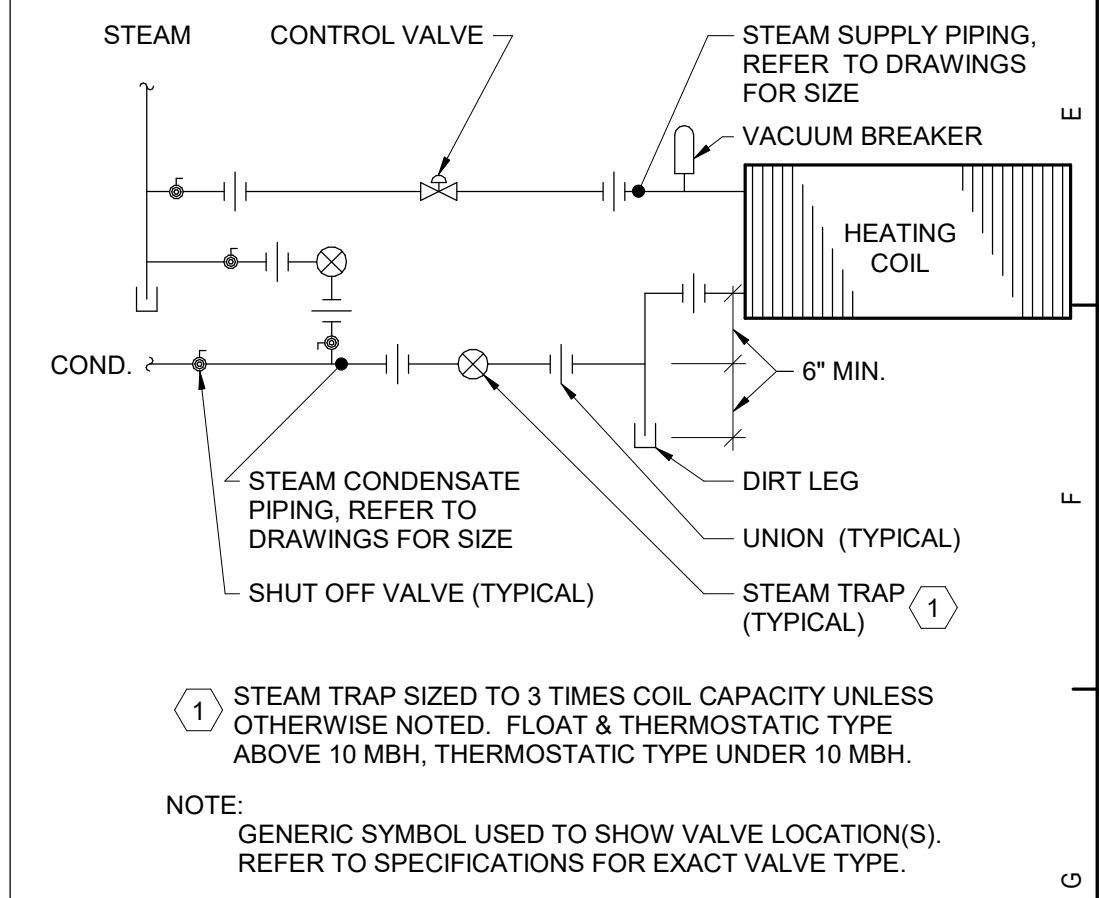

2 Steam Coil Piping Schematic
NTS

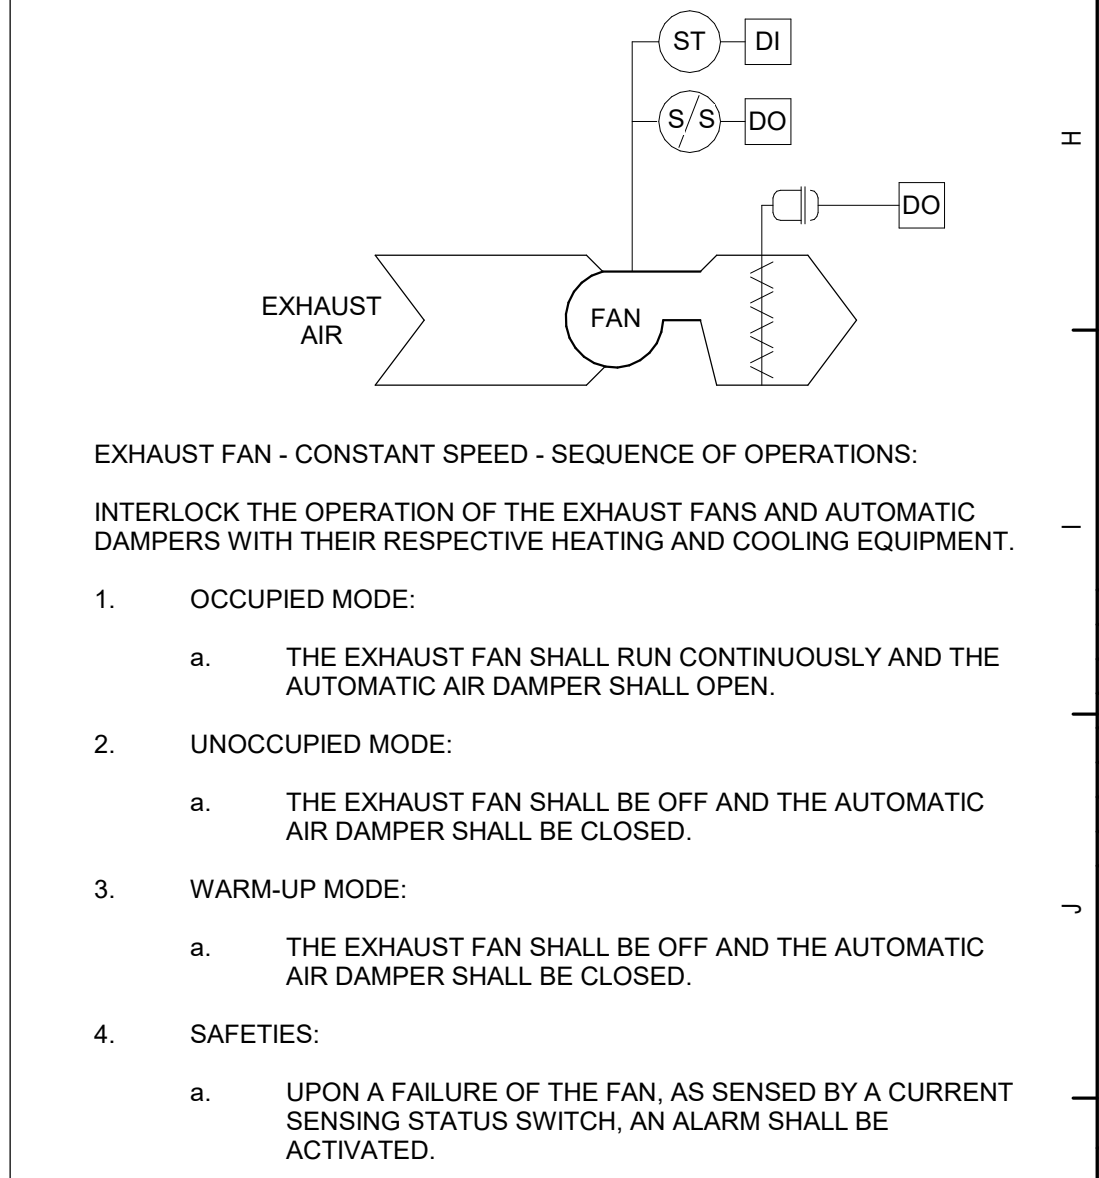

3 Exhaust Fan - Constant Speed
NTS

TEMPERATURE CONTROLS SYMBOLS LIST

- AI ANALOG IN
- AO ANALOG OUT
- COM COMMUNICATIONS PORT
- CS AIRBORNE CONTAMINANT SENSOR
- DI DIGITAL IN
- DO DAMPER MOTOR
- DO DIGITAL OUT
- EMCS ENERGY MANAGEMENT CONTROL SYSTEM
- F FLOW (WATER/AIR)
- FM FLOW METER
- FS AIR FLOW SENSOR
- FZ FREEZE STAT
- H HUMIDITY SENSOR
- HL HIGH LIMIT
- KWH KILOWATT HOUR METER
- LL LOW LIMIT
- M/S MANUAL SWITCH STOP / START
- P PRESSURE SENSOR
- AP DIFFERENTIAL PRESSURE
- PS POSITION SENSOR
- S/S STOP / START
- SD SMOKE DETECTOR
- ST STATUS
- START STARTER
- T ADJUSTABLE THERMOSTAT
- TS TEMPERATURE SENSOR
- VFD VARIABLE FREQUENCY DRIVE
- WS WATER SENSOR
- % PERCENT
- ES END SWITCH
- BS BOILER SWITCH

S.E.D. Control No. 13-02-00-01-0-003-016

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BID SET





Beacon City School District
Beacon, New York

Reconstruction to:
South Ave Elementary School

Details, Schedules and Controls

Drawn By: JPF1/pgm	Date: 10/28/2022	Drawing Number:
Project No.: 279180-22004	DM500	

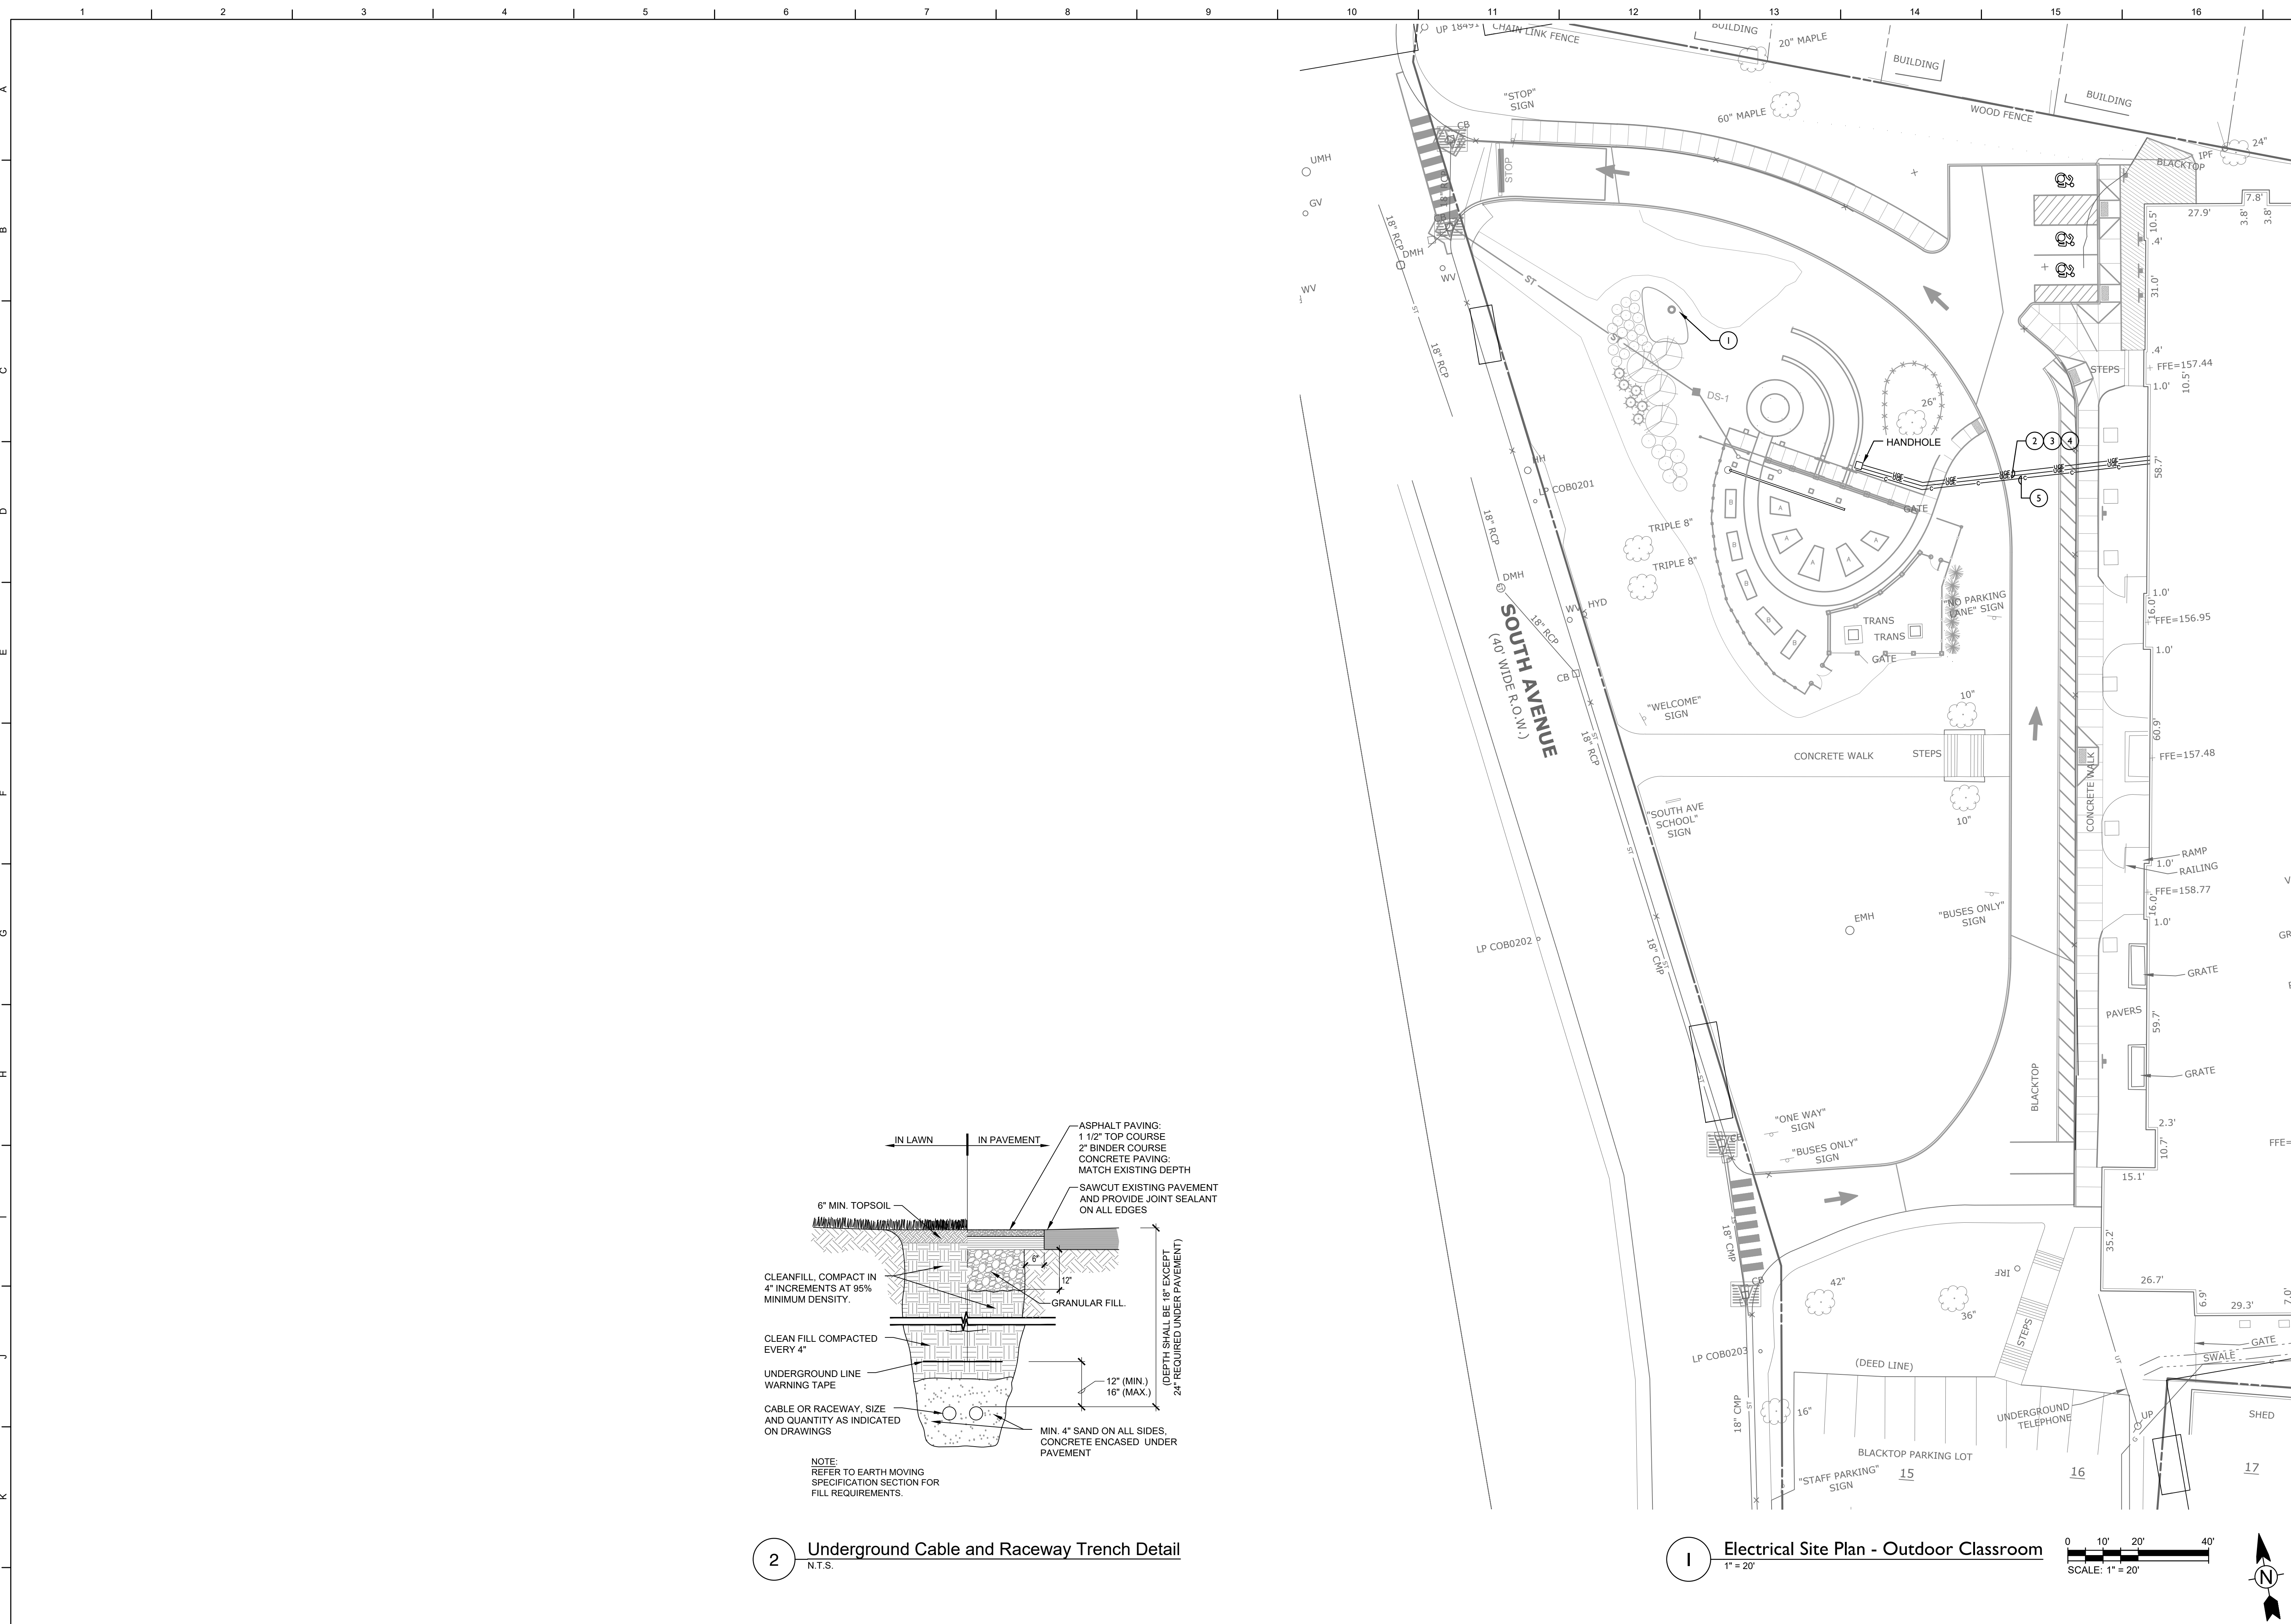

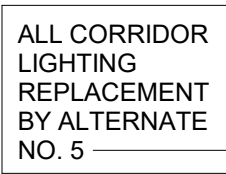

1

- 1 REMOVE LUMINAIRE(S) AND CIRCUITRY COMPLETE BACK TO SOURCE.
- 2 REMOVE WALL OR CEILING MOUNTED EMERGENCY LIGHT. REMOVE EXISTING CIRCUITRY BACK TO NEAREST JUNCTION BOX OR DEVICE OUTSIDE OF DEMOLITION AREA. MODIFY EXISTING SYSTEM CIRCUITRY TO ALLOW FOR PROPER OPERATION OF REMAINING DEVICES ON CIRCUIT.
- 3 REMOVE LIGHT SWITCH(ES) CONTROLLING CORRIDOR LUMINAIRE. REMOVE EXISTING CIRCUITRY BACK TO NEAREST JUNCTION BOX OR DEVICE OUTSIDE OF DEMOLITION AREA. MODIFY EXISTING SYSTEM CIRCUITRY TO ALLOW FOR PROPER OPERATION OF REMAINING DEVICES ON CIRCUIT. PROVIDE BLANK COVER PLATE.
- 4 REMOVE, CLEAN AND STORE CEILING MOUNTED DEVICES IN CEILINGS THAT ARE BEING REPLACED. TAG CIRCUITRY FOR RE-USE.

A. ALL ELECTRICAL DEVICES INTERFERING WITH DEMOLITION WORK SHALL BE IDENTIFIED, DISCONNECTED AND REMOVED. OTHERWISE, EXISTING CIRCUIT WIRING SHALL BE REMOVED BACK TO SOURCE AND PANEL DIRECTORIES MODIFIED ACCORDINGLY.

ANY DEVICE INTERFERING WITH DEMOLITION WORK NOT SHOWN ON ELECTRICAL DRAWINGS SHALL BE IDENTIFIED AND REMOVED WITHOUT WRITTEN AUTHORIZATION FROM THE OWNER'S REPRESENTATIVE OR THE ENGINEER.

C. ALL ELECTRICAL DEMOLITION WORK SHALL BE PROPERLY COORDINATED WITH ALL OTHER TRADES.

EC IS SOLELY RESPONSIBLE FOR THE SAFE HANDLING AND DISPOSAL OF ALL REMOVED FLUORESCENT LIGHT BALLASTS THAT MAY CONTAIN PCBs (POLYCHLORINATED BIPHENYLS). IN ACCORDANCE WITH ALL APPLICABLE A/E, OSHA, FEDERAL, STATE AND LOCAL CODES AND LAWS.

E. EC IS SOLELY RESPONSIBLE FOR THE SAFE HANDLING AND DISPOSAL OF ALL REMOVED FLUORESCENT LIGHT TUBES THAT MAY CONTAIN MERCURY. IN ACCORDANCE WITH ALL APPLICABLE A/E, OSHA, FEDERAL, STATE, AND LOCAL CODES AND LAWS.

F. AT ALL CORRIDORS WHERE NEW CECLES ARE BEING INSTALLED, DISCONNECTED OR REMOVE EXISTING CECLES, TAG EXISTING WIRING FOR REUSE.

G. ALL DEVICES THAT ARE SCHEDULED TO BE REMOVED, CLEANED, STORED AND RE-INSTALLED SHALL BE TESTED PRIOR TO REMOVAL BY ANY DAY AFTER THE DEMOLITION WORK IS COMPLETED. NOTIFY ENGINEER AND OWNER'S REPRESENTATIVE PRIOR TO REMOVAL.

A. COORDINATE ALL ELECTRICAL WORK AND POWER OUTAGES WITH OWNER AND OTHER TRADES PRIOR TO THE START OF WORK. ALL WORK SHALL BE COMPLETED PRIOR TO THE START OF OWNER'S PRIOR KNOWLEDGE AND CONSENT.

B. REFER TO DRAWING G100 FOR STANDARD SYMBOLS AND ABBREVIATIONS.

C. AT ALL CORRIDORS WHERE NEW CEILINGS ARE BEING INSTALLED, REINSTALL DEVICES ON NEW CEILINGS AS SHOWN ON NEW WORK DRAWINGS AND EXTEND/MODIFY EXISTING CIRCUITRY AS NECESSARY.

D. CIRCUIT EUT AND EMERGENCY LUMINAIRE TO UNSWITCHED HOT LINE. EXISTING CIRCUITRY AREAS BEING SERVED BY OR ADJACENT TO THE LUMINAIRE. REFER TO PLANS AND DETAILS FOR MINUTIAE INVERTER INFORMATION.

E. ANY EXISTING CEILING DEVICE(S) IN CONFLICT WITH NEW WORK SHALL BE RELOCATED AND CENTERED IN ADJACENT CEILING TILE. BEYOND EXISTING CIRCUITRY AND CONTROLS AS NECESSARY.

F. CIRCUIT WIRING FOR ALL LIGHTING CIRCUITS SHALL BE IN 1/2" EMT CONDUIT (NM) OR TYPE MC CABLE CONCEALED ABOVE CEILINGS AND IN WALLS. REFER TO SPECIFICATION SECTION 26 05 33 FOR LIGHTING. WHERE MC CABLE IS ACCEPTABLE, 1/2" CIRCUIT CONDUCTORS SHALL BE #12AWG COPPER (NM) 90°C THIN THERMOPLASTIC INSULATION.

G. PROPERLY IDENTIFY ALL CIRCUITS AT PANELS AND J-BOXES AND IN ACCORDANCE WITH PROJECT SPECIFICATIONS.

H. PROVIDE ALL ADAPTERS, COUPLINGS AND ASSOCIATED FITTINGS REQUIRED FOR COMPLETE OPERATIONAL SYSTEM.

I. WHEN INSTALLING NEW DEVICES IN EXISTING LOCATIONS, REUSE EXISTING CONDUIT/PIPE/BOXES WHERE POSSIBLE. IF IN GOOD CONDITION, EXTENDING TO NEW CONDUIT/PIPE/BOXES AS REQUIRED FOR PROPER MOUNTING OF DEVICE. CONCEAL ABOVE CEILING WITH WALLS WHERE POSSIBLE. REFER TO SPECIFICATION SECTION 26 05 33.

J. COORDINATE ALL ELECTRICAL WORK WITH OTHER TRADES.

K. TESTS OF ALL ELECTRICAL WORK SHALL BE PERFORMED IN THE PRESENCE OF THE ENGINEER OR ARCHITECT. AS EQUIPMENT IS INSTALLED AND AS SYSTEMS ARE COMPLETED. IN ADDITION AN ELECTRICAL APPROVED CERTIFICATE SHALL BE ISSUED BY AN ELECTRICAL INSPECTION AGENCY.

L. UNLESS NOTED ELSEWHERE ON THE CONTRACT DOCUMENTS, THE FOLLOWING LIST REPRESENTS THE TYPICAL MOUNTING HEIGHTS FOR THE DEVICES SHOWN:


1.	SWITCHES AND PANIC STATIONS.....	48" (TO TOP)
2.	RECEPTACLES.....	16"
3.	COMPUTER RECEPTACLES.....	48" (TO TOP)
4.	WALL (W) TELEPHONE AND CALL SWITCHES.....	48" (TO TOP)
5.	TELEPHONE OUTLETS (UNLABELED).....	16"
6.	VOLUME CONTROL.....	48" (TO TOP)
7.	TELEVISION OUTLETS.....	16"
8.	FIRE ALARM PULL STATIONS.....	48" (TO TOP)
9.	FIRE ALARM AUDIOVISUAL UNITS.....	88"
10.	(OR) BELOW CEILING, WHICHEVER IS LOWER	
11.	POWER PANELS.....	72" (TO TOP)
12.	DISCONNECT SWITCHES.....	60" (TO TOP)
13.	MOTOR STARTERS.....	60" (TO TOP)

THE HEIGHTS INDICATED SHALL BE NOMINAL TO THE BOTTOM OF THE BOX UNLESS NOTED OTHERWISE. MAINTAIN HEIGHT CONSISTENCY BETWEEN NEW AND EXISTING DEVICES.



S.E.D. Control No. 13-02-00-01-0-003-016

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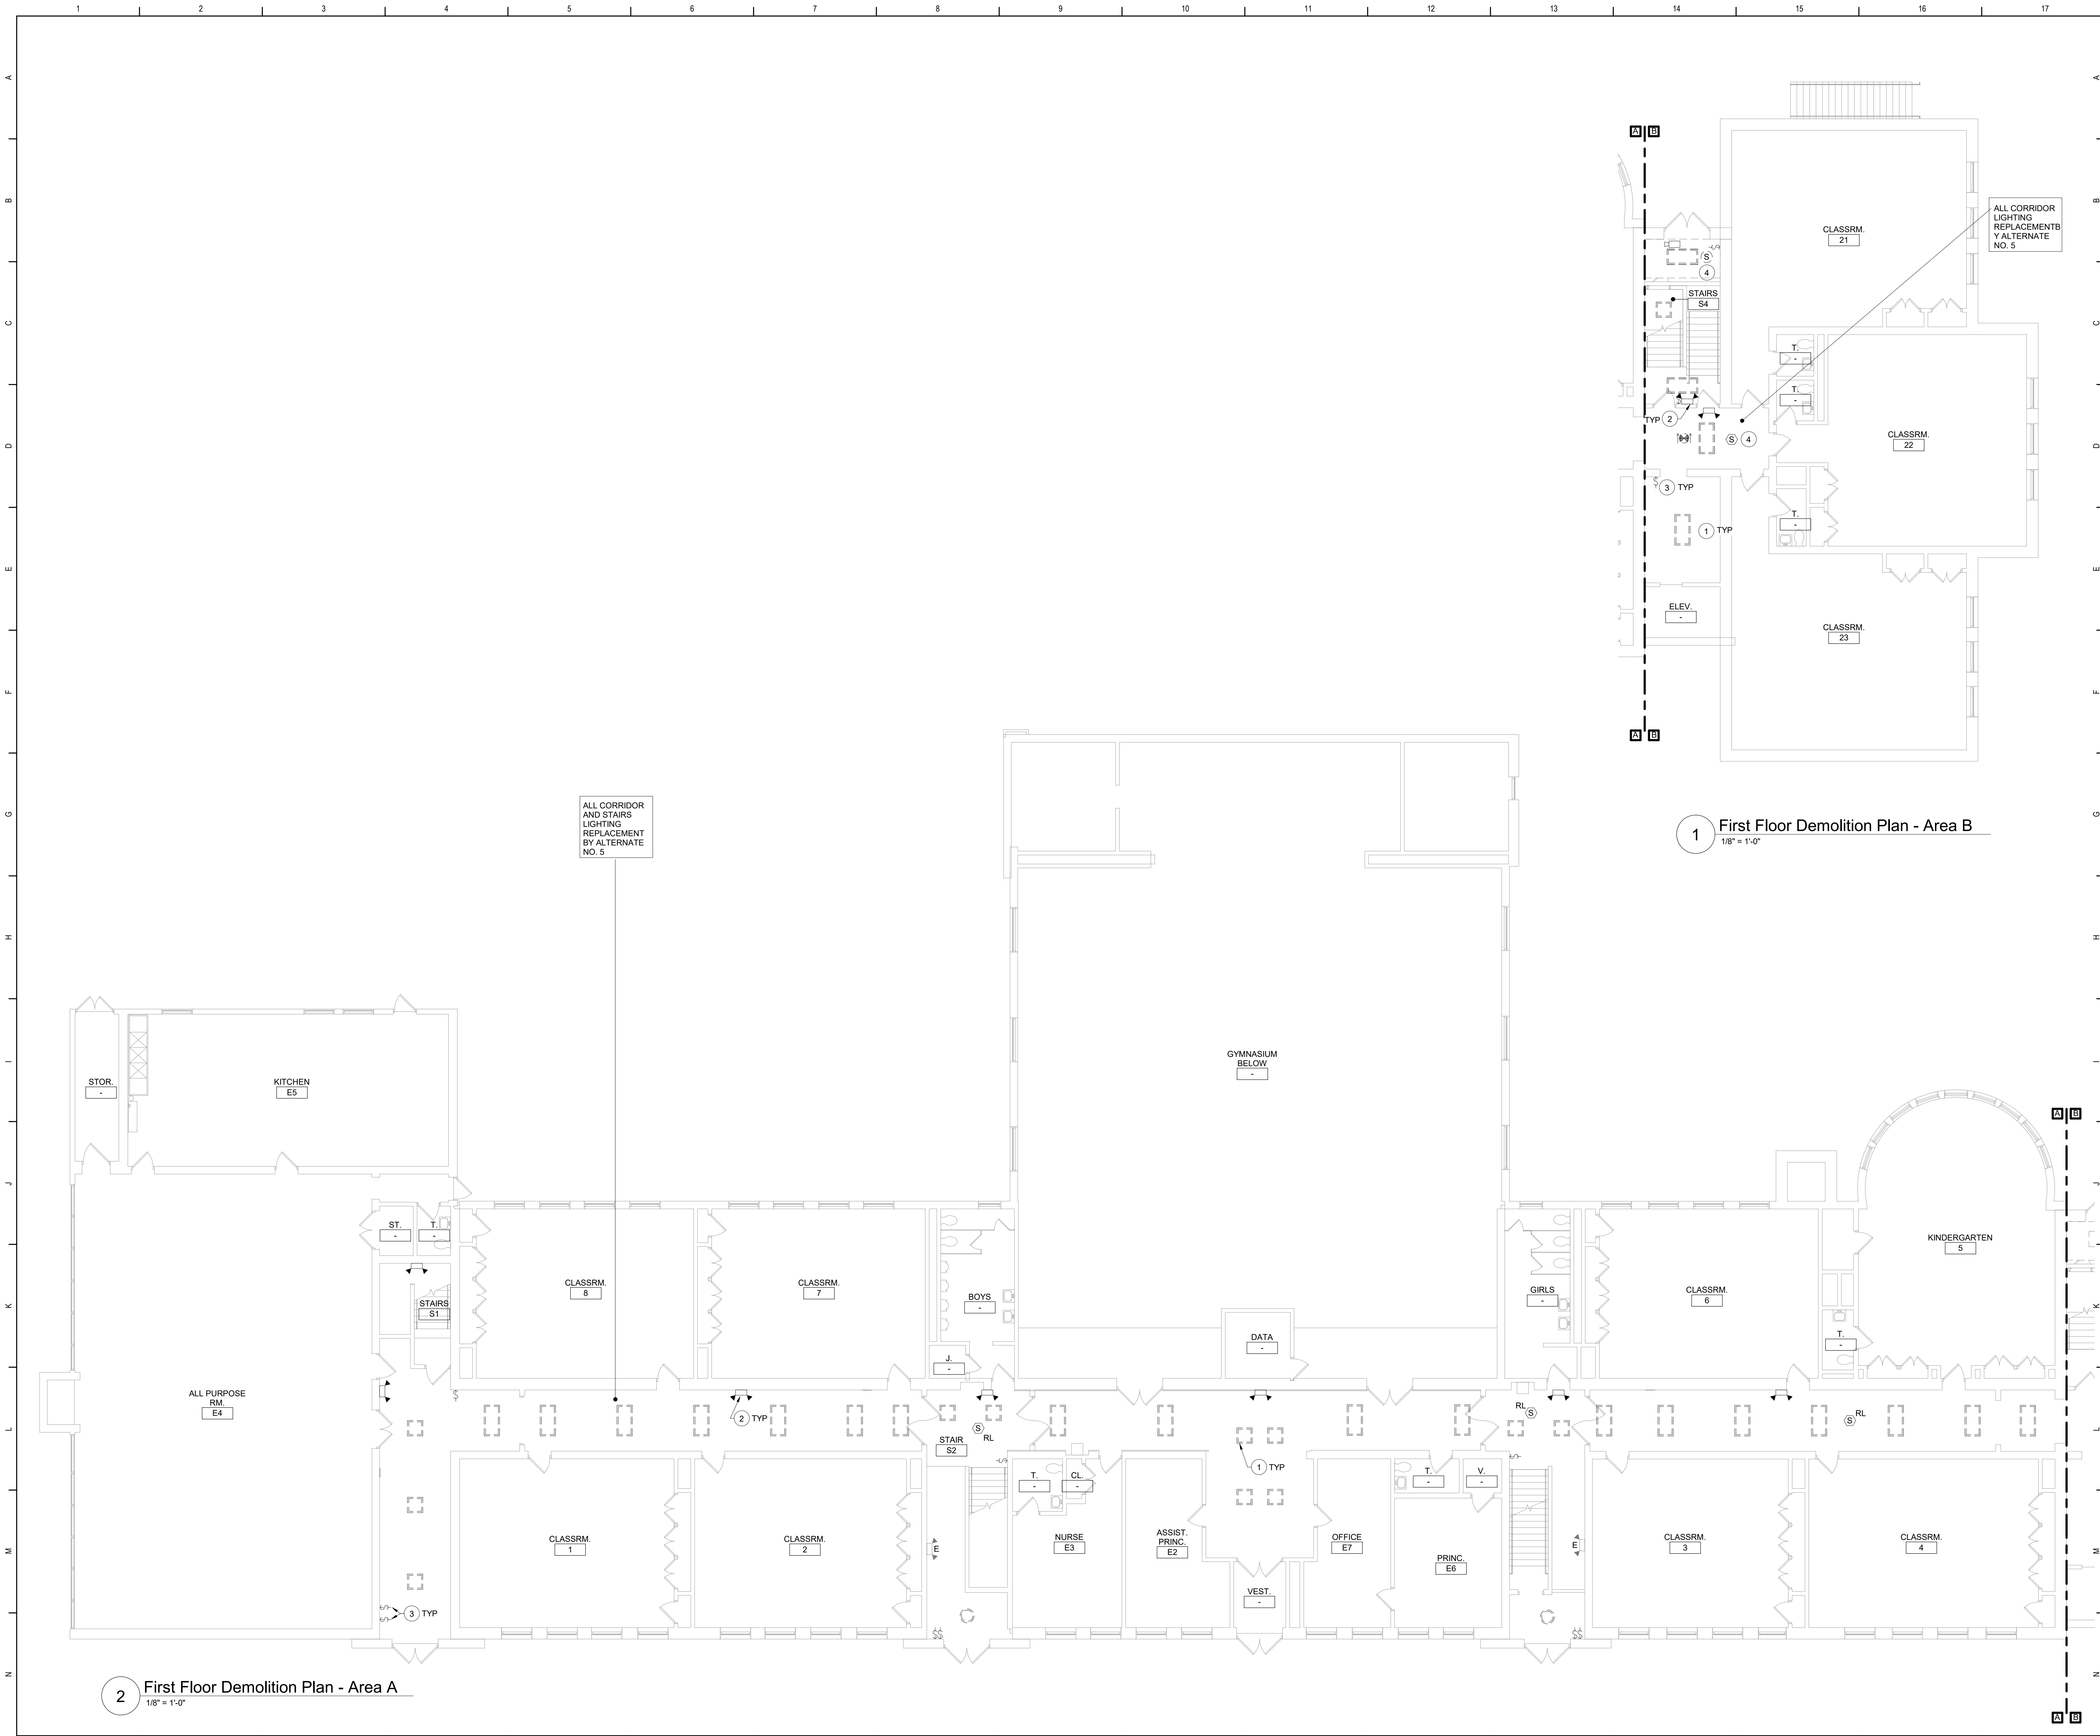


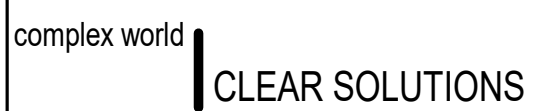Beacon City School District
Beacon, New York

Reconstruction to:
South Ave Elementary School

Ground Floor Demolition Plan - Areas A and B

Drawn By: SAS	Date: 10/28/2022	Drawing Number:
Project No.: 279180-22004		DE100




Keyed Notes:

- 1 REMOVE LUMINAIRE(S) AND CIRCUITRY COMPLETE BACK TO SOURCE.
- 2 REMOVE WALL OR CEILING MOUNTED EMERGENCY LIGHT. REMOVE EXISTING CIRCUITRY BACK TO NEAREST JUNCTION BOX OR DEVICE OUTSIDE OF DEMOLITION AREA. MODIFY EXISTING SYSTEM CIRCUITRY TO ALLOW FOR PROPER OPERATION OF REMAINING DEVICES ON CIRCUIT.
- 3 REMOVE LIGHT SWITCH(IES) CONTROLLING CORRIDOR LUMINAIRES. REMOVE EXISTING CIRCUITRY BACK TO NEAREST JUNCTION BOX OR DEVICE OUTSIDE OF DEMOLITION AREA. MODIFY EXISTING SYSTEM CIRCUITRY TO ALLOW FOR PROPER OPERATION OF REMAINING DEVICES ON CIRCUIT. PROVIDE BLANK COVER PLATE.
- 4 REMOVE, CLEAN AND STORE CEILING MOUNTED DEVICES IN CEILINGS THAT ARE BEING REPLACED. TAG CIRCUITRY FOR RE-USE.

General Notes:


A. REFER TO DRAWING DE100 FOR GENERAL NOTES

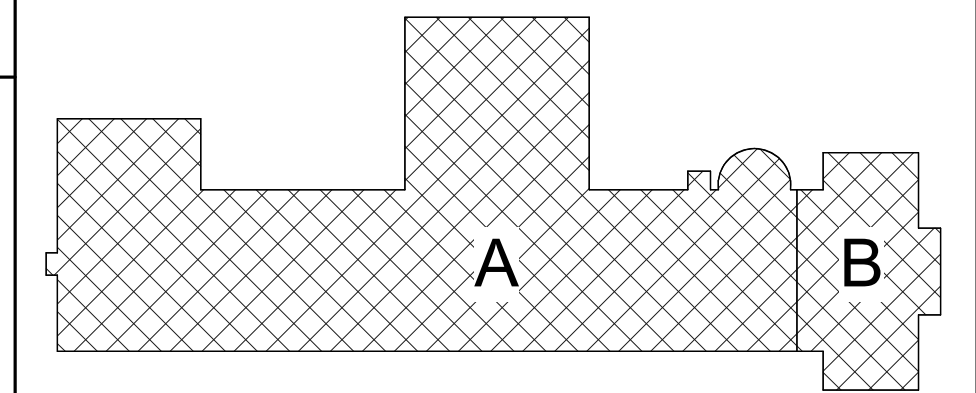

Key Plan
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S.E.D. Control No. 13-02-00-01-0-003-016

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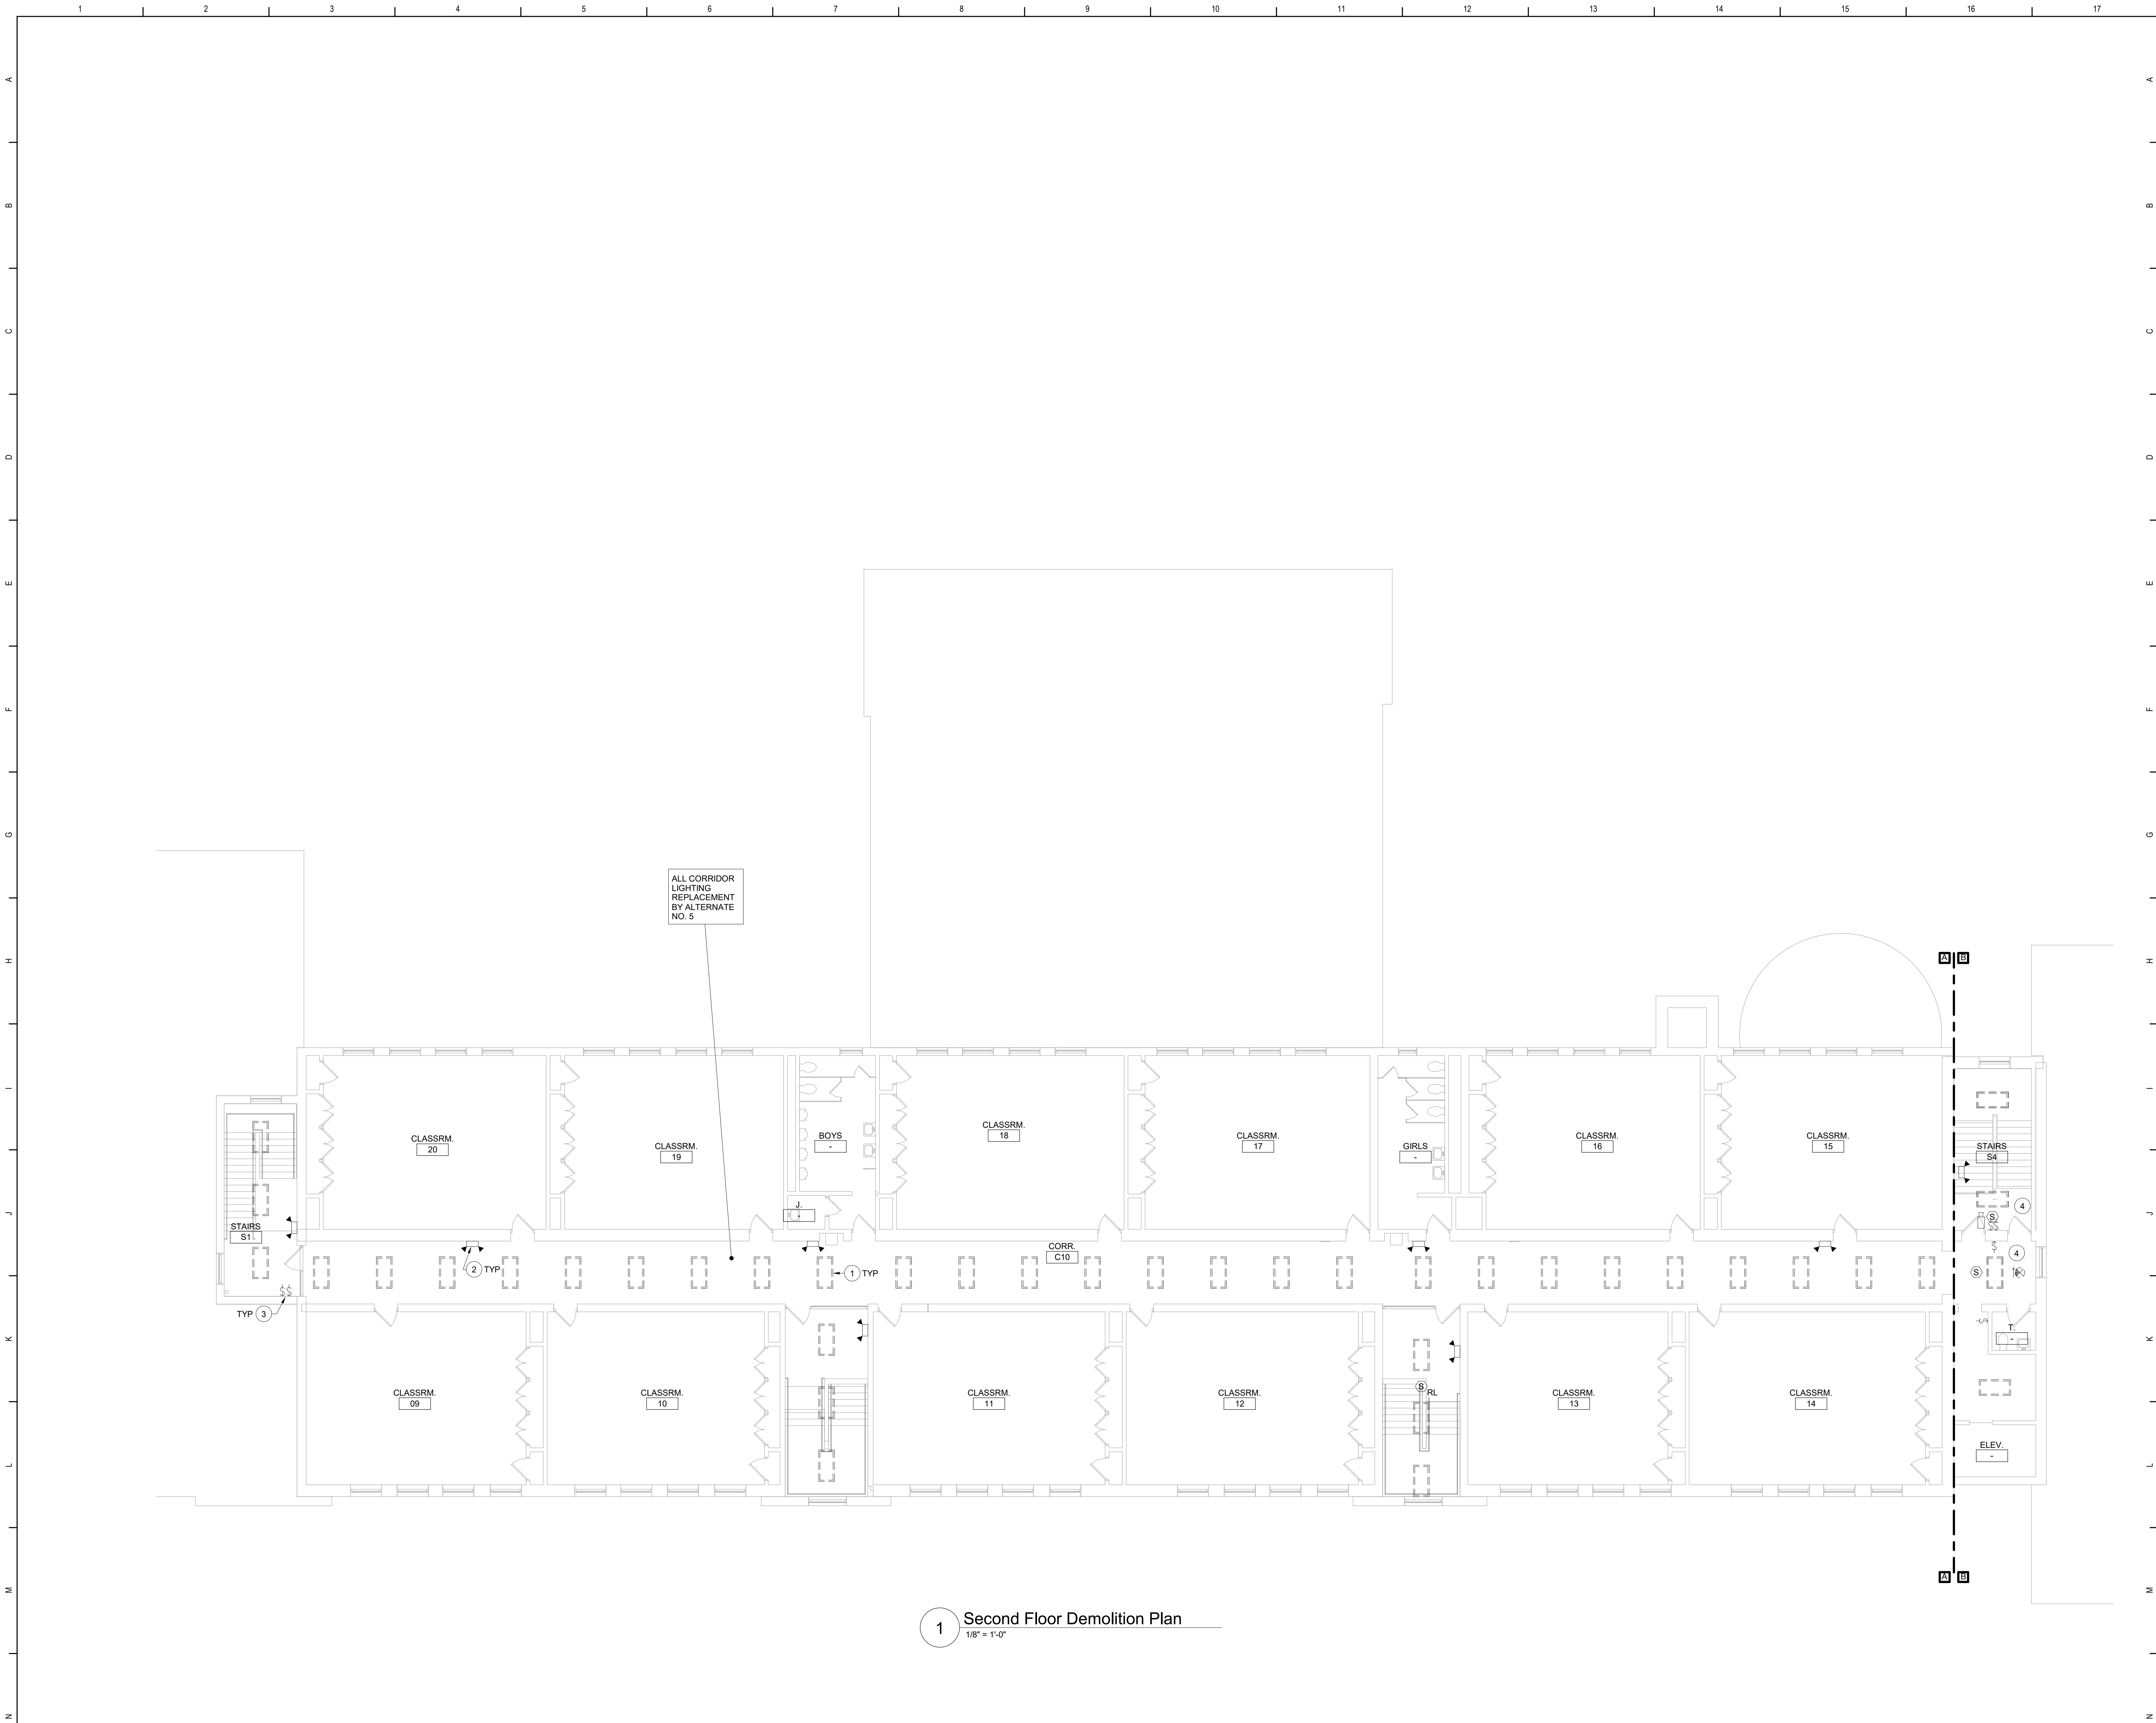


Beacon City School District
Beacon, New York

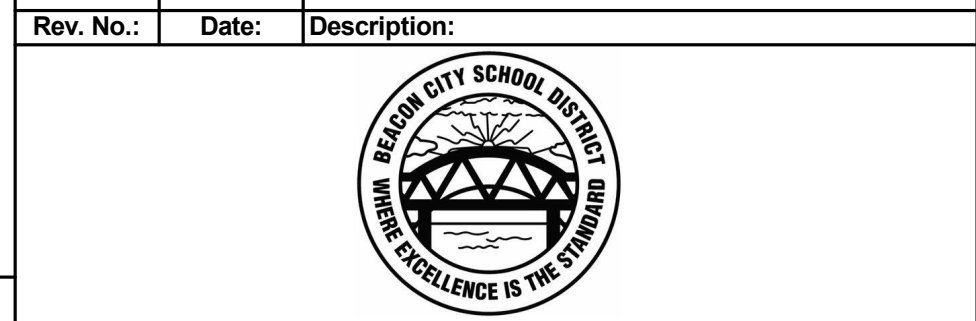Reconstruction to:
South Ave Elementary School

First Floor Demolition Plan - Areas A
and B


Drawn By: SAS	Date: 10/28/2022	Drawing Number:
Project No.: 279180-22004	DE101	



- Keyed Notes:**
- 1 REMOVE LUMINAIRE(S) AND CIRCUITRY COMPLETE BACK TO SOURCE.
 - 2 REMOVE WALL OR CEILING MOUNTED EMERGENCY LIGHT. REMOVE EXISTING CIRCUITRY BACK TO NEAREST JUNCTION BOX OR DEVICE OUTSIDE OF DEMOLITION AREA. MODIFY EXISTING SYSTEM CIRCUITRY TO ALLOW FOR PROPER OPERATION OF REMAINING DEVICES ON CIRCUIT.
 - 3 REMOVE LIGHT SWITCH(IES) CONTROLLING CORRIDOR LUMINAIRES. REMOVE EXISTING CIRCUITRY BACK TO NEAREST JUNCTION BOX OR DEVICE OUTSIDE OF DEMOLITION AREA. MODIFY EXISTING SYSTEM CIRCUITRY TO ALLOW FOR PROPER OPERATION OF REMAINING DEVICES ON CIRCUIT. PROVIDE BLANK COVER PLATE.
 - 4 REMOVE, CLEAN AND STORE CEILING MOUNTED DEVICES IN CEILINGS THAT ARE BEING REPLACED. TAG CIRCUITRY FOR RE-USE.

General Notes:


A. REFER TO DRAWING DE100 FOR GENERAL NOTES

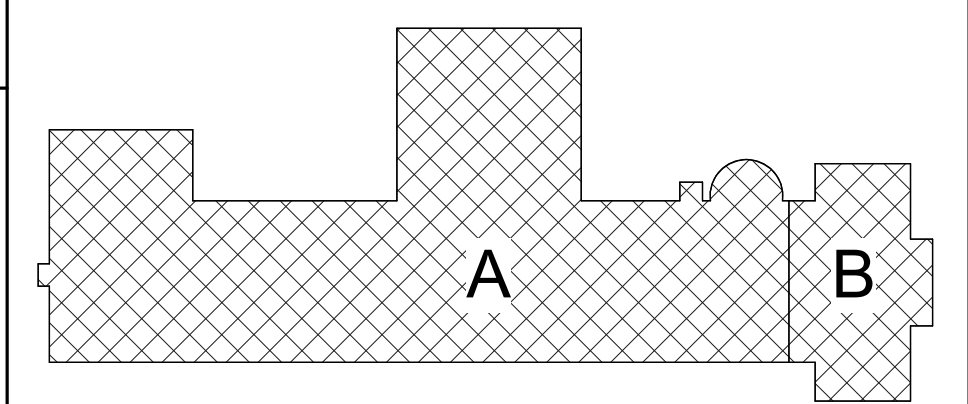

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S.E.D. Control No. 13-02-00-01-0-003-016

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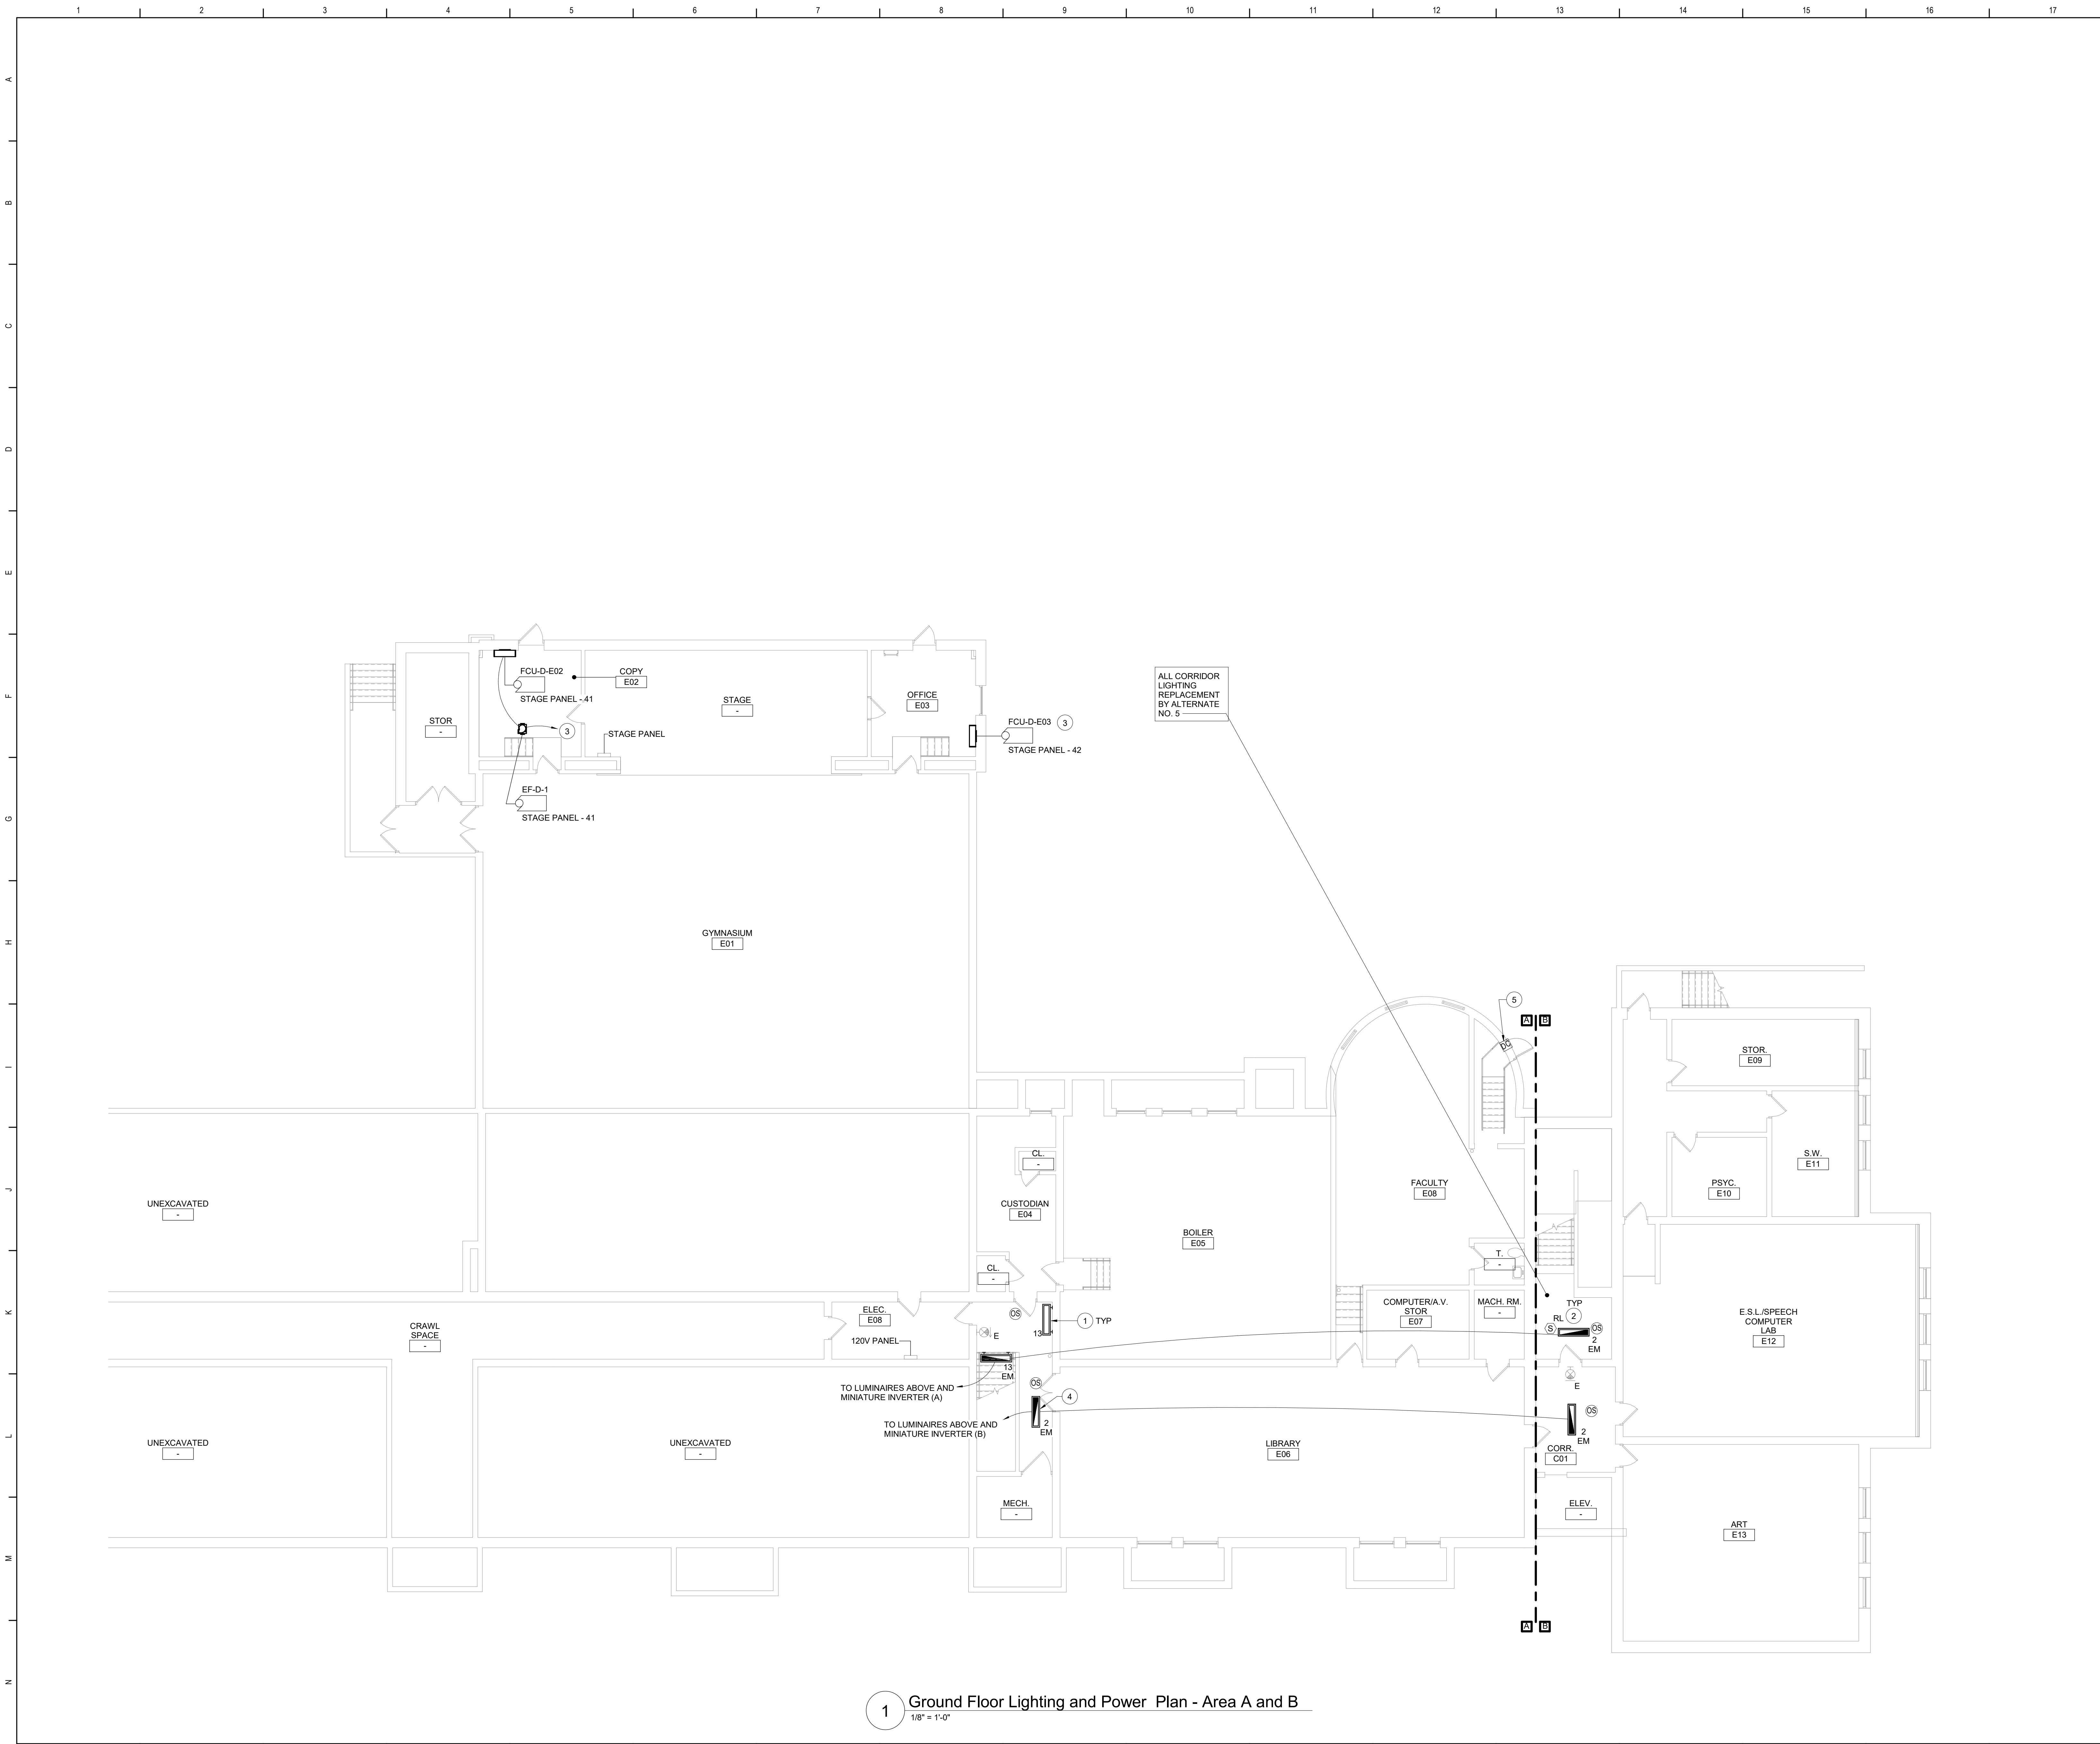


Beacon City School District
Beacon, New York

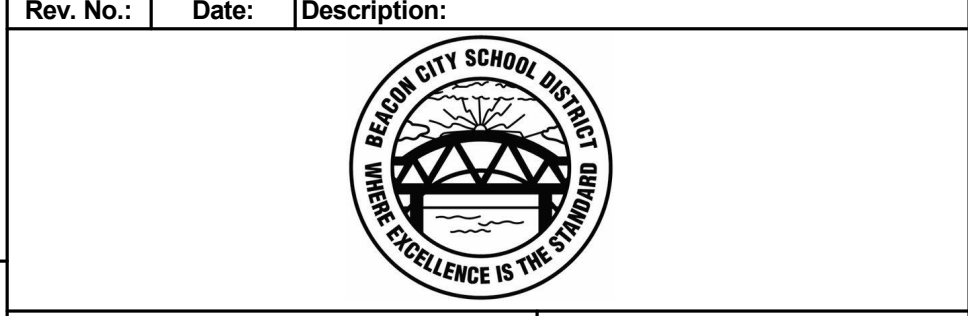Reconstruction to:
South Ave Elementary School

Second Floor Demolition Plan

Drawn By: SAS	Date: 10/28/2022	Drawing Number:
Project No.: 279180-22004	DE102	



- Keyed Notes:**
- 1 CONNECT LUMINAIRES TO EXISTING CIRCUIT BREAKER PREVIOUSLY SERVING THE AREA USING (2)#12, (1)#12 G. IN 1/2" CONDUIT. LUMINAIRES TO BE CONTROLLED BY OCCUPANCY SENSORS AND DIRECT DIGITAL CONTROL SYSTEM.
 - 2 RE-INSTALL STORED CEILING MOUNTED DEVICES IN CEILINGS THAT ARE BEING REPLACED. CENTER DEVICES IN CEILING GRID CLOSEST TO EXISTING LOCATION. MODIFY/EXTEND CIRCUITRY AS NECESSARY.
 - 3 PROVIDE 20A1P BREAKER IN AVAILABLE SPACE IN STAGE PANEL. CONNECT USING (2)#12, (1)#12 G. IN 1/2" CONDUIT. NEW BREAKER TO BE UL LISTED FOR USE IN PANEL AND MEET OR EXCEED AIC RATING OF EXISTING PANEL. AMEND PANEL DIRECTORY ACCORDINGLY.
 - 4 PROVIDE SURFACE MOUNT KIT FOR LUMINAIRE.
 - 5 PROVIDE DOOR CONTACT FOR MONITORING OF DOOR, TIE INTO EXISTING BUILDING MONITORING SYSTEM.
- General Notes:**
- A. REFER TO DRAWING DE050 FOR GENERAL NOTES.
B. REFER TO DRAWING DE050 FOR LUMINAIRE SCHEDULE.
C. SECURE ALL EXISTING UNSUPPORTED CABLES ABOVE CEILINGS IN CORRIDORS USING J HOOKS OR CABLETRAYS.
D. PATCH/REPLACE CEILING SYSTEMS TO REMAIN THAT HAVE BEEN DISTURBED BY SCHEDULED WORK.
E. INVERTER SYSTEM EMERGENCY OUTPUT CIRCUITS SHALL BE INSTALLED IN DEDICATED CONDUIT SYSTEMS AND NOT SHARED WITH OTHER ELECTRICAL CIRCUITS AS DESCRIBED IN NEC 700-9(B).
F. LIGHTING CONTROL SEQUENCES:
LOBBY/VESTIBULES/CORRIDORS:
PERSON ENTERS THE AREA, LUMINAIRES TURN ON TO 100% OUTPUT AUTOMATICALLY BY OCCUPANCY SENSOR.
PERSON EXITS THE AREA, LUMINAIRES DIM TO 50% OUTPUT (MAINTAINING EGRESS LEVEL ILLUMINATION). MANUAL CONTROL BY BUILDING MANAGEMENT SYSTEM.

Key Plan
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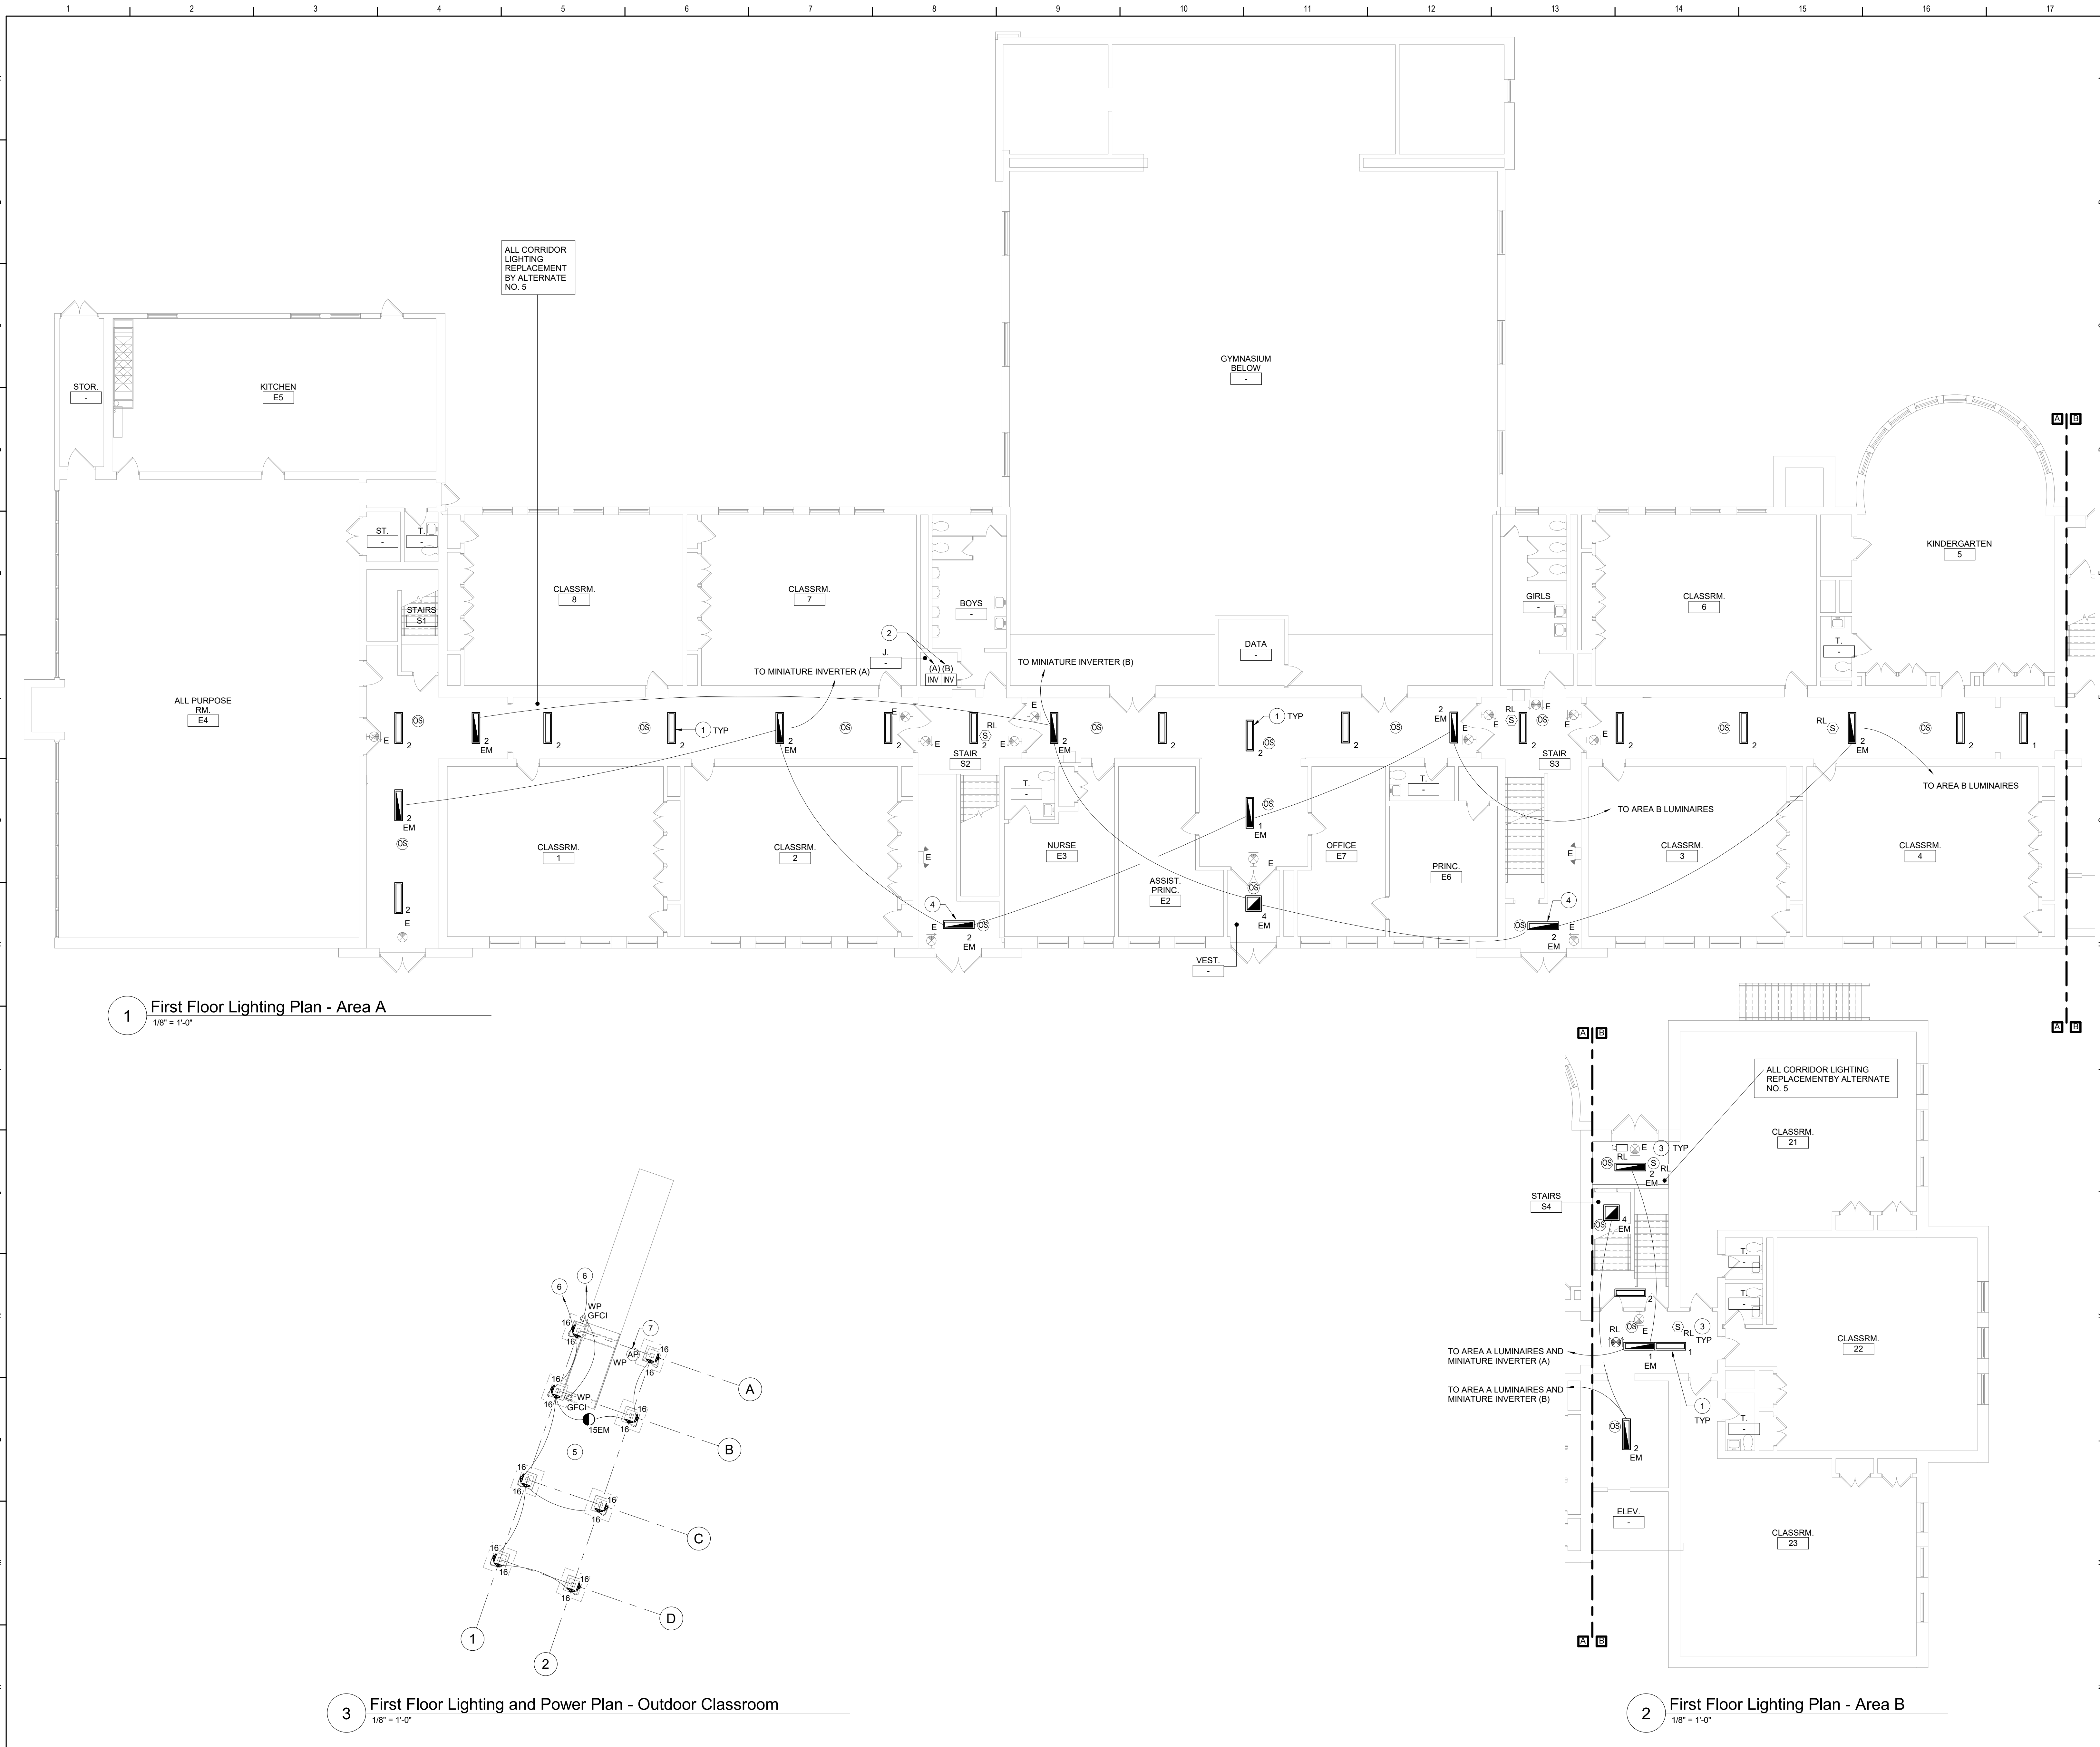
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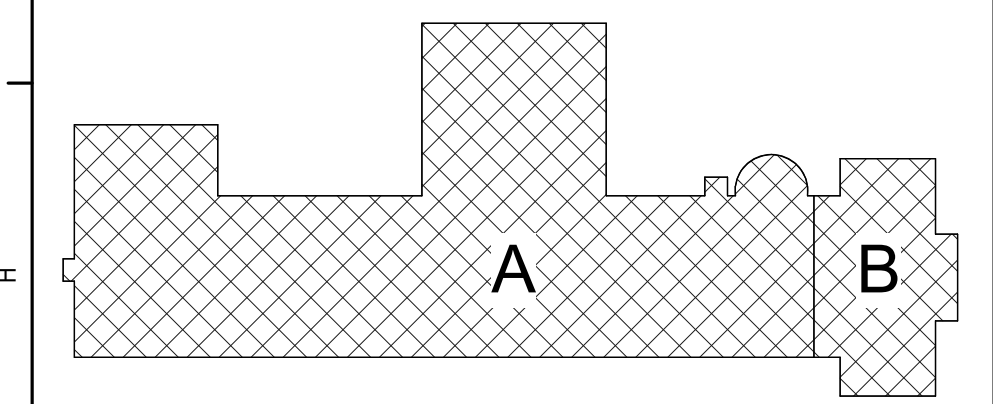
Reconstruction to:
South Ave Elementary School

Ground Floor Floor Lighting Plan -
Areas A and B

Drawn By: SAS/CR	Date: 10/28/2022	Drawing Number:
Project No.: 279180-22004	DE130	




- Keyed Notes:**
1. CONNECT LUMINAIRES TO EXISTING CIRCUIT BREAKER PREVIOUSLY SERVING THE AREA USING (2)1/2" (1)1/2" G. IN 1/2" CONDUIT. LUMINAIRES TO BE CONTROLLED BY OCCUPANCY SENSORS AND DIRECT DIGITAL CONTROL SYSTEM.
 2. PROVIDE WALL MOUNTED MINIATURE INVERTER BASED ON MODEL VESTA MAX MODEL VST-MAX-375W-UNV-4OK. MOUNT AT 72" AFF. COORDINATE FINAL LOCATION WITH OWNER. CONNECT EVERY OTHER EMERGENCY LUMINAIRE PER CORRIDOR TO ADJACENT INVERTER TO AVOID TOTAL OUTAGE UPON BATTERY FAILURE. REFER TO WIRING DIAGRAM ON DRAWING DE500.
 3. RE-INSTALL STORED CEILING MOUNTED DEVICES IN CEILINGS THAT ARE BEING REPLACED. CENTER DEVICES IN CEILING GRID CLOSEST TO EXISTING LOCATION. MODIFY/EXTEND CIRCUITRY AS NECESSARY.
 4. PROVIDE SURFACE MOUNT KIT FOR LUMINAIRE.
 5. PROVIDE PHOTOCELL. MOUNT ON EDGE OF CANOPY FACING NORTH. CONNECT SCONCES AND CANOPY LUMINAIRES WITH (2)1/2" (1)1/2" G. IN 3/4" CONDUIT TO HANDHOLE LOCATION.
 6. PROVIDE 20A1P BREAKER IN AVAILABLE SPACE IN 120V PANEL IN ELEC ROOM (SEE SHEET DE130). CONNECT USING (2)1/2" (1)1/2" G. IN 1/2" CONDUIT. NEW BREAKER TO BE UL LISTED FOR USE IN PANEL AND MEET OR EXCEED AIC RATING OF EXISTING PANEL. AMEND PANEL DIRECTORY ACCORDINGLY. SEE SHEET DE001 FOR UNDERGROUND CONDUIT LOCATION.
 7. PROVIDE WIRELESS ACCESS POINT IN WEATHERPROOF COVER. PROVIDE WATERPROOF CAT 6 CABLE FROM NEAREST DATA RACK IN BUILDING TO WIRELESS ACCESS POINT. SEE SHEET DE001 FOR MORE INFORMATION.
- General Notes:**
- A. REFER TO DRAWING DE050 FOR GENERAL NOTES.
B. REFER TO DRAWING DE500 FOR LUMINAIRE SCHEDULE.
C. SECURE ALL EXISTING UNSUPPORTED CABLES ABOVE CEILINGS IN CORRIDORS USING J HOOKS OR CABLETRAYS.
D. PATCH/REPLACE CEILING SYSTEMS TO REMAIN THAT HAVE BEEN DISTURBED BY SCHEDULED WORK.
E. INVERTER SYSTEM EMERGENCY OUTPUT CIRCUITS SHALL BE INSTALLED IN DEDICATED CONDUIT SYSTEMS AND NOT SHARED WITH OTHER ELECTRICAL CIRCUITS AS DESCRIBED IN NEC 700-9(B).
F. LIGHTING CONTROL SEQUENCES:
LOBBY/VESTIBULES/CORRIDORS:
PERSON ENTERS THE AREA. LUMINAIRES TURN ON TO 100% OUTPUT AUTOMATICALLY BY OCCUPANCY SENSOR.
PERSON EXITS THE AREA. LUMINAIRES DIM TO 50% OUTPUT (MAINTAINING EGRESS LEVEL ILLUMINATION). MANUAL CONTROL BY BUILDING MANAGEMENT SYSTEM.



Key Plan
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S.E.D. Control No. 13-02-00-01-0-003-016

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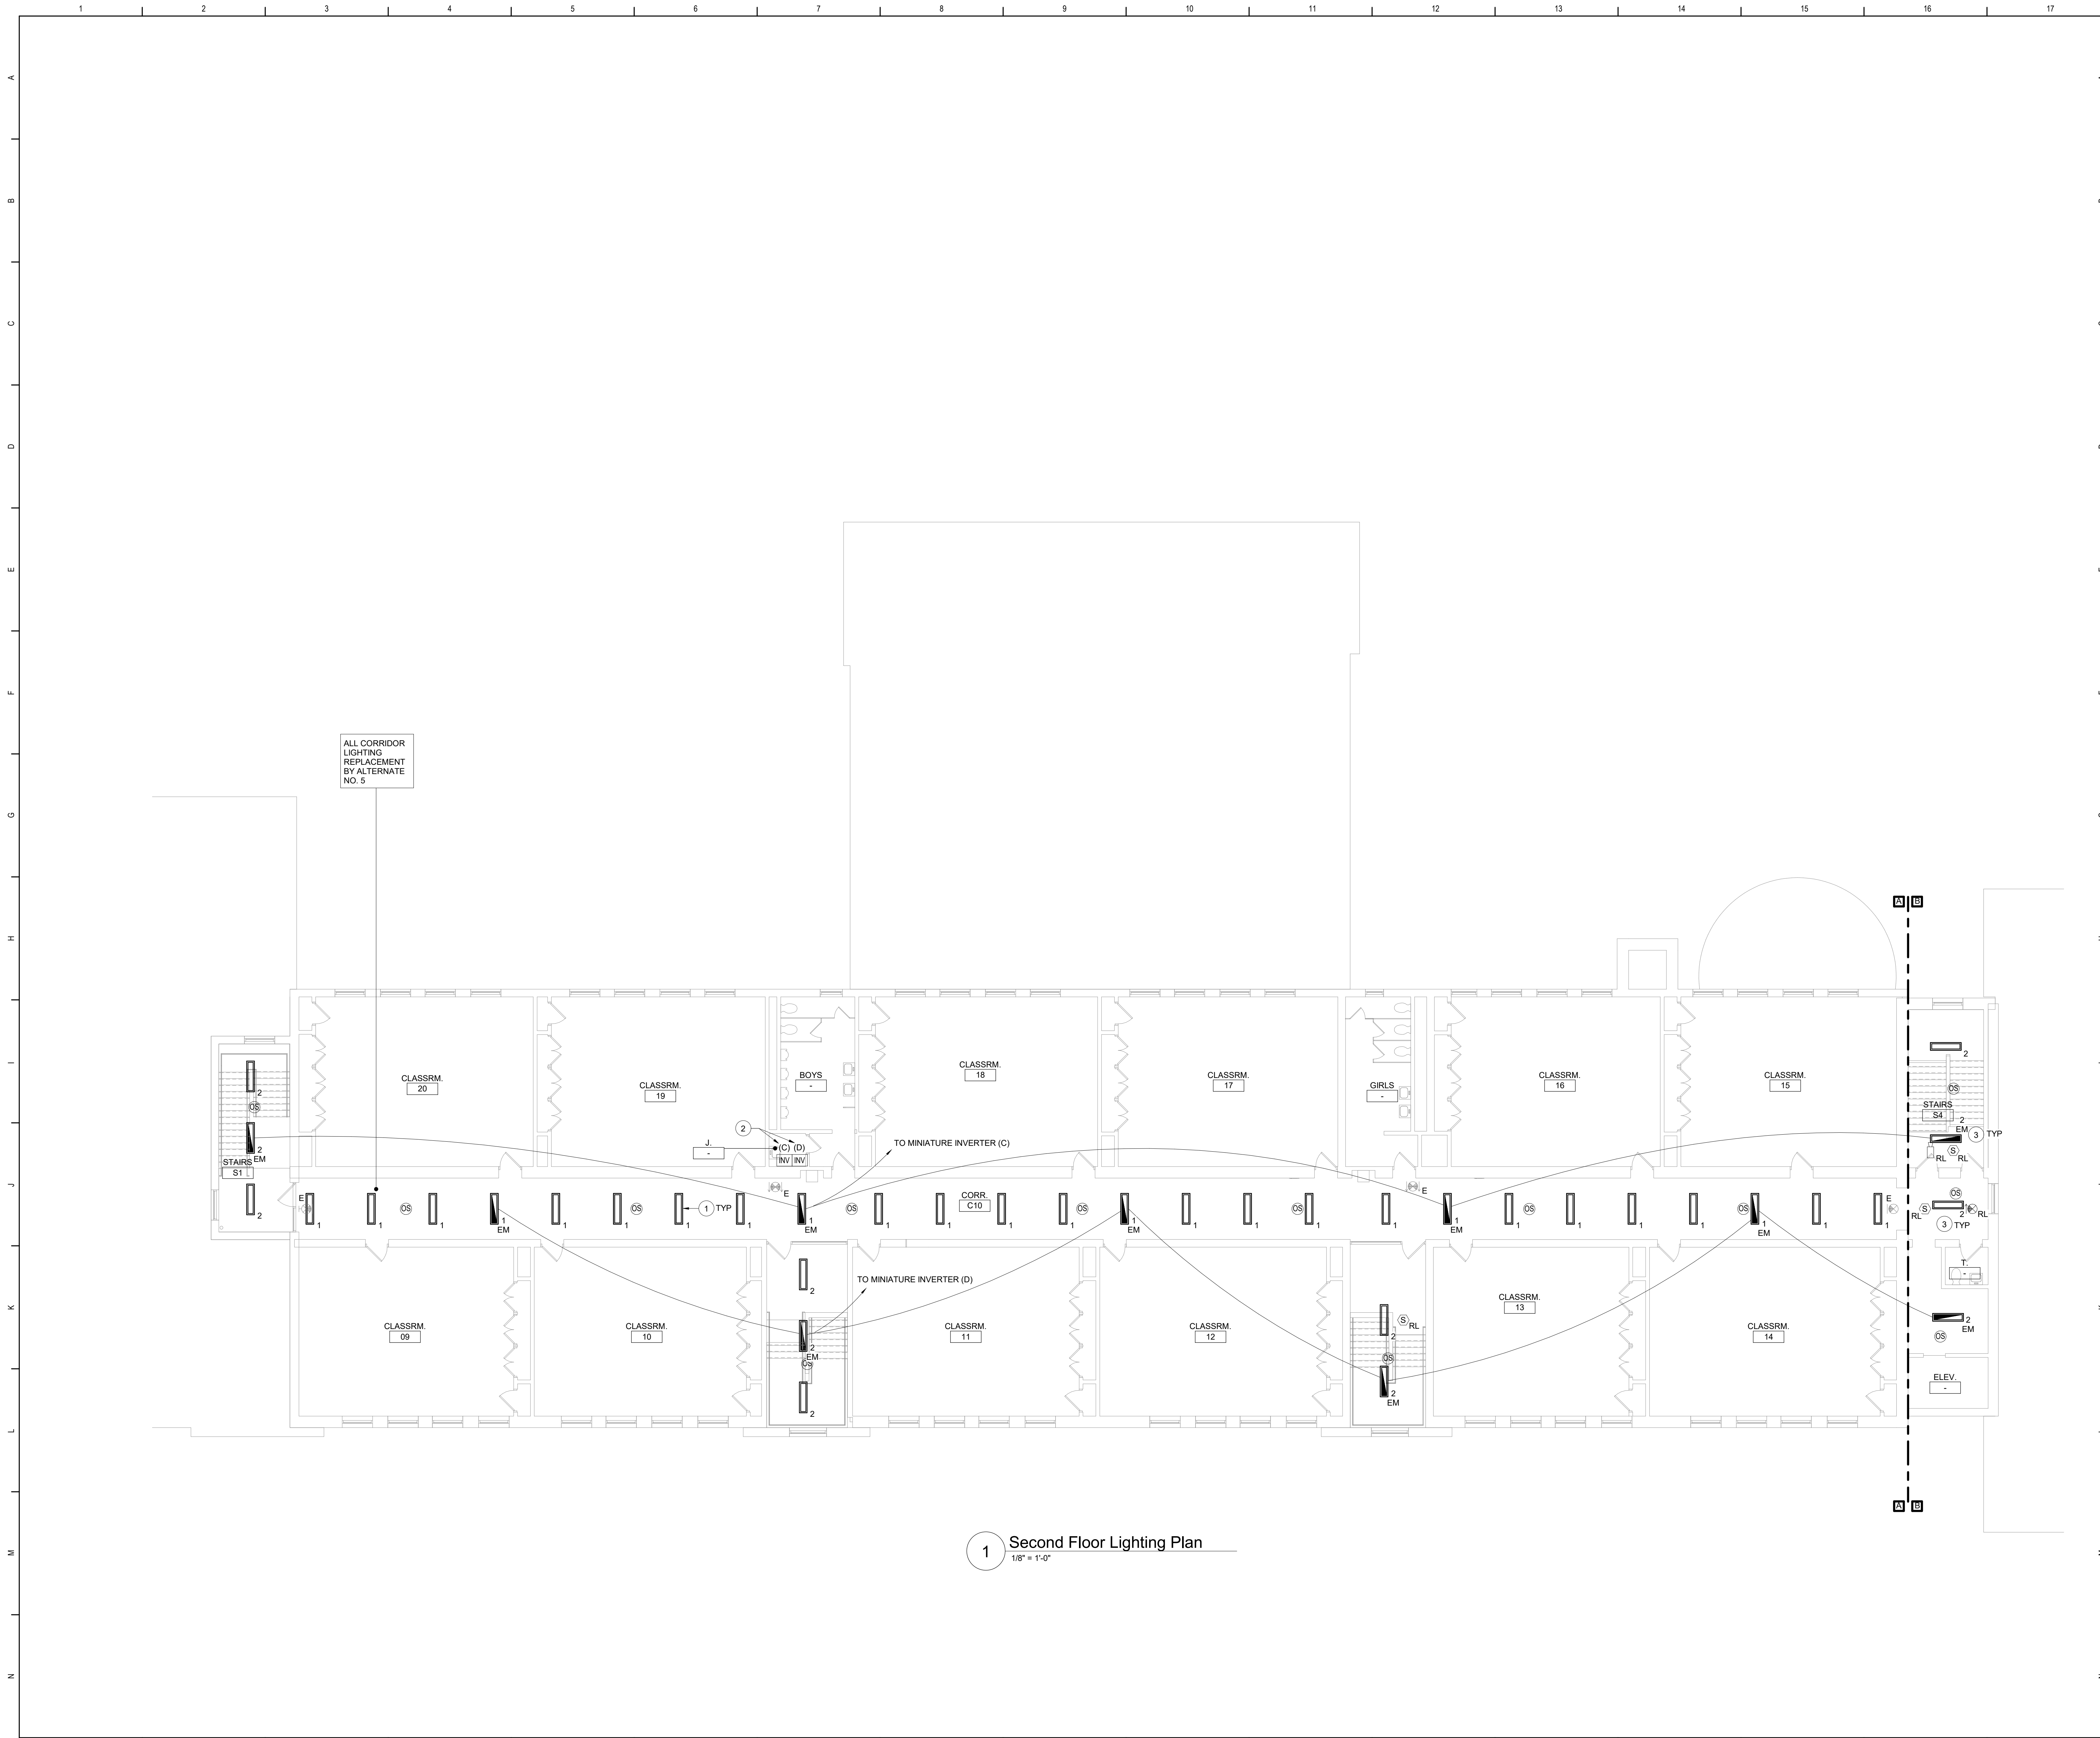


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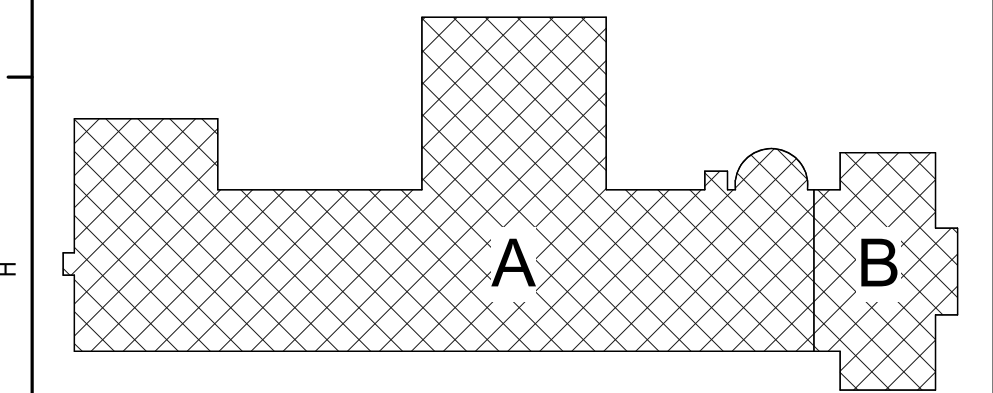
Reconstruction to:
South Ave Elementary School

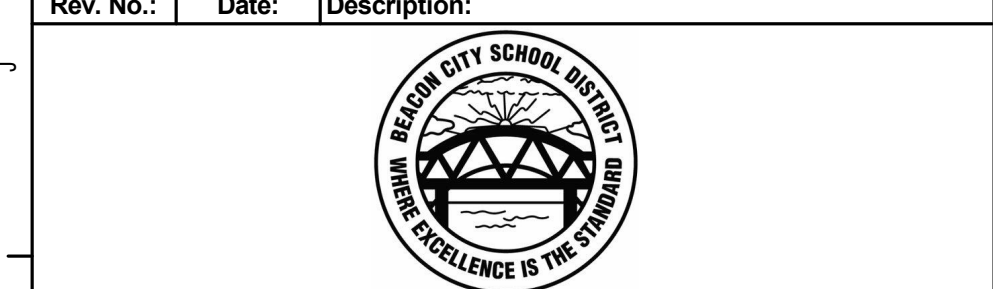First Floor Lighting Plan - Area A

Drawn By: SAS/CR	Date: 10/28/2022	Drawing Number:
Project No.: 279180-22004		DE131




- Keyed Notes:**
1. CONNECT LUMINAIRES TO EXISTING CIRCUIT BREAKER PREVIOUSLY SERVING THE AREA USING (2)#12, (1)#12 G. IN 1/2" CONDUIT. LUMINAIRES TO BE CONTROLLED BY OCCUPANCY SENSORS AND DIRECT DIGITAL CONTROL SYSTEM.
 2. PROVIDE WALL MOUNTED MINIATURE INVERTER BASED ON MODEL VESTA MAX MODEL VST-MAX-375W-UNV-4-OK. MOUNT AT 72" AFF. COORDINATE FINAL LOCATION WITH OWNER. CONNECT EVERY OTHER EMERGENCY LUMINAIRE PER CORRIDOR TO ADJACENT INVERTER TO AVOID TOTAL OUTAGE UPON BATTERY FAILURE. REFER TO WIRING DIAGRAM ON DRAWING DE500.
 3. RE-INSTALL STORED CEILING MOUNTED DEVICES IN CEILINGS THAT ARE BEING REPLACED. CENTER DEVICES IN CEILING GRID CLOSEST TO EXISTING LOCATION. MODIFY/EXTEND CIRCUITRY AS NECESSARY.
- General Notes:**
- A. REFER TO DRAWING DE050 FOR GENERAL NOTES.
B. REFER TO DRAWING DE500 FOR LUMINAIRE SCHEDULE.
C. SECURE ALL EXISTING UNSUPPORTED CABLES ABOVE CEILINGS IN CORRIDORS USING J HOOKS OR CABLETRAYS.
D. PATCH/REPLACE CEILING SYSTEMS TO REMAIN THAT HAVE BEEN DISTURBED BY SCHEDULED WORK.
E. INVERTER SYSTEM EMERGENCY OUTPUT CIRCUITS SHALL BE INSTALLED IN DEDICATED CONDUIT SYSTEMS AND NOT SHARED WITH OTHER ELECTRICAL CIRCUITS AS DESCRIBED IN NEC 700-9(B).
F. LIGHTING CONTROL SEQUENCES:
LOBBY/VESTIBULES/CORRIDORS:
PERSON ENTERS THE AREA, LUMINAIRES TURN ON TO 100% OUTPUT AUTOMATICALLY BY OCCUPANCY SENSOR.
PERSON EXITS THE AREA, LUMINAIRES DIM TO 50% OUTPUT (MAINTAINING EGRESS LEVEL ILLUMINATION). MANUAL CONTROL BY BUILDING MANAGEMENT SYSTEM.



Key Plan
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S.E.D. Control No. 13-02-00-01-0-003-016


Rev. No.	Date	Description



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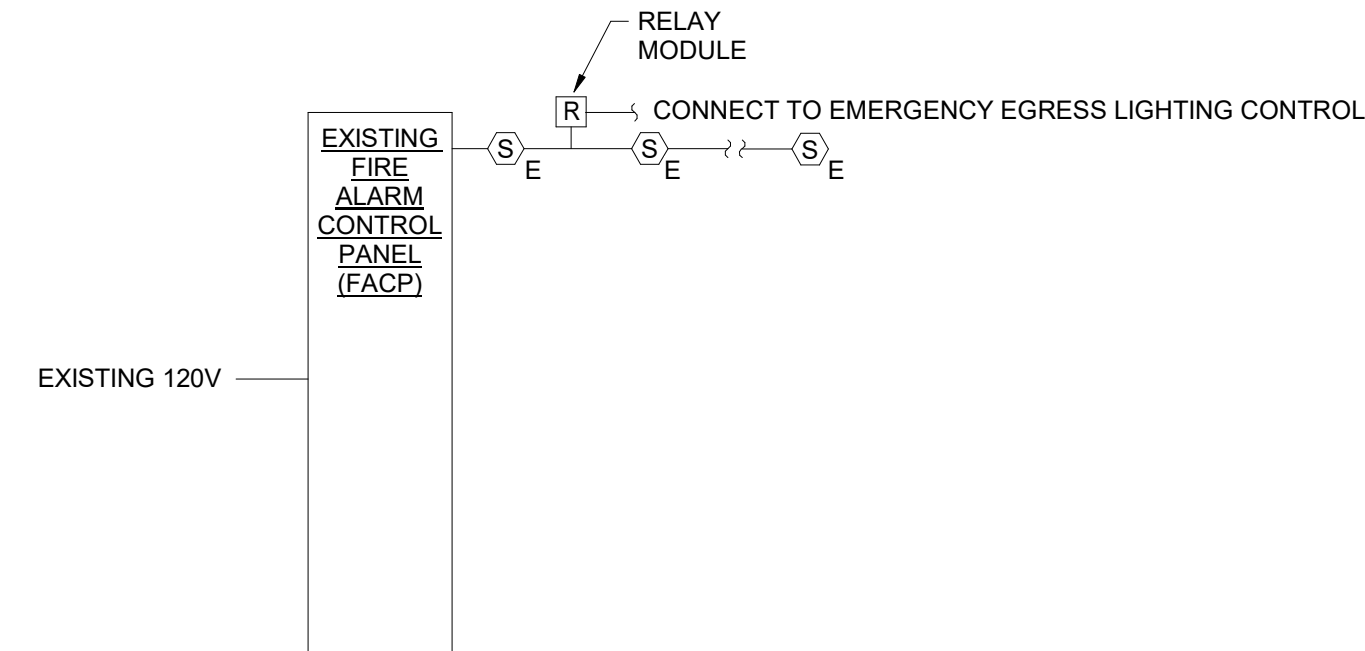
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Beacon City School District
Beacon, New York

Reconstruction to:
South Ave Elementary School

Second Floor Lighting Plan

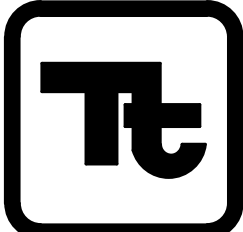Drawn By: SAS/CR	Date: 10/28/2022	Drawing Number: DE132
Project No.: 279180-22004		




FIRE ALARM SEQUENCE OF OPERATION

A. UPON ACTIVATION TROUBLE CONDITION THE FIRE ALARM PANEL SHALL GO INTO "TROUBLE" MODE INDICATING WHICH ZONE IS IN TROUBLE BY A LIGHT IN THE REMOTE ANNUNCIATOR AND AT THE FIRE ALARM PANEL.

- NOTES:
1. FIRE ALARM RISER IS INTENDED TO BE SCHEMATIC ONLY. ALL DEVICES INDICATED ON PLANS AND DETAILS ARE TO BE INSTALLED AND CONNECTED FOR PROPER OPERATION OF SYSTEM.
 2. WIRE NEW DEVICES INTO EXISTING WIRING OR PROVIDE A NEW CIRCUIT AS DIRECTED BY FIRE ALARM SYSTEM REPRESENTATIVE.


3 Fire Alarm System Wiring Diagram

NTS

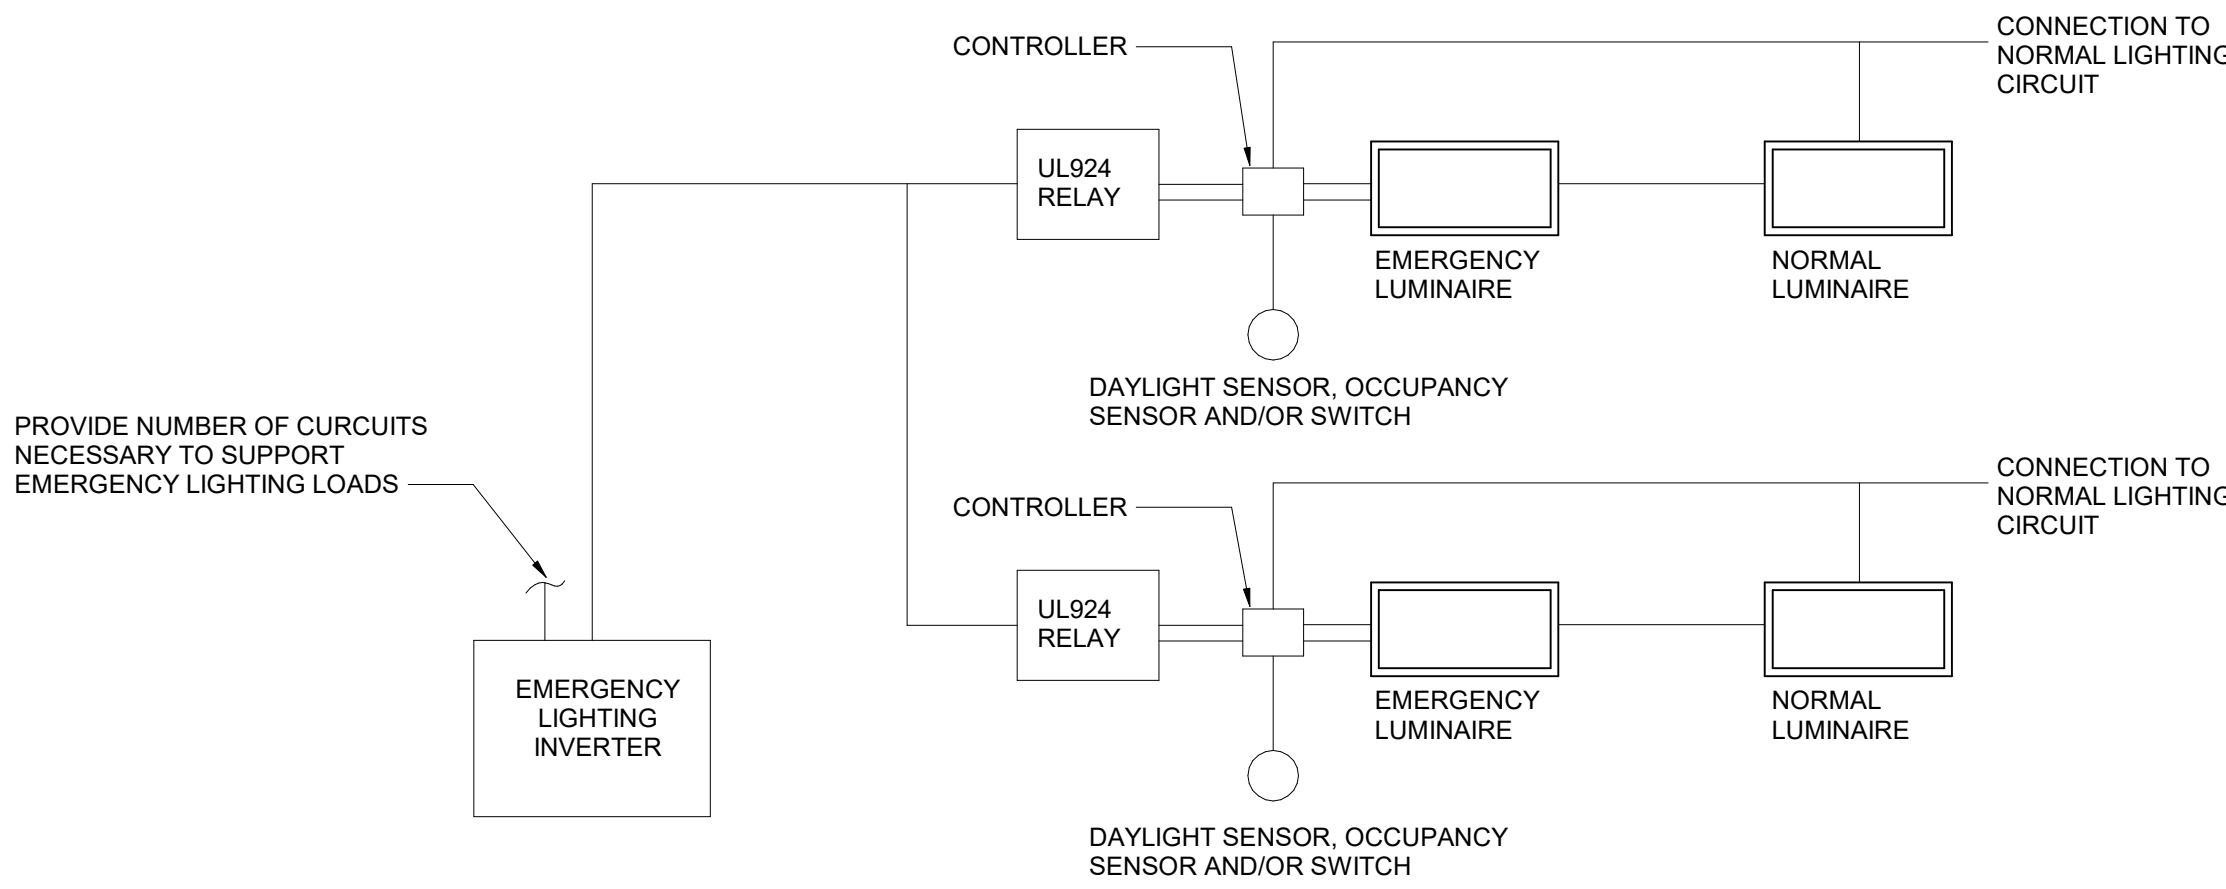


4 Emergency Miniature Inverter Wiring Diagram

1/4" = 1'-0"

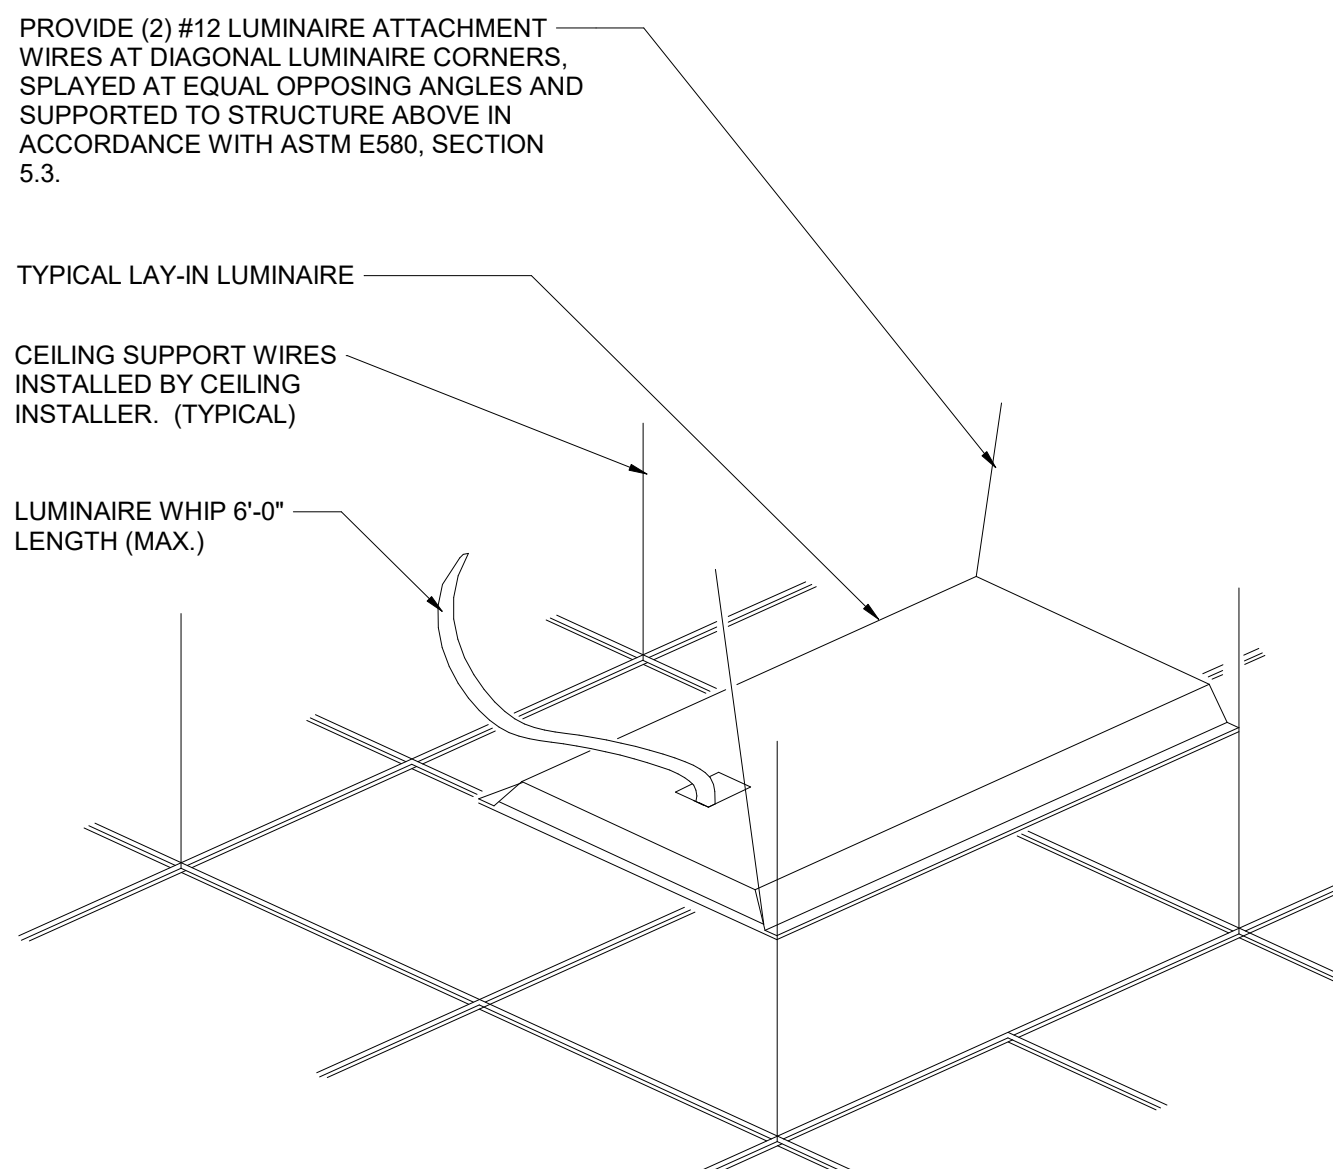

5 Typical Troffer Mounting Detail

NTS

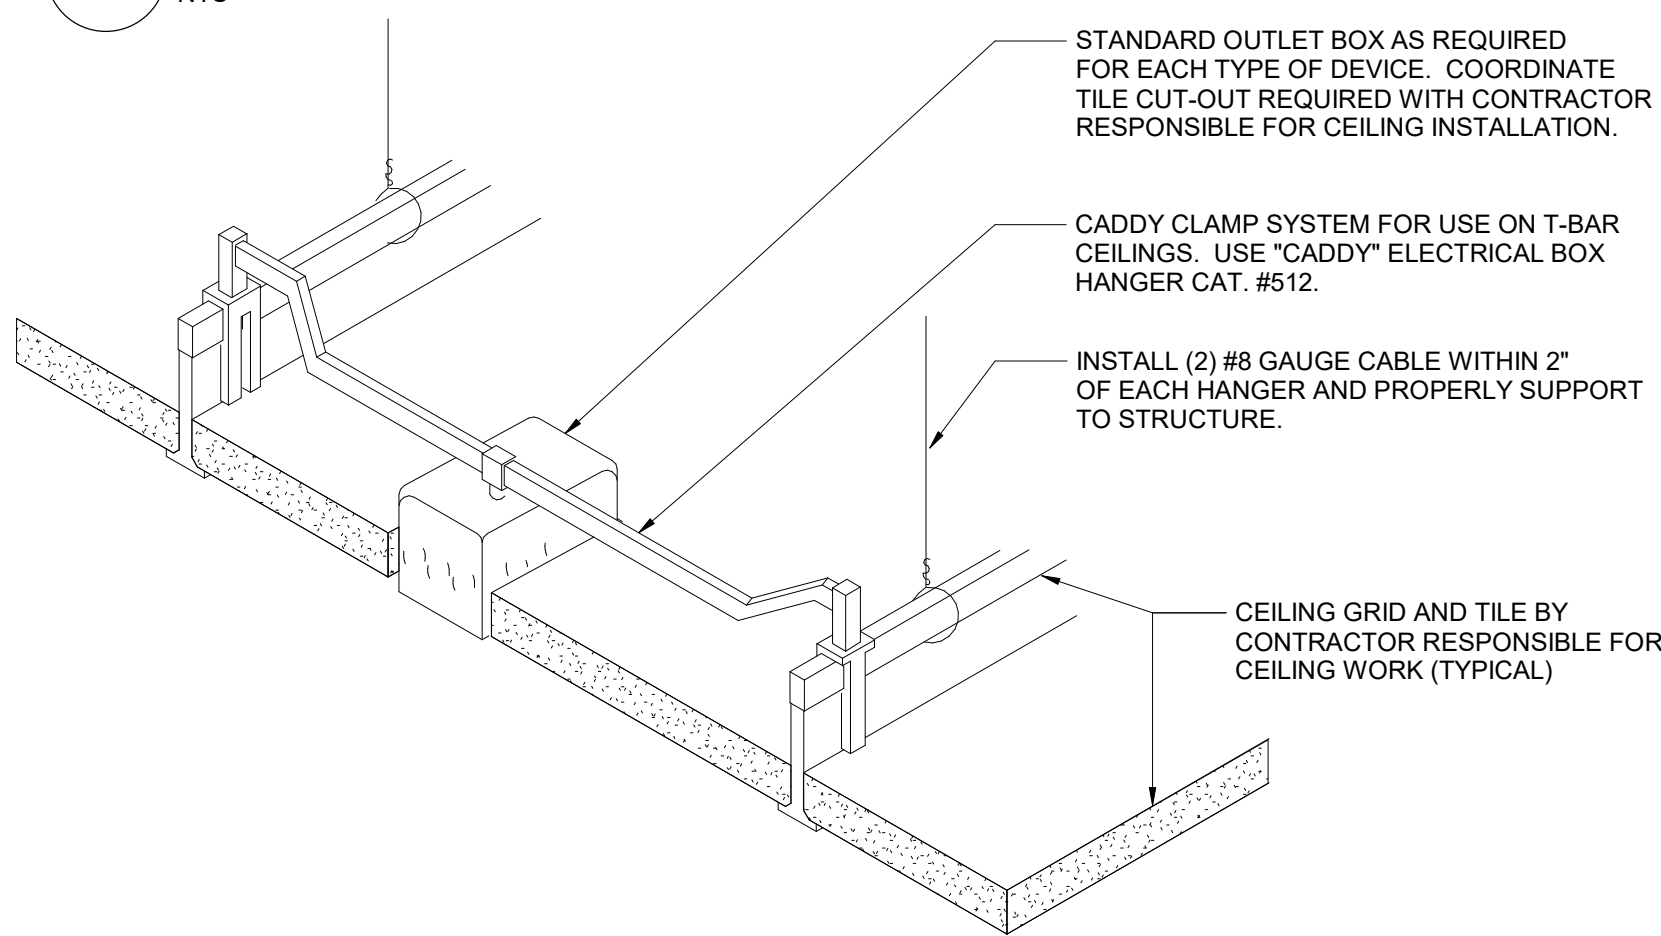


DETAIL NOTES:

- IN AREAS RECEIVING NEW CEILINGS ALL CEILING MOUNTED ITEMS (DETECTORS, SPEAKERS, ETC) ARE TO BE CENTERED WITHIN THE PATTERN OF THE CEILING PANEL. A 2'x4' PANEL SCORED TO A 2'x2' PATTERN SHALL HAVE ITEMS CENTERED IN THE 2'x2' PORTION.
- PROVIDE ADDITIONAL SUPPORT FOR EXIT SIGNS, WHERE REQUIRED.

6 Ceiling Mounting Device Detail

NTS

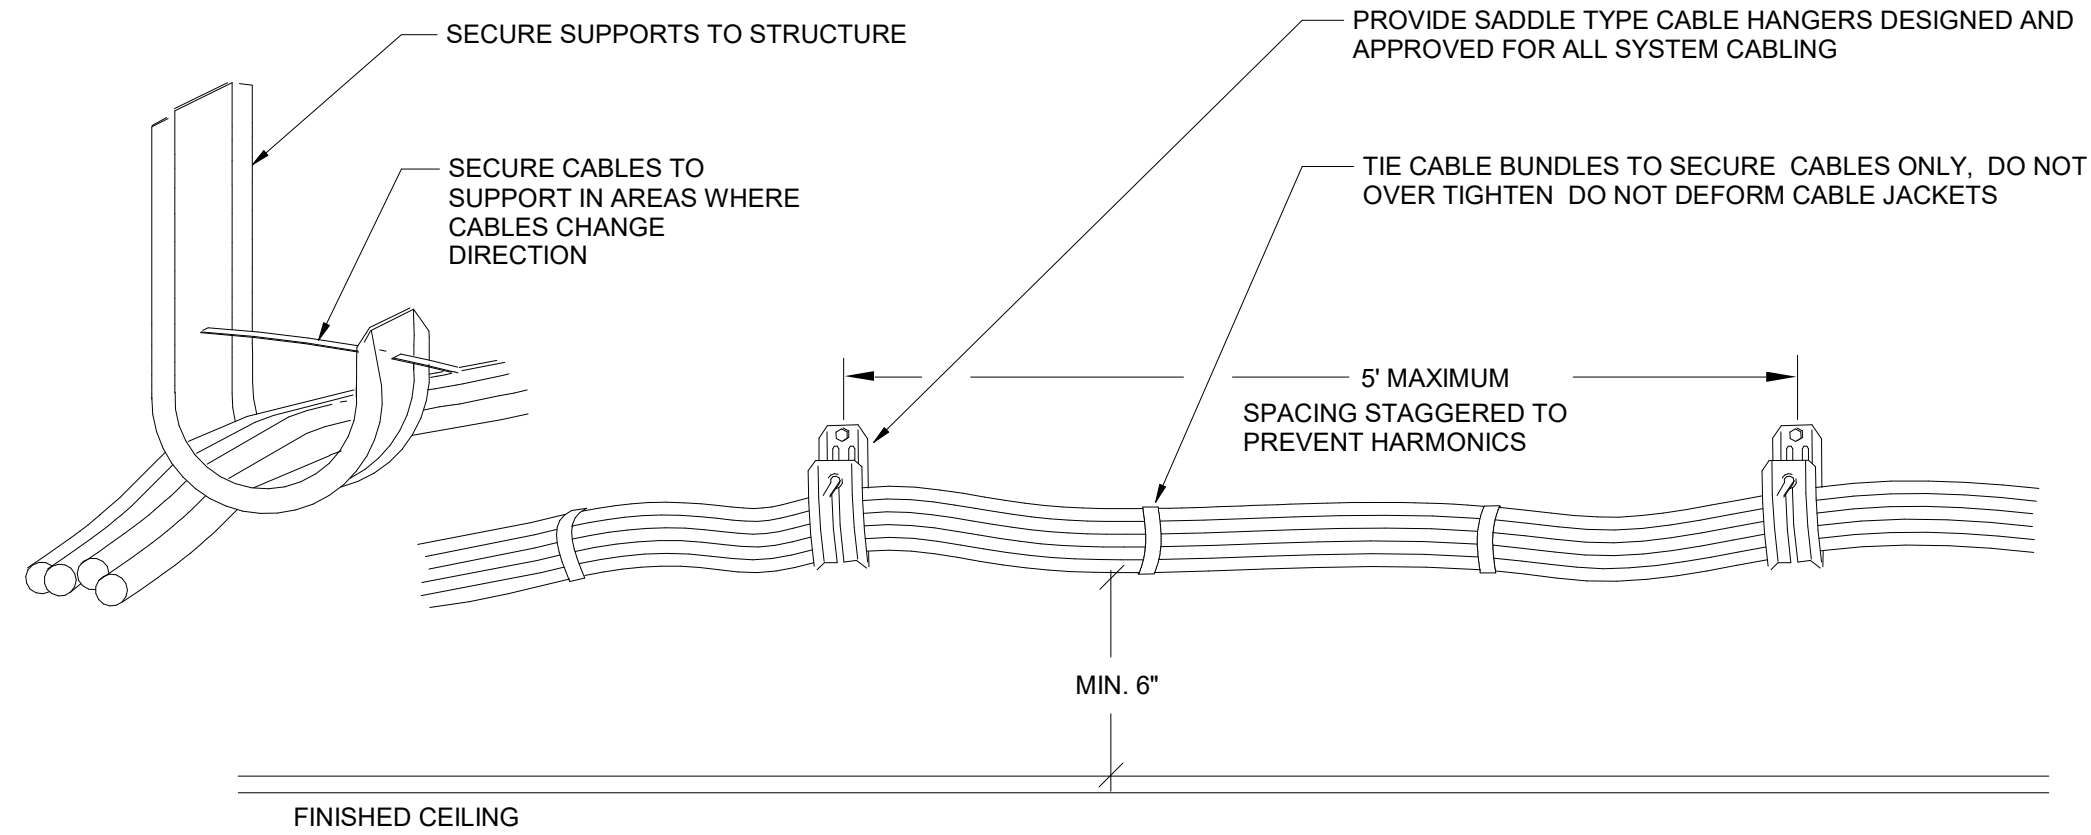

INSTALLATION NOTES:

1. LOCATE CABLE BUNDLES A MINIMUM OF 6" ABOVE REMOVABLE CEILINGS TO MAINTAIN CLEARANCE (ALONG WALLS WHERE POSSIBLE). LOCATE IN AREAS THAT ARE ACCESSIBLE.
2. USE 2 OR MORE CABLE HANGERS AT ALL TURNS TO MAINTAIN MANUFACTURER'S BEND RADIUS REQUIREMENTS.
3. THIS SUPPORT SYSTEM TO BE USED WHEREVER CABLE TRAY IS NOT INDICATED ON PLANS.

1 Typical Installation with Cable Hangars

NTS

LUMINAIRE SCHEDULE							
TYPE	SYMBOL	DESCRIPTION	LAMPS			MANUFACTURERS (OR EQUAL)	
			WATTAGE	LUMENS	TYPE	NAME	MODEL OR SERIES
1		1' x 4' TROFFER (RECESSED IN GRID)	12.2	1482	LED	SIGNIFY (DAY-BRITE)	1FP215L835-4-DS-UNV-DIM
1 EM		SAME AS TYPE 1 - CONNECTED TO EMERGENCY MINIATURE INVERTER	12.2	1482	LED	SIGNIFY (DAY-BRITE)	1FP215L835-4-DS-UNV-DIM
2		1' x 4' TROFFER (RECESSED IN GRID)	24.6	2972	LED	SIGNIFY (DAY-BRITE)	1FP230L835-4-DS-UNV-DIM
2 EM		SAME AS TYPE 2 - CONNECTED TO EMERGENCY MINIATURE INVERTER	24.6	2972	LED	SIGNIFY (DAY-BRITE)	1FP230L835-4-DS-UNV-DIM
3		1' x 4' TROFFER (RECESSED IN GRID)	31.3	3775	LED	SIGNIFY (DAY-BRITE)	1FP238L835-4-DS-UNV-DIM
3 EM		SAME AS TYPE 3 - CONNECTED TO EMERGENCY MINIATURE INVERTER	31.3	3775	LED	SIGNIFY (DAY-BRITE)	1FP238L835-4-DS-UNV-DIM
4 **		2' x 2' TROFFER (RECESSED IN GRID)	15.7	1918	LED	SIGNIFY (DAY-BRITE)	2FP220L835-2-DS-UNV-DIM
4 EM		SAME AS TYPE 4 - CONNECTED TO EMERGENCY MINIATURE INVERTER	15.7	1918	LED	SIGNIFY (DAY-BRITE)	2FP220L835-2-DS-UNV-DIM
5 **		2' x 2' TROFFER (RECESSED IN GRID)	23.4	2911	LED	SIGNIFY (DAY-BRITE)	2FP230L835-2-DS-UNV-DIM
5 EM		SAME AS TYPE 5 - CONNECTED TO EMERGENCY MINIATURE INVERTER	23.4	2911	LED	SIGNIFY (DAY-BRITE)	2FP230L835-2-DS-UNV-DIM
6 **		2' x 2' TROFFER (RECESSED IN GRID)	29.8	3856	LED	SIGNIFY (DAY-BRITE)	2FP238L835-2-DS-UNV-DIM
6 EM		SAME AS TYPE 6 - CONNECTED TO EMERGENCY MINIATURE INVERTER	29.8	3856	LED	SIGNIFY (DAY-BRITE)	2FP238L835-2-DS-UNV-DIM
7 **		2' x 2' TROFFER (RECESSED IN GRID)	35.7	4403	LED	SIGNIFY (DAY-BRITE)	2FP245L835-2-DS-UNV-DIM
7 EM		SAME AS TYPE 7 - CONNECTED TO EMERGENCY MINIATURE INVERTER	35.7	4403	LED	SIGNIFY (DAY-BRITE)	2FP245L835-2-DS-UNV-DIM
8 **		4' ROUND DOWNLIGHT	8.8	868	LED	SIGNIFY (LEDALITE)	L4R10935VB / L4RDW
8 EM		SAME AS TYPE 8 - CONNECTED TO EMERGENCY MINIATURE INVERTER	8.8	868	LED	SIGNIFY (LEDALITE)	L4R10935VB / L4RDW
9 **		4' SQUARE DOWNLIGHT	8.8	868	LED	SIGNIFY (LEDALITE)	L4R10935VB / L4RDW
9 EM		SAME AS TYPE 9 - CONNECTED TO EMERGENCY MINIATURE INVERTER	8.8	868	LED	SIGNIFY (LEDALITE)	L4R10935VB / L4RDW
10 **		2' RECESSED LINEAR. LENGTH VARIES. SEE PLANS FOR SPECIFIC LENGTHS.	14.5	1345	LED	FINELITE	HP-2-R-D-XFT-S-835
10 EM		SAME AS TYPE 10 - CONNECTED TO EMERGENCY MINIATURE INVERTER	14.5	1345	LED	FINELITE	HP-2-R-D-XFT-S-835
11 **		15/16' T-BAR LED	39	2854	LED	JLC TECH	TBSL-MW-5-24-B2-X-W
11 EM		SAME AS TYPE 11 - CONNECTED TO EMERGENCY MINIATURE INVERTER	39	2854	LED	JLC TECH	TBSL-MW-5-24-B2-X-W
12 **		2' RECESSED PERIMETER	27.6	2999	LED	PINNACLE ARCHITECTURAL LIGHTING	EV2DPM-A-835HO-4
12 EM		SAME AS TYPE 12 - CONNECTED TO EMERGENCY MINIATURE INVERTER	27.6	2999	LED	PINNACLE ARCHITECTURAL LIGHTING	EV2DPM-A-835HO-4
13		WALL MOUNT LINEAR	33.1	3361	LED	SIGNIFY (LEDALITE)	7408LBEQN047DEW
13 EM		SAME AS TYPE 13 - CONNECTED TO EMERGENCY MINIATURE INVERTER	33.1	3361	LED	SIGNIFY (LEDALITE)	7408LBEQN047DEW
14 EM		4' SURFACE MOUNTED LINEAR - CONNECTED TO EMERGENCY MINIATURE INVERTER	18.8	1780	LED	PINNACLE ARCHITECTURAL LIGHTING	EX3-WET-N-835-4-S-U-OL2-1-0-W
15 EM		LOW PROFILE SURFACE CANOPY WITH INTEGRAL BATTERY	51	5396	LED	SIGNIFY (GARDCO)	SVPG-A06-840
16		20' X 5' LINEAR WALL MOUNT SCONCE	10	175	LED	TEKA ILLUMINATION	C-AR-FS-LED-392-ART
20 **		EXIT SIGN (SINGLE FACE) WALL AND CEILING MOUNT. SEE PLANS FOR DIRECTIONAL INDICATORS	2.5		LED	SIGNIFY (CHLORIDE)	ER46L-2-W-R
** LUMINAIRE TYPE NOT USED IN THIS BUILDING						* MANUFACTURER AND MODEL NUMBER ARE PROVIDED TO SHOW BASIS OF DESIGN ONLY.	

2 Luminaire Schedule

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S.E.D. Control No. 13-02-00-01-0-003-016

Rev. No.: Date: Description:

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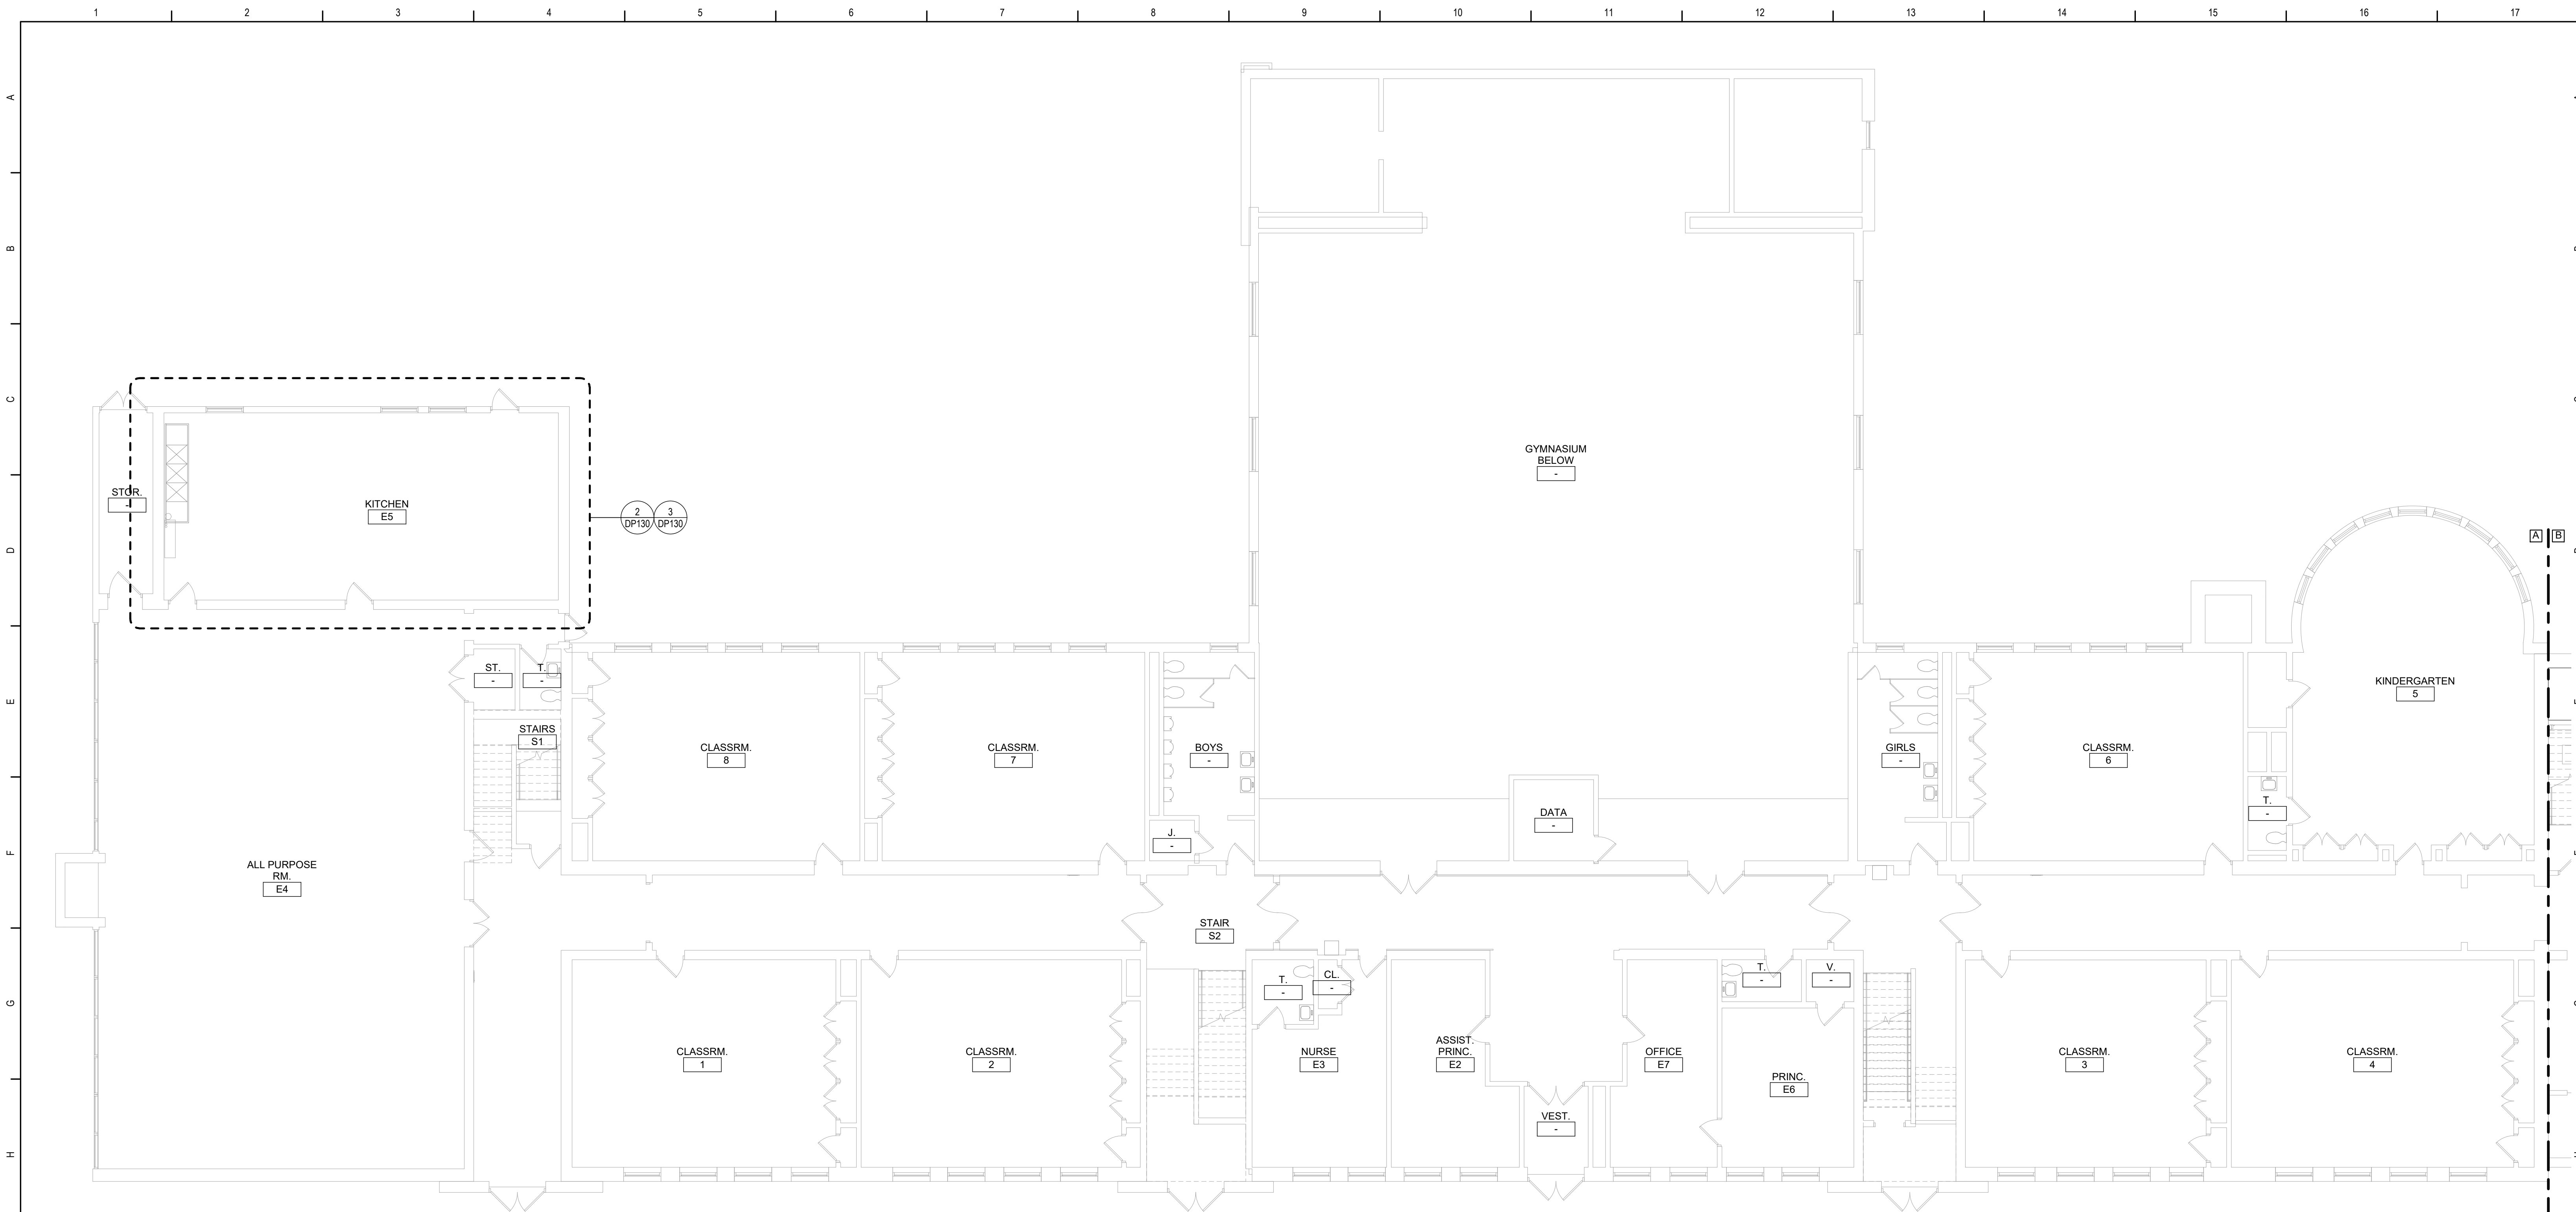
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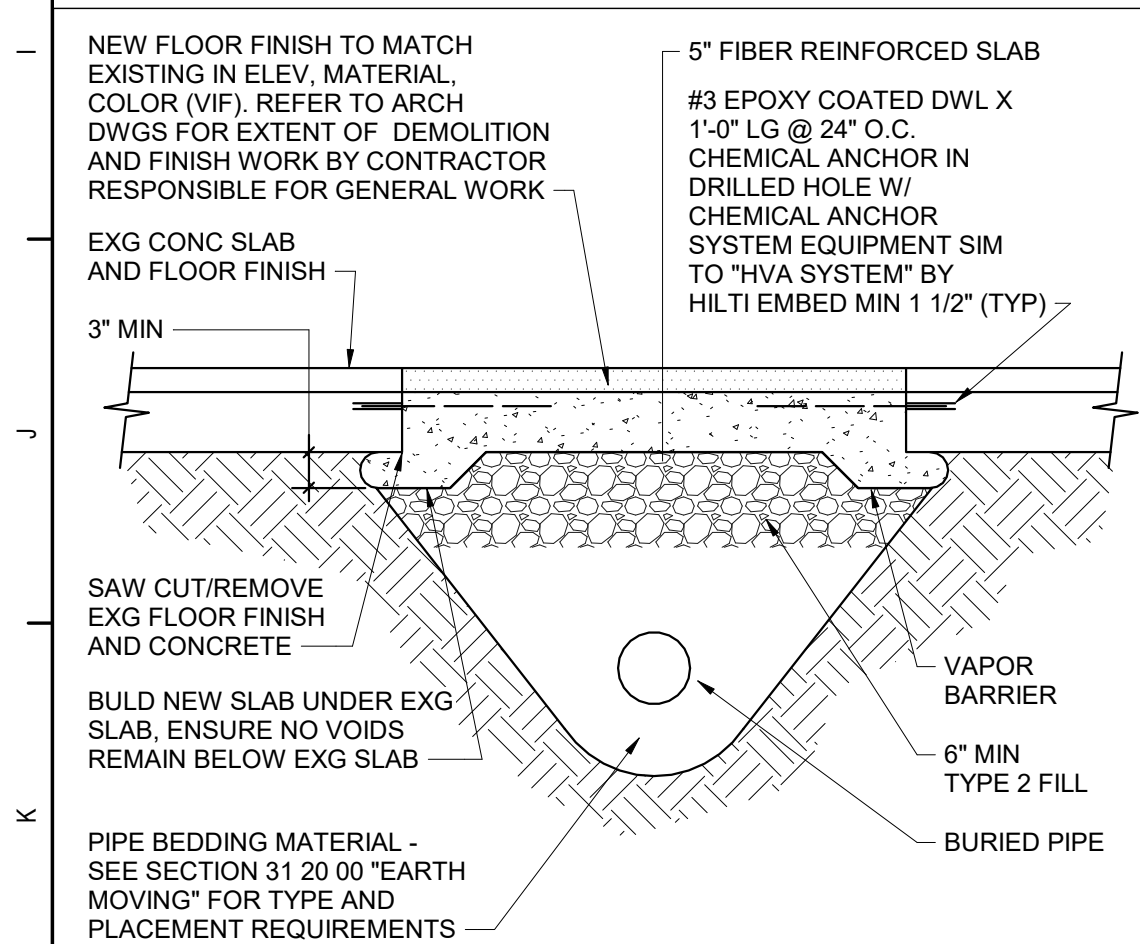
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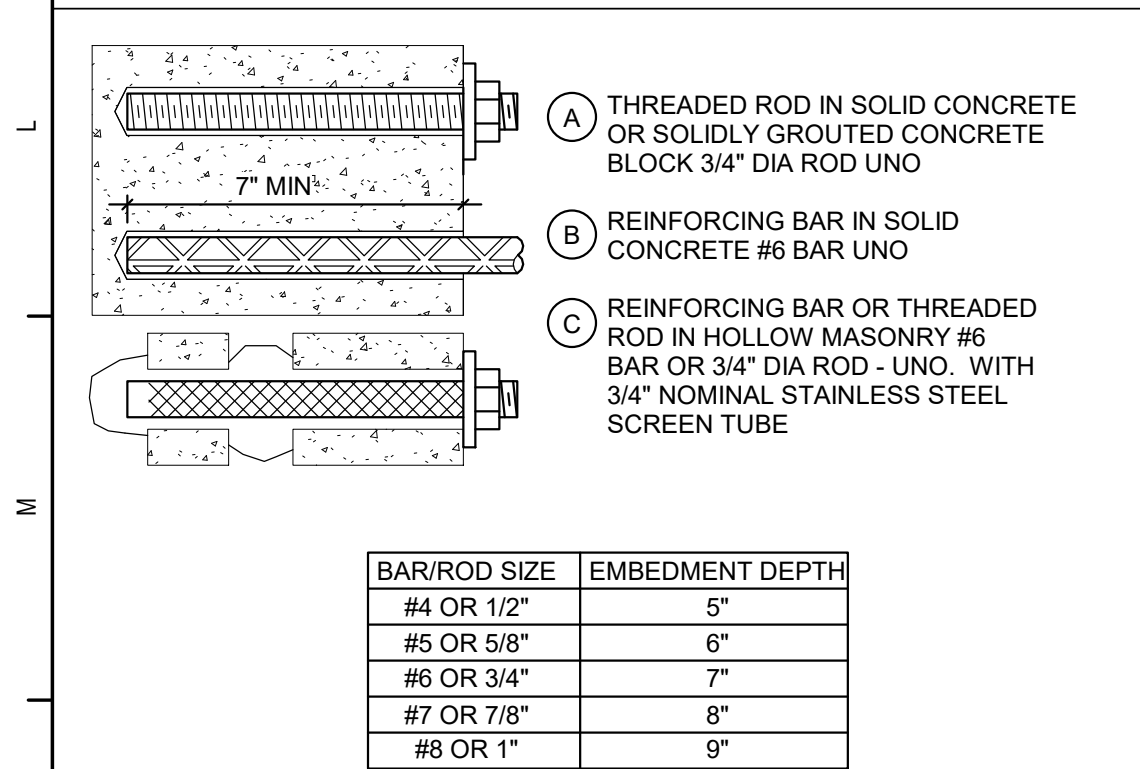
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1 First Floor Plan - Area A
1/8" = 1'-0"




4 Trenching Below Existing Slab Detail
NTS




GENERAL NOTES:
1. FOR ACCEPTABLE ADHESIVE PRODUCTS REFER TO SPECIFICATIONS.
2. COMPLY WITH MANUFACTURERS REQUIREMENTS FOR INSTALLATION.

5 Typical Chemical Anchors
NTS

Grease Interceptor Schedule														
DWG LABEL	LOCATION	DESIGN MAKE AND MODEL	GREASE RETENTION CAPACITY (POUNDS)	PDI RATED FLOW RATE (GPM)	INSTALLATION	INLET / OUTLET SIZE (NPS)	CENTERLINE OF INLET / OUTLET TO BOTTOM (INCHES)	CENTERLINE OF INLET / OUTLET TO TOP (INCHES)	EXTENSION HEIGHT (INCHES)	LENGTH (INCHES)	WIDTH (INCHES)	HEIGHT (INCHES)	VENT SIZE (NPS)	NOTES
GH-D-1	KITCHEN E5	JR SMITH 8150	100	50	FLOOR MOUNTED	3	10	6	N/A	49-1/2	27-3/4	16	2	1
NOTES:														
1. PROVIDE EXTERNAL FLOW CONTROL FITTING SUPPLIED BY SAME MANUFACTURER AS GREASE INTERCEPTOR.														

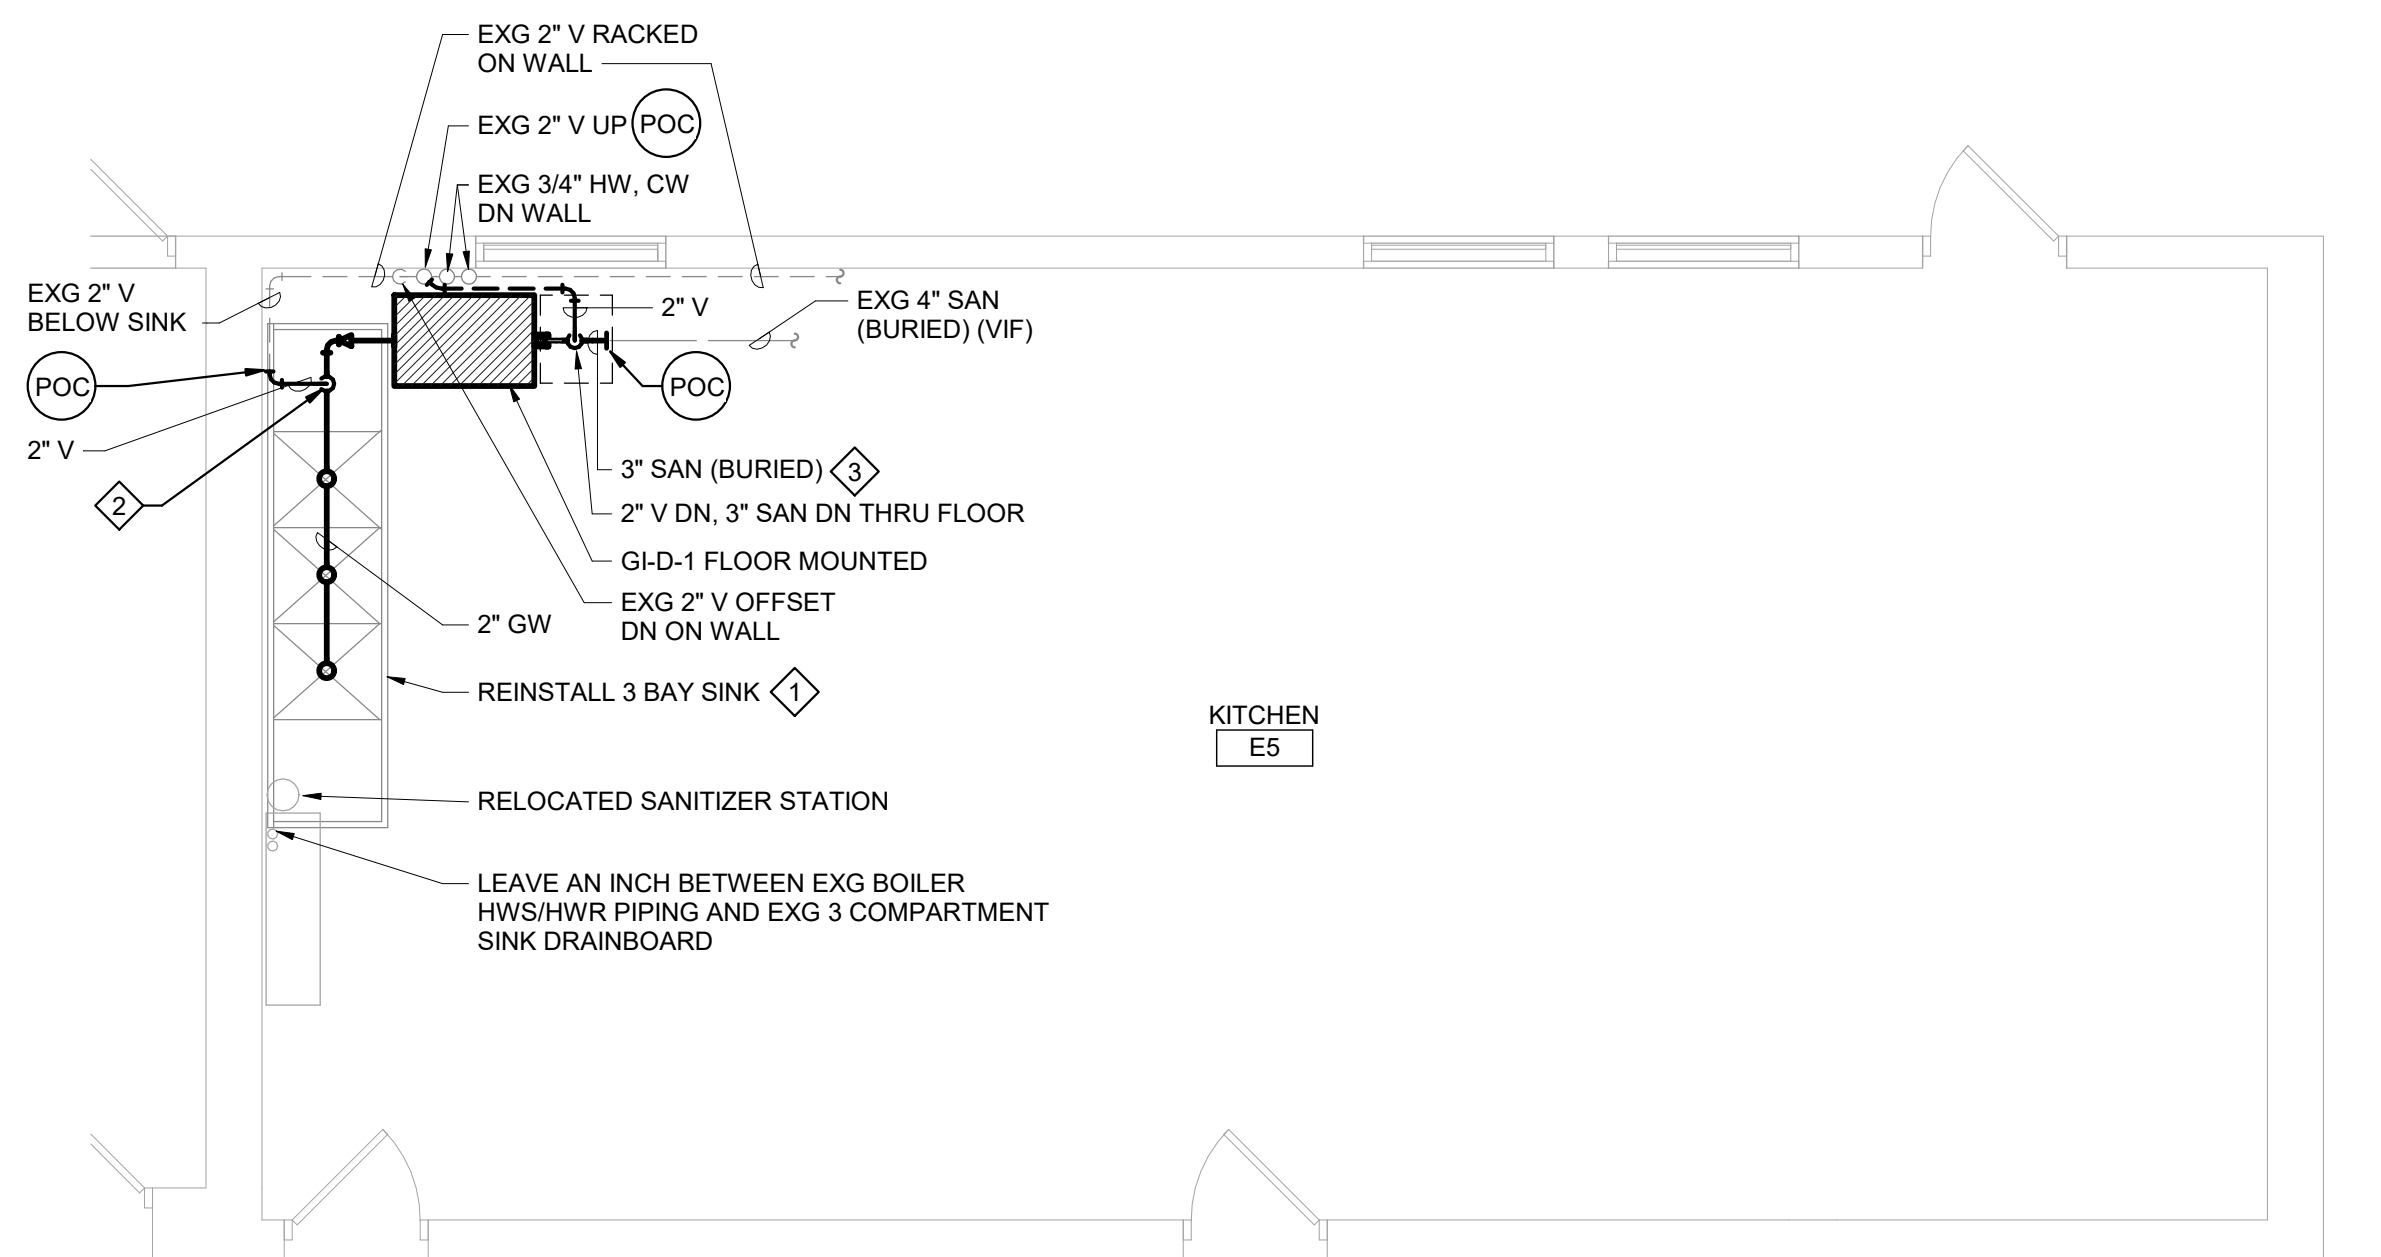

3 Kitchen E5 Plan
1/4" = 1'-0"

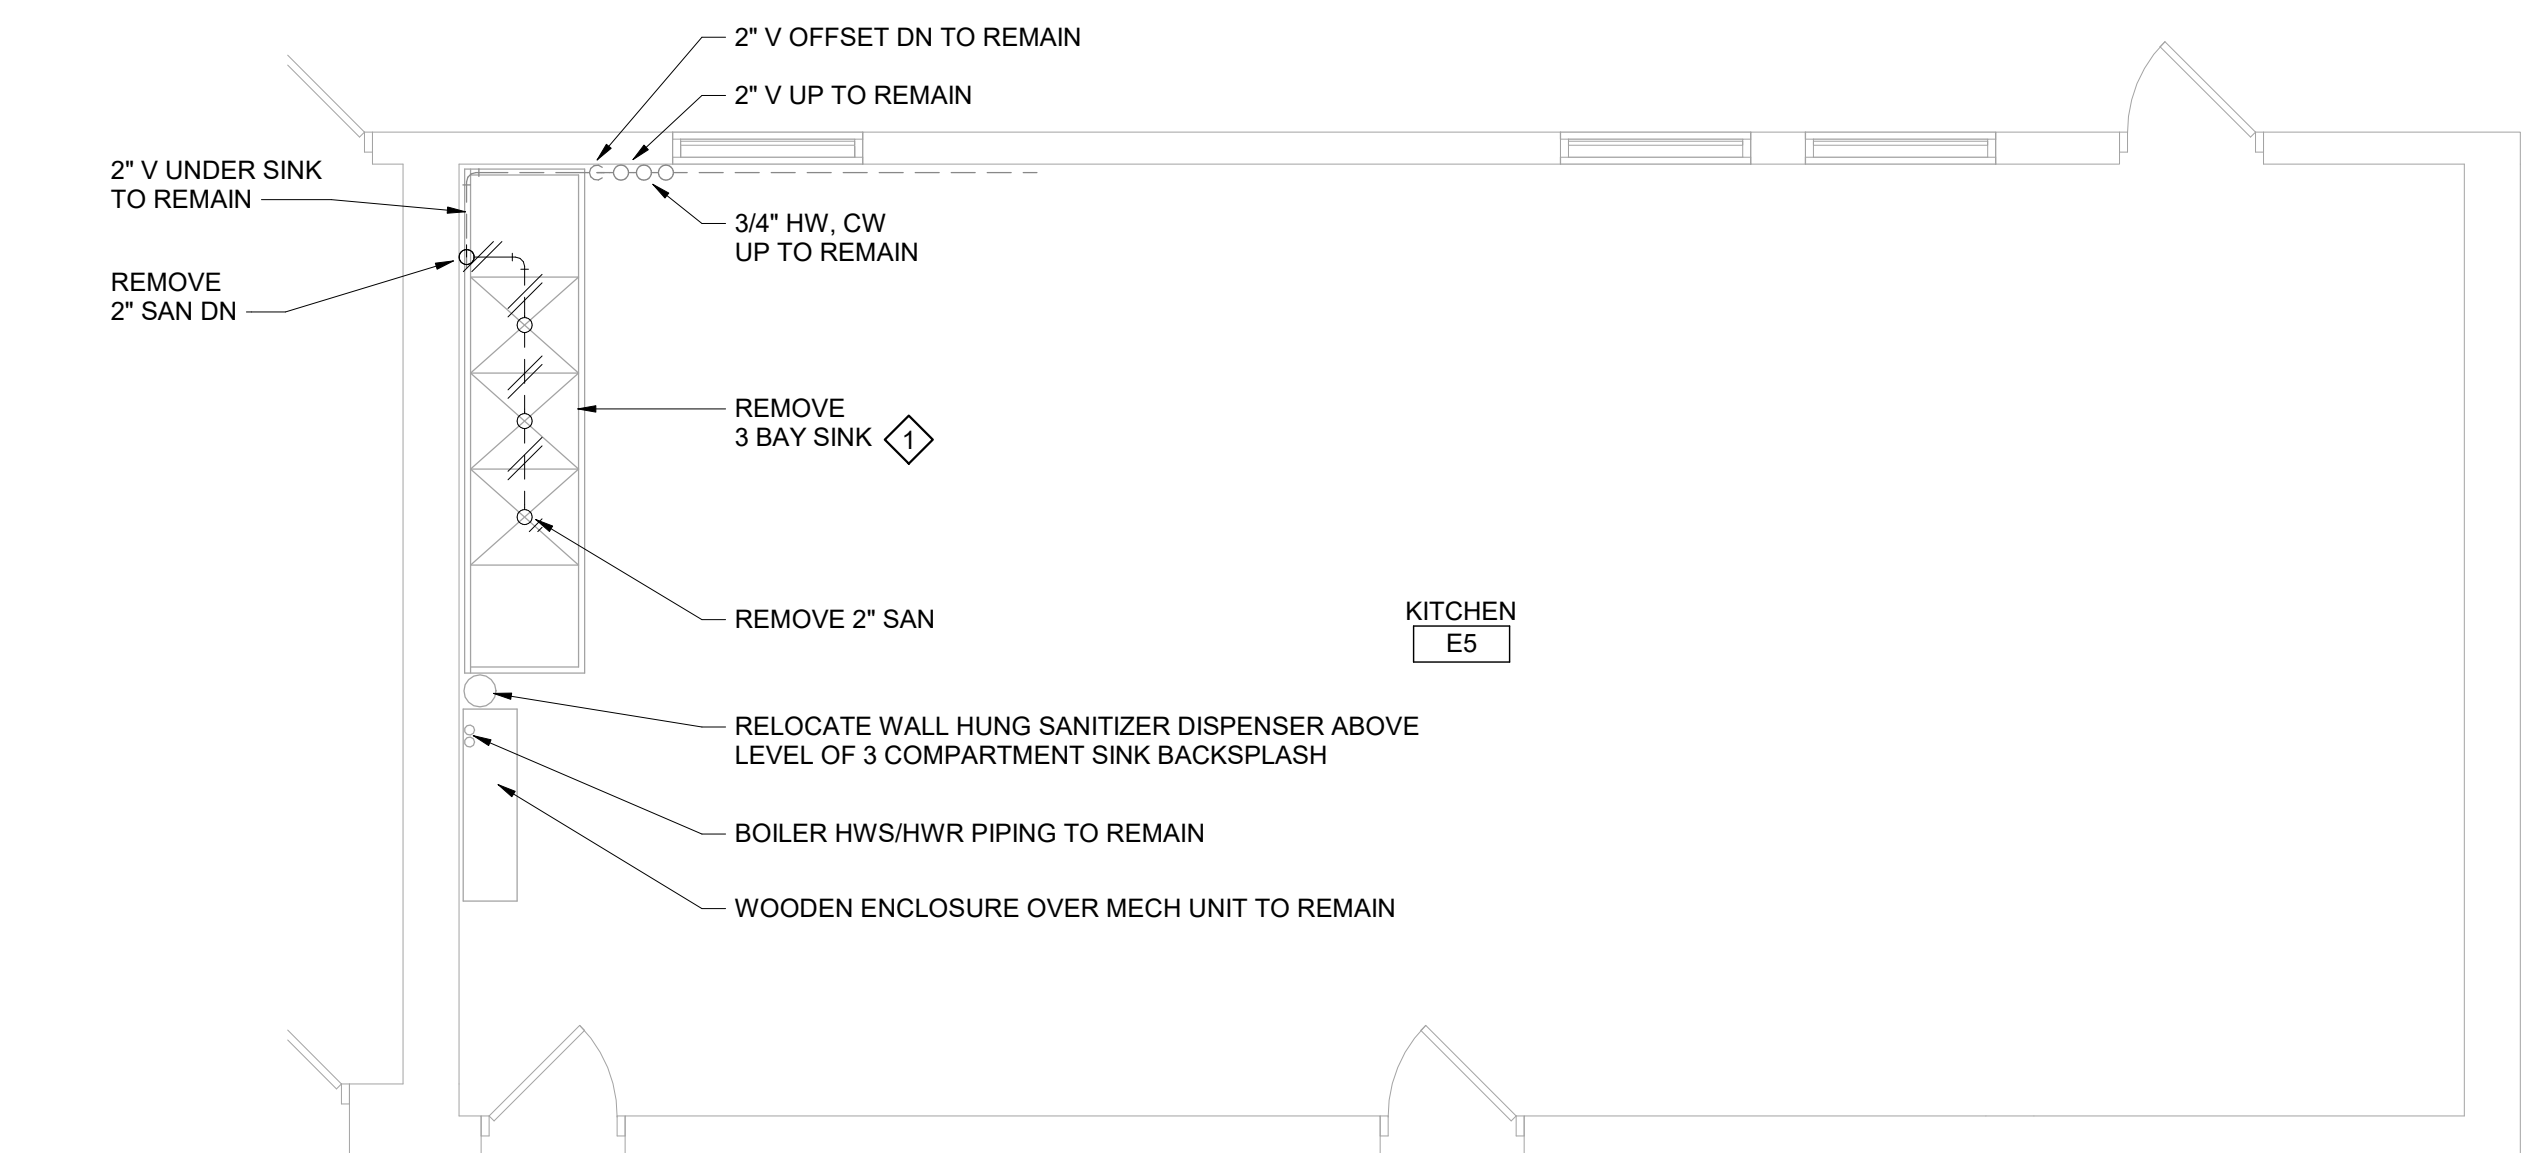


2 Kitchen E5 Demolition Plan
1/4" = 1'-0"

General Notes

- VERIFY ALL PIPING LOCATIONS, SIZES, AND ARRANGEMENTS IN FIELD PRIOR TO BID. NOTIFY ARCHITECT IN WRITING OF ANY DISCREPANCIES.
- VERIFY IN FIELD INVERT AND DIRECTION OF FLOW IN EXISTING SOIL PIPE WHERE NEW SOIL PIPE IS TO BE CONNECTED TO EXISTING SOIL PIPE.
- LEGALLY DISPOSE OF ALL DEMOLITION DEBRIS.
- INCLUDE TRENCHING, CUTTING AND PATCHING OF FLOORS, WALLS AND CEILINGS, INCLUDING CEILING TILE REMOVAL AND REPLACEMENT, WHEN REQUIRED FOR PLUMBING WORK. PATCH ABANDONED OPENINGS AND DISTURBED FINISHES TO MATCH EXISTING. TAKE PRECAUTIONS TO PROTECT STRUCTURAL INTEGRITY OF FLOOR OR WALLS WHEN TRENCHING OR CUTTING.
- MATERIALS FOR PLUMBING INSTALLATION SHALL BE NEW, UNLESS SPECIFICALLY NOTED OTHERWISE.
- REPLACE PLUMBING EQUIPMENT INDICATED. MODIFY AND EXTEND EXISTING PIPING AS REQUIRED TO MEET FIXTURE HIRTS ROUGH-IN RECOMMENDATIONS AND TO MAKE CONNECTIONS. CONCEAL PIPING WITHIN OR BEHIND WALLS, BELOW FLOORS OR ABOVE CEILINGS. PATCH DISTURBED FINISHES TO MATCH EXISTING UNLESS SPECIFICALLY NOTED OTHERWISE.

Plumbing Notes


- REMOVE 3 BAY SINK AND STORE FOR REINSTALLATION AFTER GREASE INTERCEPTOR IS INSTALLED. CLEAN TABLE BEFORE REINSTALLATION.
- FLOW CONTROL FITTING SUPPLIED BY GREASE INTERCEPTOR MANUFACTURER.
- REFER TO DETAILS 4/ DP130 AND 5/ DP130 FOR ADDITIONAL INFORMATION.

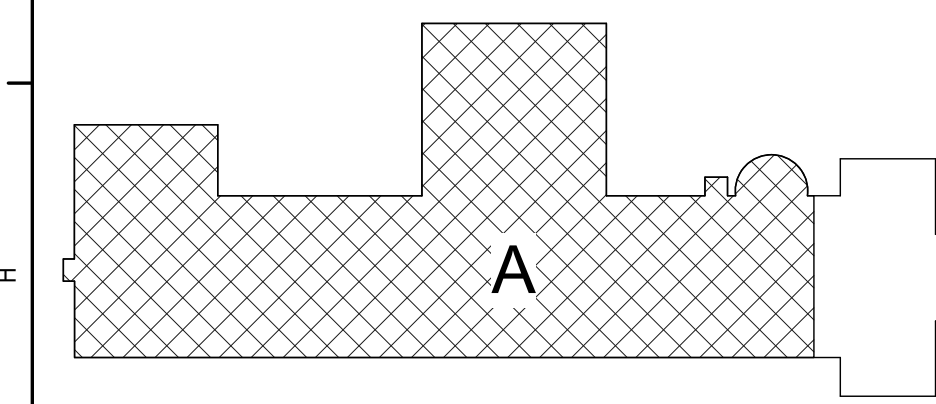

Key Plan
N.T.S.

S.E.D. Control No. 13-02-00-01-0-003-016

Rev. No.	Date	Description

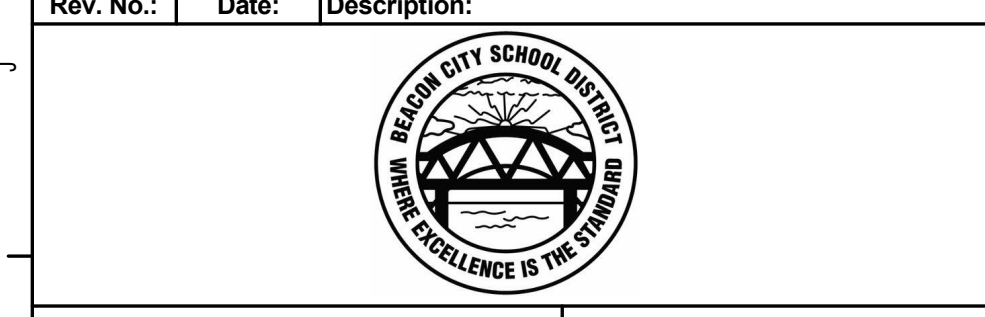

complex world
CLEAR SOLUTIONS
Tetra Tech Engineers, Architects & Landscape Architects, P.C.



Beacon City School District
Beacon, New York

Reconstruction to:
South Ave Elementary School

First Floor Plan - Area A, Details and Schedule

Drawn By: GPD / sef	Date: 10/28/2022	Drawing Number:
Project No.: 279180-22004	DP130	