






QUALITY ENVIRONMENTAL SOLUTIONS & TECHNOLOGIES, INC.  
 1376 NYS ROUTE 9  
 WAPPINGERS FALLS, NY 12590  
 TEL.: (845) 298-6031

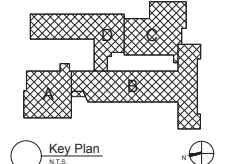

S.E.D. Control No. 13-02-00-01-0-006-022

Rev. No.	Date	Description
1	4/13/22	100% SED Submittal



Beacon City School District  
 Beacon, New York

Additions and Alterations to:  
 Glenham Elementary School

Asbestos Abatement

Client By: TIAE	Date: 10/08/2022	Drawing Number: BH100
Project No.: 279180-22004		

**ASBESTOS ABATEMENT NOTES**

ASBESTOS ABATEMENT CONTRACTOR IS RESPONSIBLE FOR TOTAL AND COMPLETE REMOVAL AND DISPOSAL OF ASBESTOS CONTAINING (ACM) MATERIAL AT LOUVER / UNIT VENTILATORS WHERE INDICATED.

REFER TO SPECIFICATION SECTION 020800 - SECTION 3.17 FOR A DESCRIPTION OF THE WORK.

**ASBESTOS ABATEMENT LEGEND**

REMOVE AND DISPOSE OF EXTERIOR ASBESTOS CONTAINING FRABLE (ACM) MATERIAL AROUND LOUVER PENETRATION (BRICK TO METAL) AT UNIT VENTILATORS.






- A. ----- REMOVE ITEMS INDICATED BY DASHED LINE.
- B. KEYED DEMOLITION TAGS REFER TO SPECIFIC LOCATIONS AS FOLLOWS:
  - 1. DEMOLITION TAGS LOCATED WITHIN THE MIDDLE OF A SPACE REFER TO DEMOLITION OF ALL ITEMS OF THAT SAME TYPE WITHIN THAT ENTIRE SPACE.
  - 2. DEMOLITION TAGS PLACED IMMEDIATELY ON OR ADJACENT TO A DASHED LINE INDICATING ITEM REMOVAL OR THAT HAVE A LEADER POINTING TO A SPECIFIC ITEM(S) REFER TO DEMOLITION OF THAT SPECIFIC ITEM ONLY OF THAT TYPE WITHIN THAT SPACE.
  - 3. DEMOLITION TAGS IN SERIES REFER TO DEMOLITION OF ALL THOSE ITEMS EITHER WITHIN THAT ENTIRE SPACE OR TO THE ENTIRE SPACE IF THE IDENTIFIED TAG IS THE ONLY ONE.
- C. WHEN AN ITEM IS INDICATED TO BE DEMOLISHED REMOVE ALL ASSOCIATED COMPONENTS AS PART OF THAT WORK.
- D. ALL ARTWORK NOT PERMANENTLY AFFIXED TO EXISTING CONSTRUCTION SHALL BE REMOVED AND STORED BY OWNER PRIOR TO BEGINNING DEMOLITION WORK. CONTACT OWNER'S ARCHITECT IF ANY ARTWORK IS ENCOUNTERED PRIOR TO START OF DEMOLITION WORK.
- E. EXISTING WINDOW-MOUNTED A/C UNITS SHALL BE REMOVED AND STORED BY OWNER PRIOR TO START OF DEMOLITION WORK.
- F. COORDINATE WITH ABATEMENT DRAWINGS PRIOR TO DEMOLITION.

1E	REMOVE WALL FULL HEIGHT AND ALL ASSOCIATED COMPONENTS. PATCH EXPOSED SURFACE TO MATCH EXISTING ADJACENT SURFACES.
1E2	REMOVE PORTION OF WALL AS INDICATED AND ALL ASSOCIATED COMPONENTS. PATCH EXPOSED SURFACES TO MATCH EXISTING ADJACENT SURFACES.
1H	PROVIDE NEW OR ENLARGE EXISTING OPENING IN WALL TO EXTENT REQUIRED TO PERFORM SCHEDULED WORK. PROVIDE LINTEL PER LATEL SCHEDULE. SEE STRU DRAWINGS. PATCH EXPOSED SURFACES TO MATCH ADJACENT FINISHES / SURFACES. COORDINATE WITH SCHEDULED WORK ON MECHANICAL DRAWINGS. SEE ABATEMENT DRAWINGS.
1P	REMOVE PORTION OF STOREROOF INSULATED PANEL TO ACCOMMODATE SCHEDULED WORK. COORDINATE WITH MECHANICAL DRAWINGS.
8A	REMOVE WINDOW AND STOREROOF SYSTEM COMPLETELY. PREPARE OPENING TO EXTENT REQUIRED TO PERFORM SCHEDULED WORK. PATCH EXPOSED SURFACES TO MATCH ADJACENT FINISHES / SURFACES.
8B	REMOVE DOOR AND FRAME COMPLETELY. PATCH EXPOSED SURFACES TO MATCH ADJACENT FINISHES / SURFACES.
9A	REMOVE PORTION OF CEILING SYSTEM AND/OR SOFFIT SYSTEM TO EXTENT REQUIRED TO PERFORM SCHEDULED WORK. CLEAN, SALVAGE AND PROTECT FOR RE-INSTALLATION.
9A1	REMOVE CEILING SYSTEM AND/OR SOFFIT SYSTEM IN ITS ENTIRETY.
9B	REMOVE PORTION OF CEILING SYSTEM AND/OR SOFFIT SYSTEM. TO EXTENT REQUIRED TO PERFORM NEW WORK. CAREFULLY TRIM CEILING GRID TO REMAIN.
9C	REMOVE CEILING- OR WALL-MOUNTED ACOUSTICAL TREATMENTS IN THEIR ENTIRETY.
9D	REMOVE FLOOR FINISH, MASTIC AND WALL BASE TO EXTENT REQUIRED TO PERFORM SCHEDULED WORK. AT ALL AREAS OF REMOVAL, LEVEL SLAB WITH ADJACENT SLABS AT LOCATIONS SCHEDULED TO RECEIVE FLOOR FINISH. INCLUDE CONCRETE FLOOR PATCHING AND LEVELING MATERIALS TO MATCH EXISTING LEVEL. PATCH TO MATCH EXISTING PATCH AREAS OF WALLS TO REMAIN THAT WERE DAMAGED BY REMOVAL OF WALL BASE.
	<b><u>SUFFIX KEY FLOOR FINISH IDENTIFICATIONS:</u></b>
	A. CARPET
	B. CERAMIC FLOOR TILE
	C. VANTCT.
9E	REMOVE WALL BASE AND ASSOCIATED MASTIC ONLY - EXISTING FLOOR FINISH TO REMAIN. PATCH AREAS OF WALLS TO REMAIN THAT WERE DAMAGED BY REMOVAL OF WALL BASE.
9F	REMOVE WALL LINT IN ITS ENTIRETY. PATCH EXPOSED SURFACES TO MATCH ADJACENT FINISHES / SURFACES TO EXTENT REQUIRED TO PERFORM SCHEDULED WORK.
10B	REMOVE TOILET COMPARTMENTS IN THEIR ENTIRETY.
10C	REMOVE TOILET AND BATH ACCESSORIES. PATCH EXPOSED SURFACES TO MATCH ADJACENT FINISHES / SURFACES TO EXTENT REQUIRED TO PERFORM SCHEDULED WORK.
12A	REMOVE CASEWORK, SHELVING AND ASSOCIATED COMPONENTS TO THE EXTENT REQUIRED TO PERFORM SCHEDULED WORK. PATCH EXPOSED SURFACES TO MATCH ADJACENT FINISHES / SURFACES. COORDINATE WITH CASEWORK AND MECHANICAL DRAWINGS.
12C	REMOVE TEACHING SURFACES INCLUDING MARKER BOARDS, TACK BOARDS AND CHALK BOARDS. TURN OVER TO OWNER PATCH EXPOSED SURFACES TO MATCH ADJACENT FINISHES AND SURFACES.



S.E.D. Control No. 13-02-00-01-0-006-022

Rev. No.:	Date:	Description:
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Tetra Tech Engineers, Architects  
& Landscape Architects, P.C.

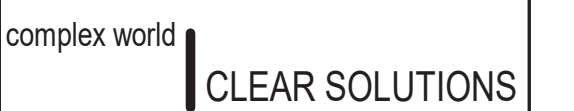
Beacon City School District  
Beacon, New York

Additions and Alterations to:  
Glenham Elementary School

First Floor Demolition Plan - Area A  
and C

Drawn By: GCK/tlg	Date: 10/28/2022	Drawing Number:  <b>BA100</b>
Project No.: <b>279180-22004</b>		



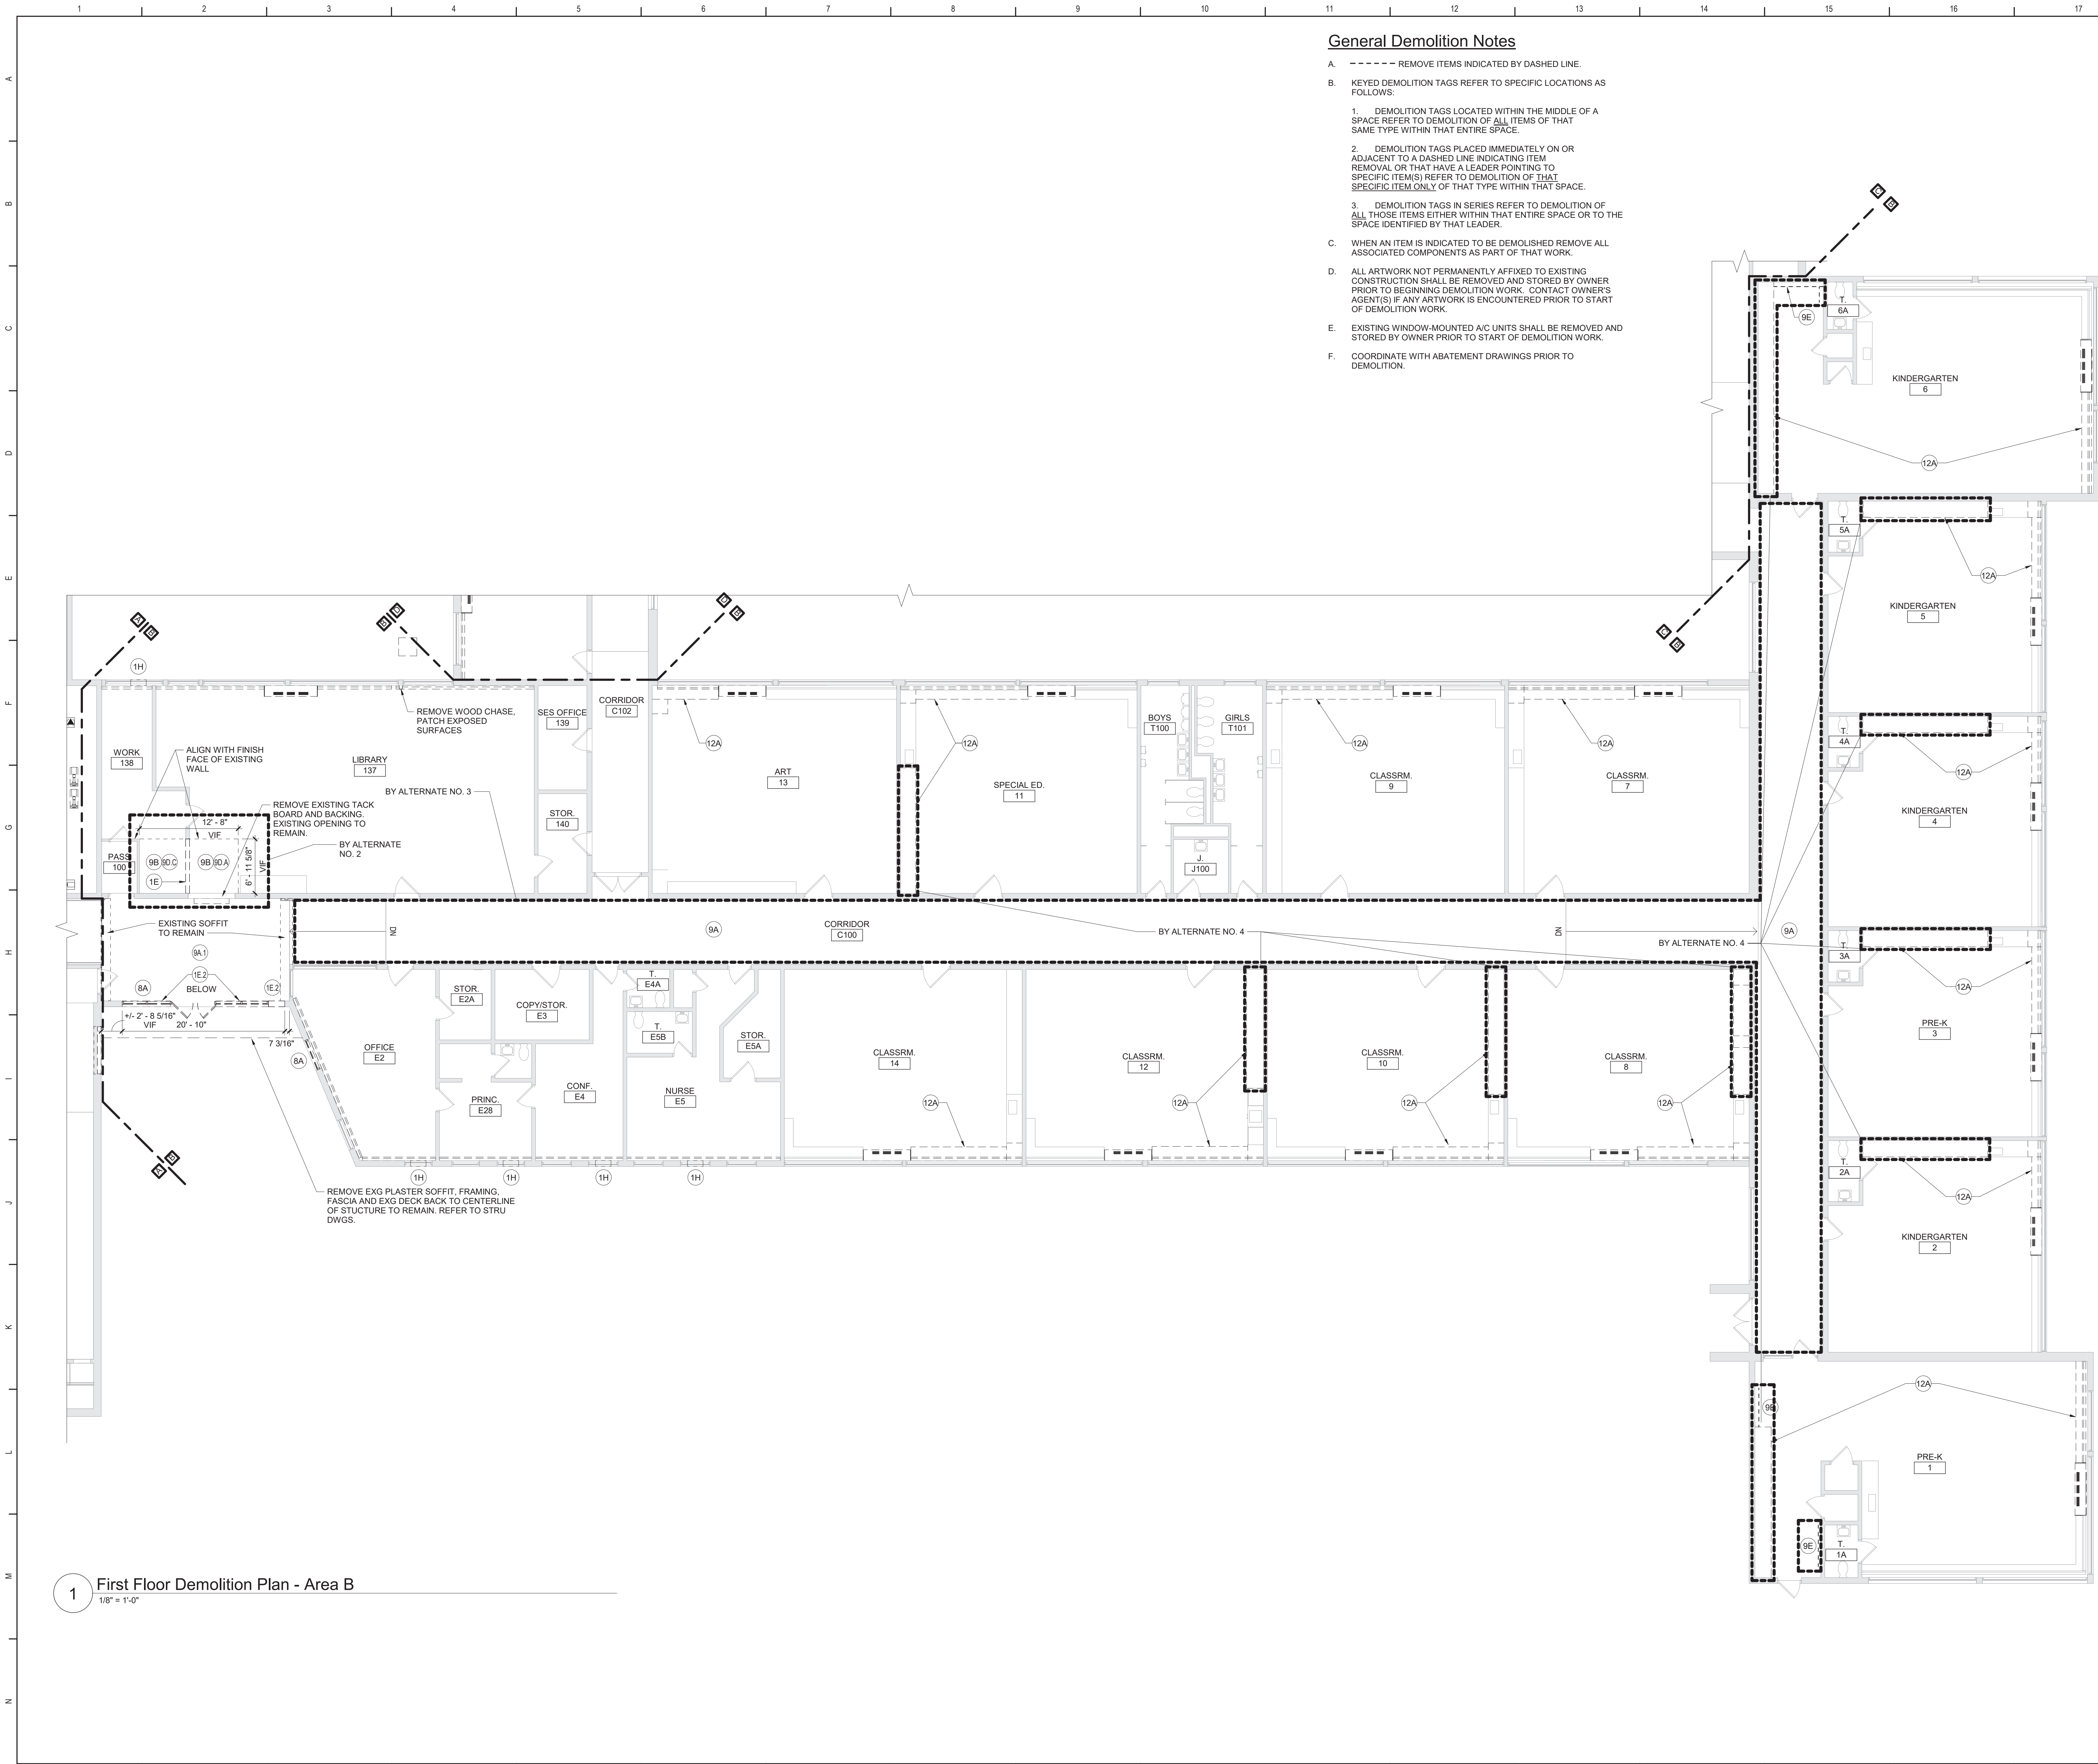


General Demolition Notes

- A. - - - - - REMOVE ITEMS INDICATED BY DASHED LINE.
- B. KEYED DEMOLITION TAGS REFER TO SPECIFIC LOCATIONS AS FOLLOWS:
- DEMOLITION TAGS LOCATED WITHIN THE MIDDLE OF A SPACE REFER TO DEMOLITION OF ALL ITEMS OF THAT SAME TYPE WITHIN THAT ENTIRE SPACE.
  - DEMOLITION TAGS PLACED IMMEDIATELY ON OR ADJACENT TO A DASHED LINE INDICATING ITEM REMOVAL OR THAT HAVE A LEADER POINTING TO SPECIFIC ITEM(S) REFER TO DEMOLITION OF THAT SPECIFIC ITEM ONLY OF THAT TYPE WITHIN THAT SPACE.
  - DEMOLITION TAGS IN SERIES REFER TO DEMOLITION OF ALL THOSE ITEMS EITHER WITHIN THAT ENTIRE SPACE OR TO THE SPACE IDENTIFIED BY THAT LEADER.
- C. WHEN AN ITEM IS INDICATED TO BE DEMOLISHED REMOVE ALL ASSOCIATED COMPONENTS AS PART OF THAT WORK.
- D. ALL ARTWORK NOT PERMANENTLY AFFIXED TO EXISTING CONSTRUCTION SHALL BE REMOVED AND STORED BY OWNER PRIOR TO BEGINNING DEMOLITION WORK. CONTACT OWNER'S AGENT(S) IF ANY ARTWORK IS ENCOUNTERED PRIOR TO START OF DEMOLITION WORK.
- E. EXISTING WINDOW-MOUNTED A/C UNITS SHALL BE REMOVED AND STORED BY OWNER PRIOR TO START OF DEMOLITION WORK.
- F. COORDINATE WITH ABATEMENT DRAWINGS PRIOR TO DEMOLITION.

Demolition Key Notes


- 1E) REMOVE WALL FULL HEIGHT AND ALL ASSOCIATED COMPONENTS. PATCH EXPOSED SURFACE TO MATCH EXISTING ADJACENT SURFACES.
- 1E2) REMOVE PORTION OF WALL AS INDICATED AND ALL ASSOCIATED COMPONENTS. PATCH EXPOSED SURFACES TO MATCH EXISTING ADJACENT SURFACES.
- 1H) PROVIDE NEW OR ENLARGE EXISTING OPENING IN WALL TO EXTENT REQUIRED TO PERFORM SCHEDULED WORK. PROVIDE LINTEL PER LINTEL SCHEDULE. SEE STRU DRAWINGS. PATCH EXPOSED SURFACES TO MATCH ADJACENT FINISHES / SURFACES. COORDINATE WITH SCHEDULED WORK ON MECHANICAL DRAWINGS. SEE ABATEMENT DRAWINGS.
- 1P) REMOVE PORTION OF STOREFRONT INSULATED PANEL TO ACCOMMODATE SCHEDULED WORK. COORDINATE WITH MECHANICAL DRAWINGS.
- 8A) REMOVE WINDOW AND STOREFRONT SYSTEM COMPLETELY. PREPARE OPENING TO EXTENT REQUIRED TO PERFORM SCHEDULED WORK. PATCH EXPOSED SURFACES TO MATCH ADJACENT FINISHES / SURFACES.
- 8B) REMOVE DOOR AND FRAME COMPLETELY. PATCH EXPOSED SURFACES TO MATCH ADJACENT FINISHES/SURFACES.
- 9A) REMOVE PORTION OF CEILING SYSTEM AND/OR SOFFIT SYSTEM, TO EXTENT REQUIRED TO PERFORM NEW WORK. CLEAN, SALVAGE AND PROTECT FOR RE-INSTALLATION.
- 9A1) REMOVE CEILING SYSTEM AND/OR SOFFIT SYSTEM IN ITS ENTIRETY.
- 9B) REMOVE PORTION OF CEILING SYSTEM AND/OR SOFFIT SYSTEM, TO EXTENT REQUIRED TO PERFORM NEW WORK. CAREFULLY TRIM CEILING GRID TO REMAIN.
- 9C) REMOVE CEILING- OR WALL-MOUNTED ACOUSTICAL TREATMENTS IN THEIR ENTIRETY.
- 9D) REMOVE FLOOR FINISH, MASTIC AND WALL BASE TO EXTENT REQUIRED TO PERFORM SCHEDULED WORK. AT ALL AREAS OF FLOOR REMOVAL, LEVEL SLAB WITH ADJACENT SLABS AT LOCATIONS SCHEDULED TO RECEIVE FLOOR FINISH. INCLUDE CONCRETE FLOOR PATCHING AND LEVELING MATERIALS TO MAKE SURFACE LEVEL. PREPARE FOR FINISH. PATCH AREAS OF WALLS TO REMAIN THAT WERE DAMAGED BY REMOVAL OF WALL BASE.
- SUFFIX KEY (FLOOR FINISH IDENTIFICATIONS):
- A. CARPET.
- B. CERAMIC FLOOR TILE.
- C. VAT/VCT.
- 9E) REMOVE WALL BASE AND ASSOCIATED MASTIC ONLY. EXISTING FLOOR FINISH TO REMAIN. PATCH AREAS OF WALLS TO REMAIN THAT WERE DAMAGED BY REMOVAL OF WALL BASE.
- 9F) REMOVE WALL TILE IN ITS ENTIRETY. PATCH EXPOSED SURFACES TO MATCH ADJACENT FINISHES / SURFACES TO EXTENT REQUIRED TO PERFORM SCHEDULED WORK.
- 10B) REMOVE TOILET COMPARTMENTS IN THEIR ENTIRETY.
- 10C) REMOVE TOILET AND BATH ACCESSORIES. PATCH EXPOSED SURFACES TO MATCH ADJACENT FINISHES / SURFACES TO EXTENT REQUIRED TO PERFORM SCHEDULED WORK.
- 12A) REMOVE CASEWORK, SHELVING AND ASSOCIATED COMPONENTS TO THE EXTENT REQUIRED TO PERFORM SCHEDULED WORK. PATCH EXPOSED SURFACES TO MATCH ADJACENT FINISHES / SURFACES. COORDINATE WITH CASEWORK AND MECHANICAL DRAWINGS.
- 12C) REMOVE TEACHING SURFACES INCLUDING MARKER BOARDS, TACK BOARDS AND CHALK BOARDS. TURN OVER TO OWNER. PATCH EXPOSED SURFACES TO MATCH ADJACENT FINISHES AND SURFACES.

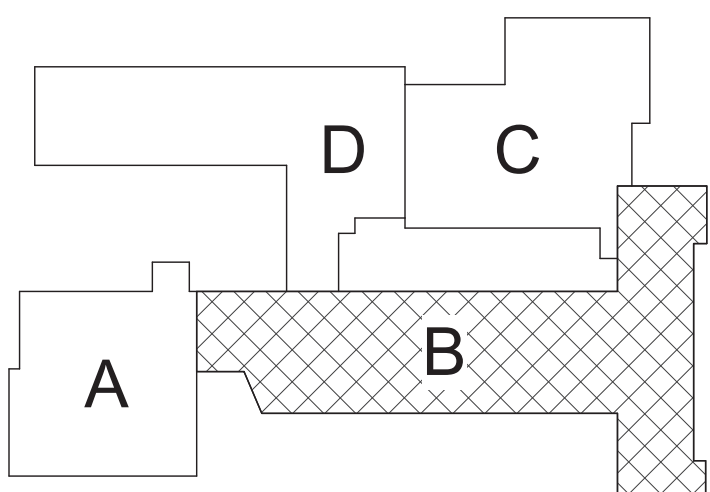

Key Plan  
N.T.S.

S.E.D. Control No. 13-02-00-01-0-006-022

Rev. No.:	Date:	Description:

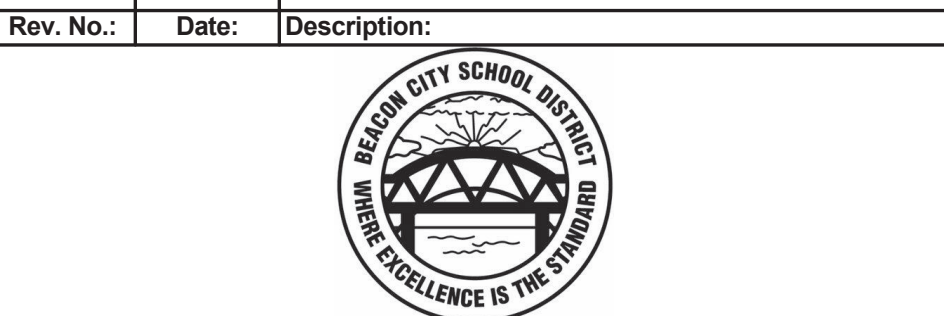

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Tetra Tech Engineers, Architects & Landscape Architects, P.C.

**BID SET**



Beacon City School District  
Beacon, New York

Additions and Alterations to:  
Glenham Elementary School

First Floor Demolition Plan - Area B

Drawn By: GCK/1lg	Date: 10/28/2022	Drawing Number: <b>BA101</b>
Project No.: 279180-22004		





- A. ----- REMOVE ITEMS INDICATED BY DASHED LINE.
- B. KEYED DEMOLITION TAGS REFER TO SPECIFIC LOCATIONS AS FOLLOWS:
  - 1. DEMOLITION TAGS LOCATED WITHIN THE MIDDLE OF A SPACE REFER TO DEMOLITION OF ALL ITEMS OF THAT SAME TYPE WITHIN THAT ENTIRE SPACE.
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- C. WHEN AN ITEM IS INDICATED TO BE DEMOLISHED REMOVE ALL ASSOCIATED COMPONENTS AS PART OF THAT WORK.
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- E. EXISTING WINDOW-MOUNTED AC UNITS SHALL BE REMOVED AND STORED BY OWNER PRIOR TO START OF DEMOLITION WORK.
- F. COORDINATE WITH ABATEMENT DRAWINGS PRIOR TO DEMOLITION.

1E	REMOVE WALL, FULL HEIGHT AND ALL ASSOCIATED COMPONENTS. PATCH EXPOSED SURFACES TO MATCH EXISTING ADJACENT SURFACES.
1F	REMOVE PORTION OF WALL AS INDICATED AND ALL ASSOCIATED COMPONENTS. PATCH EXPOSED SURFACES TO MATCH EXISTING ADJACENT SURFACES.
1H	PROVIDE NEW OR ENLARGE EXISTING OPENING IN WALL TO EXTENT REQUIRED TO PERFORM SCHEDULED WORK. PROVIDE LINTEL PER LINTEL SCHEDULE. SEE STRU DRAWINGS. PATCH EXPOSED SURFACES TO MATCH ADJACENT FINISHES / SURFACES. COORDINATE WITH SCHEDULED WORK ON MECHANICAL DRAWINGS. SEE ABATEMENT DRAWINGS.
1P	REMOVE PORTION OF STOREFRONT INSULATED PANEL TO ACCOMMODATE SCHEDULED WORK. COORDINATE WITH MECHANICAL DRAWINGS.
8A	REMOVE WINDOW AND STOREFRONT SYSTEM COMPLETELY. PREPARE FINISHING TO EXTENT REQUIRED TO PERFORM SCHEDULED WORK. PATCH EXPOSED SURFACES TO MATCH ADJACENT FINISHES / SURFACES.
8B	REMOVE DOOR AND FRAME COMPLETELY. PATCH EXPOSED SURFACES TO MATCH ADJACENT FINISHES/SURFACES.
9A	REMOVE PORTION OF CEILING SYSTEM AND/OR SOFFIT TO EXTENT REQUIRED TO PERFORM SCHEDULED WORK. CLEAN, SALVAGE AND PROTECT FOR RE-INSTALLATION.
9A1	REMOVE CEILING SYSTEM AND/OR SOFFIT SYSTEM IN ITS ENTIRETY.
9B	REMOVE PORTION OF CEILING SYSTEM AND/OR SOFFIT SYSTEM, TO EXTENT REQUIRED TO PERFORM NEW WORK. CAREFULLY RIN CEILING GRID TO REMAIN.
9C	REMOVE CEILING- OR WALL-MOUNTED ACOUSTICAL TREATMENTS IN THEIR ENTIRETY.
9D	REMOVE FLOOR FINISH, MASTIC AND WALL BASE TO EXTENT REQUIRED TO PERFORM SCHEDULED WORK. AT ALL AREAS OF REMOVAL, PROVIDE WITH CONCRETE SLAB AT LOCATIONS SCHEDULED TO RECEIVE FLOOR FINISH. INCLUDE CONCRETE FLOOR PATCHING AND LEVELING MATERIALS TO MATCH FLOOR LEVEL. PREPARE FLOOR FINISH. PATCH AREAS OF WALLS TO REMAIN THAT WERE DAMAGED BY REMOVAL OF WALL BASE.
<b><u>SUFFIX KEY (PLOR FINISH IDENTIFICATIONS):</u></b>	
A. CARPET	
B. CERAMIC FLOOR TILE	
C. VATIC	
9E	REMOVE WALL BASE AND ASSOCIATED MASTIC ONLY - EXISTING FLOOR FINISH TO REMAIN. PATCH AREAS OF WALLS TO REMAIN THAT WERE DAMAGED BY REMOVAL OF WALL BASE.
9F	REMOVE WALL, LINT IN ITS ENTIRETY. PATCH EXPOSED SURFACES TO MATCH ADJACENT FINISHES / SURFACES TO EXTENT REQUIRED TO PERFORM SCHEDULED WORK.
10B	REMOVE TOILET COMPARTMENTS IN THEIR ENTIRETY.
10C	REMOVE TOILET AND BATH ACCESSORIES. PATCH EXPOSED SURFACES TO MATCH ADJACENT FINISHES / SURFACES TO EXTENT REQUIRED TO PERFORM SCHEDULED WORK.
12A	REMOVE CASEWORK, SHELVING AND ASSOCIATED COMPONENTS TO THE EXTENT REQUIRED TO PERFORM SCHEDULED WORK. PATCH EXPOSED SURFACES TO MATCH ADJACENT FINISHES / SURFACES. COORDINATE WITH CASEWORK AND MECHANICAL DRAWINGS.
12C	REMOVE TEACHING SURFACES INCLUDING MARKER BOARDS, TACK BOARDS AND CHALK BOARDS. TURN OVER TO OWNER PATCH EXPOSED SURFACES TO MATCH ADJACENT FINISHES AND SURFACES.



S.E.D. Control No. 13-02-00-01-0-006-022

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Beacon City School District  
Beacon, New York


Additions and Alterations to:  
Glenham Elementary School

First Floor Demolition Plan - Area D


N	Drawn By: GCK/tlg	Date: 10/28/2022	Drawing Number:
	Project No.: 279180-22004		BA102

2 First Floor Plan - Area C  
1/8" = 1'-0"

1 First Floor Plan - Area A  
1/8" = 1'-0"

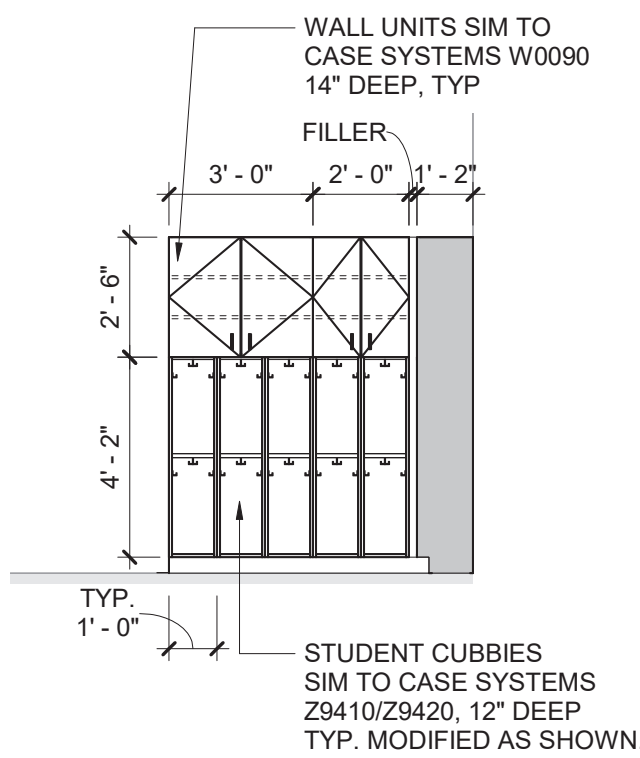

4 Classroom 15, 16-18, sim. - By Alternate No. 4  
1/4" = 1'-0"

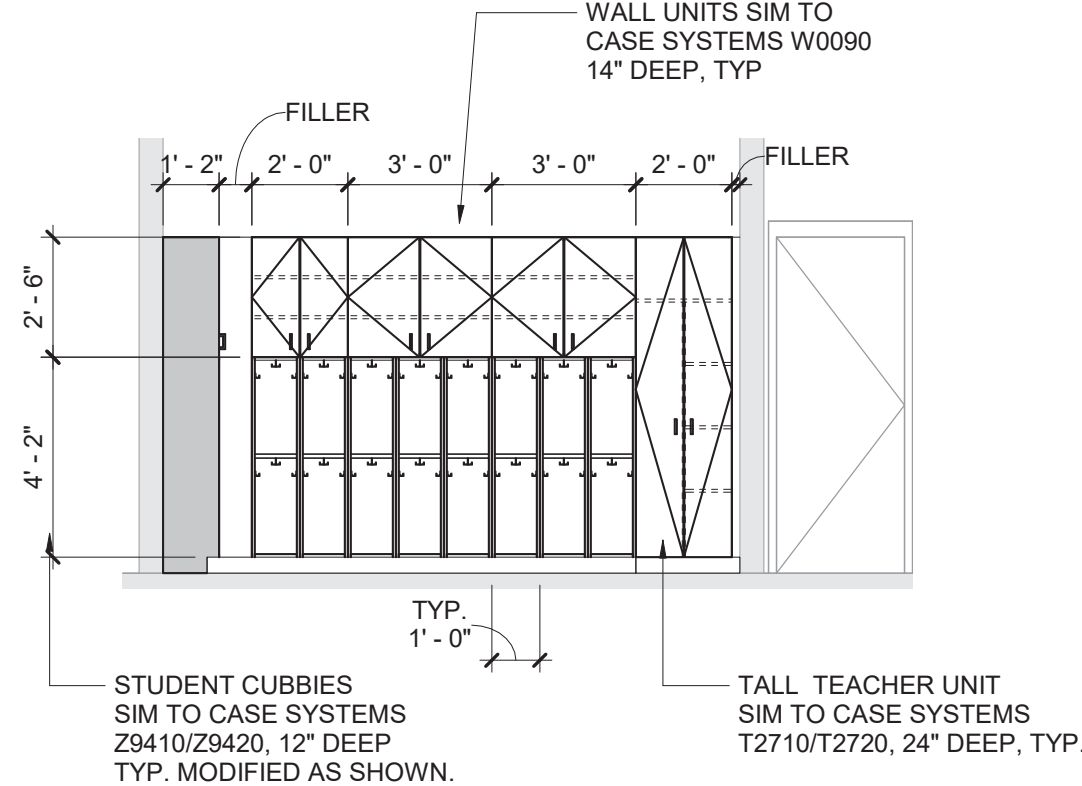

3 Classroom 15, 16-18, sim. - By Alternate No. 4  
1/4" = 1'-0"

### General Plan Notes

- A. WHERE EXISTING CONSTRUCTION IS DAMAGED OR DISTURBED, PATCH AS REQUIRED TO RESTORE SURFACES TO THEIR ORIGINAL CONDITION.
- B. PARTITION TYPE TAGS APPLY TO ENTIRE LENGTH OF WALL INDICATED BY THAT TAG, REGARDLESS OF OPENINGS WITHIN THAT WALL, TYPICAL UNLESS NOTED OTHERWISE.
- ALL EXTERIOR WALLS SHALL BE WALL/PARTITION TYPE EW1, TYPICAL UNLESS NOTED OTHERWISE.
  - ALL INTERIOR WALLS SHALL BE WALL/PARTITION TYPE P12.3, TYPICAL UNLESS NOTED OTHERWISE.
- C. PROVIDE BRACING WITHIN CHASES AS FOLLOWS:
- MASONRY WALLS: FULL-HEIGHT 4" CMU BRACES AT MAXIMUM SPACING OF 11'-0" OC.
  - GYPSON BOARD/TILE BACKING PANELS ON METAL FRAMING: FULL-HEIGHT 6" METAL STUD BRACES AT MAXIMUM SPACING OF 11'-0" OC.

### Keyed Plan Notes

- REINSTALL EXISTING CEILING PANELS AND GRID.
- INSTALL LOUVER IN EXG INSULATED PANEL, COORD WITH HVAC DRAWINGS
- INSTALL LOUVER FURNISHED BY OTHERS AT EXISTING OPENING. COORDINATE WITH MECHANICAL DRAWINGS.
- INSTALL LOUVER FURNISHED BY OTHERS AT NEW OPENING. COORDINATE WITH MECHANICAL DRAWINGS.

### Room Finish Key


- C1 CARPET - TYPE 1  
C2 CARPET - TYPE 2  
CFT1 CERAMIC FLOOR TILE - TYPE 1  
CT CERAMIC TILE COVE BASE  
CWT1 CERAMIC WALL TILE - TYPE 1  
LVT LUXURY VINYL TILE  
MCS MOISTURE CONTROL SYSTEM  
N NO WORK REQUIRED  
P PAINT SURFACE(S) INCLUDING SOFFITS  
RB RUBBER BASE  
VCT1 VINYL COMPOSITION TILE - TYPE 1

- \* SEE REFLECTED CEILING PLAN  
INDICATED CHANGE IN FLOOR FINISH

NOTE: ALL FINISHES LISTED MAY NOT BE REQUIRED FOR THIS PROJECT

RM#	
CLG*	WALL
FLR	BASE

REFER TO DRAWING BA900 FOR GENERAL FINISH NOTES  
REFER TO DRAWING BA900 FOR CASEWORK NOTES

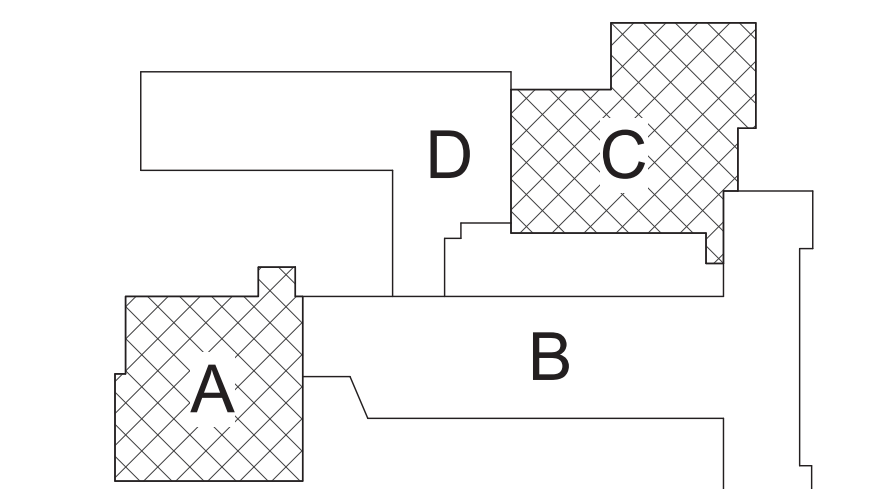

Key Plan  
N.T.S.

S.E.D. Control No. 13-02-00-01-0-006-022

Rev. No.: Date: Description:



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Tetra Tech Engineers, Architects  
& Landscape Architects, P.C.



Beacon City School District  
Beacon, New York

Additions and Alterations to:  
Glenham Elementary School

First Floor Plan - Area A and C

Drawn By:  
GCK/ig


Date:  
10/28/2022

Project No.:  
279180-22004

Drawing Number:

BA130



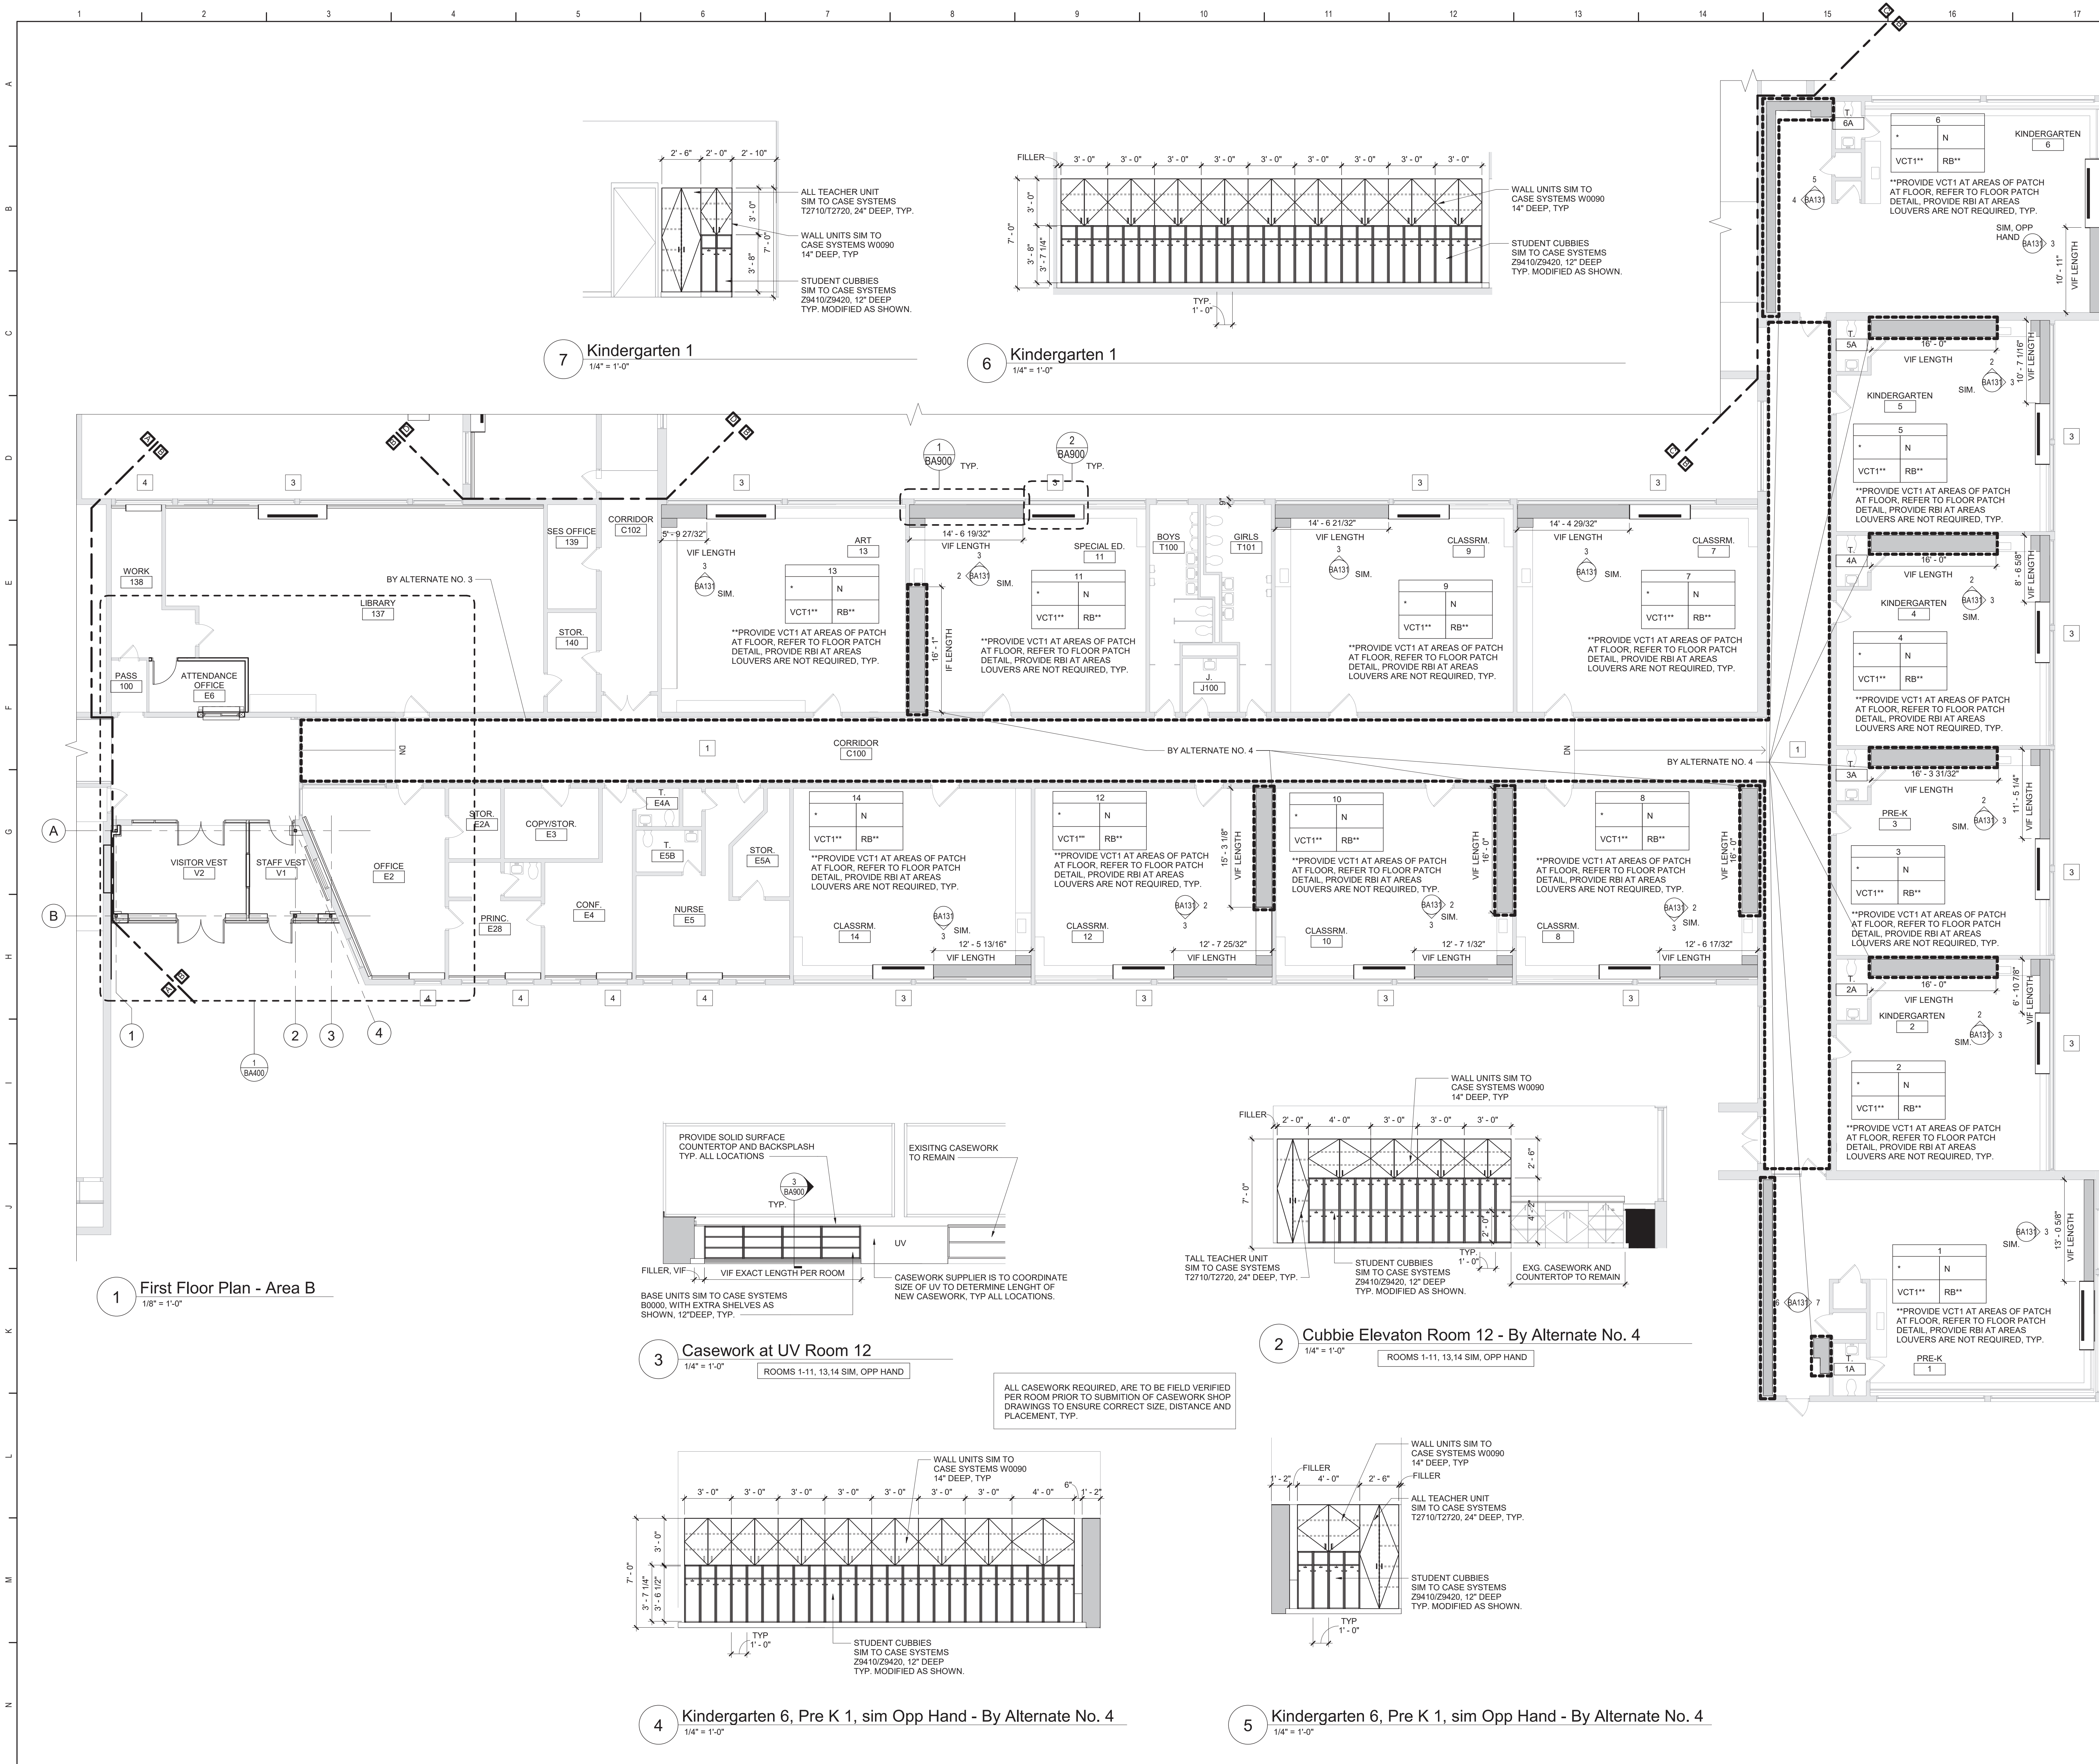

### General Plan Notes

- WHERE EXISTING CONSTRUCTION IS DAMAGED OR DISTURBED, PATCH AS REQUIRED TO RESTORE SURFACES TO THEIR ORIGINAL CONDITION.
- PARTITION TYPE TAGS APPLY TO ENTIRE LENGTH OF WALL INDICATED BY THAT TAG, REGARDLESS OF OPENINGS WITHIN THAT WALL, TYPICAL UNLESS NOTED OTHERWISE.
  - ALL EXTERIOR WALLS SHALL BE WALL/PARTITION TYPE EW1, TYPICAL UNLESS NOTED OTHERWISE.
  - ALL INTERIOR WALLS SHALL BE WALL/PARTITION TYPE PI2.3, TYPICAL UNLESS NOTED OTHERWISE.
- PROVIDE BRACING WITHIN CHASES AS FOLLOWS:
  - MASONRY WALLS: FULL-HEIGHT 4" CMU BRACES AT MAXIMUM SPACING OF 11'-0" OC.
  - GYPSON BOARD/TILE BACKING PANELS ON METAL FRAMING: FULL-HEIGHT 6" METAL STUD BRACES AT MAXIMUM SPACING OF 11'-0" OC.

### Keyed Plan Notes

- REINSTALL EXISTING CEILING PANELS AND GRID.
- INSTALL LOUVER IN EXG INSULATED PANEL, COORD WITH HVAC DRAWINGS
- INSTALL LOUVER FURNISHED BY OTHERS AT EXISTING OPENING. COORDINATE WITH MECHANICAL DRAWINGS.
- INSTALL LOUVER FURNISHED BY OTHERS AT NEW OPENING. COORDINATE WITH MECHANICAL DRAWINGS.


### Room Finish Key

C1	CARPET - TYPE 1
C2	CARPET - TYPE 2
CT	CERAMIC FLOOR TILE - TYPE 1
CWT	CERAMIC WALL TILE - TYPE 1
LVT	LUXURY VINYL TILE
MCS	MOISTURE CONTROL SYSTEM
N	NO WORK REQUIRED
PS	PAINT SURFACE(S) INCLUDING SOFFITS
RB	RUBBER BASE
VCT1	VINYL COMPOSITION TILE - TYPE 1

SEE REFLECTED CEILING PLAN  
INDICATED CHANGE IN FLOOR FINISH  
NOTE: ALL FINISHES LISTED MAY NOT BE REQUIRED FOR THIS PROJECT

FINISHES SHOWN IN ROOM FINISH BOX ARE FOR ALL WALLS AND ENTIRE FLOOR AND CEILING. REFER TO EACH ROOM FOR MORE INFORMATION.	RM#
CLG*	WALL
FLR	BASE

REFER TO DRAWING BA900 FOR GENERAL FINISH NOTES  
REFER TO DRAWING BA900 FOR CASEWORK NOTES

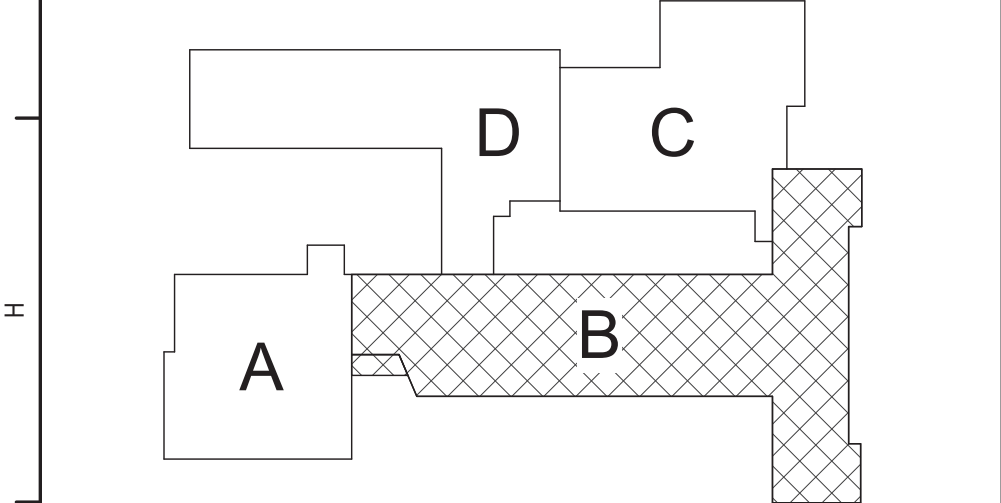

Key Plan  
N.T.S.

S.E.D. Control No. 13-02-00-01-0-006-022

Rev. No.: Date: Description:



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Tetra Tech Engineers, Architects & Landscape Architects, P.C.




Beacon City School District  
Beacon, New York

Additions and Alterations to:  
Glenham Elementary School

First Floor Plan - Area B

Drawn By: GCK/lig	Date: 10/28/2022	Drawing Number:
Project No.: 279180-22004	BA131	



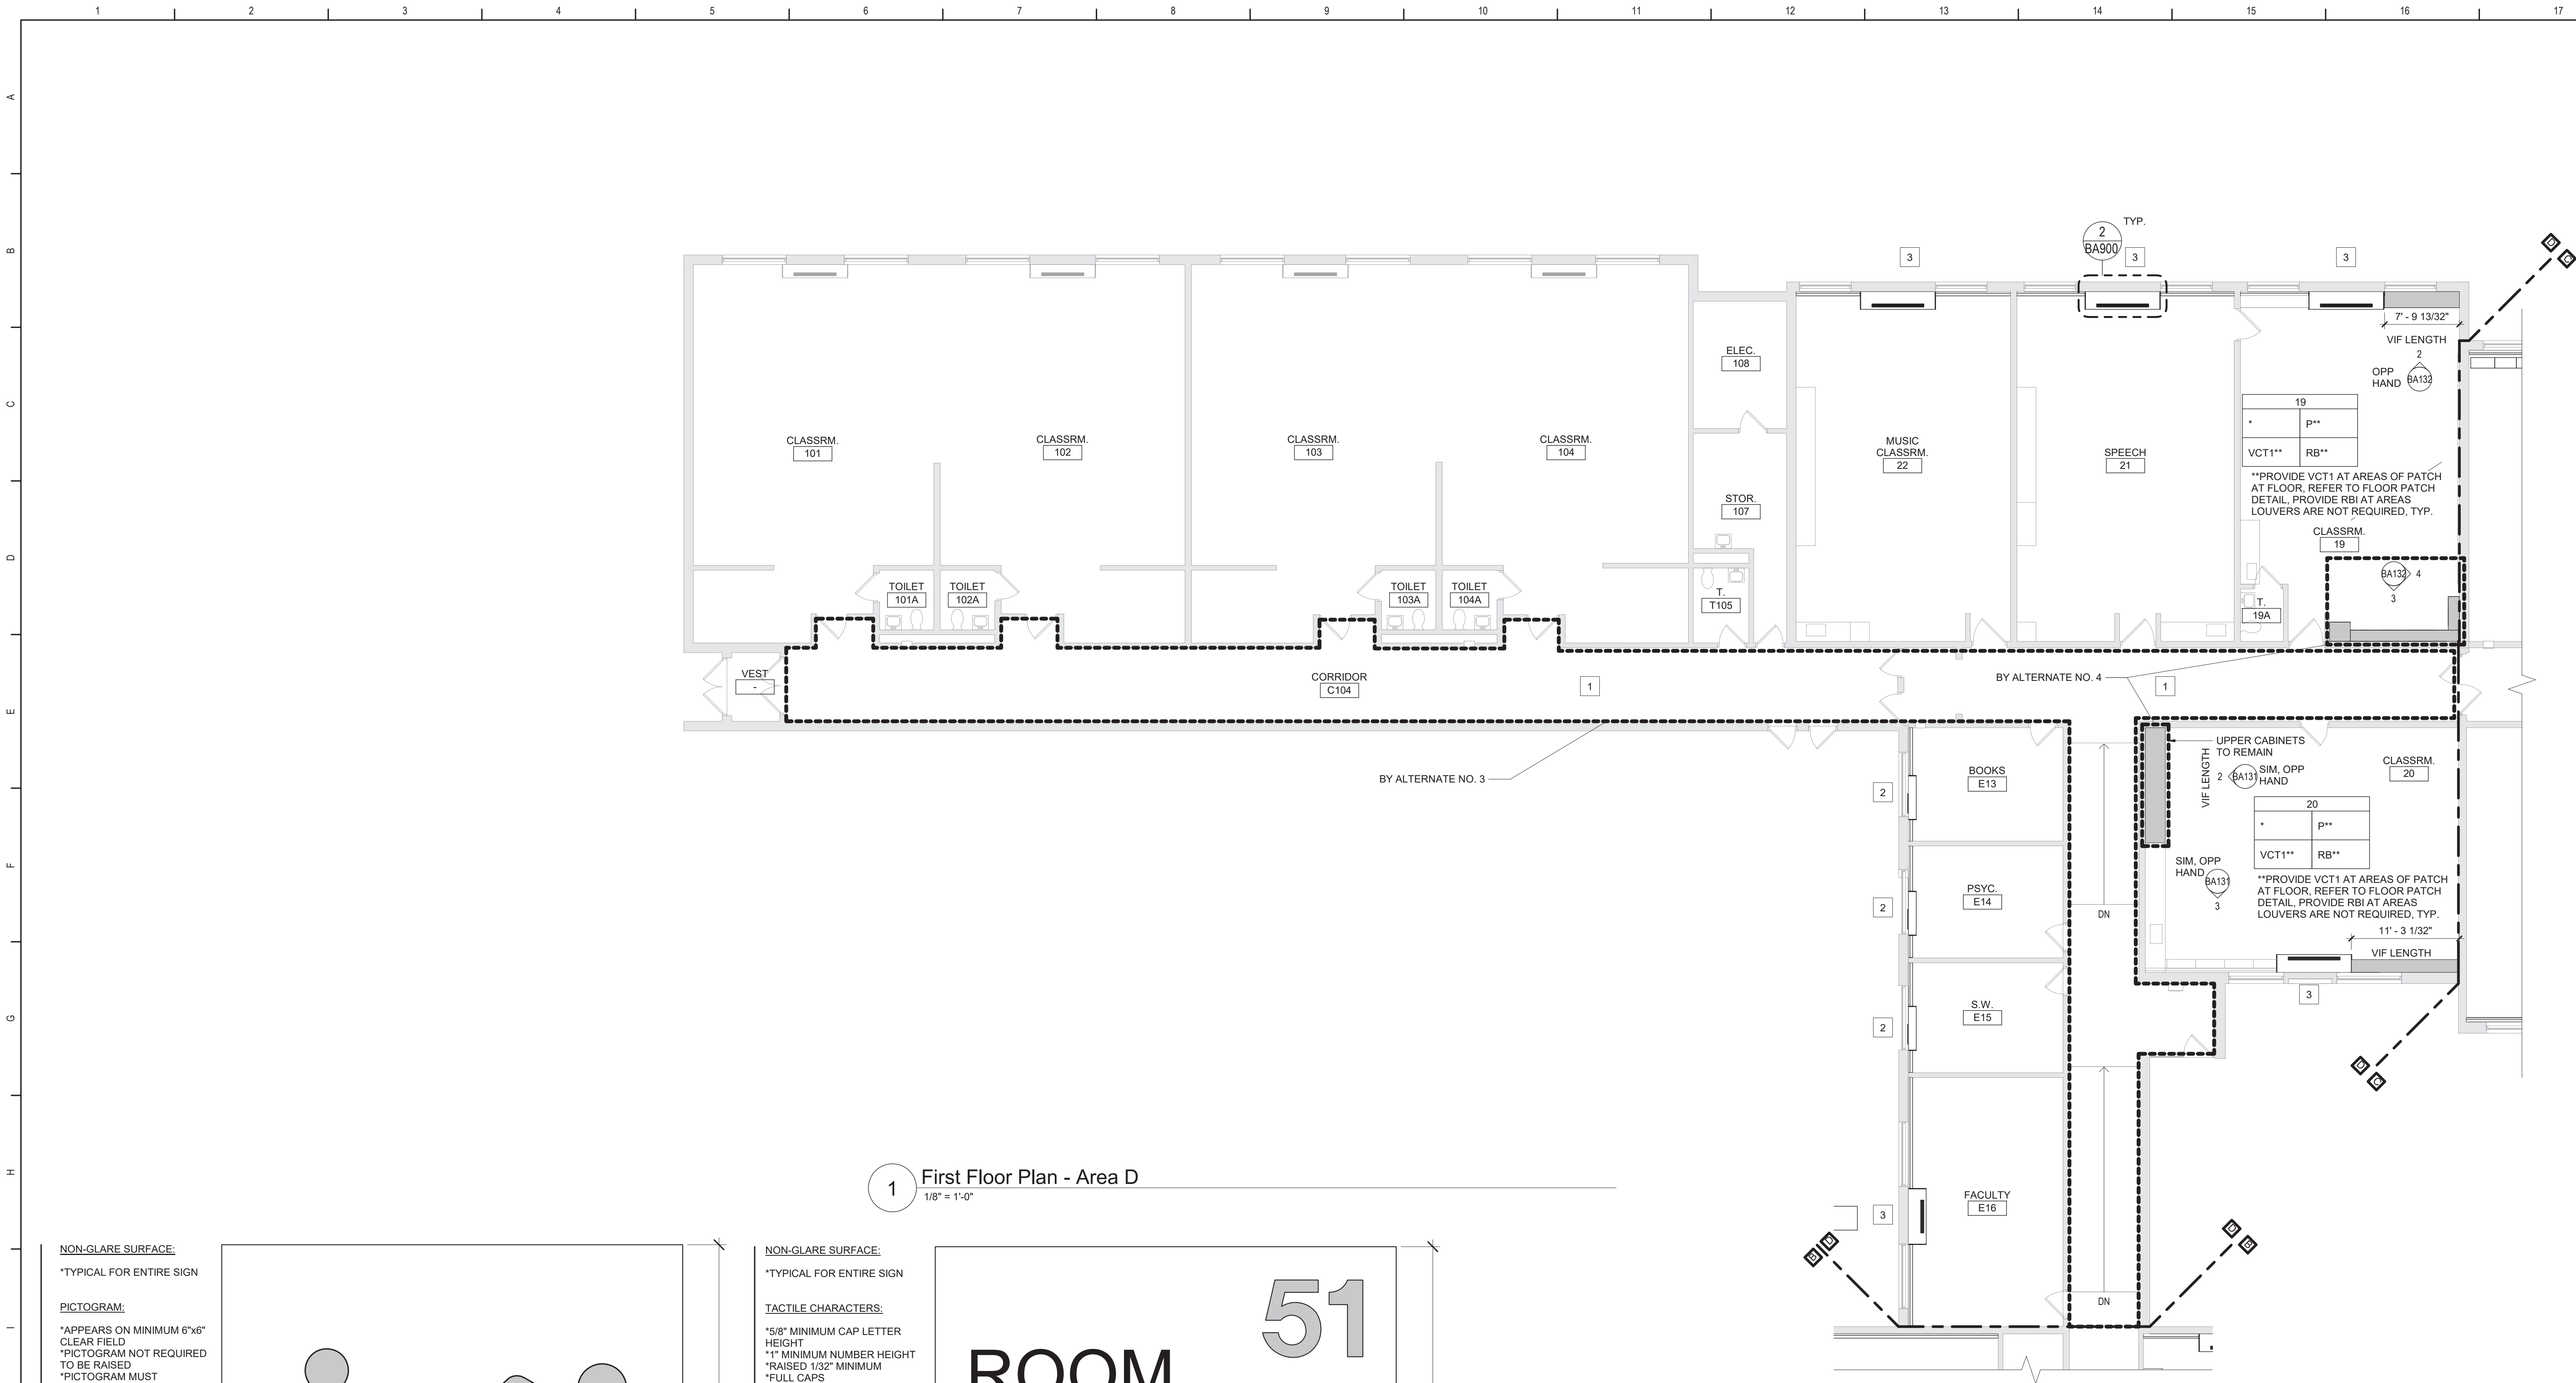

General Plan Notes

- A. WHERE EXISTING CONSTRUCTION IS DAMAGED OR DISTURBED, PATCH AS REQUIRED TO RESTORE SURFACES TO THEIR ORIGINAL CONDITION.
- B. PARTITION TYPE TAGS APPLY TO ENTIRE LENGTH OF WALL INDICATED BY THAT TAG, REGARDLESS OF OPENINGS WITHIN THAT WALL, TYPICAL UNLESS NOTED OTHERWISE.
1. ALL EXTERIOR WALLS SHALL BE WALL/PARTITION TYPE EW1, TYPICAL UNLESS NOTED OTHERWISE.
2. ALL INTERIOR WALLS SHALL BE WALL/PARTITION TYPE P12.3, TYPICAL UNLESS NOTED OTHERWISE.
- C. PROVIDE BRACING WITHIN CHASES AS FOLLOWS:
1. MASONRY WALLS: FULL-HEIGHT 4" CMU BRACES AT MAXIMUM SPACING OF 11'-0" OC.
2. GYPSUM BOARD/TILE BACKING PANELS ON METAL FRAMING: FULL-HEIGHT 6" METAL STUD BRACES AT MAXIMUM SPACING OF 11'-0" OC.

Keyed Plan Notes

- 1 REINSTALL EXISTING CEILING PANELS AND GRID.
- 2 INSTALL LOUVER IN EXG INSULATED PANEL, COORD WITH HVAC DRAWINGS
- 3 INSTALL LOUVER FURNISHED BY OTHERS AT EXISTING OPENING. COORDINATE WITH MECHANICAL DRAWINGS.
- 4 INSTALL LOUVER FURNISHED BY OTHERS AT NEW OPENING. COORDINATE WITH MECHANICAL DRAWINGS.

Room Finish Key


C1	CARPET - TYPE 1
C2	CARPET - TYPE 2
CT1	CERAMIC FLOOR TILE - TYPE 1
CT	CERAMIC TILE COVE BASE
CWT1	CERAMIC WALL TILE - TYPE 1
LVT	LUXURY VINYL TILE
MCS	MOISTURE CONTROL SYSTEM
N	NO WORK REQUIRED
P	PAINT SURFACE(S) INCLUDING SOFFITS
RB	RUBBER BASE
VCT1	VINYL COMPOSITION TILE - TYPE 1

- \* SEE REFLECTED CEILING PLAN
- INDICATED CHANGE IN FLOOR FINISH

NOTE: ALL FINISHES LISTED MAY NOT BE REQUIRED FOR THIS PROJECT

RM#	CLG*	WALL
	FLR	BASE


REFER TO DRAWING BA900 FOR GENERAL FINISH NOTES  
REFER TO DRAWING BA900 FOR CASEWORK NOTES

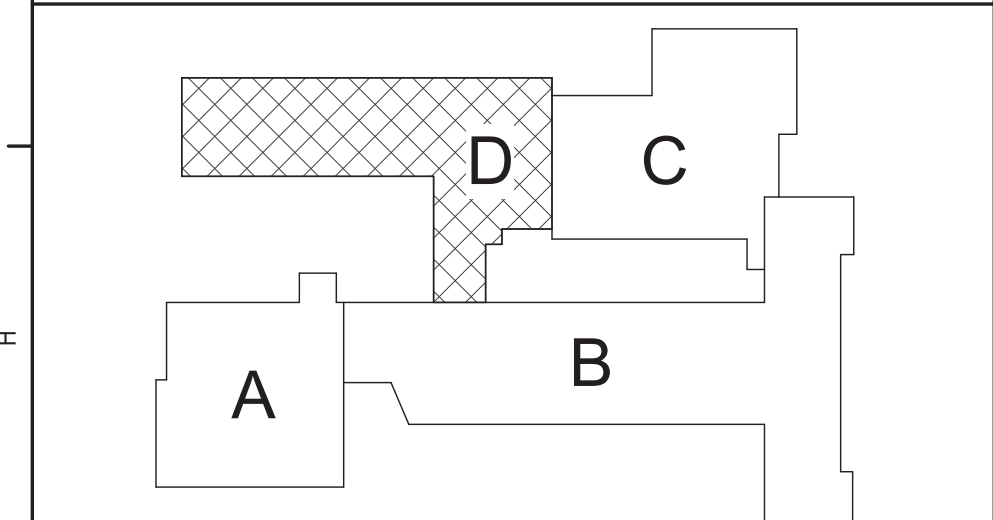

Key Plan  
N.T.S.

S.E.D. Control No. 13-02-00-01-0-006-022

Rev. No.:	Date:	Description:

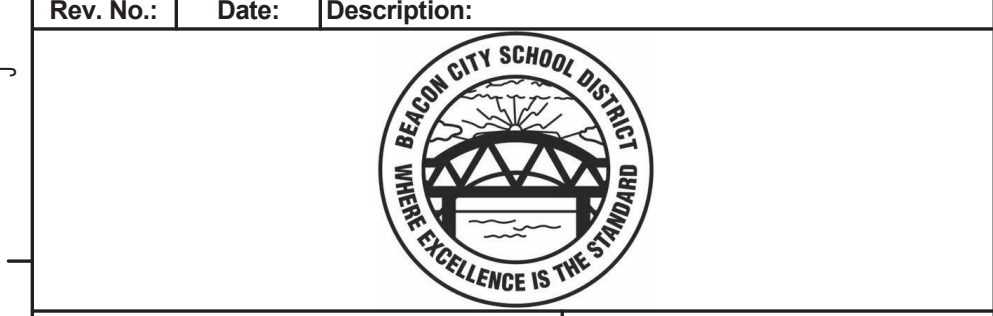

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BID SET




Beacon City School District  
Beacon, New York

Additions and Alterations to:  
Glenham Elementary School

First Floor Plan - Area D

Drawn By: GCK/lig	Date: 10/28/2022	Drawing Number:
Project No.: 279180-22004		BA132



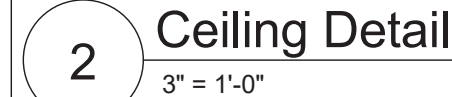

- A. LIGHTING AND OTHER CEILING-MOUNTED FIXTURES ARE SHOWN FOR DRAWING CLARITY. COORDINATE ALL CEILING WORK PRIOR TO INSTALLATION OF CEILING GRID.
- B. CEILING HEIGHT IS 9'-0" ABOVE FINISHED FLOOR (UNO).
- C. CENTER CEILING-MOUNTED ITEMS (LIGHTS, GRILLES, DETECTORS, SPRINKLER HEAD, ETC) WITHIN THE CEILING PANELS AND GRIDS. THE CENTER OF THE PANELS ARE SCORING CENTER ITEMS WITHIN THE PATTERN OF SCORED PANELS.
- D. PROVIDE EXPANSION JOINT (EJ) COVERS IN CEILINGS AND SOFFITS AT EJ LOCATIONS.
- E. PROVIDE CONTROL JOINTS IN GYPSUM BOARD CEILINGS AND SOFFITS AS DETAILED ON DRAWINGS (MAXIMUM 20'-0" CC, EVENLY SPACED, TYP UNO).
- F. PATCH CEILING SYSTEMS TO REMAIN THAT HAVE BEEN DISTURBED BY SCHEDULED WORK TO MATCH ADJACENT CONSTRUCTION PRIOR TO PAINTING.
- G. X 10'-0" DESIGNATES BOTTOM OF CEILING ABOVE FINISHED FLOOR AT THAT POINT UNO. DESIGNATION "ME" INDICATES MATCH EXISTING CEILING HEIGHT.
- H. AT ALL LOCATIONS OF GYPSUM CEILINGS - PROVIDE 24" X 24" COATED FLANGES TO BE USED FOR THE CEILING REGARDLESS OF LOCATION OR REQUIREMENT FOR ACCESS TO EQUIPMENT.


A1	X'-X"	ACOUSTIC PANEL CEILING
A2	X'-X"	ACOUSTIC PANEL CEILING
B1	X'-X"	PAINTED 1/2" EXTERIOR GRADE GYPSUM CEILING ON SUPPORT MATERIAL S (GRID) SUSPENSION SYSTEM, TYP. UNO

NOTE: AT AREAS WITH "+/-", THE INTENT IS TO MATCH EXISTING. VERIFY IN FIELD.

REFER TO BA130 SERIES DWGS FOR REINSTALLATION OF  
SALVAGED CEILING AREAS.




Rev. No.:      Date:      Description:

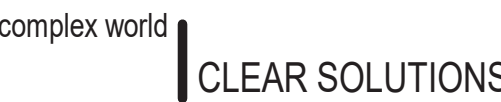

Tetra Tech Engineers, Architects  
& Landscape Architects, P.C.

Beacon City School District  
Beacon, New YorkAdditions and Alterations to:  
Glenham Elementary School

First Floor Reflected Ceiling Plan -  
Area C


Drawn By:	Date:
GCK/tlg	10/28/2022

Project No.:  
279180-22004

Drawing Number:

BA160



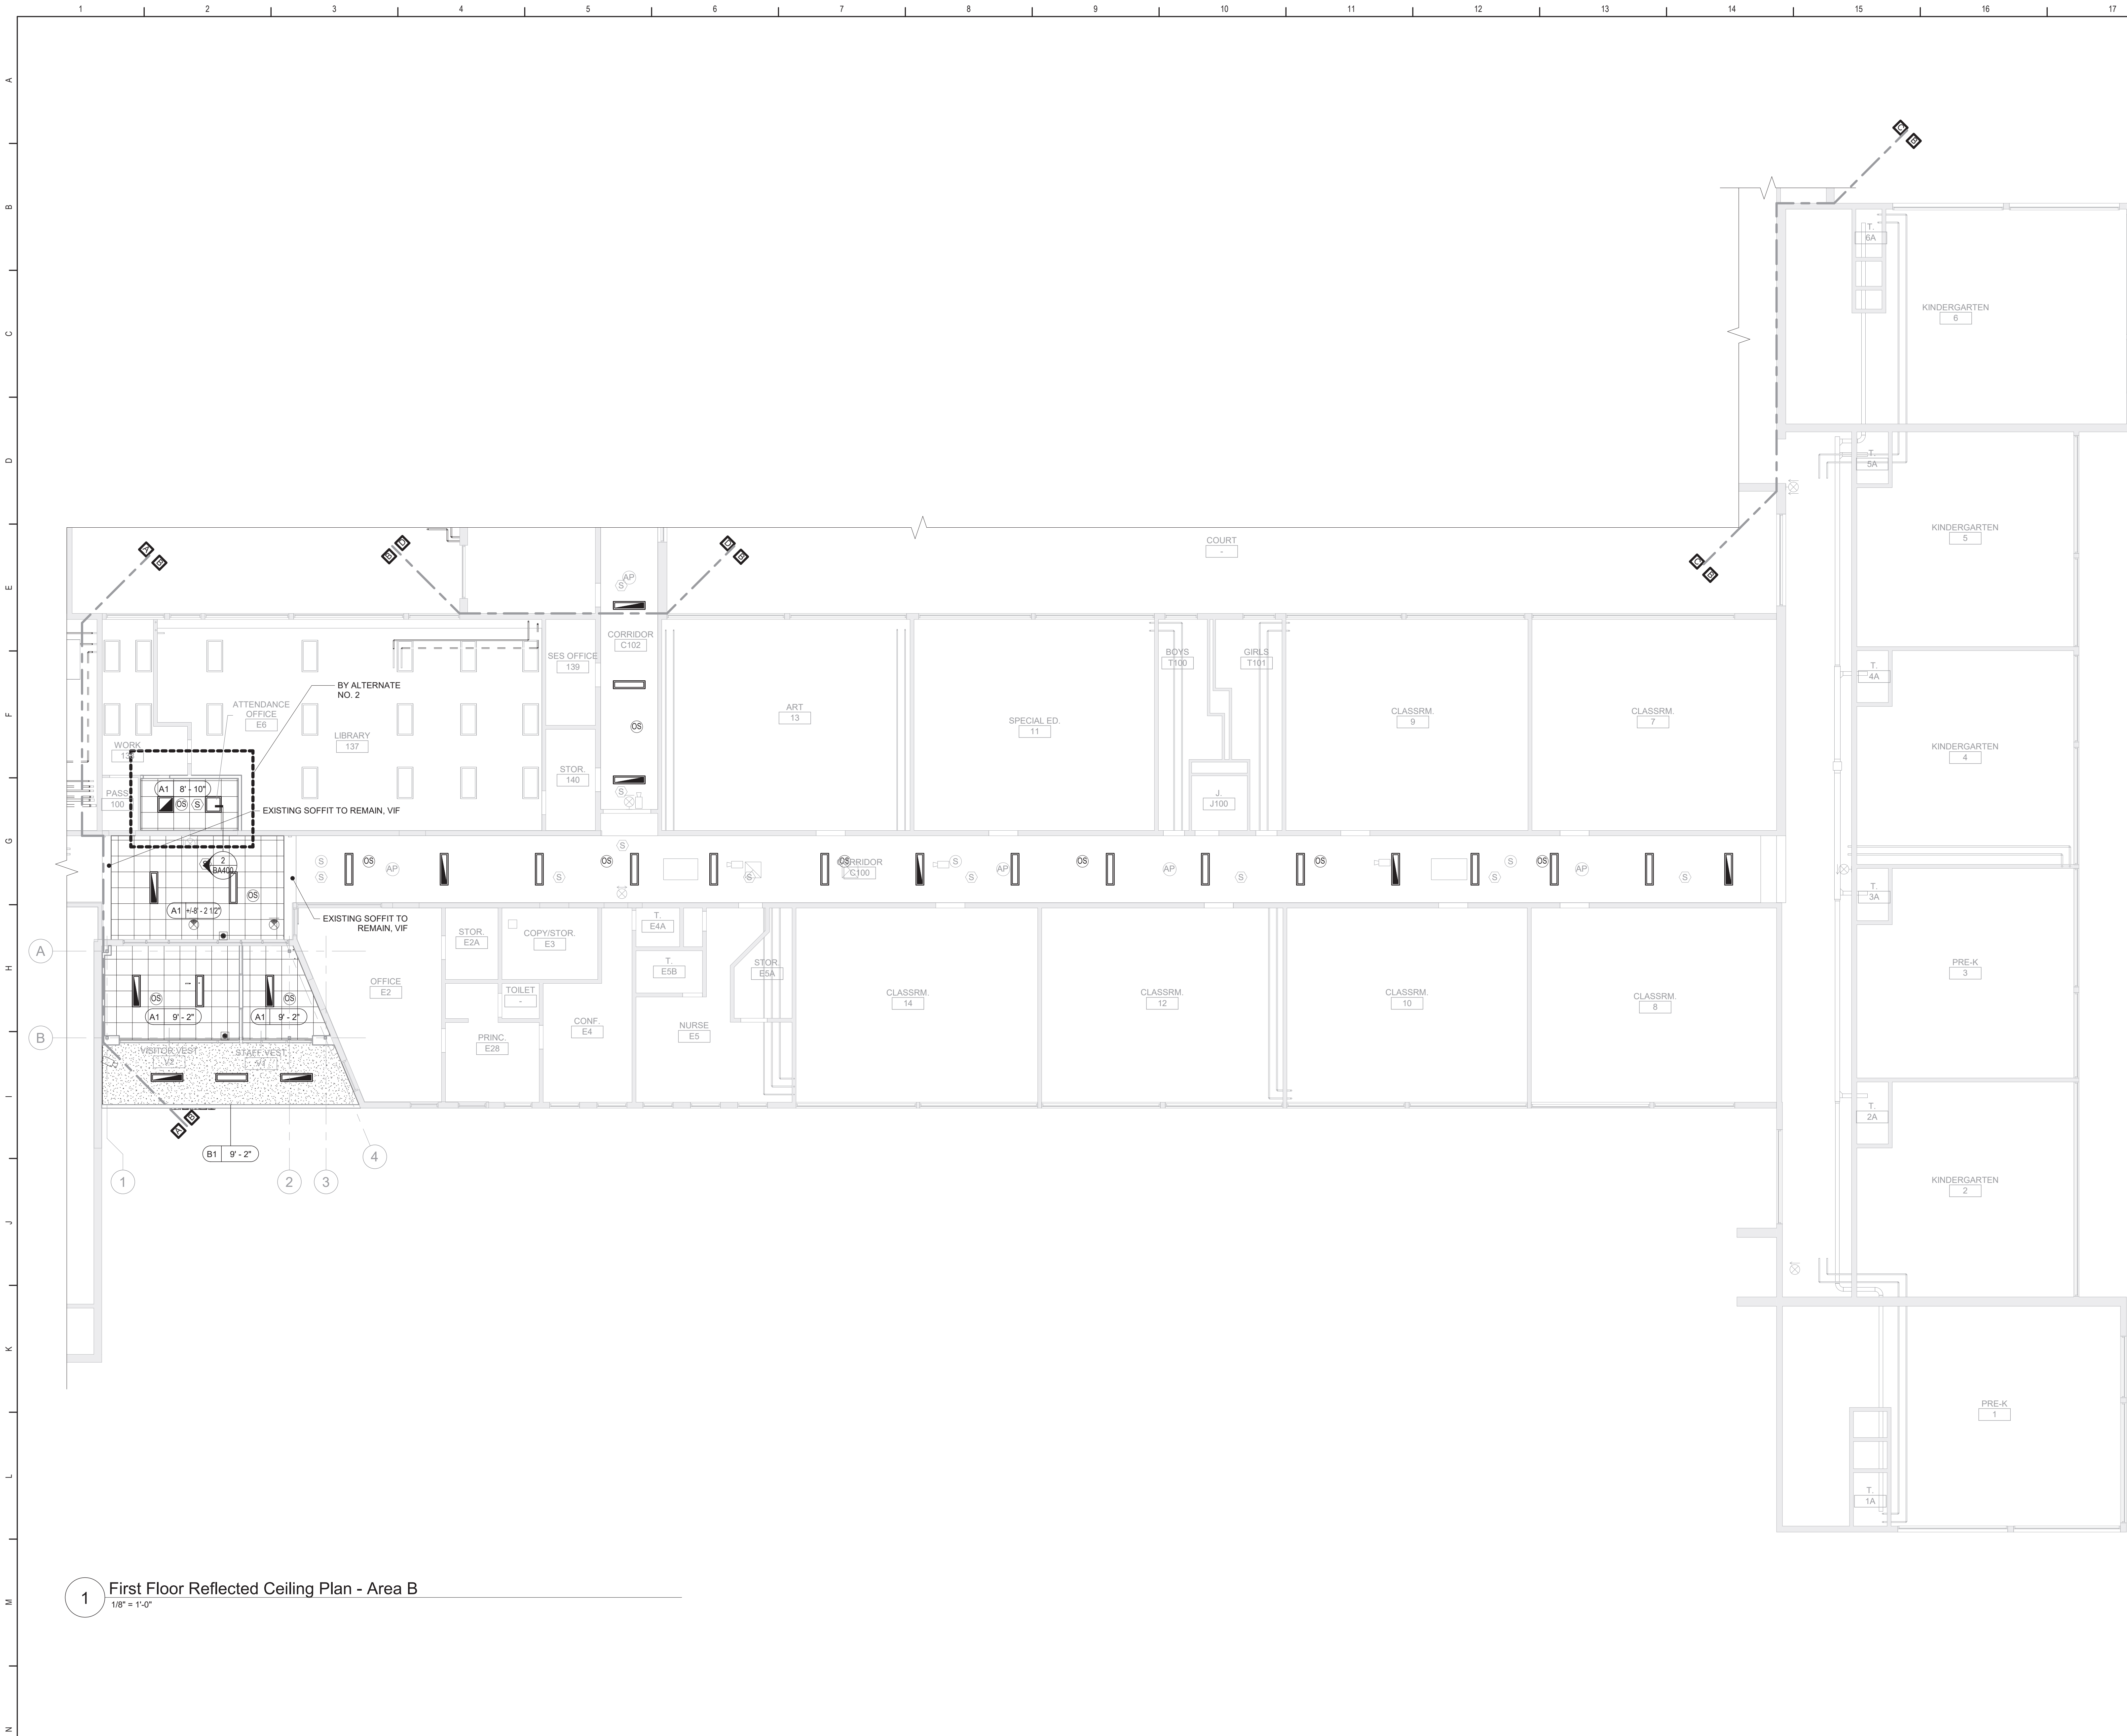

1 First Floor Reflected Ceiling Plan - Area B  
1/8" = 1'-0"


### General Ceiling Notes

- A. LIGHTING AND OTHER CEILING-MOUNTED FIXTURES ARE SHOWN FOR DRAWING CLARITY. COORDINATE ALL CEILING WORK PRIOR TO INSTALLATION OF CEILING GRID.
- B. CEILING HEIGHT IS 9'-0" ABOVE FINISHED FLOOR (UNO).
- C. CENTER CEILING-MOUNTED ITEMS (LIGHTS, GRILLES, DETECTORS, SPRINKLER HEAD, ETC) WITHIN THE CEILING PANELS AND GRIDS UNLESS THE PANELS ARE SCORED. CENTER ITEMS WITHIN THE PATTERN OF SCORED PANELS.
- D. PROVIDE EXPANSION JOINT (EJ) COVERS IN CEILINGS AND SOFFITS AT EJ LOCATIONS.
- E. PROVIDE CONTROL JOINTS IN GYPSUM BOARD CEILINGS AND SOFFITS AS DETAILED ON DRAWINGS (MAXIMUM 20'-0" OC, EVENLY SPACED, TYP UNO).
- F. PATCH CEILING SYSTEMS TO REMAIN THAT HAVE BEEN DISTURBED BY SCHEDULED WORK TO MATCH ADJACENT CONSTRUCTION PRIOR TO PAINTING.
- G. (X) 9'-0" DESIGNATES BOTTOM OF CEILING ABOVE FINISHED FLOOR AT THAT POINT UNO. DESIGNATION "ME" INDICATES MATCH EXISTING CEILING HEIGHT.
- H. AT ALL LOCATIONS OF GYPSUM CEILINGS - PROVIDE 24" X 24" CONCEALED FLANGE ACCESS DOOR REGARDLESS OF LOCATION OR REQUIREMENT FOR ACCESS TO EQUIPMENT.

### Ceiling Types

- A1 X'-X" ACOUSTIC PANEL CEILING
- A2 X'-X" ACOUSTIC PANEL CEILING
- B1 X'-X" PAINTED 1/2" EXTERIOR GRADE GYPSUM CEILING ON SUPPORT MATERIALS (GRID SUSPENSION SYSTEM, TYP UNO)

NOTE: AT AREAS WITH "x/x", THE INTENT IS TO MATCH EXISTING. VERIFY IN FIELD.  
REFER TO BA130 SERIES DWGS FOR REINSTALLATION OF SALVAGED CEILING AREAS.

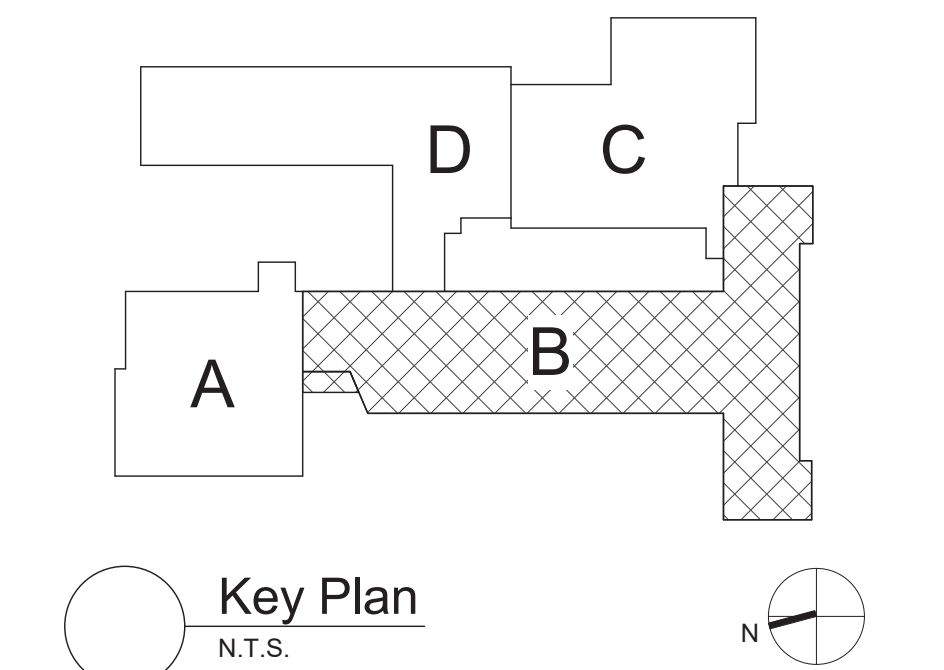

S.E.D. Control No. 13-02-00-01-0-006-022

Rev. No.: Date: Description:



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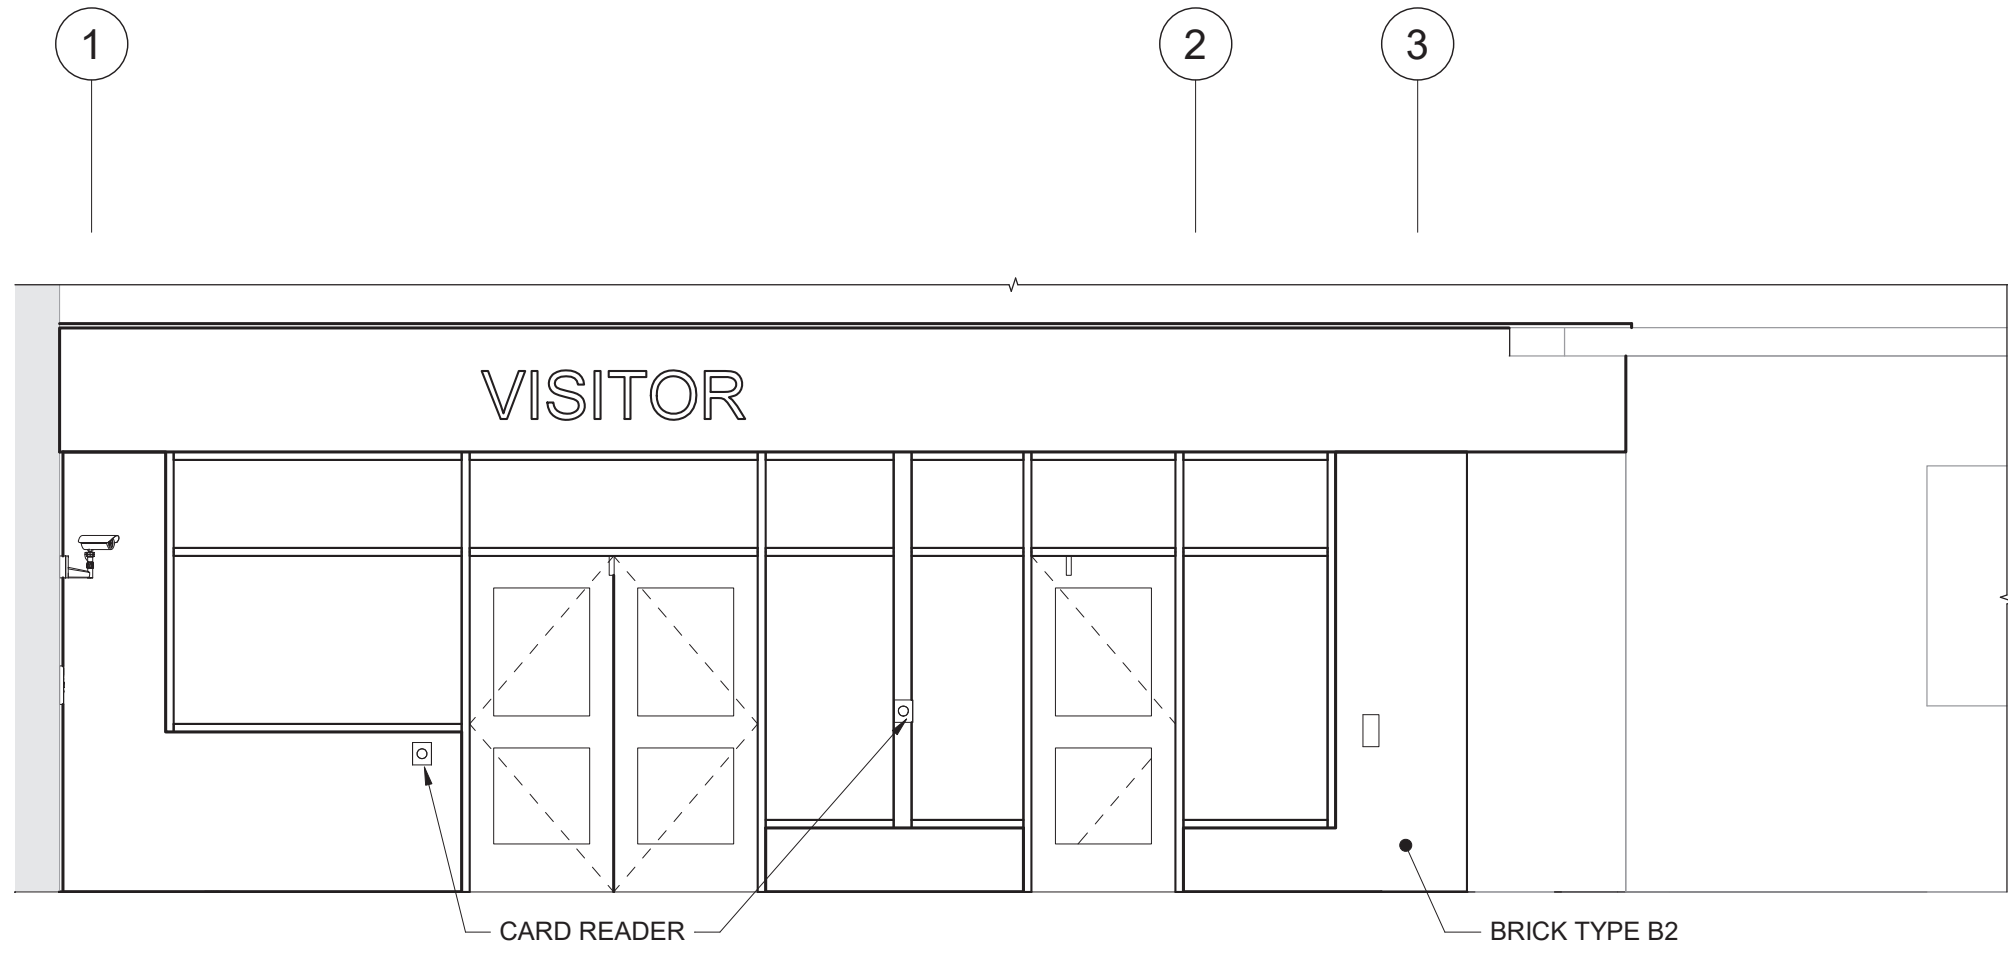
Beacon City School District  
Beacon, New York

Additions and Alterations to:  
Glenham Elementary School


First Floor Reflected Ceiling Plan -  
Area B

Drawn By: GCK/lig Date: 10/28/2022 Drawing Number:  
Project No.: 279180-22004  
BA161







4 Main Entry Elevation  
1/4" = 1'-0"

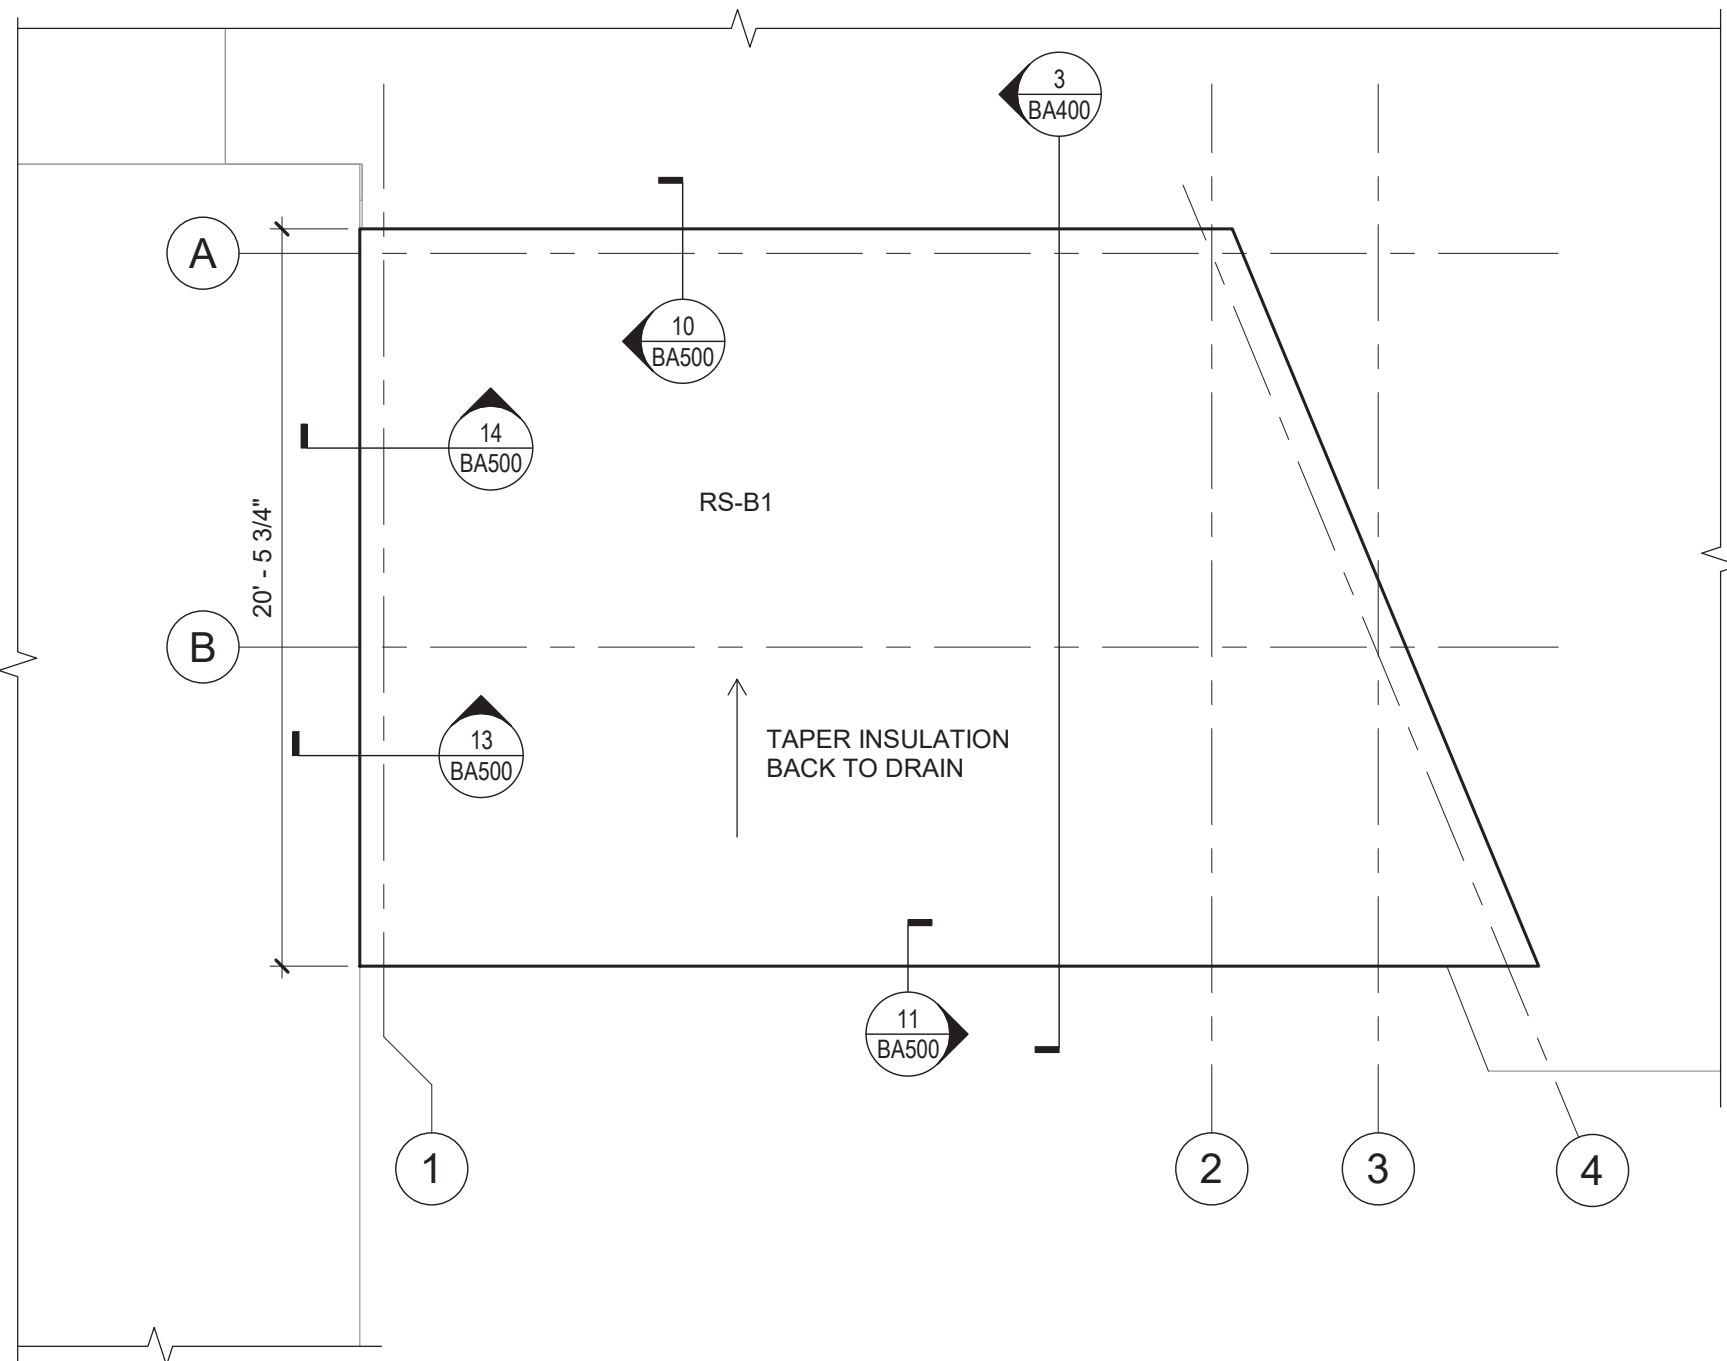


5 Roof Plan  
3/16" = 1'-0"

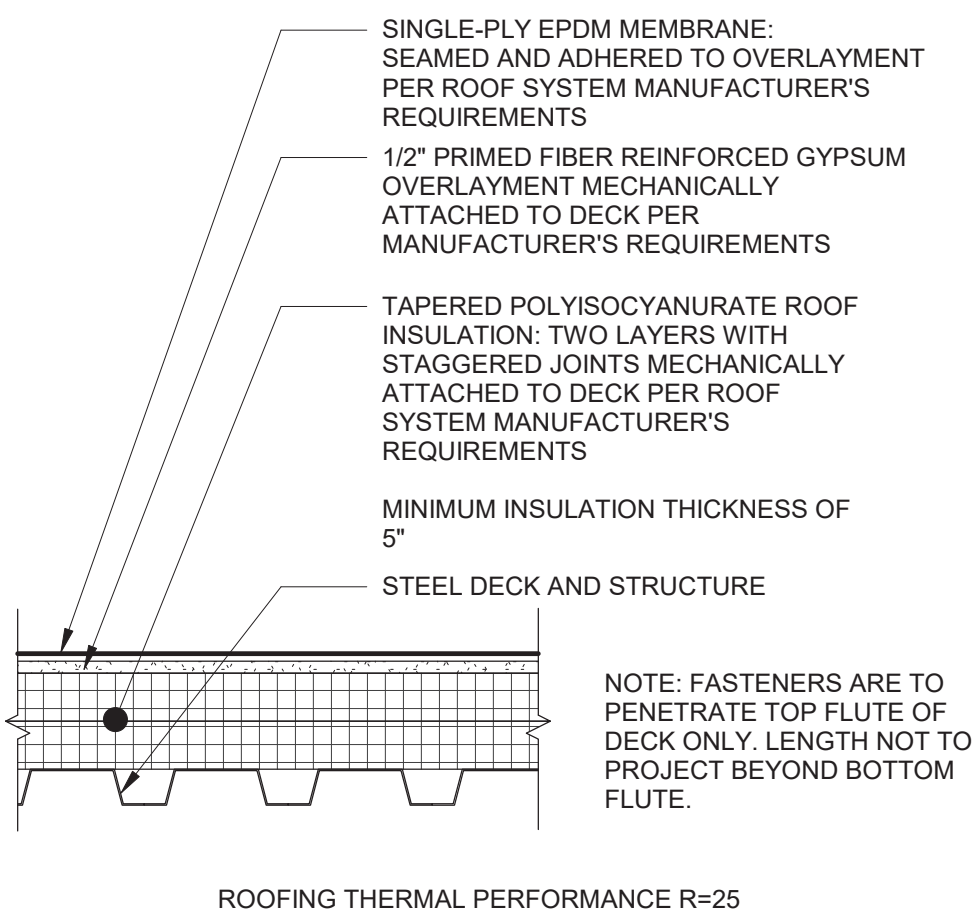


6 Roof System RS-B1  
1 1/2" = 1'-0"

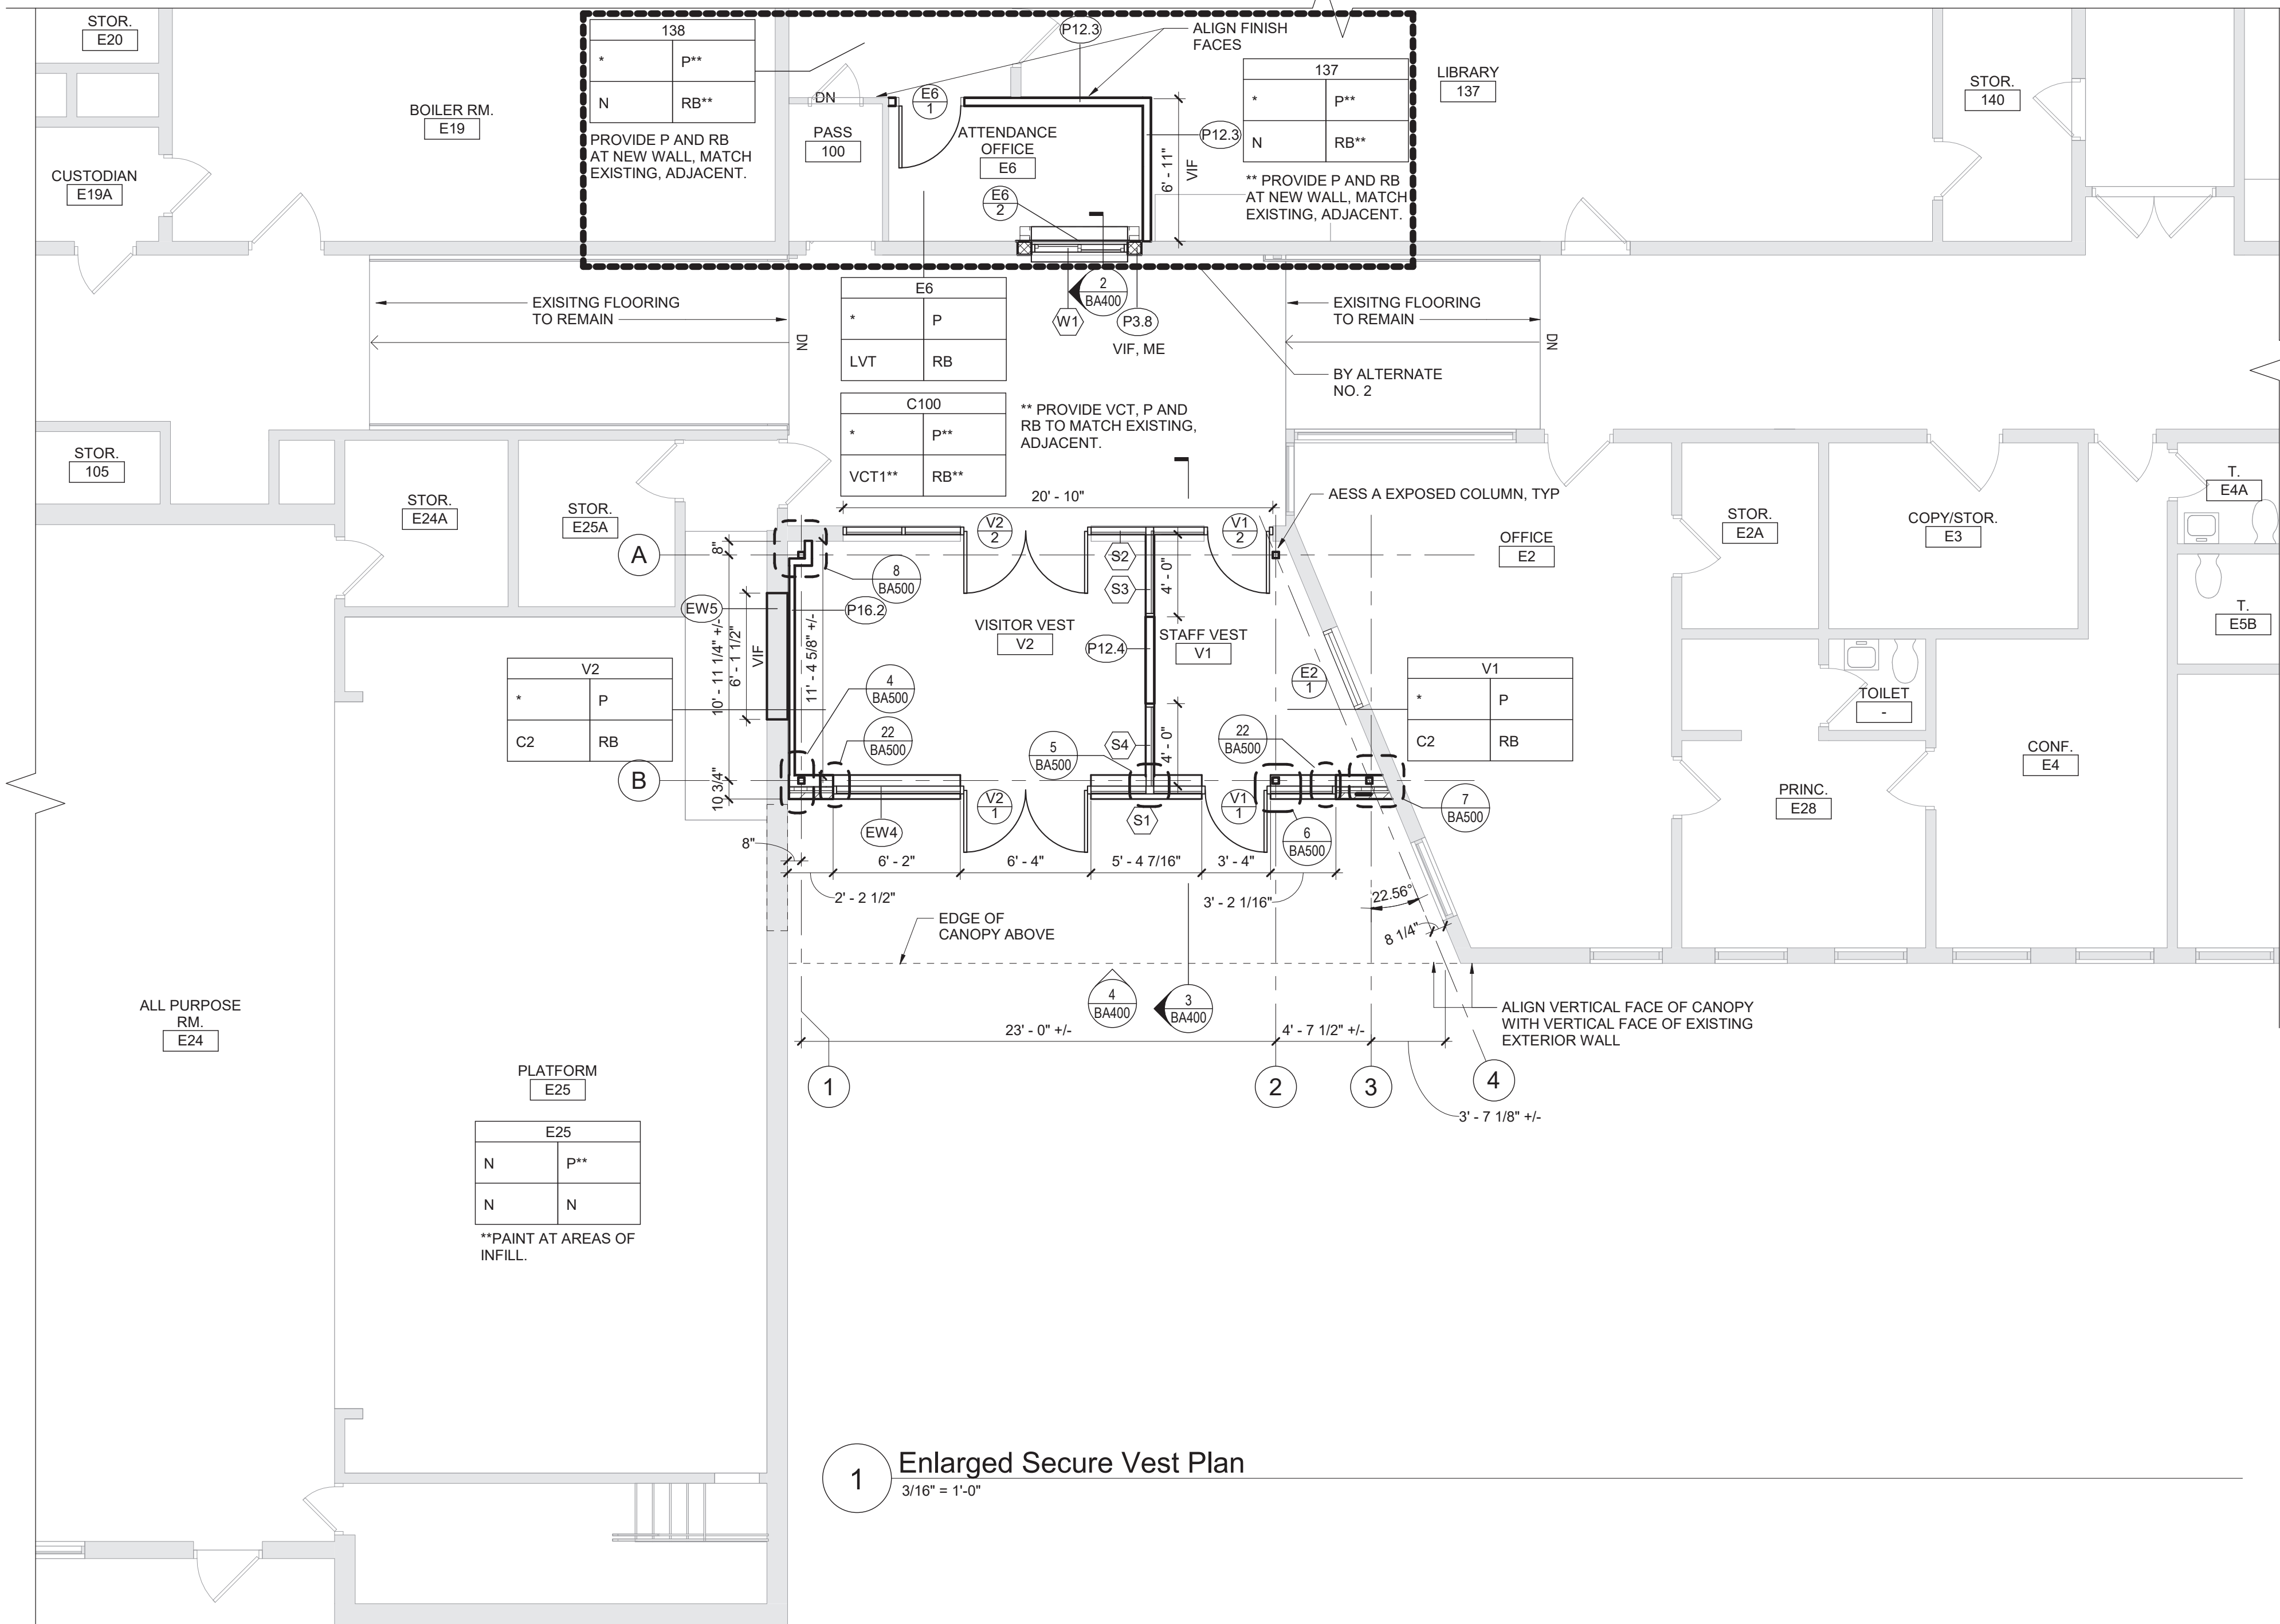

1 Enlarged Secure Vest Plan  
3/16" = 1'-0"

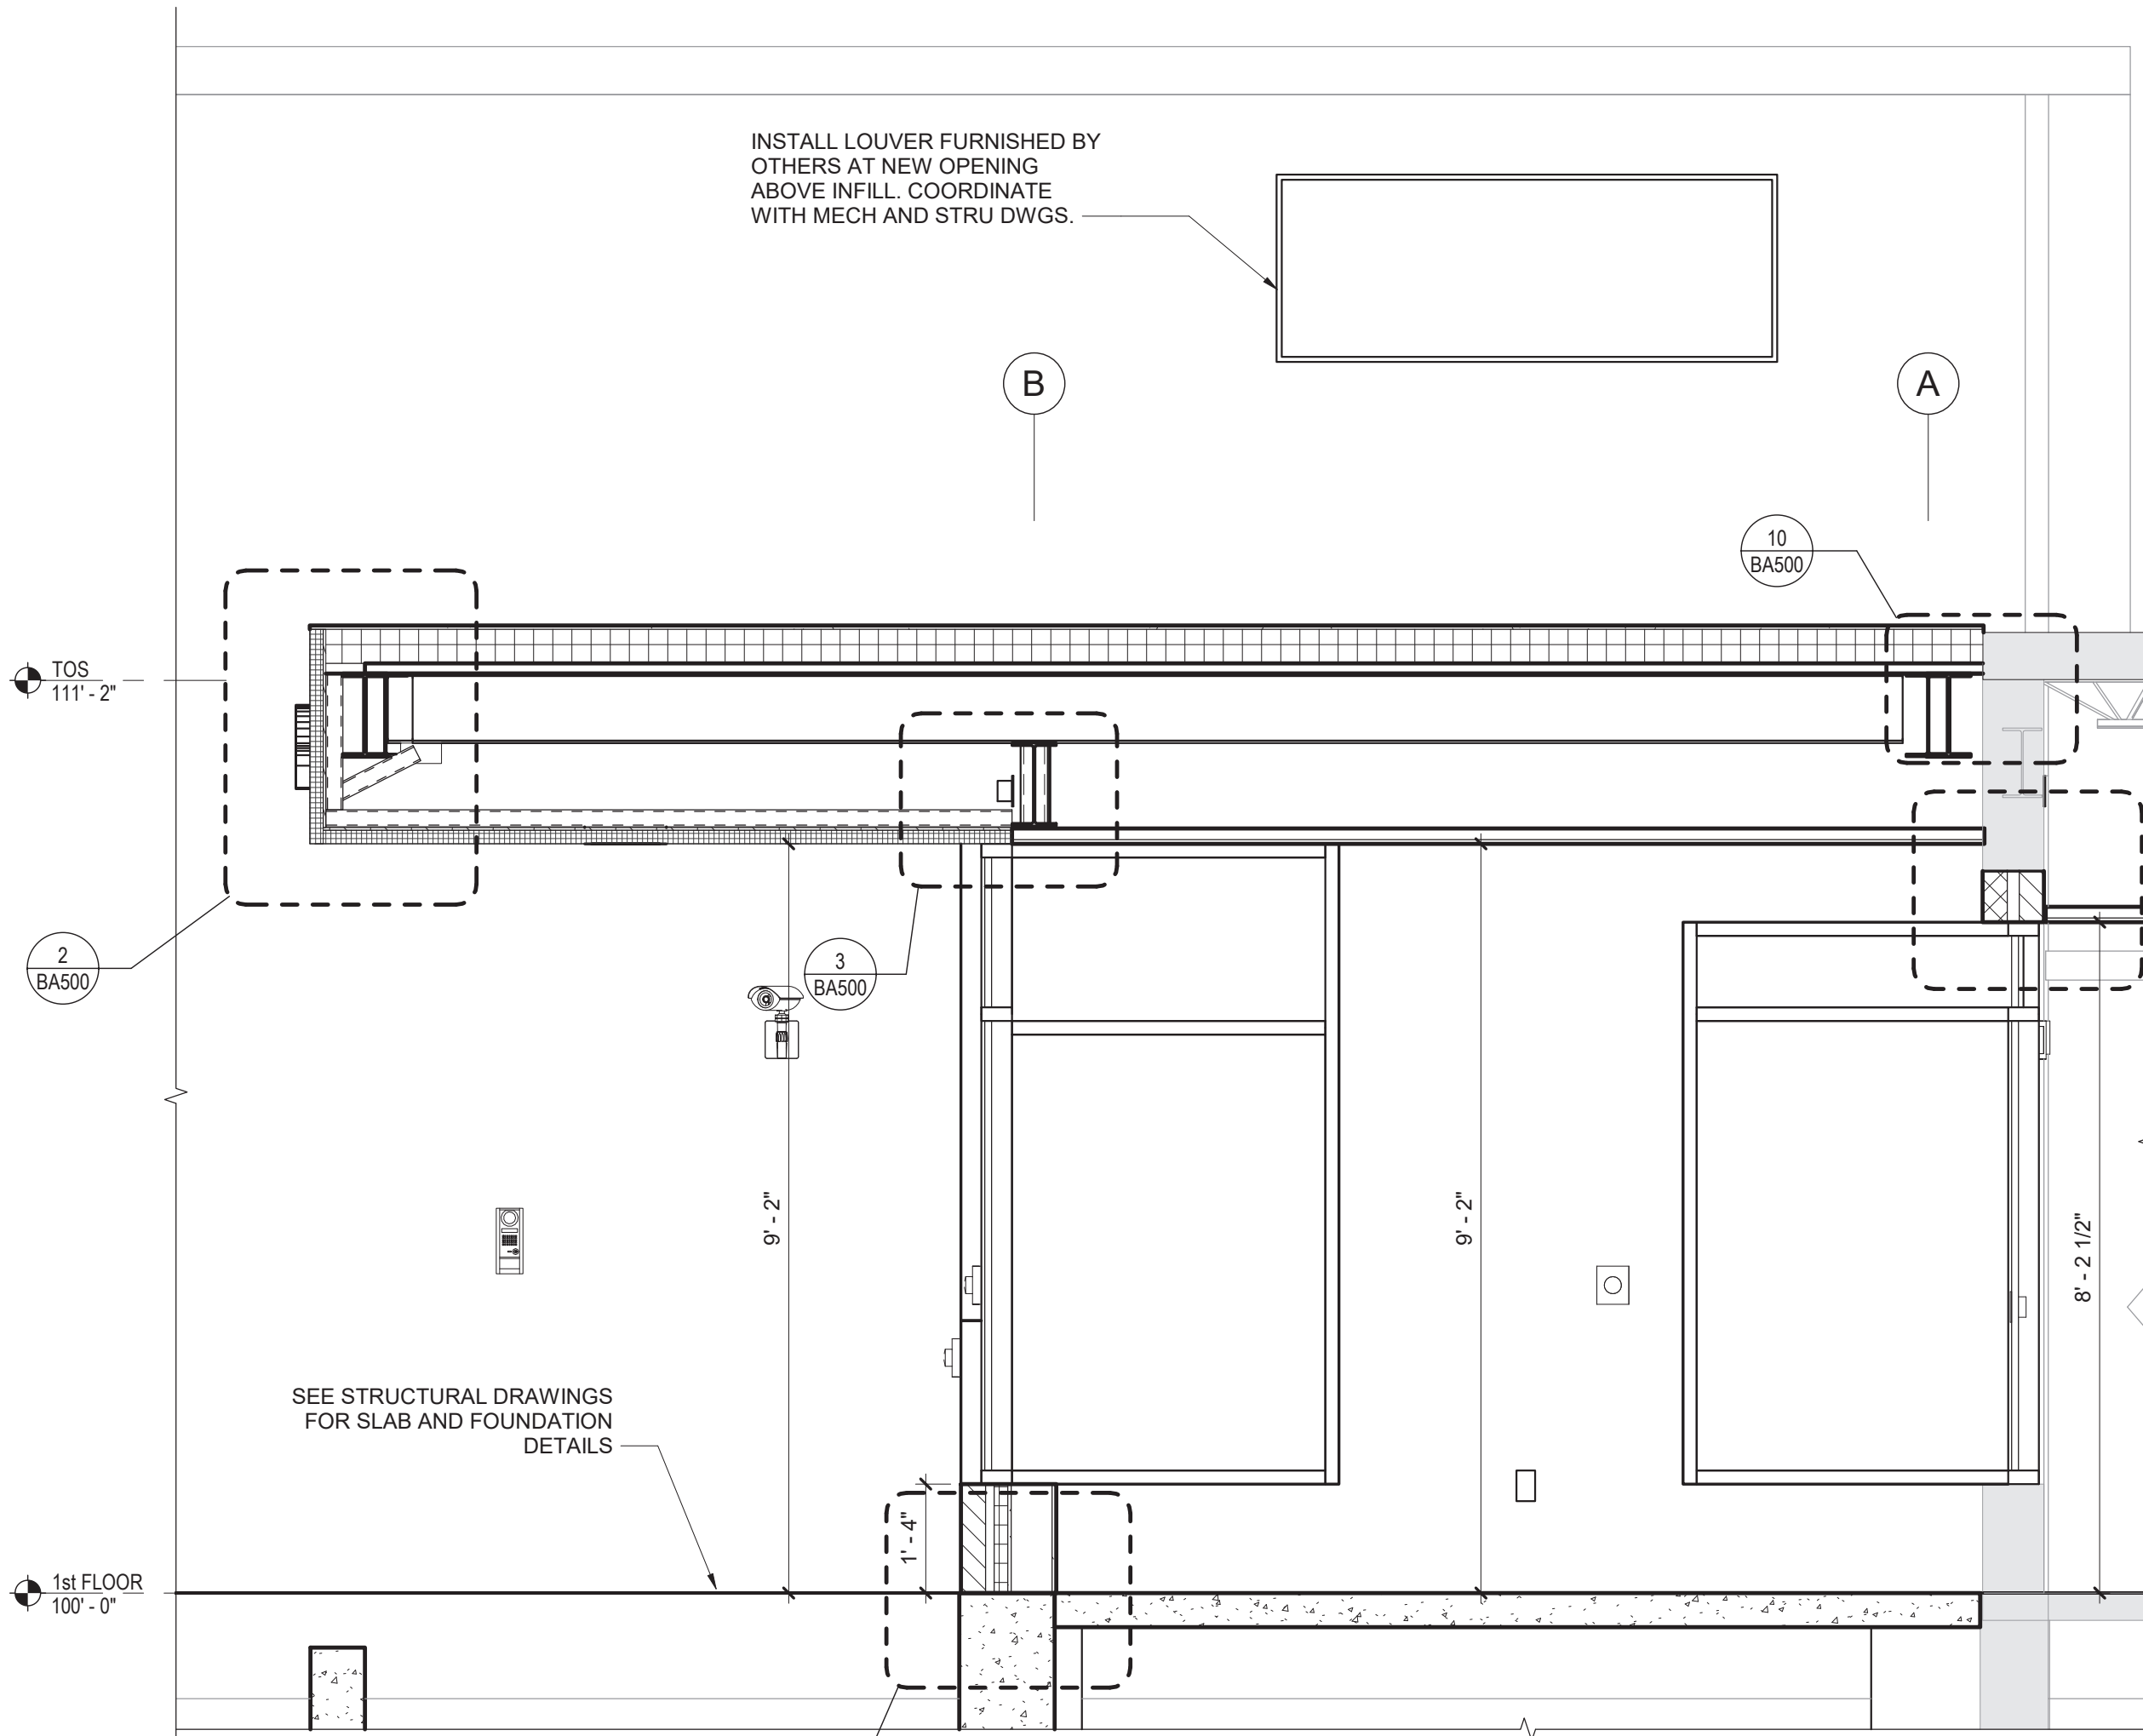

3 Section  
1/2" = 1'-0"

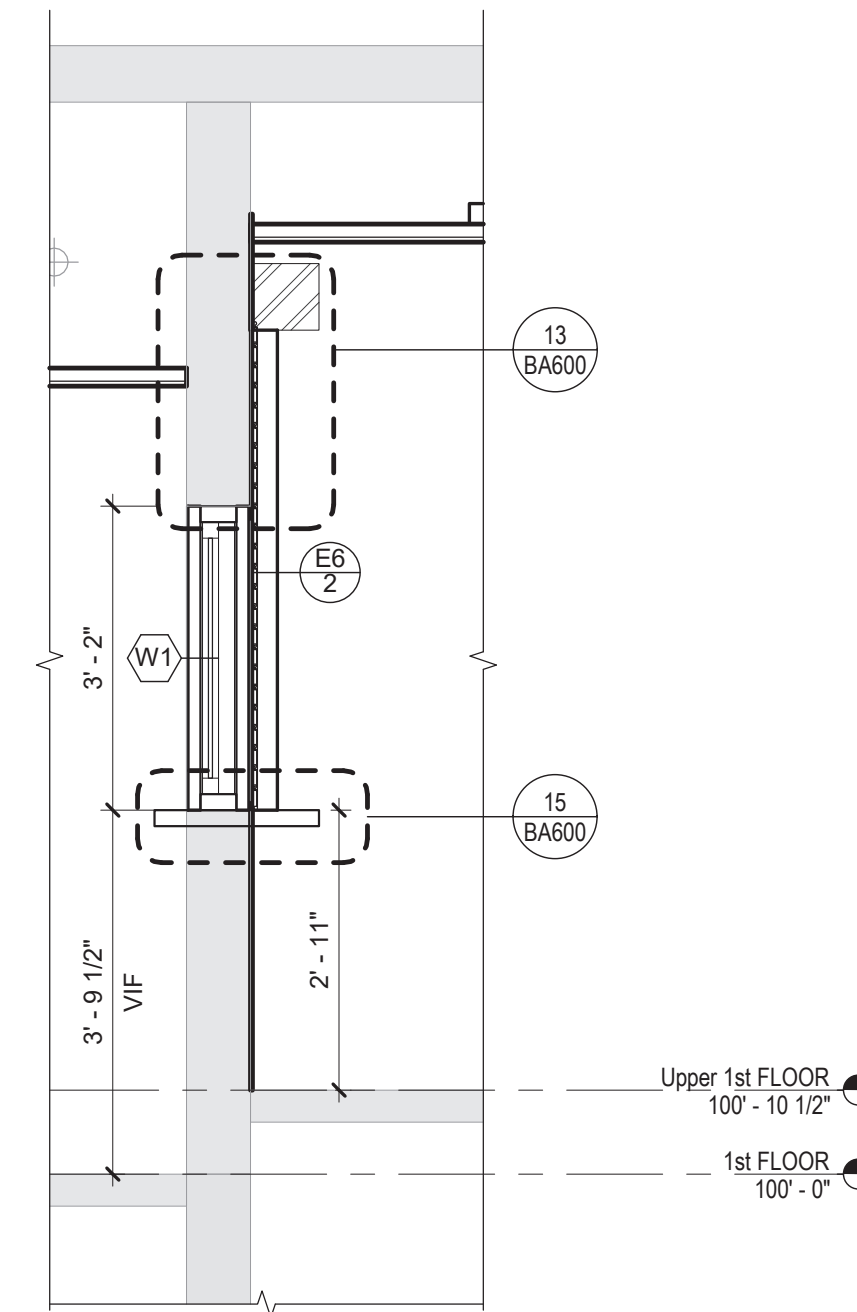

2 Storefront 1 Section  
1/2" = 1'-0"

#### Room Finish Key

C1	CARPET - TYPE 1
C2	CARPET - TYPE 2
CT1	CERAMIC FLOOR TILE - TYPE 1
CT	CERAMIC TILE COVE BASE
CWT1	CERAMIC WALL TILE - TYPE 1
LVT	LUXURY VINYL TILE
MCS	MOISTURE CONTROL SYSTEM
N	NO WORK REQUIRED
P	PAINT SURFACE(S) INCLUDING SOFFITS
RB	RUBBER BASE
VCT1	VINYL COMPOSITION TILE - TYPE 1


\* SEE REFLECTED CEILING PLAN  
INDICATED CHANGE IN FLOOR FINISH

NOTE: ALL FINISHES LISTED MAY NOT BE REQUIRED FOR THIS PROJECT

FINISHES SHOWN IN ROOM FINISH BOX ARE FOR ALL WALLS AND ENTIRE FLOOR AND CEILING. REFER TO EACH ROOM FOR MORE INFORMATION.

RM#	CLG*	WALL
FLR	BASE	


REFER TO DRAWING BA900 FOR GENERAL FINISH NOTES  
REFER TO DRAWING BA900 FOR CASEWORK NOTES

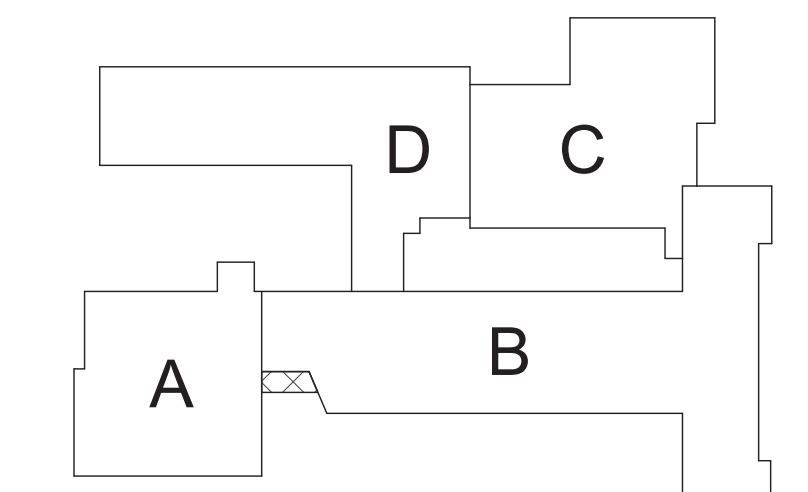

Key Plan  
N.T.S.

S.E.D. Control No. 13-02-00-01-0-006-022

Rev. No.: Date: Description:

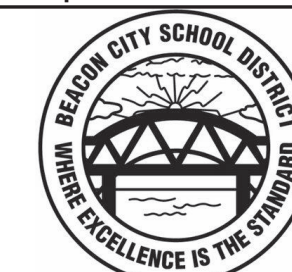

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Beacon City School District  
Beacon, New York

Additions and Alterations to:  
Glenham Elementary School

Enlarged Vestibule Plans / Elevations / Sections

Drawn By: GCK/lig  
Project No.: 279180-22004


Date: 10/28/2022

Drawing Number:


BA400

BID SET



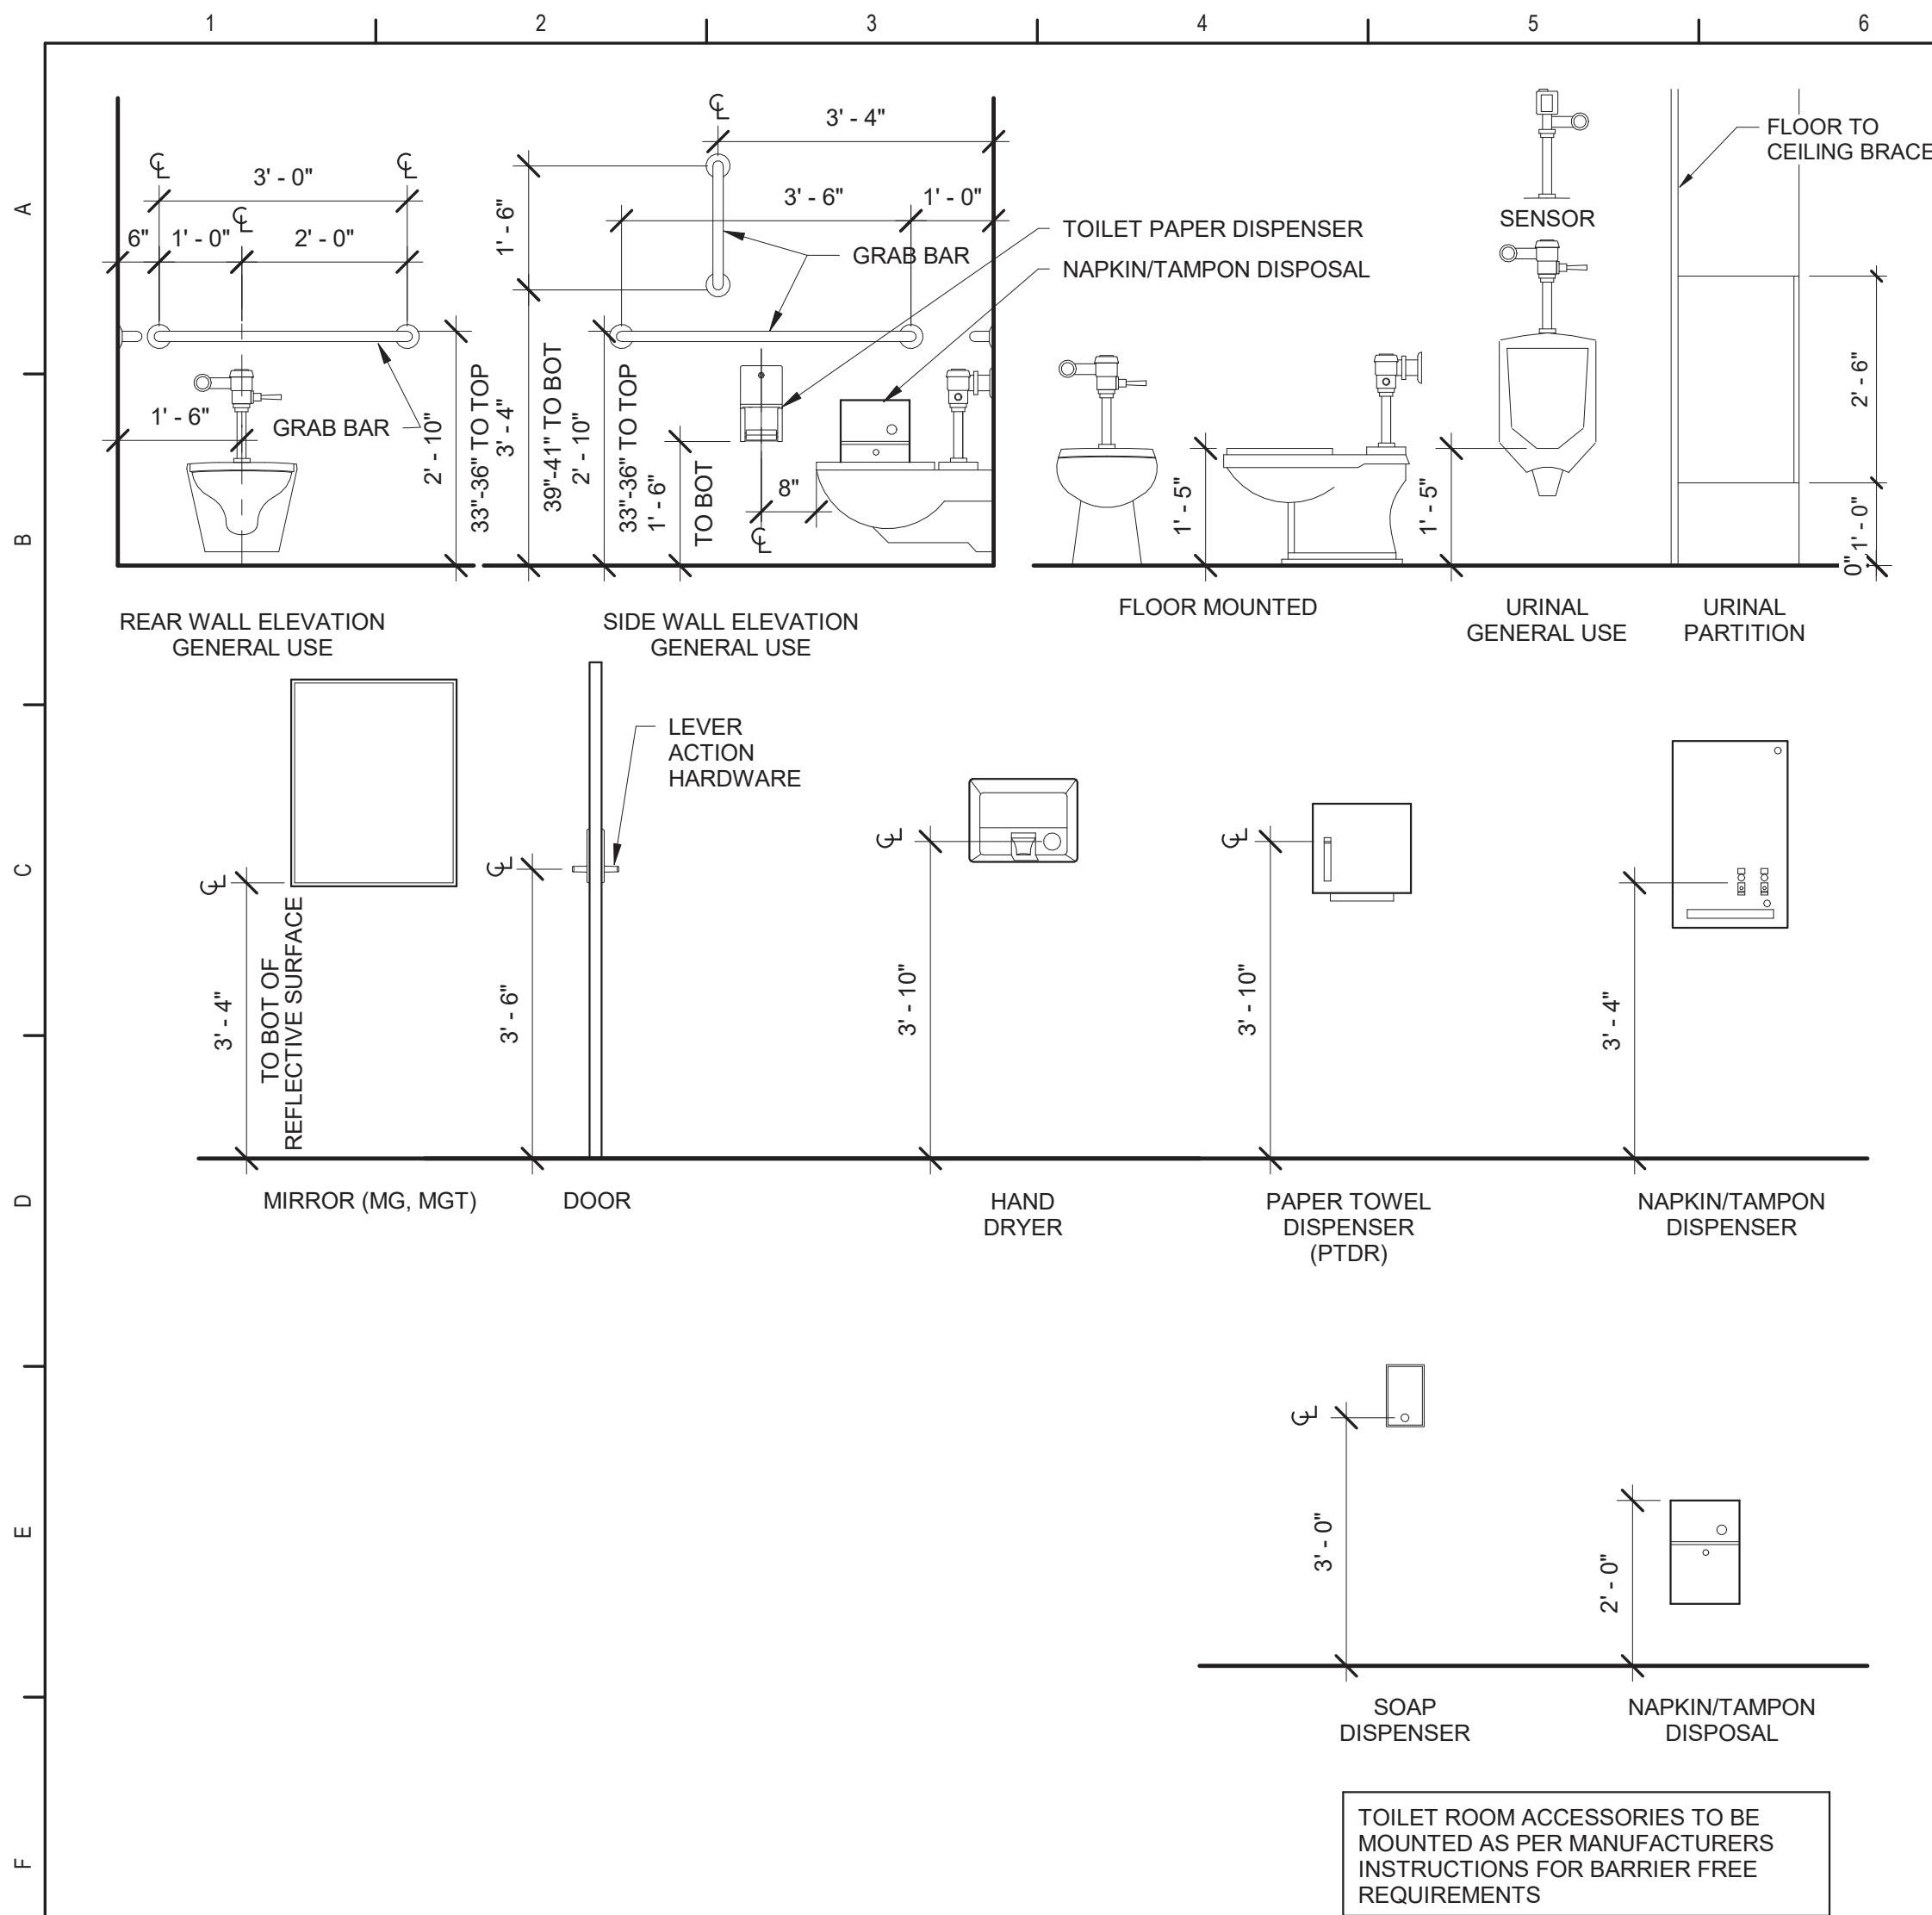


10 Toilet Accessories - Mounting Heights 7th Gr - Adult  
1/2" = 1'-0"

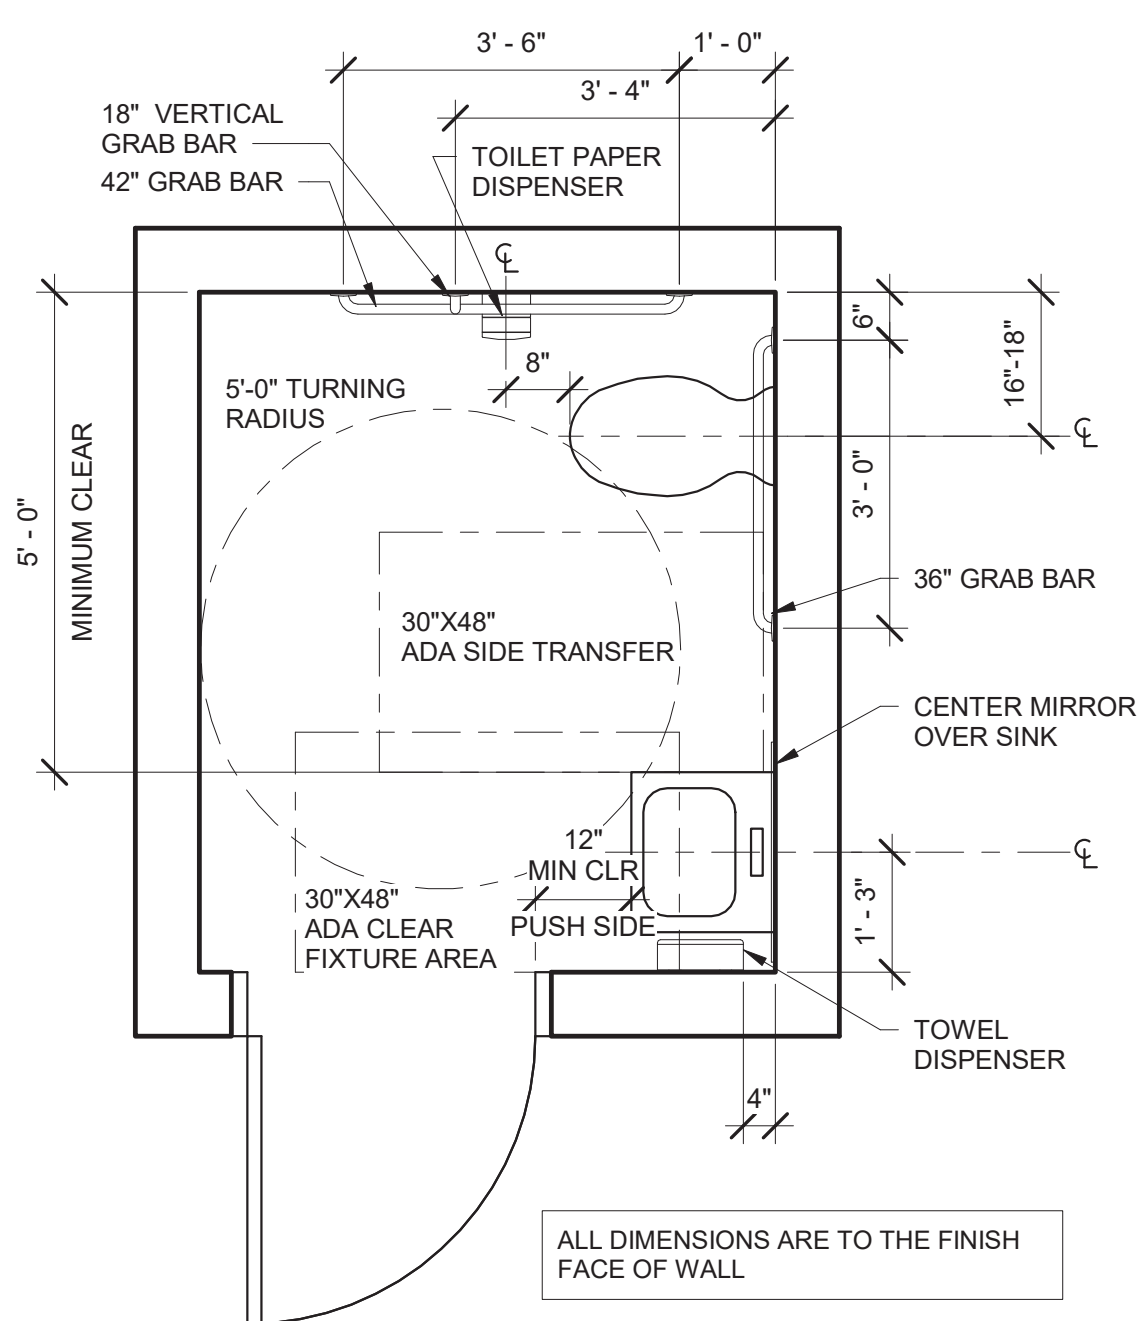


11 Typical ADA Clearances  
1/2" = 1'-0"


6 Interior Elevation - Boys  
1/4" = 1'-0"

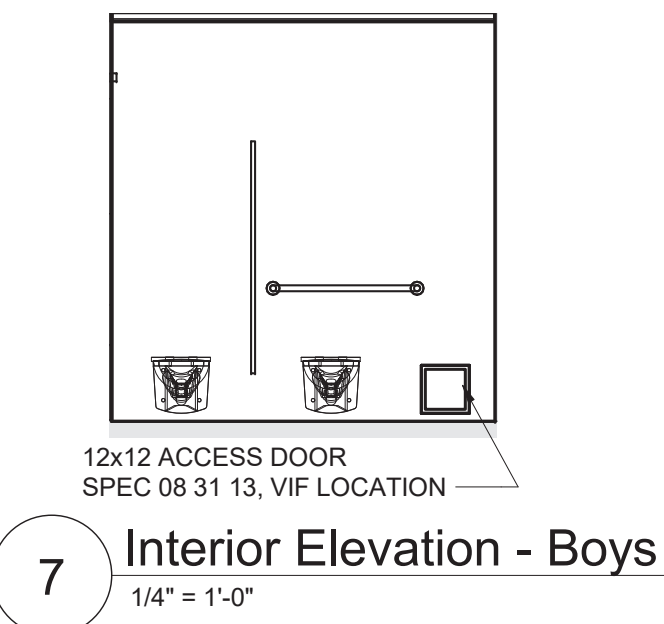


8 Interior Elevation - Boys  
1/4" = 1'-0"

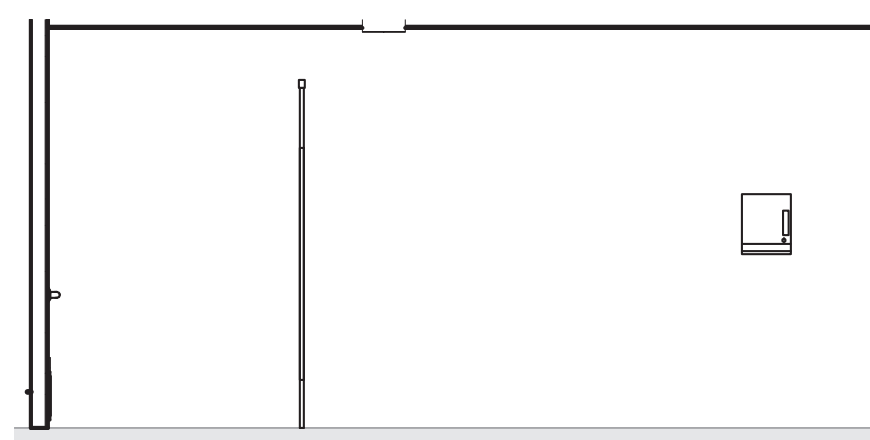


9 Interior Elevation - Boys  
1/4" = 1'-0"

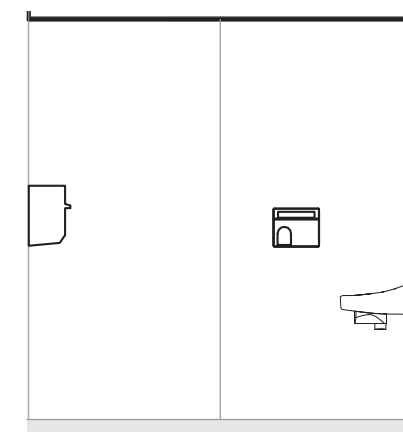


2 Interior Elevation - Girls  
1/4" = 1'-0"

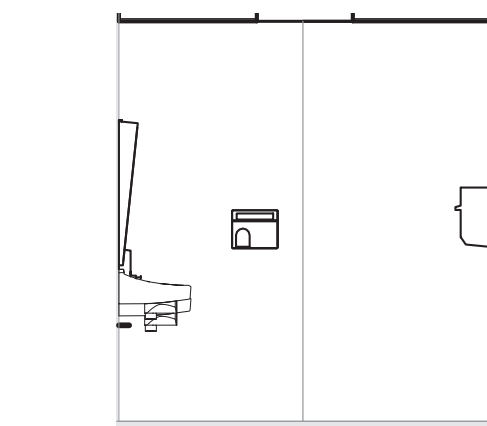

3 Interior Elevation - Girls  
1/4" = 1'-0"

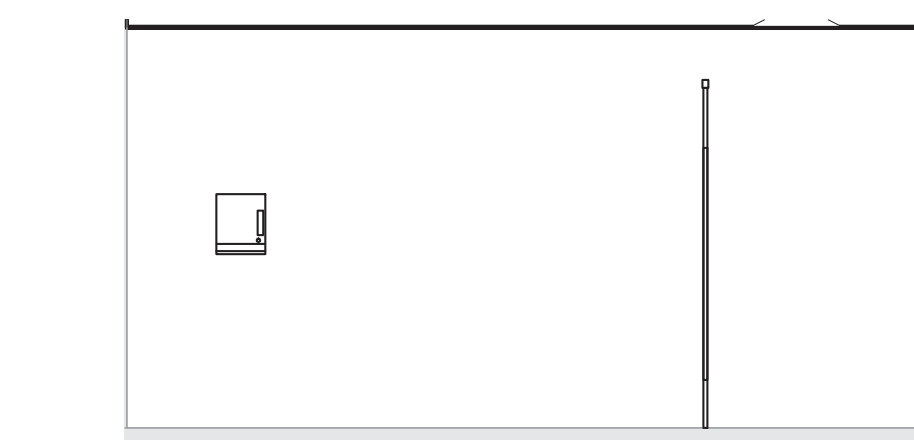


4 Interior Elevation - Girls  
1/4" = 1'-0"

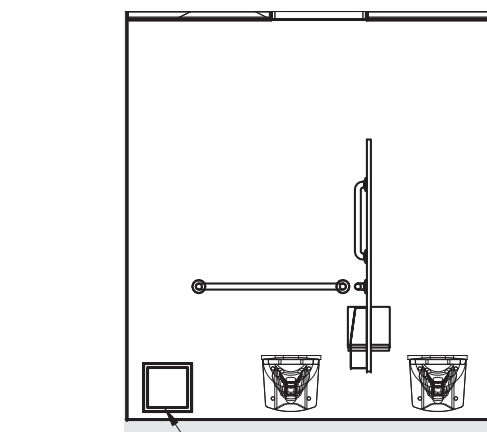


5 Interior Elevation - Girls  
1/4" = 1'-0"

1 Enlarged ADA Bathrooms Plan - By Alternate No. 1  
3/8" = 1'-0"

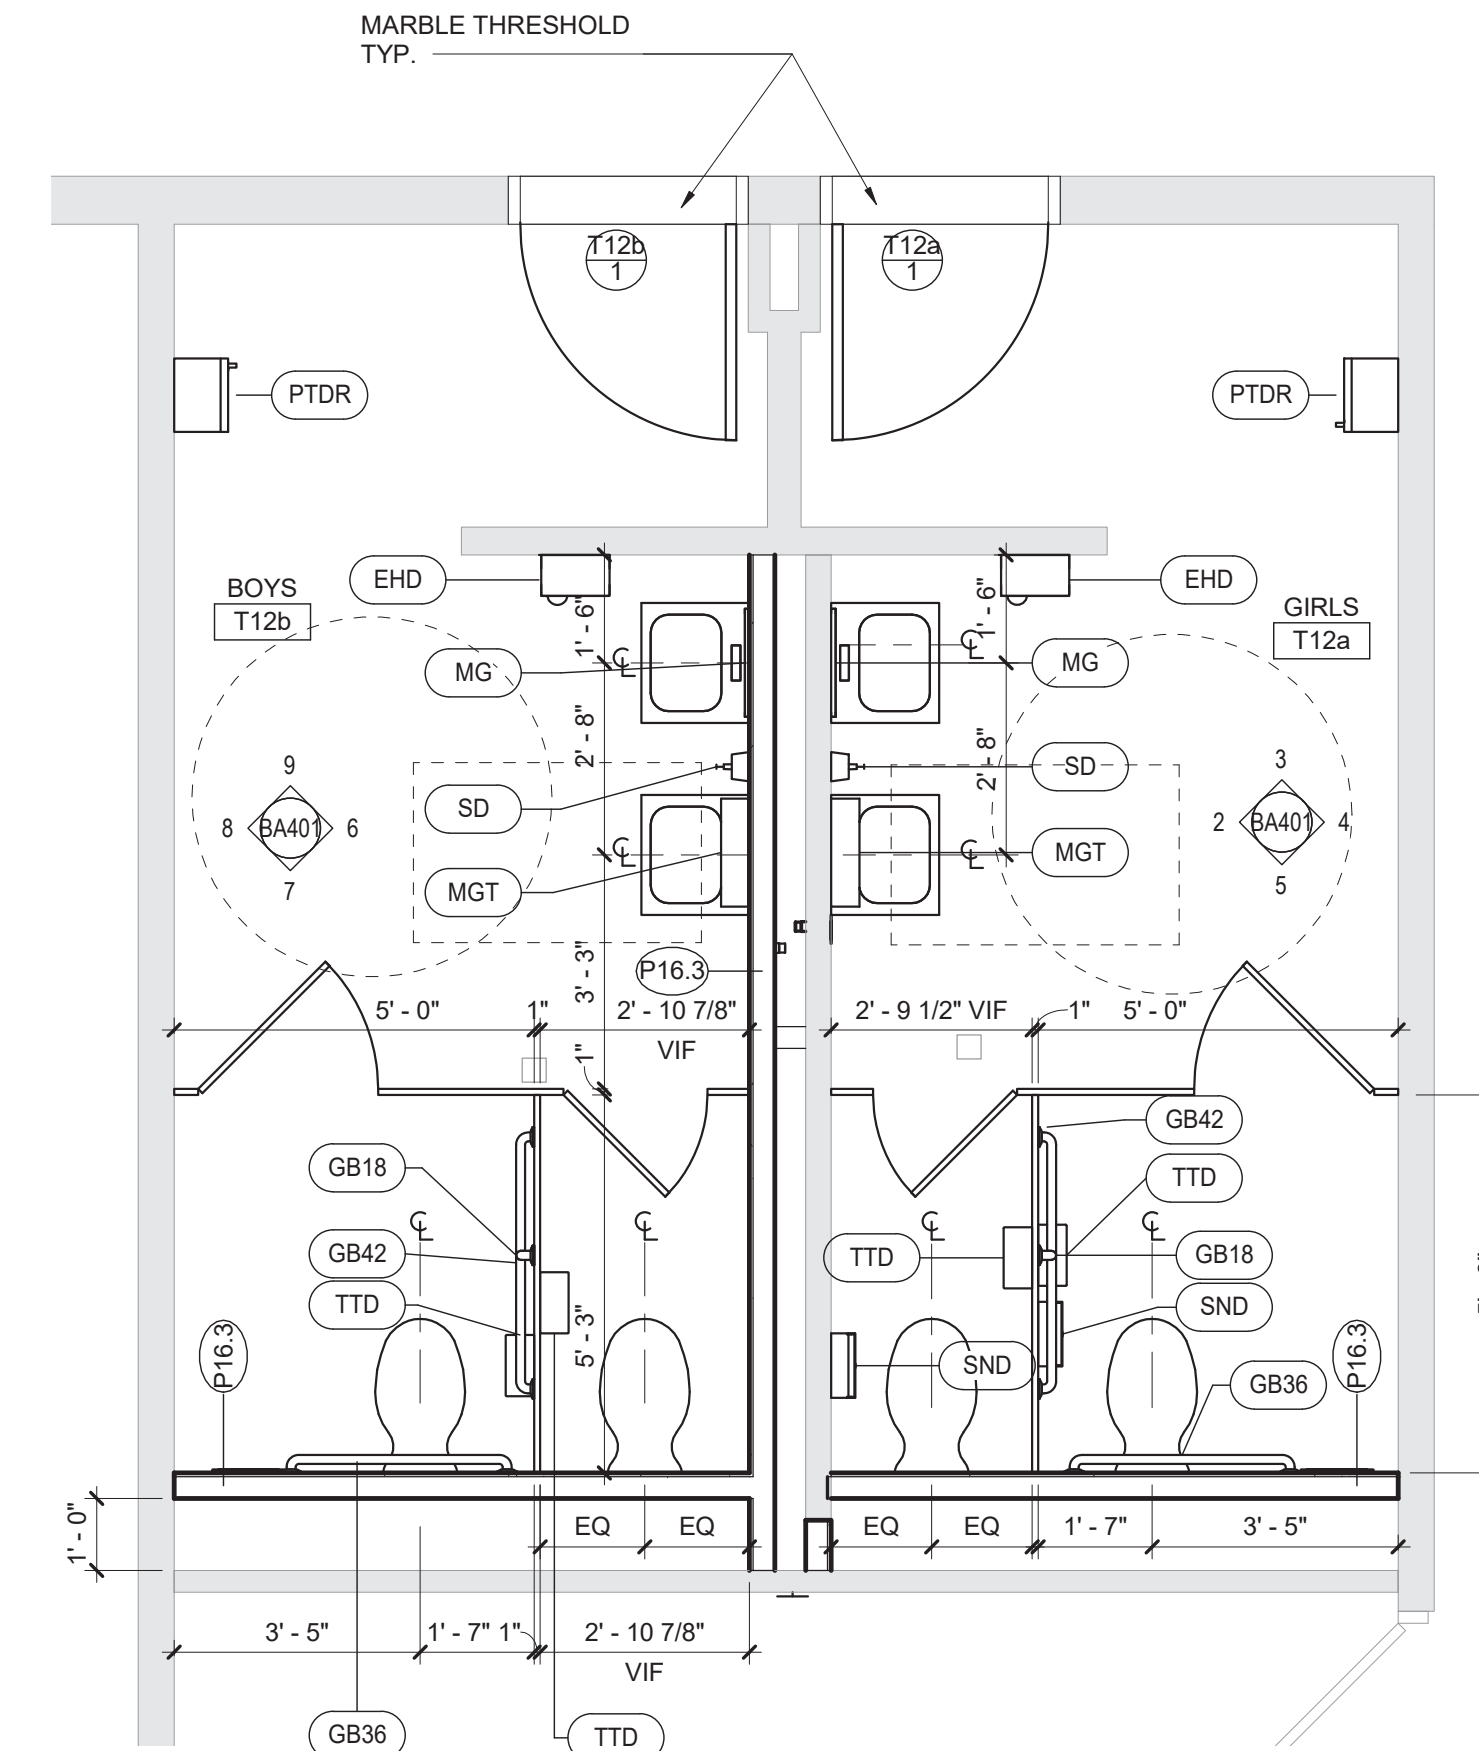

Toilet Room Accessory Schedule		
ITEM	DESCRIPTION	COMMENTS
GB18	18" GRAB BAR - VERTICAL	
GB36	36" GRAB BAR - HORIZONTAL	
GB42	42" GRAB BAR - HORIZONTAL	
EHD	ELECTRIC HAND DRYER - STANDARD	
MG	MIRROR	1'-6" x 3'-0"
MGT	MIRROR - TILT	1'-6" x 3'-0"
PTDR	PAPER TOWEL DISPENSER - ROLL	OWNER FURNISHED, CONTRACTOR INSTALLED
SND	SANITARY NAPKIN DISPOSAL	OWNER FURNISHED, CONTRACTOR INSTALLED
SD	SOAP DISPENSER - VERTICAL	OWNER FURNISHED, CONTRACTOR INSTALLED
TTD	TOILET TISSUE DISPENSER - JUMBO	OWNER FURNISHED, CONTRACTOR INSTALLED

REFER TO DRAWING BA900 FOR GENERAL FINISH NOTES  
REFER TO DRAWING BA900 FOR CASEWORK NOTES

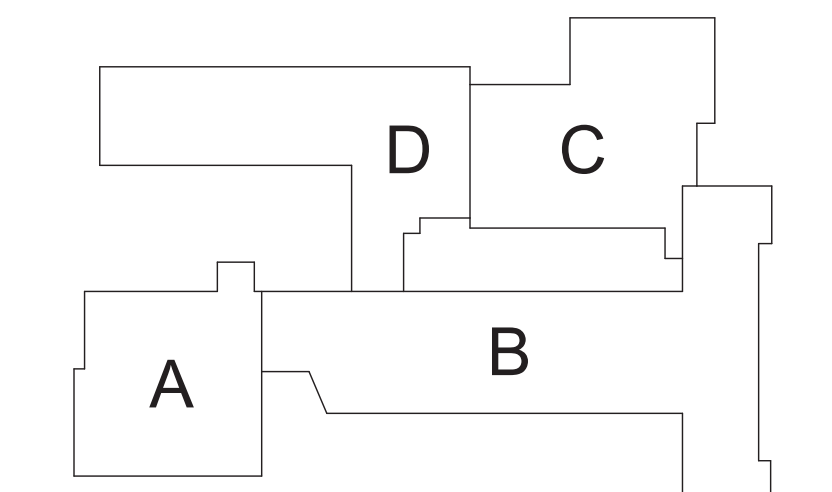

Key Plan  
N.T.S.

S.E.D. Control No. 13-02-00-01-0-006-022

Rev. No.: Date: Description:



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Beacon City School District  
Beacon, New York



Additions and Alterations to:  
Glenham Elementary School

Enlarged Toilet Room Plans / Interior  
Elevations

Drawn By: GCK/lig Date: 10/28/2022 Drawing Number:  
Project No.: 279180-22004

BID SET  
BA401



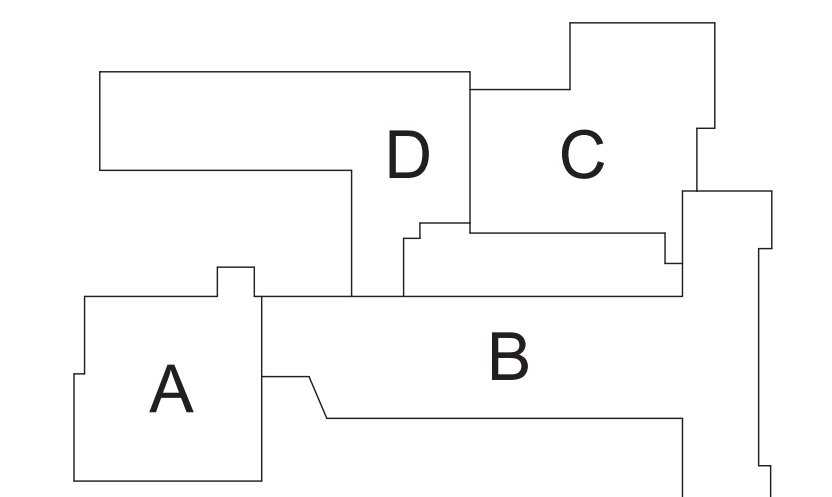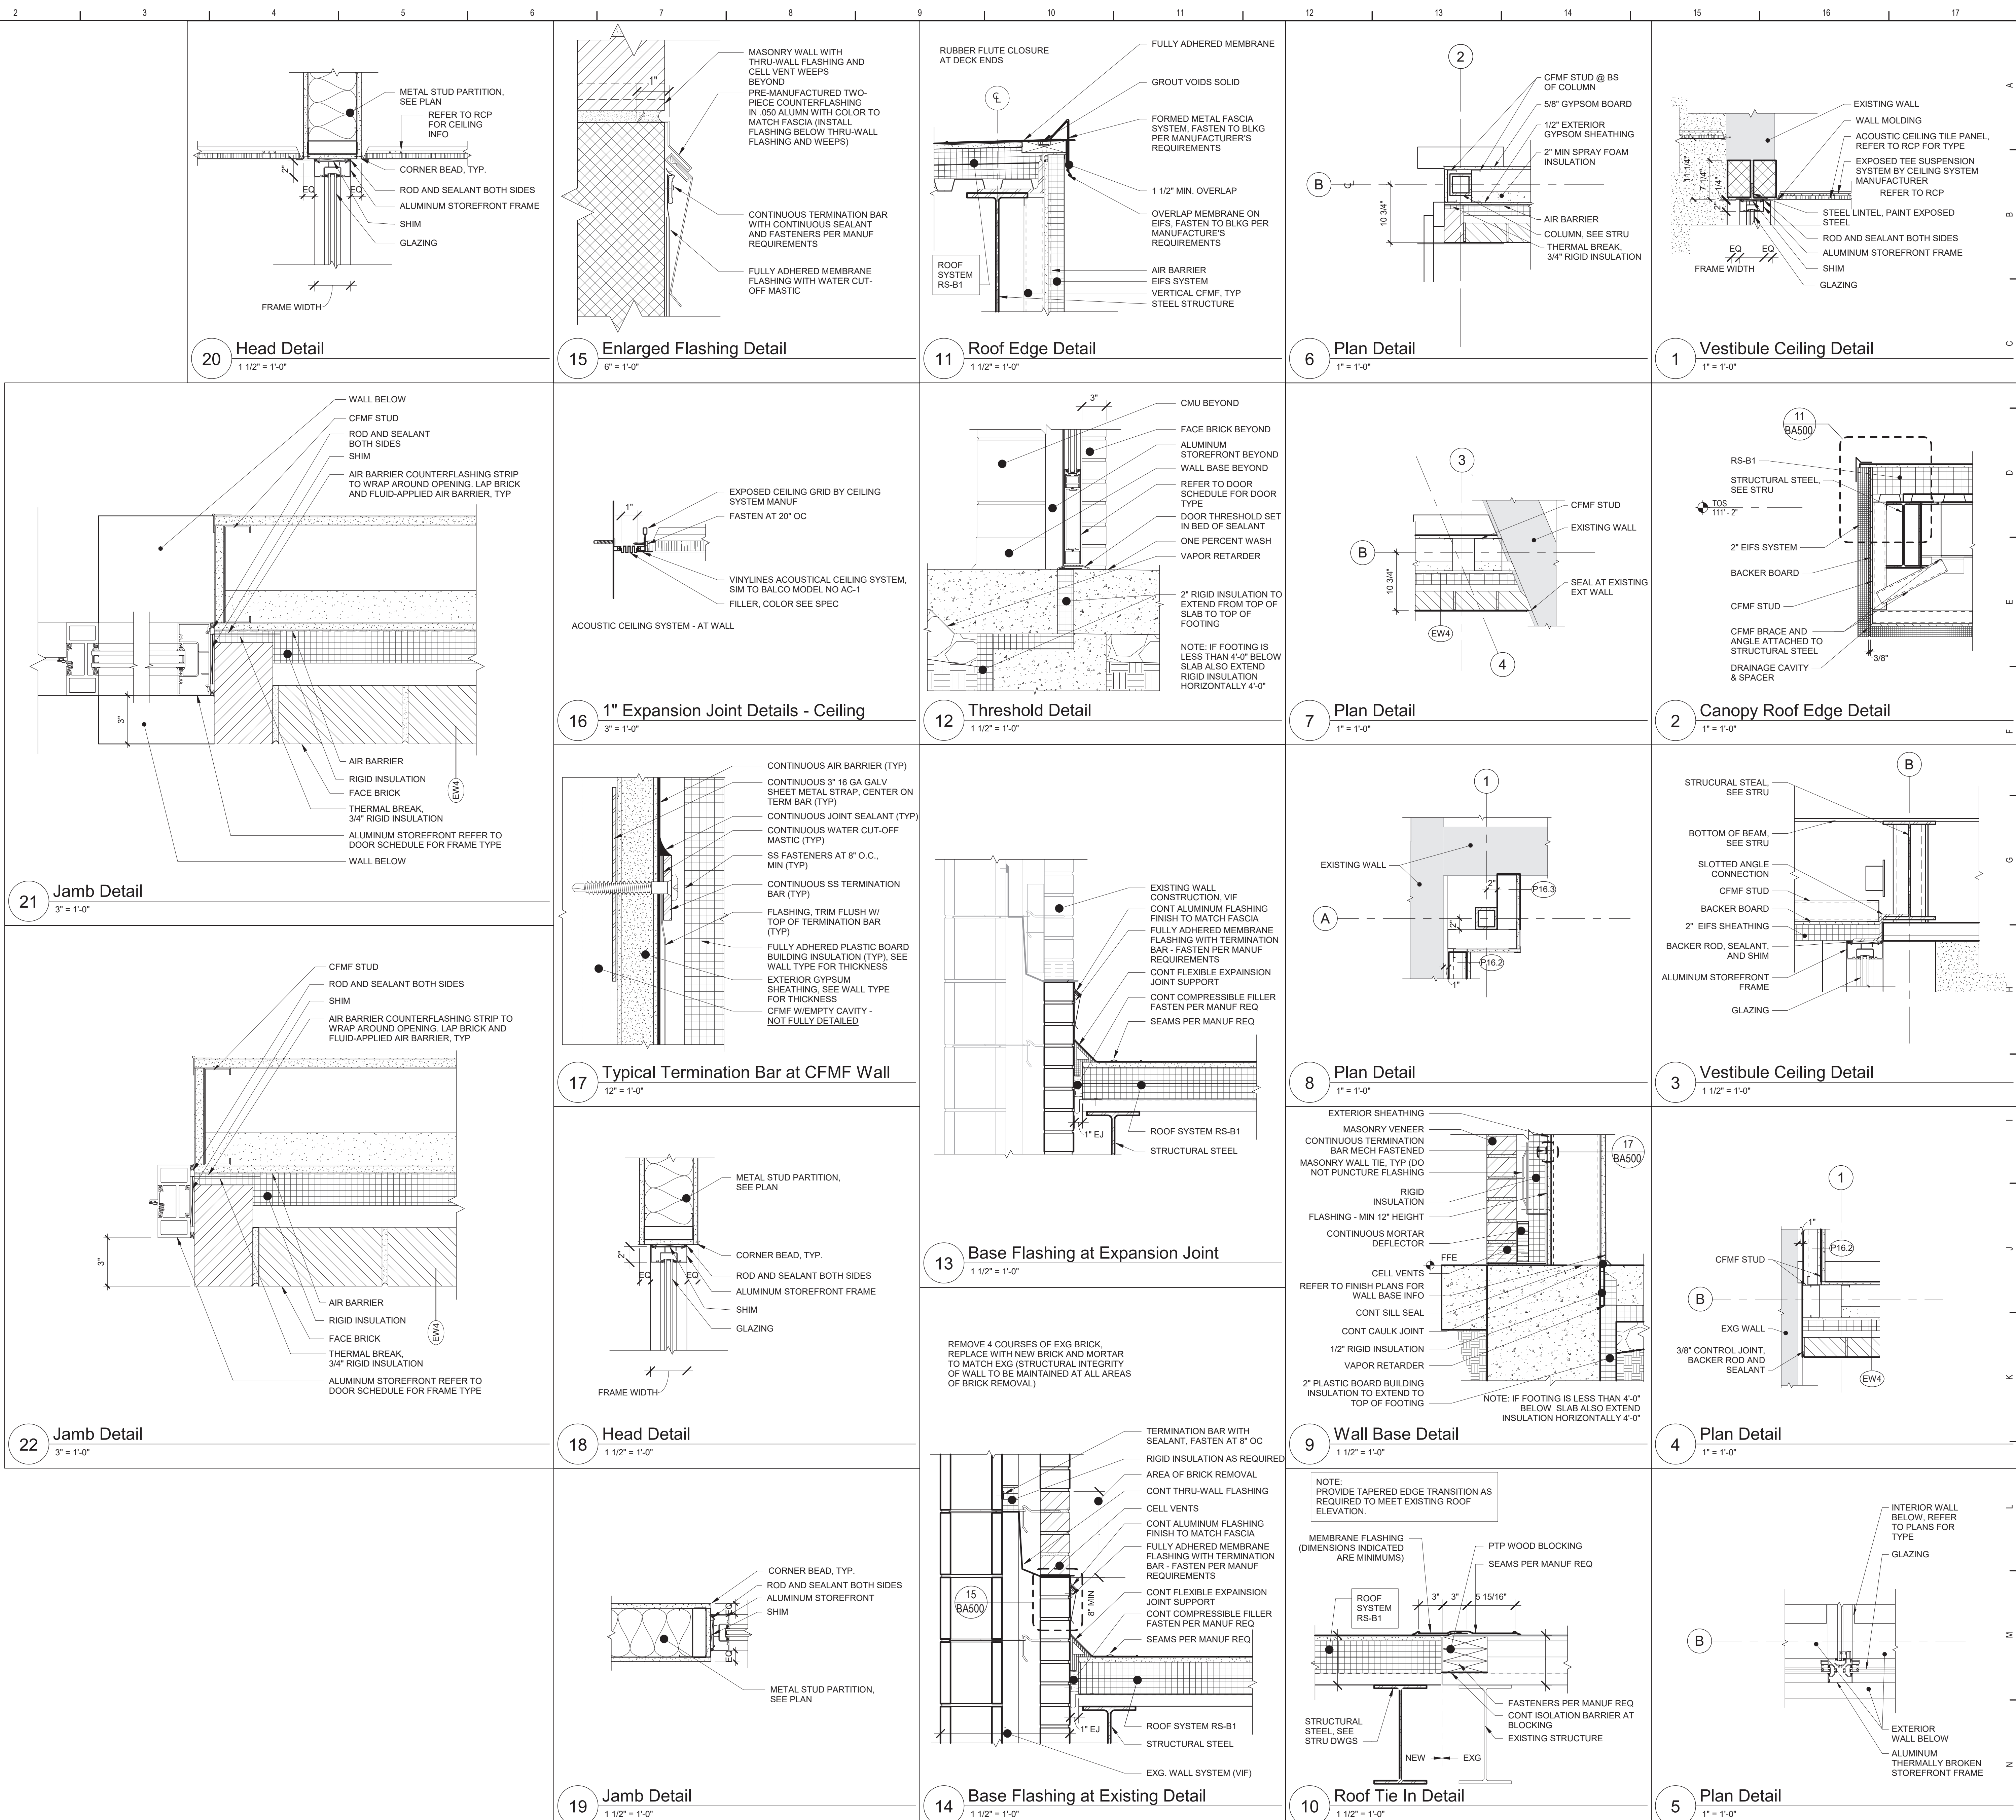

Key Plan  
N.T.S.

S.E.D. Control No. 13-02-00-01-0-006-022

Rev. No.: Date: Description:



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Beacon City School District  
Beacon, New York

Additions and Alterations to:  
Glenham Elementary School

Details

Drawn By: GCK/ltg

Date: 10/28/2022

Drawing Number:

Project No.: 279180-22004

BA500

BID SET




Door Schedule																			
ROOM NUMBER	DOOR NUMBER	DOOR					FRAME												
		TYPE	MATERIAL	WIDTH	HEIGHT	RATING	GLAZING	TYPE	MATERIAL	WIDTH	HEIGHT	RATING	GLAZING	HEAD	JAMB	SILL	HDW SET	REMARKS	
E2	1	-	-	0"	0"	-	-	F22	HM	4'-11"	5'-4"	20 MIN	FRI	J-6	J-6	J-6, SIM	12		
E6	1	N	WD	3'-0"	7'-0"	-	FC	F2	HM	3'-4"	7'-2"	-	-	H-13	J-13	-	03		
E6	2	CD1	HM	4'-10"	5'-0"	60 MIN	-	-	STL	5'-9 1/4"	5'-0"	60 MIN	-	13/BA600	14/BA600	15/BA600	13		
T12a	1	F	WD	3'-0"	7'-0"	-	-	F2	HM	3'-4"	7'-2"	-	-	H-4	J-4	-	14	NOTE 1	
T12b	1	F	WD	3'-0"	7'-0"	-	-	F2	HM	3'-4"	7'-2"	-	-	H-4	J-4	-	14	NOTE 2	
V1	1	G2	AL	3'-0"	7'-0"	-	FCE/SCL	S1	AL	0"	0"	-	FCE/SCL	3/BA500	6/BA500 AND 22/BA500	12/BA500	E17		
V1	2	G2	AL	3'-0"	7'-0"	-	FCE/SCL	S2	AL	0"	0"	-	FCE/SCL	1/BA500	22/BA500	-	E18	NOTE 3	
V2	1	G2-PR	AL	3'-0"	7'-0"	-	FCE/SCL	S1	AL	0"	0"	-	FCE/SCL	3/BA500	22/BA500	12/BA500	E19	NOTE 2	
V2	2	G2-PR	AL	3'-0"	7'-0"	-	FCE/SCL	S2	AL	0"	0"	-	FCE/SCL	1/BA500	22/BA500	-	E20 5'-9 1/4"	NOTE 3	


GENERAL NOTES:  
VERIFY ALL DIMENSIONS IN THE FIELD

SPECIFIC NOTES:  
- NOT APPLICABLE


- PROVIDE 10" HIGH BY 20" WIDE LOUVER IN DOOR. VERIFY OPENING DIMENSIONS IN FIELD.
- PROVIDE CARD READER AND ELECTRONIC HARDWARE, COORD WITH ELEC DWGS AND SECURITY CONTRACTOR
- PROVIDE CARD READER, ELECTRONIC HARDWARE AND REMOTE RELEASE, COORDINATE WITH ELEC DWGS AND SECURITY CONTRACTOR

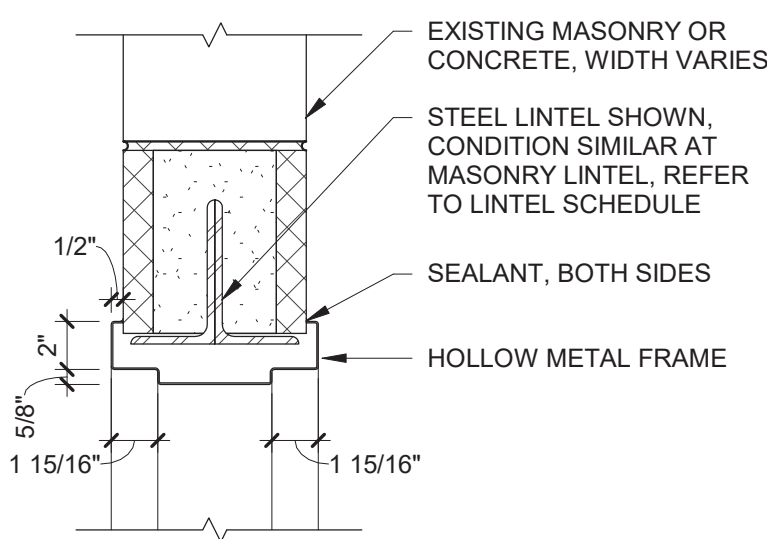


H-4

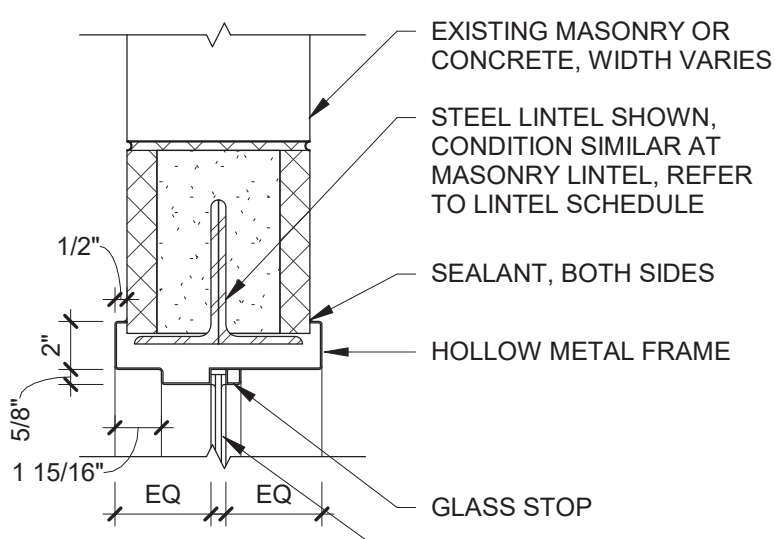


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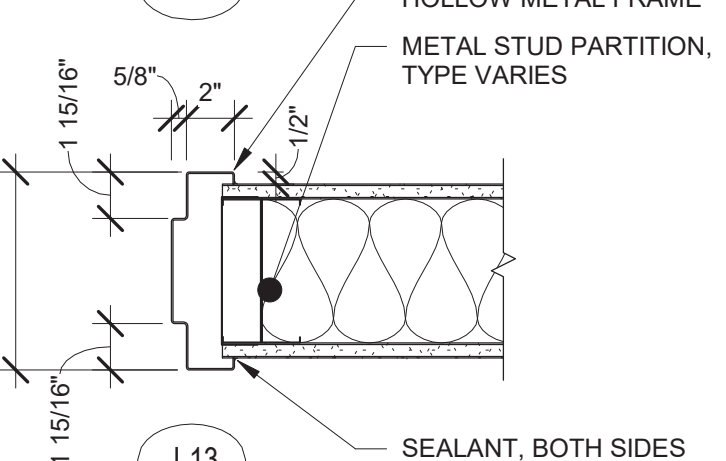
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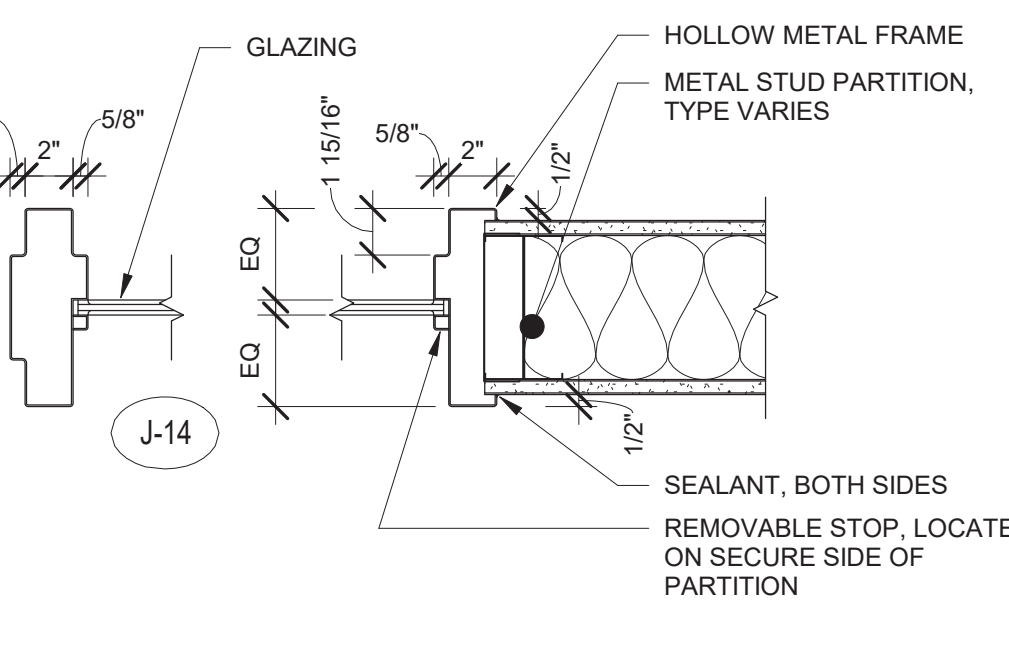
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H-13

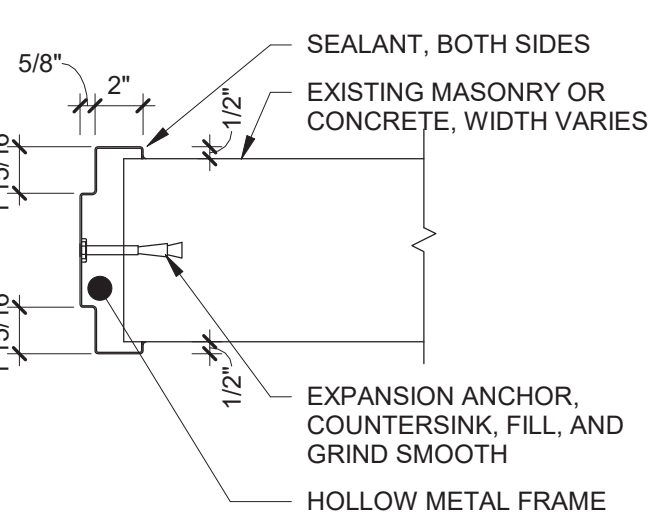


J-13

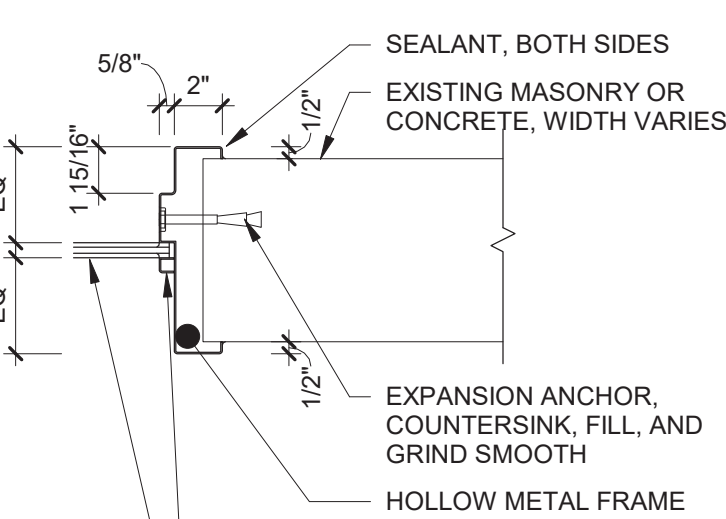

J-14

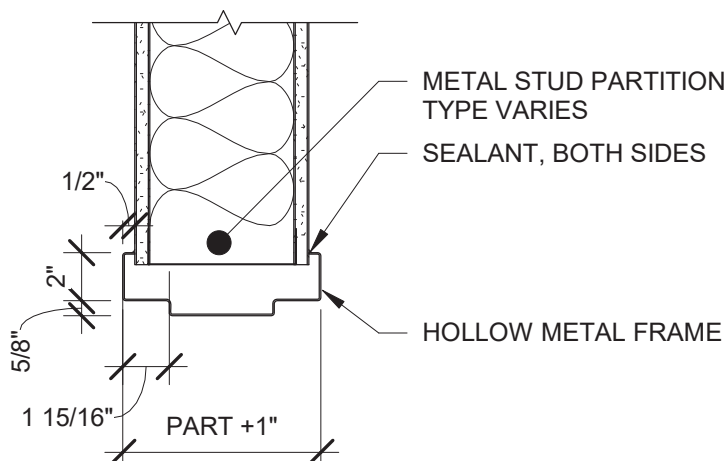
## 12 Hollow Metal Frame Details

1 1/2" = 1'-0"

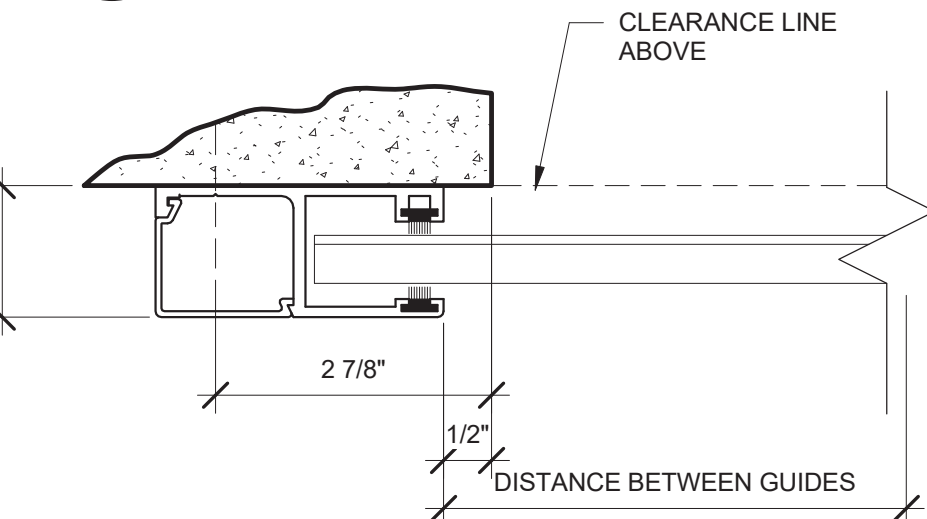


## 16 Jamb Detail

6" = 1'-0"

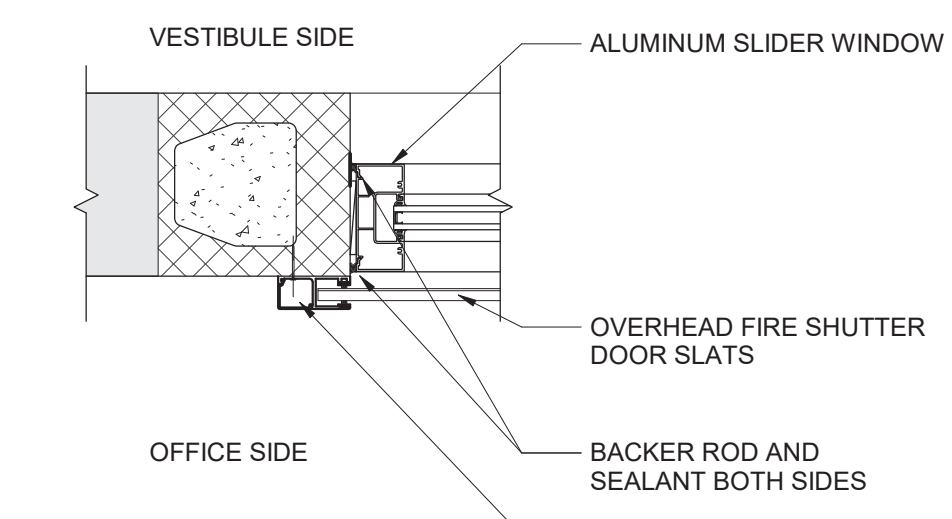


## 14 Head Detail

1 1/2" = 1'-0"

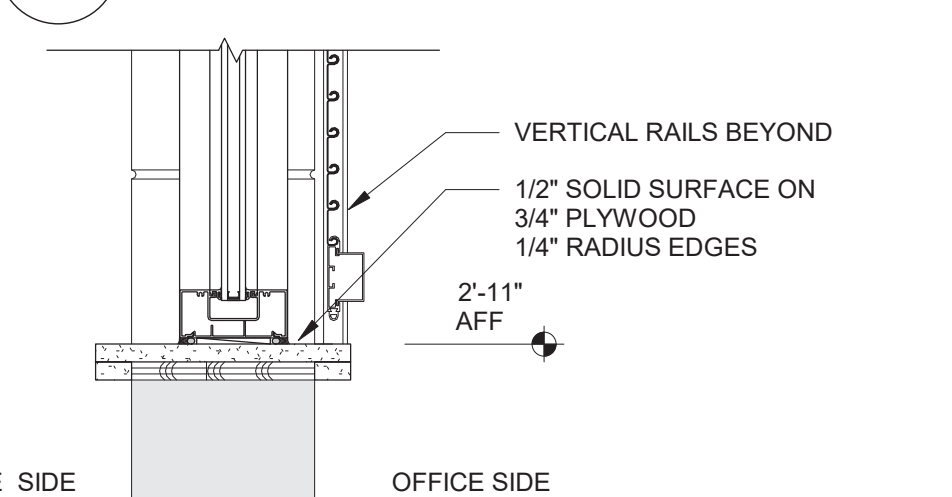


## 15 Sill Detail

1 1/2" = 1'-0"

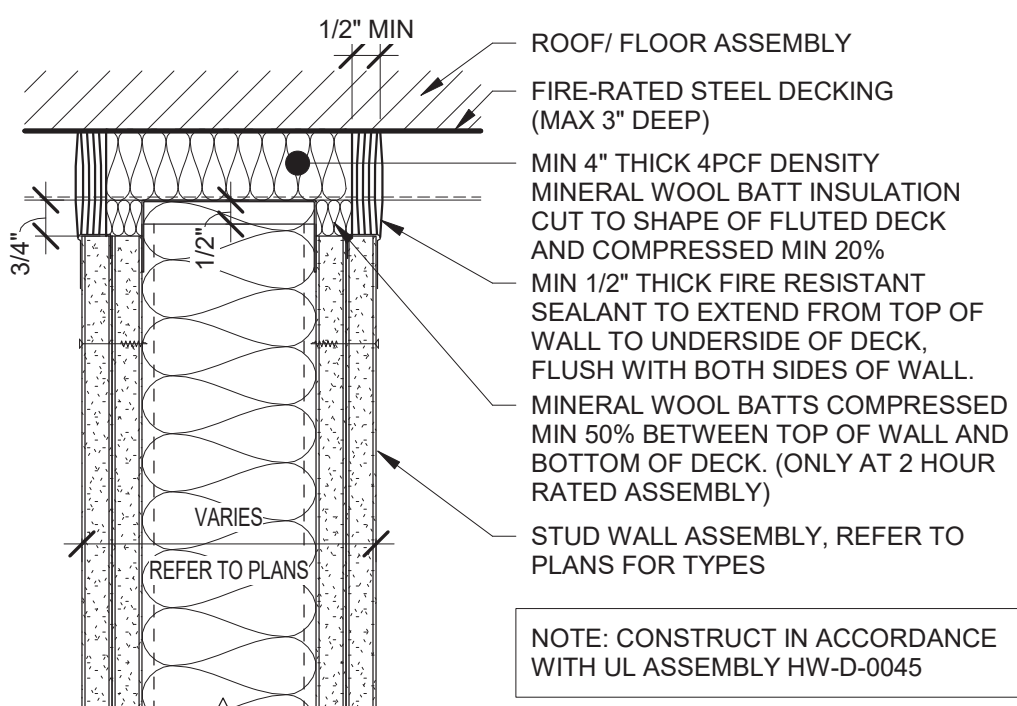


## 9 Typical Top of Wall Assembly (Rated)

3\"/>

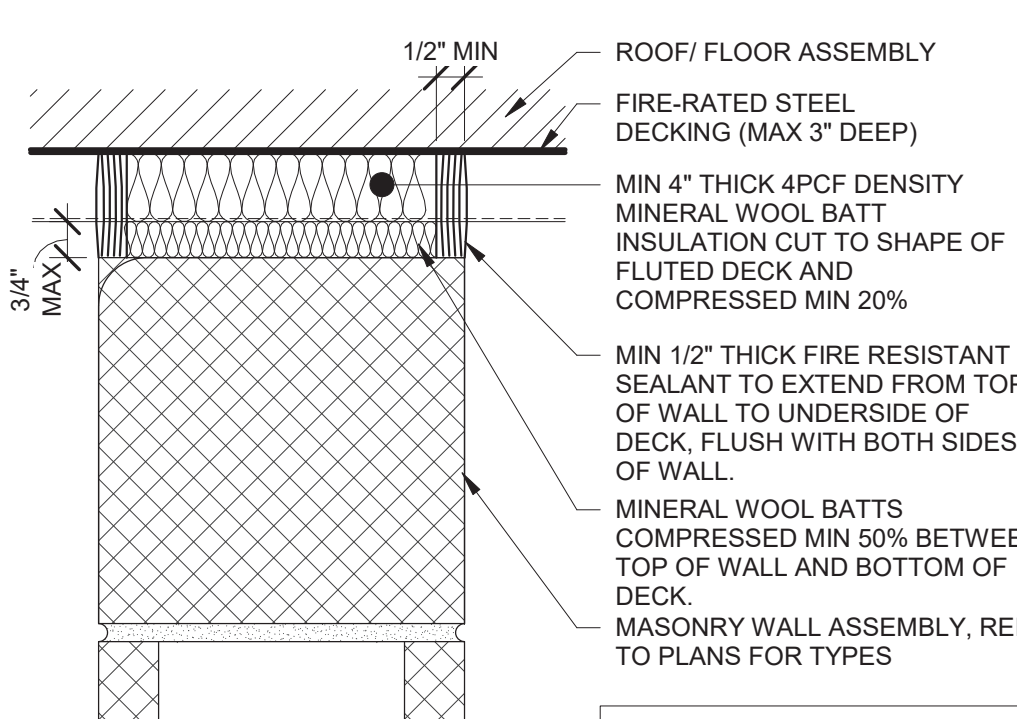


## 10 Typical Rated Top of Wall Assembly

3\"/>

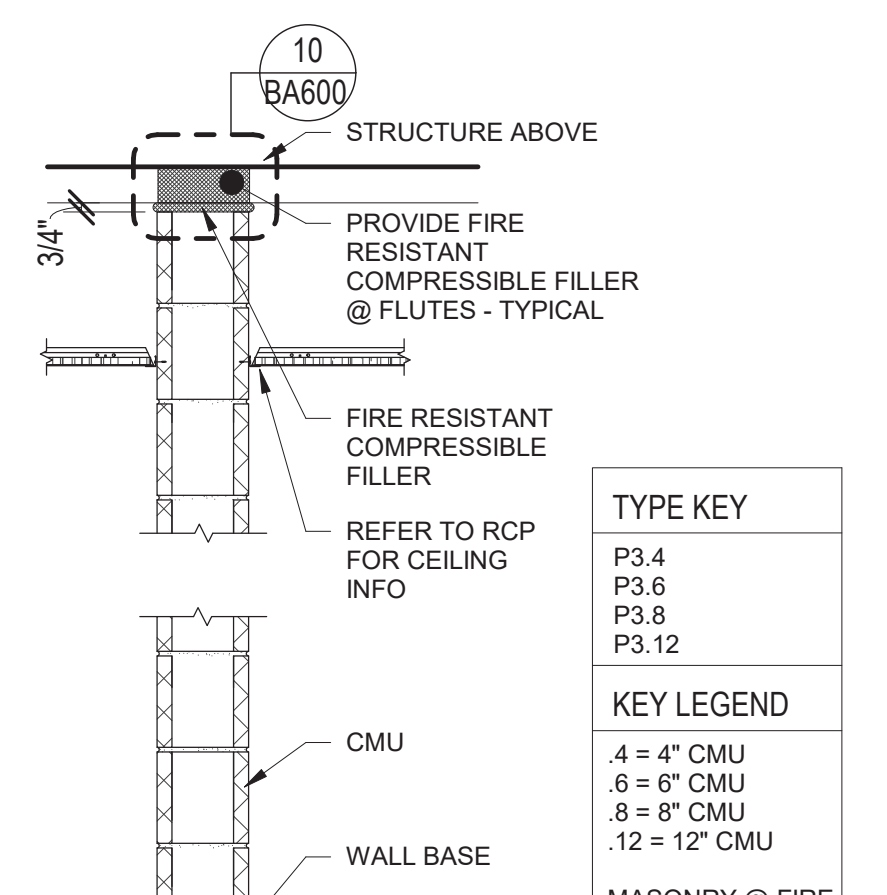


## 11 Partition Type P3

3/4\"/>

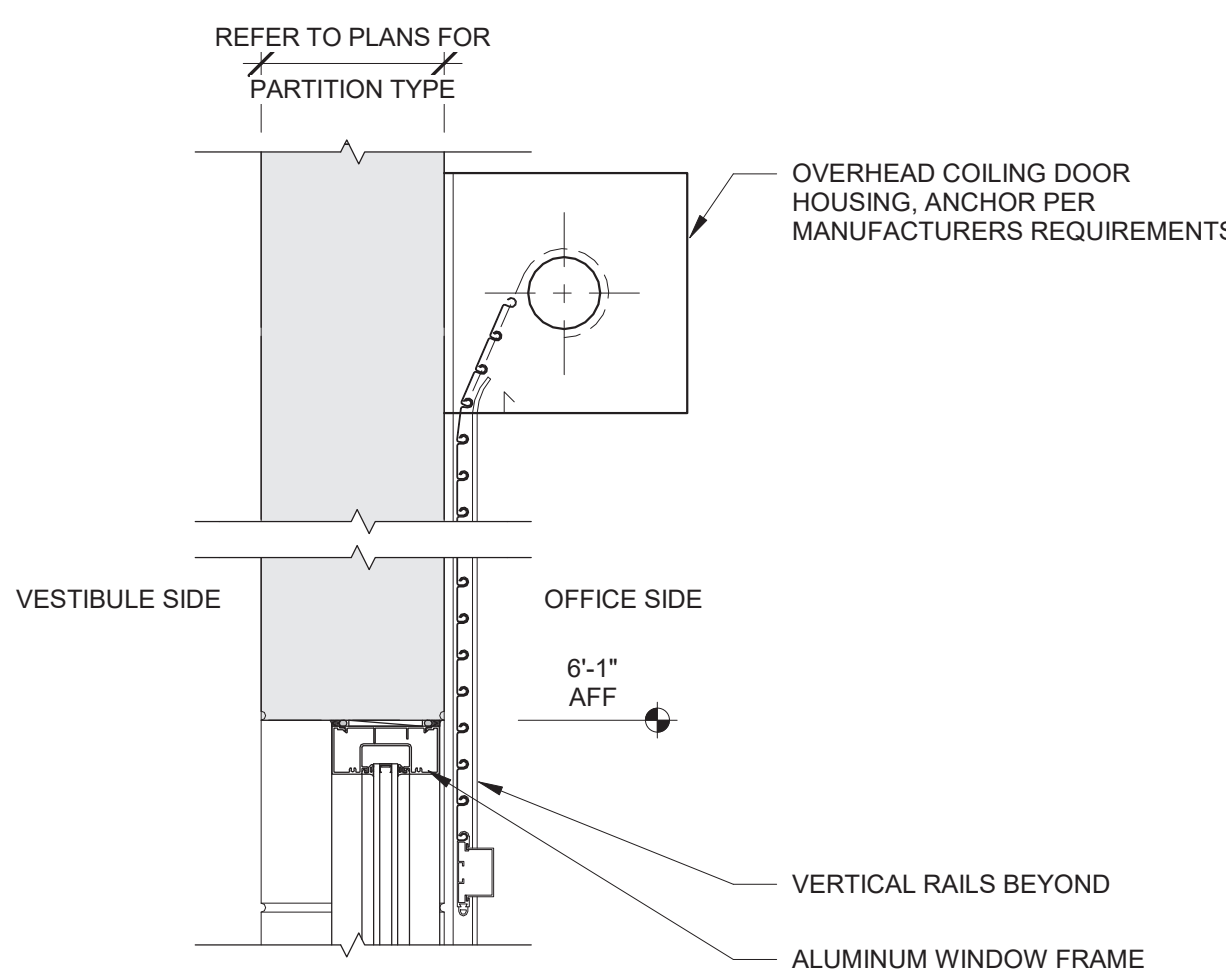


## 13 Head Detail


1 1/2\"/>

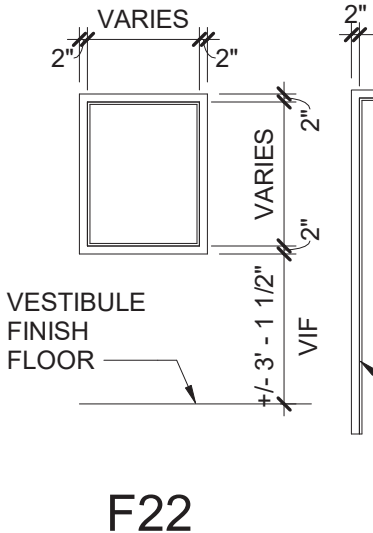


## FRAME TYPES

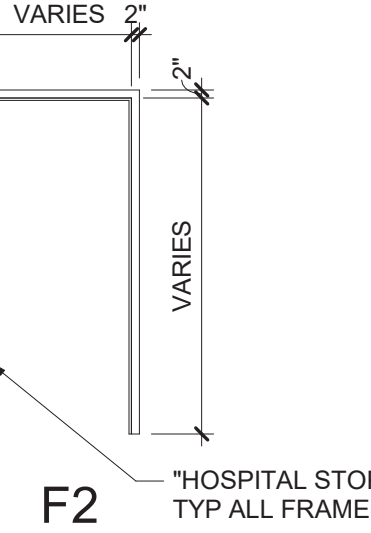


## DOOR TYPES

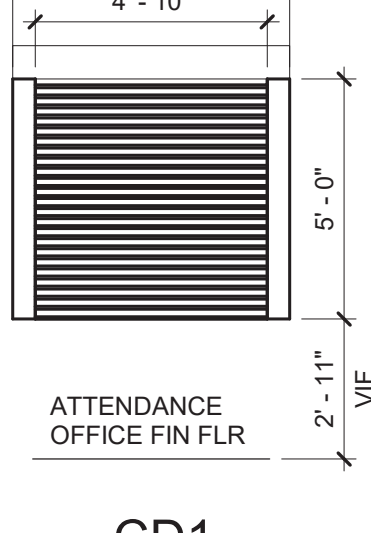


## DOOR TYPES

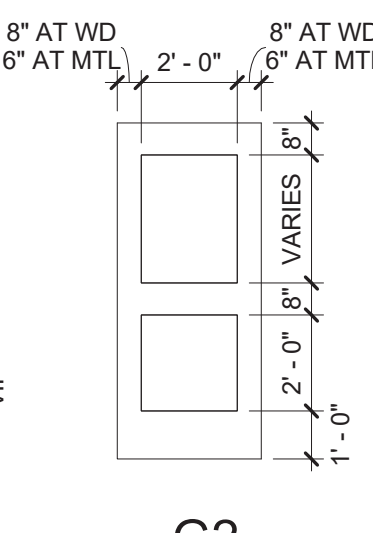

## DOOR TYPES

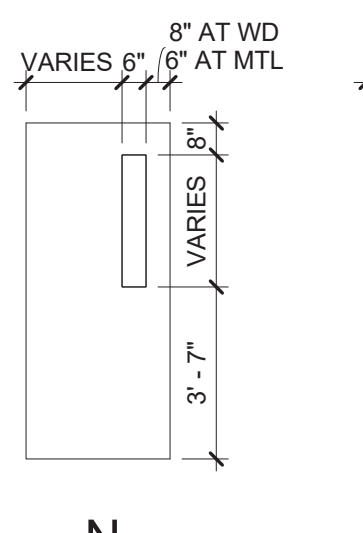


## DOOR TYPES

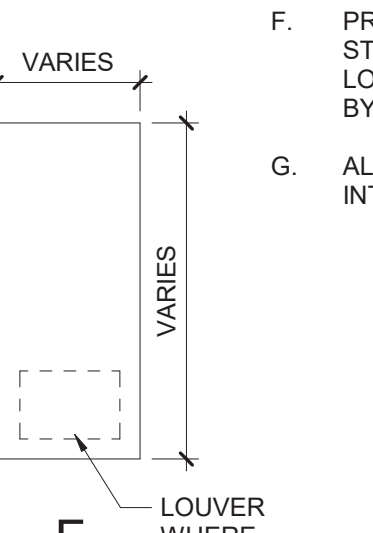

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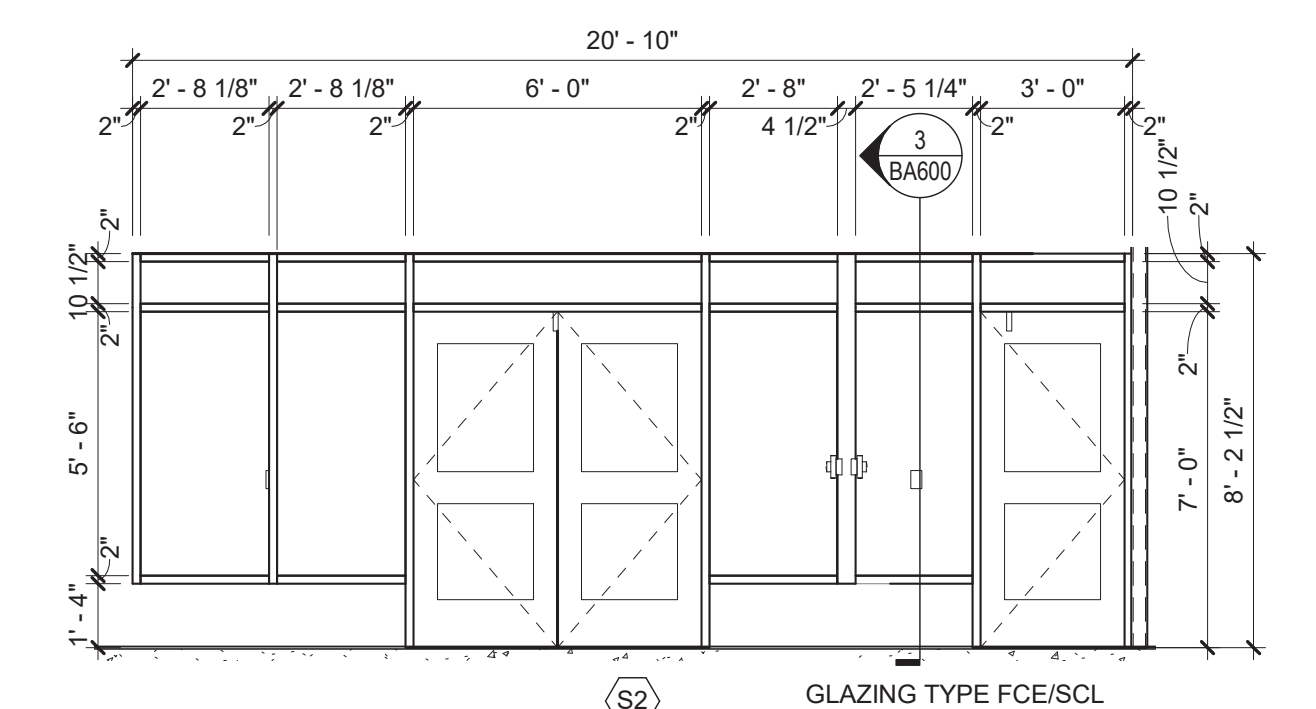
## General Window Notes

- INSULATING GLASS UNITS SHALL BE TYPE FCE/SCL, TYP UNO.
- RESCUE WINDOWS ARE INDICATED BY THE DESIGNATION "RW" ON CODE DRAWINGS.
- PROVIDE ALL ALUMINUM FLASHINGS, RECEIVERS, TRIM AND SILLS REQUIRED FOR A COMPLETE AND FINISHED INSTALLATION REGARDLESS OF IF SHOWN ON DRAWINGS.
- REFER TO WINDOW TREATMENTS AS SHOWN ON DRAWINGS.
- GLAZING SYSTEMS FRAME TYPE KEY:  
F HOLLOW METAL  
S ALUMINUM STOREFRONT  
W ALUMINUM WINDOWS
- PROVIDE INTERNAL STEEL REINFORCEMENT TO WINDOW. STOREFRONT SYSTEM AS REQUIRED TO COMPLY WITH WIND LOADING OR OTHER DESIGN CRITERIA, OR AS RECOMMENDED BY MANUFACTURER.
- ALUMINUM WINDOW, STOREFRONT FRAME EXTRUSIONS ARE INTENDED AS GENERIC GRAPHIC REPRESENTATIONS ONLY.

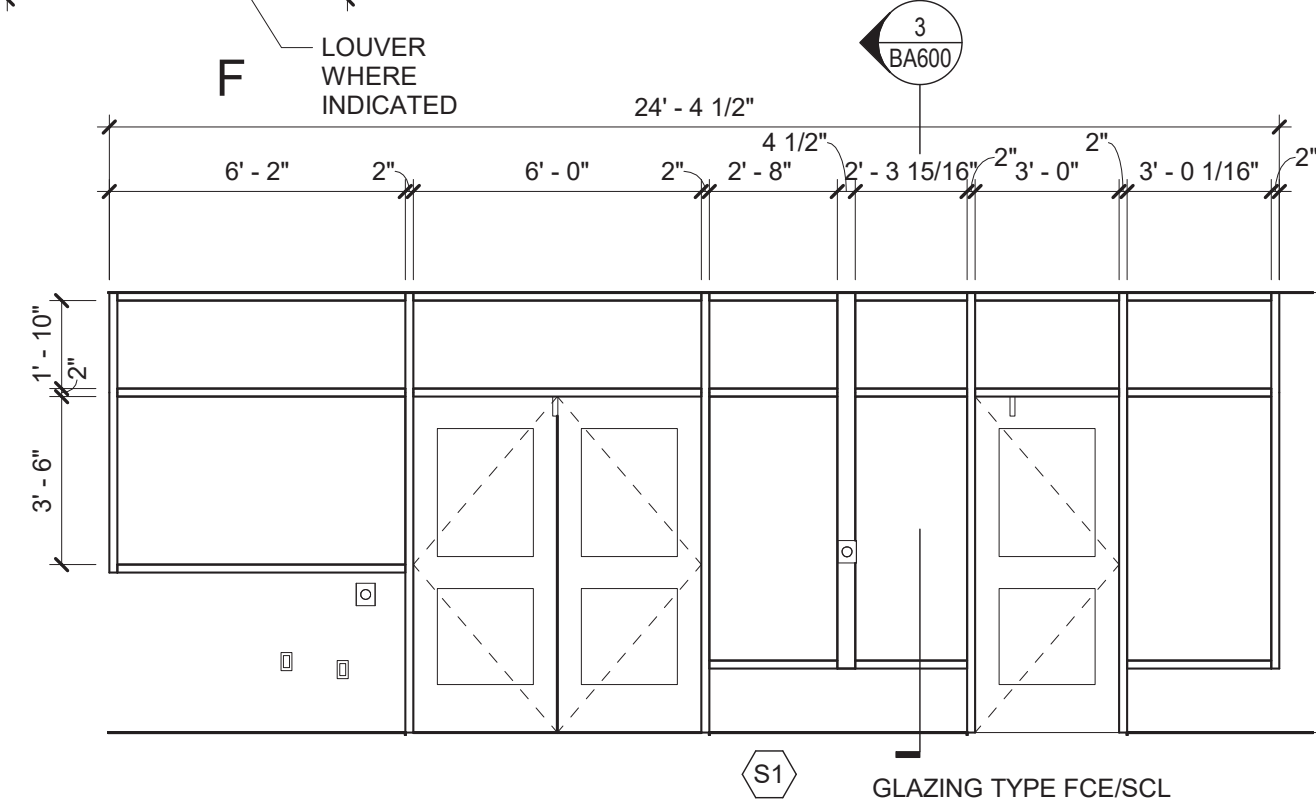


## 1 Storefront S1

1/4\"/>



## 2 Storefront S2

1/4\"/>

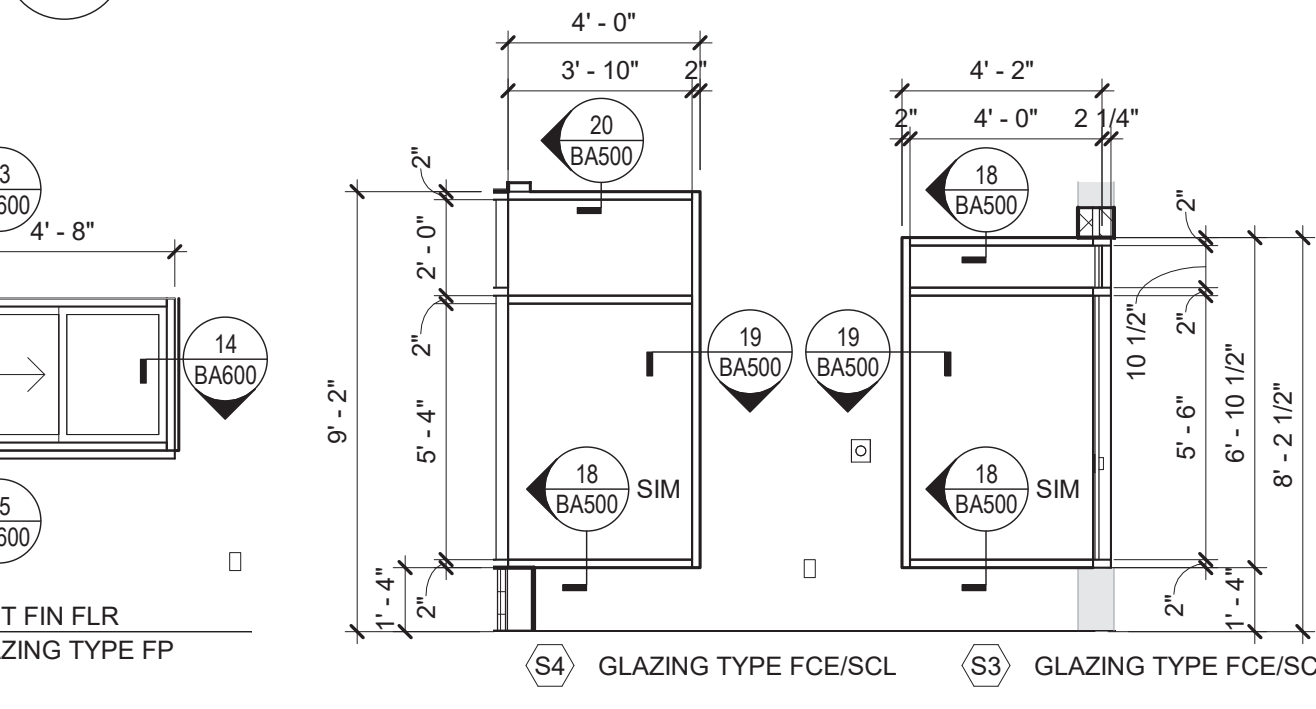


## W1

1/4\"/>

## 3 Storefront S3 and S4

1/4\"/>

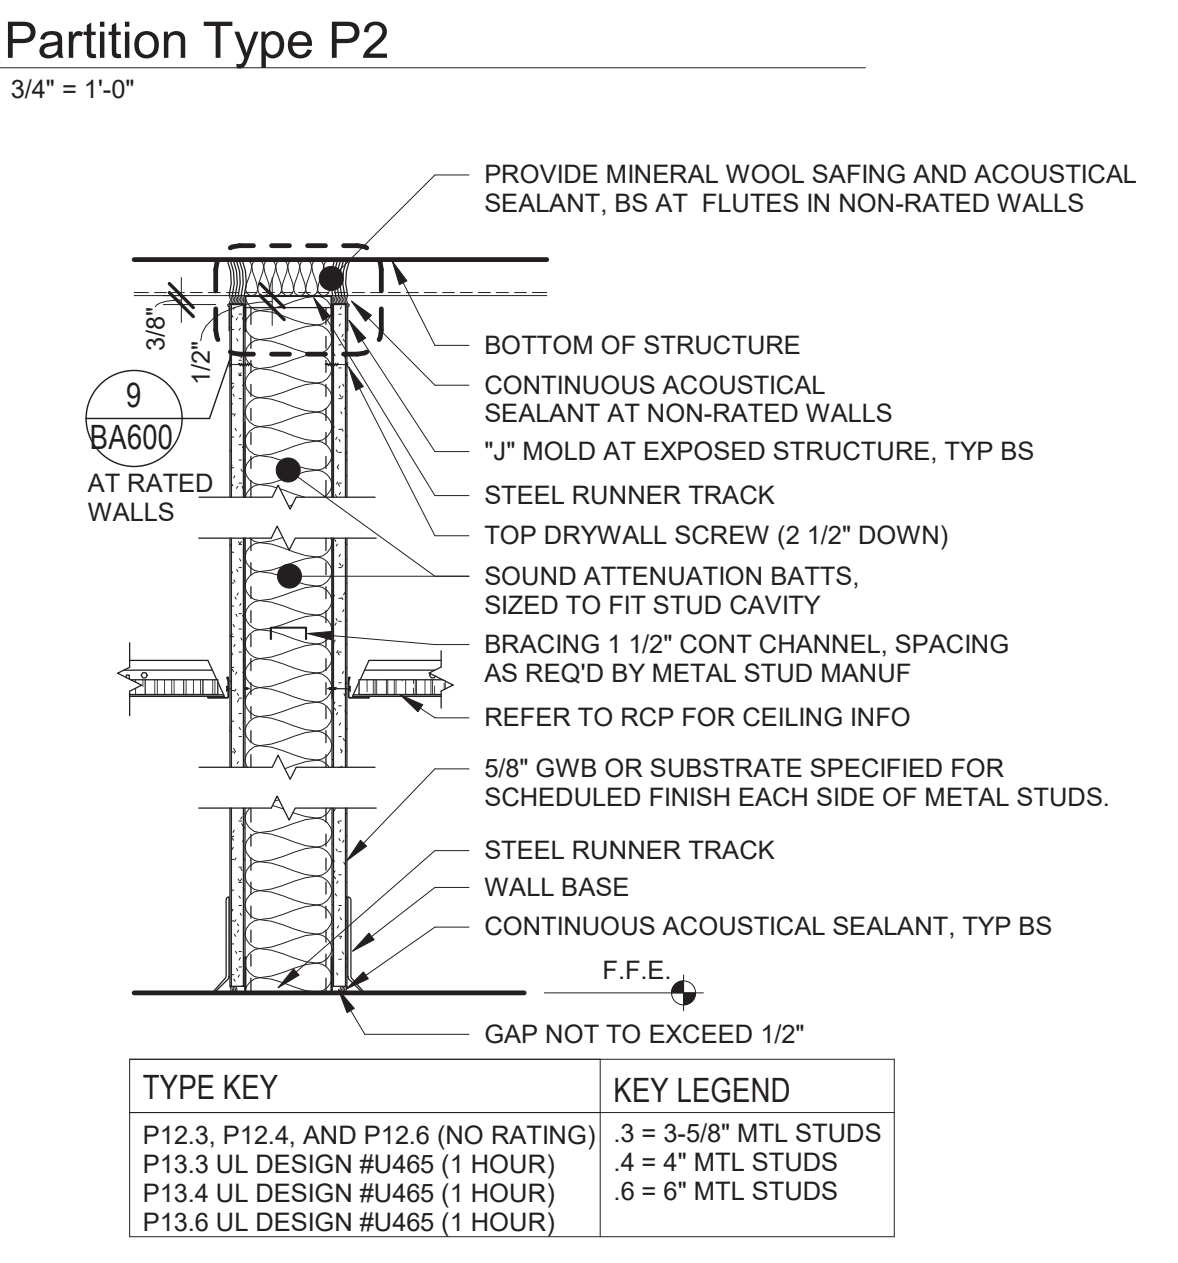


## 6 Partition Type P2

3/4\"/>


## 7 Metal Stud Partition Type P12 and P13

1 1/2\"/>

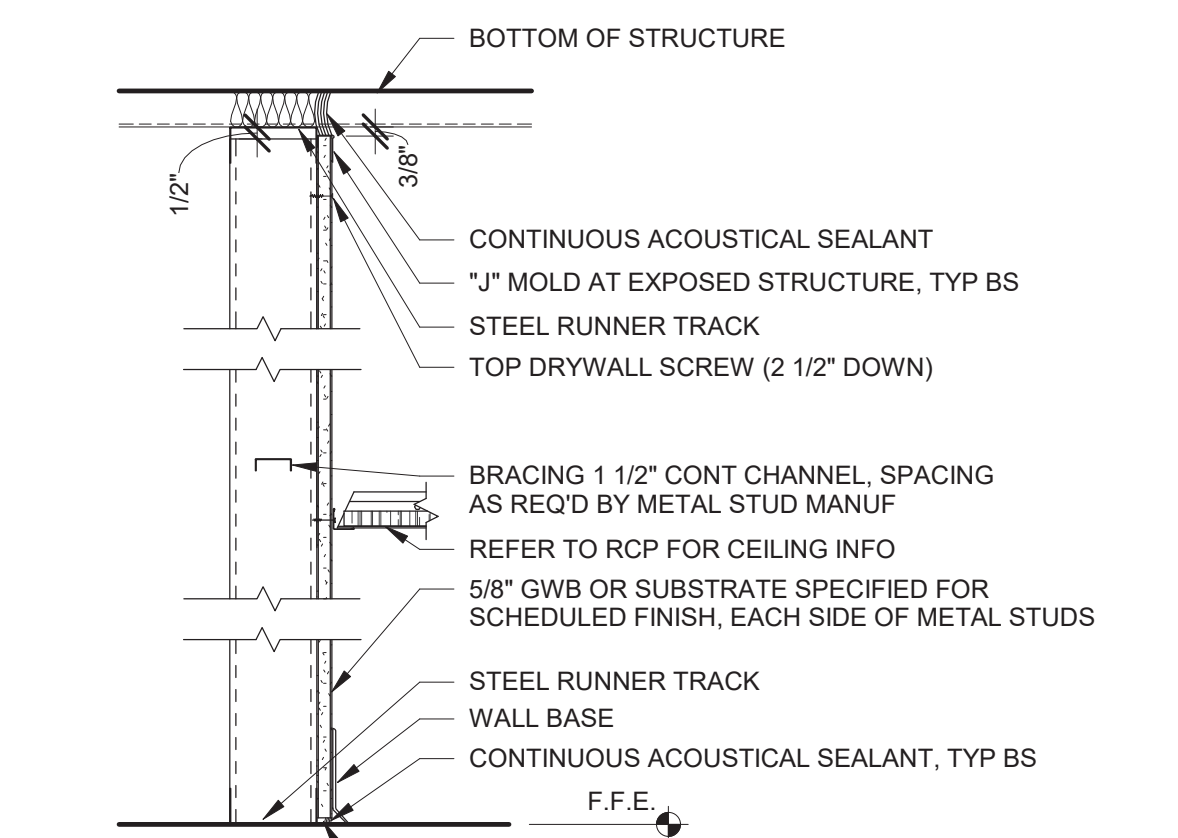

## 8 Metal Stud Partition Type P16

1 1/2\"/>

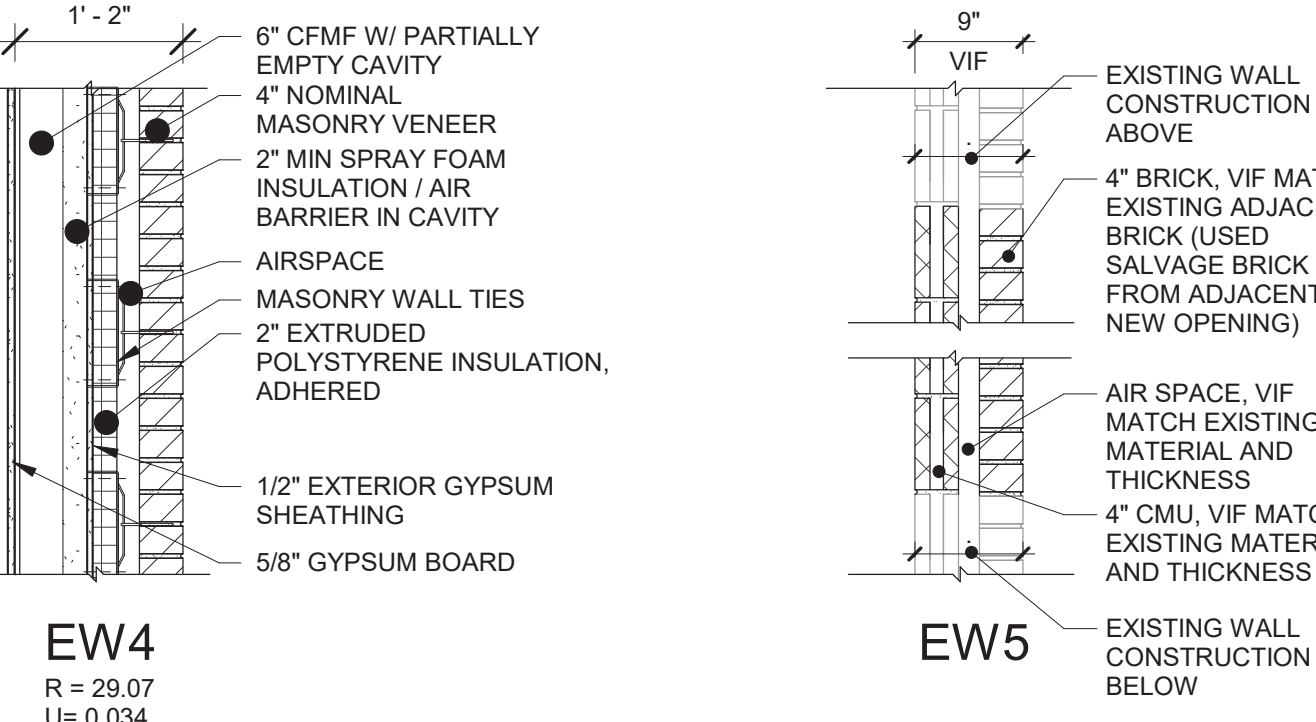

## EW4

R = 29.07  
U = 0.034

- NOTES: (APPLIES TO ALL EXTERIOR WALL TYPES)
- REFER TO STRUCTURAL AND ARCHITECTURAL DWGS FOR LOCATIONS OF COLUMN CENTERLINES. SEE STRUCTURAL DWGS FOR FOOTING, FOUNDATION, FLOOR SLAB DETAILS.
  - TOOL MORTAR JOINTS FLUSH ON CAVITY SIDE(S) OF CMU BACKUP WALL TO RECEIVE AIR BARRIER. CMU SHALL BE FREE OF DEFECTS, TYP.

## 5 Typical Exterior Wall Types

3/4\"/>

## General Door Notes


- SEE DWGS BA601 FOR ADDITIONAL INFORMATION AND DETAILS.
- HARDWARE ON DOORS FROM SPACES OF PUPIL OCCUPANCY SHALL BE A TYPE WHICH WILL ALWAYS PERMIT THE DOOR TO BE OPENED FROM THE INSIDE WITHOUT DIRECT MANIPULATION OF ANY TYPE LOCKING DEVICE.
- METAL VISION PANEL TRIM SHALL BE PAINTED SAME COLOR AS DOOR FRAMES.
- ALL DOORS WITH ELECTRO-MAGNETIC HOLD OPEN DEVICES SHALL SWING TOWARDS ADJACENT WALLS. COORDINATE ALL INSTANCES WITH CONTRACTOR RESPONSIBLE FOR ELECTRICAL WORK, AND SEE ELECTRICAL DWGS.
- APPLY CONTINUOUS JOINT SEALANT TO ALL JOINTS BETWEEN FRAMES AND WALLS, TYP ALL.
- PAINT ALL HM DOORS AND FRAMES.
- PROVIDE LINTELS AT ALL DOOR AND WINDOW OPENINGS IN ACCORDANCE WITH LINTEL SCHEDULE ON STRUCTURAL DWGS.
- PROVIDE MARBLE THRESHOLDS AT ALL TOILET ROOMS WHERE ADJACENT FINISH IS CERAMIC TILE.
- NOTE THAT DUE TO REQUIREMENTS IN THE BONYS, SOME FIRE RESISTANCE RATINGS MAY DIFFER BETWEEN DOORS (AND ITS GLASS, IF ANY) AND THAT DOORS FRAME ESPECIALLY IF THAT FRAME HAS GLASS (SIDELITES, TRANSOMS, ETC).

- VERIFY SIZES OF ALL EXISTING OPENINGS IN SCHEDULE PRIOR TO FIRST SUBMISSION OF SHOP DRAWINGS. NOTIFY ARCHITECT IF ANY ARE LESS THAN CODE MINIMUM HEIGHT OF 6'-8". ASSUME FOR BIDDING ALL EXISTING OPENINGS ARE AS NOTED IN THE SCHEDULE (VIF, TYP).
- MATERIAL DESIGNATION KEY:  
FRP FIBERGLASS REINFORCED PLASTIC  
HM HOLLOW METAL  
WD WOOD  
AL ALUMINUM  
STL STEEL  
EXO EXISTING
- ADDITIONAL DOOR SCHEDULE DESIGNATIONS:  
EXISTING TO REMAIN  
- NOT APPLICABLE  
NOT APPLICABLE OR TO BE COORDINATED WITH STOREFRONT TYPE




## 1 Storefront S1

1/4\"/>

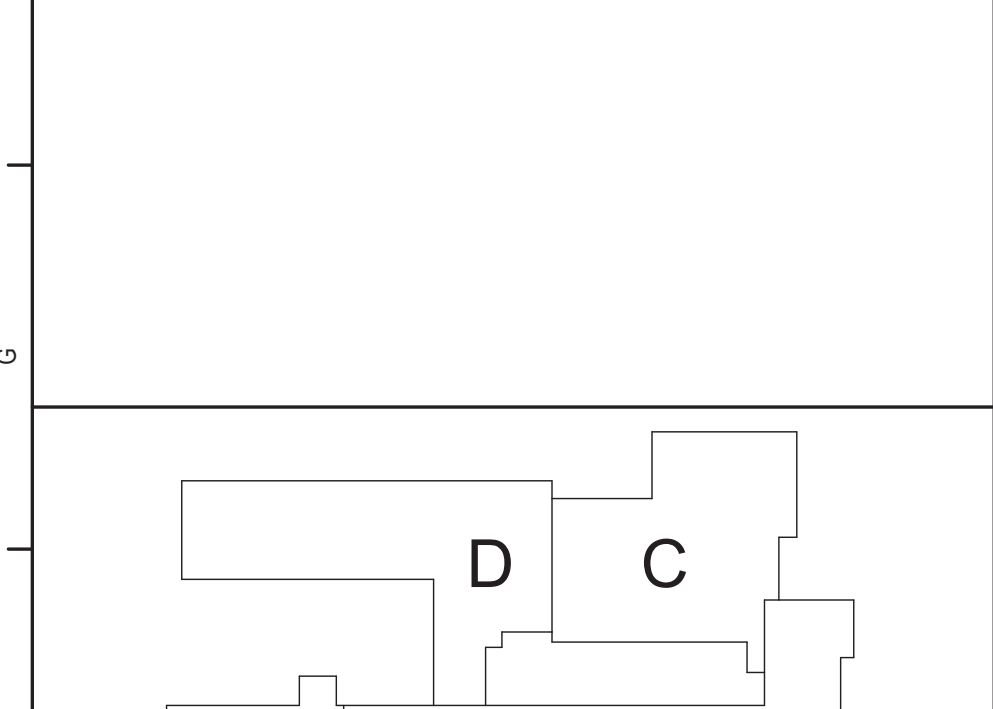

## 2 Storefront S2

1/4\"/>

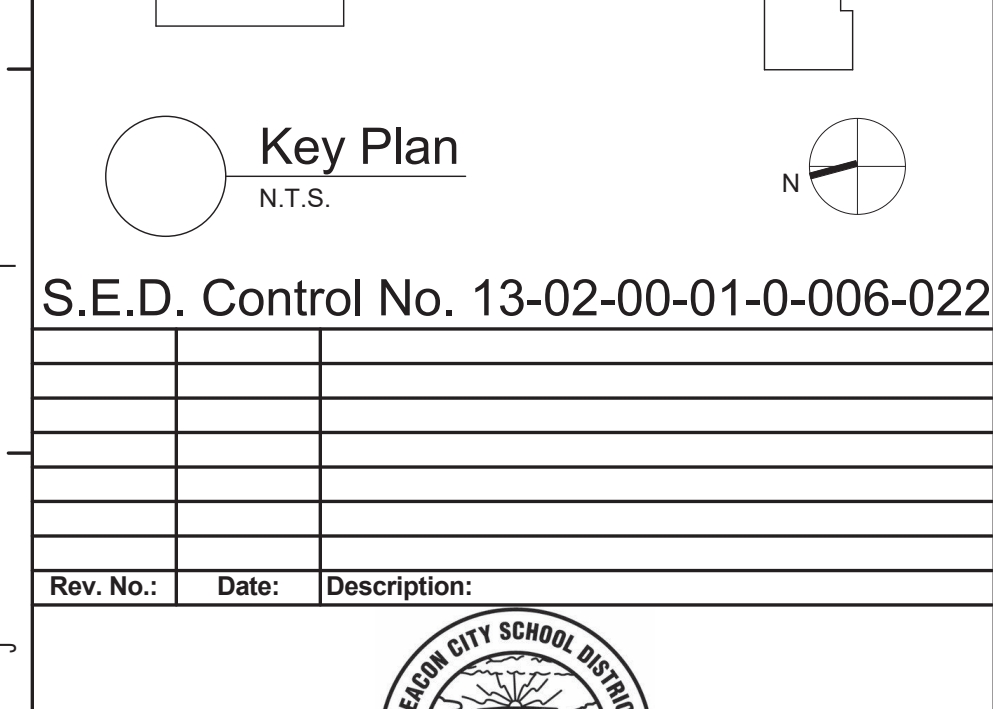

## W1

1/4\"/>



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U = 0.034

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  - TOOL MORTAR JOINTS FLUSH ON CAVITY SIDE(S) OF CMU BACKUP WALL TO RECEIVE AIR BARRIER. CMU SHALL BE FREE OF DEFECTS, TYP.

## 5 Typical Exterior Wall Types

3/4\"/>

## General Door Notes


- SEE DWGS BA601 FOR ADDITIONAL INFORMATION AND DETAILS.
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WD WOOD  
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EXO EXISTING
- ADDITIONAL DOOR SCHEDULE DESIGNATIONS:  
EXISTING TO REMAIN  
- NOT APPLICABLE  
NOT APPLICABLE OR TO BE COORDINATED WITH STOREFRONT TYPE




## 1 Storefront S1

1/4\"/>

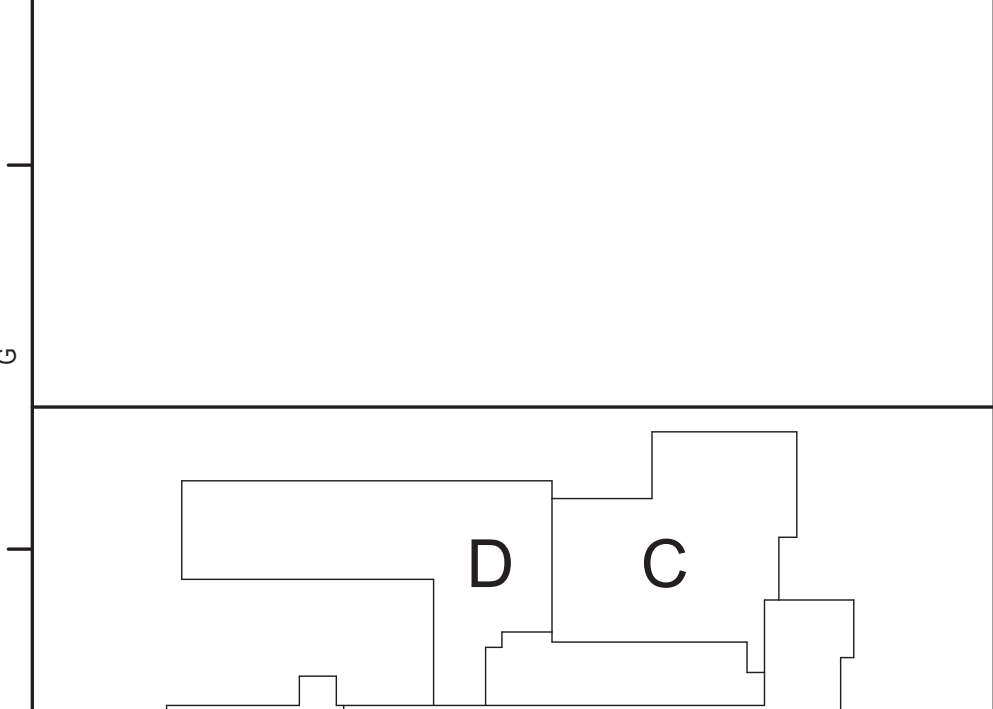

## 2 Storefront S2

1/4\"/>

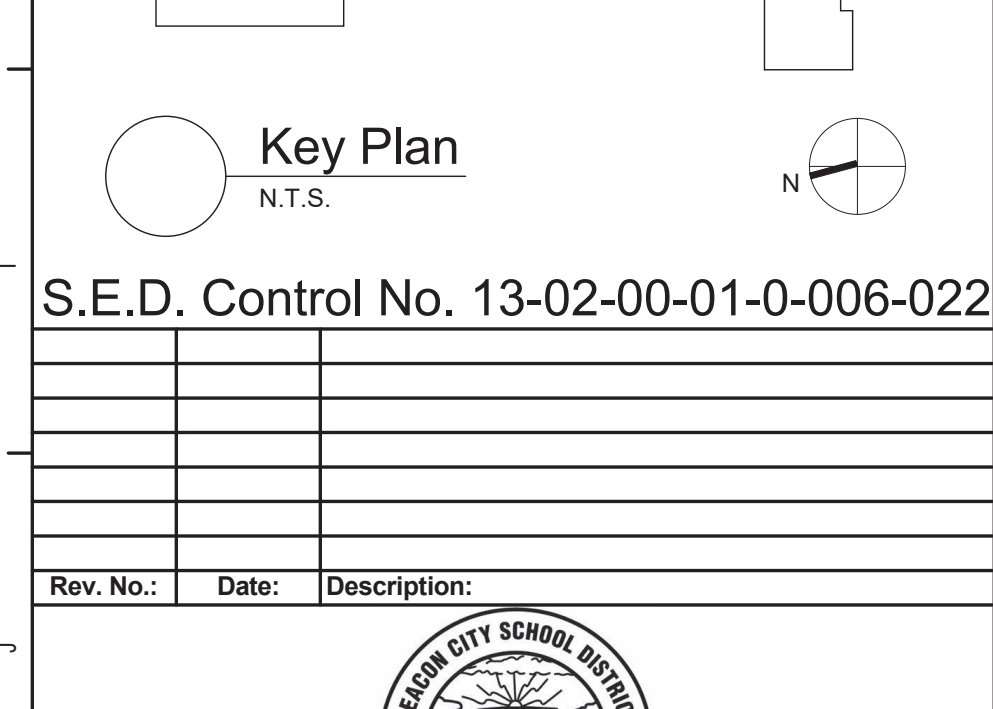

## W1

1/4\"/>



## EW4

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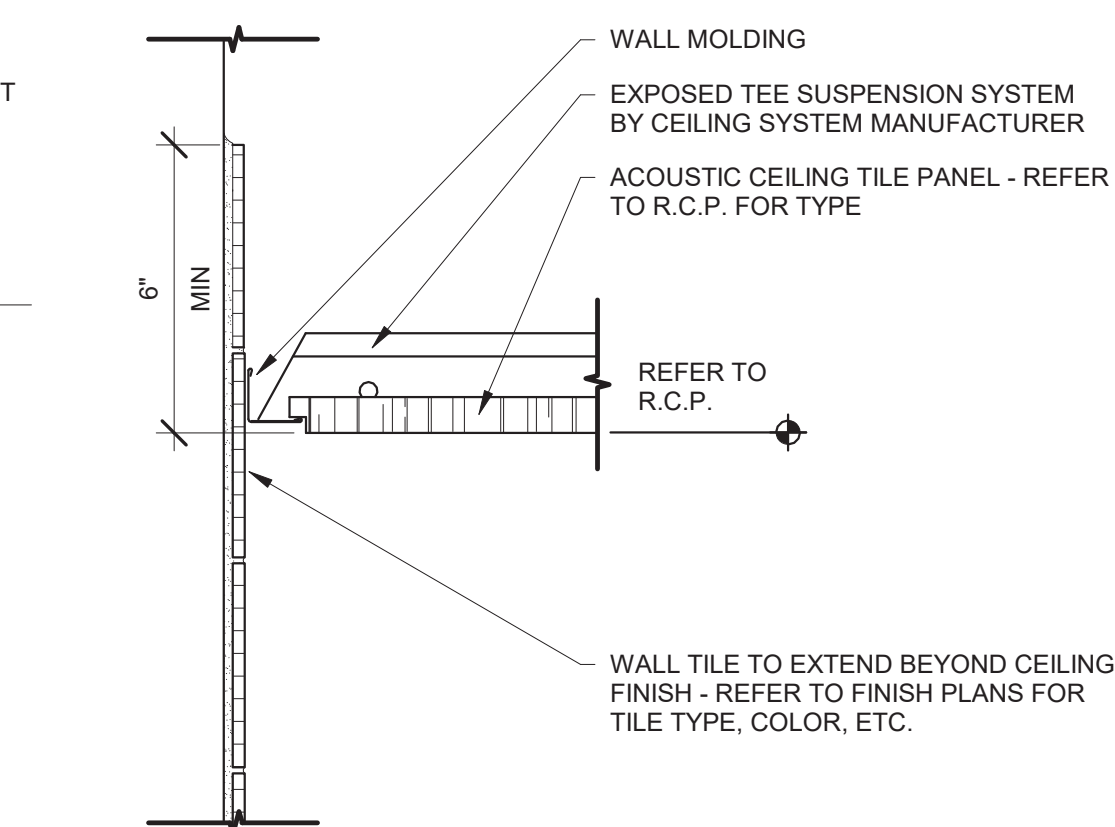
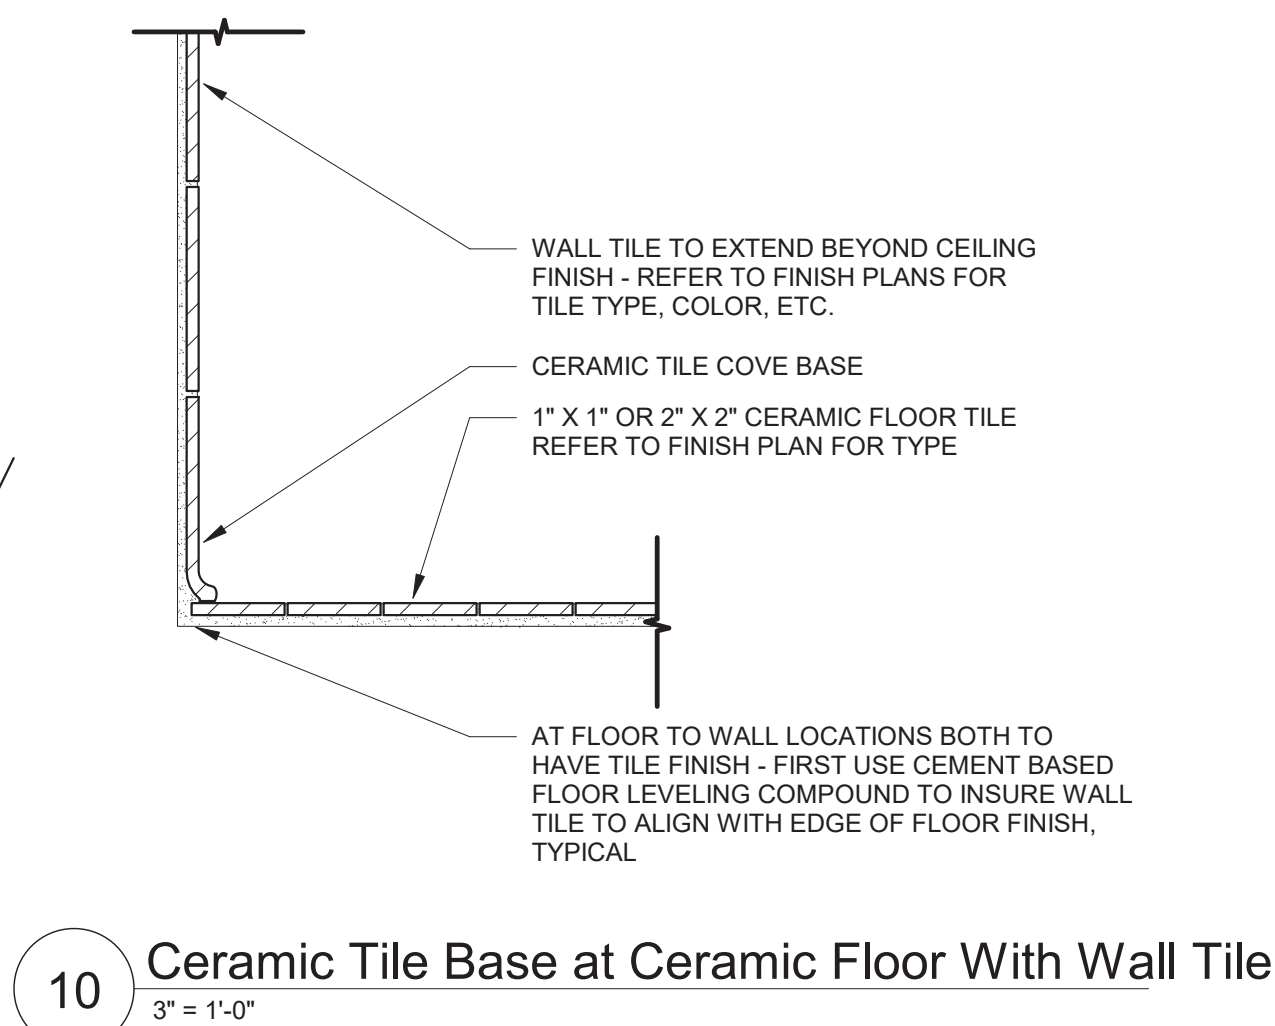
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  - TOOL MORTAR JOINTS FLUSH ON CAVITY SIDE(S) OF CMU BACKUP WALL TO RECEIVE AIR BARRIER. CMU SHALL BE FREE OF DEFECTS, TYP.

## 5 Typical Exterior Wall Types


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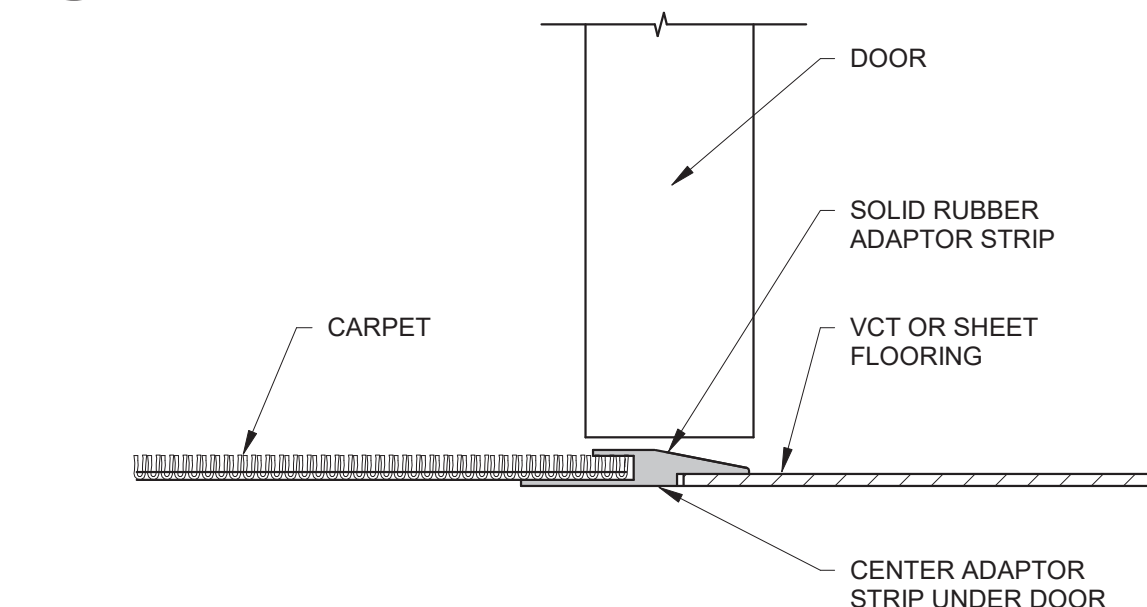
15 Existing Drain Section  
3" = 1'-0"



11 Ceramic Wall Tile at Acoustic Ceiling  
3" = 1'-0"




12 Outside Corner/ Rounded Profile  
3" = 1'-0"

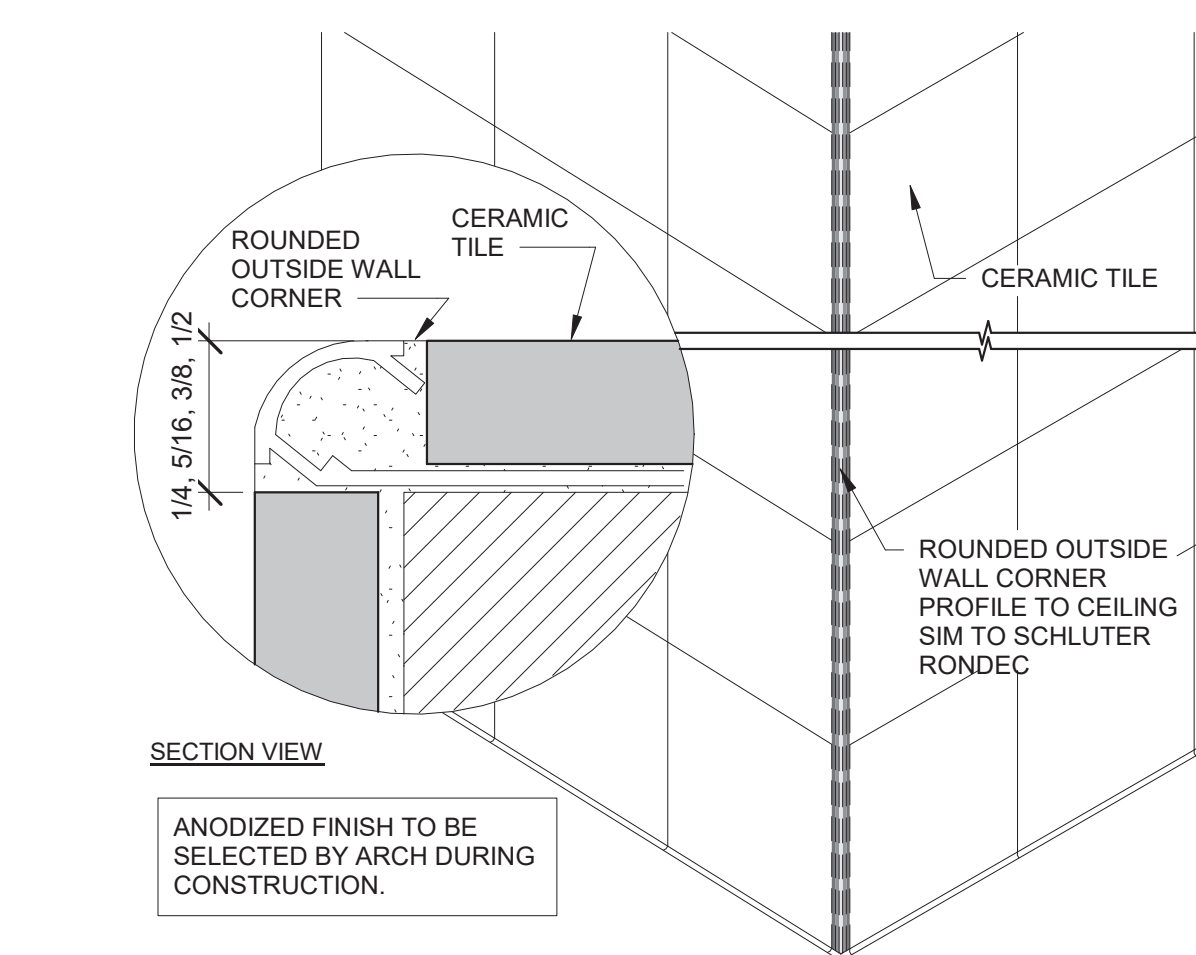


NOTE:  
REFER TO SPECIFICATIONS FOR TRANSITION AND TYPES  
REFER TO FINISH PLANS FOR ALL LOCATIONS, TYPICAL.

## 14 Threshold Detail

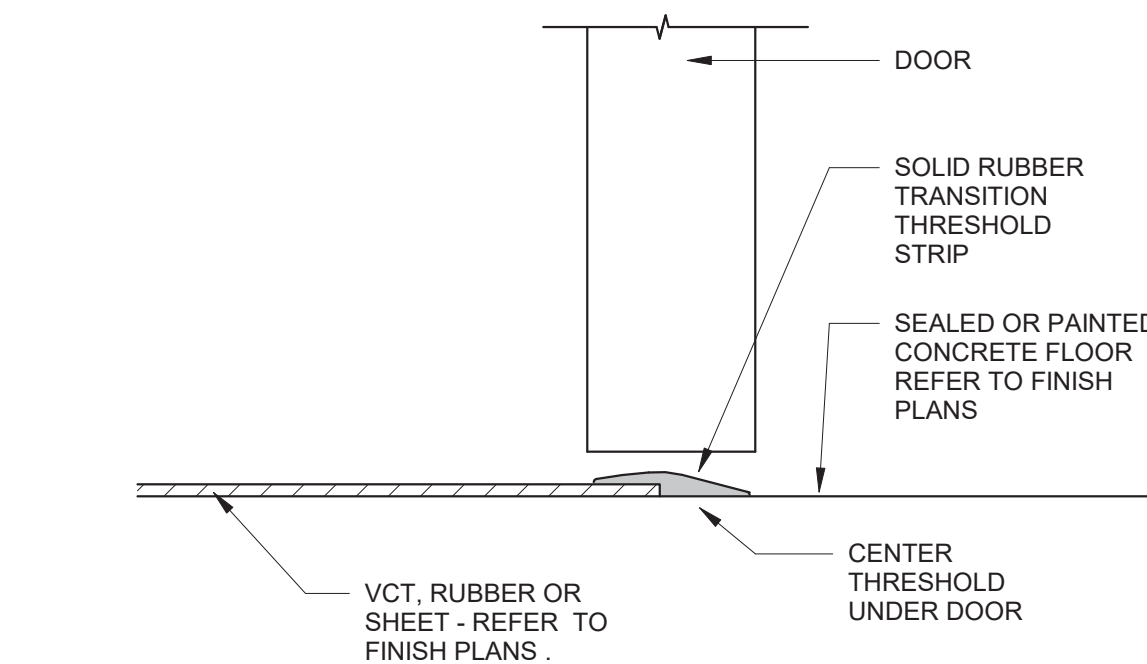


NOTE:  
REFER TO SPECIFICATIONS FOR TRANSITION TYPES.  
REFER TO FINISH PLANS FOR ALL LOCATIONS, TYPICAL .  
THRESHOLD TO MEET ALL ADA CRITERIA  
RATED DOOR UNDERCUT DISTANCE TO MEET REQUIRED NFPA CRITERIA


13 Threshold Detail  
6" = 1'-0"

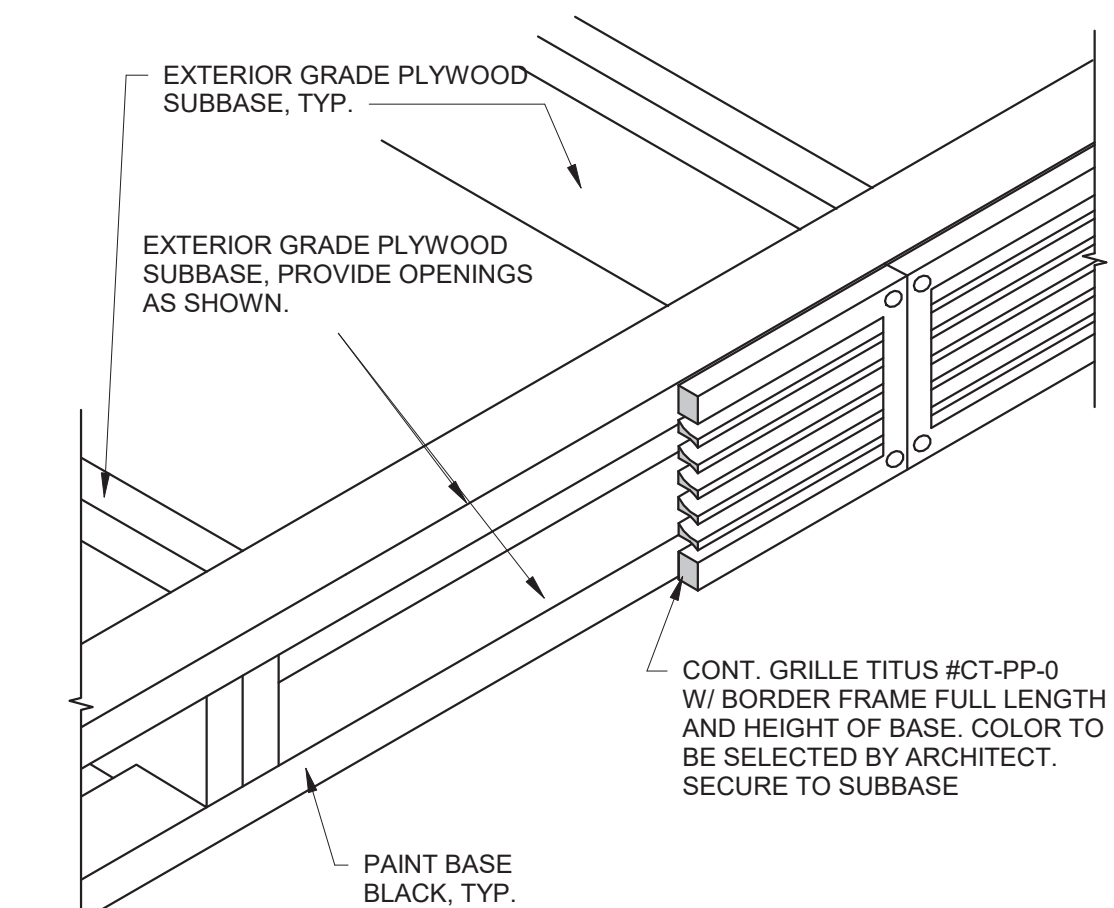


6 Base/ Grille Detail  
3" = 1'-0"

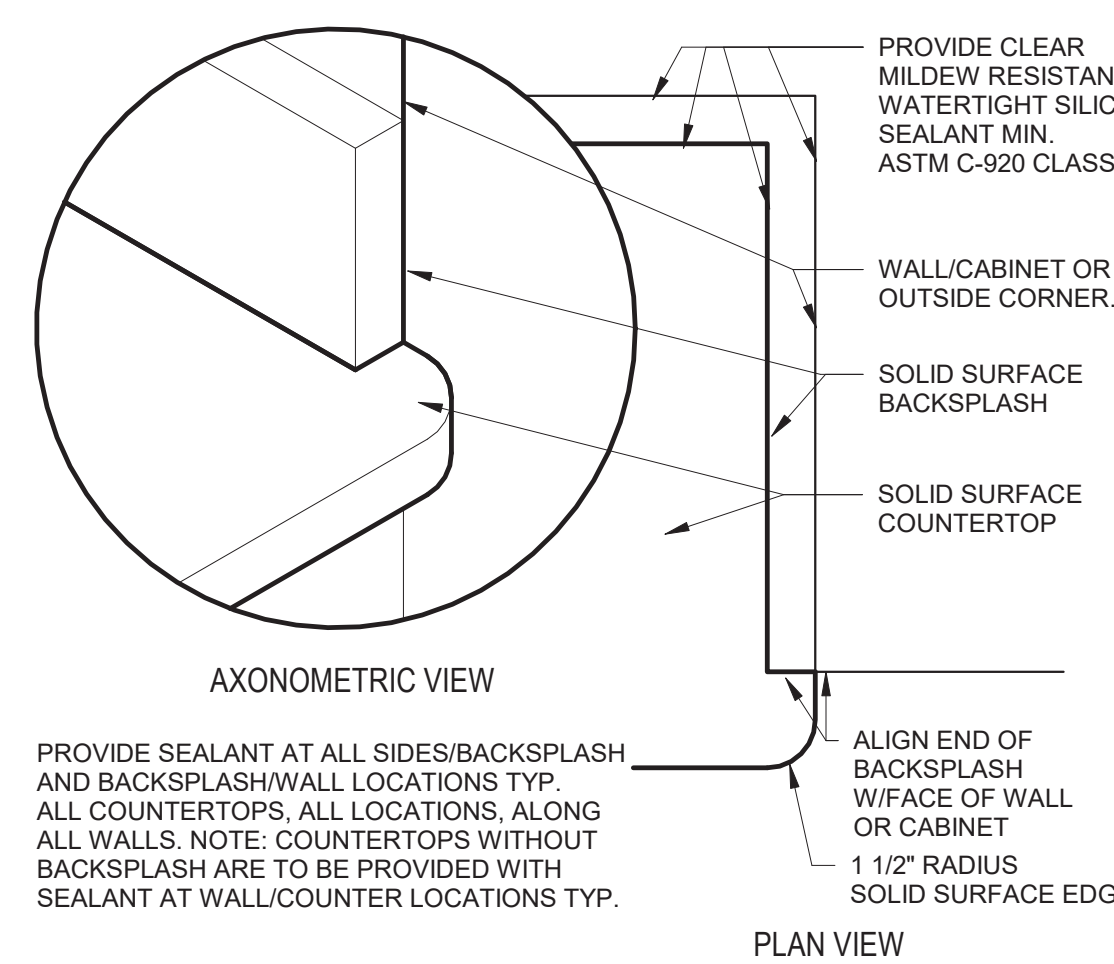

Solid Surface Countertop Edge Detail  
3" = 1'-0"

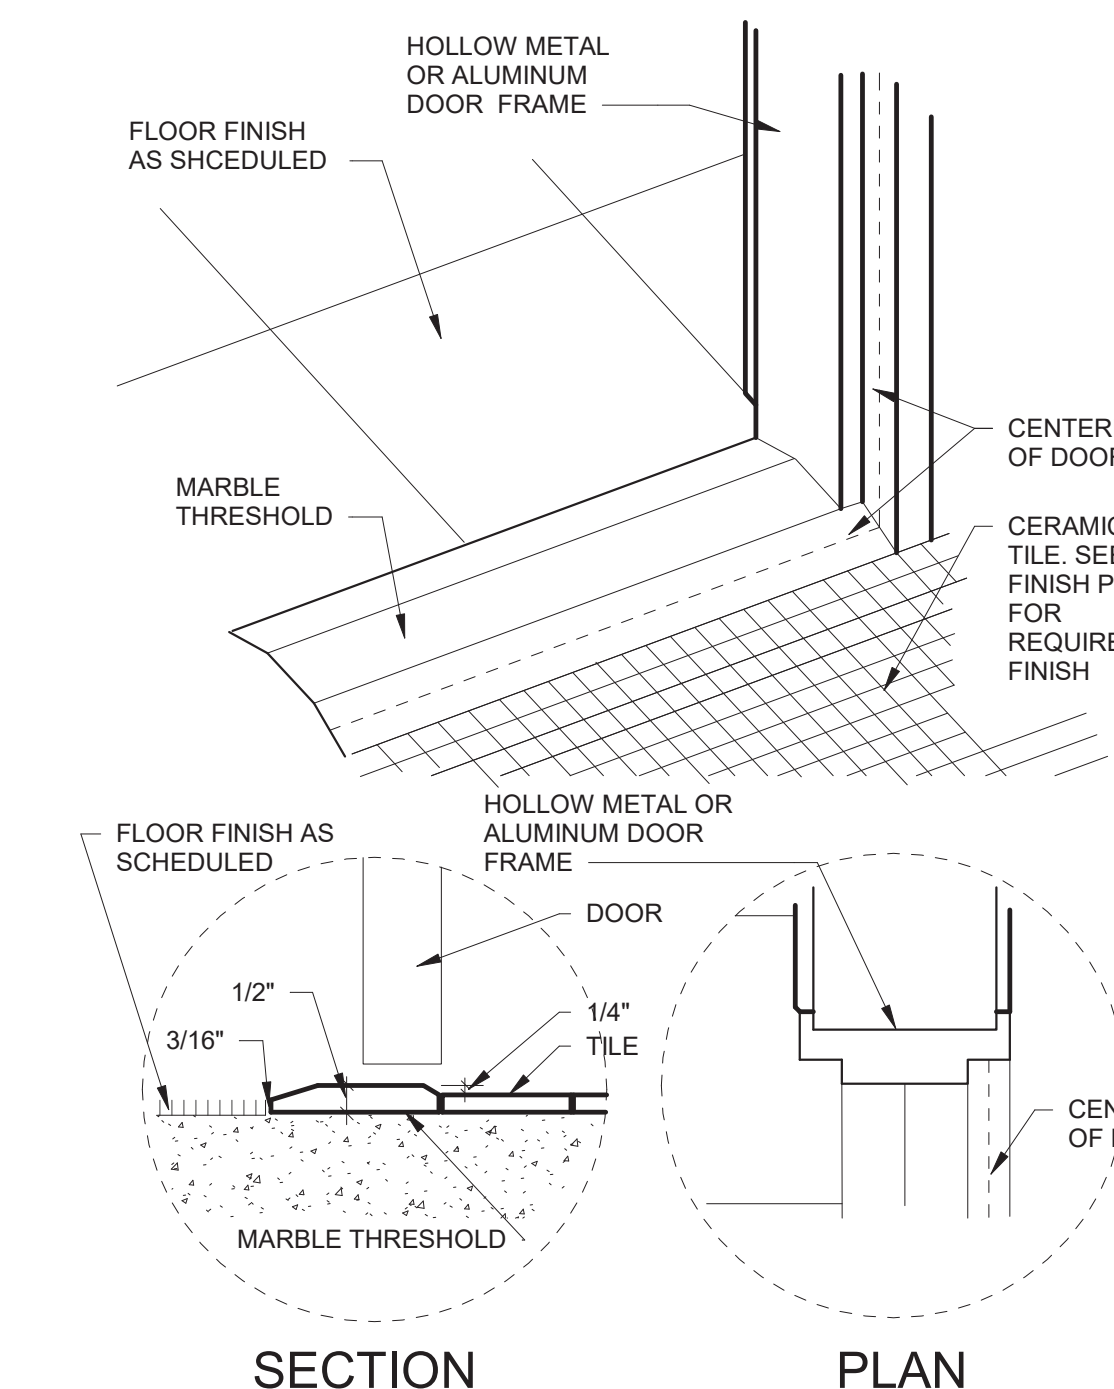


8 ADA Marble Threshold Detail  
1 1/2" = 1'-0"

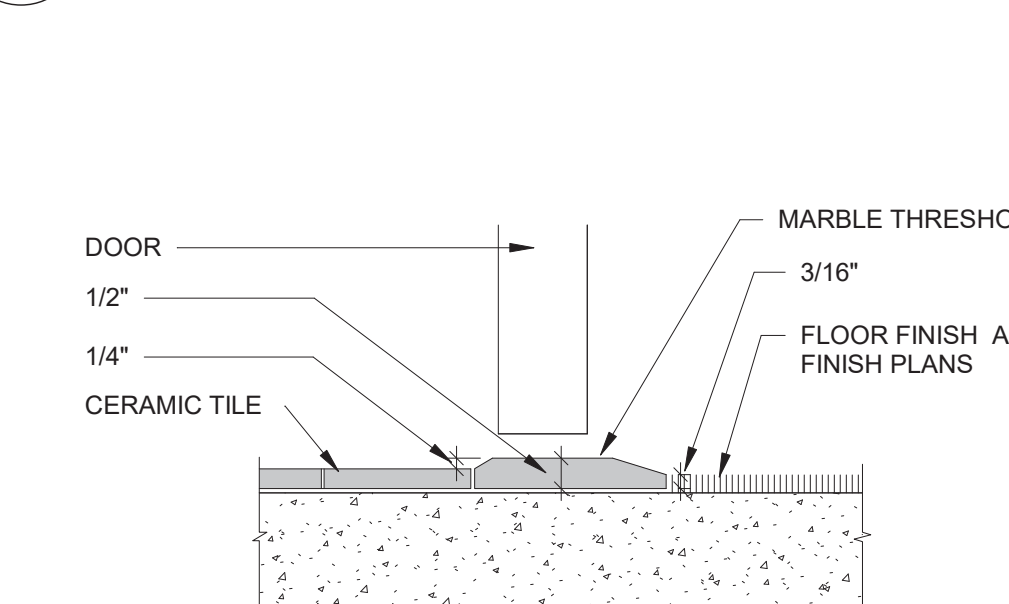


NOTE:  
REFER TO SPECIFICATION FOR THRESHOLD TYPES.  
REFER TO FINISH PLAN FOR LOCATIONS, TYPICAL  
THRESHOLD TO MEET ADA CRITERIA AND REQUIREMENTS.  
RATED DOOR UNDERCUT DISTANCE TO MEET REQUIRED NFPA CRITERIA


9 ADA Marble Threshold Detail  
12" = 1'-0"

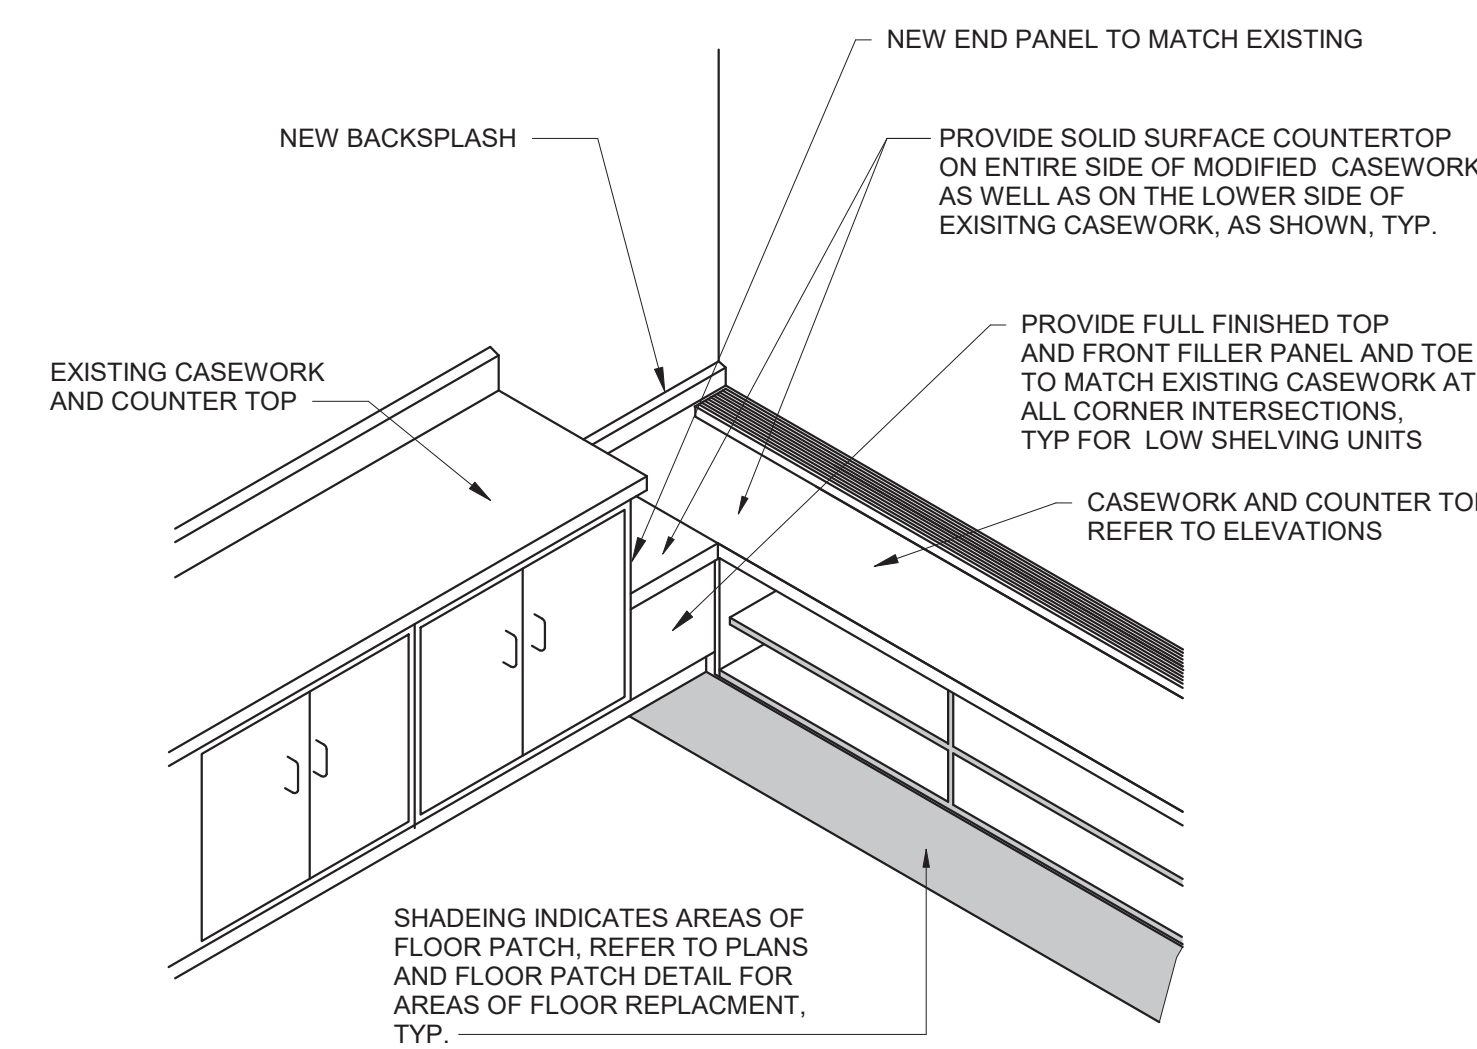


1 TYP. Corner Filler @ UV Casework Detail  
3/4" = 1'-0"

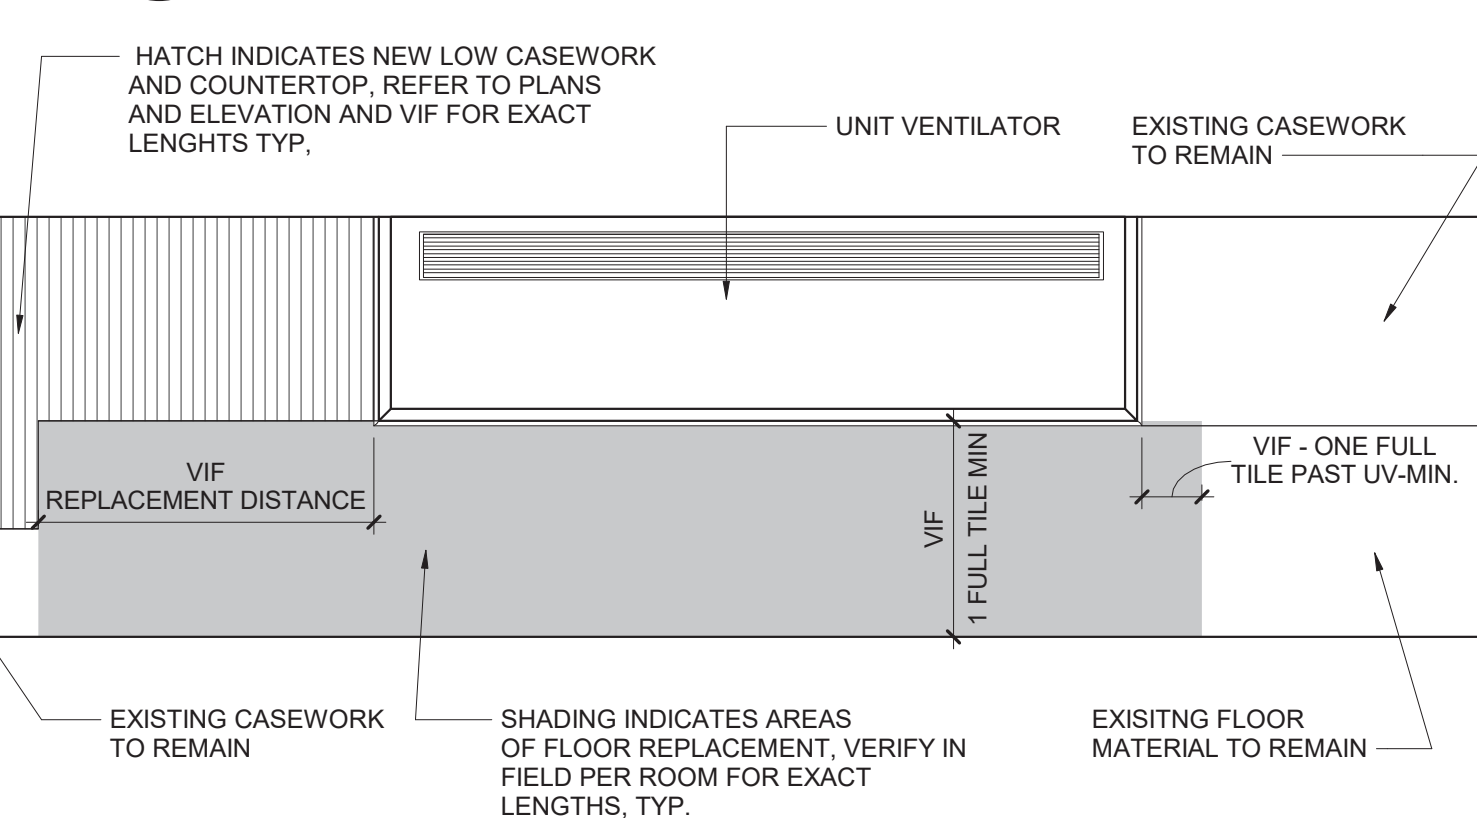


2 TYP. Floor Patch at UV Replacement Detail  
3" = 1'-0"

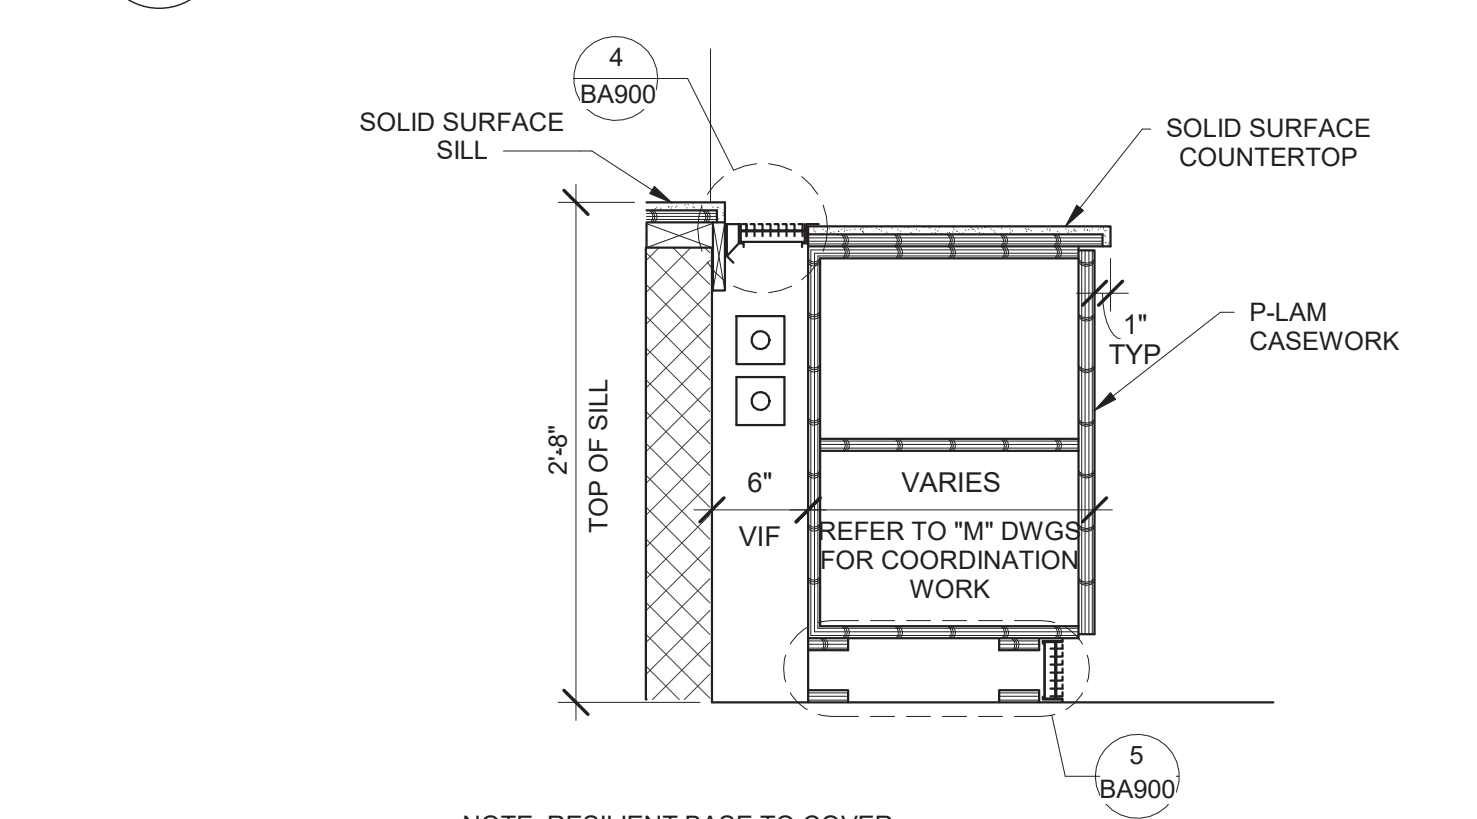

### 3 Casework/ Fin Tube Sections

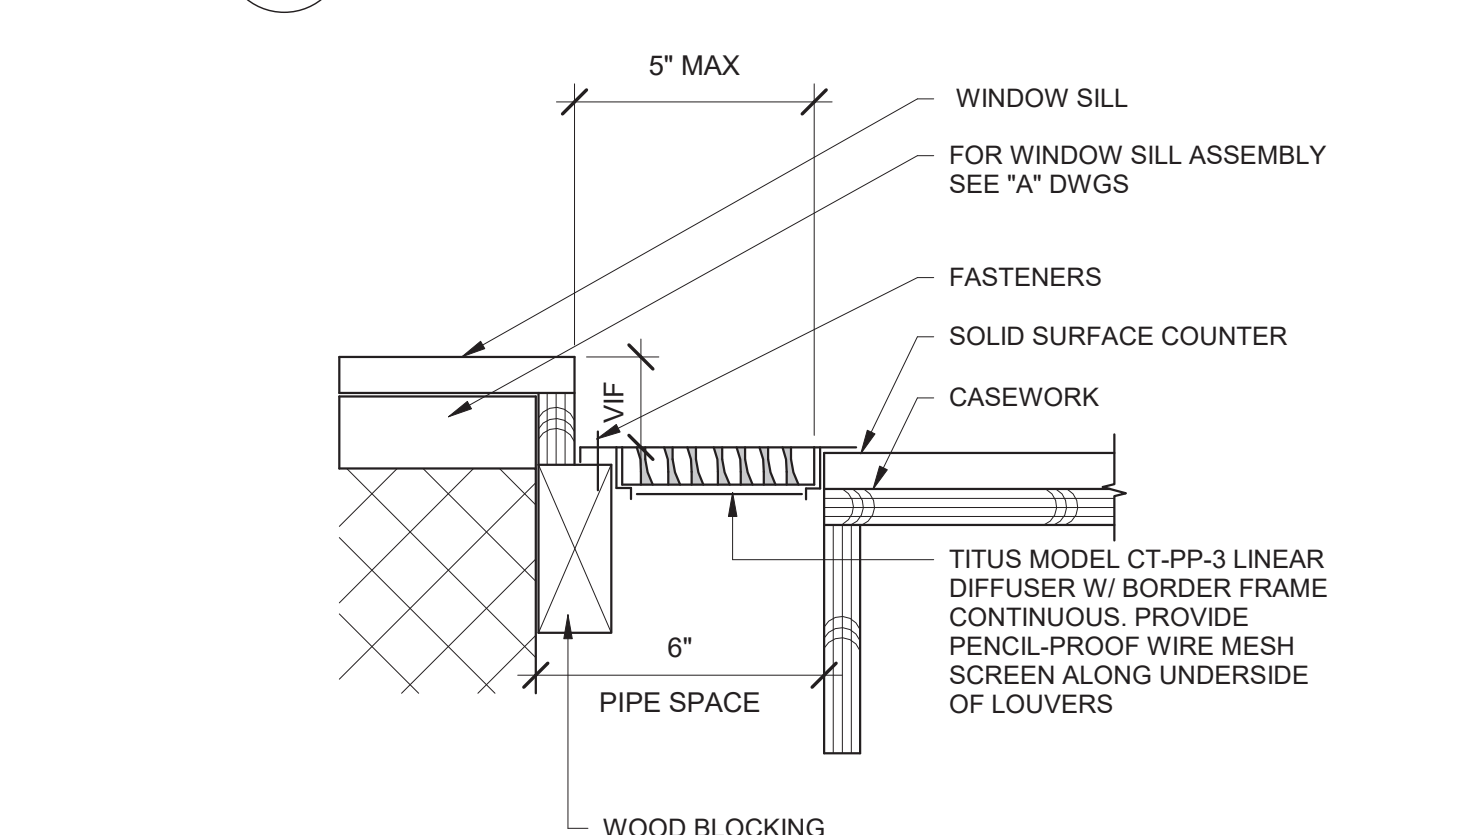

#### 4 Grille Detail

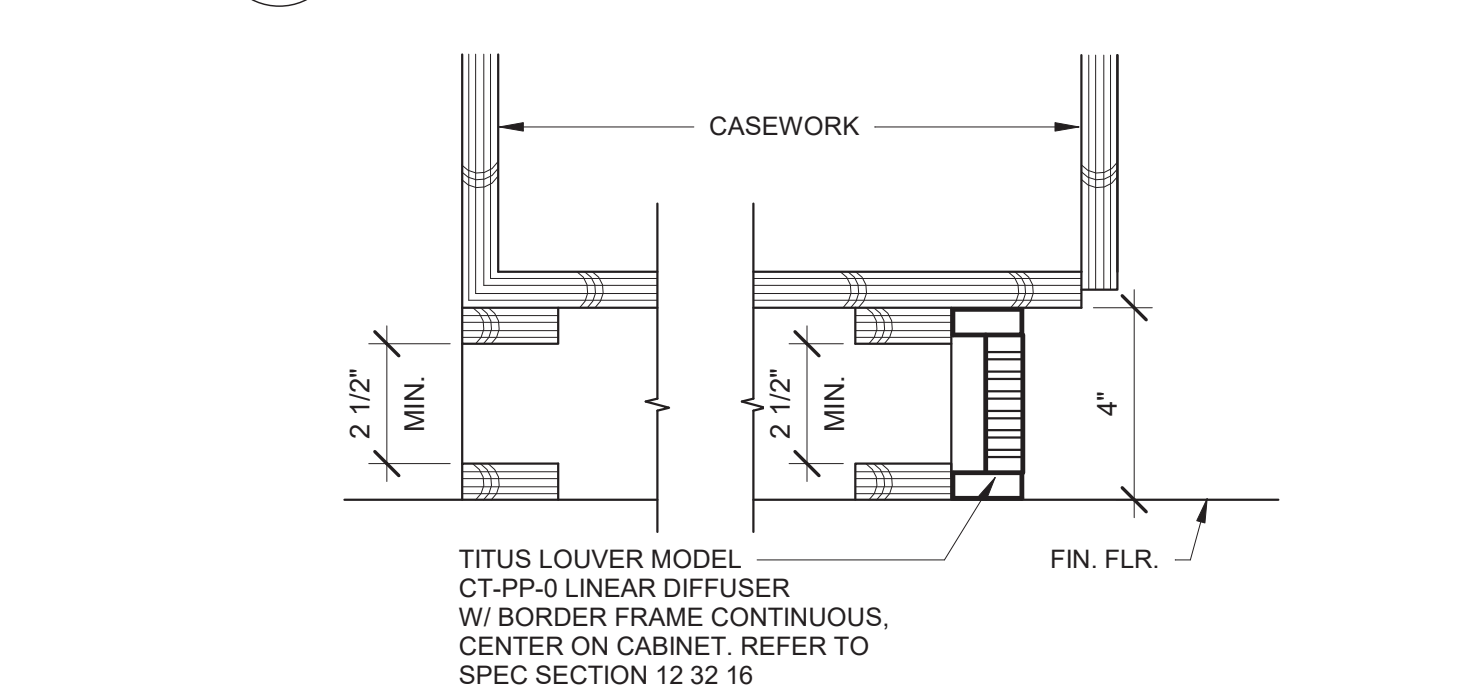


5 Base Detail  
3" = 1'-0"

## General P-Lam Casework Notes

FOR ALL CONTRACTOR RESPONSIBILITIES REFER TO  
SPECIFICATION SECTION 01 10 00/01 12 00.

- |    |   |
|----|---|
| A. | THE CASEWORK SHOWN ON THE DRAWINGS IS BASED ON CASE SYSTEMS' DESIGN CORPORATION.  |
| B. | ALL STANDARD CASEWORK DIMENSIONS ARE TO BE MODIFIED TO CORRESPOND WITH THE DIMENSIONS NOTED ON THE DRAWINGS. FIELD DIMENSIONS PRIOR TO FABRICATION OF CABINETS.   |
| C. | MODEL NUMBERS LISTED ON DRAWINGS APPLY TO ELEVATIONS SHOWN. PROVIDE OPPOSITE HAND MODELS WHERE NECESSARY.   |
| D. | PROVIDE FULL DEPTH SHELVES AT BASE, WALL AND TALL CABINETS TYPE UNLESS NOTED OTHERWISE.   |
| E. | BASE AND TALL CABINETS ARE 24 INCHES DEEP. UNO WALL CABINETS ARE 14 INCHES DEEP. UNO BASE CABINET DEPTH DOES NOT INCLUDE 1" COUNTERTOP OVERHANG, TYPE.  |
| F. | PROVIDE FINISHED ENDS, BACK EXTENSIONS, SCRIBES, AND FILLER PANELS ON ALL CABINETS. FILLER PANELS ARE NOT TO EXCEED 3" WIDE. UNLESS NOTED OTHERWISE, PROVIDE TOP AND BOTTOM FILLER PANELS AT ALL BASE, WALL, & TALL CABINETS. SUBMIT SHOP DRAWINGS SHOWING DETAILS OF THESE CONDITIONS. |
| G. | ALL COUNTERTOPS TO BE 1-1/4" SOLID SURFACE WITH 4" HIGH BACKSLASH, TYPE.  |
| H. | PROVIDE AT ALL PLAM UV SHELVING LOCATIONS-REMOVABLE BACKS IN CABINETS AT PLUMBING AND FIN TUNE VALVE LOCATIONS. PROVIDE POSITIONS OF VALVES PRIOR TO SHOP FABRICATION OF ALL CABINETS.  |
| I. | PROVIDE SHOP DRAWINGS SHOWING LOCATIONS AND DETAILS FOR SUELVES, LOUVERS, REMOVABLE PANELS, VALVE LOCATIONS, ETC ASSOCIATED WITH CASEWORK. COORDINATE WITH ALL REQUIRED CONTRACTORS.  |
| J. | PROVIDE CABINETS WITH FINISHED SIDES, INCLUDING BUT NOT LIMITED TO, LOCATIONS OF ADJACENT CABINETS OR EQUIPMENT WITH A DEPTH LESS THAN CABINET OR EQUIPMENT.  |
| K. | PROVIDE REMOVABLE BACK PANELS AT ALL SINK BASE CABINETS.  |
| L. | COUNTERTOP EDGES AT OPEN ENDS AND AT ENDS MEETING AT SUELVES UNITS WITH A DEPTH LESS THAN COUNTERTOP DEPTH TO BE AS SHOWN, REFER TO DETAIL.   |
| M. | PROVIDE CUTS AT ALL CONDITIONS THAT INTERFERE WITH COUNTERTOPS/CABINETS. SHOW TO FIT.   |
| N. | PROVIDE ALL CUTOUTS AS SHOWN ON CASEWORK PLANS AND ELEVATIONS OR AS REQUIRED. CUTOUTS ARE TO INCLUDE BUT NOT LIMITED TO, ALL ELEC BOXES, OUTLETS, AND ASSOCIATED WIRING TO FINAL HOOD.  |
| O. | PROVIDE BLOCKING AT NEW AND EXISTING GYPSUM BOARD WALLS PER MANUFACTURER RECOMMENDATIONS FOR SUPPORT OF WALL, TALL MOUNTED UNITS.   |
| P. | PROVIDE LOCKS AT ALL NEW CASEWORK DOORS/DRAWERS. A FILE UNITS.  |
| Q. | REFER TO BOTH 118" & 144" PLANS FOR LAYOUTS.  |
| R. | PROVIDE ALL STANDARD FEATURES OF CASEWORK UNITS AS INDICATED BY MODEL NUMBER OR AS SHOWN ON PLANS, DETAILS AND ELEVATIONS, INCLUDED BUT NOT LIMITED TO: SWITCHES, DIMMER, AND DIMMER.   |

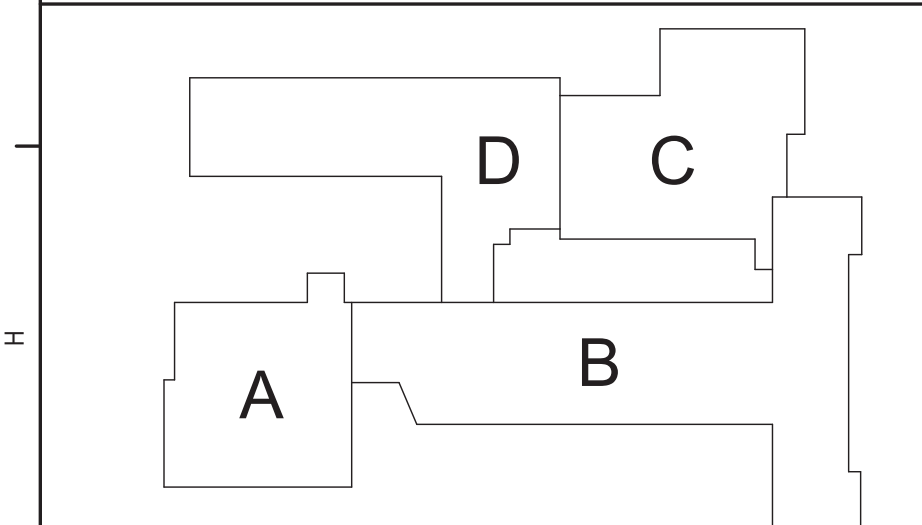

**Key Plan**  
N.T.S.

S.E.D. Control No. 13-02-00-01-0-006-022


Rev. No.:	Date:	Description:
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complex world | CLEAR SOLUTIONS

Tetra Tech Engineers, Architects  
& Landscape Architects, P.C.




Beacon City School District  
Beacon, New York

M	Additions and Alterations to: Glenham Elementary School
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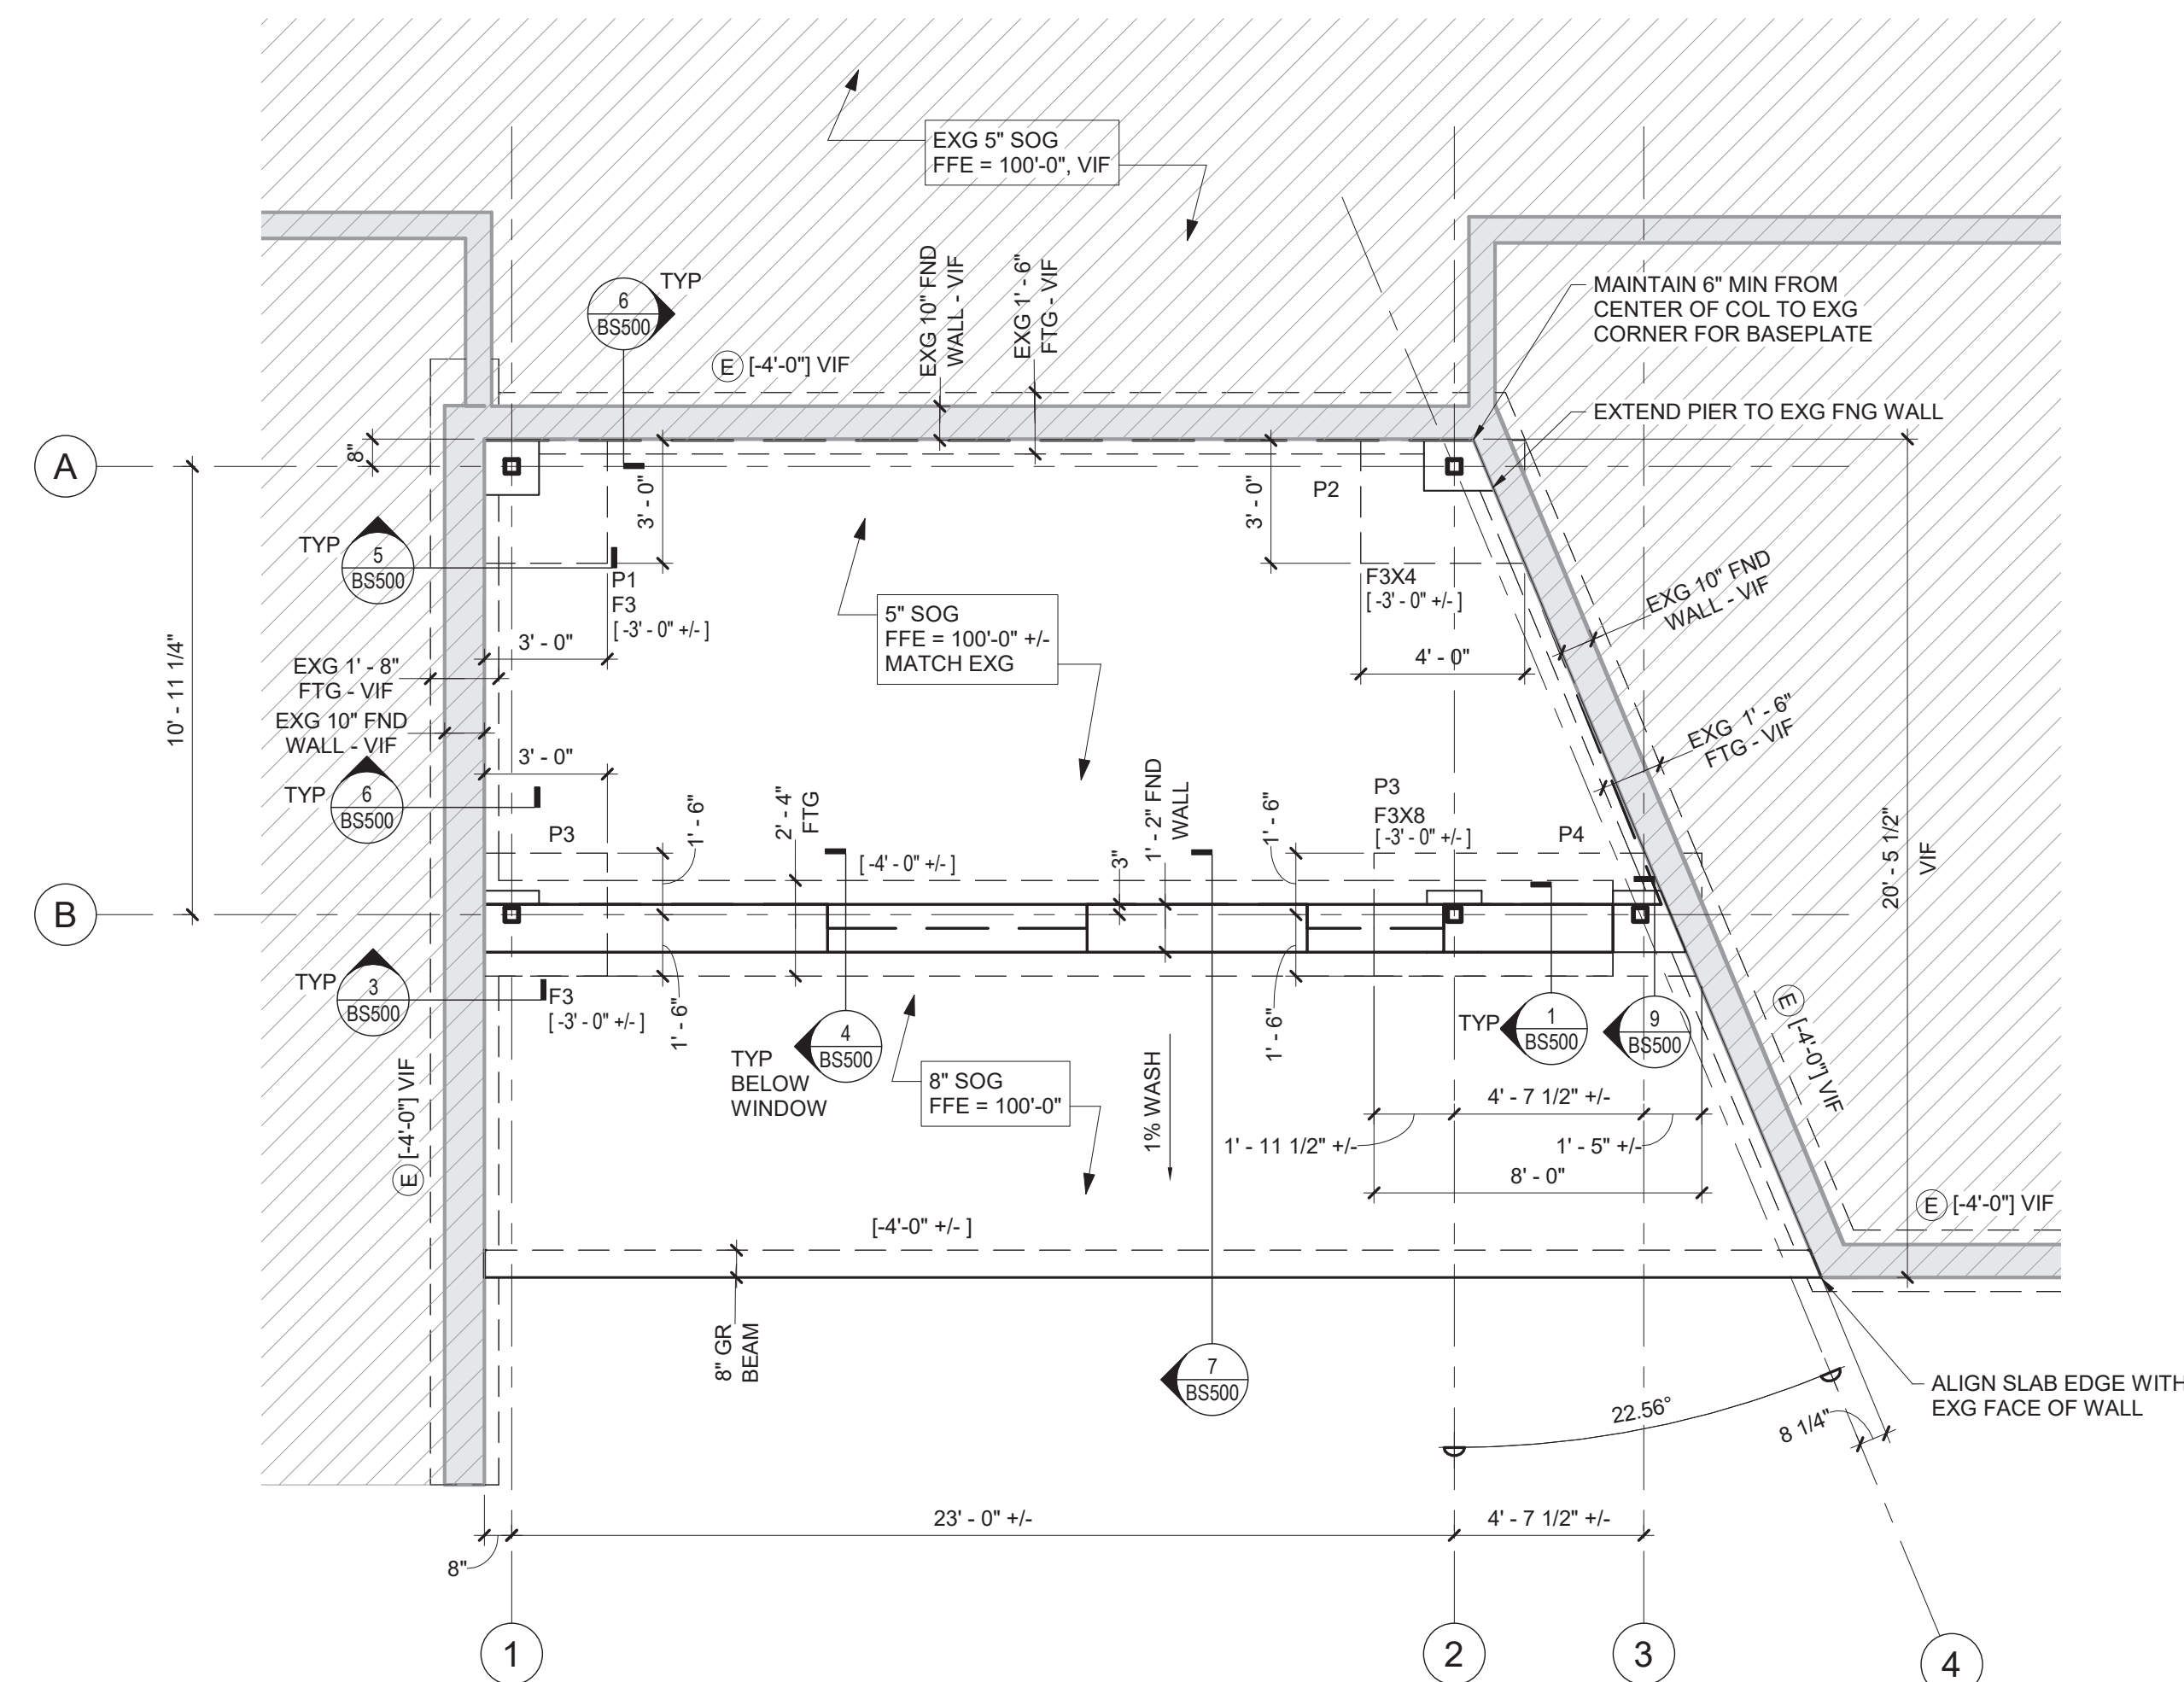
### Misc. Details

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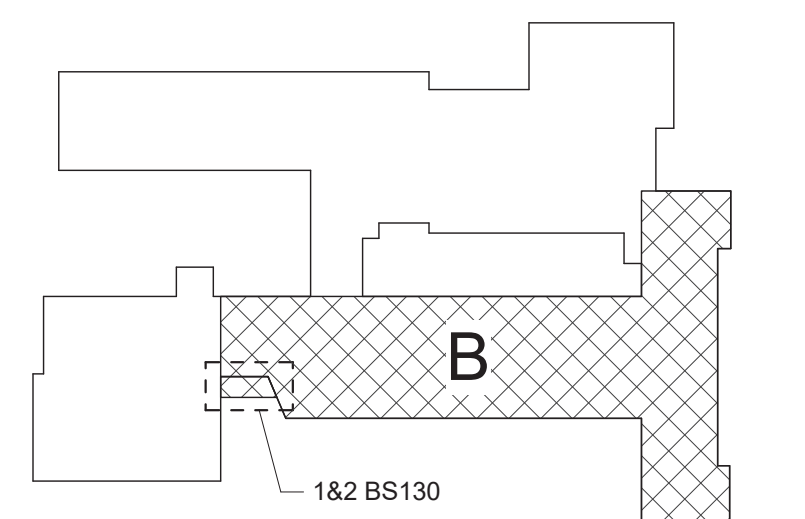
2 Partial Roof Framing Plan - Area B  
1/4" = 1'-0"  
DATUM FOR EXG TOS IS AT 111'-4 1/2"



1 Partial Foundation Plan - Area B  
1/4" = 1'-0"

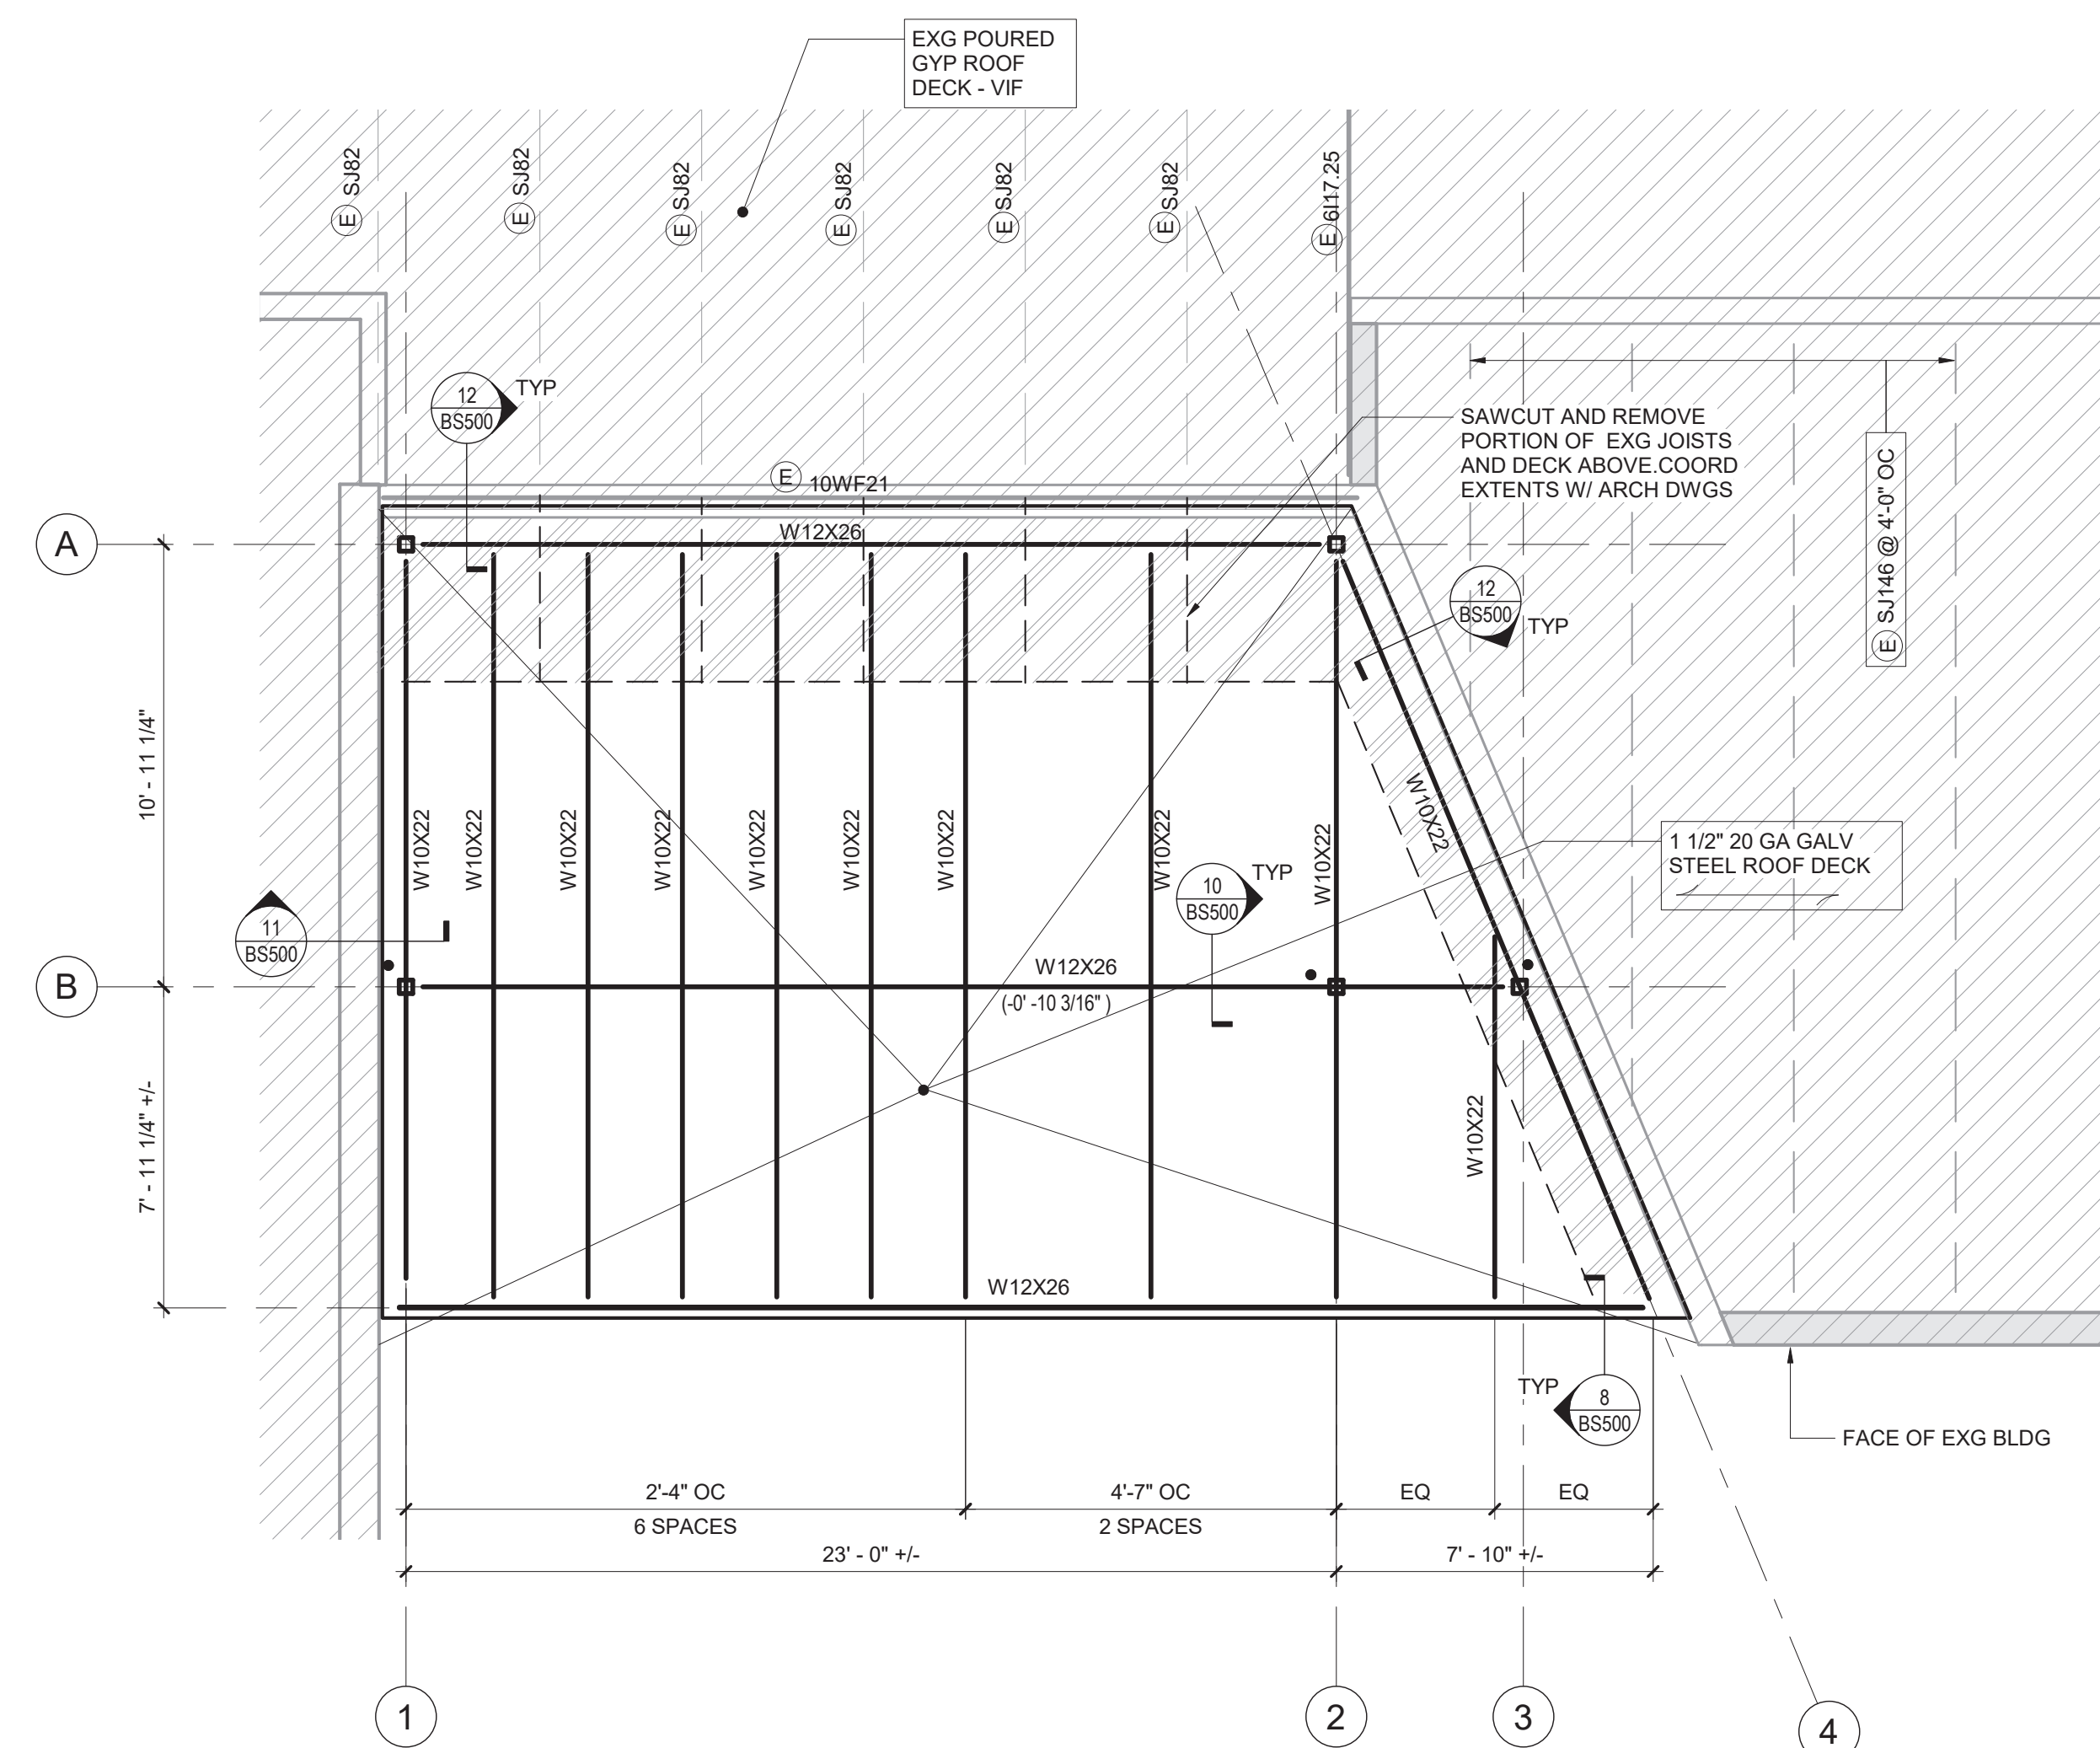General Notes:

- DIMENSIONS AND ELEVATIONS SHOWN ON PLAN AS PLUS/MINUS (+/-) AND V/F ARE TO BE CONSIDERED APPROXIMATE. EXACT VALIDATION SHALL (+/-) AND V/F DIMENSIONS ARE TO BE DETERMINED BY THE CONTRACTOR IN THE FIELD THROUGH A PRELIMINARY BUILDING LAYOUT CONTRACTOR TO VERIFY EXISTING DIMENSIONS, ELEVATIONS AND CONDITIONS AND NOTIFY A/E OF ANY DISCREPANCIES PRIOR TO COMMENCING WORK. COORDINATE INFORMATION WITH OTHER TRADES.
- B. ALL UNDERGROUND UTILITIES WITHIN THE NEW BUILDING FOOTPRINT ARE TO BE REMOVED PRIOR TO BEGINNING FOUNDATION WORK. IF ANY ARE NOT REMOVED (UNLESS NOTED OTHERWISE), REFER TO SITE DWGS FOR REMOVAL.
- C. COORDINATE SITE, LOCATION AND INVERT ELEVATION OF ALL PIPE SLEEVES PASSING THROUGH FOUNDATION WALLS AND BREAKS IN FOOTINGS WITH OTHER TRADES AND CONTRACT DOCUMENTS.
- D. BOTTOM OF NEW FOOTING ELEVATIONS ARE TO MATCH THE BOTTOM OF ADJACENT EXISTING FOOTING ELEVATIONS UNLESS NOTED OTHERWISE.
- E. TOP OF EXTERIOR FOOTING ELEVATION IS [3'-0"] FROM DATUM ELEVATION 100'-0", UNLESS INDICATED AS [xxx-xx"] ON PLAN.
- F. TOP OF INTERIOR FOOTING ELEVATION IS [4"] FROM DATUM ELEVATION 100'-0", UNLESS INDICATED AS [xxx-xx"] ON PLAN.
- G. ALL CONTINUOUS FOOTINGS ARE 2'-0" WIDE UNLESS OTHERWISE NOTED.
- H. REFER TO SHEET B5600 FOR GENERAL NOTES, PIER, FOOTING AND COLUMN SCHEDULES.
- I. TOP OF FOUNDATION WALL ELEVATION IS EQUAL TO DATUM ELEVATION 100'-0" UNO.
- J. TOP OF PIER ELEVATION IS [4"] FROM DATUM ELEVATION 100'-0", UNLESS INDICATED AS [xxx-xx"] ON PLAN.
- K. REFER TO SHEETS B5500 FOR TYPICAL FOUNDATION WALL AND SLAB DETAILS.
- L. FINISHED FLOOR DATUM ELEVATION OF 100'-0" AS SHOWN ON ARCHITECTURAL AND STRUCTURAL DRAWINGS, CORRESPONDS TO ELEVATION 232.64', AS SHOWN ON SITE AND SURVEY DRAWINGS.
- M. ALL SLABS ON GRADE ARE TO BE 5" THICK, 3500 PSI FIBER REINFORCED CONCRETE UNLESS NOTED OTHERWISE ON PLANS.
- N. REFER TO SHEET B5600 FOR GENERAL NOTES, LINTEL SCHEDULE AND SPECIFIC LINTEL DETAILS.
- O. REFER TO SHEET B5500 FOR TYPICAL DETAILS.
- P. REFER TO SHEET B5600 FOR BEAM CONNECTION SCHEDULE.
- Q. PROVIDE ALL ROOF AND FLOOR OPENING FRAMES PER DIV 05 SPEC. APPROPRIATE QUANTITIES, LOCATION, AND SIZE OF OPENINGS WITH OTHERS AND MECH, PLUMB, AND ARCH DWGS.
- R. CONTIGUOUS FASCIA ANGLES ARE REQUIRED AT ALL FLAT ROOF EDGES.
- S. ROOF DECK TO BE GALVANIZED 1 1/2" WIDE RIBBED 20 GAUGE CORRUGATED STEEL UNLESS NOTED OTHERWISE.
- T. ALL BEAM/JOIST ARE SPACED EQUALLY BETWEEN COLUMN LINE UNO.



 **Key Plan**  
N.T.S.

S.E.D. Control No. 13-02-00-01-0-006-022

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Rev. No.:	Date:	Description:
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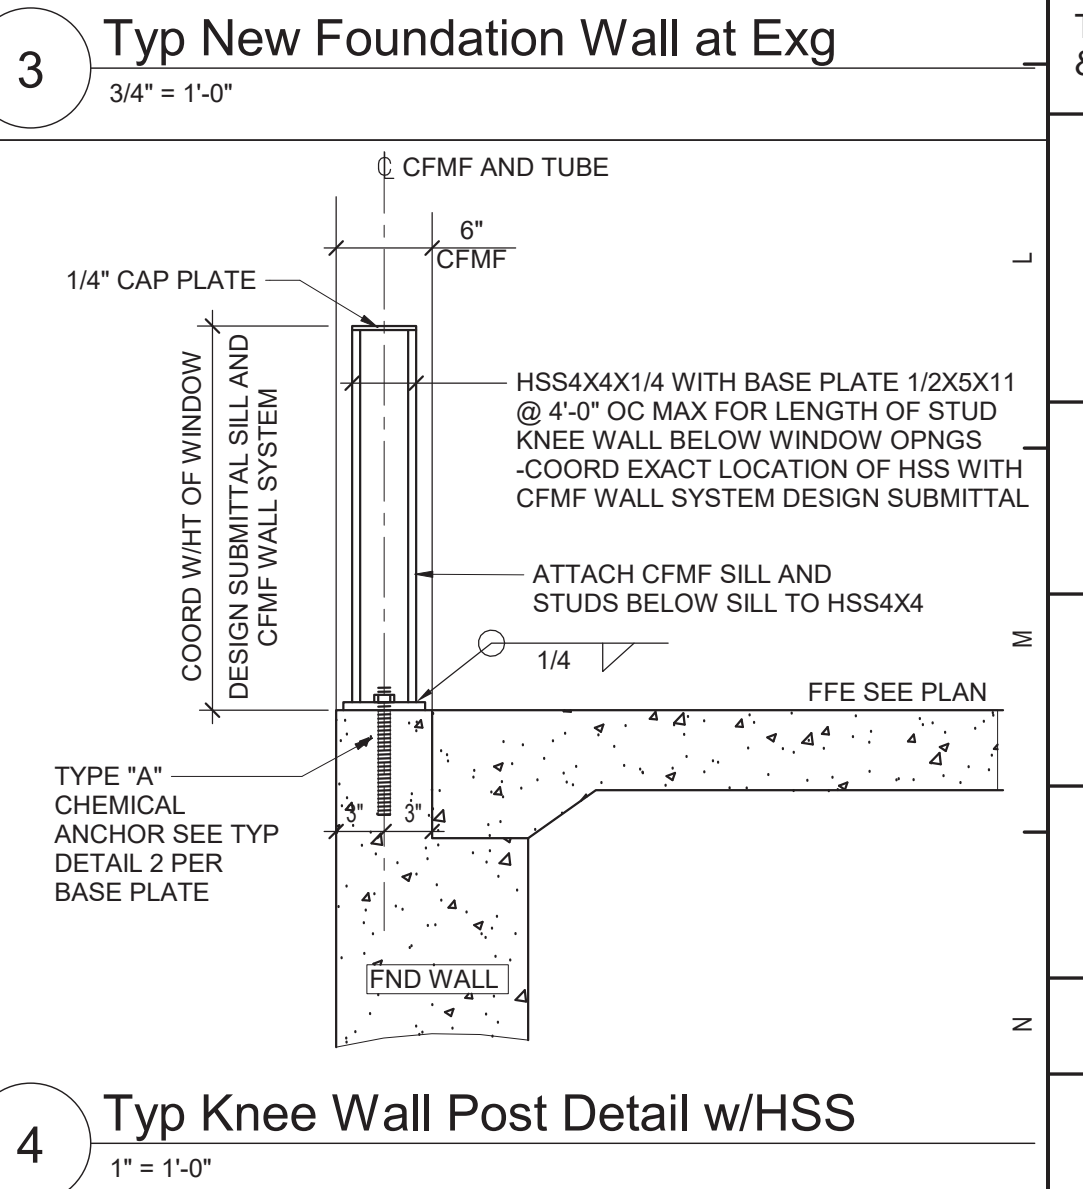
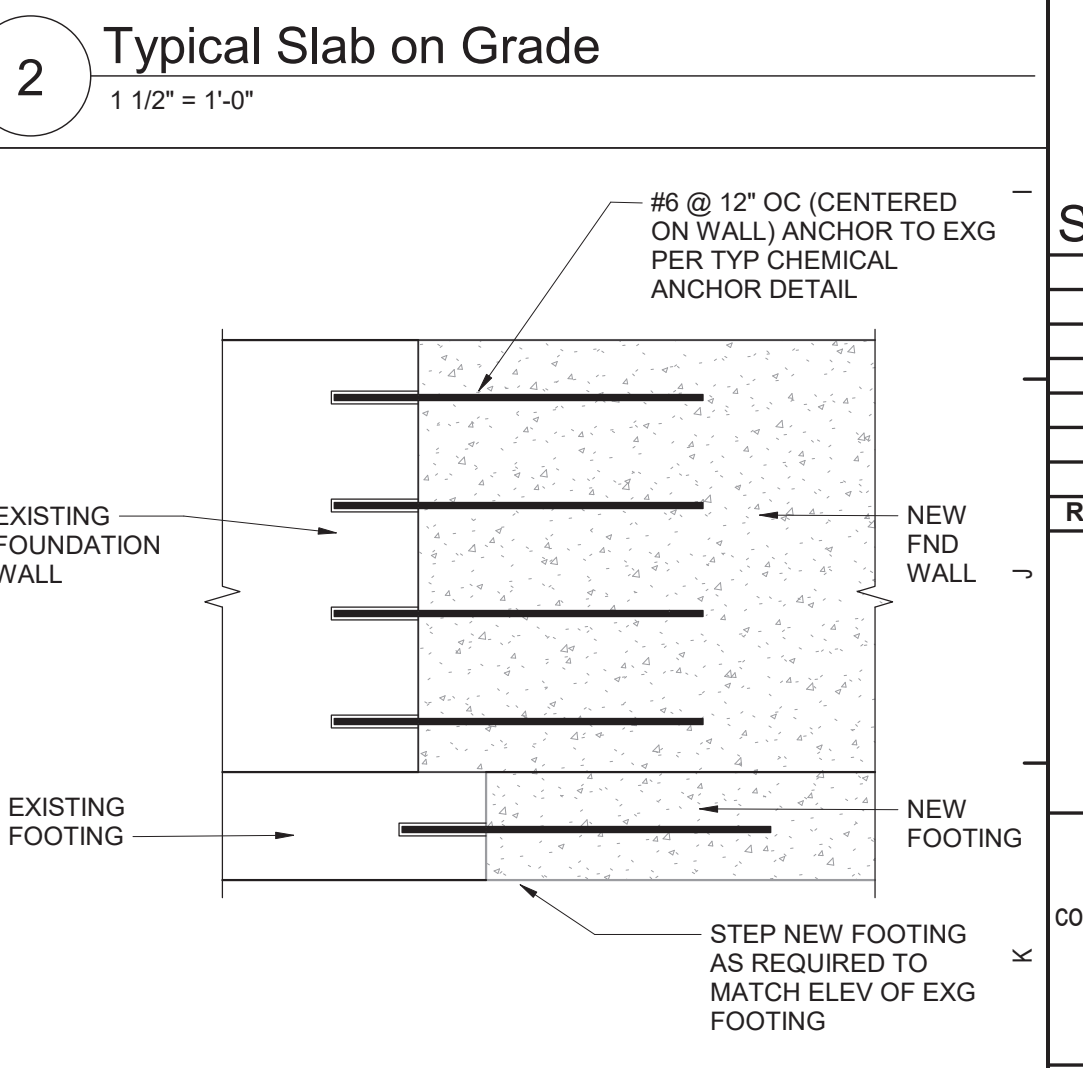
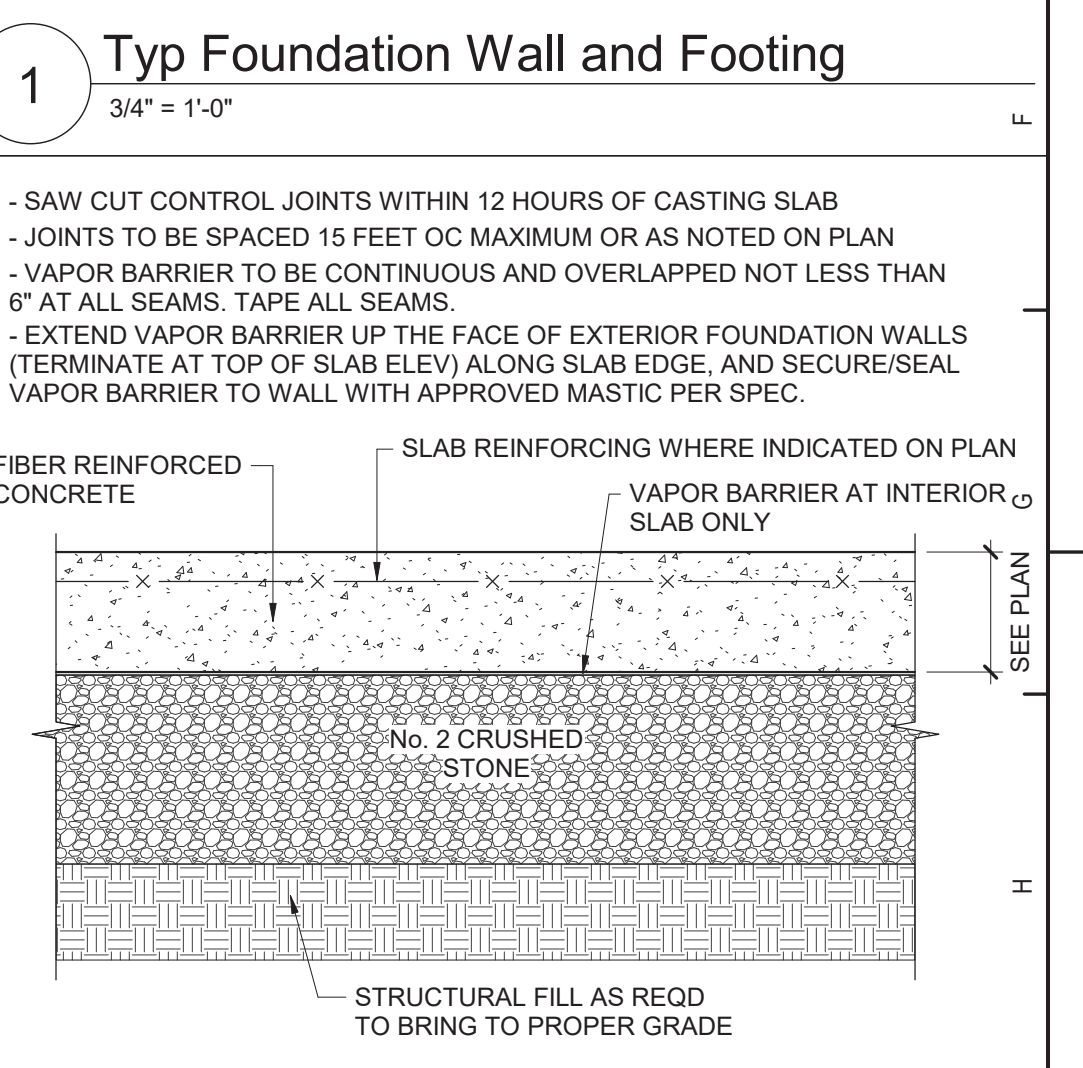
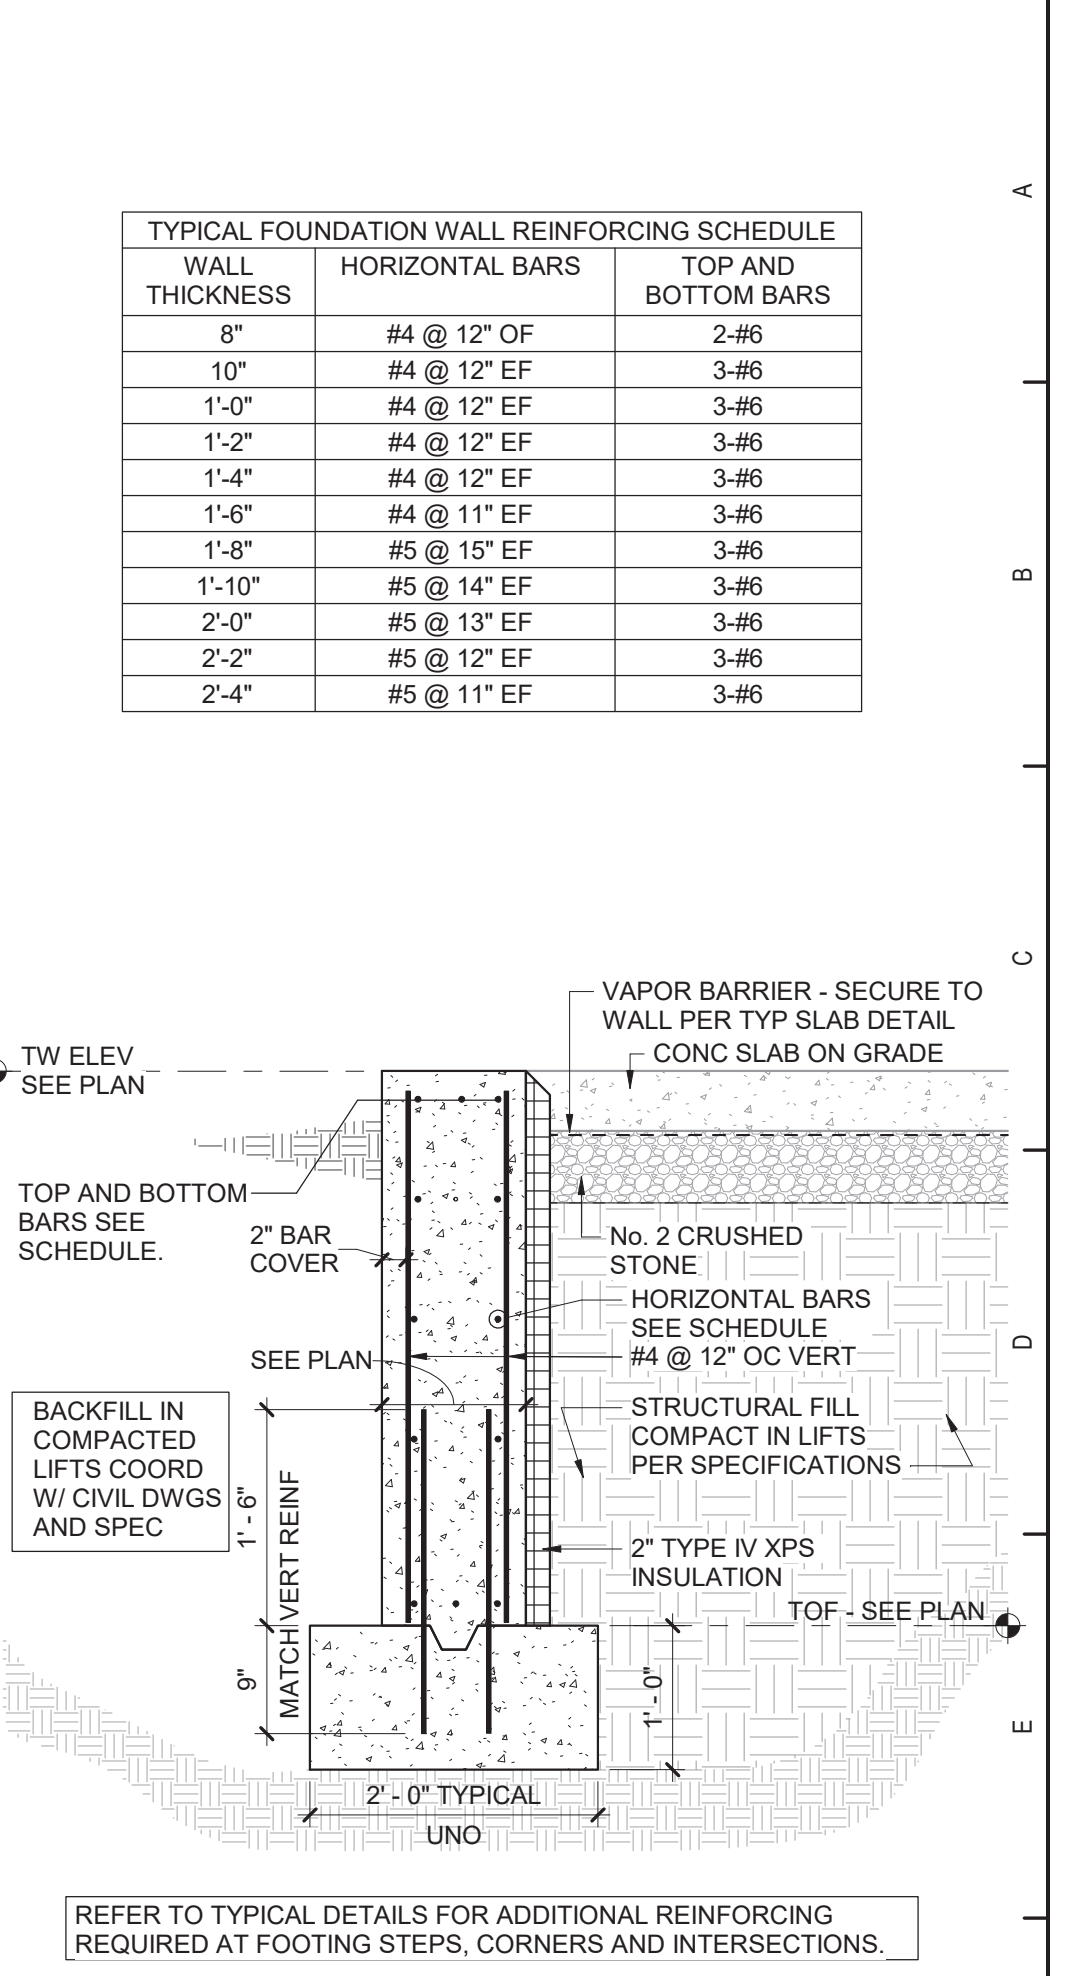
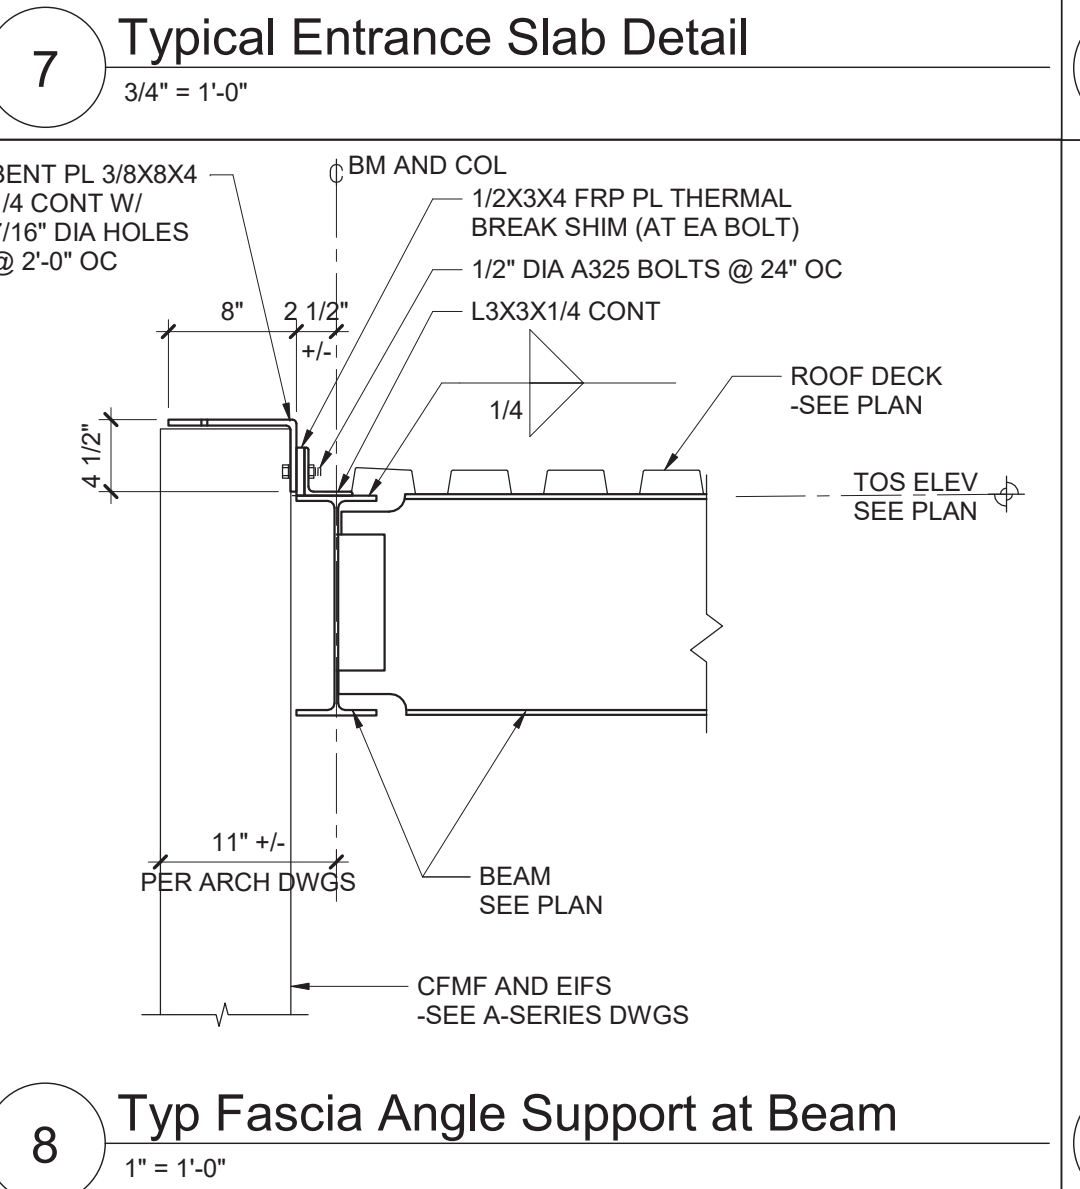
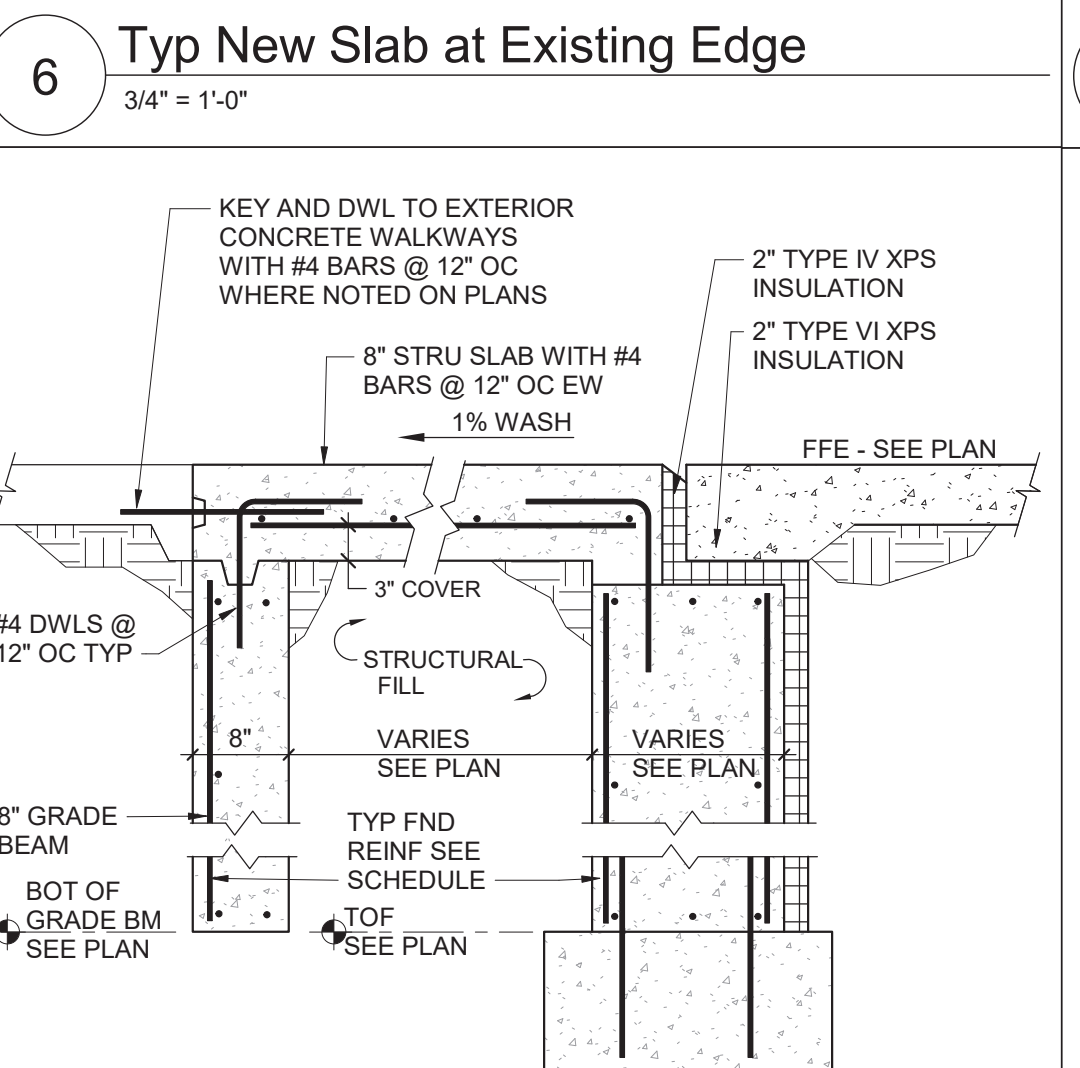
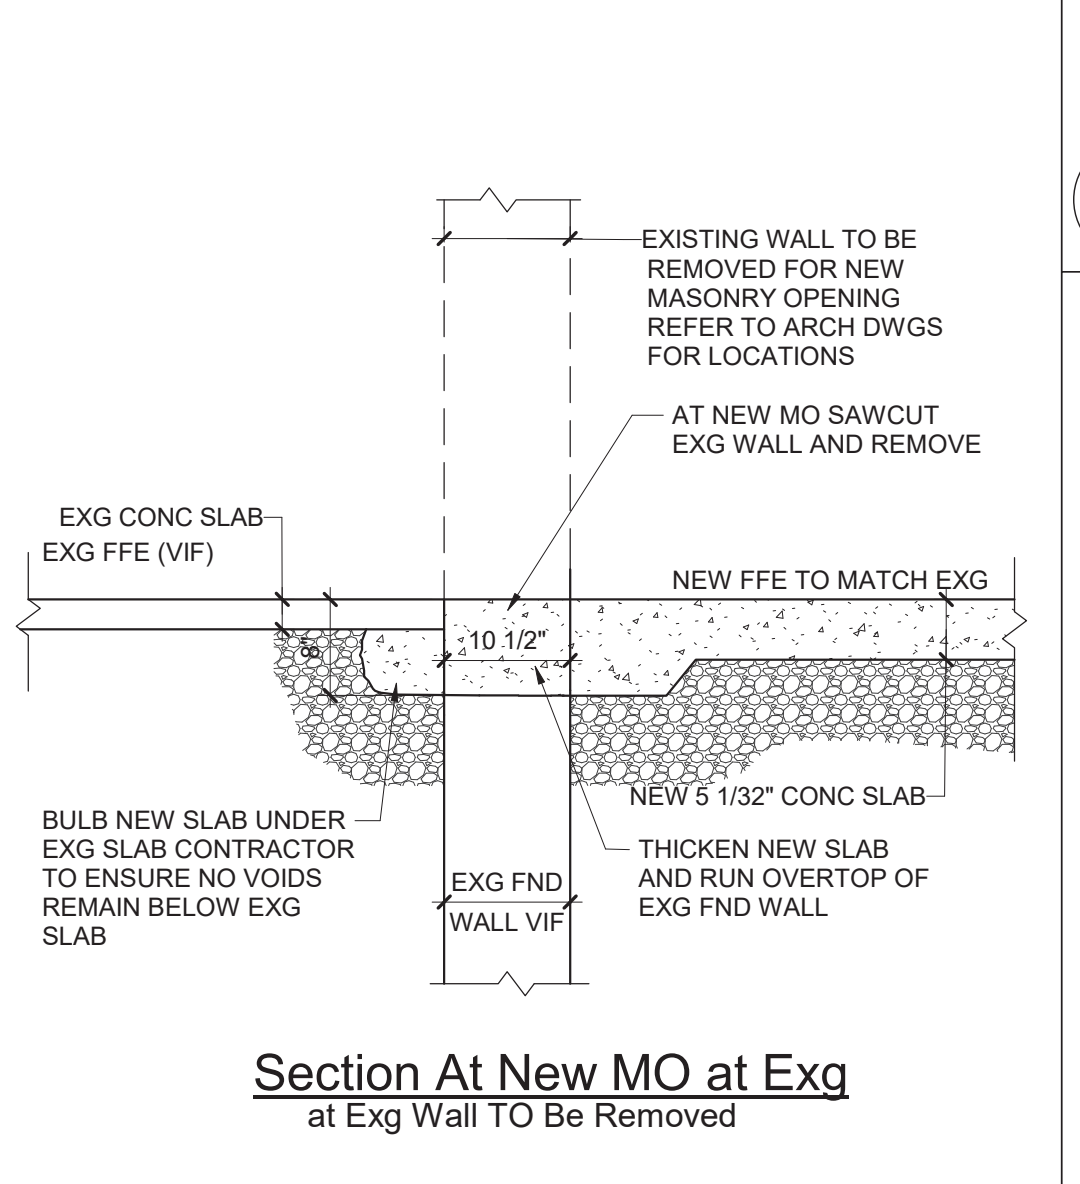
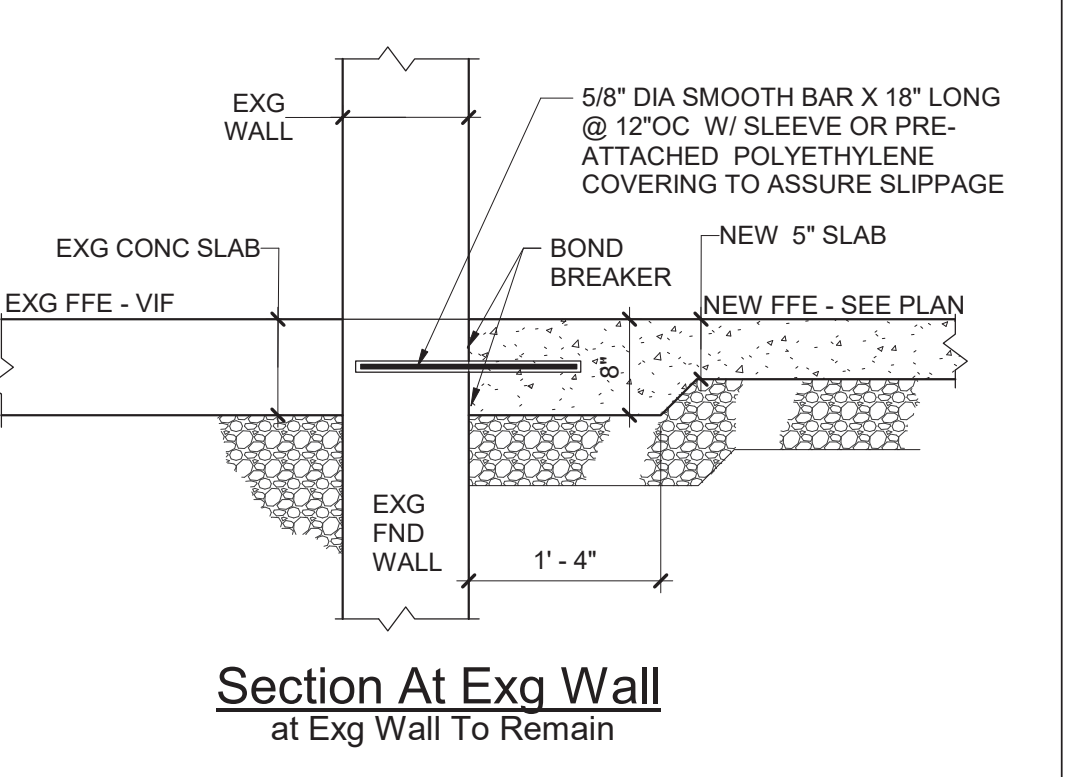
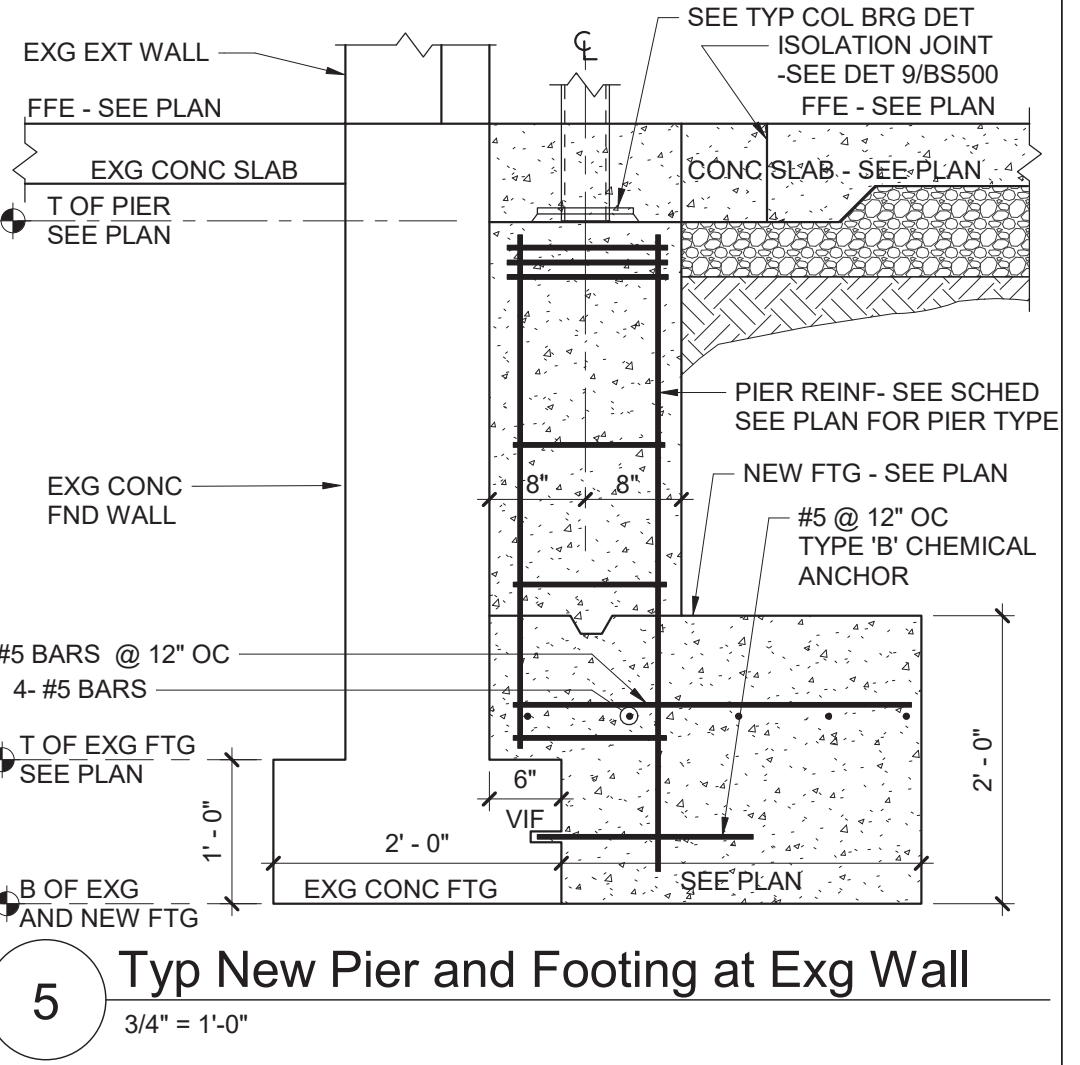
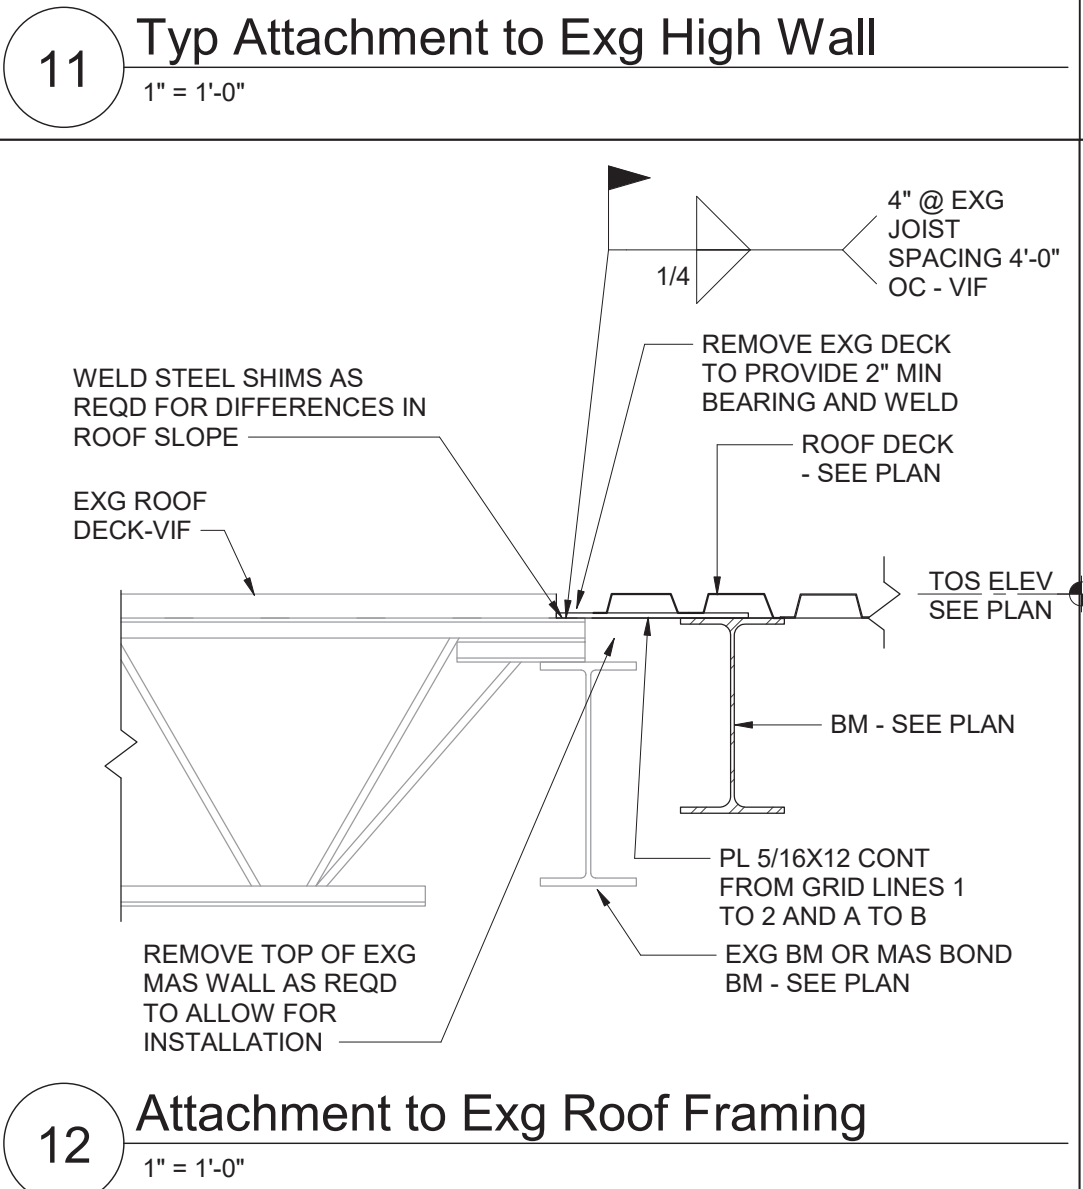
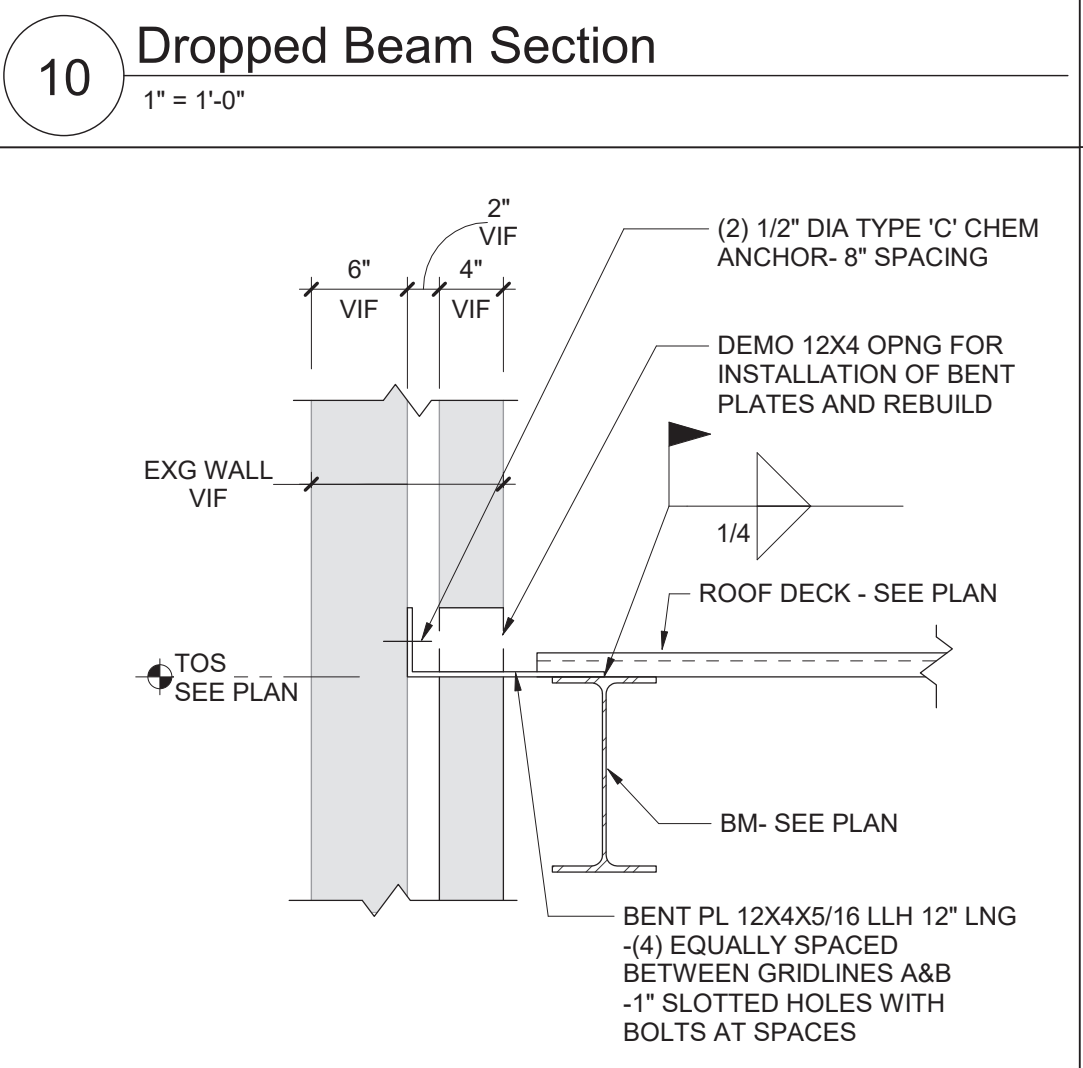
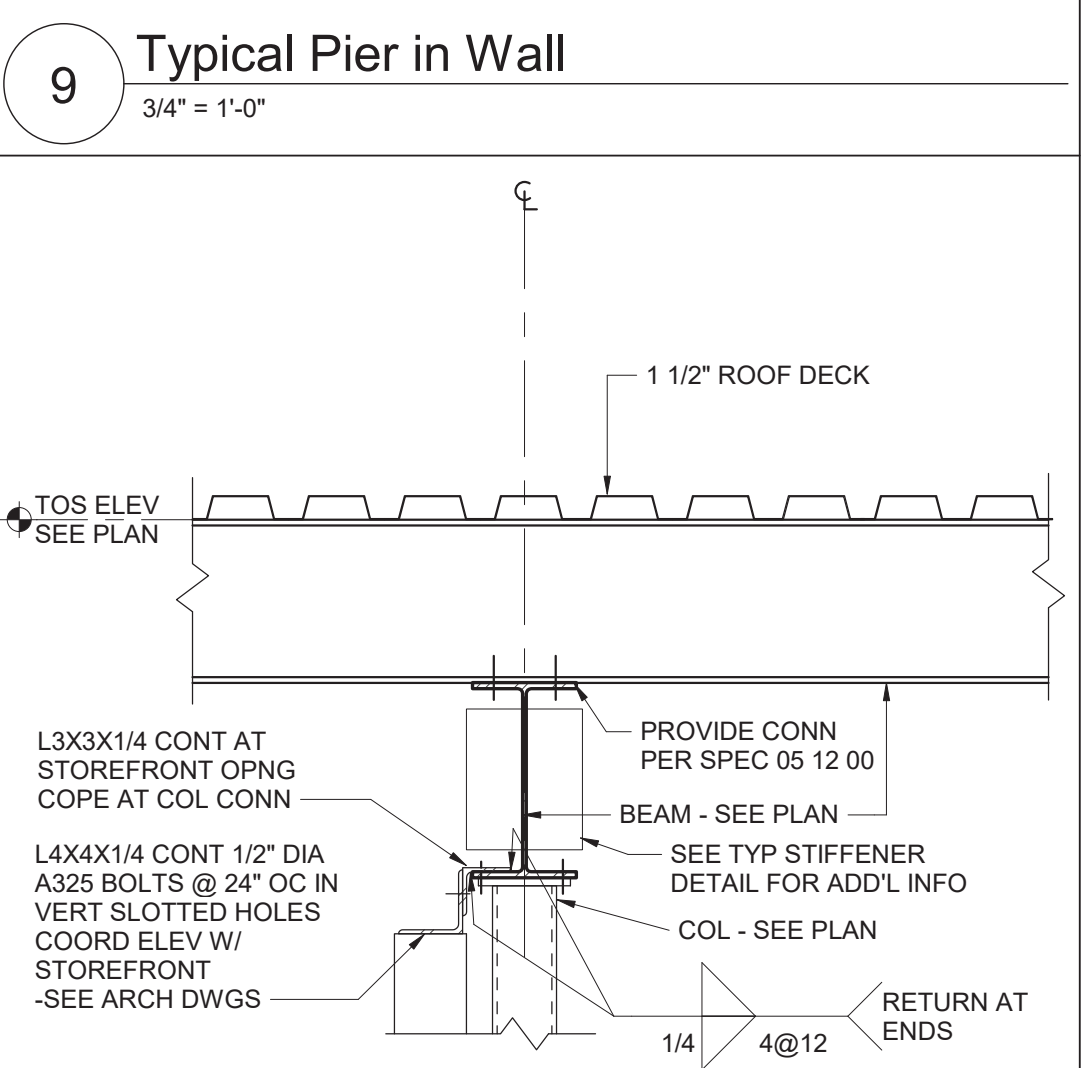
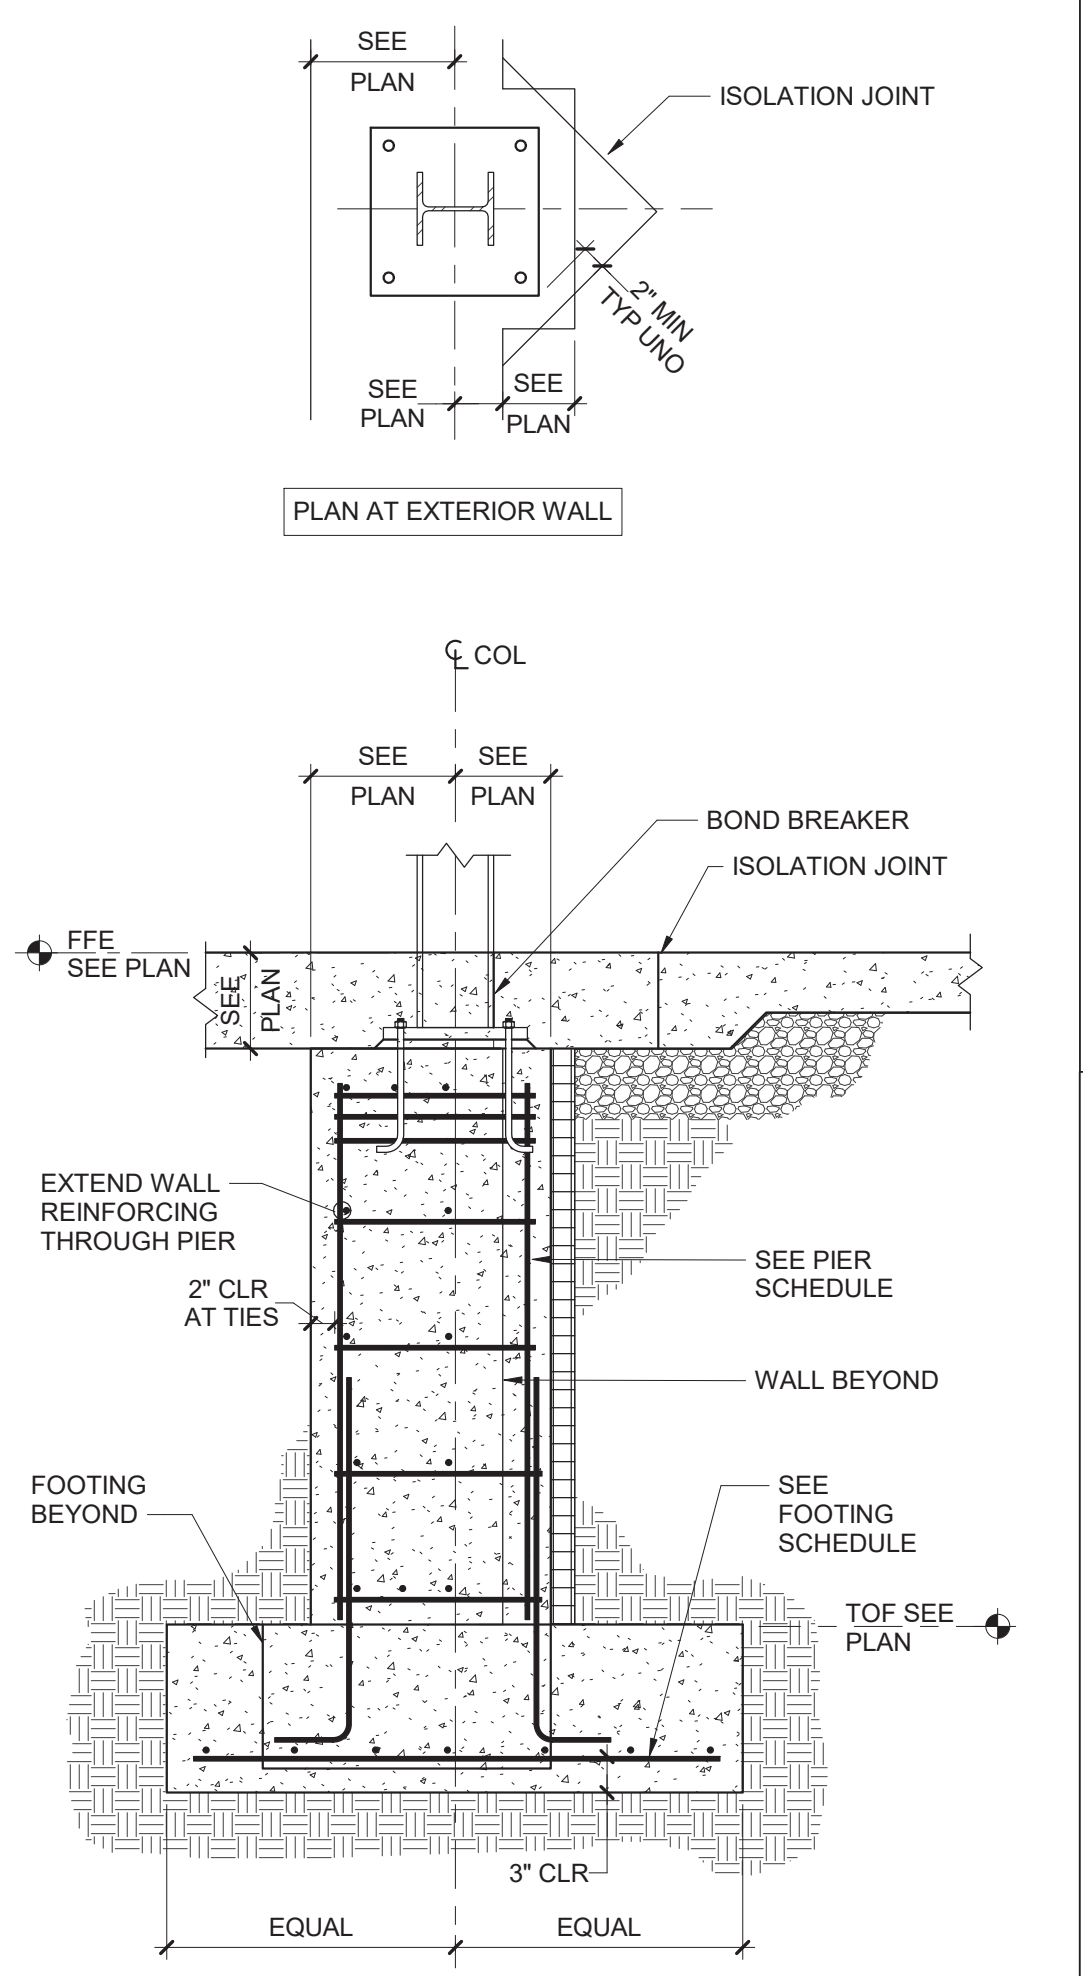
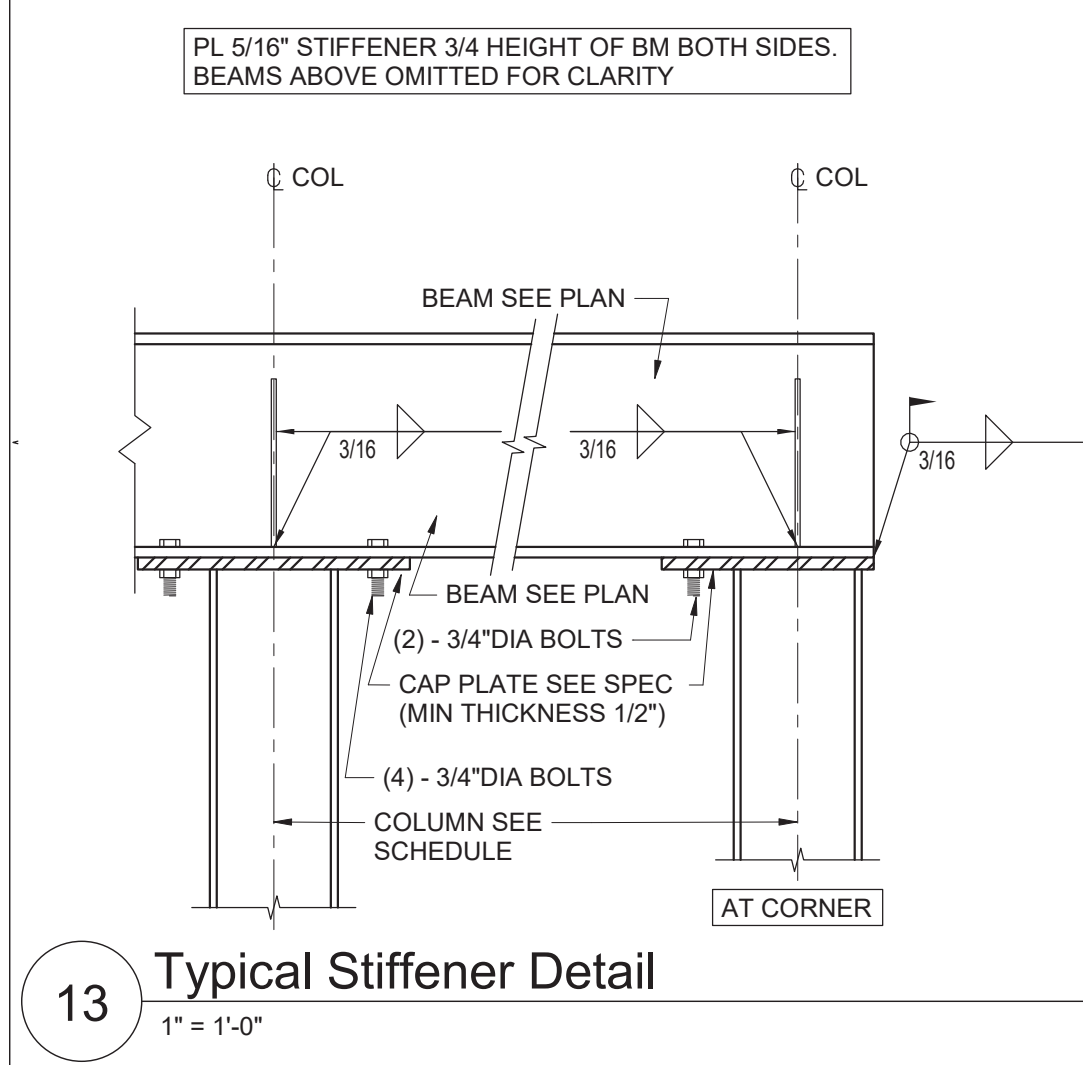
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Beacon City School District  
Beacon, New YorkAdditions and Alterations to:  
Glenham Elementary SchoolPartial Foundation and Framing Plan -  
Area B

Drawn By: DMB/kjr	Date: 10/28/2022	Drawing Number:
Project No.: 279180-22004		<b>BS130</b>





Key Plan  
N.T.S.

S.E.D. Control No. 13-02-00-01-0-006-022

Rev. No.	Date	Description

Beacon City School District  
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Beacon City School District  
Beacon, New York

Additions and Alterations to:  
Glenham Elementary School

Typical Details

Drawn By: DMB/kjr	Date: 10/28/2022	Drawing Number:
Project No.: 279180-22004		BS500



Technical drawing of a column base plate (Type A1) showing elevation and plan views.

**Elevation View (Top):**

- Shows the base plate (1" PL) attached to a column.
- Labels include: CUT BASE OF COLUMN SQUARE, NUT AND WASHER, 1" PL, 1" DIA THREADED AND NUTTED ANCHOR ROD, and TACK WELD.
- Dimensions: 2'-0" height, 12" width, and 2" thickness.

**Plan View (Bottom):**

- Shows the top view of the base plate.
- Labels include: 3/8" (pointing to a hole), 12" (width), 2" (thickness), 6" (width of central square), and 6" (width of outer square).
- Dimensions: 12" width, 2" thickness, 6" width of central square, and 6" width of outer square.

**TYPE A1**

1 1/2" = 1'-0"

UNLESS NOTED OTHERWISE, BEAM TO COLUMN AND BEAM TO GIRDER CONNECTIONS SHALL BE SIMPLE SHEAR CONNECTIONS UTILIZING FULLY PRETENSIONED HIGH-STRENGTH BOLTS IN BEARING-TYPE CONNECTIONS WITH THREADS INCLUDED IN THE SHEAR PLANE. DESIGN CHANNEL AND TUBE MEMBERS FOR THE SAME LOAD AS THE SAME DEPTH IN W SHAPE. THE CAPACITIES SHALL BE AS SHOWN BELOW, UNLESS OTHERWISE NOTED ON PLAN.

# **MINIMUM SHEAR CAPACITY SCHEDULE (FACTORED LOADS USING LRFD)**

W8	10KIPS	W24	80KIPS
W10	15KIPS	W27	100KIPS
W12	20KIPS	W30	120KIPS
W14	30KIPS	W33	140KIPS
W16	40KIPS	W36	180KIPS
W18	50KIPS	W40	220KIPS
W21	60KIPS	W44	260KIPS

## **5 Beam Connection Schedule**

12" = 1'-0"

### 1. **FOR 4" THICK WALLS**

MASONRY OPENING	LINTEL ANGLE
UP TO 6'-4"	MT 6X5.9

### 2. **FOR 6" THICK WALLS**

MASONRY OPENING	LINTEL ANGLE
(c)	
5'-0"	2- L2 1/2X2 1/2X5/16
6'-0"	2- L3/2 1/2X2 1/2X5/16 LLV
7'-0"	2- L3 1/2X2 1/2X5/16 LLV
8'-0"	2- L3 1/2X2 1/2X5/16 LLV

### 3. **FOR 8" 12" AND 16" THICK WALLS: FOR EACH 4" THICKNESS OF WALL**

MASONRY OPENING	LINTEL ANGLE
(c)	
5'-0"	L3 1/2X3 1/2X5/16
6'-0"	L4X3 1/2X5 9/16 LLV
7'-0"	L5X3 1/2X5/16 LLV
8'-0"	L5X3 1/2X5/16 LLV
9'-0"	L6X3 1/2X5/16 LLV
10'-0"	L6X3 1/2X5/16 LLV

### **LINTEL NOTES**

- ALL OPENINGS 1'-0" AND OVER REQUIRE LINTELS.
- STEEL TO BE A36.
- THIS SCHEDULE IS TYPICAL FOR ALL MASONRY OPENINGS IN NON-LOAD BEARING WALLS UNLESS OTHERWISE NOTED.
- ALL LINTELS TO HAVE MINIMUM 8" BEARING BOTH ENDS.
- BACK TO BACK ANGLES ARE TO BE STITCH WELDED TOGETHER BEFORE PLACEMENT.
- ALL LINTELS ARE TO HAVE BOTH ENDS BEAR ON SOLID MASONRY OR SOLIDLY GROUTED HOLLOW MASONRY.
- WHEN MINIMUM 8" BEARING LENGTH CAN NOT BE PROVIDED DUE TO COLUMN INTERFERENCE, PROVIDE CONNECTION OF LINTEL TO COLUMN.
- THIS LINTEL SCHEDULE IS APPLICABLE FOR USE IN EXISTING BUILDING, SHORE EXISTING STRUCTURE AND WALL AS READ FOR INSTALLATION OF NEW MAS AND LINTEL. SEE ARCHITECTURAL AND MECHANICAL DRAWINGS FOR SIZE AND LOCATION OF OPENINGS.

## **6 LinTEL Schedule**

12" = 1'-0"

FLOOR LIVE LOADS PER BCNYS 1607		
OCCUPANCY OR USE LOBBIES OFFICES TOILET ROOMS PARTITIONS	UNIFORM	CONCENTRATED
	100 PSF	
	50 PSF	2000 LBS
	60 PSF	
	15 PSF PER 1607.5	
REDUCTION IN LIVE LOADS HAS BEEN APPLIED WHERE PERMITTED PER 1607.11		
B. ROOF LIVE LOADS PER BCNYS 1607.13		
MINIMUM ROOF LIVE LOAD	20 PSF	
C. RAIN LOADS PER BCNYS 1611		
RAIN INTENSITY, I	2.75 IN/H	
RAIN LOAD, R	16 PSF	
RAIN SURCHARGE LOAD HAS BEEN APPLIED TO AREAS WHERE PONDING OCCURS IN ACCORDANCE WITH BCNYS 1611.1.		
D. SNOW LOADS PER BCNYS 1608		
GROUND SNOW, $P_g$ (FIGURE 1608.2)	30 PSF	
FLAT ROOF SNOW LOAD, $P_s$ (ACEF 7)	23.1 PSF	
SNOW EXPOSURE FACTOR, $C_e$	1.0	
THERMAL FACTOR, $C_t$	1.0	
SLOPE FACTOR, $C_s$	1.0	
SNOW LOAD IMPORTANCE FACTOR, $I_s$	1.1	
DRAFT SURCHARGE, $P_d$	76 PSF	
DRAFT WIDTH, $w$	16.83 FT	
ADDITIONAL SNOW LOADS HAVE BEEN APPLIED TO AREAS WHERE DRIFTING OCCURS IN ACCORDANCE WITH BCNYS 1608.11		
E. WIND LOAD DESIGN CRITERIA PER BCNYS 1608		
BASIC DESIGN WIND SPEED (3 SECOND GUST), $V$	121 MPH	
ALLOWABLE STRESS DESIGN WIND SPEED, $V_{\text{des}}$	93.7MPH	
RISK CATEGORY	III	
EXPOSURE CATEGORY	B	
INTERNAL PRESSURE COEFFICIENT, $GCP$	+/- 0.18	
F. SEISMIC DESIGN CRITERIA PER BCNYS 1613		
RISK CATEGORY	III	
SEISMIC IMPORTANCE FACTOR, $I_s$	1.25	
MAPPED SPECTRAL RESPONSE ACCELERATION		
AT SHORT PERIODS, $S_s$	23.3 %g	
AT 1 SECOND PERIODS, $S_1$	5.7 %g	
SEISMIC DESIGN SPECTRAL RESPONSE ACCELERATION		
AT SHORT PERIODS, $S_{s1}$	24.8 %g	
AT 1 SECOND PERIODS, $S_{s1}$	9.1 %g	
SEISMIC DESIGN CATEGORY	B	

**A. MATERIAL**

1. DESIGN BEARING PRESSURE IS ASSUMED TO BE 3,000 PSF. IF OWNERS GEOTECHNICAL ENGINEER DETERMINES THAT INSUFFICIENT BEARING IS ENCOUNTERED AT ELEVATION SHOWN ON PLANS, NOTIFY ARCHITECT BEFORE PROCEEDING.

2. DO NOT PLACE FILL UNTIL SUBMITTAL FOR FILL MATERIAL IS APPROVED BY ARCHITECT.

3. INTERIOR BACKFILL IS TO CONSIST OF STRUCTURAL FILL TO BE WITHIN 6" OF BOTTOM SLAB. THE NEXT 6" LAYER ABOVE THIS WILL BE NO. 2 CRUSHED STONE UNLESS NOTED OTHERWISE. PROVIDE A VAPOR BARRIER BETWEEN THE NO. 2 CRUSHED STONE AND THE SLAB FOR ALL INTERIOR SLABS UNLESS NOTED OTHERWISE. BACKFILL WILL BE PLACED IN MAXIMUM 6" LOOSE LAYERS MAXIMUM 4" LOOSE LAYERS FOR HAND OPERATED COMPACTION EQUIPMENT) AND COMPACTED TO A DRY DENSITY EQUAL TO 95 PERCENT OF THE MATERIAL DRY DENSITY AS DEFINED BY THE MODIFIED PROCTOR COMPACTION TEST (ASTM D1557). STRUCTURAL FILL AND STONE ARE TO BE IMPORTED FROM OFF SITE. REFER TO PROJECT MANUAL FOR OTHER FILL MATERIAL TYPES.

**B. INSTALLATION**

1. AFTER TOPSOIL IS STRIPPED, ALL AREAS WITHIN THE BUILDING FOOTPRINT ARE TO BE PROOF ROLLED WITH A SELF-PROPELLED, SMOOTH DRUM, VIBRATORY COMPACTOR WITH A MINIMUM STATIC WEIGHT OF TEN TONS. PROOF ROLLING WILL BE PERFORMED BY COMPLETING A MINIMUM OF SIX PASSES WITH THE ROLLER OPERATING IN ITS VIBRATORY MODE OVER ALL SUBGRADE AREA. SOFT OR LOOSE SOILS IDENTIFIED DURING THIS ROLLING SHOULD BE EXCAVATED AND REPLACED WITH STRUCTURAL FILL AS DIRECTED BY THE ARCHITECT. SUCH QUALITY CONTROL EXCAVATION AND BACKFILL WILL BE MEASURED AS DIRECTED BY THE ARCHITECT AND PAID FOR BY THE OWNER AS A CHANGE IN THE WORK. PROOF ROLLING OPERATIONS ARE TO BE PERFORMED UNDER THE SUPERVISION OF THE OWNERS GEOTECHNICAL ENGINEER.

2. AFTER TRENCHING EXCAVATION, BACKFILL WITH ACCEPTABLE FILL (SEE SPEC) TO WITHIN 1/4" OF FINISH GRADE / FLOOR. ALL TRENCHING WORK WITHIN THE BUILDING FOOTPRINT IS TO BE COORDINATED, THE CONTRACTOR RESPONSIBLE FOR THE SLAB ON GRADE, MUST ACCEPT IN WRITING THE QUALITY OF THE TRENCH BACKFILL AS PERFORMED BY OTHERS BEFORE BEGINNING HIS WORK OVER TOP OF THE TRENCH.

3. FOOTINGS ARE TO BEAR AT THE ELEVATIONS SHOWN ON THE PLANS. BEARING TO BE ON VIRGIN SOIL OR COMPACTED STRUCTURAL FILL.

4. THE ON SITE SOILS ARE SUSCEPTIBLE TO LOSS OF STRENGTH DUE TO WATER AND EXCESSIVE TRAFFIC BY WORKERS AND EQUIPMENT. EXCAVATION AND BACKFILL OPERATIONS ARE TO BE MAINTAINED IN A DRY CONDITION. SURFACE AND INFILTRATING WATER ARE TO BE REMOVED BY SITE GRADING AND PUMPING FROM SUMPS AS REQUIRED. THE REMOVAL AND REPLACEMENT OF SOILS REMAINED UNSTABLE DUE TO EXCESSIVE TRAFFIC OR LACK OF Dewatering PROCEDURES ARE TO BE PAID FOR BY THE CONTRACTOR.

## 2 Typ Spread Footing Reinforcement

12" = 1'-0"

**A** THREADED ROD IN SOLID CONCRETE OR SOLIDLY GROUTED CONCRETE BLOCK 3/4" DIA ROD UNO

**B** REINFORCING BAR IN SOLID CONCRETE #6 BAR UNO

**C** REINFORCING BAR OR THREADED ROD IN HOLLOW MASONRY #6 BAR OR 3/4" DIA ROD - UNO. WITH 3/4" NOMINAL STAINLESS STEEL SCREEN TUBE


BAR/ROD SIZE	EMBEDMENT DEPTH
#4 OR 1/2"	5"
#5 OR 5/8"	6"
#6 OR 3/4"	7"
#7 OR 7/8"	8"
#8 OR 1"	9"

**GENERAL NOTES**

1. FOR ACCEPTABLE ADHESIVE PRODUCTS REFER TO SPECIFICATIONS, AND COMPLY WITH MANUFACTURERS REQUIREMENTS FOR INSTALLATION.

## 3 Typical Chemical Anchors

3" = 1'-0"

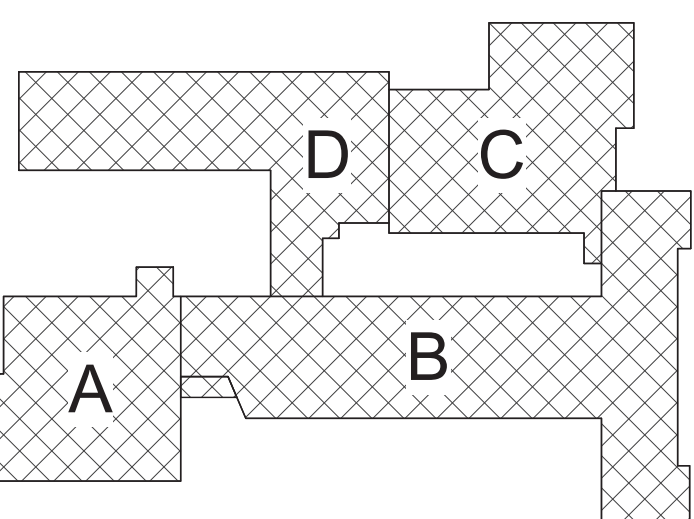

 **Key Plan**  
N.T.S.

S.E.D. Control No. 13-02-00-01-0-006-022


Rev. No.:	Date:	Description:
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Beacon City School District  
Beacon, New York

## Additions and Alterations to: Glenham Elementary School

## Notes and Schedules

Drawn By: DJB/kjr	Date: 10/28/2022	Drawing Number:  <b>BS600</b>
Project No.: <b>279180-22004</b>		

**BID SET**





A. THE FOLLOWING GENERAL NOTES APPLY TO ALL "BM" SERIES DRAWINGS.

B. REFER TO ALL CONTRACT DOCUMENTS, DRAWINGS AND SPECIFICATIONS, FOR DETAILED STANDARDS AND REQUIREMENTS.

C. REPORT UNSAFE OR UNSATISFACTORY CONDITIONS IN WRITING TO THE ARCHITECT IMMEDIATELY UPON DISCOVERY. DO NOT PROCEED WITH WORK UNLESS LABOR AND MATERIALS REQUIRED TO PROVIDE COMPLETE WORKING SYSTEMS.

D. FULFILL ALL REQUIREMENTS AT JOB MEETINGS AND ON WORK SCHEDULES.

E. DO NOT SCALE DRAWINGS. PIPING AND DUCTWORK ARE SHOWN GRAPHICALLY. PROVIDE THE FOLLOWING TO SHOW EVERY TRANSITION, FITTING, ASPECT RATIO CHANGE, ETC.: PROVIDE AS REQUIRED TO FIT WITH STRUCTURAL CONSTRAINTS. EXAMINE ALL SYSTEMS UNDER CONSTRUCTION. VERIFY ALL SYSTEMS. VERIFY ALL ACCESS, LOCATIONS, DIMENSIONS, ARRANGEMENTS, ELECTRICAL CHARACTERISTICS AND INTERFERENCE IN THE FIELD.

F. VERIFY EXTENT OF CEILING WORK SHOWN ELSEWHERE IN THE CONTRACT DOCUMENTS. PROVIDE FOR ADDITIONAL CEILING REMOVAL, PATCH, REPAIR AND REINSTALLATION AS REQUIRED FOR CONTRACT WORK.

G. DEMOLITION DRAWINGS SHOW THE GENERAL SCOPE OF ITEMS TO BE REMOVED. REMOVE AND REINSTALLATION AS REQUIRED. ALL ITEMS TO BE REMOVED, FIELD VERIFY AND REMOVE ALL ASSOCIATED ITEMS BACK TO POINT OF CONTINUED SERVICE OR TO THE THERMOCLAD SYSTEM. REMOVE AND REINSTALLATION AS REQUIRED TO FIT WITH STRUCTURAL CONSTRAINTS. EXAMINE ALL SYSTEMS UNDER CONSTRUCTION. VERIFY ALL SYSTEMS. VERIFY ALL ACCESS, LOCATIONS, DIMENSIONS, ARRANGEMENTS, ELECTRICAL CHARACTERISTICS AND INTERFERENCE IN THE FIELD.

H. REMOVE EXISTING ELEMENT TO THE OWNER, DELIVER ON SITE WHERE DESIGNATED BY THE OWNER, PROMPTLY REMOVE FROM THE SITE AND LEGALLY DISPOSE OF ANY SUCH ITEMS DECLINED BY THE OWNER.

I. IF UNANTICIPATED MECHANICAL, ELECTRICAL, OR STRUCTURAL CONDITIONS ARE ENCOUNTERED, INVESTIGATE AND REPORT BOTH TO THE ARCHITECT AND EXTENT OF THE CONFLICT. RE-ROUTE WORK AS REQUIRED.

J. CUT, DRILL, OR OTHERWISE CREATE OPENINGS AS NECESSARY TO ACCOMMODATE THE WORK. PROVIDE THE FOLLOWING TO SHOW EVERY TRANSITION, FITTING, ASPECT RATIO CHANGE, ETC.: PROVIDE AS REQUIRED TO FIT WITH STRUCTURAL CONSTRAINTS. EXAMINE ALL SYSTEMS UNDER CONSTRUCTION. VERIFY ALL SYSTEMS. VERIFY ALL ACCESS, LOCATIONS, DIMENSIONS, ARRANGEMENTS, ELECTRICAL CHARACTERISTICS AND INTERFERENCE IN THE FIELD.

K. NOTIFY ARCHITECT OF ANY CONFLICTS. DO NOT CUT ANY MECHANICAL, ELECTRICAL, OR STRUCTURAL ELEMENTS UNLESS SPECIFICALLY DIRECTED TO DO SO. PENDING RECEIPT OF DIRECTIVE, REARRANGE SCHEDULE AS NECESSARY TO CONTINUE OVERLAP OF WORK.

L. PATCH ALL DISTURBANCES RESULTING FROM DEMOLITION OR REMOVAL TO MATCH EXISTING SURFACES. PATCH TO MATCH FOLLOWING DEMOLITION, AND AGAIN FOLLOWING WORK, WHERE HOLES REMAIN FROM REMOVALS, INFLIN AND PATCH TO MATCH EXISTING SURFACES.

M. PROTECT ALL CONTRACT EQUIPMENT, ELEMENTS TO REMAIN, OWNER'S BELONGINGS, AND EQUIPMENT TO BE REUSED OR REINSTALLED BY OWNER. REMOVE AND REINSTALLATION AS REQUIRED. ALL ITEMS TO BE REMOVED, FIELD VERIFY AND REMOVE ALL ASSOCIATED ITEMS BACK TO POINT OF CONTINUED SERVICE OR TO THE THERMOCLAD SYSTEM. REMOVE AND REINSTALLATION AS REQUIRED TO FIT WITH STRUCTURAL CONSTRAINTS. EXAMINE ALL SYSTEMS UNDER CONSTRUCTION. VERIFY ALL SYSTEMS. VERIFY ALL ACCESS, LOCATIONS, DIMENSIONS, ARRANGEMENTS, ELECTRICAL CHARACTERISTICS AND INTERFERENCE IN THE FIELD.

N. THOROUGHLY CLEAN FOLLOWING DEMOLITION AND BEFORE BEGINNING CONTRACT INSTALLATIONS. THOROUGHLY CLEAN AGAIN DURING AND FOLLOWING CONTRACT WORK AS REQUIRED. PROVIDE WORK AREA CLEANUP, INCLUDING SOUND, LEGAL DISPOSAL OF ALL CONSTRUCTION DEBRIS.

O. PROVIDE TEMPORARY PIPING, DUCT, HEAT, VENTILATING, AND EXHAUST SERVICES TO REMAIN. REMOVE AND REINSTALLATION AS REQUIRED. ALL ITEMS TO BE REMOVED, FIELD VERIFY AND REMOVE ALL ASSOCIATED ITEMS BACK TO POINT OF CONTINUED SERVICE OR TO THE THERMOCLAD SYSTEM. REMOVE AND REINSTALLATION AS REQUIRED TO FIT WITH STRUCTURAL CONSTRAINTS. EXAMINE ALL SYSTEMS UNDER CONSTRUCTION. VERIFY ALL SYSTEMS. VERIFY ALL ACCESS, LOCATIONS, DIMENSIONS, ARRANGEMENTS, ELECTRICAL CHARACTERISTICS AND INTERFERENCE IN THE FIELD.

P. ALL EXCESS MATERIALS AND SCRAPS ARE CONTRACTORS' RESPONSIBILITY TO REMOVE FROM SITE UNLESS SPECIFICALLY DIRECTED OTHERWISE.

Q. EXISTING HVAC COMPONENTS IN THIS BUILDING MAY CONTAIN, BE RESPONSIBLE TO, OR BE IN CONTACT WITH, ASBESTOS. REMOVE AND REINSTALLATION AS REQUIRED. ALL ITEMS TO BE REMOVED, FIELD VERIFY AND REMOVE ALL ASSOCIATED ITEMS BACK TO POINT OF CONTINUED SERVICE OR TO THE THERMOCLAD SYSTEM. REMOVE AND REINSTALLATION AS REQUIRED TO FIT WITH STRUCTURAL CONSTRAINTS. EXAMINE ALL SYSTEMS UNDER CONSTRUCTION. VERIFY ALL SYSTEMS. VERIFY ALL ACCESS, LOCATIONS, DIMENSIONS, ARRANGEMENTS, ELECTRICAL CHARACTERISTICS AND INTERFERENCE IN THE FIELD.

R. SEAL ALL FLOOR, WALL AND CEILING PENETRATIONS PER FIRE-RESISTANT RATING. PROVIDE THE FOLLOWING TO SHOW EVERY TRANSITION, FITTING, ASPECT RATIO CHANGE, ETC.: PROVIDE AS REQUIRED TO FIT WITH STRUCTURAL CONSTRAINTS. EXAMINE ALL SYSTEMS UNDER CONSTRUCTION. VERIFY ALL SYSTEMS. VERIFY ALL ACCESS, LOCATIONS, DIMENSIONS, ARRANGEMENTS, ELECTRICAL CHARACTERISTICS AND INTERFERENCE IN THE FIELD.

S. NOT LESS THAN 1-HOUR, AND IN ACCORDANCE WITH SECTION 07 84.13 - PENETRATION FIRESTOPPING. THIS INCLUDES ALL NEW PENETRATIONS AND REPAIRS TO EXISTING PENETRATIONS CREATED BY REMOVALS, AS REQUIRED TO PERFORM THE WORK.

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Beacon City School District  
Beacon, New York

M	Additions and Alterations to: Glenham Elementary School
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### First Floor Key Plan

N	Drawn By: JPF1/pgm	Date: 10/28/2022	Drawing Number:
	Project No.: 279180-22004		BM051





BM100





A. REFER TO BM051 FOR GENERAL NOTES

B	1	REMOVE UNIT VENTILATOR, LOUVER, OUTDOOR AIR INTAKE SLEEVE AND ALL ASSOCIATED ACCESSORIES COMPLETE. REMOVE HWSR PIPING AS REQUIRED FOR U/I REMOVAL.
	2	REMOVE THERMOSTAT AND ASSOCIATED ACCESSORIES.
	3	REMOVE FINNED TUBE RADIATION AND ASSOCIATED ACCESSORIES COMPLETE. PREPARE FOR RECONNECTION.
	4	REMOVE CONDENSING UNIT, REFRIGERANT PIPING AND CONCRETE PAD.
	5	REMOVE PACKAGED HEAT PUMP, 6" DIAMETER DUCTS TO COMPRESSOR AND LOUVER COMPLETE.
	6	REMOVE ABANDONED CONDENSING UNIT AND CONCRETE PAD.
	7	REMOVE EXHAUST GRILLE AND ASSOCIATED ACCESSORIES COMPLETE. PREPARE FOR RECONNECTION.
C	FINNED TUBE RADIATION AND ASSOCIATED ACCESSORIES TO REMAIN.	



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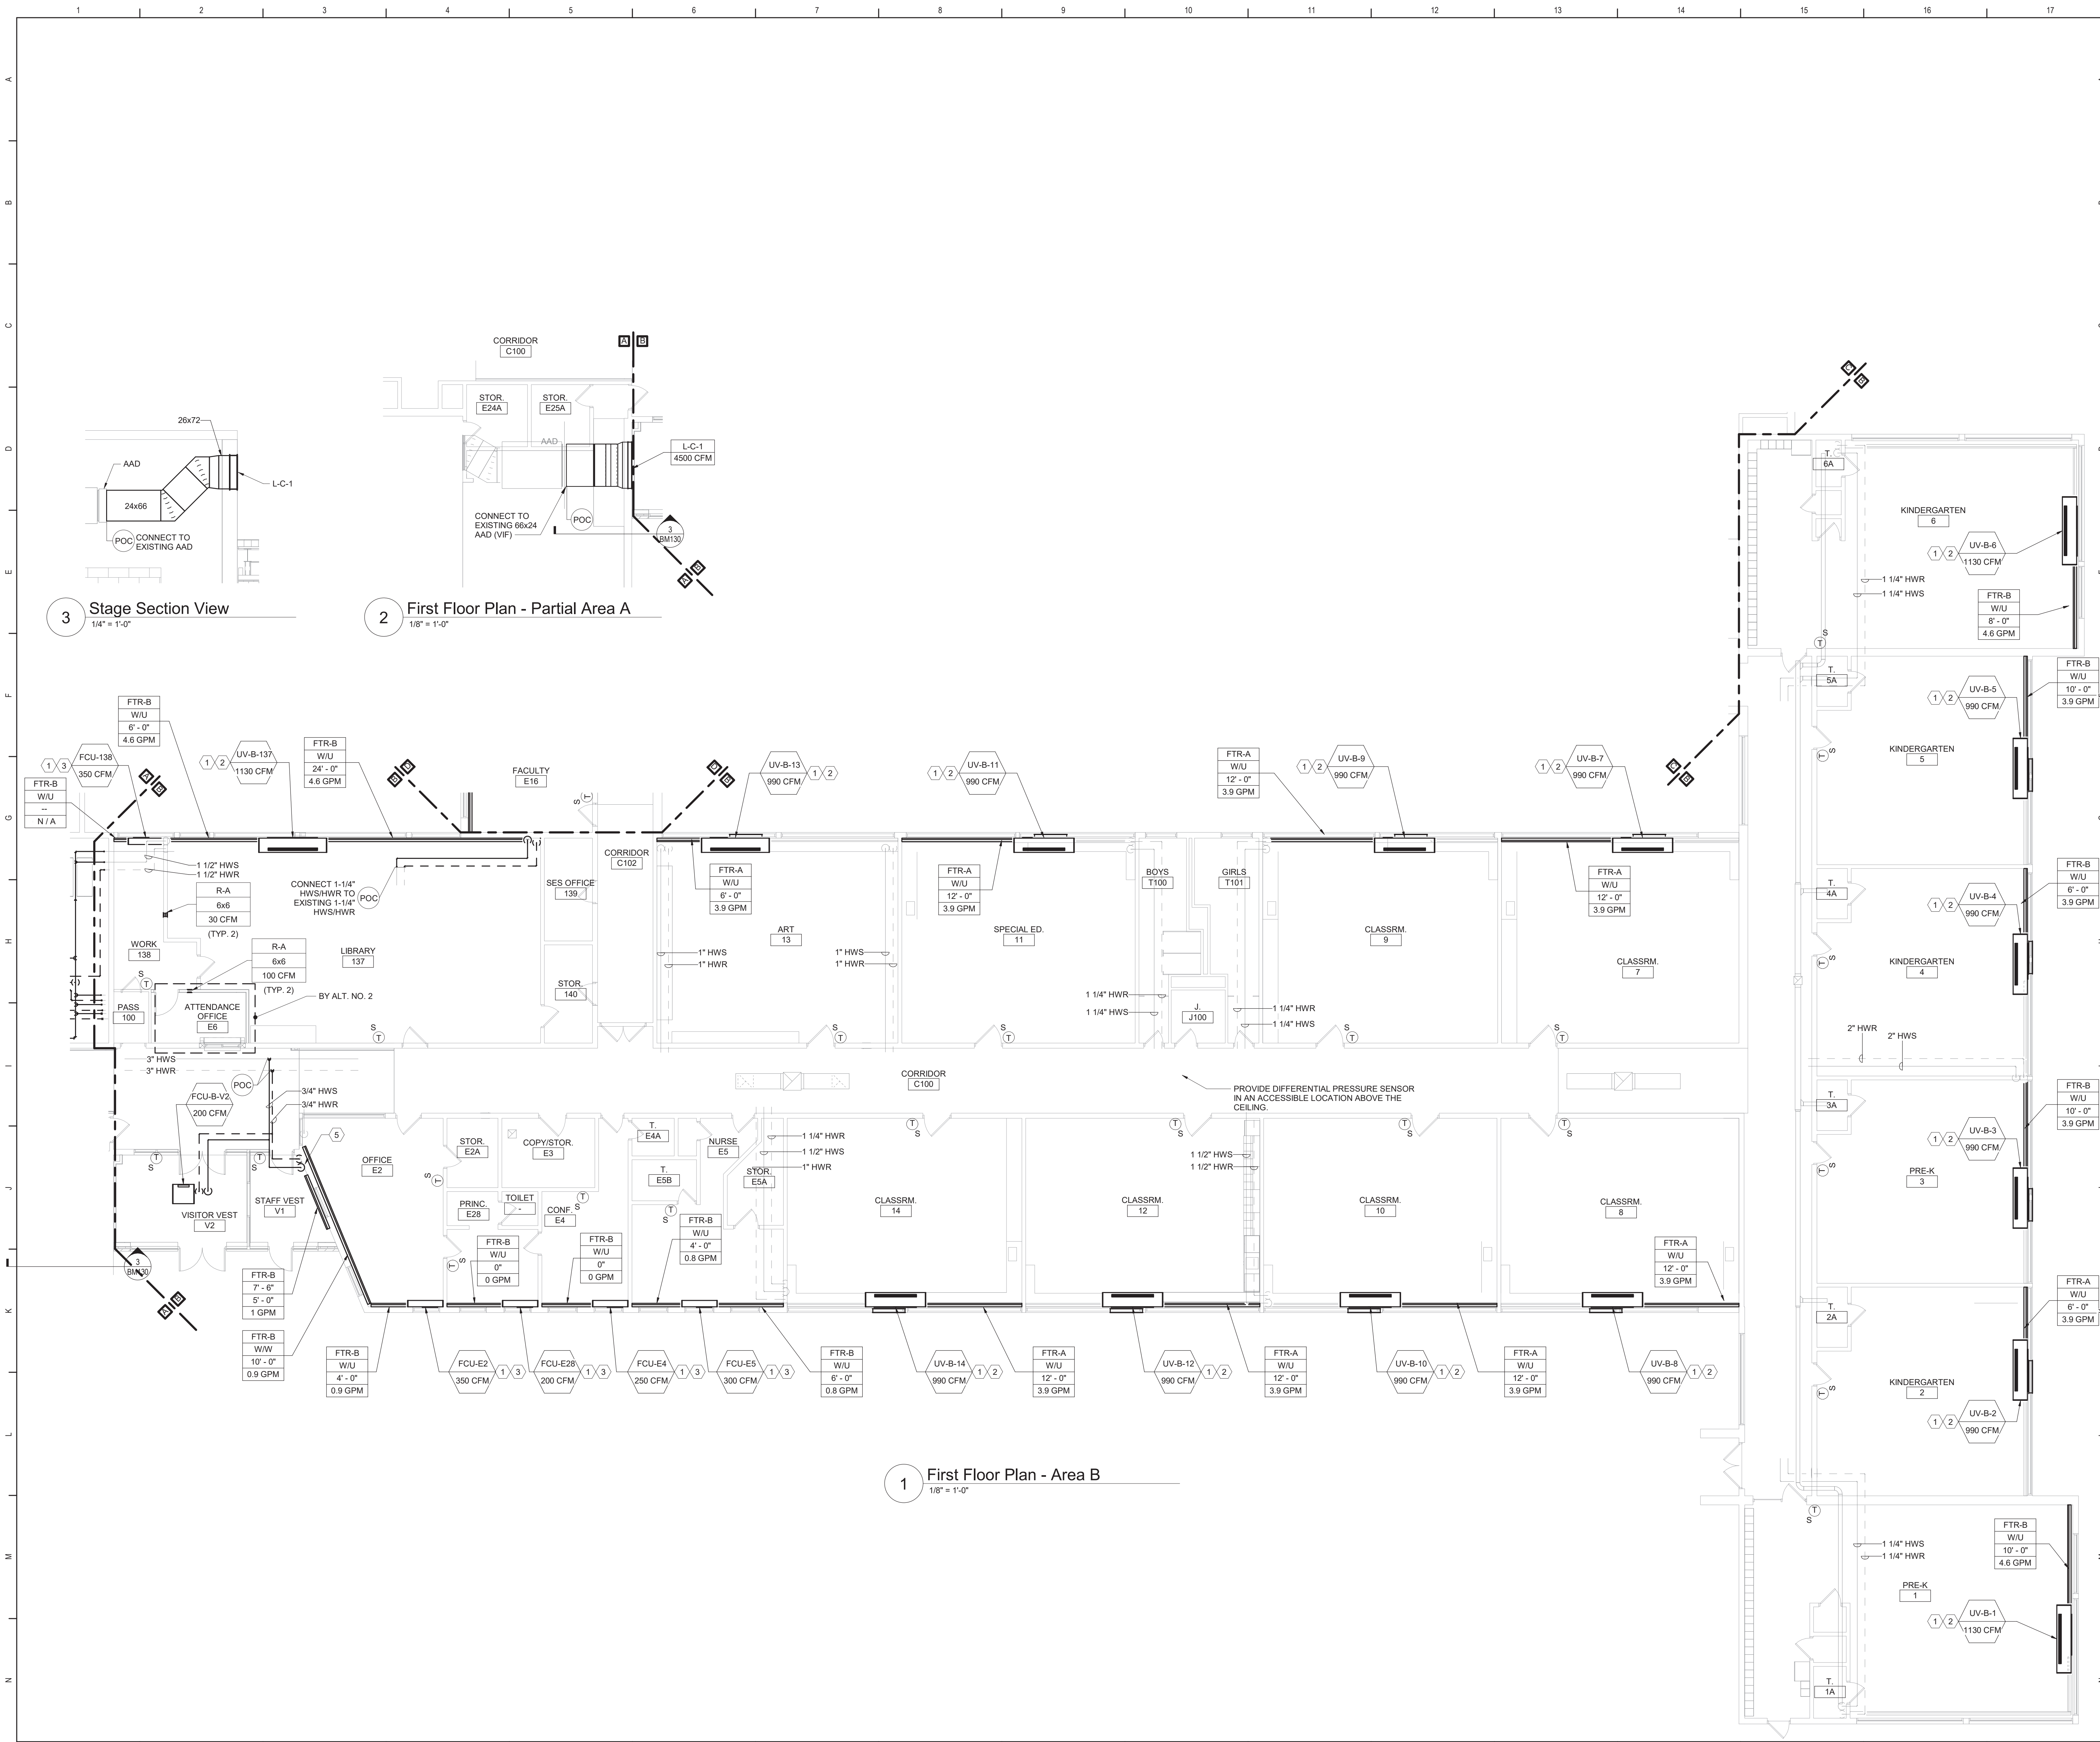
Beacon City School District  
Beacon, New York

M	Additions and Alterations to: Glenham Elementary School
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First Floor Demolition Plans - Area C  
and Partial Area D

N	Drawn By: JPF1/pgm	Date: 10/28/2022	Drawing Number:
	Project No.: 279180-22004		BM101





**General Notes**

A. REFER TO BM051 FOR GENERAL NOTES.

**KEYED NOTES:**

- EXTEND HWS/R PIPING AS REQUIRED TO MAKE CONNECTION AND PIPE PER DETAIL.
- PROVIDE LOUVER SIZED TO MATCH EXISTING OPENING. PROVIDE OA INTAKE SLEEVE AND SECURE TO LOUVER PER DETAIL. REFER TO ARCHITECTURAL DRAWINGS FOR LOUVER INSTALLATION.
- PROVIDE LOUVER AND OA INTAKE SLEEVE AND SECURE PER DETAIL. REFER TO ARCHITECTURAL DRAWINGS FOR WALL OPENING AND LOUVER INSTALLATION.
- EXTEND 1" HWS PIPING AS REQUIRED AND CONNECT INTO EXISTING 1" EXPANSION TANK PIPING.
- PROVIDE SHEET METAL PIPE ENCLOSURE.


**Key Plan**

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S.E.D. Control No. 13-02-00-01-0-006-022

Rev. No.	Date	Description

Rev. No.: Date: Description:

 **BEACON CITY SCHOOL DISTRICT**  
MAKING EXCELLENCE IN THE FUTURE

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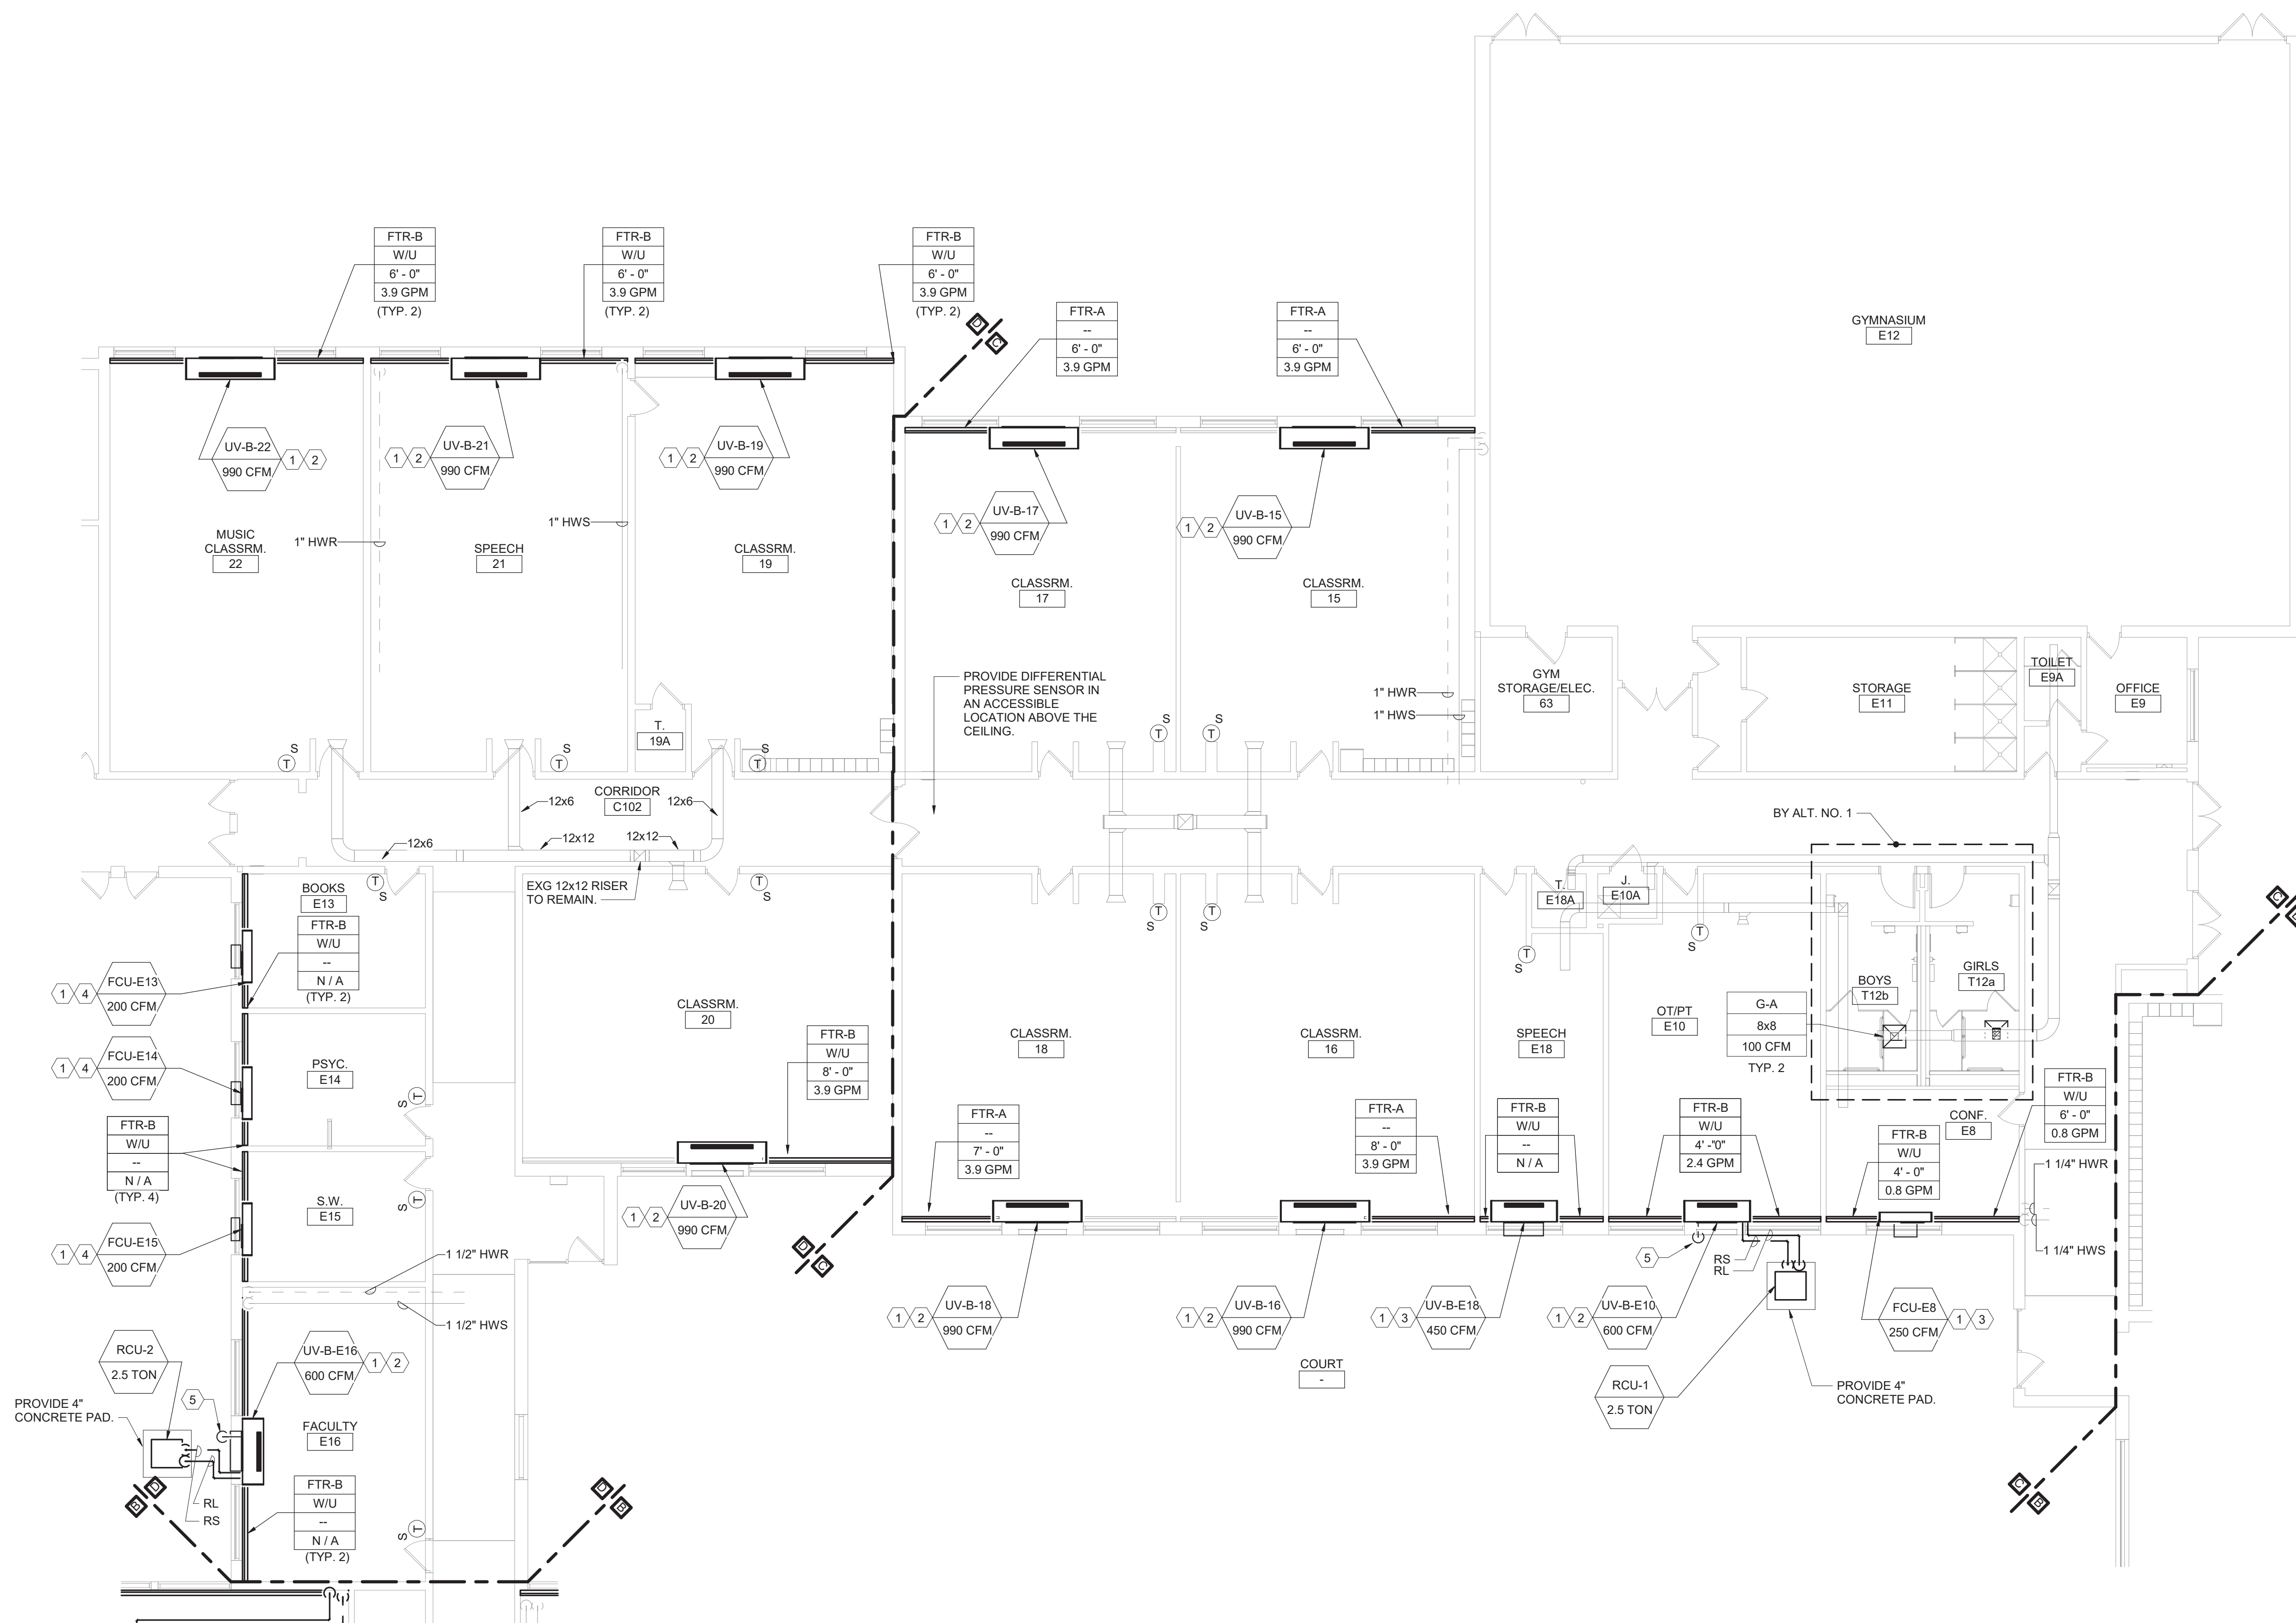
Beacon City School District  
Beacon, New York

Additions and Alterations to:  
Glenham Elementary School

First Floor Plans - Partial Area A and Area B

Drawn By: JPF/1/pgm	Date: 10/28/2022	Drawing Number:
Project No.: 279180-22004		<b>BM130</b>






1 First Floor Plan - Area C and Parital Area D  
1/8" = 1'-0"

### General Notes

- A. REFER TO BM051 FOR GENERAL NOTES.

### KEYED NOTES:

- 1 EXTEND HWS/R PIPING AS REQUIRED TO MAKE CONNECTION AND PIPE PER DETAIL.
- 2 PROVIDE LOUVER SIZED TO MATCH EXISTING OPENING. PROVIDE OA INTAKE SLEEVE AND SECURE TO LOUVER PER DETAIL. REFER TO ARCHITECTURAL DRAWINGS FOR LOUVER INSTALLATION.
- 3 PROVIDE LOUVER AND OA INTAKE SLEEVE AND SECURE PER DETAIL. REFER TO ARCHITECTURAL DRAWINGS FOR WALL OPENING AND LOUVER INSTALLATION.
- 4 PROVIDE LOUVER AND OA INTAKE SLEEVE. FIELD FABRICATE POWDER COATED SHEETMETAL PLENUM AND SECURE TO LOUVER.
- 5 PROVIDE 1" CONDENSATE DRAIN. REFER TO BM500.

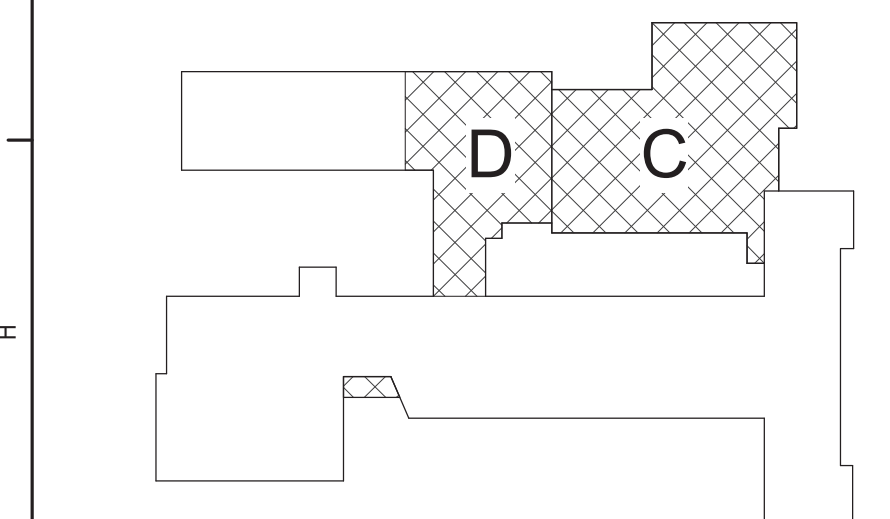

Key Plan  
N.T.S.

S.E.D. Control No. 13-02-00-01-0-006-022

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Beacon City School District  
Beacon, New York

Additions and Alterations to:  
Glenham Elementary School

First Floor Plan - Area C and Partial  
Area D

Drawn By:  
JPF1/pgm

Date:  
10/28/2022

Drawing Number:

Project No.:  
279180-22004

BM131



BID SET







Keyed Notes:


- 1 REMOVE LUMINAIRE(S) AND CIRCUITRY COMPLETE BACK TO SOURCE.
- 2 REMOVE WALL MOUNTED EMERGENCY LIGHT. REMOVE EXISTING CIRCUITRY BACK TO NEAREST JUNCTION BOX OR DEVICE OUTSIDE OF DEMOLITION AREA. MODIFY EXISTING SYSTEM CIRCUITRY TO ALLOW FOR PROPER OPERATION OF REMAINING DEVICES ON CIRCUIT.
- 3 REMOVE LIGHT SWITCH(ES) CONTROLLING CORRIDOR LUMINAIRES. REMOVE EXISTING CIRCUITRY BACK TO NEAREST JUNCTION BOX OR DEVICE OUTSIDE OF DEMOLITION AREA. MODIFY EXISTING SYSTEM CIRCUITRY TO ALLOW FOR PROPER OPERATION OF REMAINING DEVICES ON CIRCUIT. PROVIDE BLANK COVER PLATE.
- 4 REMOVE, CLEAN AND STORE FIRE ALARM STROBE.
- 5 REMOVE JUNCTION BOX.
- 6 REMOVE, CLEAN AND STORE SPEAKER.
- 7 DISCONNECT POWER CIRCUITRY TO HAND DRYER, TAG FOR RE-USE.
- 8 DISCONNECT POWER CIRCUITRY TO HVAC EQUIPMENT AND TAG FOR RE-USE.
- 9 REMOVE POWER CIRCUITRY TO HVAC EQUIPMENT COMPLETE BACK TO SOURCE. LABEL ANY UNUSED CIRCUIT BREAKERS AS "SPARE". AMEND PANEL DIRECTORY AS NECESSARY.
- 10 REMOVE RECEPTACLE COMPLETE BACK TO SOURCE.
- 11 REMOVE FIRE ALARM HORN STROBE AND TELEPHONE LINE. PREPARE FOR RE-INSTALLATION.

Demolition General Notes


- A. ALL ELECTRICAL DEVICES INTERFERING WITH DEMOLITION WORK SHALL BE DISCONNECTED AND REMOVED. UNLESS OTHERWISE NOTED, EXISTING CIRCUIT WIRING SHALL BE REMOVED BACK TO SOURCE AND PANEL DIRECTORIES MODIFIED ACCORDINGLY.
- B. ANY DEVICE INTERFERING WITH DEMOLITION WORK NOT SHOWN ON THESE DRAWINGS SHALL NOT BE REMOVED WITHOUT WRITTEN AUTHORIZATION FROM THE OWNER'S REPRESENTATIVE OR THE ENGINEER.
- C. ALL ELECTRICAL DEMOLITION WORK SHALL BE PROPERLY COORDINATED WITH ALL OTHER TRADES.
- D. EC IS SOLELY RESPONSIBLE FOR THE SAFE HANDLING AND DISPOSAL OF ALL REMOVED LUMINAIRES AND BALLASTS THAT MAY CONTAIN PCBs (POLYCHLORINATED BIPHENYLS), IN ACCORDANCE WITH ALL APPLICABLE EPA, OSHA, FEDERAL, STATE, AND LOCAL CODES AND LAWS.
- E. EC IS SOLELY RESPONSIBLE FOR THE SAFE HANDLING AND DISPOSAL OF ALL REMOVED FLUORESCENT LIGHT TUBES THAT MAY CONTAIN MERCURY. IN ACCORDANCE WITH ALL APPLICABLE EPA, OSHA, FEDERAL, STATE, AND LOCAL CODES AND LAWS.
- F. AT ALL CORRIDORS WHERE NEW CEILINGS ARE BEING INSTALLED, DISCONNECT AND REMOVE DEVICES AS INDICATED, TAG EXISTING WIRING FOR REUSE.
- G. ALL DEVICES THAT ARE SCHEDULED TO BE REMOVED, CLEANED, STORED AND RE-INSTALLED SHALL BE TESTED PRIOR TO REMOVAL. IF ANY DEVICES IS NOT IN WORKING ORDER, NOTIFY ENGINEER AND OWNER'S REPRESENTATIVE PRIOR TO REMOVAL.

General Notes


- A. COORDINATE ALL ELECTRICAL WORK AND POWER OUTAGES WITH OWNER AND OTHER TRADES PRIOR TO THE START OF CONSTRUCTION. NO POWER OUTAGES SHALL OCCUR WITHOUT OWNER'S PRIOR KNOWLEDGE AND CONSENT.
  - B. REFER TO DRAWING G100 FOR STANDARD SYMBOLS AND ABBREVIATIONS.
  - C. CIRCUIT WIRING FOR ALL LIGHTING CIRCUITS SHALL BE IN 1/2" EMT CONDUIT (MIN) OR TYPE MC CABLE CONCEALED ABOVE CEILINGS AND IN WALLS (REFER TO SPECIFICATION SECTION 26 05 33 FOR LOCATIONS WHERE MC CABLE IS ACCEPTABLE). ALL CIRCUIT CONDUCTORS SHALL BE #12AWG COPPER (MIN) 90°C THHN THERMOPLASTIC INSULATION.
  - D. CIRCUIT EXIT AND EMERGENCY LUMINAIRES TO UNSWITCHED HOT LEG OF LIGHTING CIRCUIT OF THE AREA BEING SERVED BY OR ADJACENT TO THE LUMINAIRE. REFER TO PLANS AND DETAILS FOR MINIATURE INVERTER INFORMATION.
  - E. PROPERLY IDENTIFY ALL CIRCUITS AT PANELS AND J-BOXES AND IN ACCORDANCE WITH PROJECT SPECIFICATIONS.
  - F. PROVIDE ALL ADAPTERS, COUPLINGS AND ASSOCIATED FITTINGS REQUIRED FOR COMPLETE OPERATIONAL SYSTEM.
  - G. WHEN INSTALLING NEW DEVICES IN EXISTING LOCATIONS, REUSE EXISTING CONDUIT/TRACEWAY AND BACK BOXES IF IN GOOD CONDITION. EXTENDING/INSTALL NEW CONDUIT/TRACEWAY AS REQUIRED FOR PROPER MOUNTING OF DEVICE. CONCEAL ABOVE CEILINGS OR WITHIN WALLS WHERE POSSIBLE. REFER TO SPECIFICATION SECTION 26 05 33.
  - H. COORDINATE ALL ELECTRICAL WORK WITH OTHER TRADES.
  - I. TESTS OF ALL ELECTRICAL WORK SHALL BE PERFORMED IN THE PRESENCE OF THE ENGINEER OR ARCHITECT. AS EQUIPMENT IS INSTALLED AND AS SYSTEMS ARE COMPLETED. IN ADDITION AN ELECTRIC APPROVED CERTIFICATE SHALL BE ISSUED BY AN ELECTRICAL INSPECTION AGENCY.
  - J. UNLESS NOTED ELSEWHERE ON THE CONTRACT DOCUMENTS, THE FOLLOWING LIST REPRESENTS THE TYPICAL MOUNTING HEIGHTS FOR THE DEVICES SHOWN:
    1. SWITCHES AND PANIC STATIONS.....48" (TO TOP)
    2. RECEPTACLES.....16"
    3. COMPUTER RECEPTACLES.....48" (TO TOP)
    4. WALL (W) TELEPHONE AND CALL SWITCHES.....48" (TO TOP)
    5. TELEPHONE OUTLETS (UNLABELED).....16"
    6. VOLUME CONTROLS.....48" (TO TOP)
    7. TELEVISION OUTLETS.....16"
    8. FIRE ALARM PULL STATIONS.....48" (TO TOP)
    9. FIRE ALARM AUDIO/VISUAL UNITS.....88"  
\* (OR 6' BELOW CEILING, WHICHEVER IS LOWER)
    10. POWER PANELS.....72" (TO TOP)
    11. DISCONNECT SWITCHES.....60" (TO TOP)
    12. MOTOR STARTERS.....60" (TO TOP)
- THE HEIGHTS INDICATED SHALL BE NOMINAL TO THE BOTTOM OF THE BOX UNLESS NOTED OTHERWISE. MAINTAIN HEIGHT CONSISTENCY BETWEEN NEW AND EXISTING DEVICES.

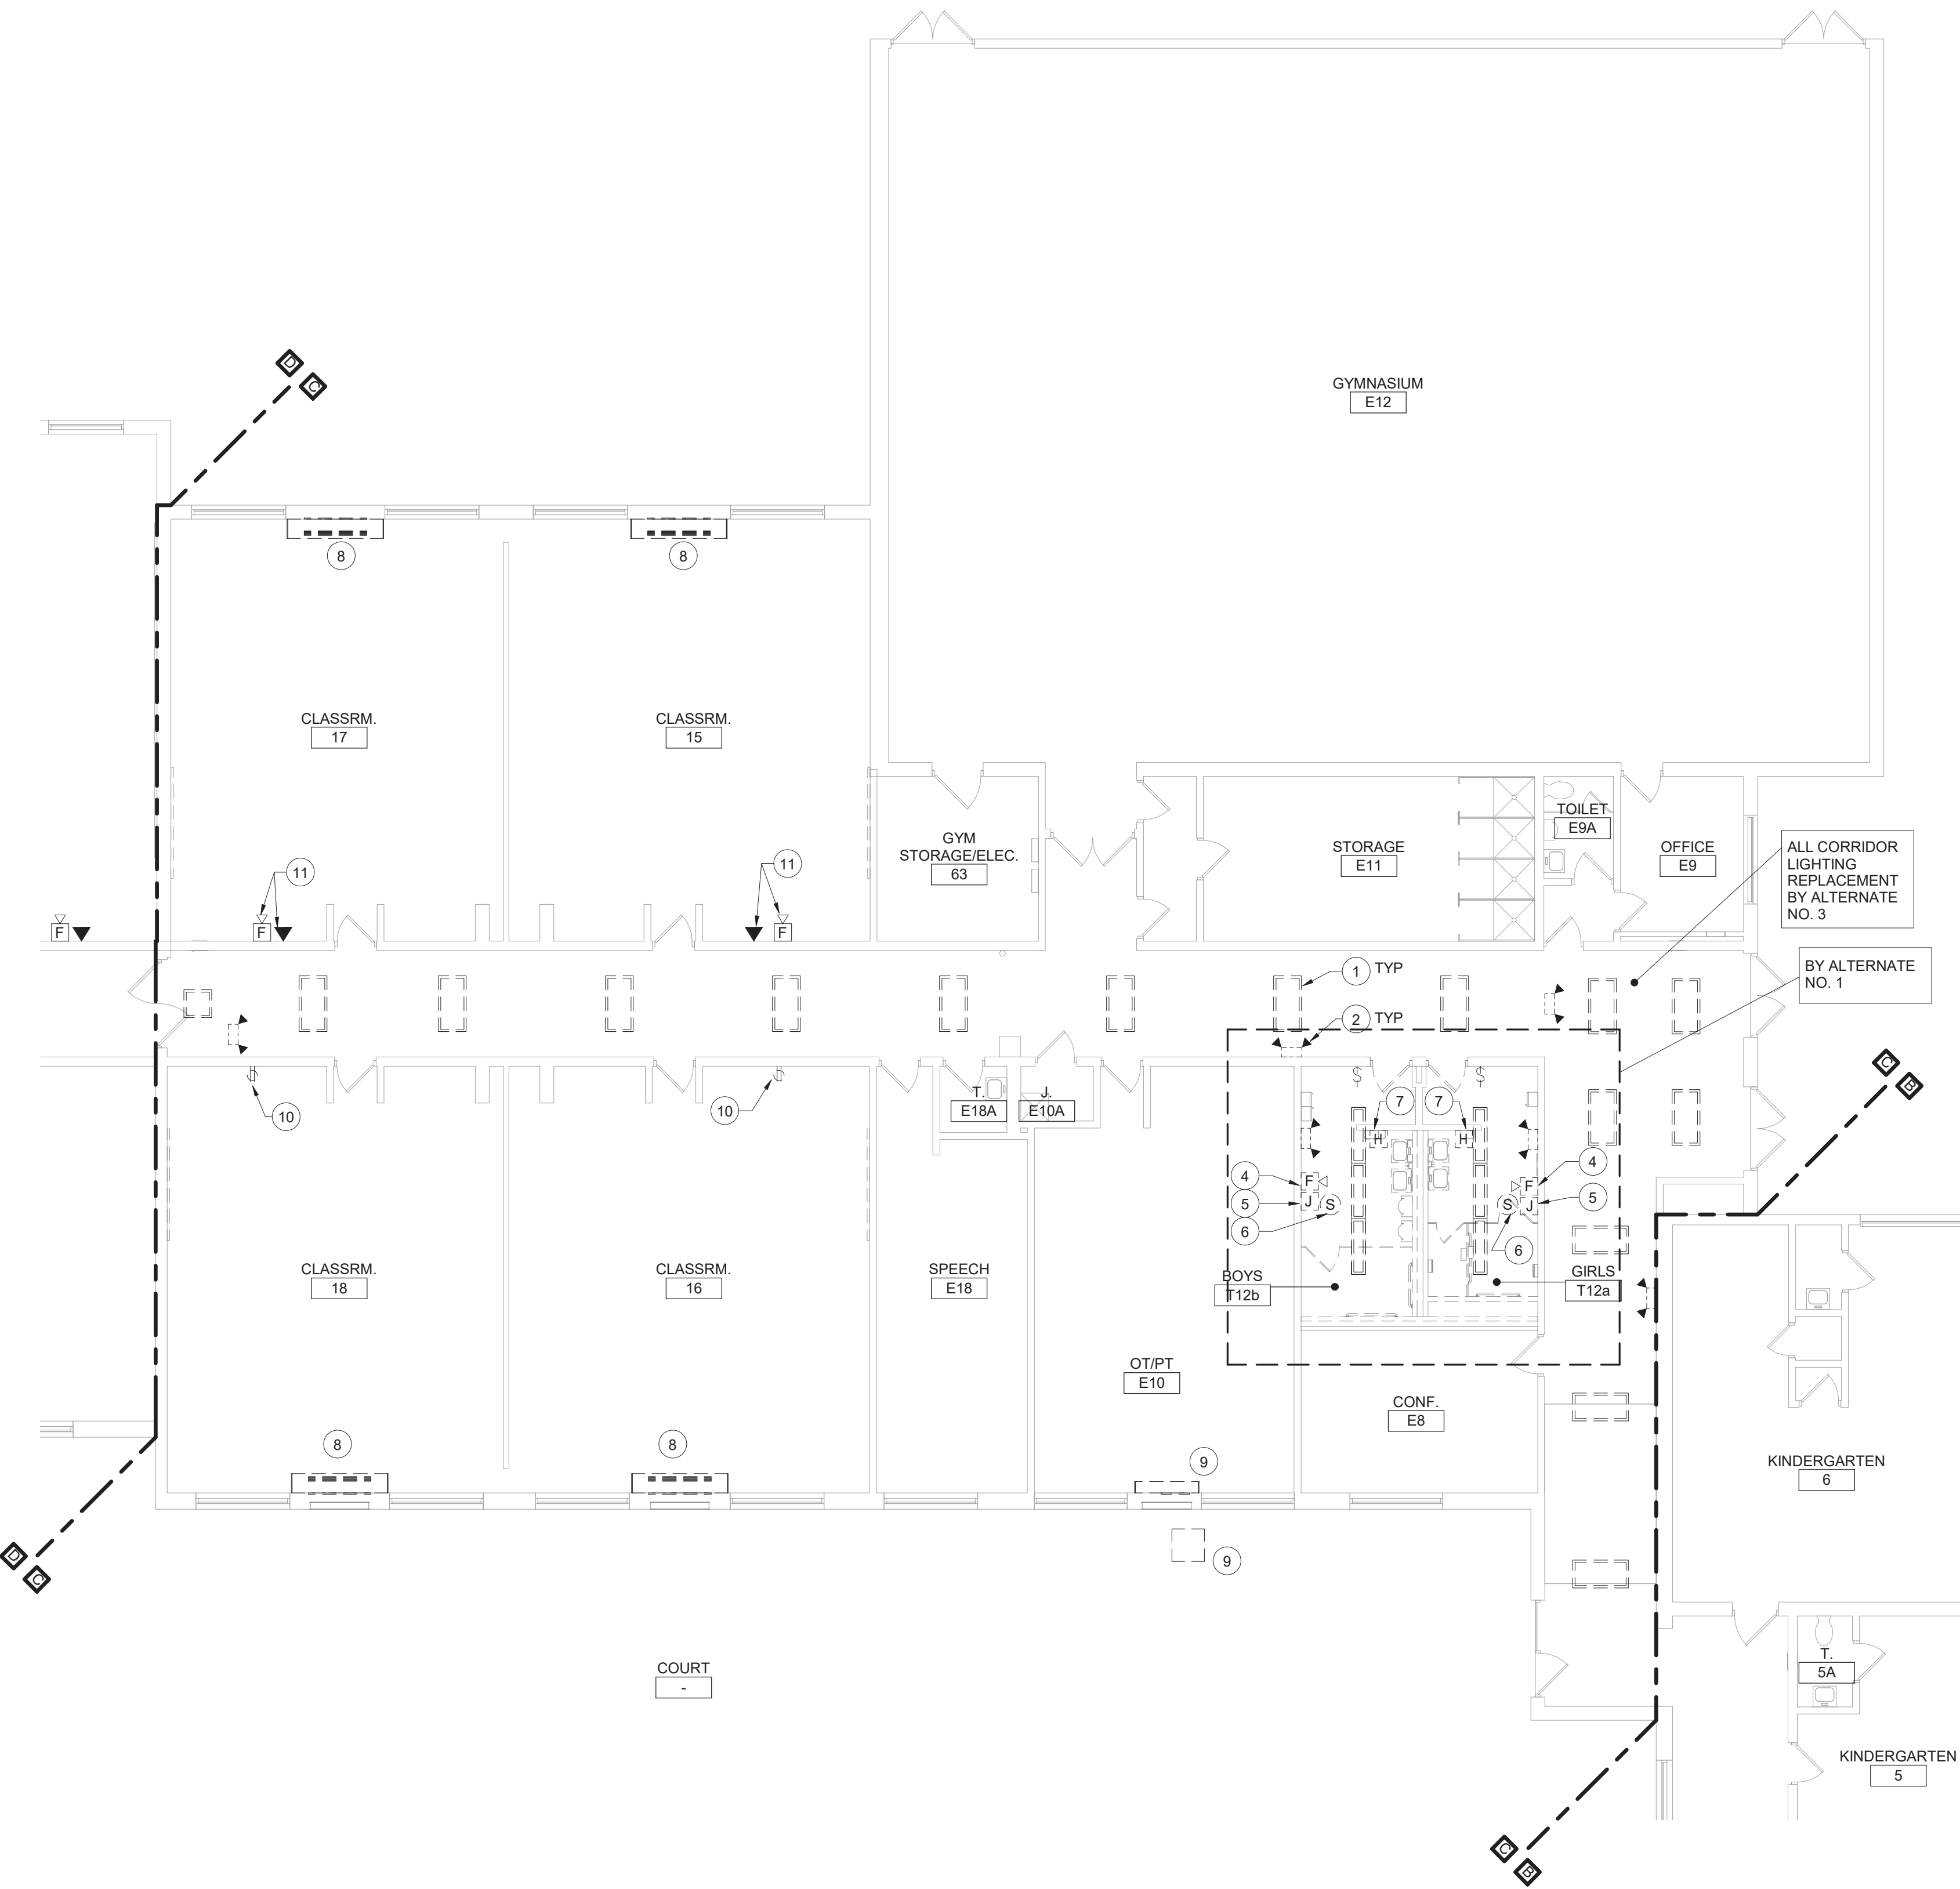

2 First Floor Demolition Plan - Area C  
1/8" = 1'-0"

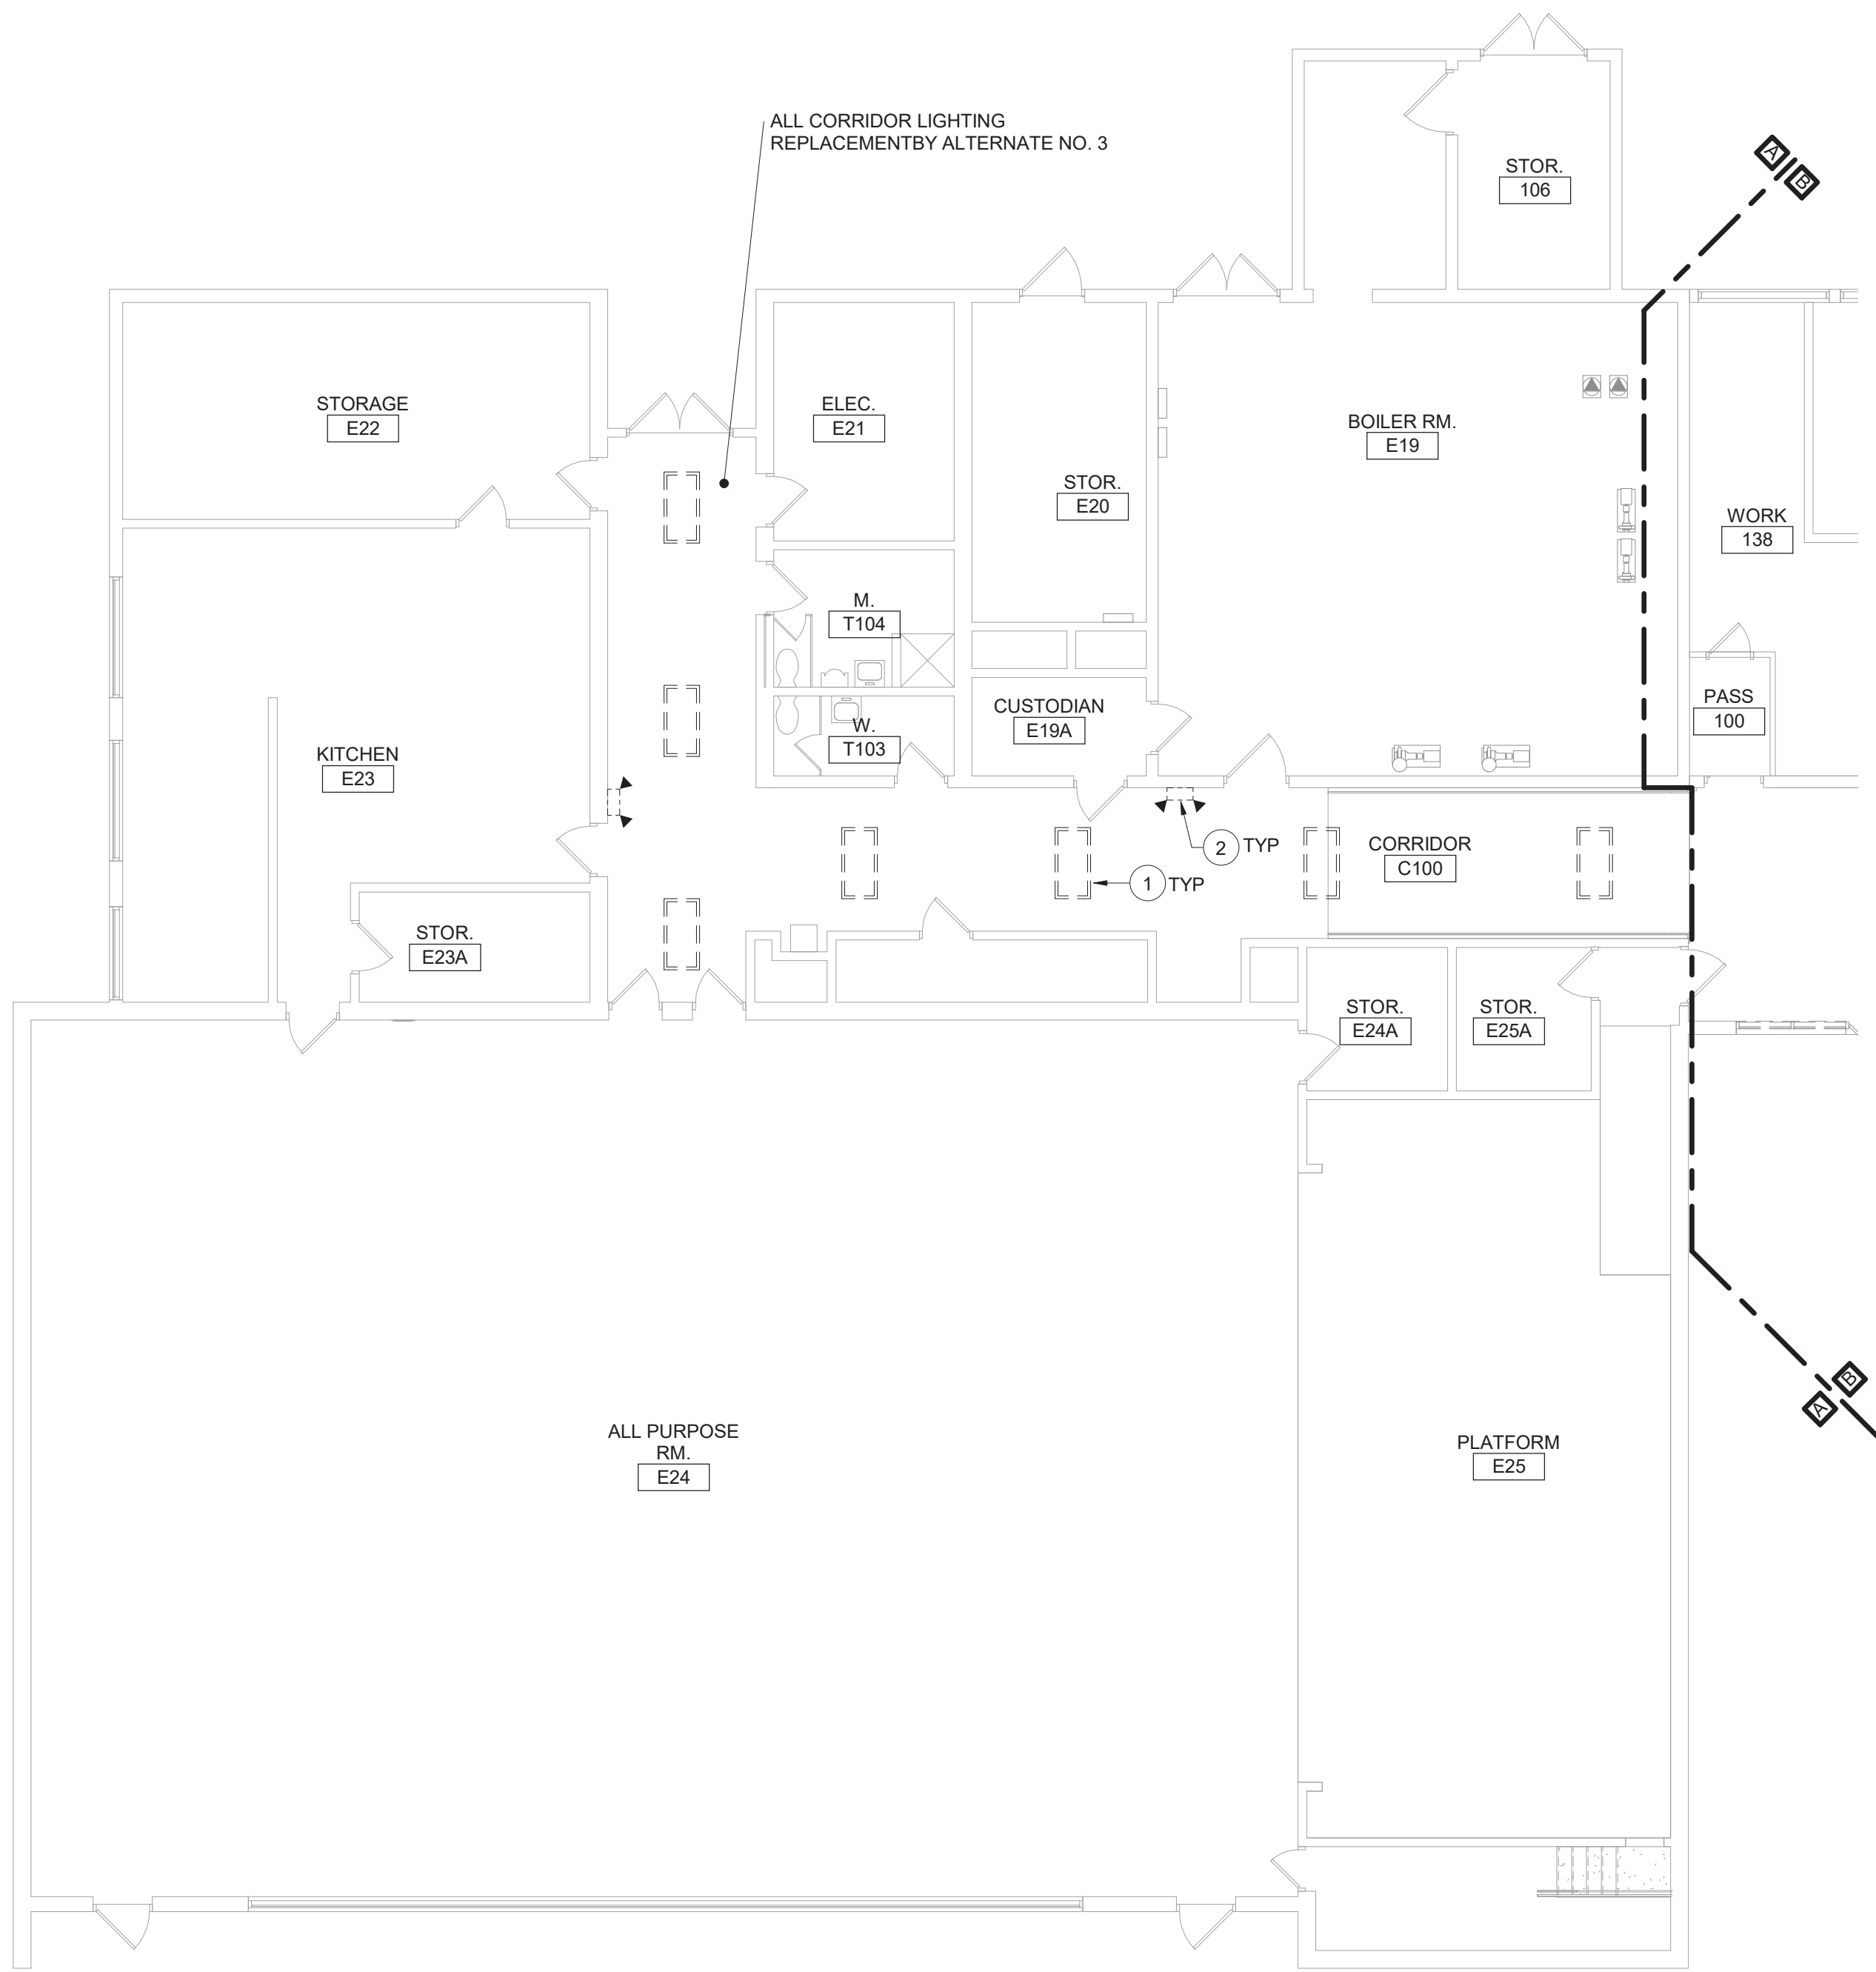


1 First Floor Demolition Plan - Area A  
1/8" = 1'-0"

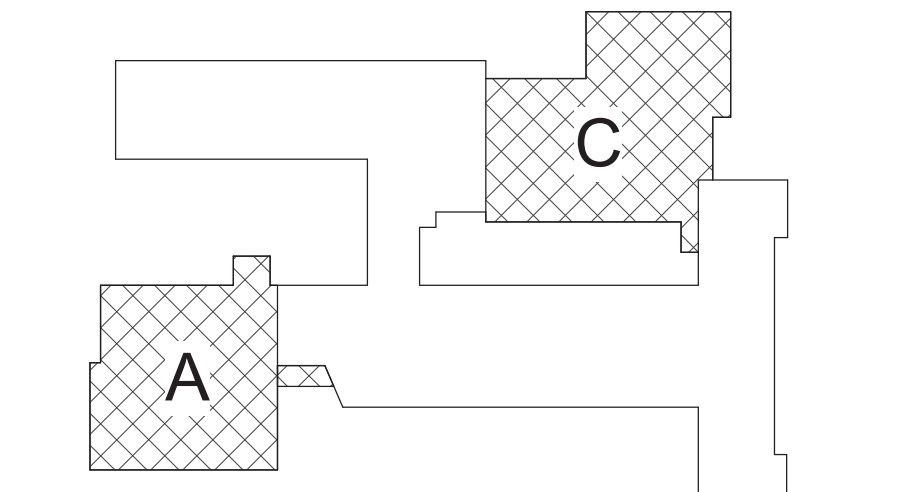

Key Plan  
N.T.S.

S.E.D. Control No. 13-02-00-01-0-006-022

Rev. No.:	Date:	Description:

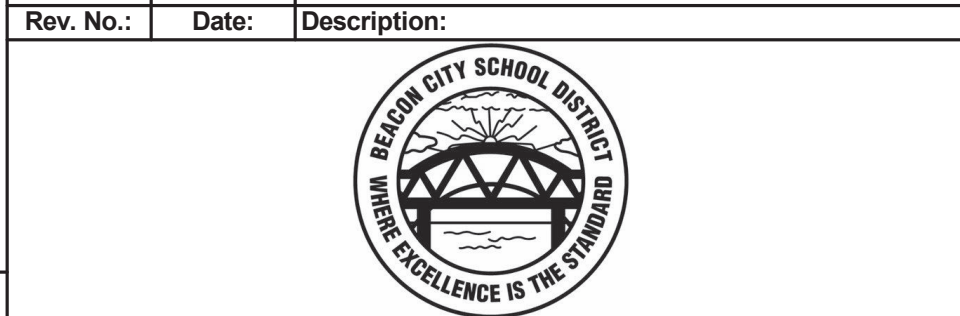

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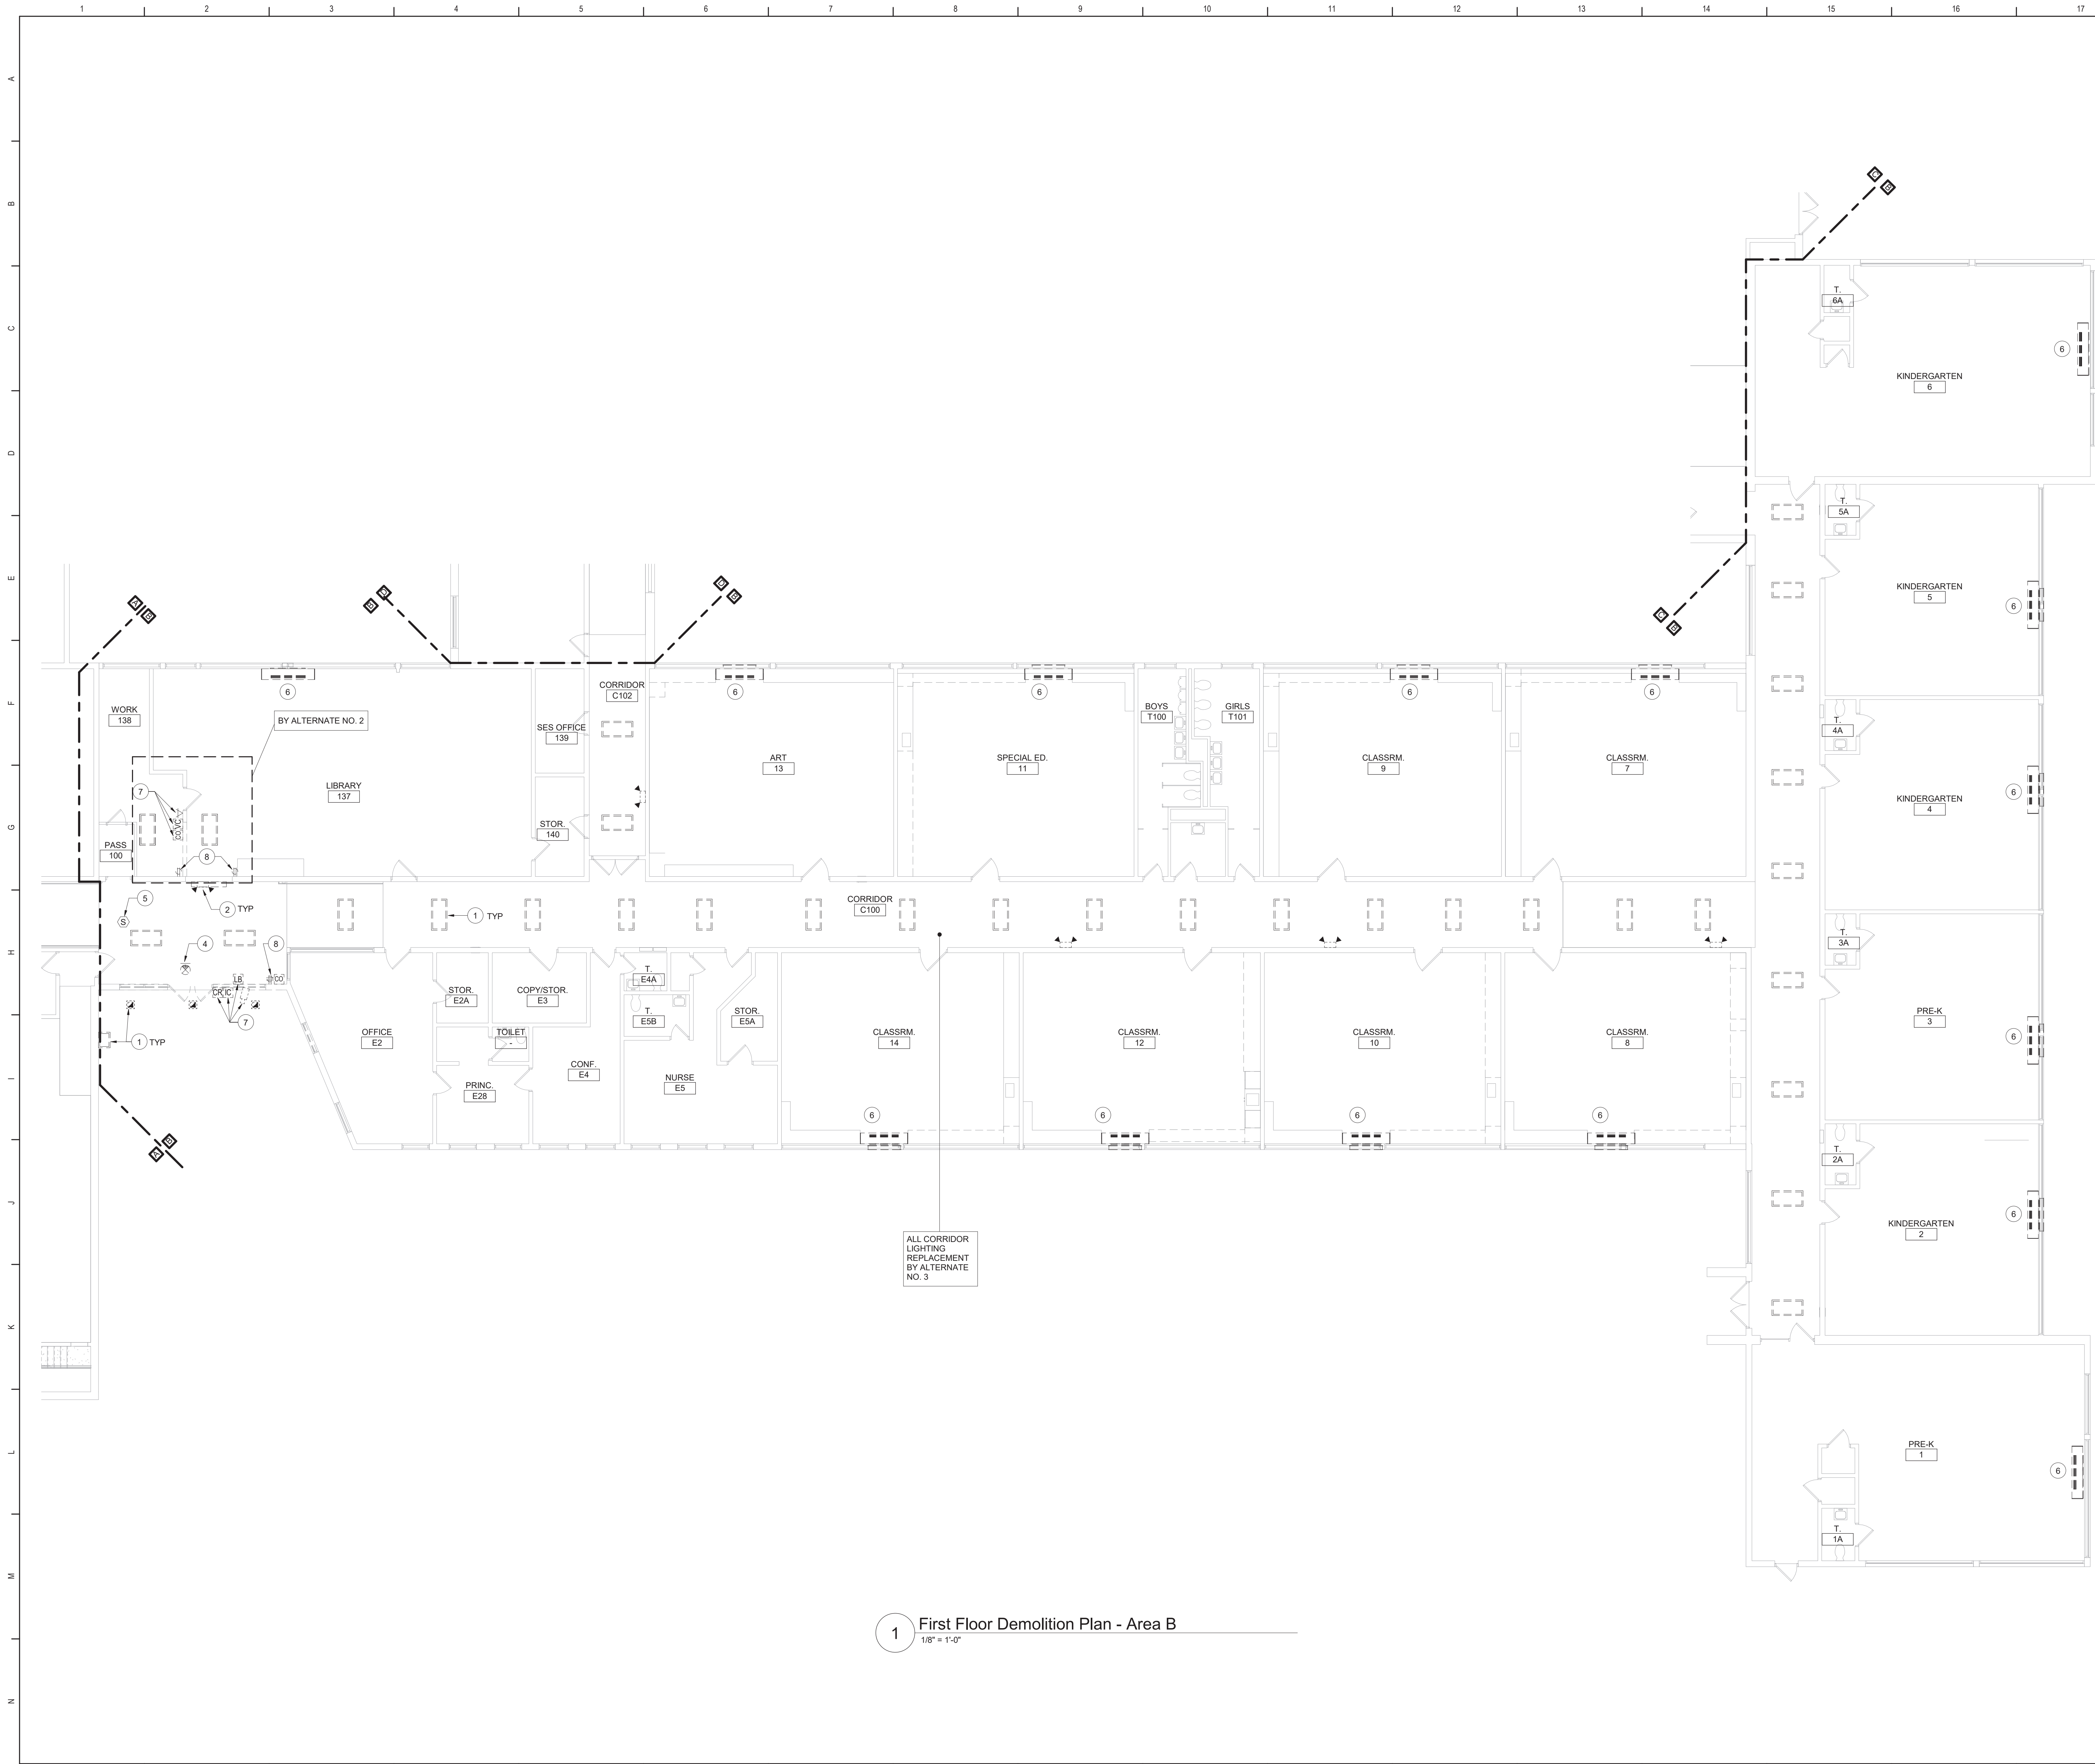
Beacon City School District  
Beacon, New York

Additions and Alterations to:  
Glenham Elementary School

First Floor Demolition Plan - Areas A  
and C

Drawn By: SAS	Date: 10/28/2022	Drawing Number:
Project No.: 279180-22004		<b>BE100</b>





- Keyed Notes:**
- 1 REMOVE LUMINAIRE(S) AND CIRCUITRY COMPLETE BACK TO SOURCE.
  - 2 REMOVE WALL MOUNTED EMERGENCY LIGHT. REMOVE EXISTING CIRCUITRY BACK TO NEAREST JUNCTION BOX OR DEVICE OUTSIDE OF DEMOLITION AREA. MODIFY EXISTING SYSTEM CIRCUITRY TO ALLOW FOR PROPER OPERATION OF REMAINING DEVICES ON CIRCUIT.
  - 3 REMOVE LIGHT SWITCH(IES) CONTROLLING CORRIDOR LUMINAIRES. REMOVE EXISTING CIRCUITRY BACK TO NEAREST JUNCTION BOX OR DEVICE OUTSIDE OF DEMOLITION AREA. MODIFY EXISTING SYSTEM CIRCUITRY TO ALLOW FOR PROPER OPERATION OF REMAINING DEVICES ON CIRCUIT. PROVIDE BLANK COVER PLATE.
  - 4 REMOVE EXIT LIGHT.
  - 5 REMOVE SMOKE DETECTOR.
  - 6 DISCONNECT POWER CIRCUITRY TO HVAC EQUIPMENT AND TAG FOR RE-USE.
  - 7 REMOVE DEVICES SHOWN, CLEAN AND STORE FOR RE-INSTALLATION.
  - 8 REMOVE RECEPTACLE. REMOVE EXISTING CIRCUITRY BACK TO NEAREST JUNCTION BOX OR DEVICE OUTSIDE OF DEMOLITION AREA. MODIFY EXISTING SYSTEM CIRCUITRY TO ALLOW FOR PROPER OPERATION OF REMAINING DEVICES ON CIRCUIT.

**General Notes:**

A. REFER TO DRAWING BE100 FOR GENERAL NOTES

**Key Plan**  
N.T.S.

S.E.D. Control No. 13-02-00-01-0-006-022

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Beacon, New York


Additions and Alterations to:  
Glenham Elementary School

First Floor Demolition Plan - Area B

Drawn By: Author	Date: 10/28/2022	Drawing Number:  <b>BE101</b>
Project No.: 279180-22004		

1 First Floor Demolition Plan - Area B  
1/8" = 1'-0"



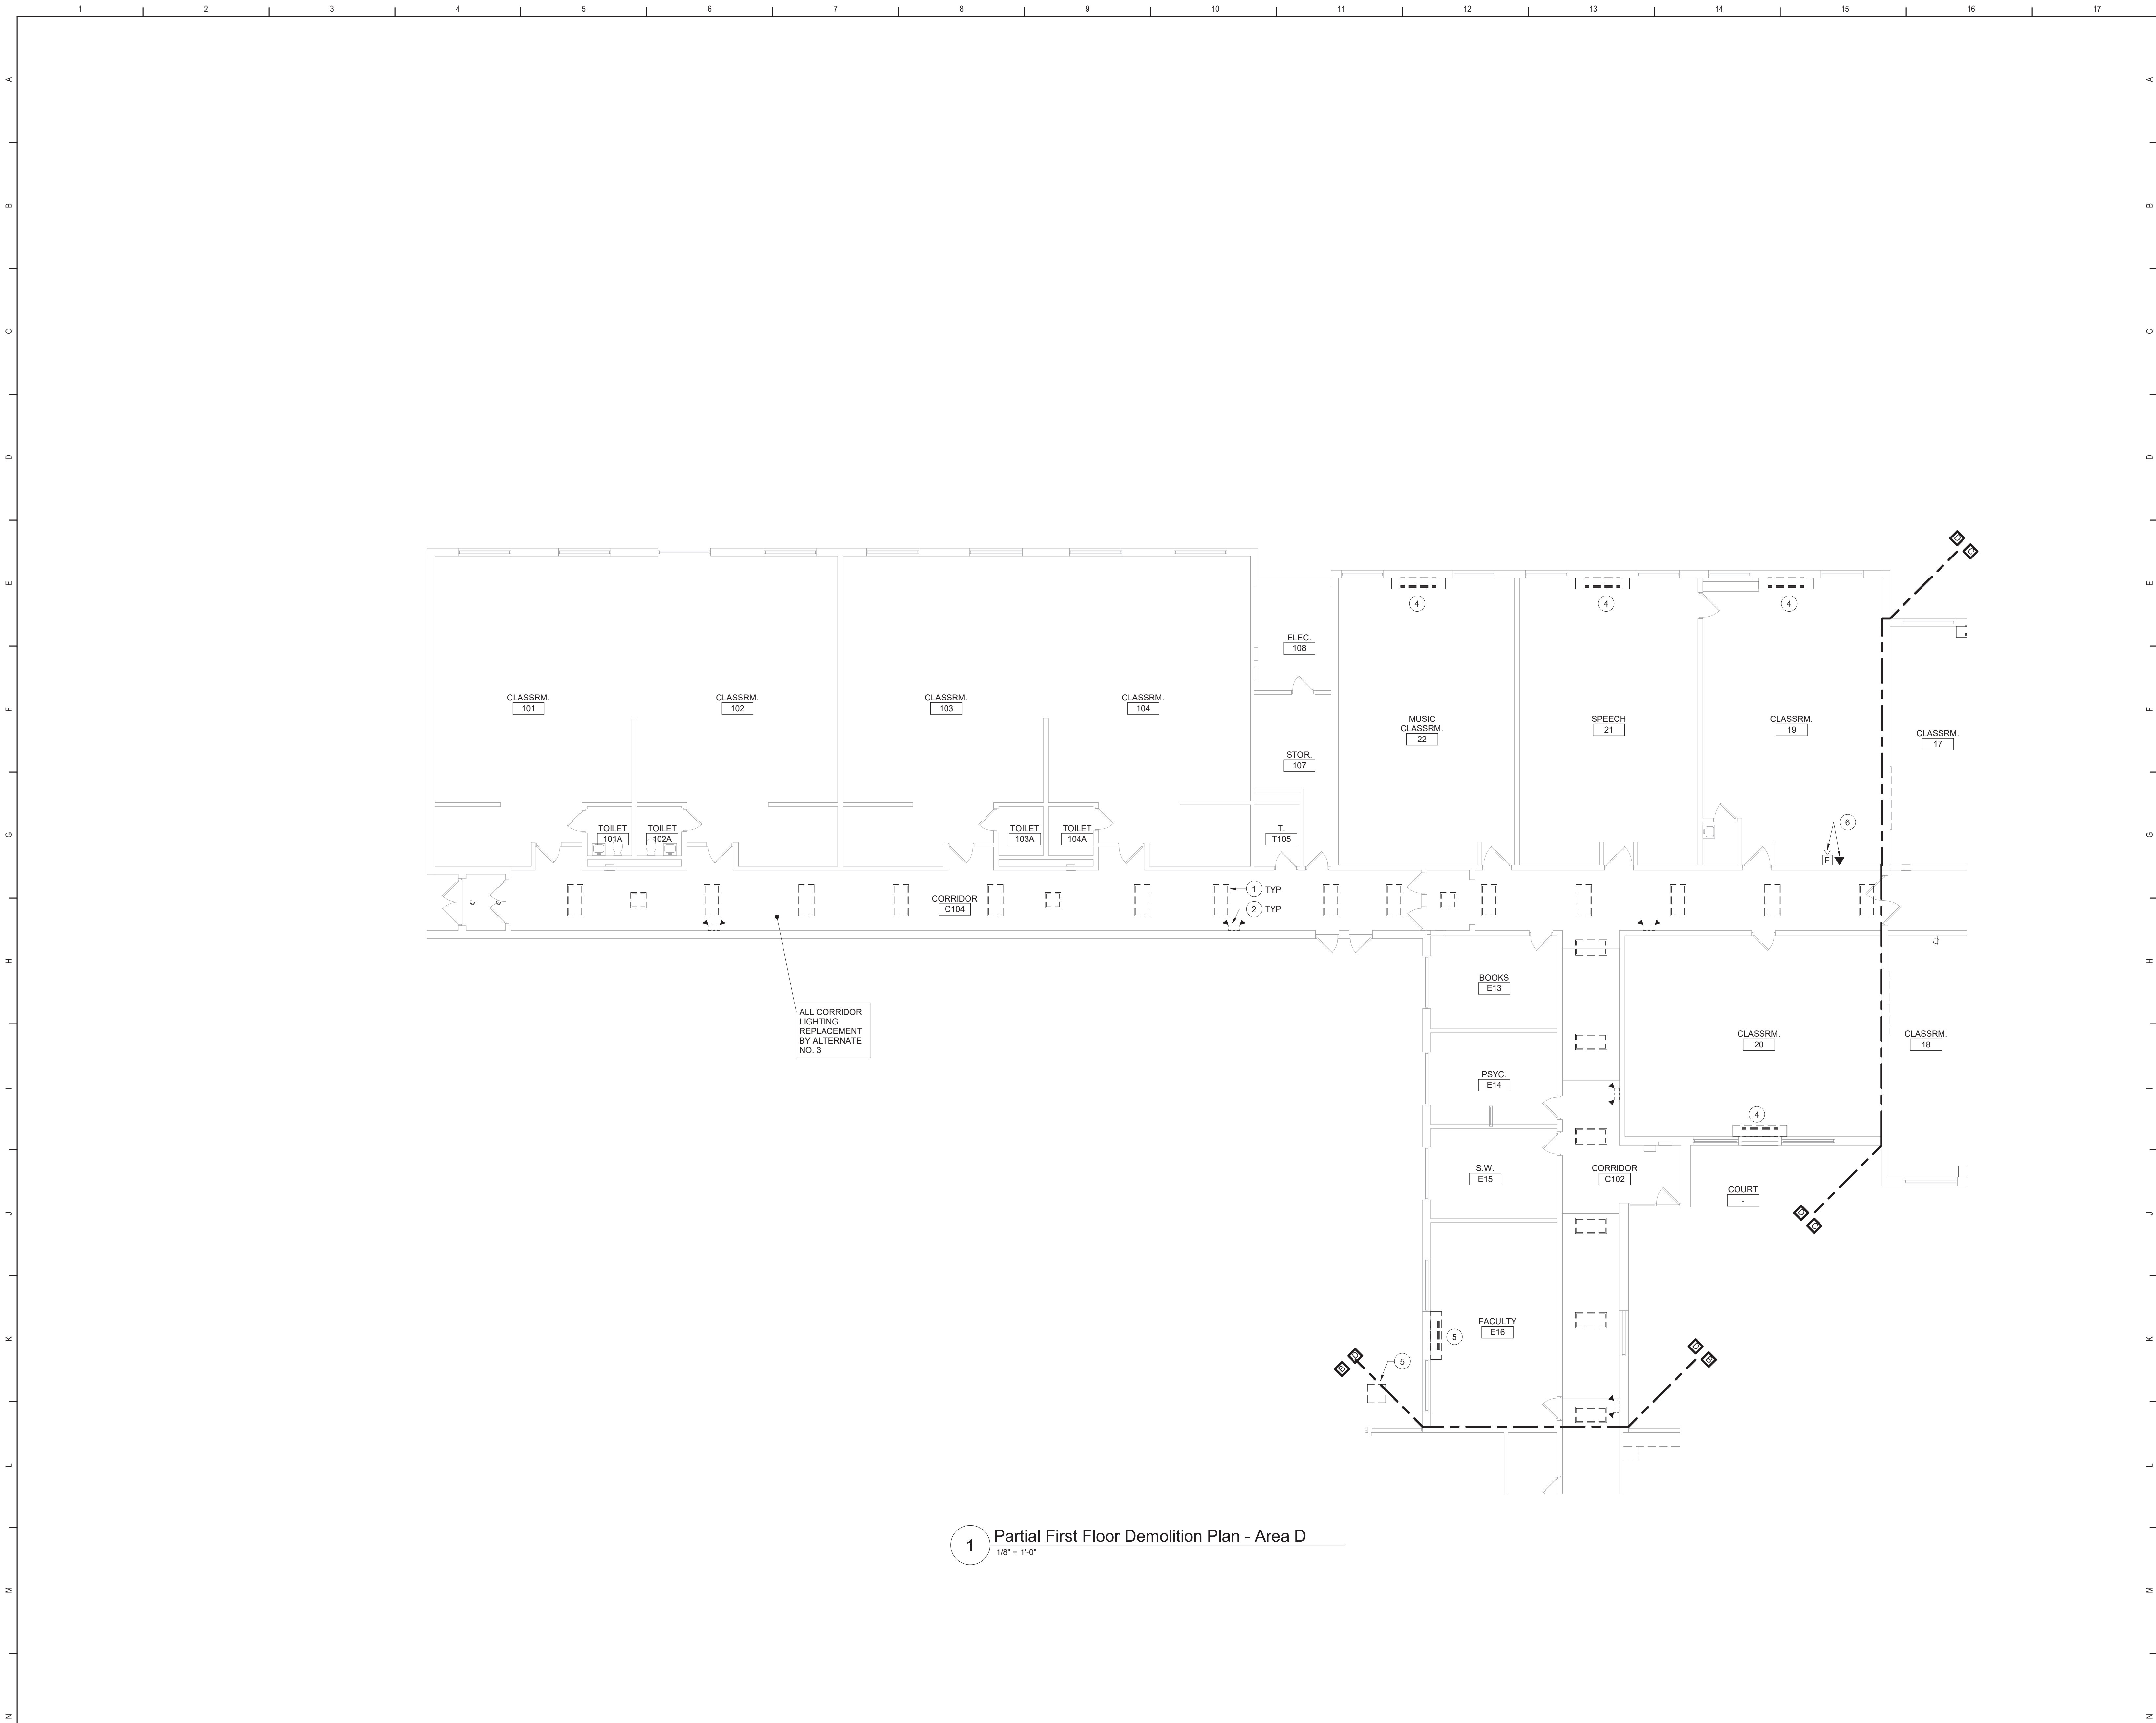


1 Partial First Floor Demolition Plan - Area D  
1/8" = 1'-0"

**Keyed Notes:**

- 1 REMOVE LUMINAIRE(S) AND CIRCUITRY COMPLETE BACK TO SOURCE.
- 2 REMOVE WALL MOUNTED EMERGENCY LIGHT. REMOVE EXISTING CIRCUITRY BACK TO NEAREST JUNCTION BOX OR DEVICE OUTSIDE OF DEMOLITION AREA. MODIFY EXISTING SYSTEM CIRCUITRY TO ALLOW FOR PROPER OPERATION OF REMAINING DEVICES ON CIRCUIT.
- 3 REMOVE LIGHT SWITCH CONTROLLING CORRIDOR LUMNAIRES. REMOVE EXISTING CIRCUITRY BACK TO NEAREST JUNCTION BOX OR DEVICE OUTSIDE OF DEMOLITION AREA. MODIFY EXISTING SYSTEM CIRCUITRY TO ALLOW FOR PROPER OPERATION OF REMAINING DEVICES ON CIRCUIT. PROVIDE BLANK COVER PLATE.
- 4 DISCONNECT POWER CIRCUITRY TO HVAC EQUIPMENT AND TAG FOR RE-USE.
- 5 REMOVE POWER CIRCUITRY TO HVAC EQUIPMENT COMPLETE BACK TO SOURCE. LABEL ANY UNUSED CIRCUIT BREAKERS AS "SPARE". AMEND PANEL DIRECTORY AS NECESSARY.
- 6 REMOVE FIRE ALARM HORN STROBE AND TELEPHONE LINE. PREPARE FOR RE-INSTALLATION.


**General Notes:**

- A. REFER TO DRAWING BE100 FOR GENERAL NOTES

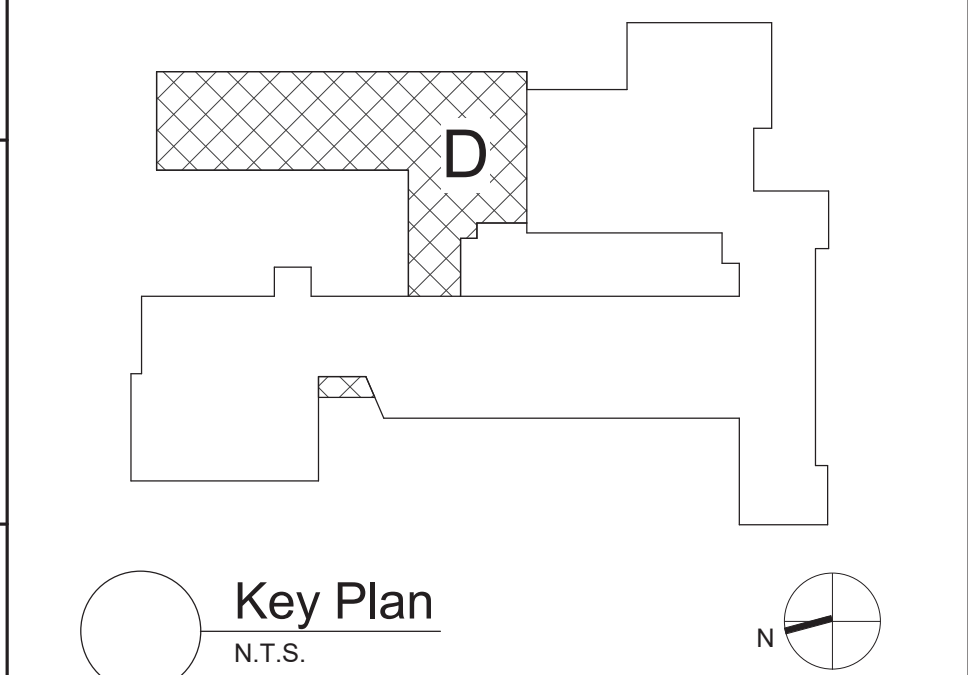

S.E.D. Control No. 13-02-00-01-0-006-022

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Additions and Alterations to:  
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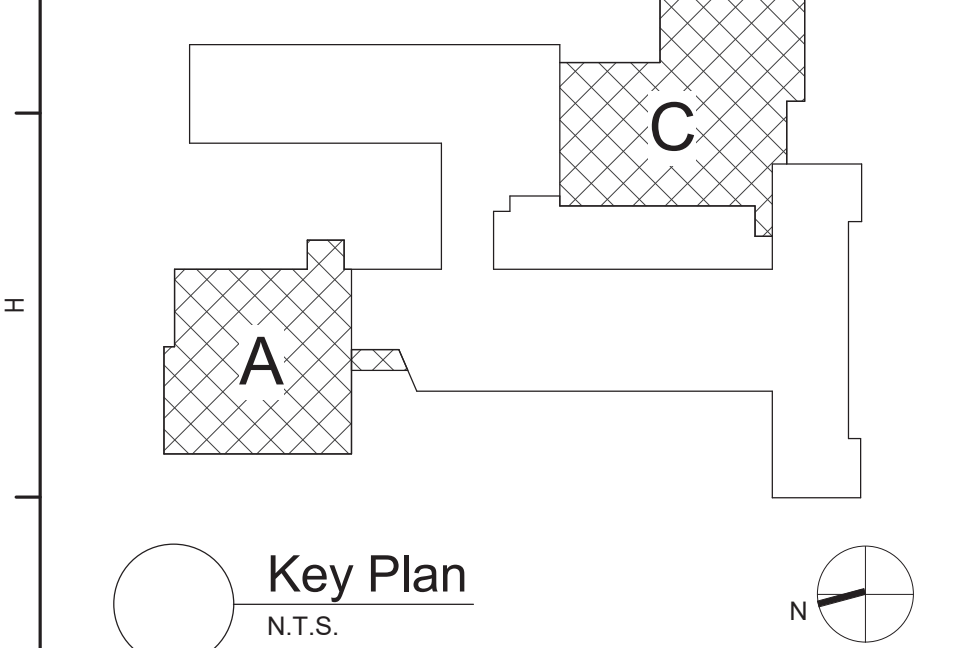
First Floor Demolition Plan - Area D

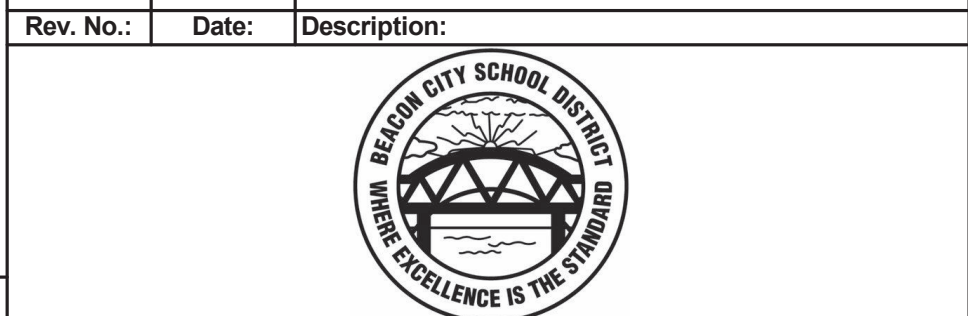Drawn By: Author	Date: 10/28/2022	Drawing Number:
Project No.: 279180-22004		<b>BE102</b>





- ## General Notes:
- A. REFER TO DRAWING BE100 FOR GENERAL NOTES.
  - B. REFER TO DRAWING BE500 FOR LUMINAIRE SCHEDULE.
  - C. ALL EXISTING LUMINAIRES TO BE REMOVED AND NEWLY DISTURBED CEILINGS IN CORRIDORS USING J HOOKS OR CABLE TRAYS.
  - D. PAINT/PAVING CEILING SYSTEMS TO REMAIN THAT HAVE BEEN DISTURBED BY SCHEDULED WORK.
  - E. INVERTER SYSTEM EMERGENCY OUTPUT CIRCUITS SHALL BE INSTALLED IN DEPENDENT CONDUIT SYSTEMS AND NOT SHARED WITH OTHER ELECTRICAL CIRCUITS AS DESCRIBED IN NEC 700-8(b).
  - F. LIGHTING CONTROL SEQUENCE:
    1. TOILETS:
      - a. PERSON ENTERS THE ROOM AND LUMINAIRES TURN ON TO 100% OUTPUT BY OCCUPANCY SENSOR. WHEN PERSON EXITS THE ROOM THE OCCUPANCY SENSOR WILL TURN OFF THE LUMINAIRES AFTER 15 MINUTES. MANUAL CONTROL BY WALL/CEILING KEYS OR SWITCHES.
    2. LOBBY/VESTIBULES/CORRIDORS:
      - a. PERSON ENTERS THE AREA AND LUMINAIRES TURN ON TO 100% OUTPUT AUTOMATICALLY BY OCCUPANCY SENSOR. PERSON EXITS THE AREA. LUMINAIRES DIM TO 50% OUTPUT. DIMMING EGRESS LIGHTS TO MAINTAIN MINIMUM MANUAL CONTROL BY BUILDING MANAGEMENT.



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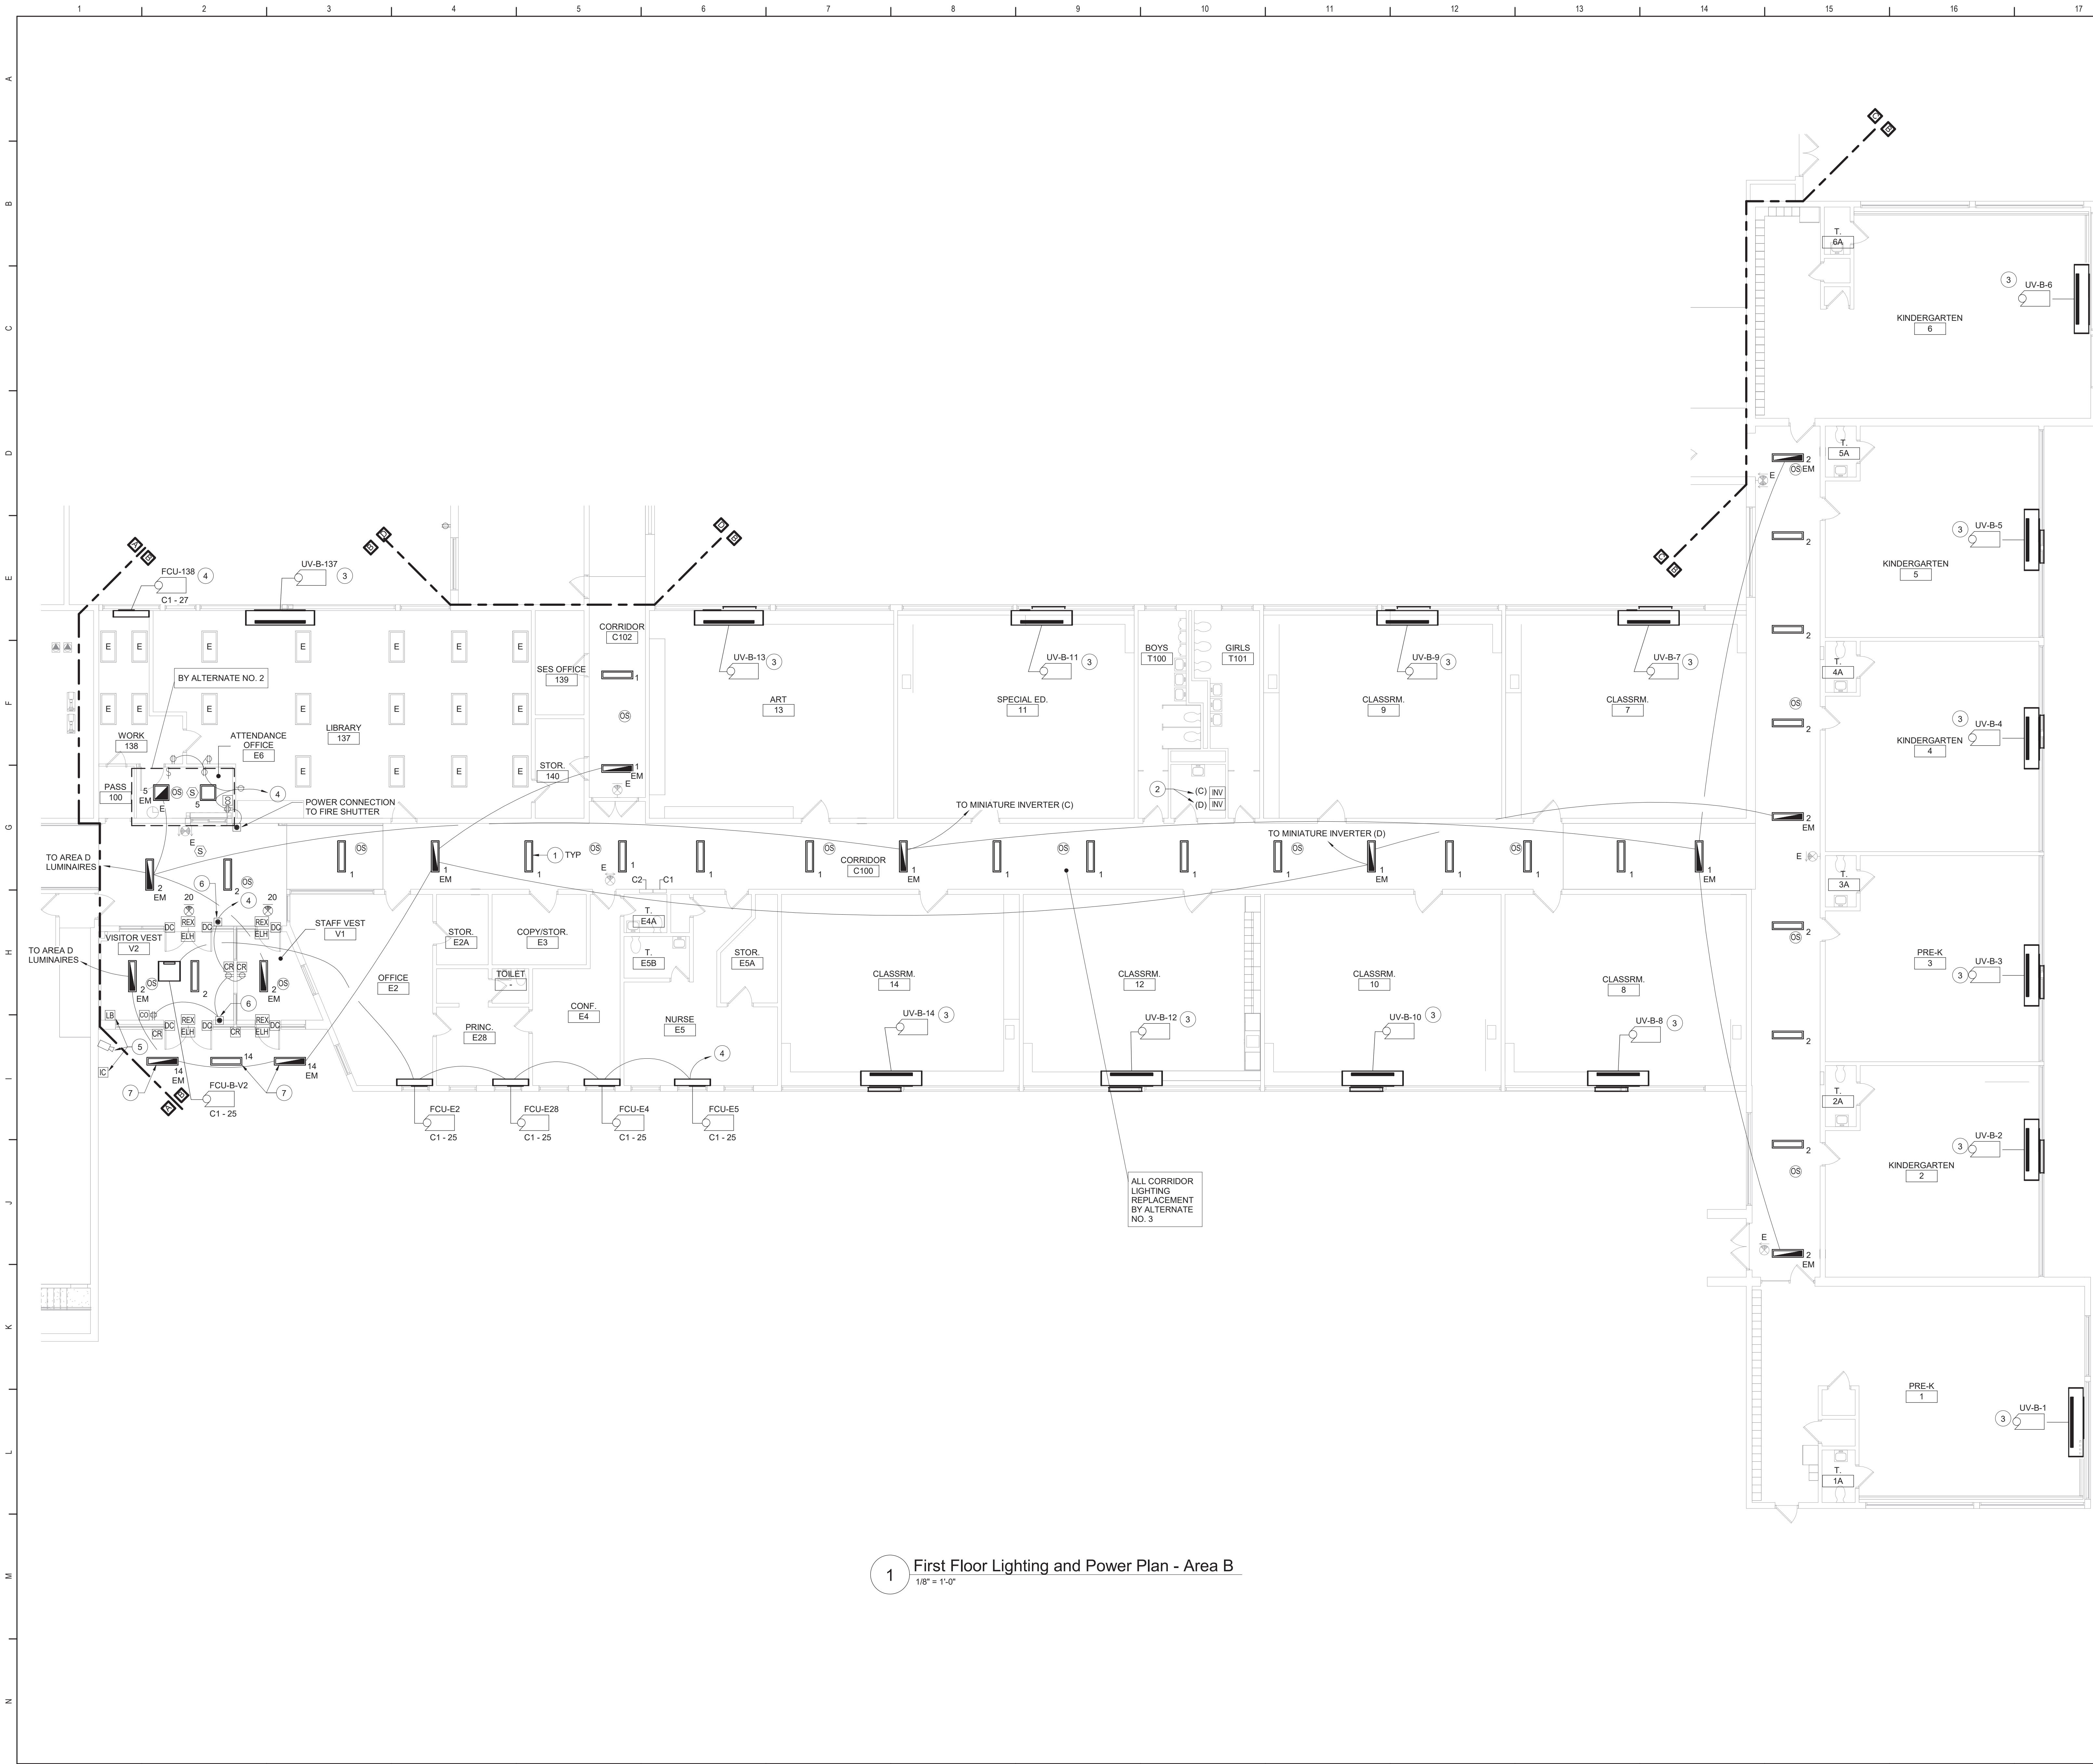
Beacon City School District Beacon, New York
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M	Additions and Alterations to: Glenham Elementary School
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First Floor Lighting and Power Plan -  
Areas A and C


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	Project No.: 279180-22004		BE130








- Keyed Notes:**
- 1 CONNECT LUMINAIRES TO EXISTING CIRCUIT BREAKER PREVIOUSLY SERVING THE AREA USING (2)1/2 (1)1/2 G. IN 1/2" CONDUIT. LUMINAIRES TO BE CONTROLLED BY OCCUPANCY SENSORS AND DIRECT DIGITAL CONTROL SYSTEM.
  - 2 PROVIDE WALL MOUNTED MINIATURE INVERTER BASED ON MODEL VESTA MAX MODEL VST-MAX-375W-UNV-4-OK. MOUNT AT 72" AFF. COORDINATE FINAL LOCATION WITH OWNER. CONNECT EVERY OTHER EMERGENCY LUMINAIRE PER CORRIDOR TO ADJACENT INVERTER TO AVOID TOTAL OUTAGE UPON BATTERY FAILURE. REFER TO WIRING DIAGRAM ON DRAWING BES00.
  - 3 RE-CONNECT TAGGED POWER CIRCUITRY TO HVAC EQUIPMENT. MODIFY/EXTEND CIRCUITRY AS NECESSARY.
  - 4 CIRCUIT TO SPARE 20A1P BREAKER IN PANEL C1 IN CORRIDOR C100. CONNECT USING (2)1/2 (1)1/2 G. IN 1/2" CONDUIT. AMEND PANEL DIRECTORY ACCORDINGLY.
  - 5 RELOCATE DEVICES TO LOCATION SHOWN. MODIFY/EXTEND CIRCUITRY AS NECESSARY.
  - 6 PROVIDE POWER CONNECTION TO POWER SUPPLY FOR DOOR HARDWARE.
  - 7 CONNECT EXTERIOR LUMINAIRES TO EXISTING CIRCUITRY PREVIOUSLY SERVING THE AREA. CONNECT LUMINAIRES TO EXISTING EXTERIOR LIGHTING CONTROLS.

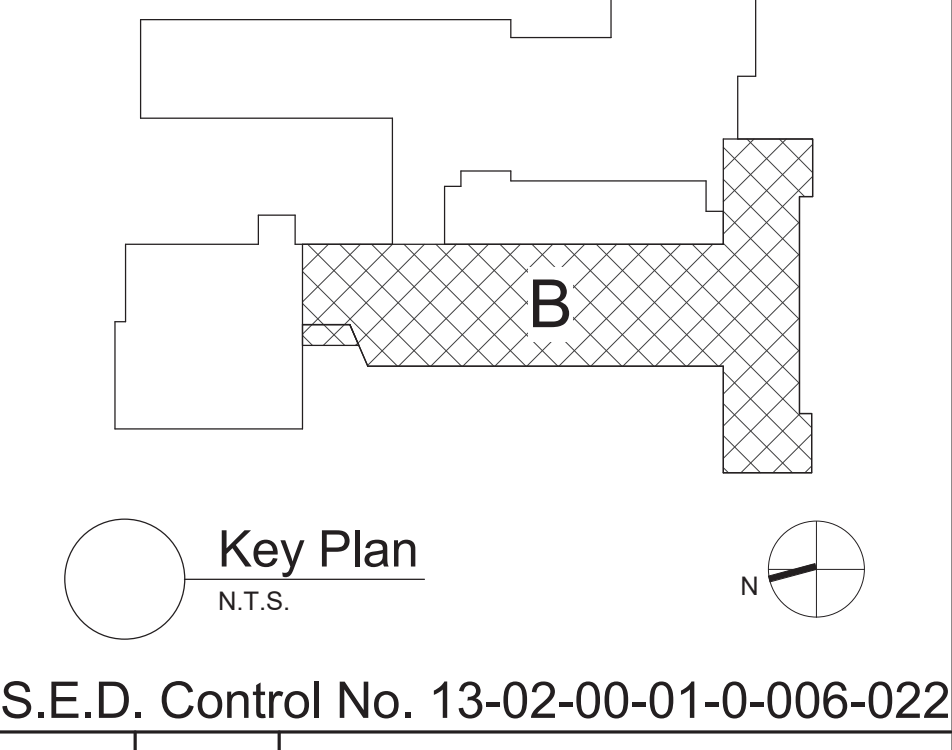- General Notes:**
- A. REFER TO DRAWING BE100 FOR GENERAL NOTES.  
B. REFER TO DRAWING BE500 FOR LUMINAIRE SCHEDULE.  
C. SECURE ALL EXISTING UNSUPPORTED CABLES ABOVE DISTURBED CEILINGS IN CORRIDORS USING J HOOKS OR CABLETRAYS.  
D. PATCH/REPLACE CEILING SYSTEMS TO REMAIN THAT HAVE BEEN DISTURBED BY SCHEDULED WORK.  
E. INVERTER SYSTEM EMERGENCY OUTPUT CIRCUITS SHALL BE INSTALLED IN DEDICATED CONDUIT SYSTEMS AND NOT SHARED WITH OTHER ELECTRICAL CIRCUITS AS DESCRIBED IN NEC 700.9(B).  
F. LIGHTING CONTROL SEQUENCES:  
LOBBY/VESTIBULES/CORRIDORS:  
PERSON ENTERS THE AREA, LUMINAIRES TURN ON TO 100% OUTPUT AUTOMATICALLY BY OCCUPANCY SENSOR. PERSON EXITS THE AREA, LUMINAIRES DIM TO 50% OUTPUT (MAINTAINING EGRESS LEVEL ILLUMINATION) - MANUAL CONTROL BY BUILDING MANAGEMENT SYSTEM.  
OFFICES:  
PERSON ENTERS THE ROOM AND LUMINAIRES TURN ON TO 50% OUTPUT BY OCCUPANCY SENSOR. WHEN PERSON EXITS THE ROOM THE OCCUPANCY SENSOR WILL TURN OFF THE LUMINAIRES AFTER 15 MINUTES. LOW VOLTAGE LIGHTING CONTROL. BUTTON CAPABLE OF ON/OFF, 50% AND 100% MAYBE BE MANUALLY ADJUSTED BY BUTTON.



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Additions and Alterations to: Glenham Elementary School								
First Floor Lighting and Power Plan - Area B								
Drawn By: CR			Date: 10/28/2022			Drawing Number: <b>BE131</b>		



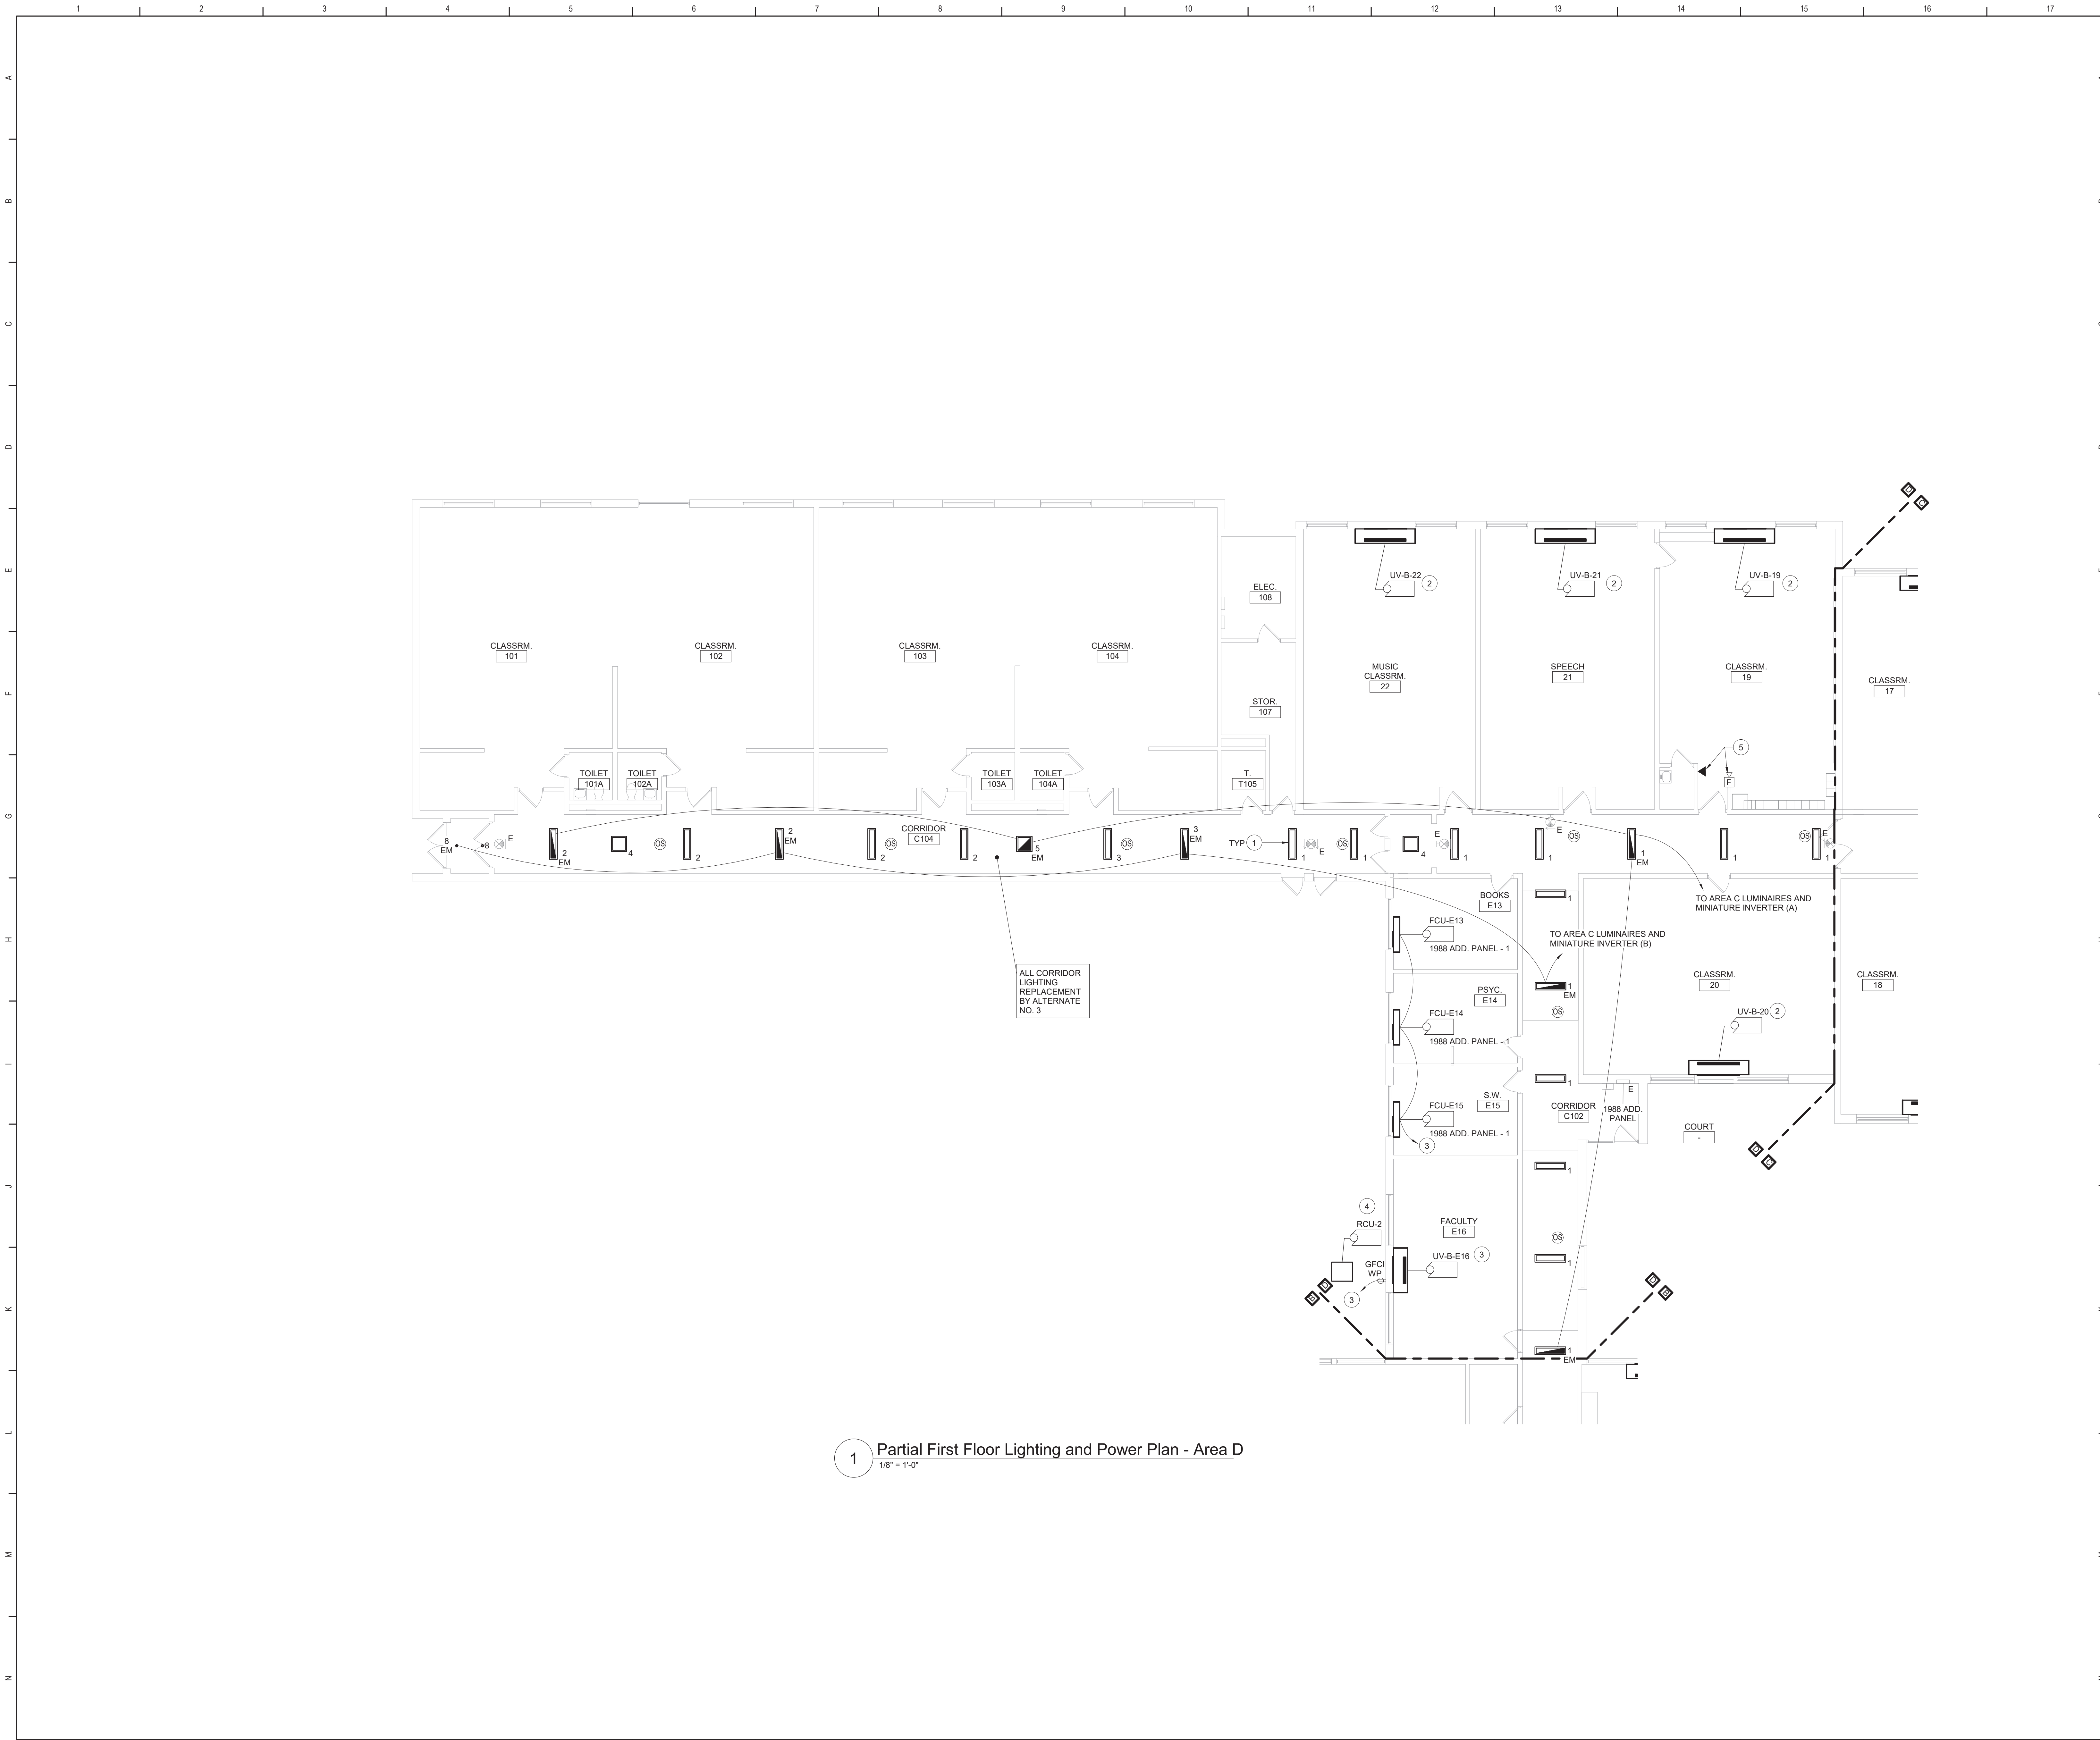


1 Partial First Floor Lighting and Power Plan - Area D  
1/8" = 1'-0"

- Keyed Notes:**
- 1 CONNECT LUMINAIRES TO EXISTING CIRCUIT BREAKER PREVIOUSLY SERVING THE AREA USING (2)#12, (1)#12 G. IN 1/2" CONDUIT. LUMINAIRES TO BE CONTROLLED BY OCCUPANCY SENSORS AND DIRECT DIGITAL CONTROL SYSTEM.
  - 2 RE-CONNECT TAGGED POWER CIRCUITRY TO HVAC EQUIPMENT. MODIFY/EXTEND CIRCUITRY AS NECESSARY.
  - 3 CIRCUIT TO SPARE 20A1P BREAKER IN PANEL 1988 ADD. PANEL IN CORR C102. CONNECT USING (2)#12, (1)#12 G. IN 1/2" CONDUIT. AMEND PANEL DIRECTORY ACCORDINGLY.
  - 4 PROVIDE 30A2P BREAKER IN AVAILABLE SPACE IN PANEL 1988 ADD. PANEL IN CORR C102. CONNECT USING (2)#10, (1)#10 G. IN 1/2" CONDUIT. REMOVE EXISTING SPARE BREAKER(S) IF NECESSARY TO PROVIDE ROOM IN PANEL. NEW BREAKER TO BE UL LISTED FOR USE IN PANEL AND MEET OR EXCEED AIC RATING OF EXISTING PANEL. AMEND PANEL DIRECTORY ACCORDINGLY.
  - 5 RE-INSTALL FIRE ALARM HORN STROBE AND TELEPHONE LINE AT LOCATION SHOWN. MODIFY/EXTEND CIRCUITRY AS NECESSARY.
- General Notes:**
- A. REFER TO DRAWING BE100 FOR GENERAL NOTES.  
B. REFER TO DRAWING BE500 FOR LUMINAIRE SCHEDULE.  
C. SECURE ALL EXISTING UNSUPPORTED CABLES ABOVE DISTURBED CEILINGS IN CORRIDORS USING J HOOKS OR CABLETRAYS.  
D. PATCH/REPLACE CEILING SYSTEMS TO REMAIN THAT HAVE BEEN DISTURBED BY SCHEDULED WORK.  
E. INVERTER SYSTEM EMERGENCY OUTPUT CIRCUITS SHALL BE INSTALLED IN DEDICATED CONDUIT SYSTEMS AND NOT SHARED WITH OTHER ELECTRICAL CIRCUITS AS DESCRIBED IN NEC 700-9(B).  
F. LIGHTING CONTROL SEQUENCES:  
LOBBY/VESTIBULES/CORRIDORS:  
PERSON ENTERS THE AREA, LUMINAIRES TURN ON TO 100% OUTPUT AUTOMATICALLY BY OCCUPANCY SENSOR.  
PERSON EXITS THE AREA, LUMINAIRES DIM TO 50% OUTPUT (MAINTAINING EGRESS LEVEL ILLUMINATION). MANUAL CONTROL BY BUILDING MANAGEMENT SYSTEM.

**Key Plan**  
N.T.S.


S.E.D. Control No. 13-02-00-01-0-006-022

Rev. No.	Date	Description

  
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Beacon City School District  
Beacon, New York

Additions and Alterations to:  
Glenham Elementary School

First Floor Lighting and Power Plan - Area D

Drawn By: CR	Date: 10/28/2022	Drawing Number:
Project No.: 279180-22004		<b>BE132</b>




## 5 Luminaire Schedule




Drawn By: SAS	Date: 10/28/2022	Drawing Number:
Project No.: 279180-22004		BE5



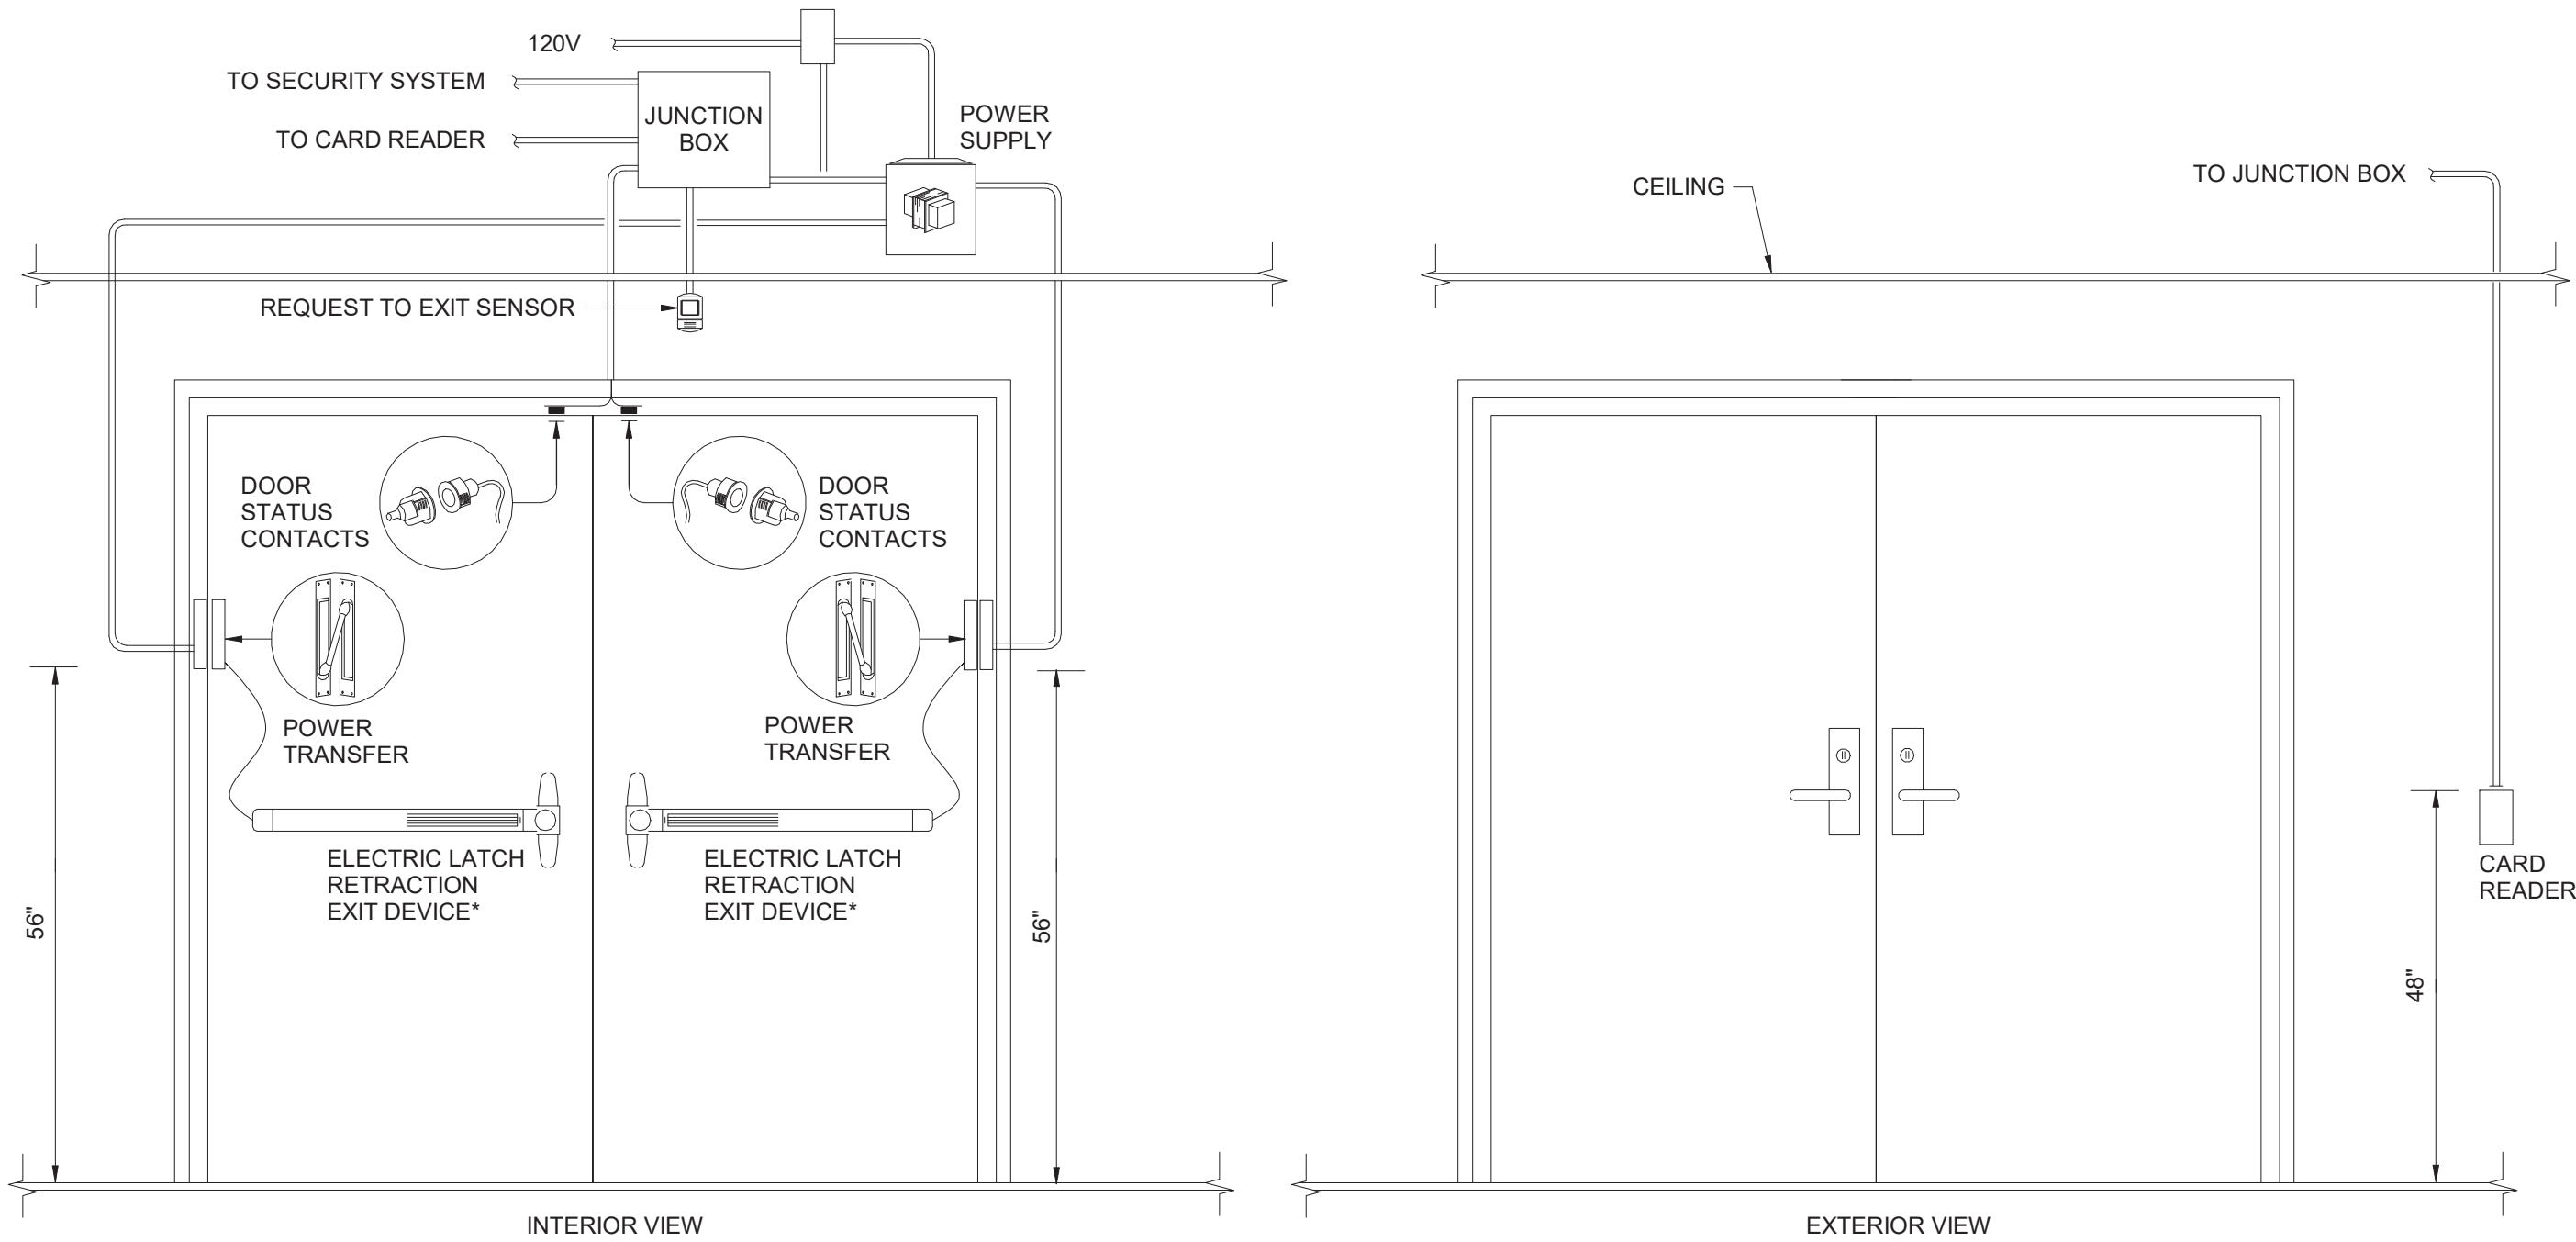


- \*NOTES:
1. PANIC HARDWARE SHALL ALWAYS REMAIN FULLY OPERATIONAL MANUALLY, NO MATTER WHAT THE STATUS OF ELECTRIC LATCH. SEE SPECIFICATION SECTION 087100 FOR FURTHER INFORMATION.
  2. VIEW MAY BE MIRRORED

## 1 Door Configurations

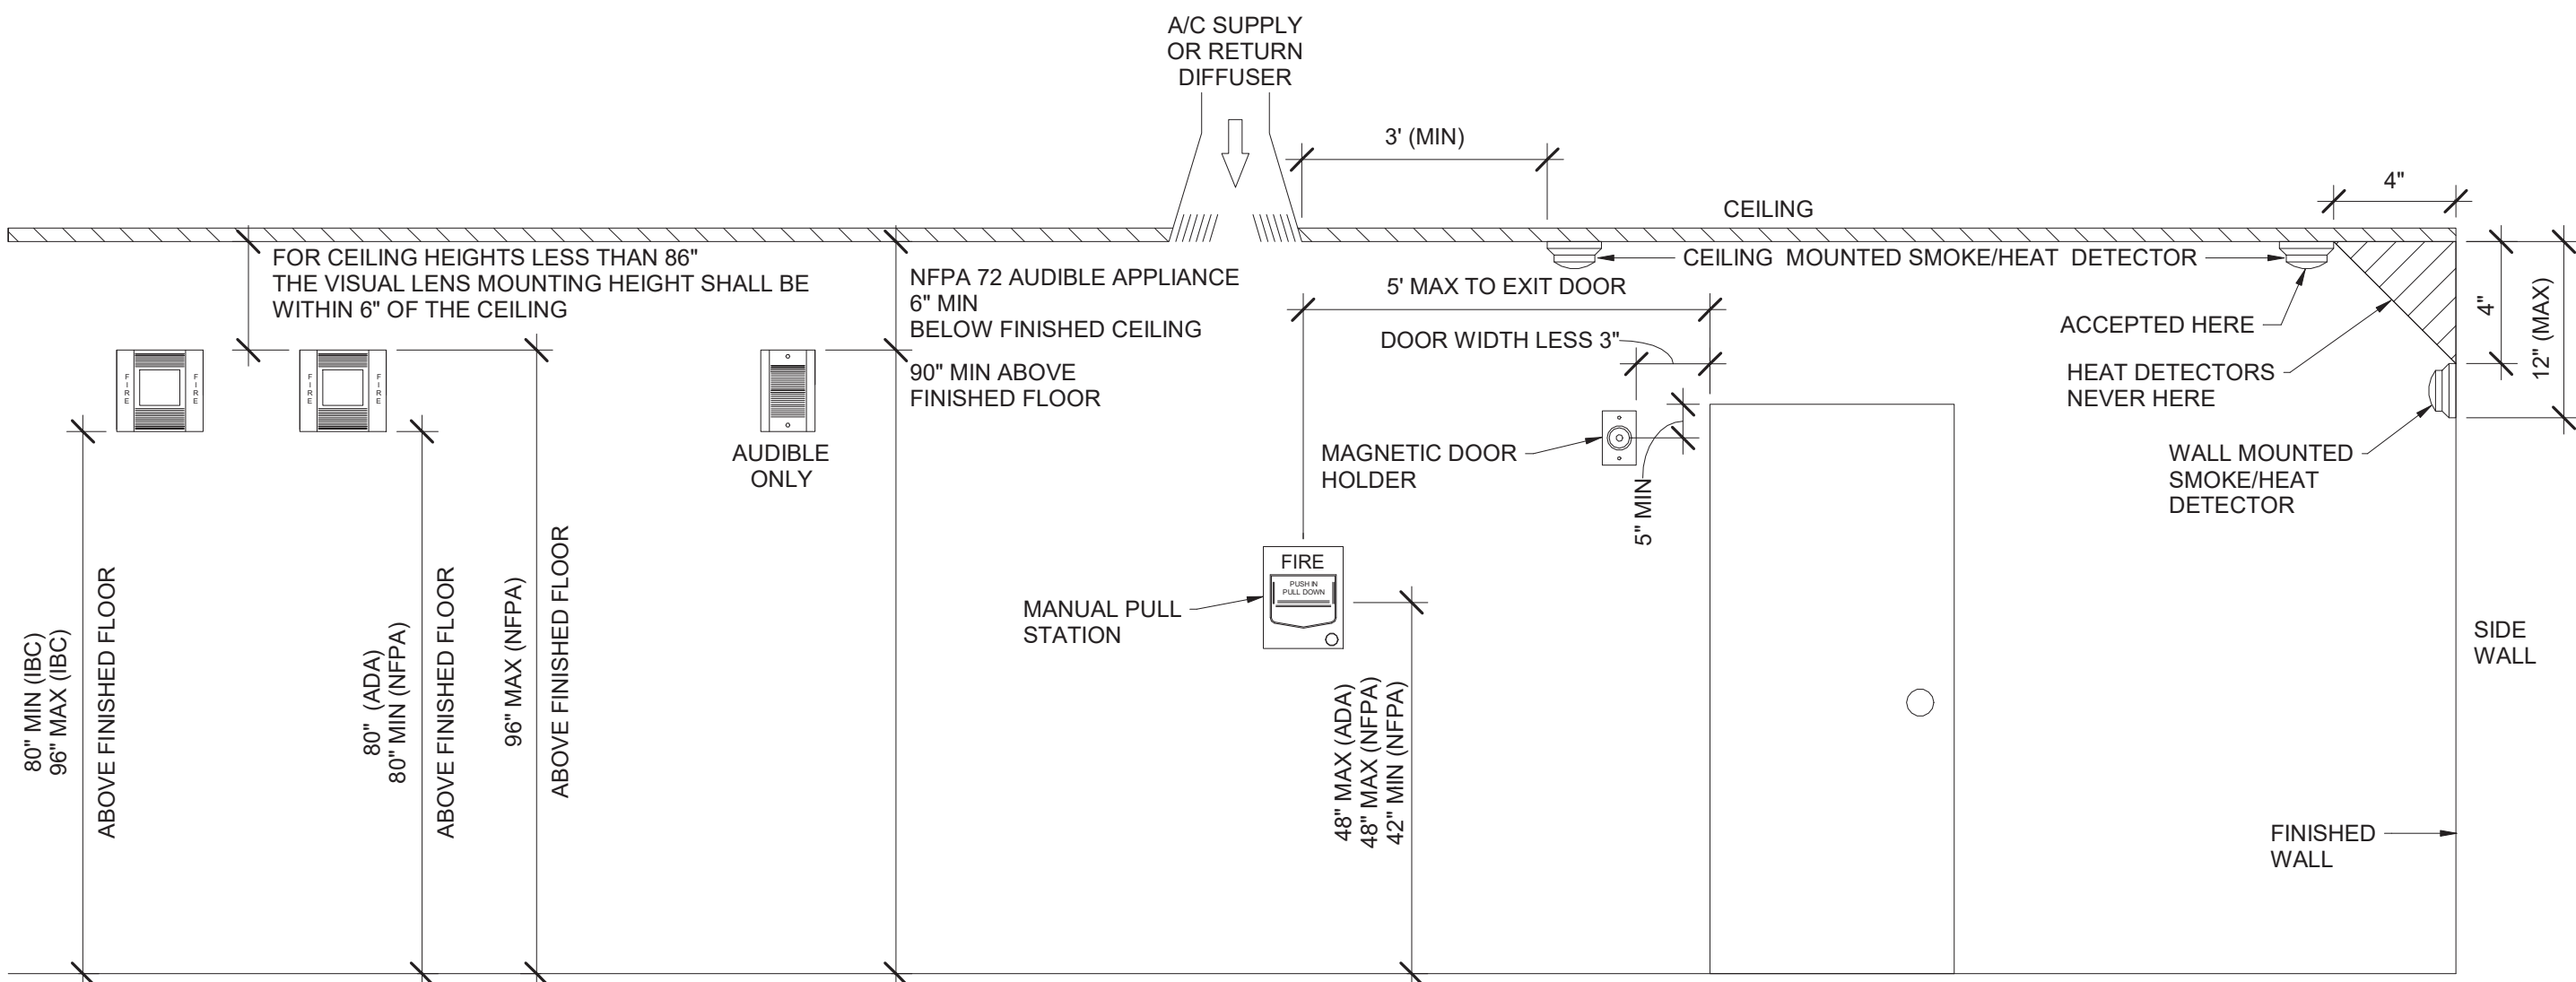


## 6 Typical Mounting Heights

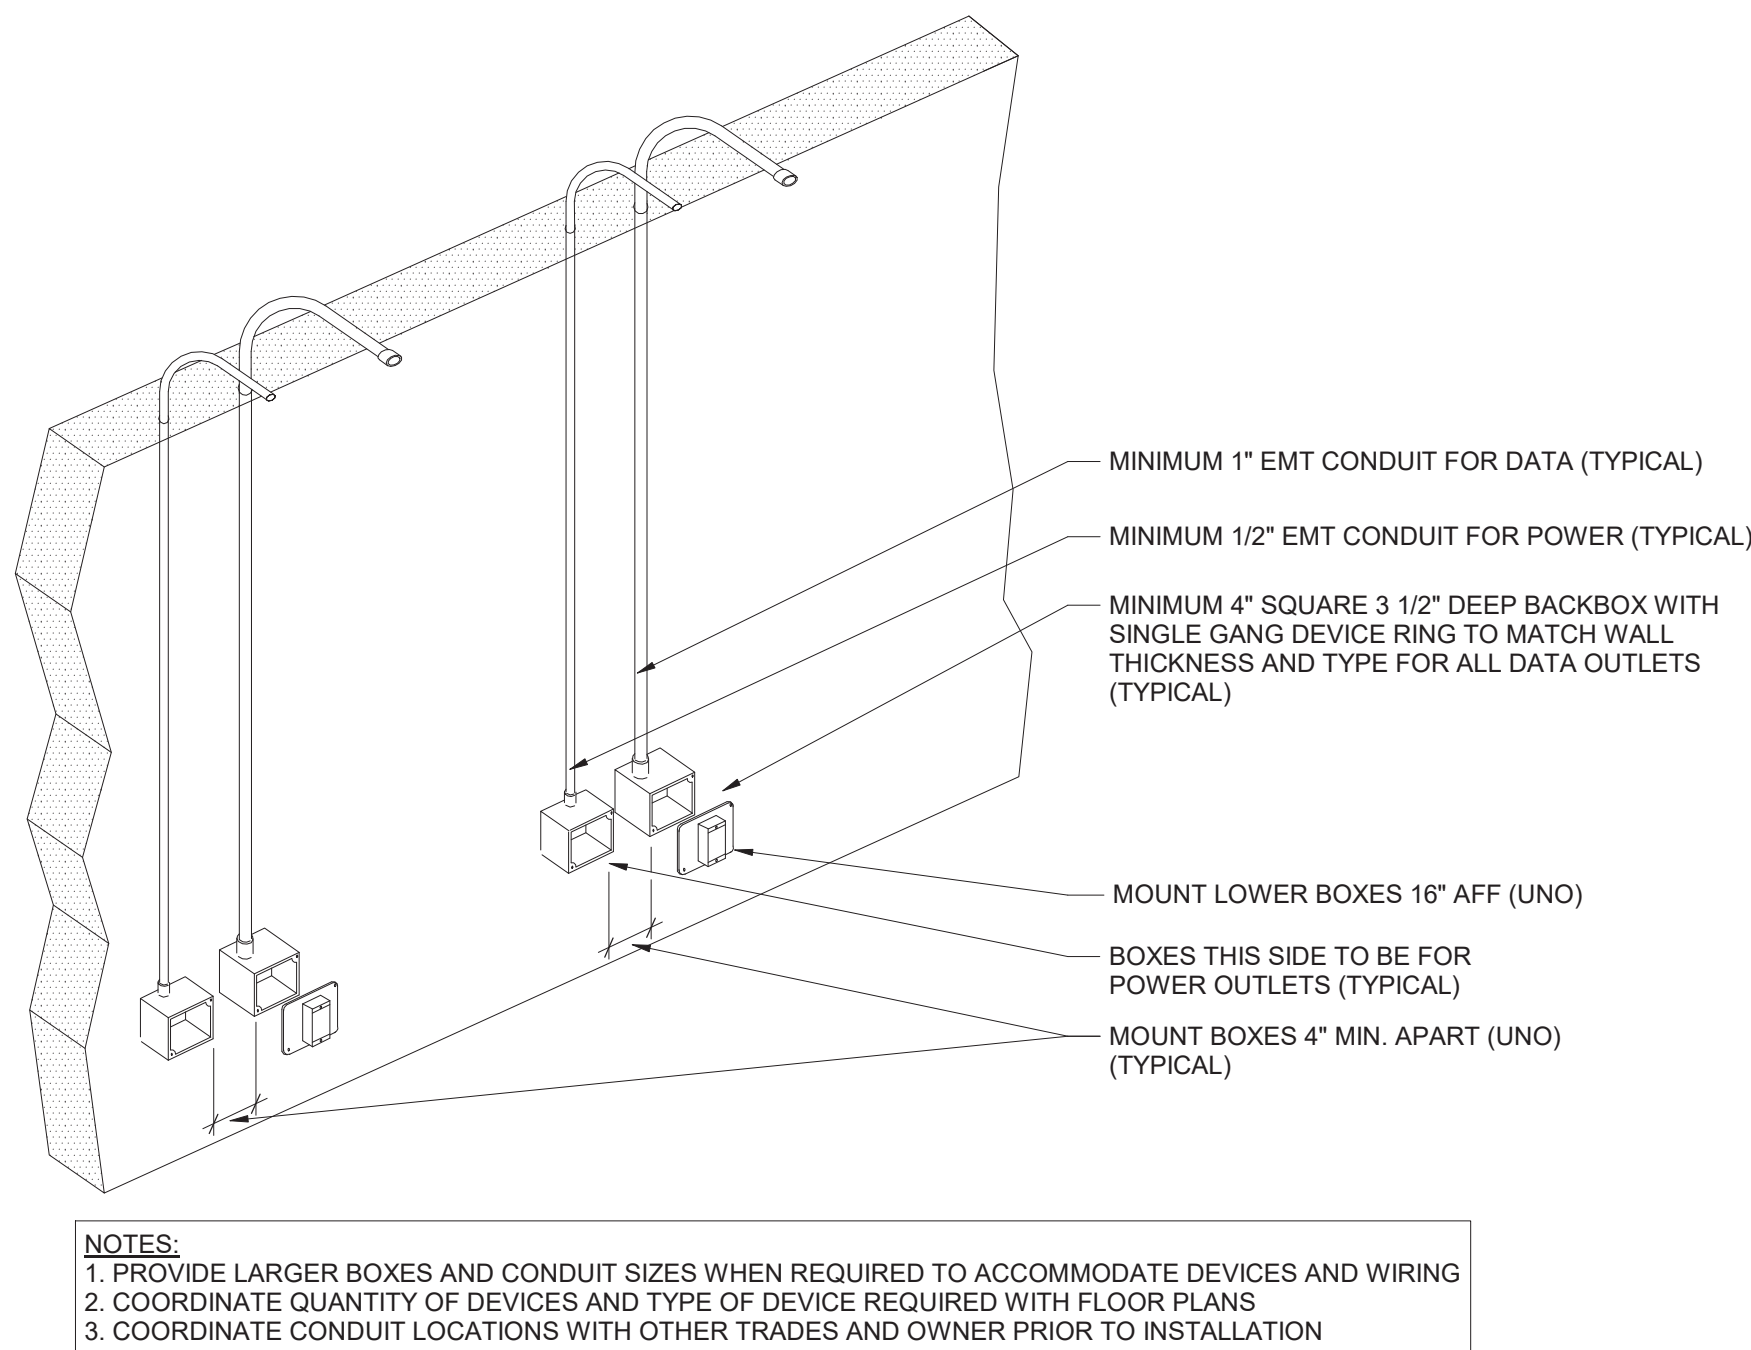

- \*NOTES:
1. PROVIDE LARGER BOXES AND CONDUIT SIZES WHEN REQUIRED TO ACCOMMODATE DEVICES AND WIRING
  2. COORDINATE QUANTITY OF DEVICES AND TYPE OF DEVICE REQUIRED WITH FLOOR PLANS
  3. COORDINATE CONDUIT LOCATIONS WITH OTHER TRADES AND OWNER PRIOR TO INSTALLATION

## 7 Conduit/Backbox Installation Detail

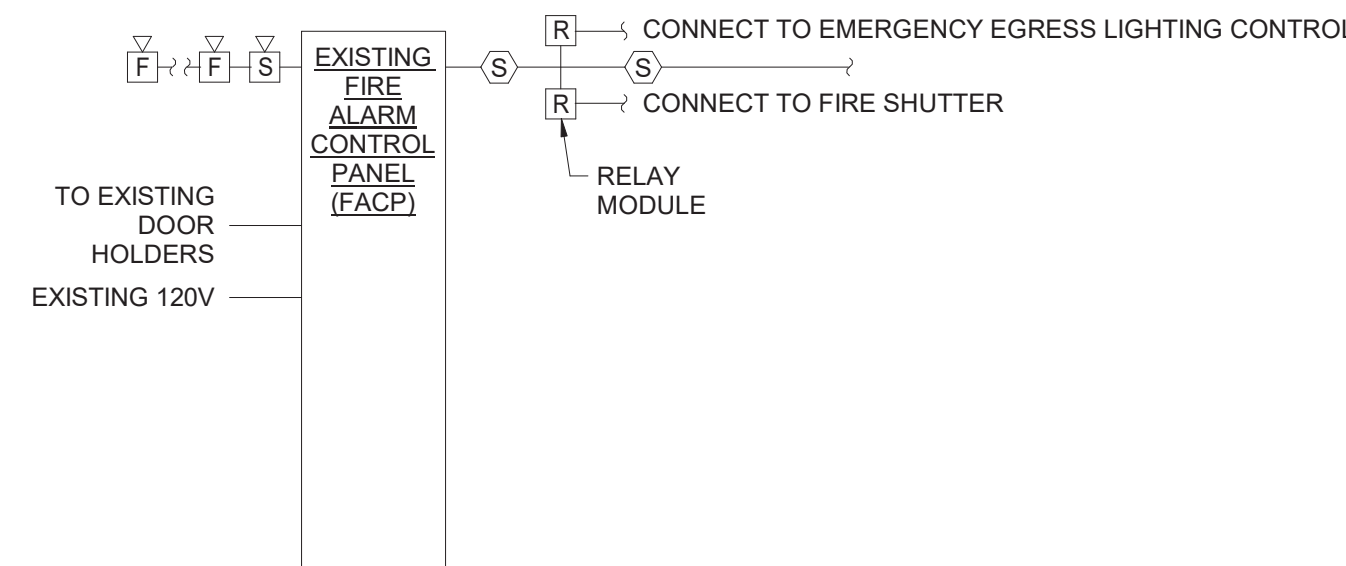


### FIRE ALARM SEQUENCE OF OPERATION


- UPON ACTIVATION OF MANUAL PULL STATIONS, HEAT DETECTORS, SMOKE DETECTORS, DUCT DETECTORS, THE FIRE ALARM PANEL WILL GO INTO ALARM AND SHOULD SOUND THE A/V DEVICES, SHUT DOWN THE FANS, RELEASE THE MAGNETIC DOOR HOLDERS, CONTACT THE LOCAL FIRE DEPARTMENT AND INDICATE WHICH ALARM ZONE THE ALARM IS IN VIA THE REMOTE ANNUNCIATORS.
- UPON ACTIVATION OF A TROUBLE CONDITION THE FIRE ALARM PANEL SHALL GO INTO "TROUBLE" MODE INDICATING WHICH ZONE IS IN TROUBLE BY A LIGHT IN THE REMOTE ANNUNCIATOR AND AT THE FIRE ALARM PANEL.

NOTE:  
FIRE ALARM RISER IS INTENDED TO BE SCHEMATIC ONLY.  
ALL DEVICES INDICATED ON PLANS AND DETAILS ARE TO  
BE INSTALLED AND CONNECTED FOR PROPER OPERATION  
OF SYSTEM.

## 4 Fire Alarm System Wiring Diagram

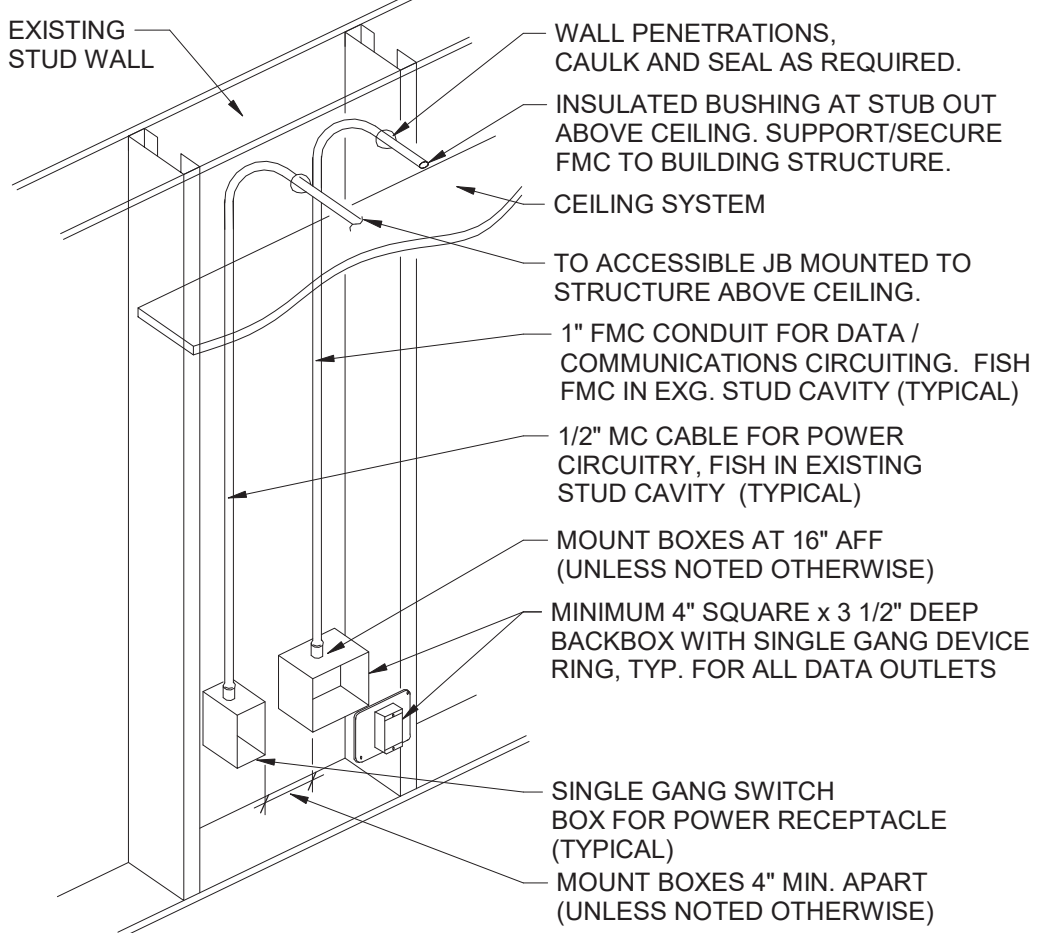


## 5 Conduit/Backbox Installation Detail (in Existing Stud Wall)

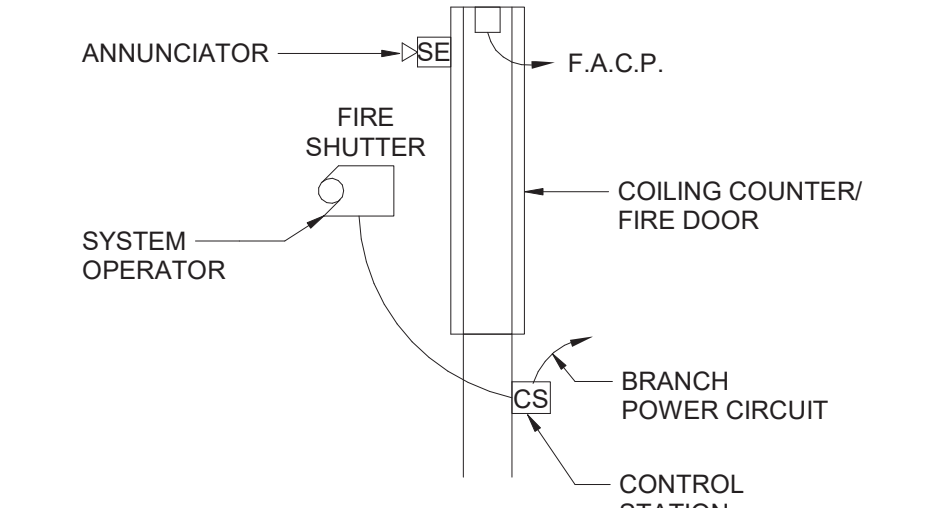

### \*NOTES:

1. INSTALL THE FOLLOWING EQUIPMENT, FURNISHED BY OTHERS:
  - CONTROL STATION(S)
  - ANNUNCIATOR(S)
2. PROVIDE A BRANCH CIRCUIT (INDICATED ON PLAN) TO SYSTEM OPERATOR VIA THE CONTROL STATION.
3. PROVIDE A 24 VDC CONNECTION FROM THE F.A.C.P. TO THE RELEASE DEVICE(S).
4. PROPERLY PROGRAM F.A.C.P. TO SIGNAL RELEASE DEVICE TO OPERATE WHEN A FIRE DETECTION APPLIANCE IN THE ADJOINING SPACES SERVED BY ROLLING FIRE DOOR(S) ARE INITIATED.

## 2 Typical Coiling Door Wiring Schematic

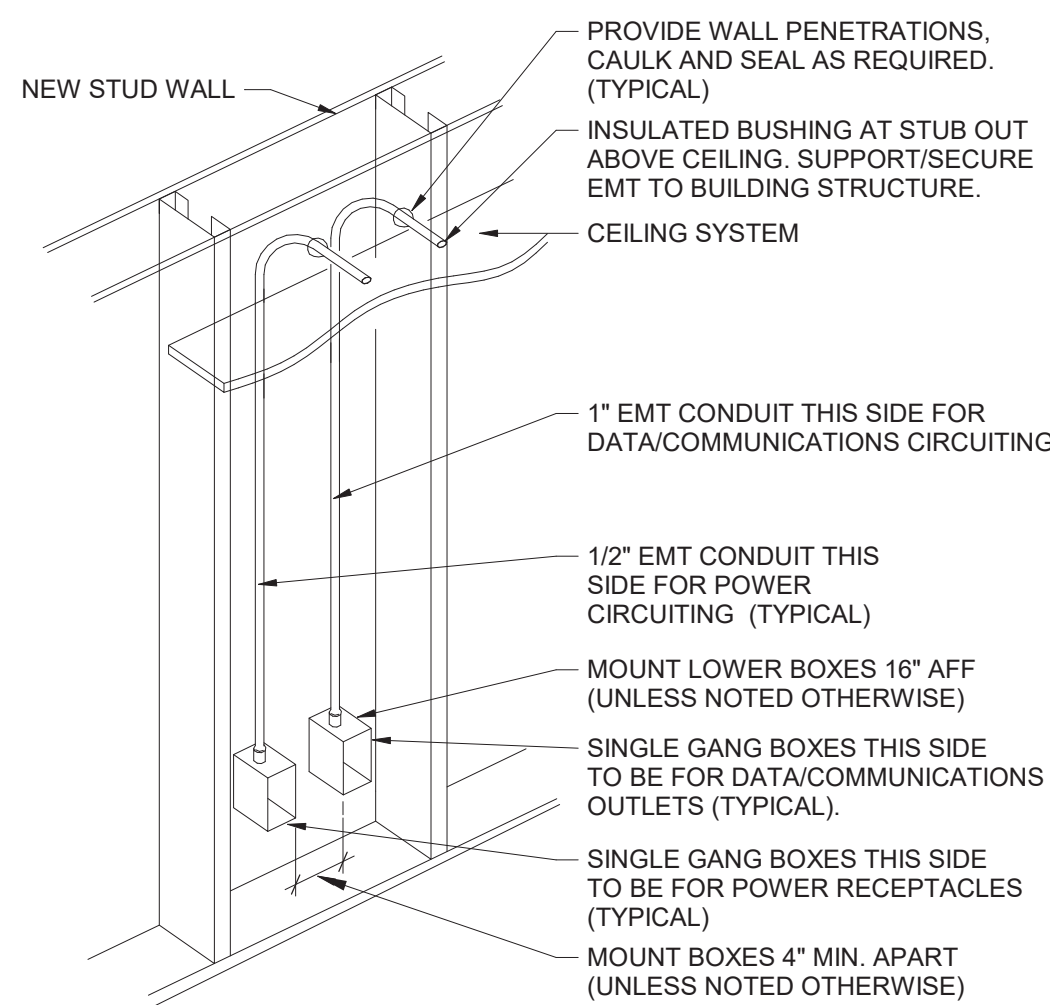

## 3 Conduit/Backbox Installation Detail

S.E.D. Control No. 13-02-00-01-0-006-022

Rev. No.: Date: Description:



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Beacon City School District  
Beacon, New York

Additions and Alterations to:  
Glenham Elementary School

Details

Drawn By: SAS  
Project No.: 279180-22004

Date: 10/28/2022


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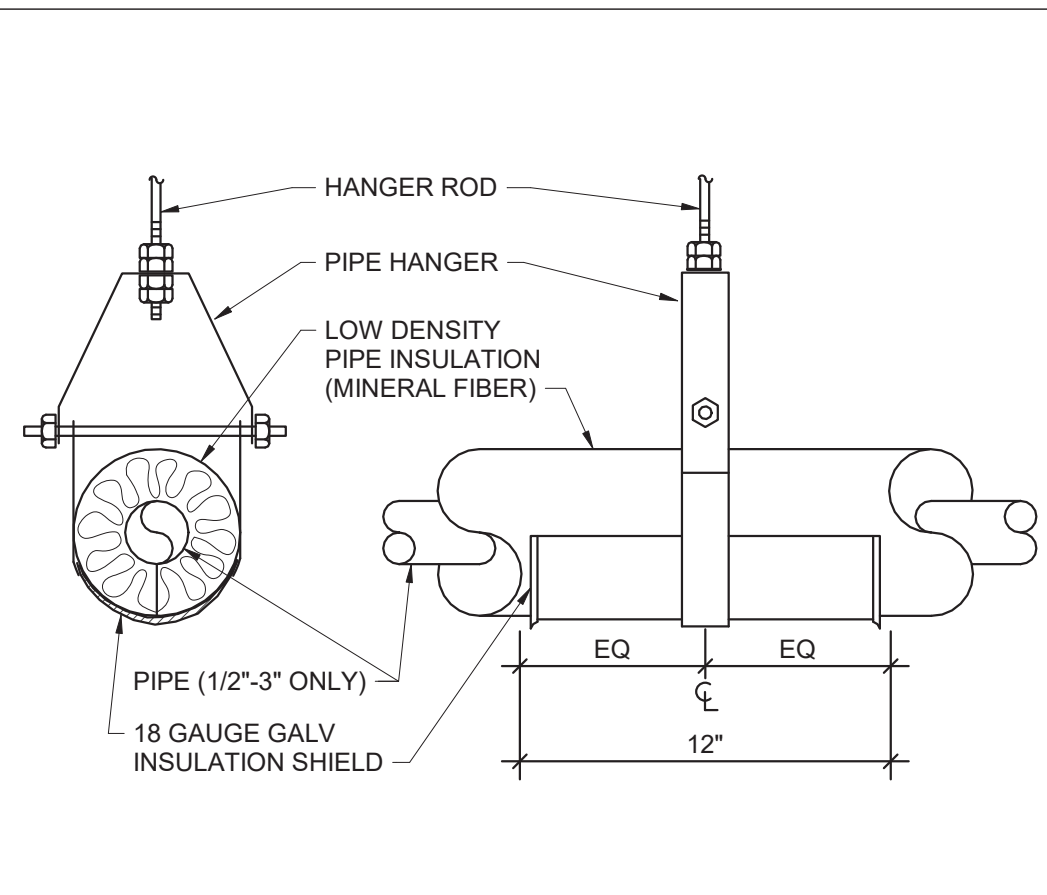
# Plumbing Fixture Schedule

DWG LABEL	ROUGH-IN CONNECTION SIZE (INCHES)				BARRIER FREE	AGE GROUP	RIM HEIGHT	DESCRIPTION	NOTES
	SAN	VENT	CW	HW					
WC "A"	4	2	1	-	NO	ADULT	15"	VITREOUS CHINA, WALL MOUNTED WITH SUPPORT, TOP SPUD, MANUAL DUAL FLUSH VALVE AND SEAT.	1, 2
WC "B"	4	2	1	-	YES	ADULT	18"	ACCESSIBLE, VITREOUS CHINA, WALL MOUNTED WITH SUPPORT, TOP SPUD, MANUAL DUAL FLUSH VALVE AND SEAT.	1, 2
LAV "A"	1 1/2	1 1/2	1/2	1/2	NO	ADULT	31"	VITREOUS CHINA, WALL MOUNTED WITH MANUAL, HARD WIRED SENSOR FAUCET, SUPPLIES, TAILPIECE AND TRAP.	1, 2
LAV "B"	1 1/2	1 1/2	1/2	1/2	YES	ADULT	34"	ACCESSIBLE, VITREOUS CHINA, WALL MOUNTED WITH MANUAL, HARD WIRED SENSOR FAUCET, SUPPLIES, OFFSET TAILPIECE, TRAP, AND INSULATION KIT.	1, 2, 3
INT WH	-	-	3/4	-	-	-	-	CONCEALED OUTLET, SELF DRAINING MODERATE CLIMATE WALL HYDRANT.	


- NOTES:
- REFER TO TOILET ROOM PLANS ON ARCHITECTURE DRAWINGS FOR FIXTURE CENTERLINE DIMENSIONS.
  - SIZES INDICATED ARE MINIMUM. LARGER SIZES SPECIFICALLY INDICATED ON DRAWINGS SUPERCEDE MINIMUM SIZES INDICATED IN THIS SCHEDULE.
  - REFER TO DETAIL 8/ BP130 FOR ADDITIONAL INFORMATION.



6 Fire Rated Metal Stud Wall Sleeve Detail

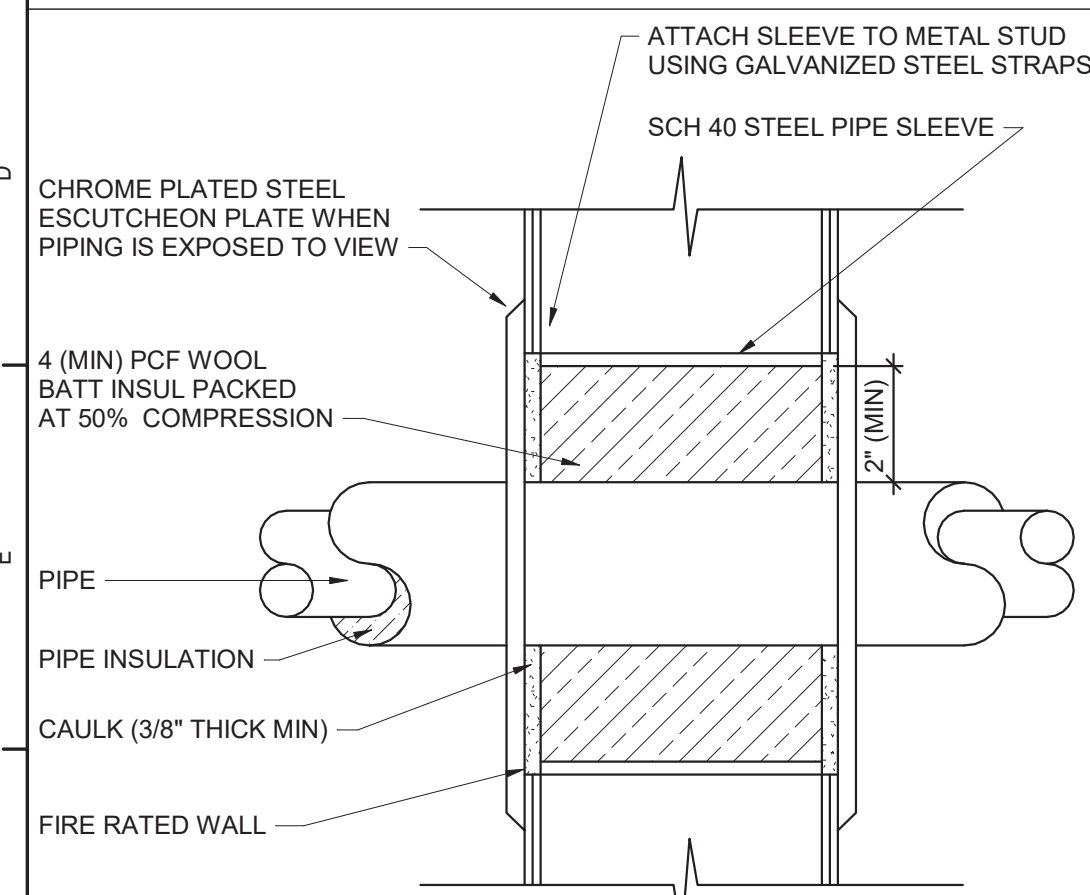


4 Insulation Shield Detail

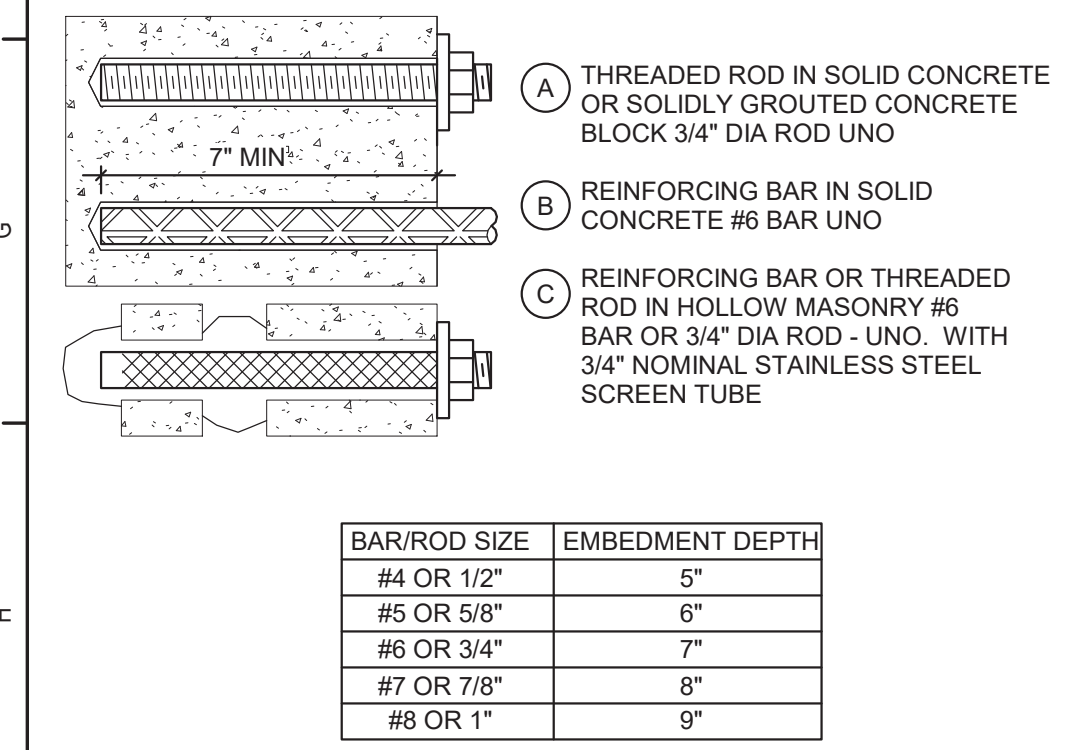


- GENERAL NOTES:
- FOR ACCEPTABLE ADHESIVE PRODUCTS REFER TO SPECIFICATIONS.
  - COMPLY WITH MANUFACTURERS REQUIREMENTS FOR INSTALLATION.


7 Typical Chemical Anchors

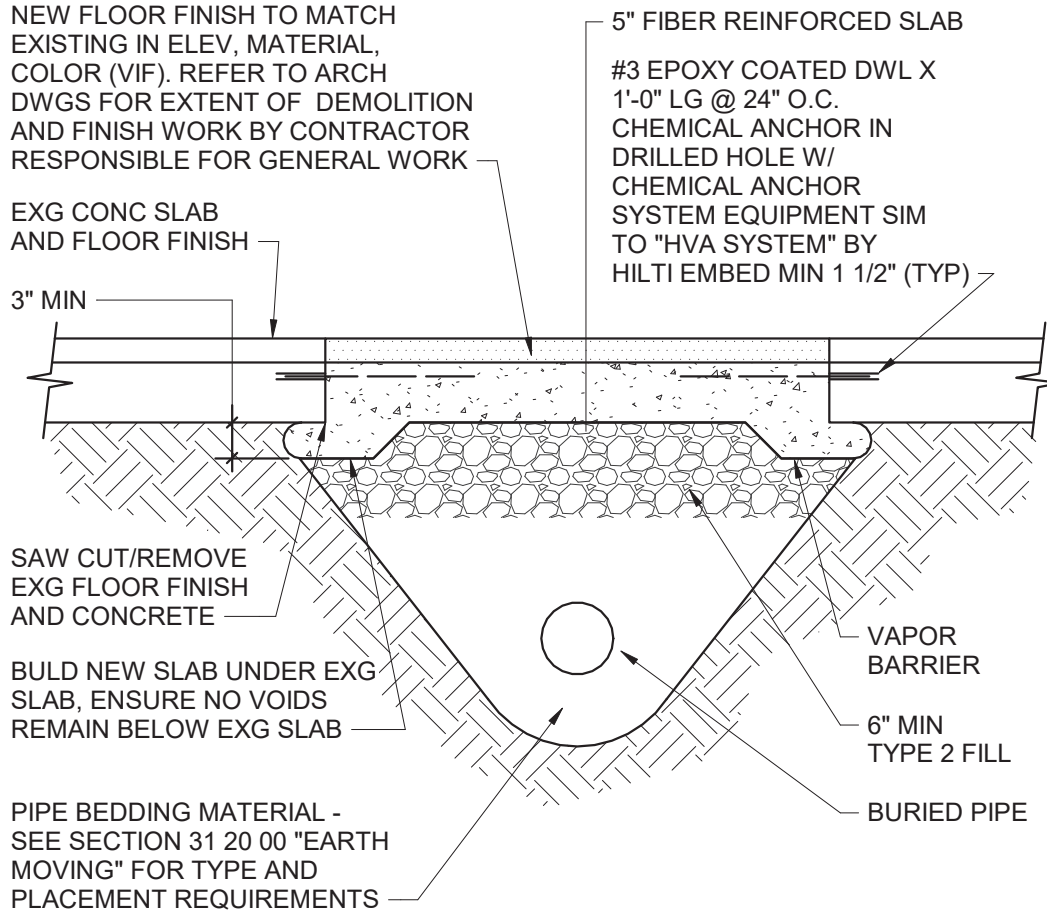


5 Trenching Below Existing Slab Detail

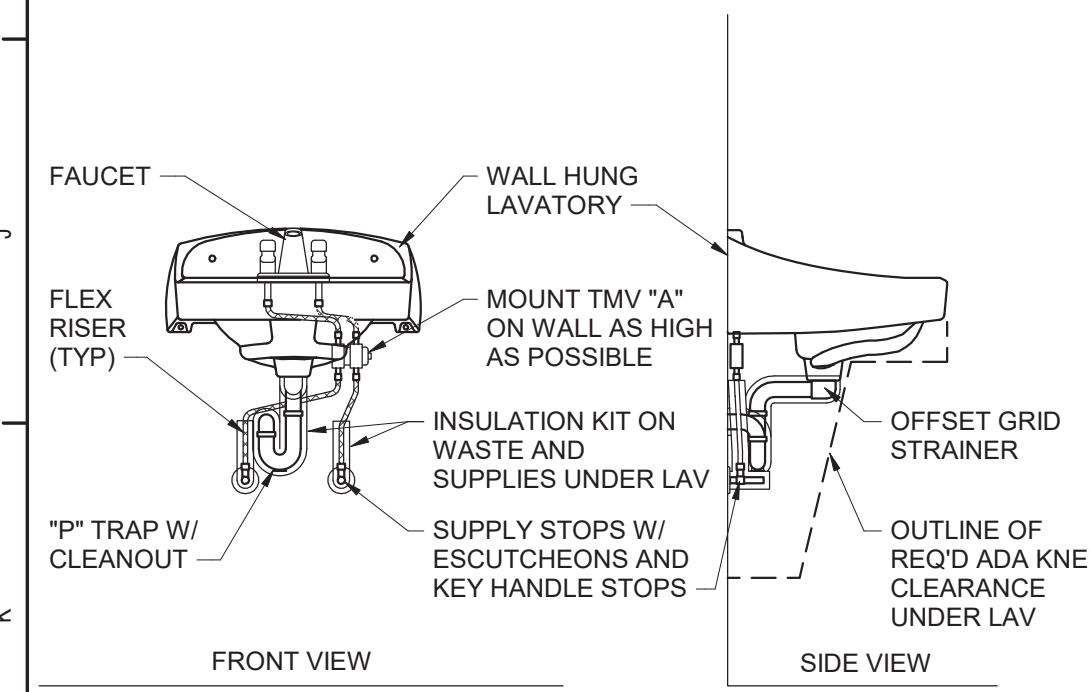


8 ADA Lavatory Rough-in Detail

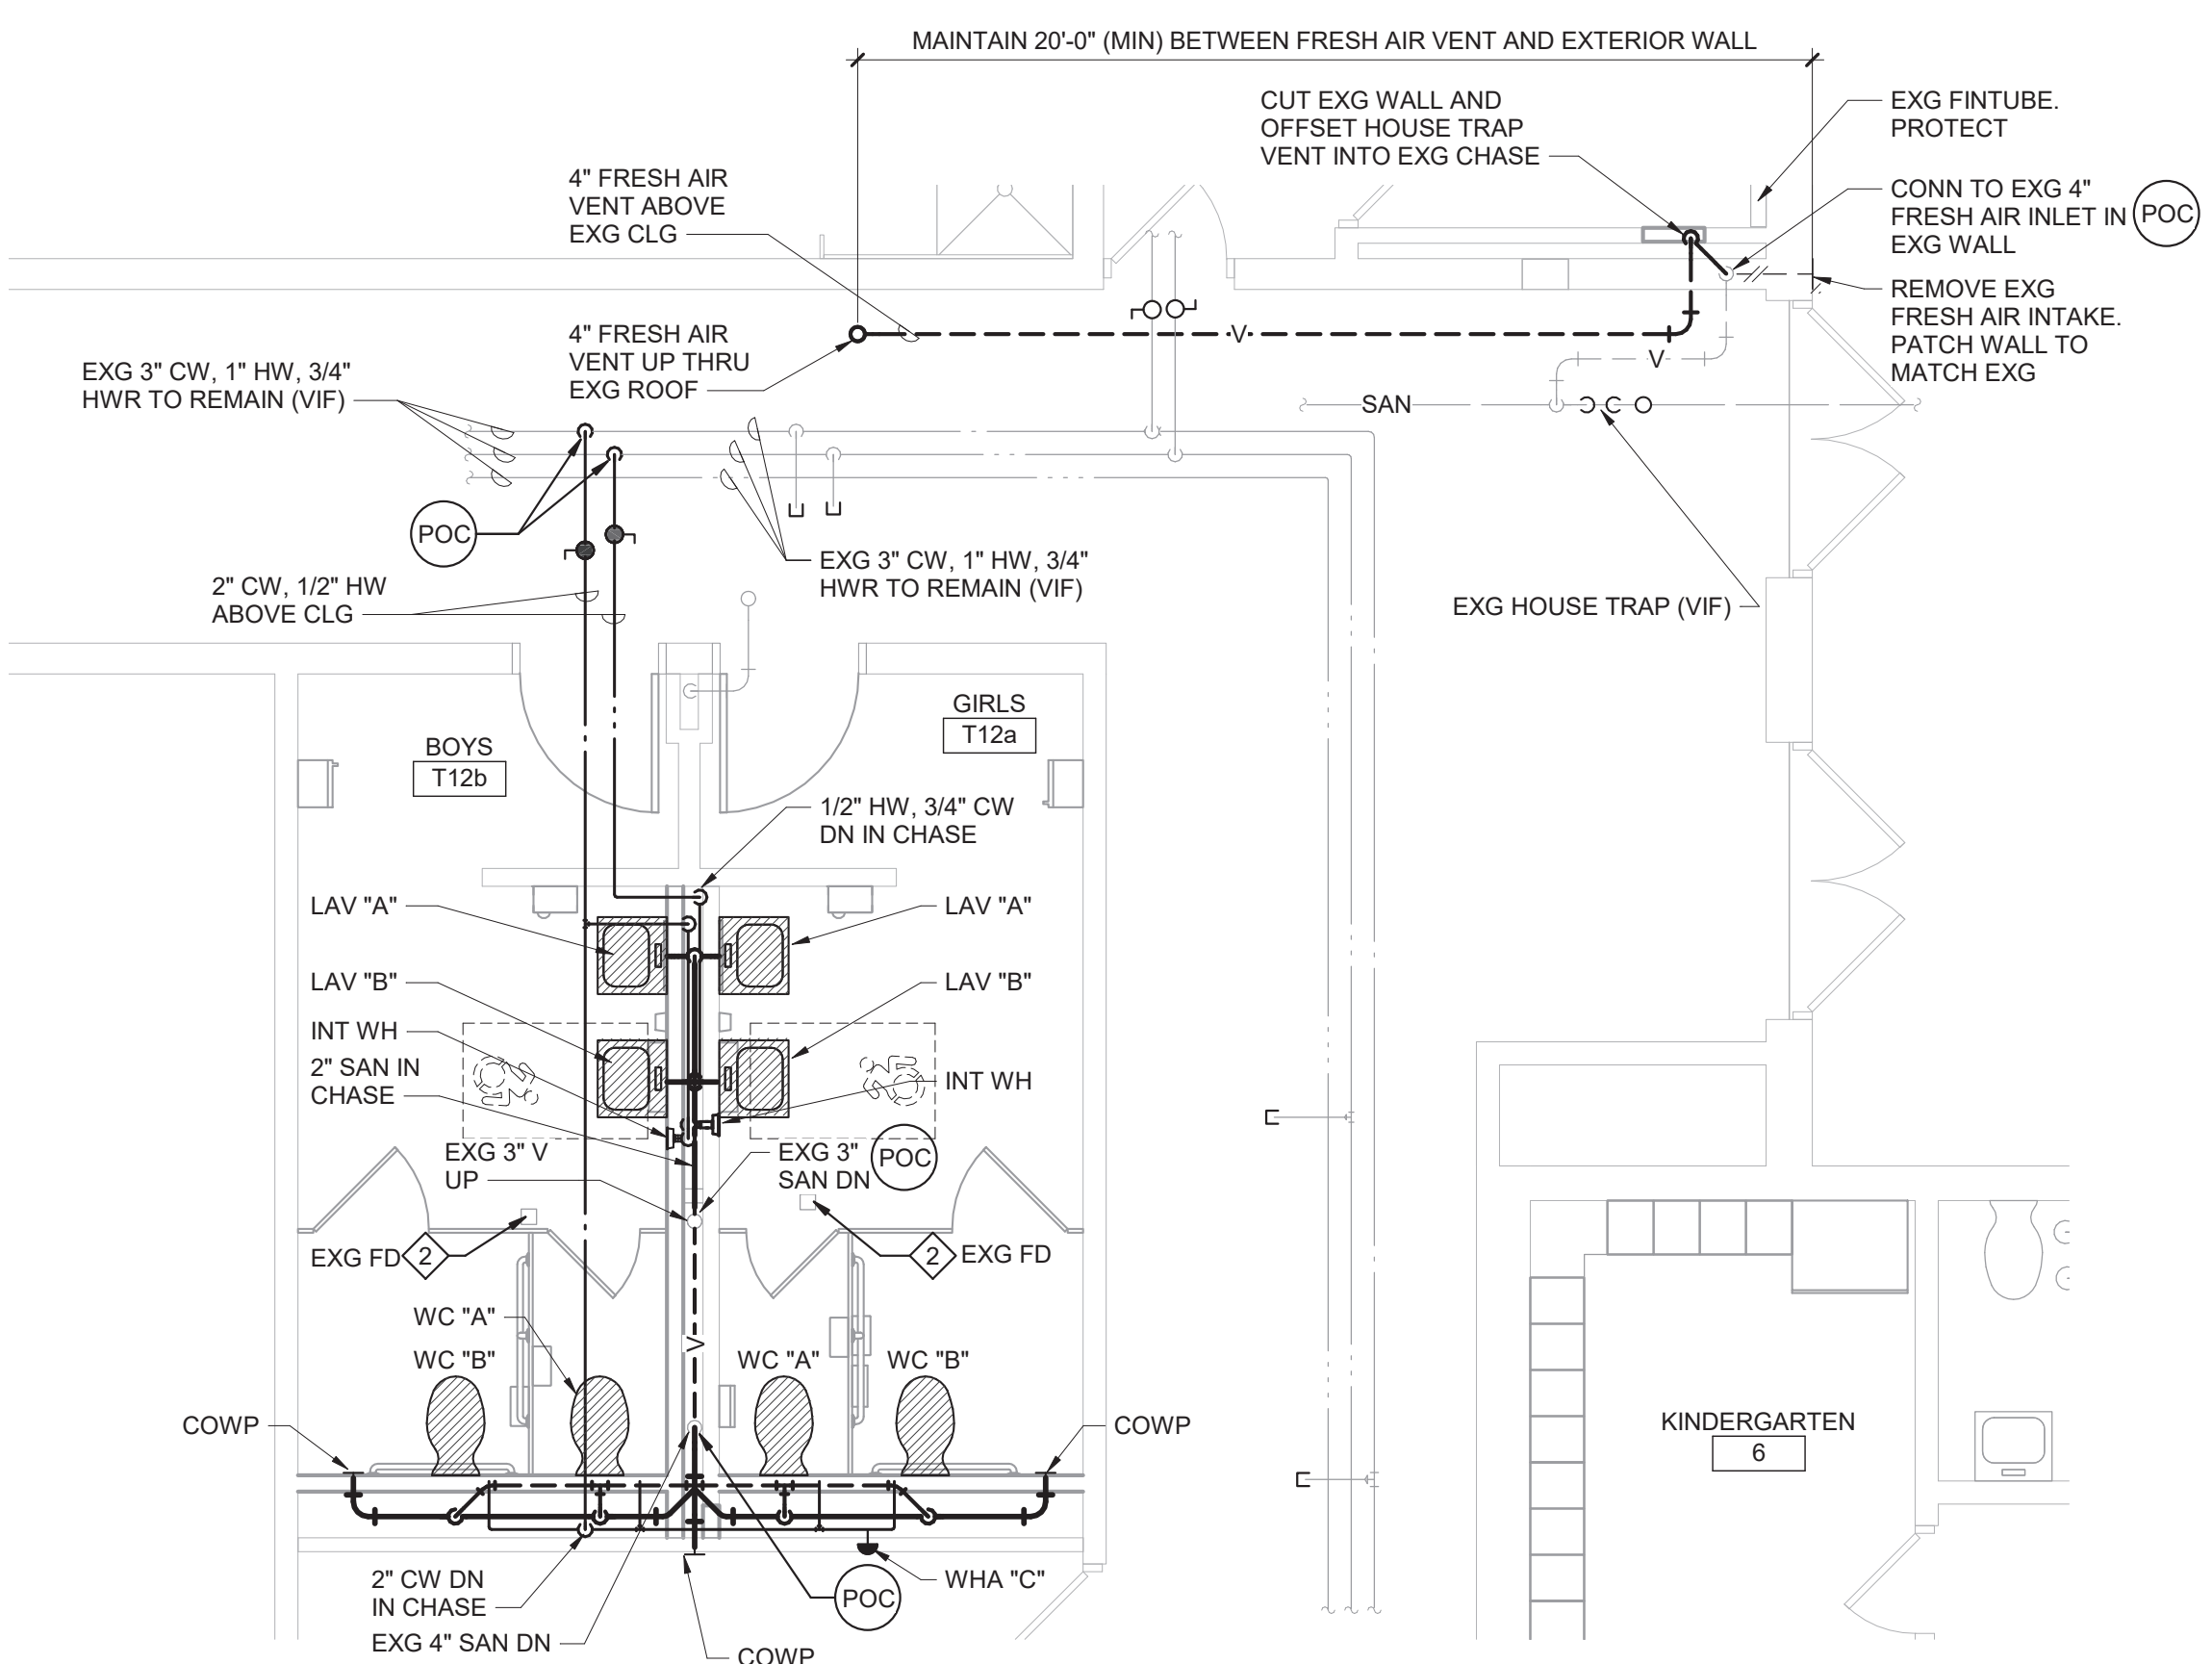

3 Toilet Rooms T12a and T12b Plan

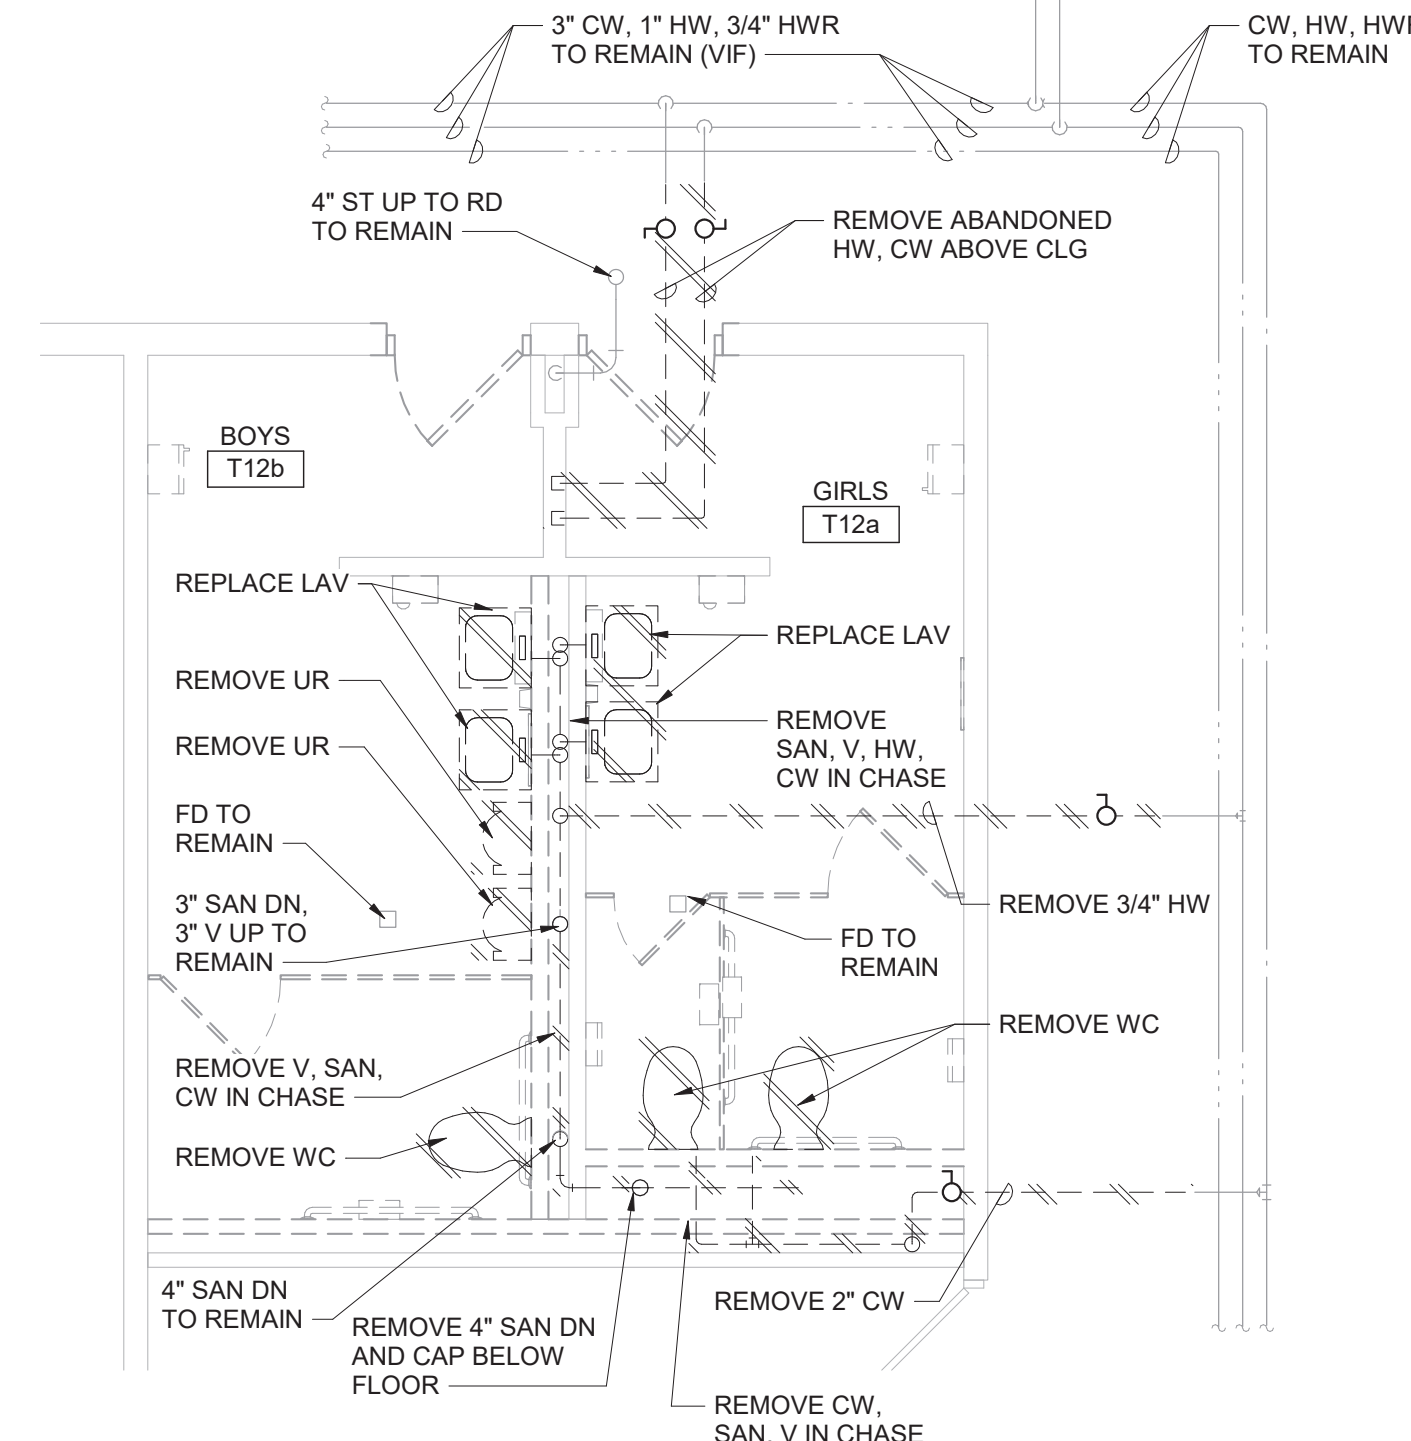

2 Toilet Rooms T12a and T12b Demolition Plan

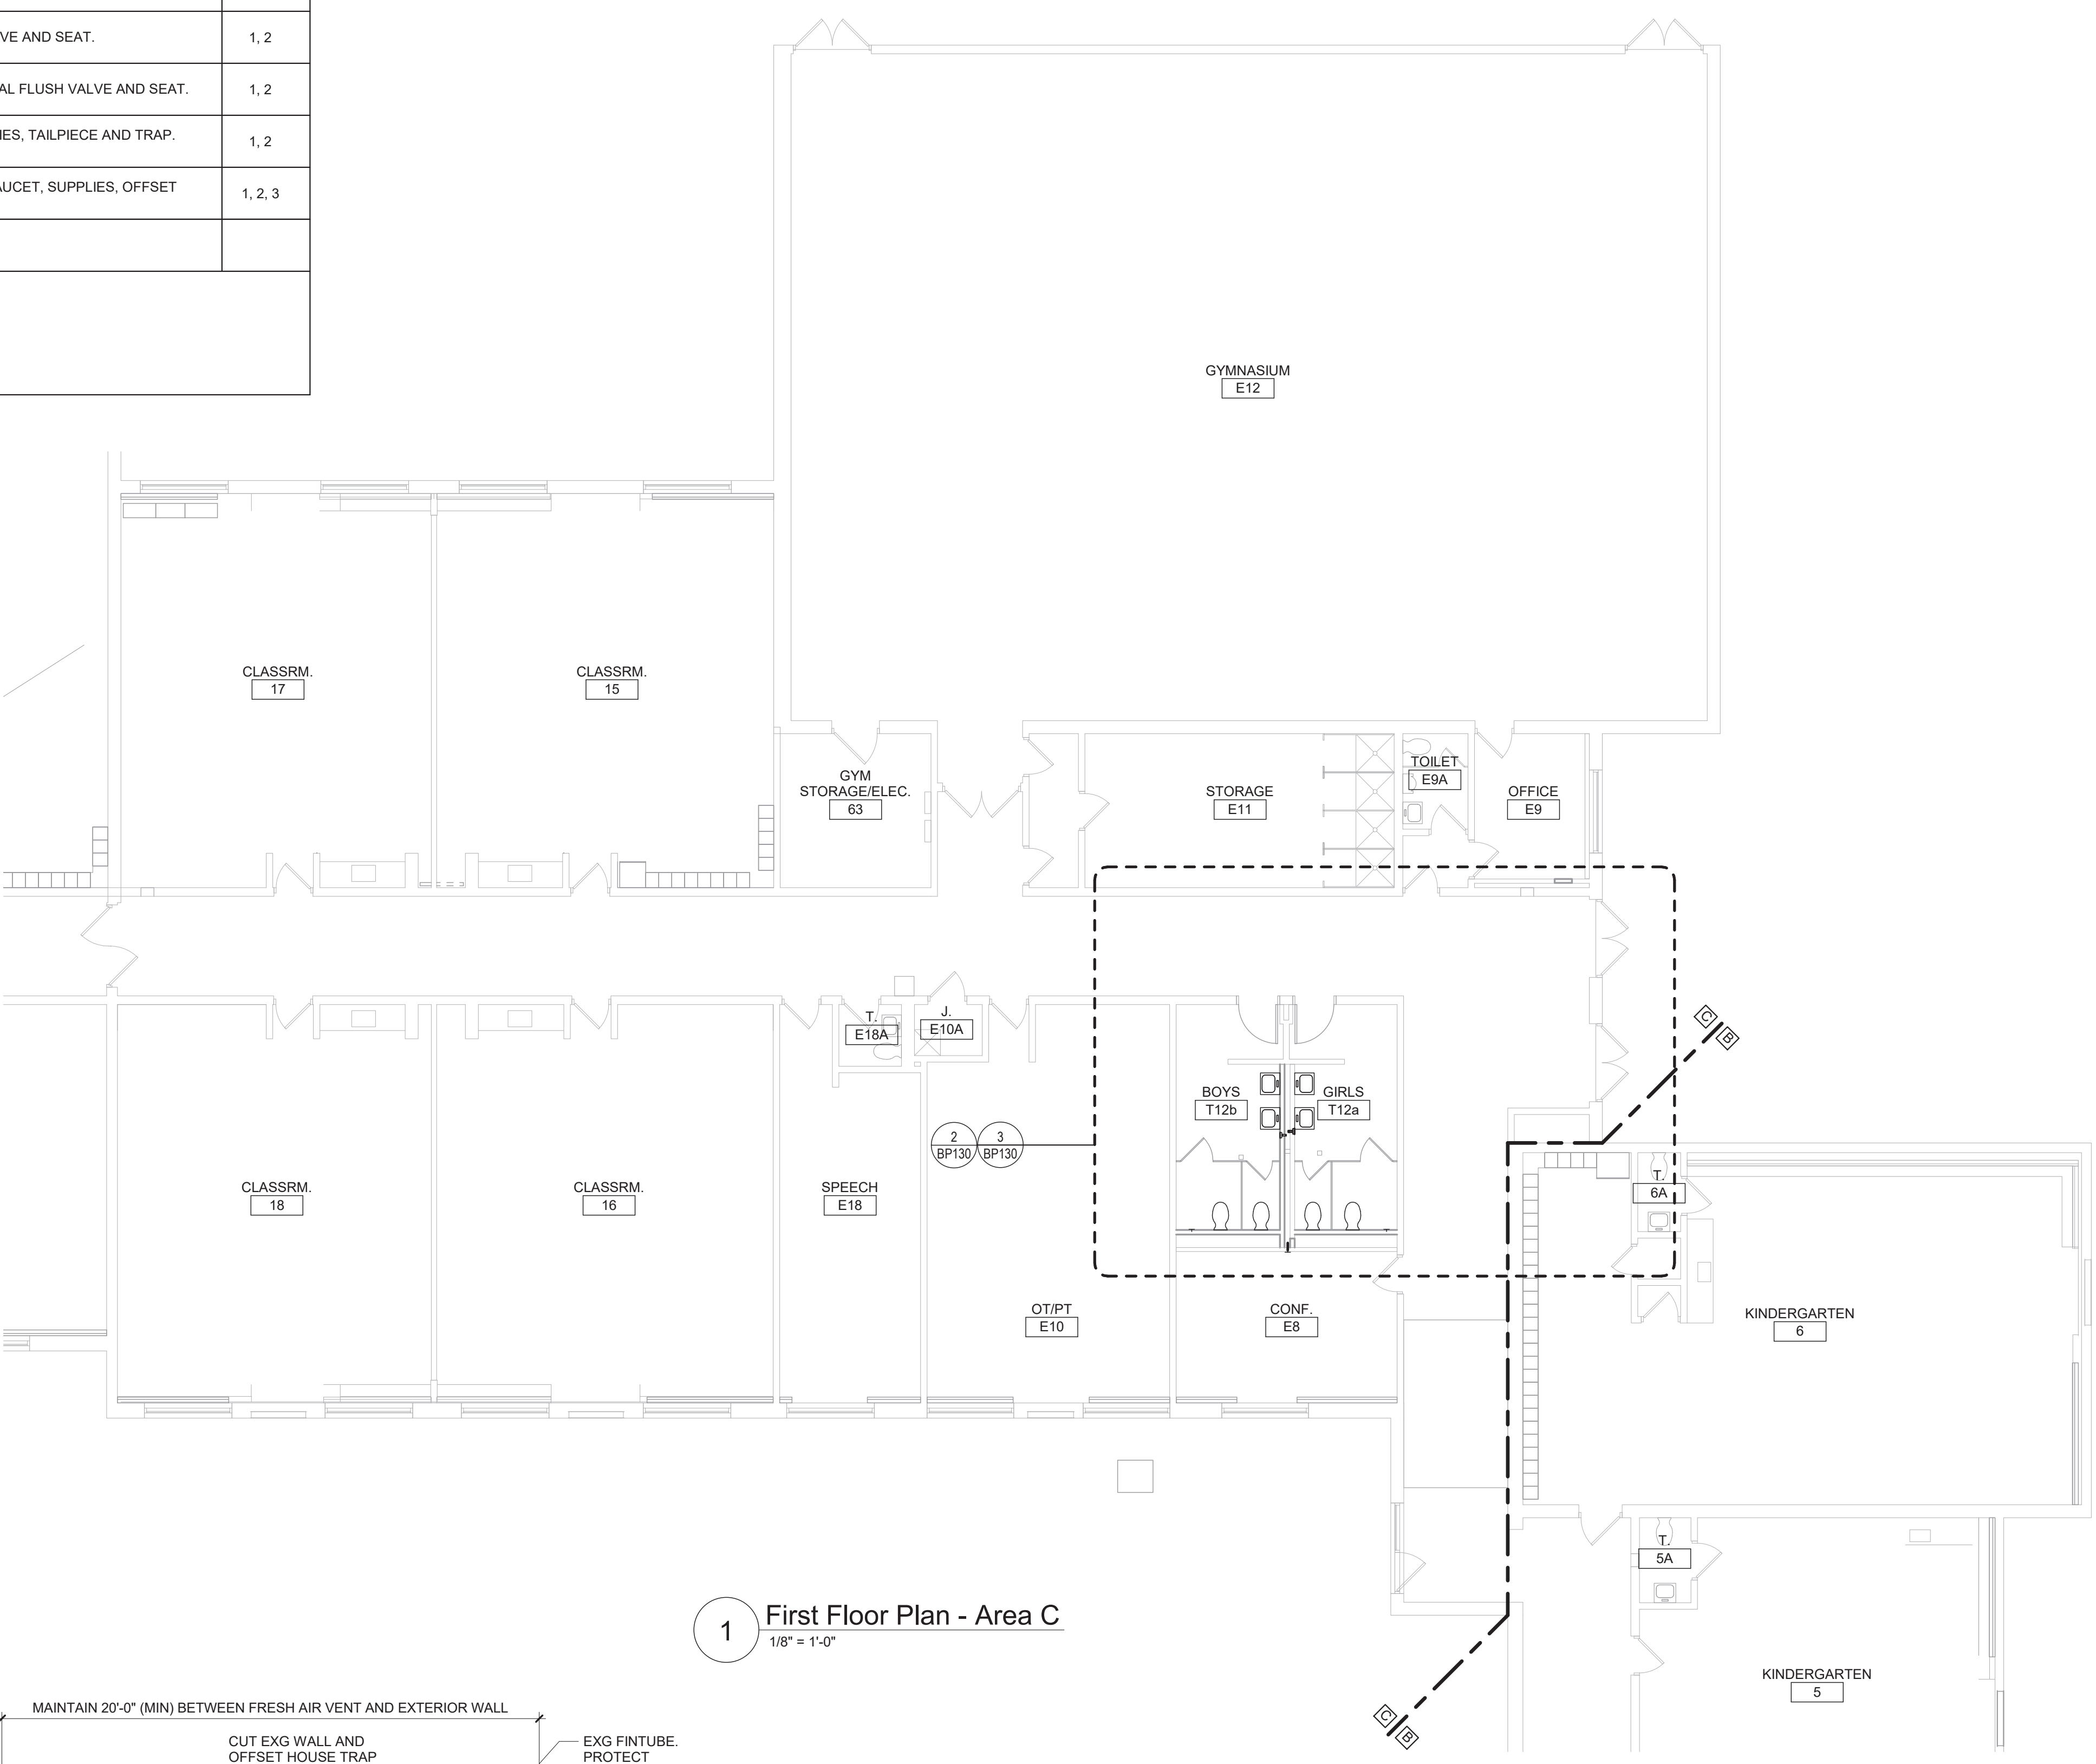


1 First Floor Plan - Area C

## General Notes

- VERIFY ALL PIPING LOCATIONS, SIZES, AND ARRANGEMENTS IN FIELD PRIOR TO BID. NOTIFY ARCHITECT IN WRITING OF ANY DISCREPANCIES.
- VERIFY IN FIELD INVERT AND DIRECTION OF FLOW IN EXISTING SOIL PIPE WHERE NEW SOIL PIPE IS TO BE CONNECTED TO EXISTING SOIL PIPE.
- LEGALLY DISPOSE OF ALL DEMOLITION DEBRIS.
- INCLUDE TRENCHING, CUTTING AND PATCHING OF FLOORS, WALLS AND CEILINGS, INCLUDING CEILING TILE REMOVAL AND REPLACEMENT, WHEN REQUIRED FOR PLUMBING WORK. PATCH ABANDONED OPENINGS AND DISTURBED FINISHES TO MATCH EXISTING. TAKE PRECAUTIONS TO PROTECT STRUCTURAL INTEGRITY OF FLOOR OR WALLS WHEN TRENCHING OR CUTTING.
- MATERIALS FOR PLUMBING INSTALLATION SHALL BE NEW, UNLESS SPECIFICALLY NOTED OTHERWISE.
- PROVIDE THROUGH PENETRATION FIRESTOPPING FOR FIRE RATED WALLS AND FLOORS. PENETRATIONS THROUGH EXISTING WALLS AND FLOORS ARE CONSIDERED TWO-HOUR PARTITIONS UNLESS SPECIFICALLY NOTED OTHERWISE. REFER TO \"A\" SERIES OR CODE COMPLIANCE DRAWINGS FOR LOCATION OF FIRE RATED WALLS AND FLOORS.
- REMOVE PLUMBING FIXTURES INDICATED, INCLUDING ASSOCIATED PIPING, FASTENERS, SUPPORTS, ETC. BACK TO POINTS OF CONCEALMENT WITHIN OR BEHIND REMAINING WALLS, BELOW FLOORS OR ABOVE CEILINGS.
- REPLACE OR RELOCATE PLUMBING FIXTURE INDICATED. MODIFY AND EXTEND EXISTING PIPING AS REQUIRED TO MEET FIXTURE MFR'S ROUGH-IN RECOMMENDATIONS AND TO MAKE CONNECTIONS. CONCEAL PIPING WITHIN OR BEHIND WALLS, BELOW FLOORS OR ABOVE CEILINGS. PATCH DISTURBED FINISHES TO MATCH EXISTING UNLESS SPECIFICALLY NOTED OTHERWISE. REFER TO \"A\" SERIES DWGS FOR EXACT LOCATION AND RIM ELEVATION OF NEW OR RELOCATED FIXTURES.
- REMOVE ABANDONED ACCESSIBLE PIPING TO MAIN BRANCHES, STACKS OR RISERS AS REQUIRED TO ELIMINATE EXPOSED PIPING AND DEAD END PIPING RUNS LONGER THAN 1'-0\".

## Plumbing Notes


- WORK IS PART OF ALTERNATE NO. 1.
- REPLACE STRAINER ON EXISTING FLOOR DRAIN.

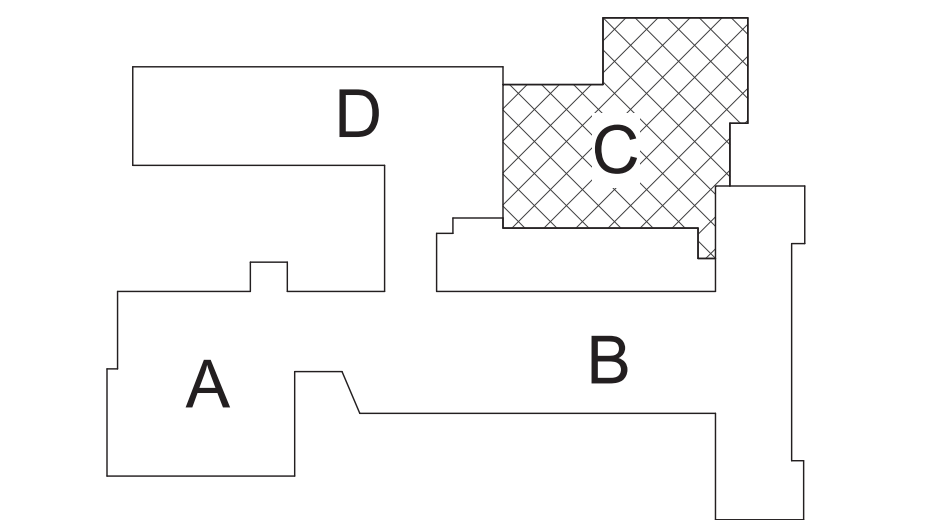

Key Plan

S.E.D. Control No. 13-02-00-01-0-006-022

Rev. No.	Date	Description

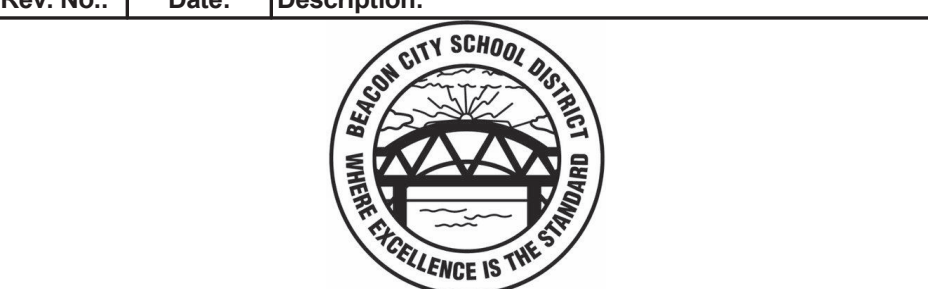

complex world  
CLEAR SOLUTIONS

Tetra Tech Engineers, Architects & Landscape Architects, P.C.



Beacon City School District  
Beacon, New York

Additions and Alterations to:  
Glenham Elementary School

First Floor Plan - Area C, Details and Schedule

Drawn By: GPD/ sef	Date: 10/28/2022	Drawing Number:
Project No.: 279180-22004		BP130