


EXISTING ORANGE & ROCKLAND UTILITY COMPANY POLE MOUNT TRANSFORMER EXISTING ORANGE & KW ROCKLAND UTILITY EXISTING 200A DISCONNECT SWITCH EXISTING SERVICE POLE TAP EXISTING CONDUCTORS AND CONNECT OVERHEAD TO LATRINE WEATHERHEAD EXISTING SERVICE POLE 3#6, #10G, OVERHEAD TO WEATHERHEAD. CONTINUE CONDUCTORS DOWN 1° RGS CONDUIT DOWN BELOW FLOOR. ROUTE CONDUIT UNDER TO EXISTING LOADCENTERS FLOOR TO BOTTOM FEED LOACENTERS LOADCENTER

POWER ONE-LINE DIAGRAM - LATRINE

E700 / 1/8" = 1'-0"

1.) THE POINT OF ATTACHMENT ON THE BUILDING TO BE DETERMINED BY THE REQUIRED MINIMAGROUND CLEARANCES OF REPRICE DROP CONDUCTORS. 2.) ALL WARNS AND MATERIALS MUST COMPORN TO THE REQUIREMENTS OF THE NATIONAL ELECTRICAL CODE AND TO APPLICABLE LOCAL CODES WHERE CONFLICT CHISTS, THE MORE STRIKEPIT CODE WILL APPLY. MATERIALS LIST MEATHERHEAD (2) SERVICE ENTRANCE CABLE IN 2° CONDUIT TO BE INSTALLED WITH BINDS EXTENDING 34° OUTSIDE OF WEATHERHEAD FOR DRIPLOCP (3) 2-HOLE CONDUIT STRAPS Natalled Every 30". **OVERHEAD SERVICE ENTRANCE DETAIL**

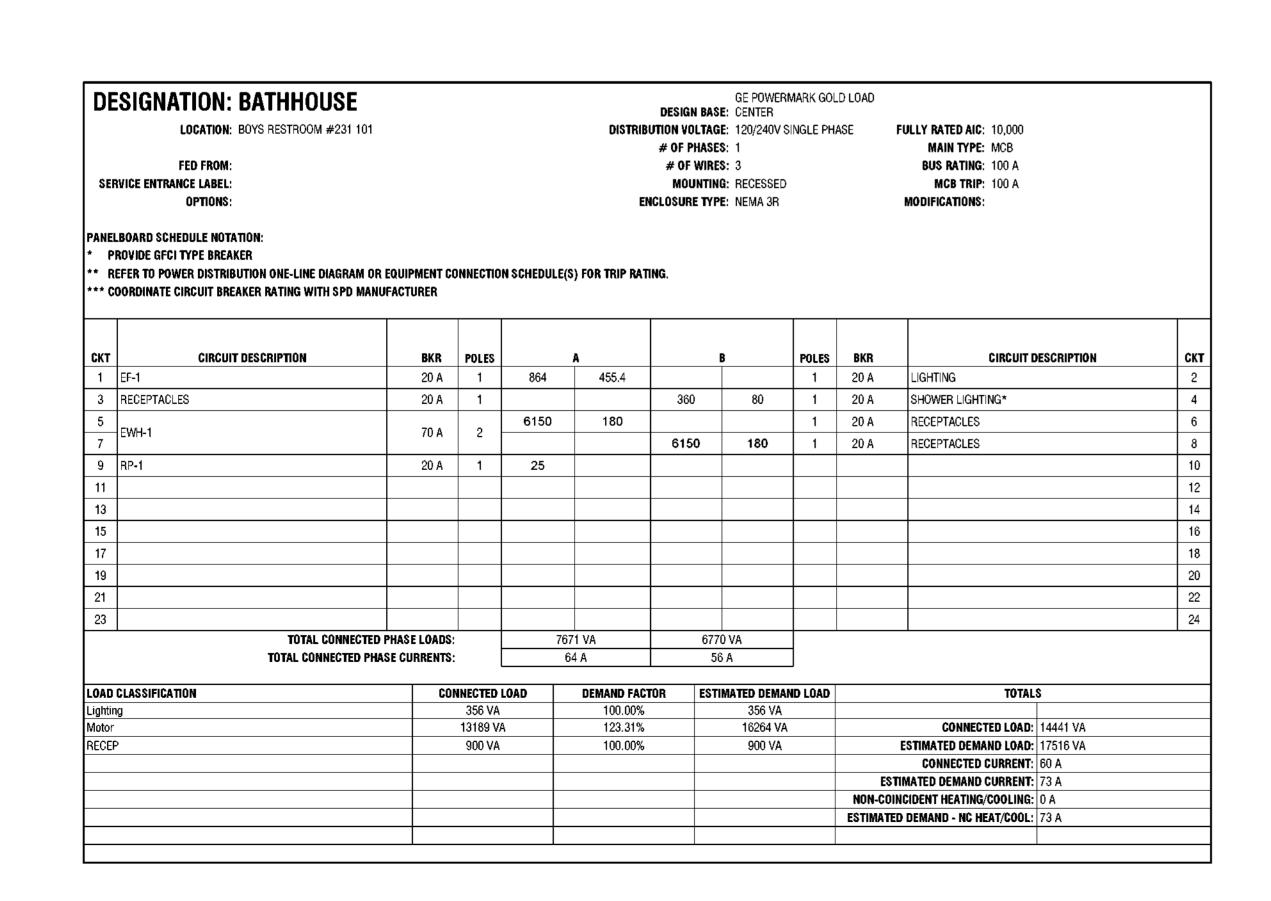

DESIGNATION: LATRINE LOCATION: FED FROM: SERVICE ENTRANCE LABEL: OPTIONS: PANELBOARD SCHEDULE NOTATION: * PROVIDE GFCI TYPE BREAKER ** REFER TO POWER DISTRIBUTION ONE-LINE DIAGRAM OR EQUI *** COORDINATE CIRCUIT BREAKER RATING WITH SPD MANUFACT												
CVT	CIRCUIT DESCRIPTION	DVD	DOL EC		Δ.		ь	DOI ES	DVD	CIDCUIT	NECCOIDTION	CNI
CKT 1	EWH-3	15 A	POLES 1	1400	1400		<u>B</u>	POLES 1	15 A	EWH-2	DESCRIPTION	2 CKT
	RECEPTACLES	20 A	1	1400	1400	180	330.4	1	20 A	LIGHTING		4
	RECEPTACLES	20 A	1	180	127	100	000.4	1	20 A	LIGHTING		6
7	TROCE TAGEO	2011	'	100	127			+ '-	20 H	Lidiffied		8
9												10
11								+				12
13												14
15												16
17												18
19								+				20
21												22
23	TOTAL CONNECTED PH	ACE I GADO		2.	103 VA		510 VA					24
	TOTAL CONNECTED PHASE				26 A		4 A	}				
		COL	CONNECTED LOAD		DEMAND FACTOR		ESTIMATED DEMAND LOAD			TOTAL	\$	
OAD.	CLASSIFICATION	001			100.00%		279 VA					
ightir	g		279 VA				0450 1/4			CONNECTED LOAD:	3612 VA	
ightir Aotor	g		2800 VA		112.50%		3150 VA				2000 1/4	
.OAD .ightir Motor RECEI	g				112.50% 100.00%		540 VA			ESTIMATED DEMAND LOAD:		
ightir Aotor	g		2800 VA						FS	ESTIMATED DEMAND LOAD: CONNECTED CURRENT:	15 A	
ightir Aotor	g		2800 VA							ESTIMATED DEMAND LOAD:	15 A 17 A	

Governor Kathy Hochul	reservation Commissioner Erik Kulle:
LICENSED ARCHITECT/ENGINEER TO ALTER	AW FOR ANY PERSON, UNLESS UNDER THE DIRECTION OF A R THIS DOCUMENT IN ANYWAY. ALTERATIONS MUST HAVE T N OF THE ALTERATIONS, DATE AND ARCHITECT'S/ENGINEER
ARCHITECT: Saratoga Associates 21 Congress Street, Suite 201 Saratoga Springs, NY 12866	SARATOGA ASSOCIAT Lavderine Accidente, Archi Englishers, and Pagrans, Pi
SURVEYOR/ST MEP ENGINEE LaBella Associates 300 State Street, Suite 201 Rochester, NY 14614 Certificate of Authorization Number: Professional Engineering: 018281 Land Surveying: 017976 Geological: 018750	
Palisades Region Palisades Interstates Mountain, 1 (845) 786-2701 Executive Direct	tate Park Commission New York 10911

Key Plan

Project Location: HARRIMAN STATE PARK

Rev No	Description	[Date:
Drawi	n By:	Seal and Signature	
JJ	S		
Desig	n By:	OF NEW CHARLES AS	Č.
	S	S SURPLIES S	16

NCH Approved By: NCH 3/16/23

Sheet Title: Drawing Number:

PARTIAL ONE-LINE DIAGRAM AND

SCHEDULES

E700

Bid Documents Project Number:

Sheet: 21059.23