# CAMP JUNIOR ON LAKE TIORATI - PHASE 3


CONTRACTS D006135 (GC), D006136 (EC), D006137 (PC) & D006138 (MC)


PROJECT PA-TI-2023-001



HARRIMAN STATE PARK TIORATI BROOK ROAD SOUTHFIELDS, NY 10975

# **Bid Documents**

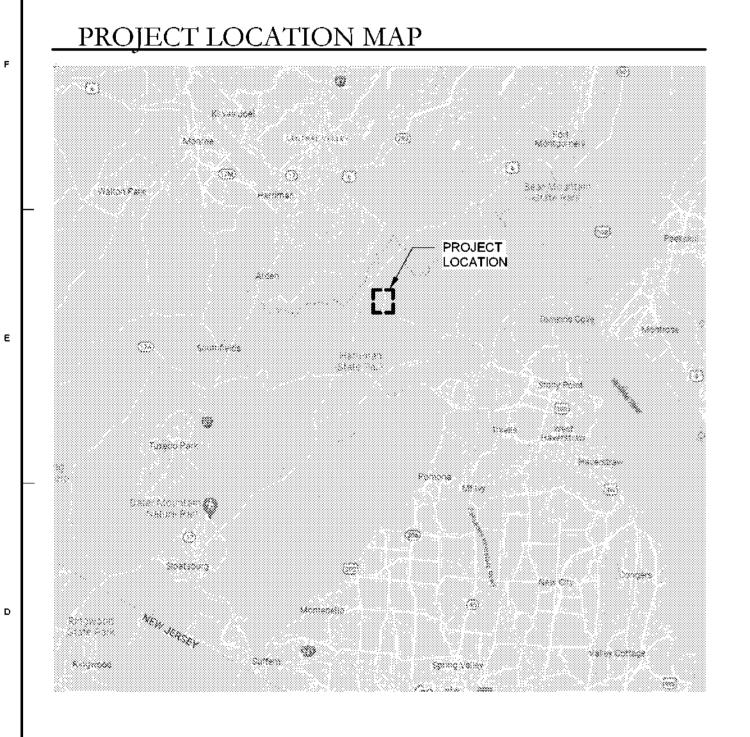

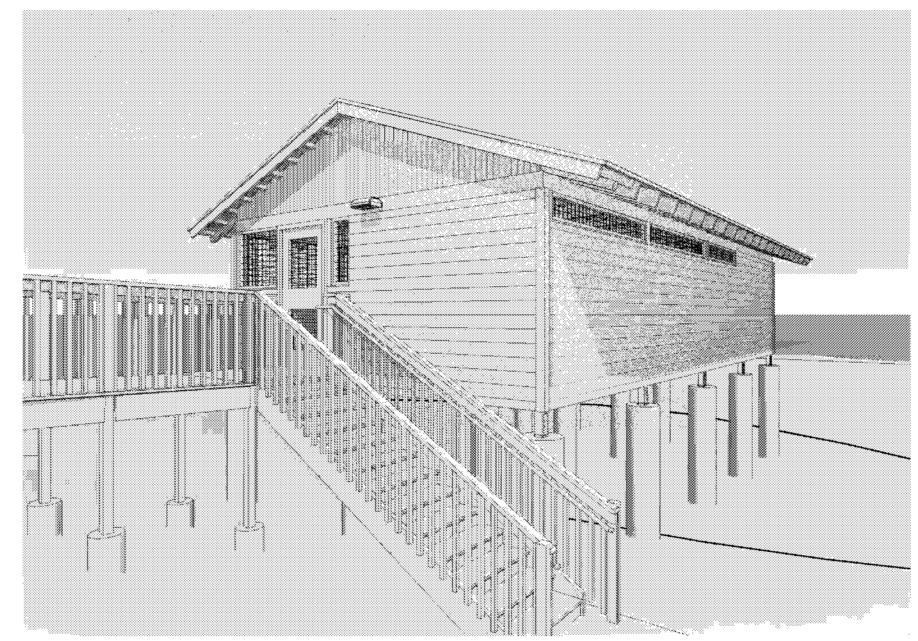




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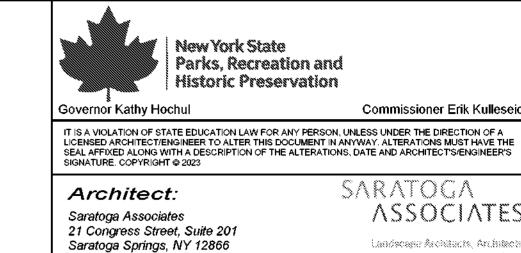
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	CAMP JUNIOR PLUMBING PLANS

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101 102 103 104 600 700	ELECTRICAL NOTES, SYMBOL LEGEND & ABBREVIATIONS BATHHOUSE #231 & #322 POWER PLANS BATHHOUSE #231 & #322 LIGHTING PLANS LATRINE #427 POWER AND LIGHTING PLANS DINING HALL #404 CANOPY LIGHTING PLANS SCHEDULES PARTIAL ONE-LINE DIAGRAM AND SCHEDULES	Drawin KE Desig LL Check	in By:  H  ked By:
		Approv	ved By:
		C7	S
		Date:	

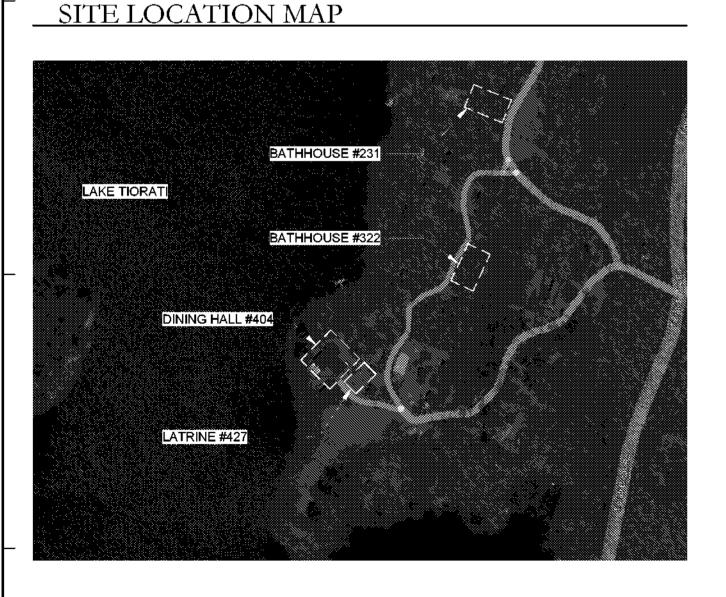

Surveyor/ Structural/ MEP Engineer:

Comment and Planners, P.C.

LaBella

LaBella Associates 105 N. Tioga Street, Suite 200 Ithaca, NY 14850

Certificate of Authorization Number: Professional Engineering: 018281 Land Surveying: 017976 Geological: 018750

Palisades Region

Palisades Interstate Park Commission Bear Mountain, New York 10911 (845) 786-2701 Executive Director: Joshua Laird

Project Title: CAMP JUNIOR ON LAKE TIORATI -PHASE 3

**Project Location:**HARRIMAN STATE PARK

**Key Plan** 

REV	VISIONS		
Rev No	Description		Date:
Drav	vn By:	Seal and Signature	
K	ET. LLH		

Drawn By:

KET, LLH

Design By:

LLH

Checked By:

CTS

Approved By:

CTS

Date:

3/16/23

COVER SHEET

**Sheet Title:** 

G100

Drawing Number:

Project Number: 21059.23

2003 A:37-5A DNA

#### **GENERAL CONSTRUCTION NOTES**

- SCOPE OF WORK: THE HARRIMAN STATE PARK CAMP JUNIOR ON LAKE TIORATI PHASE 3
- PROJECT INCLUDES, BUT NOT LIMITED TO, THE FOLLOWING SCOPE OF WORK. ALL WORK SHALL COMPLY WITH THE 2020 NEW YORK STATE UNIFORM CODE WHICH ADOPTS THE 2018 INTERNATIONAL BUILDING CODE, FIRE CODE AND ENERGY CONSERVATION CODE OF NEW YORK STATE, AS WELL AS ANY REFERENCED CODES WITHIN. ALL WORK MUST ALSO BE IN COMPLIANCE WITH THE STANDARDS ESTABLISHED BY THE NATIONAL FIRE PROTECTION ASSOCIATION, OSHA, AND ADA.
- CONSTRUCTION DOCUMENTS FOR THIS WORK HAVE BEEN PREPARED IN ACCORDANCE WITH GENERALLY ACCEPTED ARCHITECTURAL AND ENGINEERING PRACTICE TO MEET MINIMUM REQUIREMENTS OF THE LATEST EDITION OF THE BUILDING CODE OF NEW YORK STATE. IN THE EVENT OF CONFLICT BETWEEN PERTINENT CODES, REGULATIONS, AND REFERENCED STANDARDS OF THESE DRAWINGS AND SPECIFICATIONS, THE MORE STRINGENT PROVISIONS
- SHALL GOVERN. EACH PRIME CONTRACTOR SHALL RIGIDLY ADHERE TO ALL LAWS, CODES, AND ORDINANCES. WHICH APPLY TO THE WORK.
- DRAWINGS AND SPECIFICATIONS ARE INTENDED TO PROVIDE THE BASIS FOR THE PROPER COMPLETION OF THE PROJECT SUITABLE FOR THE INTENDED USE OF THE OWNER. A GENERAL BUILDING PERMIT WILL BE PROVIDED BY DIRECTOR'S REPRESENTATIVE AT NO CHARGE TO THE CONTRACTOR
- DO NOT SCALE DRAWINGS. USE DIMENSIONS AS INDICATED FOR ALL LOCATIONS. ALL DIMENSIONS ARE FRAMING TO FRAMING OF LUMBER OR FACE TO FACE OF CONCRETE/ MASONRY UNLESS OTHERWISE NOTED.
- EACH PRIME CONTRACTOR SHALL HOLD THE OWNER AND ARCHITECT HARMLESS AGAINST ANY AND ALL CLAIMS ARISING FROM WORK PERFORMED BY THE CONTRACTOR ON THE SITE. THIS INCLUDES (BUT IS NOT LIMITED TO) ALL MATERIALS, CONSTRUCTION METHODS, CRAFTSMANSHIP, CONFORMANCE, PROCEDURES, AND CONDITIONS (INCLUDING SAFETY) OF
- ON-SITE WORK RELATING TO THE CONSTRUCTION DOCUMENTS. COMMENCE WORK AFTER PRECONSTRUCTION MEETING AND PROCEED DILIGENTLY AND CONTINUOUSLY TO COMPLETION.
- PRIOR TO STARTING WORK, SUBMIT FOR APPROVAL TO THE DIRECTOR'S REPRESENTATIVE A DETAILED SCHEDULE INDICATING ALL WORK THAT MIGHT AFFECT OWNER'S USE OF PROJECT
- SITE SUCH AS UTILITY SHUT DOWNS. NOISE GENERATING CONSTRUCTION. ETC. EACH PRIME CONTRACTOR SHALL COORDINATE WITH DIRECTOR'S REPRESENTATIVE ALL WORK PROCEDURES AND ANY LOCATION OF POSSIBLE TEMPORARY UTILITIES BEFORE
- DO NOT INTERRUPT EXISTING UTILITY SERVICE WITHOUT AUTHORIZATION FROM DIRECTOR'S
- REPRESENTATIVE. PROVIDE TEMPORARY SERVICE DURING INTERRUPTIONS.
- PERFORM WORK IN A MANNER, WHICH MINIMIZES NOISE. SCHEDULE OPERATIONS AS DIRECTED BY DIRECTOR'S REPRESENTATIVE.
- THE WORDS "PROVIDE" OR "SUPPLY" SHALL INCLUDE BOTH FURNISHING AND INSTALLING THE SPECIFIED OR DETAILED ITEM, IN PLACE AND READY FOR OPERATION AND USE. ALL MATERIALS USED TO BE SELECTED AND INSTALLED IN ACCORDANCE WITH STATE.
- FEDERAL, NATIONAL AND LOCAL CODES AND INSTALLED IN ACCORDANCE WITH MANUFACTURER'S RECOMMENDED INSTALLATION PROCEDURES.
- ALL MATERIALS SHALL BE AS SPECIFIED, OR EQUAL AS APPROVED BY DIRECTOR'S REPRESENTATIVE. MATERIALS SPECIFIED INDICATE QUALITY INTENT THAT WILL BE USED AS A BASIS FOR REVIEW OF PRODUCT SUBSTITUTES, SEE GENERAL CONDITIONS. ALL ITEMS, WHICH ARE NOT SPECIFICALLY REFERRED TO, ON THESE DRAWINGS ARE TO BE
- SELECTED BY THE DIRECTOR'S REPRESENTATIVE FROM THE MANUFACTURER'S SAMPLES SHOWING FULL RANGE OF TEXTURES AND COLORS AVAILABLE. ALL MANUFACTURED MATERIALS, COMPONENTS, FASTENERS, ASSEMBLERS, ETC., SHALL BE HANDLED AND INSTALLED IN ACCORDANCE WITH MANUFACTURER'S INSTRUCTIONS AND PROVISIONS OF APPLICABLE INDUSTRY STANDARDS. WHERE SPECIFIC MANUFACTURED
- PRODUCTS ARE CALLED FOR, GENERIC EQUALS THAT MEET APPLICABLE STANDARDS AND SPECIFICATIONS MAY BE USED UNLESS OTHERWISE NOTED. ITEMS NOT EXPRESSLY SET FORTH, BUT WHICH ARE REASONABLY IMPLIED OR NECESSARY
- FOR THE PROPER PERFORMANCE OF THIS WORK SHALL BE INCLUDED.
- MINOR DETAILS NOT SHOWN OR SPECIFIED, BUT NECESSARY FOR PROPER CONSTRUCTION OF ANY PART OF THE WORK SHALL BE INCLUDED AS IF THEY WERE INDICATED IN THE
- EACH PRIME CONTRACTOR SHALL STORE MATERIALS IN AREAS DESIGNATED BY DIRECTOR'S REPRESENTATIVE. DELIVERY OF MATERIALS SHALL BE AS DIRECTED BY DIRECTOR'S REPRESENTATIVE
- EACH PRIME CONTRACTOR SHALL BE RESPONSIBLE FOR CHECKING ALL DIMENSIONS AND CONDITIONS (BOTH EXISTING AND PROPOSED), REQUIREMENTS, AND NOTES AS SHOWN ON THE DRAWINGS OR SPECIFICATIONS, AND VERIFICATION OF THE SITE CONDITIONS WHICH MAY AFFECT THE WORK DESCRIBED HERE IN. DISCREPANCIES, VARIANTS OR DEFECTS SHALL BE IMMEDIATELY REPORTED TO THE DIRECTOR'S REPRESENTATIVE IN WRITING PRIOR TO COMMENCEMENT OF ANY WORK AFFECTED BY SUCH VARIANCE (EXCEPT FOR PROVISIONAL SAFETY MEASURES, IF SUCH ARE NECESSARY), SHALL BE MADE SAFE AT THE RESPONSIBLE CONTRACTORS' TOTAL RESPONSIBILITY AND EXPENSE, INCLUDING THE COST OF
- RECTIFICATION. IF SUCH DEEMED NECESSARY BY THE DIRECTOR'S REPRESENTATIVE. EACH PRIME CONTRACTOR SHALL NOTIFY AND RECEIVE WRITTEN CLARIFICATION FROM THE DIRECTOR'S REPRESENTATIVE OF ANY VARIATIONS BETWEEN CONTRACT DOCUMENTS AND GOVERNING REGULATIONS
- EACH PRIME CONTRACTOR SHALL MAKE NO STRUCTURAL CHANGES WITHOUT WRITTEN APPROVAL FROM THE DIRECTOR'S REPRESENTATIVE.
- DEVIATIONS FROM THESE DRAWINGS WHICH ARE NOT PERFORMED WITH PROPER WRITTEN CONSENT FROM DIRECTOR'S REPRESENTATIVE ARE SOLELY AT THE RESPONSIBLE CONTRACTOR'S RISK AND THEY SHALL ACCEPT FULL LIABILITY. DEVIATIONS FROM THE APPROVED CONTRACT DOCUMENTS SHALL BE APPROVED BY THE DIRECTOR'S REPRESENTATIVE PRIOR TO INSTALLATION OF THE ASSOCIATED WORK.
- EACH PRIME CONTRACTOR SHALL PROTECT ALL EXISTING SURFACES AND ADJACENT STRUCTURES FOR THE DURATION OF THE CONTRACT WORK AND SHALL REPAIR AND DAMAGE RESULTING FROM WORK AT NO EXTRA COST OR CONTRACT TIME. EACH PRIME CONTRACTOR SHALL DOCUMENT ON DRAWINGS, ANY AND ALL DAMAGE RESULTING FROM: THE REMOVALS OF EXISTING MATERIALS AND/OR INSTALLATION OF SALVAGED OR NEW MATERIAL. SUCH ITEMS SHALL BE REPAIRED OR REPLACED TO THE SATISFACTION OF THE DIRECTOR'S
- REPRESENTATIVE EACH PRIME CONTRACTOR SHALL PROVIDE PROTECTION OF ADJACENT PROPERTY INCLUDING ALL EXISTING SITE AND LANDSCAPING ELEMENTS. IN ADDITION, THE CONTRACTOR SHALL BE RESPONSIBLE FOR PROTECTION OF WORK IN PROGRESS THROUGH TO HANDOVER TO THE DIRECTOR'S REPRESENTATIVE.
- EACH PRIME CONTRACTOR SHALL PROVIDE BARRICADES AROUND WORK AREAS AS REQUIRED TO PREVENT UNAUTHORIZED PERSONS FROM ENTERING THEREIN.
- EACH PRIME CONTRACTOR SHALL KEEP WORK SITE FREE FROM DEBRIS AND ACCUMULATED REFUSE. AND SHALL HAVE SOLE RESPONSIBILITY FOR PROTECTING ALL DANGEROUS AREAS FROM ENTRY BY UNAUTHORIZED PARTIES. SITE WILL BE LEFT BROOM CLEAN AT THE END OF EACH WORKING DAY DEPENDING ON THE STATUS AND LEVEL OF COMPLETION OF
- CONSTRUCTION. EACH PRIME CONTRACTOR SHALL LAY OUT THEIR OWN WORK, AND PROVIDE ALL DIMENSIONS
- REQUIRED FOR OTHER TRADES. (PLUMBING, ELECTRICAL, ETC.) EACH PRIME CONTRACTOR SHALL DO ALL CUTTING, PATCHING AND REPAIRING AS REQUIRED TO PERFORM ALL OF THE WORK INDICATED ON THE DRAWINGS, AND ALL OTHER WORK THAT
- MAY BE REQUIRED TO COMPLETE CONSTRUCTION. THE WORK TO BE PERFORMED CONSISTS OF FURNISHING ALL LABOR, EQUIPMENT, TOOLS, TRANSPORTATION, SUPPLIES, FEES, MATERIALS, AND SERVICES IN ACCORDANCE WITH THESE NOTES AND DRAWINGS, AND PERFORMING ALL OPERATIONS NECESSARY TO CONSTRUCT AND INSTALL IN A COMPLETE MANNER THE VARIOUS MATERIALS AND EQUIPMENT AT THE LOCATIONS INDICATED IN THE CONTRACT DOCUMENTS AND IN CONFORMITY WITH THE
- DIMENSIONS, DESIGN, AND DETAILS INDICATED IN THE CONTRACT DOCUMENTS. EACH PRIME CONTRACTOR, FOR A PERIOD OF ONE YEAR FROM THE DATE OF COMPLETION AND ACCEPTANCE BY THE OWNER, SHALL ADJUST, REPAIR, OR REPLACE AT NO COST TO THE OWNER ANY ITEM OF EQUIPMENT, MATERIAL, OR WORKMANSHIP FOUND TO BE DEFECTIVE.

#### **CONTRACTORS RESPONSIBILITIES**

- EACH PRIME CONTRACTOR SHALL REVIEW AND FAMILIARIZE THEMSELVES WITH THE GENERAL NOTES AND SPECIFICATIONS AND DETERMINE WHICH NOTES APPLY DIRECTLY TO HIS RESPONSIBILITY AND WHICH NOTES APPLY TO THEIR SUB-CONTRACTORS.
- THE SUBMISSION OF A PROPOSAL BY EACH PRIME CONTRACTOR WILL BE CONSTRUED AS EVIDENCE THAT A CAREFUL AND THOROUGH EXAMINATION OF THE PREMISES AND SITE HAVE BEEN MADE AND LATER CLAIMS FOR LABOR. MATERIALS OR EQUIPMENT REQUIRED OR FOR DIFFICULTIES ENCOUNTERED, WHICH COULD HAVE BEEN FORESEEN HAD SUCH AN EXAMINATION BEEN MADE, WILL NOT BE RECOGNIZED. IT SHALL ALSO CONSTITUTE A REPRESENTATION THAT EACH PRIME CONTRACTOR HAS CHECKED AND VERIFIED ALL DIMENSIONS, QUANTITIES, WORK, AND MATERIALS INVOLVED AND THAT THEY SHALL TAKE RESPONSIBILITY FOR ANY DEFICIENCIES THEREIN.
- EACH PRIME CONTRACTOR SHALL SUBMIT IN WRITING ALL PROPOSALS FOR ADDITIONAL WORK TO THE DIRECTOR'S REPRESENTATIVE OFFICE FOR REVIEW AND APPROVAL. WORK IS NOT TO PROCEED UNTIL A SIGNED AUTHORIZATION IS RETURNED TO THE CONTRACTOR UNLESS WORK INVOLVES AN IMMEDIATE OR IMMINENT SAFETY HAZARD, SEE GENERAL CONDITIONS AND SECTION 01250 CONTRACT MODIFICATION PROCEDURES.
- CONSTRUCTION CONTRACTOR (ALSO KNOWN AS GENERAL CONTRACTOR) SHALL BE RESPONSIBLE FOR ALL SITE WORK.
- CONSTRUCTION CONTRACTOR (ALSO KNOWN AS GENERAL CONTRACTOR) SHALL BE RESPONSIBLE FOR ALL SITE WORK AS WELL AS SITE UTILITY WORK OUTSIDE OF 5'-0" BUILDING PERIMETER (UNLESS OTHERWISE NOTED), INCLUDING BUT NOT LIMITED TO WATER DISTRIBUTION PIPING, SANITARY AND STORM SEWERS, UNDERGROUND DUCTS AND RACEWAYS FOR ELECTRICAL SYSTEMS.
- MECHANICAL CONTRACTOR WORK INVOLVES THE INSTALLATION OF ALL ITEMS OF MECHANICAL (EXHAUST VENTILATION) WORK SHOWN IN THE CONTRACT DOCUMENTS (UNLESS OTHERWISE NOTED), REQUIRED FOR A COMPLETE AND CODE COMPLIANT SYSTEM. NO WORK OUTSIDE 5'-0" OF BUILDING(S) PERIMETER IS INCLUDED IN THE MECHANICAL CONTRACT. ELECTRICAL CONTRACTOR IS RESPONSIBLE FOR 120 VAC ELECTRICAL CONNECTIONS. MECHANICAL CONTRACTOR SHALL COORDINATE THEIR WORK WITH OTHER CONTRACTORS AND UTILITIES.
- PLUMBING CONTRACTOR WORK INVOLVES THE INSTALLATION OF ALL ITEMS OF PLUMBING WORK SHOWN IN THE CONTRACT DOCUMENTS (UNLESS OTHERWISE NOTED), REQUIRED FOR A COMPLETE AND CODE COMPLIANT SYSTEM, NO WORK OUTSIDE 5'-0" OF BUILDING(S) PERIMETER IS INCLUDED IN THE PLUMBING CONTRACT EXCEPT AS OTHERWISE NOTED. PLUMBING CONTRACTOR IS RESPONSIBLE FOR CONNECTION AT THE TRANSITION POINT. PLUMBING CONTRACTOR SHALL COORDINATE THEIR WORK WITH OTHER CONTRACTORS
- ELECTRICAL CONTRACTOR WORK INVOLVES THE INSTALLATION OF ALL ITEMS OF ELECTRICAL WORK SHOWN IN THE CONTRACT DOCUMENTS (UNLESS OTHERWISE NOTED), REQUIRED FOR A COMPLETE AND CODE COMPLIANT SYSTEM. ELECTRICAL CONTRACTOR SHALL PROVIDE WEATHERHEAD WITH DRIP LOOP. INSULATORS, AND ASSOCIATED EQUIPMENT. ELECTRICAL CONTRACTOR SHALL PROVIDE OVERHEAD ELECTRICAL SERVICE CONDUCTORS BETWEEN WEATHERHEAD AND ELECTRIC UTILITY DISTRIBUTION WIRING ON THE SITE AND MAKE ALL NECESSARY CONNECTIONS, ELECTRICAL CONTRACTOR SHALL COORDINATE THEIR WORK WITH OTHER CONTRACTORS AND ELECTRIC UTILITY (ORANGE & ROCKLAND - ORANGE COUNTY, 500 ROUTE 208, MONROE, NY -TELEPHONE 1-877-434-4100).
- ELECTRICAL INSPECTIONS, BY A NYS QUALIFIED ELECTRICAL INSPECTOR, SHALL BE PERFORMED FOR ALL ELECTRICAL WORK, INCLUDING WORK THAT IS TO BE CONCEALED. THE ELECTRICAL INSPECTOR SHALL BE ENGAGED BY THE OWNER OR THE OWNER'S AGENTS, AND NOT BY THE CONTRACTOR WHOSE WORK IS TO BE INSPECTED, ANY CONFLICT OF INTEREST MUST BE DISCLOSED TO NYS OPRHP PRIOR TO COMMENCING INSPECTIONS. THE ELECTRICAL INSPECTOR IS TO SUBMIT DETAILED INSPECTION REPORTS SUBSEQUENT TO EACH INSPECTION AND A FINAL CERTIFICATE OF INSPECTION UPON COMPLETION OF CONSTRUCTION.
- ALL WORK MATERIALS ARE TO BE ORDERED SUFFICIENTLY AHEAD OF TIME SO THAT THE WORK CAN PROCEED AS SCHEDULED.
- ANY MATERIALS DELIVERED OR WORK PERFORMED CONTRARY TO THE DRAWINGS, SPECIFICATIONS AND APPROVED SHOP DRAWINGS SHALL BE REMOVED BY THE RESPONSIBLE CONTRACTOR AT THEIR EXPENSE AND SHALL BE REPLACED WITH THE OTHER MATERIALS OR WORK SATISFACTORY TO THE DIRECTOR'S REPRESENTATIVE. THE RESPONSIBLE CONTRACTOR SHALL ALSO
- MAY BE DISTURBED BY THIS REPLACEMENT. EACH PRIME CONTRACTOR WILL BE RESPONSIBLE FOR ALL COSTS INCURRED FOR DAMAGES CAUSED BY THEIR SUB-CONTRACTORS AND SHALL HAVE A COMPETENT SUPERINTENDENT ON THE PREMISES AT ALL TIMES WHEN WORK IS

ASSUME THE COST OF REPLACING ADJACENT OR CONTINGENT WORK, WHICH

- EACH PRIME CONTRACTOR SHALL KEEP THE DIRECTOR'S REPRESENTATIVE
- INFORMED OF THE PROGRESS OF THEIR WORK. PROGRESS SCHEDULE MUST BE SUBMITTED IN ACCORDANCE WITH SECTION 01 ADMINISTRATIVE REQUIREMENTS (10 DAYS PRIOR TO PRE-CONSTRUCTION
- ANY DAMAGE TO NEW OR EXISTING BUILDING FABRIC NOT DESIGNATED FOR REPAIR OR OTHER APPROVED TREATMENT DURING CONSTRUCTION IS TO BE CORRECTED AT THE RESPONSIBLE CONTRACTORS EXPENSE ONLY AFTER
- THOROUGH EXAMINATION BY THE DIRECTOR'S REPRESENTATIVE. EACH PRIME CONTRACTOR SHALL PERFORM ALL CUTTING AND PATCHING REQUIRED TO COMPLETE THE WORK OR TO MAKE ITS PARTS FIT TOGETHER PROPERLY WITHOUT COMPROMISING THE QUALITY OF THE WORK, ANY REPAIRS
- TO THE EXTERIOR SURFACES AND COMPONENTS MUST BE DISCUSSED WITH THE DIRECTOR'S REPRESENTATIVE PRIOR TO EXECUTING THE WORK. EACH PRIME CONTRACTOR SHALL BE RESPONSIBLE FOR ACCURATELY BRACING AND PROTECTING ALL WORK DURING CONSTRUCTION AGAINST DAMAGE, BREAKAGE, COLLAPSE, DISTORTIONS, AND FOR CORRECT ALIGNMENT WITH ADJACENT MATERIALS AND SURFACES, ACCORDING TO CODES AND STANDARDS
- OF GOOD PRACTICE. CONSTRUCTION LOADS SHALL NOT OVERLOAD STRUCTURE NOR SHALL BE IN
- EXCESS OF DESIGN LOADINGS INDICATED HEREIN. AT ALL TIMES EACH PRIME CONTRACTOR WILL BE RESPONSIBLE TO MAINTAIN AND PROTECT ALL EXISTING SYSTEMS FROM THE EFFECTS OF ADVERSE WEATHER (RAIN, SNOW, COLD, ETC.) WITHIN AREAS OF WORK UNDER THIS
- CONTRACT AT NO ADDITIONAL CHARGE. ALL LADDERS, AND SCAFFOLDING SHALL BE IN GOOD OPERATING CONDITION, AND SHALL CONFORM TO ALL APPLICABLE STANDARDS. ALL DAMAGED LADDERS AND ROLLING SCAFFOLDING WILL BE IMMEDIATELY REMOVED FROM THE JOB SITE. ALL PLATFORM, ACCESS, SITE SCAFFOLDING SHALL CONFORM TO THE
- LATEST REQUIREMENTS STANDARDS AND GUIDELINES ESTABLISHED BY OSHA. DURING WORK, ALL ELECTRICAL HAND TOOLS MUST BE GROUNDED PROPERLY. ALL APPROPRIATE PROTECTIVE GEAR, INCLUDING EYE GOGGLES, WILL BE WORN DURING ANY CUTTING, WHETHER BY HAND OR BY MECHANICAL MEANS OF MASONRY COMPONENTS AND ANY OTHER CONSTRUCTION OPERATIONS, WHICH
- REQUIRE SAFETY CLOTHING AND PROTECTIVE EQUIPMENT. EACH PRIME CONTRACTOR TO COORDINATE LOCATION OF ALL PARTITIONS ENCLOSING EQUIPMENT, INCLUDING WATER COOLERS, WITH APPROVED SHOP DRAWINGS PRIOR TO BEGINNING ERECTION OF PARTITIONS.
- PARTITION CONSTRUCTION IS INDICATED BY WALL TYPE THICKNESS AND ROOM FINISH SCHEDULE. NEW PARTITIONS: EXTEND ALL PARTITIONS TO +7'-5" ABOVE FINISHED FLOOR,

UNLESS OTHERWISE NOTED.

- PROVIDE 3/4" PLYWOOD BLOCKING OR 6" HIGH x 18 GA. STEEL SHEET BLOCKING IN PARTITIONS AT ALL LOCATIONS WITH SURFACE APPLIED EQUIPMENT OR ACCESSORIES, SUCH AS HANDRAILS, TOILET ACCESSORIES, WALL BUMPERS, WALL MOUNTED DOOR STOPS AND FOR SUPPORT OF WALL CABINETS, SHELVES,
- CONFIRM CHASE WALL DIMENSIONS WITH PLUMBING CONTRACTOR. NOTIFY
- ARCHITECT OF ANY DISCREPANCIES. RESTORE DAMAGED AND EXPOSED FINISHES OR PATCHED AREAS IN A MANNER WHICH ELIMINATES EVIDENCE OF PATCHING AND REFINISHING.
- INSPECT SUBSTRATES AND REPORT UNSATISFACTORY CONDITIONS IN WRITING. DO NOT PROCEED UNTIL UNSATISFACTORY CONDITIONS HAVE BEEN
- LOCATE HINGE SIDE OF DOOR FRAMES 6" FROM PERPENDICULAR WALL UNLESS OTHERWISE NOTED.
- PAINT ALL EXPOSED INTERIOR AND EXTERIOR PIPING, CONDUITS, ETC. TO MATCH ADJACENT WALL SURFACE.

#### SAFETY PLAN:

- ALL WORK TO BE DONE IN ACCORDANCE WITH THE NEW YORK STATE BUILDING CODE, AND REGULATIONS OF ALL OTHER AGENCIES HAVING JURISDICTION.
- FIRE EXTINGUISHERS FOR CLASS A FIRE HAZARDS SHALL BE PROVIDED BY CONSTRUCTION CONTRACTOR IN CONSPICUOUS LOCATION(S) THROUGHOUT THE FACILITY DURING CONSTRUCTION AND WITH THE MAXIMUM TRAVEL DISTANCE OF 75 FEET TO ANY FIRE
- STORAGE OF MATERIALS AND BUILDING SAFETY:
  - ALL BUILDING MATERIALS STORED AT THE SITE OR ANY AREAS OF THE BUILDING ARE TO BE STORED IN AN ORDERLY MANNER AND SECURED IN A LOCKED AREA(S). ACCESS TO SUCH AREA IS TO BE CONTROLLED BY BOTH CONTRACTORS AND THE OWNERS REPRESENTATIVE THE OWNERS REPRESENTATIVE MUST APPROVE STORAGE OF ALL MATERIALS.
  - NO FLAMMABLE MATERIALS ARE TO BE STORED AT THE SITE. ALL MATERIALS USED ON A DAILY BASIS ARE TO BE KEPT TIGHTLY SEALED IN THEIR RESPECTIVE MANUFACTURES' CONTAINERS, SUCH MATERIALS ARE TO BE KEPT AWAY FROM HEAT. ALL FLAMMABLE MATERIAL IS TO BE USED IN AN ADEQUATELY VENTED SPACE.
- - DEBRIS, DIRT AND DUST TO BE CLEANED UP AND CLEARED FROM THE BUILDING PERIODICALLY TO AVOID EXCESS ACCUMULATION. NO DEBRIS SHALL BE ALLOWED
- - CONSTRUCTION OPERATIONS WILL BE CONFINED TO NORMAL WORKING HOURS: MONDAY THROUGH FRIDAY, 7AM - 4:30 PM. SATURDAY WORK IS SUBJECT TO PRIOR APPROVAL BY THE DIRECTORS REPRESENTATIVE OPERATIONS OUTSIDE OF THESE HOURS, WEEKENDS, AND DESIGNATED HOLIDAYS ARE SUBJECT TO SPECIAL PERMITS THAT MUST BE FILED NO LATE THAN THE TUESDAY PRECEDING THE SUNDAY WORK BEING REQUIRED.
- EACH PRIME CONTRACTOR TO OBTAIN CONSENT OF ALL PARTIES AFFECTED BY WORK, OCCURRING OUTSIDE OF REGULAR HOURS AND SUBJECT TO CURRENT APPLICABLE BUILDING DEPARTMENT REGULATION GOVERNING HOURS OR WORK.
- CONSTRUCTION WORK WILL BE CONFINED TO THE AREA(S) DEFINED BY THE WORK AREA LIMITS AND WILL NOT CREATE DUST, DIRT OR OTHER SUCH INCONVENIENCES TO
- PRIME CONTRACTOR SHALL TAKE EVERY REASONABLE PRECAUTION TO PROTECT THE FACILITY, STAFF, AND THE PUBLIC FROM THE WORK OF THIS CONTRACT, INCLUDING PREVENTING UNAUTHORIZED ACCESS TO LADDERS, SCAFFOLDING, EQUIPMENT, OPEN TRENCHES AND OTHER HAZARDOUS AREAS.

DRAWING LEGEND

Room name

101

(101

′ 1/8" = 1'-0"

ROOM TAG

DOOR TAG

WALL TAG

NORTH ARROW

CENTERLINE

TITLE MARK

**ELEVATION MARK** 

SECTION MARK

(RELATIVE TO PROJECT DATUM)

#### SCOPE OF WORK SUMMARY:

THIS IS A GENERAL SCOPE OF WORK ONLY TO FACILITATE PROJECT UNDERSTANDING. THIS PROJECT INCLUDES, BUT NOT NECESSARILY LIMITED TO THE FOLLOWING SCOPE OF WORK AND ALL RELATED WORK TO ACCOMPLISH IT.

- GRADING AS REQUIRED FOR BUILDING CONSTRUCTION.
- EXCAVATION FOR AND INSTALLATION OF A CONCRETE PIER BUILDING FOUNDATIONS. CONSTRUCTION OF BATHHOUSE #231 & #322, LATRINE #427, DINING HALL #404 EXTERIOR
- CONSTRUCTION OF STAIR, SLOPED WALKWAYS AND PORCHES TO BATHHOUSE #231 & #
- 322 AND LATRINE #427. PROVIDE MECHANICAL, PLUMBING, AND ELECTRICAL SYSTEMS AT BATHHOUSE

DIMENSION, WALL DIMENSIONS ARE TO FACE OF

STUD, UON. DIMENSIONS LABELED AS CLEAR ARE

WALL ABOVE, WALL BELOW OR DEMOLISHED LINE TYPE

(LINE WEIGHT VARIES, SHEET DEPENDENT)

TO THE OUTERMOST EDGE OF THE

**NEW LINE WORK LINE TYPE** 

(LINE WEIGHT VARIES)

CONSTRUCTION.

BREAK MARK

**DETAIL BUBBLE** 

A200

EXTERIOR ELEVATION

INTERIOR ELEVATION

- #231 & #322 AND LATRINE #427. PROVIDE CONNECTIONS TO EXISTING ON-SITE UTILITIES, INCLUDING BUT NOT
- LIMITED TO WATER SUPPLY, SEWER, ELECTRICAL, AND COMMUNICATIONS.

# <u>Abbreviations</u>

STRUC

T&G

T.O.

TYP

UON

Above finish floor B.O. Bottom of Cast In Place Centerline CJ Control joint CMU Concrete masonry unit DIM Dimension Expansion joint **ELECT** Electrical Fire extinguisher and cabinet FEC

FIN GFRC Glass fiber reinforced concrete **GWB** Gypsum wall board Landscape Architecture MAX Maximum

Mechanical MECH MIN Minimum MRF Manufacturer MTL Metal NIC Not in Contract OC On center **PLUMB** Plumbing PT/P.T Pressure Treated PVC Polyvinyl chloride REQ'D Required R.O. Rough opening SF Square feet SIM Similar

Structural

Top of

Typical

Verify in field

Water closet

Tongue and Groove

Unless otherwise noted

Key Plan

Rev No	Description		0
Drawr	- D	Seal and Signature	

LLH	
Design By:	
LLH	
Checked By:	
CTS	
Approved By:	
CTS	
Date:	
3/16/23	

Sheet Title:

| GENERAL

21059.23

Drawing Number:

**Bid Documents** 

INFORMATION

C. ALL ELECTRICAL POWER TO BE SHUT OFF WHERE THERE ARE EXPOSED CONDUITS.


DUST CONTROL:

DEBRIS, DIRT AND DUST TO BE KEPT AT A MINIMUM AND CONFINED TO SCAFFOLDING AND TO THE IMMEDIATE CONSTRUCTION AREA.

TO ACCUMULATE: DUMPSTERS ARE TO BE REMOVED AS FILLED.

# CONSTRUCTION OPERATION AND HOURS:

- ADJACENT BUILDINGS OR PEDESTRIANS.
  - THE SITE WILL REMAIN OPEN TO THE PUBLIC DURING THE WORK OF THIS CONTRACT. EACH

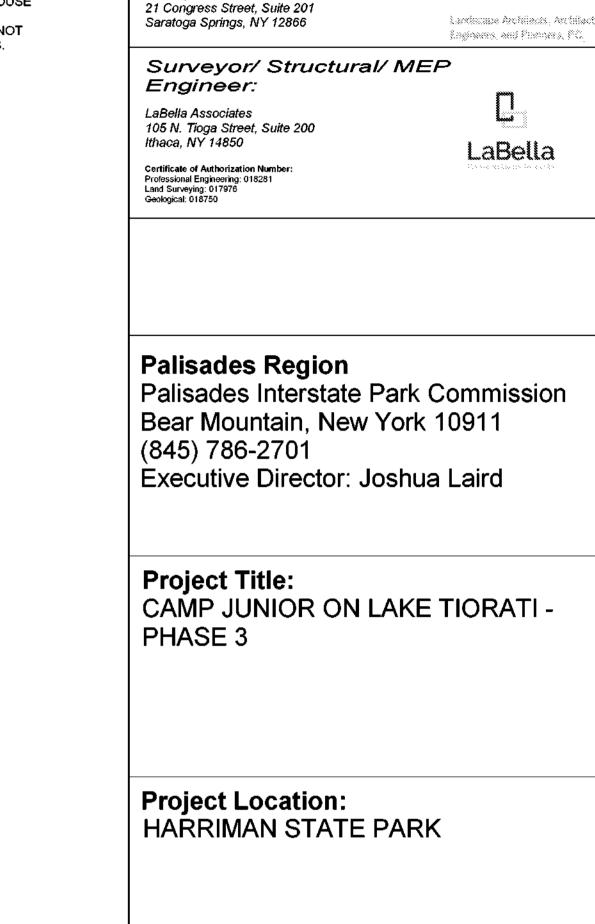

New York State

Governor Kathy Hochul

SIGNATURE, COPYRIGHT @ 2023

Architect:

Saratoga Associates

Parks, Recreation and

Historic Preservation

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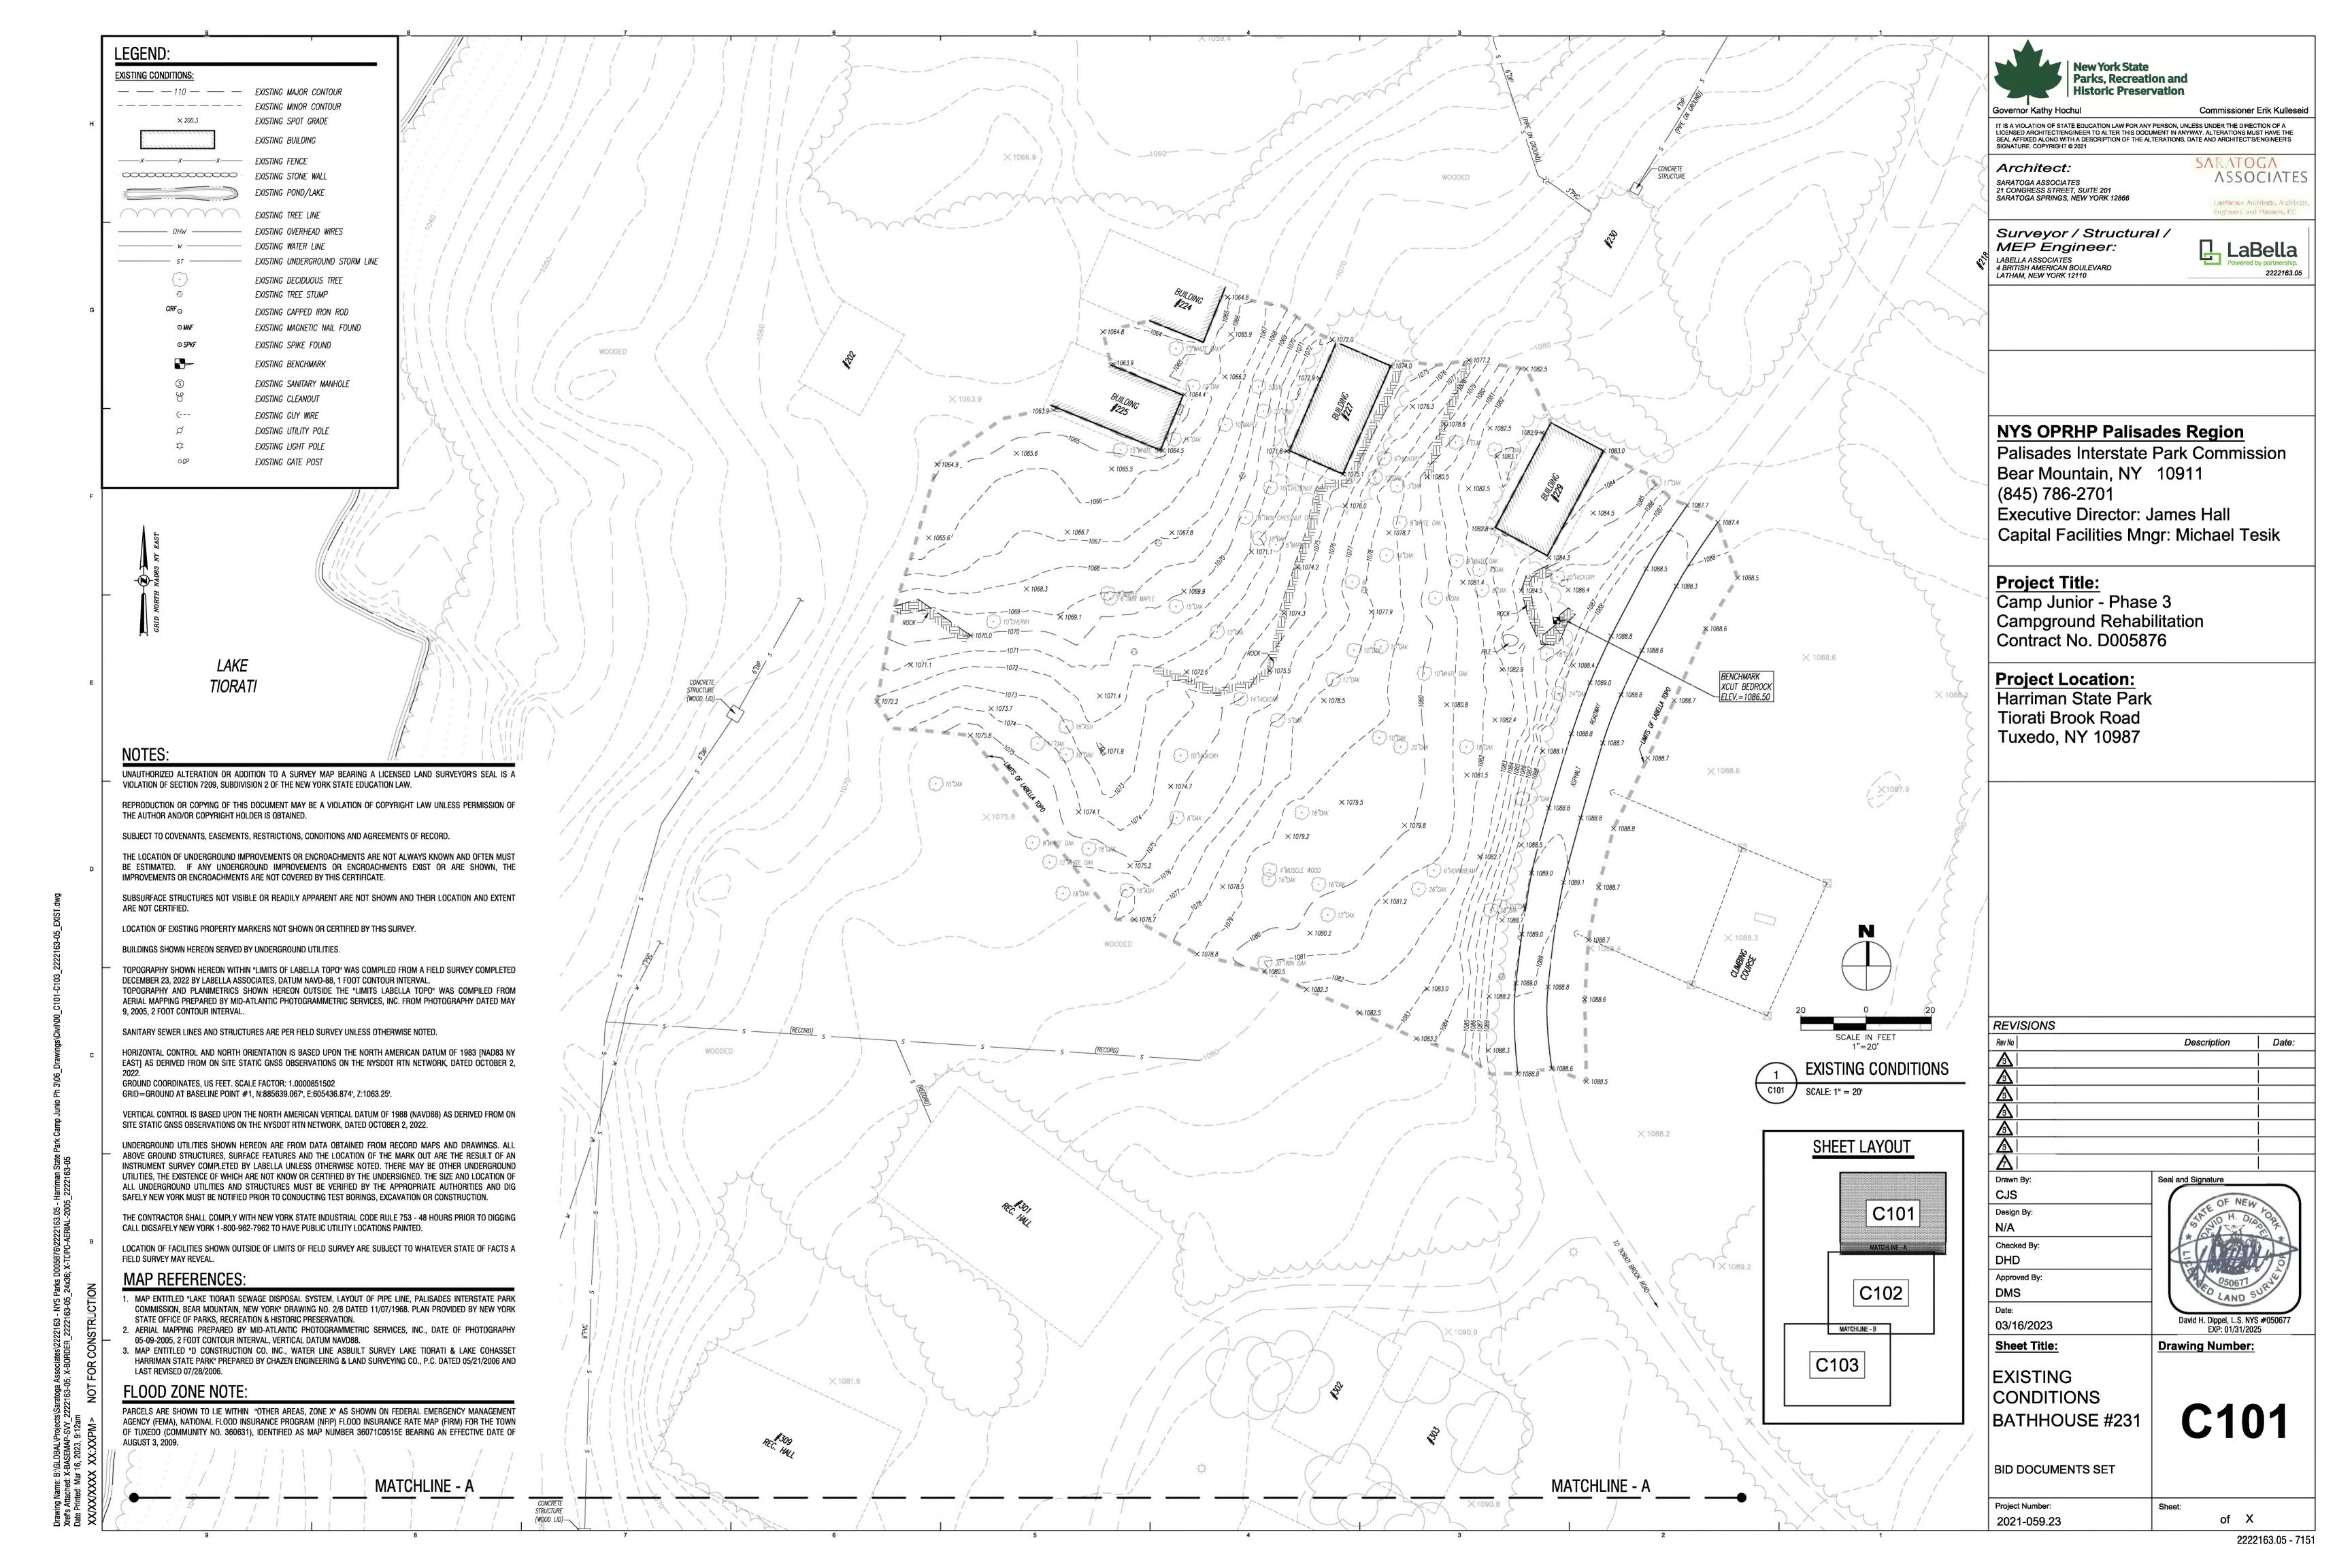
LICENSED ARCHITECT/ENGINEER TO ALTER THIS DOCUMENT IN ANYWAY, ALTERATIONS MUST HAVE THE


SEAL AFFIXED ALONG WITH A DESCRIPTION OF THE ALTERATIONS, DATE AND ARCHITECT'S/ENGINEER'S


Commissioner Erik Kulleseid


**ASSOCIATES** 


SARATOGA




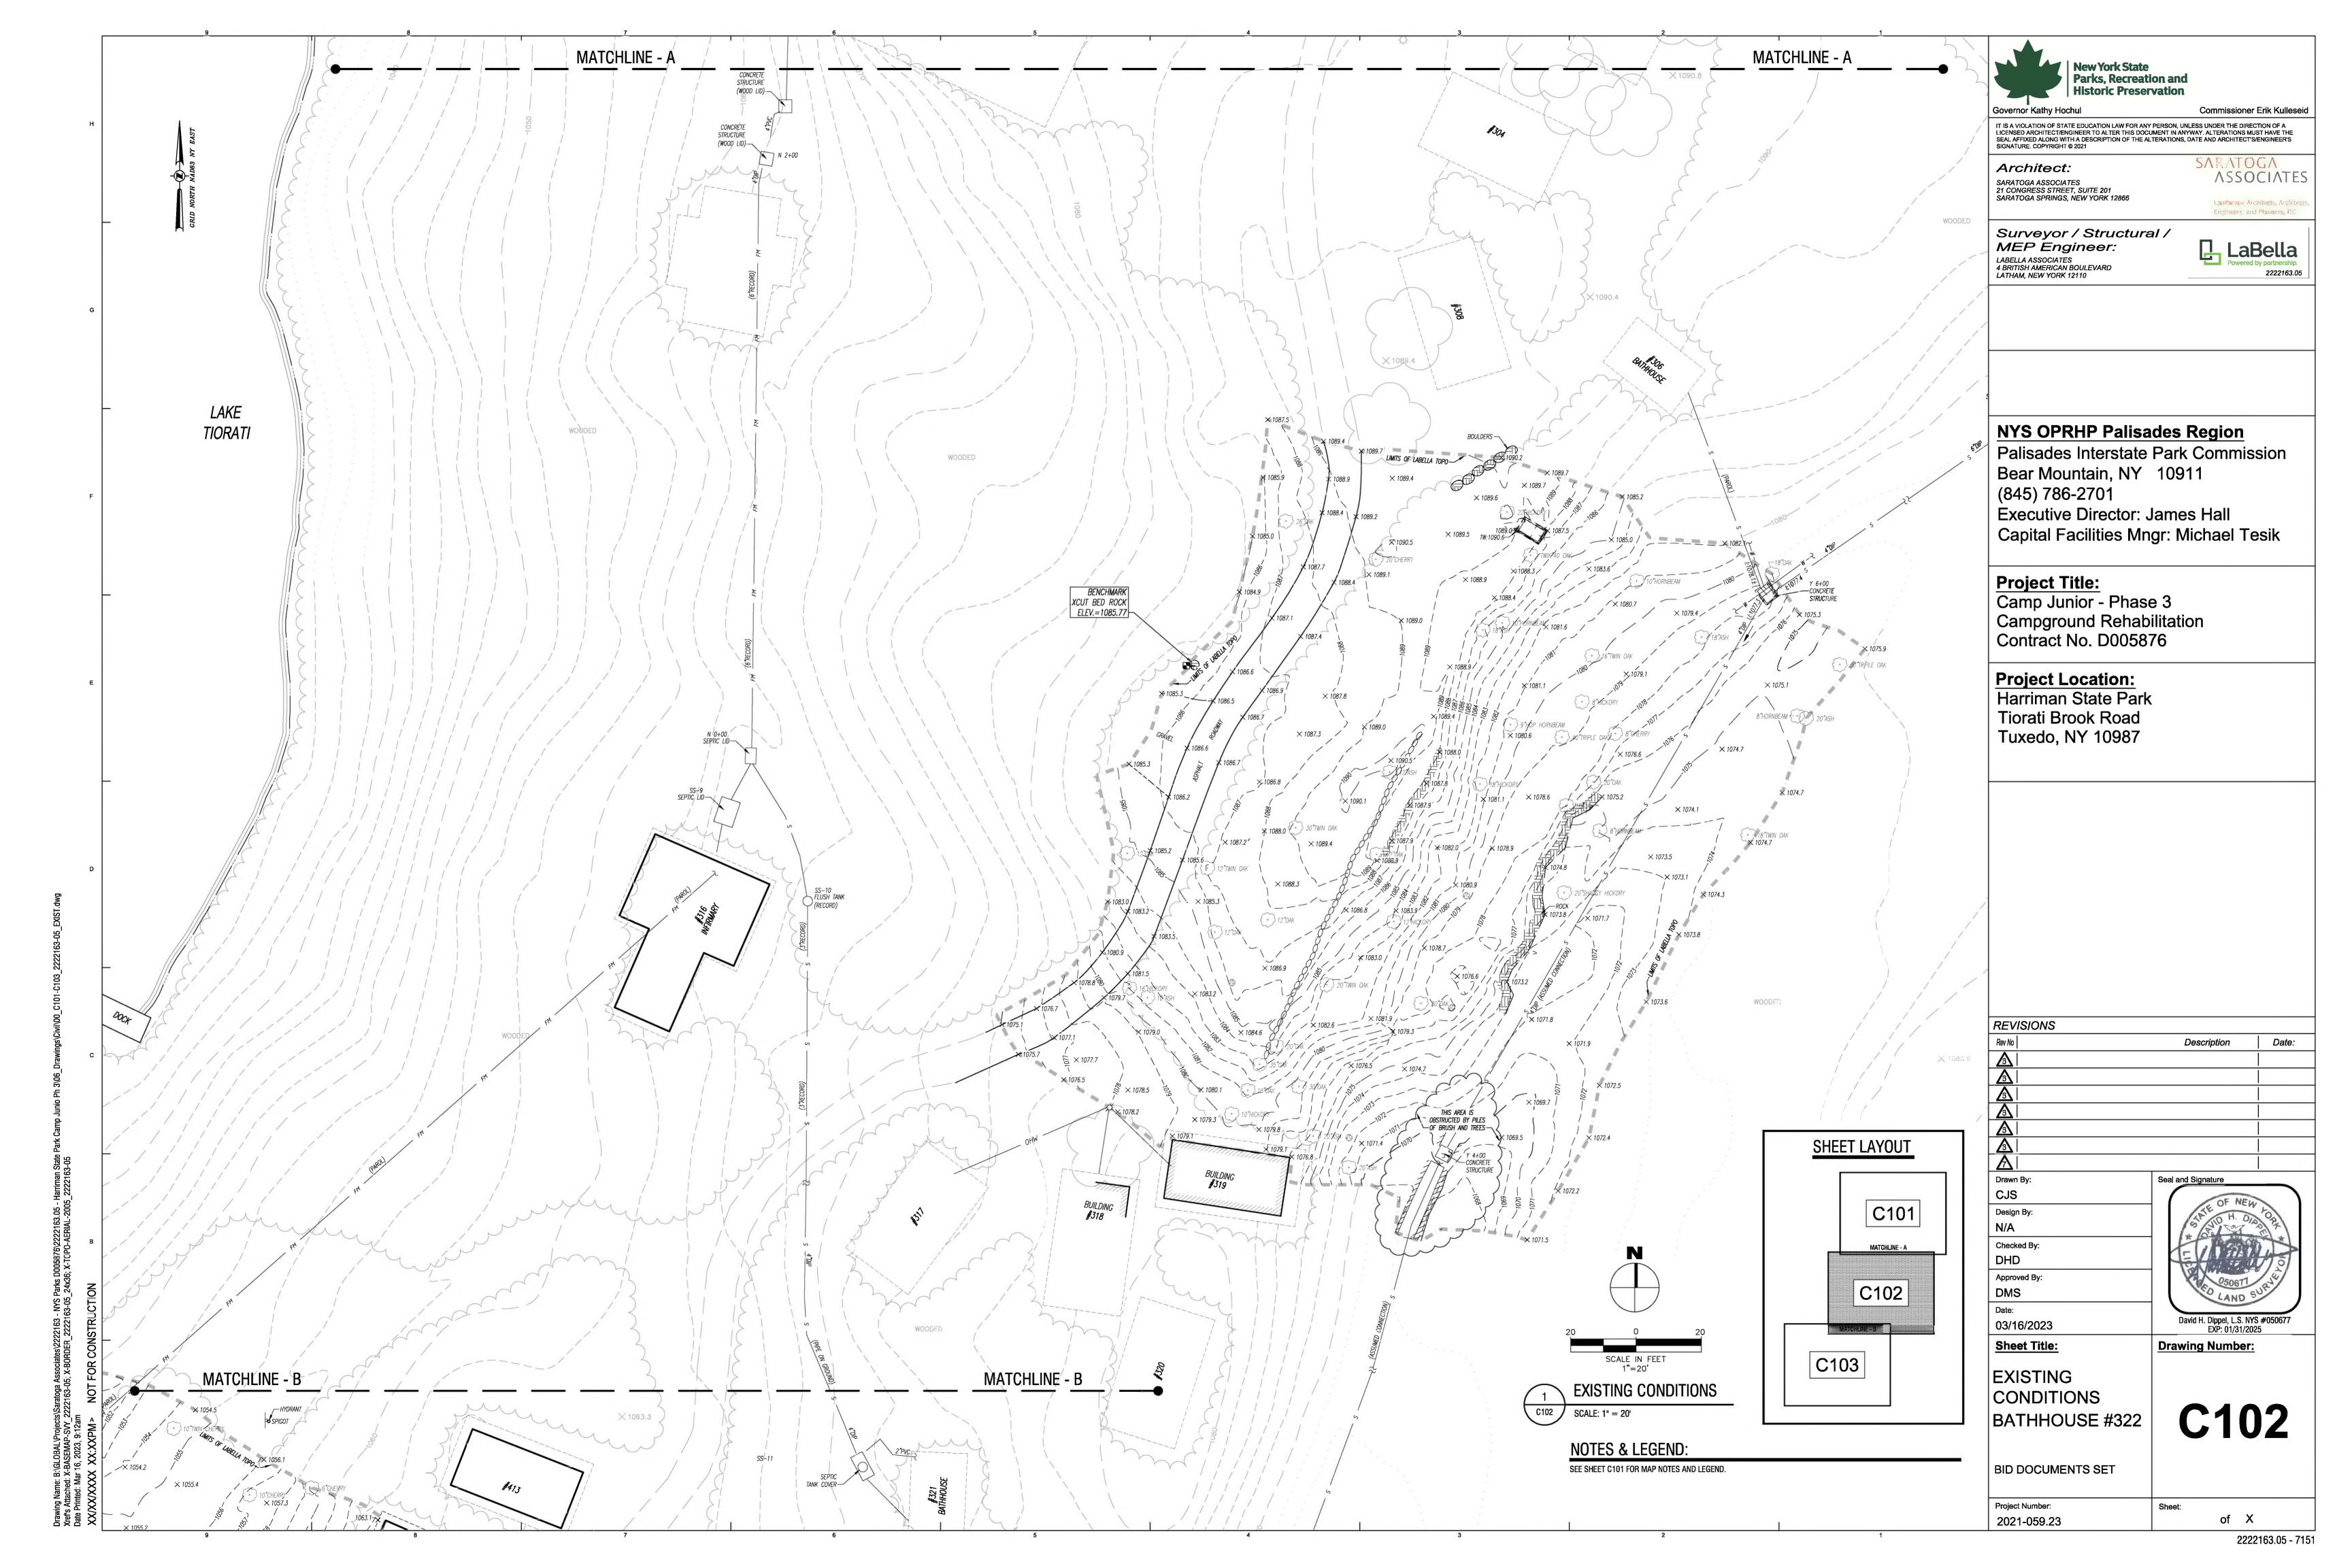

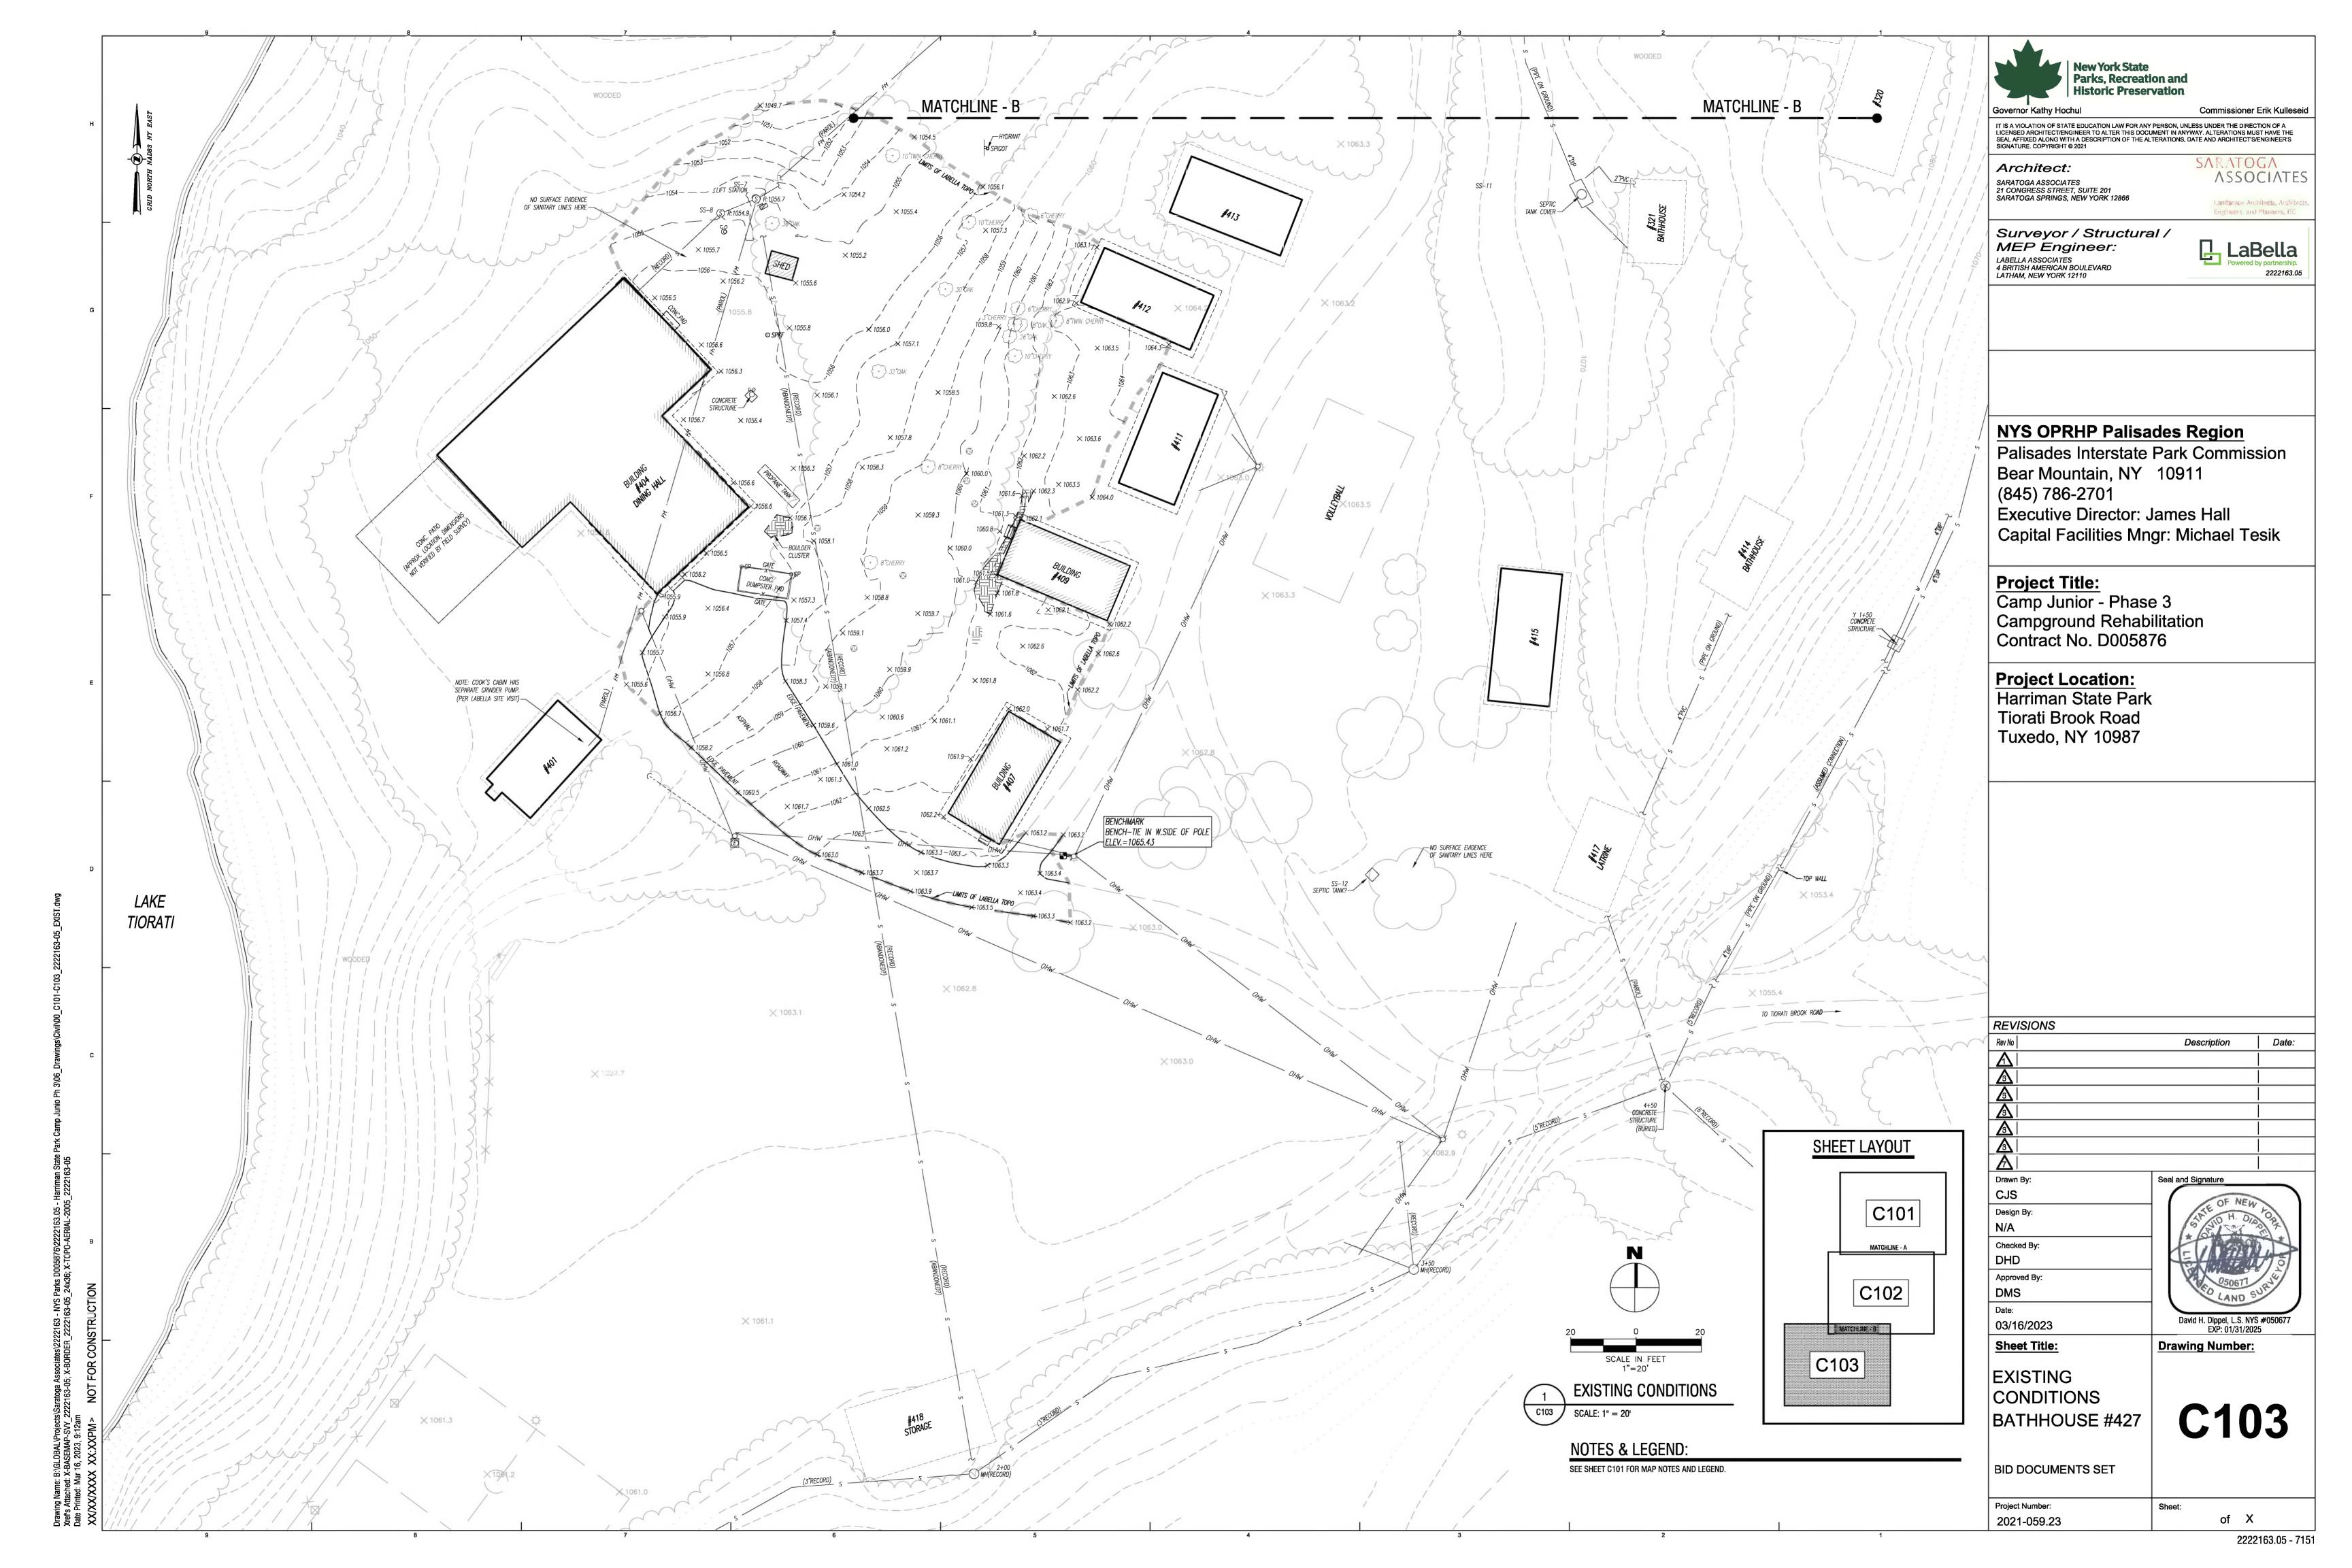

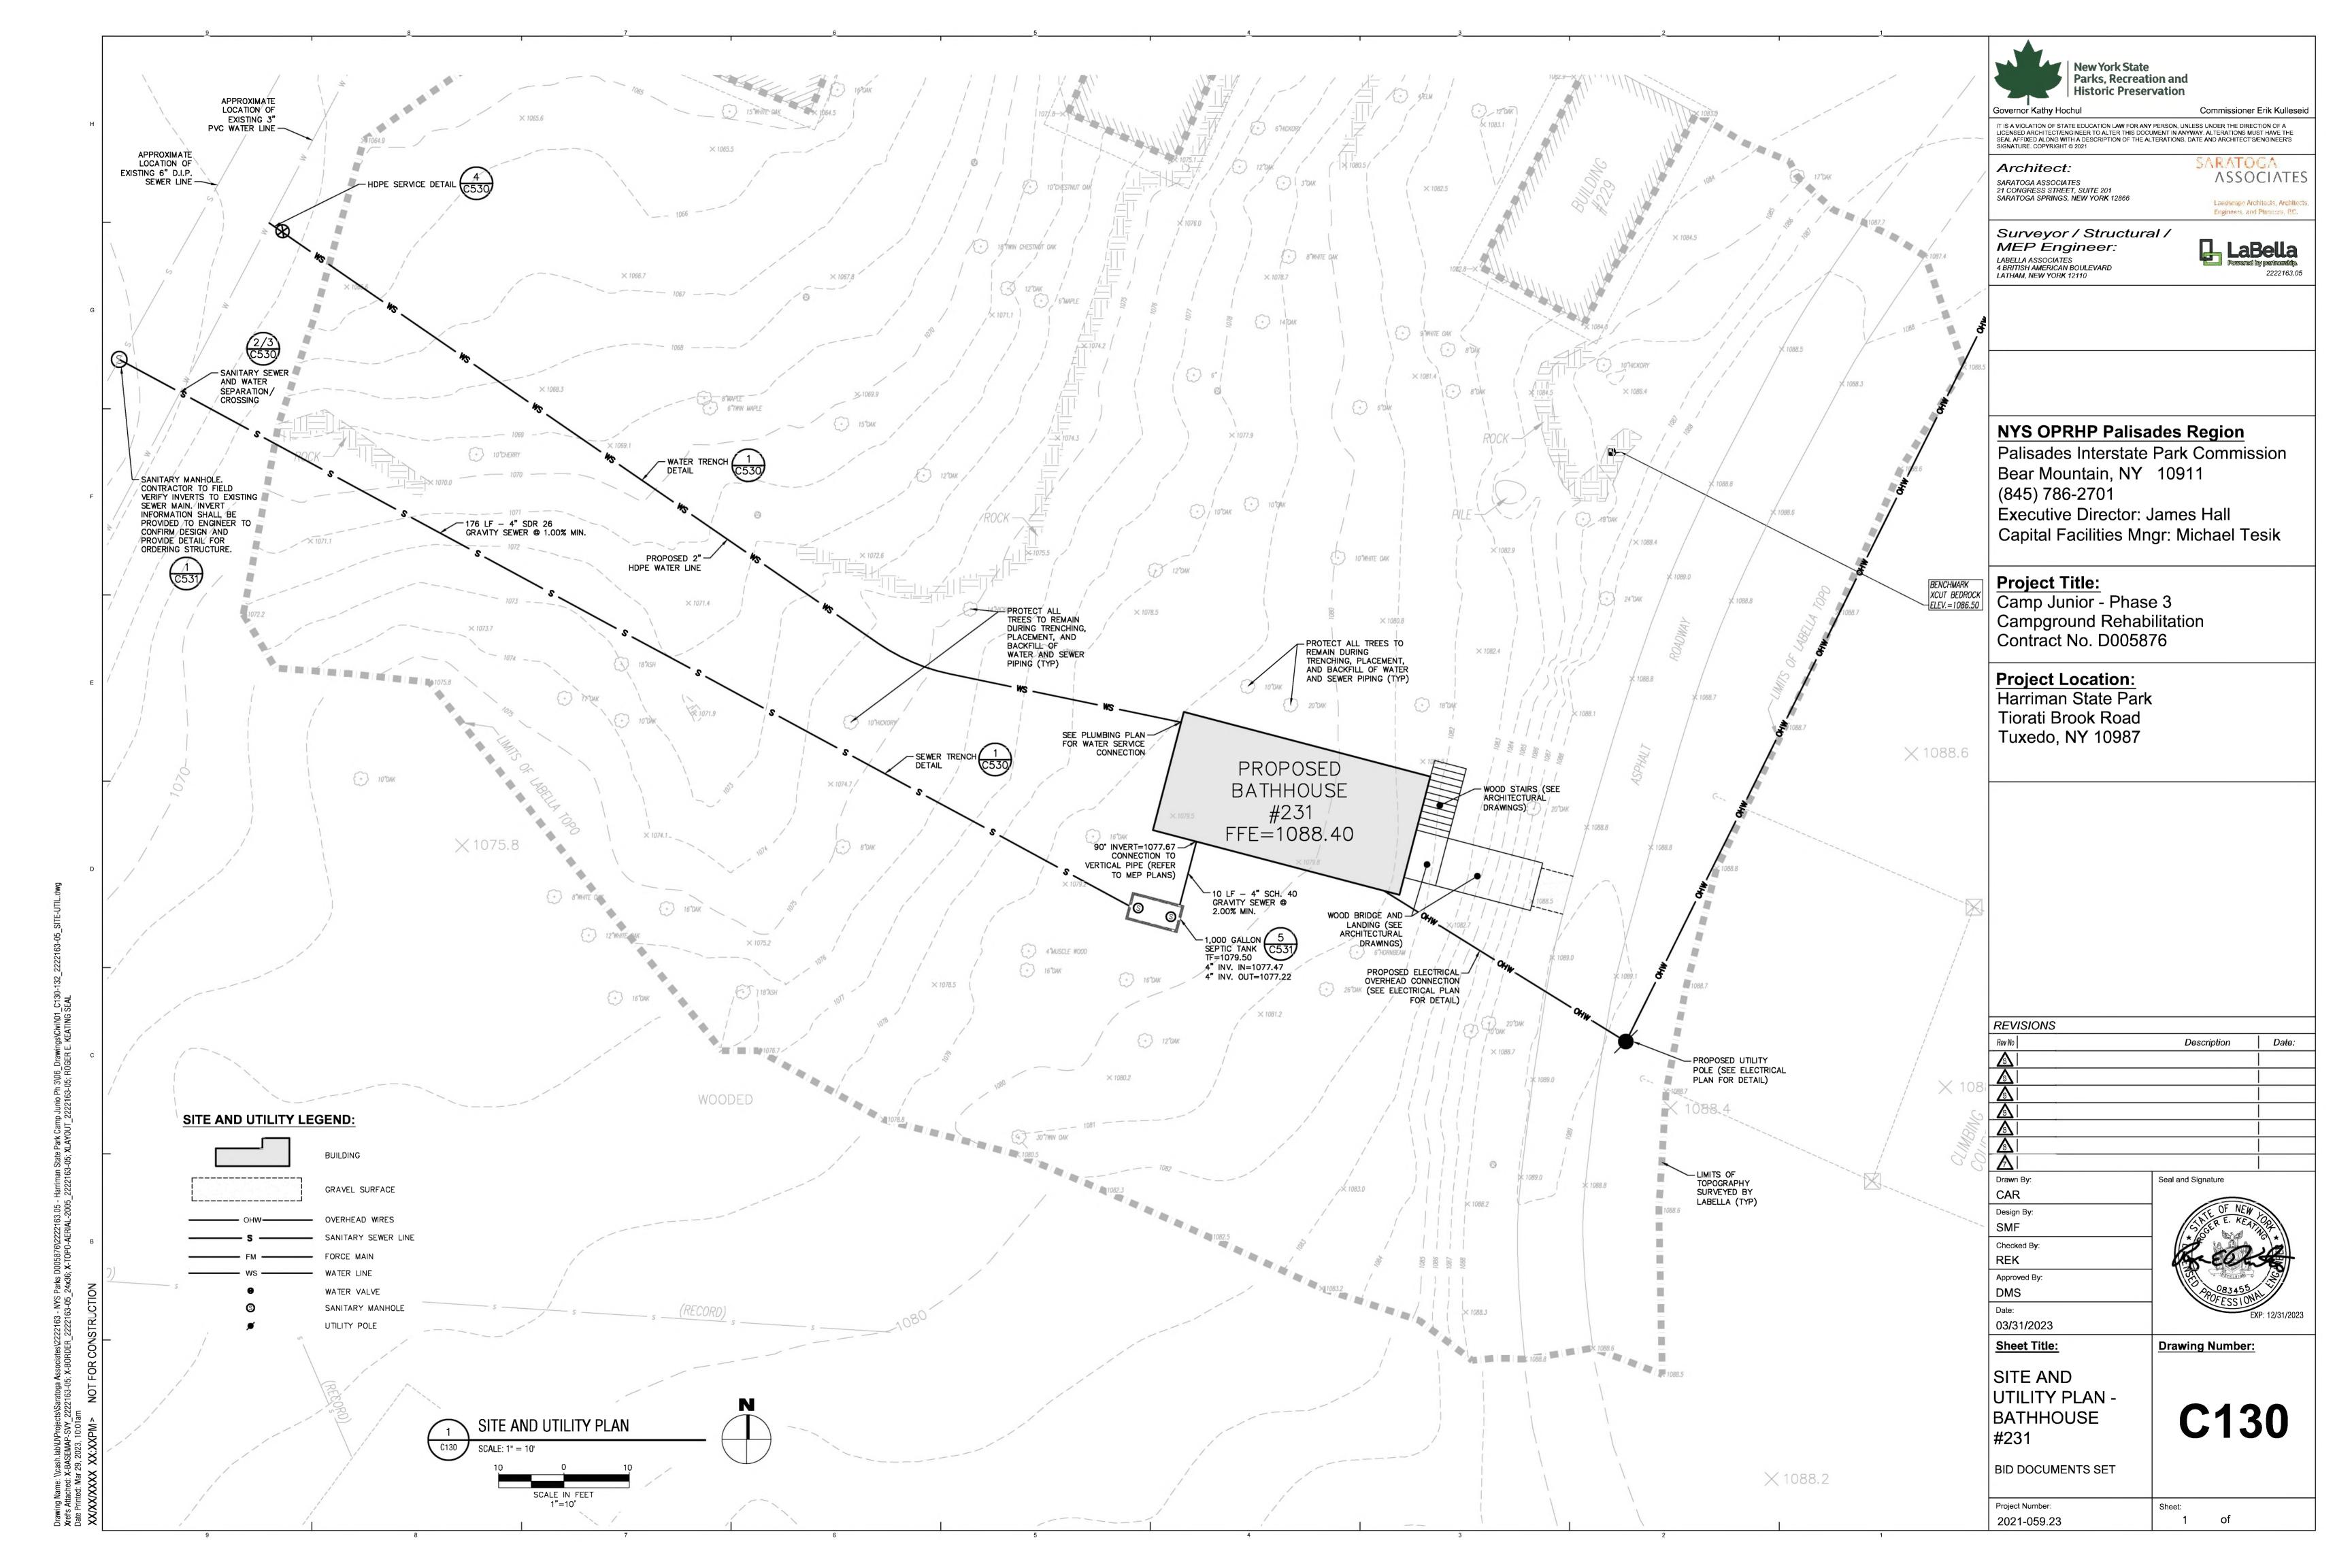

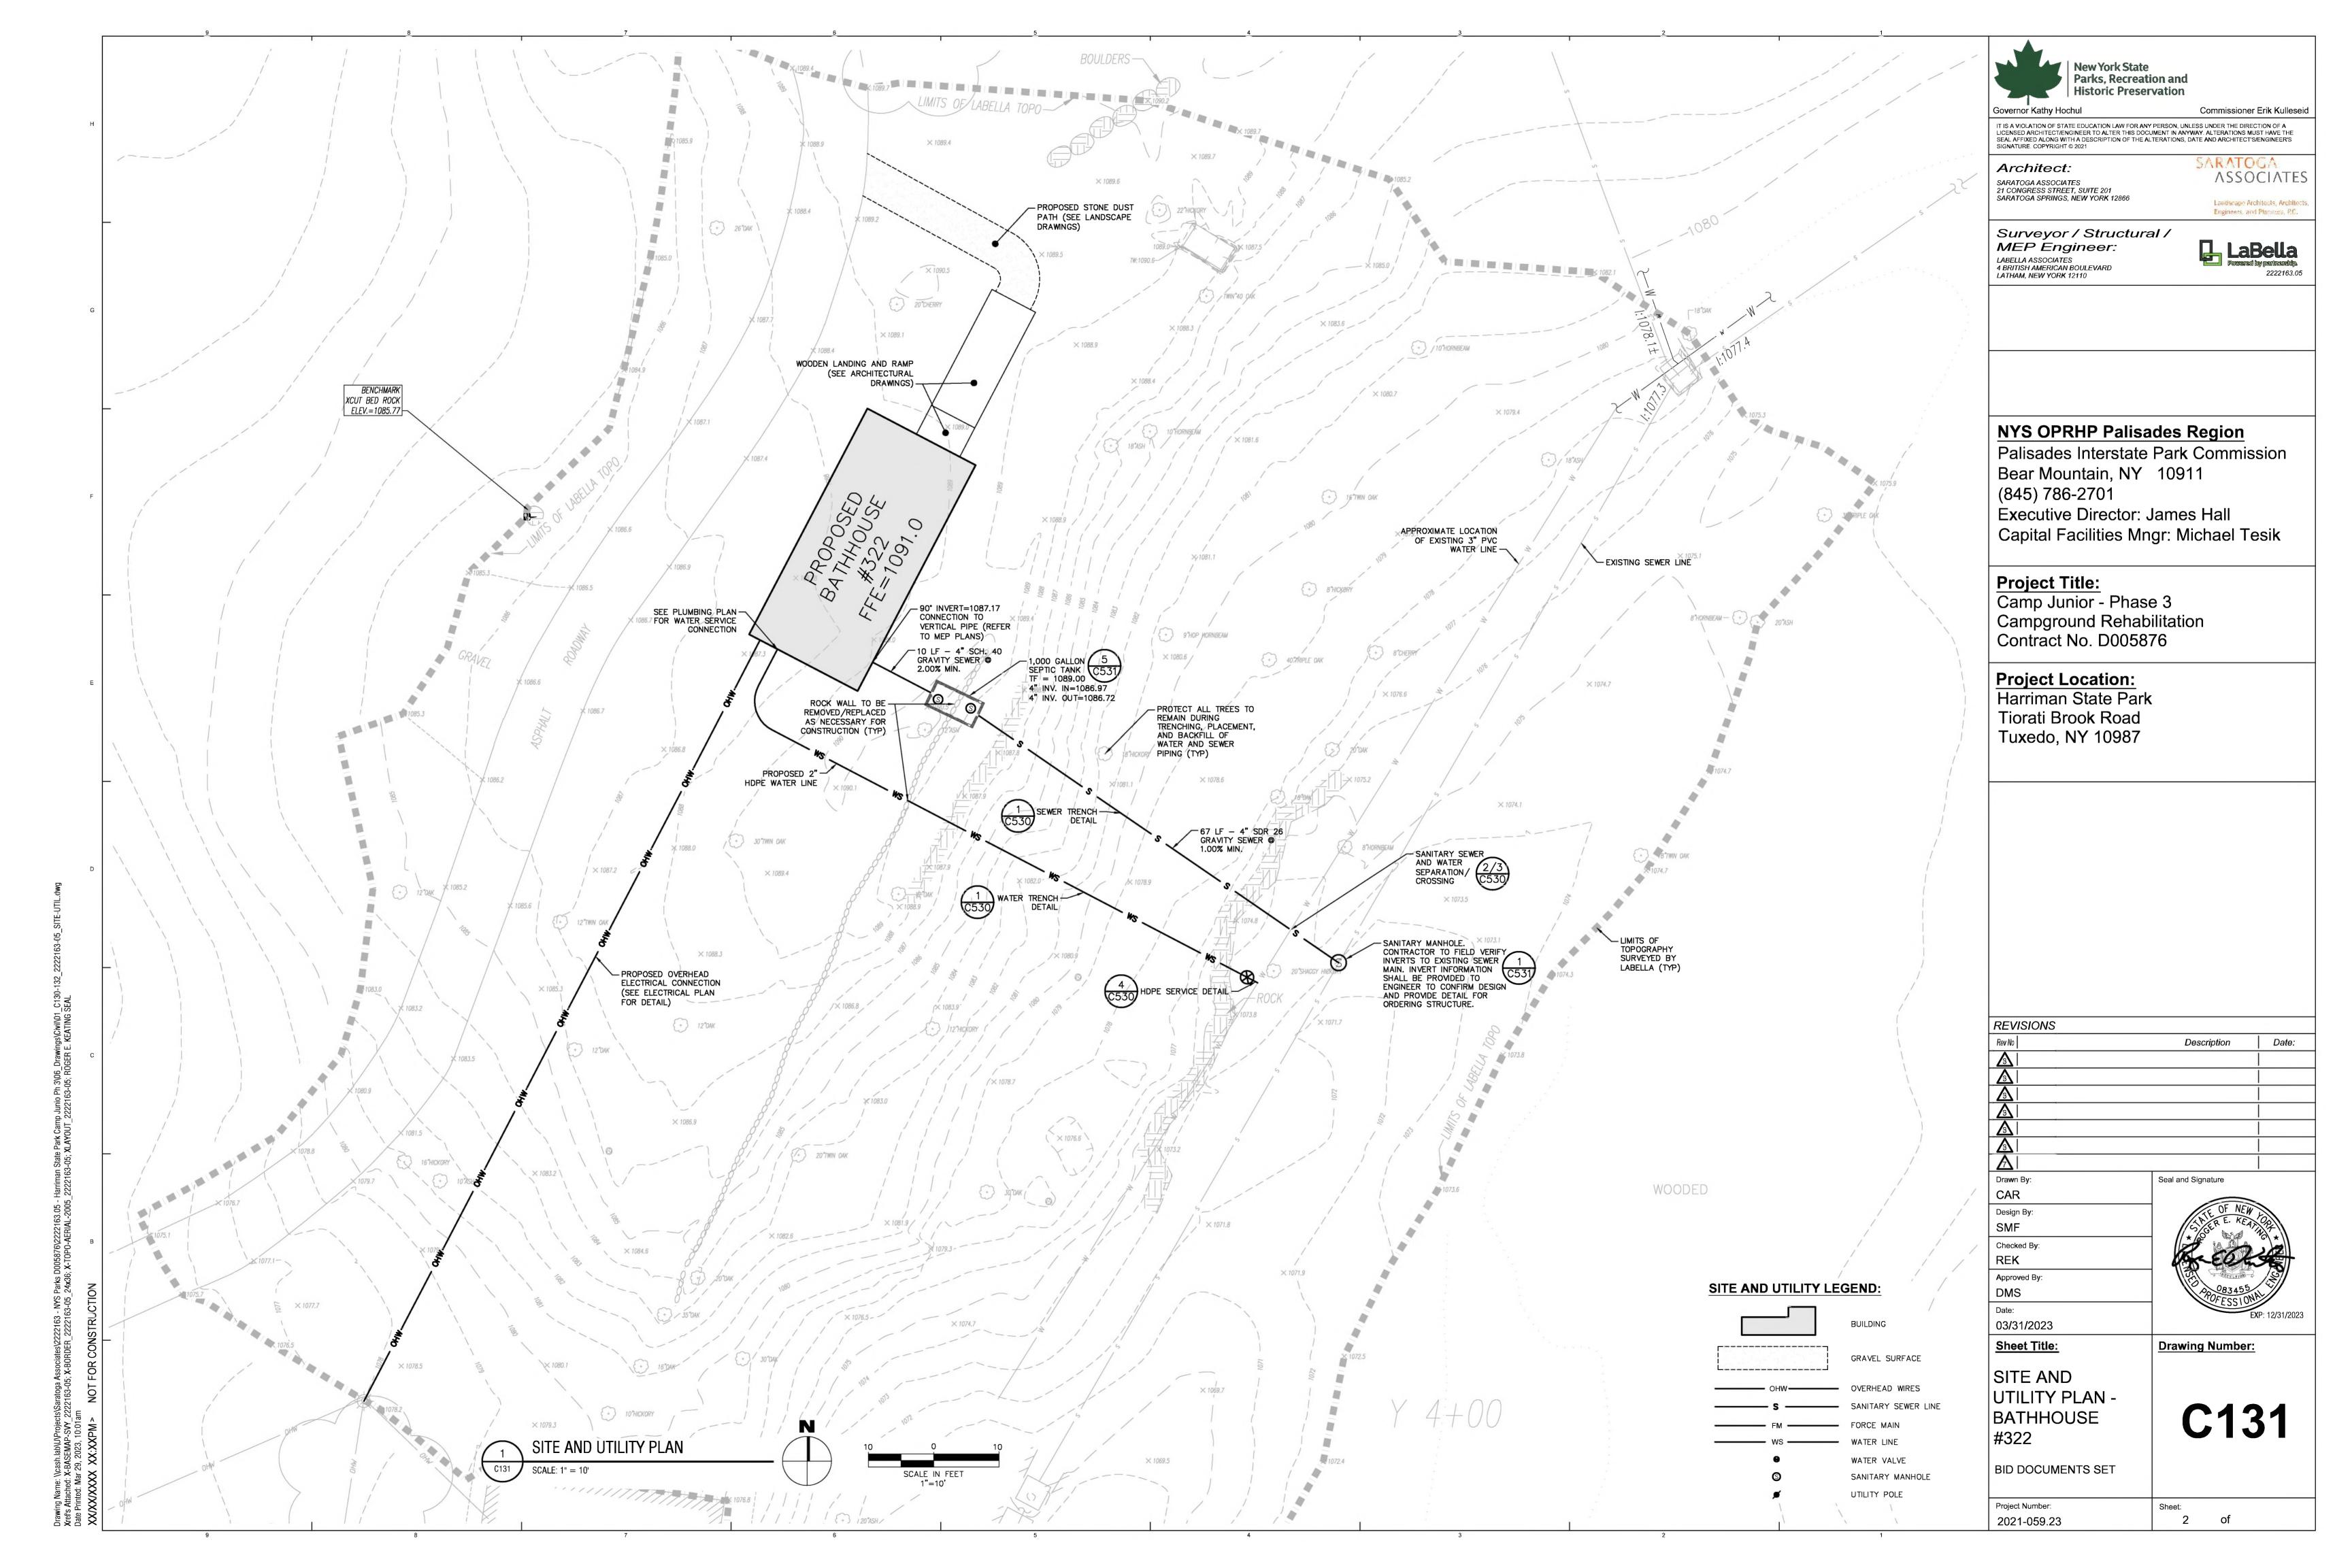

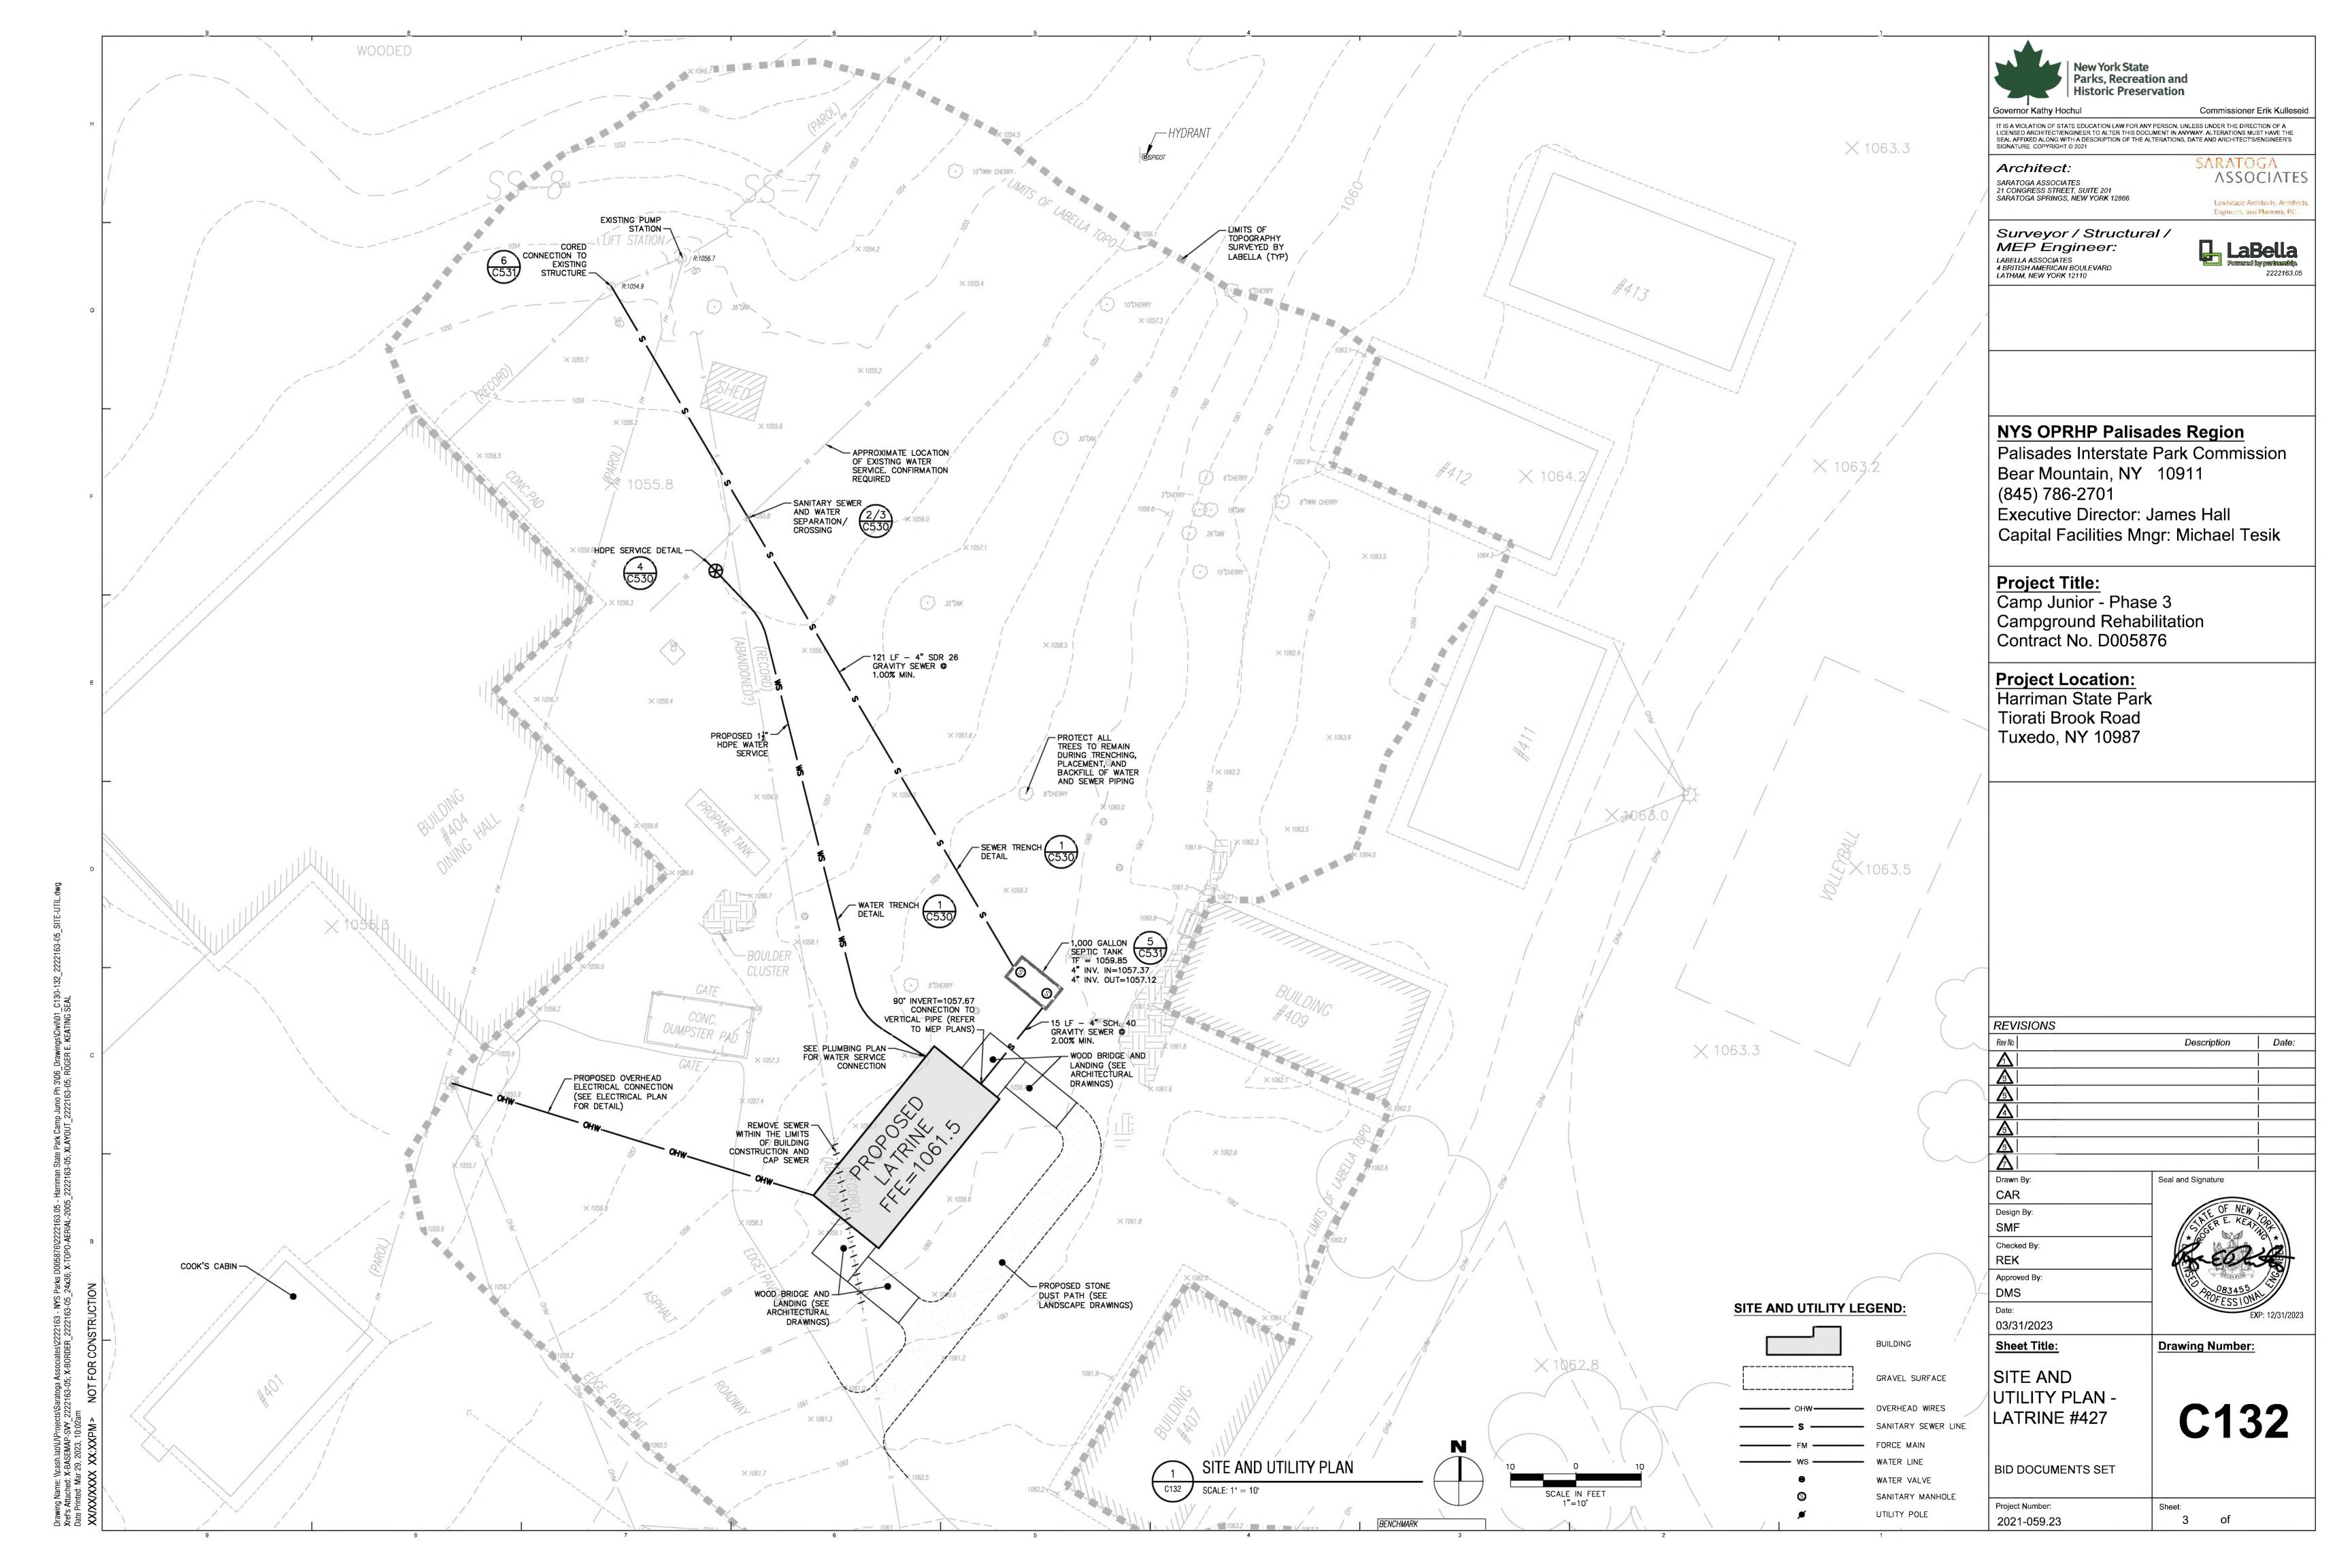

. MINIMUM COVER OVER TOP OF PIPE SHALL BE 18". IF 18" OF COVER CAN NOT BE ACHIEVED THROUGH EXCAVATION DUE TO THE PRESENCE OF ROCK, THE PIPE SHALL BE PLACED WITH 12" OF COVER TO EXISTING GRADE AND SHALL BE COVERED WITH AN ADDITIONAL 6" OF TRENCH BACKFILL MATERIAL TO OBTAIN 18" OF TOTAL COVER OVER TOP OF THE PIPE.

2. PIPE BEDDING & PIPE ZONE BACKFILL SHALL BE AN IMPORTED NATURAL RUN-OF-BANK (R.O.B.) SAND OR A MIXTURE OF CRUSHED STONE AND GRAVEL, FREE OF SOFT, NONDURABLE PARTICLES, ORGANIC MATERIALS AND ELONGATED PARTICLES, AND SHALL BE WELL GRADED FROM FINE TO COARSE PARTICLES. BEDDING GRADATIONS SHALL BE APPROVED BY THE ENGINEER AND SHALL MEET THE FOLLOWING GRADATION REQUIREMENTS:

SIEVE DESIGNATION % PASSING 100% 0-70% 3/4" NO. 40 NO. 200 0-10%

3. TRENCH BACKFILL SHALL BE A NATURAL RUN-OF-BANK (R.O.B.) OR PROCESSED GRAVEL, OR EXCAVATED MATERIAL FREE OF SOFT, NONDURABLE PARTICLES, ORGANIC MATERIALS AND ELONGATED PARTICLES, AND SHALL BE WELL GRADED FROM FINE TO COARSE PARTICLES. TRENCH BACKFILL GRADATIONS SHALL BE APPROVED BY THE ENGINEER AND SHALL MEET THE FOLLOWING GRADATION REQUIREMENTS:

% PASSING

NO. 40 0-70% NO. 200 0-10% IN NON-TRAFFIC UNPAVED AREAS TRENCH BACKFILL CAN BE MATERIALS

EXCAVATED FROM THE TRENCH AS APPROVED BY THE ENGINEER AND COMPACTED TO 90% MODIFIED PROCTOR.


4. INSTALL CONTINUOUS DETECTABLE MARKING TAPE DURING BACKFILLING OF TRENCH FOR UNDERGROUND PIPING. LOCATE TAPE BELOW FINISHED GRADE,

5. TRENCHING SHALL BE IMPLEMENTED IN ACCORDANCE WITH O.S.H.A. STANDARDS.



PIPE TRENCH DETAIL (TYPICAL) SCALE: NOT TO SCALE

1'-6" -SANITARY SEWER MAIN/LATERAL V—WATER— OR STORM MAIN OR LATERAL DRAIN EQUAL **EQUAL** FULL UNCUT LENGTH OF PIPE **VERTICAL SEPARATION** 

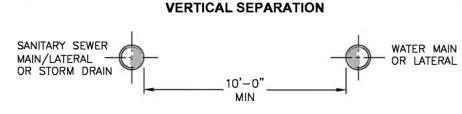

# **HORIZONTAL SEPARATION**


SCALE: NOT TO SCALE

1. NO DEVIATION IN THE SEPARATION REQUIREMENTS WILL BE PERMITTED WITHOUT THE EXPRESS APPROVAL OF THE NYS HEALTH DEPARTMENT. OFFSETTING OF WATERLINE SHALL BE REQUIRED WHERE SEPARATION DISTANCES CANNOT BE

MAINTAINED. 2. WHEN IT IS IMPOSSIBLE TO OBTAIN VERTICAL SEPARATION AS INDICATED ABOVE, BOTH THE WATER MAIN AND THE SEWER MAIN SHALL BE CONSTRUCTED OF MECHANICAL JOINT, DUCTILE IRON PIPE OR PVC WATER WORKS GRADE PRESSURE PIPE FOR 10' EACH SIDE OF CROSSING AND SHALL BE PRESSURE TESTED TO 150psi TO ASSURE WATER TIGHTNESS. SANITARY/STORM SEWER AND WATERMAIN SEPARATION DETAIL

# **WATER MAIN NOTES:**


- 1. THE WATER LINE MAY BE DEFLECTED WITHIN PIPE SPECIFICATIONS OR LAID DEEPER IN AREAS WHERE CROSSINGS WITH THE SANITARY LINE OCCUR, TO ACHIEVE THE REQUIRED 1.5' VERTICAL SEPARATION DISTANCE. (SEE WATERLINE OFFSET DETAIL FOR FURTHER INFORMATION).
- 2. WATER MAINS SHALL BE TESTED PER AWWA SECTION C 600 OR C605.
- 3. THE WATER MAIN IS TO BE INSTALLED AT A CONTINUOUS GRADE WITH NO ABRUPT HIGH OR LOW POINTS.

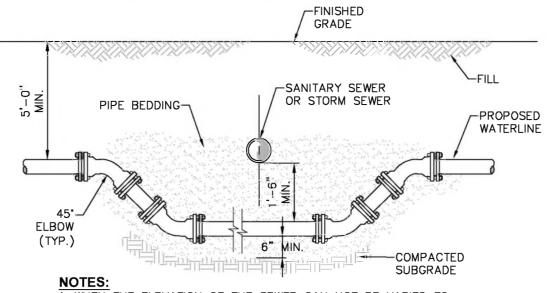


1. WHEN THE ELEVATION OF THE SEWER CAN NOT BE VARIED TO MEET THE ABOVE REQUIREMENTS, THE WATER MAIN SHALL BE RELOCATED TO PROVIDE THIS REQUIRED SEPARATION.

2. WHEN IT IS IMPOSSIBLE TO OBTAIN VERTICAL SEPARATION AS INDICATED ABOVE, BOTH THE WATER MAIN AND THE SEWER MAIN SHALL BE CONSTRUCTED OF MECHANICAL JOINT DUCTILE IRON PIPE OR PVC WATER WORKS GRADE PRESSURE PIPE FOR 10' EACH SIDE OF CROSSING AND SHALL BE PRESSURE TESTED TO 150psi TO ASSURE WATER TIGHTNESS.



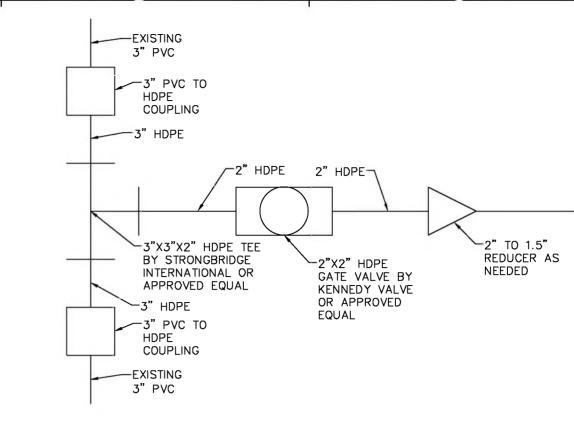

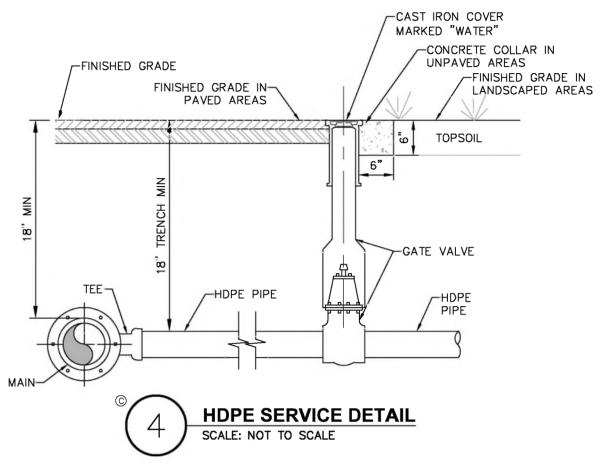



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Architect: SARATOGA ASSOCIATES 21 CONGRESS STREET, SUITE 201 SARATOGA SPRINGS, NEW YORK 12866

LATHAM, NEW YORK 12110

**ASSOCIATES** Landscape Architects, Architects Engineers, and Planners, P.C.

SARATOGA

Surveyor / Structural / MEP Engineer: LABELLA ASSOCIATES 4 BRITISH AMERICAN BOULEVARD



# NYS OPRHP Palisades Region

Palisades Interstate Park Commission Bear Mountain, NY 10911 (845) 786-2701 Executive Director: James Hall Capital Facilities Mngr: Michael Tesik

# **Project Title:**

Camp Junior - Phase 3 Campground Rehabilitation Contract No. D005876

# Project Location:

Harriman State Park Tiorati Brook Road Tuxedo, NY 10987


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REK	198-EQ4	
Approved By:	Opp. 155	
DMC	083455	/ Y//

**Sheet Title:** Drawing Number: WATER DETAILS

BID DOCUMENTS SET

03/16/2023

Project Number: 2021-059.23 4 of

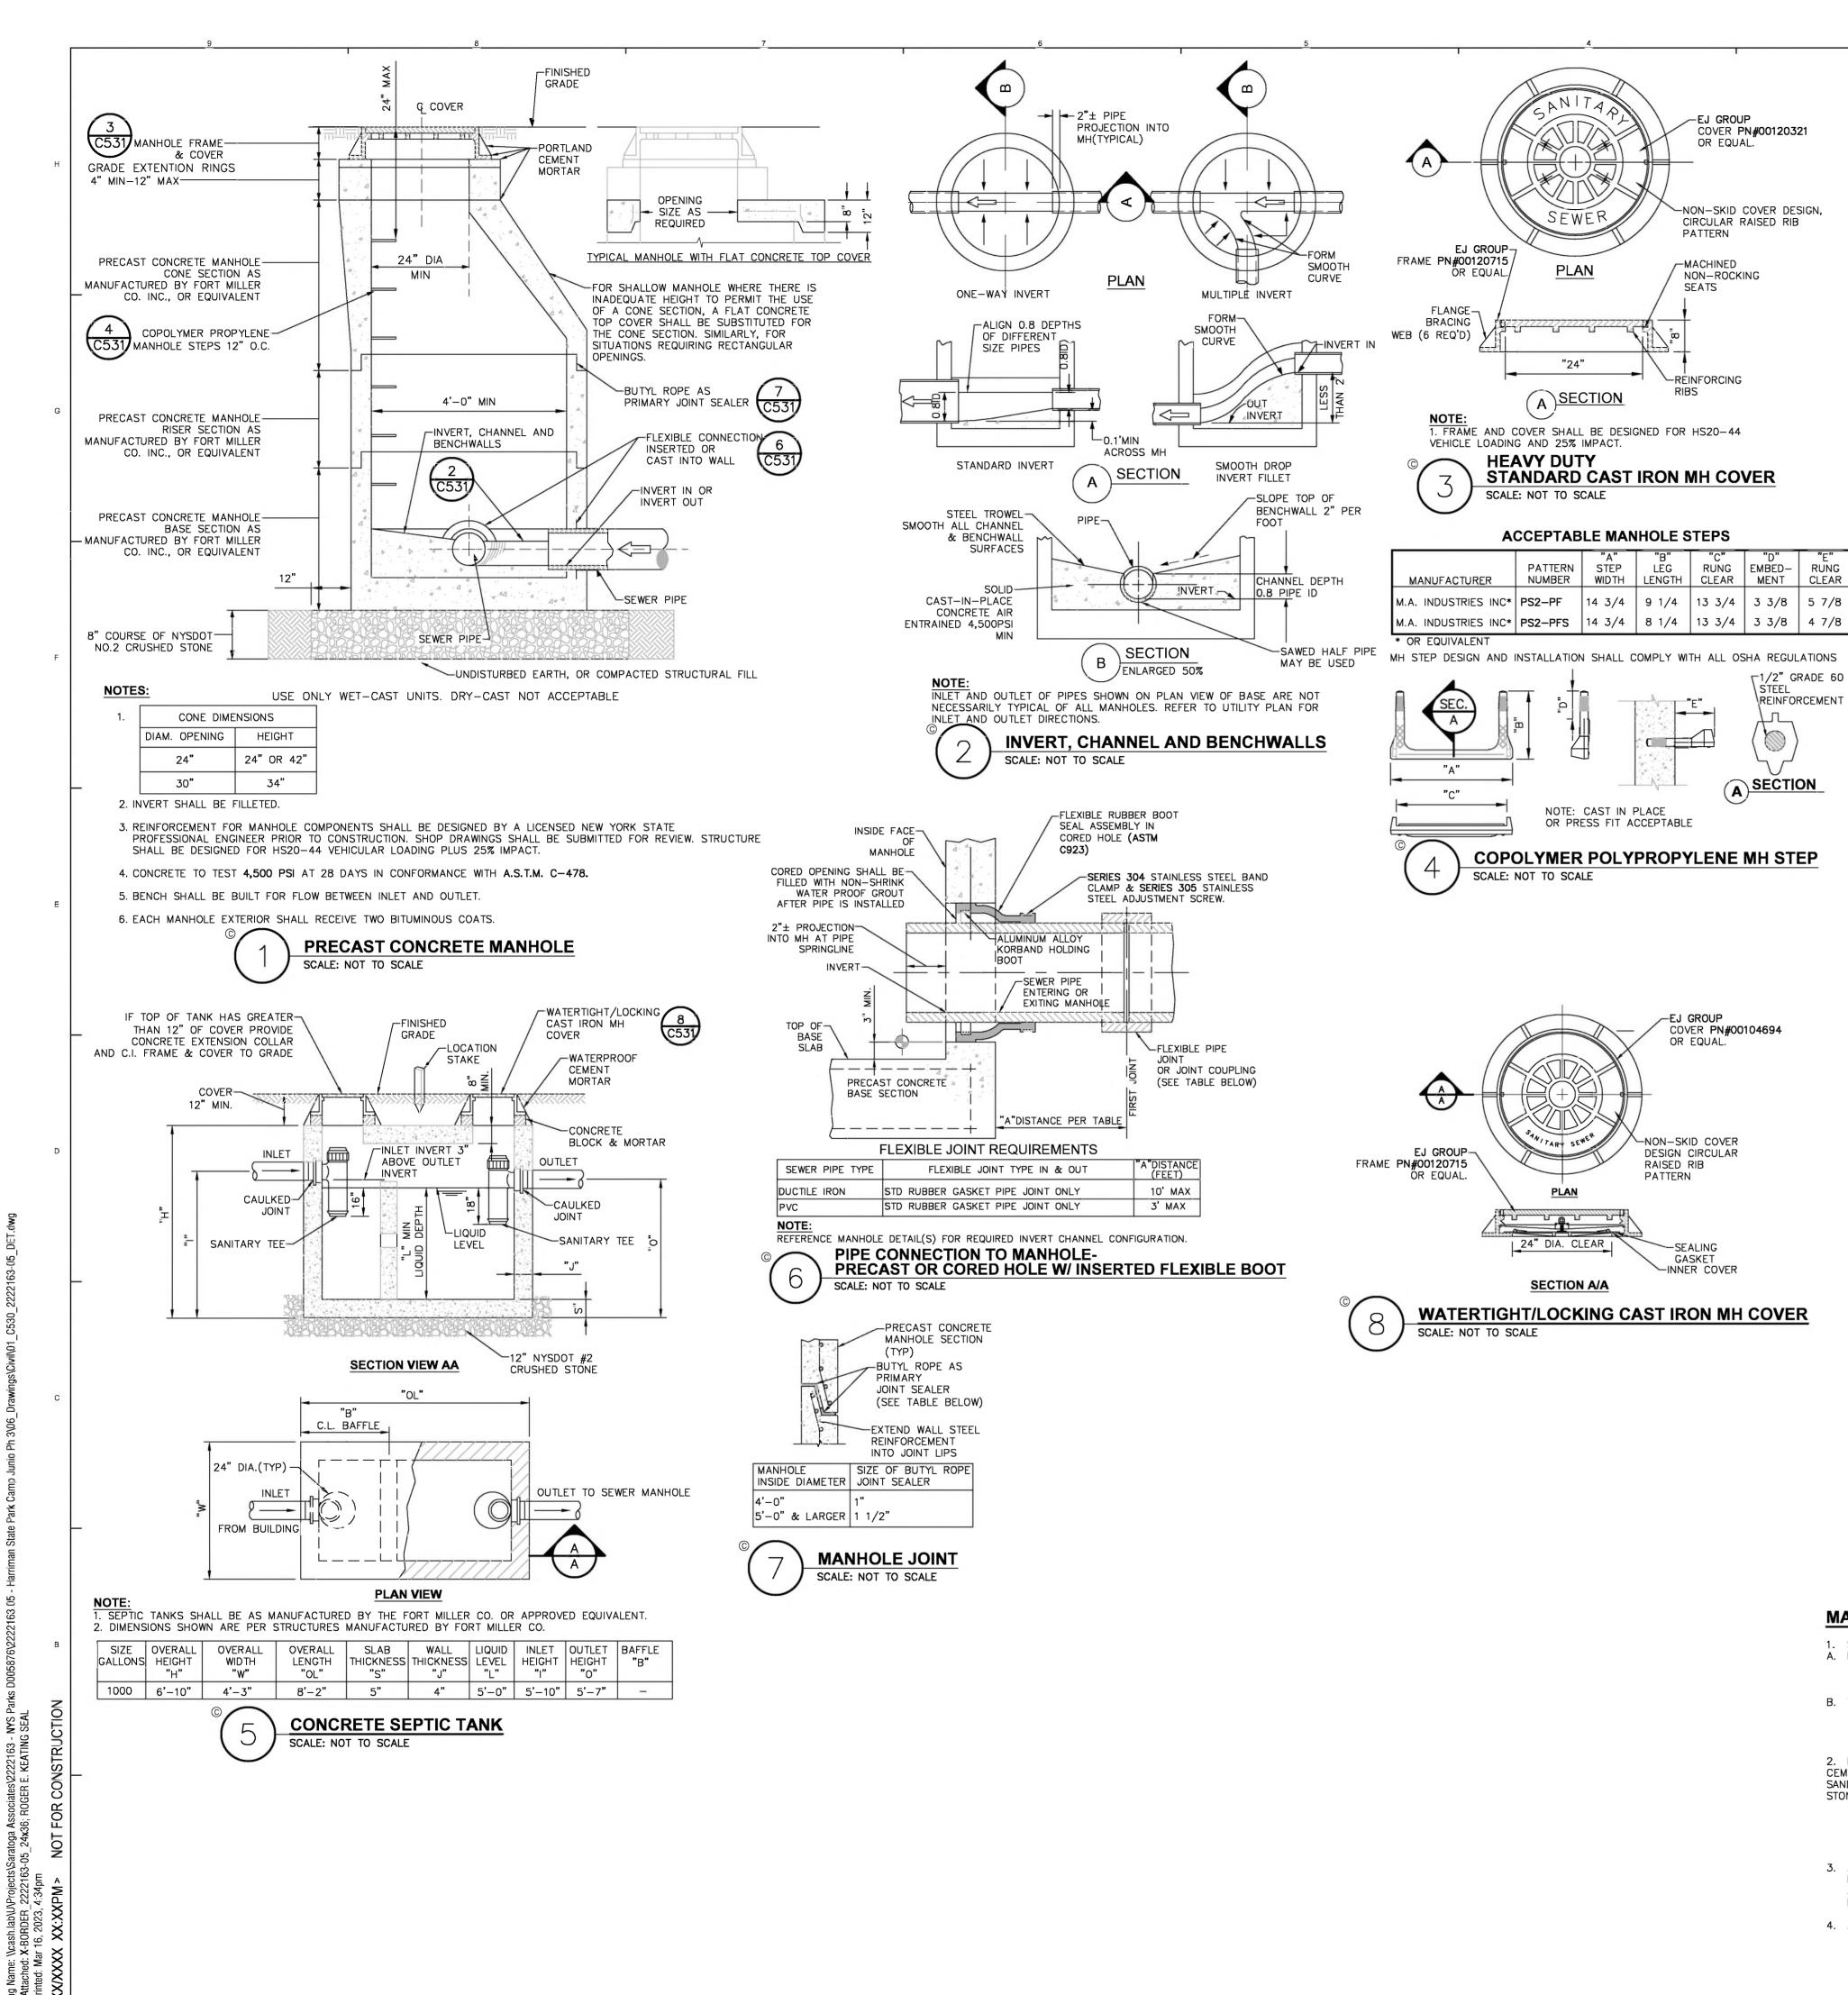

**TESTING GRAVITY SEWER SYSTEM:** 

-EJ GROUP

OR EQUAL.

PATTERN

-MACHINED

SEATS

-REINFORCING

NON-ROCKING

PLAN

"24"

NOTE: CAST IN PLACE

OR PRESS FIT ACCEPTABLE

EJ GROUP

OR EQUAL

-NON-SKID COVER

DESIGN CIRCULAR

GASKET

-INNER COVER

RAISED RIB

PATTERN

**SECTION A/A** 

COVER PN#00104694

COVER PN#00120321

-NON-SKID COVER DESIGN,

1/2" GRADE 60

REINFORCEMENT

CIRCULAR RAISED RIB

1. LOW PRESSURE AIR TESTING MAY BE ALLOWED IN LIEU OF EXFILTRATION TESTS ONLY. WHEN SO ALLOWED, TEST SHALL BE PERFORMED UNDER DIRECTION OF ENGINEER ACCORDING TO ASTM F1417. LOW PRESSURE AIR TEST IS A COMPARISON OF THE MEASURED TIME NECESSARY FOR ONE (1) PSIG PRESSURE DROP TO OCCUR, IF AT ALL, WITH MINIMUM ALLOWABLE TIME FOR THAT PRESSURE DROP TO OCCUR DETERMINED BY METHODS INDICATED IN ASTM F1417. IF THE ONE (1) PSIG PRESSURE DROP OCCURS FASTER THAN ALLOWABLE TIME, SECTION IS

2. AN AIR TEST SHALL NOT BE RUN UNTIL SECTION OF LINE TO BE TESTED HAS BEEN CLEANED OF ALL FOREIGN MATERIAL BY FLUSHING AND HAS BEEN VISUALLY INSPECTED AND APPROVED BY THE ENGINEER. CERTAIN PIPE MATERIALS PRODUCE MORE CONSISTENT RESULTS WHEN INTERIOR OF PIPE IS WETTED PRIOR TO TESTING.

3. WHERE AIR-TESTING IS TO BE USED FOR LINE ACCEPTANCE, CORROBORATIVE HYDROSTATIC TESTING SHALL BE PERFORMED ON SEWER INSTALLATION OF THE SAME PIPE SIZE, MATERIAL, AND CONDITIONS OF INSTALLATION. SEWER SECTIONS WHICH INDICATE RATES OF AIR LOSS PER UNIT OF SURFACE AREA WHICH MOST NEARLY APPROXIMATE RATE FOR PIPELINE ACCEPTANCE SHOULD BE SELECTED FOR CORROBORATIVE TESTS. AT LEAST 3 SECTIONS ARE TO BE SO TESTED. THE PURPOSE OF THESE CORROBORATIVE TESTS IS TO PERMIT A REASONABLE ASSUMPTION THAT, IF THESE 3 TEST SECTIONS MEET THE HYDROSTATIC TEST, THE BALANCE OF PROJECT ALSO MEETS OR EXCEEDS THESE REQUIREMENTS. IF AIR TEST IS NOT SUPPORTED BY ACCEPTABLE CORROBORATIVE HYDROSTATIC TESTS, COMPLETE HYDRO-STATIC TESTING OF SEWER LINES SHALL BE REQUIRED.

4. SEWERS SHALL BE LAID WITH STRAIGHT ALIGNMENT BETWEEN MANHOLES. STRAIGHT ALIGNMENT SHALL BE CHECKED EITHER USING A LASER BEAM OR LAMPING. TESTING SHALL COMPLY WITH REQUIREMENTS OF THE AUTHORITY HAVING JURISDICTION.

5. MANHOLES, WHICH CANNOT BE PROPERLY AIR TESTED, SHOULD BE VISUALLY INSPECTED AND LEAKAGE-TESTED USING INTERNAL OR EXTERNAL HYDROSTATIC PRESSURE. LEAKAGE TESTING SHALL COMPLY WITH REQUIREMENTS OF THE AUTHORITY HAVING JURISDICTION.

6 .IN AREAS WHERE CONVENTIONAL TESTING IS IMPRACTICAL (I.E. AREAS DESIGNATED BY ENGINEER WHERE EXISTING SERVICES ARE TIED INTO NEW LINE IMMEDIATELY AND ANY BLOCKAGE COULD RESULT IN HEALTH PROBLEMS) NO LINES SHALL BE BACKFILLED UNTIL EACH PIPE SECTION AND CONNECTION IS INSPECTED AND APPROVED.

7. WHERE SEWERS ARE CONSTRUCTED OF PRESSURE-RATED PIPE AND INSTALLED WITH LESS THAN 18 INCHES VERTICAL SEPARATION FROM EXISTING OR PROPOSED WATER MAINS. SEWERS SHALL BE HYDROSTATICALLY TESTED AT 150 PSI TO ASSURE WATER TIGHTNESS. HYDROSTATIC ACCEPTANCE TESTS SHALL BE CONDUCTED AS SPECIFIED FOR TESTING WATER MAINS, EXCEPT THAT TESTING MAY BE PERFORMED WITH THE PIPE SECTION PARTIALLY BACK-FILLED.

8. IF THE ALLOWABLE RATE OF INFILTRATION, EXFILTRATION, OR AIR LEAKAGE IS EXCEEDED. THE CONTRACTOR SHALL LOCATE POINTS OF EXCESSIVE LEAKAGE AND SHALL PROMPTLY CORRECT, REPAIR, AND BRING SYSTEM UP TO THE STANDARD. COSTS OF ALL SUCH REPAIRS AND CORRECTIVE MEASURES, INCLUDING COSTS OF REPEATED TESTS, SHALL BE BORN BY CONTRACTOR, THE SEWER LINE SECTION (INCLUDING MANHOLES AND BUILDING SERVICES) UNDER TEST SHALL NOT BE ACCEPTED UNTIL THESE TEST CRITERIA ARE MET.

9. SEPTIC TANK SHALL BE TESTED FOR LEAKAGE USING THE HYDROSTATIC TEST METHOD IN ACCORDANCE WITH ASTM C1227. ENGINEER TO WITNESS LEAKAGE TEST.

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**Historic Preservation** Commissioner Erik Kulleseid Governor Kathy Hochul

Architect: SARATOGA ASSOCIATES 21 CONGRESS STREET, SUITE 201 SARATOGA SPRINGS, NEW YORK 12866

LATHAM, NEW YORK 12110

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ASSOCIATES Landscape Architects, Architects Engineers, and Planners, P.C.

SARATOGA

Surveyor / Structural / MEP Engineer: LABELLA ASSOCIATES 4 BRITISH AMERICAN BOULEVARD



# NYS OPRHP Palisades Region

Palisades Interstate Park Commission Bear Mountain, NY 10911 (845) 786-2701 **Executive Director: James Hall** 

Capital Facilities Mngr: Michael Tesik

# **Project Title:**

Camp Junior - Phase 3 Campground Rehabilitation Contract No. D005876

**Project Location:** Harriman State Park Tiorati Brook Road Tuxedo, NY 10987

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# Design By: Checked By Approved By: DMS

03/16/2023 Sheet Title:

Drawing Number:

**SEWER DETAILS** 

SMF

REK

**BID DOCUMENTS SET** 

Project Number: 2021-059.23 5 of

# **MANHOLES AND OTHER BELOW GRADE STRUCTURES:**

1. STRUCTURAL DESIGN FOR MANHOLES AND OTHER BELOW-GRADE PRECAST CONCRETE STRUCTURES: A. NON-TRAFFIC LOADS:

BELOW GRADE PRECAST CONCRETE STRUCTURES SHALL BE DESIGNED TO WITHSTAND LOADS IMPOSED BY STRUCTURE WEIGHT, EARTH COVER, LATERAL PRESSURE FROM EARTH AND GROUND WATER, AND LIVE LOADS SUCH AS PEDESTRIAN TRAFFIC OR MACHINERY ON OR ABOVE THE STRUCTURE; AND

B. TRAFFIC LOADS: BELOW GRADE PRECAST CONCRETE STRUCTURES SHALL BE DESIGNED TO ALSO WITHSTAND TRAFFIC LOADS CREATED BY AN HS20-44 TRUCK PLUS 25% IMPACT AS DEFINED IN THE LATEST EDITION OF THE AMERICAN ASSOCIATION OF STATE HIGHWAY AND TRANSPORTATION OFFICIALS (AASHTO) DESIGN STANDARDS.

2. MATERIAL WHICH SHALL BE UTILIZED IN THE CONSTRUCTION OF PRECAST CONCRETE STRUCTURES:

CEMENT: ASTM C-150, TYPES I,II,III,VI SAND: NYSDOT STD. SPEC. SECTION NO. 703-0 CONCRETE SAND STONE: NYSDOT STD. SPEC. SECTION NO. 703-02 COARSE AGGREGATE STEEL BAR REINFORCEMENT: ASTM A615, GRADE 60 WIRE MESH REINFORCEMENT: ASTM A185 PLAIN CONCRETE STRENGTH (28 DAY): 4,500 PSI (F'C)


ENTRAINED AIR: 5% MIN.


ITS INTENDED USE.


3. ALL CASTINGS (FRAMES AND COVERS, FRAMES AND GRATES, ETC.) FOR USE IN CONJUNCTION WITH MANHOLES AND OTHER BELOW GRADE STRUCTURES SHALL BE MANUFACTURED FROM GRAY IRON OR DUCTILE IRON. GRAY IRON SHALL CONFORM WITH ASTM A 48, CLASS 30B AND DUCTILE IRON SHALL CONFORM WITH ASTM A 536 AND BE OF A GRADE APPROPRIATE TO


4. ALL ASTM REFERENCES SHALL BE FOR THE LATEST ACTIVE STANDARD.




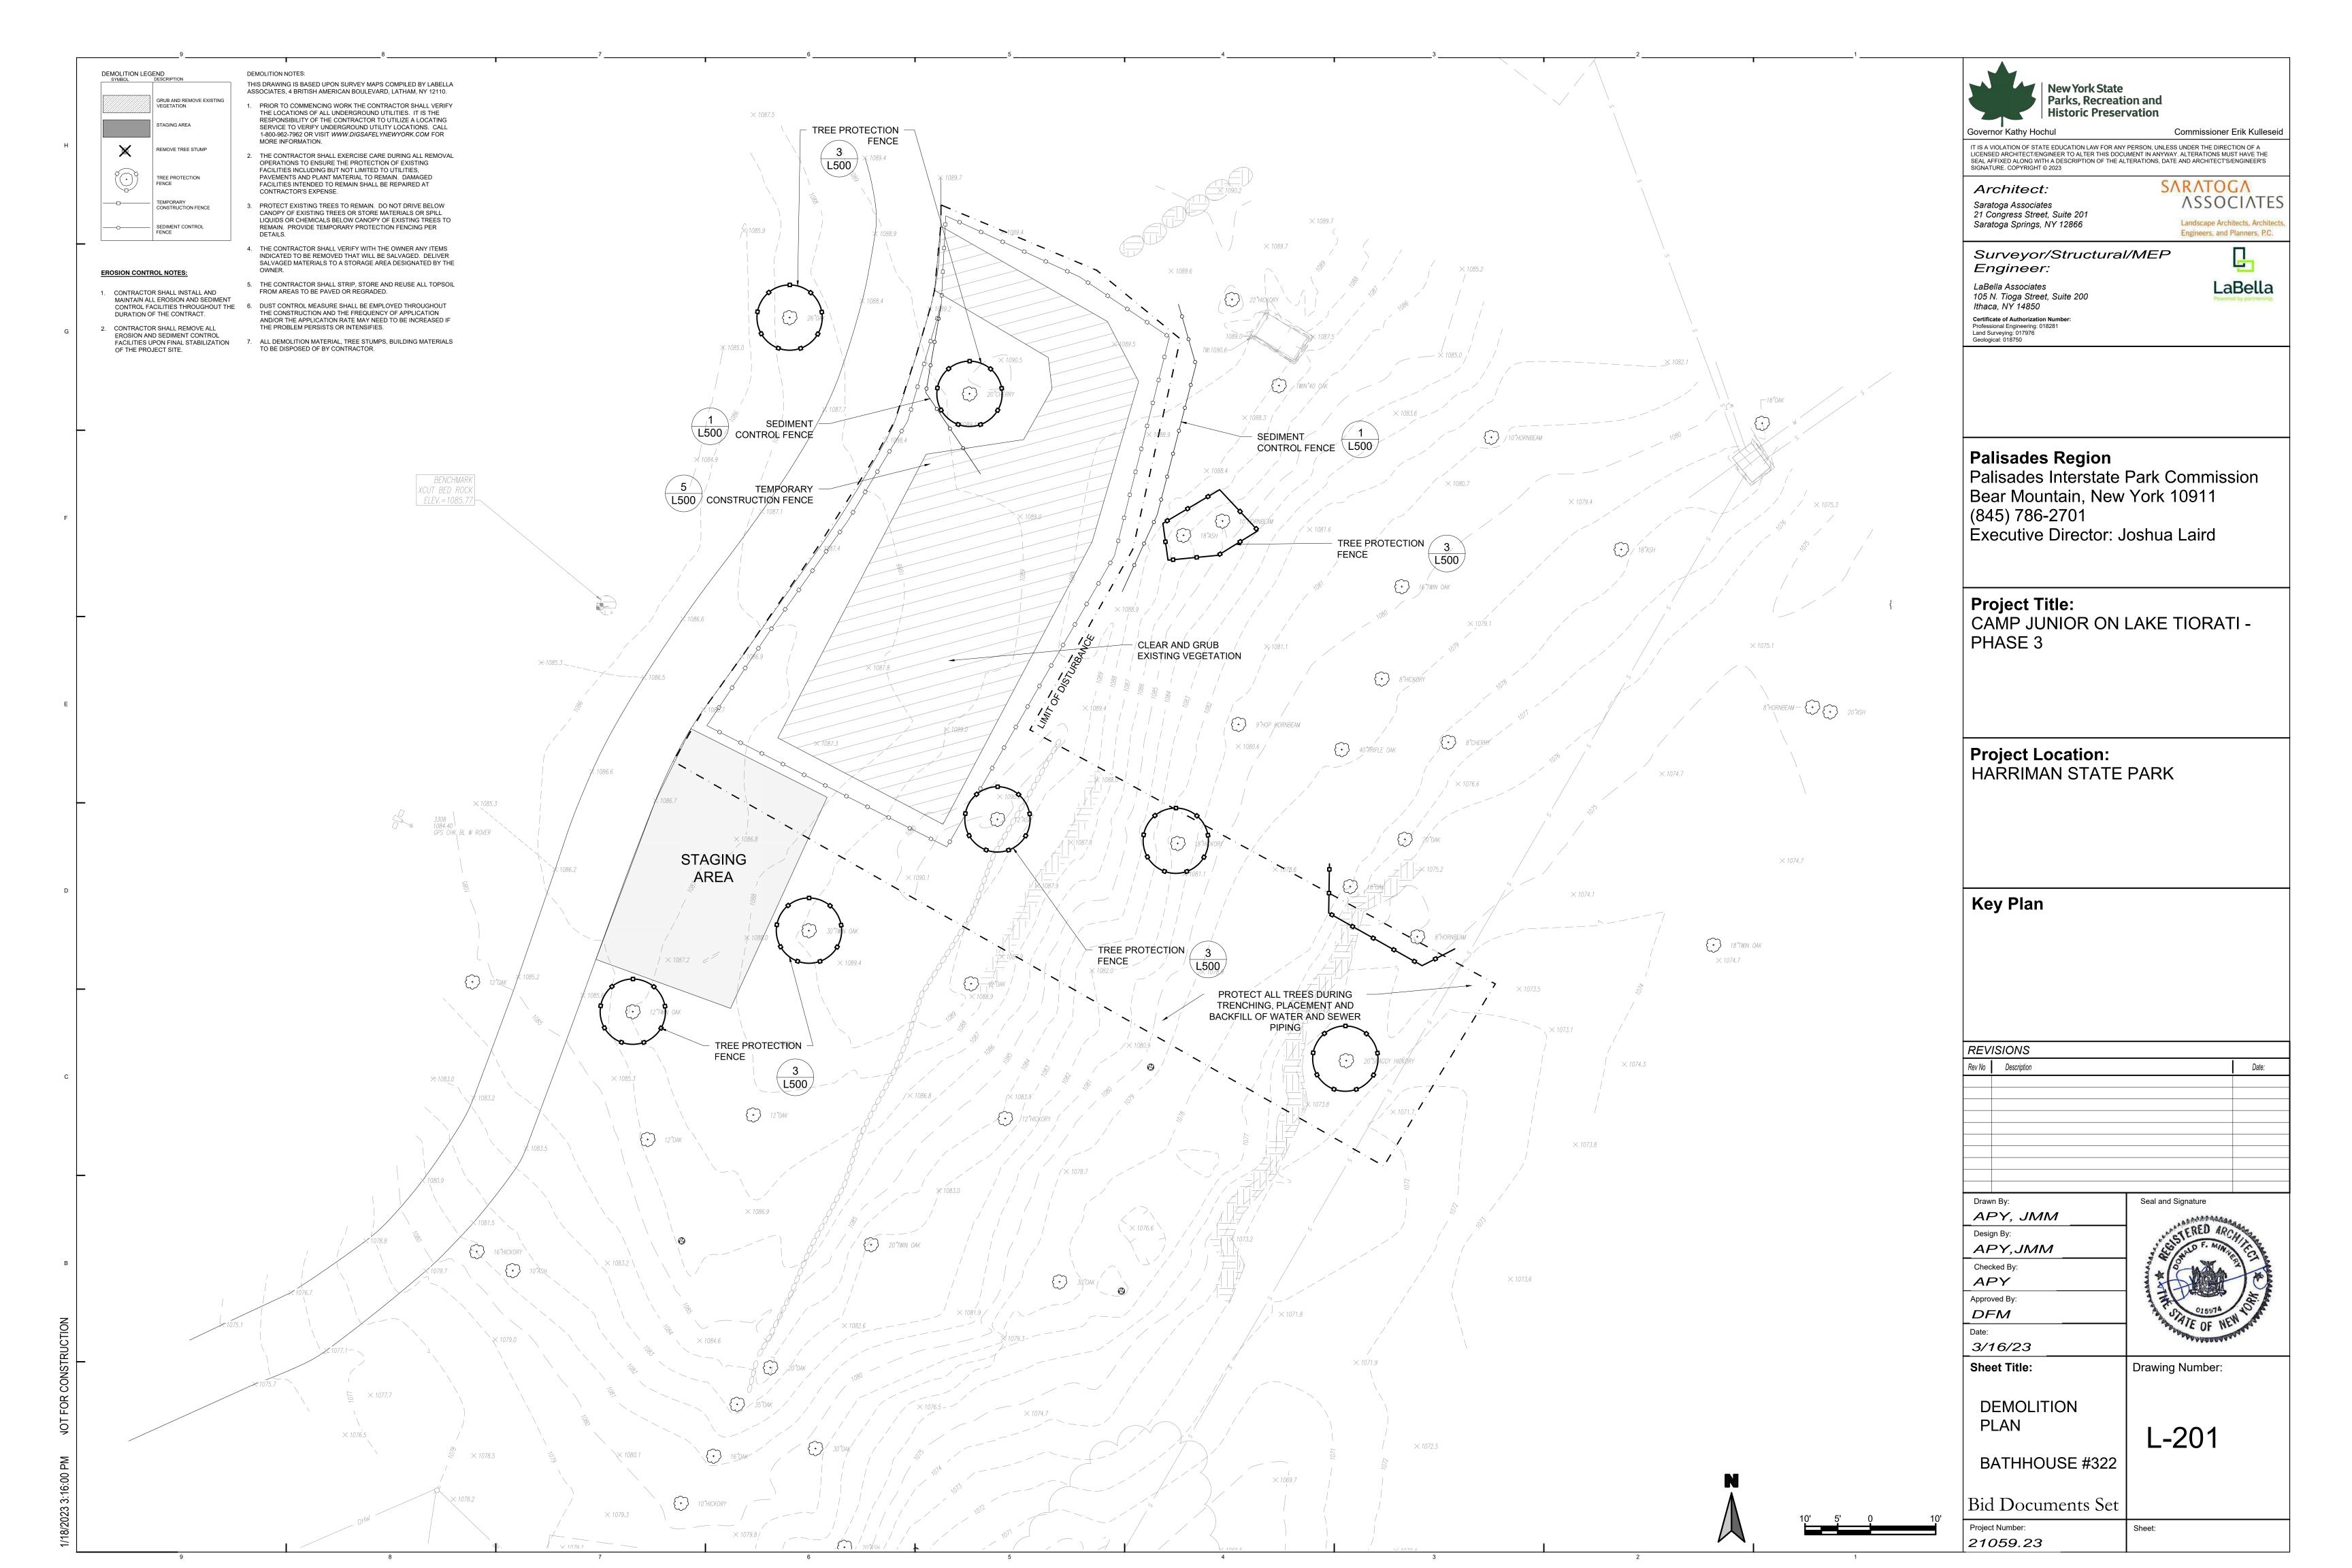


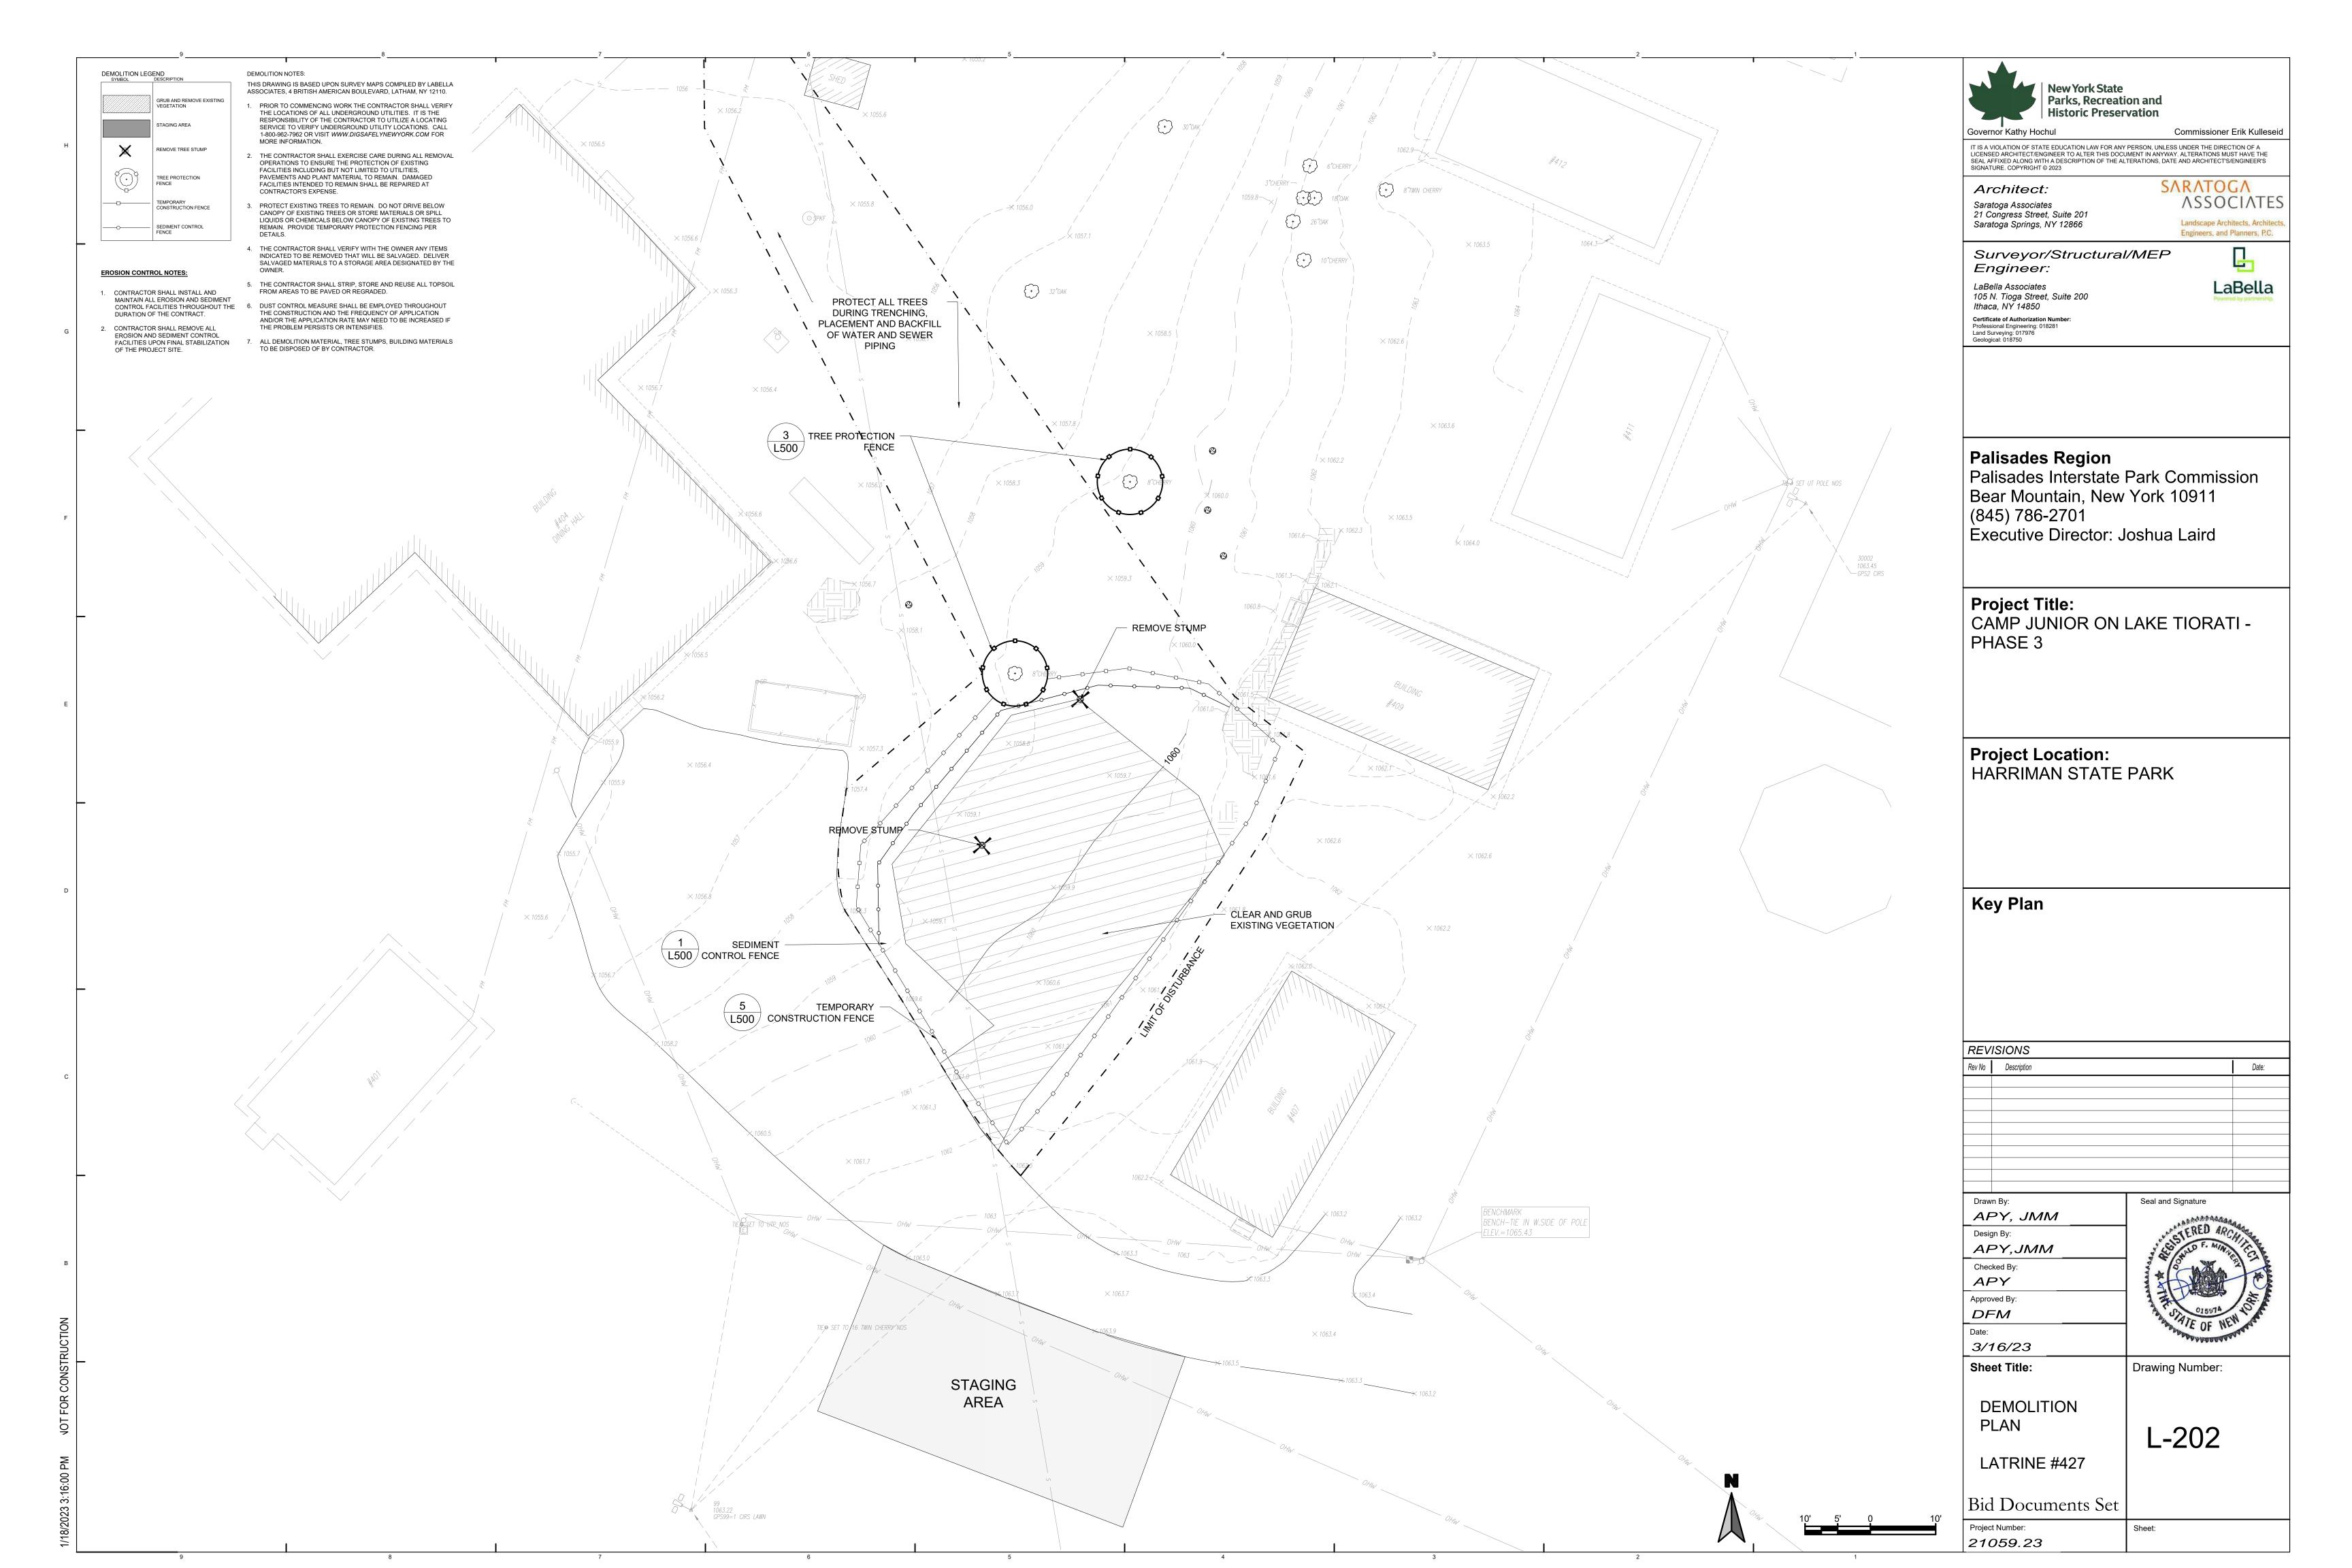

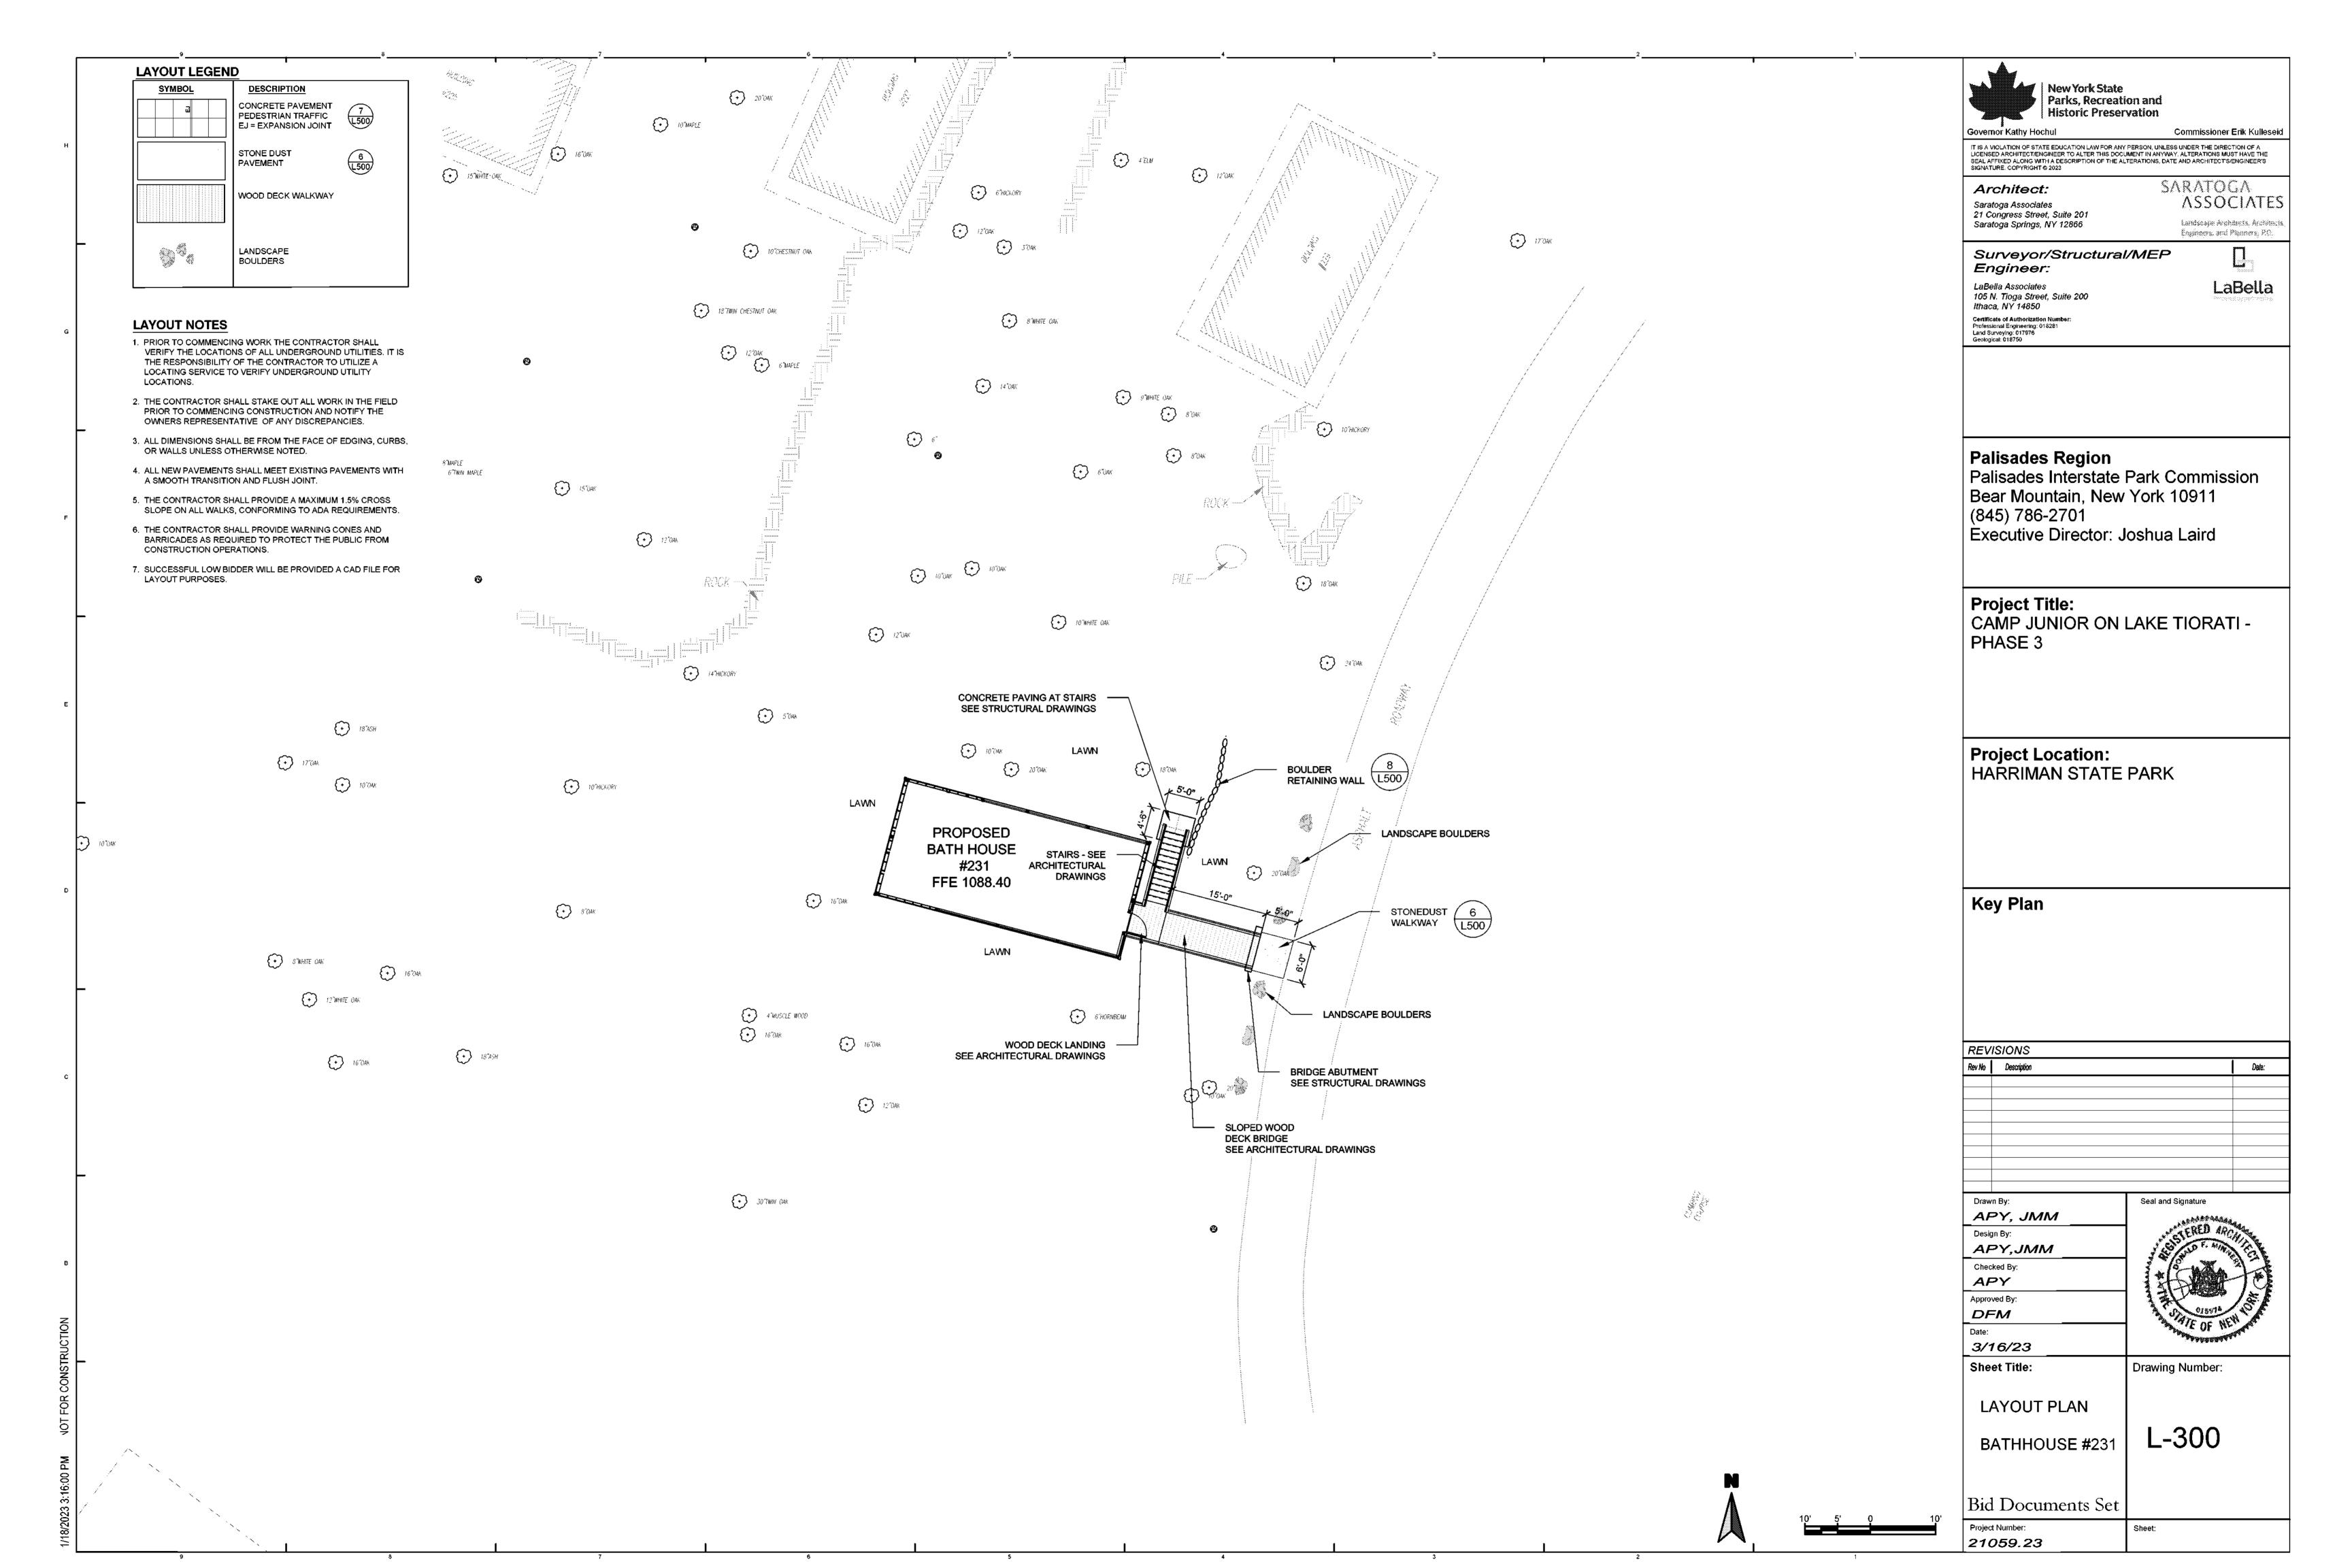


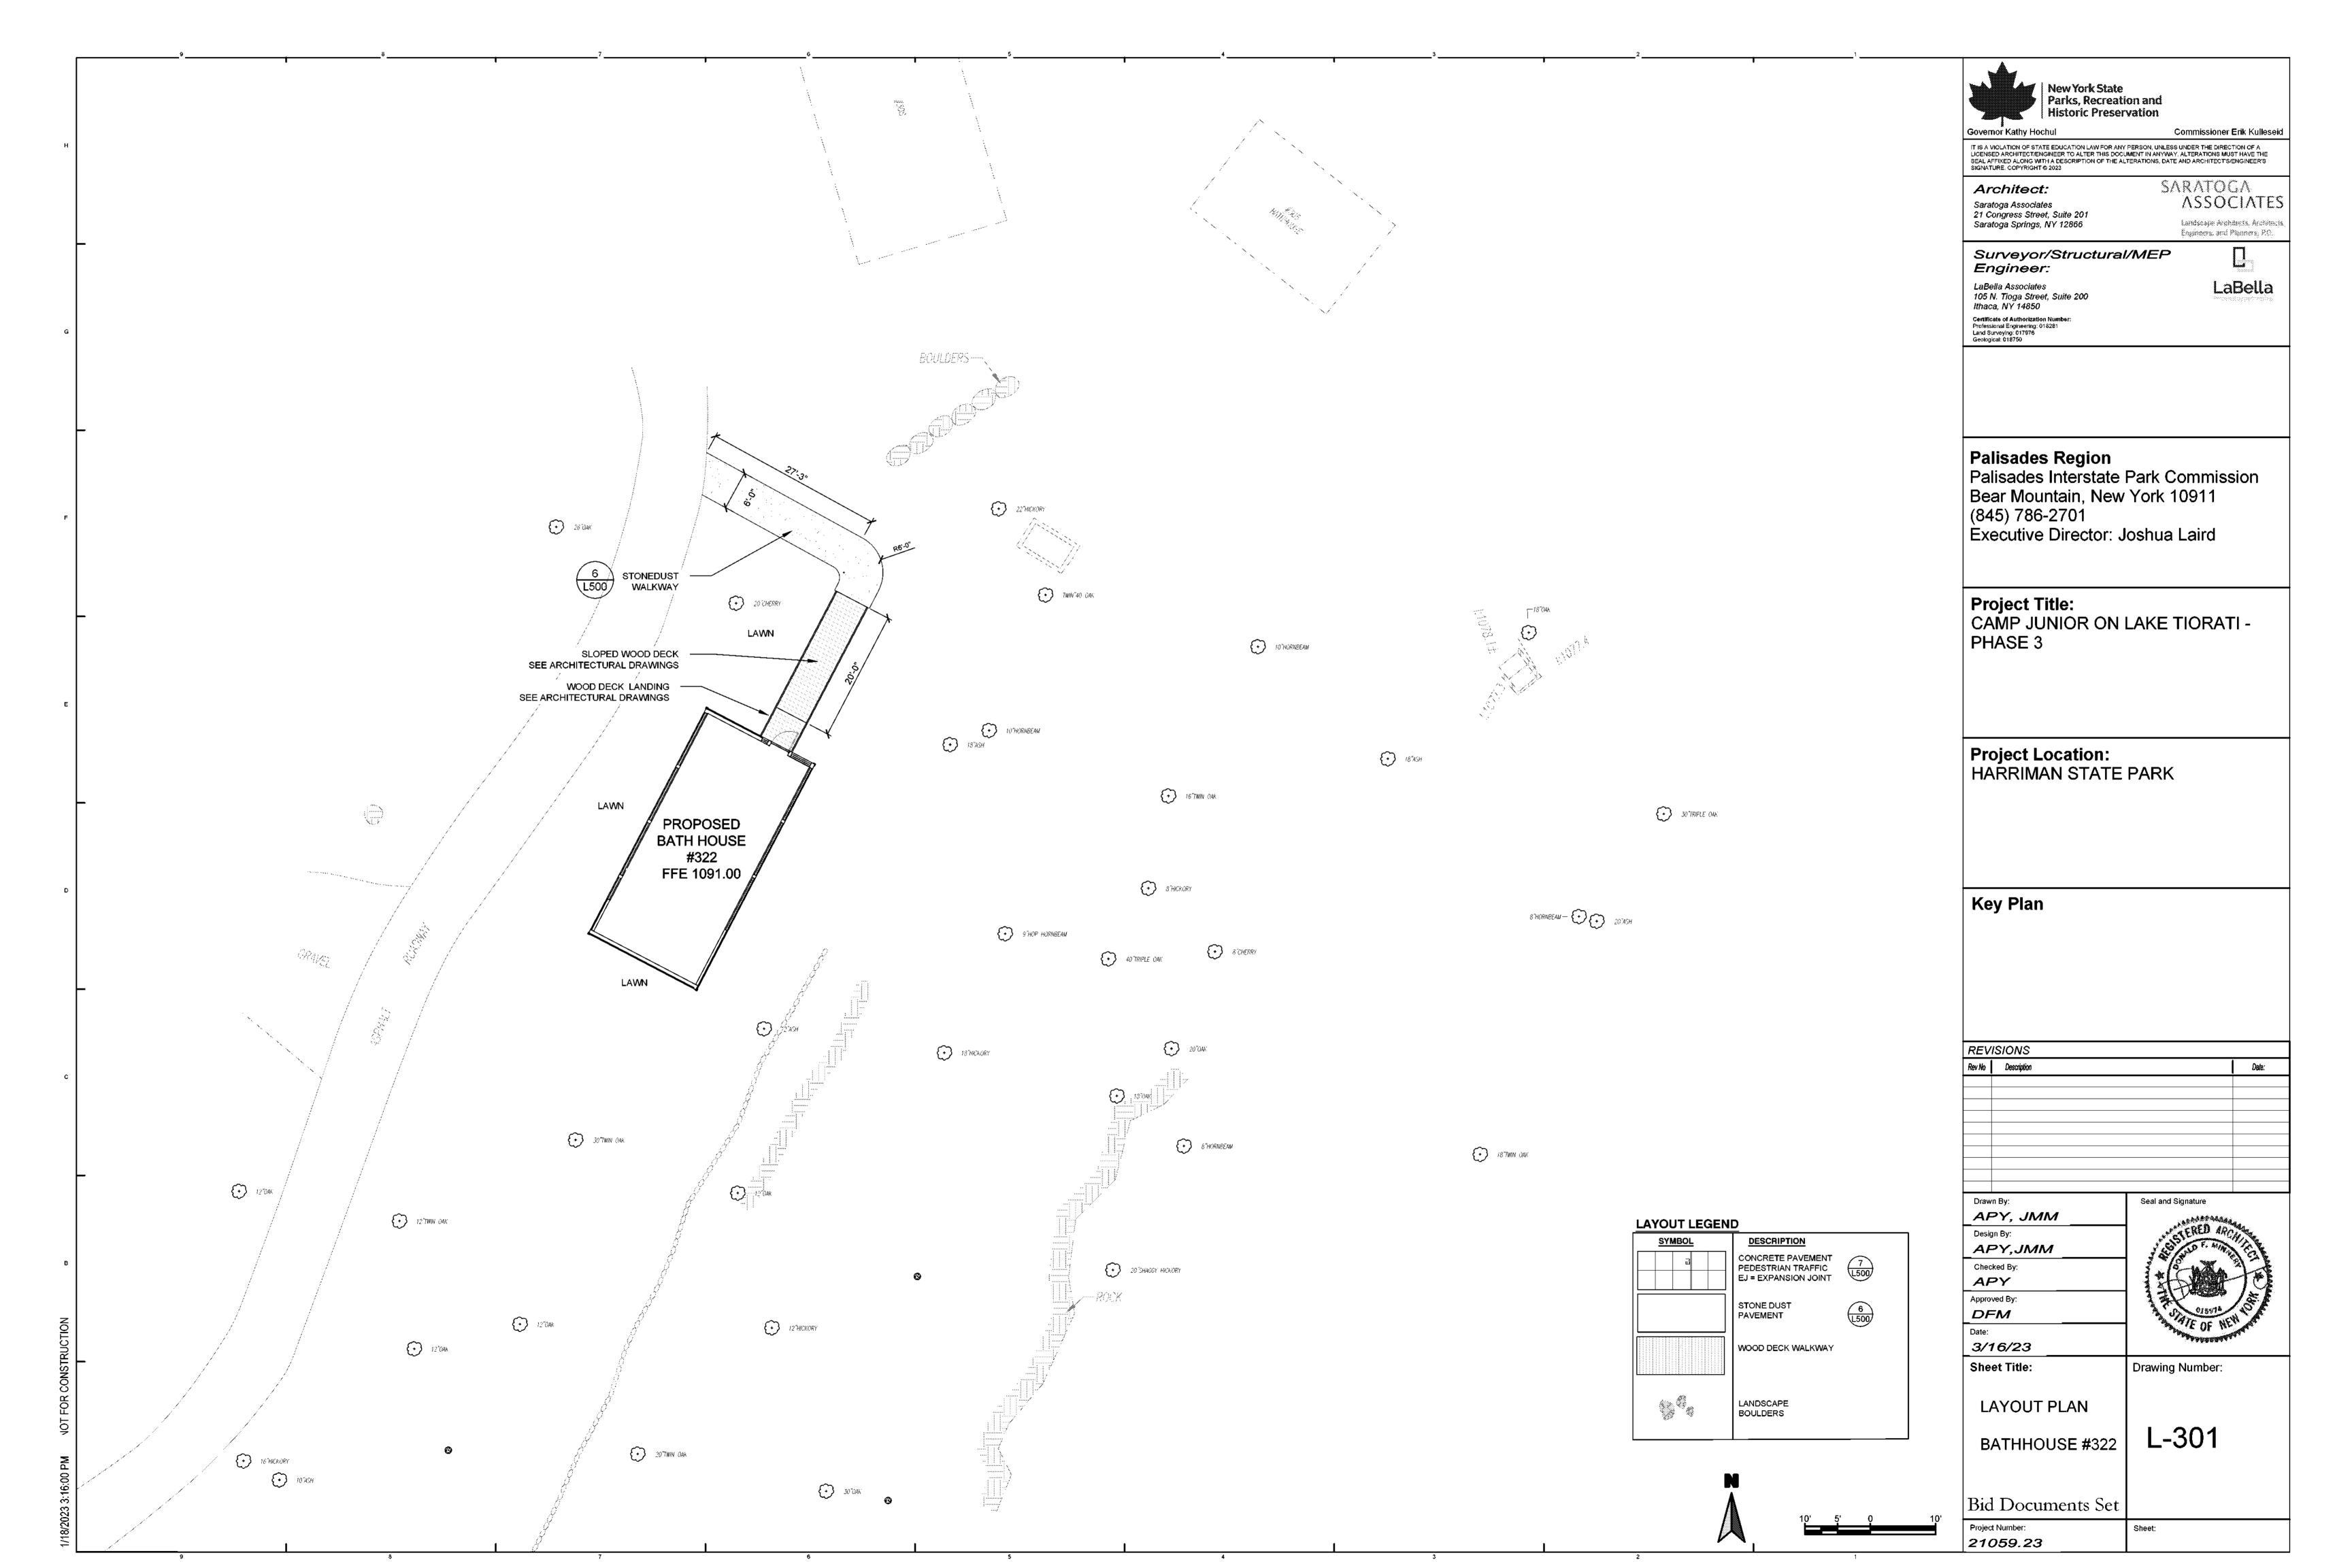


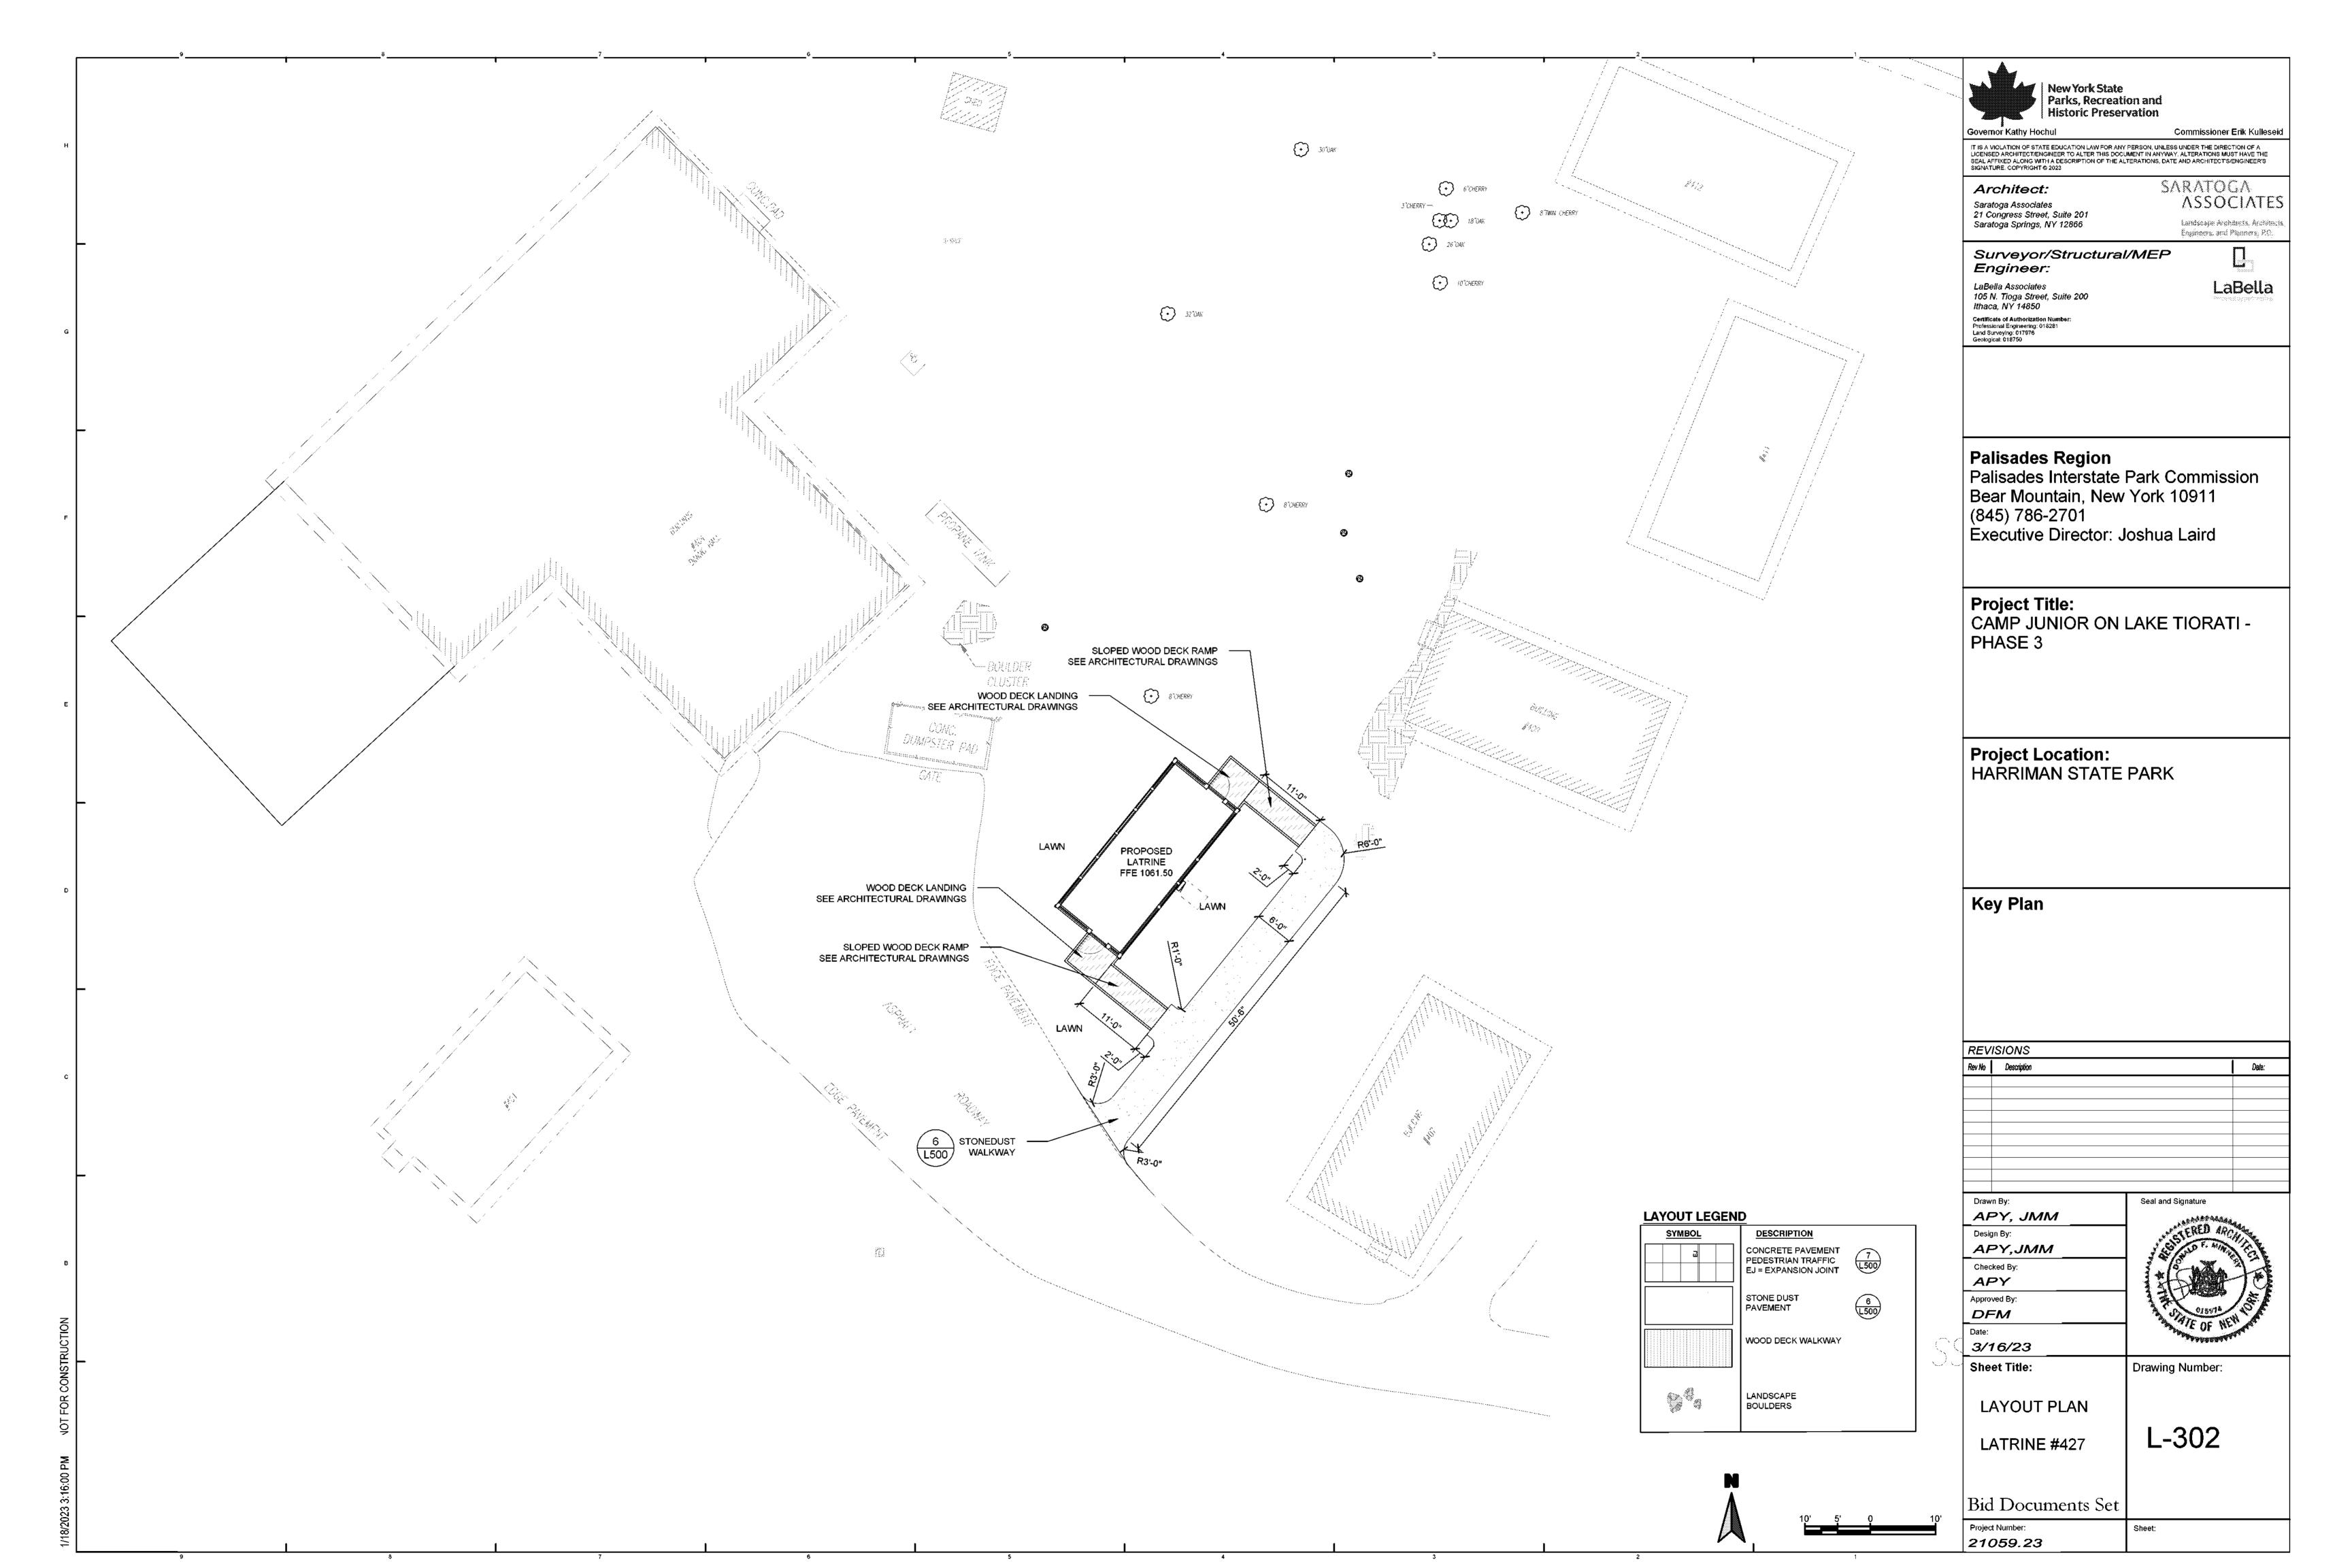

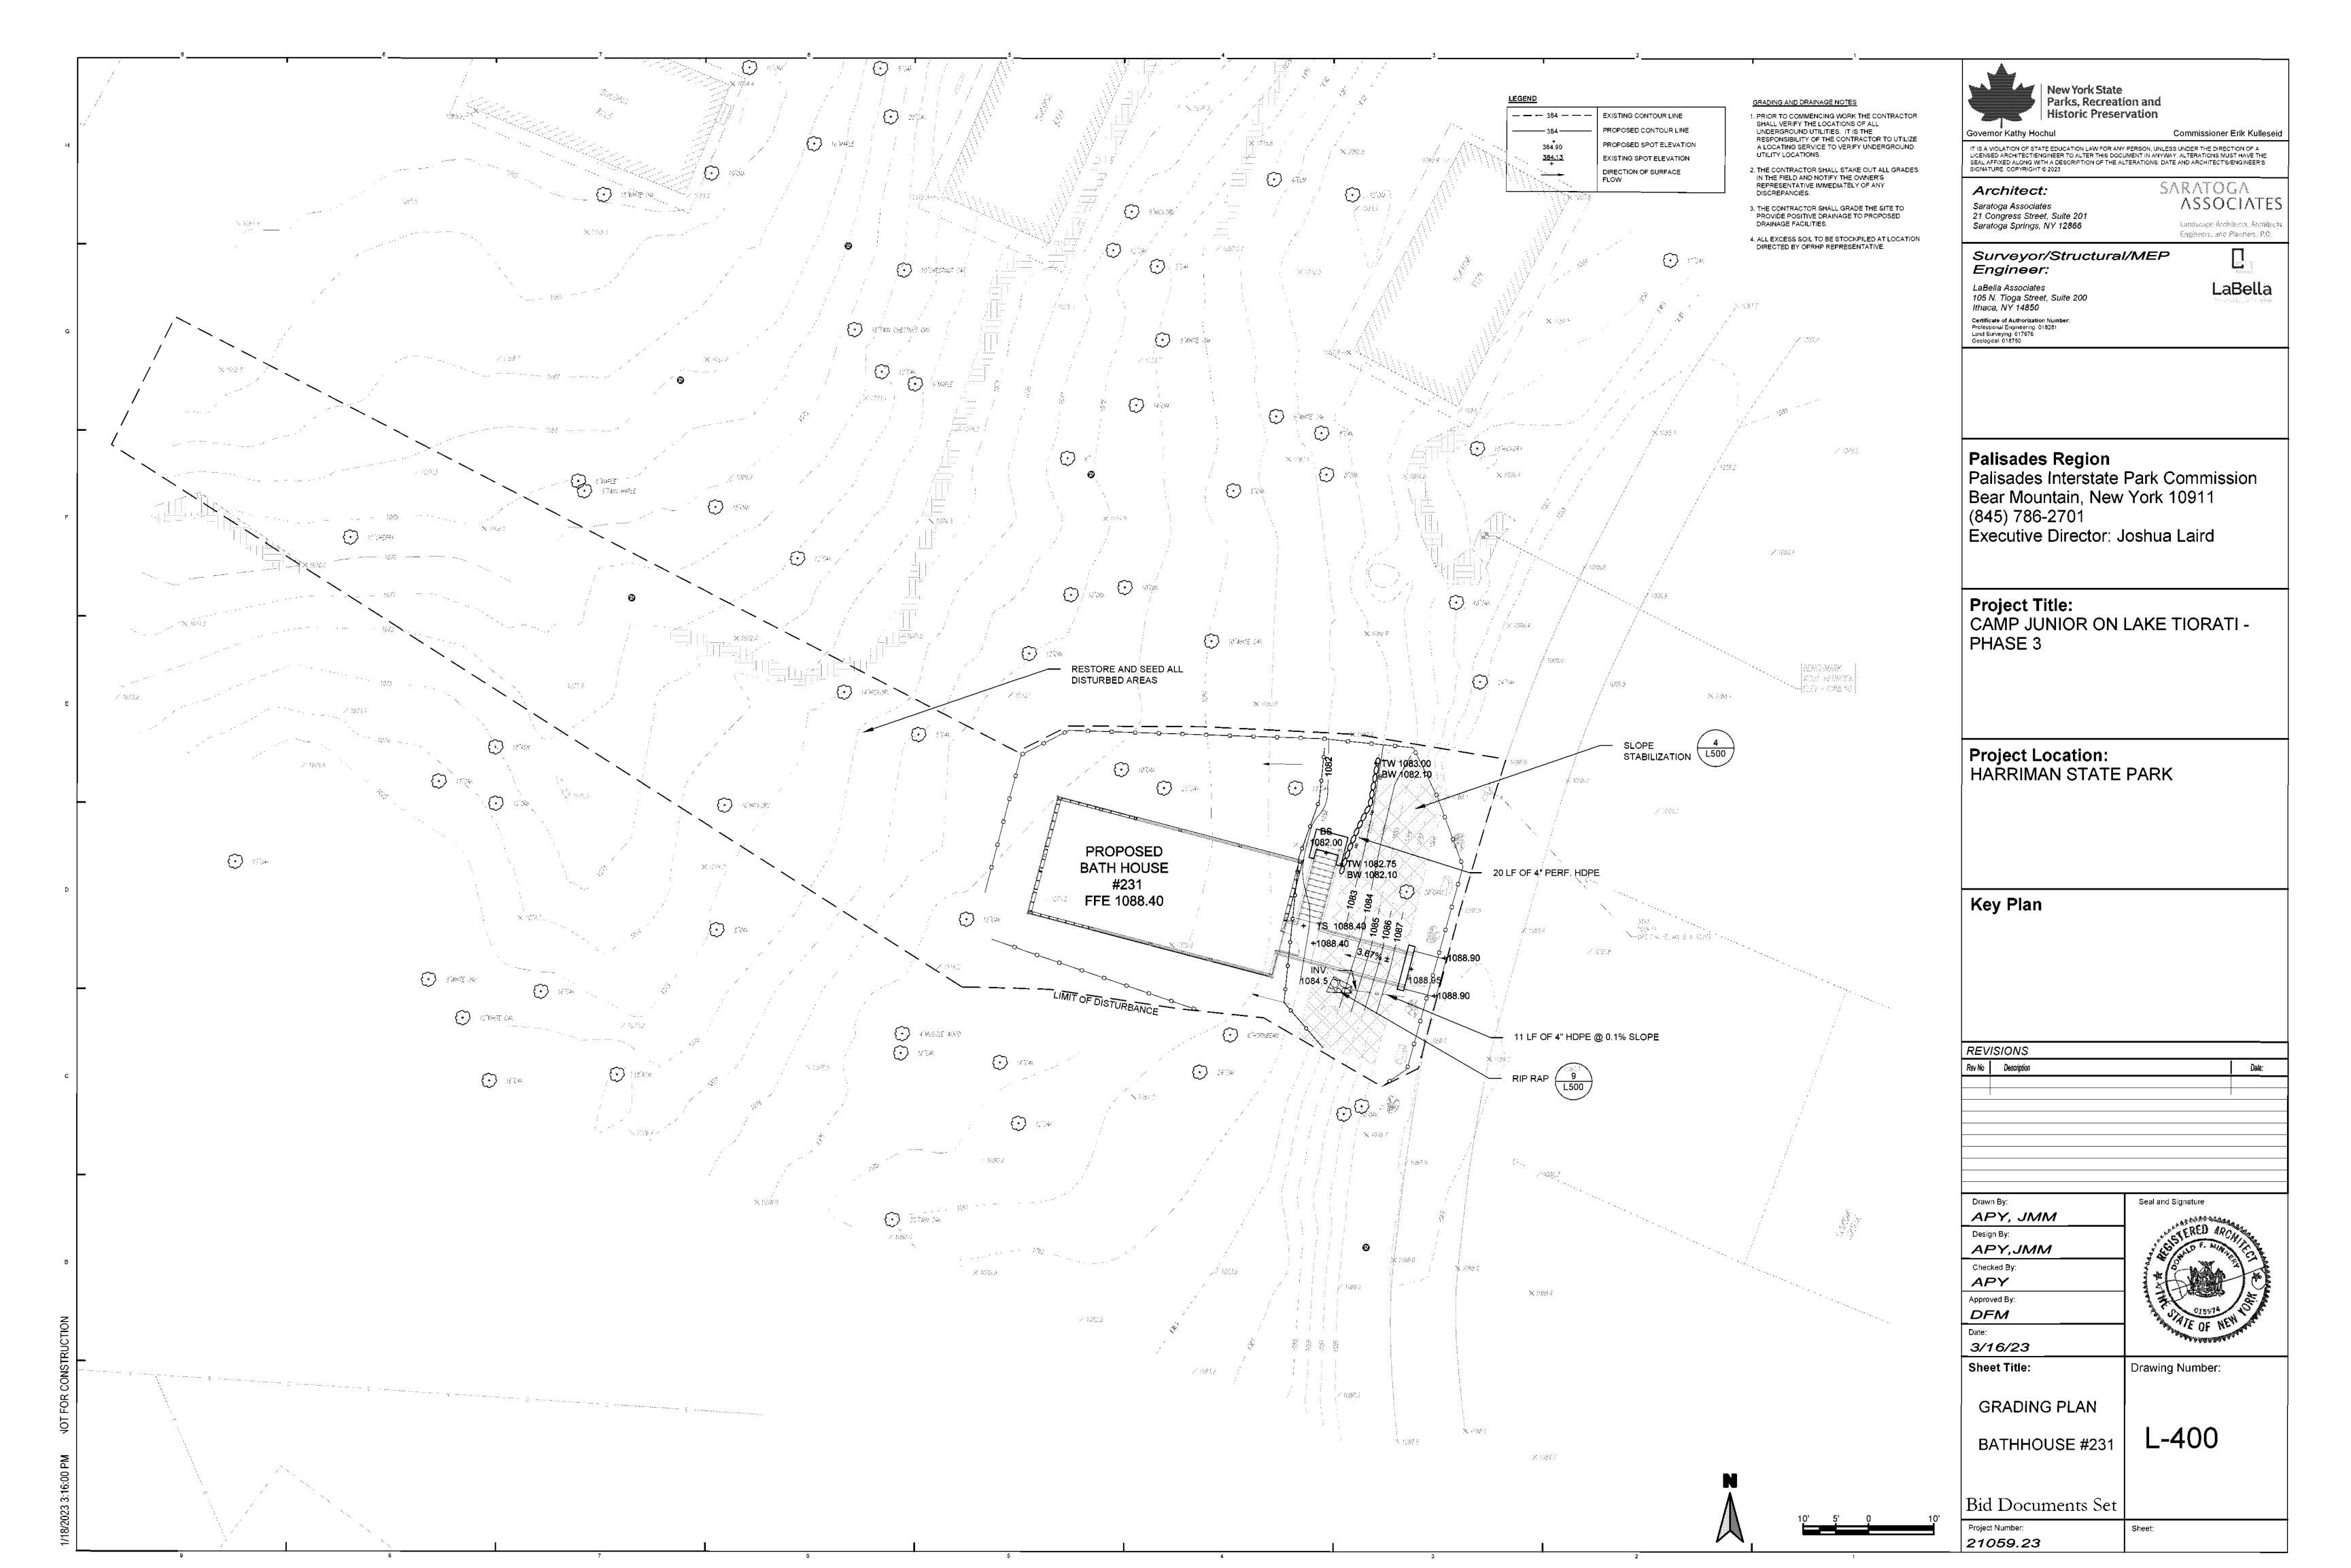



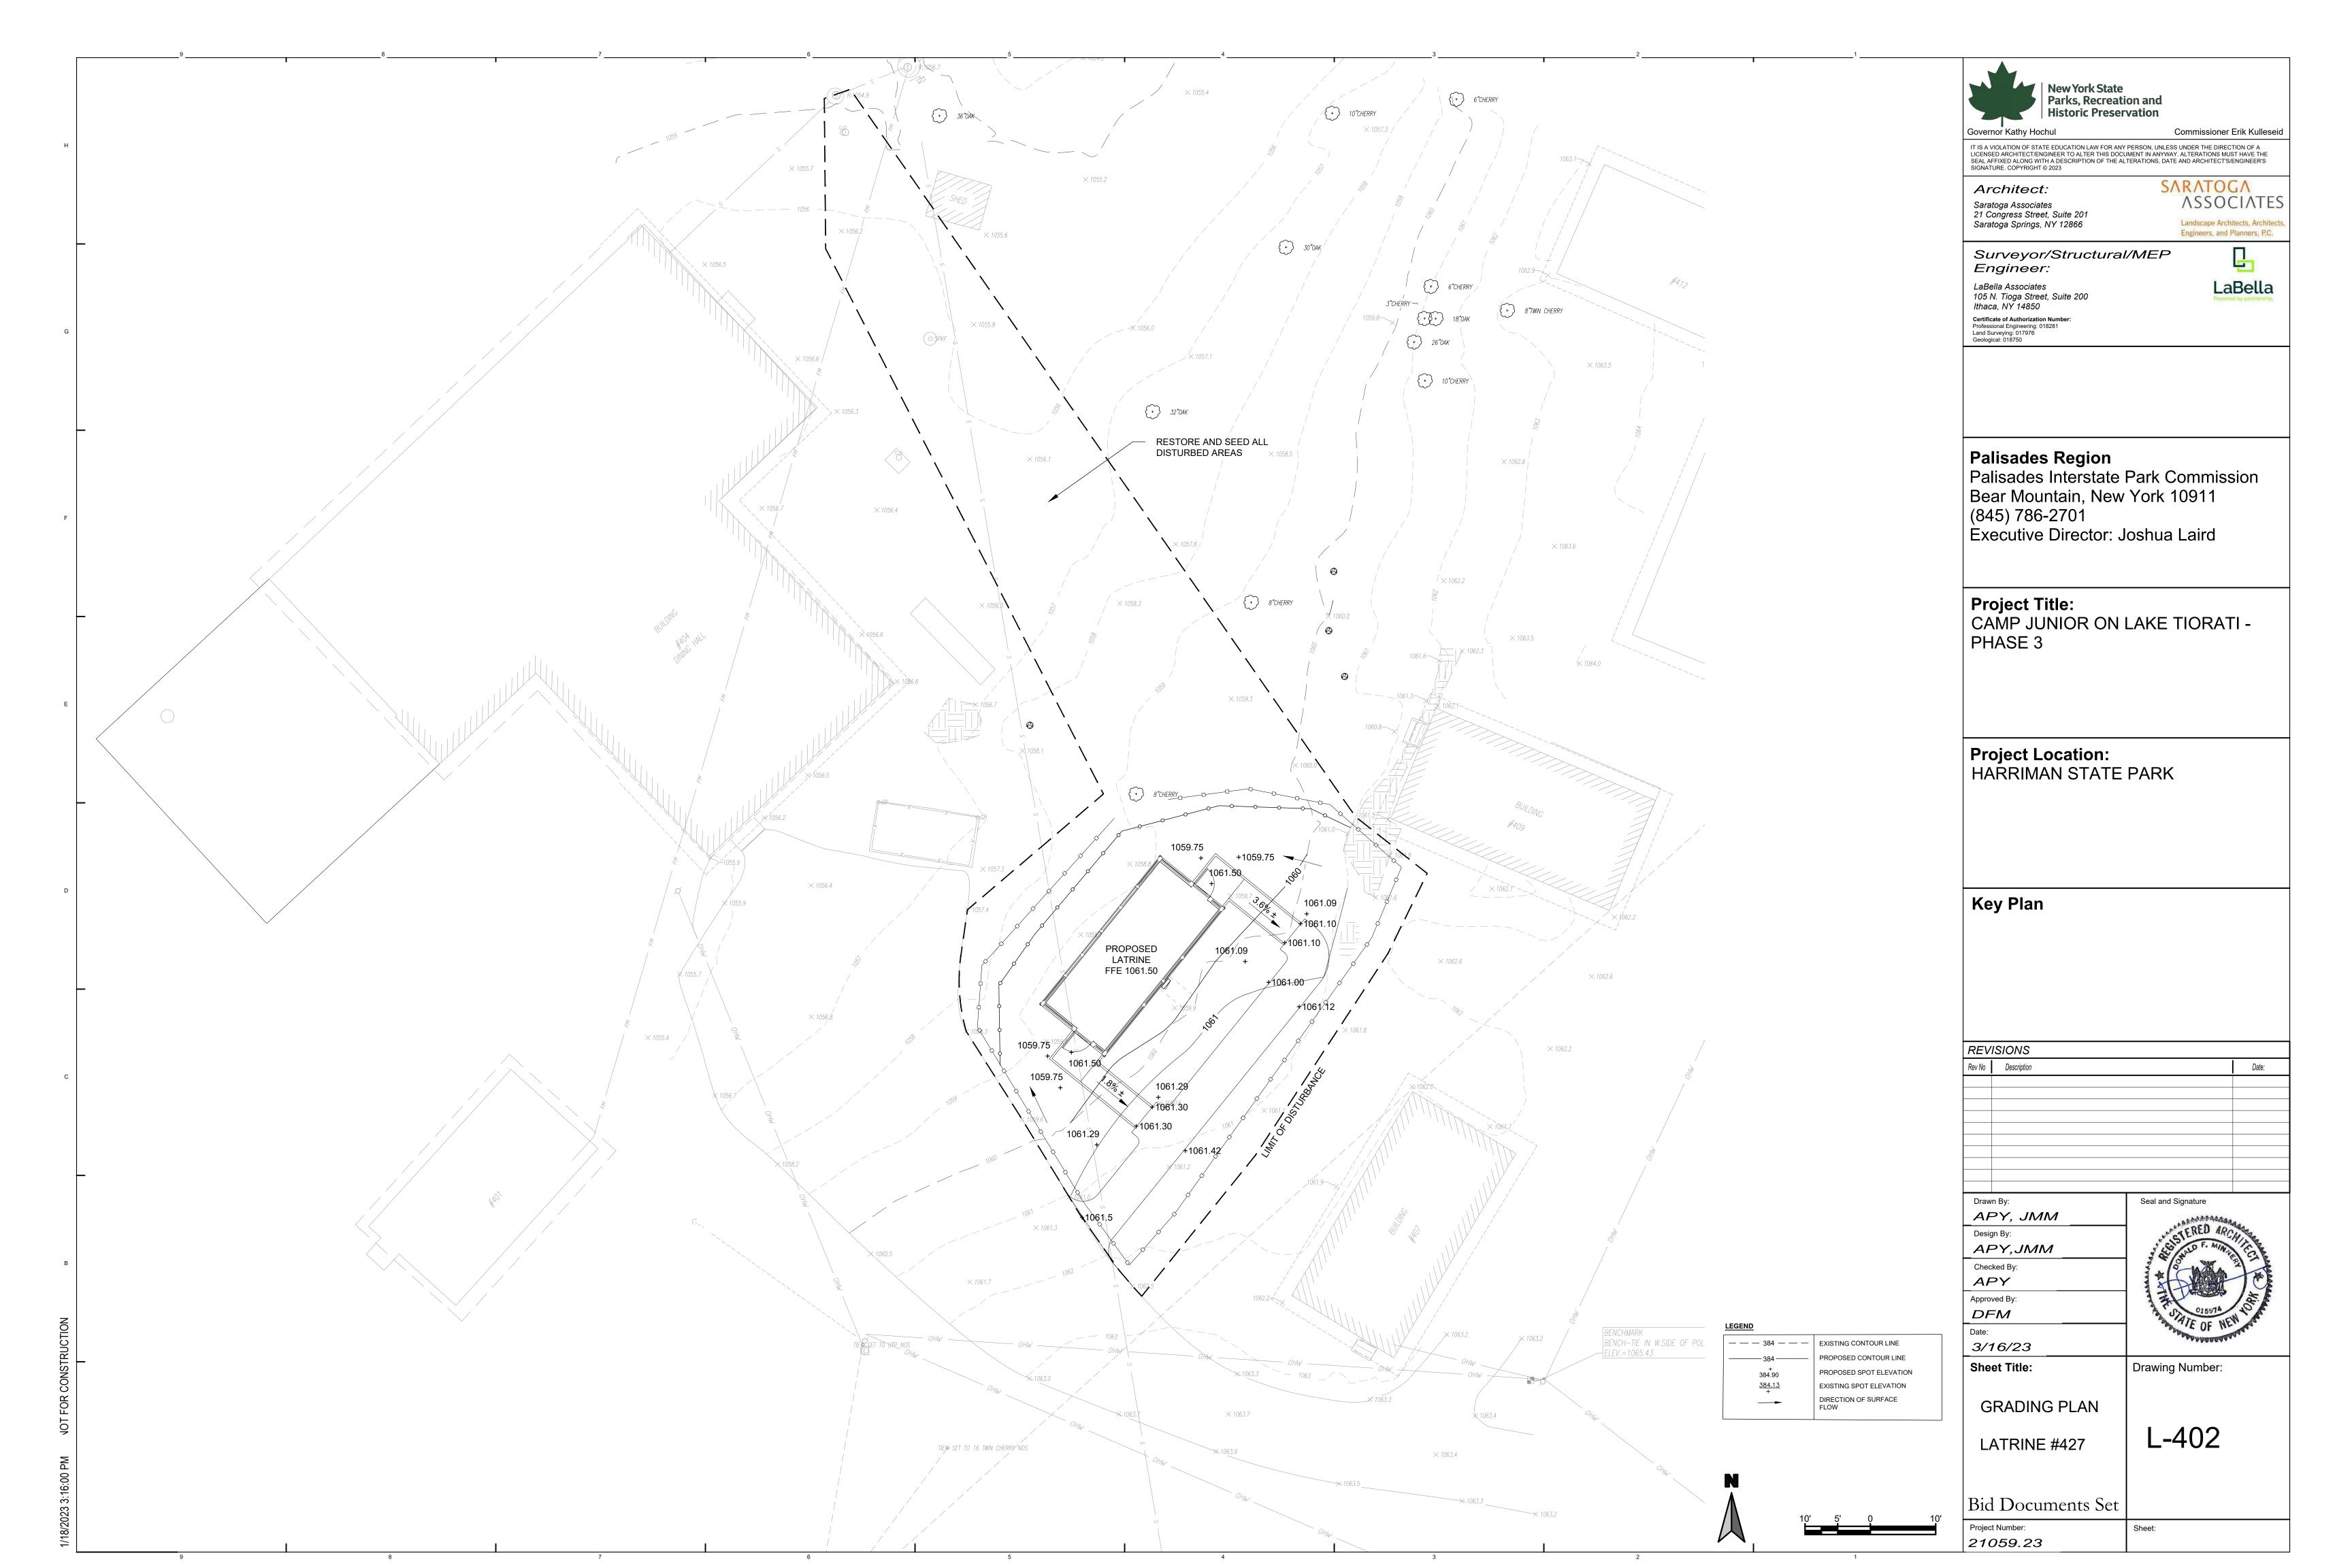

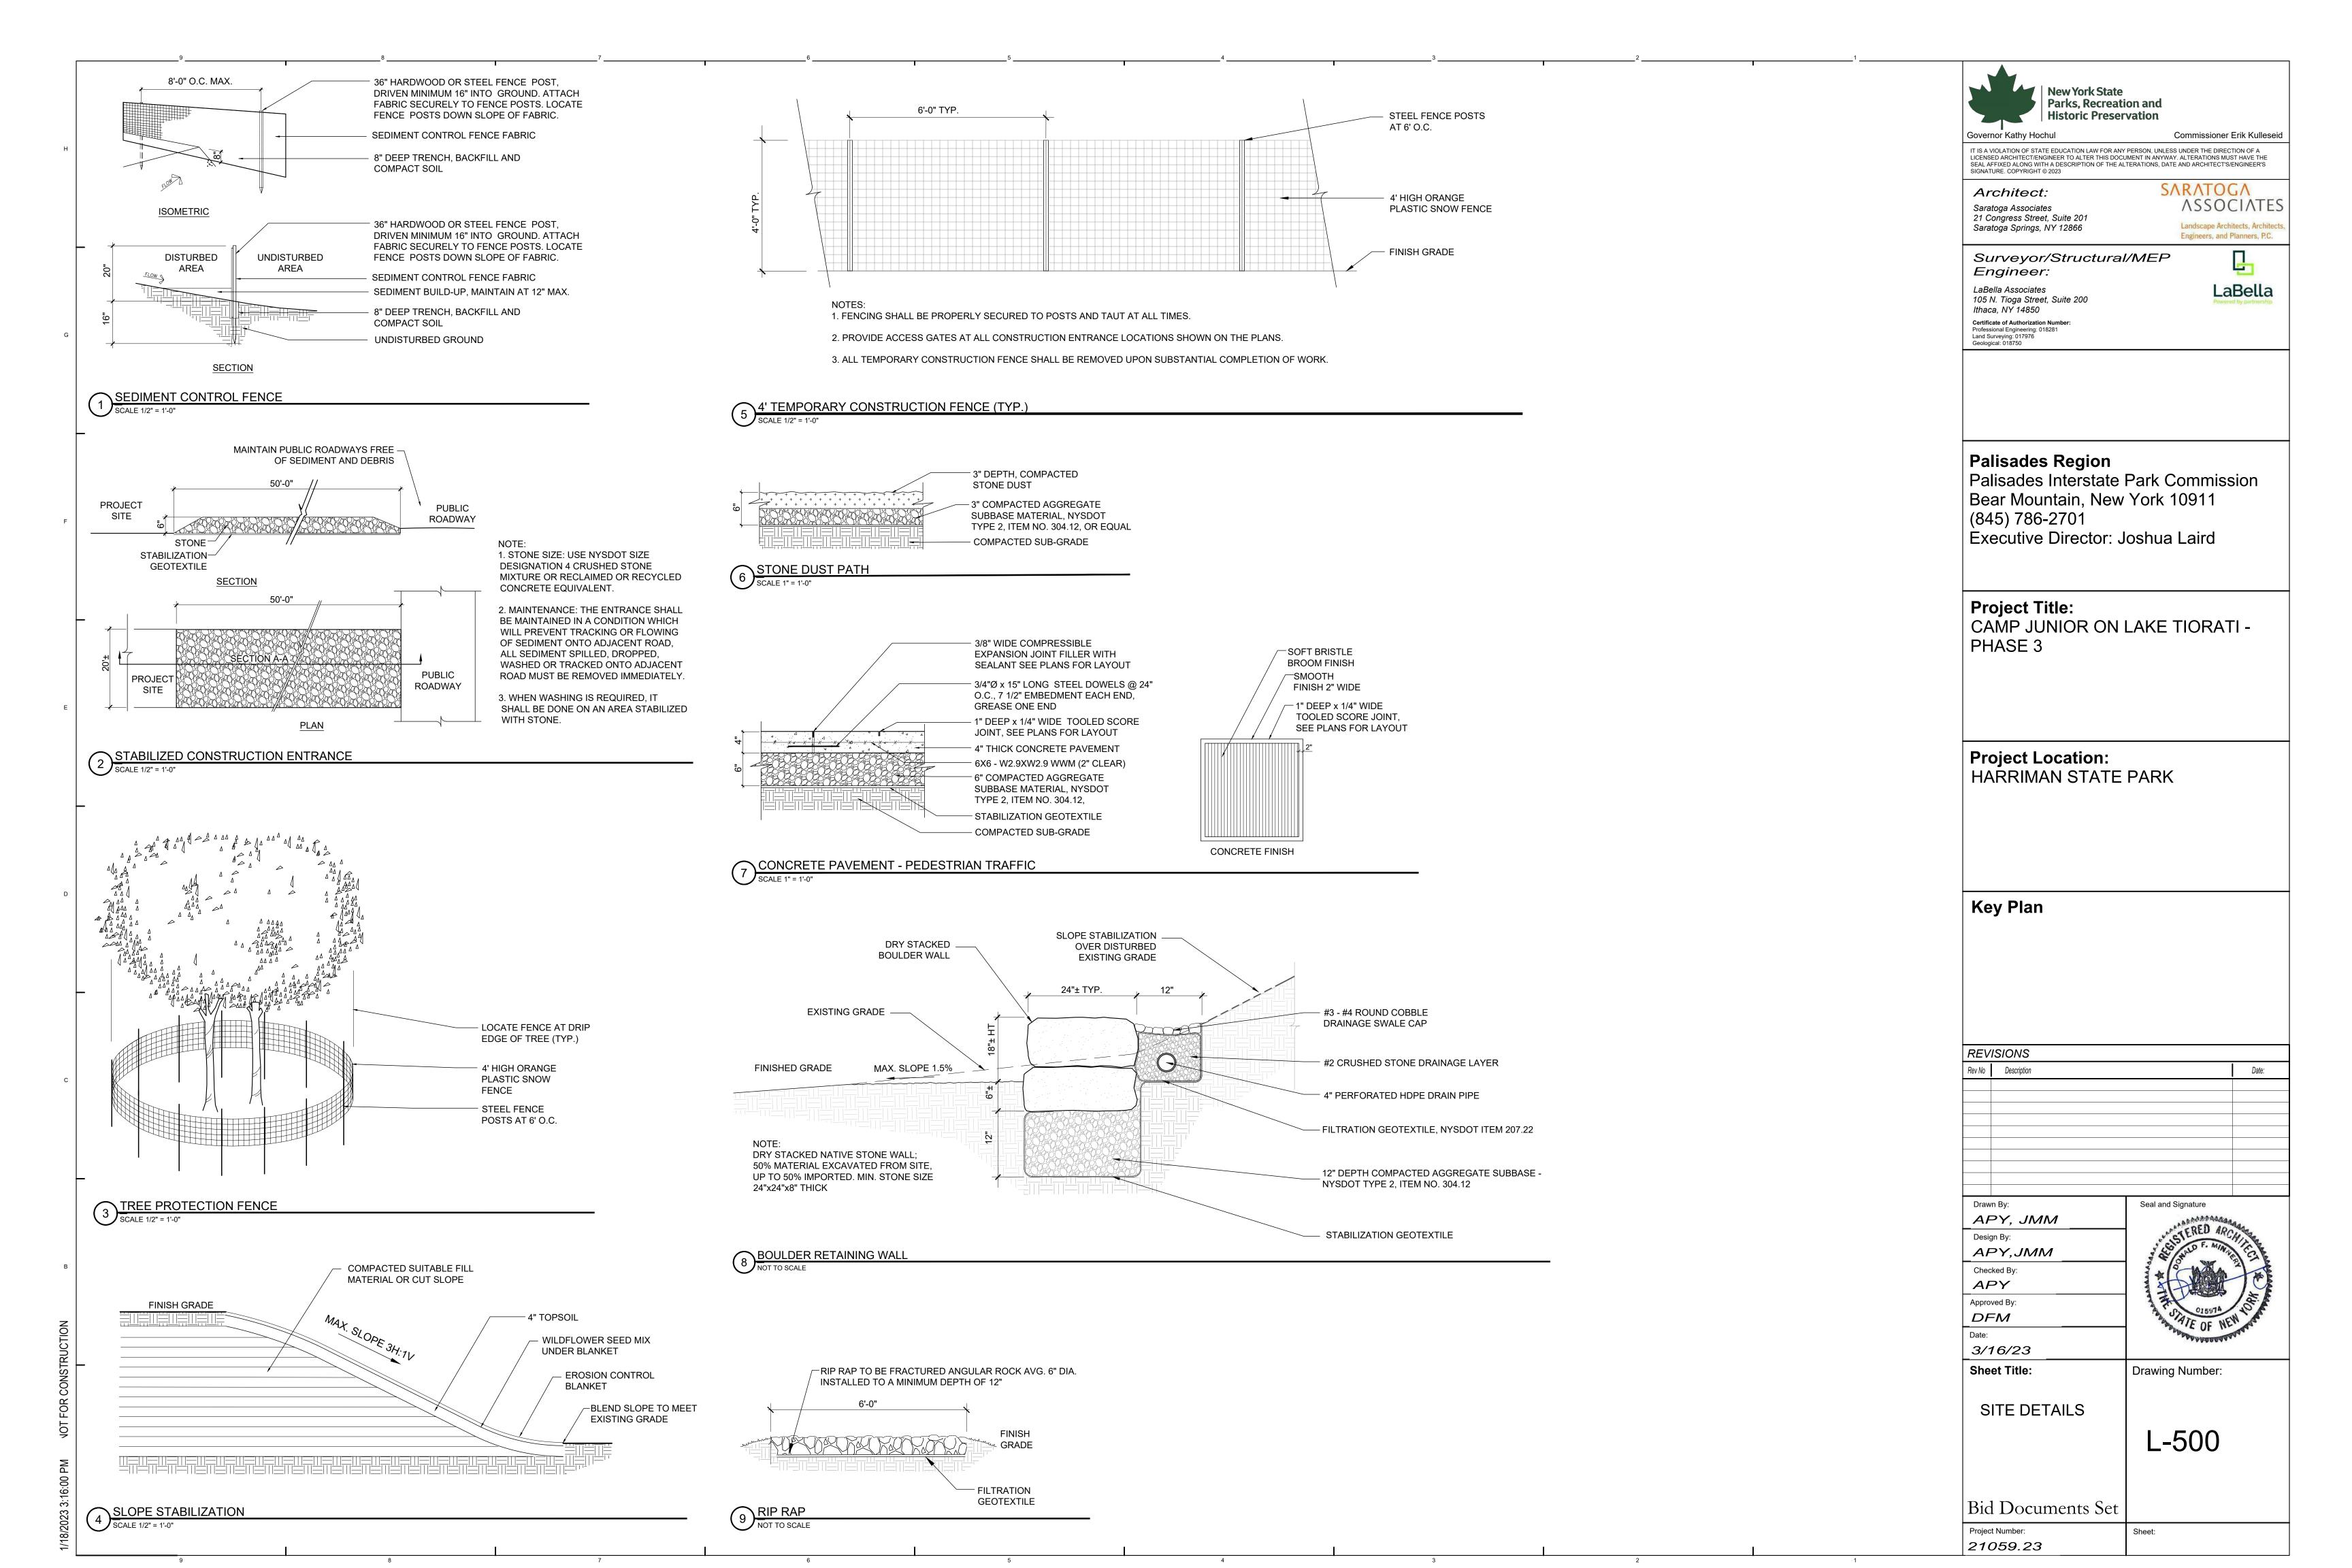

**DRAWING LEGEND** 

**GENERAL NOTES:** 

INDICATES EGRESS PATH AND DISTANCE TO EXITS

 PROJECT WILL BE EQUIPPED WITH EMERGENCY LIGHTING, REF. ELECT. DWGS, FOR LOCATIONS,

**BOYS RESTROOM** 

EXIT EXIT / DOOR WIDTH OCCUPANCY COUNT REQUIRED WIDTH (INCHES) ACTUAL EXIT WIDTH

USE GROUP IN SPACE MAX OCCUPANCY

SIGN LOCATION PER OWNER

GENERAL CONSTRUCTION CODE DATA

ALL WORK SHALL COMPLY WITH THE RELATED PROVISIONS OF THE 2020 UNIFORM CODE OF NEW YORK STATE WHICH ADOPTS THE 2018 IBC, ITS REFERENCE STANDARDS, AND ALL LOCAL LAW REGULATIONS.

TO THE BEST OF MY KNOWLEDGE, BELIEF AND PROFESSIONAL JUDGMENT, THESE PLANS AND SPECIFICATIONS ARE EXEMPT FROM THE ENERGY CONSERVATION CONSTRUCTION CODE OF NEW YORK STATE DUE TO THE SECTION

BUILDING CODE: 2020 INTERNATIONAL ENERGY CONSERVATION CODE (2020 IECC) WITH 2018 NYS SUPPLEMENT

#### BUILDING CODE SECTION

SECTION C402.1.1 LOW-ENERGY BUILDINGS

THE FOLLOWING LOW-ENERGY BUILDINGS, OR PORTIONS THEREOF SEPARATED FROM THE REMAINDER OF THE BUILDING BY BUILDING THERMAL ENVELOPE ASSEMBLIES COMPLYING WITH THIS SECTION, SHALL BE EXEMPT FROM THE BUILDING THERMAL ENVELOPE PROVISIONS OF SECTION C402.

2. THOSE THAT DO NOT CONTAIN CONDITIONED SPACE.

#### **BUILDING CODE: 2020 NYS BUILDING CODE (2018 IBC)**

# **BATHHOUSE 231 & 322**

BUILDING CODE SECT	<u>ION</u>	REQUIRED	PROVIDED
SECTION 302.1	USE GROUP		U UTILITY AND MISCELLANEOUS
SECTION 503.1	AREA - VB CONSTRUCTION	5,500 SF PER STORY	658 SF
TABLE 601	CONSTRUCTION CLASSIFICATION STRUCTURAL FRAME BEARING WALLS - EXTERIOR BEARING WALLS - INTERIOR NON-BEARING WALLS - EXTERIOR NON-BEARING WALLS - INTERIOR FLOORS ROOF	VB 0 HR. 0 HR. 0 HR. 0 HR. 0 HR. 0 HR. 0 HR.	VB 0 HR 0 HR. 0 HR. 0 HR. 0 HR. 0 HR. 0 HR.
SECTION 707.04	SHAFT ENCLOSURE	1 HR.	NA
SECTION 903.2.7	SPRINKLERS	NOT REQUIRED	-
SECTION 906	PORTABLE FIRE EXTINGUISHERS	NOT REQUIRED	•
SECTION 1004.1.2	OCCUPANT LOAD	50 GROSS (LOCKER ROOMS) 300 GROSS (MECH. ROOM) TOTAL	12 1 13
SECTION 1005.1	EGRESS WIDTH STAIRS OTHER COMPONENTS	NA 0.2" / OCC. MIN	NA 2.77" / OCC. MIN.
SECTION 1006.3.2	NUMBER OF EXITS	1 (LESS THAN 50 OCCUPANTS	5)1
SECTION 1007.1.1	ARRANGEMENT	1/2 MAX. DIAGONAL	1/2 MAX. DIAGONAL

300 FT MAX

70 FT MAX

38 FT MAX

#### LATRINE #427

**SECTION 1017.2** 

**SECTION 1017.2** 

TRAVEL DISTANCE

TRAVEL DISTANCE

LATRINE #427			
BUILDING CODE SECT	<u> FION</u>	REQUIRED	PROVIDED
SECTION 302.1	USE GROUP		U UTILITY AND MISCELLANEOUS
SECTION 503.1	AREA - VB CONSTRUCTION	5,500 SF PER STORY	324 SF
TABLE 601	CONSTRUCTION CLASSIFICATION STRUCTURAL FRAME BEARING WALLS - EXTERIOR BEARING WALLS - INTERIOR NON-BEARING WALLS - EXTERIOR NON-BEARING WALLS - INTERIOR FLOORS ROOF	VB 0 HR. 0 HR. 0 HR. 0 HR. 0 HR. 0 HR.	VB 0 HR 0 HR. 0 HR. 0 HR. 0 HR. 0 HR.
<b>SECTION 707.04</b>	SHAFT ENCLOSURE	1 HR.	NA
<b>SECTION 903.2.7</b>	SPRINKLERS	NOT REQUIRED	-
SECTION 906	PORTABLE FIRE EXTINGUISHERS	NOT REQUIRED	-
SECTION 1004.1.2	OCCUPANT LOAD	50 GROSS (LOCKER ROOM)	6
SECTION 1005.1	EGRESS WIDTH STAIRS OTHER COMPONENTS	NA 0.2" / OCC. MIN	NA 12" / OCC. MIN.
SECTION 1006.3.2	NUMBER OF EXITS	1 (LESS THAN 50 OCCUPANTS	5)1
SECTION 1007.1.1	ARRANGEMENT	1/2 MAX. DIAGONAL	1/2 MAX. DIAGONAL

300 FT MAX

# Palisades Region

Palisades Interstate Park Commission Bear Mountain, New York 10911 (845) 786-2701 Executive Director: Joshua Laird

New York State

Surveyor/ Structural/ MEP

Governor Kathy Hochul

Architect:

Saratoga Associates

Engineer:

LaBella Associates

Ithaca, NY 14850

21 Congress Street, Suite 201 Saratoga Springs, NY 12866

105 N. Tioga Street, Suite 200

Certificate of Authorization Number: Professional Engineering: 018281 Land Surveying: 017976 Geological: 018750

Parks, Recreation and

Historic Preservation

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Commissioner Erik Kulleseid

**ASSOCIATES** 

Landsume Archileos, Architects,

Engineers, and Phaners, PCL

LaBella

SARATOGA

# Project Title: CAMP JUNIOR ON LAKE TIORATI -PHASE 3

Project Location: HARRIMAN STATE PARK

# **Key Plan**

Rev No	Description		
Drawn	Ву:	Seal and Signature	
KE	T, LLH	. ex62.c.a.	

Design By: Checked By: CTSApproved By: CTS

3/16/23 Sheet Title:

Drawing Number:

LIFE SAFETY PLAN

21059.23

**A001** 

**Bid Documents** Project Number:

RESTROOM #427 109 BOYS RESTROOM

SHOWER 1 102

SHOWER 2 103

SHOWER 3

**MECHANICAL** 

106

\_\_\_ 104

**ADA SHOWER** 105

20 FT


NOTE: BATHHOUSE #322 HAS


1) BATHHOUSE #231 & #322 CODE PLAN 3/16" = 1'-0"

SIMILAR RAMP CONDITION

WITHOUT STAIRS.

2 LATRINE #427 CODE PLAN 3/16" = 1'-0"

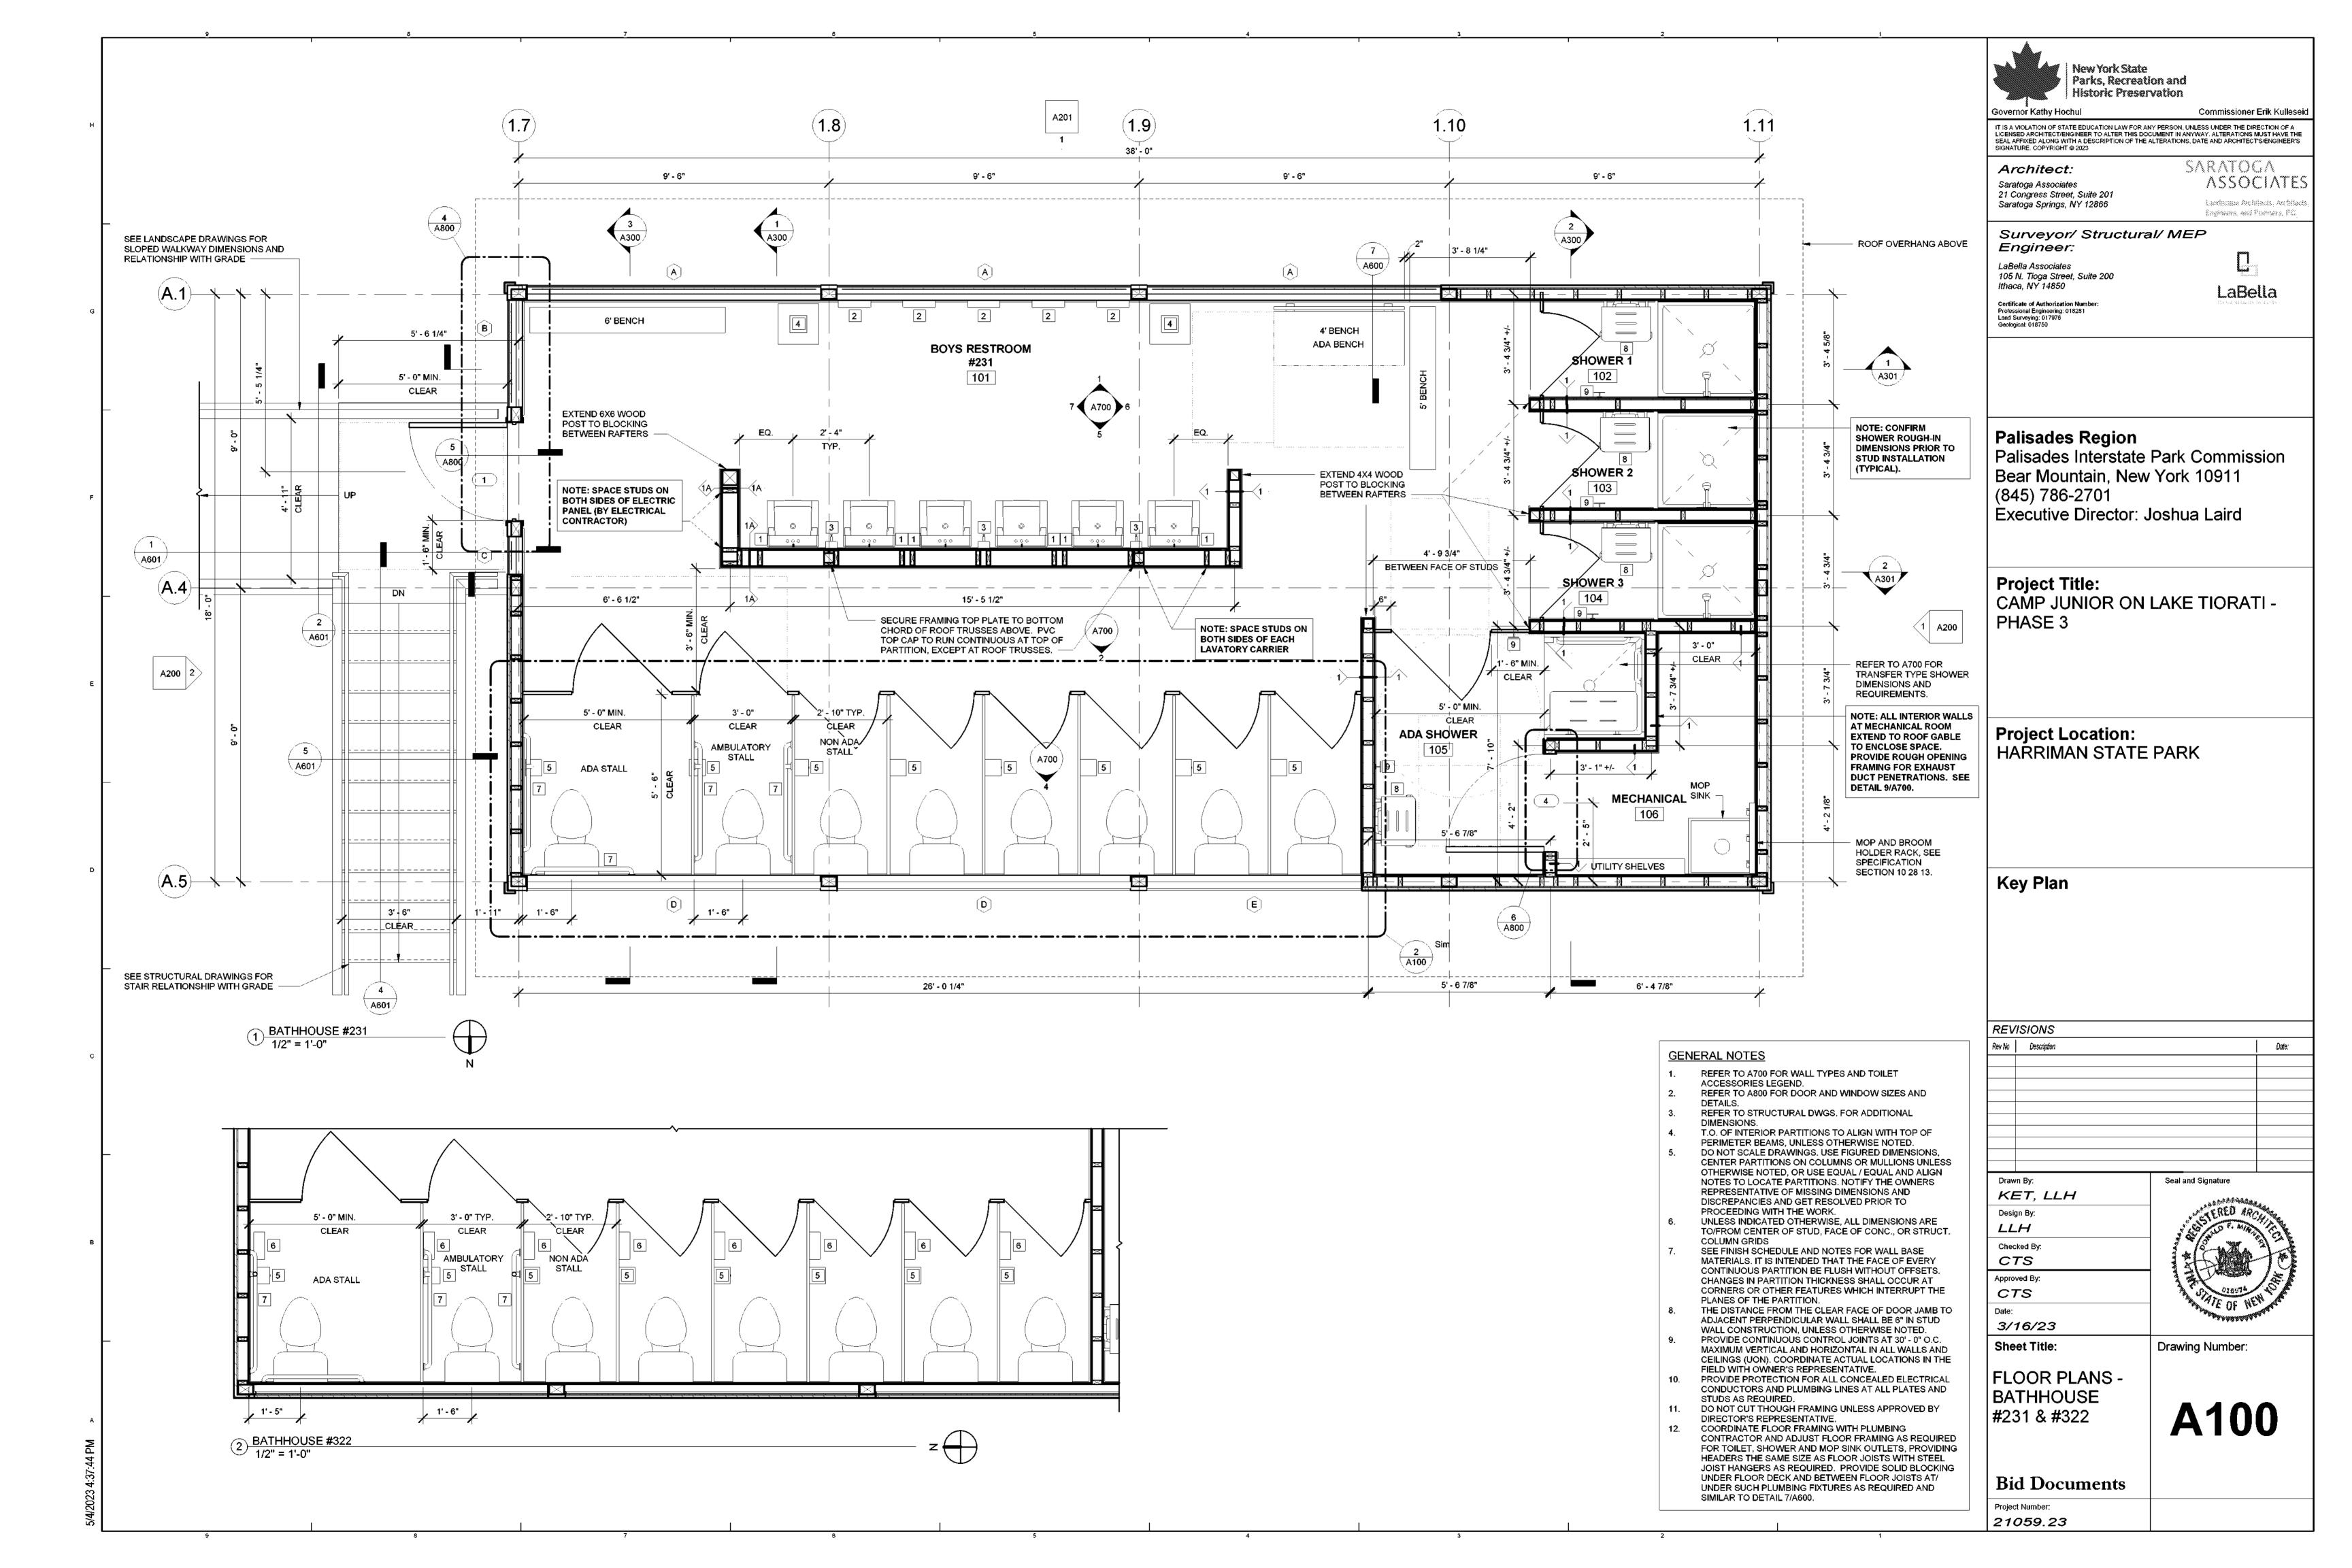

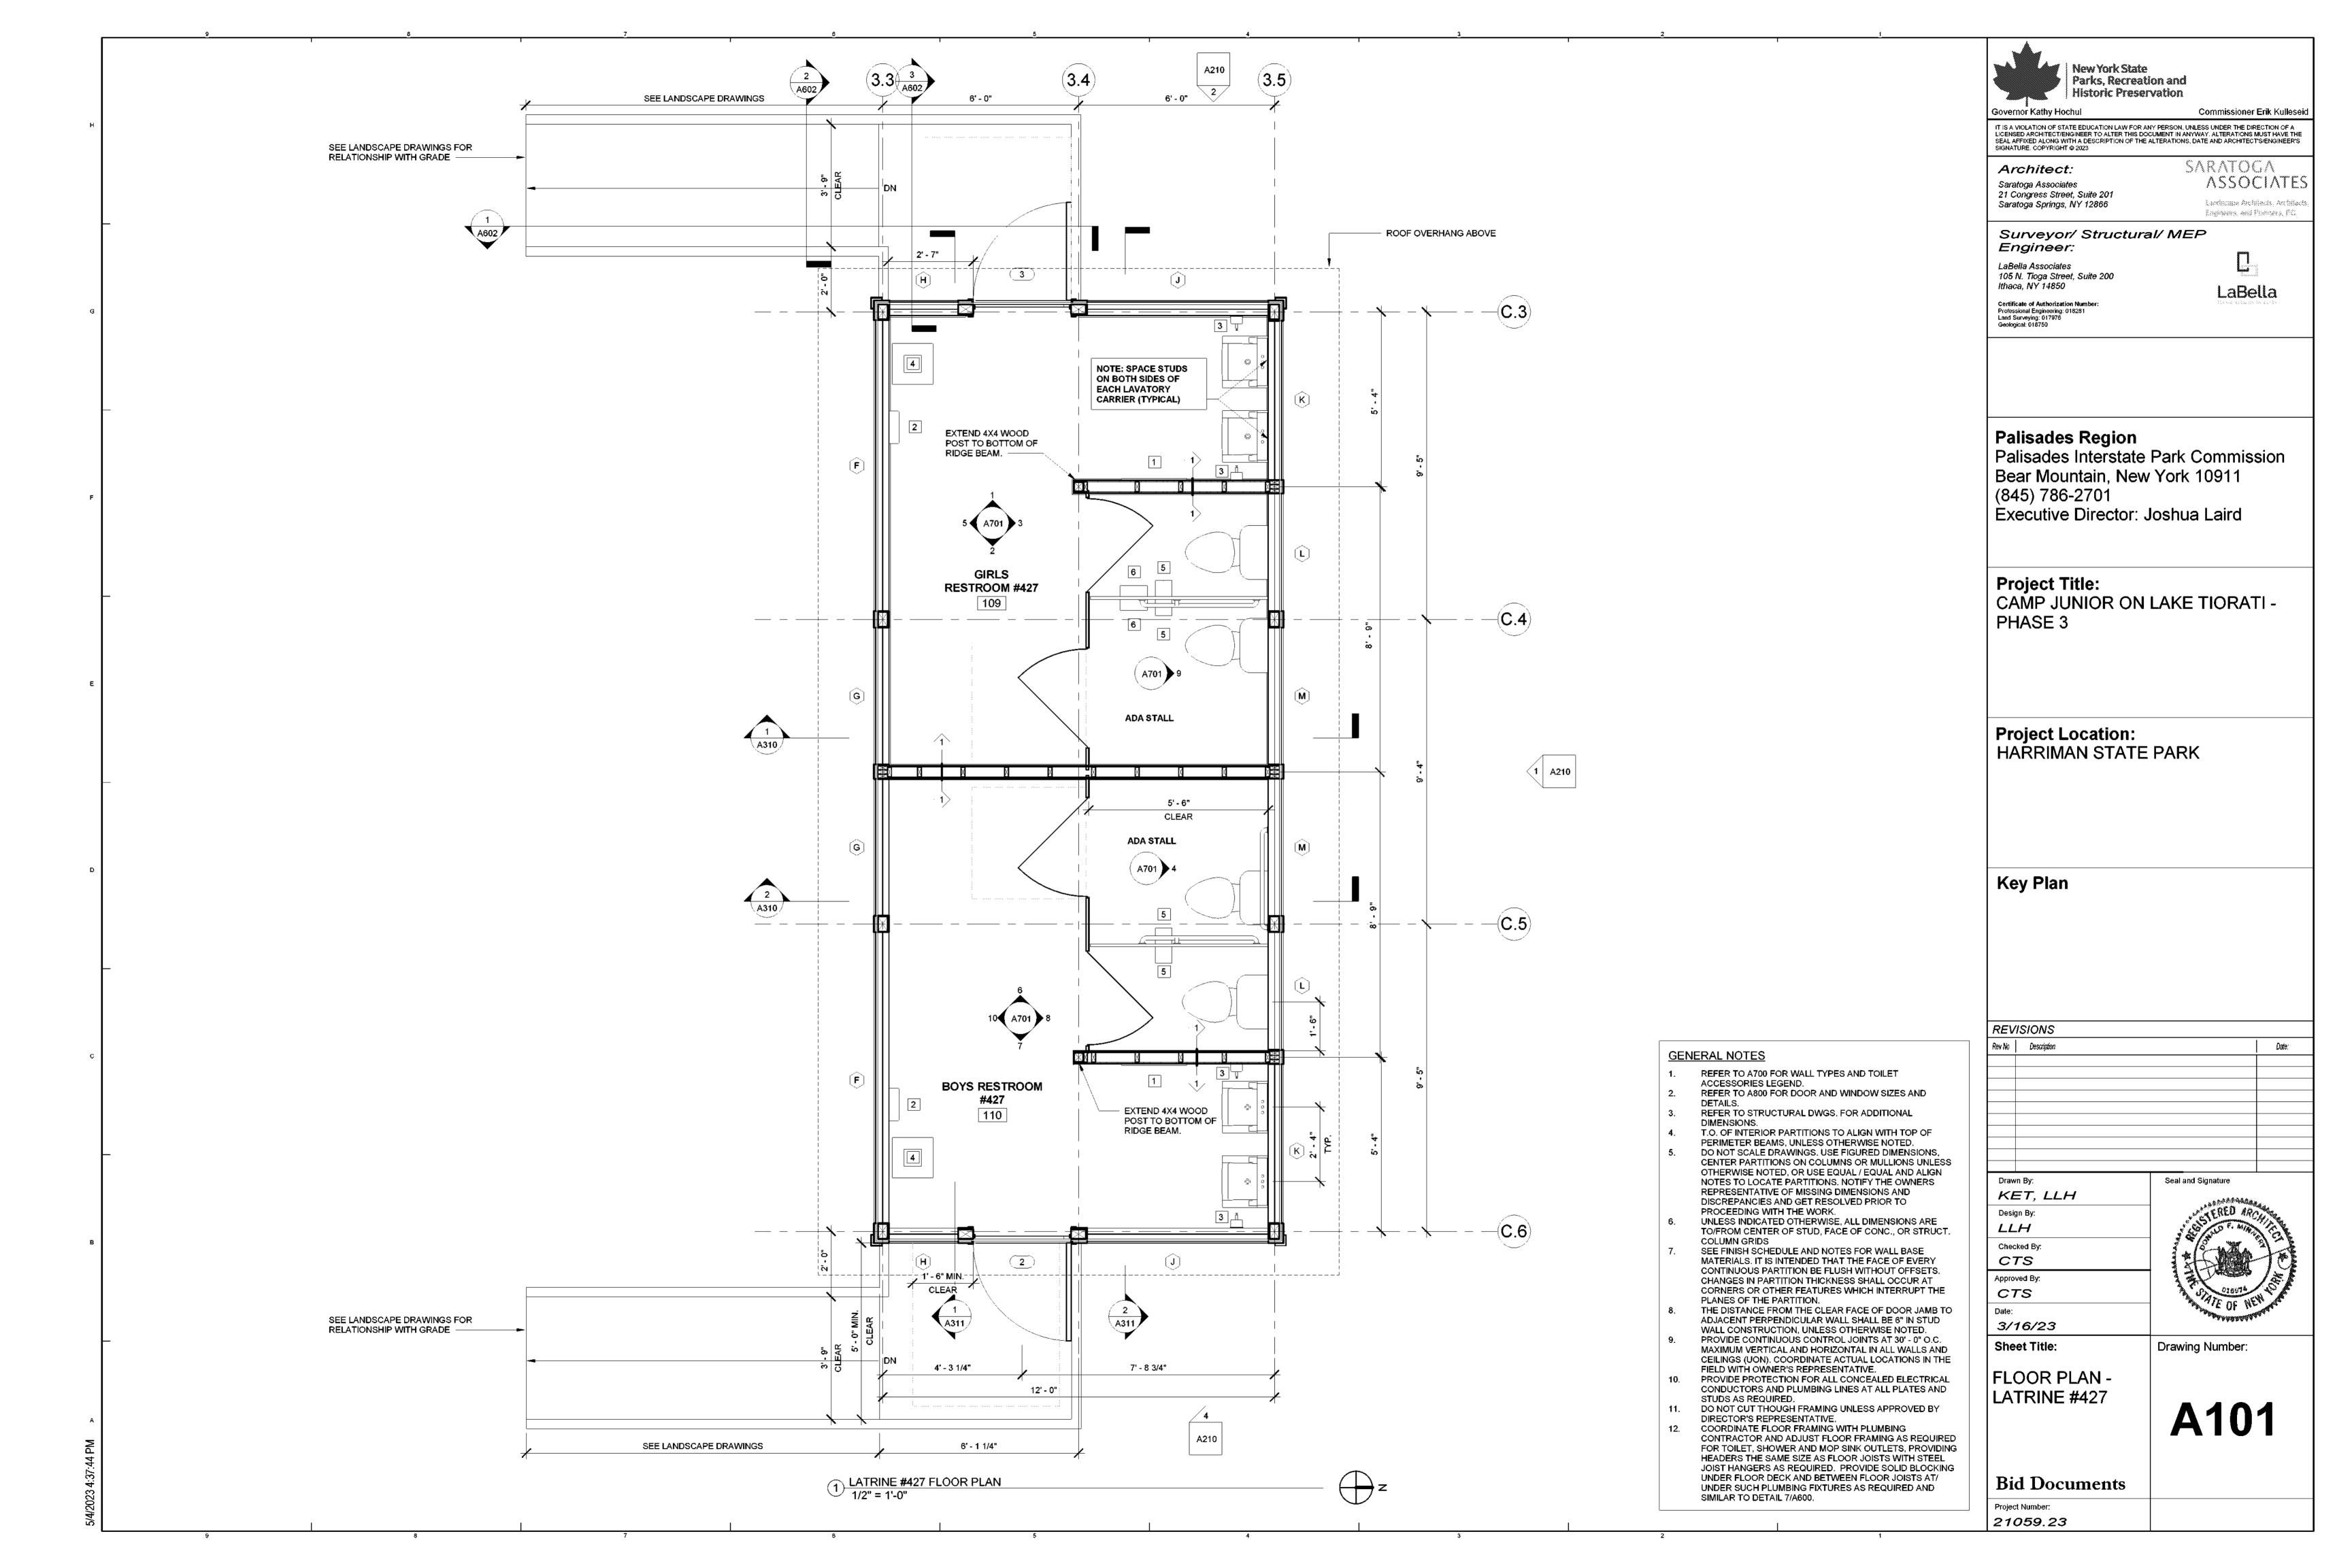

# **CANOPY GENERAL NOTES:** PROTECT ALL EXISTING CONSTRUCTION FROM DAMAGE DURING CANOPY INSTALLATION. VERIFY ALL EXISTING DIMENSIONS IN FIELD PRIOR TO INSTALLATION. NOTIFY ARCHITECT OF ANY SEE STRUCTURAL DRAWINGS FOR ROOF FRAMING PLAN AND FRAMING CONNECTION DETAILS.

(2) A320 EXISTING DINING HALL EXISTING ROOF OVERHANG ABOVE EXISTING DOOR, STAIR AND HANDRAILS, PROTECT FROM DAMAGE. NEW CANOPY COVER OVER EXISTING PATIO 2" DIA. STEEL CANOPY POST (TYP.),
 REFER TO STRUCTURAL DRAWINGS EXISTING CONCRETE SLAB TO REMAIN, PROTECT FROM DAMAGE. 12' - 5 1/2" 12' - 2" 12' - 2" 37' - **4"** 1) DINING HALL CANOPY 1/8" = 1'-0"



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Architect: Saratoga Associates 21 Congress Street, Suite 201 Saratoga Springs, NY 12866 SARATOGA ASSOCIATES Lacdissipe Architects, Architects, Engineers, and Phaners, PCL

Surveyor/ Structural/ MEP Engineer:

LaBella Associates 105 N. Tioga Street, Suite 200 Ithaca, NY 14850

LaBella

Certificate of Authorization Number: Professional Engineering; 018281 Land Surveying: 017976 Geological: 018750

Palisades Region

Palisades Interstate Park Commission Bear Mountain, New York 10911 (845) 786-2701

Executive Director: Joshua Laird

Project Title: CAMP JUNIOR ON LAKE TIORATI -PHASE 3

Project Location: HARRIMAN STATE PARK

Key Plan

REVISIONS Rev No Description Date:

Seal and Signature Drawn By: KET, LLH Design By: LLH Checked By:

CTS Approved By: CTS

3/16/23

Sheet Title:

FLOOR PLANS -DINING HALL


A102

Drawing Number:

Bid Documents

#404 CANOPY

Project Number: 21059.23

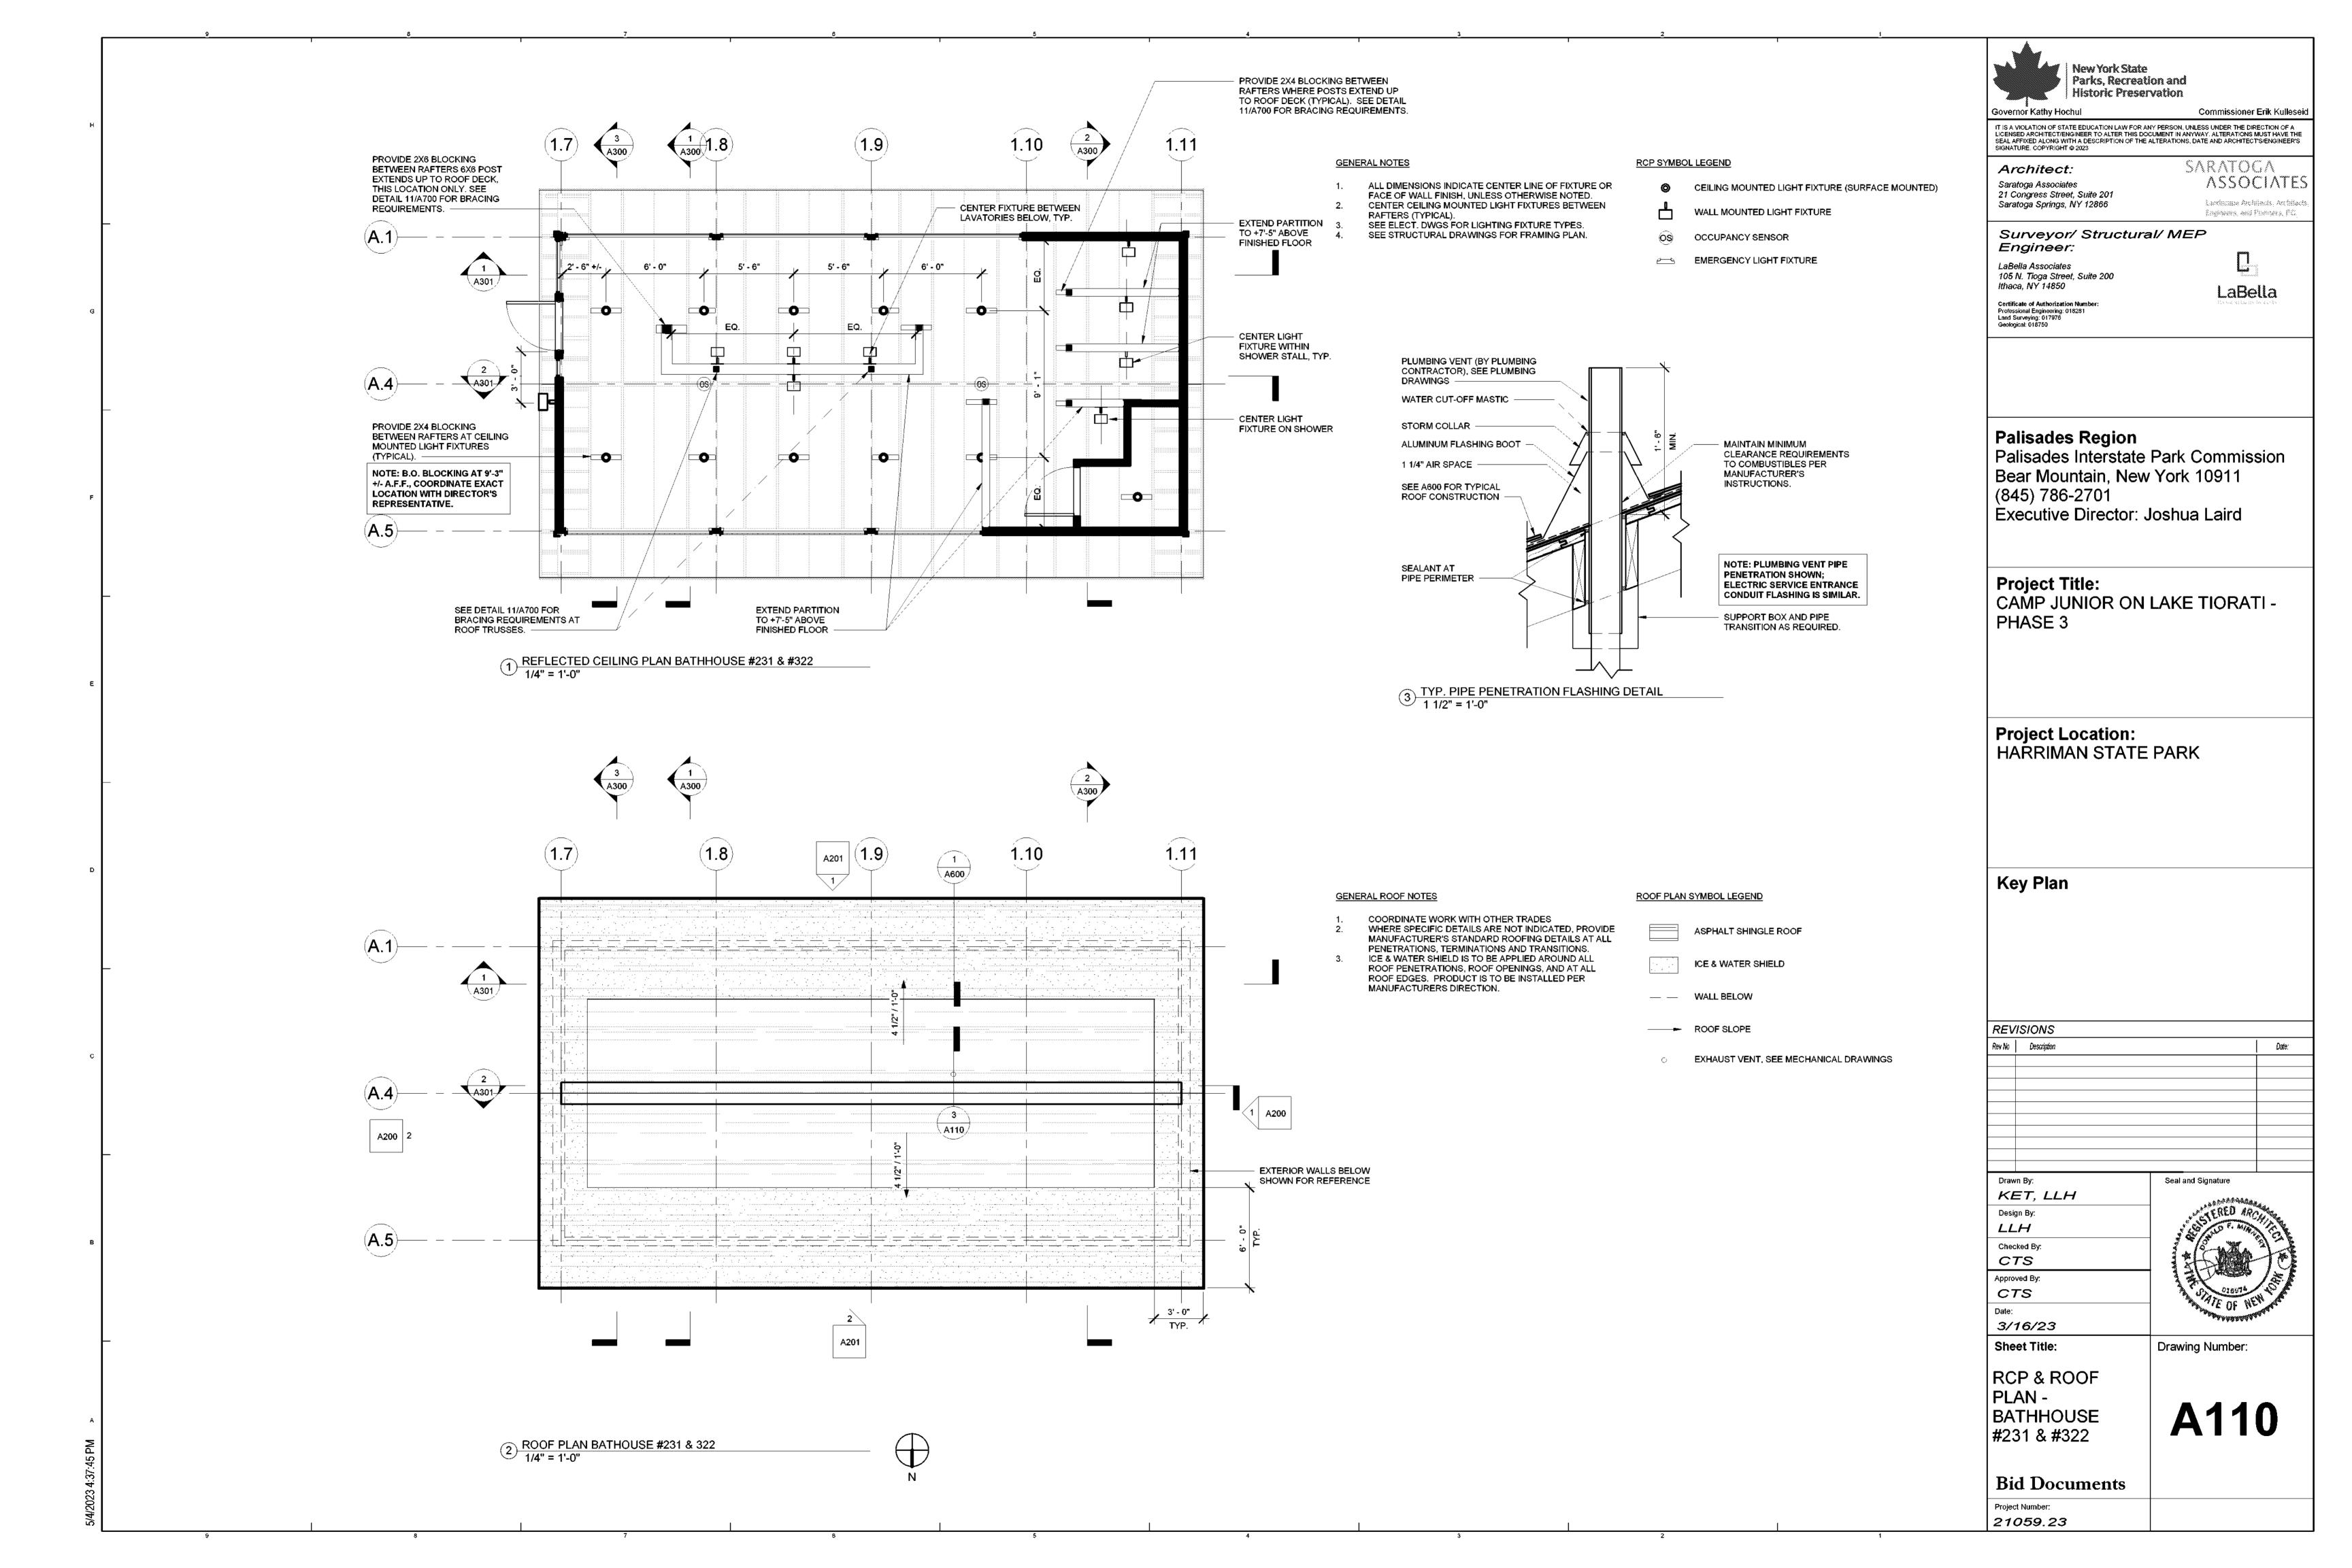

#### **GENERAL NOTES**

- ALL DIMENSIONS INDICATE CENTER LINE OF FIXTURE OR FACE OF WALL FINISH, UNLESS OTHERWISE NOTED.
- CENTER CEILING MOUNTED LIGHT FIXTURES BETWEEN RAFTERS (TYPICAL).
- SEE ELECT. DWGS FOR LIGHTING FIXTURE TYPES. SEE STRUCTURAL DRAWINGS FOR FRAMING PLAN.

#### RCP SYMBOL LEGEND

CEILING MOUNTED LIGHT FIXTURE (SURFACE MOUNTED)

WALL MOUNTED LIGHT FIXTURE

OS OCCUPANCY SENSOR

EMERGENCY LIGHT FIXTURE

#### **GENERAL ROOF NOTES**

- COORDINATE WORK WITH OTHER TRADES WHERE SPECIFIC DETAILS ARE NOT INDICATED, PROVIDE MANUFACTURER'S STANDARD ROOFING DETAILS AT ALL
- PENETRATIONS, TERMINATIONS AND TRANSITIONS. ICE & WATER SHIELD IS TO BE APPLIED AROUND ALL ROOF PENETRATIONS, ROOF OPENINGS, AND AT ALL ROOF EDGES. PRODUCT IS TO BE INSTALLED PER MANUFACTURERS DIRECTION.


#### ROOF PLAN SYMBOL LEGEND

- ASPHALT SHINGLE ROOF
- ICE & WATER SHIELD


— — WALL BELOW

ROOF SLOPE

EXHAUST VENT, SEE MECHANICAL DRAWINGS

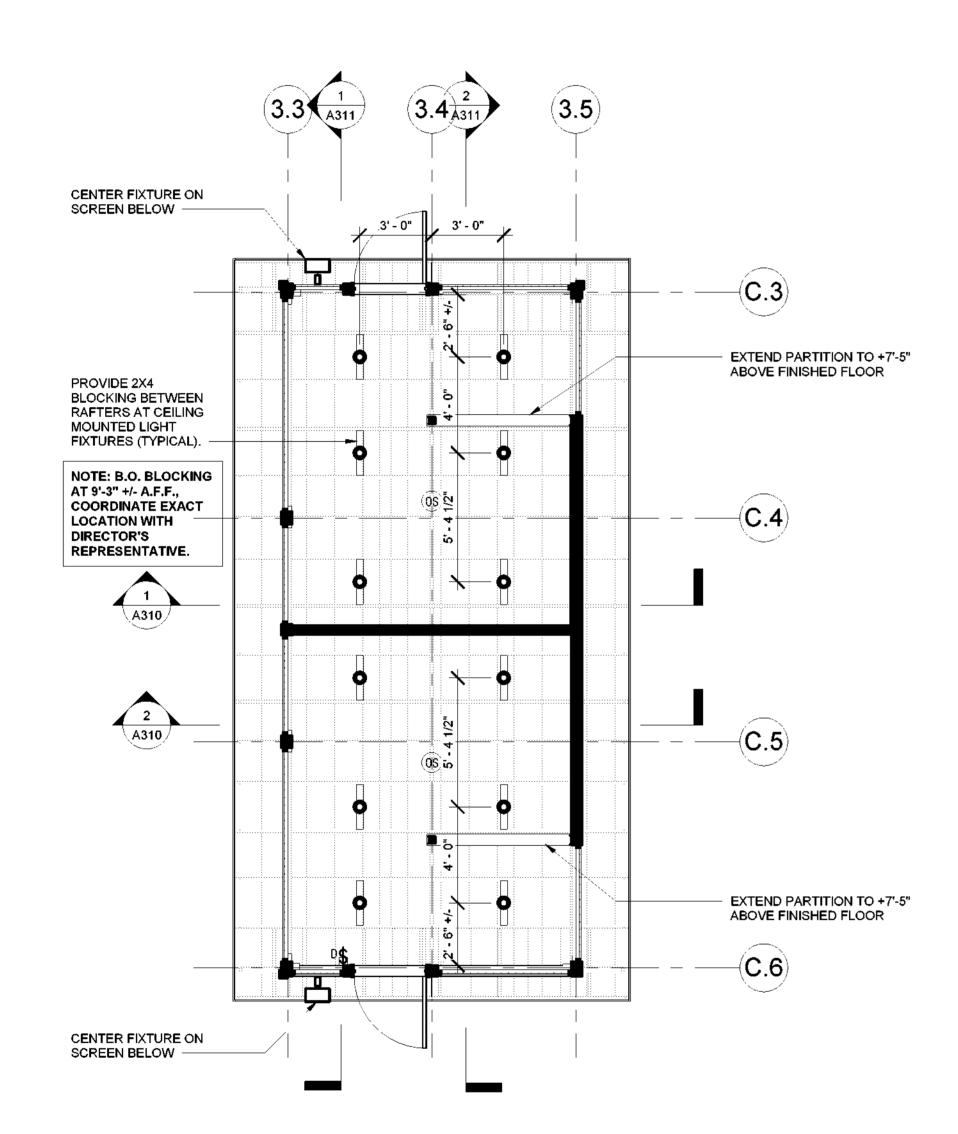


1) BUILDING #427 REFLECTED CEILING PLAN
1/4" = 1'-0"

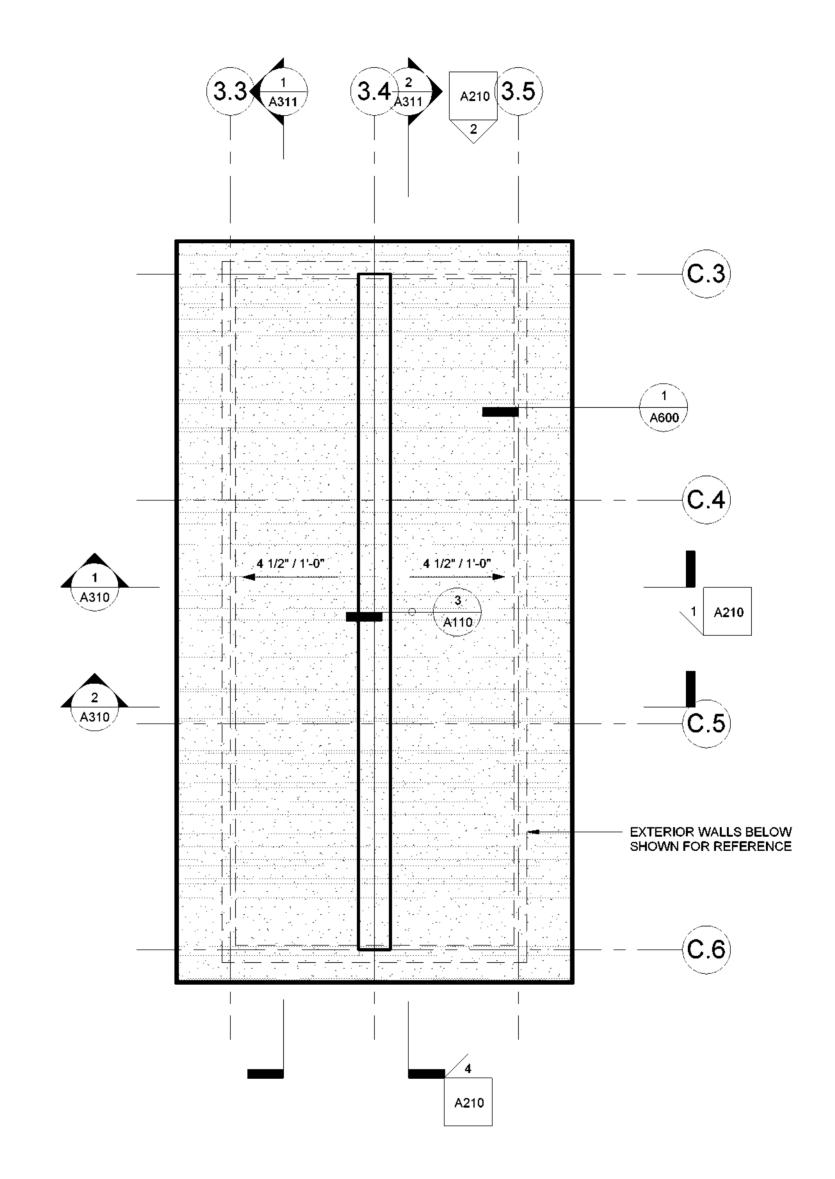

2 LATRINE #427 ROOF PLAN 1/4" = 1'-0"



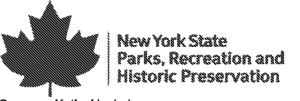

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21 Congress Street, Suite 201 Saratoga Springs, NY 12866

SARATOGA **ASSOCIATES** Lambuuse Archileots, Archilects Engineers, and Phaners, PCL

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Project Location: HARRIMAN STATE PARK

**Key Plan** 

REVISIONS Rev No Description Date:

Drawn By: KET, LLH Design By: LLH Checked By: CTS Approved By: CTS

3/16/23 Drawing Number:

Sheet Title:

#427

RCP & ROOF PLAN - LATRINE


Seal and Signature

Bid Documents


Project Number: 21059.23



- GRADE NOT SHOWN AS BATHHOUSE #231 & #322 HAVE DIFFERING SITE CONDITIONS. SEE LANDSCAPE DRAWINGS.
- SEE DRAWING A601 FOR RAMP DETAILS AT BATHHOUSE #231, SEE DRAWING A602 FOR RAMP DETAIL AT BATHHOUSE #322, SIM.
  ALL EXPOSED WOOD FRAMING, ROOF DECKING, SIDING, AND TRIM (NON
- PRESSURE-TREATED) TO BE PAINTED, SEE SPECIFICATION SECTION 09 91 01.
  SEE MECHANICAL DRAWINGS FOR DUCT/ PIPE PENETRATION LOCATIONS.
  SEE DETAIL 9/A700 FOR WALL OPENING REQUIREMENTS.

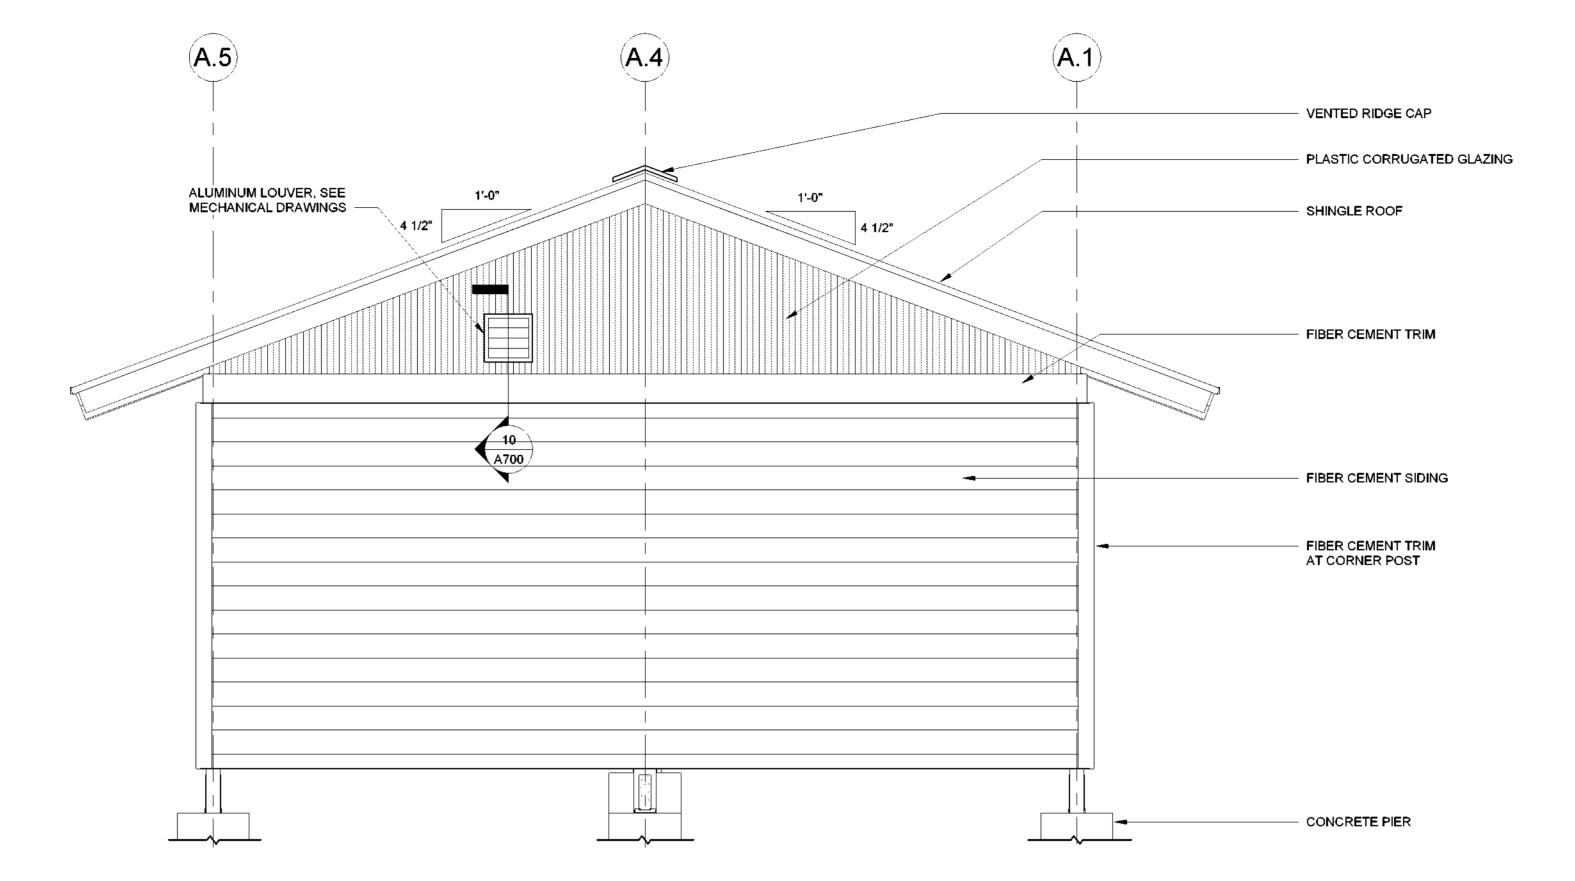

1 BATHHOUSE #231 &322 - EAST 1/2" = 1'-0"

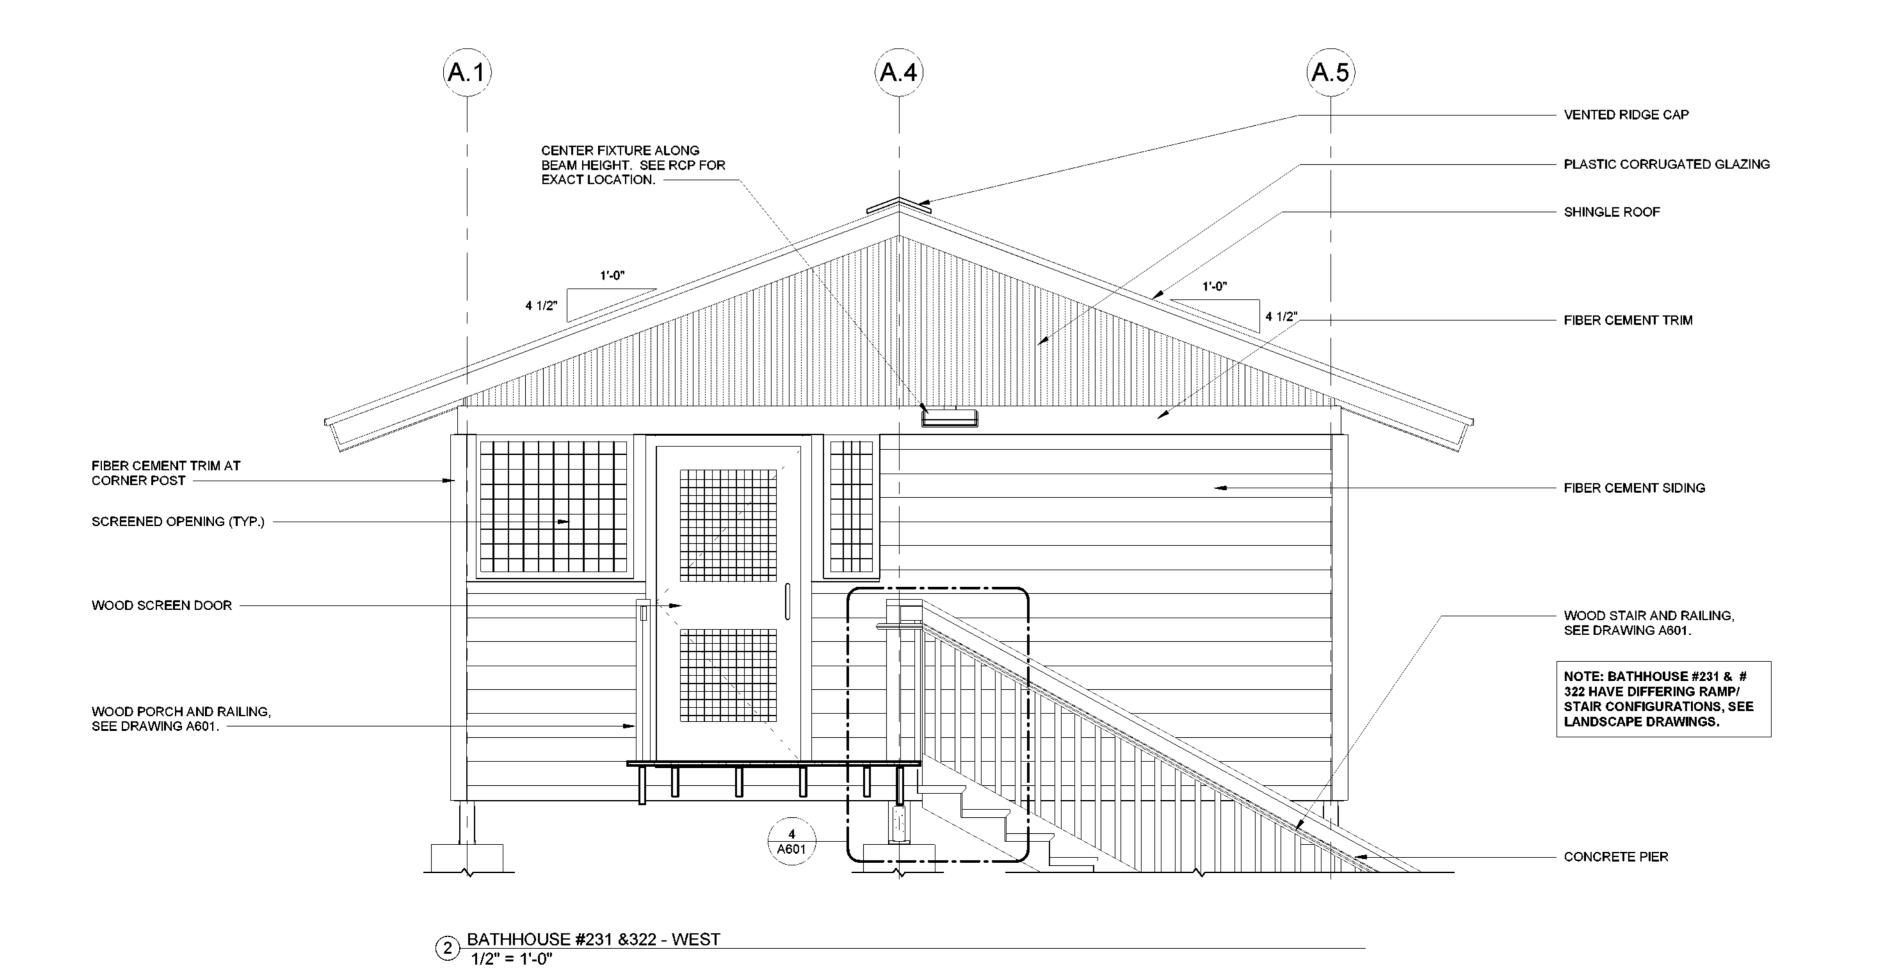

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**Key Plan** 

Drawn By:

REVISIONS Rev No Description Date:

KET, LLH Design By: Checked By: CTS Approved By: CTS

3/16/23 Sheet Title:


**ELEVATIONS -**BATHHOUSE #231 & #322


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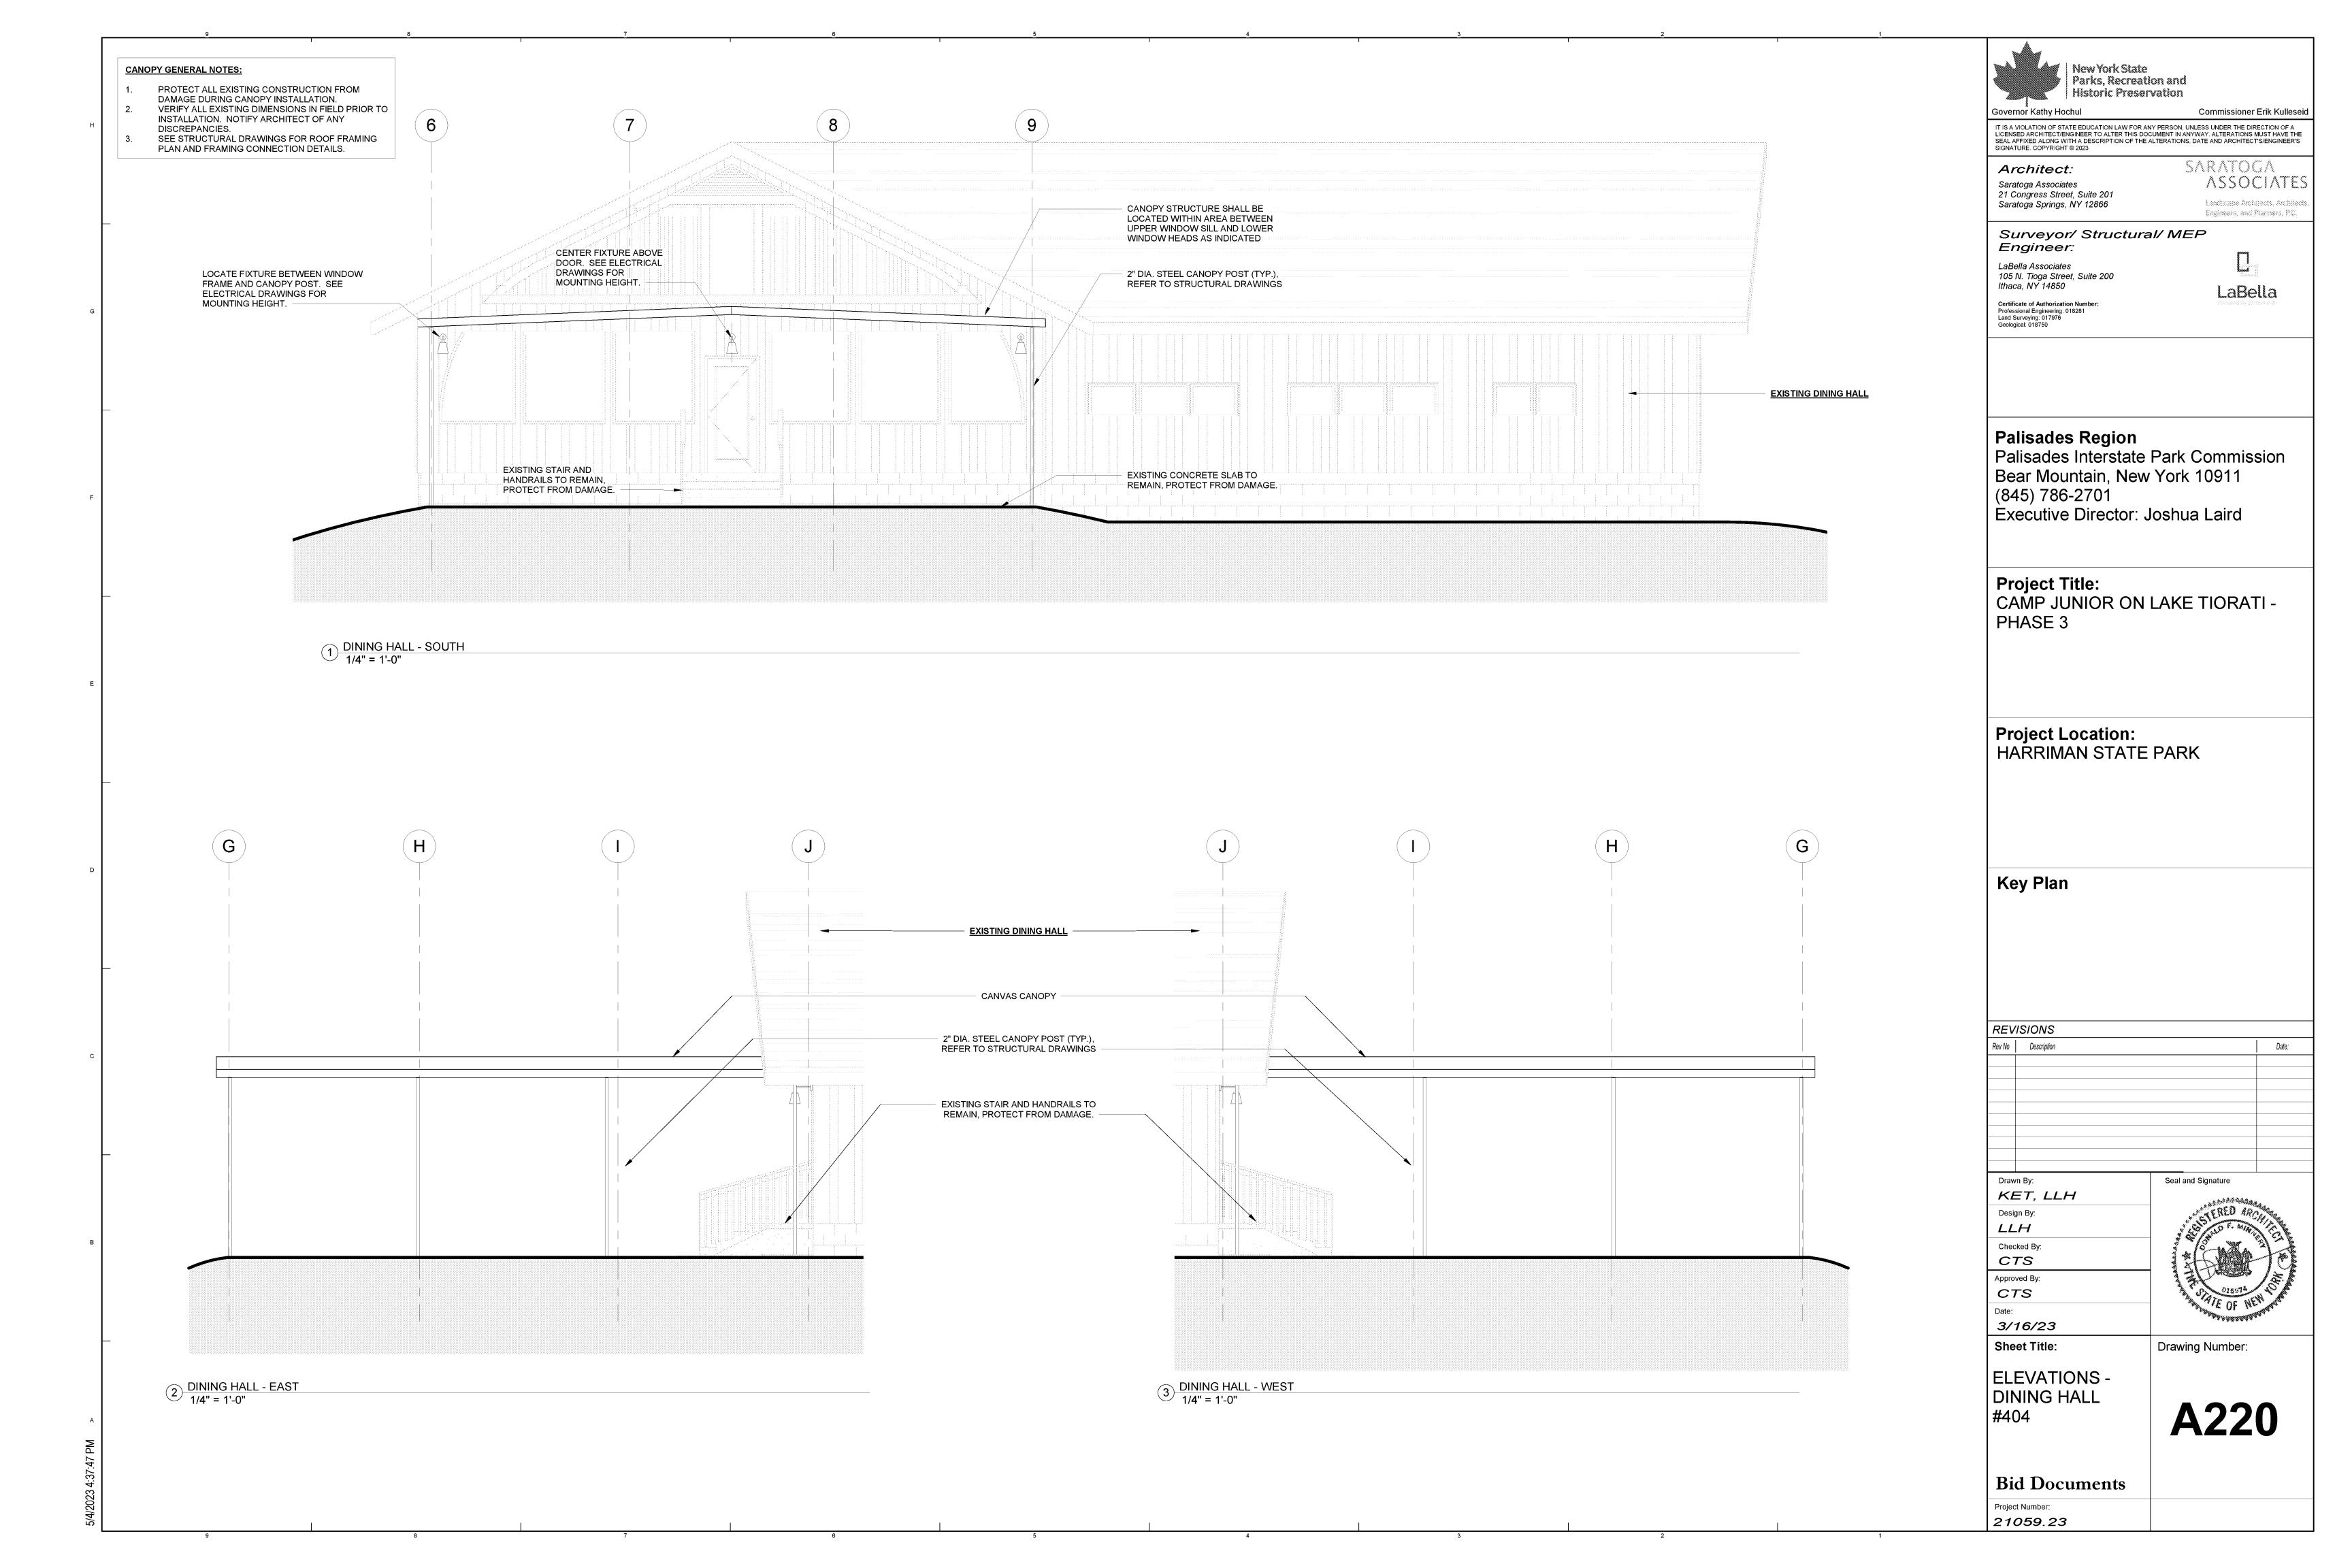
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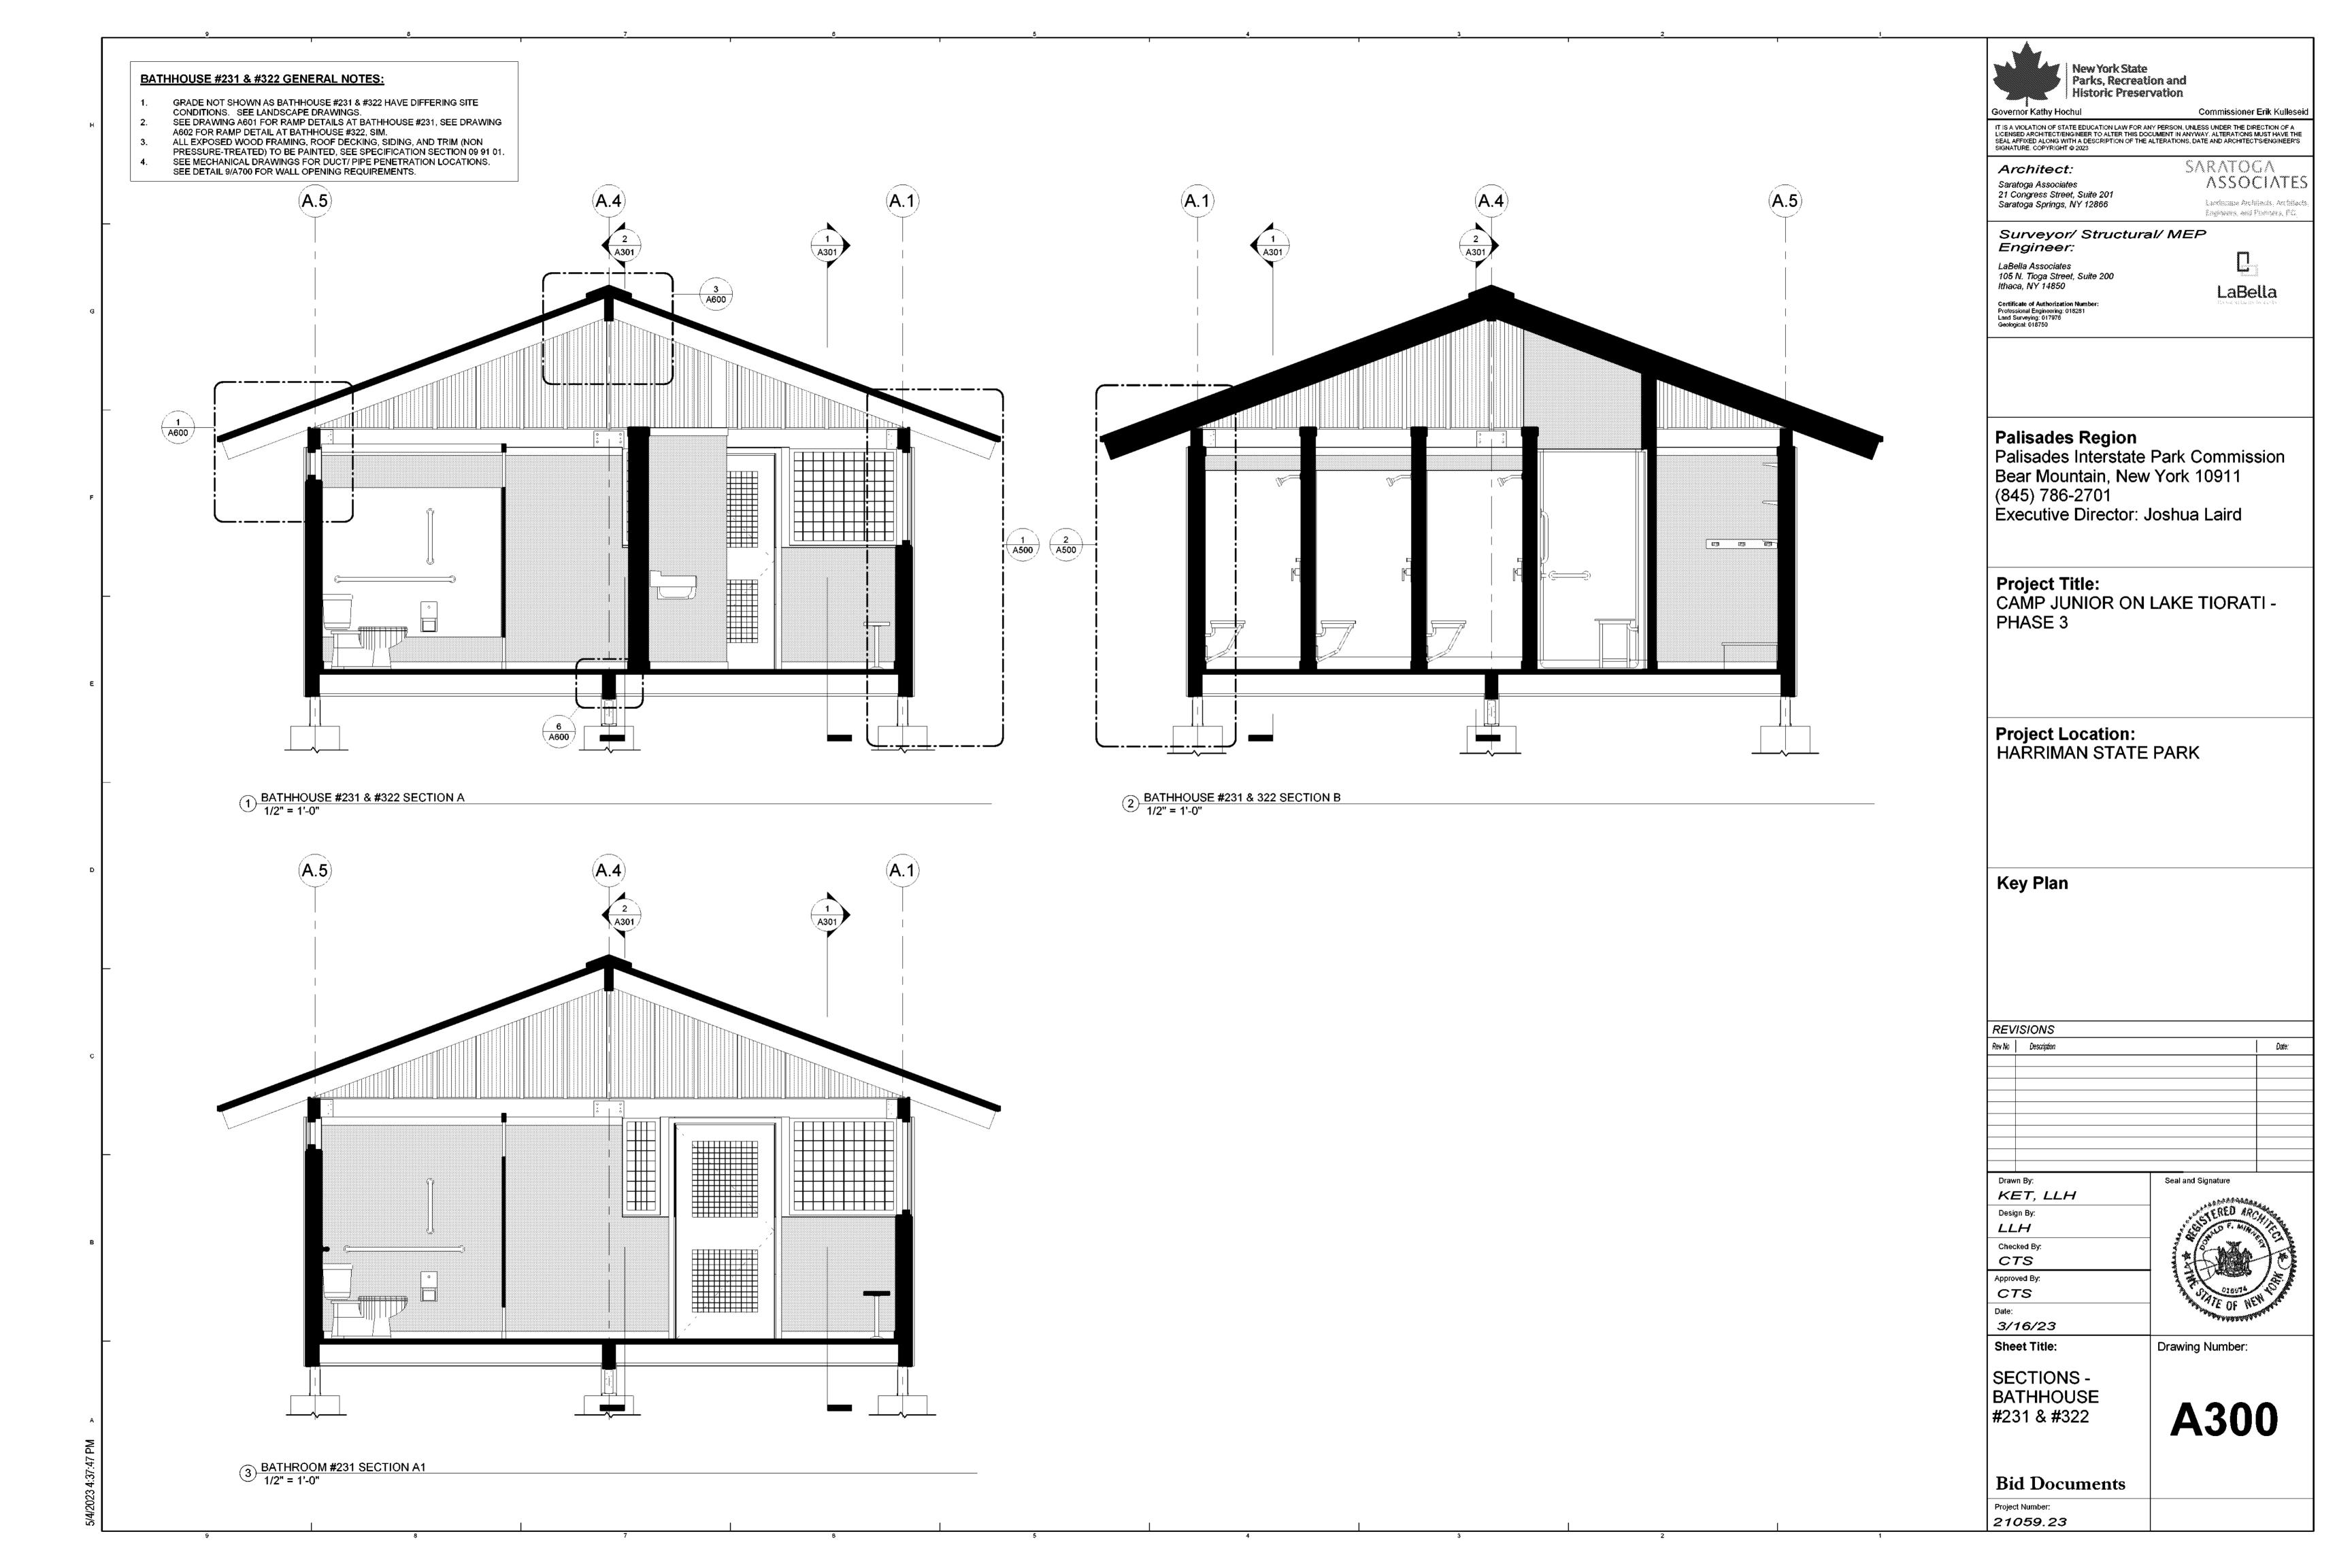
**Bid Documents** Project Number:


21059.23





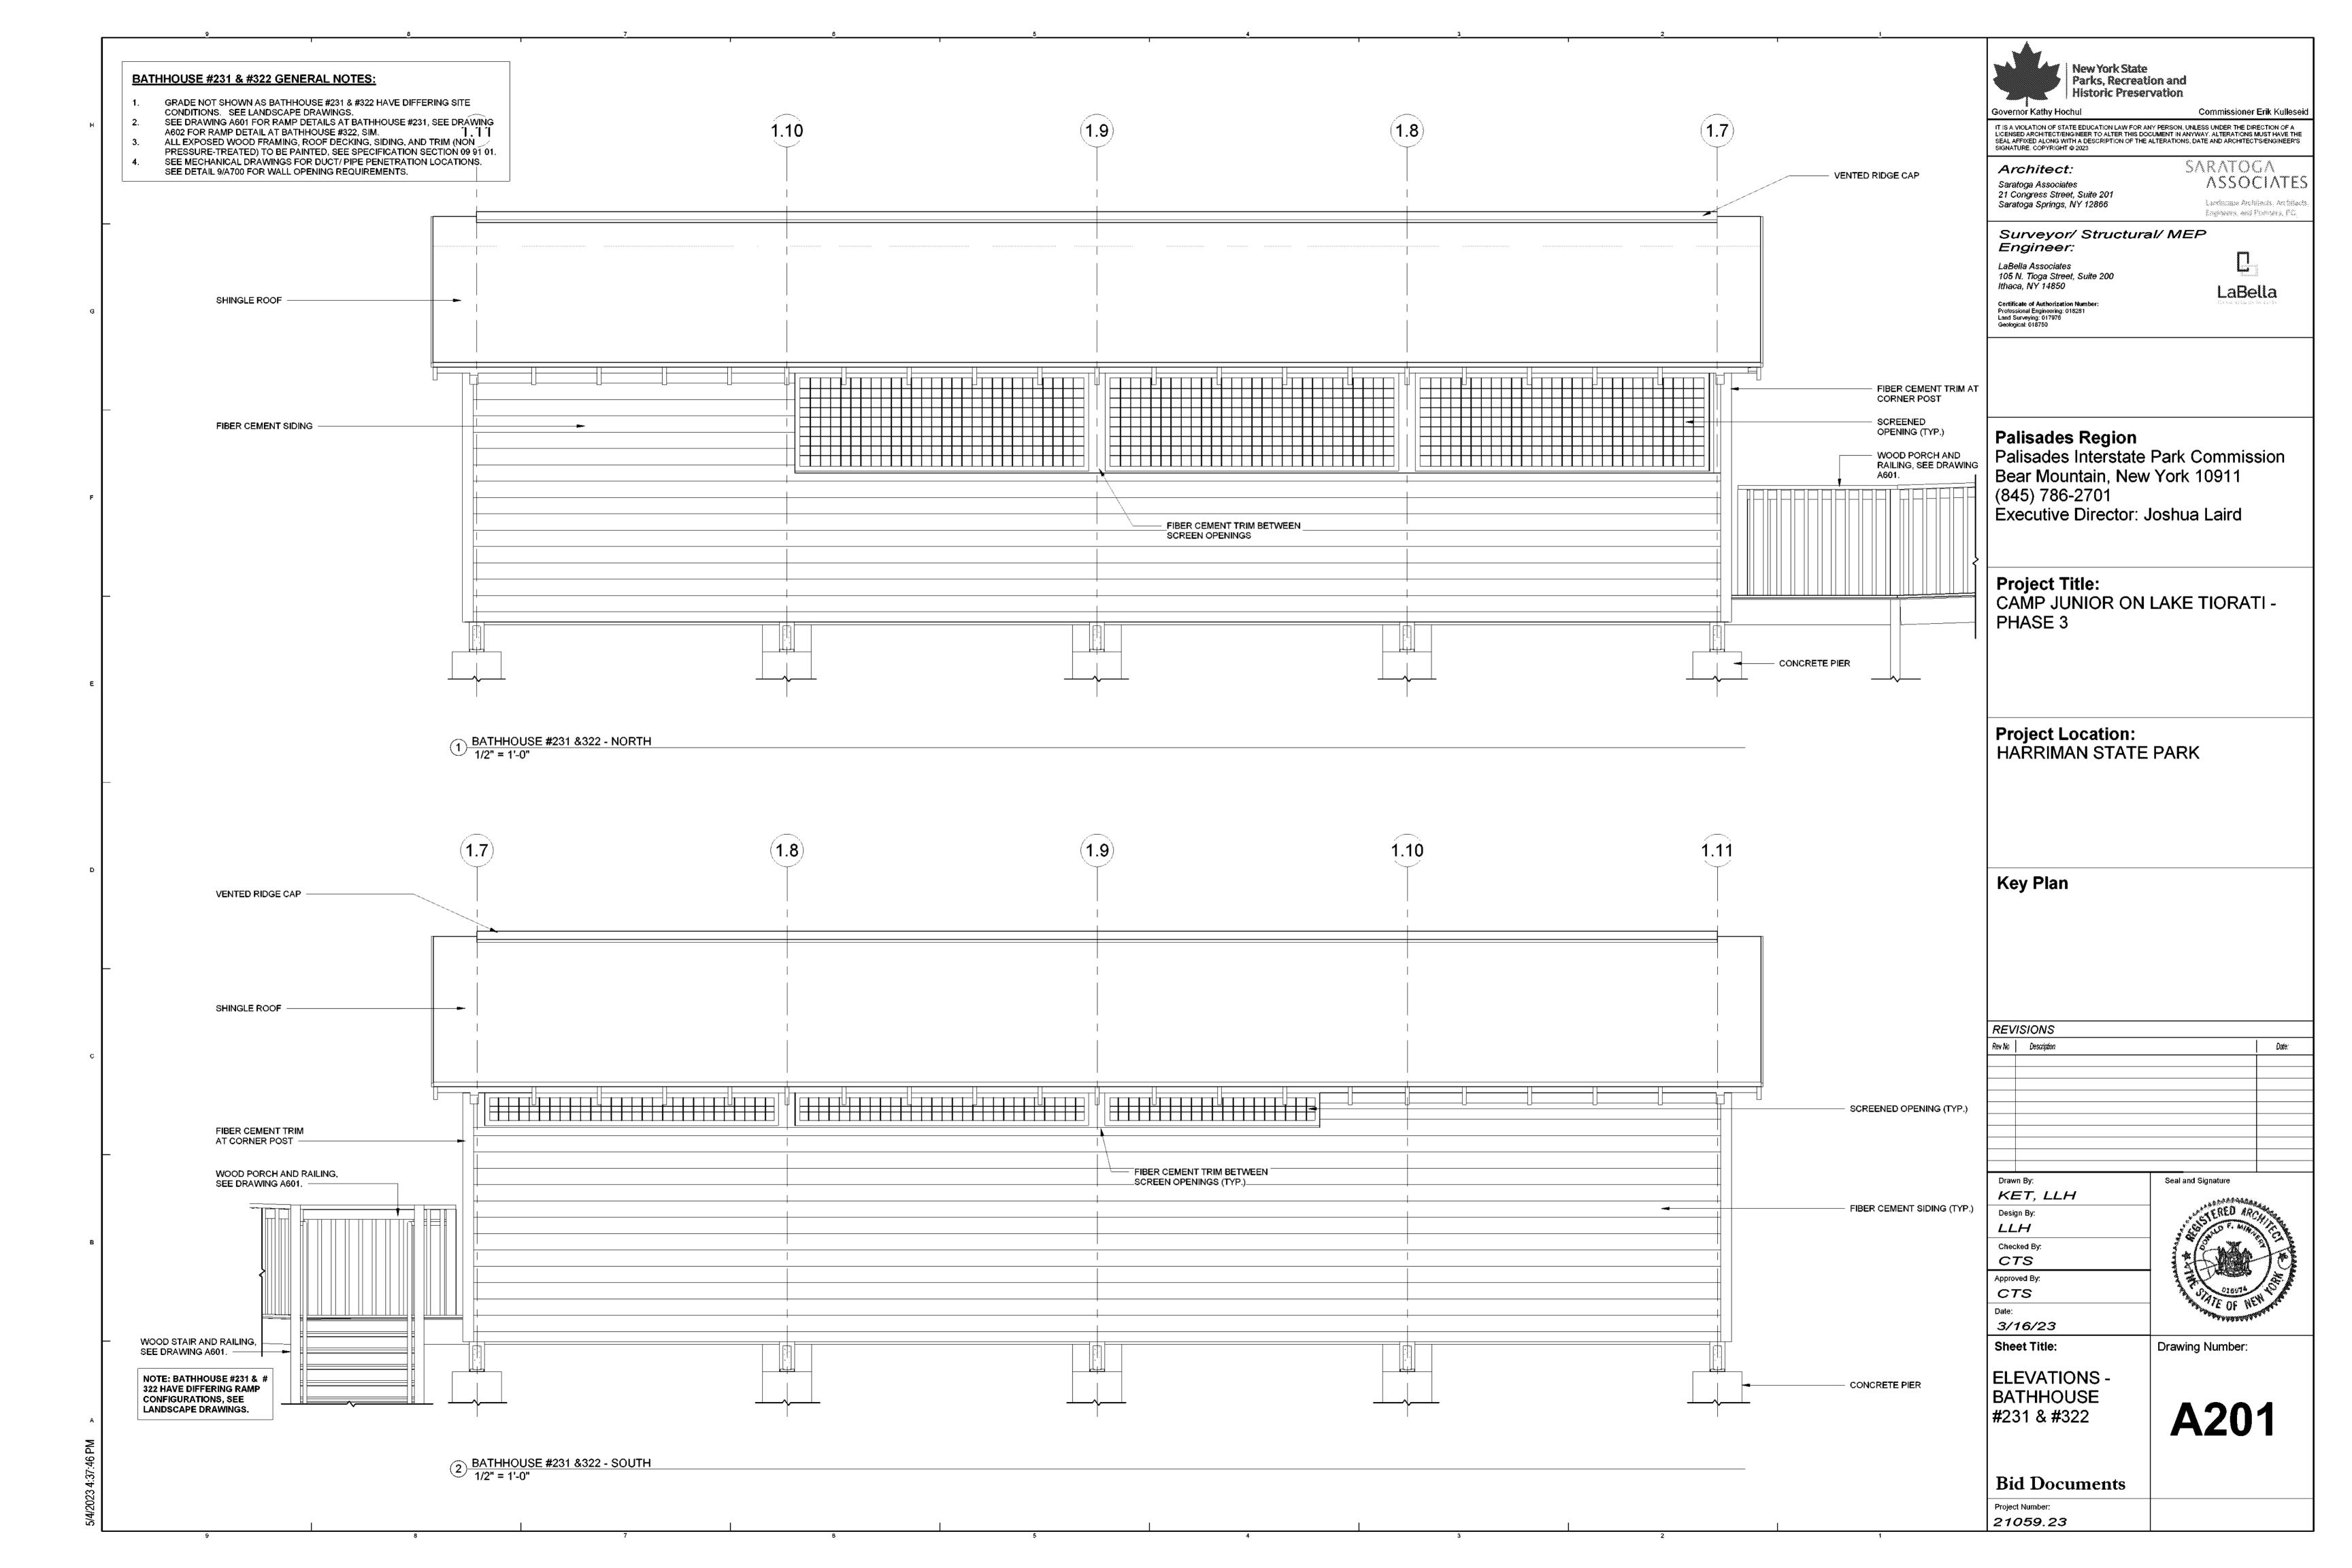


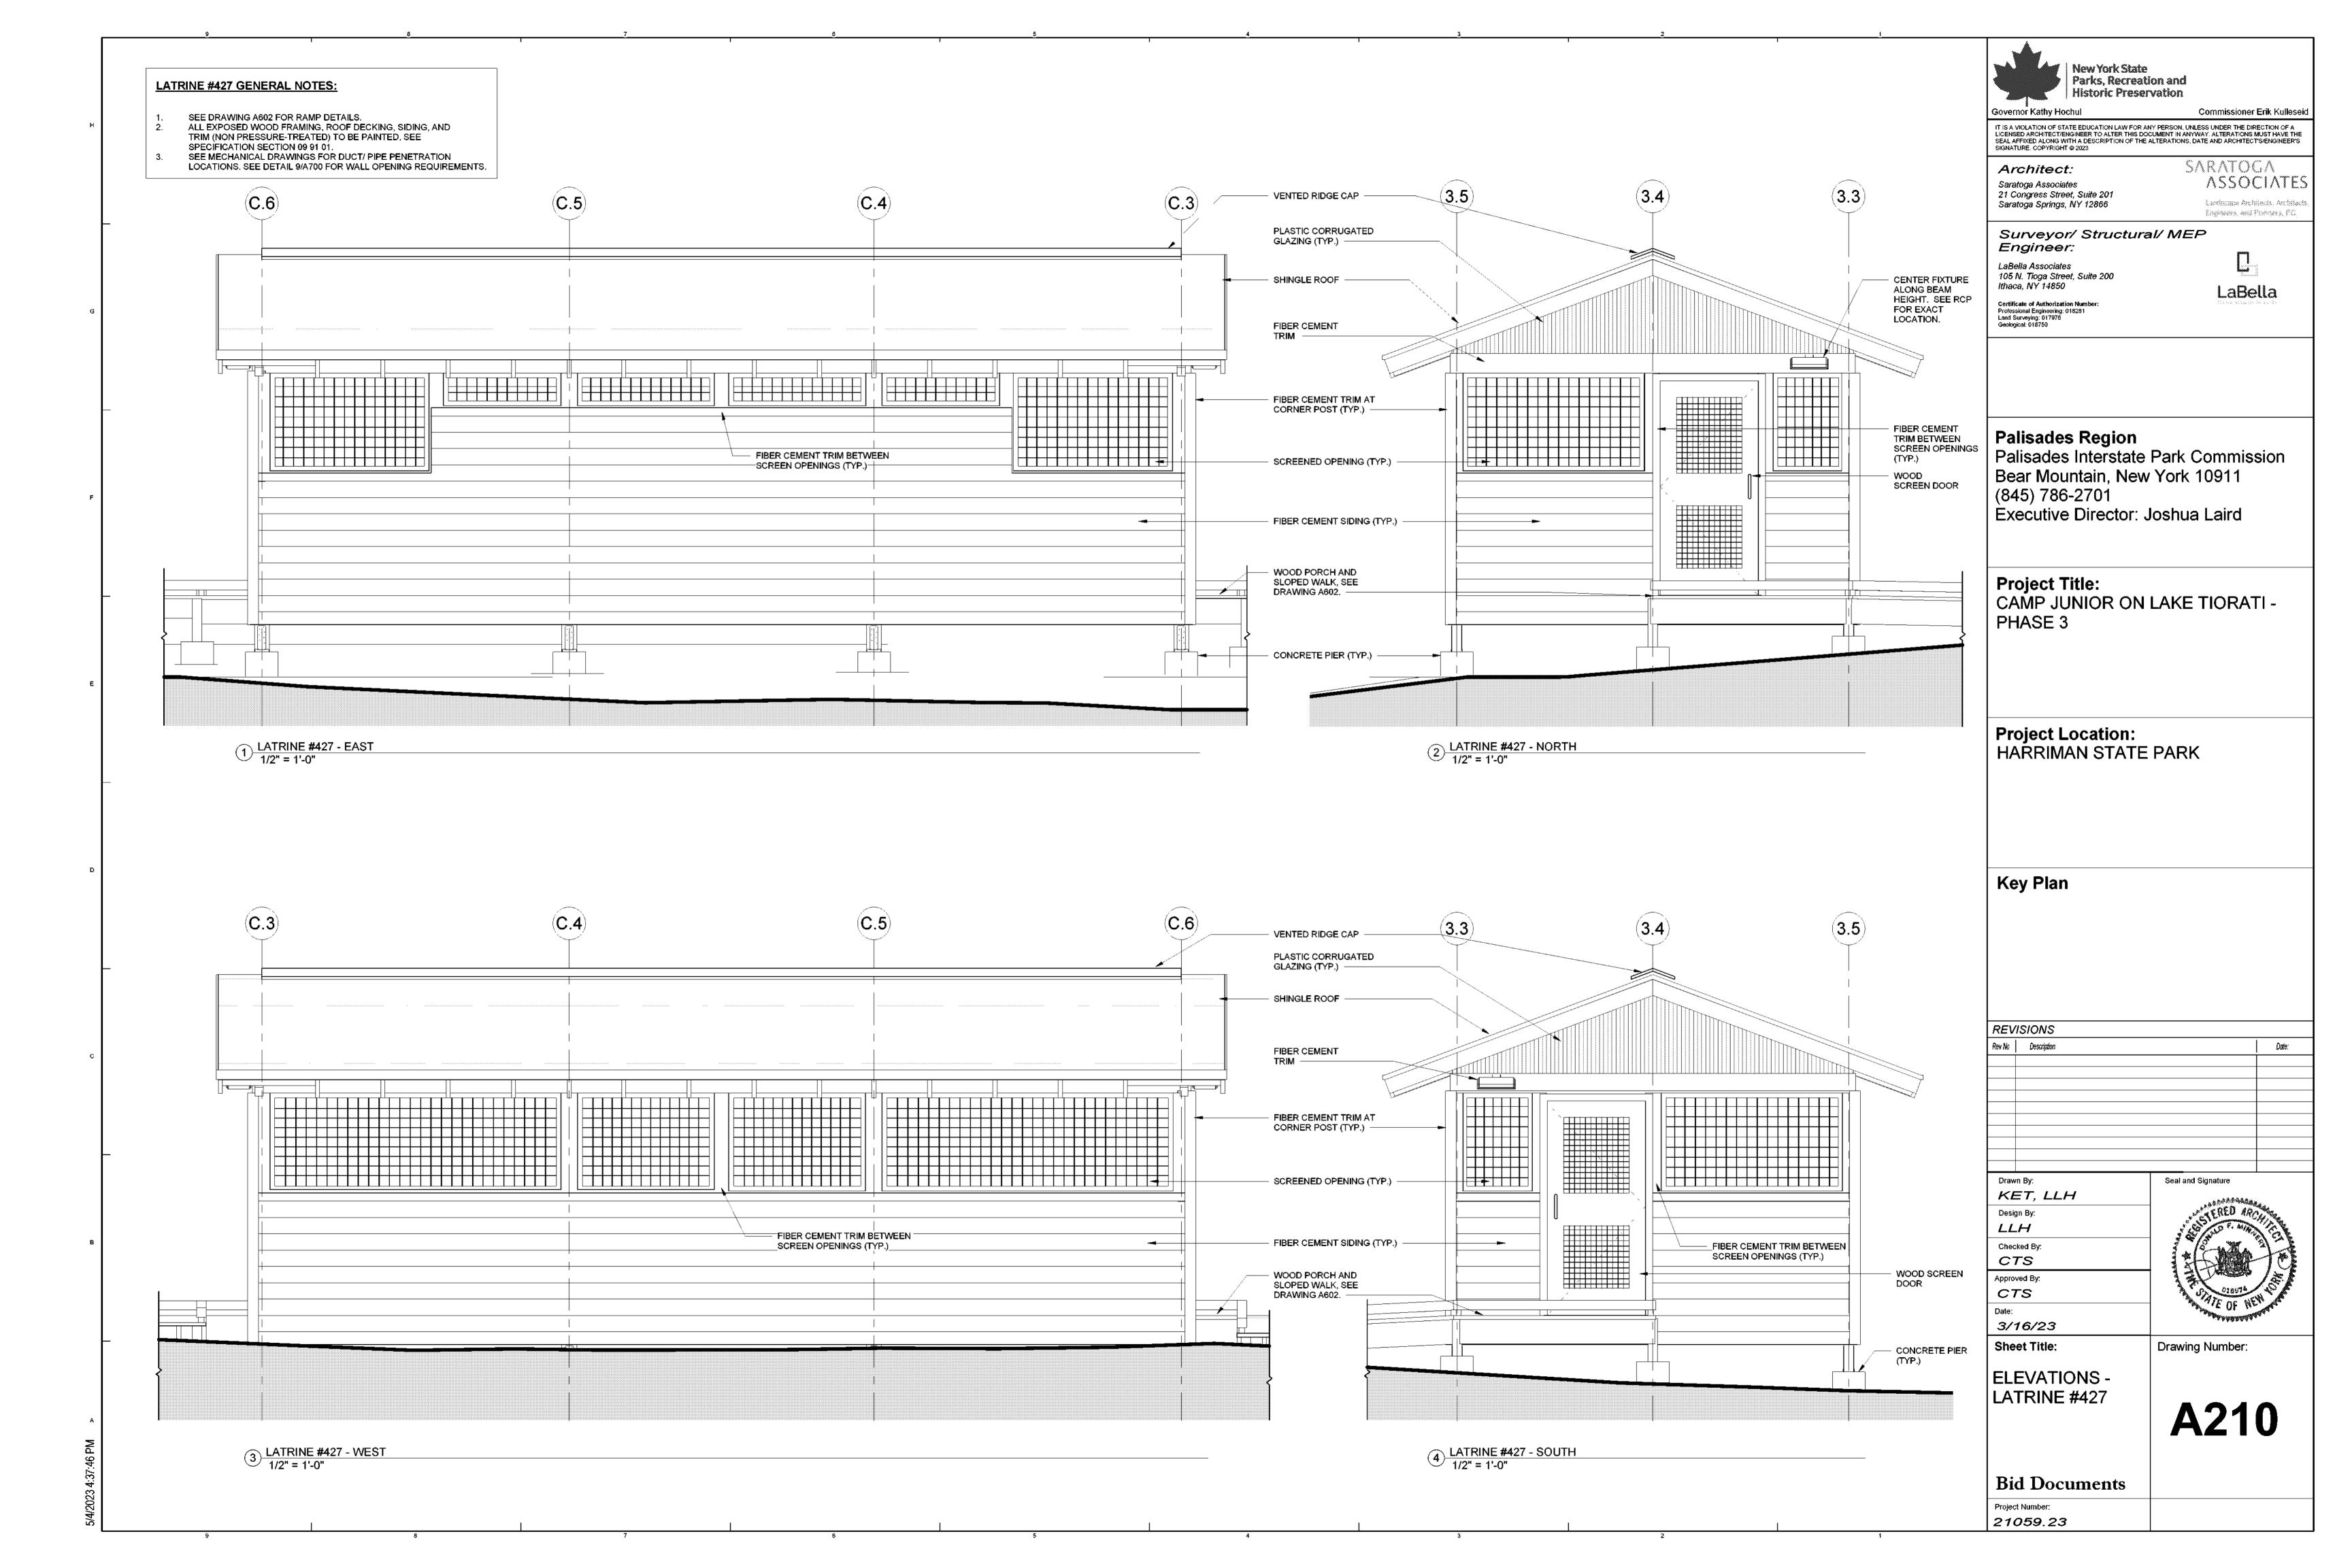


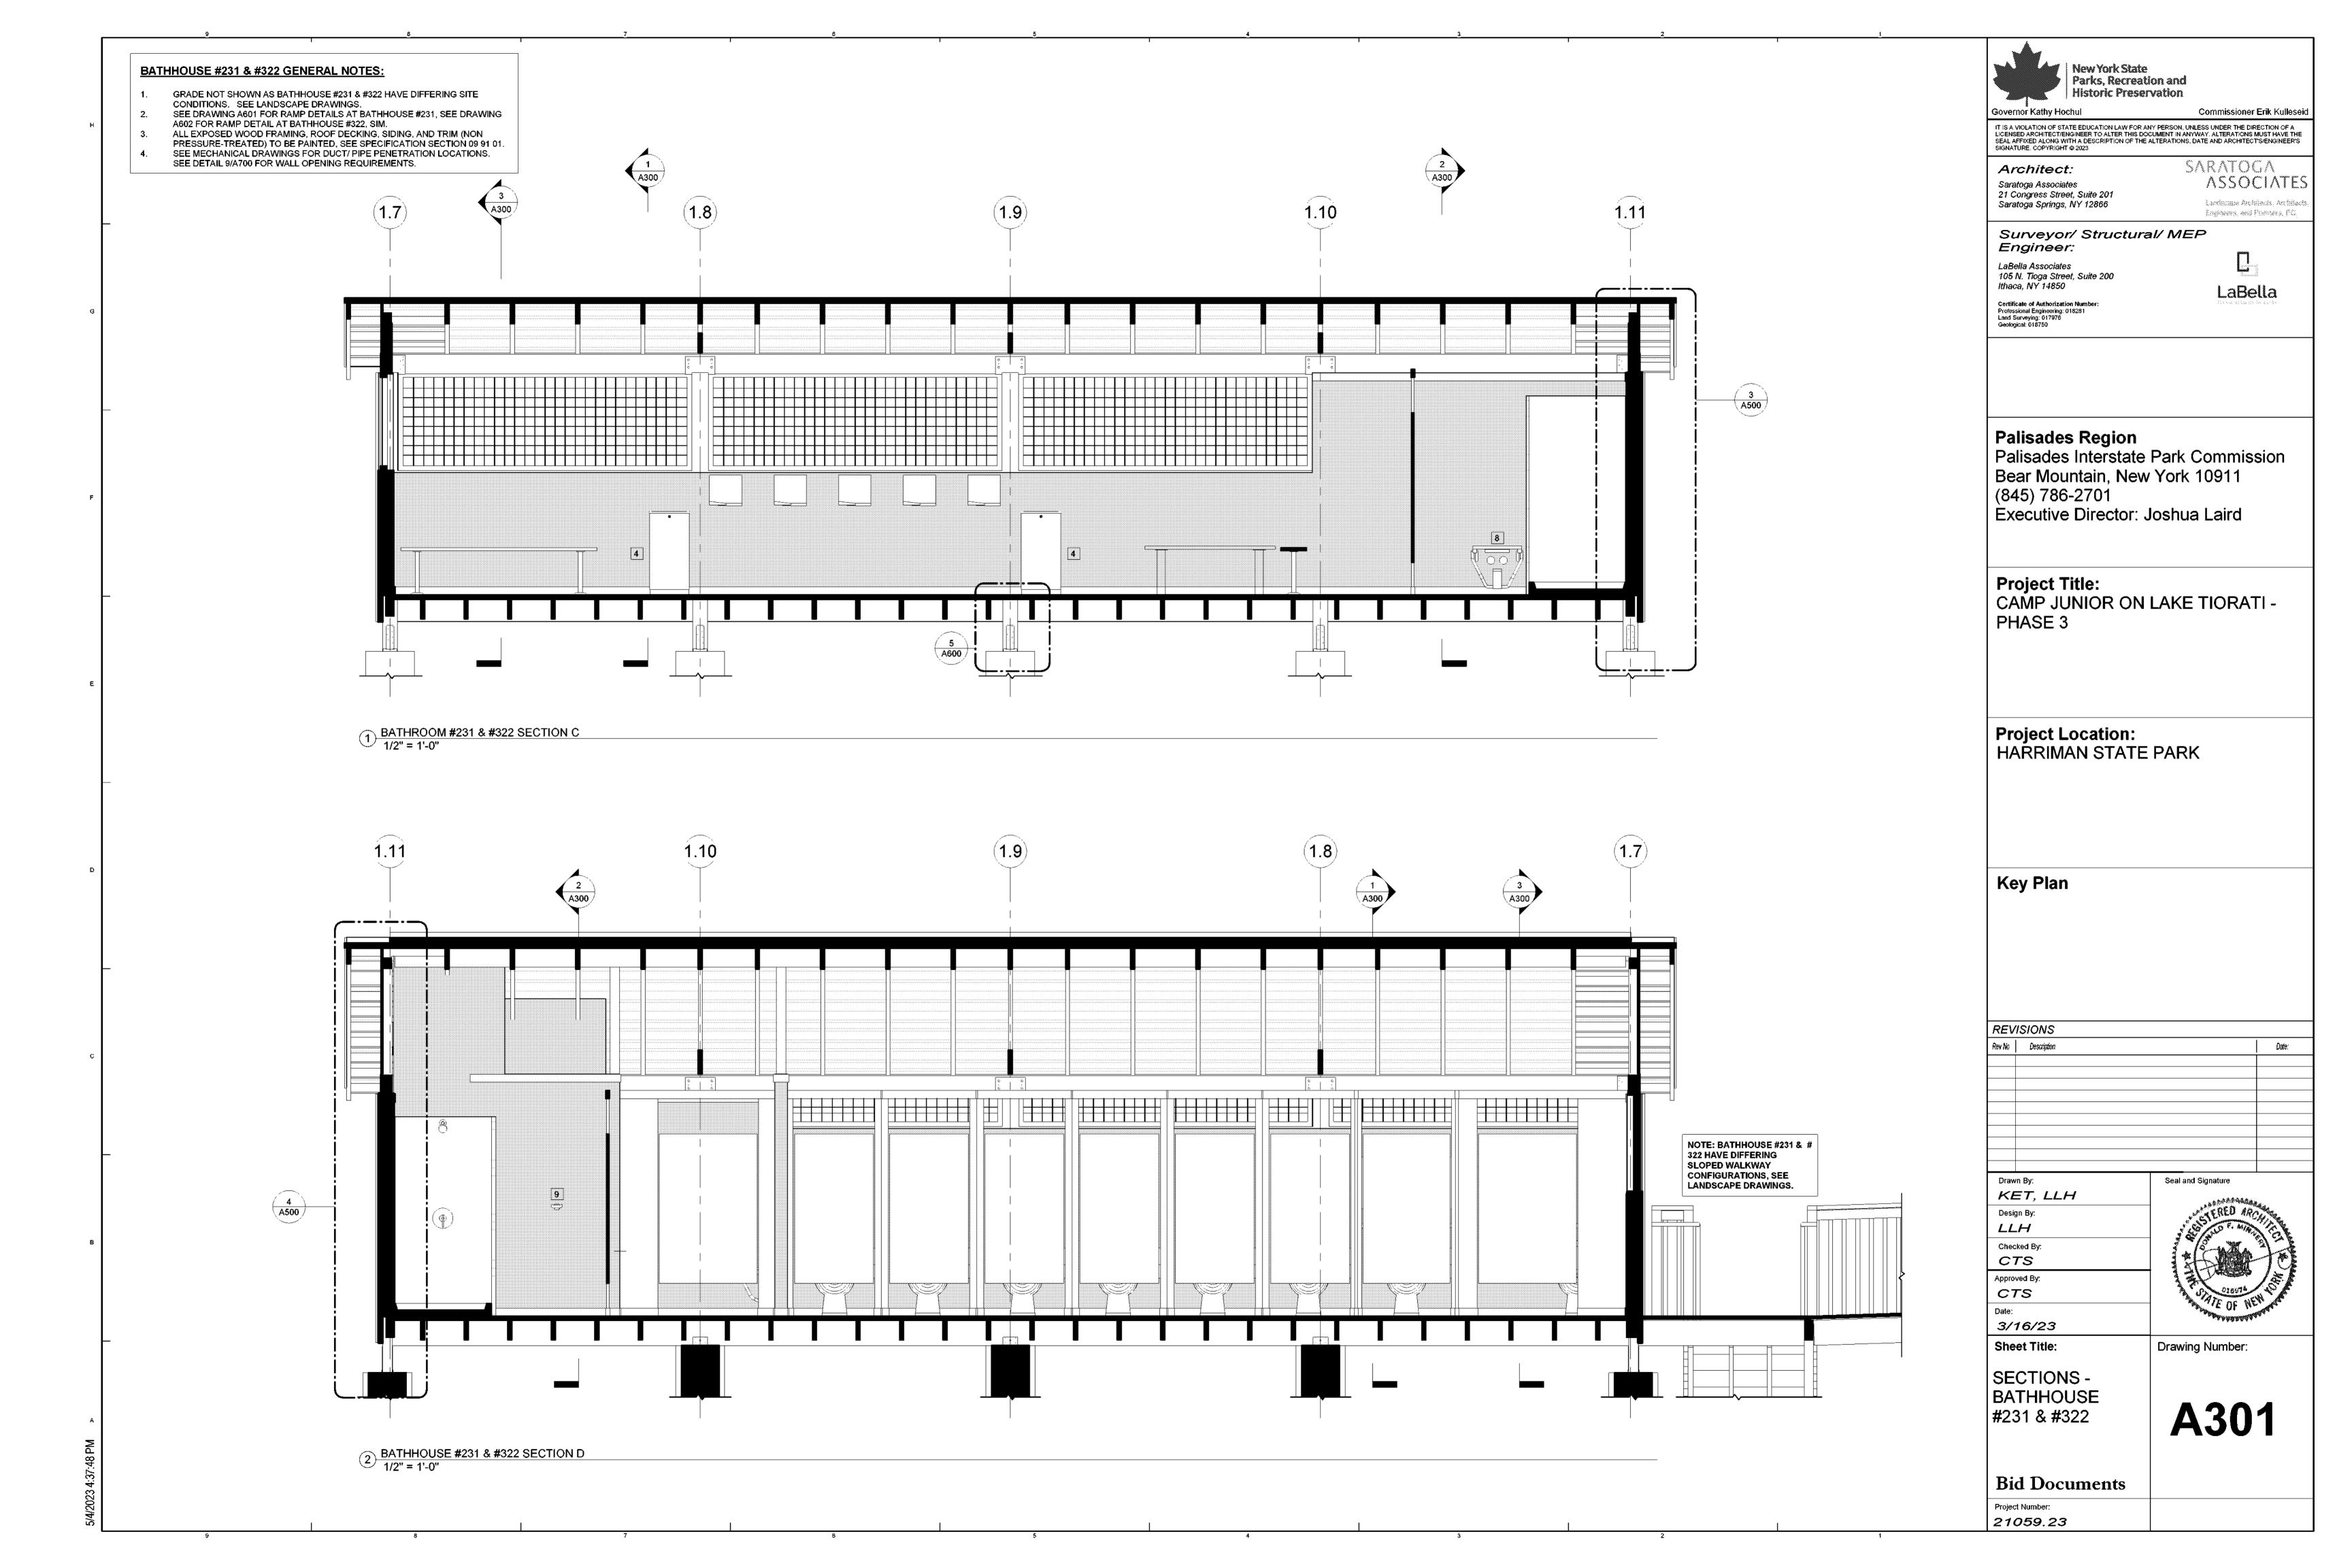

# **LATRINE #427 GENERAL NOTES:**

- SEE DRAWING A602 FOR RAMP DETAILS.
  ALL EXPOSED WOOD FRAMING, ROOF DECKING, SIDING, AND
  TRIM (NON PRESSURE-TREATED) TO BE PAINTED, SEE
  SPECIFICATION SECTION 09 91 01.
  SEE MECHANICAL DRAWINGS FOR DUCT/ PIPE PENETRATION
  LOCATIONS. SEE DETAIL 9/A700 FOR WALL OPENING REQUIREMENTS.

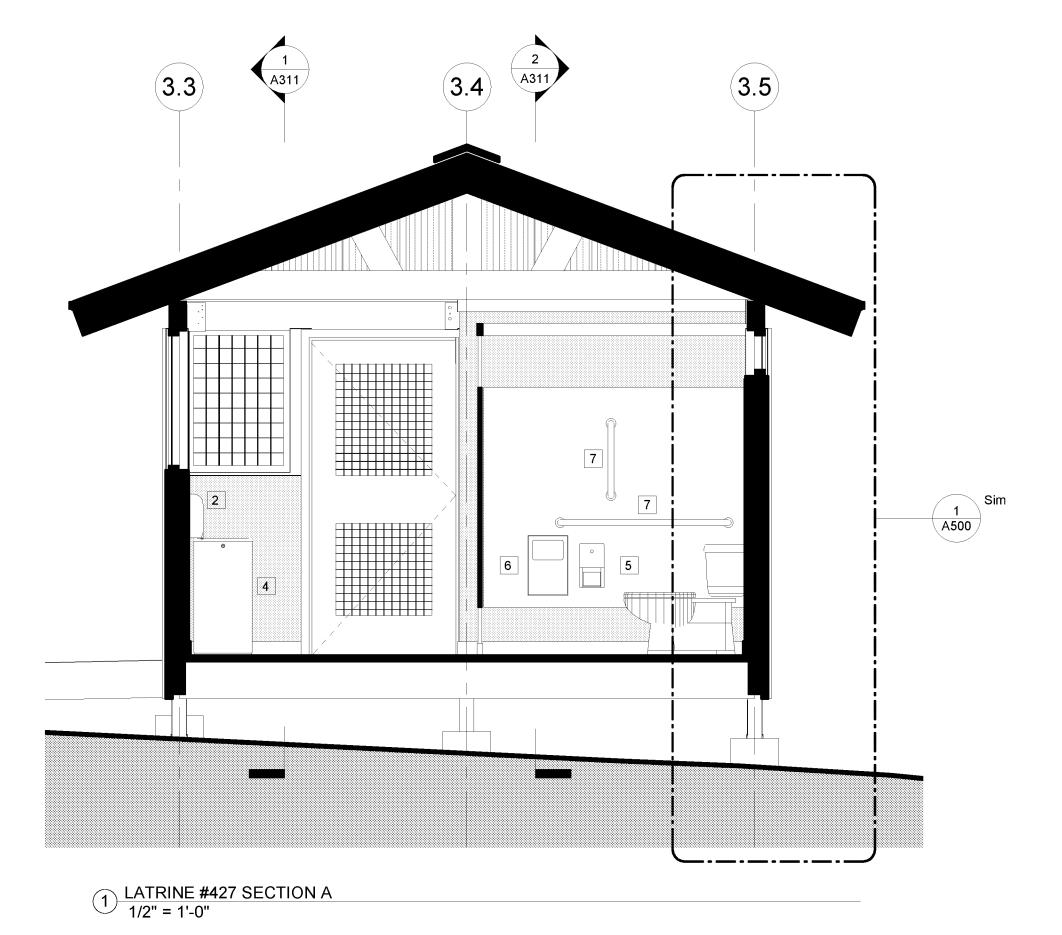

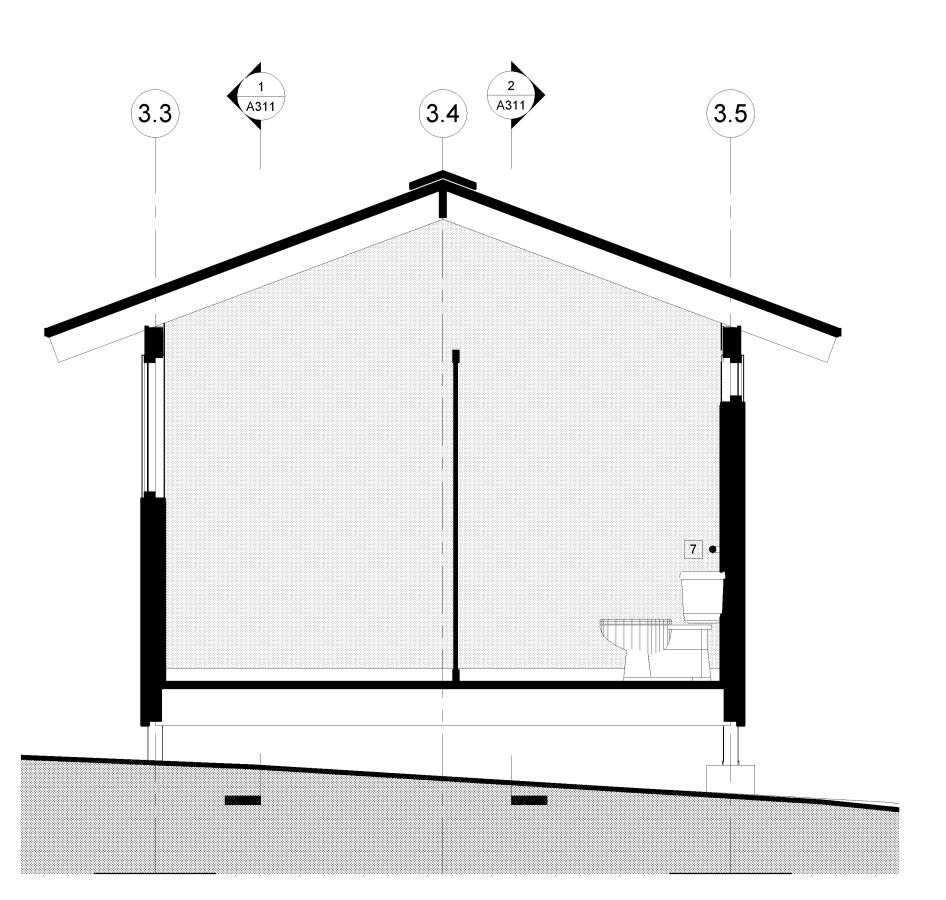

2 LATRINE #427 SECTION B 1/2" = 1'-0"



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Executive Director: Joshua Laird

Project Title: CAMP JUNIOR ON LAKE TIORATI -PHASE 3

Project Location: HARRIMAN STATE PARK

**Key Plan** 

REVISIONS Rev No Description Date:

Drawn By: KET, LLH Design By: LLH Checked By: CTSApproved By: CTS 3/16/23

Drawing Number:

Seal and Signature


SECTIONS -LATRINE #427


Sheet Title:

A310

Bid Documents Project Number:

21059.23

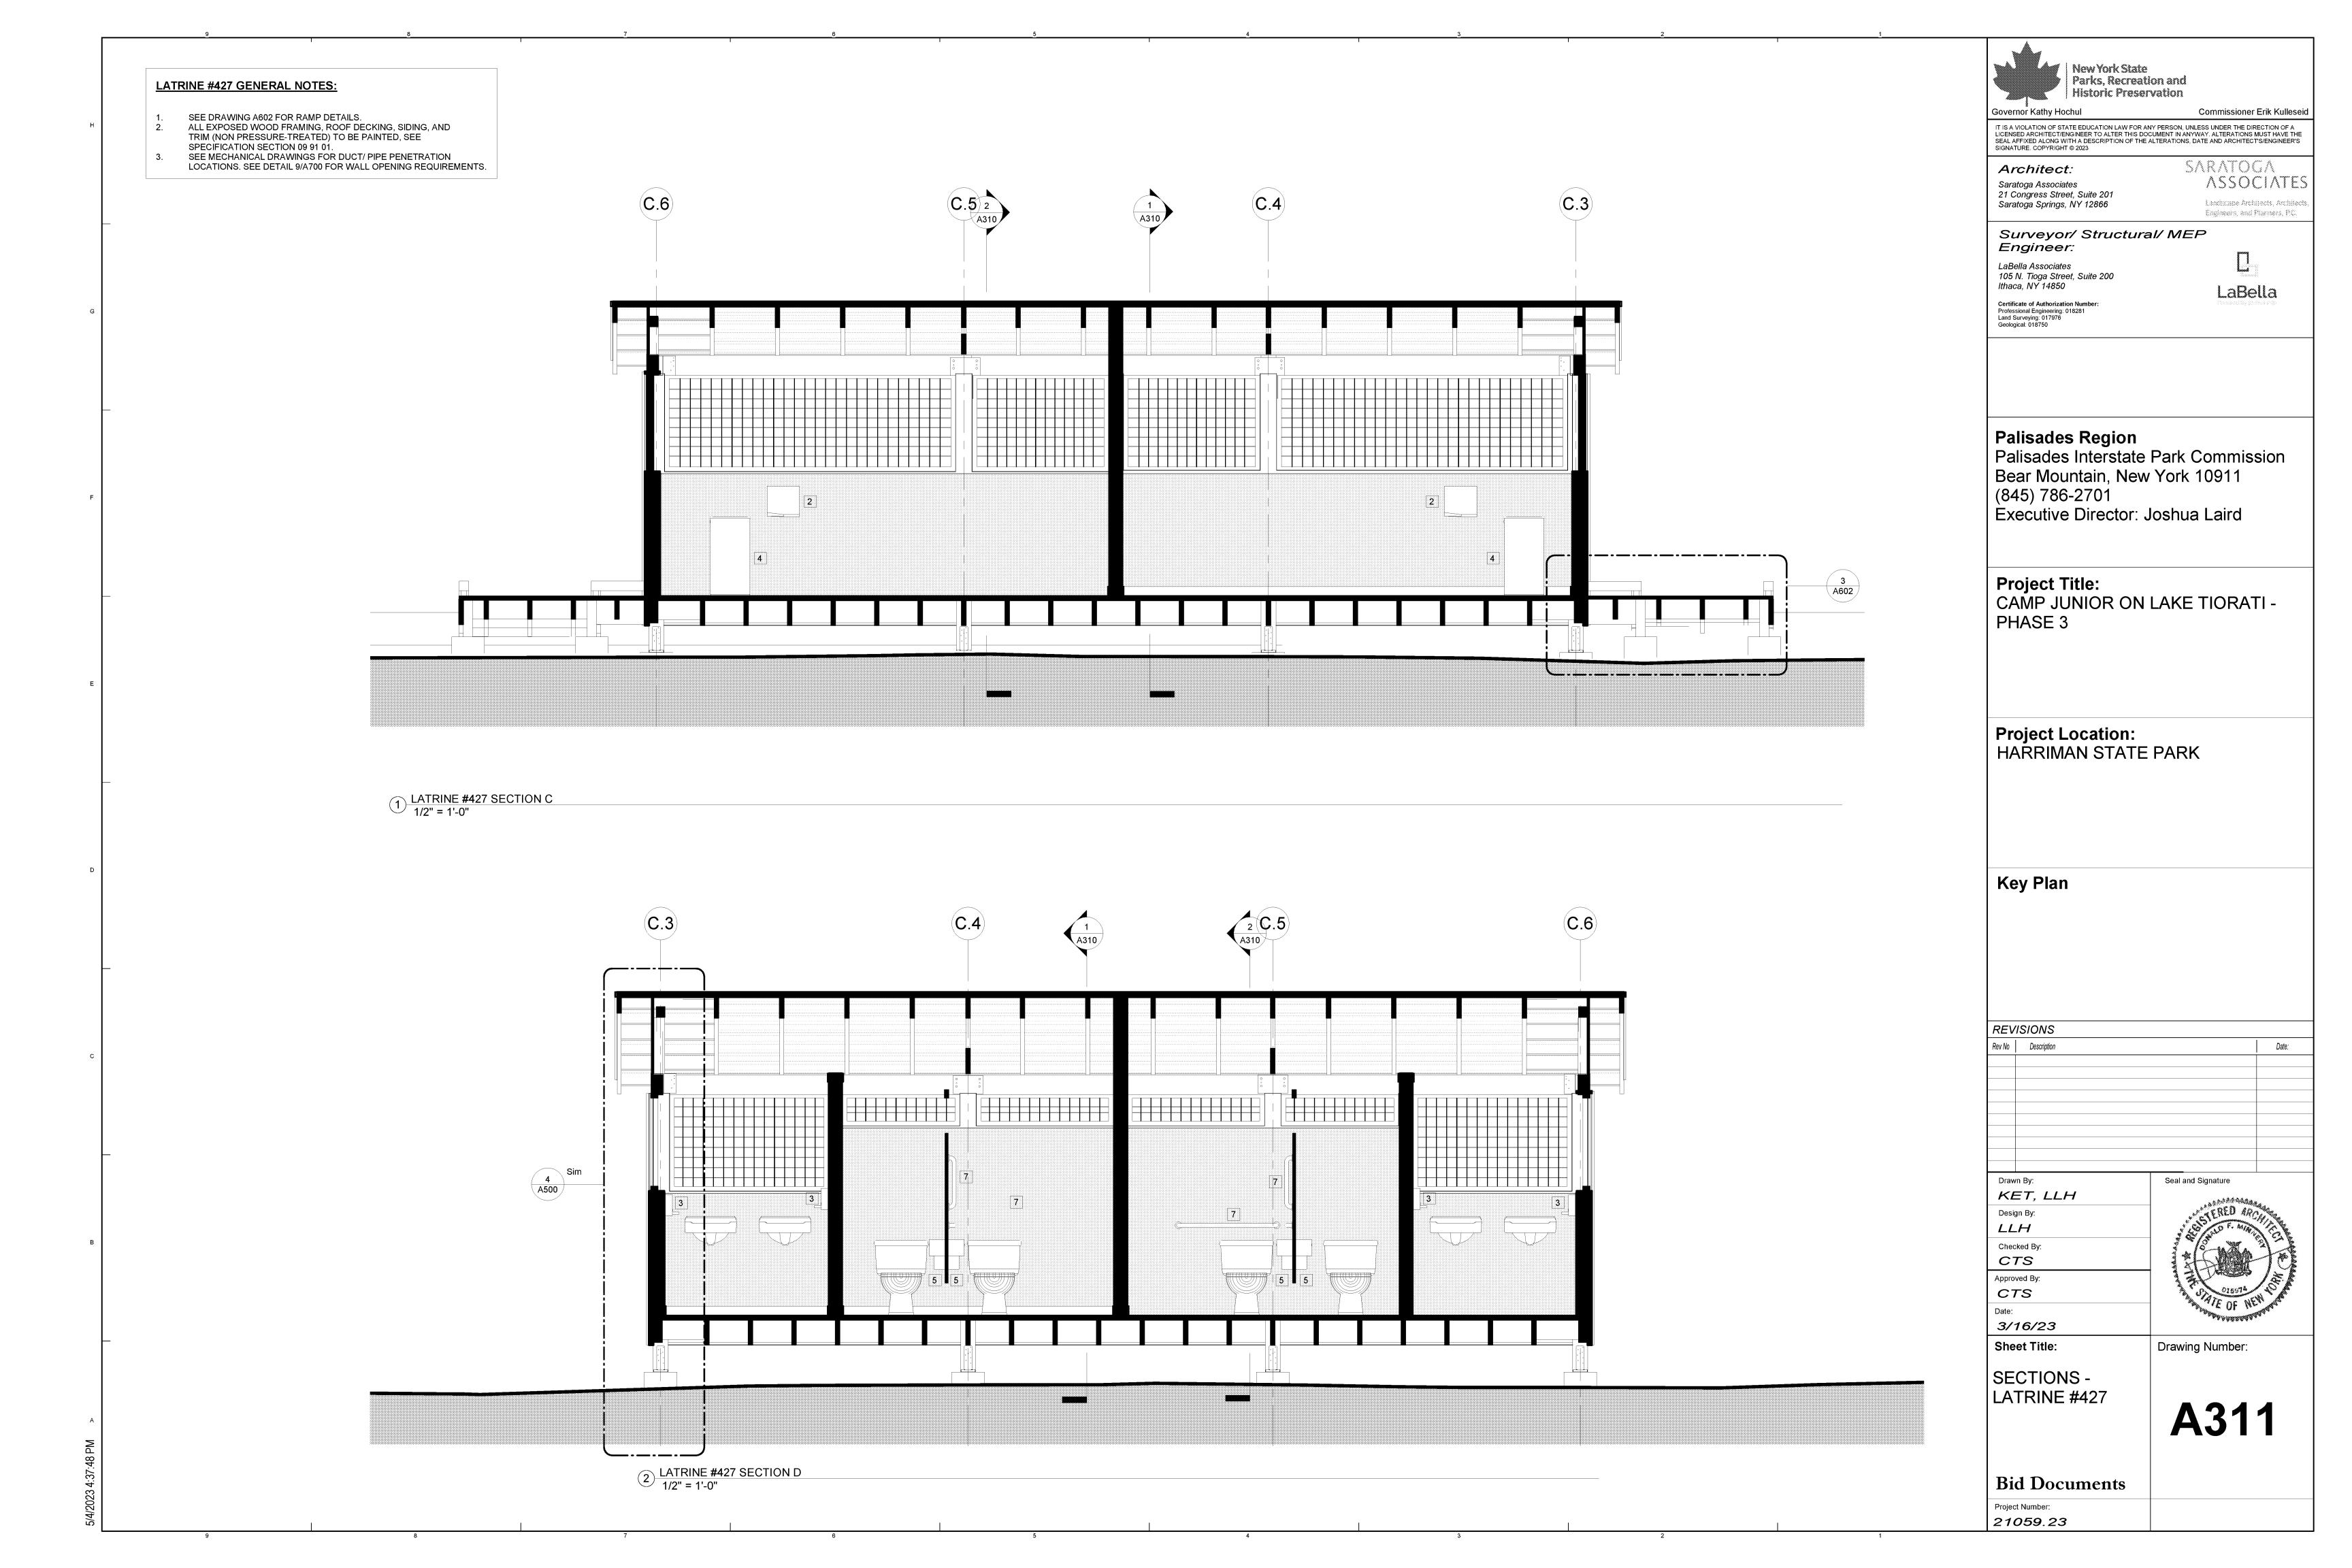

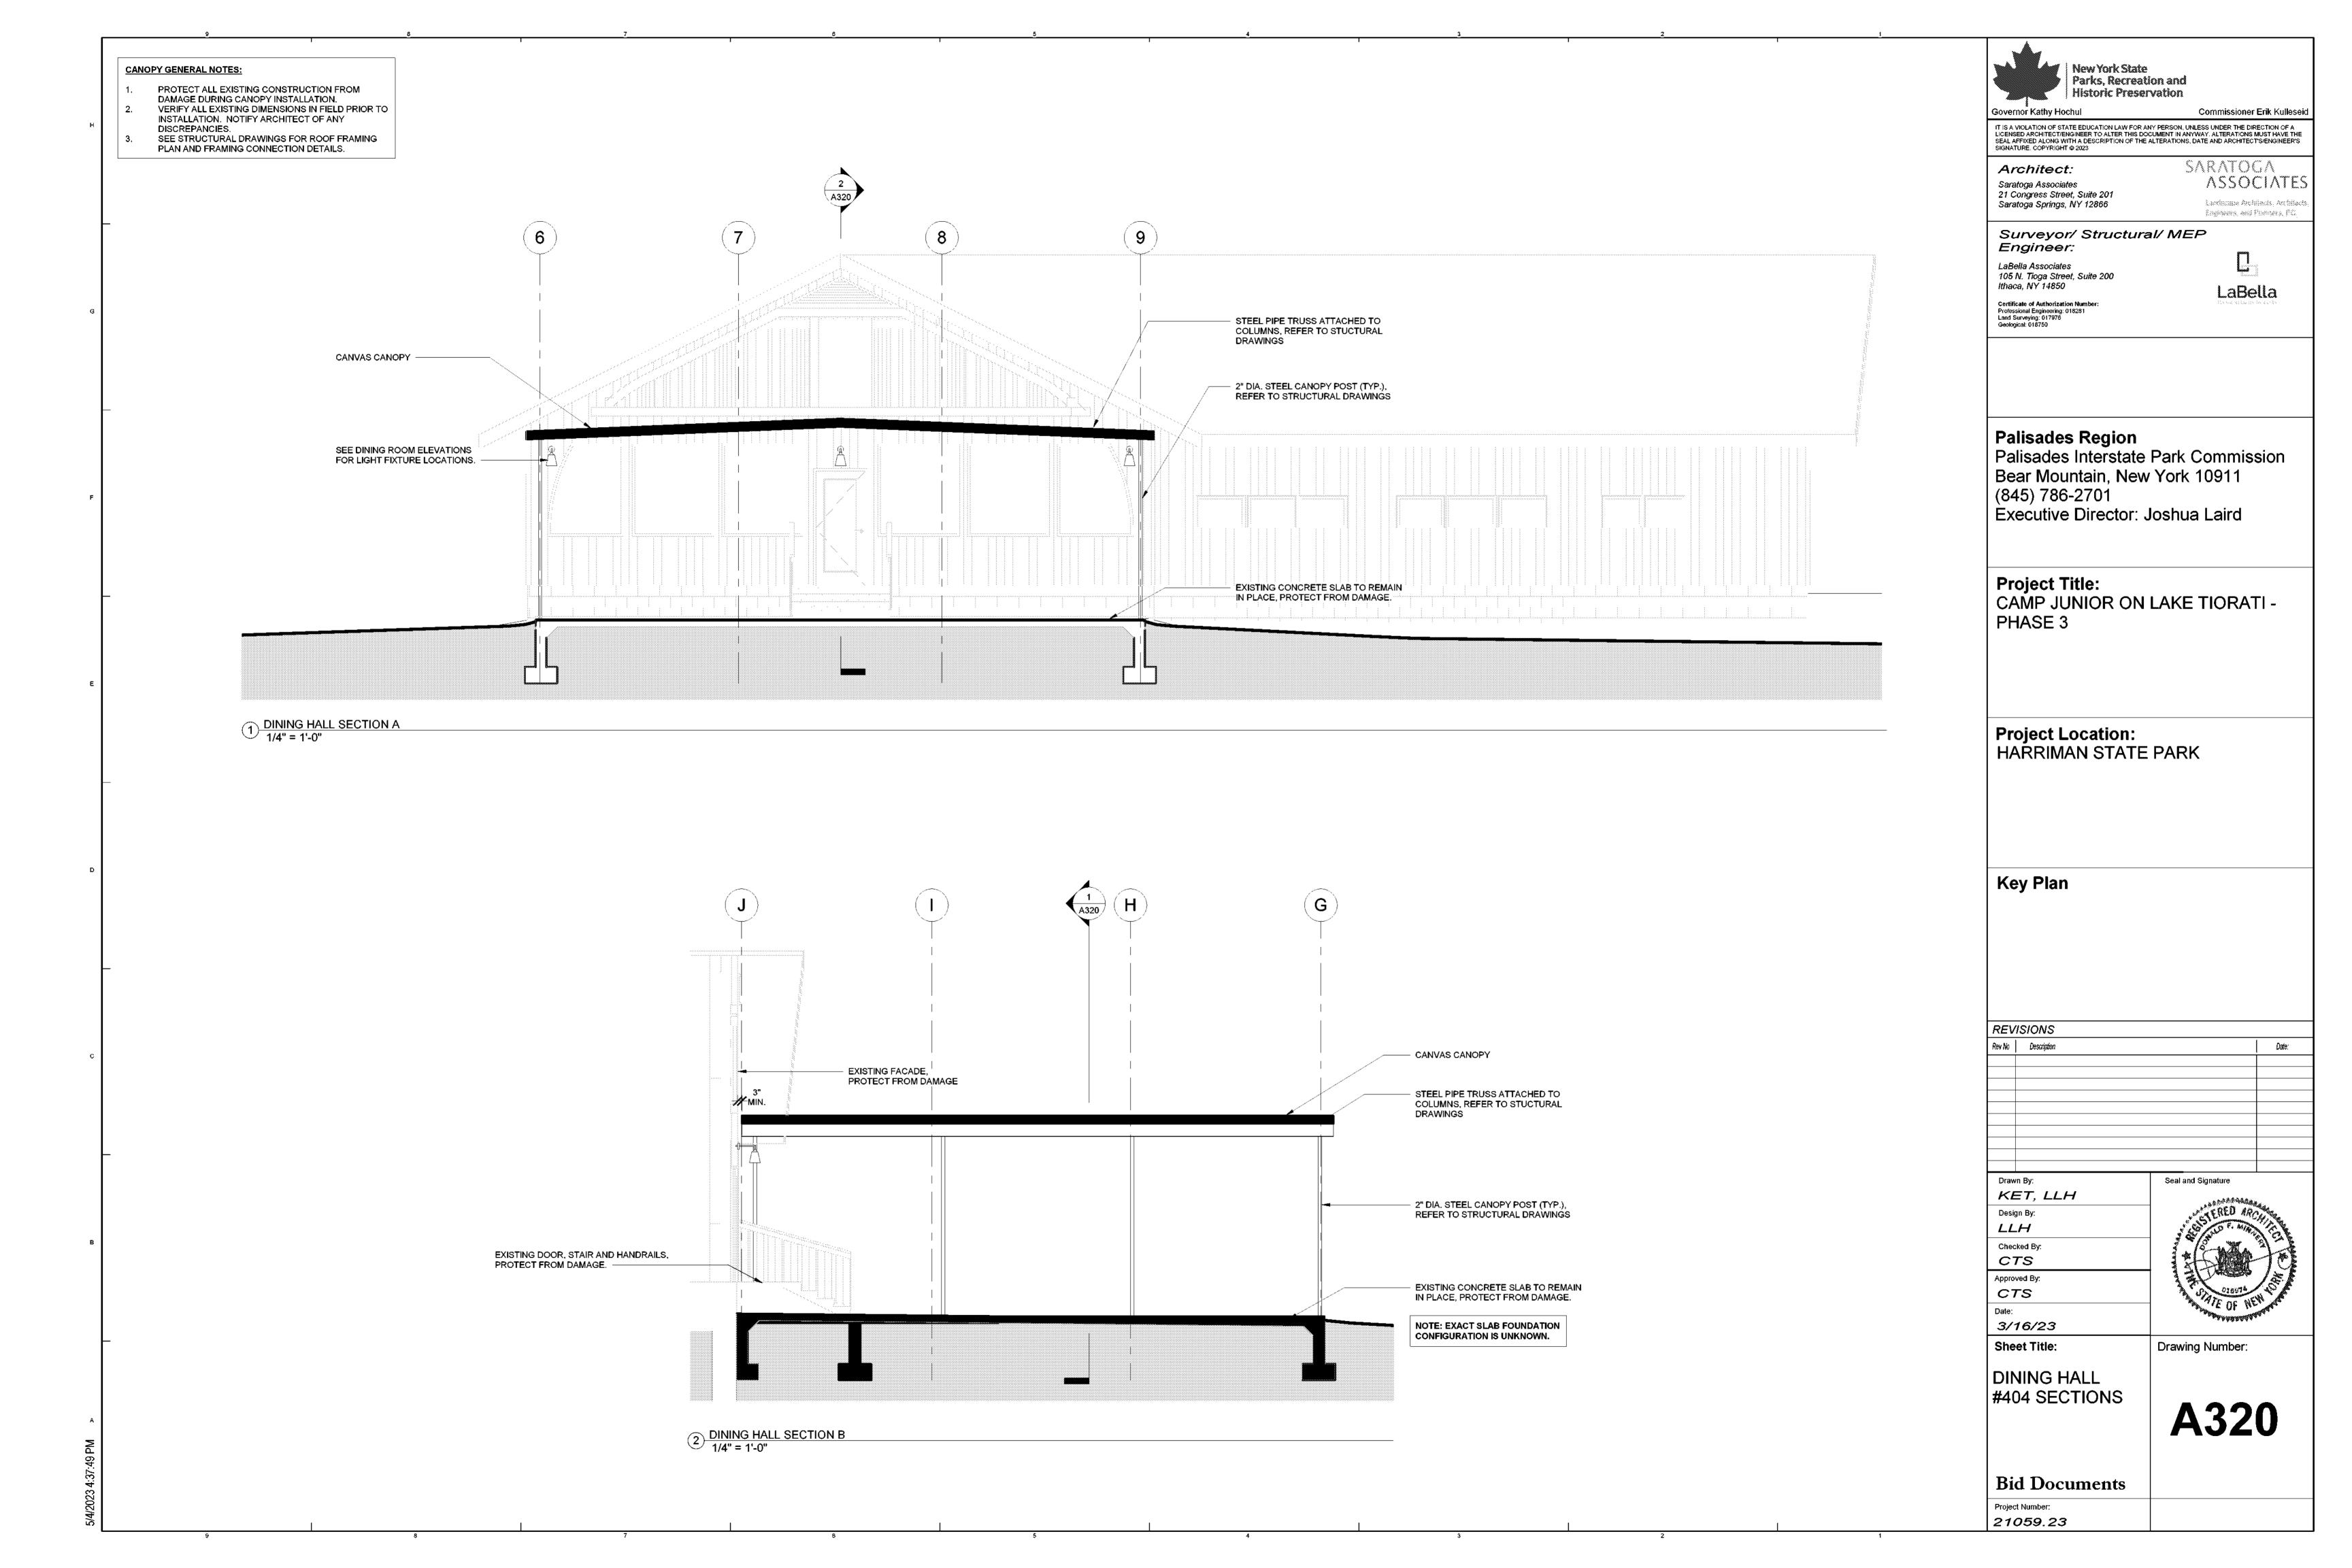

# **GENERAL NOTES:**

RAFTER ENCLOSURE

CONTINUOUS WOOD BEAM,

REFER TO STRUCT, DWGS

ALUMINUM SCREEN WITH

TRIM (TYP.) -

HARDWARE CLOTH AT INBOARD

SIDE OF OPENING, SECURE AT 6" O.C. WITH CONSTRUCTION

STAPLES PRIOR TO INSTALLING

INTERIOR

INTERIOR FINISH, SECURED TO

CONTINUOUS PT WOOD BEAM,

REFER TO STRUCT. DWGS

PT WOOD FLOOR JOISTS,

REFER TO STRUCT, DWGS

PT WOOD POST BEYOND,

REFER TO STRUCT. DWGS

STUDS, PER ROOM FINISH

SCHEDULE

1x6 COMPOSITE

DECKING

- ALL EXTERIOR SIDING AND TRIM SHALL BE SYNTHETIC (FIBER CEMENT), PRE-PRIMED AND FIELD-PAINTED,
- UNLESS OTHERWISE NOTED. SEE SPECIFICATIONS SECTIONS 07 46 49 AND 09 91 01. SCREEN 1X TRIM SHALL BE SIZED PER DRAWINGS, AND FROM S4S CEDAR, GRADE C AND BETTER CLEAR.
- SEE SPECIFICATIONS SECTION 07 62 00 FOR SHEET METAL FLASHING AT EXTERIOR WALLS.
- SEAL ALL EXPOSED WOOD AT INTERIOR WITH SPAR MARINE VARNISH. SEE SPECIFICATIONS SECTION 09 91 23. SEE MECHANICAL DRAWINGS FOR DUCT/ PIPE PENETRATION LOCATIONS. SEE DETAIL 9/A700 FOR WALL
- OPENING REQUIREMENTS.
- COORDINATE FLOOR FRAMING WITH PLUMBING CONTRACTOR AND ADJUST FLOOR FRAMING AS REQUIRED FOR TOILET, SHOWER AND MOP SINK OUTLETS, PROVIDING HEADERS THE SAME SIZE AS FLOOR JOISTS WITH STEEL JOIST HANGERS AS REQUIRED. PROVIDE SOLID BLOCKING UNDER FLOOR DECK AND BETWEEN FLOOR JOISTS AT/ UNDER SUCH PLUMBING FIXTURES AS REQUIRED AND SIMILAR TO DETAIL 7/A600.

ASPHALT SHINGLES

T&G WOOD

EXTERIOR

+3' - 9 3/4" SILL HEIGHT (TYP.)

FIBER CEMENT SIDING

1/2" SHEATHING PANELS WITH

2X4 WOOD STUD @ 16" O.C.

INTEGRATED WEATHER BARRIER

FIN. FLOOR

STEEL POST BASE

CONCRETE FOUNDATION POST,

REFER TO STRUCT. DWGS

+5' - 9 3/4" SILL HEIGHT

(AT TOILET STALLS)

1/2" X 3 1/2" PVC

CONTINUOUS PT WOOD

GIRDER, REFER TO STRUCT.

BASEBOARD

DWGS

1" = 1'-0"

BATHHOUSE #231 & 322 WALL SECTION A

1" = 1'-0"

ROOF DECKING

ROOF RAFTER.

REFER TO STRUCT.

ASPHALT SHINGLES

STRUCT. DWGS -

T&G WOOD ROOF

DECKING -

ROOF RAFTER, REFER TO

1X8 TRIM OVER ALUMINUM DRIP

AROUND RAFTERS (TYPICAL AT

**EXTERIOR** 

FLASHING, NOTCH TIGHT TO/

BUILDING PERIMETER)

FIBER CEMENT SIDING

1/2" SHEATHING PANELS

2X4 WOOD STUD @ 16" O.C.

WITH INTEGRATED


PT BOTTOM PLATE

PT WOOD POST BEYOND,

REFER TO STRUCT, DWGS

WEATHER BARRIER

TOP PLATE

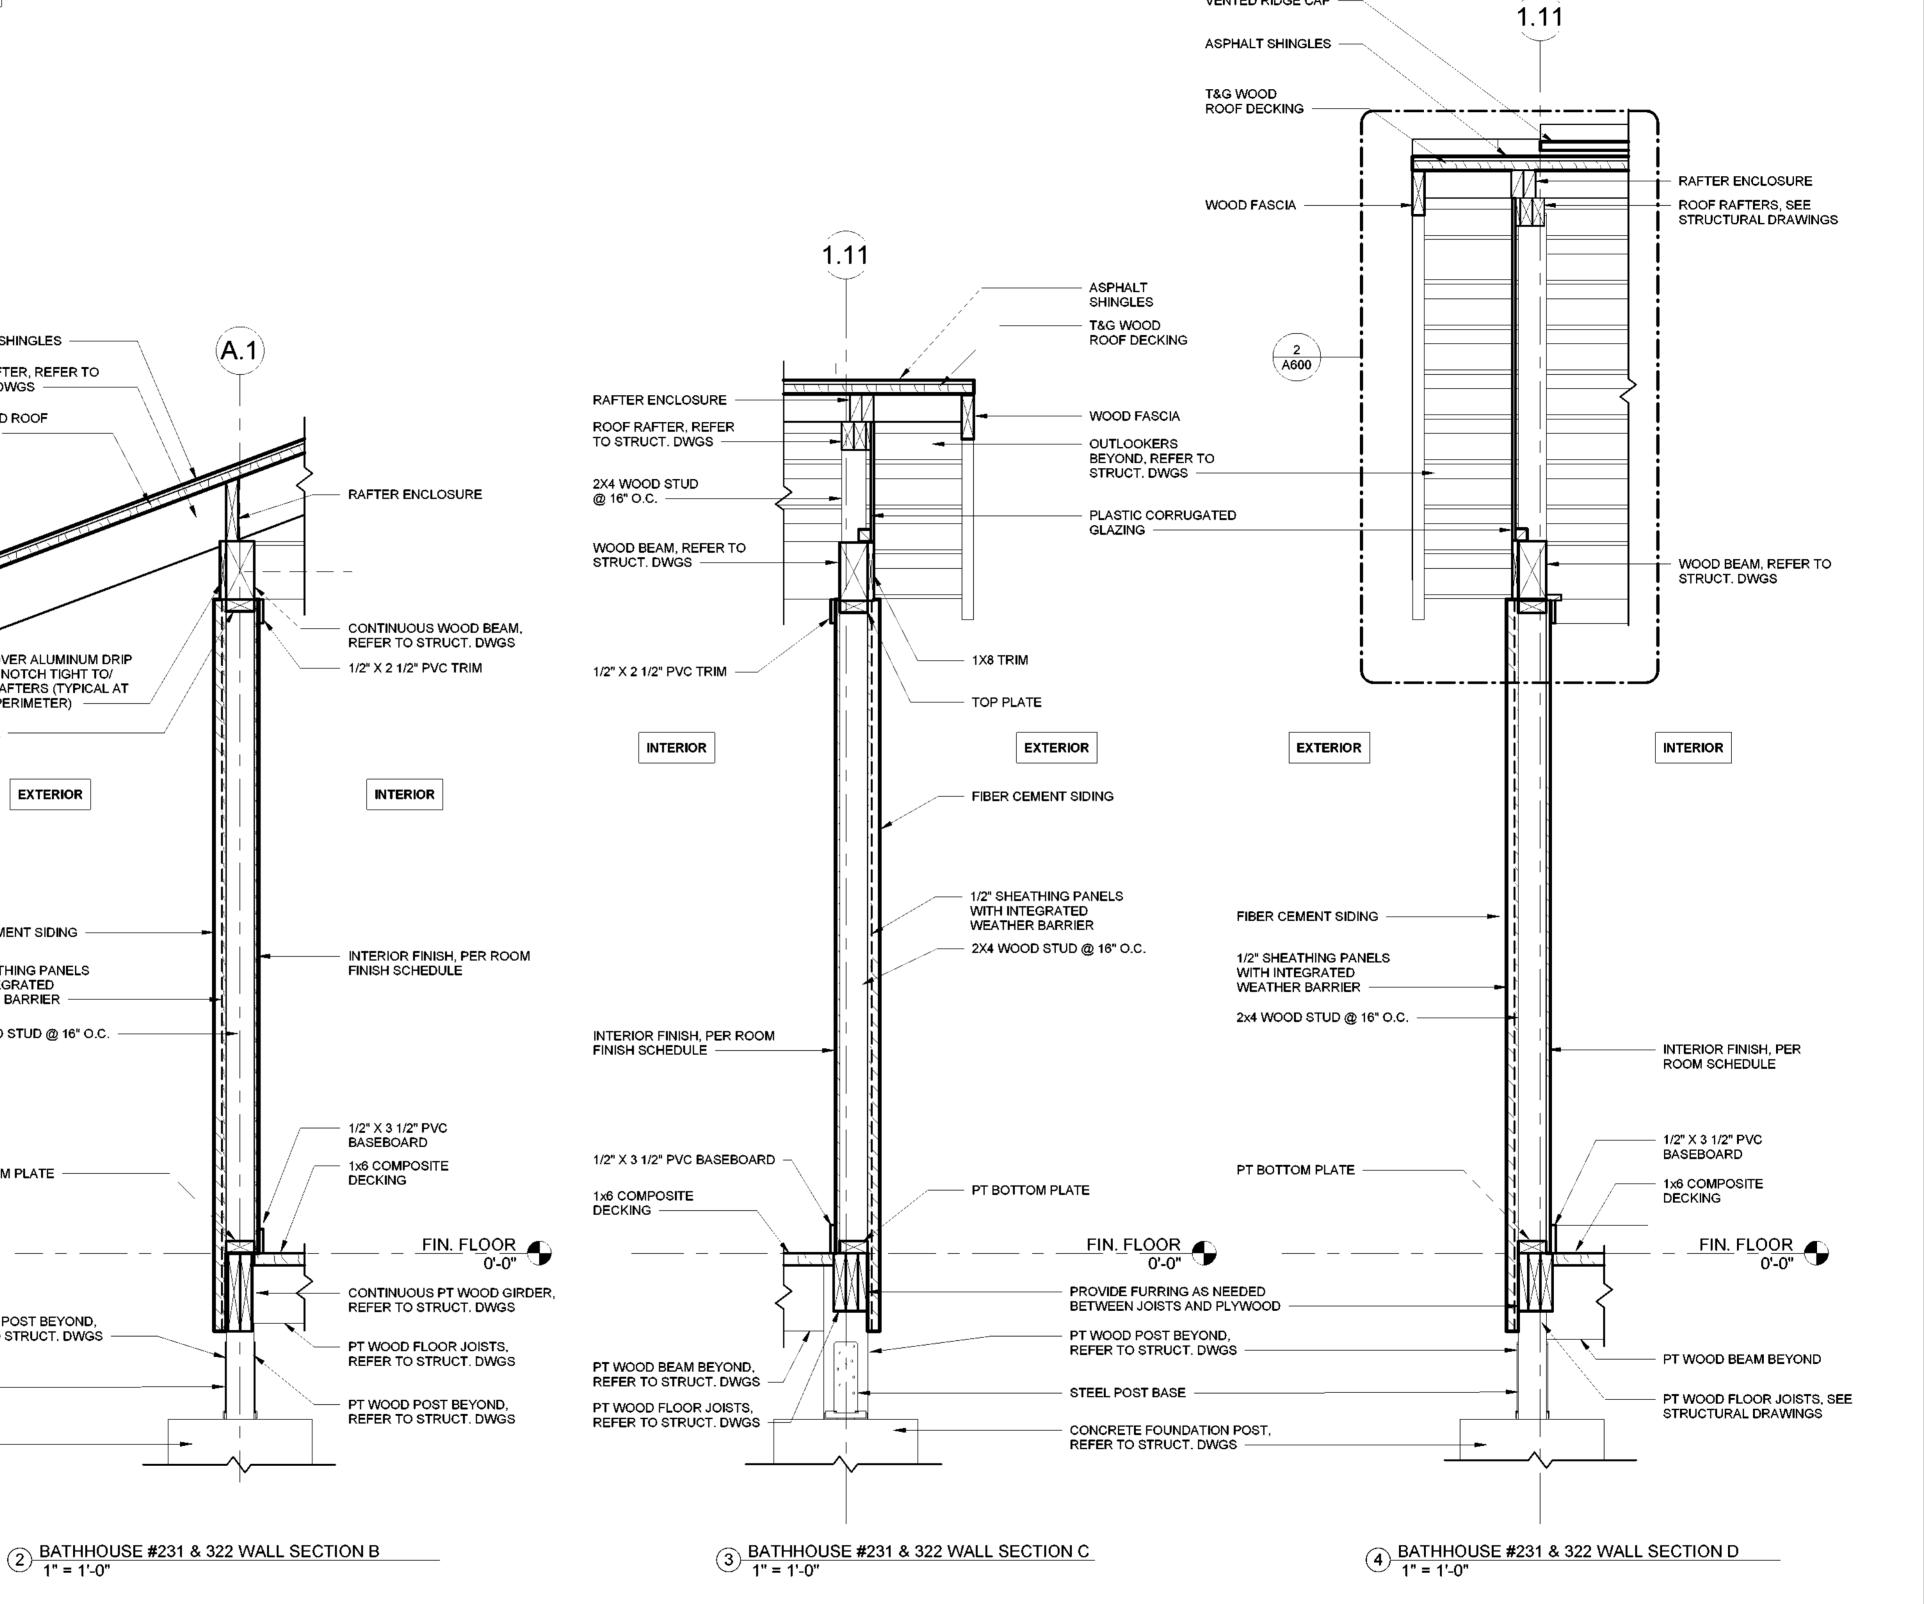

VENTED RIDGE CAP -



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Palisades Region

Palisades Interstate Park Commission Bear Mountain, New York 10911 (845) 786-2701 Executive Director: Joshua Laird

Project Title: CAMP JUNIOR ON LAKE TIORATI -

**Project Location:** HARRIMAN STATE PARK

Key Plan

PHASE 3

**REVISIONS** Rev No Description Date: Drawn By: Seal and Signature

KET, LLH Design By: Checked By: CTS Approved By: CTS

Drawing Number:


BATHHOUSE #231 & #322 WALL SECTIONS


3/16/23


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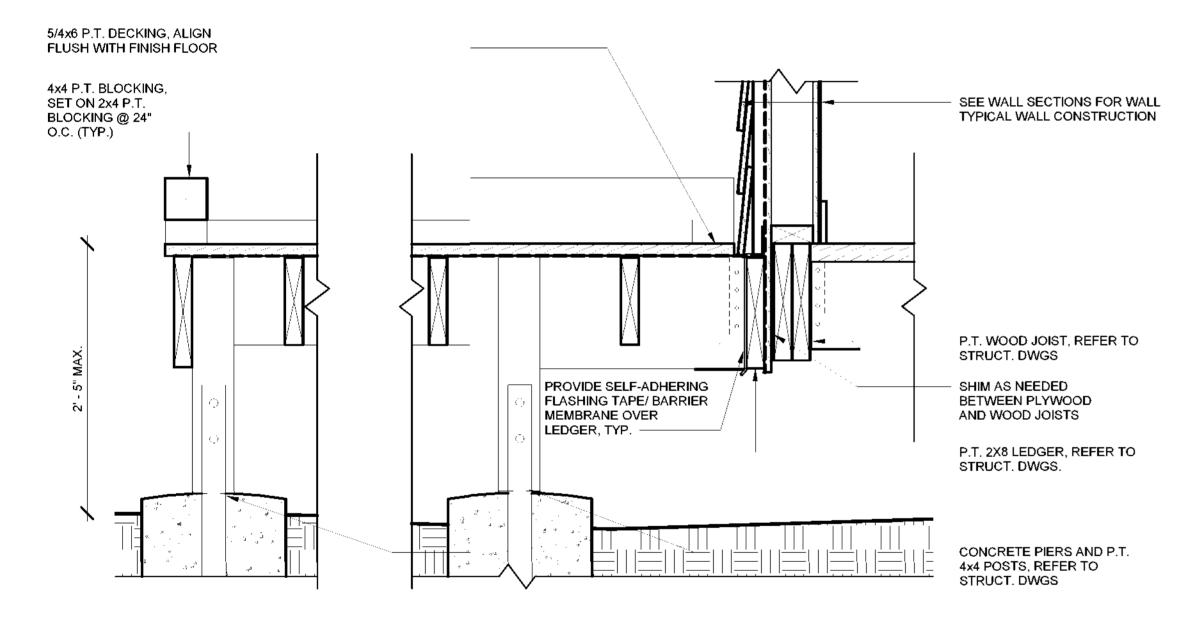
**Bid Documents** Project Number:





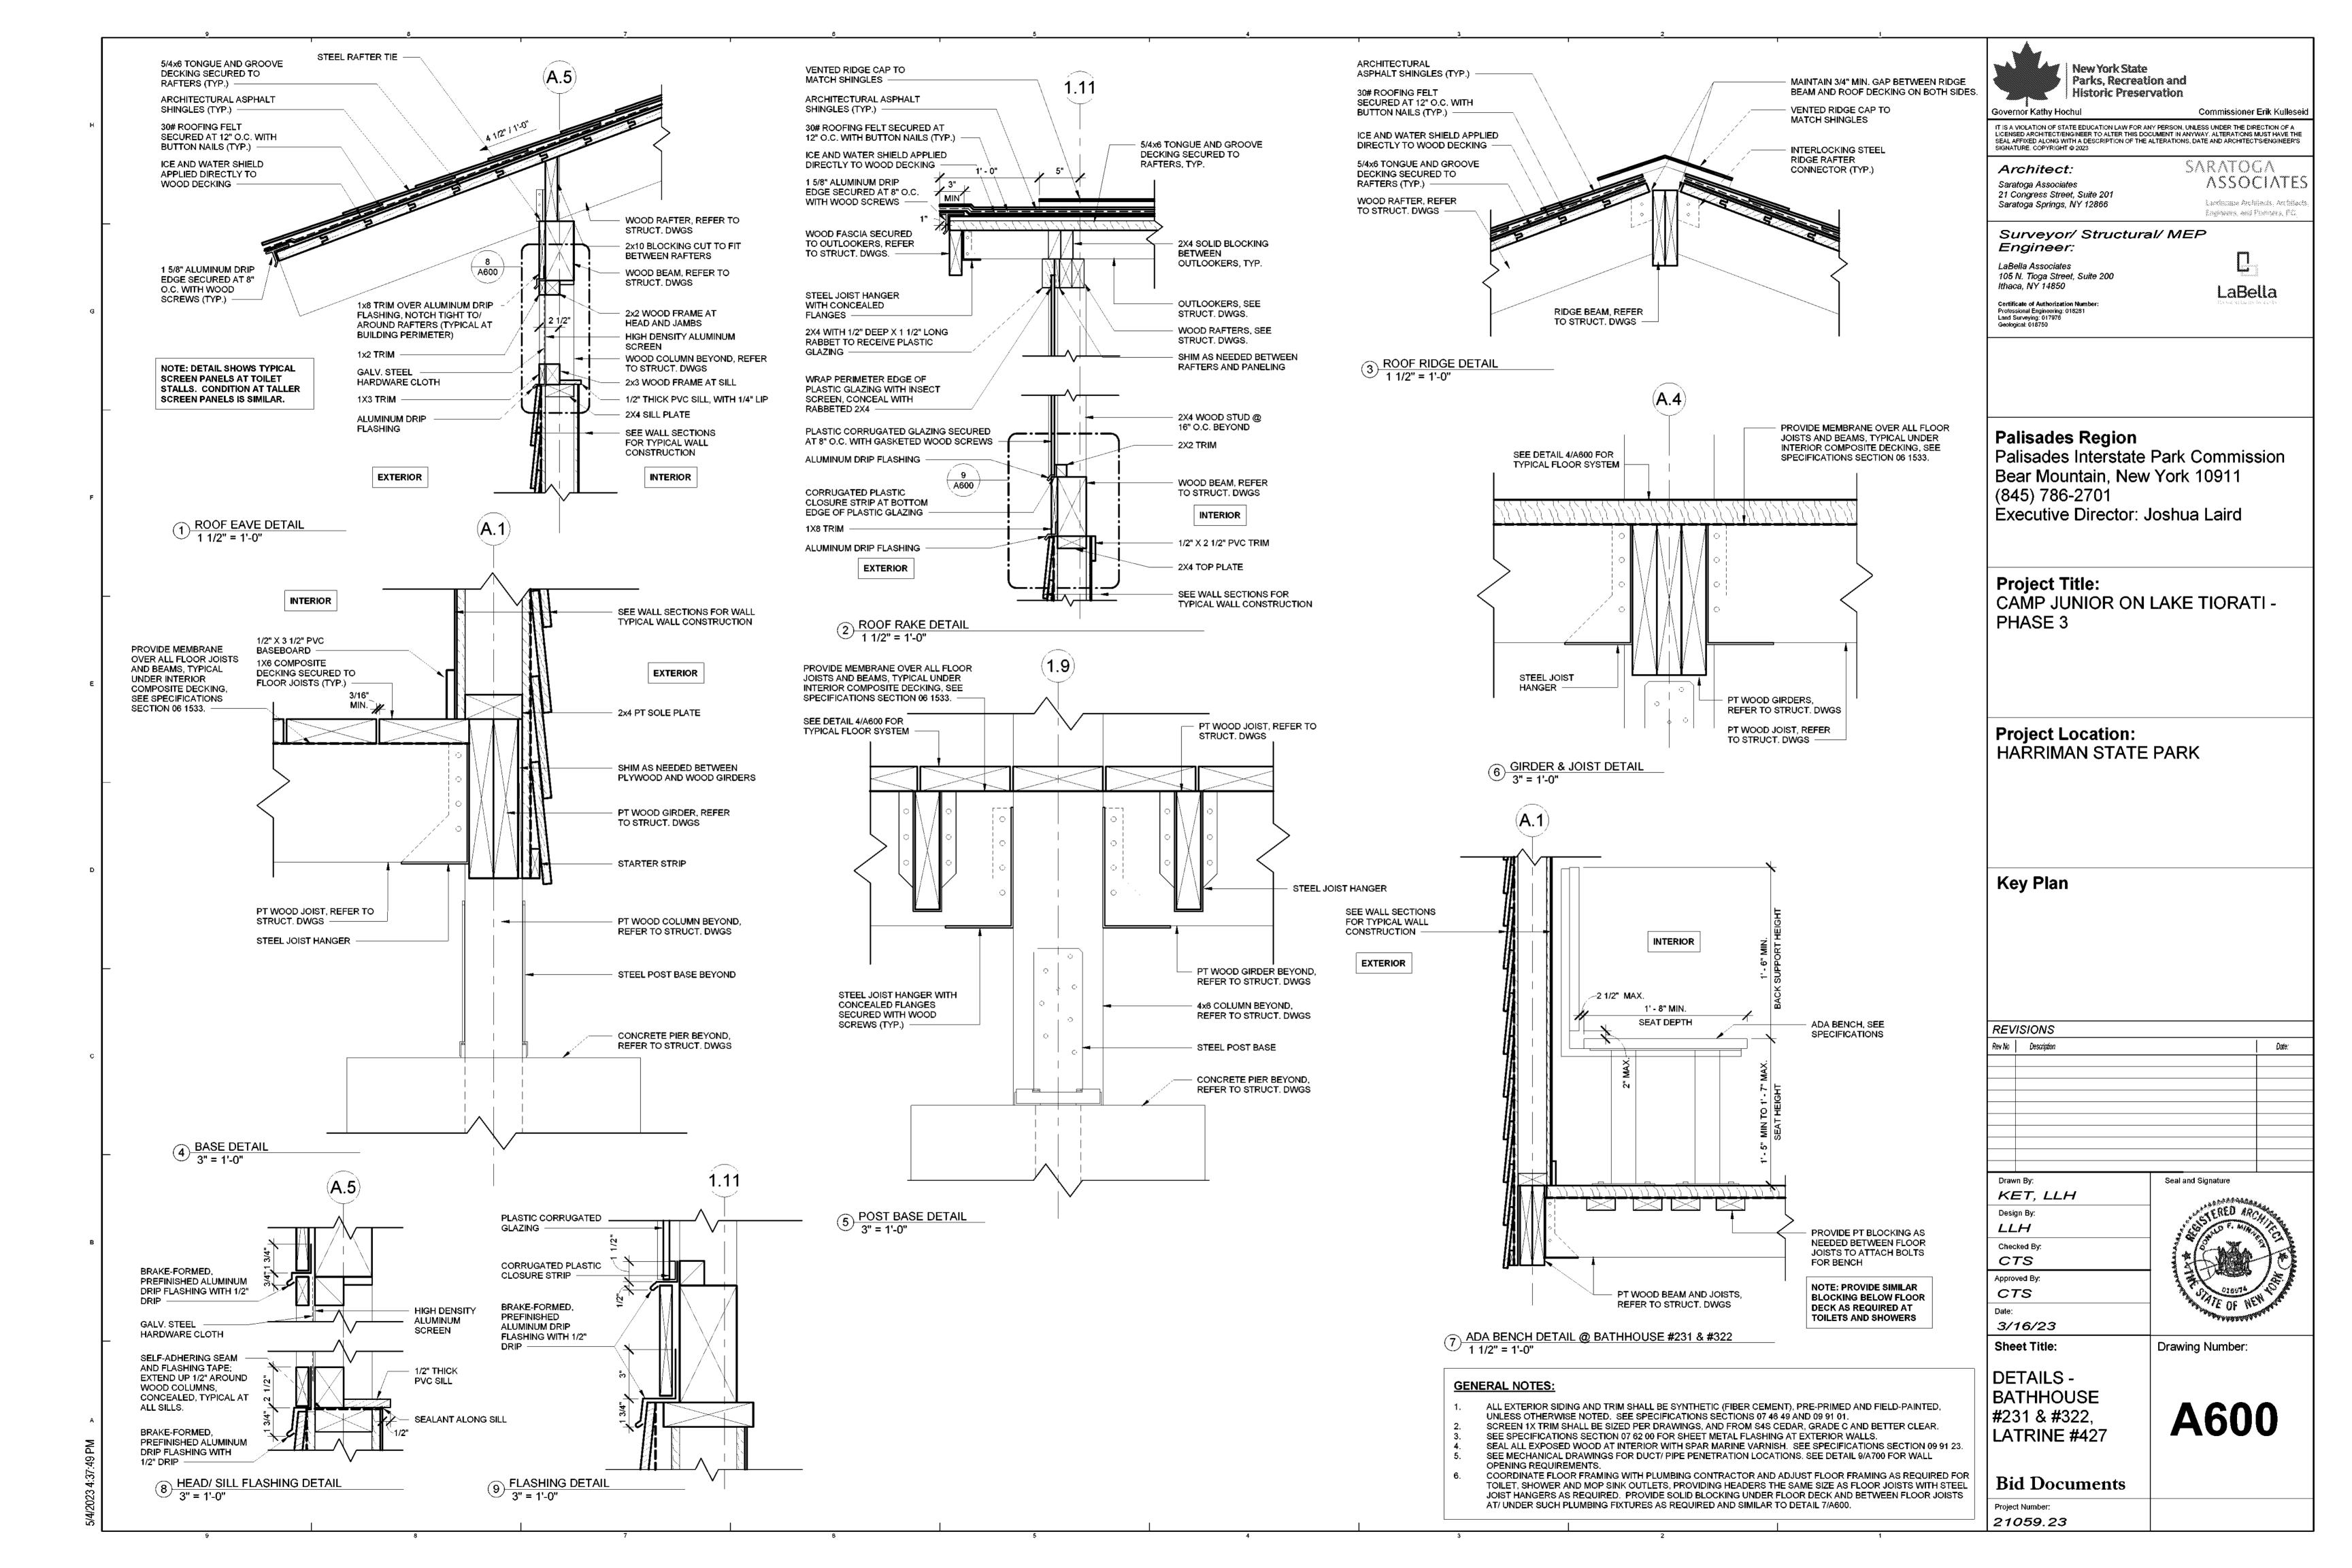

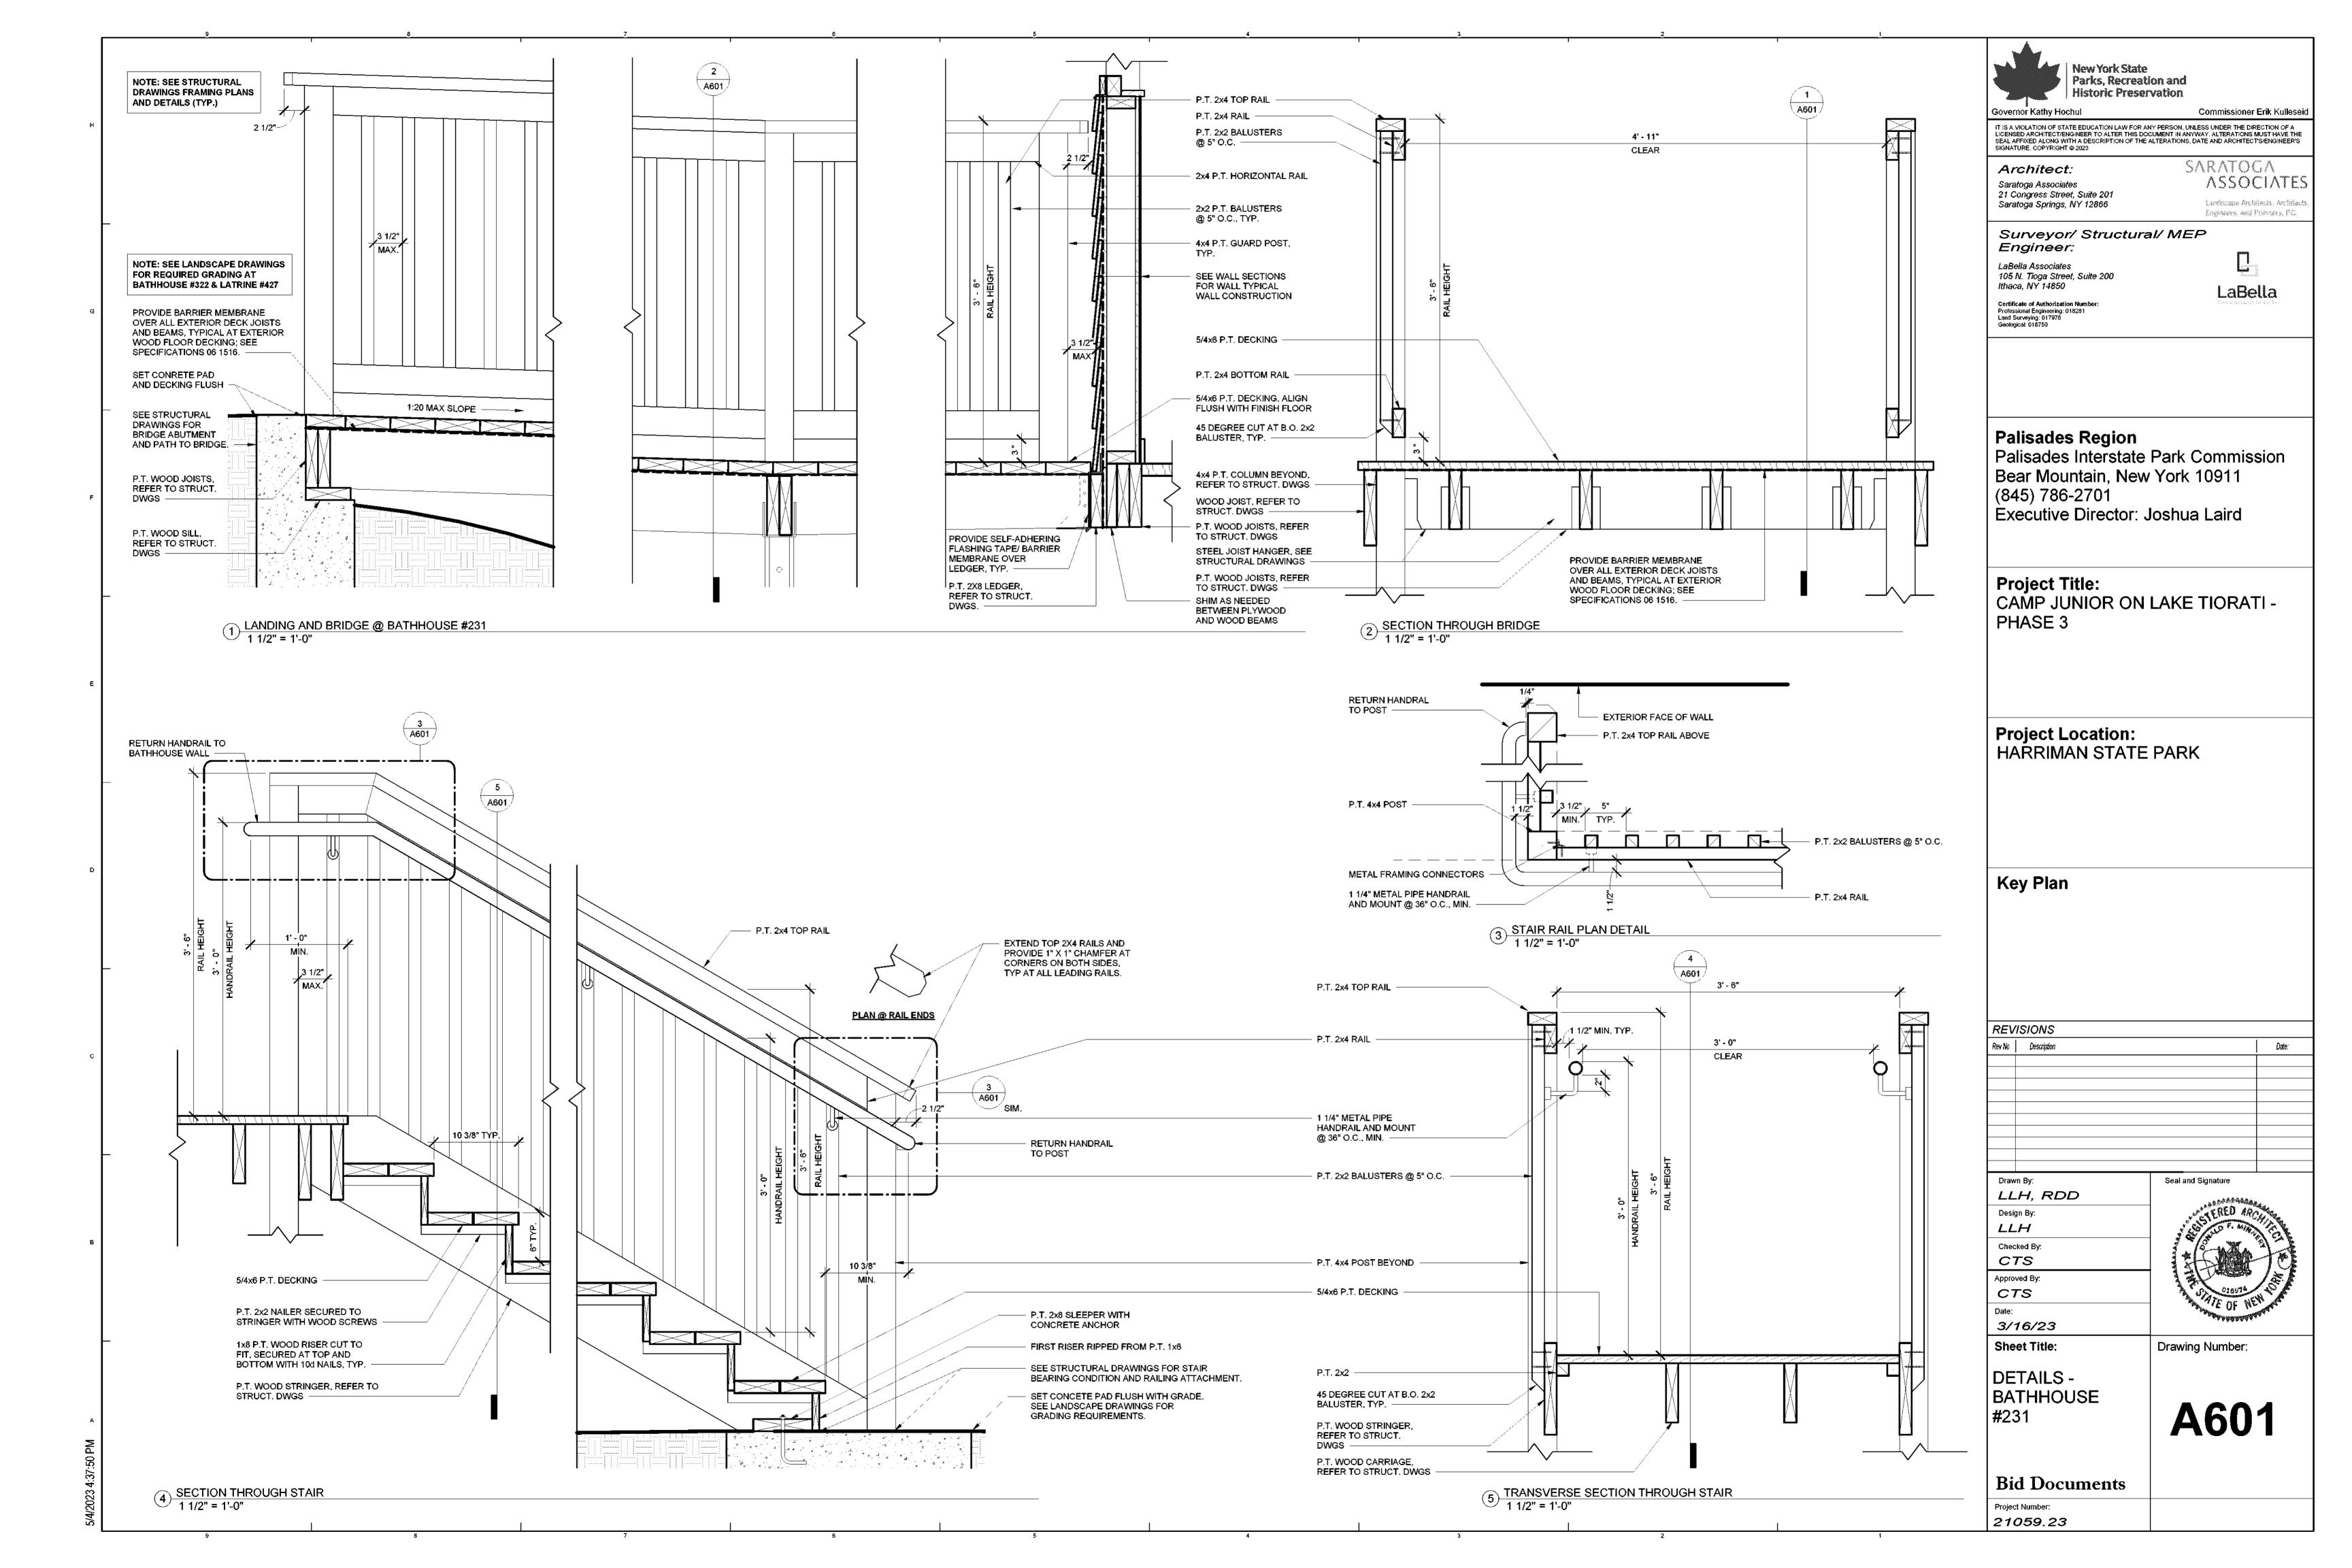1 LANDING AND SLOPED WALK DETAIL 1 1/2" = 1'-0"

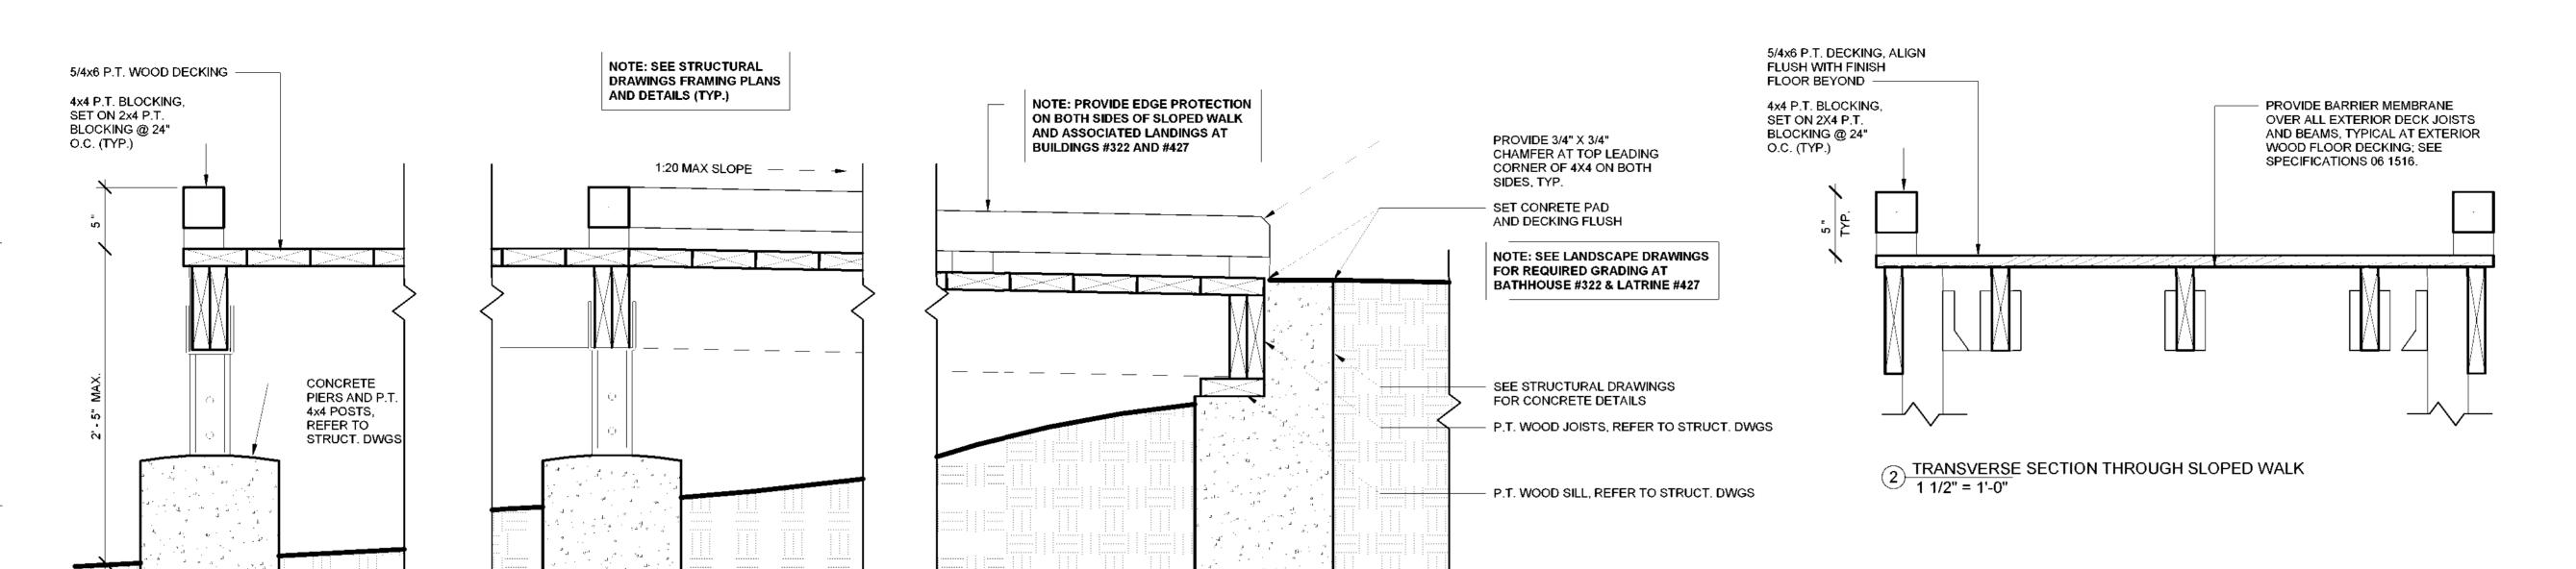


3 SECTION THROUGH DECK DETAIL 1 1/2" = 1'-0"

Governor Kathy H	Parks, Recrei Historic Pres	ation and	oor <b>Erik</b> Kul
IT IS A VIOLATION OF S LICENSED ARCHITECT.	STATE EDUCATION LAW FOR FENGINEER TO ALTER THIS WITH A DESCRIPTION OF TI	R ANY PERSON, UNLESS UNDER THE DOCUMENT IN ANYWAY, ALTERATION HE ALTERATIONS, DATE AND ARCHIT	DIRECTION O
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Palisade Bear Mo (845) 78	untain, Nev 6-2701	e Park Commi w York 10911 Joshua Laird	
Project CAMP J PHASE	UNIOR ON	N LAKE TIORA	ATI -
•	Location: IAN STAT	E PARK	
Key Pla	n		
REVISIONS Rev No Description			
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LLH Design By:		44444444 1019324	dana IRONA
LLH Checked By:		3. 23. 40. 10	
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Date: <b>3/16/23</b>		A TE OF	The state of the s
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DETAILS			
BATHHC			

#322 & LATRINE

Bid Documents

Project Number: 21059.23

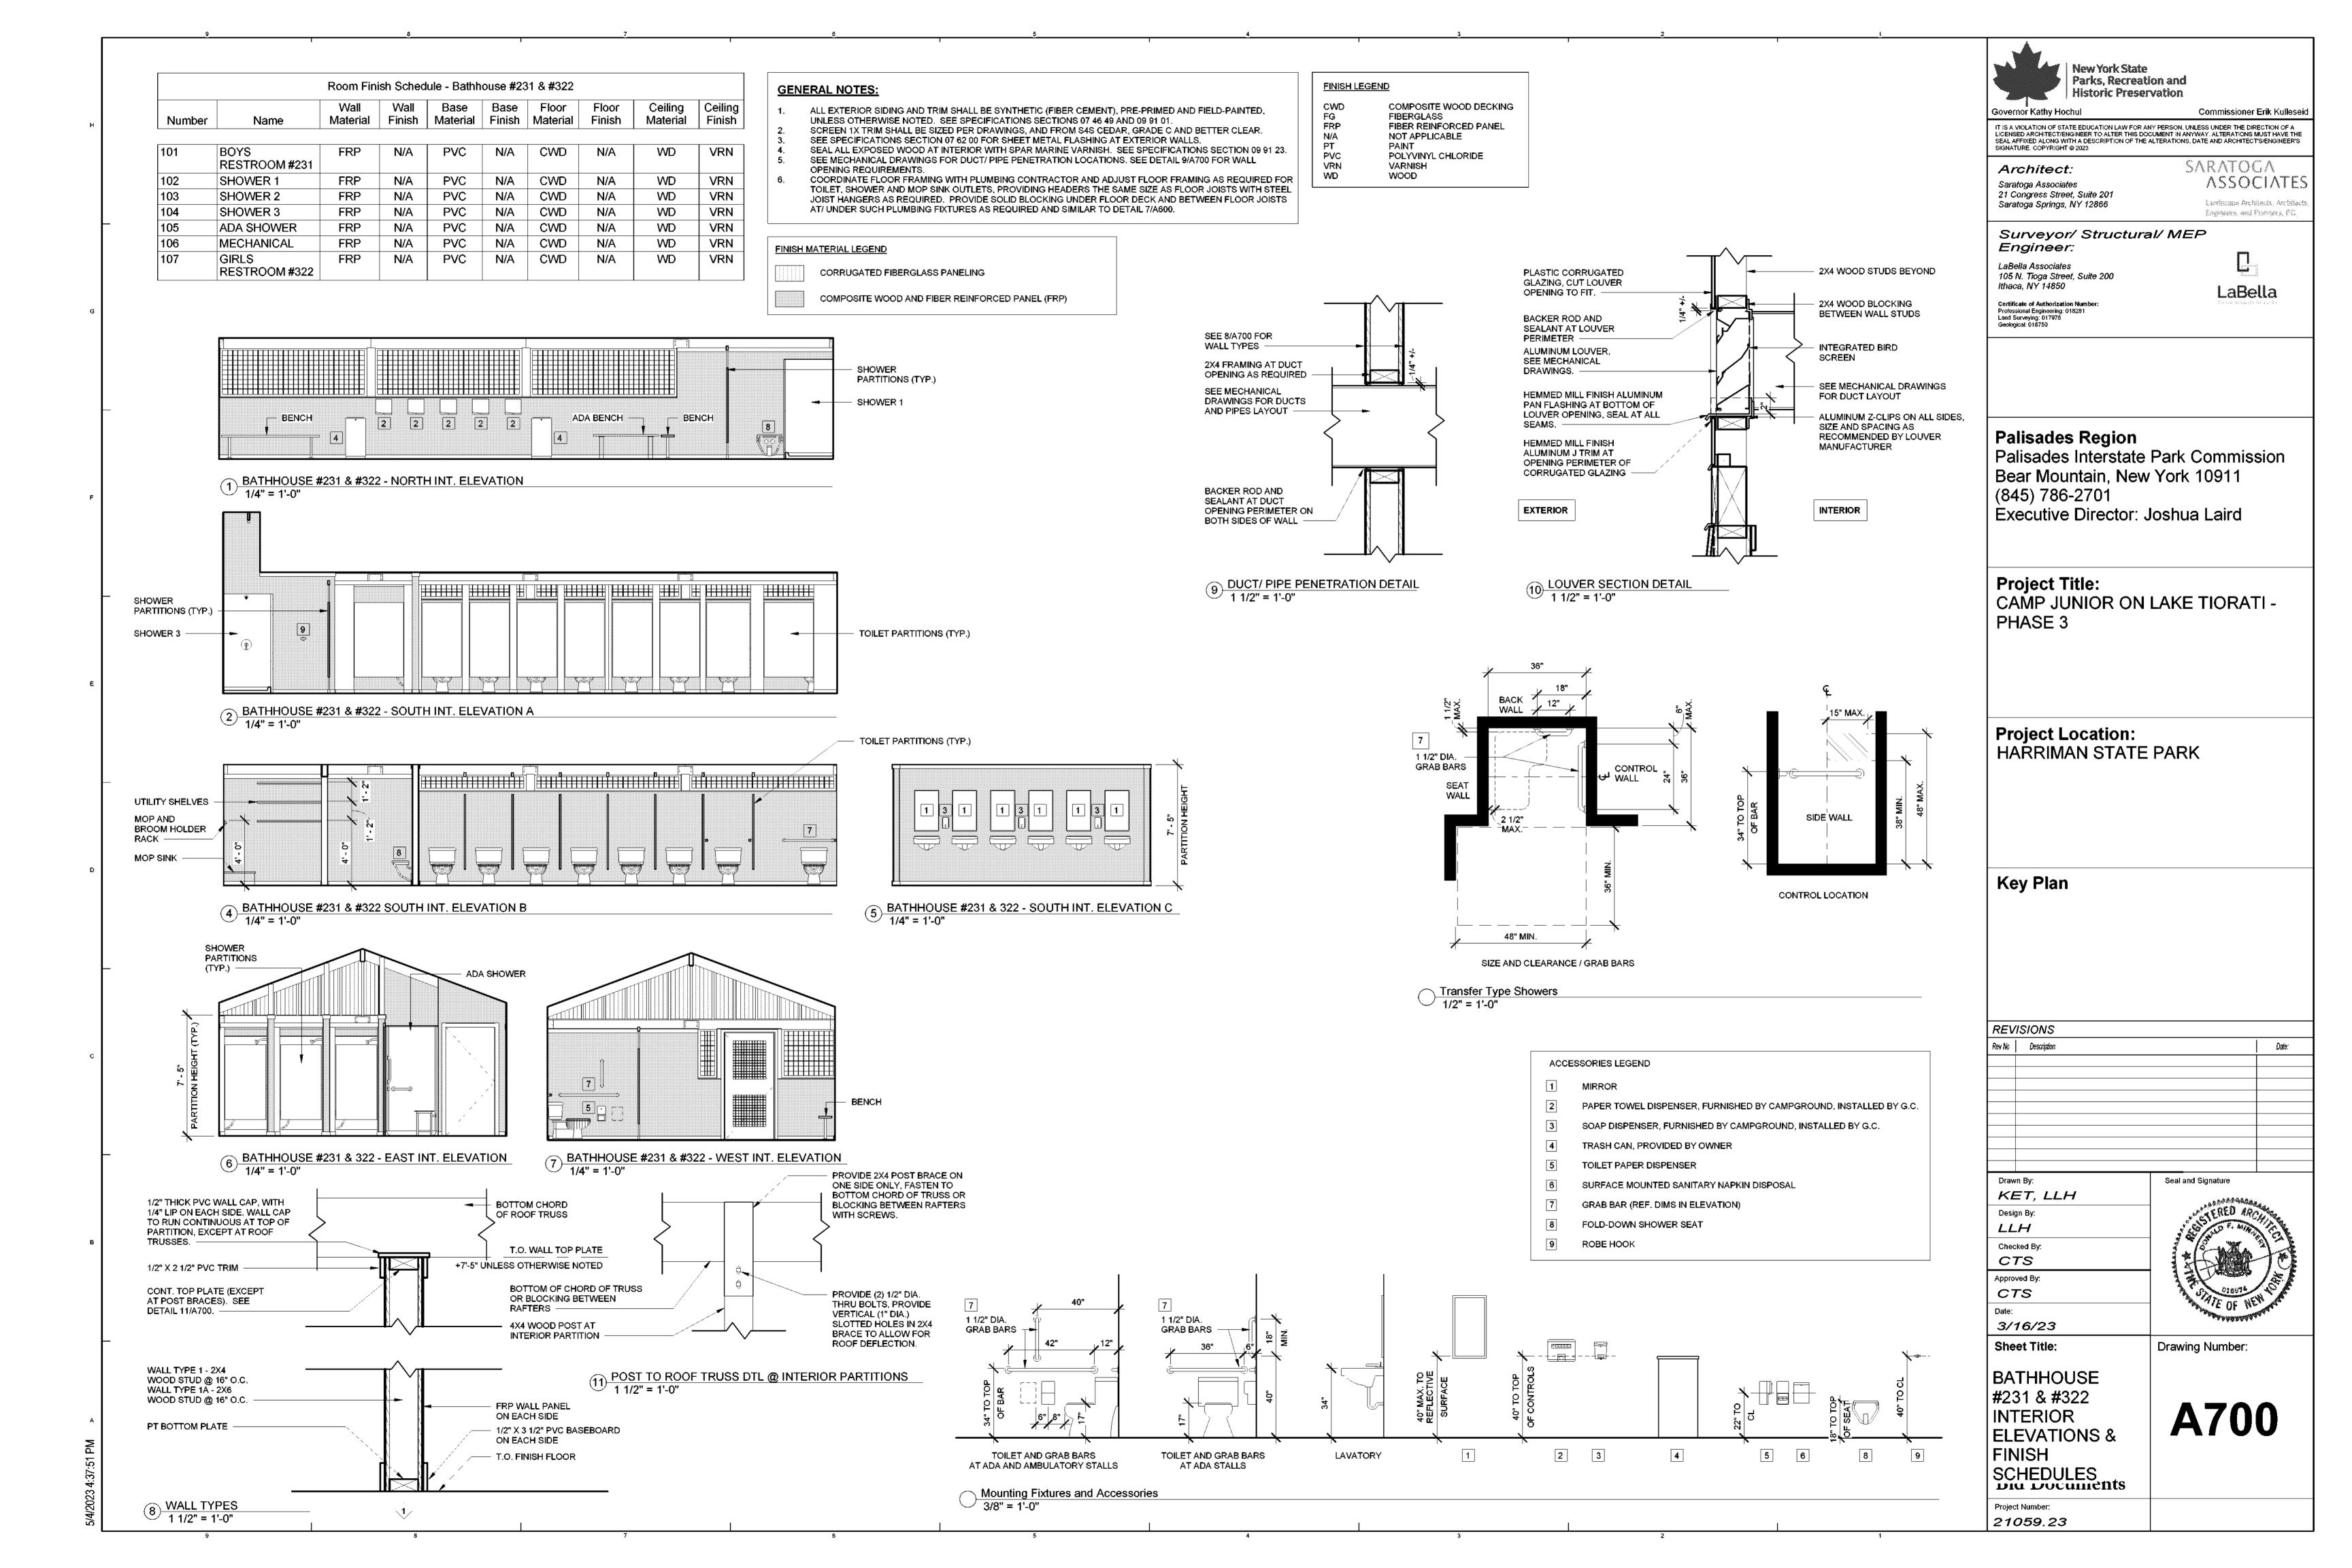

		Roor	n Finish S	Schedule -	Latrine#	427			
Number	Name	Wall Material	Wall Finish	Base Material	Base Finish	Floor Material	Floor Finish	Ceiling Material	Ceiling Finish
109	GIRLS RESTROOM #427	FRP	N/A	PVC	N/A	CWD	N/A	WD	VRN
110	BOYS RESTROOM #427	FRP	N/A	PVC	N/A	CWD	N/A	WD	VRN

#### **GENERAL NOTES:**

ALL EXTERIOR SIDING AND TRIM SHALL BE SYNTHETIC (FIBER CEMENT), PRE-PRIMED AND FIELD-PAINTED UNLESS OTHERWISE NOTED. SEE SPECIFICATIONS SECTIONS 07 46 49 AND 09 91 01.

SCREEN 1X TRIM SHALL BE SIZED PER DRAWINGS, AND FROM S4S CEDAR, GRADE C AND BETTER CLEAR. SEE SPECIFICATIONS SECTION 07 62 00 FOR SHEET METAL FLASHING AT EXTERIOR WALLS. SEAL ALL EXPOSED WOOD AT INTERIOR WITH SPAR MARINE VARNISH. SEE SPECIFICATIONS SECTION 09 91 23. SEE MECHANICAL DRAWINGS FOR DUCT/ PIPE PENETRATION LOCATIONS. SEE DETAIL 9/A700 FOR WALL

OPENING REQUIREMENTS. COORDINATE FLOOR FRAMING WITH PLUMBING CONTRACTOR AND ADJUST FLOOR FRAMING AS REQUIRED FOR TOILET, SHOWER AND MOP SINK OUTLETS, PROVIDING HEADERS THE SAME SIZE AS FLOOR JOISTS WITH STEEL JOIST HANGERS AS REQUIRED. PROVIDE SOLID BLOCKING UNDER FLOOR DECK AND BETWEEN FLOOR JOISTS AT/ UNDER SUCH PLUMBING FIXTURES AS REQUIRED AND SIMILAR TO DETAIL 7/A600.


#### FINISH LEGEND


COMPOSITE WOOD DECKING FIBERGLASS
FIBER REINFORCED PANEL
NOT APPLICABLE


FG FRP N/A PT PVC VRN WD POLYVINYL CHLORIDE VARNISH WOOD

#### FINISH MATERIAL LEGEND CORRUGATED FIBERGLASS PANELING

COMPOSITE WOOD AND FIBER REINFORCED PANEL (FRP)

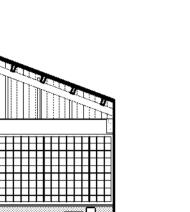

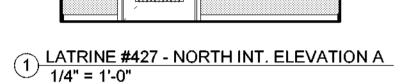

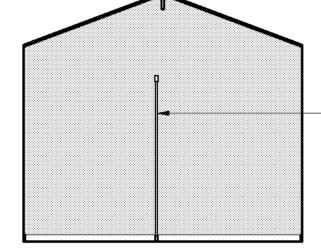

TOILET PARTITIONS


(TYP.)

MOUNT SOAP DISPENSER


**BELOW SILL** WHERE

SHOWN

2 LATRINE #427 - SOUTH INT. ELEVATION A 1/4" = 1'-0"

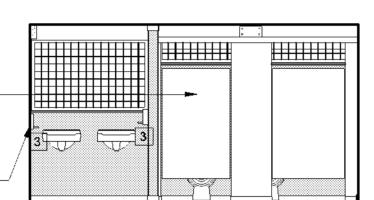



3 LATRINE #427 - EAST INT. ELEVATION A

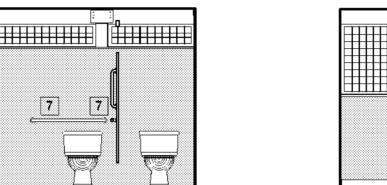


4 LATRINE #427 - EAST INT. ELEVATION A-B
1/4" = 1'-0"

5 LATRINE #427 - WEST INT. ELEVATION A
1/4" = 1'-0"

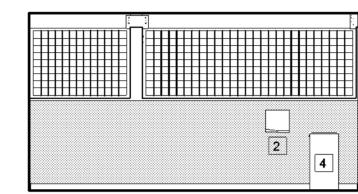


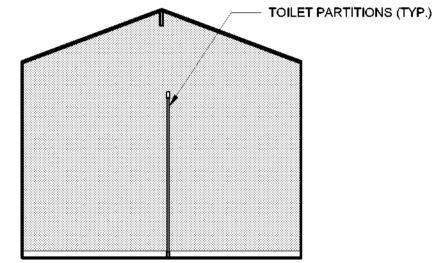


6 LATRINE #427 - NORTH INT. ELEVATION B 1/4" = 1'-0"

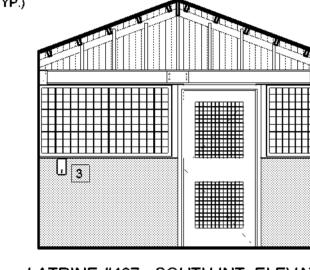


7 LATRINE #427 - SOUTH INT. ELEVATION B 1/4" = 1'-0"

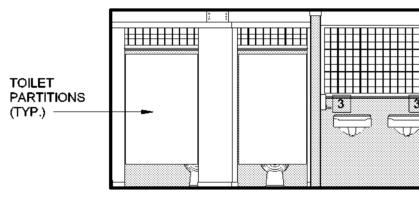

8 LATRINE #427 - EAST INT. ELEVATION B
1/4" = 1'-0"

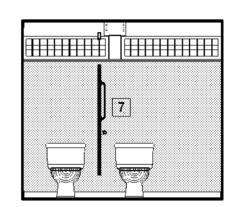


9 LATRINE #427 - EAST INT. ELEVATION B-B

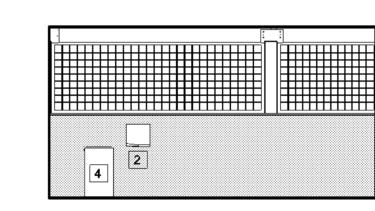

10 LATRINE #427 - WEST INT. ELEVATION B

CESSORIES	LEGEND

- PAPER TOWEL DISPENSER, FURNISHED BY CAMPGROUND, INSTALLED BY G.C.
- SOAP DISPENSER, FURNISHED BY CAMPGROUND, INSTALLED BY G.C.
- TRASH CAN, PROVIDED BY OWNER
- TOILET PAPER DISPENSER
- SURFACE MOUNTED SANITARY NAPKIN DISPOSAL
- GRAB BAR (REF. DIMS IN ELEVATION)
- FOLD-DOWN SHOWER SEAT
- ROBE HOOK

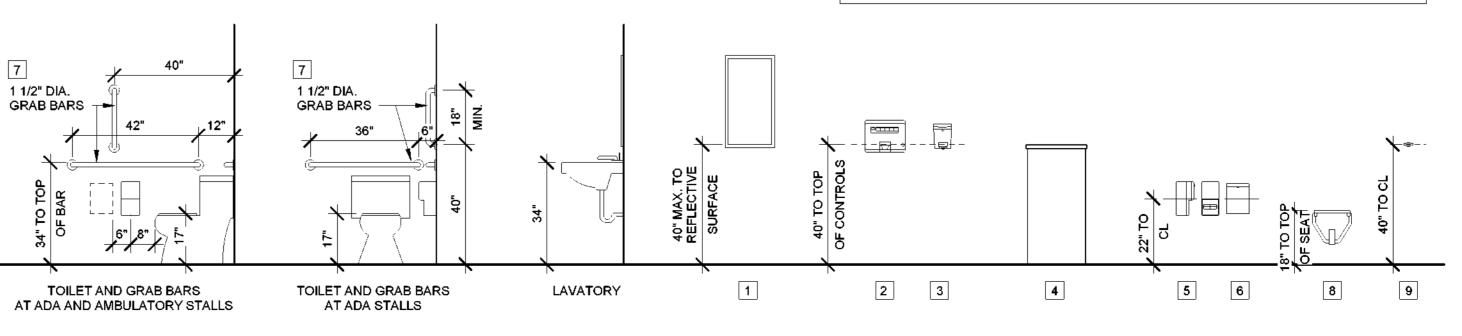

Mounting Fixtures and Accessories
3/8" = 1'-0"



Historic Preservation Governor Kathy Hochul Commissioner Erik Kulleseid

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Architect: Saratoga Associates 21 Congress Street, Suite 201 Saratoga Springs, NY 12866 SARATOGA **ASSOCIATES** Lacrónumos Architects, Architects Engineers, and Phoness, P.C.

Surveyor/ Structural/ MEP Engineer:

LaBella Associates 105 N. Tioga Street, Suite 200 Ithaca, NY 14850

Certificate of Authorization Number: Professional Engineering: 018281 Land Surveying: 017976 Geological: 018750

LaBella

Palisades Region

Palisades Interstate Park Commission Bear Mountain, New York 10911 (845) 786-2701

Executive Director: Joshua Laird

Project Title: CAMP JUNIOR ON LAKE TIORATI -PHASE 3

**Project Location:** HARRIMAN STATE PARK

**Key Plan** 

REV	REVISIONS				
Rev No	Description				Date:

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3/16/23

Sheet Title:

21059.23

Drawn By:

KET,

Design By:

Checked By: CTSApproved By: CTS

LLH


LATRINE #427 INTERIOR ELEVATIONS


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Drawing Number:

**Bid Documents** 

Project Number:



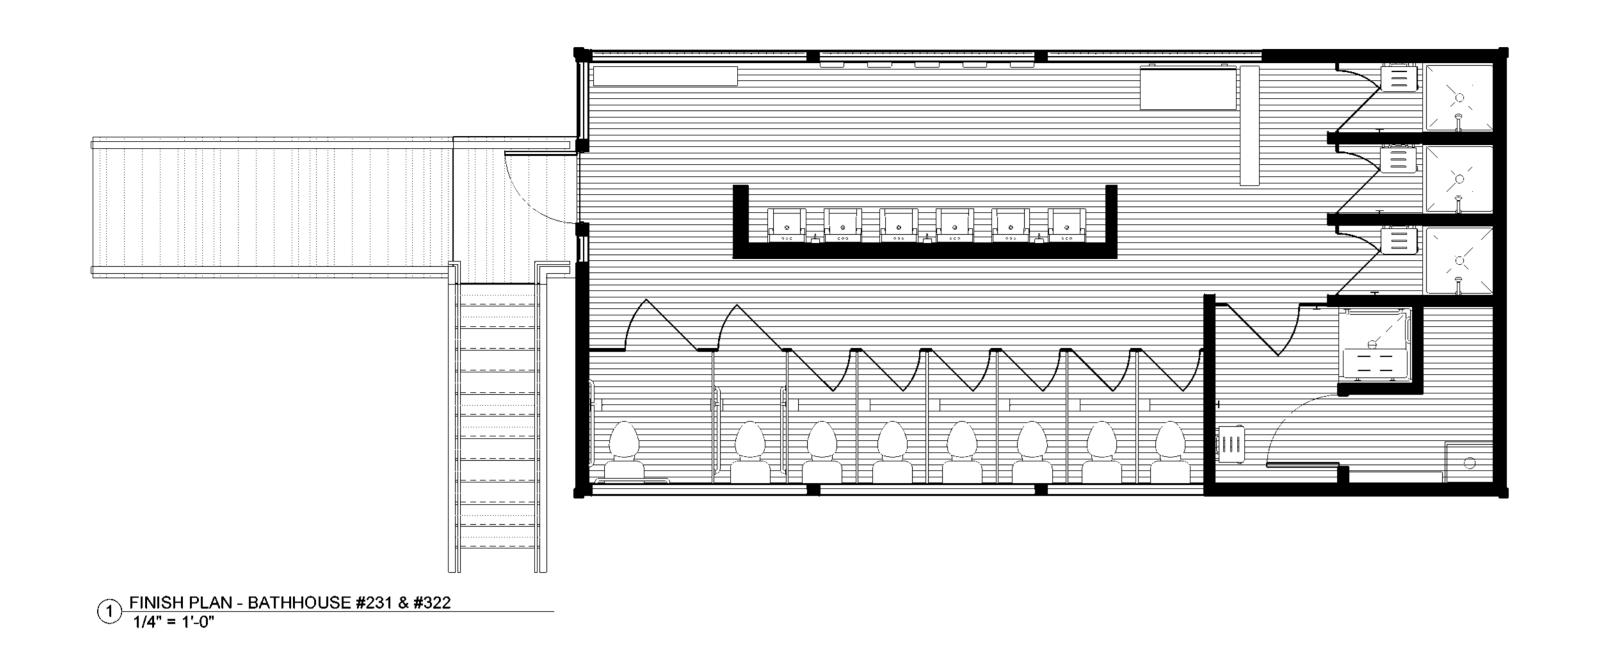

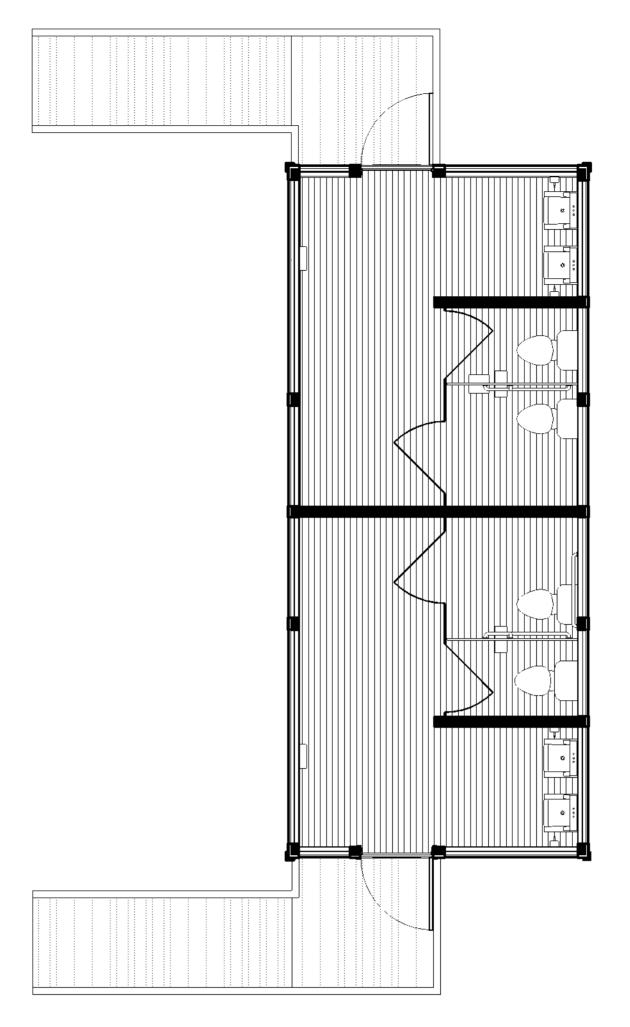2 FINISH PLAN - LATRINE BUILDING #427 1/4" = 1'-0"



New York State
Parks, Recreation and
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Architect: Saratoga Associates 21 Congress Street, Suite 201 Saratoga Springs, NY 12866

FINISH MATERIAL LEGEND

COMPOSITE WOOD DECKING

PT WOOD DECKING

SARATOGA ASSOCIATES Laceticusce Architects, Architects, Engineers, and Phoness, P.C.

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REVISIONS Rev No Description Date:

Drawn By: KET, LLH Design By: LLH Checked By: CTS Approved By: CTS

Drawing Number:

Seal and Signature

FINISH PLANS

3/16/23

Sheet Title:

21059.23

Bid Documents Project Number:

#### Door and Frame Schedule Door Frame Detail Hardware Door Frame Frame From Room: Name Door No. Width | Height | Elev. | Material Finish Type Finish Set No. Material Head BOYS RESTROOM #231 WD 5/A800 4/A800 5/A800 | 3' - 0" | 6' - 8" | A BOYS RESTROOM #427 PT 5/A800 | 4/A800 | 5/A800 | GIRLS RESTROOM #427 3'-0" | 6'-8" | A WD 5/A800 | 4/A800 | 5/A800 | 01 ADA SHOWER WD VRN WD 02 Α 7/A800 | 6/A800 | 7/A800 | GIRLS RESTROOM #322 3' - 0" 6' - 8" A WD PT WD PT 5/A800 4/A800 5/A800

WIDTH

VVD	ГІ	SIAGOO	4//1000	SIAGUU
		-1 1/2"		
	1 1/2"			
			٨	

2 DOOR FRAME TYPES
1/2" = 1'-0"

		Windo	w Schedule		
Mark	Width	Height	Sill	Jamb	Head
Α	9' - 0"	3' - 0"	1/A600	4/A800	1/A600
В	3' - 4"	3' - 0"	1/A600	4/A800	1/A600
С	1' - 2"	3' - 0"	1/A600	4/A800	1/A600
D	9' - 0"	1' - 0"	1/A600	4/A800	1/A600
E	6' - 7"	1' - 0"	1/A600	4/A800	1/A600
F	8' - 11"	3' - 0"	1/A600	4/A800	1/A600
G	4' - 2"	3' - 0"	1/A600	4/A800	1/A600
Н	2' - 2"	3' - 0"	1/A600	4/A800	1/A600
J	5' - 7"	3' - 0"	1/A600	4/A800	1/A600
K	4' - 11"	3' - 0"	1/A600	4/A800	1/A600
L	3' - 7"	1' - 0"	1/A600	4/A800	1/A600
М	4' - 2"	1' - 0"	1/A600	4/A800	1/A600

TEE HINGES, CENTER

ALUMINUM SCREEN

WITH HARDWARE

SIDE OF OPENING

BUTT HINGES,

REQUIRED.

1 DOOR ELEVATIONS

3 TYP. WINDOW ELEVATION 1/2" = 1'-0"

<sup>/</sup> 1/2" = 1'-0"

EQUALLY SPACED


SEE SPECIFICATIONS

SECTION 08 71 00 FOR

ADDITIONAL HARDWARE

CLOTH AT INBOARD

OF HORIZONTAL RAILS

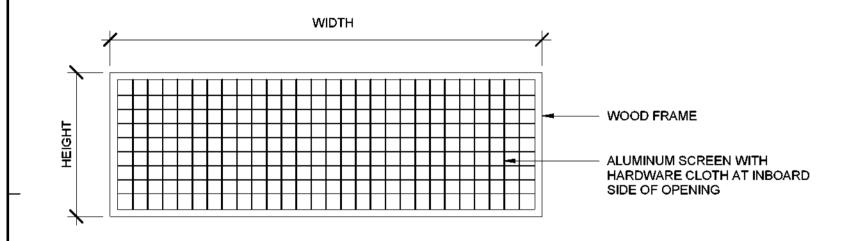

#### FINISH LEGEND

	<del></del>
CWD	COMPOSITE WOOD DECKING
FG	FIBERGLASS
FRP	FIBER REINFORCED PANEL
N/A	NOT APPLICABLE
PT	PAINT
PVC	POLYVINYL CHLORIDE
VRN	VARNISH

A800

WOOD


#### **DOOR AND WINDOW NOTES:**


- CONTRACTOR SHALL FIELD VERIFY AND COORDINATE ALL DIMENSIONS PRIOR TO CONSTRUCTION AND
- ORDERING MATERIALS. PAINT ALL EXPOSED EXTERIOR WOOD TRIM AT DOORS AND WINDOWS. SEAL ALL EXPOSED INTERIOR
- WOOD TRIM WITH VARNISH. REFER TO SPECIFICATIONS SECTION 08 71 00 FOR DOOR HARDWARE SCHEDULE.

1X2 DOOR STOP SECURED AT


12" O.C.WITH 10d NAILS


4X6 WOOD POST

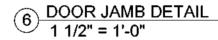


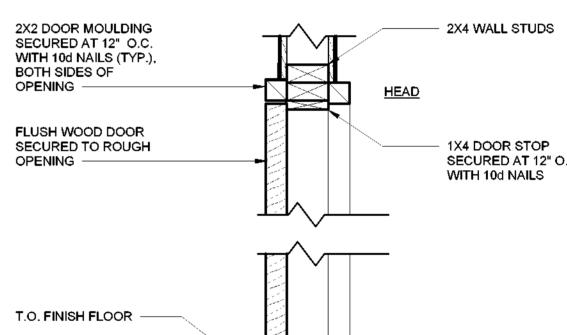

7 DOOR HEAD/ SILL DETAIL 1 1/2" = 1'-0"

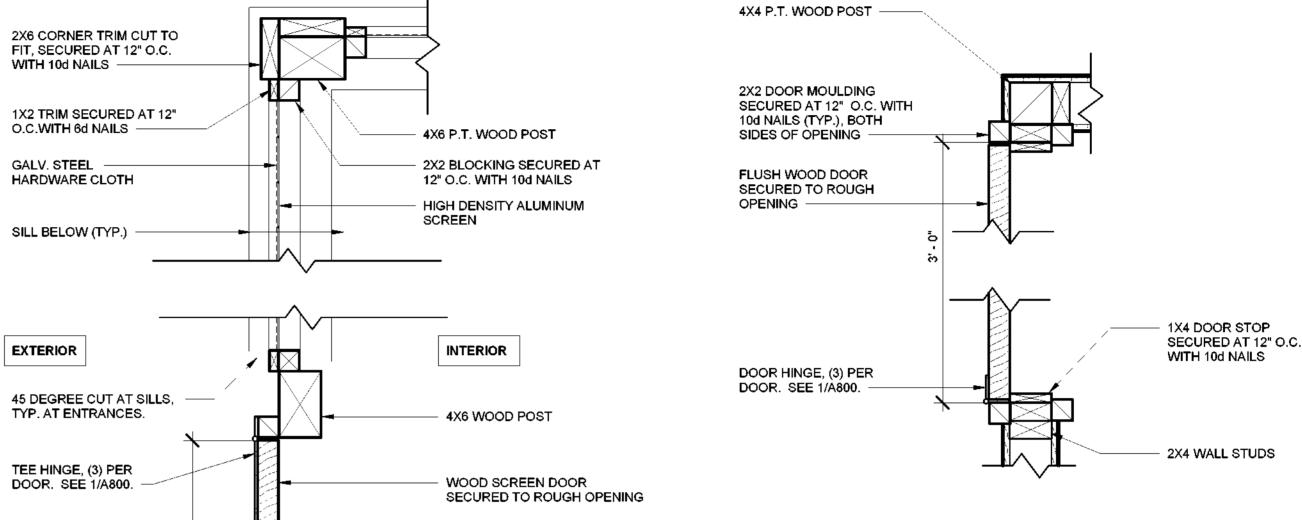

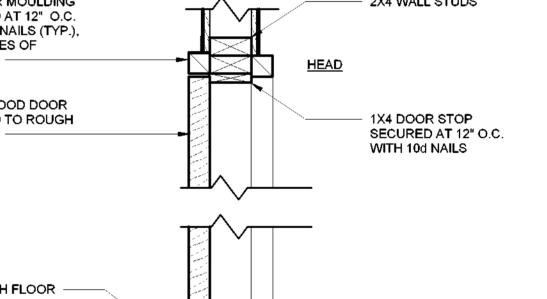


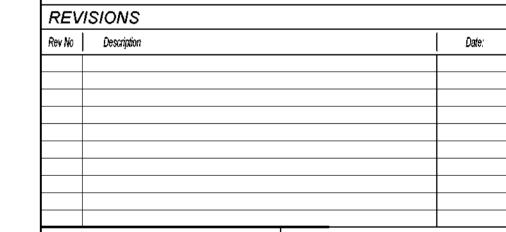


Drawn By: KET, LLH Design By: LLH Checked By: CTS Approved By: CTS 3/16/23

Drawing Number:

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LaBella

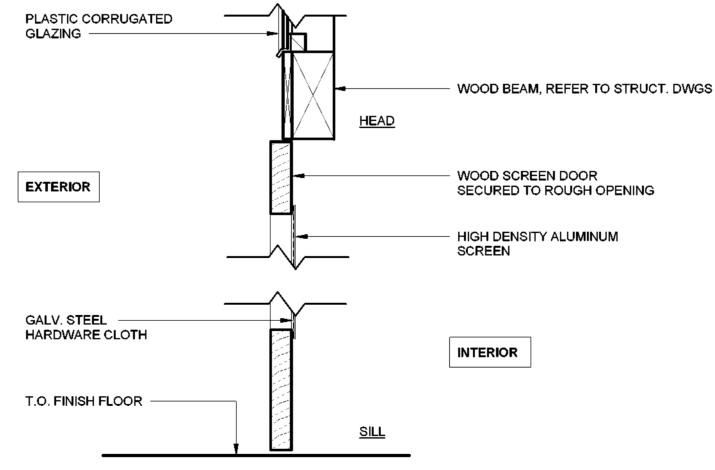SARATOGA

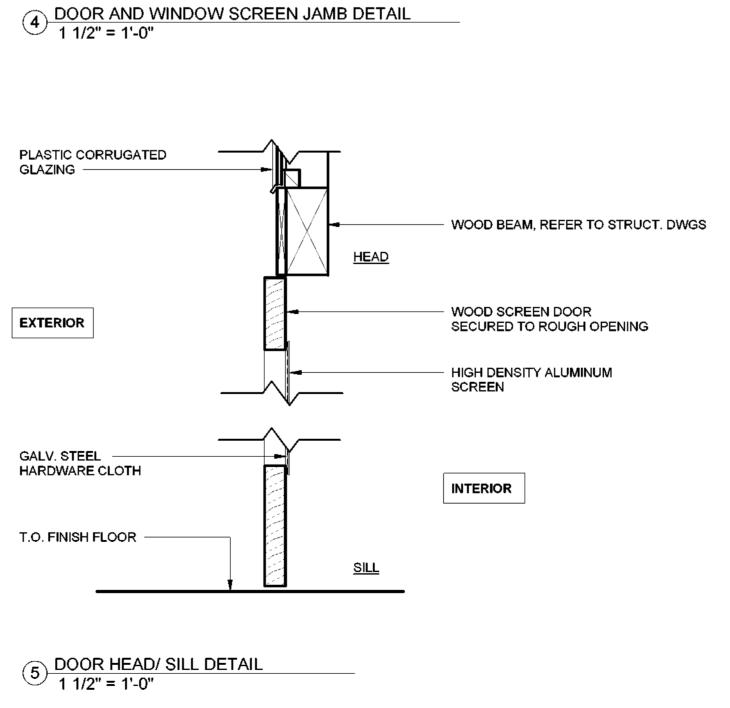Commissioner Erik Kulleseid

**ASSOCIATES** 

Lastinuase Archileots, Archilects

Engioeers, and Phansers, P.C.

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Project Title: CAMP JUNIOR ON LAKE TIORATI -PHASE 3

**Project Location:** HARRIMAN STATE PARK

**Key Plan** 

Seal and Signature

DOORS AND WINDOWS

Sheet Title:

21059.23

#### **GENERAL STRUCTURAL NOTES:**

- 1. BUILDING CODE: BUILDING CODE OF NEW YORK STATE, LATEST EDITION
- 2. CONSTRUCTION LOADING: DURING CONSTRUCTION, THE GENERAL CONTRACTOR SHALL LIMIT AND CONTROL CONSTRUCTION LOADING, INCLUDING BUT NOT LIMITED TO:
- a. MATERIAL STOCKPILING AND EQUIPMENT TO PRECLUDE OVERSTRESSING, CONSTRUCTION LIVE LOAD IN EXCESS OF 20 PSF, OR DAMAGE TO ANY STRUCTURAL ELEMENT.
- 3. COORDINATION WITH OTHER DISCIPLINES: THE CONTRACTOR SHALL COORDINATE ALL STRUCTURAL WORK WITH THE
- ARCHITECTURAL, ELECTRICAL, MECHANICAL, PLUMBING AND FIRE PROTECTION DRAWINGS AND SPECIFICATIONS. 4. EXISTING CONDITIONS: THE INFORMATION SHOWN ON THESE DOCUMENTS IS THE BEST REPRESENTATION OF EXISTING CONDITIONS AVAILABLE TO THE ENGINEER. IT IS THE CONTRACTOR'S RESPONSIBILITY TO FIELD VERIFY AND BRING TO THE ENGINEER'S AND CONSTRUCTION MANAGER'S ATTENTION ANY DISCREPANCIES PRIOR TO COMMENCING WORK.
- 5. EXISTING STRUCTURES: ALL EXISTING STRUCTURES ADJACENT TO NEW WORK ARE TO BE ADEQUATELY PROTECTED AND/OR SUPPORTED DURING CONSTRUCTION. THE CONTRACTOR SHALL BE RESPONSIBLE FOR REPAIRING ANY NEW OR EXISTING CONSTRUCTION DAMAGED WHILE WORK IS IN PROGRESS.
- 6. OPENINGS: THE CONTRACTOR SHALL BE RESPONSIBLE FOR COORDINATING SIZE AND LOCATION OF ALL OPENINGS IN NEW AND EXISTING CONSTRUCTION WITH THE DISCIPLINE REQUIRING THEM.

- 1. NO GEOTECHNICAL INFORMATION WAS AVAILABLE AT THE TIME OF DESIGN. ASSUMED ALLOWABLE BEARING PRESSURE = 1,500 PSF. 2. TAKE ALL NECESSARY PRECAUTIONS WHEN EXCAVATING OR DRILLING ADJACENT TO EXISTING STRUCTURES TO AVOID DISTURBING EXISTING FOUNDATIONS. DO NOT EXCAVATE BELOW EXISTING FOUNDATIONS. CONTACT THE ENGINEER IF EXISTING CONDITIONS DIFFER FROM THOSE SHOWN ON THE DRAWING.
- 3. ALL EXCAVATIONS SHALL FULLY CONFORM TO LOCAL, STATE AND FEDERAL SAFETY REGULATIONS.
- 4. DO NOT BACKFILL AGAINST CONCRETE ELEMENTS UNTIL PLACED CONCRETE HAS REACHED 75% OF ITS SPECIFIED 28-DAY
- 5. ALLOW TESTING AGENCY TO INSPECT AND APPROVE ALL COMPACTED SUBGRADE AND FILL LAYERS PRIOR TO FURTHER BACKFILL AND/OR PLACEMENT OF CONCRETE, TESTING AND INSPECTION RESULTS SHALL BE APPROVED BY THE GEOTECHNICAL ENGINEER.
- 6. THE SUITABILITY AND STABILITY OF EXISTING SOILS AND FILL, THE DEPTHS AND LATERAL LIMITS OF UNSUITABLE MATERIAL TO BE REMOVED, AND ADEQUACY OF FOUNDATION BEARING GRADES SHALL BE DETERMINED BY THE PROJECT GEOTECHNICAL ENGINEER.
- 7. BACKFILL AND FILL MATERIALS SHALL BE COMPACTED TO 95% OF MAXIMUM DRY DENSITY ACCORDING TO THE MODIFIED PROCTOR. TEST (ASTM D-1557). ALL EXISTING BACKFILL SHALL BE RECOMPACTED AS SUCH.
- 8. EXCAVATION AND BACKFILL OPERATIONS SHALL BE MAINTAINED IN A DRY CONDITION, SURFACE AND INFILTRATING WATER SHALL BE REMOVED BY SITE GRADING AND/OR BY PUMPING FROM SUMPS AS REQUIRED.

#### **CONCRETE NOTES:** 1. SUBMITTALS

- a. SUBMIT SHOP DRAWINGS FOR REINFORCING, INCLUDING ALL NECESSARY ACCESSORIES TO HOLD REINFORCING SECURELY IN PLACE, FOR REVIEW AND APPROVAL, WHERE RESUBMITTAL OF SHOP DRAWINGS IS REQUIRED, ALL REVISIONS SHALL BE CLEARLY IDENTIFIED BY CLOUDING AND REVISION TAGS.
- b. SUBMIT FOR REVIEW ALL MATERIALS AND METHODS FOR CONCRETE CURING.
- 2. PROVIDE THE FOLLOWING MINIMUM CONCRETE CLEAR COVER FOR REINFORCING STEEL, UNLESS OTHERWISE NOTED.:
- a. CONCRETE PLACED AGAINST EARTH: 3.0 IN.
- b. FORMED SURFACES IN CONTACT WITH EARTH OR EXPOSED TO WEATHER
- #6 THROUGH #18 BARS: 2.0 IN.
- 1.5 IN. #5 BARS AND SMALLER: c. FORMED SURFACES NOT IN CONTACT WITH EARTH OR EXPOSED TO WEATHER
- #14 AND #18 BARS:
- 1.5 IN.
- #11 BARS AND SMALLER: 3. ALL CONCRETE WORK, CONSTRUCTION, AND REINFORCING DETAILS SHALL CONFORM TO THE "BUILDING CODE OF NEW YORK STATE,"
- LATEST EDITION\*. ALL REINFORCING STEEL SHALL BE DETAILED, FABRICATED AND PLACED IN ACCORDANCE WITH ACI 318.
- ALL REINFORCING BARS SHALL CONFORM TO ASTM A615 GRADE 60.
- 6. ALL REINFORCING SHALL BE LAPPED OR EMBEDDED IN ACCORDANCE WITH ACI 318, UNLESS OTHERWISE NOTED.
- 7. PROVIDE CORNER BARS TO MATCH ALL HORIZONTAL REINFORCING AT CORNERS OR INTERSECTIONS.
- 8. CHAMFER EXTERIOR CORNERS AND EDGES OF PERMANENTLY EXPOSED CONCRETE.
- 9. PRIOR TO PLACEMENT OF CONCRETE, A FIELD REPRESENTATIVE SHALL BE INFORMED A MINIMUM OF 24 HOURS IN ADVANCE OF PLACEMENT, TO ALLOW INSPECTION OF REINFORCING STEEL, AND PREPARATION FOR TAKING CONCRETE SAMPLES. INDEPENDENT TESTS ARE REQUIRED FOR ALL CONCRETE PLACEMENTS.
- 10. INSTALLATION OF REINFORCEMENT SHALL BE COMPLETED AT LEAST 24 HOURS PRIOR TO THE SCHEDULED CONCRETE PLACEMENT.
- 11. W.W.R. SHALL CONFORM TO ASTM A1064 AND SHALL BE FABRICATED INTO FLAT SHEETS.
- 12. CHEMICAL ADHESIVE: HILTI HIT-HY 200, SIMPSON SET EPOXY, OR DEWALT AC100+ GOLD.
- 13. GROUT: NON-METALLIC/NON-SHRINK STRUCTURAL GROUT. FIVE STAR GROUT OR APPROVED EQUAL. 14. SYNTHETIC MICRO-FIBER: FIBRILLATED POLYPROPYLENE MICRO-FIBERS ENGINEERED AND DESIGNED FOR USE IN CONCRETE.
- COMPLYING WITH ASTM C 1116/C 1116M, TYPE III. 15. PROTECT CONCRETE FROM PREMATURE DRYING IMMEDIATELY AFTER PLACEMENT, CURING OF CONCRETE SLABS MUST START
- WITHIN 2 HOURS AFTER FINISHING OPERATIONS ARE COMPLETE. SLABS-ON-GRADE SHALL BE WET CURED FOR 7 DAYS. CURING 16. SLABS-ON-GRADE SHALL HAVE CONTROL JOINTS AS SHOWN ON PLANS, SAW CUT JOINTS SHALL BE MADE WITHIN 12 HOURS OF PLACING SLAB. AFTER CONCRETE IS CURED AND READY FOR PLACEMENT OF FLOOR FINISH, ALL SLABS INSIDE THE BUILDING SHALL
- 17. CONCRETE SHALL BE CONTROLLED, PROPORTIONED, MIXED AND PLACED IN THE PRESENCE OF A REPRESENTATIVE OF AN APPROVED
- TESTING AGENCY. 18. CONDUIT OR PIPES SHALL BE PLACED UNDER SLABS-ON-GRADE.
- 19. ALUMINUM CONDUITS OR PIPES SHALL NOT BE PLACED IN CONCRETE. 20. AIR-ENTRAINING ADMIXTURE SHALL CONFORM TO ASTM C260 AND WATER-REDUCING ADMIXTURES SHALL CONFORM TO ASTM C494

#### WOOD FRAMING NOTES: SUBMITTALS:

- a. CONTRACTOR SHALL PROVIDE ALL CONNECTION DETAILS FOR REVIEW PRIOR TO CONSTRUCTION. CONTRACTOR SHALL SUBMIT ENGINEERING DATA FOR ALL CONNECTORS AND CONNECTIONS NOT SHOWN ON THE DRAWINGS.
- b. SUBMIT DESIGN CALCULATIONS AND SHOP DRAWINGS FOR ALL ENGINEERED TRUSSES AND TRUSS CONNECTORS, PREPARED AND SEALED BY A PROFESSIONAL ENGINEER LICENSED IN THE STATE OF NEW YORK , TO THE ENGINEER OF RECORD FOR REVIEW BEFORE 2. WOOD CONSTRUCTION SHALL CONFORM TO THE LATEST EDITION OF THE NATIONAL FOREST PRODUCTS ASSOCIATION'S (NFPA)
- NATIONAL DESIGN SPECIFICATIONS (NDS) AND CHAPTER 23 OF THE BUILDING CODE OF NYS, LATEST EDITION. 3. MINIMUM DESIGN VALUES SHALL BE AS FOLLOWS UNLESS OTHERWISE NOTED:
- 4. WOOD IN CONTACT WITH MASONRY, CONCRETE OR EARTH, OR WITHIN 1'-0" OF GRADE OR EXPOSED TO THE EXTERIOR SHALL BE PRESSURE PRESERVATIVE TREATED. 5. FRAMING ANCHORS AND MISCELLANEOUS METAL DEVICES FOR ALL FRAMING SHALL BE GALVANIZED STEEL OF AT LEAST 16 GAGE
- THICKNESS (G90 FOR INTERIOR APPLICATION, G185 OR STAINLESS STEEL FOR EXTERIOR). INSTALL IN STRICT ACCORDANCE WITH MANUFACTURER'S RECOMMENDATIONS. USE FASTENERS AND FASTENING METHODS RECOMMENDED BY THE MANUFACTURER. EXTERIOR EXPOSED ANCHORS AND ANCHORS IN CONTACT WITH PRESSURE TREATED WOOD TO BE STAINLESS OR GALVANIZED
- 6. BUILT-UP FRAMING MEMBERS SHALL BE FASTENED IN ACCORDANCE WITH NDS STANDARDS UNLESS OTHERWISE NOTED. 7. NOTCHES, COPES, AND HOLES IN WOOD MEMBERS ARE NOT PERMITTED UNLESS SPECIFICALLY DETAILED. NOTCHES, COPES, AND HOLES IN PRE-ENGINEERED MEMBERS SHALL BE IN ACCORDANCE AND APPROVED BY THE MANUFACTURER.
- 8. ROOF TRUSSES, INCLUDING DESIGN, FRAMING CONNECTORS, BRACING ERECTION AND QUALITY SHALL CONFORM TO THE
- SPECIFICATIONS AND RECOMMENDATIONS OF NFPA AND THE TRUSS PLATE INSTITUTE (TPI). 9. SHEATHING SHALL BE RATED AS FOLLOWS (CHECK THAT IT MEETS DESIGN LOADS)
- a. WALL: APA RATED 24" O.C. EXPOSURE I (7/16" MIN. THICKNESS)
- b. FLOOR: APA RATED 24/16, EXPOSURE I (3/4" MIN. THICKNESS) c. ROOF: APA RATED 48/24, EXPOSURE I (5/8" MIN. THICKNESS)
- 10. SHEATHING SHALL BE CONTINUOUS OVER TWO OR MORE SUPPORTS. FLOOR AND ROOF SHEATHING SHALL BE ORIENTED WITH THE
- STRENGTH AXIS PERPENDICULAR TO THE SUPPORTS. WALL SHEATHING CAN BE ORIENTED PERPENDICULAR OR PARALLEL
- 11. WALL SHEATHING SHALL HAVE 2X BLOCKING OR FRAMING MEMBERS BEHIND ALL PANEL EDGES. 12. UNLESS NOTED OTHERWISE, THE MINIMUM FASTENING FOR SHEATHING SHALL BE AS FOLLOWS:
- a. WALL: 8d COMMON NAILS @ 6" O.C. (EDGE) & 12" O.C. (FIELD)
- b. FLOOR: GLUED AND 10d COMMON NAILS @ 6" O.C. (PANEL EDGES) AND 12" O.C. (FIELD)
- c. ROOF: 10d COMMON NAILS@ 6" O.C. (PANEL EDGES) AND 12" O.C. (FIELD) d. GWB: #6 - 1 1/4" SCREWS AT 8" (EDGE) AND 12" (FIELD).
- 13. WOOD CONNECTORS: SIMPSON STRONG-TIE CONNECTORS USED AS BASIS OF DESIGN, USP STRUCTURAL CONNECTORS OF EQUAL STRENGTH ARE ACCEPTABLE.
- 14. BOLTS THROUGH WOOD MEMBERS SHALL BE ASTM A307.

#### STRUCTURAL DESIGN TABLE - IBC 2018 (IN ACCORDANCE WITH APPLICABLE BUILDING CODE)

		I	
BUILDING DATA:			
LOCATION		HARRIMAN STATE PARK	
BUILDING OCCUPANCY RISK CATEGORY		Ш	IBC 2018 TABLE 1604.5
APPLICABLE BUILDING CODE		2020 NYS BUILDING CODE	
FLOOR LIVE LOAD:			
TOILET ROOMS	LL1	60 PSF	ASCE 7-16 TABLE C4.3-1
SNOW LOAD:			
SNOW LOAD IMPORTANCE FACTOR	Is	1.00	ASCE 7-16 TABLE 1.5-2
GROUND SNOW LOAD	Pg	31.6 PSF	IBC 2018 FIGURE 1608.2
SNOW EXPOSURE FACTOR	Ce	1.0	ASCE 7-16 TABLE 7.3-1
THERMAL FACTOR	Ct	1.2	ASCE 7-16 TABLE 7.3-2
FLAT ROOF SNOW	Pf	26.5 PSF	ASCE 7-16 SECTION 7.3
WIND LOAD (COMPONENTS & CLADDING):			
ULTIMATE DESIGN WIND SPEED (3-SECOND GUST)	Vult	112 mph	ASCE 7-16 SECTION 26.5
NOMINAL DESIGN WIND SPEED (3-SECOND GUST)	Vasd	87 mph	IBC 2018 SECTION 1609.3.1
EXPOSURE CATEGORY		В	ASCE 7-16 SECTION 26.7
INTERNAL PRESSURE COEFFICIENT	GCpi	+0.18/-0.18	ASCE 7-16 SECTION 26.13
EARTHQUAKE LOAD:			
SOIL SITE CLASSIFICATION		D	ASCE 7-16 SECTION 20.3
SPECTRAL RESPONSE ACCELERATION AT 0.2 SEC	Ss	0.278g	ASCE 7-16 FIGURE 22-1
SPECTRAL RESPONSE ACCELERATION AT 1.0 SEC	S1	0.06g	ASCE 7-16 SECTION 11.4.2
SEISMIC IMPORTANCE FACTOR	le	1.00	ASCE 7-16 TABLE 1.5-2
DESIGN SPECTRAL RESPONSE COEFFICIENT	SDS	0.292g	ASCE 7-16 SECTION 11.4.5
DESIGN SPECTRAL RESPONSE COEFFICIENT	SD1	0.096g	ASCE 7-16 SECTION 11.4.5
SEISMIC DESIGN CATEGORY		В	ASCE 7-16 TABLE 11.6-(1&2)

	AREAS OF INSPECTION & TESTING		FREQUENCY OF INSPECTION OR TESTING		REFERENCE STANDARD		IBC REFERENCE
1.	VERIFY MATERIALS BELOW SHALLOW FOUNDATIONS ARE ADEQUATE TO ACHIEVE THE DESIGN BEARING CAPACITY.		PERIODIC -		-		1705.6
2.	VERIFY EXCAVATIONS ARE EXTENDED TO PROPER DEPTH AND H REACHED PROPER MATERIAL.	IAVE	PERIODIC				
3.	PERFORM CLASSIFICATION AND TESTING OF COMPACTED FILL MATERIALS		PERIODIC				
4.	<ol> <li>VERIFY USE OF PROPER MATERIALS, DENSITIES, AND LIFT THICKNESS DURING PLACEMENT AND COMPACTION OF COMPACTED FILL.</li> </ol>		CONTINUOUS				
5.	PRIOR TO PLACEMENT OF COMPACTED FILL, INSPECT SUBGRAD AND VERIFY THAT SITE HAS BEEN PREPARED PROPERLY.	E	PERIODIC				
	CAST-IN-PLACE CONCRETE - REQUIREME	NTS F	FOR SPECIAL INSPECTION	& TE	STING		
	AREAS OF INSPECTION & TESTING	FREQUENCY OF REFERENCE INSPECTION OR TESTING STANDARD		IBO	REFERENCE		
1.	INSPECT REINFORCEMENT, INCLUDING PRESTRESSING TENDONS, AND VERIFY PLACEMENT.	PERIODIC			I 318 CH. 20, 25.2, 25.3, 5.6.1 - 26.6.3		1908.4
2.	INSPECT ANCHORS CAST IN CONCRETE		PERIODIC	AC	318: 17.8.2		-
3.	INSPECT ANCHORS POST-INSTALLED IN HARDENED						

EARTHWORK - REQUIREMENTS FOR SPECIAL INSPECTION & TESTING

	AREAS OF INSPECTION & TESTING	INSPECTION OR TESTING	STANDARD	IBC REFERENCE
1.	INSPECT REINFORCEMENT, INCLUDING PRESTRESSING TENDONS, AND VERIFY PLACEMENT.	PERIODIC	ACI 318 CH. 20, 25.2, 25.3, 26.6.1 - 26.6.3	1908.4
2.	INSPECT ANCHORS CAST IN CONCRETE	PERIODIC	ACI 318: 17.8.2	-
3.	INSPECT ANCHORS POST-INSTALLED IN HARDENED CONCRETE MEMBERS. b a. ADHESIVE ANCHORS INSTALLED IN HORIZONTALLY OR UPWARDLY INCLINED ORIENTATIONS TO RESIST SUSTAINED TENSION LOADS. b. MECHANICAL ANCHORS AND ADHESIVE ANCHORS NOT DEFINED IN 4.a.	CONTINUOUS PERIODIC	ACI 318: 17.8.2.4 ACI 318: 17.8.2	-
4.	VERIFY USE OF REQUIRED DESIGN MIX.	PERIODIC	ACI 318: CH. 19, 26.4.3, 26.4.4	1904.1, 1904.2, 1908.2, 1908.3
5.	PRIOR TO CONCRETE PLACEMENT, FABRICATE SPECIMENS FOR STRENGTH TESTS, PERFORM SLUMP AND AIR CONTENT TESTS, AND DETERMINE THE TEMPERATURE OF THE `CONCRETE.	CONTINUOUS	ASTM C172 ASTM C31 ACI 318: 26.4, 26.12	1908.10
6.	INSPECT CONCRETE AND SHOTCRETE PLACEMENT FOR PROPER APPLICATION TECHNIQUES.	CONTINUOUS	ACI 318: 26.5	1908.6, 1908.7, 1908.8
7.	VERIFY MAINTENANCE OF SPECIFIED CURING TEMPERATURE AND TECHNIQUES.	PERIODIC	ACI 318: 26.5.3 - 26.5.5	1908.9
8.	VERIFY IN-SITU CONCRETE STRENGTH, PRIOR TO STRESSING OF TENDONS IN POST-TENSIONED CONCRETE AND PRIOR TO REMOVAL OF SHORES AND FORMS FROM BEAMS AND STRUCTURAL SLABS.	PERIODIC	ACI 318: 26.11.2	•
9.	INSPECT FORMWORK FOR SHAPE, LOCATION AND DIMENSIONS OF THE CONCRETE MEMBER BEING FORMED.	PERIODIC	ACI 318; 26.11.2 (b)	-

WHERE APPLICABLE. SEE SECTION 1705.12. SPECIAL INSPECTIONS FOR SEISMIC RESISTANCE.

SPECIFIC REQUIREMENTS FOR SPECIAL INSPECTION SHALL BE INCLUDED IN THE RESEARCH REPORT FOR THE ANCHOR ISSUED BY AN APPROVED SOURCE IN ACCORDANCE WITH 17.8.2 IN ACI
318, OR OTHER QUALIFICATION PROCEDURES. WHERE SPECIFIC REQUIREMENTS ARE NOT PROVIDED, SPECIAL INSPECTION REQUIREMENTS SHALL BE SPECIFIED BY THE REGISTERED DESIGN

PROFESSIONAL AND SHALL BE APPROVED BY THE BUILDING OFFICIAL PRIOR TO THE COMMENCEMENT OF THE WORK.



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Architect: Saratoga Associates 21 Congress Street, Suite 201

Governor Kathy Hochul

SARATOGA **ASSOCIATES** Lacobuse Architects, Architects Engineers, and Floriners, E.C.

Commissioner Erik Kulleseid

Surveyor/Structural/MEP Engineer:

LaBella Associates 105 N. Tioga Street, Suite 200 Ithaca, NY 14850

Certificate of Authorization Number: Professional Engineering: 018281 Land Surveying: 017978 Geological: 018750

Saratoga Springs, NY 12866

LaBella

Palisades Region

Palisades Interstate Park Commission Bear Mountain, New York 10911 (845) 786-2701 Executive Director: Joshua Laird

Project Title: CAMP JUNIOR ON LAKE TIORATI -PHASE 3

**Project Location:** HARRIMAN STATE PARK

**Key Plan** 

REVISIONS Rev No Description Date:

Drav	vn By:
M	CRB
Desi	ign By:
M	CM
Chec	cked By:
M	CM
Appro	oved By:
M	CM
Date:	
3/	16/23

Sheet Title:

NOTES

GENERAL

Drawing Number:


EXPIRATION DATE: 10/31/2025

Seal and Signature

Bid Documents Project Number:

2222163.05



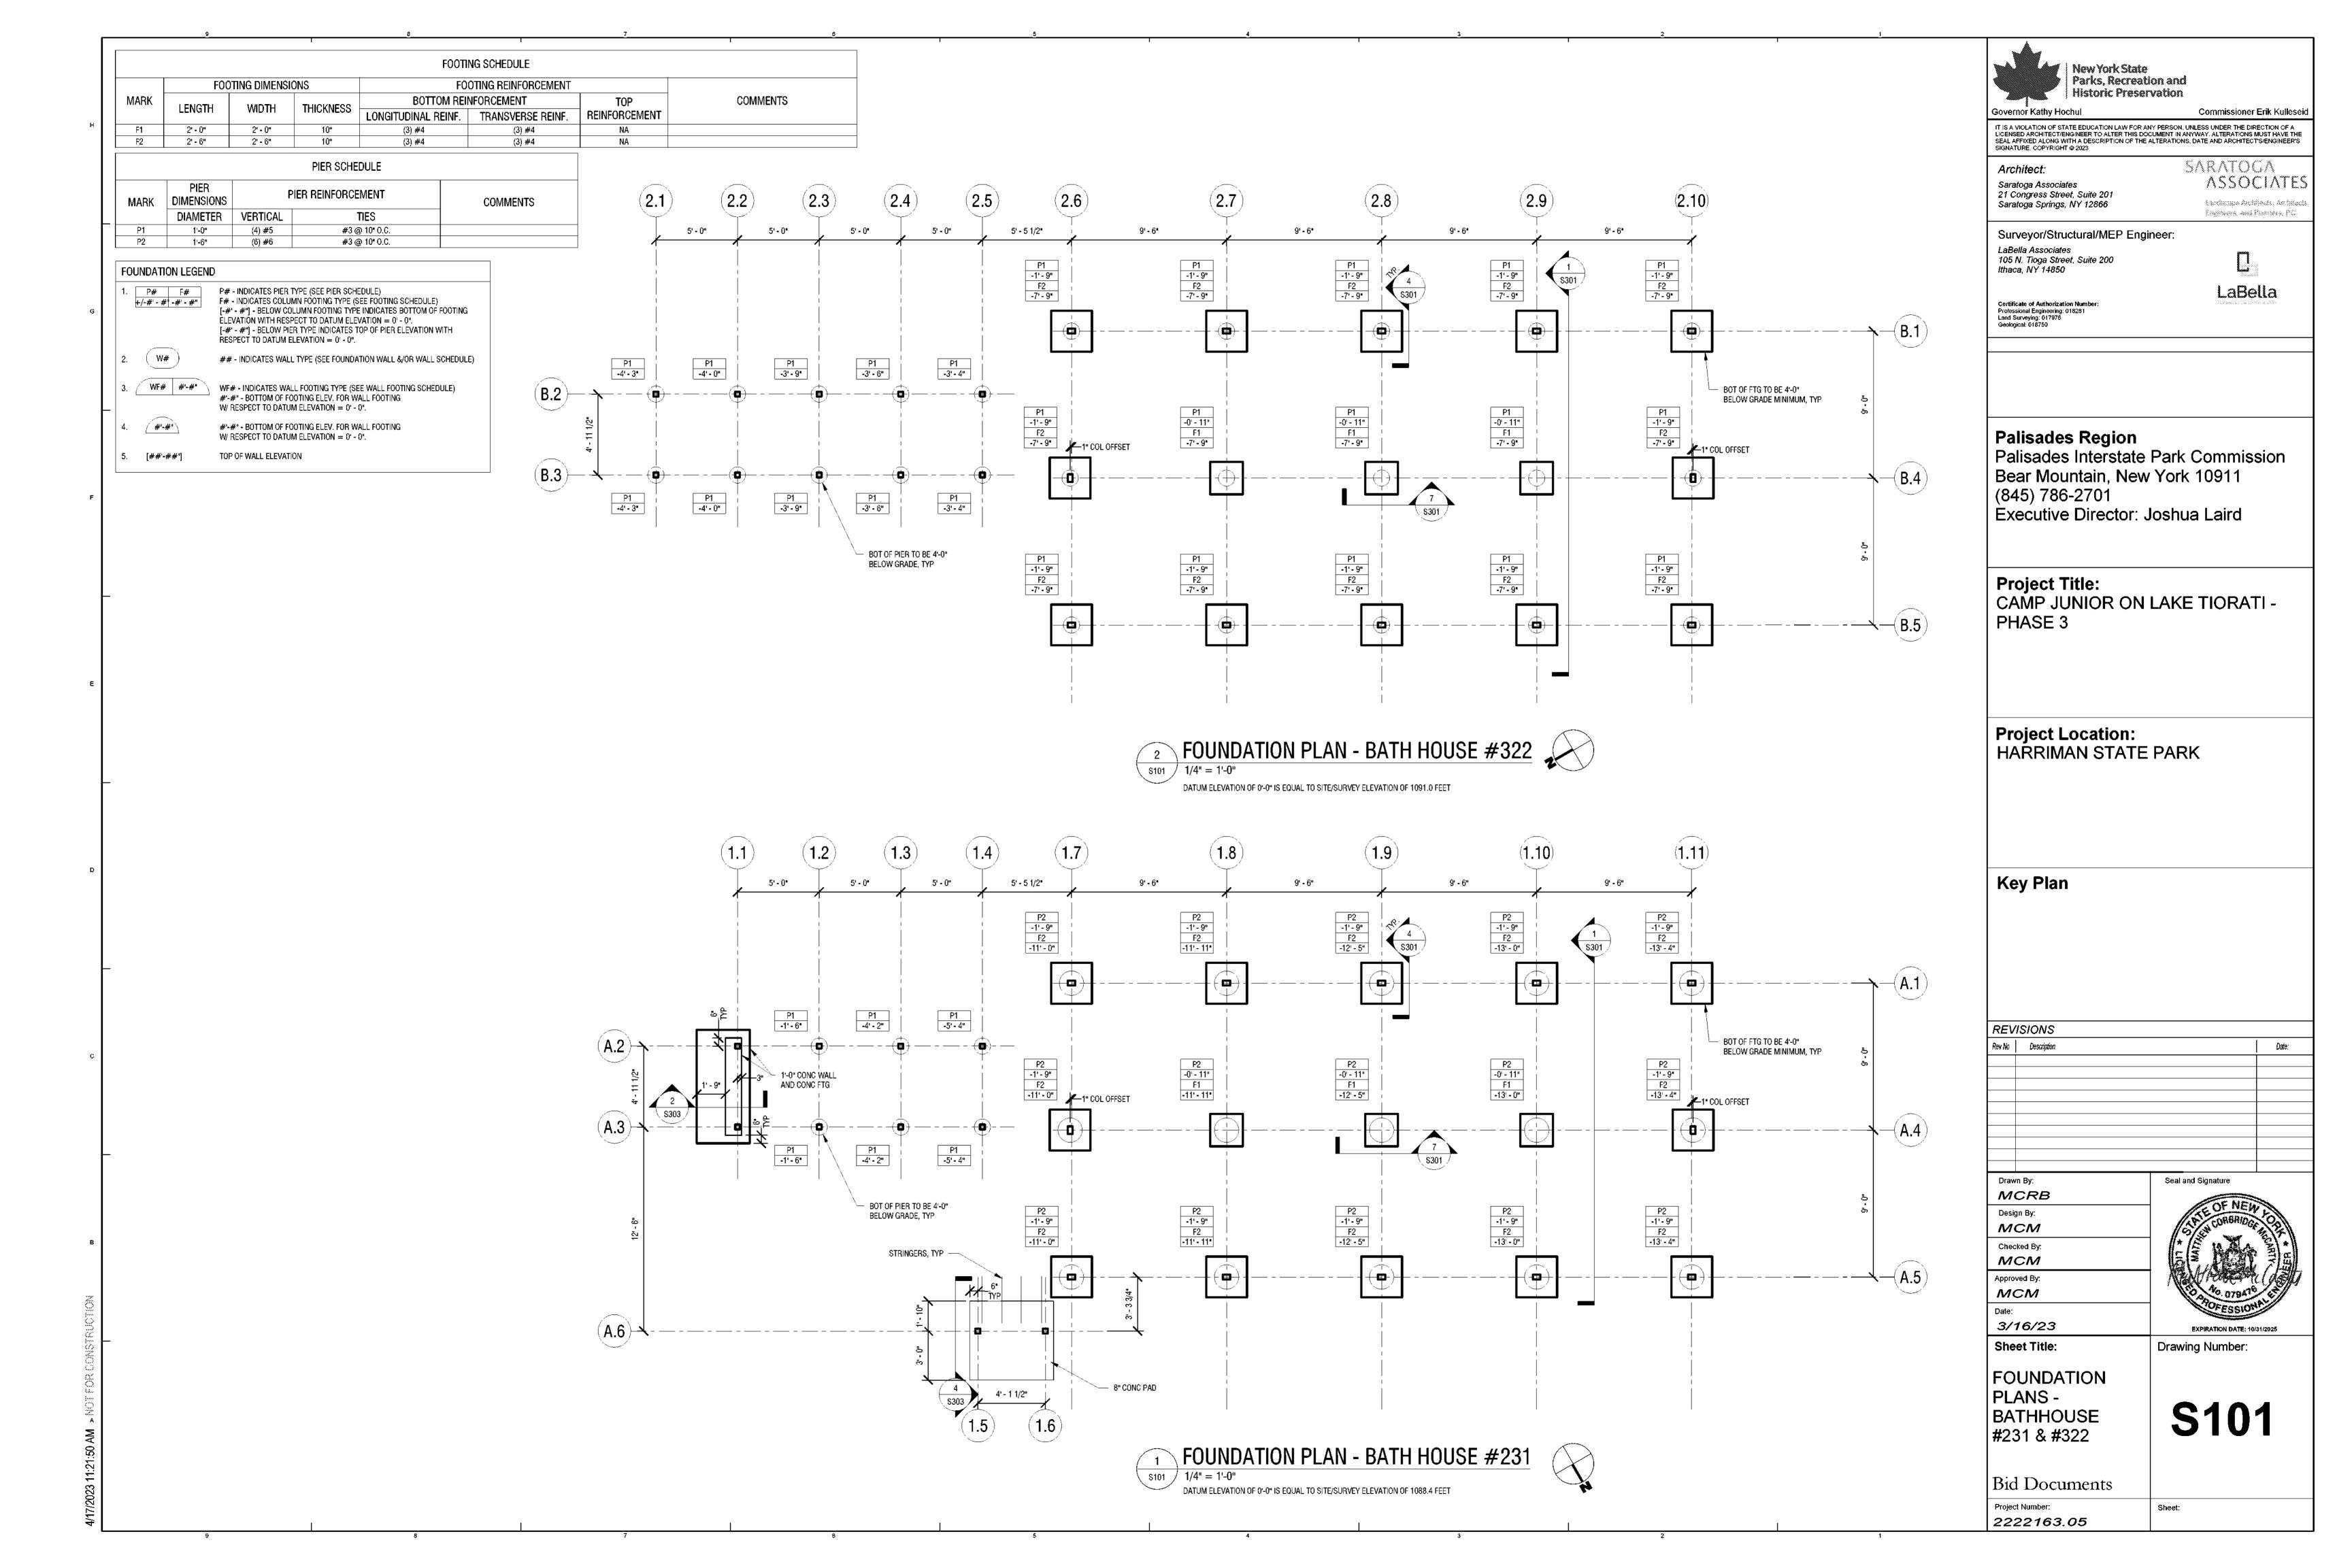

				FOOTI	NG SCHEDULE		
	FOC	TING DIMENSIO	ONS	FO	OTING REINFORCEMENT		
MARK	LENGTH	WIDTH	THICKNESS	BOTTOM REI	NFORCEMENT	TOP	COMMENTS
	LENGIII	WIDITI	ITHORNESS	LONGITUDINAL REINF.	TRANSVERSE REINF.	REINFORCEMENT	
F1	2' - 0"	2' - 0"	10"	(3) #4	(3) #4	NA	
F2	2' - 6"	2' - 6"	10"	(3) #4	(3) #4	NA	

#### PIER SCHEDULE

MARK	PIER DIMENSIONS	F	PIER REINFORCEMENT	COMMENTS
	DIAMETER	VERTICAL	TIES	
P1	1'-0"	(4) #5	#3 @ 10* O.C.	
P2	1'-6"	(6) #6	#3 @ 10" O.C.	

FOUNDATION LEGEND

+/-#' - #" -#' - #"

P# - INDICATES PIER TYPE (SEE PIER SCHEDULE)
F# - INDICATES COLUMN FOOTING TYPE (SEE FOOTING SCHEDULE)
[-#' - #'] - BELOW COLUMN FOOTING TYPE INDICATES BOTTOM OF FOOTING

ELEVATION WITH RESPECT TO DATUM ELEVATION = 0' - 0".

[-#' - #"] - BELOW PIER TYPE INDICATES TOP OF PIER ELEVATION WITH RESPECT TO DATUM ELEVATION = 0' - 0''.

( w# )

## - INDICATES WALL TYPE (SEE FOUNDATION WALL &/OR WALL SCHEDULE)


´ WF# │#'-#" ``

WF# - INDICATES WALL FOOTING TYPE (SEE WALL FOOTING SCHEDULE) #-#" - BOTTOM OF FOOTING ELEV. FOR WALL FOOTING
W/ RESPECT TO DATUM ELEVATION = 0' - 0".

/ #'-#"\

#'-#" - BOTTOM OF FOOTING ELEV. FOR WALL FOOTING W/ RESPECT TO DATUM ELEVATION = 0' - 0".

TOP OF WALL ELEVATION

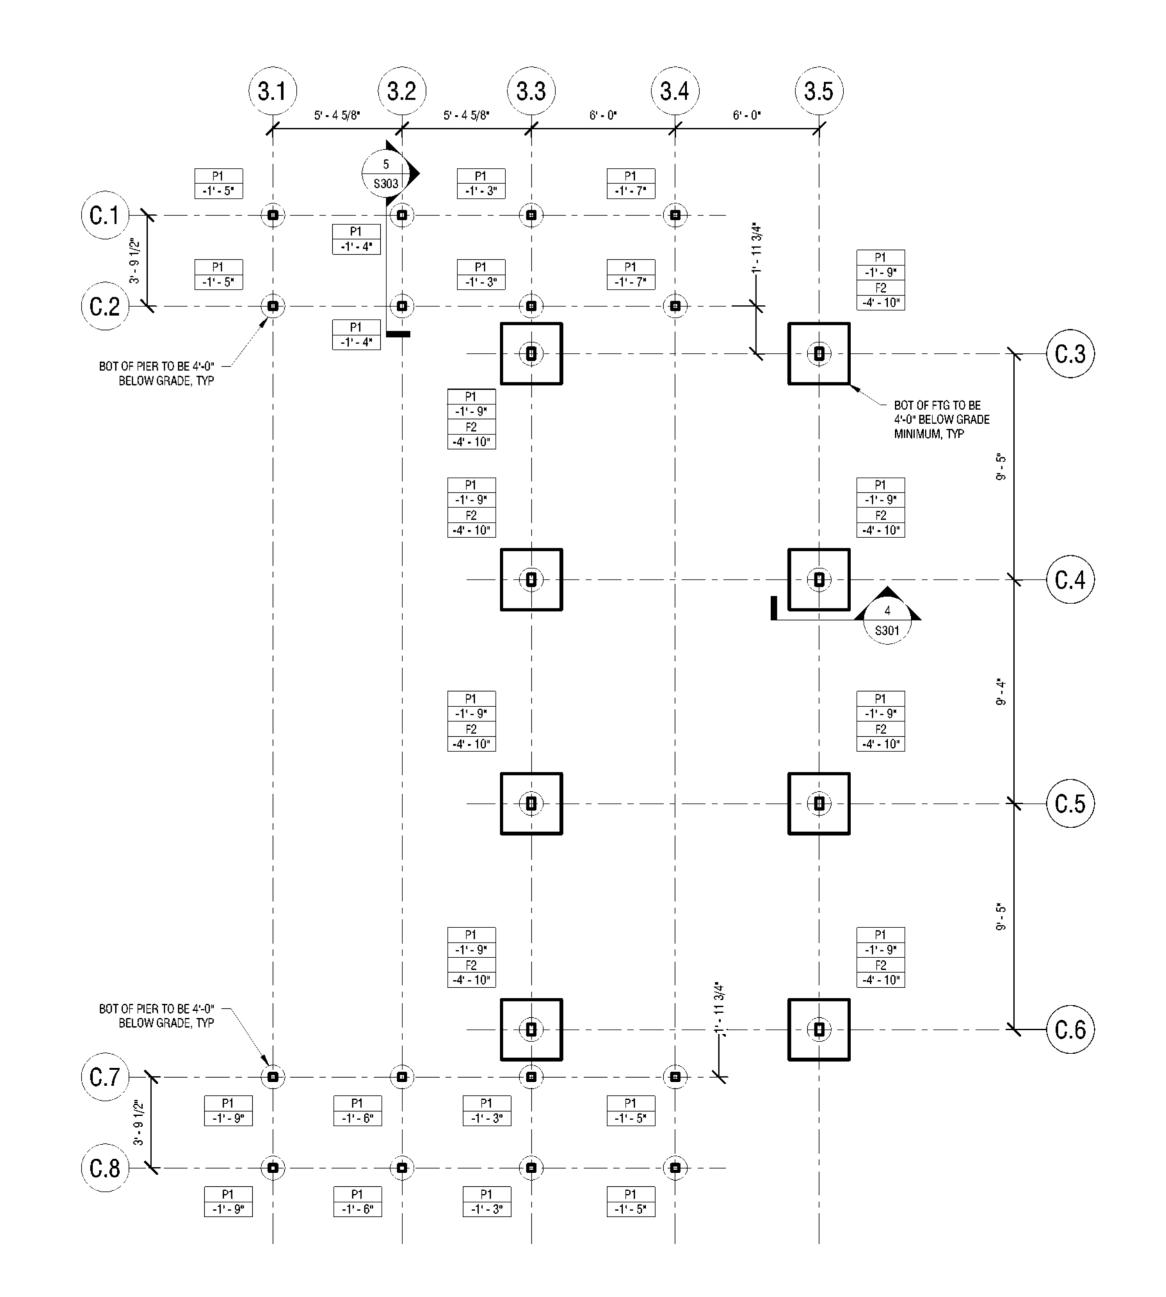





New York State Parks, Recreation and Historic Preservation

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Architect: Saratoga Associates

SARATOGA **ASSOCIATES** - Lambaupe Architeats, Architects,

Surveyor/Structural/MEP Engineer:

LaBella Associates 105 N. Tioga Street, Suite 200 Ithaca, NY 14850

21 Congress Street, Suite 201 Saratoga Springs, NY 12866

LaBella

Engineers, and Pompers, PCC

Certificate of Authorization Number: Professional Engineering: 018281 Land Surveying: 017976 Geological: 018750

Palisades Region

Palisades Interstate Park Commission Bear Mountain, New York 10911 (845) 786-2701 Executive Director: Joshua Laird

Project Title: CAMP JUNIOR ON LAKE TIORATI -

Project Location: HARRIMAN STATE PARK

**Key Plan** 

PHASE 3

REVISIONS Rev No Description Date: Seal and Signature

MCRB Design By: MCM Checked By: MCM Approved By: MCM 3/16/23

Sheet Title:


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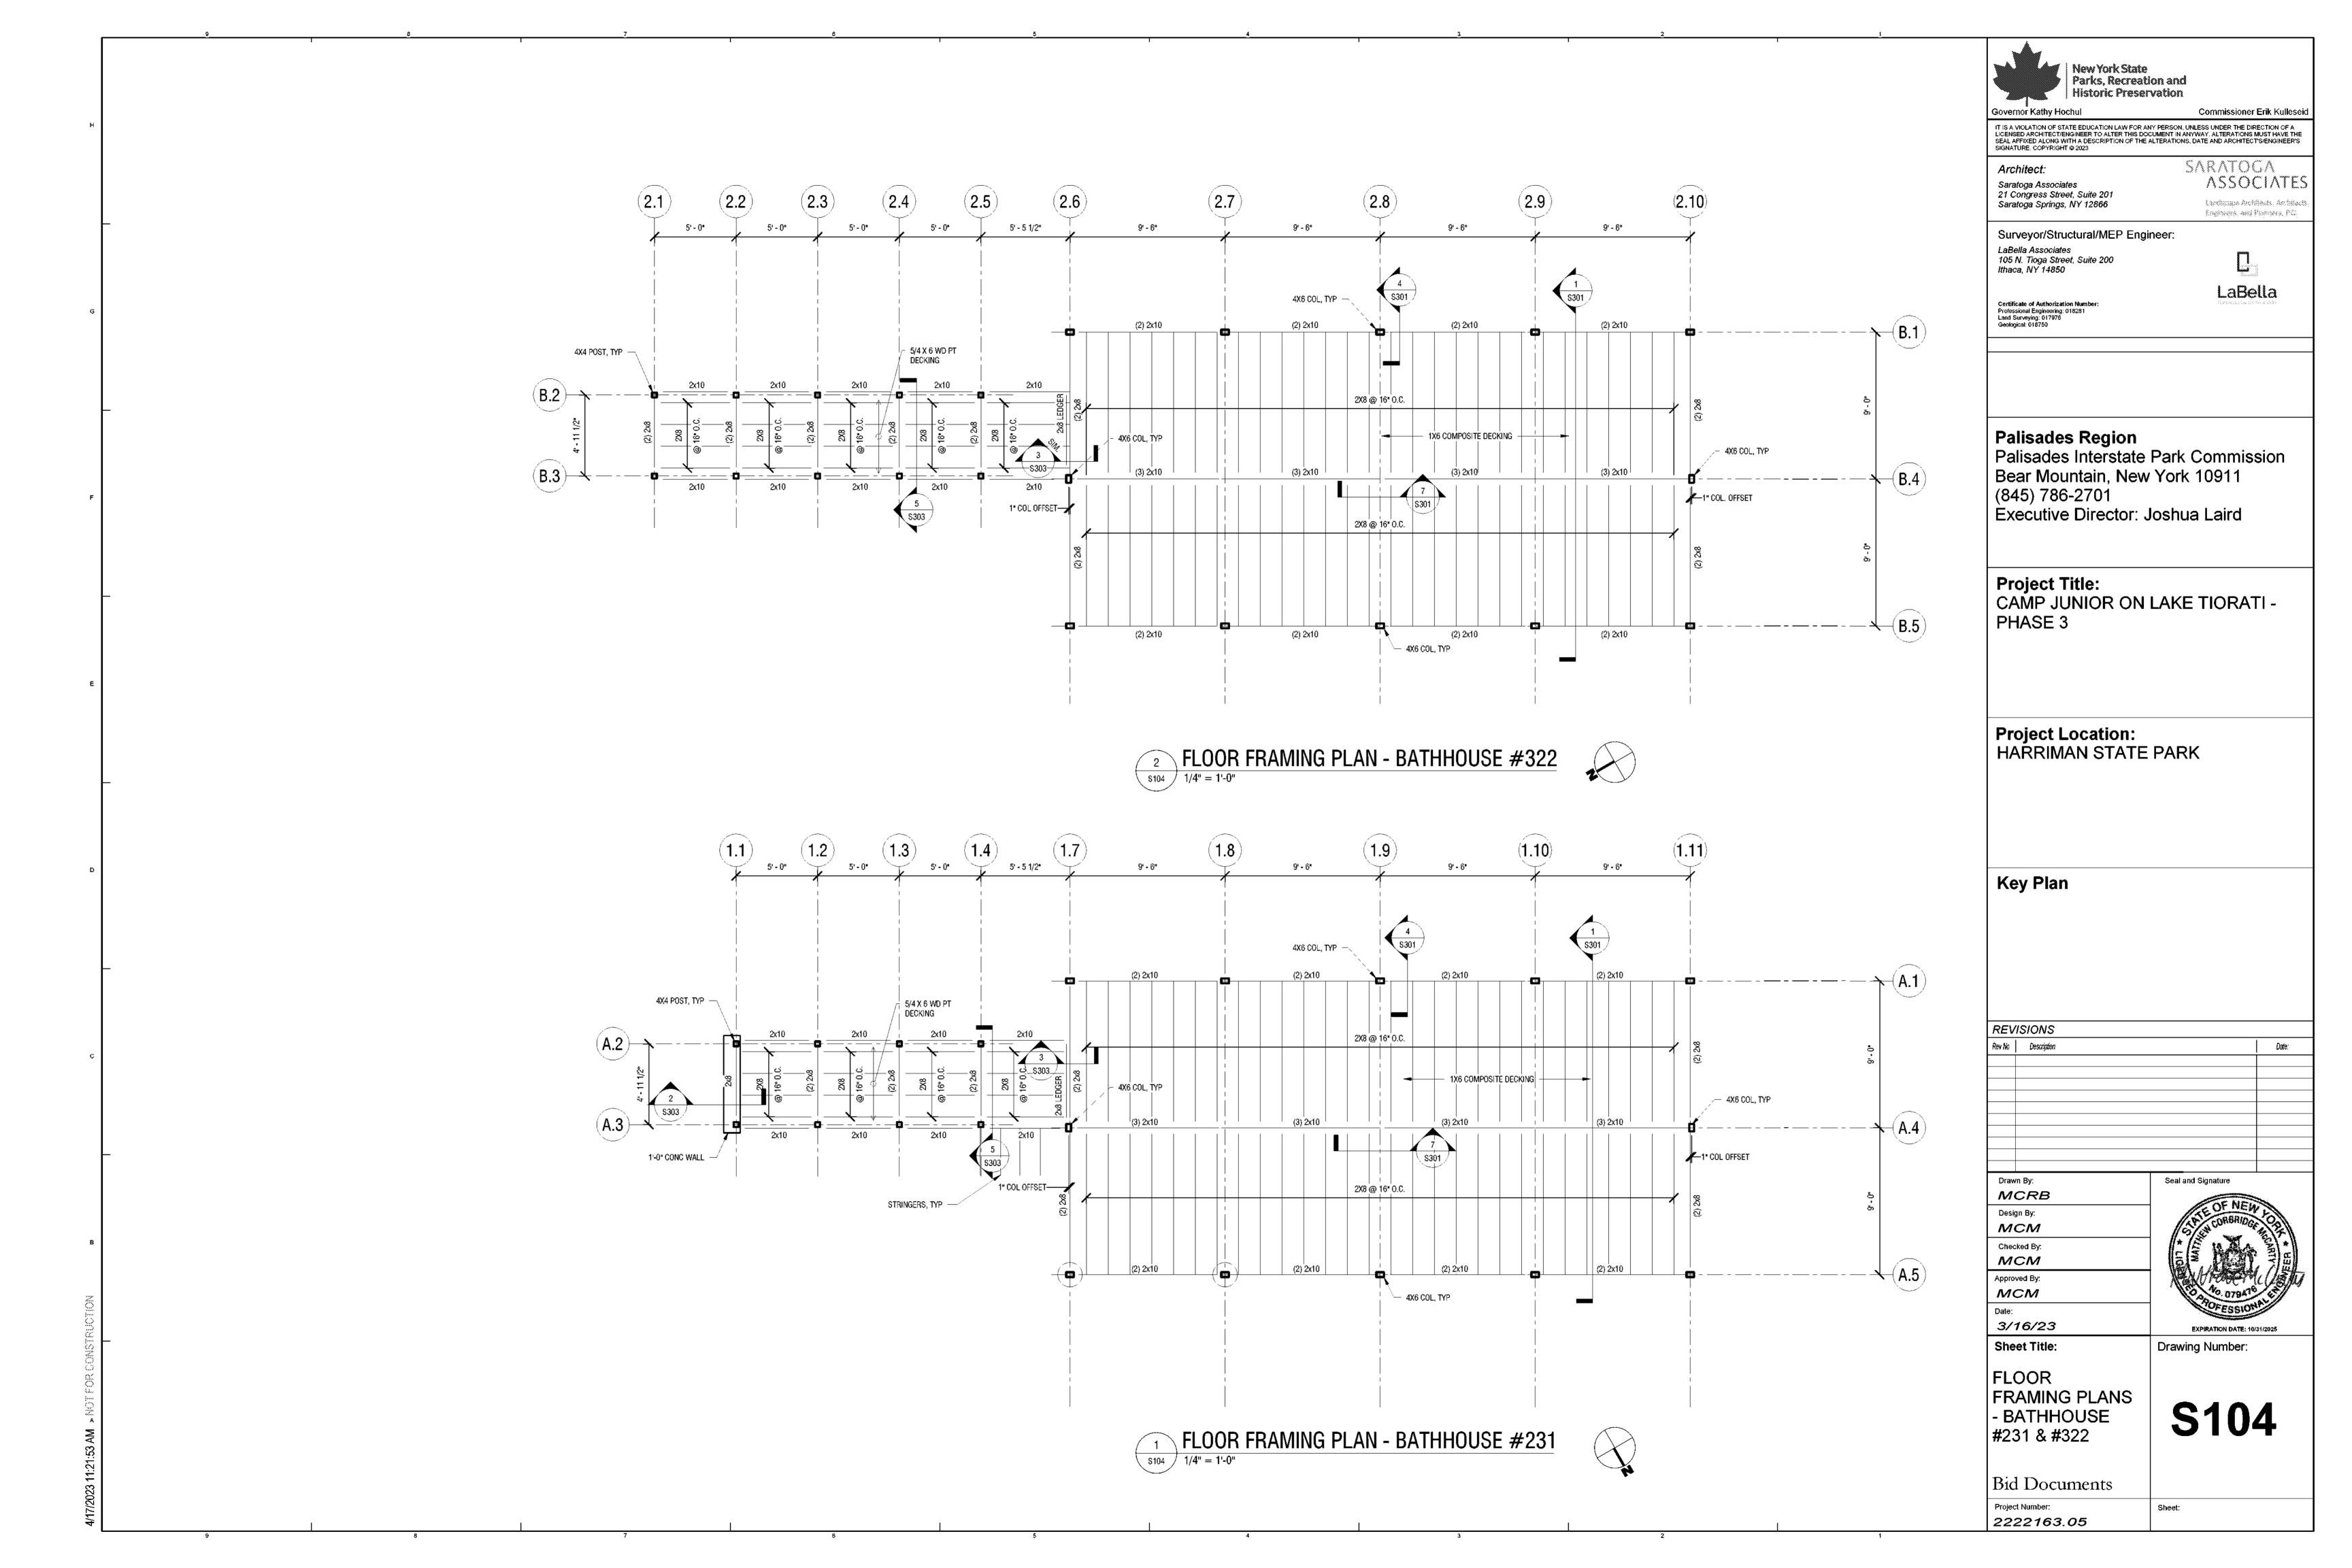
**S102** 


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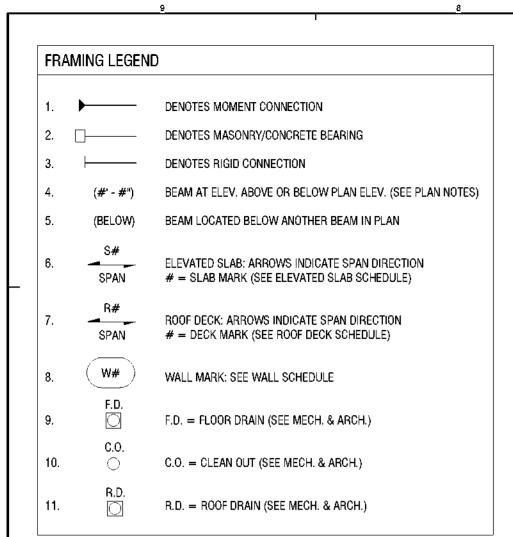
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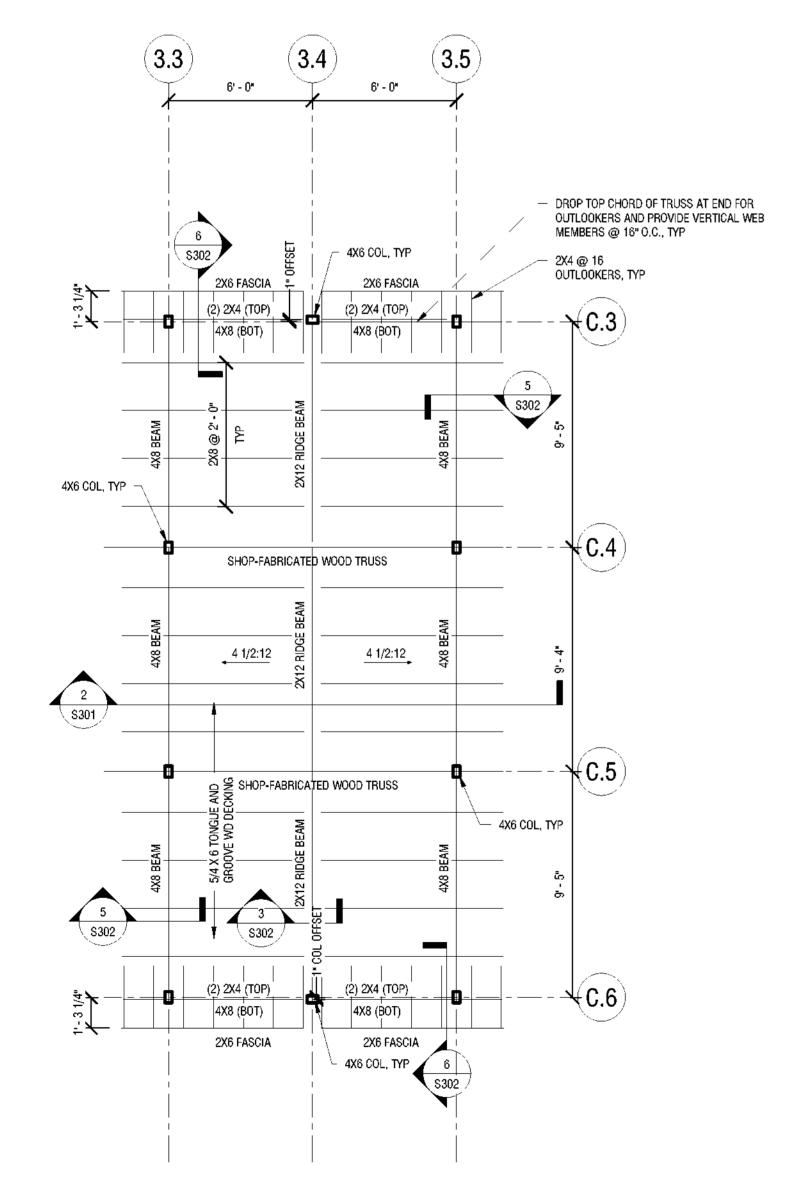
Bid Documents Project Number: 2222163.05








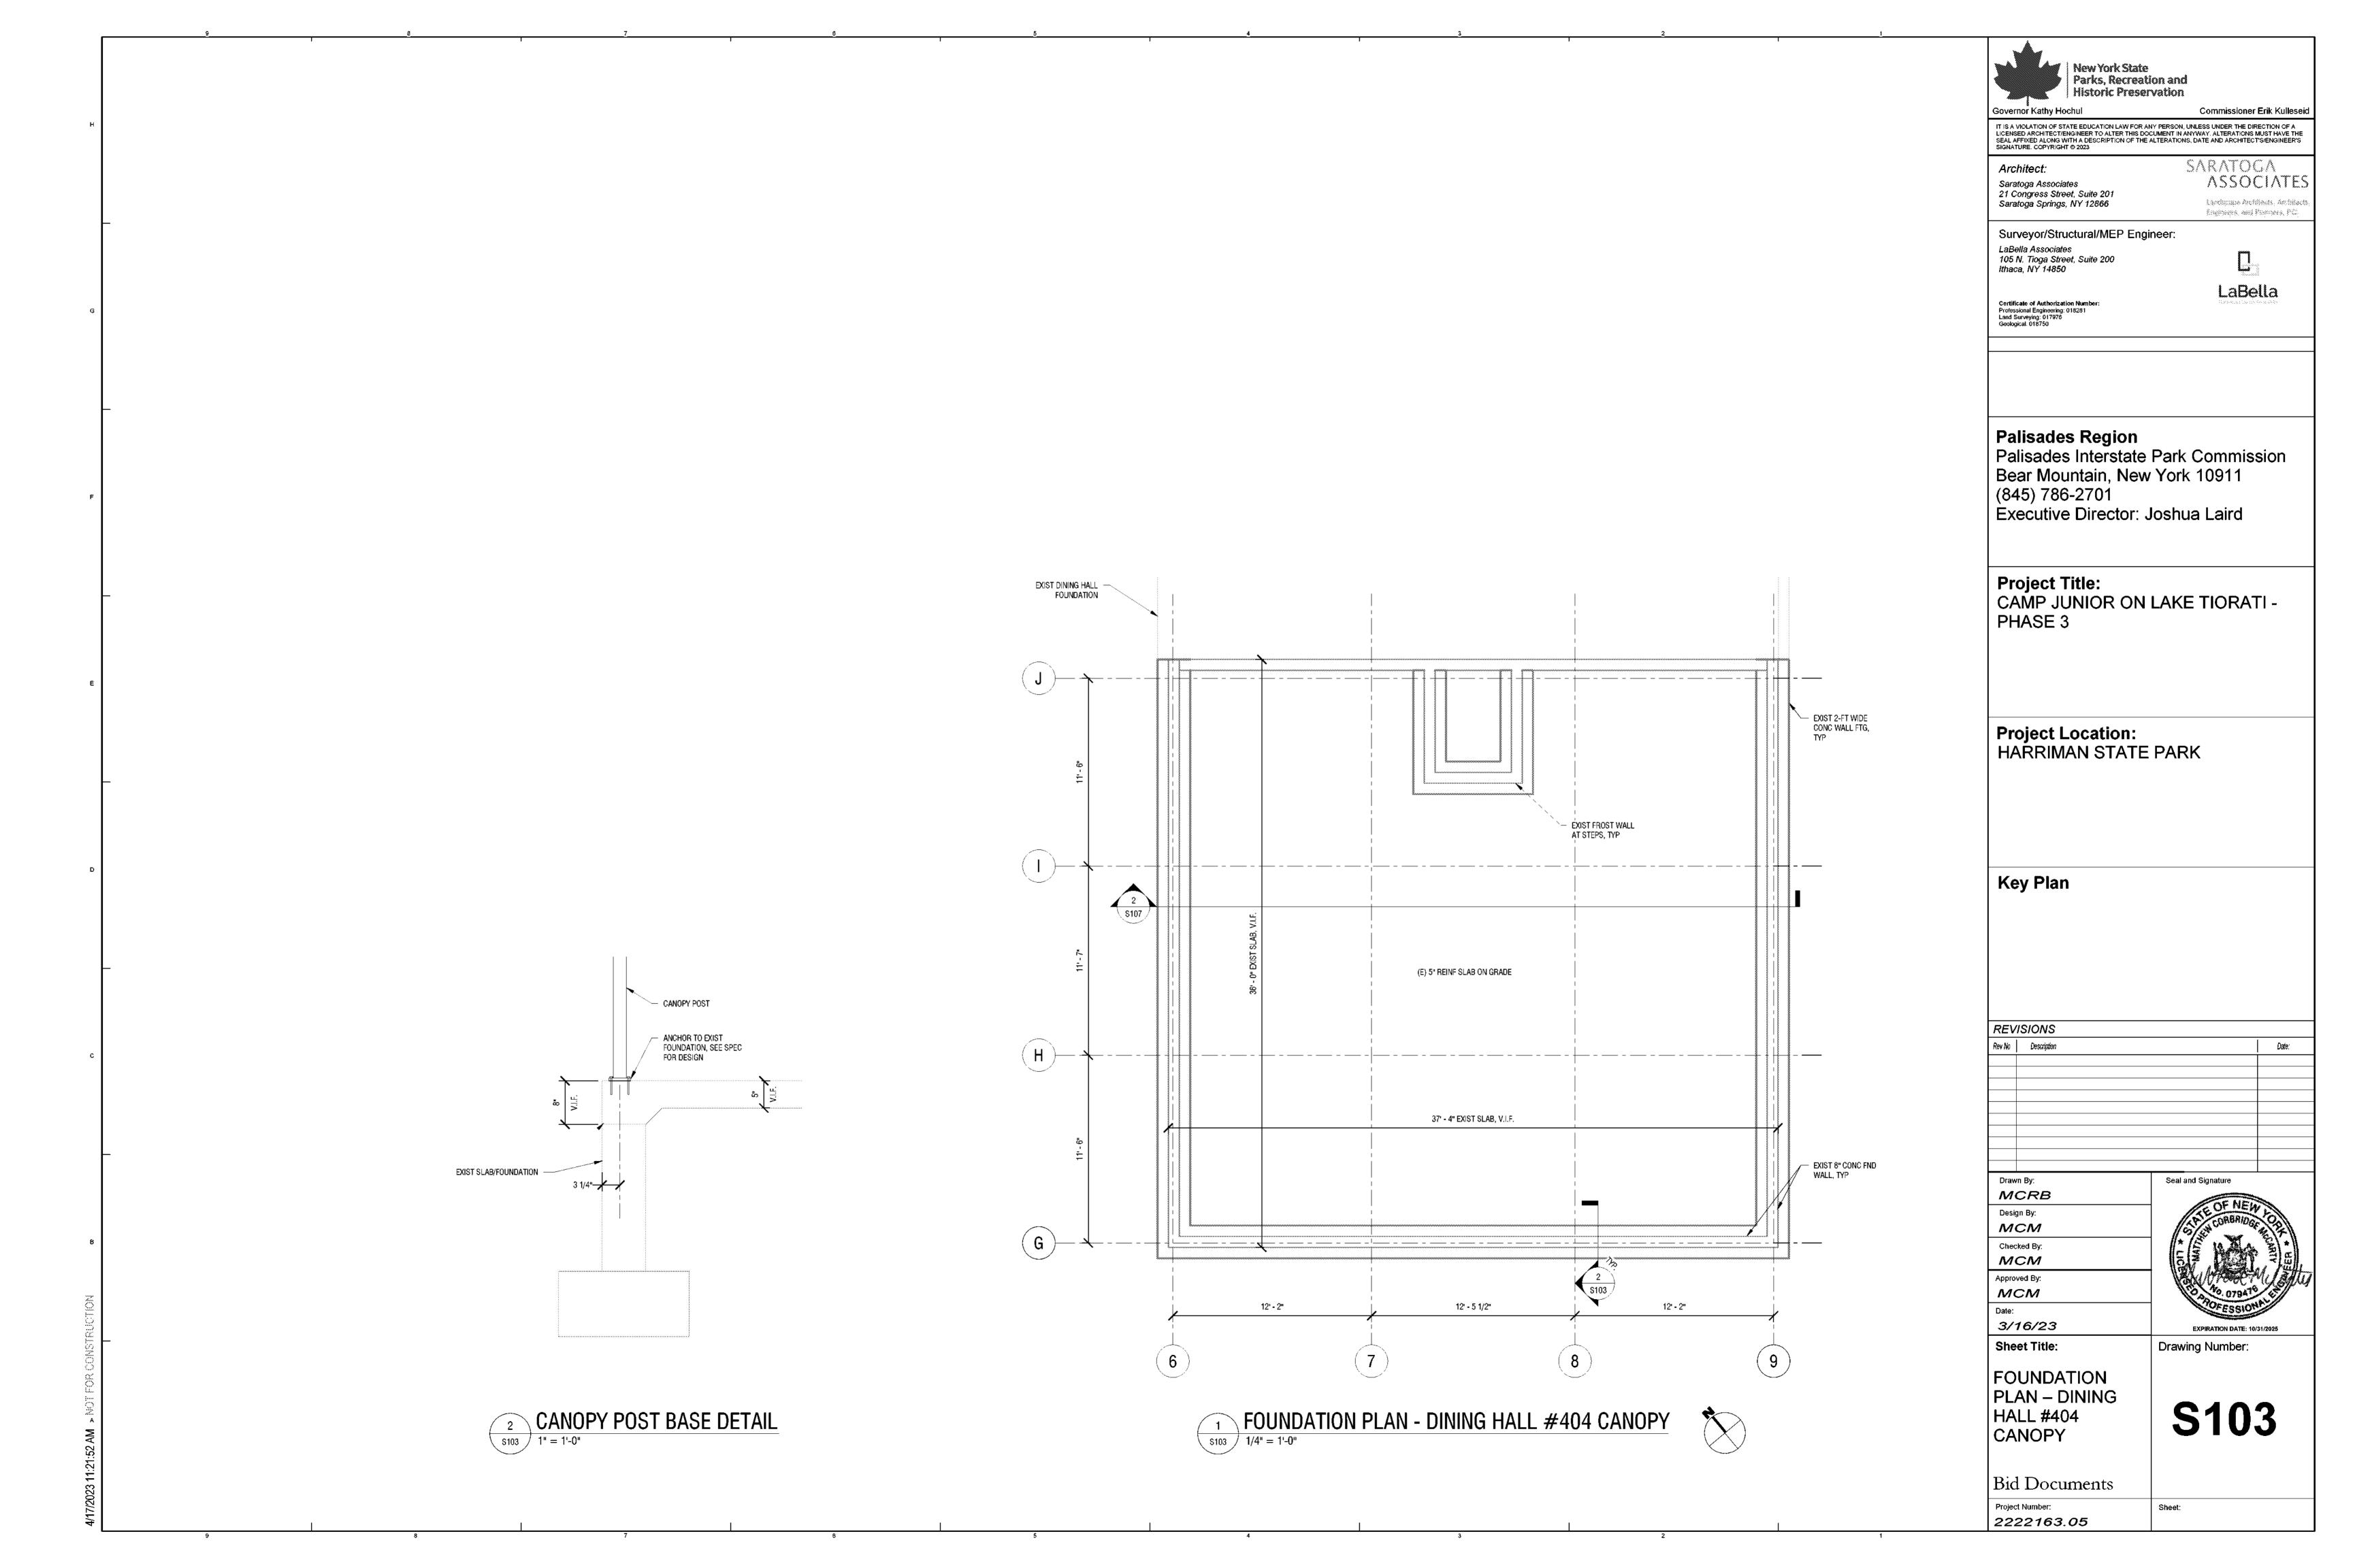

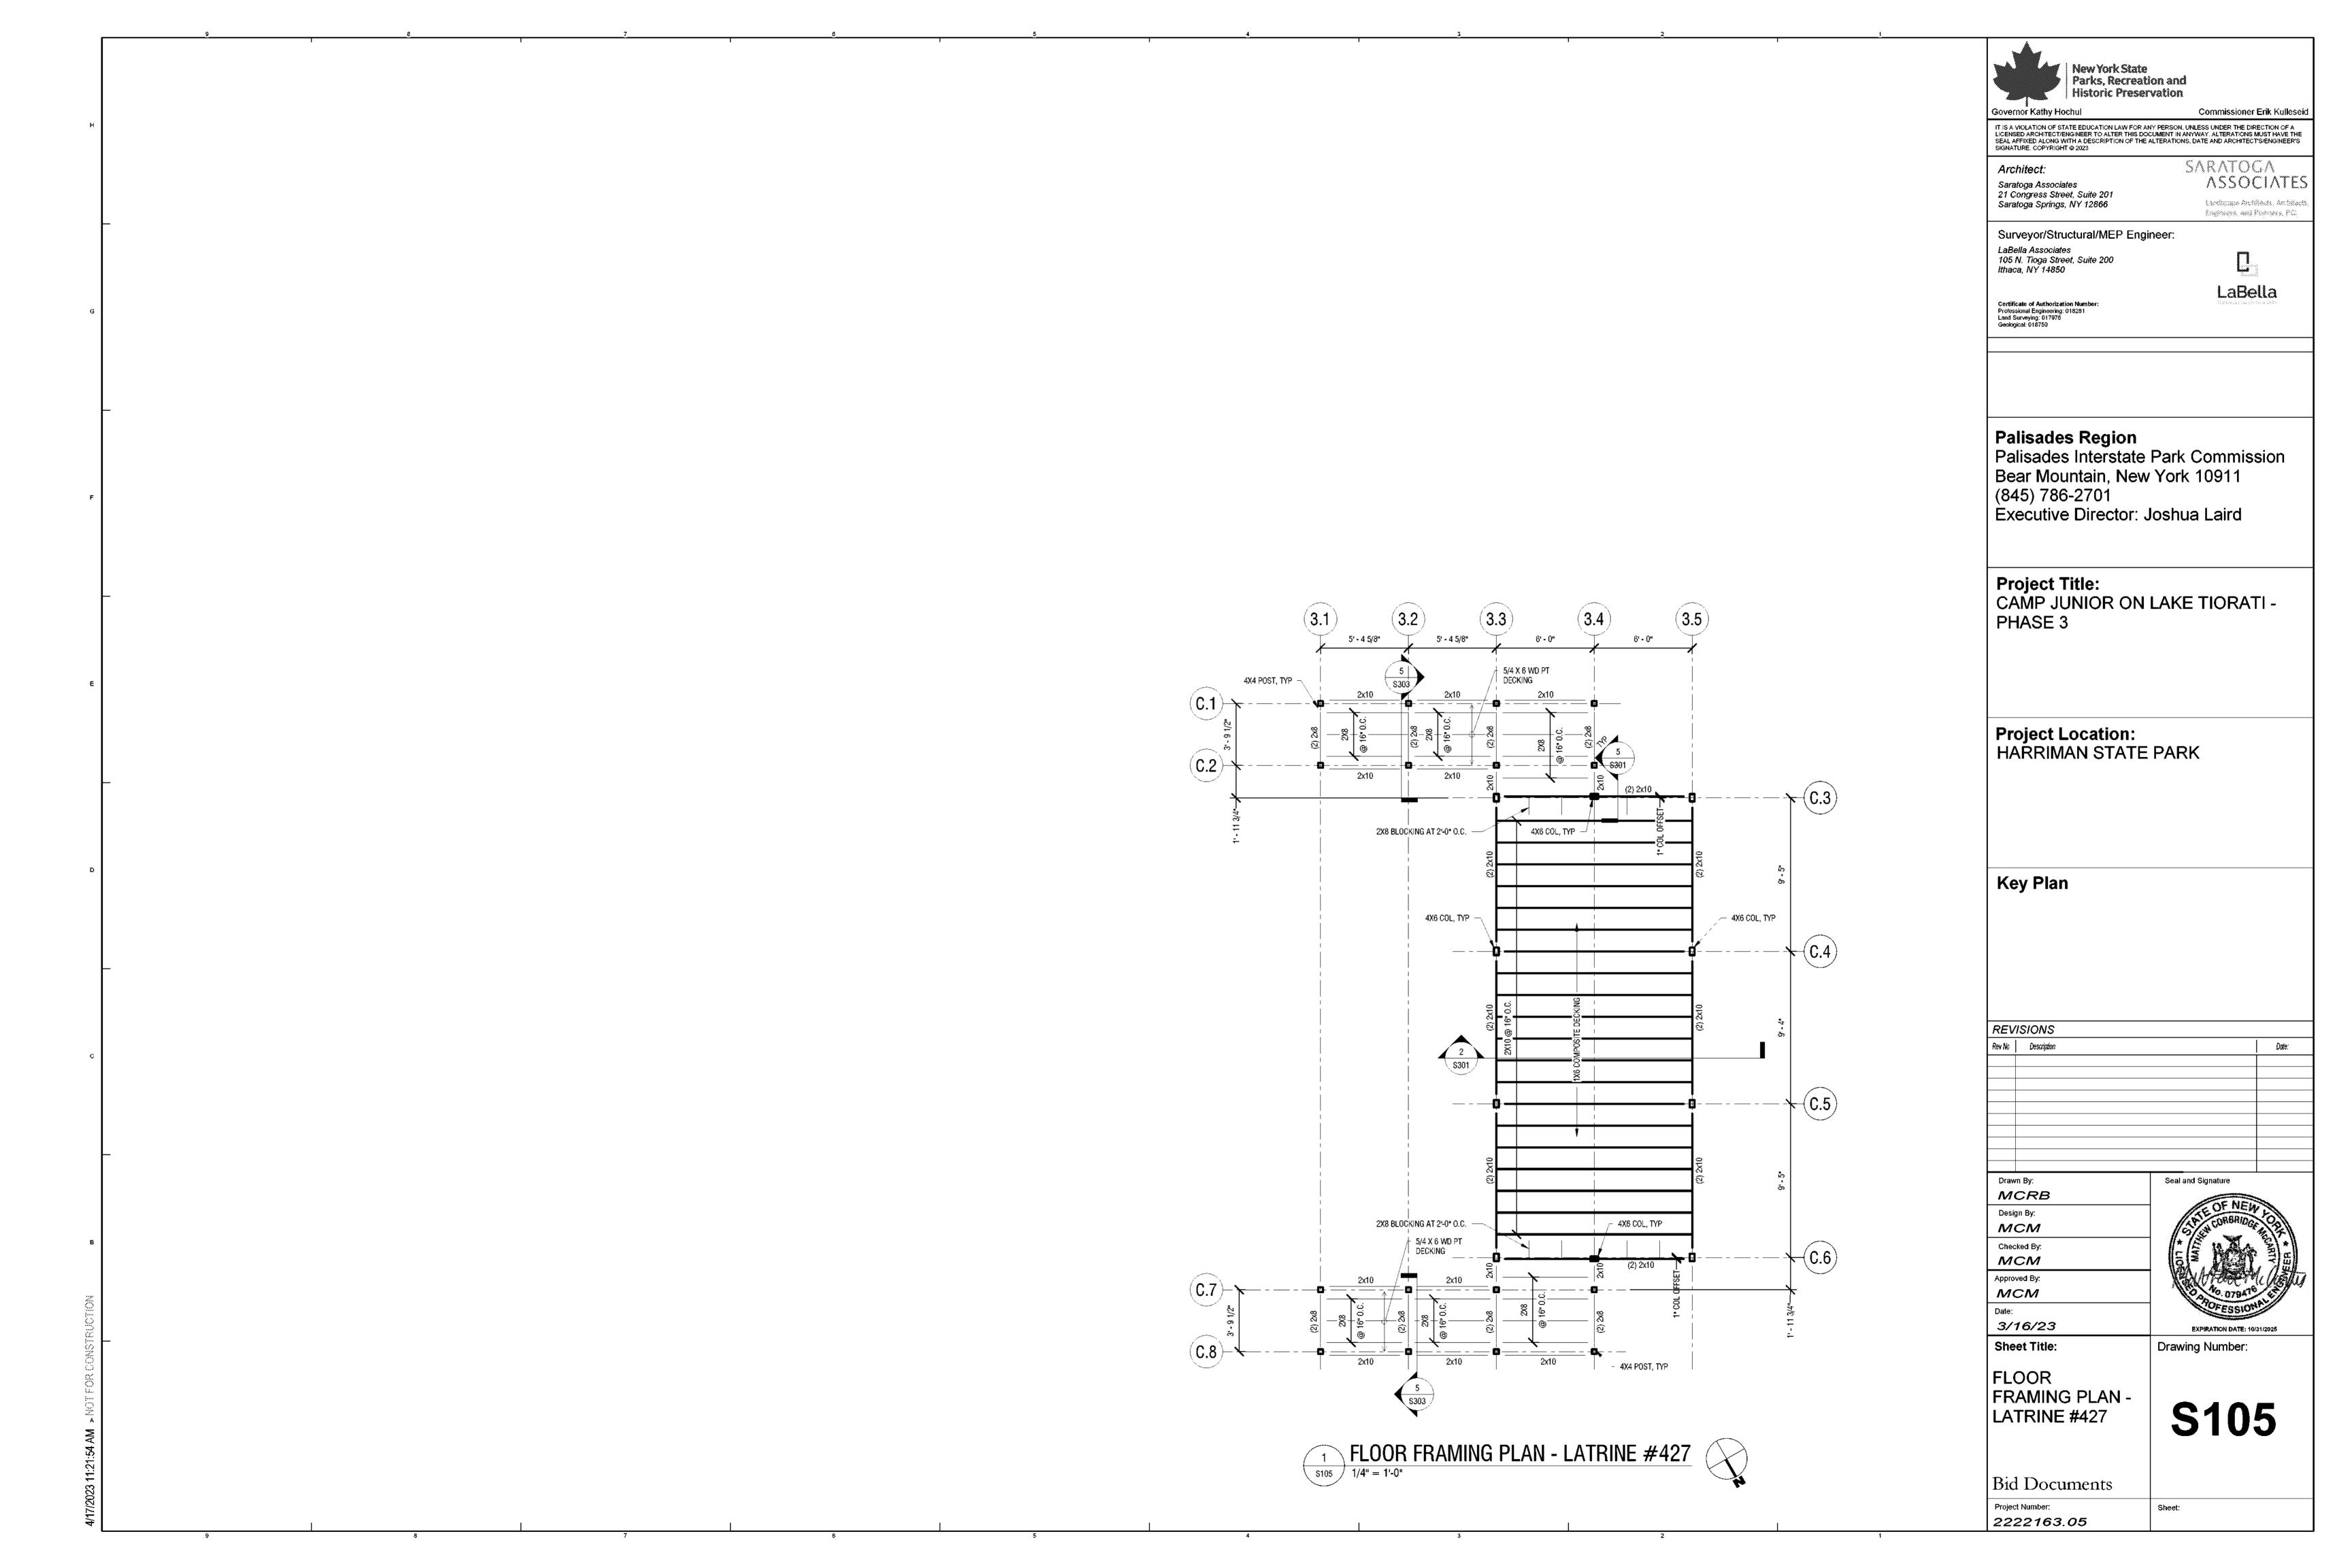



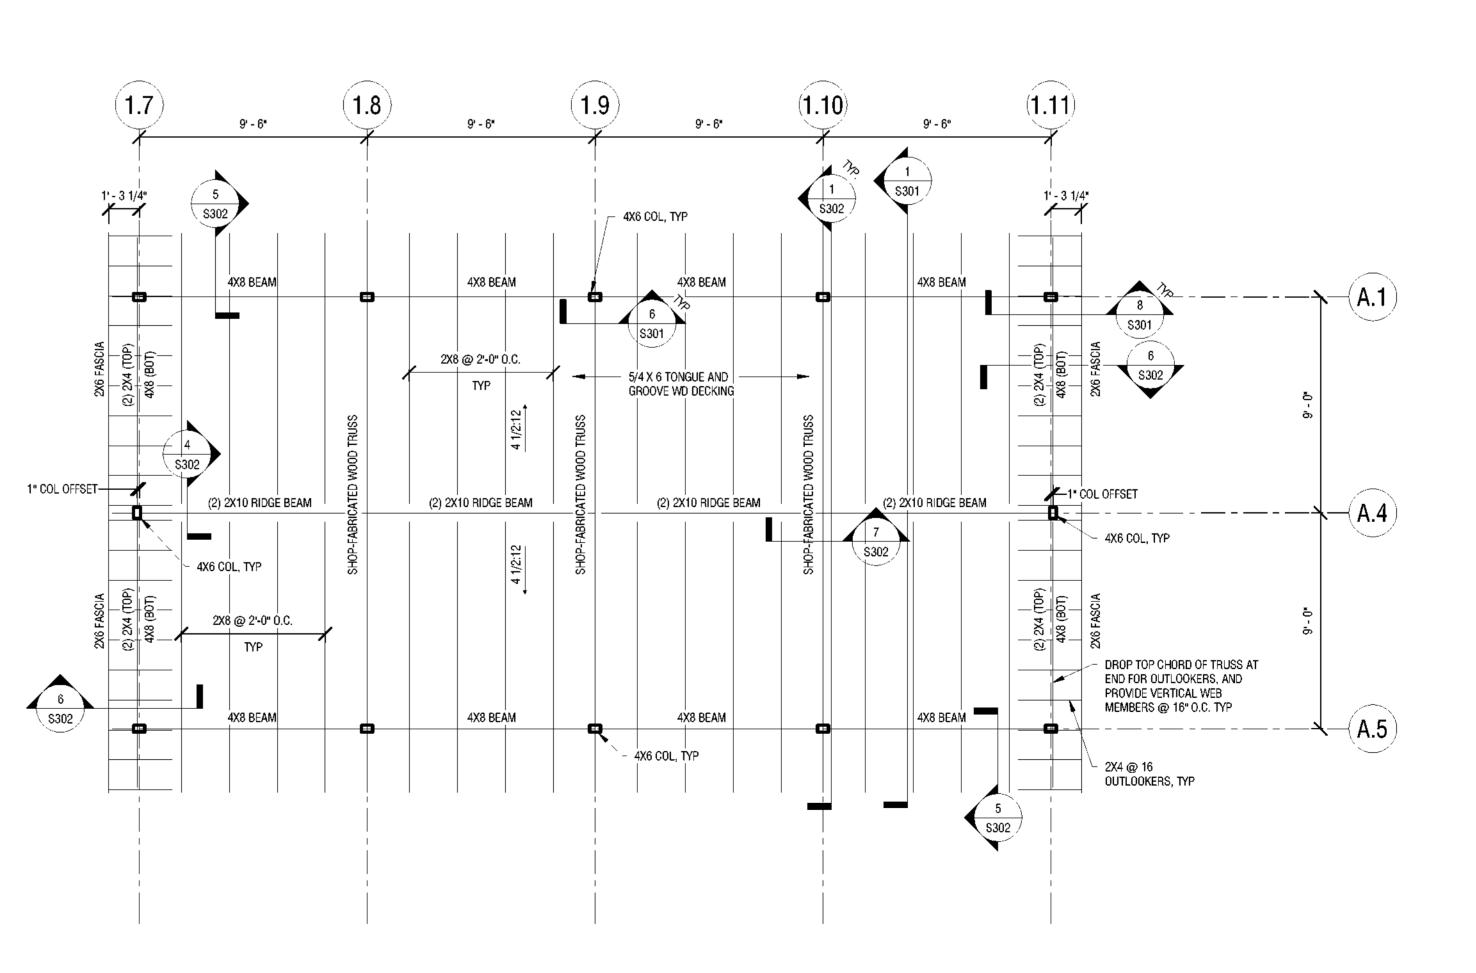

ROOF FRAMING PLAN - BATHHOUSE #231 AND #322

COLUMN GRID TAGS SHOWN ARE FOR BATHHOUSE #231, SEE OTHER PLANS FOR BATHHOUSE #322 TAGS.

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Architect: Saratoga Associates 21 Congress Street, Suite 201 Saratoga Springs, NY 12866 SARATOGA **ASSOCIATES** - Lambaupe Architeats, Architects,

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Surveyor/Structural/MEP Engineer:

LaBella Associates 105 N. Tioga Street, Suite 200 Ithaca, NY 14850

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Palisades Region

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Project Title: CAMP JUNIOR ON LAKE TIORATI -PHASE 3

Project Location: HARRIMAN STATE PARK

Key Plan

REVISIONS Rev No Description Date: Seal and Signature

MCRB Design By: MCM Checked By: MCM Approved By: MCM

EXPIRATION DATE: 10/31/2025 Drawing Number:

Sheet Title:


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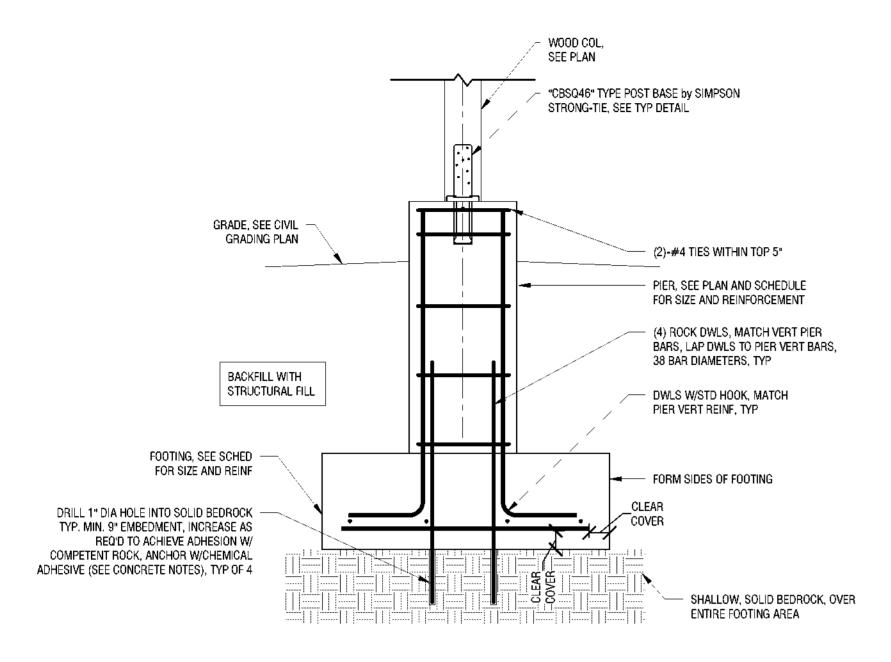
ROOF FRAMING PLANS

**S106** 


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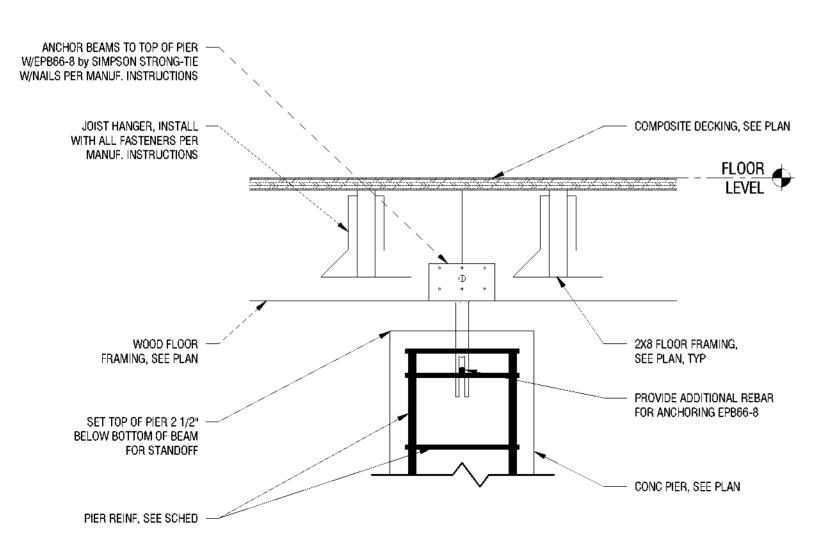





## TYPICAL PIER AND FOOTING AT BEDROCK s301 / 3/4" = 1'-0"

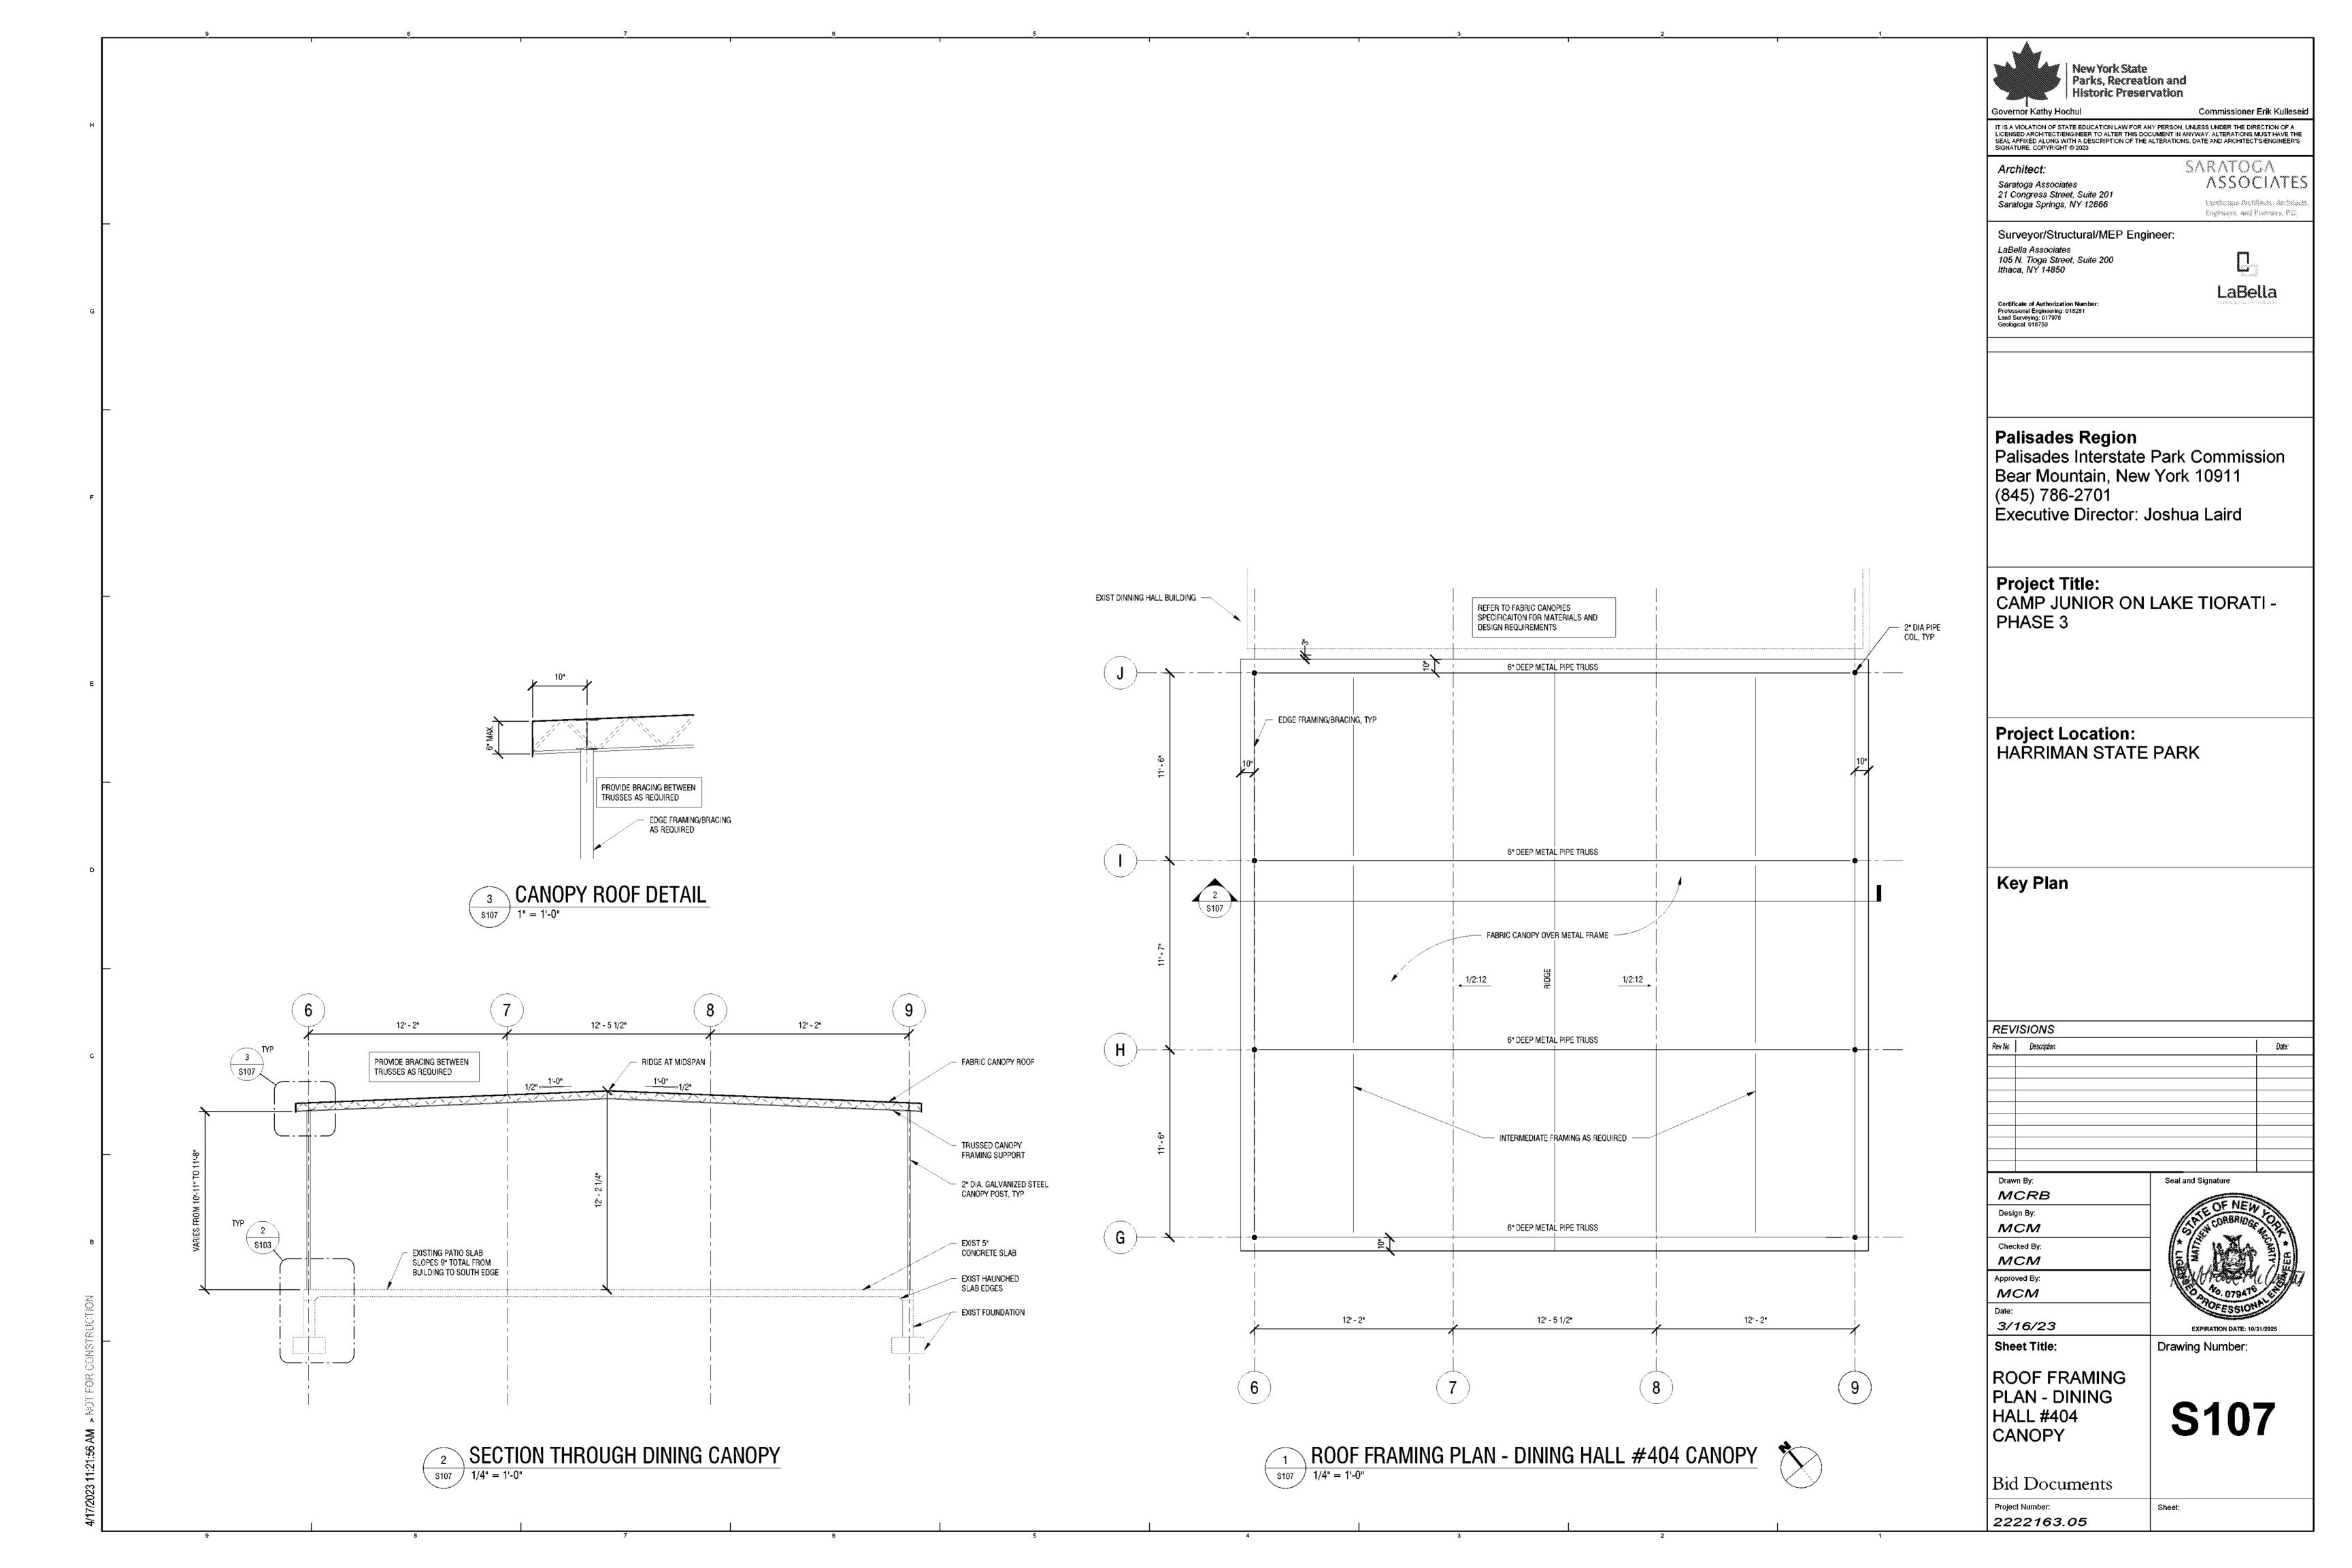


## TYPICAL TRUSS AT END S301

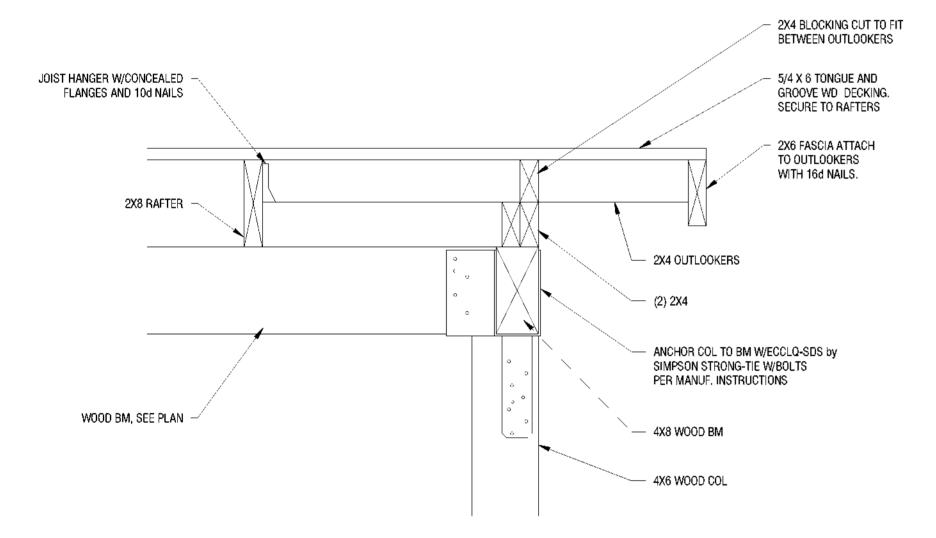


WOOD FRAMING TO CONCRETE PIER CONNECTION 1 1/2" = 1'-0"

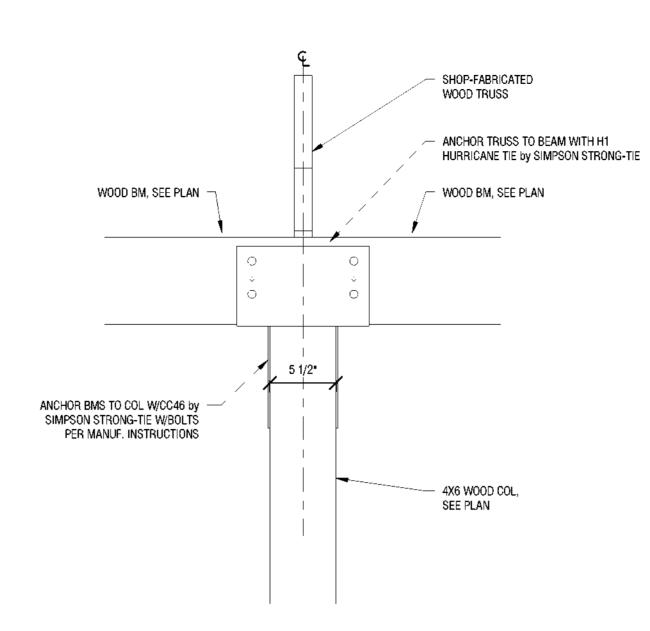


## 6 TYPICAL TRUSS AND BEAM AT COLUMN s301 / 1 1/2" = 1'-0"

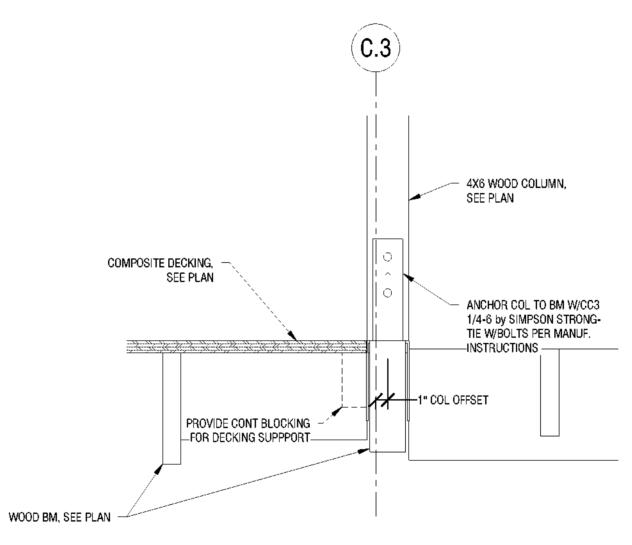


#### COLUMN ON BEAM 1 1/2" = 1'-0" S301

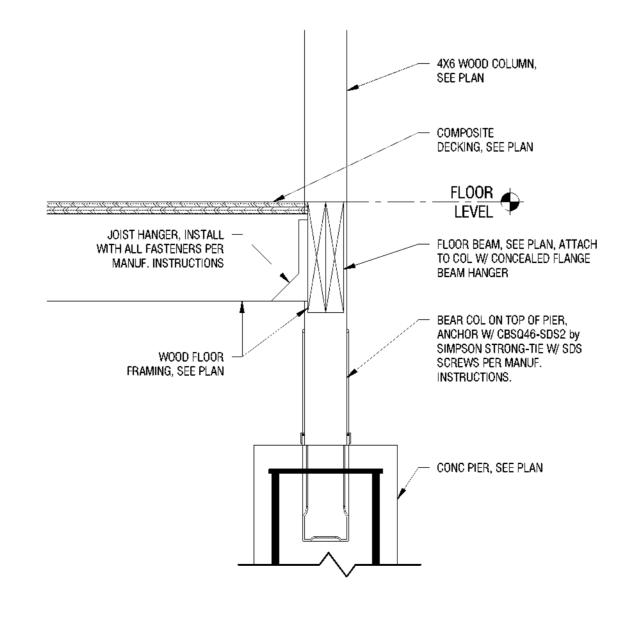


TYPICAL COLUMN BEARING AT PIER s301 / 1 1/2" = 1'-0"

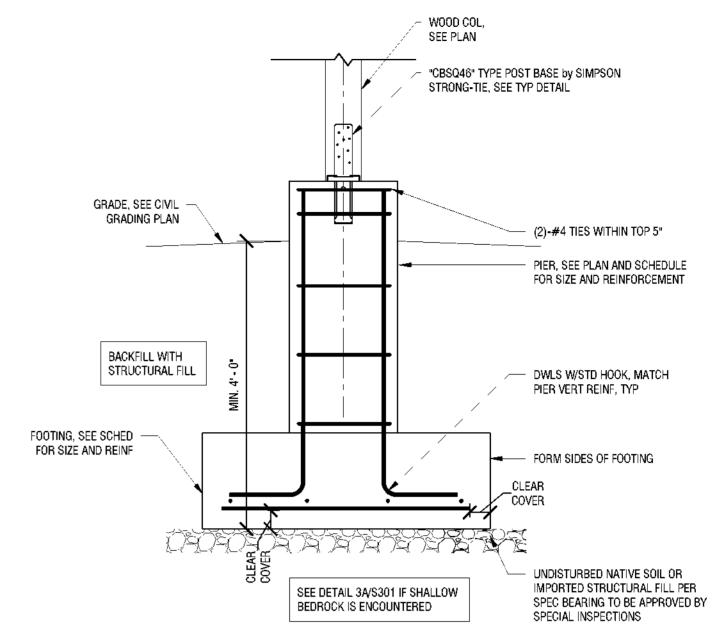


## TYPICAL PIER AND FOOTING $3/4^{\circ} = 1'-0^{\circ}$

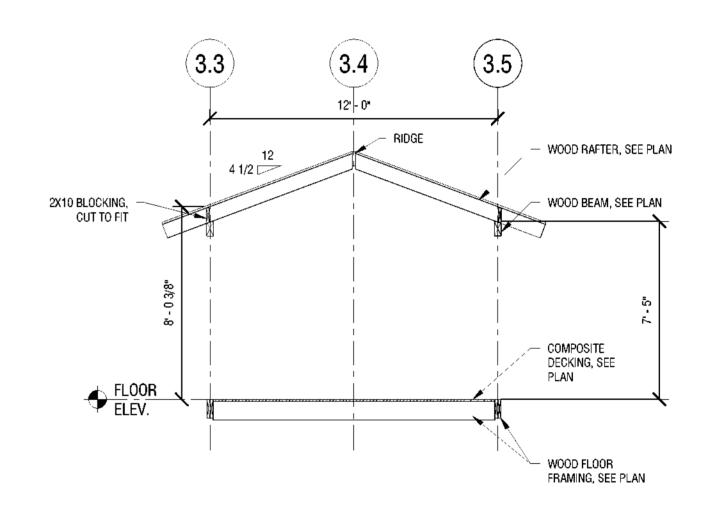

#### TYPICAL SECTION THROUGH LATRINE #427 1/4" = 1'-0" S301

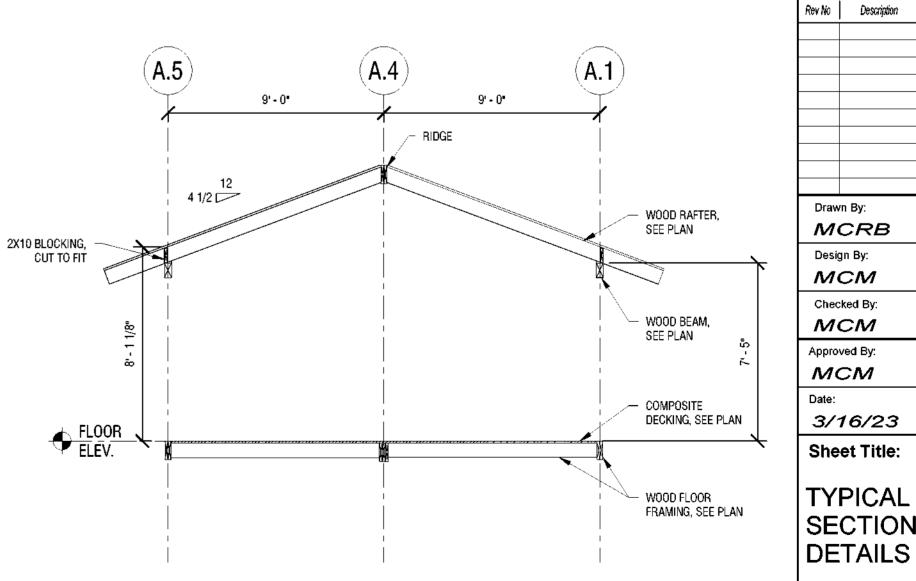

TYPICAL SECTION THROUGH BATHHOUSE 1/4" = 1'-0" S301

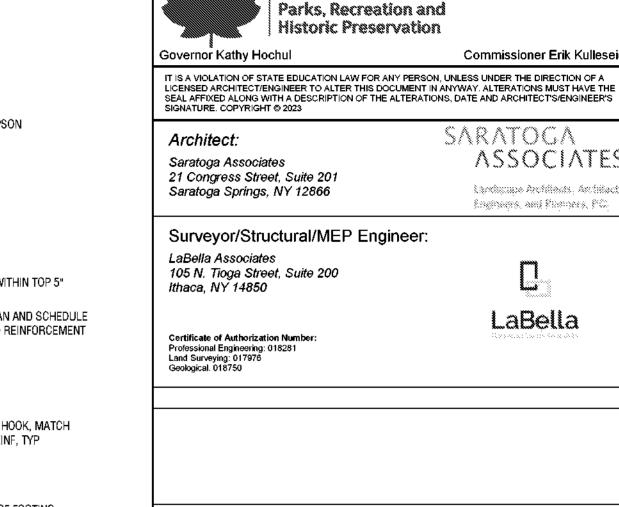

Palisades Region

Palisades Interstate Park Commission Bear Mountain, New York 10911 (845) 786-2701 **Executive Director: Joshua Laird** 

New York State

Parks, Recreation and Historic Preservation

Commissioner Erik Kulleseid

**ASSOCIATES** 

Laydayupe Architects, Architects Engineers, and Permers, P.O.

LaBella

SARATOGA

Project Title: CAMP JUNIOR ON LAKE TIORATI -PHASE 3

**Project Location:** HARRIMAN STATE PARK

**Key Plan** 

Drawn By:  MCRB  Design By:  MCM  Checked By:  MCM  Approved By:  MCM  Date:  3/16/23  Sheet Title:  Drawing Number:	REV	ISIONS	
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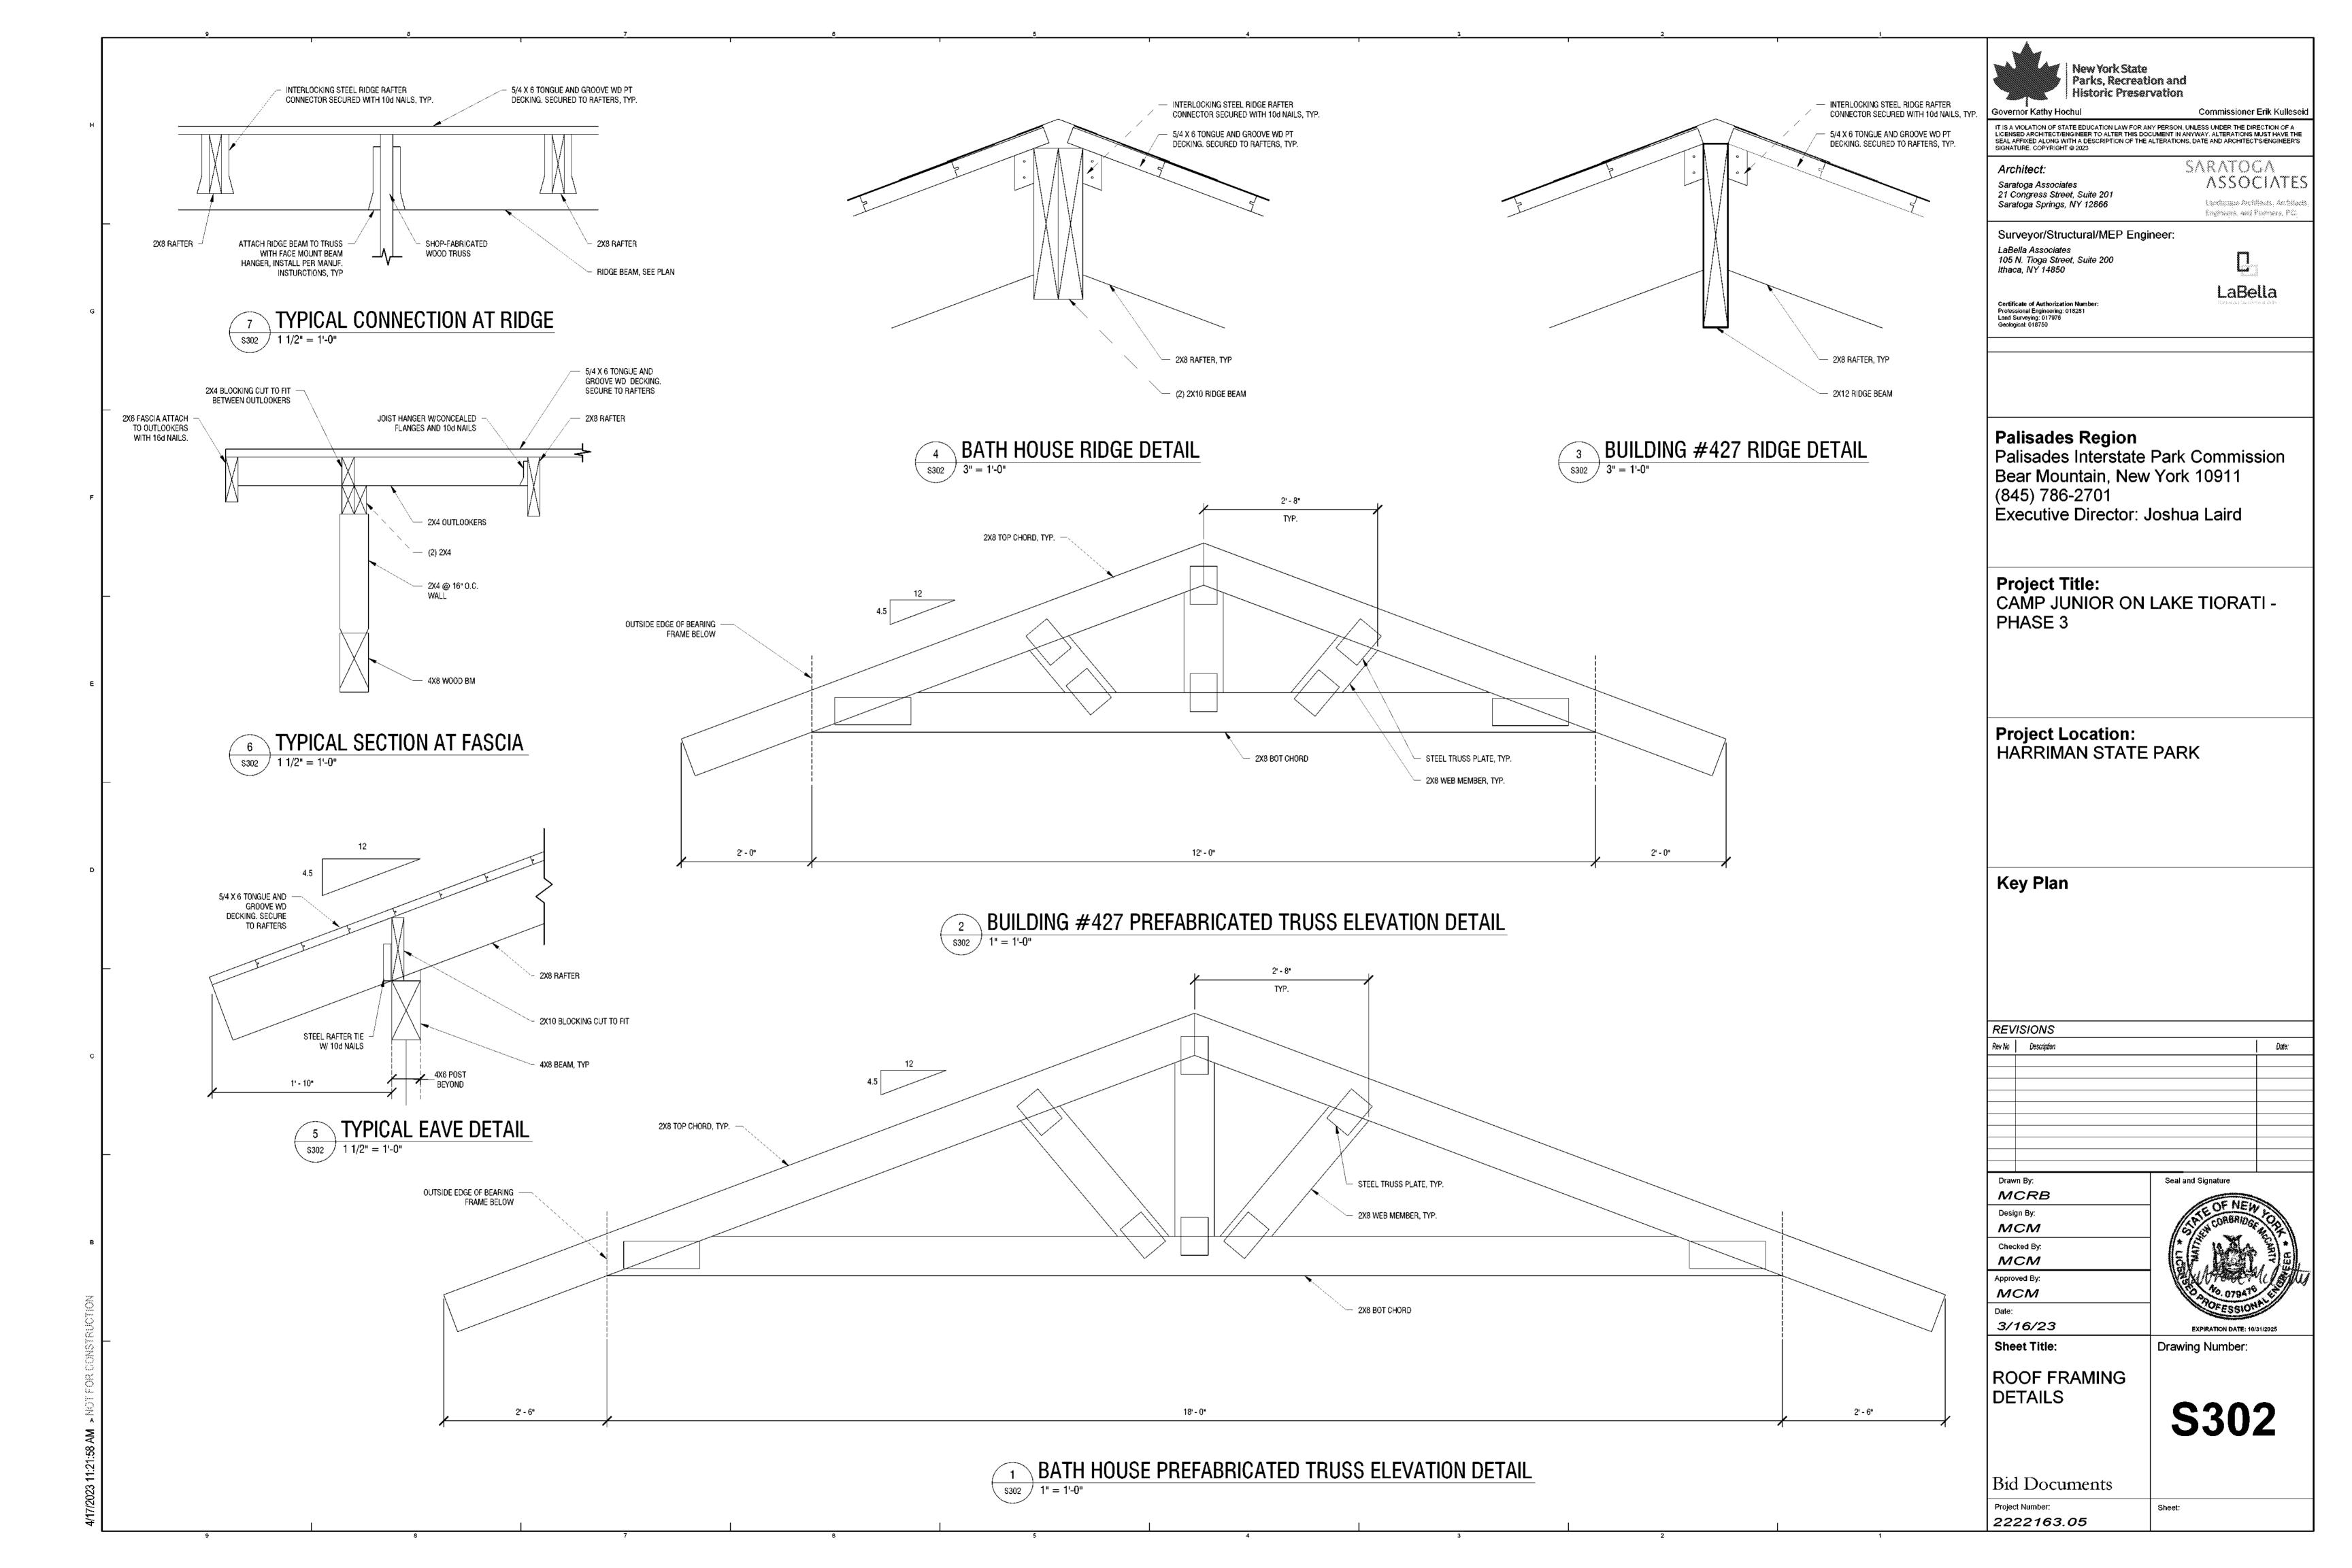
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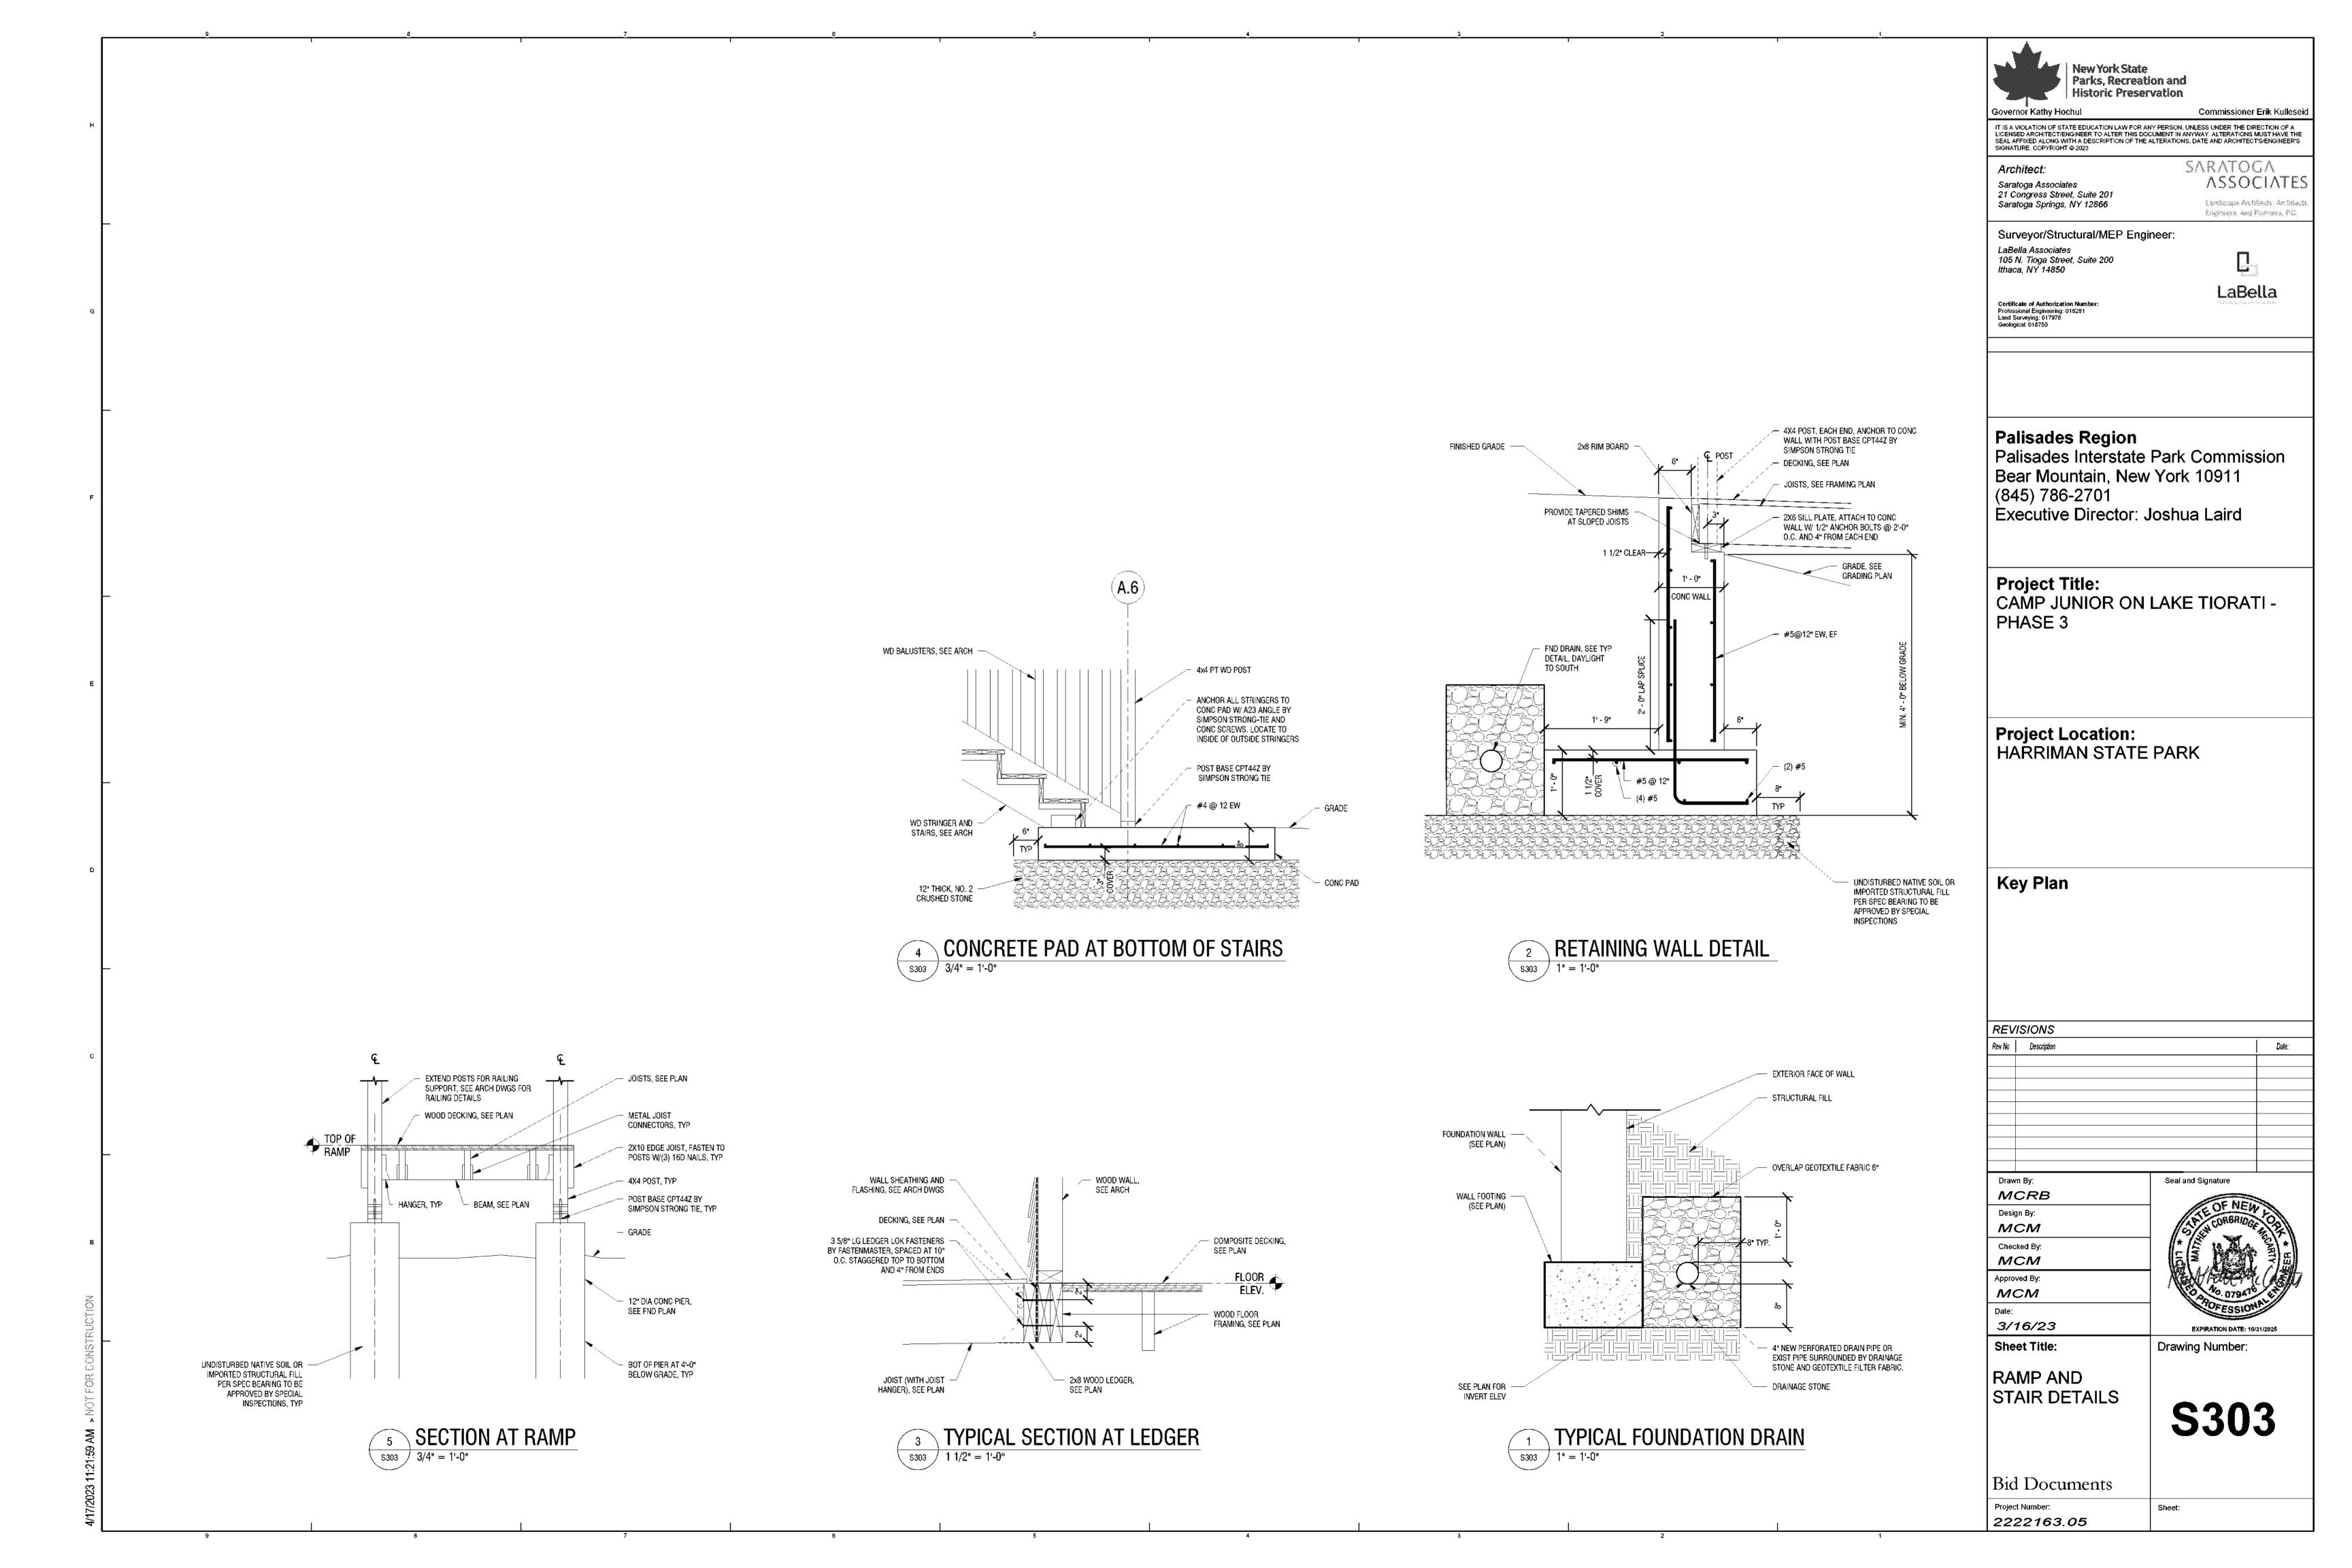
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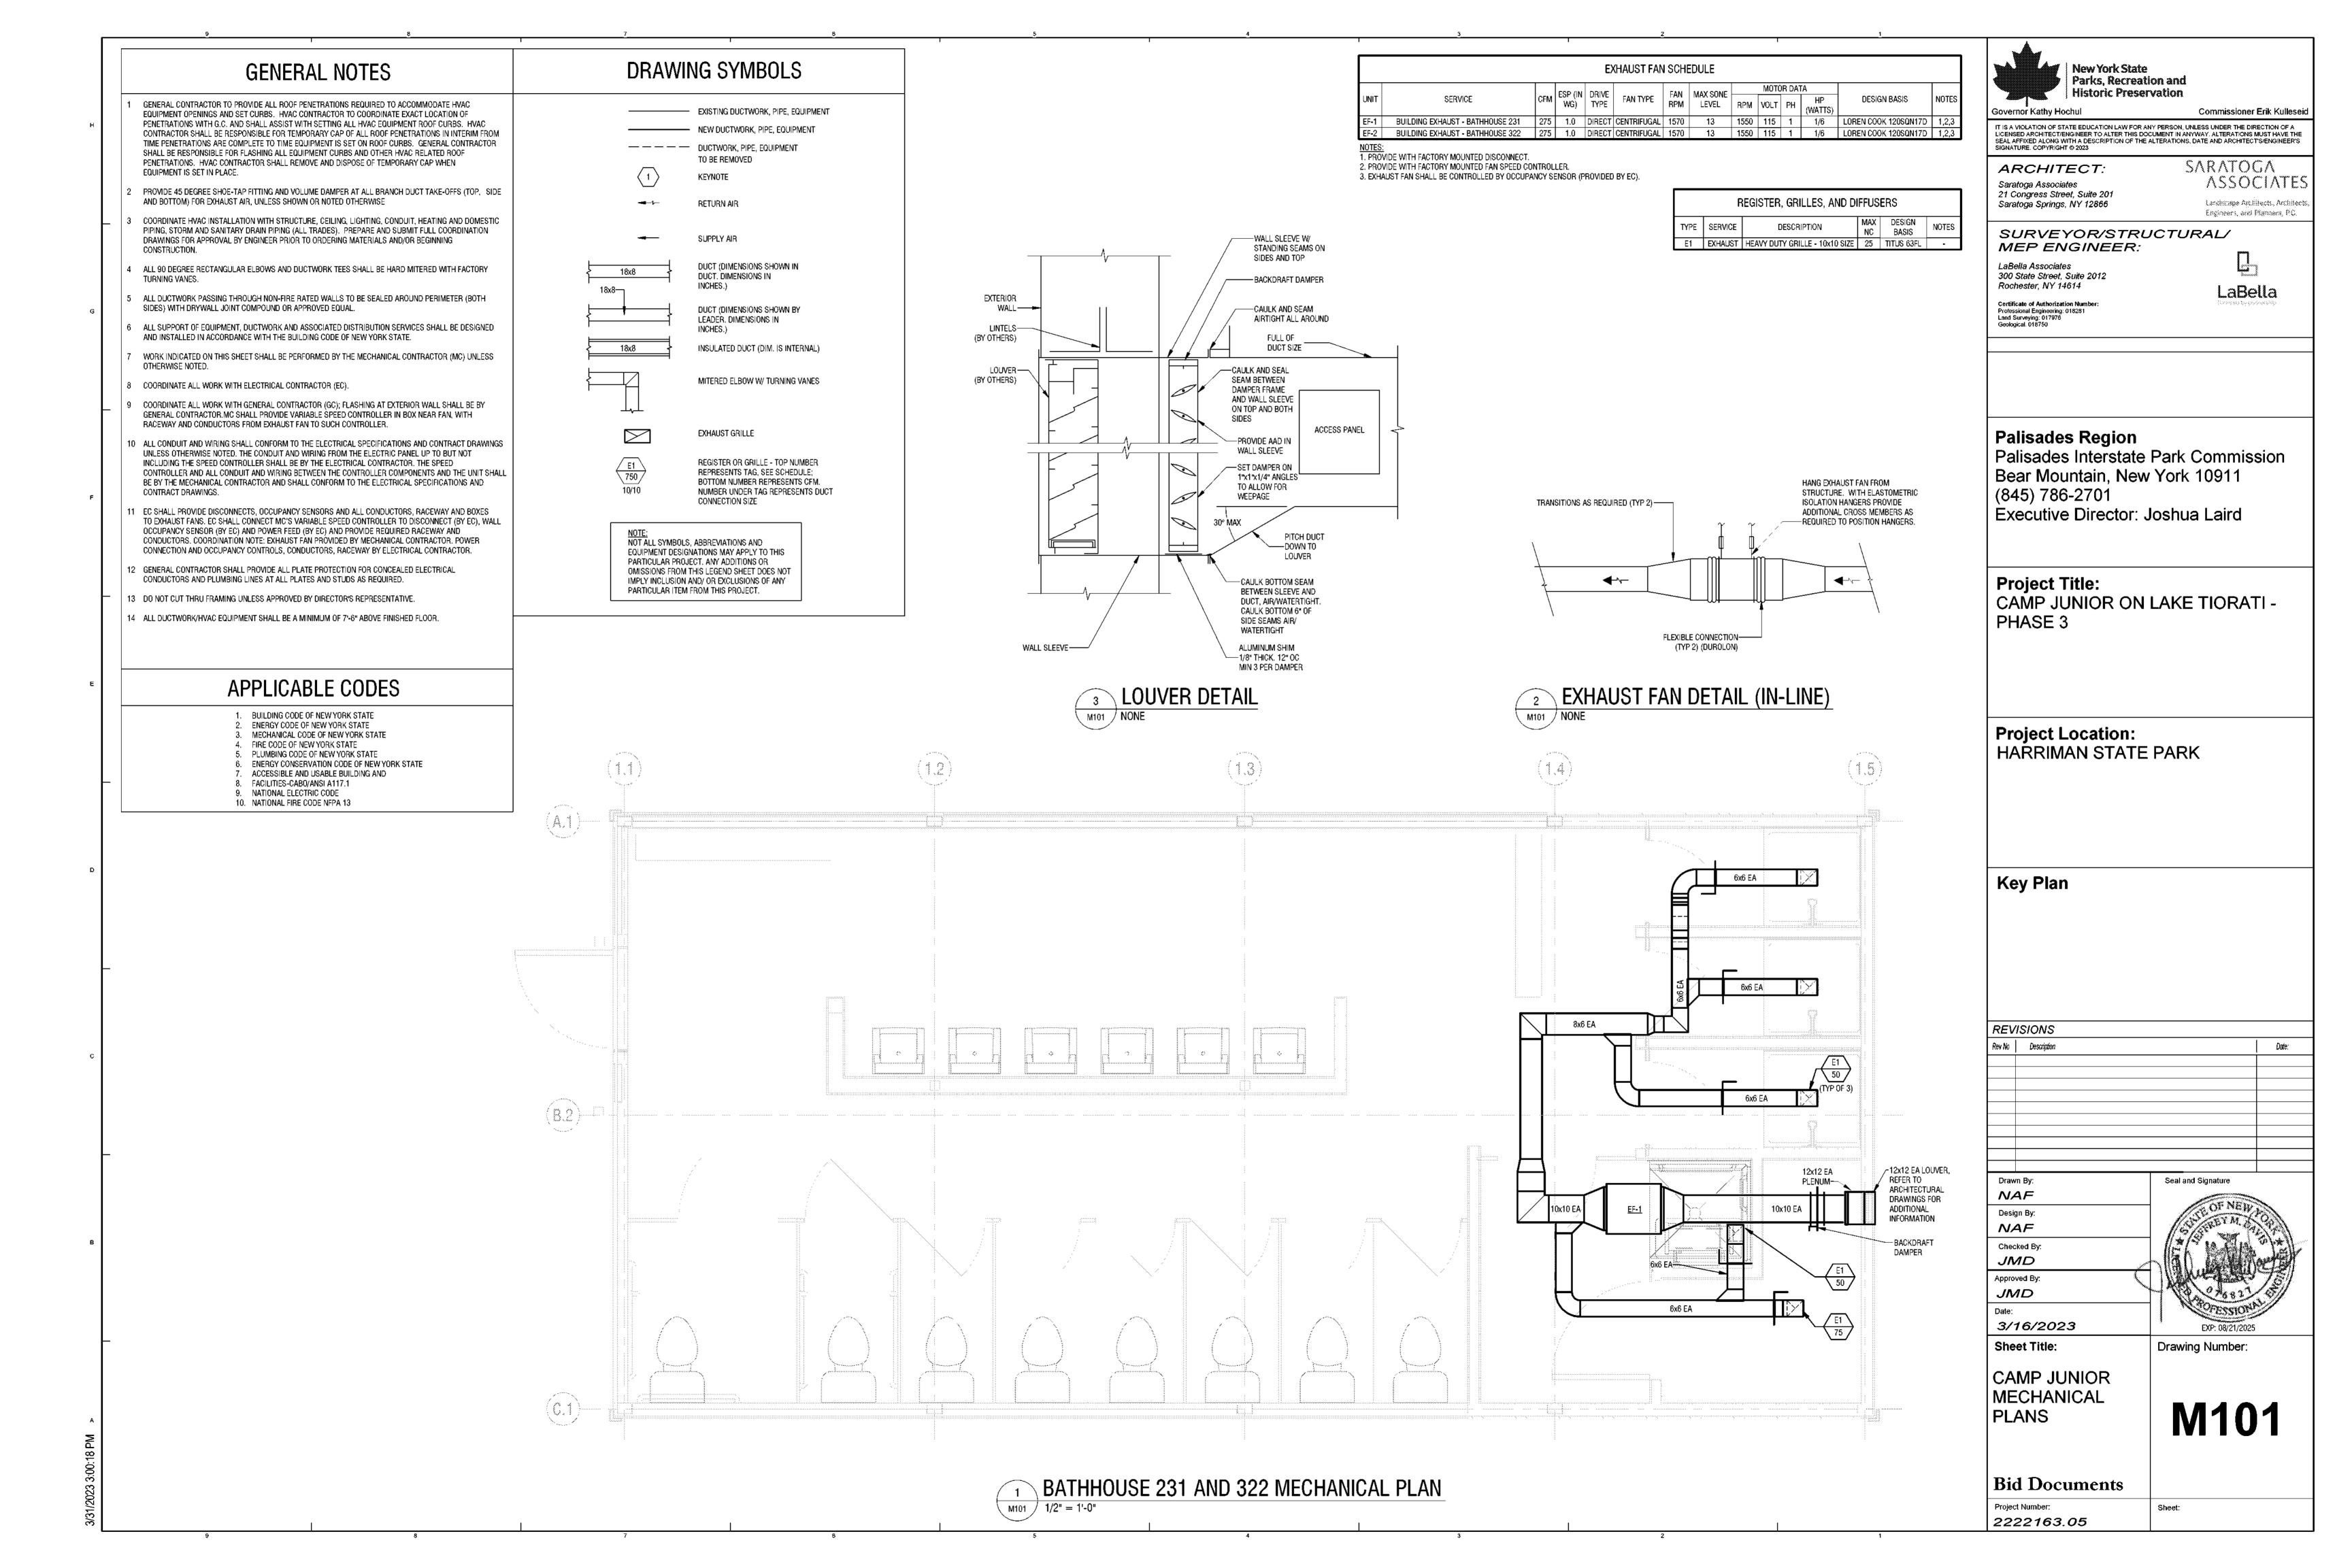
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**S301** 

Sheet:







#### DRAWING SYMBOLS **GENERAL NOTES** ELECTRIC WATER HEATER SCHEDULE DO NOT SHUT DOWN ANY PLUMBING OR RELATED SYSTEMS WITHOUT BUILDING OWNER'S ELECTRICAL DATA PRIOR WRITTEN APPROVAL. FOLLOW ALL OWNER REQUIREMENTS AND SHUT DOWN BUILDING SERVICE LOCATION TOTAL WATTS V/Ph/Hz SAN—SAN—SANITARY DRAIN PROCEDURES AS WELL AS ALL REQUIREMENTS OF THIS PROJECT. EWH-1 BATHHOUSE 231 DOMESTIC HOT WATER MECH ROOM 12300 240/1/60 30°ø x 70° H EWH-2 BATHHOUSE 322 DOMESTIC HOT WATER MECH ROOM 12300 240/1/60 30°g x 70° H - - - DCW- - - DOMESTIC COLD WATER IF REQUIRED, PROVIDE SHUT DOWNS AND TIE-INS DURING OFF HOURS TO AVOID EWH-3 LATRINE 427 DOMESTIC HOT WATER UNDER SINK 1400 115/1/60 9" L x 9" W x 15" H DISRUPTION OF BUILDING SYSTEMS, COORDINATE ALL SHUT DOWN REQUIREMENTS PRIOR DOMESTIC HOT WATER SUPPLY EWH-4 LATRINE 427 DOMESTIC HOT WATER UNDER SINK 1400 115/1/60 9" L x 9" W x 15" H TO SUBMITTING BID (INCLUDE ALL REQUIRED DURING OFF HOURS IN BID). DOMESTIC HOT WATER RECIRC PROVIDE ALL WORK IN COMPLIANCE WITH ALL LOCAL, STATE AND FEDERAL CODES. OBTAIN ALL REQUIRED PERMITS. BRANCH OFF TOP OF PIPE PLUMBING FIXTURE SCHEDULE PROVIDE ALL REQUIRED EXCAVATION, BACKFILL AND COMPACTION FOR ALL PIPING CONNECTION (IN) UNDERGROUND WORK. SUPPORT MANUFACTURER REMARKS BRANCH OFF BOTTOM OF PIPE CHICAGO FAUCETS FIELD VERIFY EXACT LOCATION, DEPTH, COMPOSITION AND CONDITION OF ALL PIPING, ADA **POWERS** WALL MOUNTED PIPE TURNED UP VALVES AND SYSTEMS AS REQUIRED FOR WORK OF THE CONTRACT. **POWERS** WALL MOUNTED FLOOR MOUNTED AMERICAN STANDARD PROVIDE SCHEDULE 40 BLACK STEEL PIPE SLEEVES FOR ALL UNDERGROUND PIPING PIPE TURNED DOWN AMERICAN STANDARD PASSING THROUGH OR UNDER FOOTINGS, WALLS, FOUNDATION WALLS, SLABS FLOORS FLOOR MOUNTED AND/OR UNDERGROUND STRUCTURES. REFER TO THE PROJECT SPECIFICATIONS FOR WALL MOUNTED GERBER ADDITIONAL REQUIREMENTS. GERBER WALL MOUNTED FLOOR MOUNTED ZURN WHERE PIPING IS LOCATED OVER FOOTINGS AND/OR OTHER UNDERGROUND STRUCTURES, 2 FLOOR MOUNTED ELKAY BALL VALVE ROLL DOWN AS REQUIRED TO CONNECT TO SYSTEMS NOTED. PROVIDE ALL REQUIRED OFFSETS, FITTINGS AND CONNECTIONS. FIXTURE TRIM: KEY NOTE 1/2" STAINLESS STEEL BRAIDED HOSE SUPPLY WITH ESCUTCHEON AND 1/4" TURN ANGLE STOP, 1.28 GPF, PITCH ALL SANITARY, WASTE, AND STORM PIPING AS FOLLOWS: PIPING SMALLER THAN 3", HEAVY WEIGHT INJECTION MOLDED SOLID PLASTIC, BLACK ELONGATED SEAT, OPEN FRONT LESS COVER WITH PITCH AT 2 PERCENT (1/4" PER FOOT) MINIMUM. 3" AND LARGER, PITCH AT 1 PERCENT STAINLESS STEEL SELF SUSTAINING CHECK HINGES, SIMILAR TO BEMIS MODEL 1955-SST. PROVIDE FLOOR (1/8" PER FOOT) MINIMUM. FLANGE, SEALANT AND ANCHOR BOLTS. CONNECT TO SITE PIPING OUTSIDE BUILDING AS SHOWN. PROVIDE ALL REQUIRED OFFSETS, DECK MOUNTED CHROME PLATED DIE-CAST METAL FAUCET WITH INFRARED SENSOR, BATTERY POWER FITTINGS AND CONNECTIONS. FIELD VERIFY EXACT LOCATION, DEPTH AND COMPOSITION SUPPLY, MULTI-LAMINAR SPRAY, 0.50 GPM, SIMILAR TO SLOAN SF-2450-4-BAT-TEE-CP-0.5GPM-MLM-IR-FCT. APPLICABLE CODES OF SITE SERVICES AND COORDINATE ALL WORK WITH SITE CONTRACTOR. ASSE 1070 APPROVED TEMPERING VALVE, SIMILAR TO POWERS MODEL LFe480. CHROME PLATED CAST BRASS GRID STRAINER WITH 1-1/4" TAILPIECE, SIMILAR TO MCGUIRE MODEL 8902, CHROME PLATED CAST BRASS SUPPLIES WITH LOOSE KEY ANGLE STOP AND SET-SCREW ESCUTCHEON, PROVIDE TRAP AND SUPPLY 0 COORDINATE ALL VENT TERMINATIONS ABOVE ROOF WITH HVAC CONTRACTOR. ALL VENT BUILDING CODE OF NEW YORK STATE COVERING TO MEET ADA REQUIREMENTS, SIMILAR TO "PRO-WRAP". TERMINATIONS ABOVE ROOF SHALL BE A MINIMUM 10'-0" AWAY FROM ANY HVAC OUTSIDE MECHANICAL CODE OF NEW YORK STATE AIR INTAKE (ROOFTOP UNIT, LOUVER, ETC.). FIRE CODE OF NEW YORK STATE DECK MOUNTED CHROME PLATED DIE-CAST METAL FAUCET WITH METAL WRIST HANDLES, NON-METERING, PLUMBING CODE OF NEW YORK STATE 0.50 GPM, 4" CENTERSET, 4" RIGID SPOUT, SIMILAR TO GERBER GC045542. ASSE 1070 APPROVED TEMPERING 1 PROVIDE SINGLE HOSE BIBB WITH VACUUM BREAKER (HB) UNDER LAVATORY(S) IN ALL ENERGY CONSERVATION CONSTRUCTION CODE O VALVE, SIMILAR TO POWERS MODEL LFe480. CHROME PLATED CAST BRASS GRID STRAINER WITH 1-1/4\* TOILET ROOMS WITH FLOOR DRAINS. ONE REQUIRED PER ROOM. **NEW YORK STATE** TAILPIECE, SIMILAR TO MCGUIRE MODEL 8902, CHROME PLATED CAST BRASS SUPPLIES WITH LOOSE KEY ACCESSIBLE AND USUABLE BUILDING AND ANGLE STOP AND SET-SCREW ESCUTCHEON. FACILITIES-CABO/ANSI A117.1 12 REFER TO ARCHITECTURAL DRAWINGS AND THE PROJECT SPECIFICATIONS FOR ANY NATIONAL ELECTRIC CODE D. DEEP SEAL P-TRAP AND ASSE 1072 APPROVED MECHANICAL SEAL, SIMILAR TO "SURE-SEAL". PROJECT PHASING REQUIREMENTS. NFPA 13: STANDARD FOR THE INSTALLATION OF SPRINKLER SYSTEMS CHROME PLATED CAST BRASS WALL FAUCET WITH VACUUM BREAKER, PAIL HOOK, WALL BRACE AND HOSE 3 THE ENTIRE PLUMBING SYSTEM SHALL BE IN ACCORDANCE WITH THE LATEST EDITION OF OUTLET, SIMILAR TO FIAT MODEL 830-AA. STAINLESS STEEL HOSE BRACKET WITH RUBBER GRIP AND HOSE. THE PLUMBING CODE OF NEW YORK STATE AND LOCAL PLUMBING INSPECTOR. SIMILAR TO FIAT MODEL 832-AA, STAINLESS STEEL MOP HANGER SIMILAR TO FIAT MODEL 889-CC, VINYL **EQUIPMENT** BUMPER GUARDS ON EXPOSED EDGES SIMILAR TO FIAT MODEL E-77-AA. STAINLESS STEEL WALL GUARDS ON 14 CONTRACTOR SHALL COORDINATE AND PROVIDE ALL NECESSARY PIPING & PLUMBING ADJACENT WALLS SIMILAR TO FIAT MODEL MSG2424. FITTINGS, PIPING, MISCELLANEOUS ITEMS REQUIRED FOR A COMPLETE INSTALLATION OF **DESIGNATIONS** ALL PLUMBING RELATED ITEMS. RECIRCULATION PUMP SCHEDULE 15 PITCH ALL POTABLE WATER PIPING TO DRAIN BEFORE BUILDING SHUTOFF. FEET OF PUMP HP VOLTS AMPS MANUFACTURER MODEL NOTE: <u>DWH</u> DOMESTIC WATER HEATER 16 ALL PIPING PENETRATIONS THROUGH NEW WALL OR FLOOR SHALL BE SEALED TO EQUAL RP-1 WATER SERVICE ROOM 6 5 25 115 0.23 GRUNDFOS UP15-10 THE RATING OF THE NEW, EXISTING WALL OR FLOOR. EXPANSION TANK ELECTRIC WATER COOLER 7 THE ENTIRE DOMESTIC WATER SYSTEM SHALL BE DISINFECTED IN ACCORDANCE TO THE LOCAL CODE & HEALTH DEPARTMENT REQUIREMENTS. <u>EWH</u> ELECTRIC WATER HEATER HOSE BIBB 18 THE BACKFLOW PREVENTION DEVICE SHALL BE INSTALLED PER STATE AND LOCAL CODE & PER AUTHORITY HAVING JURISDICTION REQUIREMENTS. LAVATORY <u>LAV</u> MOP SINK 19 ALL (VTR'S) VENT THRU ROOF PENETRATIONS INDICATED ON PLANS ARE PRELIMINARY. FINAL LOCATIONS SHALL BE COORDINATED WITH ALL TRADES.

20 CONTRACTOR SHALL INSULATE ALL PLUMBING PIPING PER SPECIFICATION

COMPONENTS AND ELECTRICAL DISTRIBUTION PANELS.

STRUCTURAL CEILING, WHICHEVER IS LOWER).

CONTRACTOR UNLESS NOTED OTHERWISE.

REPRESENTATIVE.

1 MAINTAIN 3'-0" CLEARANCE IN FRONT OF ALL DOMESTIC WATER SYSTEM PIPING

22 COORDINATE ELECTRICAL AND PLUMBING TRADES. DO NOT LOCATE PIPING ABOVE


REQUIRED. DO NOT CUT THRU FRAMING UNLESS APPROVED BY DIRECTOR'S

25 COORDINATE LOCATION AND ROUTING OF PLUMBING LINES WITH OTHER TRADES.

ELECTRICAL DISTRIBUTION PANELS, WITHIN 6'-0" ABOVE THE TOP OF THE PANEL (OR THE

23 THE PLUMBING CONTRACTOR SHALL COORDINATE ALL VERTICAL AND HORIZONTAL RUNS WITH GENERAL CONTRACTOR PRIOR TO FRAMING, GENERAL CONTRACTOR SSHALL PROVIDE ALL PLATE PROTECTION FOR CONCEALED LINES AT ALL PLATES AND STUDS AS

24 ALL WORK ON THESE PLUMBING DRAWINGS SHALL BE PERFORMED BY THE PLUMBING

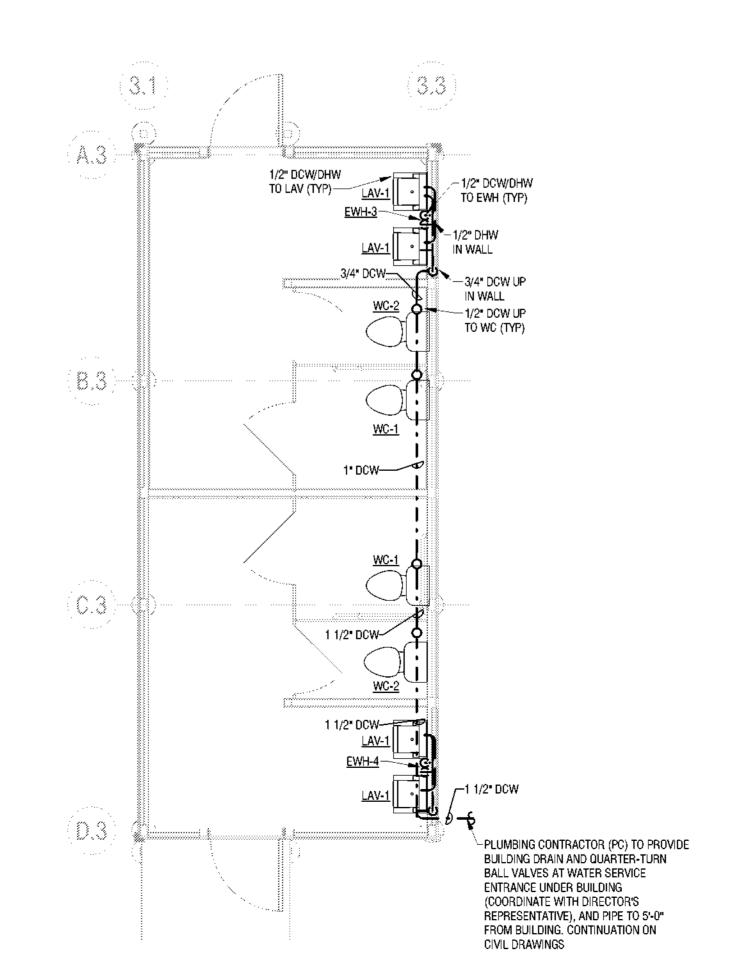

LATRINE 427 PLUMBING PLAN - DOMESTIC

MANUFACTURER

LOCHINVAR

LOCHINVAR

EEMAX

EEMAX

MODEL

952-CP

450-4103SC

450-4002

215AA.104

215AA.104

PLYMOUTH G0012314

PLYMOUTH G0012314

Z415B

FLR-1X


MODEL

LCA-120AkW

EMT1


EMT1

DIMENSIONS

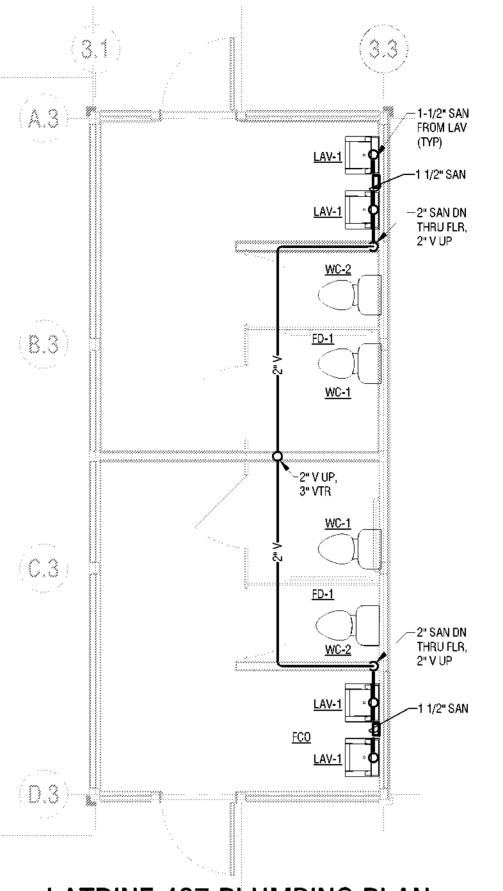

LATRINE 427 PLUMBING PLAN -5 SANITARY/VENT

P101  $\int 1/4^{-} = 1'-0^{-}$ 

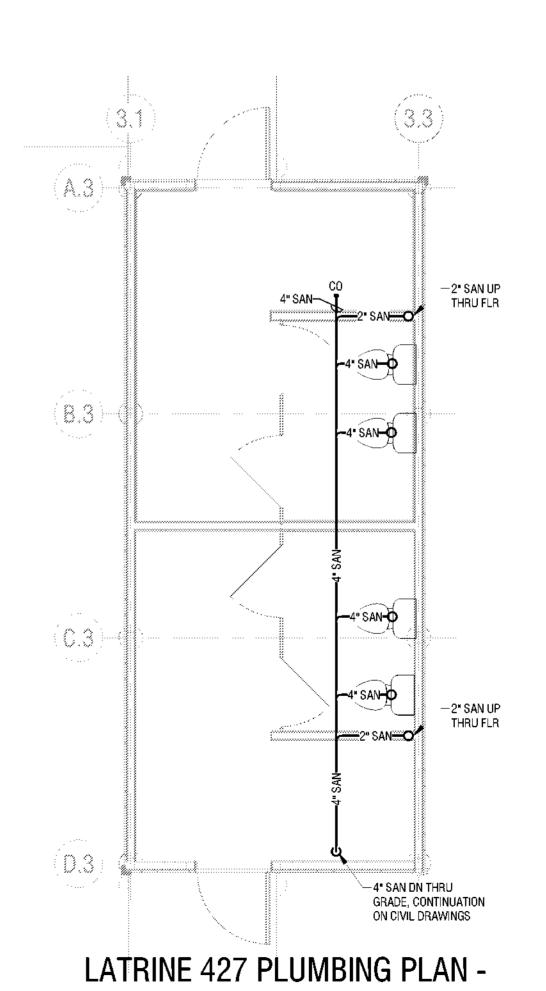

UNDERFLOOR SANITARY/VENT

/ 1/4" = 1'-0"



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SURVEYOR/STRUCTURAL/ MEP ENGINEER:

LaBella Associates 300 State Street, Suite 2012 Rochester, NY 14614

Certificate of Authorization Number Professional Engineering: 018281 Land Surveying: 017976 Geological: 018750

Saratoga Springs, NY 12866

Landstone Architects, Architects

Engineers, and Planners, P.C.

LaBella

Palisades Region

Palisades Interstate Park Commission Bear Mountain, New York 10911 (845) 786-2701 Executive Director: Joshua Laird

**Project Title:** CAMP JUNIOR ON LAKE TIORATI -PHASE 3

**Project Location:** HARRIMAN STATE PARK

**Key Plan** 

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CAMP JUNIOR PLUMBING PLANS

Sheet Title:

P101

Sheet:

Drawing Number:

**Bid Documents** Project Number:

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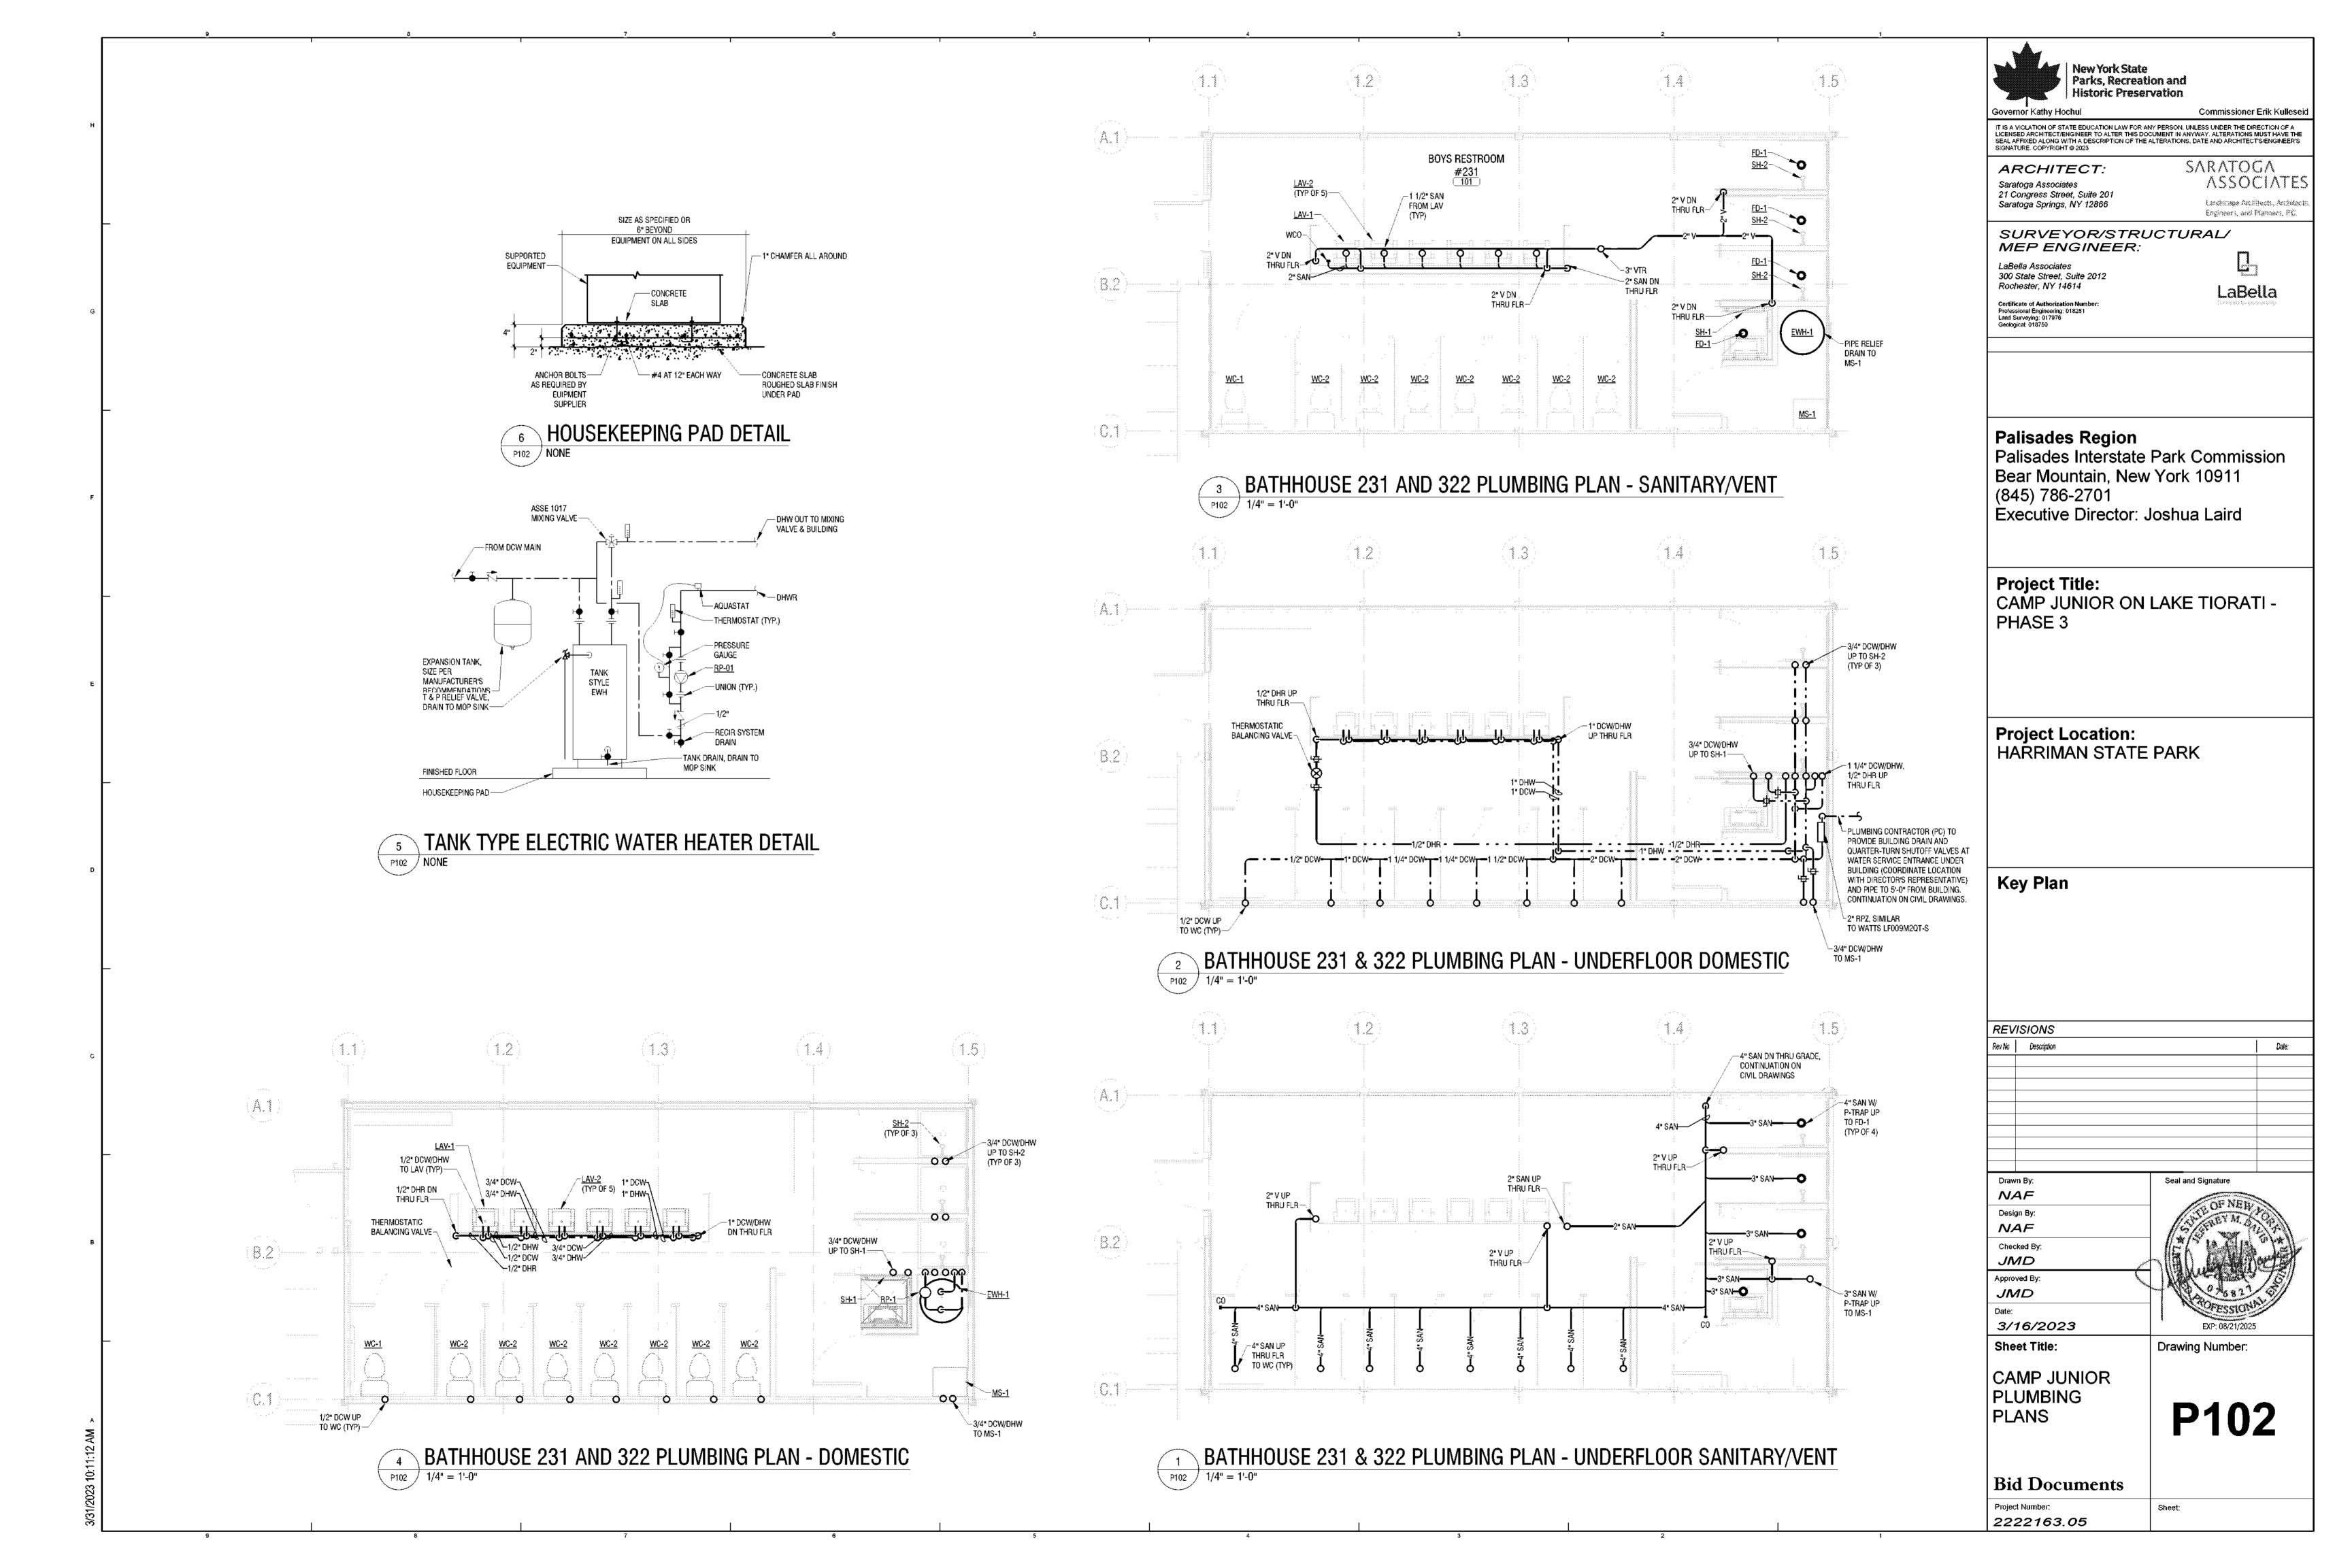
SHOCK ABSORBER (WATER HAMMER

ARRESTOR)

URINAL WATER CLOSET

WCO WALL CLEANOUT

<u>WC</u>



### **ELECTRICAL LEGEND**

#### **ELECTRICAL GENERAL NOTES**

- FOR EXACT LOCATIONS AND SURFACE FINISH CONDITIONS OF CEILINGS, WALLS, OR FLOORS, REFER TO ARCHITECTURAL DRAWINGS.
- 2. FOR EXACT LOCATION OF FACILITY EXPANSION JOINTS, FIRE RATED WALLS, AND SMOKE WALLS, REFER TO ARCHITECTURAL DRAWINGS.
- 3. VERIFY EXACT LOCATION OF CONNECTION POINTS PRIOR TO ROUGH-IN.
- 4. COORDINATE LOCATIONS OF ALL RECEPTACLES AND LUMINAIRES IN MECHANICAL SPACES WITH HVAC CONTRACTOR PRIOR TO ROUGH-IN TO AVOID CONFLICTS WITH EQUIPMENT AND DUCTWORK.
- MOUNTING HEIGHTS ARE TO CENTER OF DEVICE OR EQUIPMENT UNLESS NOTED OTHERWISE, EXCEPT FOR PENDANT LIGHTING WHICH ARE TO THE BOTTOM OF THE LUMINAIRE. FOR AREAS WITH DIFFERENT FLOOR LEVELS, HEIGHT IS BASED UPON CLOSEST FLOOR OR LANDING TO DEVICE, EQUIPMENT, OR LUMINAIRE, ELEVATIONS GIVEN ON LEGEND SHEET ARE UNLESS NOTED OTHERWISE ON DRAWINGS.
- PROVIDE RACEWAY, WIRE AND CABLE, ASSOCIATED FITTINGS AND CONNECTORS, AND COMPLETE CONNECTIONS REQUIRED FOR DESIGNATED BRANCH CIRCUITS FROM DEVICE(S) TO FINAL OVERCURRENT DEVICE AND TO LOCAL CONTROL DEVICE(S) PER SPECIFICATIONS.
- MINIMUM BRANCH CIRCUIT WIRE SIZE SHALL BE #12 AWG. SIZE BRANCH CIRCUIT CONDUCTORS AS PER NEC AND AS SCHEDULED ON THIS DRAWING BASED ON ACTUAL CIRCUIT DISTANCE, INCLUDE GROUND CONDUCTOR DERATINGS.
- 8. PULL A SEPARATE NEUTRAL CONDUCTOR FOR ALL BRANCH CIRCUITS REQUIRING A NEUTRAL CONNECTION. DERATE CONDUCTORS PER NEC ACCORDINGLY, MULTIWIRE BRANCH CIRCUITS ARE NOT ACCEPTABLE.
- 9. PROVIDE GROUNDING PER NEC & TIA 607B. PROVIDE GREEN GROUND CONDUCTOR IN ALL BRANCH AND FEEDER CIRCUITS.
- 10. DO NOT INSTALL ANY NEW WORK DIRECTLY ABOVE ANY ELECTRICAL PANELS, SWITCHBOARDS, SWITCHGEAR, OR TRANSFORMERS.
- 11. CONFIRM ALL LABELS AND ROOM NUMBERS WITH OWNER PRIOR TO FINALIZING LABELING AND PROGRAMMING.
- 12. COORDINATE FINAL OUTLET LOCATION WITH ALL TRADES AND FURNITURE/MILLWORK PLACEMENT PRIOR TO ROUGH-IN. GENERAL CONTRACTOR SHALL PROVIDE ALL DRILLING AND GROMMETING IN FURNITURE/CASEWORK FOR CORD ACCESS IF REQUIRED.
- 13. SWITCHES SHOWN SIDE BY SIDE OR GANGED SHALL BE INSTALLED UNDER A COMMON COVERPLATE, UNLESS NOTED OTHERWISE.
- 14. PROVIDE FIRESTOPPING AT ALL PENETRATIONS THROUGH FIRE RATED WALLS, FLOORS, CEILINGS, & ROOFS AS CALLED OUT ON ARCHITECTURAL PLANS, PROVIDE ACOUSTICAL SEALANT AT PENETRATIONS THROUGH ALL NON-FIRE RATED WALLS, FLOORS, & CEILINGS.
- 15. PROVIDE CONDUIT EXPANSION JOINTS AT ALL EXPANSION JOINTS AS CALLED OUT ON ARCHITECTURAL PLANS.
- 16. SITE PLAN CONDUIT ROUTING SHOWN FOR INTENT. REFERENCE CIVIL DRAWINGS FOR UNDERGROUND COORDINATION AND DISTANCE OF RUNS. COORDINATE WITH ALL TRADES.
- 17. WORK INDICATED ON THIS SHEET SHALL BE PERFORMED BY THE ELECTRICAL CONTRACTOR (EC) UNLESS OTHERWISE NOTED.
- 18. COORDINATE ALL WORK WITH THE WORK OF ALL OTHER CONTRACTORS.
- 19. ELECTRICAL CONTRACTOR (EC) SHALL PROVIDE CIRCUIT BREAKER, RACEWAY AND CONDUCTORS TO FEED EWH-1, ALONG WITH SAFETY DISCONNECT SWITCH FOR SAME.
- 20. ELECTRICAL CONTRACTOR (EC) SHALL PROVIDE CIRCUIT BREAKER, RACEWAY AND CONDUCTORS TO FEED EWH-2, ALONG WITH SAFETY DISCONNECT SWITCH FOR SAME.
- 21. EC SHALL PROVIDE DISCONNECTS, OCCUPANCY SENSORS AND ALL CONDUCTORS, RACEWAY AND BOXES TO EXHAUST FANS. EC SHALL CONNECT MC'S VARIABLE SPEED CONTROLLER TO DISCONNECT (BY EC), WALL OCCUPANCY SENSOR (BY EC) AND POWER FEED (BY EC) AND PROVIDE REQUIRED RACEWAY AND CONDUCTORS.
- 22. THE CONDUIT AND WIRING FROM THE ELECTRIC PANEL UP TO BUT NOT INCLUDING THE SPEED CONTROLLER SHALL BE BY THE ELECTRICAL CONTRACTOR. THE SPEED CONTROLLER AND ALL CONDUIT AND WIRING BETWEEN THE CONTROLLER COMPONENTS AND THE UNIT SHALL BE BY THE MECHANICAL CONTRACTOR AND SHALL CONFORM TO THE ELECTRICAL SPECIFICATIONS AND CONTRACT DRAWINGS.
- 23. COORDINATION NOTE: EXHAUST FAN PROVIDED BY MECHANICAL CONTRACTOR. POWER CONNECTION AND OCCUPANCY CONTROLS, CONDUCTORS, RACEWAY BY ELECTRICAL CONTRACTOR.

### **ABBREVIATIONS**

	/ (DDI (E VI) (	10110	
•	DEGREES	kAlC	KILOAMPERE INTERRUPTING CURRENT
		kAIR	
Δ	DELTA		KILOAMPERE INTERRUPTING RATING
Ω	OHMS	КО	KNOCK OUT
Ø	PHASE	kV	KILOVOLT
Υ	WYE	kVA	KILOVOLT AMPERE
		kW	KILOWATT
Α	AMPERE	kWh	KILOWATT HOUR
AFCI	ARC-FAULT CIRCUIT INTERRUPTING		
AF	AMPERE FUSE	LED	LIGHT EMITTING DIODE
AFF	ABOVE FINISHED FLOOR	LTG	LIGHTING
AFS	AMPERE FRAME SIZE	LV	LOW VOLTAGE
		LV	LOW VOLTAGE
AFG	ABOVE FINISHED GRADE		
AHJ	AUTHORITY HAVING JURISDICTION	MC	MECHANICAL CONTRACTOR
AHU	AIR HANDLING UNIT	MCA	MINIMUM CIRCUIT AMPERES
AIC	AMPERE INTERRUPTING CAPACITY	MCB	MAIN CIRCUIT BREAKER
ALUM	ALUMINUM	MECH	MECHANICAL
AM	AMMETER	MFR	MANUFACTURER
ANN	ANNUNCIATOR	MH	MANHOLE
ANSI	AMERICAN NATIONAL STANDARDS INSTITUTE	MIN	MINIMUM
ATS	AUTOMATIC TRANSFER SWITCH	MLO	MAIN LUGS ONLY
		IVILO	WAIN LOGS ONLY
AV	AUDIO VISUAL	NEO	NATIONAL ELECTRICAL CODE
AVG	AVERAGE	NEC	NATIONAL ELECTRICAL CODE
AWG	AMERICAN WIRE GAUGE	NEMA	NATIONAL ELECTRICAL MANUFACTURERS ASSOCIATION
		NFPA	NATIONAL FIRE PROTECTION ASSOCIATION
BFC	BELOW FINISHED CEILING	NIC	NOT IN CONTRACT
BFG	BELOW FINISHED GRADE	NL	NIGHT LIGHT
BLDG	BUILDING	NTS	NOT TO SCALE
2224			1011000/111
CND	CONDUIT	0C	ON CENTER
CB	CIRCUIT BREAKER		
		ОH	OVERHEAD
CKT	CIRCUIT	_	
CLG	CEILING	Ρ	POLE
CM	CONSTRUCTION MANAGER	PA	PUBLIC ADDRESS
CO	COMPANY	PB	PULLBOX
CU	COPPER	PC	PERSONAL COMPUTER
00	0011 211	PH	PHASE
DC	DIRECT CURRENT		
DC		PNL	PANEL
DIA	DIAMETER	PLC	PROGRAMMABLE LOGIC CONTROLLER
DISC	DISCONNECT	POE	POWER OVER ETHERNET
DN	DOWN	PRI	PRIMARY
DWG	DRAWING	PT	POTENTIAL TRANSFORMER
		PTZ	PAN TILT ZOOM
EA	EACH	PVC	POLYVINYL CHLORIDE
EC	ELECTRICAL CONTRACTOR	PWR	POWER
		FVVI	POWER
ECB	ENCLOSED CIRCUIT BREAKER	505	DESI FATER AFILINA BLANA
EF	EXHAUST FAN	RCP	REFLECTED CEILING PLANS
EGC	EQUIPMENT GROUNDING CONDUCTOR	RECPT	RECEPTACLE
ELEC	ELECTRIC	RMC	RIGID METAL CONDUIT
EMT	ELECTRICAL METALLIC TUBING		
EQUIP	EQUIPMENT	SCHED	SCHEDULE
EXH	EXHAUST	SEC	SECONDARY
	and the set I	SPDT	SINGLE POLE DOUBLE THROW
ELD	EL OOP		SINGLE POLE SINGLE THROW
FLR	FLOOR	SPST	SINGLE PULE SINGLE IMKUVV
FU SW	FUSED SWITCH	T. (C	TOPICAL
FTL	FEED THRU LUGS	TYP	TYPICAL
GC	GENERAL CONTRACTOR	UGND	UNDERGROUND
GEC	GROUND ELECTRODE CONDUCTOR	UNO	UNLESS NOTED OTHERWISE
GEN	GENERATOR		
GFCI	GROUND FAULT CIRCUIT INTERRUPTING	٧	VOLT
GFI	GROUND FAULT INTERRUPTING	VA VA	VOLT-AMPERE
G		٧n	YOU! AND UTE
u	GROUND	w	MATT
LID.	HODOEDOMED	W	WATT
HP	HORSEPOWER	WAN	WIRELESS ACCESS POINT
HTR	HEATER	WAP	WEATHERPROOF COVER
		WP	WEATHER RESISTANT
ID	INSIDE DIAMETER	WR	WIRE SIZING AMPS
IMC	INTERMEDIATE METAL CONDUIT		<del></del>
	THE THE POST OF TH	XFMR	TRANSFORMER
LDOV	IUNCTION DOV	AL IVII L	TRAIN VIINEIL

J-BOX JUNCTION BOX

### **DEVICE SUBSCRIPTS**

ROMAN NUMERAL INDICATES QUANTITY OF GANGED DEVICES UNDER COMMON FACEPLATE HEIGHT OF DEVICE ABOVE FINISHED FLOOR (IN INCHES) LOWER CASE LETTER(S) INDICATES SWITCH CONTROL ARRANGEMENT NUMERAL INDICATES BRANCH CIRCUIT NUMBER (POWER & LIGHTING)/CANDELA RATING (FIRE ALARM DEVICES) WITH AUXILIARY CONTACTS INSTALL ABOVE COUNTER, AT 40° AFF, COORDINATE WITH GC

BLANKFACE GFCI CORD DROP RECEPTACLE CLOCK HANGER RECEPTACH INSTALL FLUSH IN CEILING

INSTALL ON SURFACE OF CEILING CONTROL POINT IDENTIFIER (\* INDICATES CONTROL NUMBER) RECEPTACLE FOR COPIER, INSTALL 18" AFF

REMOVE DEVICE AND INSTALL BLANK COVERPLATE

RECEPTACLE FOR COFFEE . INSTALL 44\* AFF DIMMER SWITCH (LIGHTING CONTROL) EXISTING BACKBOX TO REMAIN AND BE REUSED EXISTING BACKBOX WITH NEW DEVICE

EQUIPMENT SUPPLIED BY OWNER EXISTING TO BE REMOVED EXISTING TO BE RELOCATED

EXISTING TO REMAIN RECEPTACLE FOR WATER COOLER, COORDINATE EXACT LOCATION WITH GC & PC PRIOR TO ROUGH-IN

EXPLOSION PROOF INSTALL FLUSH IN FLOOR INSTALL IN FLOORBOX/POKETHRU FIRE RATED ASSEMBLY GROUND FAULT CIRCUIT INTERRUPTING RECEPTACLE

GROUND FAULT CIRCUIT INTERRUPTING BREAKER PROTECTED FEED THROUGH GROUND FAULT CIRCUIT INTERRUPTING PROTECTED INSTALL HORIZONTALLY HIGH ABUSE COVERPLATE WITH CENTER PIT REJECT SCREWS

ISOLATED GROUND RECEPTACLE KEY OPERATED LOCATOR STYLE TOGGLE SWITCH (PILOT LIGHT 'ON' WHILE DEVICE IS OFF OR UNPOWERED)

LOW VOLTAGE INSTALL IN MULLION MONITORING POINT IDENTIFIER (\* INDICATES MONITORING POINT NUMBER)

RECEPTACLE FOR MICROWAVE , INSTALL IN UPPER CABINET, COORDINATE EXACT LOCATION WITH GC PRIOR TO ROUGH-IN INDICATES NEW DEVICE

NOT IN CONTRACT/PROVIDE BY OTHERS NIGHT LIGHT LUMINAIRE (UNSWITCHED / INTEGRAL NIGHT LIGHT STYLE RECEPTACLE INTEGRAL NIGHT LIGHT STYLE GFCI RECEPTACLE

OCCUPANCY SENSOR (AUTOMATIC 'ON' LIGHTING SENSOR SWITCH) PILOT STYLE TOGGLE SWITCH (PILOT LIGHT ON WHILE DEVICE IS ON OR POWERED) FOR PHONE, INSTALL 54\* AFF POWER INDICATING RECEPTACLE

RECEPTACLE FOR PROJECTOR, INSTALL FLUSH IN CEILING BACKBOX FOR AUTODOOR PUSH PLATE RELAY DESIGNATION (\* INDICATES RELAY NUMBER) RECEPTACLE FOR REFRIGERATOR, INSTALL 44" AFF INSTALL ON SURFACE SURGE PROTECTOR STYLE RECEPTACLE

INSTALL IN SURFACE RACEWAY SPLIT WIRED RECEPTACLE FOR REMOTE SWITCHING DIGITAL ELECTRONIC INTERVAL TIMER (LIGHTING SWITCH) TAMPER RESISTANT

DIGITAL ELECTRONIC PROGRAMMABLE TIME SWITCH (LIGHTING SWITCH) FOR TELEVISION/MONITOR, INSTALL 72\* AFF INSTALL UNDER COUNTER. COORDINATE EXACT LOCATION WITH GC PRIOR TO ROUGH-IN RECEPTACLE WITH USB CHARGING PORTS

RECEPTACLE FOR VENDING MACHINE, INSTALL 44" AFF VACANCY SENSOR (MANUAL 'ON' LIGHTING SENSOR SWITCH) INSTALL 44" AFF

DEVICE ZONE IDENTIFIER (\* INDICATES ZONE NUMBER)

**WIRE GUARD** WEATHERPROOF DEVICE / WEATHERPROOF WHILE-IN-USE EXTRA DUTY COVER & WEATHER RESISTANT RECEPTACLE WEATHERPROOF SPRING LOADED COVER (WEATHERPROOF WHEN CLOSED), WEATHER RESISTANT RECEPTAGLE WEATHER RESISTANT DEVICE/WEATHER RESISTANT RECEPTACLE

## **GENERAL LINEWORK DESCRIPTIONS & DRAWINGS NOTES**

EXISTING WORK / FUTURE PROVISIONS / NOT IN CONTRACT WORK WIRE AND / OR CONDUIT RUN CONTINUED ON REFERENCED DETAIL

DRAWING KEYED NOTES

#### BRANCH CIRCUIT CONDUCTOR SIZING

### CIRCUIT NOTATION:

11,13 — CIRCUIT NUMBER(S) 1LNL1 -- SOURCE PANELBOARD (IF OTHER THAN NOTED ON SHEET/CIRCUIT BOUNDARY)

PROVIDE MINIMUM WIRE SIZE AS FOLLOWED UNLESS NOTED OTHERWISE: 20A CB - #12 AWG

30A CB - #10 AWG 40A CB - #8 AWG

50A CB - #8 AWG INCREASE SIZE OF CONDUCTOR FOR DISTANCE AS SHOWN BELOW IN 20A BRANCH CIRCUIT CONDUCTOR SIZING SCHEDULE.

#### 20A BRANCH CIRCUIT CONDUCTOR SIZING SCHEDULE:

MAXIMUM BRANCH CIRCUIT LENGTH AT 120V (FEET) MAXIMUM BRANCH CIRCUIT LENGTH AT 277V (FEET)

1. INCREASE ALL BRANCH CIRCUIT CONDUCTORS AS INDICATED BASED ON LENGTH OF CIRCUIT, INCLUDING EQUIPMENT GROUNDING

TRANSITION FROM LARGER CONDUCTOR SIZE TO #12 AWG FOR FINAL TERMINATION TO OUTLET DEVICE. PROVIDE JUNCTION BOX WITHIN 10' OF OUTLET AND EXTEND #12 AWG CONDUCTORS TO OUTLET.

4. SCHEDULE ASSUMES 12A LOAD, FOR LOADS HIGHER THAN 12A, INCREASE CONDUCTOR SIZE.

#### **EQUIPMENT CONNECTIONS**

3. LENGTHS ARE FROM OVERCURRENT PROTECTIVE DEVICE, ALONG CIRCUIT ROUTING, TO CENTER OF EQUIPMENT LOAD.

SINGLE PHASE MOTOR/PUMP CONNECTION, REFER TO EQUIPMENT CONNECTION SCHEDULE

THREE PHASE MOTOR/PUMP CONNECTION, REFER TO EQUIPMENT CONNECTION SCHEDULE SINGLE POINT EQUIPMENT CONNECTION, REFER TO EQUIPMENT CONNECTION SCHEDULE

#### **PANELBOARDS**

#### PANELBOARD - FLOOR PLAN NOTATION:

DOOR STYLE (DESIGNATES VOLTAGE):

208/120V OR 240V SYSTEM

SIZE (DESIGNATES PANELBOARD TYPE):

PANELBOARD

FILL (DESIGNATES BRANCH TYPE):

NORMAL BRANCH PANELBOARD

### **ELECTRICAL DEVICES**

#### **GENERAL ELECTRICAL DEVICE NOTATION:**

15 +30 INSTALLATION HEIGHT TO CENTER OF DEVICE IN INCHES //F OTHER TIME. SOURCE PANELBOARD (IF OTHER THAN -NOTED ON SHEET/CIRCUIT BOUNDARY) SUBSCRIPT (IF APPLICABLE)

NEMA 5-20R DUPLEX RECEPTACLE, 18" AFF NEMA 5-20R GFCI DUPLEX RECEPTACLE, 18\* AFF

WP = WEATHERPROOF COVER

#### LIGHTING CONTROL DEVICES

NOTE: LIGHTING CONTROL DEVICES SHOW FUNCTIONAL REQUIREMENTS, NOT ALL DEVICES NEEDED FOR A FULLY FUNCTIONING SYSTEM, DEPENDING ON CONFIGURATION AND MANUFACTURER, DEVICES SUCH AS POWER PACKS, RELAYS, SINGLE/DOUBLE/TRIPLE OUTPUT ROOM CONTROLLERS MAY BE NECESSARY, REFER TO DETAILS & SPECIFICATIONS.

SINGLE POLE TOGGLE SWITCH, 44" AFF

SINGLE POLE KEYED SWITCH, 44\* AFF


OCCUPANCY SENSOR SWITCH, DUAL TECHNOLOGY SINGLE POLE, WALL-BOX STYLE, 44" AFF

OCCUPANCY SENSOR, LOW VOLTAGE, DUAL TECHNOLOGY, WIDE VIEW, CEILING MOUNTED

PHOTOCELL DEVICE, LINE VOLTAGE, 12" ABOVE ROOF, AIMED NORTH

#### **LIGHTING**

#### **GENERAL LUMINAIRE NOTATION:**

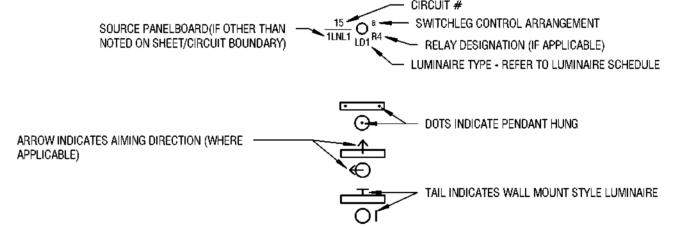


ILLUMINATED EXIT SIGN - SINGLE/DOUBLE FACE AS SHOWN - DIRECTION OF ARROWS AS INDICATED - CEILING, SURFACE

GEOMETRIC SHAPE LUMINAIRE, RECESSED OR SURFACE MOUNTED PER LUMINAIRE SCHEDULE

WALL, OR PERPENDICULAR WALL AS SHOWN

SELF CONTAINED BATTERY LIGHTING UNIT

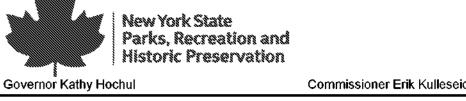

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ARCHITECT: Saratoga Associates 21 Congress Street, Suite 201

Saratoga Springs, NY 12866

SARATOGA **ASSOCIATES** Lacobassam Architeots, Ambilacts Engineers, and Planners, P.C.

LaBella

SURVEYOR/STRUCTURAL/ MEP ENGINEER:

LaBella Associates 300 State Street, Suite 201 Rochester, NY 14614

Certificate of Authorization Number Professional Engineering: 018281 Land Surveying: 017976 Geological: 018750

Palisades Region

Palisades Interstate Park Commission Bear Mountain, New York 10911 (845) 786-2701 Executive Director: Joshua Laird

Project Title: CAMP JUNIOR ON LAKE TIORATI -PHASE 3

**Project Location:** HARRIMAN STATE PARK

**Key Plan** 

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Rev No	Description	Date:
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Seal and Signature

Drawing Number:

JJS Design By: JJS Checked By: NCH Approved By: NCH

Sheet Title: ELECTRICAL NOTES, SYMBOL

3/16/23

Project Number:

21059.23

E001 LEGEND, & **ABBREVIATIONS** 

**Bid Documents** 

Sheet:

### **DRAWING NOTES:**

CIRCUIT RECEPTACLES TO 20A1/1P CIRCUIT BREAKER IN BATHHOUSE PANEL USING 2#12, 1 #12G IN 1/2C\*, CIRCUIT NUMBER AS INDICATED.

#### **KEYED NOTES:**

- PROVIDE OCCUPANCY SENSOR AND POWER PACK TO CONTROL EXHAUST FAN 1. COORDINATE LOCATION OF EXHAUST FAN WITH MECHANICAL CONTRACTOR.
- MOUNT PANELBOARD AT 6'6 ABOVE FINISH FLOOR TO THE TOP OF TRIM.



Governor Kathy Hochul Commissioner Erik Kulleseid IT IS A VIOLATION OF STATE EDUCATION LAW FOR ANY PERSON, UNLESS UNDER THE DIRECTION OF A LICENSED ARCHITECT/ENGINEER TO ALTER THIS DOCUMENT IN ANYWAY. ALTERATIONS MUST HAVE THE SEAL AFFIXED ALONG WITH A DESCRIPTION OF THE ALTERATIONS, DATE AND ARCHITECT'S/ENGINEER'S SIGNATURE. COPYRIGHT © 2023

SARATOGA ASSOCIATES ARCHITECT: Saratoga Associates 21 Congress Street, Suite 201 Saratoga Springs, NY 12866 Lacdisupe Architects, Architects,

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Key Plan

REVISIONS Rev No Description Date:

JJS Design By: JJS Checked By: NCH Approved By: NCH

BATHHOUSE

POWER PLANS

#231 & #322


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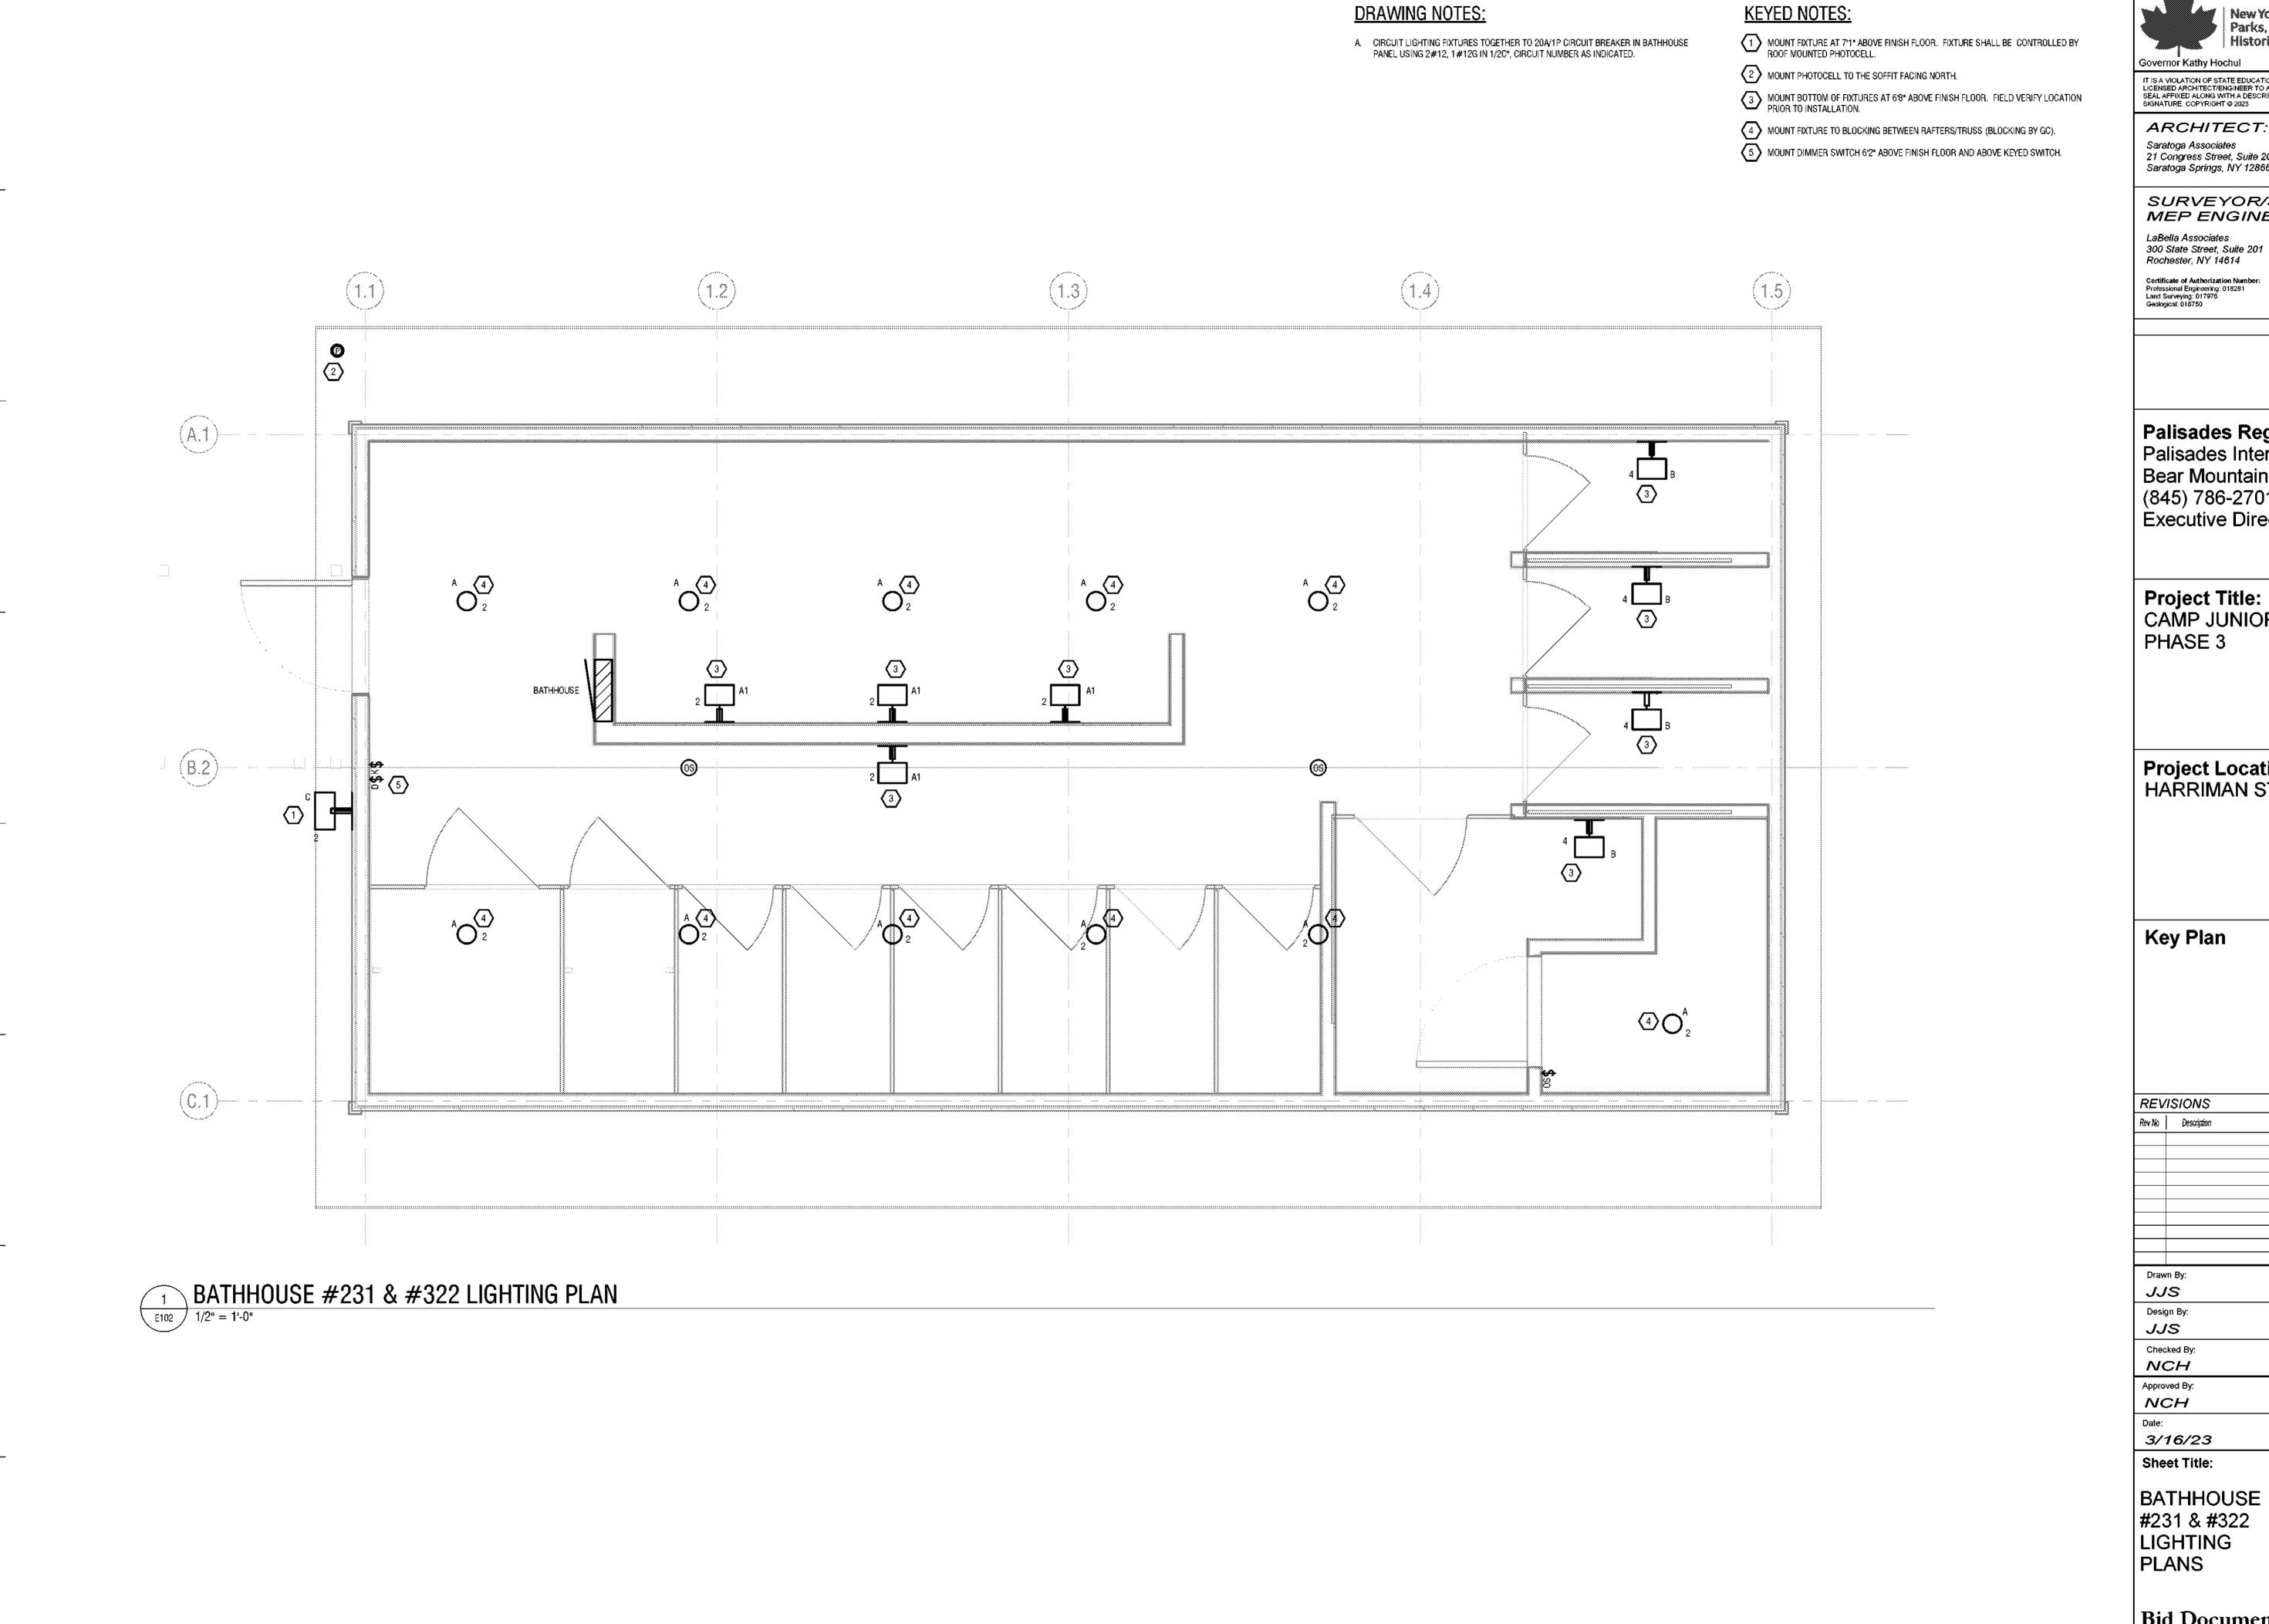
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New York State
Parks, Recreation and
Historic Preservation

Commissioner Erik Kulleseid

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ARCHITECT: Saratoga Associates 21 Congress Street, Suite 201 Saratoga Springs, NY 12866 SARATOGA ASSOCIATES Lacdisupe Architects, Architects, Engineers, and Planners, P.C.

SURVEYOR/STRUCTURAL/ MEP ENGINEER:

LaBella
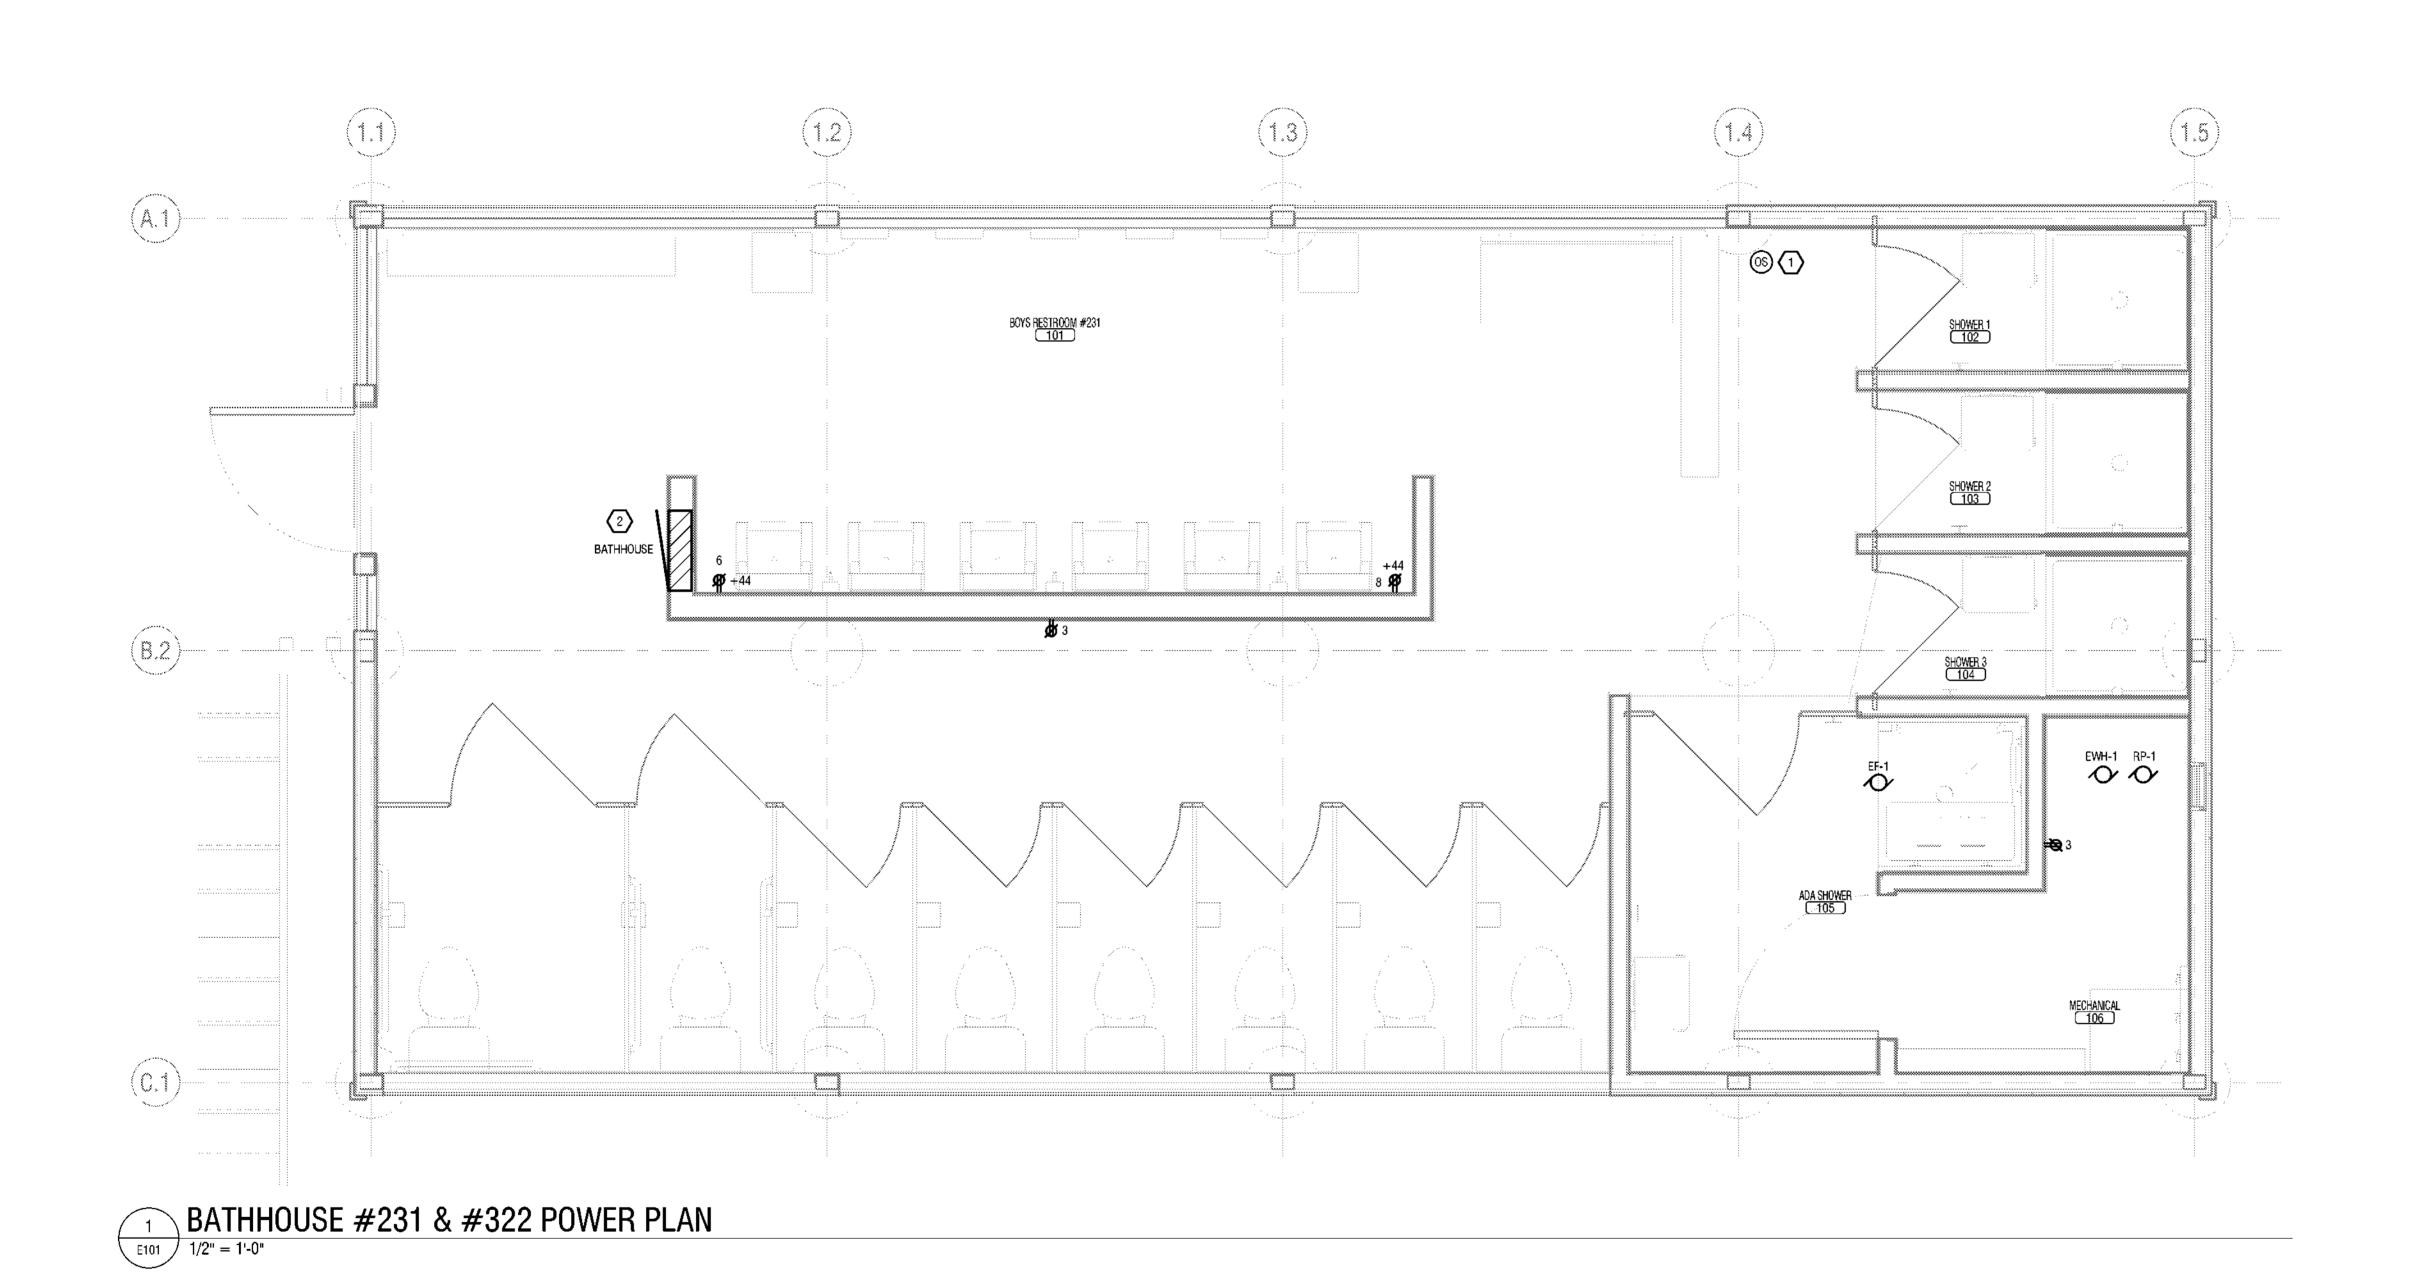
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Date:

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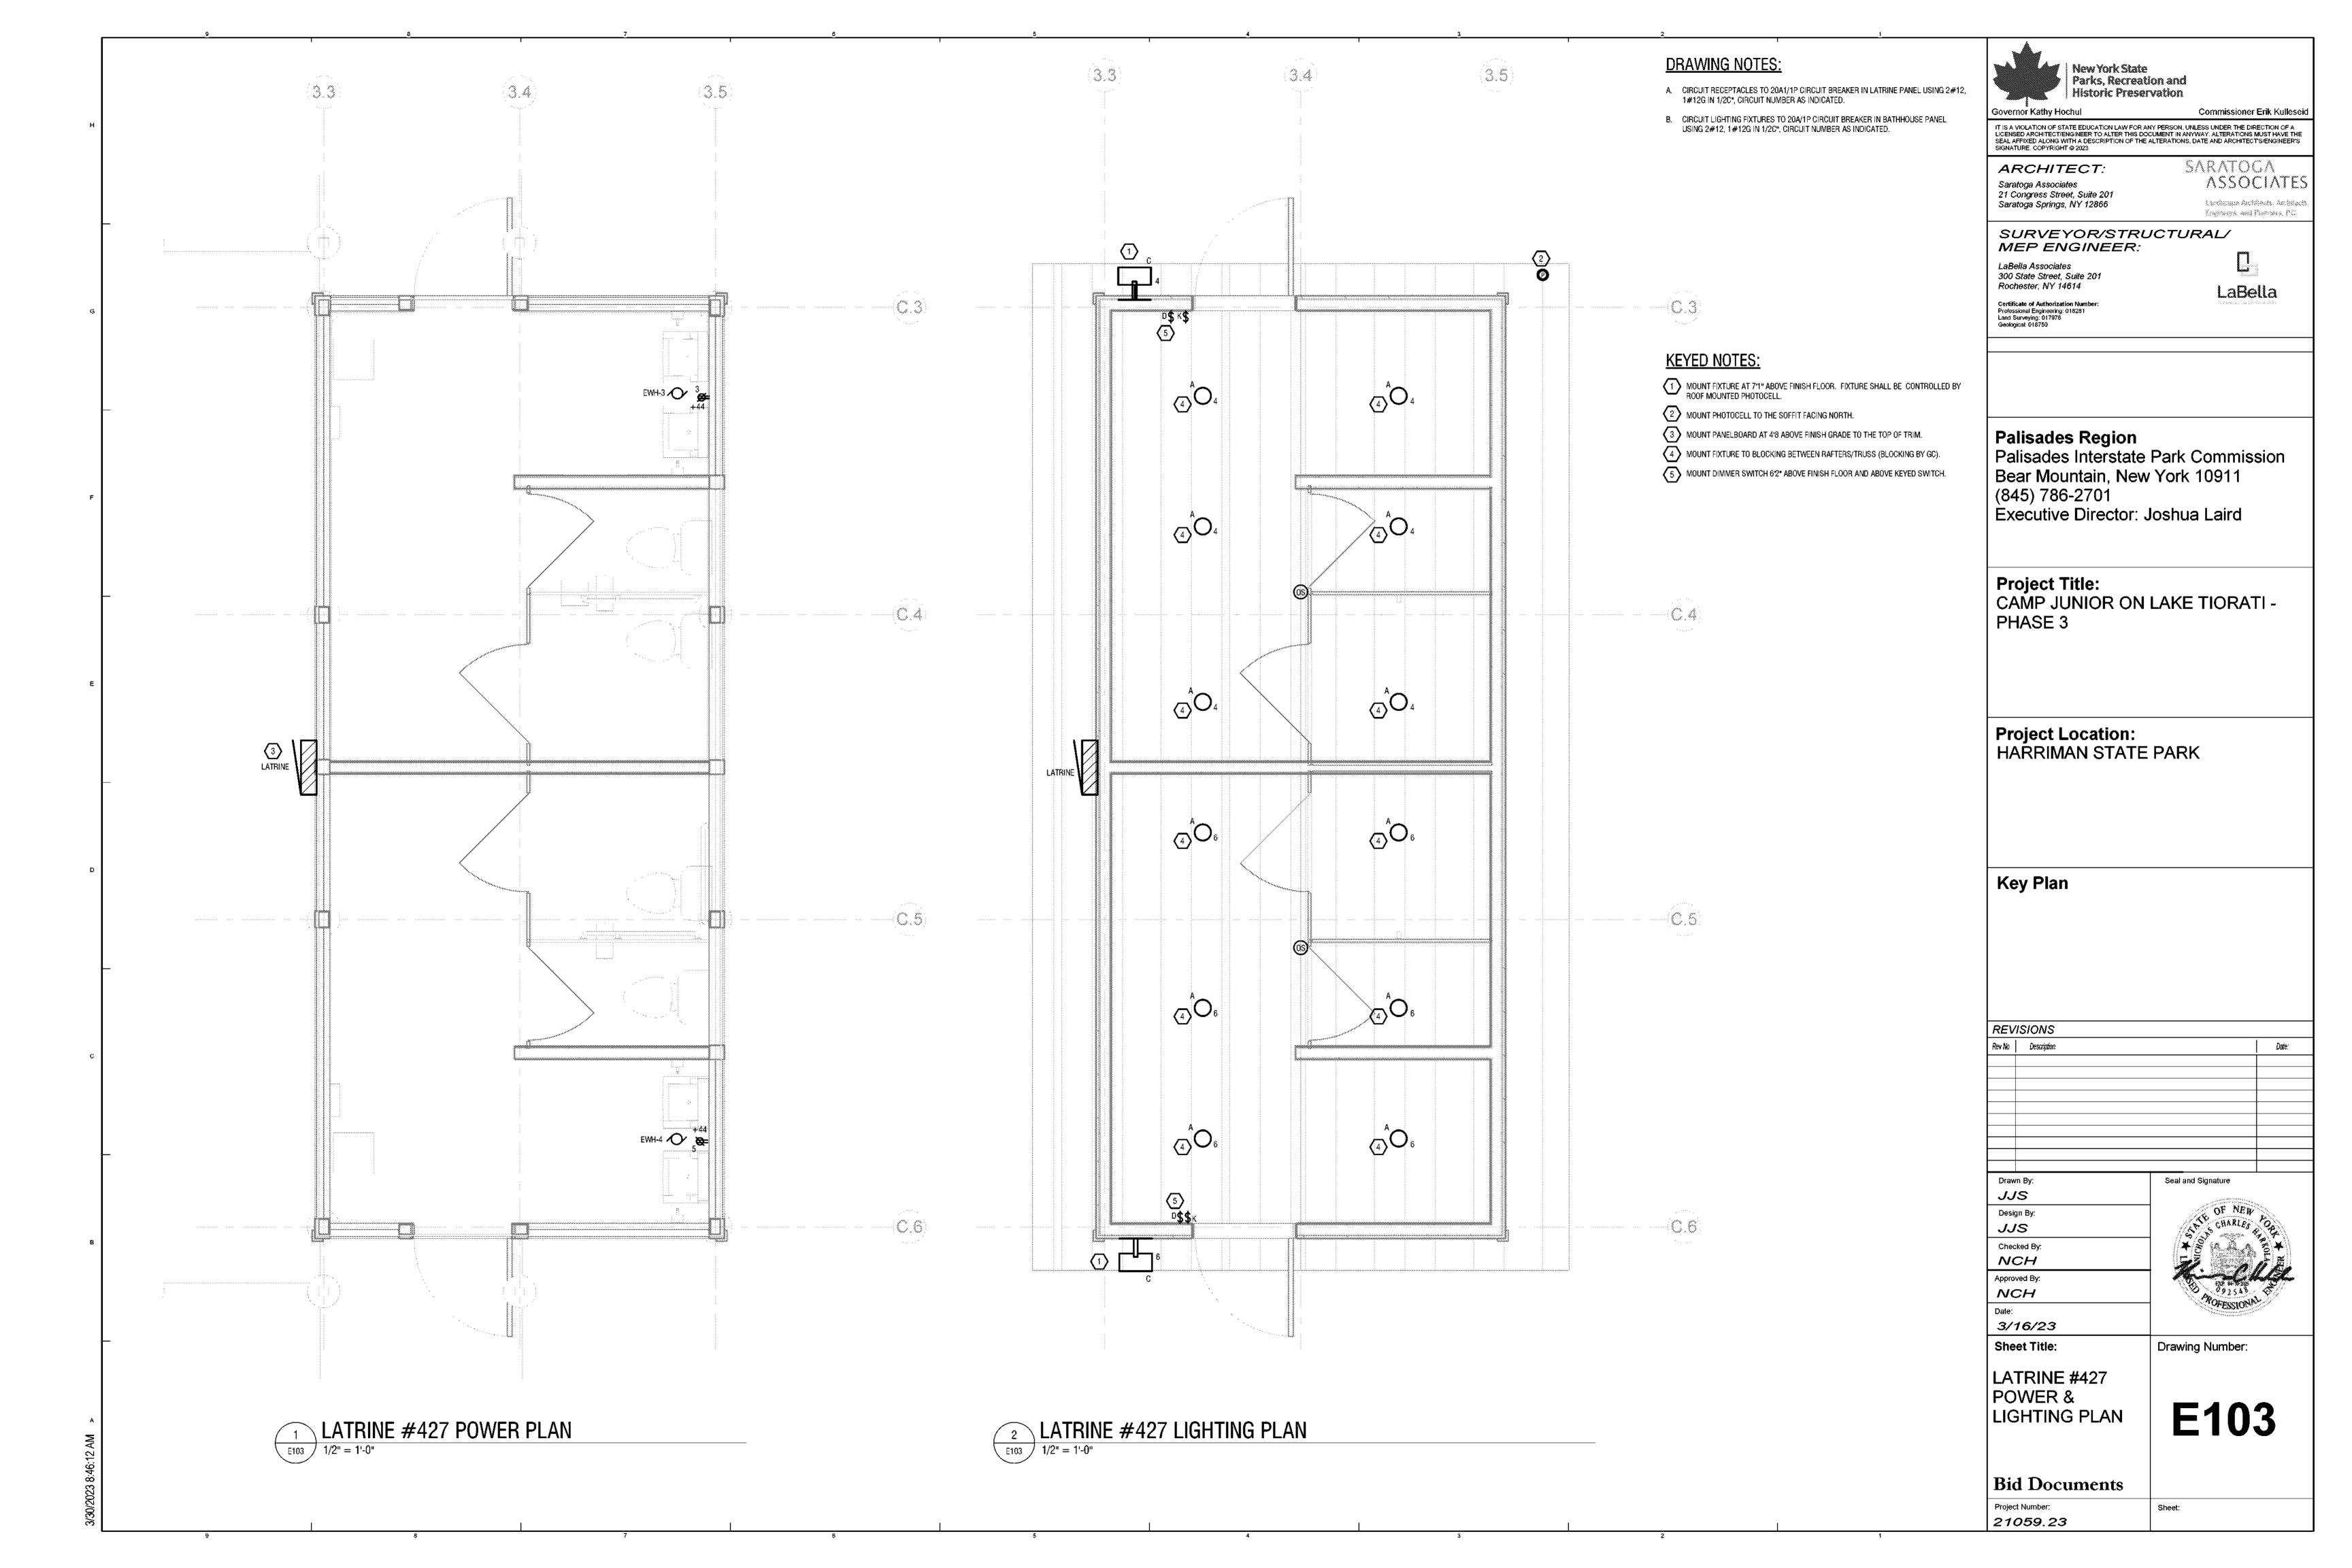
Drawing Number:

BATHHOUSE

21059.23

E102

**Bid Documents** Project Number:



# New York State Parks, Recreation and Historic Preservation **KEYED NOTES:** Governor Kathy Hochul MOUNT FIXTURE AT 10'-0" ABOVE FINISH FLOOR. CIRCUIT NEW LIGHTING FIXTURES USING 2#12, 1#12G IN 1/2"C TO EXISTING CIRCUIT FEEDING THE EXIT SIGNS. ROUTE CONDUIT ON THE INSIDE OF THE BUILDING AND COME THROUGH EXTERIOR OF THE BUILDING AT THE LIGHT FIXTURES. IT IS A VIOLATION OF STATE EDUCATION LAW FOR ANY PERSON, UNLESS UNDER THE DIRECTION OF A LICENSED ARCHITECT/ENGINEER TO ALTER THIS DOCUMENT IN ANYWAY. ALTERATIONS MUST HAVE THE SEAL AFFIXED ALONG WITH A DESCRIPTION OF THE ALTERATIONS, DATE AND ARCHITECT'S/ENGINEER'S SIGNATURE. COPYRIGHT © 2023 SARATOGA ASSOCIATES ARCHITECT: Saratoga Associates 21 Congress Street, Suite 201 Saratoga Springs, NY 12866 Layringue Architects, Architects Engineers, and Planners, P.D. SURVEYOR/STRUCTURAL/ MEP ENGINEER: LaBella Associates 300 State Street, Suite 201 Rochester, NY 14614 LaBella Certificate of Authorization Number: Professional Engineering: 018281 Land Surveying: 017976 Geological: 018750 Palisades Region Palisades Interstate Park Commission Bear Mountain, New York 10911 (845) 786-2701 Executive Director: Joshua Laird Project Title: CAMP JUNIOR ON LAKE TIORATI -PHASE 3 Project Location: HARRIMAN STATE PARK **Key Plan** REVISIONS Rev No Description Date: Seal and Signature JJS Design By: JJS Checked By: NCH Approved By: NCH DINING HALL #404 CANOPY LIGHTING PLAN 3/16/23 Sheet Title: Drawing Number: DINING HALL #404 CANOPY E104 LIGHTING PLANS **Bid Documents** Project Number: 21059.23

### **LUMINAIRE SCHEDULE**

ID	LAI TYPE	MP WATTS	MANUFACTURER	MODEL	DESCRIPTION	COLOR TEMP	LUMEN OUTPUT	NOTES
Α	LED	17	RAB LIGHTING	VX100DG HOUSING	SURFACE MOUNT	2700K	1600	PROVIDE RAB LIGHTING A21-17-E26-927-DIM LED BULB
A1	LED	17	RAB LIGHTING	VXBR100DG HOUSING	WALL MOUNT	2700K	1600	PROVIDE RAB LIGHTING A21-17-E26-927-DIM LED BULB
В	LED	20	COOPER LIGHTING FAIL-SAFE SERIES	B95-HE-BRZ-LD4-20-30-CL-UNV-EDC1	WALL MOUNT	3000K	1200	HORIZONTAL ORIENTATION
С	LED	26	RAB LIGHTING	FFLED26Y/E*	WALL MOUNT	3000K	3952	BRONZE FINISH, PROVIDE RAB LIGHTING PART VXCA WIRING BOX WITH XC1A COVER BOTH IN BRONZE FINISH

							E	QUIPMENT (	CONNEC	TION SCHED	ULE				
								PROTECTIVE	NUMBER						
						POWER	CIRCUIT	DEVICE	OF	CONDUCTORS	CONTROLLER	CONTROLLER	CONTROLLER		
DESIGNATION	LOCATION	DESCRIPTION	LOAD	VOLTAGE	PHASE	SOURCE	NUMBER	RATING (A)	POLES	& CONDUIT	TYPE	SIZE	<b>ACCESSORIES</b>	DISCONNECT	NOTES
EF-1	MECHANICAL	EXHAUST FAN	864 VA	115 V	1	BATHHOUSE	1	20	1	2#12, 1#12G, 1/2°C	OCCUPANCY SENSOR	20A -		FACTORY MOUNTED	
EF-2	MECHANICAL	EXHAUST FAN	864 VA	115 V	1			20	1	2#12, 1#12G, 1/2°C	OCCUPANCY SENSOR	20A -		FACTORY MOUNTED	SAME AS EF-1 EXCEPT LOCATED IN BATHHOUSE #322
EWH-1	MECHANICAL	ELECTRIC WATER HEATER	13200 VA	240 V	1	BATHHOUSE	5,7	70	2	2#8, 1#8G, 3/4°C	INTEGRAL			100AF/70AT FUSED DISCONNECT	CONFRIM CIRCUIT BREAKER REQUIRED WITH MANUFACTURER
EWH-2	MECHANICAL	ELECTRIC WATER HEATER	13200 VA	240 V	1			70	2	2#8, 1#8G, 3/4"C	INTEGRAL			100AF/70AT FUSED DISCONNECT	SAME AS EWH-1 EXCEPT LOCATED IN BATHHOUSE #322
EWH-3	MECHANICAL	ELECTRIC WATER HEATER	1400 VA	115 V	1	LATRINE	1	20	1	2#12, 1#12G, 1/2°C	-			PROVIDE GFI TYPE RECEPTACLE	
EWH-4	MECHANICAL	ELECTRIC WATER HEATER	1400 VA	115 V	1	LATRINE	2	20	1	2#12, 1#12G, 1/2*C	-			PROVIDE GFI TYPE RECEPTACLE	
RP-1	MECHANICAL	RECIRCULATION PUMP	25 VA	120 V	1	BATHHOUSE	9	15	1	2#8, 1#8G, 3/4°C	-			PROVIDE GFI TYPE RECEPTACLE	



Governor Kathy Hochul

Commissioner Erik Kulleseic

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ARCHITECT:
Saratoga Associates
21 Congress Street, Suite 201
Saratoga Springs, NY 12866

SARATOGA ASSOCIATES

SURVEYOR/STRUCTURAL/ MEP ENGINEER:

LaBella Associates 300 State Street, Suite 201 Rochester, NY 14614

n Number: 18281

Certificate of Authorization Number: Professional Engineering: 018281 Land Surveying: 017976 Geological: 018750 LaBella

Palisades Region

Palisades Interstate Park Commission Bear Mountain, New York 10911 (845) 786-2701 Executive Director: Joshua Laird

Project Title: CAMP JUNIOR ON LAKE TIORATI -PHASE 3

Project Location: HARRIMAN STATE PARK

**Key Plan** 

Rev No Description Date:

Drawn By: Seal and Signature

Drawn By:

JJS

Design By:

JJS

Checked By:

NCH

Approved By:

NCH

Drawing Number:

SCHEDULES

3/16/23

Sheet Title:

21059.23


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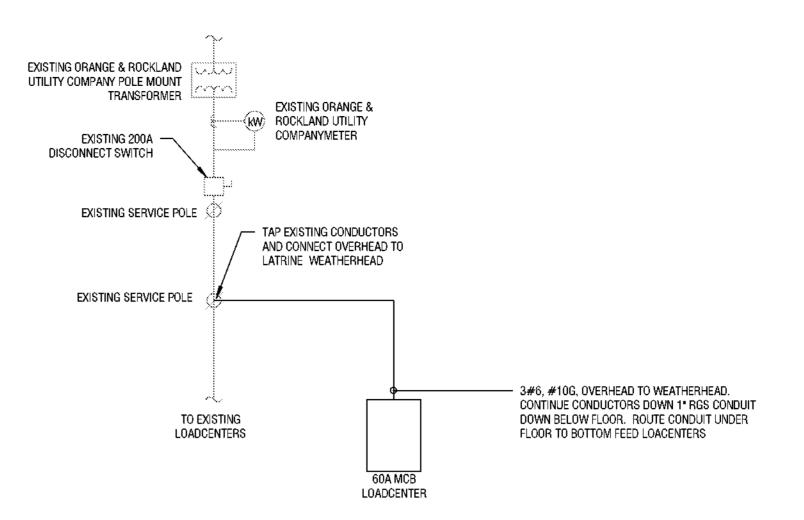
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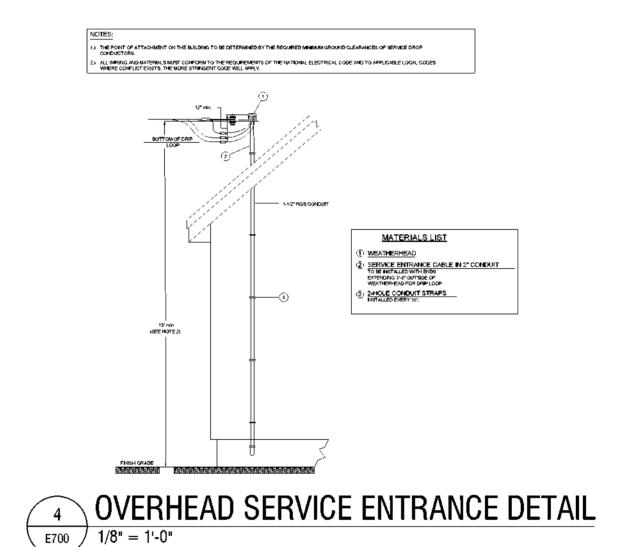
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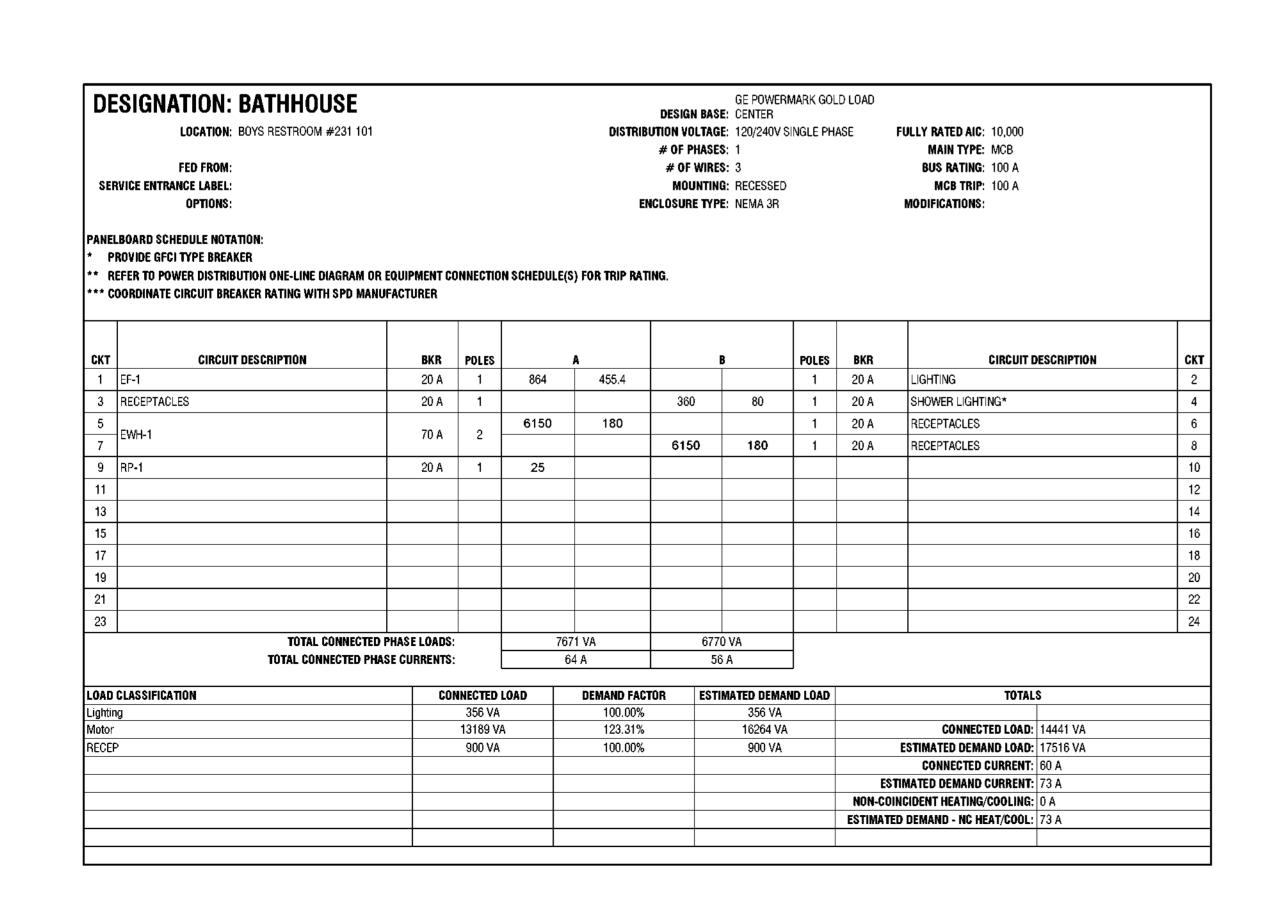




POWER ONE-LINE DIAGRAM - LATRINE

E700 / 1/8" = 1'-0"



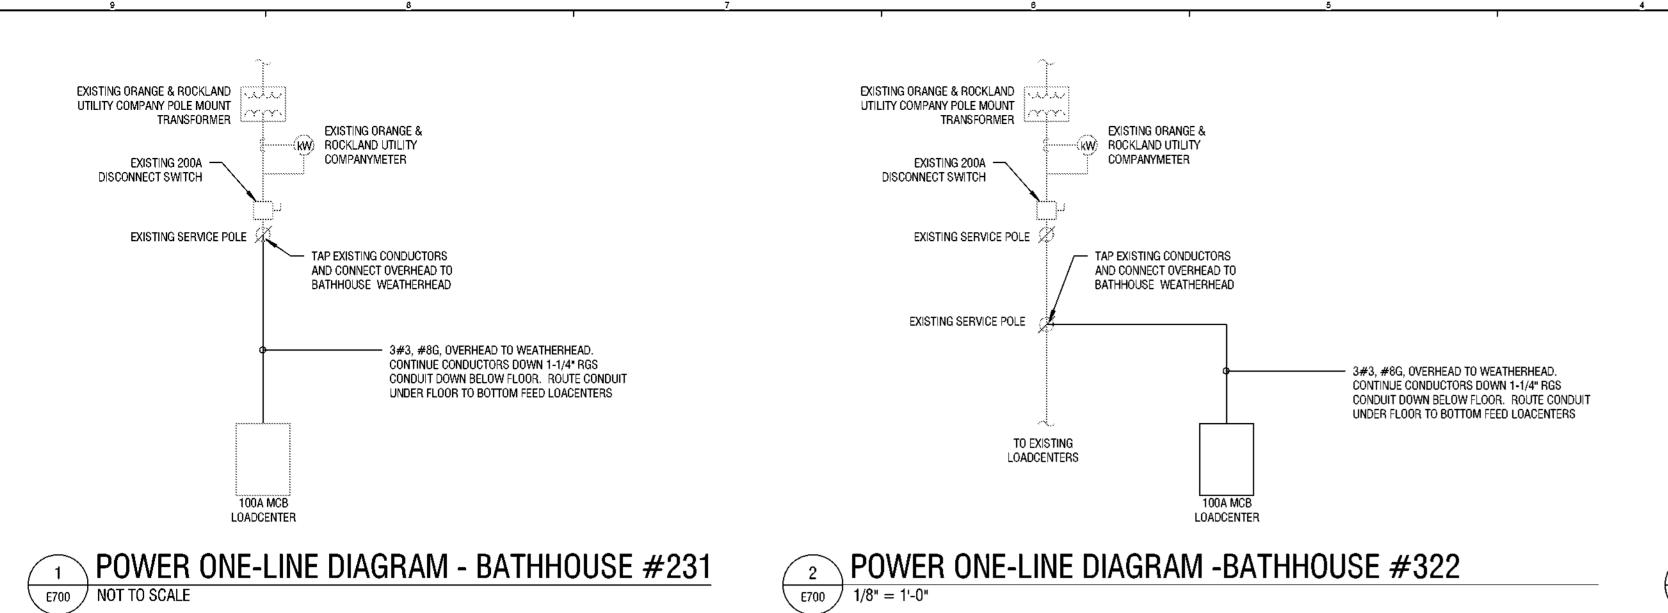

SEF Panei * P ** R	ESIGNATION: LATRINE  LOCATION:  FED FROM:  RVICE ENTRANCE LABEL:  OPTIONS:  LBOARD SCHEDULE NOTATION:  ROVIDE GFCI TYPE BREAKER  EFER TO POWER DISTRIBUTION ONE-LINE DIAGRAM OR I		ONNECTIO	N SCHEDULE	EM	UTION VO # OF PI # OF V Mou ICLOSURE	GE POWI BASE: CENTER LTAGE: 120/240° HASES: 1 MIRES: 3 NTING: SURFACE TYPE: NEMA 3F	Ē.		FULLY RATED AIC: 10,000 MAIN TYPE: MCB BUS RATING: 100 A MCB TRIP: 60 A MODIFICATIONS:		
CKT	CIRCUIT DESCRIPTION	BKR 15 A	POLES 1	1400	1400		В	POLES	BKR 15.A		DESCRIPTION	CKT
	EWH-3 RECEPTACLES	15 A 20 A	1	1400	1400	180	330.4	1	15 A 20 A	EWH-2 LIGHTING		2
	RECEPTACLES	20 A	1	180	127	100	330.4	1	20 A	LIGHTING		6
7	RECEPTACLES	20 A	'	100	127			+ '-	20 A	LIGHTING		8
9								+				10
11								-				12
13								_				14
15								_				16
17												18
19												20
21												22
23												24
	TOTAL CONNECTED I TOTAL CONNECTED PHAS				103 VA 26 A		510 VA 4 A					
OAD	CLASSIFICATION	CO	NNECTED	LOAD	DEMAND FACT	TOR	ESTIMATED DEN	IAND LOAD		TOTAL	.s	
ightir.			279 VA		100.00%		279 V	A				
Aotor			2800 VA		112.50%		3150 V			CONNECTED LOAD:		
RECER	,		540 VA		100.00%		540 V	A		ESTIMATED DEMAND LOAD: CONNECTED CURRENT:		
				-+					ES	STIMATED DEMAND CURRENT:		
				1							1 1 1	
									NON-CO	DINCIDENT HEATING/COOLING:	0 A	

Saratoga Associates 21 Congress Street, Suite 201 Saratoga Springs, NY 12866  SURVEYOR/STRUCTURAL/ MEP ENGINEER:  LaBella Associates 300 State Street, Suite 201 Rochester, NY 14614  Certificate of Authorization Number: Professional Engineering: 018281 Land Surveying: 017978 Geological: 016750  Palisades Region Palisades Interstate Park Commiss Bear Mountain, New York 10911 (845) 786-2701 Executive Director: Joshua Laird		Commissioner Erik Ku
Saratoga Associates 21 Congress Street, Suite 201 Saratoga Springs, NY 12866  SURVEYOR/STRUCTURAL/ MEP ENGINEER:  LaBella Associates 300 State Street, Suite 201 Rochester, NY 14614  Certificate of Authorization Number: Professional Engineering: 018281 Land Surveying: 017976 Geological: 018750  Palisades Region Palisades Interstate Park Commiss Bear Mountain, New York 10911 (845) 786-2701 Executive Director: Joshua Laird	D ARCHITECT/ENGINEER TO ALTER TH FIXED ALONG WITH A DESCRIPTION O	THIS DOCUMENT IN ANYWAY. ALTERATIONS MUST HAV
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Palisades Interstate Park Commiss Bear Mountain, New York 10911 (845) 786-2701 Executive Director: Joshua Laird	rveying: 017976	
	isades Intersta	ate Park Commission lew York 10911
Project Title: CAMP JUNIOR ON LAKE TIORAT PHASE 3	,	

Key Plan

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Rev No	Description	Date.
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NCH 3/16/23 Sheet Title: Drawing Number:

E700 DIAGRAM AND SCHEDULES

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Project Number: Sheet: 21059.23