


Mechanical Legend :

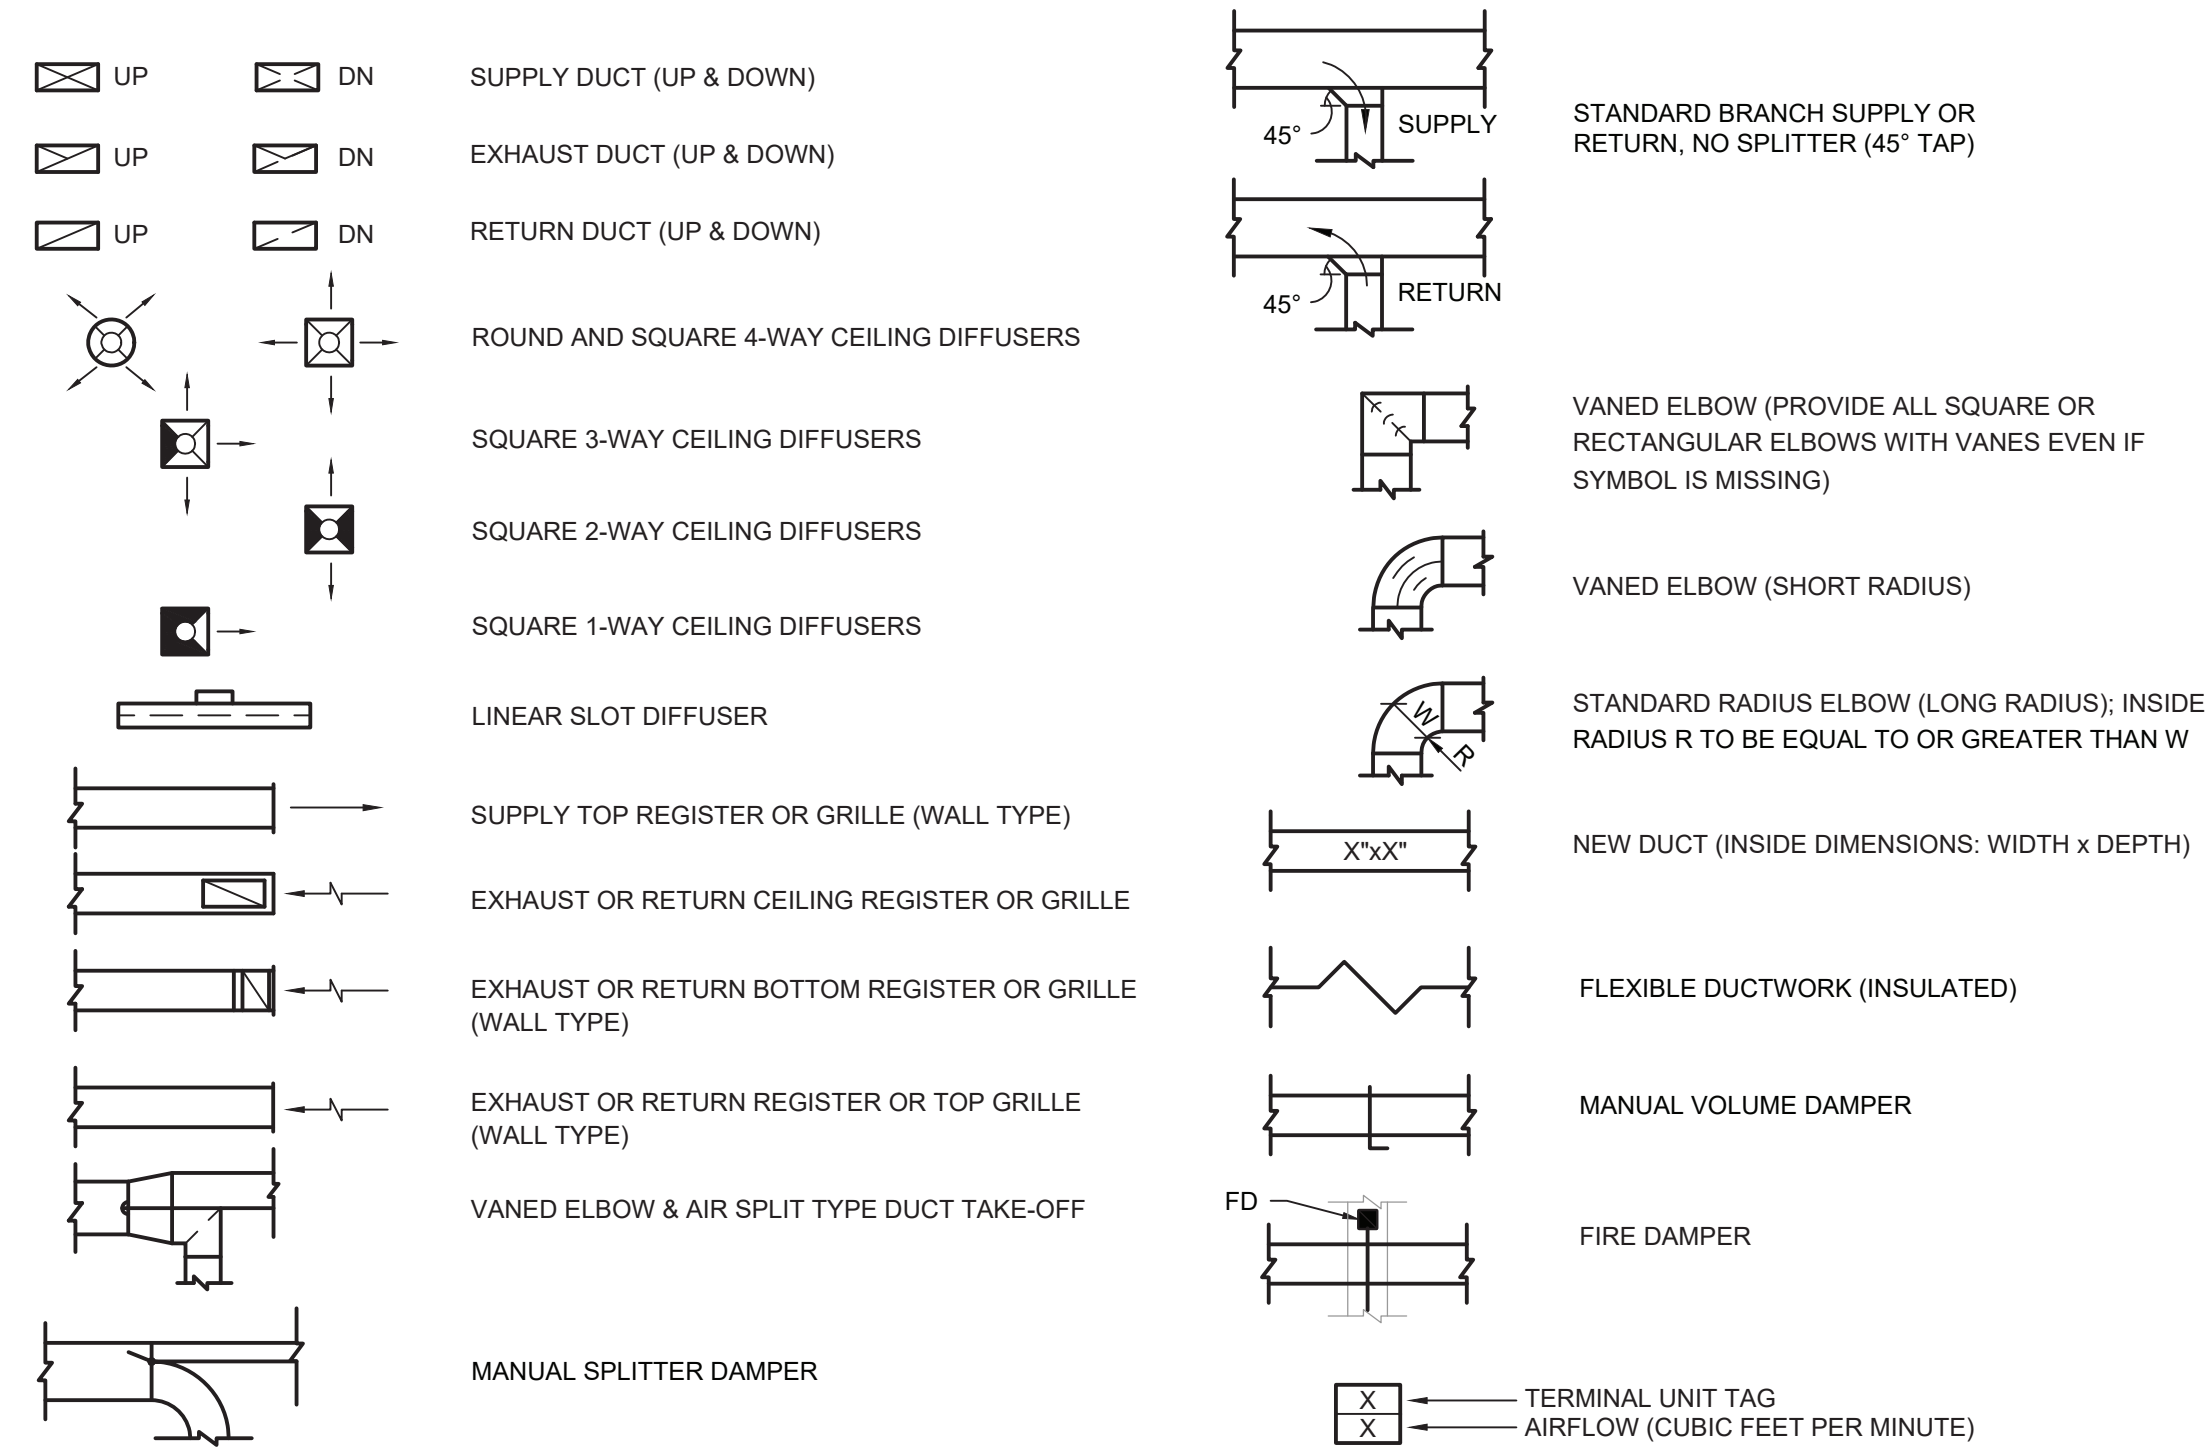

AIR-COOLED HEAT PUMP SCHEDULE																							
EQUIPMENT TAG	MANUFACTURER (OR ACCEPT. EQUAL)	MODEL	INDOOR UNITS SERVED	COMPRESSOR TYPE	NOM. COOL CAPACITY (MBH)	NOM. HEAT CAPACITY (MBH)	TOTAL COOL CAPACITY (MBH) @65°F AMB.	TOTAL HEAT CAPACITY (MBH) @-10°F AMB.	OUTDOOR OPERATING TEMP. RANGE (°F)		AHRI EFFICIENCY RATINGS				REFRIGERANT	SOUND PRESSURE LEVEL COOLING/ HEATING (dBA)	ELECTRICAL POWER REQUIREMENTS					WEIGHT (LB)	NOTES
									COOLING	HEATING	EER	IEER	COP47F	COP17F			VOLT.	PHASE	Hz.	MCA	MOCP		
HP-1	HITACHI	HVAHR384B32S	SEE INDOOR UNIT SCHEDULE	INVERTER SCROLL HERMETIC	384,000	432,000	340.6	216.9	23 TO 122	-13 TO 59	9.6	19.6	3.37	2.20	R410A	69	208	3	60	58 & 46 x2	70 & 60 x2	776 & 774 x2	PROVIDE W/ REQUIRED PIPING ACCESSORIES; INSTALL PER MANUFACTURER REQUIREMENTS

INDOOR MINI-SPLIT UNIT SCHEDULE																						
EQUIPMENT TAG	MANUFACTURER (OR ACCEPT. EQUAL)	MODEL	MINI-SPLIT UNIT TYPE	AREA OF BUILDING SERVED	AIRFLOW (CFM)	COOLING			HEATING			PAIRED OUTDOOR UNIT	EXTERNAL STATIC PRESSURE (IN. W.C.)	ELECTRICAL POWER REQUIREMENTS				WEIGHT (LB)	NOTES			
						CAPACITY (MBH)	EDB (°F)	EWB (°F)	CAPACITY (MBH)	EDB (°F)	EWB (°F)			VOLT.	PHASE	Hz.	W					
FCU-1	HITACHI	HIDM008B23S	DUCTED MEDIUM STATIC	DIRECTOR'S OFFICE	250	7.3	80.0	67.0	4.6	70.0	60.0	HP-1	0.50	208	1	60	157	57	SEE VRF SYSTEM NOTES			
FCU-2	HITACHI	HIDM012B23S	DUCTED MEDIUM STATIC	FILE ROOM	450	11.0	80.0	67.0	7.0	70.0	60.0		0.50	208	1	60	157	60	SEE VRF SYSTEM NOTES			
FCU-3	HITACHI	HIDM012B23S	DUCTED MEDIUM STATIC	STAFF LOUNGE	280	11.0	80.0	67.0	7.0	70.0	60.0		0.50	208	1	60	157	60	SEE VRF SYSTEM NOTES			
FCU-4	HITACHI	HICM008B23S	DUCTED MEDIUM STATIC	QUIET STUDY ROOM	250	7.3	80.0	67.0	4.6	70.0	60.0		0.50	208	1	60	157	57	SEE VRF SYSTEM NOTES			
FCU-5	HITACHI	HIDM018B23S	DUCTED MEDIUM STATIC	STAFF WORK ROOM	600	16.4	80.0	67.0	10.5	70.0	60.0		0.50	208	1	60	190	79	SEE VRF SYSTEM NOTES			
FCU-6	HITACHI	HIDM012B23S	DUCTED MEDIUM STATIC	FRIENDS ROOM	360	11.0	80.0	67.0	7.0	70.0	60.0		0.50	208	1	60	157	60	SEE VRF SYSTEM NOTES			
FCU-7	HITACHI	HIDH072B21S	DUCTED HIGH STATIC	MULTI PURPOSE ROOM/ARTS AND CRAFTS	1,925	65.7	80.0	67.0	41.9	70.0	60.0		0.50	208	1	60	840	258	SEE VRF SYSTEM NOTES			
FCU-8	HITACHI	HIDM027B23S	DUCTED MEDIUM STATIC	VESTIBULE/HALL	760	24.7	80.0	67.0	15.7	70.0	60.0		0.50	208	1	60	190	79	SEE VRF SYSTEM NOTES			
FCU-9	HITACHI	HIDH036B22S	DUCTED HIGH STATIC	CHILDREN ZONE 1	1,200	32.9	80.0	67.0	20.9	70.0	60.0		0.50	208	1	60	259	106	SEE VRF SYSTEM NOTES			
FCU-10	HITACHI	HIDH048B22S	DUCTED HIGH STATIC	CENTRAL ZONE 1	1,250	43.8	80.0	67.0	27.9	70.0	60.0		0.50	208	1	60	259	106	SEE VRF SYSTEM NOTES			
FCU-11	HITACHI	HIDH036B22S	DUCTED HIGH STATIC	CENTRAL ZONE 2	800	32.9	80.0	67.0	20.9	70.0	60.0		0.50	208	1	60	259	106	SEE VRF SYSTEM NOTES			
FCU-12	HITACHI	HIDH036B22S	DUCTED HIGH STATIC	ADULT ZONE 1	1,000	32.9	80.0	67.0	20.9	70.0	60.0		0.50	208	1	60	259	106	SEE VRF SYSTEM NOTES			
FCU-13	HITACHI	HIDH048B22S	DUCTED HIGH STATIC	ADULT ZONE 2	1,260	43.8	80.0	67.0	27.9	70.0	60.0		0.50	208	1	60	259	106	SEE VRF SYSTEM NOTES			

ENERGY RECOVERY VENTILATOR SCHEDULE																													
EQUIPMENT TAG	MANUFACTURER (OR ACCEPT. EQUAL)	MODEL	FRESH AIR FLOW RATE (CFM)	EXHAUST AIR FLOW RATE (CFM)	ROOM EXH. AIR (°F)				OUTSIDE AIR (°F)				SUPPLY AIR (°F)				RECOVERY EFFECTIVENESS				ELECTRICAL DATA						WEIGHT (LB)	NOTES	
					WINTER		SUMMER		WINTER		SUMMER		WINTER		SUMMER		SENSIBLE		TOTAL		MOTOR		VOLT.	PHASE	Hz.	FLA			MOCP
					DB	WB	DB	WB	DB	WB	DB	WB	DB	WB	DB	WB	WINTER	SUMMER	WINTER	SUMMER	QTY.	PWR.							
ERV-1	RENEWAIRE	HE-4XJINV-S35VV-DANT-WL	2500	2500	70.0	51.4	75.0	62.5	4.6	2.6	90.2	72.9	51.8	40.0	79.2	67.6	72.1%	72.1%	70.2%	53.6%	2	2 HP	208	3	60	14.8	20	-	PROVIDE W/ MERV-13 FILTERS, ECM MOTORS, DISCONNECT SWITCH, BACKDRAFT DAMPERS, TIMER FOR OCCUPIED OPERATION & ELEC DUCT HEATER

AIR GRILLE/DIFFUSER SCHEDULE															
EQUIPMENT TAG	MANUFACTURER (OR ACCEPT. EQUAL)	MODEL	AIR DEVICE TYPE	AIRFLOW (CFM)		MAX AIR PRESS. DROP (IN. W.C.)	MOUNTING	PANEL/FRAME SIZE (IN.)	NECK SIZE (IN.)	MAX NC	DAMPER	FINISH	NOTES		
				MIN.	MAX.										
D-1	KRUEGER	PLQ-6-F23-24x24-PR10-IB-44	SQUARE PLAQUE FACE DIFFUSER	50	175	0.10	LAY-IN	24"x24"	6"Ø	20	OBD	WHITE	-		
D-2	KRUEGER	PLQ-8-F23-24x24-PR10-IB-44	SQUARE PLAQUE FACE DIFFUSER	176	300	0.10	LAY-IN	24"x24"	8"Ø	20	OBD	WHITE	-		
D-3	KRUEGER	PLQ-10-F23-24x24-PR10-IB-44	SQUARE PLAQUE FACE DIFFUSER	301	435	0.10	LAY-IN	24"x24"	10"Ø	20	OBD	WHITE	-		
R-1/EG-1	KRUEGER	S80P-20x20-F23-24x24-00-00-00-44	PERFORATED FACE RETURN GRILLE	0	1,600	0.10	LAY-IN	24"x24"	20"x20"	25	-	WHITE	FURNISH & INSTALL FULL-SIZE SHEET METAL PLENUM BOX ON REAR OF GRILLE, PAINT INSIDE FLAT BLACK		

VENTILATION SCHEDULE											
SYSTEM	SPACE SERVED	SPACE TYPE	SPACE AREA (SQ. FT.)	OCCUPANTS PER 1000 SQ. FT.	# OF OCCUPANTS	CFM PER PERSON	CFM PER SQ. FT.	CALCULATED VENTILATION RATE (CFM)	ZONE AIR DISTRIBUTION EFFECTIVENESS	ADJUSTED VENTILATION RATE (CFM)	PROVIDED VENTILATION RATE (CFM)
FCU-1	DIRECTOR'S OFFICE	OFFICE	180	5	1	5	0.06	16	0.8	20	20
FCU-2	FILE ROOM	OFFICE	300	5	2	5	0.06	28	0.8	35	35
FCU-3	STAFF LOUNGE	BREAK ROOM	181	50	1	5	0.12	16	0.8	20	20
FCU-4	QUIET STUDY ROOM	CONFERENCE	206	50	11	5	0.06	67	0.8	84	85
FCU-5	STAFF WORK ROOM	OFFICE	644	5	4	5	0.06	59	0.8	73	75
FCU-6	FRIENDS ROOM	LIBRARY	301	50	4	5	0.06	56	0.8	70	70
FCU-7	MULTI PURPOSE ROOM	MULTI USE ASSEMBLY	881	100	89	7.5	0.06	720	0.8	900	900
	ARTS AND CRAFTS	STORAGE	110	0	0	0	0.12	13	0.8	17	20
FCU-8	VESTIBULE/HALL	CORRIDOR	462	0	0	0	0.06	28	0.8	35	35
FCU-9	CHILDREN ZONE	LIBRARY	898	10	9	5	0.12	153	0.8	191	200
FCU-10	CENTRAL ZONE 1	LIBRARY	1,277	10	13	5	0.12	218	0.8	273	275
FCU-11	CENTRAL ZONE 2	LIBRARY	1,027	10	11	5	0.12	178	0.8	223	225
FCU-12	ADULT ZONE 1	LIBRARY	840	10	9	5	0.12	146	0.8	182	185
FCU-13	ADULT ZONE 2	LIBRARY	1,637	10	17	5	0.12	281	0.8	352	355


VRF System Notes:

- WIRED 7 DAY PROGRAMMABLE THERMOSTAT SHALL BE FURNISHED BY MECHANICAL CONTRACTOR FOR EACH INDOOR UNIT. THERMOSTATS SHIP LOOSE FOR FIELD INSTALLATION AND WIRING BY THE MECHANICAL CONTRACTOR.
- MECHANICAL CONTRACTOR TO PROVIDE CENTRAL CONTROLLER FOR LOCAL SET POINT CONTROL AND SYSTEM VIEWING. CONTROLLER TO BE INSTALLED AND WIRING BY MECHANICAL CONTRACTOR. 24V POWER BY ELECTRICAL CONTRACTOR.
- DISCONNECT SWITCH FOR CONDENSING UNITS AND INDOOR UNITS SHALL BE FURNISHED AND INSTALLED BY THE ELECTRICAL CONTRACTOR.
- EXTERNAL SUPPORTS FOR INDOOR AND CONDENSING UNITS SHALL BE FURNISHED AND INSTALLED BY THE MECHANICAL CONTRACTOR.
- FILTER RACK AND 2" PLEATED MERV-13 FILTERS FOR DUCTED UNITS SHALL FURNISHED AND INSTALLED BY THE MECHANICAL CONTRACTOR. FILTER RACK SHALL BE GALVANIZED STEEL, FULLY INSULATED & FACTORY ASSEMBLED. TYPICAL OF FLT-H SERIES OR EQUAL
- CONDENSATE PUMPS SHIP FOR FIELD INSTALLATION BY MECHANICAL CONTRACTOR FOR WALL MOUNTED UNITS. DUCTED UNITS FURNISHED WITH FACTORY MOUNTED CONDENSATE PUMP. MECHANICAL CONTRACTOR TO PROVIDE CONDENSATE PIPING FROM ALL UNITS TO SANITARY DRAIN. FIELD VERIFY EXACT ROUTING AND TERMINATION POINT IN BUILDING.
- PROVIDE REFRIGERANT ISOLATION VALVES ON LIQUID AND GAS LINES AT EVERY FAN COIL UNIT.

KEY PLAN:

'CORNWALL PUBLIC LIBRARY'

HUDSON ST.

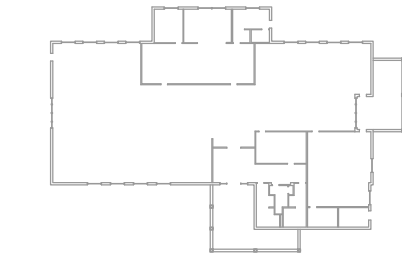


PROJECT:

CORNWALL PUBLIC LIBRARY
HVAC SYSTEM REPLACEMENT PROJECT
395 HUDSON STREET
CORNWALL, NEW YORK 12518
SED #:44-03-01-06-6-009-006

SUB-CONSULTANT:

ENGINEER:

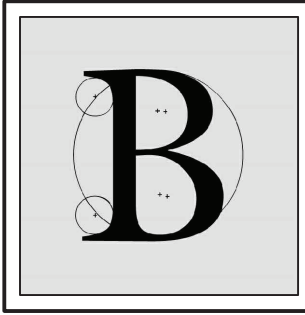

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MATTHEW G. BLAKE, P.E., LEED AP
NY - 89039 NJ - GE050037 PA - PE079303
MA - 53197 CT - 32283 FL - 85928

MECHANICAL SCHEDULES

DATE:	DRN	CHK	DESCRIPTION
01.26.2023	BJK	BJK	CONSTRUCTION DWGS
REV.	DATE	DRN	CHK DESCRIPTION

PROJECT NO.

2150

SHEET NO.

M.102



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THICKNESS & REINFORCING SCHEDULE - * LOW PRESSURE DUCTWORK

* NOTE: LOW PRESSURE DUCTWORK SHALL BE DUCTWORK IN WHICH THE PRESSURE DOES NOT EXCEED 2" WATER GAUGE.


GREATEST DUCT DIMENSION	STEEL DUCTS U.S. STANDARD GAUGE	ALUMINUM DUCTS B & S GAUGE	LONGITUDINAL SEAM	TRANSVERSE JOINT SMALLEST DIMENSION	TRANSVERSE JOINT GREATEST DIMENSION	REINFORCING (ALL DUCTS 18" THRU 54" SHALL BE CROSSBROKEN)
12" OR LESS	26	24(0.020")	PITTSBURGH OR ACME LOCK	DRIVE SLIP OR POCKET LOCK OR BAR SLIP	PLAIN "S" SLIP OR POCKET LOCK OR BAR SLIP	NONE REQUIRED
13" THRU 18"	24	22(0.025")	PITTSBURGH OR ACME LOCK	DRIVE SLIP OR POCKET LOCK OR BAR SLIP	PLAIN "S" SLIP OR POCKET LOCK OR BAR SLIP	NONE REQUIRED
19" THRU 30"	24	22(0.025")	PITTSBURGH OR ACME LOCK	HEMMED "S" SLIP OR BAR SLIP OR DRIVE SLIP OR 1" POCKET LOCK	HEMMED "S" SLIP OR BAR SLIP OR 1" POCKET LOCK	IF TRANSVERSE JOINTS ARE LOCATED 4'-0" OR LESS ON CENTER NO REINFORCING IF ON 8'-0" CENTERS REINFORCE WITH 1"x1"x1/8" ANGLES AT 4 FT. O.C. FASTENED ON 8" CENTERS
31" THRU 42"	22	20(0.032")	PITTSBURGH OR ACME LOCK	DRIVE SLIP 18" OR LESS BAR SLIP REINFORCED BAR SLIP OR POCKET LOCK	BAR SLIP OR REINFORCED BAR SLIP OR POCKET LOCK	IF TRANSVERSE JOINTS ARE LOCATED 4'-0" OR LESS ON CENTER NO REINFORCING IF ON 8'-0" CENTERS REINFORCE WITH 1"x1"x1/8" ANGLES AT 4 FT. O.C. FASTENED ON 8" CENTERS
43" THRU 54"	22	20(0.032")	PITTSBURGH LOCK	1 1/4" BAR SLIP, OR REINFORCED BAR SLIP, OR 1 1/2" POCKET LOCK	1 1/4" BAR SLIP, OR REINFORCED BAR SLIP, OR 1 1/2" POCKET LOCK	IF TRANSVERSE JOINTS ARE LOCATED 4'-0" OR LESS ON CENTER NO REINFORCING IF ON 8'-0" CENTERS REINFORCE WITH 1"x1"x1/8" ANGLES AT 4 FT. O.C. FASTENED ON 8" CENTERS
55" THRU 60"	20	18(0.040")	PITTSBURGH LOCK	1 1/4" BAR SLIP, OR REINFORCED BAR SLIP, OR 1 1/2" POCKET LOCK	1 1/4" BAR SLIP, OR REINFORCED BAR SLIP, OR 1 1/2" POCKET LOCK	IF TRANSVERSE JOINTS ARE LOCATED 4'-0" OR LESS ON CENTER NO REINFORCING IF ON 8'-0" CENTERS REINFORCE WITH 1"x1"x1/8" ANGLES AT 4 FT. O.C. FASTENED ON 8" CENTERS
61" THRU 84"	20	18(0.040")	PITTSBURGH LOCK	REINFORCED BAR SLIP, OR ANGLE SLIP, ALTERNATE BAR SLIP, OR ANGLE REINFORCED POCKET LOCK	REINFORCED BAR SLIP, OR ANGLE SLIP, ALTERNATE BAR SLIP, OR ANGLE REINFORCED POCKET LOCK	REINFORCE ALL SIDES OVER 60" WITH 1 1/2"x1 1/2"x1/8" ANGLES ON 2'-0" CENTERS. SIDES UNDER 60" NEED NO REINFORCING IF JOINTS ARE ON 4'-0" CENTERS. IF JOINTS ARE ON 8'-0" CENTERS REINFORCE WITH 1 1/2"x1 1/2"x1/8" ANGLES ON 4'-0" CENTERS.
85" THRU 96"	18	16(0.051") (LONGITUDINAL SEAM MAY BE STANDING SEAM)	PITTSBURGH LOCK	1 1/2" COMPANION ANGLES, OR ANGLE REINFORCED POCKET LOCK, OR 1 1/2" ANGLE SLIP OR REINFORCED BAR SLIP	1 1/2" COMPANION ANGLES, OR ANGLE REINFORCED POCKET LOCK, OR 1 1/2" ANGLE SLIP OR REINFORCED BAR SLIP	REINFORCE ALL SIDES OVER 84" WITH 1 1/2"x1 1/2"x3/16" ANGLES ON 2'-0" CENTERS. SIDES 61" THRU 84" REINFORCE WITH 1 1/2"x1 1/2"x1/8" ANGLES ON 2'-0" CENTERS. SIDES 60" OR LESS NEED NO REINFORCING IF JOINTS ARE ON 4'-0" CENTERS. IF JOINTS ARE ON 8'-0" CENTERS REINFORCE WITH 1 1/2"x1 1/2"x1/8" ANGLES ON 4'-0" CENTERS.
OVER 96"	18	16(0.051") (LONGITUDINAL SEAM MAY BE STANDING SEAM)	PITTSBURGH LOCK	2" COMPANION ANGLE, OR 2"x2"x1/4" ANGLE SLIP, OR 2"x2"x1/4" ANGLE REINFORCED POCKET LOCK OR REINFORCED BAR SLIP	2" COMPANION ANGLE, OR 2"x2"x1/4" ANGLE SLIP, OR 2"x2"x1/4" ANGLE REINFORCED POCKET LOCK OR REINFORCED BAR SLIP	REINFORCE ALL SIDES OVER 96" WITH 2"x2"x1/4" ANGLES ON 2'-0" CENTERS. REINFORCE ALL SIDES 85" THRU 96" WITH 1 1/2"x1 1/2"x3/16" ANGLES ON 2'-0" CENTERS. REINFORCE ALL SIDES 61" THRU 84" WITH 1 1/2"x1 1/2"x1/8" ANGLES ON 2'-0" CENTERS. REINFORCE ALL SIDES UNDER 60" WITH 1 1/2"x1 1/2"x1/8" ANGLES IF JOINTS ARE 8'-0" ON CENTER. NO REINFORCING IF JOINTS ARE 4'-0" ON CENTER.



- NOTE:
- ALL VANED ELBOWS SHALL BE CONSTRUCTED AND INSTALLED AS DETAILED BY SMACNA.
 - WHEN W1 IS NOT EQUAL TO W2, VANE SHALL BE SINGLE VANE TYPE REGARDLESS OF W DIMENSION.
 - ALL SINGLE VANES SHALL HAVE A 2" RADIUS, 1-1/2" MAXIMUM SPACE BETWEEN VANES AND A 3/4" TRAILING EDGE.
 - WHEN W EQUALS W2 AND W1 IS GREATER THAN 20" VANES SHALL BE DOUBLE VANE TYPE.

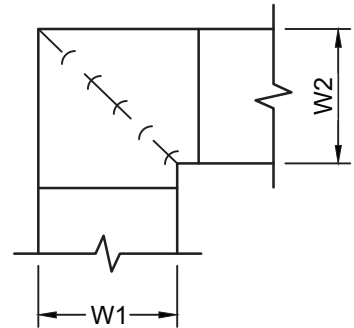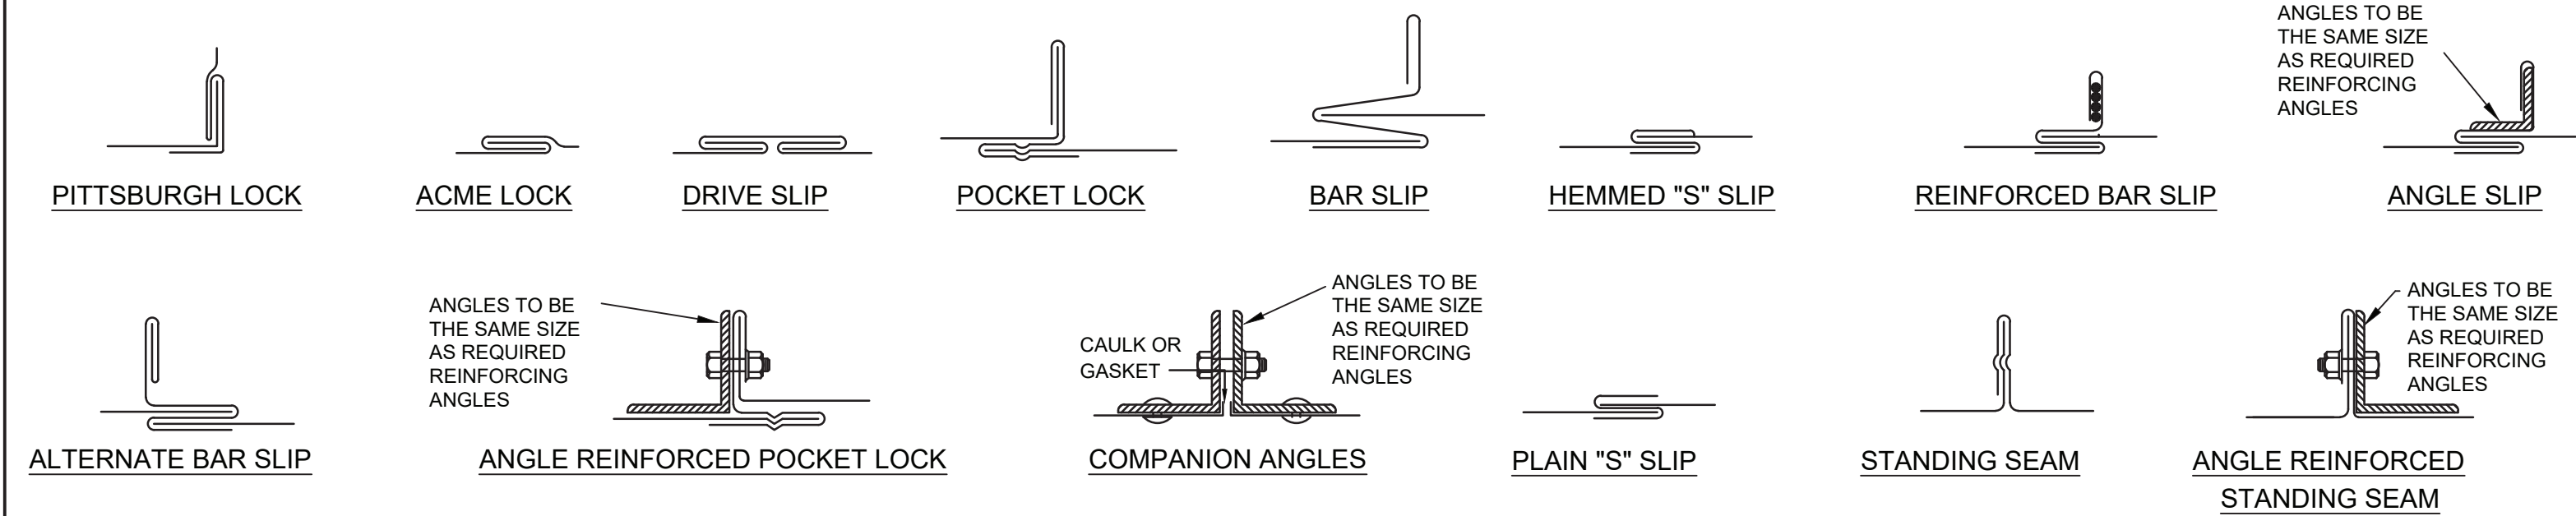2 Ductwork Squared Elbow Detail


M.103 N.T.S.

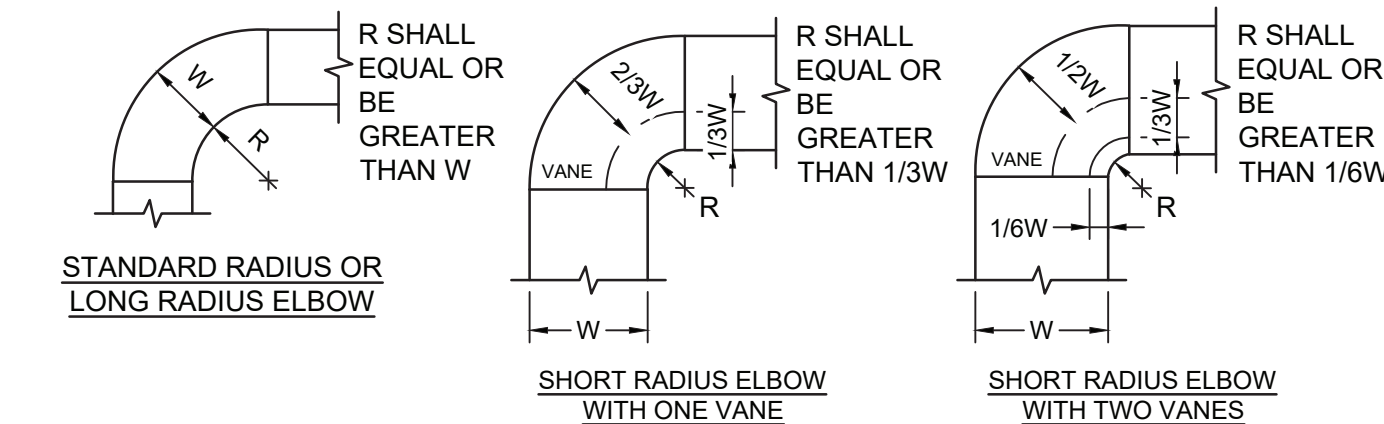

- NOTE:
- THE INTERIOR SURFACE OF ALL RADIUS ELBOWS SHALL BE MADE ROUND.
 - ALL STANDARD RADIUS ELBOWS CAN BE SUBSTITUTED WITH SHORT RADIUS ELBOWS. ALL SHORT RADIUS ELBOWS SHALL HAVE VANES. VANES SHALL BE CONSTRUCTED, SUPPORTED AND FASTENED AS RECOMMENDED BY SMACNA.

5 Ductwork Radius Elbow Detail


M.103 N.T.S.

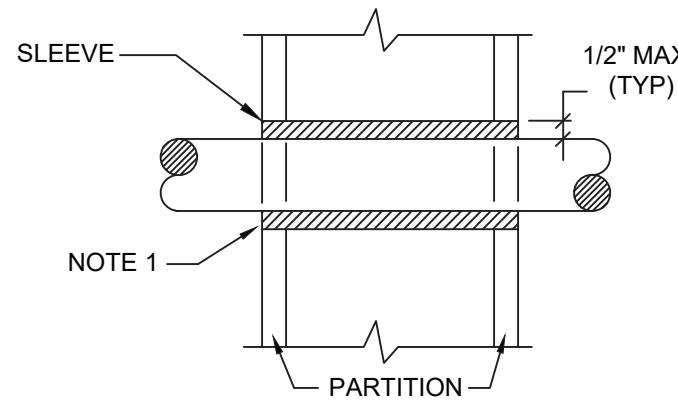

- NOTES:
- AT FIRE RATED PARTITIONS, ADD ADDITIONAL LAYER OF FIRE SAFING INSULATION AROUND PENETRATION SO AS TO FILL CAVITY.
 - DUCT AND PIPE PENETRATIONS THRU CORRIDOR WALLS ABOVE THE CEILING ARE TO BE FIRE STOPPED AROUND THE PENETRATION.

3 Pipe Penetrations Detail


M.103 N.T.S.

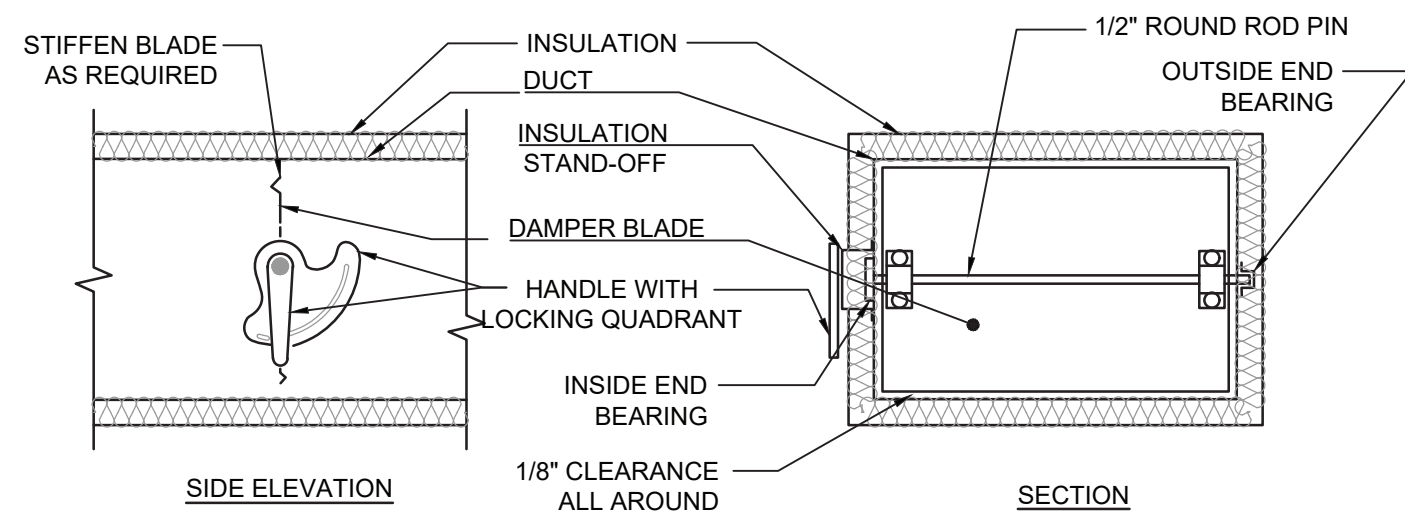

- NOTE:
- DELETE INSULATION STAND-OFF ON DUCTWORK WITHOUT EXTERIOR INSULATION.
 - DETAIL SHOWS SINGLE-BLADE DAMPER. DAMPER INSTALLATION SHALL BE SIMILAR FOR MULTI-BLADE DAMPERS & ROUND DAMPERS.


6 Ductwork Volume Damper Detail

M.103 N.T.S.

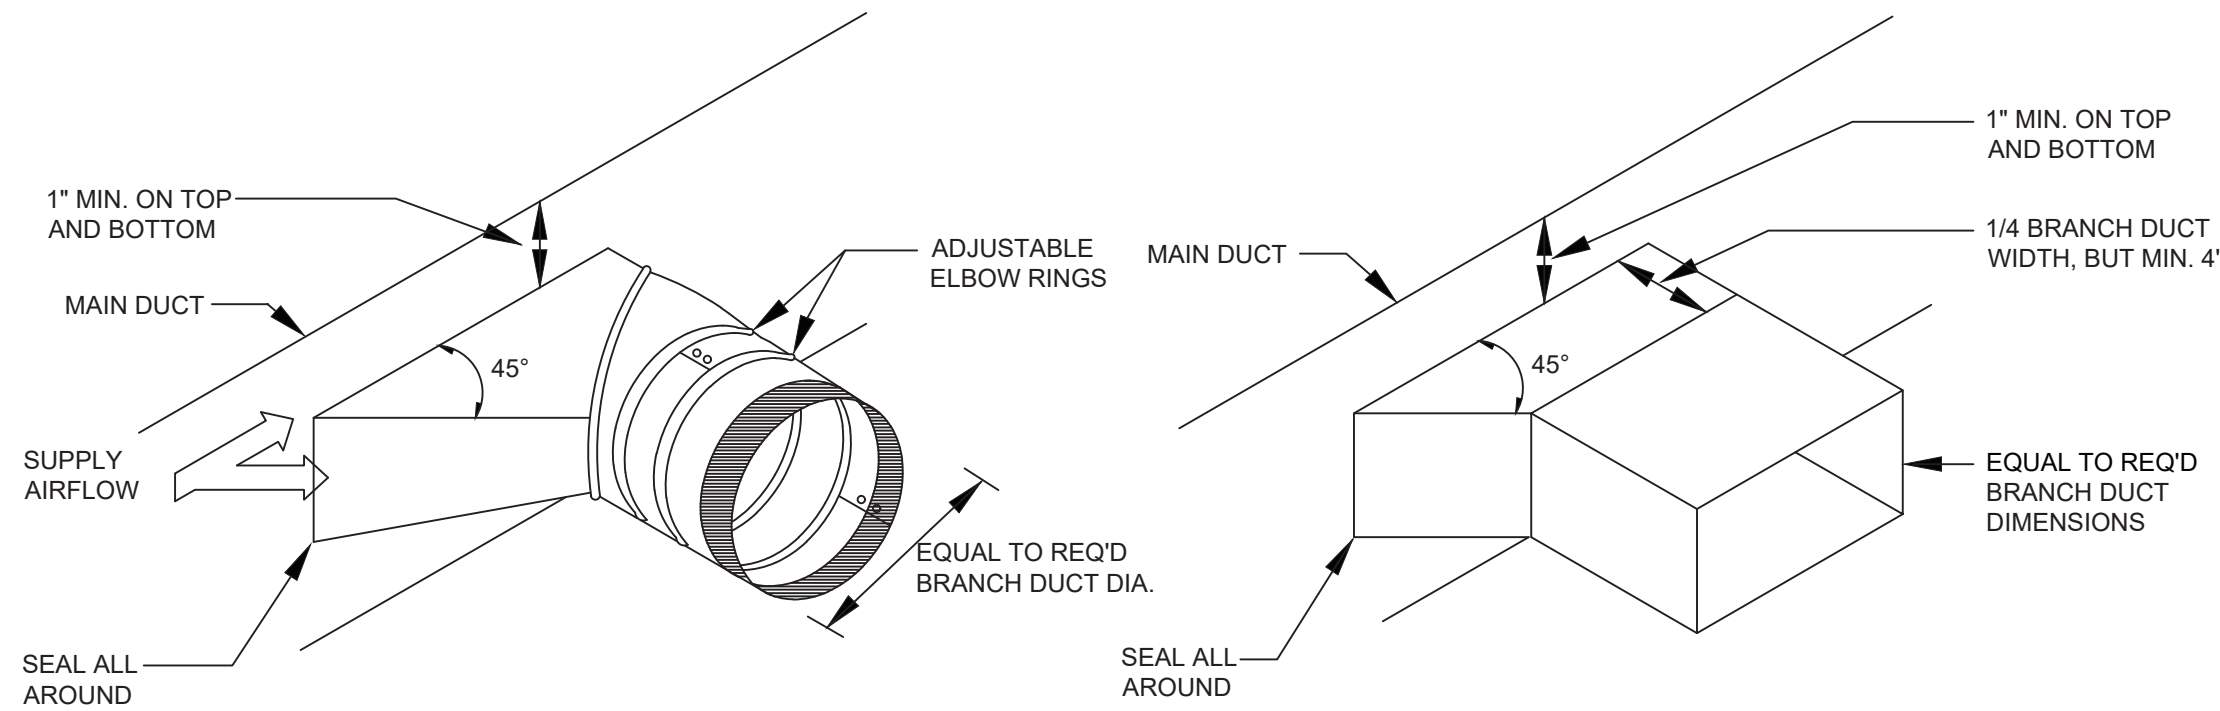

4 Typical Branch Take-Off Fitting Detail


M.103 N.T.S.

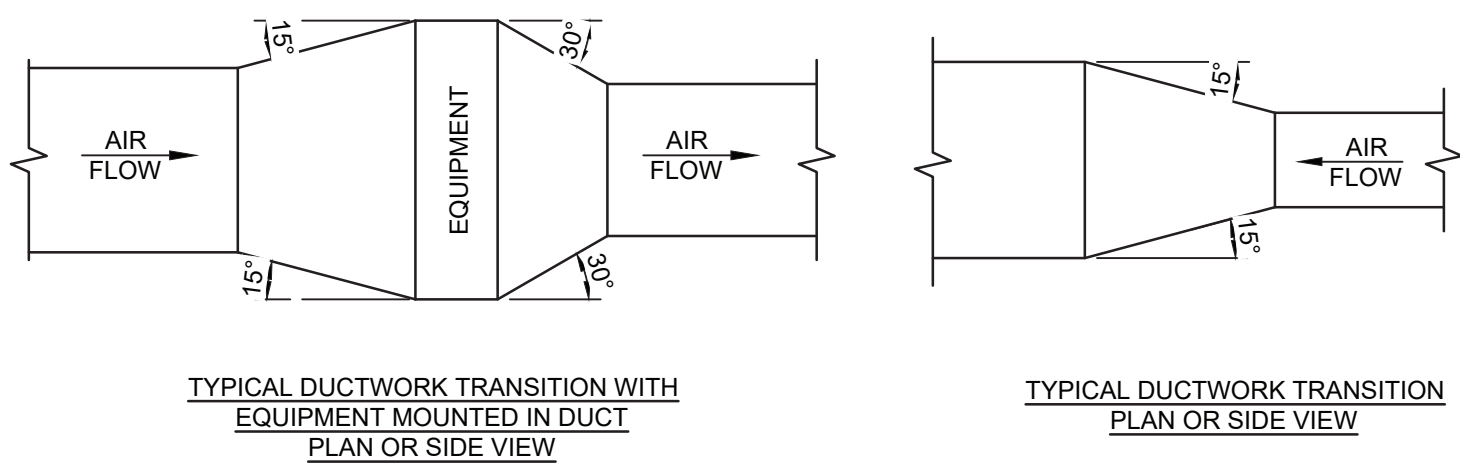

- NOTE:
- UNLESS OTHERWISE INDICATED ON PLANS, MAXIMUM ANGLES SHOWN SHALL APPLY.

7 Ductwork Transition Detail

M.103 N.T.S.

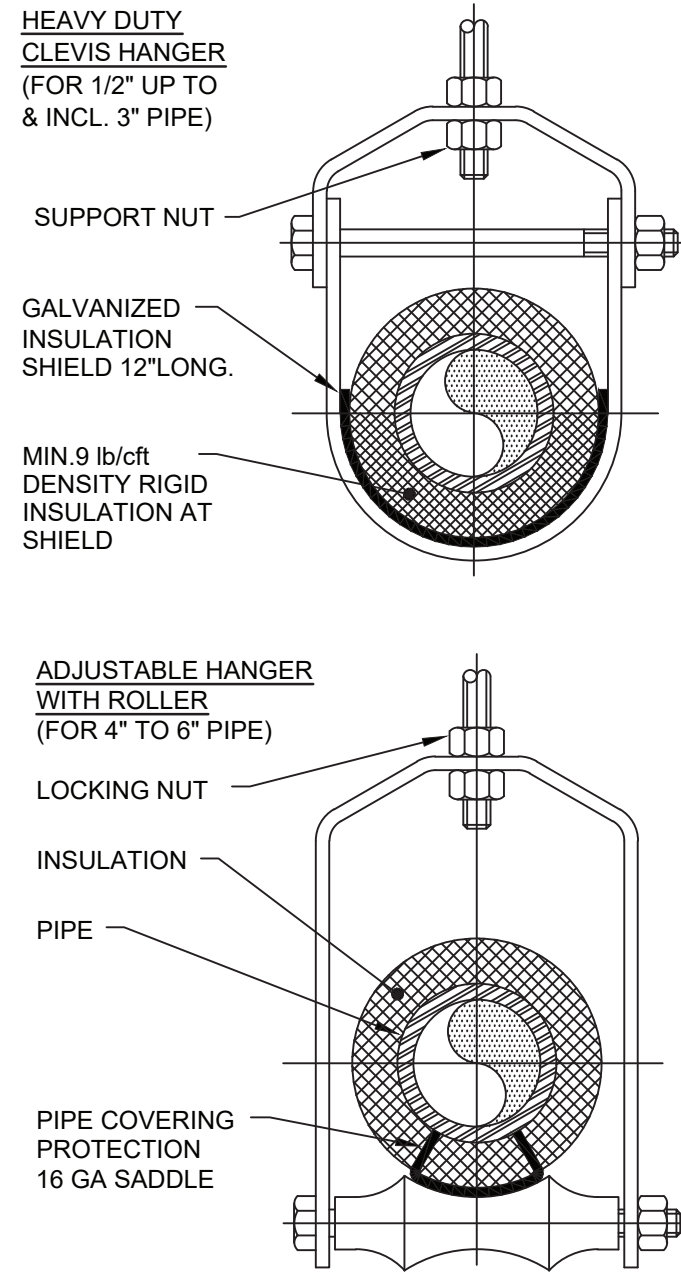

- NOTES:
- PIPE 8" AND LARGER SHALL HAVE ROLLER SUPPORTED WITH DUAL RODS.
 - FOR CHW SERVICE OVER 3" REPLACE SADDLE WITH 12" LONG 14 GA SHIELD WITH RIGID INSULATION BETWEEN PIPE AND SHIELD.

PIPE Ø (IN.)	MAX. SPACING BETWEEN HANGERS (FT.)			MIN. ROD SIZE (IN.)
	STEEL PIPE	COPPER PIPE	CPVC	
1/2 THRU 1	7	5	5	3/8
1-1/2 THRU 2	9	8	6	3/8
2-1/2	11	9	7.5	1/2
3	12	10	7.5	1/2
4	14	12	8.5	5/8
6	17	14	9	3/4
8	19	16	10	7/8
10	22	18	10.5	7/8


1 Pipe Hanger Support

M.103 N.T.S.

KEY PLAN:

'CORNWALL PUBLIC LIBRARY'

HUDSON ST.

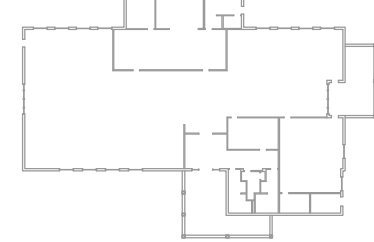


PROJECT:

CORNWALL PUBLIC LIBRARY
HVAC SYSTEM REPLACEMENT PROJECT
395 HUDSON STREET
CORNWALL, NEW YORK 12518
SED #44-03-01-06-6-009-006

SUB-CONSULTANT:

ENGINEER:

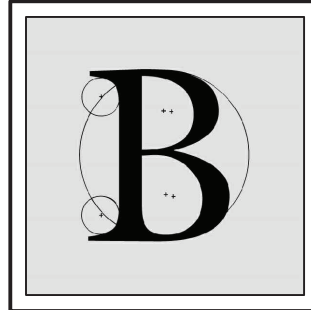

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MATTHEW G. BLAKE, P.E., LEED AP
NY - 89039 NJ - GE050037 PA - PE079303
MA - 53197 CT - 32283 FL - 85928

MECHANICAL SCHEDULE & DETAILS

DATE:	DRN	CHK	DESCRIPTION
01.26.2023	BJK	BJK	CONSTRUCTION DWGS

REV.	DATE	DRN	CHK	DESCRIPTION

PROJECT NO.


2150

SHEET NO.

M.103

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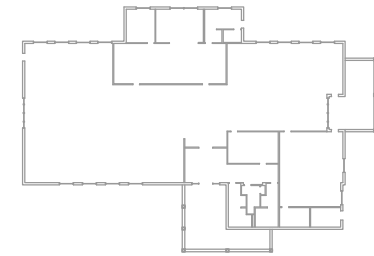


1 VRF System Piping Diagram
M.104 N.T.S.

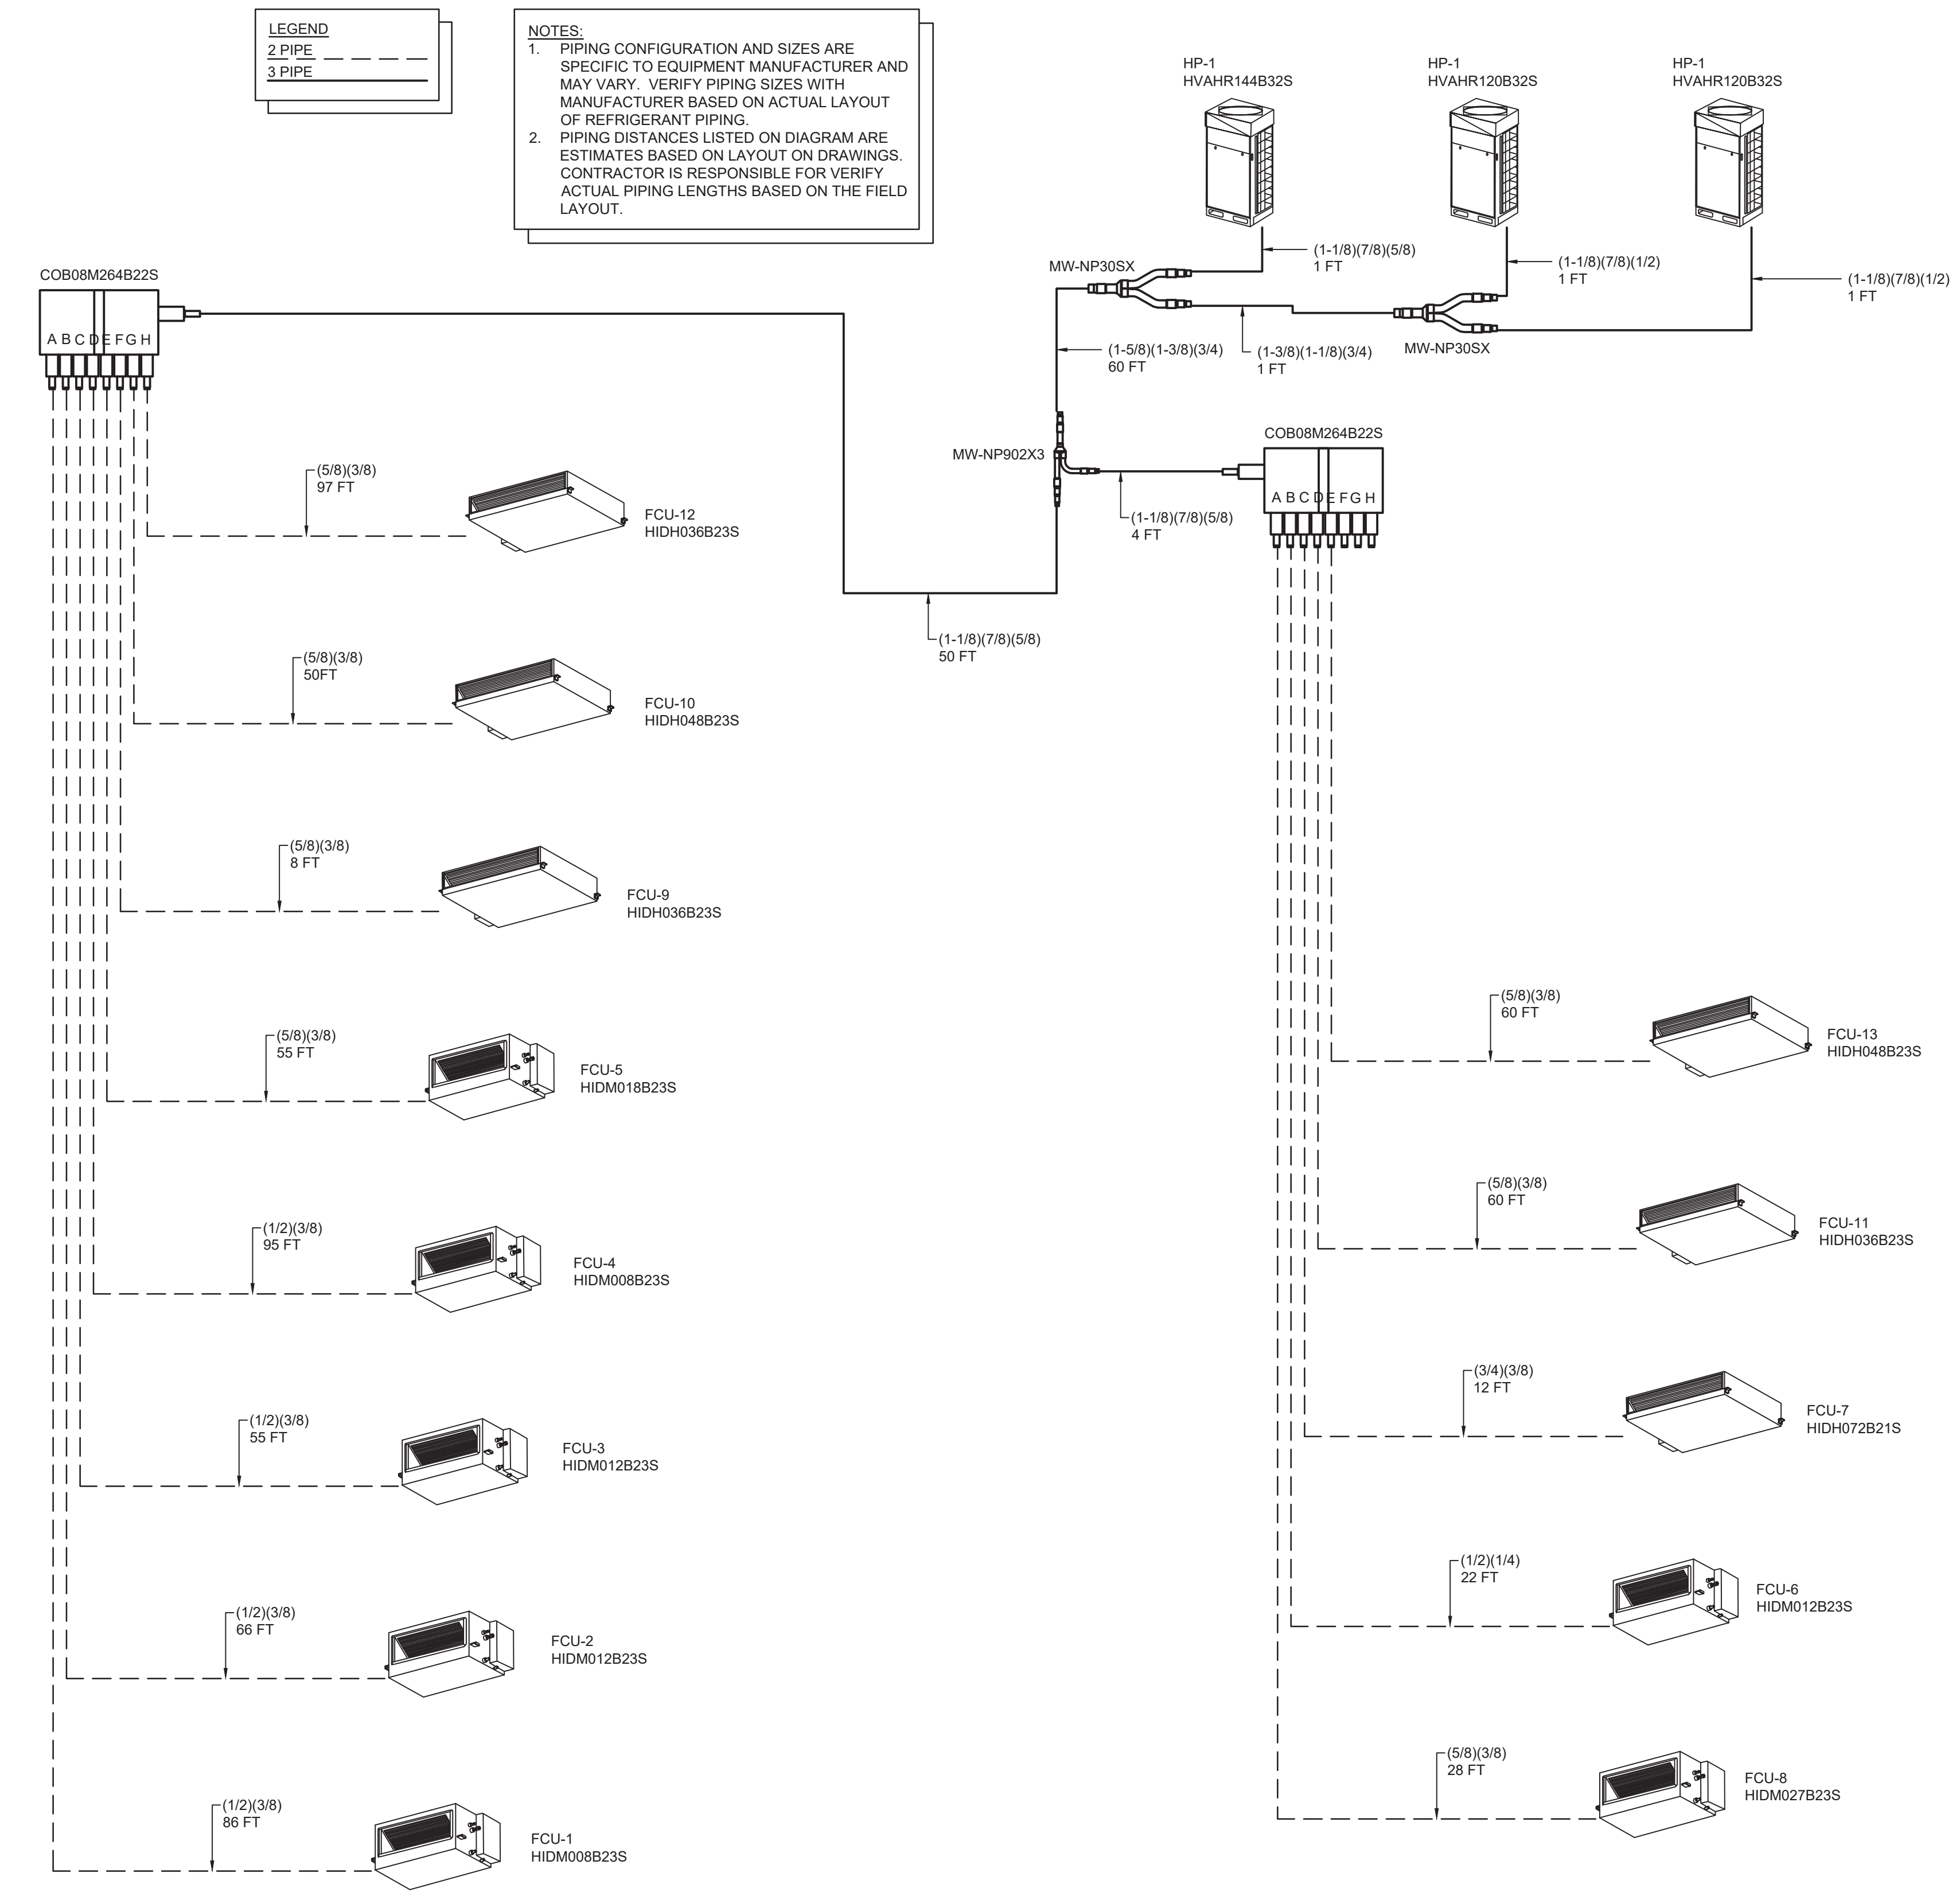KEY PLAN:

'CORNWALL PUBLIC LIBRARY'

HUDSON ST.




PROJECT:

CORNWALL PUBLIC LIBRARY
HVAC SYSTEM REPLACEMENT PROJECT
395 HUDSON STREET
CORNWALL, NEW YORK 12518
SED #:44-03-01-06-6-009-006

SUB-CONSULTANT:

ENGINEER:

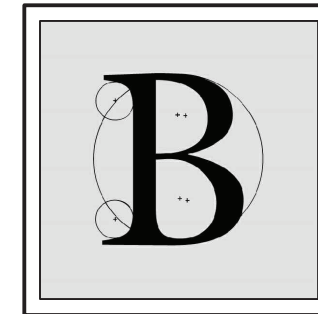

BLAKE ENGINEERING PLLC

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WESTTOWN, NEW YORK 10998
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MBLAKE@BLAKEENGINEERINGPLLCCOM



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MA - 53197 CT - 32283 FL - 85928


VRF SYSTEM PIPING
DIAGRAM

DATE:		DRN	CHK	DESCRIPTION
01.26.2023		BJK	BJK	CONSTRUCTION DWGS
REV.	DATE:	DRN	CHK	DESCRIPTION

PROJECT NO.	SHEET NO.
2150	M.104

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1
MD.201

Mechanical Demolition Plan

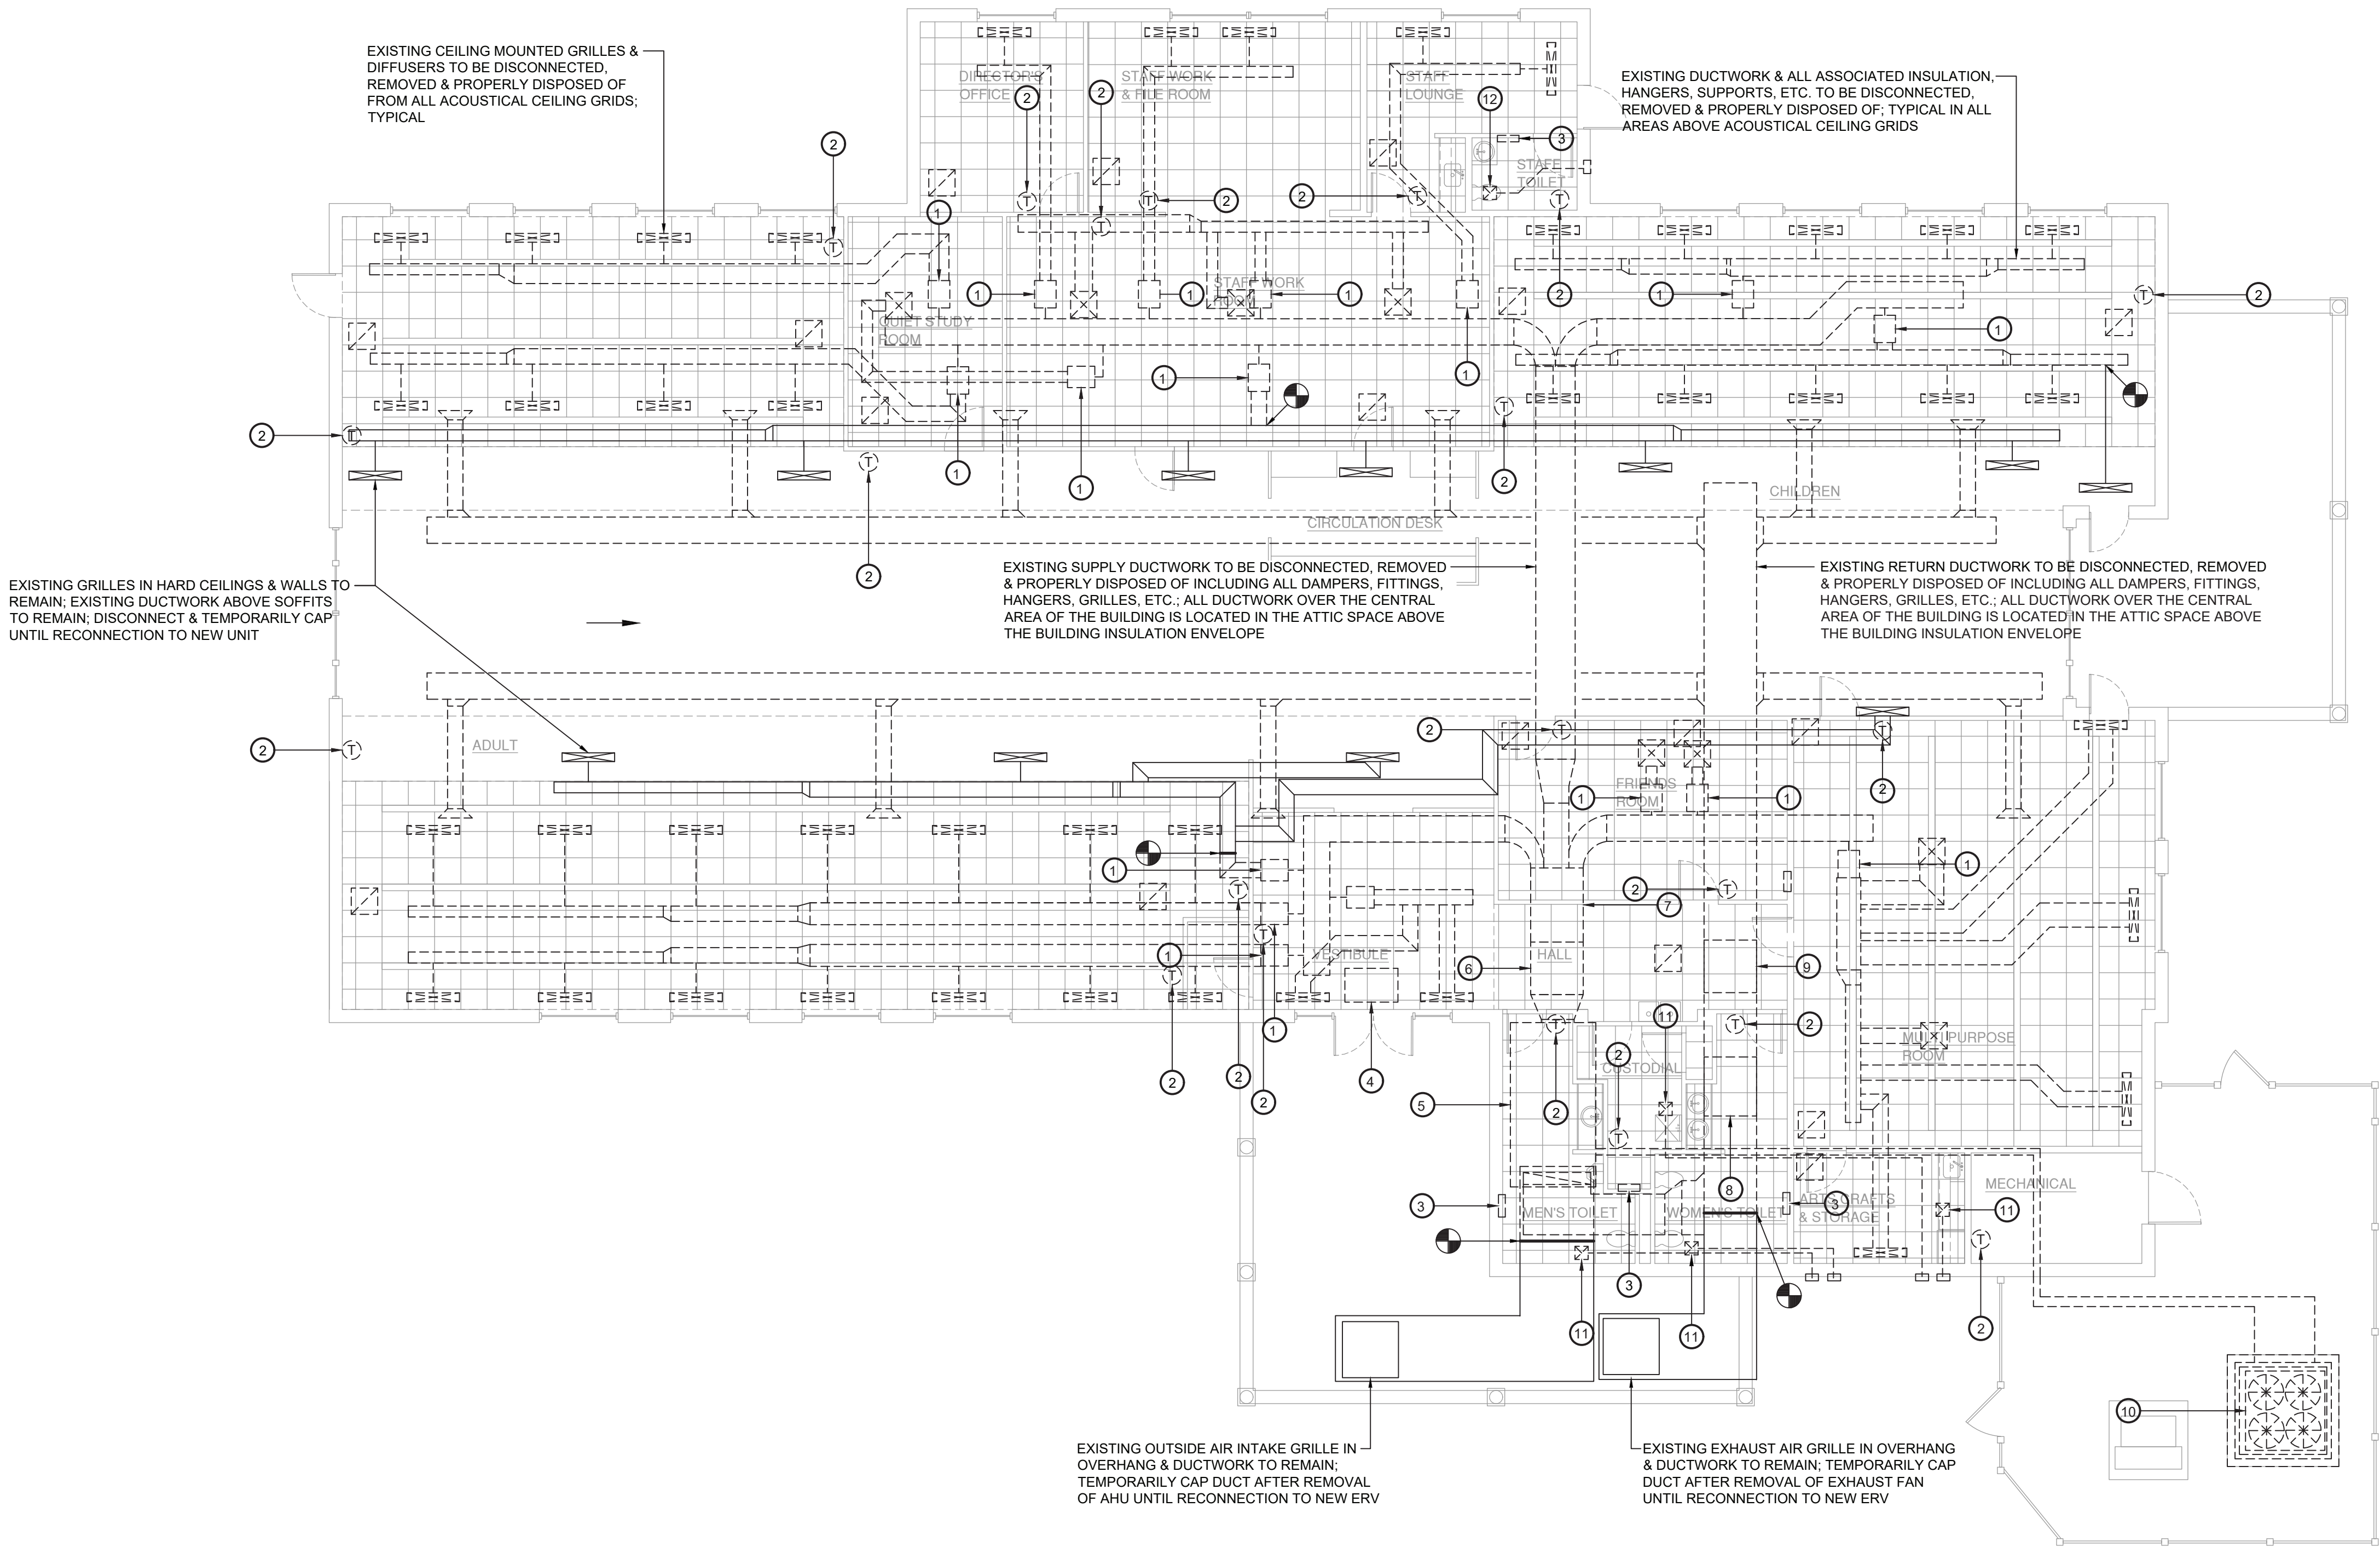Scale: 1/8" = 1'-0"


Key Notes:

- EXISTING VAV BOX TO BE DISCONNECTED, REMOVED & PROPERLY DISPOSED OF INCLUDING ALL ASSOCIATED DUCTWORK, PIPING, VALVES, HANGERS, CONTROLS, ETC.
- EXISTING THERMOSTAT & ASSOCIATED CONTROL WIRING TO BE DISCONNECTED, REMOVE & PROPERLY DISPOSED OF.
- EXISTING WALL MOUNTED HOT WATER CABINET HEATER TO BE DISCONNECTED, REMOVED & PROPERLY DISPOSED OF INCLUDING ALL PIPING, CONTROLS, ETC.
- EXISTING WALL MOUNTED HOT WATER CABINET HEATER TO BE DISCONNECTED, REMOVED & PROPERLY DISPOSED OF INCLUDING ALL PIPING, CONTROLS, ETC.
- EXISTING AIR HANDLING UNIT TO BE DISCONNECTED, REMOVED & PROPERLY DISPOSED OF INCLUDING ALL ASSOCIATED DUCTWORK, PIPING, VALVES, HANGERS, CONTROLS, ETC.
- EXISTING SUPPLY AIR DUCT SILENCER TO BE DISCONNECTED, REMOVED & PROPERLY DISPOSED OF INCLUDING ANY ASSOCIATED INSULATION, HANGERS, SUPPORTS, ETC.
- EXISTING GAS FIRED HUMIDIFIER TO BE DISCONNECTED, REMOVED & PROPERLY DISPOSED OF INCLUDING ANY ASSOCIATED PIPING, VENTING, DUCTWORK, HANGERS, SUPPORTS, ETC.
- EXISTING EXHAUST FAN TO BE DISCONNECTED, REMOVED & PROPERLY DISPOSED OF INCLUDING ALL ASSOCIATED DUCTWORK, HANGERS, CONTROLS, ETC.
- EXISTING RETURN AIR DUCT SILENCER TO BE DISCONNECTED, REMOVED & PROPERLY DISPOSED OF INCLUDING ANY ASSOCIATED INSULATION, HANGERS, SUPPORTS, ETC.
- EXISTING CONDENSING UNIT TO BE DISCONNECTED, REMOVED & PROPERLY DISPOSED OF INCLUDING ALL ASSOCIATED PIPING, CONTROLS, ETC. RECOVER & DISPOSE OF REFRIGERANT PER EPA GUIDELINES.
- EXISTING EXHAUST FAN TO BE DISCONNECTED, REMOVED & PROPERLY DISPOSED OF INCLUDING ANY ASSOCIATED DUCTWORK, HANGERS, SUPPORTS, ETC.
- EXISTING EXHAUST FAN TO BE REMAIN; REMOVE AND STORE OR SECURE FAN AS NECESSARY TO REPLACE CEILING; REINSTALL AS NEEDED IN NEW CEILING SYSTEM.

KEY PLAN:

'CORNWALL PUBLIC LIBRARY'

HUDSON ST.

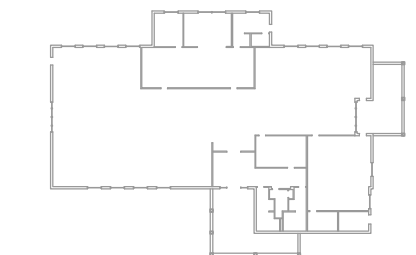


PROJECT:

CORNWALL PUBLIC LIBRARY
HVAC SYSTEM
REPLACEMENT PROJECT
395 HUDSON STREET
CORNWALL, NEW YORK 12518
SED #44-03-01-06-6-009-006

SUB-CONSULTANT:

ENGINEER:

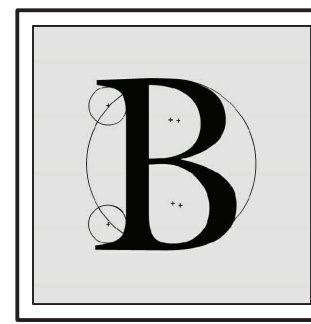

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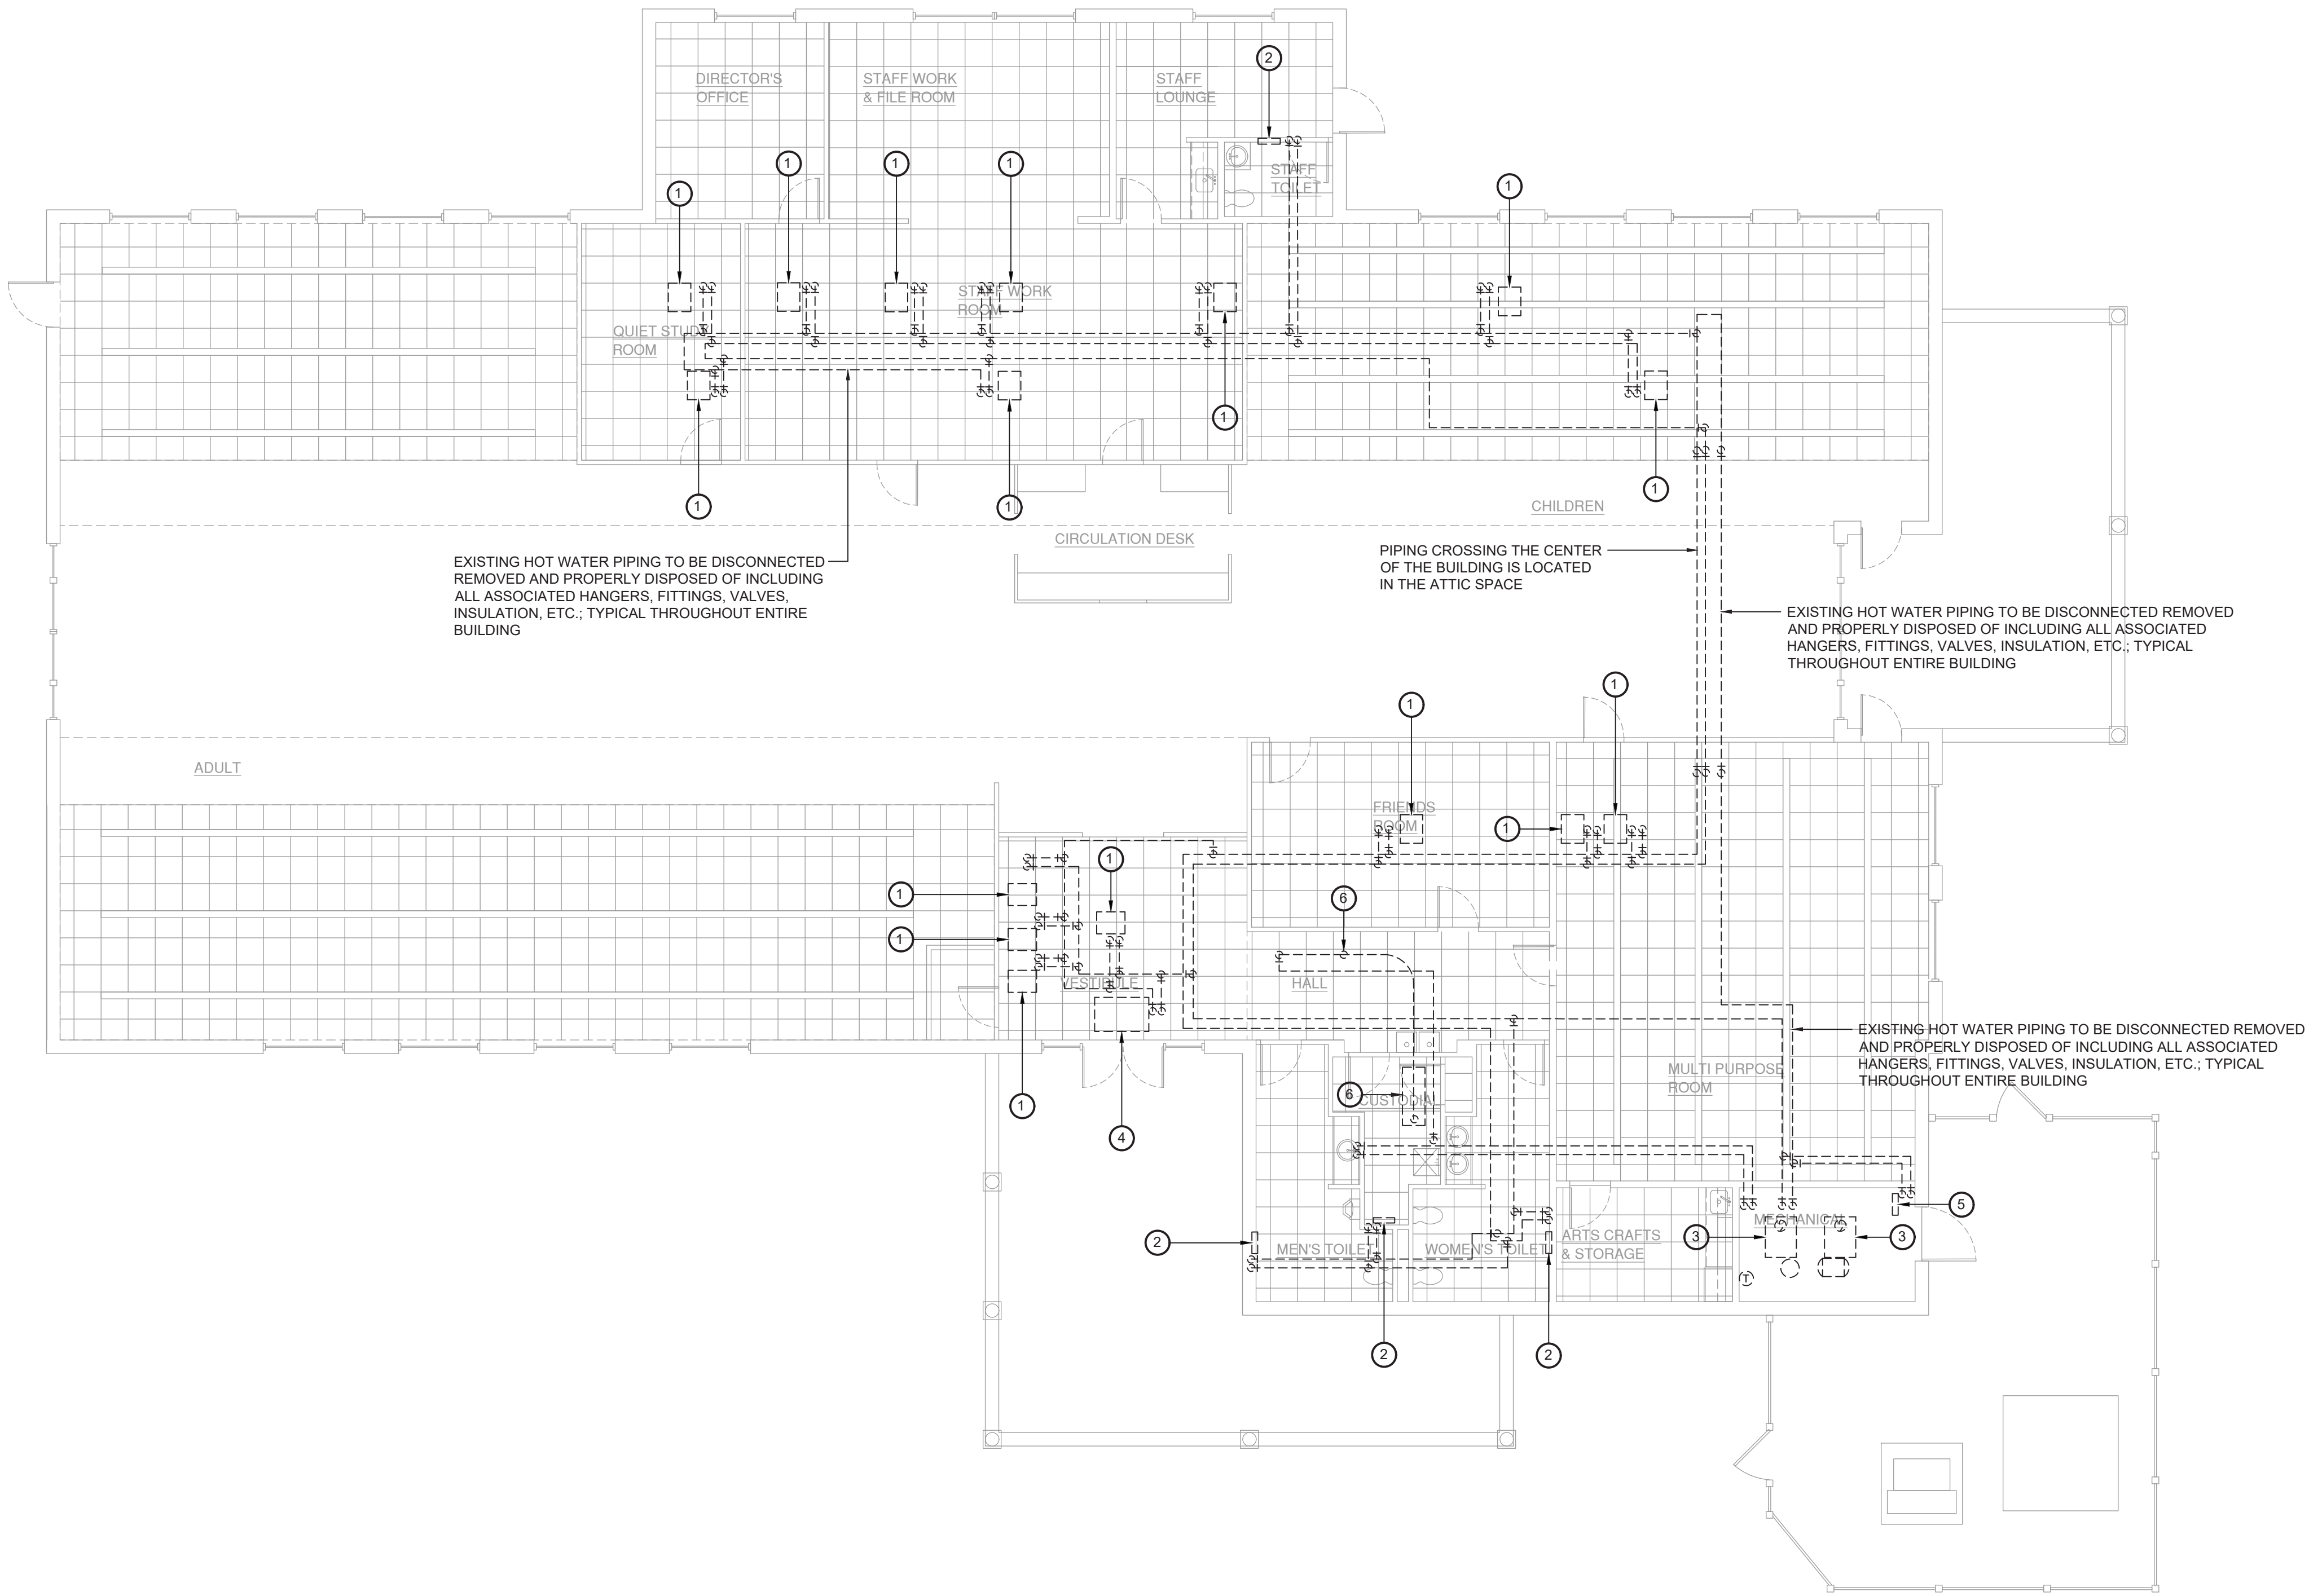
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MA - 53197 CT - 32283 FL - 85928

MECHANICAL DEMOLITION PLAN

DATE:		DRN	CHK	DESCRIPTION
01.26.2023		BJK	BJK	CONSTRUCTION DWGS
REV.	DATE:	DRN	CHK	DESCRIPTION

PROJECT NO.	SHEET NO.
2150	MD.201

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1 Hydronic Demolition Plan
MD.202 Scale: 1/8" = 1'-0"


Key Notes:

- 1 EXISTING VAV BOX TO BE DISCONNECTED, REMOVED & PROPERLY DISPOSED OF INCLUDING ALL ASSOCIATED DUCTWORK, PIPING, VALVES, HANGERS, CONTROLS, ETC.
- 2 EXISTING WALL MOUNTED HOT WATER CABINET HEATER TO BE DISCONNECTED, REMOVED & PROPERLY DISPOSED OF INCLUDING ALL PIPING, CONTROLS, ETC.
- 3 EXISTING GAS FIRED HOT WATER BOILER TO BE DISCONNECTED, REMOVED & PROPERLY DISPOSED OF INCLUDING ALL VENTS, PUMPS, PIPING, AIR SEPARATOR, EXPANSION TANK, ACCESSORIES, CONTROLS, ETC.
- 4 EXISTING CEILING MOUNTED HOT WATER CABINET HEATER TO BE DISCONNECTED, REMOVED & PROPERLY DISPOSED OF INCLUDING ALL PIPING, CONTROLS, ETC.
- 5 EXISTING HOT WATER UNIT HEATER TO BE DISCONNECTED, REMOVED & PROPERLY DISPOSED OF INCLUDING ALL PIPING, CONTROLS, ETC.
- 6 EXISTING GAS FIRED HUMIDIFIER TO BE DISCONNECTED, REMOVED & PROPERLY DISPOSED OF INCLUDING ANY ASSOCIATED VENTING, PIPING, DUCTWORK, HANGERS, SUPPORTS, ETC.

KEY PLAN:

'CORNWALL PUBLIC LIBRARY'

HUDSON ST.

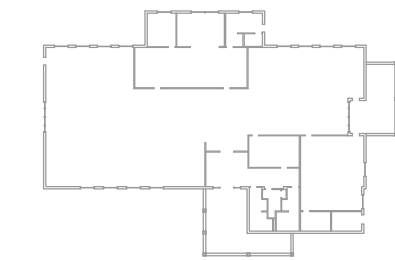


PROJECT:

CORNWALL PUBLIC LIBRARY
HVAC SYSTEM REPLACEMENT PROJECT
395 HUDSON STREET
CORNWALL, NEW YORK 12518
SED #:44-03-01-06-6-009-006

SUB-CONSULTANT:

ENGINEER:

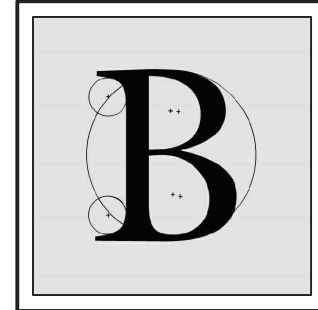

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HYDRONIC DEMOLITION PLAN

DATE:		DRN	CHK	DESCRIPTION
01.26.2023		BJK	BJK	CONSTRUCTION DWGS
REV.	DATE:	DRN	CHK	DESCRIPTION

PROJECT NO.


2150

SHEET NO.

MD.202

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1 Mechanical Ductwork Plan
M.201 Scale: 1/8" = 1'-0"


Key Notes:

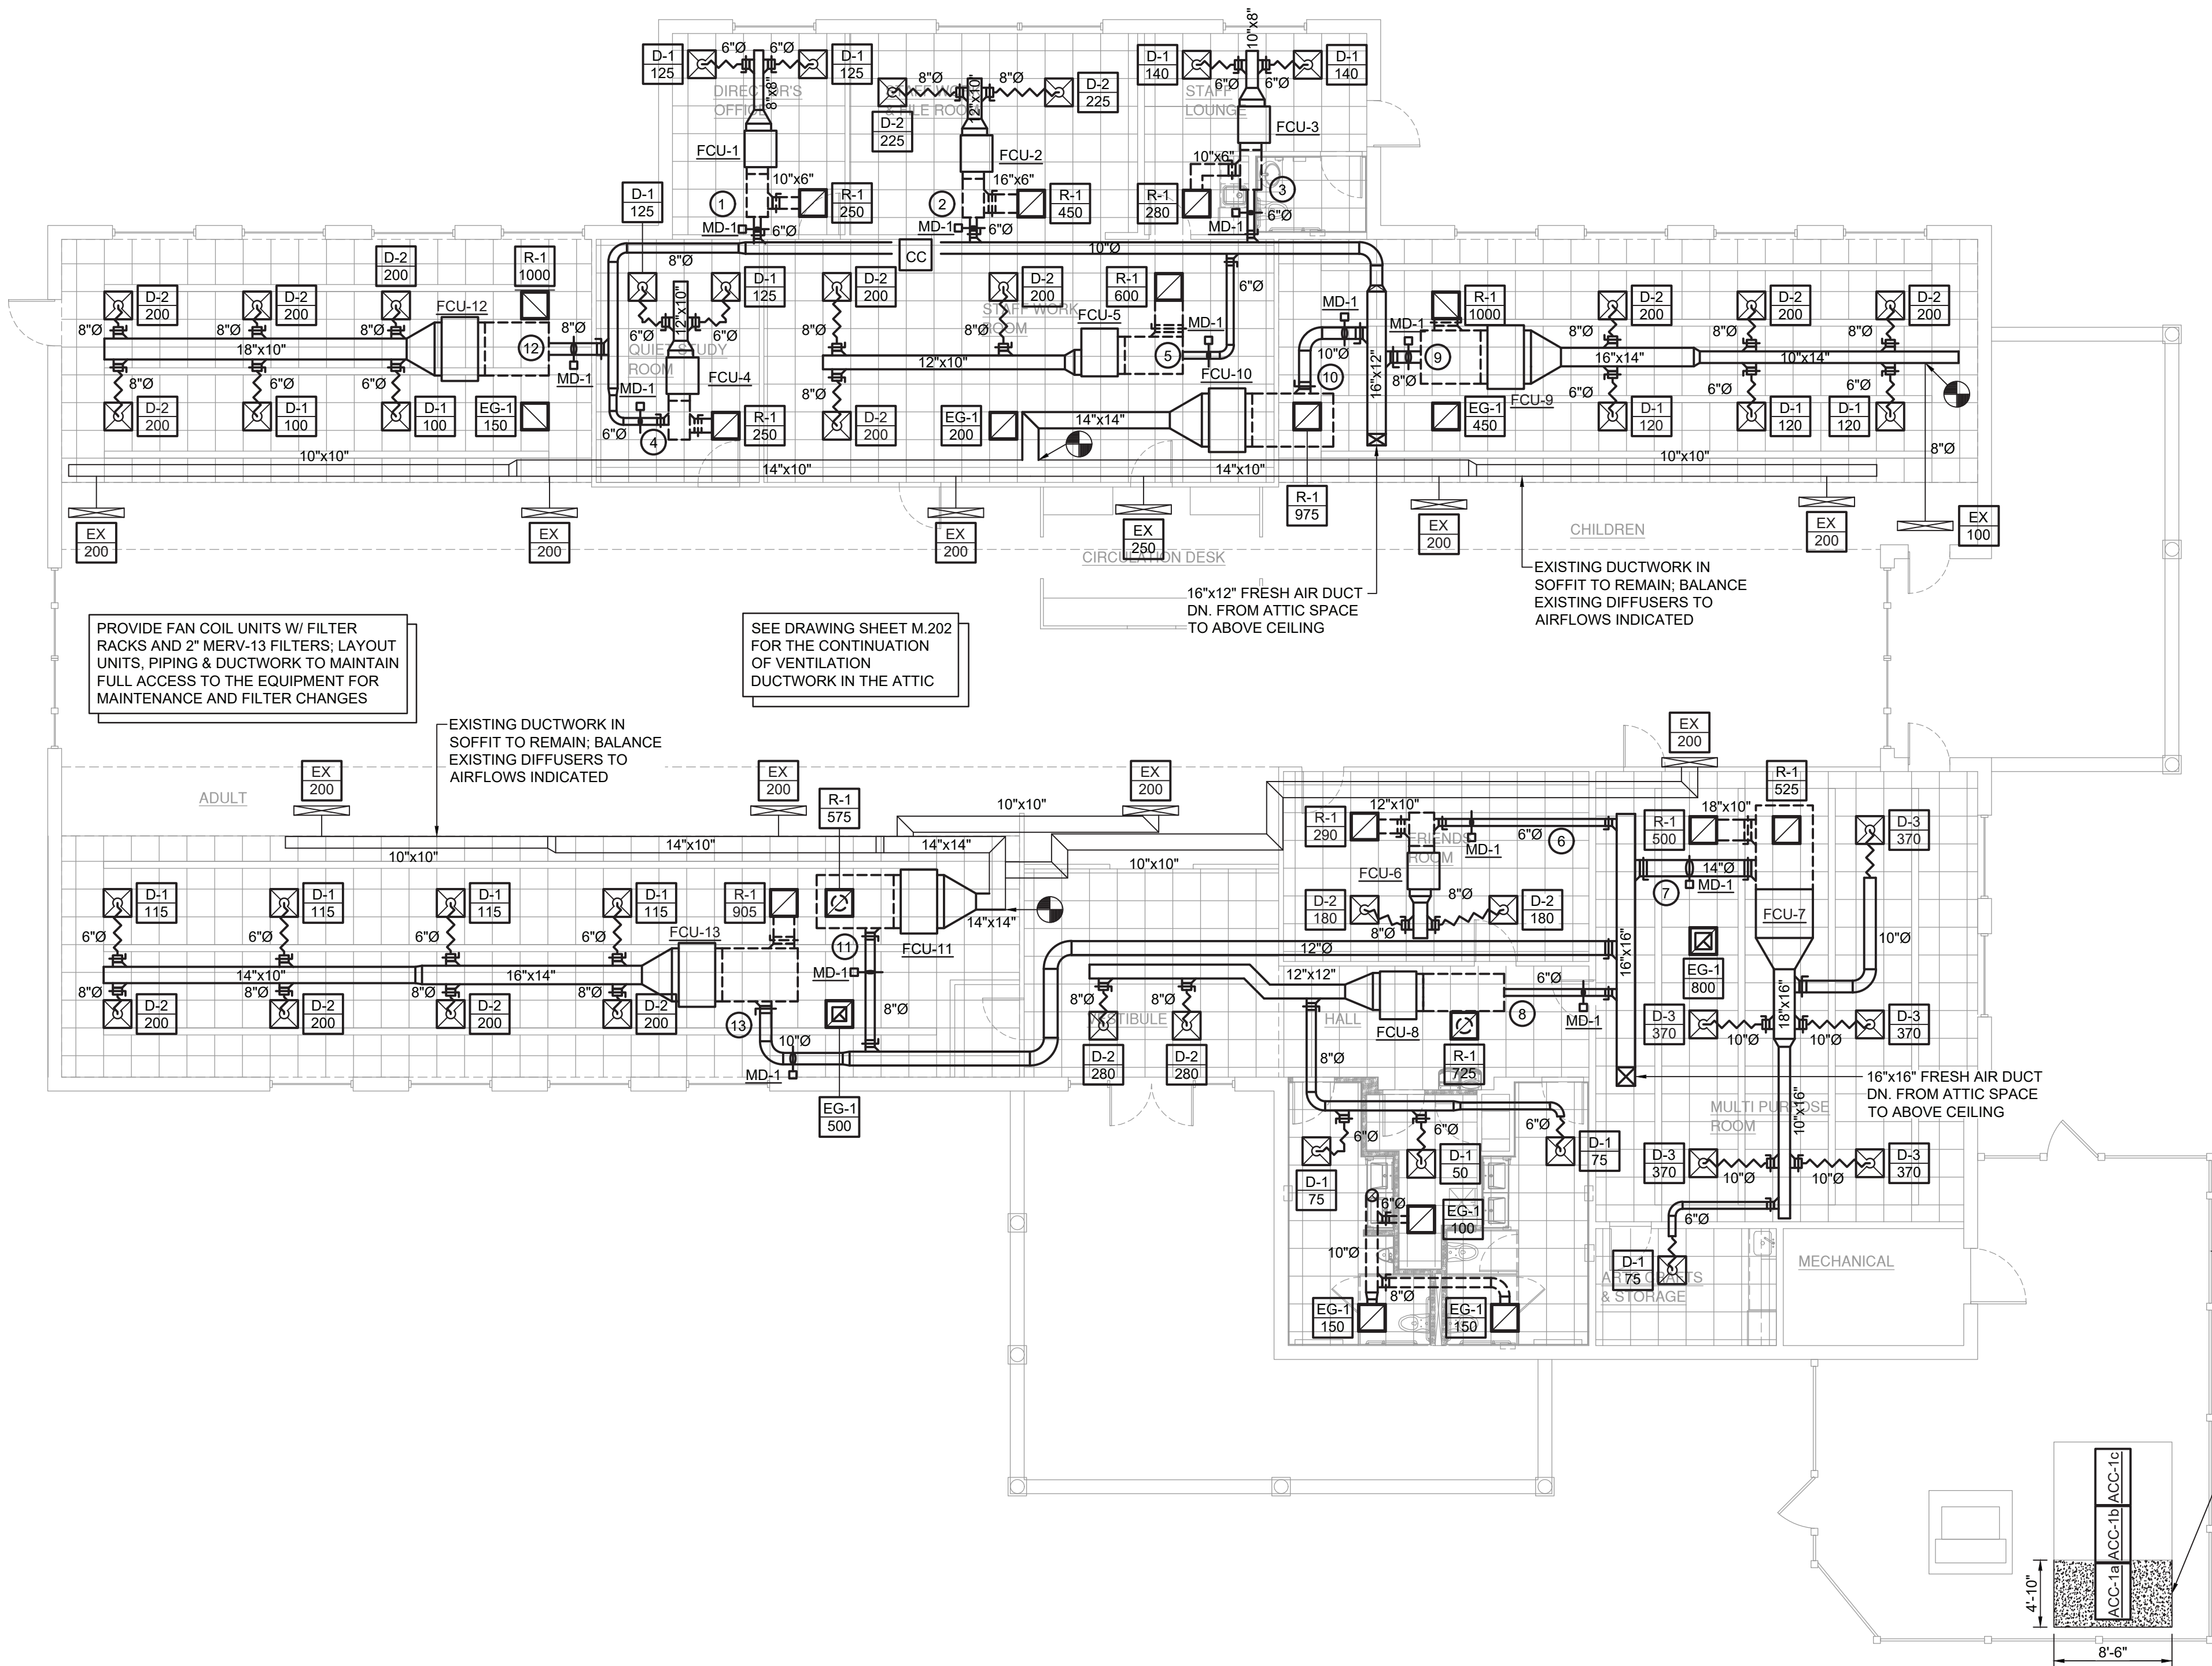- 1 BALANCE OUTSIDE AIR TO 20 CFM
- 2 BALANCE OUTSIDE AIR TO 35 CFM
- 3 BALANCE OUTSIDE AIR TO 20 CFM
- 4 BALANCE OUTSIDE AIR TO 85 CFM
- 5 BALANCE OUTSIDE AIR TO 75 CFM
- 6 BALANCE OUTSIDE AIR TO 70 CFM
- 7 BALANCE OUTSIDE AIR TO 920 CFM
- 8 BALANCE OUTSIDE AIR TO 35 CFM
- 9 BALANCE OUTSIDE AIR TO 200 CFM
- 10 BALANCE OUTSIDE AIR TO 275 CFM
- 11 BALANCE OUTSIDE AIR TO 225 CFM
- 12 BALANCE OUTSIDE AIR TO 185 CFM
- 13 BALANCE OUTSIDE AIR TO 355 CFM

KEY PLAN:

'CORNWALL PUBLIC LIBRARY'

HUDSON ST.

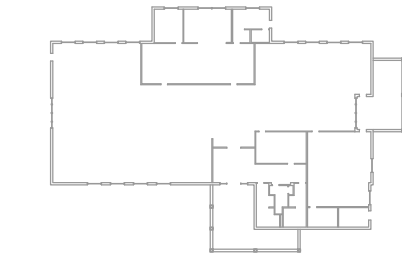


PROJECT:

CORNWALL PUBLIC LIBRARY
HVAC SYSTEM REPLACEMENT PROJECT
395 HUDSON STREET
CORNWALL, NEW YORK 12518
SED #44-03-01-06-6-009-006

SUB-CONSULTANT:

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MECHANICAL DUCTWORK PLAN

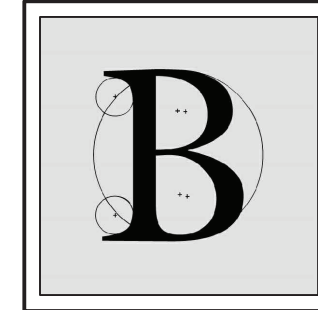
DATE:	DRN	CHK	DESCRIPTION
01.26.2023	BJK	BJK	CONSTRUCTION DWGS

REV.	DATE	DRN	CHK	DESCRIPTION
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PROJECT NO.	SHEET NO.
2150	M.201

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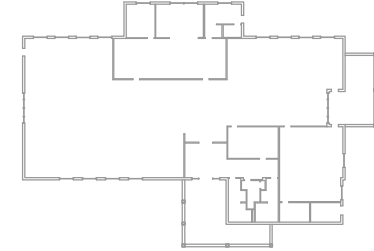


1 Attic Mechanical Plan
M.202 Scale: 1/8" = 1'-0"

KEY PLAN:

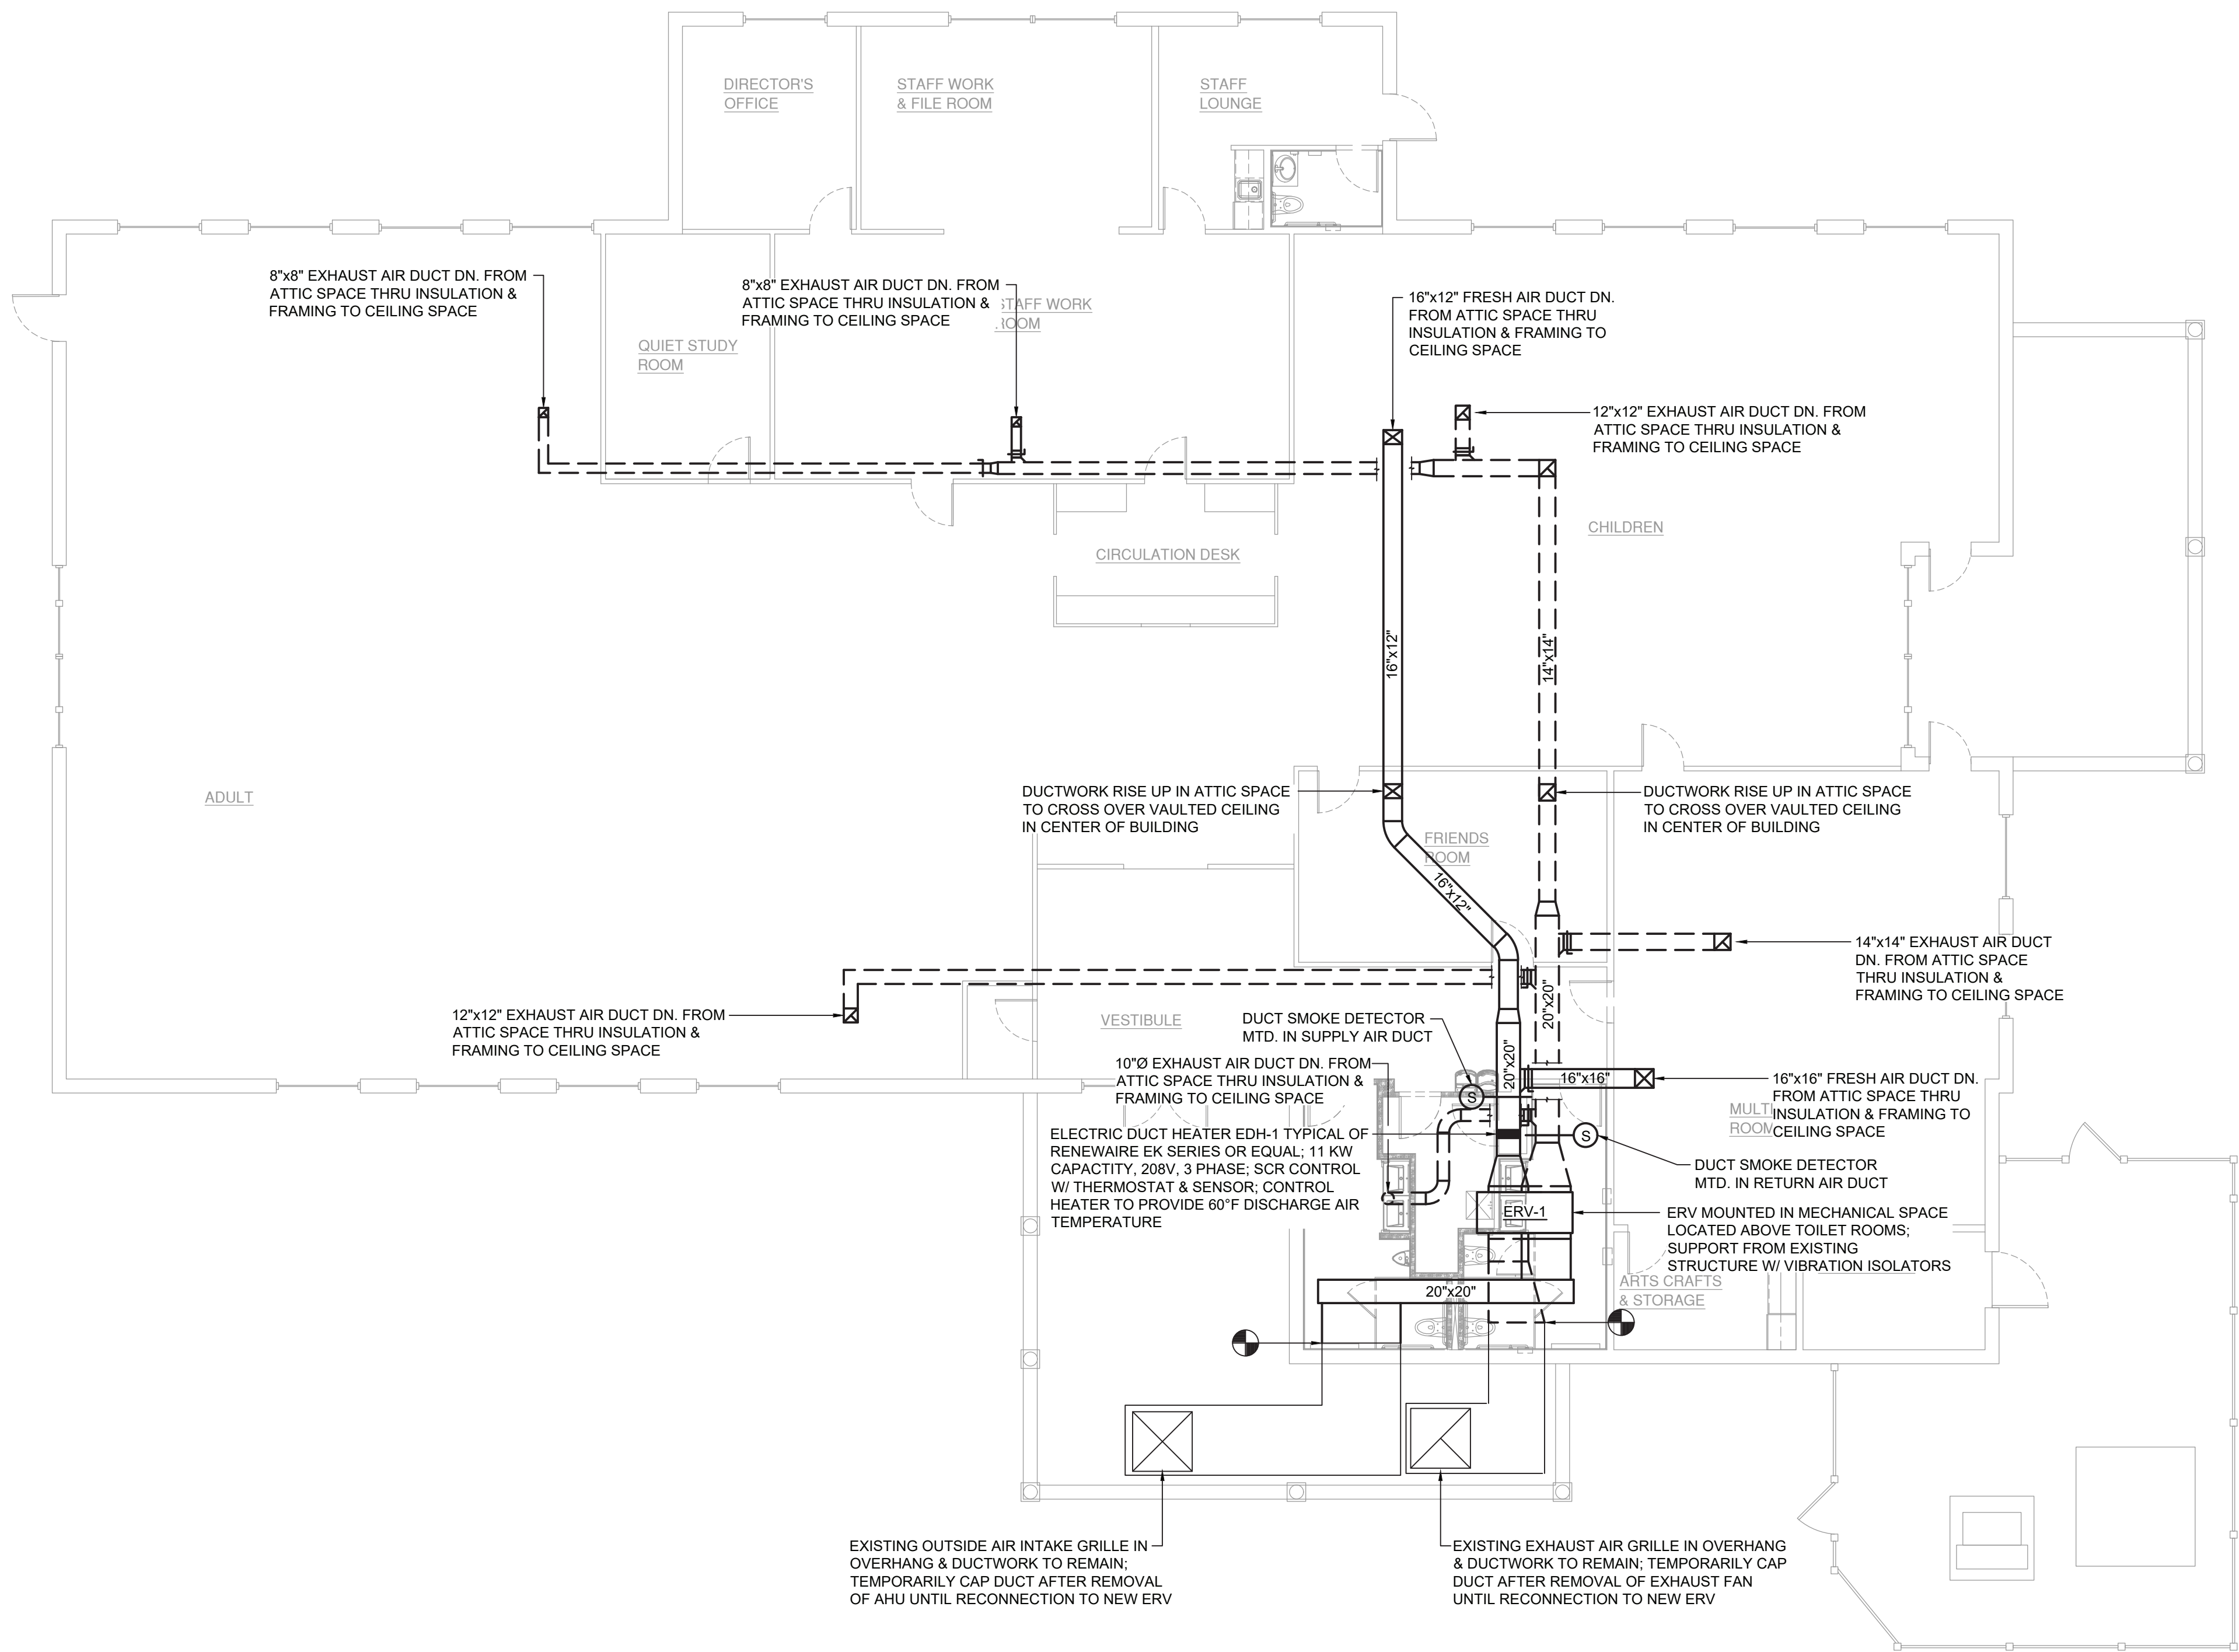'CORNWALL PUBLIC LIBRARY'

HUDSON ST.




PROJECT:

CORNWALL PUBLIC LIBRARY
HVAC SYSTEM REPLACEMENT PROJECT
395 HUDSON STREET
CORNWALL, NEW YORK 12518
SED #:44-03-01-06-6-009-006

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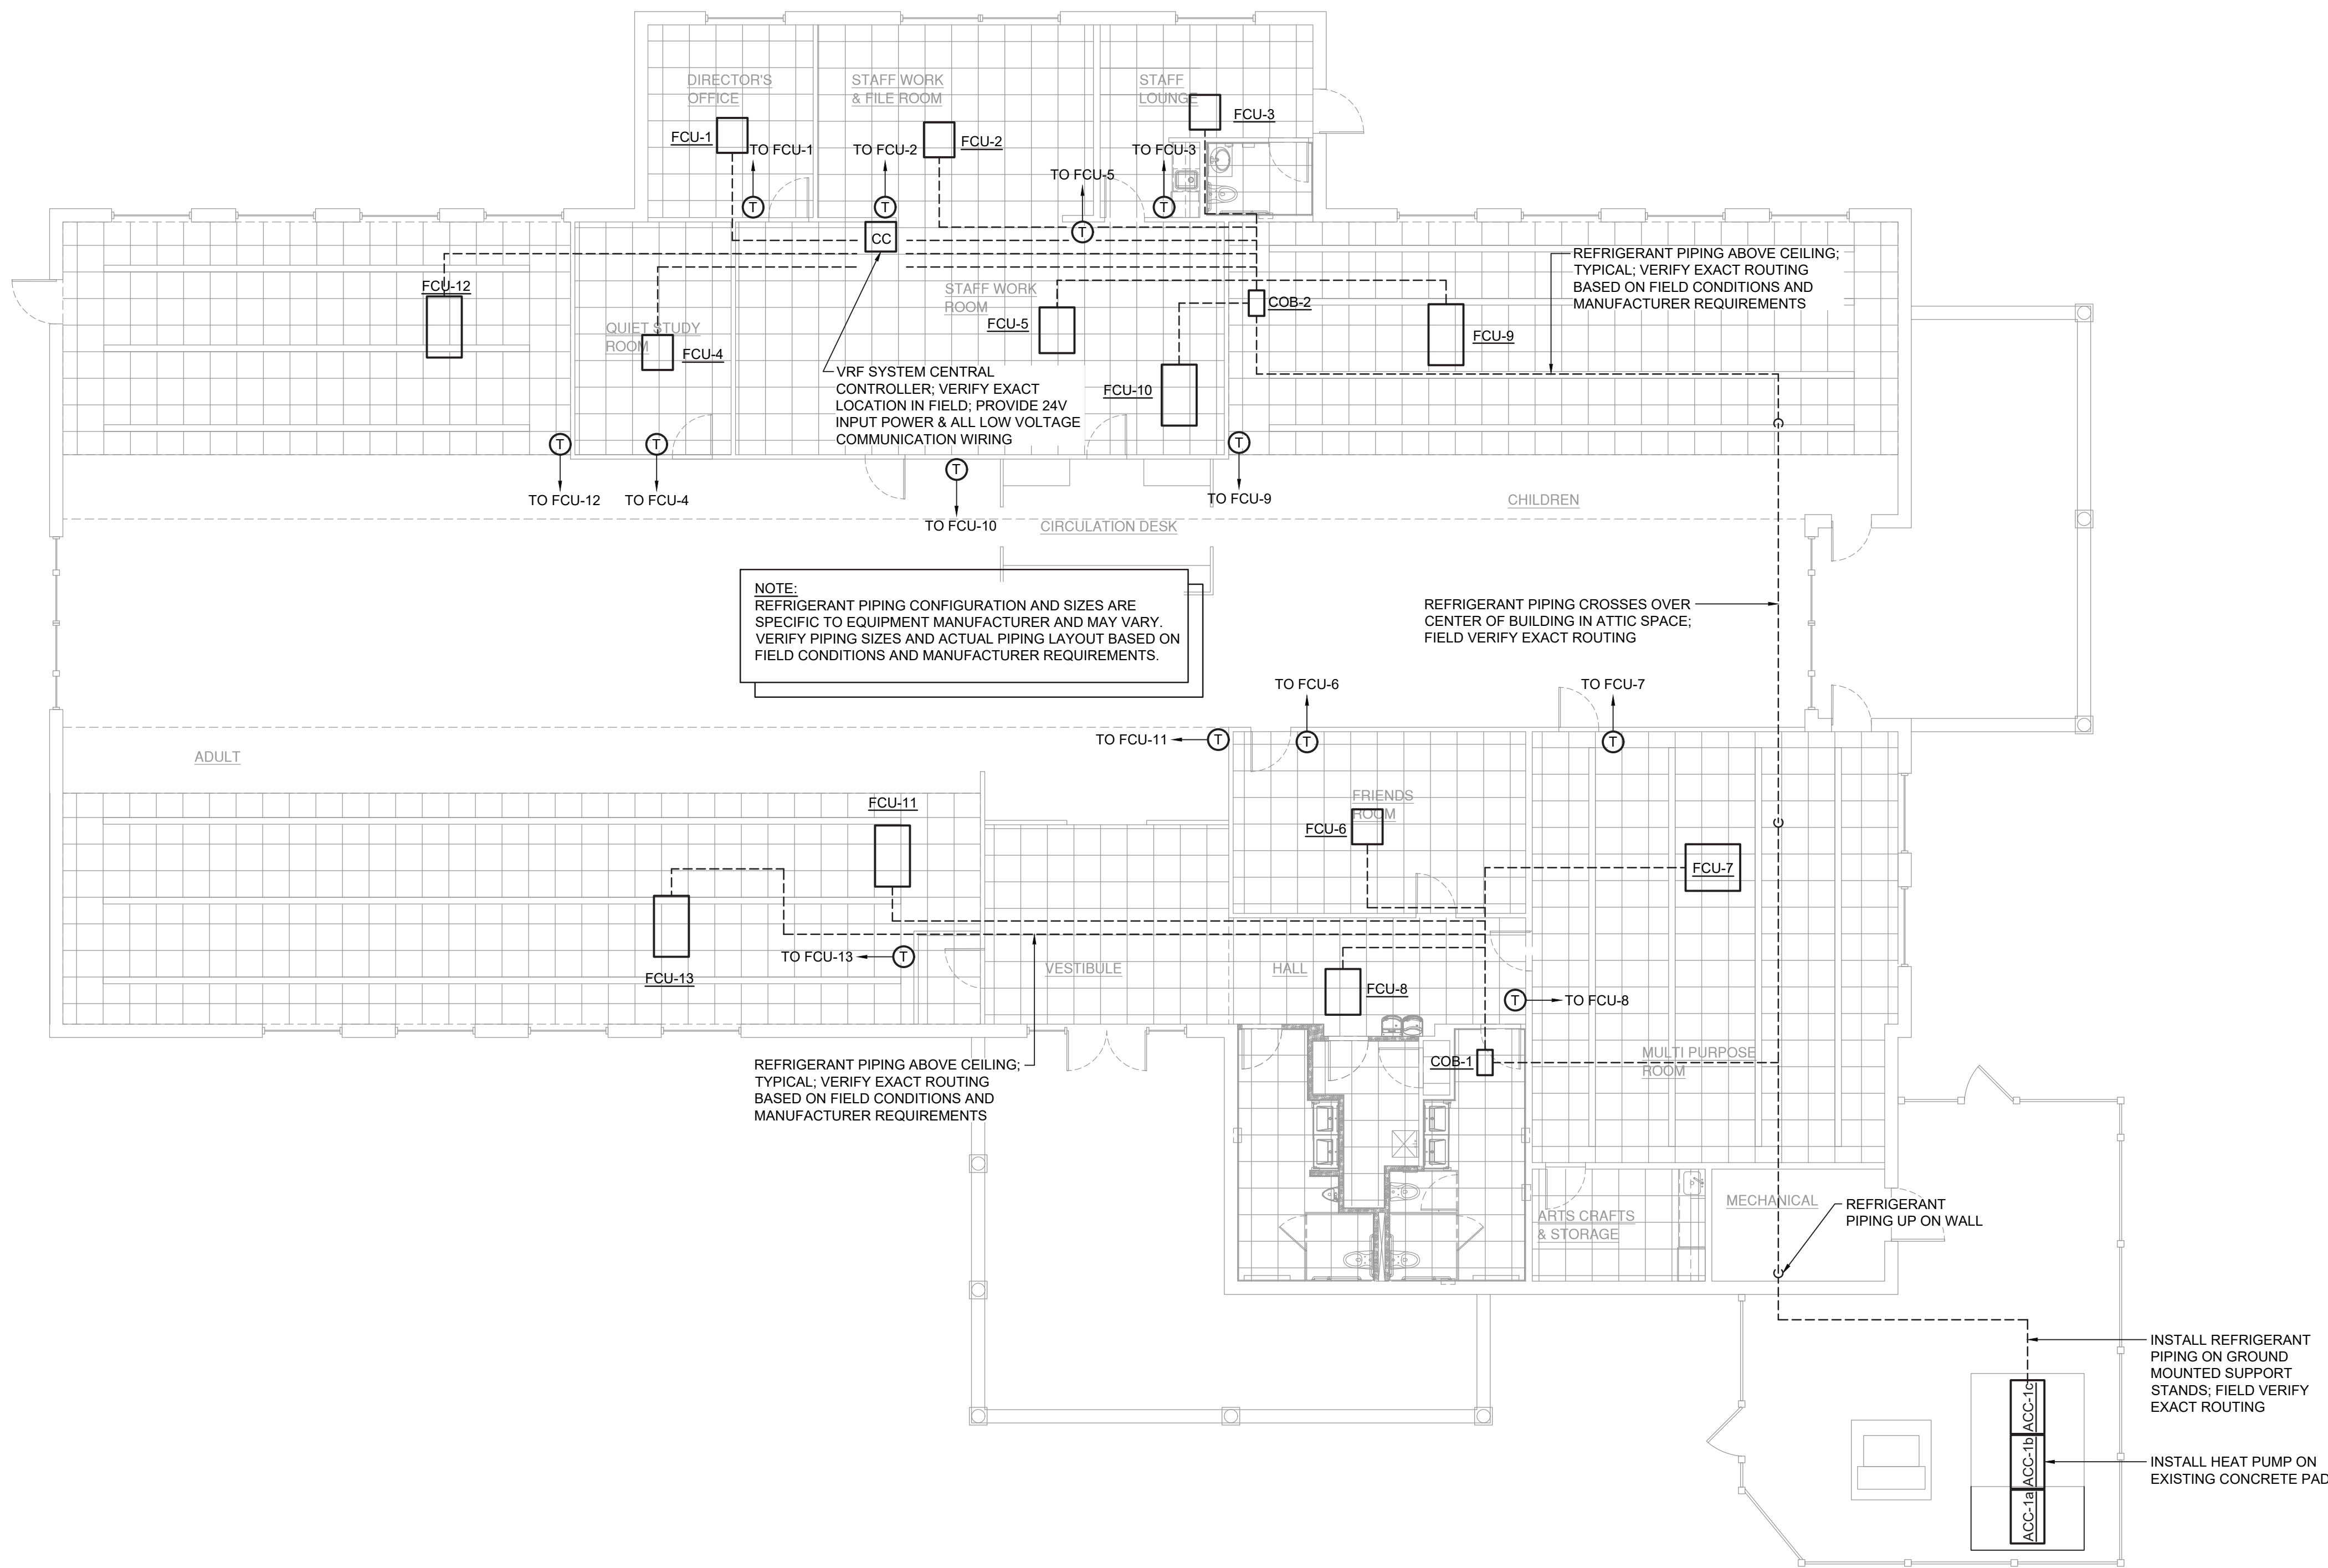
ATTIC MECHANICAL PLAN

DATE:		DRN	CHK	DESCRIPTION
01.26.2023		BJK	BJK	CONSTRUCTION DWGS
REV.	DATE:	DRN	CHK	DESCRIPTION

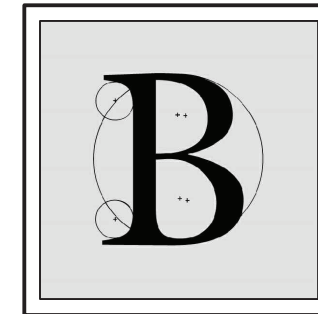PROJECT NO.	SHEET NO.
2150	M.202

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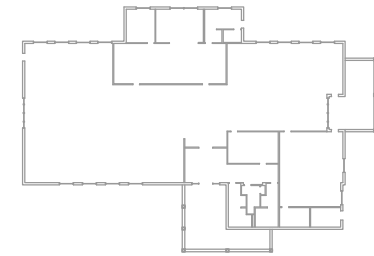


1 Mechanical Piping Plan
M.301 Scale: 1/8" = 1'-0"

KEY PLAN:

'CORNWALL PUBLIC LIBRARY'

HUDSON ST.




PROJECT:

CORNWALL PUBLIC LIBRARY
HVAC SYSTEM REPLACEMENT PROJECT
395 HUDSON STREET
CORNWALL, NEW YORK 12518
SED #:44-03-01-06-6-009-006

SUB-CONSULTANT:

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MA - 53197 CT - 32283 FL - 85928

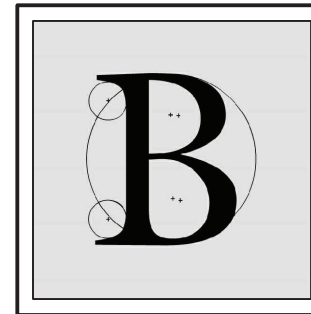MECHANICAL PIPING PLAN

DATE:	DRN	CHK	DESCRIPTION
01.26.2023	BJK	BJK	CONSTRUCTION DWGS

REV.	DATE	DRN	CHK	DESCRIPTION

PROJECT NO.	SHEET NO.
2150	M.301

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