

NUFACTURER/MODEL ACCEPTABLE EQUAL)	REMARKS
RN MODEL #Z5615-BWL-AM HET; WALL HUNG W/ PF; FURNISH W/ SEAT MODEL #Z5955SS-EL AND DEL# ZEMS6000AV-HET	INSTALL PER ADA & MANUFACTURER'S REQUIREMENTS; FURNISH FLUSHOMETER HARDWIRING KITS FOR INSTALLATION BY EC
/ANTAGE MODEL #Z5758.234.00; WHITE JRNISH W/ HARDWIRED SENSOR FLUSH VALVE	INSTALL PER ADA & MANUFACTURER'S REQUIREMENTS; FURNISH FLUSHOMETER HARDWIRING KITS FOR INSTALLATION BY EC
OAN ELWF-82000; PROVIDE HARDWIRED SENSOR UG IN ADAPTER & DAISY CHAIN ELECTRICAL AP & ADA TRAP/STOP/SUPPLY PROTECTORS	INSTALL PER ADA & MANUFACTURER'S REQUIREMENTS
EVEL ADA COOLER TYPICAL OF ELKAY MODEL PH STAINLESS	INSTALL PER ADA & MANUFACTURER'S REQUIREMENTS
DDEL #MSB-2424; SHEET MOLDING COMPOUND AUCET #830-AA, HOSE & BRACKET #832-AA, MOP WALL GUARD #MSG2424	INSTALL PER MANUFACTURER'S REQUIREMENTS
CAL OF AO SMITH MODEL #DEL-20S-4; 20 GAL. @ 90F RISE; 4 KW INPUT; 208V, 1 PHASE	INSTALL PER MANUFACTURER'S REQUIREMENTS
DAN ELC-41000; PROVIDE HARDWIRED SENSOR UG IN ADAPTER W/ ADA STRAINER, P-TRAP & ECTORS	INSTALL PER ADA & MANUFACTURER'S REQUIREMENTS
IT SINK TYPICAL OF ELKAY ELU131655PD; 1042 & PERFECT DRAIN FITTING MODEL LKPD1	INSTALL PER ADA & MANUFACTURER'S REQUIREMENTS

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	DOMESTIC COLD WATER SUPPLY
	110 °F DOMESTIC HOT WATER SUPPLY
	140 °F DOMESTIC HOT WATER SUPPLY
	HOT WATER RETURN
	SANITARY SEWER, ABOVE GRADE
	SANITARY SEWER, BELOW GRADE
	PLUMBING VENT
	STORM WATER, ABOVE GRADE
	STORM WATER, BELOW GRADE
	LP GAS PIPING
	DIRECTION OF PIPE SLOPE (DOWN)
	CONCENTRIC REDUCER OR INCREASER
	ECCENTRIC REDUCER
	TOP CONNECTION, 45° OR 90°
	BOTTOM CONNECTION, 45° OR 90°
	SIDE CONNECTION
	CAPPED OUTLET
	RISE OR DROP IN PIPE
	UNION
	PIPE UP
	PIPE DOWN
	POINT OF CONNECTION BETWEEN NEW AND EXISTING WORK
	STRAINER
	HOSE BIB
	SOLENOID VALVE
	GATE VALVE
	GLOBE VALVE
	CHECK VALVE
	BUTTERFLY VALVE
	FULL PORT BALL VALVE
	PRESSURE GAUGE
	FLOOR CLEANOUT W/ DECK PLATE
	CLEANOUT
	WALL CLEANOUT
	CLEANOUT TO GRADE
	PLUMBING FIXTURE MARK


Plumbing Notes:

1. ALL MATERIALS AND EQUIPMENT ARE TO BE NEW, UNUSED, AND FREE FROM DEFECTS OF ANY KIND. THE BASIS OF QUALITY SHALL BE THE LATEST REVISION OF ASTM, ANSI, OR OTHER ACCEPTABLE STANDARDS.


- 2. THESE DRAWINGS ARE DIAGRAMMATIC, AND INDICATE GENERAL ARRANGEMENT OF WORK. THE CONTRACTOR SHALL BE RESPONSIBLE TO HAVE REVIEWED THE SITE FOR HIS WORK PRIOR TO HAVING SUBMITTED HIS PROPOSAL. NO ADDITIONAL COMPENSATION WILL BE ALLOWED FOR CONDITIONS FOUND DURING THE COURSE OF THE CONTRACT.
- 3. THE CONTRACTOR SHALL COORDINATE HIS WORK WITH THAT OF ALL OTHER TRADES.
- 4. ALL WORK INCLUDING LABOR AND MATERIALS SHALL BE FULLY GUARANTEED FOR ONE (1) YEAR FROM THE DATE OF PAYMENT AND FINAL ACCEPTANCE BY THE OWNER AND ENGINEER.
- 5. ALL CUTTING, PATCHING, FIRE-STOPPING, AND SURFACE RESTORATION IN CONNECTION WITH THIS TRADE SHALL BE COMPLETED BY THIS CONTRACTOR.
- 6. A MINIMUM OF FOUR (4) COPIES OF SHOP DRAWINGS SHALL BE SUBMITTED TO THE ENGINEER FOR APPROVAL PRIOR TO ORDERING AND INSTALLATION OF THE EQUIPMENT AND/OR MATERIALS. BY SUBMITTING SHOP DRAWINGS, THE CONTRACTOR REPRESENTS THAT ACTUAL FIELD CONDITIONS ARE VERIFIED BY HIM AND ARE REFLECTED ON HIS SUBMITTALS.
- 7. THIS CONTRACTOR SHALL PAY ALL FEES, GIVE ALL NOTICES, FILE ALL NECESSARY DRAWINGS, AND OBTAIN ALL PERMITS, INSPECTIONS AND CERTIFICATES OF APPROVAL REQUIRED IN CONNECTION WITH WORK UNDER THIS CONTRACT.
- 6. ALL WORK IN ASSOCIATION WITH THIS CONTRACT SHALL BE COMPLETED IN STRICT COMPLIANCE WITH THE 2020 BUILDING CODE OF NEW YORK STATE, 2020 PLUMBING CODE OF NEW YORK STATE. 2020 FUEL GAS CODE OF NEW YORK STATE & 2020 ENERGY CONSERVATION CONSTRUCTION CODE OF NEW YORK STATE.
- 7. WHERE THE PROJECT INVOLVES A GAS SERVICE, THIS CONTRACTOR SHALL BE RESPONSIBLE FOR ALL COORDINATION, APPLICATIONS AND FEES OF ALL WORK ASSOCIATED WITH THE LOCAL GAS UTILITY COMPANY. ALL WORK INVOLVING THE GAS UTILITY COMPANY SHALL BE COMPLETED IN ACCORDANCE WITH THEIR REGULATIONS AND GUIDELINES.
- 8. ALL DOMESTIC COLD AND HOT WATER PIPING AND FITTINGS ARE TO BE INSULATED WITH 1" THICK RIGID ONE-PIECE MOLDED SECTIONAL FIBERGLASS PIPE COVERING WITH UNIVERSAL JACKET. ALL JOINTS ARE TO BE COMPLETELY SEALED A MINIMUM OF 6" BEYOND JOINT ENDS.
- 9. ALL PIPING SHALL BE PROPERLY SUPPORTED AND ROUTED PARALLEL OR PERPENDICULAR TO BUILDING WALLS. THE CONTRACTOR SHALL FURNISH AND INSTALL ALL SUPPORT HANGERS AND MISCELLANEOUS METALS REQUIRED FOR PROPER INSTALLATION OF WORK.
- 10. PIPING SYSTEM MATERIALS ARE TO BE AS FOLLOWS:
- 10.1. DOMESTIC WATER DISTRIBUTION CHLORINATED POLYVINYL CHLORIDE (CPVC) PLASTIC PIPE AND FITTINGS. JOINTS SHALL BE MADE IN ACCORDANCE WITH ASTM D 2846 USING A PRIMER AND SOLVENT CEMENT CONFORMING TO ASTM F 493.
- 10.2. SANITARY DRAINAGE & VENT SCHEDULE 40 POLYVINYL CHLORIDE (PVC) PLASTIC PIPE AND FITTINGS. JOINTS SHALL BE MADE IN ACCODANCE WITH ASTM D 2855 USING A PRIMER CONFORMING TO ASTM F 656 AND SOLVENT CEMENT CONFORMING TO ASTM D 2564.
- 10.3. GAS DISTRIBUTION SCHEDULE 40 BLACK STEEL PIPE WITH MALLEABLE IRON THREADED FITTINGS & THREAD JOINT COMPOUND FOR PIPING UP THRU 4" DIAMETER. JOINTS MUST BE WELDED FOR PIPING OVER 4" DIAMETER. WHERE PIPING IS TO BE INSTALLED BELOW GRADE, PIPING AND FITTINGS ARE TO BE COATED WITH A CORROSION-RESISTENT MATERIAL.
- 11. ALL EXPOSED PIPING, FITTINGS, TRAPS, ESCUTCHEONS, VALVES, ETC. SHALL BE CHROME PLATED.
- 12. SLOPE SANITARY DRAINAGE PIPING 2" DIAMETER AND SMALLER NOT LESS THAN 1/4" PER FOOT. SLOPE SANITARY DRAINAGE PIPING OVER 2" DIAMETER NOT LESS THAN 1/8" PER FOOT.
- 13. INSTALL A CLEANOUT AT THE BASE OF EACH SOIL STACK, AT EACH CHANGE IN DIRECTION, AT INTERVALS NOT OVER 50 FEET AND ELSEWHERE AS SHOWN ON DRAWINGS OR REQUIRED BY CODE.
- 14. PROVIDE EXPOSED PIPING WITH CHROME PLATED CAST BRASS ESCUTCHEON WITH SET SCREW WHERE PENETRATING FLOORS, CEILINGS, WALLS OR PARTITIONS.
- 15. TEST PIPING AND PROVE TIGHT FOR AT LEAST TWO HOURS IN ACCORDANCE WITH REQUIREMENTS OF AUTHORITIES HAVING JURISDICTION AND/OR AS SPECIFIED. TEST SHALL BE PERFORMED IN THE PRESENCE OF THE ENGINEER AND LOCAL INSPECTOR. TEST SHALL BE REPEATED IF NECESSARY UNTIL FINAL APPROVAL OF SYSTEM IS OBTAINED.
- 15.1. WATER & GAS PIPING TO BE AIR-PRESSURE TESTED TO 1-1/2 TIMES MAXIMUM WORKING PRESSURE.
- 15.2. DRAINAGE, WASTE & VENT PIPING TO BE TESTED BY FILLING THE SYSTEM WITH WATER TO 10-FEET ABOVE HIGHEST POINT.
- 16. SUPPORT HORIZONTAL PIPING UTILIZING A SPACING PER PIPING MANUFACTURER'S REQUIREMENTS.
- 17. INSTALL VALVES ON THE ENTIRE DISTRIBUTION SYSTEM, SO LOCATED AS TO GIVE COMPLETE CONTROL TO ALL FIXTURES AND EQUIPMENT.
- 18. INSTALL DRAIN VALVES AT BASE OF ALL RISERS AND AT LOW POINTS OF PIPING SYSTEM.
- 19. THE CONTRACTOR IS RESPONSIBLE TO TEST ALL EQUIPMENT, PIPING, FIXTURES, AND SYSTEMS INSTALLED UNDER THIS CONTRACT TO ENSURE PROPER OPERATION PRIOR TO FINAL ACCEPTANCE BY THE OWNER AND ENGINEER.
- 20. THE CONTRACTOR IS RESPONSIBLE TO DETERMINE WHETHER SPECIAL LICENSING IS REQUIRED IN ORDER TO PERFORM THE REQUIRED WORK IN THE MUNICIPALITY WHERE THE PROJECT IS LOCATED. IF THE CONTRACTOR CANNOT OBTAIN THE REQUIRED LICENSING TO COMPLETE THE WORK WITHIN THE PROJECT SCHEDULE, THEN THE CONTRACTOR SHALL NOT BE PERMITTED TO BID ON THIS PROJECT.
- 21. CONTRACTOR IS RESPONSIBLE TO CREATE AND SUBMIT RED-LINE "AS-BUILT" PLANS TO THE ENGINEER AT THE END OF THE PROJECT. AS-BUILT PLANS SHALL ACCURATELY REPRESENT THE SYSTEMS AS THEY WERE INSTALLED.

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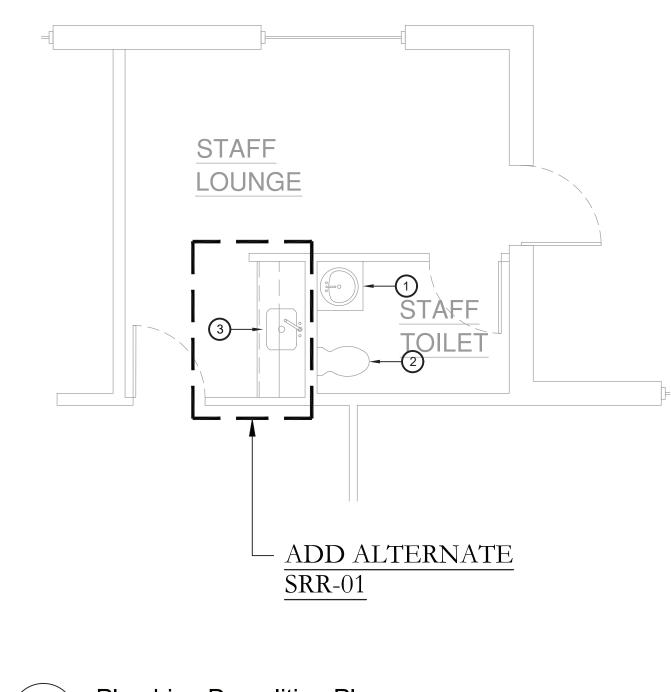


KEY PLAN: Key Notes: 'CORNWALL PUBLIC EXISTING LAVATORY TO BE DISCONNECTED, REMOVED & PROPERLY DISPOSED OF. DEMOLISH SANITARY, VENT & WATER LIBRARY' PIPING BACK TO MAINS AT FLOOR AND/OR WALL & CAP; MAINTAIN SERVICES FOR RECONNECTION TO NEW FIXTURE(S) HUDSON ST. EXISTING WATER CLOSET TO BE DISCONNECTED, REMOVED & TRUE NORTH PROPERLY DISPOSED OF. DEMOLISH SANITARY, VENT & WATER 2 PIPING BACK TO MAINS AT FLOOR AND/OR WALL & CAP; MAINTAIN SERVICES FOR RECONNECTION TO NEW FIXTURE(S) $\mathbf{\nabla}$ PROJECT NORTH EXISTING URINAL TO BE DISCONNECTED, REMOVED & PROPERLY **—** 3 DISPOSED OF. DEMOLISH SANITARY, VENT & WATER PIPING BACK TO MAINS AT FLOOR AND/OR WALL & CAP; MAINTAIN SERVICES FOR RECONNECTION TO NEW FIXTURE(S) EXISTING DRINKING FOUNTAIN TO BE DISCONNECTED, REMOVED PROJECT: & PROPERLY DISPOSED OF. DEMOLISH SANITARY, VENT & WATER (4) PIPING BACK TO MAINS AT FLOOR AND/OR WALL & CAP; MAINTAIN CORNWALL PUBLIC SERVICES FOR RECONNECTION TO NEW FIXTURE(S) LIBRARY EXISTING ELECTRIC WATER HEATER TO BE DISCONNECTED, 5 REMOVED & PROPERLY DISPOSED OF. DEMOLISH SANITARY, VENT HVAC SYSTEM & WATER PIPING BACK TO MAINS AT FLOOR AND/OR WALL & CAP; MAINTAIN SERVICES FOR RECONNECTION TO NEW FIXTURE(S) **REPLACEMENT PROJECT** EXISTING GAS FIRED HUMIDIFIER TO BE REMOVED BY MC; 395 HUDSON STREET 6 PLUMBING CONTRACTOR TO DISCONNECT GAS AND WATER LINES FROM UNIT PRIOR TO REMOVAL CORNWALL, NEW YORK 12518 SED #:44-03-01-06-6-009-006 EXISTING GAS FIRED BOILER TO BE REMOVED BY MC; PLUMBING 7 CONTRACTOR TO DISCONNECT GAS AND DOMESTIC WATER LINES FROM UNIT PRIOR TO REMOVAL DISCONNECT, REMOVE & PROPERLY DISPOSE OF ALL NATURAL GAS PIPING INSIDE OF THE BUILDING SERVING THE GAS 8 HUMIDIFIER AND BOILERS; FIELD VERIFY EXACT ROUTING AND SUB-CONSULTANT: QUANTITY MODIFY EXISTING NATURAL GAS METER RISER; REMOVE ALL PIPING FROM INSIDE THE BUILDING BACK TO THE RISER; MAINTAIN 9 GAS SERVICE TO EXISTING GENERATOR; COORDINATE W/ UTILITY COMPANY FOR MODIFICATIONS TO SERVICE RISER EXISTING MOP SINK TO BE DISCONNECTED, REMOVED & 10 PROPERLY DISPOSED OF. DEMOLISH SANITARY, VENT & WATER PIPING BACK TO MAINS AT FLOOR AND/OR WALL & CAP; MAINTAIN SERVICES FOR RECONNECTION TO NEW FIXTURE(S) ENGINEER: -ADD ALTERNATE PC-01 BLAKE ENGINEERING PLLC 1898 COUNTY ROUTE 1 WESTTOWN, NEW YORK 10998 TEL:845-467-9207 FAX:845-767-5050 MBLAKE@BLAKEENGINEERINGPLLC.COM NOT VALID FOR CONSTRUCTION UNLESS SIGNED AND SEALED BY ENGINEER MATTHEW G. BLAKE, P.E., LEED AP NY - 89039 NJ - GE050037 PA - PE079303 MA - 53197 CT - 32283 FL - 85928 PLUMBING DEMOLITION PLAN DRN CHK DESCRIPTION DATE: 01.26.2023 BJK BJK CONSTRUCTION DWGS DATE: DRN CHK DESCRIPTION PROJECT NO. SHEET NO. PD.201 2150 UNAUTHORIZED ALTERATION OR ADDITION TO THIS PLAN IS A VIOLATION OF SECTION 7209, SUBDIVISION 2, OF THE NEW YORK STATE EDUCATION LAW. COPYRIGHT © 2022 BY BLAKE ENGINEERING PLLC

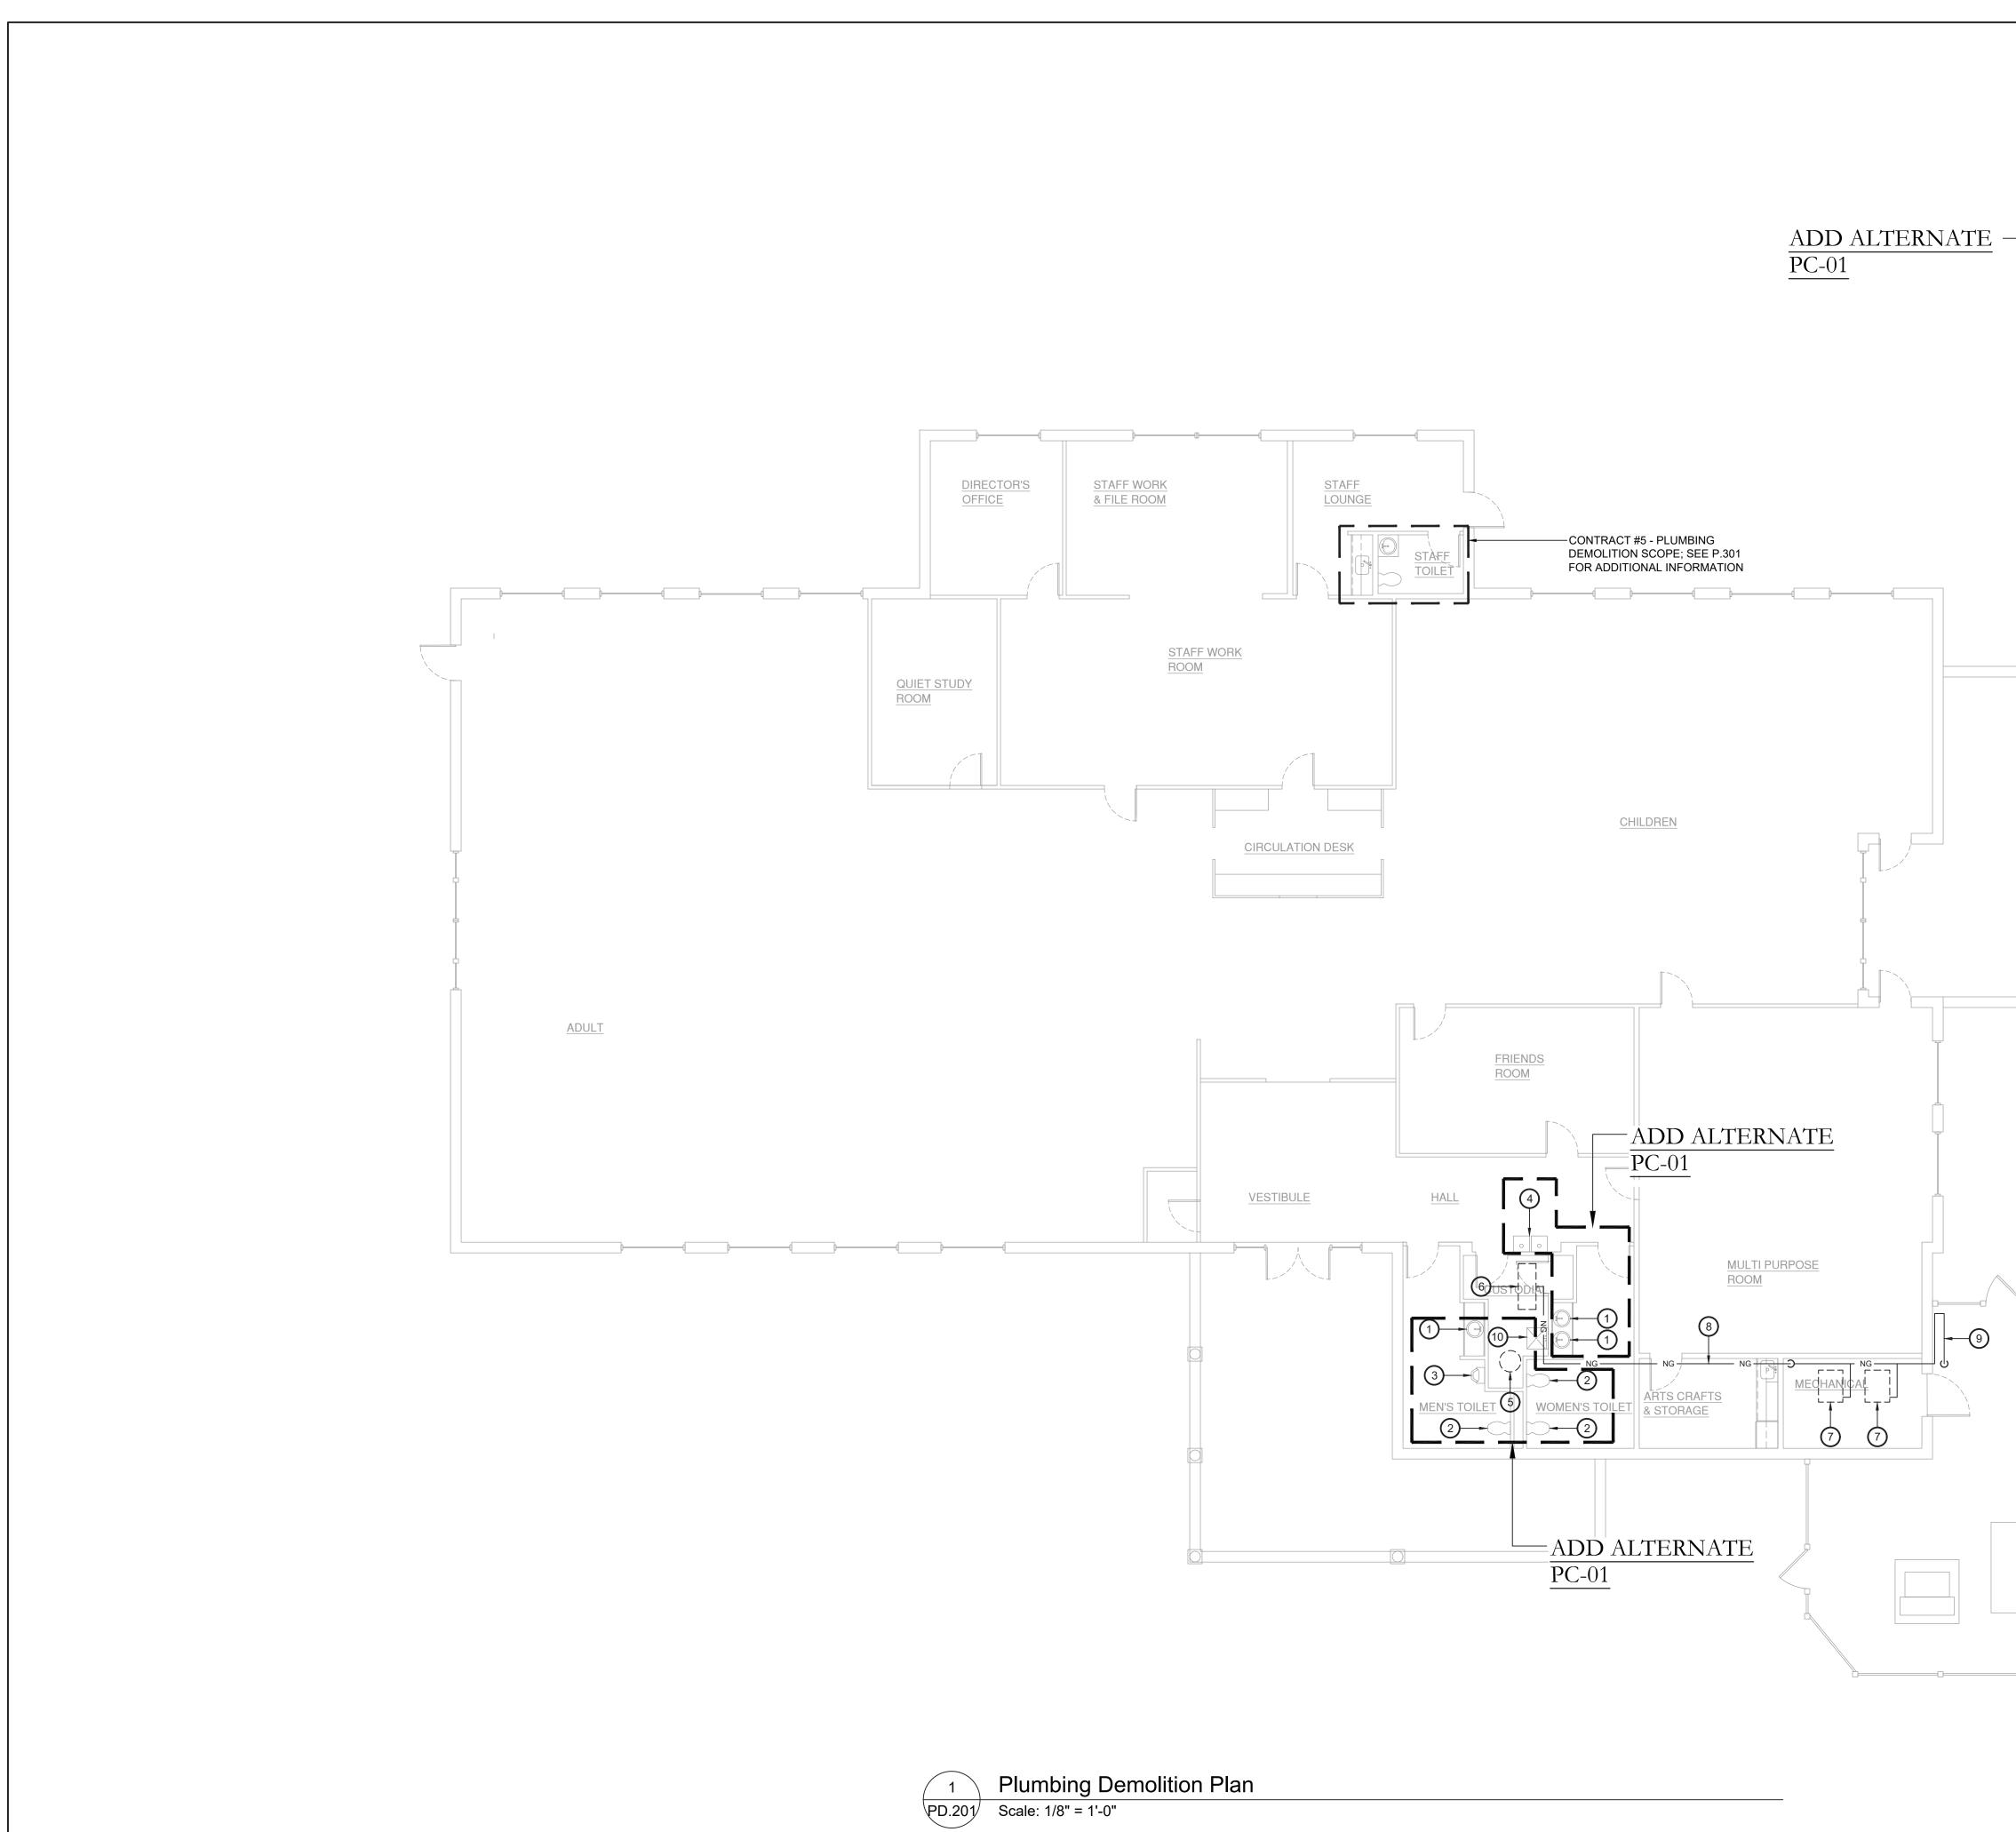

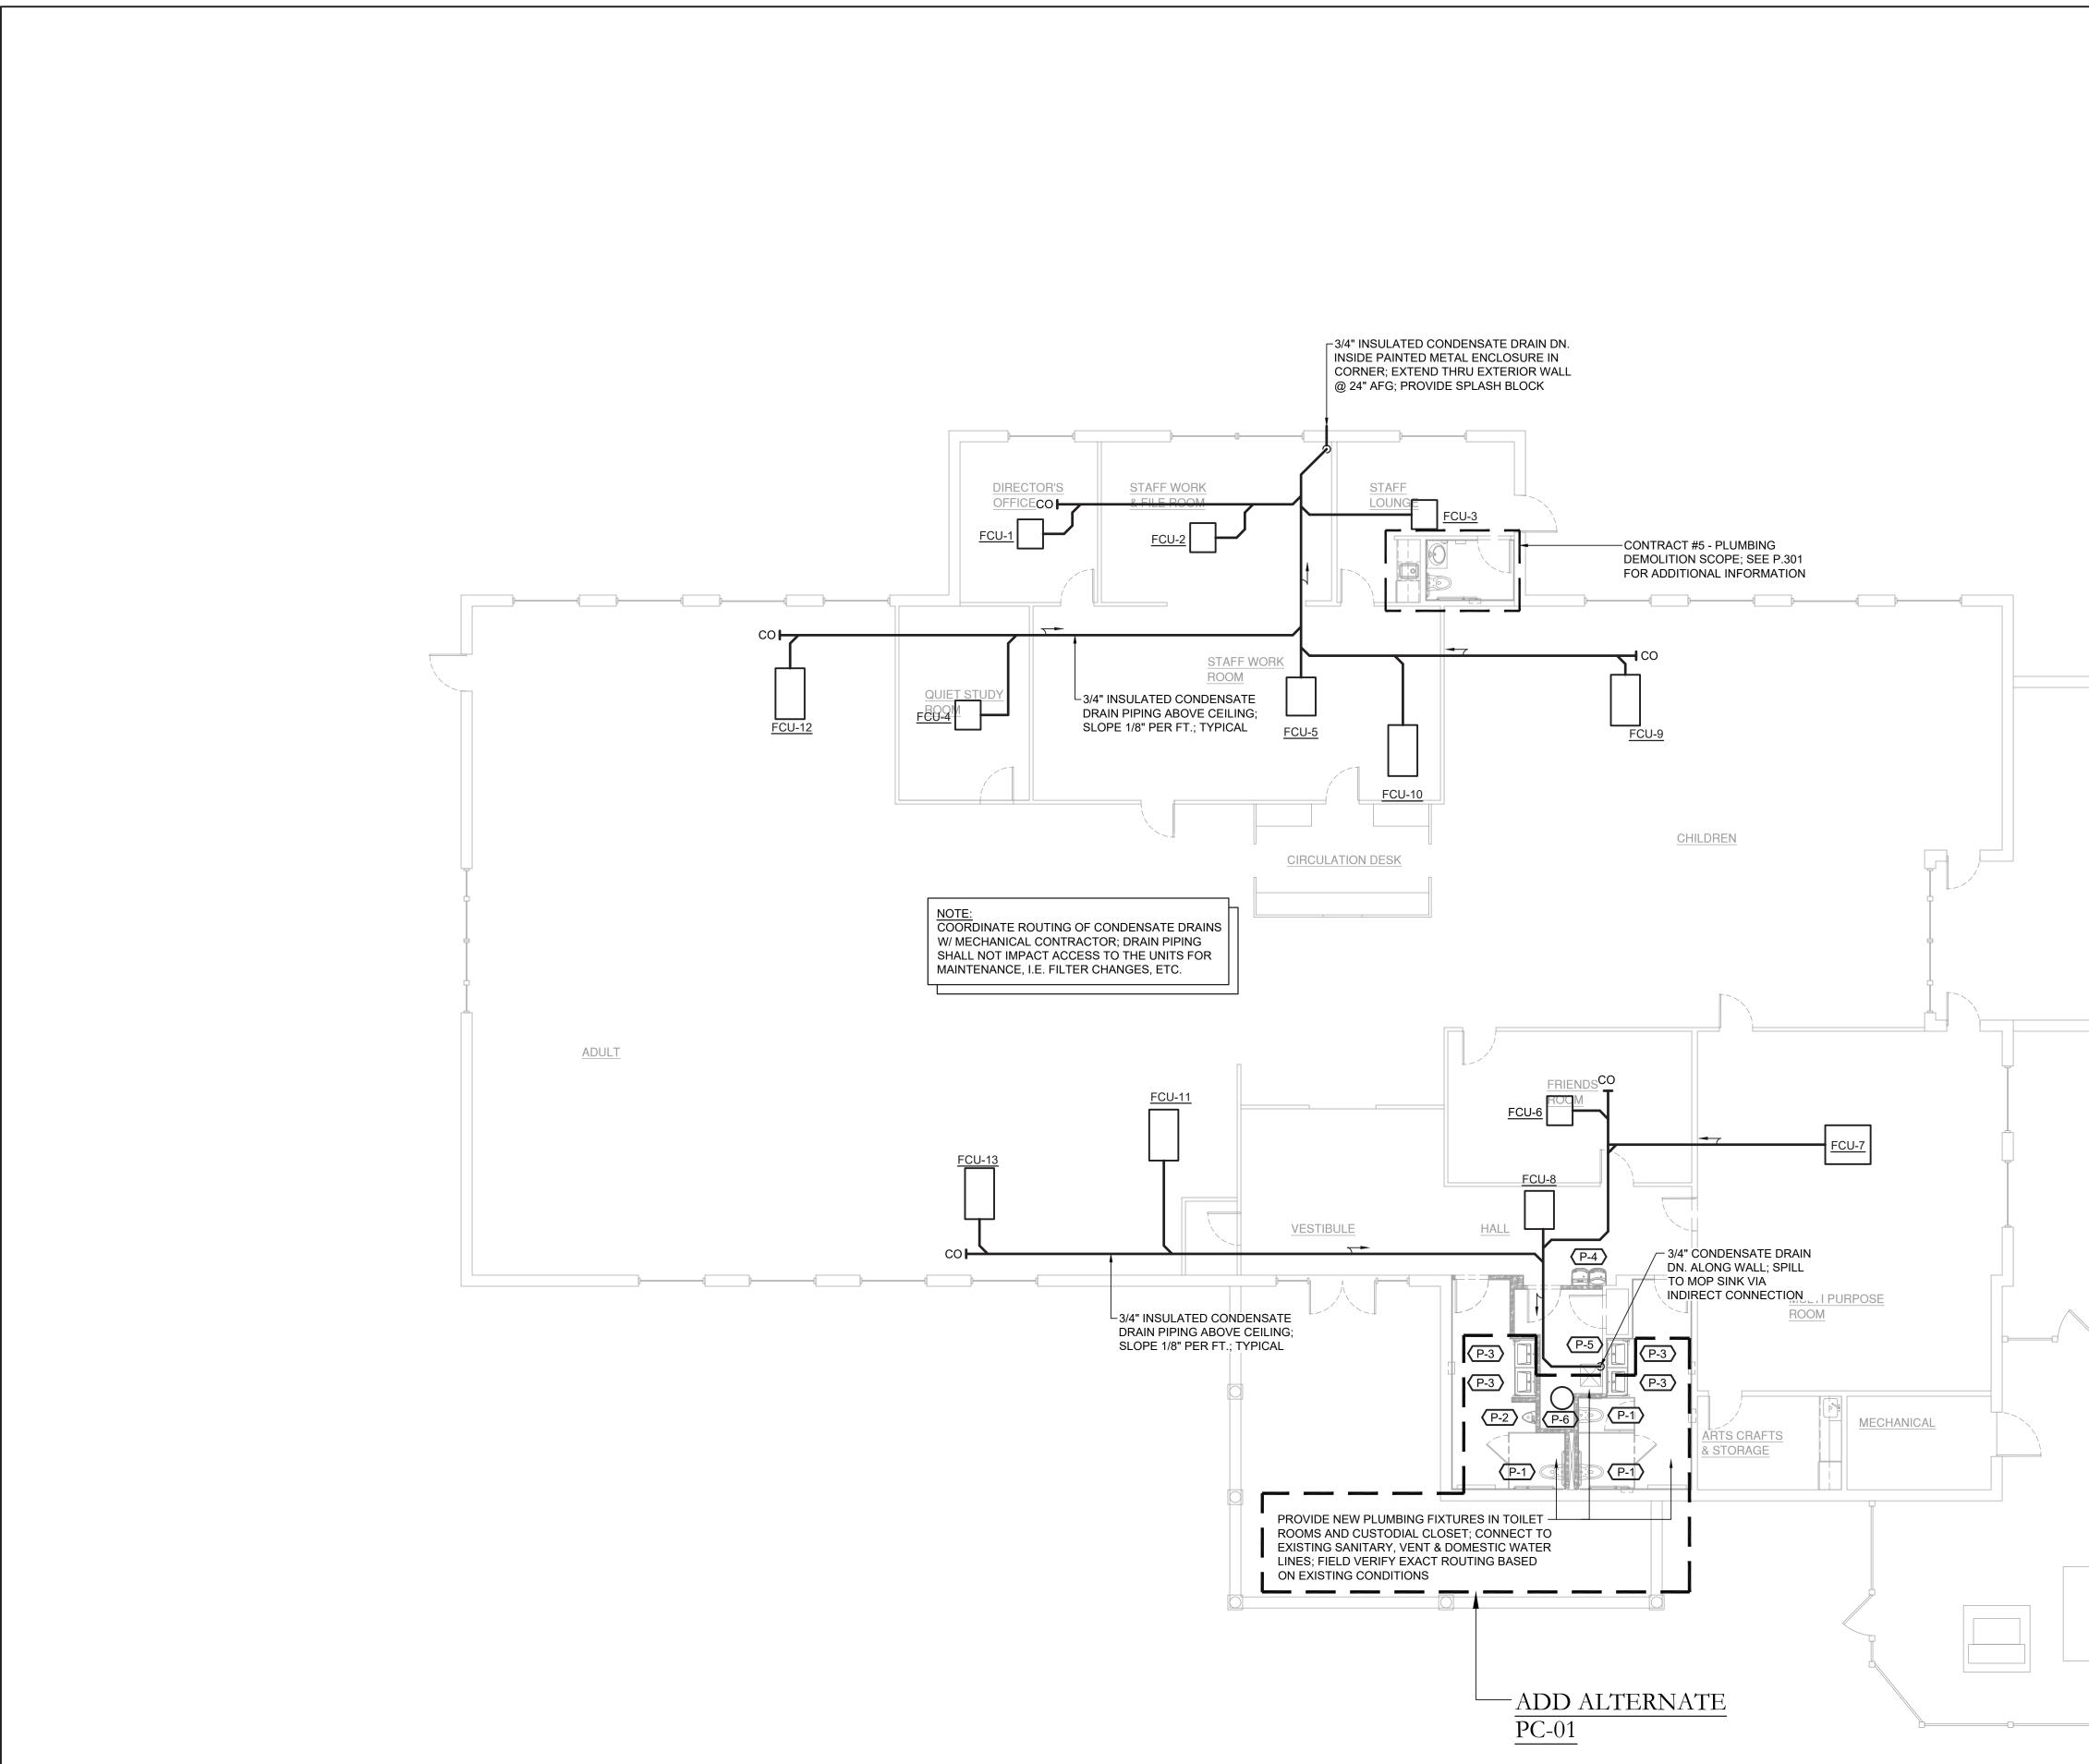


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KEY PLAN: CORNWALL PUBLIC
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HUDSON ST. TRUE NORTH
PROJECT: CORNWALL PUBLIC
LIBRARY HVAC SYSTEM
REPLACEMENT PROJECT
395 HUDSON STREET CORNWALL, NEW YORK 12518 SED #:44-03-01-06-6-009-006
SLD #.++-03-01-00-0-009-000
SUB-CONSULTANT:
ENGINEER:
BLAKE
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1898 COUNTY ROUTE 1 WESTTOWN, NEW YORK 10998
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ET ATE OF NEW LOB
FREE OB9039 PROFESSIONAL ENGLISHING
NOT VALID FOR CONSTRUCTION UNLESS SIGNED AND SEALED BY ENGINEER
MATTHEW G. BLAKE, P.E., LEED AP
NY - 89039 NJ - GE050037 PA - PE079303 MA - 53197 CT - 32283 FL - 85928
PLUMBING PLAN
DATE: DRN CHK DESCRIPTION 01.26.2023 BJK BJK CONSTRUCTION DWGS
REV. DATE: DRN CHK DESCRIPTION
PROJECT NO. SHEET NO.
2150 P.201
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Plumbing Demolition Plan P.301 Scale: 1/4" = 1'-0"





Plumbing Plan Scale: 1/4" = 1'-0"

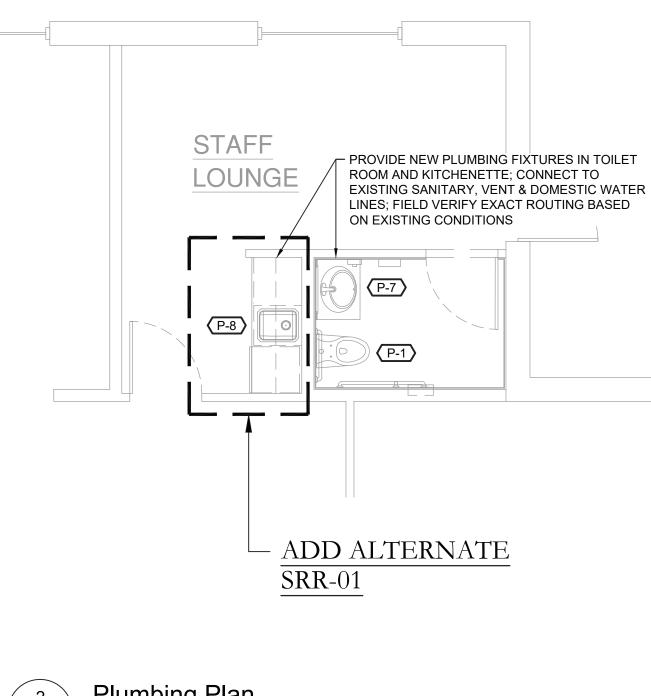KEY PLAN: Key Notes: 'CORNWALL PUBLIC EXISTING LAVATORY TO BE DISCONNECTED, REMOVED & (1)PROPERLY DISPOSED OF. DEMOLISH SANITARY, VENT & WATER LIBRARY' PIPING BACK TO MAINS AT FLOOR AND/OR WALL & CAP; MAINTAIN SERVICES FOR RECONNECTION TO NEW FIXTURE(S) HUDSON ST. EXISTING WATER CLOSET TO BE DISCONNECTED, REMOVED & TRUE NORTH 2 PROPERLY DISPOSED OF. DEMOLISH SANITARY, VENT & WATER ╺╼╼┯╧╧╧└╴╶╛┯╤┙ PIPING BACK TO MAINS AT FLOOR AND/OR WALL & CAP; MAINTAIN \bigcirc SERVICES FOR RECONNECTION TO NEW FIXTURE(S) PROJECT NORTH EXISTING KITCHENETTE SINK TO BE DISCONNECTED, REMOVED & PROPERLY DISPOSED OF. DEMOLISH SANITARY, VENT & WATER PIPING BACK TO MAINS AT FLOOR AND/OR WALL & CAP; MAINTAIN 3 SERVICES FOR RECONNECTION TO NEW FIXTURE(S) PROJECT: CORNWALL PUBLIC LIBRARY HVAC SYSTEM REPLACEMENT PROJECT 395 HUDSON STREET CORNWALL, NEW YORK 12518 SED #:44-03-01-06-6-009-006 SUB-CONSULTANT: ENGINEER: BLAKE ENGINEERING PLLC 1898 COUNTY ROUTE 1 WESTTOWN, NEW YORK 10998 TEL:845-467-9207 FAX:845-767-5050 MBLAKE@BLAKEENGINEERINGPLLC.COM NOT VALID FOR CONSTRUCTION UNLESS SIGNED AND SEALED BY ENGINEER MATTHEW G. BLAKE, P.E., LEED AP NY - 89039 NJ - GE050037 PA - PE079303 MA - 53197 CT - 32283 FL - 85928 STAFF RESTROOM & KITCHENETTE PLUMBING PLAN (CONTRACT #5) DRN CHK DESCRIPTION DATE: 01.26.2023 BJK BJK CONSTRUCTION DWGS DATE: DRN CHK DESCRIPTION PROJECT NO. SHEET NO. P.301 2150 UNAUTHORIZED ALTERATION OR ADDITION TO THIS PLAN IS A VIOLATION OF SECTION 7209, SUBDIVISION 2, OF THE NEW YORK STATE EDUCATION LAW. COPYRIGHT © 2022 BY BLAKE ENGINEERING PLLC