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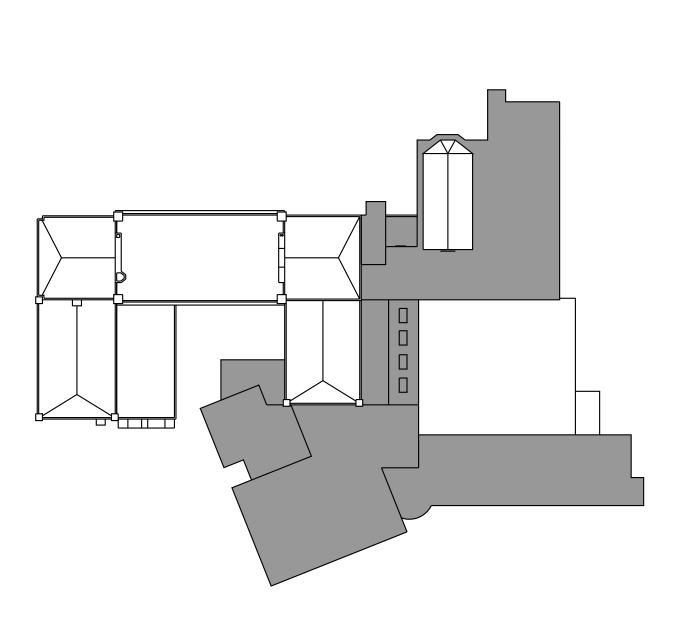
285 Main Street, Mount Kisco, NY 10549

APRIL 20, 2023 ISSUED FOR BID DESIGN TEAM


DISTRICT-WIDE ROOFING PROJECT

CROTON-HARMON UNION FREE SCHOOL DISTRICT


10 GERSTEIN STREET, CROTON-ON-HUDSON, NY 10520




Croton-Harmon High School 36 Old Post Road Croton-on-Hudson, NY

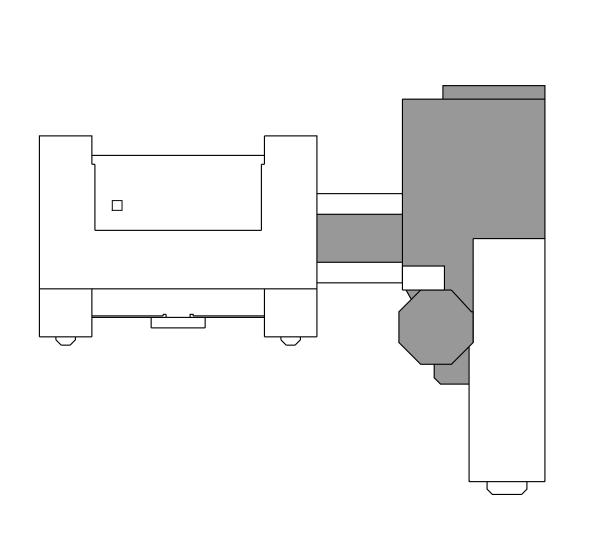


Pierre Van Cortlandt Middle School 3 Glen Place Croton-on-Hudson, NY

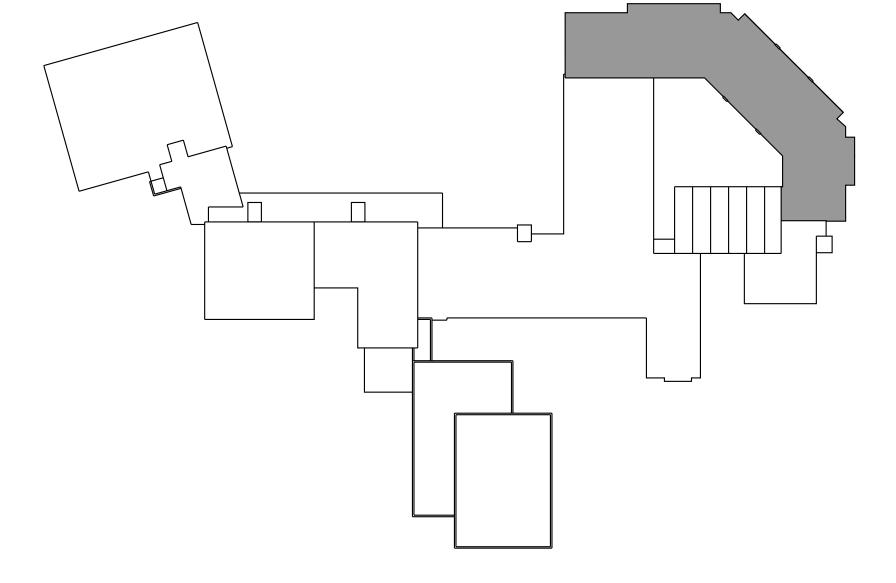

Carrie E. Tompkins Elementary School 8 Gerstein Street Croton-on-Hudson, NY

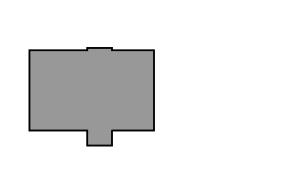

CHUFSD District Office 10 Gerstein Street Croton-on-Hudson, NY

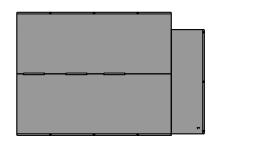

Bus Garage 427 Yorktown Road Croton-on-Hudson, NY

LIST OF DRAWINGS:

CROTON-HARMON HIGH SCHOOL

CROTON-HARMON HS ROOF WALKWAY PADS PLAN

ROOFING DETAILS 1-12

ROOFING DETAILS 25-36

ROOFING DETAILS 37-

HS LOG-1 HIGH SCHOOL ROOFING LOGISTICS

PIERRE VAN CORTLANDT MIDDLE SCHOOL

PVC MIDDLE SCHOOL ROOF PLAN

ROOFING DETAILS 1-12 ROOFING DETAILS 13-

SECTIONS & DETAILS

LEGEND, NOTES, SCHEDULE, DETAILS & PART. ROOF PLANS

ELECTRICAL LEGENDS, NOTES, AND ABBREVIATIONS

ROOF ELECTRICAL REMOVALS AND NEW POWER PLAN

PIERRE VAN CORTLANDT MS ROOFING LOGISTICS

CET ELEMENTARY SCHOOL ROOF PLAN

ROOFING DETAILS 1-13

CARRIE E. TOMPKINS ELEMENTARY SCHOOL

CARRIE E. TOMPKINS ES ROOFING LOGISTICS

DISTRICT OFFICE

DISTRICT OFFICE ROOF PLAN


AD-2 ROOFING DETAILS 1-

BUS GARAGE

BS-1 BUS GARAGE ROOF PLAN

NYSED No.

66-02-02-03-0-001-032 CH HIGH SCHOOL 66-02-02-03-0-002-029 PVC MIDDLE SCHOOL 66-02-02-03-0-003-033 CET ELEMENTARY 66-02-02-03-1-010-007 DISTRICT OFFICE 66-02-02-03-5-004-008 BUS GARAGE

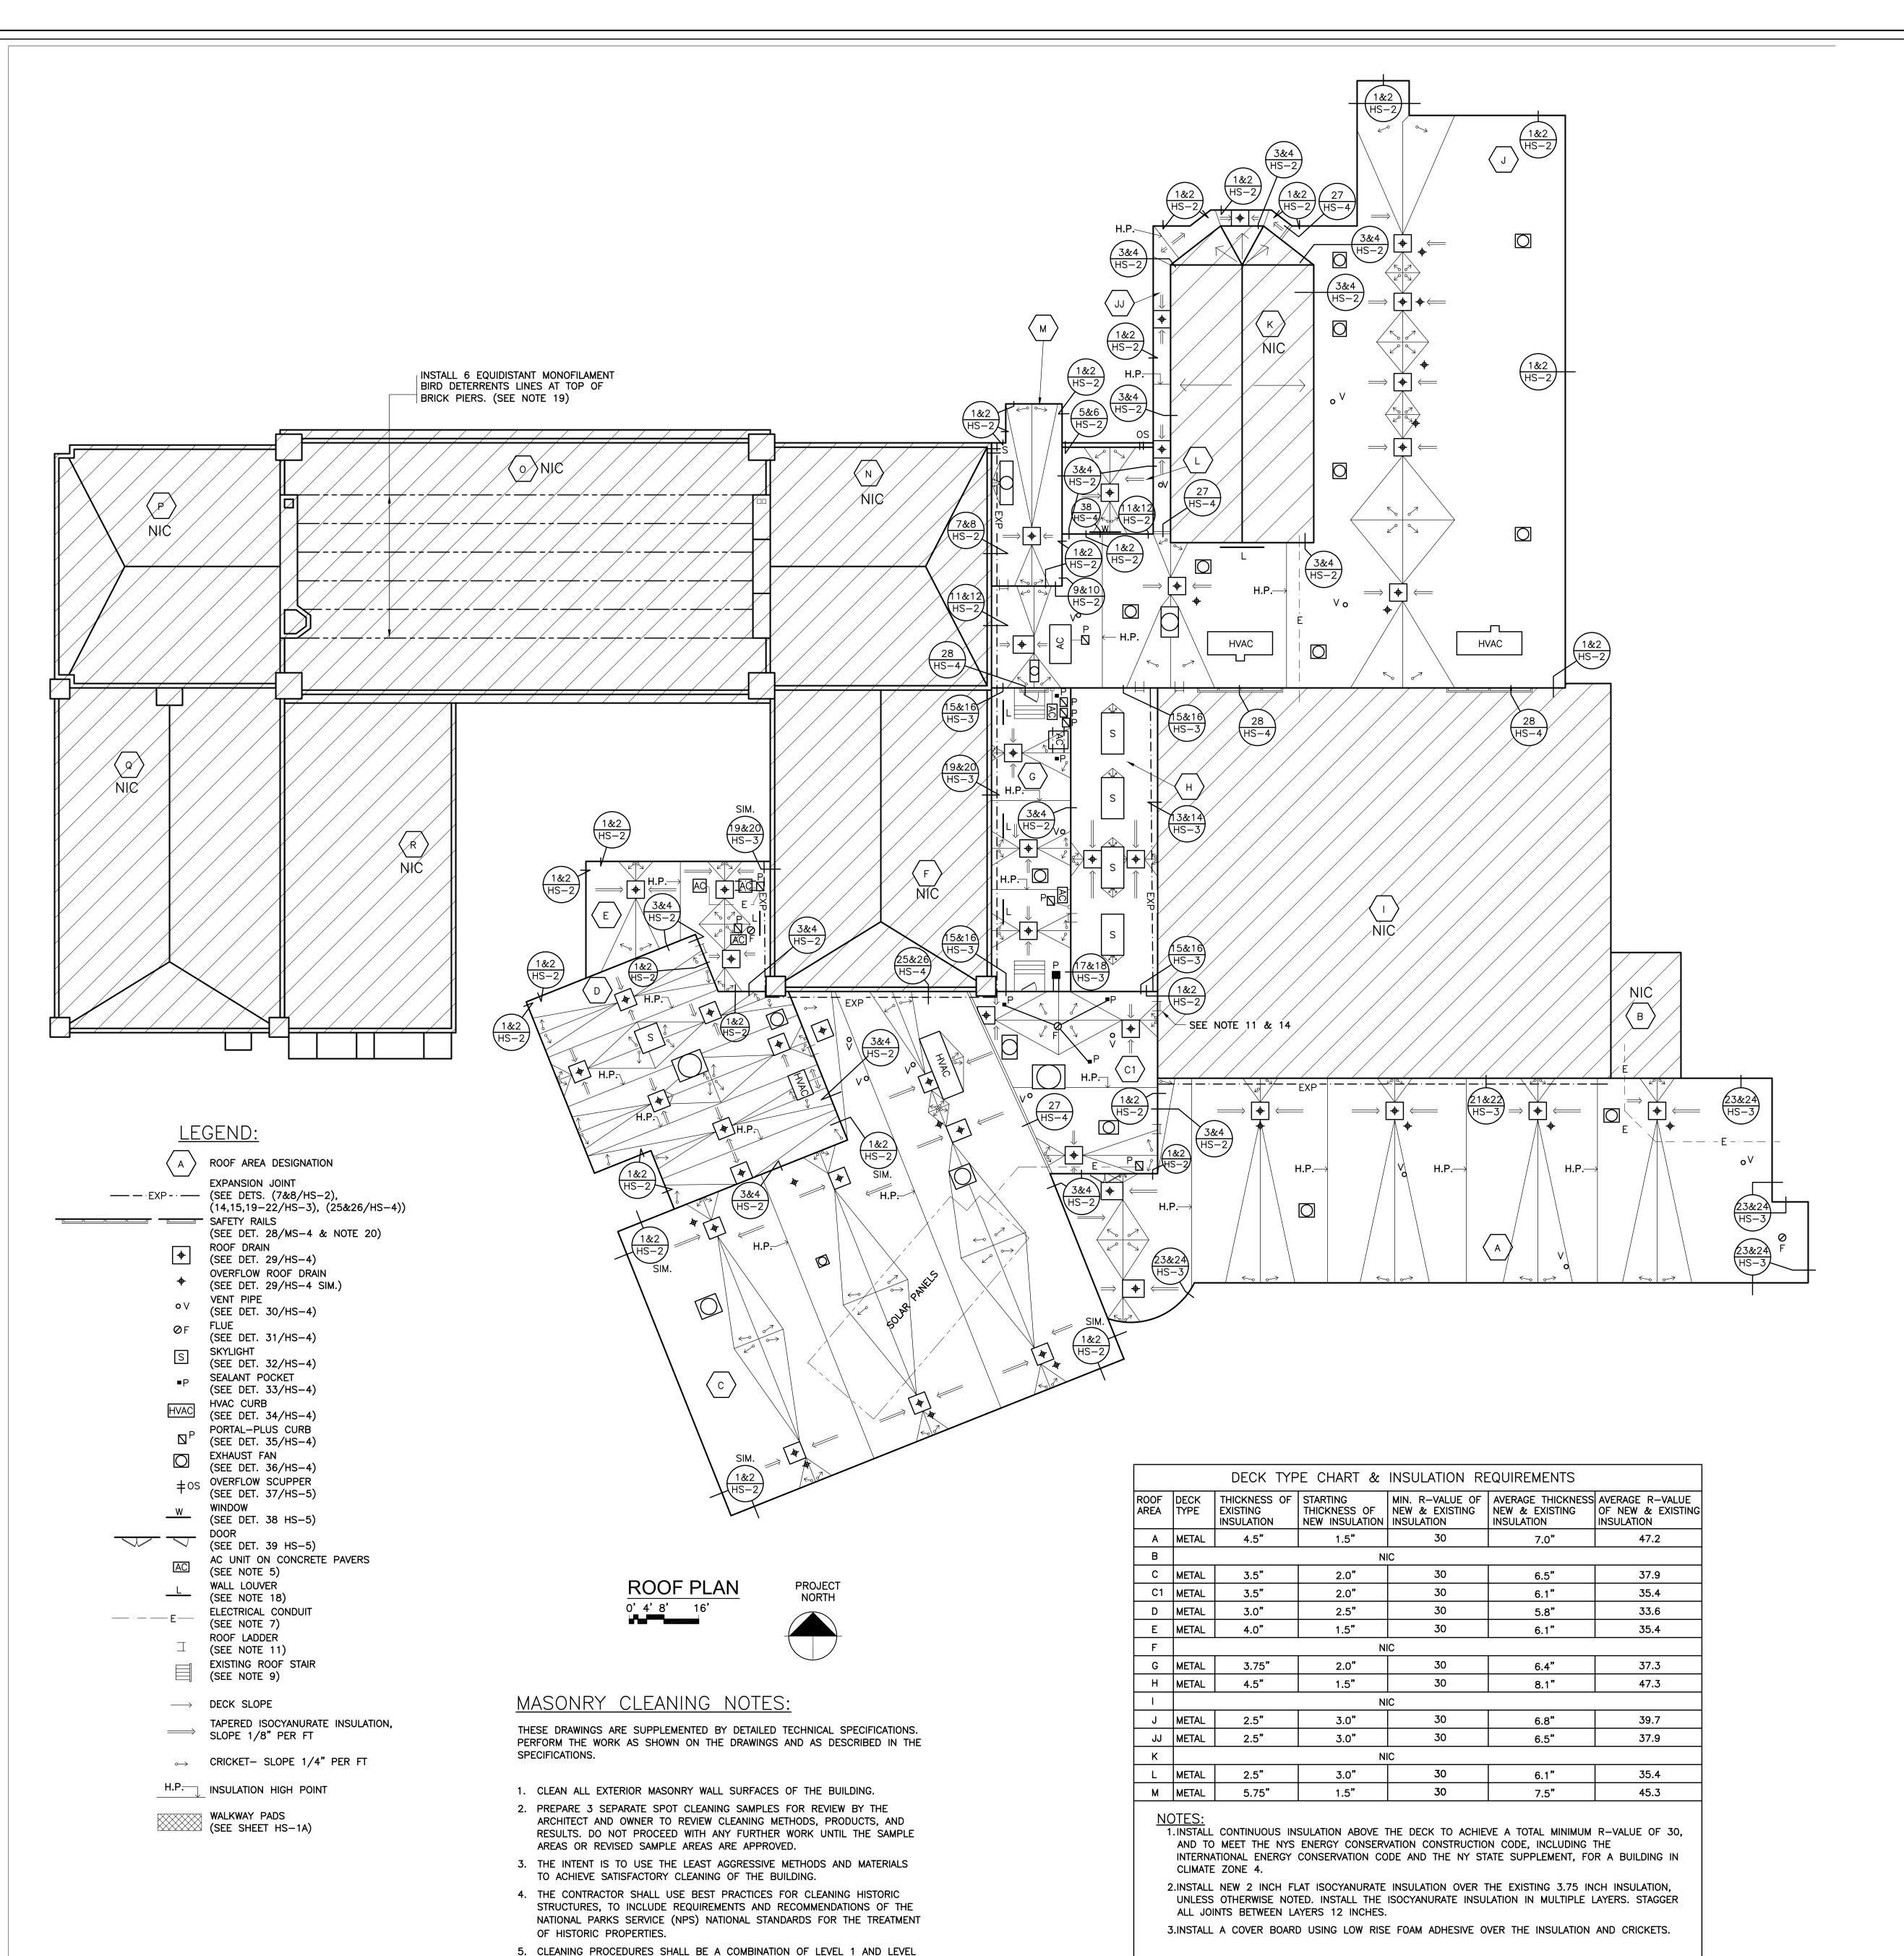

2 PROCEDURES AND PRODUCTS, DEPENDING ON THE SOIL LEVEL.

6. PRIOR TO COMMENCING CLEANING PROCEDURES, ENSURE BUILDING

COMPONENTS TO INCLUDE LANDSCAPING.

OPENINGS ARE CLOSED, PROTECT AIR INLETS, AND PROTECT ADJACENT

GENERAL NOTES:

ADDITIONAL FASTENER REQUIREMENTS.

THESE DRAWINGS ARE SUPPLEMENTED BY DETAILED TECHNICAL SPECIFICATIONS. PERFORM THE WORK AS SHOWN ON THE DRAWINGS AND AS DESCRIBED IN THE SPECIFICATIONS.

1. DIMENSIONS AND CONDITIONS ON THE ROOF PLAN AND DETAILS ARE APPROXIMATE AND SHALL BE CONFIRMED BY THE CONTRACTOR.

2. ONLY CERTAIN FASTENERS ARE SHOWN ON THE DRAWINGS, REFER TO THE SPECIFICATIONS FOR

3. TEST EACH DRAIN LINE WITH A RUNNING HOSE FOR AT LEAST ONE HOUR PRIOR TO STARTING ANY OTHER WORK ON SITE. PROVIDE A WRITTEN REPORT OF ANY CLOGGED LINES TO THE OWNER.

A.CLOGGED DRAIN LINES REPORTED TO THE OWNER BEFORE WORK STARTS WILL BE CLEANED BY THE

B.COVER & PROTECT ALL DRAIN OPENINGS AT THE BEGINNING OF EACH WORK DAY. REMOVE THE COVERS AT THE END OF EACH DAY AND BEFORE PRECIPITATION OCCURS.

C.PERFORM WHATEVER WORK IS REQUIRED SO ALL DRAIN LINES ARE CLEAN AND FREE FLOWING UPON COMPLETION OF THE PROJECT.

5. REMOVE AND RESET EXISTING SMALL AC CONDENSERS ON 2 X 2 FOOT X 2 INCH THICK CONCRETE PAVERS SET ON WALKWAY PADS. FASTEN THE CONDENSERS TO THE PAVERS WITH STAINLESS STEEL NAIL-INS. DISCONNECT, ADJUST, MODIFY, AND RECONNECT THE EXISTING SUPPLY & RETURN LINES AND

6. REMOVE AND RESET SITE LIGHT FIXTURES, WIRES AND CONDUITS THAT INTERFERE WITH THE WORK. REPLACE COMPONENTS THAT CANNOT BE PROPERLY REINSTALLED.

7. REMOVE EXISTING ROOF TOP ELECTRICAL CONDUIT AND GAS PIPE SUPPORTS. RE-SET THE CONDUIT AND PIPES ON ADJUSTABLE HEIGHT FACTORY MANUFACTURED PIPE SUPPORTS PLACED ON WALKWAY PADS SPACED 5 FEET ON CENTER. SECURE THE CONDUITS AND PIPES TO THE PIPE SUPPORTS WITH GALVANIZED CLIPS & BOLTS.

8. WIRE BRUSH, PRIME & PAINT ROOF TOP EQUIPMENT HOUSINGS, EXTERIOR & INTERIOR ACCESS LADDERS, EXTERIOR STAIRS, BULKHEAD DOORS & DOOR FRAMES (BOTH SIDES), GAS LINES, AND THE VENT PIPES. DO NOT PAINT OVER EQUIPMENT NAME PLATES AND LABELS.

9. REMOVE AND RESET THE EXISTING STEEL STAIRS; MODIFY THEM TO FIT ON TOP OF THE NEW ROOF ASSEMBLY WHICH HAS ADDITIONAL INSULATION.

10. REPAIR EXHAUST EQUIPMENT HOUSINGS SO THEY ARE WATERTIGHT; REPLACE ANY MISSING PIECES.

11. REMOVE, MODIFY AND REMOUNT THE EXISTING LADDERS - REWORK THEM SO THEY ARE OSHA COMPLIANT, AND SO THE TOP RUNG ALIGNS WITH THE UPPER ROOF SURFACE. SCRAPE, PRIME AND PAINT THE LADDERS. FILL OLD FASTENER HOLES WITH COLOR MATCHING MORTAR.

12. RE-CAULK VERTICAL MASONRY CONTROL AND EXPANSION JOINTS IN THE CHANGE IN ELEVATION WALLS ABOVE LOWER-LEVEL ROOFS BEING REPLACED. REMOVE EXISTING SEALANT AND BACK UP MATERIALS, AND INSTALL NEW BACKER ROD AND SEALANT.

13. RE-CAULK JOINTS BETWEEN THE WALL LOUVERS AND MASONRY FACADE. REMOVE EXISTING SEALANT AND BACK UP MATERIALS, AND INSTALL NEW BACKER ROD AND SEALANT

14. REBUILD A SECTION OF DETERIORATED BRICK MASONRY ADJOINING THIS LADDER.

15. INSULATE EXISTING DRAIN LINES WHERE EXPOSED INSIDE THE BUILDING, ALL NEW DRAIN LINES, AND THE UNDERSIDES OF THE NEW DRAIN BOWLS.

16. POWER WASH AND CLEAN DECORATIVE CAST STONE ROOF COMPONENTS AT THE EAVES OF ROOF AREAS A, C, D AND E, THEN INSTALL CLEAR WATER REPELLENT.

17. INSTALL WALKWAY PADS WHERE INDICATED ON SHEET HS-1A WALKWAY PAD ROOF PLAN , AT ALL ROOF ACCESS POINTS. AND AROUND ALL HVAC UNITS.

18. REMOVE AND RESET UNIT HEATER GRILLS AND LOUVERS IN THE CHANGE IN ELEVATION WALLS, INSTALL THE NEW CAP FLASHINGS TO EXTEND UNDER THE GRILL AND LOUVER SILLS.

19. INSTALL BLACK 8 GA MONOFILAMENT BIRD DETERRENT LINES, BETWEEN THE MASONRY PIERS ON ROOF AREA O - SPACED ABOUT 5 FEET APART. SECURE THE ENDS OF THE LINES USING 3/8 INCH DIAMETER EPOXY SET EYE BOLTS, THIMBLES AND CRIMPS - WITH MONOFILAMENT TENSIONERS AT ONE END OF EACH LINE.

20. INSTALL PIPE GUARD SAFETY RAILS AT THE EAVES OF ROOF AREA J, WHERE SHOWN ON THE ROOF PLAN AND WHERE HVAC EQUIPMENT IS LOCATED LESS THAN 10 FEET FROM THE ROOF EAVES.

21. REMOVE AND DISPOSE OF THE EXISTING BALLASTED SOLAR PANEL SYSTEM ON ROOF 'C'. REMOVAL SHALL INCLUDE: SOLAR PANELS, CHASSIS SUPPORTS, BALLASTS, WIRING, CONDUIT, WIRING RACEWAYS, ETC. THE CONTRACTOR SHALL ENGAGE A LICENSED ELECTRICIAN TO SAFELY DISCONNECT THE PANELS AND REMOVE THE ELECTRICAL WIRING AND CONDUIT BACK TO THE ELECTRICAL INVERTER BELOW ROOF

CODE COMPLIANCE REQUIREMENTS:

1. INSTALL NEW ROOFING TO MEET THE FOLLOWING MINIMUM REQUIREMENTS: A. NEW YORK STATE UNIFORM FIRE PREVENTION AND BUILDING CODE. INCLUDES BY REFERENCE THE NEW YORK STATE ENERGY CONSERVATION

B. UNDERWRITERS LABORATORIES INC. CLASS A EXTERNAL FIRE RATING ROOF ASSEMBLIES TESTED IN ACCORDANCE WITH ASTM E 108 OR UL 790.

C. UNDERWRITERS LABORATORIES INC. STANDARD 1256 FOR ROOF ASSEMBLIES WITH FOAM INSULATION.

2. INSTALL ROOFING TO COMPLY WITH THE WIND UPLIFT REQUIREMENTS OF THE NY STATE UNIFORM FIRE PREVENTION AND BUILDING CODE, BASED ON THIS CRITERIA: RISK CATEGORY III

BASIC WIND SPEED 130 MPH EXPOSURE CATEGORY BUILDING HEIGHT 30 FT.

3. INSTALL ROOFING AS INDICATED TO RESIST THE FOLLOWING UPLIFT LOADS, CALCULATED IN ACCORDANCE WITH ASCE 7 USING A SAFETY FACTOR OF 2: FIELD ZONE: 90 PSF PERIMETER ZONE: 135 PSF CORNER ZONE: 150 PSF

4. FABRICATE AND INSTALL ROOF PERIMETER FLASHINGS THAT COMPLY WITH THE NY STATE UNIFORM FIRE PREVENTION AND BUILDING CODE AND WITH ANSI/SPRI ES-1 "WIND STANDARD FOR EDGE SYSTEMS USED WITH LOW SLOPE ROOFING SYSTEMS", ON A BUILDING USING THE CRITERIA DESCRIBED ABOVE.

5. FABRICATE AND INSTALL WOOD BLOCKING COMPONENTS TO RESIST A FORCE OF 275 POUNDS PER LINEAL FOOT APPLIED IN ANY DIRECTION.

ROOF PROTECTION NOTES:

1. AVOID WALKING ON NEW AND EXISTING ROOF AREAS.

2. DO NOT STORE MATERIAL OR EQUIPMENT, AND DO NOT PILE DEBRIS ON NEW AND EXISTING ROOF AREAS.

3. INSTALL 1 INCH THICK EXTRUDED POLYSTYRENE INSULATION OVER 6 MIL FIRE RETARDANT POLYETHYLENE, COVERED WITH 2x10 WOOD PLANKS TO PROTECT ROOFING WHERE CONSTRUCTION WORK AND TRAFFIC WILL OCCUR.

4. NEATLY CUT AND POSITION ROOF PROTECTION COMPONENTS TO FIT WITHIN 1/2 INCH OF ROOF PENETRATIONS, EAVES AND CHANGE IN ELEVATION WALLS.

5. DO NOT COVER THE ROOF DRAINS. MAINTAIN THE ROOF DRAIN STRAINERS VISIBLE AND CLEAR AT ALL TIMES.

2022 CAPITAL PROJECTS

DISTRICT WIDE **ROOFING PROJECT**

CROTON-HARMON UNION FREE SCHOOL DISTRICT 10 GERSTEIN STREET CROTON-ON-HUDSON, NEW YORK



P:914.666.5900 KGDARCHITECTS.COM

NY SED PROJECT CONTROL NO.

HIGH SCHOOL 66-02-02-03-0-001-032 MIDDLE SCHOOL 66-02-02-03-0-002-029 ELEMENTARY SCHOOL 66-02-02-03-0-003-033 NEW BUSINESS OFFICE 66-02-02-03-1-010-007 **BUS GARAGE** 66-02-02-03-5-004-008

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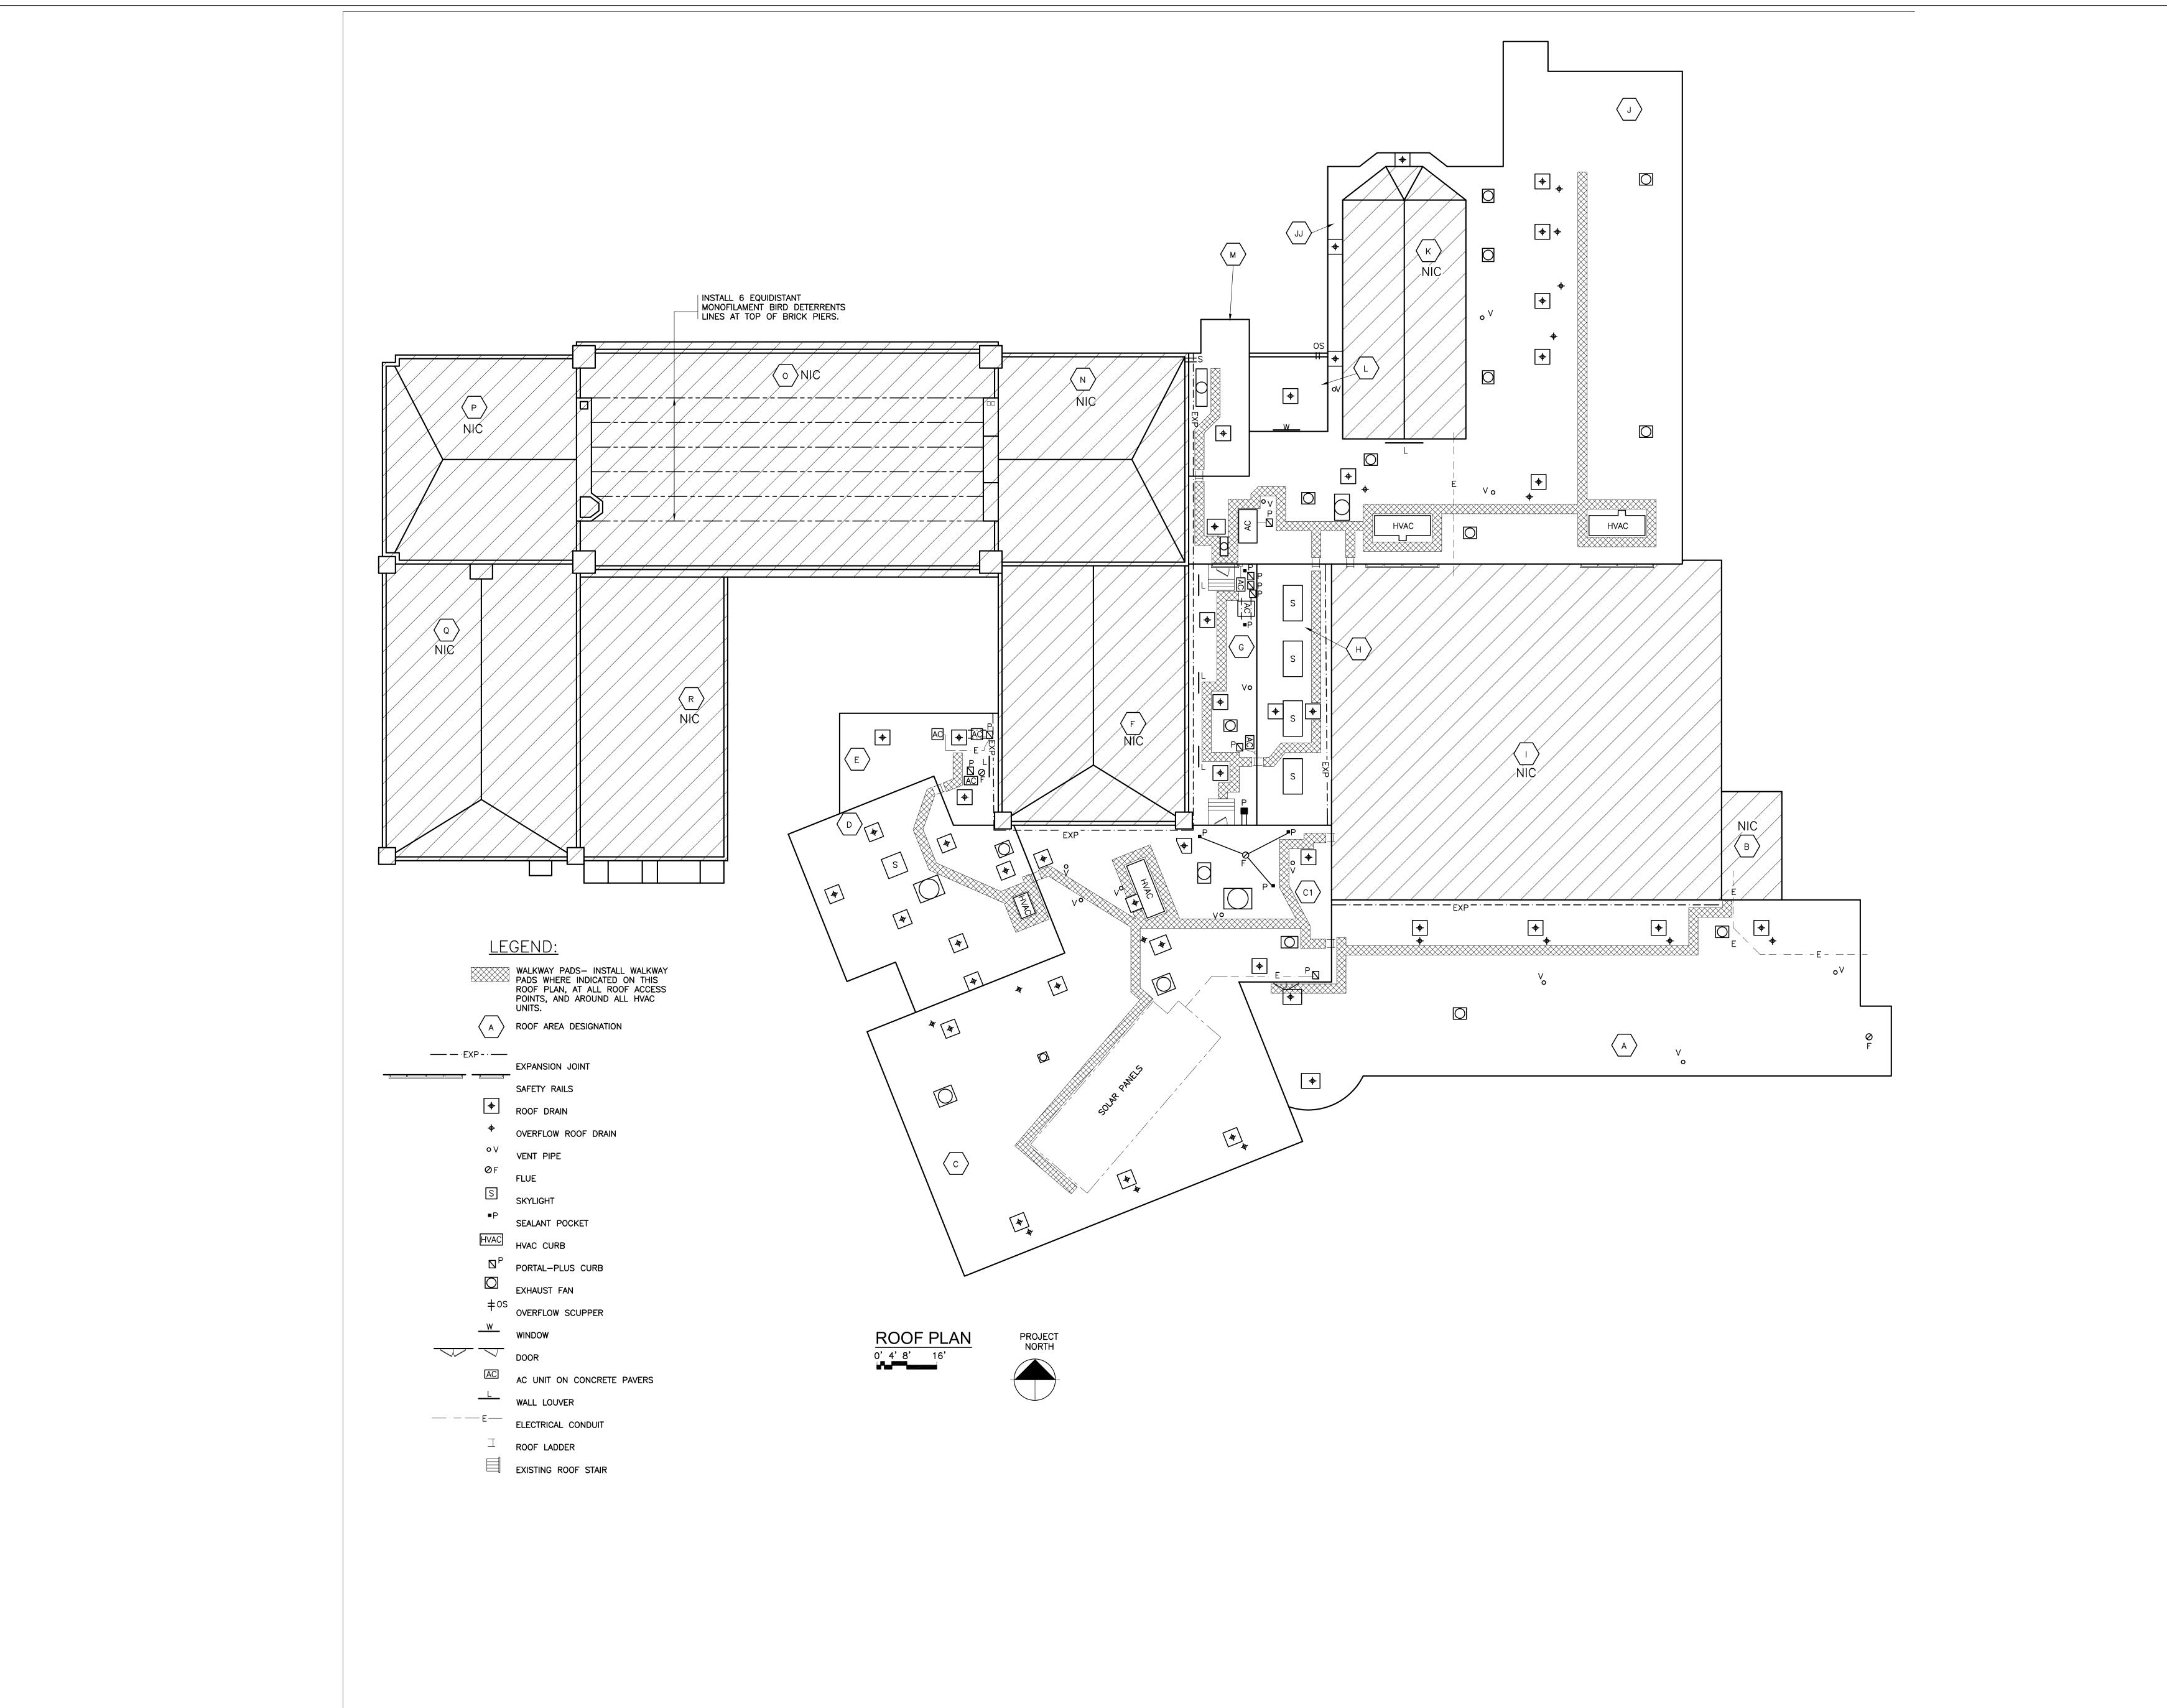
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2 4/20/2023 ISSUED FOR BID 1 3/17/2023 CONSTRUCTION DOCUMENTS Sheet Title

HIGH SCHOOL **ROOF PLAN**

Job No. 03/17/2023 2023-1002 Drawn / Checked

AS NOTED



DISTRICT WIDE ROOFING PROJECT

CROTON-HARMON UNION FREE SCHOOL DISTRICT 10 GERSTEIN STREET CROTON-ON-HUDSON, NEW YORK



285 MAIN STREET MOUNT KISCO . NEW YORK . 10549
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NY SED PROJECT CONTROL NO.

HIGH SCHOOL 66-02-02-03-0-00

HIGH SCHOOL 66-02-02-03-0-001-032
MIDDLE SCHOOL 66-02-02-03-0-002-029
ELEMENTARY SCHOOL 66-02-02-03-0-003-033
NEW BUSINESS OFFICE 66-02-02-03-1-010-007
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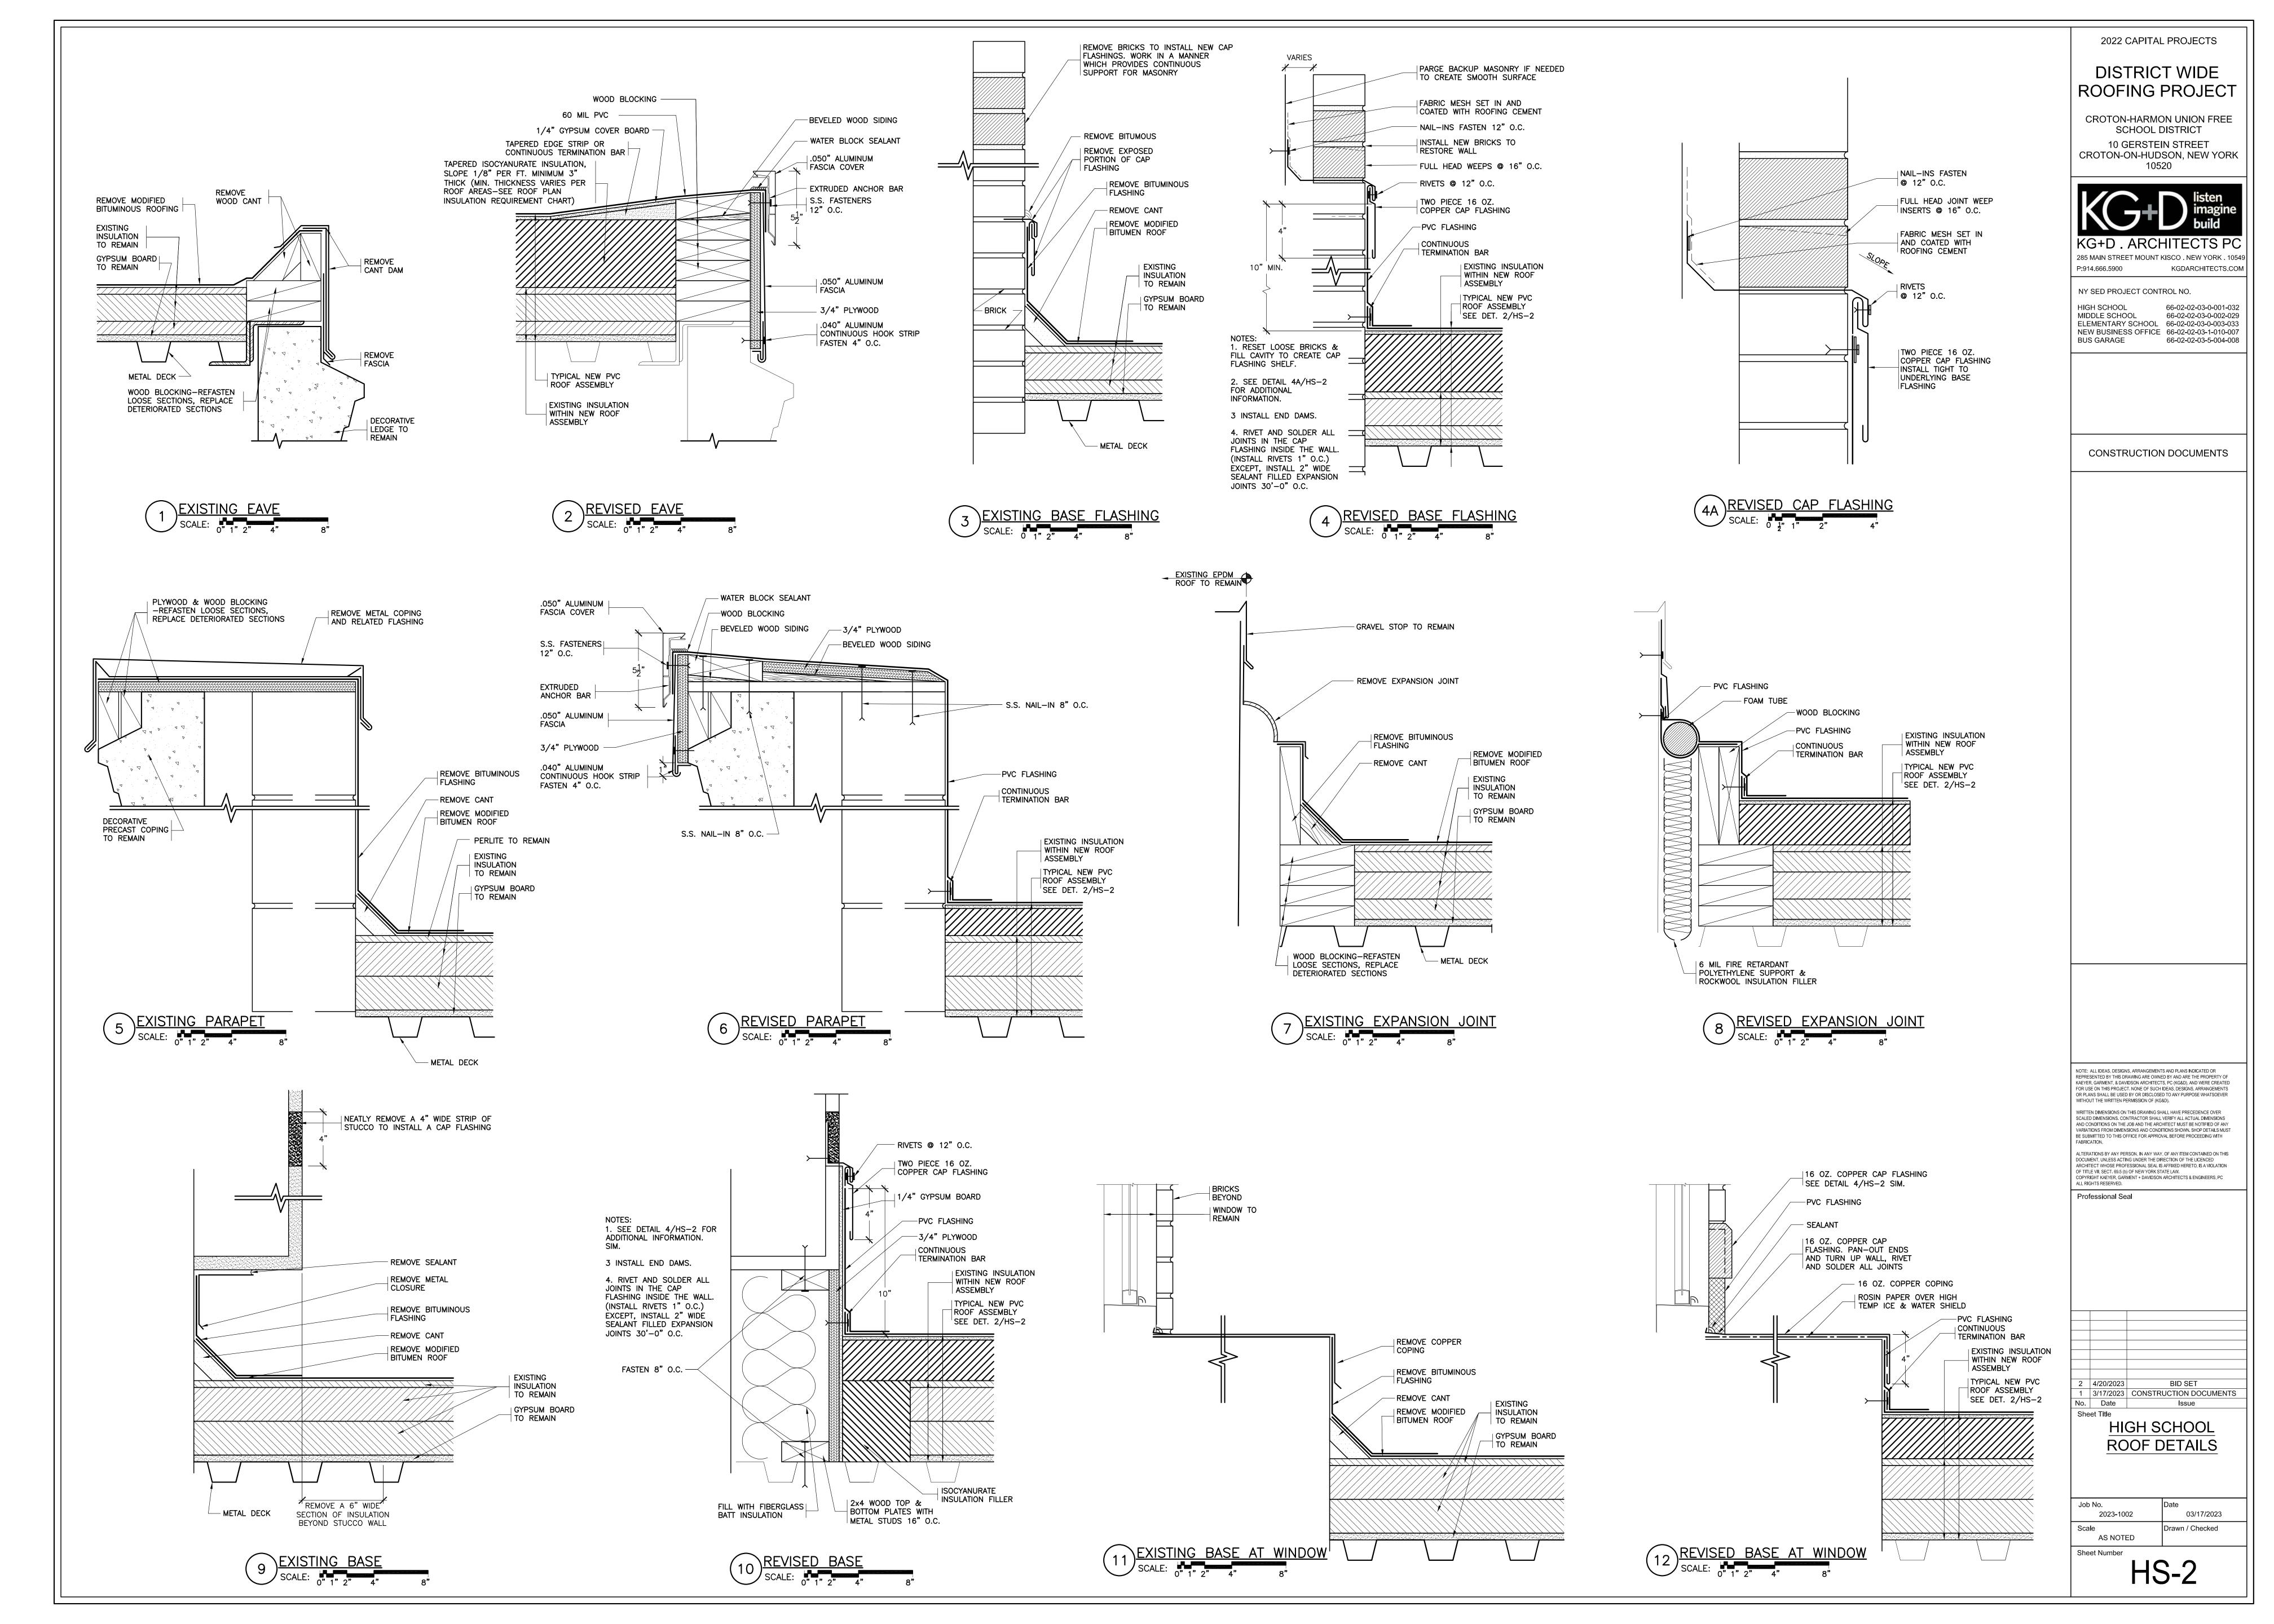
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1 3/17/2023 CONSTRUCTION DOCUMENTS
No. Date Issue
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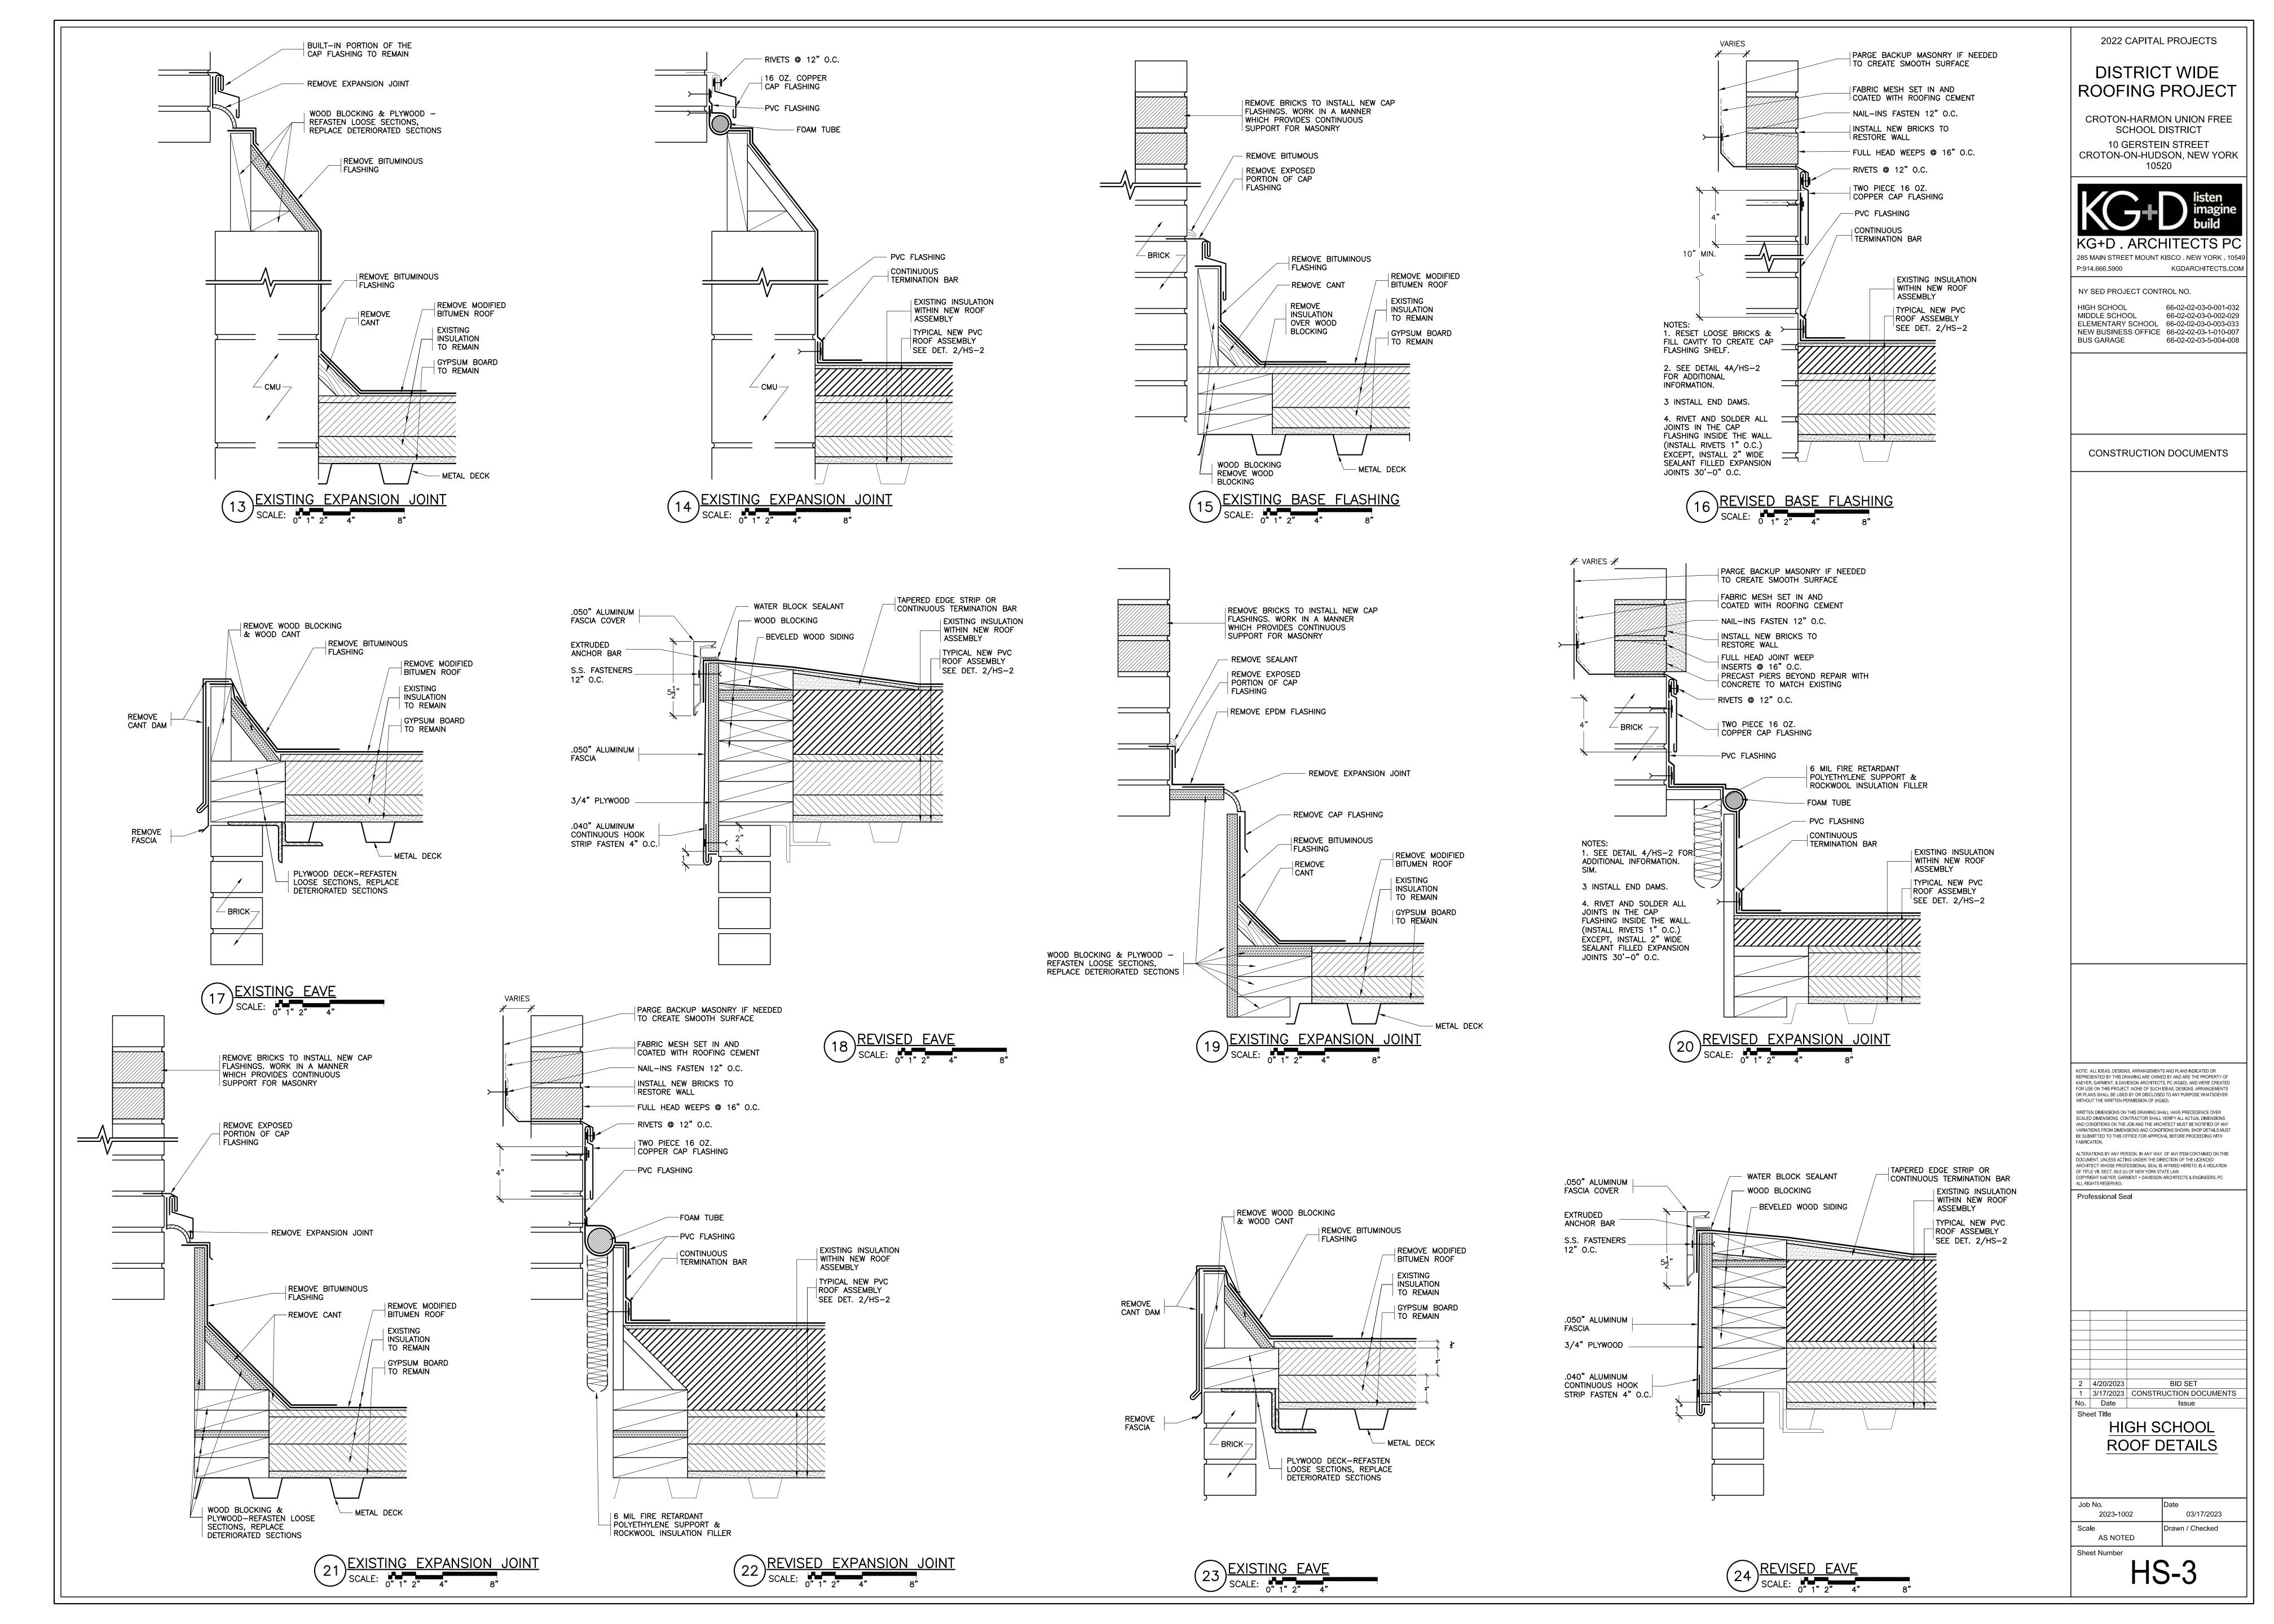
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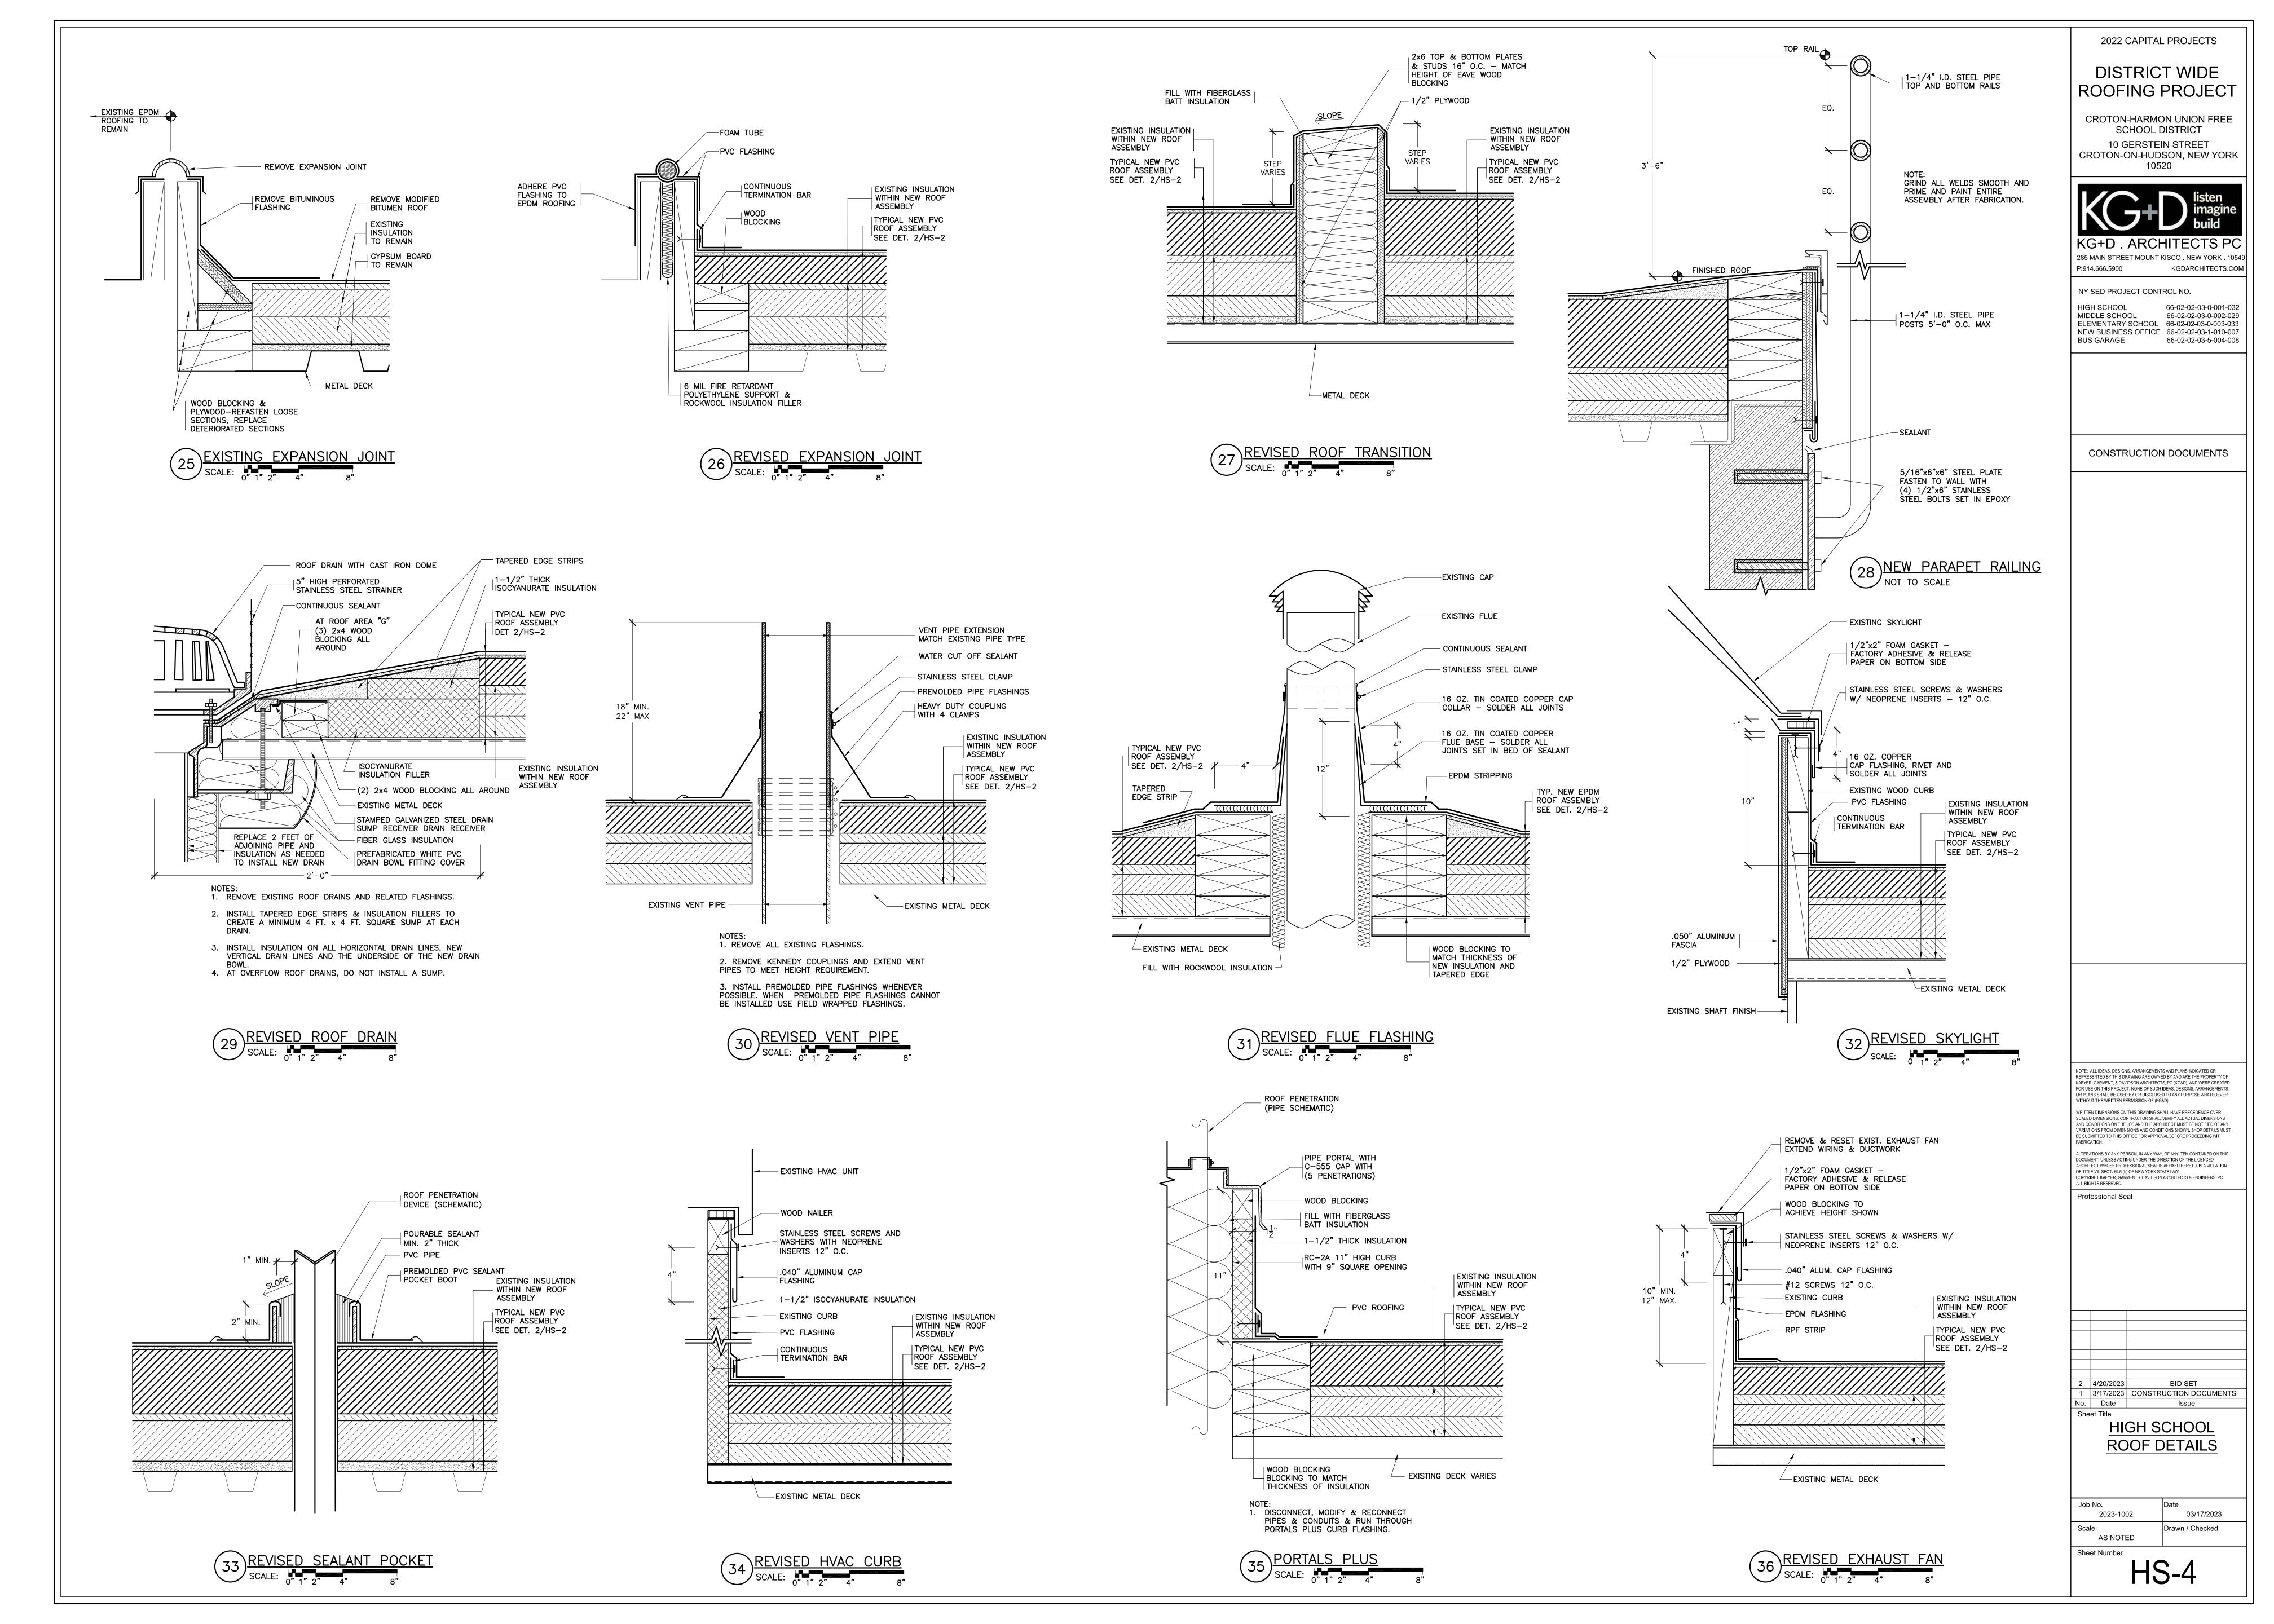
Job No. Date 03/17/2023


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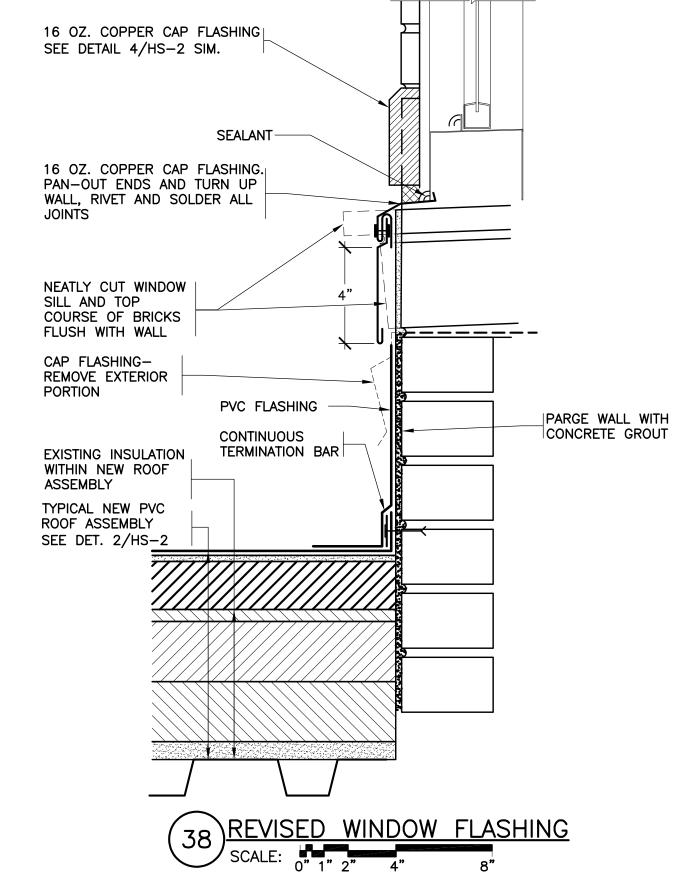
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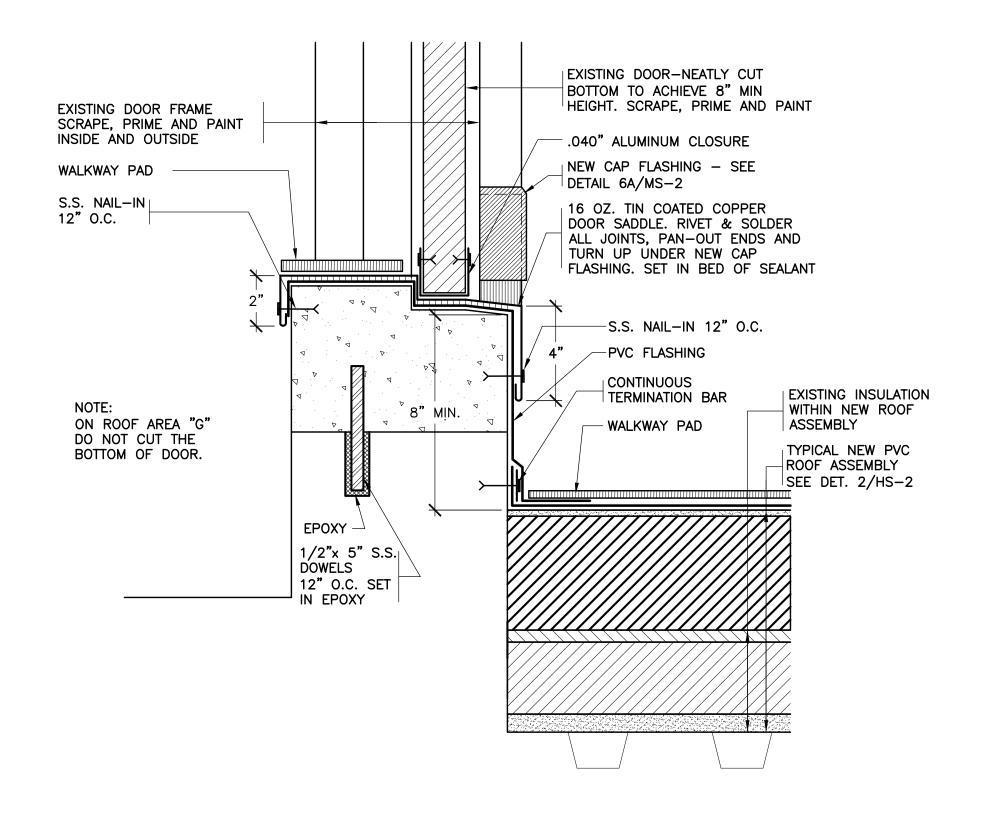










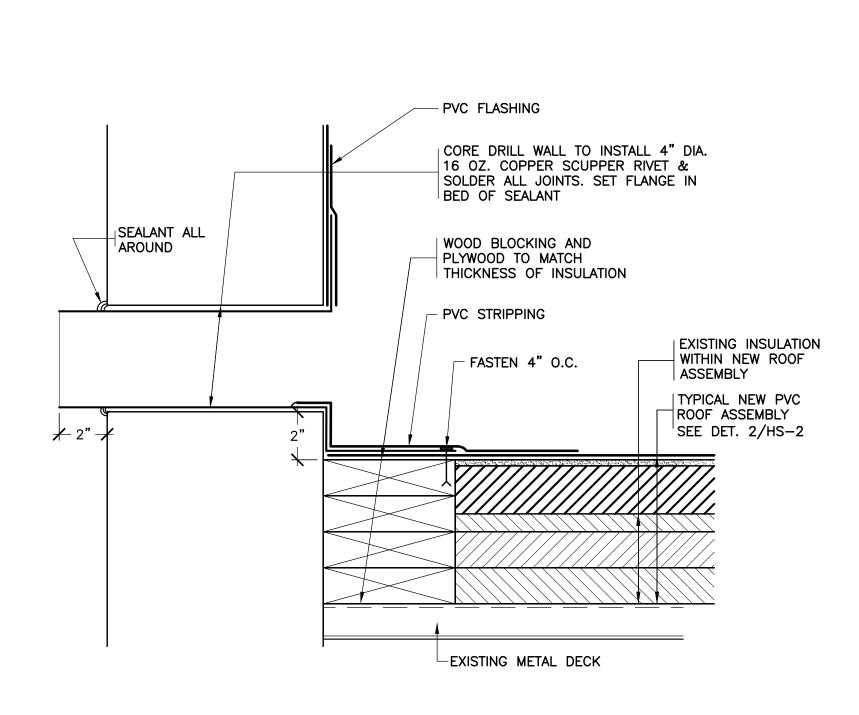

DISTRICT WIDE **ROOFING PROJECT**

CROTON-HARMON UNION FREE SCHOOL DISTRICT 10 GERSTEIN STREET CROTON-ON-HUDSON, NEW YORK



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66-02-02-03-0-001-032 66-02-02-03-0-002-029 HIGH SCHOOL MIDDLE SCHOOL ELEMENTARY SCHOOL 66-02-02-03-0-003-033 NEW BUSINESS OFFICE 66-02-02-03-1-010-007 BUS GARAGE 66-02-02-03-5-004-008

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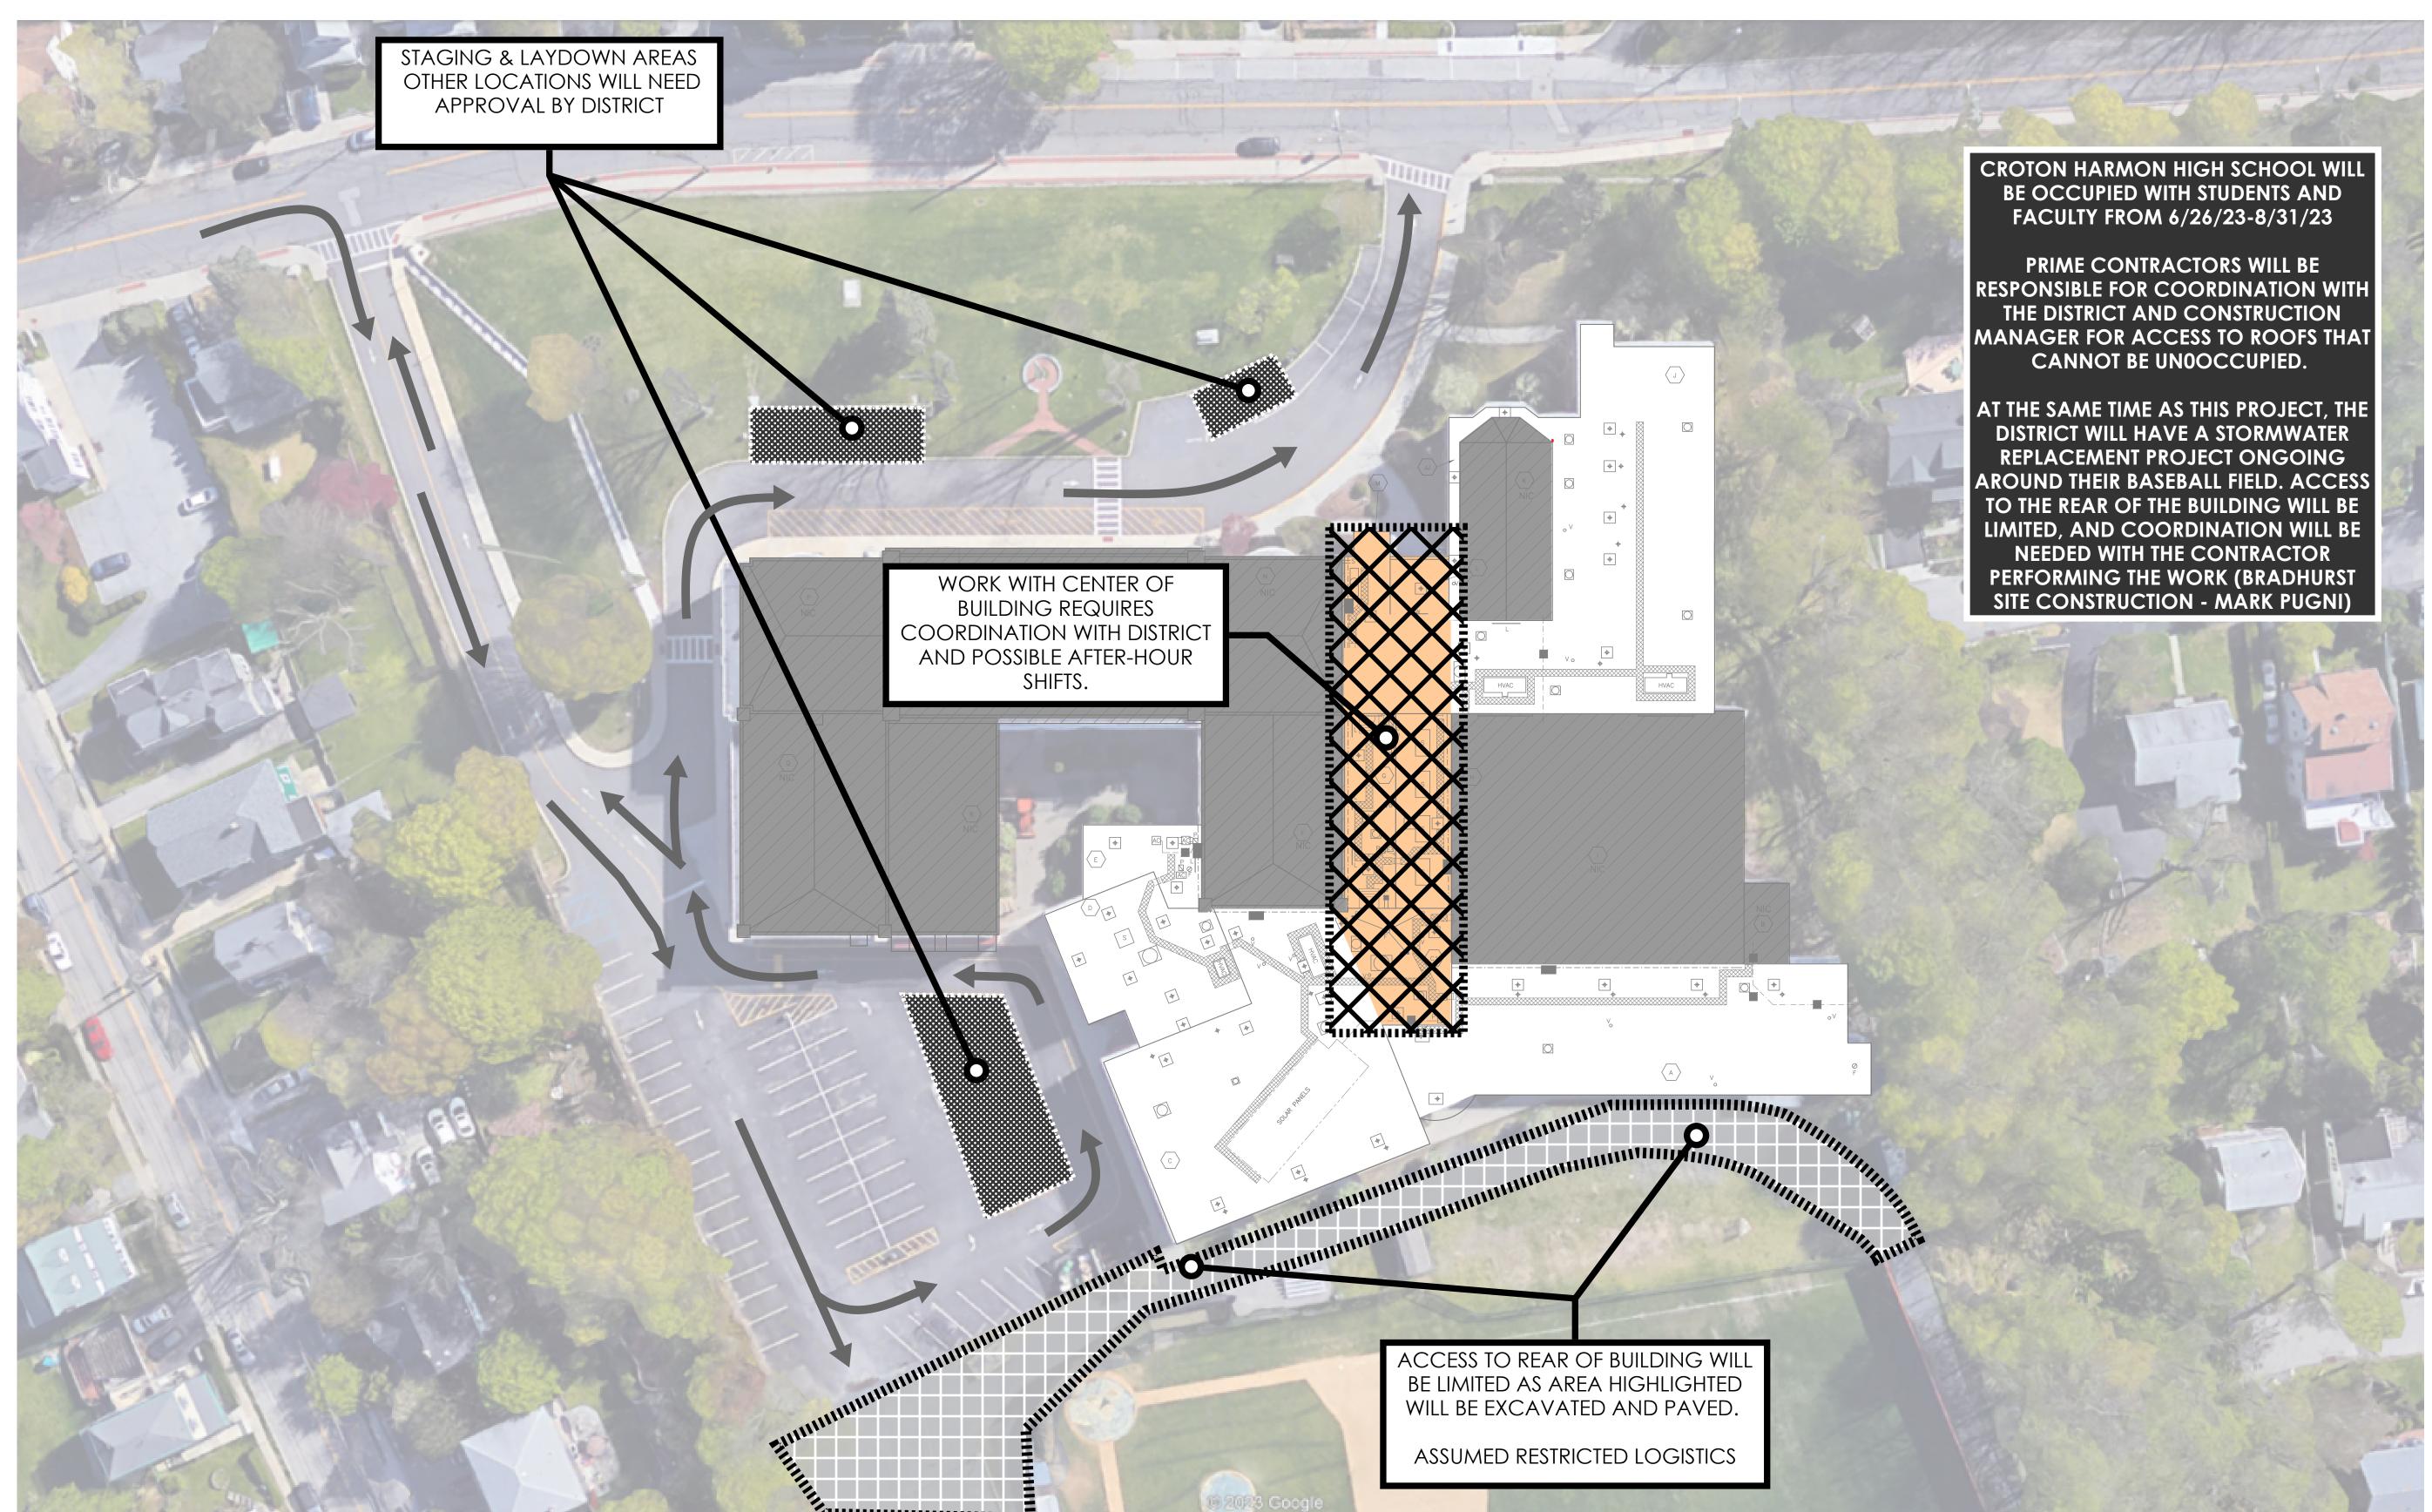
FABRICATION.

2 4/20/2023 1 3/17/2023 CONSTRUCTION DOCUMENTS

HIGH SCHOOL **ROOF DETAILS**

03/17/2023 Drawn / Checked AS NOTED


HS-5



HS LOG-1

CROTON-HARMON HIGH SCHOOL ROOF PROJECT - OVERALL STAGING AND PHASING PLAN

SCALE = N.T.S.

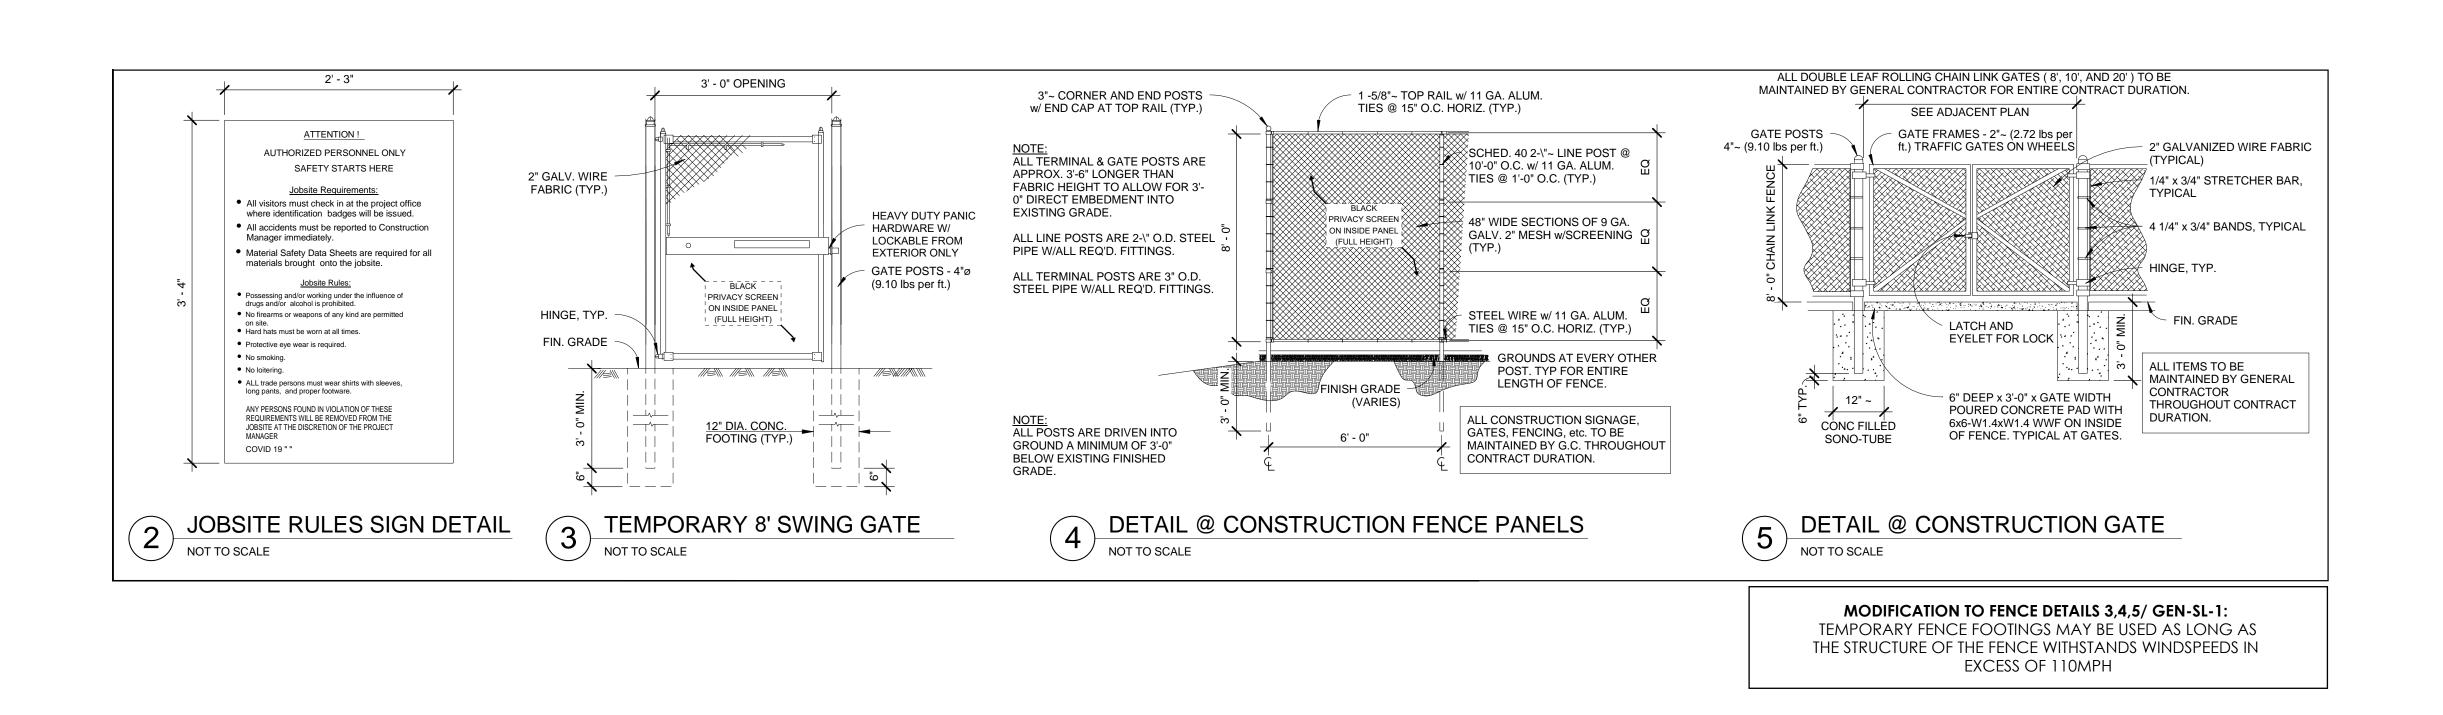

GENERAL LOGISTICS NOTES

- 1. ROOFING CONSTRUCTION TRADE PRIME CONTRACTOR IS **TO PROVIDE 6'-0" TALL CONSTRUCTION** FENCE W/ PRIVACY SCREEN AROUND ALL STORED MATERIAL AND ACTIVE WORK AREAS WHERE WORK IS BEING PERFORMED OVERHEAD OR AT GROUND LEVEL.
- 2. ALL PRIME CONTRACTORS TO UTILIZE THE STAGING LOCATION, PROVIDED BY THE ROOFING CONTRACTOR. EACH PRIME CONTRACTOR SHALL COORDINATE MATERIAL AND EQUIPMENT WITHIN STAGING LOCATIONS, WITH THE OTHER PRIME CONTRACTORS AND CM.
- . MATERIAL WILL NOT BE PERMITTED TO BE STORED OUTSIDE FENCED-IN AREAS OR IN AREAS NOT DESIGNATED BY THE CONSTRUCTION MANAGER/OWNER. MATERIAL STORAGE ON THE INTERIOR OF THE BUILDING THAT IS NOT USED WITHIN 72HRS, WILL NOT BE PERMITTED.
- I. ALL CRANES PICKS SHOULD BE SCHEDULED TO TAKE PLACE DURING THE SUMMER MONTHS, OR DURING AFTER-HOURS. THE PRIME CONTRACTOR PERFORMING THE CRANE PICK ASSUMES ALL RESPONSIBILITY FOR RESTORATION OF THE LANDSCAPE/HARDSCAPE THROUGH APPROVAL BY THE ARCHITECT/CIVIL ENGINEER/CM.

CRANE PICKS THAT REQUIRE UTILIZING THE VILLAGE/TOWN/CITY/STATE ROAD WILL REQUIRE THE CONTRACTOR TO FILE ANY PERMITS NEEDED TO SHUTDOWN THE ROAD/LANES FOR THEIR CRANE OPERATIONS. ANY COST ASSOCIATED WITH THE PERMITTING PROCESS OR FINES INCURRED AS A RESULT OF NOT FILING THE CORRECT PERMITS, WILL BE THE RESPONSIBILITY OF THAT CONTRACTOR PERFORMING THE CRANE PICK.

CRANE PICKS, BOOM LIFTS OR ANY OVERHEAD MATERIAL TRANSPORTATION WILL NOT BE ALLOWED WITHIN 20' OF AN OCCUPIED SPACE. THE PRIME CONTRACTOR PERFORMING THE CRANE PICK/BOOMING, WILL BE REQUIRED TO SUBMIT A CRANE/BOOM LOGISTICS PLAN SHOWING THE WORKING RADIUS OF THE EQUIPMENT AWAY FROM OCCUPIED SPACES.

- 5. THE ROOFING PRIME CONTRACTOR PROVIDING THE STAGING LOCATION IS RESPONSIBLE TO REPAIR THE GRADE, GRASS, SHRUBBERY, AND HARDSCAPES (ASPHALT/CONCRETE) AFTER REMOVAL OF FENCING AND MATERIAL FROM WITHIN THE STAGING LOCATION. THIS INCLUDES ANY REPAIRS AS A RESULT OF THEIR EQUIPMENT AND ACTIVITIES AROUND THE BUILDING AS A RESULT OF THEIR WORK. DAMAGE TO THE LANDSCAPE/HARDSCAPE AS A RESULT OF ANOTHER PRIME CONTRACTOR, OUTSIDE OF THE STAGING AREA, WILL BE THE RESPONSIBILITY OF THAT CONTRACTOR TO REPAIR.
- THIS INCLUDES RESTORING ANY TEMPORARY LOGISTICS FOR EGRESS, SUCH AS WALKWAYS, ASPHALT RAMPS, ETC.,.
- 6. DELIVERIES ARE TO BE COORDINATED WITH THE CM AND OWNER TO AVOID INTERFERENCE WITH SCHOOL ACTIVITIES.
- 7. DUMPSTERS AND REFUSE CONTAINERS, PROVIDED BY THE ROOFING PRIME CONTRACTOR ARE FOR USE BY FOR ALL PRIME CONTRACTORS, AND ARE PERMITTED WITHIN STAGING AREAS. IF DUMPSTERS ARE NEEDED OUTSIDE OF STAGING AREAS, THEY WILL NEED TO BE SECURED AND SURROUNDED BY ADDITIONAL FENCING, LOCKED WITH PRIVACY MESH AND SIGNAGE APPROVED BY THE CM AND THE OWNER.
- 8. EACH PRIME CONTRACTOR IS REQUIRED TO COORDINATE WITH THE CONSTRUCTION MANAGER AND ANY OTHER TRADE- THEIR OWN WORK, IN WHICH THEY MAY IMPACT OTHER TRADES OR THE OWNER AND IT'S PROPERTY.
- 9. THE ROOFING CONSTRUCTION PRIME CONTRACTOR IS TO PROVIDE AND MAINTAIN PERIODICALLY ALL TEMPORARY CONSTRUCTION SIGNAGE AS SHOWN ON THE LOGISTICS PLANS AND PER NYSED, OSHA AND LOCAL/FEDERAL GOVERNMENT REGULATION.
- THIS INCLUDES BUT IS NOT LIMITED TO:

 JOBSITE RULES SIGN (3'-4" X 2'-3") SECURED TO SITE FENCE AT EACH ENTRANCE OF

THE STAGING AREA (4 MINIMUM - 1 AT EACH LOCATION)

• "PERSONAL PROTECTIVE EQUIPMENT/ HARD HATS REQUIRED" SIGNAGE AT 20'

- INTERVALS ON ENTIRE PERIMETER OF SITE FENCE.

 "NOTICE PREVENT SPREAD OF CORONAVIRUS, SANITIZE/WASH YOUR HANDS FREQUENTLY", "WEAR FACE MASK WHILE MAINTAINING SOCIAL DISTANCING"
- 10. EACH PRIME CONTRACTOR WILL BE REQUIRED TO SCHEDULE DELIVERIES WITH THE CONSTRUCTION MANAGER AND THE DISTRICT. THE DISTRICT AND/OR THE CONSTRUCTION MANAGER HOLD THE RIGHT TO REJECT DELIVERIES IF NOT SCHEDULED WITH THE CONSTRUCTION MANAGER OR DISTRICT WITH 72 HOURS OF THE DELIVERY.
- 11. EACH PRIME CONTRACTOR IS REQUIRED TO PROVIDE A (2X) DEDICATED FLAGMEN WHEN ACCEPTING DELIVERIES WITHIN/FROM THE STREET TO THE DEDICATED STAGING AREA. THE SITE AND SURROUNDING AREA MAY BE ACTIVE WITH STUDENTS AND FACULTY, REQUIRING THE UTMOST PROTECTION AND SAFETY.
- 12. PARKING FOR CONSTRUCTION PERSONNEL WILL BE ALLOWED ON SITE IN EXISTING PARKING SPACES DURING SUMMER CONSTRUCTION. ANY PARKING BEFORE OR AFTER THE SUMMER, CONTRACTOR'S WILL BE REQUIRED TO PARK OFF-SITE, AT NO ADDITIONAL COST TO THE OWNER.
- 13. WORKERS ARE REQUIRED TO WEAR ID BADGES, HIGH VISIBILITY VESTS, HARD HATS AND ALL OTHER REQUIRED PPE AT ALL TIMES WHILE ON SITE.

 WORKERS/PERSONNEL WITHOUT THESE REQUIREMENTS WILL BE ASKED TO BE REMOVED FROM THE SITE WITH A ONE-STRIKE POLICY.
- 4. INTERACTION BETWEEN CONSTRUCTION PERSONNEL AND STAFF/STUDENTS IS NOT PERMITTED. ANY PERSONNEL FOUND INTERACTING WITH STUDENTS OR FACULTY MAY BE ESCORTED BY LAW ENFORCEMENT FROM THE SITE. THIS IS A ZERO-STRIKE POLICY.
- 5. REFERENCE DIVISION 01 OF THE SPECIFICATIONS FOR ALL OTHER LOGISTICAL REQUIREMENTS IN HAND WITH INFORMATION INCLUDED ON THE LOGISTICS PLANS.
- 16. EACH PRIME CONTRACTOR MUST IMPLEMENT AND FOLLOW ALL NYS GUIDELINES AND REGULATIONS REGARDING COVID-19. INCLUDING BUT NOT LIMITED TO HAND WASHING/SANITIZING STATIONS, DISINFECTING, SOCIAL DISTANCING, CONTACT TRACING LOGS, ETC.. COVID-19 PROTOCOLS, POLICY AND PROCEDURES MUST BE DETAILED AND INCLUDED IN EACH PRIME CONTRACTOR'S SAFETY MANUAL AND LOGISTICS PLAN AND IS TO BE SUBMITTED TO THE CONSTRUCTION MANAGER WEEKLY. THIS REQUIREMENT EXTENDS TO ALL SUBCONTRACTORS OF THE PRIME CONTRACTOR.

2022 CAPITAL PROJECTS

DISTRICT WIDE ROOFING PROJECT

CROTON-HARMON UNION FREE SCHOOL DISTRICT 10 GERSTEIN STREET CROTON-ON-HUDSON, NEW YORK



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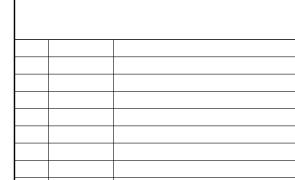
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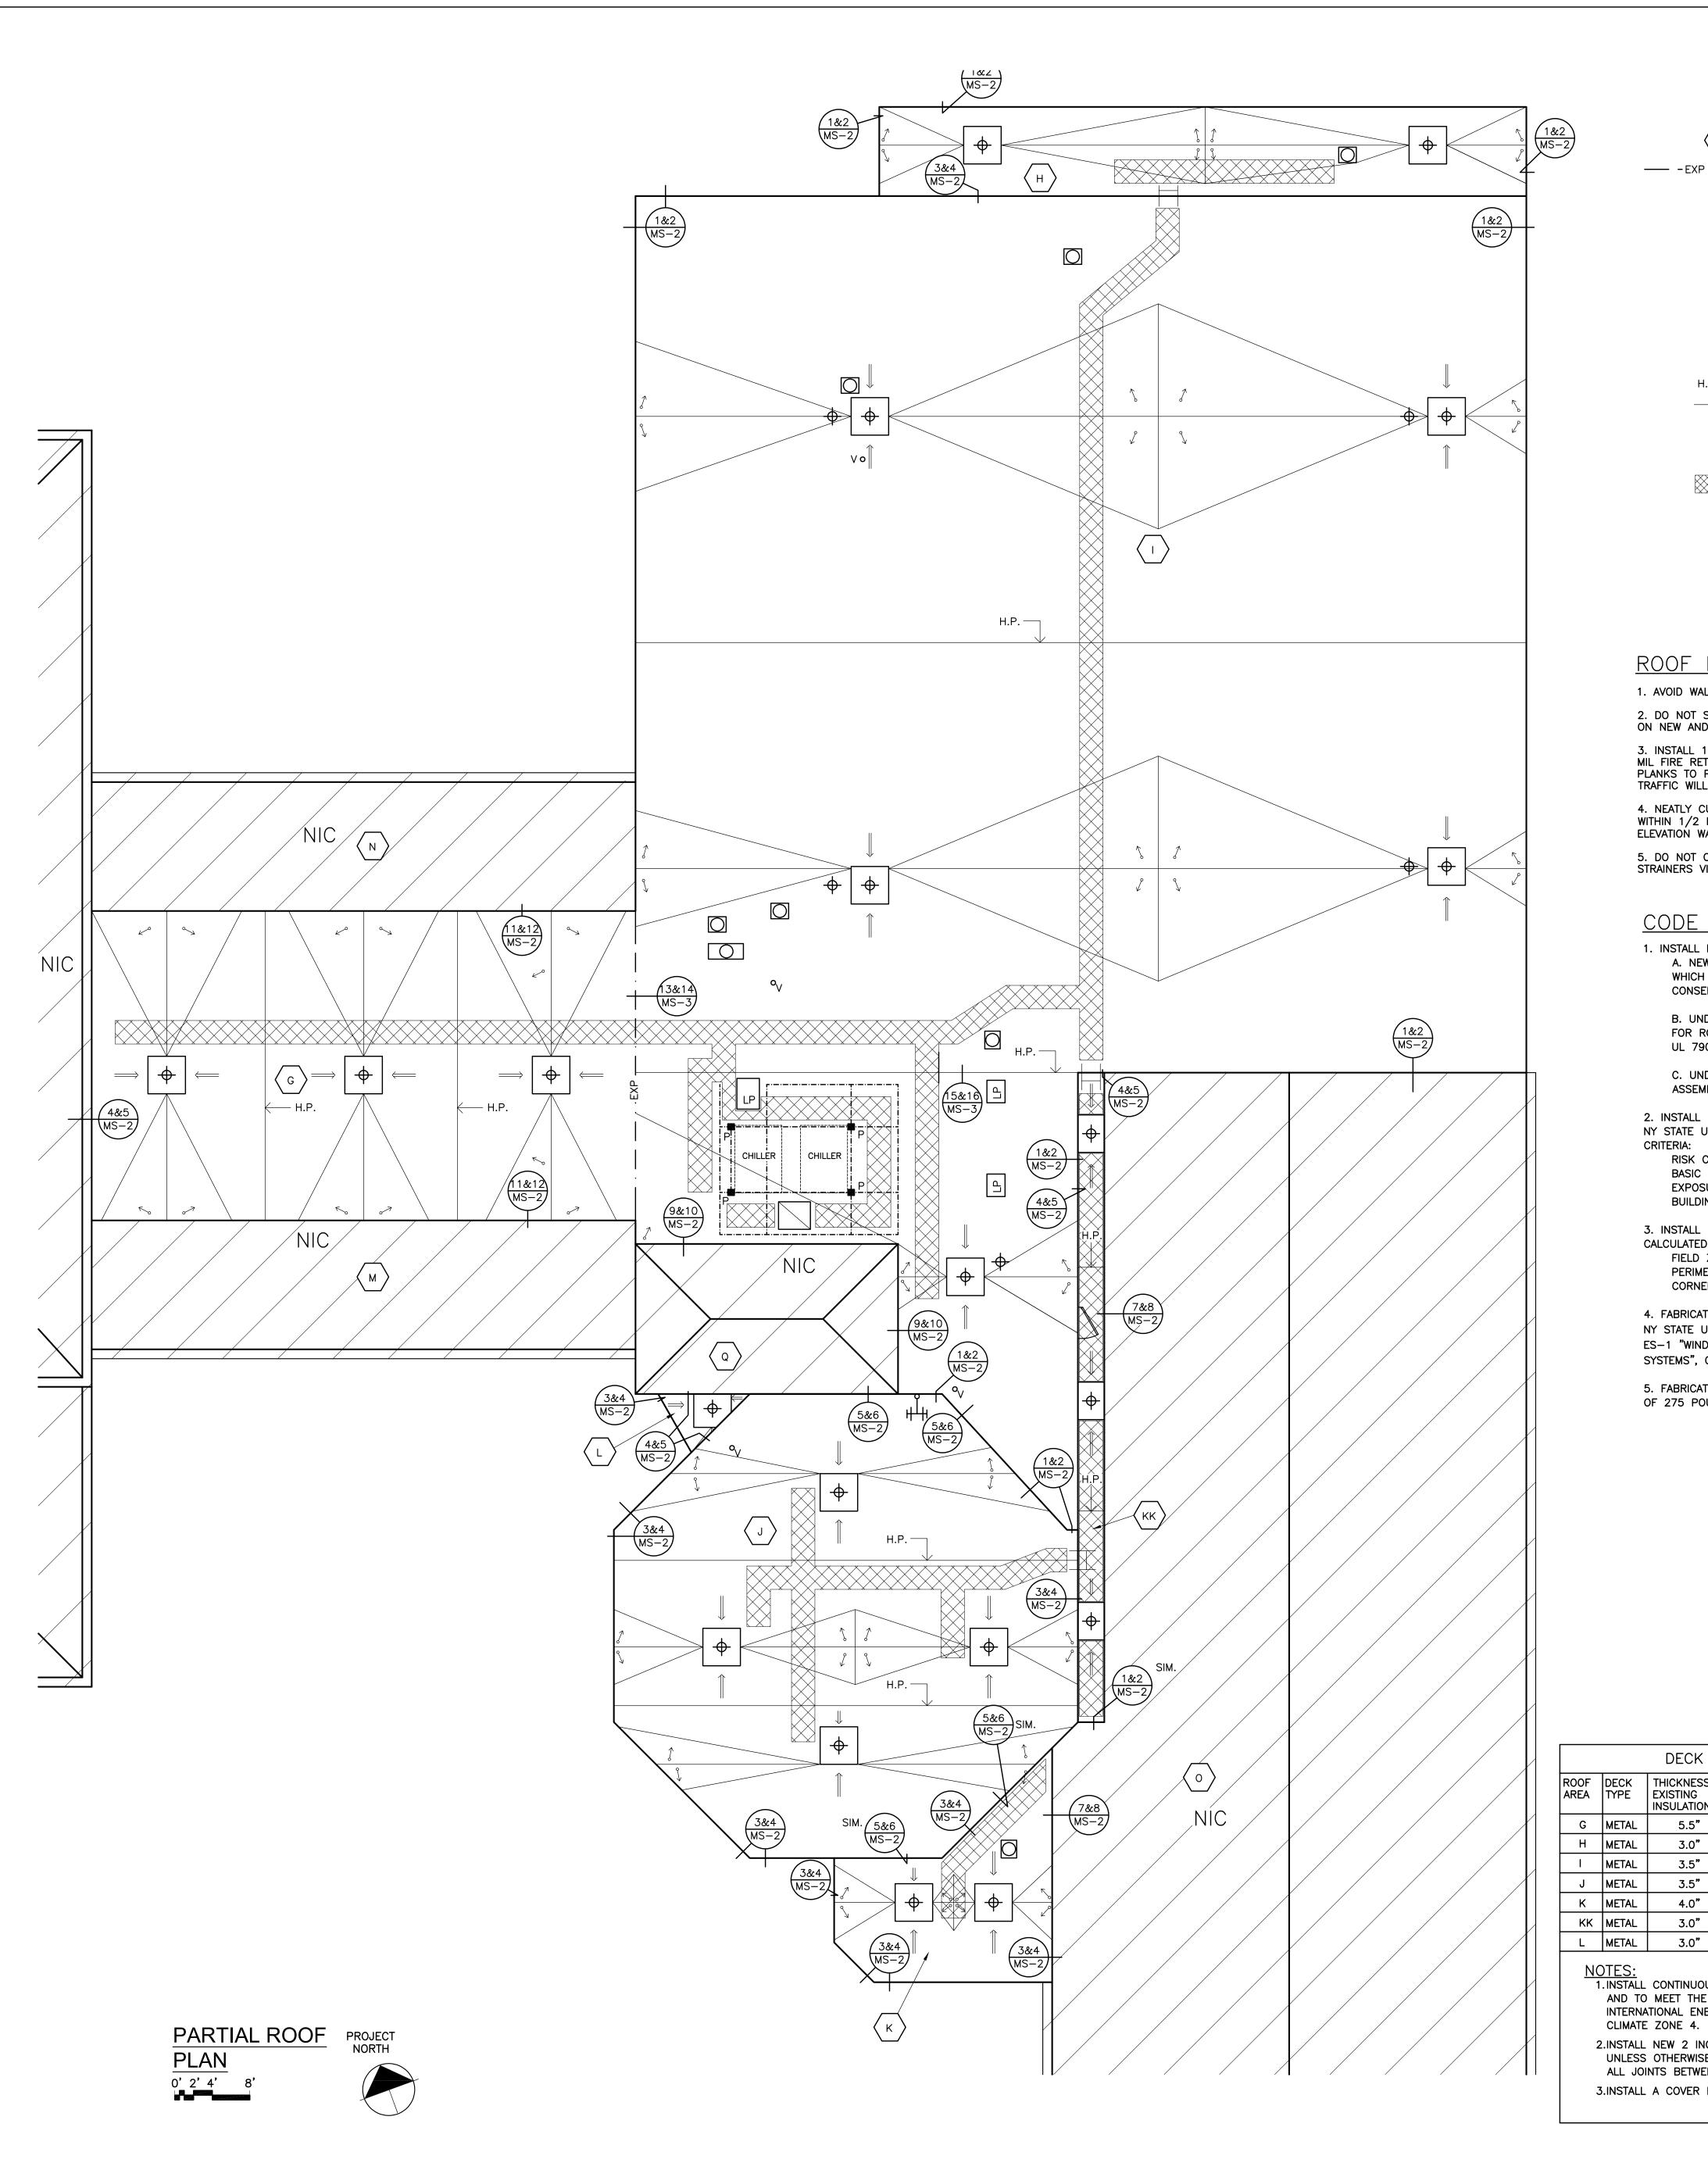
HIGH SCHOOL ROOFING LOGISTICS

Job No. 2023-1002 Date 4/18/23

Scale Drawn / Checked JH - TCC

Sheet Number

HS LOG-1



ROOF AREA DESIGNATION **EXPANSION JOINT** (SEE DET. 13&14/MS-3) ROOF DRAIN

(SEE DET. 17/MS-3) OVERFLOW ROOF DRAIN (SEE DET. 17/MS-3) SIMILAR

VENT PIPE (SEE DET. 18/MS-3)

CURB PENETRATION (SEE DET. 18/MS-3 & NOTE 13) SIMILAR LOUVERED PENTHOUSE

(SEE DET. 19/MS-3) SEALANT POCKET (SEE DET. 20/MS-3) ACCESS DOOR

(SEE DET. 21/MS-3) INSULATION HIGH POINT TAPERED ISOCYANURATE INSULATION, ⇒ SLOPE 1/8" PER FT

WALKWAY PADS

ROOF PROTECTION NOTES:

1. AVOID WALKING ON NEW AND EXISTING ROOF AREAS.

2. DO NOT STORE MATERIAL OR EQUIPMENT, AND DO NOT PILE DEBRIS ON NEW AND EXISTING ROOF AREAS.

3. INSTALL 1 INCH THICK EXTRUDED POLYSTYRENE INSULATION OVER 6 MIL FIRE RETARDANT POLYETHYLENE, COVERED WITH 2x10 WOOD PLANKS TO PROTECT ROOFING WHERE CONSTRUCTION WORK AND TRAFFIC WILL OCCUR.

4. NEATLY CUT AND POSITION ROOF PROTECTION COMPONENTS TO FIT WITHIN 1/2 INCH OF ROOF PENETRATIONS, EAVES AND CHANGE IN ELEVATION WALLS.

5. DO NOT COVER THE ROOF DRAINS. MAINTAIN THE ROOF DRAIN STRAINERS VISIBLE AND CLEAR AT ALL TIMES.

CODE COMPLIANCE REQUIREMENTS:

1. INSTALL NEW ROOFING TO MEET THE FOLLOWING MINIMUM REQUIREMENTS: A. NEW YORK STATE UNIFORM FIRE PREVENTION AND BUILDING CODE, WHICH INCLUDES BY REFERENCE THE NEW YORK STATE ENERGY CONSERVATION CODE.

B. UNDERWRITERS LABORATORIES INC. CLASS A EXTERNAL FIRE RATING FOR ROOF ASSEMBLIES TESTED IN ACCORDANCE WITH ASTM E 108 OR UL 790.

C. UNDERWRITERS LABORATORIES INC. STANDARD 1256 FOR ROOF ASSEMBLIES WITH FOAM INSULATION.

2. INSTALL ROOFING TO COMPLY WITH THE WIND UPLIFT REQUIREMENTS OF THE NY STATE UNIFORM FIRE PREVENTION AND BUILDING CODE, BASED ON THIS

RISK CATEGORY III BASIC WIND SPEED 130 MPH EXPOSURE CATEGORY E BUILDING HEIGHT 30 FT.

3. INSTALL ROOFING AS INDICATED TO RESIST THE FOLLOWING UPLIFT LOADS, CALCULATED IN ACCORDANCE WITH ASCE 7 USING A SAFETY FACTOR OF 2: FIELD ZONE: 90 PSF PERIMETER ZONE: 135 PSF

CORNER ZONE: 150 PSF

4. FABRICATE AND INSTALL ROOF PERIMETER FLASHINGS THAT COMPLY WITH THE NY STATE UNIFORM FIRE PREVENTION AND BUILDING CODE AND WITH ANSI/SPRI ES-1 "WIND STANDARD FOR EDGE SYSTEMS USED WITH LOW SLOPE ROOFING SYSTEMS", ON A BUILDING USING THE CRITERIA DESCRIBED ABOVE.

5. FABRICATE AND INSTALL WOOD BLOCKING COMPONENTS TO RESIST A FORCE OF 275 POUNDS PER LINEAL FOOT APPLIED IN ANY DIRECTION.

GENERAL NOTES:

1. THESE DRAWINGS ARE SUPPLEMENTED BY DETAILED TECHNICAL SPECIFICATIONS. PERFORM THE WORK AS SHOWN ON THE DRAWINGS AND AS DESCRIBED IN THE SPECIFICATIONS.

2. DIMENSIONS AND CONDITIONS ON THE ROOF PLAN AND DETAILS ARE APPROXIMATE AND SHALL BE

CONFIRMED BY THE CONTRACTOR.

3. ONLY CERTAIN FASTENERS ARE SHOWN ON THE DRAWINGS, REFER TO THE SPECIFICATIONS FOR ADDITIONAL FASTENER REQUIREMENTS.

4. TEST EACH DRAIN LINE WITH A RUNNING HOSE FOR AT LEAST ONE HOUR PRIOR TO STARTING ANY OTHER WORK ON SITE. PROVIDE A WRITTEN REPORT OF ANY CLOGGED LINES TO THE OWNER. A.CLOGGED DRAIN LINES REPORTED TO THE OWNER BEFORE WORK STARTS WILL BE CLEANED BY THE

B.COVER & PROTECT ALL DRAIN OPENINGS AT THE BEGINNING OF EACH WORK DAY. REMOVE THE COVERS AT THE END OF EACH DAY AND BEFORE PRECIPITATION OCCURS.

C.PERFORM WHATEVER WORK IS REQUIRED SO ALL DRAIN LINES ARE CLEAN AND FREE FLOWING UPON COMPLETION OF THE PROJECT.

5. REMOVE AND RESET ANY SITE LIGHT FIXTURES, WIRES AND CONDUITS THAT INTERFERE WITH THE NEW EAVE FLASHINGS. REPLACE COMPONENTS THAT CANNOT BE PROPERLY REINSTALLED.

6. REMOVE EXISTING ROOF TOP ELECTRICAL CONDUIT AND GAS PIPE SUPPORTS. RE-SET THE CONDUIT AND PIPES ON ADJUSTABLE HEIGHT FACTORY MANUFACTURED PIPE SUPPORTS PLACED ON WALKWAY PADS SPACED 5 FEET ON CENTER. SECURE THE CONDUITS AND PIPES TO THE PIPE SUPPORTS WITH GALVANIZED CLIPS & BOLTS.

7. WIRE BRUSH, PRIME & PAINT ROOF TOP EQUIPMENT HOUSINGS, EXTERIOR & INTERIOR ACCESS LADDERS, BULKHEAD DOORS & DOOR FRAMES (BOTH SIDES), GAS LINES, AND THE VENT PIPES. DO NOT PAINT OVER EQUIPMENT NAME PLATES AND LABELS.

8. REPAIR EXHAUST EQUIPMENT HOUSINGS SO THEY ARE WATERTIGHT; REPLACE ANY MISSING PIECES.

9. REMOVE, MODIFY AND REMOUNT THE EXISTING LADDERS - REWORK THEM SO THEY ARE OSHA COMPLIANT. SCRAPE, PRIME AND PAINT THE LADDERS. FILL OLD FASTENER HOLES WITH COLOR MATCHING

10. RE-CAULK ALL VERTICAL MASONRY CONTROL AND EXPANSION JOINTS IN THE CHANGE IN ELEVATION WALLS ABOVE LOWER LEVEL ROOFS. REMOVE EXISTING SEALANT AND BACK UP MATERIALS, AND INSTALL NEW BACKER ROD AND SEALANT.

11. INSULATE THE EXISTING DRAIN LINES WHERE EXPOSED INSIDE THE BUILDING, ALL NEW DRAIN LINES, AND THE UNDERSIDES OF THE NEW DRAIN BOWLS.

12. INSTALL NEW WALKWAY PADS WHERE SHOWN ON THE ROOF PLAN.

13. REMOVE CURB AT PIPE PENETRATION AND INSTALL, FASTEN A 22 GA. GALVANIZED PLATE ON TOP OF METAL DECK. REMOVE EXTEND AND MODIFY, WIRING & PIPES, FLASH AS PER DETAIL 18/MS-3 (VENT PIPE SIMILAR).

CUPOLA REHABILITATION NOTES

THE CUPOLA IS NOT ILLUSTRATED IN THESE DRAWINGS; VISUALLY INSPECT IT.

A. SCRAPE AND REMOVE ALL LOOSE AND PEELING PAINT. UTILIZE DROP CLOTHES AND HEPA VACUUMS TO COLLECT AND DISPOSE OF THE PAINT CHIPS

B. INSTALL EXTERIOR SPACKLE TO FILL VOIDS WHERE PAINT WAS REMOVED, THEN SAND THE SPAKLE

C. REMOVE AND REPLACE ROTTED AND DETERIORATED WOOD COMPONENTS

D. BACK PRIME NEW WOOD BEFORE INSTALLATION; SPOT PRIME THE SPACKLE AND THEN PRIME THE

ENTIRE CUPOLA USING EXTERIOR ALKYD PRIMER. E. INSTALL TWO FINISH COATS OF EXTERIOR ALKYD PAINT, COLORS TO BE SELECTED.

F. INSTALL A NEW WEATHER VANE, SUPPORTED WITH A 3/4 INCH DIAMETER STAINLESS STEEL ROD, SECURED TO BRACKETS MOUNTED WITHIN THE CUPOLA.

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DISTRICT WIDE

ROOFING PROJECT

CROTON-HARMON UNION FREE

SCHOOL DISTRICT

10 GERSTEIN STREET

CROTON-ON-HUDSON, NEW YORK

10520

285 MAIN STREET MOUNT KISCO . NEW YORK . 10549

ELEMENTARY SCHOOL 66-02-02-03-0-003-033

NEW BUSINESS OFFICE 66-02-02-03-1-010-007

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		DECK TYP	E CHART &	INSULATION RE	QUIREMENTS	
ROOF AREA	DECK TYPE	THICKNESS OF EXISTING INSULATION	STARTING THICKNESS OF NEW INSULATION	MIN. R-VALUE OF NEW & EXISTING INSULATION		AVERAGE R-VALUE OF NEW & EXISTING INSULATION
G	METAL	5.5"	1.5"	30	7.6"	44.7
Н	METAL	3.0"	2.5"	30	5.5"	31.9
1	METAL	3.5"	2.0"	30	6.9"	40.4
J	METAL	3.5"	2.0"	30	6.0"	34.8
K	METAL	4.0"	1.5"	30	6.2"	36.0

30

30

6.2"

5.8**"**

36.0

33.6

NOTES:

1.INSTALL CONTINUOUS INSULATION ABOVE THE DECK TO ACHIEVE A TOTAL MINIMUM R-VALUE OF 30, AND TO MEET THE NYS ENERGY CONSERVATION CONSTRUCTION CODE. INCLUDING THE INTERNATIONAL ENERGY CONSERVATION CODE AND THE NY STATE SUPPLEMENT, FOR A BUILDING IN

2.5"


2.5"

3.0"

3.0**"**


2.INSTALL NEW 2 INCH FLAT ISOCYANURATE INSULATION OVER THE EXISTING 3.75 INCH INSULATION, UNLESS OTHERWISE NOTED. INSTALL THE ISOCYANURATE INSULATION IN MULTIPLE LAYERS. STAGGER ALL JOINTS BETWEEN LAYERS 12 INCHES.


3.INSTALL A COVER BOARD USING LOW RISE FOAM ADHESIVE OVER THE INSULATION AND CRICKETS.

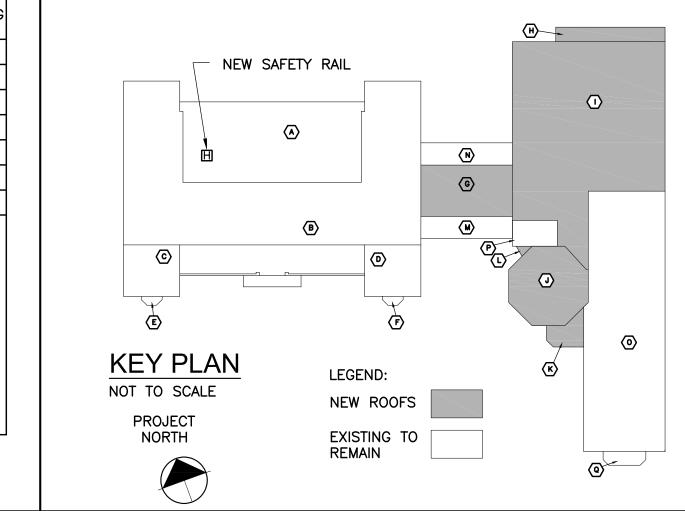

2 4/20/2023 1 3/17/2023 CONSTRUCTION DOCUMENTS No. Date Sheet Title PIERRE VAN CORTLANDT M.S **ROOF PLAN**

> 2023-1002 03/17/2023 Scale Drawn / Checked AS NOTED

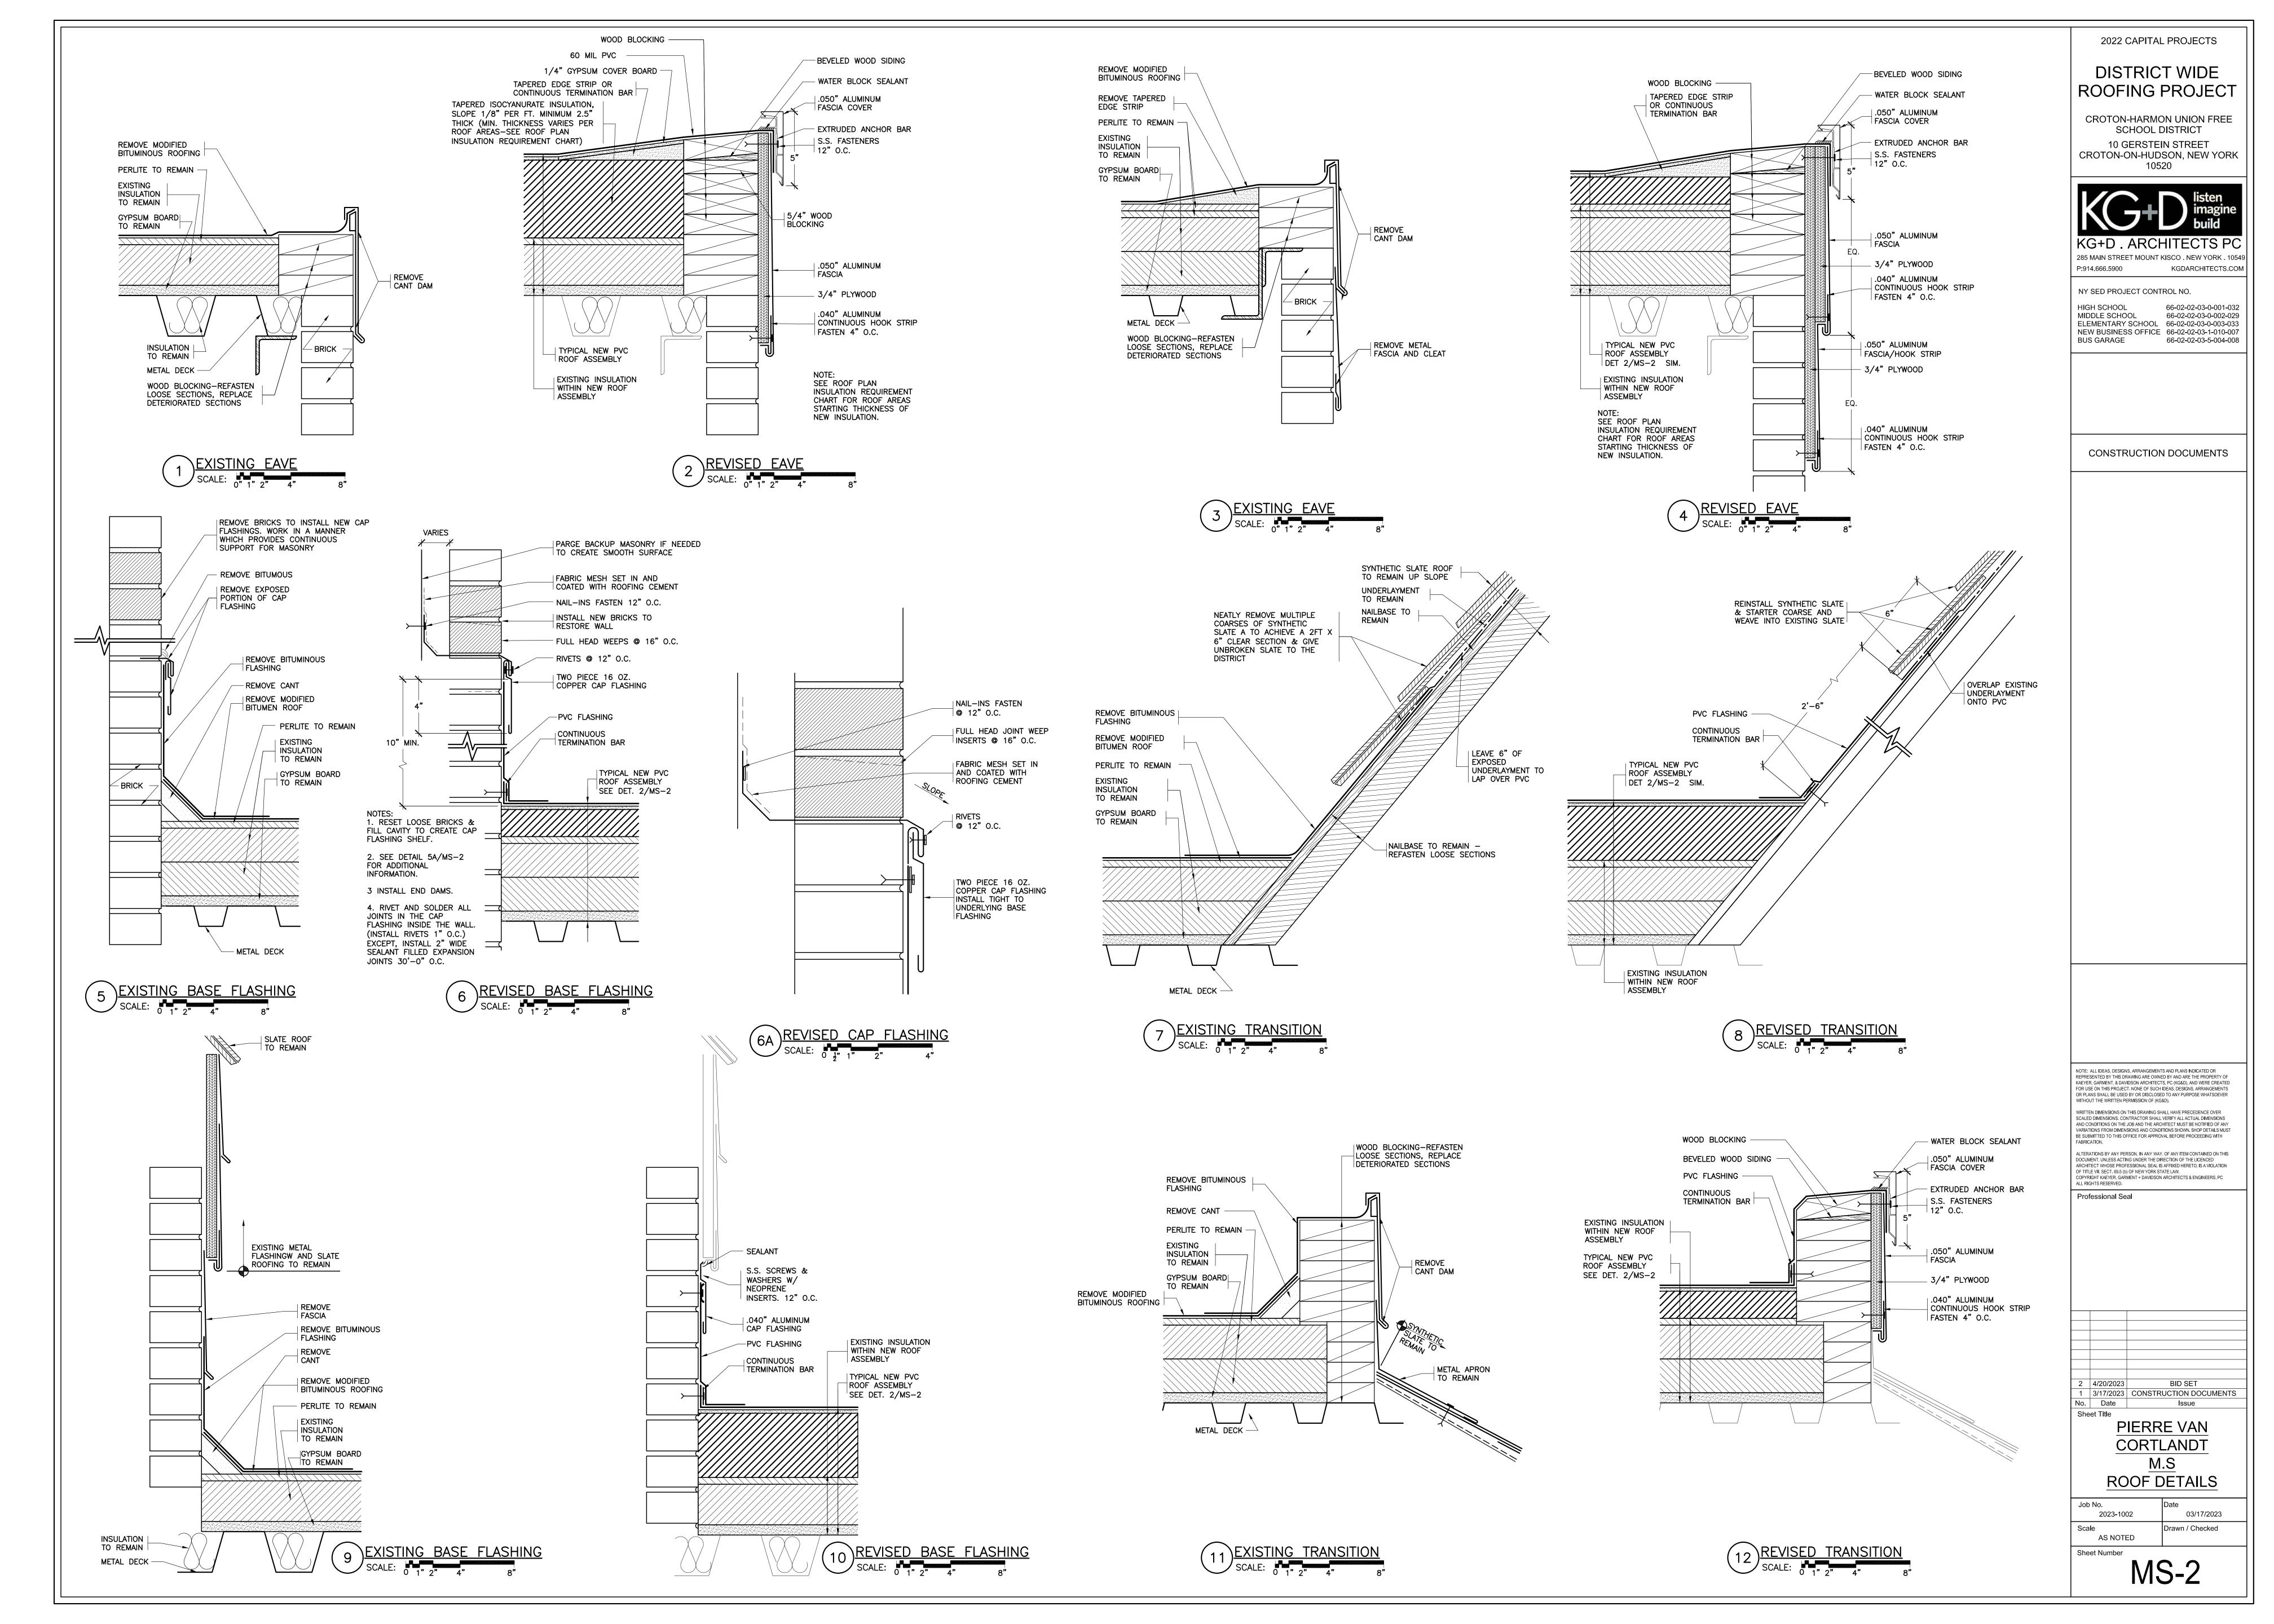

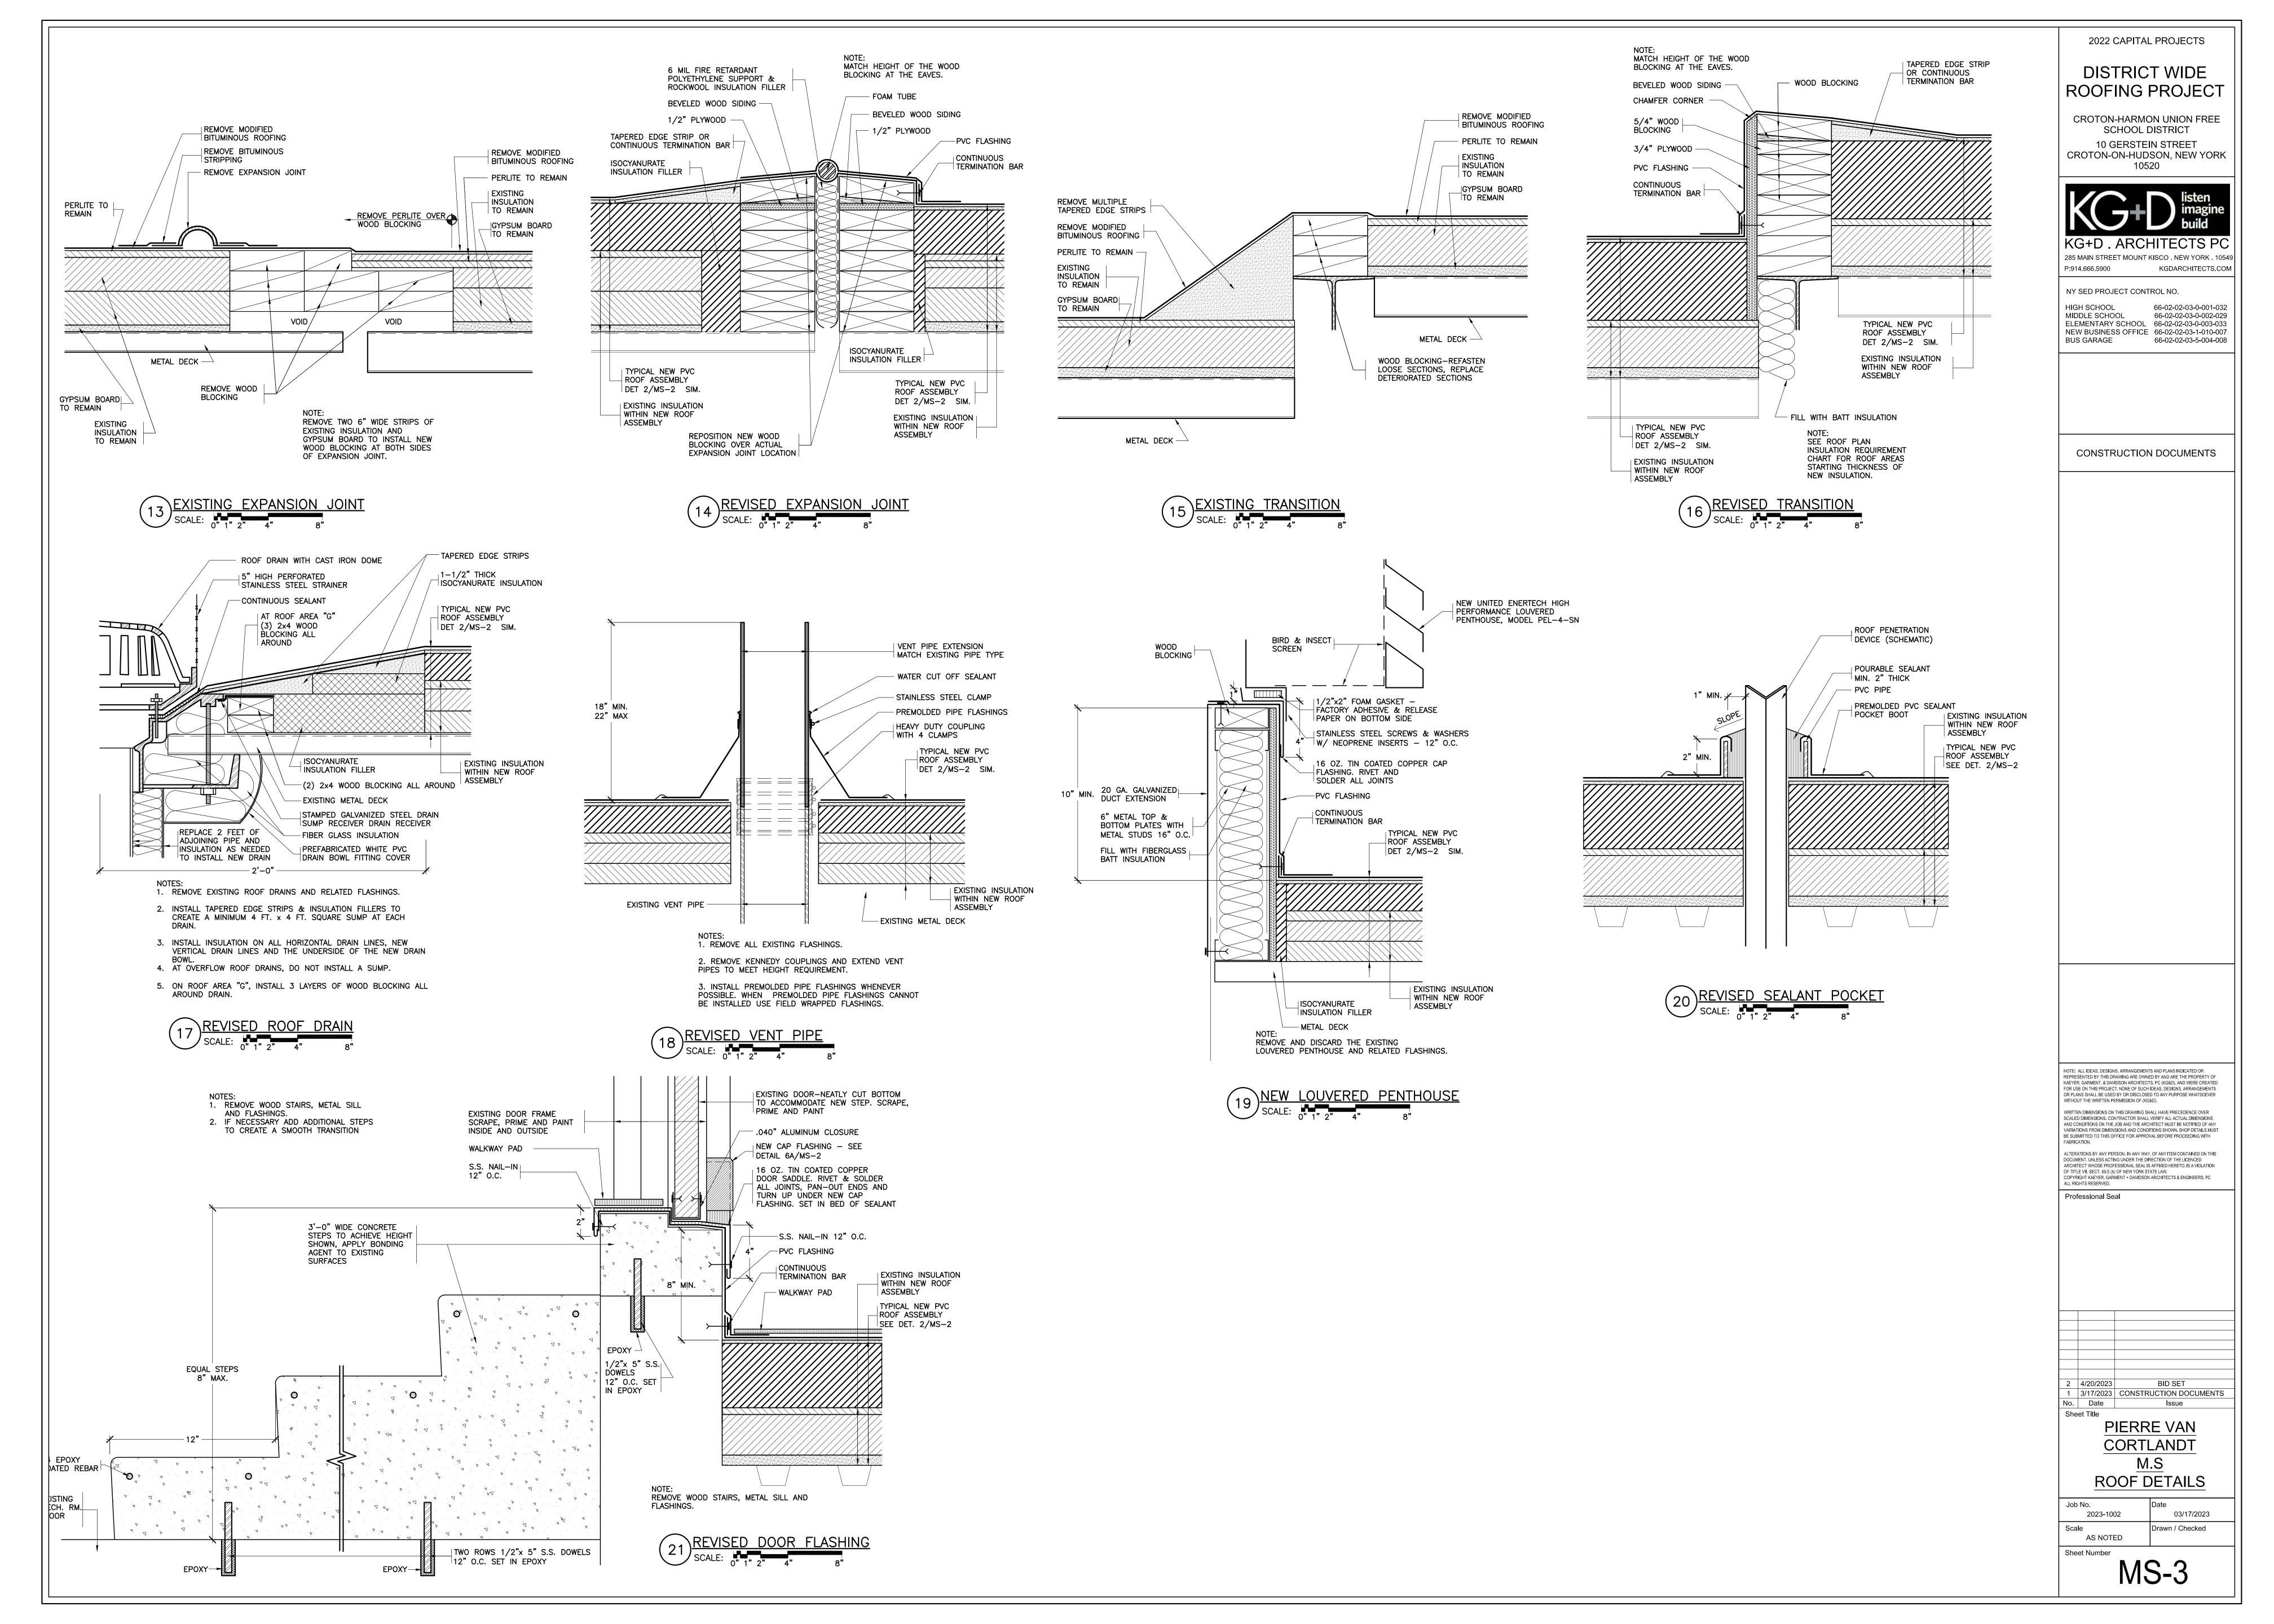

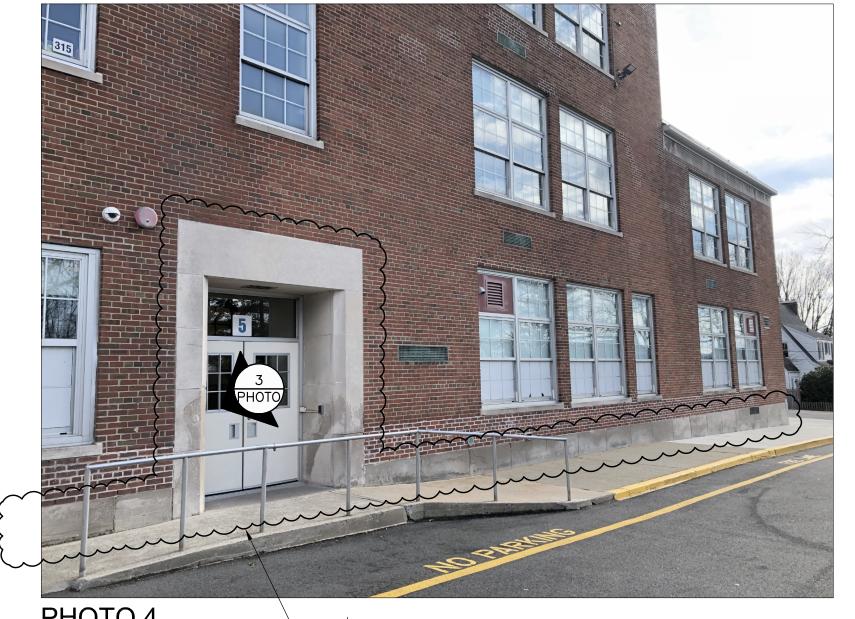


PHOTO 4 AREA OF CAST STONE PATCHING



PHOTO 5 AREA OF CAST STONE PATCHING



PHOTO 6 AREA OF CAST STONE PATCHING



AREA OF CAST STONE PATCHING






PHOTO 3




PHOTO 2



PHOTO 1

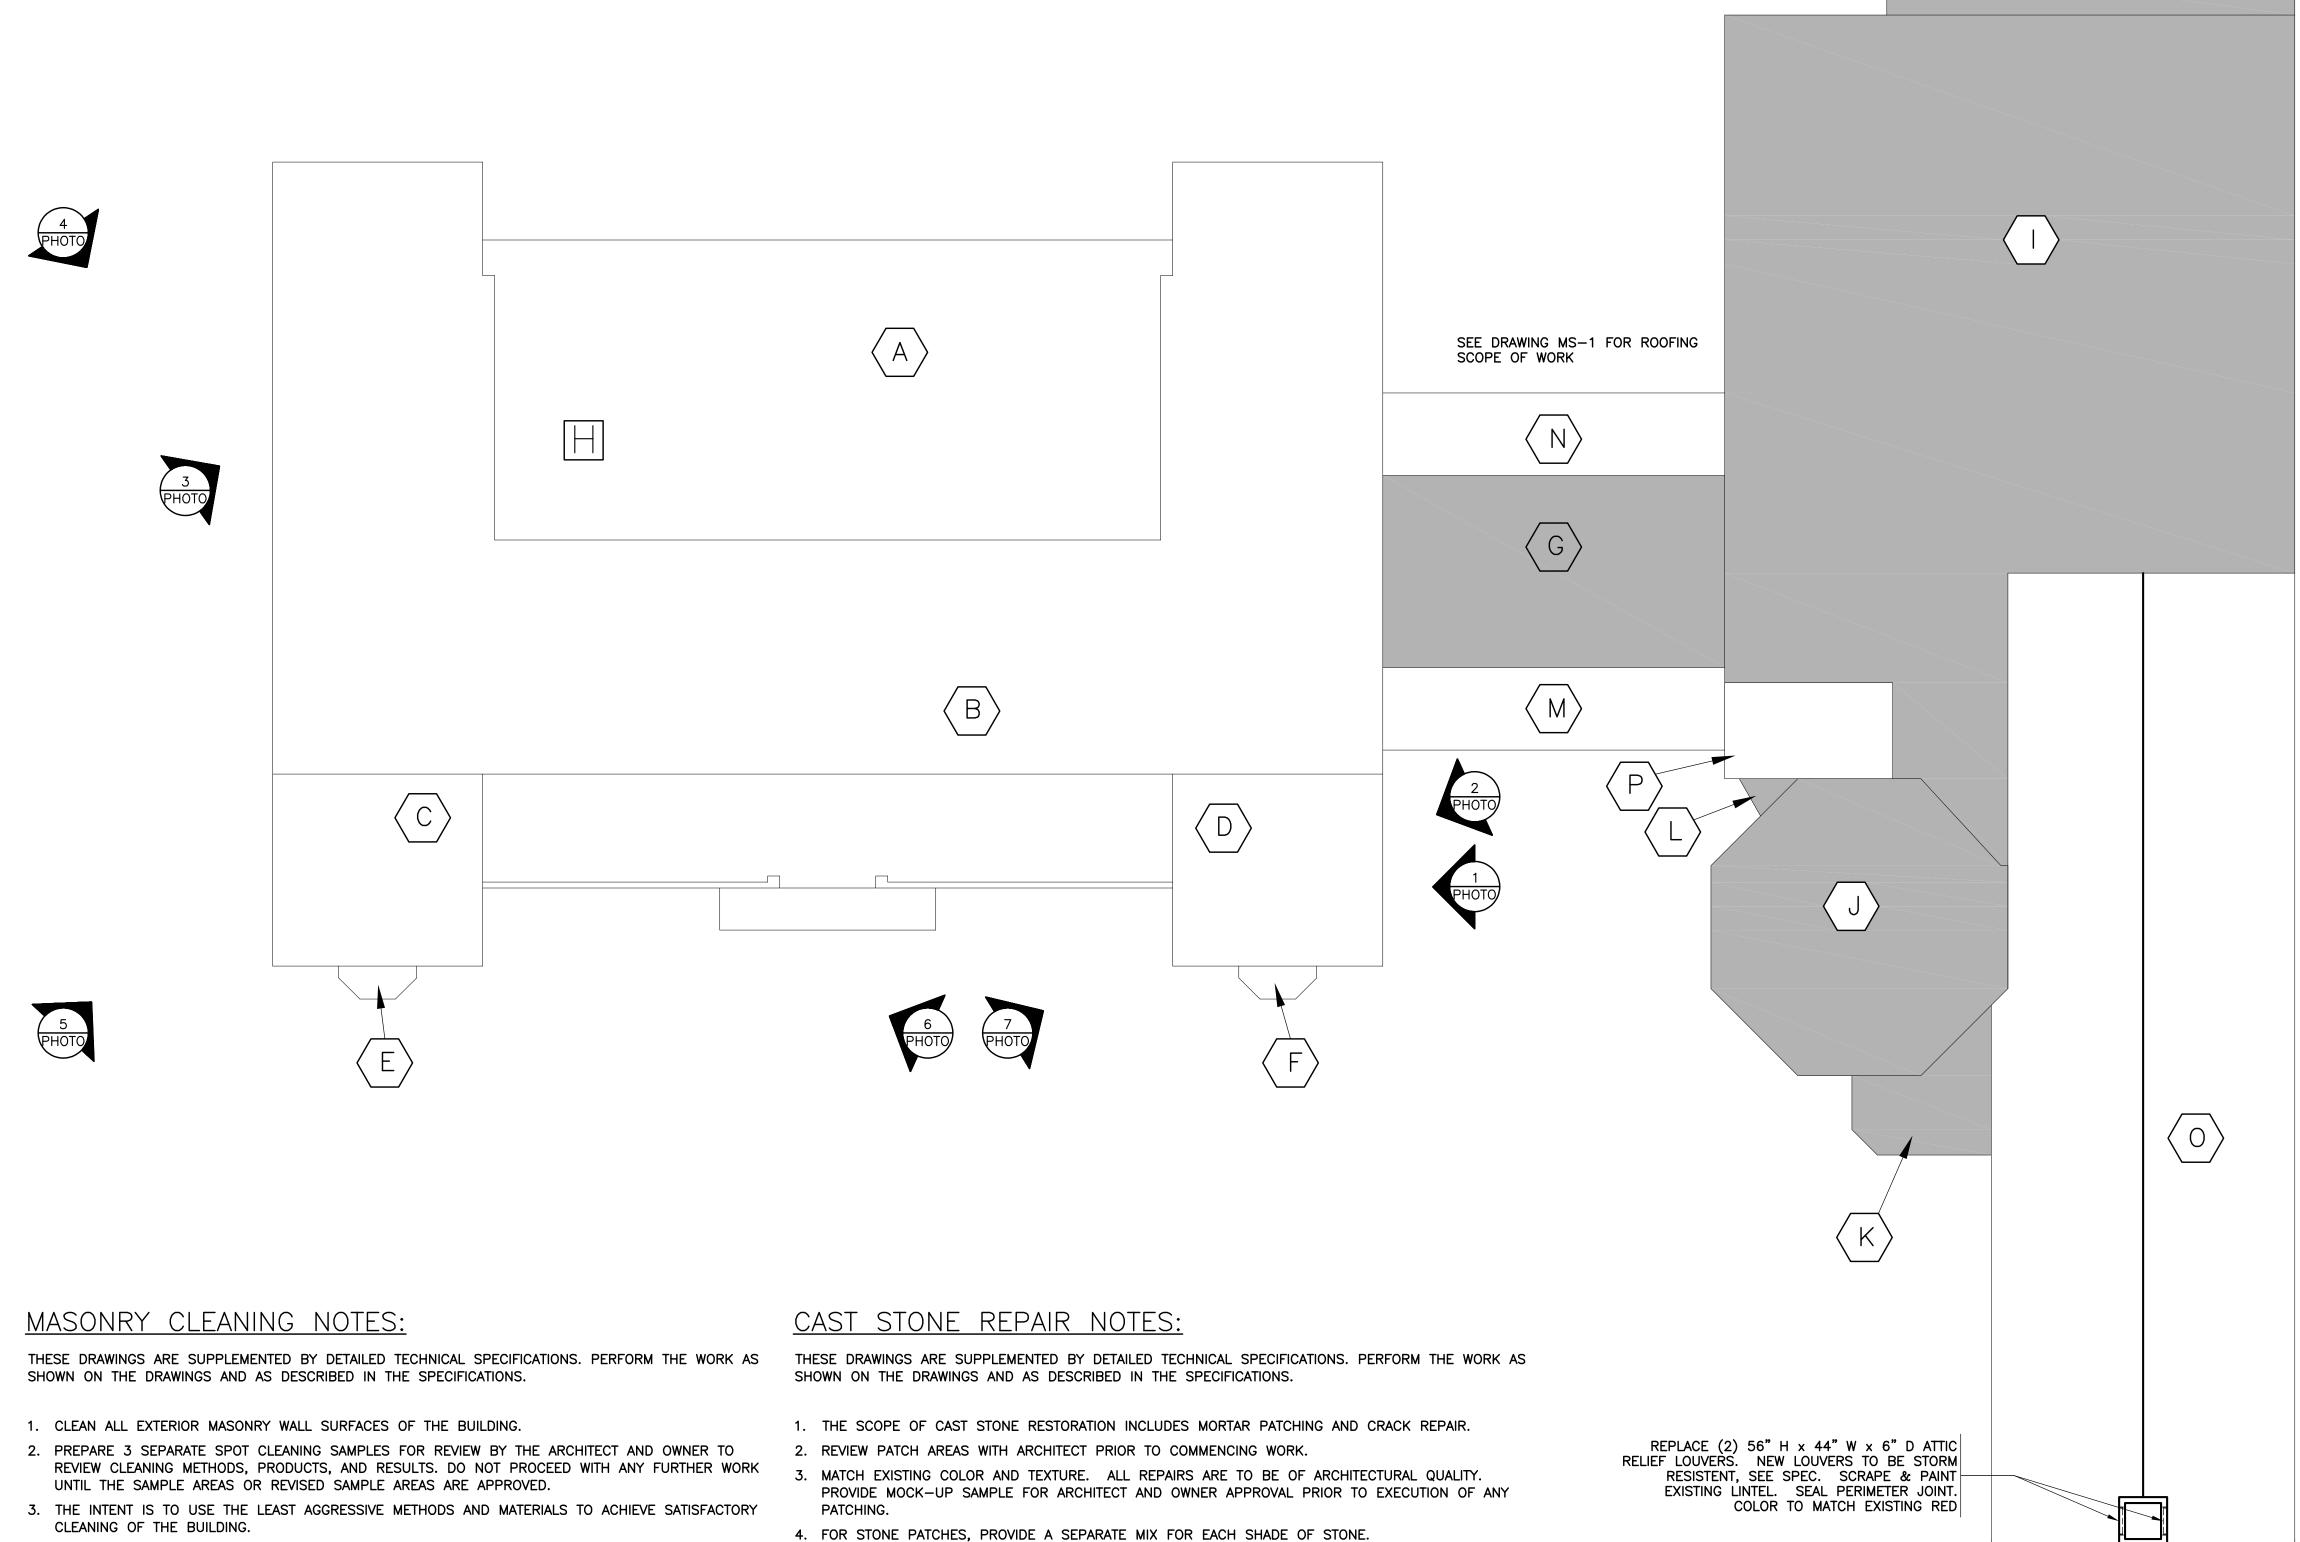

- 4. THE CONTRACTOR SHALL USE BEST PRACTICES FOR CLEANING HISTORIC STRUCTURES, TO INCLUDE REQUIREMENTS AND RECOMMENDATIONS OF THE NATIONAL PARKS SERVICE (NPS) NATIONAL
- STANDARDS FOR THE TREATMENT OF HISTORIC PROPERTIES. 5. CLEANING PROCEDURES SHALL BE A COMBINATION OF LEVEL 1 AND LEVEL 2 PROCEDURES AND PRODUCTS, DEPENDING ON THE SOIL LEVEL.
- 6. PRIOR TO COMMENCING CLEANING PROCEDURES, ENSURE BUILDING OPENINGS ARE CLOSED, PROTECT AIR INLETS, AND PROTECT ADJACENT COMPONENTS TO INCLUDE LANDSCAPING.
- 5. LIGHTLY MIST THE REPAIR WITH WATER TO WET THE ENTIRE SURFACE. MIST APPROXIMATELY 30 MINUTES TO 1 HOUR AFTER COMPLETION ON COOL OR CLOUDY DAYS. MIST APPROXIMATELY 2 HOURS OR LONGER ON HOT OR SUNNY DAYS. MIST SEVERAL TIMES A DAY FOR AT LEAST THREE DAYS FOLLOWING REPAIR COMPLETION.
- 6. FOLLOW MANUFACTURER'S INSTRUCTIONS AND RECOMMENDATIONS FOR EACH PRODUCT.
- 7. AMBIENT AIR AND STONE TEMPERATURES SHOULD BE ABOVE 40 DEGREES F DURING AND 24 HOURS AFTER PATCHING. AVOID PATCHING WHEN TEMPERATURES EXCEED 90 DEGREES F.
- 8. AFTER CURING, THE CONTRACTOR SHALL SOUND ALL REPAIR PATCHES AND REPAIR FAILED PATCHES. ALL REPLACEMENT PATCHES SHALL BE SOUNDED AND REPLACED UNTIL NONE FAIL.
- 9. CRACKS SHALL BE ROUTED TO $\frac{1}{2}$ " DEPTH, MIN. AND FILLED WITH PATCHING MORTAR.

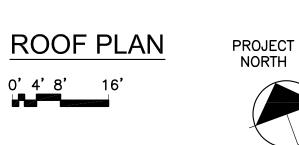

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ROOFING PROJECT

P 914 666 5900

HIGH SCHOOL

BUS GARAGE

MIDDLE SCHOOL

NY SED PROJECT CONTROL NO.

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CONSTRUCTION DOCUMENTS

CROTON-HARMON UNION FREE SCHOOL DISTRICT 10 GERSTEIN STREET CROTON-ON-HUDSON, NEW YORK

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Sheet Title

ISSUED FOR BID 2 4/20/2023 1 3/17/2023 CONSTRUCTION DOCUMENTS

PIERRE VAN CORTLANDT MASONRY REPAIR

Job No. 03/17/2023 2023-1002

Drawn / Checked AS NOTED

General Notes:

The purpose of these drawings is to show the structural work associated with the installation of new dunnage framing on the roof of Pierre Van Cortlandt Middle School in Croton-on-Hudson, NY.

The work shown on these drawings has been designed in accordance with the structural

requirements of the 2020 edition of the Building Code of New York State.

The structural components have been designed for the following loads:

A. Roof loads:

Snow:	
Ground snow load, p _q	30 psf
Flat roof snow load, p _f	30 psf*
Exposure factor, C _e	1.0
Importance factor, I _s	1.1
Thermal factor, C _t	1.0
Rain loads: in accordance with Section 1611	
Rainfall intensity (100-year 15-minute interval), i	6.00 in./h
Wind design data:	
Basic Design Wind Speed (3-second gust): V	120 mph
Allowable Stress Design Wind Speed, Vasd	93 mph
Risk category	III
Wind Exposure	В

Wind design for existing buildings:

Not required since the proposed alterations do not increase the demand-capacity ratio of any wind load carrying structural element by more than 10 percent cumulative since the original

C. Earthquake design data:

Earthquake design for existing buildings:
Not required since the proposed alterations do not increase the demand-capacity ratio of any seismic load carrying structural element by more than 10 percent cumulative since the original construction.

200 lbs

50 lbs

D. Special loads:

Machinery/Equipment: See Plan

E. Guardrails (load applied in any direction):

Top rail concentrated or Top rail uniform load Intermediate rail concentrated load

Existing buildings: For existing structural elements carrying gravity loads, the proposed alterations do not increase the stress in any structural element by more than 5 percent nor does it decrease the strength of any structural element to less than required by the building code for new structures.

- This structure has been designed to be self-supporting and stable after the work shown on these drawings has been completed. The stability of the structure prior to completion is solely the responsibility of the contractor. This responsibility extends to all related aspects of the construction activity including, but not limited to, erection methods, erection sequence, temporary bracing, forms, shoring, use of equipment, and similar construction procedures. Review of the construction by the engineer is for conformance with design aspects only, not to review the contractor's construction procedures. Lack of comment on the part of the engineer with regard to construction procedures is not to be interpreted as approval of those procedures.
- Jobsite safety and construction procedures are solely the responsibility of the contractor. Review of the construction by the engineer is for conformance with design aspects only, not to review the contractor's provisions for job site safety. Lack of comment by the engineer is not to be interpreted as approval of those aspects of work.
- PDF digital files of all erection and detail shop drawings for structural steel indicating the fabricator, manufacturer, finish, layout, and all accessories, must be submitted to and be checked by the contractor and subcontractor and bear the checker's initials before submission to the architect for review prior to fabrication. Fabrication and/or delivery to the site of components prior to receiving approved shop drawings shall be at the fabricator's own risk.
- Testing and inspection of structural steel, and other work are described in the project "Statement of Special Inspections". The contractor shall review the "Statement of Special Inspections" and coordinate the scheduling of inspections with the special inspector. Uninspected work that required inspections may be rejected solely on that basis.
- If faulty construction procedures, or material, result in defective work that requires additional engineering time to devise corrective measures, professional fees may be charged to the contractor at the standard hourly rate of additional services. Such fees may be withheld from the general contractor's payment.
- The contractor shall <u>field verify existing conditions</u> before proceeding with any work. The contractor shall field verify all dimensions noted "±" that are indicated on the drawings.

 Do not scale drawings.

Codes and Standards References

1 Structural steel: Design, fabricati

Design, fabrication and erection of structural steel shall conform to the AISC 360-16 "Specification for Structural Steel for Buildings" as adopted on July 7, 2016, by the American Institute of Steel Construction (AISC) and the 15th Edition of the AISC Steel Construction Manual.

Structural Steel Notes:

Design fabrication and erection of structural steel shall conform to the American Institute of Steel Construction's "Specification for Structural Steel for Buildings", indicated in the code reference section of these general notes.

2 Materials:

Wide flange shapes: ASTM A 992 Grade 50 American standard shapes, angles,

Plates and bars: ASTM A 36

Structural steel tubing,
Round:

ASTM A 500, Grade C (Fy=46 ksi)

Bolts ASTM F3125, Grade A 325
Welding electrode ASTM E 70xx, low hydrogen

Welding electrode

ASTM E 70xx, low hydrogen

All welding shall conform to American Welding Society's AWS D1.1 "Structural Welding Code-Steel" code for arc and gas welding and be performed by a certified welder in accordance with A.W.S.


- standards.


 4 High strength bolts: install high-strength bolts according to Research Council on Structural Connections' (RCSC's) "Specification for Structural Joints Using High-Strength Bolts" for type of bolt
- and type of joint specified.

 Joint type: Snug tightened unless otherwise noted.
- 5 Beam end connections shall be designed for a shear reaction of 12 kips (service load for allowable stress design).
- The fabricator is responsible for designing connections for the reactions shown on these plans. The reactions shown are "service" loads for "Allowable Stress Design" (ASD). Connections may be designed for these values using the conventional "Allowable Stress Design" method, as specified in the AISC Steel Construction Manual indicated in the code reference section of these general notes.
- Full or partial penetration groove welds shall be ultrasonic tested, as indicated in the Statement of Special Inspections, and shall be detailed to allow for such ultrasonic testing.
- All steel members and bolting exposed to weather shall be cleaned in accordance with the Steel Structures Painting Council Specification SP 6 for Commercial Blast Cleaned and hot-dipped galvanized in accordance with ASTM A 123 and ASTM A 153. Minimum acceptable zinc coating weight shall be 2 oz./sq. Ft. See architectural specifications for finished paint if required. Clean
- areas where galvanizing is damaged or missing and repair galvanizing to comply with ASTM A 780.

 Split cantilevers for steel beams shall be designed for the full moment capacity of the beam unless
- 10 Unless otherwise noted, at cantilever beam connection to top of columns, provide welded 3/4" cap plate with (4)-3/4" diameter A 325 bolts on beam gage. Provide 1/2" minimum fitted stiffeners welded at both sides of beam web. Locate stiffeners over column flange on cantilever side.
- Provide 1/4" closure plates with seal weld at ends of all HSS members.

 Existing steel surfaces to receive field welds shall be thoroughly cleaned and free from paint, rust,
- Submittals to the engineer are required for certificates of compliance for structural steel, bolts, nuts, washers, and weld filler material prior to the fabrication of any steel

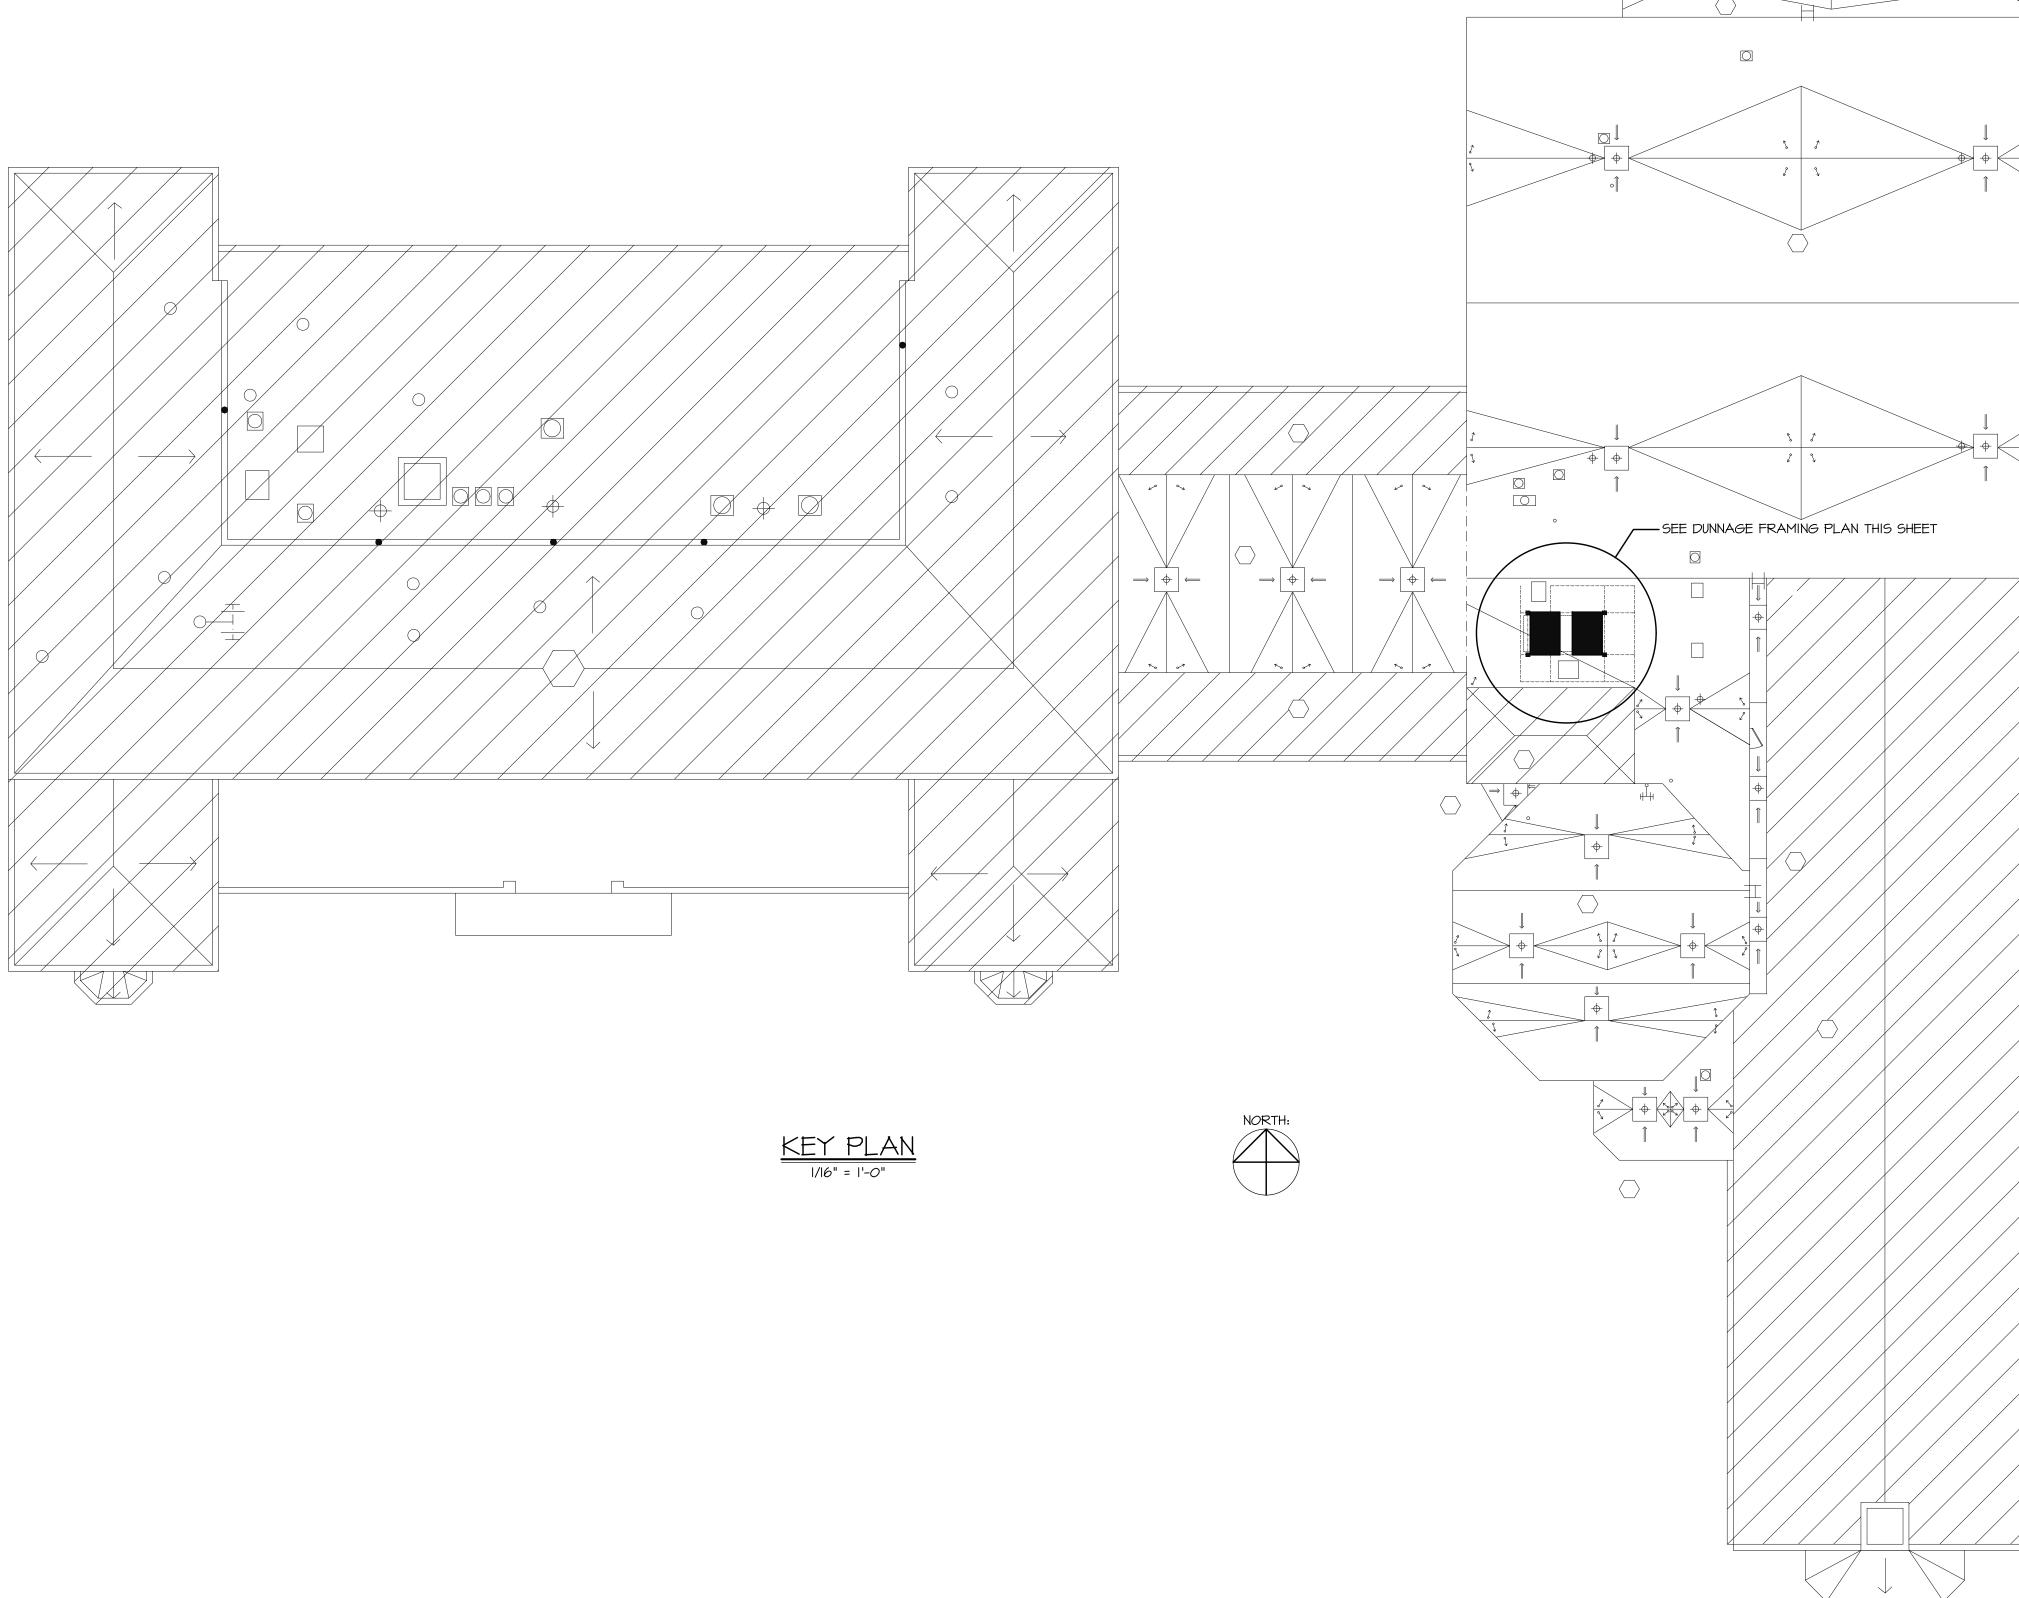

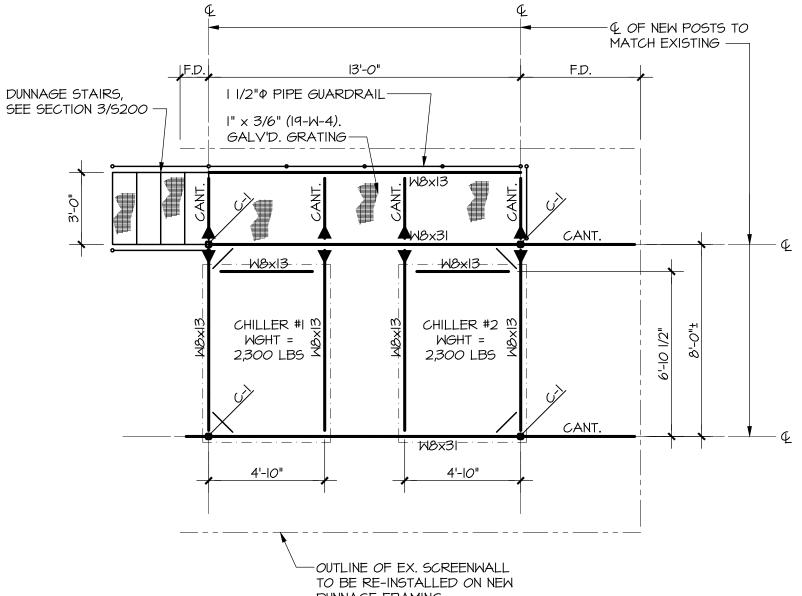

DUNNAGE FRAMING PLAN



- TOP OF NEW DUNNAGE STEEL ELEVATION: +3'-2" MIN. ABOVE TOP OF SUPPORTING ROOF STEEL.
- "C-I" INDICATES NEW GALY'D DUNNAGE POST HSS 3.500x0.300.
- ALL EXTERIOR STEEL FRAMING AND FASTENERS SHALL BE HOT-DIP GALVANIZED. SEE GENERAL NOTES FOR MORE INFORMATION.
- ALL FRAMING SHOWN IS NEW UNLESS INDICATED AS EXISTING (EX.)
- SEE GENERAL NOTES FOR ADDITIONAL INFORMATION.

2022 CAPITAL PROJECTS

DISTRICT WIDE ROOFING PROJECT

CROTON-HARMON UNION FREE SCHOOL DISTRICT 10 GERSTEIN STREET CROTON-ON-HUDSON, NEW YORK 10520



NY SED PROJECT CONTROL NO.

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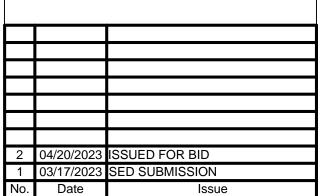
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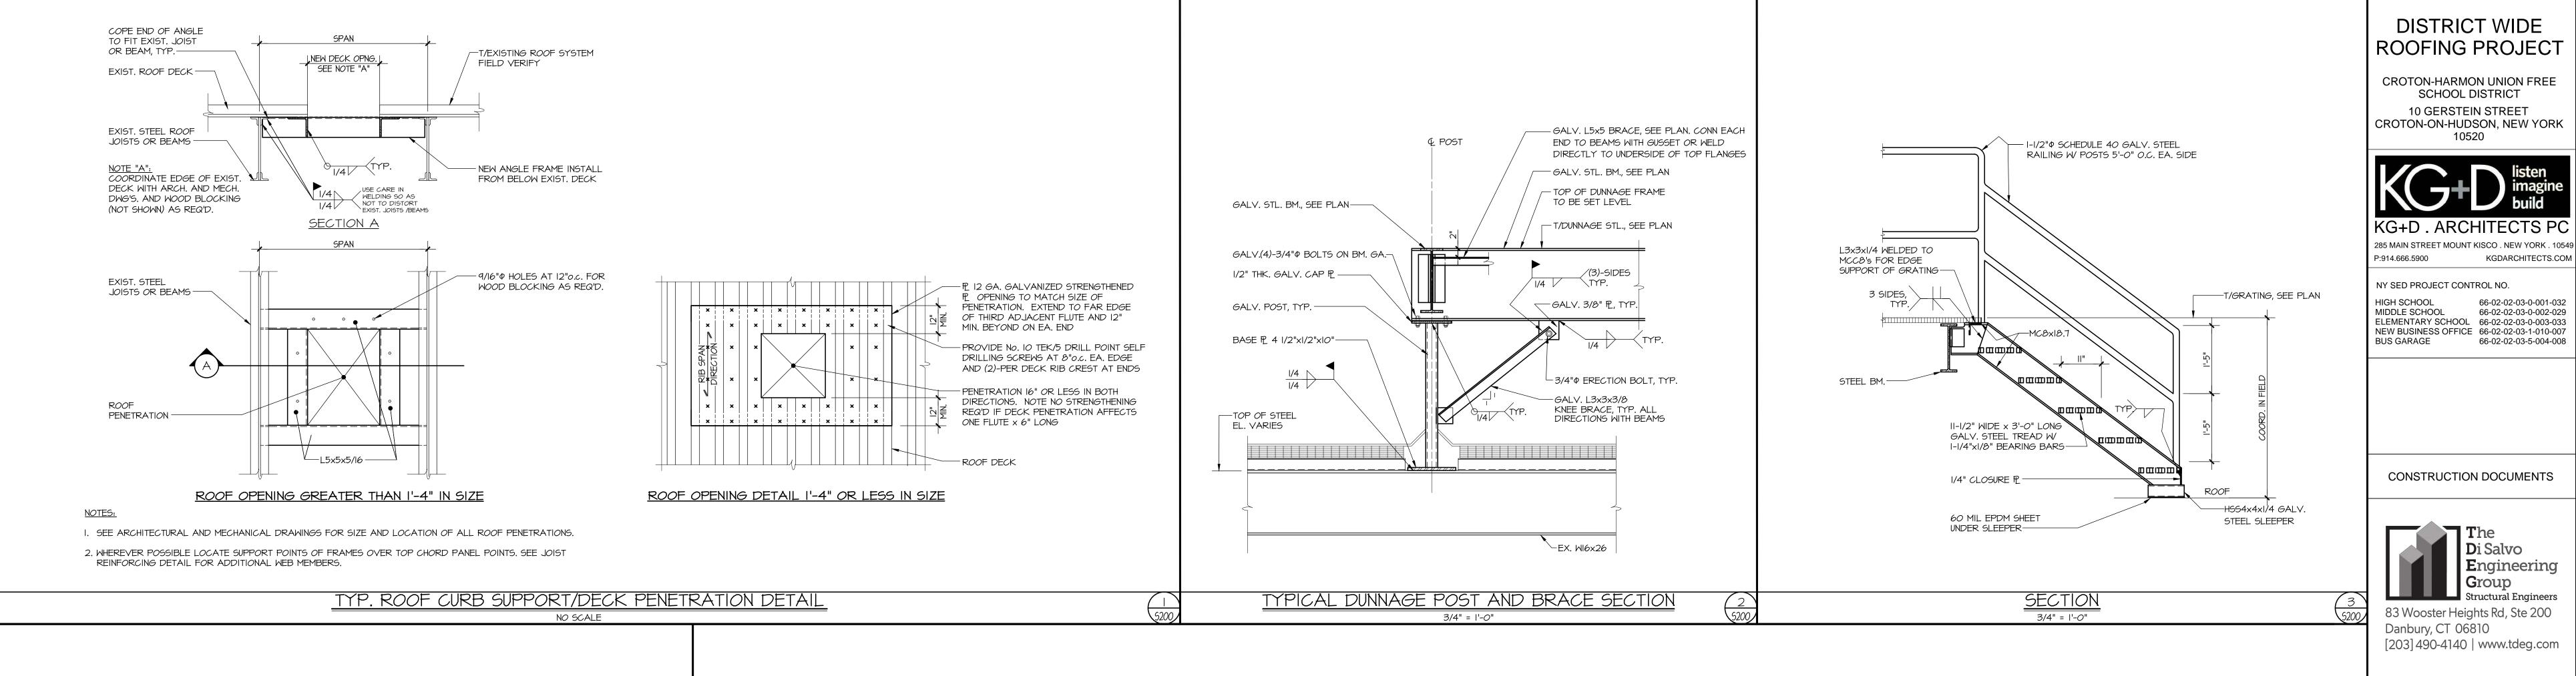
including attorney fees arising out of or resulting therefrom


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GENERAL NOTES
AND DUNNAGE
FRAMING PLAN

S100






DISTRICT WIDE **ROOFING PROJECT**

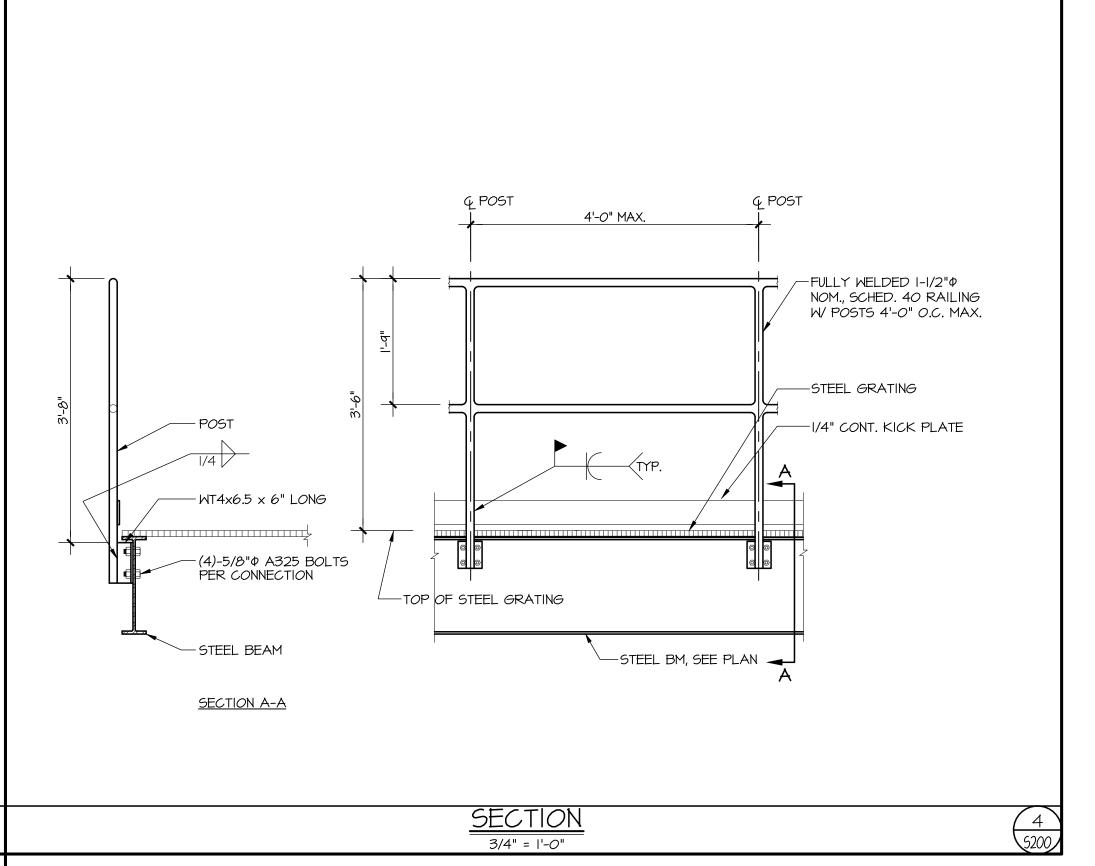CROTON-HARMON UNION FREE SCHOOL DISTRICT 10 GERSTEIN STREET CROTON-ON-HUDSON, NEW YORK



KGDARCHITECTS.COM NY SED PROJECT CONTROL NO.

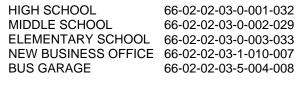

CONSTRUCTION DOCUMENTS

83 Wooster Heights Rd, Ste 200

Danbury, CT 06810 [203]490-4140 | www.tdeg.com

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SECTIONS AND **DETAILS**

03/17/2023

S200


	LEGEND					
	EXISTING DUCTWORK, EQUIPMENT, ETC. TO REMAIN					
	EXISTING DUCTWORK, EQUIPMENT, ETC. TO BE REMOVED					
— ECHWS —	EXISTING CHILLED WATER SUPPLY PIPE					
— ECHWR —	EXISTING CHILLED WATER RETURN PIPE					
—CHWS —	CHILLED WATER SUPPLY PIPE					
—CHWR —	CHILLED WATER RETURN PIPE					
	FLOW DIRECTION WITHIN PIPE					
─ ₩	SHUT OFF VALVE					
─₩ ─	COMBINATION BALANCING & SHUT-OFF VALVE					
—战—	2 - WAY CONTROL VALVE					
	PIPE CONNS. (BOTTOM; TOP 45 OR 90; PIPE UP) EXISTING CHILLER IDENTIFICATION					
CHL EXIST						
(CHL)	NEW CHILLER IDENTIFICATION					
0	POINT OF DISCONNECTION					
•	POINT OF CONNECTION, NEW TO EXISTING					
AFF	ABOVE FINISHED FLOOR					
G.C.	GENERAL CONTRACTOR					
	SECTION/DETAIL/ELEVATION/PART PLAN NUMBER DRAWING NUMBER SECTION/ELEVATION IDENTIFICATION					


REMOVAL NOTES:


 $oldsymbol{\mathbb{O}}$ THE SCOPE OF REMOVAL SHOWN ON "REMOVALS" DRAWINGS IS DIAGRAMMATIC ONLY AND INDICATES THE INTENT OF THE WORK TO BE PERFORMED AND NOT THE COMPLETE SCOPE OF DEMOLITION AND/OR REMOVAL WORK. IT SHALL BE THE RESPONSIBILITY OF THIS CONTRACTOR TO REMOVE ANY RELATED MECHANICAL DEVICES EVEN IF NOT SPECIFICALLY INDICATED TO BE REMOVED ON THESE DRAWINGS IN ORDER TO ACCOMMODATE NEW WORK.

2 DEVICES SHOWN CROSS HATCHED ON DRAWINGS ARE ITEMS TO BE REMOVED. ANY DEVICES REMOVED SHALL INCLUDE (BUT SHALL NOT BE LIMITED TO) THE REMOVAL OF ALL ASSOCIATED PIPING, CONTROLS, ETC. THAT ARE NOT INCORPORATED IN THE NEW LAYOUT, UNTIL SUCH REMOVAL IS COMPLETE. THIS CONTRACTOR SHALL PERFORM ALL WORK REQUIRED TO INSURE CONTINUITY OF SERVICE TO EXISTING REMAINING EQUIPMENT. NO EXTRAS RELATING TO THE SCOPE OF WORK

DESCRIBED WILL BE ALLOWED. 3 EQUIPMENT, PIPING, ETC., REQUIRED TO RECONNECT SHALL BE INSTALLED CONCEALED WITHIN THE NEW SUSPENDED CEILINGS, PARTITIONS AND/OR WALLS, FLOORS, NO SURFACE MOUNTED OR EXPOSED EQUIPMENT, PIPING, ETC., SHALL BE PERMITTED, UNLESS SPECIFICALLY INDICATED WHERE PIPING IS INSTALLED EXPOSED. 4 ALL ITEMS TO BE REMOVED SHALL BE REVIEWED WITH THE OWNER PRIOR TO REMOVAL OWNER SHALL HAVE FIRST SALVAGE RIGHTS. ITEMS THE OWNER WISHES TO KEEP SHALL BE REMOVED WITH CARE AND STORED AS DIRECTED BY OWNER. ITEMS THE OWNER DOES NOT WISH

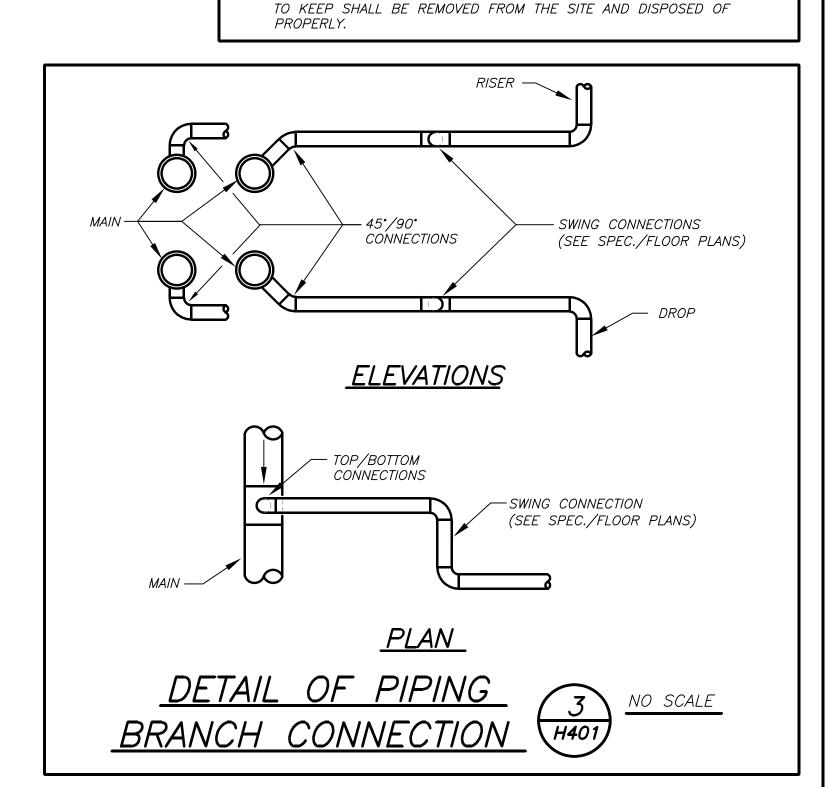

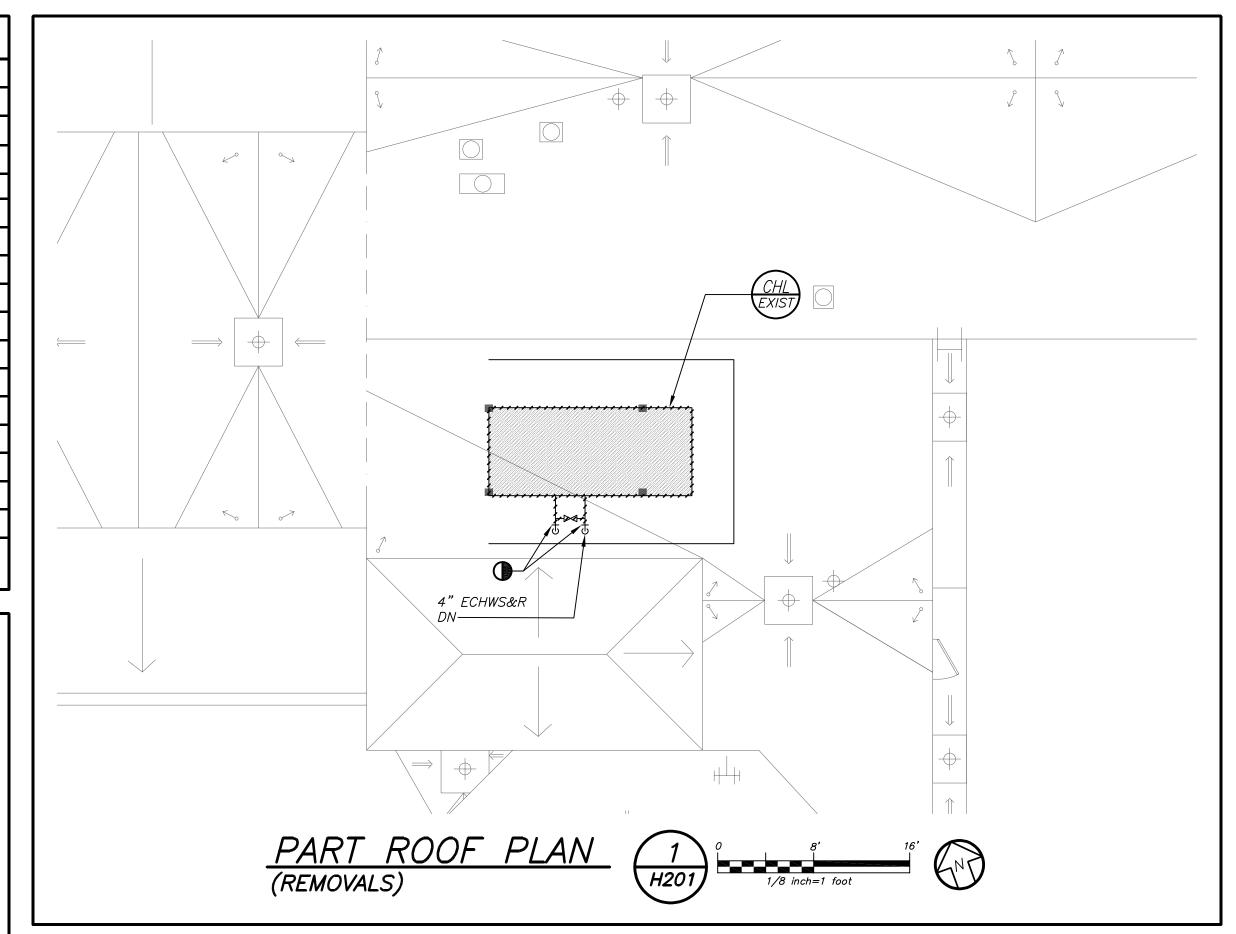

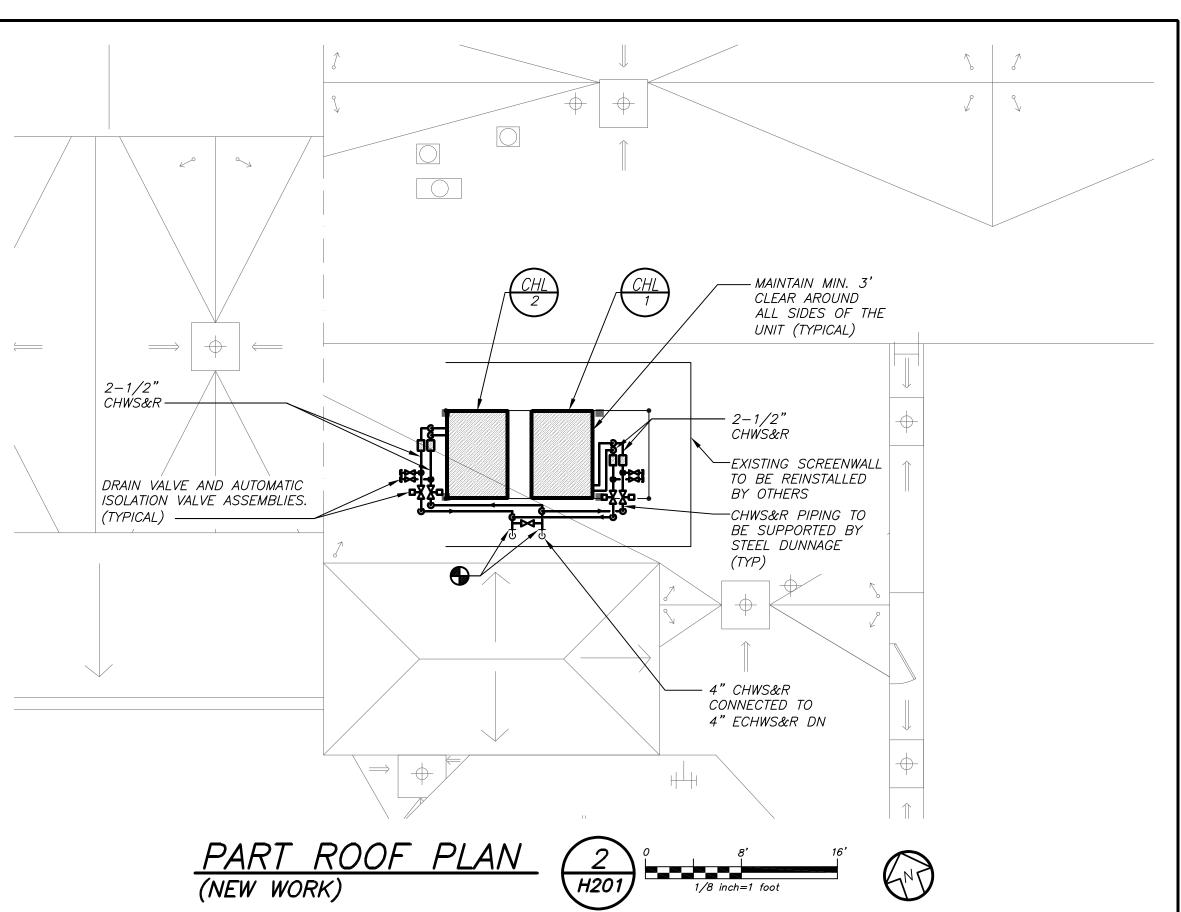

SCHEDULE OF AIR COOLED CHILLERS												
MARK	SERVICE	LOCATION	MODEL Nº ①	COOLING CAPACITY (TONS)	GPM	COMPRESSOR QTY / SIZE	COND. FAN QTY / WATTS	ELECTRIC SERVICE	MCA	MOCP	PHYSICAL DATA DIMENSION / WEIGHT	REMARKS
CHL 1	CHILLED WATER	ROOF	ACHH40VBAB	<i>35</i>	84	4/10 TONS	4/900	208/3/60	147.9	150	85"X60"X88"/2300LBS	REFER TO 234502899002
<u>CHI</u> 2	CHILLED WATER	ROOF	ACHH40VBAB	<i>35</i>	84	4/10 TONS	4/900	208/3/60	147.9			REFER TO 234567899002
N (1) AS MANUFACTURED BY "LC"												

- **N** (1) AS MANUFACTURED BY "(1)".
- ${m {\it U}}$ (2) DESIGN CONDITIONS BASED ON OUTDOOR AMBIENT TEMPERATURE 95°F COOLING, 44°F LWT AND 54°F EWT 3) REFRIGERANT USED SHALL BE R-410a.
- (4) INSTALL PER MANUFACTURER'S RECOMMENDATIONS. (5) E.E.R. = 10.82, NPLV = 19.40
- 6 BASED ON ARI STANDARD 370, MAXIMUM 87 dbA SOUND POWER LEVEL, MAXIMUM 55 dBA SOUND PRESSURE LEVEL @ 30FT. 7 ALL COMPRESSORS SHALL BE INVERTER TYPE.
- 8 PROVIDE LG MULTISITE EDGE 10 CONTROLLERS MODEL PBASE10 WITH ENCLOSURE PANEL AND SOFTWARE FOR INTERFACE WITH ATC SUB—CONTRACTOR.
- EACH CONTROLLER CONTROLS TWO (2) CHILLER MODULES.
- PROVIDE START-UP SERVICE AND COMMISSIONING BY FACTORY CERTIFIED TECHNICIAN. (10) PROVIDE NEOPRENE VIBRATION ISOLATION PADS. SECURE TO NEW DUNNAGE. (1) PROPYLENE GLYCOL 30%. CONTRACTOR RESPONSIBLE TO PROVIDE GLYCOL.
- 12 BEFORE WORK BEGINS, CONTRACTOR TO DETERMINE THE EXISTING FLOW FROM EACH CHILLED WATER PUMP WITH ALL CONTROL VALVES FULLY OPEN. AT CONCLUSION OF PROJECT, CONTRACTOR SHALL BALANCE SYSTEM TO MAINTAIN THOSE FLOW RATES AT SIMILAR CONDITIONS (NUMBER OF PUMPS OPERATING, VALVE POSITIONS, ETC.)


DISTRICT WIDE **ROOFING PROJECT** CROTON-HARMON UNION FREE SCHOOL DISTRICT 10 GERSTEIN STREET CROTON-ON-HUDSON, NEW YORK 285 MAIN STREET MOUNT KISCO . NEW YORK . 10549 P:914.666.5900 KGDARCHITECTS.COM NY SED PROJECT CONTROL NO. 66-02-02-03-0-001-032 66-02-02-03-0-002-029 HIGH SCHOOL MIDDLE SCHOOL ELEMENTARY SCHOOL 66-02-02-03-0-003-033 NEW BUSINESS OFFICE 66-02-02-03-1-010-007 BUS GARAGE 66-02-02-03-5-004-008

2022 CAPITAL PROJECTS

BARILE GALLAGHER & ASSOCIATES

CONSULTING ENGINEERS
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CONSTRUCTION DOCUMENTS

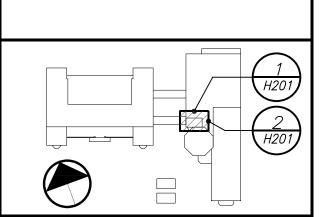

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 1
 04/20/2023
 ISSUED FOR BID

 1
 03/17/2023
 CONSTRUCTION DOCUMENTS

 No.
 Date
 Issue

LEGEND, NOTES, SCHEDULE, **DETAILS & PART**

ROOF PLANS 04/17/2023 2023-1002

Drawn / Checked AS NOTED BGA / BGA

H201

GENERAL NOTES

- 1. DRAWINGS ARE DIAGRAMMATIC AND INDICATE THE GENERAL ARRANGEMENT OF SYSTEMS AND WORK. CONTRACTOR SHALL FURNISH ALL NECESSARY OUTLETS, SUPPORTS, FITTINGS AND ACCESSORIES TO FULFILL APPLICABLE CODES, REGULATIONS, BUILDING STANDARDS AND THE BEST PRACTICES OF THE TRADE FOR FIRST CLASS ELECTRICAL INSTALLATION.
- 2. THE DRAWINGS INDICATE SIZE AND GENERAL LOCATION OF WORK. SCALED DIMENSIONS SHALL NOT BE USED. THE EXACT LOCATION AND ELEVATION OF ALL ELECTRICAL EQUIPMENT SHALL BE COORDINATED IN FIELD WITH RESPECTIVE CONTRACTOR/OWNER.
- 3. WHERE PANELBOARDS, SWITCHES, CIRCUIT BREAKERS, ETC. ARE EXISTING AND TO BE REUSED THE CONTRACTOR SHALL CLEAN AND REFURBISH THE EQUIPMENT. THIS SHALL INCLUDE TIGHTENING ALL CONNECTIONS, REPLACING DEFECTIVE MECHANISMS AND PROVIDING ALL REQUIRED AND NECESSARY MISCELLANEOUS COMPONENTS SO THAT THE EQUIPMENT SHALL BE IN PERFECT WORKING ORDER.
- 4. THE CONTRACTOR SHALL COORDINATE WITH THE OWNER PRIOR TO SUBMISSION OF BID TO DETERMINE WHAT WORK MUST BE PERFORMED AFTER NORMAL BUSINESS HOURS. UNLESS OTHERWISE DIRECTED ANY NOISY WORK (CHOPPING, CORE DRILLING, HAMMERING, ETC.) AND BUILDING POWER INTERRUPTIONS SHALL BE PERFORMED OUTSIDE OF NORMAL BUSINESS HOURS. CONFIRM NORMAL BUSINESS HOURS WITH BUILDING OWNER. NO ADDITIONAL COST WILL BE CHARGED TO OWNER FOR WORK PERFORMED OUTSIDE NORMAL BUSINESS HOURS.
- 5. ALL WORK WHERE SHOWN WITH DARK/SOLID LINES ON THE DRAWINGS IS NEW UNLESS OTHERWISE NOTED. WHERE SHOWN WITH DASHED LINES WITH LETTER (E) IS EXISTING TO REMAIN, WITH LETTER (R) IS EXISTING TO BE REMOVED, WITH LETTER (ER) IS EXISTING RELOCATED, WITH LETTER (RN) IS EXISTING TO BE REPLACED WITH NEW AND WITH LETTER (RR) IS EXISTING TO BE REMOVED AND RELOCATED.
- 6. CIRCUIT NUMBERS TO EXISTING PANELS ARE SHOWN FOR INTENT ONLY. ACTUAL CIRCUIT NUMBERS TO BE USED SHALL BE AS PER FIELD CONDITIONS BY UTILIZING SPARE CIRCUITS, BREAKERS OR SPACES IN EXISTING PANEL, SIZE AS INDICATED ON THE PLANS. THE ELECTRICAL CONTRACTOR SHALL BALANCE LOAD OF CIRCUITS EVENLY ON ALL PHASES.
- 7. FEEDERS AND BRANCH CIRCUITRY SHALL BE RUN IN MINIMUM 3/4" CONDUIT UNLESS OTHERWISE NOTED. FINAL CONNECTIONS TO MOTORS MAY BE MADE WITH FLEXIBLE METALLIC CONDUIT (NO LONGER THAN 18"). IN UNFINISHED AREAS CONDUIT SHALL BE RUN EXPOSED AND IN FINISHED AREAS CONDUIT SHALL BE RUN CONCEALED.
- 8. PROVIDE PANEL NAME PLATE MADE OF BLACK LAMINATED PLASTIC WITH WHITE ENGRAVED LETTERING AND TYPE WRITTEN DIRECTORY FOR ALL NEW AND EXISTING PANELS BEING USED FOR THIS PROJECT.
- 9. ALL CONDUCTORS SHALL BE COPPER, TYPE THHN/THWN INSULATED. ALL CONDUCTORS SHALL HAVE 600 VOLT RATED INSULATION UNLESS OTHERWISE NOTED.
- 10. THE USE OF FLEXIBLE CONDUIT FROM LIGHTING FIXTURES TO JUNCTION BOX IS PERMITTED ONLY WHEN A SEPARATE GROUND WIRE IS INSTALLED WITH THE CONDUCTORS INSIDE FLEXIBLE CONDUIT. THE GROUND WIRE MUST BOND THE FIXTURE HOUSING TO THE JUNCTION BOX. MAXIMUM LENGTH 6'-0".
- 11. EXACT LOCATION AND MOUNTING HEIGHTS OF ALL DEVICES SHALL BE COORDINATED WITH THE ARCHITECT PRIOR TO THE INSTALLATION.
- 12. WALL MOUNTED EQUIPMENT (SWITCHES, RECEPTACLES, ETC.,) SHALL BE SURFACE MOUNTED IN UNFINISHED AREAS AND ON EXISTING CONCRETE BLOCK WALLS AND FLUSH MOUNTED IN NEW WALLS/PARTITIONS.
- 13. CONDUIT RUNS SHALL BE PARALLEL WITH OR AT RIGHT ANGLES TO WALLS AND CEILINGS. CONDUIT SHALL BE SUPPORTED BY APPROVED MEANS. SUPPORTS FOR HORIZONTAL RUNS OF CONDUIT SHALL NOT EXCEED SEVEN FEET ON CENTERS.
- 14. PROVIDE PULL BOXES, JUNCTION BOXES, CONDUIT ELBOWS AND OFFSETS TO SUIT FIELD CONDITIONS AND THE NATIONAL ELECTRICAL CODE.
- 15. ALL EMPTY CONDUIT SHALL BE PROVIDED WITH A DRAGWIRE.
- 16. THE MINIMUM WIRE SIZE FOR 120 VOLT BRANCH CIRCUITS SHALL BE NO. 12 AWG, EXCEPT OVER 100' IN LENGTH SHALL BE NO. 10 AWG.
- 17. PROVIDE ALL REQUIRED AND NECESSARY ACCESSORIES (EX. CONNECTORS, ADAPTERS, BUSHINGS, CLAMPS, ETC.) TO FACILITATE COMPLETE INSTALLATION.
- 18. COORDINATE LOCATION OF ALL MECHANICAL EQUIPMENT WITH HVAC CONTRACTOR IN FIELD. FUSES FOR ALL MOTOR LOADS SHALL BE DUAL ELEMENT TIME DELAY TYPE.
- 19. ALL JUNCTION OR OUTLET BOXES SHALL BE INSTALLED SO AS TO ALLOW ACCESS TO COVER. PROVIDE ARCHITECT APPROVED ACCESS DOORS OR PLATES AS REQUIRED IN AREAS WHERE UNOBSTRUCTED ACCESS TO BOX OR OUTLET IS NOT POSSIBLE.
- 20. PRIOR TO ANY CHASING, CHOPPING OR CORE DRILLING BEING PERFORMED, THE CONTRACTOR SHALL FIELD INVESTIGATE CONDITIONS AND COORDINATE ALL WORK TO ENSURE THAT IT WILL BE IN HARMONY AND NOT AFFECT ANY EXISTING BUILDING SYSTEMS. THIS WORK MUST BE APPROVED BY BUILDING OWNER PRIOR TO PROCEEDING.
- 21. OPENINGS AROUND ELECTRICAL PENETRATIONS THROUGH FIRE RESISTANCE RATED WALLS, PARTITIONS, FLOORS OR CEILINGS SHALL BE FIRE STOPPED USING APPROVED METHODS. ALL SLEEVES MUST HAVE BUSHINGS. SEALANT SHALL BE 3 HOUR FIRE BARRIER #CP-25 (NO LESS THAN 3" THICK BACKED UP WITH MINERAL WOOL).
- 22. ALL PANELBOARD COVERS SHALL BE INSTALLED IN PLACE AT THE COMPLETION OF EACH DAYS WORK.
- 23. PREPARE 'AS-BUILT' DRAWINGS THAT REFLECT ACTUAL CONSTRUCTION AND SHOW DEVIATIONS FROM DESIGN DRAWINGS.
- 24. ALL NEW CIRCUIT BREAKERS INSTALLED INTO EXISTING PANELBOARDS SHALL BE UL LISTED FOR USE IN THE PANEL.

GENERAL REMOVAL NOTES

- BEFORE COMMENCING WORK, EXAMINE ALL ADJOINING AREAS THAT MAY BE AFFECTED BY REMOVAL. REPORT TO THE GENERAL CONTRACTOR ANY CONDITION THAT PREVENTS PERFORMANCE OF THE WORK.
- 2. BECOME THOROUGHLY FAMILIAR WITH EXISTING CONDITIONS WHERE CONNECTIONS MUST BE MADE, CHANGED OR ALTERED. THE INTENT OF THE WORK IS SHOWN ON THE DRAWINGS AND DESCRIBED HEREINAFTER AND NO CONSIDERATION WILL BE GRANTED BY REASON OF LACK OF FAMILIARITY ON THE PART OF THE CONTRACTOR WITH ACTUAL PHYSICAL CONDITIONS AT THE SITE. INSPECT EACH AND EVERY AREA AFFECTED BY THE ALTERATION OF THE SPACE BEFORE SUBMITTAL OF BID.
- ALL ELECTRICAL EQUIPMENT IN THE AREA OF WORK IS EXISTING TO BE REMOVED UNLESS OTHERWISE NOTED. THIS SHALL INCLUDE BUT NOT BE LIMITED TO THE FOLLOWING: A. DISTRIBUTION BOARDS AND PANELBOARDS.
- CIRCUIT BREAKERS AND DISCONNECT SWITCHES.
- POWER AND DISCONNECTED. ALL POWER CONDUCTORS, CONTROL WIRING AND CONDUIT ASSOCIATED WITH MECHANICAL EQUIPMENT SUCH AS FANS, AIR CONDITIONING UNITS. PUMPS.

4. ALL CONDUCTORS AND CONDUIT ASSOCIATED WITH REMOVED ELECTRICAL

EQUIPMENT SHALL BE REMOVED COMPLETELY BACK TO ITS SOURCE OF

- ETC. DESIGNATED FOR REMOVAL ON THE HVAC AND PLUMBING REMOVAL DRAWINGS SHALL BE REMOVED CLEAR BACK TO THE SOURCE OF POWER AND DISCONNECTED. ALL MOTOR STARTERS, DISCONNECT SWITCHES, CONTROL DEVICES, ETC. SHALL BE REMOVED. REFER TO MECHANICAL AND PLUMBING DRAWINGS FOR ADDITIONAL INFORMATION.
- 6. CIRCUIT BREAKERS AND/OR SWITCHES IN PANELBOARD(S) OR DISTRIBUTION BOARD(S) MADE SPARE DUE TO REMOVAL SHALL BE DESIGNATED AS SUCH ON THE PANEL SCHEDULE.
- 7. THE ELECTRICAL CONTRACTOR SHALL BE RESPONSIBLE TO TRACE AND RELOCATE ALL EXISTING FEEDERS AND BRANCH CIRCUIT WIRING WHICH PASSES THROUGH THE REMOVAL AREA THAT SERVE EXISTING OCCUPIED SPACES TO REMAIN. COORDINATE WITH BUILDING MANAGER PRIOR TO ANY SHUTDOWNS OR DISRUPTIONS THAT MAY BE REQUIRED TO ACCOMPLISH THIS
- 8. DISPOSE OF ALL REMOVED EQUIPMENT, WHICH IS NOT INTENDED TO BE REUSED. PRIOR TO DISPOSAL, CONTACT BUILDING MANAGER TO DETERMINE IF ANY REMOVED EQUIPMENT IS DESIRED FOR STOCK.
- 9. EXISTING CIRCUIT BREAKERS IN PANEL(S) ARE TO BE RE-USED. ELECTRICAL CONTRACTOR TO DISCONNECT PANEL AND CIRCUIT BREAKERS WITH GREAT CARE TO ENSURE AGAINST DAMAGE. THIS CONTRACTOR SHALL PROVIDE NEW CIRCUIT BREAKERS AS REQUIRED. ALL NEW CIRCUIT BREAKERS INSTALLED INTO EXISTING PANELBOARDS SHALL BE UL LISTED FOR USE IN THE PANEL.
- 10. EXISTING EQUIPMENT DESIGNATED FOR REUSE SHALL BE CLEANED, REFURBISHED AND RESTORED TO OPTIMUM PERFORMANCE. THIS SHALL INCLUDE BUT NOT LIMITED TO CLEANING OF LIGHT FIXTURES, REPLACEMENT OF INOPERABLE BALLASTS AND LAMPS, RESISTANCE TESTING OF BRANCH CIRCUITRY AND FEEDERS, ETC.
- 1. EXTEND EXISTING CIRCUITRY TO THOSE DEVICES THAT ARE TO BE RELOCATED. MATCH EXISTING TYPE AND SIZE. RELOCATION OF EXISTING EQUIPMENT SHALL BE PERFORMED ONLY UPON OWNERS ACCEPTANCE OF EXISTING EQUIPMENT.
- 12. EXTEND EXISTING CIRCUITS SERVING EQUIPMENT TO REMAIN FROM PANELS THAT ARE TO BE REMOVED TO NEW PANELS OR EXISTING PANELS THAT ARE TO REMAIN.

<i>ABBREVIATIONS</i>						
ABBV. DESCRIPTION						
Α	AMP/AMPERE					
AWG	AMERICAN WIRE GAUGE					
С	CONDUIT					
C.B.	CIRCUIT BREAKER					
CHL	CHILLER					
CKT	CIRCUIT					
(E)	EXISTING TO REMAIN					
E.C.	ELECTRICAL CONTRACTOR					
EXIST.	EXISTING					
G,GRD	GROUND					
GFI	GROUND FAULT INTERRUPTER					
HVAC	HEATING, VENTILATING AND AIR—CONDITIONING UNIT					
KVA	KILOVOLT AMPERE					
мсв	MAIN CIRCUIT BREAKER					
MDP	MAIN DISTRIBUTION PANEL					
NTS	NOT TO SCALE					
PNL	PANEL					
(R)	REMOVE EXISTING					
RECPT	RECEPTACLE					
W	WATT					
WP	WEATHERPROOF					

ABBREVIATIONS			LEGEND		
BBV.	DESCRIPTION	1 📂			
Α	AMP/AMPERE	┪┝──			
AWG	AMERICAN WIRE GAUGE	3	HOMERUN TO DESIGNATED PANEL, ARROWHEAD INDICATES SINGLE POLE CIRCUIT. HOM CONSIST OF 2#12-3/4"C U.O.N.		
С	CONDUIT				
C.B.	CIRCUIT BREAKER		HOMERUN TO DESIGNATED PANEL, NUMBERS IN PARENTHESIS INDICATE MULTIPLE CIRC 3-HOTS AND 1-GROUND U.O.N.		
CHL	CHILLER		- 11010 1 0NOOND 0.0.N.		
CKT	CIRCUIT]	EXISTING TO REMAIN		
(E)	EXISTING TO REMAIN	J			
E.C.	ELECTRICAL CONTRACTOR	* - *	EXISTING TO BE REMOVED		
EXIST.	EXISTING	」├──			
G,GRD	GROUND		NEW		
GFI	GROUND FAULT INTERRUPTER		20A FLUSH WALL MOUNTED GROUND FAULT INTERRUPTING TYPE DUPLEX RECEPTACE		
HVAC	HEATING, VENTILATING AND AIR—CONDITIONING UNIT		#GF5362.		
KVA	KILOVOLT AMPERE		SURFACE MOUNTED EXISTING ELECTRICAL PANELBOARD.		
мсв	MAIN CIRCUIT BREAKER	1 			
MDP	MAIN DISTRIBUTION PANEL	240/3	HEAVY DUTY TYPE DISCONNECT SWITCH WITH FINAL FLEXIBLE EQUIPMENT CONNECTION INDICATES VOLTAGE, 3 INDICATES NO. OF POLES, 60 INDICATES AMPERE RATING, NF		
NTS	NOT TO SCALE		NON-FUSED(OR FUSE SIZE) U.O.N. REFER TO SPECIFICATION AND DRAWINGS FOR EN		
PNL	PANEL	WP	'WP' WHERE USED INDICATES WEATHERPROOF ENCLOSURE (NEMA 3R).		
(R)	REMOVE EXISTING	1	MOTOR (F.B.O. WIRED BY ELEC.) — NUMBER INDICATES HORSEPOWER. REFER TO PAI		
RECPT	RECEPTACLE		SCHEDULES FOR WIRING AND OVER CURRENT PROTECTION.		
W	WATT	1	TAG SYMBOL. NUMERAL DENOTES REFERENCE TO A WORK NOTE.		
WP	WEATHERPROOF	」├──	MECHANICAL EQUIPMENT IDENTIFICATION:		
		*	EQUIPMENT ABBREVIATION (FE, SF, HV, ETC. SEE ABBREVIATIONS ON THIS DWG.) EQUIPMENT NUMBER		

---- DETAIL/PART PLAN NUMBER

- DRAWING NUMBER

DISTRICT WIDE ROOFING PROJECT OMERUN SHALL CROTON-HARMON UNION FREE IRCUIT, I.E. SCHOOL DISTRICT 10 GERSTEIN STREET CROTON-ON-HUDSON, NEW YORK ACLE HUBBELL 285 MAIN STREET MOUNT KISCO . NEW YORK . 10549 P.914.666.5900 NY SED PROJECT CONTROL NO. TION. 240 F INDICATES HIGH SCHOOL ENCLOSURE. MIDDLE SCHOOL ELEMENTARY SCHOOL 66-02-02-03-0-003-033 NEW BUSINESS OFFICE 66-02-02-03-1-010-007 **BUS GARAGE** PANEL BARILE GALLAGHER & ASSOCIATES CONSULTING ENGINEERS 39 MARBLE AVE PLEASANTVILLE, NY 10570 914.328.6060 GENERAL@BGA-ENG.com www.BGA-ENG.com CONSTRUCTION DOCUMENTS


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66-02-02-03-5-004-008



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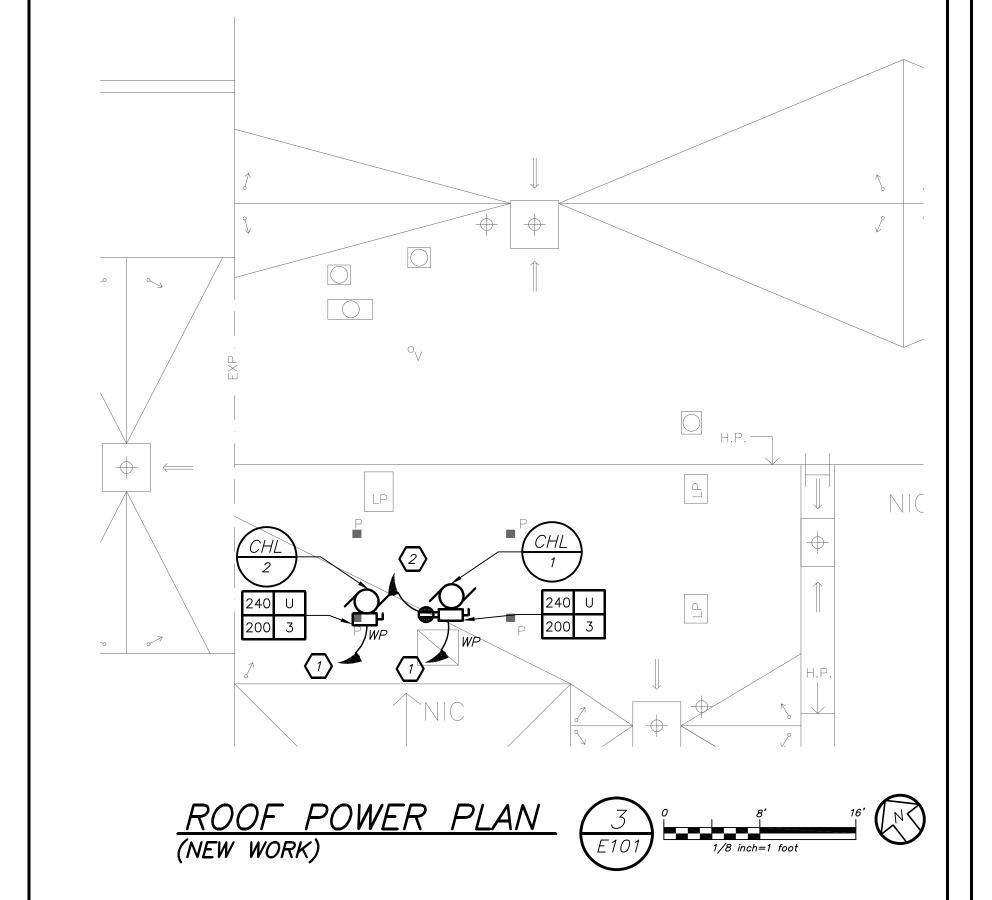
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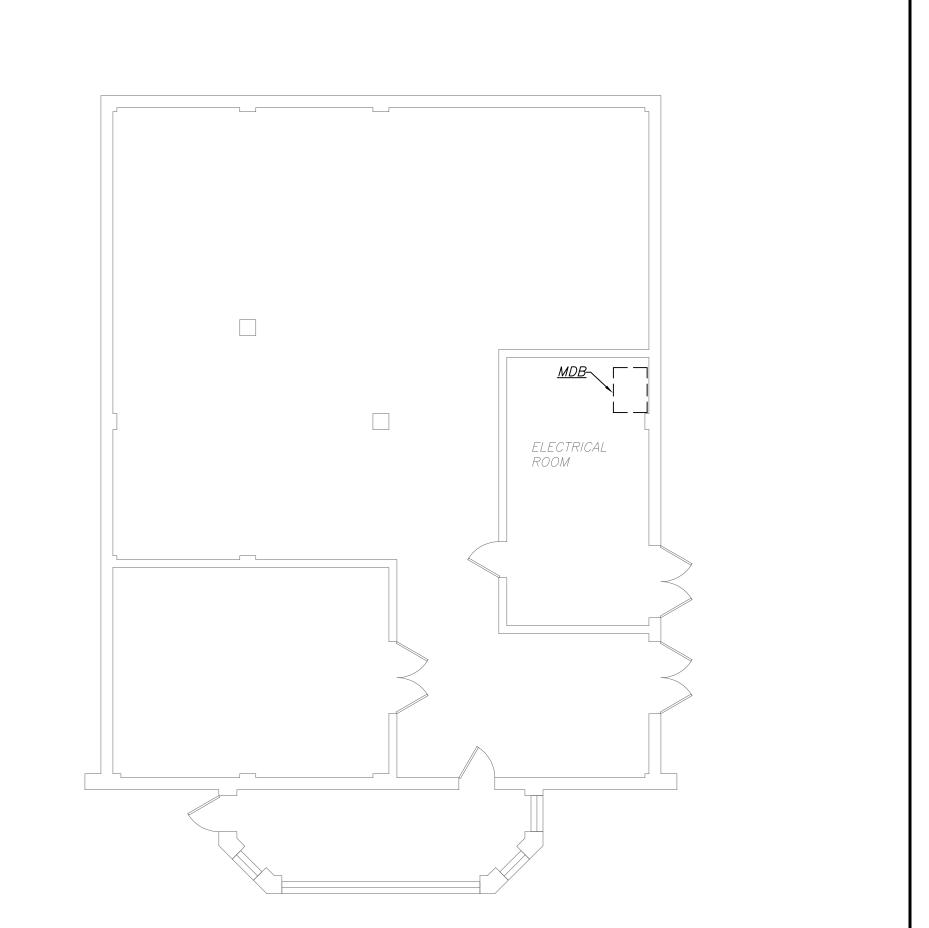
ELECTRICAL LEGENDS, NOTES, AND **ABBREVIATIONS**

2023-1002 04/17/2023 rawn / Checked AS NOTED BGA / BGA


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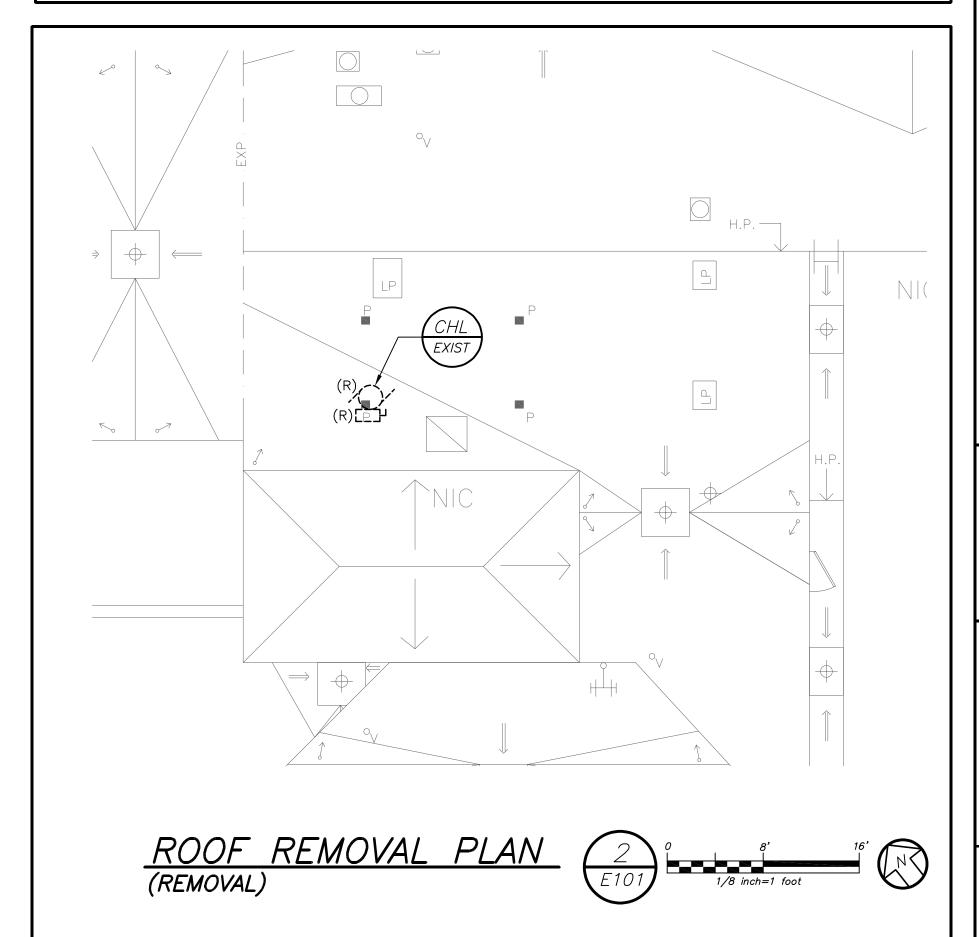
DBE: TAB: $E001 - Y:\CROTON-HARMON$ UFSD $\CHUFSD - PVC$ Chiller Repl - Roof Repl $(2335.00)\Drawings\Electrical\233500E001.dwg <math>-$ DATE: Apr 17, 2023 - 4:41pm

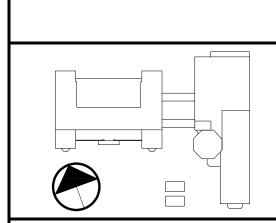







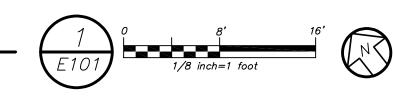

GENERAL NOTES:

- 1. ALL DISCONNECTS AND STARTERS SHALL BE REMOVED. REMOVE ALL BRANCH CIRCUITRY AND CONDUIT SHALL BE REMOVED BACK TO SOURCE.
- PROVIDE 3#1/0+1#6G IN 2" CONDUIT TO MDB IN THE MAIN ELECTRICAL ROOM. PROVIDE 3P-150 AMP BREAKER AT DISTRIBUTION BOARD.
- PROVIDE 2#12+1#12G IN 3/4" C TO PANEL LP LOCATED BELOW CHILLER IN 2ND FLOOR HALLWAY.

CROTON-ON-HUDSON, NEW YORK 10520 NY SED PROJECT CONTROL NO. HIGH SCHOOL 66-02-02-03-0-001-032 MIDDLE SCHOOL 66-02-02-03-0-002-029 ELEMENTARY SCHOOL 66-02-02-03-0-003-033 NEW BUSINESS OFFICE 66-02-02-03-1-010-007 BUS GARAGE 66-02-02-03-5-004-008 CONSULTING ENGINEERS

39 MARBLE AVE PLEASANTVILLE, NY 10570

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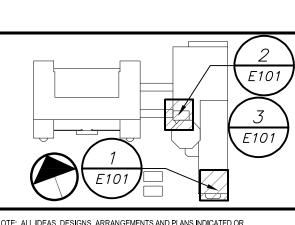
CONSTRUCTION DOCUMENTS

2022 CAPITAL PROJECTS

DISTRICT WIDE ROOFING PROJECT

CROTON-HARMON UNION FREE SCHOOL DISTRICT

10 GERSTEIN STREET



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1 04/20/2023 ISSUED FOR BID
1 03/17/2023 CONSTRUCTION DOCUMENTS
No. Date Issue


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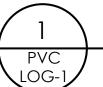
ROOF ELECTRICAL

REMOVALS AND NEW POWER PLAN

04/17/2023 2023-1002 Drawn / Checked BGA / BGA AS NOTED Sheet Number


E101



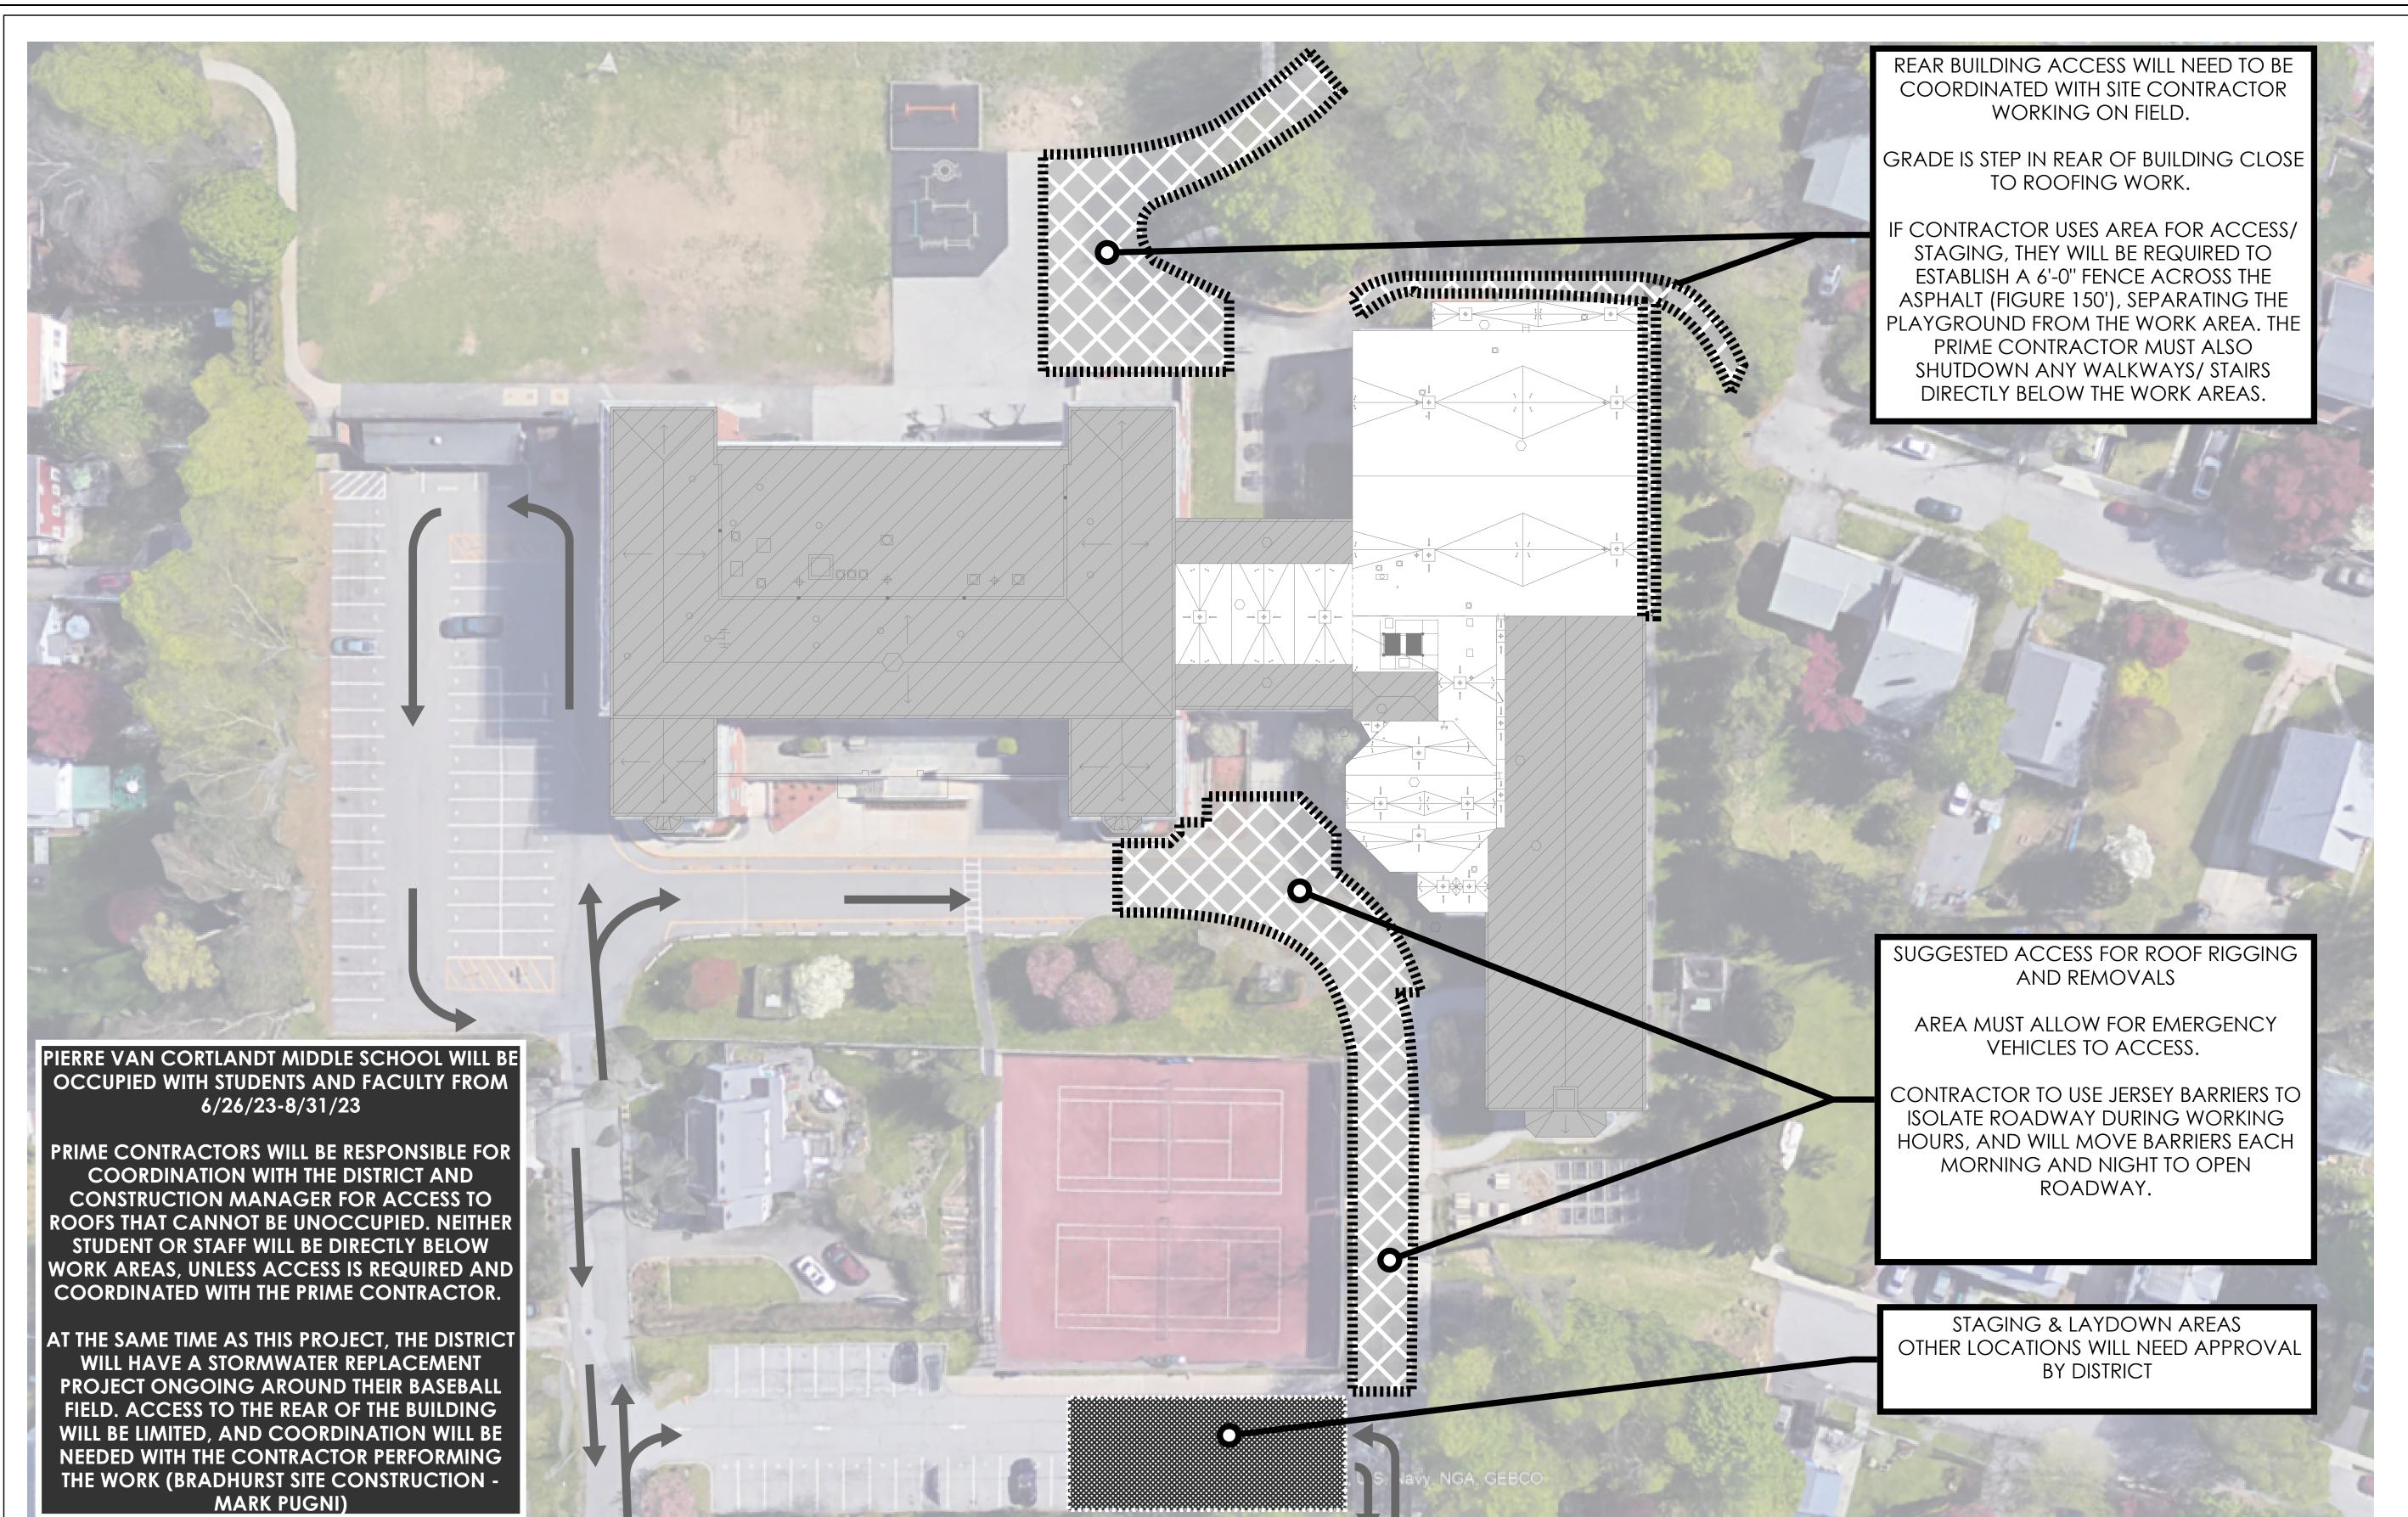

PIERRE VAN CORTLANDT MIDDLE SCHOOL ROOFING PROJECT - OVERALL STAGING AND PHASING PLAN

SCALE = N.T.S.

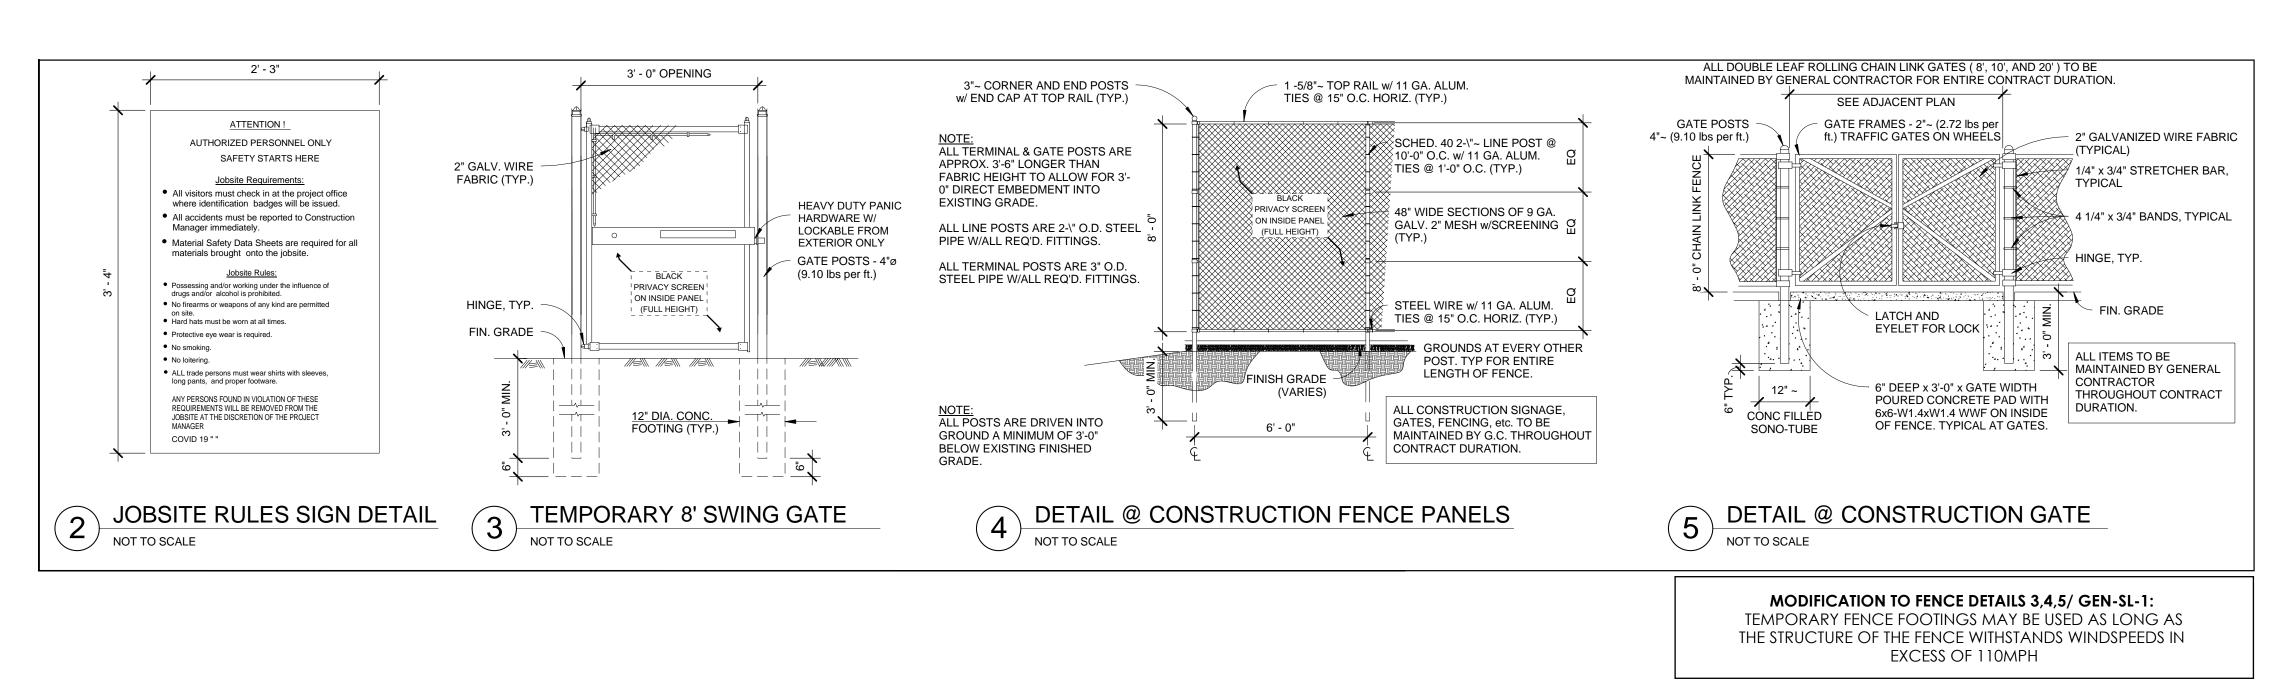

GENERAL LOGISTICS NOTES

. ROOFING CONSTRUCTION TRADE PRIME CONTRACTOR IS TO PROVIDE 6'-0" TALL CONSTRUCTION FENCE W/ PRIVACY SCREEN AROUND ALL STORED MATERIAL AND ACTIVE WORK AREAS WHERE WORK IS BEING PERFORMED OVERHEAD OR AT GROUND

2. ALL PRIME CONTRACTORS TO UTILIZE THE STAGING LOCATION, PROVIDED BY THE ROOFING CONTRACTOR. EACH PRIME CONTRACTOR SHALL COORDINATE MATERIAL AND EQUIPMENT WITHIN STAGING LOCATIONS, WITH THE OTHER PRIME CONTRACTORS

. MATERIAL WILL NOT BE PERMITTED TO BE STORED OUTSIDE FENCED-IN AREAS OR IN AREAS NOT DESIGNATED BY THE CONSTRUCTION MANAGER/OWNER. MATERIAL STORAGE ON THE INTERIOR OF THE BUILDING THAT IS NOT USED WITHIN 72HRS, WILL NOT BE PERMITTED.

. ALL CRANES PICKS SHOULD BE SCHEDULED TO TAKE PLACE DURING THE SUMMER MONTHS, OR DURING AFTER-HOURS. THE PRIME CONTRACTOR PERFORMING THE CRANE PICK ASSUMES ALL RESPONSIBILITY FOR RESTORATION OF THE LANDSCAPE/HARDSCAPE THROUGH APPROVAL BY THE ARCHITECT/CIVIL ENGINEER/CM.

CRANE PICKS THAT REQUIRE UTILIZING THE VILLAGE/TOWN/CITY/STATE ROAD WILL REQUIRE THE CONTRACTOR TO FILE ANY PERMITS NEEDED TO SHUTDOWN THE ROAD/LANES FOR THEIR CRANE OPERATIONS. ANY COST ASSOCIATED WITH THE PERMITTING PROCESS OR FINES INCURRED AS A RESULT OF NOT FILING THE CORRECT PERMITS, WILL BE THE RESPONSIBILITY OF THAT CONTRACTOR PERFORMING THE CRANE PICK.

CRANE PICKS, BOOM LIFTS OR ANY OVERHEAD MATERIAL TRANSPORTATION WILL NOT E ALLOWED WITHIN 20' OF AN OCCUPIED SPACE. THE PRIME CONTRACTOR PERFORMING THE CRANE PICK/BOOMING, WILL BE REQUIRED TO SUBMIT A CRANE/BOOM LOGISTICS PLAN SHOWING THE WORKING RADIUS OF THE EQUIPMENT AWAY FROM OCCUPIED SPACES.

. THE ROOFING PRIME CONTRACTOR PROVIDING THE STAGING LOCATION IS RESPONSIBLE TO REPAIR THE GRADE, GRASS, SHRUBBERY, AND HARDSCAPES (ASPHALT/CONCRETE) AFTER REMOVAL OF FENCING AND MATERIAL FROM WITHIN THE STAGING LOCATION. THIS INCLUDES ANY REPAIRS AS A RESULT OF THEIR EQUIPMENT AND ACTIVITIES AROUND THE BUILDING AS A RESULT OF THEIR WORK. DAMAGE TO THE LANDSCAPE/HARDSCAPE AS A RESULT OF ANOTHER PRIME CONTRACTOR, OUTSIDE OF THE STAGING AREA, WILL BE THE RESPONSIBILITY OF THAT CONTRACTOR TO REPAIR.

THIS INCLUDES RESTORING ANY TEMPORARY LOGISTICS FOR EGRESS, SUCH AS WALKWAYS, ASPHALT RAMPS, ETC.,.

6. DELIVERIES ARE TO BE COORDINATED WITH THE CM AND OWNER TO AVOID INTERFERENCE WITH SCHOOL ACTIVITIES.

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3. EACH PRIME CONTRACTOR IS REQUIRED TO COORDINATE WITH THE CONSTRUCTION MANAGER AND ANY OTHER TRADE- THEIR OWN WORK, IN WHICH THEY MAY IMPACT OTHER TRADES OR THE OWNER AND IT'S PROPERTY.

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THIS INCLUDES BUT IS NOT LIMITED TO: •JOBSITE RULES SIGN (3'-4" X 2'-3") SECURED TO SITE FENCE AT EACH ENTRANCE OF

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2022 CAPITAL PROJECTS

DISTRICT WIDE **ROOFING PROJECT**

CROTON-HARMON UNION FREE SCHOOL DISTRICT 10 GERSTEIN STREET CROTON-ON-HUDSON, NEW YORK



285 MAIN STREET MOUNT KISCO . NEW YORK . 10549 KGDARCHITECTS.COM

NY SED PROJECT CONTROL NO.

HIGH SCHOOL MIDDLE SCHOOL 66-02-02-03-0-002-029

ELEMENTARY SCHOOL 66-02-02-03-0-003-033 NEW BUSINESS OFFICE 66-02-02-03-1-010-007 66-02-02-03-5-004-008

CONSTRUCTION

550 7th Ave 14th Floor, New York, NY 10018 1279 Rte 300 1st Floor, Newburgh, NY 12550

CONSTRUCTION DOCUMENTS


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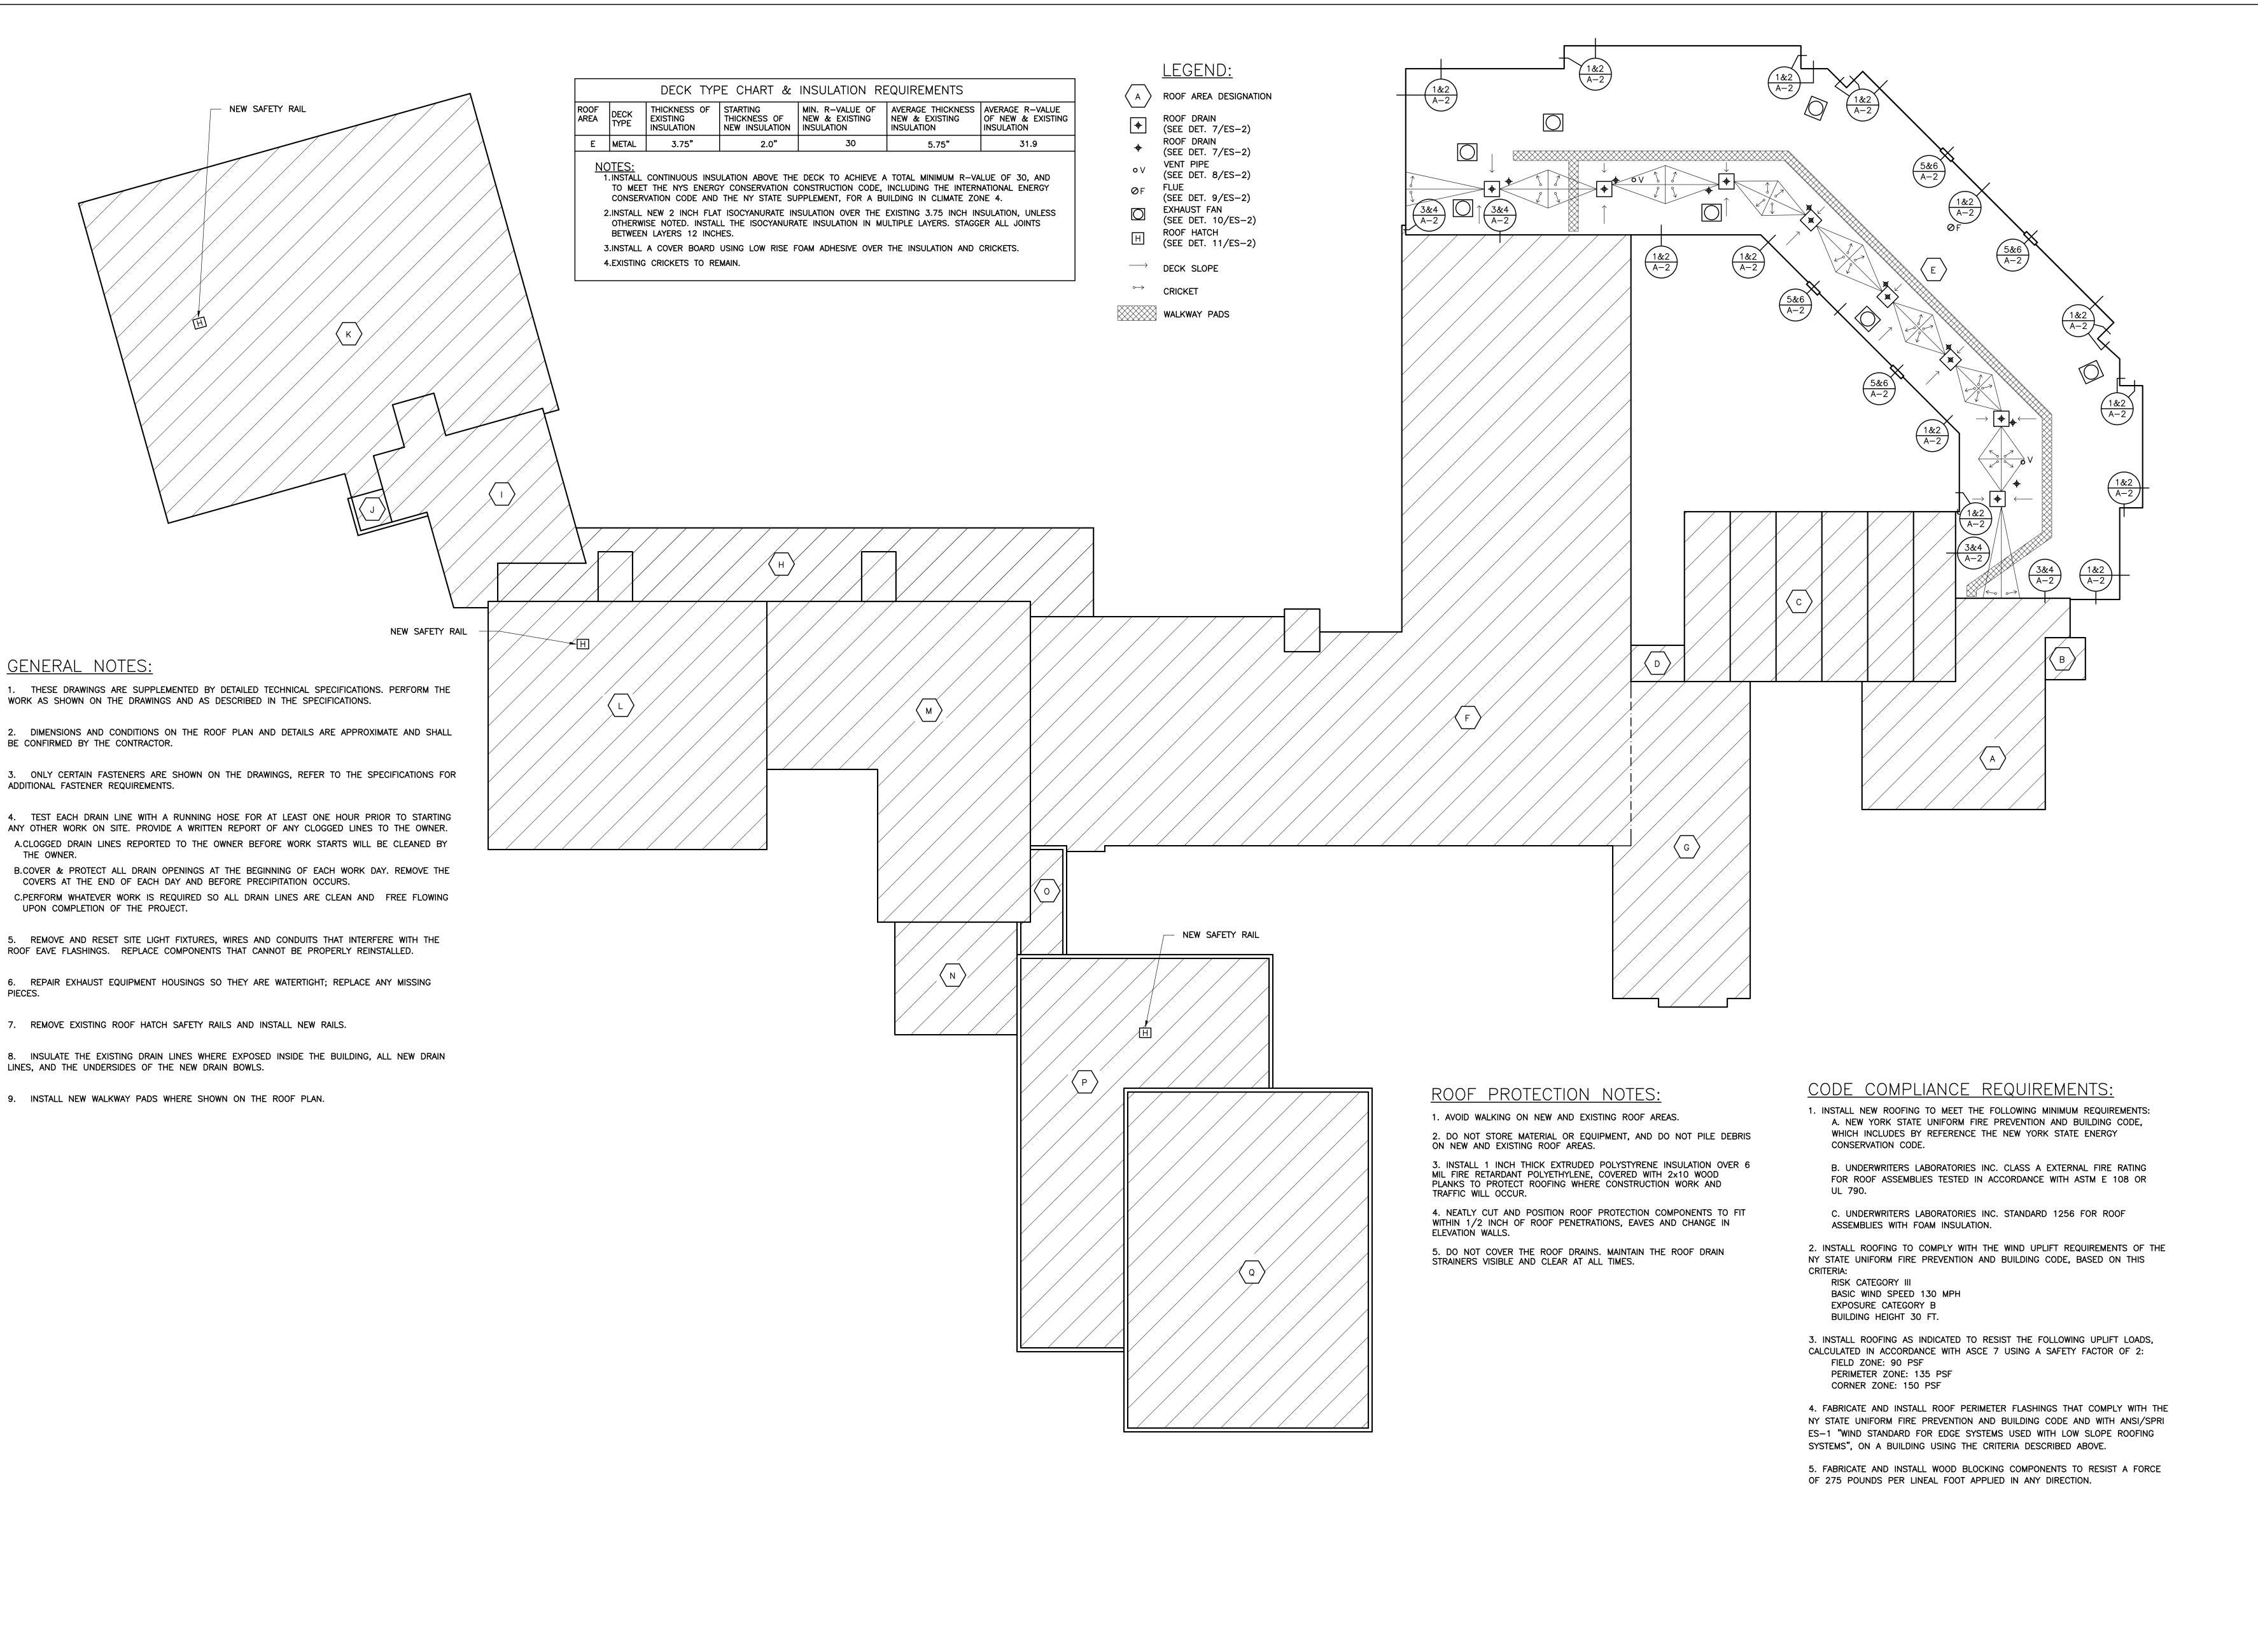


4/20/2023 ISSUED FOR BID Sheet Title

> PIERRE VAN **CORTLANDT MS** LOGISTICS

2023-1002	4/18/23
Scale N.T.S.	Drawn / Checked JH - TCC
Sheet Number	

PVC LOG-1

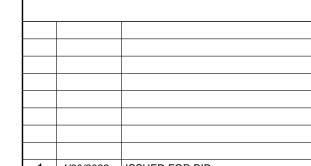

ROOF PLAN

2022 CAPITAL PROJECTS

DISTRICT WIDE ROOFING PROJECT

CROTON-HARMON UNION FREE SCHOOL DISTRICT 10 GERSTEIN STREET CROTON-ON-HUDSON, NEW YORK



NY SED PROJECT CONTROL NO.

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HIGH SCHOOL 66-02-02-03-0-001-032 MIDDLE SCHOOL 66-02-02-03-0-002-029 ELEMENTARY SCHOOL 66-02-02-03-0-003-033 NEW BUSINESS OFFICE 66-02-02-03-1-010-007 BUS GARAGE 66-02-02-03-5-004-008

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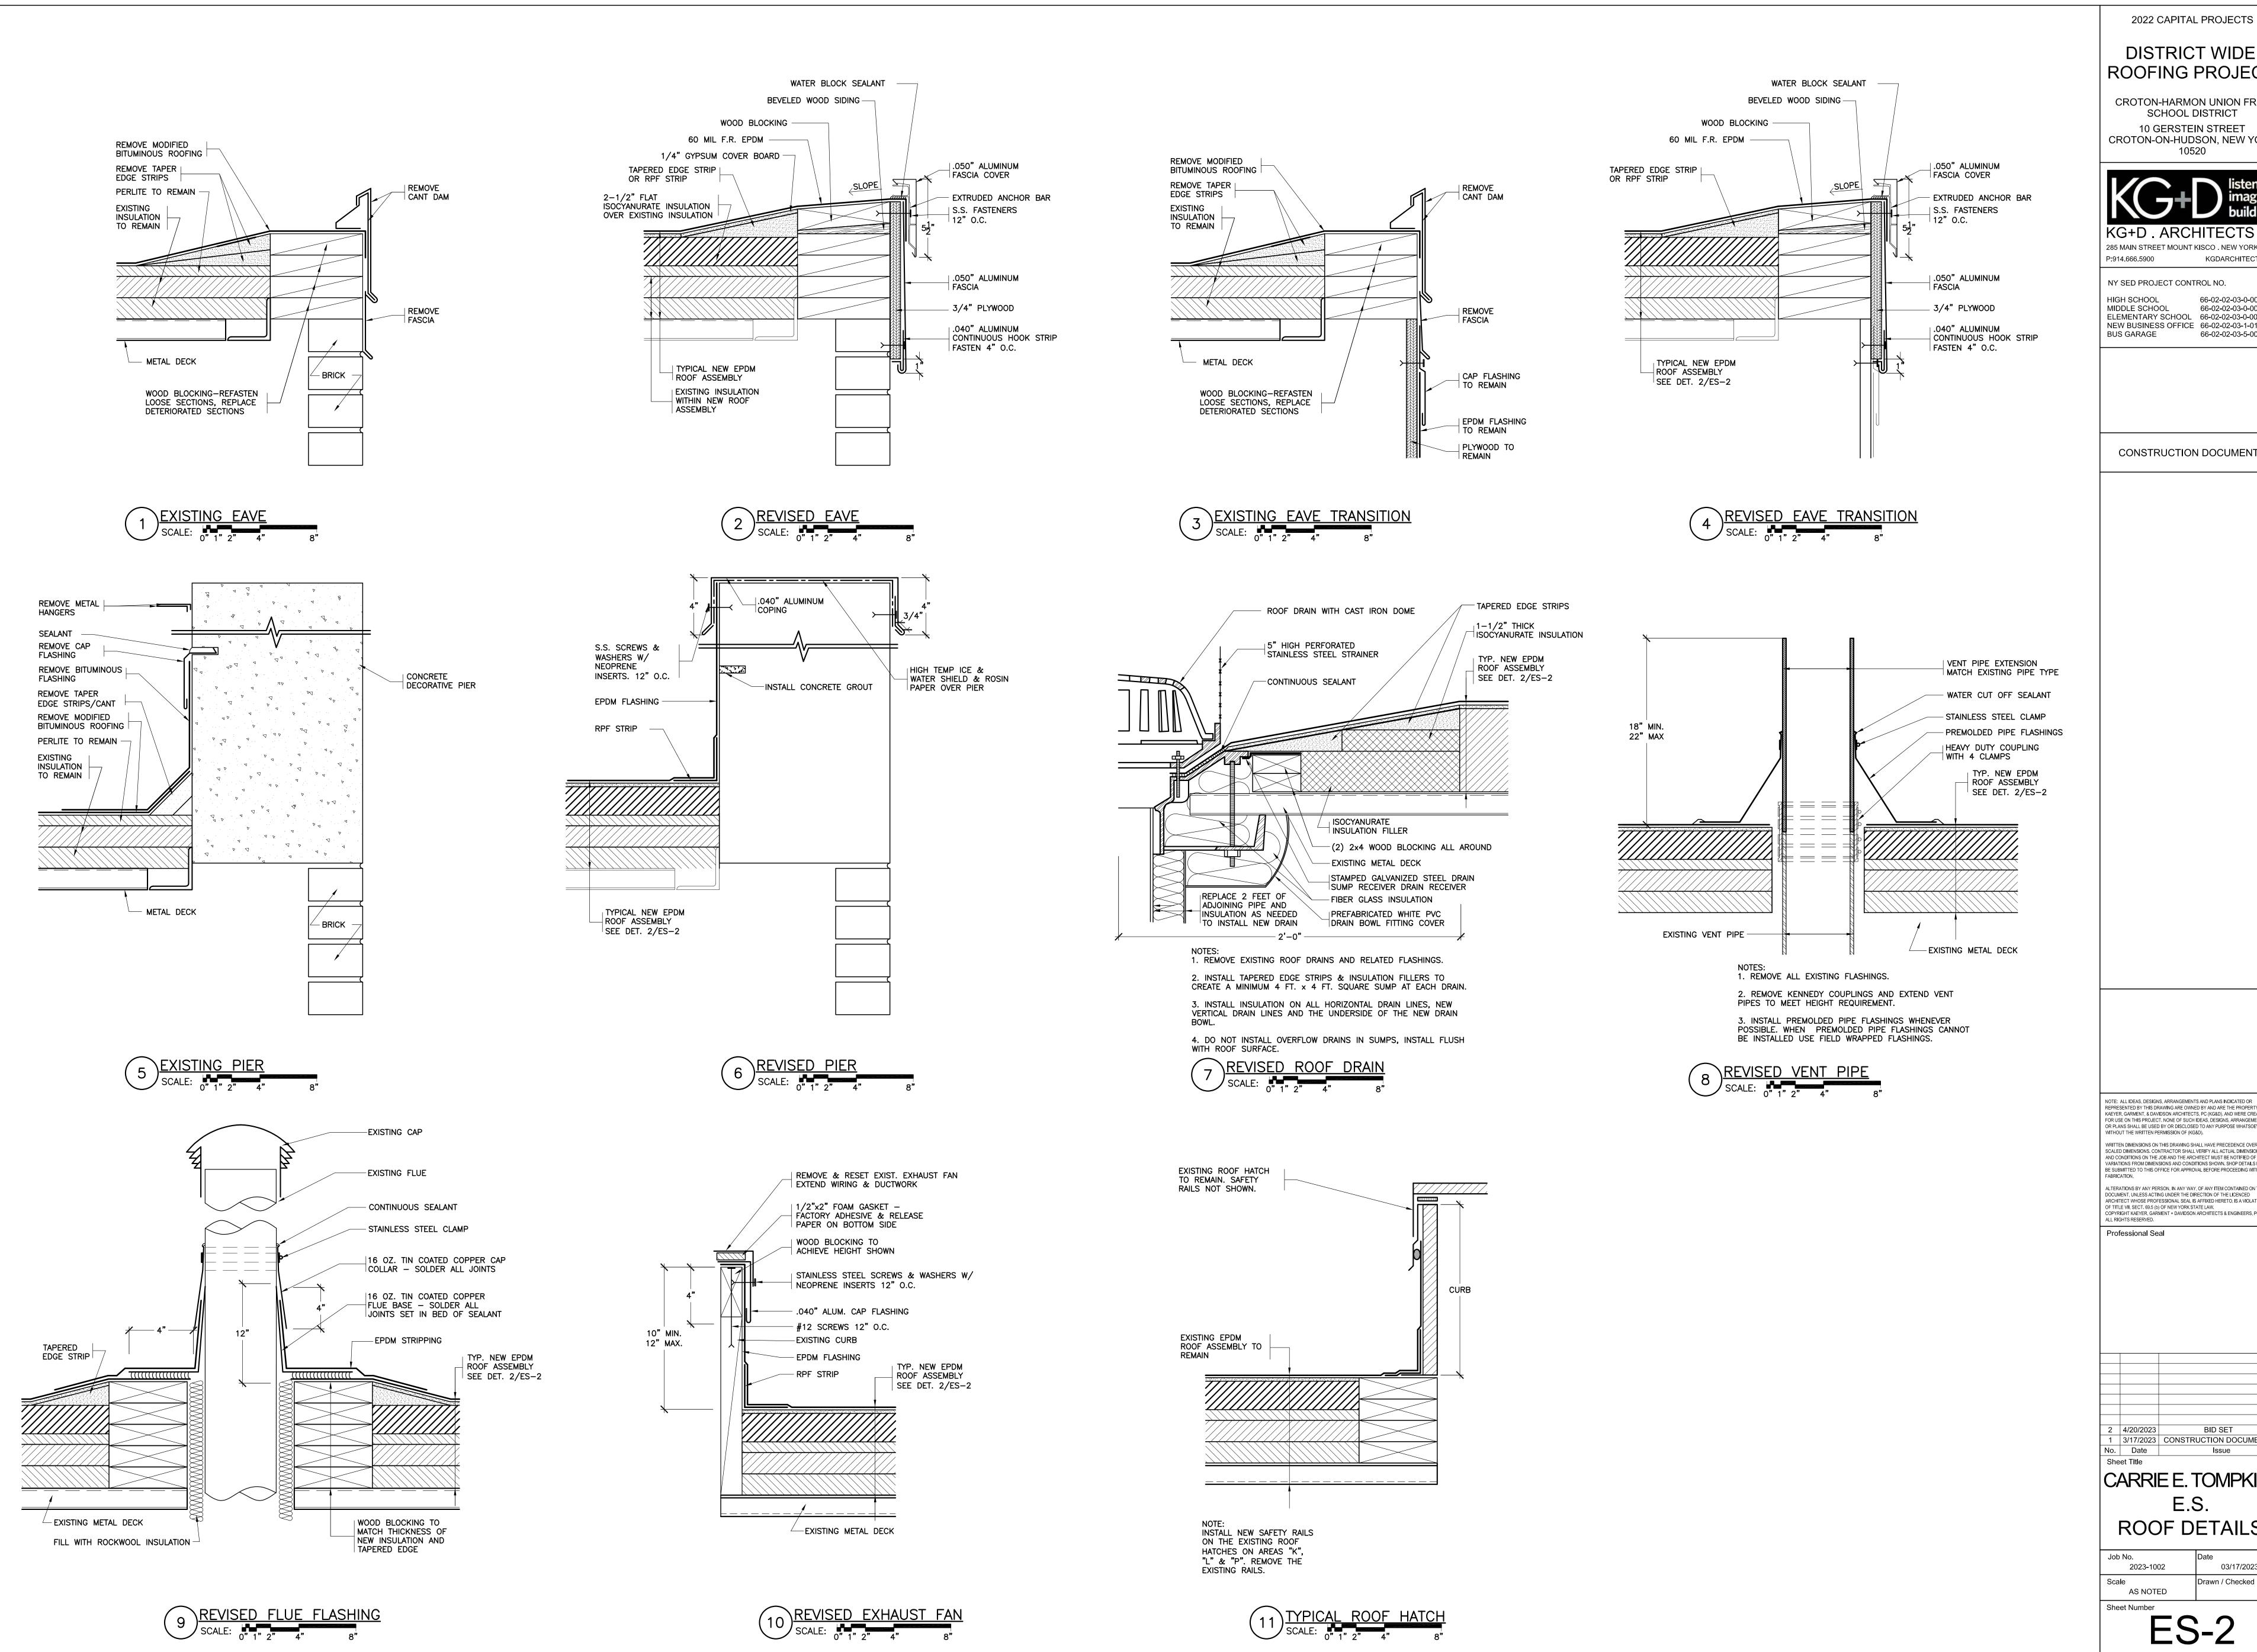
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CARRIE E. TOMPKINS E.S. ROOF PLAN

ES-1



DISTRICT WIDE ROOFING PROJECT

CROTON-HARMON UNION FREE SCHOOL DISTRICT 10 GERSTEIN STREET CROTON-ON-HUDSON, NEW YORK



NY SED PROJECT CONTROL NO.

66-02-02-03-0-001-032 66-02-02-03-0-002-029 HIGH SCHOOL MIDDLE SCHOOL ELEMENTARY SCHOOL 66-02-02-03-0-003-033 NEW BUSINESS OFFICE 66-02-02-03-1-010-007 66-02-02-03-5-004-008 BUS GARAGE

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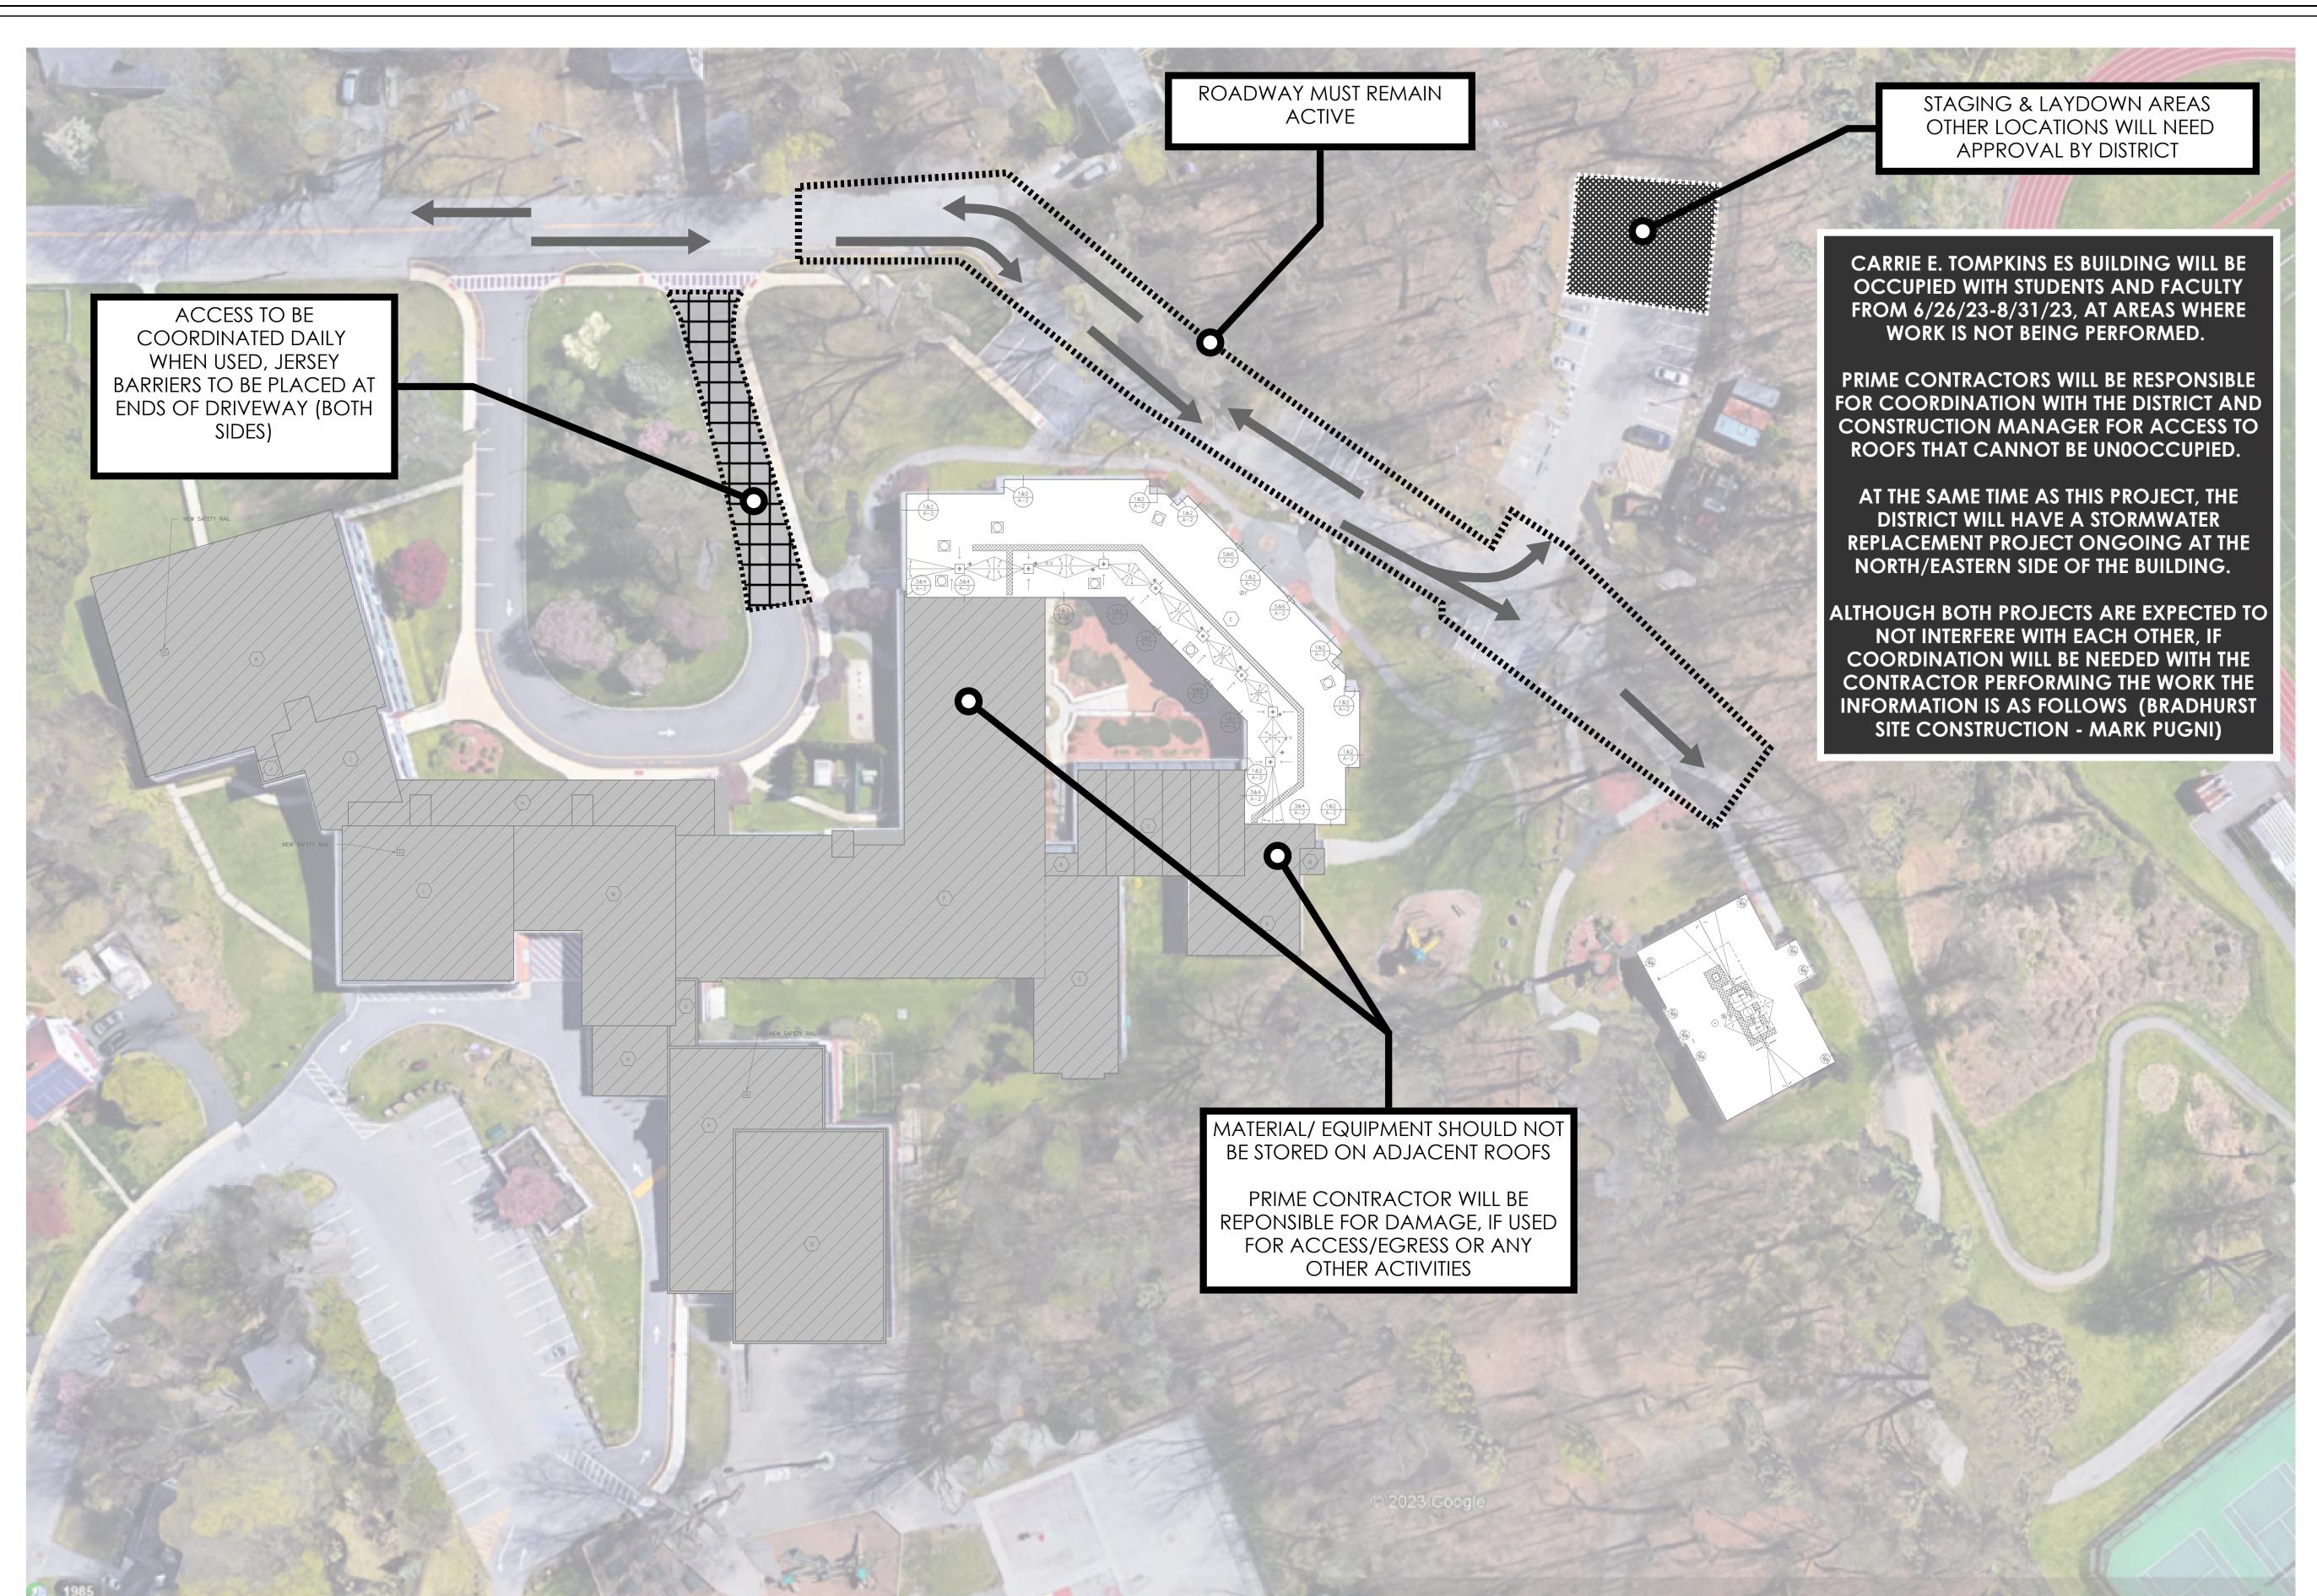
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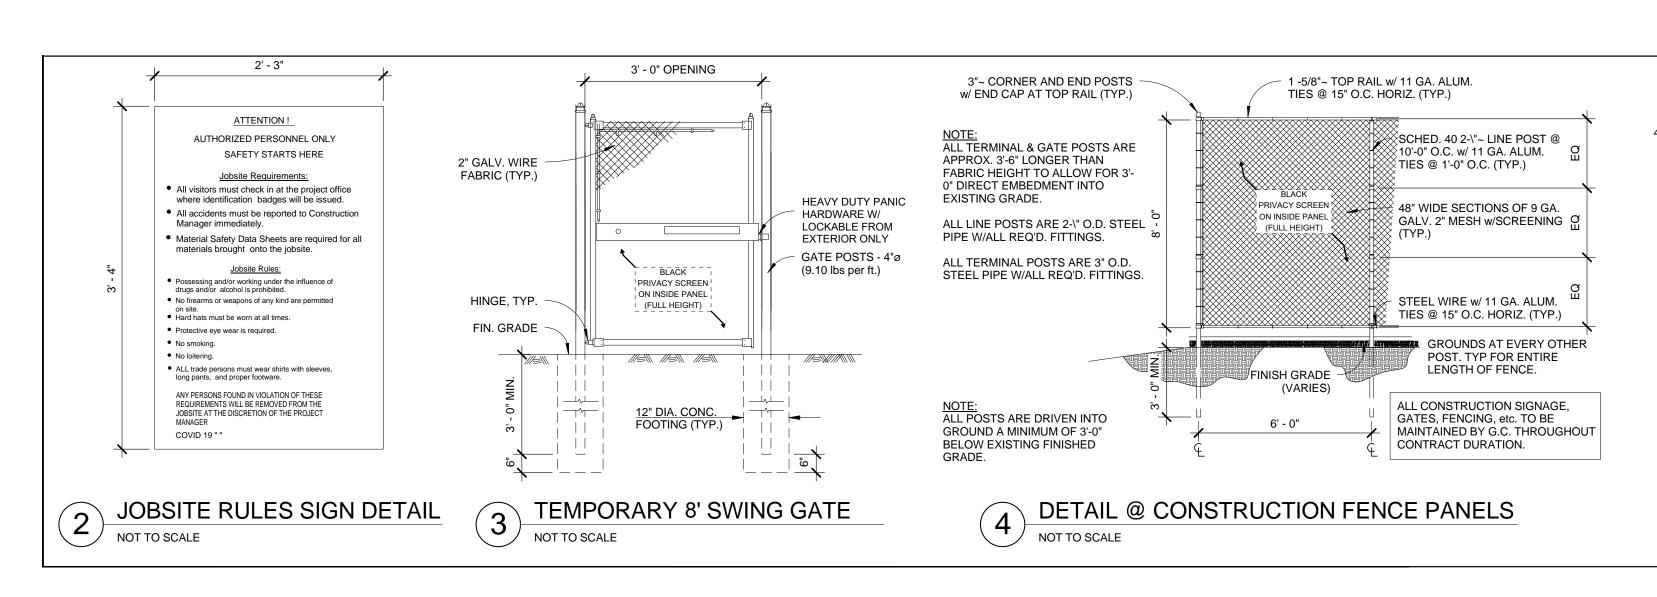
E.S. ROOF DETAILS

03/17/2023 2023-1002 Drawn / Checked AS NOTED

ES-2



CARRIE E. TOMPKINS ES & DISTRICT OFFICE ROOF PROJECT - OVERALL STAGING AND PHASING PLAN SCALE = N.T.S.



ALL DOUBLE LEAF ROLLING CHAIN LINK GATES (8', 10', AND 20') TO BE MAINTAINED BY GENERAL CONTRACTOR FOR ENTIRE CONTRACT DURATION. SEE ADJACENT PLAN GATE FRAMES - 2"~ (2.72 lbs per GATE POSTS 2" GALVANIZED WIRE FABRIC ft.) TRAFFIC GATES ON WHEELS 4"~ (9.10 lbs per ft.) 1/4" x 3/4" STRETCHER BAR, 4 1/4" x 3/4" BANDS, TYPICAL HINGE, TYP. LATCH AND EYELET FOR LOCK ALL ITEMS TO BE MAINTAINED BY GENERAL 6" DEEP x 3'-0" x GATE WIDTH POURED CONCRETE PAD WITH DURATION. 6x6-W1.4xW1.4 WWF ON INSIDE CONC FILLED OF FENCE. TYPICAL AT GATES. SONO-TUBE

5 DETAIL @ CONSTRUCTION GATE NOT TO SCALE

> MODIFICATION TO FENCE DETAILS 3,4,5/ GEN-SL-1: TEMPORARY FENCE FOOTINGS MAY BE USED AS LONG AS THE STRUCTURE OF THE FENCE WITHSTANDS WINDSPEEDS IN EXCESS OF 110MPH

GENERAL LOGISTICS NOTES

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THE STAGING AREA (4 MINIMUM - 1 AT EACH LOCATION) • "PERSONAL PROTECTIVE EQUIPMENT/ HARD HATS REQUIRED" SIGNAGE AT 20' INTERVALS ON ENTIRE PERIMETER OF SITE FENCE. • "NOTICE – PREVENT SPREAD OF CORONAVIRUS, SANITIZE/WASH YOUR HANDS

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CROTON-HARMON UNION FREE SCHOOL DISTRICT 10 GERSTEIN STREET CROTON-ON-HUDSON, NEW YORK



285 MAIN STREET MOUNT KISCO . NEW YORK . 1054

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NY SED PROJECT CONTROL NO.

HIGH SCHOOL MIDDLE SCHOOL

ELEMENTARY SCHOOL 66-02-02-03-0-003-033 NEW BUSINESS OFFICE 66-02-02-03-1-010-007 66-02-02-03-5-004-008

CONSTRUCTION

550 7th Ave 14th Floor, New York, NY 10018 1279 Rte 300 1st Floor, Newburgh, NY 12550

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1 4/20/2023 ISSUED FOR BID No. Date Sheet Title

CARRIE E. TOMPKINS **ES & DISTRICT OFFICE ROOFING LOGISTICS**

4/18/23 2023-1002 Scale rawn / Checked N.T.S. JH - TCC

Sheet Number

CET/DO LOG-1

DECK TYPE CHART & INSULATION REQUIREMENTS								
ROOF AREA	DOF DECK TYPE EXISTING THICKNESS OF INSULATION — (FLAT)		STARTING THICKNESS OF NEW INSULATION	MIN. R-VALUE OF NEW & EXISTING INSULATION	AVERAGE THICKNESS NEW & EXISTING INSULATION	AVERAGE R-VALUE OF NEW & EXISTING INSULATION		
Α	METAL	2.75"	3"	30	7.7"	45.3		
	_	_	<u> </u>		_			

NOTES:

1.INSTALL CONTINUOUS INSULATION ABOVE THE DECK TO ACHIEVE A MINIMUM TOTAL R-VALUE OF 30, AND TO MEET THE NYS ENERGY CONSERVATION CONSTRUCTION CODE, INCLUDING THE INTERNATIONAL ENERGY CONSERVATION CODE AND THE NY STATE SUPPLEMENT, FOR A BUILDING IN CLIMATE ZONE 4.

2.INSTALL NEW TAPERED ISOCYANURATE INSULATION THAT SLOPES 1/8 INCH PER FOOT; MINIMUM STARTING THICKNESS 3 INCHES ON TOP OF THE EXISTING 2.75" INSULATION, UNLESS OTHERWISE NOTED. INSTALL THE ISOCYANURATE INSULATION IN MULTIPLE LAYERS, WITH THE THICKEST LAYER BEING 3 INCHES. STAGGER ALL JOINTS BETWEEN LAYERS AT LEAST 12 INCHES.

3.INSTALL ISOCYANURATE INSULATION CRICKETS OVER THE TAPERED INSULATION.

4.INSTALL A COVER BOARD USING LOW RISE FOAM ADHESIVE OVER THE INSULATION AND CRICKETS.

ROOF PROTECTION NOTES:

1. AVOID WALKING ON NEW AND EXISTING ROOF AREAS.

2. DO NOT STORE MATERIAL OR EQUIPMENT, AND DO NOT PILE DEBRIS ON NEW AND EXISTING ROOF AREAS.

3. INSTALL 1 INCH THICK EXTRUDED POLYSTYRENE INSULATION OVER 6 MIL FIRE RETARDANT POLYETHYLENE, COVERED WITH 2x10 WOOD PLANKS TO PROTECT ROOFING WHERE CONSTRUCTION WORK AND TRAFFIC WILL OCCUR.

4. NEATLY CUT AND POSITION ROOF PROTECTION COMPONENTS TO FIT WITHIN 1/2 INCH OF ROOF PENETRATIONS, EAVES AND CHANGE IN ELEVATION WALLS.

5. DO NOT COVER THE ROOF DRAINS. MAINTAIN THE ROOF DRAIN STRAINERS VISIBLE AND CLEAR AT ALL TIMES.

CODE COMPLIANCE REQUIREMENTS:

1. INSTALL NEW ROOFING TO MEET THE FOLLOWING MINIMUM REQUIREMENTS: A. NEW YORK STATE UNIFORM FIRE PREVENTION AND BUILDING CODE, WHICH INCLUDES BY REFERENCE THE NEW YORK STATE ENERGY CONSERVATION CODE.

B. UNDERWRITERS LABORATORIES INC. CLASS A EXTERNAL FIRE RATING FOR ROOF ASSEMBLIES TESTED IN ACCORDANCE WITH ASTM E 108 OR

C. UNDERWRITERS LABORATORIES INC. STANDARD 1256 FOR ROOF ASSEMBLIES WITH FOAM INSULATION.

2. INSTALL ROOFING TO COMPLY WITH THE WIND UPLIFT REQUIREMENTS OF THE NY STATE UNIFORM FIRE PREVENTION AND BUILDING CODE, BASED ON THIS CRITERIA:

RISK CATEGORY III BASIC WIND SPEED 130 MPH EXPOSURE CATEGORY B BUILDING HEIGHT 30 FT.


3. INSTALL ROOFING AS INDICATED TO RESIST THE FOLLOWING UPLIFT LOADS, CALCULATED IN ACCORDANCE WITH ASCE 7 USING A SAFETY FACTOR OF 2: FIELD ZONE: 90 PSF

PERIMETER ZONE: 135 PSF CORNER ZONE: 150 PSF

4. FABRICATE AND INSTALL ROOF PERIMETER FLASHINGS THAT COMPLY WITH THE NY STATE UNIFORM FIRE PREVENTION AND BUILDING CODE AND WITH ANSI/SPRI ES-1 "WIND STANDARD FOR EDGE SYSTEMS USED WITH LOW SLOPE ROOFING SYSTEMS", ON A BUILDING USING THE CRITERIA DESCRIBED ABOVE.

5. FABRICATE AND INSTALL WOOD BLOCKING COMPONENTS TO RESIST A FORCE OF 275 POUNDS PER LINEAL FOOT APPLIED IN ANY DIRECTION.

1&2

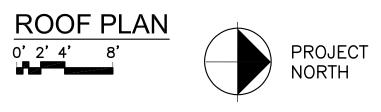

ROOF AREA DESIGNATION

LEGEND:

ROOF DRAIN
(SEE DET. 3/AD-2) VENT PIPE (SEE DET. 4/AD-2)

EXHAUST FAN (SEE DET. 5/AD-2) ROOF HATCH

(SEE DET. 6/AD-2) DP PORTAL-PLUS CURB (SEE DET. 7/AD-2) HVAC CURB (SEE DET. 8/AD-2)

SEALANT POCKET (SEE DET. 9/AD-2) GAS PIPE

TAPERED ISOCYANURATE INSULATION, SLOPE 1/8" PER FT

→ CRICKET – SLOPE 1/4" PER FT

WALKWAY PADS

GENERAL NOTES:

1. THESE DRAWINGS ARE SUPPLEMENTED BY DETAILED TECHNICAL SPECIFICATIONS. PERFORM THE WORK AS SHOWN ON THE DRAWINGS AND AS DESCRIBED IN THE SPECIFICATIONS.

2. DIMENSIONS AND CONDITIONS ON THE ROOF PLAN AND DETAILS ARE APPROXIMATE AND SHALL BE CONFIRMED BY THE CONTRACTOR.

3. ONLY CERTAIN FASTENERS ARE SHOWN ON THE DRAWINGS, REFER TO THE SPECIFICATIONS FOR ADDITIONAL FASTENER REQUIREMENTS.

4. TEST EACH DRAIN LINE WITH A RUNNING HOSE FOR AT LEAST ONE HOUR PRIOR TO STARTING ANY OTHER WORK ON SITE. PROVIDE A WRITTEN REPORT OF ANY CLOGGED LINES TO THE OWNER. A.CLOGGED DRAIN LINES REPORTED TO THE OWNER BEFORE WORK STARTS WILL BE CLEANED BY THE

B.COVER & PROTECT ALL DRAIN OPENINGS AT THE BEGINNING OF EACH WORK DAY. REMOVE THE COVERS AT THE END OF EACH DAY AND BEFORE PRECIPITATION OCCURS.

C.PERFORM WHATEVER WORK IS REQUIRED SO ALL DRAIN LINES ARE CLEAN AND FREE FLOWING UPON COMPLETION OF THE PROJECT.

5. REMOVE AND RESET EXISTING AC CONDENSERS ON 2 X 2 FOOT X 2 INCH THICK CONCRETE PAVERS SET ON WALKWAY PADS A MINIMUM OF 10 FT. AWAY FROM THE ROOF EAVE. FASTEN THE CONDENSERS TO THE PAVERS WITH STAINLESS STEEL NAIL-INS. DISCONNECT, ADJUST, MODIFY, AND RECONNECT THE EXISTING SUPPLY & RETURN LINES AND CONDUITS.

6. REMOVE AND RESET SITE LIGHT FIXTURES, WIRES AND CONDUITS THAT INTERFERE WITH THE NEW EAVE FLASHINGS. REPLACE COMPONENTS THAT CANNOT BE PROPERLY REINSTALLED.

7. REMOVE EXISTING ROOF TOP ELECTRICAL CONDUIT AND GAS PIPE SUPPORTS. RE-SET THE CONDUIT AND PIPES ON ADJUSTABLE HEIGHT FACTORY MANUFACTURED PIPE SUPPORTS PLACED ON WALKWAY PADS SPACED 5 FEET ON CENTER. SECURE THE CONDUITS AND PIPES TO THE PIPE SUPPORTS WITH GALVANIZED CLIPS & BOLTS.

8. REPAIR EXHAUST EQUIPMENT HOUSINGS SO THEY ARE WATERTIGHT; REPLACE ANY MISSING PIECES.

9. INSULATE ALL NEW DRAIN LINES, AND THE UNDERSIDES OF THE NEW DRAIN BOWLS.

10. INSTALL NEW WALKWAY PADS WHERE SHOWN ON THE ROOF PLAN.

CONSTRUCTION DOCUMENTS

2022 CAPITAL PROJECTS

DISTRICT WIDE

ROOFING PROJECT

CROTON-HARMON UNION FREE

SCHOOL DISTRICT

10 GERSTEIN STREET CROTON-ON-HUDSON, NEW YORK

285 MAIN STREET MOUNT KISCO . NEW YORK . 1054

ELEMENTARY SCHOOL 66-02-02-03-0-003-033

NEW BUSINESS OFFICE 66-02-02-03-1-010-007

NY SED PROJECT CONTROL NO.

KGDARCHITECTS.COM

66-02-02-03-0-001-032 66-02-02-03-0-002-029

66-02-02-03-5-004-008

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HIGH SCHOOL

BUS GARAGE

MIDDLE SCHOOL

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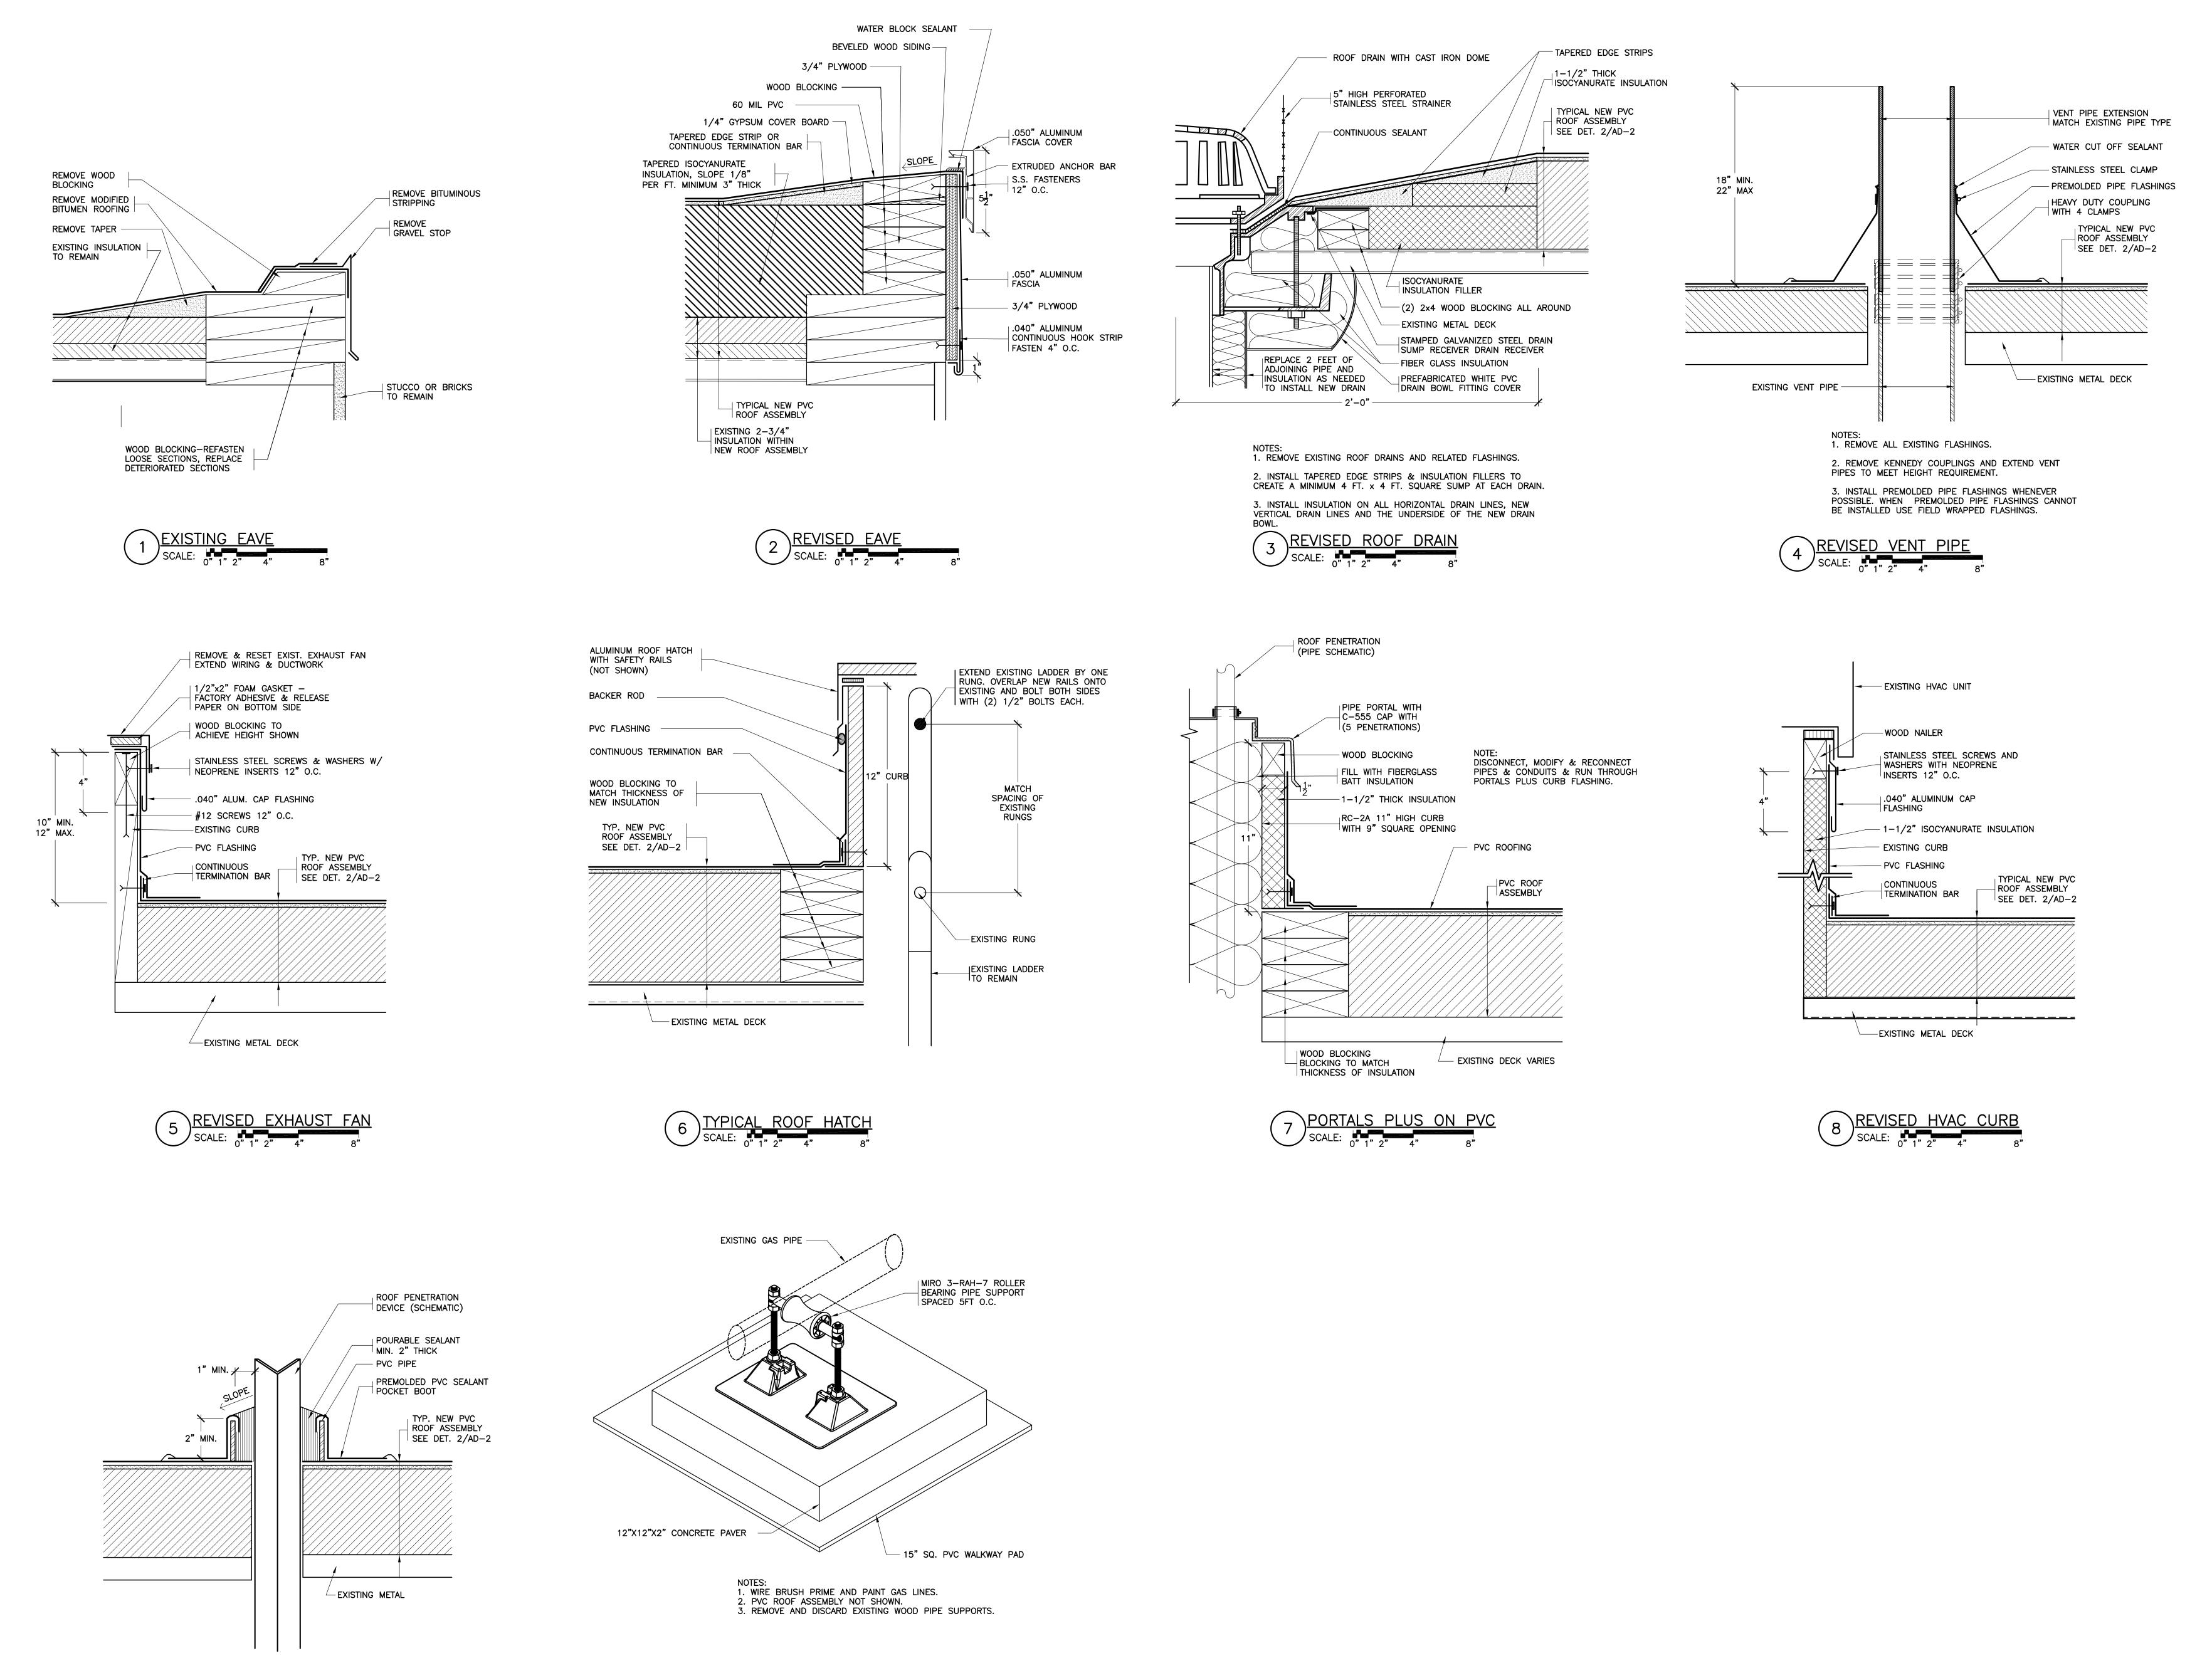
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No. Date Issue **ADMIN**

ROOF PLAN

03/17/2023 Drawn / Checked

AS NOTED

AD-1



10 GAS PIPE SUPPORT NOT TO SCALE

9 REVISED SEALANT POCKET
SCALE: 0" 1" 2" 4" 8"

2022 CAPITAL PROJECTS

DISTRICT WIDE **ROOFING PROJECT**

CROTON-HARMON UNION FREE SCHOOL DISTRICT 10 GERSTEIN STREET CROTON-ON-HUDSON, NEW YORK



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66-02-02-03-0-001-032 66-02-02-03-0-002-029 HIGH SCHOOL MIDDLE SCHOOL ELEMENTARY SCHOOL 66-02-02-03-0-003-033 NEW BUSINESS OFFICE 66-02-02-03-1-010-007 66-02-02-03-5-004-008 BUS GARAGE

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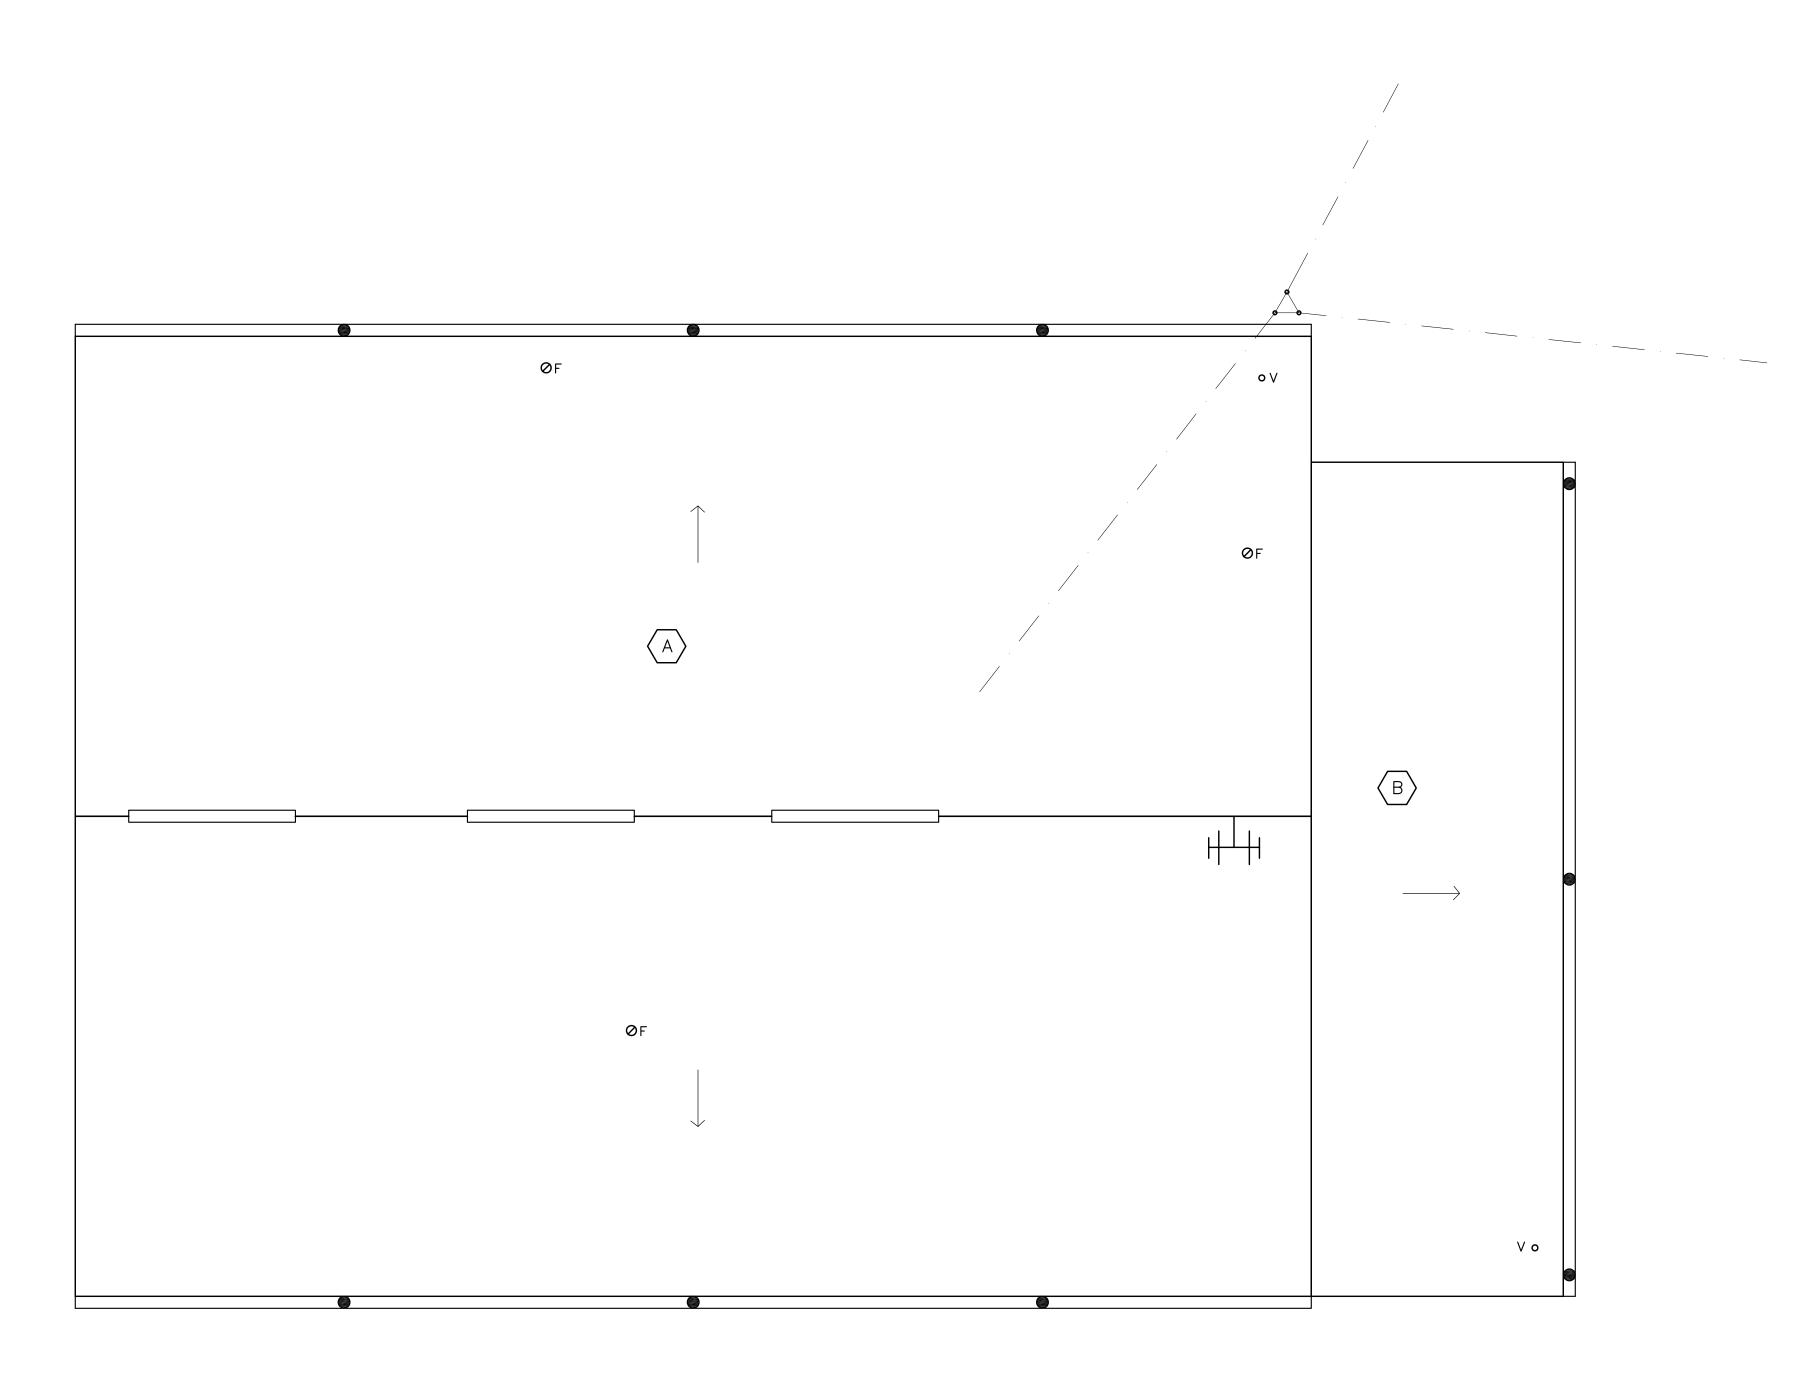
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2 4/20/2023 1 3/17/2023 CONSTRUCTION DOCUMENTS
No. Date Issue

Sheet Title **ADMIN** ROOF DETAILS

03/17/2023 2023-1002 Drawn / Checked

AS NOTED





<u>LEGEND:</u>

A ROOF AREA DESIGNATION

ØF FLUE

 \longrightarrow DECK SLOPE ANTENNA

○ V VENT PIPE

OF FLUE GUTTER & LEADER

GENERAL NOTES:

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3. ONLY CERTAIN FASTENERS ARE SHOWN ON THE DRAWINGS, REFER TO THE SPECIFICATIONS FOR ADDITIONAL FASTENER REQUIREMENTS.

4. CLEAN THE GUTTERS.

5. TEST EACH DOWNSPOUT WITH A RUNNING HOSE FOR AT LEAST ONE HOUR PRIOR TO STARTING ANY OTHER WORK ON SITE. REMOVE, CLEAN AND REINSTALL ANY CLOGGED DOWNSPOUTS.

6. INSTALL A NEW STORM COLLAR AND FLUE PIPE CAP, ON THE UNIT HEATER FLUE.

7. REMOVE LOOSE SCREWS, AND SCREWS WITH CRUSHED OR DETERIORATED NEOPRENE WASHERS; INSTALL ONE SIZE LARGER STAINLESS STEEL SCREWS & WASHERS WITH NEOPRENE INSERTS IN THE SAME HOLES.

8. INSTALL WHITE ETERNABOND SELF ADHESIVE ROOF SEAL STRIPS OVER SEAMS IN THE RIDGE CAP-VENT ASSEMBLY AND OVER SEAMS ON THE METAL ROOF ALONG ALL FOUR RAKE ENDS.

9. REPLACE THE GUY WIRE ATTACHMENT EYE-BOLTS, WITH 1/2 DIAMETER STAINLESS STEEL EYE BOLTS; DRILL OUT THE EXISTING HOLES SO THE NEW BOLTS FIT. INSTALL THE EYE BOLTS WITH DOUBLE NUTS AND WASHERS ABOVE AND BELOW THE METAL ROOF PANELS, SET THE WASHERS IN SEALANT.

2022 CAPITAL PROJECTS

DISTRICT WIDE **ROOFING PROJECT**

CROTON-HARMON UNION FREE SCHOOL DISTRICT 10 GERSTEIN STREET CROTON-ON-HUDSON, NEW YORK



NY SED PROJECT CONTROL NO.

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HIGH SCHOOL 66-02-02-03-0-001-032 MIDDLE SCHOOL 66-02-02-03-0-002-029 ELEMENTARY SCHOOL 66-02-02-03-0-003-033 NEW BUSINESS OFFICE 66-02-02-03-1-010-007 BUS GARAGE 66-02-02-03-5-004-008

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BUS GARAGE ROOF PLAN

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BS-1