




2 PLUMBING: THIRD FLOOR PLAN 1/8" = 1'-0"

SCALE: 1/8" = 1'-0"

0 4' 8'

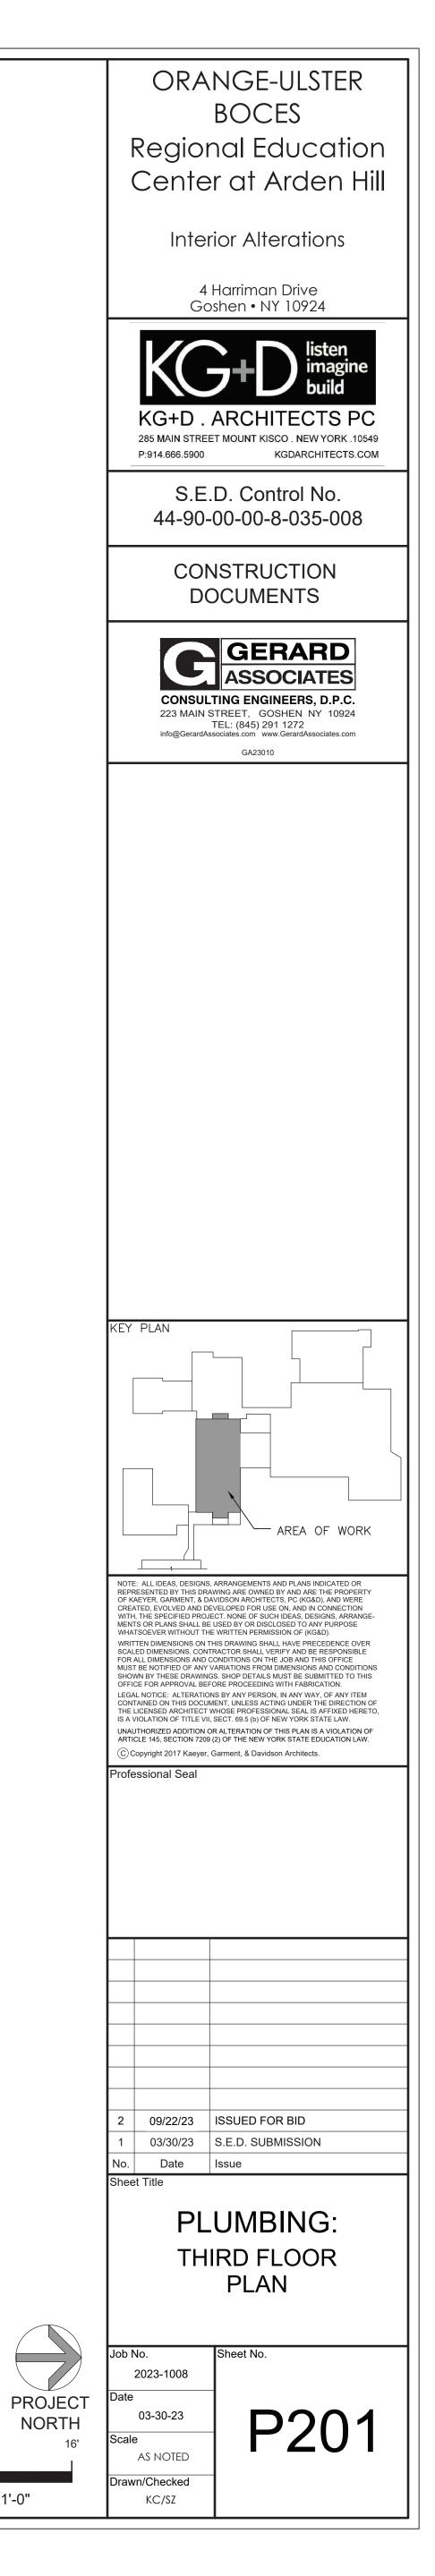

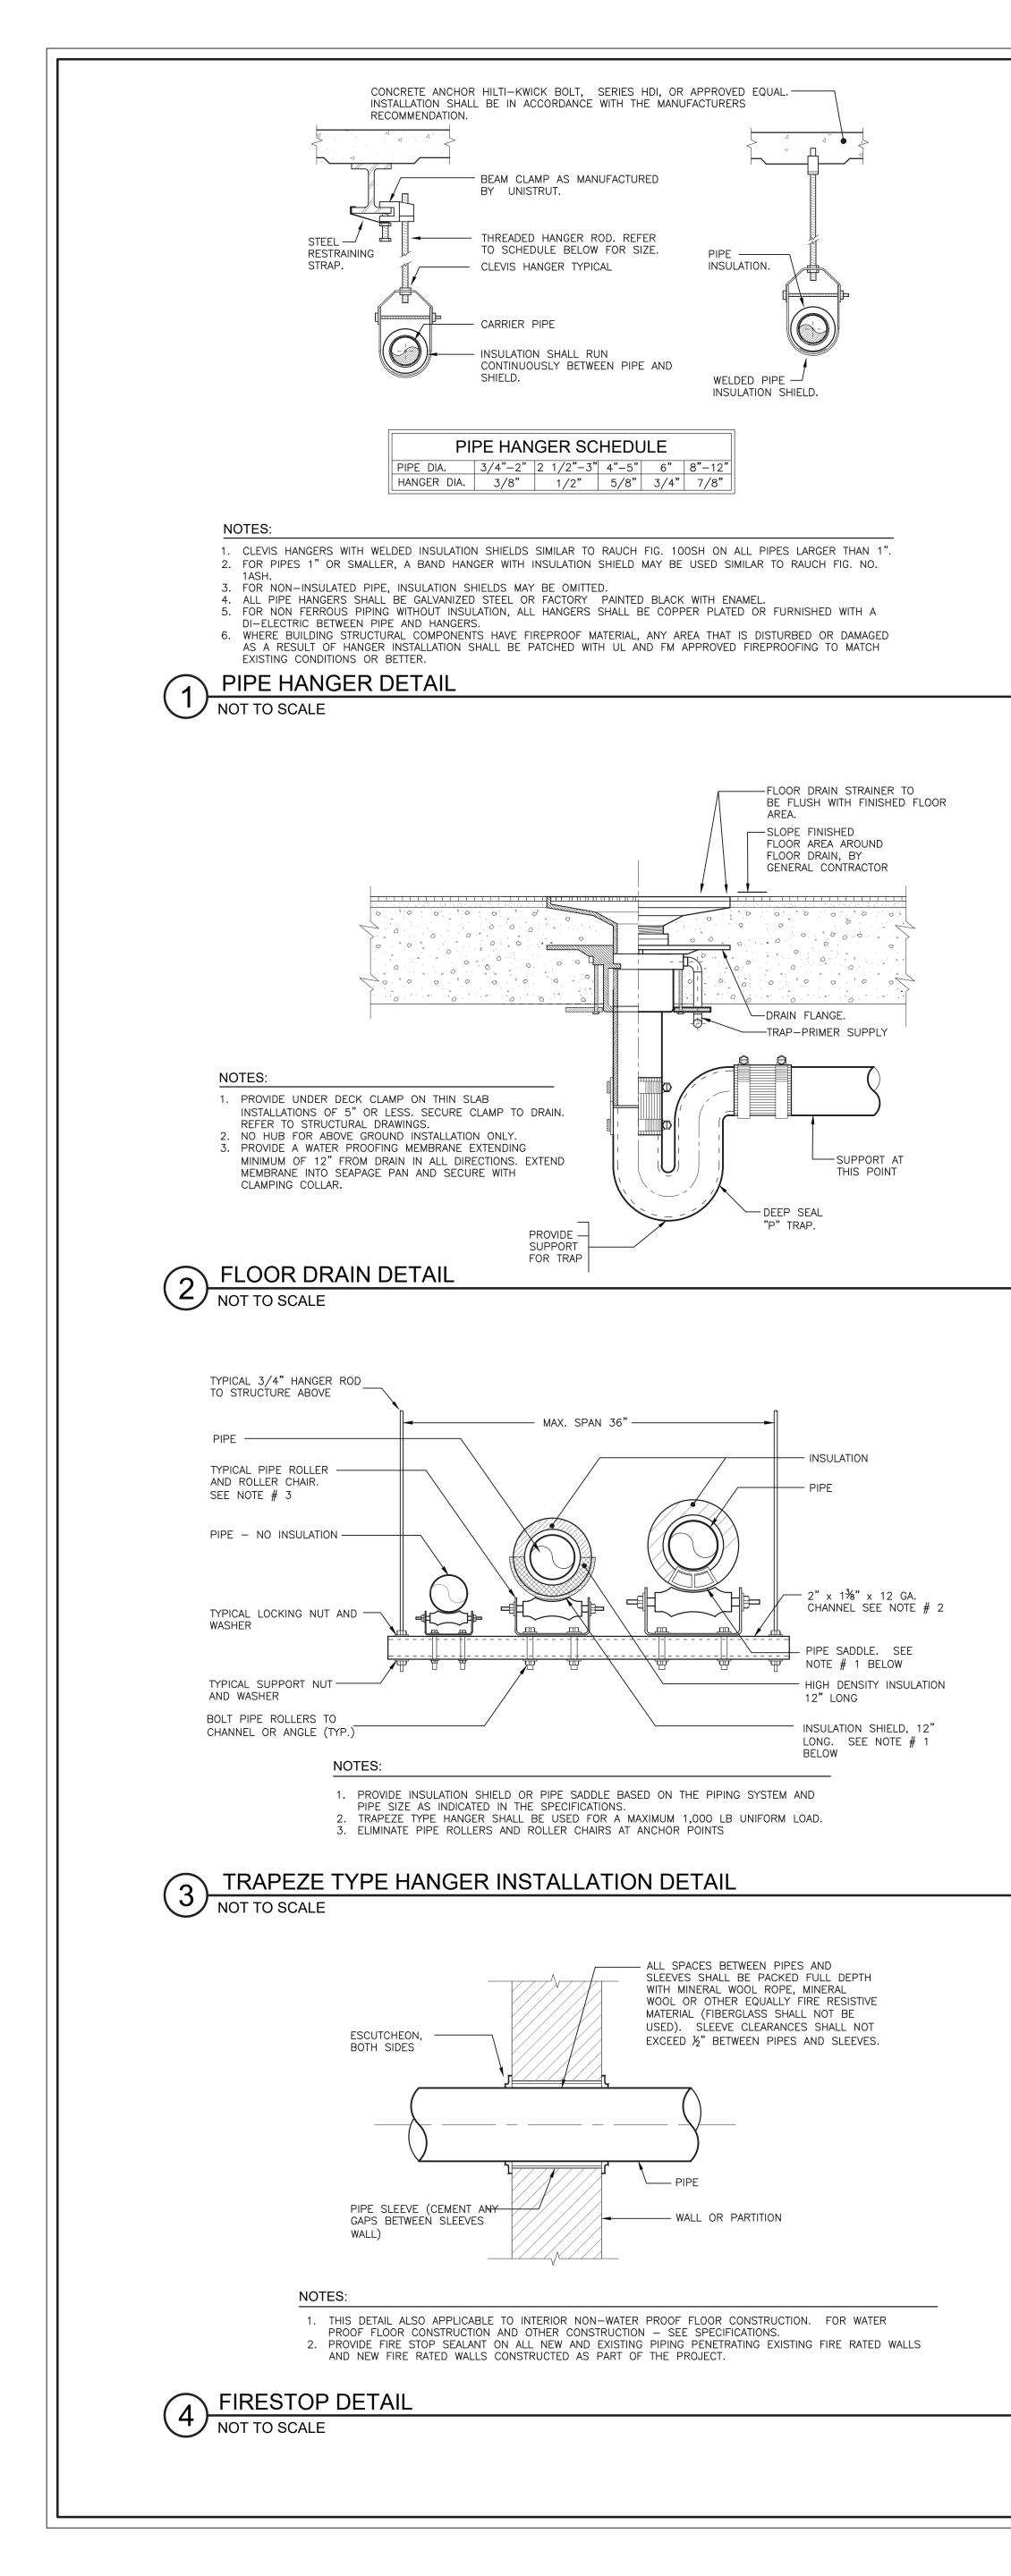

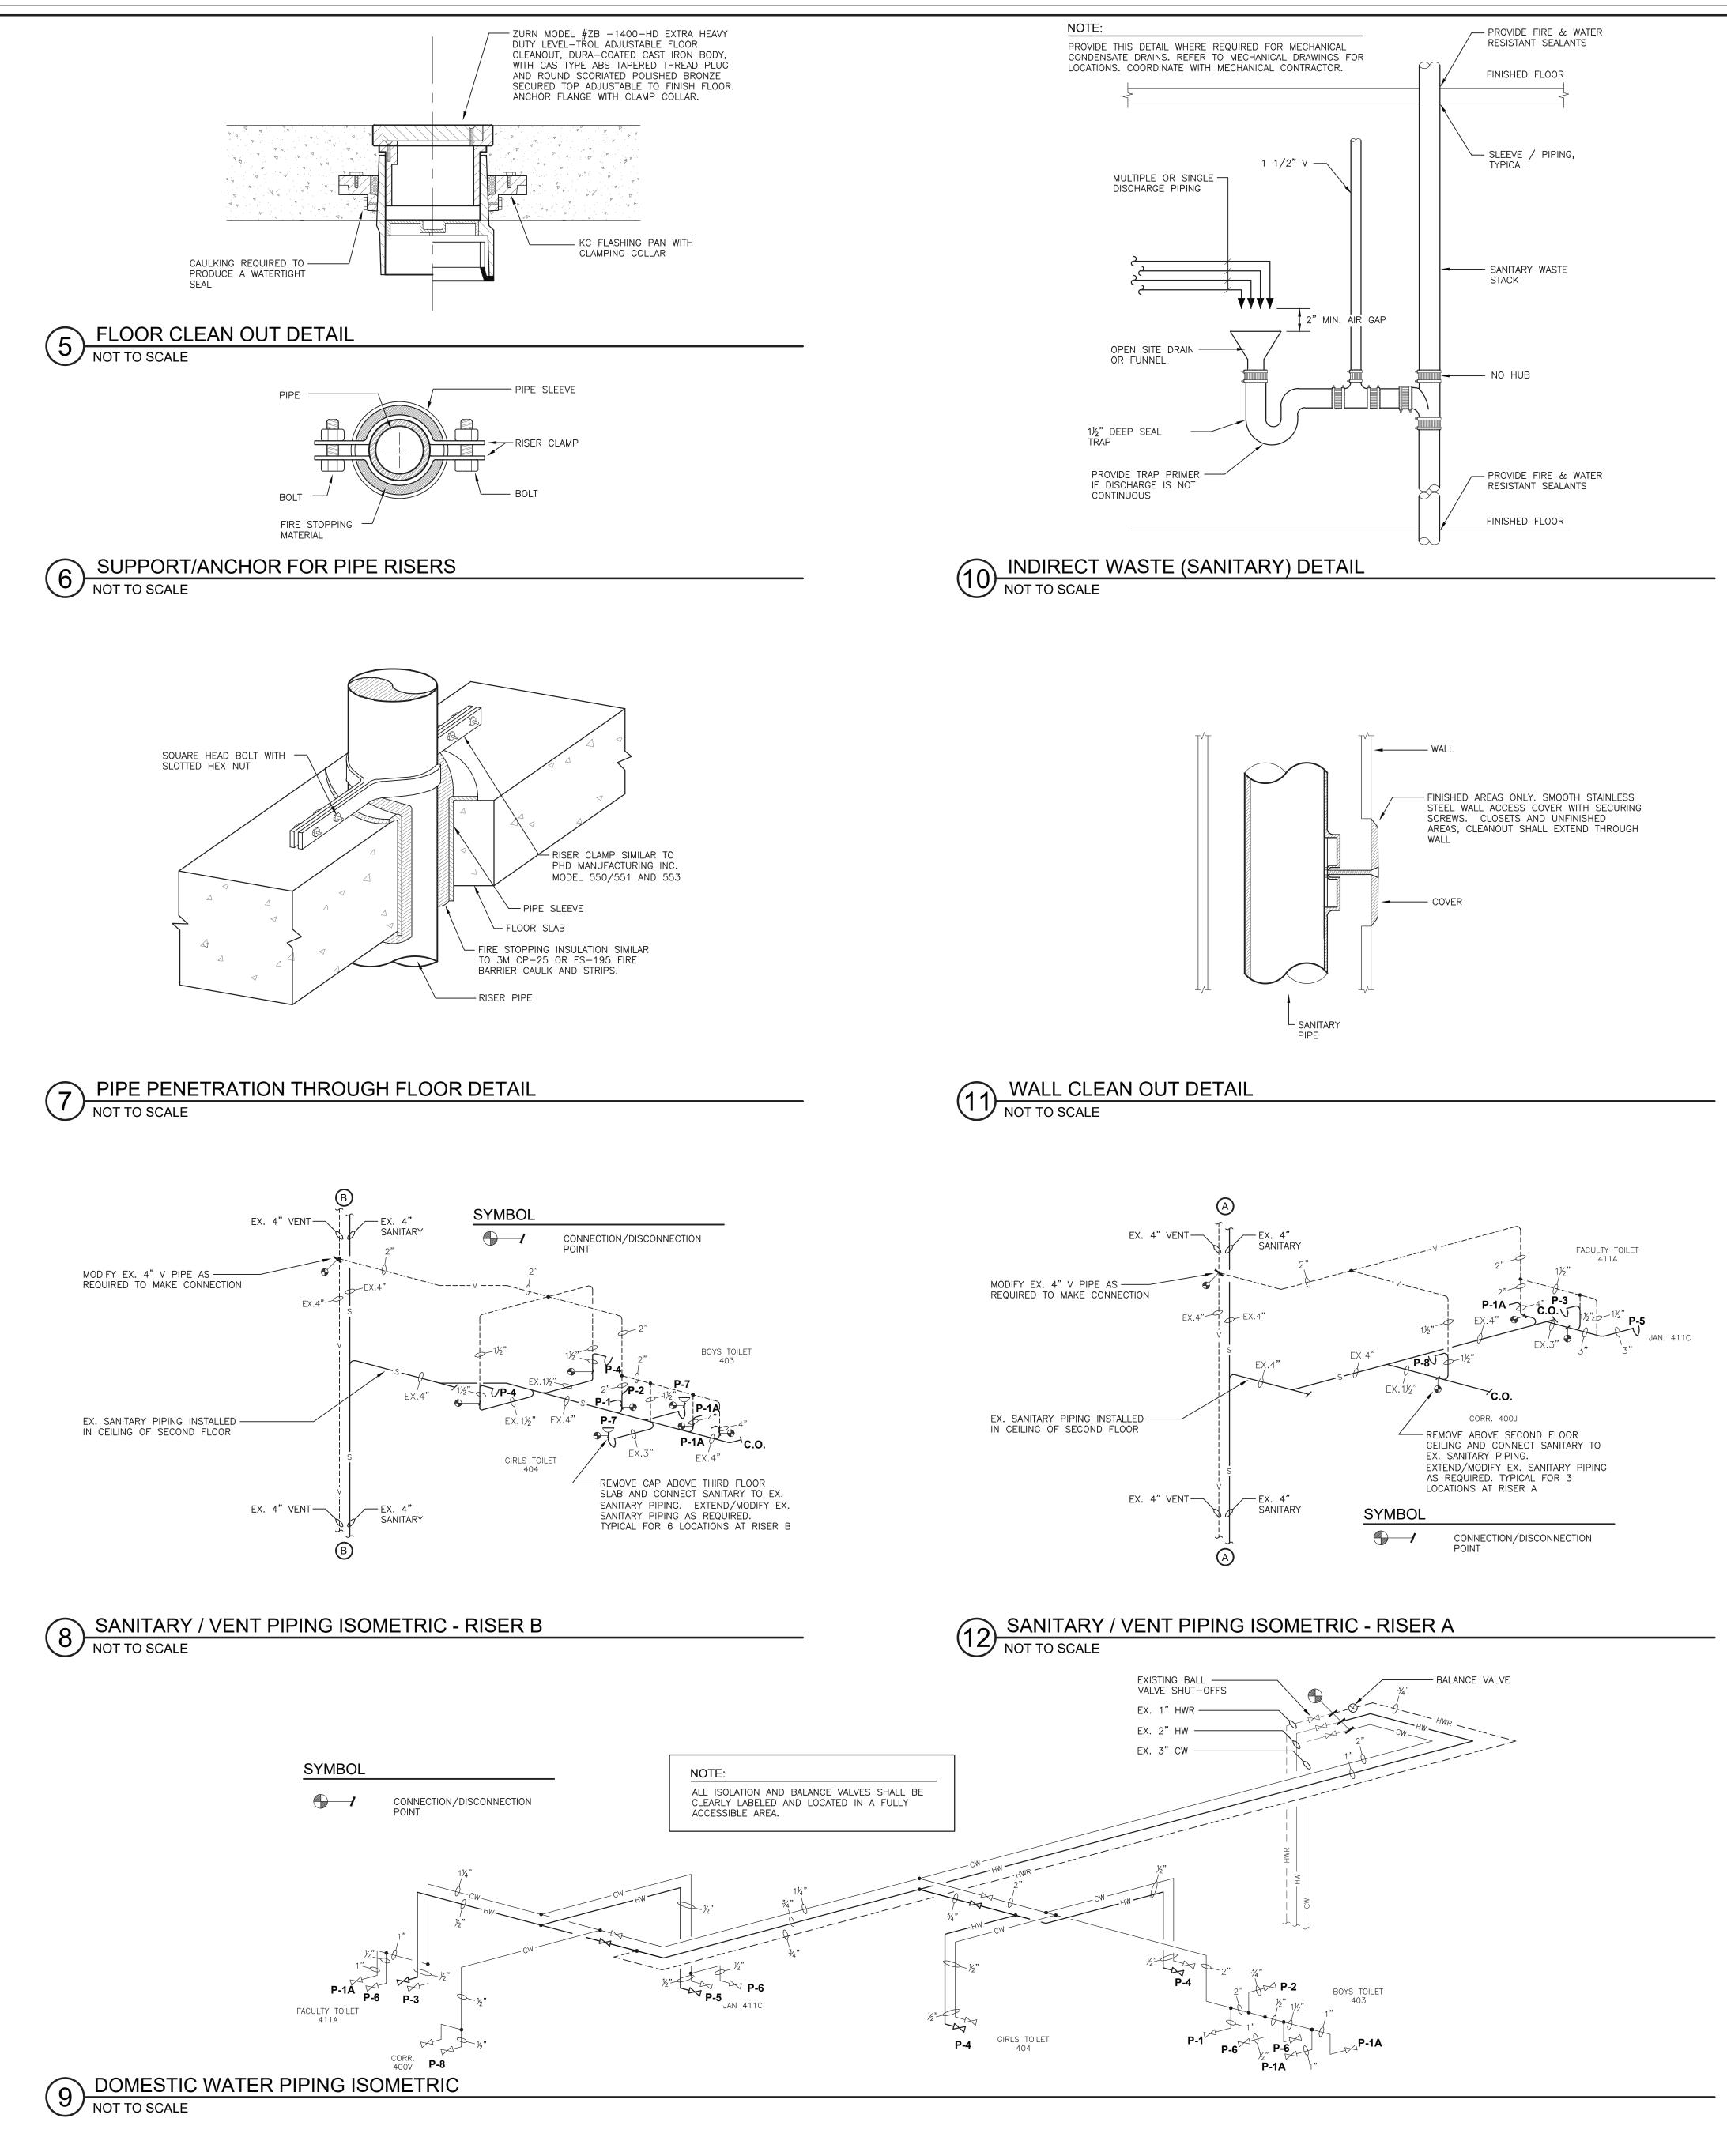

ORANGE-ULSTER BOCES
Regional Education
Center at Arden Hill
Interior Alterations
4 Harriman Drive Goshen • NY 10924
listen imagine
KG+D . ARCHITECTS PC
285 MAIN STREET MOUNT KISCO . NEW YORK .10549 P:914.666.5900 KGDARCHITECTS.COM
S.E.D. Control No. 44-90-00-00-8-035-008
CONSTRUCTION
DOCUMENTS
GERARD ASSOCIATES
CONSULTING ENGINEERS, D.P.C. 223 MAIN STREET, GOSHEN NY 10924 TEL: (845) 291 1272 info@GerardAssociates.com www.GerardAssociates.com
GA23010
NOTE: ALL IDEAS, DESIGNS, ARRANGEMENTS AND PLANS INDICATED OR
REPRESENTED BY THIS DRAWING ARE OWNED BY AND ARE THE PROPERTY OF KAEYER, GARMENT, & DAVIDSON ARCHITECTS, PC (KG&D), AND WERE CREATED, EVOLVED AND DEVELOPED FOR USE ON, AND IN CONNECTION WITH, THE SPECIFIED PROJECT. NONE OF SUCH IDEAS, DESIGNS, ARRANGE- MENTS OR PLANS SHALL BE USED BY OR DISCLOSED TO ANY PURPOSE WHATSOEVER WITHOUT THE WRITTEN PERMISSION OF (KG&D).
WRITTEN DIMENSIONS ON THIS DRAWING SHALL HAVE PRECEDENCE OVER SCALED DIMENSIONS. CONTRACTOR SHALL VERIFY AND BE RESPONSIBLE FOR ALL DIMENSIONS AND CONDITIONS ON THE JOB AND THIS OFFICE MUST BE NOTIFIED OF ANY VARIATIONS FROM DIMENSIONS AND CONDITIONS SHOWN BY THESE DRAWINGS. SHOP DETAILS MUST BE SUBMITTED TO THIS OFFICE FOR APPROVAL BEFORE PROCEEDING WITH FABRICATION.
LEGAL NOTICE: ALTERATIONS BY ANY PERSON, IN ANY WAY, OF ANY ITEM CONTAINED ON THIS DOCUMENT, UNLESS ACTING UNDER THE DIRECTION OF THE LICENSED ARCHITECT WHOSE PROFESSIONAL SEAL IS AFFIXED HERETO, IS A VIOLATION OF TITLE VII, SECT. 69.5 (b) OF NEW YORK STATE LAW. UNAUTHORIZED ADDITION OR ALTERATION OF THIS PLAN IS A VIOLATION OF ADDICIDE 146 SECTION 3700 (D) OF THE NEW YORK STATE FUNCTION IN AW
ARTICLE 145, SECTION 7209 (2) OF THE NEW YORK STATE EDUCATION LAW. © Copyright 2017 Kaeyer, Garment, & Davidson Architects. Professional Seal
2 09/22/23 ISSUED FOR BID
1 03/30/23 S.E.D. SUBMISSION No. Date Issue Sheet Title
PLUMBING:
DETAILS
Job No. Sheet No. 2023-1008
Date 03-30-23 P501
Scale AS NOTED Drawn/Checked
KC/SZ

PLI	UMBING NOTES:
1.	ALL PLUMBING WORK SHALL BE INSTALLED IN ACCORDANCE WITH 2022 VERSION OF NYS EDUCATION DEPARTMENT MANUAL PLANNING STANDARDS FOR SCHOOL BUILDINGS, THE 2020 VERSION OF THE PLUMBING CODE, FIRE CODE, BUILDING CODE ENERGY CONSERVATION CONSTRUCTION CODE OF NEW YORK STATE, ALL LOCAL CODES AND GENERALLY ACCEPTED STANDARDS.
2.	CONTRACTOR SHALL PROVIDE ALL FIXTURES, PIPING, VALVES, ACCESS DOORS, HANGERS, FITTINGS AND MISCELLANEOUS COMPON NOT NECESSARILY DETAILED ON THESE DRAWINGS TO RENDER THE PLUMBING SYSTEMS COMPLETE, OPERABLE, AND IN ACCORD. WITH APPLICABLE CODES AND GENERALLY ACCEPTED INDUSTRY STANDARDS.
3.	CONTRACTOR SHALL COORDINATE LOCATIONS OF ALL PIPING AND EQUIPMENT WITH OTHER TRADES TO AVOID CONFL ROUGHING-IN DIMENSIONS OF FIXTURES MUST BE COORDINATED WITH GENERAL CONTRACTOR. SEE ARCHITECT'S DRAWINGS
4.	EXACT LOCATIONS AND ELEVATIONS OF PLUMBING FIXTURES. ALL PIPE OPENINGS THROUGH PARTITIONS, FLOORS AND CEILINGS SHALL HAVE PIPE SLEEVES. FOR PIPE PENETRATING FIRE R PARTITIONS, CEILINGS AND FLOORS THE CONTRACTOR SHALL SEAL AROUND ALL PIPE PENETRATIONS WITH HILTI INTUMESCENT STOP MATERIAL BETWEEN THE PIPE AND SLEEVE TO MAINTAIN FIRE AND SMOKE RATINGS. PROVIDE FIRE STOP SEALANT ON EXISTING PIPING PENETRATING NEW FIRE RATED WALLS CONSTRUCTED AS PART OF THE PROJECT.
5.	CONTRACTOR SHALL PITCH ALL SANITARY AND STORM PIPING UNDER 3" A MINIMUM OF $\frac{1}{4}$ " PER FOOT. SANITARY AND STORM P 3" AND ABOVE MAY BE PITCHED A MINIMUM OF $\frac{1}{6}$ " PER FOOT.
6.	CONTRACTOR SHALL GUARANTEE ALL WORKMANSHIP AND MATERIAL INSTALLED UNDER THIS CONTRACT FREE FROM DEFECTS FOR PERIOD OF ONE (1) YEAR FROM DATE OF SUBSTANTIAL COMPLETION AND ACCEPTANCE BY THE OWNER AND AGREES TO REP DEFECTIVE WORK (INCLUDING ALL REQUIRED LABOR AND MATERIAL) AT NO ADDITIONAL COST TO OWNER DURING THE GUARA PERIOD.
7.	CONTRACTOR SHALL SUBMIT SHOP DRAWINGS ON ALL EQUIPMENT, PIPING, INSULATION, VALVES AND PLUMBING FIXTURES TO ON AND ARCHITECT FOR APPROVAL. DEMONSTRATE NEW PLUMBING SYSTEMS TO OWNERS AND REVIEW MAINTENANCE PROCEDURES.
8. 9.	PROVIDE CHROME PLATED ESCUTCHEON PLATES WHERE PIPES PASS THROUGH WALLS, FLOORS AND CEILINGS IN FINISHED AREAS CONTRACTOR SHALL COORDINATE FINAL LOCATIONS OF ALL PIPING IN FINISHED AREAS WITH GENERAL CONTRACTOR TO ENCONCEALMENT OF ALL PIPING IN WALLS, FLOORS, CEILINGS AND UNDER VANITIES.
	CONTRACTOR SHALL LOCATE ALL PIPING ON THE WARM SIDE OF BUILDING INSULATION ENVELOPE. CONTRACTOR SHALL FURNISH AND INSTALL ALL CONTROL WIRING (24V) AND (120V) FOR SYSTEMS SHOWN ON PLUMBING DRAW AND TRANSFORMERS, CONDUIT, JUNCTION BOXES, CONDUCTORS, THERMOSTATS, APPURTENANCES AND ALL NECESSARY EQUIPMEN
12.	MAKE SYSTEMS COMPLETE AND OPERABLE. CONTRACTOR SHALL PAY FOR ALL PERMITS AND INSPECTIONS FEES REQUIRED BY LOCAL AUTHORITY HAVING JURISDICTION.
13.	CONTRACTOR SHALL PROVIDE ACCESS DOORS FOR ALL VALVES CONCEALED IN WALLS/CEILINGS. ACCESS DOORS SHALL APPROPRIATE FIRE RATING TO MAINTAIN INTEGRITY OF WALL/CEILING. ACCESS DOORS TO BE INSTALLED BY GENERAL CONTRACTOR
	CONTRACTOR SHALL NOT DRILL OR CUT ANY STRUCTURAL MEMBERS WITHOUT PERMISSION OF ARCHITECT, OR STRUCTURAL ENGINE CONTRACTOR IS RESPONSIBLE FOR INSULATING ALL DOMESTIC HOT AND COLD WATER PIPING AND HOT WATER RECIRCULATION.
16.	PLUMBING INSULATION SCHEDULE ON THIS DRAWING. ALL DOMESTIC WATER PIPING CONNECTIONS TO PLUMBING EQUIPMENT SHALL BE COPPER TYPE "L".
	ALL NEW PIPES ARE TO BE SUPPORTED FROM STRUCTURE, NOT FROM EXISTING PIPING OR DUCTWORK. CONTRACTOR SHALL BE RESPONSIBLE FOR DRAINING (AND PROPER DISPOSAL OF ALL DRAINED WATER) AND REFILLING EXIS
	SYSTEMS AS REQUIRED FOR COMPLETION OF WORK. CONNECTIONS TO EXISTING UTILITIES AND SERVICES ARE SHOWN ACCORDING TO THE BEST INFORMATION AVAILABLE. CONTRACTOR SHALL VERIFY THE EXACT LOCATIONS, INVERT ELEVATIONS, AND SIZES OF EXISTING PLUMBING SERVICES IN FIELD,
20.	SHALL CONNECT NEW PLUMBING SERVICES AS INDICATED ON DRAWINGS. PROVIDE DIELECTRIC FITTINGS OR COUPLINGS WHEREVER DISSIMILAR METALS ARE JOINED.
	PROVIDE SHUTOFF VALVES AT ALL FIXTURES AND EQUIPMENT ON COLD WATER AND HOT WATER SUPPLY PIPES. ALL WORK SHALL BE PROPERLY TESTED, BALANCED, AND CLEANED AND DISINFECTED.
23.	A CLEANOUT SHALL BE LOCATED AT ALL CHANGES IN DIRECTION AND AT THE BASE OF EACH STACK AND LEADER.
	ALL MOTOR STARTERS AND DISCONNECT SWITCHES FOR PLUMBING EQUIPMENT SHALL BE FURNISHED BY THE PLUMBING CONTRA AND INSTALLED BY THE ELECTRICAL CONTRACTOR, UNLESS OTHERWISE NOTED. DISCONNECT SWITCHES FURNISHED BY PLUMBING CONTRACTOR FOR PLUMBING EQUIPMENT SHALL BE HEAVY DUTY TYPE. FIXTURE (GENERAL):
	A. FIXTURE SHALL BE COMPLETE WITH REQUIRED TRIM, INCLUDING BUT NOT LIMITED TO: SUPPORTS, FAUCETS, SUPPLIES, VALVES, 17 GAUGE WASTE TAILPIECES, TRAPS, SEATS, FLUSHOMETER, VACUUM BREAKER, BOLTS, GASKETS CHROME PL EXUTCHEONS, CAST BRASS FLOOR FLANGE AND BOLT CAPS. ALL SCREWS SHALL BE VALDELPROOF.
	 B. EXPOSED METAL TRIM AND ROUGHING SHALL BE CHROME PLATED NICKEL BRASS. CHROME PLATED CAST BRASS 'P' TRAPS SCREW PLUG CLEANOUT, SLIP-JOINT INLET AND FEMALE CAST SWIVEL THREADED ELBOW OUTLET. CHROME PLATED B NIPPLE AT WALL WITH CHROME PLATED ESCUTCHEON. SWING SPOUTS SHALL HAVE 140' SWING LIMIT STOPS. C. SUPPORT WALL FIXTURES SECURELY ON APPROVED COMMERCIAL GRADE CARRIERS AS MANUFACTURED BY JAY R. SMITH, JC
29.	OR ZURN. PIPE TESTING:
	A. UPON COMPLETION OF THE ENTIRE SANITARY DRAIN AND VENT SYSTEM AND STORM WATER SYSTEM, THE CONTRACTOR S PERFORM AN AIR TEST WITNESSED BY AUTHORITY HAVING JURISDICTION. AIR SHALL BE FORCED INTO THE SYSTEM UNTIL TH IS A UNIFORM GAUGE PRESSURE OF 5 PSI OR SUFFICIENT TO BALANCE A 10 INCH COLUMN OF MERCURY. THIS TEST SHAL HELD FOR A PERIOD OF AT LEAST 15 MINUTES.
	 B. WATER SUPPLY SYSTEM TEST SHALL BE DONE ON COMPLETION OF A SECTION OF OR THE ENTIRE WATER SUPPLY SYSTEM, SYSTEM, OR THE PORTION COMPLETED, SHALL BE TESTED AND PROVED TIGHT UNDER A WATER PRESSURE NOT LESS THAN WORKING PRESSURE OF THE SYSTEM: OR, BY AN AIR TEST OF NOT LESS THAN 50 PSI. TEST PRESSURE SHALL BE HELD A MINIMUM OF 15 MINUTES. THE WATER UTILIZED FOR TESTS SHALL BE OBTAINED FROM A POTABLE SOURCE OF SUPPLY. C. REFER TO SPECIFICATIONS FOR ADDITIONAL TESTING REQUIREMENTS.
30.	DOMESTIC WATER PIPING DISINFECTION:
	A. ALL OPEN ENDS OF PIPING, VALVES AND EQUIPMENT SHALL BE PLUGGED EXCEPT WHEN ACTUAL WORK IS BEING PERFOR TO MINIMIZE ACCUMULATION OF DIRT AND DEBRIS.B. THE CONTRACTOR SHALL DISINFECT WATER PIPING BEFORE IT IS PLACED IN SERVICE.
	 C. THE CONTRACTOR SHALL FURNISH ALL EQUIPMENT AND MATERIALS NECESSARY TO DO THE WORK OF DISINFECTING, AND S PERFORM THE WORK IN ACCORDANCE WITH THE PROCEDURE OUTLINED IN THE AWWA C651 OR AWWA C652 OR AS DESCH BELOW.
	 D. SYSTEM OR PART THEREOF SHALL BE FILLED WITH A WATER/CHLORINE SOLUTION CONTAINING AT LEAST 50 PARTS PER MIL OF CHLORINE AND THE SYSTEM OR PART THEREOF SHALL BE ALLOWED TO STAND FOR 24 HOURS. E. DURING THE DISINFECTION PERIOD, CARE SHALL BE EXERCISED TO PREVENT CONTAMINATION OF WATER IN THE STREET MAIN
	THE ACTIVE WATER PIPING WITHIN THE BUILDING. F. FOLLOWING REQUIRED STANDING TIME, THE SYSTEM SHALL BE FLUSHED WITH CLEAN POTABLE WATER UNTIL THE CHLORIN PURGED FROM THE SYSTEM.
31.	PIPING AND EQUIPMENT IDENTIFICATION: A. CONTRACTOR TO PROVIDE OPTI-CODE LABELS FOR ALL NEW PIPING. LABELS SHALL INDICATE SERVICE AND FLOW DIREC
	LETTERS AND ARROWS INDICATING FLOW SHALL BE 2 1/2" HIGH, PLACED EVERY 10' AND SHALL BE WHITE ON A G BACKGROUND AND SHALL CONFORM TO ANSI AND OSHA STANDARDS. LABELS SHALL BE APPLIED OVER INSULATION ONLY. B. VALVE SERVICE IDENTIFICATION TAGS: NUMBER 19 B&S GAGE BRASS, WITH 1/4" HIGH VALVE SERVICE ABBREVIATED LETTE
	ON ONE LINE OVER 1/2" HIGH VALVE SERVICE CHART NUMBER, BOTH DEEP STAMPED AND BLACK FILLED; AND WITH 3/16" HOLE FOR BRASS "S" HOOK OR BRASS JACK CHAIN FASTENER. C. PROVIDE VALVE SERVICE IDENTIFICATION CHART MOUNTED IN LOCATION COORDINATED WITH OWNER'S REPRESENTATIVE. FI
	 D. EQUIPMENT SHALL HAVE 3" HIGH BLACK LAMACOID NAME PLATES WITH WHITE ENGRAVED LETTERS PERMANENTLY FASTENEI ALL NEW EQUIPMENT.
	CONTRACTOR SHALL BE RESPONSIBLE FOR PROVIDING START-UP OF ALL NEW EQUIPMENT, CONTROLS, AND ETC. TO ENCORRECT OPERATION OF INSTALLED DEVICES.
	CONTRACTOR SHALL PROVIDE OWNER WITH CATALOG DATA, OPERATING INSTRUCTIONS, MAINTENANCE INSTRUCTIONS, AND REC (AS-BUILT) DRAWINGS OF ALL COMPLETED WORK.
	CONTRACTOR IS RESPONSIBLE FOR COORDINATING ALL CUTTING, PATCHING, AND PAINTING ASSOCIATED WITH PLUMBING WORK THE GENERAL CONTRACTOR, WHO SHALL PERFORM THE WORK. ALL FLOORS AND WALLS WHERE AN EXISTING PIPE HAS REMOVED AND NOT REPLACED SHALL BE PATCHED BY THE GENERAL CONTRACTOR, THIS CONTRACTOR SHALL COORDINATE. ALL NEW HOLES IN WALLS AND FLOORS SHALL BE CORE DRILLED BY THIS CONTRACTOR. PRIOR TO CORE DRILLING FLO

	SYMBO	LS AND ABBREVIATIONS
SYMBOL	ABBREVIATION	DESCRIPTION
	DN.	DOWN
_	GPH	GALLONS PER HOUR
_	GPM	GALLONS PER MINUTE
	TYP.	TYPICAL
	V	VOLTS
	VTR	VENT THROUGH ROOF
	CW	DOMESTIC COLD WATER
	HW	DOMESTIC HOT WATER
	HWR	DOMESTIC HOT WATER RETURN
	S	SANITARY
	V	VENT
Ţ		BALL VALVE
<u> </u>	_	MANUAL AIR VENT
	_	THERMOMETER
	_	PRESSURE GAUGE
<u> </u>	_	UNION
\bigcirc	CODP	CLEANOUT DECK PLATE
	EX.	EXISTING TO REMAIN
	DEM.	EXISTING TO BE REMOVED
	NEW	NEW WORK
o	_	ELBOW UP
c	_	ELBOW DOWN
	_	TEE UP
	_	TEE DN
		TRAP
	FD	FLOOR DRAIN
	_	POINT OF DISCONNECT/CONNECT
_	МС	MECHANICAL CONTRACTOR
_	VTR	VENT THROUGH ROOF
_	RTU	ROOFTOP UNIT
	RD	
	PRV	PRESSURE REDUCING VALVE
-	°F	DEGREES FAHRENHEIT
-	IN	
-	PSIG	POUNDS PER SQUARE INCH
-	Н	HEIGHT
-		WIDTH
-	L	LENGTH
ø	DIA	DIAMETER
]	-	PIPE CAP
-	MIN	MINIMUM
-	MAX	MAXIMUM
-	FT ²	SQUARE FEET
	CO	CLEAN OUT
	WCO	WALL CLEAN OUT
— SD —	SD	STORM DRAIN
, ⊢_Ţ_	_	HOSE-BIBB
+	-	WALL HYDRANT
-	PC	PLUMBING CONTRACTOR

								PLUMBIN	IG EQUIPMEN	T SCHEDULE
TAG	SYMBOLS		F	PLUMBING C	ONNECTIONS			MANUFACTURER	CATALOG #	DESCRIPTION
	PLAN	ELEVATION	SAN./STORM	VENT	COLD	НОТ	GAS			
P-1	\sum		4"	2"	1"	_	_	KOHLER	K-4325	WALL-MOUNTED, VITREOUS CHINA, ELONGATED BOWL, FLUSHOMETER TOILET WITH CONCEALED TRAPWAY, DIRECT-FED SIPHON JET ACTION, AND 1-1/2" TOP SPUD. FIXTURE COLOR SHALL BE WHITE. PROVIDE COMMERCIAL HEAVY DUTY PLASTIC TOILET SEAT, BEMIS MODEL 1955CT AND COMMERCIAL GRADE FLOOR MOUNTED VERTICAL ADJUSTABLE CLOSET CARRIERS. P-1A IS ADA ACCESSIBLE, REFER TO ARCHITECTURAL DRAWINGS FOR MOUNTING HEIGHTS.
P-1A			·	L				ZURN	ZER6000AV-TM -WS1-DF	EXPOSED, BATTERY POWERED, GEAR DRIVEN, ELECTRONIC SENSOR OPERATED WATER CLOSET FLUSHOMETER WITH: MANUAL OVERRIDE BUTTON, CONTROL STOP WITH VANDAL-RESISTANT CAP AND VACUUM BREAKER. DUAL FLUSH, LOW CONSUMPTION, 1.6/1.1 GALLONS PER FLUSH. ADA COMPLIANT.
P-2			2"	1½"	3⁄4"		_	KOHLER	K-4991-ET	WALL-MOUNTED, VITREOUS CHINA, LOW CONSUMPTION, WASHOUT FLUSHING ACTION URINAL WITH FLUSHING RIM, EXTENDED SIDES FOR PRIVACY AND ¾" TOP SPUD INLET. FIXTURE COLOR SHALL BE WHITE. PROVIDE COMMERCIAL GRADE FLOOR MOUNTED URINAL CARRIER WITH BEARING PLATE. REFER TO ARCHITECTURAL DRAWINGS FOR MOUNTING HEIGHTS.
			2	172	/4			ZURN	ZER6003AV-CPM -EWS	EXPOSED, BATTERY POWERED, SENSOR OPERATED URINAL FLUSHOMETER WITH MANUAL OVERRIDE BUTTON, CONTROL STOP WITH VANDAL-RESISTANT CAP AND VACUUM BREAKER. LOW CONSUMPTION, 0.5 GALLONS PER FLUSH. ADA COMPLIANT.
P-3			1¼"	1¼"	1/2"	<i>y</i> ₂ "	_	KOHLER	K-1728	19¼"(L)×17¼"(W) WALL-HUNG, VITREOUS CHINA, D-SHAPED BOWL LAVATORY WITH FRONT OVERFLOW, CONCEALED ARM SUPPORTS, FAUCET LEDGE, AND SELF-DRAINING DECK AREA. FIXTURE COLOR SHALL BE WHITE. PROVIDE: COMMERCIAL GRADE, FLOOR MOUNTED CONCEALED ARM SUPPORTS; OFFSET LAVATORY GRID STRAINER (MCGUIRE MANUFACTURING PART NUMBER 155WC); AND TRUEBRO MODEL 103 E-Z LAV GUARD. P-3 IS ADA ACCESSIBLE. REFER TO ARCHITECTURAL DRAWINGS FOR MOUNTING HEIGHTS. LAVATORY SHALL BE ADA COMPLIANT.
								ZURN	Z6915-XL-TMV1-N	ADA COMPLIANT, LOW-LEAD COMPLIANT, BATTERY POWERED, CHROME PLATED CAST BRASS BODY, SENSOR FAUCET WITH: INFRARED PROXIMITY SENSOR, THIRTY SECOND TIME OUT FEATURE, IN LINE FILTER, (4) "AA" BATTERIES, 0.5 GPM VANDAL-RESISTANT LAMINAR FLOW, AND THERMOSTATIC MIXING VALVE.
P-4			1½"	1½"	¥2"	½"	_	BRADLEY	LVGD2	VERGE LAVATORY SYSTEM, TWO-STATION WITH STANDARD LAVATORY SPACING POSITIONED ON 30" CENTERS. EVERO GEO SERIES BOWL CONSTRUCTED OF: A NATURAL QUARTZ SURFACE MADE OF A BLEND OF BIO-BIASED RESIN, NATURAL QUARTZ AND GRANITE; 300 SERIES STAINLESS STEEL ACCESS PANEL; HEAVY GAUGE STAINLESS STEEL, WALL MOUNTED SUPPORT FRAME. WATER SUPPLIES, VALVES, WASTE ASSEMBLY SHALL BE CONCEALED WITHIN UNIT TO PROVIDE VANDAL-RESISTANCE. LAVATORY SYSTEM SHALL BE LEAD FREE, NSF 372 COMPLIANT AND ADA COMPLIANT. SYSTEM SHALL HAVE 4" CENTER SET DRILLING FOR FAUCETS. PROVIDE TMA NAVIGATION THERMOSTATIC MIXING VALVE ASSEMBLY WITH STOPS AND SUPPLY HOSES. COLOR SHALL BE SELECTED BY ARCHITECT. PROVIDE SINGLE CHROME-PLATED P-TRAP, STAINLESS STEEL GRID STRAINER DRAIN ASSEMBLY AND COMMERCIAL GRADE, FLOOR MOUNTED CONCEALED ARM SUPPORT. P-4 IS ADA ACCESSIBLE. REFER TO ARCHITECTURAL DRAWINGS FOR MOUNTING HEIGHTS.
								ZURN	Z6915-XL-TMV1-N	ADA COMPLIANT, LOW-LEAD COMPLIANT, BATTERY POWERED, CHROME PLATED CAST BRASS BODY, SENSOR FAUCET WITH: INFRARED PROXIMITY SENSOR, THIRTY SECOND TIME OUT FEATURE, IN LINE FILTER, (4) "AA" BATTERIES, 0.5 GPM VANDAL-RESISTANT LAMINAR FLOW, AND THERMOSTATIC MIXING VALVE.
P-5			3"	1½"	¥2"	¥2"	_	ACORN	TNC-24	PRECAST MOP SINK, ONE PIECE TERRAZZO COMPOSED OF MARBEL CHIPS IN PORTLAND CEMENT. MOP SINK SHALL BE 24"X 24" NEO-CORNER STYLE WITH 12" STANDARD HEIGHT FRONT SHOULDER. INTEGRAL DRAIN WITH A REMOVABLE STAINLESS STEEL GRID STRAINER FOR INSIDE CAULK CONNECTION TO 3" PIPE. PROVIDE STAINLESS STEEL CAPS ON ALL SHOULDERS, 36" HOSE WITH WALL HANGER, AND MOP HANGER.
								SPEAKMAN	SEF-9000-TW	FAUCET WITH EYEWASH/DRENCH HOSE. UNIT SHALL BE COMPLETE WITH SPEAKMAN SC-5811-RCP SERVICE SINK FAUCET CONNECTED TO EYEWASH. EYEWASH SHALL BE ACTIVATED BY SQUEEZE VALVE AND INCLUDE (2) YELLOW PLASTIC SPRAY HEADS WITH FLIP TOP DUST CAPS, INTEGRAL VACUUM BREAKER AND CHECK VALVE. PROVIDE SE-370 THERMOSTATIC MIXING VALVE. SERVICE SINK FAUCET SHALL HAVE VANDAL RESISTANT FOUR-ARM HANDLES, CAST BRASS NOZZLE WITH ¾" HOSE THREAD, PAIL HOOK AND TOP BRACE OUTLET, AND INTEGRAL VACUUM BREAKER.
P-6	+	, <u> </u>	-	_	3⁄4"	_	_	WOODFORD	24	CHROME, ANTI-SIPHON, VACUUM BREAKER PROTECTED WALL FAUCET WITH $\frac{3}{4}$ " MALE HOSE THREAD, POLYCARBONATE WHEEL HANDLE AND LOOSE TEE KEY, AND $\frac{3}{4}$ " INLET.
P-7		▽	3"	1½"	-	-	_	WATTS	FD-100-M	VANDAL-PROOF, EPOXY COATED CAST IRON FLOOR DRAIN WITH ANCHOR FLANGE, REVERSIBLE CLAMPING COLLAR WITH PRIMARY & SECONDARY WEEPHOLES, ADJUSTABLE SQUARE HEEL-PROOF NICKEL BRONZE STRAINER, AND 3" NO HUB OUTLET. FLOOR DRAIN SHALL BE COMPLETE WITH 6"x6" STRAINER, AND TRAP PRIMER TAPPING. PROVIDE SURESEAL MODEL SS3009V WATERLESS INLINE 3" DRAIN TRAP SEAL.
P-8			1½"	1½"	1/2"	_	_	ELKAY	LZSTL8WSVRLK	BOTTLE FILLING STATION AND BI-LEVEL ADA VANDAL-RESISTANT COOLER, FILTERED, REFRIGERATED, AND LIGHT GRAY. FIXTURE FEATURES: ANTIMICROBIAL, FILTERED, GREEN TICKER, HANDS FREE, LAMINAR FLOW, REAL DRAIN, VISUAL FILTER MONITOR, VANDAL RESISTANT BUBBLER, ELECTRONIC BOTTLE FILLER SENSOR WITH ELECTRONIC FRONT AND SIDE BUBBLER PUSHBAR ACTIVATION. WALL MOUNTED. CHILLING CAPACITY OF 8 GALLONS PER HOUR OF 50°F DRINKING WATER AT 90°F AMBIENT. ELECTRICAL: 115V/60Hz., 6.0 FULL LOAD AMPS, 370 WATTS. ADA COMPLIANT, NSF 61 CERTIFIED. REFER TO ARCHITECTURAL DRAWINGS FOR MOUNTING HEIGHTS AND COOLER CONFIGURATION. PROVIDE COMMERCIAL GRADE, IN-WALL, FLOOR MOUNTED FIXTURE SUPPORT AND (2) SPARE FILTERS.

PIPE SIZE -		HORIZONTAL IG (FEET)	-	TEEL ROD ZE (INCHES)	HANGER TYPE STEEL	MAXIMUM VERTICAL SPACING (FEET)	
(INCHES)	COPPER TUBE	CAST IRON	TUBING	PIPING		COPPER TUBE	CAST IRON
1⁄2"	6	5	1⁄4"	³ ⁄8"	BAND	10	15
3⁄4"	6	5	1⁄4"	³ ⁄8"	BAND	10	15
1"	6	5	1⁄4"	<u>3∕8</u> "	BAND	10	15
11⁄4"	6	5	1⁄4"	<u>3∕8</u> "	CLEVIS	10	15
11/2"	6	5	1⁄4"	³ ⁄8"	CLEVIS	10	15
2"	10	5	1⁄4"	³ ⁄8"	CLEVIS	10	15
21/2"	10	5	3⁄8"	1⁄2"	CLEVIS	10	15
3"	10	5	3⁄8"	1/2"	CLEVIS	10	15
4"	10	5	1/2"	5⁄8"	CLEVIS	10	15
5"	10	5	1/2"	⁵ ⁄8"	CLEVIS	10	15
6"	10	5	1/2"	3⁄4"	CLEVIS	10	15
8"	10	5	5⁄8"	7⁄8"	CLEVIS	10	15
10"	10	5	5⁄8"	7⁄8"	CLEVIS	10	15
12"	10	5	5/8"	7⁄8"	CLEVIS	10	15

1. MAXIMUM HORIZONTAL SPACING OF CAST-IRON PIPE HANGERS SHALL BE INCREASED TO 10 FEET WHERE 10 FOOT LENGTHS OF PIPE ARE INSTALLED. 2. INSTALL HANGER OR SUPPORT CLOSE TO THE POINT OF CHANGE OF DIRECTION IN ALL PIPE RUNS.

3. INSTALL ADDITIONAL HANGERS ON SUPPORTS AT CONCENTRATED LOADS.

4. SUPPORT ALL BRANCH PIPING OVER 5'-0" IN LENGTH.

5. SUPPORT VERTICAL PIPING AT EVERY FLOOR.

[
WATTS WA	WATTS WATER HAMMER ARRESTOR					
NO. 15 SIZE	FIXTURE UNITS	CROSS REF. PDI STANDARD				
1/2"M1	1-11	А				
3/4" M1	12-32	В				
1"M1	33-60	С				
1-1/4" M1	61-113	D				
1-1/2" M1	114—154	E				
2" M1	155-330	F				

PLUMBING PIPING FITTING SCHEDULE						
SERVICE	SIZE (IN)	MATERIAL	TYPE/WEIGHT	STANDARD		
WATER PIPE (ABOVE GROUND)	ALL	COPPER	LEAD-FREE SOLDER ASTM B828	ASTM B 16.22		
SANITARY, VENT, AND STORM (ABOVE GROUND)	ALL	SERVICE WEIGHT CAST IRON	NO-HUB ASTM C1277 ASTM C564	ASTM A 74		

PLUMBING PIPING MATERIAL SCHEDULE					
SERVICE SIZE (IN) MATERIAL TYPE/WEIGHT STANDARE					
WATER PIPE (ABOVE GROUND)	ALL	COPPER	TYPE L TUBE	ASTM B 88	
SANITARY, VENT, AND STORM (ABOVE GROUND)	ALL	CAST IRON	SERVICE WEIGHT	ASTM A 74	

PLUMBING PIPE INSULATION SCHEDULE						
	INSULATION THI	CKNESS (INCHES)				
SERVICE	PIPE SIZE	(INCHES)				
	BELOW 11/2"	1 ¹ / ₂ " AND OVER				
COLD WATER	1/2"	1"				
HOT WATER	1 "	1½"				
HOT WATER RECIRCULATION	1"	11/2"				
HORIZONTAL STORM PIPING	1"	1 "				
NOTES:						
 PIPE COVERING SHALL BE FIBERGLASS PIPE INSULATION WITH: FIRE RETARDANT VAPOR BARRIER JACKET, 0.23 K-FACTOR AT 75°F MEAN TEMPERATURE, FLAME SPREAD = 25, SMOKE DEVELOPED = 50. 						

2. FITTINGS AND VALVES SHALL BE PROVIDED WITH PREMOLDED FITTING COVERS WITH PVC JACKETING EQUAL IN THICKNESS AND MATERIAL TO ADJOINING PIPE INSULATION.

3. ALL EXISTING UNINSULATED STORM DRAIN PIPING ON THIRD FLOOR SHALL BE INSULATED AS PART OF THIS PROJECT. PLUMBING CONTRACTOR TO COORDINATE IN FIELD.

1
ORANGE-ULSTER
BOCES Regional Education
Center at Arden Hill
Interior Alterations
4 Harriman Drive
Goshen • NY 10924
Iisten imagine build
KG+D . ARCHITECTS PC
P:914.666.5900 KGDARCHITECTS.COM
S.E.D. Control No. 44-90-00-00-8-035-008
CONSTRUCTION DOCUMENTS
GERARD
CONSULTING ENGINEERS, D.P.C.
223 MAIN STREET, GOSHEN NY 10924 TEL: (845) 291 1272 info@GerardAssociates.com www.GerardAssociates.com GA23010
0,20010
NOTE: ALL IDEAS, DESIGNS, ARRANGEMENTS AND PLANS INDICATED OR REPRESENTED BY THIS DRAWING ARE OWNED BY AND ARE THE PROPERTY OF KAEYER, GARMENT, & DAVIDSON ARCHITECTS, PC (KG&D), AND WERE CREATED, EVOLVED AND DEVELOPED FOR USE ON, AND IN CONNECTION WITH, THE SPECIFIED PROJECT. NONE OF SUCH IDEAS, DESIGNS, ARRANGE-
WITH, THE SPECIFIED PROJECT. NONE OF SUCH IDEAS, DESIGNS, ARRANGE- MENTS OR PLANS SHALL BE USED BY OR DISCLOSED TO ANY PURPOSE WHATSOEVER WITHOUT THE WRITTEN PERMISSION OF (KG&D). WRITTEN DIMENSIONS ON THIS DRAWING SHALL HAVE PRECEDENCE OVER SCALED DIMENSIONS. CONTRACTOR SHALL VERIFY AND BE RESPONSIBLE
FOR ALL DIMENSIONS AND CONDITIONS ON THE JOB AND THIS OFFICE MUST BE NOTIFIED OF ANY VARIATIONS FROM DIMENSIONS AND CONDITIONS SHOWN BY THESE DRAWINGS. SHOP DETAILS MUST BE SUBMITTED TO THIS OFFICE FOR APPROVAL BEFORE PROCEEDING WITH FABRICATION.
LEGAL NOTICE: ALTERATIONS BY ANY PERSON, IN ANY WAY, OF ANY ITEM CONTAINED ON THIS DOCUMENT, UNLESS ACTING UNDER THE DIRECTION OF THE LICENSED ARCHITECT WHOSE PROFESSIONAL SEAL IS AFFIXED HERETO, IS A VIOLATION OF TITLE VII, SECT. 69.5 (b) OF NEW YORK STATE LAW.
UNAUTHORIZED ADDITION OR ALTERATION OF THIS PLAN IS A VIOLATION OF ARTICLE 145, SECTION 7209 (2) OF THE NEW YORK STATE EDUCATION LAW.
Professional Seal
2 09/22/23 ISSUED FOR BID
1 03/30/23 S.E.D. SUBMISSION No. Date Issue
PLUMBING:
EQUIPMENT SCHEDULES AND
NOTES
Job No. Sheet No.
2023-1008 Date
03-30-23 P701
AS NOTED
Drawn/Checked KC/SZ