## CHESTER UNION FREE SCHOOL DISTRICT

# CHESTER ACADEMY STEM LAB ALTERATIONS

64 HAMBLETONIAN AVENUE CHESTER, NY 10918

REISSUE FOR BID - JANUARY 18, 2023


# CHESTER ACADEMY STEM LAB ALTERATIONS

NY SED Project Control No. 44-02-01-02-0-009-006

KG+D Project No. 2021-1080

### **DESIGN TEAM**

## CONSTRUCTION DOCUMENTS

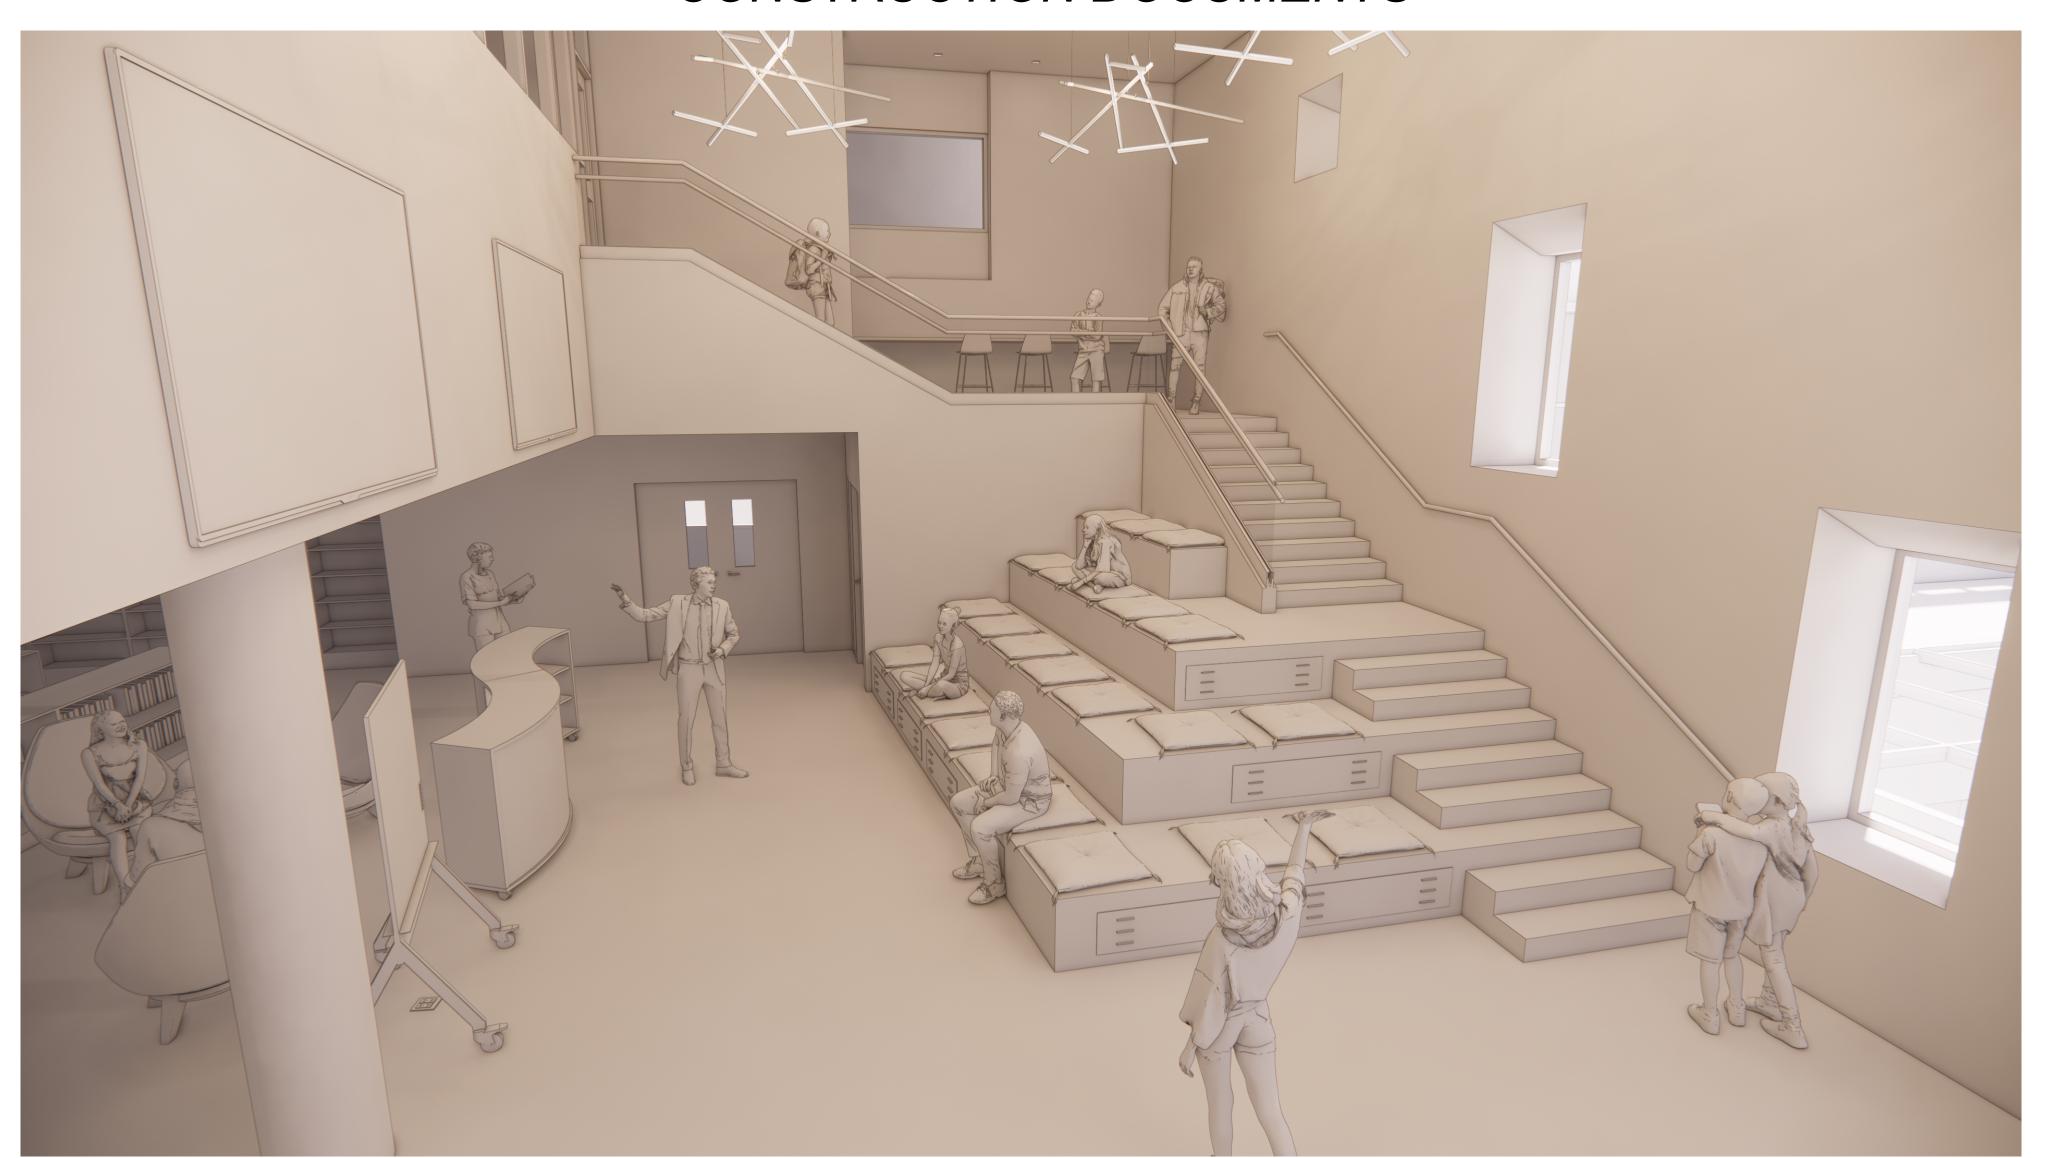

## LIST OF DRAWINGS

GENERAL		PLUMBING	
G001	GENERAL INFORMATION	SP201	SPRINKLER NEW WORK PLANS
CODE COMPLIA	ANCE	MECHANICAL	
CC001	CODE COMPLIANCE INFORMATION	M001	MECHANICAL SYMBOLS AND GENERAL NOTES
CC002	CODE COMPLIANCE PLANS & INFO	M101	MECHANICAL DEMOLITION PLANS
STRUCTURE		M201	MECHANICAL NEW WORK PLANS
S101	2ND AND 3RD PARTIAL FLOOR FRAMING PLAN	M601	MECHANICAL SCHEDULES
ARCHITECTUR	E	M701	MECHANICAL DETAILS 1 OF 2
A101	DEMOLITION PLANS	M702	MECHANICAL DETAILS 2 OF 2
A201	AREA OF WORK FLOOR PLANS	ELECTRICAL	
A401	INTERIOR ELEVATIONS	E001	ELECTRICAL SYMBOLS, ABBREVIATIONS & NOTES
A440	MILLWORK DETAILS	E101	ELECTRICAL PLANS - DEMOLITION
A501	FINISH PLANS AND SCHEDULES & SIGNAGE INFORMATION	E201	ELECTRICAL PLANS - LIGHTING
A502	FURNITURE AND EQUIPMENT PLANS & SCHEDULES	E301	ELECTRICAL PLANS - POWER
A601	AREA OF WORK REFLECTED CEILING PLAN	E601	ELECTRICAL SCHEDULES
A701	STAIR PLANS & SECTIONS	E701	ELECTRICAL DETAILS
A901	DOOR, FRAME AND PARTITION TYPES & DETAILS		

# ARCHITECT **KG+D Architects, P.C**

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# STRUCTURAL ENGINEER The DiSalvo Engineering Group

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## SPECIFICATION CONSULTANT Sue McClymonds Architect

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#### PROJECT ABBREVIATIONS

AFF	ABOVE FINISH FLOOR	GALV	GALVANIZED	RCP	REFLECTED CEILING PLAN
ACM	ASBESTOS CONTAINING MATERIAL	GFB	GROUND FACE BLOCK	REFL	REFLECTED
ACPL	ACOUSTIC PANEL	GFRG	GLASS FIBER REINFORCED GYPSUM	REQD	REQUIRED
ACT	ACOUSTIC CEILING TILE	GL	GLASS	RB	RUBBER BASE
ADJ	ADJUSTABLE	GOG	GOGGLE	RTN	RETURN
ACC	AR CONDITIONING	GWB	GYPSUM WALLBOARD	RA BEV	RETURN AIR
AESS	ARCHITECTURAL EXPOSED STRUCTURAL STEEL		LICIOLIT ACC	REV	REVISED/REVISION
AHAP	AS HIGH AS POSSIBLE ALUMINUM	H HDW	HEIGHT AFF	RFI RO	REQUEST FOR INFORMATION
ALUM AMP	ACRYLIC MODIFIED POLYESTER	HDWD	HARDWARE HARDWOOD	RO RT	ROUGH OPENING RUBBER TREATD/TILE
APPROX	APPROXIMATE	HDWD	HEAD	RTB	RUBBER TREAD BASE
AFFROX	AFFIOAIWATE	HDR	HEADER	RTT	RESILIENT TERRAZZO TILE
BEPO	BROADCAST EPOXY	HVAC	HEATING, VENTILATING, AIR CONDITIONING	RW	RESCUE WINDOW
BTW	BETWEEN	HR	HOUR	1 ( ) (	NEGOGE WINDOW
BLKG	BLOCKING	HT	HEIGHT	S	SAFETY GLZING/SEE SPEC
BOT	BOTTOM	HM	HOLLOW METAL	SCHED	SCHEDULE/SCHEDULED
BLDG	BUILDING	HMFR	HOLLOW METAL FRAME	SECT	SECTION
BL	BUILDING LINE	HORIZ	HORIZONTAL	SFB	SPLIT FACE BLOCK
		HC	HANDICAP	SH	SHELVING/SHELF/SHELVES
CAB	CABINET			SIM	SIMILAR
CB	CEMENT BOARD	IF	INSIDE FACE	SL	SLATE
CI	CAST IRON	IN	INCH/INCHES	STC	SOUND TRANSMISSION CLASS
CLG	CEILING	INCL	INCLUDE/INCLUSIVE	SPEC	SPECIFICATION
CL	CENTER LINE	INFO	INFORMATION	SQFT	SQUARE FOOT
CMU	CONCRETE MASONRY UNIT	INSUL	INSULATION	ST	SAND, STAIN & SEAL
COL	COLUMN	INT	INTERIOR	STSTL	STAINLESS STEEL
CONC	CONCRETE			STL	STEEL
CONF	CONFERENCE	JC	JANITOR'S CLOSET	STR	STRUCTURAL/STRUCTURE
CONST	CONSTRUCTION	JT	JOINT	SUSP	SUSPENDED/SUSPENSION
CONTR	CONTRACTOR			_	
CONT	CONTINUOUS	KPL	KICK PLATE	<u>T</u>	TOP
CPT	CARPET	KD	KNOCKDOWN	TB	TACKBOARD
CT	CERAMIC TILE	KO	KNOCKOUT	TBD	TO BE DETERMINED
CTB	CERAMIC TILE BASE		LANDIATED	TERR	TERRAZZO
DA	DEVICE ADDANGEMENT	LAM	LAMINATED	TFF	TOP FINISHED FLOOR
DA	DEVICE ARRANGEMENT		LAMINATED GLASS	TMP GL	TEMPERED GLASS
DET	DETAIL DRINKING FOUNTAIN	LTC	LIGHT	THERMO	THERMOSTAT
DF		LTG LWC	LIGHTING	T&B TO	TOP AND BOTTOM
DIM DR	DIMENSION DOOR	LIN	LIGHT WEIGHT CONCRETE LINOLEUM	TOS	TOP OF TOP OF STEEL
DN	DOWN	LIIN	LINOLEUW	TOSS	TOP OF STEEL TOP OF STRUCTURAL SLAB
DWG	DRAWING	MAINT	MAINTAIN/MAINTENANCE	TOES	TOP OF STRUCTURAL SLAB
DVVO	DIAWING	MAX	MAXIMUM	TRT	TERRAZZO RESILIENT TILE
EE	EACH END	MFG	MANUFACTURER	TYP	TYPICAL
EIFS	EXTERIOR INSULATION FINISH SYSTEM		MASONRY	111	TITIOAL
EJ	EXPANSION JOINT	MO	MASONRY OPENING	UNFIN	UNFINISHED
ELEC	ELECTRIC/ELECTRICAL	MATL	MATERIAL	UNO	UNLESS NOTED OTHERWISE
EL/ELEV	ELEVATION	MECH	MECHANICAL	UR	UNRINAL
ENCL	ENCLOSURE	MTL	METAL	UTIL	UTILITY
EOD	EDGE OF DECK	MCP	METAL COMPOSITE PANEL	· · · -	J
EOS	EDGE OF SLAB	MCB	METAL CORNER BEAD	VAT	VINYL ASBESTOS TILE
EPO	EPOXY	MS	METAL STUD	VCT	VINYL COMPOSITE TILE
EPS	EDGE OF POUR STOP	MLWK	MILL WORK	VEN	VENEER
EQ	EQUAL	MIN	MINIMUM	VERT	VERTICAL
ES	EACH SIDE	MISC	MISCELLANEOUS	VET	VINYL ENHANCED TILE
EXST	EXISTING	MLDG	MOLDING	VIF	VERIFY IN FIELD
ETR	EXISTING TO REMAIN	MTG	MOUNTING	VRS	VINYL REDUCER STRIP
ETRE	EXISTING TO BE RELOCATED			VT	VINYL TILE
EXP JT	EXPANSION JOINT	NIC	NOT IN CONTRACT	VWC	VINYL WALL COVERING
EXT	EXTERIOR	NTS	NOT TO SCALE	14/5	14/1 UTED 0 A DD
EW	EACH WAY	NO	NUMBER	WB	WHITEBOARD
EAD	FADDIC	00	ON CENTED	WC	WATER CLOSET
FAB	FABRIC FACE TO FACE	OC	ON CENTER	WF	WATER FOUNTAIN
FTF FIN	FACE TO FACE FINISHED	OPNG OPP	OPENING OPPOSITE	WGL W/	WIRE GLASS
FIN FA	FINISHED FIRE ALARM	OPP	OPPOSITE HAND	W/C	WITH WHEEL CHAIR
FD	FLOOR DRAIN	OTS	OPEN TO STRUCTURE	W/O	WITHOUT
FDMPR	FIRE DAMPER	OUT	OUTLET	WOM	WALK OFF MAT
FE	FIRE EXTINGUISHER	OD	OUTSIDE DIAMETER	WD	WOOD
FEC	FIRE EXTINGUISHER CABINET	OF	OUTSIDE FACE	WD BLKG	WOOD BLOCKING
FF	FACTORY FINISH	O.	001015217102	WD DR	WOOD DOOR
FHC	FIRE HOSE CABINET	Р	PAINTED	WP	WATERPROOFING
FHVC	FIRE HOSE VALVE CABINET	PT	PORCELAIN TILE	WR	WARDROBE
FR	FIRE RATED	PTB	PORCELAIN TILE BASE	WW	WINDOW WALL
FRD	FRENCH DRAIN	PR	PAIR		
FFSC	FIRE RATED ASSEMBLY (DOORS)	PNL	PANEL	YD	YARD
FRTD	FIRE RETARDANT	PTN	PARTITION	YCO	YARD CLEANOUT
FIX	FIXTURE	PL	PROPERTY LINE		
FL/FLR	FLOOR	PLAM	PLASTIC LAMINATE	ZCC	ZINC COATED COPPER
FLUOR	FLUORESCENT	PLMB	PLUMBING		
FL MTD	FLUSH MOUNTED		PLYWOOD		
FT	FOOT/FEET	PTWD	PRESERVATIVE TREATED WOOD		
FDN	FOUNDATION  FRITZ FLOOR (BTT) TILE	OT	OLIADDY TILE		
FRITZ	FRITZ FLOOR (RTT) TILE	QT OTB	QUARRY TILE		
		QTB QTY	QUARRY TILE BASE QUANTITY		
		QII	QUANTITI		

### UNIFORM SAFETY STANDARDS FOR SCHOOL **CONSTRUCTION & MAINTENANCE PROJECTS**

THE OCCUPIED PORTION OF THE EXISTING SCHOOL BUILDING SHALL ALWAYS COMPLY WITH THE MINIMUM REQUIREMENTS NECESSARY TO MAINTAIN A CERTIFICATE OF OCCUPANCY.

ALL SCHOOL AREAS TO BE DISTURBED DURING RENOVATION OR DEMOLITION HAVE BEEN OR WILL BE TESTED FOR LEAD AND ASBESTOS.

GENERAL SAFETY AND SECURITY STANDARDS FOR CONSTRUCTION PROJECTS:

- (A) ALL CONSTRUCTION MATERIALS SHALL BE STORED IN A SAFE AND SECURE MANNER
- FENCES AROUND CONSTRUCTION SUPPLIES OR DEBRIS SHALL BE MAINTAINED.
- GATES SHALL ALWAYS BE LOCKED UNLESS A WORKER IS IN ATTENDANCE TO PREVENT UNAUTHORIZED ENTRY
- DURING EXTERIOR RENOVATION WORK, OVERHEAD PROTECTION SHALL BE PROVIDED FOR ANY SIDEWALKS OR AREAS IMMEDIATELY BENEATH THE WORK SITE OR SUCH AREAS SHALL BE FENCED OFF AND PROVIDED WITH WARNING SIGNS TO PREVENT ENTRY.
- WORKERS SHALL BE REQUIRED TO WEAR PHOTO-IDENTIFICATION BADGES AT ALL TIMES FOR IDENTIFICATION AND SECURITY PURPOSES WHILE WORKING AT OCCUPIED SITES.

SEPARATION OF CONSTRUCTION AREAS FROM OCCUPIED SPACES:

CONSTRUCTION AREAS WHICH ARE UNDER THE CONTROL OF A CONTRACTOR AND THEREFORE NOT OCCUPIED BY DISTRICT STAFF OR STUDENTS SHALL BE SEPARATED FROM OCCUPIED AREAS. PROVISIONS SHALL BE MADE TO PREVENT THE PASSAGE OF DUST AND CONTAMINANTS INTO OCCUPIED PARTS OF THE BUILDING. PERIODIC INSPECTION AND REPAIRS OF THE CONTAINMENT BARRIERS MUST BE MADE TO PREVENT EXPOSURE TO DUST OR CONTAMINANTS. GYPSUM BOARD MUST BE USED IN EXIT WAYS OR OTHER AREAS THAT REQUIRE FIRE RATED SEPARATION. HEAVY DUTY PLASTIC SHEETING MAY BE USED ONLY FOR A VAPOR, FINE DUST OR AIR INFILTRATION BARRIER, AND SHALL NOT BE USED TO SEPARATE OCCUPIED SPACES FROM CONSTRUCTION AREAS.

- (A) A SPECIFIC STAIRWELL AND/OR ELEVATOR SHOULD BE ASSIGNED FOR CONSTRUCTION WORKER USE DURING WORK HOURS. IN GENERAL, WORKERS MAY NOT USE CORRIDORS, STAIRS OR ELEVATORS DESIGNATED FOR STUDENTS OR SCHOOL STAFF.
- LARGE AMOUNTS OF DEBRIS MUST BE REMOVED BY USING ENCLOSED CHUTES OR A SIMILAR SEALED SYSTEM. THERE SHALL BE NO MOVEMENT OF DEBRIS THROUGH HALLS OF OCCUPIED SPACES OF THE BUILDING. NO MATERIAL SHALL BE DROPPED OR THROWN OUTSIDE THE WALLS OF THE BUILDING.
- ALL OCCUPIED PARTS OF THE BUILDING AFFECTED BY RENOVATION ACTIVITY SHALL BE CLEANED AT THE CLOSE OF EACH WORKDAY. SCHOOL BUILDINGS OCCUPIED DURING A CONSTRUCTION PROJECT SHALL MAINTAIN REQUIRED HEALTH, SAFETY AND EDUCATIONAL CAPABILITIES AT ALL TIMES THAT CLASSES ARE IN SESSION.

A PLAN DETAILING HOW EXITING REQUIRED BY THE APPLICABLE BUILDING CODE WILL BE MAINTAINED.

A PLAN DETAILING HOW ADEQUATE VENTILATION WILL BE MAINTAINED DURING CONSTRUCTION.

CONSTRUCTION AND MAINTENANCE OPERATIONS SHALL NOT PRODUCE NOISE IN EXCESS OF 60 DBA IN OCCUPIED SPACES OR SHALL BE SCHEDULED FOR TIMES WHEN THE BUILDING OR AFFECTED BUILDING SPACES ARE NOT OCCUPIED OR ACOUSTICAL ABATEMENT MEASURES SHALL BE TAKEN.

THE CONTRACTOR SHALL BE RESPONSIBLE FOR THE CONTROL OF CHEMICAL FUMES, GASES, AND OTHER CONTAMINATES PRODUCED BY WELDING, GASOLINE OR DIESEL ENGINES, ROOFING, PAVING, PAINTING, ETC. TO ENSURE THEY DO NOT ENTER OCCUPIED PORTIONS OF THE BUILDING OR AIR INTAKES.

THE CONTRACTOR SHALL BE RESPONSIBLE TO ENSURE THAT ACTIVITIES AND MATERIALS WHICH RESULT IN "OFF-GASSING" OF VOLATILE ORGANIC COMPOUNDS SUCH AS GLUES, PAINTS, FURNITURE, CARPETING, WALL COVERING, DRAPERY, ETC. ARE SCHEDULED, CURED OR VENTILATED IN ACCORDANCE WITH MANUFACTURERS RECOMMENDATIONS BEFORE A SPACE CAN BE OCCUPIED.

LARGE AND SMALL ASBESTOS ABATEMENT PROJECTS AS DEFINED BY 12NYCRR56 SHALL NOT BE PERFORMED WHILE THE BUILDING IS OCCUPIED". NOTE, IT IS OUR INTERPRETATION THAT THE TERM "BUILDING", AS REFERENCED IN THIS SECTION, MEANS A WING OR MAJOR SECTION OF A BUILDING THAT CAN BE COMPLETELY ISOLATED FROM THE REST OF THE BUILDING WITH SEALED NON COMBUSTIBLE CONSTRUCTION. THE ISOLATED PORTION OF THE BUILDING MUST CONTAIN EXITS THAT DO NOT PASS THROUGH THE OCCUPIED PORTION AND VENTILATION SYSTEMS MUST BE PHYSICALLY SEPARATED AND SEALED AT THE ISOLATION BARRIER. EXTERIOR WORK SUCH AS ROOFING, FLASHING, SIDING, OR SOFFIT WORK MAY BE PERFORMED ON OCCUPIED BUILDINGS PROVIDED PROPER VARIANCES ARE IN PLACE AS REQUIRED, AND COMPLETE ISOLATION OF VENTILATION SYSTEMS AND AT WINDOWS IS PROVIDED. CARE MUST BE TAKEN TO SCHEDULE WORK SO THAT CLASSES ARE NOT DISRUPTED BY NOISE OR VISUAL DISTRACTION.

SURFACES THAT WILL BE DISTURBED BY RECONSTRUCTION MUST HAVE A DETERMINATION MADE AS TO THE PRESENCE OF LEAD. PROJECTS WHICH DISTURB SURFACES THAT CONTAIN LEAD SHALL HAVE IN THE SPECIFICATIONS A PLAN PREPARED BY A CERTIFIED LEAD RISK ASSESSOR OR SUPERVISOR WHICH DETAILS PROVISIONS FOR OCCUPANT PROTECTION, WORKSITE PREPARATION, WORK METHODS, CLEANING AND CLEARANCE TESTING WHICH ARE IN GENERAL ACCORDANCE WITH THE HUD GUIDELINES.

### SHEET IDENTIFICATION LEGEND

DISCIPLINE DESIGNATOR SHEET TYPE DESIGNATOR SEQUENCE NUMBER

GENERAL CODE COMPLIANCE CC PHASING HAZARDOUS MATERIAL ABATEMENT CIVIL LANDSCAPE STRUCTURAL **ARCHITECTURAL** FIRE PROTECTION PLUMBING

> **MECHANICAL** ELECTRICAL

DISCIPLINE DESIGNATORS

**GENERAL** DEMOLITION **PLANS EXTERIOR ELEVATIONS & BUILDING SECTIONS ENLARGED PLANS & INTERIOR ELEVATIONS** FINISHES REFLECTED CEILING PLANS VERTICAL CIRCULATION WALL SECTIONS & ENLARGED DETAILS TYPICAL DETAILS

SHEET TYPE DESIGNATOR

CHESTER ACADEMY STEM LAB **ALTERATIONS** 

> CHESTER UNION FREE SCHOOL DISTRICT

**64 HAMBLETONIAN AVENUE** CHESTER, NY 10918




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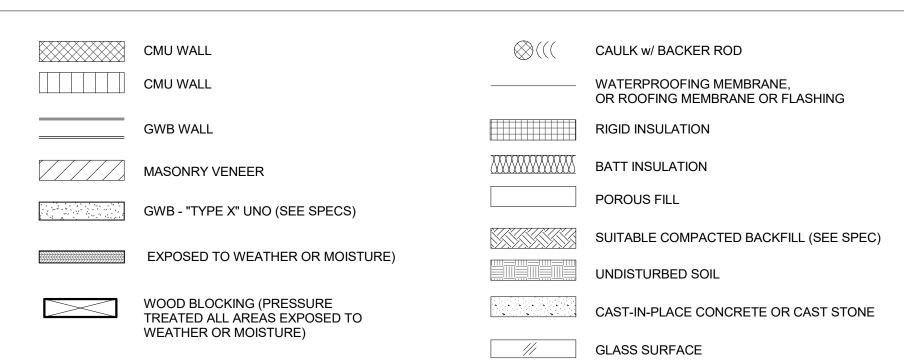
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CONSTRUCTION **DOCUMENTS** 

#### SYMBOLS LEGEND



### MATERIALS LEGEND

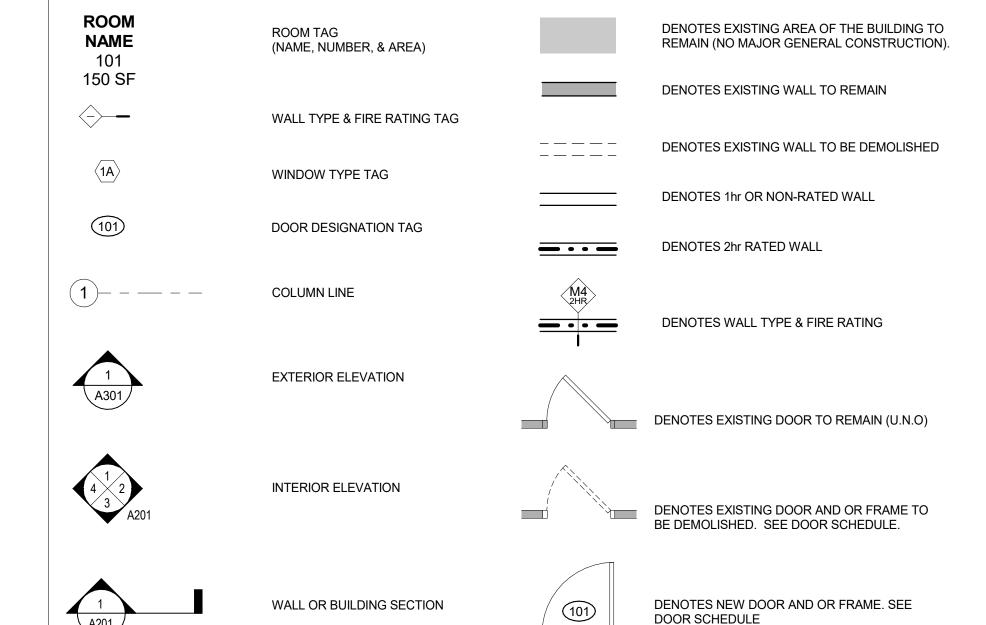

### PROJECT INFORMATION

OWNER CHESTER UNION FREE SCHOOL DISTRICT

**64 HAMBLETONIAN AVENUE** CHESTER. NEW YORK 10918

TELEPHONE: 845.572.5004

PROJECT CHESTER ACADEMY LOCATION 64 HAMBLETONIAN AVENUE CHESTER, NEW YORK 10918

ALTERATIONS (LEVEL 2 - 2020 EBCNYS) TYPE OF PROJECT

NYSED NUMBER 44-02-01-02-0-009-006 PROJECT COMMENCEMENT JANUARY 11 2023 PROJECT COMPLETION AUGUST 01 2023 /5\

APPLICABLE CODES 2020 NEW YORK STATE UNIFORM FIRE PREVENTION AND BUILDING CODE

2020 EXISTING BUILDING CODE OF NEW YORK STATE

1998 MANUAL OF PLANNING STANDARDS. THE UNIVERSITY OF THE STATE OF NEW YORK. THE STATE EDUCATION DEPARTMENT

ANSI A117/1-09 ACCESSIBLE & USABLE BUILDINGS AND FACILITES

\*SEE DRAWINGS ON CODE COMPLIANCE PLANS FOR WORK AREAS & ADDITIONAL INFORMATION\*

BUILDING KEY PLAN EYER GARMENT & DAVIDSON ARCHITECTS PC (KG&D), AND WERE CREA OR USE ON THIS PROJECT. NONE OF SUCH IDEAS, DESIGNS, ARRANGEMEN R PLANS SHALL BE USED BY OR DISCLOSED TO ANY PURPOSE WHATSOEVE THOUT THE WRITTEN PERMISSION OF (KG&D).

AREA OF WORK

ED DIMENSIONS. CONTRACTOR SHALL VERIFY ALL ACTUAL DIMENSIONS CONDITIONS ON THE JOB AND THE ARCHITECT MUST BE NOTIFIED OF A RIATIONS FROM DIMENSIONS AND CONDITIONS SHOWN. SHOP DETAILS MU E SUBMITTED TO THIS OFFICE FOR APPROVAL BEFORE PROCEEDING WITH

TERATIONS BY ANY PERSON, IN ANY WAY, OF ANY ITEM CONTAINED ON THIS OCUMENT, LINESS ACTING LINDER THE DIRECTION OF THE LICENCED. HITECT WHOSE PROFESSIONAL SEAL IS AFFIXED HERETO, IS A VIOLATION F TITLE VII, SECT. 69.5 (b) OF NEW YORK STATE LAW. OPYRIGHT KAEYER, GARMENT + DAVIDSON ARCHITECTS & ENGINEERS. P.

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01/18/2023 REISSUE FOR BID 11/02/2022 ISSUE FOR BID 05/25/2022 NYSED - CONST. DOCS. No. Date

> **GENERAL INFORMATION**

01/11/2023 2021-1080 Drawn / Checked AS NOTED

**Sheet Number** 

### CHAPTERS 3-6: OCCUPANCY, AREA, AND **CONSTRUCTION TYPES**

USE + OCCUPANCY CLASSIFICATION: E (EDUCATIONAL)

**IB - PARTIALLY SPRINKLERED** CONSTRUCTION CLASSIFICATION:

FIRE RESTISTANCE RATING REQUIRMENTS WALL (BEARING): 2 HRS WALL (NON-BEARING): 0 HRS 2 HRS FLOORS: ROOF: 1 HRS

#### **BUILDING HEIGHT & AREA:**

\*PRE-EXISTING NON-CONFORMING\* (NS = NONSPRINKLERED)

ACTUAL 54'-0" +/-PERMITTED(NS) HEIGHT **STORIES** FLOOR AREA UNLIMITED 132,600 SF

TOTAL PROJECT SCOPE AREA: 5,170 SF (RENOVATION)

### CHAPTER 7: FIRE & SMOKE PROTECTION

LOCATION **ASSEMBLY** FIRE-RESISTANCE RATING FIRE PARTITION 1 HOUR STAIR ENCLOSURES

SMOKE STOPS

SEE DRAWING CC002 FOR LOCATION OF FIRE-RESISTANCE RATED CONSTRUCTION

### **CHAPTER 10: MEANS OF EGRESS**

**DRAWING SHOW ROOM USE DESIGNATION** CC002 CC002 ROOM SQUARE FOOTAGE ROOM OCCUPANCY LOADS CC002 TRAVEL DISTANCES CC002

ASSEMBLY SPACE CAPACITY CALCULATIONS(NY BC) CC002 DOOR CAPACITY CALCULATIONS CC002

NYS BC TABLE 1017.2 200'-0 MAX EXIT ACCESS TRAVEL DISTANCE (UNSPRINKLERED)

75'-0 MAX COMMON PATH OF TRAVEL (UNSPRINKLERED)

NYS BS SECTION 1005.3 EXIT STAIR WIDTHS

0.3" / OCCUPANT (NS) 0.2" / OCCUPANT (NS) OTHER EGRESS COMPONENTS

NYSED MANUAL OF PLANNING STANDARDS 120'-0" TO STAIR ENCLOSURE FROM CORRIDOR 50'-0" TO EXIT FROM ALL ROOMS 1500 SF AND UNDER 75'-0" TO SEPARATE SMOKE ZONE IN OPEN PLANNED AREAS NO DEADEND CORRIDORS (<1.5 x WIDTH, MAX 20'-0")

### **CHAPTER 11: ACCESSIBILITY**

ITEM	DRAWING SHOWN
INTERIOR ACCESSIBLE ROUTE	CC002
ACCESSIBLE ENTRANCES	CC002
SIGNAGE	A501 & SPECIFICATIONS
DOOR APPROACH CLEARANCES	CC002 & FLOOR PLANS
DOOR HARDWARE	SPECIFICATIONS

### PROGRAM NOMENCLATURE

**STEM LAB (ENTIRE PROJECT/SCOPE)** 

**LEARNING COMMONS - SECOND FLOOR OF STEM LAB** - LEARNING STUDIO

LIBRARY LIBRARY ASSEMBLY LIBRARY BOOK STACKS

**WORKING MEZZANINE DESIGN COLLABORATION** COLLAB ROOM (RM 201B) **WORK ROOM** COLLAB ROOM (RM 202B) - COLLAB ROOM (RM 202)


**PRODUCTION STUDIO** - THIRD FLOOR OF STEM LAB

- PRODUCTION CLASSROOM - PRODUCTION LAB

### **EXISTING SMOKE ZONES**

THE RENOVATIONS FOR THIS PROJECT ONLY ALTERS THE SECOND AND THIRD FLOORS OF THE SCHOOL (THE FLOOR PLANS BELOW ARE EXISTING PLANS TO SHOW SMOKE ZONES NEAR THE AREAS OF WORK)



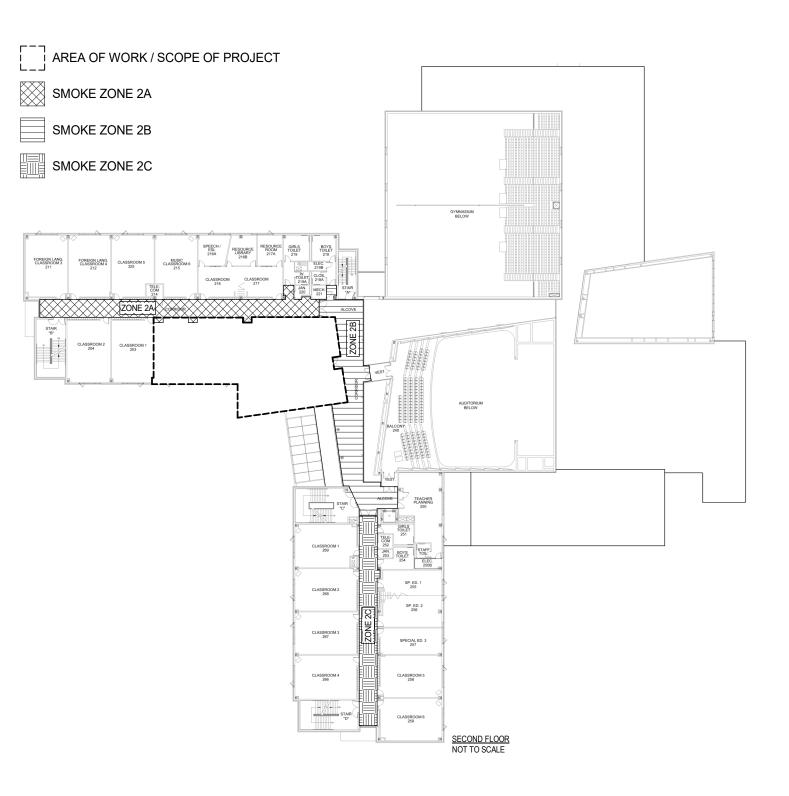


### PROJECT SCOPE, AREA OF WORK, CLASSIFICATION OF WORK, AND APPLICABLE CODES


PROJECT SCOPE:

THIS PROJECT INVOLVES ALTERATIONS OF AN EXISTING SCHOOL TO UPDATE THE STEM LAB PROGRAM. THROUGH THE USE OF A LEARNING STAIR, THE STEM LAB HAS A DESIGNATED SPACE FOR THE PRODUCTION STUDIO AND ONE FOR THE LIBRARY PROGRAM.

AREA OF WORK:

THE RENOVATIONS FOR THIS PROJECT ONLY ALTERS THE SECOND AND THIRD FLOORS OF THE SCHOOL (THE FLOOR PLANS BELOW ARE OVERALL EXISTING PLANS TO SHOW AREAS OF WORK VS NO WORK.)

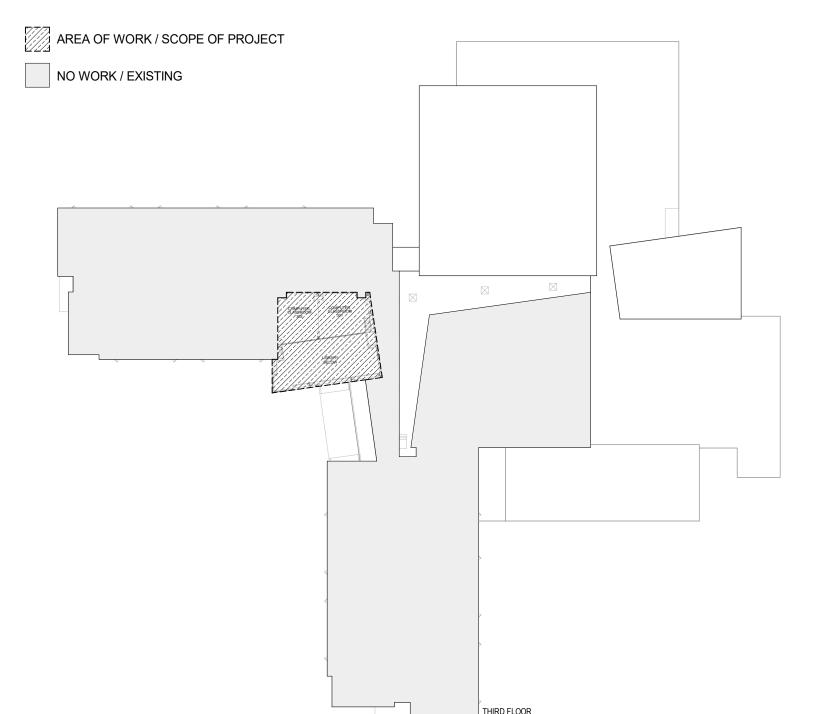

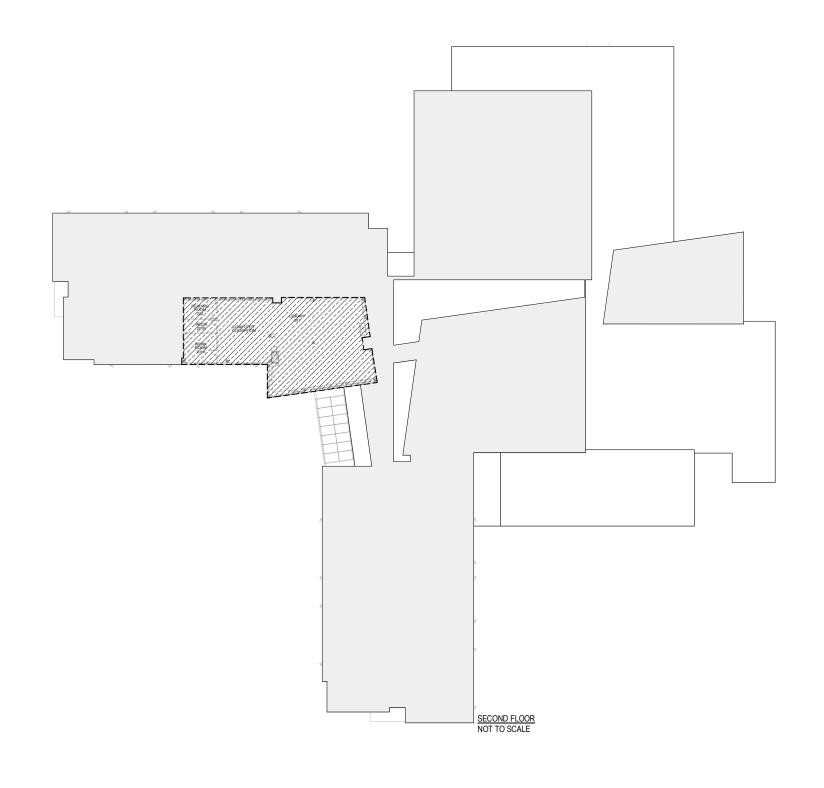

CLASSIFICATION OF WORK: ALTERATIONS (LEVEL 2 - 2020 EBCNYS)

**APPLICABLE CODES:** 

2020 NEW YORK STATE UNIFORM FIRE PREVENTION & BUILDING CODE

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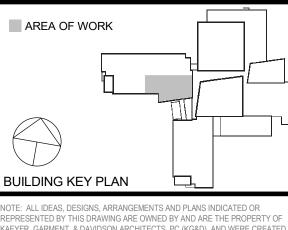


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NY SED PROJECT CONTROL NO. 44-02-01-02-0-009-006

CONSTRUCTION

**DOCUMENTS** 



YER, GARMENT, & DAVIDSON ARCHITECTS, PC (KG&D), AND WERE CREA R PLANS SHALL BE USED BY OR DISCLOSED TO ANY PURPOSE WHATSOEVE THOUT THE WRITTEN PERMISSION OF (KG&D).

TITLE VII, SECT. 69.5 (b) OF NEW YORK STATE LAW.

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01/18/2023 REISSUE FOR BID 11/02/2022 ISSUE FOR BID 06/16/2022 NYSED - ADDENDUM #1 05/25/2022 NYSED - CONST. DOCS.

> CODE COMPLIANCE INFORMATION

01/11/2023 2021-1080 Drawn / Checked AS NOTED

CC001


#### ASSEMBLY SPACE EGRESS CAPACITY CALCULATIONS PER NYS BS: 1005.3.1, 1005.3.2, 1006.3.2 & NYSED MPS **REQUIRED PROVIDED** PER NYS BC AREA LOCATION OCCUPANT EGRESS MAXIMUM EGRESS # OF MAXIMUM WIDTH EXITS EGRESS PATHS WIDTH EXITS | EGRESS PATHS 200'-0" EXIT ACCESS TRAVEL DISTANCE 75'-2" EXIT ACCESS TRAVEL DISTANCE **LEARNING STUDIO** 3,981 SF | 168 OCC. 33" (SEE LEARNING (OCC x 0.20") 75'-0" COMMON PATH OF TRAVEL DISTANCE 67'-6" COMMON PATH OF TRAVEL DISTANCE COMMONS OCCUPANCY TABLE FOR MORE DETAIL)


**NOTE:** ASSUME WHEN THE LIBRARY ASSEMBLY IS FULLY OCCUPIED, SPACES OUTSIDE THE LEARNING COMMONS ARE NOT FULLY OCCUPIED.


NYSED PLANNING STANDARDS: ANY POINT IN A CORRIDOR, OTHER THAN THE GROUND FLOOR CORRIDOR, SHALL NOT EXCEED 120 FEET ALONG THE LINE OF TRAVEL TO THE STAIR ENCLOSURE OF AN EXIT STAIRWAY.

\*\*ALL CORRIDOR PATHS OF TRAVEL (TO A STAIR ENCLOSURES) ARE EXISTING CONFORMING CONDITIONS\*\*

OCCUPANCY TABLE - LEARNING COMMONS							
LOCATION	ROOM NAME / SPACE	ROOM NUMBER	AREA	FUNCTION OF SPACE	CODE FACTOR	OCCUPANT LOAD	
LEARNING STUDIO			3,981 SF			168 OCC	
	LIBRARY ASSEMBLY	201-a	1,636 SF	ASSEMBLY - unconcentrated	<u>15</u>	110 OCC	
	LIBRARY BOOK STACKS	201-b	581 SF	LIBRARY - stack area	100	6 OCC	
	WORKING MEZZANINE	201-m	120 SF	ASSEMBLY - unconcentrated	<u>15</u>	8 OCC	
	DESIGN COLLABORATION	201A	806 SF	LIBRARY - reading room	50	17 OCC	
	COLLAB	201B	141 SF	EDUCATIONAL - classroom	20	8 OCC	
	WORK ROOM	202A	570 SF	LIBRARY - reading room	50	12 OCC	
	COLLAB	202B	127 SF	EDUCATIONAL - classroom	20	7 OCC	
COLLAB (202)	COLLAB	202	123 SF	EDUCATIONAL - classroom	20	7 OCC	

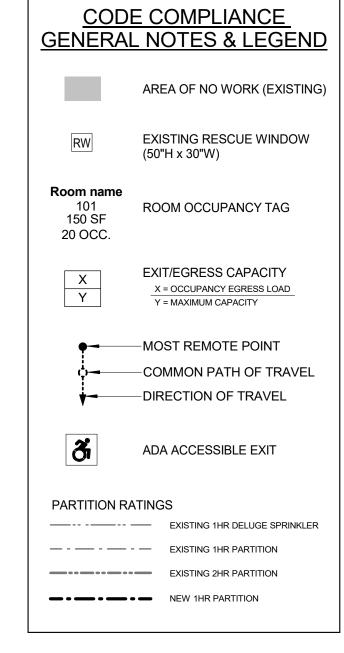

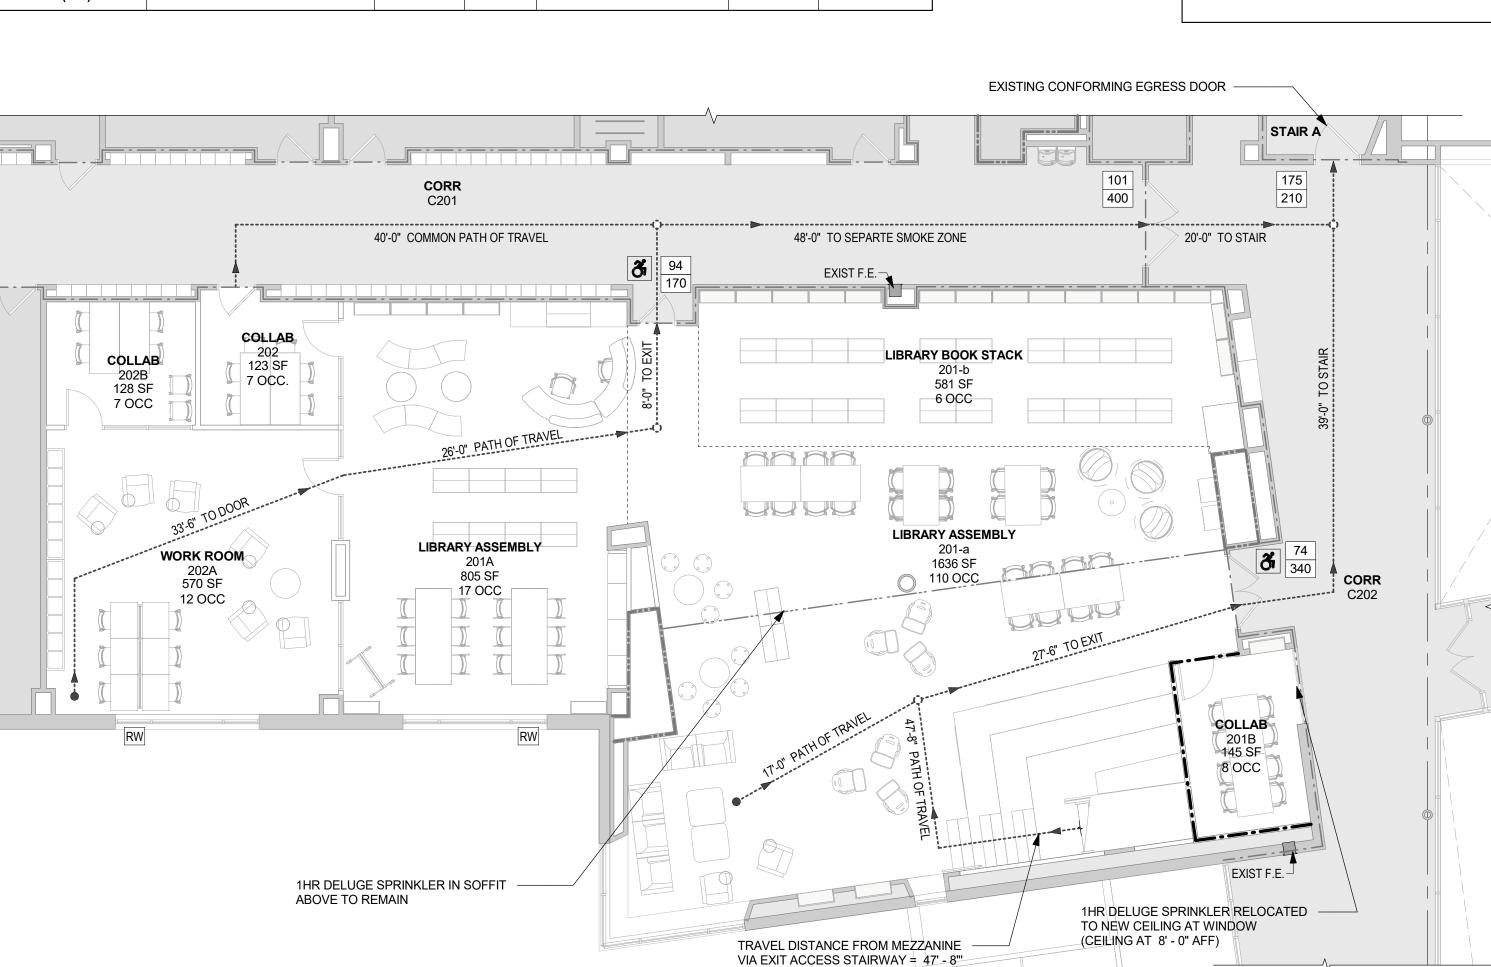

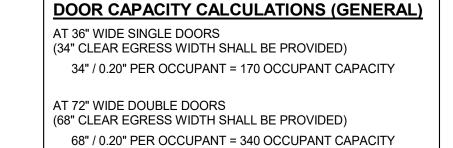


### DOOR CAPACITY CALCULATIONS (GENERAL) AT 44" WIDE SINGLE DOORS

(42" CLEAR EGRESS WIDTH SHALL BE PROVIDED)
42" / 0.20" PER OCCUPANT = 210 OCCUPANT CAPACITY

AT 84" WIDE DOUBLE DOORS (80" CLEAR EGRESS WIDTH SHALL BE PROVIDED) 80" / 0.20" PER OCCUPANT = 400 OCCUPANT CAPACITY

OCCUPANCY TABLE - PRODUCTION STUDIO						
LOCATION	ROOM NAME / SPACE	ROOM NUMBER	AREA	FUNCTION OF SPACE	CODE FACTOR	OCCUPANT LOAD
PRODUCTION STUDIO			1,185 SF			43 OCC
	PRODUCTION LAB	301	601 SF	EDUCATIONAL - shop	50	13
	PRODUCTION CLASSROOM	302	584 SF	EDUCATIONAL - classroom	20	30

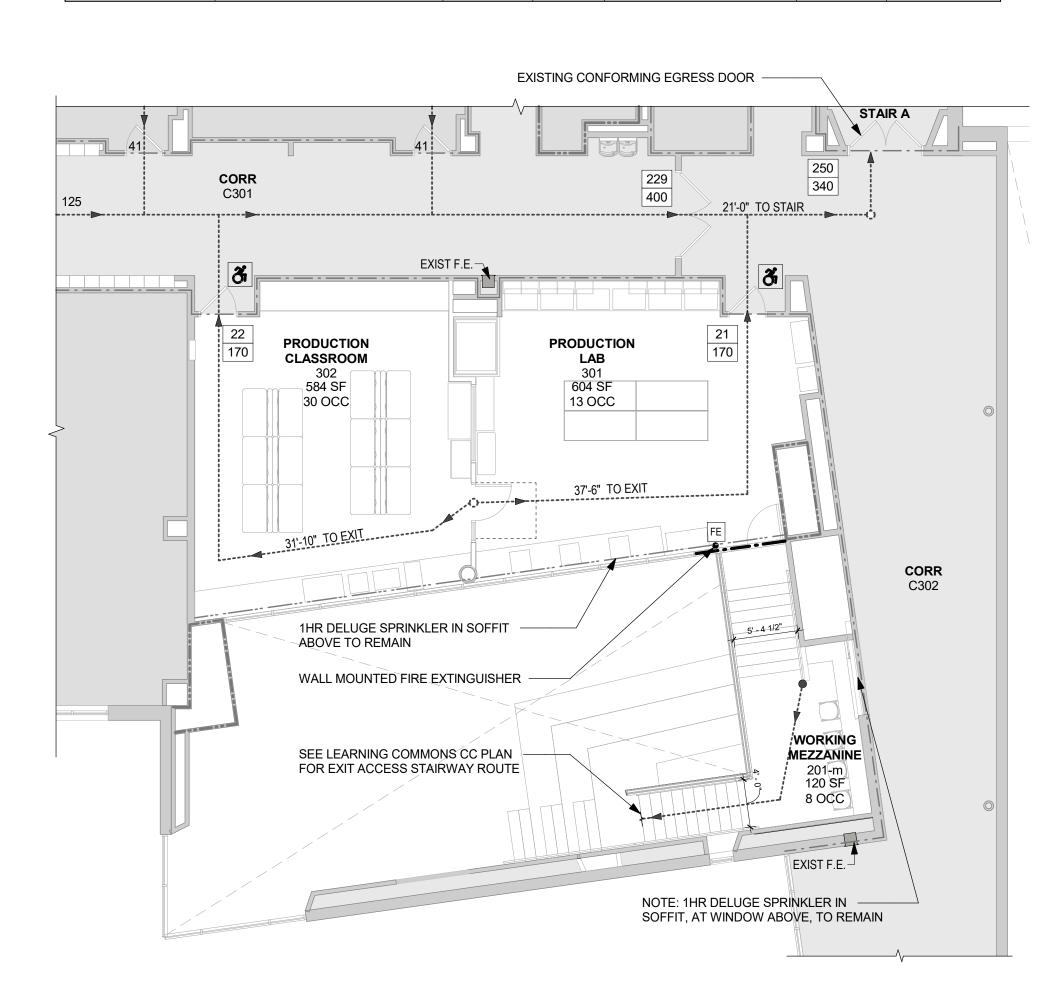

PRODUCTION STUDIO (3RD FL) - CC PLAN

1 LEARNING COMMONS (2ND FL) - CC PLAN

1/8" = 1'-0"

CHESTER ACADEMY
STEM LAB
ALTERATIONS

CHESTER UNION FREE SCHOOL DISTRICT



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NY SED PROJECT CONTROL NO.

44-02-01-02-0-009-006

CONSTRUCTION DOCUMENTS

BUILDING KEY PLAN

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CODE COMPLIANCE PLANS & INFO

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 2021-1080
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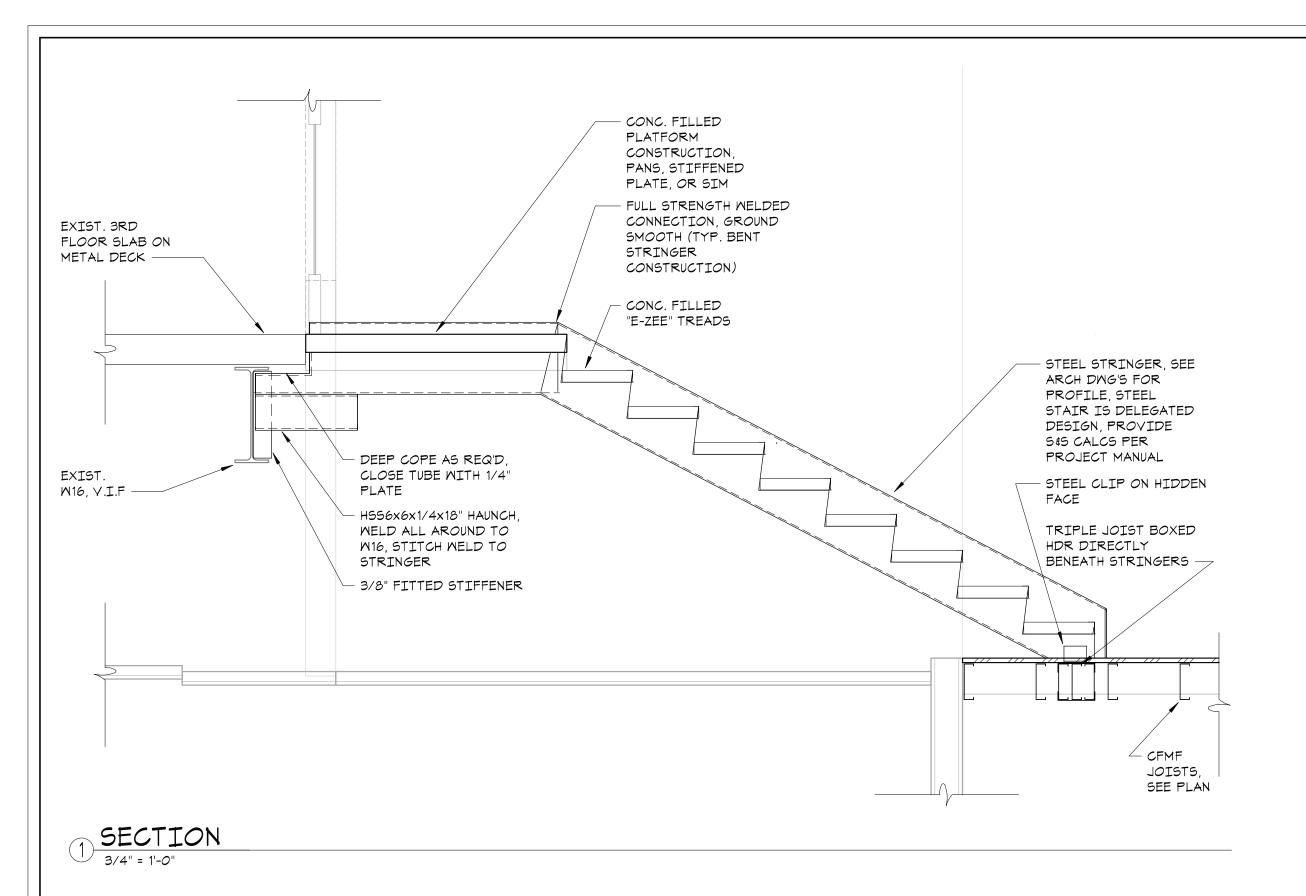
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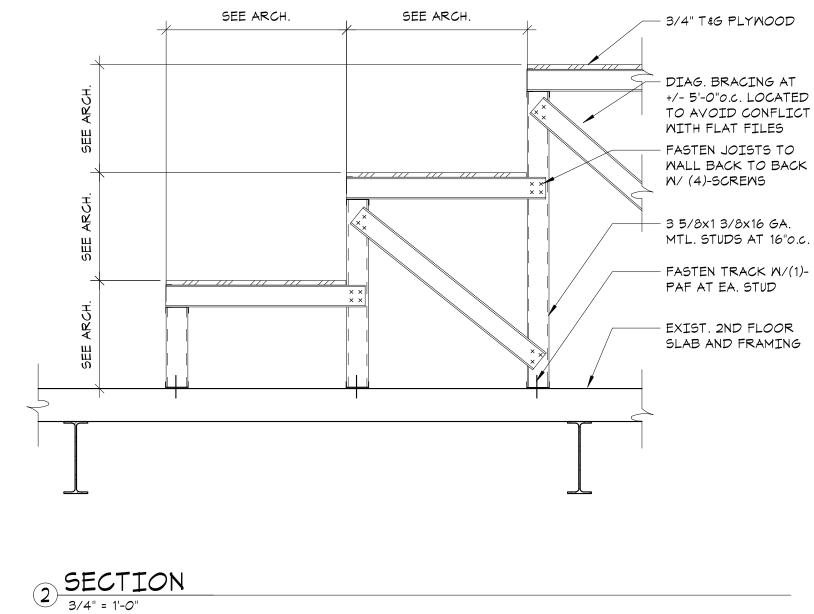
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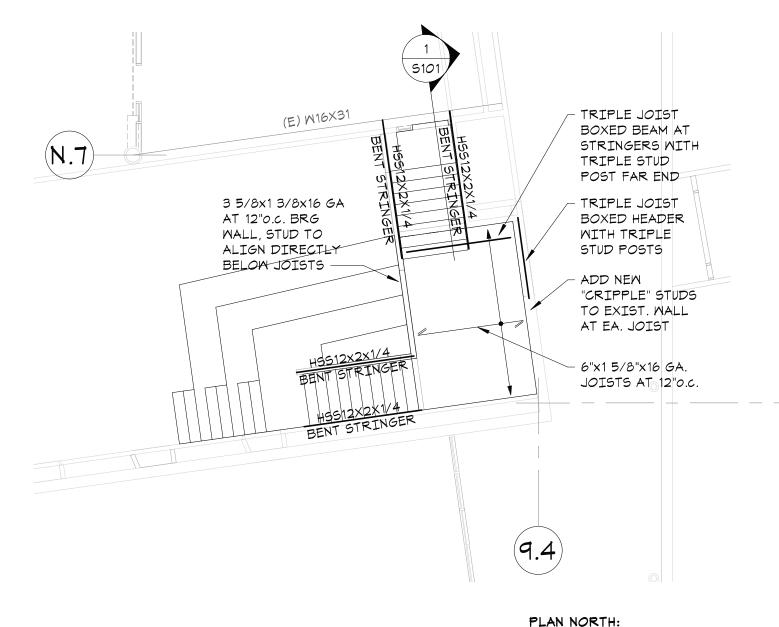
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Sheet Title

CC002







3RD FLOOR FRAMING PLAN

1/8"=1'-0"

CHESTER ACADEMY STEM LAB **ALTERATIONS** 

> **CHESTER UNION FREE** SCHOOL DISTRICT

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CONSTRUCTION **DOCUMENTS** 

General Notes:

1 The purpose of these drawings is to show the structural work associated with proposed learning stair commons area at Chester Academy, 64 Hambletonian Ave., Chester, NY

2 The work shown on these drawings has been designed in accordance with the structural requirements of the 2020 edition of the Building Code of New York State which is part of the New York State Uniform Fire Prevention and Building Code and is based upon the 2018 International Building Code.

3 The structural components have been designed for the following loads: A. Uniform live load: Assembly areas

Platforms (assembly)

Stairs and exits

00 psf

B. Earthquake design data: Risk category Seismic importance factor, le: Seismic design category: Earthquake design for existing buildings: Not required since the proposed alterations do not increase the demand-capacity ratio of any seismic load carrying structural element by more than 10 percent cumulative since the original construction.f C. Guardrails (load applied in any direction):

Top rail concentrated 200 lbs

Top rail uniform load

Intermediate rail concentrated load

4 This structure has been designed to be self-supporting and stable after the work shown on these drawings has been completed. The stability of the structure prior to completion is solely the responsibility of the contractor. This responsibility extends to all related aspects of the construction activity including, but not limited to, erection methods, erection sequence, temporary bracing, forms, shoring, use of equipment, and similar construction procedures. Review of the construction by the engineer is for conformance with design aspects only, not to review the contractor's construction procedures. Lack of comment on the part of the engineer with regard to construction

procedures is not to be interpreted as approval of those procedures. Jobsite safety and construction procedures are solely the responsibility of the contractor. Review of the construction by the engineer is for conformance with design aspects only, not to review the contractor's provisions for job site safety. Lack of comment by the engineer is not to be interpreted as approval of those aspects of work.

6 PDF digital files of all erection and detail shop drawings for steel stair and cold-formed metal framing, indicating the fabricator, manufacturer, finish, layout, and all accessories, must be submitted to and be checked by the contractor and subcontractor and bear the checker's initials before submission to the architect for review prior to fabrication. Fabrication and/or delivery to the site of components prior to receiving approved shop drawings shall be at the fabricator's own risk.

Deferred submittals: Deferred submittals are those portions of the design that are not submitted at the time of application and are to be submitted to the building official within a specified period. The following deferred submittals shall be submitted to the engineer for approval.

A. Cold-formed metal framing

B. Steel stair After approval by the engineer, the deferred submittal documents shall be submitted to the building official for approval. Deferred submittal items shall not be installed until the deferred submittal documents have been approved by the building official.

8 Testing and inspection is described in the project "Statement of Special Inspections". The contractor shall review the "Statement of Special Inspections" and coordinate the scheduling of inspections with the special inspector. Uninspected work that required inspections may be

rejected solely on that basis. If faulty construction procedures, or material, result in defective work that requires additional engineering time to devise corrective measures, professional fees may be charged to the contractor at the standard hourly rate of additional services. Such fees may be withheld

from the general contractor's payment. 0 The contractor shall verify all dimensions, elevations and angles with architectural drawings and existing conditions before proceeding with

11 The contractor and subcontractors shall obtain the latest copies of approved plans and surveys and they shall familiarize themselves thoroughly with these plans before commencing any work. 12 These drawings are supplemented by a detailed technical

specification. The notes shown under certain categories of work are intended to summarize basic requirements. 13 Work shown as "Typical Details" apply throughout the project as

required. Work shown as "Sections" shall be considered to apply for the same and similar conditions in the building.

14 Some details of the work are shown on the architectural drawings. A careful review and study of these details are necessary before the full scope of the work can be comprehended.

15 Do not scale drawings. Codes and Standards References

1 Cold formed metal framing: Design, fabrication and erection of cold-formed metal framing shall conform to the American Iron and Steel Institute's "Specification for the Design of Cold-formed Steel Structural Members", 2016.

Connections to Existing Masonry or Hardened Concrete:

All proprietary anchoring systems (expansion, adhesive anchoring systems, etc.) to be installed into hardened concrete and masonry elements are to be installed in strict accordance with the manufacturer's instructions for drilling and preparation of holes, for spacing and edge distance requirements, and for the utilization of supplemental components for the anchoring systems such as screen tubes, doweling adhesives, etc.

Connections to hardened concrete shall be made with anchors conforming to ACI 318, as specified in the code reference section of these general notes, for cracked concrete, and Chapter 19 of the state building code indicated at the beginning of these general notes.

A. Mechanical anchors shall be either i. Hilti "Kwik HUS-EZ" screw anchor (use only in permanently

dry, interior non-corrosive environments) ii. Simpson "Titen HD" screw ancho, zinc-plated or galvanized iii. Dewalt "Screw-Bolt+" screw anchor, zinc-plated or galvanized Cold-Formed Metal Framing Notes:

Design, fabrication and erection of cold-formed metal framing shall conform to the American Iron and Steel Institute's "Specification for the Design of Cold-formed Steel Structural Members", current edition as referenced by the applicable building code, and the specifications of the manufacturer of the cold-formed metal framing.

All studs and/or joists and accessories shall be of the type, size, steel thickness and spacing shown on the drawings. Studs, tracks, bracing and bridging shall be manufactured per ASTM C 955.

All studs, joists and accessories shall be formed from steel that conforms to the requirements of ASTM A 1003 with a yield as follows: 16 ga.(0.054") or heavier 50 ksi ii. 18 ga (0.043") or lighter 33 ksi

4. All studs, joists and accessories shall be galvanized with a minimum G-60 coating. Connections shall be accomplished with self-driving screws or welding so that the connection meets or exceeds the design loads required at

that connection. All connections shall be made using a minimum of three (4) No. 10-16 screws, unless otherwise shown on drawings.

Screw spacing and edge distance shall not be less than 1". Minimum connection angle thickness shall be 16 gage, but no thinner than the material of the members that are being connected.

9. Joists shall be located directly over bearing studs or a load distribution member shall be provided to transfer loads. 10. Avoid holes at ends of members. However, should holes occur, provide additional reinforcing at the ends of the member where holes

occur, unless otherwise noted. 11. Provide lateral blocking, bridging, and web stiffeners for vertical and horizontal framing members, and other framing members as required and in accordance with manufacturer's specifications or

recommendations, unless indicated otherwise on the drawings. 12. Track: 16 gage minimum securely anchored to adjacent structure or

13. All framing components: cut squarely or at an angle to fit squarely against abutting members. All members: held firmly in position until properly fastened, erect member level, plumb, and true to line and to dimensions and elevations indicated. 14. Studs: Seated squarely in the track with the stud web and flanges

15. Splices in studs and other framing components: Not permitted. 16. Submittals to the engineer are required for certificates of compliance

abutting the track web, and securely attached to the flanges or web of

for framing members (studs, joists, tracks, etc.), screws, and accessories (connection clips, stiffeners, etc.) prior to delivery to the


17. Shop drawings: Show layout, spacing, sizes, thickness, material specification, and types of cold-formed metal framing. Show fastening and anchorage details, including mechanical fasteners. Show reinforcing channels, opening framing, supplemental framing, strapping, bracing, bridging, splices, accessories, connection details, and attachment to adjoining work.

Wood Structural Panels:

1 Wood Structural Panels commonly referred to as sheathing panels shall conform to U.S. Product Standard DOC PS 1 or PS 2, and bear the APA grade-trademark of the American Plywood Association. Sheathing panels shall be APA rated sheathing, Exposure 1, with a

minimum span index rating of 32/16. Sheathing panels on flat surfaces shall be installed with face grain or panel long dimension perpendicular across supports and continuous over two or more spans. Provide 1/8" space between panel edges parallel to face grain or panel long dimension, 1/16" space between

panel edges over supporting members. 4 Floor sheathing shall be glued to supporting members with construction adhesive such as PL 200, laid in a continuous 1/4 inch wide bead along the member length.

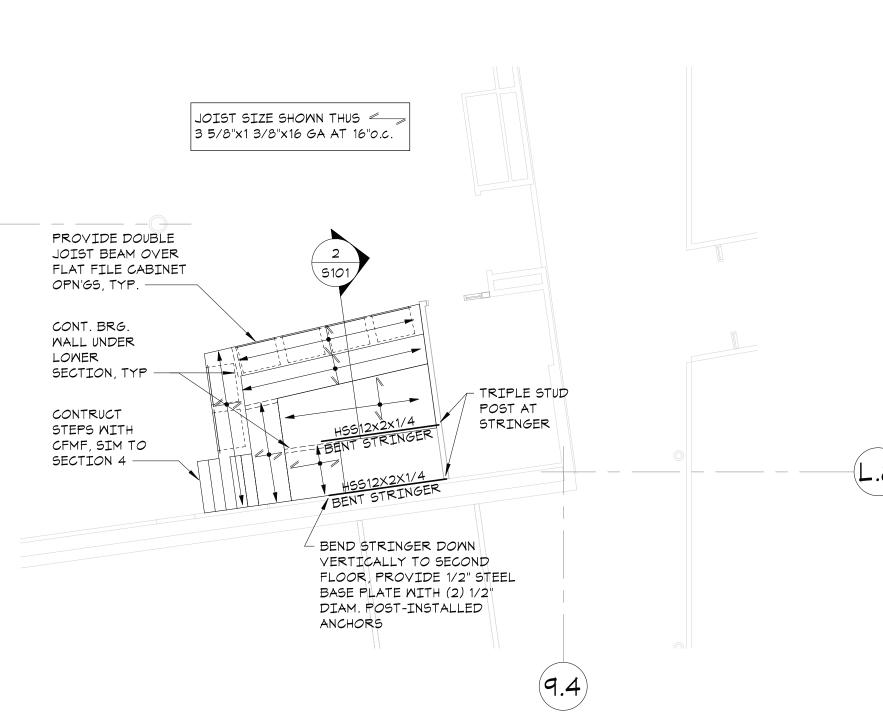


### PLAN NORTH: 2ND FLOOR FRAMING PLAN

1/8"=1'-0" • TOP OF EXISTING SECOND FLOOR SLAB ELEVATION: +/-14'-0" ABOVE DATUM.

 SEE ARCHITECTURAL DRAWING FOR ALL LEARNING STAIR ELEVATIONS AND DIMENSIONS.


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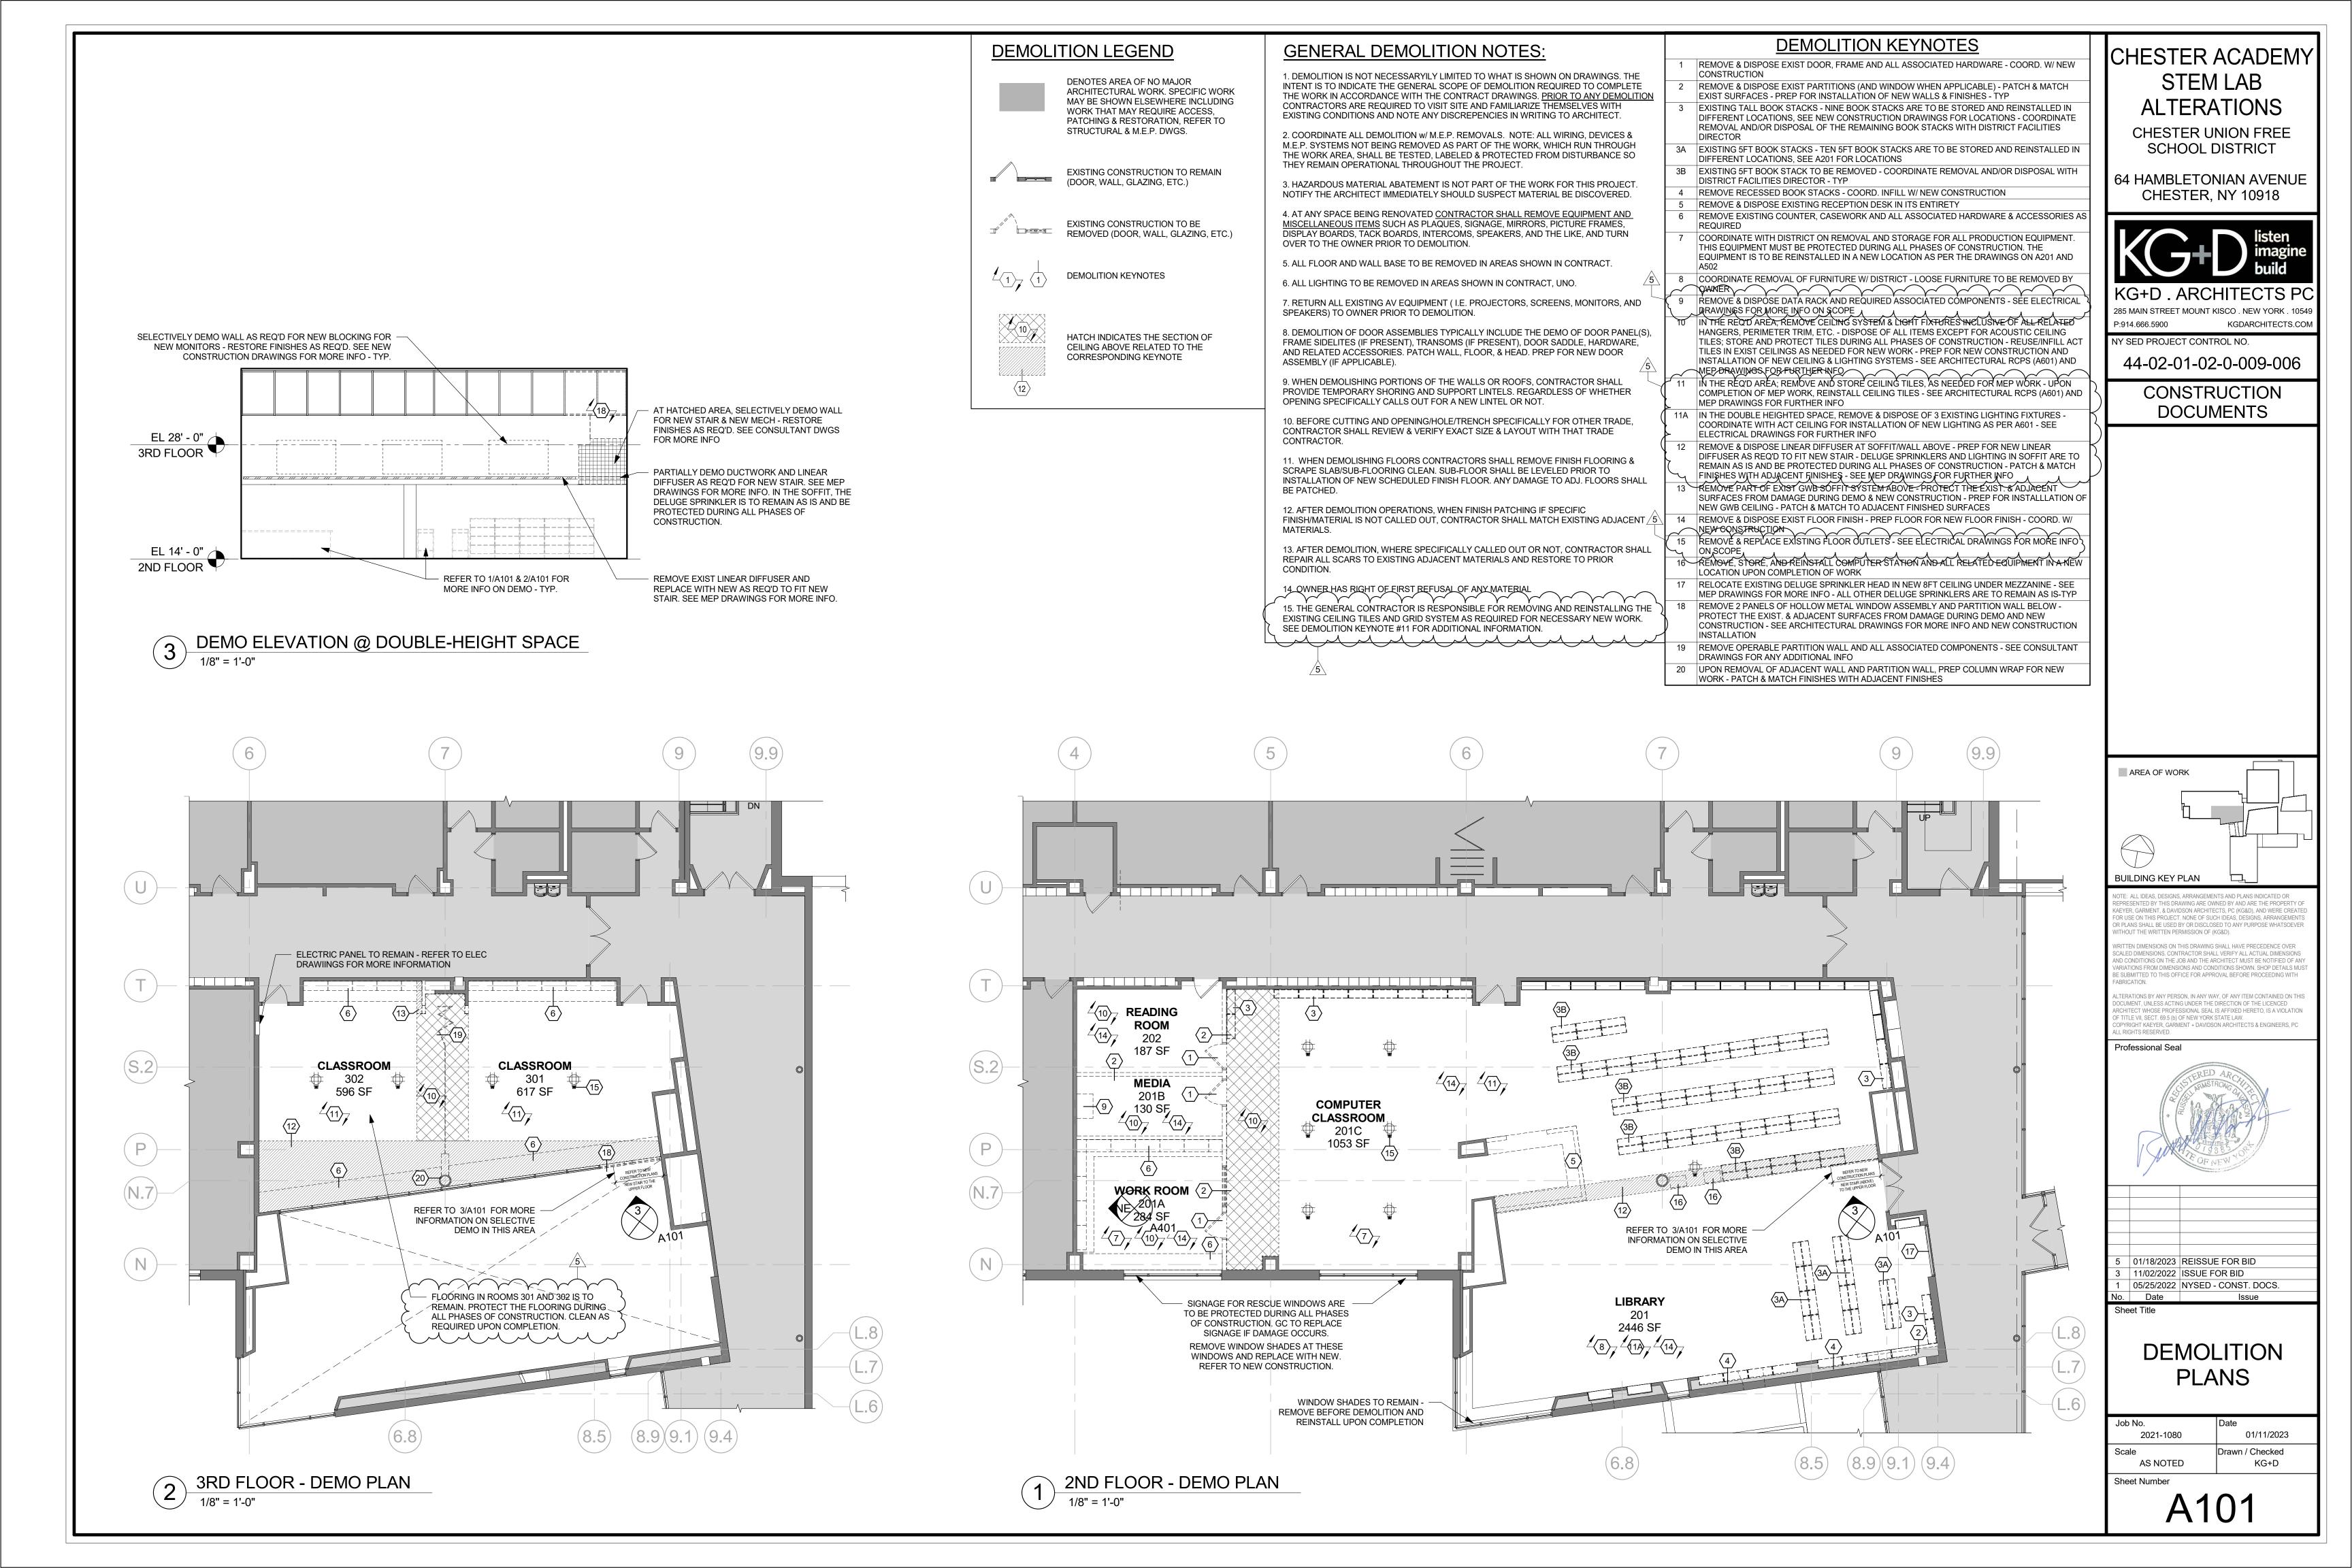


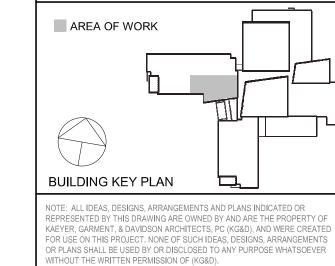
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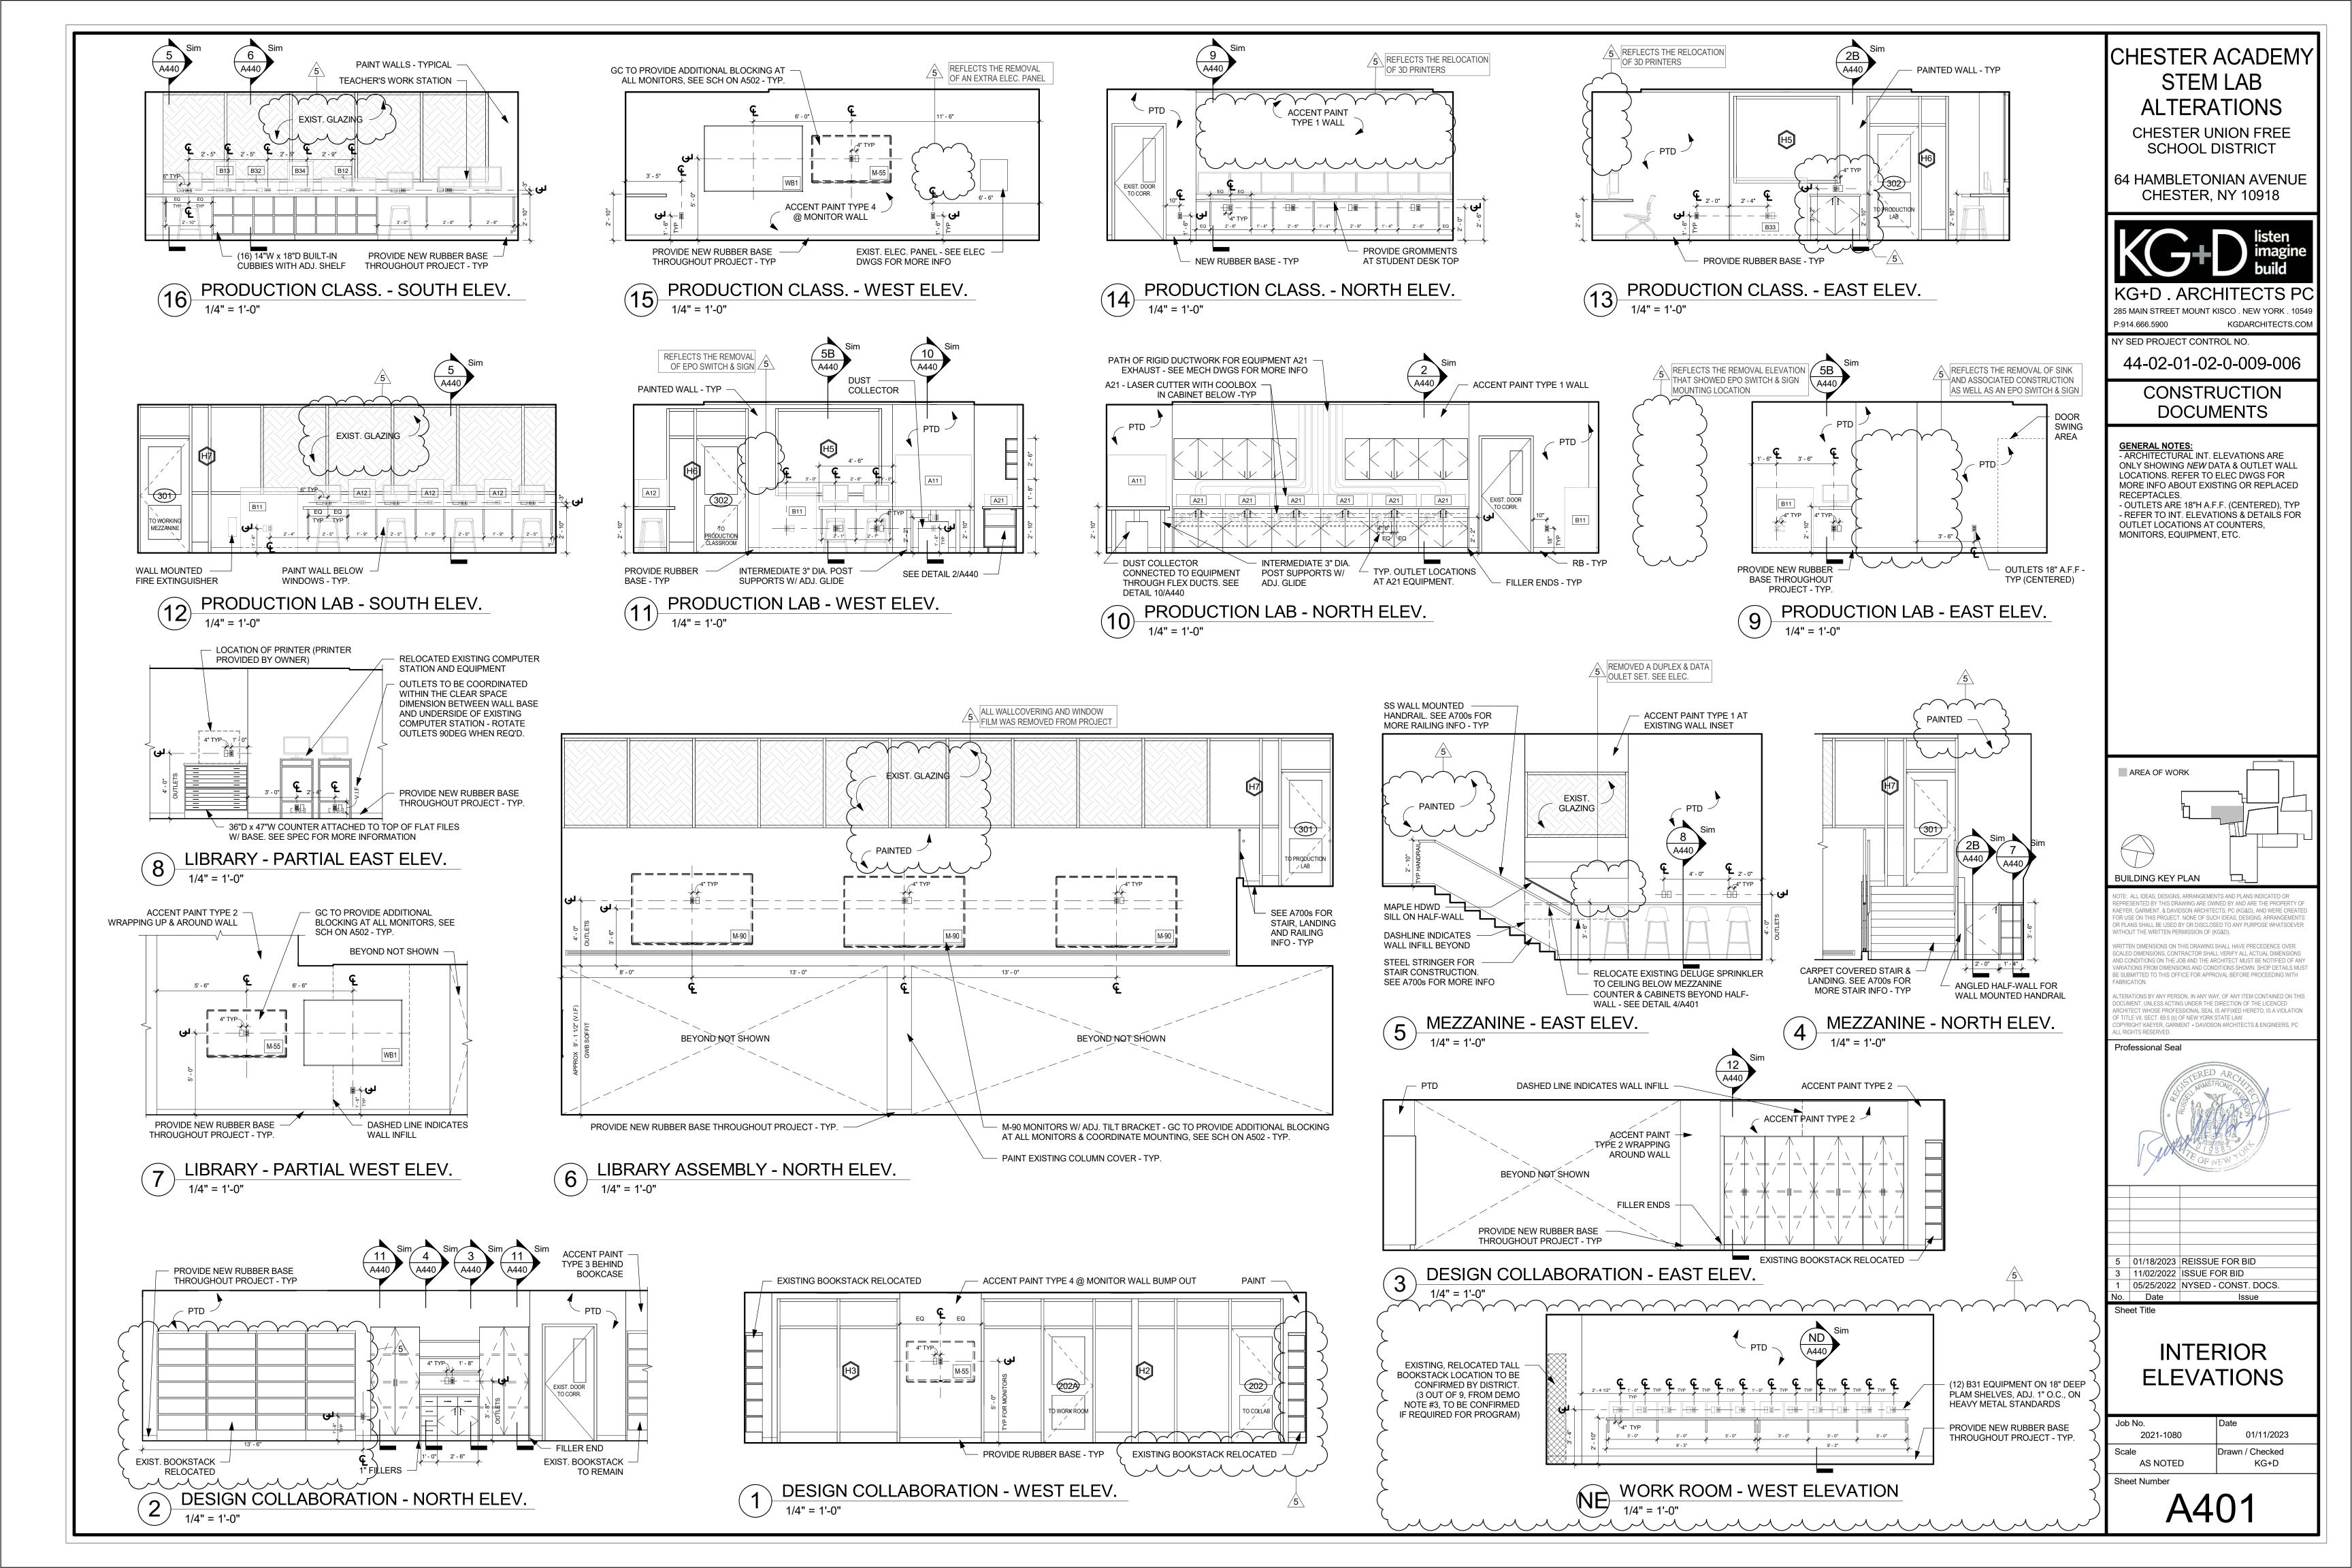
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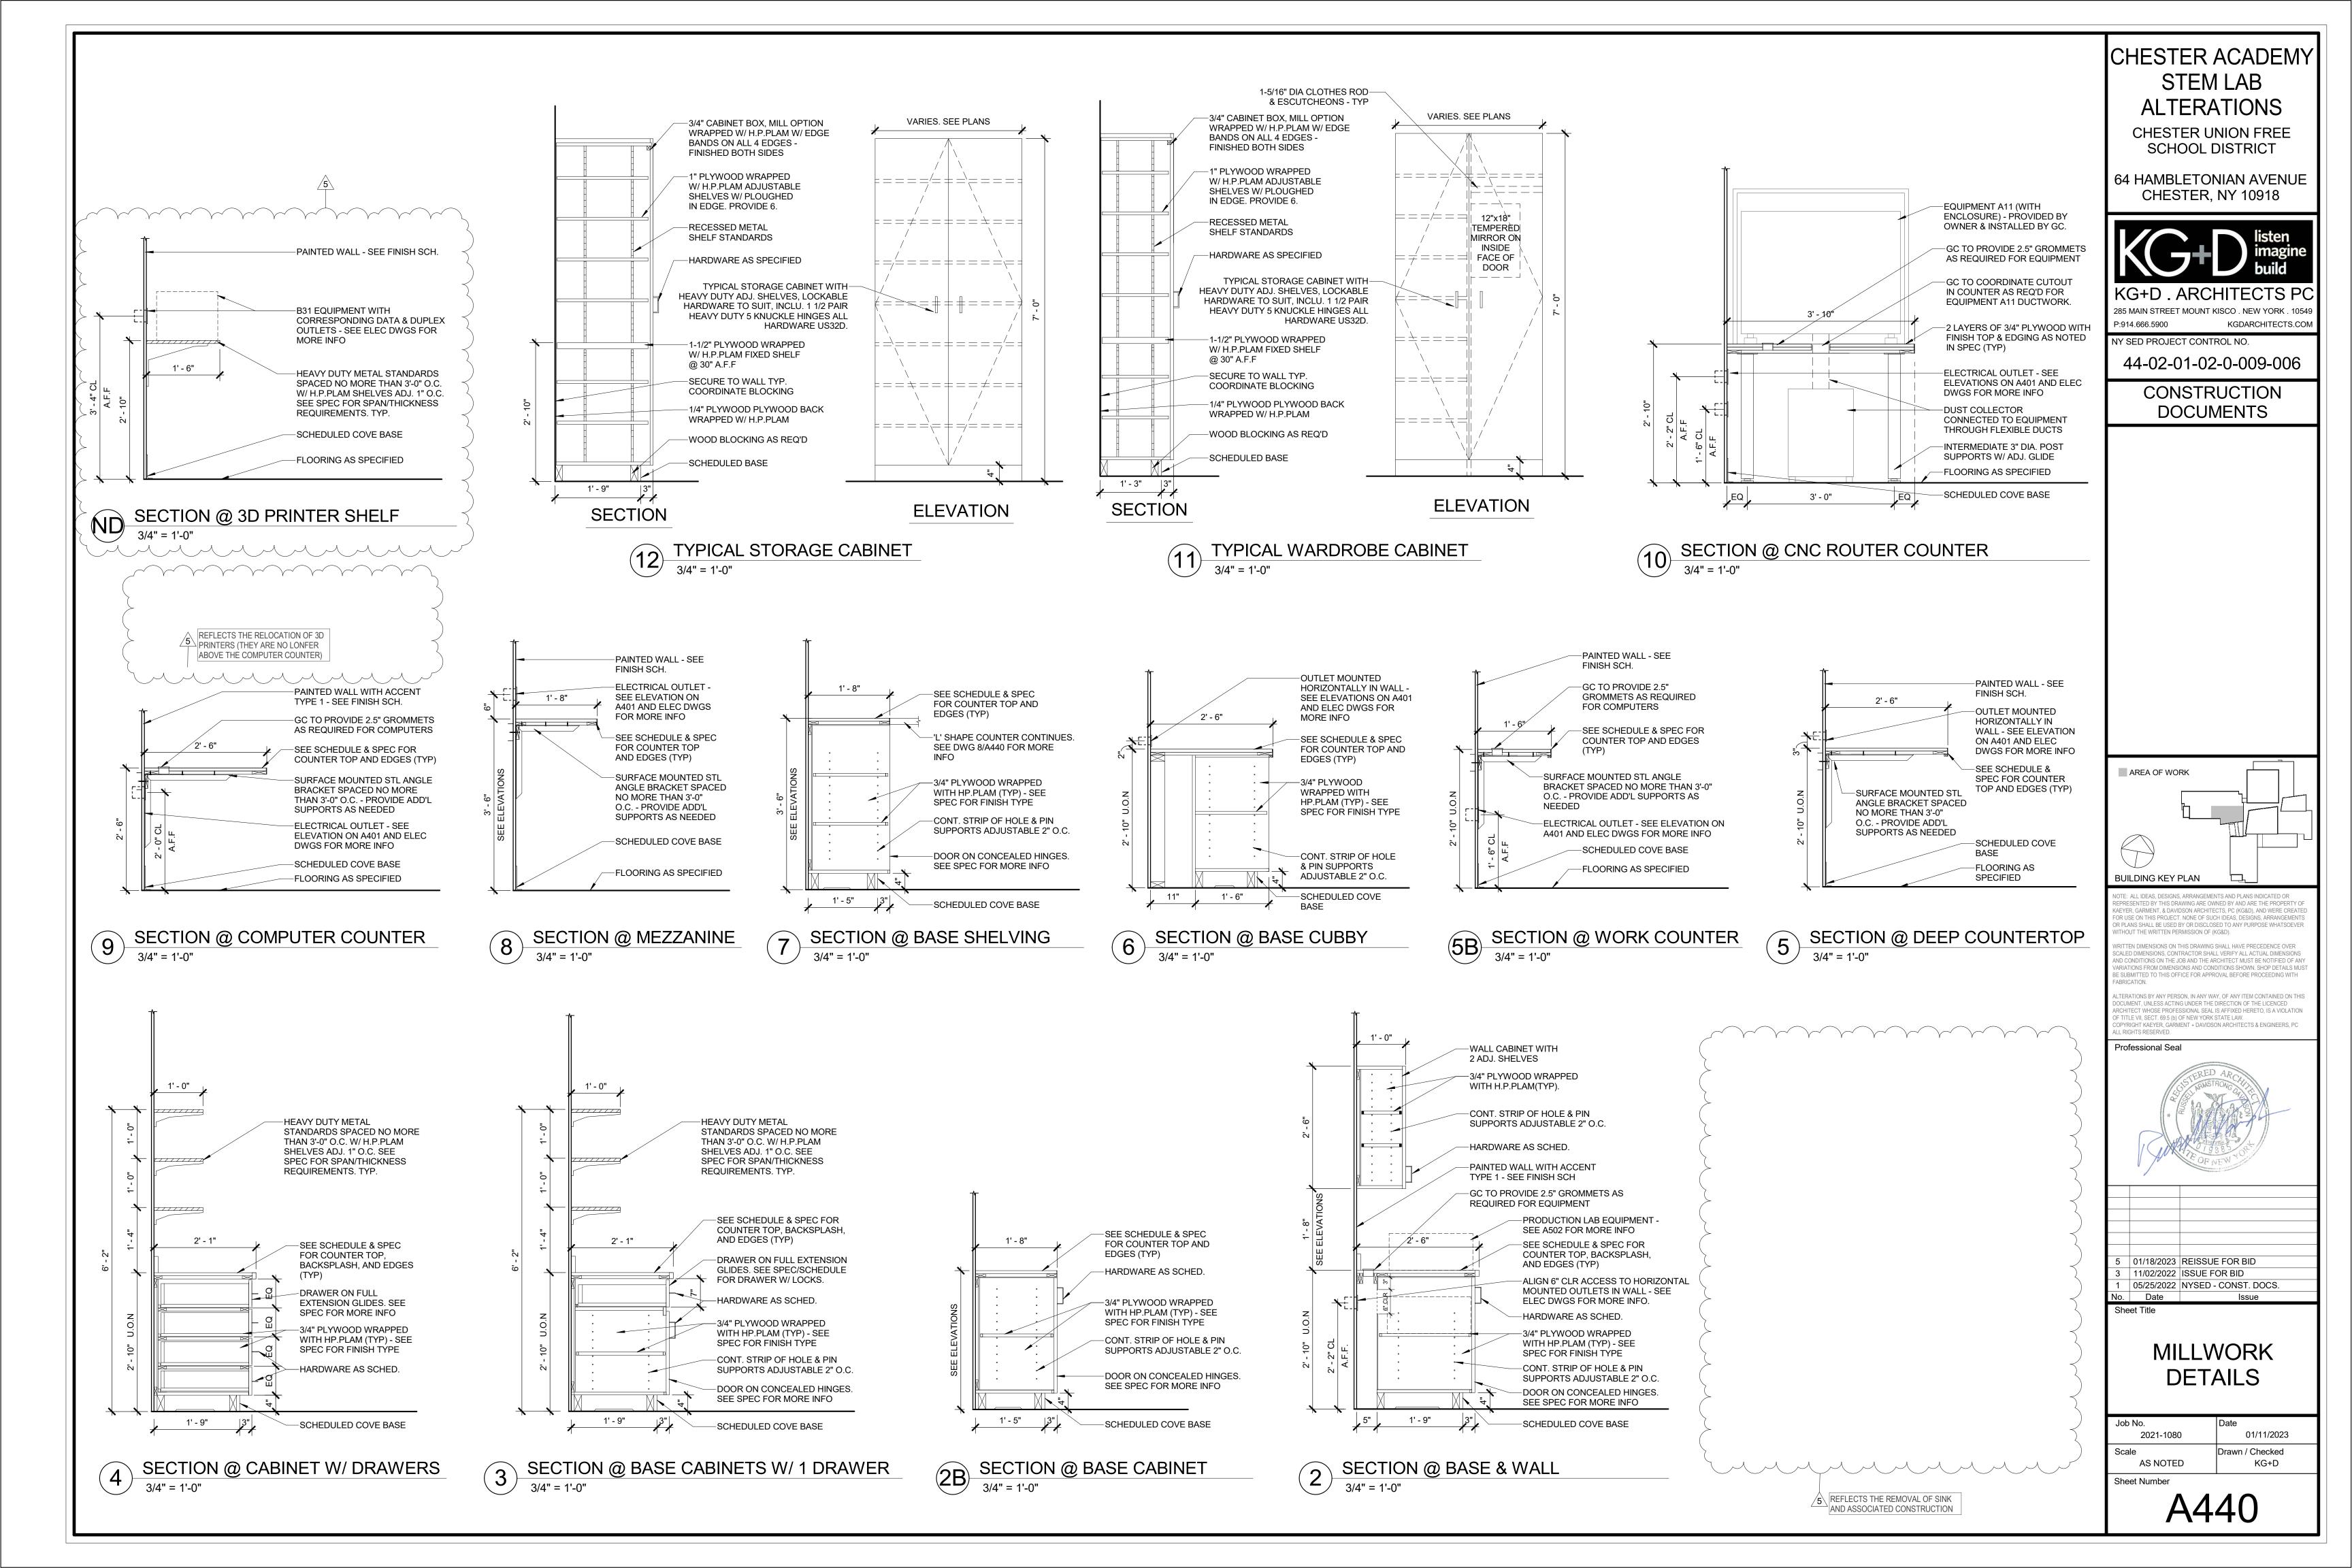
PARTIAL FLOOR FRAMING PLAN


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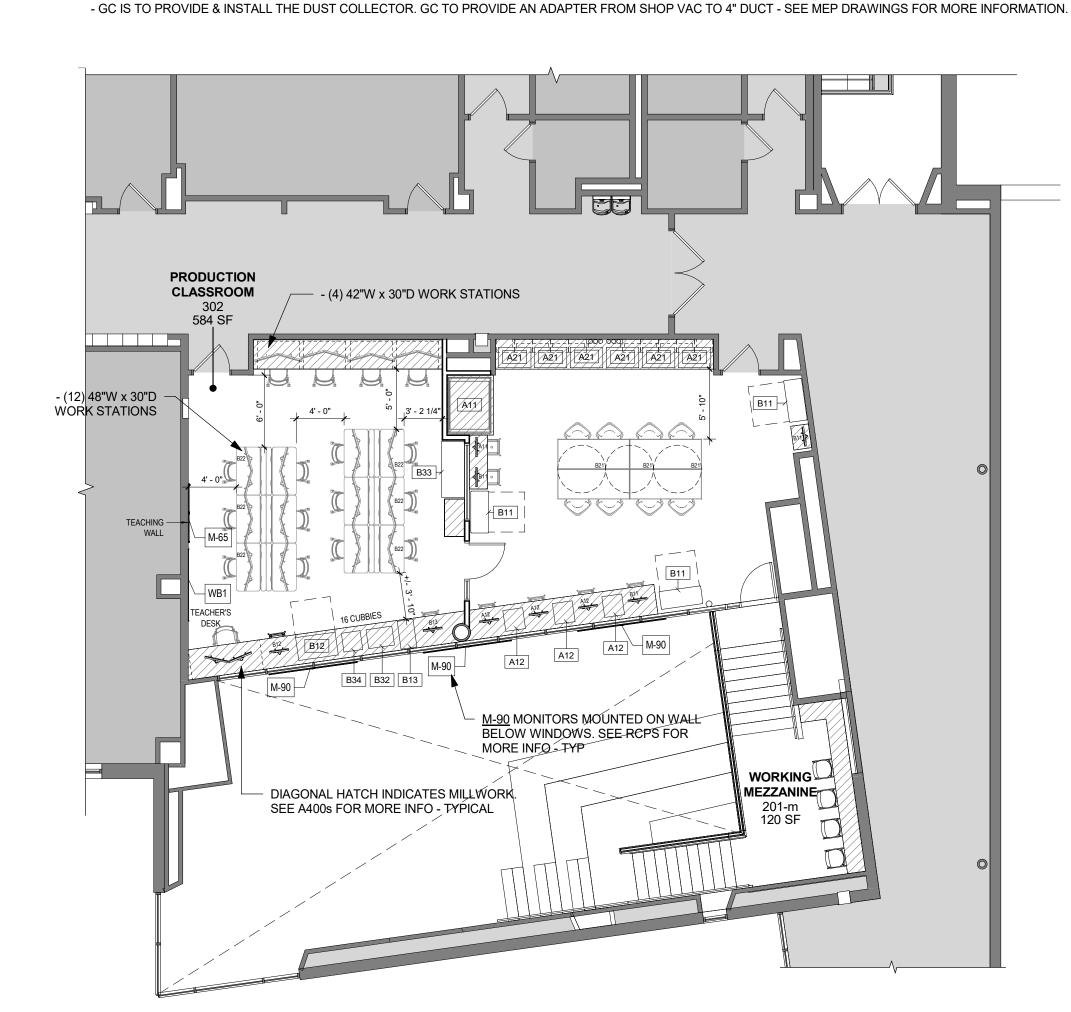





#### PRODUCTION STUDIO EQUIPMENT

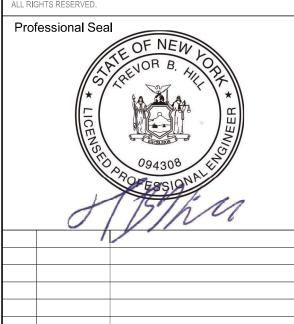Equip.	QTY	Equipment Type	Vendor and Model	Dimensions in Drawings
Tag	provided			(inches WxDxH)
A-11	1	Counter CNC Router	Shopbot - Desktop MAX CNC Router	56 x 43 x 38 - invision enclosure
	1	Dust Collector	Shopbot - Fein 9-20-28 Turbo II Vacuum/Dust Extractor	15.75 x 23 x 21.75 - below counter
A-12	3	Counter CNC Milling Machine	Bantam Tools - CNC Milling Machine	20 x2 1 x 20
A-21	6	Counter Laser Cutter	Full Spectrum Laser - Muse 3D-45W Laser Cutter	32.5 x 20.5 x 8.5
	6	Coolbox	Full Spectrum Laser - Muse Coolbox V2	12 x 20.5 x 8.5 - below (in cabinet)
B-11	3	Standup Vinyl Cutter	US Cutter - SAC720IIARM - Titan3 Vinyl Cutter 28"	42 x 18 x 48
B-12	1	Counter Vinyl Printer/Cutter	Roland - VersaSTUDIO BN-20 Vinyl Printer/Cutter	40 x 23 x 12
B-13	1	Counter TShirt Printer	Roland - VersaSTUDIO BT-12 Direct-to-Garment Printer	16 x 28 x 24
B-21	3 (storage)	3D Scanner with Turntable	Afinia - EinScan-SE (Elite) 3D Scanner with Turntable	22 x 9 x 9 - storage
B-22	6 (storage)	Oculus Headset	Oculus - Quest2 Advanced All-in-One VR Headset 256GB	18 x 18 x 12 - storage
			(carrying case & link cable kit)	
B-31	12	Counter 3D Printer	Makerbot - Sketch 3D Printer	17 x 15 x 12
				ALL 12 IN WORKROOM 202A - 1
			(	ALONG WEST, WALL . , ,
B-32	1	Counter Flatbed Scanner	Epson - Expression 12000XL Scanner	26 x 29 x 9
B-33	1	Standup Plotter	HP - DesignJet T730 Wireless 36" Plotter	56 x 23 x 46
B-34	1	Counter Printer	HP - LaserJet Enterprise M607 Printer	19 x 19 x 24

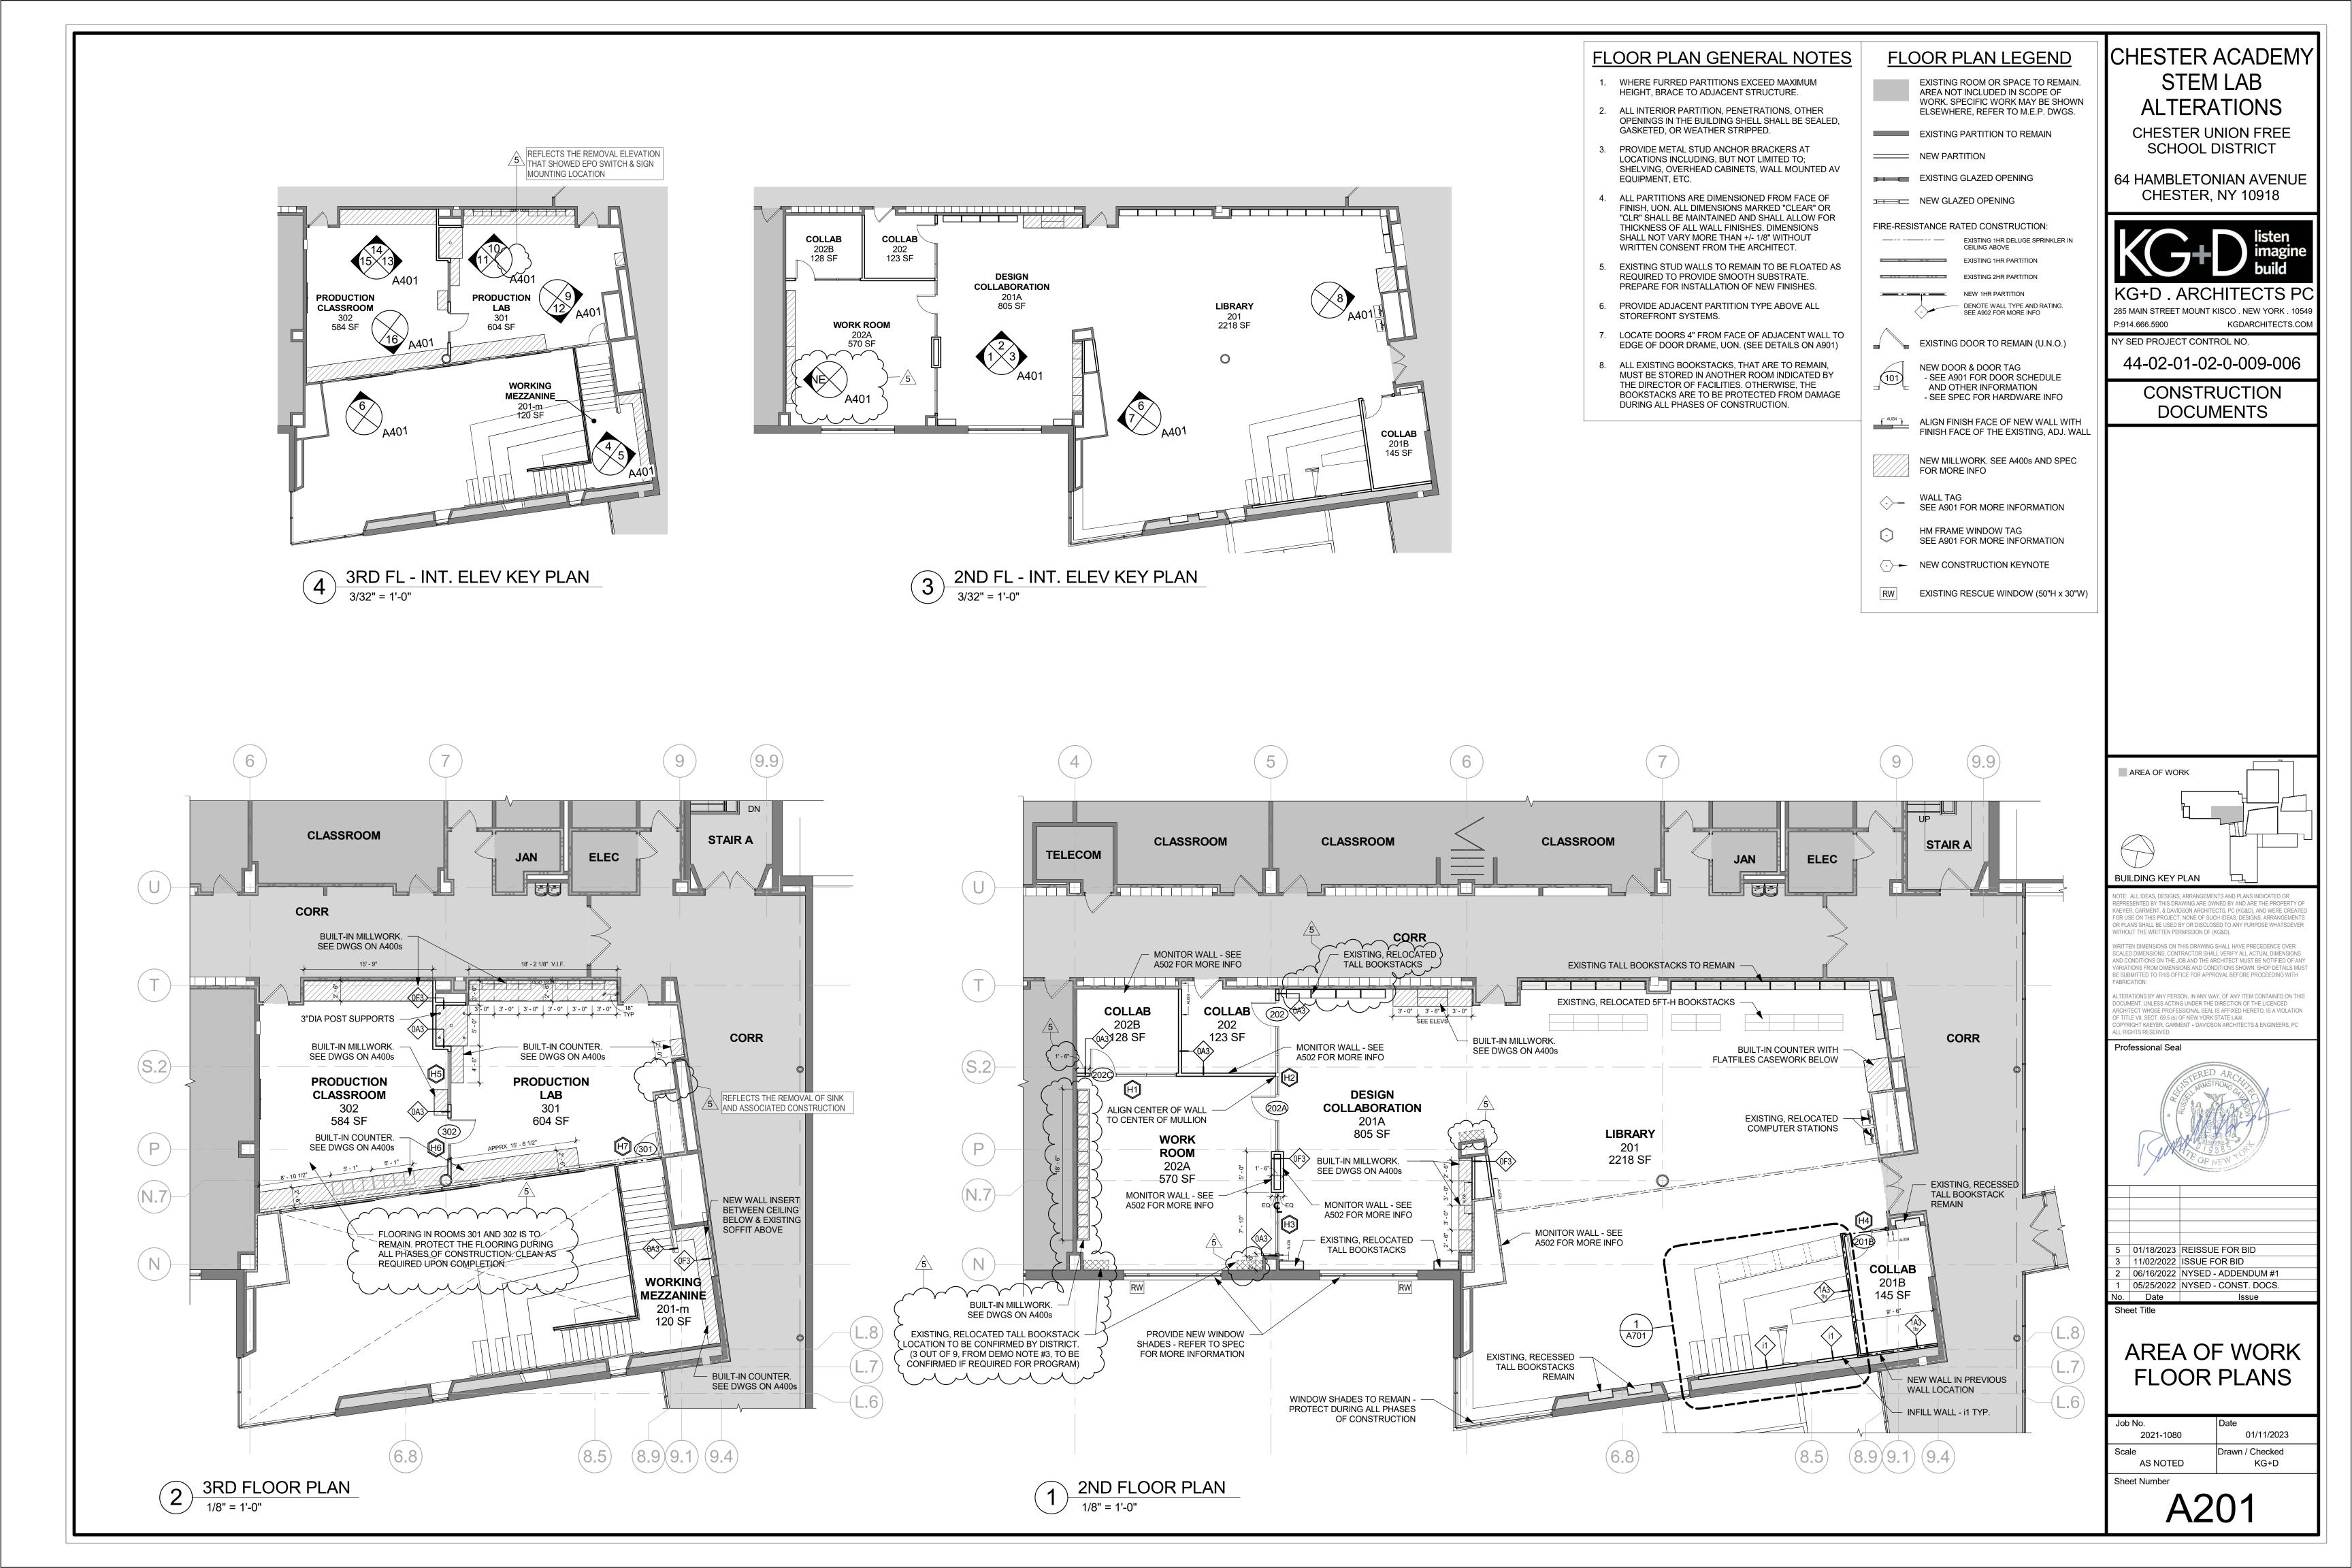NOTE:
- ALL EQUIPMENT, BUT THE ITEM NOTED BELOW, IS SUPPIED BY OWNER AND INSTALLED BY GC. FOR ADDITIONAL NOTES, SEE MEP DRAWINGS.

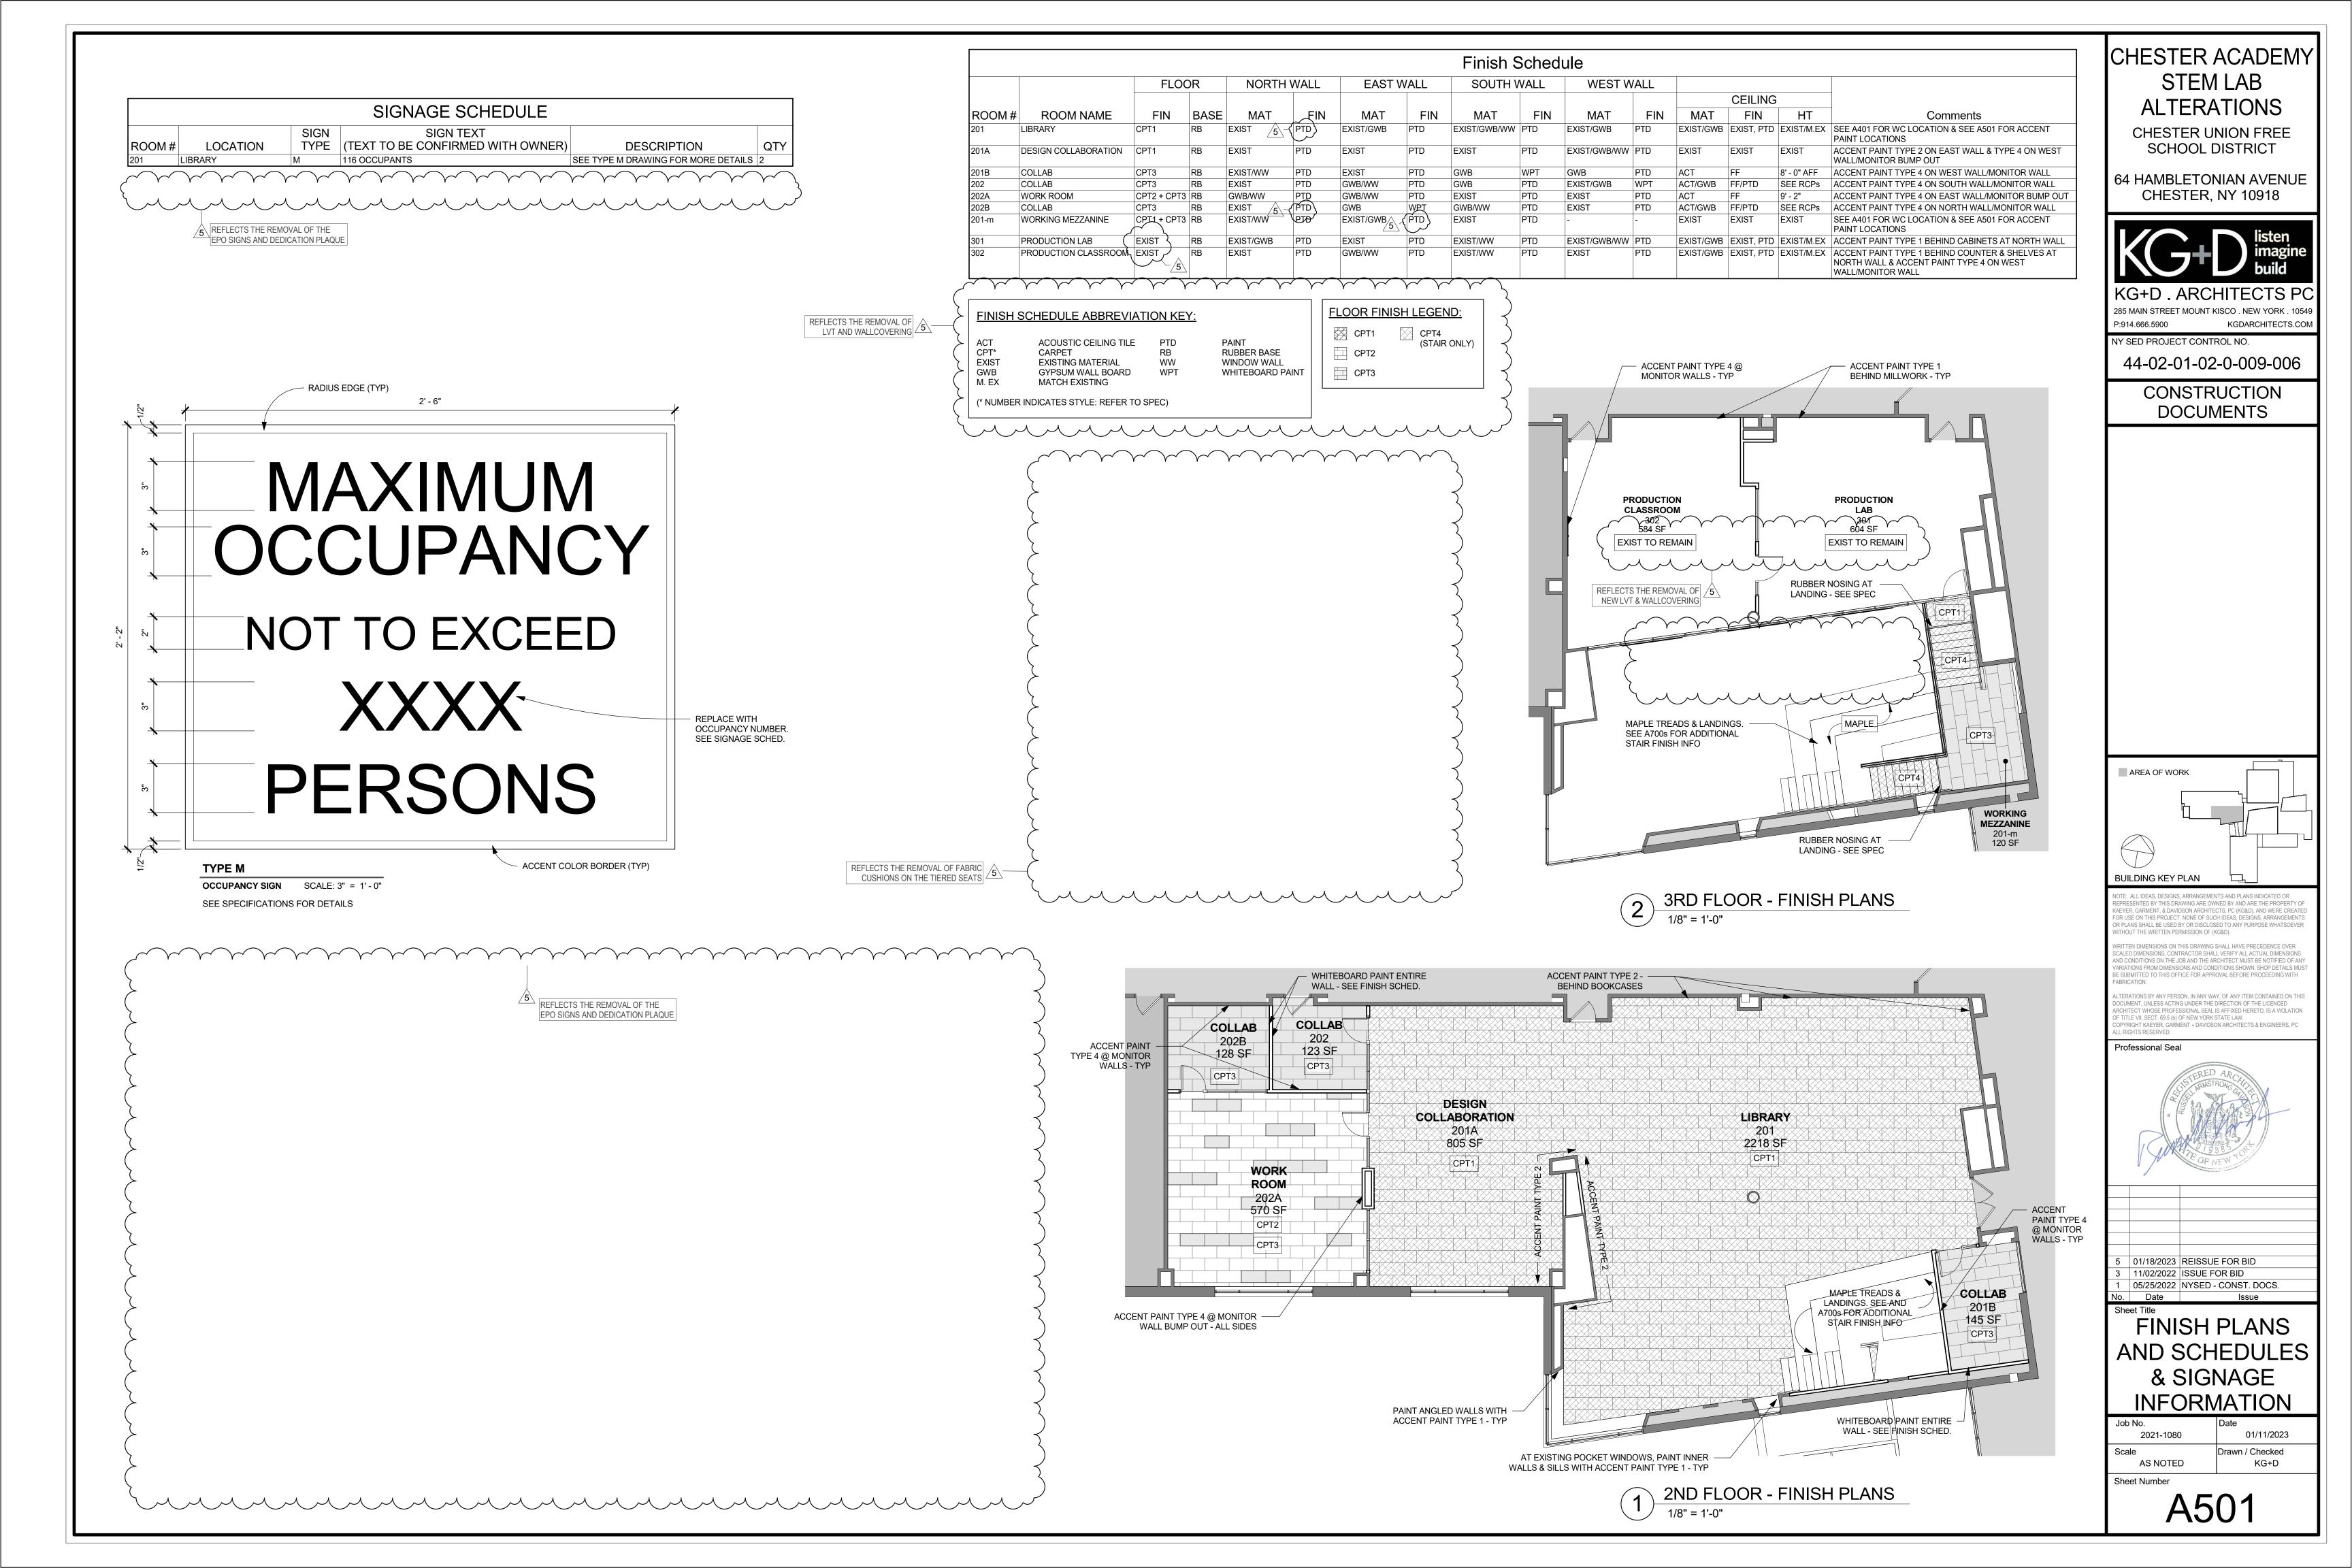

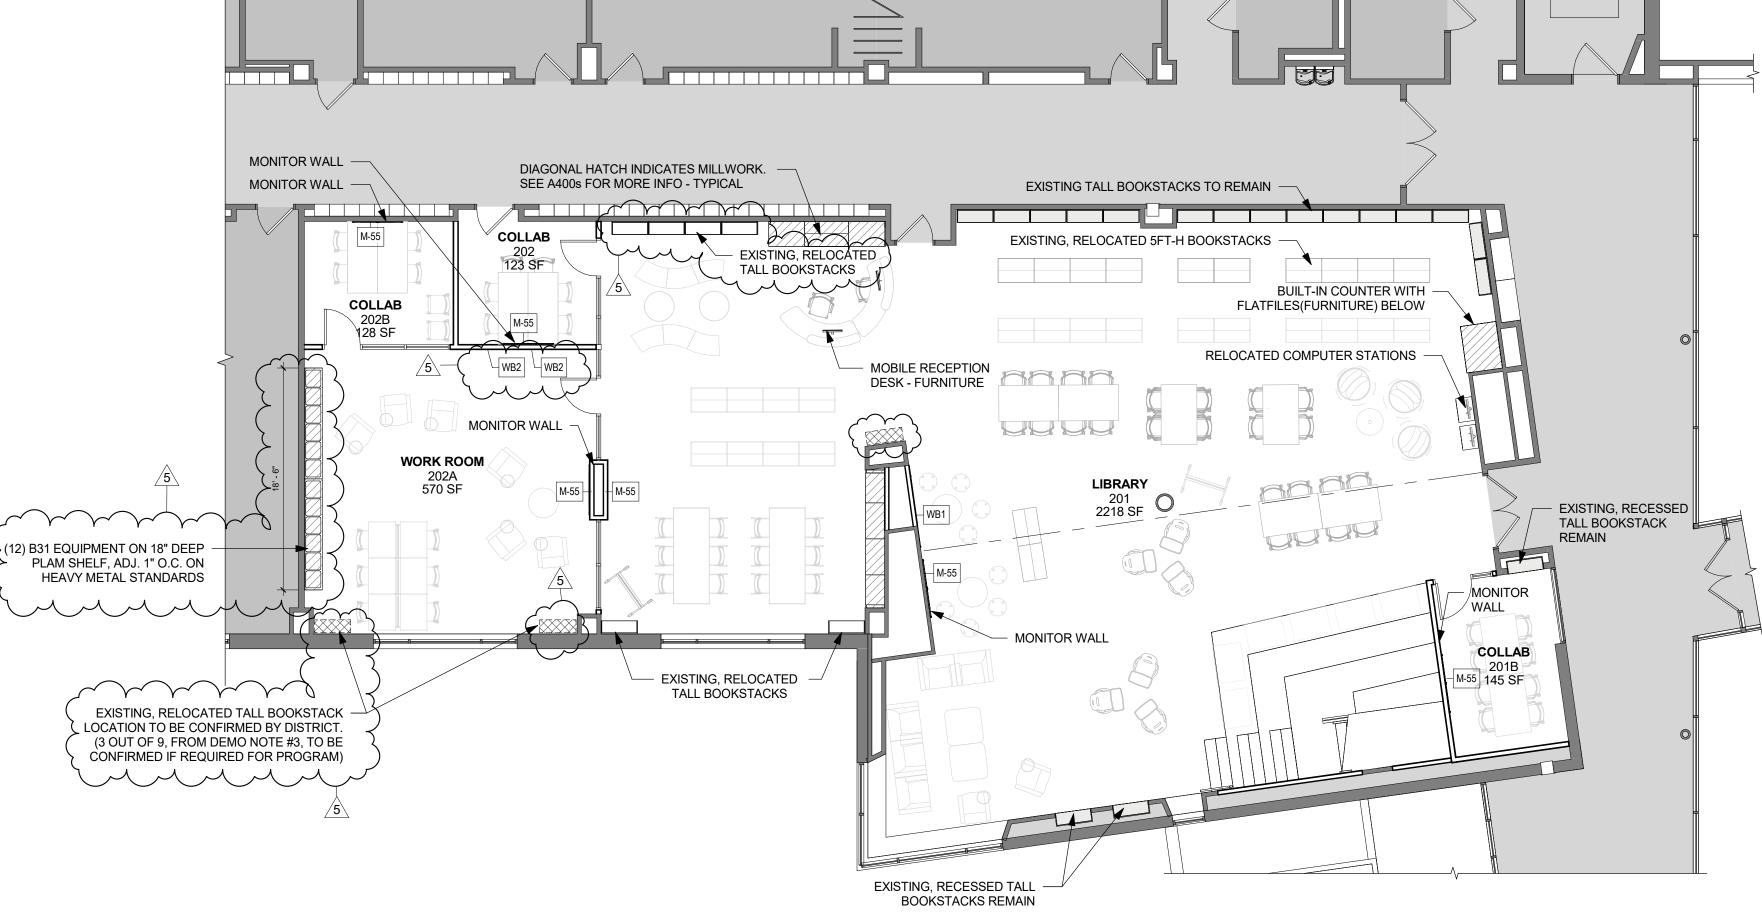

WHITEBOARD AND MONITOR SCHEDULE

TAG QTY

MT-55 6 MT-65 1

MT-90 3

- GC TO PROVIDE ADDITONAL BLOCKING AS REQ'D FOR MONITORS

- MT-90 MONITORS TO BE ON ADJUSTABLE TILTING BRACKET PROVIDED BY THE OWNER

- GC TO COORDINATE AV EQUIPMENT INSTALL WITH OWNERS

72"W x 48"H MAGNETIC | WB1 | 2

48"W x 72"H MAGNETIC | WB2 | 2

GENERAL NOTES
- ALL MONITORS & ARE SUPPLIED BY OWNER

WHITEBOARD

WHITEBOARD

55" MONITOR

65" MONITOR

90" MONITOR

LOCATION

CLASSROOM AND LIBRARY ASSEMBLY

COLLABORATION

LIBRARY ASSEMBLY

CLASSROOM

(SEE 6/A401)

COMMENTS

GC TO COORDINATE WITH ARCHITECT ON FINAL LOCATION

COORDINATE MONITOR W/ EXIST. LINEAR MECH. LOUVER CHESTER ACADEMY
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ALTERATIONS

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64 HAMBLETONIAN AVENUE CHESTER, NY 10918



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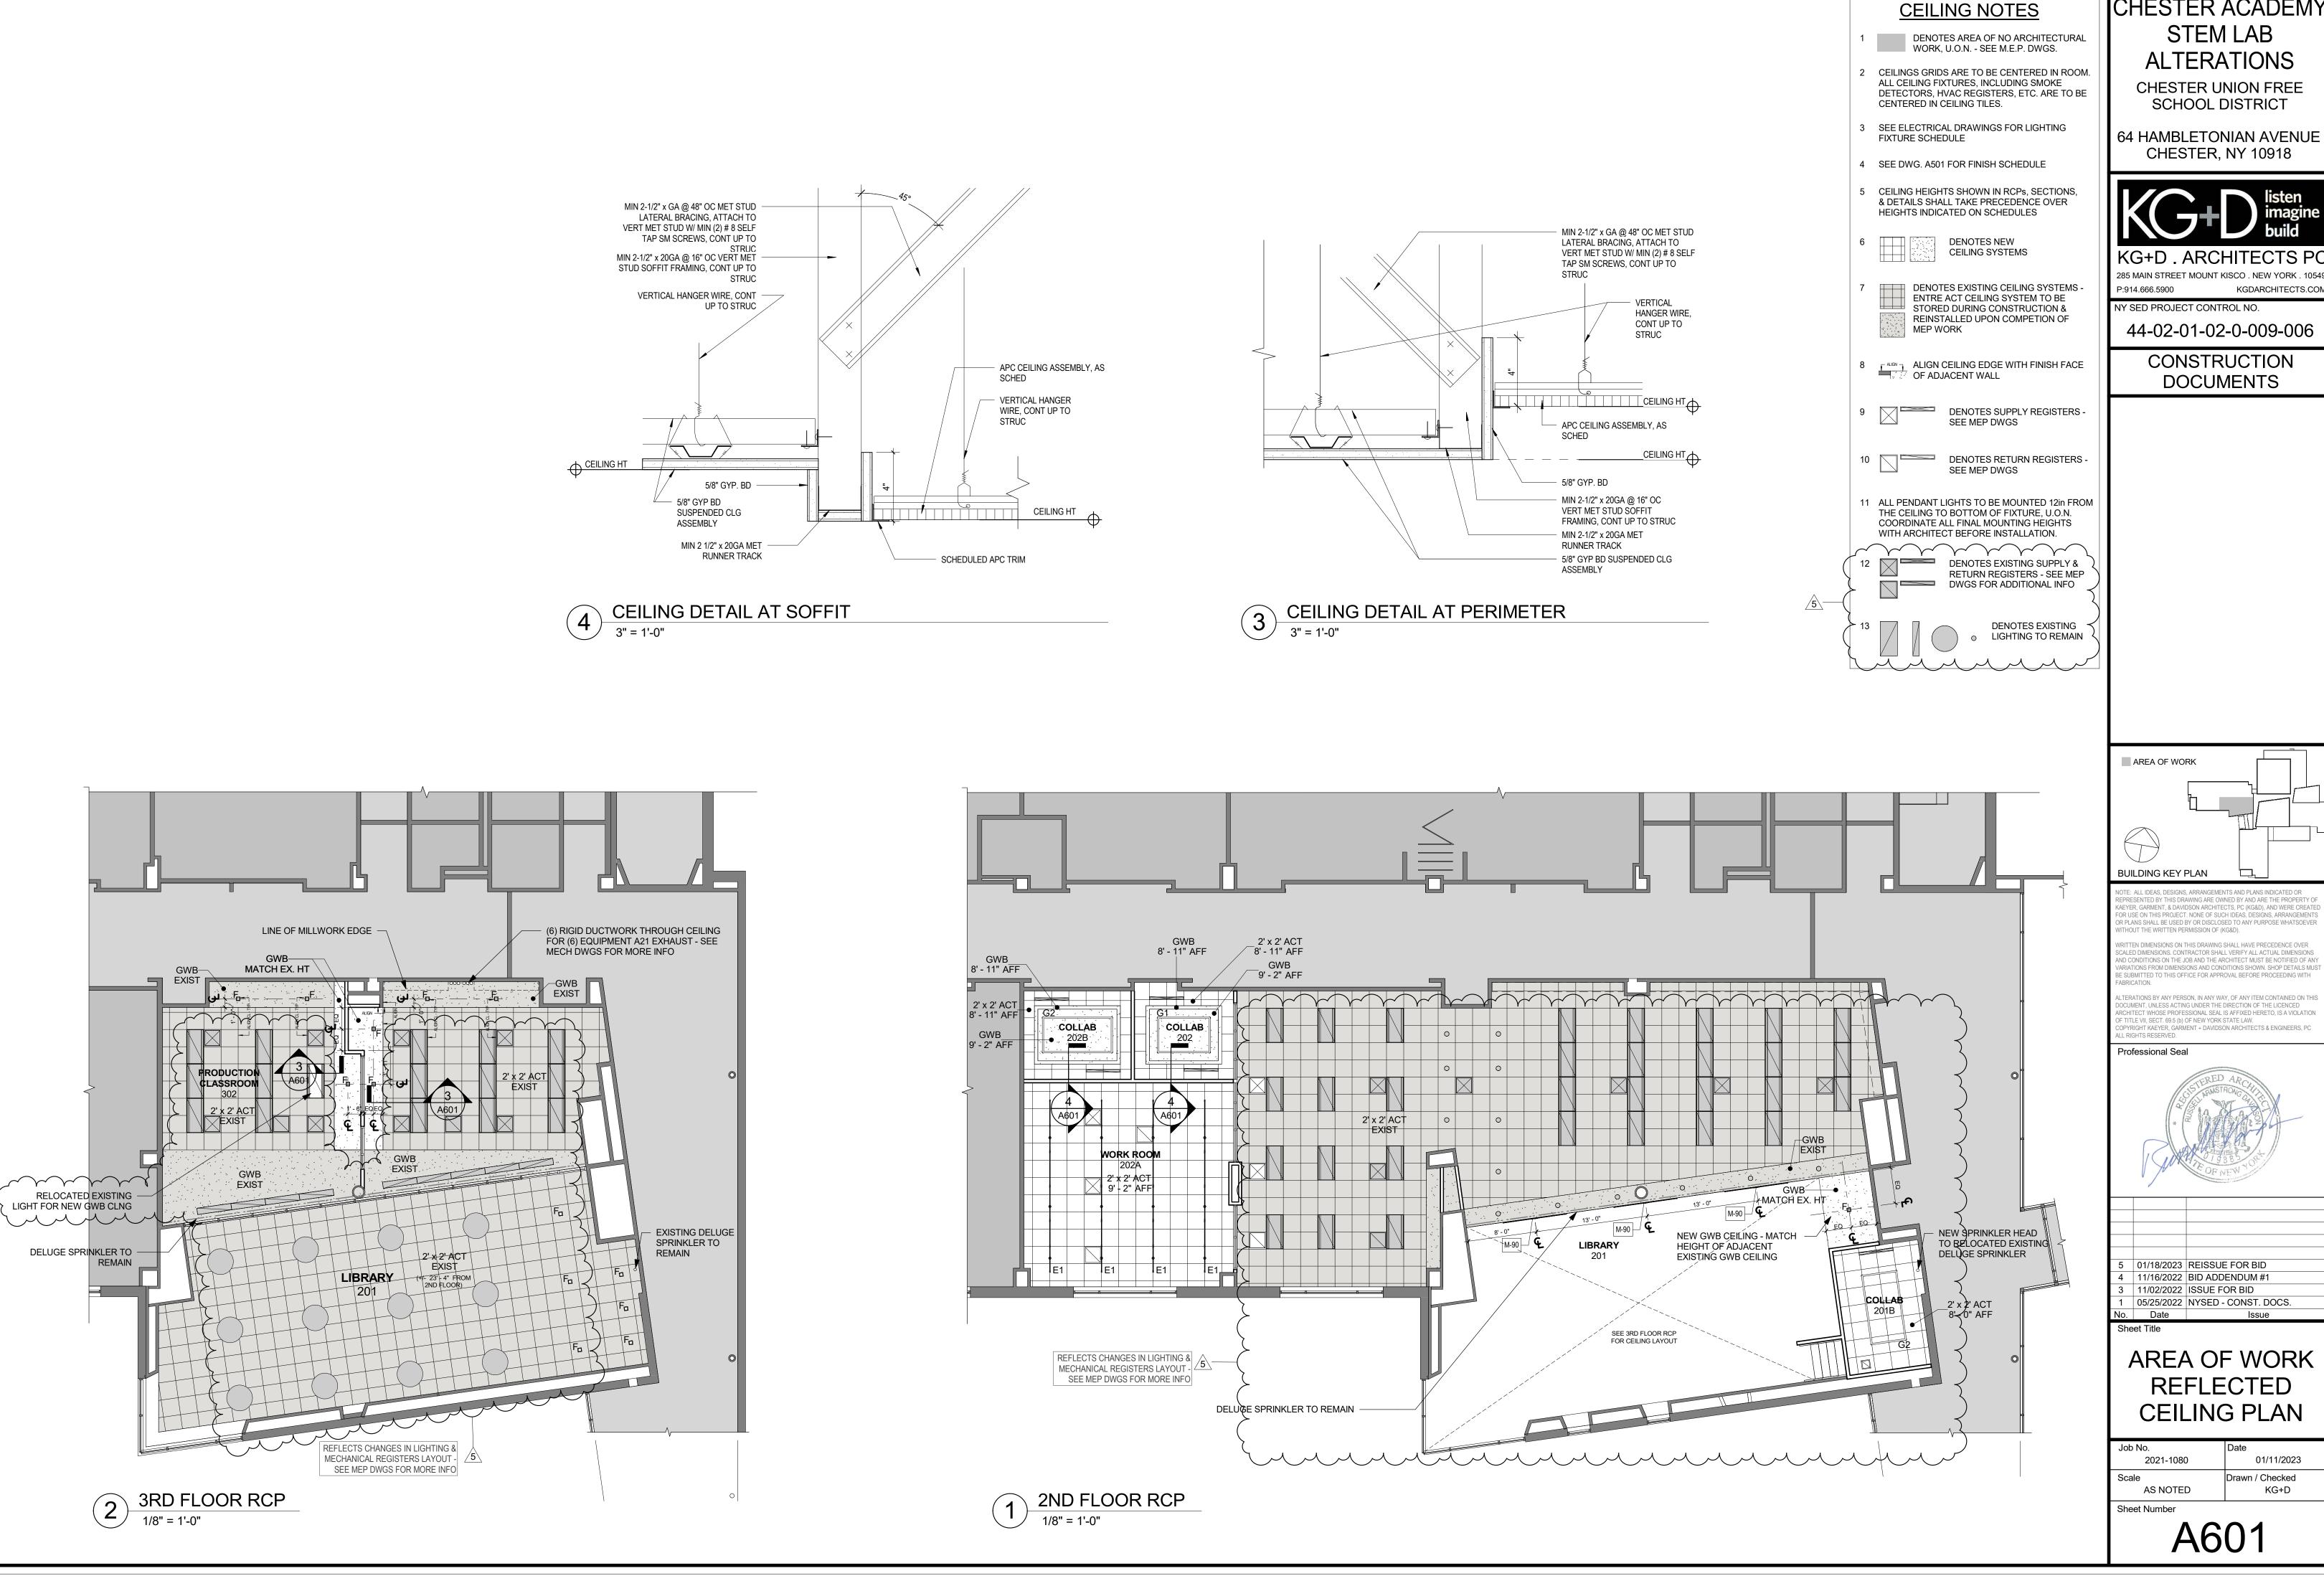
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2 3RD FLOOR EQUIPMENT PLAN

1/8" = 1'-0" FURNITURE N.I.C.

1 2ND FLOOR EQUIPMENT PLAN

1/8" = 1'-0" FURNITURE N.I.C.



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CHESTER, NY 10918




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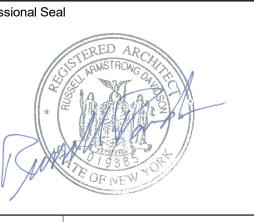
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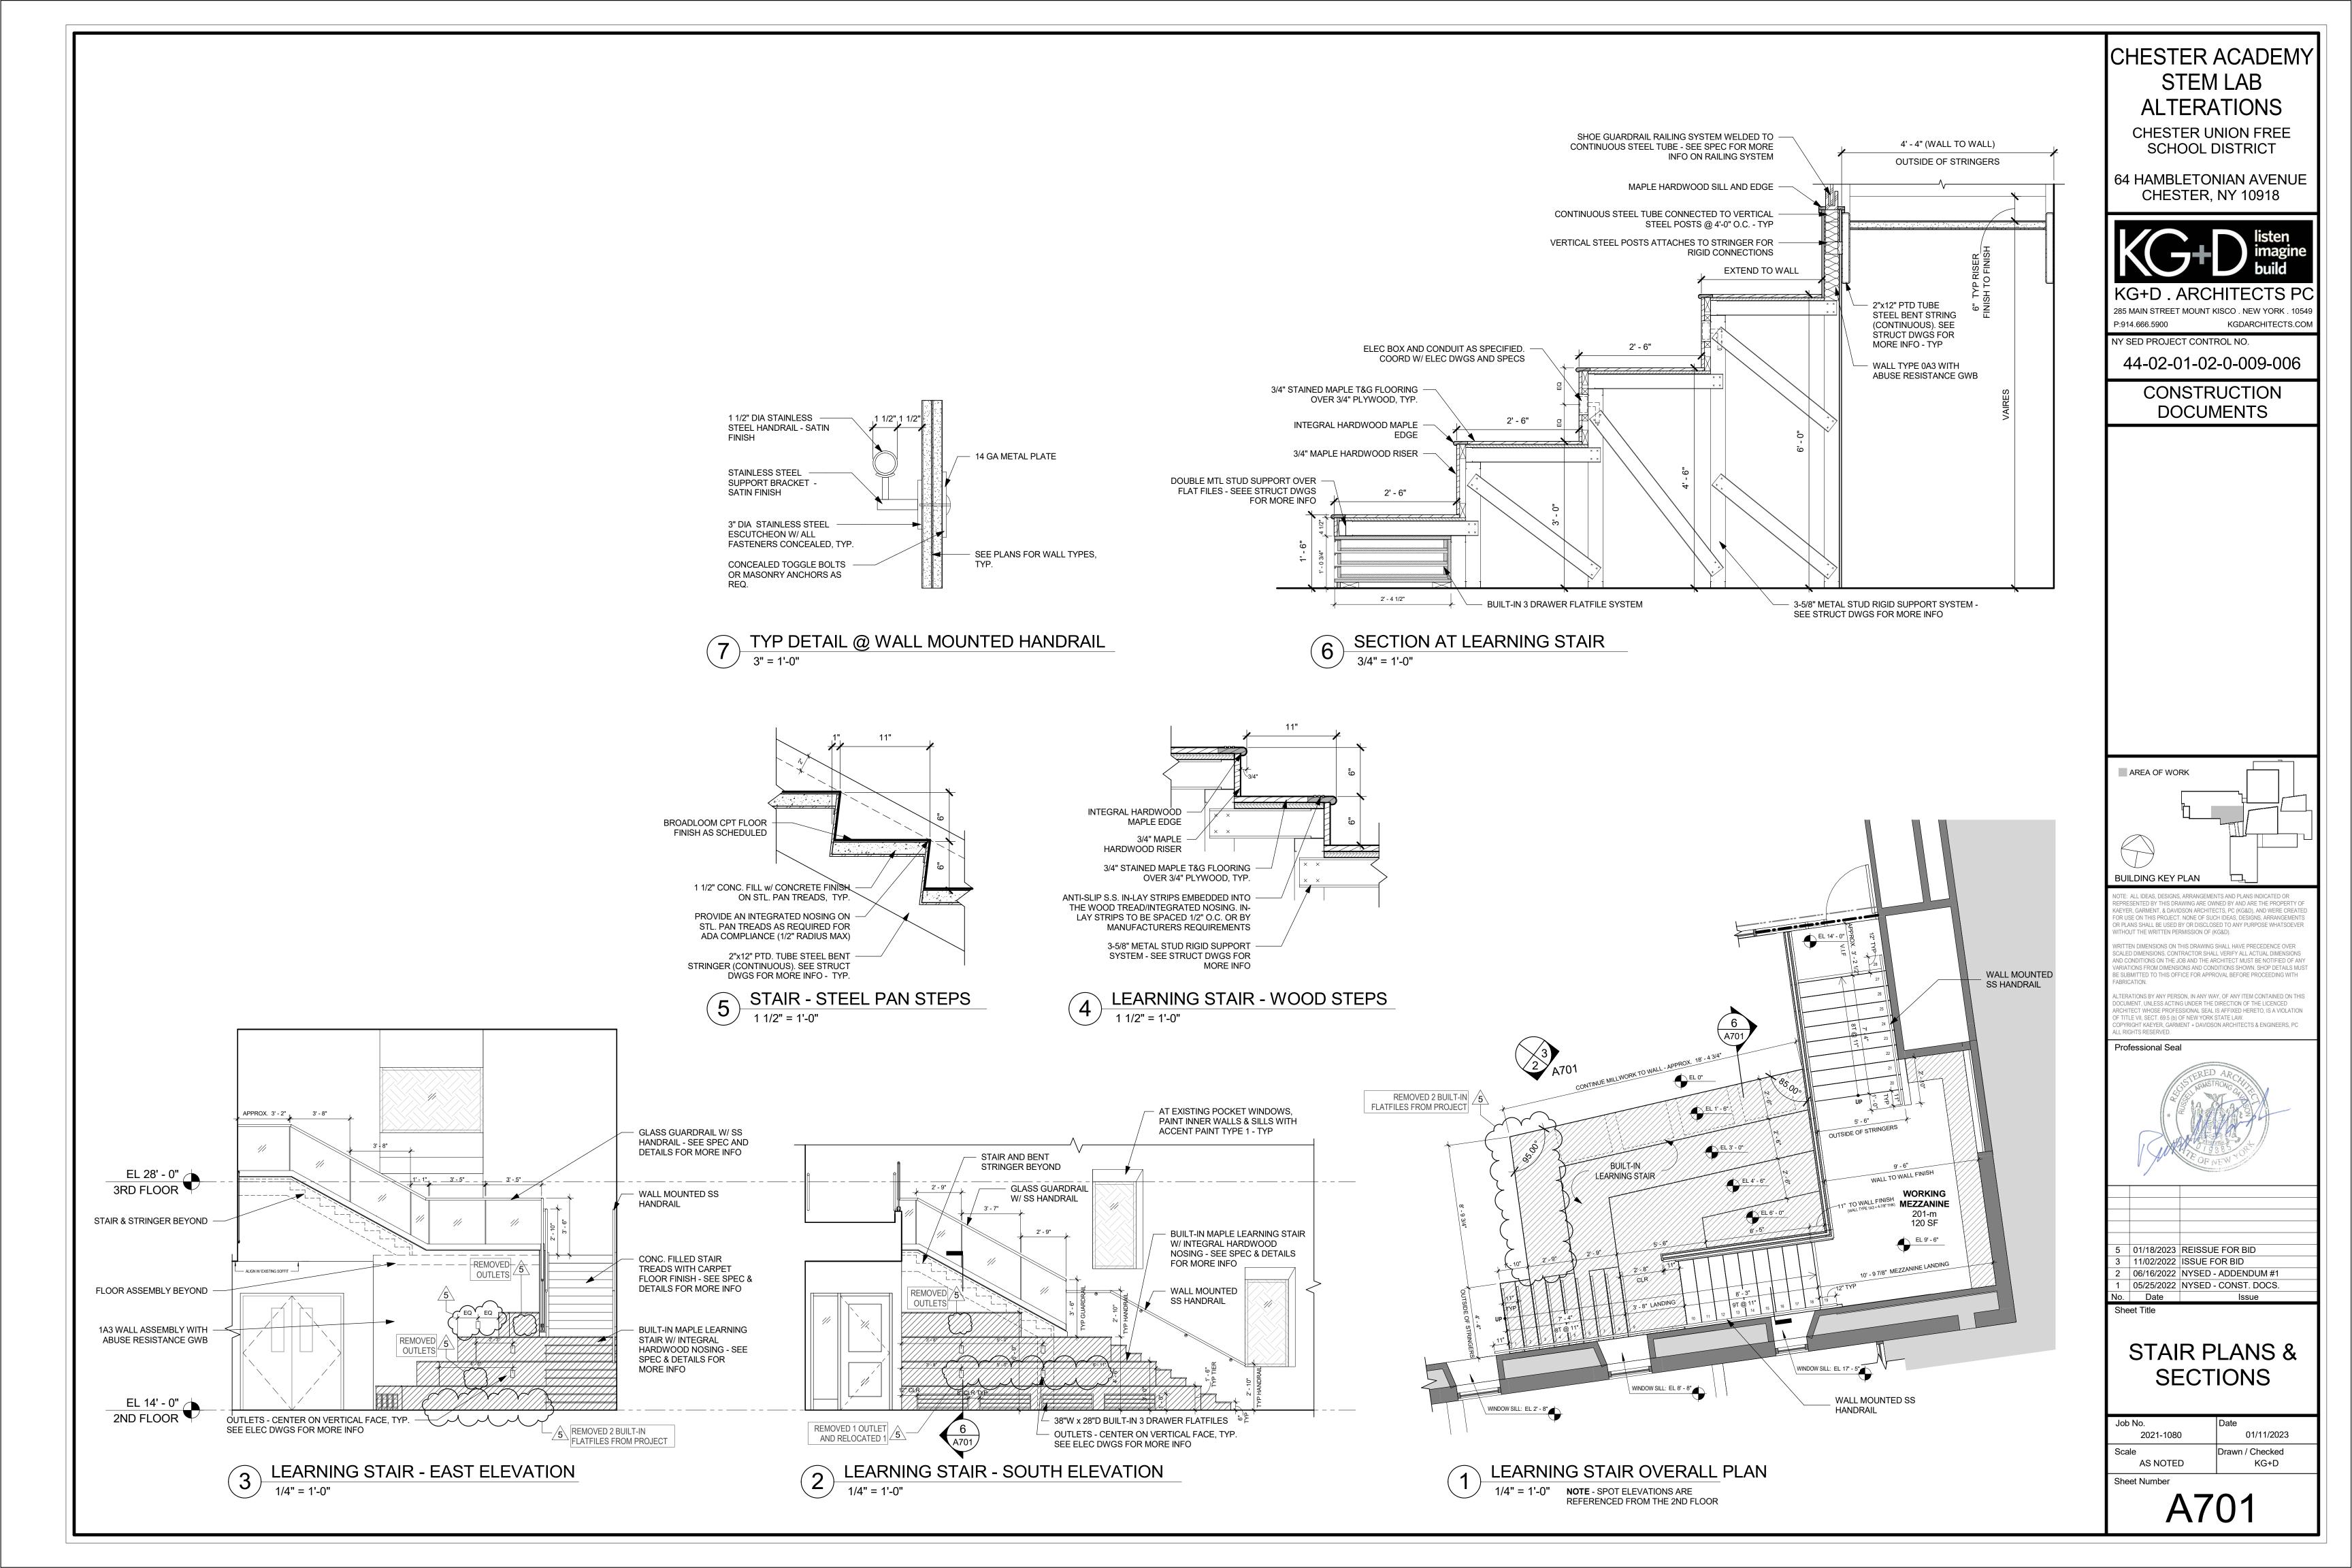
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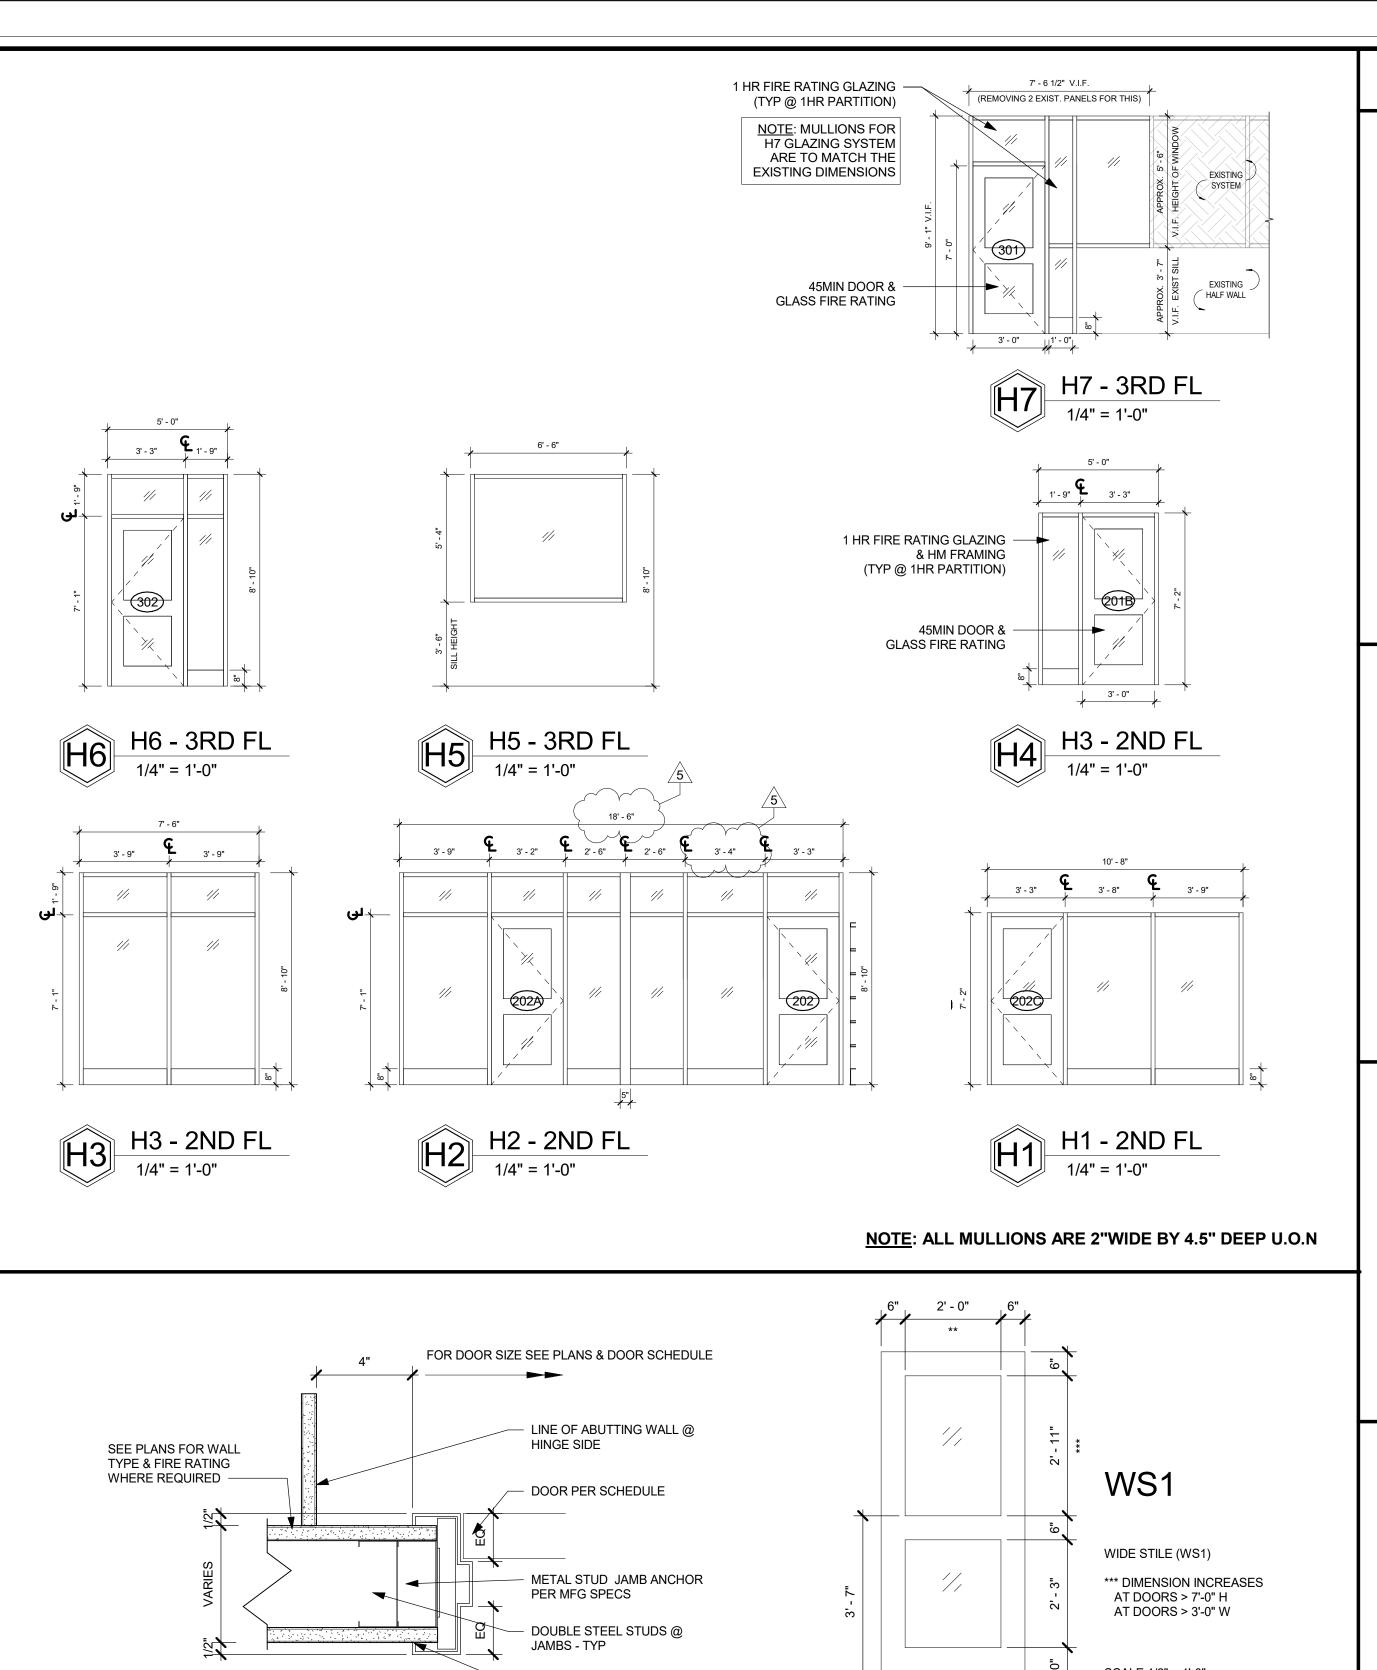
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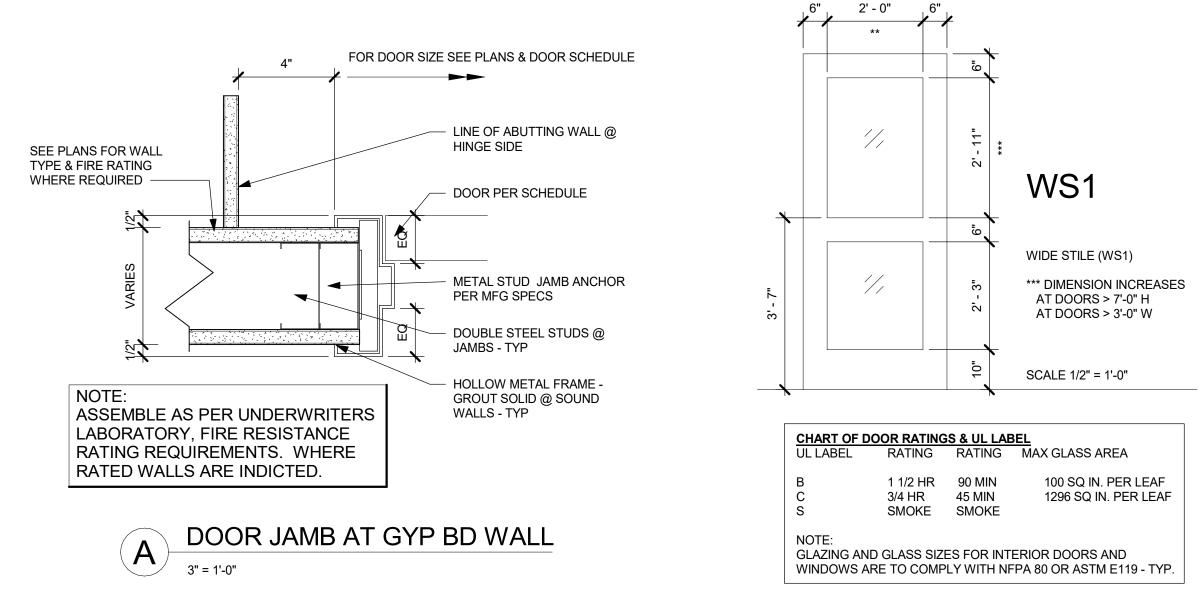
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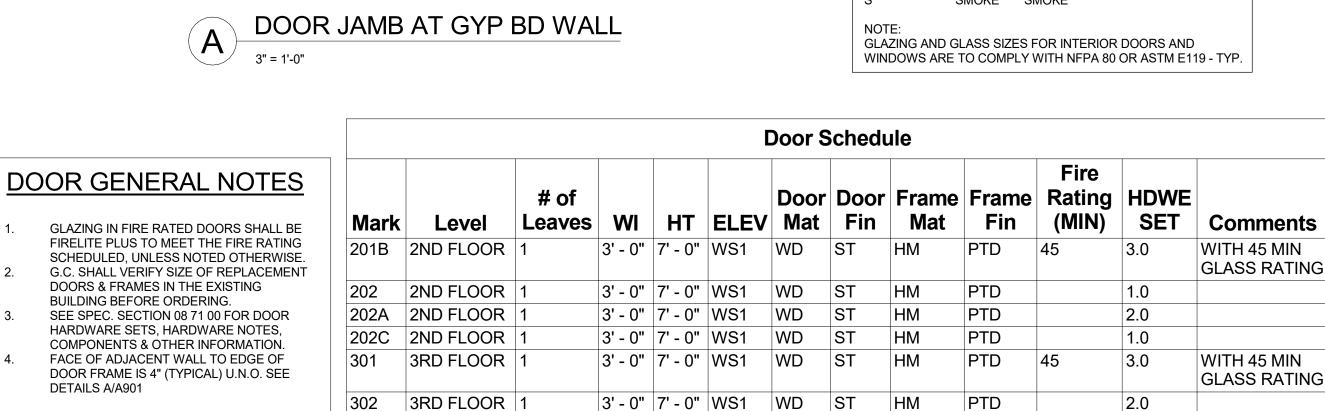
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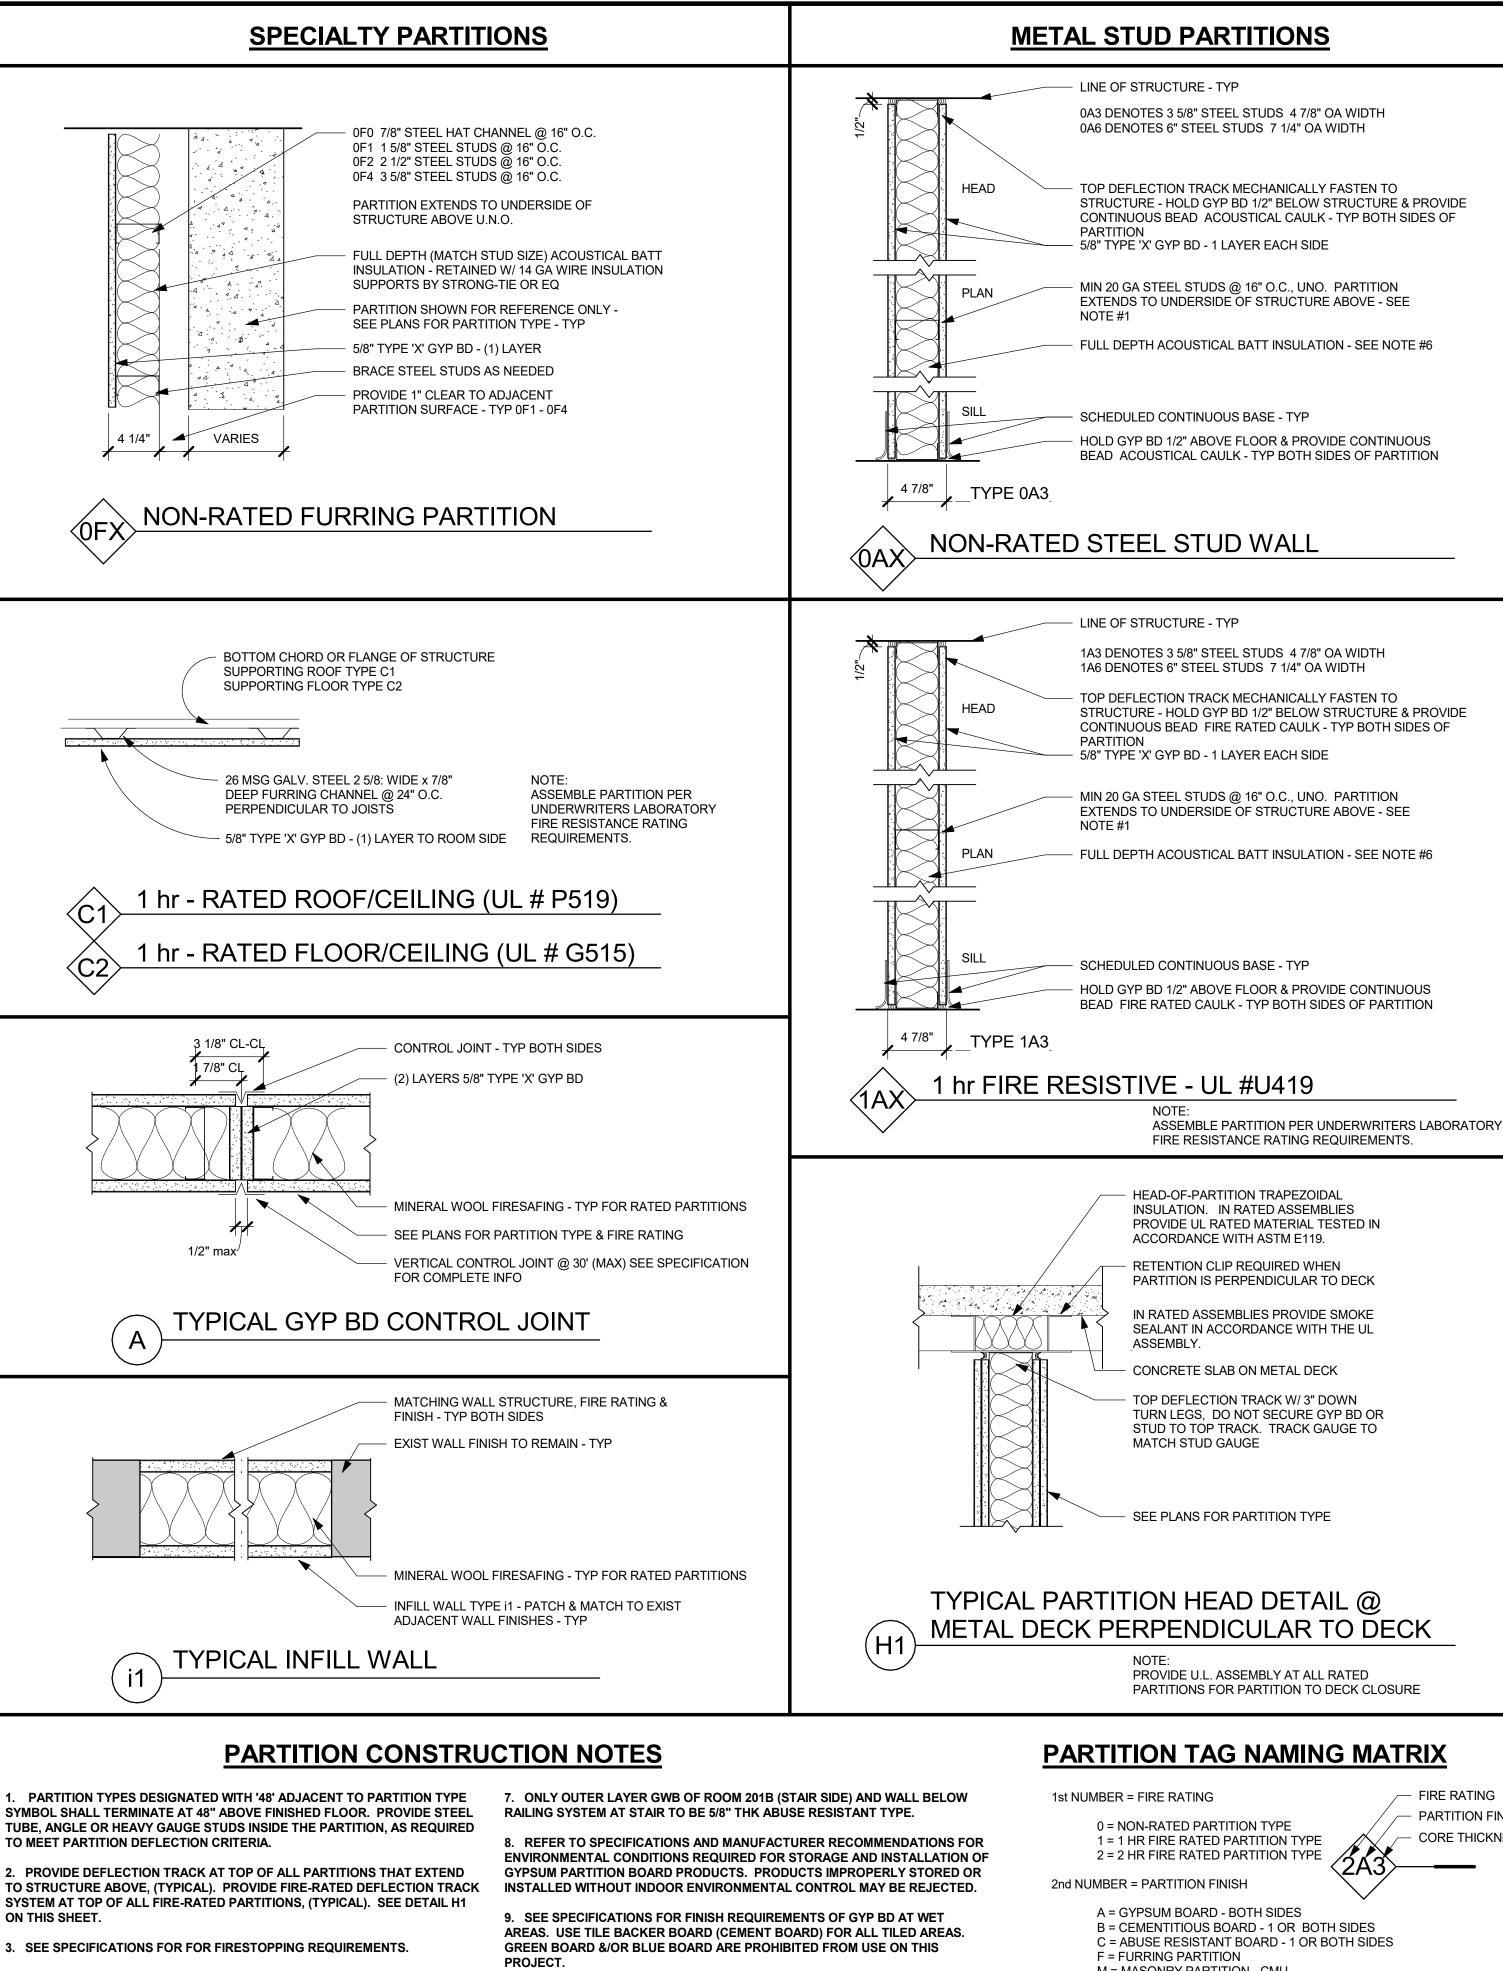
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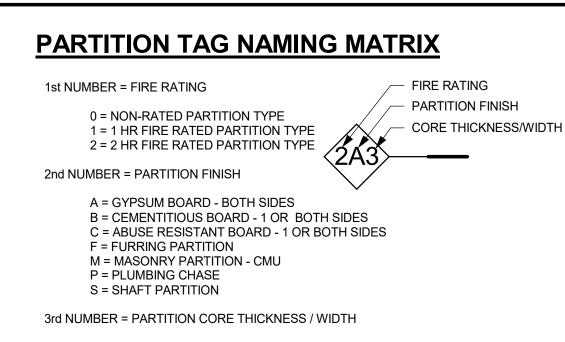






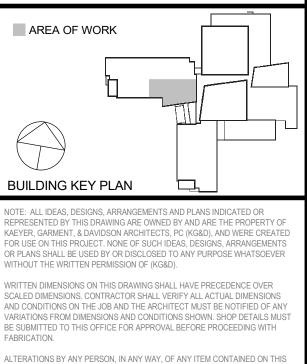

- 2. PROVIDE DEFLECTION TRACK AT TOP OF ALL PARTITIONS THAT EXTEND
- 3. SEE SPECIFICATIONS FOR FOR FIRESTOPPING REQUIREMENTS.
- 4. WHERE ACOUSTICAL BATT INSULATION IS USED IN PARTITIONS: SEAL AIRTIGHT W/ NON-HARDENING ACOUSTICAL SEALANT AT TOP. BOTTOM & SIDES. PARTITION MOUNTED ELECTRICAL BOXES SHOULD BE OFFSET MIN 24" (NOT BACK TO BACK) W/ PERIMETER OF BOXES SEALED AIR-TIGHT W/ NON-HARDENING ACOUSTICAL PUTTY PADS. PIPE & DUCT PENETRATIONS SHALL BE SLEEVED. PACKED W/ 10lb. DENSITY CLOSED CELL FOAM, & SEALED TO PARTITION W/ NON-HARDENING ACOUSTICAL SEALANT. FIRE RATED PARTITIONS TO RECEIVE FIRE RATED PUTTY PADS - TYP
- 5. PROVIDE 'INSULHOLD' HANGERS OR EQ BATT RETAINING CLIPS HORIZONTALLY @ MAX 48" SPACING PER MFG SPECS IN ALL SINGLE SIDED (GYP BD) FURRING PARTITIONS.
- 6. COORDINATE REQUIRED STUD GAUGE WITH STRUCTURAL DRAWINGS TYP
- 10. ASSEMBLE ALL RATED PARTITION TYPES PER UNDERWRITERS LABORATORY FIRE RESISTANCE RATING REQUIREMENTS.
- 11. METALLIC BOXES LOCATED ON OPPOSITE SIDES OF PARTITIONS OR PARTITIONS SHOULD BE SEPARATED BY A MINIMUM HORIZONTAL DISTANCE OF 24 IN. THIS MINIMUM SEPARATION DISTANCE BETWEEN METALLIC BOXES MAY BE REDUCED WHEN WALL-OPENING PROTECTIVE MATERIALS (CLIV) ARE INSTALLED ACCORDING TO THE REQUIREMENTS OF THEIR CERTIFICATION.
- 12. METALLIC BOXES SHALL NOT BE INSTALLED ON OPPOSITE SIDE OF PARTITIONS OR PARTITIONS OF STAGGERED STUD CONSTRUCTION UNLESS WALL-OPENING PROTECTIVE MATERIALS ARE INSTALLED WITH THE METALLIC BOXES IN ACCORDANCE WITH CERTIFICATION REQUIREMENTS FOR THE PROTECTIVE MATERIALS.



0 = 7/8" HAT CHANNEL 1 = 1-5/8" STUD

2 = 2-1/2" STUD 3 = 3-5/8" STUD OR 4" CMU BLOCK 4 = 4" STUD

6 = 6" STUD OR 5-5/8" CMU BLOCK

8 = 8" STUD OR 7-5/8" CMU BLOCK

10 = 10" STUD OR 9-5/8" CMU BLOCK

12 = 12" STUD ORT 11-5/8" CMU BLOCK

TYPES & DETAILS 2021-1080 01/11/2023 Scale Drawn / Checked

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DOOR, FRAME

**AND PARTITION** 

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SCHOOL DISTRICT

64 HAMBLETONIAN AVENUE

CHESTER, NY 10918

285 MAIN STREET MOUNT KISCO . NEW YORK . 105

44-02-01-02-0-009-006

CONSTRUCTION

**DOCUMENTS** 

Y SED PROJECT CONTROL NO.

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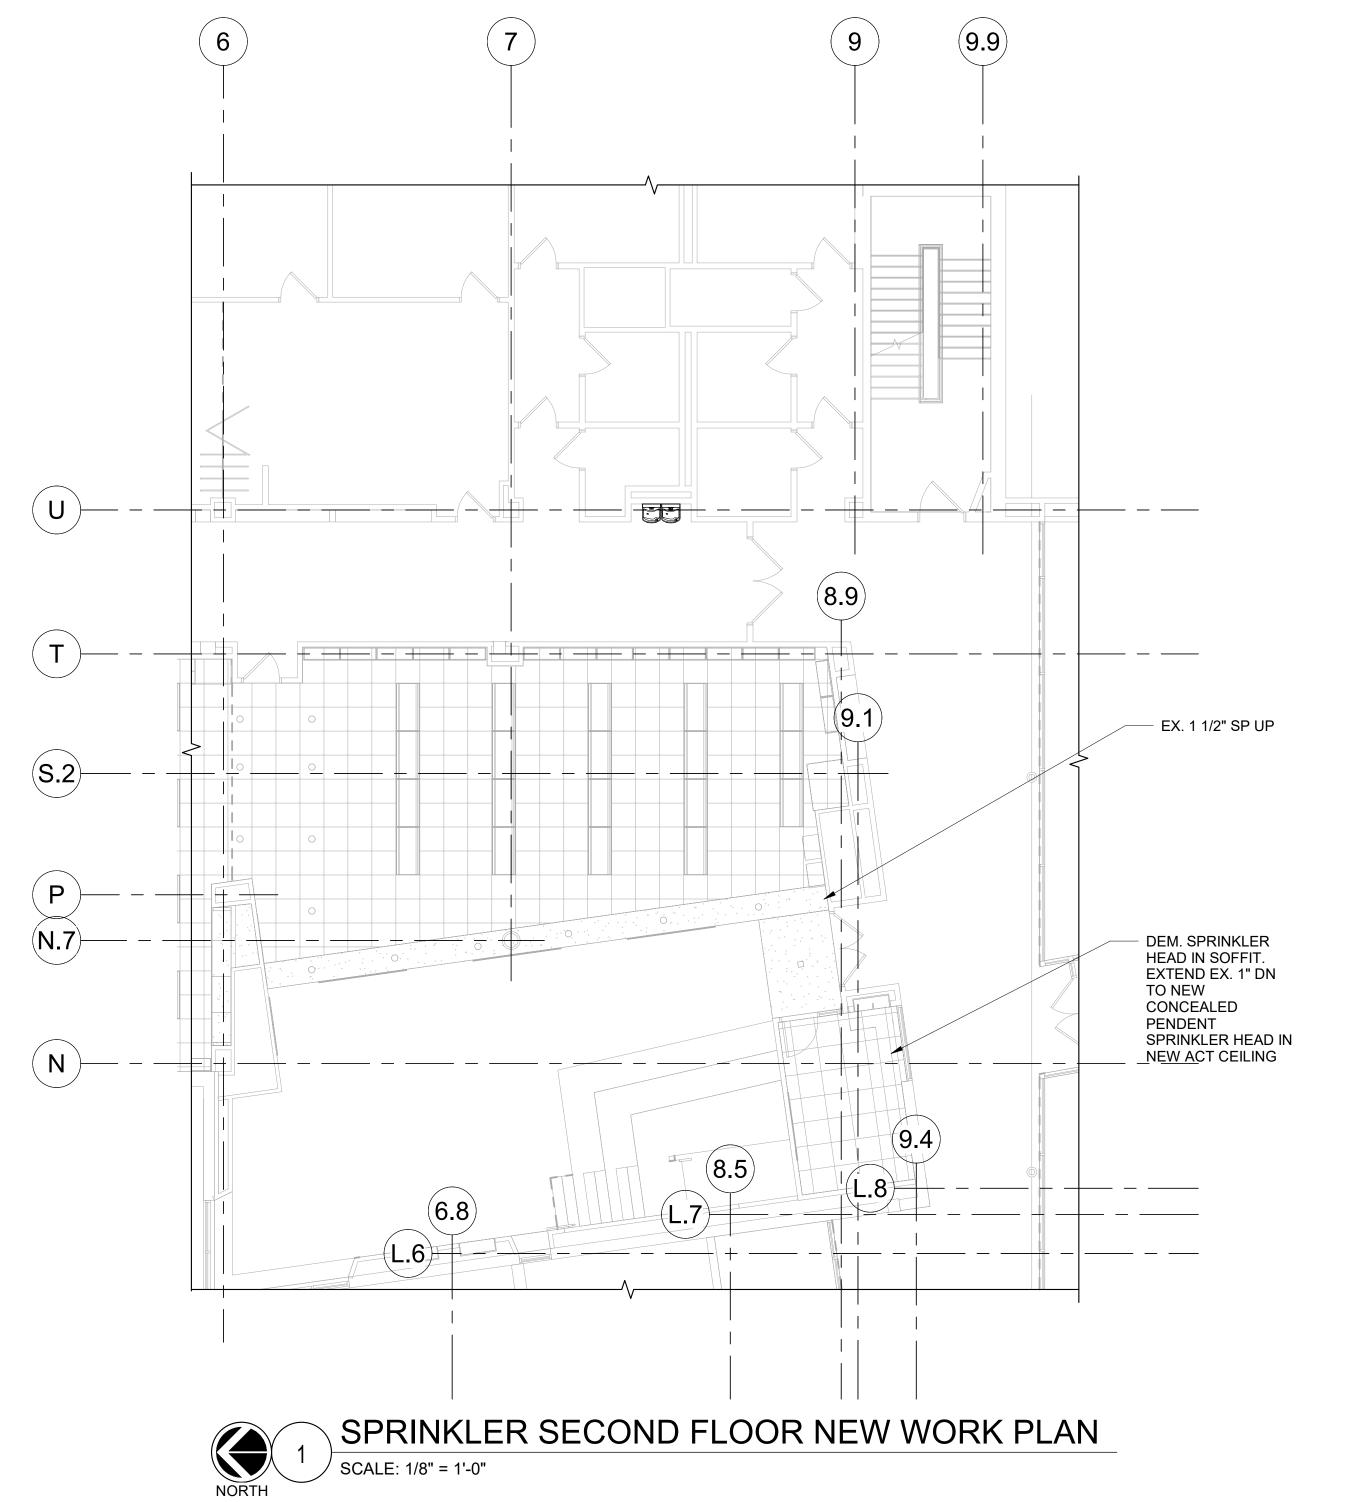
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PROVIDE U.L. ASSEMBLY AT ALL RATED PARTITIONS FOR PARTITION TO DECK CLOSURE

SYMBOL & ABBREVIATIONS						
SYMBOL	ABBREVIATION	DESCRIPTION				
	EX.	EXISTING TO REMAIN				
	NEW	NEW WORK				
	DEM.	EXISTING TO BE REMOVED				
•	-	PENDANT SPRINKLER HEAD, CONCEALED OR EXPOSED AS NOTED.				
0	-	NEW UPRIGHT SPRINKLER HEAD				



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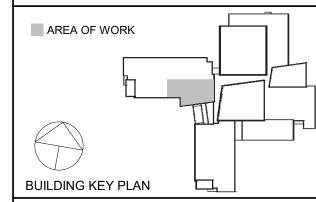
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### SPRINKLER NEW **WORK PLANS**

Job No.	Date
NKGD0245.00	05/25/2022
Scale	Drawn / Checked
AS NOTED	BS / RJ
Sheet Number	

SP201

SYMBOL	ABBREVIATION	DESCRIPTION	SYMBOL	ABBREVIATION	DESCRIPTION	(
-	ADDITEVIATION	ACCESS DOOR		EX.	EXISTING TO REMAIN	1
		ABOVE FINISHED FLOOR				
-	AFF			REL.	REMOVE AND RELOCATE	
-	AHC	ABOVE HUNG CEILING		NEW	NEW WORK	2
-	AP	ACCESS PANEL		DEM.	EXISTING TO BE REMOVED	
-	BTU	BRITISH THERMAL UNIT	— D —	-	DRAIN	3
-	CFM	CUBIC FEET PER MINUTE	—— HWS ——	HWS	HOT WATER SUPPLY	
-	Q.	CENTERLINE	HWR	HWR	HOT WATER RETURN	
-	DIA. OR Ø	DIAMETER				4
-	EA	EXHAUST AIR	T	-	THERMOSTAT	5
-	EAT	ENTERING AIR TEMPERATURE	M	-	MOTORIZED DAMPER	
-	EF-	EXHAUST FAN	⟨S⟩	-	SMOKE DETECTOR	6
-	EL	ELEVATION	<b>→</b> √-	-	AIR INTO REGISTER	
	ER	EXHAUST REGISTER	•	_	POINT OF CONNECTION DISCONNECTION	7
_	ESP	EXTERNAL STATIC PRESSURE	-[	TR	TOP REGISTER SUPPLY	
	GPM	GALLONS PER MINUTE	<u></u> -√-	TR	TOP REGISTER RETURN	8
		HEATING, VENTILATING AND AIR	<u> </u>			
-	HVAC-	CONDITIONING UNIT		SR	SUPPLY REGISTER	
-	LF	LINEAR FEET		CD	1-WAY	9
-	МВН	1000 BRITISH THERMAL UNITS PER HOUR		CD	2-WAY	
-	MER	MECHANICAL EQUIPMENT ROOM		CD	2-WAY	1
-	NC	NORMALLY CLOSED		CD	3-WAY	
-	NIC	NOT IN CONTRACT		CD	4-WAY	
-	NO	NORMALLY OPEN		*CD	RELOCATED CEILING DIFFUSER	1
-	OAI	OUTSIDE AIR INTAKE		LD	LINEAR DIFFUSER	
-	RA	RETURN AIR		RR/RG	RETURN REGISTER/GRILLE	
-	RF-	RETURN FAN		*RR/*RG	RELOCATED RETURN REGISTER/GRILLE	
_	RPM	REVOLUTIONS PER MINUTE		VAV	VAV BOX	1
	RTU-	ROOFTOP UNIT		VAV		
					VAV BOX WITH REHEAT	1
-	SA	SUPPLY AIR		CV	CONSTANT VOLUME BOX	
-	SP	STATIC PRESSURE		-	SUPPLY DUCT UP	
-	TD	TRANSFER DUCT		-	SUPPLY DUCT DOWN	
-	TSP	TOTAL STATIC PRESSURE		-	RETURN DUCT UP	1
-	TYP.	TYPICAL		-	RETURN DUCT DOWN	
-	U.O.N.	UNLESS OTHERWISE NOTED	2	-	TRANSITION FROM SQUARE TO ROUND DUCT	1
-	WG	INCHES OF WATER GAUGE	}	-	TRANSITION	
-	WMS	WIRE MESH SCREEN	{ D →	-	DUCT DROP	1
			{ R→ }	-	DUCT RISE	
A	-	2-WAY VALVE		-	SQUARE VANED ELBOW	
$\overline{\Box}$	_	GATE VALVE		_	DUCT RISE	
	_	GLOBE VALVE		-	DUCT DROP	1
<del></del>	-			-	DUCT TRANSITION	
<u> </u>		TEE DOWN		AL	ACOUSTIC LINING	1
	-	ELBOW DOWN				1
	-	TEE UP		FD/AD	FIRE DAMPER W/ ACCESS DOOR	
<u> </u>	-	ELBOW UP		SD/AD	SMOKE DAMPER W/ ACCESS DOOR  COMBINATION FIRE/SMOKE DAMPER	
	-	CONCENTRIC REDUCER		CFSD	W/ ACCESS DOOR	
	-	ECCENTRIC REDUCER		VD	VOLUME DAMPER	
	-	PIPE GUIDE		AL	ACOUSTIC LINING	
×	-	PIPE ANCHOR	6x8	-	DUCT SIZE - 1ST FIGURE IS SIDE SHOWN	
⊢ <del>∡</del> l	-	STRAINER	<b>-</b>	FC	FLEXIBLE CONNECTION	
<b>-</b>	-	FLOW ARROW				
@	-	BALANCING VALVE	SECT#	_	SECTION CALLOUT	
<u></u>	-	MANUAL AIR VENT	DWG#			
	_	AUTO AIR VENT	CD-A CFM	-	CEILING DIFFUSER	
			<del></del>		EXHAUST REGISTER	
<u> </u>	-	ANGLE GLOBE VALVE	ER-A CFM	-		
<u>Z</u>	-	ANGLE GATE VALVE	RR-A CFM	-	RETURN REGISTER	
<u></u>	-	BALL VALVE	SR-A CFM	-	SUPPLY REGISTER	
<u></u>	-	CHECK VALVE	TR-A CFM	-	TOP REGISTER	
1 1	-	UNION	VAV-A CFM	-	VARIABLE AIR VOLUME BOX	

#### RAL NOTES

RACT DRAWINGS, AS FAR AS THEY RELATE TO THE GENERAL ARRANGEMENT AND ION OF EQUIPMENT, SHEET METAL, AND PIPING, SHALL BE UNDERSTOOD AS AMMATIC. ANY CHANGES TO EQUIPMENT, SHEET METAL, AND PIPING LOCATIONS SSARY TO AVOID INTERFERENCE WITH OTHER TRADES SHALL BE MADE AT NO COST, AND MUST BE APPROVED BY THE ENGINEER.

- ECHANICAL CONTRACTOR SHALL INSTALL FIRE DAMPERS WITH ACCESS DOORS IN ICTS PENETRATING FIRE RATED WALLS, WHETHER SPECIFICALLY SHOWN ON THE INGS OR NOT.
- ECHANICAL CONTRACTOR SHALL FURNISH AND INSTALL VOLUME DAMPERS IN VORK AS REQUIRED TO BALANCE THE AIRFLOW AT ALL REGISTERS AND SERS TO THE CFM'S INDICATED ON PLAN, WHETHER SPECIFICALLY SHOWN ON THE NGS OR NOT.
- ECHANICAL CONTRACTOR SHALL FIELD VERIFY ALL EXISTING CONDITIONS PRIOR E BEGINNING OF WORK, AND SHALL COORDINATE ALL WORK WITH OTHER TRADES
- DIMENSIONS SHOWN ON MECHANICAL DRAWINGS REFER TO INSIDE CLEAR DUCT SIONS. WHERE DUCTWORK IS LINED, THE MECHANICAL CONTRACTOR SHALL ASE THE SIZE OF DUCT TO COMPENSATE FOR LINING.
- E THERMOSTATS AND TEMPERATURE SENSORS 5'-6" ABOVE FINISHED FLOOR S OTHERWISE NOTED. COORDINATE LOCATION WITH FURNITURE, CABINETS, ETC. I ARCHITECTURAL DRAWINGS.
- DINATE DUCTWORK, GRILLE, DIFFUSER AND REGISTER LOCATIONS WITH LIGHTS, EDETECTORS, AND THE ARCHITECTURAL PLANS.
- ECHANICAL CONTRACTOR SHALL NOTE THAT, IN ADDITION TO THE FICATIONS AND DETAILS GIVEN IN THESE PLANS FOR PIPE HANGERS AND ORTS, ALL HANGERS AND SUPPORTS SHALL BE DESIGNED AND INSTALLED IN LIANCE WITH APPLICABLE SEISMIC CODES.
- ECHANICAL CONTRACTOR SHALL SUBMIT FOR REVIEW A COMPOSITE SHOP ING, FULLY COORDINATED WITH ALL OTHER TRADES, INDICATING DUCTWORK, BING AND SPRINKLER PIPING, SMOKE DETECTORS, LIGHTS, CONDUITS, SMOKE TORS, DIFFUSERS, GRILLES, ETC.
- ORK SHALL COMPLY WITH STATE BUILDING CODE, LOCAL BUILDING CODE, AND BY CODE REQUIREMENTS. IN CASE OF CONFLICT BETWEEN THE CONTRACT MENTS AND A GOVERNING CODE OR ORDINANCE, THE MORE STRINGENT ARD SHALL APPLY.
- G CONSTRUCTION, ALL OPEN OR INCOMPLETE DUCTWORK SHALL BE CAPPED HT WITH WITH HEAVY POLYETHYLENE PLASTIC. AFTER THE INSTALLATION OF VORK, REGISTERS, GRILLES, AND DIFFUSERS, THE CONTRACTOR SHALL BLANK L REGISTERS, GRILLES, AND DIFFUSERS WITH HEAVY POLYETHYLENE PLASTIC APE AIR TIGHT, IN AREAS THAT ARE UNDER CONSTRUCTION, UNTIL WORK IS LETE IN THOSE AREAS.
- GENERAL CONSTRUCTION IS COMPLETE, VACUUM CLEAN ALL DIFFUSERS, TERS, GRILLES, AND HVAC EQUIPMENT. REMOVE ANY CONSTRUCTION DEBRIS. CE ALL AIR FILTERS WITH NEW.
- WNER'S PERMANENT HVAC EQUIPMENT (EXISTING / NEW) SHALL NOT BE USED BY ONTRACTOR DURING CONSTRUCTION FOR TEMPORARY HEATING, COOLING, LATION, OR ANY OTHER PURPOSE. IF TEMPORARY HEATING, COOLING, ATION, OR AIRFLOW IS REQUIRED AT ANY POINT DURING CONSTRUCTION, THE RACTOR SHALL PROVIDE TEMPORARY HEATING, COOLING, OR VENTILATION MENT, DUCTWORK, CONTROLS, AND POWER AT THEIR OWN EXPENSE.
- EXISTING BUILDING STRUCTURAL COMPONENTS HAVE FIREPROOF MATERIAL, REA THAT IS DISTURBED OR DAMAGED AS A RESULT OF MECHANICAL WORK, DING THE INSTALLATION OF HANGERS FOR PIPING. DUCTWORK. OR EQUIPMENT. BE PATCHED WITH UL AND FM APPROVED FIREPROOFING TO MATCH EXISTING.
- ECHANICAL CONTRACTOR SHALL BE RESPONSIBLE FOR OBTAINING ALL SARY PERMITS AND FOR PAYING RELATED FEES.
- ECHANICAL CONTRACTOR SHALL PROVIDE ALL CUTTING, PATCHING, CORE NG, ACCESS PANELS, PAINTING, AND FINAL RESTORATION REQUIRED TO TATE THE INSTALLATION OF HVAC DUCTWORK, CONTROL CONDUITS, AND PIPING, DING ABOVE CEILINGS AND IN SHAFTS THAT WILL NOT BE REPLACED OR OPENED R ANY OTHER SCOPE OF WORK RELATED TO THIS PROJECT. CONTRACTOR TO VE AND REPLACE CEILINGS, AND OPEN AND PATCH SHAFTS AND WALLS, AS RED TO EXECUTE THE MECHANICAL WORK.
- ECHANICAL CONTRACTOR SHALL BE RESPONSIBLE FOR THE CLEANING OF ALL NG SUPPLY AIR DUCTWORK WITHIN THE PROJECT AREA.
- AC CONTROL WIRING SHALL BE RUN IN EMT.
- UIPMENT, MATERIALS, PRODUCTS, ETC., USED/INSTALLED ABOVE THE CEILING BE PLENUM RATED.
- N LOAD HAS BEEN CALCULATED IN ACCORDANCE WITH THE PROCEDURES RIBED IN CHAPTERS 27 AND 28 OF THE ASHRAE HANDBOOK OF FUNDAMENTALS.

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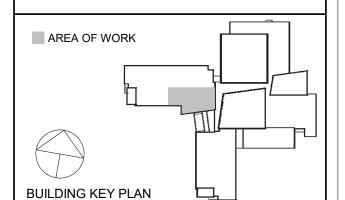
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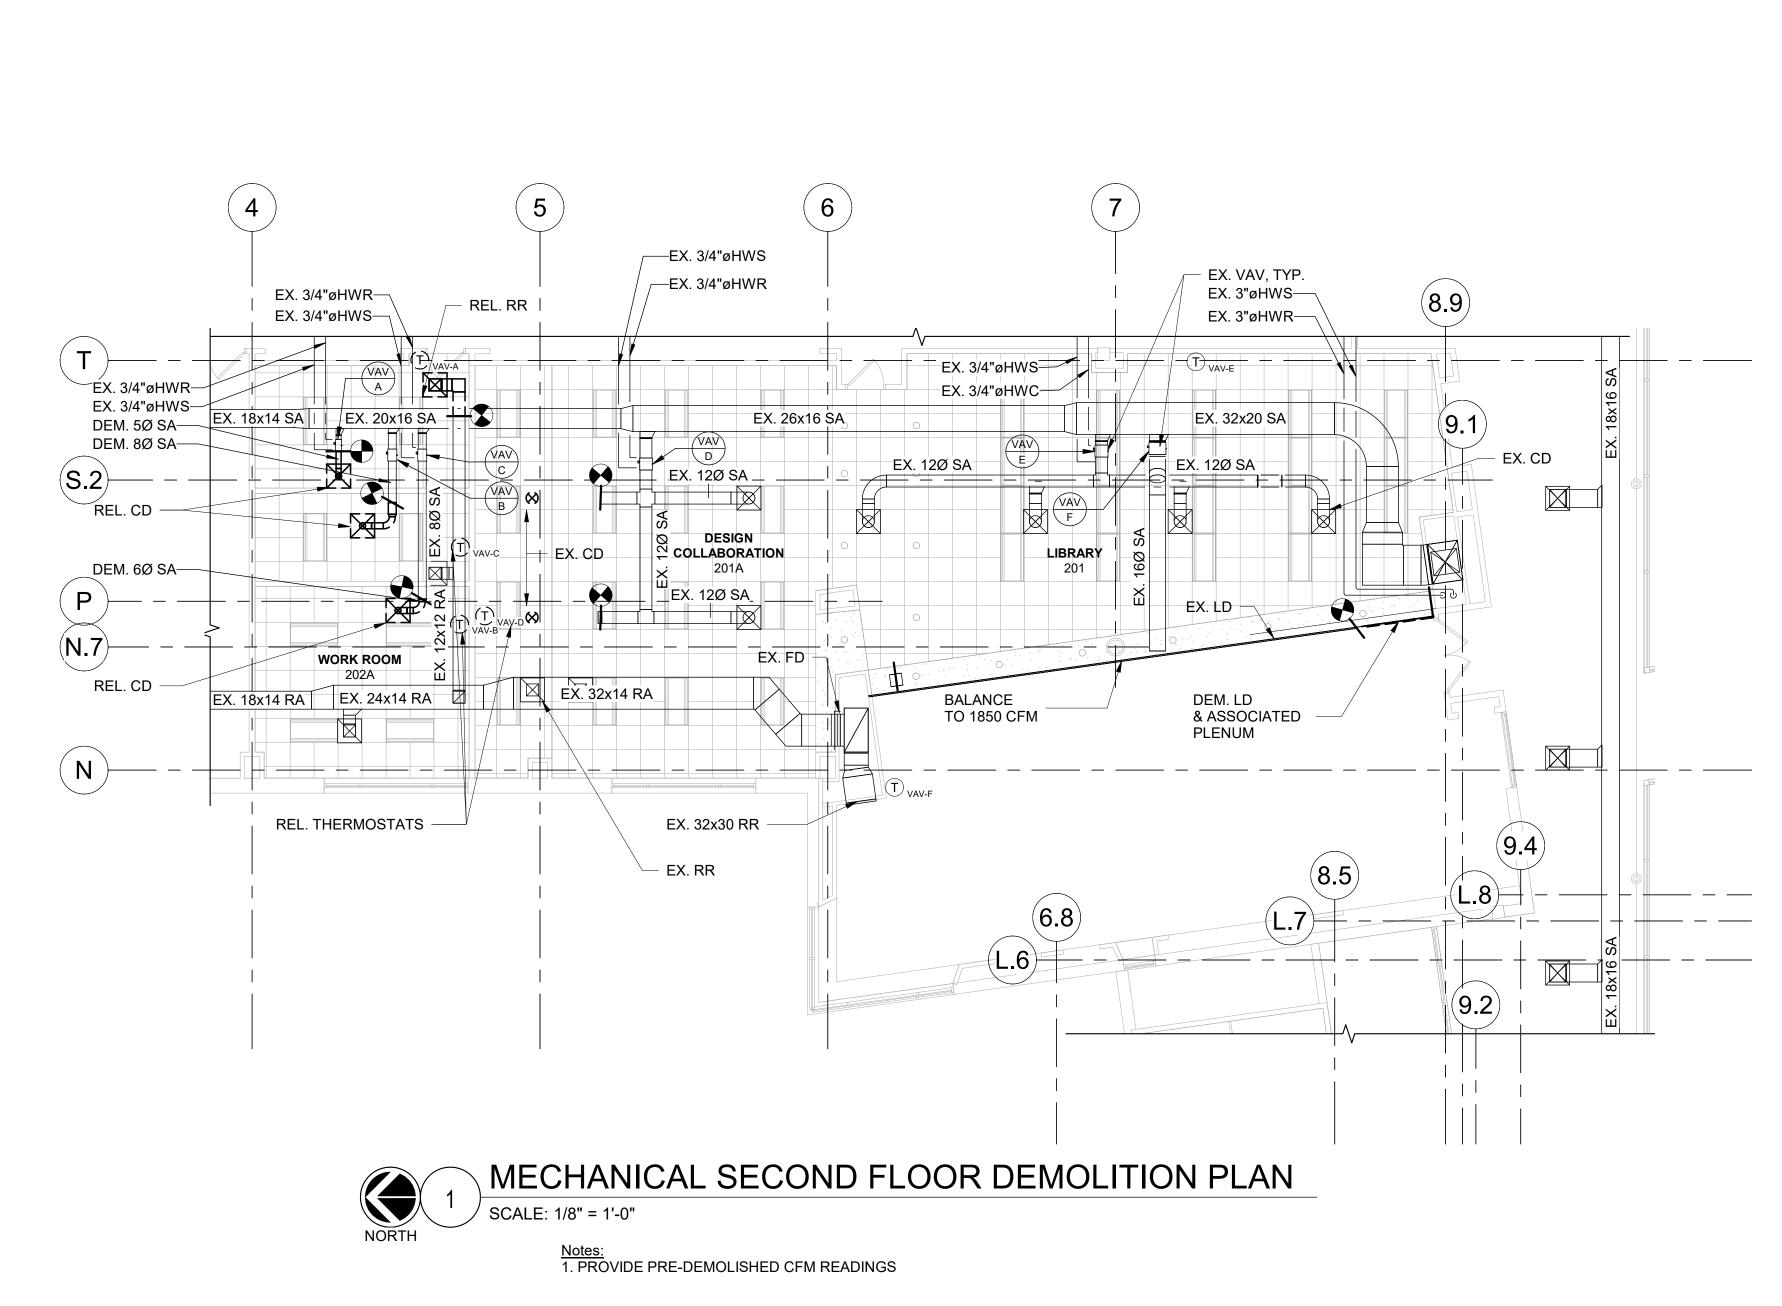
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2	06/16/2022	NYSED ADDENDUM #1

05/25/2022 CONSTRUCTION DOCUMENTS No. Date

MECHANICAL SYMBOLS AND **GENERAL NOTES** 

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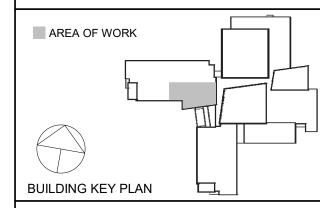
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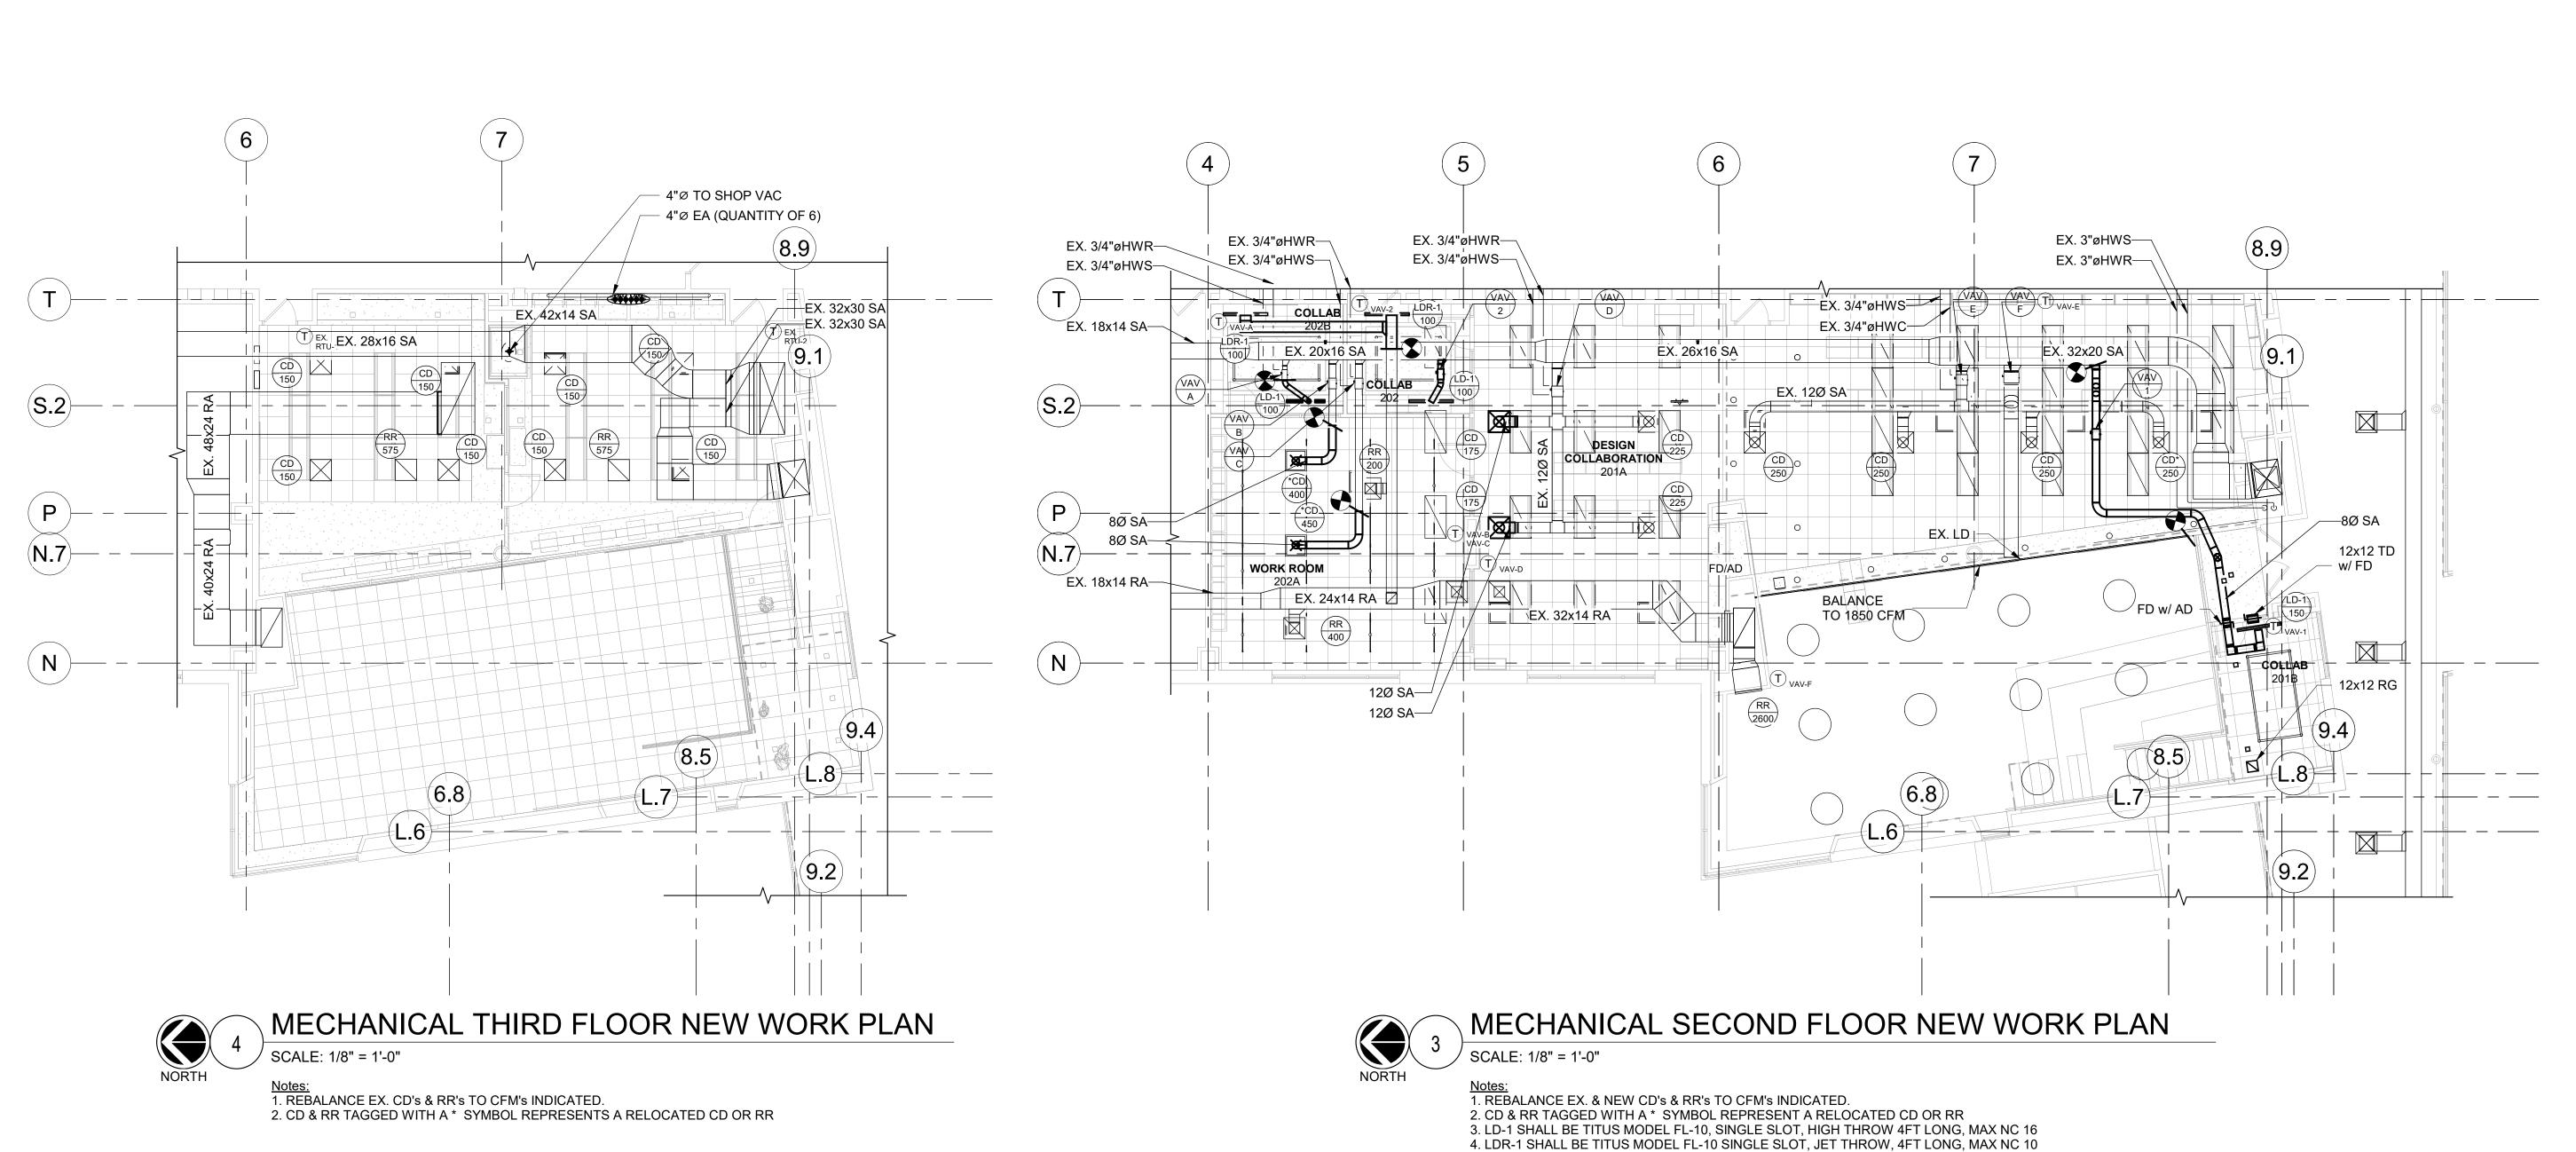
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No. Date Issue Sheet Title

> MECHANICAL **DEMOLITION PLANS**

NKGD0245.00 05/25/2022	Job No.	Date
	NKGD0245.00	05/25/2022
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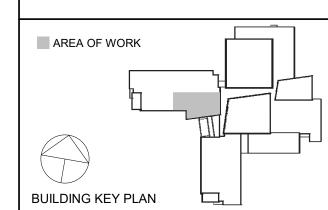
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05/25/2022 CONSTRUCTION DOCUMENTS No. Date Sheet Title

> MECHANICAL **NEW WORK PLANS**

Job No. 05/25/2022 NKGD0245.00 Scale Drawn / Checked AS NOTED

#### VARIABLE AIR VOLUME BOX SCHEDULE

DESIGNATION	VAV-1	VAV-2
INLET SIZE	8"Ø	6"Ø
MINIMUM CFM	100	65
AVAILABLE RANGE (CFM)	100 - 150	65 - 100
MAX. DESIGN CFM	150	100
	· ·	· ·

1. VAV BOXES BASED ON TITUS MODEL DESV.

2. VAV BOXES SHALL BE SINGLE DUCT, COOLING ONLY OR COOLING/ELECTRIC HEATING AS INDICATED WITH DIGITAL ELECTRONIC PRESSURE INDEPENDENT

3. BOXES SHALL BE PROVIDED WITH SHEETMETAL CONTROL ENCLOSURE BY TERMINAL MANUFACTURER.

4. AUTOMATIC TEMPERATURE CONTROLS CONTRACTOR SHALL FURNISH AND INSTALL ALL VAV BOX CONTROLS

5. AUTOMATIC TEMPERATURE CONTROLS CONTRACTOR SHALL FURNISH AND INSTALL DISCONNECT SWITCH AND TRANSFORMER FOR EACH BOX, BOX SHALL BE U.L. LISTED AND LABELED.

6. MAXIMUM RADIATED NC< 30, MAXIMUM DISCHARGE NC< 28.

7. BOXES SHALL HAVE 1" ACOUSTIC LINING.

### VENTILATION AIR SCHEDULE

HVAC UNIT	FLOOR	ROOM NUMBER	ROOM NAME	GROSS AREA (SQ.FT.)	NO. OF OCCU- PANTS PER 1000 SQ.FT. [4]	NO. OF OCCU- PANTS [4]	MIN. CODE OUTDOOR AIR REQUIRMENT (BASED ON CFM PER PERSON) [2]	MIN CODE OUTDOOR AIR REQUIRMENT (BASED ON SQ.FT.) [3]	DESIGN SUPPLY AIR (CFM)	DESIGN OUTDOOR AIR (CFM)
AHU-2	SECOND	201	LIBRARY	2050	10	21	105	250	2850	355
AHU-2	SECOND	201A	DESIGN COLLAB	830	35	30	300	100	800	400
AHU-2	SECOND	201B	COLLAB	145	50	8	40	10	100	50
AHU-2	SECOND	202	COLLAB	125	50	7	35	10	100	45
AHU-2	SECOND	202A	WORKROOM	570	35	20	200	70	850	270
AHU-2	SECOND	202B	COLLAB	130	50	7	35	10	150	45
AHU-2	THIRD	301	PRODUCTION LAB	605	35	22	220	75	600	295
AHU-2	THIRD	302	PRODUCTION CLASSROOM	585	35	21	210	70	600	280

#### MINIMUM CODE REQUIREMENTS:

1.) THE VENTILATION AIR SCHEDULE ABOVE MEETS OR EXCEEDS THE REQUIREMENTS FOR ALL SPACES BASED ON THE MECHANICAL CODE OF THE STATE OF NEW YORK, TABLE 403.3.

2.) THE MINIMUM OUTDOOR AIR REQUIREMENT PER PERSON:

AUDITORIUM = 15 CFM PER PERSON CAFETERIA = 20 CFM PER PERSON

CLASSROOMS = 15 CFM PER PERSON

CONFERENCE ROOMS = 20 CFM PER PERSON

GYMNASIUM = 20 CFM PER PERSON LIBRARY = 20 CFM PER PERSON

NURSING ROOM = 25 CFM PER PERSON

MUSIC CLASSROOM = 15 CFM PER PERSON

OFFICE SPACES = 20 CFM PER PERSON

RECEPTION AREA = 15 CFM PER PERSON

SCIENCE CLASSROOMS = 20 CFM PER PERSON

STAGE = 15 CFM PER PERSON THEATER LOBBY = 20 CFM PER PERSON

TOILET ROOMS = 75 CFM PER WATER CLOSET OR URINAL

3.) THE MINIMUM OUTDOOR AIR REQUIREMENT PER/SF:

CORRIDORS = 0.1 CFM PER/SF

LOCKER ROOMS = 0.50 CFM PER/SF

STORAGE = 0.15 CFM PER/SF

4.) THE NUMBER OF OCCUPANTS IS BASED ON THE LOCAL SCHOOL DISTRICT ALLOWABLE CLASS SIZE, OR THE NUMBER OF PEOPLE PER SQ.FT. AS PER THE NY STATE MECHANICAL CODE, TABLE 403.3.

5.) IN ROOMS WITH A PEAK OCCUPANCY OF LESS THAN THREE HOURS DURATION, THE OUTDOOR AIR VENTILATION RATE IS DETERMINED ON THE BASIS OF AVERAGE OCCUPANCY OVER THE DURATION OF THE OPERATION OF THE SYSTEM, OR NO LESS THAN FIFTY PERCENT OF MAXIMUM OCCUPANCY, WHICHEVER IS GREATER, AS PER ASHRAE 62, SECTION 6.1.3.4.

6.) THE SAMPLE CALCULATION BELOW IS FOR THE JUNIOR AUDITORIUM:

No. OF OCCUPANTS = 111

AVERAGE OCCUPANCY = 56 [NOTE 5]

OUTDOOR AIR REQUIREMENT = 15 CFM PER OCCUPANT

MIN CODE OUTDOOR AIR REQUIREMENT = 56 x 15 = 840 CFM

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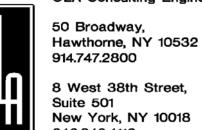
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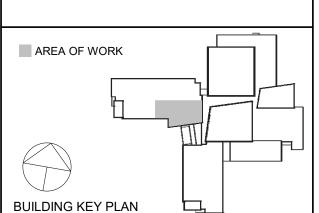


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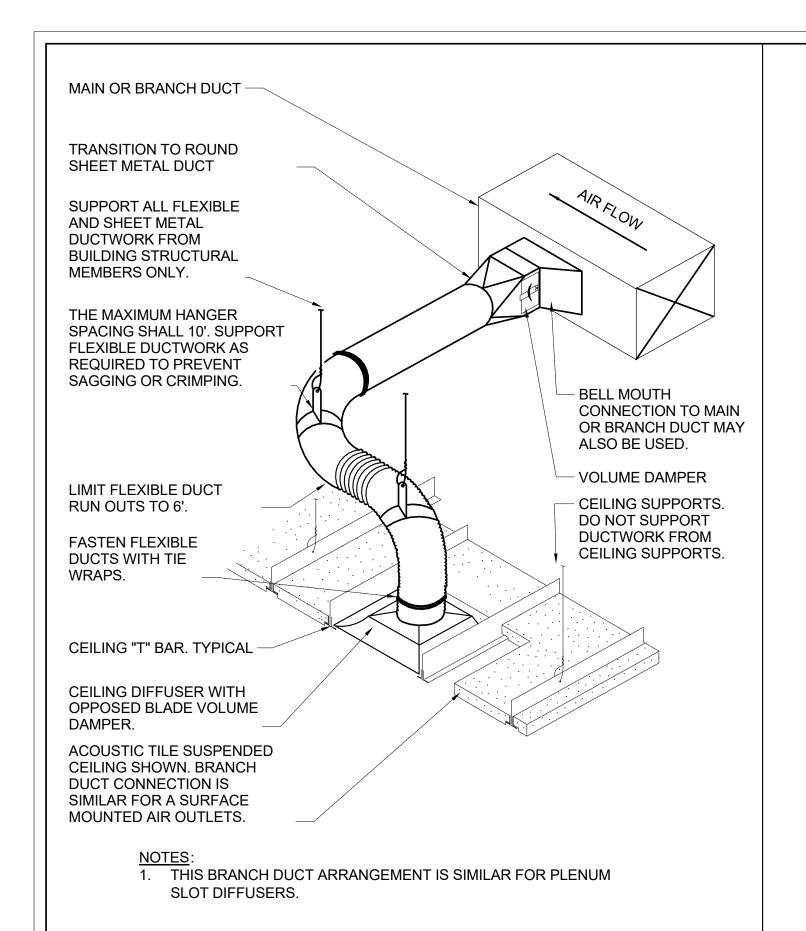
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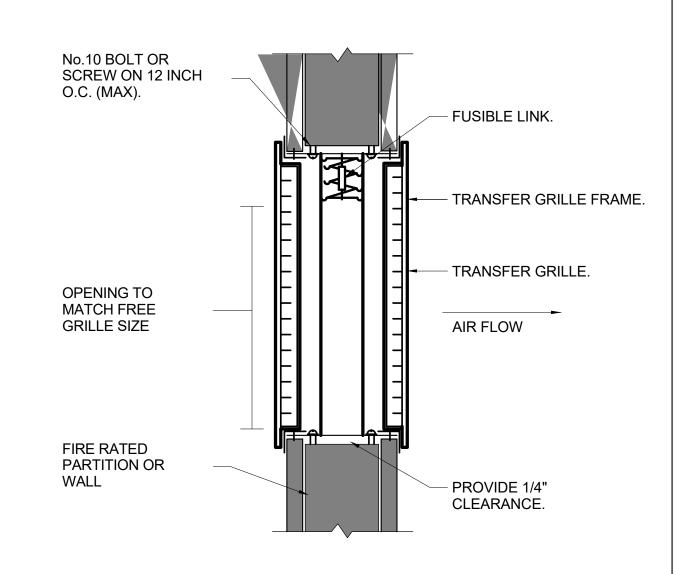
4	01/18/2023	REISSUE FOR BID
3	11/02/2022	ISSUE FOR BID
2	06/16/2022	NYSED ADDENDUM #1
1	05/25/2022	CONSTRUCTION DOCUMENTS

No. Date Sheet Title

### MECHANICAL SCHEDULES

Job No.	Date
NKGD0245.00	07/09/15
Scale	Drawn / Checked
AS NOTED	Author Checker






1. FIRE DAMPERS TO BE CONSTRUCTED AND INSTALLED ACCORDING TO NFPA 90A UL LABELS.

- 2. MULTI-BLADE PIVOTED FIRE DAMPERS MEETING THE ABOVE STANDARD WILL BE ACCEPTABLE.
- 3. FIRE DAMPERS SHALL CONFORM TO N.Y.C. MANUFACTURING B.S. AND A. NUMBER 100-65 SM.

# TRANSFER AIR FIRE DAMPER DETAIL

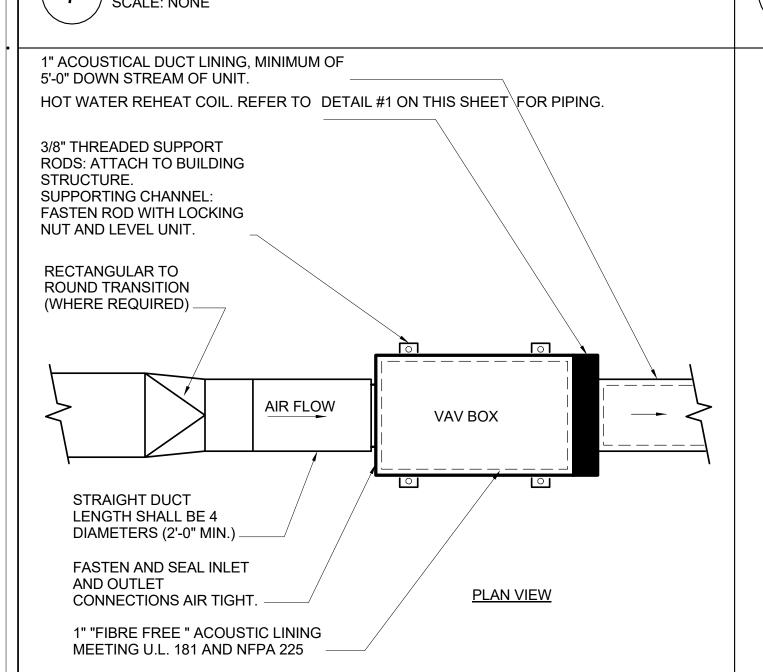


FLEXIBLE DUCT CONNECTION DETAIL

#### 1.) THE OPERATION OF VARIABLE VOLUME TERMINAL UNITS ARE AFFECTED BY EXCESSIVE TURBULENCE ON THE ENTERING SIDE OF EACH TERMINAL UNIT. THEREFORE, TERMINAL UNITS MUST NOT BE INSTALLED TO CLOSE TO MAIN DUCTS, **ELBOWS AND FITTINGS.**

- 2.) WHEN MINIMUM UPSTREAM STRAIGHT DUCT CONNECTION TO TERMINALS AS INDICATED ABOVE CANNOT BE MAINTAINED, PROVIDE ORIFICE PLATE, STRAIGHTENING VANES OR OTHER DEVICE AS RECOMMENDED BY TERMINAL UNIT MANUFACTURER AND SUBMIT TO ENGINEER FOR REVIEW PRIOR TO INSTALLATION.
- 3.) TERMINAL UNITS SHALL BE PROVIDED WITH CONTROLS ON LEFT OR RIGHT SIDE AS REQUIRED BY FIELD CONDITIONS. FOR UNITS WITH ELECTRONIC CONTROLS FURNISH NEMA 1 RATED ENCLOSURE AND U.L. II TRANSFORMER AND DISCONNECT SWITCH.
- 4.) ARRANGE ACCESS TO PERMIT EASY FIELD BALANCING AND MAINTENANCE. 5.) COORDINATE THE LOCATION, SIZE, AND QUANTITY OF REQUIRED ACCESS DOORS. INDICATE REQUIREMENT IN SHEET-METAL SHOP DRAWING SUBMITTAL FOR COORDINATION WITH G.C.
- 6.) ALL ANCHORS AND INSERTS SHALL HAVE NEW YORK CITY BOARD OF STANDARDS AND APPEALS (BSA) APPROVAL


#### VARIABLE AIR VOLUME (VAV) **BOX INSTALLATION DETAIL** SCALE: NONE

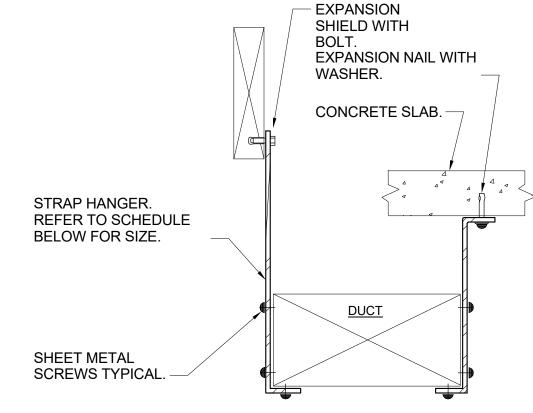

- 1. FOR DUCTS OVER 49" WIDE, THE STRAP HANGER SHALL BE TURNED UNDER THE BOTTOM OF THE DUCT. 2. WHERE EXISTING BUILDING STRUCTURAL COMPONENTS HAVE
- FIREPROOF MATERIAL, ANY AREA THAT IS DISTURBED OR DAMAGED AS A RESULT OF HANGER INSTALLATION SHALL BE PATCHED WITH UL AND FM APPROVED FIREPROOFING TO MATCH
- 3. ALL ANCHORS AND INSERTS SHALL HAVE NEW YORK CITY BOARD OF STANDARD AND APPEALS, (BSA) APPROVAL.

HANGER STRAP SCHEDULE						
DUCT SIZE	HANGER SIZE	MAXIMUM SPACING				
UP TO 2 SQ. FT.	1" x 1/ <sub>16</sub> "	8'-0"				
2 SQ. FT. TO 4 SQ. FT.	1" x 1/8"	8'-0"				
4 SQ. FT. TO 10 SQ. FT.	1" x 1/8"	6'-0"				
OVER 10 SQ. FT.	1" x 1/8"	4'-0"				


## **DUCT HANGER DETAIL**

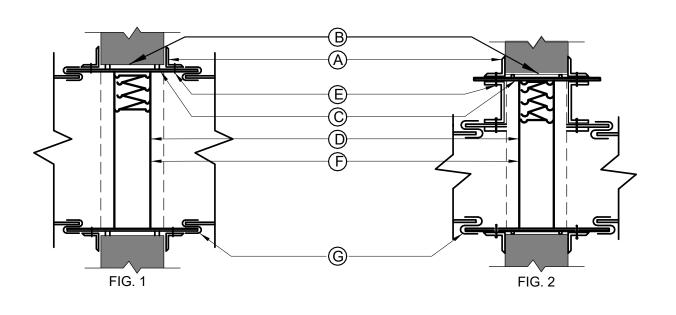

- 1. RETAINING ANGLES SHALL BE A MINIMUM 1-1/2"x1-1/2"x16 GAUGE AND
- MUST OVERLAP THE STRUCTURAL OPENING BY A MINIMUM OF 1". CLEARANCE BETWEEN SLEEVE AND OPENING SHALL BE 1/8" PER LINEAR FOOT, AS PER SMACNA FIG. 2-1.
- 3. STEEL SLEEVE SHALL BE AS PER SMACNA TABLE 2-2.
- U.L. APPROVED FIRE DAMPER. SECURE RETAINING ANGLES TO SLEEVE ONLY AT 8" CENTERS AS PER
- SMACNA FIG. 2-1. SECURE DAMPER TO SLEEVE AT 8" CENTERS AS PER SMACNA FIG. 2-1.
- CONNECT DUCT TO SLEEVE WITH BREAK-AWAY CONNECTION AS PER SMACNA FIG. 2-2.
- 8. FIRE DAMPERS TO BE CONSTRUCTED AND INSTALLED ACCORDING TO NFPA 90A, UL LABELS AND THE LATEST ISSUE OF S.M.A.C.N.A. CHAPTER 2.
- CURTAIN TYPE FIRE DAMPERS SHOWN, MULTI-BLADE PIVOTED FIRE
- DAMPERS MEETING THE ABOVE STANDARD WILL BE ACCEPTABLE. 10. PROVIDE ACCESS DOORS. INSTALL (1) AD FOR EACH FIRE DAMPER AS
- PER SMACNA FIG. 6-1. 11. FOR DUCT 12" OR LESS IN DEPTH, FIRE DAMPER SHALL BE OUT OF THE
- AIR STREAM. REFER TO FIGURE 2.

## 12. FIRE DAMPERS SHALL CONFORM TO N.Y.C. MANUFACTURING B.S. AND A.


## SHUTTER TYPE FIRE DAMPER AND SLEEVE DETAIL

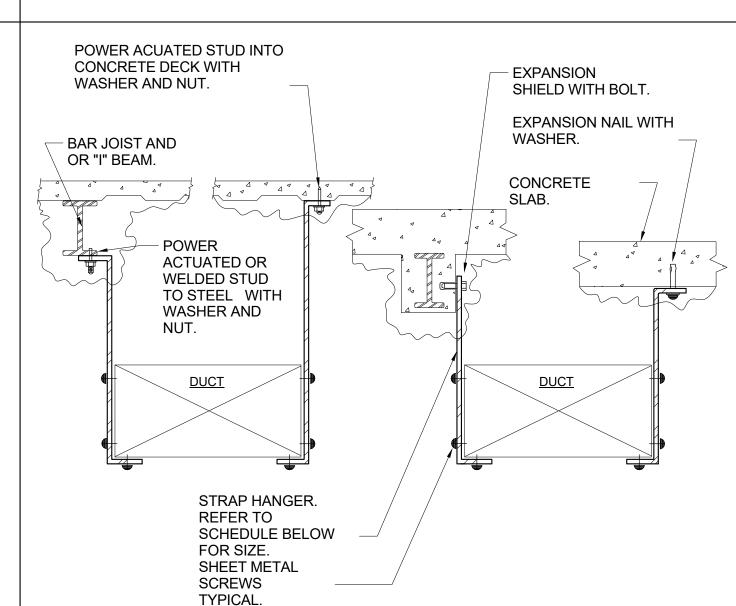


- 1. FOR DUCTS OVER 49" WIDE, THE STRAP HANGER SHALL BE TURNED UNDER THE BOTTOM OF THE DUCT.
- WHERE EXISTING BUILDING STRUCTURAL COMPONENTS HAVE FIREPROOF MATERIAL, ANY AREA THAT IS DISTURBED OR DAMAGED AS A RESULT OF HANGER INSTALLATION SHALL BE PATCHED WITH UL AND FM APPROVED FIREPROOFING TO MATCH
- 3. ALL ANCHORS AND INSERTS SHALL HAVE NEW YORK CITY BOARD OF STANDARD AND APPEALS, (BSA) APPROVAL

HANGER STRAP SCHEDULE						
DUCT SIZE	HANGER SIZE	MAXIMUM SPACING				
UP TO 2 SQ. FT.	1" x 1/ <sub>16</sub> "	8'-0"				
2 SQ. FT. TO 4 SQ. FT.	1" x 1/8"	8'-0"				
4 SQ. FT. TO 10 SQ. FT.	1" x 1/8"	6'-0"				
OVER 10 SQ. FT.	1" x 1/ <sub>8</sub> "	4'-0"				

## **DUCT HANGER DETAIL**

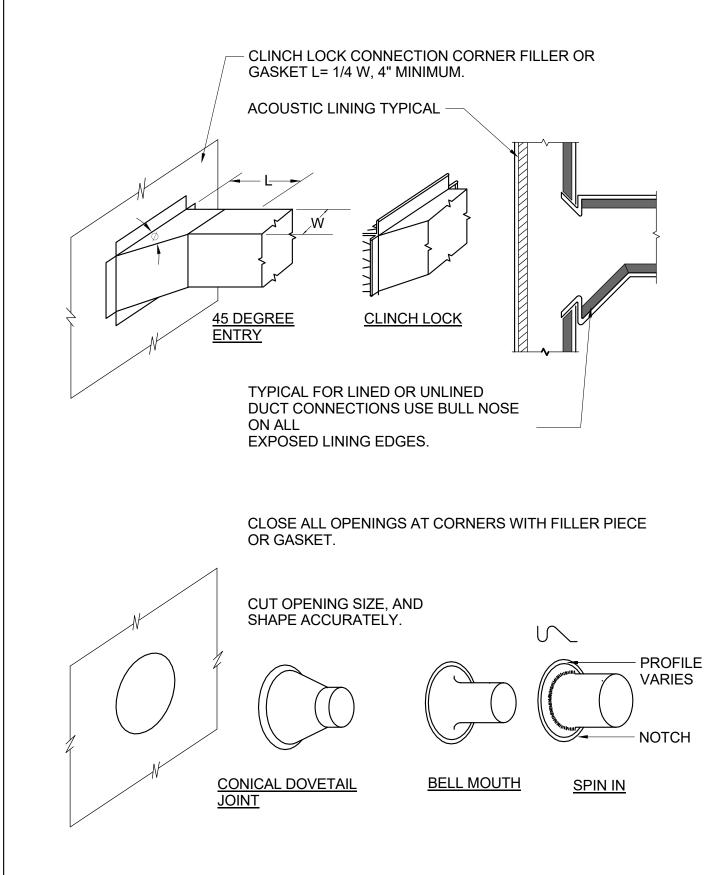

# **DUCT BRANCH CONNECTION DETAIL**

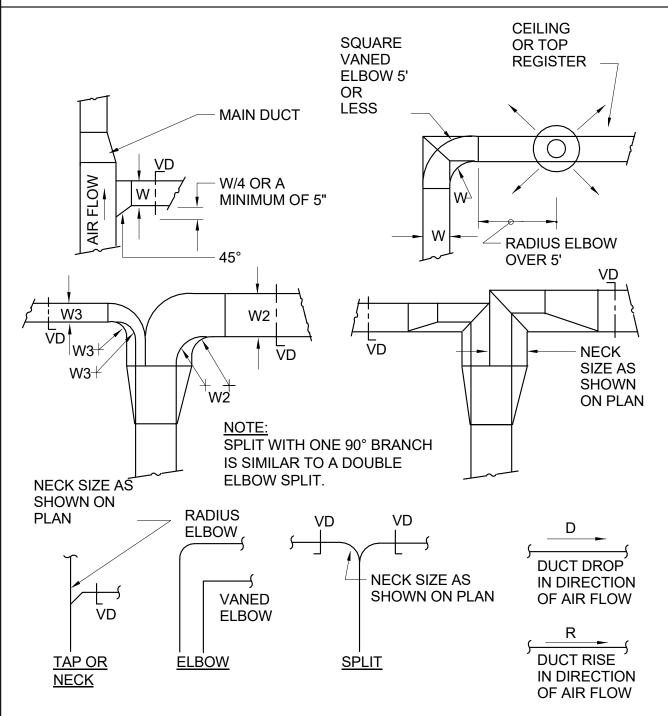

- SINGLE LINE REPRESENTATIONS REFER TO DOUBLE LINE DETAILS. 2. USE RADIUS OR SQUARE VANED BENDS FOR BOTH ELBOWS AND SPLITS AS DETERMINED BY SPACE LIMITATIONS, AND THE DISTANCE FROM AIR
- ALL SQUARE ELBOWS SHALL HAVE FACTORY TURNING VANES, AND MAINTAIN A CONSTANT WIDTH.
- 4. WHERE DUCTS SPLIT, THE SOLID LINE REPRESENTATION IS PREFERRED, UNLESS PRECLUDED BY SPACE, OR OTHERWISE INDICATED.
- 5. USE ELBOW SPLIT FOR BRANCH CONNECTIONS ONLY WHERE NECK SIZE IS GIVEN.

## **DUCT BRANCH TAKE-OFF DETAIL**

### CHESTER ACADEMY STEM LAB **ALTERATIONS**

CHESTER UNION FREE SCHOOL DISCTRICT

64 HAMBLETONIAN AVENUE CHESTER, NY 10918



285 MAIN STREET MOUNT KISCO . NEW YORK . 10549 P:914.666.5900 KGDARCHITECTS.COM

44-02-01-02-0-009-006


NY SED PROJECT CONTROL NO.

#### CONSTRUCTION **DOCUMENTS**



50 Broadway, Hawthorne, NY 10532

8 West 38th Street New York, NY 10018 646.849.4110

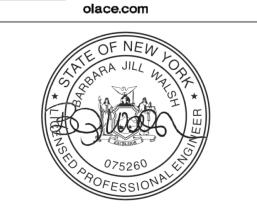

AREA OF WORK BUILDING KEY PLAN

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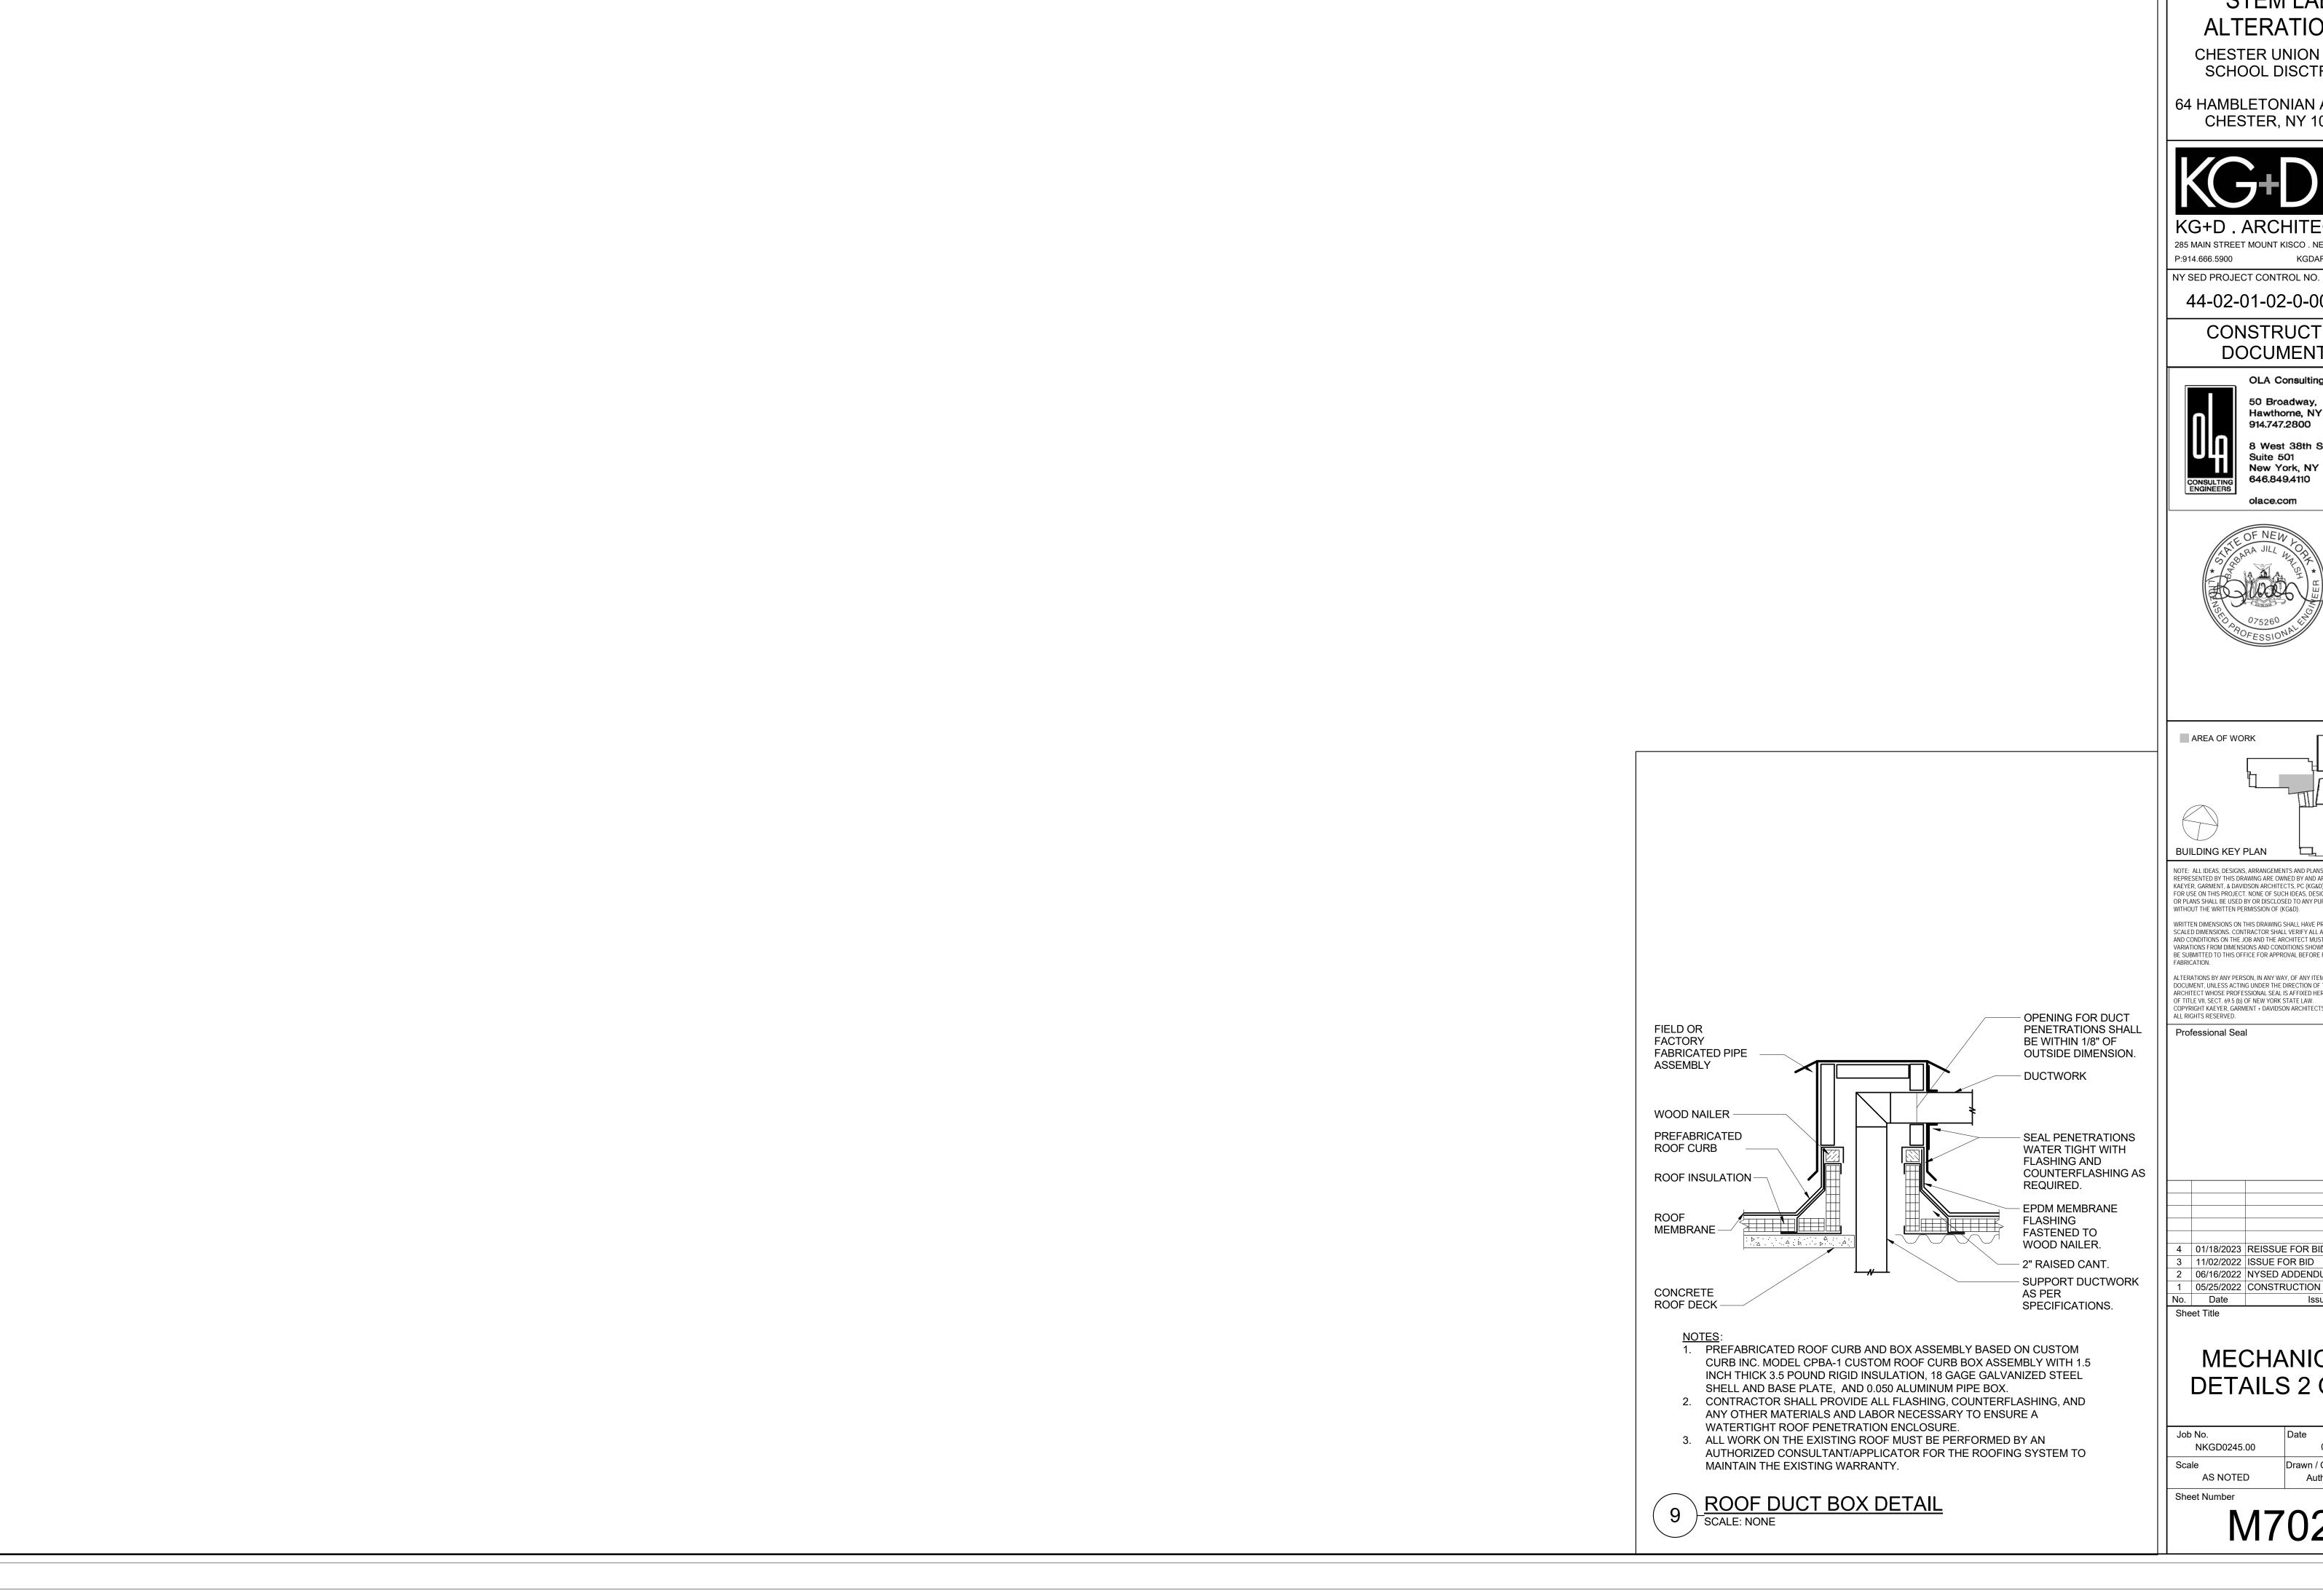
3 11/02/2022 ISSUE FOR BID 2 06/16/2022 NYSED ADDENDUM #1 05/25/2022 CONSTRUCTION DOCUMENTS No. Date Issue

Sheet Title

**MECHANICAL** DETAILS 1 OF 2

Job No. NKGD0245.00 05/25/2022 Scale Drawn / Checked AS NOTED **Author Checker** 

Sheet Number



CHESTER UNION FREE SCHOOL DISCTRICT

64 HAMBLETONIAN AVENUE CHESTER, NY 10918



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44-02-01-02-0-009-006

CONSTRUCTION


## DOCUMENTS

OLA Consulting Engineers 50 Broadway, Hawthorne, NY 10532

914.747.2800 Suite 501 New York, NY 10018

646.849.4110



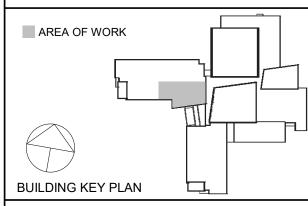

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4 01/18/2023 REISSUE FOR BID 3 11/02/2022 ISSUE FOR BID 2 06/16/2022 NYSED ADDENDUM #1

1 05/25/2022 CONSTRUCTION DOCUMENTS

MECHANICAL DETAILS 2 OF 2

Issue

NKGD0245.00

07/09/15 Drawn / Checked AS NOTED Author Checker

SYMBOLS A	AND ABB	REVIATIONS					
SYMBOL		N DESCRIPTION	SYMBOL	ABBREVIATION	DESCRIPTION	SYMBOL	ABBREVIATION DESCRIPTION
	-		0	-	PUSHBUTTON	01111502	
		CONDUIT AND WIRING					
	-	CONDUIT & WIRING TO BE REMOVED UON	HD	-	ELECTRIC HAND DRYER		NIC NOT IN CONTRACT
	-	HOMERUN TO PANEL, ARROWS INDICATE # 1P	EPO	EPO	EMERGENCY POWER OFF SWITCH		NTS NOT TO SCALE
4	-	MULTI-POLE HOMERUN	<u></u>	СВ	CIRCUIT BREAKER		P POLE
	-	ELECTRICAL EQUIPMENT AS INDICATED	<u></u>	-	ENCLOSED CIRCUIT BREAKER		PBO PROVIDED BY OTHERS
I <u></u> I	-	ELECTRICAL EQUIPMENT TO BE REMOVED UON	200AS	-	FUSED SWITCH		PNL PANEL
M	-	ELECTRIC METER	G	GEN	GENERATOR		PVC POLY VINYL CHLORIDE
J	-	JUNCTION BOX	4	-	GENERATOR RECEPTACLE		REL. REMOVE AND RELOCATE
	-	FUSED DISCONNECT SWITCH	OR	GND	GROUND AS PER LOCAL CODE		RGS RIGID GALVANIZED STEEL
	-	UNFUSED DISCONNECT SWITCH	OR ①	-	GROUND ROD		RTU ROOF TOP UNIT
	-	COMBINATION MOTOR STARTER/FUSED DISC.	No of	-	TRANSFER SWITCH		SCH SCHEDULE
	-	MOTOR STARTER	www OR T	XFMR	TRANSFORMER		SPD SURGE PROTECTION DEVICE
	_						
	_	MOTOR		CT	CURRENT TRANSFORMER		SW SWITCH(ES)
4	-	BATTERY WALL PACK EMERGENCY LIGHT FIXTURE	M——	MD	MOTORIZED DAMPER		TELCO TELEPHONE COMPANY
	-	EXIT LIGHT, FACES-SHADED, CHEVRON-ARROW	— — —	SD OR CFSD	SMOKE DAMPER		TYP TYPICAL
S <sub>x</sub>	-	SINGLE POLE SWITCH (x - INDICATES FIXTURE BEING CONTROLLED)		UH	UNIT HEATER		UG UNDERGROUND
				VAV	VARIABLE AIR VOLUME BOX		UON UNLESS OTHERWISE NOTED
$S_x^3$	-	THREE WAY SWITCH (x - INDICATES FIXTURE BEING CONTROLLED)		A	AMPERE(S)		VIF VERIFY IN FIELD
		(x - INDICATES FIXTURE BEING CONTROLLED)		AC	AIR CONDITIONER		V VOLT(S)
S <sub>x</sub> <sup>L</sup>	-	ACUITY nLIGHT WALLPOD LOW VOLTAGE SWITCH		ACC	AIR CONDITIONER CONDENSER		VSD VARIABLE SPEED DRIVE
,		WITH DIMMING: nPODMA DX WH (x - INDICATES FIXTURES BEING CONTROLLED)		AFF	ABOVE FINISHED FLOOR		WG WIRE GUARD
S <sub>M</sub>	-	MOTOR RATED TOGGLE SWITCH		AF	AMPERAGE OF FUSE		WH WATER HEATER
	-	WALL MOUNTED OCCUPANCY SENSOR		AGL	ABOVE GRADE LEVEL		WP WEATHERPROOF
<u> </u>	-	ACUITY nLIGHT OCCUPANCY SENSOR CEILING MTD		AHU	AIR HANDLING UNIT	NOTES:	WEXTILITY ROOT
U D	-						BBREVIATIONS MAY NOT BE APPLICABLE FOR THIS PROJECT. RE SCHEDULE FOR LIGHT FIXTURE SYMBOLS.
GFI		DUPLEX RECEPTACLE (U - INDICATES DUPLEX OUTLET WITH USB TYPE C		AL	ALUMINIUM		
		PORTS. GFI - INDICATES GROUND FAULT INTERRUPTER)		ARC	ARC FAULT INTERRUPTER	TYPICAL BRA	NCH CIRCUIT WIRING LEGEND
				AS	AMPERAGE OF SWITCH	2-#12 & 1-#12	GND (1-1P-20A OR 1-1P-15A CB)
<del></del>	-	DOUBLE DUPLEX RECEPTACLE		ATS	AUTOMATIC TRANSFER SWITCH	<del>&gt;</del> 3-#12 & 1-#12	GND (3P-20A OR 3P-15A CB)
$\ominus$	-	SPECIAL RECEPTACLE		AWG	AMERICAN WIRE GAUGE	———⇒ 2-#12 & 1-#12	GND (2P-20A OR 2P-15A CB)
igwedge	-	COMBINATION TELEPHONE/DATA OUTLET		BCW	BARE COPPER WIRE	CIRCUIT #	LIGHT FIXTURE TYPE SWITCH CONTROL
⊕ OR      ⊕ FLR	-	FLOOR MOUNTED DEVICE AS INDICATED ON PLANS		BLDG	BUILDING	RECEPTAC	
•	-	COMBINATION DATA & TV OUTLET		С	CONDUIT	NOTES:	CIRCUIT #
$\Diamond$	-	TV OUTLET		CD	CANDELA		77V CIRCUIT SHALL HAVE A DEDICATED NEUTRAL CONDUCTOR.
F	-	FIRE ALARM MANUAL PULL STATION		СКТ	CIRCUIT		HOMERUNS ARE NOT PERMITTED.  LL BE INCREASED FOR VOLTAGE DROP AND DERATING AS PER
<b>E</b> KI	-	FIRE ALARM COMBINATION SPEAKER/VISUAL		CLG	CEILING	APPLICABLE ELECT	RICAL CODE. FOR CIRCUITS THAT ARE BETWEEN 100' AND 150' IN
		DEVICE (15/75 CD - STROBE)		COL	COLUMN	ARE BETWEEN 150'	D NEUTRAL CONDUCTORS SHALL BE #10 AWG. FOR CIRCUITS THAT AND 225' IN LENGTH, PHASE AND NEUTRAL CONDUCTORS SHALL BE
(E)	-	FIRE ALARM CEILING MOUNTED SPEAKER		CU	COPPER	#8 AWG. FOR LEN WITH ENGINEER.	GTHS GREATER THAN 225' IN LENGTH, VERIFY CONDUCTOR SIZES
	_						
S EL; SH; SC		SMOKE DETECTOR. EL - ELEVATOR LOBBY; SH - SMOKE HATCH; SC - PLENUM RATED ABOVE		CUH	CABINET UNIT HEATER		
(-)		CEILING		DEM.	DEMOLISH AND REMOVE	_	
S AC	-	DUCT MOUNTED SMOKE DETECTOR		DISC	DISCONNECT		
H	-	HEAT DETECTOR		DIM	DIMMER		
©	-	CARBON MONOXIDE DETECTOR		DWG	DRAWING		
Ê	-	FIRE ALARM BELL		ELEV	ELEVATOR		
TS	-	FIRE ALARM TAMPER SWITCH		EMT	ELECTRICAL METALLIC TUBING		
WF	-	FIRE ALARM WATER FLOW SWITCH		EM	EMERGENCY		
DR	-	FIRE ALARM DOOR RELEASE		EX.	EXISTING TO REMAIN		
ANN	-	FIRE ALARM ANNUNCIATOR PANEL		F	FLOOR		
CM	CM	FIRE ALARM CONTROL MODULE		FBO	FURNISHED BY OTHERS		
MM	MM	FIRE ALARM MONITORING MODULE		GEN	GENERATOR		
FACP	FACP	FIRE ALARM CONTROL PANEL		GFI	GROUND FAULT INTERRUPTER		
BPS	BPS	BOOSTER POWER SUPPLY		HP	HORSEPOWER		
DGP	DGP	DATA GATHERING PANEL		HVAC	HEATING VENTILATION AIR CONDITIONING		
FSS	FSS	FIRE SUPPRESSION SYSTEM PANEL		IG	ISOLATED GROUND		
R	-	FIRE ALARM RELAY		IMC	INTERMEDIATE METAL CONDUIT		
<b>-</b>	EOL	END OF LINE RESISTOR		KVA	KILO-VOLT-AMPERE		
PA	-	WALL MOUNTED PUBLIC ADDRESS SPEAKER		KW	KILO-WATT		
+ PH	-	PUBLIC ADDRESS TELEPHONE		MAX	MAXIMUM		
(SP)	-	CEILING MOUNTED PUBLIC ADDRESS SPEAKER		MCB	MAIN CIRCUIT BREAKER		
Q B	-	PUBLIC ADDRESS BELL		MIN	MINIMUM		

#### GENERAL NOTES

- 1. ALL WORK SHOWN IS NEW UNLESS OTHERWISE NOTED (UON) EXISTING TO REMAIN (EX.).
- 2. THE DRAWINGS ARE TO BE CONSIDERED SCHEMATIC ONLY AND DO NOT NECESSARILY
- SHOW THE EXACT LOCATIONS AND DETAILS OF THE WORK TO BE INSTALLED. 3. THE ELECTRICAL CONTRACTOR SHALL BE RESPONSIBLE FOR OBTAINING ALL NECESSARY PERMITS AND PAYING ALL FEES ASSOCIATED WITH THIS WORK INCLUDING FILING WITH THE
- UTILITY COMPANY (AS REQUIRED), AND WITH LOCAL AUTHORITY HAVING JURISDICTION. 4. ELECTRICAL CONTRACTOR SHALL BE RESPONSIBLE TO HIRE A THIRD PARTY ELECTRICAL INSPECTION AGENCY TO PROVIDE UL INSPECTIONS AND SUBMIT A CERTIFICATE OF
- 5. ALL WORK SHALL COMPLY WITH 2020 NEW YORK STATE BUILDING CODE, 2020 NEW YORK STATE ENERGY CONSERVATION CONSTRUCTION CODE AND 2017 NATIONAL ELECTRICAL CODE. IN CASE OF CONFLICT BETWEEN THE CONTRACT DOCUMENTS AND A GOVERNING CODE OR ORDINANCE, THE MORE STRINGENT STANDARD SHALL APPLY.
- 6. ALL CONDUCTORS SHALL BE COPPER UON "ON DRAWINGS"

INSPECTION PRIOR TO FINAL REQUEST FOR PAYMENT.

- 7. ELECTRONIC FILES OF THE ELECTRICAL DRAWINGS ARE AVAILABLE TO THE CONTRACTOR. THE ENGINEER MAY GRANT THE CONTRACTOR A LIMITED LICENSE TO MAKE A DERIVATIVE WORK OF THE DATABASE FOR THE PURPOSE OF SHOP DRAWINGS, SUBMITTALS AND AS-BUILT DRAWINGS. UPON REQUEST, THE ENGINEER SHALL PROVIDE A RELEASE FORM THAT MUST BE SIGNED AND RETURNED BY THE CONTRACTOR PRIOR TO RELEASE OF THE NY SED PROJECT CONTROL NO. ELECTRONIC FILES.
- 8. CIRCUIT NUMBERS ARE FOR INFORMATION PURPOSES ONLY. ACTUAL CIRCUIT NUMBERS SHALL BE DETERMINED IN THE FIELD.
- CORE DRILLING OR TRENCHING THROUGH AN EXISTING FLOOR SLAB, WHEN REQUIRED, SHALL BE COORDINATED WITH THE OWNER. FLOOR SLABS SHALL BE RADAR SCANNED PRIOR TO CORE DRILLING OR TRENCHING. ALL WORK. INCLUDING CORE DRILLING. RADAR SCAN, INSTALLATION OF FIRE STOPPING, & CONDUIT/CABLE INSTALLATION SHALL BE PERFORMED DURING NON-BUSINESS HOURS AND INCLUDED IN BASE BID. USE EXTREME CAUTION DURING ANY CUTTING OPERATION TO AVOID DAMAGE TO EXISTING EQUIPMENT/SYSTEMS. ANY ITEMS DAMAGED AS A RESULT OF CORE DRILLING SHALL BE REPAIRED AT NO COST TO THE CLIENT. ALL CORES SHALL BE FIRE SEALED.
- 10. WHERE GFI RECEPTACLES ARE CIRCUITED WITH GENERAL CONVENIENCE RECEPTACLES, THE GFI RECEPTACLE SHALL BE THE LAST DEVICE ON THE CIRCUIT.
- 11. INSTALL CONDUIT EXPANSION FITTINGS AT ALL LOCATIONS WHERE CONDUITS CROSS BUILDING OR STRUCTURE EXPANSION JOINTS.
- 12. UNLESS OTHERWISE NOTED, DISCONNECT SWITCHES, STARTERS, HOAS AND MOTOR RATED TOGGLE SWITCHES FOR MECHANICAL PUMPS, CABINET AND UNIT HEATERS, RETURN FANS, ROOF FANS, VAV BOXES, COMPRESSORS, FAN COIL UNITS, AIR HANDLERS AND CONDENSERS SHALL BE FURNISHED BY THE MECHANICAL CONTRACTOR AND INSTALLED BY THE ELECTRICAL CONTRACTOR. COORDINATE ALL WORK WITH THE MECHANICAL CONTRACTOR.
- 13. DISCONNECT SWITCHES FOR MOTORIZED DAMPERS, CFSD/SD AND VAV BOXES SUPPLIED BY MECHANICAL CONTRACTOR AND INSTALLED AND WIRED BY ELECTRICAL CONTRACTOR. SWITCHES NOT SHOWN ON PLANS.
- 14. EACH DUPLEX AND QUAD RECEPTACLE SHALL BE LABELED WITH THE CIRCUIT NUMBER WHICH IT SERVES. ALPHANUMERICS TO BE 1/8" HIGH AND BLACK ON CLEAR BACKGROUND. LABELS SHALL BE SELF ADHESIVE. IDENTIFY ASSOCIATED PANEL AND CIRCUIT NUMBER.
- 15. THE ELECTRICAL CONTRACTOR SHALL PROVIDE ALL CUTTING, PATCHING, PAINTING, AND FINAL RESTORATION REQUIRED TO FACILITATE THE DEMOLITION AND INSTALLATION OF ALL ELECTRICAL EQUIPMENT, INCLUDING BUT NOT LIMITED TO PANELBOARDS, CONDUITS, WIRING, DEVICES, FIXTURES, ETC. INCLUDING ABOVE CEILINGS. CONTRACTOR TO REMOVE AND REPLACE CEILINGS, AND OPEN AND PATCH WALLS, AS REQUIRED TO EXECUTE THE ELECTRICAL WORK.

### DEFINITION OF TERMS

- WHEREVER IN THE CONTRACT DOCUMENTS THE WORD "CLIENT" IS USED, IT MUST BE UNDERSTOOD THAT "CHESTER SCHOOL DISTRICT" IS INTENDED.
- 2. WHEREVER IN THE CONTRACT DOCUMENTS THE WORD "ARCHITECT" IS USED, IT MUST BE UNDERSTOOD THAT "KG&D ARCHITECTS, PC" IS INTENDED.
- 3. WHEREVER IN THE CONTRACT DOCUMENTS THE WORD "ENGINEER" IS USED, IT MUST BE UNDERSTOOD THAT "OLA CONSULTING ENGINEERS" IS INTENDED.
- 4. "WORK" MUST BE DEEMED TO CONSIST OF ALL LABOR AND OPERATIONS, TRANSPORTATION, HOISTING, MATERIALS, TOOLS, EQUIPMENT, SERVICES, INSPECTIONS, INVESTIGATIONS, COORDINATION AND SUPERVISION REQUIRED AND / OR REASONABLY NECESSARY TO PRODUCE THE CONSTRUCTION REQUIRED BY THE CONTRACT DOCUMENTS.
- 5. "FURNISH" MEANS THE DESIGN, FABRICATION, PURCHASE AND DELIVERY TO THE JOB SITE.
- 6. "INSTALL OR INSTALLATION" MEANS THE ACT OF PHYSICALLY PLACING, APPLYING, SETTING, ERECTING, ANCHORING, SECURING, ETC., CONSTRUCTION MATERIALS, EQUIPMENT, FURNISHINGS, APPLIANCES, AND SIMILAR ITEMS SPECIFIED AND FURNISHED AT THE JOB SITE. INSTALLATION OF SPECIFIED ITEMS MUST BE COMPLETE IN ALL RESPECTS.
- "PROVIDE" MEANS TO FURNISH AND INSTALL CONSTRUCTION MATERIAL, EQUIPMENT, ETC. AS DEFINED ABOVE.
- 8. THE FOLLOWING ARE DEFINITIONS OF SHOP DRAWING STAMP ACTIONS:
- A. "NO EXCEPTIONS TAKEN" MEANS THAT THE SHOP DRAWING IS CORRECT AS TO PERFORMANCE, CAPACITY, ETC. AND SUBSTANTIAL CONFORMANCE TO THE CONTRACT DRAWINGS AND SPECIFICATIONS. FABRICATION AND/OR PURCHASE MAY COMMENCE.
- B. "MAKE CORRECTIONS NOTED" MEANS THAT THE SHOP DRAWING IS CORRECT AS TO PERFORMANCE, CAPACITY, ETC. AND SUBSTANTIAL CONFORMANCE TO THE CONTRACT DRAWINGS AND/OR SPECIFICATIONS, SUBJECT TO AND IN COMPLIANCE WITH THE ANNOTATIONS AND/OR CORRECTIONS INDICATED ON THE SHOP DRAWING. FABRICATION AND/OR PURCHASE MAY COMMENCE.
- C. "AMEND AND RESUBMIT" MEANS THAT THE COMMENTS AND/OR CORRECTION ARE SO EXTENSIVE AND IMPORTANT THAT THE REVIEWER WANTS TO SEE HOW THE COMMENTS AND/OR CORRECTIONS ARE RESOLVED PRIOR TO RELEASE FOR FABRICATION AND/OR PURCHASE. FABRICATIONS AND/OR PURCHASE MAY NOT COMMENCE.
- D. "REJECTED" MEANS THAT THE SHOP DRAWING DOES NOT COMPLY OR CONFORM TO THE CONTRACT DRAWINGS AND/OR SPECIFICATIONS. FABRICATION AND/OR PURCHASE MAY NOT COMMENCE.

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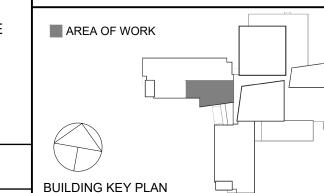
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### **ELECTRICAL SYMBOLS ABBREVIATIONS &** NOTES

Job No.	Date
KGD0245.00	05/18/2022
Scale	Drawn / Checked
NONE	JL / JF
Sheet Number	

E001

#### **DEMOLITION KEY NOTES**

- DEMOLISH ALL ELECTRICAL FIXTURES AND DEVICES IN THIS ROOM INCLUDING LIGHT FIXTURES, LIGHT SWITCHES, OCCUPANCY SENSORS, RECEPTACLES, DATA/TELEPHONE OUTLETS AND CABLE OUTLETS. MAINTAIN WIRING FOR NEW FIXTURES AND DEVICES AS REQUIRED. TRACE CIRCUITRY AS NEEDED TO VERIFY EXACT CIRCUIT NUMBER AND QUANTITY OF DEVICES ON EACH CIRCUIT. NO MORE THAN 6 RECEPTACLES SHALL BE ON A SINGLE 20-AMP BRANCH CIRCUIT. IDENTIFY AND TAG EACH NEW DEVICE WITH ASSOCIATED PANEL NAME AND CIRCUIT NUMBER PER SPECIFICATIONS. SEE E-301 FOR ADDITIONAL INFORMATION.
- REMOVE, STORE, AND REINSTALL FIRE-ALARM DEVICES AND PUBLIC ADDRESS DEVICES IN THIS ROOM, INCLUDING SMOKE DETECTOR(S), SPEAKER STROBE(S) AND PUBLIC ADDRESS SPEAKERS IN ORDER TO ACCOMMODATE DEMOLITION AND INSTALLATION OF CEILING AND WALLS. EXTEND AND/OR MODIFY WIRING AS NEEDED TO REINSTALL /4\DEVICES,\_\_\_
- 4 NOT USED.
- ALL EXISTING FIRE-ALARM DEVICES AND PUBLIC ADRESS SPEAKERS IN THIS ROOM/AREA SHALL REMAIN U.O.N..

#### **DEMOLITION NOTES**

- ALL EQUIPMENT SHALL BE DISCONNECTED AND ALL ASSOCIATED WIRE AND CONDUIT SHALL BE REMOVED BACK TO POWER SOURCE ORIGINATION UNLESS OTHERWISE NOTED (UON) EXISTING TO REMAIN (EX.).
- 2. CONTRACTOR SHALL VERIFY EXTENT OF DEMOLITION WORK IN THE FIELD PRIOR TO BID AND SHALL INCLUDE ALL LABOR AND MATERIALS IN BASE BID INCLUDING ALL TEMPORARY CONNECTIONS, CONDUIT AND WIRE IN ORDER TO ACCOMMODATE CONSTRUCTION AND PROVIDE CONTINUOUS SERVICE TO DEVICES AND SYSTEMS TO REMAIN, TEMPORARY AND PERMANENTLY.
- CIRCUIT BREAKER, CONDUIT AND CONDUCTOR SIZES INDICATED SHALL BE FIELD VERIFIED PRIOR TO BID.
- ALL EXISTING ELECTRICAL EQUIPMENT NO LONGER IN USE, SUCH AS DISCONNECT SWITCHES, MOTOR CONTROLLERS, ETC. SHALL BE REMOVED UON.
- ALL DISCONNECTED & REMOVED EXISTING ELECTRICAL ITEMS THAT ARE NOT BEING REUSED SHALL BE RETURNED TO THE OWNER OR DISPOSED OF AS
- THE CONTRACTOR SHALL INCLUDE IN THE BASE BID FOR ALL MATERIAL & LABOR REQUIRED FOR THE EXTENSIONS, REROUTING & RELOCATION OF EXISTING SYSTEM COMPONENTS, EQUIPMENT, WIRING, CONDUITS & CABLING SO AS TO MAINTAIN OPERATION OF ALL SYSTEMS THROUGHOUT THE BUILDING DURING DEMOLITION & CONSTRUCTION PHASES.
- REMOVE, STORE, AND REINSTALL CEILING TILES AND DEVICES AS NEEDED TO ACCOMMODATE ELECTRICAL WORK. REPLACE CEILING TILES WHICH BECOME DAMAGED DURING THE COURSE OF WORK.
- PATCH AND REPAIR ALL OPENINGS AFTER REMOVAL OF DEVICES AND EQUIPMENT. SEE NOTES ON DRAWING E001 FOR ADDITIONAL INFORMATION.

(9.9)

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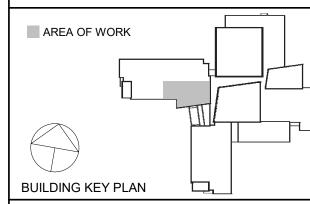
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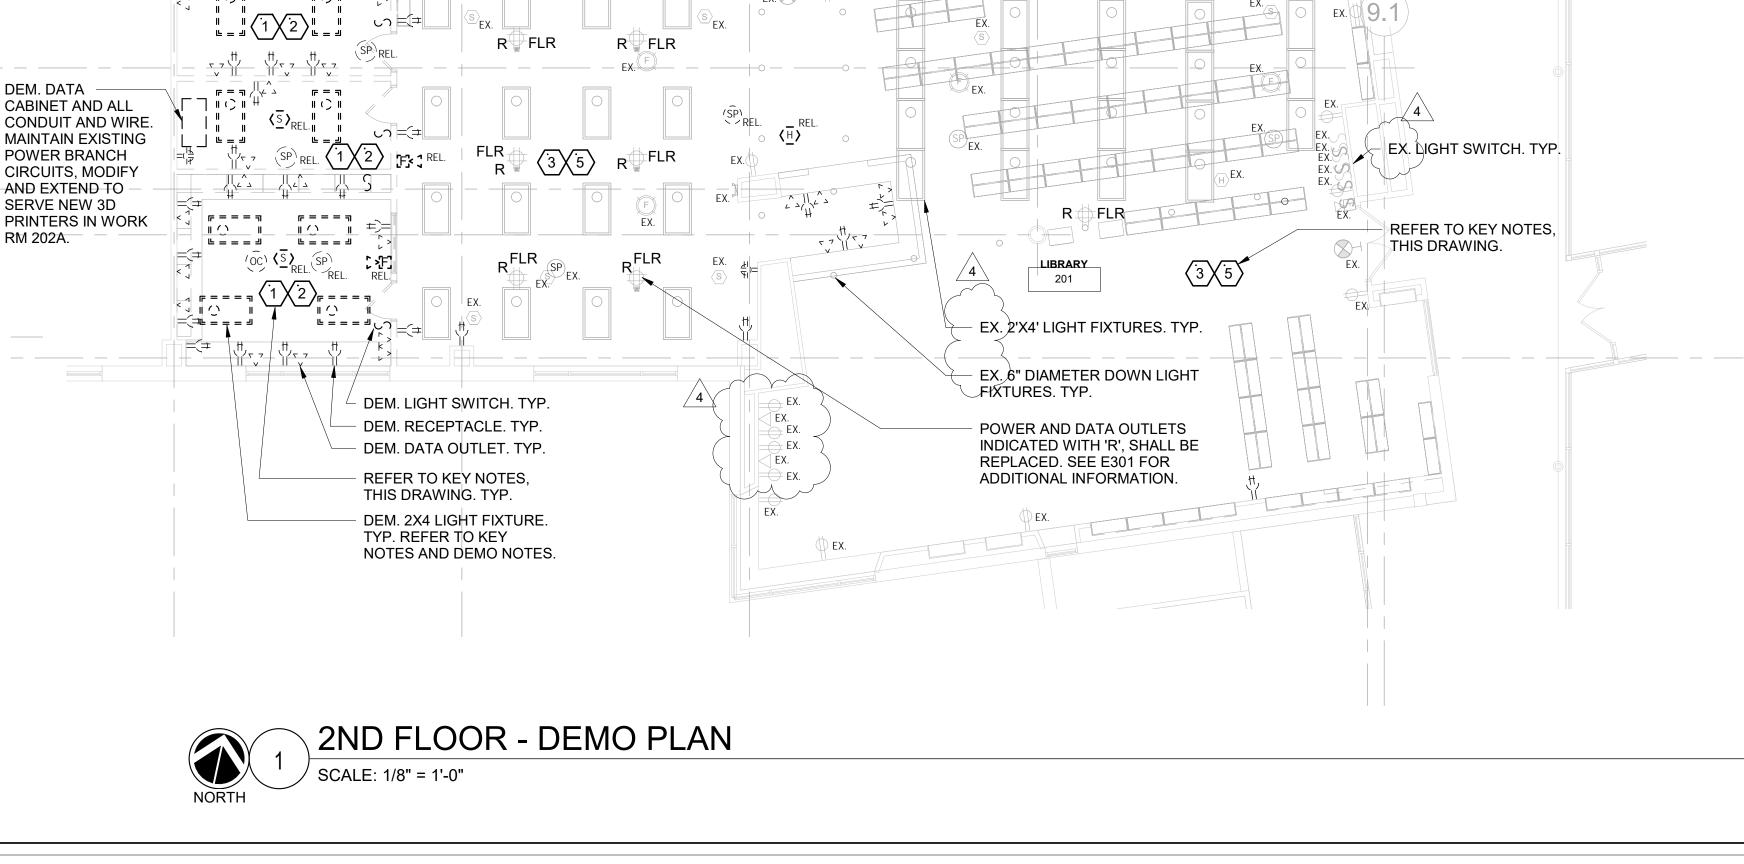
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**ELECTRICAL** PLANS -**DEMOLITION** 


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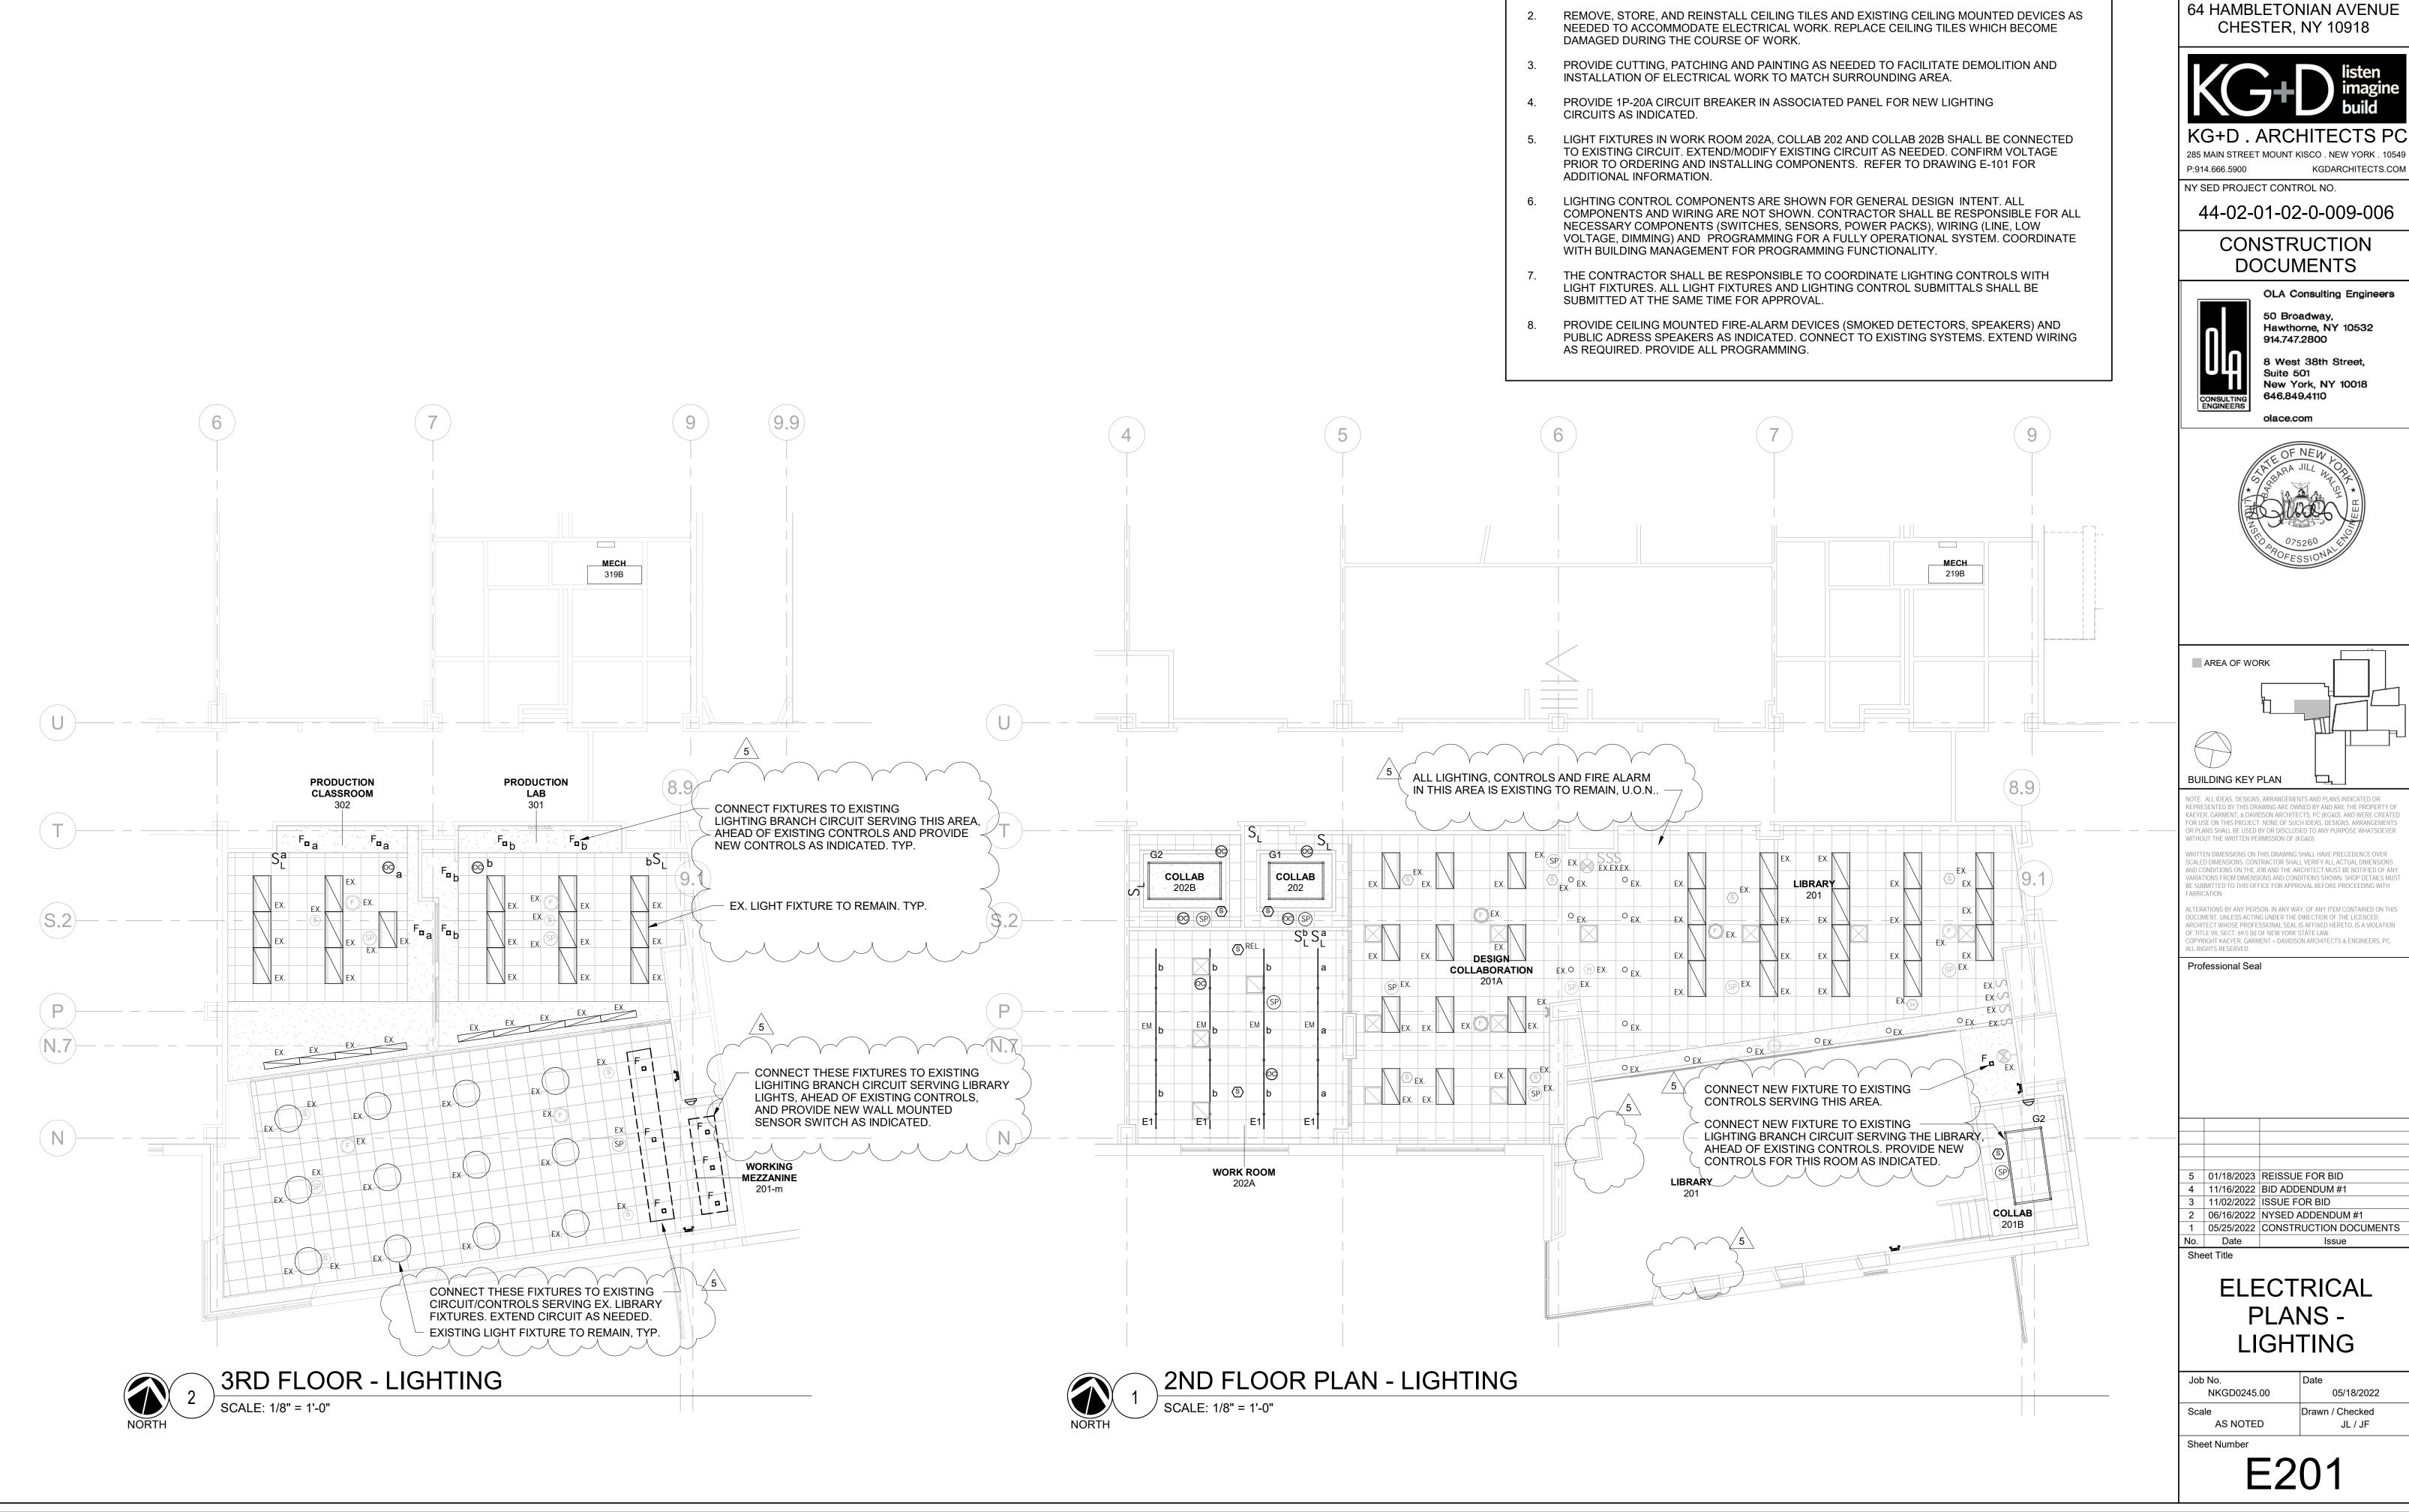
E101



CORR C201



(9.9)

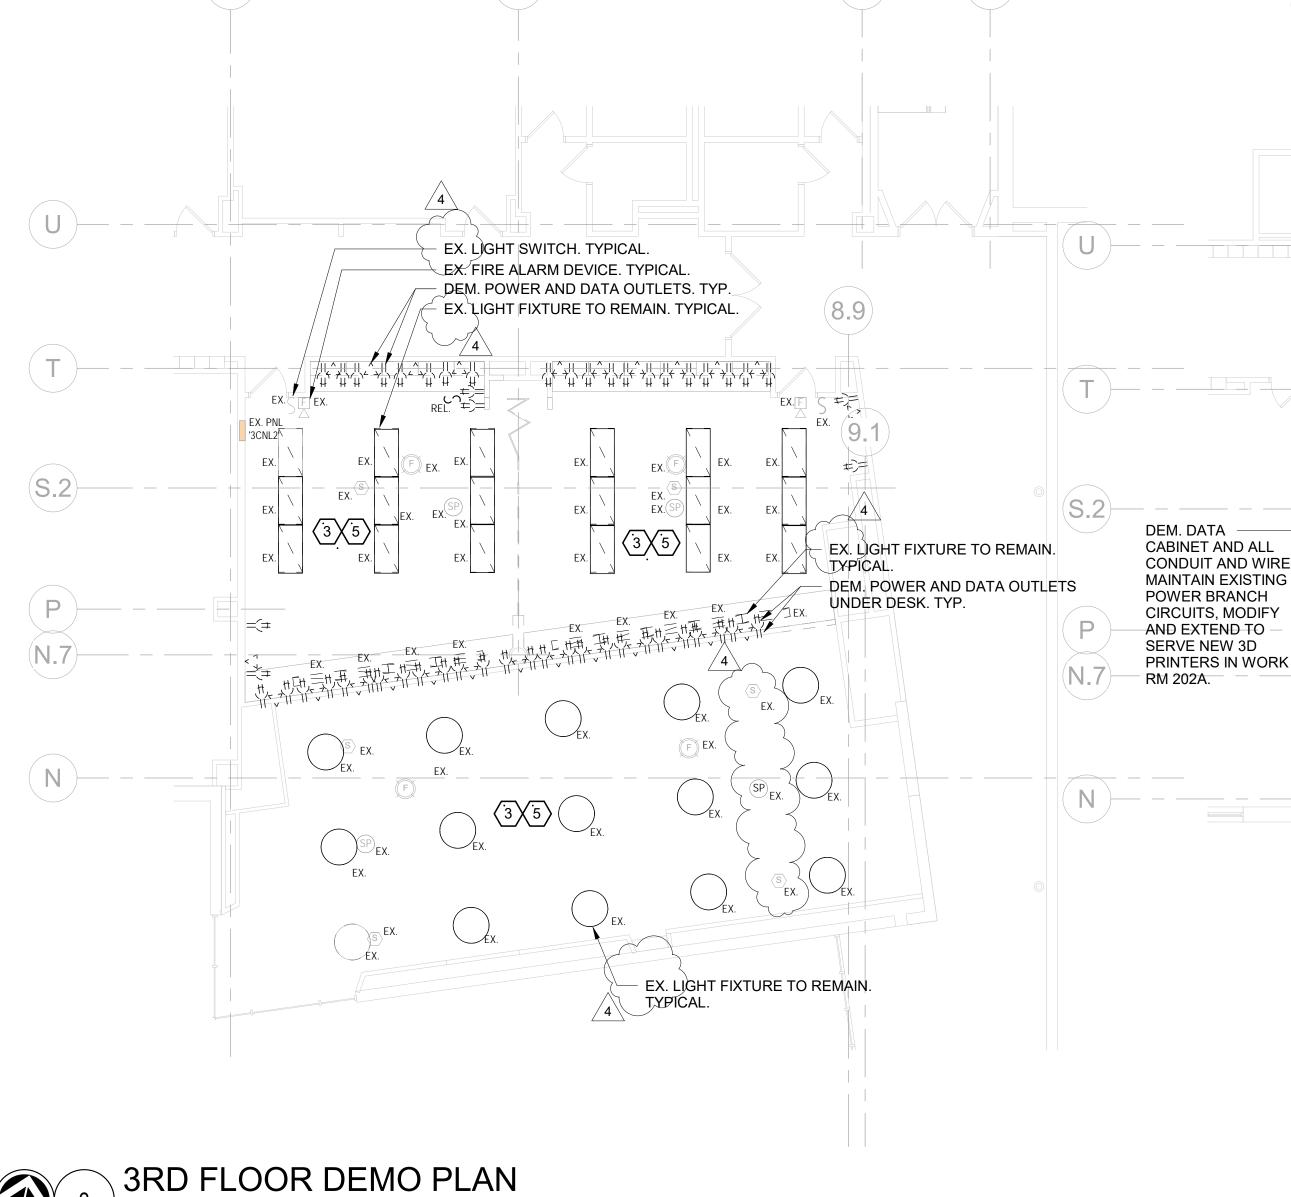

**NOTES** 

LIGHTS INDICATED AS EMERGENCY (EM) SHALL CONTAIN INTEGRAL OR REMOTE BATTERY

PACK AND EMERGENCY TEST SWITCH. THESE FIXTURES SHALL BE INSTALLED SO THAT UNDER NORMAL CONDITIONS THEY ARE CONTROLLED WITH ADJACENT AREA/ROOM LIGHTS,

AND IN THE EVENT OF A POWER OUTTAGE, THEY AUTOMATICALLY ILLUMINATE FOR 90

MINUTES. REFER TO LIGHTING FIXTURE SCHEDULE ON DRAWING E601 FOR ADDITIONAL

INFORMATION. PROVIDE CONSTANT HOT SENSING CIRCUIT TO MONITOR UTILITY VOLTAGE. PROVIDE UL924 POWER PACKS COMPATIBLE WITH LOCAL LOW VOLTAGE CONTROL SYSTEM.

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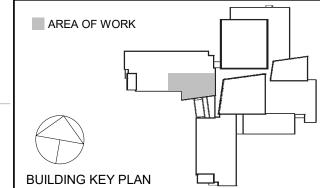


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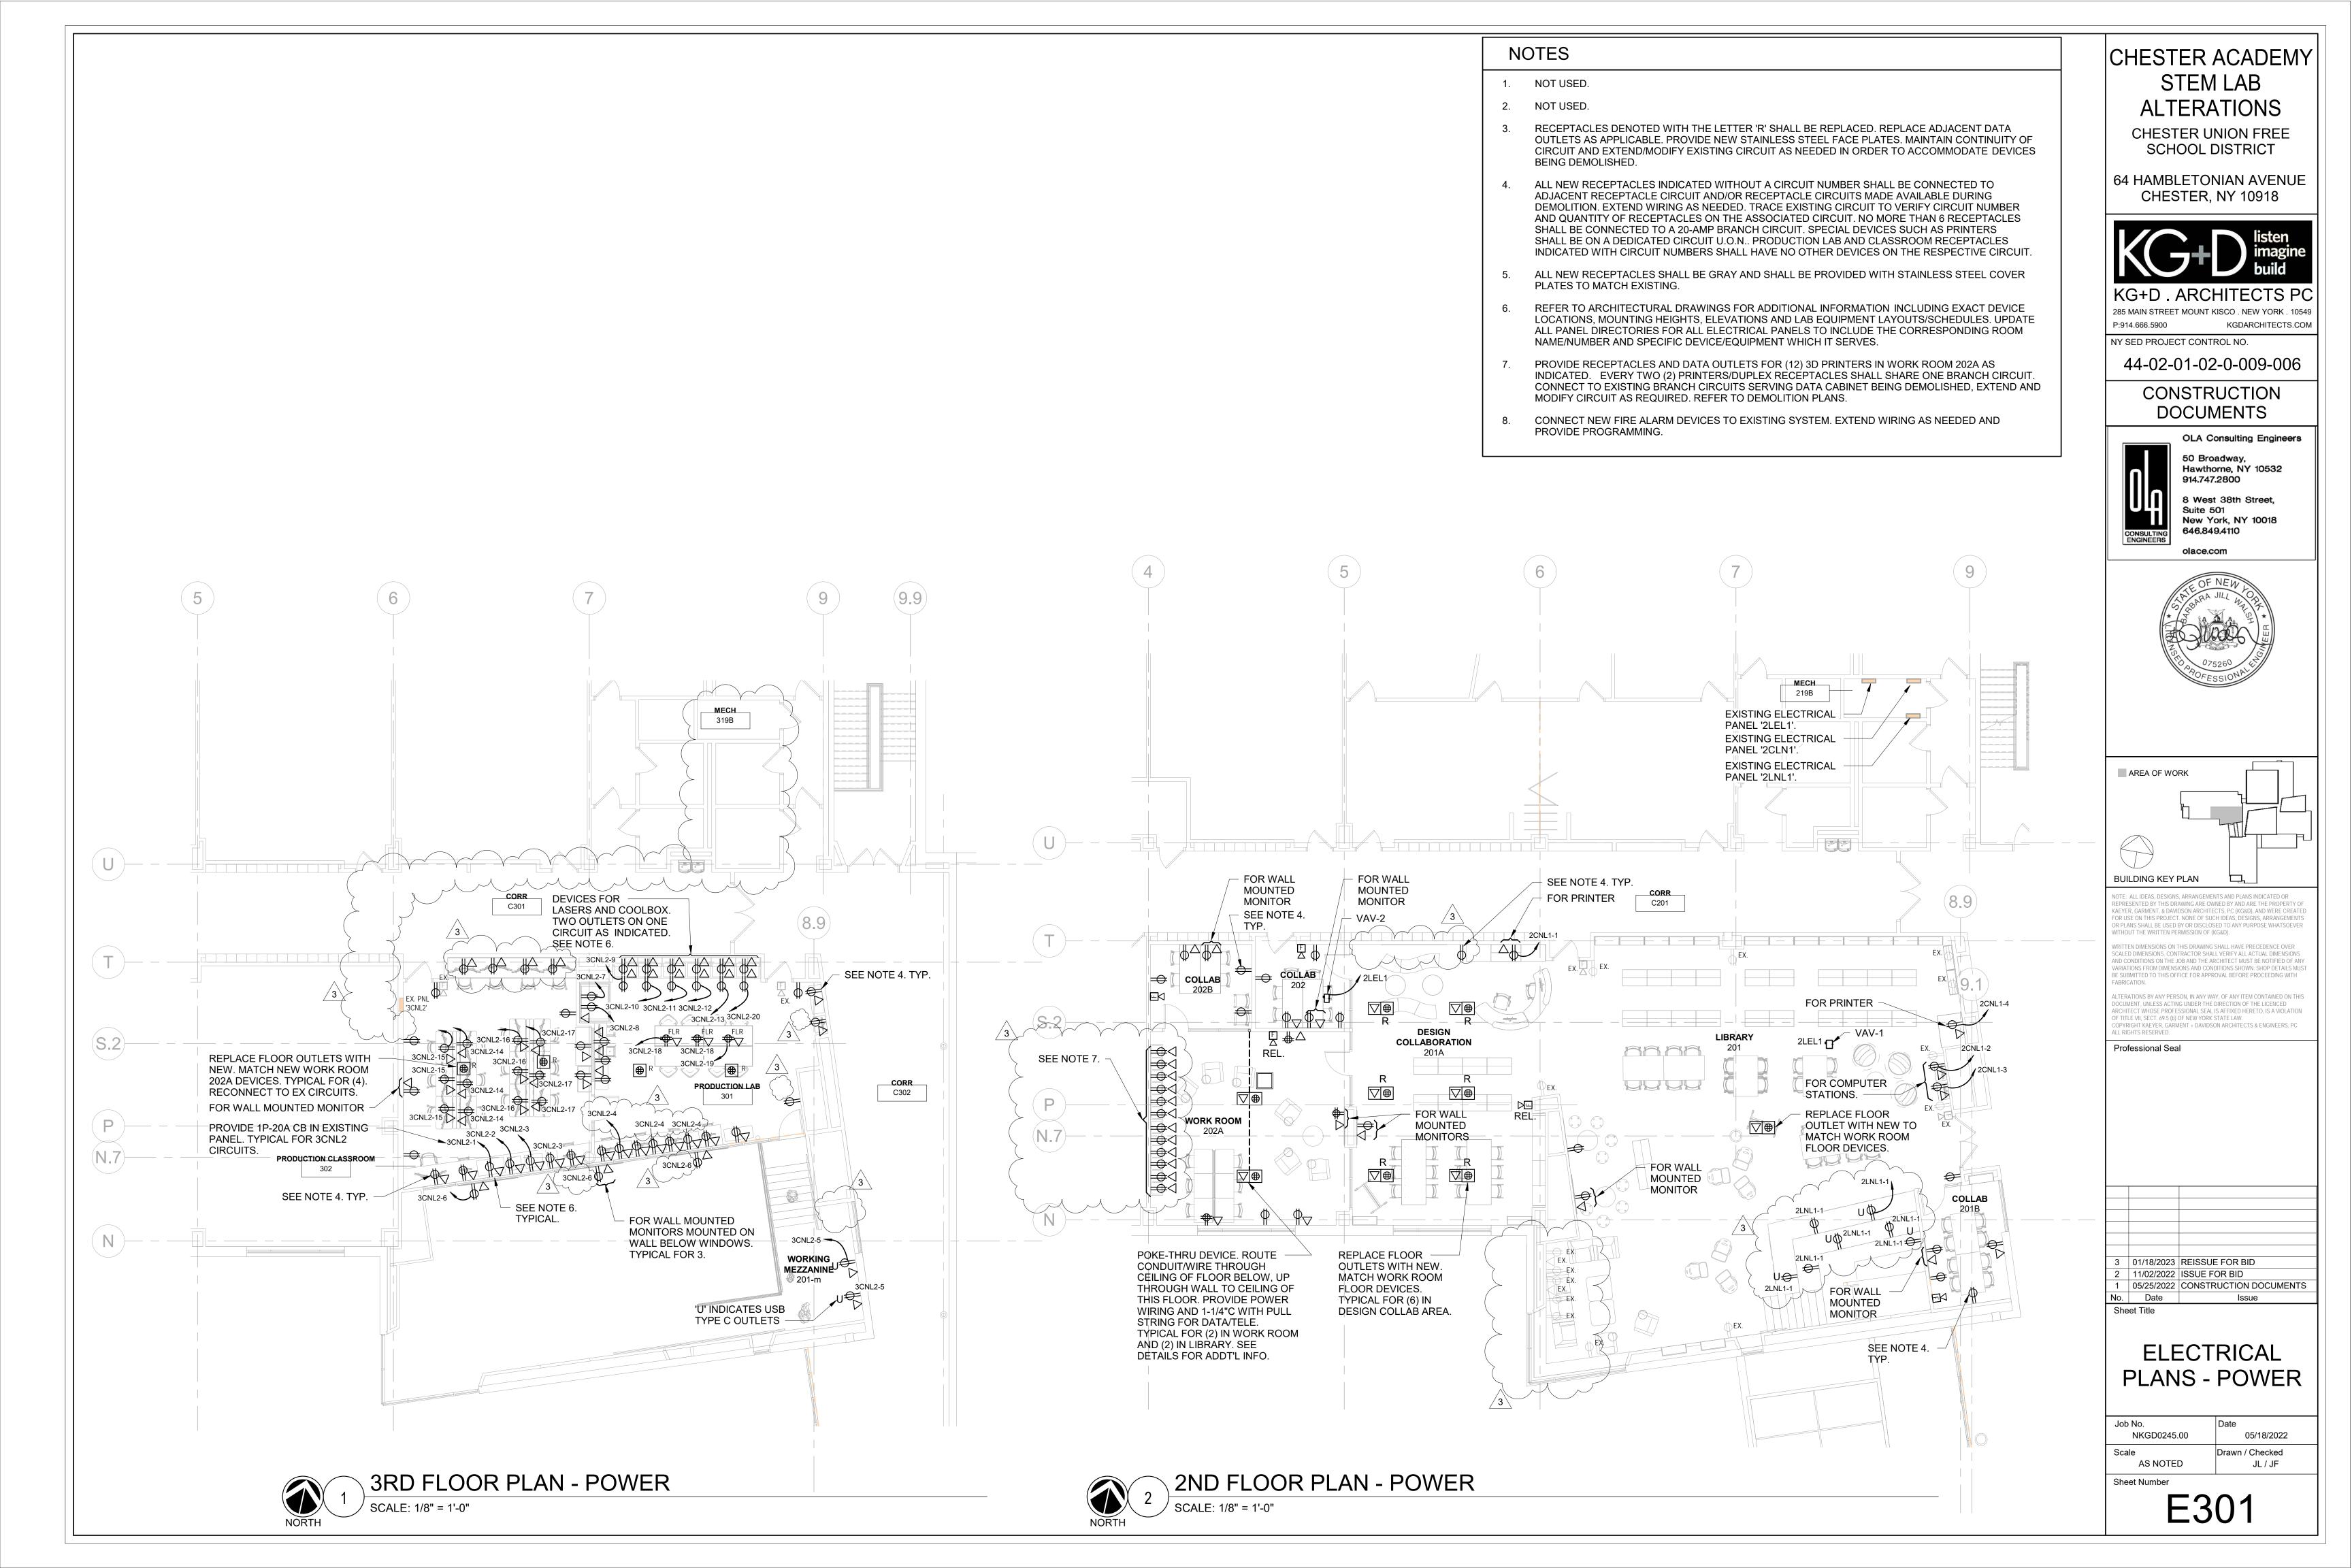
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**ELECTRICAL** PLANS -LIGHTING

JL / JF



				1 1/(1 01	RE SCHED		
FIXTURE DESIGNATION	MANUFACTURER	CATALOG NUMBER	LAMPS	VOLTS	MOUNTING	LUMENS	REMARKS
~~~~						***************************************	
E1	DELRAY	SLTR4-6-H0-W30-D-SLRDTB SLTM4-8-H0-W30-D-SLRDTB-EM	LED 3000K	120-277	PENDANT	14432	ADJUSTABLE LED SINGLE LAMP PENDANT: 20FT. 6FT RIGHT, 8FT MIDDLE AND 6FT LEFT. CONNECT TOGETHER
·····		SLTL4-6-H0-W30-D-SLRDTB	140[W]		· · · · · · · · · · · · · · · · · · ·	· · · · · · · · · · · · · · · · · · ·	WITH AN STJR PIECE BETWEEN EACH
		NVTN-3-SH-23W-					
F	PRECISE LED	30K-90C-3G-60D-ST1-AT-SO WITH NVTN-3-TRIM	LED 3000K	120-277	RECESSED	2120	NOVATION LED 3 INCH SHALLOW DOWN. MOUNTED AT GYP AN ACT CEILINGS.
G1	LF ILLUMINATION	-BS-WH-ADPT-SQ-UNV-3G	23[W]	120 277	PENDANT	400/ET	AFT V SET LAVOUT LIGHTING TO INCLUDE ALL ADDRODDIATE
GI	LF ILLOWINATION	(2)GSA-05L-9030-LN-048-SS (2)GSA-05L-9030-LN-072-SS	1000K	120-277	PENDANT	400/FT	4FT X 6FT LAYOUT. LIGHTING TO INCLUDE ALL APPROPRIATE ACCESSORIES NEEDED FOR INSTALLATION.
		WITH (4)GSA-2WY-SS	5[W/ft]				
G2	LF ILLUMINATION	(2)GSA-05L-9030-LN-048-SS (2)GSA-05L-9030-LN-096-SS	LED 3000K	120-277	PENDANT	400/FT	4FT X 8FT LAYOUT. LIGHTING TO INCLUDE ALL APPROPRIATE ACCESSORIES NEEDED FOR INSTALLATION.
· · · · · · · · · · · · · · · · · · ·		WITH (4)GSA-2WY-SS	5[W/ft]		····		
	LITHONIA		LED	120-277	SURFACE		DUAL HEAD EMERGENCY BATTERY WALL PACK LIGHT.
لُكُ	LIGHTING	ELM2-LED	3[W]				MATCH FINISHES OF EXISTING EMERGENCY LIGHTS.

### NOTES:

- 1. VERIFY ALL FIXTURE CATALOG NUMBERS FOR INTENDED APPLICATIONS WITH REQUIRED ACCESSORIES.
- 2. LIGHT FIXTURES INDICATED AS EMERGENCY (EM) ON DRAWINGS SHALL CONTAIN AN EMERGENCY BACK-UP BATTERY AND SHALL CONTAIN A VISUAL INDICATING CHARGE LAMP AND TEST SWITCH. IF IT IS NOT POSSIBLE TO INSTALL THE EMERGENCY BATTERY IN THE FIXTURE, THE CONTRACTOR SHALL FURNISH & INSTALL A REMOTE EMERGENCY BATTERY. EACH EM LIGHT FIXTURE SHALL BE CONNECTED SO THAT THE FIXTURE CAN BE SWITCHED UNDER NORMAL CONDITIONS AND IN THE EVENT OF A POWER OUTAGE, THE FIXTURE SHALL AUTOMATICALLY ILLUMINATE FOR 90 MINUTES WITH A 1200 LUMEN OUTPUT (TOTAL FROM FIXTURE), MINIMUM. PROVIDE CONSTANT HOT SENSING CIRCUIT FOR UTILITY POWER SENSING AND CONNECT TO ASSOCIATED LOCAL LIGHTING CIRCUIT, AHEAD OF ALL CONTROLS.
- 3. EMERGENCY WALL PACKS SHALL BE CONNECTED TO THE LOCAL LIGHTING CIRCUIT.
- 4. PROVIDE DRIVERS REQUIRED TO OPERATE LIGHT FIXTURES.
- 5. IN THE EVENT THE CONTRACTOR CHOOSES TO SUBSTITUTE LIGHT FIXTURES FOR THOSE THAT ARE SPECIFIED ON THE LIGHT FIXTURE SCHEDULE, THE CONTRACTOR SHALL SUBMIT POINT-TO-POINT PHOTOMETRIC CALCULATIONS FOR ALL AREAS WHERE THE SUBSTITUTED FIXTURES ARE INDICATED TO BE INSTALLED ON THE DRAWINGS. THESE CALCULATIONS SHALL BE SUBMITTED ALONG WITH THE LIGHT FIXTURE SHOP DRAWINGS.

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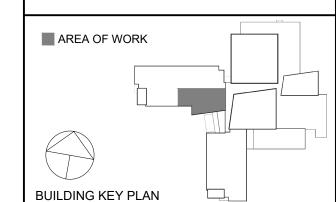
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#### **ELECTRICAL** SCHEDULES

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KGD0245.00	05/18/2022
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E601

