
SOUTH ORANGETOWN CENTRAL SCHOOL DISTRICT **PHASE 1: 2022 BOND**

WILLIAM O. SCHAEFER ELEMENTARY SED#: 50-03-01-06-0-012-019 COTTAGE LANE ELEMENTARY SED#: 50-03-01-06-0-010-022 TAPPAN ZEE HIGH SCHOOL SED#: 50-03-01-06-0-006-032 WILLIAM O. SCHAEFER SOUND & LOCKDOWN SED#: 50-03-01-06-0-012-020 COTTAGE LANE SOUND & LOCKDOWN SED#: 50-03-01-06-0-010-023 COTTAGE LANE LIBRARY SOUND & LOCKDOWN SED#: 50-03-01-06-8-023-002 WOS OUTDOOR CLASSROOM SED#: 50-03-01-06-7-053-001 CLE OUTDOOR CLASSROOM SED#: 50-03-01-06-7-054-001 SOMS OUTDOOR CLASSROOM SED#: 50-03-01-06-7-056-00 TZHS OUTDOOR CLASSROOM SED#: 50-03-01-06-7-055-001

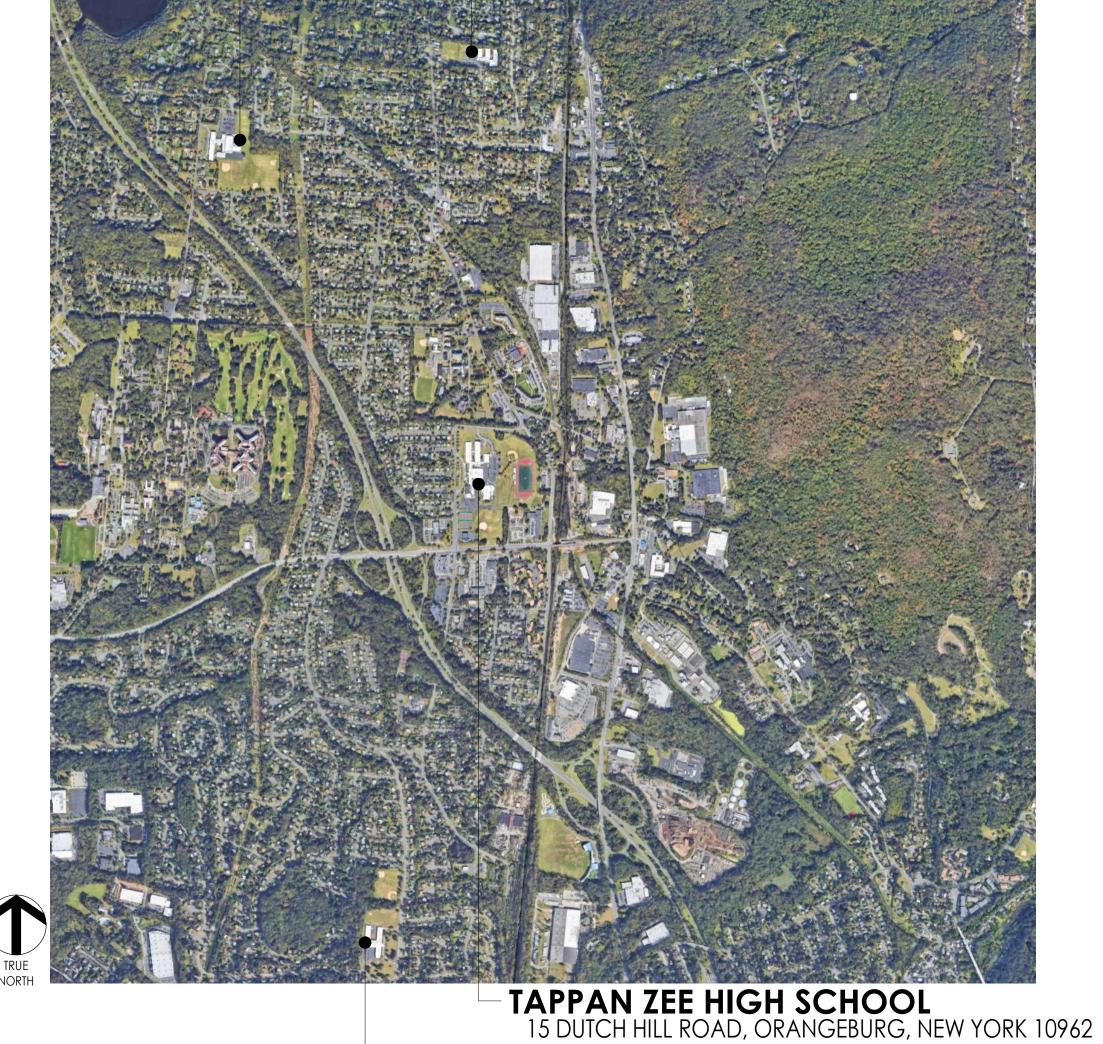

COTTAGE LANE ELEMENTARY SCHOOL 120 COTTAGE LANE, BLAUVELT NY 10913



VOLUME 1

BID DOCUMENTS SOUTH ORANGETOWN CSD DISTRICT OFFICE ADDRESS 160 VAN WYCK RD. BLAUVELT, NY 10913

A						
AFF	ABOVE FINISHED FLOOR					
AP	ACCESS PANEL					
ACOUS	ACOUSTICAL					
ACT	ACOUSTICAL CEILING TILE					
AWP	ACOUSTICAL WALL PANEL					
ADJ	ADJACENT					
A/C	AIR CONDITIONING					
ALT	ALTERNATE					
ALUM	ALUMINUM					
AB	ANCHOR BOLT					
ANOD	ANODIZED					
APPROX	APPROXIMATE					
ARCH	ARCHITECT, ARCHITECTURAL					
AD	AREA DRAIN					
АСМ	ASBESTOS CONTAINING MATERIAL					
@	AT					
AUTO	AUTOMATIC					
В	· ·					
BP	BEARING PLATE					
BM	BENCH MARK					
BITUM	BITUMINOUS					
BLK	BLOCK					
BLKG	BLOCKING					
BD	BOARD					
BOT	BOTTOM					
BRK	BRICK					
BLDG	BUILDING					
BN	BULLNOSE					
С						
САВ	CABINET					
Cl	CAST IRON					
СВ	CATCH BASIN OR CHALK BOARD					
CLG	CEILING					
CLG HT	CEILING HEIGHT					
CL	CENTER LINE					
CER	CERAMIC					
CIRC	CIRCUMFERENCE					
СО	CLEAN OUT					
CLR	CLEAR					
COL	COLUMN					
CONC	CONCRETE					
СМИ	CONCRETE MASONRY UNIT					
CONST	CONSTRUCTION					
CJT	CONSTRUCTION JOINT					
CONT	CONTINUOUS					
CONTR	CONTRACTOR					
CJ	CONTROL JOINT					

PROJECT ABBREVIATIONS

D	
DP	DAMP PROOFING
DEMO	DEMOLISH
DEPT	DEPARTMENT
DET,DTL	DETAIL
DIA	DIAMETER
DIM	DIMENSION
DISP	DISPENSER
DSP	DISPOSAL
DO	DITTO, REPEAT, SAME
DR	DOOR
DBL	DOUBLE
DN	DOWN
DS	DOWNSPOUT
DT	DRAIN TILE
DWR	DRAWER
DWG	DRAWING
DF	DRINKING FOUNTAIN
E	
EA	EACH
EF	EACH FACE
EW	EACH WAY
E	EAST
ELEC	ELECTRICAL
ELEV	ELEVATION
EL	
EMER	ELEVATOR EMERGENCY
ENCL	ENCLOSURE
ENTR	ENTRANCE
EQ	EQUAL
EQUIP	
EST	ESTIMATE(D)
EXHST	EXHAUST
EXIST	EXISTING
EXP	EXPANSION
EJ	EXPANSION JOINT
F	540040
FAB	FABRICATE
FT	FEET
FIG	FIGURE
FIN	FINISH
FF	FINISH FLOOR
FEC	FIRE EXTINGUISHER CABINET
FH	FIRE HOSE
FL,FLR	FLOOR
FD	FLOOR DRAIN
FTG	FOOTING
FND	FOUNDATION

FS	FULL SIZE
FUT	FUTURE
G	
GALV	GALVANIZED
G	GAS
GA	GAUGE
GEN	GENERAL
GC	GENERAL CONTRACTOR
GL	GLASS, GLAZING
GB	GRAB BAR
GR	GRADE, GRADING
GSF	GROSS SQUARE FOOT
GYP	GYPSUM
GYP BD	GYPSUM BD
GWB	GYPSUM WALL BOARD
Н	
HDWR	HARDWARE
HDWD	HARDWOOD
HVAC	HEATING, VENTILATING & AIR
	CONDITIONING
ht, hgt	HEIGHT
HEX	HEXAGONAL
HWY	HIGHWAY
НМ	HOLLOW METAL
HORZ	HORIZONTAL
HB	HOSE BIBB
HW	HOT WATER
HR	HOUR
IN	INCH
INCL	INCLUDING
INSUL	INSULATION
INT	INTERIOR
INTERM	INTERMEDIATE
INV	INVERT
J	INVERI
JAN	JANITOR
JS	JANITOR SINK
JT	JOINT
K	30111
KIT	KITCHEN
LBL	
LAB	
LAV	
LYR	LAYER

LDR	LEADER
LH	LEFT HAND
LIB	LIBRARY
LT	LIGHT
LW	LIGHT WEIGHT
М	
МАСН	MACHINE
МН	MAN HOLE
МНС	MAN HOLE CC
MFR	MANUFACTUR
MFRR	MANUFACTUR
MAS	MASONRY
МО	MASONRY OPI
MAT	MATERIALS
MAX	MAXIMUM
MECH	MECHANICAL
MET	METAL
MTL	METAL
М	METER
MEZZ	MEZZANINE
MIN	MINIMUM
MISC	MISCELLANEO
MR	MOISTURE RESI
MTD	MOUNTED
Ν	
NAT	NATURAL
NRC	NOISE REDUCT
NOM	NOMINAL
Ν	NORTH
NIC	NOT IN CONTR
NTS	NOT TO SCALE
NO, #	NUMBER
0	
OC	ON CENTER
OPNG	OPENING
OD	OUTSIDE DIAM
ОН	OVERHEAD
Р	
PT	PAINT(ED)
PR	PAIR
PTR	PAPER TOWEL
PKG	PARKING
PART BD	PARTICLE BOA
PART	PARTITION
PVMT	PAVEMENT
PL	PLATE
Plbg	PLUMBING
PLYWD	PLYWOOD

ARCHITECT CERTIFICATION

TO THE BEST OF MY KNOWLEDGE, INFORMATION AND BELIEF, THE PLANS AND SPECIFICATIONS ARE IN ACCORDANCE WITH APPLICABLE REQUIREMENTS OF THE BUILDING CODE OF NEW YORK STATE, THE ENERGY CONSERVATION CONSTRUCTION CODE OF NEW YORK STATE, NYSDOL INDUSTRIAL CODE RULE 56 AND THE CONSTRUCTION STANDARD OF THE NEW YORK STATE EDUCATION DEPARTMENT. NO ASBESTOS CONTAINING MATERIALS ARE SPECIFIED FOR USE IN NEW CONSTRUCTION.

---- COLUMN CENTERLINE A DETAIL #3 on SHEET A201 BUILDING SECTION (NO.) or WALL SECTION (LETTER) on SHEET A101 + 100.75 A101/ + 100.75 ROOM NUMBER 1000 INTERIOR ELEVATIONS _ 100 __ _ ² # 2 and #3 on SHEET A501 EXTERIOR ELEVATIONS #3 on SHEET A301 100

First Name Last Name Registered Architect

N.Y.S. Registration No.

Registration Expiration Date

WILLIAM O. SCHAEFER ELEMENTARY SCHOOL 140 LESTER DRIVE, TAPPAN, NEW YORK 10983

OWNER



SOUTH ORANGETOWN CENTRAL SCHOOL DISTRICT 160 VAN WYCK RD. BLAUVELT, NY 10913 .845.680.1000 www.socsd.org

ARCHITECT



CPL | Architecture Engineering Planning ewburgh, NY 12550 . 845.567.6700 CPLteam.com

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PVC	POLTVINTL CHLORIDE
PC CONC	PRECAST CONCRETE
PRE FAB	PREFABRICATED
PT	PRESSURE TREATED
PL	PROPERTY LINE
Q	
QTY	QUANTITY
R	
RAD	RADIUS
RECP	RECEPTACLE
RE:	REFER TO
REF	REFERENCE
REFR	REFRIGERATOR
REINF	REINFORCED(ING)
req'd	REQUIRED
REV	REVISED
RH	RIGHT HAND
R	RISER
RD	ROOF DRAIN
RM	ROOM
RO	ROUGH OPENING
S	
SAN	SANITARY
SCHED	SCHEDULE
SEC	SECOND
SECT	SECTION
SIM	SIMILAR
SSM	SOLID SURFACE MATERIAL
STC	SOUND TRANSMISSION COEFFICIENT
SPEC	SPECIFICATION
SQ	SQUARE
SS	STAINLESS STEEL
STD	STANDARD
STL	STEEL
STOR	STORAGE
SGFT	STRUCTURAL GLAZED FACING TILE
ST STL	STRUCTURAL STEEL
STRUCT	STRUCTURE, STRUCTURAL
SUSP	SUSPENDED
SAT	SUSPENDED ACOUSTICAL TILE
T	
TEL	TELEPHONE
TEMP	TEMPERATURE
THK	THICKNESS
TPD	TOILET PAPER DISPENSER
TOS	TOP OF SLAB/STEEL
TOW	TOP OF WALL


POLYVINYL CHLORIDE

TYP	TYPICAL		
U			
UNFIN	UNFINISHED		
UNO	UNLESS NOTED OTHERWISE		
U	URINAL		
V			
VEN	VENEER		
VIF	VERIFY IN FIELD		
VEST	VESTIBULE		
VOL VOLUME			
W			
WC	WATER CLOSET		
WT	WEIGHT		
WWF	WELDED WIRE FABRIC		
WWM	WELDED WIRE MESH		
W	WEST		
WIND	WINDOW		
W/	WITH		
W/O	WITHOUT		
WD	WOOD		
Y			
YD	YARD		

CPL Architecture Engineering Planning 50 Front Street Suite 202, Newburgh, NY 12550 CPLteam.com
SOUTH ORANGETOWN Central School District
Capital Improvements Bond Essential Infrastructure for Student Health, Safety and Success
PROJECT INFORMATION Project Number 14457.20 Client Name SOUTH ORANGETOWN CENTRAL SCHOOL DISTRICT Project Name
PHASE 1: 2022 BOND
CERTIFICATE #018330 REGISTRATION EXPIR. DATE Lauren Tarsio 09/30/26 Richard Waite 11/30/23 160 VAN WYCK RD. BLAUVELT, NY 10913 Anthony Marchetti 05/31/24 Dave Hart 02/28/25 Jennifer Wengender 06/30/24
SOUTH ORANGETOWN CSD WILLIAM O. SCHAEFER ELEMENTARY SED#: 50-03-01-06-0-012-01 COTTAGE LANE ELEMENTARY SED#: 50-03-01-06-0-010-022 TAPPAN ZEE HIGH SCHOOL SED#:50-03-01-06-0-006-032 WILLIAM O. SCHAEFER S&L SED#:50-03-01-06-0-012-020 COTTAGE LANE S&L SED#: 50-03-01-06-0-012-020 COTTAGE LANE S&L SED#: 50-03-01-06-0-010-023 COTTAGE LANE S&L SED#: 50-03-01-06-8-023-002 WOS OUTDOOR CLASSROOM SED#: 50-03-01-06-7-053-001 SOMS OUTDOOR CLASSROOM SED#: 50-03-01-06-7-054-001 CLE OUTDOOR CLASSROOM SED#: 50-03-01-06-7-055-001 TZHS OUTDOOR CLASSROOM SED#: 50-03-01-06-7-055-001

PROJECT ISSUE & REVISION SCHEDUL

PROFESSIONAL STAMPS

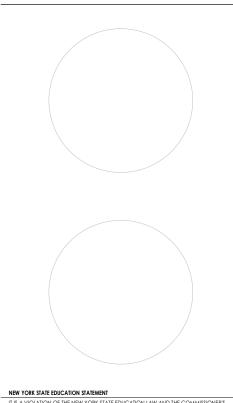

'= 1'-0''

SHEET INFORMATION

Issued	Scale
10/18/23	12
Project Status	
BID DOCUMENTS	
Drawn By	Cheo
LF	LT
Drawing Title	
COVER	



PARTITION TYPE 1† (1hr RATED) SEE PARTITION LEGEND	с	PROPERTY LINE	300 ³⁰ 12"	CASEWORK TAG
REVISION NO. 1	X	FENCE	A	ACCESSORY TAG
EXISTING SPOT ELEVATION	\bigcirc	EXISTING TREE TO REMAIN	(w1)	WINDOW TAG (TYPE LETTER)
FINISHED SPOT ELEVATION		EXISTING TREE TO BE REMOVED	<1i>	EQUIPMENT SYMBOL (NUMBER)
EXISTING CONTOURS	•	BENCHMARKS: FLOOR ELEV., or OTHER VERTICAL ELEV.	(1000-1)	DOOR TAG
FINISHED CONTOURS	A	KEYNOTE SYMBOL: DEMOLITION and NEW CONSTRUCTION	1 A101	VIEW NAME 1/8" = 1'-0"

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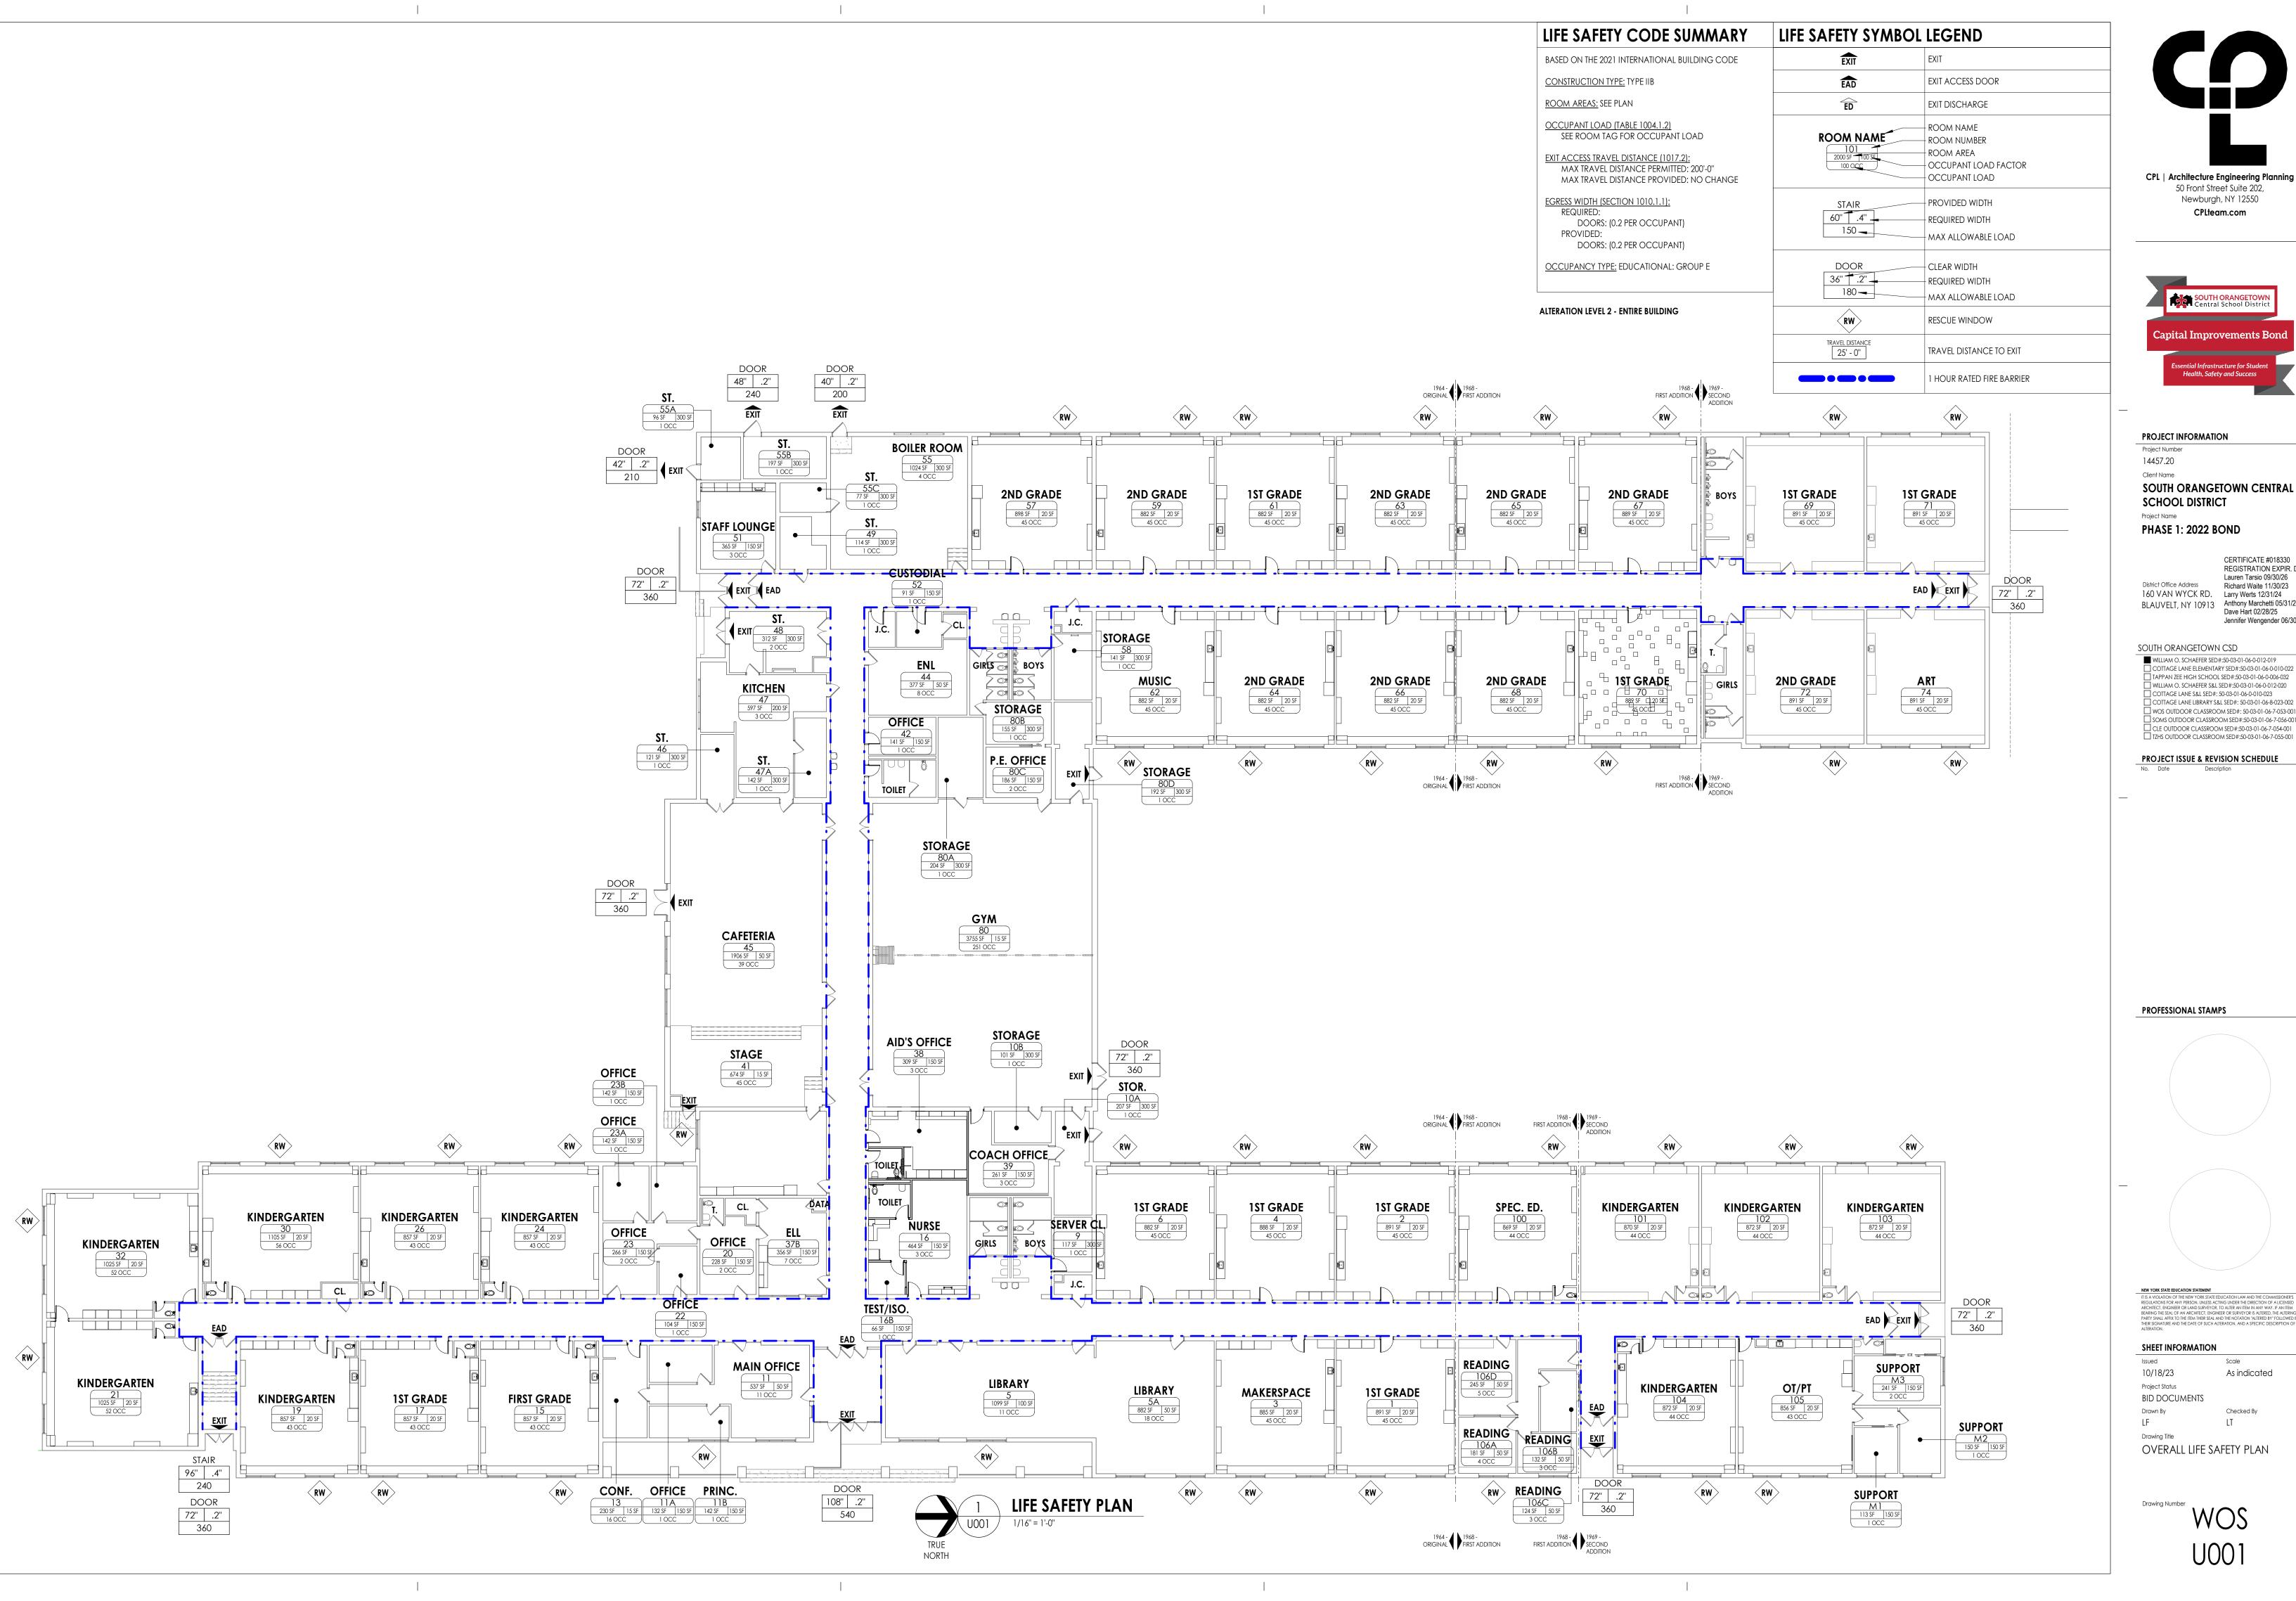
DRAV	VING LIST	DRAWI	NG LIST	DRAWI	NG LIST
GENERAL		TZHS A300	INTERIOR ELEVATION & STRUCTURAL DETAILS	WOS E105	FIRST FLOOR DEMOLITION PLAN - AREA F
GEN TOO	1 COVER			WOS E106	ROOF DEMOLITION PLAN-AREA A
GEN TOO	2 DRAWING LIST	INTERIORS GEN 1000	INTERIORS GENERAL	WOS E107 WOS E108	ROOF DEMOLITION PLAN-AREA B ROOF DEMOLITION PLAN-AREA C
GENERAL		GEN 1000 GEN 1001	TYPICAL INTERIOR DETAILS	WOS E108	ROOF DEMOLITION PLAN-AREA C ROOF DEMOLITION PLAN -AREA E
WOS U00	01 OVERALL LIFE SAFETY PLAN	_		WOS E110	ROOF DEMOLITION PLAN -AREA F
GENERAL		INTERIORS WOS 1200	PARTIAL FIRST FLOOR FINISH PLAN - AREA A & AREA B	WOS E200 WOS E201	FIRST FLOOR NEW WORK PLAN - AREA A FIRST FLOOR NEW WORK PLAN - AREA B
	01 OVERALL LIFE SAFETY PLAN	WOS 1201	PARTIAL FIRST FLOOR FINISH PLAN - AREA C	WOS E202	FIRST FLOOR NEW WORK PLAN - AREA C
		WOS 1202	PARTIAL FIRST FLOOR FINISH PLAN - AREA E & AREA F	WOS E203	FIRST FLOOR NEW WORK PLAN - AREA D
	US MATERIAL 100 ASBESTOS ABATEMENT PLAN			WOS E204 WOS E205	FIRST FLOOR NEW WORK PLAN - AREA E FIRST FLOOR NEW WORK PLAN - AREA F
		CLE I200	PARTIAL FIRST FLOOR FINISH PLAN - AREA B	WOS E210	ROOF NEW WORK PLAN - AREA A
	US MATERIAL 00 ASBESTOS ABATEMENT PLAN	CLE 1201	PARTIAL FIRST FLOOR FINISH PLAN - AREA D&E	WOS E211	ROOF NEW WORK PLAN - AREA B ROOF NEW WORK PLAN - AREA C
	ASDESTOS ADATEMENT FLAN	VOLUME 2 HVAC		WOS E212 WOS E213	ROOF NEW WORK PLAN - AREA C
CIVIL		GEN H000	HVAC SYMBOLS LEGEND AND CONTRACTOR NOTES	WOS E214	ROOF NEW WORK PLAN - AREA E
	00 DEMOLITION PLAN 00 SITE PLAN	GEN H500 GEN H501	MECHANICAL CONTROLS MECHANICAL CONTROLS	WOS E215 WOS E300	ROOF NEW WORK PLAN - AREA F FIRST FLOOR LIGHTING PLAN - AREA A
		GEN H502	MECHANICAL CONTROLS	WOS E301	FIRST FLOOR LIGHTING PLAN - AREA B
		GEN H503		WOS E302	FIRST FLOOR LIGHTING PLAN - AREA C
	00 DEMOLITION PLAN 00 SITE PLAN	GEN H504 GEN H800	MECHANICAL CONTROLS HVAC DETAILS	WOS E303 WOS E304	FIRST FLOOR LIGHTING PLAN - AREA D FIRST FLOOR LIGHTING PLAN - AREA E
CLE C20				WOS E305	FIRST FLOOR LIGHTING PLAN - AREA F
CLE C30	00 DETAILS	HVAC WOS H100	FIRST FLOOR DEMOLITION PLANS- AREA A	WOS E900 WOS E901	ELECTRICAL SCHEDULES ELECTRICAL SCHEDULES
CIVIL		WOS H101	FIRST FLOOR DEMOLITION PLANS- AREA B	WOS E902	
	00 DEMOLITION PLAN 200 SITE PLAN		FIRST FLOOR DEMOLITION PLAN- AREA D	ELECTRICAL	
30/M3 C.Z	SIIE FLAIN		FIRST FLOOR DEMOLITION PLANS- AREA D FIRST FLOOR DEMOLITION PLANS- AREA E	CLE E001	ELECTRICAL ONE LINE DIAGRAM
CIVIL			FIRST FLOOR DEMOLITION PLANS- AREA F	CLE E002	ELECTRICAL DEMOLITION SITE PLAN
	00 DEMOLITION PLAN 00 SITE PLAN	WOS H110 WOS H111	ROOF HVAC DEMOLITION PLANS- AREA A ROOF HVAC DEMOLITION PLANS- AREA B	CLE E003 CLE E100	ELECTRICAL NEW WORK SITE PLAN FIRST FLOOR DEMOLITION PLAN - AREA A
	I.	WOS H112	ROOF HVAC DEMOLITION PLANS- AREA C	CLE E101	FIRST FLOOR DEMOLITION PLAN - AREA B
	00 GENERAL NOTES	WOS H113	ROOF HVAC DEMOLITION PLAN - AREA D	CLE E102	FIRST FLOOR DEMOLITION PLAN - AREA C
GEN C30 GEN C30		WOS H114 WOS H115	ROOF HVAC DEMOLITION PLAN- AREA E ROOF HVAC DEMOLITION PLAN- AREA F	CLE E103 CLE E104	FIRST FLOOR DEMOLITION PLAN - AREA D FIRST FLOOR DEMOLITION PLAN - AREA E
	02 DETAIL SHEET 2	WOS H200	FIRST FLOOR HVAC NEW WORK PLAN- AREA A	CLE E105	FIRST FLOOR DEMOLITION PLAN - AREA F
STRUCTURA	AL	WOS H201 WOS H202	FIRST FLOOR HVAC NEW WORK PLAN- AREA B FIRST FLOOR HVAC NEW WORK PLAN- AREA C	CLE E110 CLE E111	ROOF DEMOLITION PLAN - AREA A ROOF DEMOLITION PLAN - AREA B
WOS S20		WOS H202 WOS H204	FIRST FLOOR HVAC NEW WORK PLAN- AREA C	CLE E112	ROOF DEMOLITION PLAN - AREA D
CTDUCT		WOS H205	FIRST FLOOR HVAC NEW WORK PLAN- AREA F	CLE E113	ROOF DEMOLITION PLAN - AREA D
STRUCTURA CLE S20		WOS H210 WOS H211	ROOF HVAC NEW WORK PLAN-AREA A ROOF HVAC NEW WORK PLAN-AREA B	CLE E114 CLE E115	ROOF DEMOLITION PLAN - AREA E ROOF DEMOLITION PLAN - AREA F
CLE S20		WOS H212	ROOF HVAC NEW WORK PLAN-AREA C	CLE E200	FIRST FLOOR NEW WORK PLAN - AREA A
STOUCTUD		WOS H213		CLE E201	FIRST FLOOR NEW WORK PLAN - AREA B
STRUCTURA		WOS H214 WOS H215	ROOF HVAC NEW WORK PLAN-AREA E ROOF HVAC NEW WORK PLAN-AREA F	CLE E202 CLE E203	FIRST FLOOR NEW WORK PLAN - AREA C FIRST FLOOR NEW WORK PLAN - AREA D
		WOS H300	FIRST FLOOR HVAC PIPING PLAN- AREA A	CLE E204	
STRUCTURA TZHS S20		WOS H301 WOS H302	FIRST FLOOR HVAC PIPING PLAN- AREA B FIRST FLOOR HVAC PIPING PLAN- AREA C	CLE E205 CLE E210	FIRST FLOOR NEW WORK PLAN - AREA F ROOF NEW WORK PLAN - AREA A
12113 320		WOS H304	FIRST FLOOR HVAC PIPING PLAN- AREA E	CLE E210	ROOF NEW WORK PLAN - AREA B
		WOS H305	FIRST FLOOR HVAC PIPING PLAN- AREA F	CLE E212	ROOF NEW WORK PLAN - AREA C
GEN S80 GEN S80		WOS H600 WOS H601	VRF PIPING VRF PIPING	CLE E213 CLE E214	ROOF NEW WORK PLAN - AREA D ROOF NEW WORK PLAN - AREA E
GEN S80	2 STRUCTURAL TYPICAL DETAILS	WOS H900	MECHANICAL SCHEDULES	CLE E215	ROOF NEW WORK PLAN - AREA F
GEN S80		WOS H901 WOS H902	MECHANICAL SCHEDULES MECHANICAL SCHEDULES	CLE E300 CLE E301	FIRST FLOOR LIGHTING PLAN - AREA A FIRST FLOOR LIGHTING PLAN - AREA B
GEN S80				CLE E302	FIRST FLOOR LIGHTING PLAN - AREA C
GEN S80		HVAC		CLE E303	FIRST FLOOR LIGHTING PLAN - AREA D
GEN S80	0UTDOOR CLASSROOM STRUCTURE	CLE H100 CLE H101	BOILER ROOM DEMOLITION PLAN FIRST FLOOR HVAC DEMOLITION PLAN - AREA A	CLE E304 CLE E305	FIRST FLOOR LIGHTING PLAN - AREA E FIRST FLOOR LIGHTING PLAN - AREA F
ARCHITECT		CLE H102	FIRST FLOOR HVAC DEMOLITION PLAN - AREA B	CLE E800	ELECTRICAL DETAILS
WOS A10		CLE H103 CLE H104	FIRST FLOOR HVAC DEMOLITION PLAN - AREA C FIRST FLOOR HVAC DEMOLITION PLAN - AREA D	CLE E900 CLE E901	ELECTRICAL SCHEDULES ELECTRICAL SCHEDULES
WOS A10		CLE H104	FIRST FLOOR HVAC DEMOLITION PLAN - AREA E		
WOS All		CLE H106	FIRST FLOOR HVAC DEMOLITION PLAN - AREA F	ELECTRICAL	
WOS A11 WOS A11	11 DEMOLITION ROOF PLAN - AREA C&D 12 DEMOLITION ROOF PLAN - AREA E&F	CLE H111 CLE H112	ROOF HVAC DEMOLITION PLAN - AREA A ROOF HVAC DEMOLITION PLAN - AREA B	SOMS E200 SOMS E300	EXTERIOR CLASSROOM NEW WORK PLAN EXTERIOR CLASSROOM LIGHTING PLAN
WOS A20		CLE H113	ROOF HVAC DEMOLITION PLAN - AREA C		
WOS A20 WOS A20		CLE H114 CLE H115	ROOF HVAC DEMOLITION PLAN - AREA D ROOF HVAC DEMOLITION PLAN - AREA E	ELECTRICAL TZHS E101	FIRST FLOOR ELECTRICAL DEMOLITION PLAN
WOS A21		CLE H116	ROOF HVAC DEMOLITION PLAN - AREA F	TZHS E200	FIRST FLOOR ELECTRICAL DEMOETING FLAN
WOS A21		CLE H201	FIRST FLOOR DUCTWORK NEW WORK PLAN - AREA A	TZHS E201	
WOS A21 WOS A60		CLE H202 CLE H203	FIRST FLOOR DUCTWORK NEW WORK PLAN - AREA B FIRST FLOOR DUCTWORK NEW WORK PLAN - AREA C	TZHS E300	FIRST FLOOR LIGHTING PLAN
WOS A60	01 REFLECTED CEILING PLAN - AREA C&D	CLE H204	FIRST FLOOR DUCTWORK NEW WORK PLAN - AREA D		
WOS A60 WOS A70		CLE H205 CLE H206	FIRST FLOOR DUCTWORK NEW WORK PLAN - AREA E FIRST FLOOR DUCTWORK NEW WORK PLAN - AREA F	GEN TOOO	SYMBOLS & ABBREVIATIONS
WOS A70		CLE H206 CLE H211	ROOF HVAC NEW WORK PLAN - AREA A	SOUND & LOC	
WOS A70	03 ENLARGED FLOOR PLANS AND INTERIOR ELEVATIONS	CLE H212	ROOF HVAC NEW WORK PLAN - AREA B	WOS TOO1	KEY PLAN
WOS A80 WOS A81		CLE H213 CLE H214	ROOF HVAC NEW WORK PLAN - AREA C ROOF HVAC NEW WORK PLAN - AREA D	WOS T100 WOS T101	FIRST FLOOR DEMOLITION PLAN - AREA A FIRST FLOOR DEMOLITION PLAN - AREA B
	DOOR & WINDOW SYSTEMS TYPES & SCHEDULES	CLE H215	ROOF HVAC NEW WORK PLAN - AREA E	WOS T102	FIRST FLOOR DEMOLITION PLAN - AREA C
ARCHITECT	TURAL	CLE H216 CLE H300	ROOF HVAC NEW WORK PLAN - AREA F BOILER ROOM PIPING NEW WORK PLAN	WOS T103 WOS T104	FIRST FLOOR DEMOLITION PLAN - AREA D FIRST FLOOR DEMOLITION PLAN - AREA E
	DO DEMOLITION PLAN - AREA A&B	CLE H300	FIRST FLOOR PIPING NEW WORK PLAN - AREA A	WOS 1104 WOS 1105	FIRST FLOOR DEMOLITION PLAN - AREA E
CLE A10		CLE H302	FIRST FLOOR PIPING NEW WORK PLAN - AREA B	WOS T200	FIRST FLOOR NEW WORK PLAN - AREA A
CLE A10 CLE A10		CLE H303 CLE H304	FIRST FLOOR PIPING NEW WORK PLAN - AREA C FIRST FLOOR PIPING NEW WORK PLAN - AREA D	WOS T201 WOS T202	FIRST FLOOR NEW WORK PLAN - AREA B FIRST FLOOR NEW WORK PLAN - AREA C
CLE A11	10 DEMOLITION ROOF PLAN AREA A&B	CLE H305	FIRST FLOOR PIPING NEW WORK PLAN - AREA E	WOS T203	FIRST FLOOR NEW WORK PLAN - AREA D
CLE A11 CLE A11	11 DEMOLITION ROOF PLAN AREA C 12 DEMOLITION ROOF PLAN AREA D&E	CLE H306 CLE H600	FIRST FLOOR PIPING NEW WORK PLAN - AREA F VRF PIPING SCHEMATICS	WOS T204 WOS T205	FIRST FLOOR NEW WORK PLAN - AREA E FIRST FLOOR NEW WORK PLAN - AREA F
CLE A11		CLE H600	VRF PIPING SCHEMATICS VRF PIPING SCHEMATICS	WOS 1203	DETAILS
CLE A20		CLE H900 CLE H901	HVAC SCHEDULES HVAC SCHEDULES	WOS T701 WOS T702	DETAILS DETAILS
CLE A20 CLE A20			SED CALCS	WOS 1702 WOS 1703	DETAILS
CLE A20	03 NEW WORK PLAN - AREA F			WOS T704	
CLE A21 CLE A21		PLUMBING WOS P000	PLUMBING LEGEND, NOTES, & DETAILS	SOUND & LOC	CKDOWN
CLE A21	12 NEW WORK ROOF PLAN AREA D&E	WOS P100	PARTIAL FIRST FLOOR PLUMBING DEMOLITION PLANS - AREAS A&B	CLES TOO1	KEY PLAN
CLE A21 CLE A50		WOS P101 WOS P102	PARTIAL FIRST FLOOR PLUMBING DEMOLITION PLAN - AREA C PARTIAL FIRST FLOOR PLUMBING DEMOLITION PLANS - AREAS E&F	CLES T100 CLES T101	FIRST FLOOR DEMOLITION PLAN - AREA A FIRST FLOOR DEMOLITION PLAN - AREA B
CLE ASC		WOS P102 WOS P200	PARTIAL FIRST FLOOR PLUMBING DEMOLITION PLANS - AREAS & A	CLES TIOT	FIRST FLOOR DEMOLITION PLAN - AREA B
CLE A60		WOS P201	PARTIAL FIRST FLOOR PLUMBING NEW WORK PLAN - AREA C	CLES T103	FIRST FLOOR DEMOLITION PLAN - AREA D
CLE A60 CLE A60		WOS P202	PARTIAL FIRST FLOOR PLUMBING NEW WORK PLANS - AREAS E&F	CLES T104 CLES T105	FIRST FLOOR DEMOLITION PLAN - AREA E FIRST FLOOR DEMOLITION PLAN - AREA F
CLE A60	03 REFLECTED CEILING PLAN - AREA F	PLUMBING		CLES T200	FIRST FLOOR PLAN NEW WORK - AREA A
CLE A70 CLE A70		CLE P101	RENOVATION PLAN	CLES T201 CLES T202	FIRST FLOOR PLAN NEW WORK - AREA B FIRST FLOOR PLAN NEW WORK - AREA C
CLE A70		ELECTRICAL		CLES T202 CLES T203	FIRST FLOOR PLAN NEW WORK - AREA C
CLE A80	01 VERTICAL CIRCULATION DETAILS	GEN E000	ELECTRICAL SYMBOLS LEGEND, NOTES & SYSTEM DIAGRAMS	CLES T204	FIRST FLOOR PLAN NEW WORK - AREA E
CLE A81 CLE A90				CLES T205 CLES T700	FIRST FLOOR PLAN NEW WORK - AREA F DETAILS
	D1 WINDOW TYPES	WOS E100	FIRST FLOOR DEMOLITION PLAN - AREA A	CLES T701	DETAILS
ARCHITECT	TURAL	WOS E101 WOS E102	FIRST FLOOR DEMOLITION PLAN - AREA B FIRST FLOOR DEMOLITION PLAN - AREA C	CLES T702 CLES T703	DETAILS DETAILS
TZHS A10	00 DEMOLITION PLAN	WOS E102 WOS E103	FIRST FLOOR DEMOLITION PLAN - AREA D	CLES 1703	DETAILS
TZHS A20	00 NEW WORK PLAN	WOS E104	FIRST FLOOR DEMOLITION PLAN - AREA E		




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	District Office Address 160 VAN WYCK R	П	CERTIFICATE #018330 REGISTRATION EXPIR. DA Lauren Tarsio 09/30/26 Richard Waite 11/30/23 Larry Werts 12/31/24
	BLAUVELT, NY 109		Anthony Marchetti 05/31/24 Dave Hart 02/28/25 Jennifer Wengender 06/30/24
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SOUTH ORANGETON Central School Dist Capital Improvements Bong Health, Safety and Success SOUTH ORANGETOWN CENTRAL PHASE 1: 2022 BOND CERTIFICATE #018330 REGISTRATION EXPIR. DATES: Lauren Tarsio 09/30/26 Richard Waite 11/30/23 160 VAN WYCK RD. Larry Werts 12/31/24 BLAUVELT, NY 10913 Anthony Marchetti 05/31/24 Dave Hart 02/28/25 Jennifer Wengender 06/30/24 WILLIAM O. SCHAEFER SED#:50-03-01-06-0-012-019 COTTAGE LANE ELEMENTARY SED#:50-03-01-06-0-010-022

TAPPAN ZEE HIGH SCHOOL SED#:50-03-01-06-0-006-032


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CLE OUTDOOR CLASSROOM SED#:50-03-01-06-7-054-001 TZHS OUTDOOR CLASSROOM SED#:50-03-01-06-7-055-001

PROJECT ISSUE & REVISION SCHEDULE

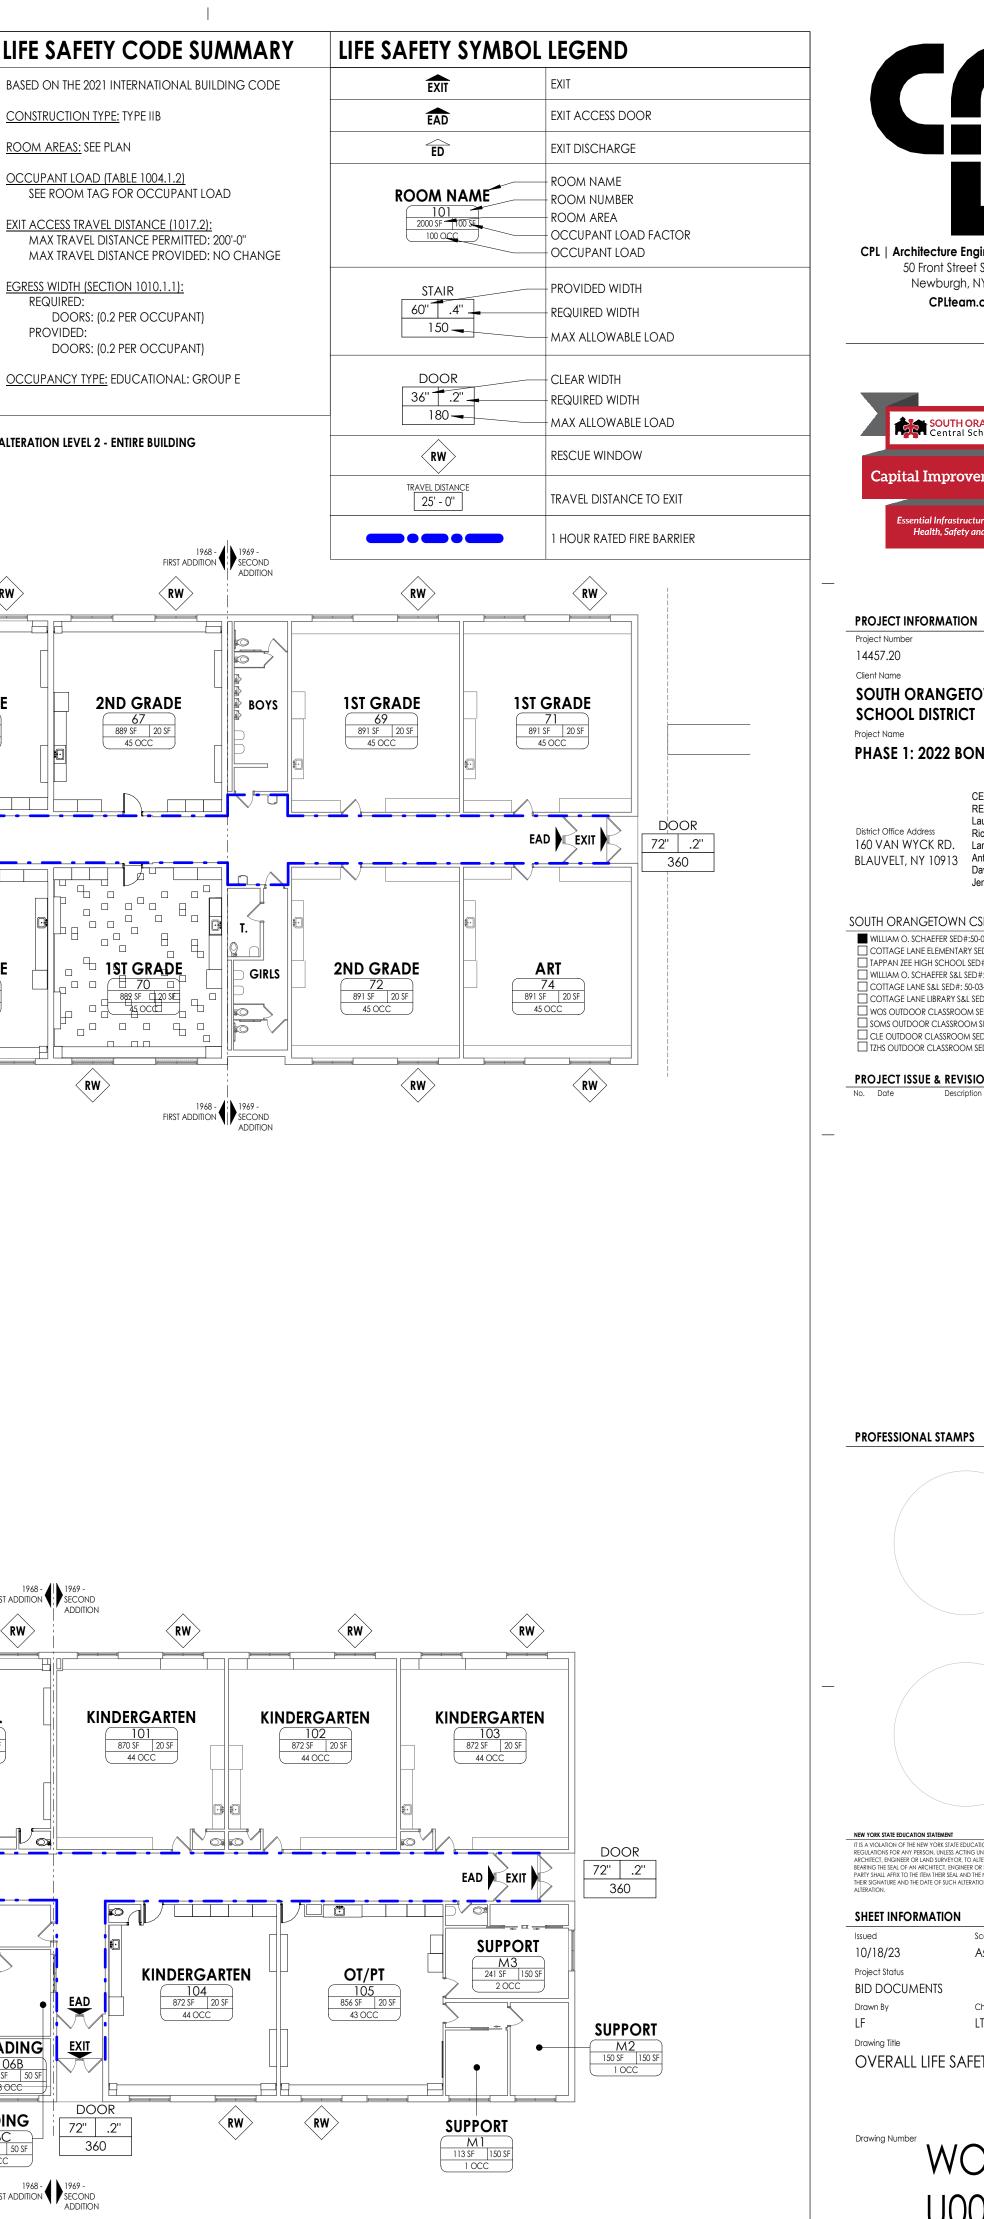
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WOS



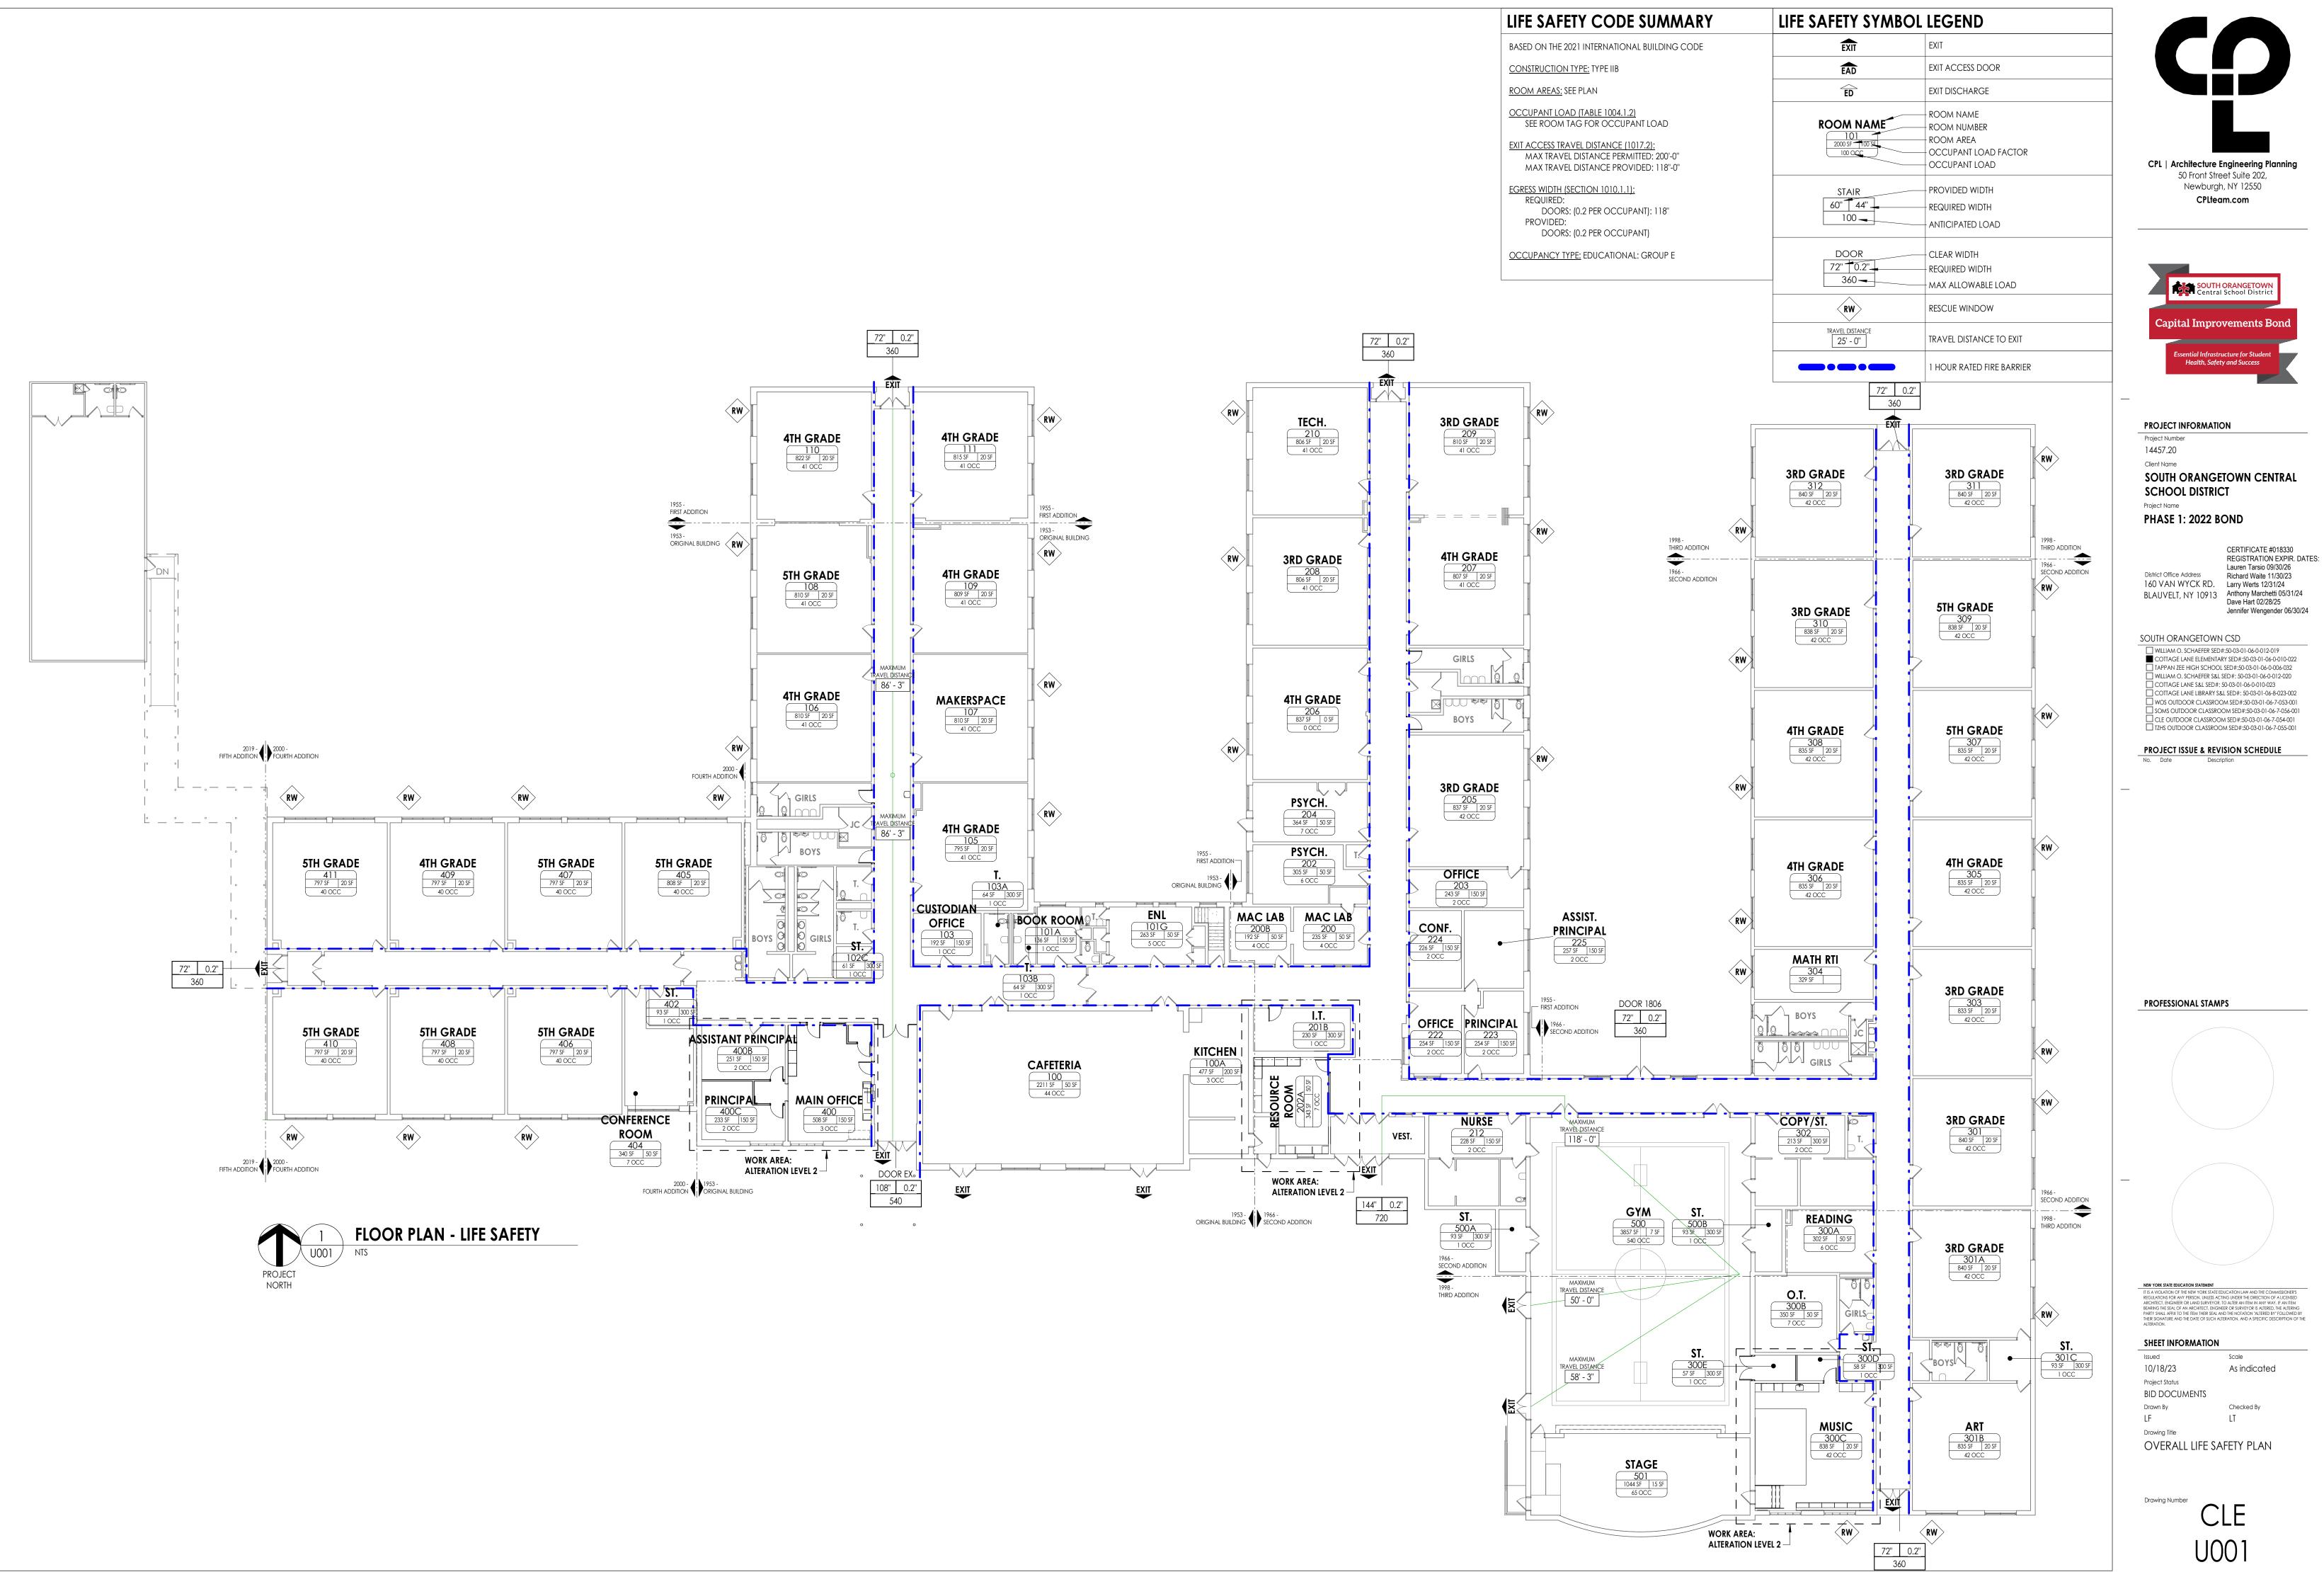

ASBESTOS ABATEMENT GENERAL NOTES

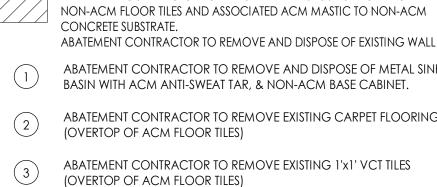

ABATEMENT CONTRACTOR TO REMOVE AND DISPOSE OF BOTH ACM AND


- ABATEMENT CONTRACTOR TO REMOVE AND DISPOSE OF EXISTING WALL BASE. ABATEMENT CONTRACTOR TO REMOVE AND DISPOSE OF METAL SINK
- ABATEMENT CONTRACTOR TO REMOVE EXISTING CARPET FLOORING
- ABATEMENT CONTRACTOR TO REMOVE EXISTING 1'x1' VCT TILES (OVERTOP OF ACM FLOOR TILES)

GENERAL ASBESTOS DEMOLITION NOTES:

- ALL DRAWINGS ARE A GRAPHIC REPRESENTATION OF APPROXIMATE LOCATIONS OF MATERIALS TO BE ABATED. IF THERE ARE ANY DISCREPANCIES WITH WHAT EXISTS TO WHAT IS INDICATED ON THE CONTRACT DOCUMENTS, THE CONTRACTOR SHALL REPORT SAID DISCREPANCIES TO THE ARCHITECT PRIOR TO SUBMITTING A BID. THE INTENT OF THIS PROJECT IS TO COMPLETELY REMOVE ASBESTOS CONTAINING MATERIALS INDICATED AND TO PROVIDE A CLEAN ACM FREE WORK AREA POST ABATEMENT.
- ALL ABATEMENT PROCEDURES TO BE IN ACCORDANCE WITH STANDARDS SET FORTH BY NEW YORK STATE DEPARTMENT OF LABOR INDUSTRIAL CODE RULE 56 AND ALL APPLICABLE REGULATIONS.
- THE CONTRACTOR SHALL PATCH TO MATCH ANY DISTURBED AREAS AND FINISHES AS A RESULT OF THEIR ABATEMENT WORK. ANY DAMAGE SHALL BE REPAIRED TO THE OWNER'S AND ARCHITECT'S SATISFACTION AT NO ADDITIONAL COST TO THE OWNER.
- THE CONTRACTOR SHALL COORDINATE THE LOCATION OF THE ASBESTOS DUMPSTER WITH THE OWNER.
- THE CONTRACTOR MAY APPLY FOR PROJECT SPECIFIC VARIANCES. USE OF SUCH VARIANCES ARE SUBJECT TO APPROVAL BY THE OWNER AND ARCHITECT.

CPL | Architecture Engineering Planning 50 Front Street Suite 202, Newburgh, NY 12550 CPLteam.com SO SO Central School Di apital Improvements Bong Health, Safety and Success **PROJECT INFORMATION** Project Number 14457.20 Client Name SOUTH ORANGETOWN CENTRAL SCHOOL DISTRICT Project Name PHASE 1: 2022 BOND CERTIFICATE #018330 REGISTRATION EXPIR. DATES: Lauren Tarsio 09/30/26 District Office Address Richard Waite 11/30/23 160 VAN WYCK RD. Larry Werts 12/31/24 BLAUVELT, NY 10913 Anthony Marchetti 05/31/24 Dave Hart 02/28/25 Jennifer Wengender 06/30/24 south orangetown CSD WILLIAM O. SCHAEFER SED#:50-03-01-06-0-012-019 COTTAGE LANE ELEMENTARY SED#:50-03-01-06-0-010-022 TAPPAN ZEE HIGH SCHOOL SED#:50-03-01-06-0-006-032 WILLIAM O. SCHAEFER S&L SED#:50-03-01-06-0-012-020 COTTAGE LANE S&L SED#: 50-03-01-06-0-010-023 COTTAGE LANE LIBRARY S&L SED#: 50-03-01-06-8-023-002 WOS OUTDOOR CLASSROOM SED#: 50-03-01-06-7-053-001 SOMS OUTDOOR CLASSROOM SED#:50-03-01-06-7-056-001 CLE OUTDOOR CLASSROOM SED#:50-03-01-06-7-054-001 TZHS OUTDOOR CLASSROOM SED#:50-03-01-06-7-055-001 PROJECT ISSUE & REVISION SCHEDULE No. Date Description

PROFESSIONAL STAMPS

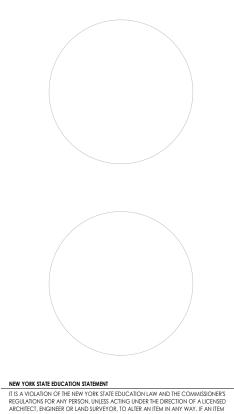

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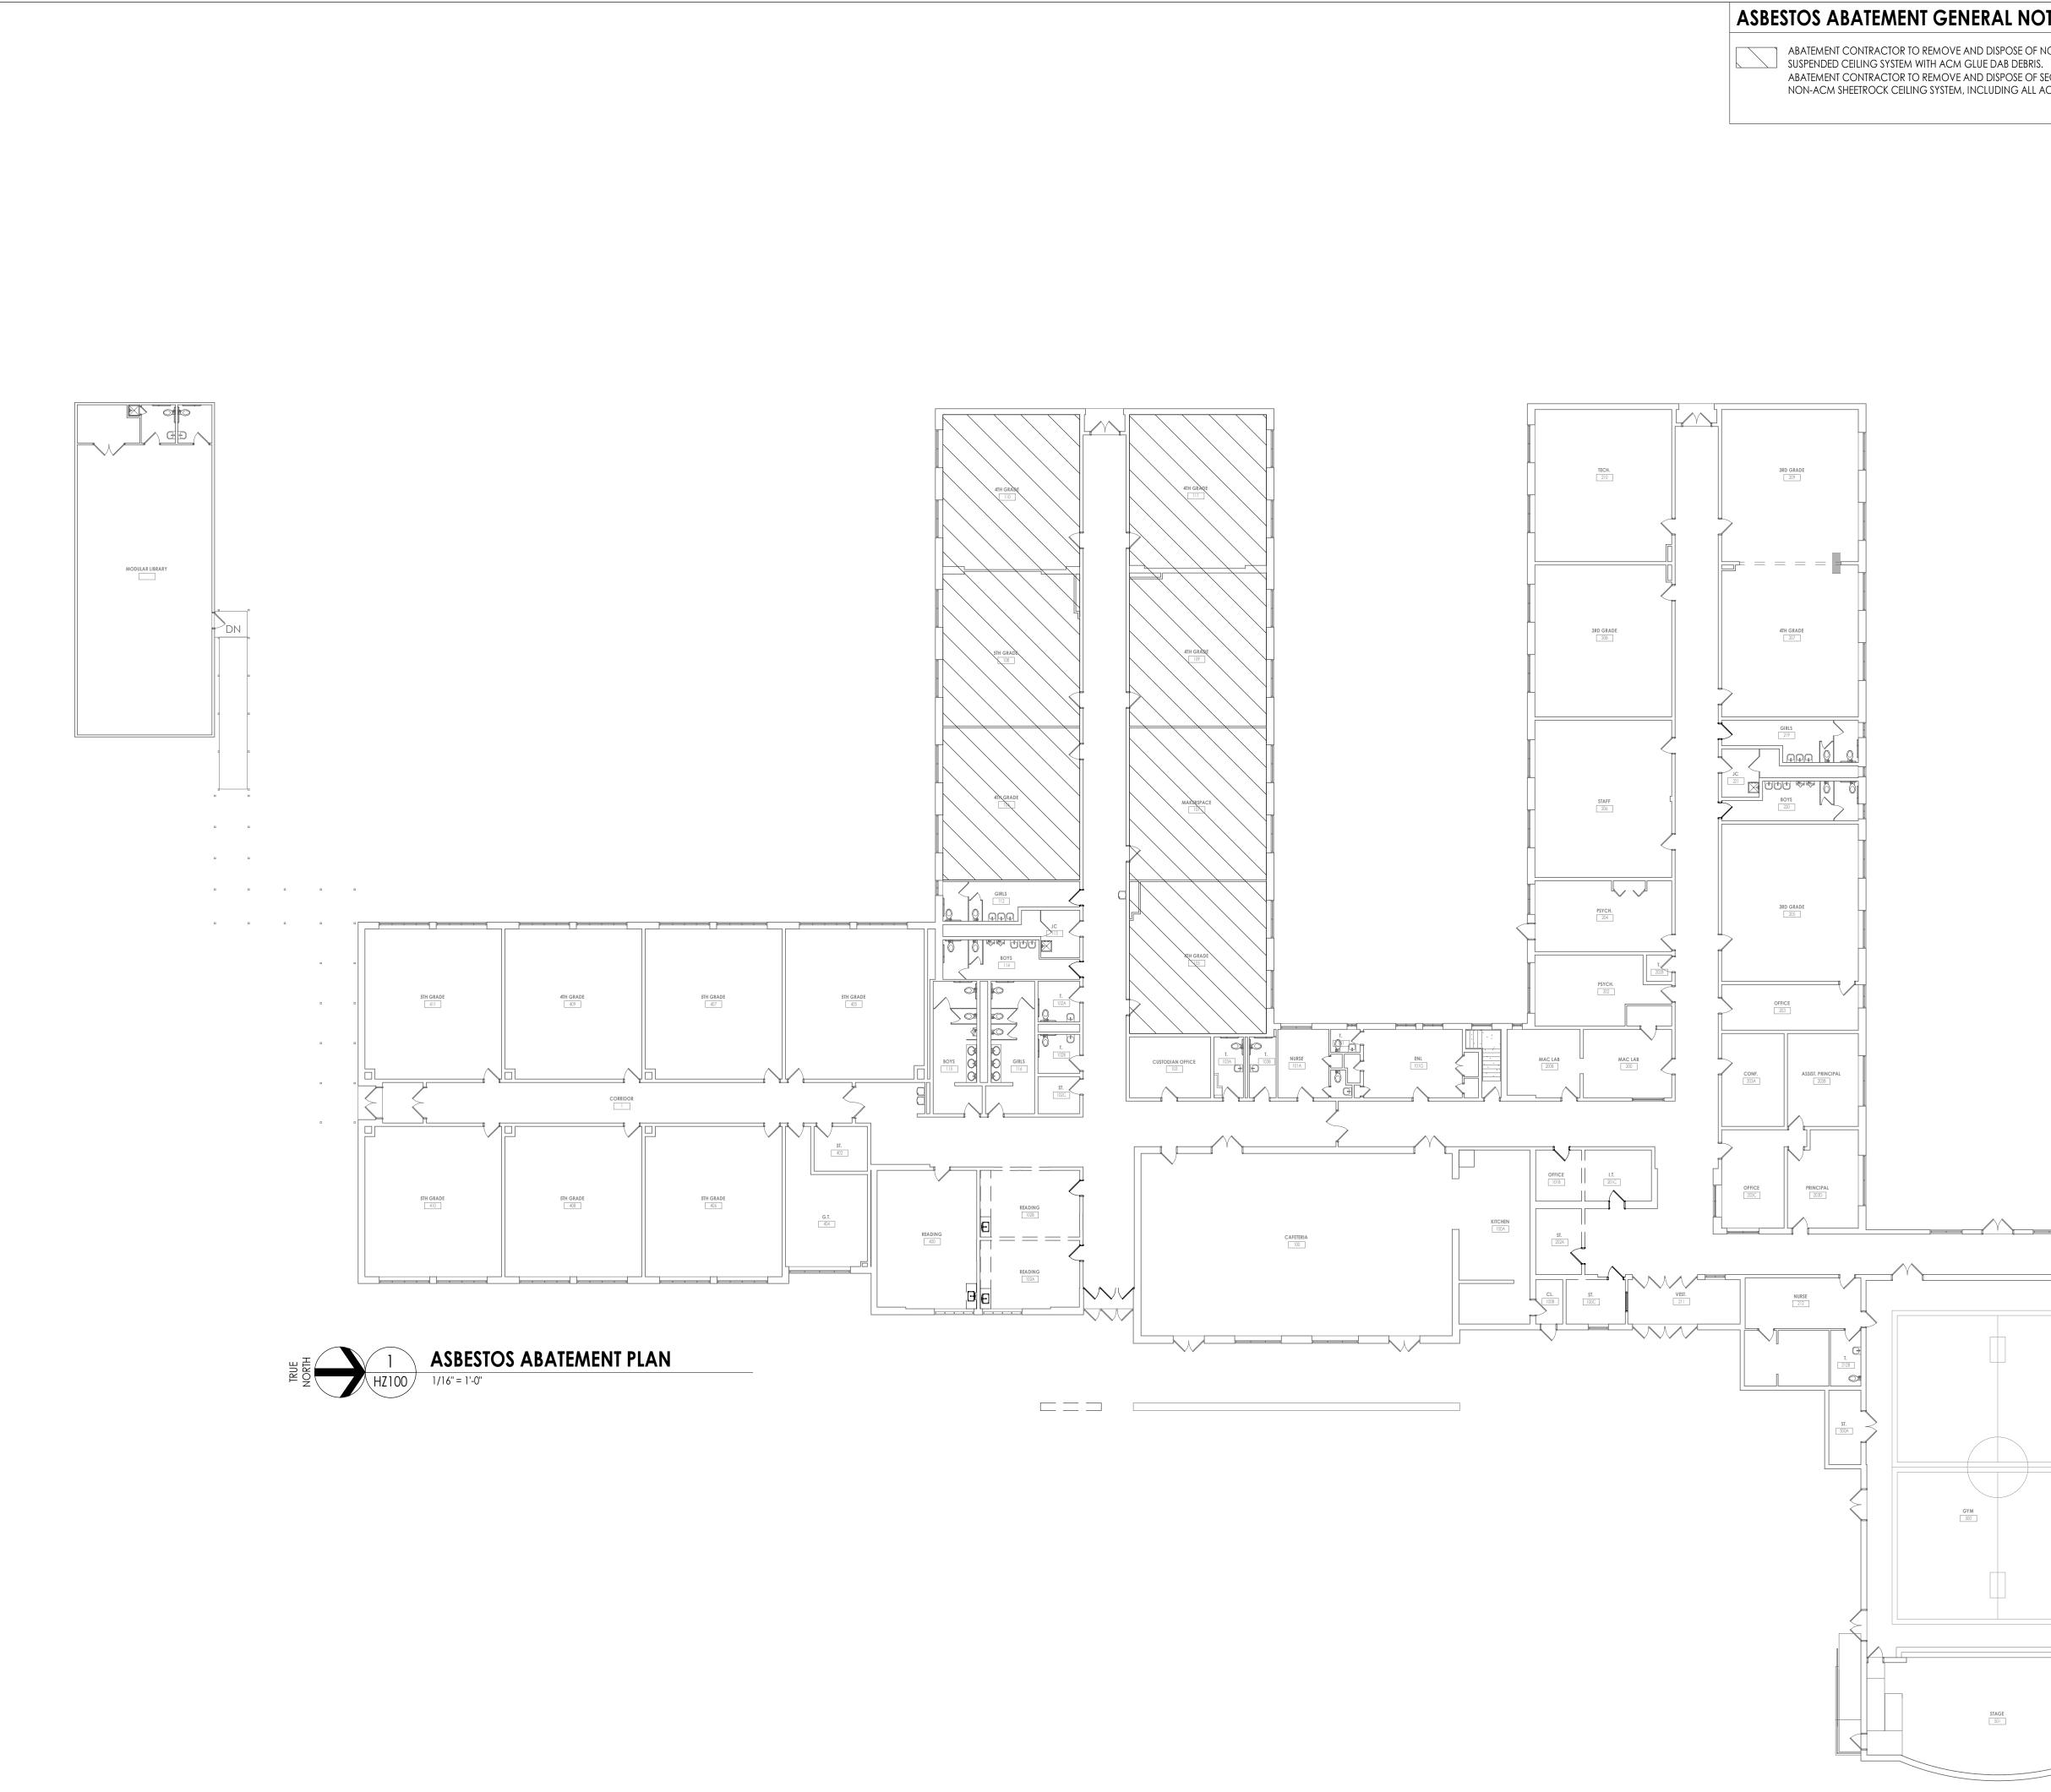
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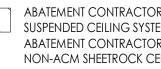
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ASBESTOS ABATEMENT PLAN










ABATEMENT CONTRACTOR TO REMOVE AND DISPOSE OF NON-ACM ABATEMENT CONTRACTOR TO REMOVE AND DISPOSE OF SECONDARY NON-ACM SHEETROCK CEILING SYSTEM, INCLUDING ALL ACM GLUE DABS.

ABATEMENT GENERAL NOTES

- ALL DRAWINGS ARE A GRAPHIC REPRESENTATION OF APPROXIMATE LOCATIONS OF MATERIALS TO BE ABATED. IF THERE ARE ANY DISCREPANCIES WITH WHAT EXISTS TO WHAT IS INDICATED ON THE CONTRACCT DOCUMENTS, THE CONTRACTOR SHALL REPORT SAID DISCREPANCIES TO THE ARCHITECT PRIOR TO SUBMITTING A BID. THE INTENT OF THIS PROJECT IS TO COMPLETELY REMOVE ASBESTOS CONTAINING MATERIALS INDICATED AND TO PROVIDE A CLEAN ACM FREE WORK AREA POST ABATEMENT.
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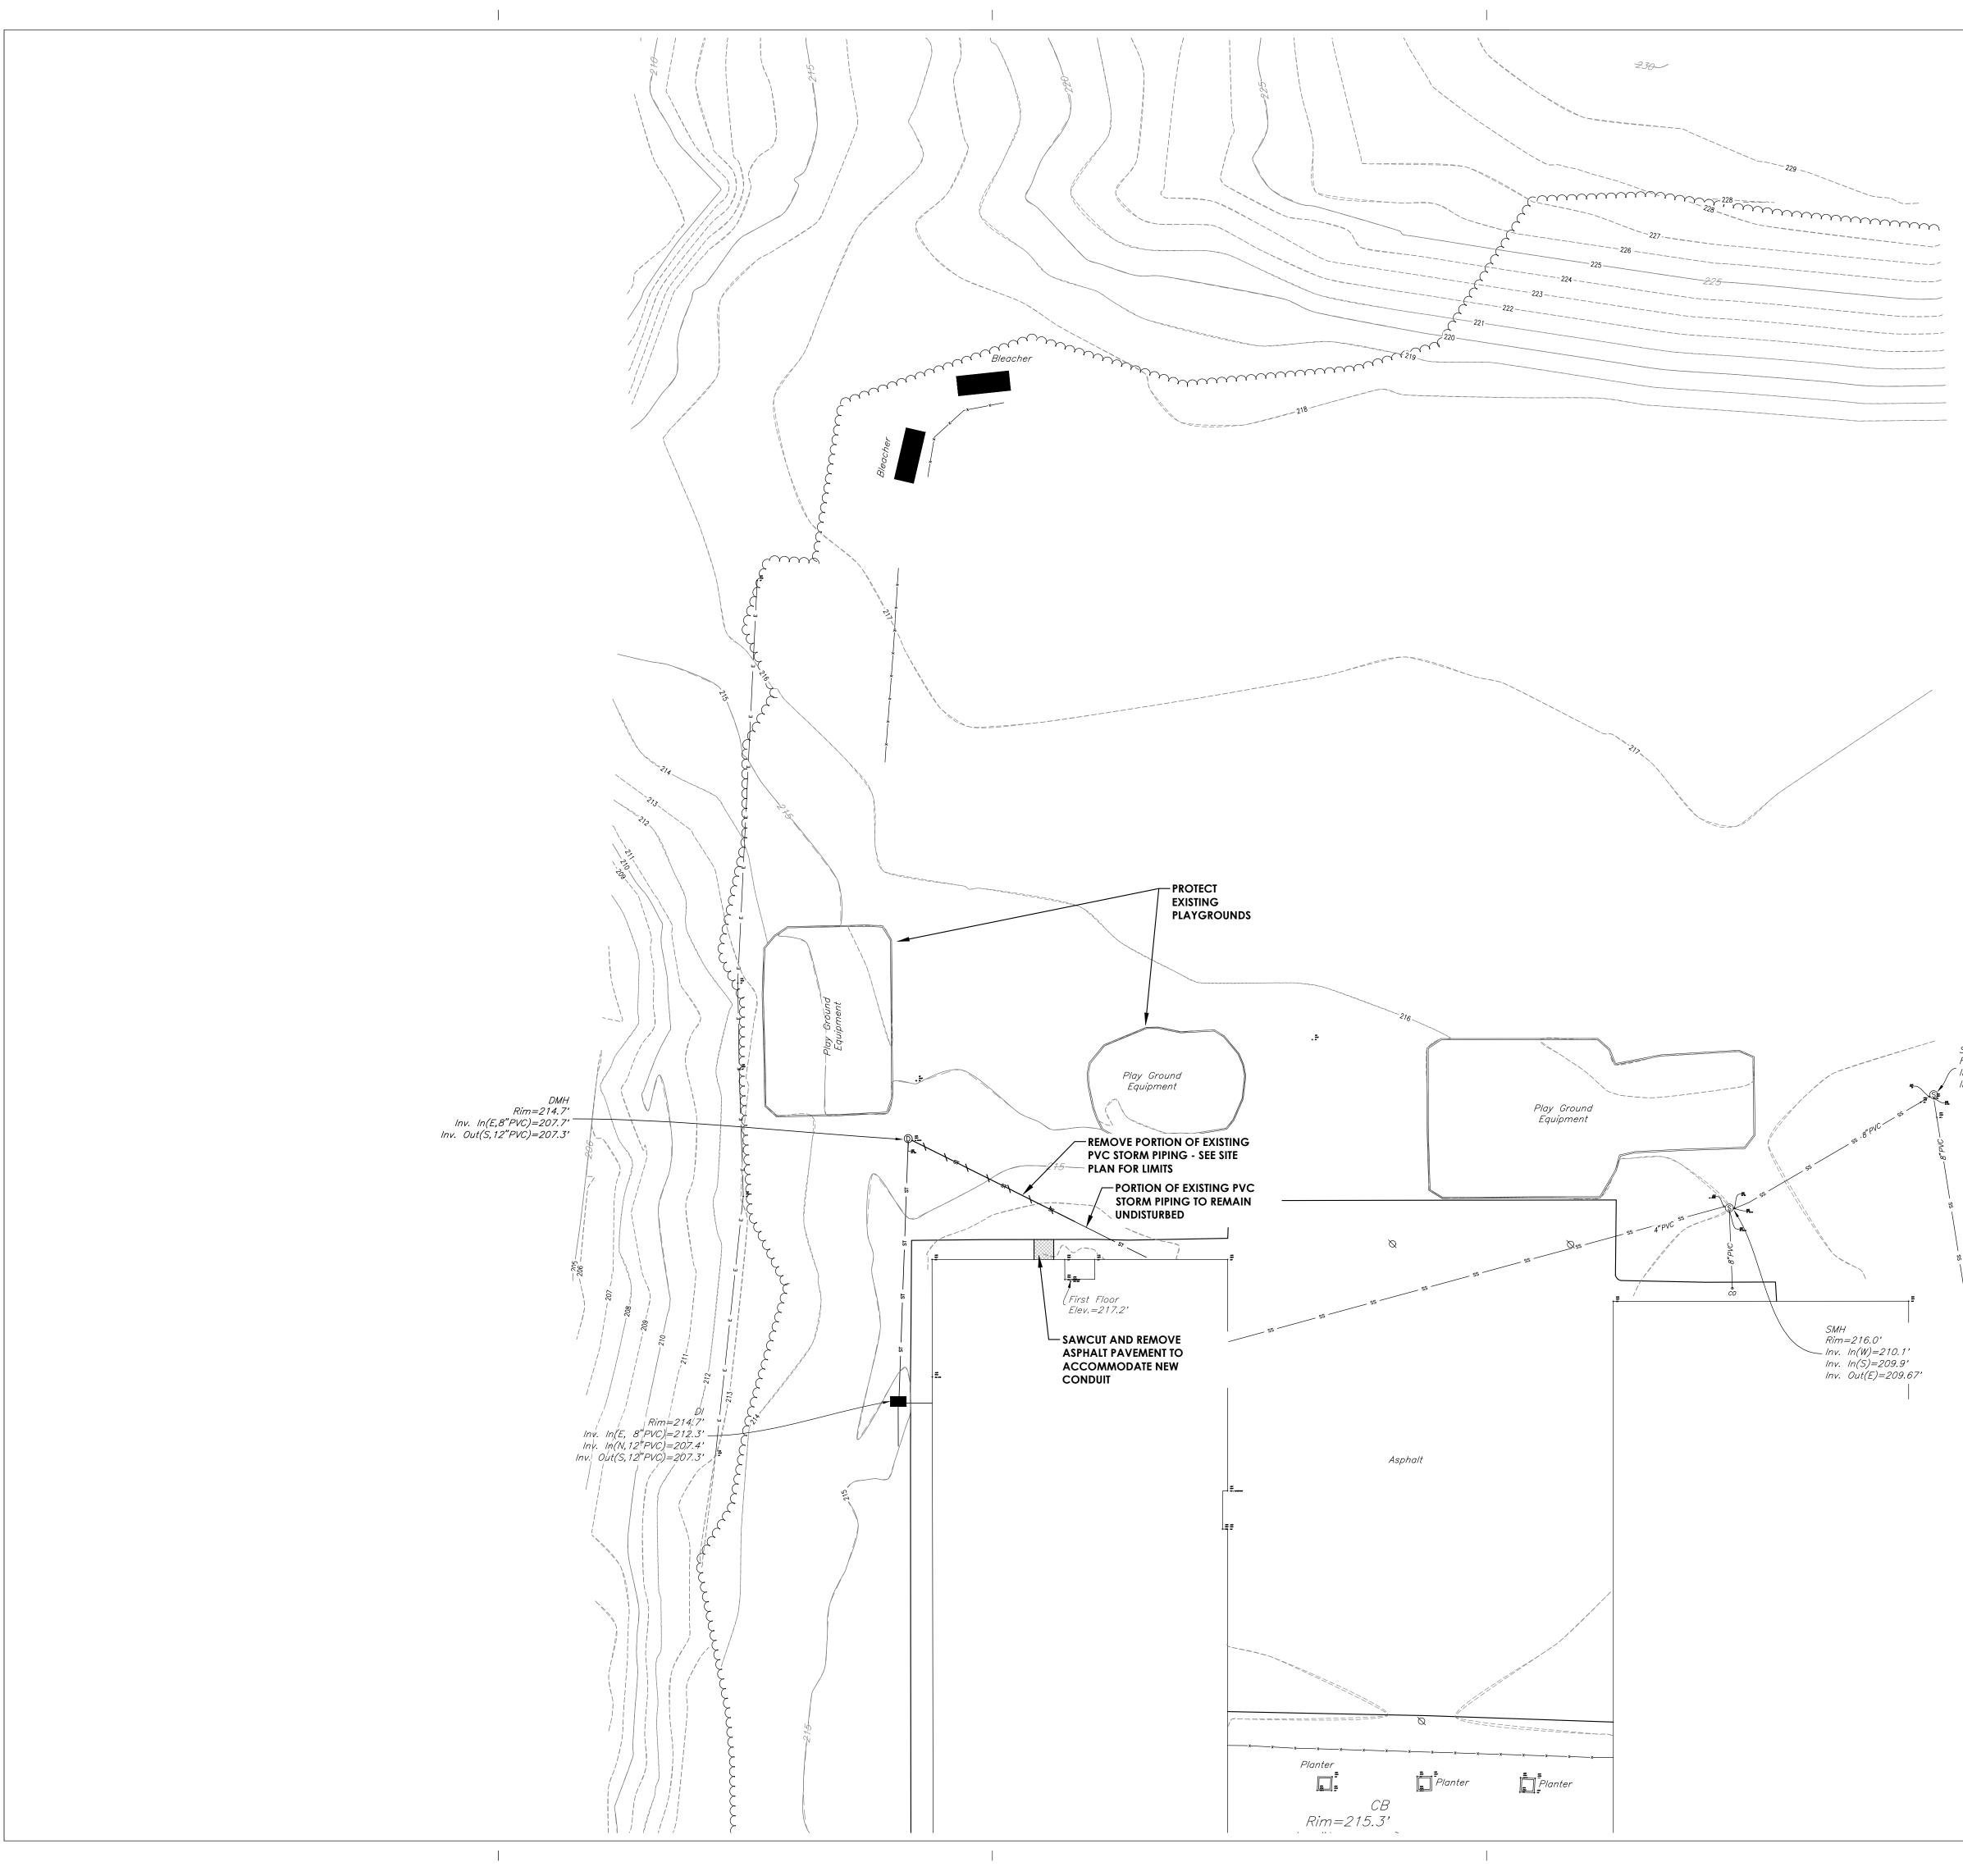


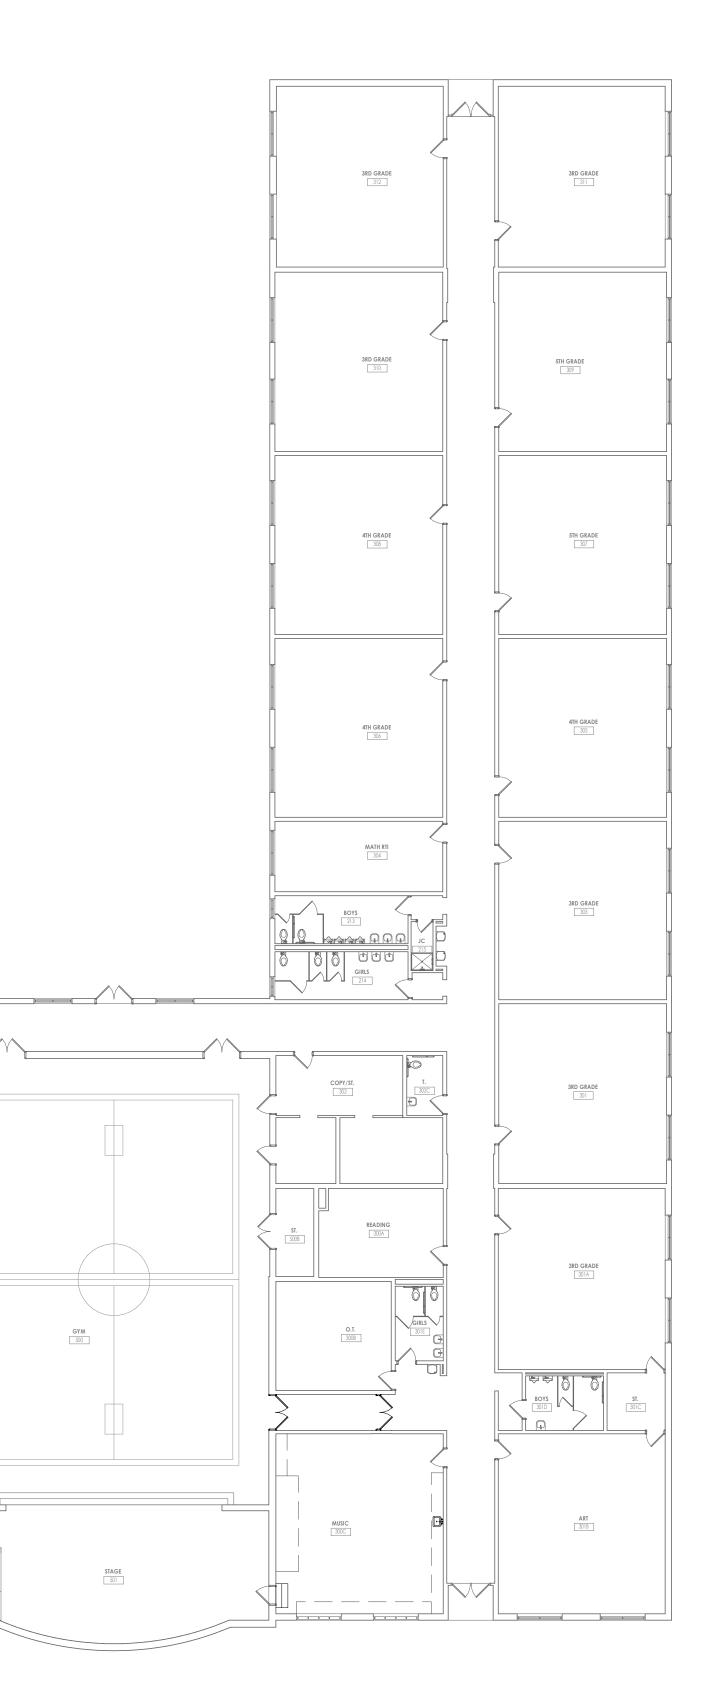
CPL | Architecture Engineering Planning 50 Front Street Suite 202, Newburgh, NY 12550 CPLteam.com <u>apital Improvements Bon</u>g PROJECT INFORMATION Project Number 14457.20 Client Name SOUTH ORANGETOWN CENTRAL SCHOOL DISTRICT Project Name PHASE 1: 2022 BOND CERTIFICATE #018330 REGISTRATION EXPIR. DATES: Lauren Tarsio 09/30/26 District Office Address Richard Waite 11/30/23 160 VAN WYCK RD. Larry Werts 12/31/24 BLAUVELT, NY 10913 Anthony Marchetti 05/31/24 Dave Hart 02/28/25 Jennifer Wengender 06/30/24 South orangetown CSD WILLIAM O. SCHAEFER SED#:50-03-01-06-0-012-019 COTTAGE LANE ELEMENTARY SED#:50-03-01-06-0-010-022 TAPPAN ZEE HIGH SCHOOL SED#:50-03-01-06-0-006-032 WILLIAM O. SCHAEFER S&L SED#: 50-03-01-06-0-012-020 COTTAGE LANE S&L SED#: 50-03-01-06-0-010-023 COTTAGE LANE LIBRARY S&L SED#: 50-03-01-06-8-023-002 WOS OUTDOOR CLASSROOM SED#:50-03-01-06-7-053-001 SOMS OUTDOOR CLASSROOM SED#:50-03-01-06-7-056-001 CLE OUTDOOR CLASSROOM SED#:50-03-01-06-7-054-001 TZHS OUTDOOR CLASSROOM SED#:50-03-01-06-7-055-001 **PROJECT ISSUE & REVISION SCHEDULE** No. Date Description PROFESSIONAL STAMPS EW YORK STATE EDUCATION STATE DLATION OF THE NEW YORK STATE EDUCATION LAW AND THE COM EGULATIONS FOR ANY PERSON, UNLESS ACTING UNDER THE DIRECTION OF A LICENS RCHITECT, ENGINEER OR LAND SURVEYOR, TO ALTER AN ITEM IN ANY WAY. IF AN ITE BEARING THE SEAL OF AN ARCHITECT, ENGINEER OR SURVEYOR IS ALTERED, PARTY SHALL AFFIX TO THE ITEM THEIR SEAL AND THE NOTATION "ALTERED BY SHEET INFORMATION Issued Scale 10/18/23 As indicated Project Status **BID DOCUMENTS** Drawn By Checked By LF LT Drawing Title

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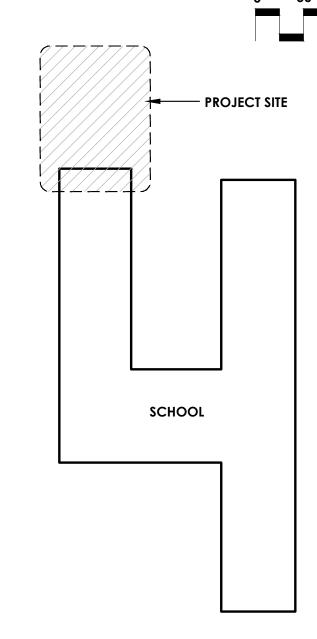
ASBESTOS ABATEMENT PLAN






SMH Rim=215.7'

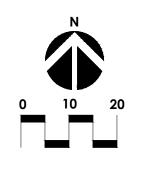(Inv. In(SW)=210.5' Inv. Out(SE)=210.4' #





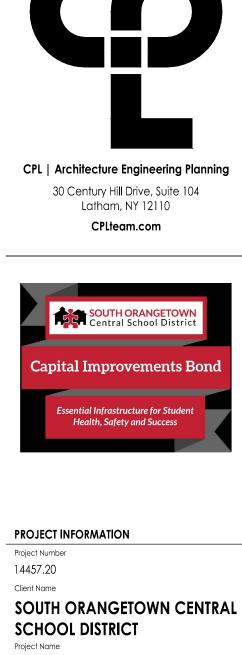

PHASE 1: 2022 BOND

CERTIFICATE #018330 Project Address

REGISTRATION EXPIR. DATES: Lauren Tarsio 09/30/26 Richard Waite 11/30/23 160 VAN WYCK RD. Larry Werts 12/31/24 BLAUVELT, NY 109134 Anthony Marchetti 05/31/24 Dave Hart 02/28/25 Jennifer Wengender 06/30/24

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 WILLIAM O SCHAEFER SED#: 50-03-01-06-0-012-019

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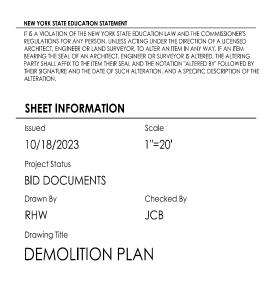
PROJECT ISSUE & REVISION SCHEDULE No. Date Description

PROFESSIONAL STAMPS


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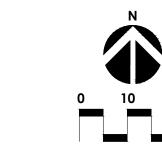





SMH

Rim=216.0'

_____ Inv. In(W)=210.1'

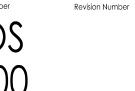

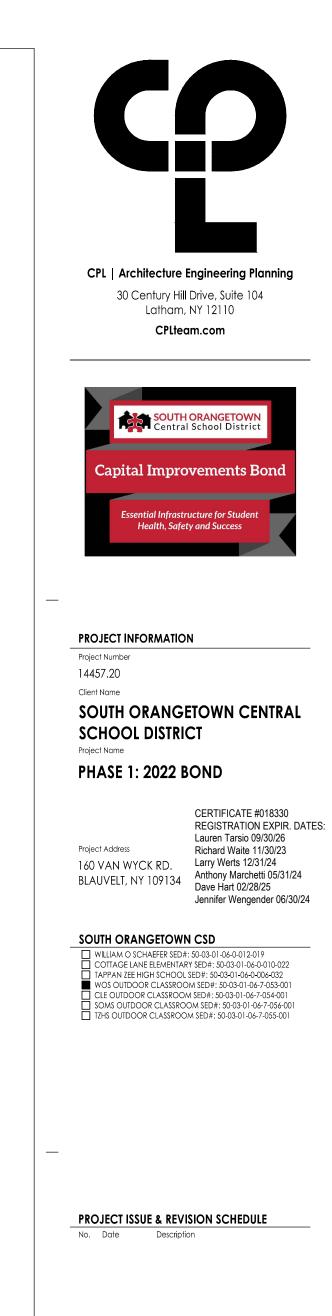


ALL DISTURBED AREAS ARE TO RECEIVE 6" OF APPROVED TOPSOIL AND BE SEEDED WITH 5311 CONSERVATION MIX (ERNMX-114 BY ERNST SEEDS) @ 100-200 POUNDS PER ACRE

30.0% Festuca rubra (Creeping Red Fescue) 25.0% Poa pratensis, 'Selway' (Kentucky Bluegrass, 'Selway') 25.0% Poa pratensis, Appalachian (Kentucky Bluegrass, Appalachian) 10.0% Lolium multiflorum (Annual Ryegrass)



10.0% Lolium perenne, 'Confetti III' (Perennial Ryegrass, 'Confetti III' (turf type)



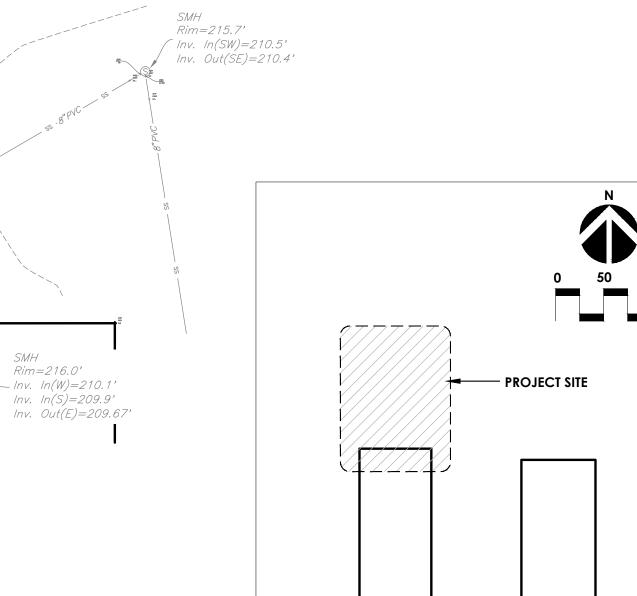

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SITE PLAN	

Revision Number




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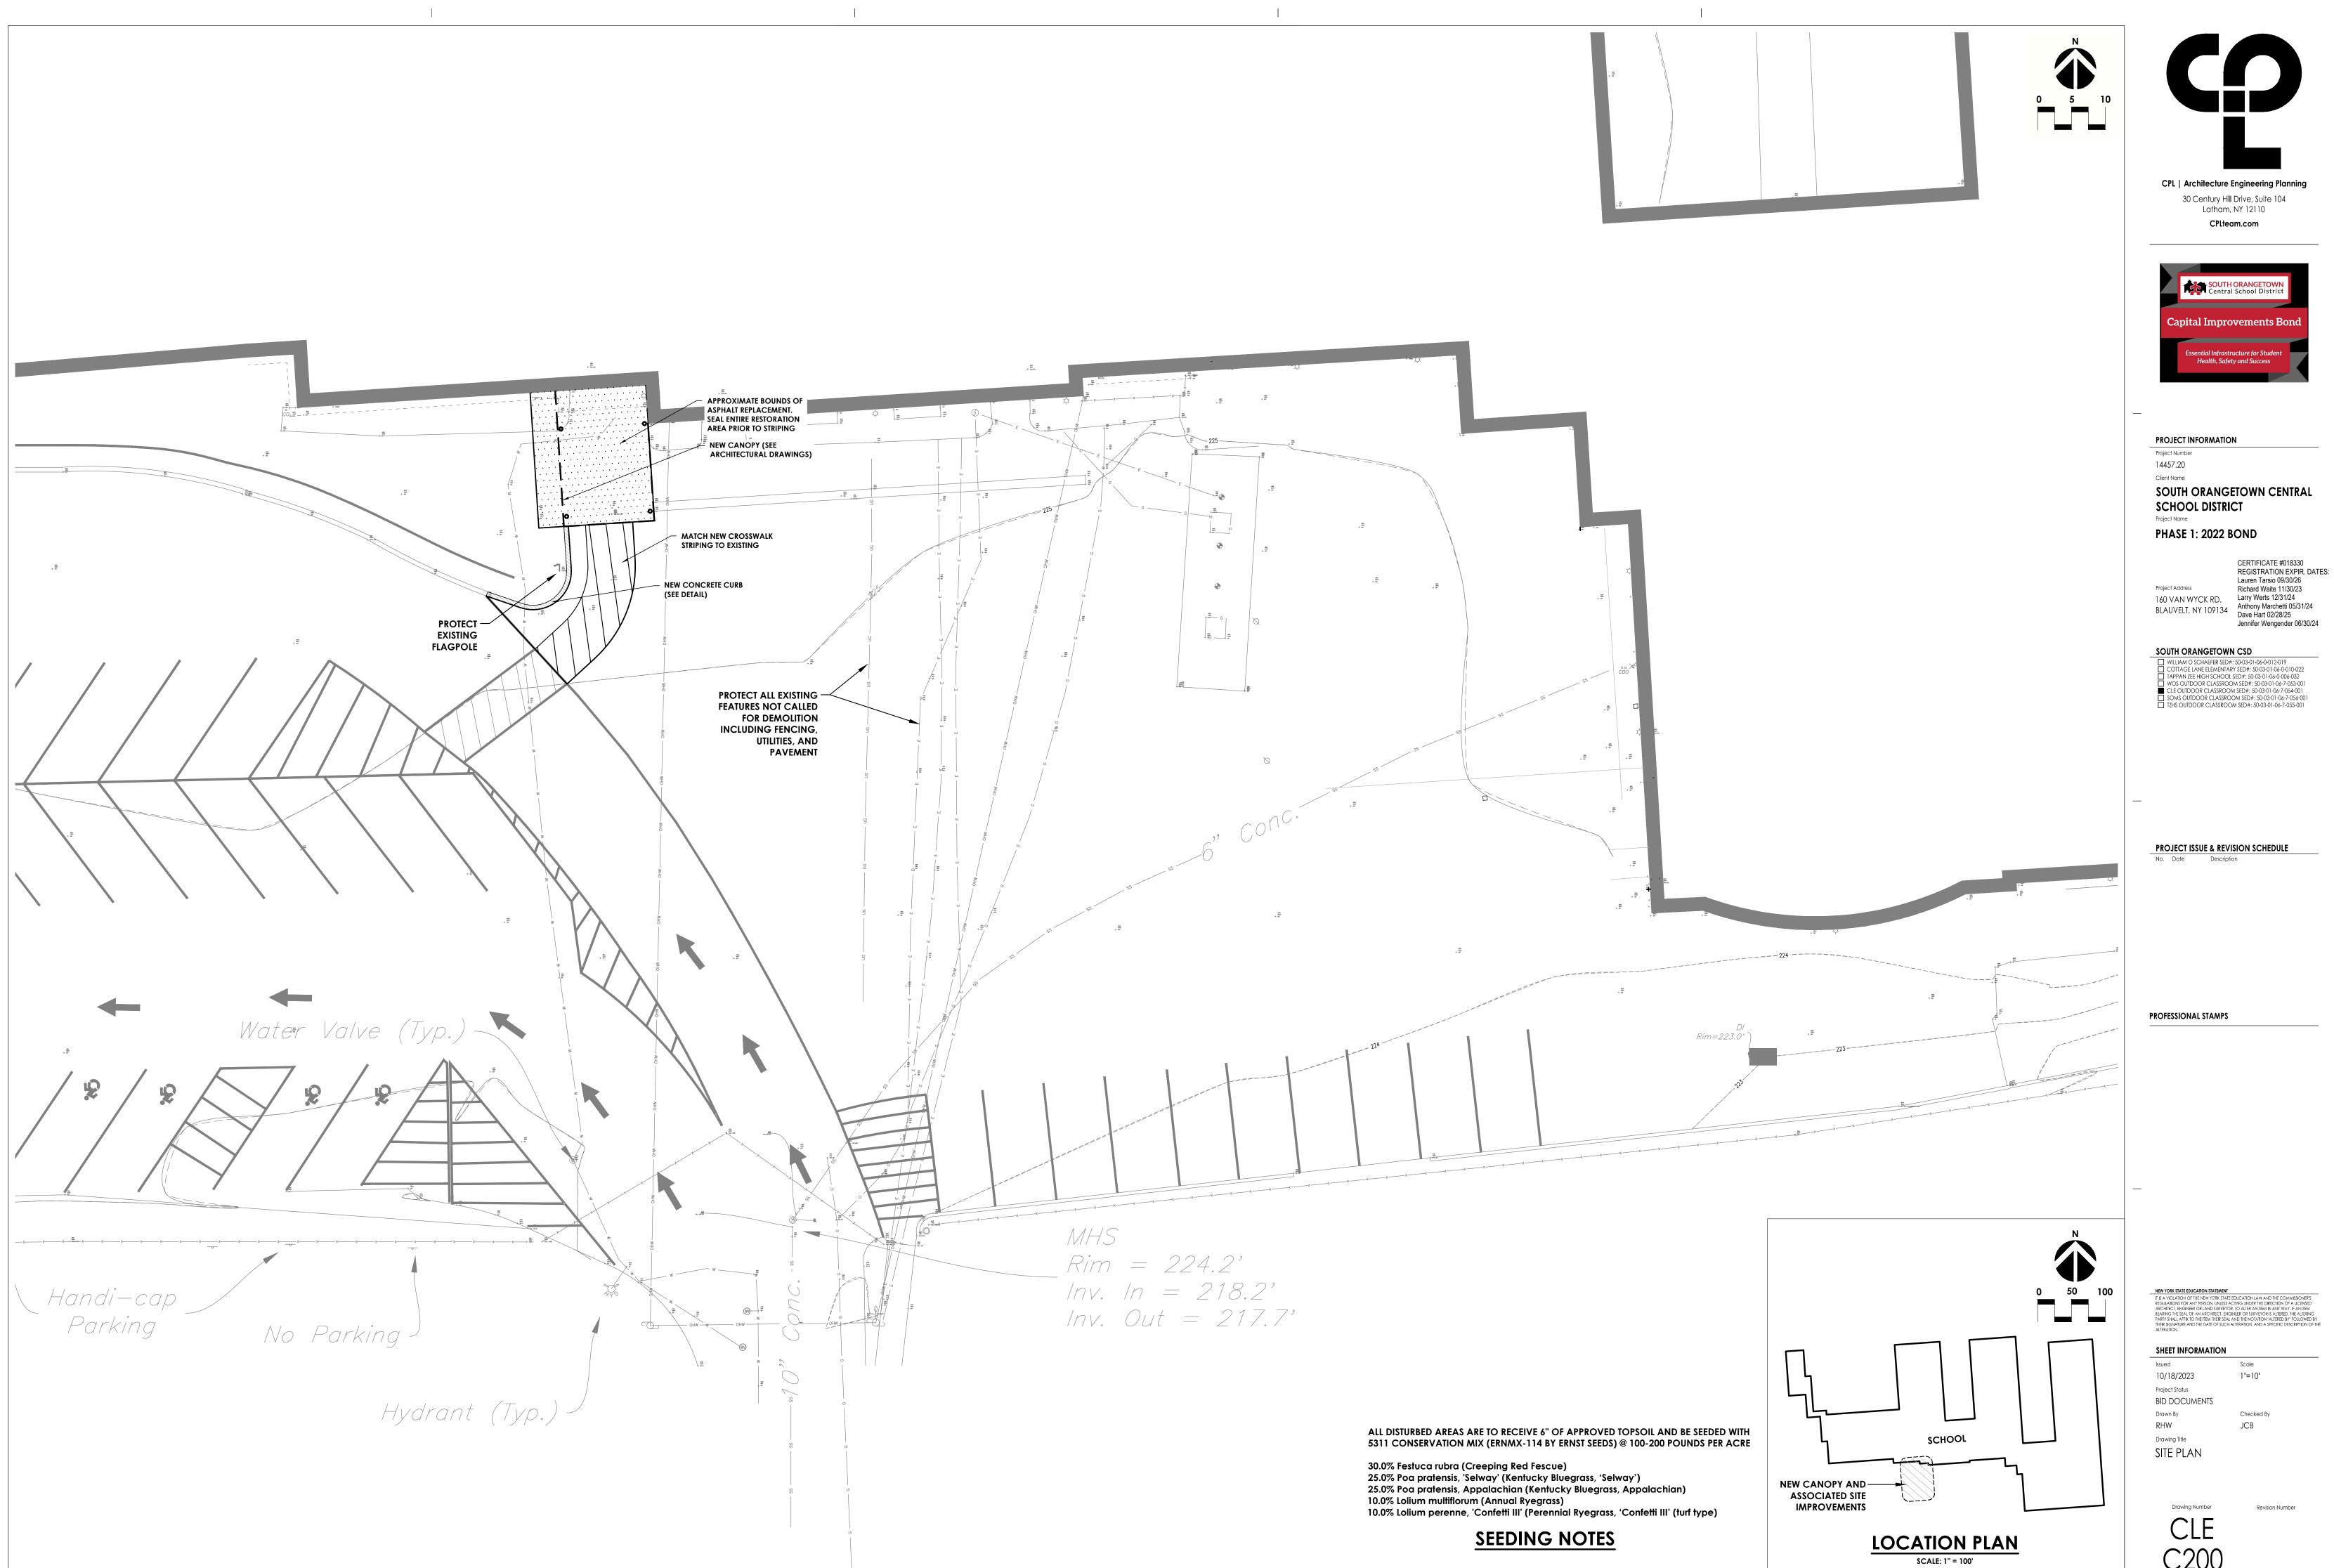
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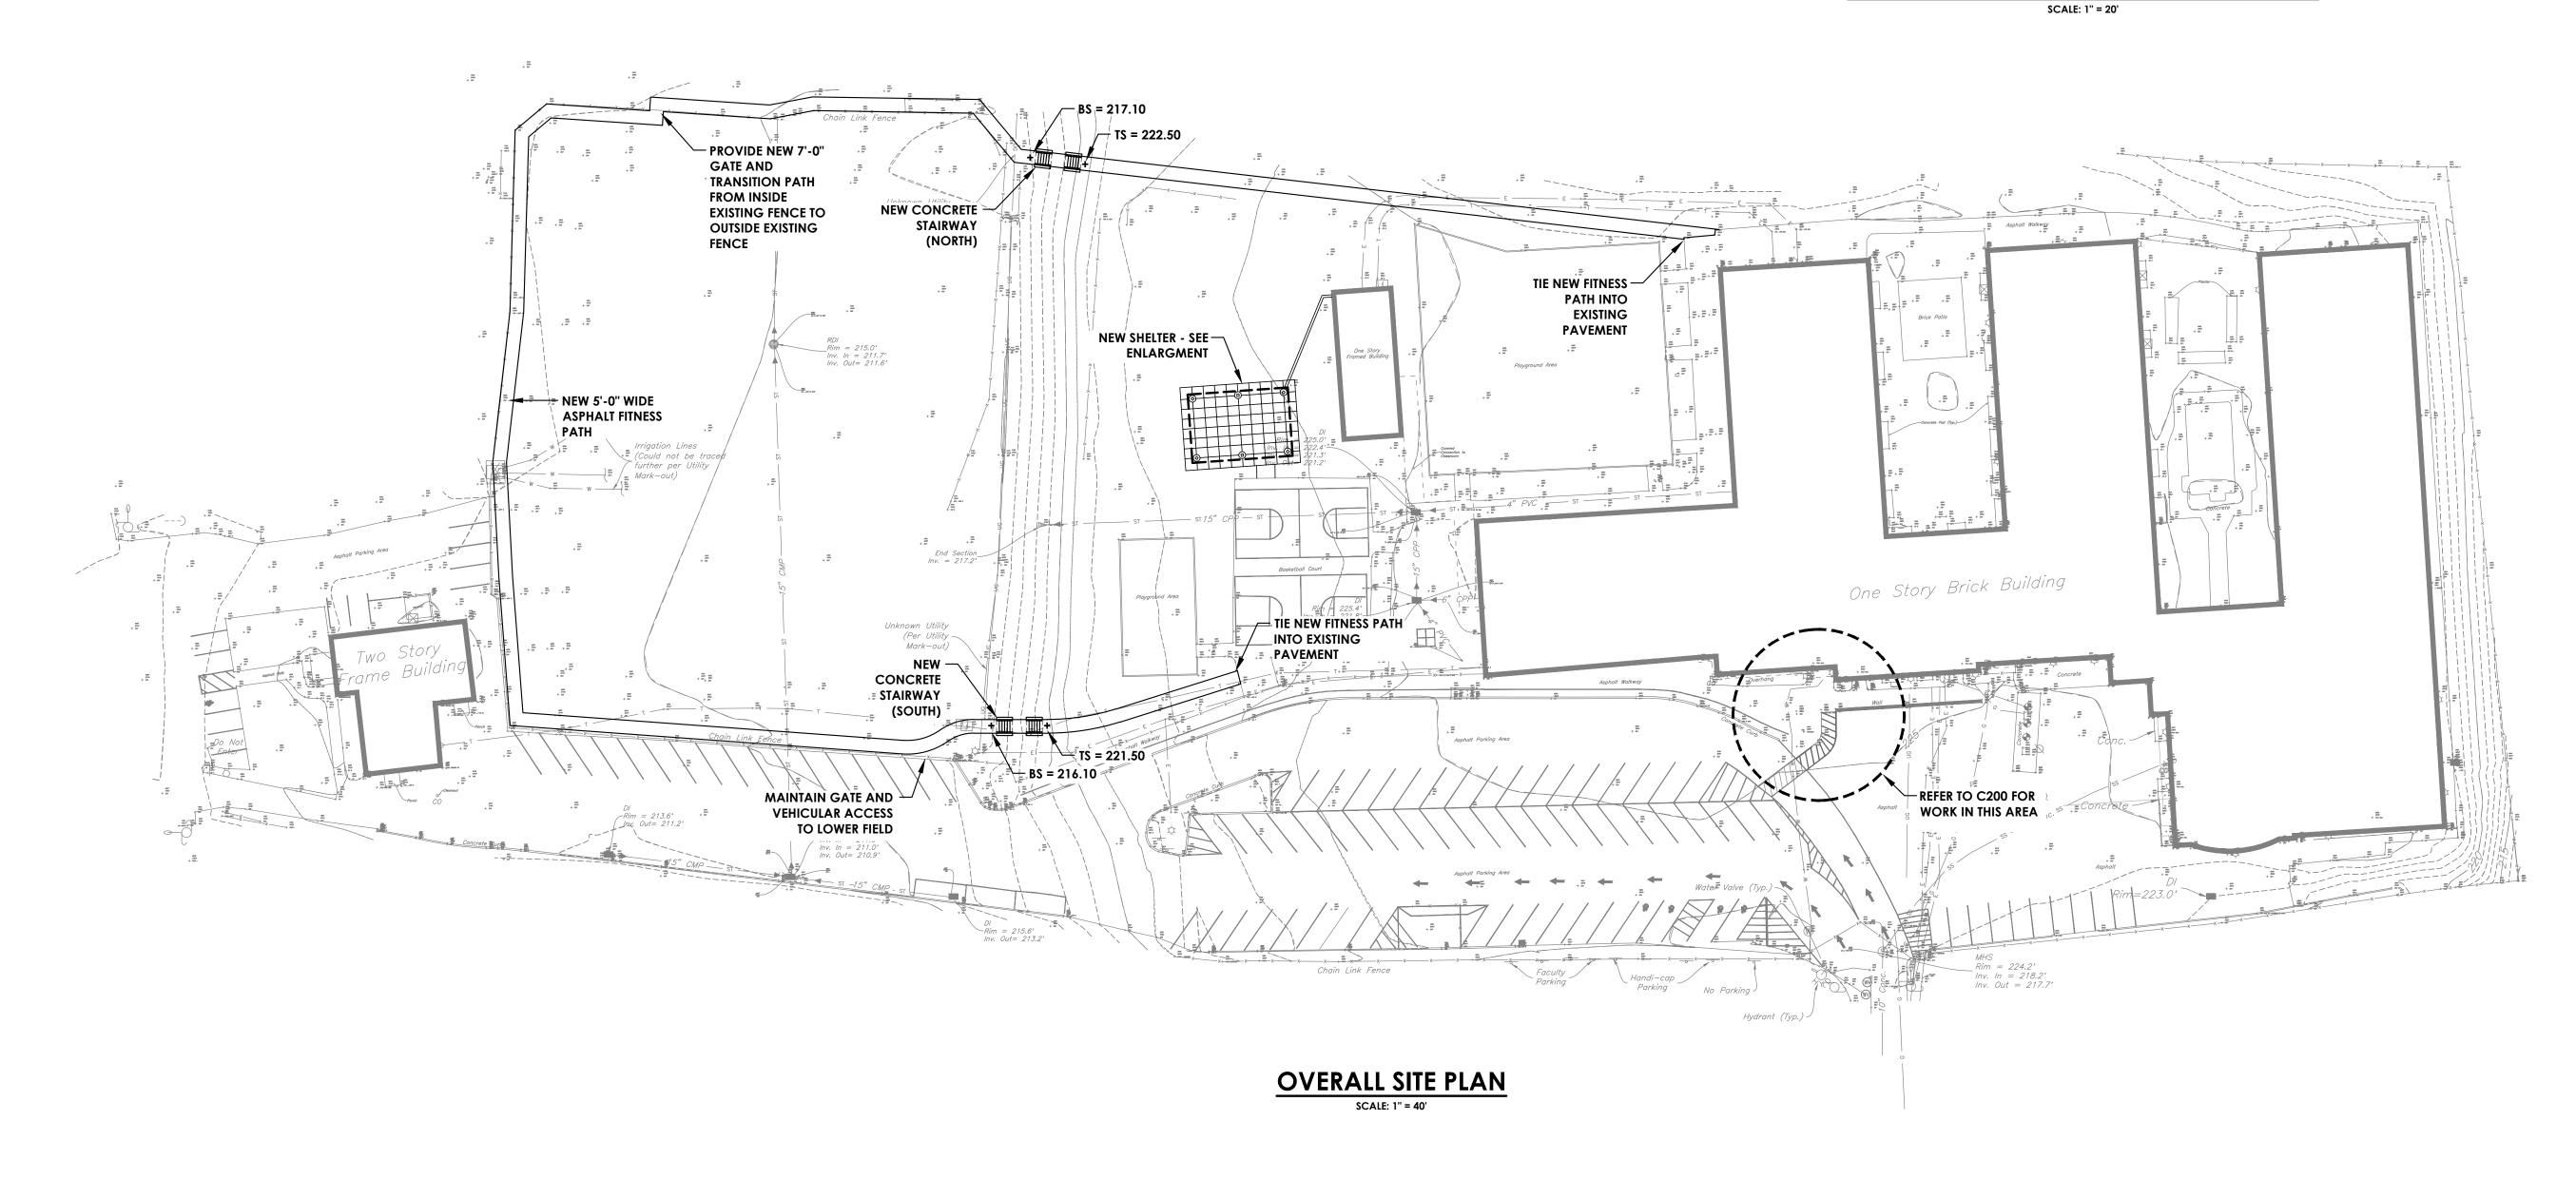




SEEDING NOTES





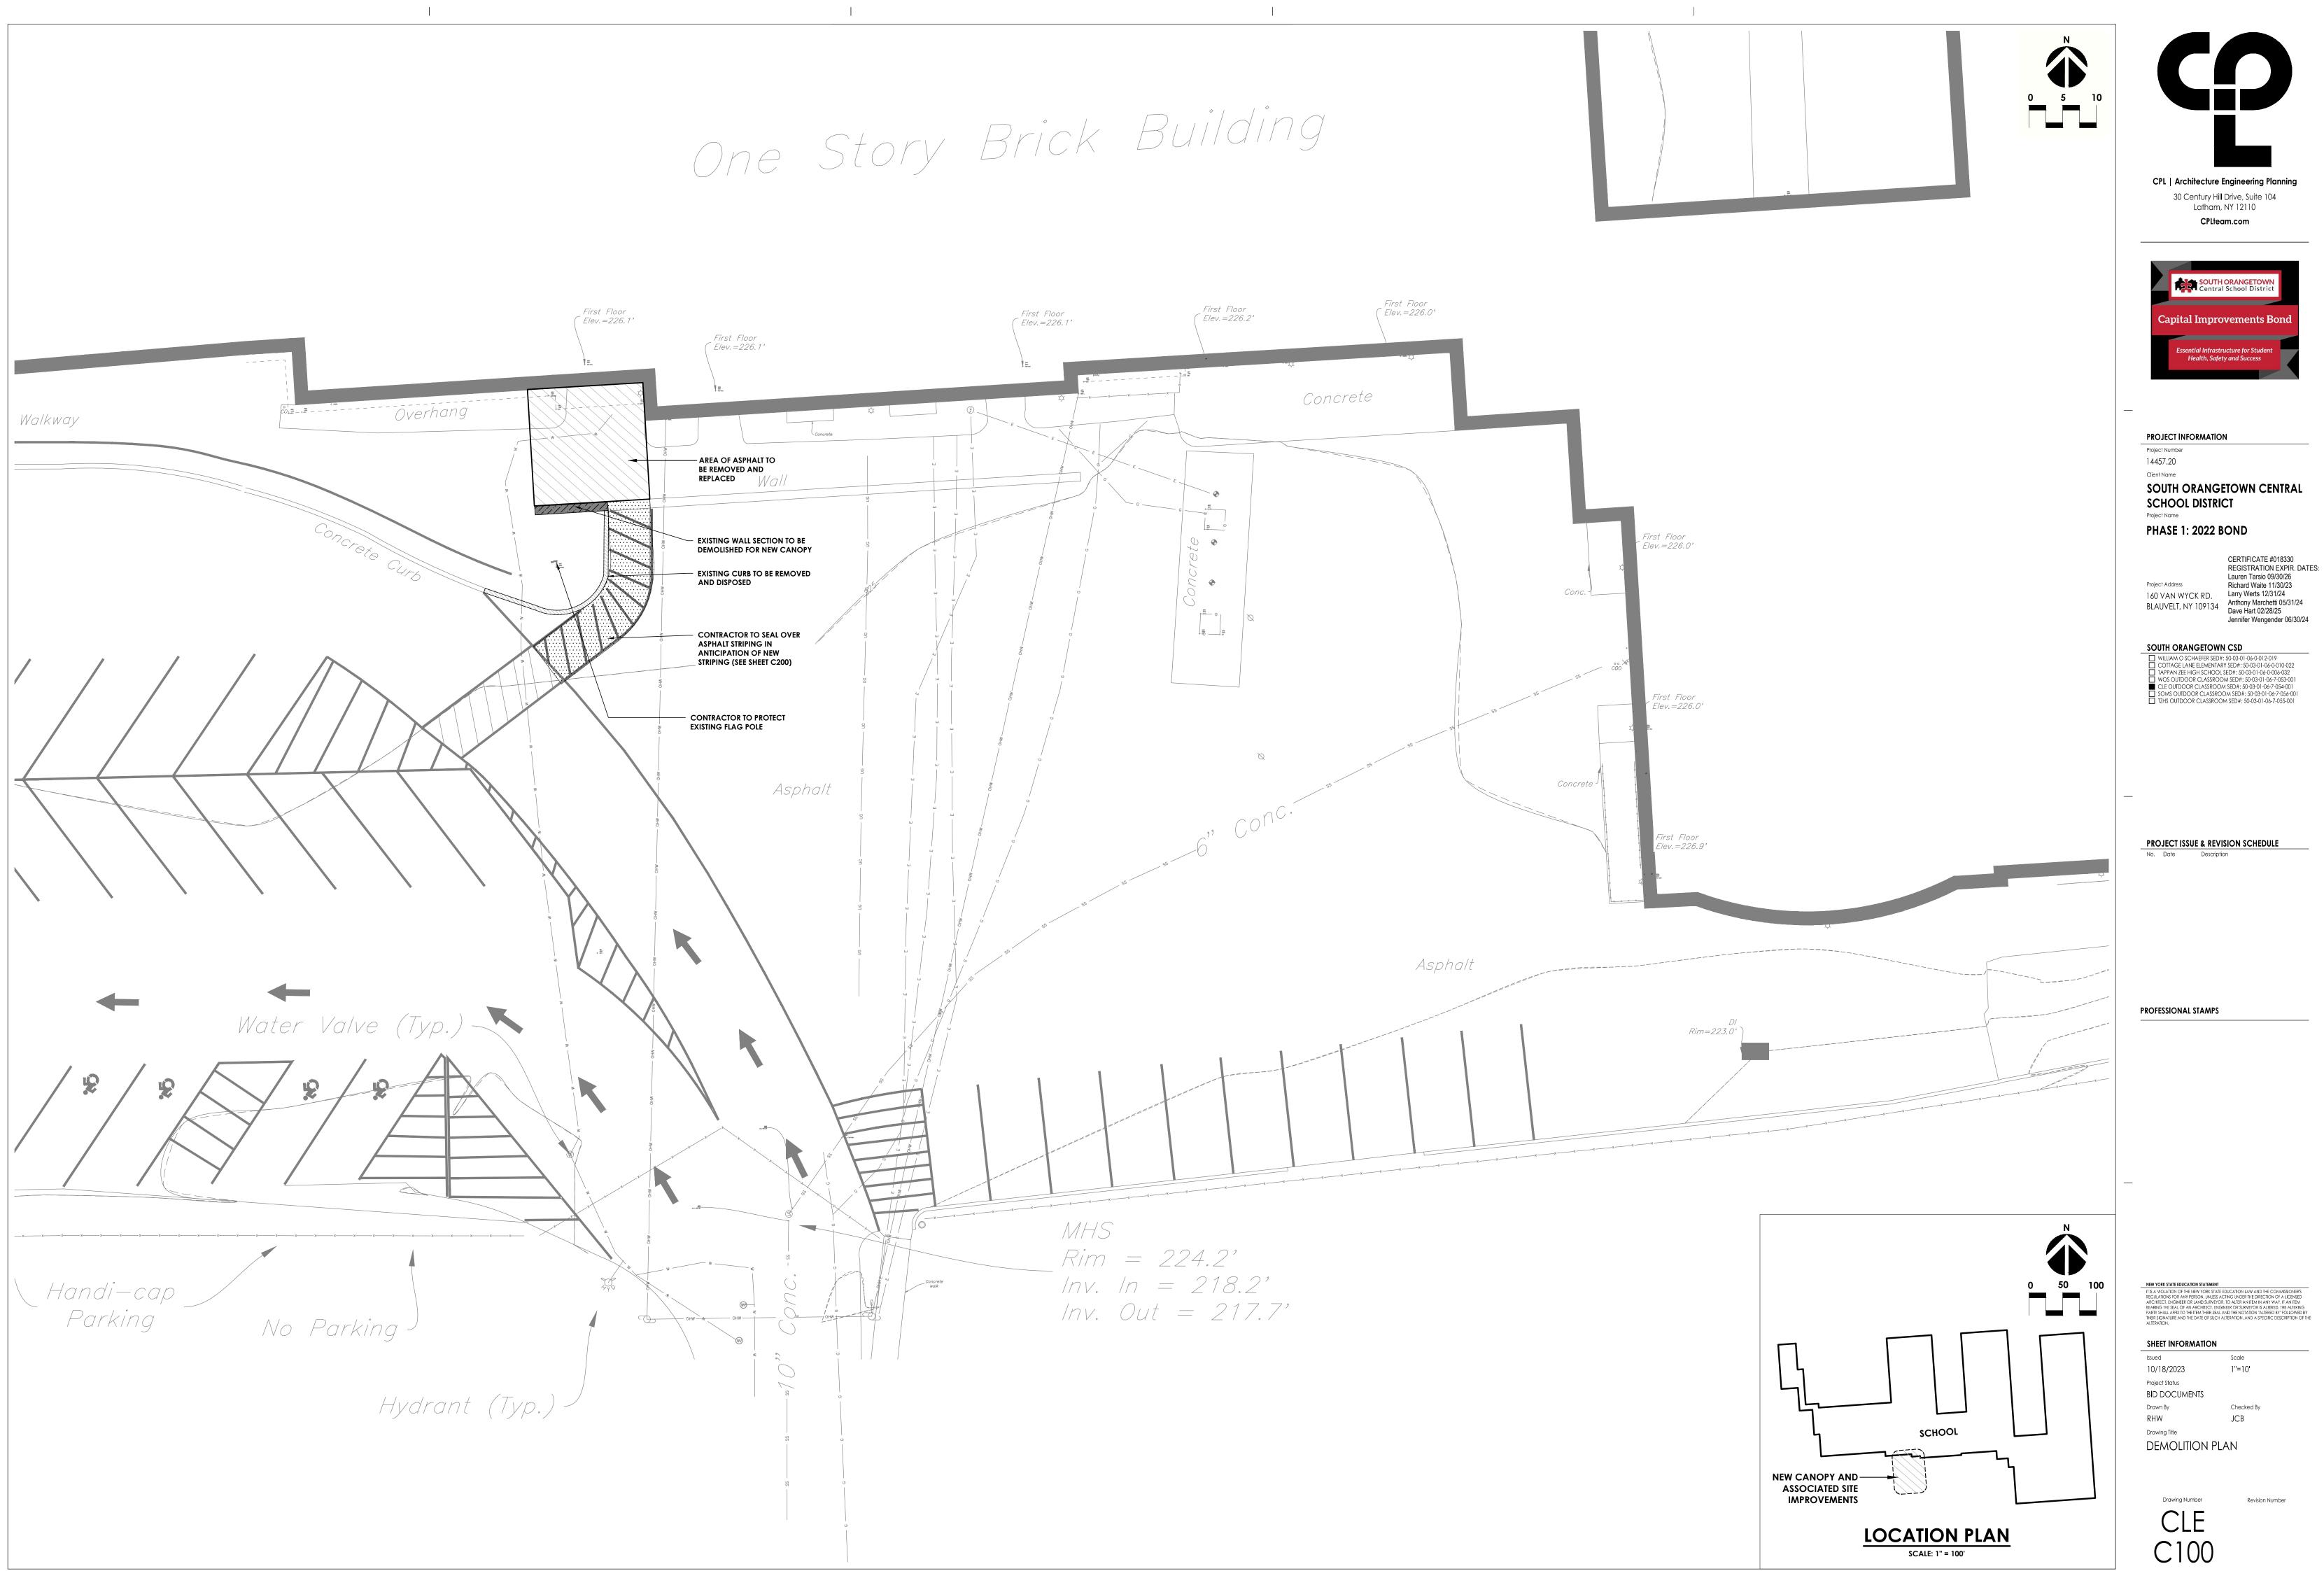


SEEDING NOTES

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OUTDOOR CLASSROOM ENLARGEMENT



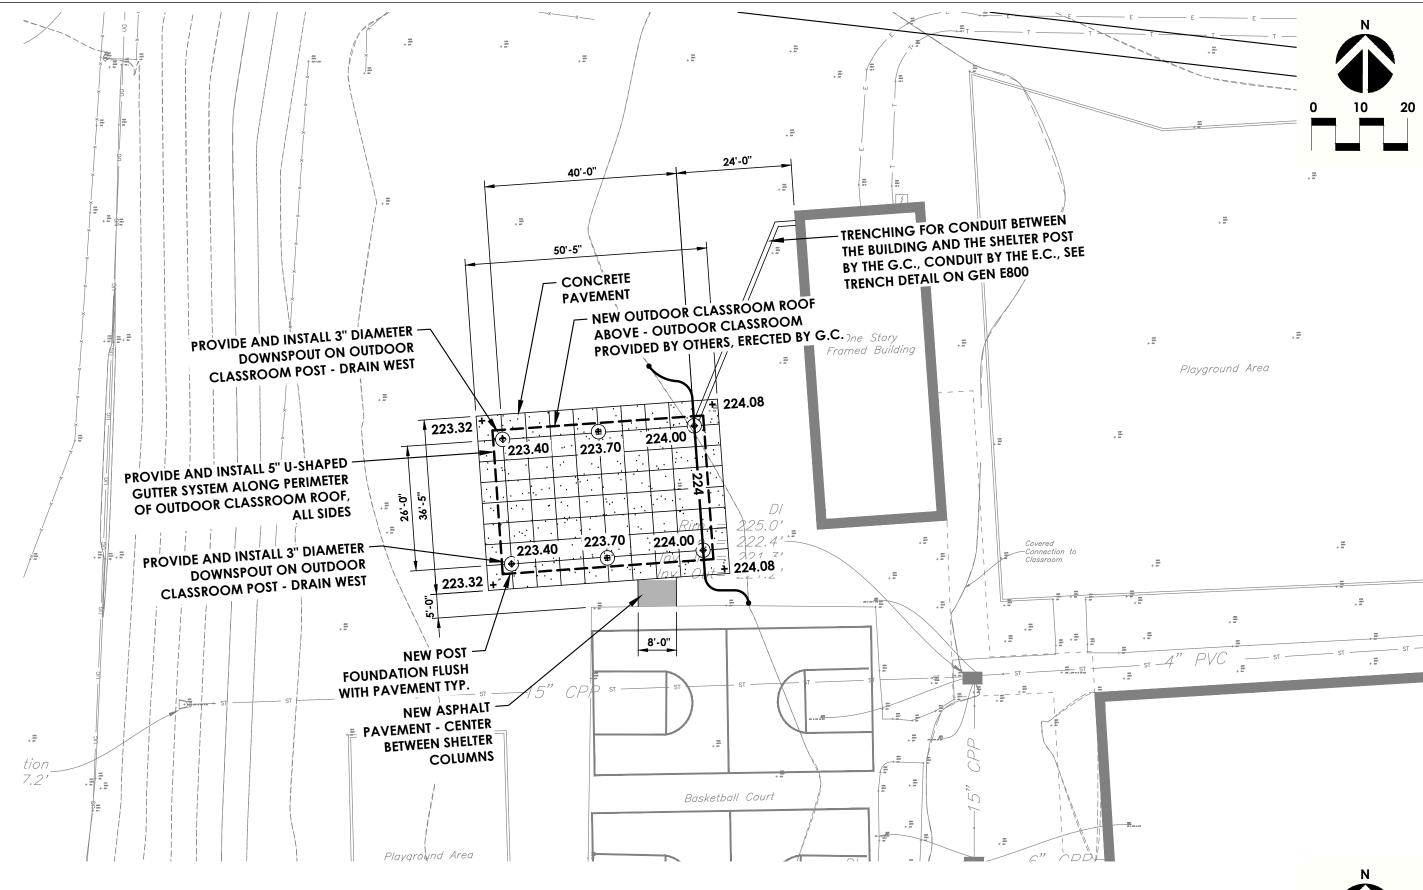

PROJECT INFORMATION Project Number

14457.20 Client Name SOUTH ORANGETOWN CENTRAL SCHOOL DISTRICT

Project Name PHASE 1: 2022 BOND

CERTIFICATE #018330 REGISTRATION EXPIR. DATES: Project Address 160 VAN WYCK RD. Larry Werts 12/31/24 BLAUVELT, NY 109134 BLAUVELT, NY 109134 BLAUVELT, NY 109134

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Lauren Tarsio 09/30/26 Richard Waite 11/30/23 Jennifer Wengender 06/30/24

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 TZHS OUTDOOR CLASSROOM SED#: 50-03-01-06-7-055-001

PROJECT ISSUE & REVISION SCHEDULE No. Date Description

PROFESSIONAL STAMPS

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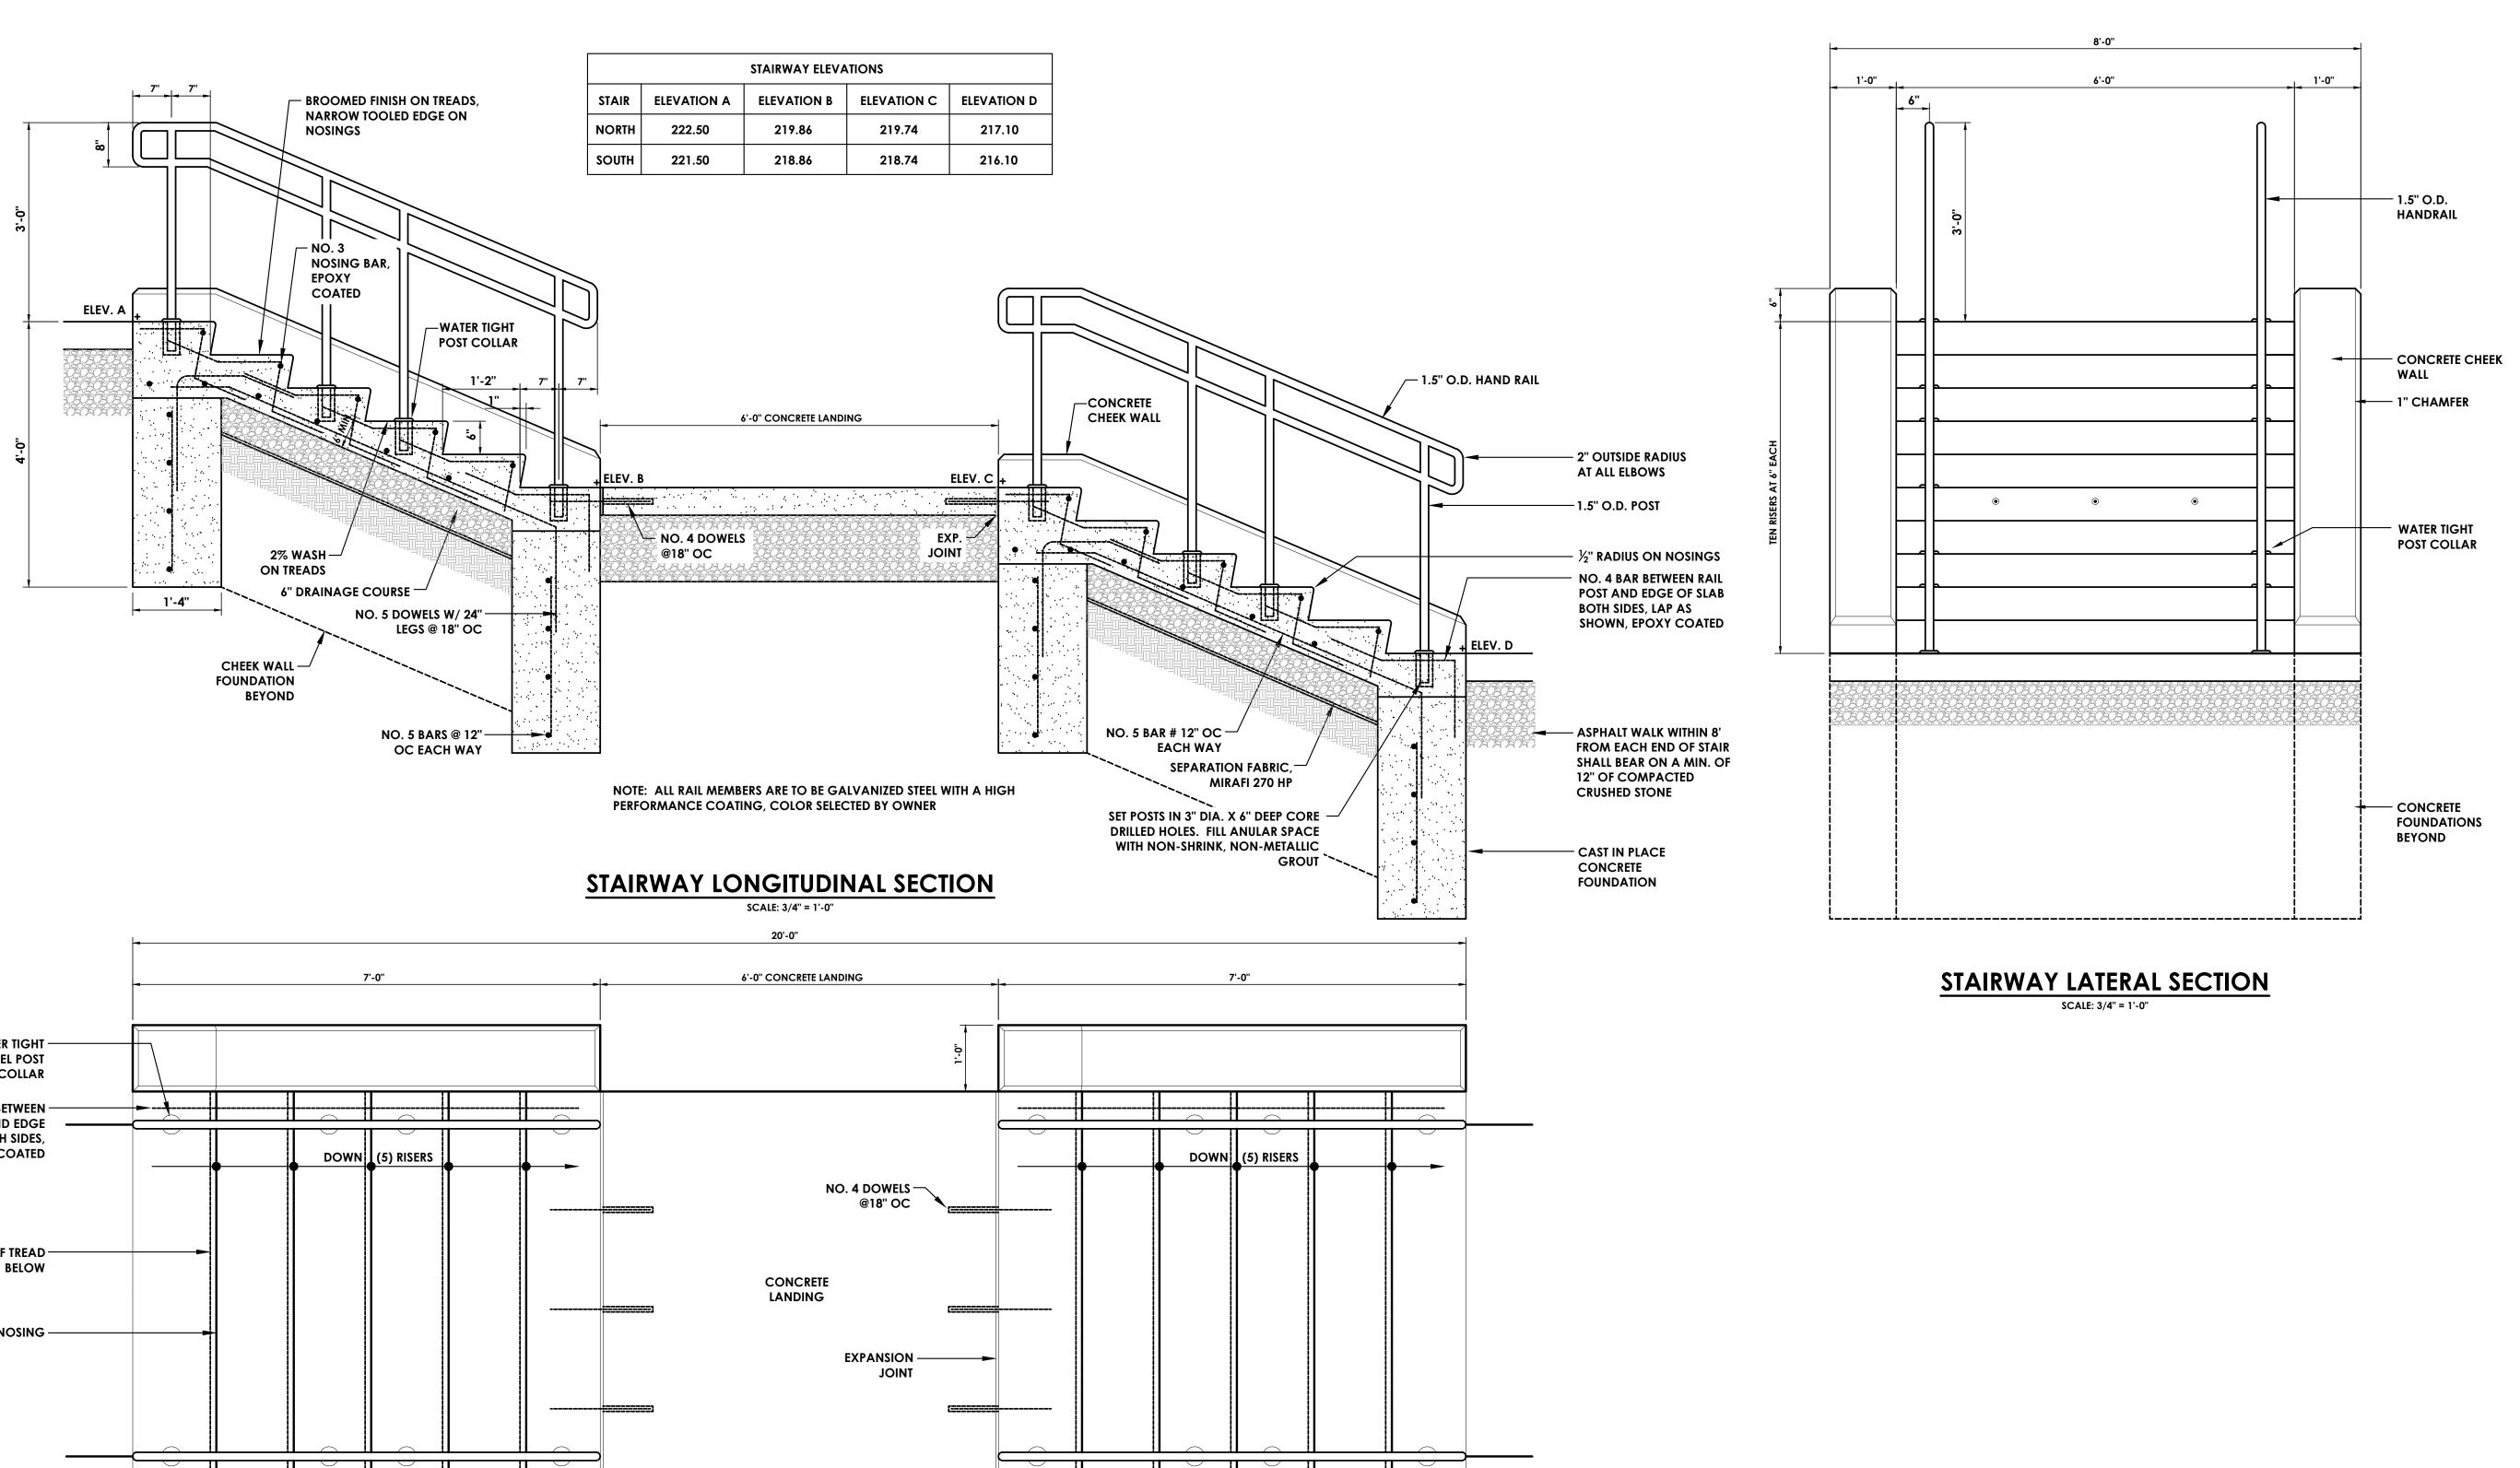
NEW YORK STATE EDUCATION STATEMENT


lssued Scale 10/18/2023 AS NOTED Project Status **BID DOCUMENTS** Drawn By Checked By RHW JCB

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STAIRWAY PLAN VIEW

SCALE: 3/4" = 1'-0"

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CPL | Architecture Engineering Planning 30 Century Hill Drive, Suite 104 Latham, NY 12110 CPLteam.com ntral School Dis Capital Improvements Bond PROJECT INFORMATION Project Number 14457.20 Client Name SOUTH ORANGETOWN CENTRAL SCHOOL DISTRICT Project Name PHASE 1: 2022 BOND CERTIFICATE #018330 REGISTRATION EXPIR. DATES: Lauren Tarsio 09/30/26 Project Address Richard Waite 11/30/23 160 VAN WYCK RD. Larry Werts 12/31/24 BLAUVELT, NY 109134 Anthony Marchetti 05/31/24 Dave Hart 02/28/25 Jennifer Wengender 06/30/24 SOUTH ORANGETOWN CSD □ WILLIAM O SCHAEFER SED#: 50-03-01-06-0-012-019 □ COTTAGE LANE ELEMENTARY SED#: 50-03-01-06-0-010-022
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NEW YORK STATE EDUCATION STATEMENT

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10/18/2023 Project Status **BID DOCUMENTS** Drawn By RHW
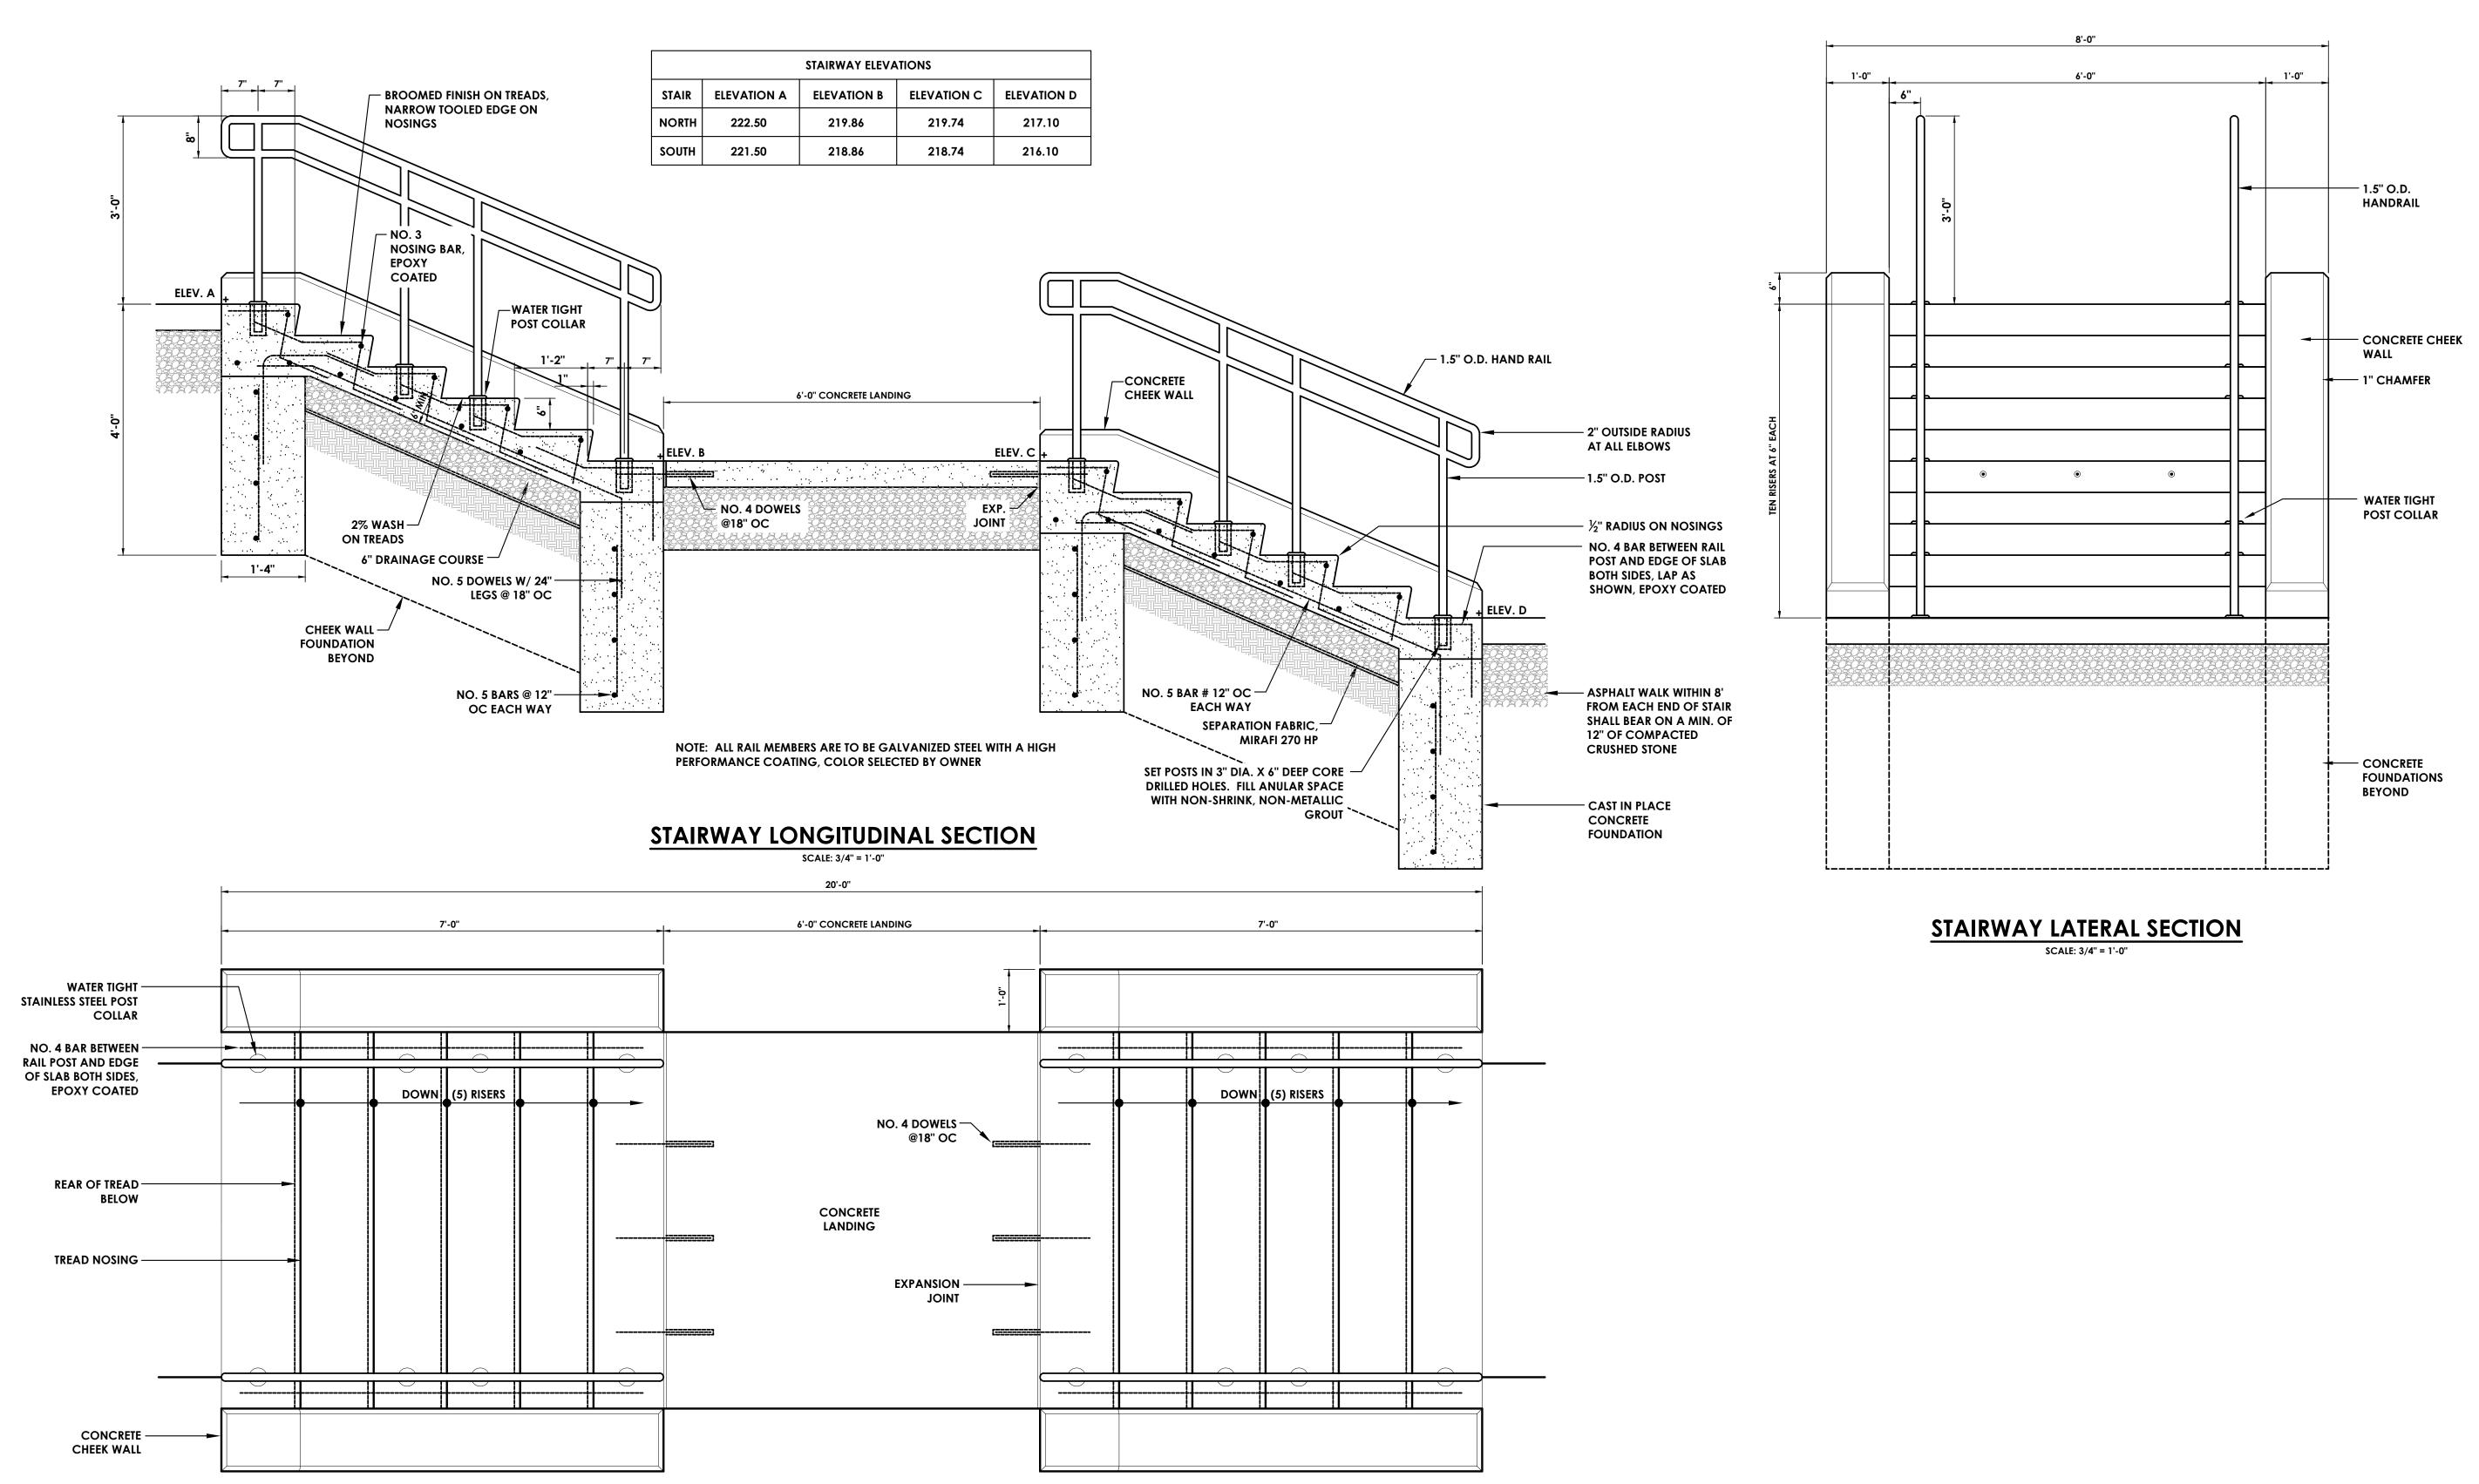
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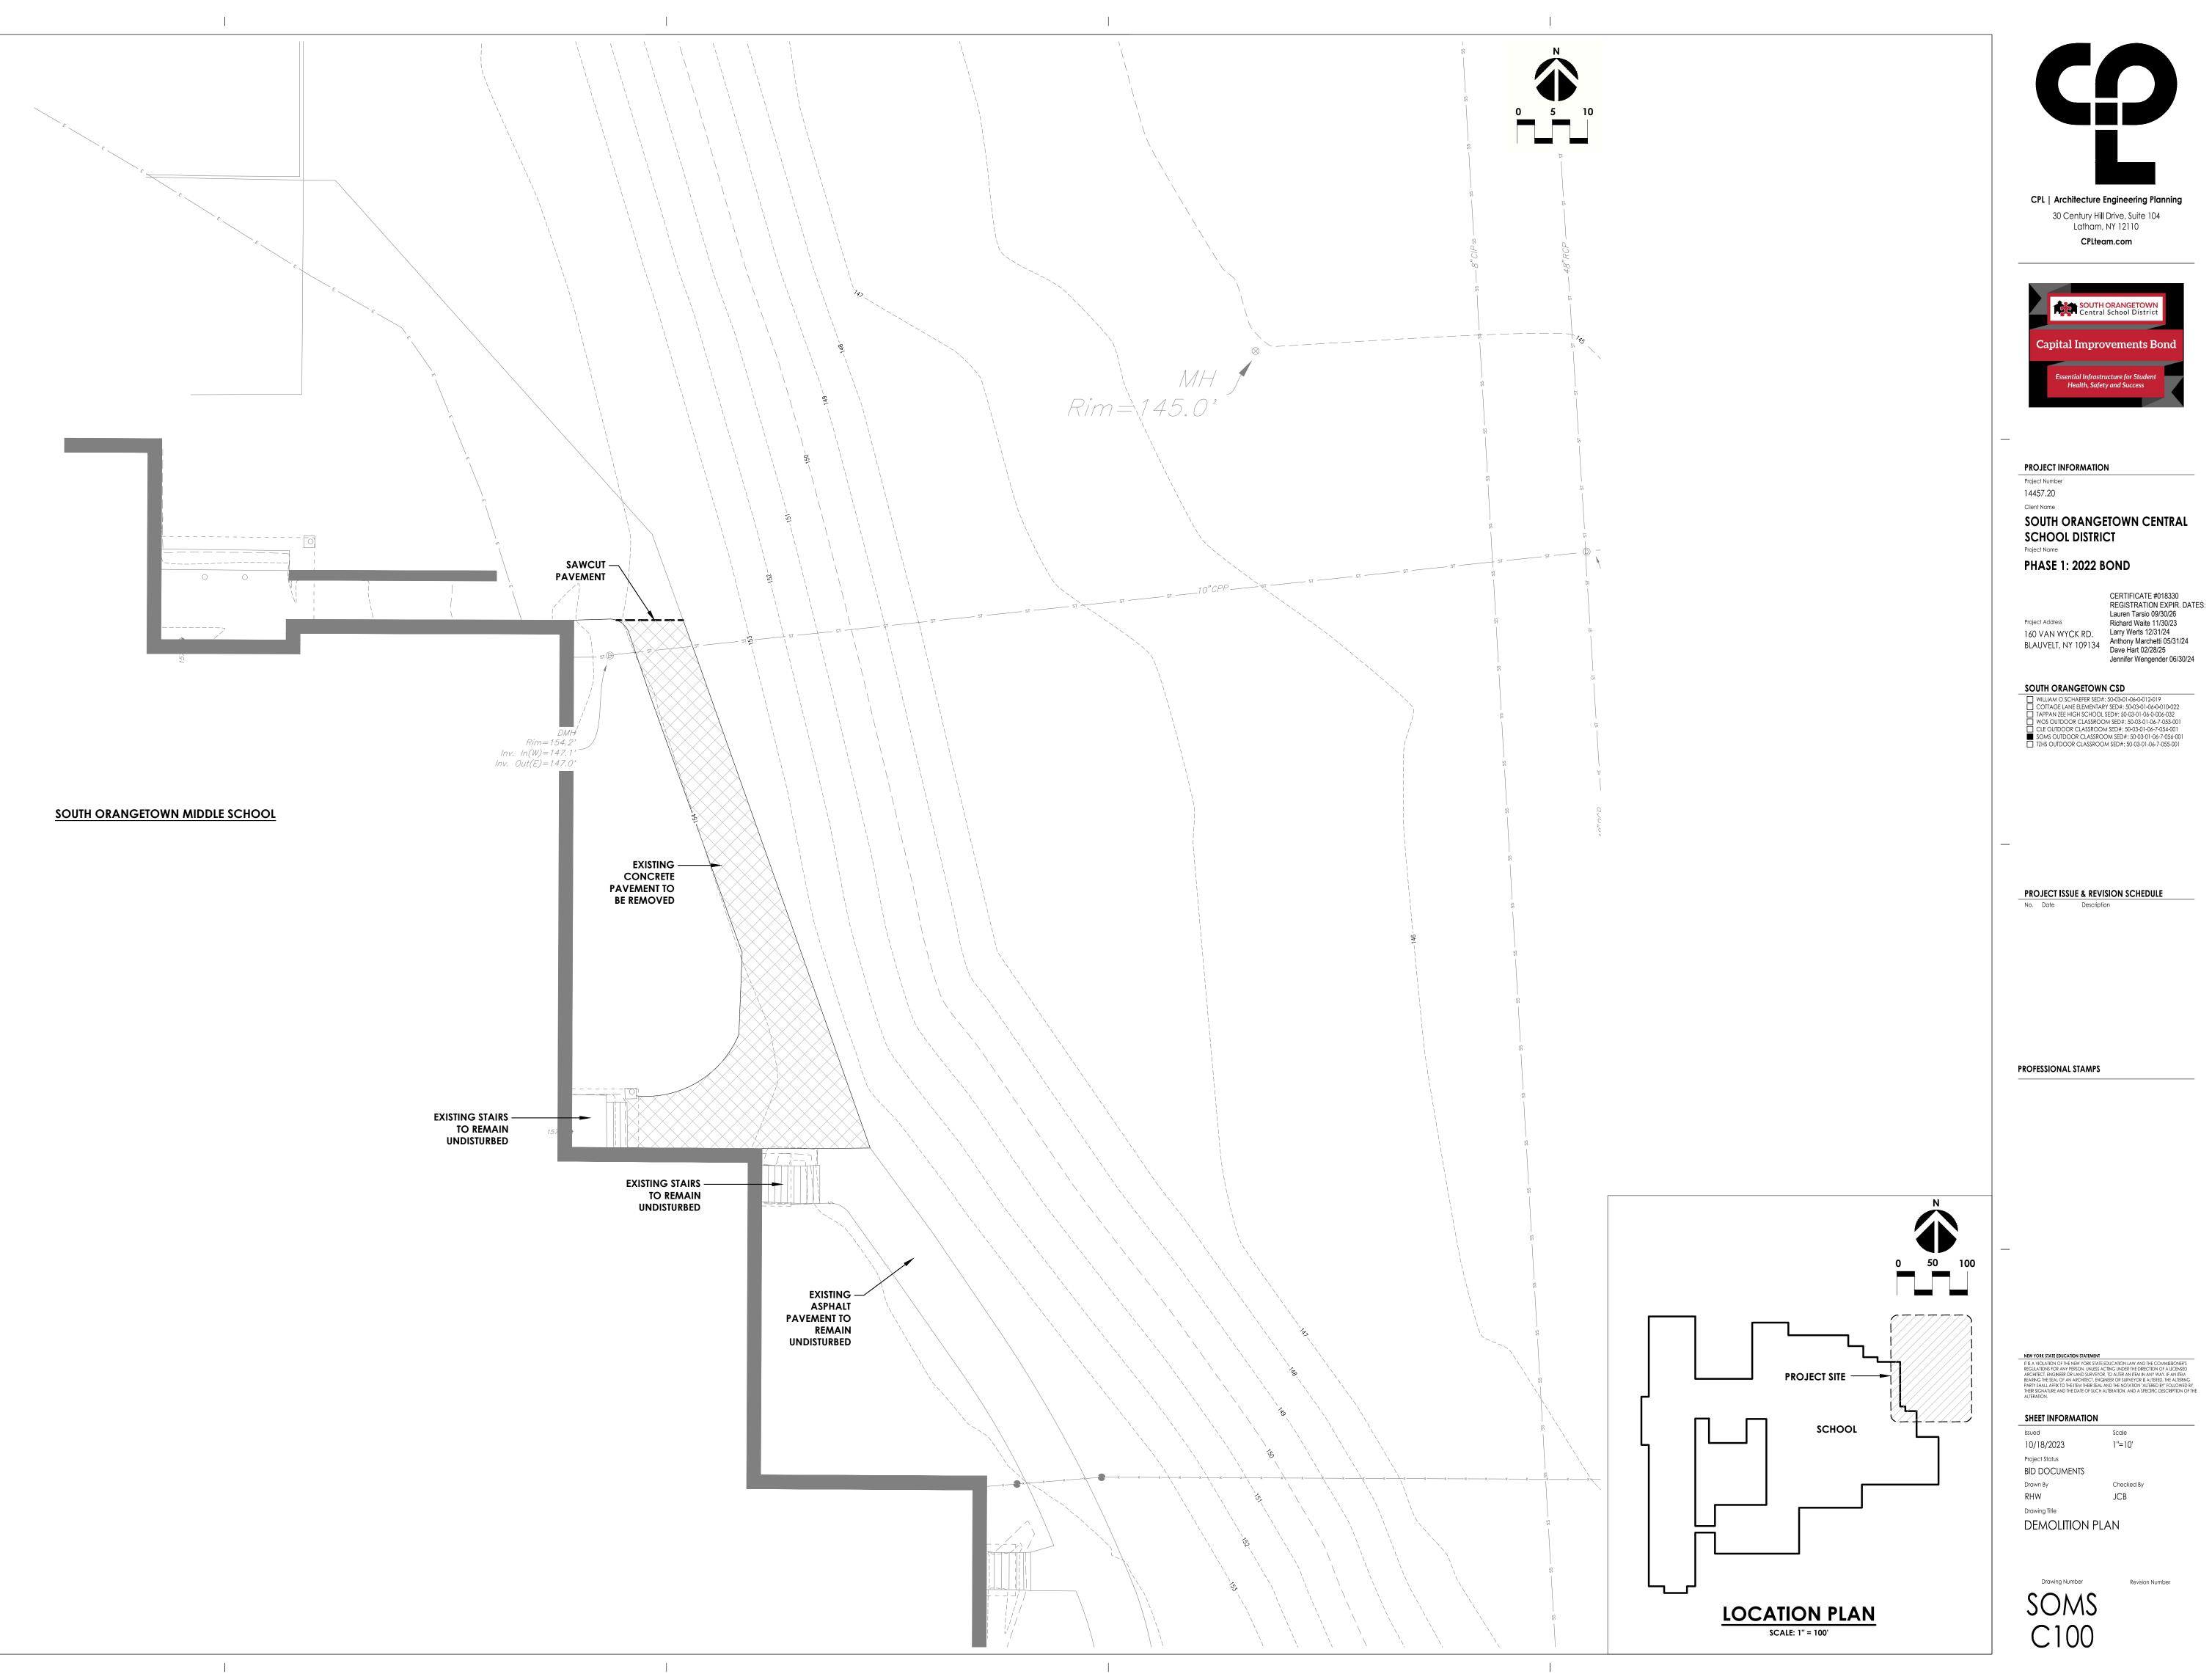
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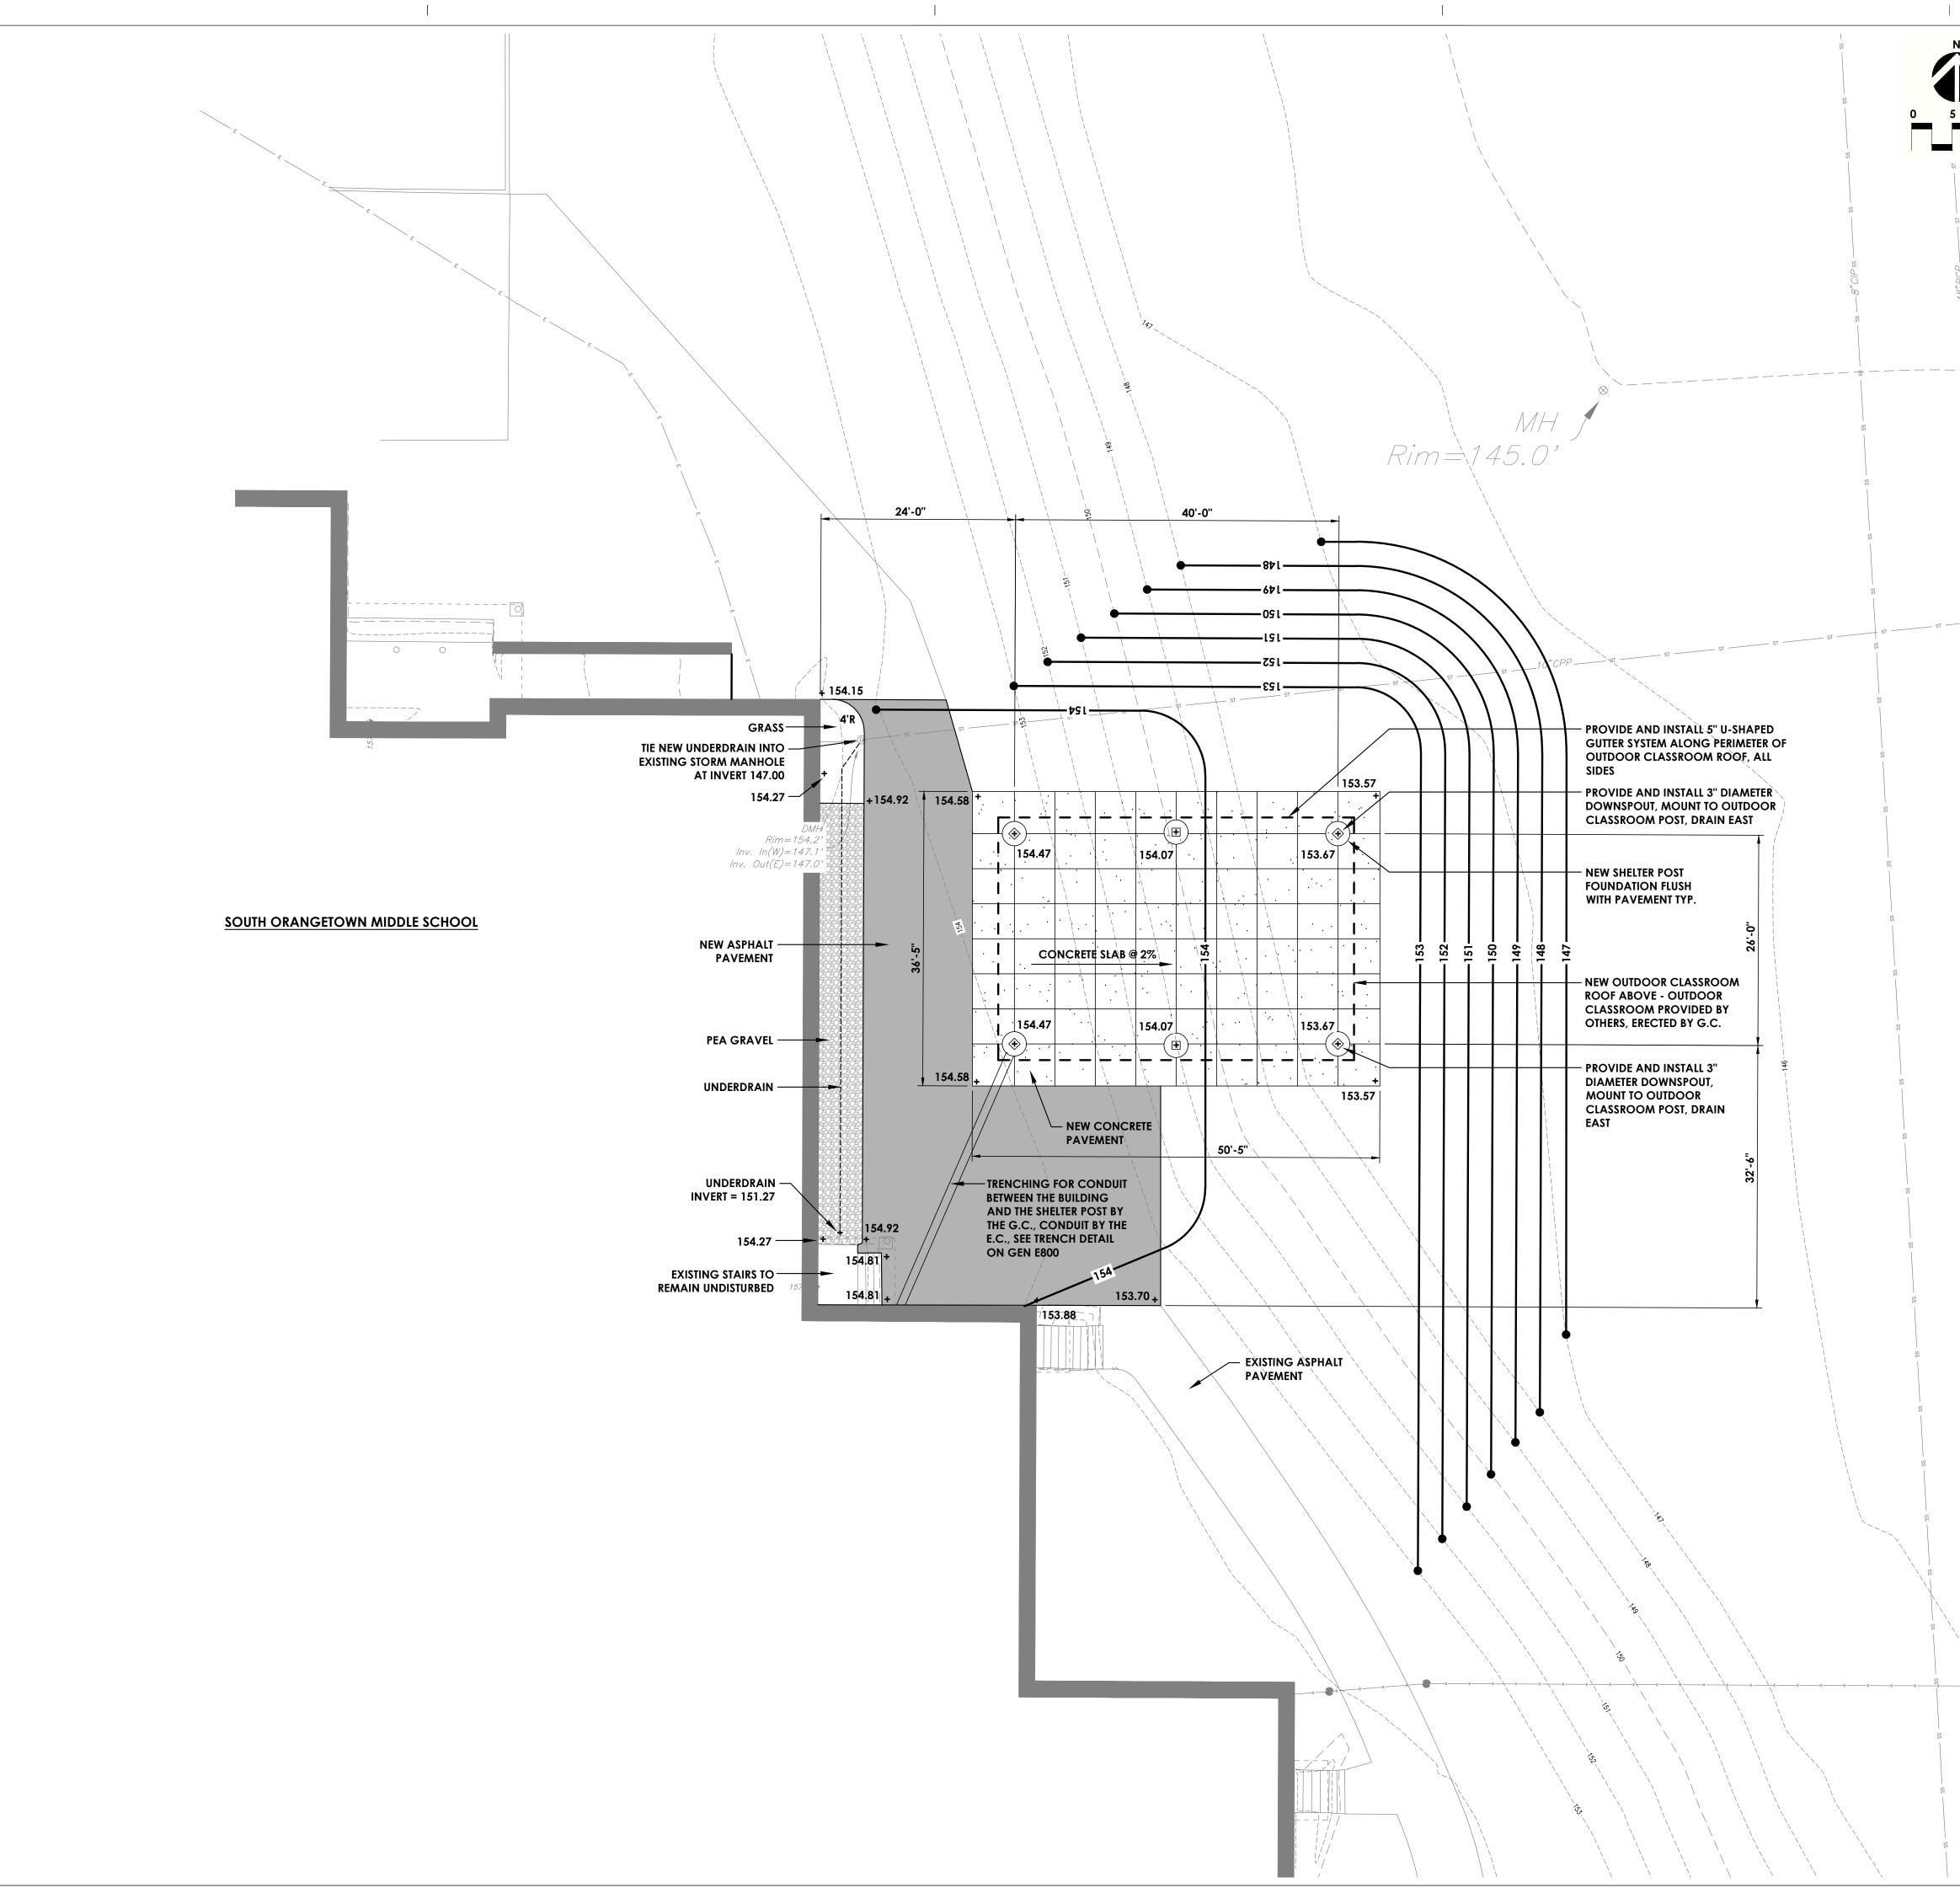
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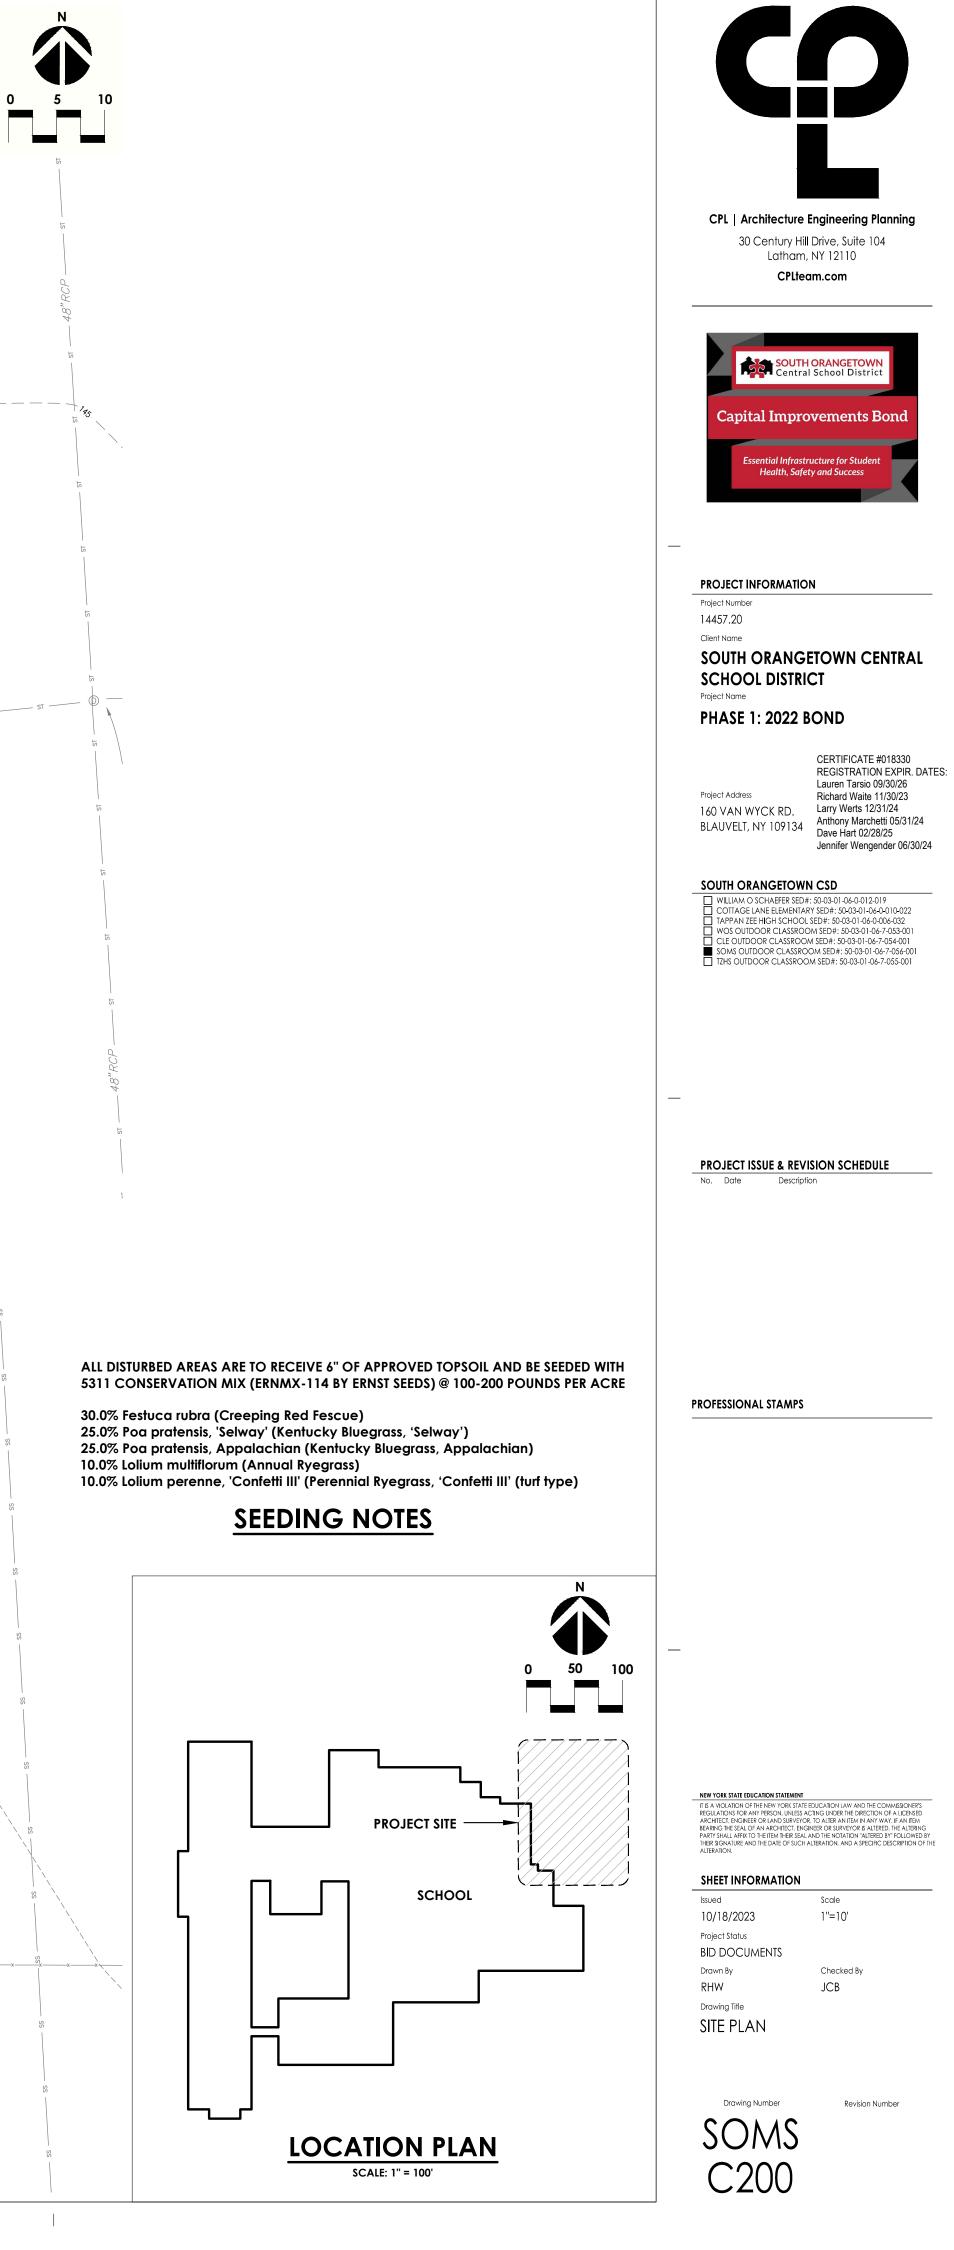
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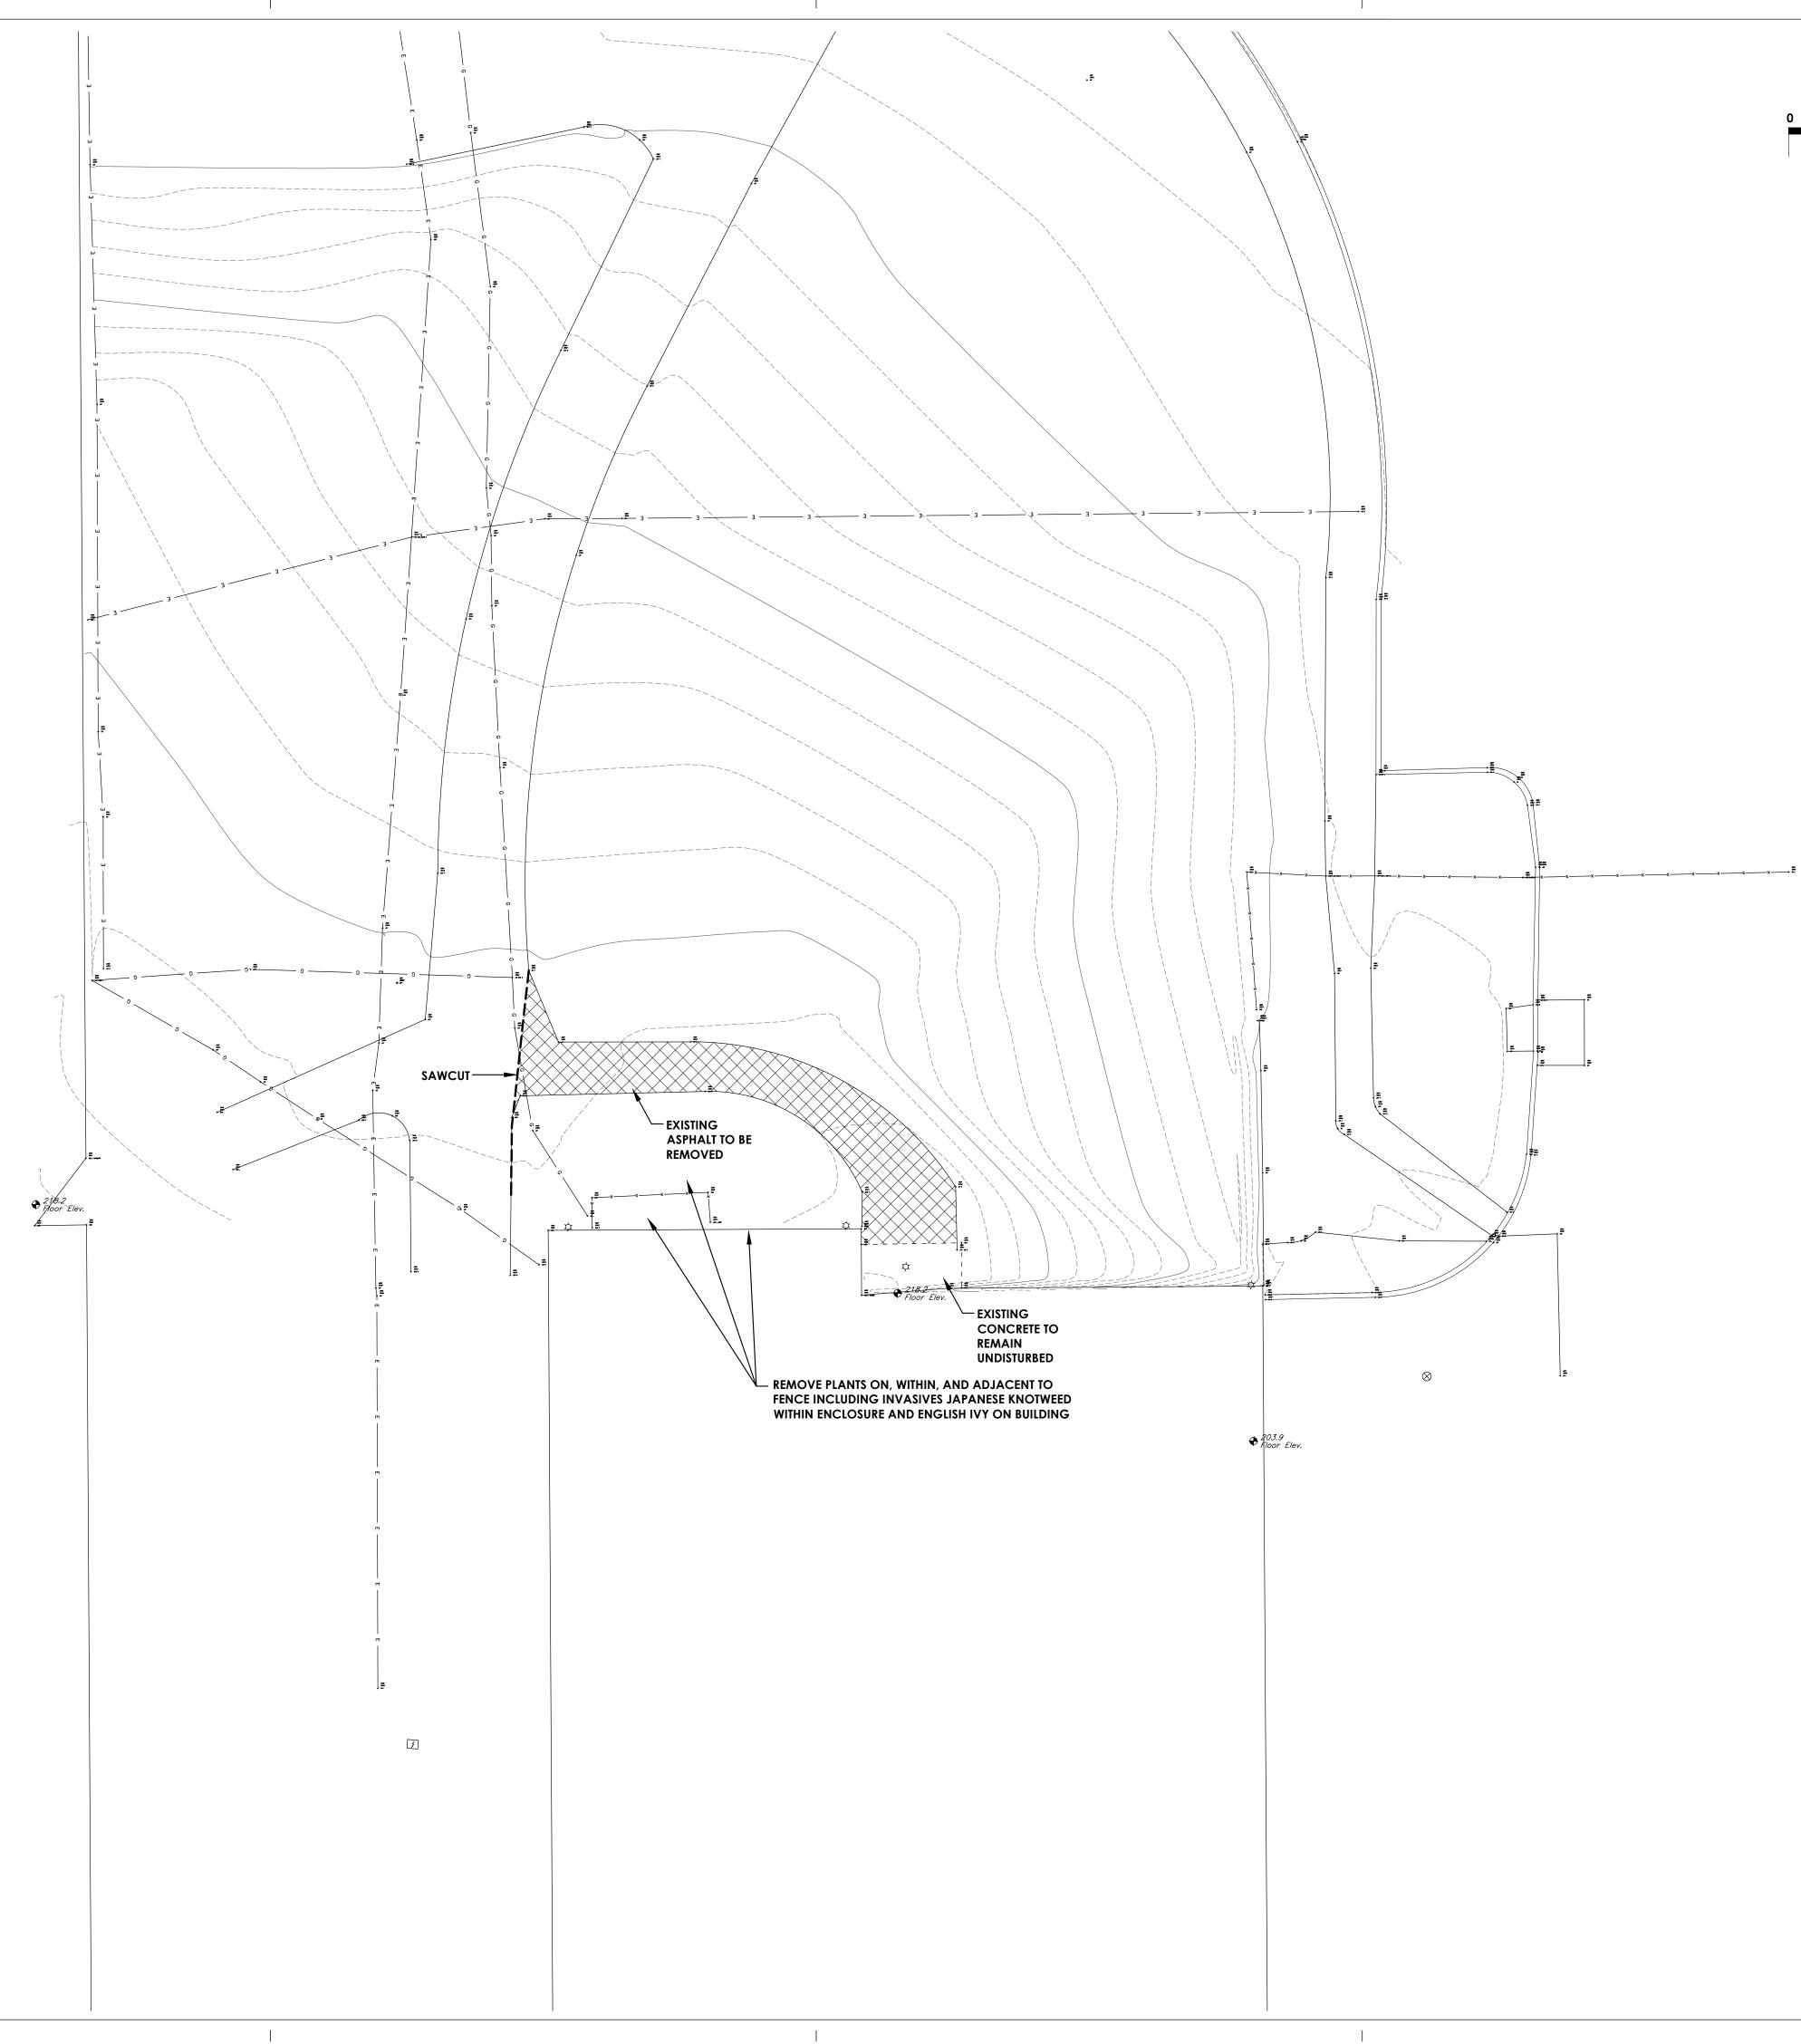















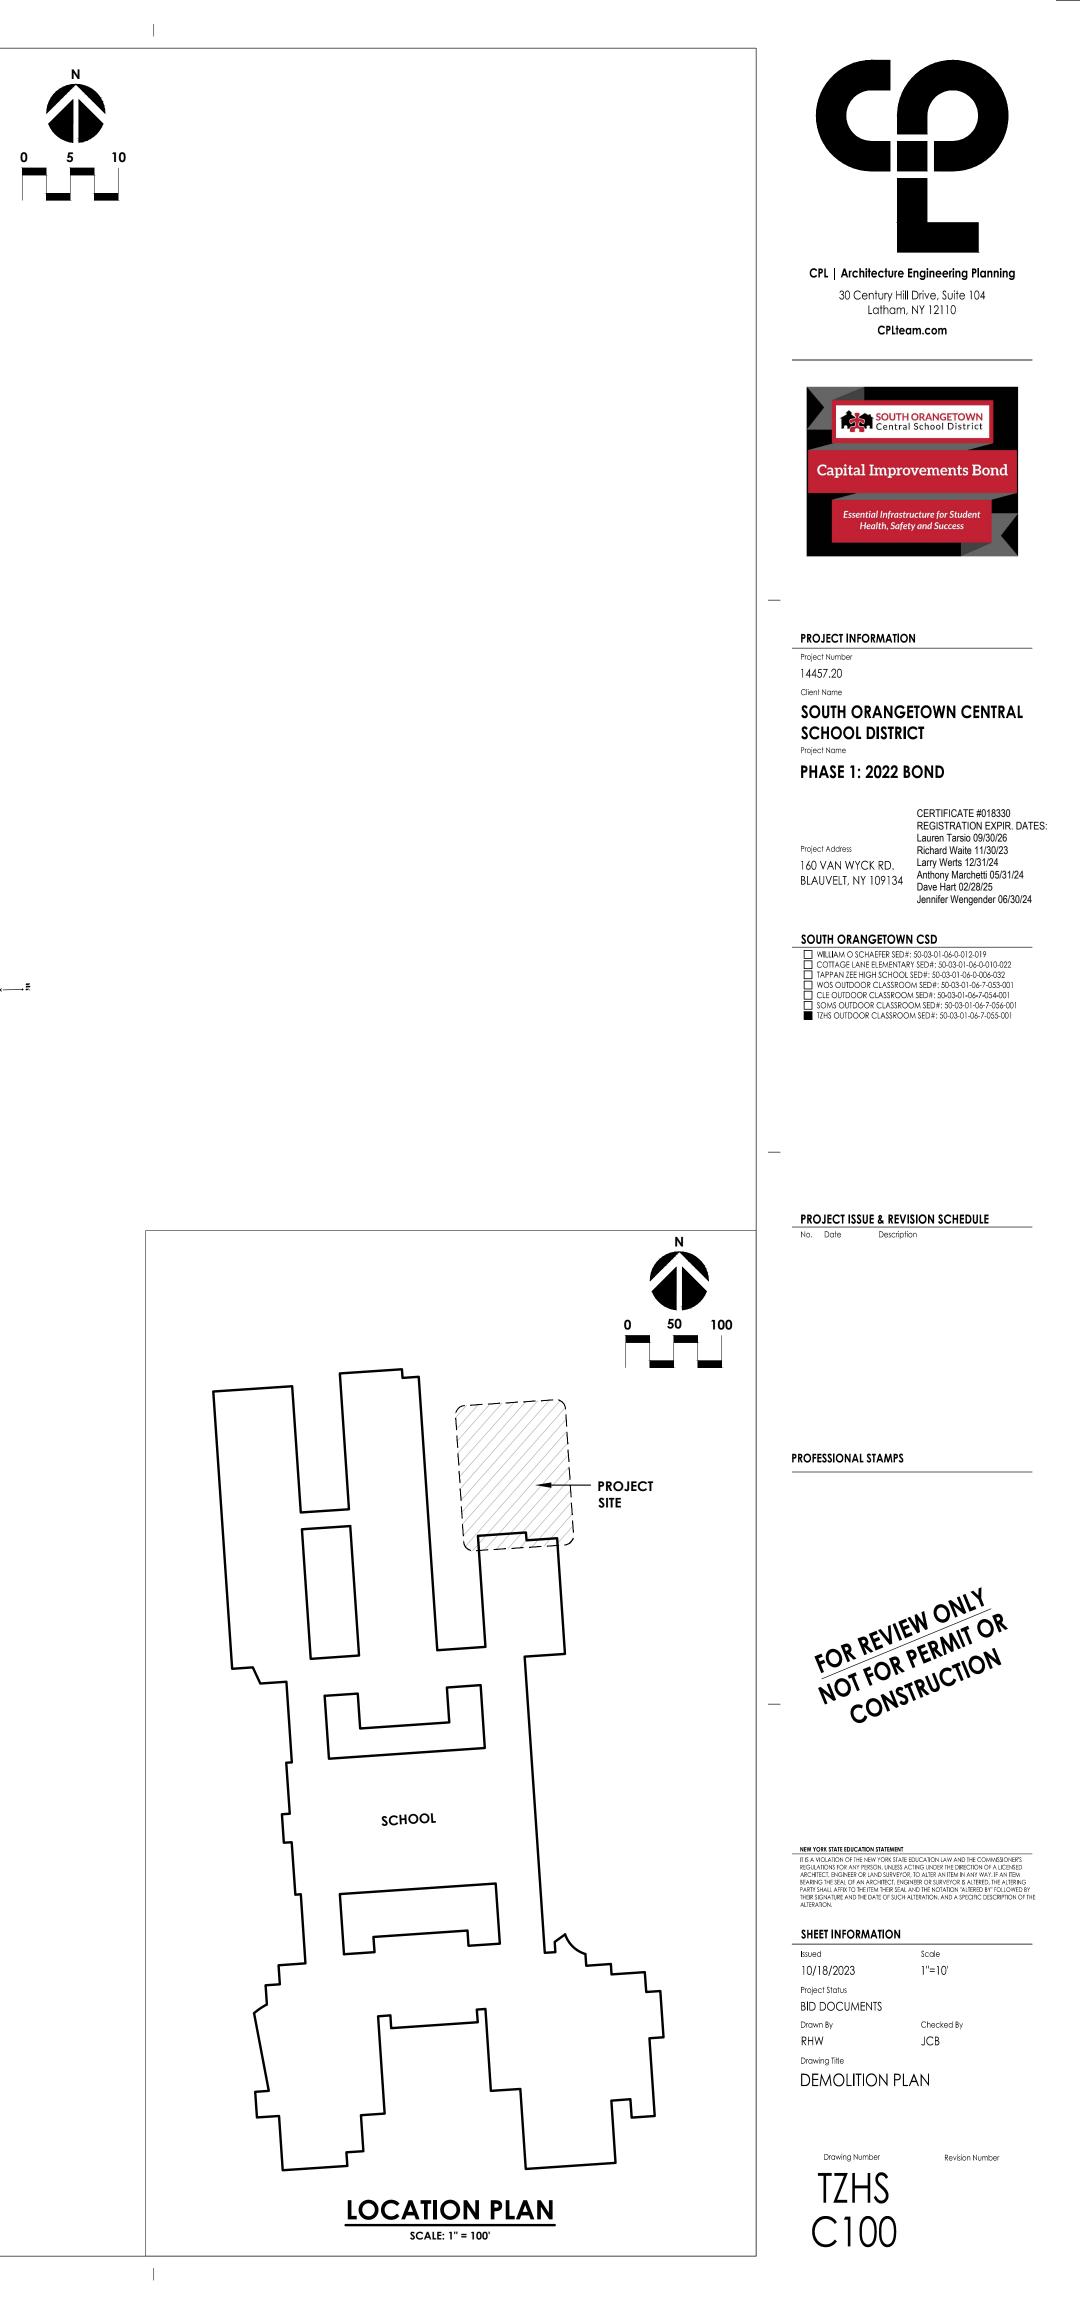

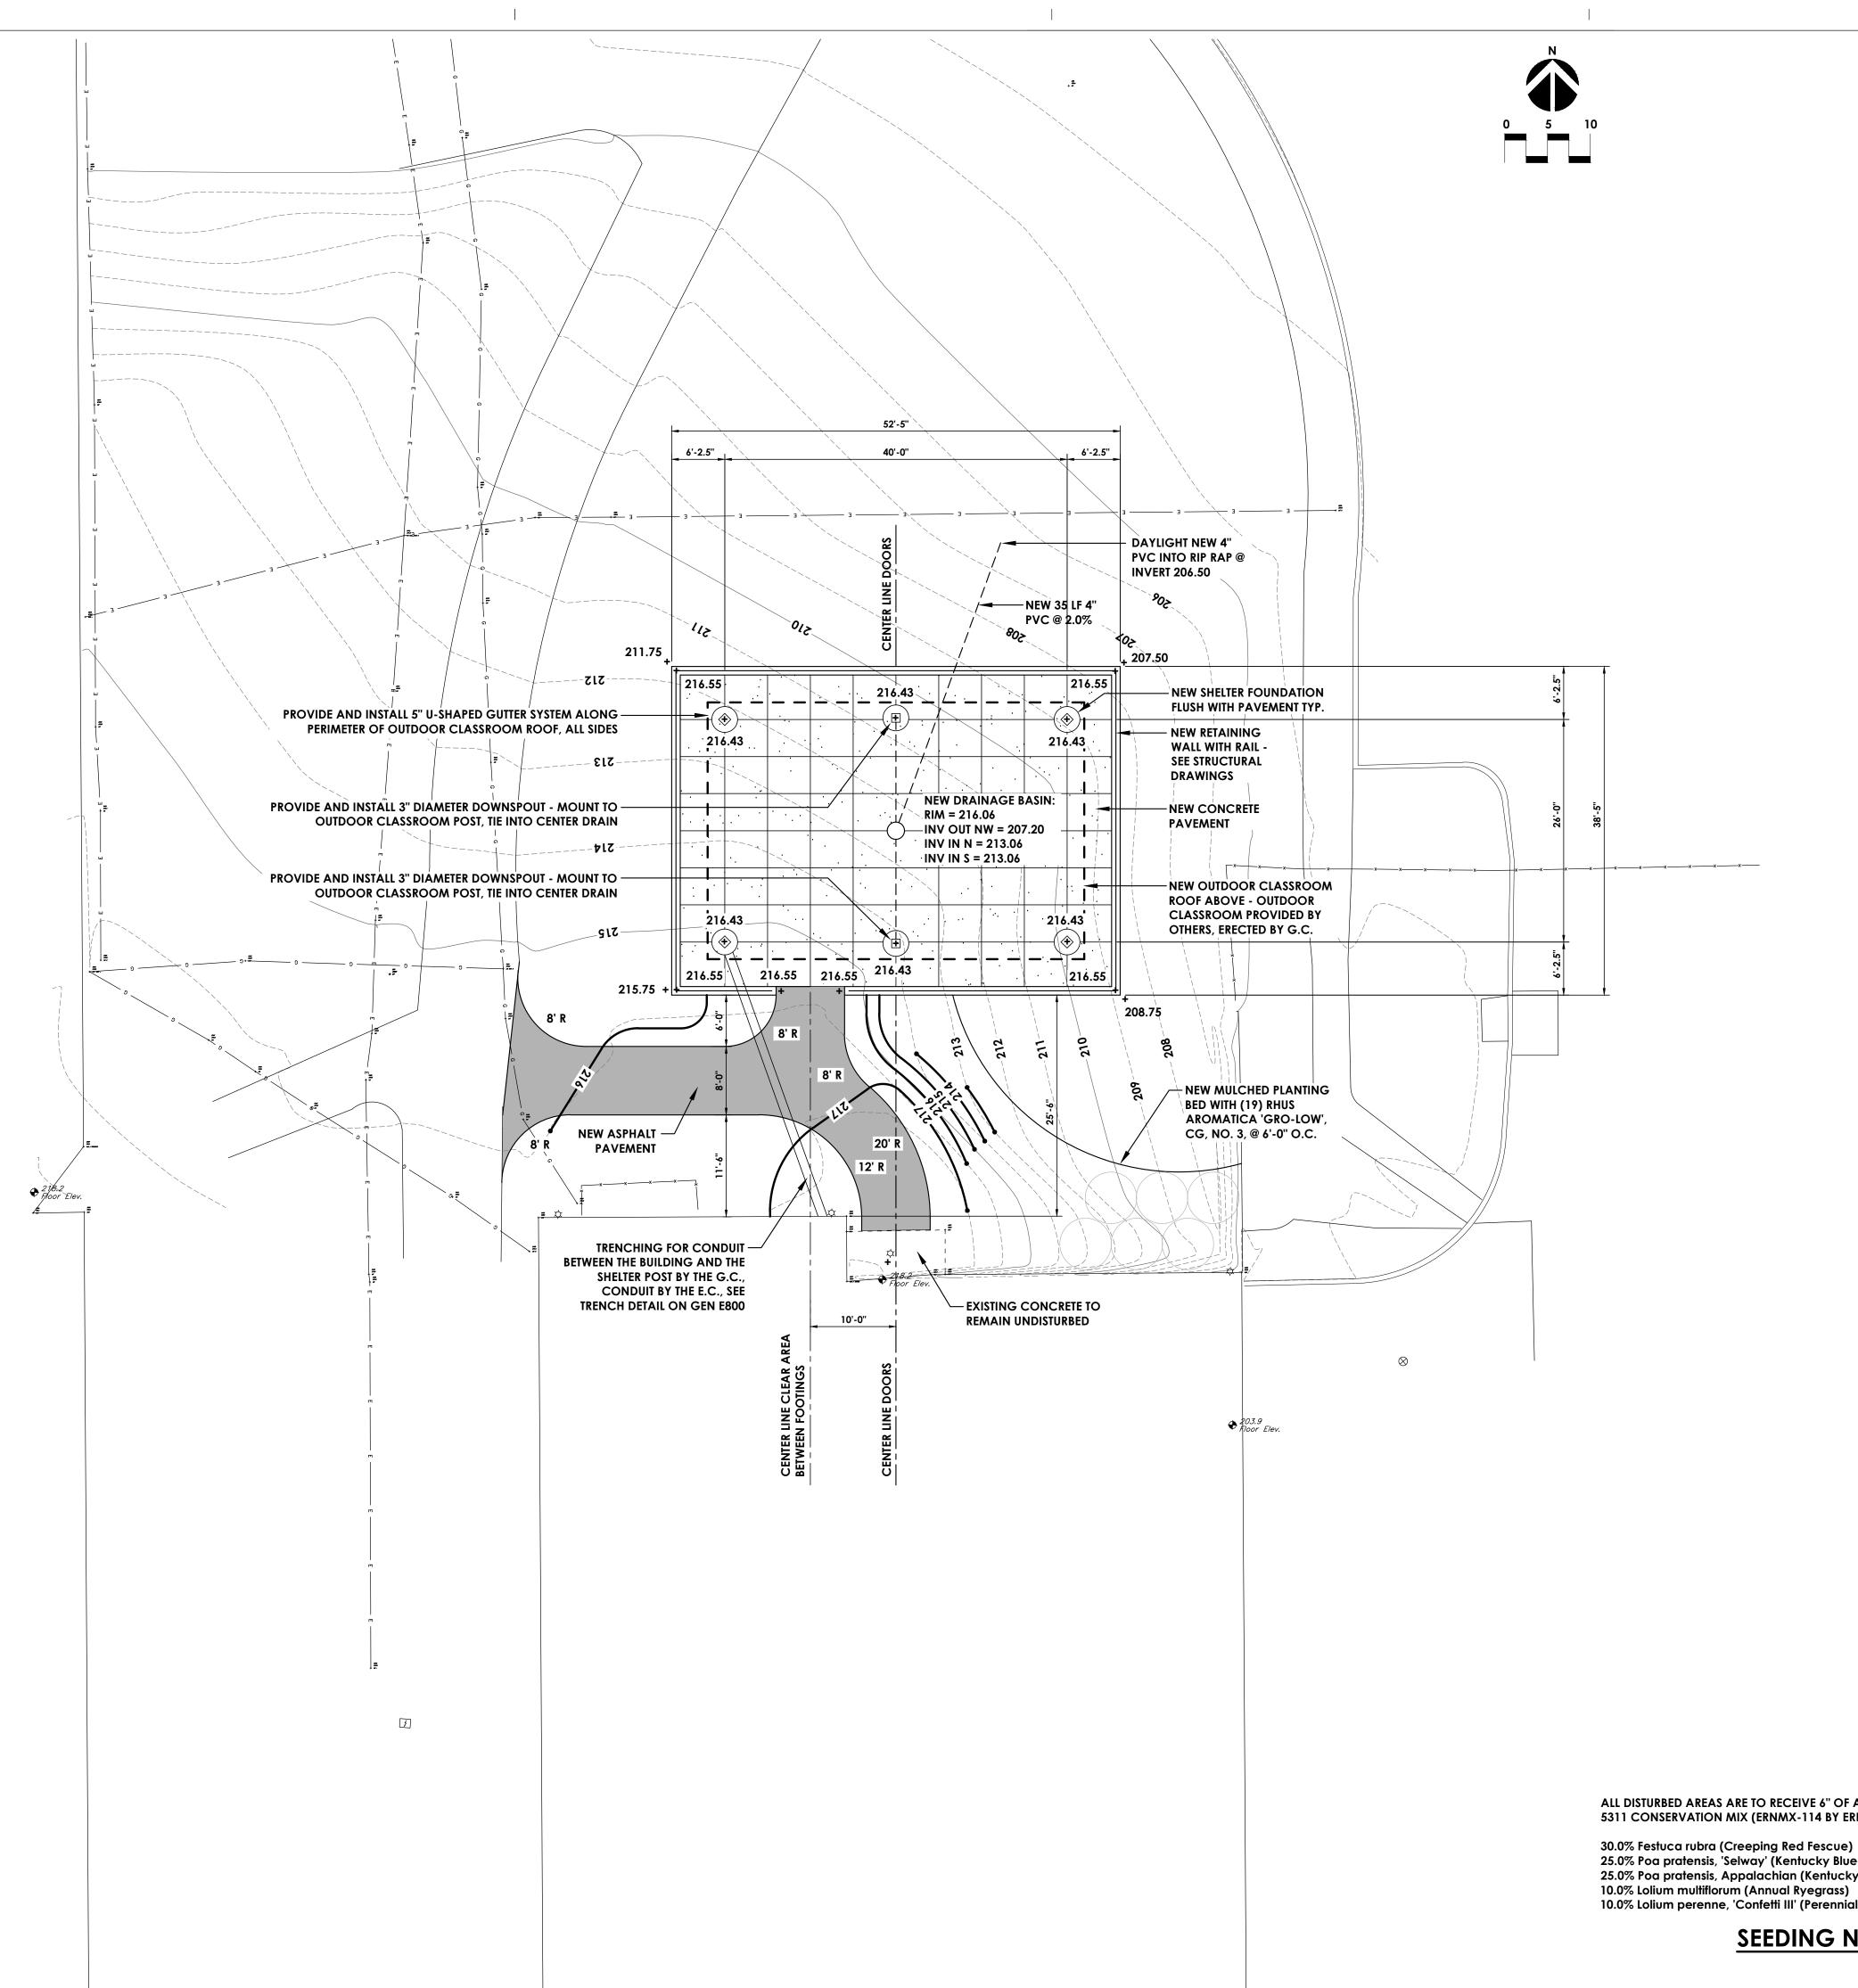

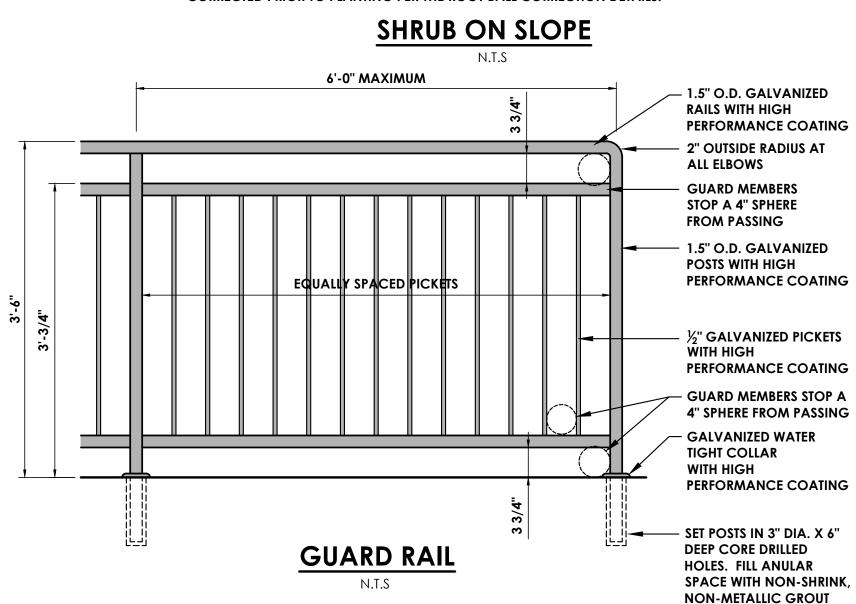

SEEDING NOTES

25.0% Poa pratensis, 'Selway' (Kentucky Bluegrass, 'Selway') 25.0% Poa pratensis, Appalachian (Kentucky Bluegrass, Appalachian) 10.0% Lolium multiflorum (Annual Ryegrass) 10.0% Lolium perenne, 'Confetti III' (Perennial Ryegrass, 'Confetti III' (turf type)

1


ALL DISTURBED AREAS ARE TO RECEIVE 6" OF APPROVED TOPSOIL AND BE SEEDED WITH 5311 CONSERVATION MIX (ERNMX-114 BY ERNST SEEDS) @ 100-200 POUNDS PER ACRE

4" X 8" SOIL RING -**AROUND PERIMETER OF** ROOT BALL, CENTER ON DOWNHILL SIDE OF ROOT BALL FOR 240° FINISHED GRADE

CORRECTED BALLED AND BURLAPPED OR CONTAINERIZED ROOT BALL PLACE ROOT BALL

ON EXISTING OR

RECOMPACTED SOIL

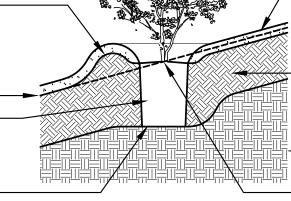

- 4" SHREDDED HARDWOOD BARK MULCH, KEEP CLEAR OF STEMS, NO MORE THAN 1" OF MULCH ON TOP OF ROOT BALL - PLANTING SOIL MIX

TO INCLUDE 3/4 TOPSOIL AND 1/4 ORGANIC MATTER

- EXISTING SOIL

- ORIGINAL SLOPE SHALL PASS THROUGH THE POINT WHERE THE TRUNK MEETS SOIL

NOTES:

1. DO NOT HEAVILY PRUNE SHRUBS AT PLANTING. PRUNE ONLY CROSSOVER LIMBS, CO-DOMINANT LEADERS, AND BROKEN OR DEAD BRANCHES. SOME INTERIOR TWIGS AND LATERAL BRANCHES MAY BE PRUNED, HOWEVER, DO NOT REMOVE THE TERMINAL BUDS OF BRANCHES THAT EXTEND TO THE EDGE OF THE CROWN.

2. PRIOR TO MULCHING, LIGHTLY TAMP SOIL AROUND THE ROOT BALL IN 6" LIFTS TO BRACE SHRUB. DO NOT OVER COMPACT. WHEN PLANTING HOLE HAS BEEN BACKFILLED POUR WATER AROUND THE ROOT BALL TO SETTLE THE SOIL.

3. ROOT BALLS OF BOTH CONTAINERIZED AND BALLED AND BURLAPPED PLANTS SHALL BE CORRECTED PRIOR TO PLANTING PER THE ROOT BALL CORRECTION DETAILS.

> - PROJECT SITE SCHOOL

> > LOCATION PLAN

SCALE: 1" = 100'



PROJECT INFORMATION Project Number 14457.20 Client Name SOUTH ORANGETOWN CENTRAL SCHOOL DISTRICT Project Name

CERTIFICATE #018330

PHASE 1: 2022 BOND

Project Address 160 VAN WYCK RD. BLAUVELT, NY 109134	REGISTRATION EXPIR. DATES: Lauren Tarsio 09/30/26 Richard Waite 11/30/23 Larry Werts 12/31/24 Anthony Marchetti 05/31/24 Dave Hart 02/28/25 Jennifer Wengender 06/30/24
SOUTH ORANGETOWN	CSD

WILLIAM O SCHAEFER SED#: 50-03-01-06-0-012-019 COTTAGE LANE ELEMENTARY SED#: 50-03-01-06-0-010-022 TAPPAN ZEE HIGH SCHOOL SED#: 50-03-01-06-0-006-032 WOS OUTDOOR CLASSROOM SED#: 50-03-01-06-7-053-001 CLE OUTDOOR CLASSROOM SED#: 50-03-01-06-7-054-001 SOMS OUTDOOR CLASSROOM SED#: 50-03-01-06-7-056-001 TZHS OUTDOOR CLASSROOM SED#: 50-03-01-06-7-055-001

PROJECT ISSUE & REVISION SCHEDULE No. Date Description

PROFESSIONAL STAMPS



NEW YORK STATE EDUCATION STATEMENT THE A VIOLATION OF THE NEW YORK STATE EDUCATION LAW AND THE COMMISSIONER'S REGULATIONS FOR ANY PERSON, UNLESS ACTING UNDER THE DIRECTION OF A LICENSED ARCHITECT, ENGINEER OR LAND JURYEVER TO A LITER ANT THE NIA NY WAY, IF AN ITEM BEARING THE SEAL OF AN ARCHITECT, ENGINEER OR SURVEYOR IS ALTERED, THE ALTERING PARY SHALL AFRY TO THE ITEM THER SEAL AND THE NOTATION 'ALTERED PY FOLLOWED BY THEIR SIGNATURE AND THE DATE OF SUCH ALTERATION, AND A SPECIFIC DESCRIPTION OF THI ALTERATION. SHEET INFORMATION ssued Scale

Revision Number

10/18/2023 1"=10' Project Status **BID DOCUMENTS** Drawn By Checked By RHW JCB Drawing Title SITE PLAN



GENERAL NOTES

- 1. ALL PRIME CONTRACTORS ARE RESPONSIBLE FOR SECURING THE PROJECT SITE AT THE END OF EACH WORK DAY. ALL MAN AND EQUIPMENT GATES TO REMAIN CLOSED DURING THE WORK DAY, TO PREVENT PATRONS AND STAFF FROM ENTERING THE CONSTRUCTION WORK AREAS. IF TEMPORARY CONSTRUCTION FENCING IS REMOVED TO ACCESS ACTIVE WORK AREAS, IT MUST BE IMMEDIATELY RESTORED UPON COMPLETION OF WORK OR AT THE END OF THE WORK DAY
- 2. DELIVERIES TO BE COORDINATED AROUND THE SCHOOL'S DAILY OPERATIONS AND WITH THE CONSTRUCTION MANAGER.

DEMOLITION NOTES

- 1. PROTECT ALL UTILITIES, EXISTING DEVICES & ROAD SIGNS THAT ARE TO REMAIN
- 2. STORE ON-SITE AND REUSE PARKING/BUILDING/STREET SIGNS WHEREVER POSSIBLE. REUSED SIGNS TO BE MOUNTED TO NEW SIGN POSTS. PROPERLY DISPOSE OF ALL REMAINING SIGNS AND POSTS THAT WERE NOT REUSED.
- 3. REMOVE & PROPERLY DISPOSE OF ALL TREES, BRUSH & DEBRIS WITHIN LIMITS OF DISTURBANCE AS DESIGNATED (CLEARING AND GRUBBING SHALL INCLUDE THE REMOVAL AND DISPOSAL OF ALL ORGANIC MATERIAL, INCLUDING STUMPS AND ROOT SYSTEMS UNDER PROPOSED PAVEMENT). ALL TREES TO REMAIN ARE TO BE PROTECTED FROM DAMAGE.
- 4. REMOVE & STOCK PILE ON SITE ALL TOP SOIL WITHIN AREA OF DISTURBANCE FOR LATER USE. EXCESS TOPSOIL TO BE STOCKPILED AT DESIGNATED LOCATION. THE TOPSOIL PILE LOCATION SHALL BE SURROUNDED WITH SILT FENCE AND SEEDED WITH LAWN GRASS SEED MIXTURE
- 5. COORDINATE WITH OWNER'S REPRESENTATIVE TO INSPECT GROUND DURING TOPSOIL REMOVAL & CLEARING AND GRUBBING PROCESS. POT HOLES RESULTING FROM TREE ROOT REMOVAL SHALL BE BACKFILLED & COMPACTED WITH STRUCTURAL BACKFILL AS DIRECTED BY OWNER'S REPRESENTATIVE
- 6. PROOF ROLL THE NEWLY EXPOSED SUBGRADE IN THE PRESENCE OF OWNER'S REPRESENTATIVE. UNDERCUT UNSUITABLE SUBGRADE AS DIRECTED BY OWNER'S REPRESENTATIVE.
- 7. PROTECT TREES, UTILITY POLES, GUY WIRES, POSTS, EDGE OF CONCRETE WALKS & CURB, AND ROOT SYSTEMS TO REMAIN AS NOTED, OR AS REQUIRED, FROM DAMAGE DURING CONSTRUCTION. CONTRACTOR SHALL REPAIR OR REPLACE AS NECESSARY ANY ITEM DAMAGED DURING CONSTRUCTION AT NO ADDITIONAL COST TO THE OWNER.
- 8. CONTRACTOR TO TAKE PRECAUTIONS TO PROTECT EXISTING ROOTS DURING CONSTRUCTION. ROOTS SHALL BE CLEAN CUT AS DIRECTED BY THE OWNER'S REPRESENTATIVE
- 9. ALL UNDERGROUND UTILITIES AND THEIR LOCATION SHOWN HEREON ARE APPROXIMATE. CONTRACTOR IS RESPONSIBLE TO VERIFY ALL EXISTING UTILITIES AND VERIFY THEIR LOCATIONS AND DEPTHS PRIOR TO BEGINNING CONSTRUCTION. THE CONTRACTOR IS RESPONSIBLE FOR ALL REPAIRS TO EXISTING UTILITIES IF DAMAGED BY WORK
- 10. IF REQUIRED ADJUST ELEVATIONS OF ALL BURIED UTILITY LINES, UNITS & DEVICES TO PROVIDE MINIMUM REQUIRED COVER FOR FINISHED GRADE ELEVATIONS (COORDINATE WITH UTILITY PROVIDERS).
- 11. TEMPORARY CONSTRUCTION FENCING SHALL BE INSTALLED & MAINTAINED THROUGHOUT TIME OF CONSTRUCTION.
- 12. CONTRACTOR TO COORDINATE ALL WORK DONE RELATED TO UTILITY POLES AND OVERHEAD LINES WITH UTILITY PROVIDERS.
- 13. CONTRACTOR SHALL REMOVE ALL EXISTING UNDERGROUND UTILITIES DESIGNATED, AND FILL EXCAVATION AREA WITH STRUCTURAL FILL AND COMPACTED IN 6" LIFTS.
- 14. CONTRACTOR TO ADJUST UTILITY STRUCTURES, COVERS, OR OTHER SURFACE FEATURES AS NEEDED TO FINISH GRADES.
- 11. CONTRACTOR SHALL PRESERVE AND PROTECT FROM DAMAGE ALL TREES, FENCES AND OTHER OBSTACLES WITHIN THE ROW AND EASEMENT. 12. CONTRACTOR SHALL RETAIN THE SERVICES OF A QUALIFIED TREE EXPERT TO REMOVE, WHERE NECESSARY, BRANCHES WHICH INTERFERE WITH THE CONSTRUCTION OPERATIONS, OR REPAIR TREES HAVING SUFFERED DAMAGE BY CONSTRUCTION ACTIVITIES. COST TO BE INCLUDED IN
- 13. THE CONTRACTOR SHALL LOCATE, FLAG AND PRESERVE SURVEY MONUMENTS AND PROPERTY CORNER MARKERS. THE CONTRACTOR SHALL HAVE A LICENSED SURVEYOR REESTABLISH ANY PROPERTY CORNERS OR SURVEY MONUMENTS DISTURBED DURING CONSTRUCTION AT NO ADDITIONAL COST TO THE OWNER.

CONCRETE WASHOUT FACILITY NOTES:

CONDITIONS WHERE PRACTICE APPLIES:

THE VARIOUS ITEMS BID OF THE CONTRACT

WASHOUT FACILITIES SHALL BE PROVIDED FOR EVERY PROJECT WHERE CONCRETE WILL BE POURED OR OTHERWISE FORMED ON THE SITE, THIS FACILITY WILL RECEIVE HIGHLY ALKALINE WASH WATER FROM THE CLEANING OF CHUTES, MIXERS, HOPPERS, VIBRATORS, PLACING EQUIPMENT, TROWELS, AND SCREEDS. UNDER NO CIRCUMSTANCES WILL WASH WATER FROM THESE OPERATIONS BE ALLOWED TO INFILTRATE INTO THE SOIL OR ENTER SURFACE WATERS.

DESIGN CAPACITY:

THE WASHOUT FACILITY SHOULD BE SIZED TO CONTAIN SOLIDS, WASH WATER, AND RAINFALL AND SIZED TO ALLOW FOR THE EVAPORATION OF THE WASH WATER AND RAINFALL. WASH WATER SHALL BE ESTIMATED AT 7 GALLONS PER CHUTE AND 50 GALLONS PER HOPPER OF THE CONCRETE PUMP TRUCK AND/OR DISCHARGING DRUM. THE MINIMUM SIZE SHALL BE 8 FEET BY 8 FEET AT THE BOTTOM AND 2 FEET IF EXCAVATED, THE SIDE SLOPES SHALL BE 2 HORIZONTAL TO 1 VERTICAL.

LOCATION:

LOCATE THE FACILITY A MINIMUM OF 100 FEET FROM DRAINAGE SWALES, STORM DRAIN INLETS, WETLANDS, STREAMS AND OTHER SURFACE WATERS. PREVENT SURFACE WATER FROM ENTERING THE STRUCTURE EXCEPT FOR THE ACCESS ROAD. PROVIDE APPROPRIATE ACCESS WITH A GRAVEL ACCESS ROAD SLOPED DOWN TO THE STRUCTURE. SIGNS SHALL BE PLACED TO DIRECT DRIVERS TO THE FACILITY AFTER THEIR LOAD IS DISCHARGED.

LINER:

ALL WASHOUT FACILITIES WILL BE LINED TO PREVENT LEACHING OF LIQUIDS INTO THE GROUND. THE LINER SHALL BE PLASTIC SHEETING WITH A MINIMUM THICKNESS OF 10 MILS WITH NO HOLES OR TEARS, AND ANCHORED BEYOND THE TOP OF THE PIT WITH AN EARTHEN BERM, SAND BAGS, STONE, OR OTHER STRUCTURAL APPURTENANCE EXCEPT AT THE ACCESS POINT, IF PRE-FABRICATED WASHOUTS ARE USED THEY MUST ENSURE THE CAPTURE AND CONTAINMENT OF THE CONCRETE WASH AND BE SIZED BASED ON THE EXPECTED FREQUENCY OF CONCRETE POURS. THEY SHALL BE SITED AS NOTED IN THE LOCATION CRITERIA.

MAINTENANCE:

- 1. ALL CONCRETE WASHOUT FACILITIES SHALL BE INSPECTED DAILY. DAMAGED OR LEAKING FACILITIES SHALL BE DEACTIVATED AND REPAIRED OR REPLACED IMMEDIATELY. EXCESS RAINWATER THAT HAS ACCUMULATED OVER HARDENED CONCRETE SHOULD BE PUMPED TO A STABILIZED AREA, SUCH AS A GRASS FILTER STRIP.
- 2. ACCUMULATED HARDENED MATERIAL SHALL BE REMOVED WHEN 75% OF THE STORAGE CAPACITY OF THE STRUCTURE IS FILLED. ANY EXCESS WASH WATER SHALL BE PUMPED INTO A CONTAINMENT VESSEL AND PROPERLY DISPOSED OF OFF SITE. 3. DISPOSE OF THE HARDENED MATERIAL OFF-SITE IN A CONSTRUCTION/DEMOLITION LANDFILL.
- 4. THE PLASTIC LINER SHALL BE REPLACED WITH EACH CLEANING OF THE WASHOUT FACILITY.
- 5. INSPECT THE PROJECT SITE FREQUENTLY TO ENSURE THAT NO CONCRETE DISCHARGES ARE TAKING PLACE IN NON-DESIGNATED AREAS.

SIDEWALK NOTES

- 1. THE DIMENSIONS AND SLOPE PRESENTED IN THE DETAILS ARE THE MINIMUM NECESSARY TO COMPLY WITH THE ADA AND NYSDOT STANDARDS. ANY DEVIATION LESS THAN THE MINIMUM WIDTH OR GREATER THAN THE MAXIMUM SLOPE FROM THESE STANDARDS MUST BE DOCUMENTED WITH THE STANDARDS BEING MET TO THE GREATEST EXTENT PRACTICABLE AND CONSISTENT WITH THE MOST CURRENT ADAAG.
- 2. THE DETAILS PROVIDED ARE NOT DRAWN TO SCALE. THE QUANTITY OF DOMES DEPICTED ON THE DETECTABLE WARNING UNIT (THE DOMES AND THE ENTIRE 24" LEVEL SURFACE) IS FOR ILLUSTRATION ONLY.
- 3. CURB RAMPS, LANDINGS AND BLENDED TRANSITIONS MAY REQUIRE THE USE OF DETECTABLE WARNINGS. DETECTABLE WARNINGS SHOWN FOR ILLUSTRATION ONLY. REFER TO THE DETECTABLE WARNING DETAILS FOR DETAILS ON PLACEMENT, ORIENTATION & DIMENSIONS. REFER TO CHAPTER 18 OF THE HIGHWAY DESIGN MANUAL FOR MORE INFORMATION.
- 4. THE CONFIGURATIONS SHOWN GENERICALLY REPRESENT THE MOST COMMON SITUATIONS ENCOUNTERED. THEY ARE INTENDED TO PRESENT CURB RAMP DESIGN CONCEPTS. SITE CONDITIONS AT INDIVIDUAL LOCATIONS REQUIRE SPECIFIC DESIGNS.
- 5. COORDINATE TRAFFIC CONTROL DEVICES, UTILITY LOCATIONS, SIGNS, STREET FURNITURE AND DRAINAGE TO ENSURE A CONTINUOUS PEDESTRIAN ACCESS ROUTE AT ALL CURB RAMP LOCATIONS. GUIDANCE FOR CROSSWALK MARKINGS AND TRAFFIC CONTROL DEVICES IS PROVIDED IN THE MUTCH.
- 6. GRATES SHALL NOT BE LOCATED ON CURB RAMPS, BLENDED TRANSITIONS OR LANDINGS. ACCESS TO COVERS OF SIMILAR SURFACES SHALL COMPLY WITH APPLICABLE SURFACE REQUIREMENTS.
- 7. UTILITIES, SIGNS AND OTHER FIXED OBJECTS MAY NOT BE PLACED ON A CURB, OR IN A MANNER THAT INTERFERES WITH THE USE OF THE CURB RAMP.
- 8. THE SURFACE OF ALL CURB RAMPS SHALL BE STABLE, FIRM AND SLIP RESISTANT. A COARSE BROOM FINISH RUNNING PERPENDICULAR TO THE SLOPE SHALL BE PROVIDED ON CONCRETE RAMP SURFACES. EXCLUSIVE OF THE DETECTABLE WARNING FIELDS

SEDIMENT AND EROSION CONTROL NOTES

- . ALL EROSION AND SEDIMENT CONTROL MEASURES SHALL BE IN ACCORDANCE WITHNYS STANDARDS AND SPECIFICATIONS FOR EROSION AND SEDIMENT CONTROL (BLUE BOOK) LATEST EDITION, THE SWPPP, AND LOCAL GOVERNING SOIL AND WATER CONSERVATION AGENCY RECOMMENDATIONS AND STANDARDS. CONTRACTOR SHALL SUBMIT PROPOSED SEQUENCING OF WORK TO THE OWNER'S REPRESENTATIVE FOR REVIEW PRIOR TO START OF WORK. CONTRACT PLANS INDICATE THE SUGGESTED MINIMUM MEASURES REQUIRED.
- 2. SEDIMENT FROM THE SITE SHALL BE PREVENTED FROM DISCHARGING TO ANY SURFACE WATER OR STORMWATER PIPING SYSTEM BY THE INSTALLATION OF EROSION AND SEDIMENTATION CONTROL MEASURES AND PRACTICES PRIOR TO OR CONCURRENT WITH LAND DISTURBING ACTIVITIES.
- 3. ALL SLOPES GREATER THAN 1:4 SHALL BE STABILIZED WITH JUTE MESH.
- 4. CONTRACTOR SHALL APPOINT A PERSON TO BE RESPONSIBLE FOR ALL EROSION AND SEDIMENT CONTROL MEASURES. THIS PERSON SHALL BE TRAINED IN ACCORDANCE WITH NYSDEC REQUIREMENTS FOR EROSION AND SEDIMENT CONTROL ACTIVITIES.
- 5. CONSTRUCT STABILIZED CONSTRUCTION ENTRANCE IN ACCORDANCE WITH DETAIL. COORDINATE LOCATION WITH OWNER PRIOR TO ANY ON-SITE ACTIVITIES.
- 6. PROVIDE AND MAINTAIN INLET PROTECTION ON ALL EXISTING AND NEW CATCH BASINS, MANHOLES AND INLETS UNTIL DRAINAGE AREAS ARE STABILIZED. USE COMPOST FILTER SOCK IN PLACE OF FILTER FABRIC IN PAVED AREAS.
- 7. PROVIDE AND MAINTAIN SILT FENCE AROUND PERIMETER OF ALL WORK AREAS, EXCAVATED SOIL STOCKPILES, AND BETWEEN DISTURBED AREAS AND DRAINAGE WAYS OR WATER BODIES. COORDINATE LOCATIONS WITH OWNER AS WORK PROGRESSES AND AREAS ARE STABILIZED. SILT FENCE TO BE INSTALLED AND ENTRENCHED (MIN 6" BELOW GROUND ELEVATION). SILT SOCK MAY USED ON PAVED OR GRAVEL AREAS.
- 8. ALL EXPOSED SUBGRADE AREAS INTENDED FOR PAVEMENT SHALL BE STABILIZED WITH SUBBASE STONE WITHIN THREE (3) DAYS OF EXCAVATION / PAVEMENT REMOVALS
- 9. EROSION CONTROL MEASURES SHALL BE IN PLACE PRIOR TO ANY SOIL DISTURBANCE ACTIVITIES, INCLUDING GRADING OR FILLING OPERATIONS AND INSTALLATION OF PROPOSED STRUCTURES OR UTILITIES.
- 10. CONTRACTOR SHALL MAINTAIN EROSION CONTROL MEASURES AT ALL TIMES. IF FULL IMPLEMENTATION OF THE APPROVED PLAN DOES NOT PROVIDE FOR EFFECTIVE EROSION CONTROL. ADDITIONAL EROSION AND SEDIMENT CONTROL MEASURES SHALL BE IMPLEMENTED
- 11. ALL SOIL EROSION AND SEDIMENTATION CONTROL MEASURES AND PRACTICES, WHETHER TEMPORARY OR PERMANENT, SHALL BE MAINTAINED AT ALL TIMES UNTIL CONSTRUCTION IS COMPLETED AND THE WORK AREAS ARE STABILIZED.
- 12. CONSTRUCT TEMPORARY SILT FENCING ALONG BOTTOM EDGE OF ALL SLOPES AND/OR AS SHOWN, AS DESIGNATED, OR AS DIRECTED BY OWNERS **REPRESENTATIVE**
- 13. CONSTRUCT TEMPORARY STONE CHECK DAMS ALONG DITCH LINES AS SPECIFIED AND/OR AS SHOWN, AS DESIGNATED, OR AS DIRECTED BY OWNER'S REPRESENTATIVE.
- 14. ALL EROSION AND SEDIMENT CONTROL MEASURES MUST BE INSPECTED AND MAINTAINED WEEKLY. CONTRACTOR SHALL KEEP ON FILE A RECORD OF THE **REQUIRED INSPECTION REPORTS.**
- 15. ALL DISTURBED AREAS, EXPOSED SLOPES AND SWALES SHALL BE VEGETATED (TEMPORARY SEEDED) WITHIN 14 CALENDAR DAYS FOLLOWING COMPLETION OF ANY PHASE OF GRADING
- 16. JUTE MESH OR OTHER STABILIZATION FABRIC SHALL BE APPLIED TO ANY SLOPES GREATER THAN 1V:4H IMMEDIATELY UPON COMPLETION OF GRADING ACTIVITIES. MESH OR OTHER MEASURE SHALL BE ADEQUATELY SECURED.
- 17. TEMPORARY SEEDING SHALL BE SEEDED RYE GRASS AT A RATE OF FIVE (5) LBS PER 1,000 SQUARE FEET OF AREA. CONTINUALLY REAPPLY TEMPORARY SEEDING AT FIRST SIGN OF EROSION OR DETERIORATION OF THE SURFACE GRADE
- 18. PERMANENT GROUND COVER SHALL BE INSTALLED ON ALL DISTURBED AREAS WITHIN 5 WORKING DAYS FOLLOWING COMPLETION OF CONSTRUCTION OR DEVELOPMENT.
- 19. ALL EROSION AND SEDIMENT CONTROL MEASURES SHALL BE REMOVED COMPLETELY UPON FINAL STABILIZATION. COORDINATE TIMING OF REMOVAL WITH OWNER'S REPRESENTATIVE 20. CONTRACTOR SHALL FLUSH CLEAN ALL EXISTING AND NEW STORM PIPING WITHIN PROJECT LIMITS AFTER FINAL STABILIZATION IS COMPLETE.
- 21. WALKWAYS TO BE KEPT FREE AND CLEAR OR DEBRIS, REFUSE AND SILT AT ALL TIMES.
- 22. DEBRIS, VEGETATION AND OTHER SPOILS REMOVED AS PART OF THE CONSTRUCTION ACTIVITIES SHALL BE DISPOSED OF AT UPLAND LOCATIONS ABOVE THE REACH OF HIGH WATER AND IN ACCORDANCE WITH LOCAL LAWS AND REGULATIONS. SEDIMENT DISPOSSAL IN WATER BODY, WETLANDS, FLOODWAYS OR THE 100-YEAR FLOODPLAIN IS STRICTLY PROHIBITED.
- 23. DURING CONSTRUCTION, NO WET OR FRESH CONCRETE OR LEACHATE SHALL BE ALLOWED TO ESCAPE INTO ANY WETLANDS OR WATERS OF NEW YORK STATE. NOR SHALL WASHINGS FROM READY-MIX CONCRETE TRUCKS, MIXERS OR OTHER DEVICES BE ALLOWED TO ENTER ANY WETLAND OR WATERS. ONLY WATERTIGHT OR WATERPROOF FORMS SHALL BE USED. WET CONCRETE SHALL NOT BE POURED TO DISPLACE WATER WITHIN THE FORMS.
- 24. CONTRACTOR TO CONSTRUCT A TEMPORARY CONCRETE WASHOUT AREA ADJACENT TO EACH WORK AREA ENTRANCE.
- 25. THE CONTROL OF DUST ORIGINATING FROM THE CONSTRUCTION OPERATIONS IS CONSIDERED A CRITICAL RESPONSIBILITY OF THE CONTRACTOR. THE ENGINEER WILL BE THE FINAL JUDGE OF THE ADEQUACY OF THE CONTRACTOR'S DUST CONTROL EFFORTS. WORK MAY BE SUSPENDED BY THE ENGINEER UNTIL ADEQUATE DUST CONTROL IS ATTAINED.

TOPSOIL AND SEEDING NOTES:

SEEDING NOTES:

- 2. SEED MIXTURES:

RAPIDLY GERMINATING ANNUAL RYEGRASS: 30 LBS PER ACRE PERENNIAI RYEGRASS:

CEREAL RYE: FOR USE ON LAWN AREAS (AREAS TO BE MAINTAINED)

ALTERNATE A (SUNNY SITE) 65% KENTUCKY BLUE GRASS BLEND: 20% PERENNIAL RYEGRASS: 15% FINE FESCUE:

ALTERNATE B (SHADY SIT 80% KENTUCKY BLUE GRASS BLEND*: 20% PERENNIAL RYEGRASS: * SHADE TOLERANT

- BE INCREASED 10% WHEN HYDRO-SEEDING.
- 4. MULCH SEEDED AREAS WITH STRAW MULCH (2000 LBS PER ACRE).
- TOPSOIL APPLICATION NOTES:
- 3. APPLY TOPSOIL IN THE FOLLOWING AMOUNTS FOR INTENDED USE:
- MOWED LAWN: 4-8 INCHES 2-4 INCHES UNMOWED AREA:

TOPSOIL MATERIAL NOTES:

- AND SHALL MEET THE FOLLOWING CRITERIA; MATERIAL
- MORE THAN 15% CLAY.

LESS THAN 10% GRAVEL BY VOLUME. INSPECTION & MAINTENANCE NOTES:

GROWTH

- IMMEDIATELY.

6. SOIL SHALL MAINTAIN A pH OF 6.0-7.0.

1. PROVIDE FRESH, CLEAN, NEW SEED COMPLYING WITH ESTABLISHED TOLERANCES FOR GERMINATION AND PURITY IN ACCORDANCE WITH THE U.S. DEPARTMENT OF AGRICULTURE RULES AND REGULATIONS UNDER THE LATEST EDITION OF THE FEDERAL SEED ACT. SEED SHALL BE MIXED BY THE DEALER AND SHALL BE DELIVERED TO THE SITE IN SEALED CONTAINERS WHICH SHALL BEAR THE DEALER'S GUARANTEE ANALYSIS.

FOR TEMPORARY SEEDING - OR - AREAS THAT WILL NOT BE MAINTAINED:

100 LBS PER ACRE 30 LBS PER ACRE

85-114 LBS PER ACRE 26-35 LBS PER ACRE 19-26 LBS PER ACRE 130-175 LBS PER ACRE

105-138 LBS PER ACRE 25-37 LBS PER ACRE 130-175 LBS PER ACRE

3. APPLY SEED UNIFORMLY BY HAND, CYCLONE SEEDER, OR HYDRO SEEDER (SLURRY INCLUDING SEED AND FERTILIZER). HYDRO-SEEDINGS, WHICH INCLUDE MULCH, MAY BE LEFT ON SOIL SURFACE. SEEDING RATES MUST

5. IRRIGATE TO FULLY SATURATE SOIL LAYER, BUT NOT TO DISLODGE PLANTING SOIL.

6. SEED BETWEEN APRIL 1ST AND MAY 15TH OR AUGUST 15TH AND OCTOBER 15TH. SEEDING MAY OCCUR BETWEEN MAY 15TH AND AUGUST 15TH IF ADEQUATE IRRIGATION IS PROVIDED.

1. TOPSOIL SHALL BE DISTURBED TO A UNIFORM DEPTH OVER THE AREA. IT SHALL NOT BE PLACED WHEN IT IS PARTIALLY FROZEN, MUDDY OR ON FROZEN SLOPES OVER ICE, SNOW OR STANDING WATER.

2. TOPSOIL PLACED AND GRADED ON SLOPES STEEPER THAN 5% SHALL BE PROMPTLY FERTILIZED, SEEDED AND STABILIZED BY "TRACKING" WITH SUITABLE EQUIPMENT.

4. COMPLETE ROUGH GRADING AND FINAL GRADE, ALLOWING FOR DEPTH OF TOPSOIL TO BE ADDED. SCARIFY ALL COMPACT, SLOWLY PERMEABLE, MEDIUM AND FINE TEXTURED SUBSOIL AREAS. SCARIFY AT APPROXIMATELY RIGHT ANGLES TO THE SLOPE DIRECTION IN SOIL AREAS THAT ARE STEEPER THAN 5%.

5. REMOVE REFUSE, WOODY PLANT PARTS, STONES OVER 3 INCHES IN DIAMETER, AND OTHER LITTER.

THE FURNISHINGS OF NEW TOPSOIL SHALL BE OF A BETTER OR EQUAL QUALITY OF THE EXISTING ADJACENT TOPSOIL

D TOPSOIL SHALL HAVE AT LEAST 2%, BUT NOT MORE THAN 6% BY WEIGHT OF FINE TEXTURED STABLE ORGANIC

D TOPSOIL SHALL HAVE NOT LESS THAN 20% FINE TEXTURED MATERIAL (PASSING THE NO. 200 SIEVE) AND NOT

TOPSOIL SHALL BE RELATIVELY FREE OF STONES OVER 1" DIAMETER, THRASH, NOXIOUS WEEDS, AND WILL HAVE

1. TEMPORARY SEEDING AND PLANTING WILL BE INSPECTED FOR BARE SPOTS, WASHOUTS, AND UNHEALTHY

2. TEMPORARY SEEDINGS SHALL BE PERIODICALLY INSPECTED. AT A MINIMUM 95% OF THE SOIL SURFACE SHOULD BE COVERED BY VEGETATION. IF ANY EVIDENCE OF EROSION OR SEDIMENTATION IS APPARENT. REPAIRS SHALL BE MADE AND OTHER TEMPORARY MEASURES USED IN THE INTERIM. (MULCH, FILTER BARRIERS, CHECK DAMS, ETC.) 3. ALL MULCHES MUST BE INSPECTED PERIODICALLY. IN PARTICULAR AFTER RAINSTORMS. TO CHECK FOR RILL

EROSION, IF LESS THAN 90% OF THE SOIL SURFACE IS COVERED BY MULCH, ADDITIONAL MULCH SHALL BE APPLIED

4. AERATE COMPACTED OR HEAVY USED AREAS, ANNUALLY AS SOON AS THE SOIL MOISTURE CONDITIONS PERMIT. AERATE AREA 6 TO 8 TIMES USING A SPOON HOLLOW TINE TYPE AERATION. DO NOT USE SPIKE EQUIPMENT. 5. RESEED BARE AND THIN AREAS ANNUALLY WITH ORIGINAL SPECIES.





PROJECT INFORMATION Project Number 14457.20 Client Name SOUTH ORANGETOWN CENTRAL SCHOOL DISTRICT

PHASE 1: 2022 BOND

Project Address 160 VAN WYCK RD. BLAUVELT, NY 109134

Proiect Nar

Lauren Tarsio 09/30/26 Richard Waite 11/30/23 Larry Werts 12/31/24 Anthony Marchetti 05/31/24 Dave Hart 02/28/25 Jennifer Wengender 06/30/24

CERTIFICATE #018330

REGISTRATION EXPIR. DATES:

SOUTH ORANGETOWN CSD WILLIAM O SCHAEFER SED#: 50-03-01-06-0-012-019 OTTAGE LANE ELEMENTARY SED#: 50-03-01-06-0-010-022 TAPPAN 7FF HIGH SCHOOL SED#: 50-03-01-06-0-006-032 WOS OUTDOOR CLASSROOM SED#: 50-03-01-06-7-053-001 LE OUTDOOR CLASSROOM SED#: 50-03-01-06-7-054-00 OMS OUTDOOR CLASSROOM SED#: 50-03-01-06-7-056-001 TZHS OUTDOOR CLASSROOM SED#: 50-03-01-06-7-055-001

PROJECT ISSUE & REVISION SCHEDULE No. Date Description

PROFESSIONAL STAMPS

SHEET INFORMATION

ssued

Drawn By

RHW

NEW YORK STATE EDUCATION STATEMENT

Scale 10/18/2023 AS NOTED Proiect Status **BID DOCUMENTS** Checked By JCB

S A VIOLATION OF THE NEW YORK STATE EDUCATION LAW AND THE COMMISS GULATIONS FOR ANY PERSON, UNLESS ACTING UNDER THE DIRECTION OF A LI RCHITECT, ENGINEER OR LAND SURVEYOR, TO ALTER AN ITEM IN ANY WAY. IF A

BEARING THE SEAL OF AN ARCHITECT, ENGINEER OR SURVEYOR IS ALTERED, THE ALTE


HEIR SIGNATURE AND THE DATE OF SUCH ALTERATION, AND A SPECIFIC DESCR

AFFIX TO THE ITEM THEIR SEAL AND THE N

Drawing Title GENERAL NOTES



Revision Number

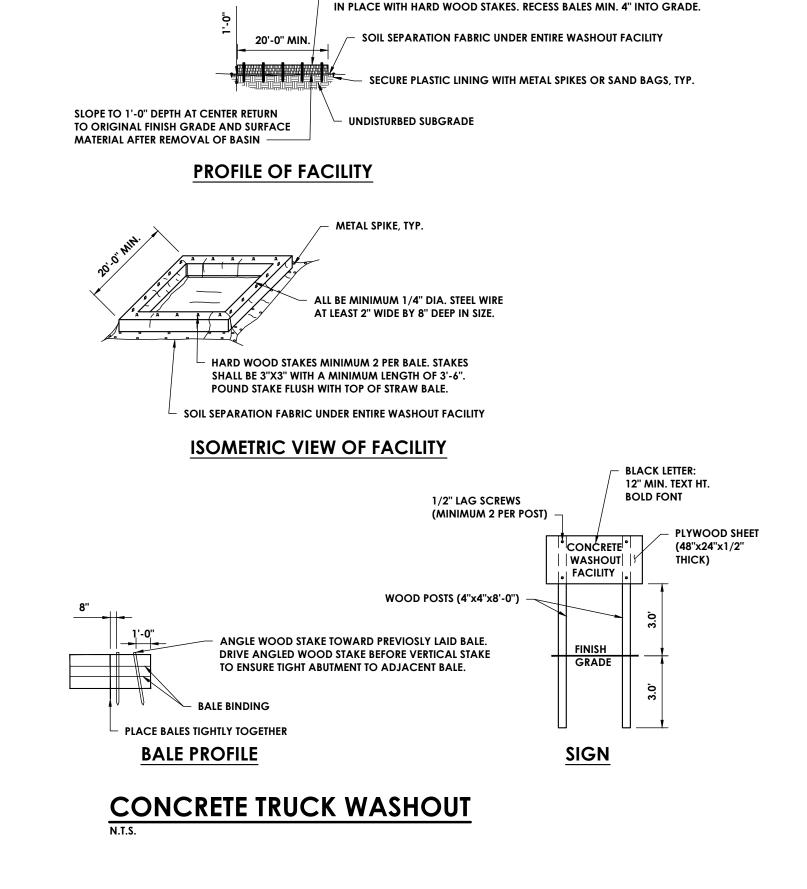

- SIDE WALLS CONSTRUCTED WITH STRAW BALES LAID END TO END AND HELP

SOIL STOCKPILE

2. SEE SILT FENCE DETAIL FOR MAINTENANCE AND INSPECTIONS.

DAYS.

INSPECTION & MAINTENANCE NOTES: 1. SOIL AND TOPSOIL STOCKPILE SHALL BE SEEDED IF THEY ARE TO REMAIN DORMANT FOR 30


4. SEE SPECIFICATIONS ON INSTALLATION OF SILT FENCE.


3. UPON COMPLETION OF SOIL STOCKPILING, EACH PILE SHALL BE SURROUNDED WITH EITHER SILT FENCING OR HAY BALES AND STABILIZED WITH VEGETATION OR COVERED.


2. MAXIMUM SLOPE OF STOCKPILE SHALL BE 1:2.

SPECIFICATION AND INSTALLATION NOTES:

1. AREA CHOSEN FOR STOCKPILING OPERATIONS SHALL BE DRY AND STABLE.

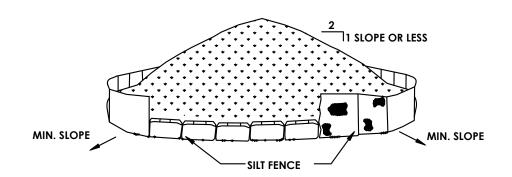

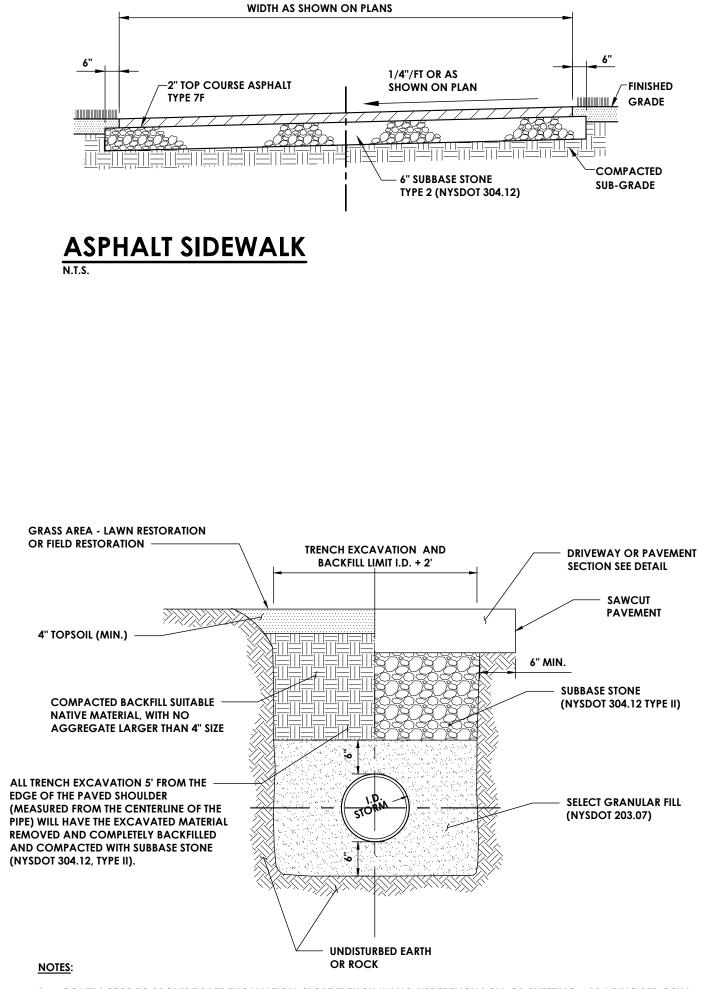

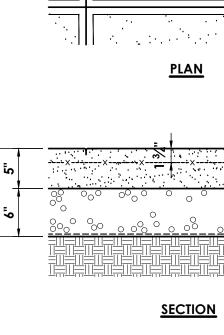


CONCRETE PAVEMENT N.T.S

1. CONTRACTOR TO PROVIDE SAFE EXCAVATION; SLOPE TRENCH WALLS, USE TRENCH BOX, OR SHEETING & BRACING PER OSHA SPECIFICATIONS. TRENCH BOX OR SHEETING AND BRACING TO BE LIFTED ABOVE THE SPRING LINE OR PIPE BEFORE BACKFILLING ABOVE SPRING LINE.


2. PAVEMENT BACKFILL AND RESTORATION REQUIREMENTS SHALL APPLY TO WORK PERFORMED UNDER PROPOSED ROADWAYS.

3. ALL WORK FOR STORM SEWER TRENCHING SHALL BE INCLUDED. THIS WORK INCLUDES, BUT IS NOT LIMITED TO TRENCHING, EXCAVATION AND ALL BACKFILL. NO ADDITIONAL PAYMENTS WILL BE MADE FOR BACKFILL.

STORM SEWER TRENCH N.T.S.

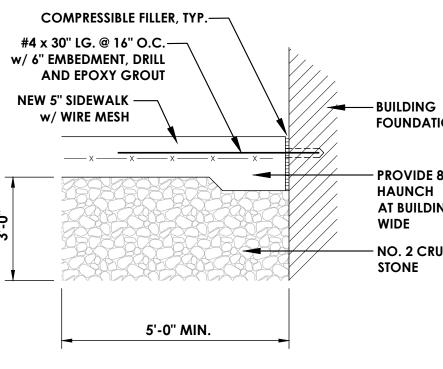

CONCRETE SLAB AT DOORWAY

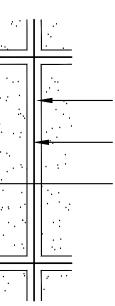

2" SMOOTH TROWELED PICTURE FRAME FINISH BOTH SIDES OF ALL JOINTS - CONTROL JOINT, LOCATE PER LAYOUT PLAN MEDIUM BROOM FINISH

 $-1\frac{1}{4}$ " tooled control joint -6X6XW2.9XW2.9 WELDED WIRE MESH

- BASE COURSE, NYSDOT 304.12, 2 LIFTS COMPACTED

- SEPARATION FABRIC, MIRAFI 500X

FOUNDATION WALL

– PROVIDE 8" THICK HAUNCH AT BUILDING FACE, 12" – NO. 2 CRUSHED

N.T.S

CPL | Architecture Engineering Planning 30 Century Hill Drive, Suite 104 Latham, NY 12110 CPLteam.com

PROJECT INFORMATION Project Number 14457.20 Client Name SOUTH ORANGETOWN CENTRAL

SCHOOL DISTRICT

Project Name **PHASE 1: 2022 BOND**

CERTIFICATE #018330

Project Address 160 VAN WYCK RD. Larry Werts 12/31/24 BLAUVELT, NY 109134

REGISTRATION EXPIR. DATES: Lauren Tarsio 09/30/26 Richard Waite 11/30/23 Anthony Marchetti 05/31/24 Dave Hart 02/28/25 Jennifer Wengender 06/30/24

SOUTH ORANGETOWN CSD WILLIAM O SCHAEFER SED#: 50-03-01-06-0-012-019
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TZHS OUTDOOR CLASSROOM SED#: 50-03-01-06-7-055-001

PROJECT ISSUE & REVISION SCHEDULE No. Date Description

PROFESSIONAL STAMPS

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Drawn By

RHW

NEW YORK STATE EDUCATION STATEMENT

Issued 10/18/2023 Project Status **BID DOCUMENTS**

Scale AS NOTED

Drawing Title

Checked By


Revision Number

Details 1

JCB





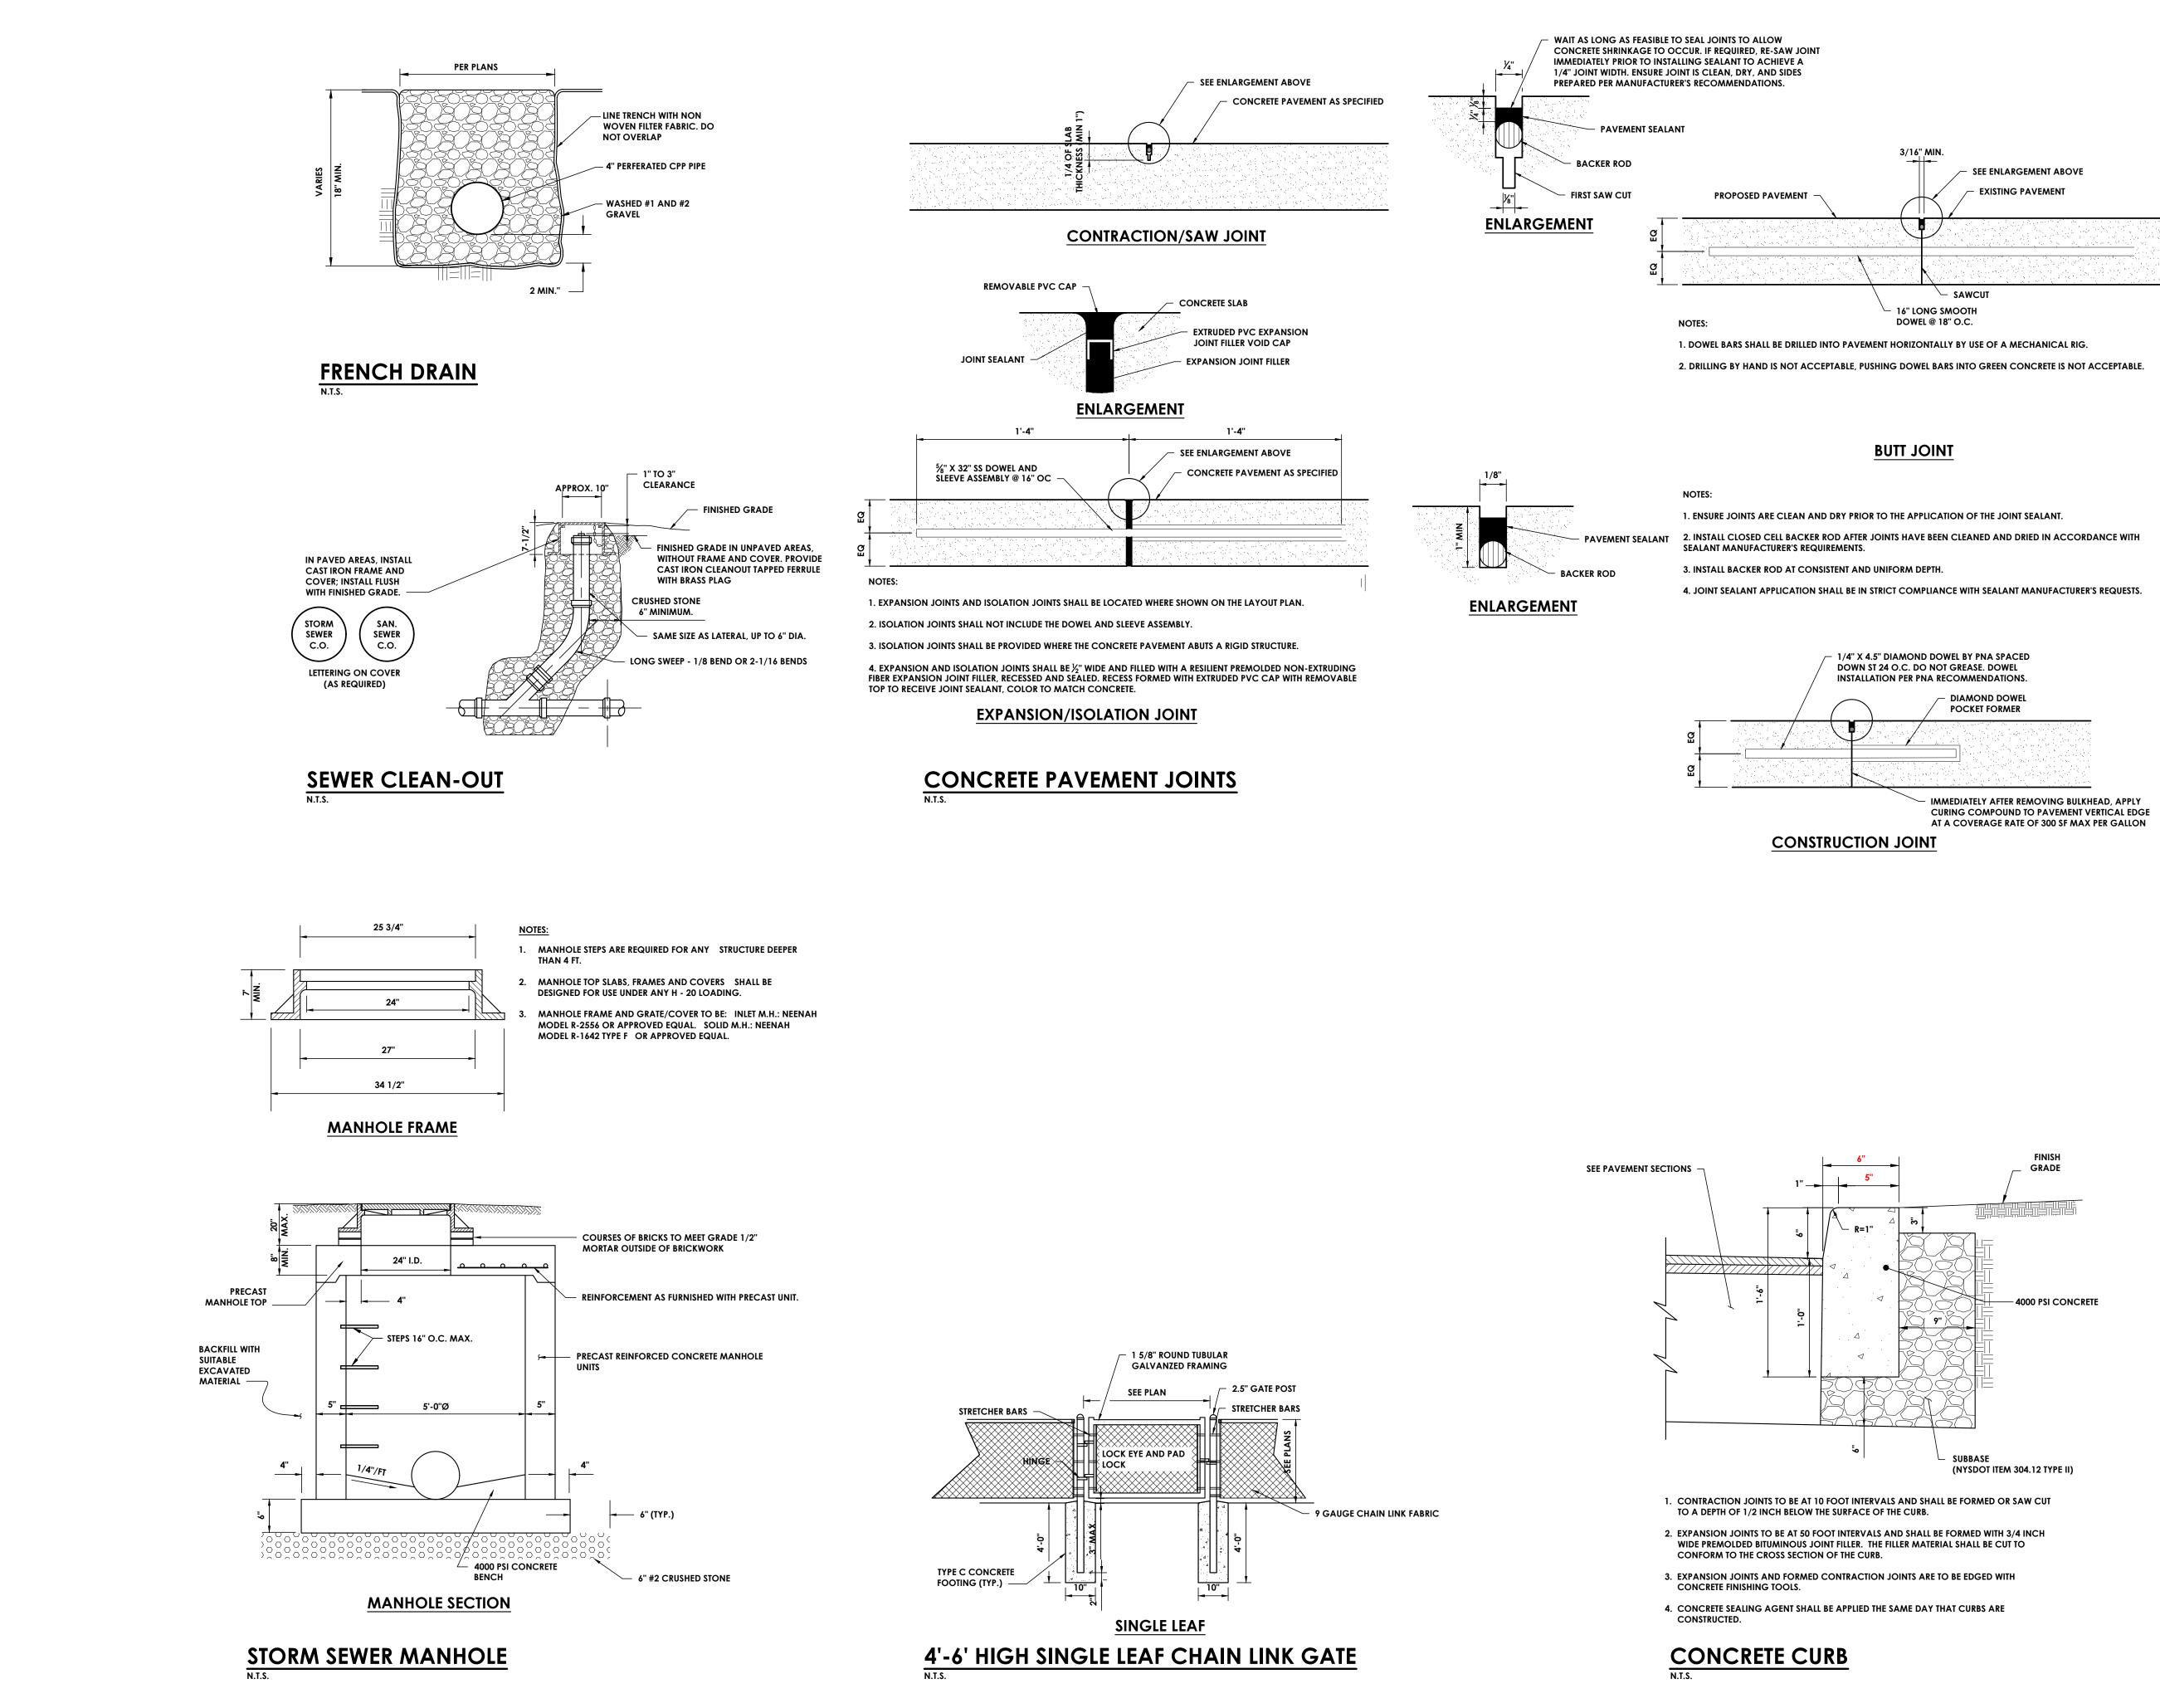

CPL | Architecture Engineering Planning 30 Century Hill Drive, Suite 104 Latham, NY 12110 CPLteam.com



PROJECT INFORMATION Project Number 14457.20 Client Name SOUTH ORANGETOWN CENTRAL SCHOOL DISTRICT Project Name

PHASE 1: 2022 BOND

Project Address 160 VAN WYCK RD. Larry Werts 12/31/24 BLAUVELT, NY 109134

REGISTRATION EXPIR. DATES: Lauren Tarsio 09/30/26 Richard Waite 11/30/23 Anthony Marchetti 05/31/24 Dave Hart 02/28/25 Jennifer Wengender 06/30/24

CERTIFICATE #018330

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HALL AFFIX TO THE ITEM THEIR SEAL AND THE NOTATION "ALTERED BY

Issued 10/18/2023 Project Status **BID DOCUMENTS** Drawn By

RHW Drawing Title Details 2 Checked By JCB


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Scale









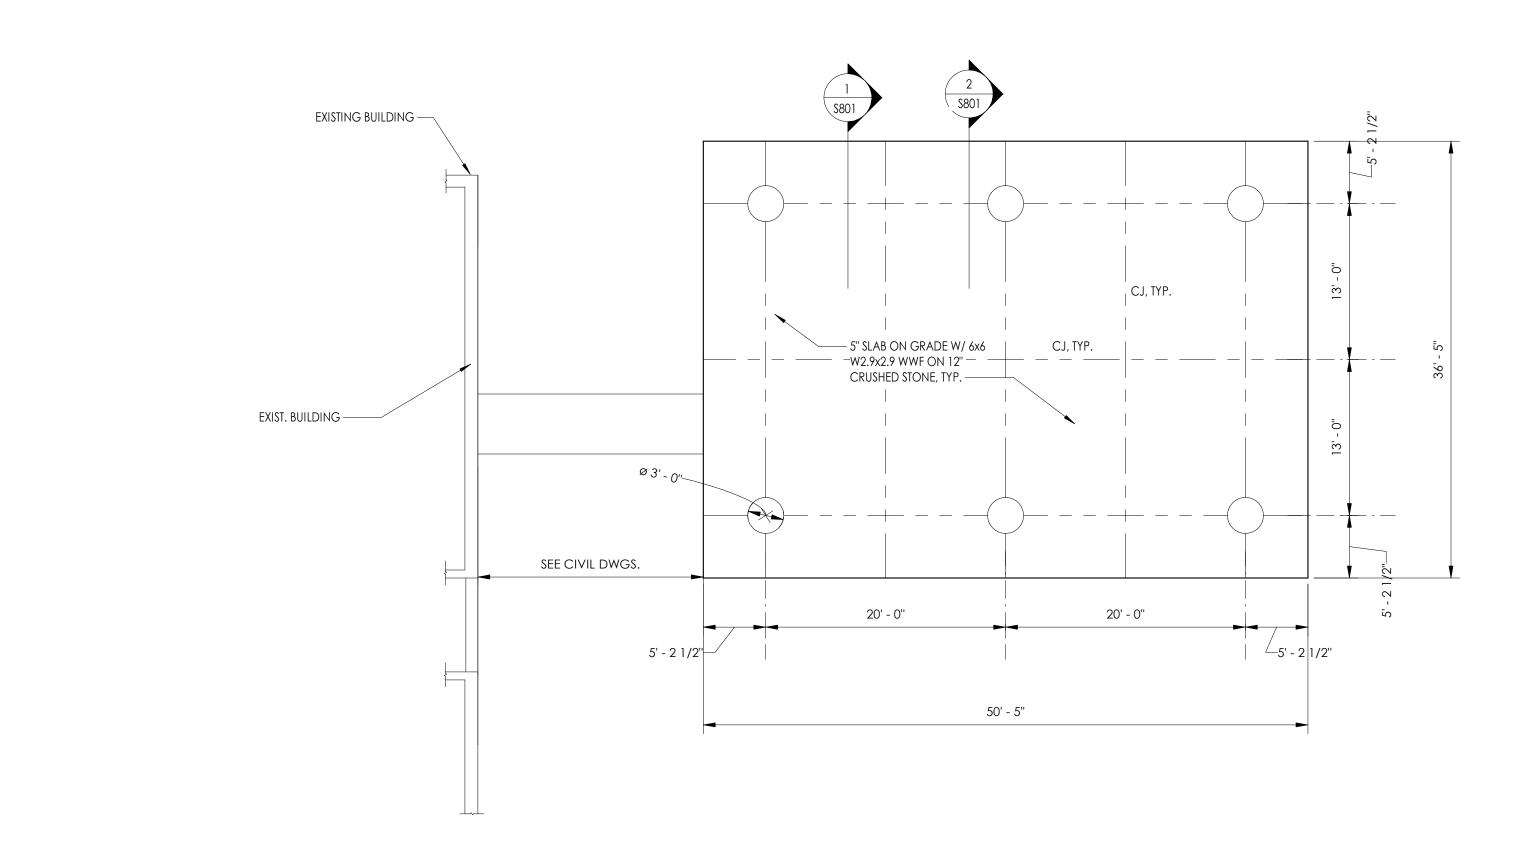


FOUNDATION AND SLAB PLAN NOTES


- 1. DATUM 0'-0" = ELEVATION 216.42' = FINISHED FLOOR SLAB ELEVATION.
- 2. ASSUMED ALLOWABLE SOIL BEARING CAPACITY IS 2000 PSF (NATURAL SOILS OR FILL).
- 3. EXTERIOR FOOTING SHALL BEAR AT A MINIMUM OF 4'-0" BELOW FINISHED GRADE UNLESS NOTED OTHERWISE.
- 4. FOOTINGS SHALL BE CENTERED ABOUT COLUMN LINES AND FOUNDATION WALLS UNLESS NOTED OTHERWISE.


- 5. CONCRETE SLAB-ON-GRADE SHALL BE 5" THICK, NORMAL WEIGHT REINFORCED CONCRETE UNLESS NOTED OTHERWISE, OVER VAPOR BARRIER AND 12" COMPACTED CRUSHED STONE.
- 6. REFER TO ARCHITECTURAL DRAWINGS FOR FLOOR FINISHES, FLOOR DRAINS, FLOOR SLOPES,
- DEPRESSED/RAISED SLAB AREAS, AND WATERPROOFING.
- 7. REFER TO DRAWING GEN-S800 FOR ALL DESIGN LOADS AND OTHER INFORMATION PERTINENT TO THE STRUCTURAL DESIGN.


- 8. THE FOLLOWING DENOTES SYMBOL REPRESENTATION:
 FD = FLOOR DRAIN
- CJ = SLAB CONTROL JOINTS
- TS = THICKENED SLAB

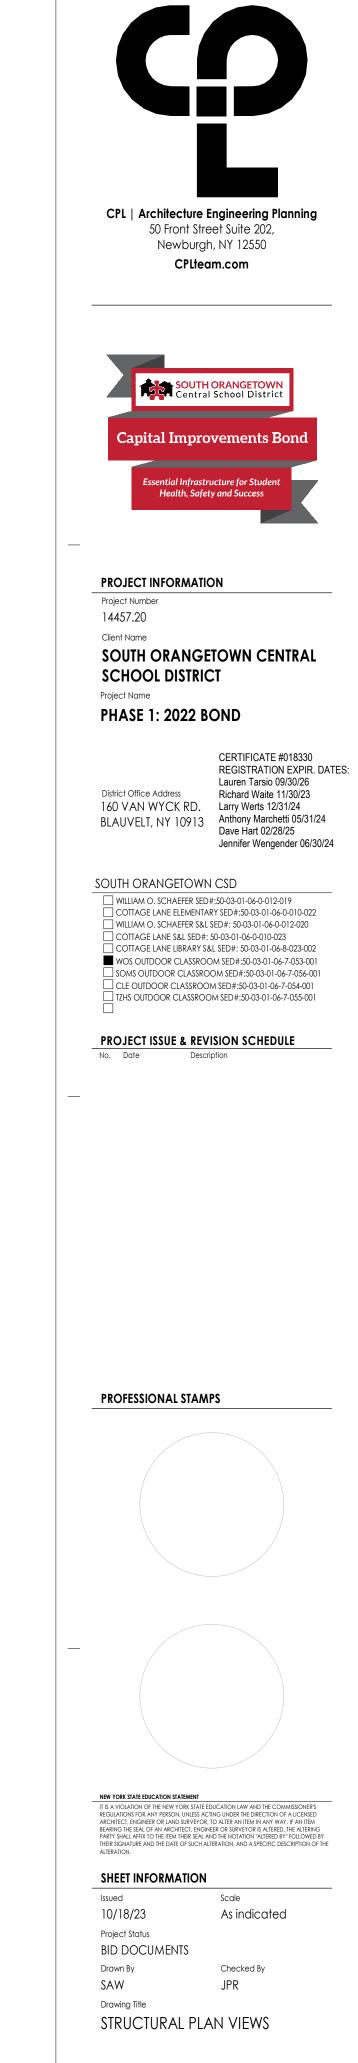



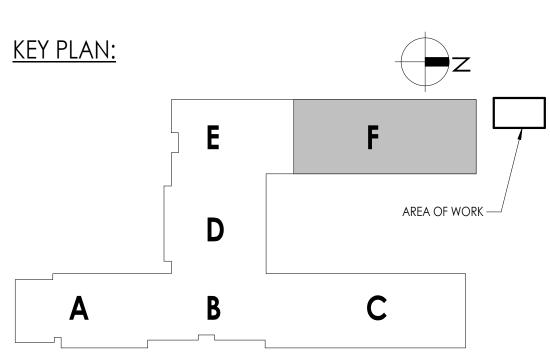

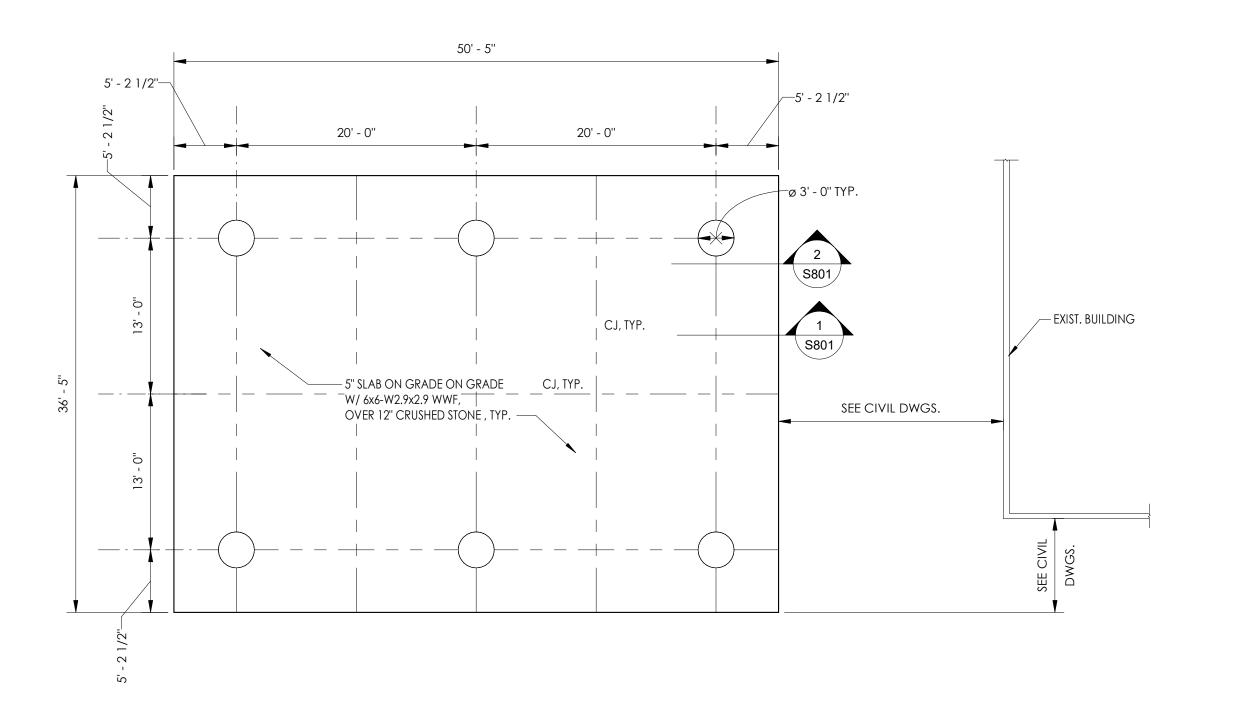

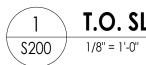

T.O. SLAB - PRE-FAB LOCATION CLE


FOUNDATION AND SLAB PLAN NOTES


- 1. DATUM 0'-0" = ELEVATION 224.0' = FINISHED FLOOR SLAB ELEVATION.
- 2. ASSUMED ALLOWABLE SOIL BEARING CAPACITY IS 2000 PSF (NATURAL SOILS OR FILL).
- 3. EXTERIOR FOOTING SHALL BEAR AT A MINIMUM OF 4'-0" BELOW FINISHED GRADE UNLESS NOTED OTHERWISE.
- 4. [XX'-XX"] DENOTES TOP OF PROPOSED FOOTING ELEVATION AS REFERENCED FROM FINISHED FLOOR SLAB.
- 5. (-XX'-XX") DENOTES TOP OF EXISTING FOOTING AS REFERENCED FROM FINISHED FLOOR ELEVATION. WHERE NEW FOOTING ABUTS EXISTING, MATCH BEARING ELEVATION OF EXISTING.
- 6. NO PIPES OR CONDUIT SHALL BE PLACED IN THE FOOTINGS. REFER TO PLUMBING AND ELECTRICAL DRAWINGS, AND UTILITY PLANS FOR ALL LOCATIONS AND ELEVATIONS OF PENETRATIONS THROUGH FOUNDATION WALLS. DO NOT EMBED PIPING WITHIN OR PASS PIPING VERTICALLY OR HORIZONTALLY THROUGH FOUNDATIONS WITHOUT REVIEW AND APPROVAL BY THE ENGINEER. STEP TOP OF FOOTINGS DOWN TO ALLOW PIPES OR CONDUIT TO RUN OVER TOP OF FOOTINGS.
- 7. FOOTINGS SHALL BE CENTERED ABOUT COLUMN LINES AND FOUNDATION WALLS UNLESS NOTED OTHERWISE.
- 8. CONCRETE SLAB-ON-GRADE SHALL BE 5" THICK NORMAL WEIGHT CONCRETE WITH 6X6 2.9X2.9 WWF, OVER VAPOR BARRIER AND 12" COMPACTED CRUSHED STONE.
- 9. THICKEN SLAB AND PROVIDE ADDITIONAL REINFORCEMENT AT EXTERIOR FACE OF PERIMETER COLUMNS.
- 10. REFER TO ARCHITECTURAL DRAWINGS FOR FLOOR FINISHES, FLOOR DRAINS, FLOOR SLOPES, DEPRESSED/RAISED SLAB AREAS, AND WATERPROOFING.
- 11. REFER TO DRAWING GEN-S800 FOR ALL DESIGN LOADS AND OTHER INFORMATION PERTINENT TO THE STRUCTURAL DESIGN.

- 12. THE FOLLOWING DENOTES SYMBOL REPRESENTATION: FD = FLOOR DRAIN
- CJ = SLAB CONTROL JOINTS TS
- = THICKENED SLAB


		50 Front Stre Newburgt	Engineering Planning eet Suite 202, h, NY 12550 am.com
		Capital Impro	ORANGETOWN I School District
		PROJECT INFORMATIOn Project Number 14457.20	ON
		Client Name	
		SCHOOL DISTRIC Project Name PHASE 1: 2022 B	
		District Office Address 160 VAN WYCK RD. BLAUVELT, NY 10913	CERTIFICATE #018330 REGISTRATION EXPIR. DAT Lauren Tarsio 09/30/26 Richard Waite 11/30/23 Larry Werts 12/31/24 Anthony Marchetti 05/31/24 Dave Hart 02/28/25 Jennifer Wengender 06/30/24
		WILLIAM O. SCHAEFER S&L COTTAGE LANE S&L SED#: COTTAGE LANE LIBRARY S& WOS OUTDOOR CLASSROC SOMS OUTDOOR CLASSROC CLE OUTDOOR CLASSROC	#:50-03-01-06-0-012-019 RY SED#:50-03-01-06-0-010-022 SED#: 50-03-01-06-0-012-020
		PROFESSIONAL STAM	PS
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		PARTY SHALL AFFIX TO THE ITEM THEIR SEAL A	TING UNDER THE DIRECTION OF A LICENSED
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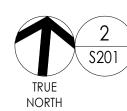
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- CJ = SLAB CONTROL JOINTS
- TS = THICKENED SLAB



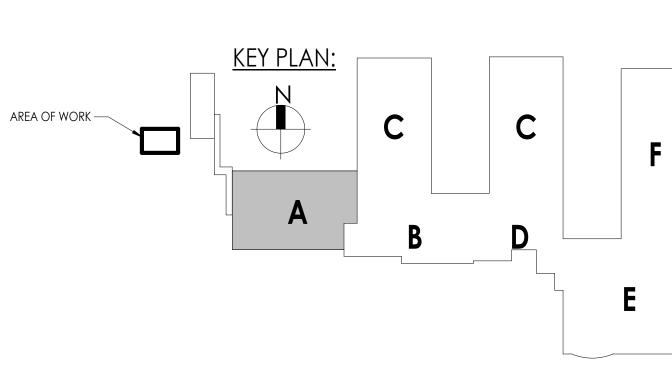

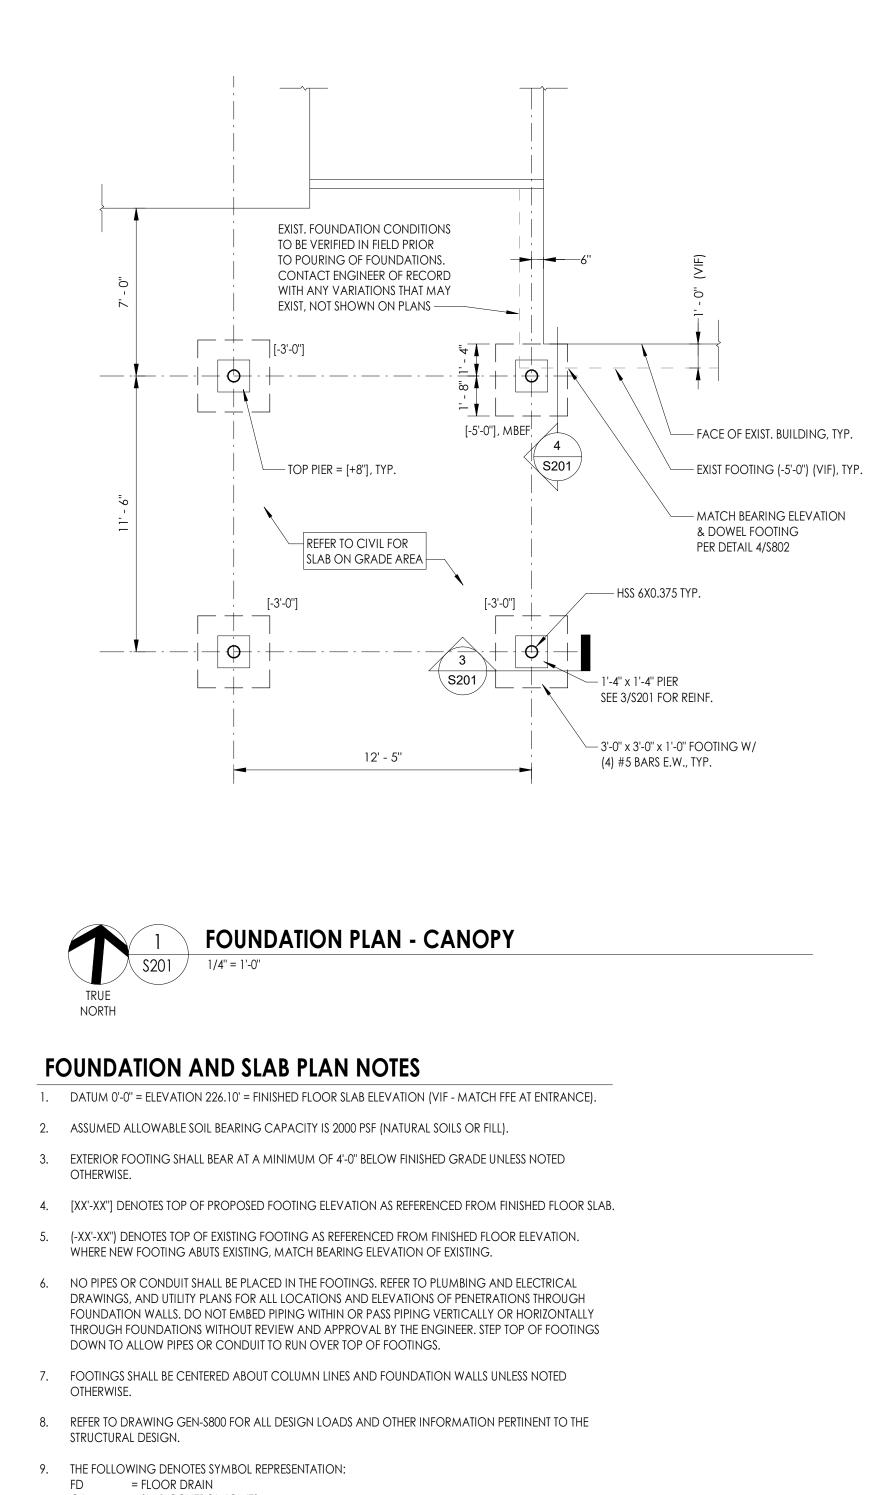CANOPY FRAMING PLAN

ROOF FRAMING PLAN NOTES

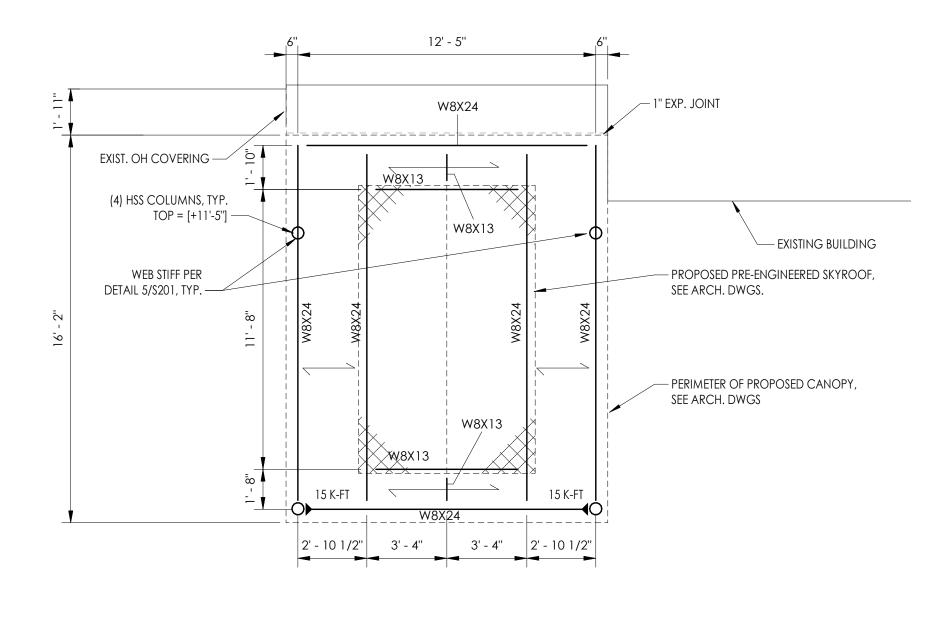
- 1. TOP OF STEEL/BOTTOM OF DECK ELEVATION 12'-1", UNLESS NOTED OTHERWISE BY (+ OR -).
- 2. REFER TO ARCHITECTURAL, MECHANICAL, ELECTRICAL AND PLUMBING DRAWINGS FOR PENETRATIONS NOT SHOWN, AND ALL LOCATIONS SEE TYPICAL DETAILS FOR ADDITIONAL REINFORCEMENT REQUIREMENTS AT OPENINGS. CONTRACTOR TO COORDINATE.
- 3. METAL ROOF DECK SHALL BE 20 GAUGE, 1 1/2" WIDE RIB, UNLESS NOTED OTHERWISE.
- 4. FINAL SKYLIGHT WEIGHTS SHALL BE VERIFIED WITH MANUFACTURER BY CONTRACTOR. CONTRACTOR TO NOTIFY ENGINEER PRIOR TO INSTALLING SKYLIGHT.

#3 TIES @ 10" O.C. W/ 1 ADDNL. @ TOP


(8) VERT. #5 BARS —

(3) #5 BARS


#5 DOWELS x 24" LG 18" O.C. ACROSS FTG DRILL & EPOXY GROUT, 6" MIN. EMBED

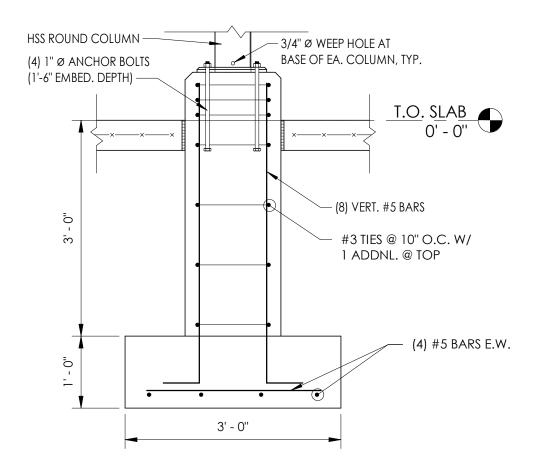



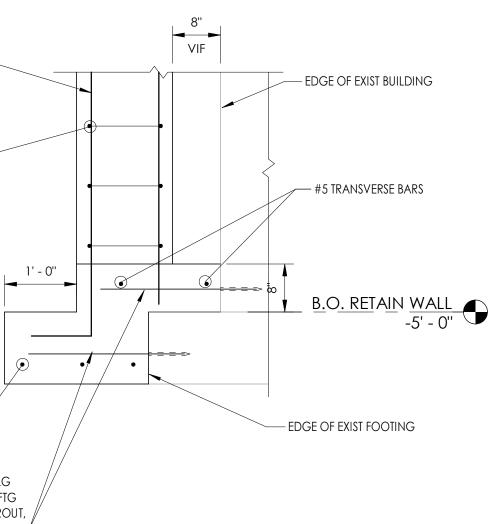




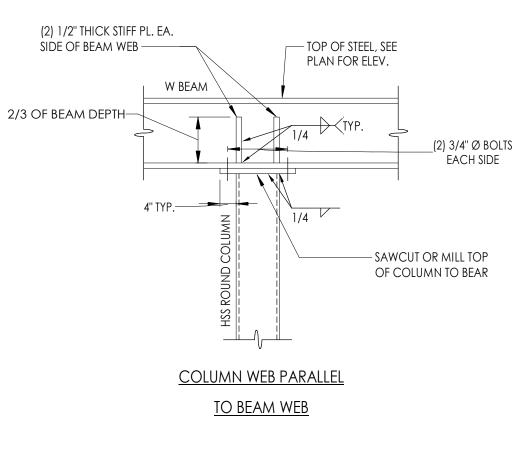




BEAM BEARING ON COLUMN DETAIL

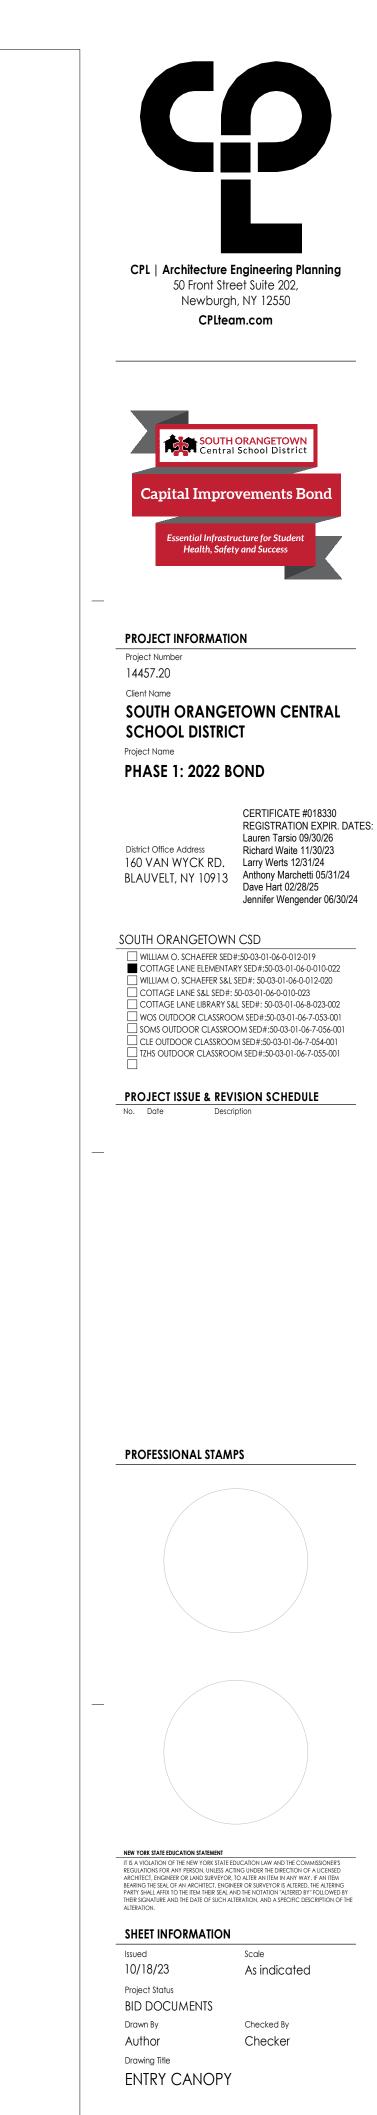

Drawing Number

S20[°]

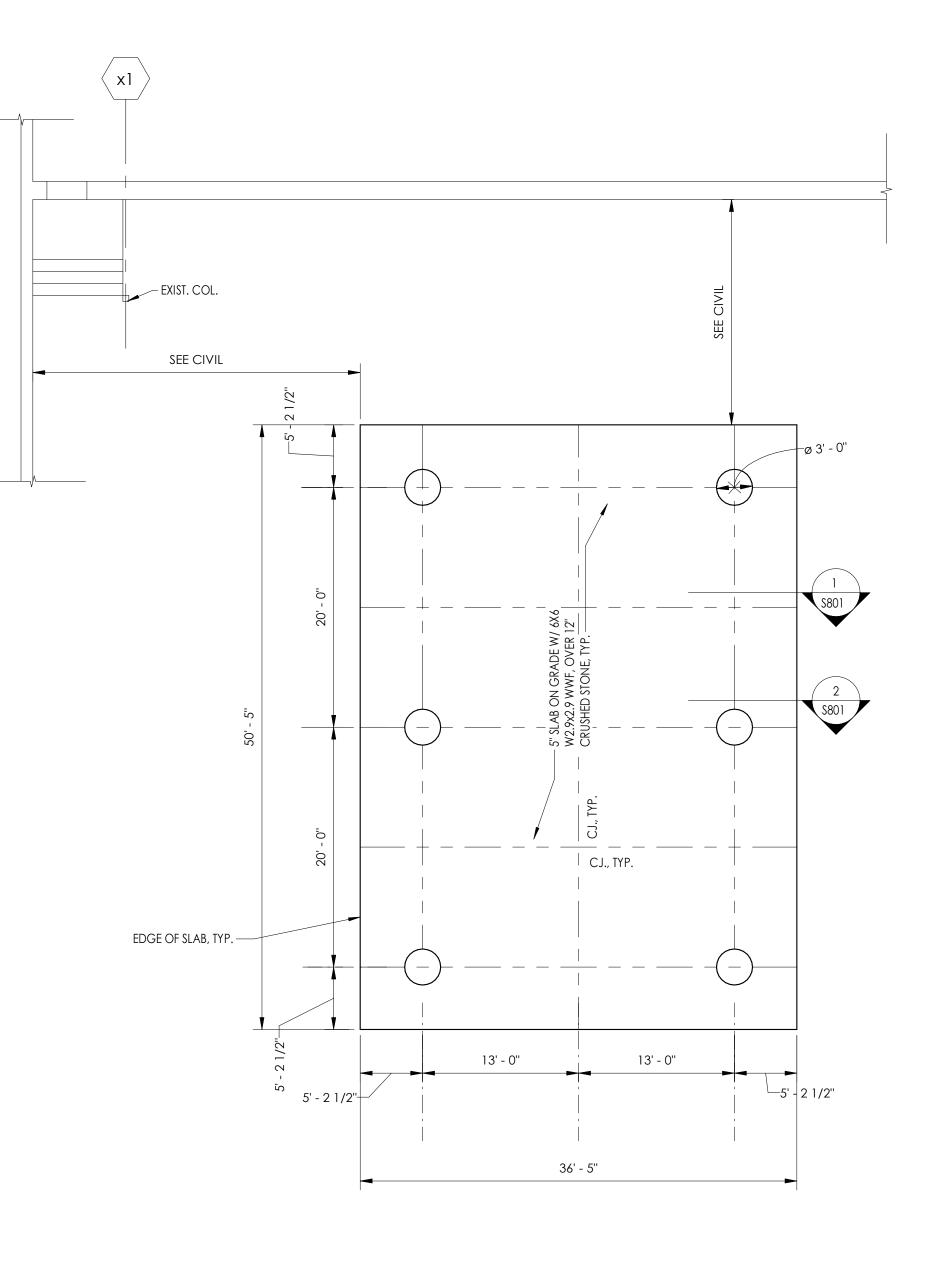




FOUNDATION AND SLAB PLAN NOTES

- 1. DATUM 0'-0" = ELEVATION 154.0' = FINISHED FLOOR SLAB ELEVATION.
- 2. ASSUMED ALLOWABLE SOIL BEARING CAPACITY IS 2000 PSF (NATURAL SOILS OR FILL).
- 3. EXTERIOR FOOTING SHALL BEAR AT A MINIMUM OF 4'-0" BELOW FINISHED GRADE UNLESS NOTED OTHERWISE.
- 4. FOOTINGS SHALL BE CENTERED ABOUT COLUMN LINES AND FOUNDATION WALLS UNLESS NOTED OTHERWISE.
- 5. CONCRETE SLAB-ON-GRADE SHALL BE 5" THICK, NORMAL WEIGHT REINFORCED CONCRETE UNLESS NOTED OTHERWISE, OVER VAPOR BARRIER AND 12" COMPACTED CRUSHED STONE.
- 6. REFER TO ARCHITECTURAL DRAWINGS FOR FLOOR FINISHES, FLOOR DRAINS, FLOOR SLOPES,
- DEPRESSED/RAISED SLAB AREAS, AND WATERPROOFING.
- 7. REFER TO DRAWING GEN-S800 FOR ALL DESIGN LOADS AND OTHER INFORMATION PERTINENT TO THE STRUCTURAL DESIGN.

8. THE FOLLOWING DENOTES SYMBOL REPRESENTATION:

FD = FLOOR DRAIN CJ = SLAB CONTROL JOINTS TS = THICKENED SLAB

CPL Architecture Engineering Planning 50 Front Street Suite 202, Newburgh, NY 12550 CPLiteam.com
Exerct ial Infrastructure for Student Health, Safety and Success
Project INFORMATION Project Number 14457.20 Client Name SOUTH ORANGETOWN CENTRAL SCHOOL DISTRICT Project Name PHASE 1: 2022 BOND
CERTIFICATE #018330 REGISTRATION EXPIR. DAT Lauren Tarsio 09/30/26 Richard Waite 11/30/23 160 VAN WYCK RD. BLAUVELT, NY 10913 Anthony Marchetti 05/31/24 Dave Hart 02/28/25 Jennifer Wengender 06/30/24
SOUTH ORANGETOWN CSD WILLIAM O. SCHAEFER SED#: 50-03-01-06-0-012-019 COTTAGE LANE ELEMENTARY SED #: 50-03-01-06-0-010-022 WILLIAM O. SCHAEFER S&L SED#: 50-03-01-06-0-012-020 COTTAGE LANE ELEMENTARY S&L SED#: 50-03-01-06-0-010-023 COTTAGE LANE LIBRARY S&L SED#: 50-03-01-06-0-010-023 WOS OUTDOOR CLASSROOM SED#: 50-03-01-06-7-053-001 SOMS OUTDOOR CLASSROOM SED#: 50-03-01-06-7-054-001 T2HS OUTDOOR CLASSROOM SED#: 50-03-01-06-7-055-001 DESCRIPTION
PROFESSIONAL STAMPS

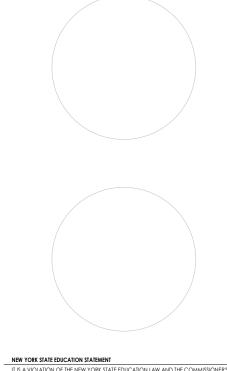


THE A VIGATEL DOCTION STRUCTURE THE EDUCATION LAW AND THE COMMISSIONERS REGULATIONS FOR ANY PERSON, UNLESS ACTING UNDER THE DIRECTION OF A LICENSED ARCHITECT, ENGINEER OR LAND SURVEYOR, TO ALTER AN ITEM BEARING THE SEAL OF AN ARCHITECT, ENGINEER OR SURVEYOR IS ALTERED, THE ALTERING PARTY SHALL AFFIL TO THE TIEM THEIR SEAL AND THE NOTATION "ALTERED BY" FOLLOWED THEIR SIGNATURE AND THE DATE OF SUCH ALTERATION, AND A SPECIFIC DESCRIPTION OF ALTERATION.

SHEET INFORMATION Issued

Scale 10/18/2023 As indicated Project Status **BID DOCUMENTS** Drawn By Checked By SAW JPR Drawing Title

STRUCTURAL PLAN VIEWS




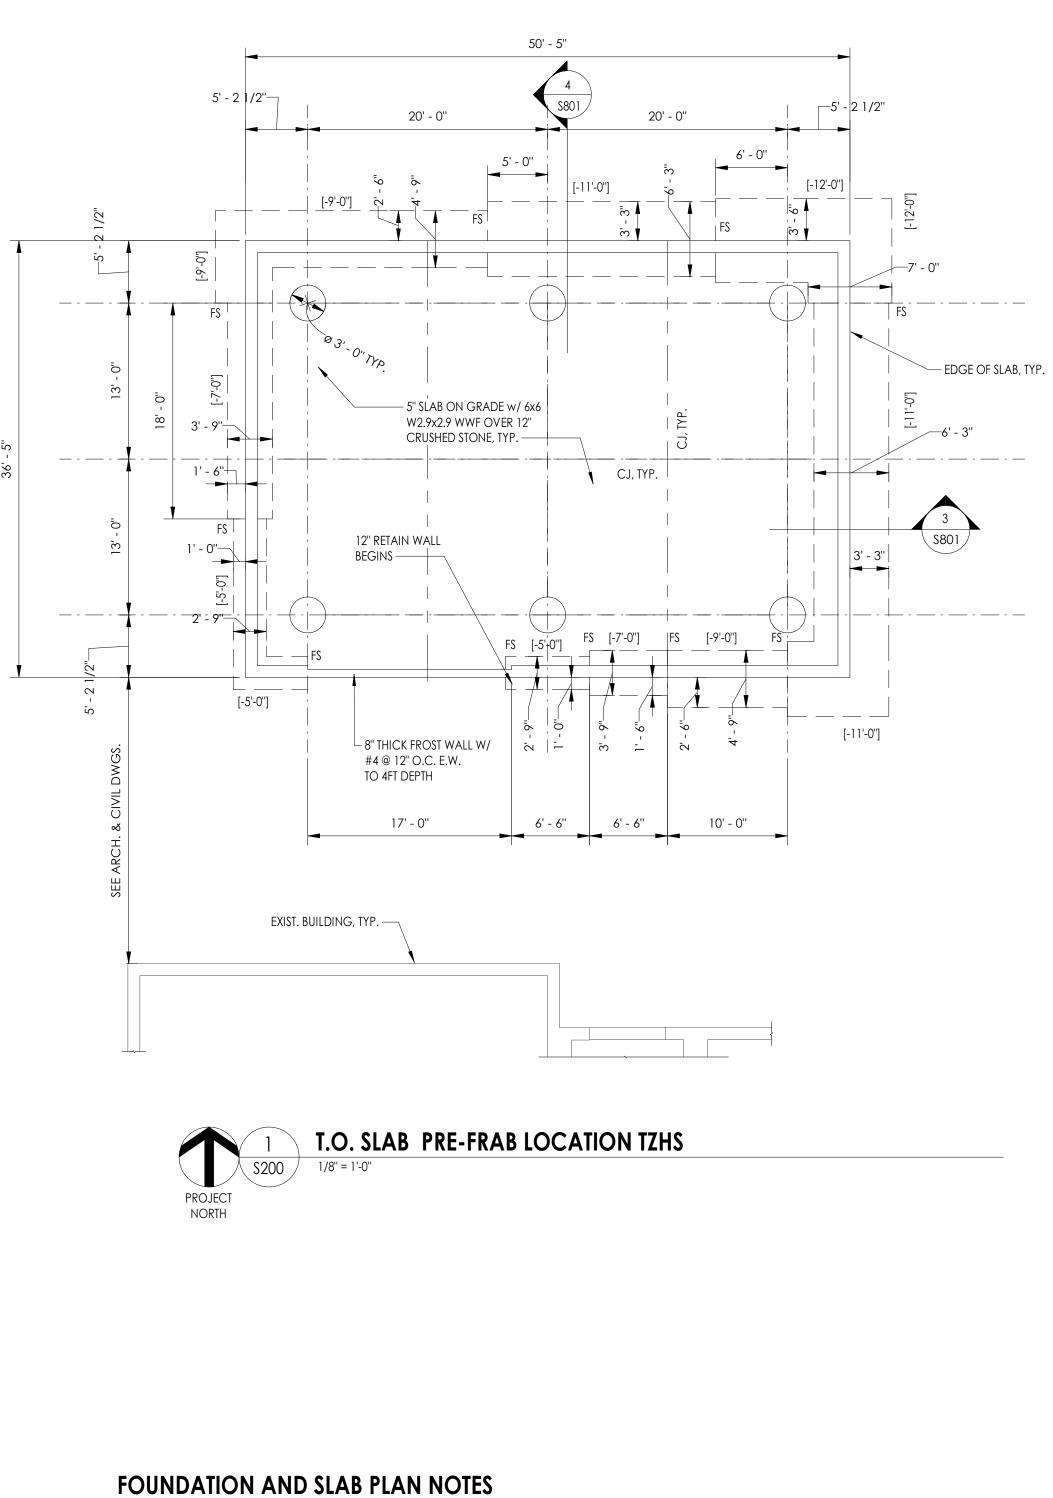


1. DATUM 0'-0" = ELEVATION 216.55' = FINISHED FLOOR SLAB ELEVATION.

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SHEET INFORMATION Issued Scale

10/18/2023 As indicated Project Status **BID DOCUMENTS** Drawn By Checked By SAW JPR Drawing Title

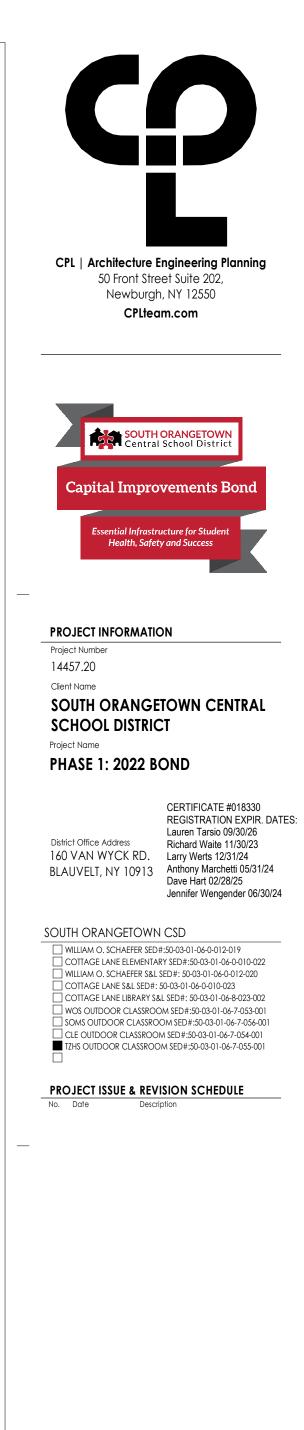STRUCTURAL PLAN VIEWS

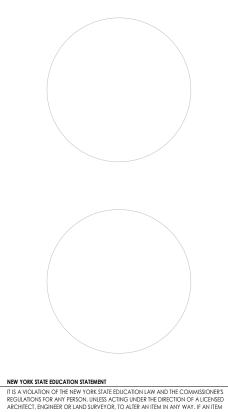

<u>KEY PLAN:</u>	TRUE

GENERAL NOTES

- THE STRUCTURE SHOWN ON THESE DRAWING IS SOUND ONLY IN ITS COMPLETED FORM. THE CONTRACTOR SHALL BE RESPONSIBLE FOR PROVIDING THE DESIGN, ADEQUACY, SAFETY AND STABILITY OF TEMPORARY ERECTION BRACING AND SHORING.
- WHERE A DETAIL, TYPICAL DETAIL, SECTION, TYPICAL SECTION OR PLAN NOTE IS SHOWN FOR ONE CONDITION, IT SHALL APPLY FOR ALL SIMILAR OR LIKE CONDITIONS UNLESS NOTED OTHERWISE.
- ALL DESIGN, INCLUDING MATERIAL STRESSES AND METHODS OF CONSTRUCTION SHALL BE IN COMPLIANCE WITH THE 2020 BUILDING CODE OF NEW YORK STATE, THE UNIFORM BUILDING CODE, OSHA AND GOVERNING AGENCIES HAVING JURISDICTION.
- REFER TO THE "SPECIAL INSPECTIONS" SECTION OF THE SPECIFICATIONS FOR PROJECT REQUIREMENTS AND PERTINENT INFORMATION.
- THE CONTRACTOR SHALL FIELD VERIFY ALL DIMENSIONS, ELEVATIONS AND SITE CONDITIONS SHOWN ON THE DRAWINGS AND IMMEDIATELY NOTIFY THE OWNER'S REPRESENTATIVE OF ANY DISCREPANCIES PRIOR TO ORDERING OR FABRICATING MATERIALS OR OTHERWISE PROCEEDING WITH THE WORK.
- THE CONTRACTOR SHALL BE RESPONSIBLE FOR MEANS, METHODS, TECHNIQUES, SEQUENCES, AND PROCEDURES IN ORDER TO COMPLY WITH THE CONSTRUCTION DOCUMENTS. THE CONTRACTOR SHALL PROVIDE ALL LABOR, MATERIAL, EQUIPMENT AND SERVICES REQUIRED TO EXECUTE AND COMPLETE ALL ITEMS OF WORK AS SHOWN OR INDICATED ON THE DRAWINGS AND AS SPECIFIED HEREIN, INCLUDING INCIDENTAL ITEMS TO EFFECT A FINISHED AND COMPLETE JOB, EVEN THOUGH SUCH ITEMS ARE NOT SHOWN OR PARTICULARLY MENTIONED.
- THE ENGINEER IS NOT RESPONSIBLE FOR THE DESIGN OF STEEL STAIRS, PRECAST CONCRETE, HANDRAILS, CURTAIN WALL/WINDOW SYSTEMS, COLD-FORMED METAL FRAMING, OR OTHER SYSTEMS NOT SHOWN ON THE STRUCTURAL DRAWINGS, SUCH SYSTEMS SHALL BE DESIGNED, FURNISHED, AND INSTALLED AS REQUIRED BY OTHER PORTIONS OF THE CONTRACT DOCUMENTS.
- THE GENERAL CONTRACTOR SHALL USE CONSTRUCTION METHODS THAT ARE IN STRICT ACCORDANCE WITH MANUFACTURER'S SPECIFICATIONS.
- CONTRACTOR SHALL BE COMPLETELY RESPONSIBLE FOR ADEQUATELY SHORING AND BRACING EXISTING CONSTRUCTION WHILE PERFORMING NEW WORK.
- 0. DIMENSIONS ARE NOT TO BE DERIVED BY SCALING THESE DRAWINGS. IF THERE ARE ANY QUESTIONS REGARDING DIMENSIONS, CONTACT THE ARCHITECT/ENGINEER FOR INFORMATION PRIOR TO SUBMITTING 4. SHOP DRAWINGS.
- THE CONTRACTOR SHALL COORDINATE ALL STRUCTURAL WORK WITH THE ARCHITECTURAL AND MECHANICAL DRAWINGS AND SPECIFICATIONS, AND WITH THE WORK OF ALL OTHER TRADES.
- THE CONTRACTOR SHALL COORDINATE ALL SIZES AND LOCATIONS OF FLOOR, ROOF AND WALL PENETRATIONS WITH MECHANICAL, PLUMBING AND ARCHITECTURAL DRAWINGS. ALL PENETRATIONS NOT SHOWN ON STRUCTURAL DRAWINGS MUST BE APPROVED BY THE DESIGN PROFESSIONAL, UNLESS NOTED OTHERWISE.
- 13. THE CONTRACTOR SHALL RESTORE TO ITS ORIGINAL CONDITION ALL SITE APPURTENANCES DAMAGED UNDER THIS CONTRACT AT NO ADDITIONAL COST TO THE OWNER.
- 14. INFORMATION IN THESE STRUCTURAL NOTES IS A SELECTED SUMMARY OF REQUIREMENTS. REFER TO SPECIFICATIONS FOR AMPLIFICATIONS OF REQUIREMENTS.
- 5. WHERE MEMBER LOCATIONS ARE NOT SPECIFICALLY DIMENSIONED, MEMBERS ARE EITHER LOCATED ON COLUMN LINES OR ARE EQUALLY SPACED BETWEEN LOCATED MEMBERS.
- 6. THESE DRAWINGS DO NOT INCLUDE NECESSARY COMPONENTS FOR CONSTRUCTION SAFETY. CONTRACTOR SHALL BE SOLELY RESPONSIBLE FOR CONSTRUCTION SAFETY.

EXISTING CONSTRUCTION NOTES

- BEFORE PROCEEDING WITH ANY WORK WITHIN THE EXISTING FACILITY, THE CONTRACTOR SHALL VERIFY ALL 5. DIMENSIONS AND CONDITIONS OF THE EXISTING BUILDING AT THE JOB SITE AND REPORT ANY DISCREPANCIES FROM ASSUMED CONDITIONS SHOWN ON THE DRAWINGS TO THE ARCHITECT AND ENGINEER PRIOR TO THE FABRICATION AND ERECTION OF ANY MEMBERS.
- THE CONTRACTOR SHALL FIELD VERIFY THE DIMENSIONS, ELEVATIONS, ETC. NECESSARY FOR THE PROPER CONSTRUCTION AND ALIGNMENT OF THE NEW WORK TO THE EXISTING WORK.
- WORK SHOWN ON THE DRAWINGS IS NEW, UNLESS NOTED AS EXISTING.
- EXISTING CONSTRUCTION SHOWN ON THE DRAWINGS WAS OBTAINED FROM OWNER AND LIMITED SITE OBSERVATION. THESE DRAWINGS OF EXISTING CONSTRUCTION ARE AVAILABLE FOR CONTRACTOR USE. HOWEVER, THE AVAILABLE DRAWINGS OF EXISTING CONSTRUCTION MAY NOT NECESSARILY BE COMPLETE. 10. ALL EXPOSED CONCRETE PIER CORNERS SHALL BE CHAMFERED 3/4". THE CONTRACTOR SHALL FIELD VERIFY ALL PERTINENT INFORMATION.
- IF ANY ARCHITECTURAL, STRUCTURAL, OR MECHANICAL MEMBERS OR COMPONENTS NOT DESIGNATED FOR REMOVAL INTERFERE WITH THE NEW WORK, THE ARCHITECT SHALL BE NOTIFIED IMMEDIATELY AND APPROVAL MUST BE OBTAINED PRIOR TO REMOVAL OF THOSE MEMBERS.
- THE CONTRACTOR SHALL SAFELY SHORE EXISTING CONSTRUCTION TO ALLOW THE INSTALLATION OF NEW WORK. ALL SHORING METHODS AND SEQUENCING OF DEMOLITION SHALL BE THE RESPONSIBILITY OF THE CONTRACTOR AND HIS ENGINEER.
- THE CONTRACTOR SHALL SUBMIT A DETAILED PLAN FOR SHORING, BRACING AND PROTECTION OF THE EXISTING CONSTRUCTION. THE PLAN SHALL INCLUDE CONSTRUCTION SEQUENCE, BEAR THE SEAL AND SIGNATURE OF A PROFESSIONAL ENGINEER REGISTERED IN THE STATE OF NEW YORK, AND BE SUBMITTED TO THE ENGINEER OF RECORD FOR REVIEW PRIOR TO THE BEGINNING OF WORK.
- THE CONTRACTOR SHALL VERIFY THE LOCATION OF EXISTING UTILITIES PRIOR TO THE START OF CONSTRUCTION AND TAKE CARE TO PROTECT EXISTING UTILITIES THAT ARE TO REMAIN IN SERVICE.
- THE CONTRACTOR SHALL REPAIR ALL DAMAGE CAUSED DURING CONSTRUCTION WITH SIMILAR MATERIALS AND WORKMANSHIP TO RESTORE CONDITIONS TO LEVELS ACCEPTABLE TO THE DESIGN PROFESSIONAL.
- 10. THE CONTRACTOR SHALL ENSURE THAT ALL CONSTRUCTION METHODS USED WILL NOT CAUSE DAMAGE TO THE ADJACENT BUILDINGS AND PROPERTY. THIS SHALL INCLUDE ALL FOUNDATION INSTALLATION.

SPECIAL INSPECTION NOTES

- THE OWNER'S TESTING LABORATORY/INSPECTION AGENCY SHALL PROVIDE SPECIAL INSPECTION SERVICES IN ACCORDANCE WITH THE 2020 BUILDING CODE OF NEW YORK STATE FOR THE FOLLOWING ITEMS AND WITH THE SCHEDULE OF SPECIAL INSPECTIONS OF THE PROJECT DOCUMENTS.
- A. CONCRETE CONSTRUCTION
 - ANCHORS INSTALLED IN CONCRETE. CONCRETE WORK.
- REINFORCING STEEL PLACEMENT. d. ADHESIVE ANCHORS.
- B. SOILS a. PREPARED EARTH FILL
- C. DEEP FOUNDATIONS a. PIER FOUNDATIONS.
- D. SPECIAL CASES: EARTH RETENTION SYSTEMS, ROCK ANCHORS, ETC.
- 2. STATEMENT OF SPECIAL INSPECTIONS
- A. SPECIAL INSPECTION IS REQUIRED FOR THE ITEMS LISTED ABOVE. REFER TO PROJECT SPECIFICATIONS FOR TYPE AND EXTENT OF EACH SPECIAL INSPECTION AND EACH TEST. THE SPECIFICATION ALSO INDICATES WHETHER CONTINUOUS OR PERIODIC INSPECTION IS REQUIRED FOR THE ITEMS LISTED ABOVE ADDITIONAL INFORMATION.
- B. APPROVED SPECIAL INSPECTORS SHALL FURNISH INSPECTION REPORTS TO THE BUILDING OFFICIAL OR HIS/HER DESIGNEE AND TO THE DESIGN PROFESSIOANL WHICH INDICATE THAT THE WORK INSPECTED WAS DONE IN CONFORMANCE WITH THE APPROVED CONSTRUCTION DOCUMENTS. A FINAL REPORT WHICH DOCUMENTS THE RESULTS OF THE SPECIAL INSPECTIONS PERFORMED INCLUDING CORRECTION OF ANY DEFICIENCIES IDENTIFIED DURING INSPECTION SHALL BE SUBMITTED PERIODICALLY AT A FREQUENCY APPROVED PRIOR TO CONSTRUCTION.

CAST-IN-PLACE CONCRETE NOTES

- GENERAL ALL CONCRETE WORK, CONSTRUCTION AND REINFORCING DETAILS SHALL CONFOR/ BUILDING CODE OF NEW YORK STATE, AND "THE SPECIFICATIONS OF THE AMERICAN INSTITUTE BUILDING CODE REQUIREMENTS" (ACI-318).
- 2. ALL CONCRETE SHALL ATTAIN A MINIMUM COMPRESSIVE STRENGTH OF 3,000 PSI AT 2 CONFORM TO THE REQUIREMENTS OF THE SCHEDULE BELOW, UNLESS NOTED OTHERW SPECIFICATIONS FOR MIX DESIGN REQUIREMENTS.

LOCATION	W/C RATIO	SLUMP (±1")	% AIR (±1%)	MAXIMUM AGGREGATE	MIN @
BURIED FOUNDATIONS	.50	3.5"	N/A	1 1/2"	3
EXPOSED RETAINING WALLS AND FOUNDATION WALLS	.45	3.5"	5.5	1 1/2"	Ľ
SLAB ON GRADE (EXT.)	.45	3.5"	5.5	3/4"	Ę

- CONTRACTOR SHALL SUBMIT MIX DESIGNS PROPORTIONED BY A LICENSED TESTING L 4. PROVIDE MINIMUM OF FOUR (4) CYLINDERS PER EACH FIFTY (50) YARDS OR FRACTIC
- POURED IN ONE DAY. BREAK ONE AT 7 DAYS AND TWO AT 28 DAYS. WHERE NEW CONCRETE IS TO BE POURED ONTO EXISTING CONCRETE, BONDING IS RE
- NOTED IN ACI 301. CONDUITS AND PIPES OF ALUMINUM SHALL NOT BE EMBEDDED IN CONCRETE.
- **REINFORCING STEEL**
- 1. ALL REINFORCING STEEL AND ACCESSORIES SHALL BE DETAILED, FABRICATED AND PL ACCORDANCE WITH "ACI MANUAL OF STANDARD PRACTICE FOR DETAILING CONCI STRUCTURES" (ACI-315).
- REINFORCING STEEL SHALL CONFORM TO ASTM A-615 GRADE 60. WELDED WIRE FAB CONFORM TO ASTM A-185.
- 3. LAP SPLICES AND EMBEDMENT LENGTHS SHALL CONFORM TO ACI 318 CHAPTER 12.
- PROVIDE CORNER BARS TO MATCH HORIZONTAL REINFORCING WHERE FOOTINGS, V MEET AT CORNERS OR INTERSECT. THIS ALSO INCLUDES INTERSECTIONS OF CONCRETE MASONRY WORK.
- PROVIDE SHOP DRAWINGS FOR REINFORCING INCLUDING ALL NECESSARY ACCESSC REINFORCING SECURELY IN PLACE.
- CLEAR COVER CONCRETE PROTECTION FOR REINFORCING STEEL SHALL BE AS FOLLO
- CONCRETE CAST AGAINST EARTH. - FORMED SURFACES IN CONTACT WITH SOIL OR EXPOSED TO WEATHER.
- FORMED SURFACES NOT IN CONTACT WITH SOIL OR EXPOSED TO WEATHER.

FOUNDATIONS

- 1. ALL FOUNDATIONS ARE TO BEAR ON APPROVED BEARING MATERIAL
- 2. ALL FOUNDATION EXCAVATIONS ARE SUBJECT TO APPROVAL BY THE OWNER'S REPRES BEFORE ANY CONCRETE IS PLACED.
- 3. ALL FORMS AND REINFORCING STEEL IN PLACE SHALL BE APPROVED BY THE OWNER'S REPRESENTATIVE BEFORE ANY CONCRETE IS PLACED.
- 4. NO FOUNDATION SHALL BE PLACED IN WATER OR ON FROZEN GROUND.
- IN GENERAL, EXTERIOR CONSTRUCTION SHALL BE CARRIED DOWN A MINIMUM OF 4'-FINISHED EXTERIOR GRADE.
- 6. CENTERLINE OF FOOTINGS, WALLS, GRADE BEAMS, COLUMNS, AND BEAMS SHALL CC OTHERWISE NOTED.
- 7. REFER TO ARCHITECTURAL AND CIVIL DRAWINGS FOR FOUNDATION DRAINAGE.
- 8. ALL EXTERIOR CONCRETE USED ABOVE GRADE SHALL HAVE AN AIR ENTRAINING AGEI
- 9. RUB ALL SIGHT EXPOSED CONCRETE AFTER FORMS HAVE BEEN REMOVED.
- 11. ALL GROUT FOR BASE PLATES SHALL BE NON-SHRINK WITH A MINIMUM COMPRESSIVE 5,000 PSI AT 28 DAYS.
- 12. ANCHOR BOLTS ASTM F1554, Fy=36 KSI, 1" DIAMETER UNLESS NOTED OTHERWISE.
- 13. ISOLATION JOINT ASPHALT IMPREGNATED FILLER STRIP CONFORMING TO ASTM D-94
- 14. ALL STEEL COLUMNS BELOW GRADE SHALL BE TWICE COATED WITH A BITUMINOUS CO
- 15. CONTRACTOR SHALL VERIFY ALL DIMENSIONS ON THE JOB BEFORE COMMENCING W ARCHITECTURAL DRAWINGS FOR ANY DIMENSIONS AND DETAILS NOT SHOWN. REFER ARCHITECTURAL, MECHANICAL, AND ELECTRICAL DRAWINGS FOR LOCATION AND D ANY OPENING, SLEEVES, INSERTS, SLAB DEPRESSIONS, ETC.

SLABS-ON-GRADE

- UNDER SLABS ON GRADE: POROUS 6-INCH LIFT WASHED OF "CRUSHED STONE" MATER CONSISTING OF A 50/50 MIX OF #1's AND #2's, ASTM #57 STONE.
- 2. SLAB-ON-GRADE REINFORCEMENT SHALL BE 6x6-W2.9x2.9 WWF, UNLESS NOTED OTHER
- PLACEMENT OF WELDED WIRE REINFORCEMENT SHALL BE AT A CONSISTENT DEPTH OF 3. TOP OF SLAB, AND SHALL BE PROPERLY CHAIRED.
- 4. WET CURE FOR 7 DAYS BEFORE APPLYING ANY WHEELED TRAFFIC OR MASONRY PART
- CONCRETE SLAB CONTROL JOINTS SHALL BE CUT INTO THE SLABS AT A DEPTH OF 1/41 THICKNESS WITHIN 12 HOURS OF PLACING THE CONCRETE, MAXIMUM SPACING OF I CONTROL JOINTS, UNLESS NOTED OTHERWISE, SHALL BE 15'-0" O/C IN EACH DIRECTIC TYPICALLY RUN BETWEEN COLUMNS AND TERMINATE AT A COLUMN ISOLATION POUR OF ANY INDIVIDUAL JOINTED AREA SHALL NOT EXCEED 1.5 TIMES ITS WIDTH.
- CONSTRUCTION/COLD JOINTS: TERMINATE DAY'S CONCRETE WORK AT A CONTROL LOCATION. PROVIDE A KEYWAY OR DOWELS FOR CONTINUATION OF WORK WITH NE CONTINUE 50% OF SLAB REINFORCEMENT THROUGH CONSTRUCTION AND CONTRAC
- 7. CONCRETE SURFACE SHALL BE HARD STEEL TROWEL FINISH.
- 8. REFER TO ARCHITECTURAL, MECHANICAL, ELECTRICAL AND PLUMBING DRAWINGS FO FINISHES, SLAB DEPRESSIONS, THICKENED SLABS, EQUIPMENT PADS/CURBS, ELEVATIONS ENCASED OR EMBEDED ITEMS.
- 9. PLUMBING AND ELECTRICAL CONDUITS SHALL BE PLACED BELOW THE SLAB AND NOT SLAB. VERTICAL PENETRATIONS ARE ALLOWED.
- 10. PROVIDE ONE #4 BAR, 4'-0" LONG, DIAGONAL AT CORNERS AND OPENINGS IN SLABS

#14 (#43)

#18 (#57)

NP

NP

124"

108"

	SIGN CRITERIA NOTES	GENERAL WOOD FRAMING NOTES
	<u>GENERAL BUILDING CODE</u> - THE CONSTRUCTION DOCUMENTS ARE BASED ON THE REQUIREMENTS OF THE 2020 BUILDING CODE OF NEW YORK STATE.	1. DETAILS OF WOOD FRAMING SUCH AS NAILING, BLOCKING, BRIDGING, FIRESTOPPING, ETC. SHALL CONFORM TO THE AMERICAN WOOD COUNCIL (AWC) MANUALS AND SUPPLEMENTS.
2.	BUILDING RISK CATEGORY - THE BUILDING HAS BEEN ASSIGNED A RISK CATEGORY IN ACCORDANCE WITH PREVIOUSLY MENTIONED CODE WITH THE FOLLOWING CRITERIA:	2. DO NOT NOTCH, BORE, OR CUT MEMBERS FOR PIPES, DUCTS, CONDUITS, OR ANY OTHER REASON EXCEPT AS SHOWN ON THE DRAWINGS OR AS SPECIFICALLY APPROVED IN ADVANCE BY THE ENGINEER.
	A. RISK CATEGORY: III, SUBSTANTIAL HAZARD TO HUMAN LIFE IN THE EVENT OF FAILURE.	3. MAKE ALL BEARINGS FULL UNLESS OTHERWISE INDICATED ON THE DRAWINGS. FINISH ALL BEARING SURFACES ON WHICH STRUCTURAL MEMBERS ARE TO REST SO AS TO GIVE SURE AND EVEN SUPPORT.
3.		WHERE FRAMING MEMBERS SLOPE, CUT OR NOTCH THE ENDS AS REQUIRED TO GIVE UNIFORM BEARING SURFACE.
	A. THE DEAD LOADS ARE THE SELF WEIGHT OF MATERIALS OF CONSTRUCTION INCORPORATED INTO AND ON THE BUILDING.	4. PLACE ALL PLYWOOD SHEATHING WITH FACE GRAIN PERPENDICULAR TO SUPPORTS AND CONTINUOUSLY OVER AT LEAST THREE SUPPORTS. CENTER JOINTS ACCURATELY OVER SUPPORTS, STAGGER THE END JOINTS
	B. THE UNIFORMLY DISTRIBUTED AND/OR CONCENTRATED LIVE LOADS USED IN THE DESIGN OF THE BUILDING ARE BASED ON THE FOLLOWING INTENDED USE OR OCCUPANCIES:	OF PLYWOOD PANELS TO ACHIEVE CONTINUITY OVER TRUSSES.
	a. CORRIDORS: 100 POUNDS PER SQUARE FOOT (PSF) b. STAIRS AND EXITS: 100 PSF / 300 LB ON TREADS, 4 SQUARE INCH AREA	 5. NAILING: A. USE ONLY COMMON WIRE NAILS OR SPIKES OF THE DIMENSIONS SHOWN ON THE NAILING
	c.LOBBIES:100 PSFd.OFFICE:50 PSFe.CLASSROOMS:40 PSFf.ROOFS:20 PSF / 300 LB ON MAINTENANCE SURFACE	 SCHEDULE, EXCEPT WHERE OTHERWISE CALLED FOR ON THE DRAWINGS. B. FOR CONDITIONS NOT COVERED IN THE NAILING SCHEDULE, PROVIDE PENETRATION INTO THE PIECE OF RECEIVING THE POINT OF NOT LESS THAN 1/2 THE LENGTH OF THE NAIL OR SPIKE PROVIDED, HOWEVER, THAT 16D NAILS MAY BE USED TO CONNECT TWO PIECES OF TWO INCH NOMINAL
4.	g. PARTITION LOADS: 15 PSF, WHERE APPLICABLE ROOF SNOW LOAD DATA - SNOW LOADS ARE BASED ON CHAPTER 7 OF THE AMERICAN SOCIETY OF	THICKNESS. C. DO ALL NAILING WITHOUT SPLITTING WOOD. PRE-BORE AS REQUIRED. REPLACE ALL SPLIT MEMBERS.
	CIVIL ENGINEERS, MINIMUM DESIGN LOADS FOR BUILDINGS AND OTHER STRUCTURES, ASCE 7 AND THE FOLLOWING CRITERIA: A. GROUND SNOW LOAD (Pg): 30 PSF	6. BOLTING - DRILL HOLES 1/16 INCH LARGER IN DIAMETER THAN THE BOLTS BEING USED. DRILL STRAIGHT AND TRUE FROM ONE SIDE ONLY. BOLT THREADS SHALL NOT BEAR ON WOOD. USE WASHERS UNDER HEAD AND NUT WHERE BOTH BEAR ON WOOD; USE WASHERS UNDER ALL NUTS.
	B. FLAT-ROOF SNOW LOAD (Pf): 27.7 PSF C. SNOW EXPOSURE FACTOR (Ce): 1.0 D. SNOW LOAD IMPORTANCE FACTOR (Is): 1.1 E. THERMAL FACTOR (Ct): 1.2	 SCREWS - FOR LAG SCREWS AND WOOD SCREWS, PRE-BORE HOLES SAME DIAMETER AS ROOT OF THREAD; ENLARGE HOLES TO SHANK DIAMETER FOR LENGTH OF SHANK. SCREW, DO NOT DRIVE, ALL LAG SCREWS AND WOOD SCREWS.
	F.SLOPE FACTORS (Cs):1.0G.UNBALANCED SNOW LOADS (Pd):54 PSFH.WIDTH OF UNBALANCED SNOW LOAD:9.28 FT	8. ALL FASTENERS IN CONTACT WITH PRESSURE TREATED WOOD SHALL BE HOT DIPPED ZINC- COATED GALVANIZED STEEL, STAINLESS STEEL, SILICON BRONZE, OR COPPER. THE COATING WEIGHTS FOR ZINC-COATED SHALL BE IN ACCORDANCE WITH ASTM A153.
	<u>WIND DESIGN DATA</u> - WIND PRESSURES ARE BASED ON CHAPTER 26 OF THE AMERICAN SOCIETY OF CIVIL ENGINEERS, MINIMUM DESIGN LOADS FOR BUILDINGS AND OTHER STRUCTURES, ASCE 7 AND THE	FRAMING MATERIALS
	FOLLOWING CRITERIA:	1. FRAMING LUMBER (NOMINAL 2" THICK) SHALL BE KILN DRIED NO. 2 HEM-FIR, NO. 1/NO. 2 SPRUCE-PINE-FIR, OR NO. 2 DOUGLAS FIR, SURFACED FOUR SIDES, CONFORMING TO THE FOLLOWING REQUIREMENTS:
	A.BASIC DESIGN WIND SPEED (V):124 MPHB.ALLOWABLE STRESS DESIGN WIND SPEED (Vasd):96 MPHC.RISK CATEGORY:IIID.WIND EXPOSURE:CE.INTERNAL PRESSURE COEFFICIENT (GCPi):0F.COMPONENTS AND CLADDING:SEE DIAGRAM	 A. MOISTURE CONTENT NOT TO EXCEED 19%. B. MINIMUM ALLOWABLE BENDING STRESS (Fb) TO BE NOT LESS THAN 875 PSI. C. MINIMUM ALLOWABLE COMPRESSIVE STRESS (Fc) TO BE NOT LESS THAN 1150 PSI. D. MINIMUM ALLOWABLE HORIZONTAL SHEAR STRESS (Fv) TO BE NOT LESS THAN 135 PSI. E. MODULUS OF ELASTICITY:
6.	EARTHQUAKE DESIGN DATA - THE STRUCTURE AND COMPONENTS OF THE BUILDING HAVE BEEN DESIGNED IN ACCORDANCE WITH THE PREVIOUSLY MENTIONED CODE WITH THE FOLLOWING CRITERIA:	E = 1,400,000 PSI, Emin = 510,000 PSI. F. EACH PIECE OF LUMBER CLEARLY MARKED WITH GRADE MARK OF APPLICABLE GRADING
	A.RISK CATEGORY:IIIB.SEISMIC IMPORTANCE FACTOR (Ie):1.25C.0.2 SEC MAPPED SPECTRAL RESPONSE (Ss):0.299	ASSOCIATION. G. EACH PIECE OF LUMBER MUST BE SOUND, THOROUGHLY SEASONED, WELL MANUFACTURED AND FREE OF EXCESSIVE WARP THAT CANNOT BE CORRECTED BY PROPER NAILING. SPLIT LUMBER SHALL BE REJECTED.
	D.1 SEC MAPPED SPECTRAL RESPONSE (S1):0.062E.SITE CLASS:DF.0.2 SEC SPECTRAL RESPONSE COEF. (Sds):0.311	 PLYWOOD SHEATHING SHALL CONFORM TO U.S. VOLUNTARY PRODUCT STANDARD PS1-95 AND/OR PS2-92.
	G.1 SEC SPECTRAL RESPONSE COEF. (Sd1):0.099H.SEISMIC DESIGN CATEGORY:D	A. ROOF SHEATHING: 1/2" APA STRUCTURAL 1 RATED EXPOSURE 1, SPAN RATING 32/16.
	I.BASIC SEISMIC FORCE-RESISTING SYSTEMS:TIMBER FRAMEJ.DESIGN BASE SHEAR(S):PER TRUSS MANUFACTURERK.SEISMIC MODIFICATION COEF. (CS):0.21	B. ADHESIVE SHALL BE APA APPROVED ELASTOMERIC CONSTRUCTION ADHESIVE SUCH AS BF GOODRICH PL400.
	L.RESPONSE MODIFICATION COEF. (R):1.5M.ANALYSIS PROCEDURE USED:EQUIVALENT LATERAL FORCE PROCEDURE (ELFP)	3. WOOD THAT IS EMBEDDED IN EARTH OR CONCRETE, OR PLACED ON CONCRETE IN DIRECT CONTACT WITH THE EARTH, OR DIRECTLY EXPOSED TO WEATHER SHALL BE PRESERVATIVE-TREATED INCLUDING BUT NOT
	GEOTECHNICAL INFORMATION - THE STRUCTURE HAS BEEN DESIGNED BASED ON THE FOLLOWING CRITERIA:	 LIMITED TO POSTS, BEAMS, COLUMNS, JOISTS, SLEEPERS, SILLS, AND SOLE PLATES. NAILS - COMMON NAILS, EXCEPT WHERE NOTED, MEETING FEDERAL SPECIFICATION FF-N-1-1. USE
	A. ASSUMED ALLOWABLE BEARING: 2000 PSF	GALVANIZED NAILS AT ALL EXPOSED LOCATIONS.
8.	FLOOD DESIGN DATA - THE BUILDING IS NOT LOCATED IN WHOLE OR IN PART WITHIN A FLOOD HAZARD AREA AS ESTABLISHED PER THE PREVIOUSLY MENTIONED CODE.	5. JOIST HANGERS AND FRAMING ANCHORS - MINIMUM 14 GA. MATERIAL, EXCEPT WHERE NOTED OR RECOMMENDED BY ACCEPTABLE MANUFACTURERS.
	ROOF RAIN LOAD DATA - THE DESIGN RAINFALL BASED ON THE 100-YEAR HOURLY RAINFALL RATE OR	6. MISCELLANEOUS FASTENERS:
	DETERMINED BY LOCAL WEATHER USED IN THE DESIGN OF THE BUILDING IS BASED ON THE FOLLOWING: A. RAIN INTENSITY (i): 3.0 IN/HR	 A. LAG SCREWS - HEX HEAD, CONFORMING TO FEDERAL SPECIFICATIONS FF-B-561, 3/8" DIAMETER EXCEPT AS NOTED. LENGTH OF EMBEDMENT 75% OF MEMBER THICKNESS, MAXIMUM 6". B. MACHINE BOLTS AND THREADED RODS - ASTM A307, 5/8" DIAMETER EXCEPT WHERE NOTED. C. STEEL HARDWARE - ASTM A36.
	SEISMIC DEMANDS ON NON-STRUCTURAL COMPONENTS, AND CONNECTIONS OF THOSE COMPONENTS TO THE PRIMARY STRUCTURE SHALL BE DESIGNED IN ACCORDANCE WITH THE PREVIOUSLY MENTIONED CODE, THE GENERAL SEISMIC CRITERIA LISTED ABOVE, AND THE REQUIREMENTS OF ASCE 7, CHAPTER 13	7. PROVIDE BOLTING ASSEMBLY INCLUDING PLATE WASHERS, LOCK WASHERS, NUTS BOLTS, ETC.
	AS APPROPRIATE.	PRE-FABRICATED WOOD TRUSS NOTES
	HANDRAILS AND GUARDS - THE HANDRAIL ASSEMBLIES AND GUARDS SHALL BE DESIGNED FOR 50 PLF OR A CONCENTRATED LOAD OF 200 LBS AT ANY POINT APPLIED IN ANY DIRECTION AT THE TOP AND TO TRANSFER THIS LOAD THROUGH THE SUPPORTS TO THE STRUCTURE. THESE LOADS NEED NOT BE ASSUMED TO ACT CONCURRENTLY.	1. PRE-FABRICATED WOOD TRUSSES SHALL COMPLY WITH THE REQUIREMENTS OF THE FOLLOWING; CODES AND STANDARDS AMERICAN INSTITUTE OF TIMBER CONSTRUCTION, "NATIONAL DESIGN SPECIFICATIONS FOR STRESS-GRADE LUMBER AND ITS FASTENINGS" NATIONAL FOREST PRODUCTS ASSOCIATION, AND THE TRUSS PLATE INSTITUTE, "HANDLING, INSTALLING, AND BRACING METAL PLATE CONNECTED WOOD TRUSSES"
12.	INTERIOR WALLS AND PARTITIONS - INTERIOR WALLS AND PARTITIONS THAT EXCEED 6 FEET IN HEIGHT SHALL HAVE ADEQUATE STRENGTH TO RESIST LOADS THEY ARE SUBJECT TO, BUT NOT LESS THAN A HORIZONTAL UNIFORM LOAD OF 5 PSF.	 SHOP DRAWINGS SHALL CLEARLY SHOW ALL TRUSS DIMENSION, MEMBER SIZES, TEMPORARY AND
13.	FUTURE EXPANSION - NO PROVISIONS HAVE BEEN MADE IN THE STRUCTURAL DESIGN FOR FUTURE HORIZONTAL OR VERTICAL BUILDING EXPANSION.	PERMANENT BRACING, CONNECTOR PLATE SIZES, AND MISCELLANEOUS ANCHORS. CALCULATIONS SHALL INDICATE ASSUMED LOADINGS, MEMBER FORCES, JOINT DISPLACEMENTS, AND DESIGN OF ALL CONNECTIONS.
	RESTRAINED CONSTRUCTION CLASSIFICATION - IN ACCORDANCE WITH ASTM E 119, ALL FLOOR CONSTRUCTION IS CLASSIFIED AS RESTRAINED CONSTRUCTION.	3. PRE-FABRICATED TRUSSES SHALL BE DESIGNED BY A PROFESSIONAL ENGINEER REGISTERED IN THE STATE OF NEW YORK.
15.	<u>ROOF TOP EQUIPMENT ANCHORAGE</u> - ALL ROOF TOP EQUIPMENT CURBS, MECHANICAL EQUIPMENT, TIE DOWNS, AND CONNECTIONS OF ALL EQUIPMENT TO BUILDING STRUCTURE FOR WIND AND SEISMIC LOADING ARE TO BE DESIGNED BY A REGISTERED PROFESSIONAL ENGINEER RETAINED BY THE	AND SEAL OF A PROFESSIONAL ENGINEER LICENSED IN THE STATE OF NEW YORK. ALL PREENGINEERED TRUSS SHOP DRAWINGS SHALL BE AVAILABLE ON THE JOB SITE DURING THE TIMES OF INSPECTION AND
	EQUIPMENT SUPPLIER.	SHALL BEAR CLEAR INDICATION THAT THEY HAVE BEEN REVIEWED AND APPROVED BY THE PROJECT STRUCTURAL ENGINEER OF RECORD.
		 TRUSSES SHALL BE DESIGNED TO SUSTAIN THE LOADS, AND LOAD COMBINATIONS, AND BE WITHIN THE DEFLECTION CRITERIA AS MANDATED BY THE 2020 BUILDING CODE OF NEW YORK STATE. A. TOP CHORD DEAD LOAD 10 PSF
	CONCRETE REINFORCING LAP/EMBEDMENT SCHEDULE	A. TOP CHORD DEAD LOAD TOPSF B. TOP CHORD LIVE/SNOW LOAD SEE SNOW LOADS IN DESIGN CRITERIA C. BOTTOM CHORD DEAD LOAD 10 PSF D. BOTTOM CHORD LIVE LOAD 10 PSF E. UPLIFT 20 PSF
	BAR SIZE SI (METRIC) LAP LENGTH EMBEDMENT LENGTH f'c = 3,000 PSI f'c = 4,000 PSI f'c = 3,000 PSI f'c = 4,000 PSI	e. UPLIFI 20 PSF6. TRUSSES SHALL BE DESIGNED TO EXERT NO HORIZONTAL THRUST AT THEIR POINTS OF SUPPORT.
	#3 (#10) 22" 20" 17" 15" #4 (#13) 29" 25" 22" 19"	7. LUMBER SPECIES AND GRADE SHALL BE AS SPECIFIED BY TRUSS MANUFACTURER.
	#5 (#16) 36" 32" 28" 24" #6 (#19) 43" 38" 33" 29"	8. CONNECTOR PLATES SHALL BE A MINIMUM 20 GAUGE GALVANIZED "GANGNAIL" CONNECTOR. TRUSS MANUFACTURER SHALL SUBMIT ENGINEERING DATA ON PARTICULAR PLATES USED.
	#7 (#22) 63" 54" 48" 42" #8 (#25) 72" 62" 55" 48" #0 (#20) 21" 70" 62" 55" 48"	9. STRAP ANCHORS AND METAL TIES MINIMUM 18 GAUGE MATERIAL, EXCEPT WHERE NOTED.
	#9 (#29) 81" 70" 62" 54" #10 (#32) 91" 79" 70" 61" #11 (#24) 101" 87" 70" 61"	10. ERECT TRUSSES IN STRICT ACCORDANCE WITH INSTRUCTIONS FROM THE TRUSS MANUFACTURER. DO NOT HANDLE TRUSSES IN ANY WAY WHICH WILL WEAKEN THEM OR CAUSE TRUSSES TO DISTORT ABOUT THEIR
	#11 (#36) 101" 87" 78" 67" #14 (#42) NP NP 92" 91"	WEAK AXIS. DO NOT PLACE ANY LOADS ON TRUSSES BEFORE THEY HAVE BEEN INSTALLED AND FULLY

11. FURNISH AND INSTALL ALL TRUSS BRACING IN STRICT ACCORDANCE WITH THE TRUSS PLATE INSTITUTE'S "BUILDING COMPONENT SAFETY INFORMATION BOOKLET, BCSI 1-03, AND RELATED SUMMARY SHEETS.

BRACED.

12. BUILT-UP TRUSSES SHALL CONSIST OF TWO OR MORE SINGLE TRUSSES, FABRICATED AS INDIVIDUAL TRUSSES, AND FASTENED TOGETHER TO FORM A SINGLE TRUSS. ALL HARDWARE REQUIRED FOR CONNECTIONS BETWEEN PREENGINEERED TRUSSES SHALL BE DESIGNED AND SPECIFIED BY THE TRUSS DESIGN ENGINEER.

	E	XCAVATION & BACKFILL NOTES
NG, ETC. SHALL	1.	THE SITE SHALL BE PREPARED IN ACCORDANCE WITH SPECIFICATIONS AND THE CIVIL DRAWINGS.
ITS.	2.	EXCAVATIONS TO BE SHEETED AND BRACED, OR LAID BACK TO PREVENT SLOUGHING IN OF THE EXCAVATED AREAS PER OSHA REGULATIONS.
THER REASON EXCEPT E ENGINEER. H ALL BEARING	3.	ALL EXCAVATIONS AND GRADES PREPARED FOR BEARING SHALL BE INSPECTED BY A QUALIFIED GEOTECHNICAL ENGINEER TO VERIFY THE DESIGN ASSUMPTIONS AND REPORT NONCONFORMING
EVEN SUPPORT. UNIFORM BEARING	4.	CONDITIONS. THE CONTRACTOR SHALL DETERMINE THE EXTENT OF CONSTRUCTION DEWATERING REQUIRED FOR TH
		EXCAVATION. THE CONTRACTOR SHALL SUBMIT TO THE GEOTECHNICAL ENGINEER FOR REVIEW THE PROPOSED PLAN FOR DEWATERING, PRIOR TO EXCAVATION.
AGGER THE END JOINTS	5.	PLACE ALL FOOTINGS ON FIRM, DRY, LEVEL, ACCEPTABLE BEARING SOIL.
	6.	FROST DEPTH FOR THIS PROJECT IS 4'-0" BELOW GRADE. FINISH GRADE SHALL BE MAINTAINED A MINIMUM OF 3'-0" ABOVE TOP OF FOUNDATIONS UNLESS NOTED OTHERWISE.
THE NAILING RATION INTO THE PIECE	7.	TOP OF FOOTING ELEVATIONS PROVIDED ON CONSTRUCTION DRAWINGS ARE FOR PURPOSES OF DESIGN. NOTIFY THE ENGINEER IF TOP OF FOOTING ELEVATIONS NEED TO BE ADJUSTED BASED ON
SPIKE PROVIDED,		CONTRACTOR'S FIELD COORDINATION OR GEOTECHNICAL ENGINEER'S RECOMMENDATIONS.
NCH NOMINAL CE ALL SPLIT MEMBERS.	8.	REMOVE AND DISPOSE OF LEGALLY FROM SITE; UNACCEPTABLE BEARING SOIL, EXCESS EXCAVATED MATERIAL, ASPHALT MATERIAL (SEE SITE PLANS).
d. Drill straight and Ers under head and	9.	WHERE FILL IS REQUIRED UNDER BEARING CONDITIONS, IT SHALL BE SELECTED AND PLACED IN ACCORDANCE WITH INSTRUCTIONS OF A QUALIFIED GEOTECHNICAL ENGINEER TO MAINTAIN DESIG BEARING PRESSURE.
R AS ROOT OF THREAD; VE, ALL LAG SCREWS	10.	THE DESIGN OF WALLS RETAINING EARTH DOES NOT INCLUDE HYDROSTATIC PRESSURE LOADS UNLESS NOTED OTHERWISE, AND ASSUMES A DRAINAGE SYSTEM IS IN PLACE WHERE REQUIRED.
ZINC- COATED VEIGHTS FOR ZINC-	11.	BACKFILL WITHIN BUILDING - TO WITHIN 6 INCHES OF UNDERSIDE OF FLOOR SLAB SHALL BE "SUBBASE COURSE" (NYSDOT 304.12 - TYPE 2) CONSISTING OF HARD DURABLE PEBBLES, ROCK FRAGMENTS AND SOIL BINDER. IT SHALL BE FREE OF CLAY, ORGANIC MATTER, AND OTHER DELETERIOUS MATERIAL. GRADATION: 2 INCHES MAXIMUM SIZE, 25-60% PASSING THE 1/4" SIEVE, 5-40% PASSING NO. 40 SIEV AND NOT MORE THAN 10% PASSING NO. 200 SIEVE.
o. 2 SPRUCE-PINE-FIR,	12.	UNDER SLABS ON GRADE - POROUS 6 INCH LIFT OF WASHED "CRUSHED STONES" CONSISTING OF: 50/ MIX OF #1's AND #2's., ASTM #57 STONE.
REQUIREMENTS: PSI.	13.	BACKFILL OUTSIDE OF BUILDING - "SELECT GRANULAR FILL" (NYSDOT 203.07) CONSISTING OF SAND, F GRAVEL, COARSE SILT, OR SIMILAR NON-COHESIVE HARD DURABLE MATERIALS AND SOIL BINDERS WITHOUT EXCESSIVE CLAY, ORGANIC MATTER, OR FROZEN OR DELETERIOUS MATERIAL. GRADATION: INCHES MAXIMUM SIZE, 0-70% PASSING THE #40 SIEVE AND 0-15% PASSING THE #200 SIEVE.
35 PSI.	14	

- WITHIN BUILDING 95% DRY DENSITY MODIFIED PROCTOR. OUTSIDE OF BUILDING - 95% DRY DENSITY MODIFIED PROCTOR.
- 15. FILL PLACEMENT BACKFILL SHALL NOT BE PLACED AGAINST WALLS UNTIL THE WALLS HAVE ACHIEVED SPECIFIED DESIGN STRENGTH. PLACE FILL SIMULTANEOUSLY ON EACH SIDE OF FOUNDATION WALL IN 6 INCH LIFTS. THE MAXIMUM DIFFERENCE IN ELEVATION ON EITHER SIDE OF WALL SHALL NOT EXCEED 1'-6"

6 32/16.	COMPONENTS AND CLADDING DESIGN PRESSURES						
'e such as bf		EFFECTIVE WIND AREA					
DIRECT CONTACT WITH	ZONE	10 SQ. FT.	20 SQ. FT.	50 SQ. FT.	100 SQ. FT.		
NCLUDING BUT NOT	1	20.3 / -62.0 PSF	18.3 / -62.0 PSF	16.0 / -37.7 PSF	16.0 / -19.3 PSF		
	2e	20.3 / -62.0 PSF	18.3 / -62.0 PSF	16.0 / -37.7 PSF	16.0 / -19.3 PSF		
N FF-N-1-1. USE	2n	20.3 / - 90.3 PSF	18.3 / -78.1 PSF	16.0 / -62.0 PSF	16.0 / -49.7 PSF		
	2r	20.3 / - 90.3 PSF	18.3 / -78.1 PSF	16.0 / -62.0 PSF	16.0 / -49.7 PSF		
VHERE NOTED OR	3e	20.3 / -90.3 PSF	18.3 / -78.1 PSF	16.0 / -62.0 PSF	16.0 / -49.7 PSF		
	3r	20.3 / -107.4 PSF	18.3 / -92.0 PSF	16.0 / -71.7 PSF	16.0 / -56.3 PSF		
	4	33.5 / -36.4 PSF	32.0 / -34.8 PSF	30.0 / -32.9PSF	28.5 / -31.3 PSF		
561, 3/8" DIAMETER		33.5 / -47.9 PSF	32.0 / -42.0 PSF	30.0 / -37.9 PSF	28.5 / -34.8 PSF		
AXIMUM 6". WHERE NOTED.	OVERHANG 1 & 1'	-71.0 PSF	-71.0 PSF	-61.5 PSF	-54.1 PSF		
	OVERHANG 2e	-99.4 PSF	-86.6 PSF	-69.7.3 PSF	-56.8 PSF		
BOLTS, ETC.	OVERHANG 2n	-99.4 PSF	-86.6 PSF	-69.7.3 PSF	-56.8 PSF		
	OVERHANG 2r	-99.4 PSF	-86.6 PSF	-69.7.3 PSF	-56.8 PSF		
	OVERHANG 3e	-116.5 PSF	-100.5 PSF	-79.6 PSF	-63.7 PSF		
FOLLOWING: CODES	OVERHANG 3r	-136.4 PSF	-115.0 PSF	-86.7 PSF	-65.4 PSF		

SCHEDULE NOTES:

|3e |

2n


1. PRESSURES SHOWN ARE APPLIED NORMAL TO THE SURFACE.

2. PLUS AND MINUS SIGNS SIGNIFY PRESSURES ACTING TOWARD AND AWAY FROM THE SURFACE, RESPECTIVELY.

4. SEE 'DESIGN CRITERIA NOTES' ON DRAWING S-800 FOR OTHER PERTINENT INFORMATION.

5. ALL NET DESIGN WIND PRESSURE VALUES ARE TAKEN FROM ASCE 7-16 SECTION 30.5. ALL WIND PRESSURES ARE TO BE CONSIDERED AS ULTIMATE VALUES.



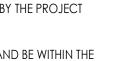



IUFACTURER. DO NOT STORT ABOUT THEIR



2n ¦3r|3r¦ 2n EXTERIOR WALLS GABLE ROOF (SLOPE $7^\circ < \theta < 20^\circ$)

COMPONENT AND CLADDING PRESSURE ZONE DIAGRAMS (FOR USE WITH SCHEDULE ABOVE)

3. DISTANCE 'a' SHALL BE: 5'-0" FOR ALL INSTANCES SHOWN IN THE DIAGRAMS BELOW. ' 3r | 3r | 2n SEE ROOF TYPES

NEW YORK STATE EDUCATION STATEMEN ON OF THE NEW YORK GULATIONS FOR ANY PERSON, UNLESS ACTING UNDER THE DIRECTIO CT, ENGINEER OR LAND SURVEYOR, TO ALTER AN ITEM IN ANY WAY. IF AN EARING THE SEAL OF AN ARCHITECT, ENGINEER OR SURVEYOR IS ALTERED, THE ALTER ARTY SHALL AFFIX TO THE ITEM THEIR SEAL AND THE NOTATION "ALTERED BY" FOLLOW LED SCINATED AND THE DATE OS FULL ALTERATION AND A SECURIC DESCRIPTION SHEET INFORMATION Issued Scale 10/18/2023 As indicated Proiect Status

BID DOCUMENTS Drawn By Checked By JPR


Drawing Title STRUCTURAL TYPICAL NOTES


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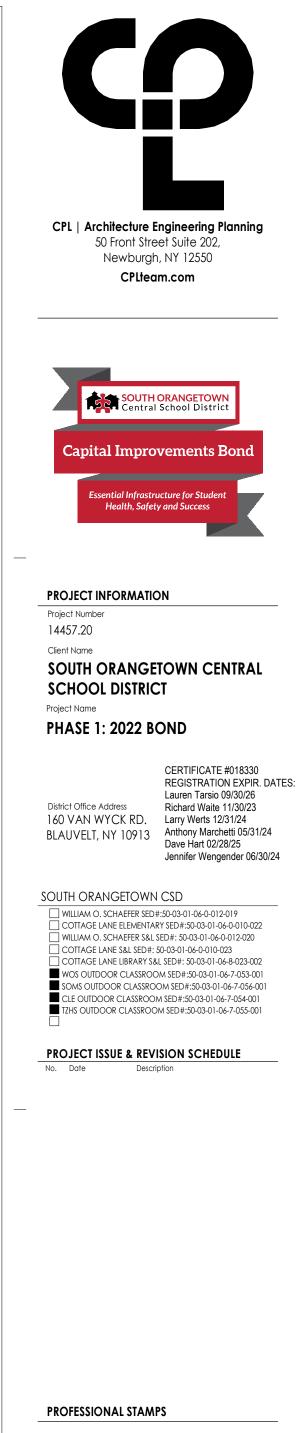



D FOR THE CPL | Architecture Engineering Planning 50 Front Street Suite 202, Newburgh, NY 12550 CPLteam.com IN DESIGN s unless nts and **PROJECT INFORMATION** . 40 SIEVE, Project Number 14457.20 GOF: 50/50 Client Name SOUTH ORANGETOWN CENTRAL SCHOOL DISTRICT SAND, FINE **PHASE 1: 2022 BOND** DATION: 4 CERTIFICATE #018330 REGISTRATION EXPIR. DATES: Lauren Tarsio 09/30/26 District Office Address Richard Waite 11/30/23 160 VAN WYCK RD. Larry Werts 12/31/24 BLAUVELT, NY 10913 Anthony Marchetti 05/31/24 Dave Hart 02/28/25 Jennifer Wengender 06/30/24 SOUTH ORANGETOWN CSD WILLIAM O. SCHAEFER SED#:50-03-01-06-0-012-019 COTTAGE LANE ELEMENTARY SED#:50-03-01-06-0-010-022 WILLIAM O. SCHAEFER S&L SED#: 50-03-01-06-0-012-020 COTTAGE LANE S&L SED#: 50-03-01-06-0-010-023 COTTAGE LANE LIBRARY S&L SED#: 50-03-01-06-8-023-002 WOS OUTDOOR CLASSROOM SED#:50-03-01-06-7-053-001 SOMS OUTDOOR CLASSROOM SED#:50-03-01-06-7-056-001 LE OUTDOOR CLASSROOM SED#:50-03-01-06-7-054-001 HS OUTDOOR CLASSROOM SED#:50-03-01-06-7-055-001 **PROJECT ISSUE & REVISION SCHEDUL**

PROFESSIONAL STAMPS



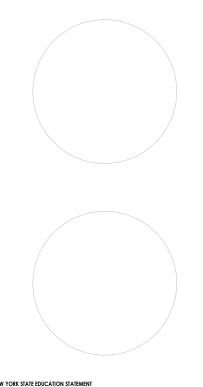

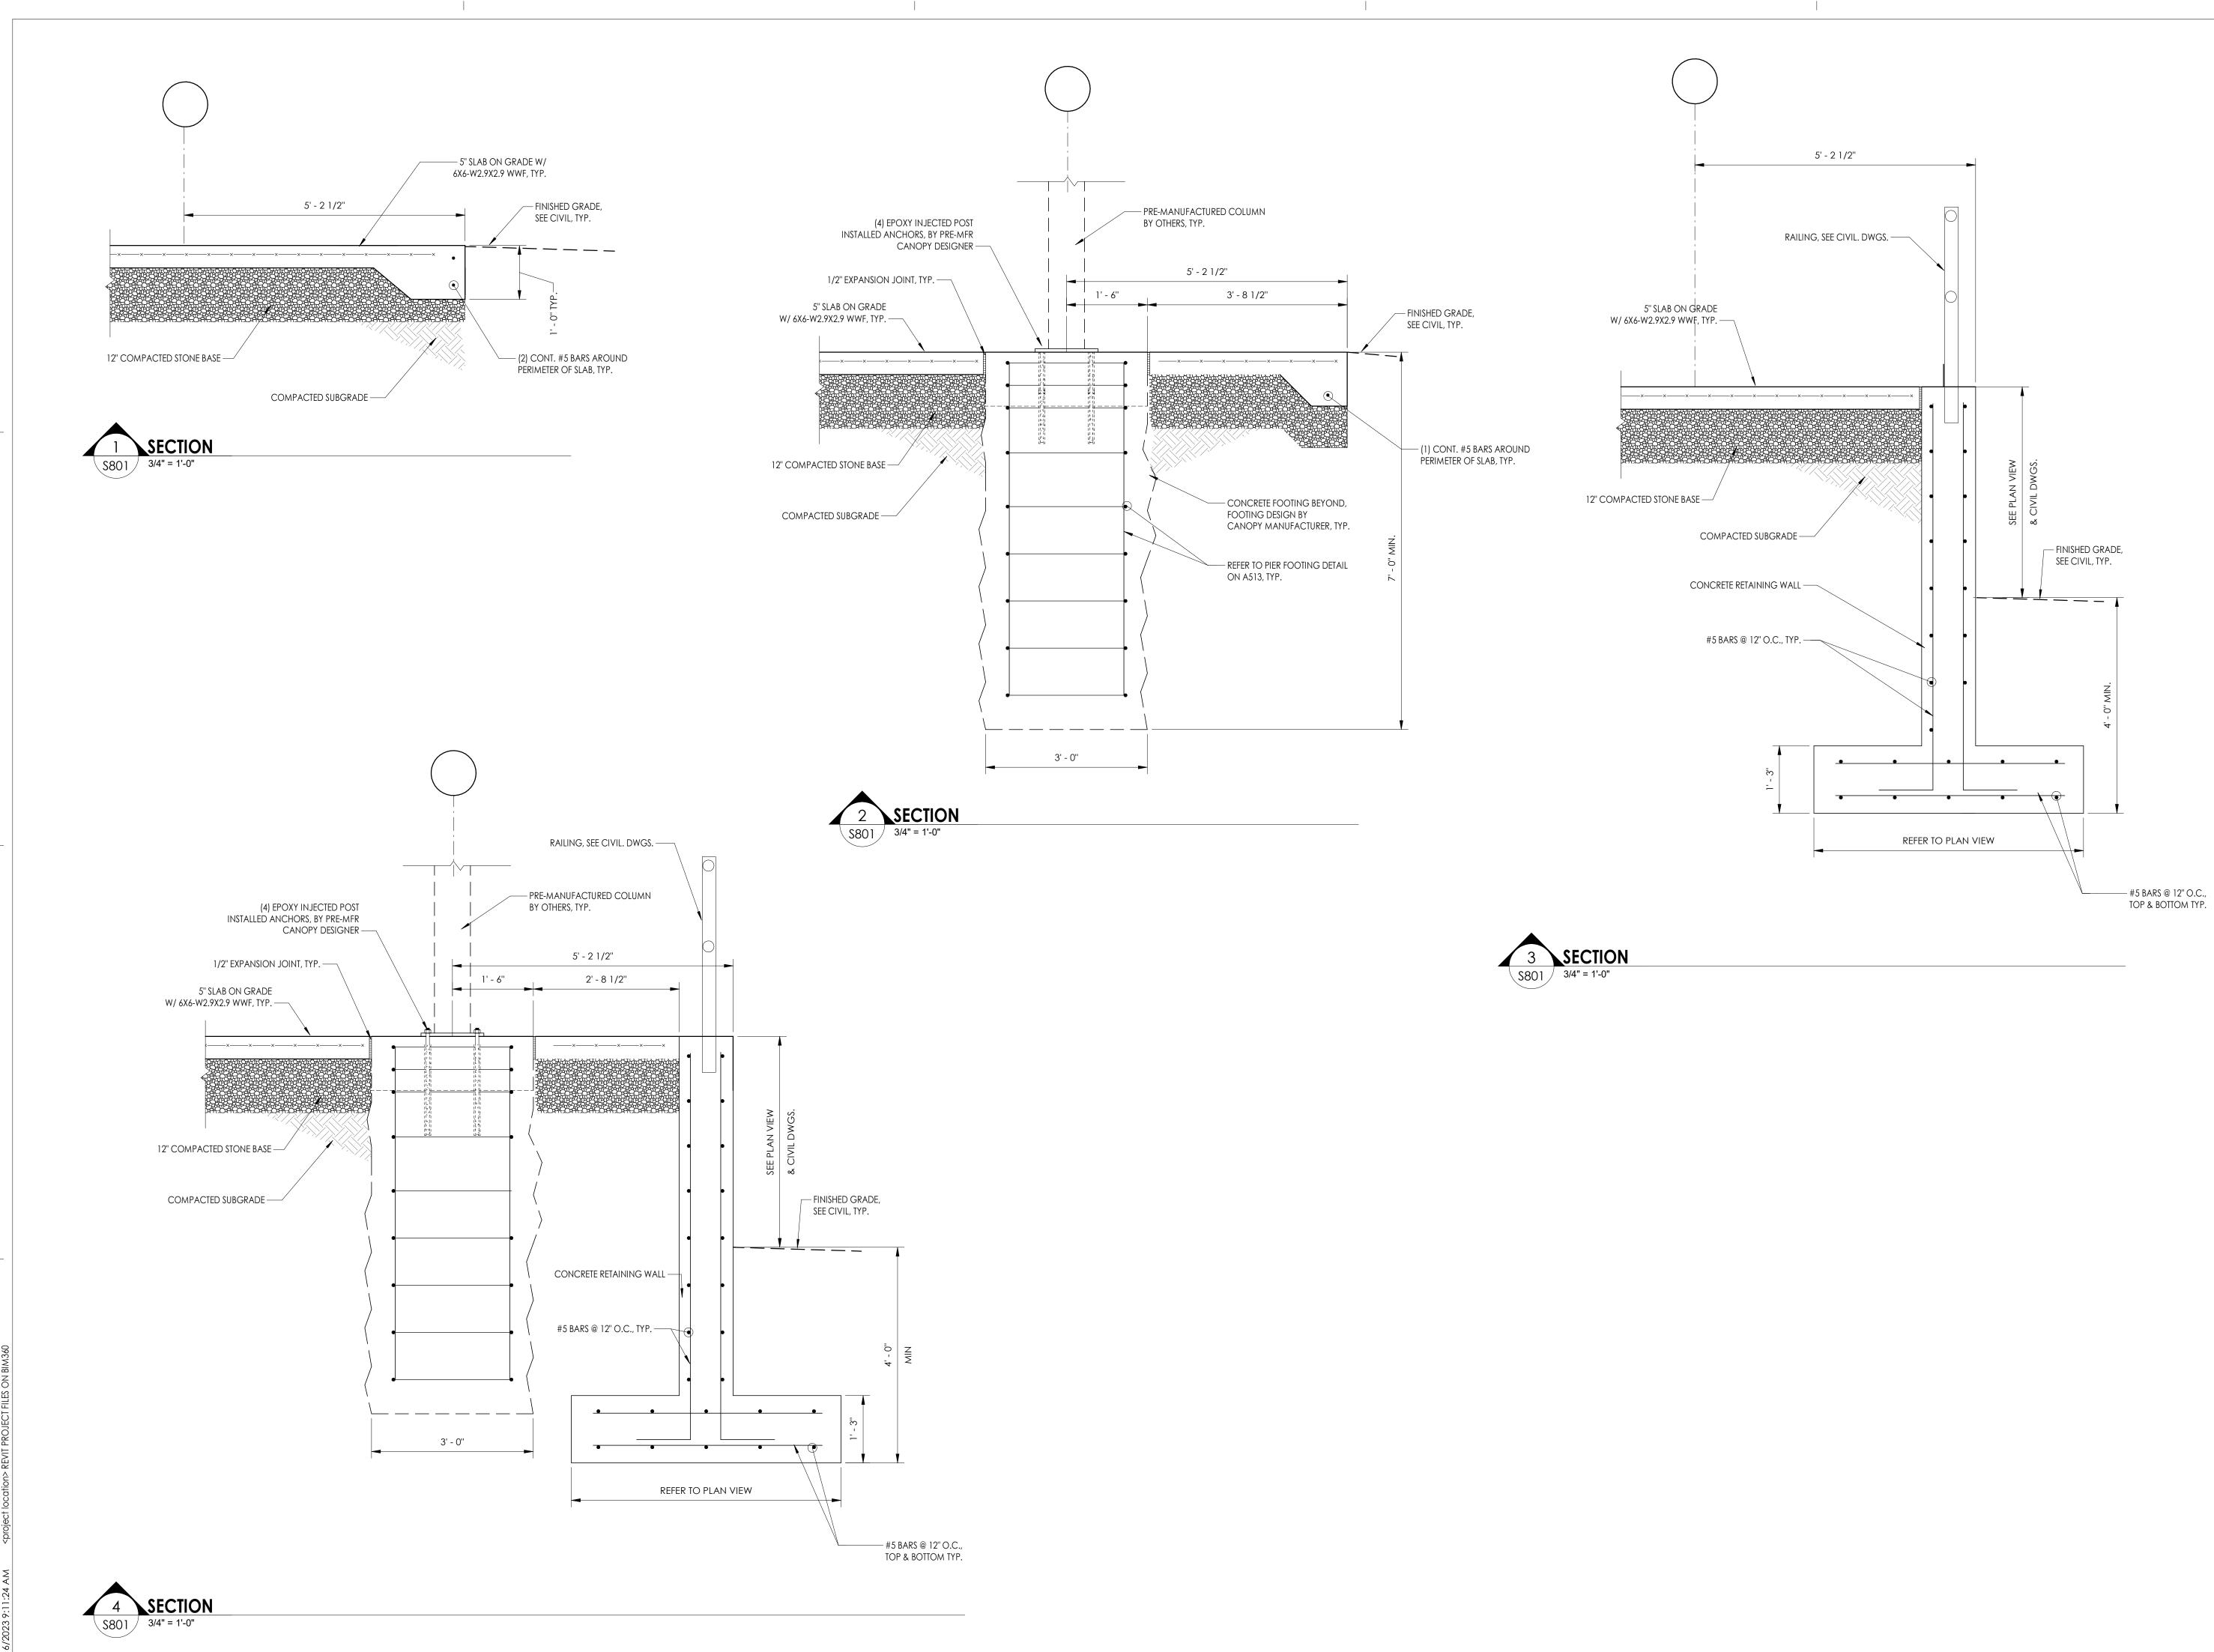


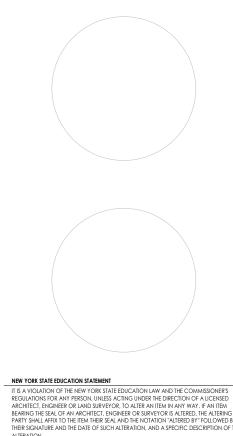


SHEET INFORMATION

Issued	Scale					
10/18/2023	3/4" = 1'-0"					
Project Status	Project Status					
BID DOCUMENTS						
Drawn By	Checked By					
SAW	JPR					
Drawing Title						
STRUCTURAL TYPICAL DETAILS						

Drawing Number GEN S801

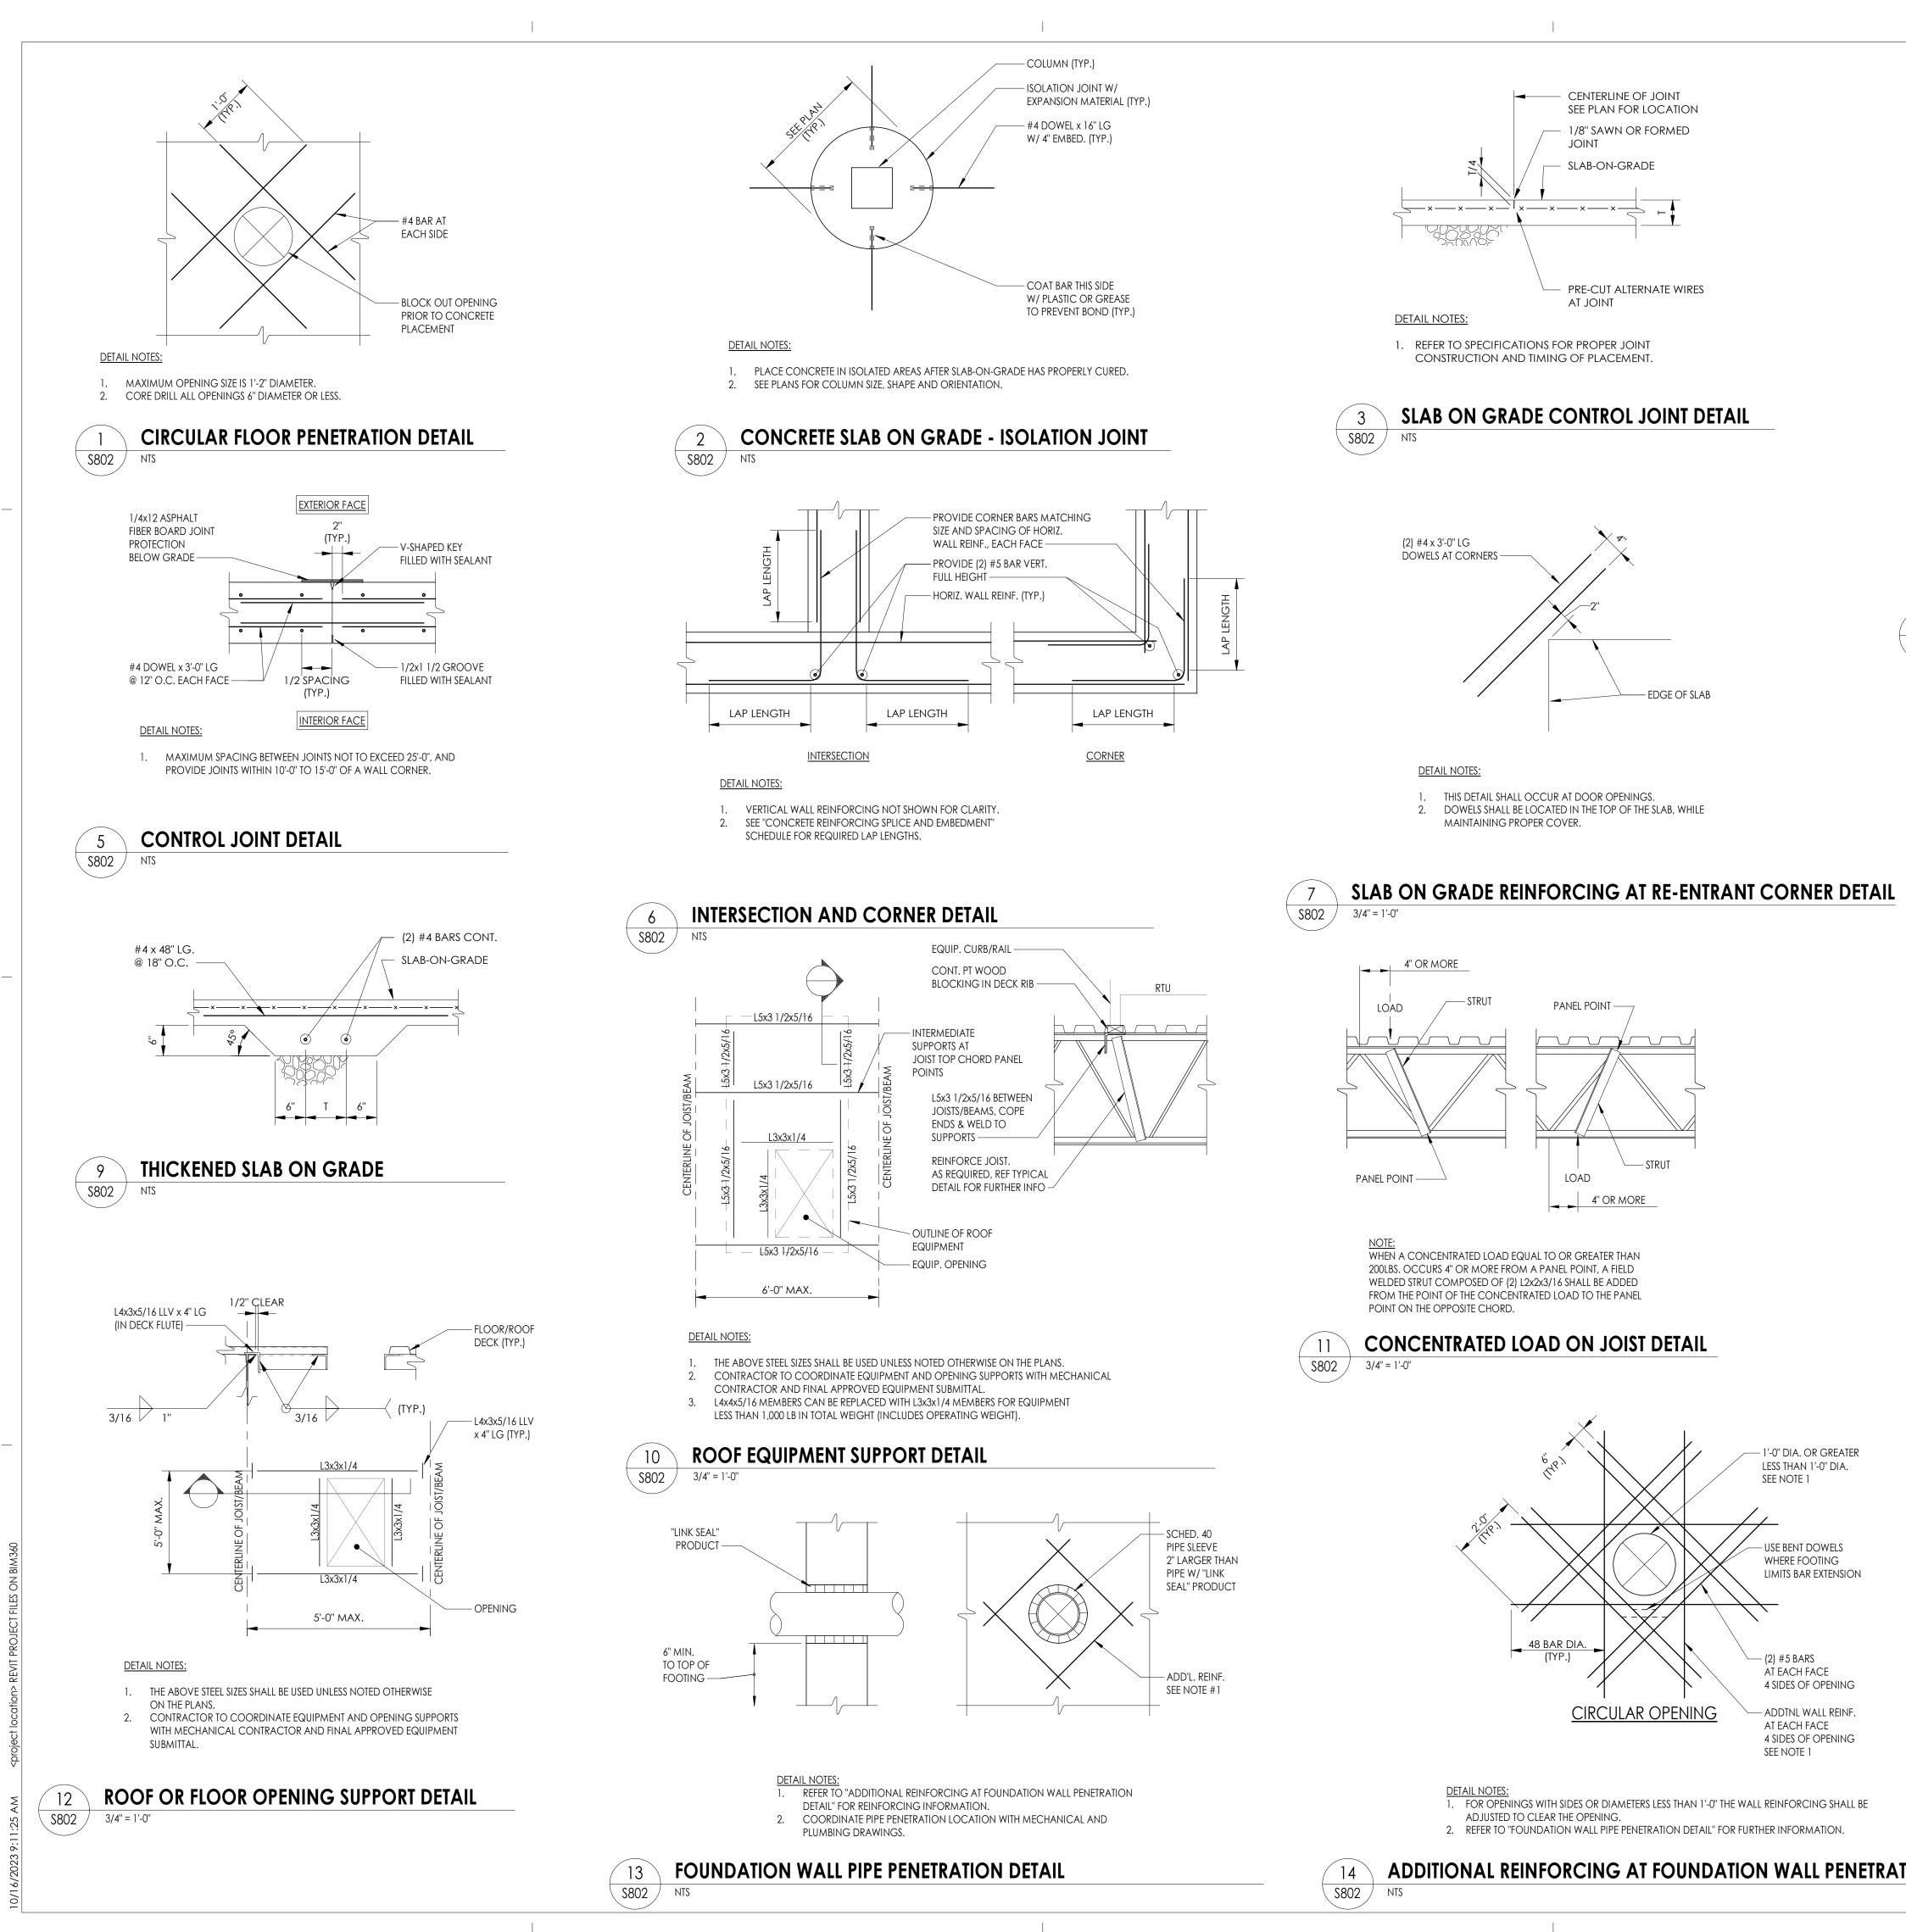


ADDITIONAL REINFORCING AT FOUNDATION WALL PENETRATION DETAIL

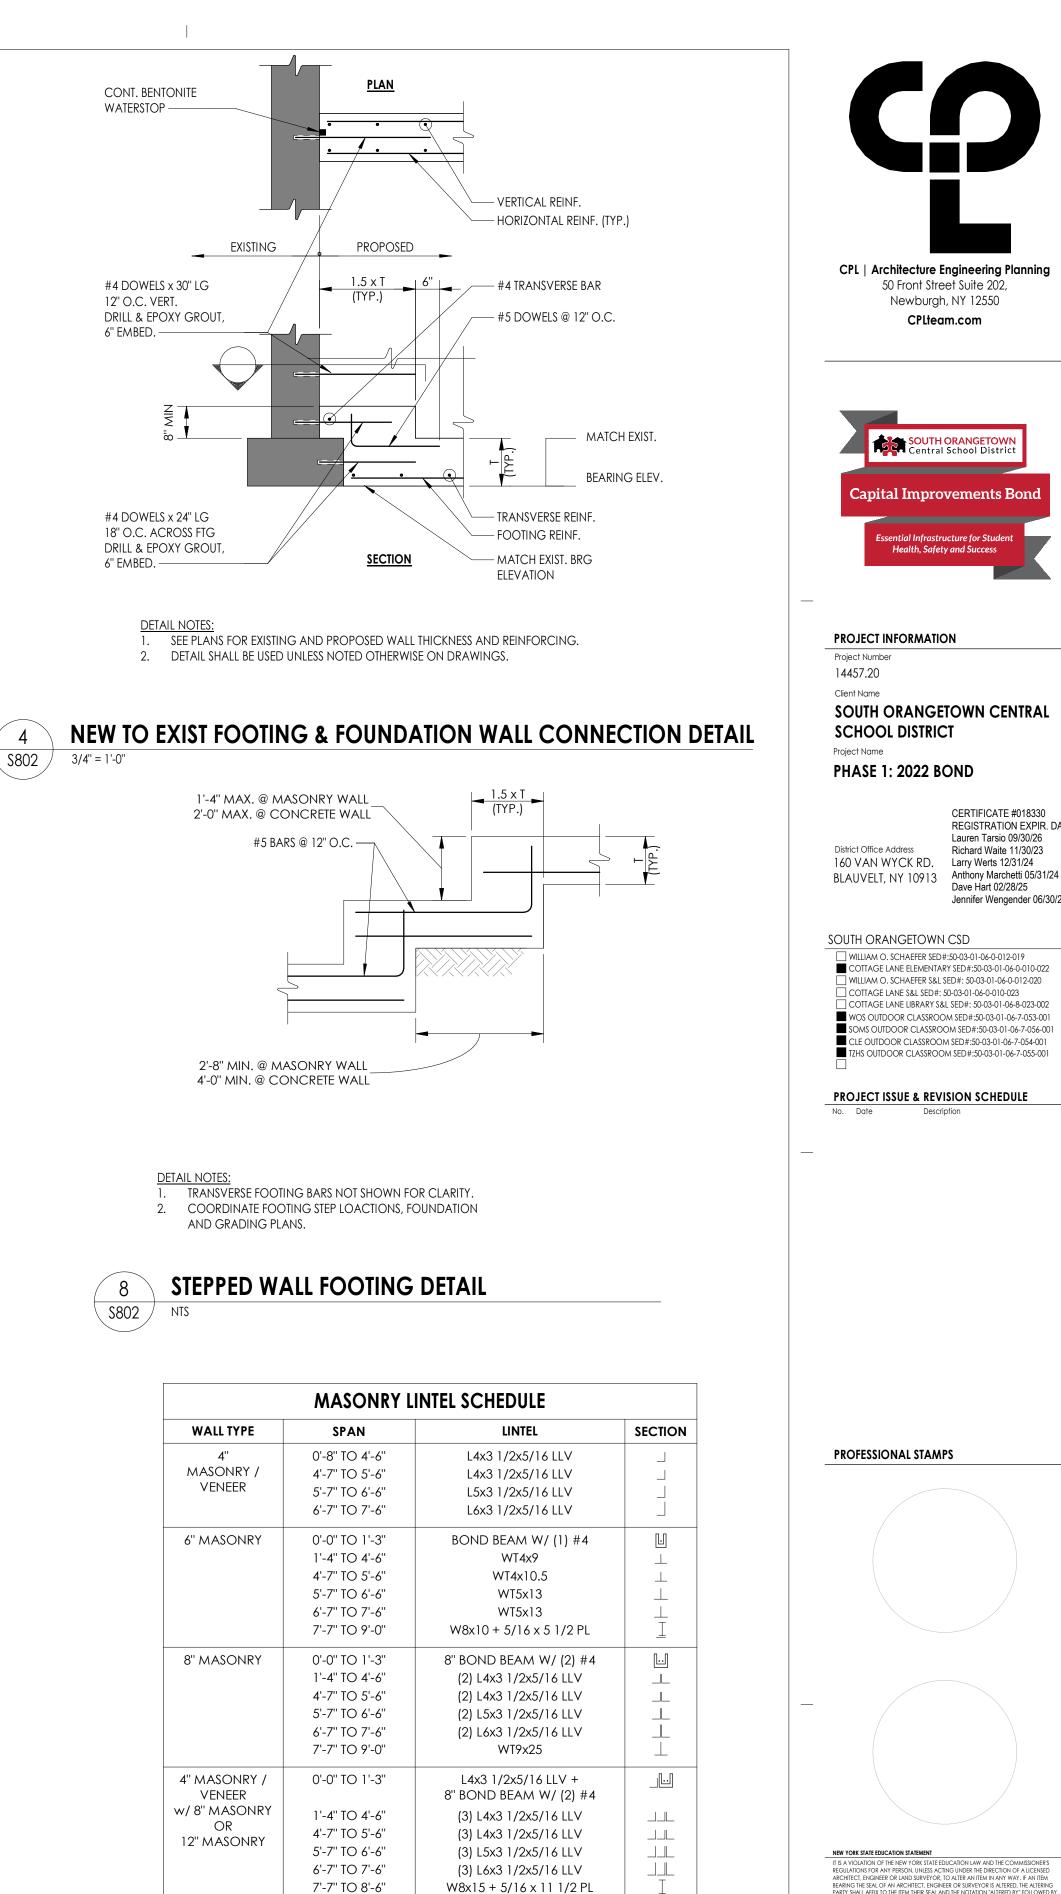

SCHEDULE NOTES:

1. PROVIDE LINTELS OVER ALL MASONRY OPENINGS AS SCHEDULED UNLESS NOTED OTHERWISE ON THE DRAWINGS.

- MINIMUM BEARING FOR ALL LINTELS SHALL BE 8" EACH END. 3. GROUT SOLID AREA 16" W x 24" H BELOW BEARING UNLESS NOTED OTHERWISE ON
- THE DRAWINGS. 4. COORDINATE MASONRY OPENING SIZES AND LOCATIONS WITH ARCHITECTURAL,
- MECHANICAL AND PLUMBING DRAWINGS. CONTRACTOR SHALL PROVIDE AN ADDITIONAL 50 FEET OF L5x3-1/2x5/16 ANGLE.
- 6. FOR MASONRY OPENING SPANS GREATER THAN 6'-0", BOLT ASSEMBLIES
- TOGETHER AT 1/3 POINTS. 7. FOR ALL W AND WT SHAPE LINTELS, PROVIDE A 1/2x5x7 BEARING PLATE WITH (2)
- 1/2" DIAMETER x 6" LONG HEADED STUDS, EACH END. 8. STEEL LINTELS EXPOSED TO THE EXTERIOR SHALL BE GALVANIZED UNLESS NOTED
- OTHERWISE.

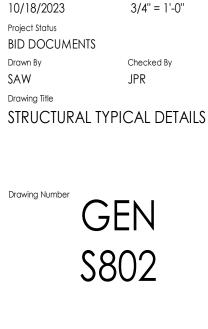

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CPLteam.com

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ealth. Safety and Succes

SOUTH ORANGETOWN CENTRAL

160 VAN WYCK RD. Larry Werts 12/31/24

WILLIAM O. SCHAEFER SED#:50-03-01-06-0-012-019 COTTAGE LANE ELEMENTARY SED#:50-03-01-06-0-010-022

COTTAGE LANE S&L SED#: 50-03-01-06-0-010-023 COTTAGE LANE LIBRARY S&L SED#: 50-03-01-06-8-023-002

PROJECT ISSUE & REVISION SCHEDULE

PROFESSIONAL STAMPS

NEW YORK STATE EDUCATION STATEMEN

SHEET INFORMATION

Issued

10/18/2023

Project Status

Drawn By

Drawing Title

Drawing Number

SAW

ECT, ENGINEER OR LAND SURVEYOR, TO ALTER AN ITEM IN ANY WAY, IF AN

Scale

ARING THE SEAL OF AN ARCHITECT, ENGINEER OR SURVEYOR IS ALTERED, THE ALTE RTY SHALL AFFIX TO THE ITEM THEIR SEAL AND THE NOTATION "ALTERED BY" FOLLOV

WILLIAM O. SCHAEFER S&L SED#: 50-03-01-06-0-012-020

VOS OUTDOOR CLASSROOM SED#:50-03-01-06-7-053-001 SOMS OUTDOOR CLASSROOM SED#:50-03-01-06-7-056-001 LE OUTDOOR CLASSROOM SED#:50-03-01-06-7-054-001

S OUTDOOR CLASSROOM SED#:50-03-01-06-7-055-001

CERTIFICATE #018330

Richard Waite 11/30/23

Dave Hart 02/28/25

REGISTRATION EXPIR. DATES: Lauren Tarsio 09/30/26

Jennifer Wengender 06/30/24

152.5

14457.20

Client Name

SCHOOL DISTRICT

District Office Address

GENERAL INFORMATION:

MATERIALS:

DESCRIPTION TUBE STEEL SCHEDULE PIPE RMT PIPE LIGHT GAGE COLD FORMED

STRUCTURAL STEEL PLATE

ROOF PANELS (STEEL) ANCHOR BOLTS

A500 (GRADE B) A53 (GRADE B) A519 A1003 (GRADE 50) A36 A653 SEE SHEET 2.1

ASTM DESIGNATION

NOTES: UNLESS NOTED OTHERWISE, THIS STRUCTURE WAS DESIGNED TO ONLY SUPPORT WHAT IS SHOWN ON THESE DRAWINGS. THE MANUFACTURER MUST BE CONTACTED IF ANYTHING ELSE IS TO BE ATTACHED TO THIS STRUCTURE (WALLS, COLUMN WRAPS, RAILINGS, ETC.) SO THE DESIGN OF THIS STRUCTURE CAN BE REVIEWED AND POSSIBLY REVISED.

UNLESS NOTED OTHERWISE, THIS STRUCTURE WAS DESIGNED ASSUMING A 20' SEPARATION BETWEEN ANY ADJACENT STRUCTURE WITH AN EAVE HEIGHT EQUAL TO OR GREATER THAN THE EAVE HEIGHT OF THIS STRUCTURE. IF THAT SEPARATION DOES NOT EXIST, THE MANUFACTURER MUST BE CONTACTED SO THE DESIGN OF THIS STRUCTURE CAN BE REVIEWED AND POSSIBLY REVISED.

STRUCTURAL STEEL SHALL BE DETAILED, FABRICATED, AND ERECTED IN ACCORDANCE WITH THE LATEST EDITION OF THE AMERICAN INSTITUTE OF STEEL CONSTRUCTION (AISC) SPECIFICATION MANUAL.

ALL WELDING IS PERFORMED BY AMERICAN WELDING SOCIETY CERTIFIED WELDERS AND CONFORMS TO THE LATEST EDITION OF AWS D1.1 OR D1.3 AS REQUIRED.

PARTS SHOWN MAY BE UPGRADED DUE TO STANDARDIZED FABRICATION. REFER TO THE SHIPPING BILL OF MATERIALS AND FINAL INSTALLATION INSTRUCTIONS INCLUDED WITH THE STRUCTURE FOR POSSIBLE SUBSTITUTIONS AND IMPROVEMENTS.

FOR PROPER FIELD INSTALLATION OF THE BUILDING IT IS RECOMMENDED THAT THE PRIMARY FRAME INSTALLER AND THE ROOF INSTALLER HAVE A MINIMUM FIVE (5) YEARS DOCUMENTED EXPERIENCE INSTALLING THIS TYPE OF PRODUCT.

FOR PROPER FIELD INSTALLATION OF THE BUILDING IT IS RECOMMENDED THAT ELECTRIC WIRING, IF REQUIRED, BE RUN THROUGH THE STRUCTURAL MEMBERS BEFORE THE BUILDING IS ERECTED.

FABRICATOR APPROVALS: CITY OF PHOENIX, AZ APPROVED FABRICATOR #C08-2010 CITY OF LOS ANGELES, CA APPROVED FABRICATOR #1596 CITY OF RIVERSIDE, CA APPROVED FABRICATOR #SP06-0033 CITY OF HOUSTON, TX APPROVED FABRICATOR #470 CLARK COUNTY, NV APPROVED FABRICATOR #264 STATE OF UTAH APPROVED FABRICATOR 02008-14


CERTIFICATES: MIAMI-DADE COUNTY CERTIFICATE OF COMPETENCY NO. 19-0806.05 PCI (POWDER COATING INSTITUTE) 4000 CERTIFIED

VERIFICATION AND INSPE 1. INSPECTION OF HIGH S A. BEARING TYPE CONNE **B. PRETENSIONED AND SL**

VERIFICATION AND INSPE 1. INSPECT REINFORCEME AND VERIFY PLACEMENT. 3. INSPECT ANCHORS CAS 4.INSPECT ANCHORS POS MEMBERS.


A. ADHESIVE ANCHORS IN INCLINED ORIENTATIONS B. MECHANICAL ANCHORS 4.A


6. PRIOR TO CONCRETE PL STRENGTH TESTS, PERFOR DETERMINE THE TEMPERA 7. INSPECT CONCRETE AN APPLICATOIN TECHNIQUE 12. INSPECT FORMWORK THE CONCRETE MEMBER

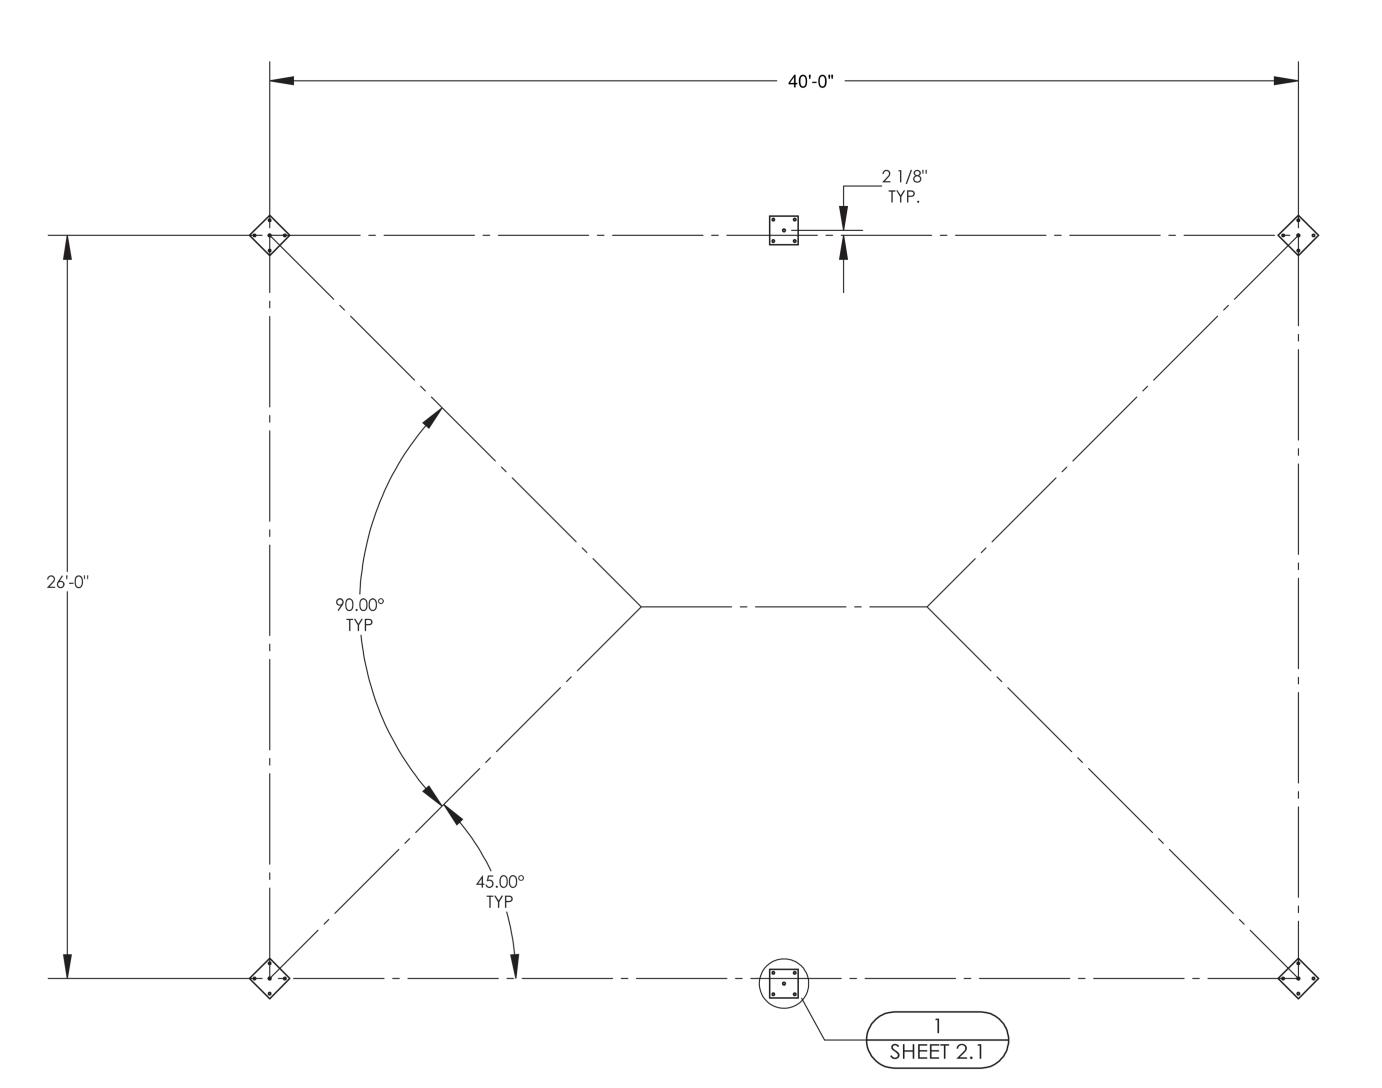



DRAWINGS SHOWN FOR REFERENCE ONLY. STRUCTURE TO BE PROVIDED BY OTHERS AND ERECTED BY GENERAL CONSTRUCTION CONTRACTOR.


REQUIRED VERIFICATION AND INSPECTIONS OF STEEL CONSTRUCTION				
PECTIONS	CONTINUOUS	PERIODIC	REFERENCED STANDARD	IBC REFERENCE
STRENGTH BOLTING				
ECTIONS	-	Х	AISC 360 SECTION N5.6	1705.2.1
SLIP-CRITICAL JOINTS USING TURN-OF-NUT	Х	Х	AISC 300 SECTION NS.0	1705.2.1
REQUIRED VERIFICATION AND INSPECT	IONS OF CONCR	RETE CONST	RUCTION	
PECTIONS	CONTINUOUS	PERIODIC	REFERENCED STANDARD	IBC REFERENCE
IENT, INCLUDING PRESTRESSING TENDONS,		v	ACI 318: Ch. 20, 25.2,	1009.4
Γ.	-	Х	25.3, 26.6.1-26.6.3	1908.4
ST IN CONCRETE	-	Х	ACI 318: 17.8.2	-
ST-INSTALLED IN HARDENED CONCRETE				
NSTALLED IN HORIZONTALLY OR UPWARDLY	х		ACI 318: 17.8.2.4	
S TO RESIST SUSTAINED TENSION LOADS	^	-	ACI 510. 17.0.2.4	-
RS AND ADHESIVE ANCHORS NOT DEFINED IN		х	ACI 318: 17.8.2	
	-	^	ACI 516. 17.6.2	-
PLACEMENT, FABRICATE SPECIMENS FOR			ASTM C172ASTM C31ACI	
RM SLUMP AND AIR CONTENT TESTS, AND	х	-	318: 26.5, 26.12	1908.1
ATURE OF THE CONCRETE.			516. 20.5, 20.12	
ND SHOTCRETE PLACEMENT FOR PROPER	x	-	ACI 318: 26.5	1908.6, 1908.7,
JES.	~		ACI 310. 20.3	1908.8
FOR SHAPE, LOCATION AND DIMENSIONS OF	_	х	ACI 318: 26.11.1.2(b)	-
BEING FORMED	_	~	ACI 310. 20.11.1.2(D)	

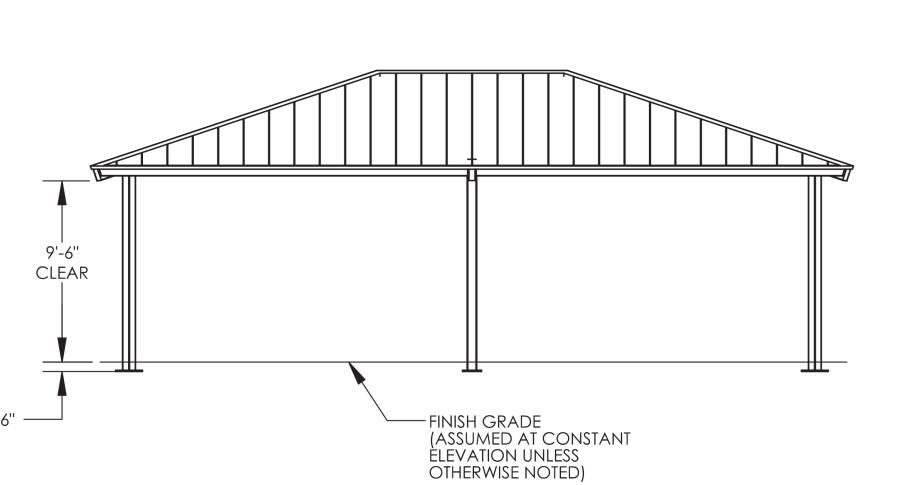


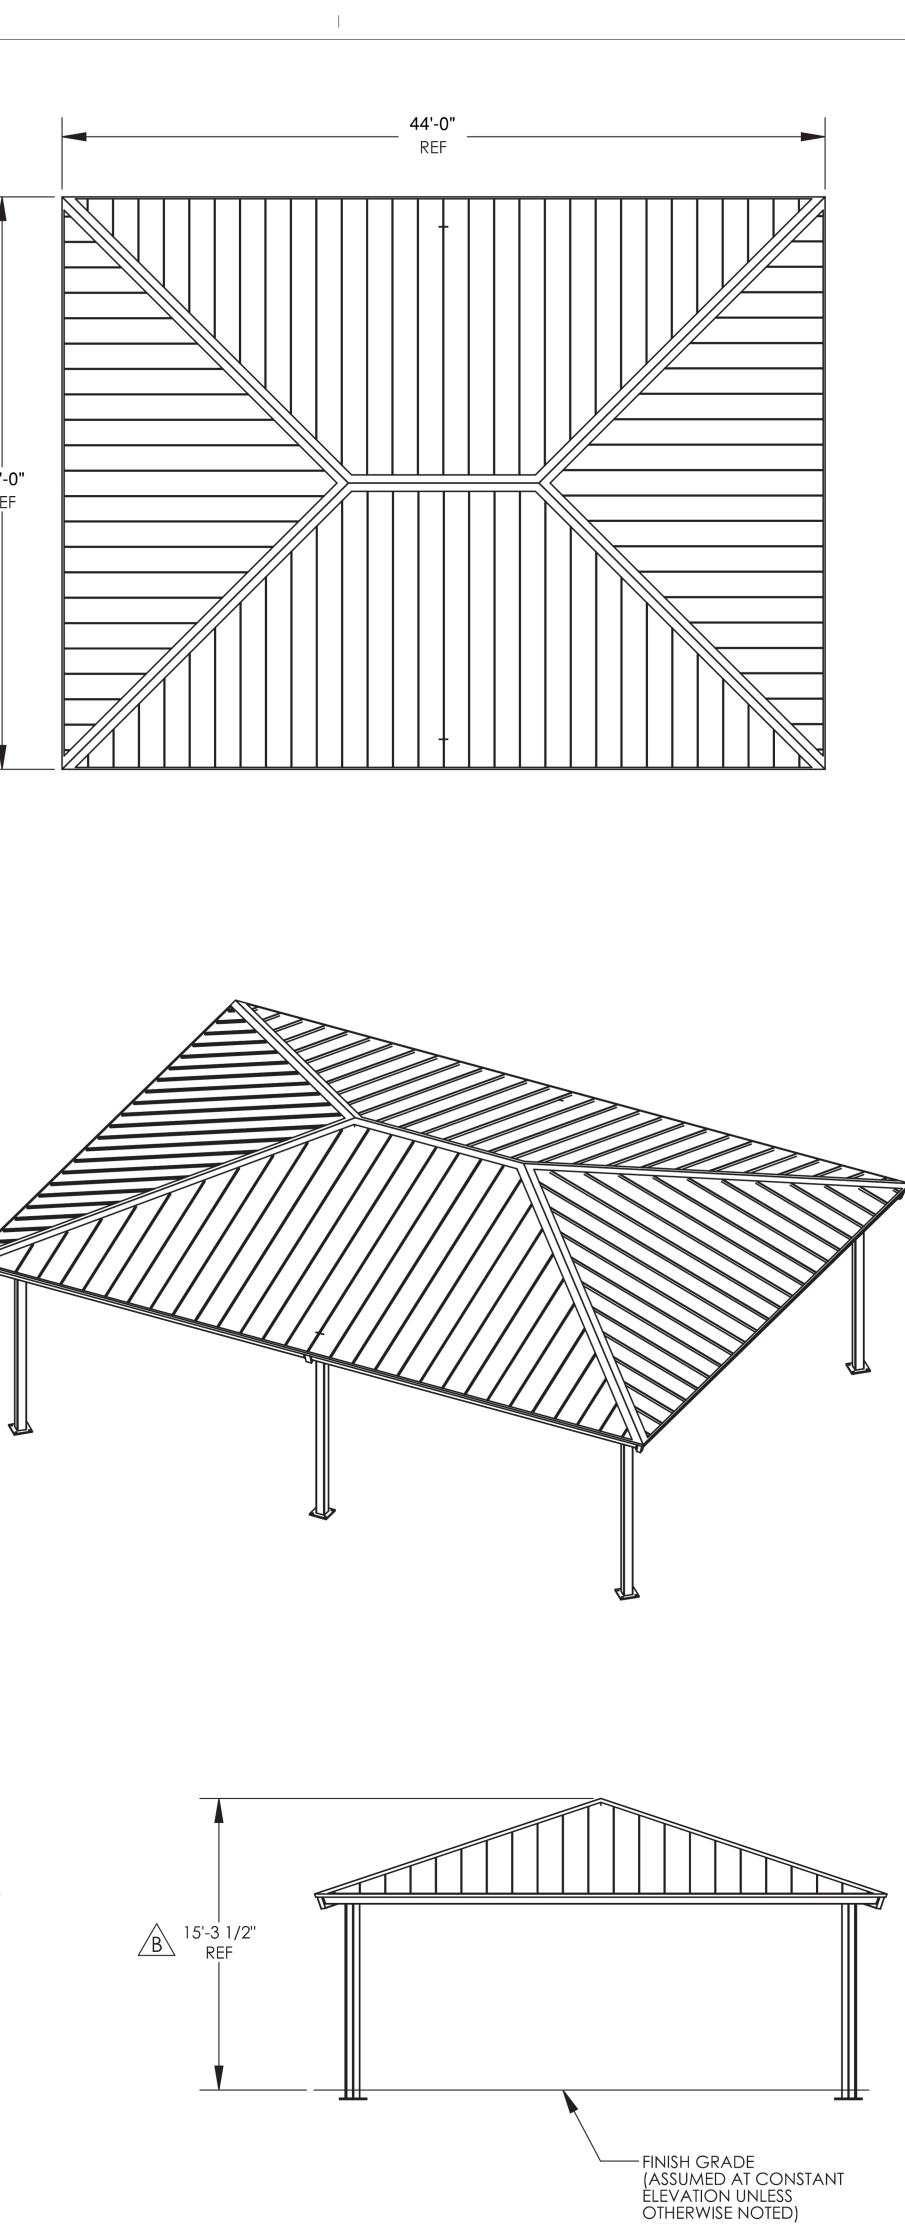


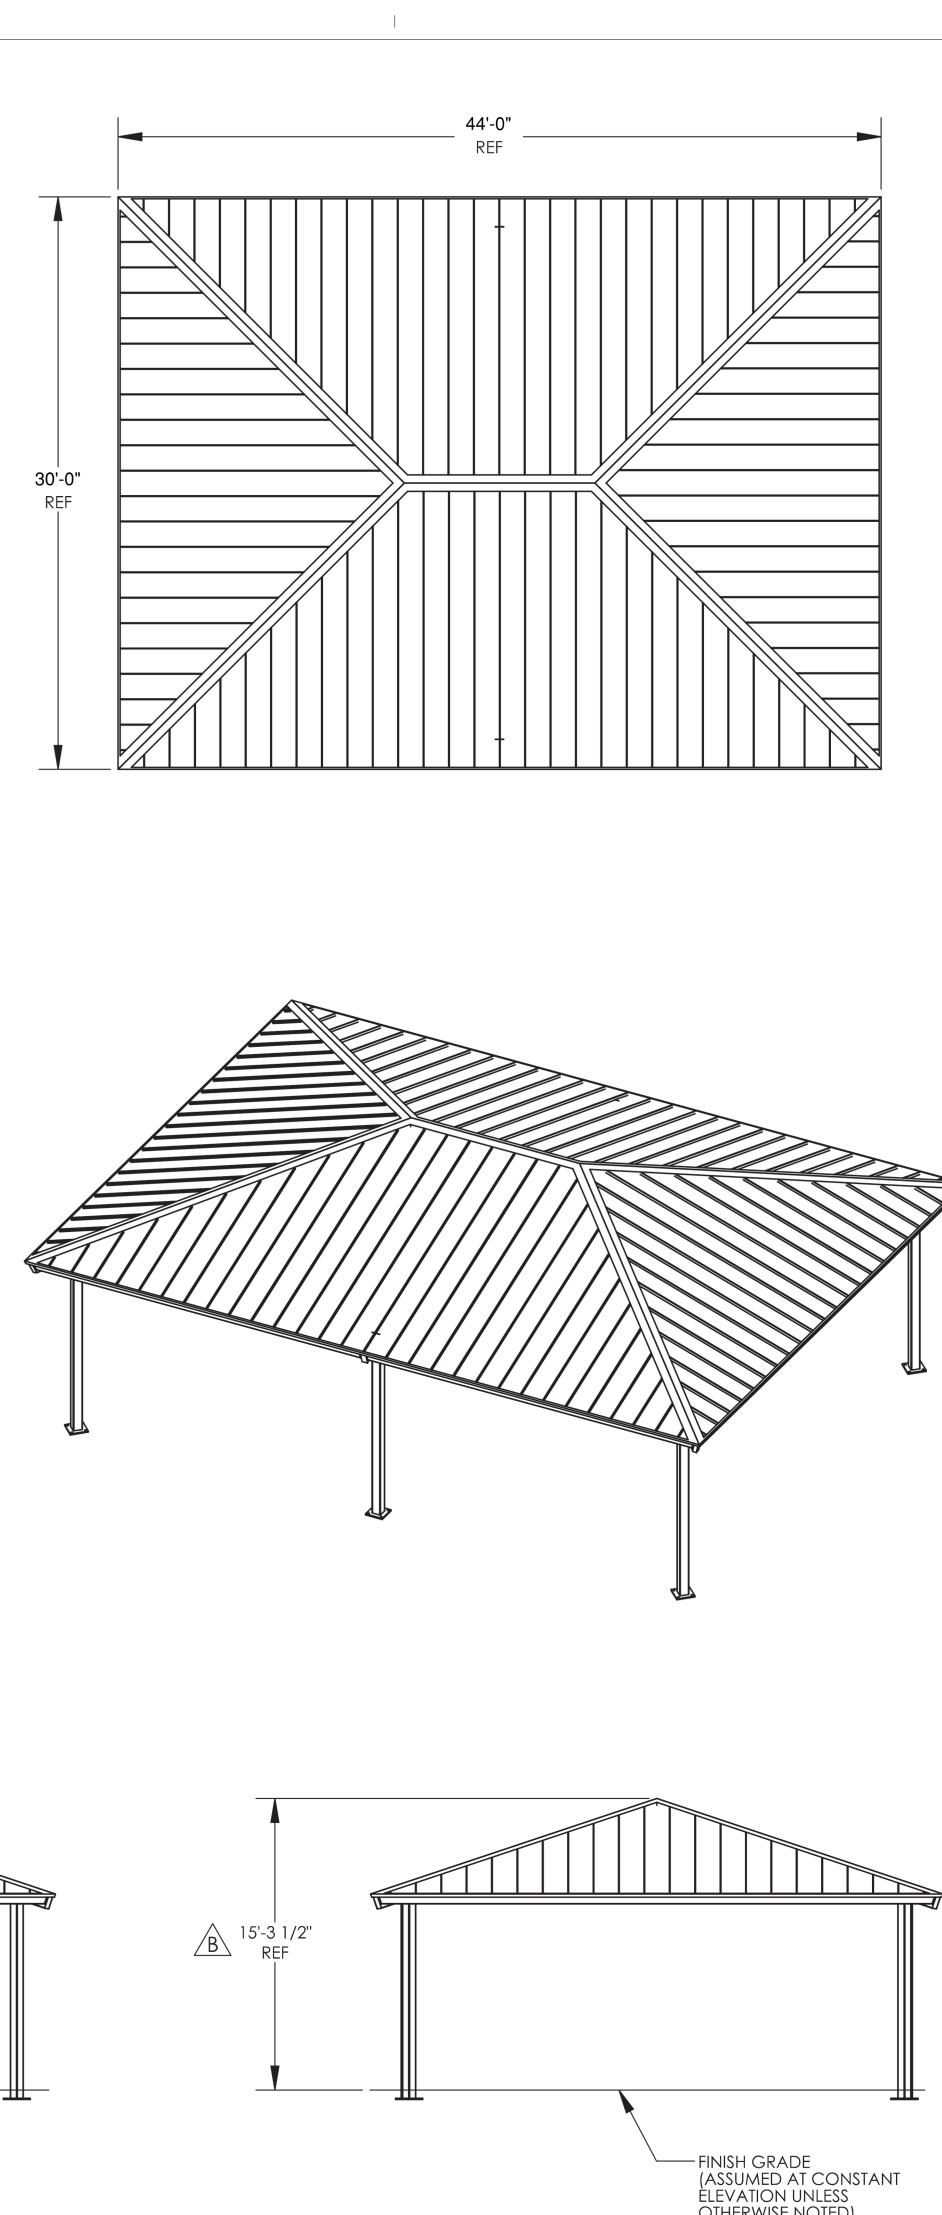


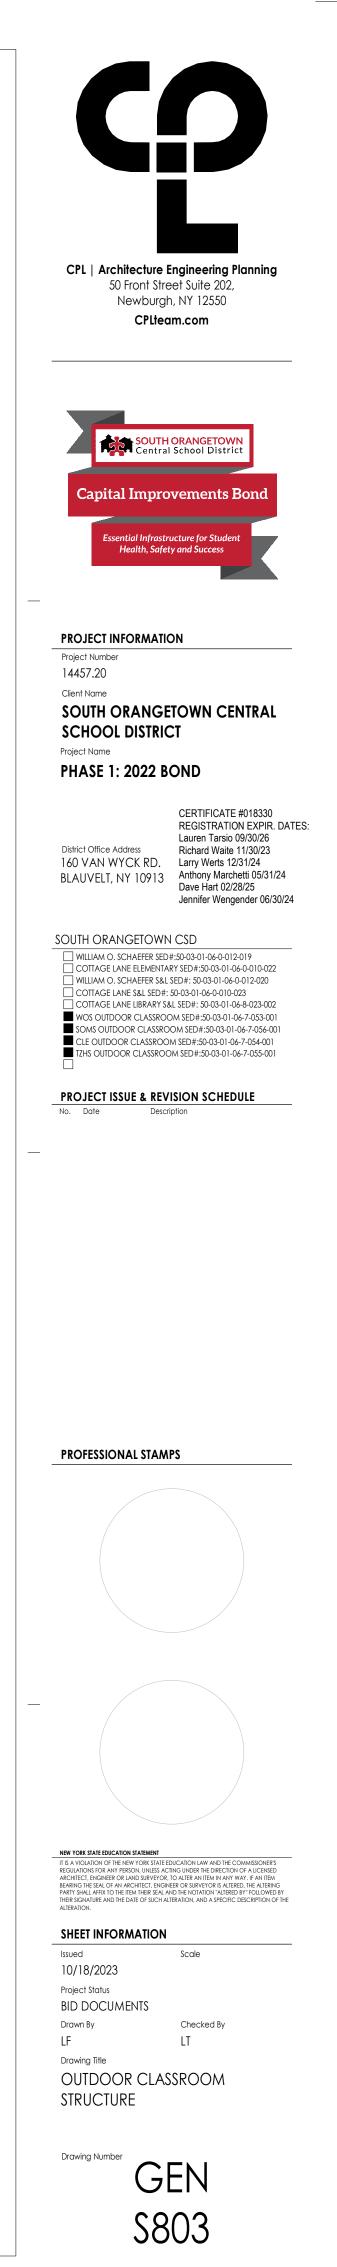


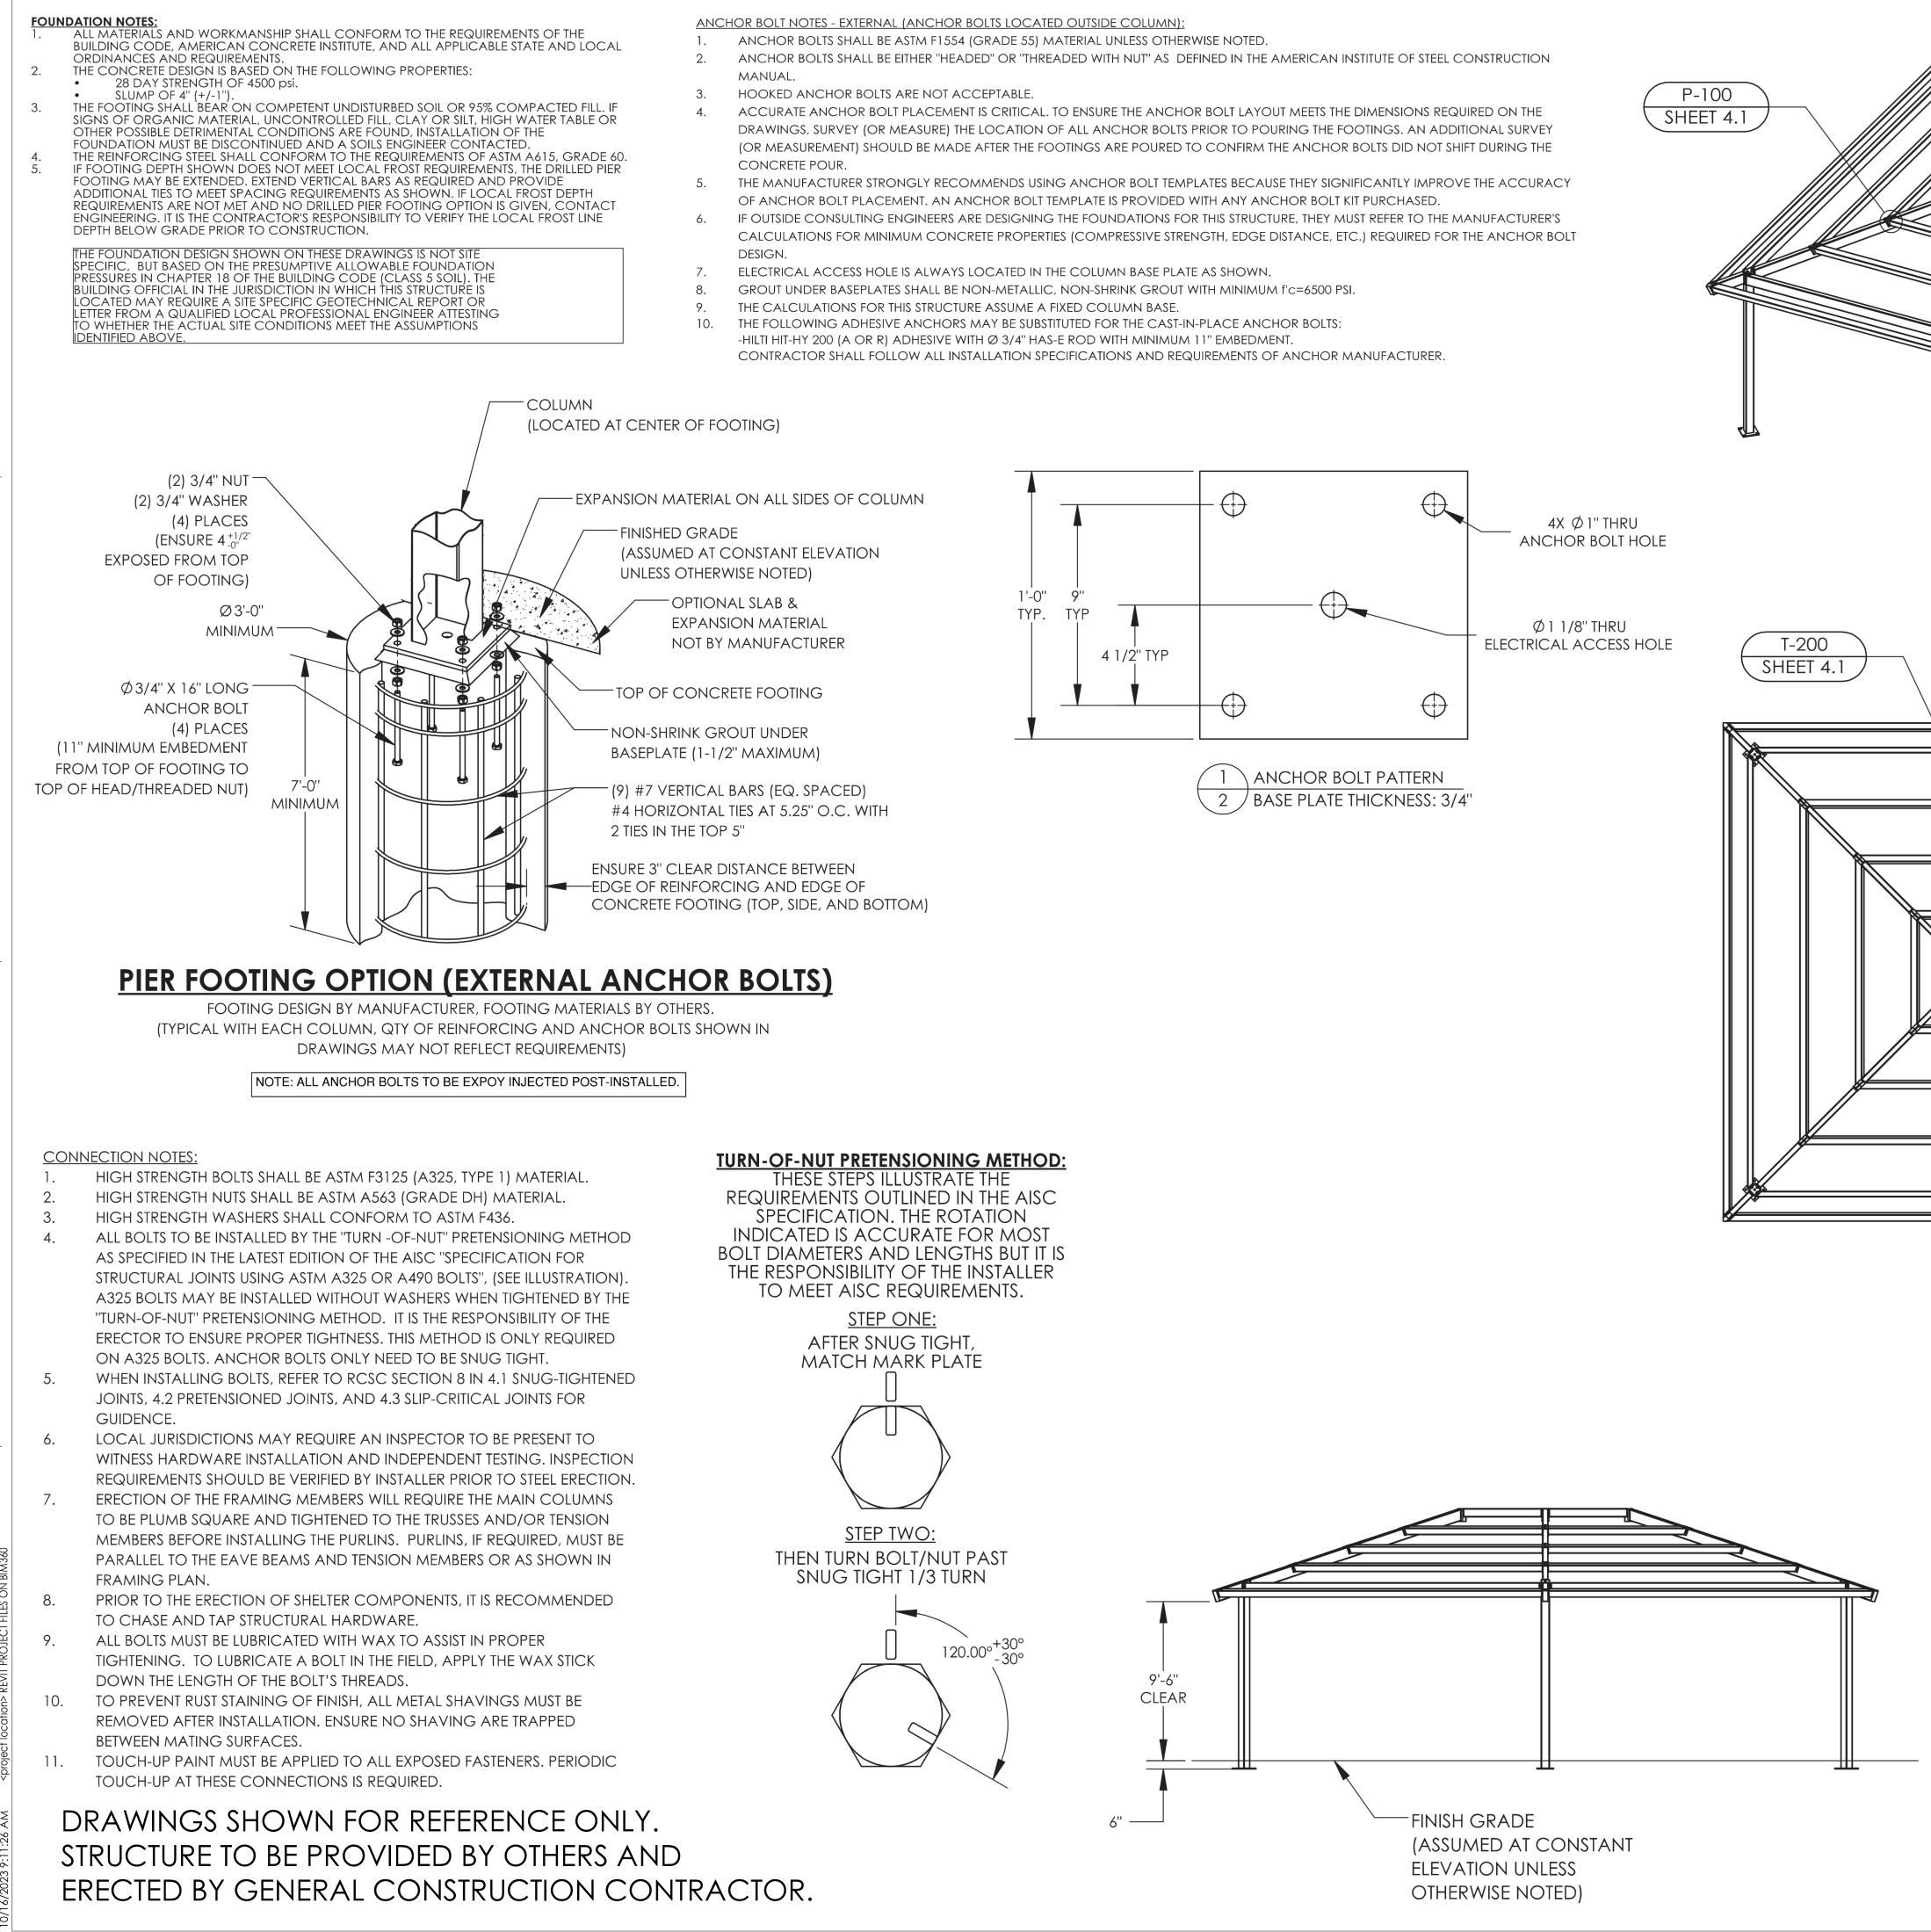

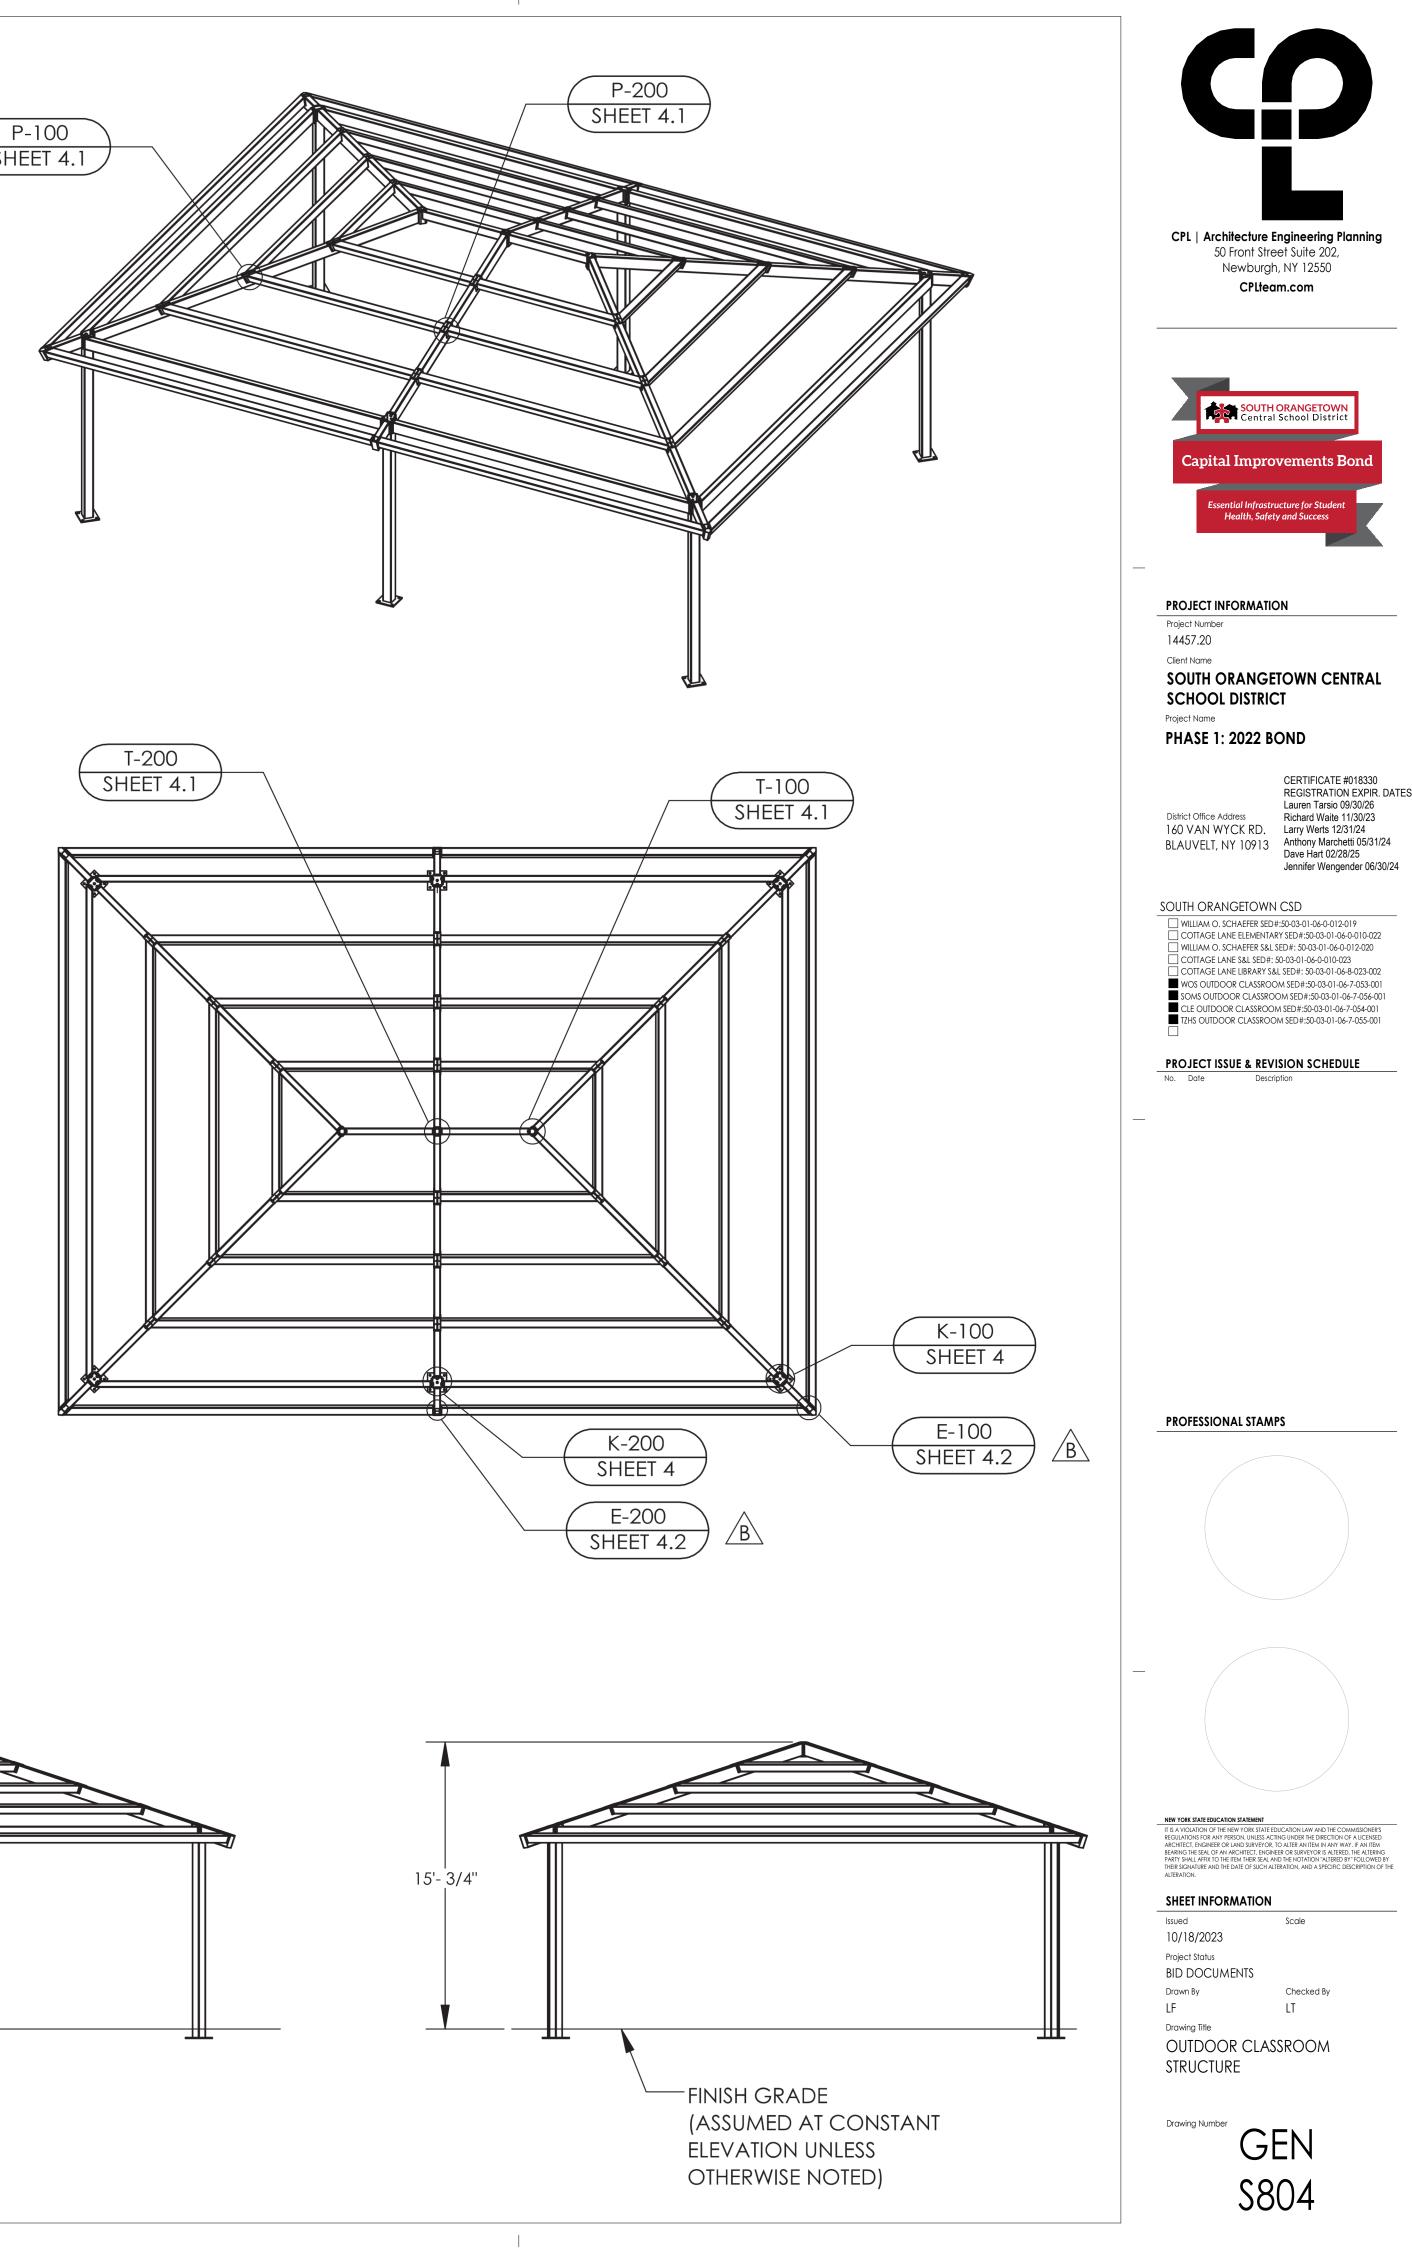

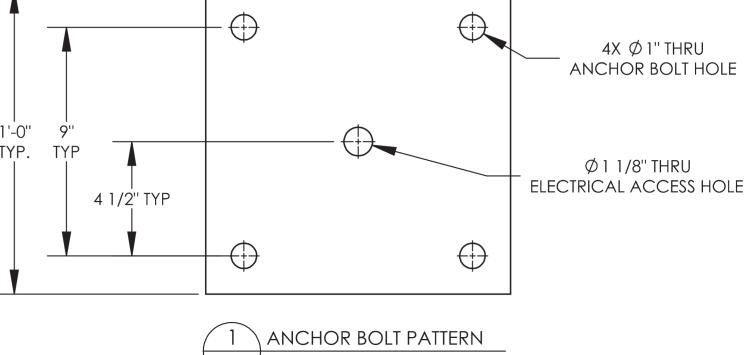


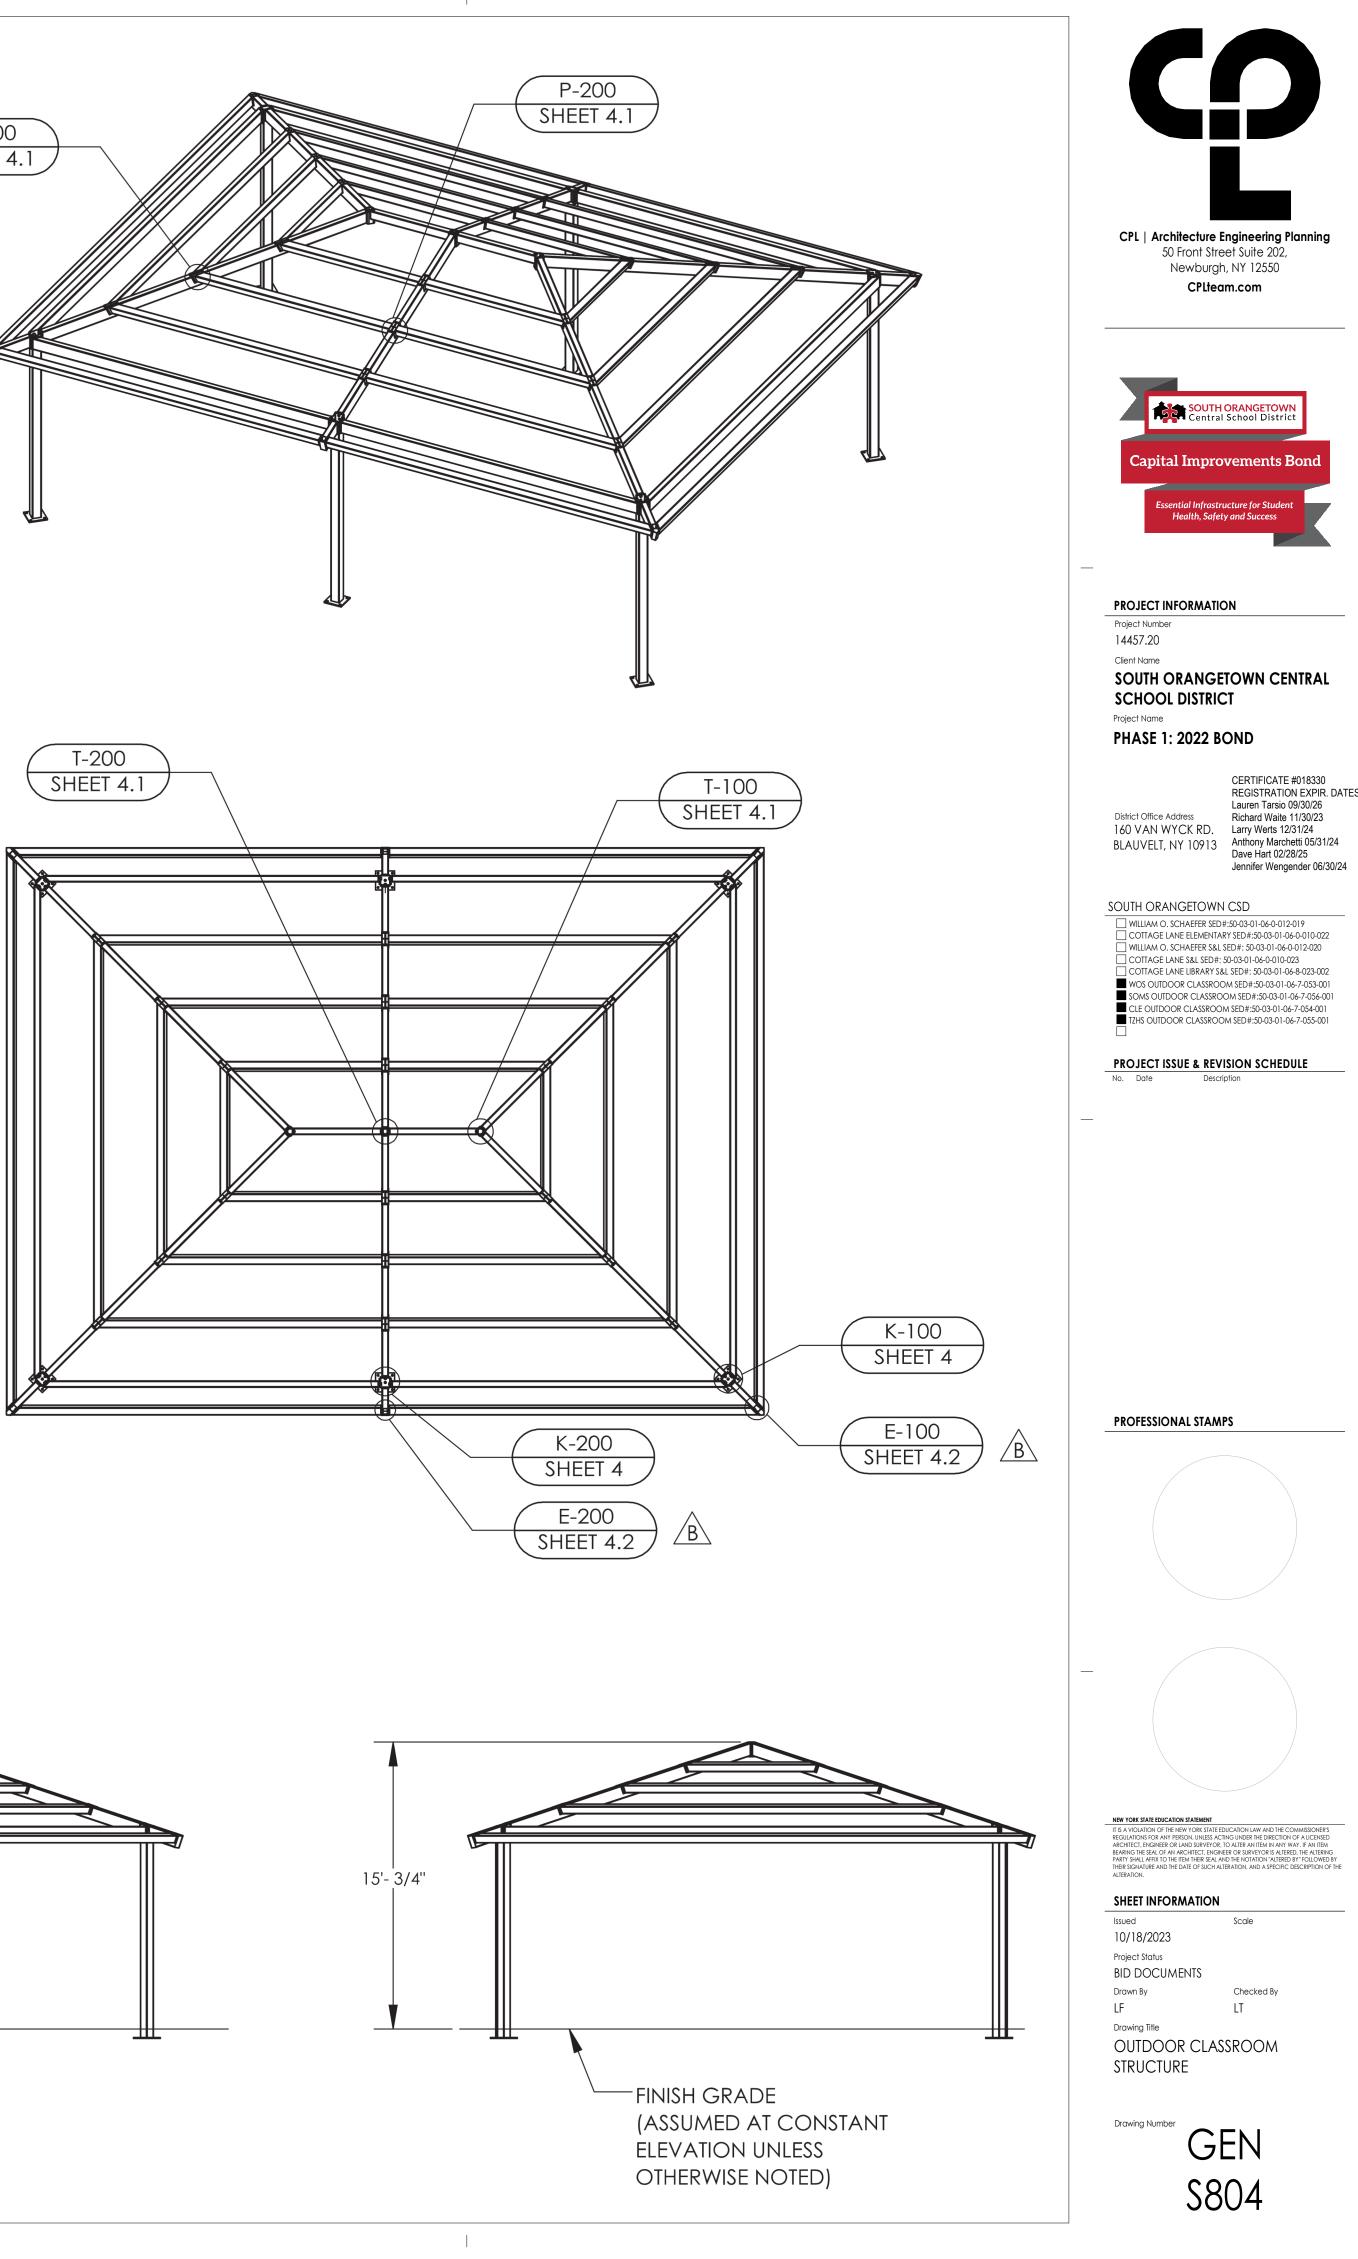

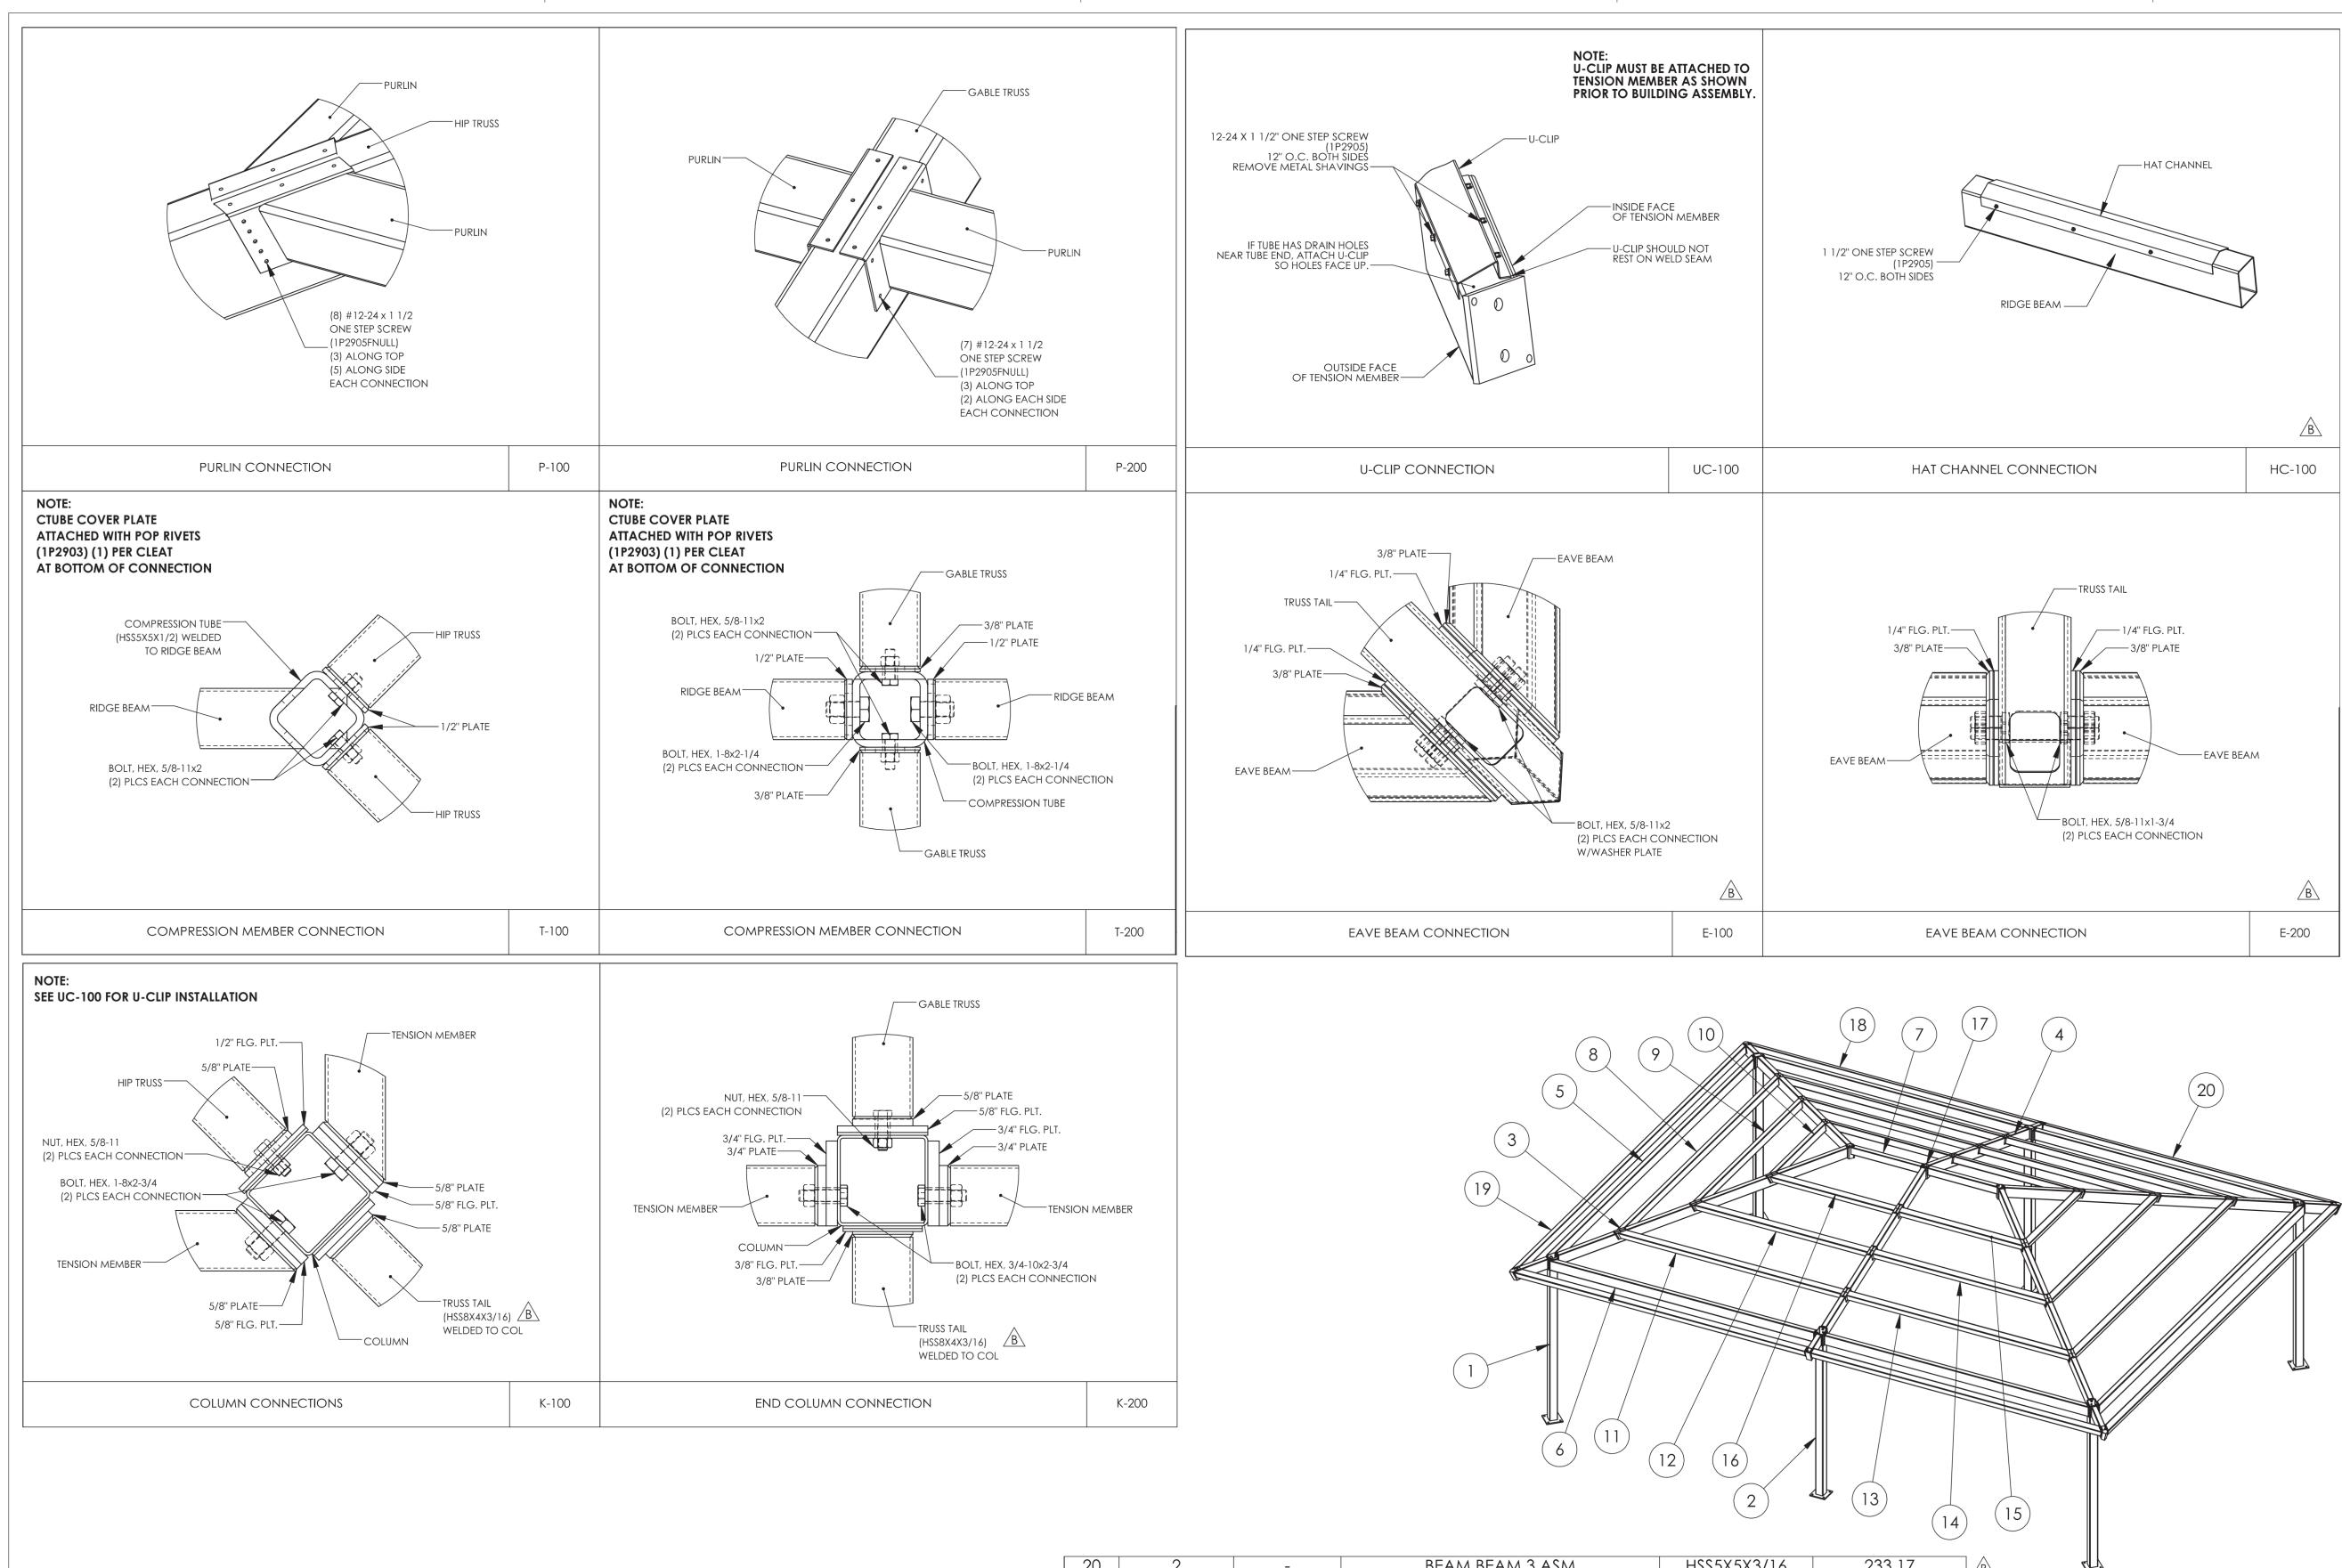

DRAWINGS SHOWN FOR REFERENCE ONLY. STRUCTURE TO BE PROVIDED BY OTHERS AND ERECTED BY GENERAL CONSTRUCTION CONTRACTOR.

233.17 347.67 BEAM BEAM 3 ASM HSS5X5X3/16 -EAVE BEAM 2 ASM HSS5X5X3/16 19 -233.18 HSS5X5X3/16 18 EAVE BEAM 1 ASM -20.08 C-TUBE ASM HSS5X5X1/2 17 -HSS5X5X3/16 99.59 CORNER PURLIN 6 ASM 16 -99.59 HSS5X5X3/16 CORNER PURLIN 5 ASM 15 -HSS5X5X3/16 139.04 CORNER PURLIN 4 ASM 14 -CORNER PURLIN 3 ASM HSS5X5X3/16 178.48 13 -CORNER PURLIN 2 ASM HSS5X5X3/16 139.04 12 -CORNER PURLIN 1 ASM HSS5X5X3/16 178.49 11 -END PURLIN 3 ASM HSS5X5X3/16 79.87 10 -158.76 237.66 END PURLIN 2 ASM HSS5X5X3/16 -HSS5X5X3/16 END PURLIN 1 ASM -78.72 R-BEAM ASM HSS6X4X3/16 -TENSION MEMBER 2 ASM HSS8X4X3/16 264.73 6 _ 383.34 TENSION MEMBER 1 ASM HSS8X4X3/16 -200.20 273.42 GABLE TRUSS ASM HSS8X4X3/16 -HIP TRUSS ASM HSS8X4X3/16 -250.70 SIDE COLUMN ASM HSS6X6X3/16 -CORNER COLUMN ASM 261.87 HSS6X6X3/16 -ITEM FRAME/QTY. PART NO. DESCRIPTION MATERIAL WEIGHT

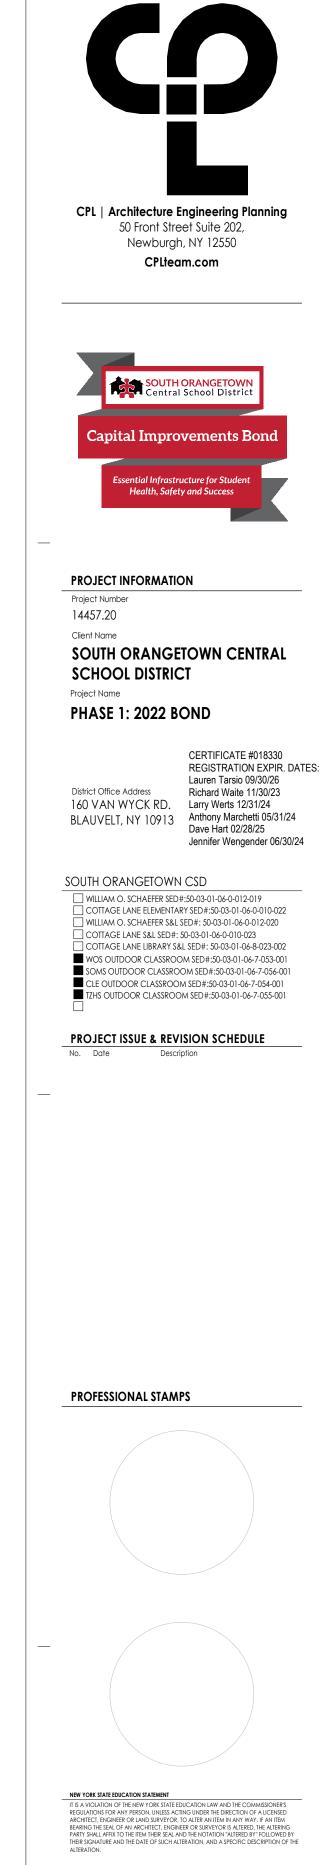


SHEET INFORMATION

STRUCTURE

Issued Scale 10/18/2023 Project Status **BID DOCUMENTS** Drawn By Checked B ΙF Drawing Title OUTDOOR CLASSROOM

Drawing Number GEN S805

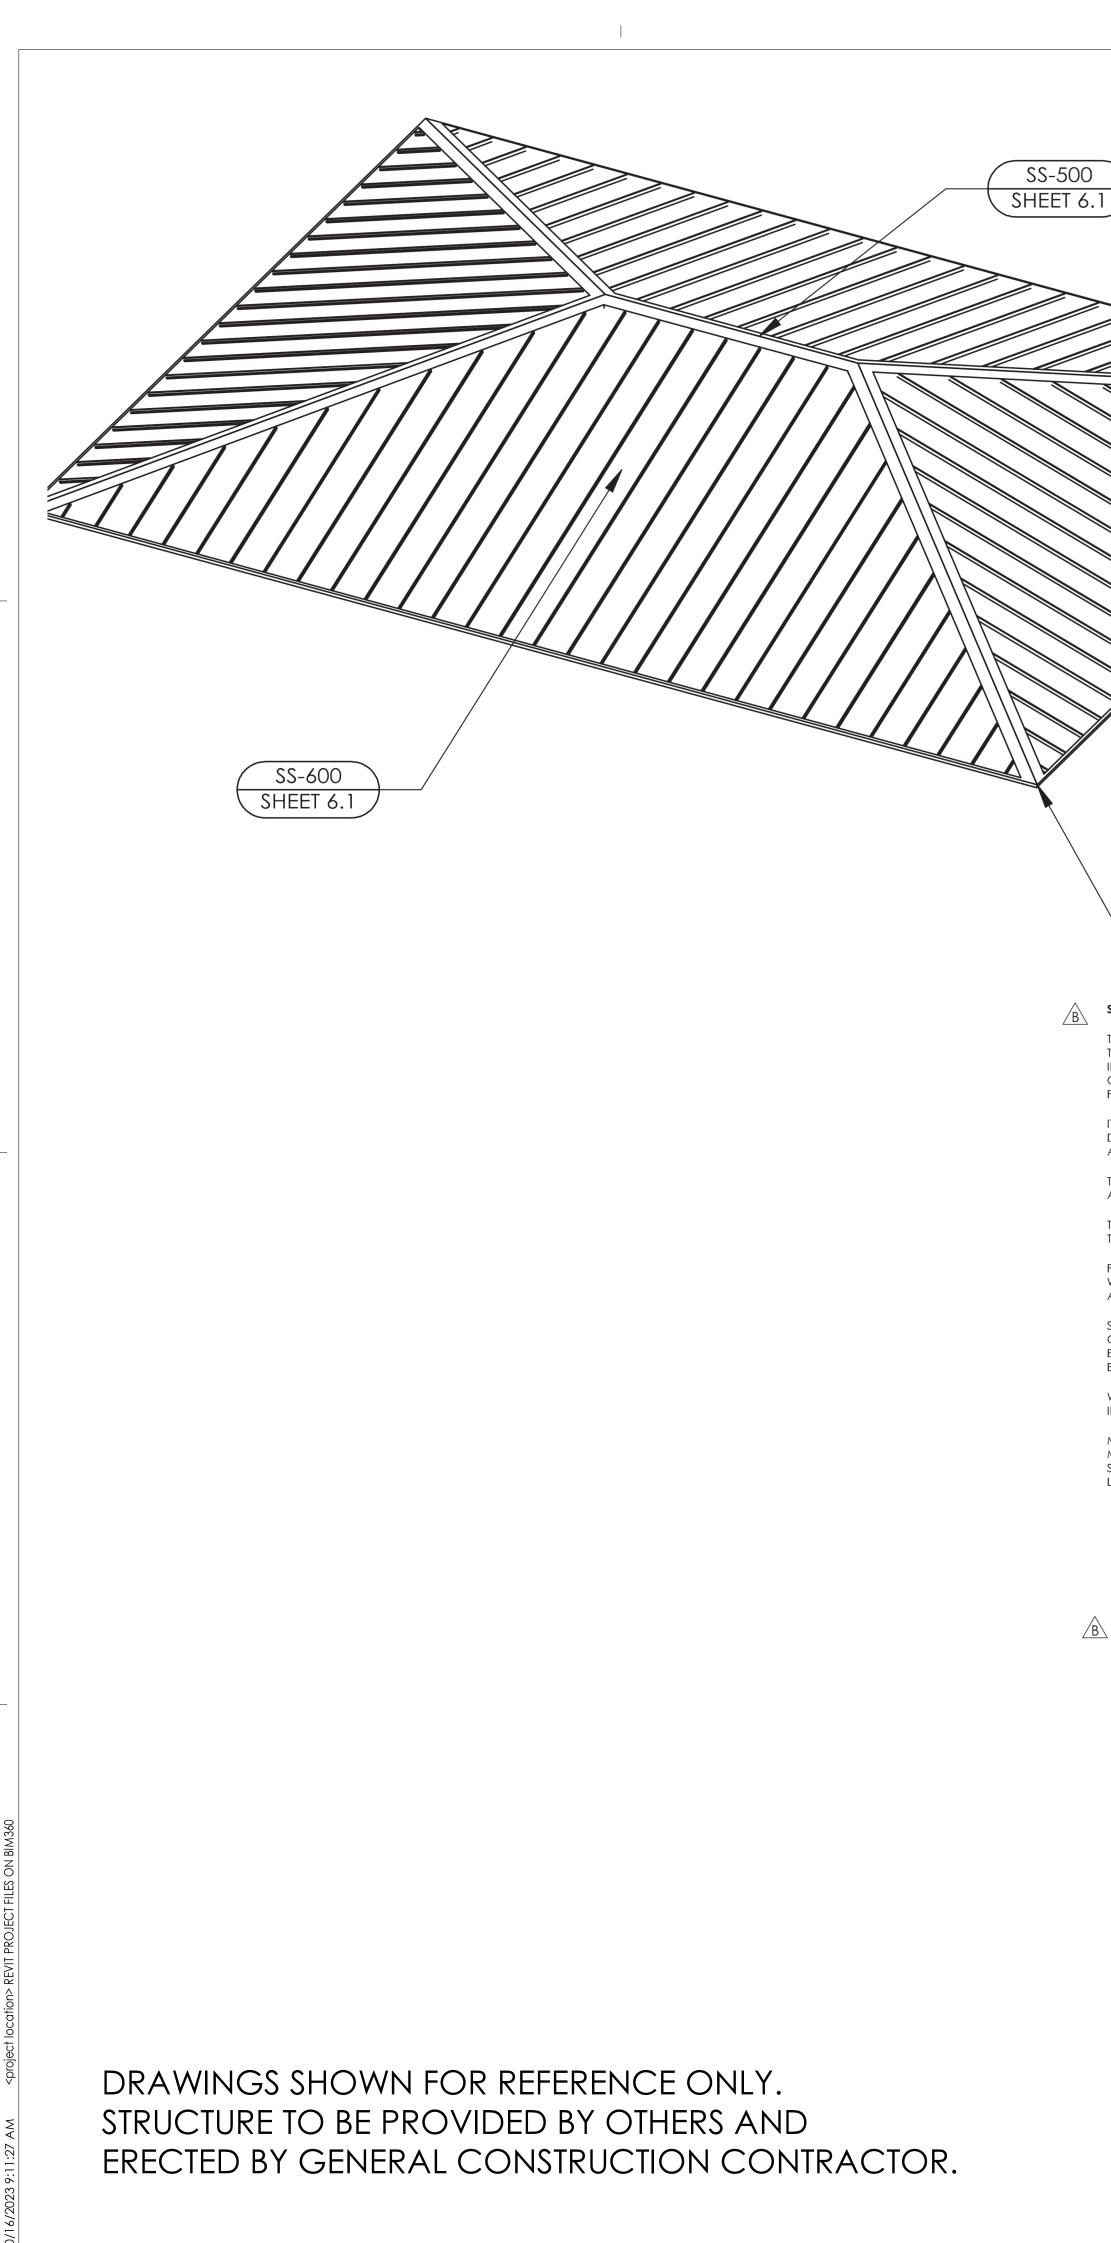

SS-300 SHEET 6 SS-101 SHEET 6

<u>B</u>

STANDING SEAM INSTALLATION NOTES:

THE DETAILS SHOWN ARE SUGGESTIONS OR GUIDELINES ON HOW TO ERECT THE SYSTEMS. THE INFORMATION SHOWN IS ACCURATE, BUT IT IS NOT INTENDED TO COVER ALL INSTANCES, BUILDING REQUIREMENTS, DESIGNS OR CODES. THE DETAILS MAY REQUIRE CHANGES OR REVISIONS DUE TO FIELD CONDITIONS.

IT SHALL BE THE RESPONSIBILITY OF THE ERECTOR TO ENSURE THAT THE DETAILS MEET PARTICULAR BUILDING REQUIREMENTS AND TO ASSURE ADEQUATE WATER TIGHTNESS.

THE ERECTOR SHOULD THOROUGHLY FAMILIARIZE HIMSELF/HERSELF WITH ALL ERECTION INSTRUCTIONS BEFORE STARTING WORK.

THE PANELS SHOULD BE INSTALLED PLUMB, STRAIGHT, AND ACCURATELY TO THE ADJACENT WORK.

FLASHING AND TRIM SHALL BE INSTALLED TRUE, AND IN PROPER ALIGNMENT, WITH ANY EXPOSED FASTENERS EQUALLY SPACED FOR THE BEST APPEARANCE.

SEALANT SHALL BE FIELD APPLIED ON DRY, CLEAN SURFACES. SOME FIELD CUTTING AND FITTING OF PANELS AND FLASHING IS TO BE EXPECTED BY THE ERECTOR AND MINOR FIELD CORRECTIONS ARE A PART OF NORMAL ERECTION WORK.

WORKMANSHIP SHALL BE OF THE BEST INDUSTRY STANDARDS AND INSTALLATION SHALL BE PERFORMED BY EXPERIENCED METAL CRAFTSMEN.

METAL SHAVINGS FROM DRILLING OR INSTALLATION OF ROOF FASTENERS MUST BE CAREFULLY REMOVED FROM THE ROOF BY BRUSHING OR SWEEPING AT THE END OF EACH DAY DURING INSTALLATION. SHAVINGS LEFT ON THE ROOF WILL QUICKLY RUST AND STAIN THE ROOF FINISH.

STANDING SEAM INSTALLATION NOTES:

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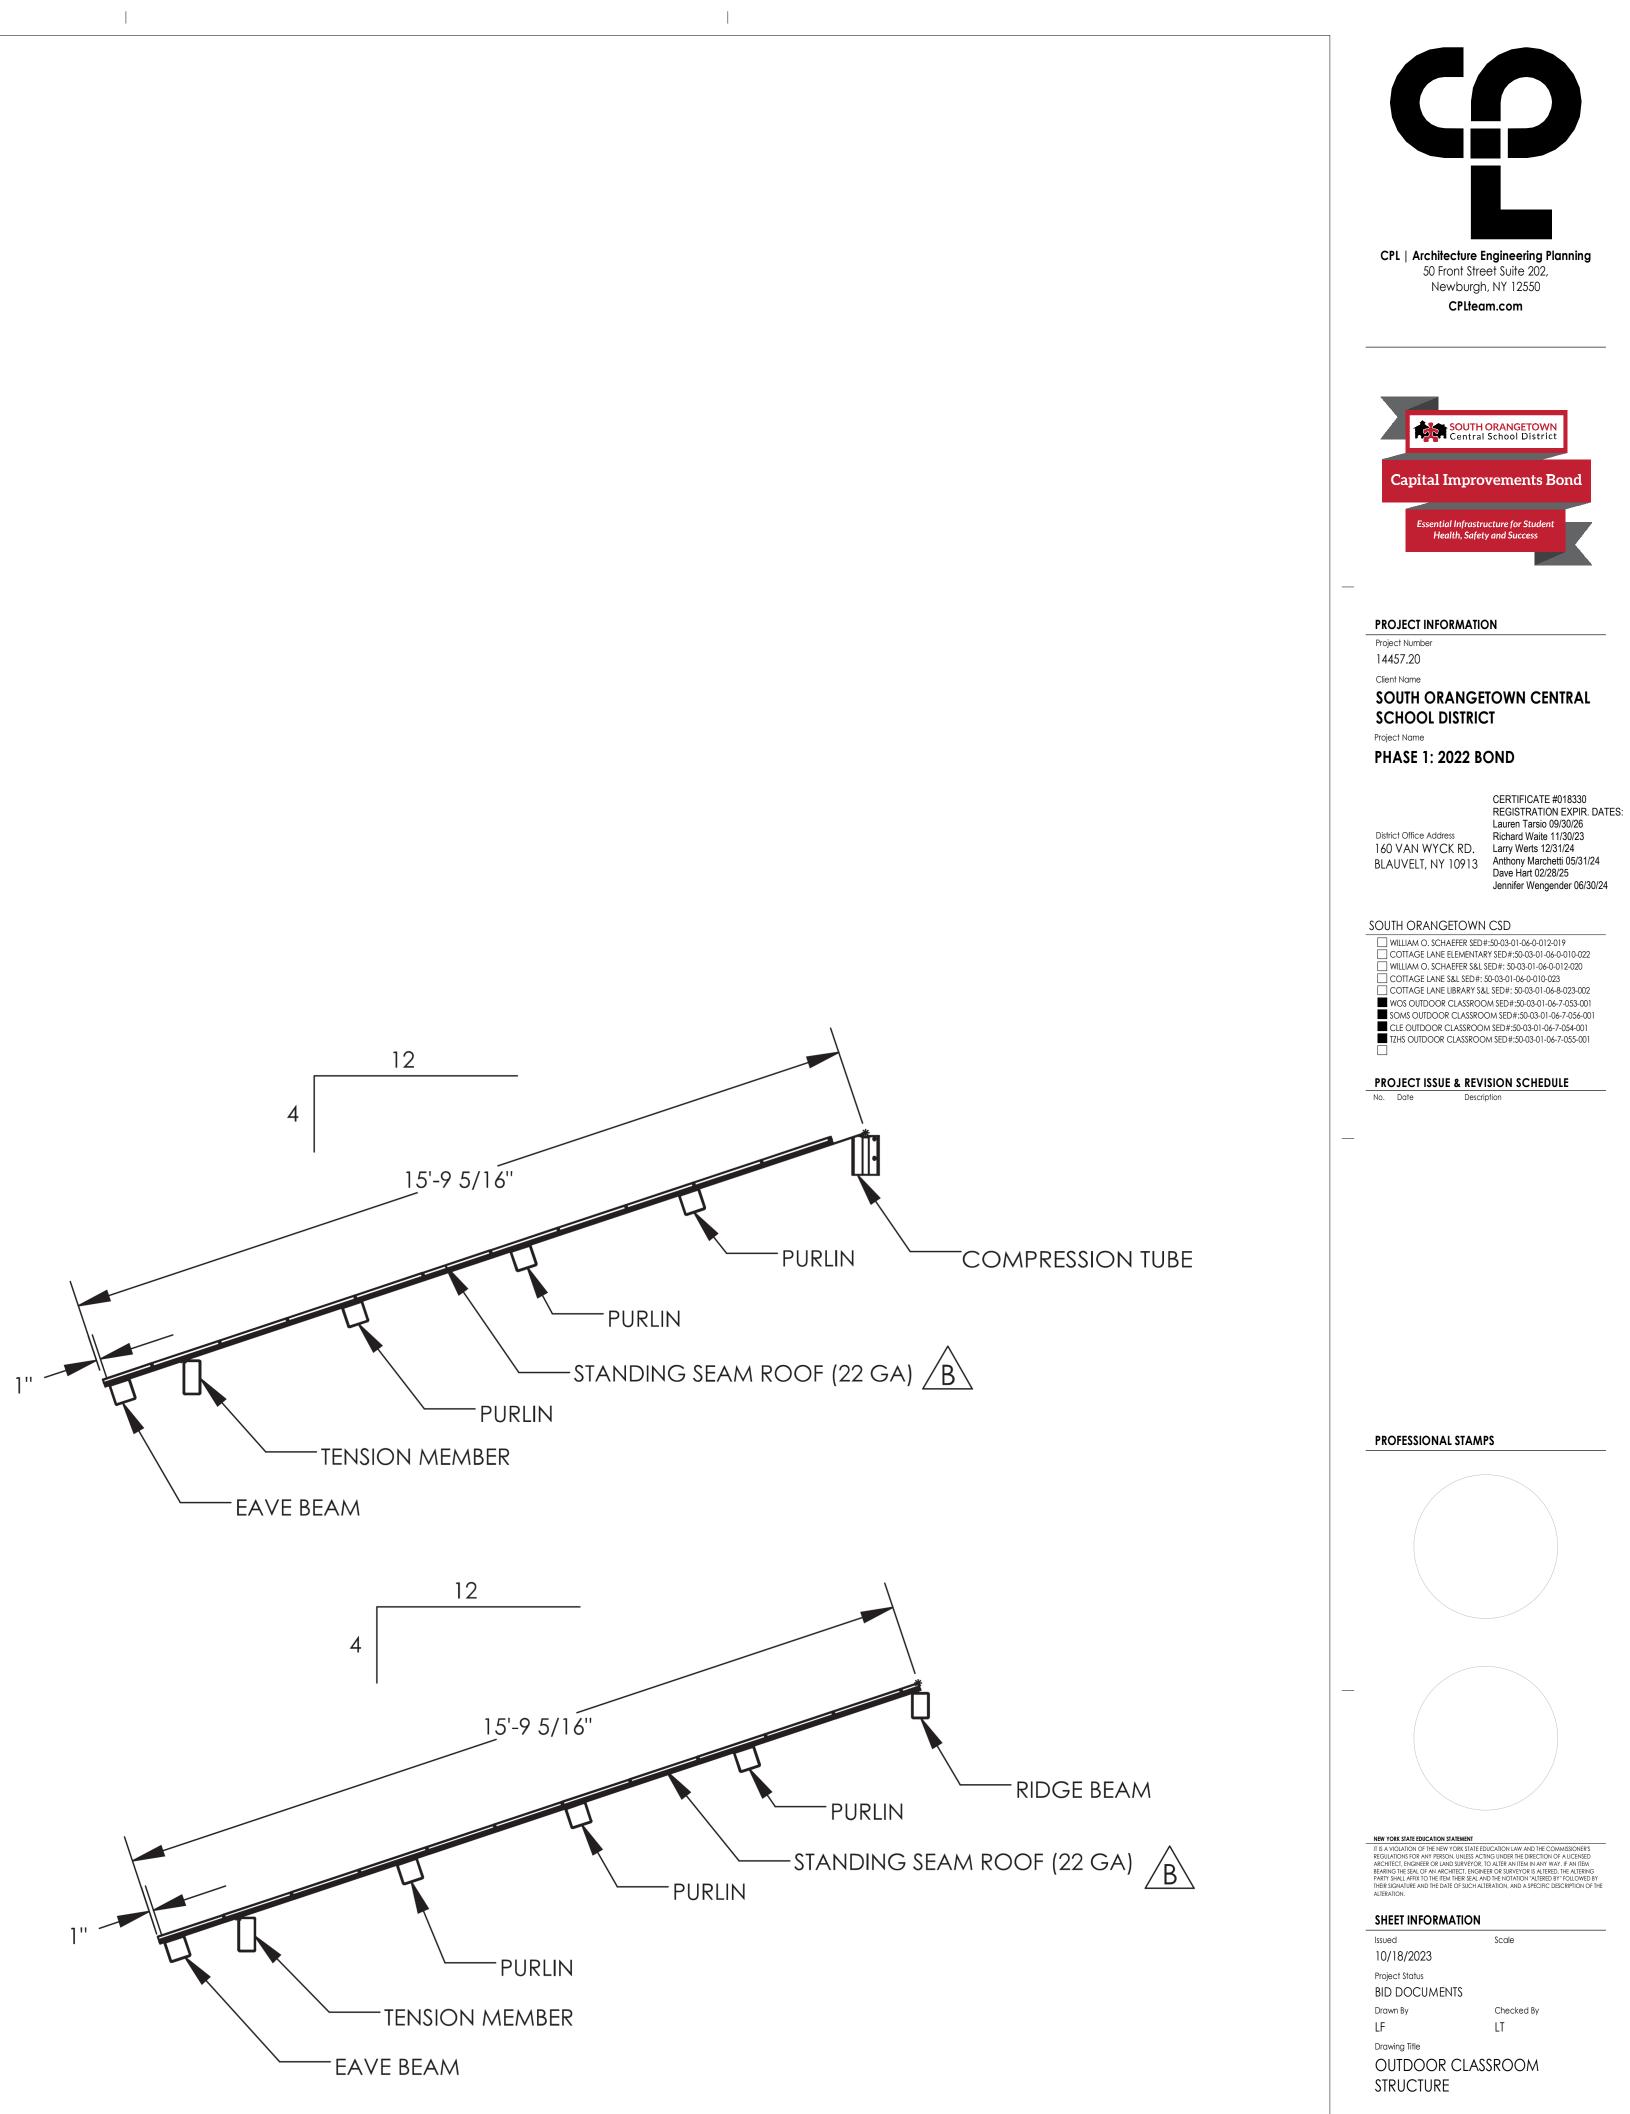
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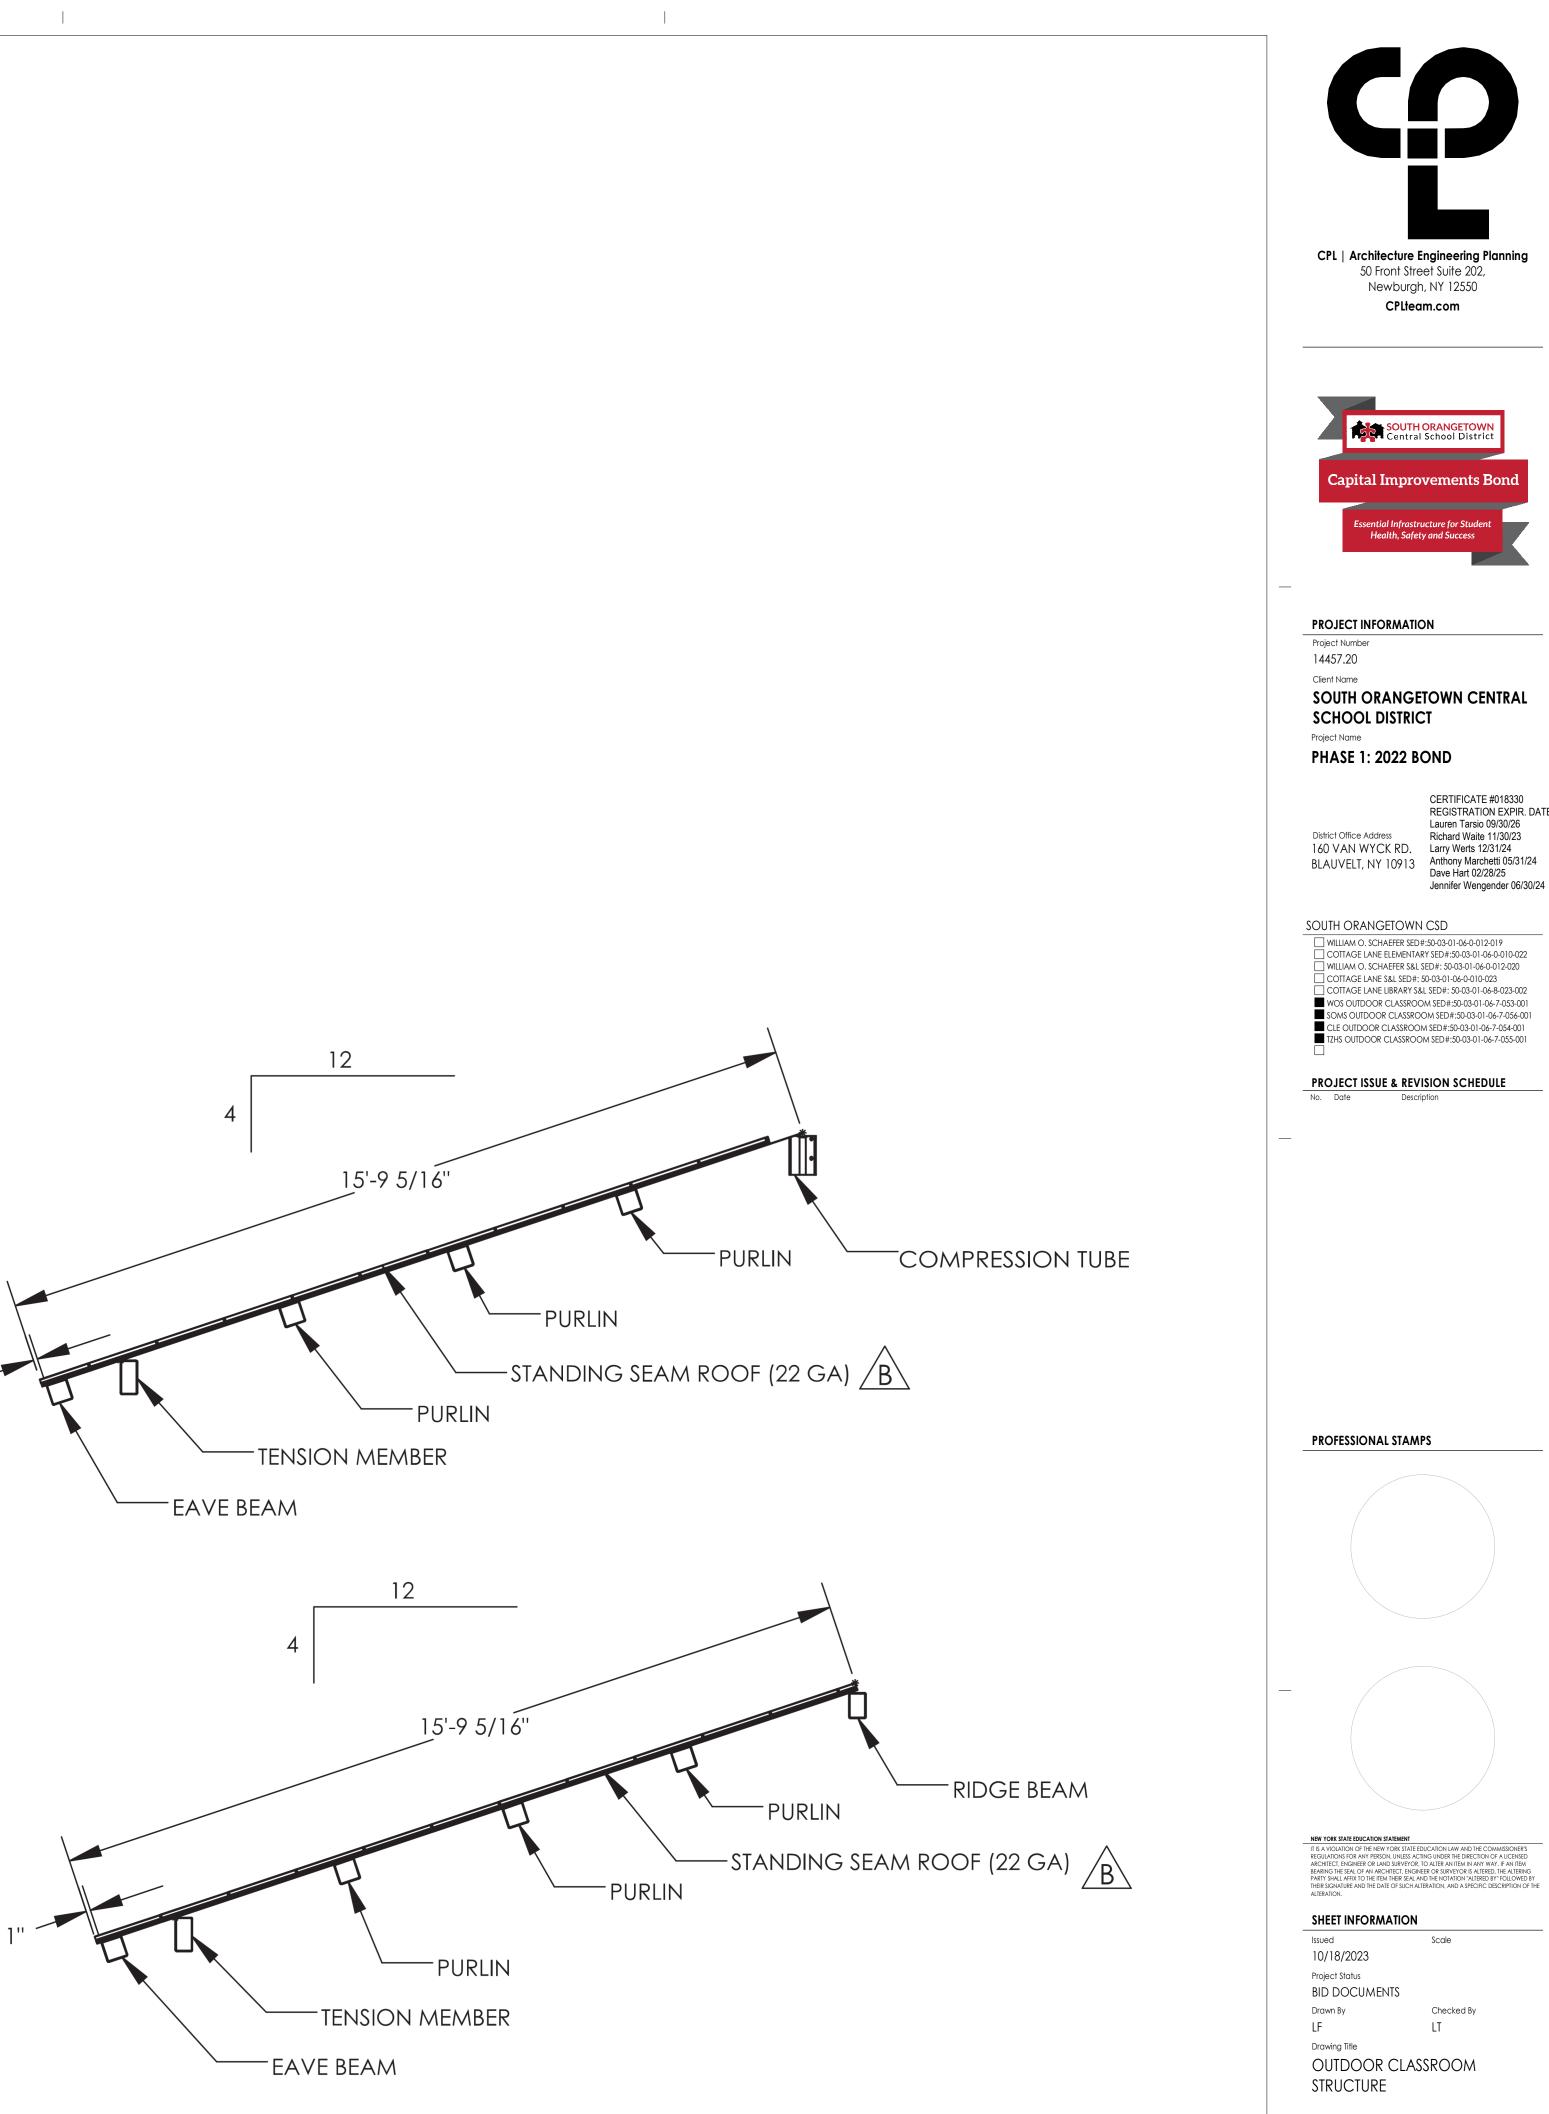
FLASHING AND TRIM SHALL BE INSTALLED TRUE, AND IN PROPER ALIGNMENT, WITH ANY EXPOSED FASTENERS EQUALLY SPACED FOR THE BEST APPEARANCE.

SEALANT SHALL BE FIELD APPLIED ON DRY, CLEAN SURFACES. SOME FIELD CUTTING AND FITTING OF PANELS AND FLASHING IS TO BE EXPECTED BY THE ERECTOR AND MINOR FIELD CORRECTIONS ARE A PART OF NORMAL ERECTION WORK.


WORKMANSHIP SHALL BE OF THE BEST INDUSTRY STANDARDS AND INSTALLATION SHALL BE PERFORMED BY EXPERIENCED METAL CRAFTSMEN.


METAL SHAVINGS FROM DRILLING OR INSTALLATION OF ROOF FASTENERS MUST BE CAREFULLY REMOVED FROM THE ROOF BY BRUSHING OR SWEEPING AT THE END OF EACH DAY DURING INSTALLATION. SHAVINGS LEFT ON THE ROOF WILL QUICKLY RUST AND STAIN THE ROOF FINISH.






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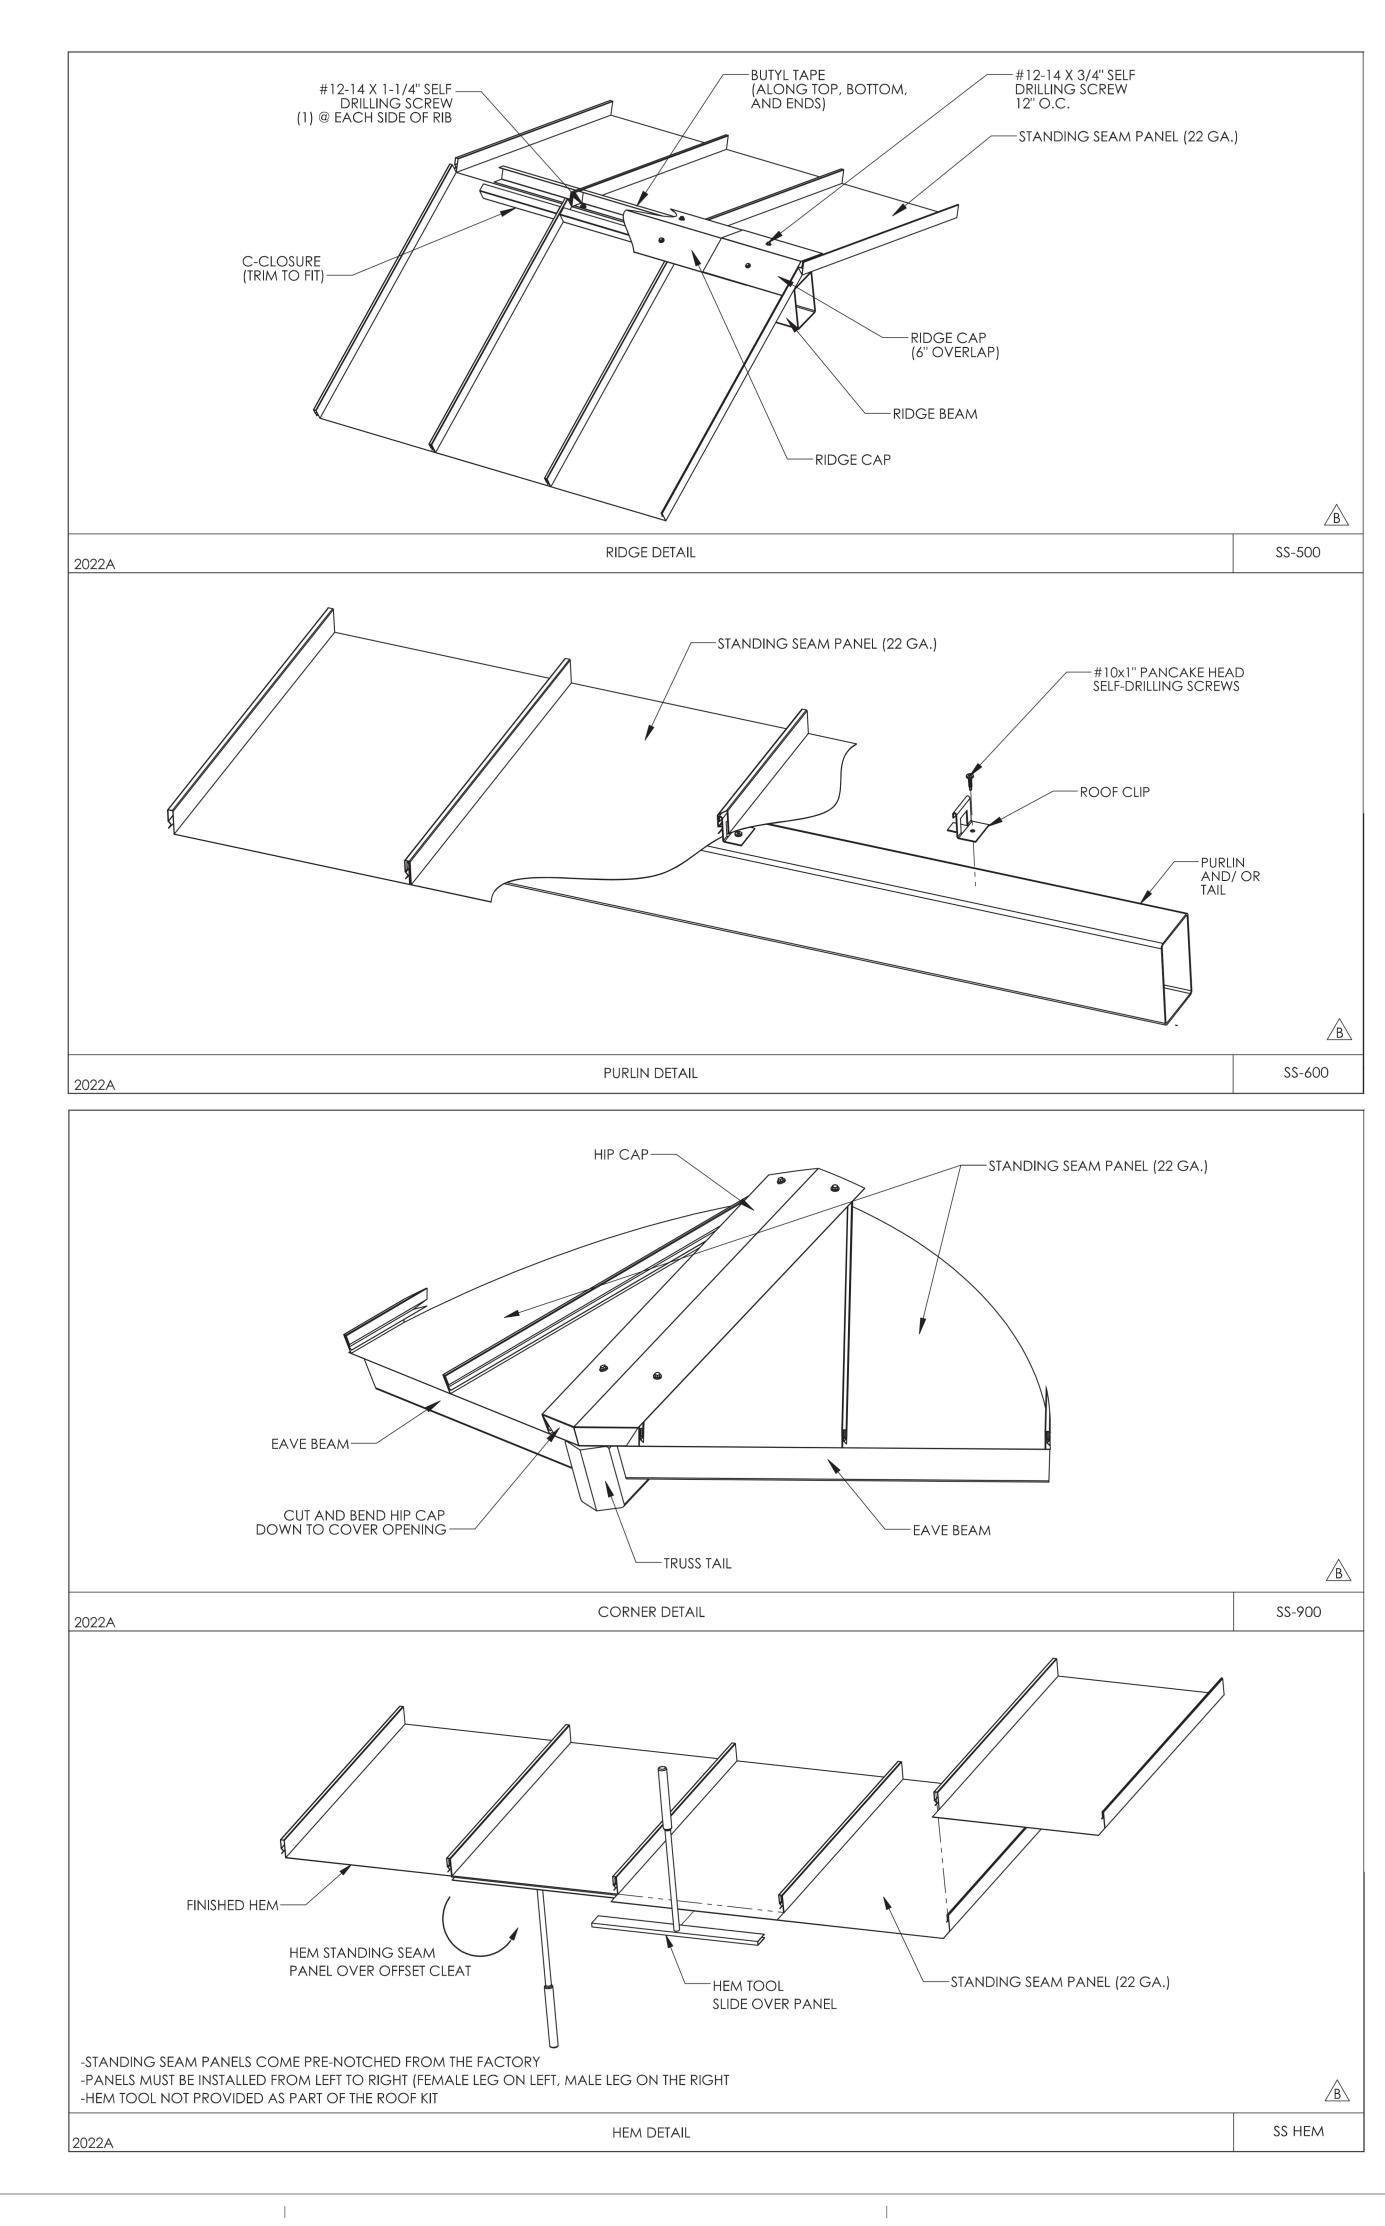


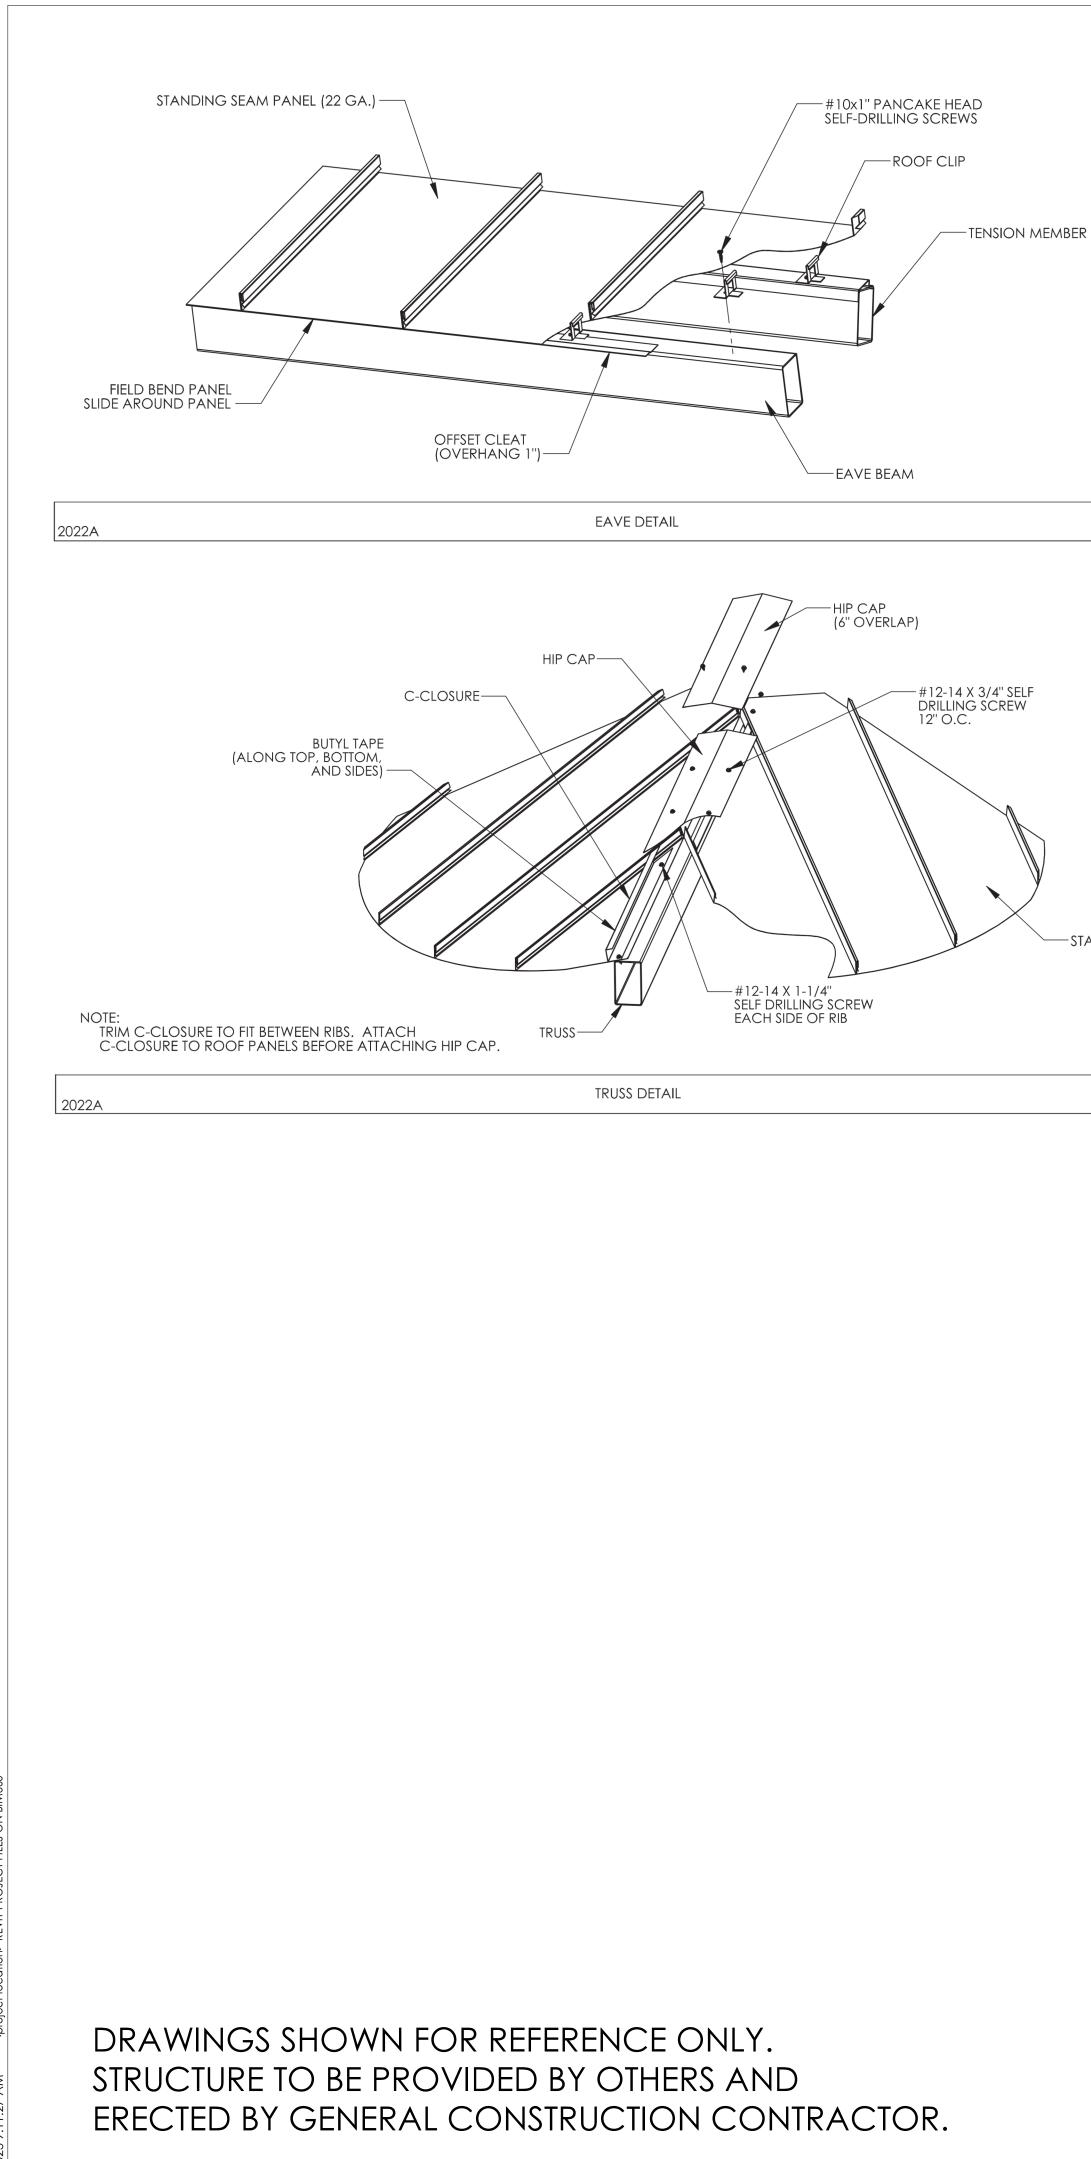

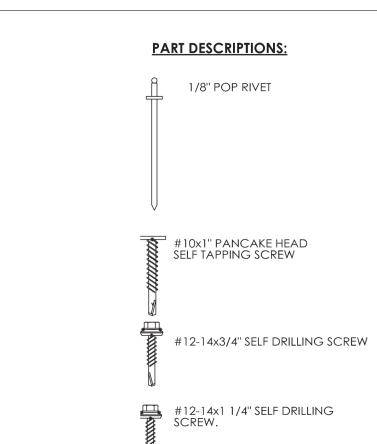


-STANDING SEAM PANEL (22 GA.)



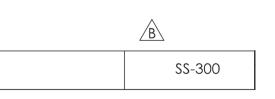



gineering Planning t Suite 202, NY 12550 A.com RANGETOWN chool District ements Bond ture for Student and Success COWN CENTRAL M CERTIFICATE #018330 REGISTRATION EXPIR. DA Lauren Tarsio 09/30/26 Richard Waite 11/30/23 Larry Werts 12/31/24 Anthony Marchetti 05/31/24 Dave Hart 02/28/25 Jennifer Wengender 06/30/2 CSD 60:03-01-06-0-012-019 SED#:50:03-01-06-0-010-022 DE: 50:03-01-06-0-012-020 -03-01-06-0-012-019 SED#:50:03-01-06-7-055-001 SED#:50:03-01-06-7-055-001 SED#:50:03-01-06-7-055-001 SED#:50:03-01-06-7-055-001 SED#:50:03-01-06-7-055-001
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Checked By LT
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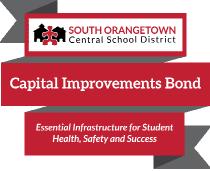
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PROJECT INFORMATION Project Number 14457.20 Client Name SOUTH ORANGETOWN CENTRAL SCHOOL DISTRICT

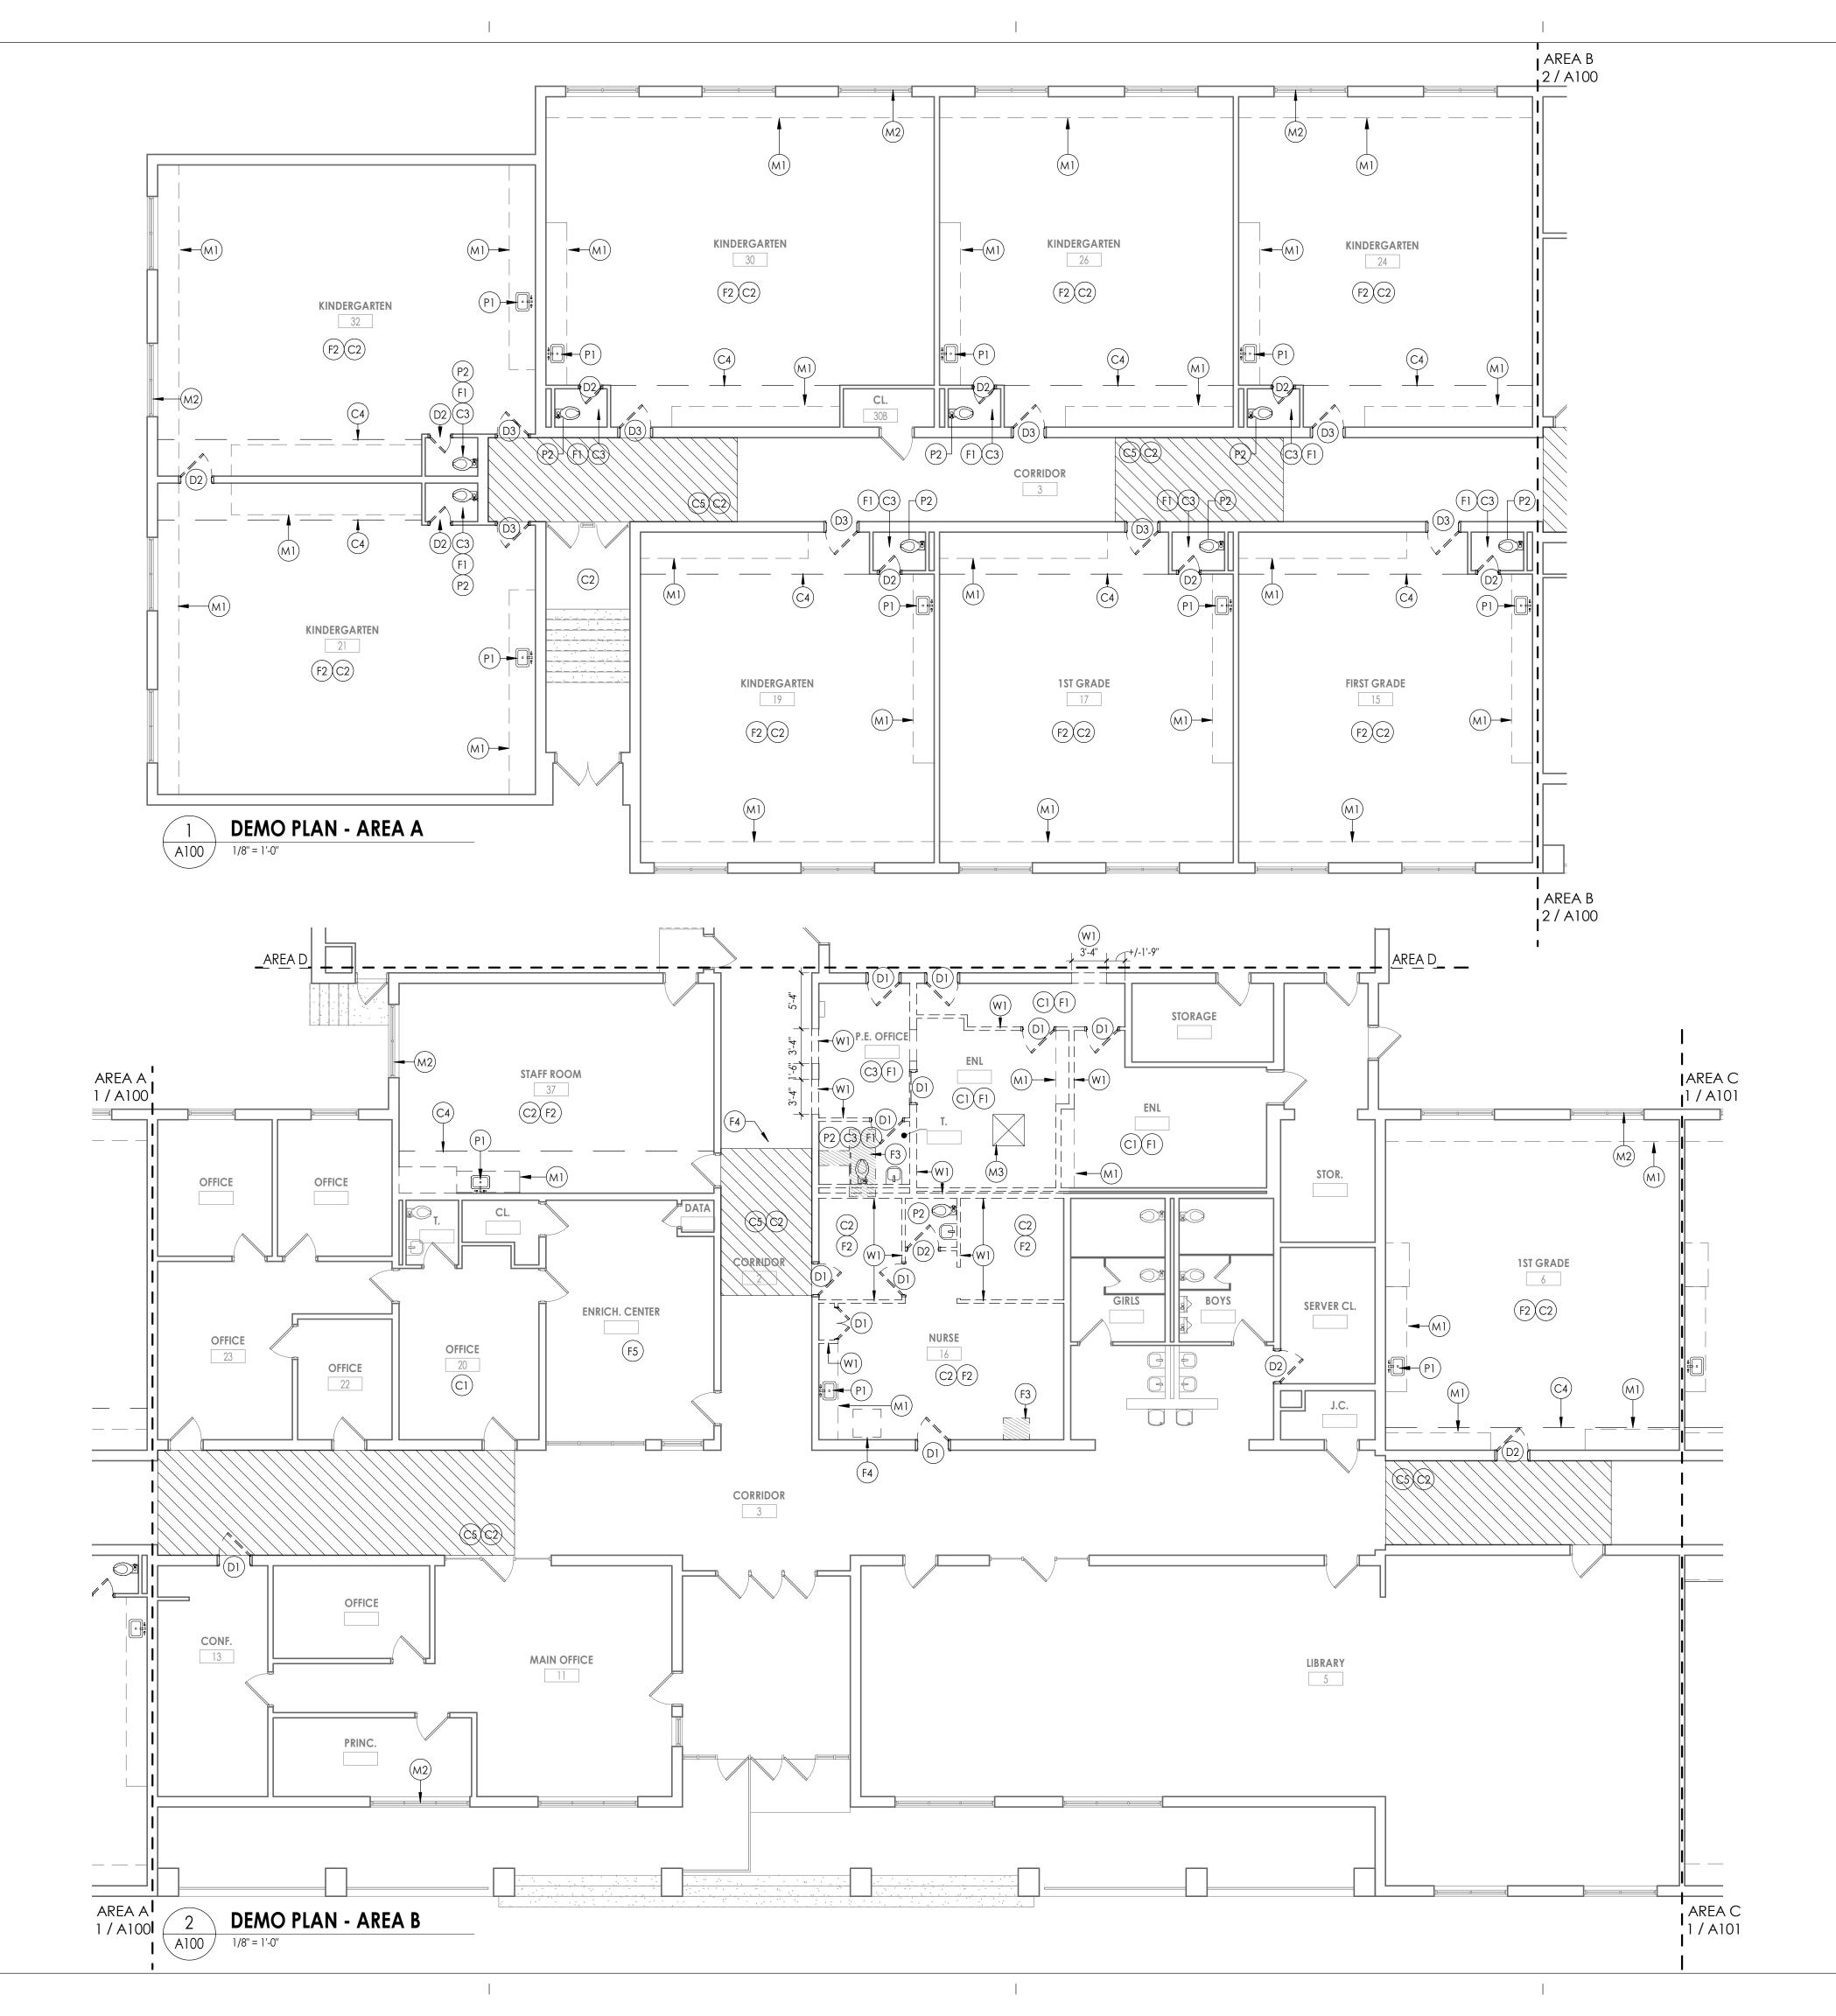PHASE 1: 2022 BOND

Project Name

CERTIFICATE #018330 District Office Address

REGISTRATION EXPIR. DATES: Lauren Tarsio 09/30/26 Richard Waite 11/30/23 160 VAN WYCK RD. Larry Werts 12/31/24 BLAUVELT, NY 10913 Anthony Marchetti 05/31/24 Dave Hart 02/28/25

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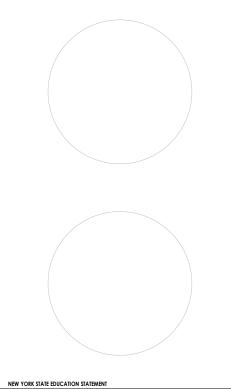
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TZHS OUTDOOR CLASSROOM SED#:50-03-01-06-7-055-001

PROJECT ISSUE & REVISION SCHEDULE No. Date

PROFESSIONAL STAMPS



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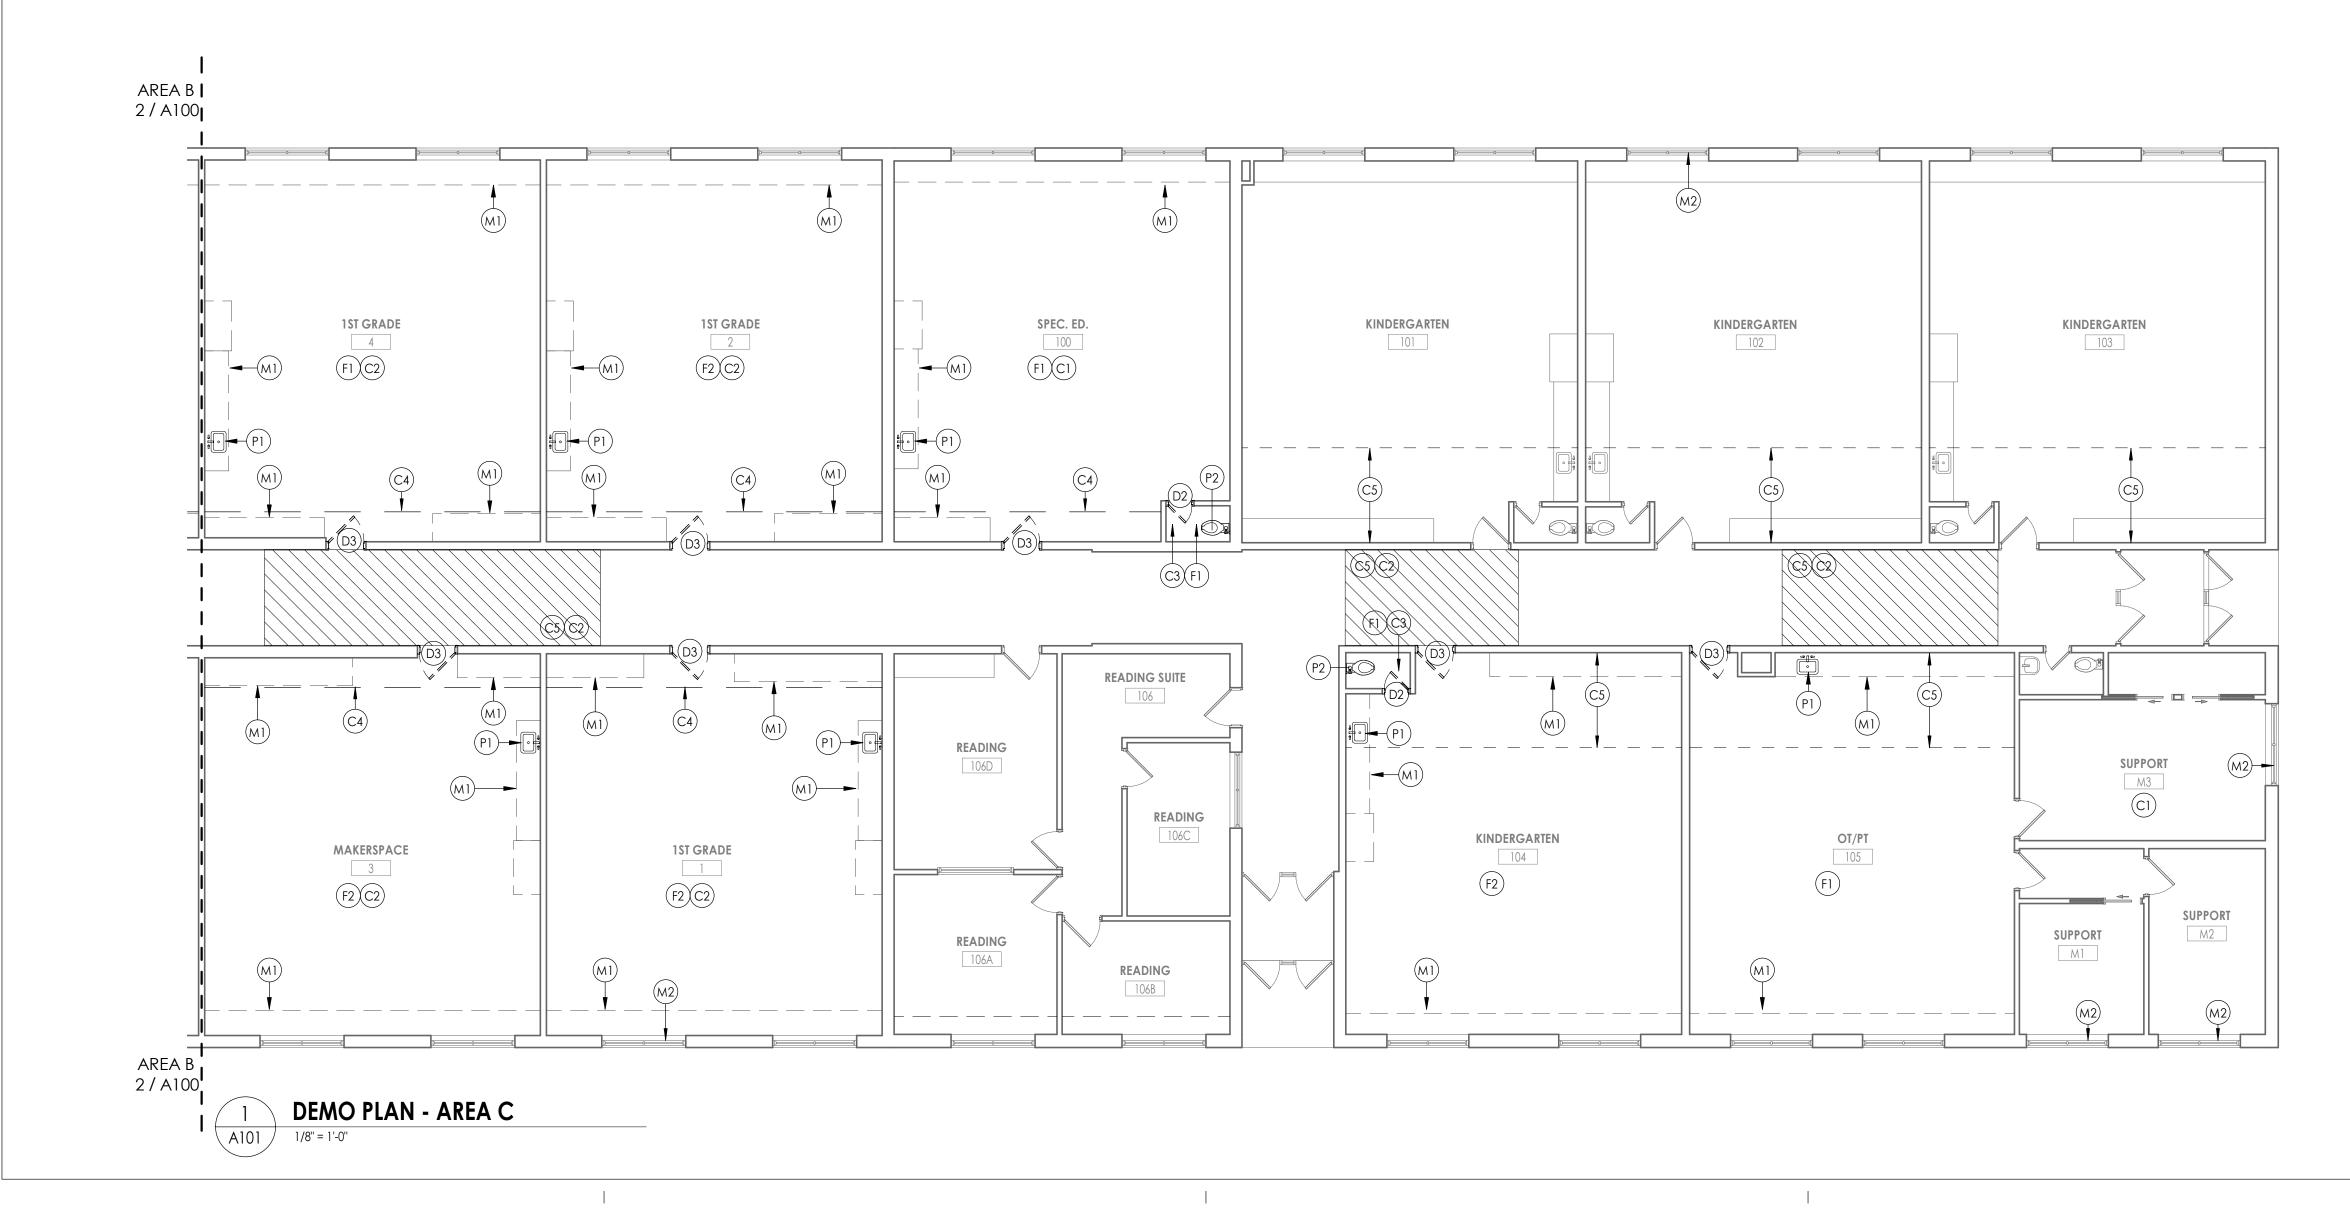
SHEET INFORMATION

Issued	Scale
10/18/23	As indicated
Project Status	
BID DOCUMENTS	
Drawn By	Checked By
LF	LT
Drawing Title	

DEMOLITION PLAN - AREA A&B

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	A100

<u>KEY PLAN:</u>		Z
	E	F
	D	
Α	В	C



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CERTIFICATE #018330 REGISTRATION EXPIR. DATES: Lauren Tarsio 09/30/26 Richard Waite 11/30/23 160 VAN WYCK RD. Larry Werts 12/31/24 BLAUVELT, NY 10913 Anthony Marchetti 05/31/24 Dave Hart 02/28/25 Jennifer Wengender 06/30/24


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PROJECT ISSUE & REVISION SCHEDULE No. Date Description

PROFESSIONAL STAMPS




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SHEET INFORMATION

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10/18/23	As indicated
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Drawn By	Checked By
LF	LT
Drawing Title	
DEMOLITION PLAN - AREA C	

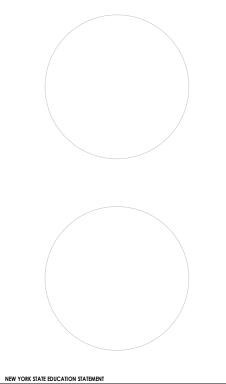Drawing Number WOS A101



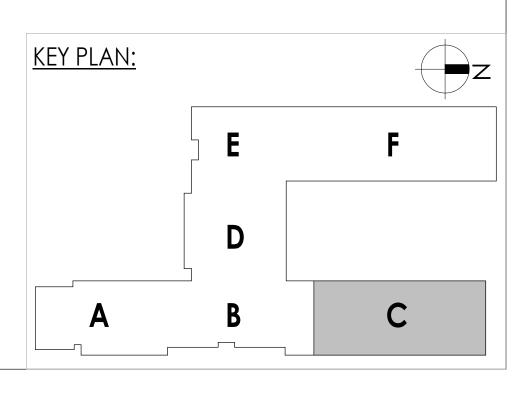

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PHASE 1: 2022 BOND

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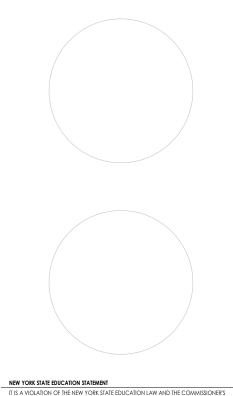
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PROJECT ISSUE & REVISION SCHEDULE No. Date

PROFESSIONAL STAMPS




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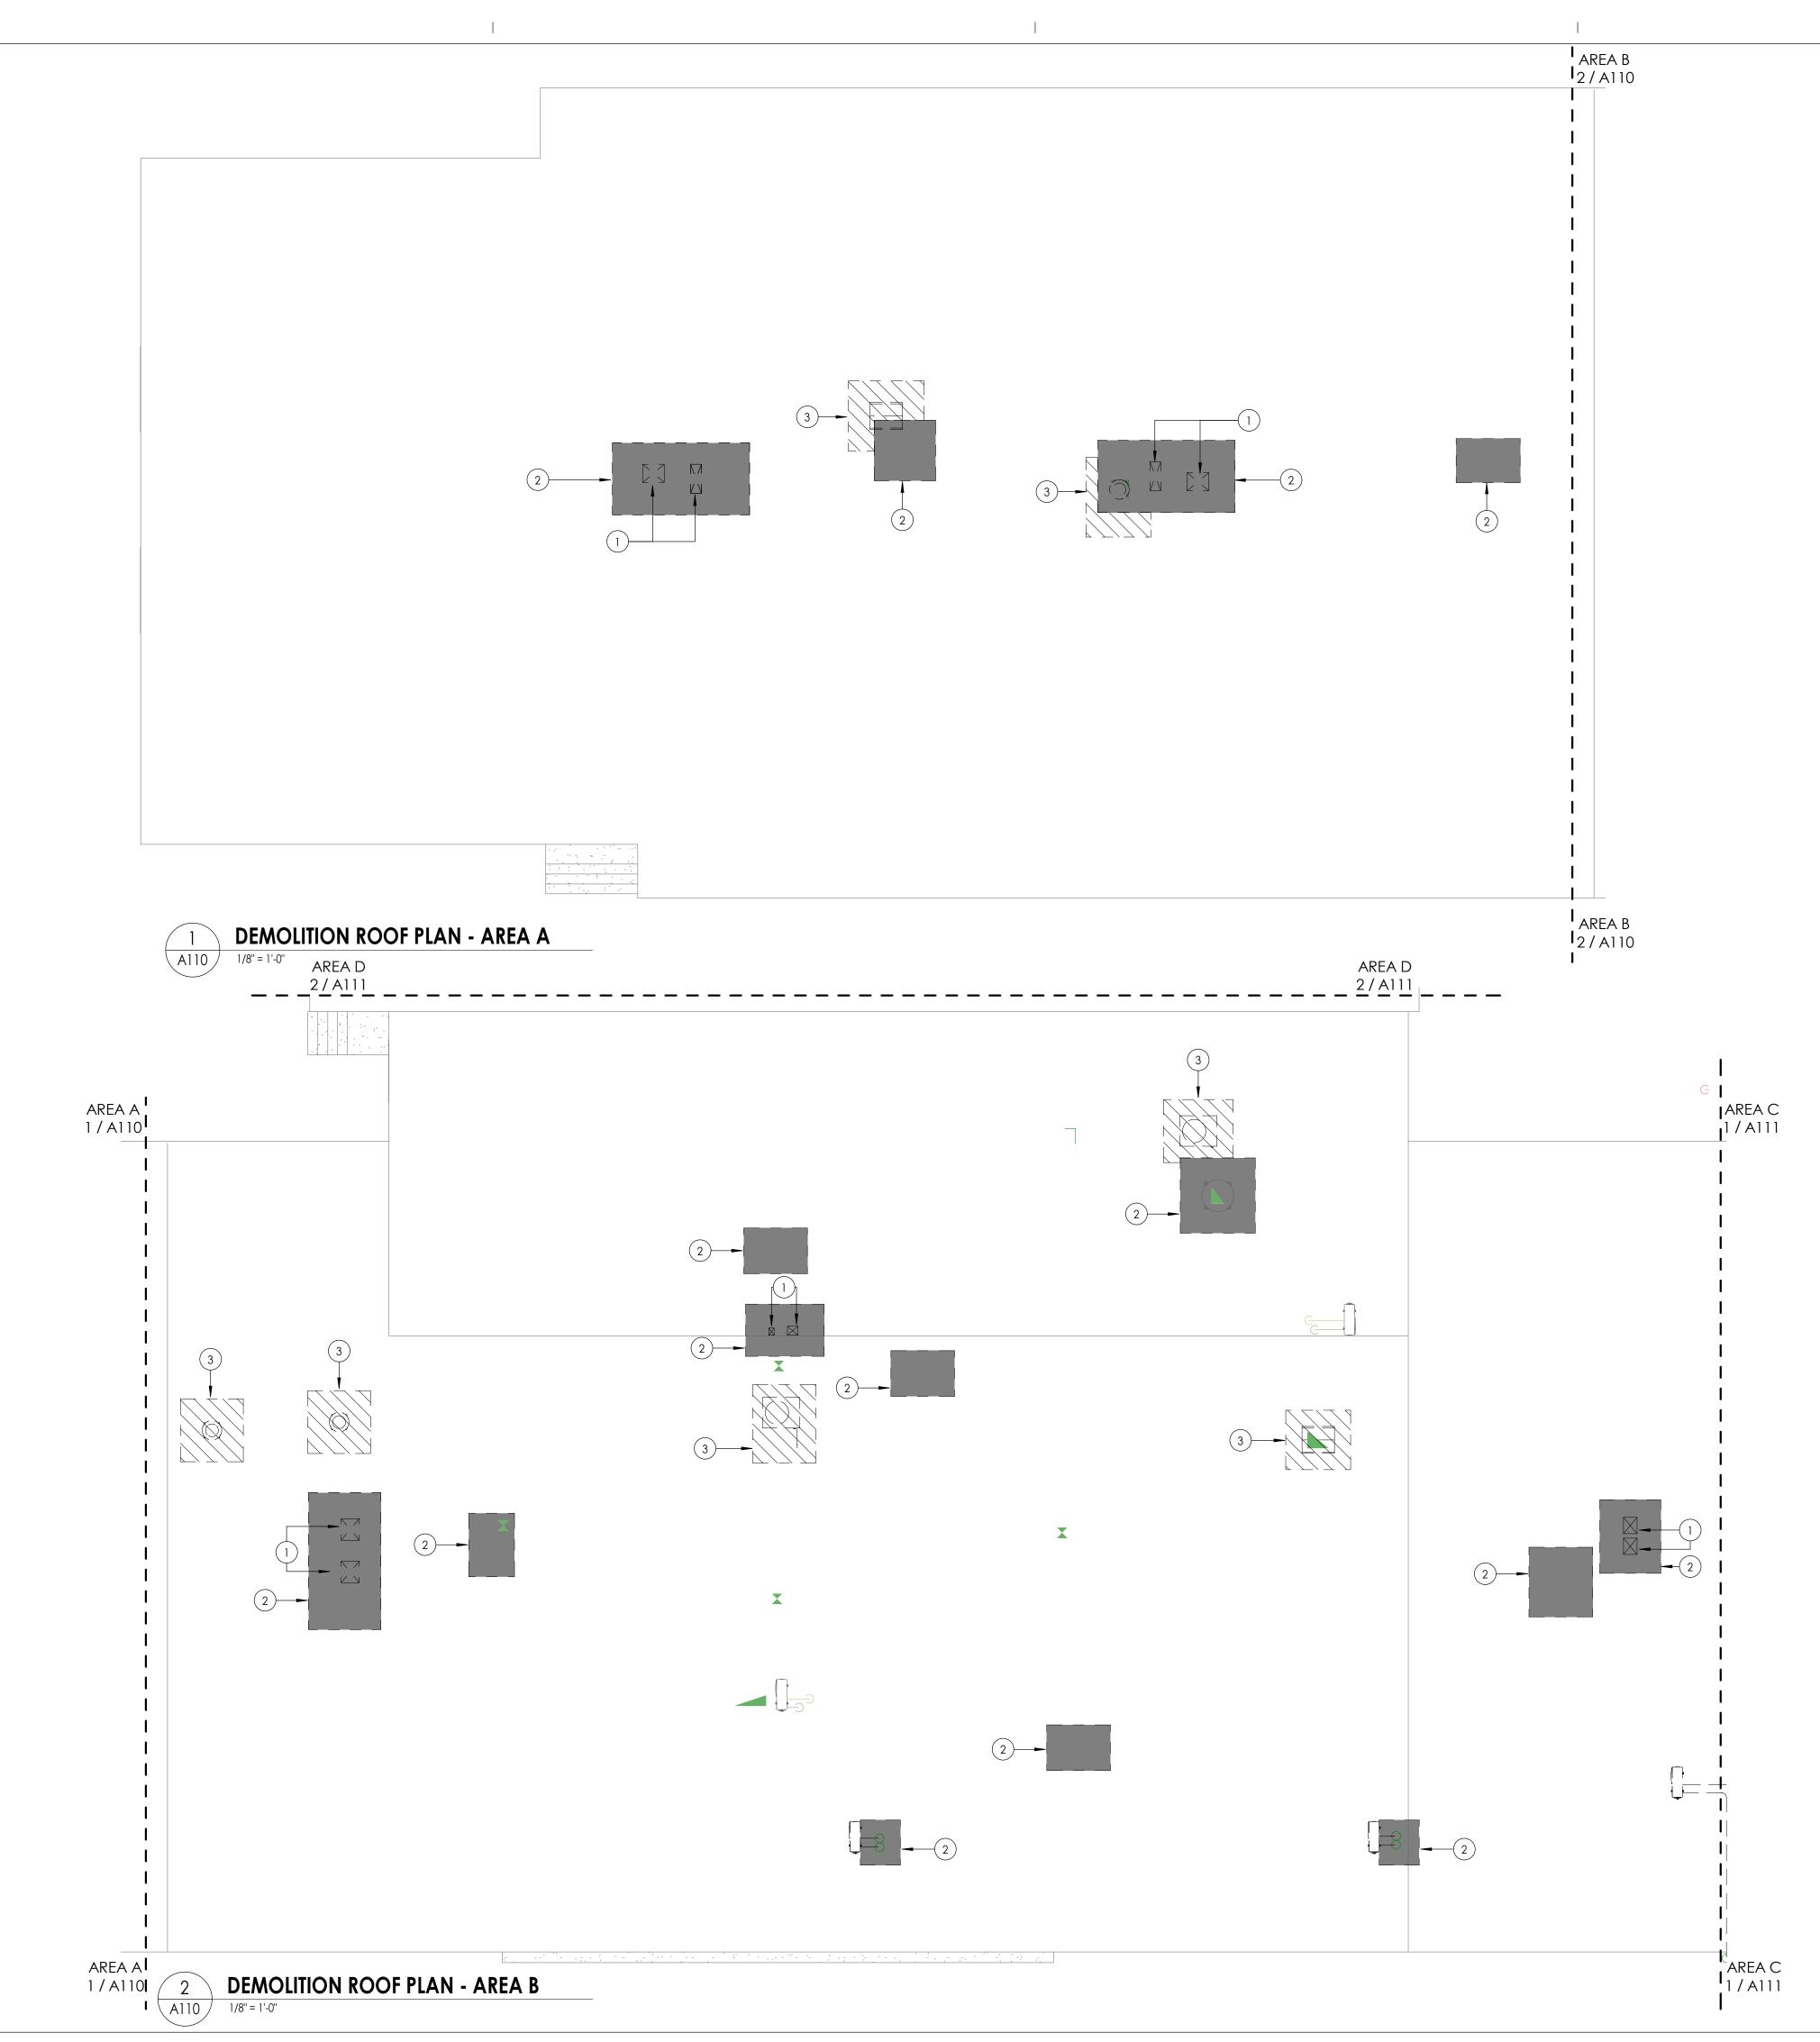
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Drawing Title	

DEMOLITION PLAN - AREA E&F






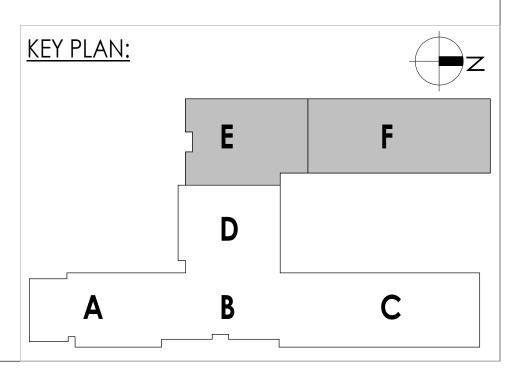

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- THE CONTRACTOR SHALL MAINTAIN AND CONTINUE SAFE ACCESS TO ALL EXITS FOR THE BUILDING OCCUPANTS DURING CONSTRUCTION.

DEMOLITION ROOF PLAN KEYNOTES



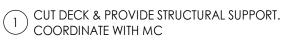

- 2 REMOVE ROOF SYSTEM DOWN TO ROOF DECK. COORDINATE WITH MC
- EXISTING MECHANICAL UNIT TO BE REMOVED BY M.C. A STATE OF THE STATE OF TH ROOFING SYSTEM PER DETAIL



14457.20 Client Name SOUTH ORANGETOWN CENTRAL SCHOOL DISTRICT

Project Name PHASE 1: 2022 BOND

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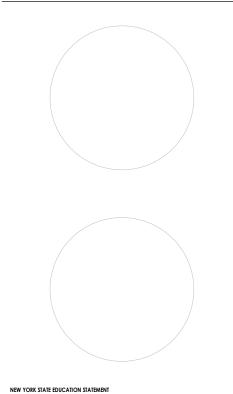
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PROJECT ISSUE & REVISION SCHEDULE No. Date Description

PROFESSIONAL STAMPS



ATION OF THE NEW YORK STATE ED II IS A VIDATION OF THE NEW TORK SINGLE DUCATION LAW AND THE COMMISSIONEE REGULATIONS TOR ANY PERSON, UNLESS ACTING UNDER THE DIRECTION OF A LICENSE RACHITECT, ENGINEER OR LAND SURVEYOR, TO ALTER AN ITEM IN ANY WAY. IF AN ITEM BEARING THE SEAL OF AN ARCHITECT, ENGINEER OR SURVEYOR AS LATERED, THE ALTERN PARTY SHALL AFFIX TO THE ITEM THER SEAL AND THE NOTATION "ALTERED BY" FOLLOWED THEIR SIGNATURE AND THE DATE OF SUCH ALTERATION, AND A SPECIFIC DESCRIPTION OF ALTERATION.


SHEET INFORMATION

Issued	Scale
10/18/23	As indicated
Project Status	
BID DOCUMENTS	
Drawn By	Checked By
LF	LT
Drawing Title	

DEMOLITION ROOF PLAN - AREA A&B



<u>KEY PLAN:</u>		Z
	E	F
	D	
Α	В	С

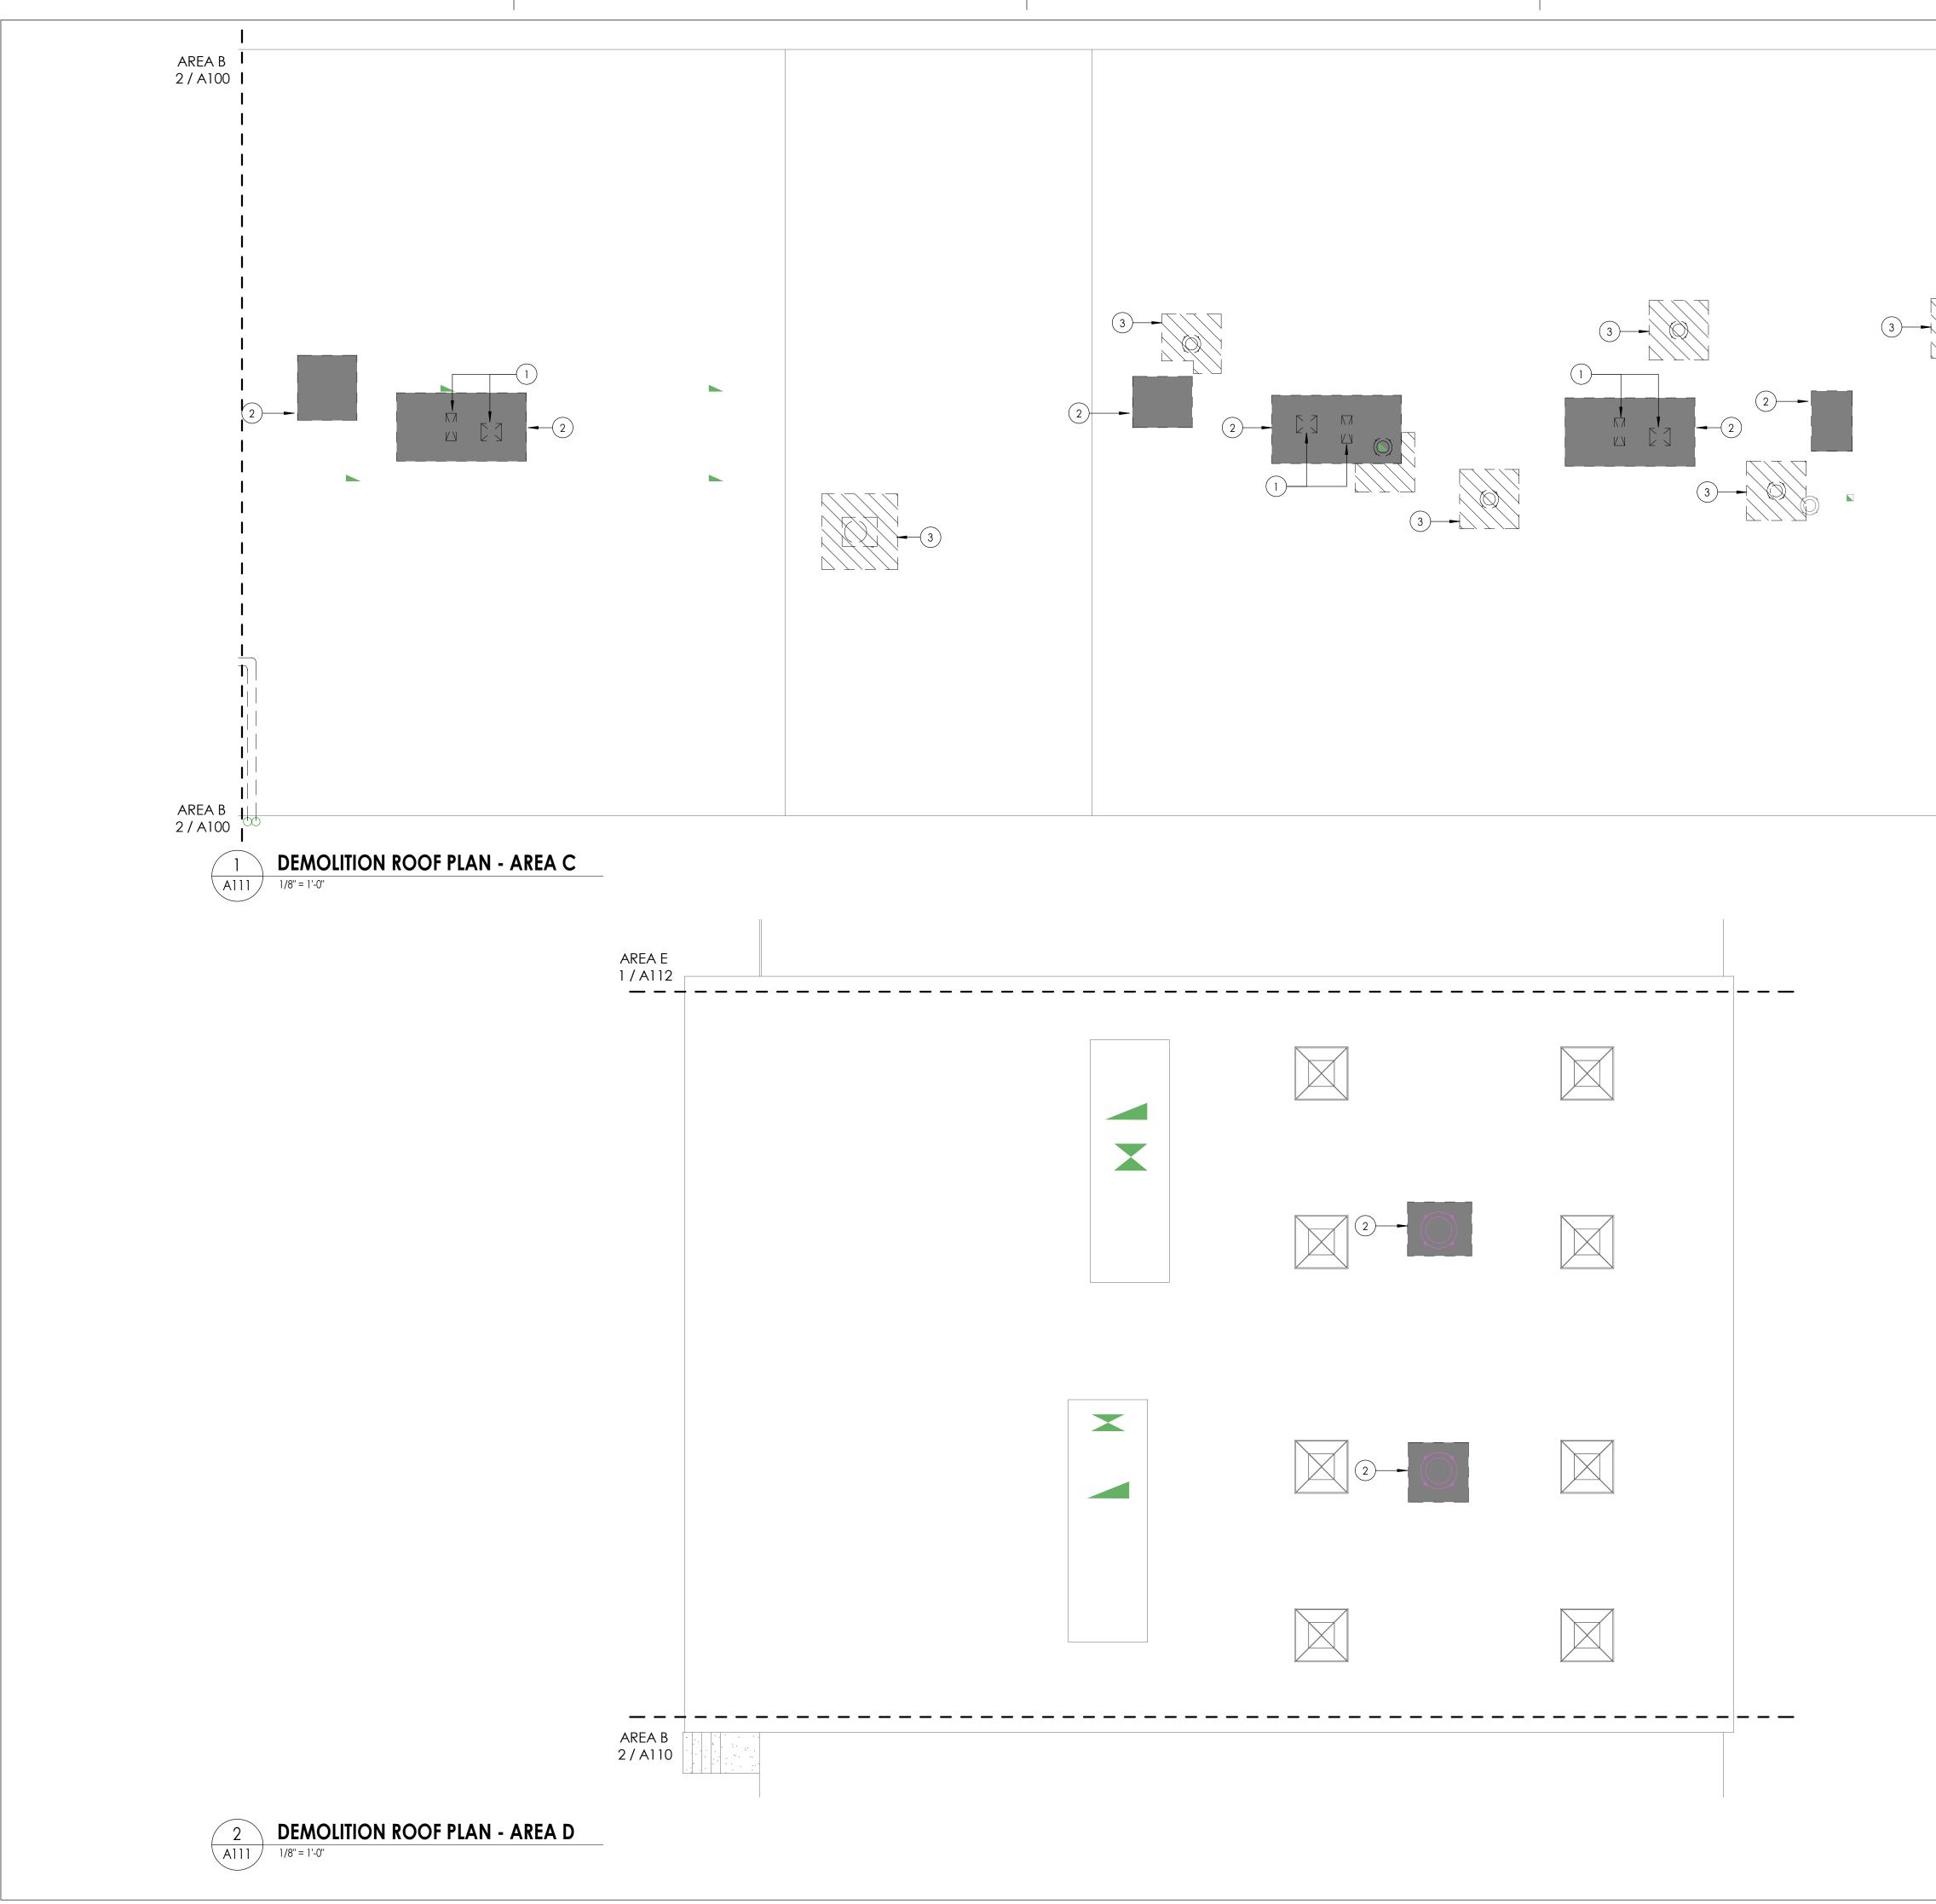

DEMOLITION GENERAL NOTES

- . IT IS THE CONTRACTOR'S RESPONSIBILITY TO FAMILIARIZE THEMSELVES WITH ALL EXISTING CONDITIONS AND DETAILS INVOLVED IN THE DEMOLITION WORK.
- THE OWNER SHALL PROVIDE THE CONTRACTOR WITH A LIST OF ALL ITEMS TO BE SALVAGED PRIOR TO CONSTRUCTION.
- THE CONTRACTOR SHALL PROTECT ADJACENT SURFACES AND FINISHES NOT SCHEDULED FOR DEMOLITION WORK AND SHALL REPAIR ANY DAMAGED AREAS AS A
- RESULT OF CONTRACTED WORK AT NO ADDITIONAL COST TO THE OWNER. THE CONTRACTOR SHALL COORDINATE THE DEMOLITION WORK WITH THE OVERALL
- PROJECT PHASING.
- THE CONTRACTOR SHALL MAINTAIN AND CONTINUE SAFE ACCESS TO ALL EXITS FOR THE BUILDING OCCUPANTS DURING CONSTRUCTION.

DEMOLITION ROOF PLAN KEYNOTES



- UT DECK & PROVIDE STRUCTURAL SUPPORT. COORDINATE WITH MC
- REMOVE ROOF SYSTEM DOWN TO ROOF DECK. COORDINATE WITH MC
- EXISTING MECHANICAL UNIT TO BE REMOVED BY M.C. (3) G.C. TO REMOVE CURB AND INFILL ROOF DECK AND ROOFING SYSTEM PER DETAIL



Project Name PHASE 1: 2022 BOND

District Office Address

160 VAN WYCK RD. Larry Werts 12/31/24 BLAUVELT, NY 10913 Anthony Marchetti 05/31/24

REGISTRATION EXPIR. DATES: Lauren Tarsio 09/30/26 Richard Waite 11/30/23 Dave Hart 02/28/25 Jennifer Wengender 06/30/24


CERTIFICATE #018330

South orangetown CSD

- WILLIAM O. SCHAEFER SED#:50-03-01-06-0-012-019 COTTAGE LANE ELEMENTARY SED#:50-03-01-06-0-010-022 TAPPAN ZEE HIGH SCHOOL SED#:50-03-01-06-0-006-032 WILLIAM O. SCHAEFER S&L SED#:50-03-01-06-0-012-020 COTTAGE LANE S&L SED#: 50-03-01-06-0-010-023 COTTAGE LANE LIBRARY S&L SED#: 50-03-01-06-8-023-002
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PROJECT ISSUE & REVISION SCHEDULE No. Date Description

PROFESSIONAL STAMPS

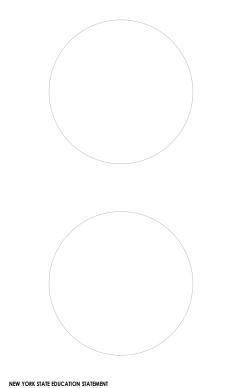


TION OF THE NEW YORK STATE EDU BEARING THE SEAL OF AN ARCHITECT, INGINEER OR SUPPORTS AN PARTY SHALL AFFIX TO THE ITEM THEIR SEAL AND THE NOTATION "ALTE THEIR SIGNATURE AND THE DATE OF SUCH ALTERATION, AND A SPECIF ALTERATION.


SHEET INFORMATION

Issued	Scale
10/18/23	As indicated
Project Status	
BID DOCUMENTS	
Drawn By	Checked By
LF	LT
Drawing Title	
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DEMOLITION ROOF PLAN C&D






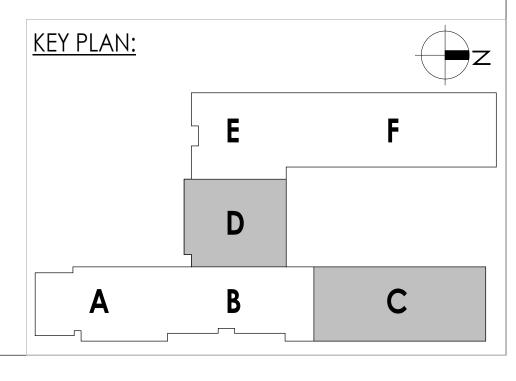
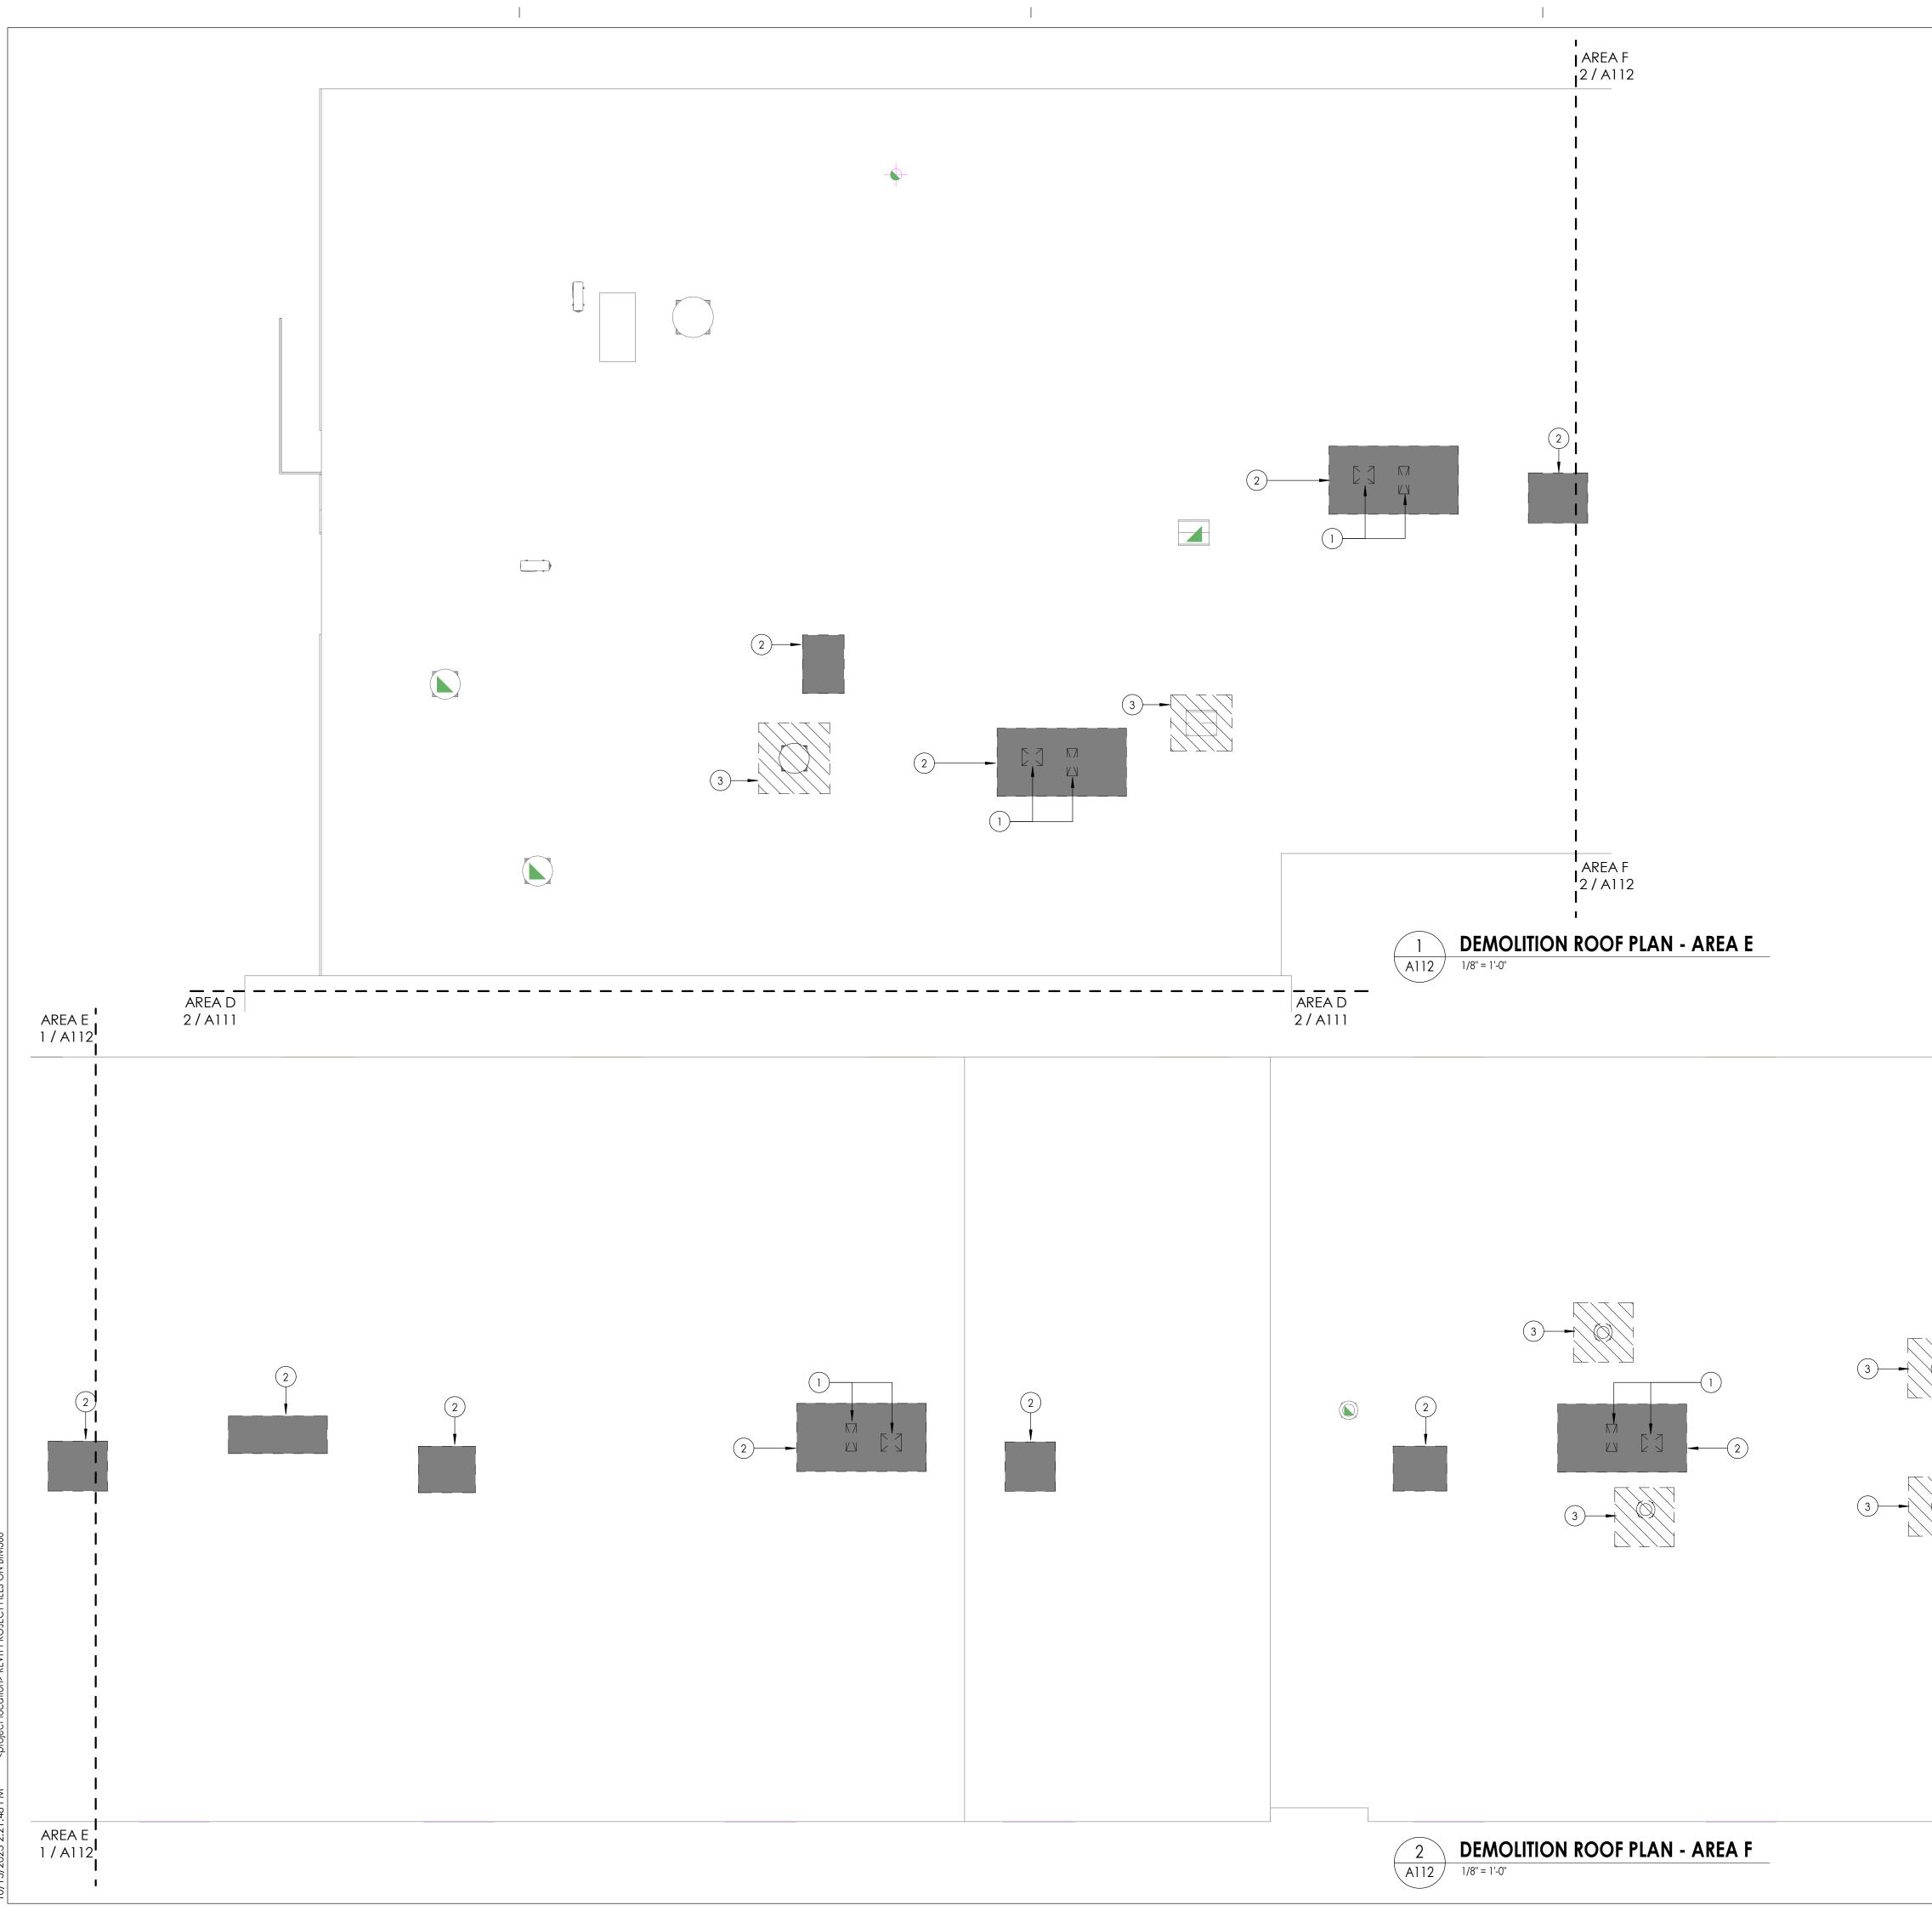
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DEMOLITION ROOF PLAN KEYNOTES



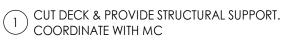

- 2 REMOVE ROOF SYSTEM DOWN TO ROOF DECK. COORDINATE WITH MC
- EXISTING MECHANICAL UNIT TO BE REMOVED BY M.C. 3 G.C. TO REMOVE CURB AND INFILL ROOF DECK AND ROOFING SYSTEM PER DETAIL ROOFING SYSTEM PER DETAIL



SOUTH ORANGETOWN CENTRAL SCHOOL DISTRICT Project Name

PHASE 1: 2022 BOND

District Office Address

160 VAN WYCK RD. Larry Werts 12/31/24 BLAUVELT, NY 10913 Anthony Marchetti 05/31/24

REGISTRATION EXPIR. DATES: Lauren Tarsio 09/30/26 Richard Waite 11/30/23 Dave Hart 02/28/25 Jennifer Wengender 06/30/24


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South orangetown CSD

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PROJECT ISSUE & REVISION SCHEDULE No. Date Description

PROFESSIONAL STAMPS




LATION OF THE NEW YORK STATE ED II IS A VIDLAILOR UT THE NEW TURK SIAILE EDUCATION AW AND THE COMMISSIONEE REGULATIONS FOR ANY PERSON, UNLESS ACTING UNDER THE DIRECTION OF A LICENSE ARCHITECT, ENGINEER OR LAND SURVEYOR, TO ALTER AN ITEM IN ANY WAY. IF AN ITEM BARING THE SEAL OF AN ARCHITECT, ENGINEER OR SURVEYOR AL ALTERD, THE ALTERN PARTY SHALL AFFX TO THE ITEM THER SEAL AND THE NOTATION "ALTERED BY" FOLLOWER THER SIGNATURE AND THE DATE OF SUCH ALTERATION, AND A SPECIFIC DESCRIPTION OF ALTERATION.

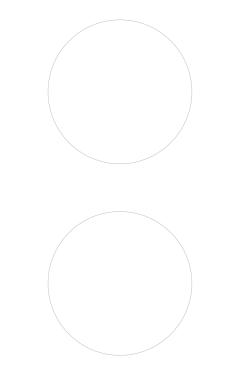
SHEET INFORMATION

Issued	Scale
10/18/23	As indicated
Project Status	
BID DOCUMENTS	
Drawn By	Checked By
LF	LT
Drawing Title	


DEMOLITION ROOF PLAN - AREA E&F



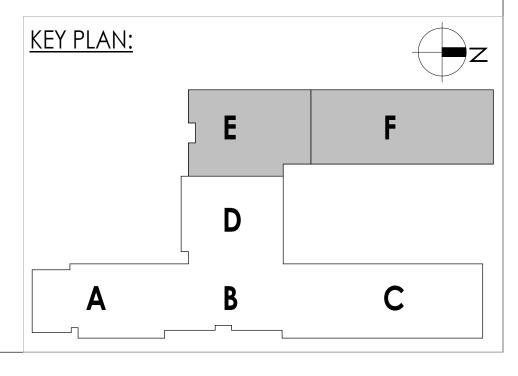

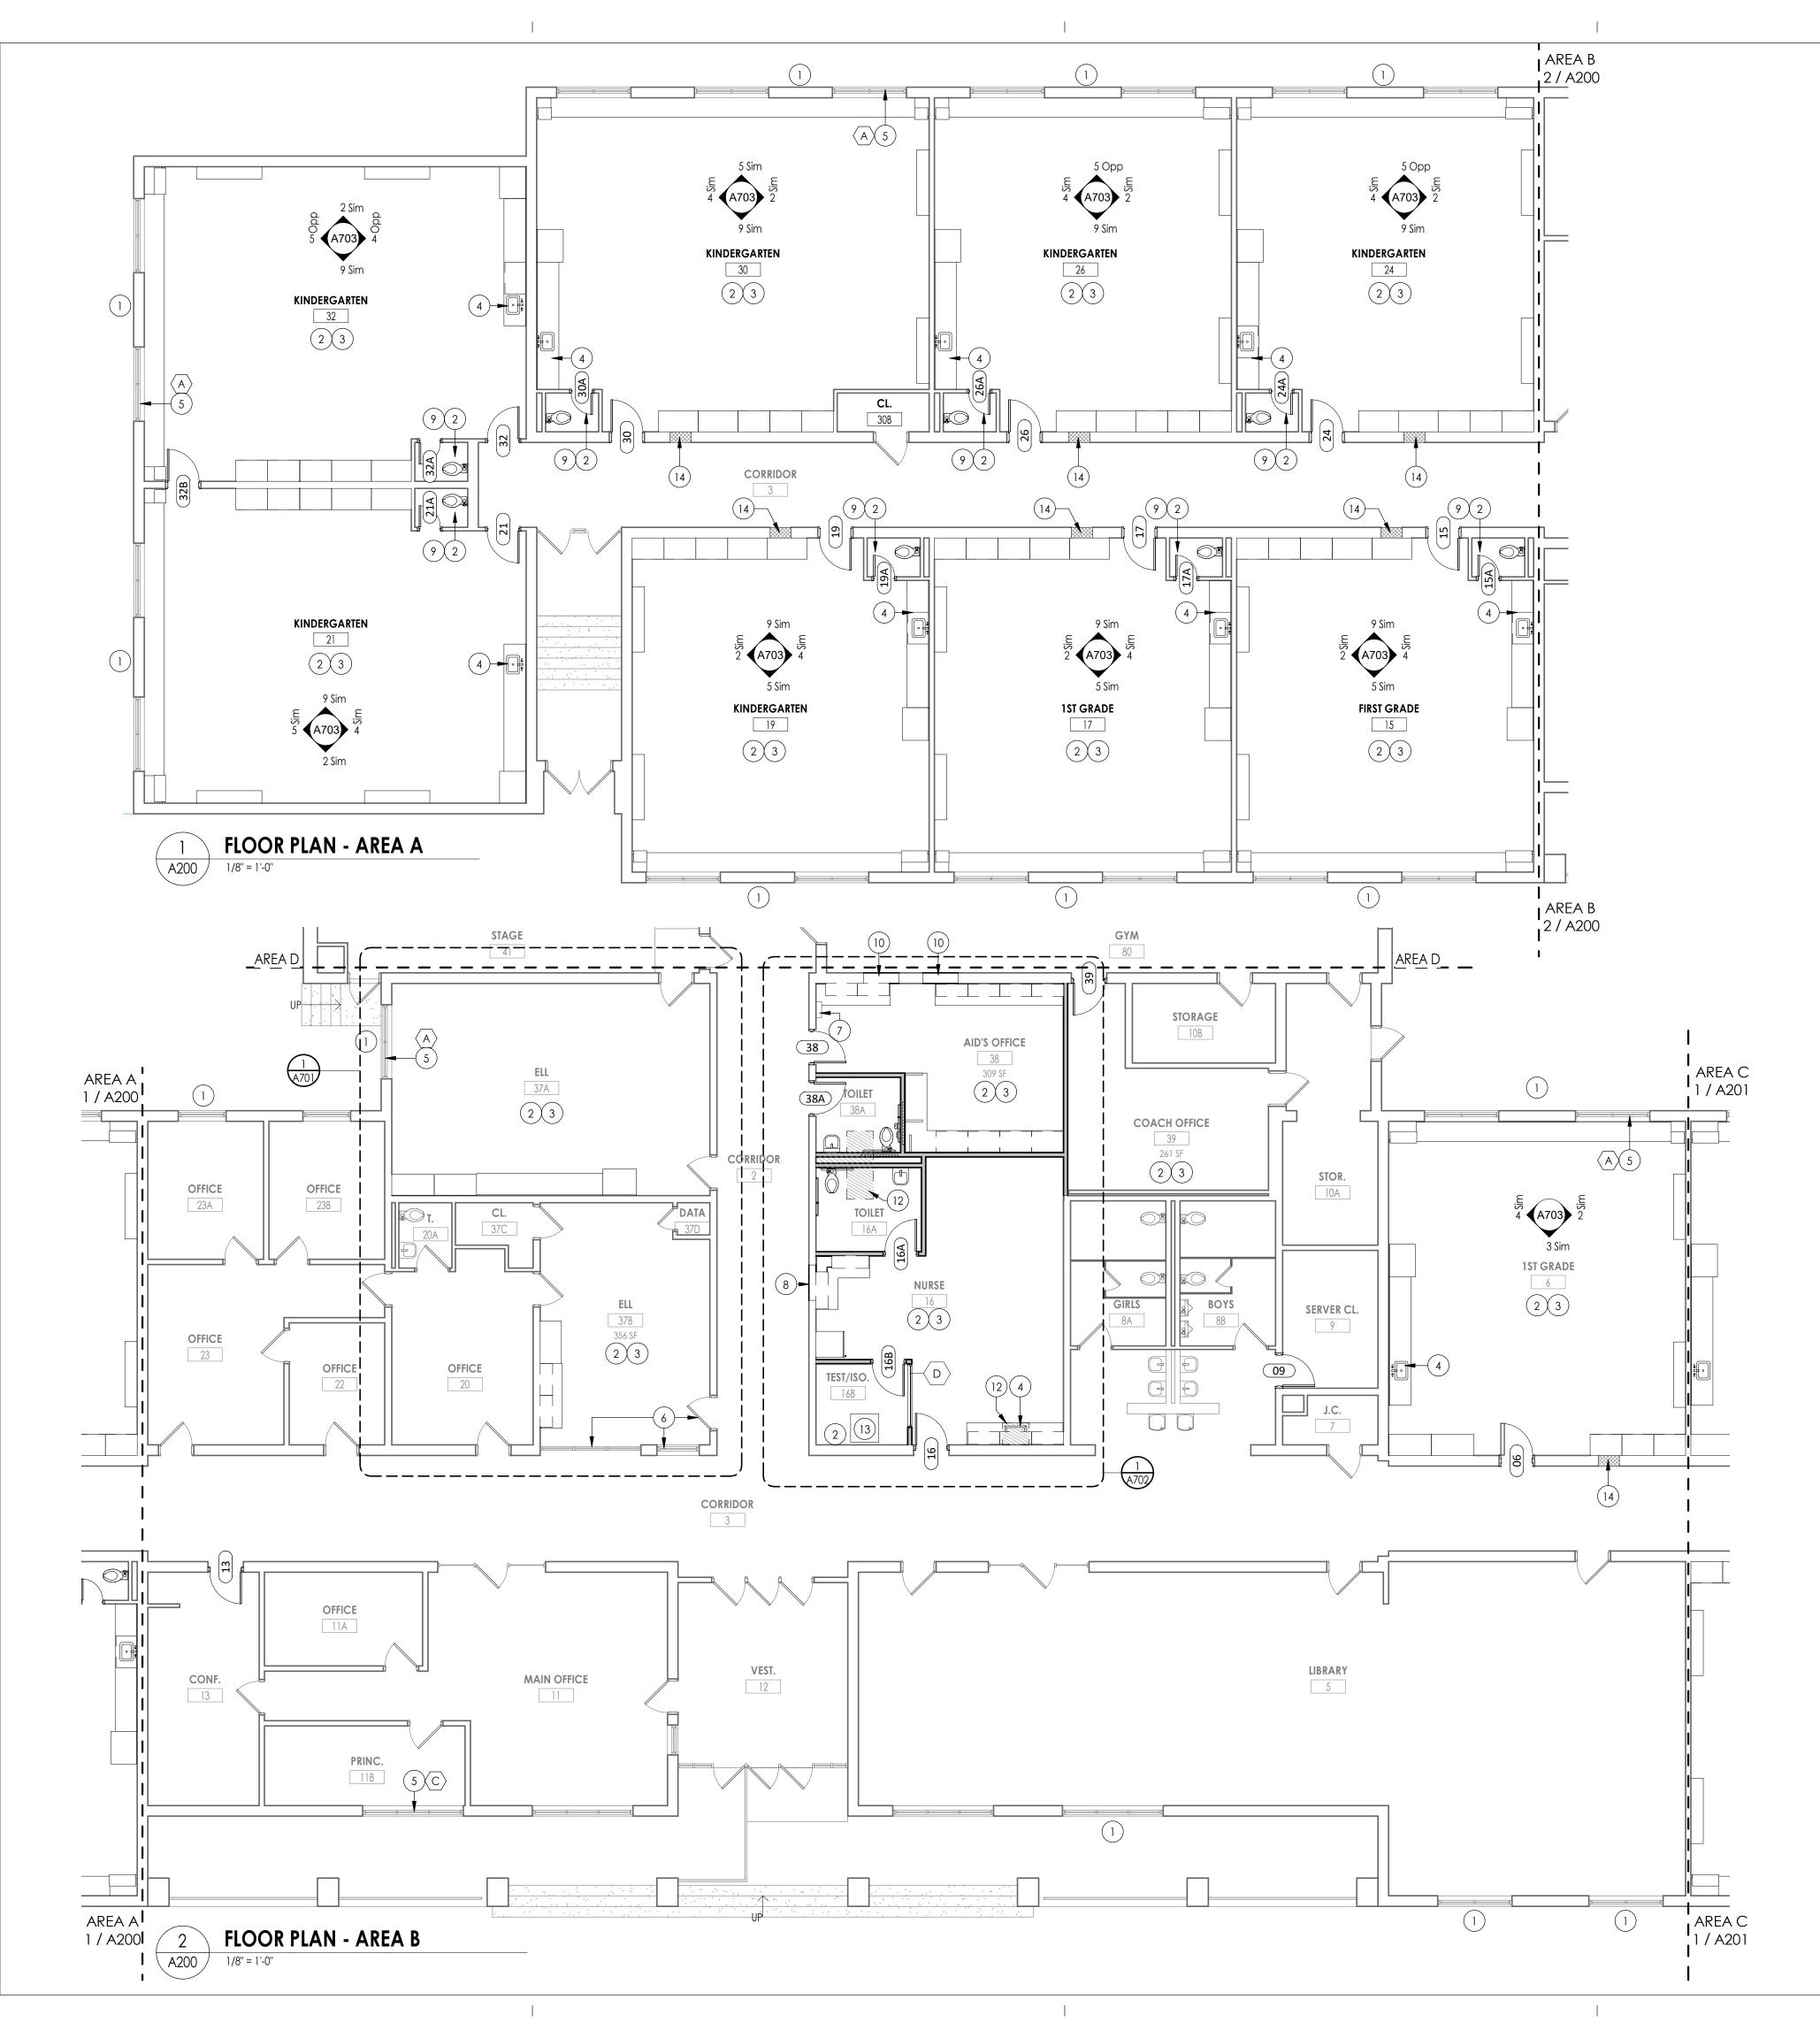

2023 2:21:50 PM <project location> REVIT PROJECT FILES ON BIM360

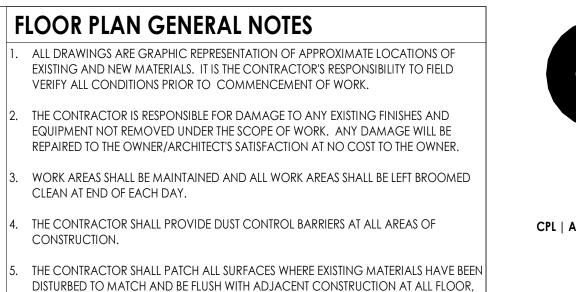


WALL, AND CEILING LOCATIONS.6. CONTRACTOR SHALL COORDINATE WITH OTHER TRADES FOR SEQUENCING OF WORK.


FLOOR PLAN KEY NOTES

- 1 INFILL EXTERIOR MASONRY WALL AT DEMOLISHED UV LOCATIONS. REFER TO DETAIL 1/A810
- 2 NEW FLOORING & WALL BASE AS SPECIFIED, REFER TO 1200 SHEETS.
- (3) NEW CASEWORK REFER TO ELEVATIONS
- (4) NEW SINK BY PC
- (5) REPLACE WINDOW PANE WITH NEW GLAZING AT EXISTING AC REMOVAL
- (6) APPLY GRAPHIC PRIVACY FILM TO EXISTING GLAZING
- (7) EXISTING ELEC. PANEL TO REMAIN REFER TO ELECTRICAL DWGS
- (8) INFILL DEMOLISHED DOOR OPENING W/ CMU WALL.
- 9 NEW TOILET BY PC
- 10 INFILL DEMOLISHED DOOR OPENING W/ CMU WALL TOOTH, IN NEW WORK TO EXISTING APPLY PROTECTIVE PADDING GYM SIDE TO MATCH EXISTING.
- 11 ALTERNATE 1/ GC-01: INFILL DEMOLISHED UV LOCATION WITH NEW CASEWORK TO MATCH EXISTING. REFER TO A800 FOR DETAILS.
- (12) INFILL CONCRETE FLOOR SLAB. REFER TO DETAIL 3/A810
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- 14 INFILL FIRE RATED MASONRY WALL OPENING W/ MATERIALS TO MATCH EXISTING AS REQUIRED FROM THE REMOVAL OF EXISTING LOW AND HIGH AIR RELIEF GRILLES. REFER TO MECHANICAL DRAWINGS.

FLOOR PLAN LEGEND

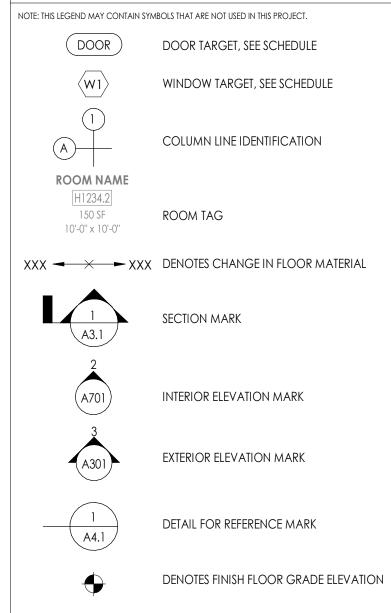

XXX WALL TYPE SEE A/400

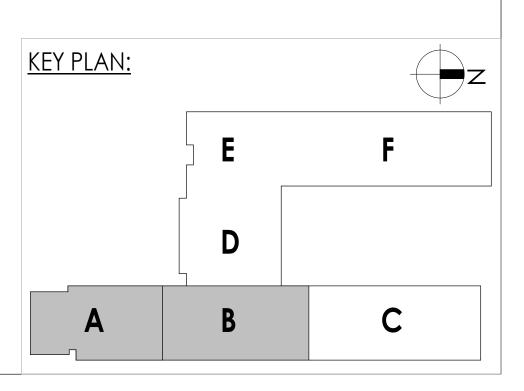



PROJECT INFORMATION
Project Number
14457.20
Client Name
SOUTH ORANGETOWN CENTRAL
SCHOOL DISTRICT

Project Name
PHASE 1: 2022 BOND

CERTIFICATE #018330 REGISTRATION EXPIR. DATES: Lauren Tarsio 09/30/26 Richard Waite 11/30/23 Larry Werts 12/31/24 BLAUVELT, NY 10913 BLAUVELT, NY 10913 Anthony Marchetti 05/31/24 Dave Hart 02/28/25 Jennifer Wengender 06/30/24

South orangetown CSD

 WILLIAM O. SCHAEFER SED#:50-03-01-06-0-012-019

 COTTAGE LANE ELEMENTARY SED#:50-03-01-06-0-010-022

 TAPPAN ZEE HIGH SCHOOL SED#:50-03-01-06-0-010-022

 WILLIAM O. SCHAEFER S&L SED#:50-03-01-06-0-012-020

 COTTAGE LANE S&L SED#:50-03-01-06-0-012-020

 COTTAGE LANE S&L SED#:50-03-01-06-0-010-023

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 COTTAGE LANE LIBRARY S&L SED#: 50-03-01-06-7-053-001


 WOS OUTDOOR CLASSROOM SED#: 50-03-01-06-7-056-001

 CLE OUTDOOR CLASSROOM SED#:50-03-01-06-7-054-001

TZHS OUTDOOR CLASSROOM SED#:50-03-01-06-7-055-001

PROJECT ISSUE & REVISION SCHEDULE

PROFESSIONAL STAMPS

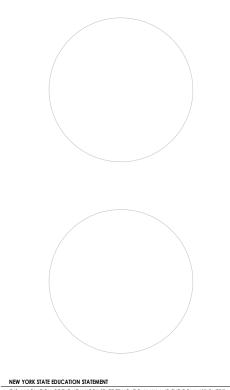


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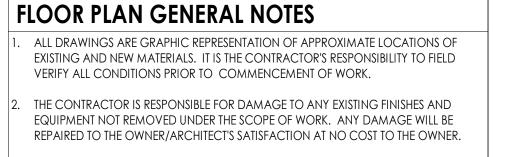
SHEET INFORMATION

Issued	Scale
10/18/23	As indicated
Project Status	
BID DOCUMENTS	
Drawn By	Checked By
LF	LT
Drawing Title	
NEW WORK PLAN	ا ـ ARFA A&

NEW WORK PLAN - AREA A&B





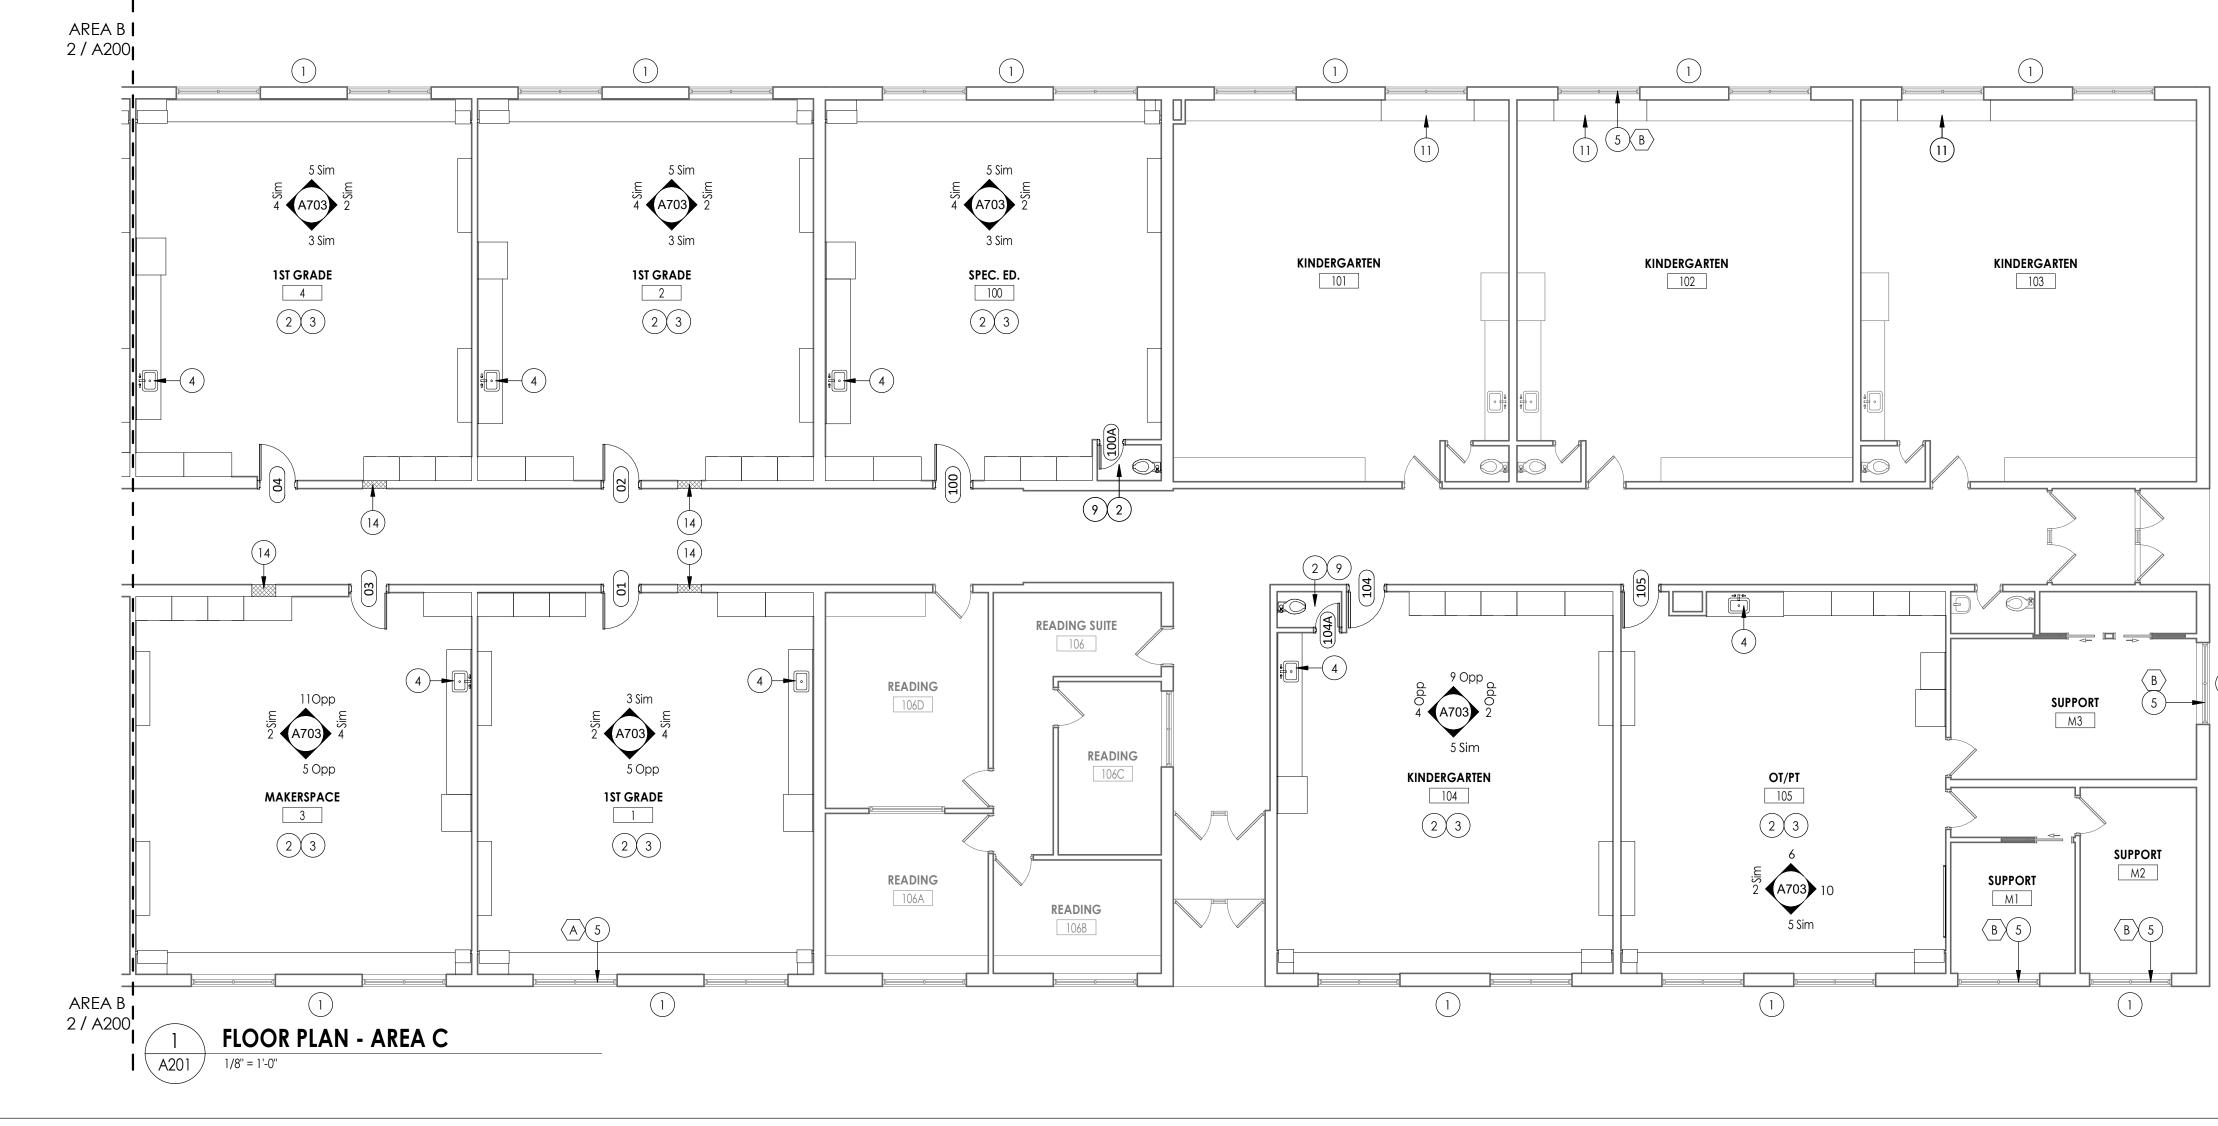


- work areas shall be maintained and all work areas shall be left broomed CLEAN AT END OF EACH DAY.
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FLOOR PLAN KEY NOTES

- INFILL EXTERIOR MASONRY WALL AT DEMOLISHED UV LOCATIONS. REFER TO DETAIL 1/A810
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- (4) NEW SINK BY PC
- (5) REPLACE WINDOW PANE WITH NEW GLAZING AT EXISTING AC REMOVAL
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FLOOR PLAN LEGEND


NOTE: THIS LEGEND MAY CONTAIN SYMBOLS THAT ARE NOT USED IN THIS PROJECT.



DENOTES FINISH FLOOR GRADE ELEVATION

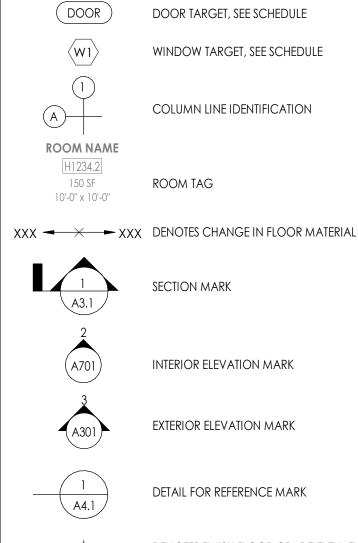XXX WALL TYPE SEE A/400



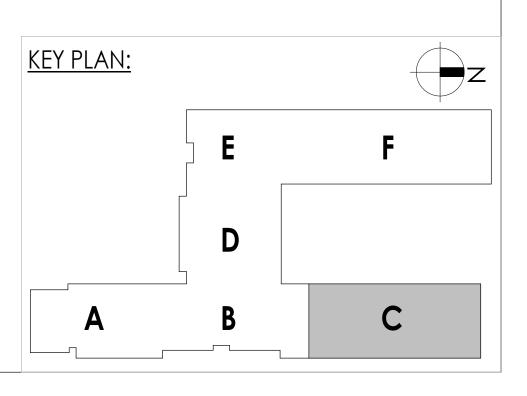



PROJECT INFORMATION Project Number 14457.20 Client Name SOUTH ORANGETOWN CENTRAL SCHOOL DISTRICT

Project Name PHASE 1: 2022 BOND

District Office Address 160 VAN WYCK RD. BLAUVELT, NY 10913	CERTIFICATE #018330 REGISTRATION EXPIR. DATES: Lauren Tarsio 09/30/26 Richard Waite 11/30/23 Larry Werts 12/31/24 Anthony Marchetti 05/31/24 Dave Hart 02/28/25
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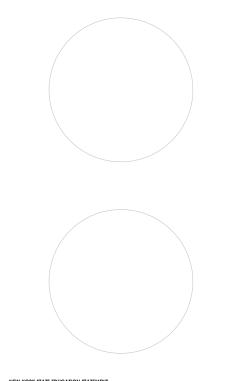
hetti 05/31/24 Jennifer Wengender 06/30/24

south orangetown CSD WILLIAM O. SCHAEFER SED#:50-03-01-06-0-012-019 COTTAGE LANE ELEMENTARY SED#:50-03-01-06-0-010-022] TAPPAN ZEE HIGH SCHOOL SED#:50-03-01-06-0-006-032 WILLIAM O. SCHAEFER S&L SED#:50-03-01-06-0-012-020 COTTAGE LANE S&L SED#: 50-03-01-06-0-010-023 COTTAGE LANE LIBRARY S&L SED#: 50-03-01-06-8-023-002

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PROJECT ISSUE & REVISION SCHEDULE o. Date

PROFESSIONAL STAMPS



NEW YORK STATE EDUCATION STATEM LATION OF THE NEW YORK STATE EDUCATION LAW AND THE Egulations for any person, unless acting under the direction of a licen RCHITECT, Engineer or land surveyor, to alter an item in any way. If an i BEARING THE SEAL OF AN ARCHITECT, INCIDENT OR JUD ALTER AN ITEM IN ANY WAY. BEARING THE SEAL OF AN ARCHITECT, INCIDENT OR SURVEYOR IS ALTERED TH PARTY SHALL AFFIX TO THE ITEM THEIR SEAL AND THE NOTATION "ALTERED BY" FC THEIR SIGNATURE AND THE DATE OF SUCH ALTERATION, AND A SPECIFIC DESCRI ULTERATION.

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Issued	Scale
10/18/23	As indicated
Project Status	
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Drawn By	Checked By
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Drawing Title	
NEW WORK PLAN	I - AREA C

Drawing Number WOS A201




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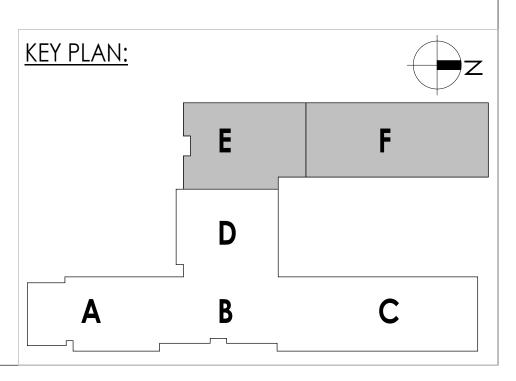
FLOOR PLAN LEGEND

NOTE: THIS LEGEND MAY CONTAIN SYMBOLS THAT ARE NOT USED IN THIS PROJECT.



DENOTES FINISH FLOOR GRADE ELEVATION

XXX WALL TYPE SEE A/400

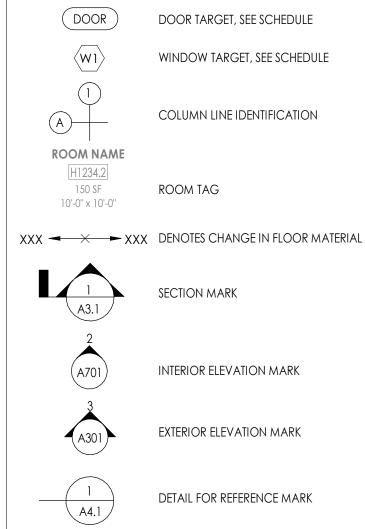



PHASE 1: 2022 BOND

CERTIFICATE #018330 REGISTRATION EXPIR. DATES: District Office Address 160 VAN WYCK RD. Larry Werts 12/31/24 BLAUVELT, NY 10913 Anthony Marchetti 05/31/24


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south orangetown CSD WILLIAM O. SCHAEFER SED#:50-03-01-06-0-012-019 COTTAGE LANE ELEMENTARY SED#:50-03-01-06-0-010-022 TAPPAN ZEE HIGH SCHOOL SED#:50-03-01-06-0-006-032 WILLIAM O. SCHAEFER S&L SED#:50-03-01-06-0-012-020 COTTAGE LANE S&L SED#: 50-03-01-06-0-010-023 COTTAGE LANE LIBRARY S&L SED#: 50-03-01-06-8-023-002 WOS OUTDOOR CLASSROOM SED#: 50-03-01-06-7-053-001

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PROJECT ISSUE & REVISION SCHEDULE o. Date






NEW YORK STATE EDUCATION STATEM OLATION OF THE NEW YORK STATE EDUCATION LAW AND THE CC II IS A VIOLATION OF THE NEW TURK JULIESS ACTING UNDER THE DIRECTION OF A LICENS REQUILATIONS FOR ANY PERSON, UNLESS ACTING UNDER THE DIRECTION OF A LICENS ARCHITECT, ENGINEER OR LAND SURVEYOR, TO ALTER AN ITEM IN ANY WAY. IF AN ITE BEARING THE SEAL OF AN ARCHITECT, INCIDENTE OR SURVEYOR, IS ALTERED. THE ALTER PARTY SHALL AFFIX TO THE ITEM THER SEAL AND THE NOTATION "ALTERED BY" FOLLOWI THEIR SIGNATURE AND THE DATE OF SUCH ALTERATION, AND A SPECIFIC DESCRIPTION ALTERATION.
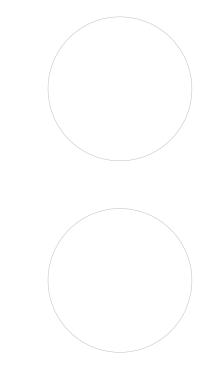
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10/18/23	As indicated
Project Status	
BID DOCUMENTS	
Drawn By	Checked By
LF	LT
Drawing Title	
NEW WORK PLAN	L AREA E&

NEW WORK PLAN - AREA E&F

Drawing Number WOS A202

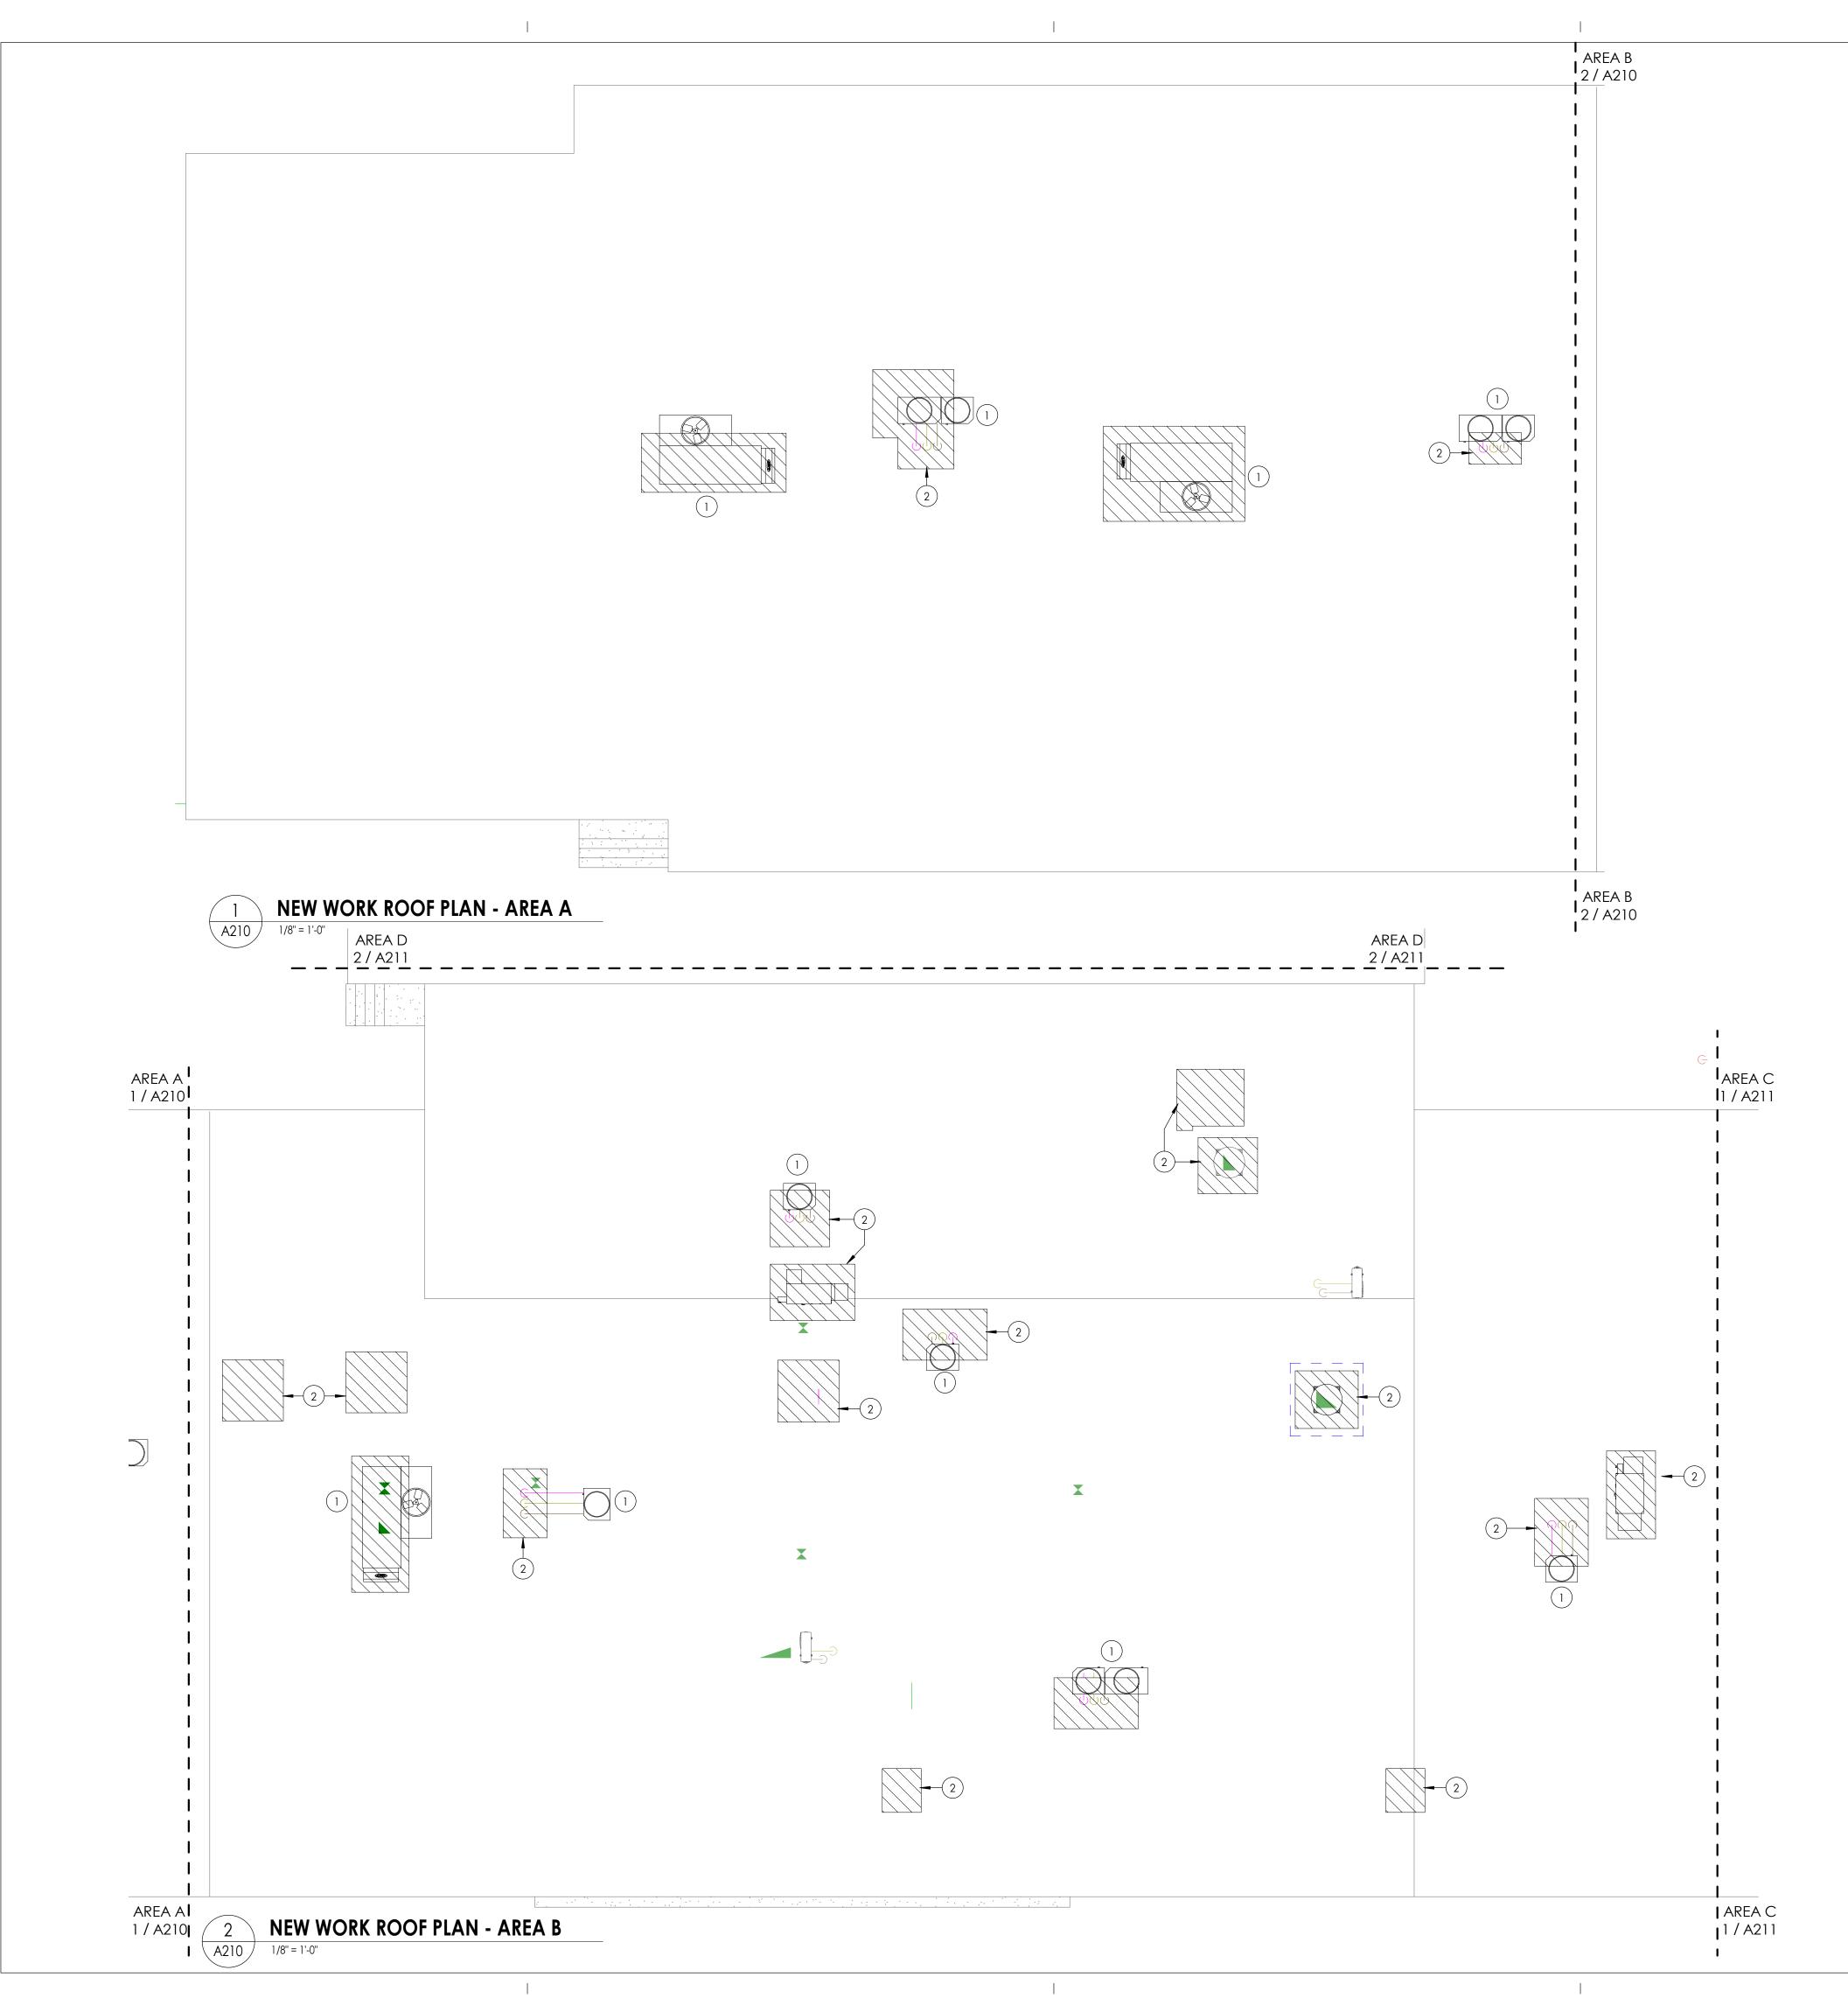

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ROOF PLAN LEGEND



ROOF PLAN KEYNOTES

MECHANICAL EQUIPMENT AND ROOF CURB BY MC. GC. TO SET CURB AND \bigcirc Flash into existing roofing. Patch roofing to match existing as req'd.

INFILL ROOF DECK AND ROOFING SYSTEM AT MECHANICAL UNIT



PROJECT INFORMATION Project Number 14457.20 Client Name SOUTH ORANGETOWN CENTRAL SCHOOL DISTRICT

Project Name PHASE 1: 2022 BOND

CERTIFICATE #018330 District Office Address


REGISTRATION EXPIR. DATES: Lauren Tarsio 09/30/26 Richard Waite 11/30/23 160 VAN WYCK RD. Larry Werts 12/31/24 BLAUVELT, NY 10913 Anthony Marchetti 05/31/24 Dave Hart 02/28/25 Jennifer Wengender 06/30/24

South orangetown CSD

- WILLIAM O. SCHAEFER SED#:50-03-01-06-0-012-019 COTTAGE LANE ELEMENTARY SED#:50-03-01-06-0-010-022 TAPPAN ZEE HIGH SCHOOL SED#:50-03-01-06-0-006-032 WILLIAM O. SCHAEFER S&L SED#:50-03-01-06-0-012-020 COTTAGE LANE S&L SED#: 50-03-01-06-0-010-023 COTTAGE LANE LIBRARY S&L SED#: 50-03-01-06-8-023-002 WOS OUTDOOR CLASSROOM SED#: 50-03-01-06-7-053-001
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PROJECT ISSUE & REVISION SCHEDULE No. Date Description

PROFESSIONAL STAMPS

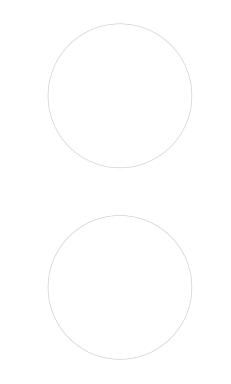

BEARING THE SEAL OF AN ARCHITECT, ENC PARTY SHALL AFFIX TO THE ITEM THEIR SEAL THEIR SIGNATURE AND THE DATE OF SUCH / ALTERATION.


SHEET INFORMATION

ndicated
ked By

NEW WORK ROOF PLAN - AREA A&B

wing Number	WOS
	A210

<u>KEY PLAN:</u>		Z
	E	F
	D	
Α	B	С

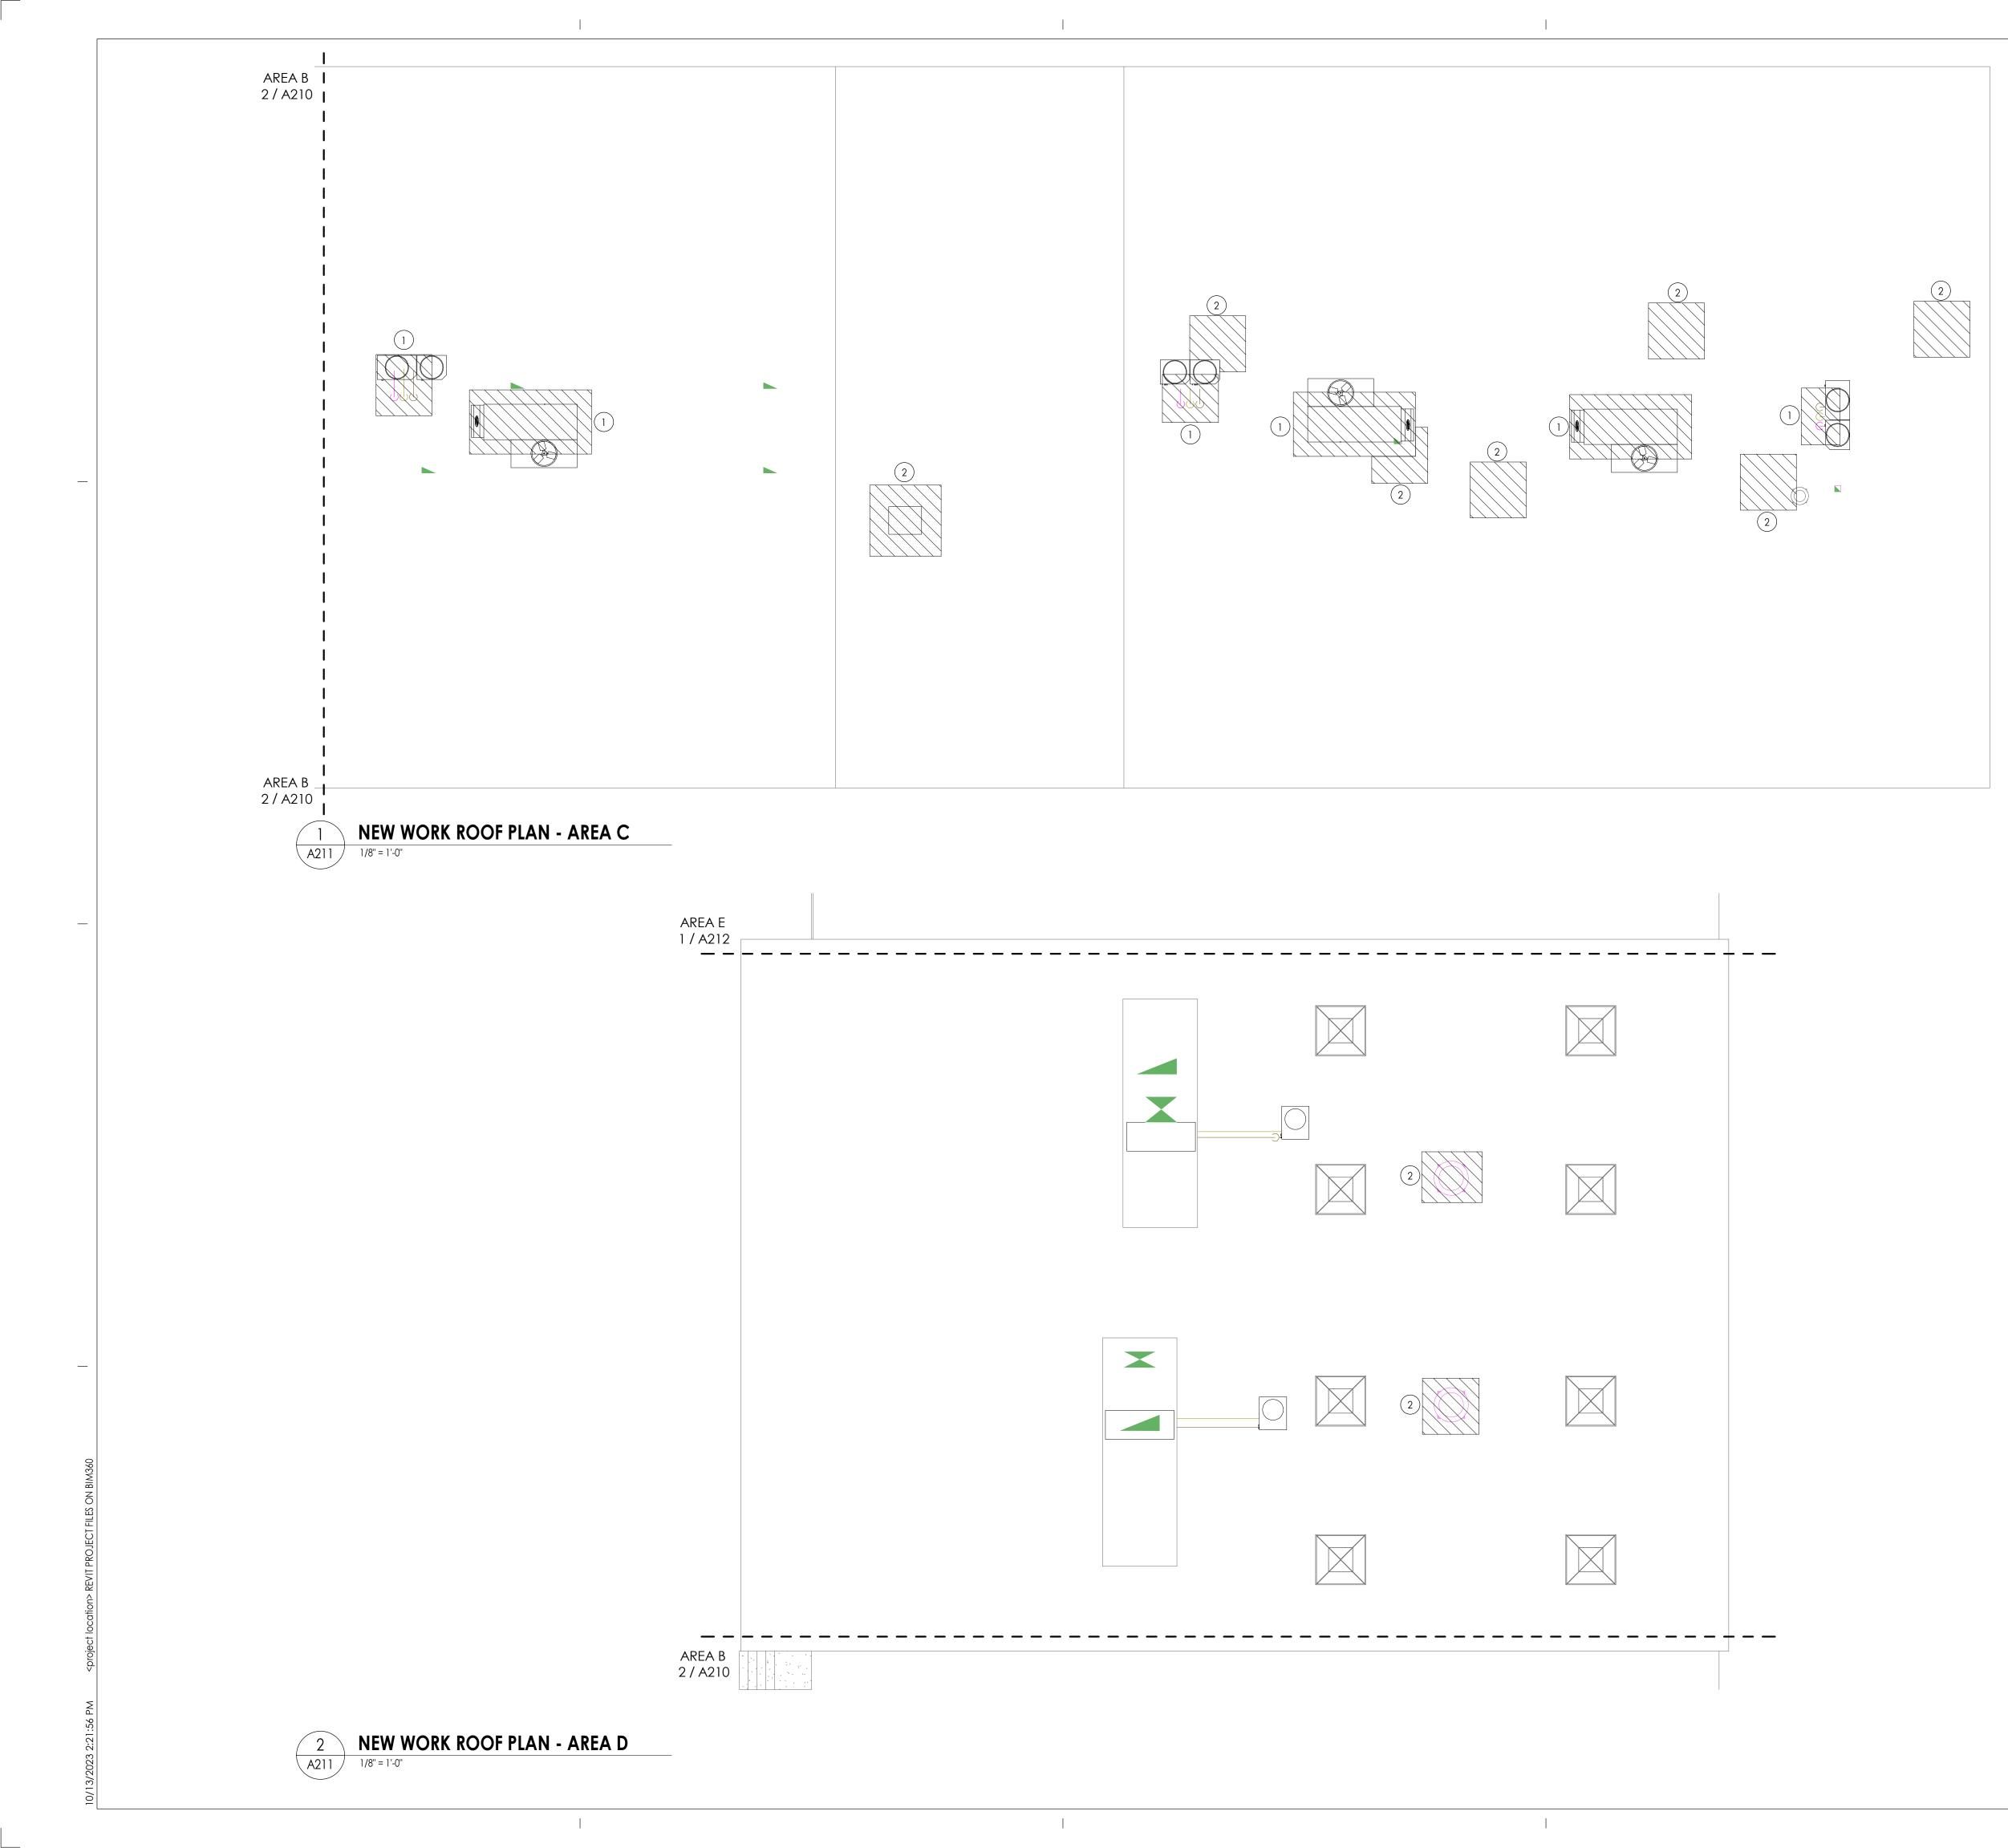

- ALL DRAWINGS ARE GRAPHIC REPRESENTATION OF APPROXIMATE LOCATIONS OF EXISTING AND NEW MATERIALS. IT IS THE CONTRACTOR'S RESPONSIBILITY TO FIELD VERIFY ALL CONDITIONS PRIOR TO COMMENCEMENT OF WORK.
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- WORK AREAS SHALL BE MAINTAINED AND ALL WORK AREAS SHALL BE LEFT BROOMED CLEAN AT END OF EACH DAY.
- THE CONTRACTOR SHALL PROVIDE DUST CONTROL BARRIERS AT ALL AREAS OF CONSTRUCTION.
- THE CONTRACTOR SHALL PATCH ALL SURFACES WHERE EXISTING MATERIALS HAVE BEEN DISTURBED TO MATCH AND BE FLUSH WITH ADJACENT CONSTRUCTION AT ALL FLOOR, WALL, AND CEILING LOCATIONS.
- CONTRACTOR SHALL COORDINATE WITH OTHER TRADES FOR SEQUENCING OF WORK.

ROOF PLAN LEGEND



PROVIDE NEW ROOFING SYSTEM TO MATCH EXISTING AT REMOVED MECHANICAL EQUIPMENT.

ROOF PLAN KEYNOTES

MECHANICAL EQUIPMENT AND ROOF CURB BY MC. GC. TO SET CURB AND \bigcirc Flash into existing roofing. Patch roofing to match existing as req'd.

INFILL ROOF DECK AND ROOFING SYSTEM AT MECHANICAL UNIT



PROJECT INFORMATION Project Number 14457.20 Client Name SOUTH ORANGETOWN CENTRAL SCHOOL DISTRICT

PHASE 1: 2022 BOND

Project Name

CERTIFICATE #018330 REGISTRATION EXPIR. DATES: Lauren Tarsio 09/30/26 District Office Address Richard Waite 11/30/23

160 VAN WYCK RD. Larry Werts 12/31/24 BLAUVELT, NY 10913 Anthony Marchetti 05/31/24

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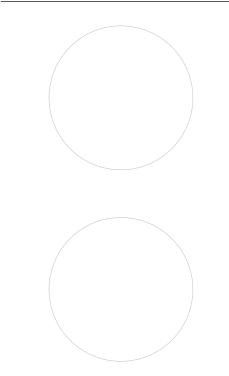
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PROJECT ISSUE & REVISION SCHEDULE No. Date


PROFESSIONAL STAMPS





SHEET INFORMATION

Issued	Scale
10/18/23	As indicated
Project Status	
BID DOCUMENTS	
Drawn By	Checked By
LF	LT
Drawing Title	
NEW WORK ROO	F PLAN - ARE

NEW WORK ROOF PLAN - AREA C&D

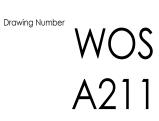

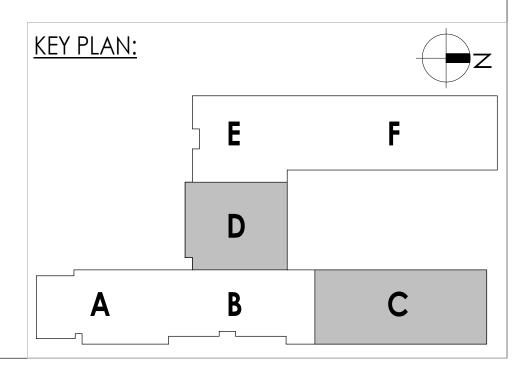

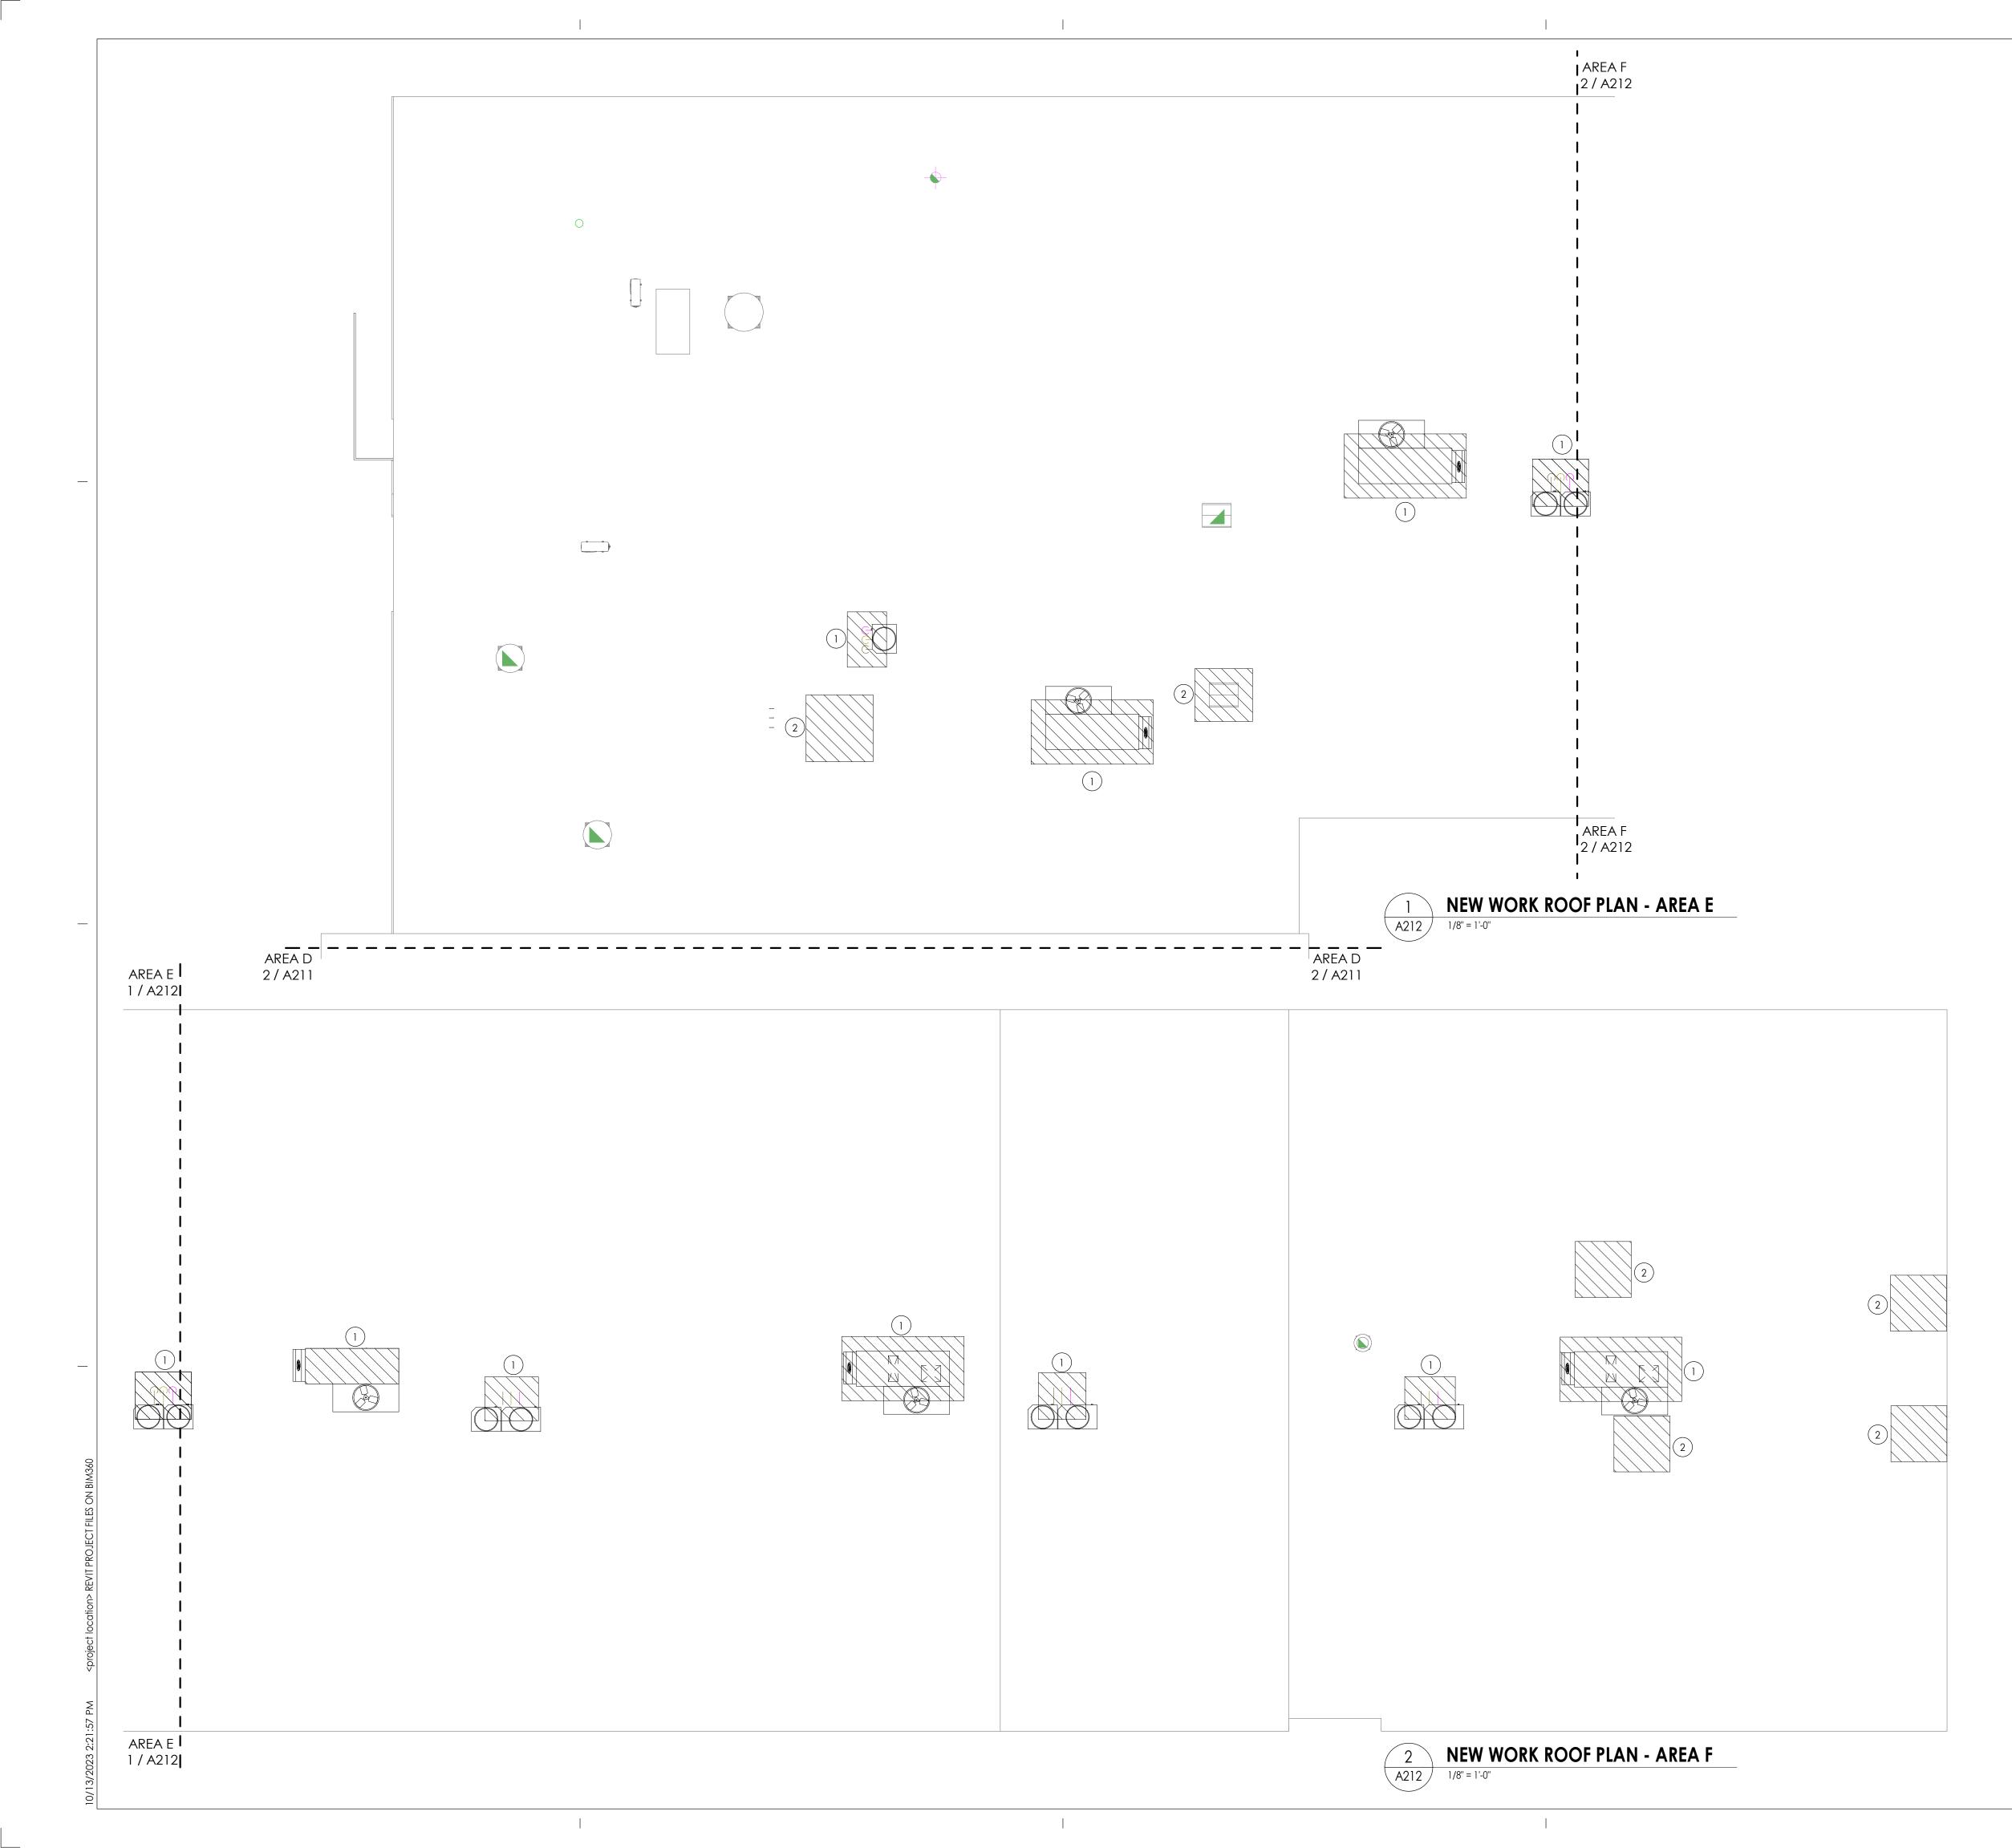

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ROOF PLAN LEGEND



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Project Name PHASE 1: 2022 BOND

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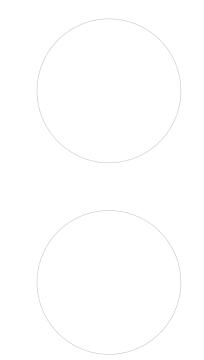
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PROJECT ISSUE & REVISION SCHEDULE No. Date Description

PROFESSIONAL STAMPS




TION OF THE NEW YORK STATE ED BEARING THE SEAL OF AN ARCHITECT, ENGINEER OR SURVEY PARTY SHALL AFFIX TO THE ITEM THEIR SEAL AND THE NOTATIO THEIR SIGNATURE AND THE DATE OF SUCH ALTERATION, AND

SHEET INFORMATION

Issued Scale 10/18/23 As indicated Project Status BID DOCUMENTS Drawn By Checked By LF LT Drawing Title

NEW WORK ROOF PLAN - AREA E&F



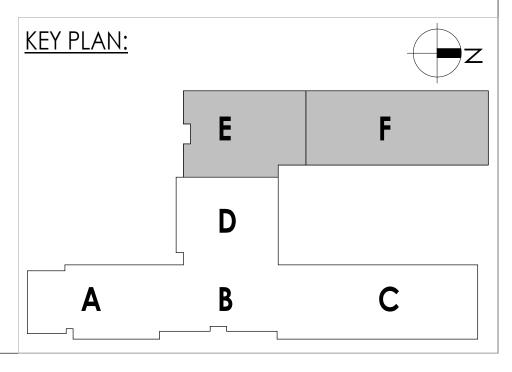



GENERAL CEILING NOTES

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- 3. FOR ANY DISCREPANCY BETWEEN THE REFLECTED CEILING PLAN AND THE FLOOR PLAN: THE FLOOR PLAN SHALL TAKE PRECEDENCE. ANY DISCREPANCY SHALL BE CALLED TO THE ATTENTION OF THE ARCHITECT.
- 4. FIRE STOP MECHANICAL, ELECTRICAL AND PLUMBING ITEMS, INCLUDING BUT NOT LIMITED TO DUCTWORK AND CONDUIT PENETRATIONS THROUGH FLOORS AND WALLS.
- 5. COORDINATE CEILING INSTALLATIONS WITH MECHANICAL, ELECTRICAL AND PLUMBING DRAWINGS.
- 6. REFER TO "H" SERIES DRAWINGS FOR DIFFUSERS AND GRILLE LOCATIONS. 7. REFER TO "E" SERIES DRAWINGS FOR LIGHTING TYPES AND CONTROLS.
- 8. REFER TO "P" OR "FP" SERIES DRAWINGS FOR SPRINKLER HEAD LOCATIONS. 9. WORK AREAS SHALL BE MAINTAINED AND ALL WORK AREAS SHALL BE LEFT
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- 10. CENTER CEILING GRID (EACH WAY) IN ROOMS SCHEDULED TO RECEIVE ACOUSTICAL CEILING SYSTEMS UNLESS OTHERWISE NOTED.
- 11. VERIFY WITH ARCHITECT THE INSTALLATION OF ANY CEILING TILES LESS THAN 4" IN WIDTH.
- 12. PROVIDE MOISTURE RESISTANT GYP. BD. AT ALL TOILET ROOM, JANITOR'S CLOSET AND OTHER WET LOCATION CEILING ASSEMBLIES.
- 13. ALL GYP. BD. CEILINGS AND SOFFITS SHALL BE PRIMED AND PAINTED SCHEDULED COLOR ON ALL FACES AND UNDERSIDE SURFACE. 14. VERIFY SOFFIT SIZE WITH MILLWORK SHOP DRAWINGS. PROVIDE 2" OVERHANG ON
- EXPOSED EDGES UNLESS NOTED OTHERWISE. 15. WHERE APPLICABLE ALL FIXTURES AND DEVICES SHALL BE CENTERED ON A CEILING
- TILE. 16. INSTALL CONTROL JOINTS IN GYP. CEILINGS PER ASTM C 840.


CEILING SYMBOL LEGEND

NOTE: THIS LEGEND MAY CONTAIN SYMBOLS THAT ARE NOT USED IN THIS PROJECT.		
	2'X2' LIGHT	
	2'x4' LIGHTS	
\boxtimes	SUPPLY AIR DIFFUSERS	
	RETURN AIR DIFFUSERS	
	EXHUAST DIFFUSERS	
	LINEAR SLOT AIR DIFFUSERS	
	GYPSUM WALL BOARD CEILING	
	ACOUSTICAL CEILING TILES	
	EXISTING TO REMAIN GRID. SHOWN FOR REFERENCE ONLY	
9'-0" ACT-1	CEILING TYPE AND CEILING HEIGHT ABOVE FINISHED FLOOR	
	CUBICLE CURTAIN TRACK; RE: 'I' SERIES	
CEILING KEYNOTES		

CEILING TRACK FOR CURTAIN; REFER TO 'I' SERIES DRAWINGS FOR MORE / INFORMATION.

2 EXISTING SKYLIGHT TO REMAIN

MODIFIED ACT CEILING SYSTEM BY GC. PATCH GRID & REINSTALL SALVAGED CEILING TILES.

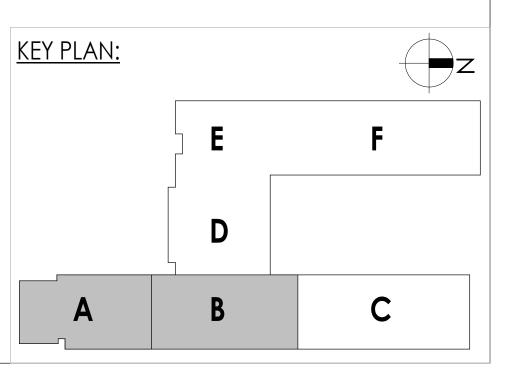



PROJECT INFORMATION Project Number 14457.20 Client Name SOUTH ORANGETOWN CENTRAL

SCHOOL DISTRICT Project Name

PHASE 1: 2022 BOND

District Office Address

Lauren Tarsio 09/30/26 Richard Waite 11/30/23 160 VAN WYCK RD. Larry Werts 12/31/24 BLAUVELT, NY 10913 Anthony Marchetti 05/31/24 Dave Hart 02/28/25 Jennifer Wengender 06/30/24

CERTIFICATE #018330 REGISTRATION EXPIR. DATES:


south orangetown CSD WILLIAM O. SCHAEFER SED#:50-03-01-06-0-012-019 COTTAGE LANE ELEMENTARY SED#:50-03-01-06-0-010-022

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PROJECT ISSUE & REVISION SCHEDULE No. Date

1 00/00/2023 SED ADDENDUM 1

PROFESSIONAL STAMPS

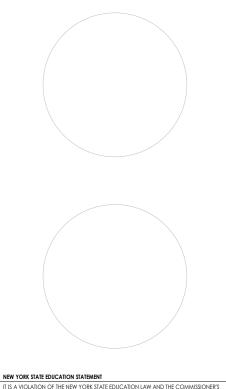

IT IS A VIOLATION OF THE NEW YORK STATE EDUCATION LAW AND THE COMMISSIONER'S REGULATIONS FOR ANY PERSON, UNLESS ACTING UNDER THE DIRECTION OF A LICENSED ARCHITECT, ENGINEER OR LAND SURVEYOR, TO ALTER AN ITEM IN ANY WAY. IF AN ITEM BEARING THE SEAL OF AN ARCHITECT, ENGINEER OR SURVEYOR IS ALTERED THE ALTERING PARTY SHALL AFRY TO THE ITEM THER SEAL AND THE NOTATION "ALTERED BY" FOLLOWED BY THERE SIGNATURE AND THE DATE OF SUCH ALTERATION, AND A SPECIFIC DESCRIPTION OF TI ALTERATION.

SHEET INFORMATION

Issued	Scale
10/18/23	As indicated
Project Status	
BID DOCUMENTS	
Drawn By	Checked By
LF	LT
Drawing Title	

REFLECTED CEILING PLAN - AREA A&B







_ _ -AREA B 2 / A600

2

A601



1/8" = 1'-0"

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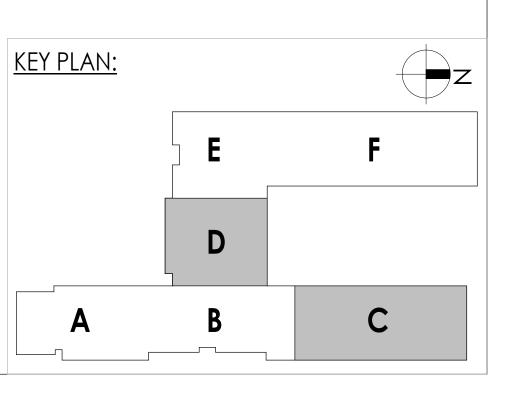
CEILING SYMBOL LEGEND

NOTE: THIS LEGEND MAY CONTAIN SYMBOLS THAT ARE NOT USED IN THIS PROJECT. 2'X2' LIGHT 2'x4' LIGHTS \boxtimes SUPPLY AIR DIFFUSERS RETURN AIR DIFFUSERS EXHUAST DIFFUSERS LINEAR SLOT AIR DIFFUSERS GYPSUM WALL BOARD CEILING · · · +--+ ACOUSTICAL CEILING TILES _ EXISTING TO REMAIN GRID. SHOWN FOR REFERENCE ONLY 9'-0" ACT-1 CEILING TYPE AND CEILING HEIGHT ABOVE FINISHED FLOOR CUBICLE CURTAIN TRACK; RE: 'I' SERIES ____

CEILING KEYNOTES

1 CEILING TRACK FOR CURTAIN; REFER TO 'I' SERIES DRAWINGS FOR MORE INFORMATION.

MODIFIED ACT CEILING SYSTEM BY GC. PATCH GRID & REINSTALL SALVAGED CEILING TILES.





PROJECT INFORMATION Project Number 14457.20

Client Name SOUTH ORANGETOWN CENTRAL SCHOOL DISTRICT Project Name

PHASE 1: 2022 BOND

CERTIFICATE #018330 REGISTRATION EXPIR. DATES: Lauren Tarsio 09/30/26 District Office Address Richard Waite 11/30/23 160 VAN WYCK RD. Larry Werts 12/31/24 BLAUVELT, NY 10913 Anthony Marchetti 05/31/24


Dave Hart 02/28/25 Jennifer Wengender 06/30/24 south orangetown CSD

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PROJECT ISSUE & REVISION SCHEDULE No. Date

1 00/00/2023 SED ADDENDUM 1

PROFESSIONAL STAMPS

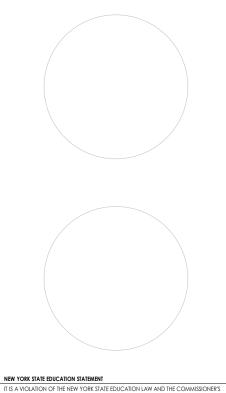

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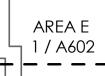
SHEET INFORMATION

Issued	Scale
10/18/23	As indicated
Project Status	
BID DOCUMENTS	
Drawn By	Checked By
LF	LT
Drawing Title	

REFLECTED CEILING PLAN - AREA C&D



AREA B 2 / A600



2 EXISTING SKYLIGHT TO REMAIN



GENERAL CEILING NOTES

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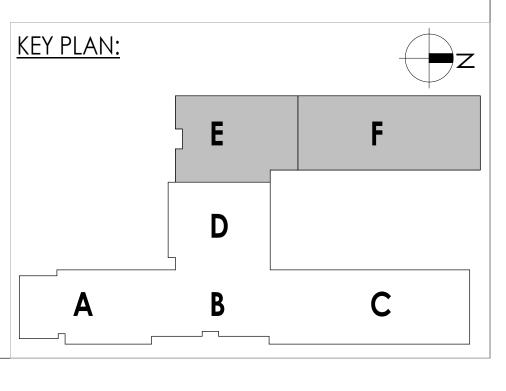
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PROJECT INFORMATION Project Number 14457.20 Client Name SOUTH ORANGETOWN CENTRAL

SCHOOL DISTRICT Project Name

PHASE 1: 2022 BOND

District Office Address

Lauren Tarsio 09/30/26 Richard Waite 11/30/23 160 VAN WYCK RD. Larry Werts 12/31/24 BLAUVELT, NY 10913 Anthony Marchetti 05/31/24 Dave Hart 02/28/25 Jennifer Wengender 06/30/24

CERTIFICATE #018330

REGISTRATION EXPIR. DATES:


south orangetown CSD WILLIAM O. SCHAEFER SED#:50-03-01-06-0-012-019 COTTAGE LANE ELEMENTARY SED#:50-03-01-06-0-010-022 TAPPAN ZEE HIGH SCHOOL SED#:50-03-01-06-0-006-032

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PROJECT ISSUE & REVISION SCHEDUL No. Date

1 00/00/2023 SED ADDENDUM 1

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SHEET INFORMATION


Issued Scale 10/18/23 As indicated Project Status BID DOCUMENTS Drawn By Checked By LF LT

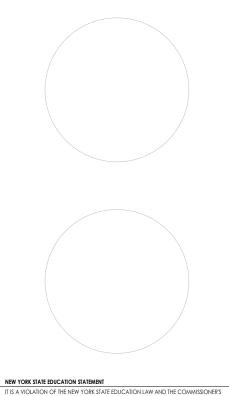Drawing Title **REFLECTED CEILING PLAN - AREA** E&F







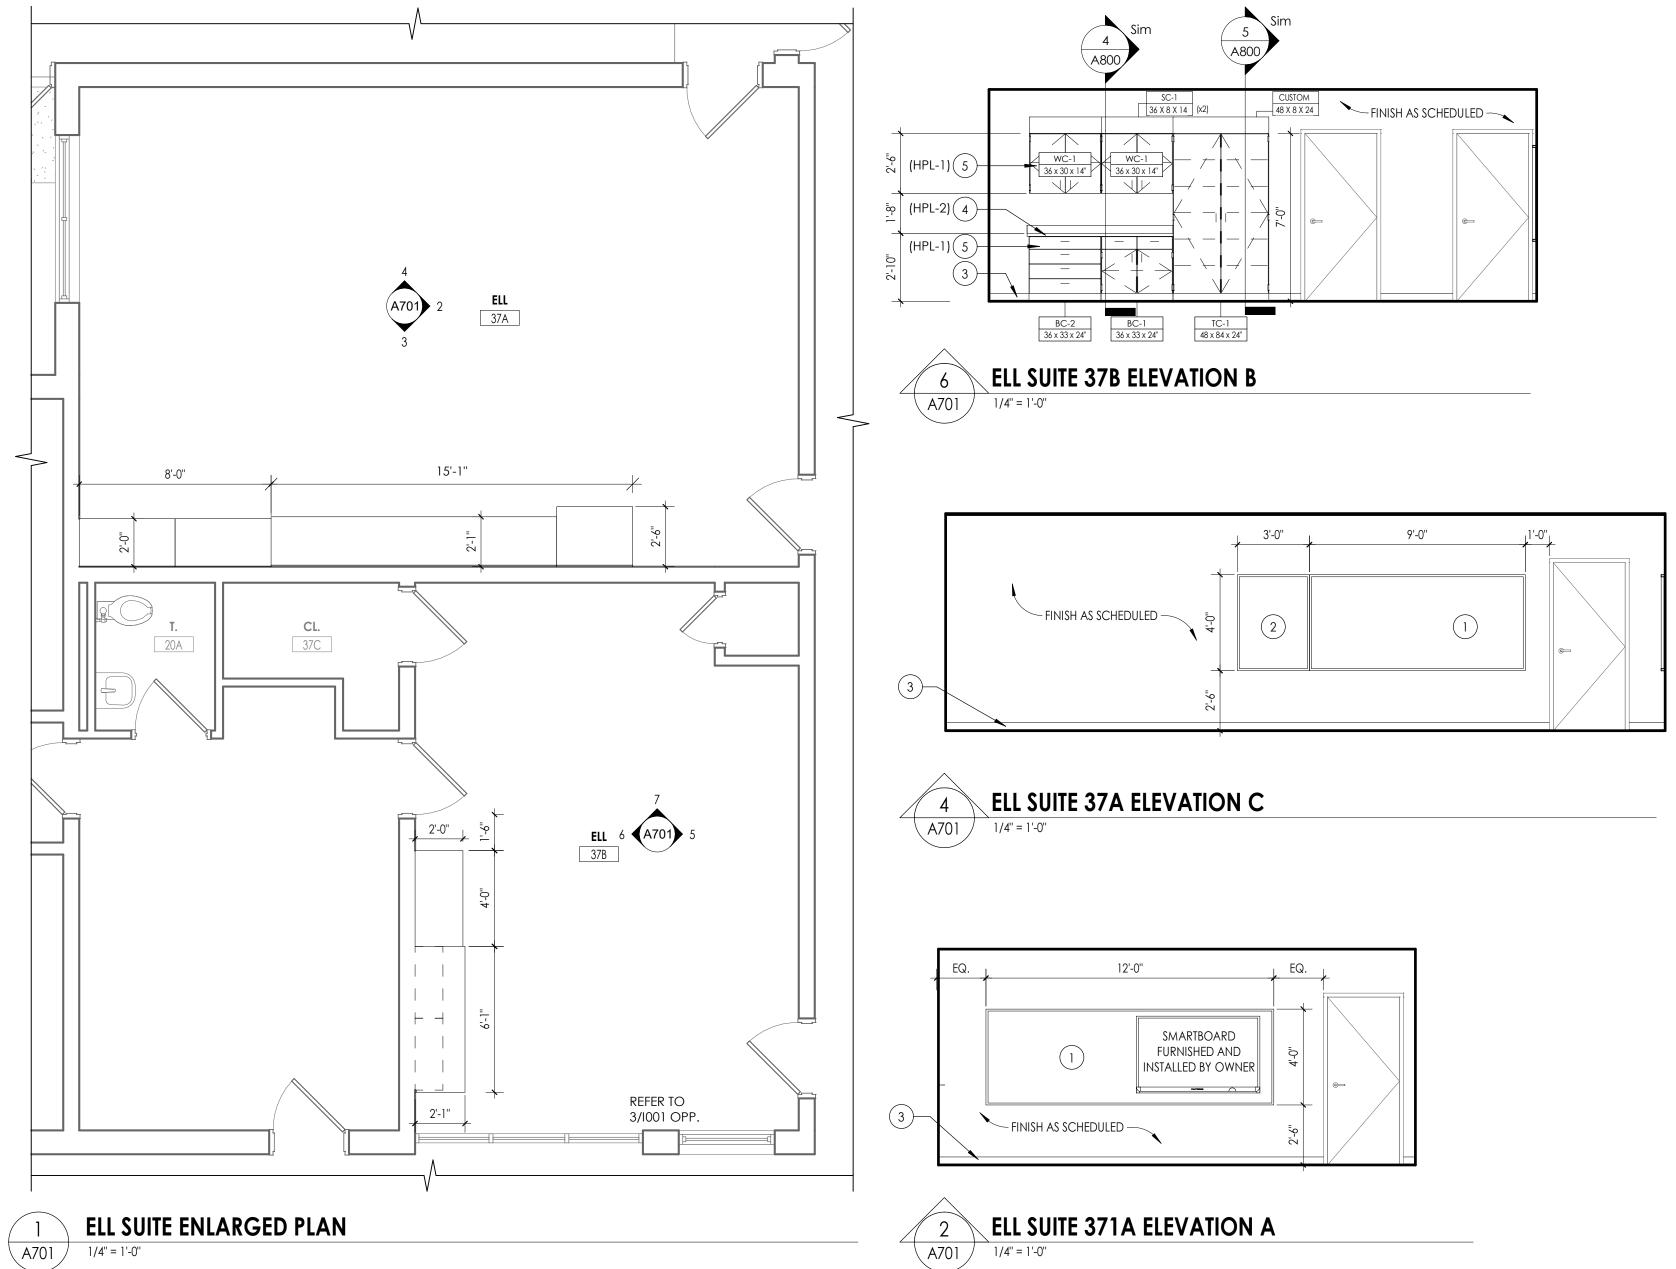


DESIGNATION	DIMENSIONS	DESCRIPTION	TMI#
ADA-1	36" X 33" X 24"	ADA SINK BASE	1136
BC-1	36" X 33" X 24"	6" DRAWER/2/DOOR/1 ADJUSTABLE SHELF	D1122
BC-2	36" X 33" X 24"	6" DRAWER/3 EQUAL DRAWERS	D4013
BC-3	36" X 33" X 24"	PAPER STORAGE/4 EQUAL DRAWERS	D5851
BC-4	36" X 29" X 21"	OPEN SHELF/1 ADJUSTABLE SHELF	B1050
BC-5	21" X 29" X 21"	OPEN SHELV/1 ADJUSTABLE SHELF	B1050
BC-6	18" X 29" X 22"	2 EQUAL DRAWERS/1 FILE DRAWER	D3007
BC-7	18" X 29" X 22"	1 DRAWER/1 FILE DRAWER	D2801
BC-8	36" X 29" X 13"	OPEN SHELF/1 ADJUSTABLE SHELF	B1050
WC-1	36" X 29" X 14"	2 DOOR/1 ADJUSTABLE SHELF	W2052
WC-2	42" X 29" X 14"	2 DOOR/1 ADJUSTABLE SHELF	W2052
WC-3	36" X 27" 14"	MAILBOX/21 COMPARTMENTS W/ LABEL HOLDERS	W1820
TC-1	48" X 84" X 24"	2 DOORS/1VERTICAL DIVIDER/8 ADJUSTABLE SHELVES	T2112
TC-2	42" X 84" X 24"	2 DOORS/1VERTICAL DIVIDER/8 ADJUSTABLE SHELVES	T2112
TC-3	30" X 84" X 24"	2 DOORS/1 VERTICAL DIVIDER/8 ADJUSTABLE SHELVES	T2112
SC-1	8.25" X 14.25"	30 DEGREE SLOPED TOP - LENGTH AS REQUIRED	A1324
CUSTOM	8.25" X 24.25"	30 DEGREE SLOPED TOP - LENGTH AS REQUIRED	A1324 AS REFERENCE

METAL CASEWORK SCHEDULE


DESCRIPTION

designation dimensions


MC-1 MC-2	36" X 30" X 16 60" X 30" X 16	•	OPEN SHELF/1 ADJUSTABLE SHELF OPEN SHELF/1 ADJUSTABLE SHELF
LEGEND: ADA = ADA BASE BC = BASE CABINET			: CASEWORK WITH DOORS/ DRA RS REQUEST. OWNER IS RESPON
TC = TALL CABIN SC = SLOPED CA	= WALL CABINET TALL CABINET SLOPED CABINET TOP = METAL CABINET		T<u>E</u>: CASEWORK PRO DTHERS. SHOWN FO

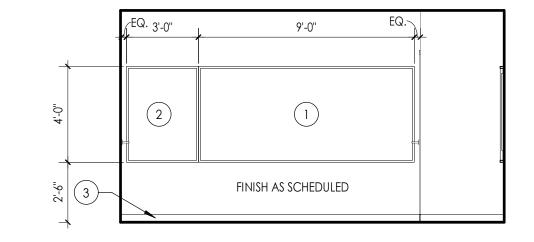



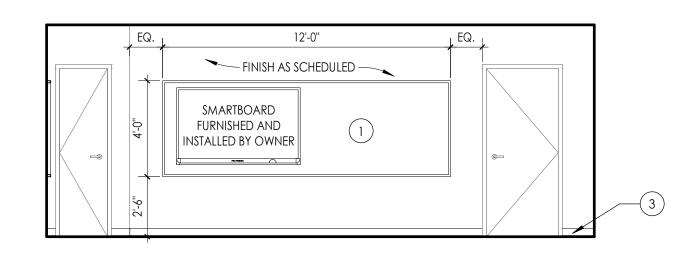



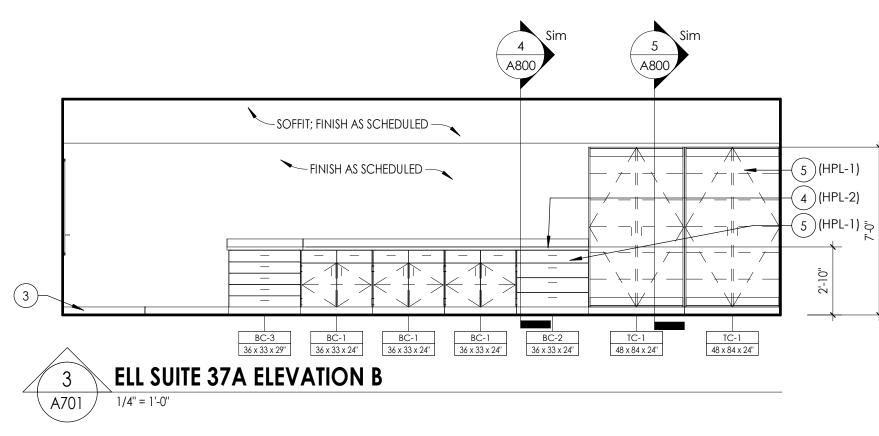

BASIS OF DESIGN MANUFACTURER: TRANE

SHL-B-D-1-05 AWERS TO RECIEVE LOCKS PER

DNSIBLE FOR KEYING.

OVIDED AND INSTALLED OR REFERENCE ONLY.

TRANE#

SHL-B-B-1-03

GENERAL INTERIOR ELEVATIONS NOTES

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- FIELD VERIFY ALL DIMENSIONS PRIOR TO SHOP DRAWING SUBMITTAL. PROVIDE SUPPORT BLOCKING AND STRAPPING FOR ALL MILLWORK, CASEWORK, AND WALL MOUNTED ACCESSORIES.
- REFER TO FINISH SCHEDULE AND COLOR LEGEND FOR FINISHES. REFER TO **A200 SERIES** DRAWINGS FOR ADDITIONAL SPECIALTIES.
- REFER TO A600 SERIES DRAWINGS FOR CEILING HEIGHTS. PROVIDE FULL FINISHED END PANELS ON ALL EXPOSED MILLWORK.
- PROVIDE FILLER PANEL WHERE MILLWORK MEETS WALL.
- PROVIDE SUPPORT BRACKETS AT WORK SURFACES, 48" MAX BETWEEN BRACKETS UNLESS NOTED OTHERWISE.). GROMMETS TO BE INSTALLED IN FIELD AND COORDINATED WITH I.T. EQUIPMENT.
- I. ALL MILLWORK TO BE LOCKABLE UNLESS NOTED OTHERWISE. 12. PROVIDE VALANCE COVER AT ALL UNDER CABINET LIGHTING WHEREVER UNDER
- CABINET LIGHTING IS REQUIRED. 13. REFER TO FINISH SCHEDULE AND A700 SERIES DRAWINGS FOR MILLWORK FINISHES. 14. REFER TO A700 FOR TOILET FIXTURE AND ACCESSORIES LEGEND AND MOUNTING
- heights. 15. REFER TO **A700 OR SPECS** FOR ALL TOILET ROOM ACCESSORIES PROVIDED BY OWNER. 16. EQUIPMENT SHOWN ON THESE DOCUMENTS ARE FOR REFERENCE ONLY AND ARE FOR THE COORDINATION OF M.E.P. INFRASTRUCTURE TO OPERATE ITEMS UNDER THIS
- scope. . IT IS THE GENERAL CONTRACTORS RESPONSIBILITY TO REFER TO OWNER FURNISHED EQUIPMENT DRAWINGS AND SUBMITTALS FOR FINAL COORDINATION AND INSTALLATION REQUIREMENTS INCLUDING BUT NOT LIMITED TO: DIMENSIONS AND LOCATIONS OF MEP CONNECTION LOCATIONS. 3. ALL FURNITURE IS PROVIDED BY OWNER UNLESS NOTED OTHERWISE.

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-) PROVIDE VINYL WRITEABLE/MAGNETIC SURFCE.
- 2) PROVIDE TACKABLE SURFACE.
-) PROVIDE BASE, AS SCHEDULED.
- 4) PROVIDE HPL COUNTERTOP, AS SCHEDULED.
- PROVIDE HPL CASEWORK, FINISHED END PANELS AND FILLERS, AS REQUIRED) (O.F.C.I.).
- (6) PROVIDE ACOUSTICAL WALL PANELS. SEE 1000 FOR ADDITIONAL DETAIL.
- (7) EXISTING EXPOSED BRICK TO REMAIN, WHERE APPLICABLE.
- 8 PROVIDE METAL SUPPORT BRACKET 4'-0" OC MAX. BASIS OF DESIGN : RAKKS EH-1818.
- PROVIDE CAST METAL LETTERING ON STAND OFFS. TEXT HEIGHT TO BE 6". FONT ⁹ TBD. GC TO VERIFY TEXT WITH OWNER.
- (10) NOT IN USE
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- (12) ALT BID SC-03: PROVIDE HPL COUNTERTOP AND CASEWORK, AS SCHEDULED.
- PROVIDE AND INSTALL MEDICUSHEALTH DOUBLEDOOR DOUBLE LOCK 13) NARCOTICS CABINET ITEM #2976M1, OR EQUAL. MOUNT WITHIN CABINET WC-1. VERIFY LOCATION WITH ARCHITECT PRIOR TO INSTALLATION.



PROJECT INFORMATION Project Number

14457.20 Client Name SOUTH ORANGETOWN CENTRAL SCHOOL DISTRICT

Project Name PHASE 1: 2022 BOND

CERTIFICATE #018330 REGISTRATION EXPIR. DATES: District Office Address


Lauren Tarsio 09/30/26 Richard Waite 11/30/23 160 VAN WYCK RD. Larry Werts 12/31/24 BLAUVELT, NY 10913 Anthony Marchetti 05/31/24 Dave Hart 02/28/25 Jennifer Wengender 06/30/24

south orangetown CSD

- WILLIAM O. SCHAEFER SED#:50-03-01-06-0-012-019 COTTAGE LANE ELEMENTARY SED#:50-03-01-06-0-010-022] TAPPAN ZEE HIGH SCHOOL SED#:50-03-01-06-0-006-032 WILLIAM O. SCHAEFER S&L SED#:50-03-01-06-0-012-020 COTTAGE LANE S&L SED#: 50-03-01-06-0-010-023 COTTAGE LANE LIBRARY S&L SED#: 50-03-01-06-8-023-002 WOS OUTDOOR CLASSROOM SED#: 50-03-01-06-7-053-001
- SOMS OUTDOOR CLASSROOM SED#:50-03-01-06-7-056-001 CLE OUTDOOR CLASSROOM SED#:50-03-01-06-7-054-001 TZHS OUTDOOR CLASSROOM SED#:50-03-01-06-7-055-001

PROJECT ISSUE & REVISION SCHEDULE No. Date

PROFESSIONAL STAMPS

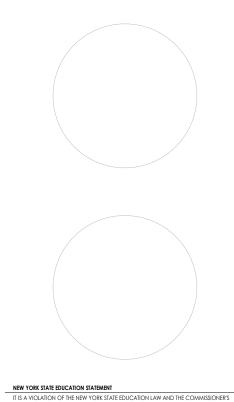

EGULATIONS FOR ANY PERSON, UNLESS ACTING UNDER THE DIRECTION OF A LICENS RCHITECT, ENGINEER OR LAND SURVEYOR, TO ALTER AN ITEM IN ANY WAY. IF AN ITE

SHEET INFORMATION

Drawn By

Drawing Title

LF

Issued 10/18/23 Project Status


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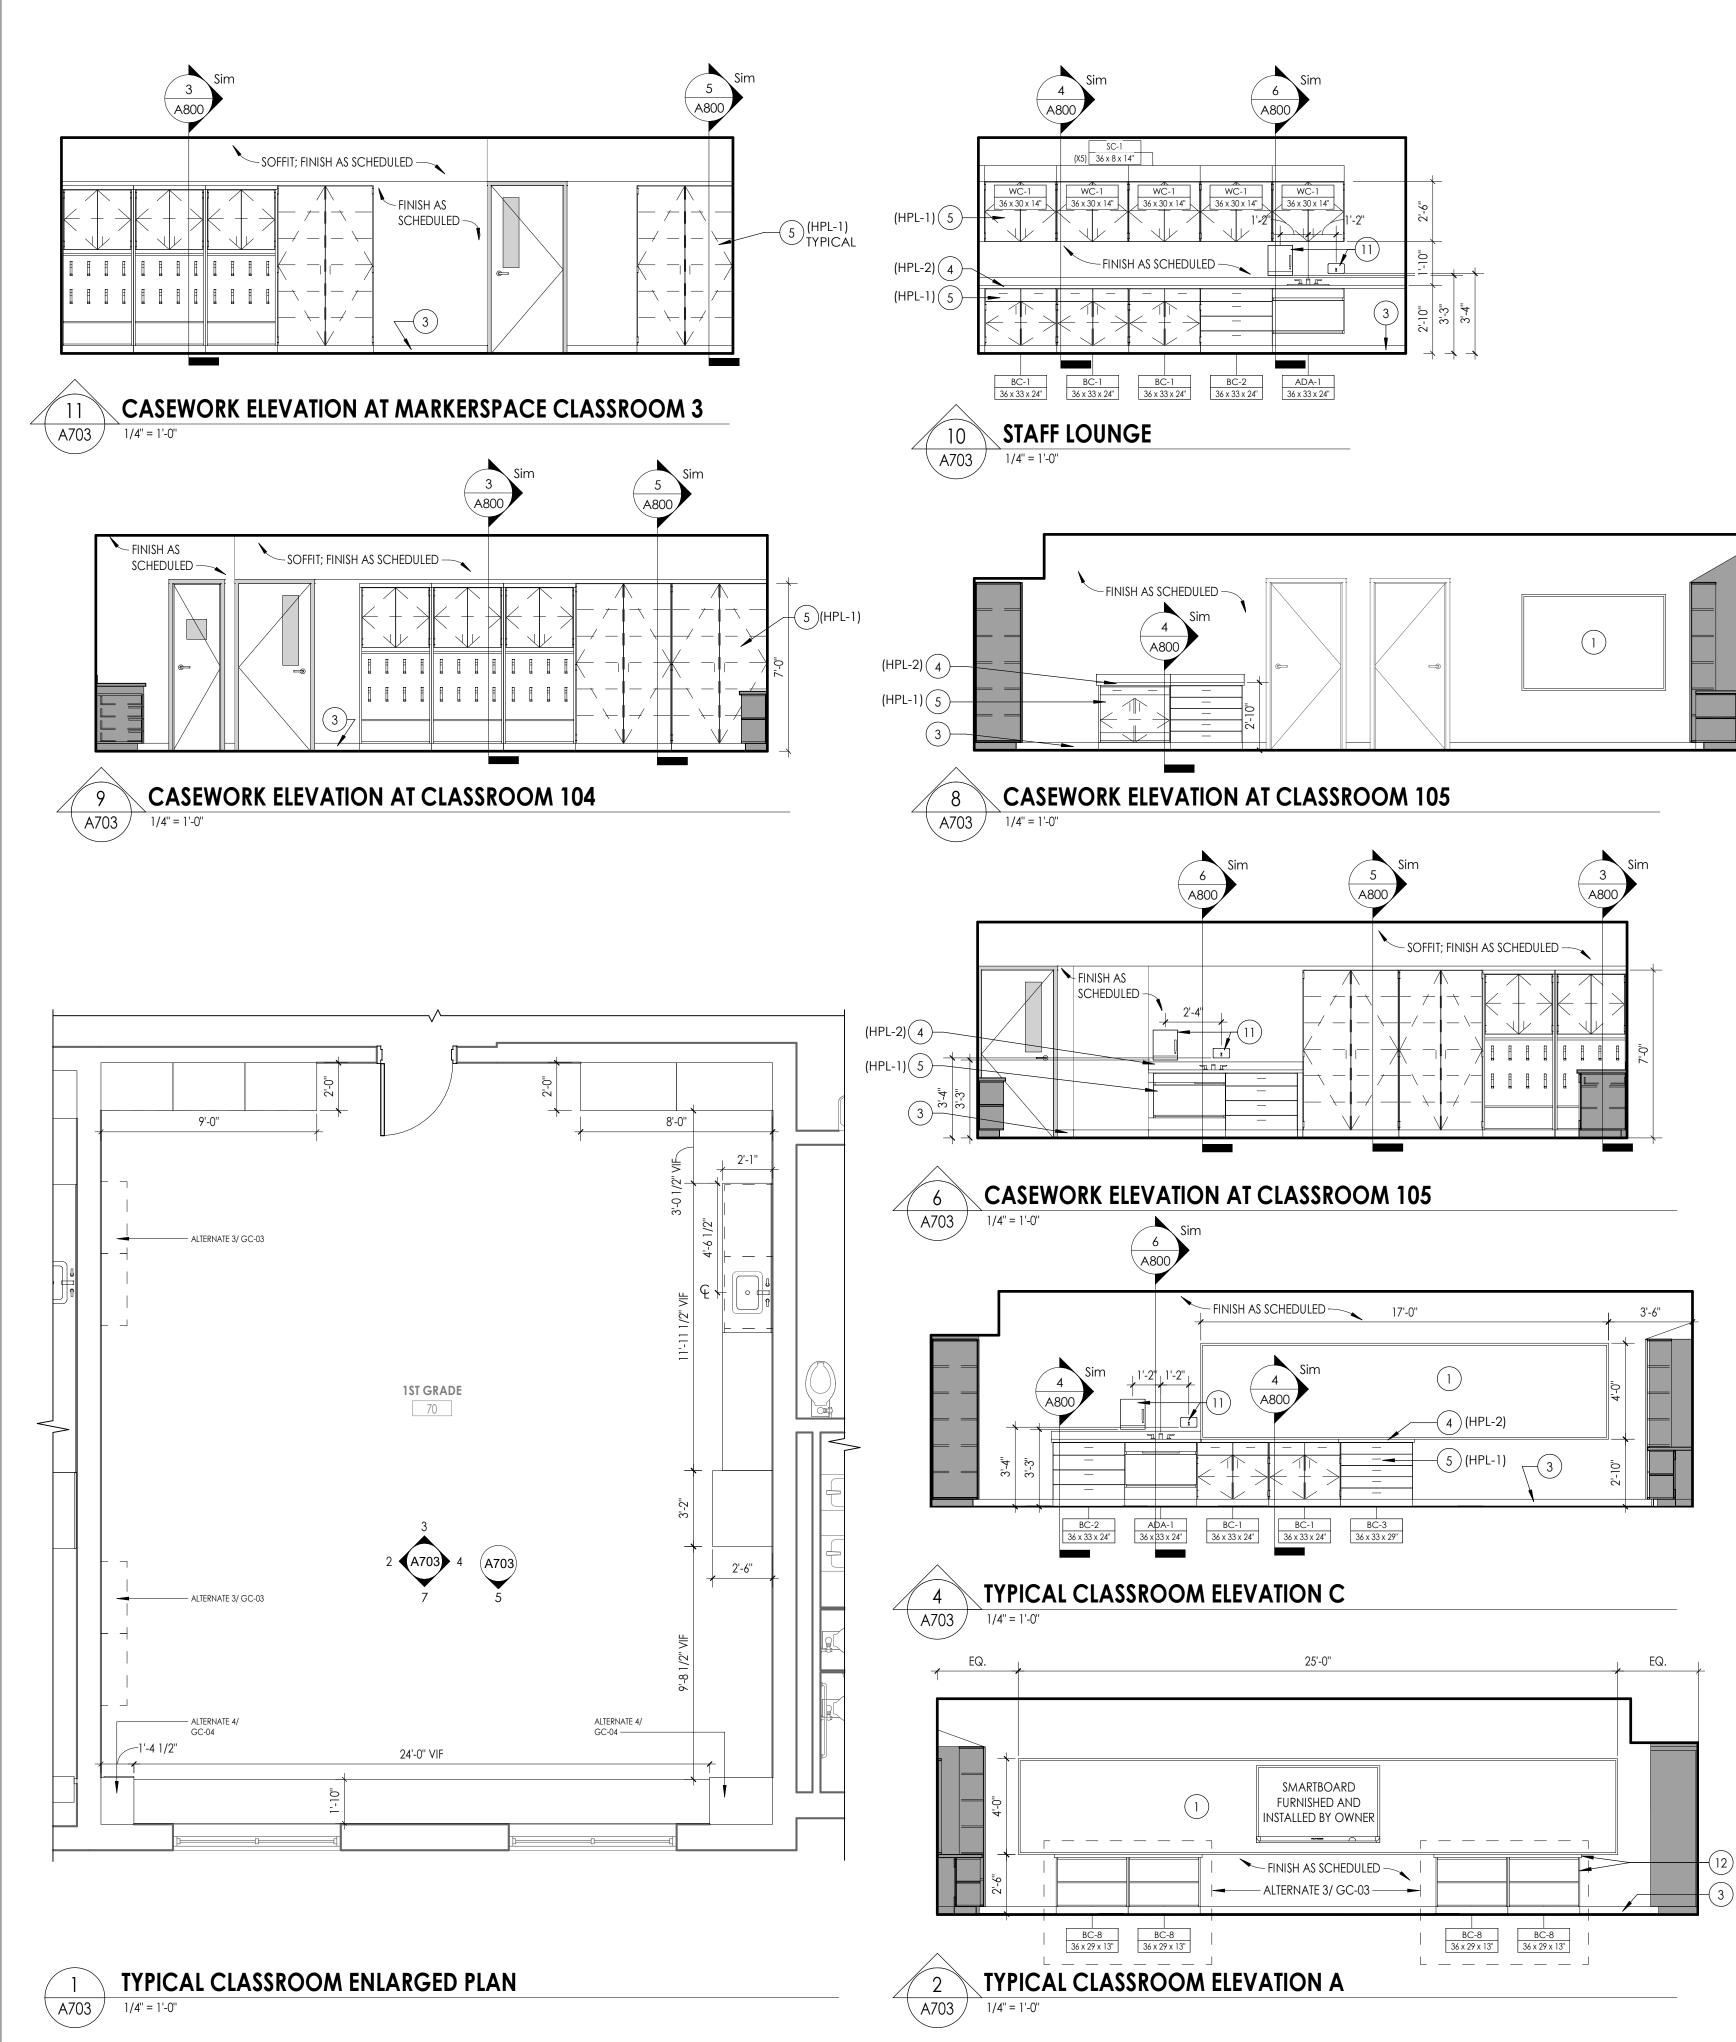
BID DOCUMENTS

Checked By LT

ELL SUITE ENLARGED FLOOR PLANS AND INTERIOR Elevations

Drawing Number WOS A701



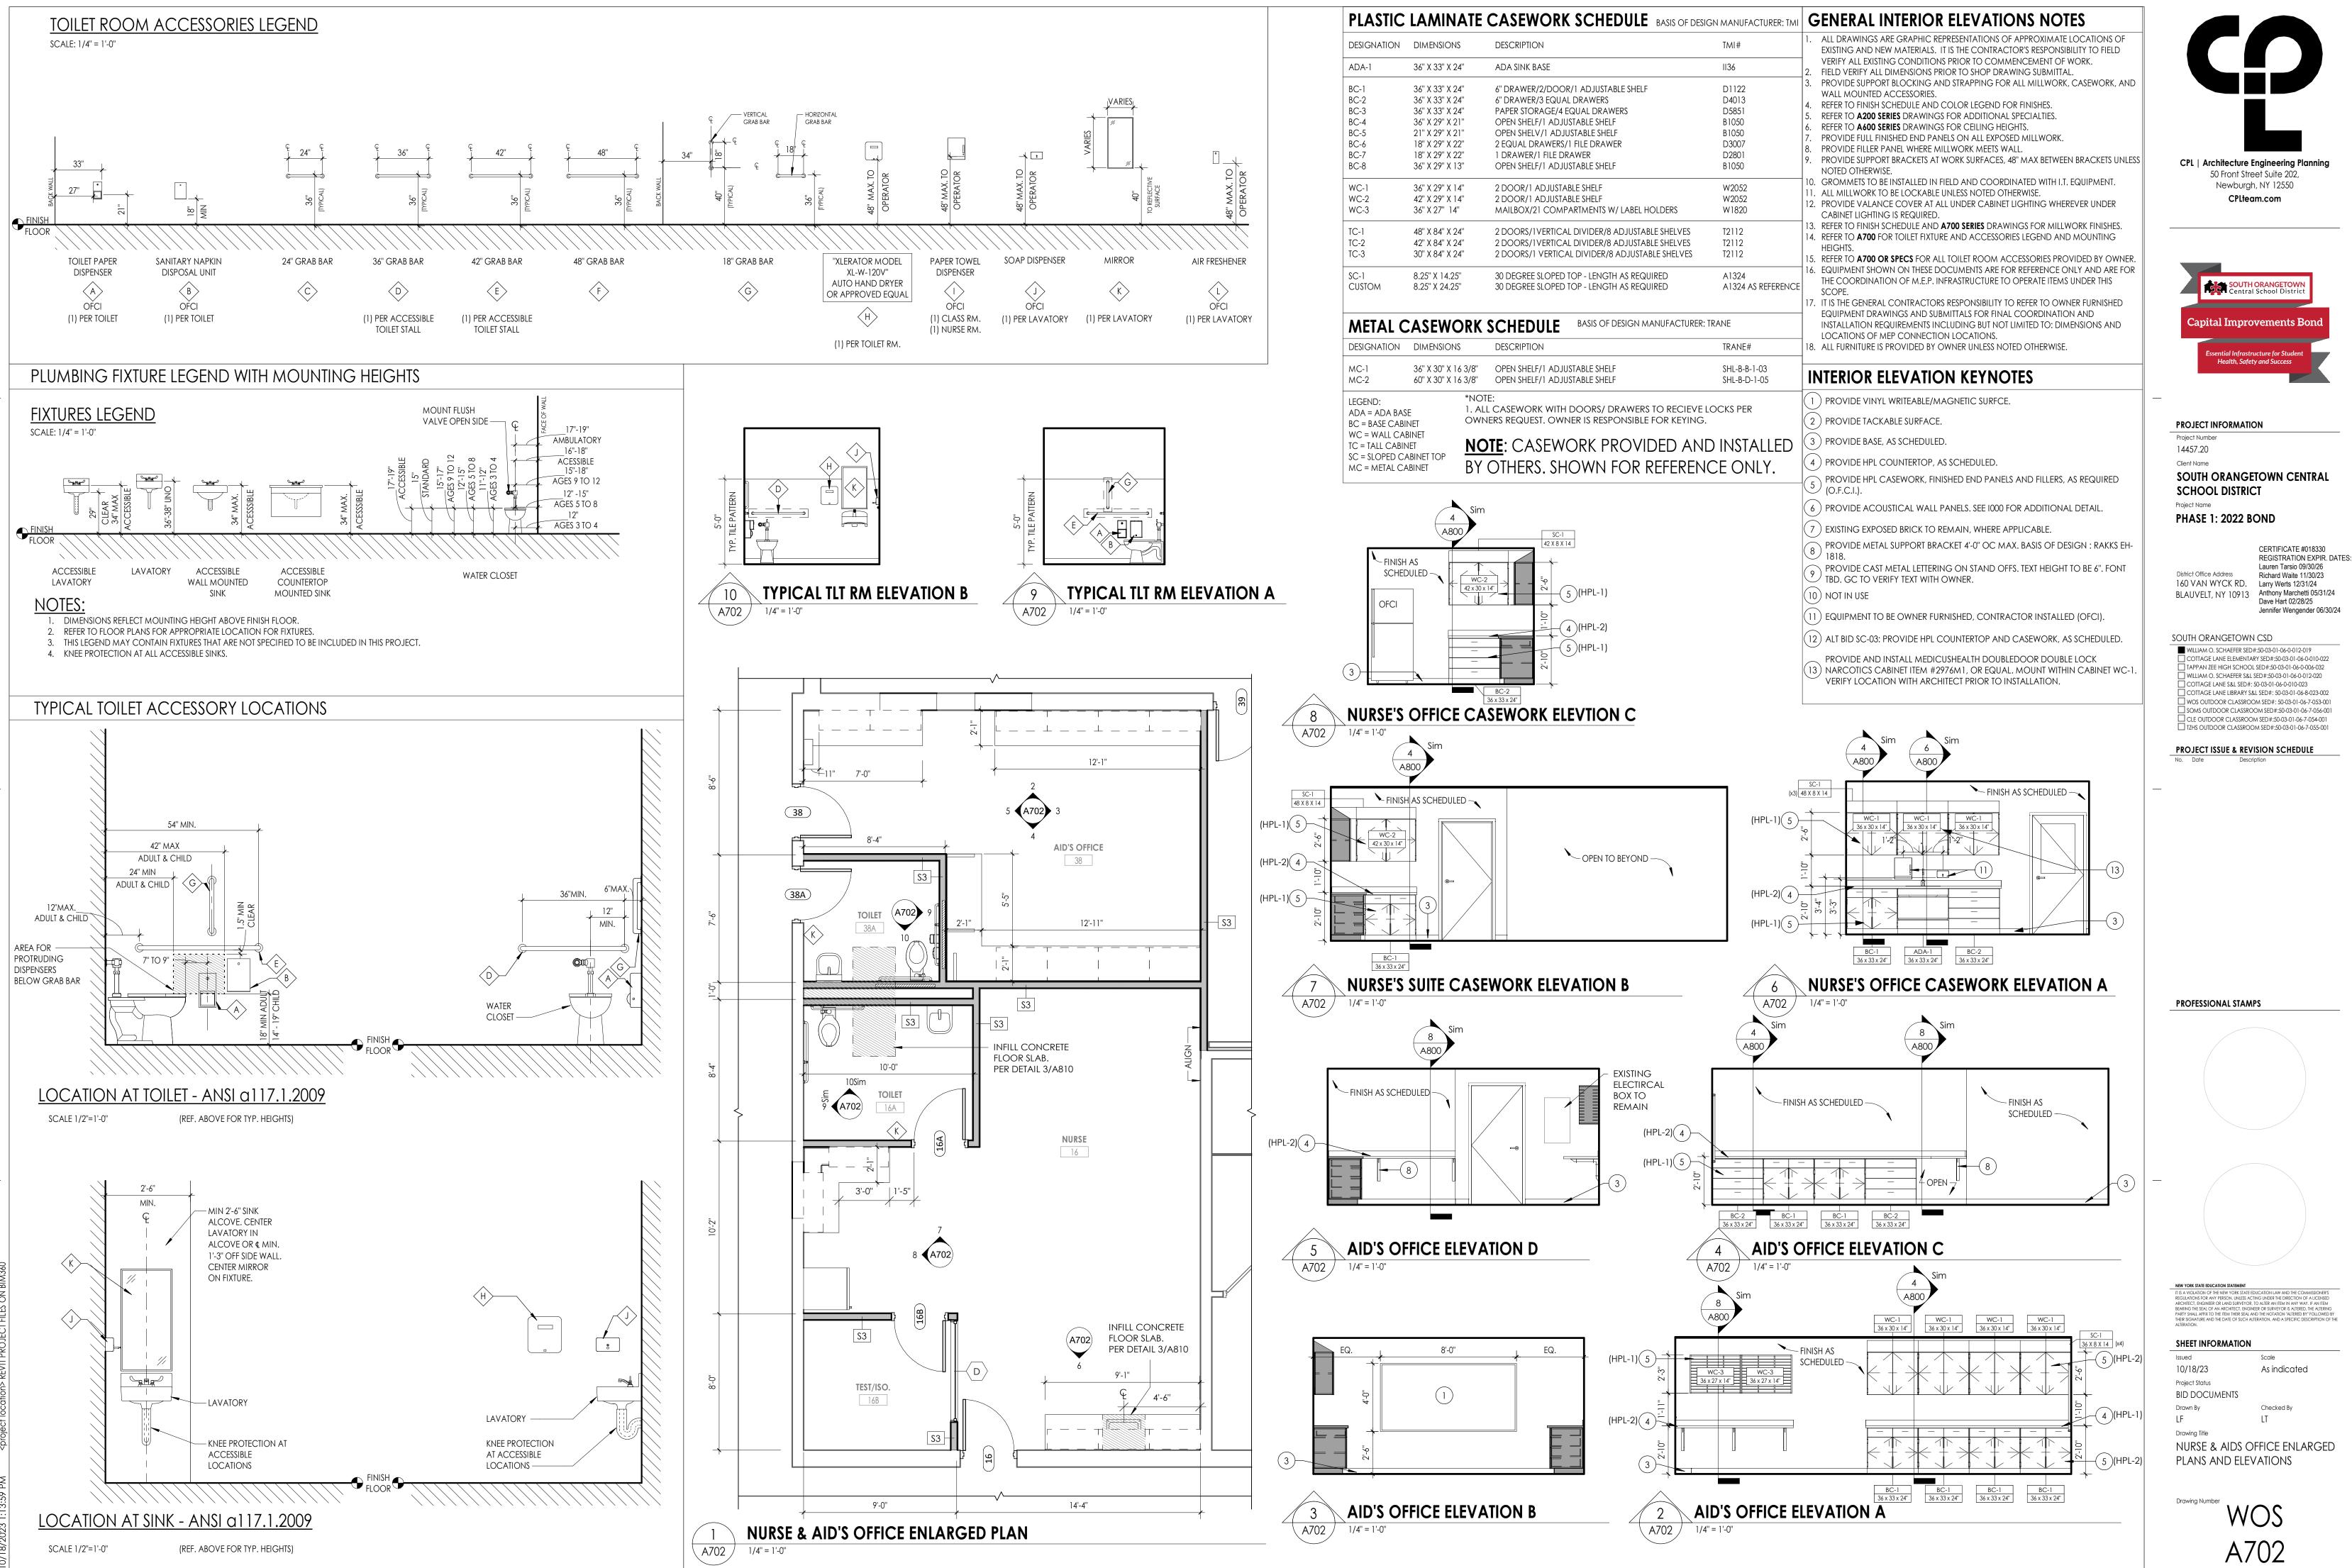


PLASTIC	LAMINATE		SIS OF DESIGN MANUFACTURER: TMI
DESIGNATION	DIMENSIONS	DESCRIPTION	TMI#
ADA-1	36" X 33" X 24"	ADA SINK BASE	1136
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METAL CASEWORK SCHEDULE

DESCRIPTION

DESIGNATION DIMENSIONS

MC-1 MC-2	36" X 30" X 60" X 30" X	OPEN SHELF/1 ADJUSTABLE SHELF OPEN SHELF/1 ADJUSTABLE SHELF
LEGEND: ADA = ADA BAS BC = BASE CABI	NET	te: Ll Casework with doors/ dra Ners request. Owner is respon
WC = WALL CA TC = TALL CABIN SC = SLOPED CA MC = METAL CA	NET ABINET TOP	 <u>DTE</u> : CASEWORK PRO OTHERS. SHOWN FO

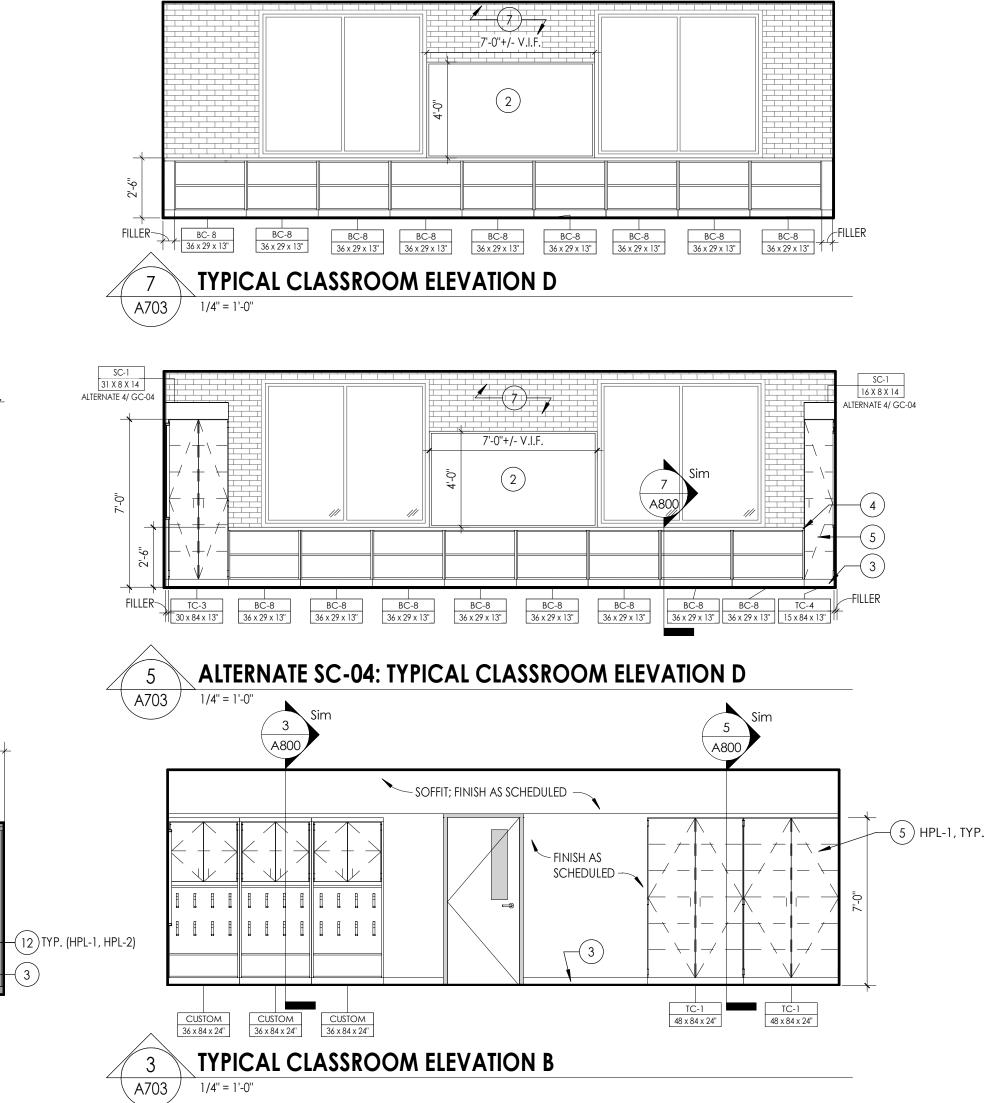

BASIS OF DESIGN MANUFACTURER: TRANE

AWERS TO RECIEVE LOCKS PER

NSIBLE FOR KEYING.

OVIDED AND INSTALLED OR REFERENCE ONLY

TRANE#

SHL-B-B-1-03

SHL-B-D-1-05

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PROJECT INFORMATION Project Number

14457.20 Client Name SOUTH ORANGETOWN CENTRAL SCHOOL DISTRICT

Project Name PHASE 1: 2022 BOND

CERTIFICATE #018330 REGISTRATION EXPIR. DATES: District Office Address


Lauren Tarsio 09/30/26 Richard Waite 11/30/23 160 VAN WYCK RD. Larry Werts 12/31/24 BLAUVELT, NY 10913 Anthony Marchetti 05/31/24 Dave Hart 02/28/25 Jennifer Wengender 06/30/24

South orangetown CSD

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PROJECT ISSUE & REVISION SCHEDULE No. Date

PROFESSIONAL STAMPS

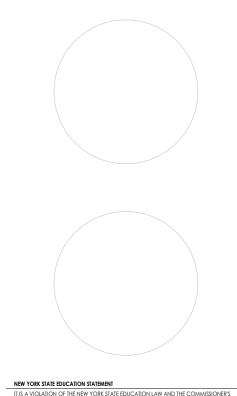

SHEET INFORMATION

Drawn By

Drawing Title

LF


Issued Scale 10/18/23 As indicated Project Status

BID DOCUMENTS


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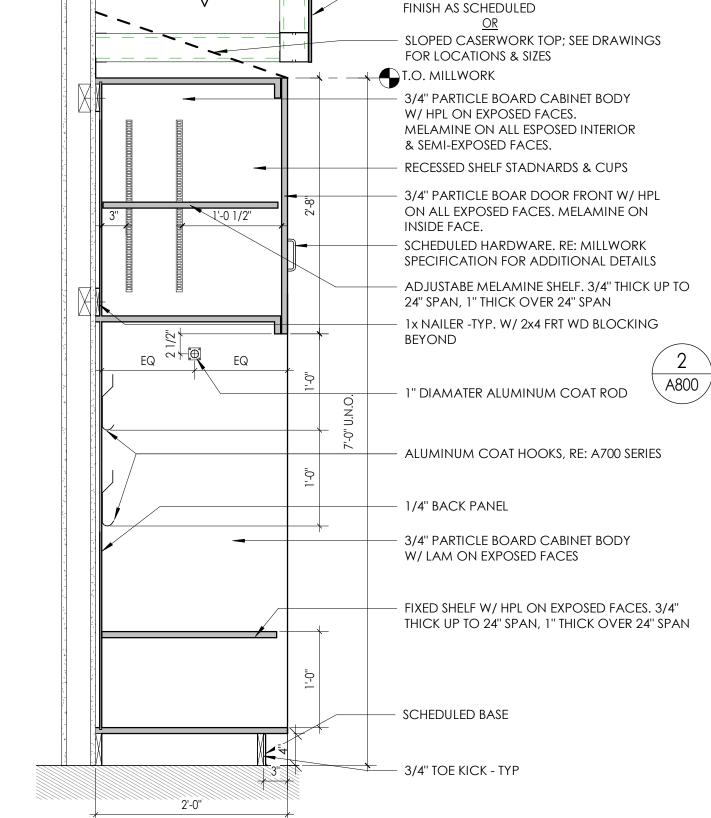
ENLARGED FLOOR PLANS AND INTERIOR ELEVATIONS

Drawing Number WOS A703



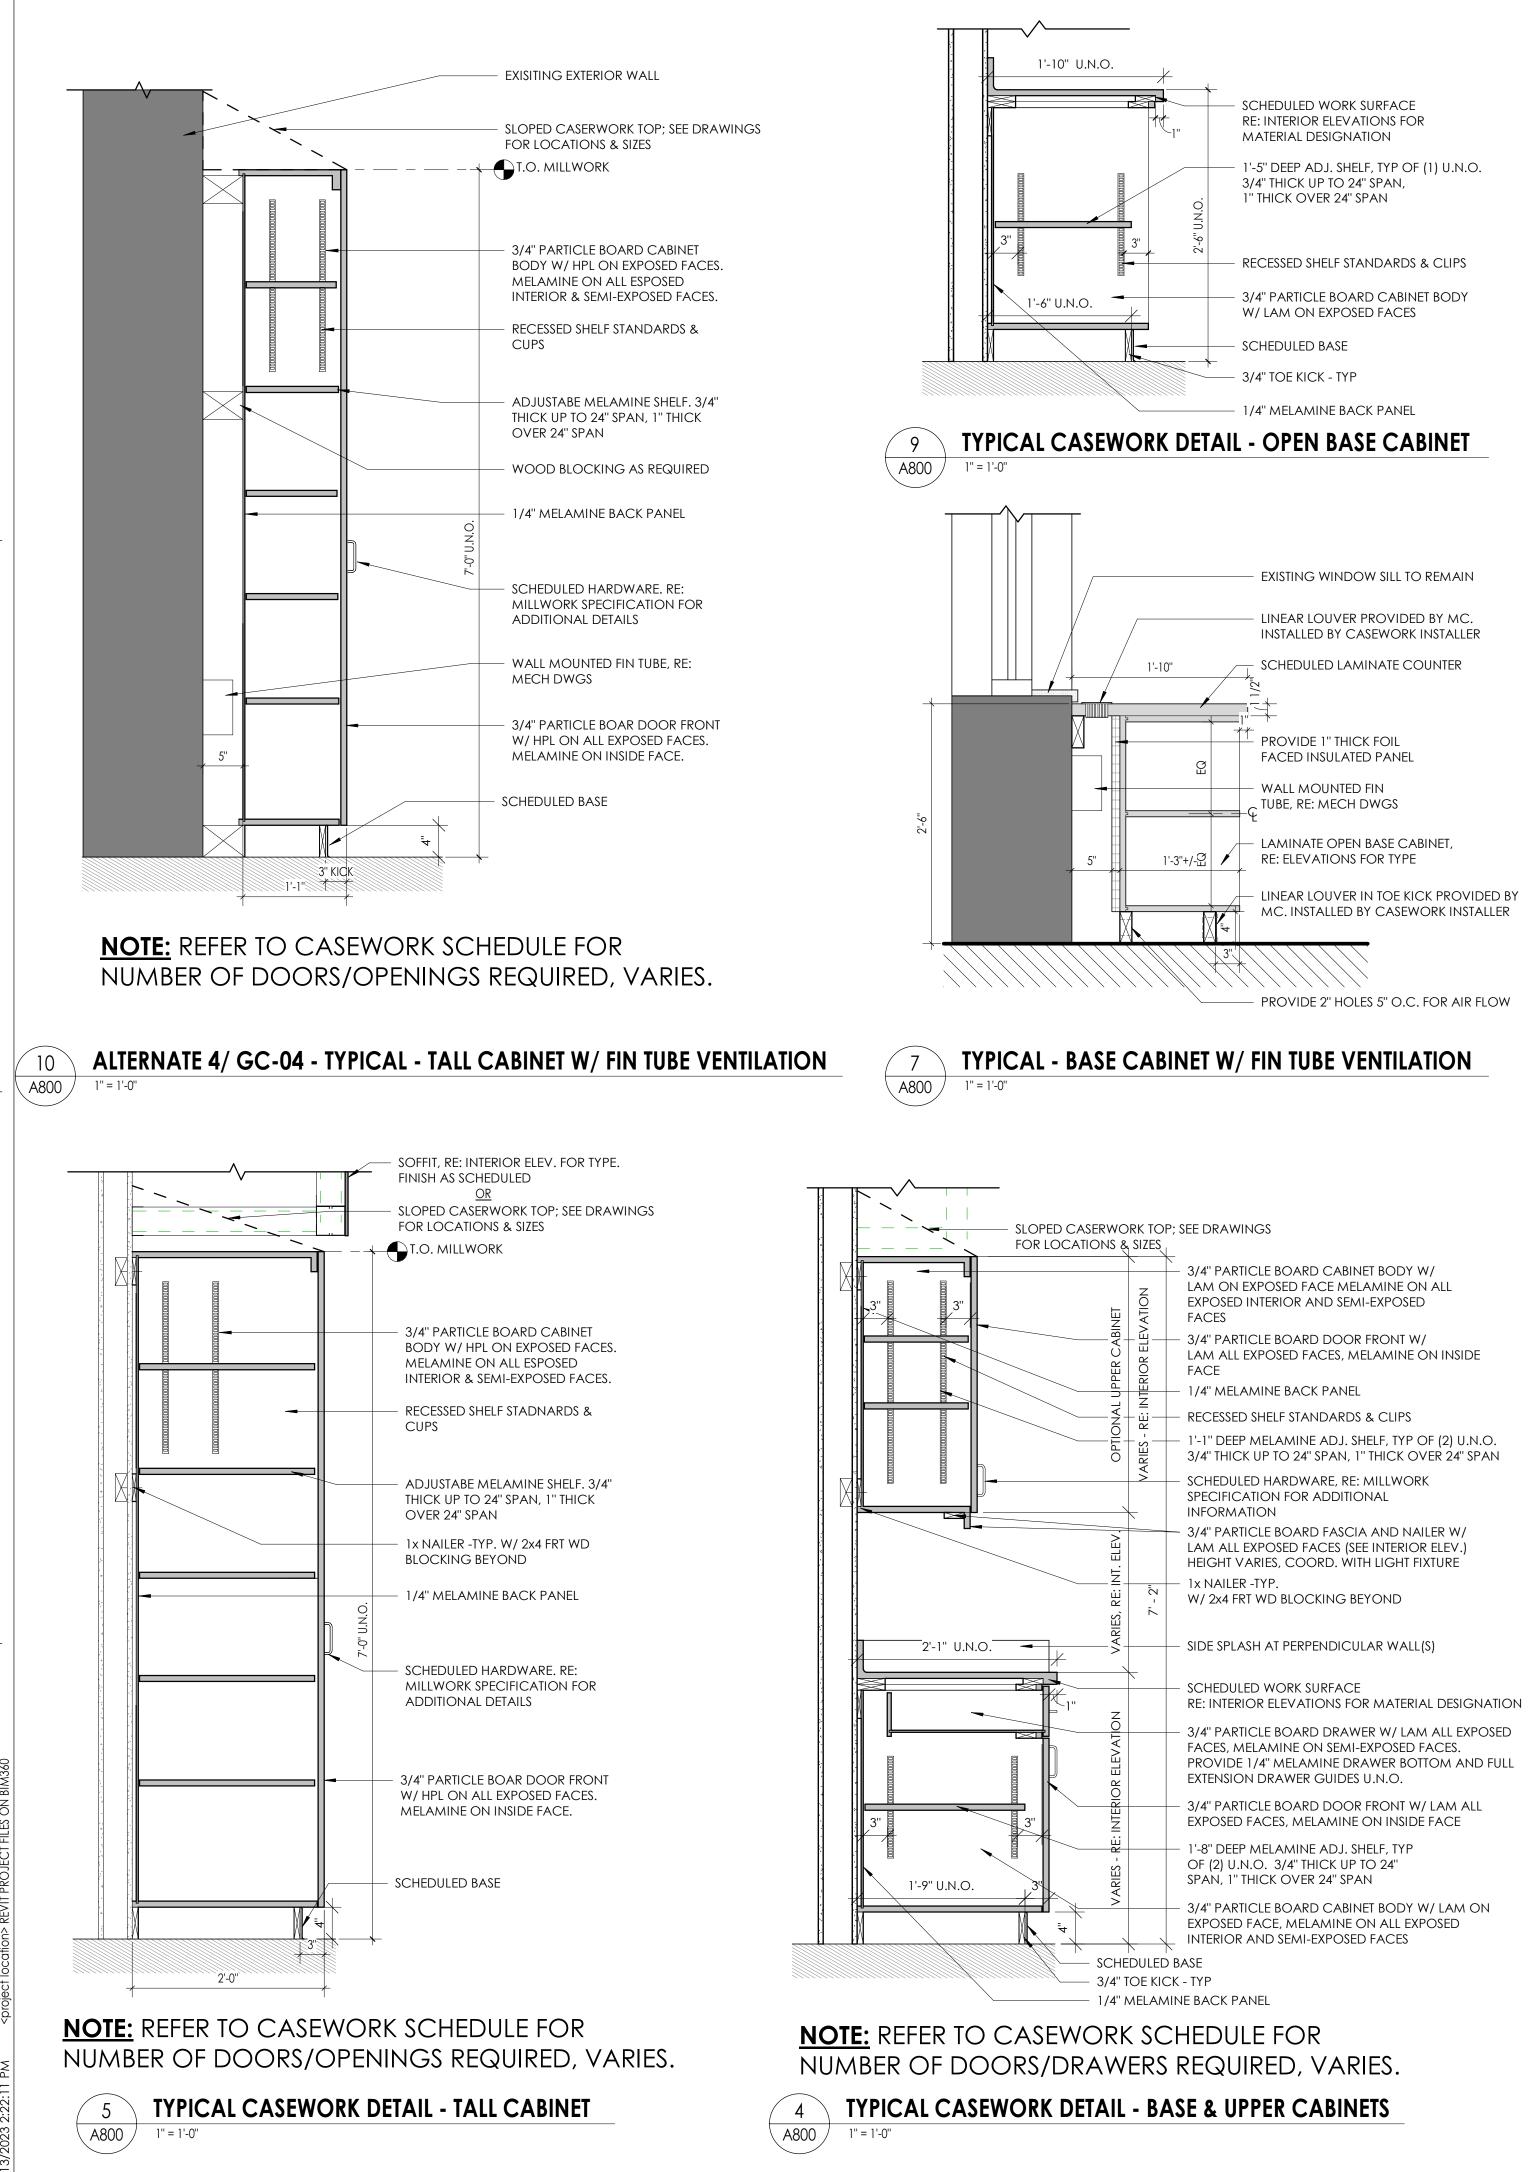



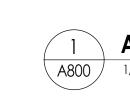

-SCHEDULED PARTITION, PROVIDE FRT 10" MIN. WOOD BLOCKING SUPPORT FOR COORD. W/ FIXTURE WORKSURFACE PER SPECIFICATION **TYPICAL CASEWORK DETAIL - ADA SINK APRON**

8 A800

6

A800 /

A800

1" = 1'-0"

1" = 1'-0"

1" = 1'-0

FOR INFORMATION SUBSTRATE PROVIDE:

-REFER TO PLUMBING DRAWINGS

(2) LAYERS 3/4" PLYWOOD SUBSTRATE,

BACKSPLASH (WHERE APPLICABLE, REFER

SPACES, COORD. LOCATION IN FIELD

LAMINATE ALL EXPOSED SIDES,

TO INTERIOR ELEVATIONS), • 3" DIA. PLASTIC GROMMET AT KNEE

• 3mm EDGE BANDING

INTERIOR ELEVATIONS)

-SCHEDULED PARTITION

(WHERE APPLICABLE, REFER TO

-SCHEDULED MILLWORK (WHERE

APPLICABLE, REFER TO INTERIOR

PROVIDE FRT WOOD BLOCKING SUPPORT FOR WORKSURFACE PER

-METAL SUPPORT

elevations)

SPECIFICATION

SCHEDULED SINK

PROVIDE:

SCHEDULED FINISH ON 3/4" PLYWOOD • BACKSPLASH,

PVC MATCHING EDGE BAND FOR HPL

• 1/8" EASED EDGES (FOR SSM)


PLYWOOD W/ LAM ALL EXPOSED FACES

ALL EXPOSED FACES

-REMOVABLE PIPING VALANCE 3/4"


SOFFIT, RE: INTERIOR ELEV. FOR TYPE.

-APRON - 3/4" PLYWOOD W/ LAM

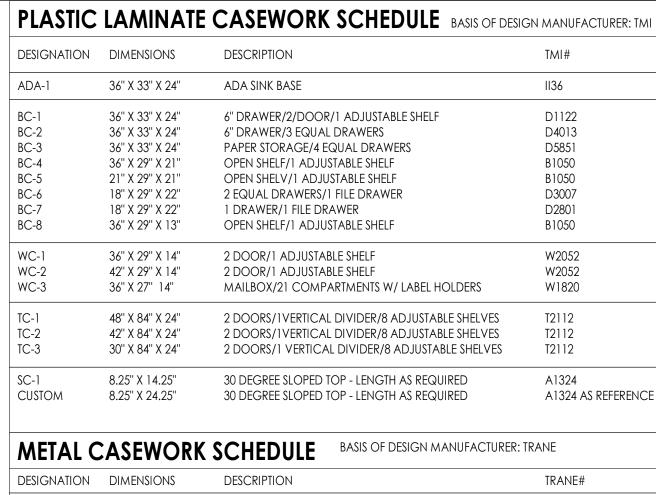


TYPICAL CASEWORK DETAIL - WORK SURFACE WITH SUPPORT BRACKET

DESIGNATION	DIMENSIONS	DESCRIPTION	TRANE#	
MC-1 MC-2	36" X 30" X 16 3/ 60" X 30" X 16 3/		SHL-B-B-1-03 SHL-B-D-1-05	
LEGEND: ADA = ADA BAS BC = BASE CABII WC = WALL CABIN TC = TALL CABIN SC = SLOPED CA MC = METAL CABIN	E 1 NET C BINET NET NET TOP	NOTE: ALL CASEWORK WITH DOORS/ DRAWERS T WNERS REQUEST. OWNER IS RESPONSIBLE F IOTE : CASEWORK PROVID Y OTHERS. SHOWN FOR RI	D RECIEVE LOCKS PER DR KEYING. ED AND INSTALLED	

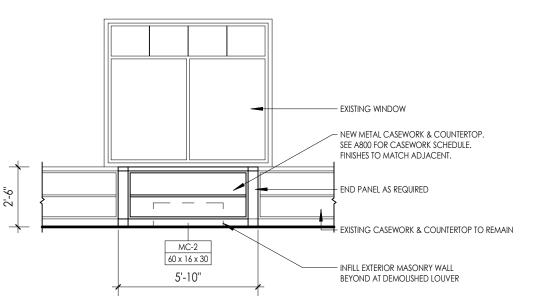



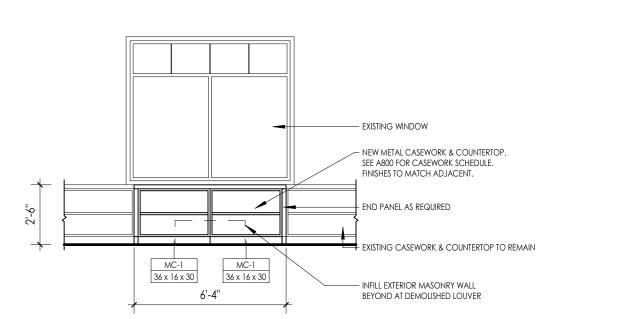

ALTERNATE 1/ GC-01 - TYPICAL CASEWORK INFILL ELEVATION AT AREA C 1/4" = 1'-0"



PROJECT INFORMATION Project Numbe 14457.20 Client Name SOUTH ORANGETOWN CENTRAL SCHOOL DISTRICT

Project Name **PHASE 1: 2022 BOND**

CERTIFICATE #018330 REGISTRATION EXPIR. DATES: Lauren Tarsio 09/30/26 District Office Address

Richard Waite 11/30/23 160 VAN WYCK RD. Larry Werts 12/31/24 BLAUVELT, NY 10913 Anthony Marchetti 05/31/24 Dave Hart 02/28/25 Jennifer Wengender 06/30/24


SOUTH ORANGETOWN CSD

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PROJECT ISSUE & REVISION SCHEDULI


PROFESSIONAL STAMPS




ON OF THE NEW YORK STATE EE ILATIONS FOR ANY PERSON, UNLESS ACTING UNDER THE DIRECTION OF A LICE ITECT, ENGINEER OR LAND SURVEYOR, TO ALTER AN ITEM IN ANY WAY. IF AN SHEET INFORMATION Issued

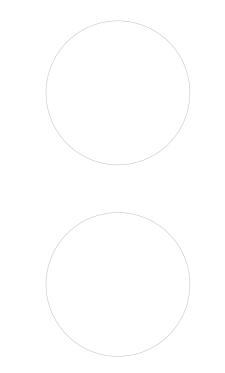Scale 10/18/23 As indicated Project Status **BID DOCUMENTS** Drawn By Checked B LF Drawing Title DETAILS




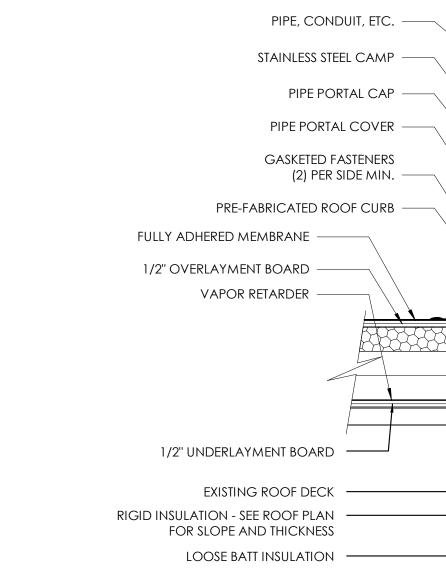



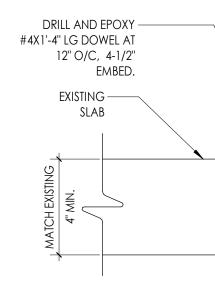





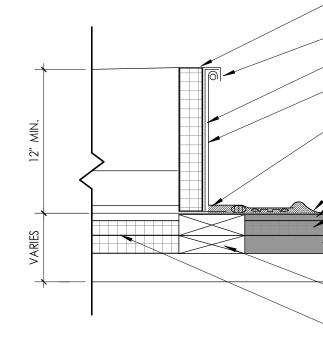





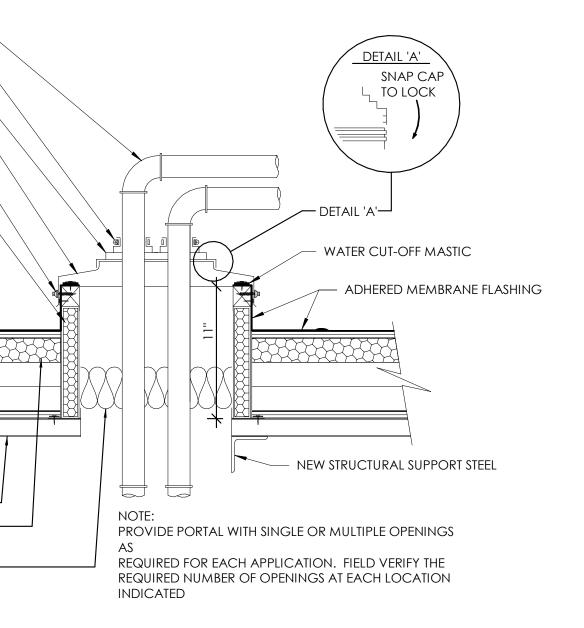

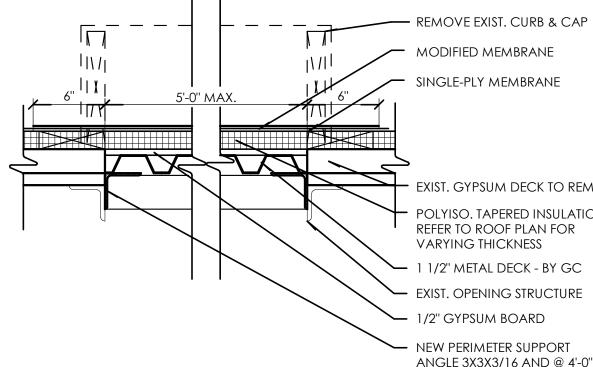

TYPICAL ROOF DECK INFILL DETAIL

4

A810


1 1/2" = 1'-0"


SINGLE-PLY MEMBRANE

EXIST. GYPSUM DECK TO REMAIN POLYISO. TAPERED INSULATION REFER TO ROOF PLAN FOR VARYING THICKNESS

→ 1 1/2" METAL DECK - BY GC EXIST. OPENING STRUCTURE 1/2" GYPSUM BOARD

- NEW PERIMETER SUPPORT ANGLE 3X3X3/16 AND @ 4'-0'' O.C. - WELD ANGLE TO EXIST. OPENING STRUCTURE

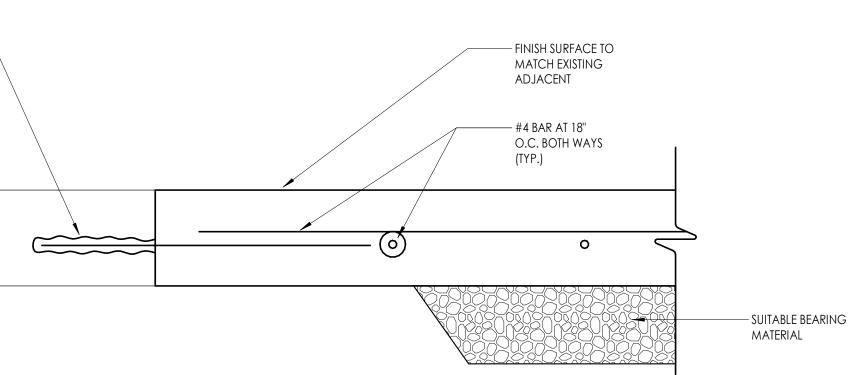

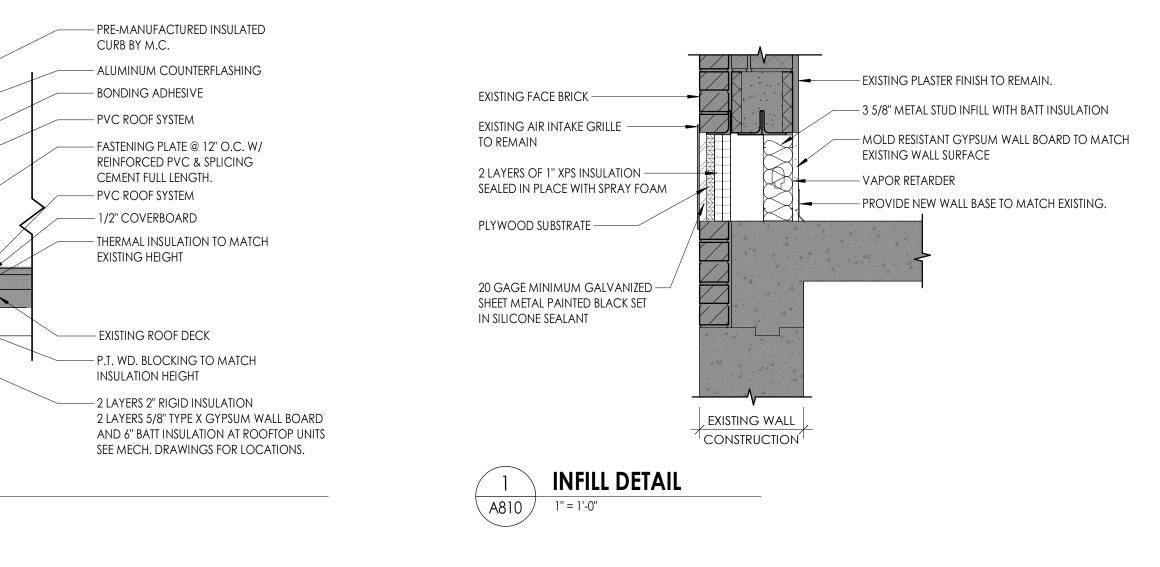

	PARTITION GENERAL NOTES	
	1. ALL WALL TYPES MAY NOT BE USED ON THIS PROJECT.	
	 UNLESS NOTED OTHERWISE ALL PARTITIONS ARE FULL HEIGHT, EXTEND & SECURE TO UNDERSIDE OF CONCRETE OR METAL DECK ABOVE. 	
	3. PROVIDE UL APPROVED JOINT AT ALL TOP OF WALL AND WALL TO WALL CONDITIONS AT ALL RATED	
	WALLS.	
	4. PROVIDE DEFLECTION TRACKS AT METAL STUD PARTITIONS THAT TERMINATE AT THE UNDERSIDE OF	
	STRUCTURE AND DECK. 5. REFER TO CODE/LIFE SAFETY DRAWINGS FOR RATED PARTITIONS AND UL ASSEMBLIES.	
	 REFER TO INTERIOR DRAWINGS FOR LOCATIONS OF WALL TILE, AND OTHER SPECIALTY WALL FINISHES. 	
	PROVIDE 5/8" TILE BACKER BOARD AT ALL WALLS RECEIVING TILE.	
	7. PROVIDE MOISTURE RESISTANT GYP. BD. AT ALL TOILET ROOMS, JANITOR'S CLOSETS AND OTHER WET	
	LOCATIONS WHERE TILE AND TILE BACKER BOARD ARE NOT INSTALLED.	CPL Architecture Engineering Planning
	8. PARTITION TYPES WITH ONE SIDE OF DOUBLE DRYWALL TO BE PLACED SO THAT THE DOUBLE SIDE IS ON CORRIDOR AND/OR HIGH TRAFFIC SIDE OF WALL.	50 Front Street Suite 202,
	9. REFER TO SPECIFICATIONS FOR METAL STUD GAUGE REQUIREMENTS.	Newburgh, NY 12550
	10. COORDINATE ALL PARTITION ACCESSORIES (APPLIED FINISHES, RESILIENT CHANNEL, ADDITIONAL	CPLteam.com
	LAYERS OF SHEATHING, SHIELDING, ETC.) ITEMS SHOWN IN TYPICAL WALL CONSTRUCTION DETAILS	
	MAY HAVE TO BE ARRANGED ON DIFFERENT SIDES OF WALL ASSEMBLY TO ACHIEVE FLUSH	
	CONTINUOUS WALL SURFACES. ANY CONFLICTS SHOULD BE BROUGHT TO THE ATTENTION OF THE ARCHITECT.	
	11. FIRESTOP/ SMOKE STOP ALL REQUIRED WALL PARTITIONS, SLABS, AND PENETRATIONS THROUGH NEW	
	AND EXISTING WALLS WITHIN THE PROJECT LIMITS IN COORDINATION WITH CODE PLAN, OR WHERE	
	COORDINATED SYSTEMS CONNECTION POINTS ARE LOCATED OUTSIDE THE PROJECT LIMIT AREA. SEE	SOUTH ORANGETOWN Central School District
N	ARCHITECTURAL, MECHANICAL, ELECTRICAL, PLUMBING DRAWINGS AND SPECIFICATION DIVISION	Central School District
	7. 12. NOTIFY OWNER AND ARCHITECT IF EXISTING NON-COMPLIANT PENETRATIONS ARE DISCOVERED NOT	
	FIRESTOPPPED IN COORDINATION WITH CODE PLAN.	Capital Improvements Bond
	13. PROVIDE CONTROL JOINT WHERE NEW PARTITIONS BUTT EXISTING CONSTRUCTION.	
	14. PROVIDE CONTROL JOINTS A MAXIMUM OF 30'-0" APART UNLESS NOTED OTHERWISE, PER ASTM C	Essential Infrastructure for Student
	840-17A. LOCATE ABOVE DOOR FRAMES WHERE POSSIBLE.	Health, Safety and Success
	15. PROVIDE SUPPORT BLOCKING AND STRAPPING FOR ALL MILLWORK, CASEWORK, AND WALL MOUNTED ACCESSORIES.	
	MOUNTED ACCESSORIES.	
		-
		PROJECT INFORMATION
		Project Number
		14457.20

Client Name SOUTH ORANGETOWN CENTRAL SCHOOL DISTRICT Project Name

PHASE 1: 2022 BOND

CERTIFICATE #018330

District Office Address


Lauren Tarsio 09/30/26 Richard Waite 11/30/23 160 VAN WYCK RD. Larry Werts 12/31/24 BLAUVELT, NY 10913 Anthony Marchetti 05/31/24 Dave Hart 02/28/25 Jennifer Wengender 06/30/24

REGISTRATION EXPIR. DATES:


south orangetown CSD

- WILLIAM O. SCHAEFER SED#:50-03-01-06-0-012-019 COTTAGE LANE ELEMENTARY SED#:50-03-01-06-0-010-022 TAPPAN ZEE HIGH SCHOOL SED#:50-03-01-06-0-006-032 WILLIAM O. SCHAEFER S&L SED#:50-03-01-06-0-012-020
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- SOMS OUTDOOR CLASSROOM SED#:50-03-01-06-7-056-001 CLE OUTDOOR CLASSROOM SED#:50-03-01-06-7-054-001 TZHS OUTDOOR CLASSROOM SED#:50-03-01-06-7-055-001

PROJECT ISSUE & REVISION SCHEDULE No. Date Description

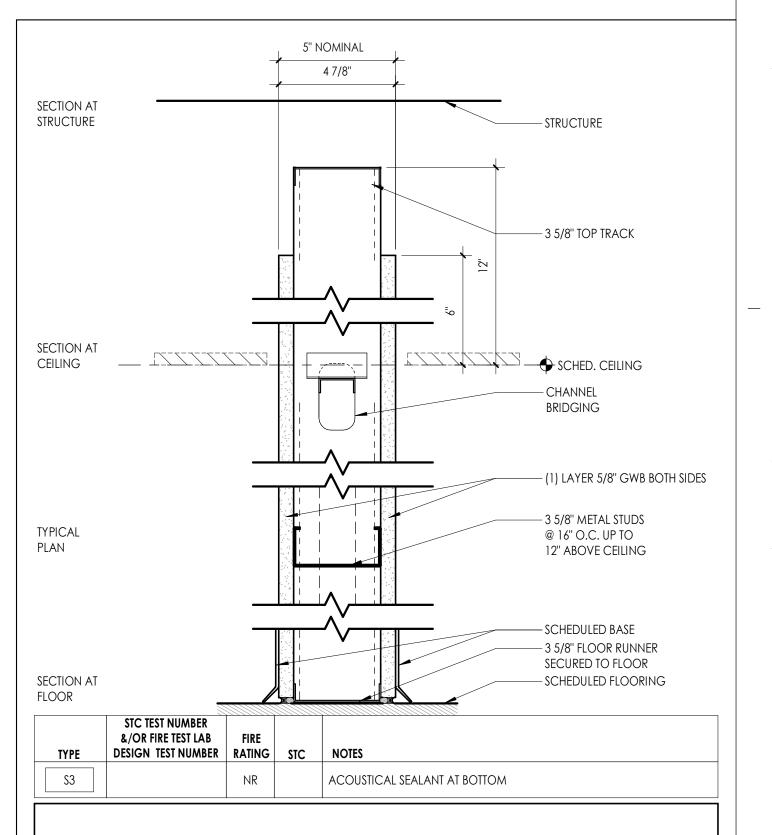

PROFESSIONAL STAMPS

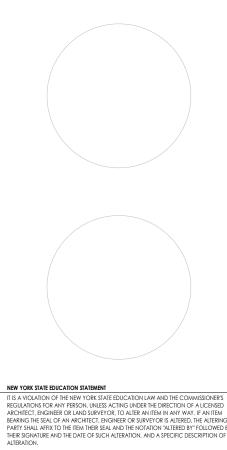


SHEET INFORMATION Issued Scale 10/18/23 As indicated Project Status **BID DOCUMENTS** Drawn By Checked By LF LT Drawing Title WALL TYPES & MISC. DETAILS





D	OOR			D	OOR PANEL	S				DOOR FRAM	E			
		-			TOTAL PANE	L DIMENSION	۱S		FR	AME DIMENS	ONS			
DOOR NUMBER		ROOM NUMBER/NAME	PANEL TYPE	WIDTH	HEIGHT	THICKNESS	UNDERCUT	FRAME TYPE	JAMB WIDTH	HEAD HEIGHT	FRAME DEPTH	FRAME FINISH	HEAD DTL	JAMB DTI
NISH FIRST F	FLOOR	13 CONF.	PNL-N-WD	3'-0"	6'-10''	0'-1 3/4"	0'-0''	FRM-00HM1	0'-2''	0'-2"	0'-5 3/4"	PNT	6/A900	5/A900
6	45	16 NURSE	PNL-G-WD	3'-0"	7'-0''	0'-1 3/4"		FRM-00HM1	0'-2"	0'-2"	0'-5 3/4"	PNT	6/A900	5/A900
6A	-	16A TOILET	PNL-F-WD	3'-0''	7'-0''	0'-1 3/4"	0'-0''	FRM-00HM1	0'-2"	0'-2"	0'-5 3/4"	PNT	8/A900	7/A900
6B	-	16B TEST/ISO.	PNL-F-WD	3'-0"	7'-0''	0'-1 3/4"	0'-0''	FRM-00HM1	0'-2''	0'-2"	0'-5 3/4"	PNT	8/A900	7/A900
3	45	38 AID'S OFFICE	PNL-F-WD	3'-0''	7'-0''	0'-1 3/4"	0'-0''	FRM-00HM1	0'-2''	0'-2"	0'-5 3/4"	PNT	6/A900	5/A900
3A	45	38A TOILET	PNL-F-WD	3'-0''	7'-0''	0'-1 3/4"	0'-0''	FRM-00HM1	0'-2''	0'-2"	0'-5 3/4"	PNT	6/A900	5/A900
)	-	39 COACH OFFICE	PNL-F-WD	3'-0''	7'-0''	0'-1 3/4"	0'-0''	FRM-00HM1	0'-2''	0'-2"	0'-5 3/4"	PNT	6/A900	5/A900
0	45	40 TOILET	PNL-F-WD	2'-8"	7'-0"	0'-1 3/4"	0'-0''	FRM-00HM1	0'-2"	0'-2"	1'-0 7/8"	PNT	4/A900	3/A900

-				-		<u>د</u>		D 000		DOOR	
		_	DOOR PANELS TOTAL PANEL DIMENSIONS					DOC	OR FRAME	DOOR	
DOOR NUMBER	FIRE RATING (MIN)	ROOM NUMBER/NAME	PANEL TYPE	WIDTH	HEIGHT			FRAME TYPE	FRAME FINISH	COMMENTS	DOOI
FINISH FIRST I 01	45	1 FIRST GRADE	PNL-N-WD	3'-0''	7'-0''	0'-1 3/4"	0'-0''	FRM-ETR	PNT		01
02	45	2 FIRST GRADE	PNL-N-WD	3'-0"	7'-0''	0'-1 3/4"	0'-0"	FRM-ETR	PNT		01
03	45	3 MAKERSPACE	PNL-N-WD	3'-0"	7'-0"	0'-1 3/4"	0'-0''	FRM-ETR	PNT		03
04	45	4 FIRST GRADE	PNL-N-WD	3'-0''	7'-0"	0'-1 3/4"	0'-0''	FRM-ETR	PNT		04
06	45	6 FIRST GRADE	PNL-N-WD	3'-0"	7'-0"	0'-4 1/256"	0'-0''	FRM-ETR	PNT		06
09	45	9 SERVER CL.	PNL-F-WD	3'-0''	7'-0"	0'-1 3/4"	0'-0''	FRM-ETR	PNT		09
15	45	15 FIRST GRADE	PNL-N-WD	3'-0"	7'-0"	0'-1 3/4"	0'-0"	FRM-ETR	PNT		15
15A	-	15A FIRST GRADE TOILET ROOM	PNL-V1-WD	2'-0''	7'-0"	0'-1 3/4"	0'-0''	FRM-ETR	PNT		15A
17	45	17 FIRST GRADE	PNL-N-WD	3'-0"	7'-0"	0'-1 3/4"	0'-0''	FRM-ETR	PNT		17
17A	-	17A FIRST GRADE TOILET ROOM	PNL-V1-WD	2'-0''	7'-0"	0'-1 3/4"	0'-0''	FRM-ETR	PNT		17A
19	45	19 FIRST GRADE	PNL-N-WD	3'-0"	7'-0"	0'-1 3/4"	0'-0''	FRM-ETR	PNT		19
19A	-	19A FIRST GRADE TOILET ROOM	PNL-V1-WD	2'-0''	7'-0''	0'-1 3/4"	0'-0''	FRM-ETR	PNT		19A
21	45	21 KINDERGARTEN	PNL-N-WD	3'-0''	7'-0''	0'-1 3/4"	0'-0''	FRM-ETR	PNT		21
21A	-	21A KINDERGARTEN TOILET ROOM	PNL-V1-WD	2'-0''	7'-0''	0'-1 3/4"	0'-0''	FRM-ETR	PNT		21A
24	45	24 KINDERGARTEN	PNL-N-WD	3'-0''	7'-0''	0'-1 3/4"	0'-0''	FRM-ETR	PNT		24
24A	-	24A KINDERGARTEN TOILET ROOM	PNL-V1-WD	2'-0''	7'-0''	0'-1 3/4"	0'-0''	FRM-ETR	PNT		24A
26	45	26 KINDERGARTEN	PNL-N-WD	3'-0''	7'-0''	0'-1 3/4"	0'-0''	FRM-ETR	PNT		26
26A	-	26A KINDERGARTEN TOILET ROOM	PNL-V1-WD	2'-0''	7'-0''	0'-1 3/4"	0'-0''	FRM-ETR	PNT		26A
30	45	30 KINDERGARTEN	PNL-N-WD	3'-0''	7'-0''	0'-1 3/4"	0'-0''	FRM-ETR	PNT		30
30A	-	30A KINDERGARTEN TOILET ROOM	PNL-V1-WD	2'-0''	7'-0''	0'-1 3/4"	0'-0''	FRM-ETR	PNT		30A
32	45	32 KINDERGARTEN	PNL-N-WD	3'-0"	7'-0''	0'-1 3/4"	0'-0''	FRM-ETR	PNT		32
32A	-	32A KINDERGARTEN TOILET ROOM	PNL-V1-WD	2'-0''	7'-0''	0'-1 3/4"	0'-0''	FRM-ETR	PNT		32A
32B	-	32 KINDERGARTEN	PNL-N-WD	3'-0"	7'-0''	0'-1 3/4"	0'-0''	FRM-ETR	PNT		32B
42	45	42 OFFICE	PNL-N-WD	2'-8"	7'-0''	0'-1 3/4"	0'-0''	FRM-ETR	PNT		42
50	45	50 J.C.	PNL-F-WD	3'-0''	7'-0''	0'-1 3/4"	0'-0''	FRM-ETR	PNT		50
52	45	52 CUSTODIAL	PNL-N-WD	3'-0''	7'-0''	0'-1 3/4"	0'-0''	FRM-ETR	PNT		52
57	45	57 SECOND GRADE	PNL-N-WD	3'-0''	7'-0''	0'-1 3/4"	0'-0''	FRM-ETR	PNT		57
59	45	59 SECOND GRADE	PNL-N-WD	3'-0''	7'-0''	0'-1 3/4"	0'-0''	FRM-ETR	PNT		59
61	45	61 FIRST GRADE	PNL-N-WD	3'-0"	7'-0''	0'-1 3/4"	0'-0''	FRM-ETR	PNT		61
62	45	62 MUSIC	PNL-N-WD	3'-0"	7'-0''	0'-1 3/4"	0'-0''	FRM-ETR	PNT		62
63	45	63 SECOND GRADE	PNL-N-WD	3'-0"	7'-0''	0'-1 3/4"	0'-0''	FRM-ETR	PNT		63
64	45	64 SECOND GRADE	PNL-N-WD	3'-0"	7'-0''	0'-1 3/4"	0'-0''	FRM-ETR	PNT		64
65	45	65 SECOND GRADE	PNL-N-WD	3'-0"	7'-0''	0'-1 3/4"	0'-0''	FRM-ETR	PNT		65
66	45	66 SECOND GRADE	PNL-N-WD	3'-0"	7'-0''	0'-1 3/4"	0'-0''	FRM-ETR	PNT		66
67	45	67 SECOND GRADE	PNL-N-WD	3'-0"	7'-0''	0'-1 3/4"	0'-0''	FRM-ETR	PNT		67
68	45	68 SECOND GRADE	PNL-N-WD	3'-0''	7'-0''	0'-1 3/4"	0'-0''	FRM-ETR	PNT		68
70	45	70 FIRST GRADE	PNL-N-WD	3'-0''	7'-0''	0'-1 3/4"	0'-0''	FRM-ETR	PNT		70
100	45	100 SPEC.ED.	PNL-N-WD	3'-0''	7'-0''	0'-1 3/4"	0'-0''	FRM-ETR	PNT		100
100A	-	100A SPEC.ED. TOILET ROOM	PNL-V1-WD	2'-0''	7'-0''	0'-1 3/4"	0'-0''	FRM-ETR	PNT		100A
104	45	104 KINDERGARTEN	PNL-N-WD	3'-0''	7'-0''	0'-1 3/4"	0'-0''	FRM-ETR	PNT		104
104A	-	104A KINDERGARTEN TOILET ROOM	PNL-V1-WD	2'-0''	7'-0''	0'-1 3/4"	0'-0''	FRM-ETR	PNT		104A
105	45	105 KINDERGARTEN	PNL-N-WD	3'-0''	7'-0''	0'-1 3/4"	0'-0''	FRM-ETR	PNT		105

NOTE: ALL EXISTING TO REMAIN FRAMES RECEIVING NEW DOORS TO BE PREPPED AND PAINTED.

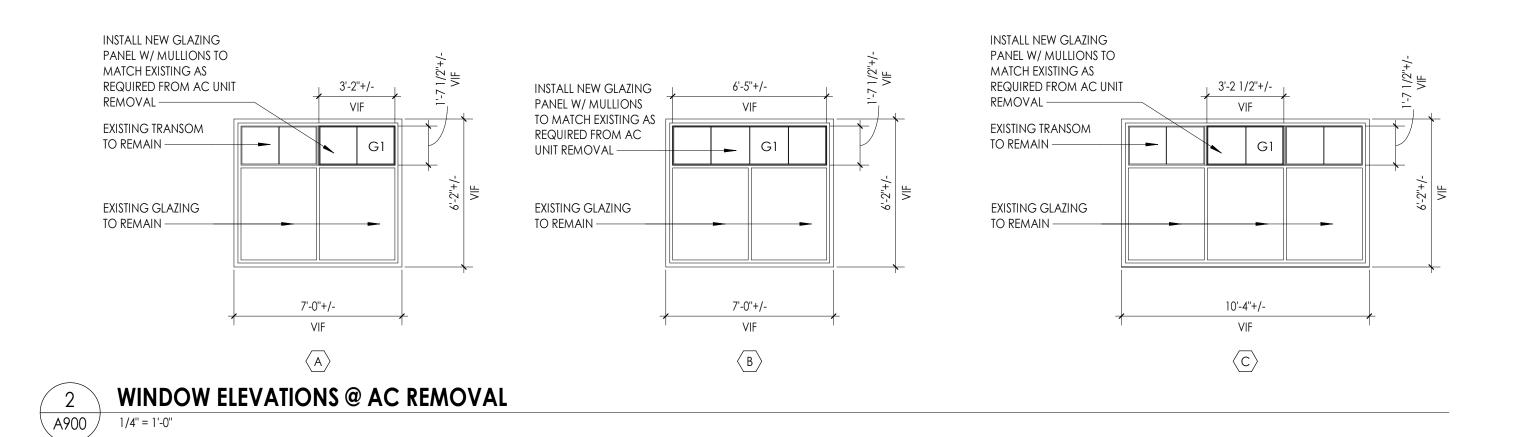


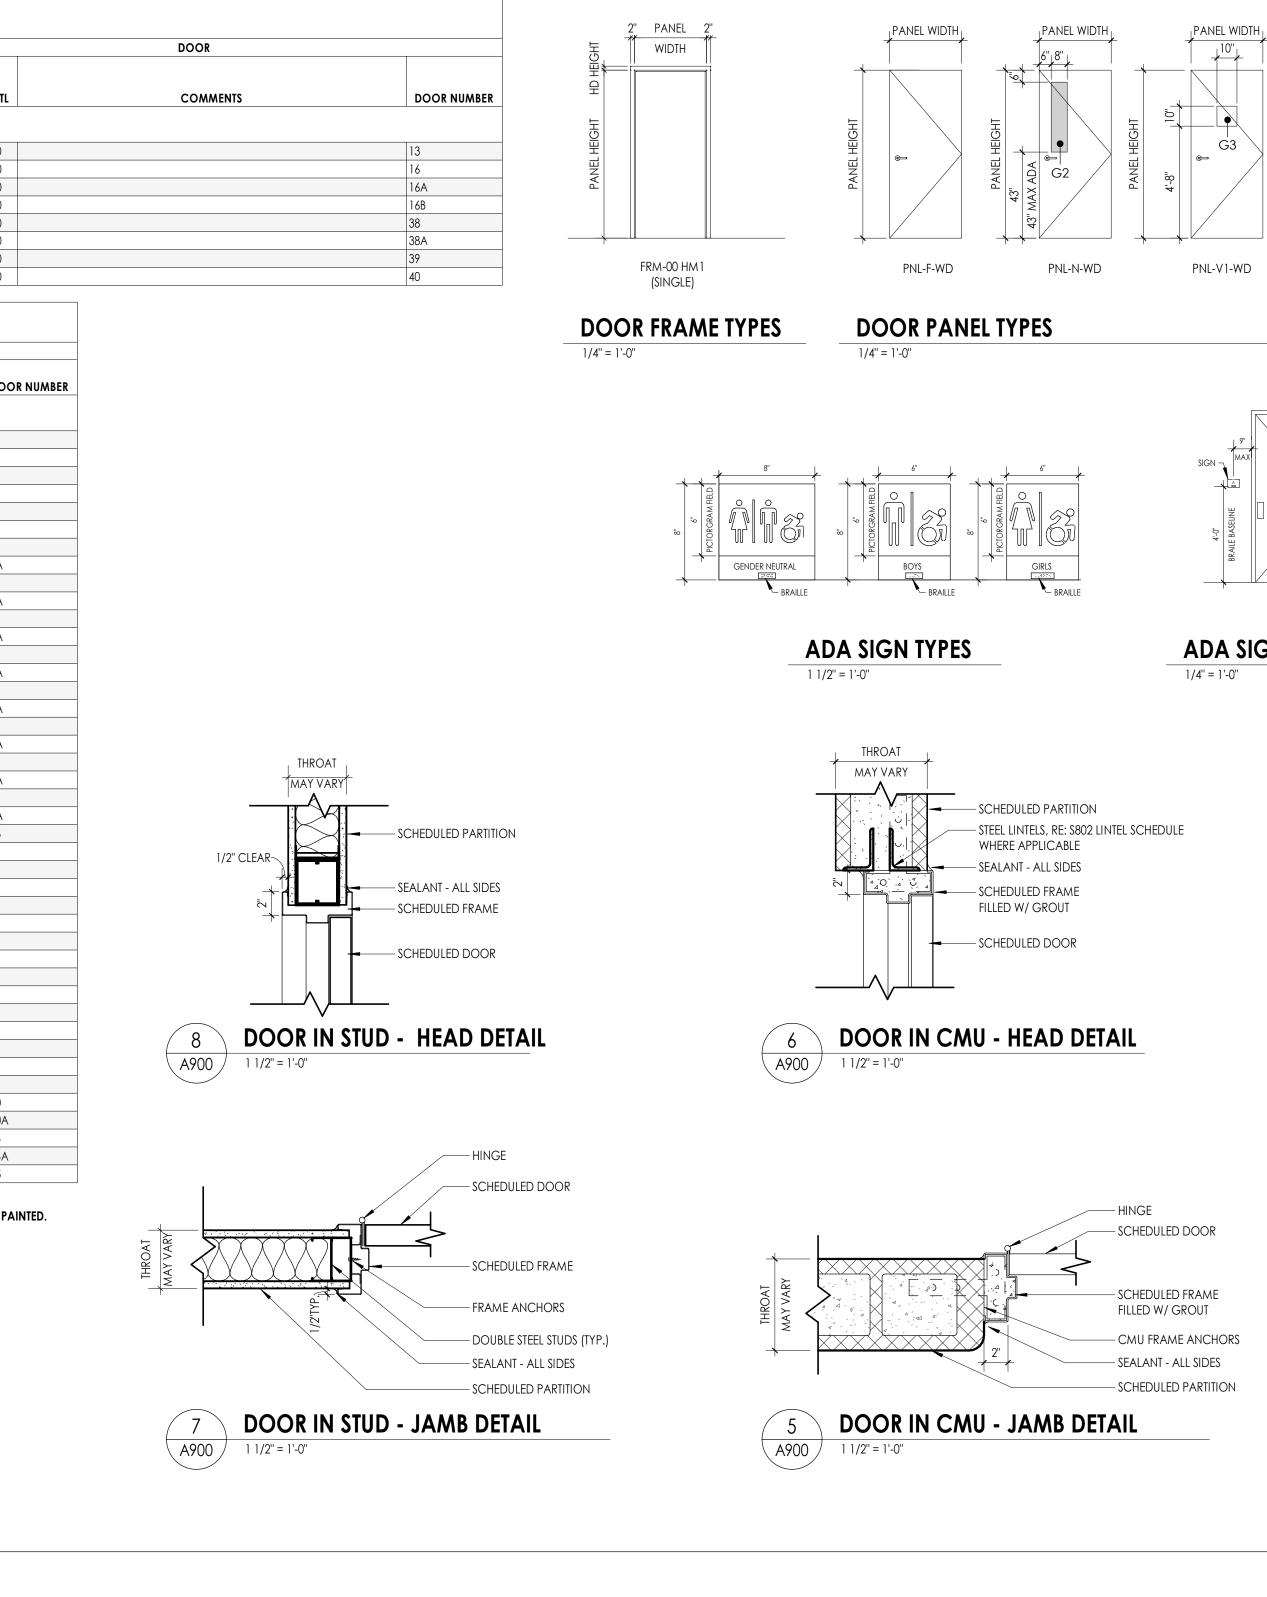

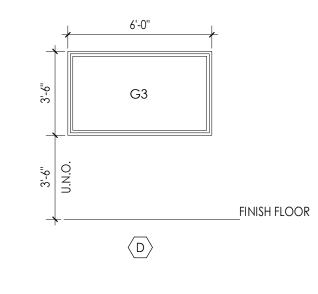



WINDOW TYPES 1/4" = 1'-0"

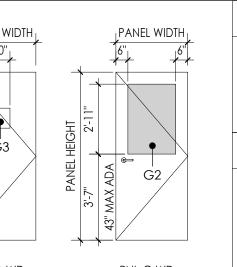

PNL-G-WD

ADA SIGN LOCATION

DOOR AND FRAME NOTES

- REFER TO A900S FOR DOOR & FRAME SCHEDULE
- 2. ALL FRAMES ARE TO RECEIVE FULL PERIMETER SEALANT. INTERIOR AND EXTERIOR 3. ALL DOOR AND WINDOW OPENING DIMENSIONS ARE TO BE VERIFIED IN FIELD AND COORDINATED WITH APPROVED SHOP DRAWINGS PRIOR TO FABRICATION. 4. SEE SCHEDULE FOR DOOR & FRAME MATERIAL

DOOR AND FRAME SCHEDULE LEGEND

NOTE: THIS LEGEND MAY CONTAIN SYMBOLS THAT ARE NOT USED IN THIS PROJECT. DOOR OR FRAME MATERIAL DOOR OR FRAME FINISH

ACR ACROVYN DOOR ACR-L ACROVYN LEAD LINED DOOR ALUM ALUMINUM HM HOLLOW METAL HM-L HOLLOW METAL LEAD LINED IHM INSULATED HOLLOW METAL

WD WOOD

WD-L WOOD LEAD LINED

GLAZING TYPES

G1 - INSULATED GLAZING

G2 - FIRE RATED GLAZING

G3 - TEMPERED GLAZING

- wood stain ST DB DARK BRONZE(ANODIZED) SS STAINLESS STEEL BE BAKED ENAMEL

PTD PAINT





PROJECT INFORMATION Project Number 14457.20 Client Name SOUTH ORANGETOWN CENTRAL SCHOOL DISTRICT

160 VAN WYCK RD. Larry Werts 12/31/24

WILLIAM O. SCHAEFER SED#:50-03-01-06-0-012-019

COTTAGE LANE S&L SED#: 50-03-01-06-0-010-023

PROJECT ISSUE & REVISION SCHEDULE

Description

COTTAGE LANE ELEMENTARY SED#:50-03-01-06-0-010-022

TAPPAN ZEE HIGH SCHOOL SED#:50-03-01-06-0-006-032

WILLIAM O. SCHAEFER S&L SED#:50-03-01-06-0-012-020

COTTAGE LANE LIBRARY S&L SED#: 50-03-01-06-8-023-002 WOS OUTDOOR CLASSROOM SED#: 50-03-01-06-7-053-001

SOMS OUTDOOR CLASSROOM SED#:50-03-01-06-7-056-001

CLE OUTDOOR CLASSROOM SED#:50-03-01-06-7-054-001 TZHS OUTDOOR CLASSROOM SED#:50-03-01-06-7-055-001

BLAUVELT, NY 10913 Anthony Marchetti 05/31/24

CERTIFICATE #018330

Lauren Tarsio 09/30/26

Richard Waite 11/30/23

Dave Hart 02/28/25

REGISTRATION EXPIR. DATES:


Jennifer Wengender 06/30/24


Project Name PHASE 1: 2022 BOND

south orangetown CSD

District Office Address

No. Date

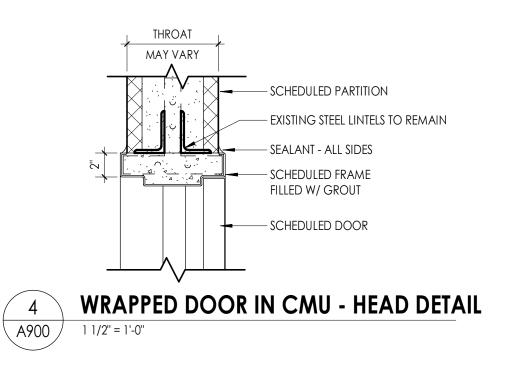

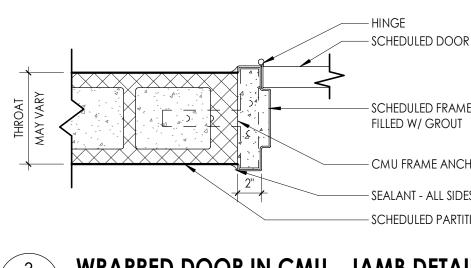



SCHEDULED FRAME FILLED W/ GROUT - CMU FRAME ANCHORS — SEALANT - ALL SIDES

- SCHEDULED PARTITION WRAPPED DOOR IN CMU - JAMB DETAIL

WINDOW GENERAL NOTES

- 1. COORDINATE ALL FRAME SIZES, TRIM EXTRUSIONS AND SILLS WITH WALL SECTIONS
- AND DETAILS. 2. ALL FRAMES ARE TO RECEIVE FULL PERIMETER SEALANT. INTERIOR AND EXTERIOR
- 3. ALL DOOR AND WINDOW DIMENSIONS ARE TO BE VERIFIED IN FIELD PRIOR TO FABRICATION.
- 4. REFER TO DIMENSION PLANS AND WALL SECTIONS FOR MULLION LAYOUT dimensions.


NEW YORK STATE EDUCATION STATEM

ION OF THE NEW YORK STATE EE GULATIONS FOR ANY PERSON, UNLESS ACTING UNDER THE DIRECTIO SEARING THE SEAL OF AN ARCHITECT, ENGINEER OR SURVEYOR PARTY SHALL AFFIX TO THE ITEM THEIR SEAL AND THE NOTATION

SHEET INFORMATION


Issued	Scale
10/18/23	As indicated
Project Status	
BID DOCUMENTS	
Drawn By	Checked By
LF	LT
Drawing Title	
DOOR & WINDO	w systems
	ГС

Drawing Number WOS A900

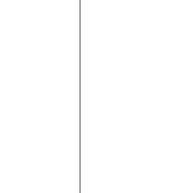

PROFESSIONAL STAMPS



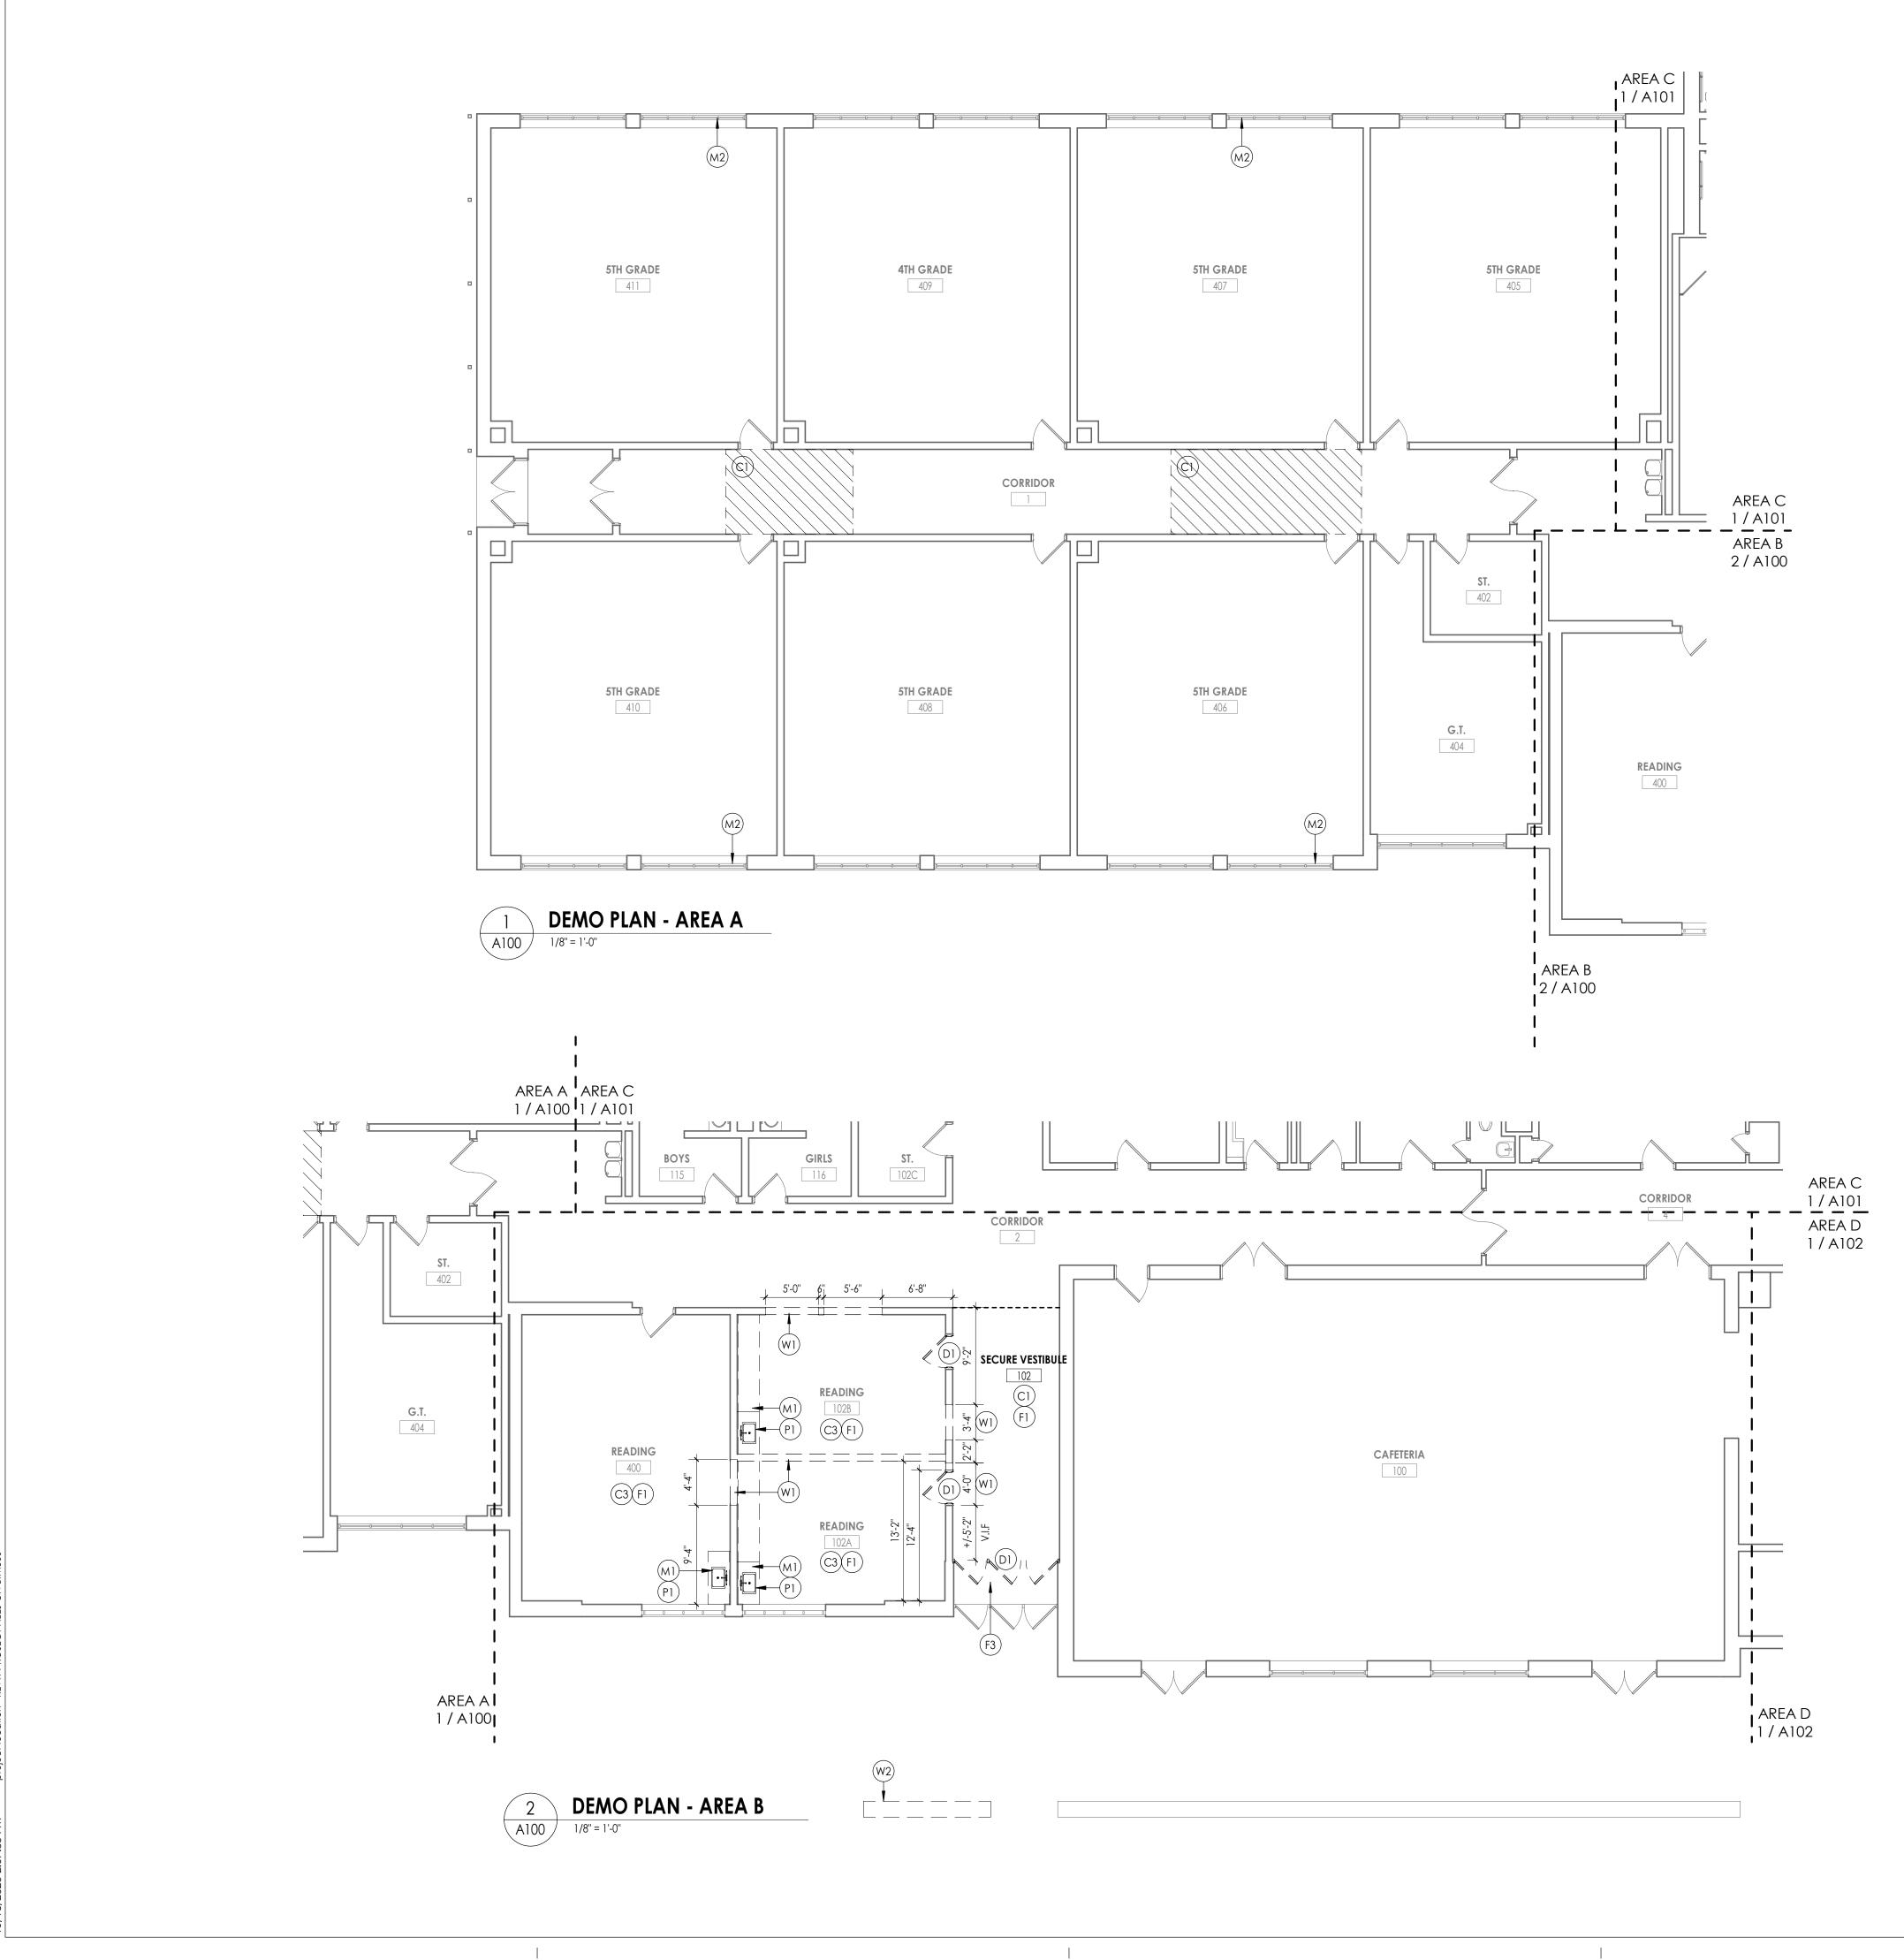

DEMOLITION GENERAL NOTES

- IT IS THE CONTRACTOR'S RESPONSIBILITY TO FAMILIARIZE THEMSELVES WITH ALL EXISTING CONDITIONS AND DETAILS INVOLVED IN THE DEMOLITION WORK.
- THE OWNER SHALL PROVIDE THE CONTRACTOR WITH A LIST OF ALL ITEMS TO BE
- SALVAGED PRIOR TO CONSTRUCTION.
- THE CONTRACTOR SHALL PROTECT ADJACENT SURFACES AND FINISHES NOT SCHEDULED FOR DEMOLITION WORK AND SHALL REPAIR ANY DAMAGED AREAS AS A RESULT OF CONTRACTED WORK AT NO ADDITIONAL COST TO THE OWNER.
- THE CONTRACTOR SHALL COORDINATE THE DEMOLITION WORK WITH THE OVERALL PROJECT PHASING.
- THE CONTRACTOR SHALL MAINTAIN AND CONTINUE SAFE ACCESS TO ALL EXITS FOR THE BUILDING OCCUPANTS DURING CONSTRUCTION.

DEMOLITION KEY NOTES

C1 REMOVE PORTION OF ACT CEILING SYSTEM TO BE MODIFIED. SALVAGE CEILING TILES TO BE REINSTALLED.

- (C2) REMOVE PLASTER CEILING SYSTEM IN ITS ENTIRETY
- (C3) REMOVE ACT CEILING SYSTEM IN ITS ENTIRETY
- C4 ACT CEILING SYSTEM & SECONDARY SHEETROCK CEILING SYSTEM REMOVED BY ABATEMENT CONTRACTOR.
- REMOVE SECONDARY ACOUSTIC CEILING SYSTEM & SUSPENSION SYSTEM IN ITS
- ENTIRETY. COORDINATE FINAL LOCATION WITH MC.
- (D1) REMOVE EXISTING DOOR, FRAME & HARDWARE IN ITS ENTIRETY
- (D2) REMOVE EXISTING DOOR & HARDWARE. EXISTING FRAME TO REMAIN.
- (F1) REMOVE EXISTING VCT FLOORING IN ITS ENTIRETY
- F2 SAW CUT & REMOVE SLAB TO FACILITATE UNDER SLAB PLUMBING WORK. COORDINATE LOCATION WITH P.C
- (F3) REMOVE CERAMIC TILE IN ITS ENTIRETY
- (M1) REMOVE EXISTING CASEWORK IN ITS ENTIRETY
- (M2) REMOVE EXISTING AC UNIT AND SURROUNDING WINDOW PANEL. OWNER TO HAVE FIRST RIGHT OF REFUSAL ON WINDOW AC'S.
- (M3) REMOVE EXISTING FIRE SHUTTER & TURN OVER TO OWNER
- (M4) REMOVE EXISTING WOOD STAIR IN ITS ENTIRETY
- (M5) REMOVE CHAIRRAIL & WAINSCOT BELOW
- PC TO DISCONNECT & REMOVE EXISTING SINK. GC TO REMOVE & SALVAGE ALL ACCESSORIES & RETURN TO OWNER.
- (W1) REMOVE EXISTING WALL CMU WALL
- (W2) REMOVE EXISTING MASONRY SITE WALL REFER TO C DRAWINGS



PROJECT INFORMATION Project Number 14457.20 Client Name SOUTH ORANGETOWN CENTRAL SCHOOL DISTRICT

PHASE 1: 2022 BOND

Project Name

CERTIFICATE #018330 District Office Address

REGISTRATION EXPIR. DATES: Lauren Tarsio 09/30/26 Richard Waite 11/30/23 160 VAN WYCK RD. Larry Werts 12/31/24 BLAUVELT, NY 10913 Anthony Marchetti 05/31/24 Dave Hart 02/28/25


Jennifer Wengender 06/30/24

south orangetown CSD

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PROJECT ISSUE & REVISION SCHEDULE No. Date Description

PROFESSIONAL STAMPS

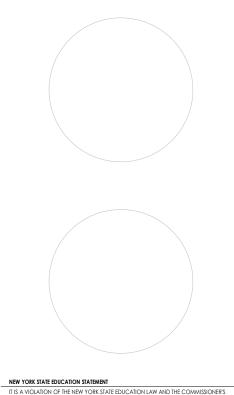


IT IS A VIOLATION OF THE NEW TORK STATE EDUCATION LW AND THE COMMISSIONEE REGULATIONS TOR ANY PERSON, UNLESS ACTING UNDER THE DIRECTION OF A LICENSE RECHITECT. ENGINEER OR LAND SURVEYOR, TO ALTER AN ITEM IN ANY WAY. IF AN ITEM BEARING THE SEAL OF AN ARCHITECT. INCIDENTE OR SURVEYOR AS LICENSE PARTY SHALL AFFIX TO THE TIEM THER SEAL AND THE NOTATION "ALTERED BY" FOLLOWE THEIR SIGNATURE AND THE DATE OF SUCH ALTERATION, AND A SPECIFIC DESCRIPTION O ALTERATION.

SHEET INFORMATION

Issued	Scale	
10/18/23	As indicated	
Project Status		
BID DOCUMENTS		
Drawn By	Checked By	
LF	LT	
Drawing Title		

DEMOLITION PLAN - AREA A&B

Drawing Number CLE A100

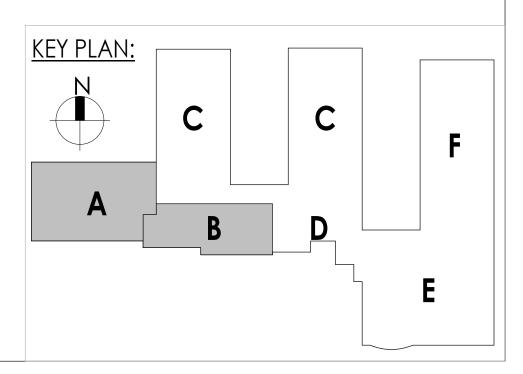





- IT IS THE CONTRACTOR'S RESPONSIBILITY TO FAMILIARIZE THEMSELVES WITH ALL EXISTING CONDITIONS AND DETAILS INVOLVED IN THE DEMOLITION WORK.
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DEMOLITION KEY NOTES

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- (D2) REMOVE EXISTING DOOR & HARDWARE. EXISTING FRAME TO REMAIN.
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- F2 SAW CUT & REMOVE SLAB TO FACILITATE UNDER SLAB PLUMBING WORK. COORDINATE LOCATION WITH P.C
- (F3) REMOVE CERAMIC TILE IN ITS ENTIRETY
- (M1) REMOVE EXISTING CASEWORK IN ITS ENTIRETY
- (M2) REMOVE EXISTING AC UNIT AND SURROUNDING WINDOW PANEL. OWNER TO HAVE FIRST RIGHT OF REFUSAL ON WINDOW AC'S.
- (M3) REMOVE EXISTING FIRE SHUTTER & TURN OVER TO OWNER
- (M4) REMOVE EXISTING WOOD STAIR IN ITS ENTIRETY
- (M5) REMOVE CHAIRRAIL & WAINSCOT BELOW
- PC TO DISCONNECT & REMOVE EXISTING SINK. GC TO REMOVE & SALVAGE ALL ACCESSORIES & RETURN TO OWNER.
- (W1) REMOVE EXISTING WALL CMU WALL
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PROJECT INFORMATION Project Number 14457.20 Client Name SOUTH ORANGETOWN CENTRAL SCHOOL DISTRICT

PHASE 1: 2022 BOND

Project Name

District Office Address 160 VAN WYCK RD. Larry Werts 12/31/24 BLAUVELT, NY 10913 Anthony Marchetti 05/31/24

CERTIFICATE #018330 REGISTRATION EXPIR. DATES: Lauren Tarsio 09/30/26 Richard Waite 11/30/23 Dave Hart 02/28/25


Jennifer Wengender 06/30/24

south orangetown CSD

- WILLIAM O. SCHAEFER SED#:50-03-01-06-0-012-019 COTTAGE LANE ELEMENTARY SED#:50-03-01-06-0-010-022 TAPPAN ZEE HIGH SCHOOL SED#:50-03-01-06-0-006-032 WILLIAM O. SCHAEFER S&L SED#: 50-03-01-06-0-012-020 COTTAGE LANE S&L SED#: 50-03-01-06-0-010-023 COTTAGE LANE LIBRARY S&L SED#: 50-03-01-06-8-023-002 WOS OUTDOOR CLASSROOM SED#:50-03-01-06-7-053-001 SOMS OUTDOOR CLASSROOM SED#:50-03-01-06-7-056-001
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PROJECT ISSUE & REVISION SCHEDULE Date Description

PROFESSIONAL STAMPS

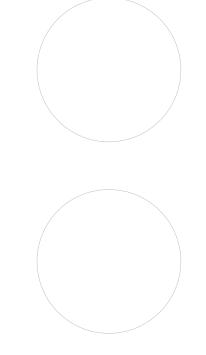

EGULATIONS FOR ANY PERSON, UNLESS ACTING UNDER THE DIRECTION OF A LICEN RCHITECT, ENGINEER OR LAND SURVEYOR, TO ALTER AN ITEM IN ANY WAY. IF AN IT


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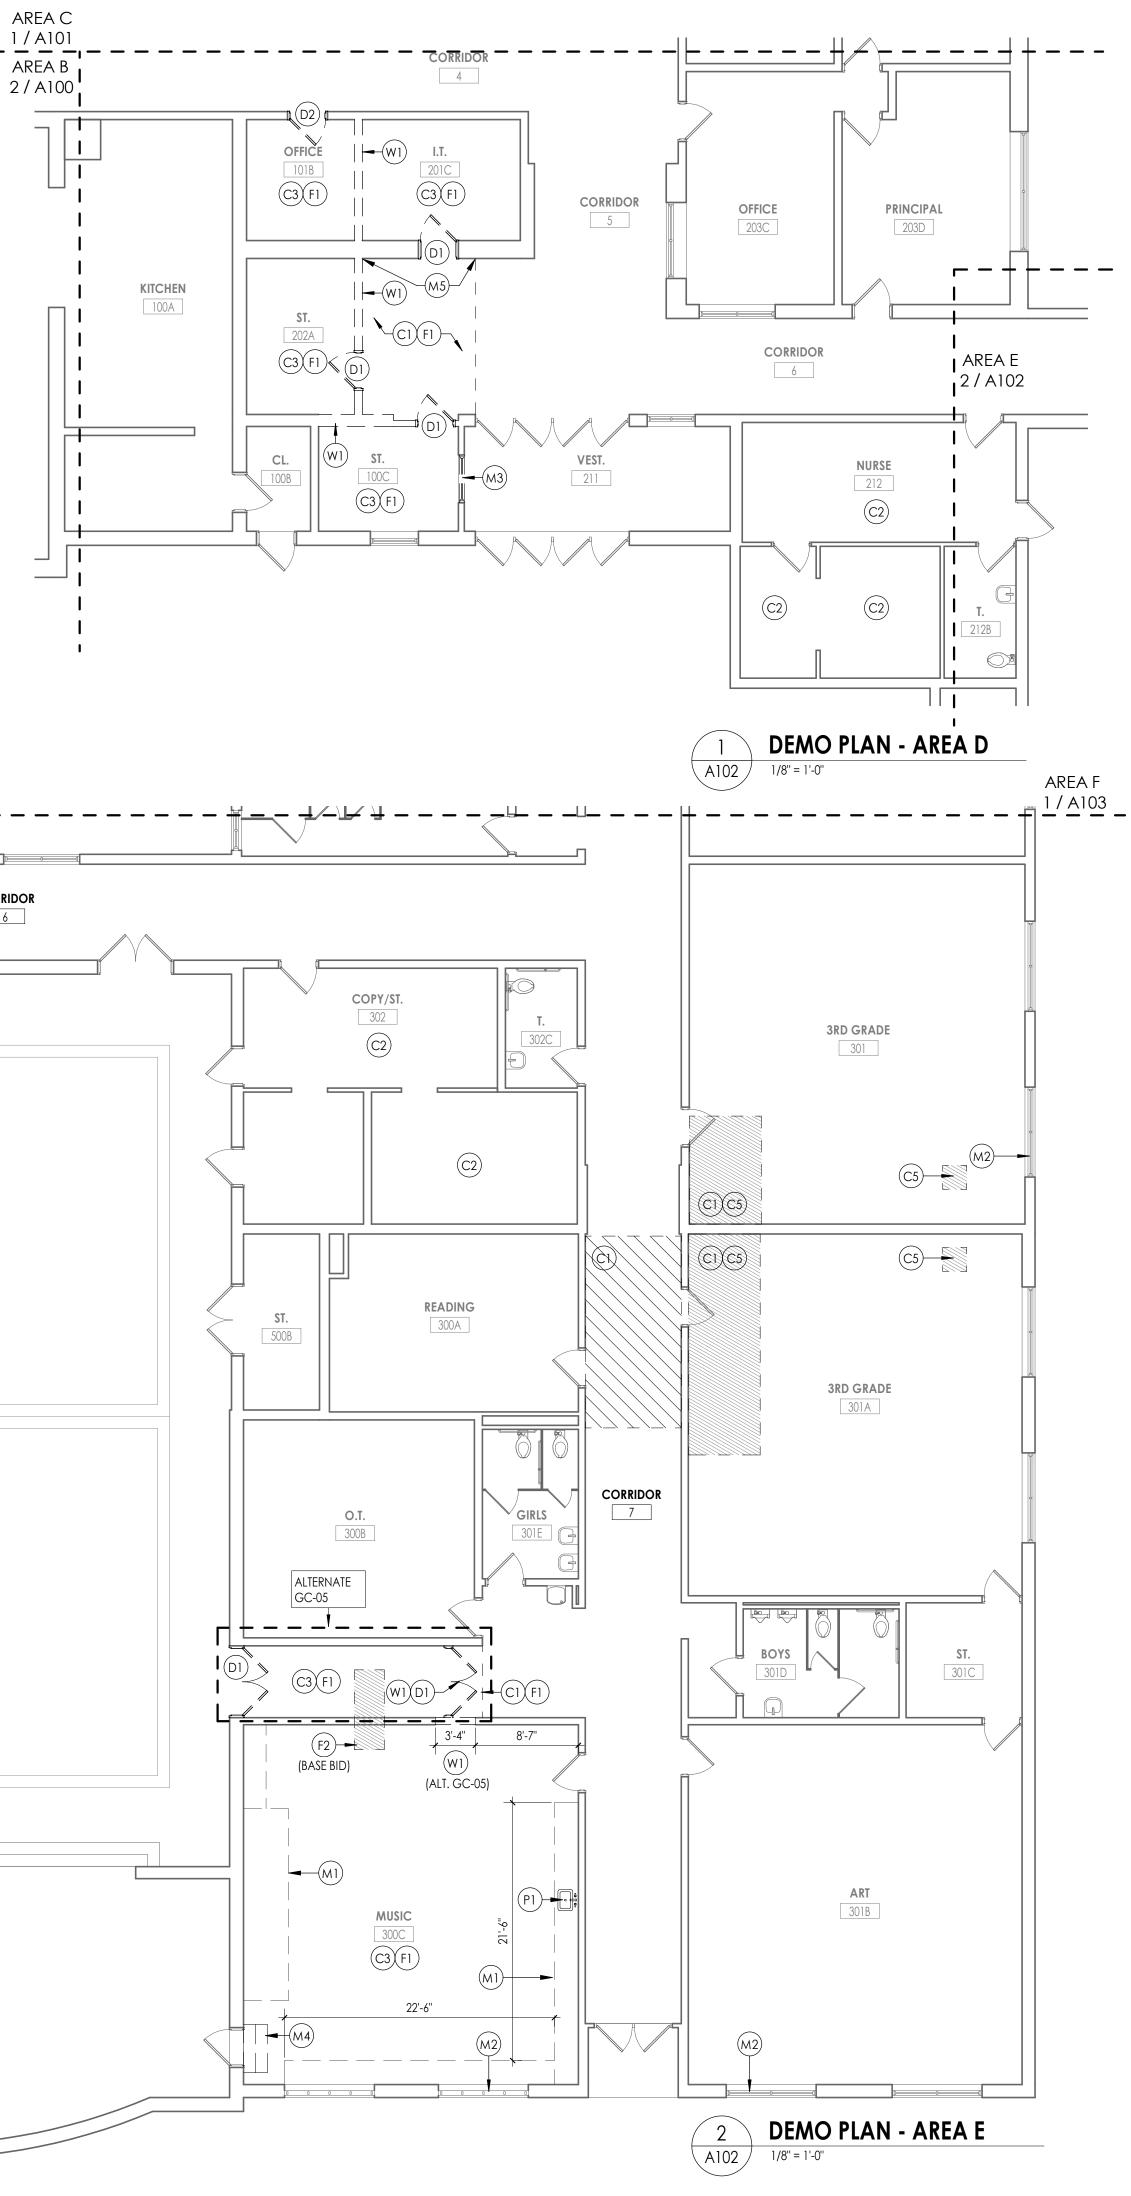
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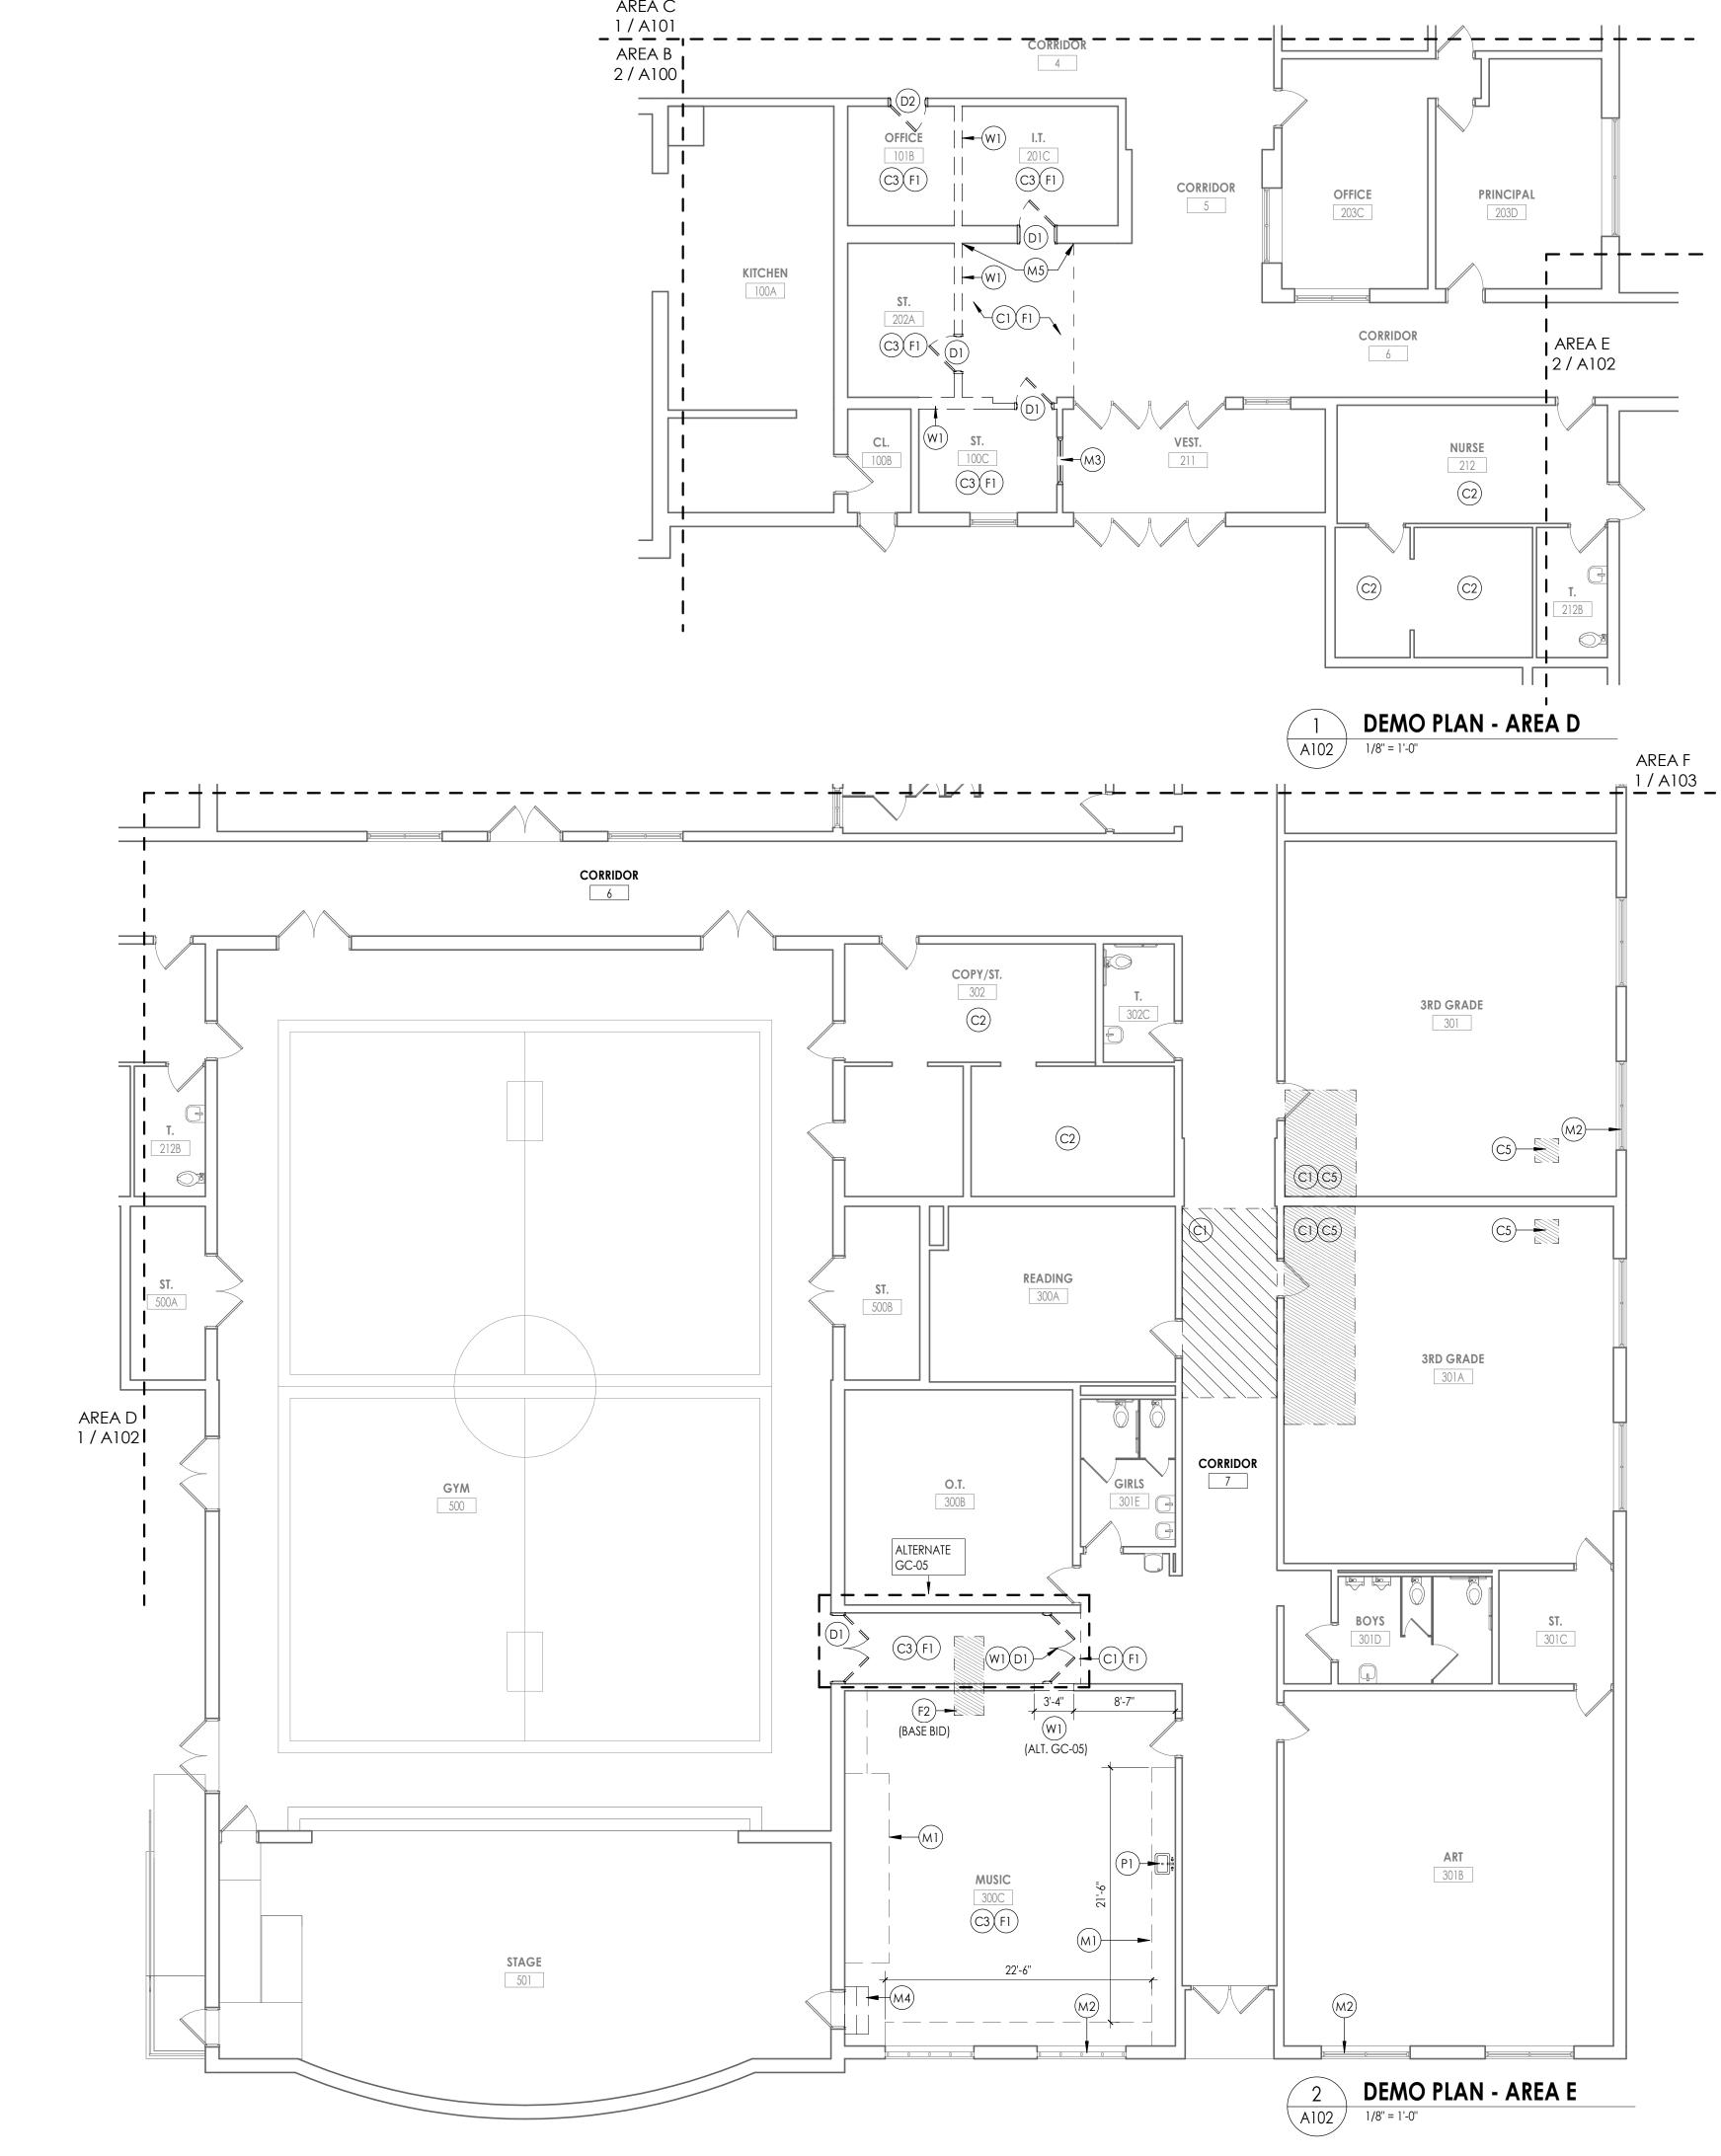
EW YORK STATE EDUCATION STATEM

Issued Scale 10/18/23 As indicated Project Status BID DOCUMENTS Drawn By Checked By LF LT Drawing Title DEMOLITION PLAN - AREA C

Drawing Number CLE A101





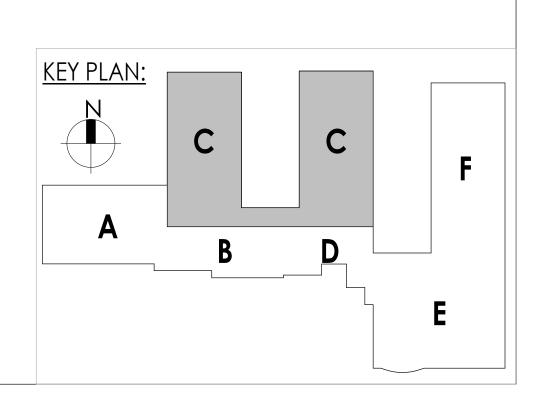

DEMOLITION GENERAL NOTES

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- (C2) REMOVE PLASTER CEILING SYSTEM IN ITS ENTIRETY
- (C3) REMOVE ACT CEILING SYSTEM IN ITS ENTIRETY
- C4 ACT CEILING SYSTEM & SECONDARY SHEETROCK CEILING SYSTEM REMOVED BY ABATEMENT CONTRACTOR.
- REMOVE SECONDARY ACOUSTIC CEILING SYSTEM & SUSPENSION SYSTEM IN ITS
- ENTIRETY. COORDINATE FINAL LOCATION WITH MC.
- (D1) REMOVE EXISTING DOOR, FRAME & HARDWARE IN ITS ENTIRETY
- (D2) REMOVE EXISTING DOOR & HARDWARE. EXISTING FRAME TO REMAIN.
- (F1) REMOVE EXISTING VCT FLOORING IN ITS ENTIRETY
- F2 SAW CUT & REMOVE SLAB TO FACILITATE UNDER SLAB PLUMBING WORK. COORDINATE LOCATION WITH P.C
- (F3) REMOVE CERAMIC TILE IN ITS ENTIRETY
- (M1) REMOVE EXISTING CASEWORK IN ITS ENTIRETY
- (M2) REMOVE EXISTING AC UNIT AND SURROUNDING WINDOW PANEL. OWNER TO HAVE FIRST RIGHT OF REFUSAL ON WINDOW AC'S.
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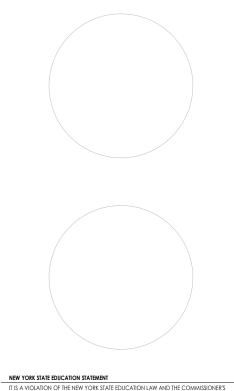
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south orangetown CSD

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PROJECT ISSUE & REVISION SCHEDULE No. Date Description

PROFESSIONAL STAMPS



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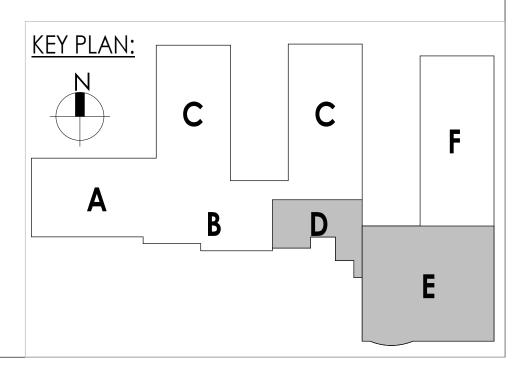
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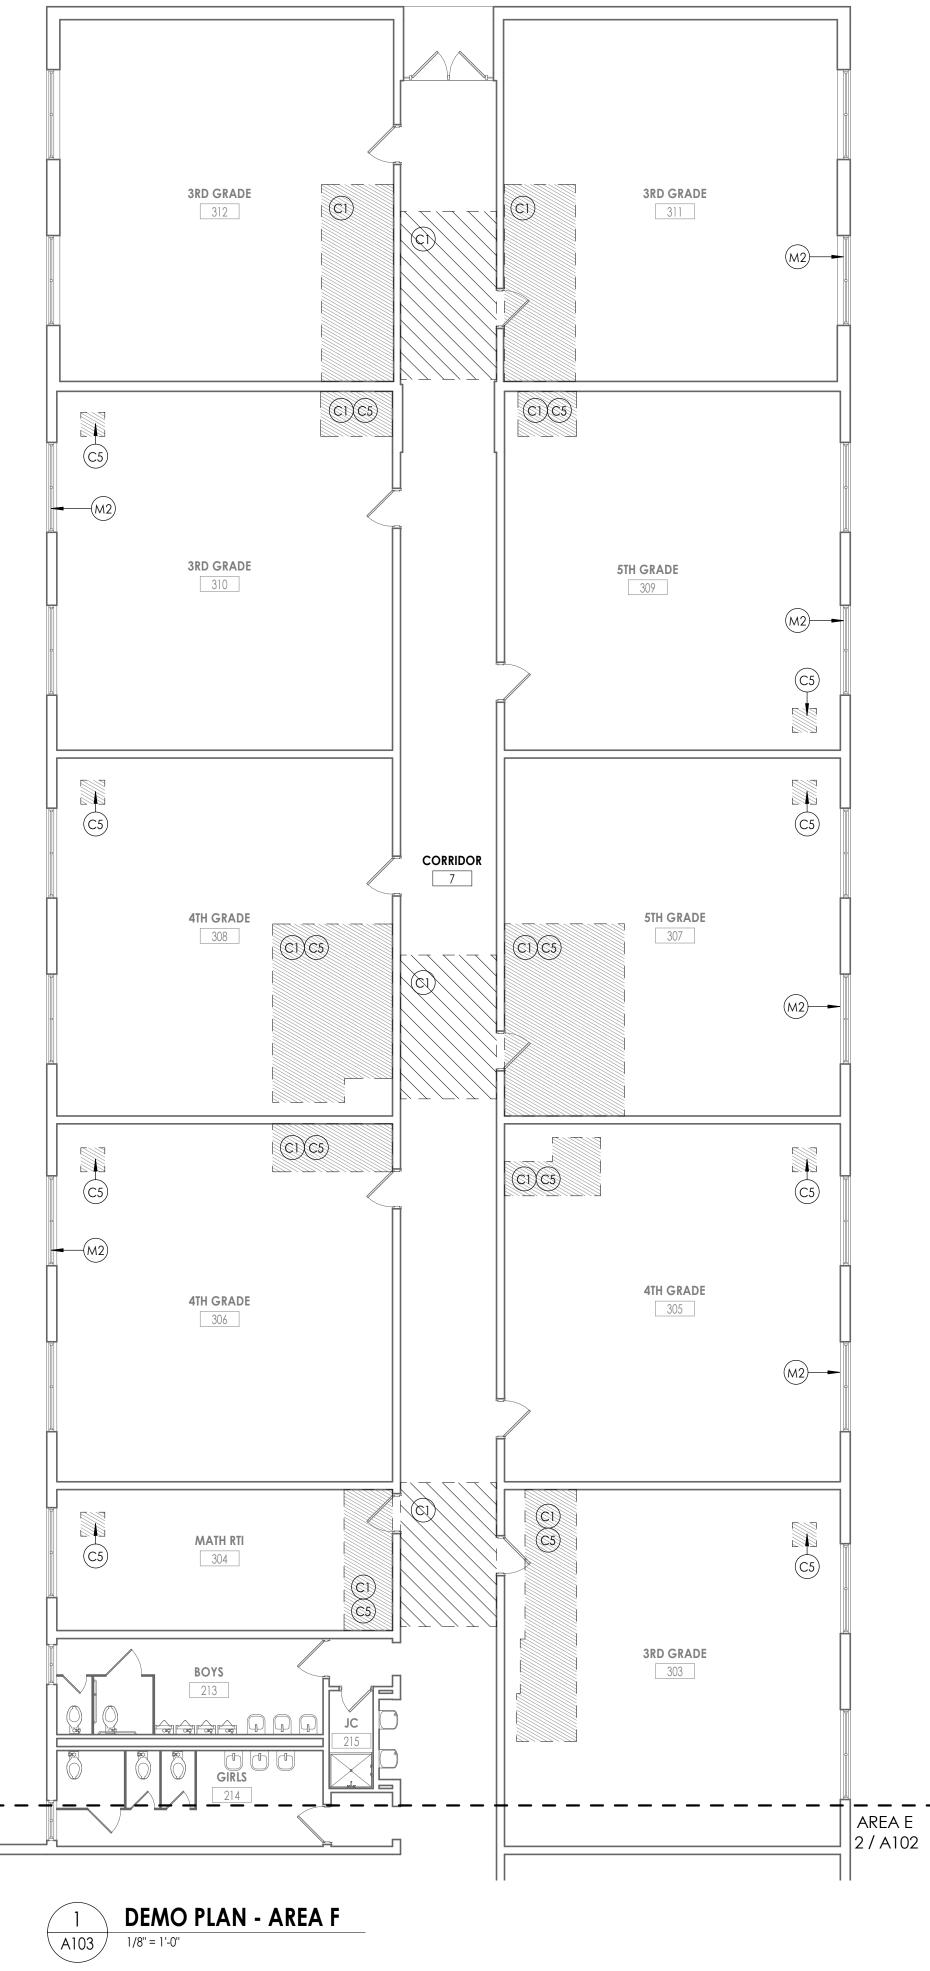
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10/18/23	As indicated
Project Status	
BID DOCUMENTS	
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LF	LT
Drawing Title	
DEMOLITION PLA	N - ARFA D&

DEMOLIIION PLAN - AREA D&E

Drawing Number







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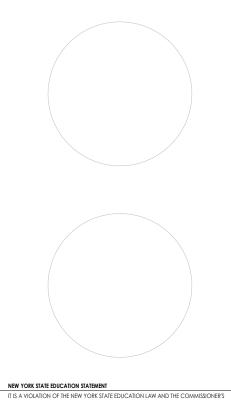
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PROJECT ISSUE & REVISION SCHEDULE No. Date Description

PROFESSIONAL STAMPS




II IS A VIDATION OF THE NEW TORK SING EDUCATION LAW AND THE COMMISSIONEE REGULATIONS TOR ANY PERSON, UNLESS ACTING UNDER THE DIRECTION OF A LICENSE RACHTECT, ENGINEER OR LAND SURVEYOR, TO ALTER AN TEM IN ANY WAY. IF AN TEM BEARING THE SEAL OF AN ARCHITECT, ENGINEER OR SURVEYOR AS LATERED, THE ALTERN PARTY SHALL AFFIX TO THE ITEM THER SEAL AND THE NOTATION "ALTERED BY" FOLLOWED THEIR SIGNATURE AND THE DATE OF SUCH ALTERATION, AND A SPECIFIC DESCRIPTION OF ALTERATION.


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Project Status	
BID DOCUMENTS	
Drawn By	Checked By
LF	LT
Drawing Title	
DEMOLITION PLA	N - ARFA F

DEMOLITION PLAN - AREA F

Drawing Number CLE A103



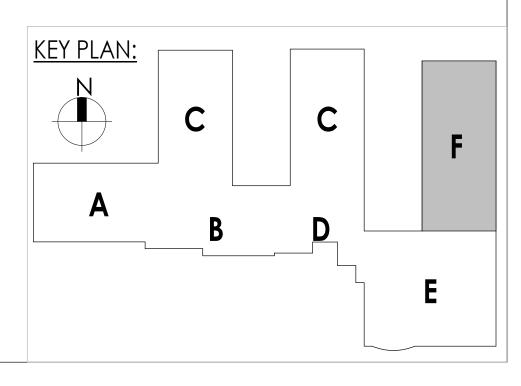

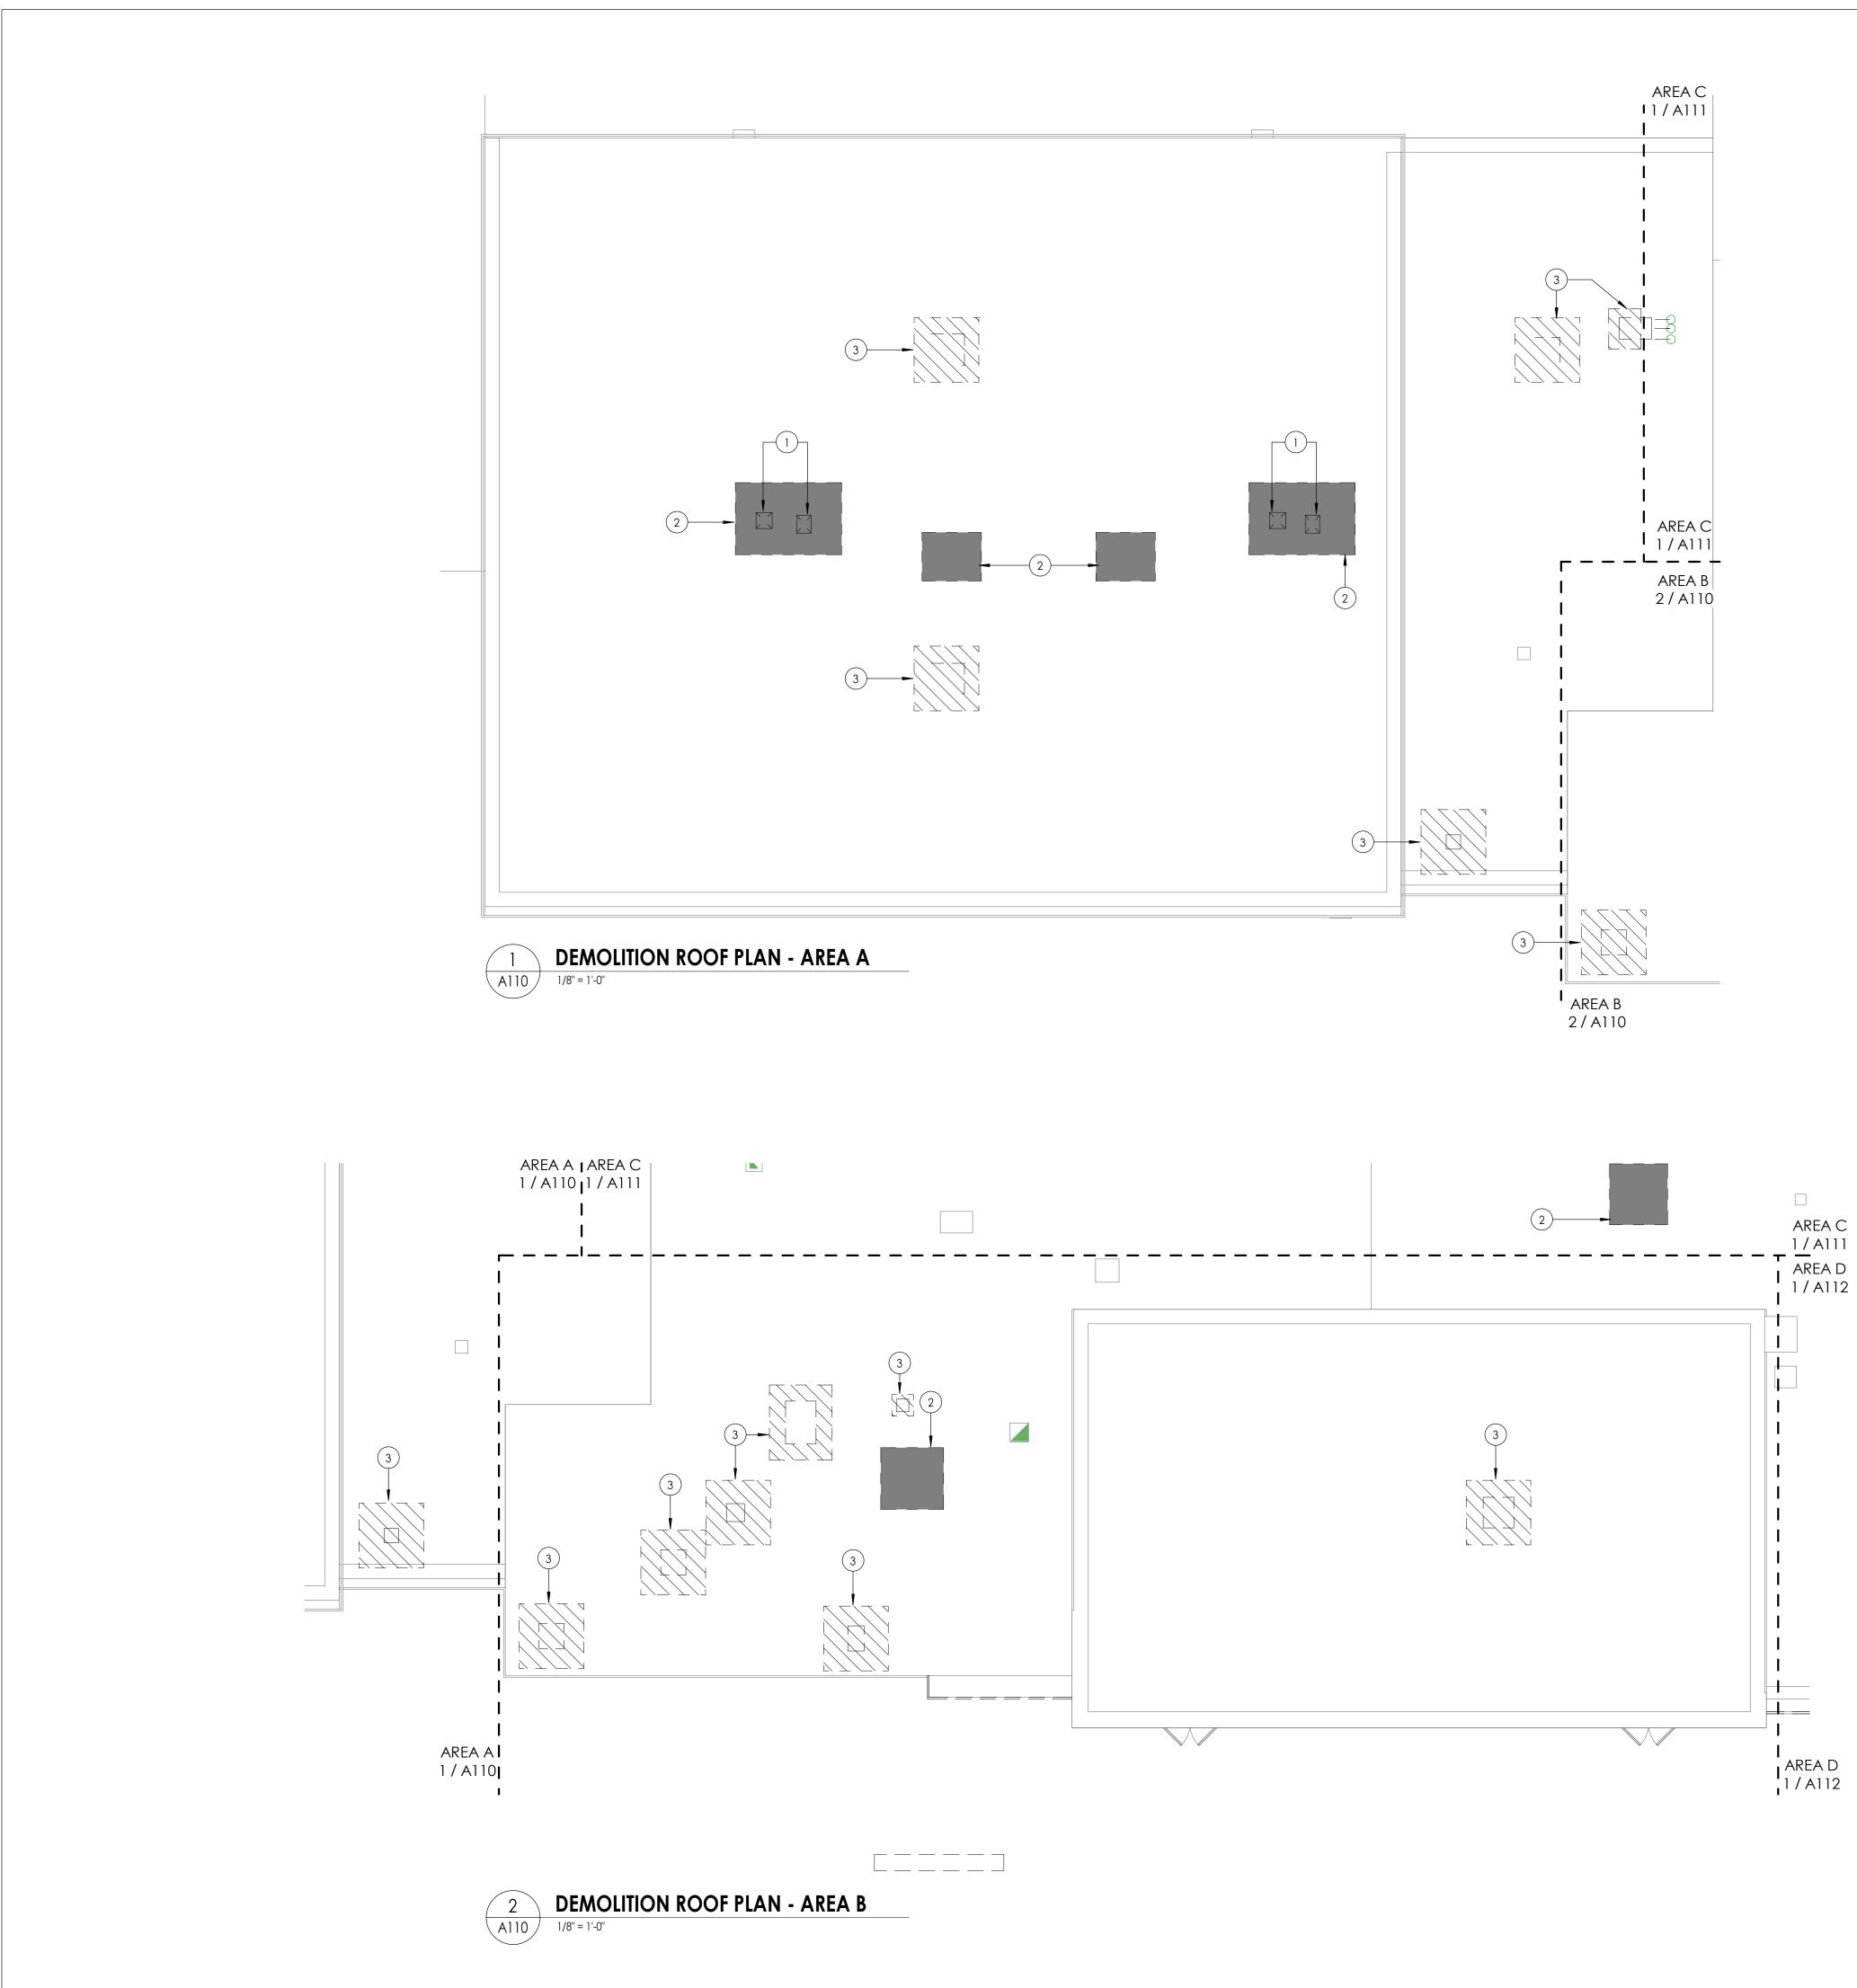
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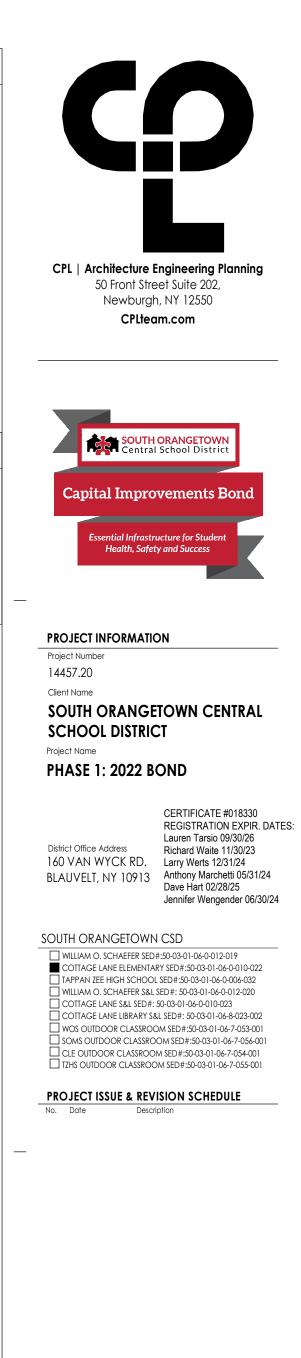
DEMOLITION ROOF PLAN KEYNOTES

(1) CUT DECK & PROVIDE STRUCTURAL SUPPORT




(2) REMOVE ROOF SYSTEM DOWN TO ROOF DECK EXISTING MECHANICAL UNIT TO BE REMOVED BY M.C.

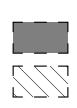G.C. TO REMOVE CURB & INFILL ROOF DECK AND ROOFING SYSTEM PER DETAIL



PROFESSIONAL STAMPS

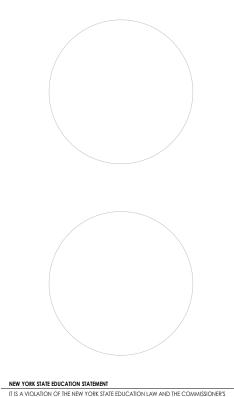


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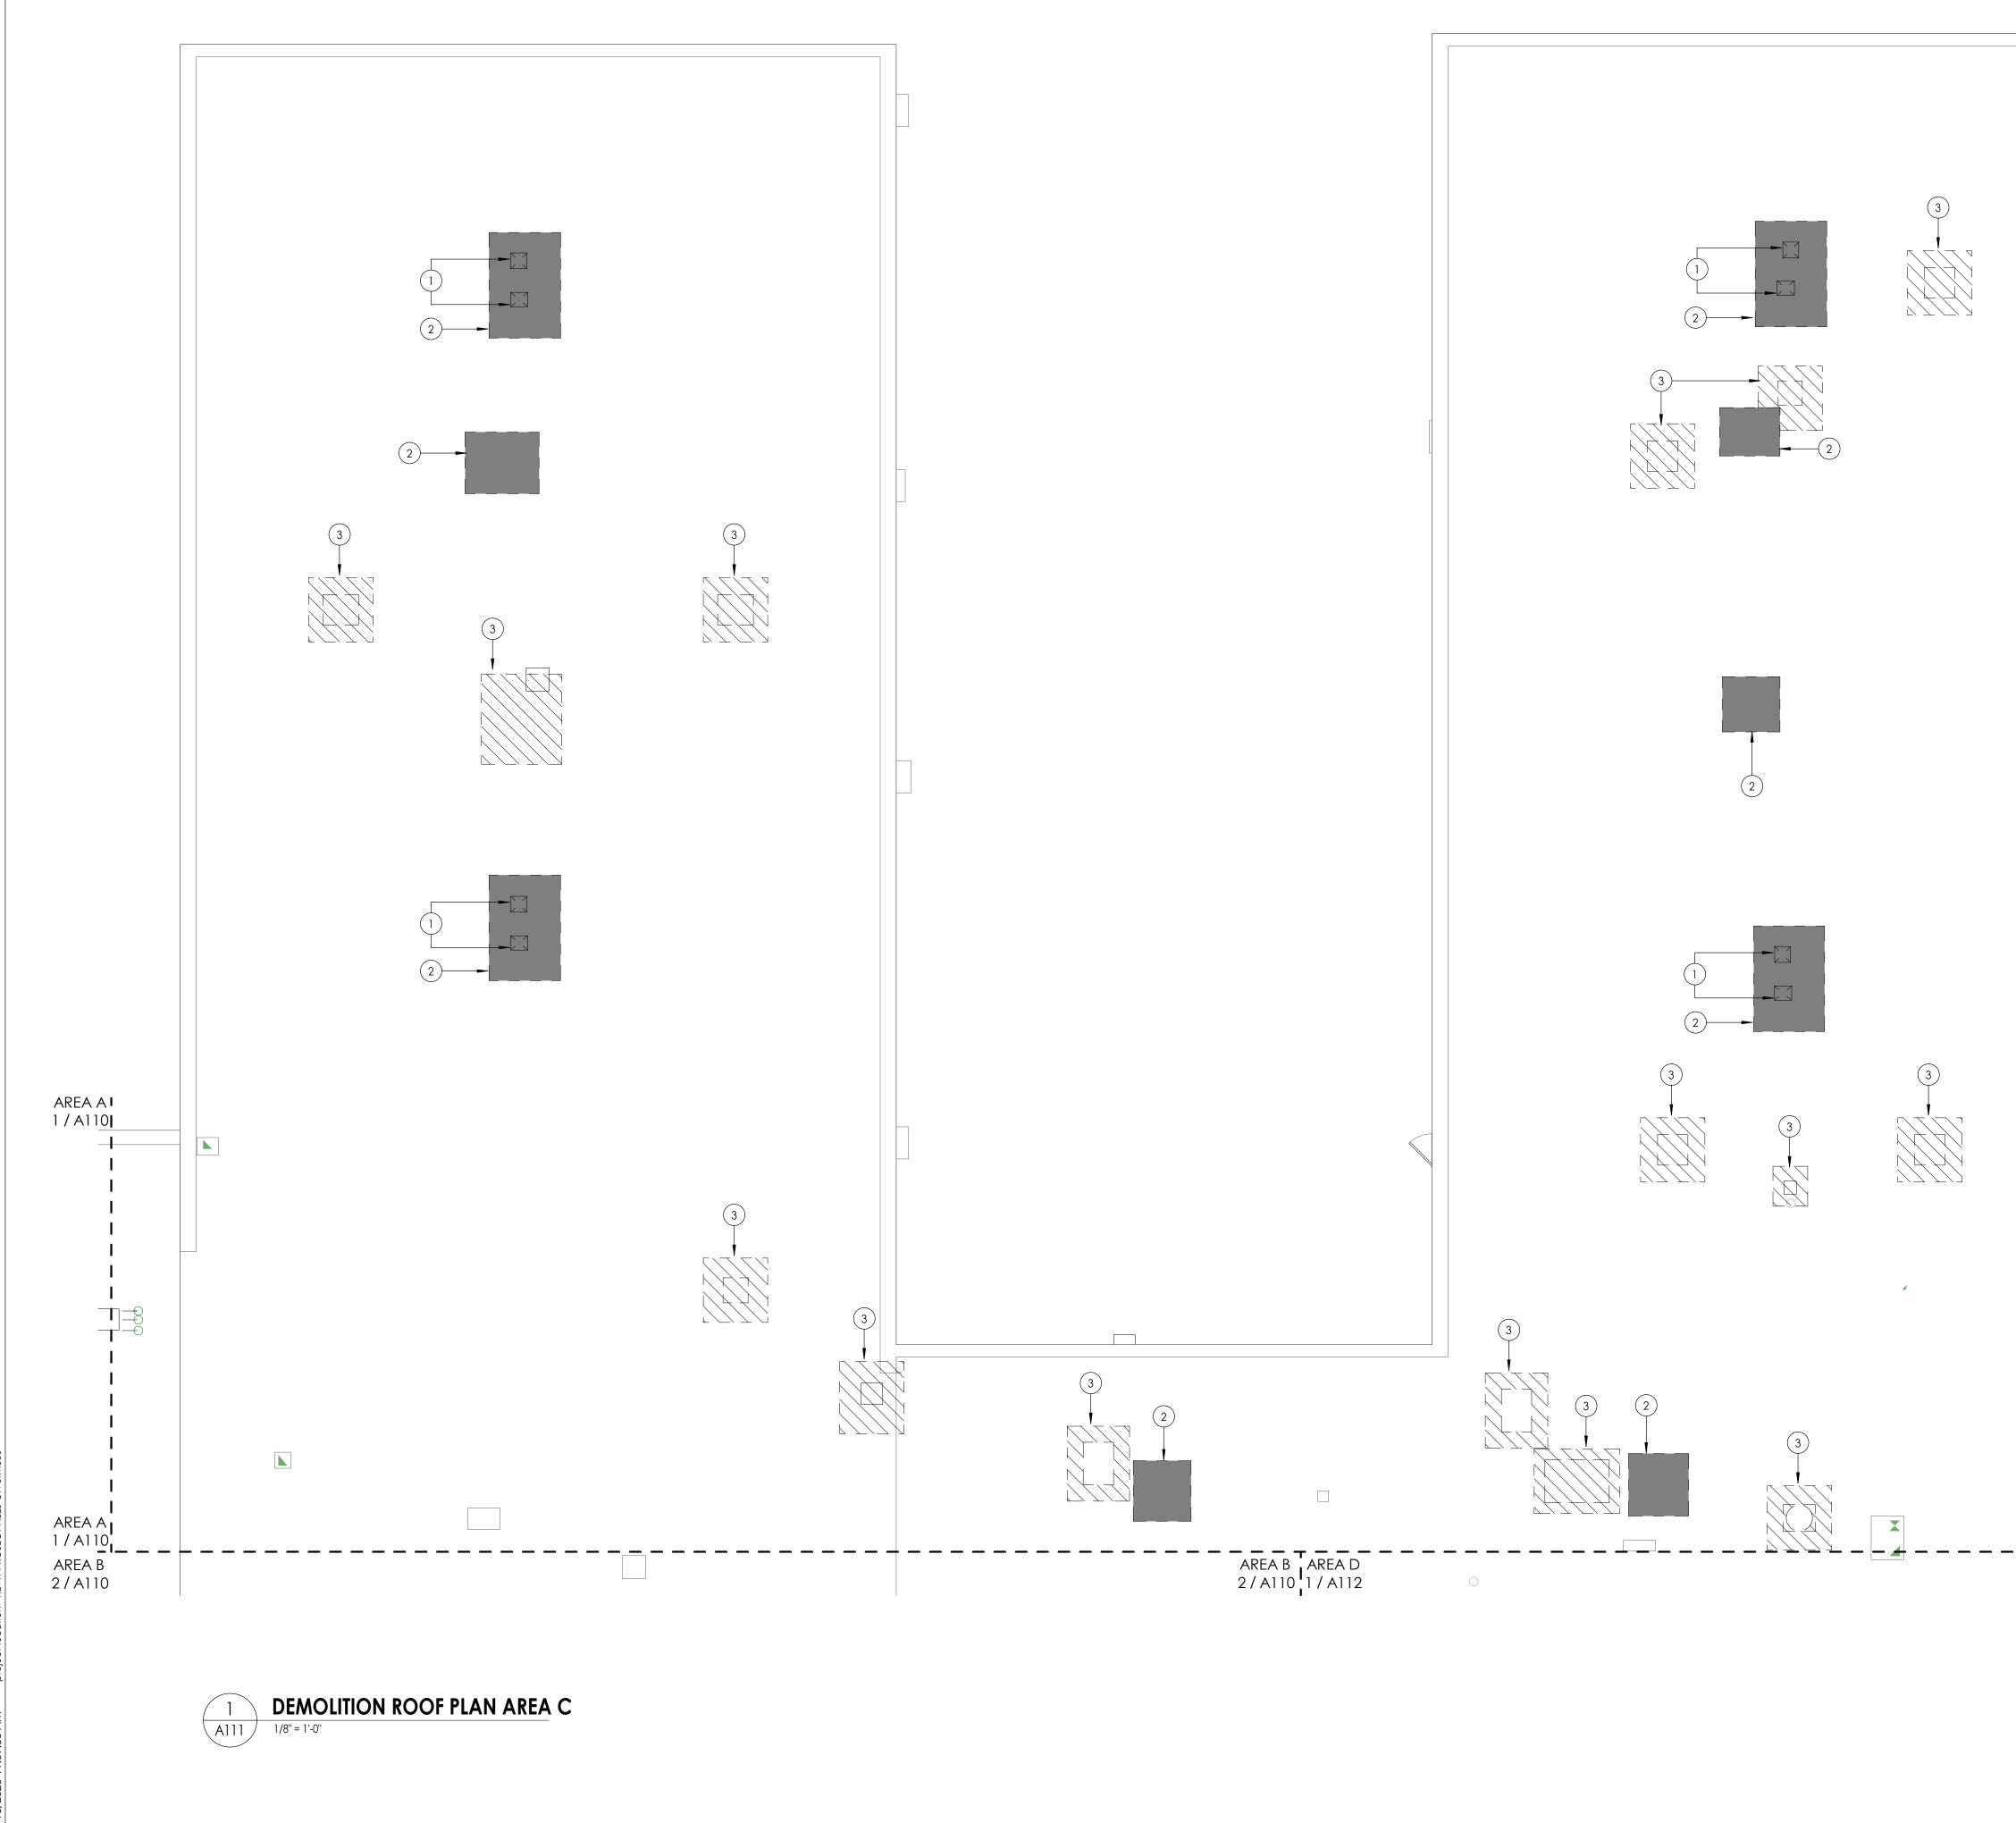
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10/18/23	As indicated
Project Status	
BID DOCUMENTS	
Drawn By	Checked By
LF	LT
Drawing Title	
DEMOLITION	ROOF PLAN ARE
A&R	
	10/18/23 Project Status BID DOCUMENTS Drawn By LF Drawing Title


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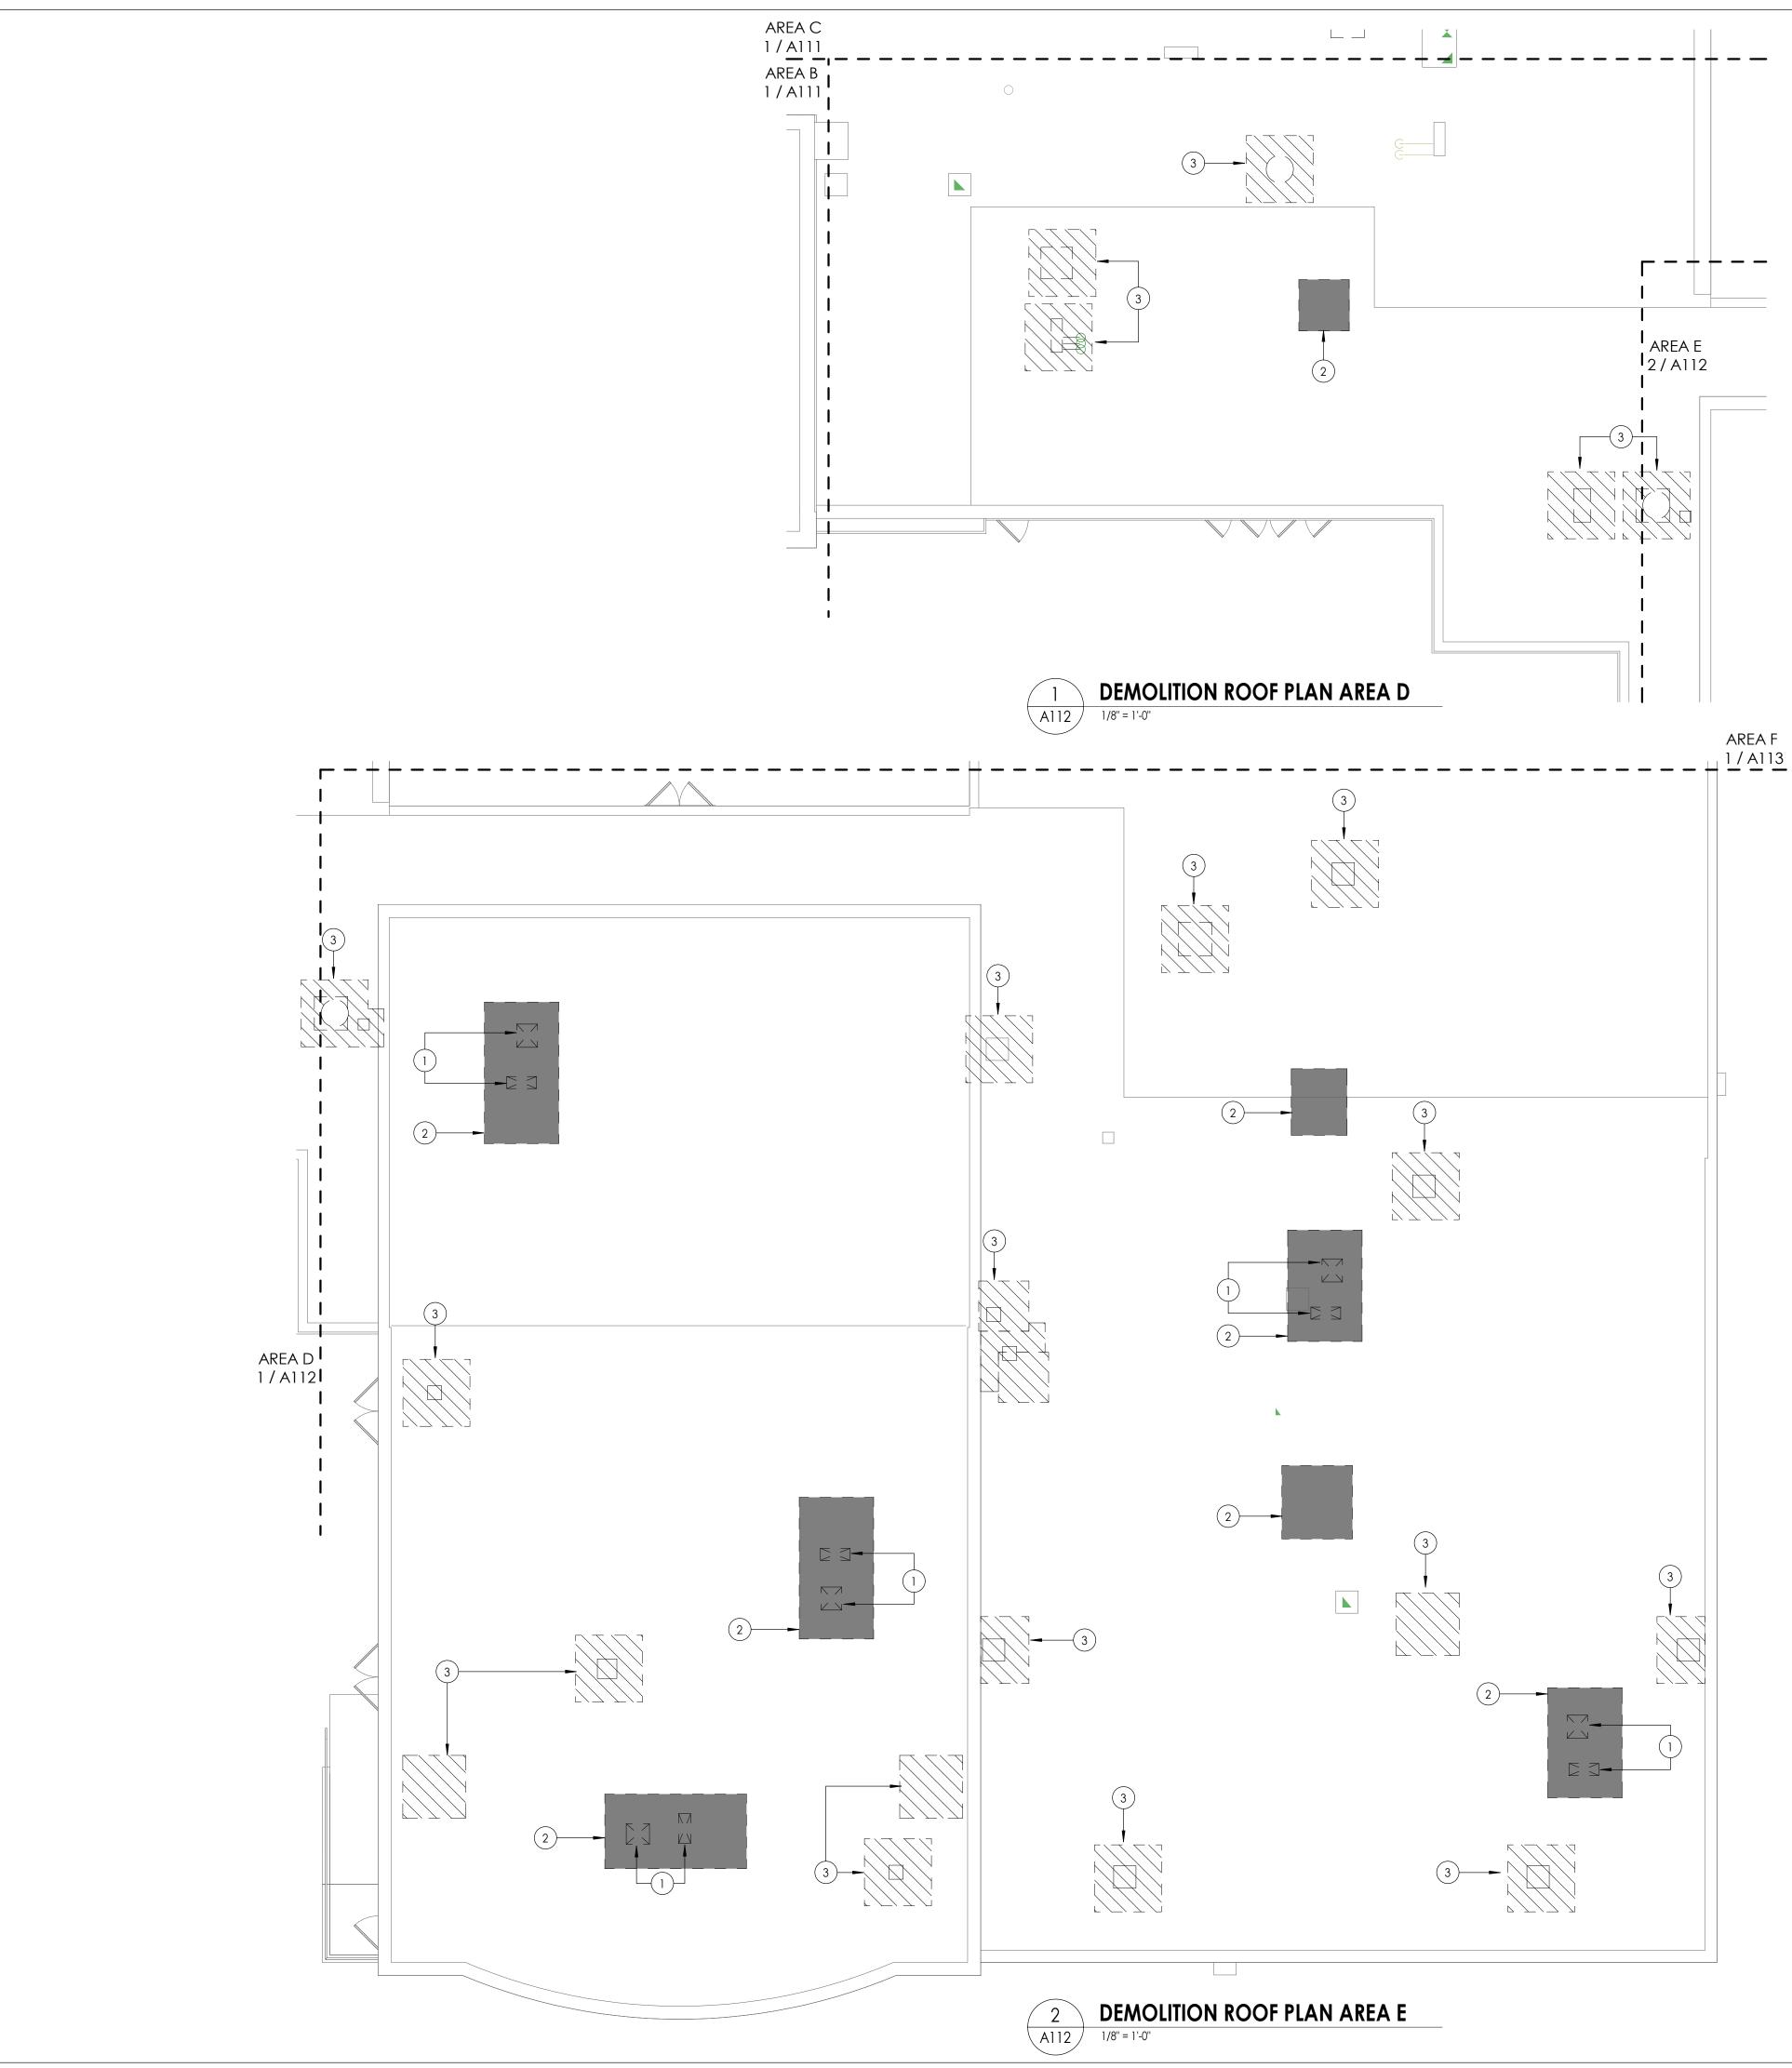




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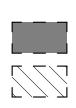


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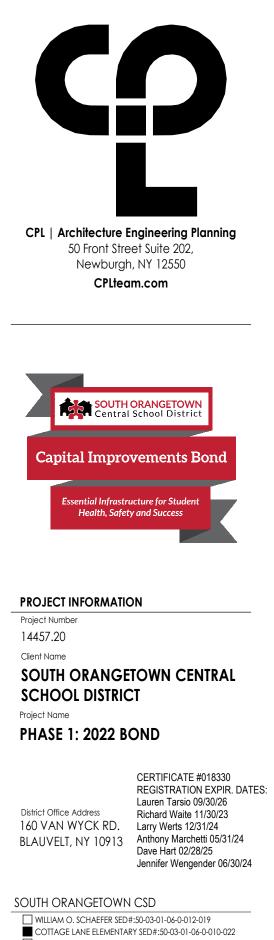
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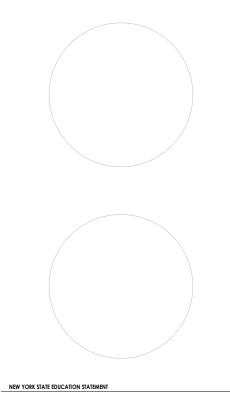
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PROJECT ISSUE & REVISION SCHEDULE No. Date Description

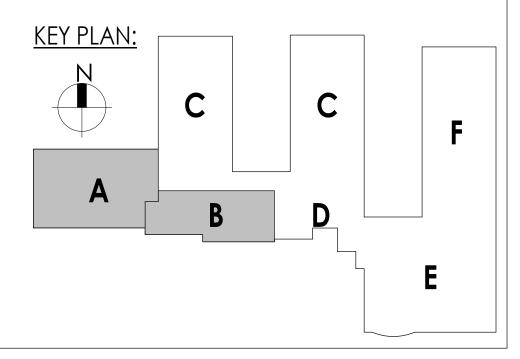
PROFESSIONAL STAMPS

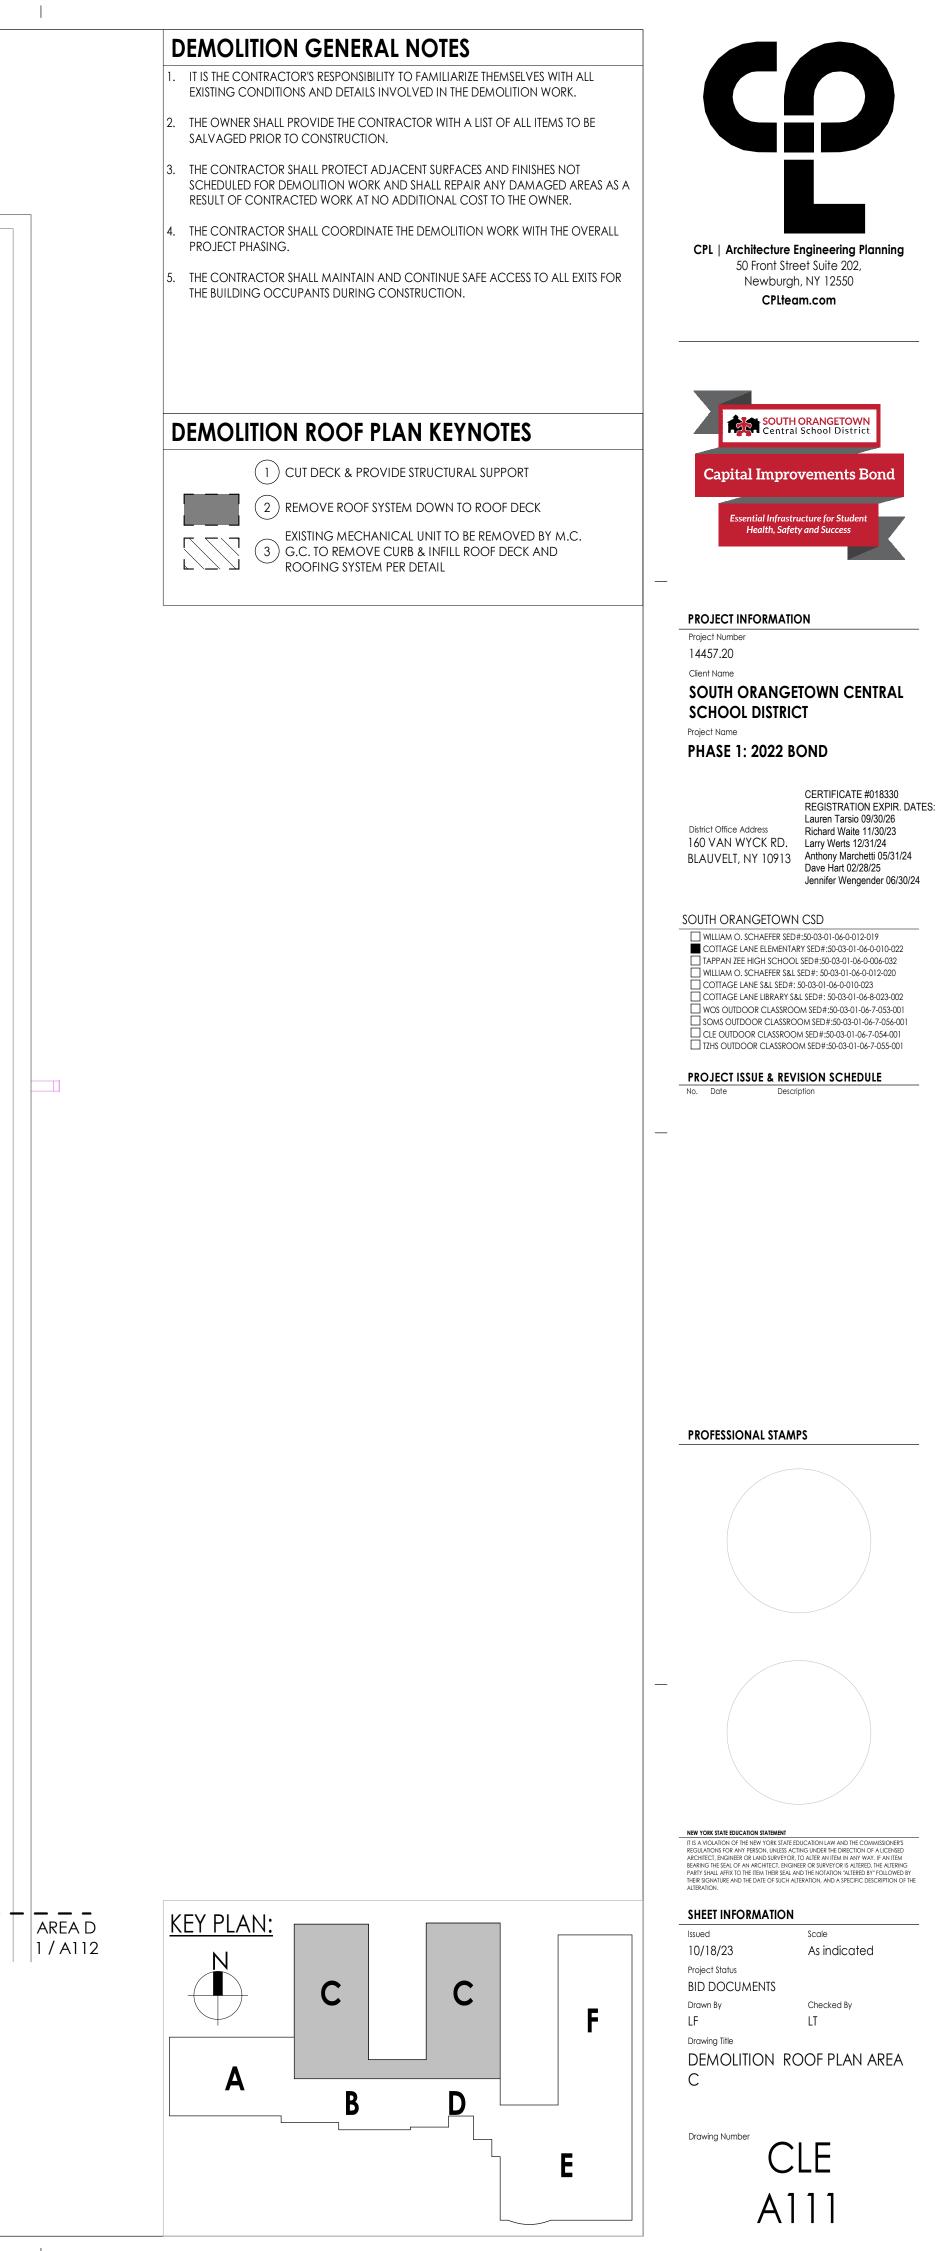

SHEET INFORMATION


Issued	Scale
10/18/23	As indicated
Project Status	
BID DOCUMENTS	
Drawn By	Checked By
LF	LT
Drawing Title	
DEMOLITION	ROOF PLAN AREA
D&F	

Drawing Number CLE A112

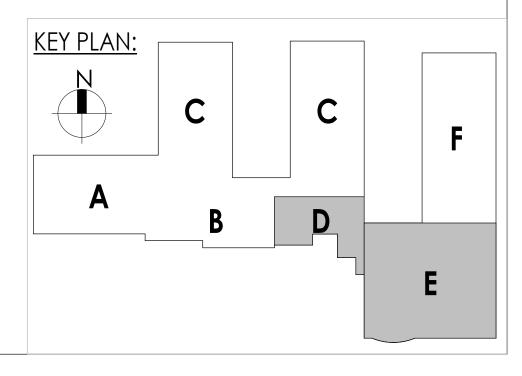



1DEMOLITION ROOF PLAN AREAA1131/8" = 1'-0"

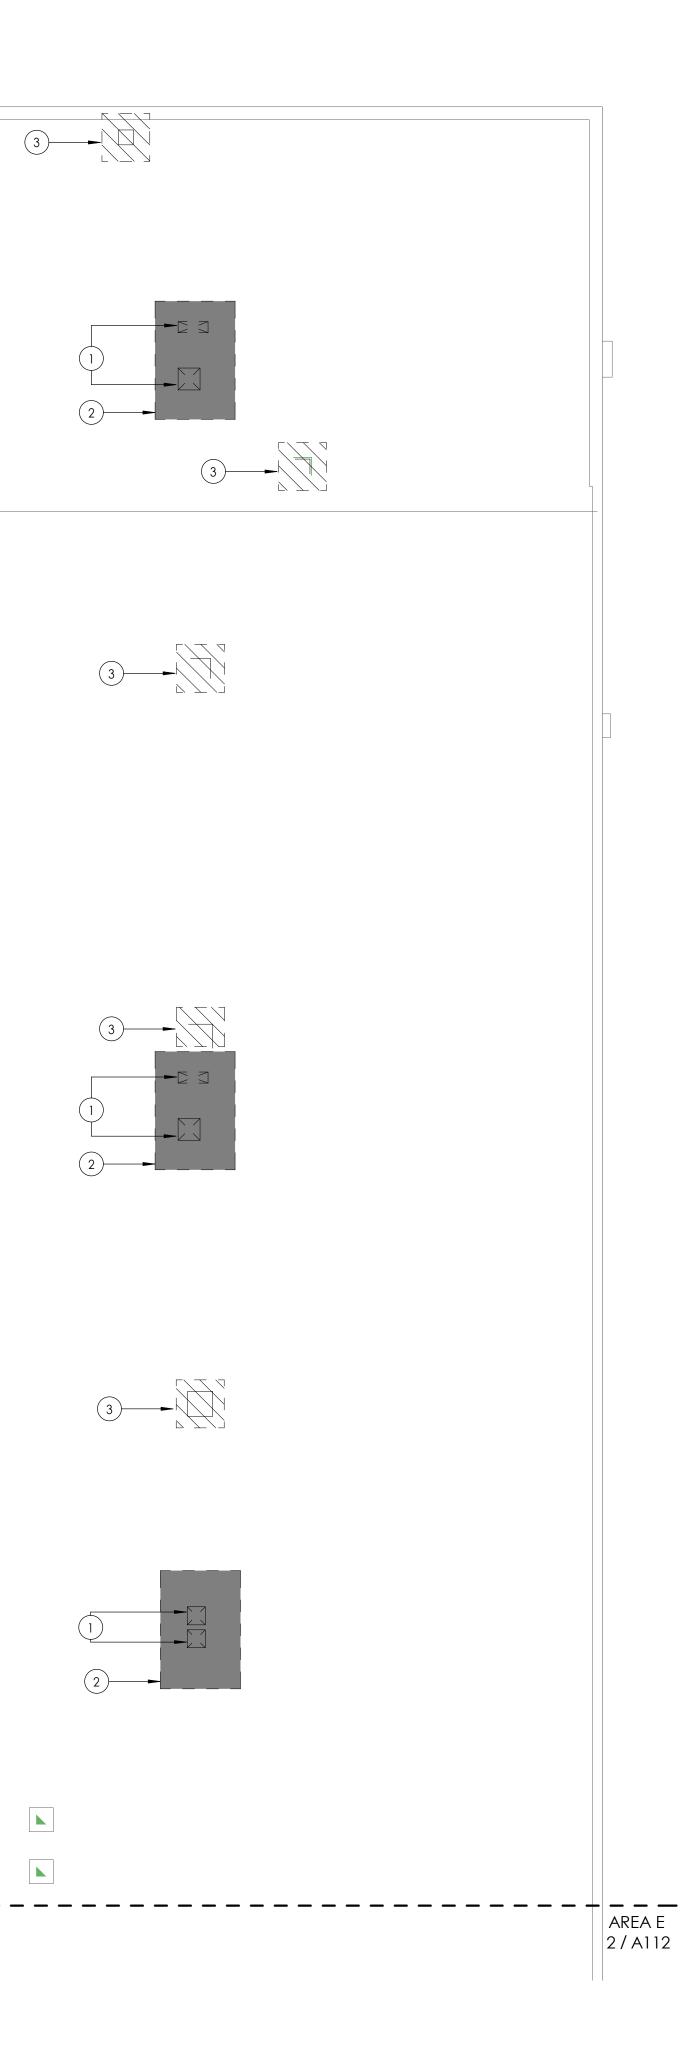


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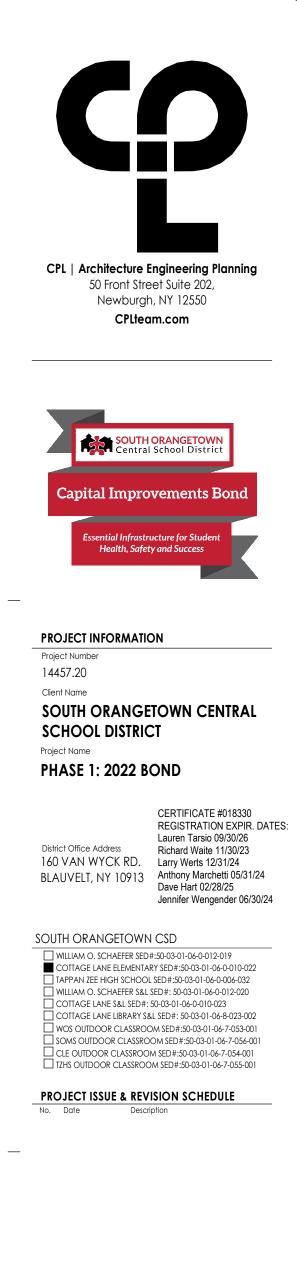
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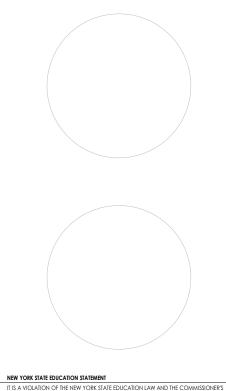


2 REMOVE ROOF SYSTEM DOWN TO ROOF DECK EXISTING MECHANICAL UNIT TO BE REMOVED BY M.C.

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PROFESSIONAL STAMPS

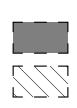


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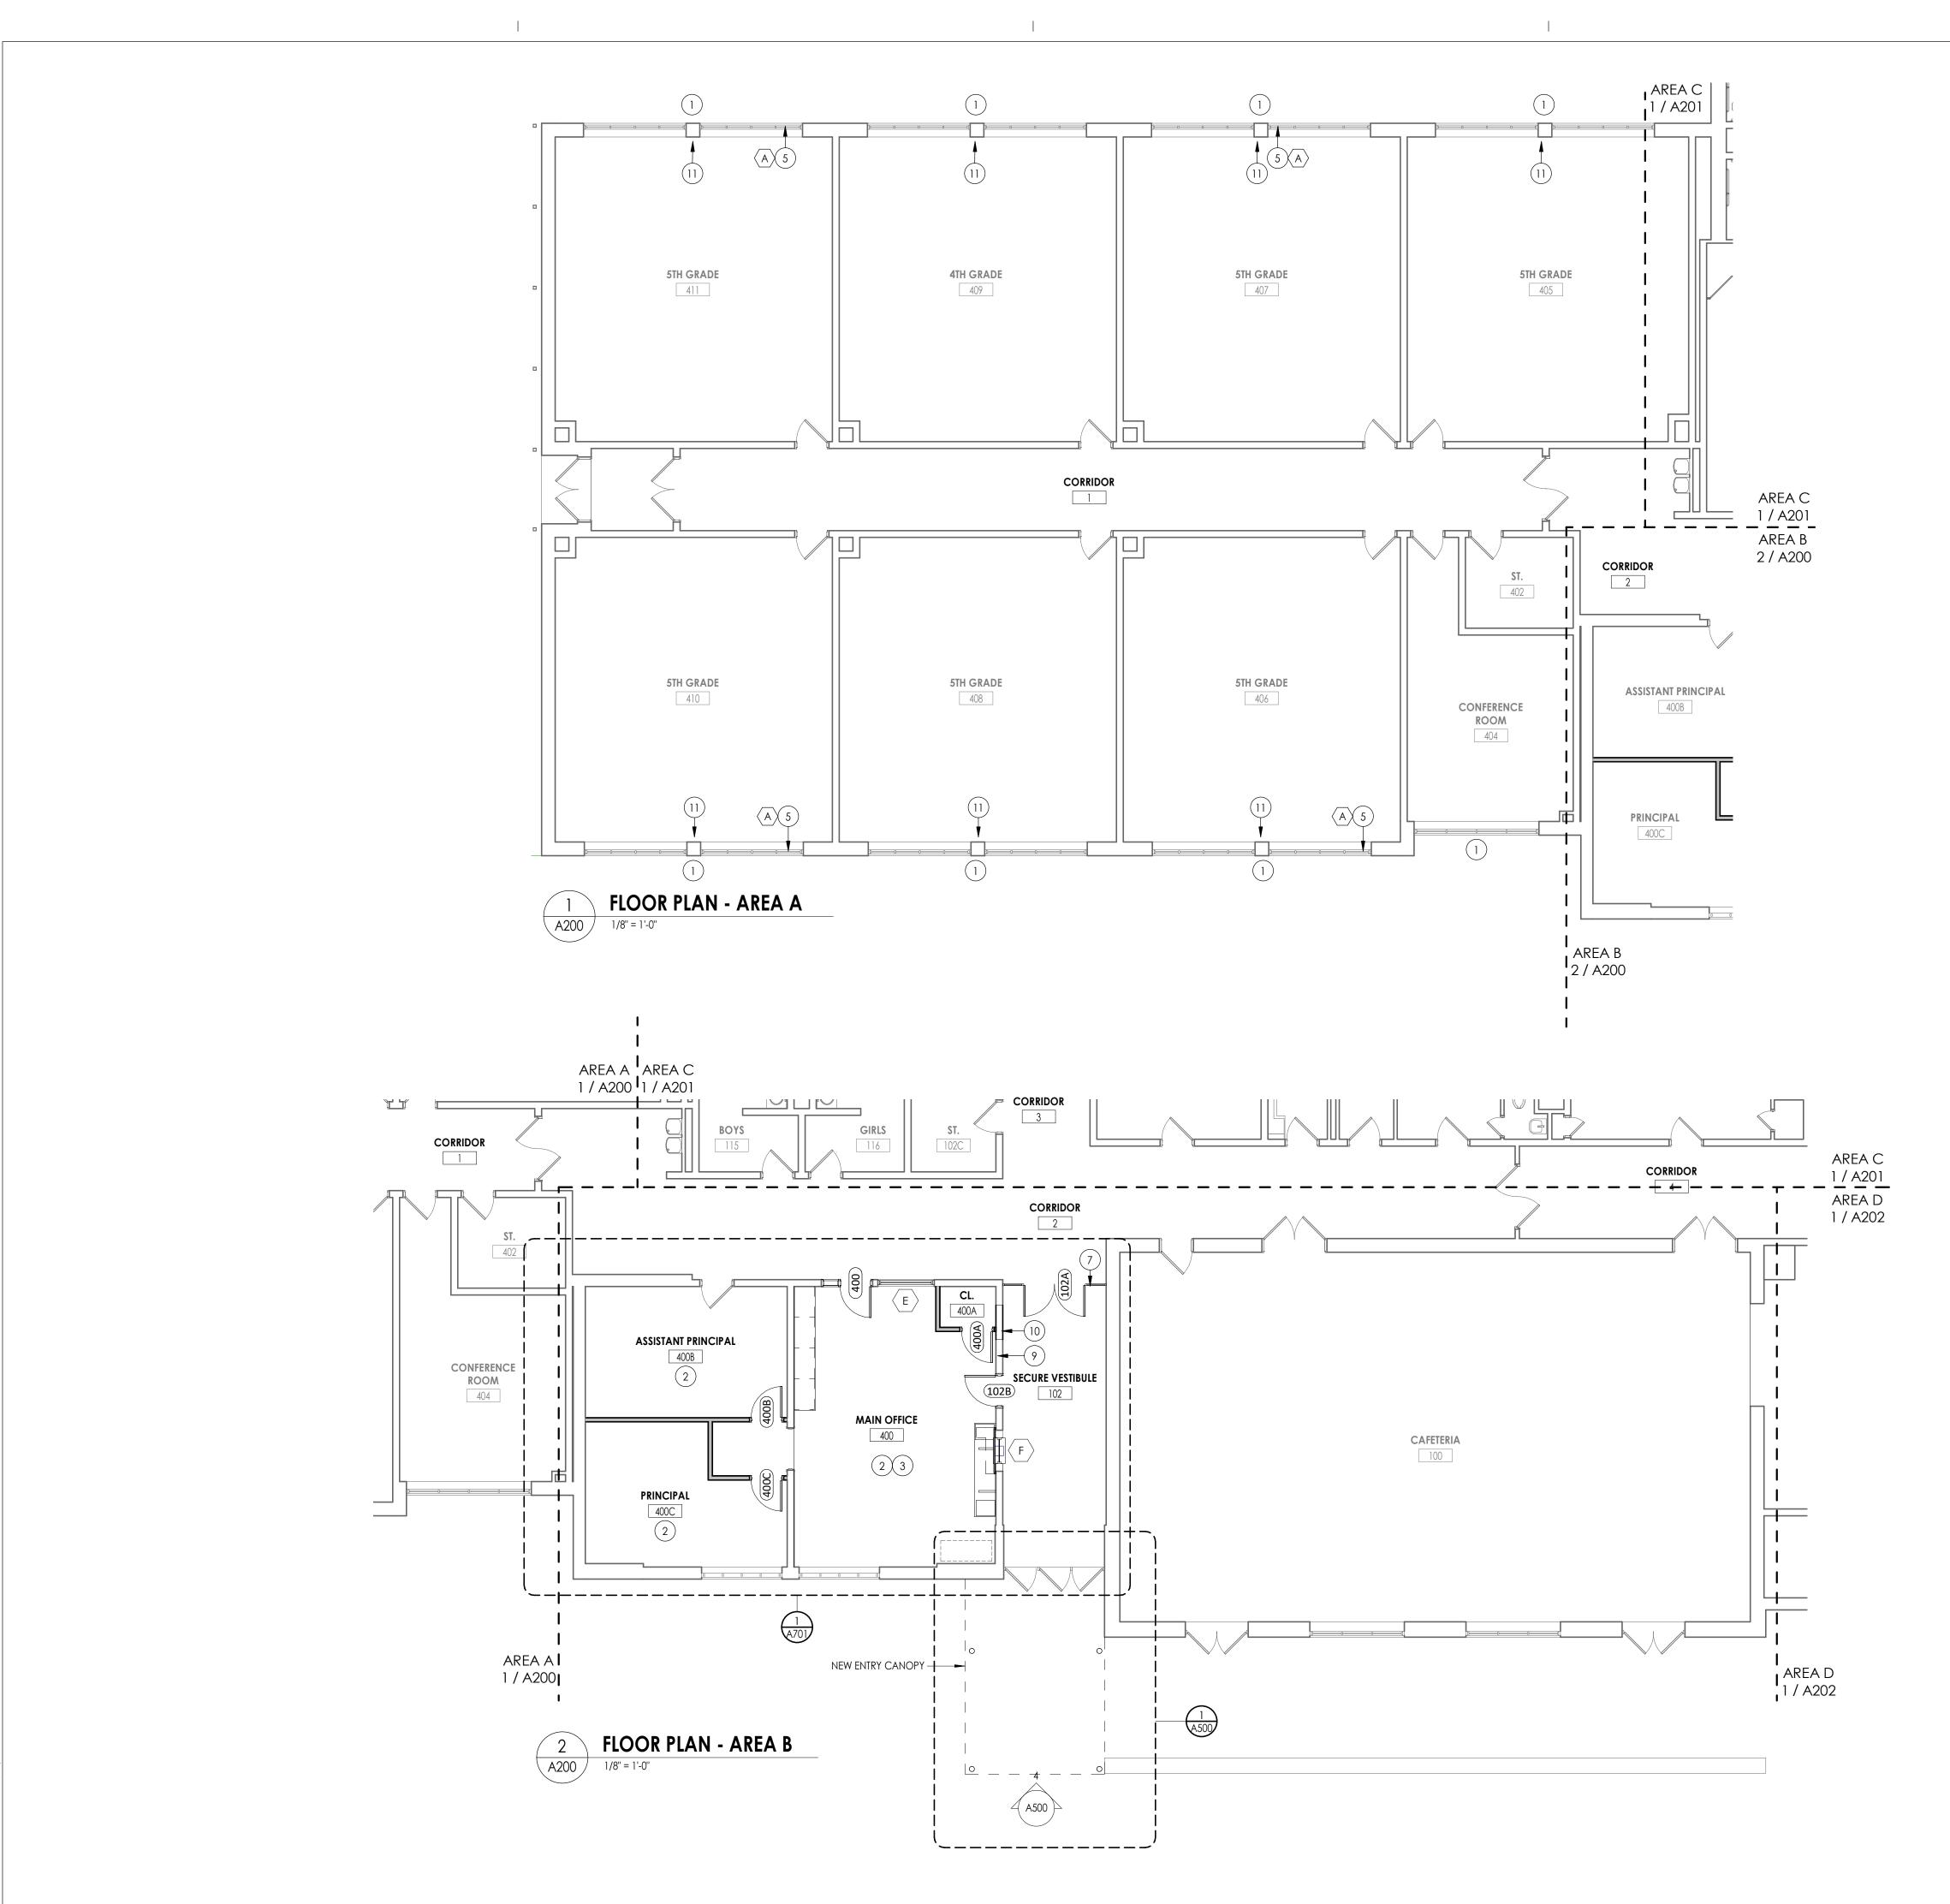
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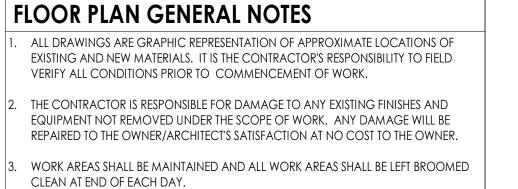
Issued	Scale
10/18/23	As indicated
Project Status	
BID DOCUMENTS	
Drawn By	Checked By
LF	LT
Drawing Title	
	ROOF PLAN ARE

DEMOLITION ROOF PLAN AREA F

Drawing Number CLE A113






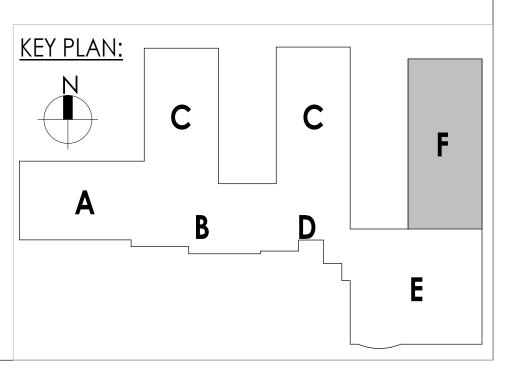

- THE CONTRACTOR SHALL PROVIDE DUST CONTROL BARRIERS AT ALL AREAS OF CONSTRUCTION.
- THE CONTRACTOR SHALL PATCH ALL SURFACES WHERE EXISTING MATERIALS HAVE BEEN DISTURBED TO MATCH AND BE FLUSH WITH ADJACENT CONSTRUCTION AT ALL FLOOR, WALL, AND CEILING LOCATIONS.
- CONTRACTOR SHALL COORDINATE WITH OTHER TRADES FOR SEQUENCING OF WORK.


FLOOR PLAN LEGEND

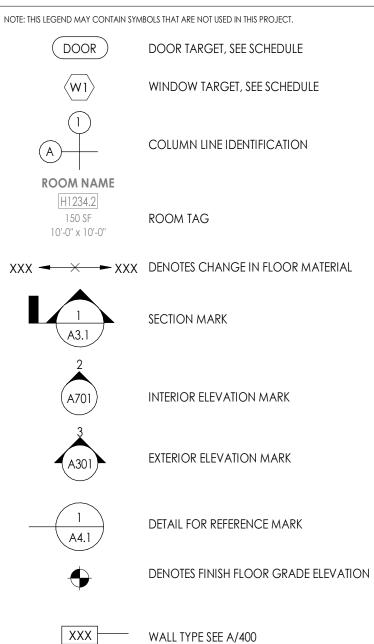


FLOOR PLAN KEY NOTES


1	INFILL EXTERIOR MASONRY WALL AT DEMOLISHED UV LOCATIONS. REFER TO DETAIL 2/A810
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- (2) NEW VCT FLOORING & WALL BASE, FULL EXTENT OF ROOM
- (3) NEW CASEWORK
- (4) NEW SINK REFER TO PLUMBING
- (5) REPLACE WINDOW PANE W/ NEW GLAZING AT EXISTING AC OPENING
- (6) INFILL DEMOLISHED DOOR OPENING W/ STUD WALL
- (7) NEW STOREFRONT SYSTEM
- (8) NEW METAL PAN STAIR & HANDRAIL
- (9) FIRE RATED TRANSACTION WINDOW
- (10) INFILL DEMOLISHED DOOR OPENING W/ CMU WALL
- 11 ALTERNATE 2/ GC-02: INFILL DEMOLISHED UV LOCATION WITH NEW CASEWORK TO MATCH EXISTING. SEE DETAIL 5/A800
- (12) INFILL CONCRETE FLOOR SLAB. REFER TO DETAIL
- (13) PATCH WALL AS REQ'D AT DEMOLISHED SPLIT SYSTEM
- (14) INFILL DEMOLISHED FIRE SHUTTER OPENING W/ STUD WALL



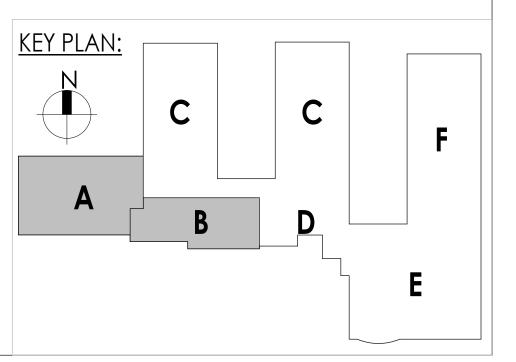

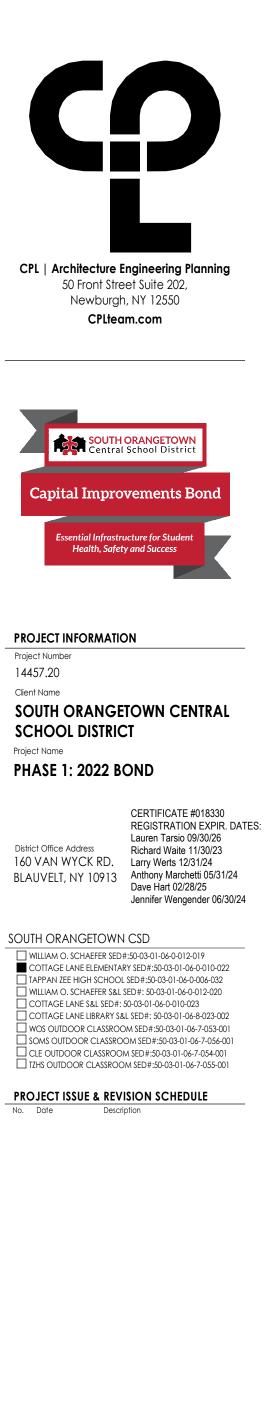PROFESSIONAL STAMPS

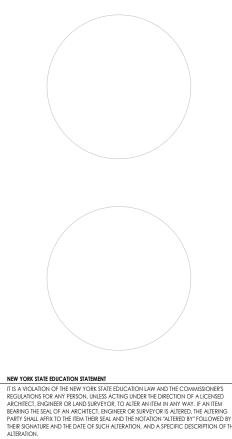


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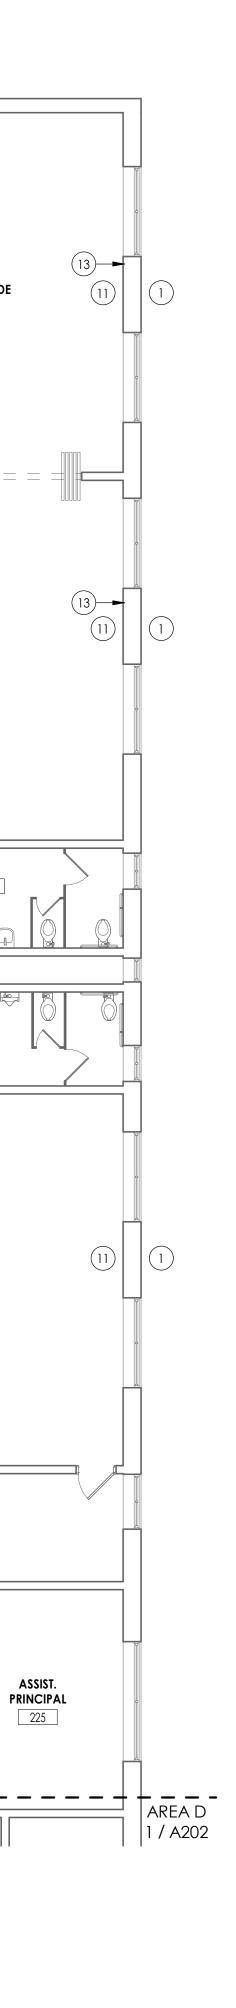
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NEW WORK PLAN	N - AREA A&E


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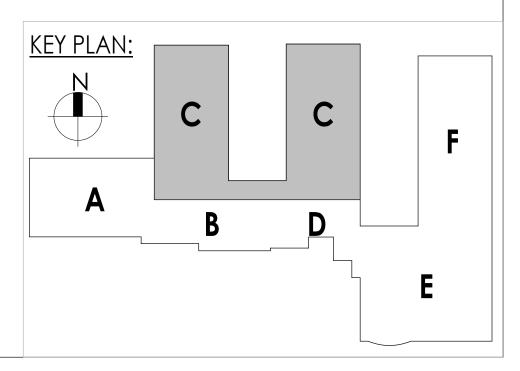





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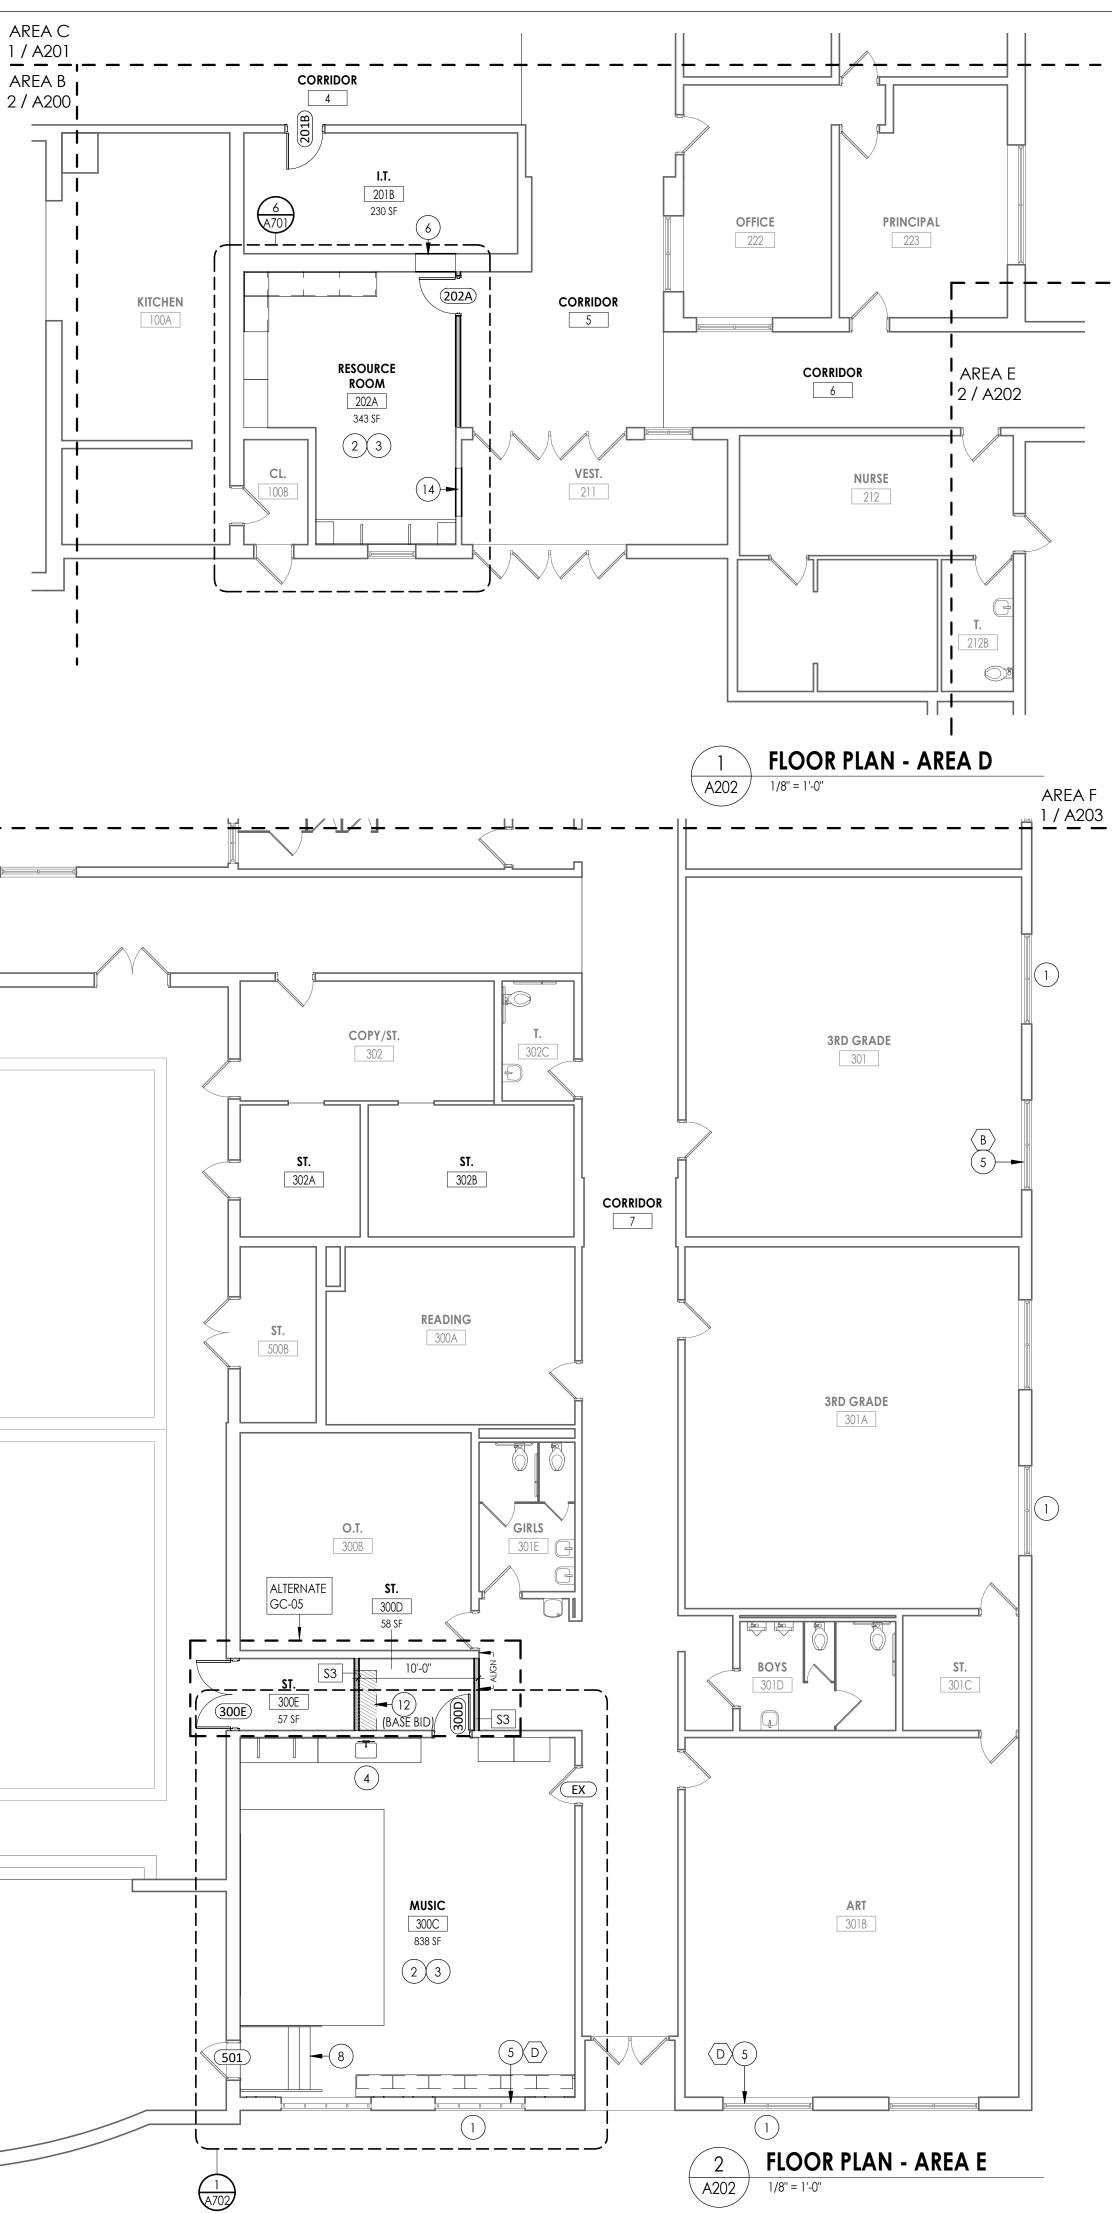
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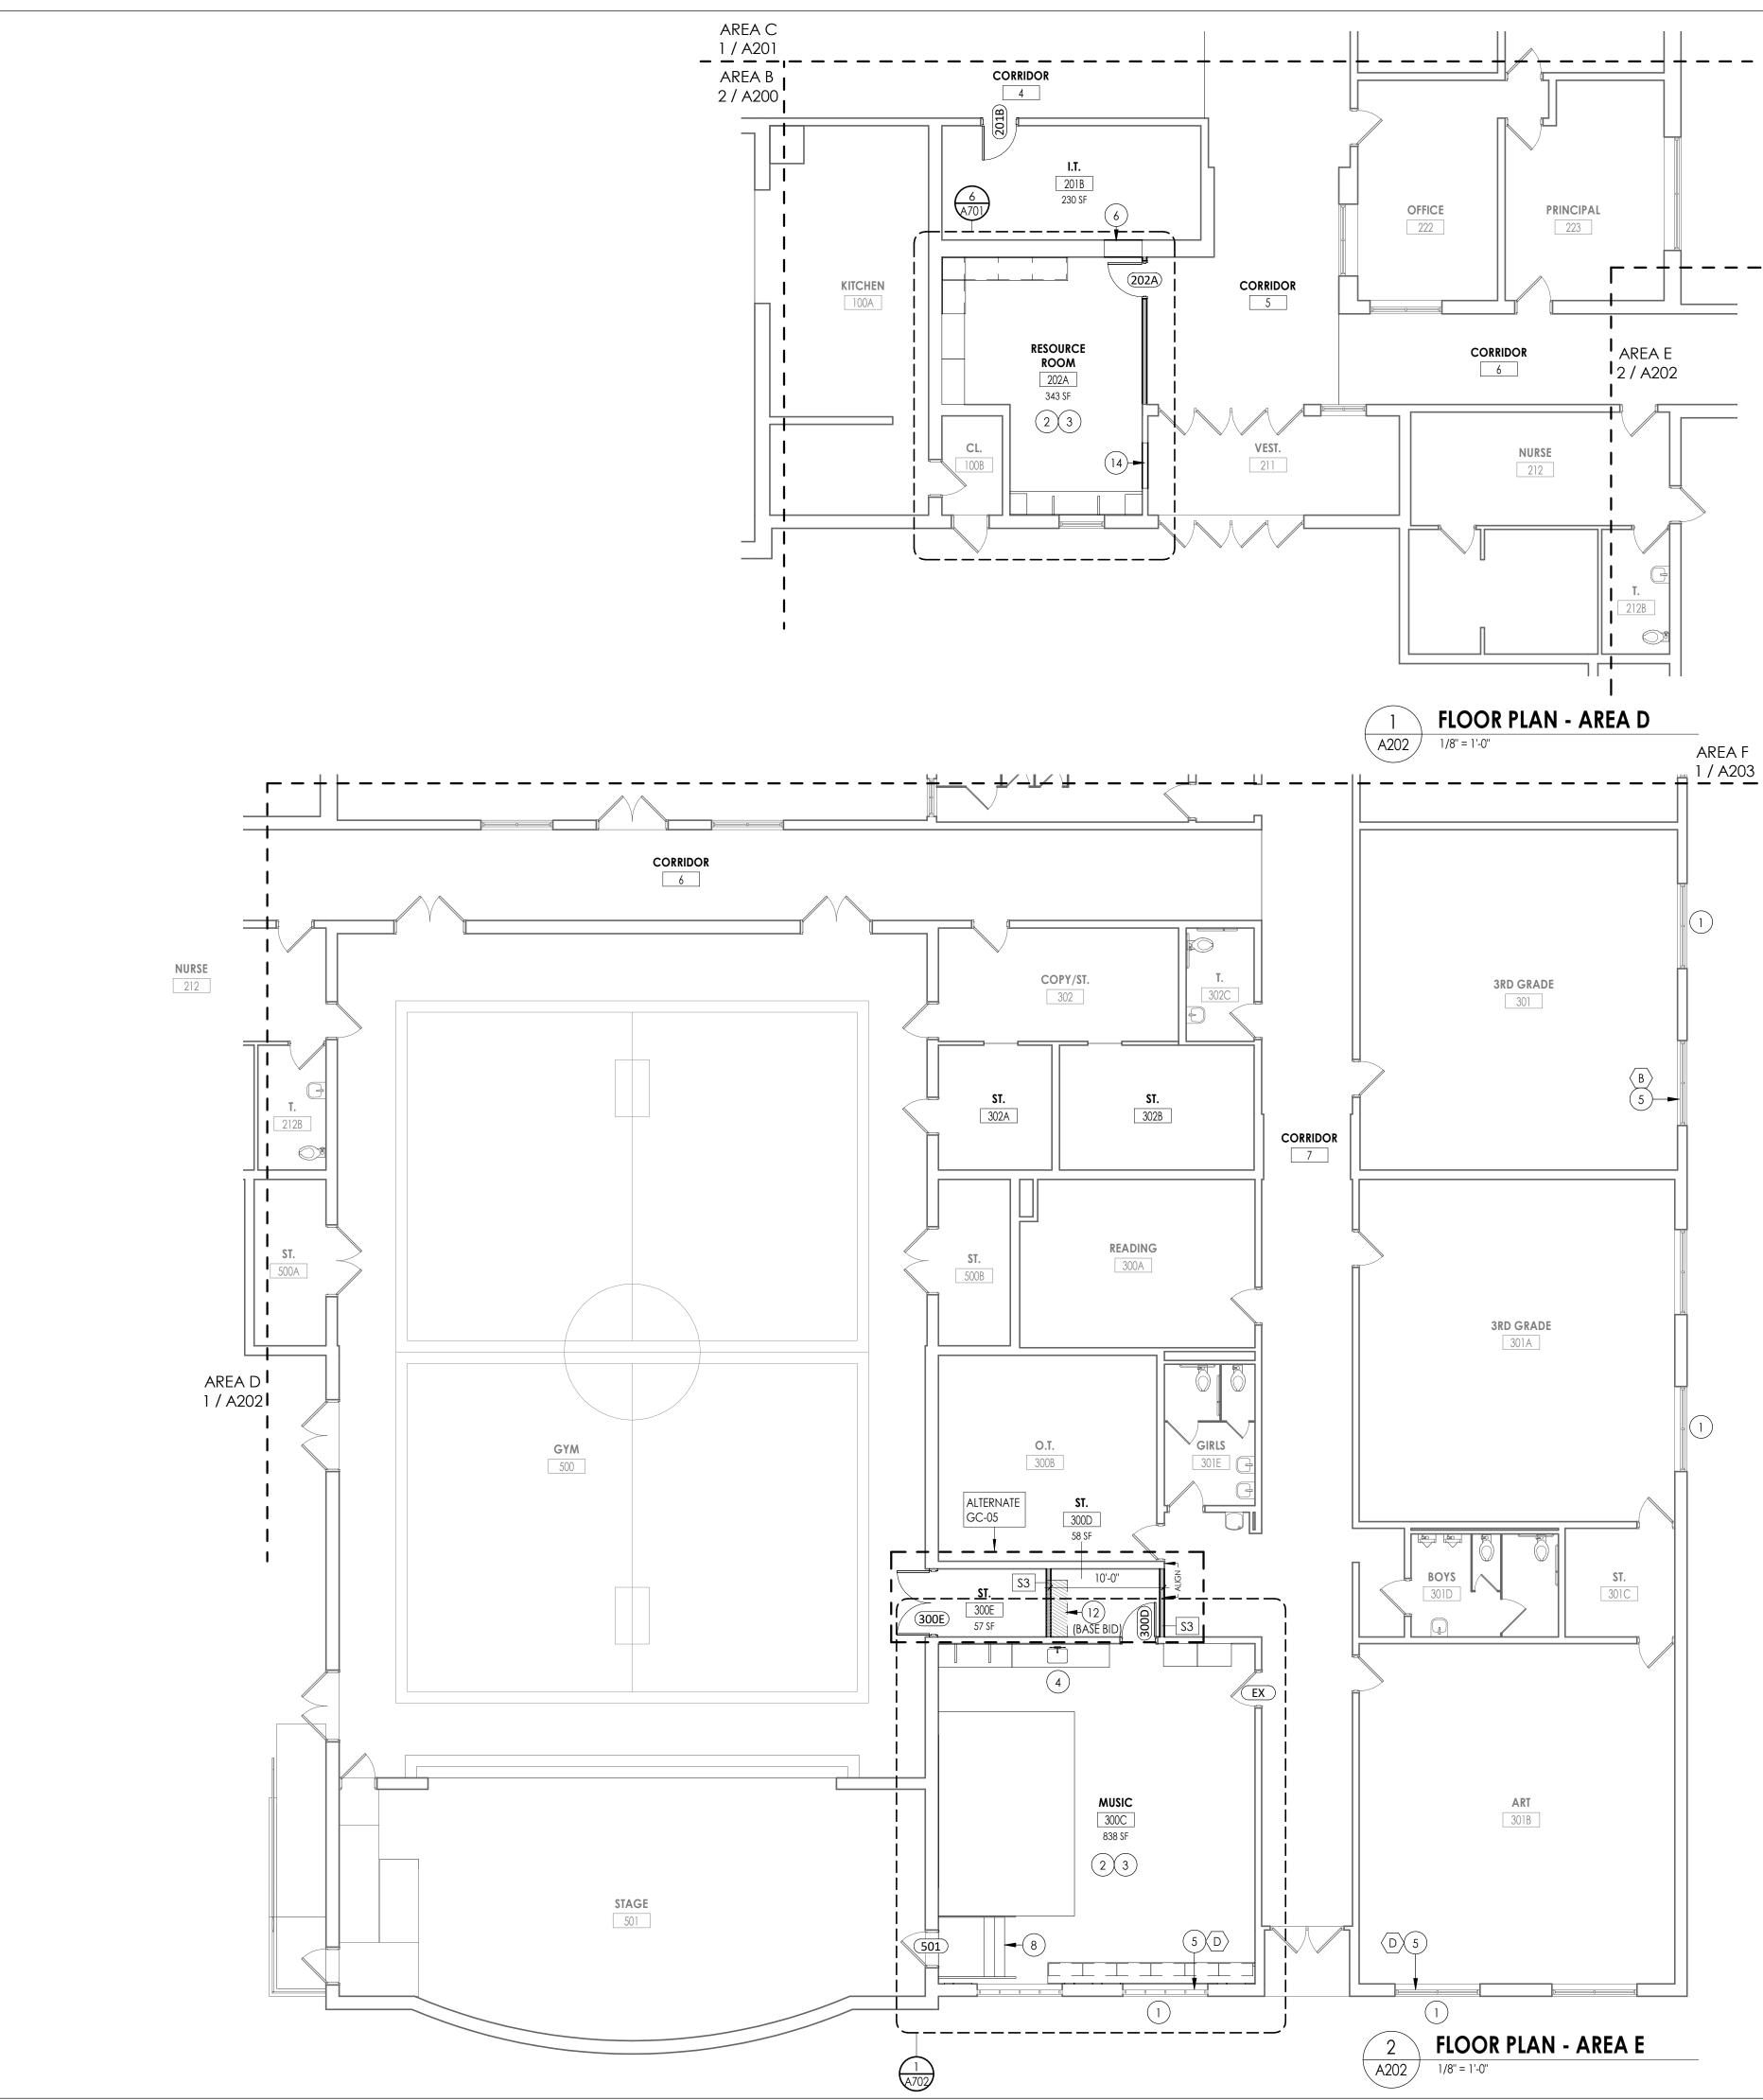
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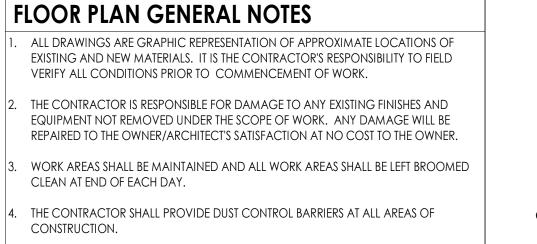
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NEW WORK PLAN - AREA C

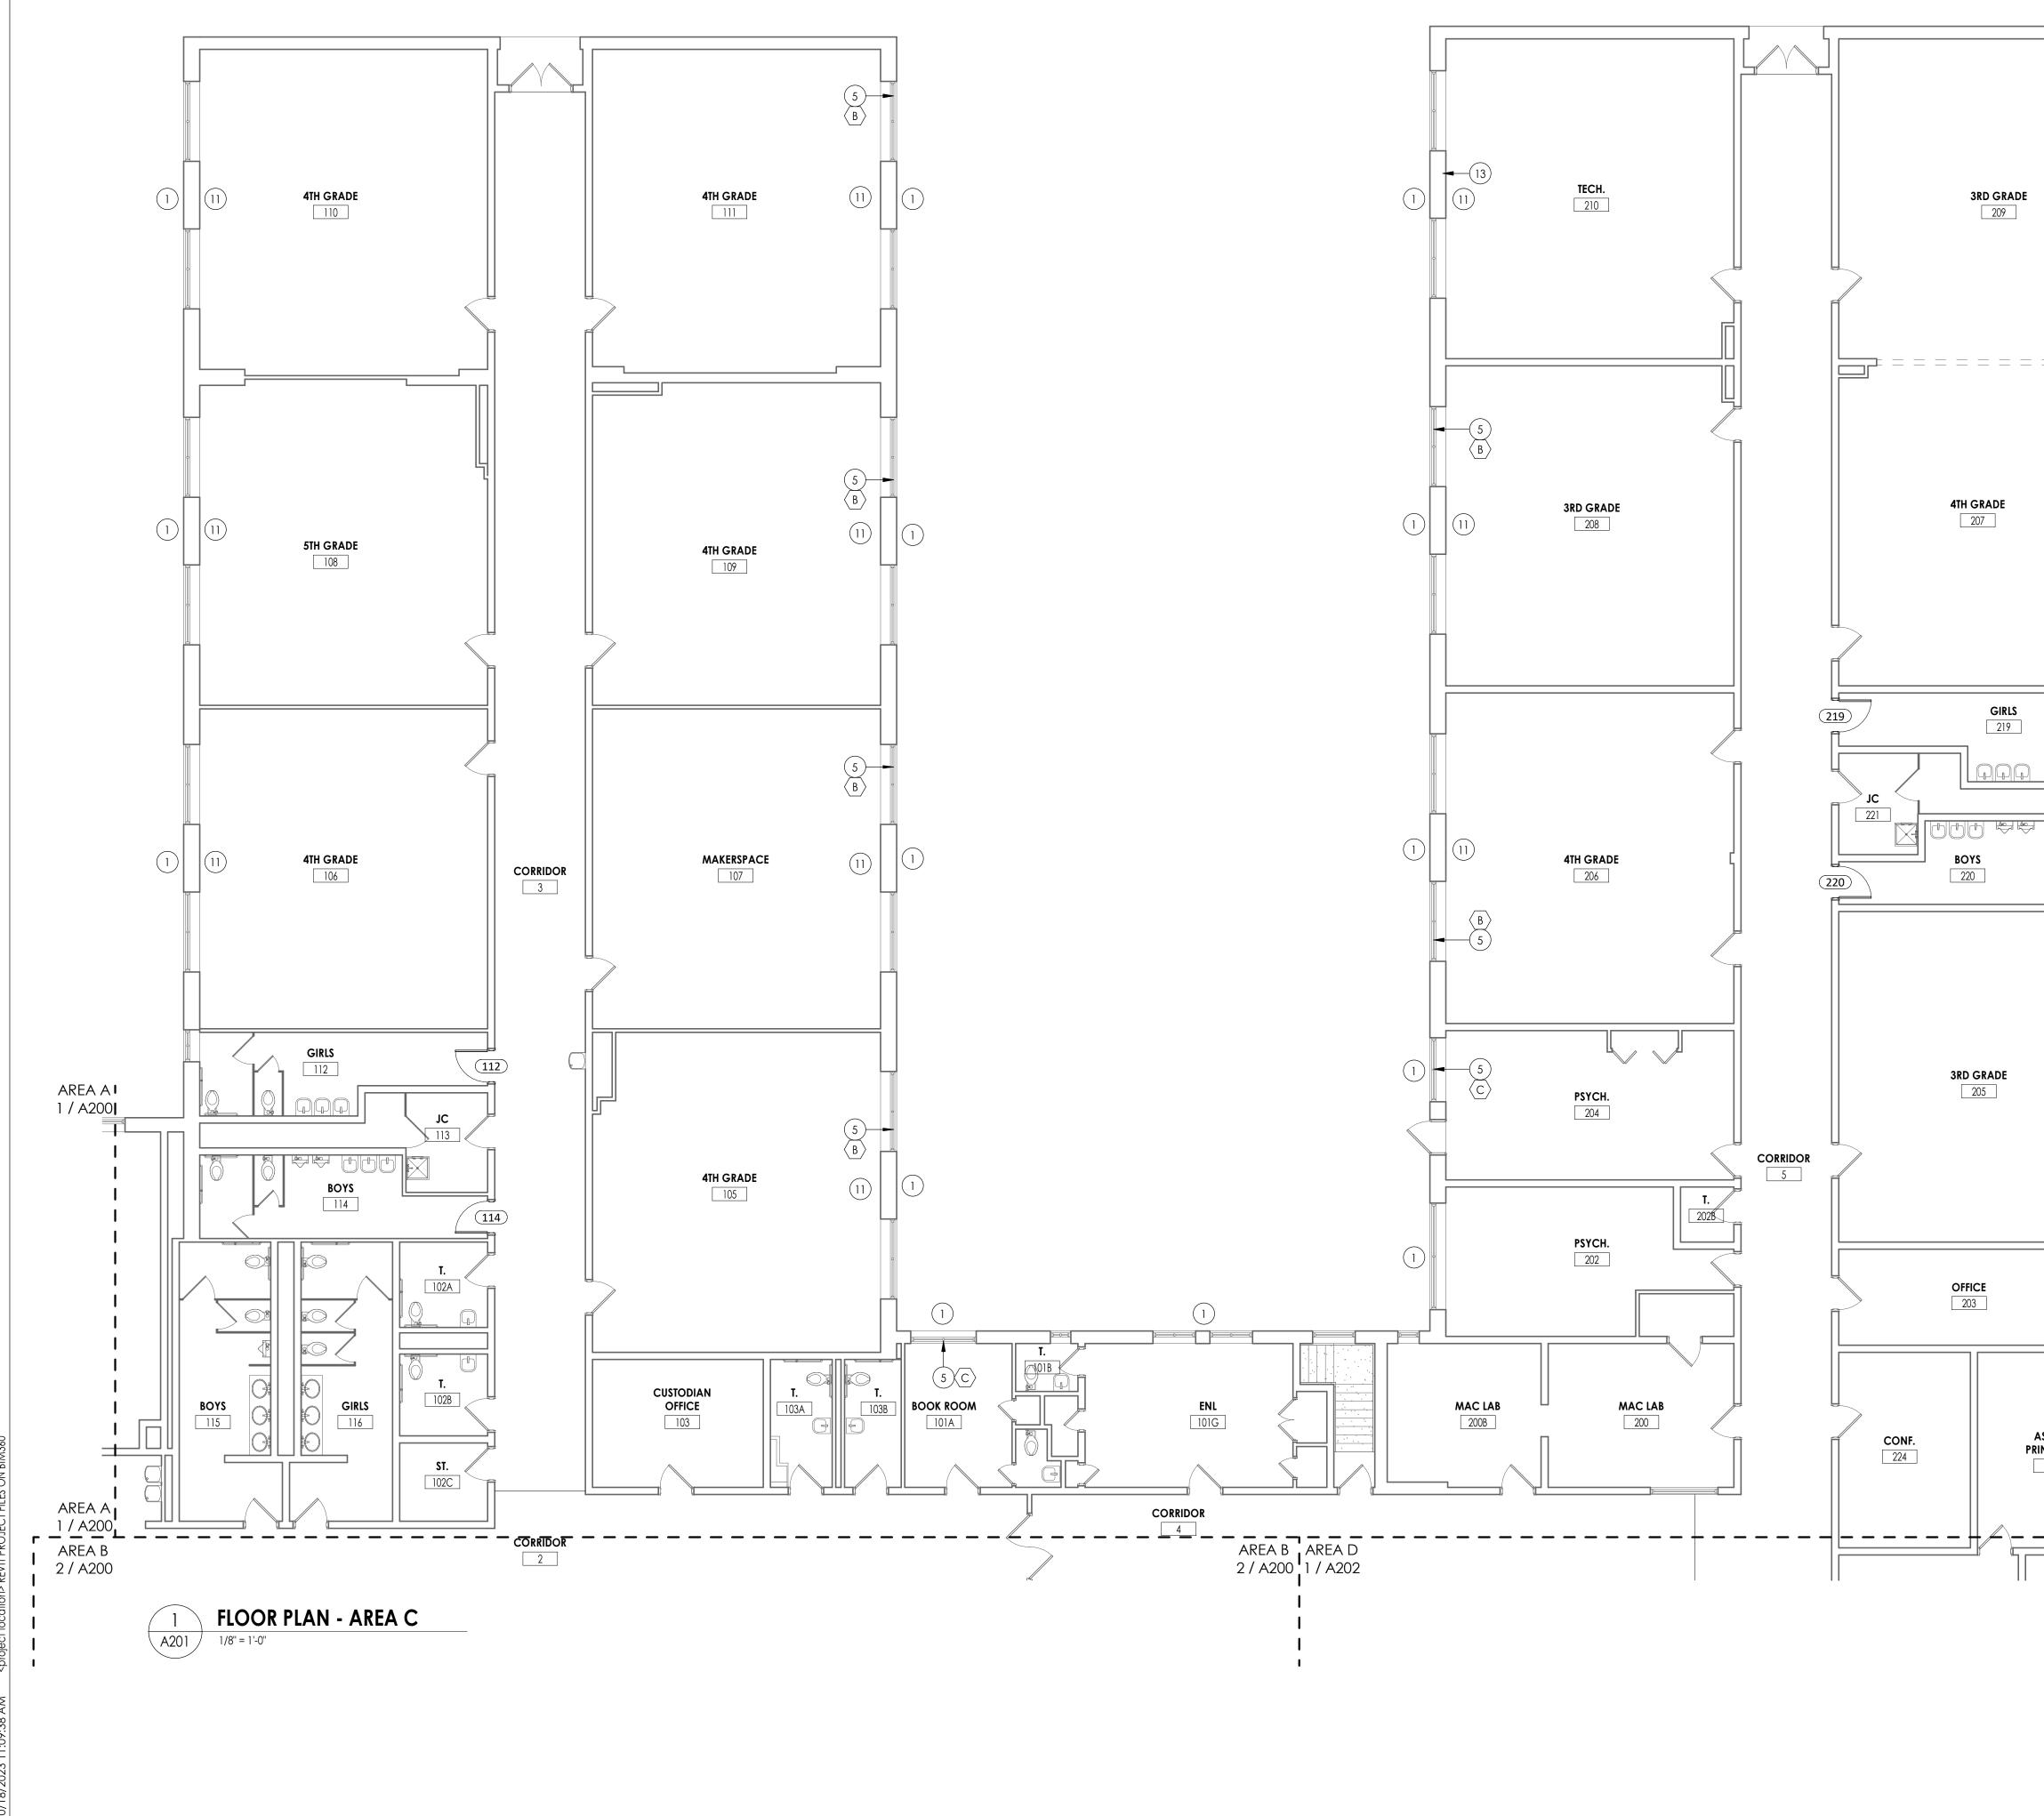




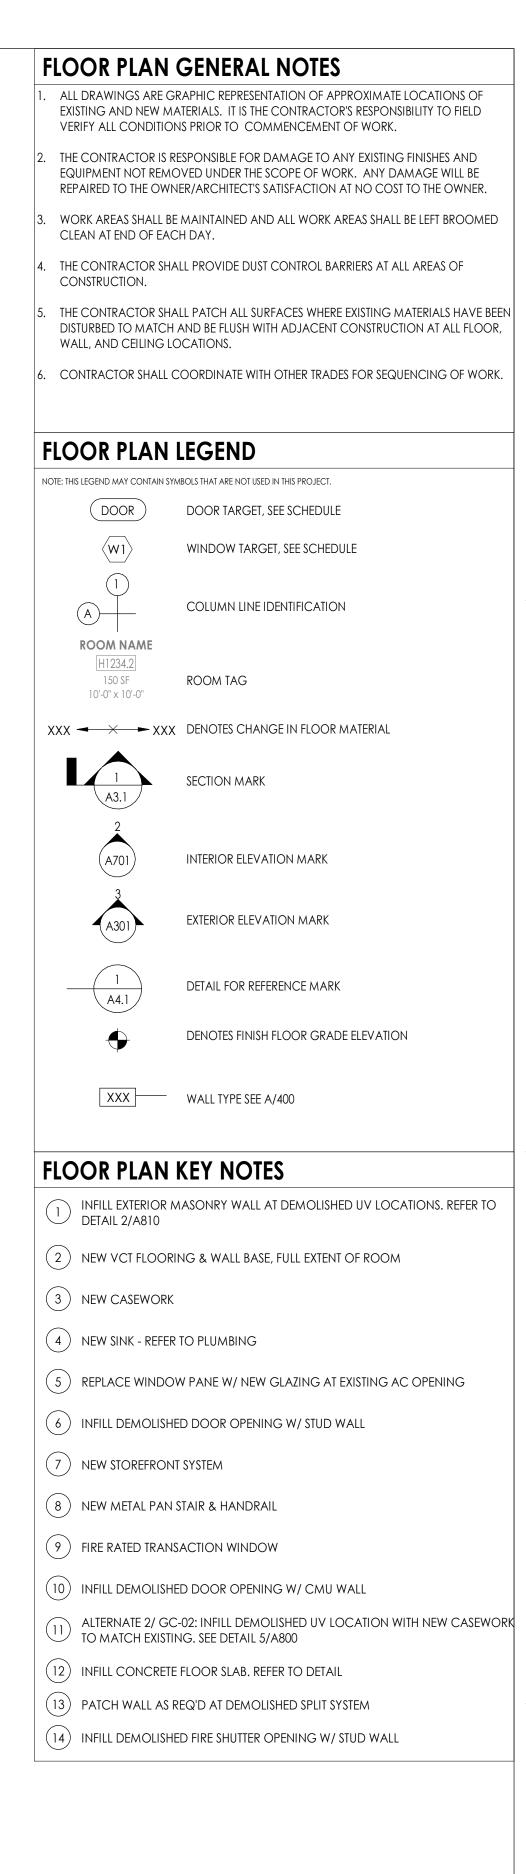
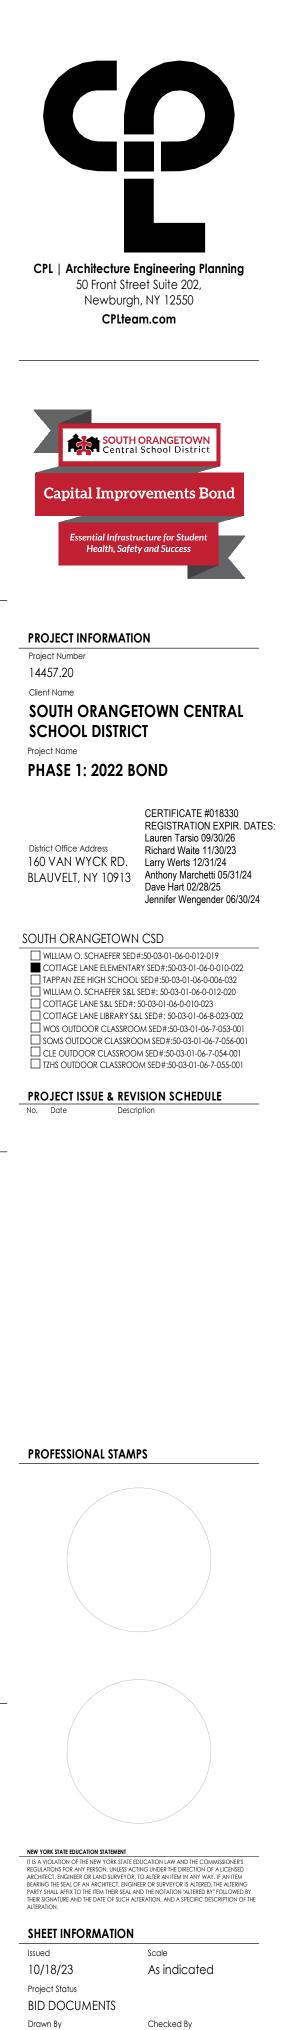
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- CONTRACTOR SHALL COORDINATE WITH OTHER TRADES FOR SEQUENCING OF WORK.


FLOOR PLAN LEGEND

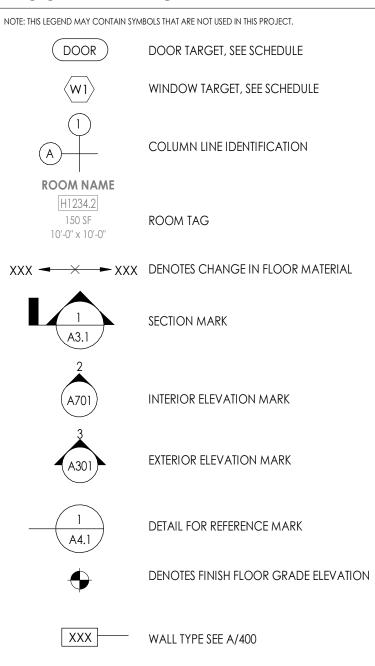



FLOOR PLAN KEY NOTES

1 INFILL EXTERIOR MASONRY WALL AT DEMOLISHED UV LOCATIONS. DETAIL 2/A810	EFER TO
---	---------

- (2) NEW VCT FLOORING & WALL BASE, FULL EXTENT OF ROOM
- (3) NEW CASEWORK
- (4) NEW SINK REFER TO PLUMBING
- (5) REPLACE WINDOW PANE W/ NEW GLAZING AT EXISTING AC OPENING
- (6) INFILL DEMOLISHED DOOR OPENING W/ STUD WALL
- (7) NEW STOREFRONT SYSTEM
- (8) NEW METAL PAN STAIR & HANDRAIL
- (9) FIRE RATED TRANSACTION WINDOW
- (10) INFILL DEMOLISHED DOOR OPENING W/ CMU WALL
- 1) ALTERNATE 2/ GC-02: INFILL DEMOLISHED UV LOCATION WITH NEW CASEWORK TO MATCH EXISTING. SEE DETAIL 5/A800
- (12) INFILL CONCRETE FLOOR SLAB. REFER TO DETAIL
- (13) PATCH WALL AS REQ'D AT DEMOLISHED SPLIT SYSTEM
- (14) INFILL DEMOLISHED FIRE SHUTTER OPENING W/ STUD WALL

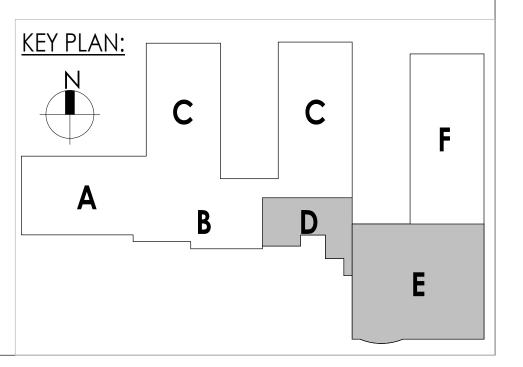

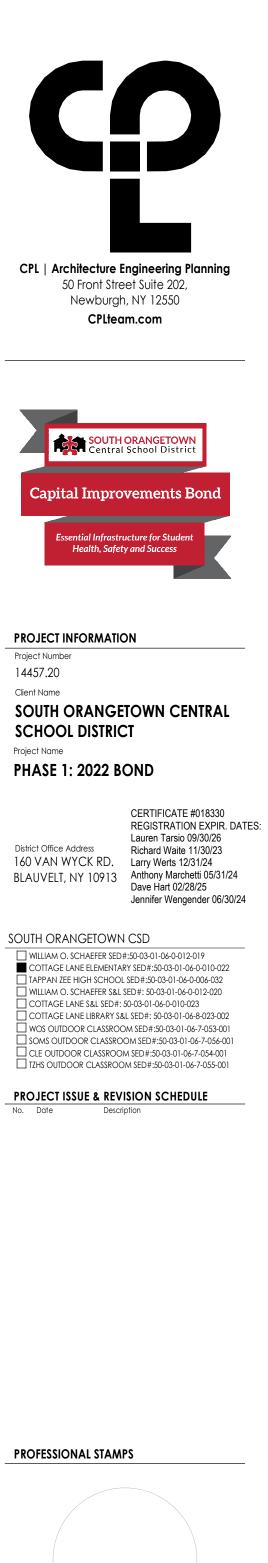

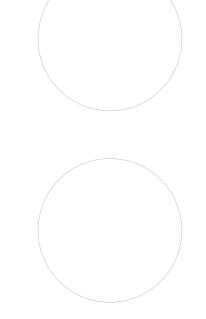

II IS A VIDLAILOR UT THE NEW TURK SIAILE EDUCATION AW AND THE COMMISSIONEE REGULATIONS FOR ANY PERSON, UNLESS ACTING UNDER THE DIRECTION OF A LICENSE ARCHITECT, ENGINEER OR LAND SURVEYOR, TO ALTER AN ITEM IN ANY WAY. IF AN ITEM BARING THE SEAL OF AN ARCHITECT, ENGINEER OR SURVEYOR AL ALTERD, THE ALTERN PARTY SHALL AFFX TO THE ITEM THER SEAL AND THE NOTATION "ALTERED BY" FOLLOWER THER SIGNATURE AND THE DATE OF SUCH ALTERATION, AND A SPECIFIC DESCRIPTION OF ALTERATION.

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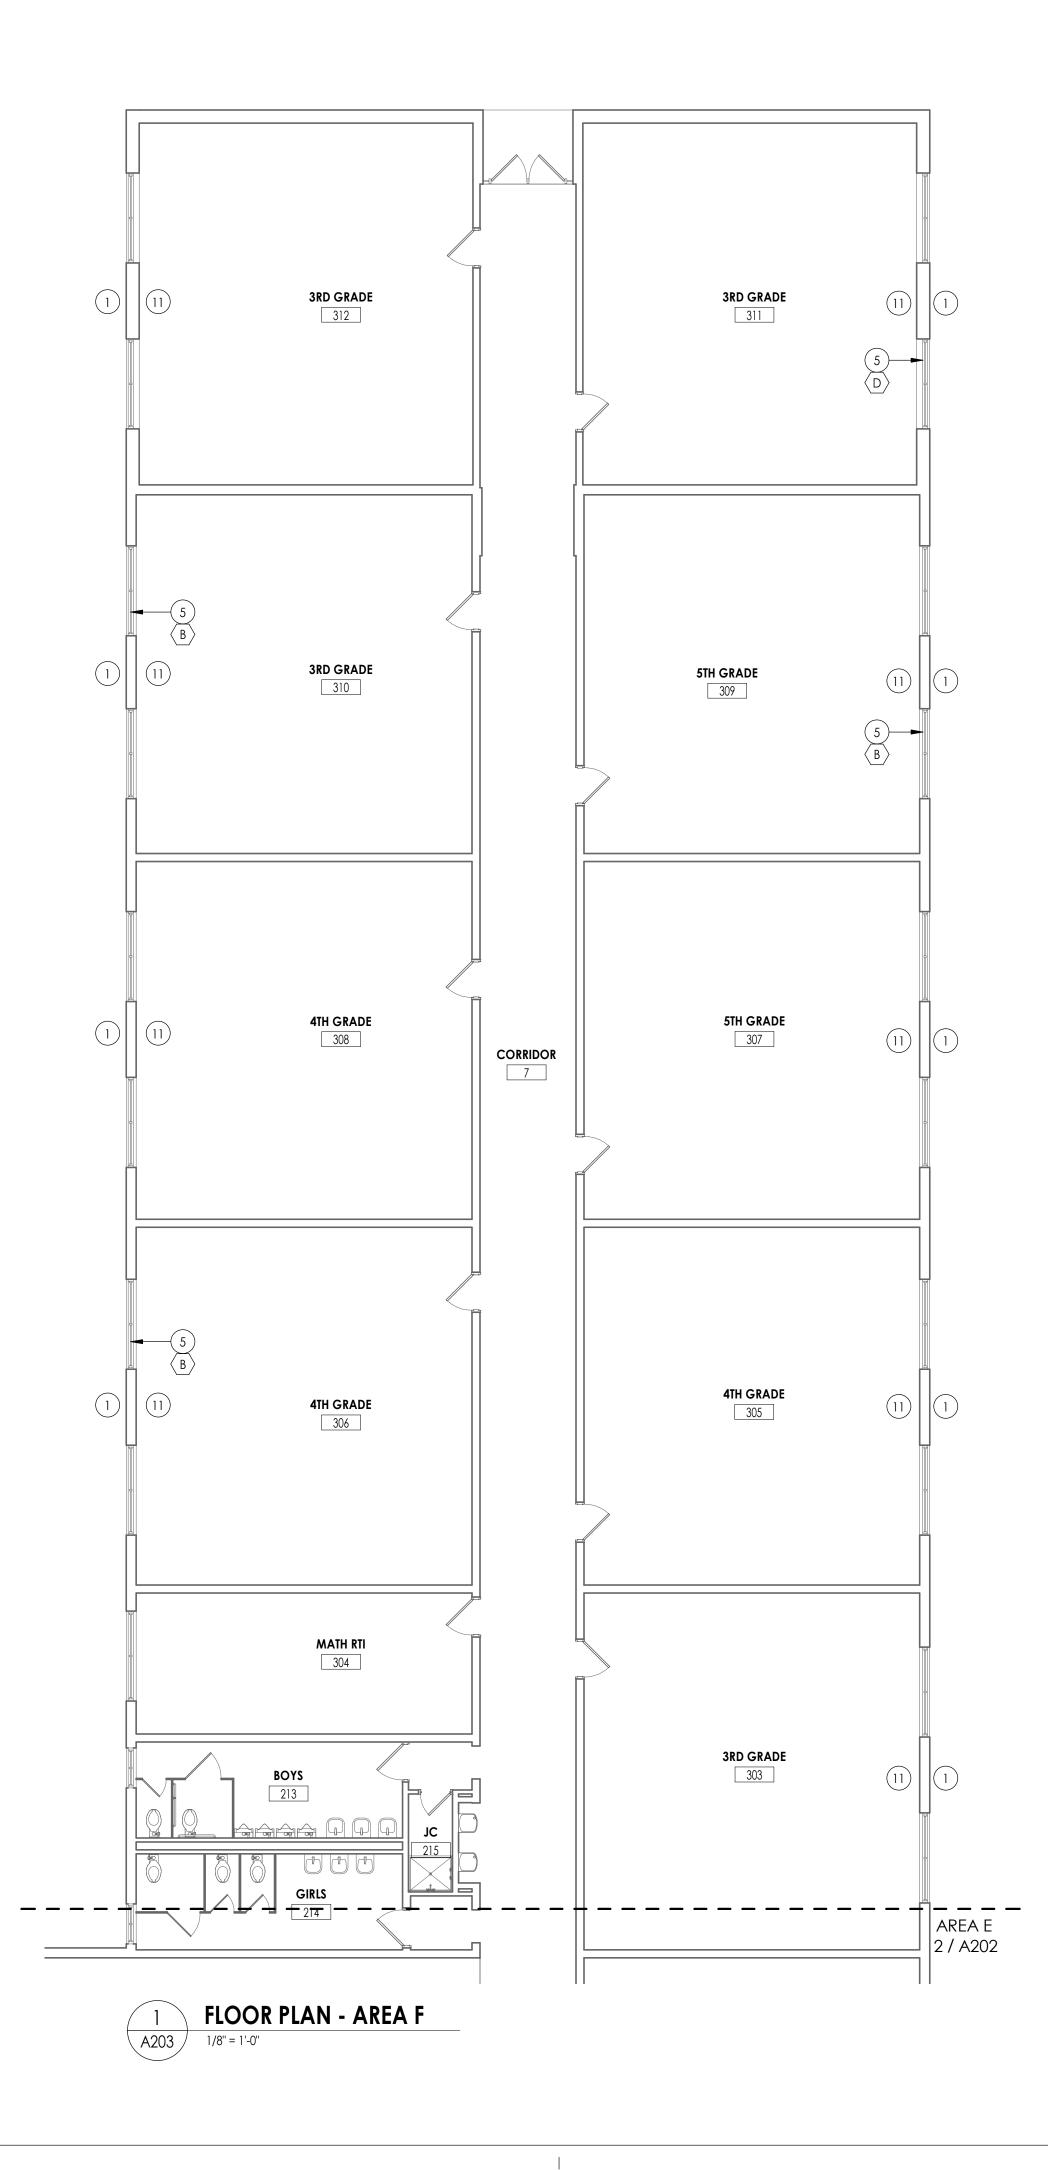
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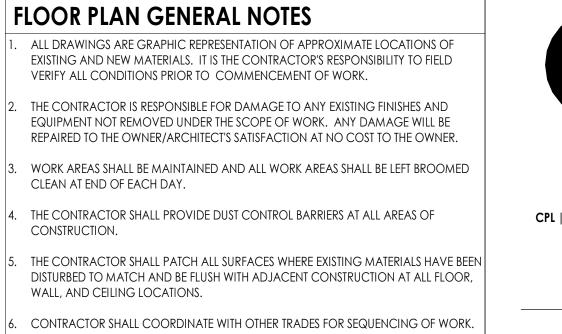
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NEW WORK PLAN	I - AREA D&E


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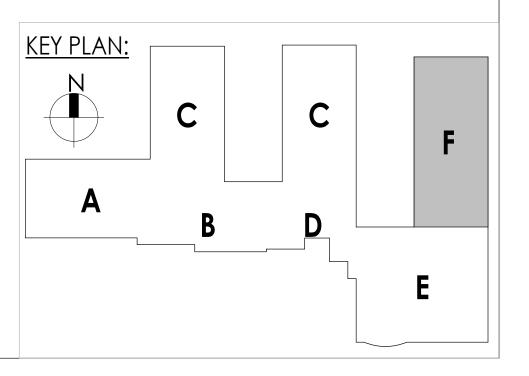


FLOOR PLAN LEGEND



	DETAIL 2/A810
2	NEW VCT FLOORING & WALL BASE, FULL EXTENT OF ROOM

- 3 NEW CASEWORK
- (4) NEW SINK REFER TO PLUMBING
- (5) REPLACE WINDOW PANE W/ NEW GLAZING AT EXISTING AC OPENING
- (6) INFILL DEMOLISHED DOOR OPENING W/ STUD WALL
- (7) NEW STOREFRONT SYSTEM
- (8) NEW METAL PAN STAIR & HANDRAIL
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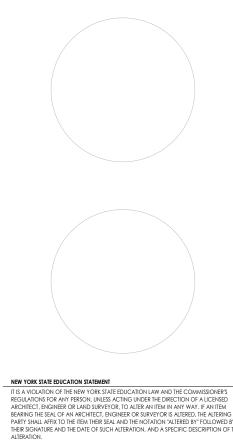


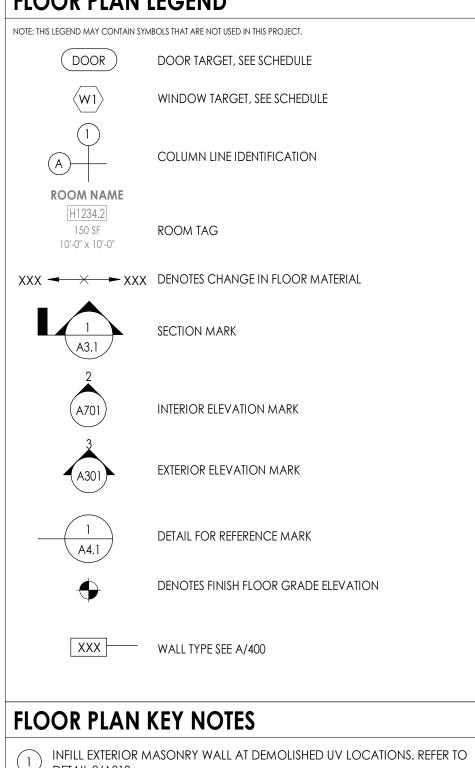south orangetown CSD WILLIAM O. SCHAEFER SED#:50-03-01-06-0-012-019 COTTAGE LANE ELEMENTARY SED#:50-03-01-06-0-010-022 TAPPAN ZEE HIGH SCHOOL SED#:50-03-01-06-0-006-032 WILLIAM O. SCHAEFER S&L SED#: 50-03-01-06-0-012-020

COTTAGE LANE S&L SED#: 50-03-01-06-0-010-023 COTTAGE LANE LIBRARY S&L SED#: 50-03-01-06-8-023-002 WOS OUTDOOR CLASSROOM SED#:50-03-01-06-7-053-001 SOMS OUTDOOR CLASSROOM SED#:50-03-01-06-7-056-001 CLE OUTDOOR CLASSROOM SED#:50-03-01-06-7-054-001 TZHS OUTDOOR CLASSROOM SED#:50-03-01-06-7-055-001

PROJECT ISSUE & REVISION SCHEDULE No. Date Description

PROFESSIONAL STAMPS




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NEW WORK PLAN	I - AREA F


Drawing Number





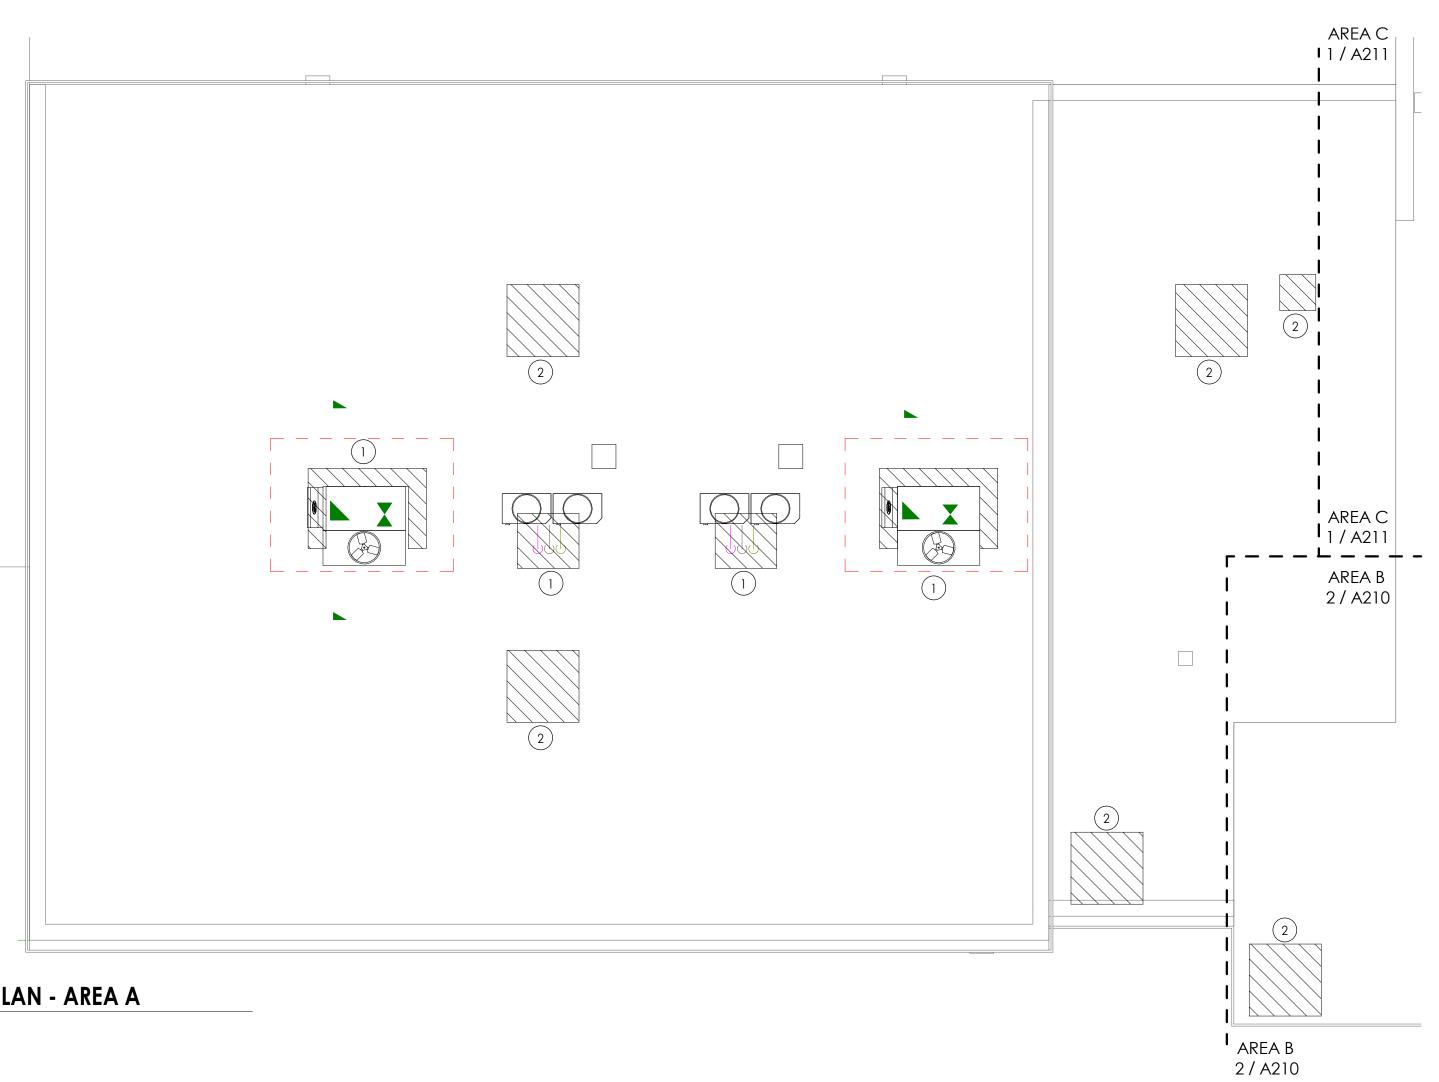

NEW WORK ROOF PLAN - AREA A

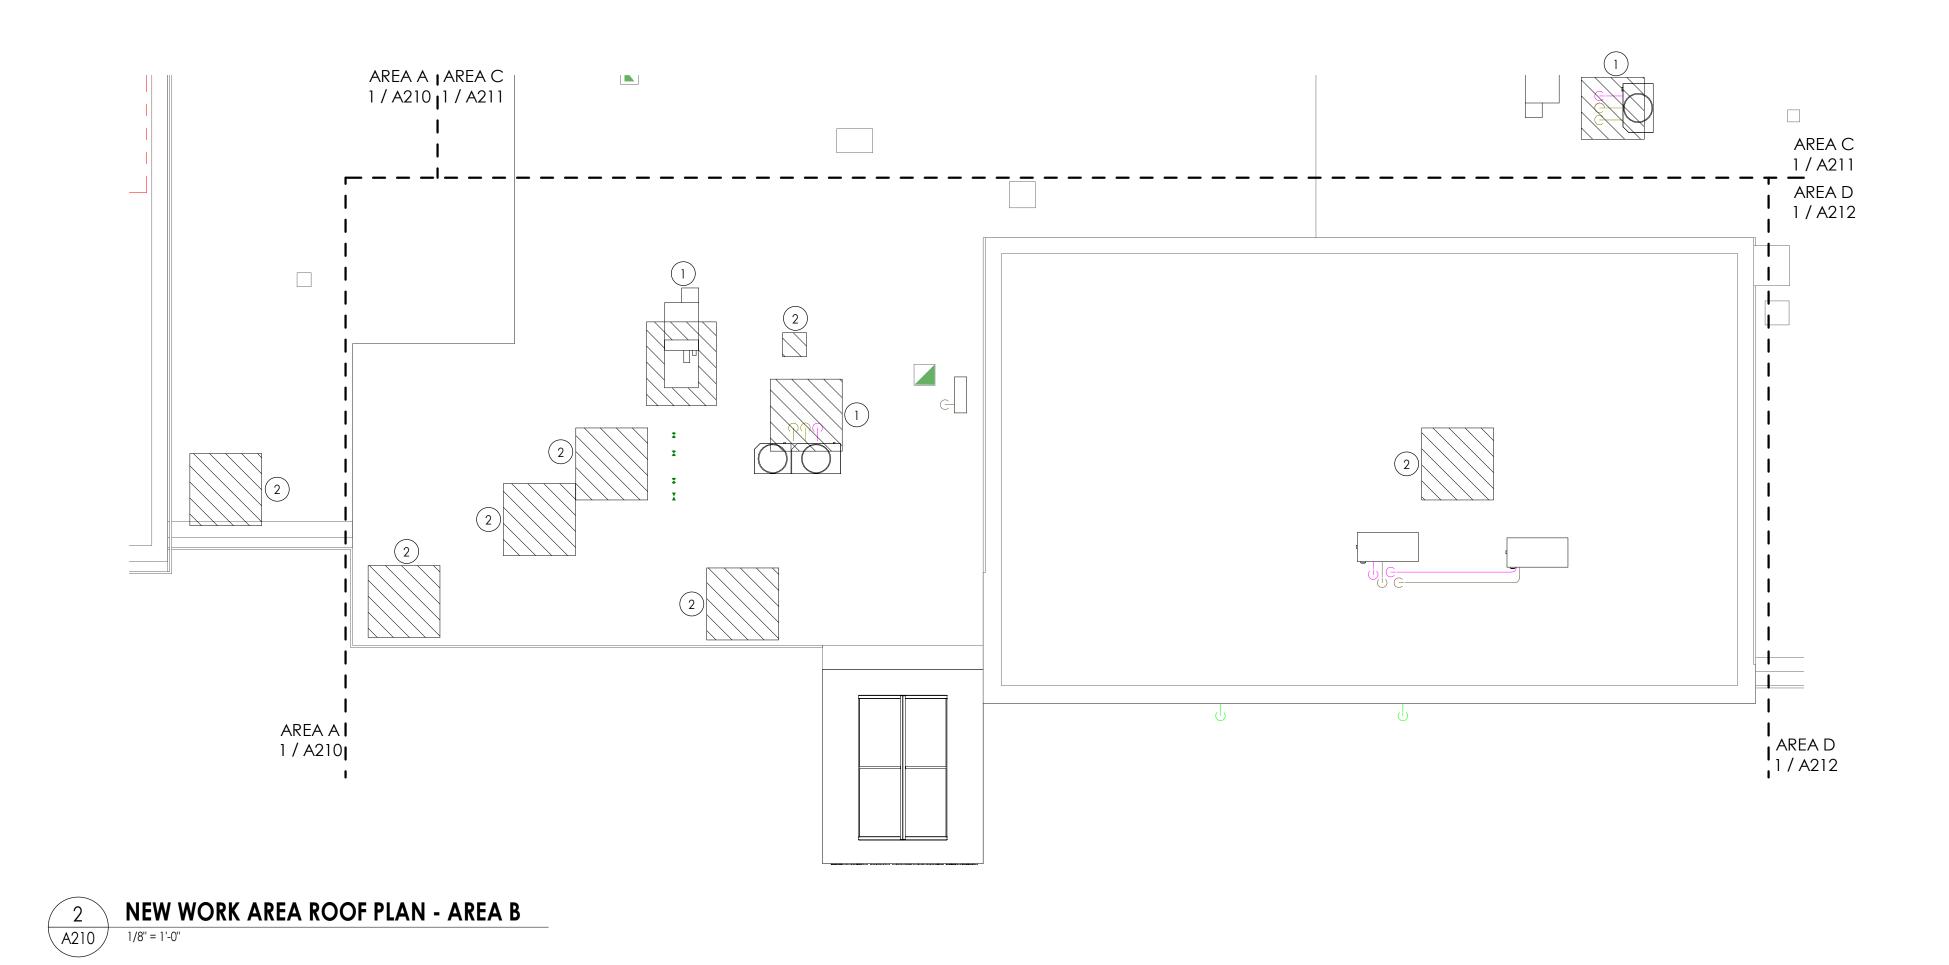

FLOOR PLAN GENERAL NOTES

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ROOF PLAN LEGEND



PROVIDE NEW ROOFING SYSTEM TO MATCH EXISTING AT REMOVED MECHANICAL EQUIPMENT.

ROOF PLAN KEYNOTES

- MECHANICAL EQUIPMENT AND ROOF CURB BY M.C., G.C. TO INSTALL CURB 1) AND FLASH INTO EXISTING ROOFING. PATCH ROOFING TO MATCH EXISTING AS REQ'D.
- 2 INFILL ROOF DECK AND ROOFING SYSTEM AT MECHANICAL UNIT REMOVAL



PROJECT INFORMATION Project Number 14457.20 Client Name SOUTH ORANGETOWN CENTRAL SCHOOL DISTRICT

Project Name PHASE 1: 2022 BOND

District Office Address


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PROJECT ISSUE & REVISION SCHEDULE No. Date Description

PROFESSIONAL STAMPS





ION OF THE NEW YORK STATE E GULATIONS FOR ANY PERSON, UNLESS ACTING UNDER THE DIRECTIO BEARING THE SEAL OF AN ARCHITECT, ENGINEER OR SURVEYOR PARTY SHALL AFFIX TO THE ITEM THER SEAL AND THE NOTATION THEIR SIGNATURE AND THE DATE OF SUCH ALTERATION, AND A ALTERATION.

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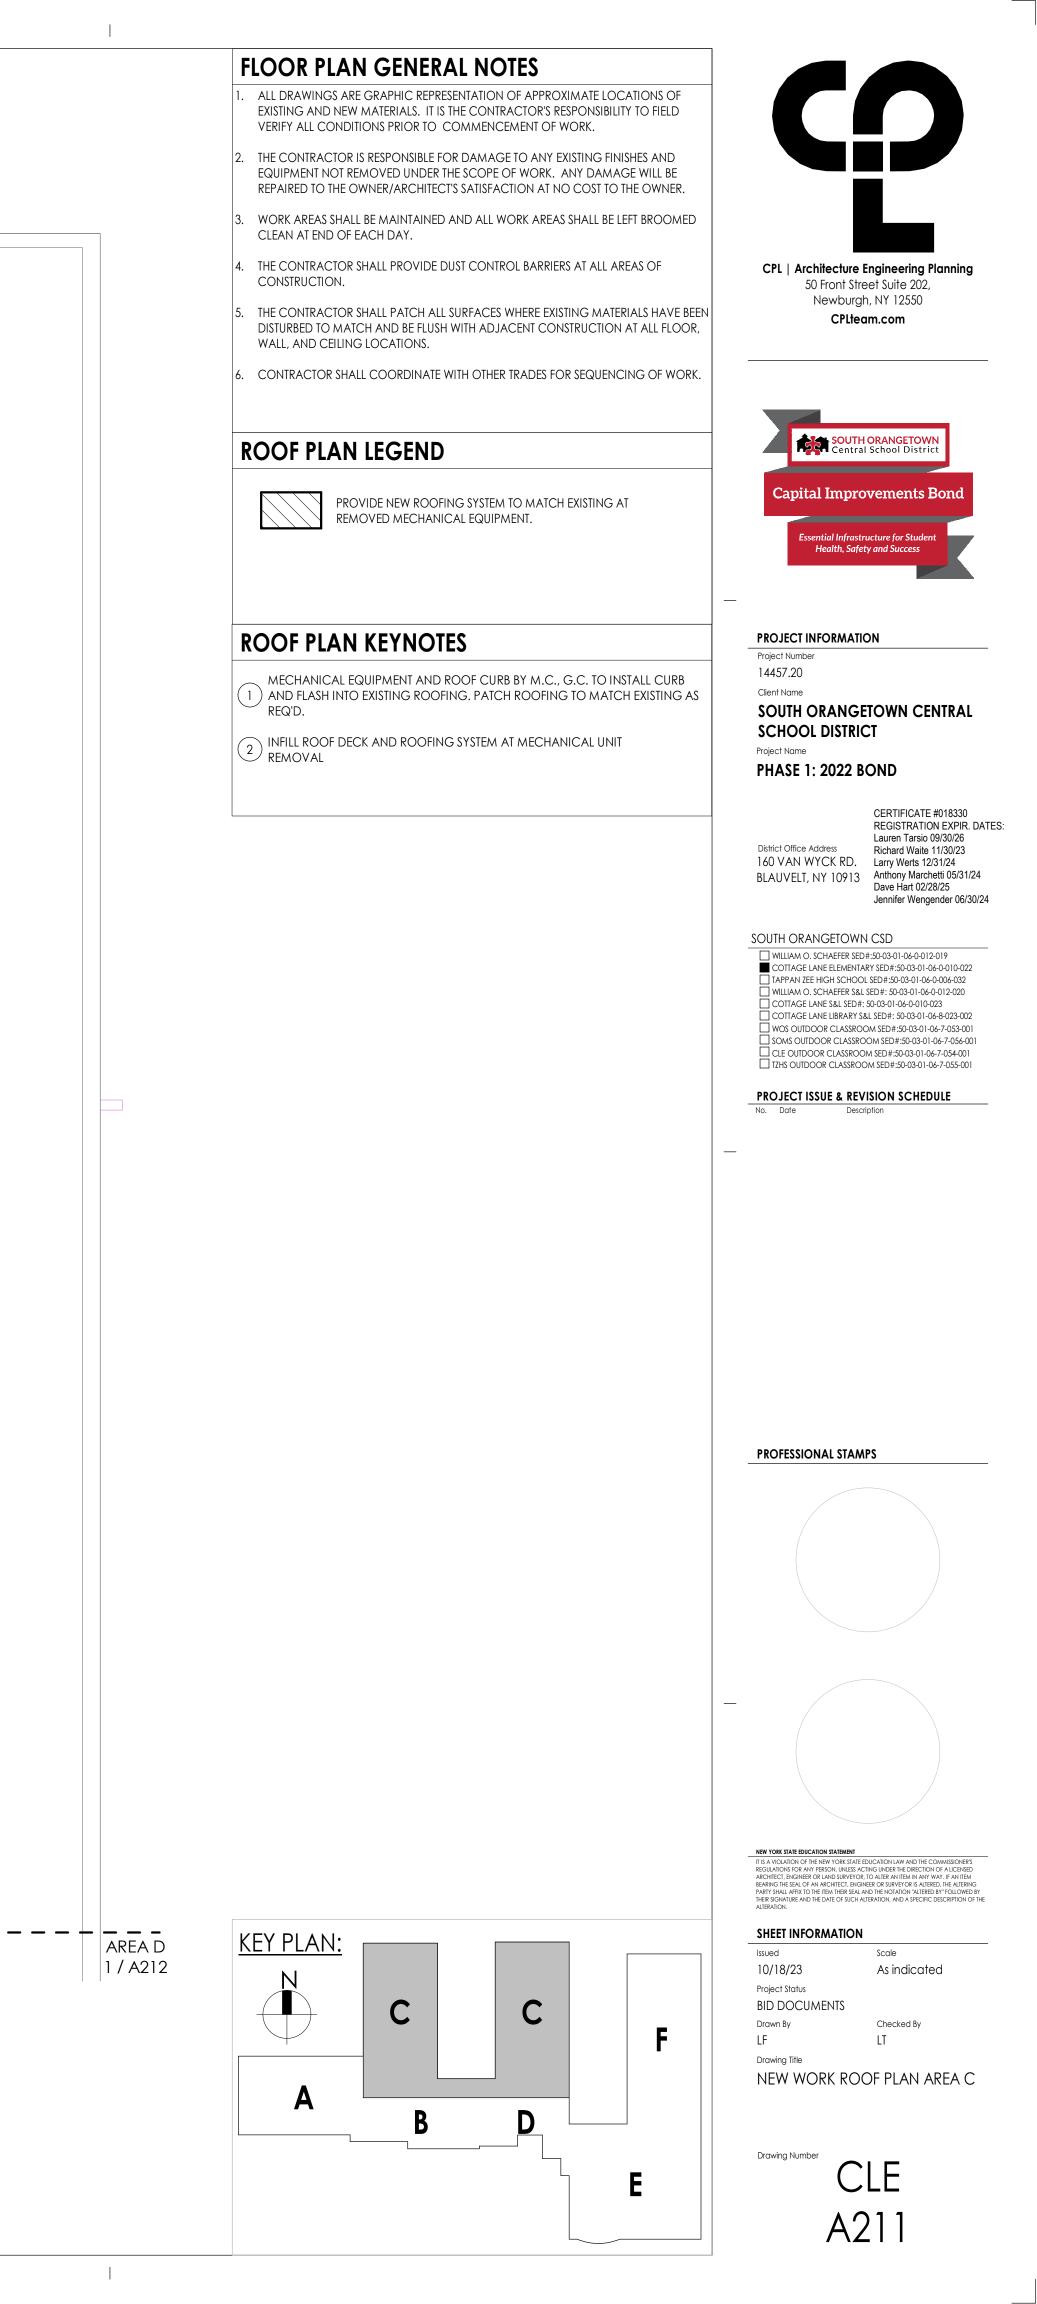
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Drawing Title NEW WORK ROC A&B)F PLAN AREA

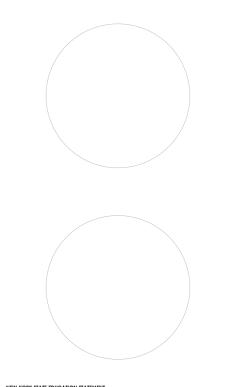Drawing Number CLE A210




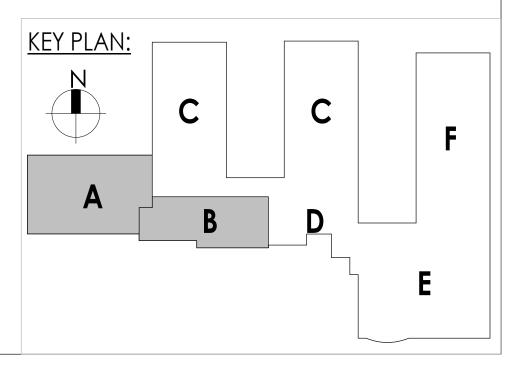
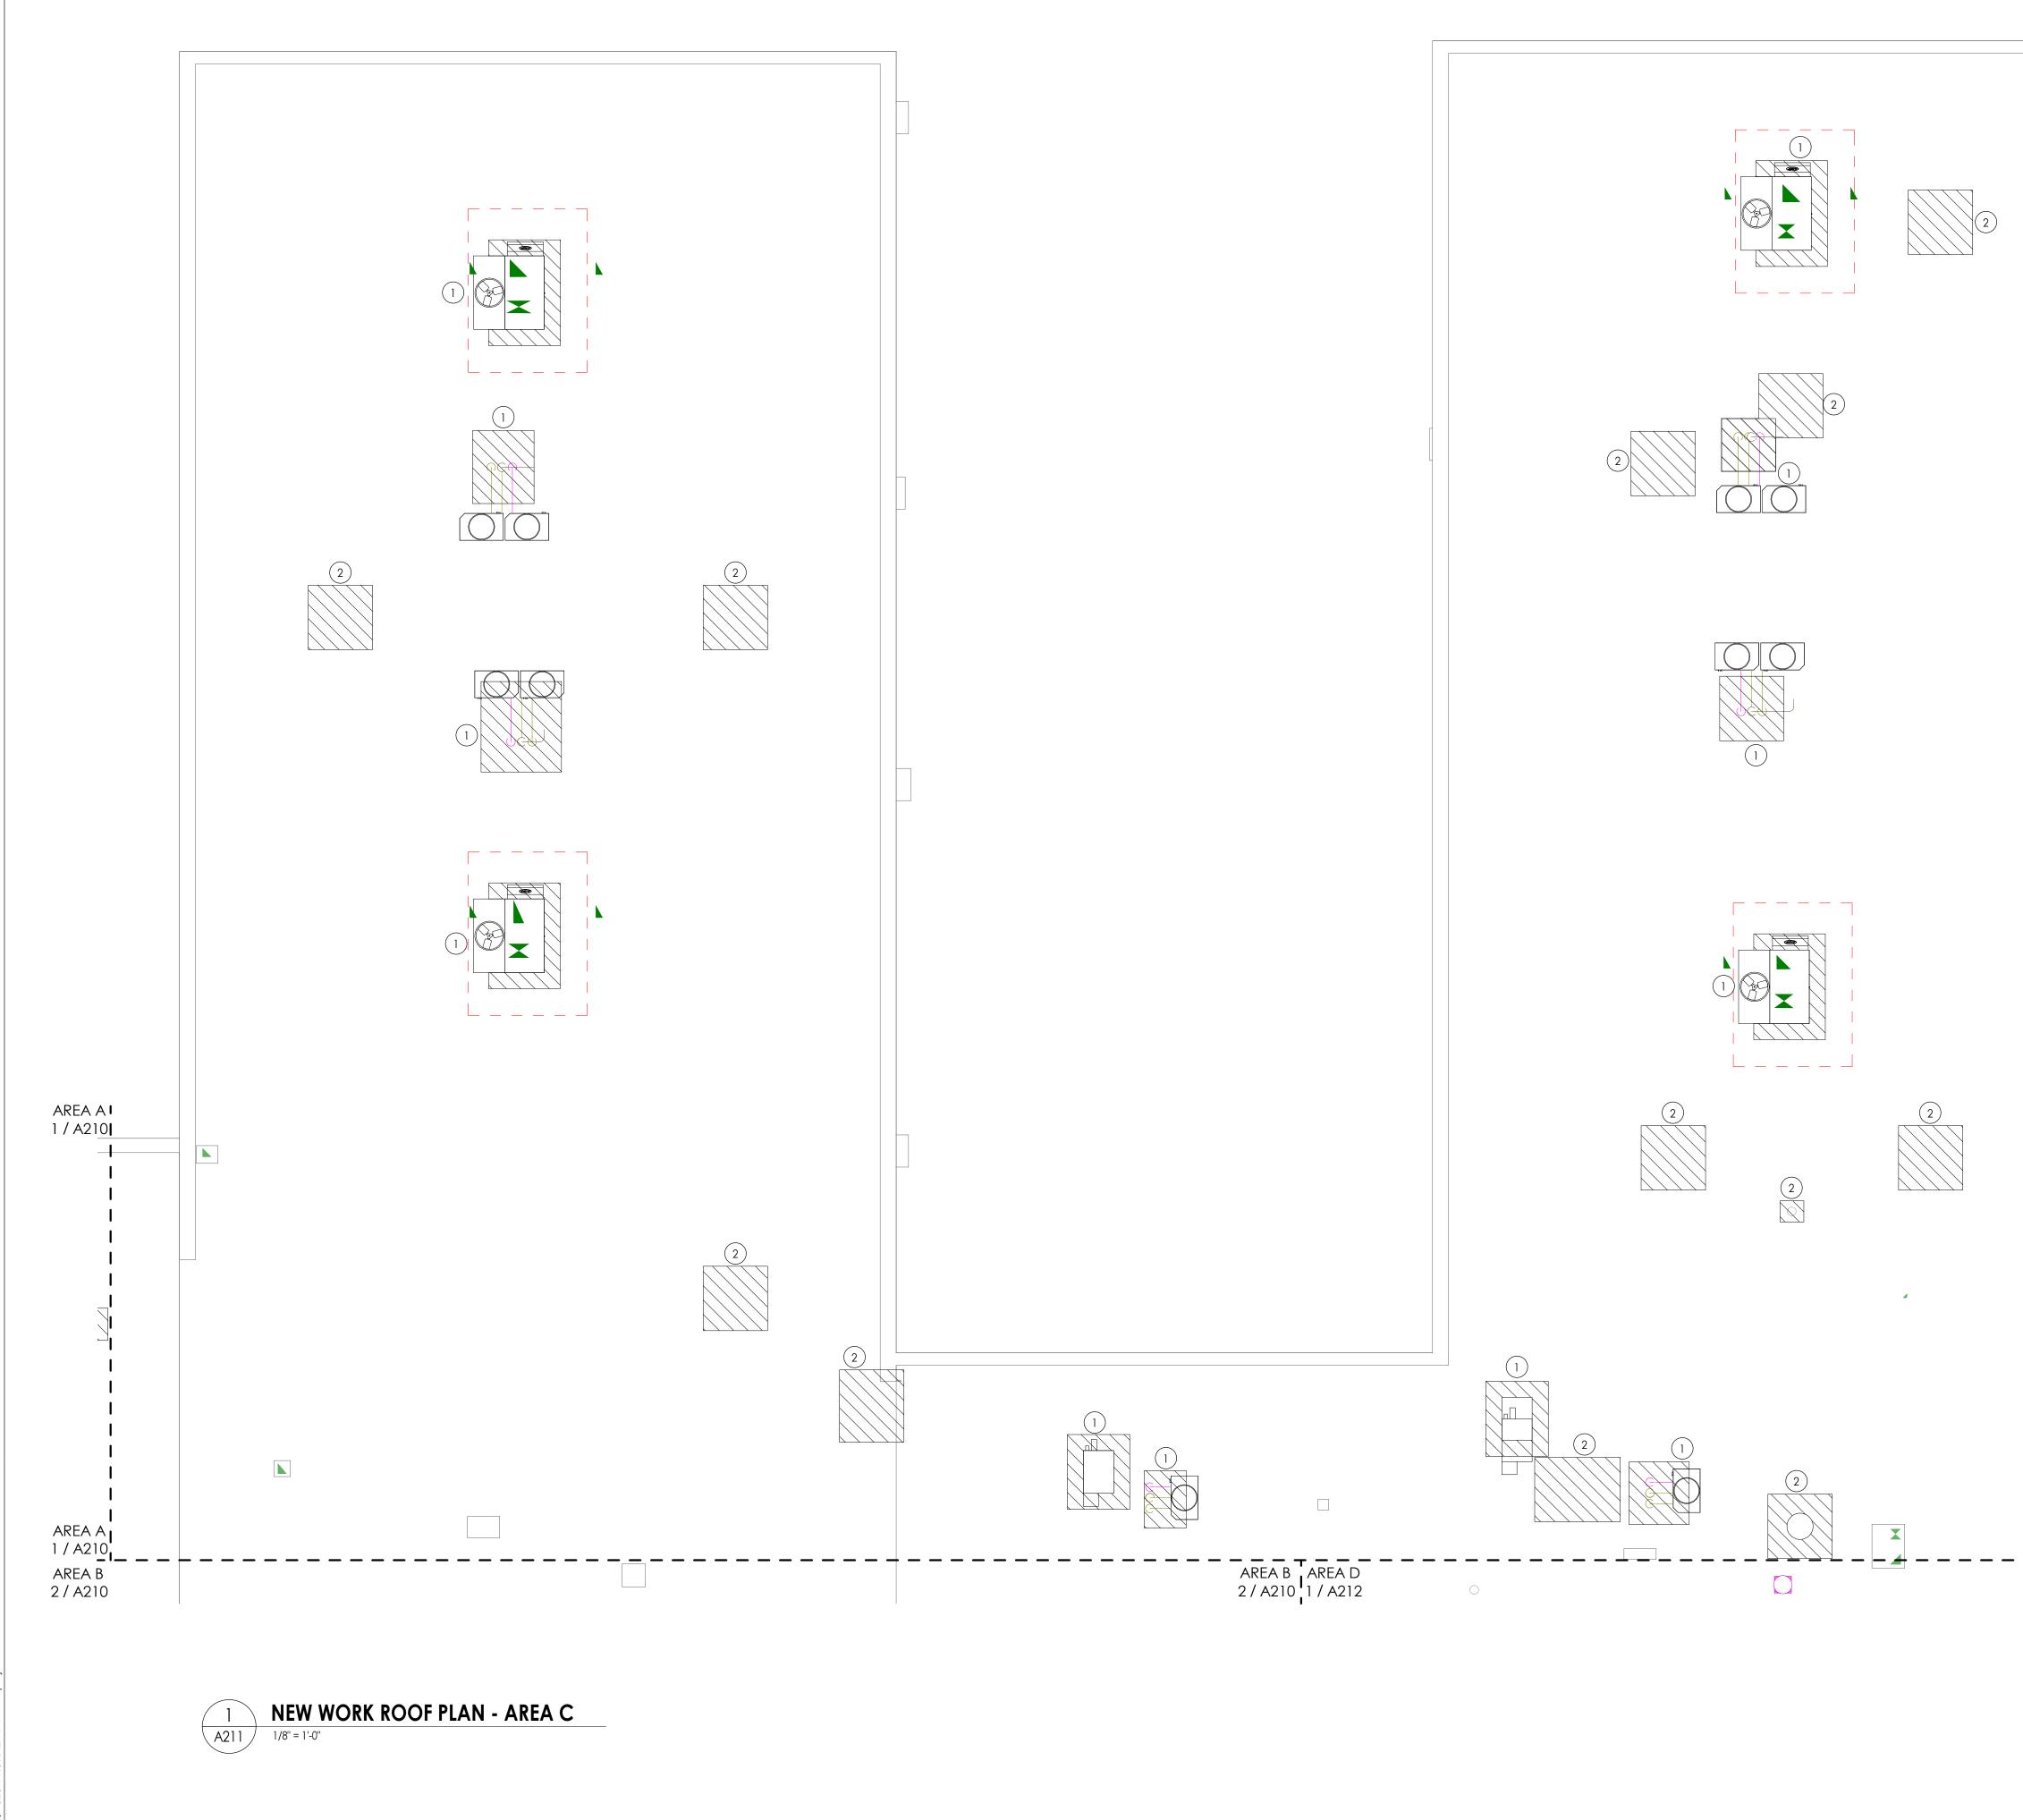
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ROOF PLAN LEGEND



PROVIDE NEW ROOFING SYSTEM TO MATCH EXISTING AT REMOVED MECHANICAL EQUIPMENT.

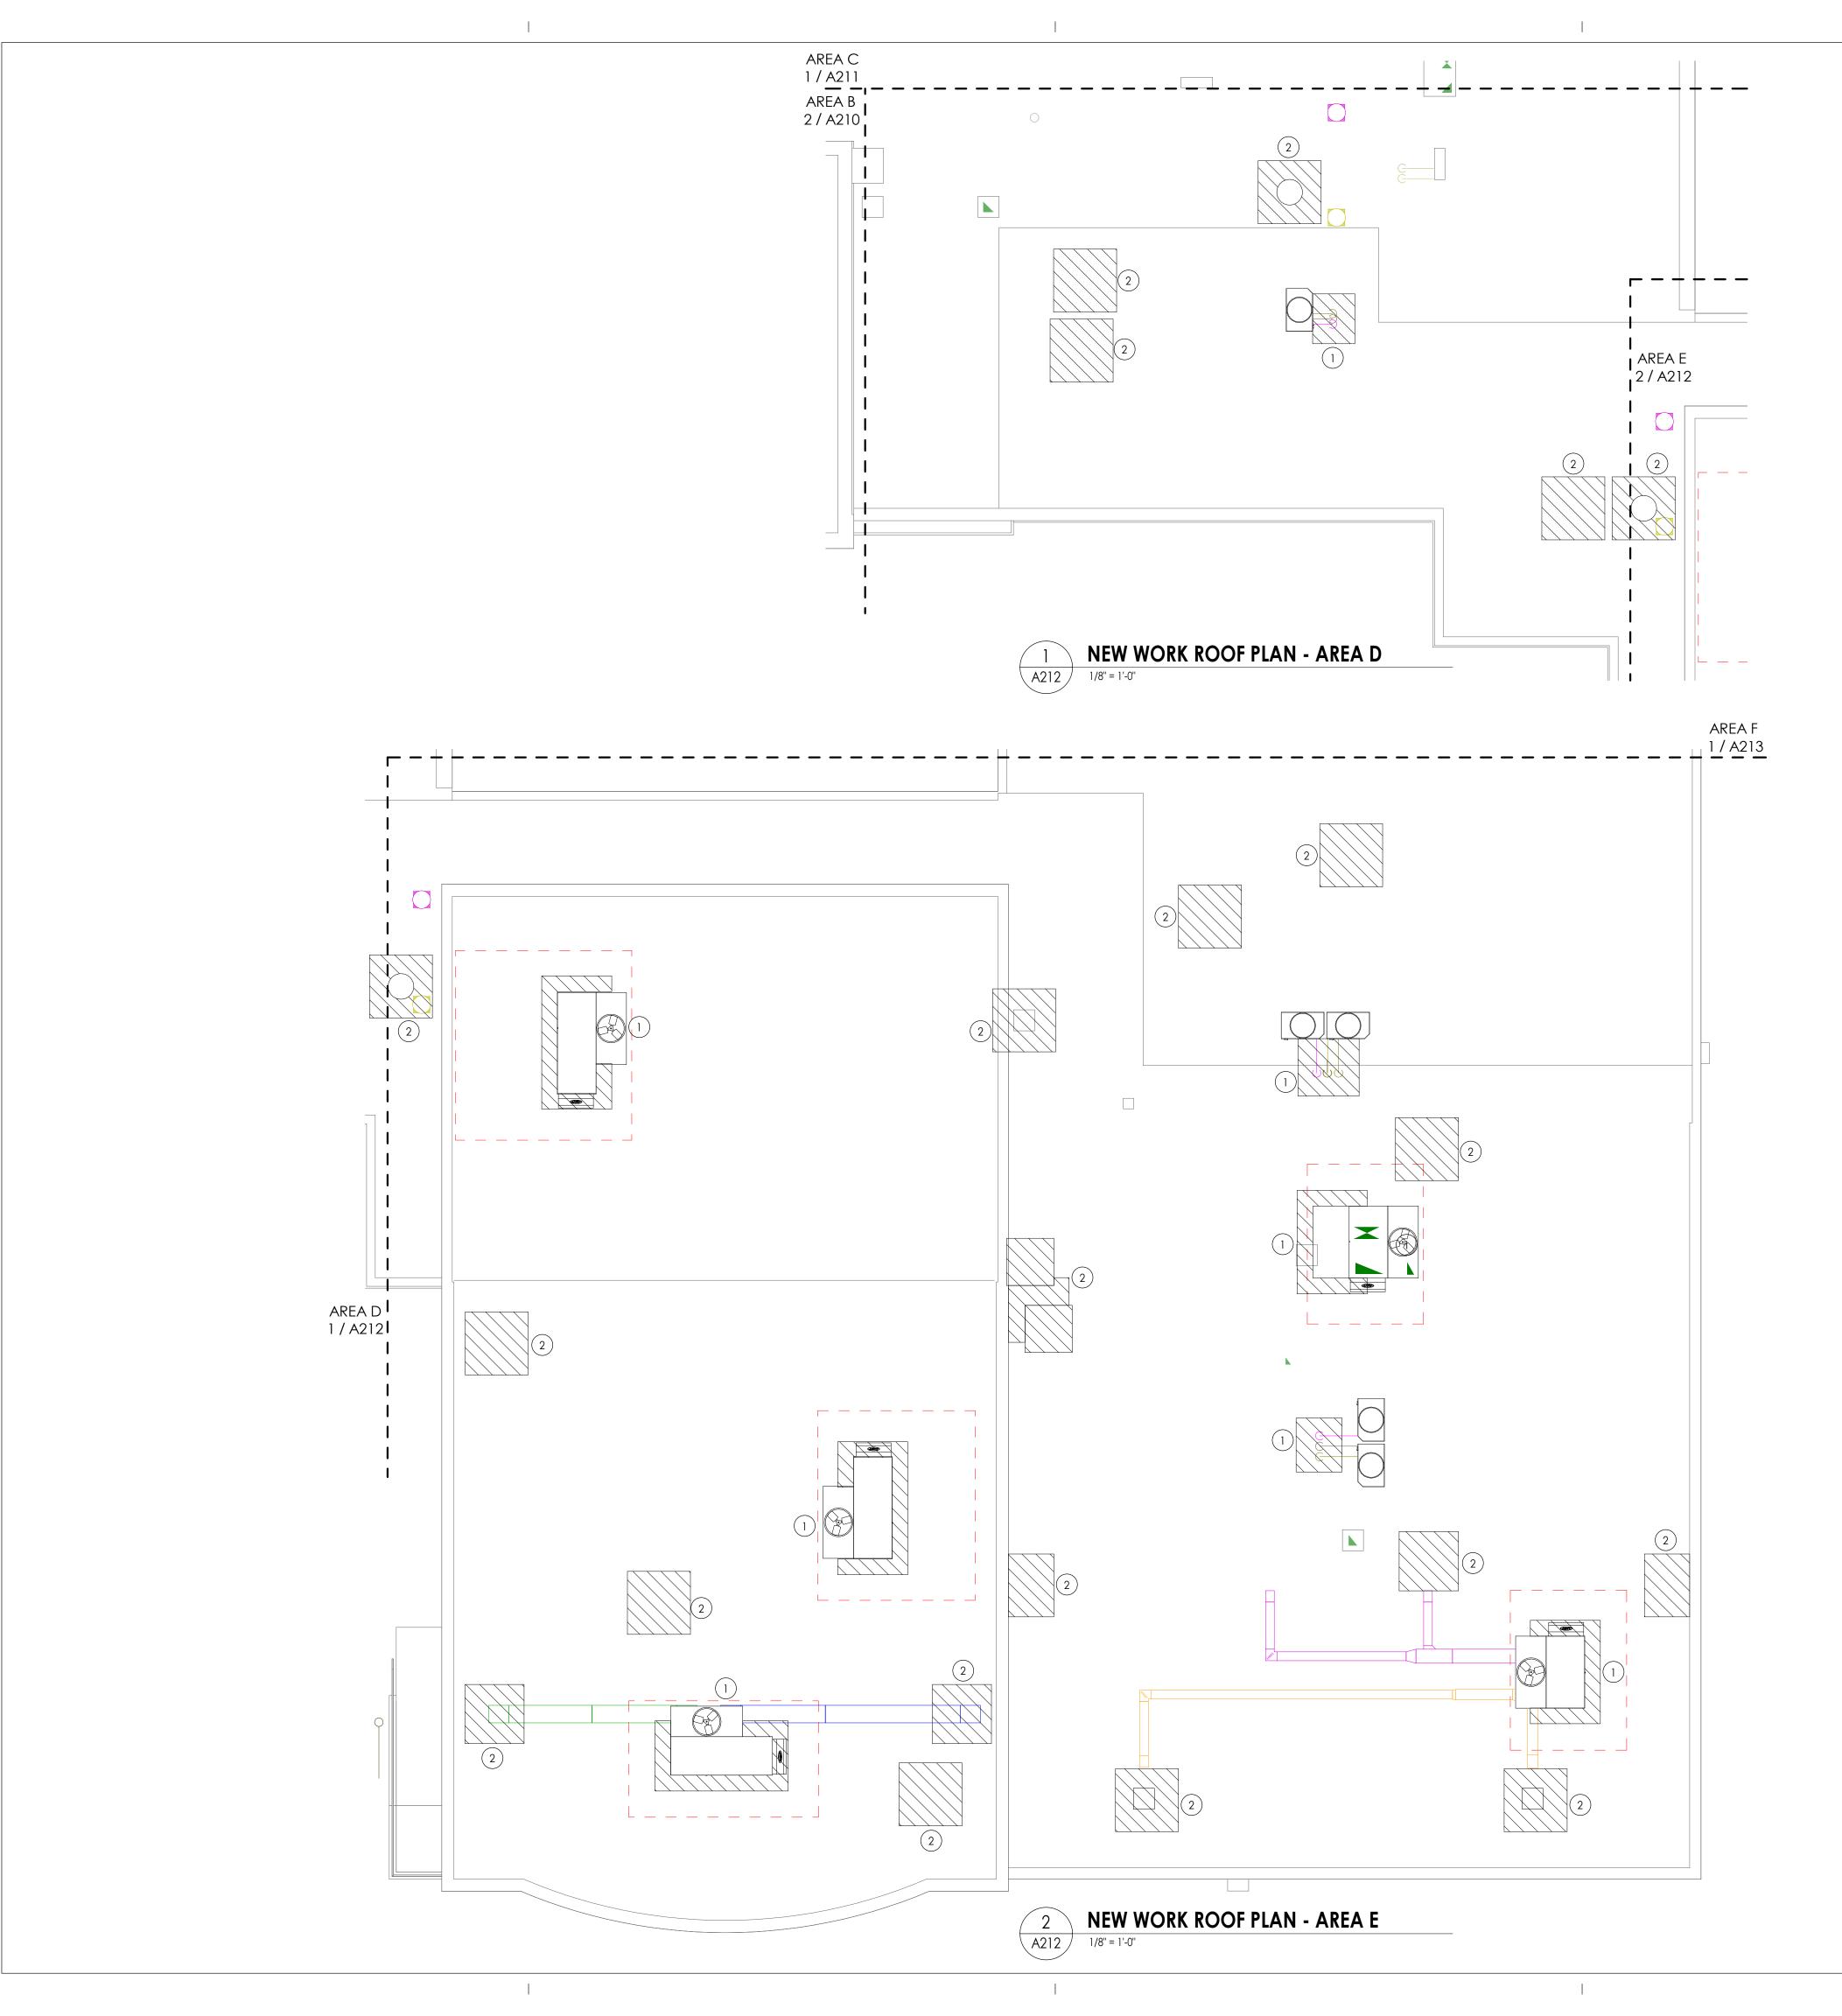ROOF PLAN KEYNOTES

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PROJECT INFORMATION Project Number 14457.20 Client Name SOUTH ORANGETOWN CENTRAL SCHOOL DISTRICT

Project Name PHASE 1: 2022 BOND

District Office Address


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PROJECT ISSUE & REVISION SCHEDULE No. Date Description

PROFESSIONAL STAMPS




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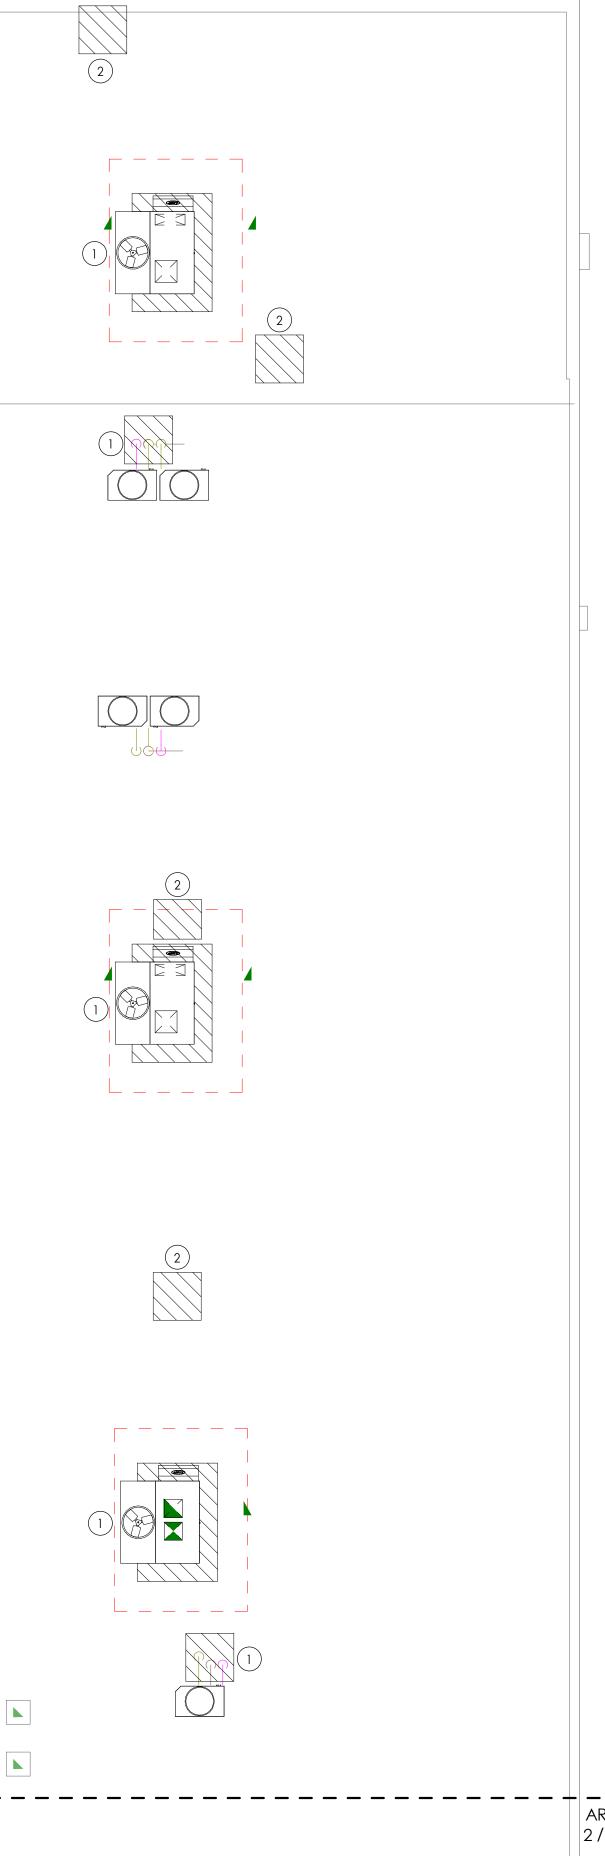
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NEW WORK ROOF PLAN - AREA F

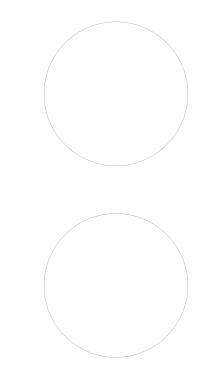

- - -AREA E 2/A212

FLOOR PLAN GENERAL NOTES
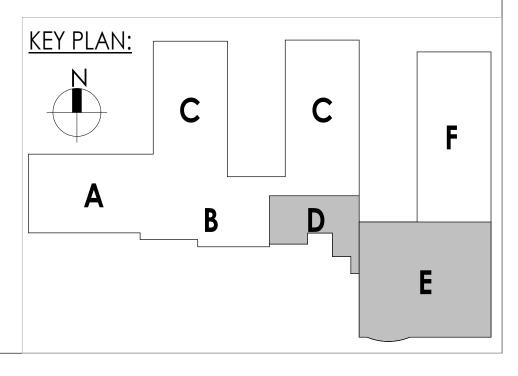
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ROOF PLAN LEGEND



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PROJECT INFORMATION Project Number 14457.20 Client Name SOUTH ORANGETOWN CENTRAL SCHOOL DISTRICT

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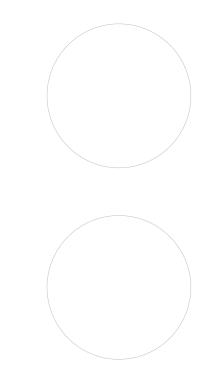
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PROJECT ISSUE & REVISION SCHEDULE No. Date Description

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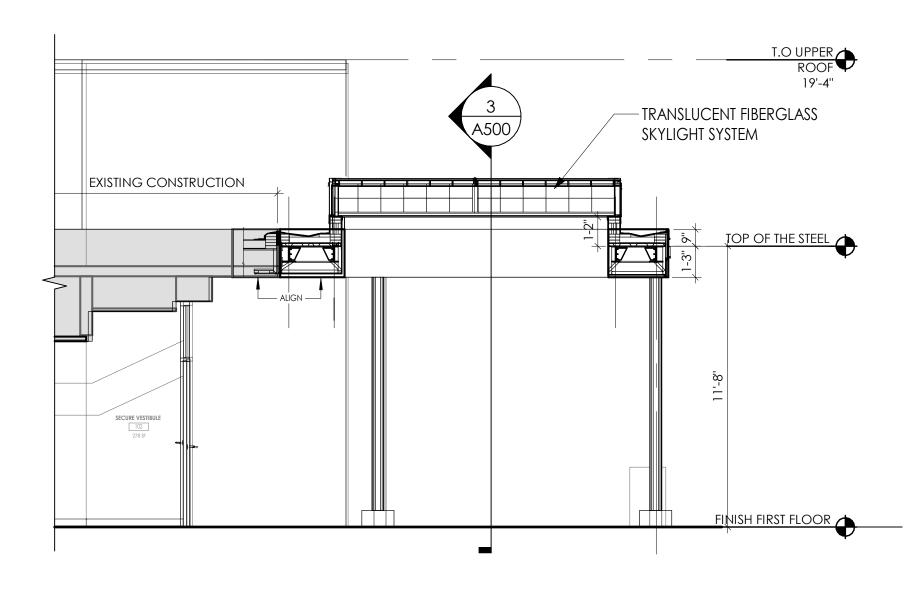
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NEW WORK ROOF PLAN - AREA F

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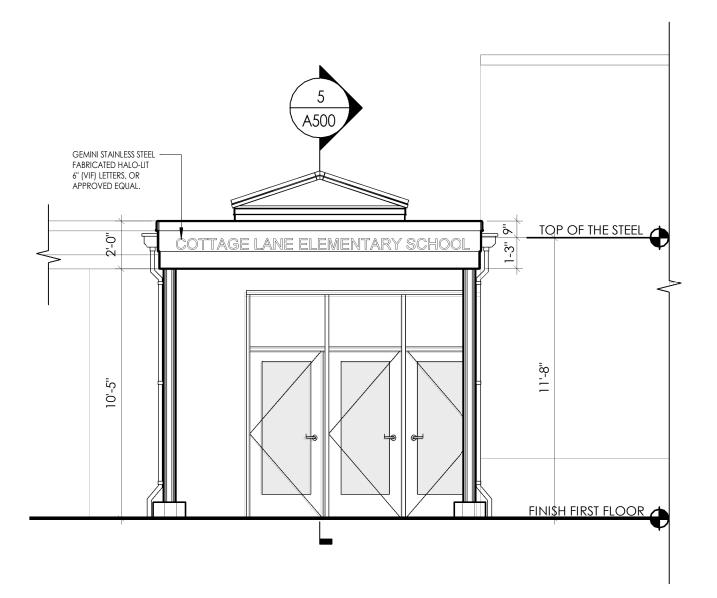
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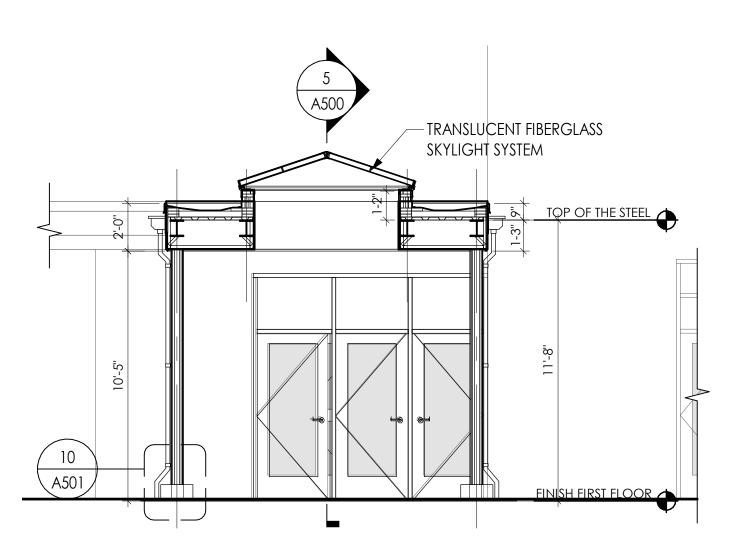


ENTRY CANOPY LONGITUDINAL SECTION

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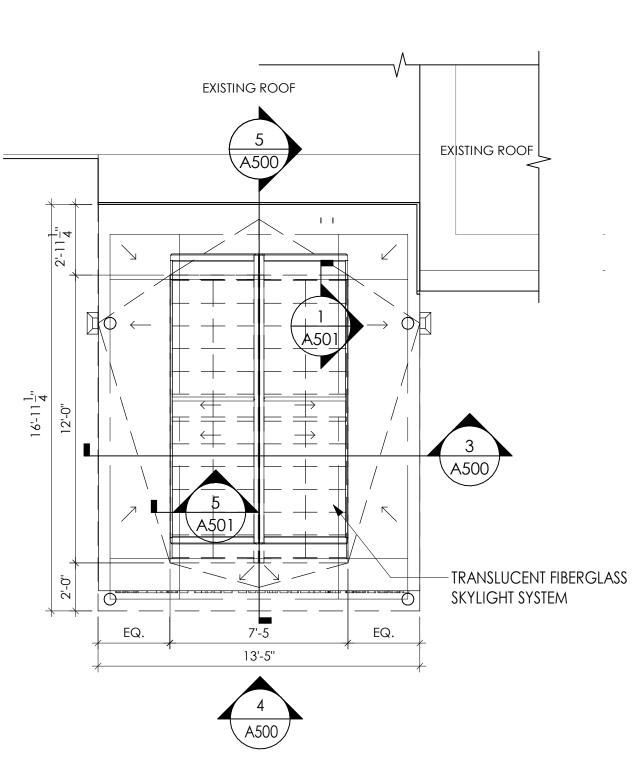






3 ENTRY CANOPY TRANSVERSE SECTION A500 1/4" = 1'-0"

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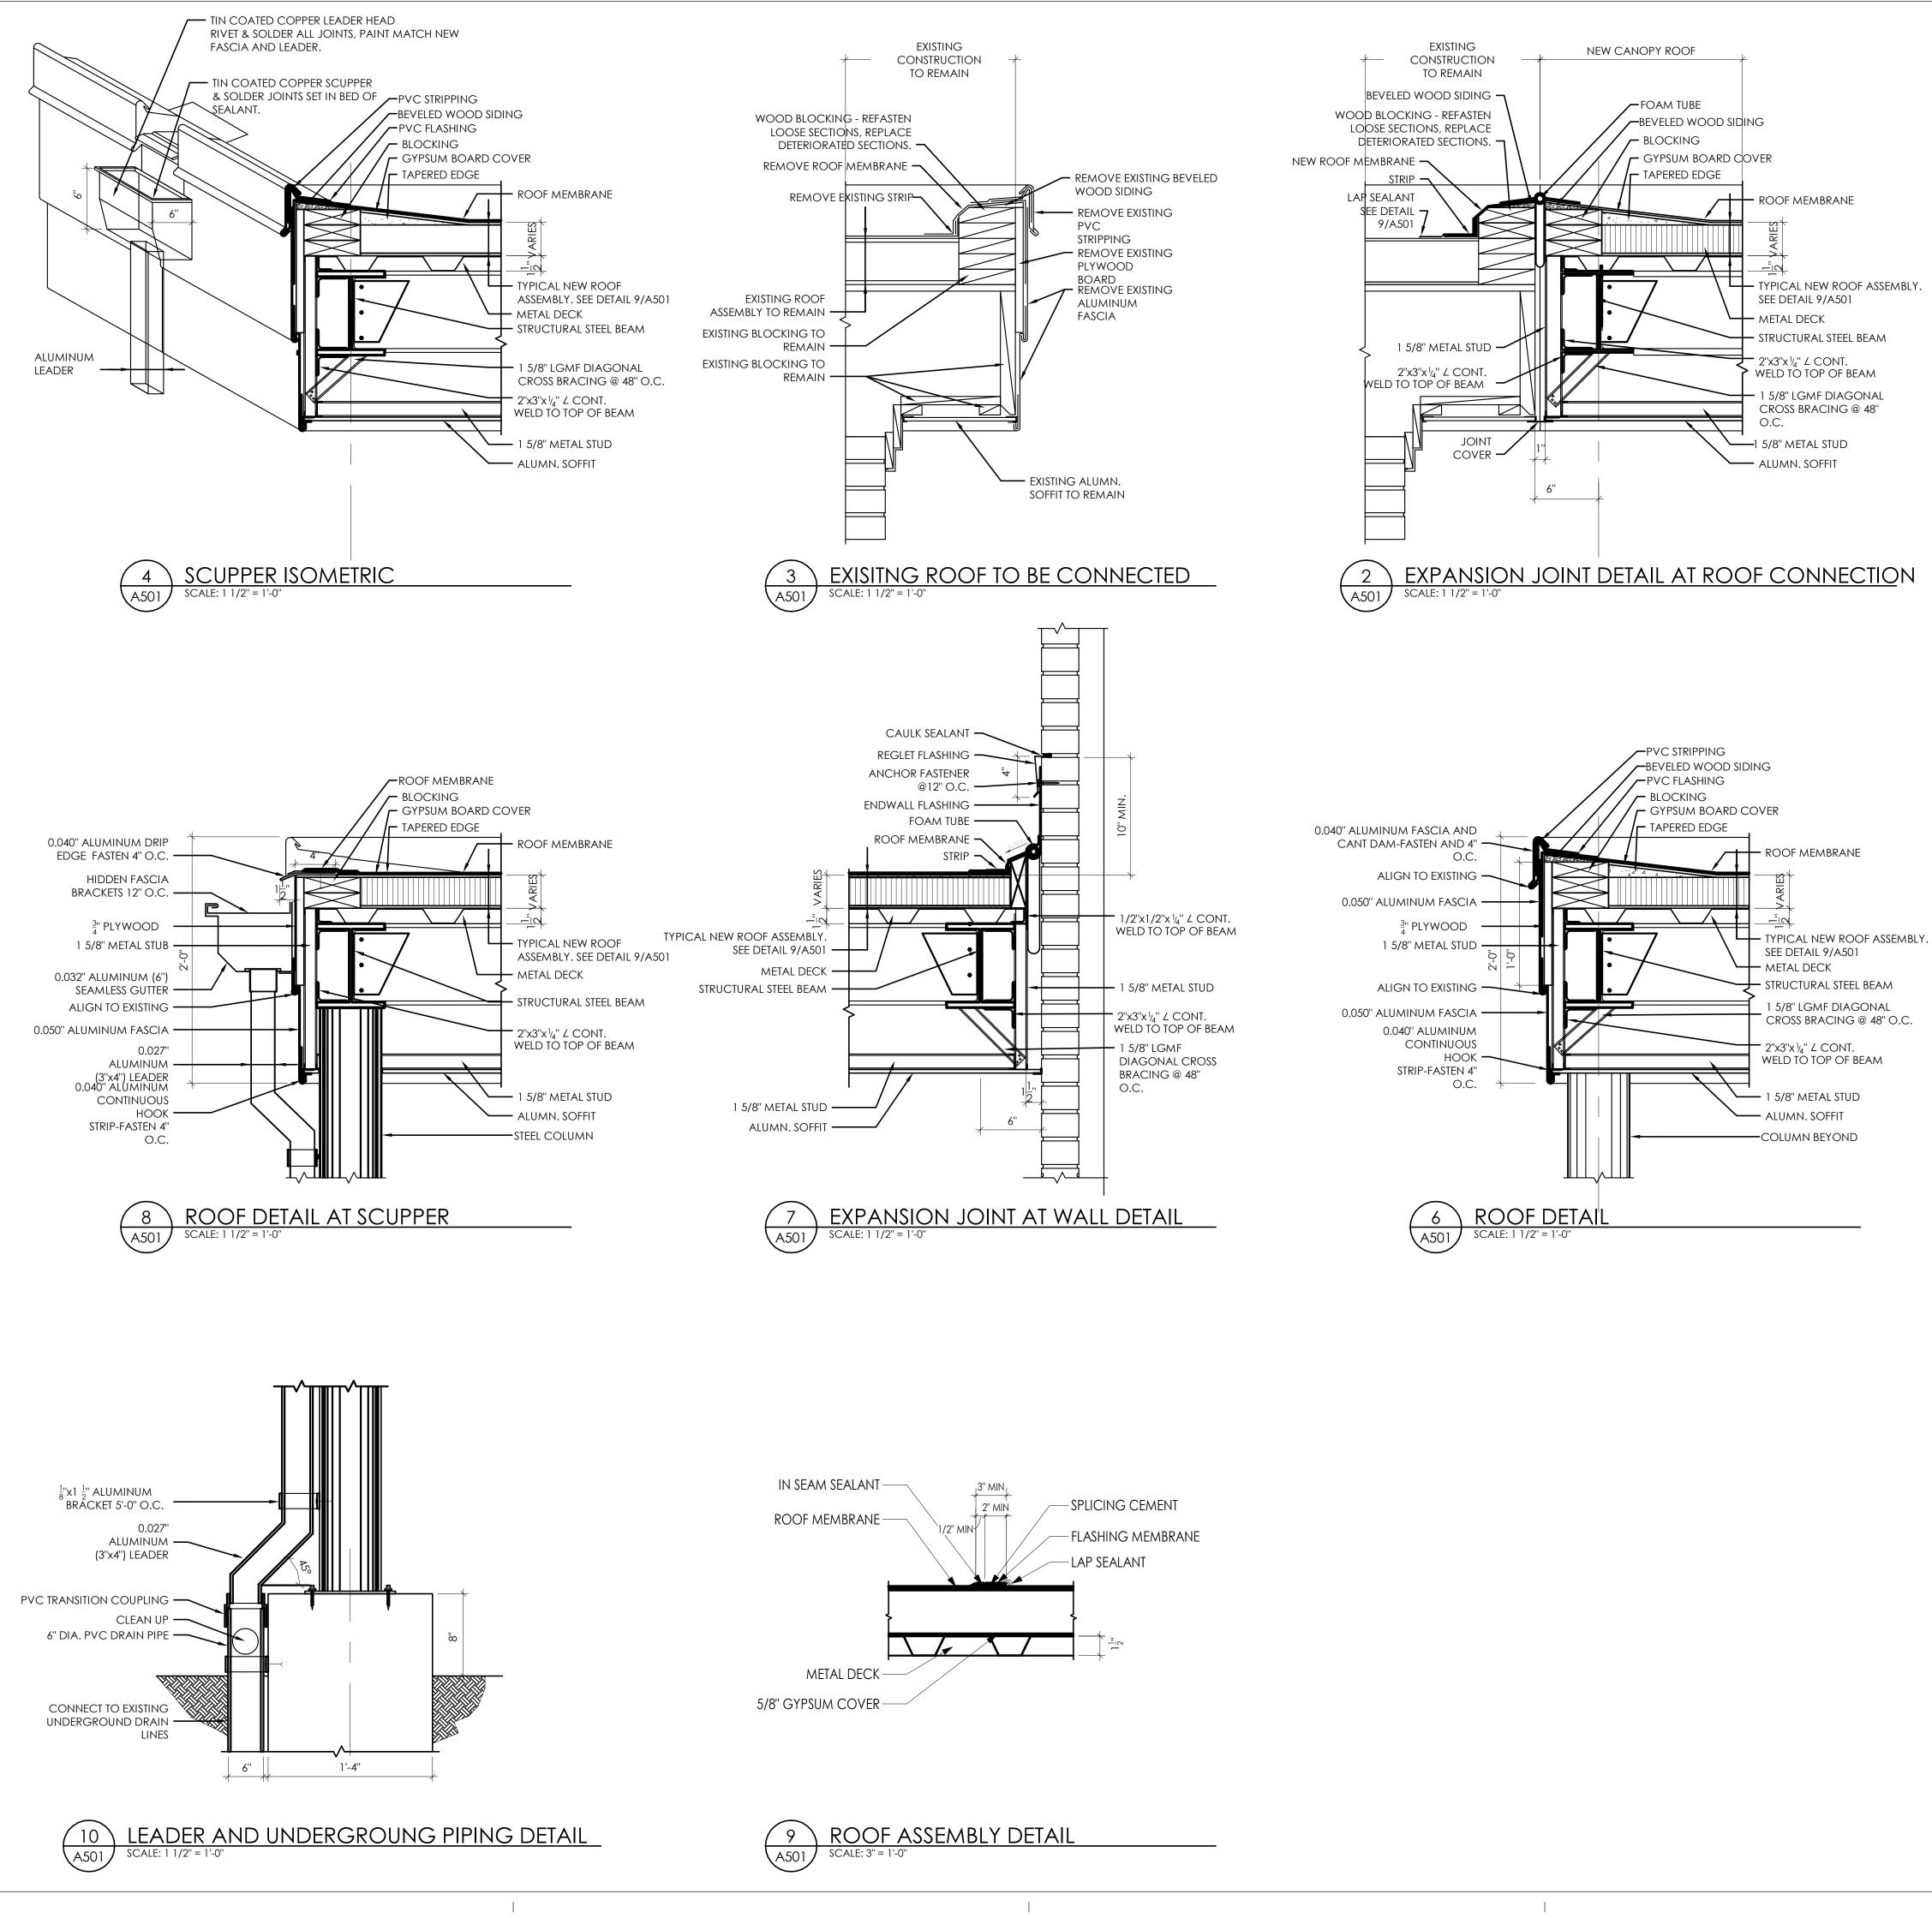





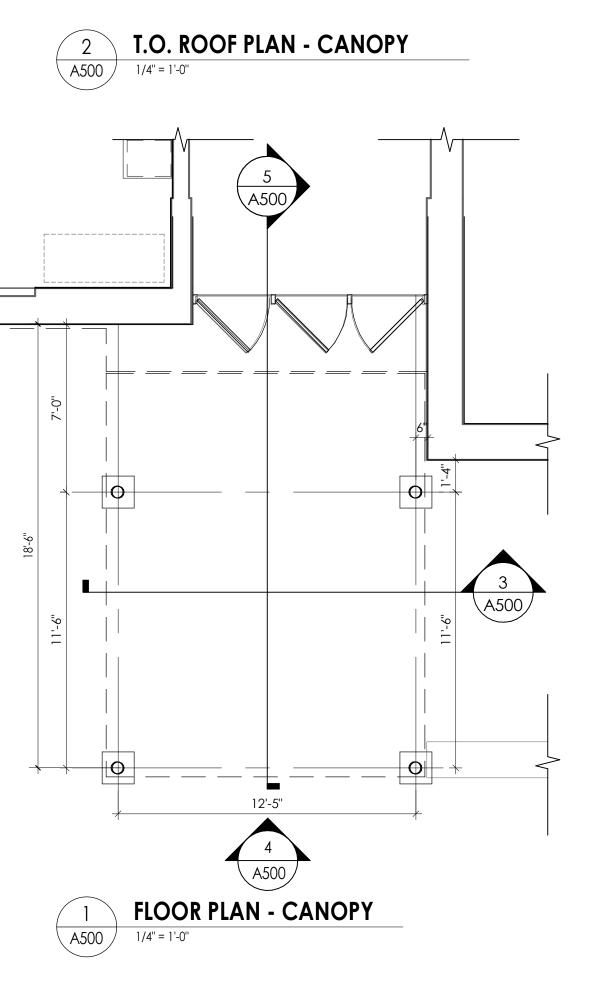


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GENERAL CEILING NOTES

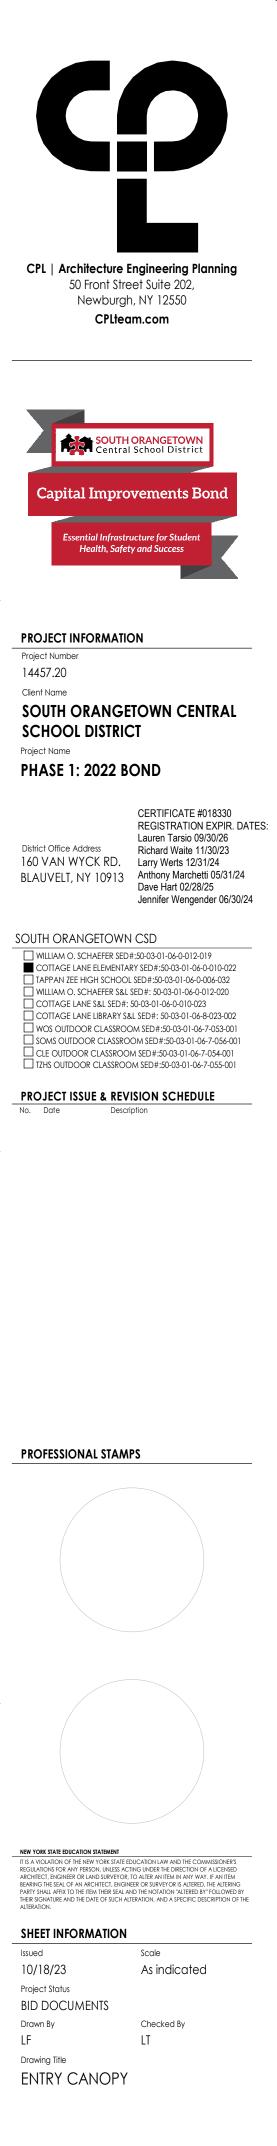
- 1. ALL DRAWINGS ARE GRAPHIC REPRESENTATION OF APPROXIMATE LOCATIONS OF NEW MATERIALS FOR CONSTRUCTION. IT IS THE CONTRACTOR'S RESPONSIBILITY TO FIELD VERIFY ALL CONDITIONS PRIOR TO COMMENCEMENT OF WORK. 2. REFER TO A200 SERIES FOR FLOOR PLAN.
- 3. FOR ANY DISCREPANCY BETWEEN THE REFLECTED CEILING PLAN AND THE FLOOR PLAN: THE FLOOR PLAN SHALL TAKE PRECEDENCE. ANY DISCREPANCY SHALL BE CALLED TO THE ATTENTION OF THE ARCHITECT.
- 4. FIRE STOP MECHANICAL, ELECTRICAL AND PLUMBING ITEMS, INCLUDING BUT NOT LIMITED TO DUCTWORK AND CONDUIT PENETRATIONS THROUGH FLOORS AND WALLS.
- 5. COORDINATE CEILING INSTALLATIONS WITH MECHANICAL, ELECTRICAL AND PLUMBING DRAWINGS.
- 6. REFER TO "H" SERIES DRAWINGS FOR DIFFUSERS AND GRILLE LOCATIONS.
- 7. REFER TO "E" SERIES DRAWINGS FOR LIGHTING TYPES AND CONTROLS. 8. REFER TO "P" OR "FP" SERIES DRAWINGS FOR SPRINKLER HEAD LOCATIONS.
- 9. WORK AREAS SHALL BE MAINTAINED AND ALL WORK AREAS SHALL BE LEFT BROOMED CLEAN AT THE END OF EACH DAY.
- 10. CENTER CEILING GRID (EACH WAY) IN ROOMS SCHEDULED TO RECEIVE
- ACOUSTICAL CEILING SYSTEMS UNLESS OTHERWISE NOTED. 11. VERIFY WITH ARCHITECT THE INSTALLATION OF ANY CEILING TILES LESS THAN 4" IN
- WIDTH. 12. PROVIDE MOISTURE RESISTANT GYP. BD. AT ALL TOILET ROOM, JANITOR'S CLOSET AND OTHER WET LOCATION CEILING ASSEMBLIES.
- 13. ALL GYP. BD. CEILINGS AND SOFFITS SHALL BE PRIMED AND PAINTED SCHEDULED COLOR ON ALL FACES AND UNDERSIDE SURFACE.
- 14. VERIFY SOFFIT SIZE WITH MILLWORK SHOP DRAWINGS. PROVIDE 2" OVERHANG ON EXPOSED EDGES UNLESS NOTED OTHERWISE. 15. WHERE APPLICABLE ALL FIXTURES AND DEVICES SHALL BE CENTERED ON A CEILING
- TILE. 16. INSTALL CONTROL JOINTS IN GYP. CEILINGS PER ASTM C 840.

CEILING SYMBOL LEGEND

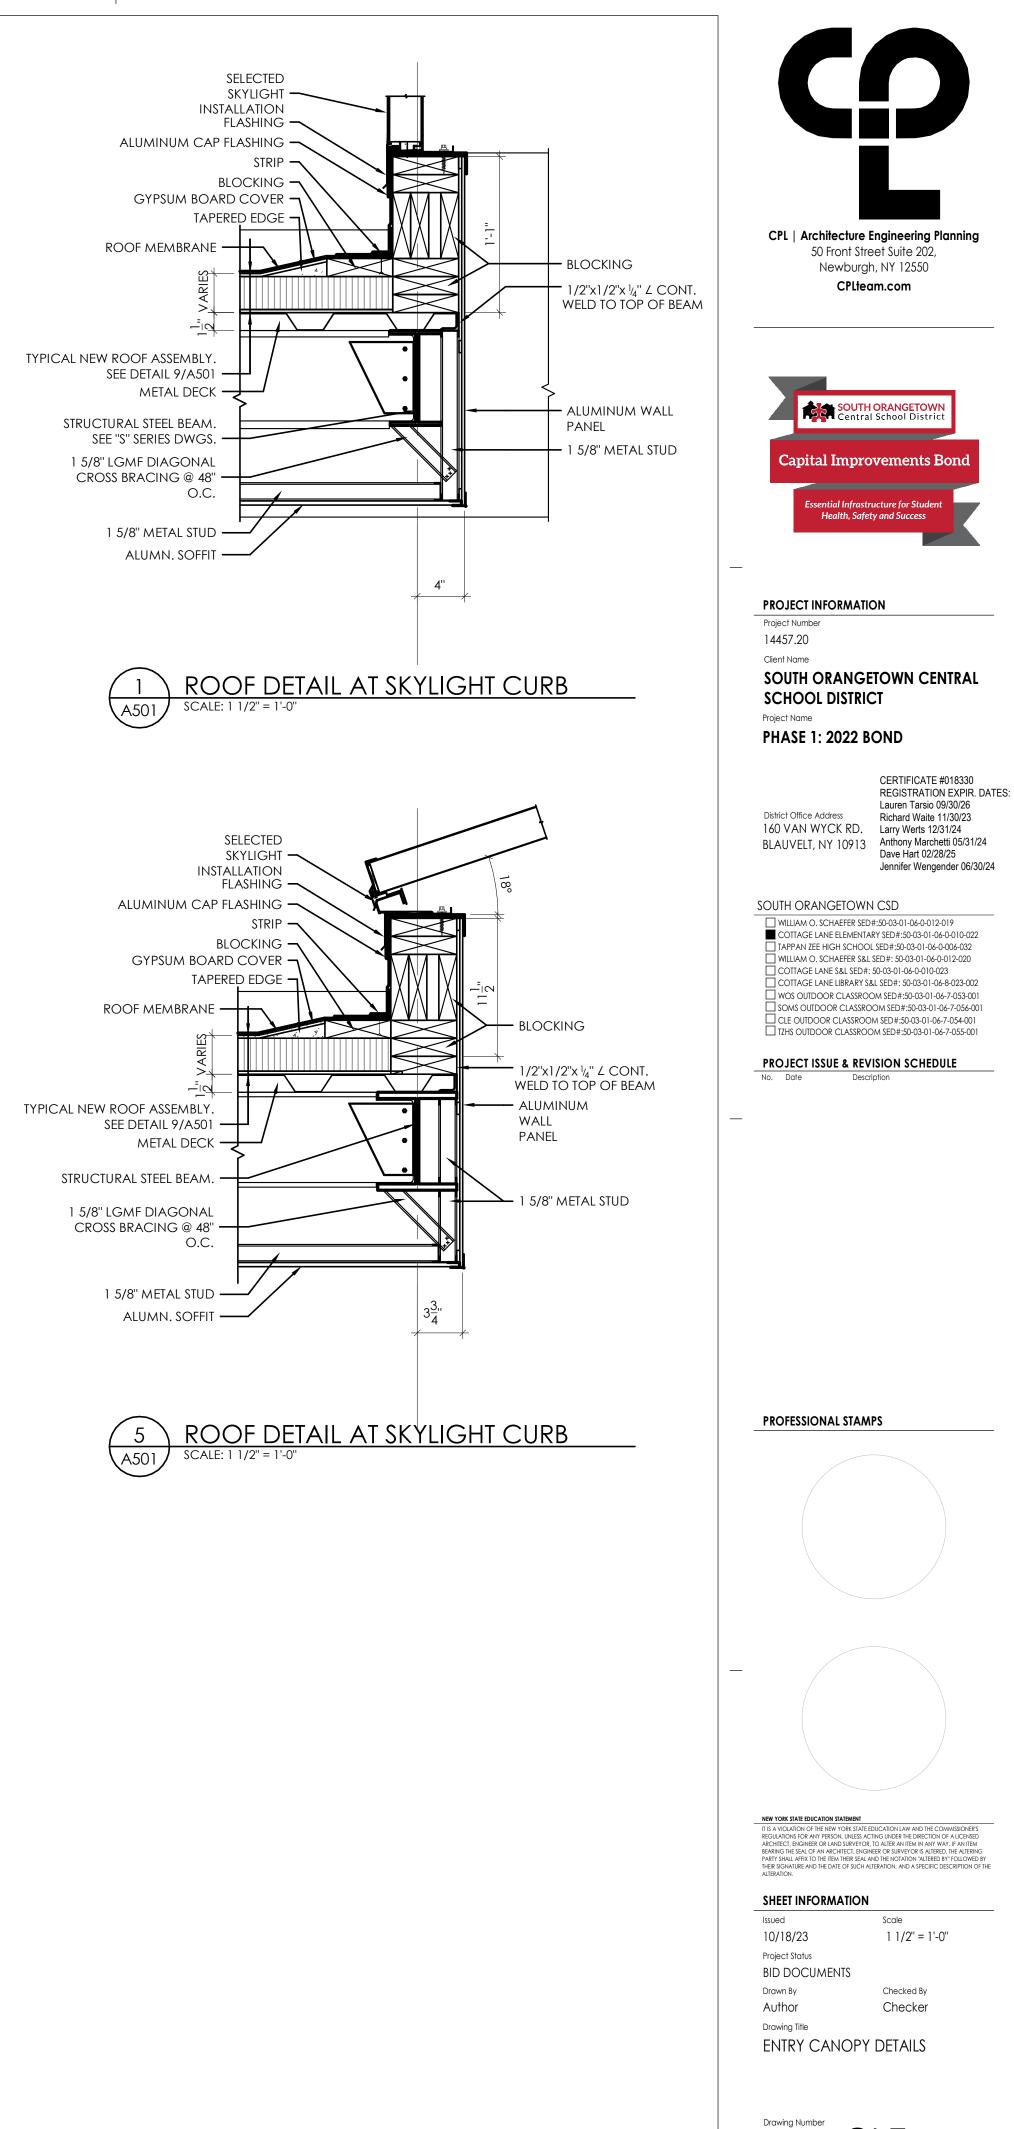	2'X2' LIGHT
	2'x4' LIGHTS
	1'X4' LINEAR LIGHT FIXTURE
\boxtimes	SUPPLY AIR DIFFUSERS
	RETURN AIR DIFFUSERS
	EXHUAST DIFFUSERS
	LINEAR SLOT AIR DIFFUSERS
$\sum_{i=1}^{n} \frac{1}{i} \sum_{i=1}^{n} \sum_{i=1}^{n} \frac{1}{i} \sum_{i=1}^{n} $	GYPSUM WALL BOARD CEILING
	ACOUSTICAL TILE CEILING
	EXISTING TO REMAIN GRID. SHOWN FOR REFERENCE ONLY
9'-0" ACT-1	CEILING TYPE AND CEILING HEIGHT ABOVE FINISHED FLOOR

CEILING KEYNOTES

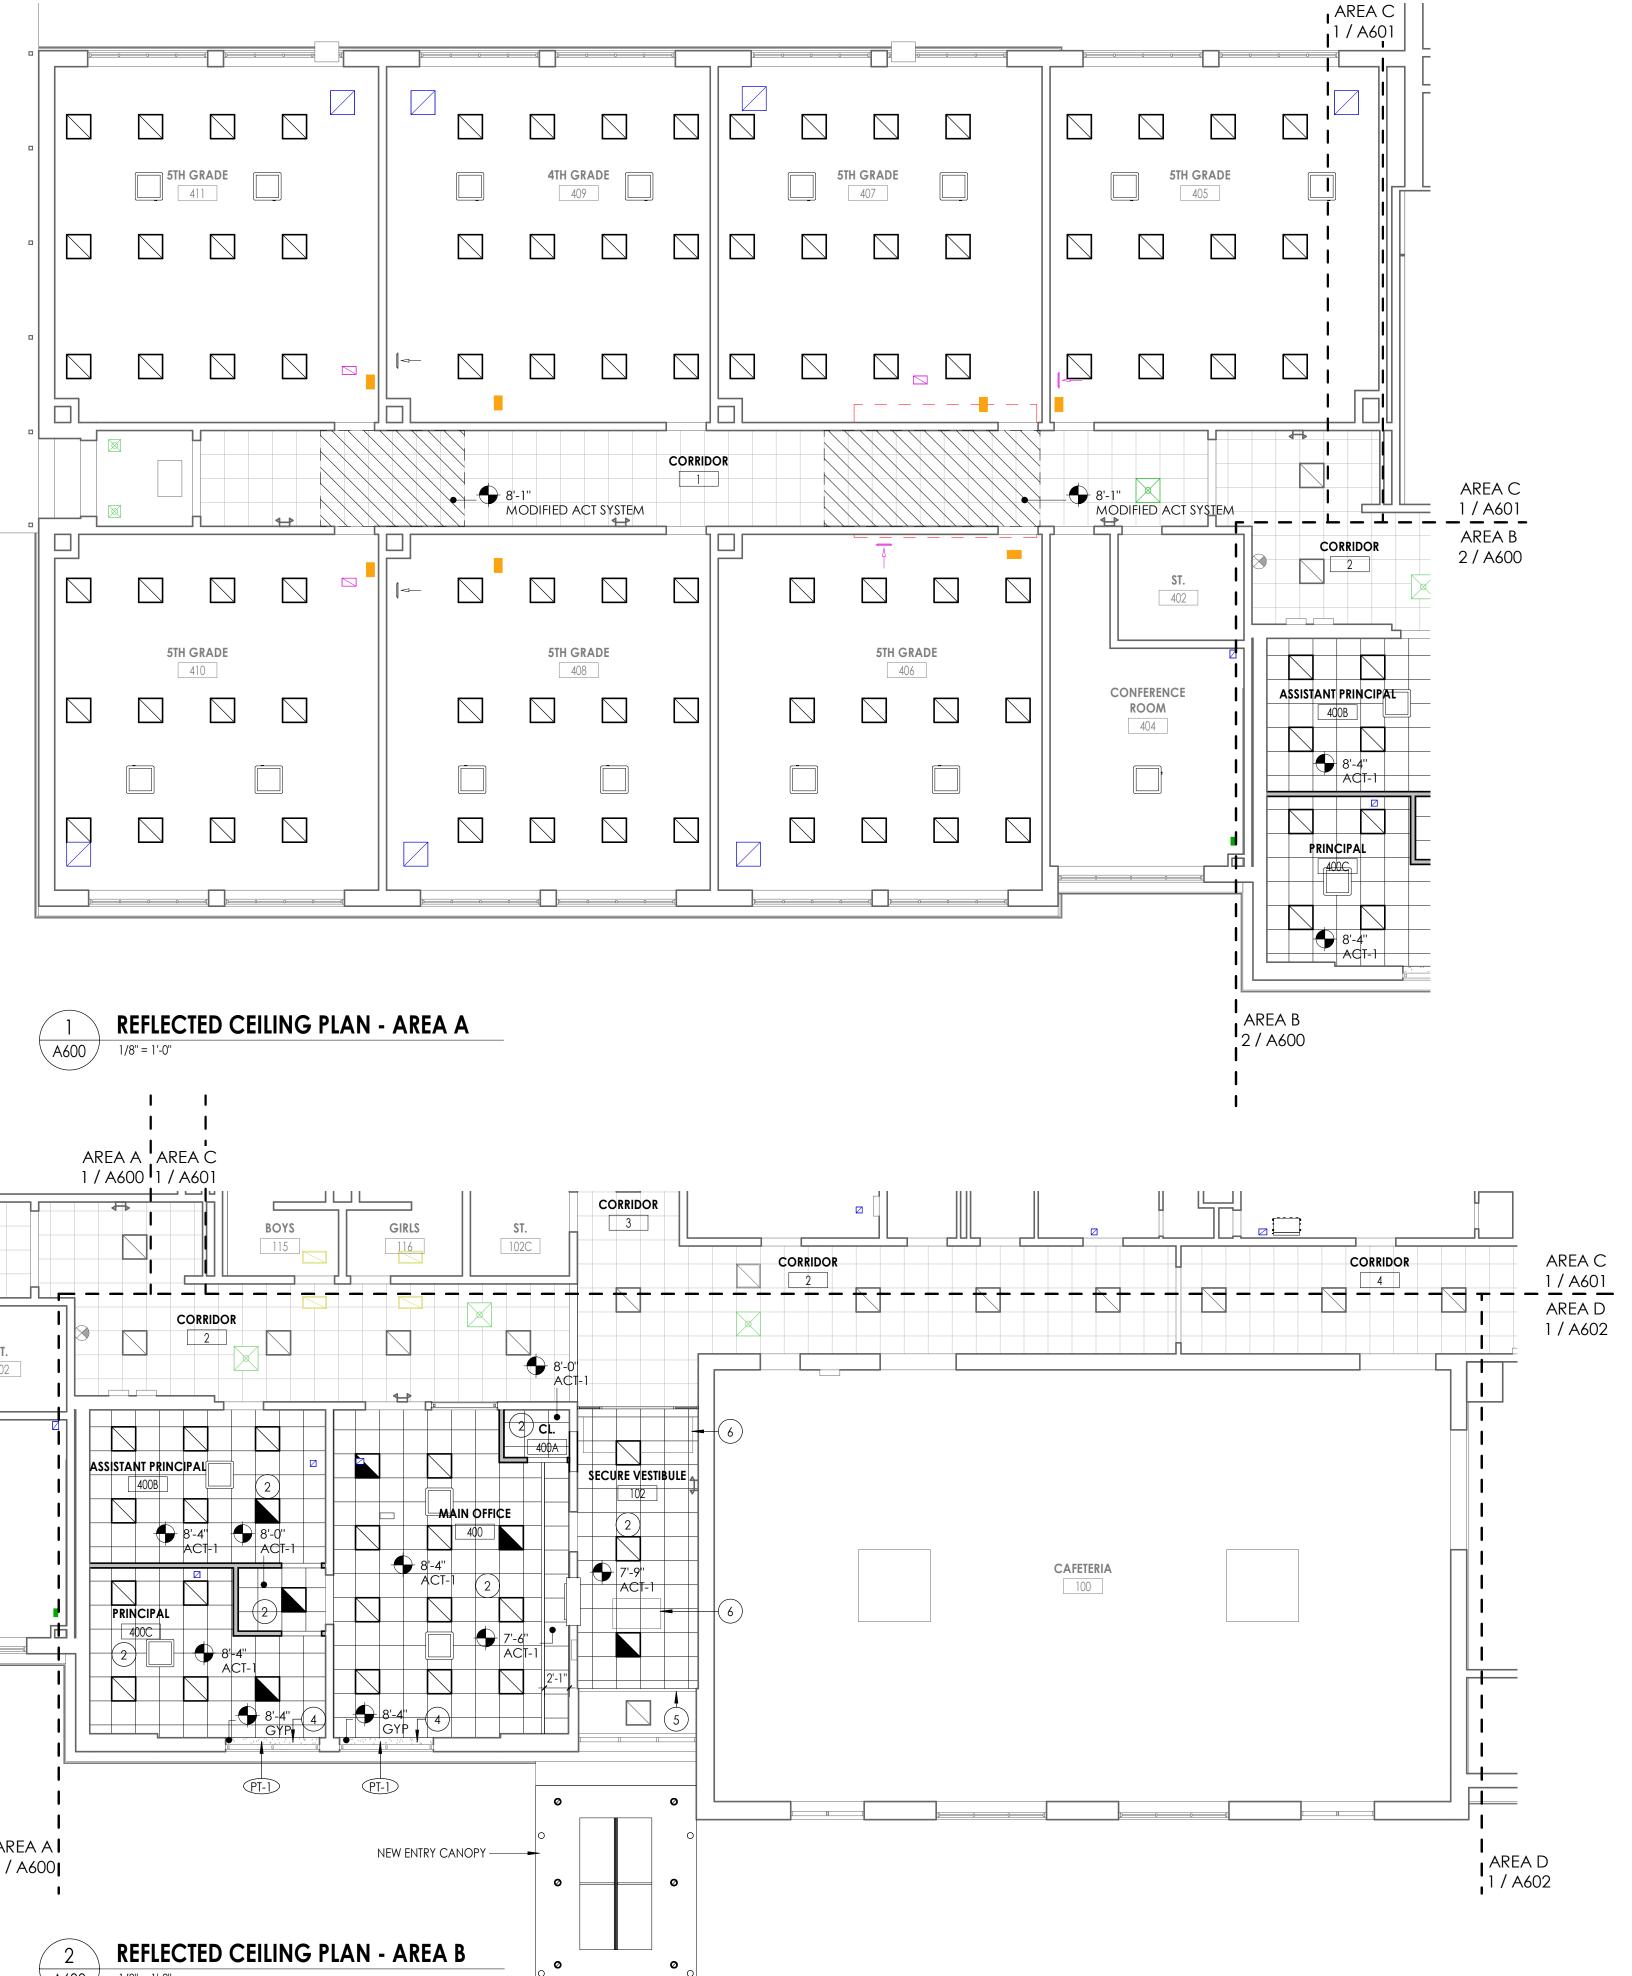- 1) RE-INSTALL SALVAGED ACT CEILING TILES
- (2) NEW ACT CEILING SYSTEM
- (3) NEW GYPSUM BOARD CEILING SYSTEM
- A NEW GYPSUM BOARD SOFFIT. COORDINATE FINAL HT. & EXTENTS W/ MECH EQUIPMENT
- (5) PATCH & PAINT EXISTING SOFFIT AND LINTEL AT DEMOLISHED FRAME
- EXISTING MECH. UNITS TO REMAIN FLUSH WITH CEILING REFER TO MECH.
- ⁶ DRAWINGS
- MODIFIED ACT CEILING SYSTEM BY GC. PATCH GRID & REINSTALL SALVAGED CEILING TILES.

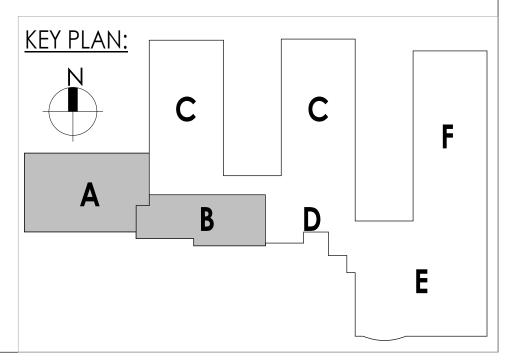



PROJECT INFORMATION		
Project Number		
14457.20		
Client Name		
SOUTH ORANG	ETOWN CENTRAL	
SCHOOL DISTR	ICT	
Project Name		
PHASE 1: 2022	BOND	
	CERTIFICATE #018330	

District Office Address


REGISTRATION EXPIR. DATES: Lauren Tarsio 09/30/26 Richard Waite 11/30/23 160 VAN WYCK RD. Larry Werts 12/31/24 BLAUVELT, NY 10913 Anthony Marchetti 05/31/24 Dave Hart 02/28/25 Jennifer Wengender 06/30/24

south orangetown CSD

- WILLIAM O. SCHAEFER SED#:50-03-01-06-0-012-019 COTTAGE LANE ELEMENTARY SED#:50-03-01-06-0-010-022 TAPPAN ZEE HIGH SCHOOL SED#:50-03-01-06-0-006-032 WILLIAM O. SCHAEFER S&L SED#: 50-03-01-06-0-012-020 COTTAGE LANE S&L SED#: 50-03-01-06-0-010-023 COTTAGE LANE LIBRARY S&L SED#: 50-03-01-06-8-023-002
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PROJECT ISSUE & REVISION SCHEDULE No. Date Description

PROFESSIONAL STAMPS

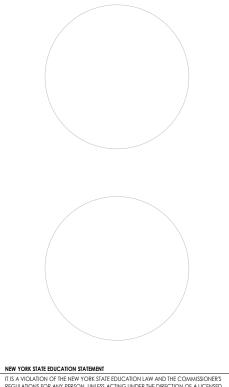

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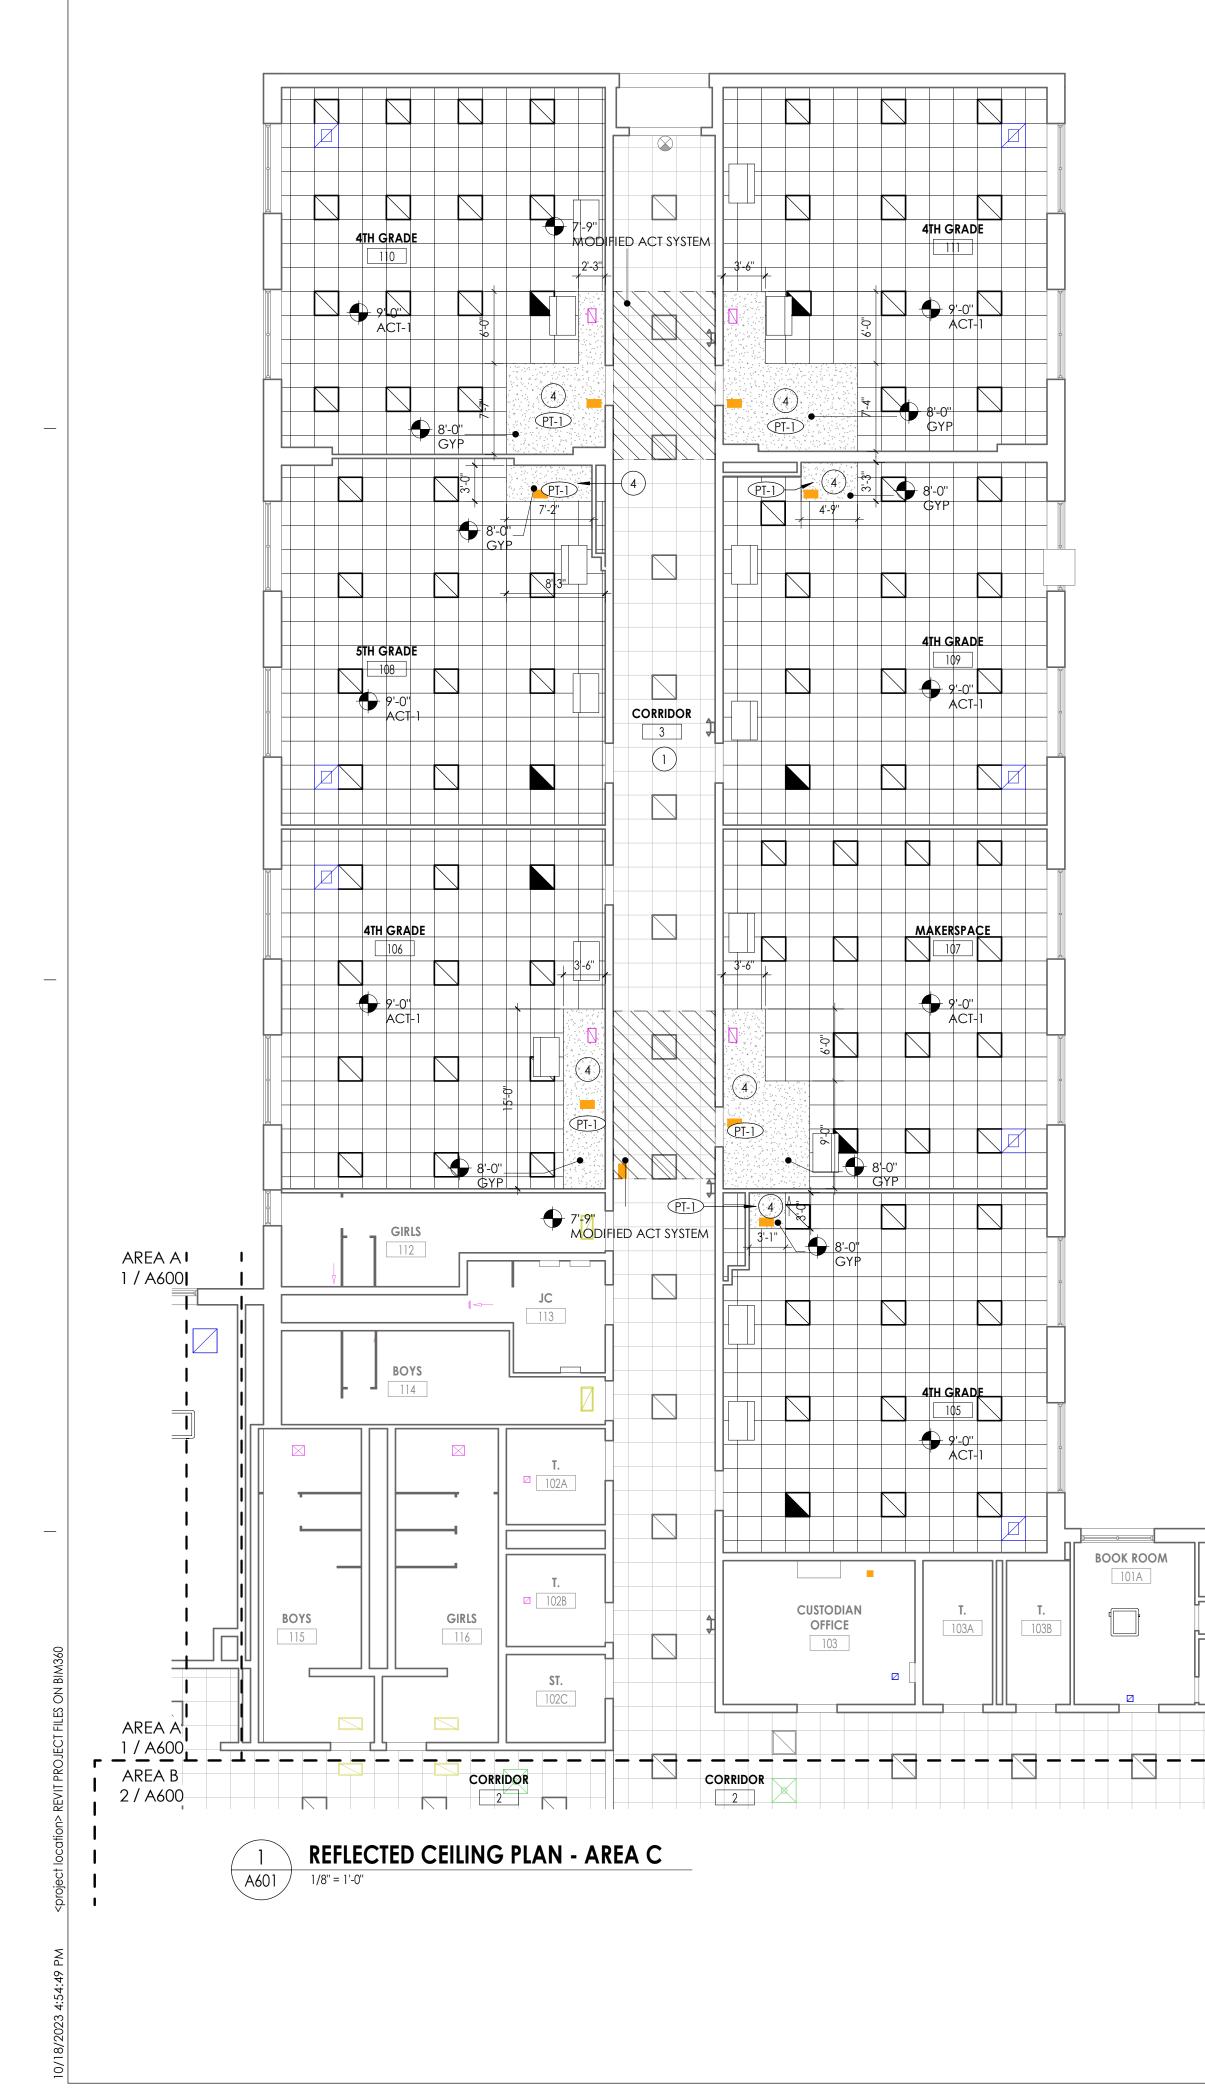
SHEET INFORMATION

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Issued	Scale
10/18/23	As indicated
Project Status	
BID DOCUMENTS	
Drawn By	Checked By
LF	LT
Drawing Title	
REFLECTED CEIL	ING PLAN - ARE

A&B

Drawing Number







GENERAL CEILING NOTES

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- 13. ALL GYP. BD. CEILINGS AND SOFFITS SHALL BE PRIMED AND PAINTED SCHEDULED COLOR ON ALL FACES AND UNDERSIDE SURFACE.
- 14. VERIFY SOFFIT SIZE WITH MILLWORK SHOP DRAWINGS. PROVIDE 2" OVERHANG ON EXPOSED EDGES UNLESS NOTED OTHERWISE.
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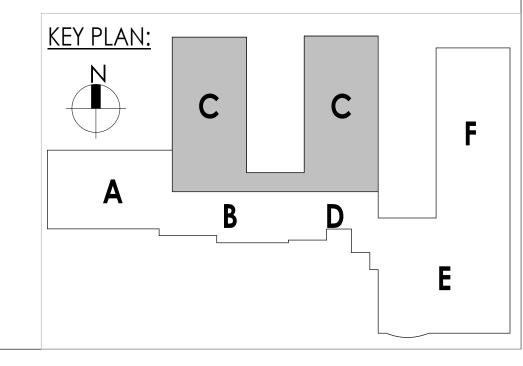
CEILING SYMBOL LEGEND

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CPL | Architecture Engineering Planning 50 Front Street Suite 202, Newburgh, NY 12550 CPLteam.com SOUTH ORANGETC Capital Improvements Bond Health, Safety and Success **PROJECT INFORMATION** Project Number 14457.20

Client Name SOUTH ORANGETOWN CENTRAL SCHOOL DISTRICT Project Name

PHASE 1: 2022 BOND

District Office Address

REGISTRATION EXPIR. DATES: Lauren Tarsio 09/30/26 Richard Waite 11/30/23 160 VAN WYCK RD. Larry Werts 12/31/24 BLAUVELT, NY 10913 Anthony Marchetti 05/31/24 Dave Hart 02/28/25 Jennifer Wengender 06/30/24

CERTIFICATE #018330


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PROJECT ISSUE & REVISION SCHEDULE No. Date Description

PROFESSIONAL STAMPS



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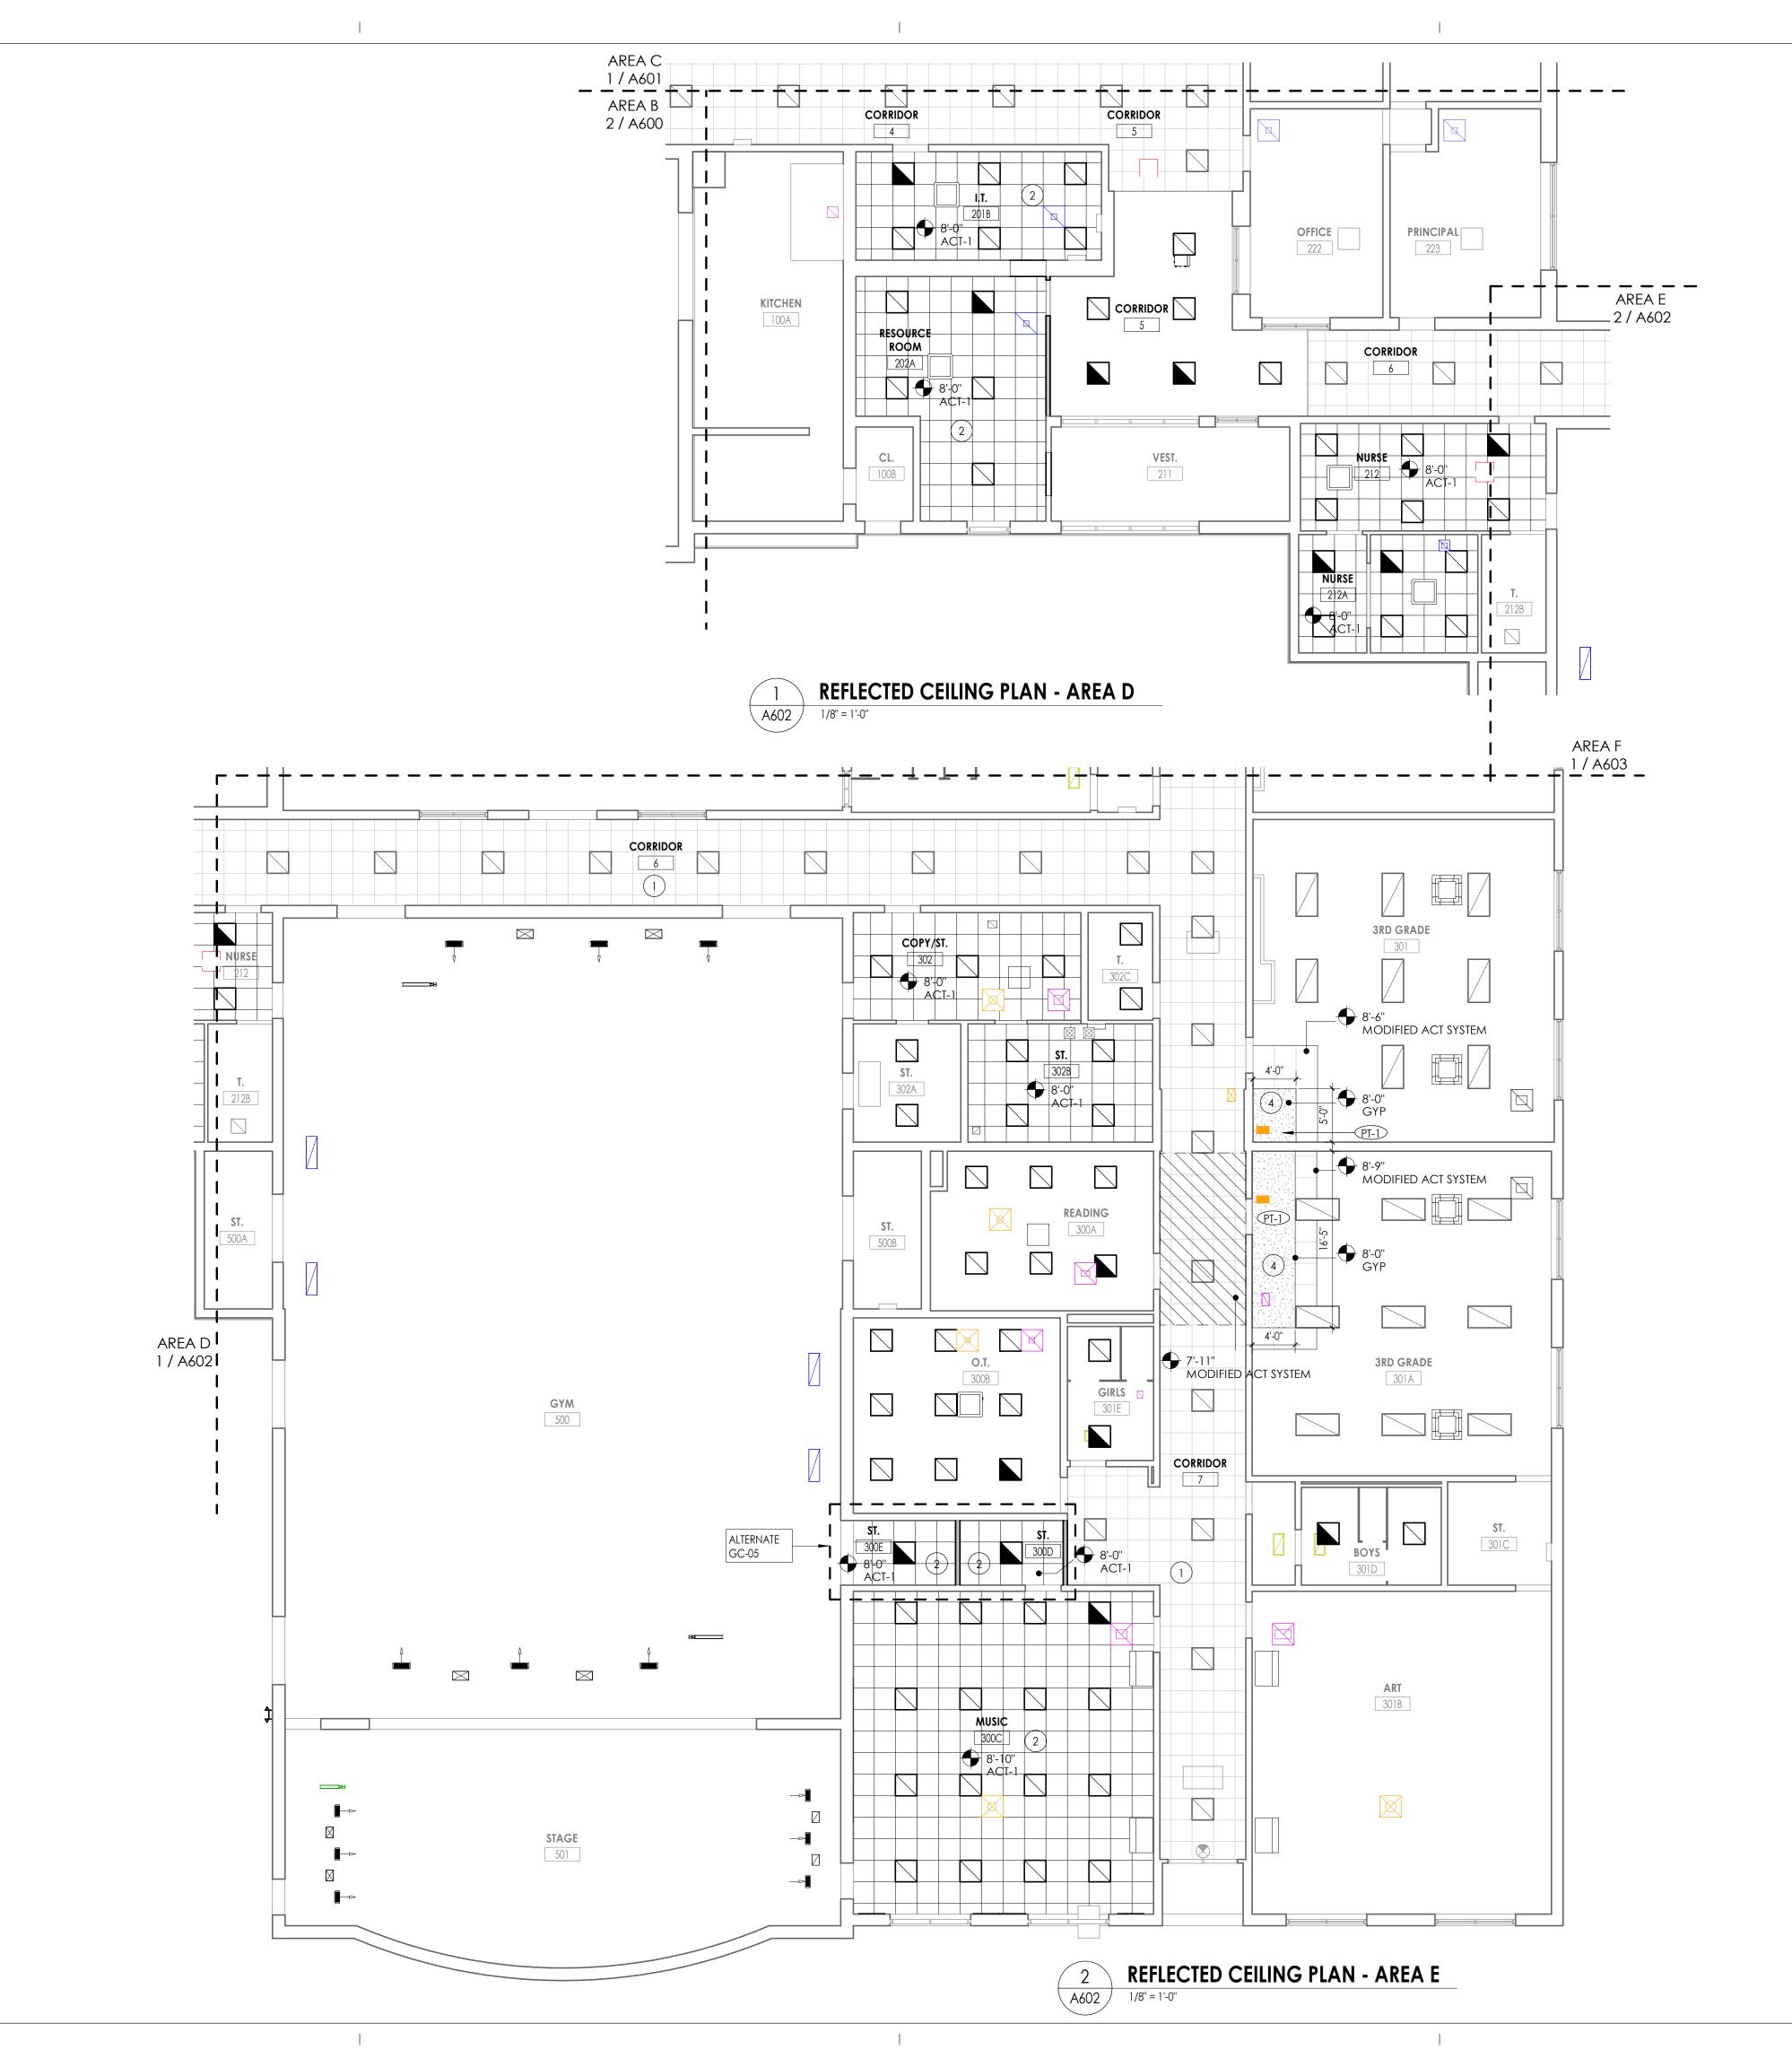
SHEET INFORMATION

Issued Scale 10/18/23 As indicated Project Status BID DOCUMENTS Drawn By Checked By LF LT Drawing Title

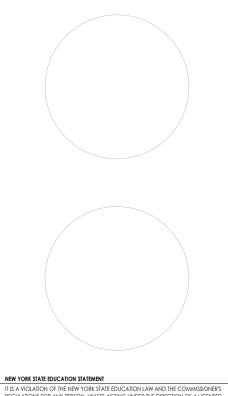REFLECTED CEILING PLAN - AREA







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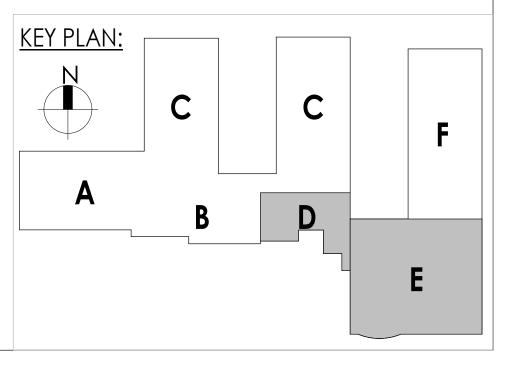
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SCHOOL DISTRICT Project Name

PHASE 1: 2022 BOND

District Office Address

REGISTRATION EXPIR. DATES: Lauren Tarsio 09/30/26 Richard Waite 11/30/23 160 VAN WYCK RD. Larry Werts 12/31/24 BLAUVELT, NY 10913 Anthony Marchetti 05/31/24 Dave Hart 02/28/25 Jennifer Wengender 06/30/24


CERTIFICATE #018330

south orangetown CSD

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PROJECT ISSUE & REVISION SCHEDULE No. Date Description

PROFESSIONAL STAMPS

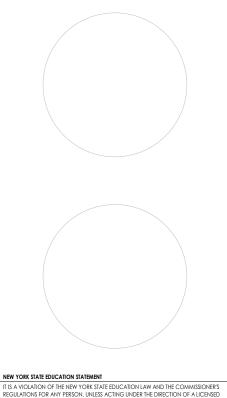


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SHEET INFORMATION

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10/18/23	As indicated
Project Status	
BID DOCUMENTS	
Drawn By	Checked By
LF	LT
Drawing Title	
REFLECTED CE	EILING PLAN - ARE/
D&E	



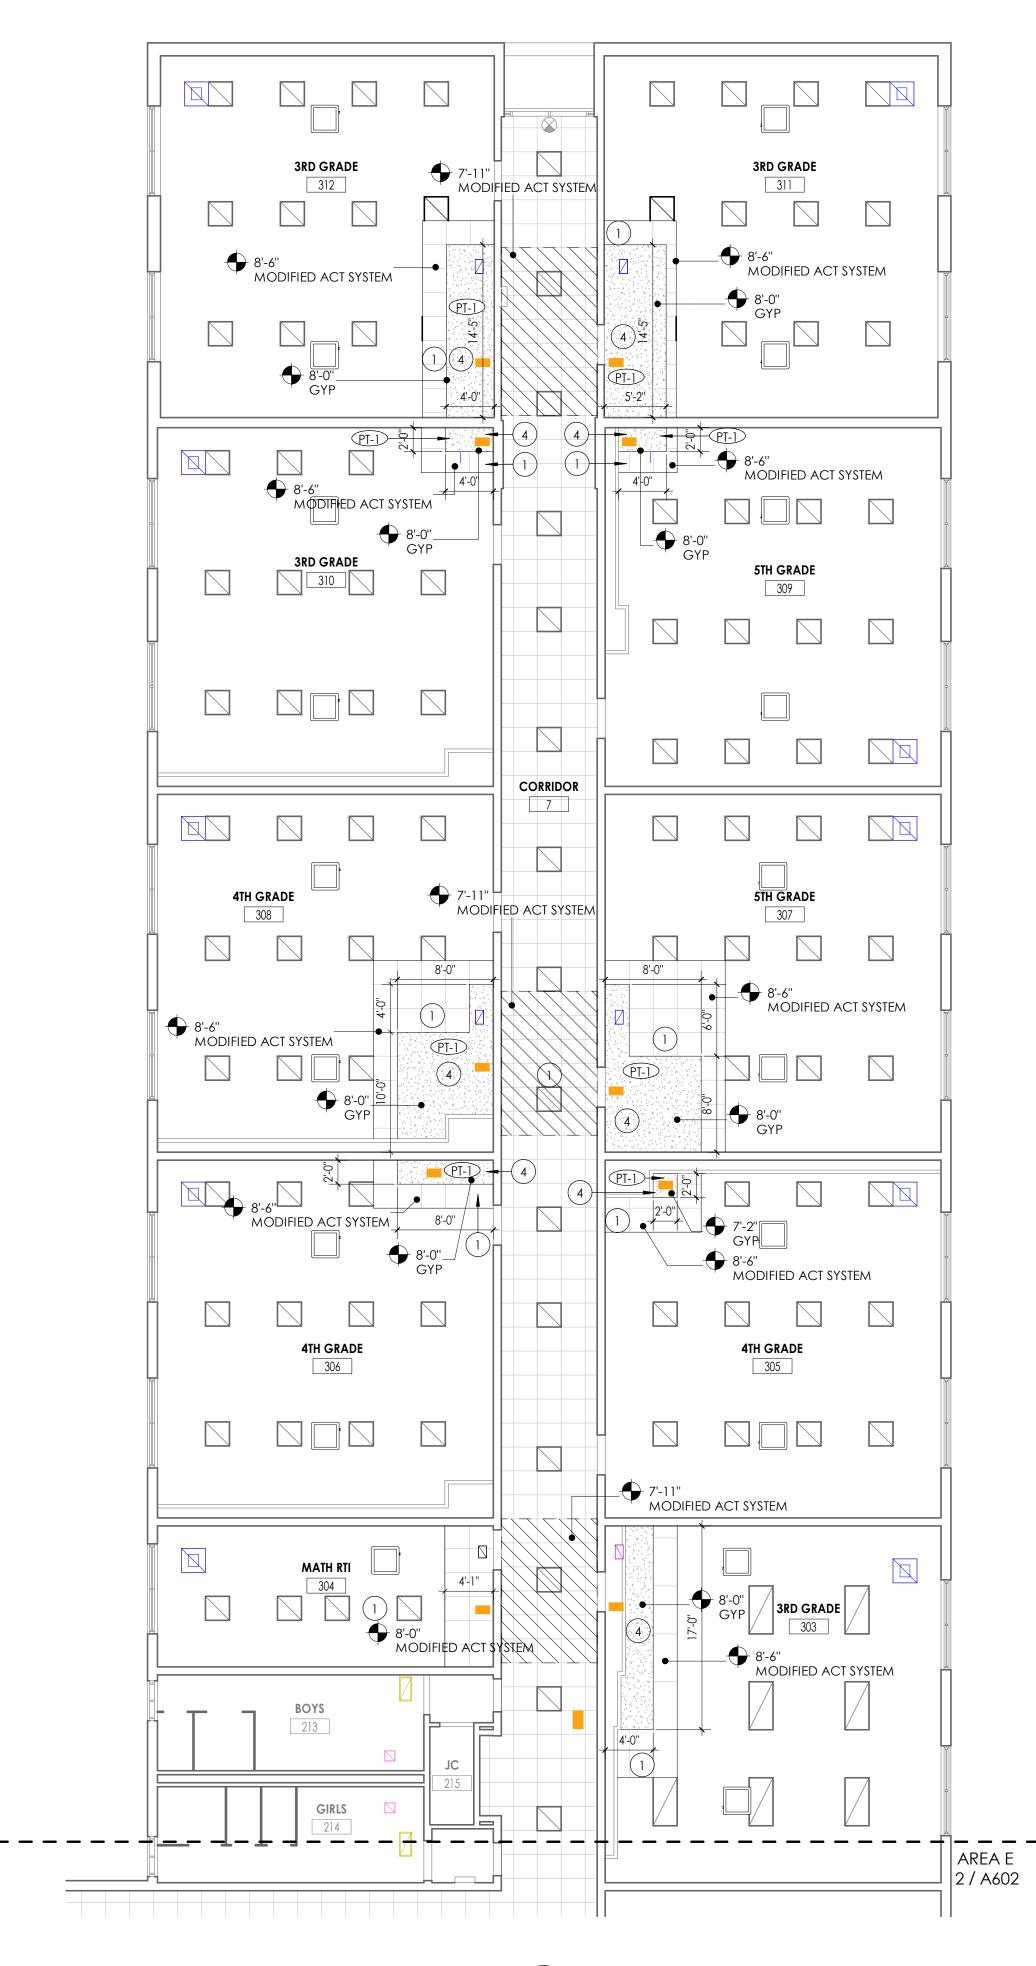

REFLECTED CEILING PLAN - AREA F A603 1/8" = 1'-0"

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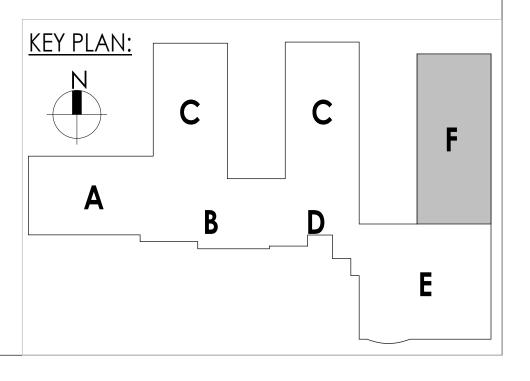
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Project Number 14457.20 Client Name SOUTH ORANGETOWN CENTRAL

SCHOOL DISTRICT Project Name

PHASE 1: 2022 BOND

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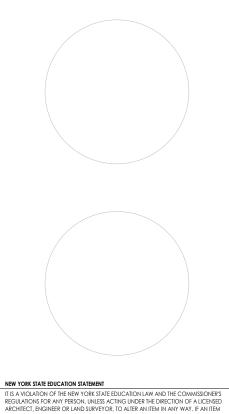
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PROJECT ISSUE & REVISION SCHEDULE No. Date Description

PROFESSIONAL STAMPS




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Drawn By	Checked By
LF	LT
Drawing Title	
REFLECTED CE	ILING PLAN - AREA
г	





designation dimension		NS	DESCRIPTION		
	ADA-1	36" X 33" X	24"	ADA SINK BASE	
	BC-1 BC-2 BC-3 BC-4 BC-5 BC-6 BC-7 BC-8	36" X 33" X 36" X 33" X 36" X 33" X 36" X 29" X 21" X 29" X 18" X 29" X 18" X 29" X 36" X 29" X	24" 24" 21" 21" 22" 22"	6" DRAWER/2/DOOR/1 6" DRAWER/3 EQUAL E PAPER STORAGE/4 EQ OPEN SHELF/1 ADJUST OPEN SHELV/1 ADJUST 2 EQUAL DRAWERS/1 F 1 DRAWER/1 FILE DRA' OPEN SHELF/1 ADJUST	DRAWERS UAL DRAWER ABLE SHELF ABLE SHELF FILE DRAWER WER
	WC-1 WC-2 WC-3	36" X 29" X 42" X 29" X 36" X 27" 1	14"	2 DOOR/1 ADJUSTABL 2 DOOR/1 ADJUSTABL MAILBOX/21 COMPAR	E SHELF
	TC-1 TC-2 TC-3	48" X 84" X 42" X 84" X 30" X 84" X	24"	2 doors/1vertical e 2 doors/1vertical e 2 doors/1 vertical	DIVIDER/8 AD
	SC-1 CUSTOM	8.25" X 14.2 8.25" X 24.2		30 DEGREE SLOPED TO 30 DEGREE SLOPED TO	
	METAL CASEW		ORK S	SCHEDULE BA	sis of desig
	DESIGNATION	DIMENSIO	NS	DESCRIPTION	
	MC-1 MC-2	36" X 30" X 60" X 30" X		OPEN SHELF/1 ADJUST OPEN SHELF/1 ADJUST	
	LEGEND: ADA = ADA BASI BC = BASE CABIN WC = WALL CABIN TC = TALL CABIN	net Binet Iet	OWNE	Casework with e R request. Owne E: CASEWO F	r is respc

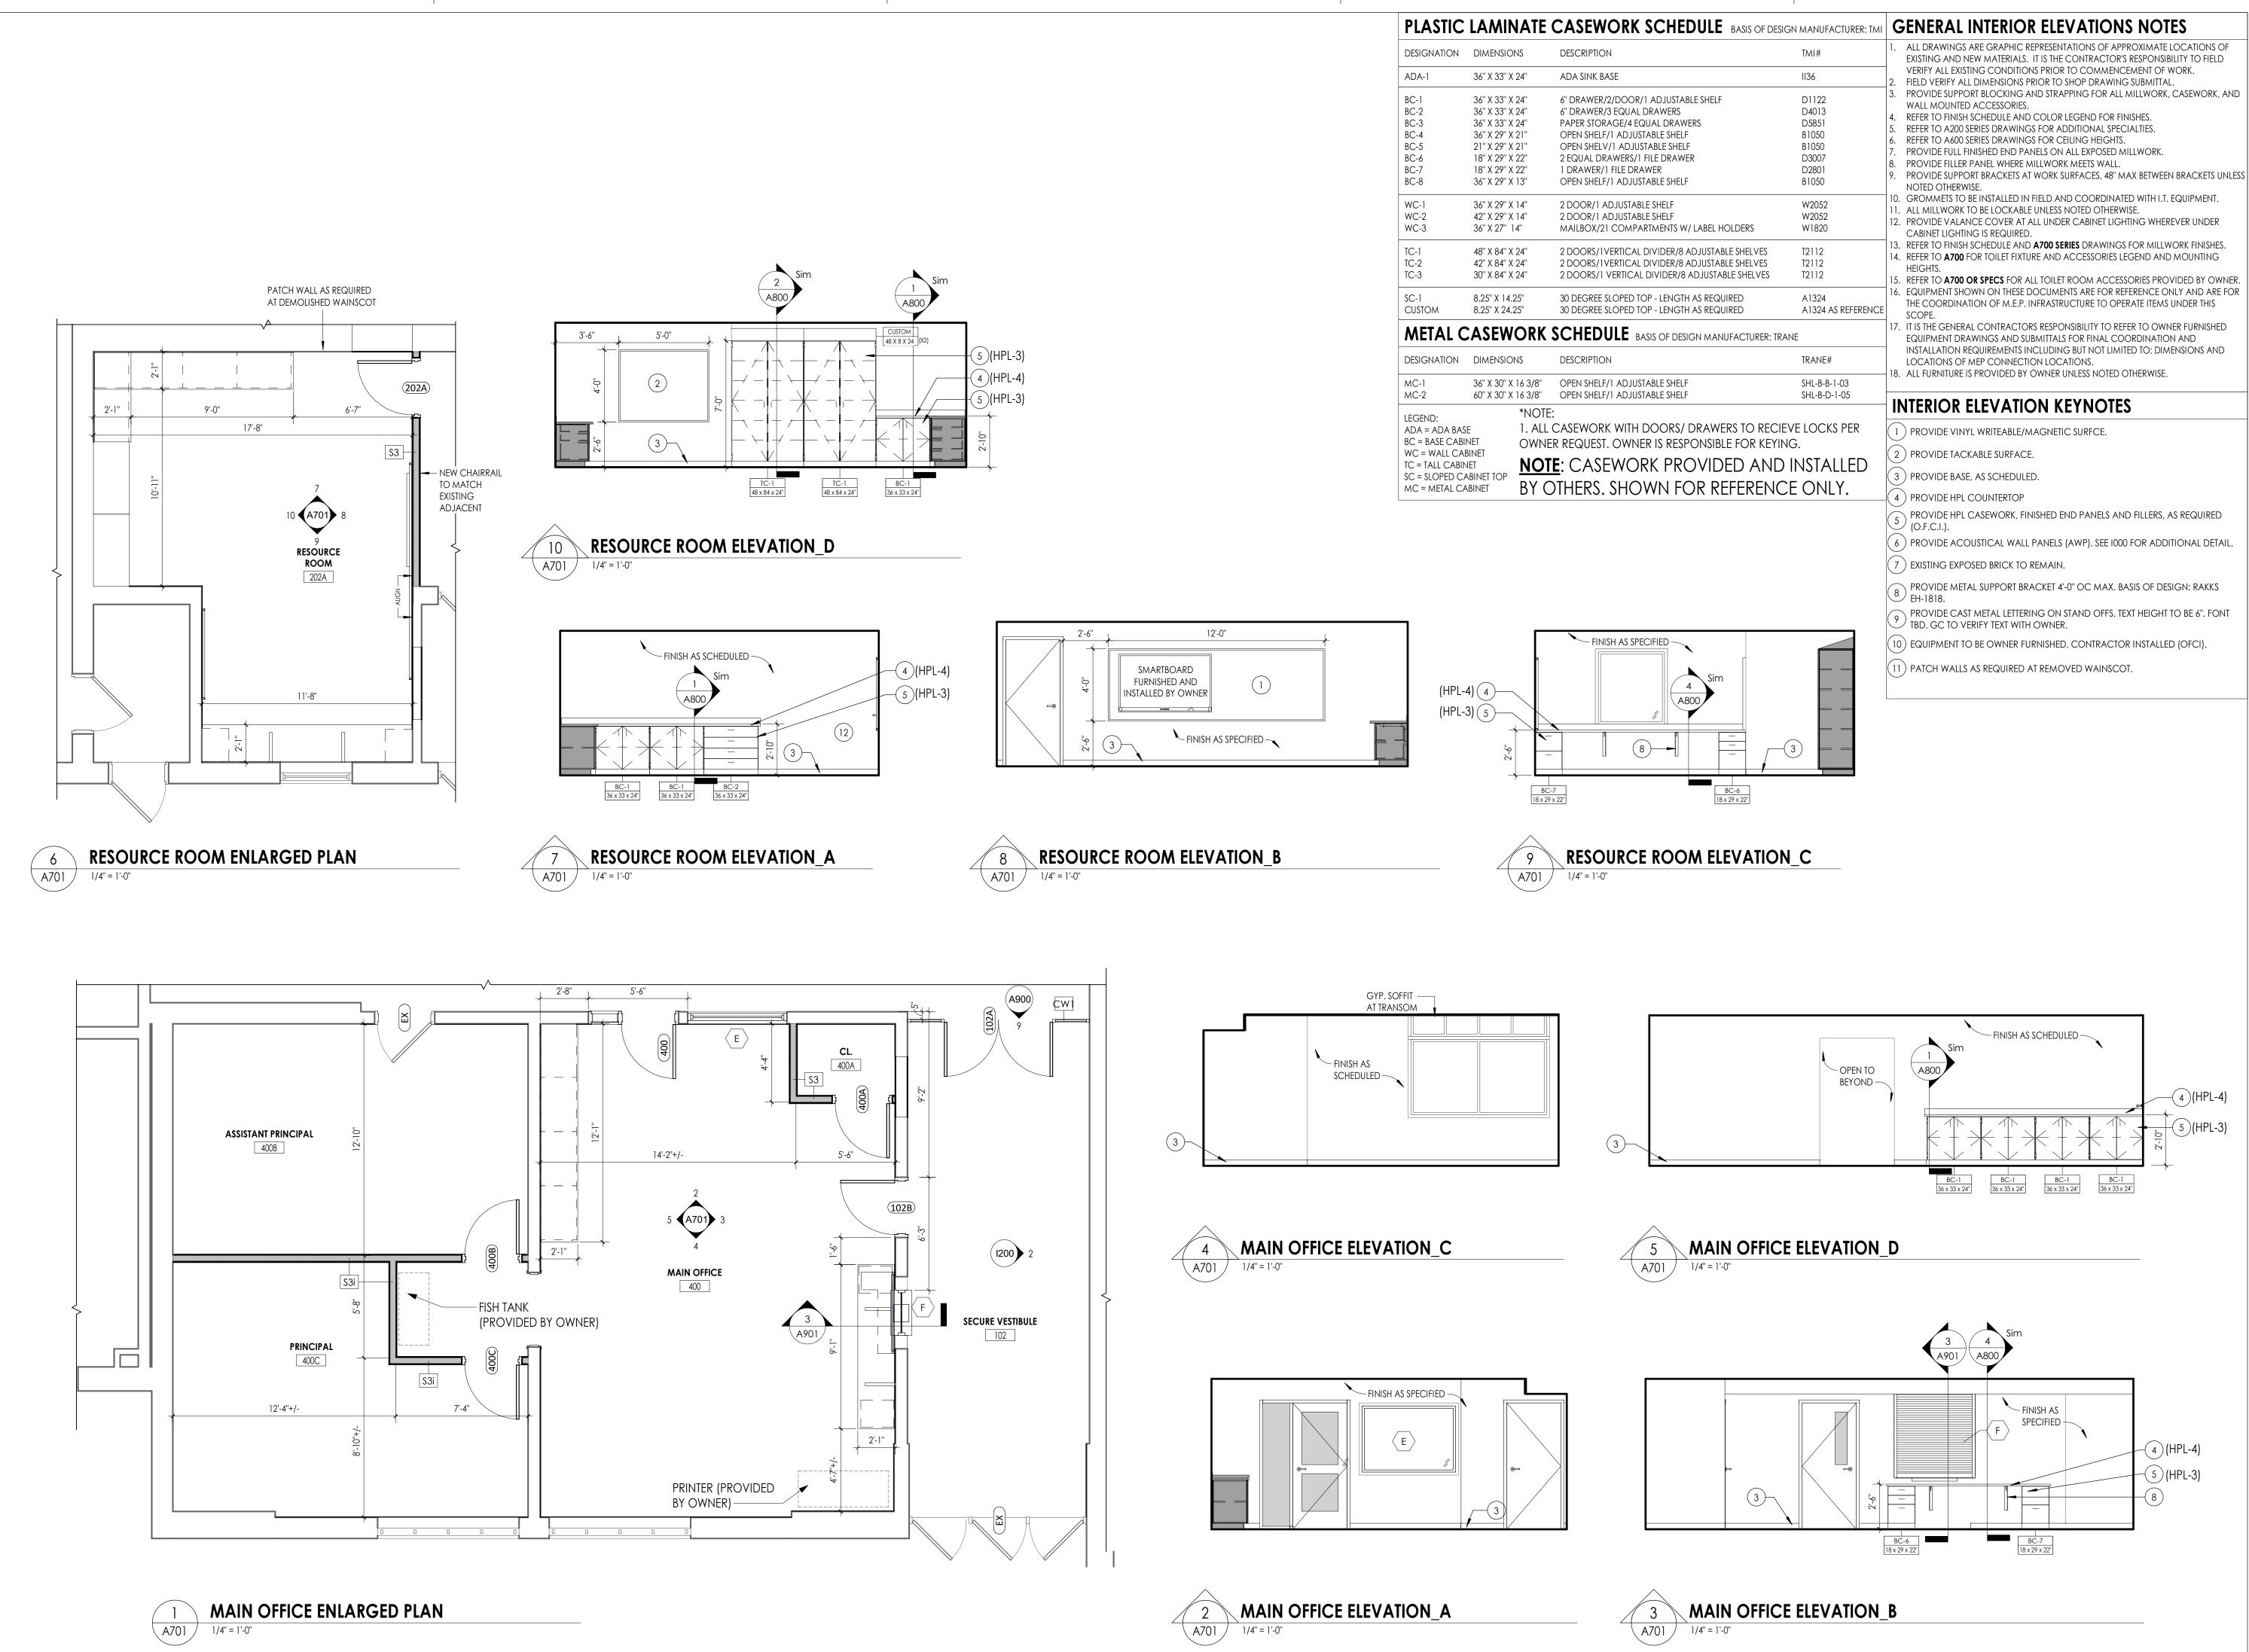CPL | Architecture Engineering Planning 50 Front Street Suite 202, Newburgh, NY 12550 CPLteam.com SOUTH ORANGETO Central School Dist Capital Improvements Bond Health, Safety and Success

PROJECT INFORMATION Project Number 14457.20 Client Name SOUTH ORANGETOWN CENTRAL SCHOOL DISTRICT

Project Name PHASE 1: 2022 BOND

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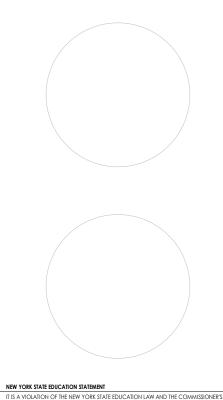
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PROFESSIONAL STAMPS



GULATIONS FOR ANY PERSON, UNLESS ACTING UNDER THE DIRECTION


SHEET INFORMATION

Issued	Scale
10/18/23	As indicated
Project Status	
BID DOCUMENTS	
Drawn By	Checked By
LF	LT
Drawing Title	


MAIN OFFICE & RESOURCE ROOM ENLARGED FLOOR PLAN AND INTERIOR ELEVATIONS

Drawing Number CLE A701



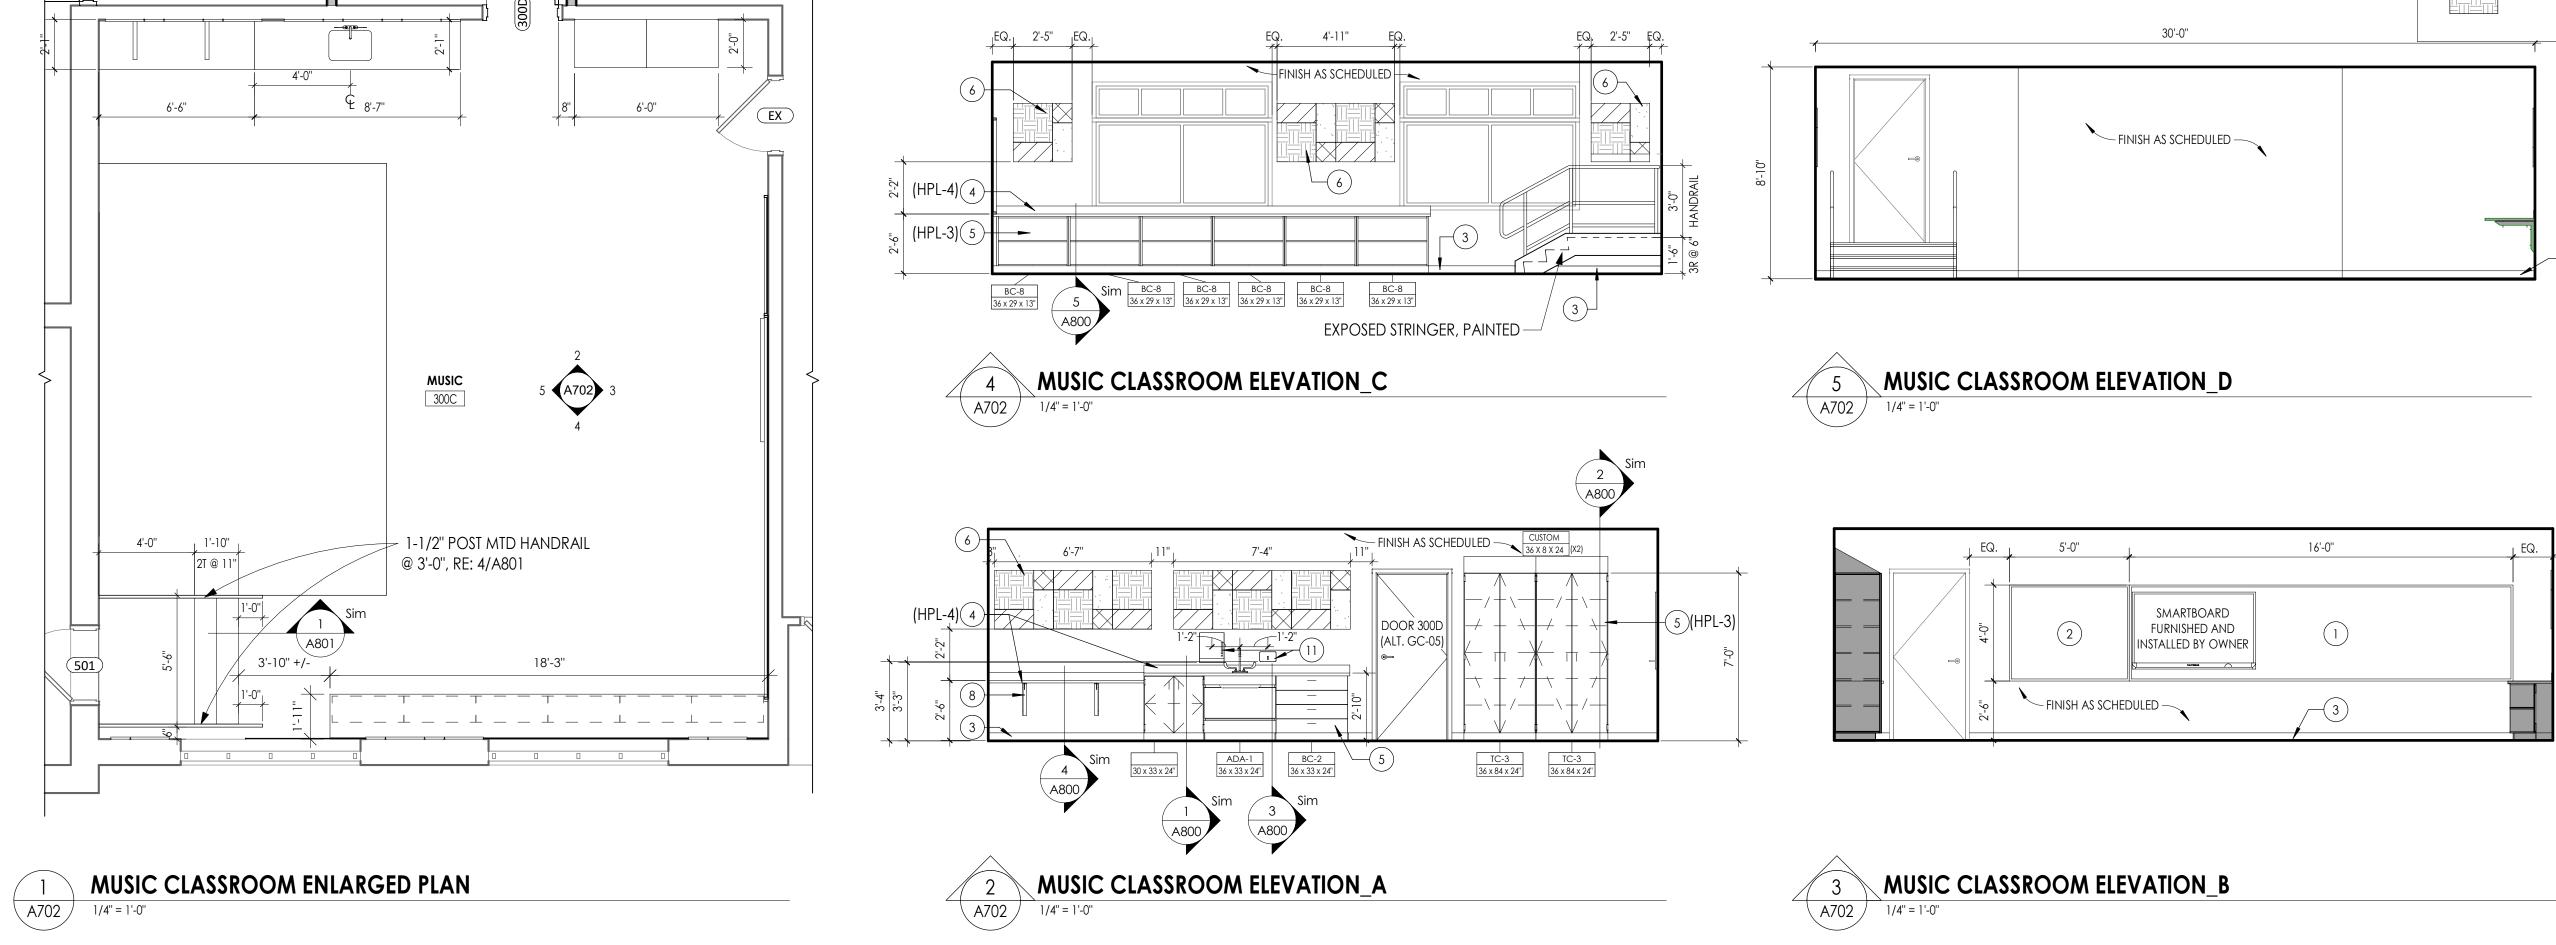

PLASTIC	LAMINATE	NATE CASEWORK SCHED		
DESIGNATION	DIMENSIONS	DESCRIPTION		
ADA-1	36" X 33" X 24"	ADA SINK BASE		
BC-1 BC-2 BC-3 BC-4 BC-5 BC-6 BC-7 BC-8	36" X 33" X 24" 36" X 33" X 24" 36" X 33" X 24" 36" X 29" X 21" 21" X 29" X 21" 18" X 29" X 22" 18" X 29" X 22" 36" X 29" X 13"	6" DRAWER/2/DOOR/1 ADJUSTABLE 6" DRAWER/3 EQUAL DRAWERS PAPER STORAGE/4 EQUAL DRAWERS OPEN SHELF/1 ADJUSTABLE SHELF OPEN SHELV/1 ADJUSTABLE SHELF 2 EQUAL DRAWERS/1 FILE DRAWER 1 DRAWER/1 FILE DRAWER OPEN SHELF/1 ADJUSTABLE SHELF		
WC-1 WC-2 WC-3	36" X 29" X 14" 42" X 29" X 14" 36" X 27" 14"	2 DOOR/1 ADJUSTABLE SHELF 2 DOOR/1 ADJUSTABLE SHELF MAILBOX/21 COMPARTMENTS W/ LA		
TC-1 TC-2 TC-3	48" X 84" X 24" 42" X 84" X 24" 30" X 84" X 24"	2 DOORS/1VERTICAL DIVIDER/8 ADJ 2 DOORS/1VERTICAL DIVIDER/8 ADJ 2 DOORS/1 VERTICAL DIVIDER/8 AD		
SC-1 CUSTOM	8.25" X 14.25" 8.25" X 24.25"	30 DEGREE SLOPED TOP - LENGTH AS 30 DEGREE SLOPED TOP - LENGTH AS		
METAL C	ASEWORK	SCHEDULE BASIS OF DESIGN		
DESIGNATION	DIMENSIONS	DESCRIPTION		
MC-1 MC-2	36" X 30" X 16 3/8" 60" X 30" X 16 3/8"	OPEN SHELF/1 ADJUSTABLE SHELF OPEN SHELF/1 ADJUSTABLE SHELF		
LEGEND: ADA = ADA BASI BC = BASE CABIN WC = WALL CABIN TC = TALL CABIN SC = SLOPED CA MC = METAL CA	NET OWNE BINET IET NOT	E: CASEWORK WITH DOORS/ DR ER REQUEST. OWNER IS RESPO EE: CASEWORK PRO DTHERS. SHOWN FOR		

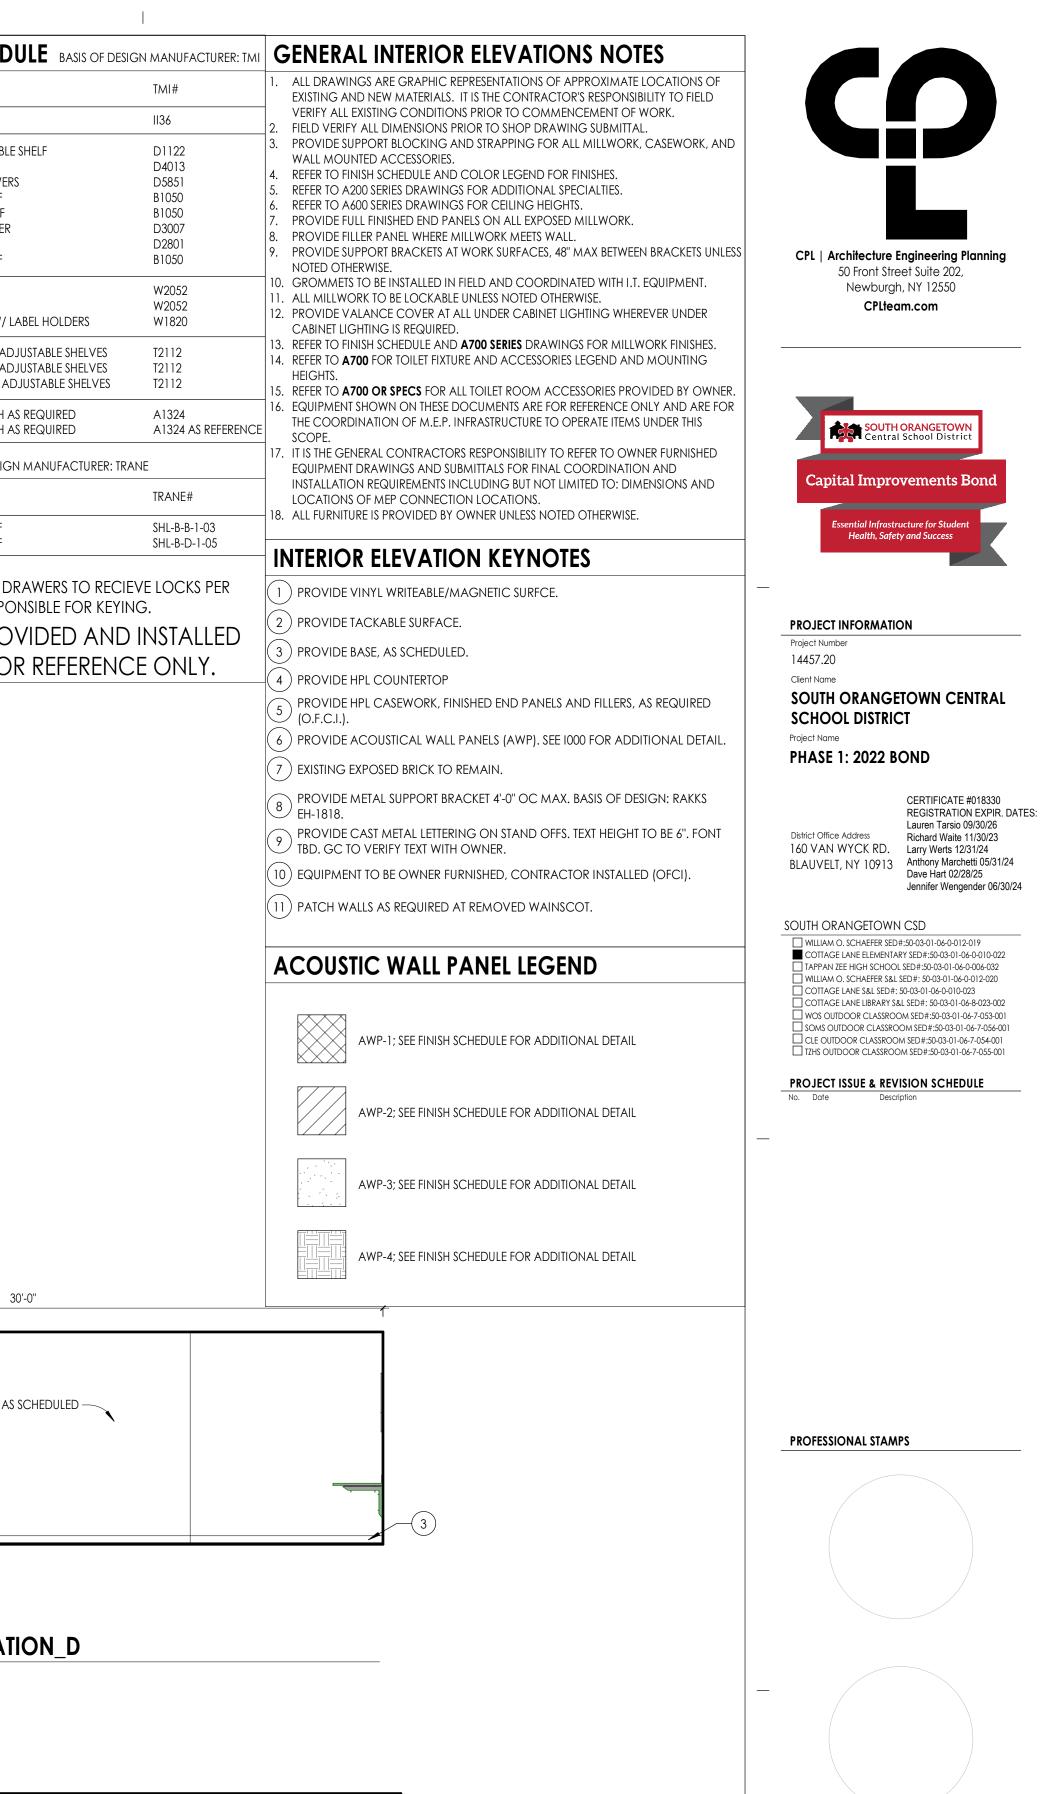

NEW YORK STATE EDUCATION STATEM

SHEET INFORMATION

Issued

10/18/23

Project Status

Drawn By

Drawing Title

Drawing Number

LF

BID DOCUMENTS

ATION OF THE NEW YORK STATE EDUCATION LAW AND THE COM Egulations for any person, unless acting under the direction of a licen Rchitect, engineer or land surveyor, to alter an item in any way. If an i

Scale

As indicated

Checked By

LT


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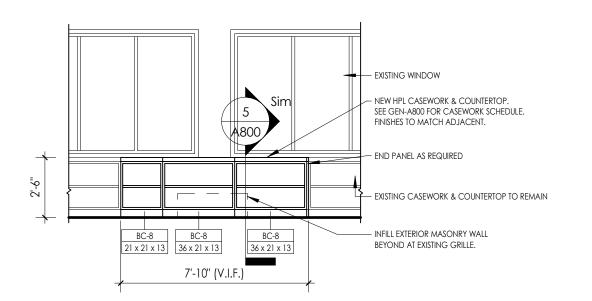
PLAN AND INTERIOR ELEVATIONS

CLE


A702





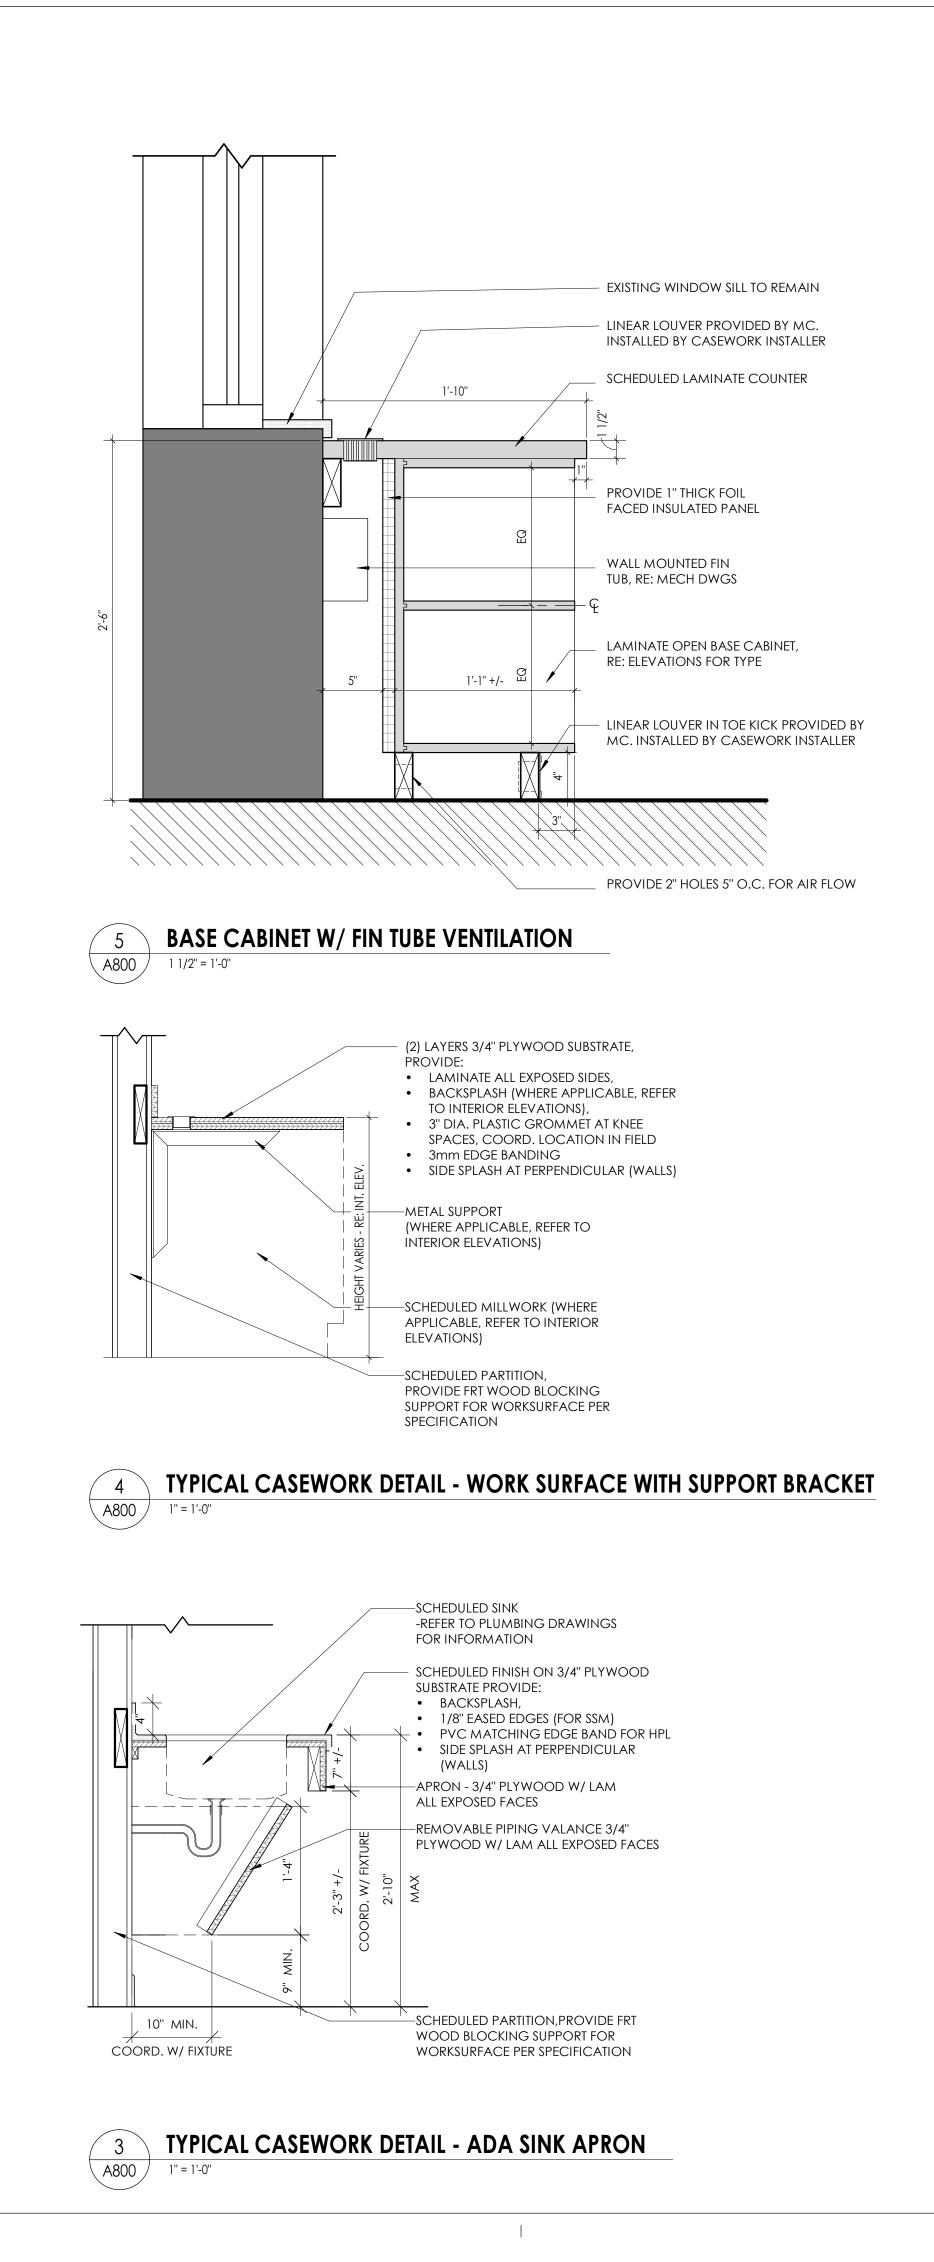




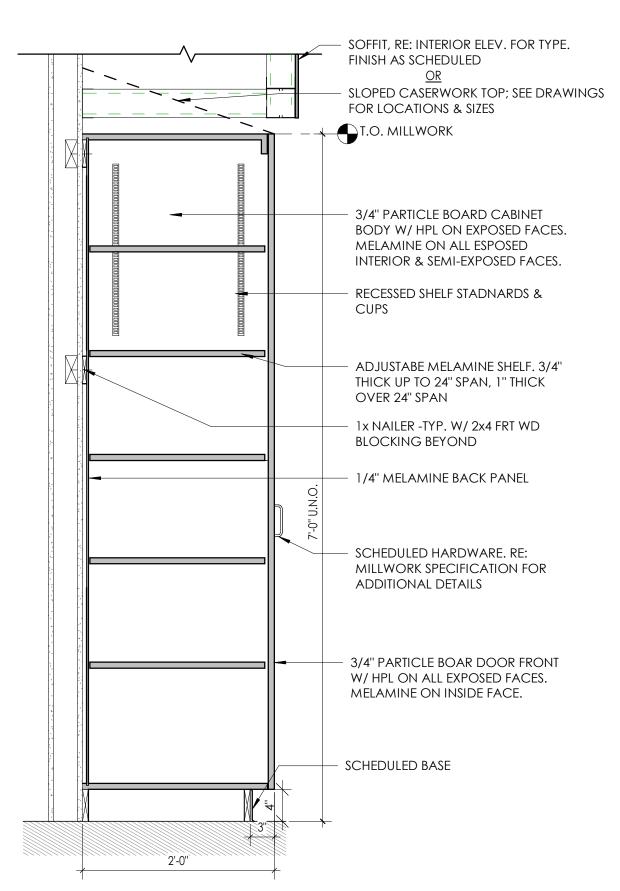


NOTE: REFER TO CASEWORK SCHEDULE FOR NUMBER OF DOORS/OPENINGS REQUIRED, VARIES.



TYPICAL CASEWORK DETAIL - TALL CABINET 1" = 1'-0"

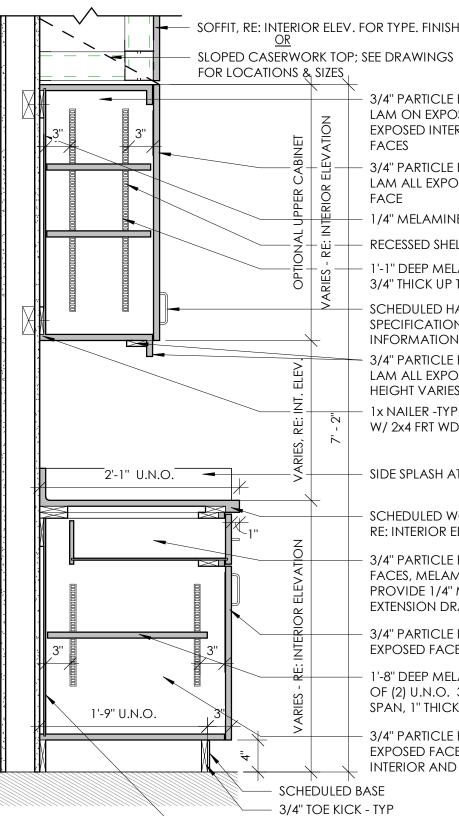

NOTE: REFER TO CASEWORK NUMBER OF DOORS/DRAWERS REQUIRED, VARIES.

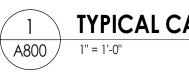

DESIGNATION	DIMENSIONS	DESCRIPTION	TMI#
ADA-1	36" X 33" X 24"	ADA SINK BASE	1136
BC-1	36" X 33" X 24"	6" DRAWER/2/DOOR/1 ADJUSTABLE SHELF	D1122
BC-2	36" X 33" X 24"	6" DRAWER/3 EQUAL DRAWERS	D4013
BC-3	36" X 33" X 24"	PAPER STORAGE/4 EQUAL DRAWERS	D5851
3C-4	36" X 29" X 21"	OPEN SHELF/1 ADJUSTABLE SHELF	B1050
BC-5	21" X 29" X 21"	OPEN SHELV/1 ADJUSTABLE SHELF	B1050
3C-6	18" X 29" X 22"	2 EQUAL DRAWERS/1 FILE DRAWER	D3007
3C-7	18" X 29" X 22"	1 DRAWER/1 FILE DRAWER	D2801
BC-8	36" X 29" X 13"	OPEN SHELF/1 ADJUSTABLE SHELF	B1050
WC-1	36" X 29" X 14"	2 DOOR/1 ADJUSTABLE SHELF	W2052
WC-2	42" X 29" X 14"	2 DOOR/1 ADJUSTABLE SHELF	W2052
WC-3	36" X 27" 14"	MAILBOX/21 COMPARTMENTS W/ LABEL HOLDERS	W1820
IC-1	48" X 84" X 24"	2 DOORS/1VERTICAL DIVIDER/8 ADJUSTABLE SHELVES	T2112
IC-2	42" X 84" X 24"	2 DOORS/1VERTICAL DIVIDER/8 ADJUSTABLE SHELVES	T2112
IC-3	30" X 84" X 24"	2 DOORS/1 VERTICAL DIVIDER/8 ADJUSTABLE SHELVES	T2112
SC-1	8.25" X 14.25"	30 DEGREE SLOPED TOP - LENGTH AS REQUIRED	A1324
CUSTOM	8.25" X 24.25"	30 DEGREE SLOPED TOP - LENGTH AS REQUIRED	A1324 AS REFERENCE
METAL C	CASEWORK	SCHEDULE BASIS OF DESIGN MANUFACTURER: TRA	ANE
DESIGNATION	DIMENSIONS	DESCRIPTION	TRANE#
MC-1	36" X 30" X 16 3/8"	OPEN SHELF/1 ADJUSTABLE SHELF	SHL-B-B-1-03
MC-2	60" X 30" X 16 3/8"	OPEN SHELF/1 ADJUSTABLE SHELF	SHL-B-D-1-05

1. ALL CASEWORK WITH DOORS/ DRAWERS TO RECIEVE LOCKS PER BC = BASE CABINET OWNER REQUEST. OWNER IS RESPONSIBLE FOR KEYING. WC = WALL CABINET **NOTE:** CASEWORK PROVIDED AND INSTALLED TC = TALL CABINET SC = SLOPED CABINET TOP BY OTHERS. SHOWN FOR REFERENCE ONLY MC = METAL CABINET



apital Improvements Bong Health, Safety and Success

PROJECT INFORMATION Project Number 14457.20 Client Name SOUTH ORANGETOWN CENTRAL SCHOOL DISTRICT

Project Name PHASE 1: 2022 BOND

District Office Address 160 VAN WYCK RD. Larry Werts 12/31/24 BLAUVELT, NY 10913 Anthony Marchetti 05/31/24

Lauren Tarsio 09/30/26 Richard Waite 11/30/23 Dave Hart 02/28/25 Jennifer Wengender 06/30/24

CERTIFICATE #018330 REGISTRATION EXPIR. DATES:

south orangetown CSD

- WILLIAM O. SCHAEFER SED#:50-03-01-06-0-012-019 COTTAGE LANE ELEMENTARY SED#:50-03-01-06-0-010-022 TAPPAN ZEE HIGH SCHOOL SED#:50-03-01-06-0-006-032
- WILLIAM O. SCHAEFER S&L SED#: 50-03-01-06-0-012-020 COTTAGE LANE S&L SED#: 50-03-01-06-0-010-023
- COTTAGE LANE LIBRARY S&L SED#: 50-03-01-06-8-023-002 WOS OUTDOOR CLASSROOM SED#:50-03-01-06-7-053-001 SOMS OUTDOOR CLASSROOM SED#:50-03-01-06-7-056-001
- CLE OUTDOOR CLASSROOM SED#:50-03-01-06-7-054-001 TZHS OUTDOOR CLASSROOM SED#:50-03-01-06-7-055-001

PROJECT ISSUE & REVISION SCHEDULE No. Date Description

- SOFFIT, RE: INTERIOR ELEV. FOR TYPE. FINISH AS SCHEDULED

serwork top; se Tions & sizes ,	e drawings
	3/4" PARTICLE BOARD CABINET BODY W/ AM ON EXPOSED FACE MELAMINE ON ALL EXPOSED INTERIOR AND SEMI-EXPOSED FACES
	8/4" PARTICLE BOARD DOOR FRONT W/ .AM ALL EXPOSED FACES, MELAMINE ON INSIDE FACE
	1/4" MELAMINE BACK PANEL
A CONAL RE:	RECESSED SHELF STANDARDS & CLIPS
	'-1" deep melamine adj. Shelf, typ of (2) u.n.o. 3/4" thick up to 24" span, 1" thick over 24" span
	SCHEDULED HARDWARE, RE: MILLWORK SPECIFICATION FOR ADDITIONAL NFORMATION
<u>Ш</u> L	3/4" PARTICLE BOARD FASCIA AND NAILER W/ .AM ALL EXPOSED FACES (SEE INTERIOR ELEV.) HEIGHT VARIES, COORD. WITH LIGHT FIXTURE
N 2 RE:	Ix NAILER -TYP. N/ 2x4 FRT WD BLOCKING BEYOND
C ARIES,	SIDE SPLASH AT PERPENDICULAR WALL(S)
A	SCHEDULED WORK SURFACE RE: INTERIOR ELEVATIONS FOR MATERIAL DESIGNATION
F F	8/4" PARTICLE BOARD DRAWER W/ LAM ALL EXPOSED FACES, MELAMINE ON SEMI-EXPOSED FACES. PROVIDE 1/4" MELAMINE DRAWER BOTTOM AND FULL EXTENSION DRAWER GUIDES U.N.O.
	8/4" PARTICLE BOARD DOOR FRONT W/ LAM ALL EXPOSED FACES, MELAMINE ON INSIDE FACE
,	I'-8" DEEP MELAMINE ADJ. SHELF, TYP OF (2) U.N.O. 3/4" THICK UP TO 24" SPAN, 1" THICK OVER 24" SPAN
C	8/4" Particle Board Cabinet Body W/ Lam On Exposed Face, melamine on all exposed Nterior and semi-exposed faces
- SCHEDULED BAS	SE
- 3/4" TOE KICK -	
- 1/4" MELAMINE	BACK PANEL
ORK SCH	EDULE FOR
	FOURED VARIES

TYPICAL CASEWORK DETAIL - BASE & UPPER CABINETS

PROFESSIONAL STAMPS

NEW YORK STATE EDUCATION STATEME ATION OF THE NEW YORK STATE EDUCATION LAW AND THE COM REGULATIONS FOR ANY PERSON, UNLESS ACTING UNDER THE DIRECTION OF A LICENS ARCHITECT, ENGINEER OR LAND SURVEYOR, TO ALTER AN ITEM IN ANY WAY. IF AN ITE BEARING THE SEAL OF AN ARCHITECT, ENGINEER OR SURVEYOR IS ALTERED, 1 PARTY SHALL AFFIX TO THE ITEM THEIR SEAL AND THE NOTATION "ALTERED BY"

SHEET INFORMATION

Issued Scale 10/18/23 As indicated Project Status **BID DOCUMENTS** Drawn By Checked By CPL CPL

Drawing Title TYPICAL CASEWORK DETAILS



EXISTING DOOR JAMB, BEYOND

EXISTING FLOOR -CONSTRUCTION to remain


EXISTING WALL -CONSTRUCTION

3 A801

2





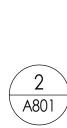

FINISH FLOORING AS SCHEDULED -

CLIP ANGLE ATTACHED TO CONC. FLOOR W/ EXP. BOLT AT EACH STRINGER EXISTING FLOOR SLAB —



PIPE HANDRAIL,CONT1 1/2'' Ø STD STEEL PIPE, PAINTED, TYP. CONT 1 1/2" Ø STD STEEL PIPE, PAINTED, TYP. -----34" CONT 1 1/2" Ø STD STEEL PIPE, PAINTED, TYP. ------ STEEL STRINGER, PAINTED, TYP. SECTION THRU POST MTD HANDRAIL 4 A801 1 1/2" = 1'-0"

 $-\Theta \rightarrow$

BOTTOM OF STAIR DETAIL


1 1/2" = 1'-0"

CONCRETE FILLED METAL PAN TREADS, TYP. -


STEEL STRINGER, PAINTED, TYP. --

TOP OF STAIR LANDING DETAIL 1 1/2" = 1'-0"

SEE PLAN

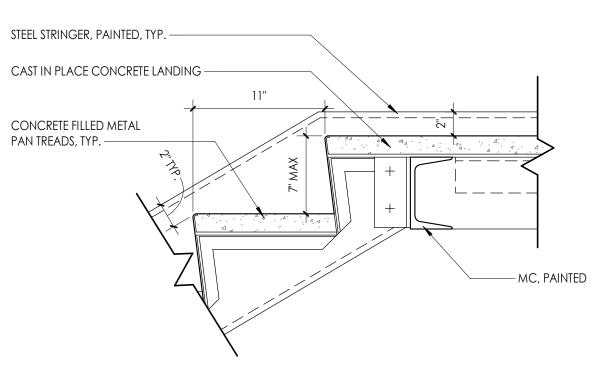

STAIR LANDING @ WALL 1 1/2" = 1'-0"

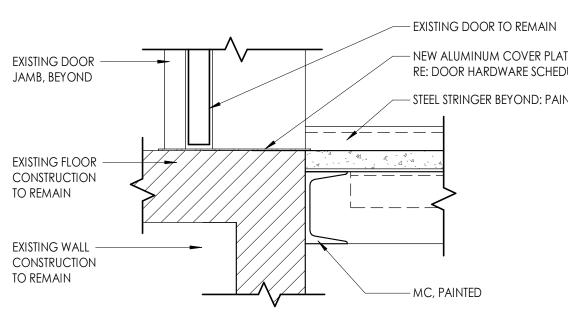

- NEW ALUMINUM COVER PLATE RE: DOOR HARDWARE SCHEDULE _____ STEEL STRINGER BEYOND: PAINTED

11"

. L)

4 A .4 -



CPL | Architecture Engineering Planning 50 Front Street Suite 202, Newburgh, NY 12550 CPLteam.com



PROJECT INFORMATION Project Number 14457.20 Client Name

SOUTH ORANGETOWN CENTRAL SCHOOL DISTRICT

Project Name

PHASE 1: 2022 BOND

CERTIFICATE #018330 REGISTRATION EXPIR. DATES: Lauren Tarsio 09/30/26

District Office Address Richard Waite 11/30/23 160 VAN WYCK RD. Larry Werts 12/31/24 BLAUVELT, NY 10913 Anthony Marchetti 05/31/24

South orangetown CSD

Dave Hart 02/28/25 Jennifer Wengender 06/30/24

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PROJECT ISSUE & REVISION SCHEDULE

PROFESSIONAL STAMPS

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Scale

1 1/2" = 1'-0"

Checked By

LT

VERTICAL CIRCULATION DETAILS

CLE

A801

NEW YORK STATE EDUCATION STATEMENT

SHEET INFORMATION

Issued

10/18/23

Project Status **BID DOCUMENTS**

Drawn By


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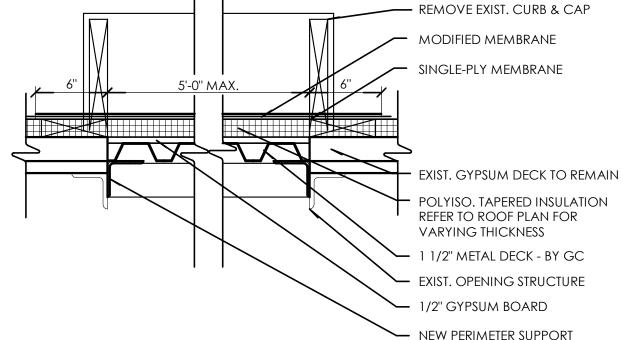
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Description


No. Date







TYPICAL ROOF DECK INFILL DETAIL

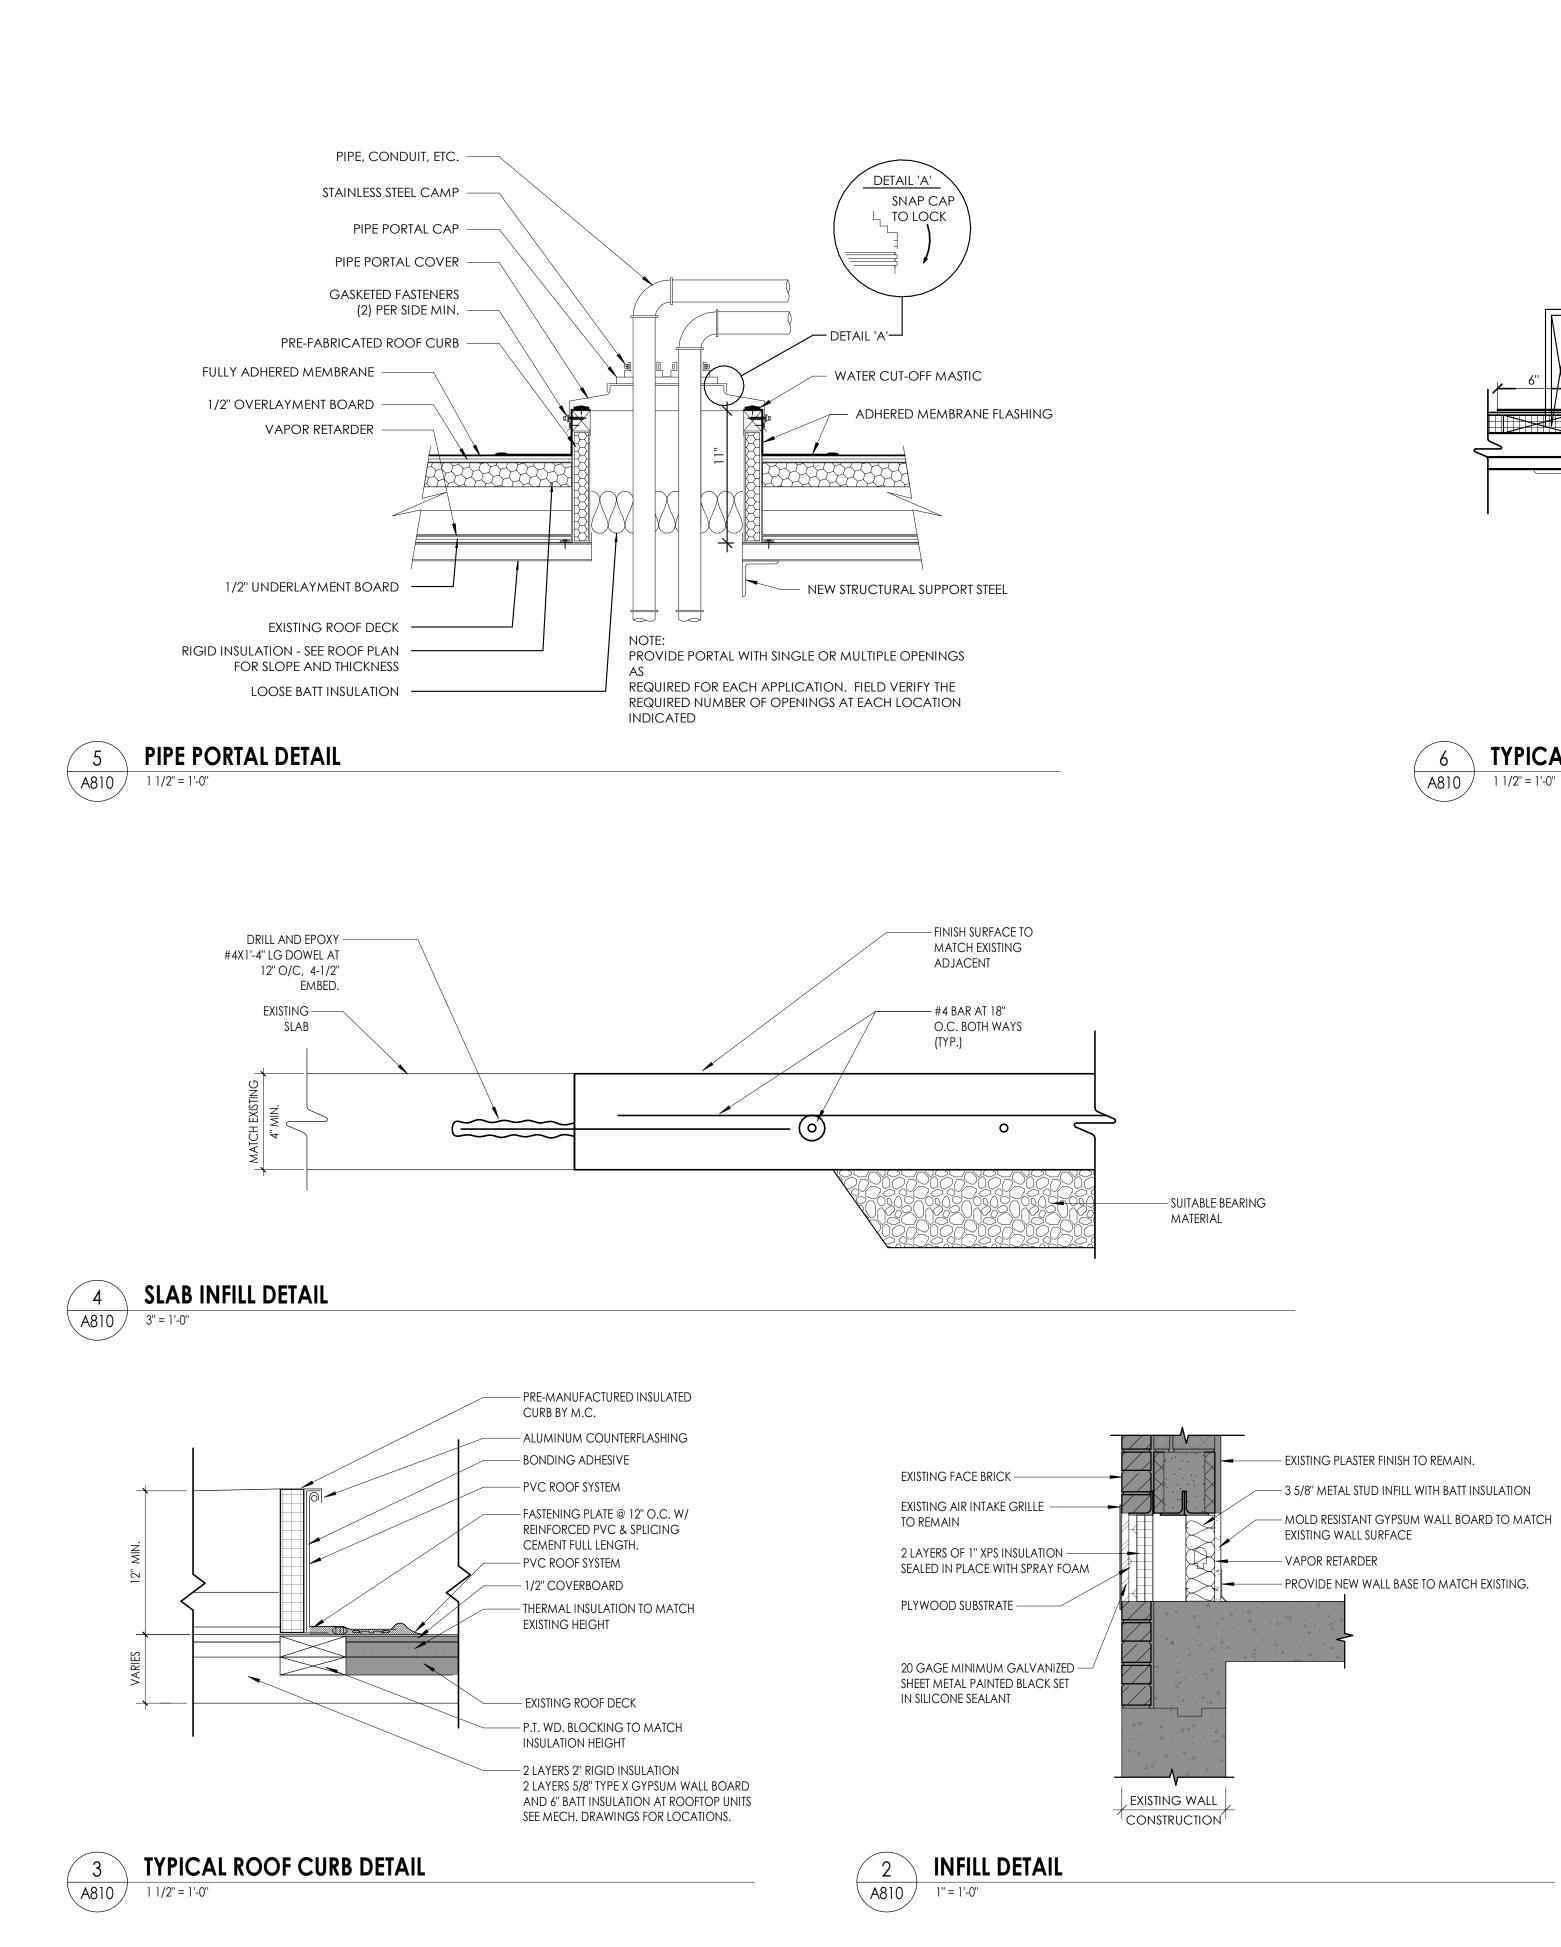

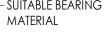

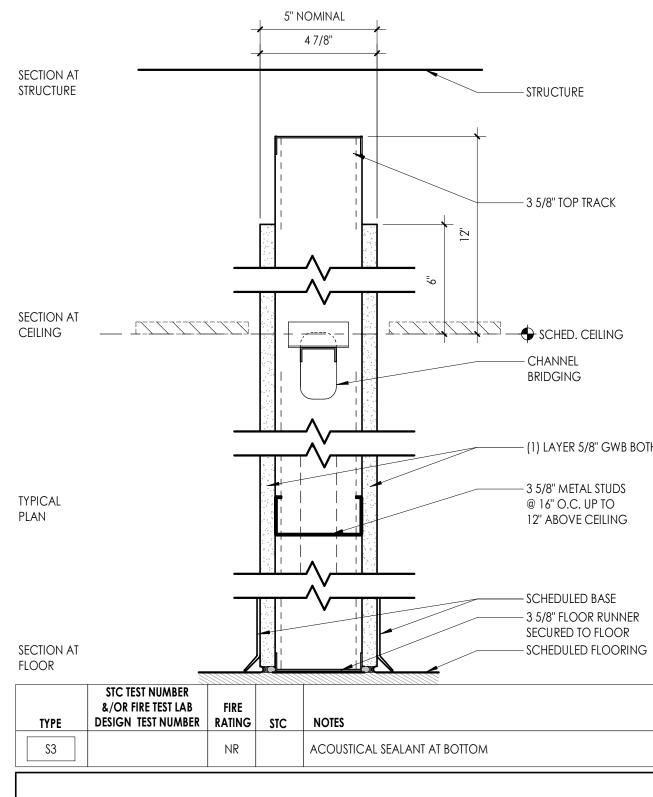

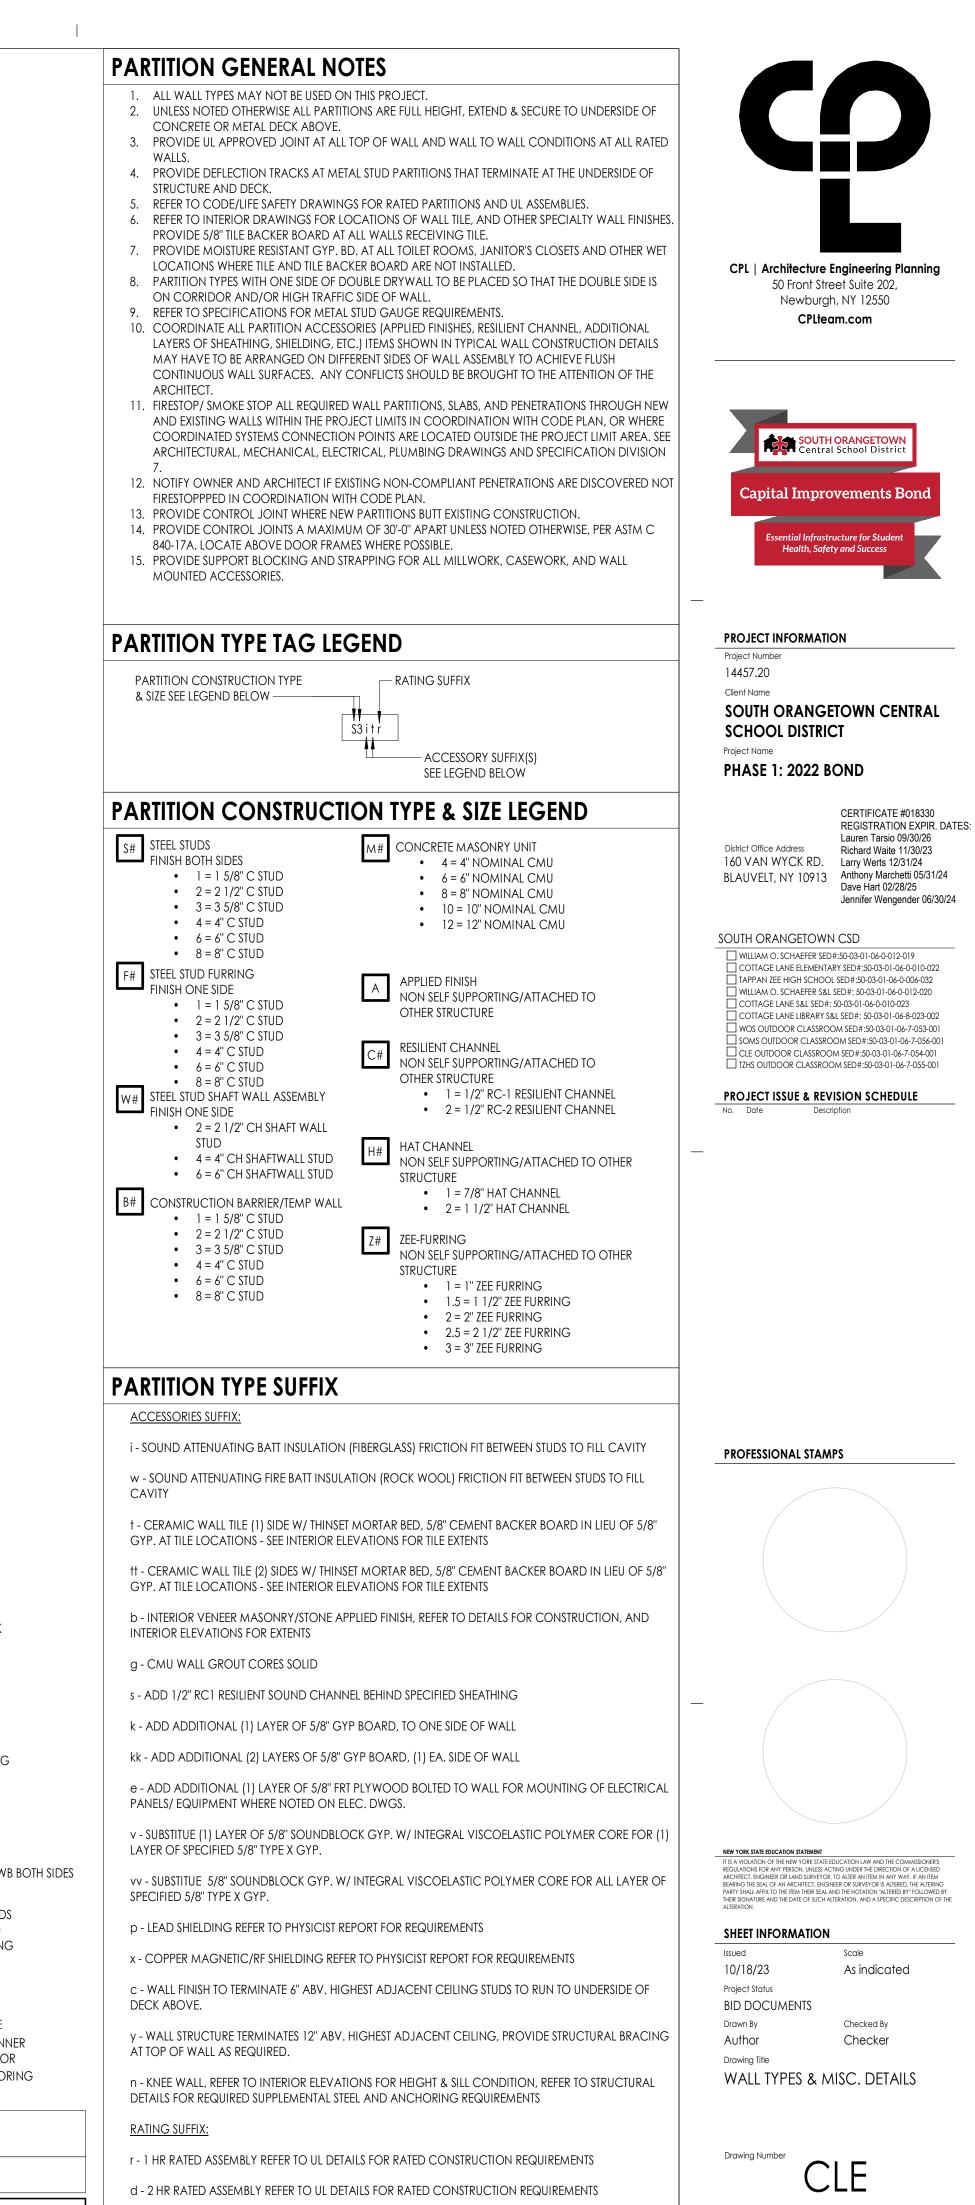


A810

- (1) LAYER 5/8" GWB BOTH SIDES

@ 16" O.C. UP TO 12" ABOVE CEILING

- 3 5/8" FLOOR RUNNER SECURED TO FLOOR

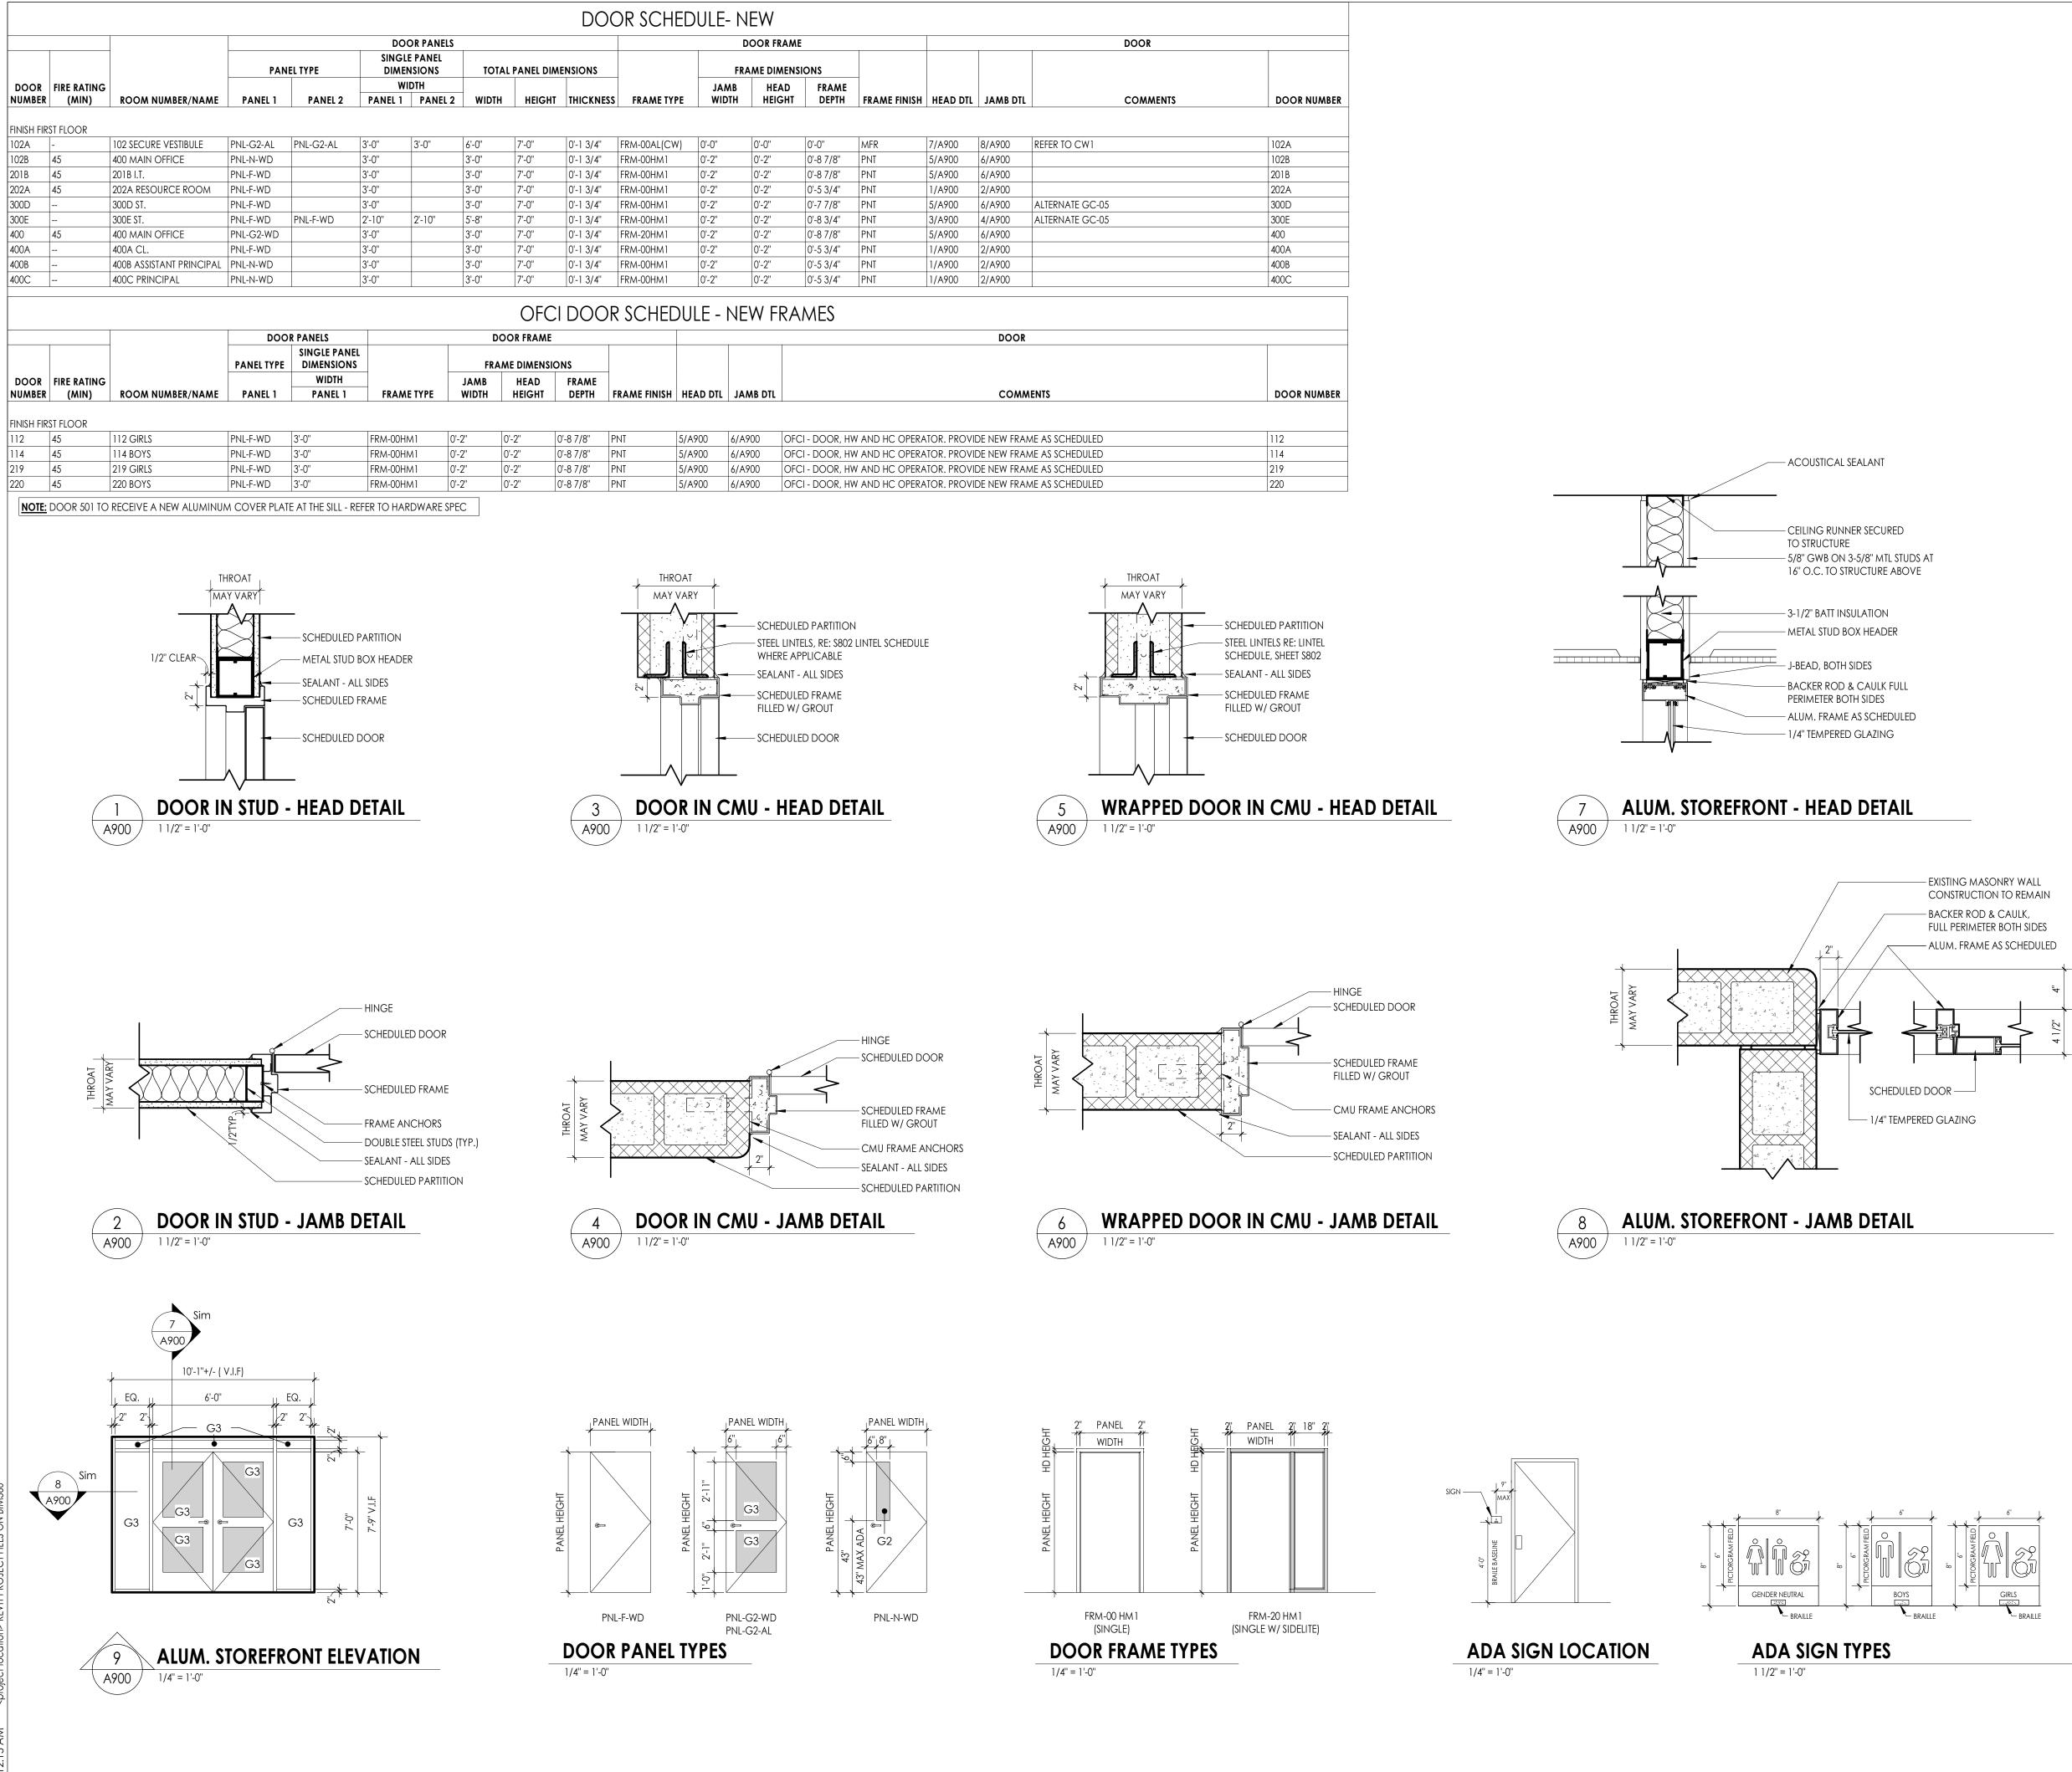

DOOR AND FRAME NOTES

- 1. ALL FRAMES ARE TO RECEIVE FULL PERIMETER SEALANT. INTERIOR AND EXTERIOR 2. ALL DOOR AND WINDOW OPENING DIMENSIONS ARE TO BE VERIFIED IN FIELD AND COORDINATED WITH APPROVED SHOP DRAWINGS PRIOR TO FABRICATION.
- 3. SEE SCHEDULE FOR DOOR & FRAME MATERIAL

DOOR AND FRAME SCHEDULE LEGEND

NOTE: THIS LEGEND MAY CONTAIN SYMBOLS THAT ARE NOT USED IN THIS PROJECT. DOOR OR FRAME MATERIAL DOOR OR FRAME FINISH

NOTE: NEW FRAMES TO BE PAINTED TO MATCH EXISTING ADJACENT.

-		
ACR	ACROVYN DOOR	PTD
ACR-L	ACROVYN LEAD LINED DOOR	ST
ALUM	ALUMINUM	DB
HM	HOLLOW METAL	SS
HM-L	HOLLOW METAL LEAD LINED	BE
IHM	INSULATED HOLLOW METAL	MFR
WD	WOOD	
WD-L	WOOD LEAD LINED	

GLAZING TYPES

G1 - INSULATED GLAZING

G2 - FIRE RATED GLAZING

G3 - TEMPERED GLAZING

PTD PAINT wood stain ST DB DARK BRONZE(ANODIZED) STAINLESS STEEL BAKED ENAMEL BE MFR MANUFACTURER





PROJECT INFORMATION Project Number 14457.20 Client Name SOUTH ORANGETOWN CENTRAL SCHOOL DISTRICT

Project Name PHASE 1: 2022 BOND

District Office Address

160 VAN WYCK RD. Larry Werts 12/31/24

BLAUVELT, NY 10913 Anthony Marchetti 05/31/24 Dave Hart 02/28/25 Jennifer Wengender 06/30/24

CERTIFICATE #018330

Lauren Tarsio 09/30/26

Richard Waite 11/30/23


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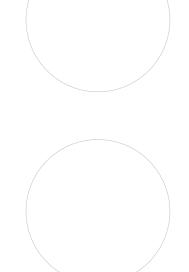
south orangetown CSD


- WILLIAM O. SCHAEFER SED#:50-03-01-06-0-012-019 COTTAGE LANE ELEMENTARY SED#:50-03-01-06-0-010-022 TAPPAN ZEE HIGH SCHOOL SED#:50-03-01-06-0-006-032 WILLIAM O. SCHAEFER S&L SED#: 50-03-01-06-0-012-020
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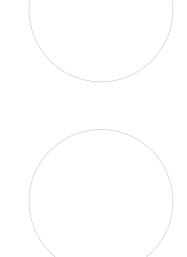
PROJECT ISSUE & REVISION SCHEDULE No. Date Description


PROFESSIONAL STAMPS







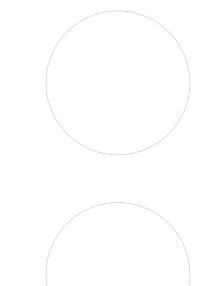


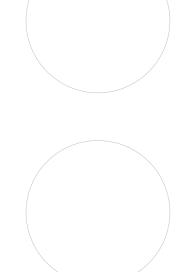


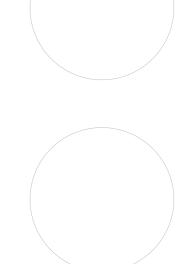


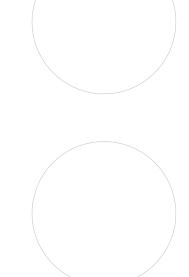


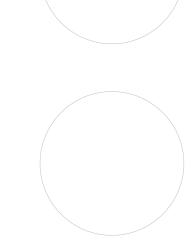


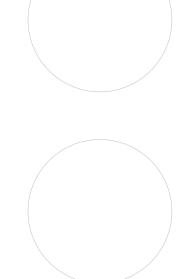


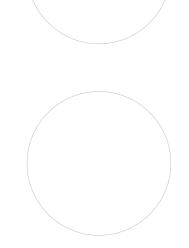

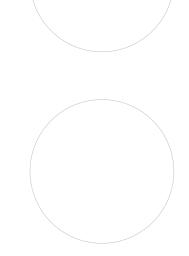

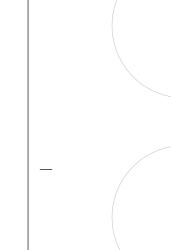

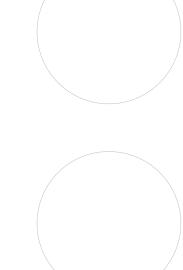

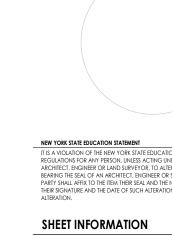



10/18/23 Project Status BID DOCUMENTS Drawn By LF Drawing Title

Issued

Drawing Number

LT

CLE


A900

Checked By

DOOR TYPES & SCHEDULES

As indicated

Scale

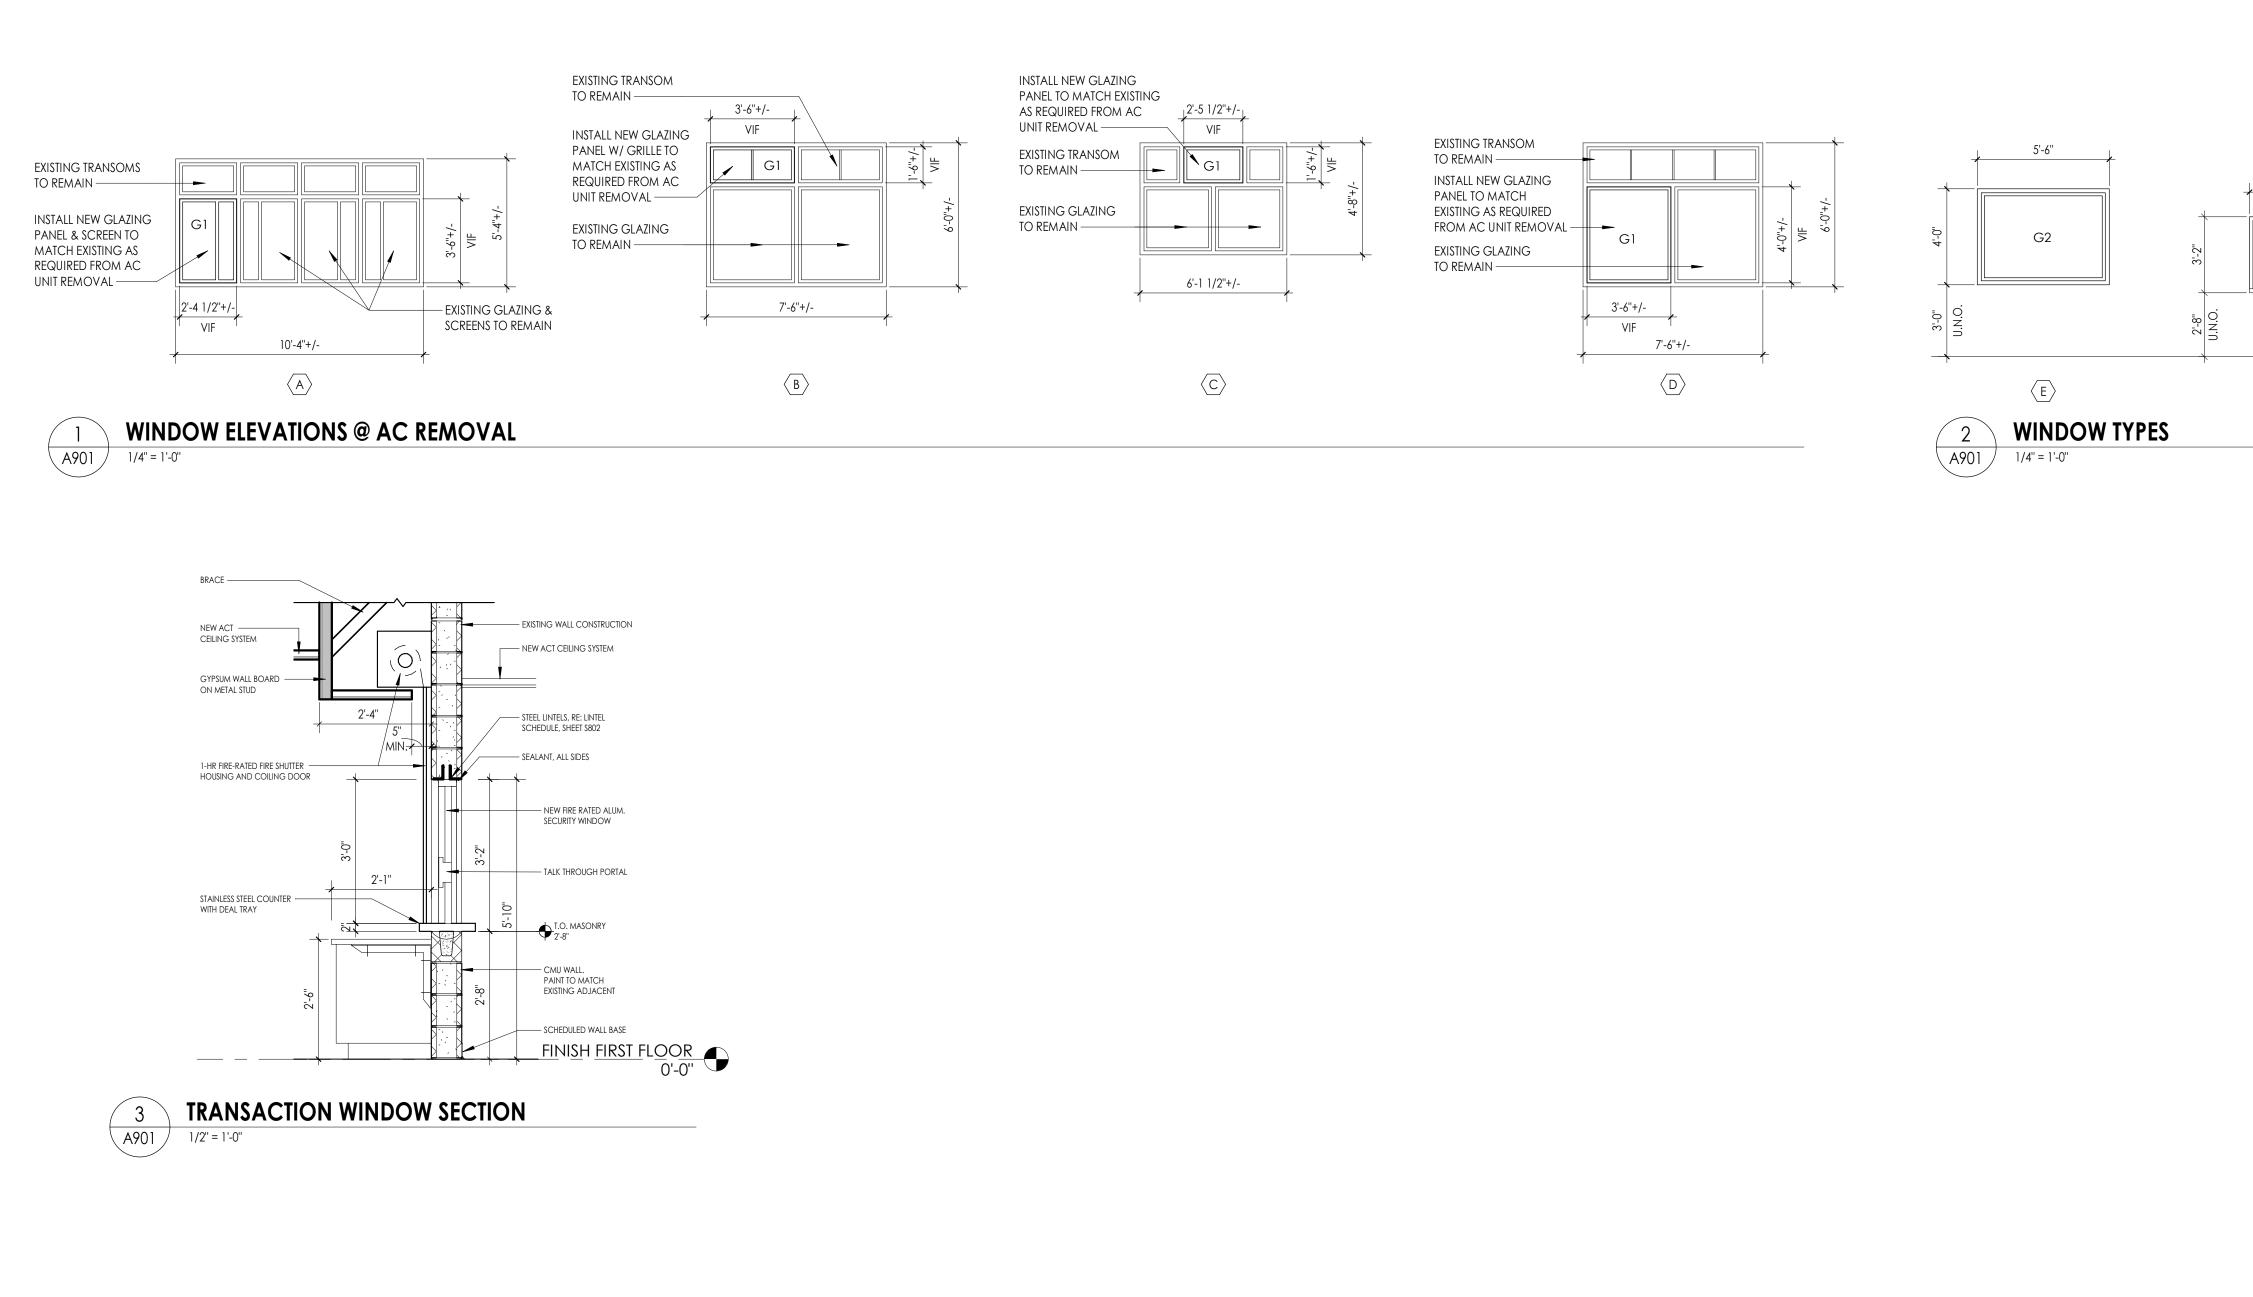




WINDOW GENERAL NOTES

- 1. COORDINATE ALL FRAME SIZES, TRIM EXTRUSIONS AND SILLS WITH WALL SECTIONS
- AND DETAILS. 2. ALL FRAMES ARE TO RECEIVE FULL PERIMETER SEALANT. INTERIOR AND EXTERIOR
- 3. ALL DOOR AND WINDOW DIMENSIONS ARE TO BE VERIFIED IN FIELD PRIOR TO FABRICATION.
- 4. REFER TO DIMENSION PLANS AND WALL SECTIONS FOR MULLION LAYOUT DIMENSIONS.

GLAZING TYPES



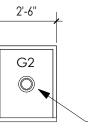

-TALK THROUGH PORTAL

FINISH FLOOR

 $\langle F \rangle$

CPL | Architecture Engineering Planning 50 Front Street Suite 202, Newburgh, NY 12550 CPLteam.com SOUTH ORANGETO Central School Dist Capital Improvements Bond Health, Safety and Success

PROJECT INFORMATION Project Number 14457.20

Client Name SOUTH ORANGETOWN CENTRAL SCHOOL DISTRICT Project Name

PHASE 1: 2022 BOND

District Office Address

160 VAN WYCK RD. Larry Werts 12/31/24 BLAUVELT, NY 10913 Anthony Marchetti 05/31/24

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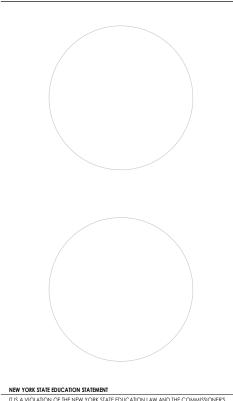
South orangetown CSD

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TZHS OUTDOOR CLASSROOM SED#:50-03-01-06-7-055-001

PROJECT ISSUE & REVISION SCHEDULE No. Date Description

PROFESSIONAL STAMPS



THE SA VICATION OF THE NEW YORK STATE EDUCATION LAW AND THE COMMISSIONER'S REGULTIONS FOR ANY PERSON, UNLESS ACTING UNDER THE DIRECTION OF A LICENSED ARCHITECT, ENGINEER OR LAND SURVEYOR, TO ALTER AN ITEM IN ANY WAY, IF AN ITEM BEARING THE SEAL OF AN ARCHITECT. BROITERE OR SURVEYOR IS ALTERED THE ALTERING PARTY SHALL AFRIX TO THE ITEM THER SEAL AND THE NOTATION "ALTERED BY FOLLOWED 8: THEIR SIGNATURE AND THE DATE OF SUCH ALTERATION, AND A SPECIFIC DESCRIPTION OF TH ALTERATION.

SHEET INFORMATION Issued

10/18/23

Project Status


Scale As indicated

BID DOCUMENTS Drawn By LF

Checked By LT

Drawing Title WINDOW TYPES



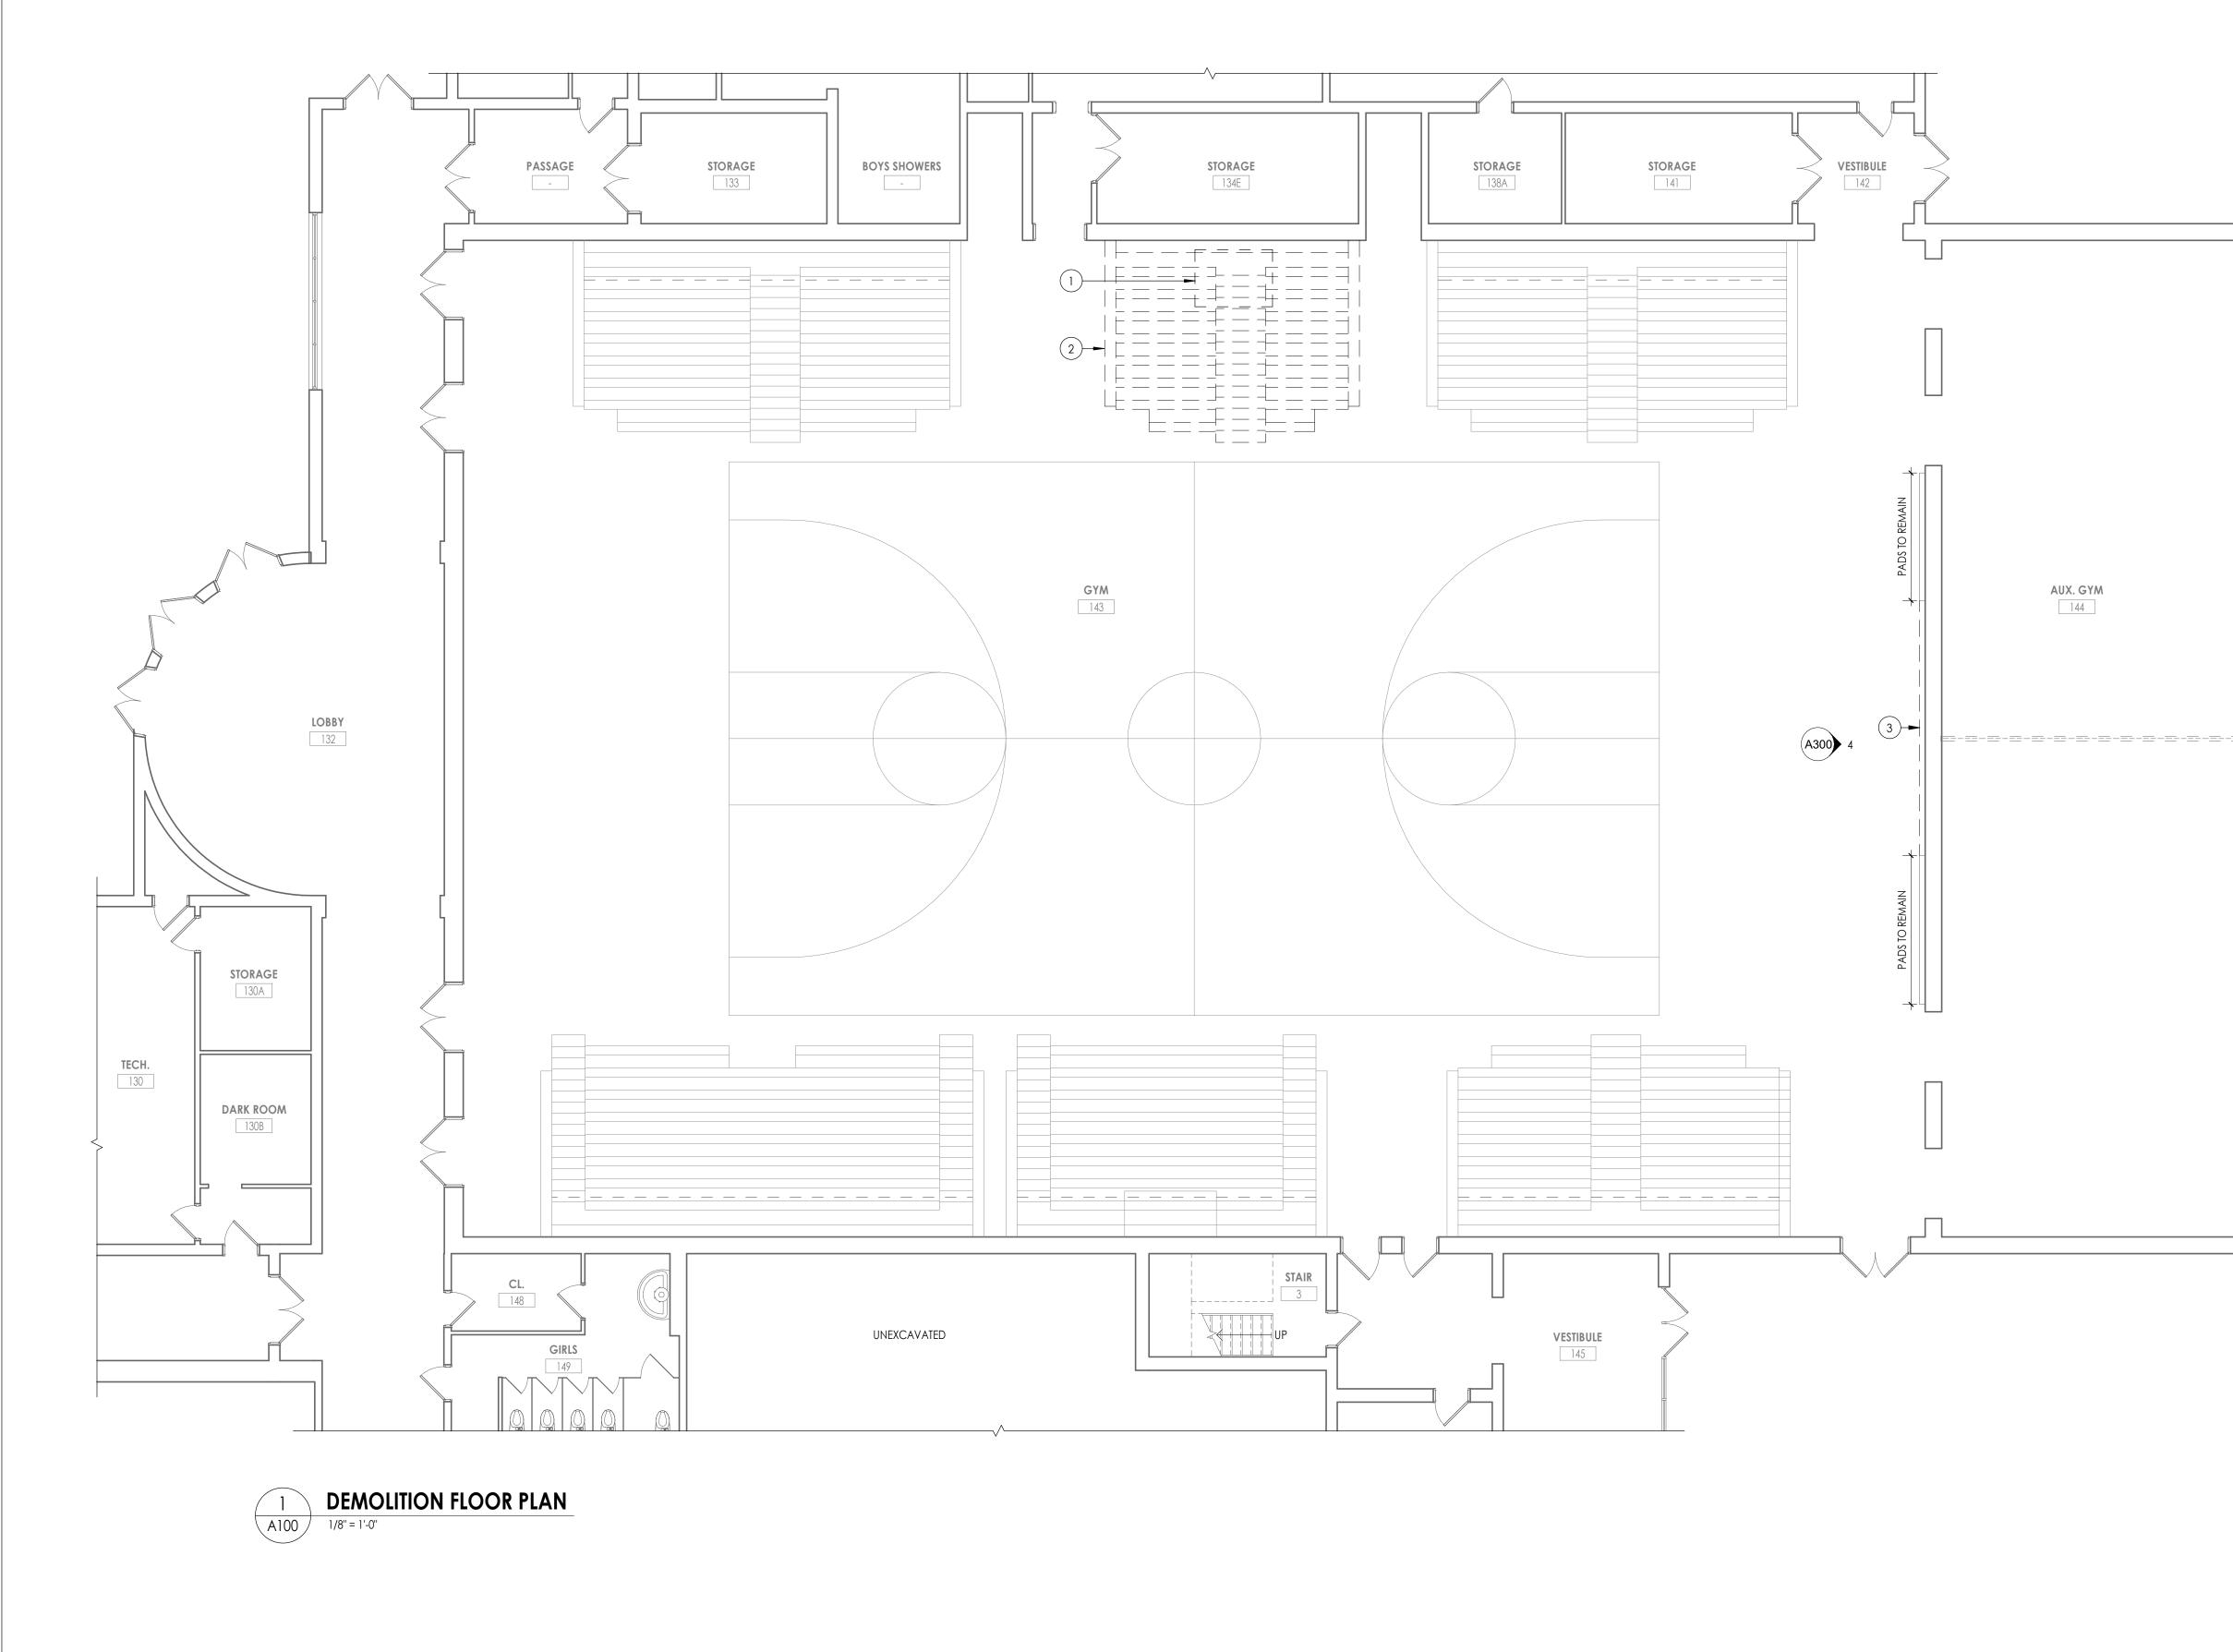

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DEMOLITION GENERAL NOTES

- I. ALL DRAWINGS ARE GRAPHIC REPRESENTATION OF APPROXIMATE LOCATIONS OF MATERIALS TO BE REMOVED. IT IS THE CONTRACTORS RESPONSIBILITY TO FIELD VERIFY ALL EXISTING CONDITIONS & DIMENSIONS PRIOR TO COMMENCEMENT OF ALL DEMOLITION WORK.
- 2. REFER TO THE MECHANICAL, ELECTRICAL AND PLUMBING DRAWINGS FOR DEMOLITION OF EXISTING UTILITIES AND SERVICES.
- THE OWNER SHALL PROVIDE THE CONTRACTOR WITH A LIST OF ALL ITEMS TO BE SALVAGED PRIOR TO CONSTRUCTION.
- 4. THE CONTRACTOR SHALL PROTECT ADJACENT SURFACES AND FINISHES NOT SCHEDULED FOR DEMOLITION WORK AND SHALL REPAIR ANY DAMAGED AREAS AS A RESULT OF CONTRACTED WORK AT NO ADDITIONAL COST TO THE OWNER.
- THE CONTRACTOR SHALL COORDINATE THE DEMOLITION WORK WITH THE OVERALL PROJECT PHASING.
 WORK AREAS SHALL BE MAINTAINED AND ALL WORK AREAS SHALL BE LEFT BROOM
- CLEANED AT END OF EACH DAY. 7. THE CONTRACTOR SHALL MAINTAIN AND CONTINUE SAFE ACCESS TO ALL EXISTS FOR THE BUILDING OCCUPANTS DURING CONSTRUCTION.
- IN THE CASE THAT ANY SUSPICIOUS MATERIALS ARE UNCOVERED THAT APPEAR TO CONTAIN HAZARDOUS MATERIALS SUCH AS BUT NOT LIMITED TO MOLD, LEAD PAINT OR ASBESTOS, LEAVE THE PREMISES AND NOTIFY THE OWNER & ABATEMENT CONTRACTOR FOR REQUIRED TESTING AND/OR REMOVALS.

DEMOLITION KEY NOTES

- 1 REMOVE & SALVAGE EXISTING BASKETBALL HOOP IN ITS ENTIRETY. RETURN TO OWNER
- 2 REMOVE & SALVAGE BLEACHER SYSTEM TO BE REINSTALLED IN ALTERNATE LOCATION.
- (3) REMOVE & SALVAGE WALL PADS TO BE REINSTALLED.



PHASE 1: 2022 BOND

CERTIFICATE #018330 REGISTRATION EXPIR. DATES: Lauren Tarsio 09/30/26

Project Address 15 DUTCH HILL ROAD ORANGEBURG, NY 109872thony Marchetti 05/31/24 Dave Hart 02/28/25 Jennifer Wengender 06/30/24

SOUTH ORANGETOWN CSD


- WILLIAM O. SCHAEFFER SED #50-03-01-06-012-019

 COTTAGE LANE ELEMENTARY SED #50-03--01-06-010-022

 TAPPAN ZEE HIGH SCHOOL SED #50-03-01-06-0-006-032
- IAFF AIV ZEE HIGH SCHOOL SED #50-03-01-06-0-006-032
 WILLIAM O. SCHAEFER S&L SED#: 50-03-01-06-0-012-020
 COTTAGE LANE S&L SED#: 50-03-01-06-0-010-023
- □ COTTAGE LANE LIBRARY S&L SED#: 50-03-01-06-8-023-002 □ WOS OUTDOOR CLASSROOM SED#: 50-03-01-06-7-053-001
- CLE OUTDOOR CLASSROOM SED#:50-03-01-06-7-054-001

PROJECT ISSUE & REVISION SCHEDULE No. Date Description

PROFESSIONAL STAMPS

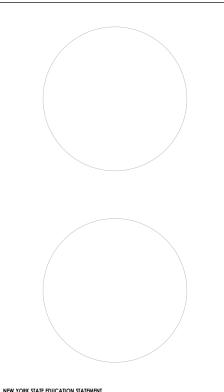



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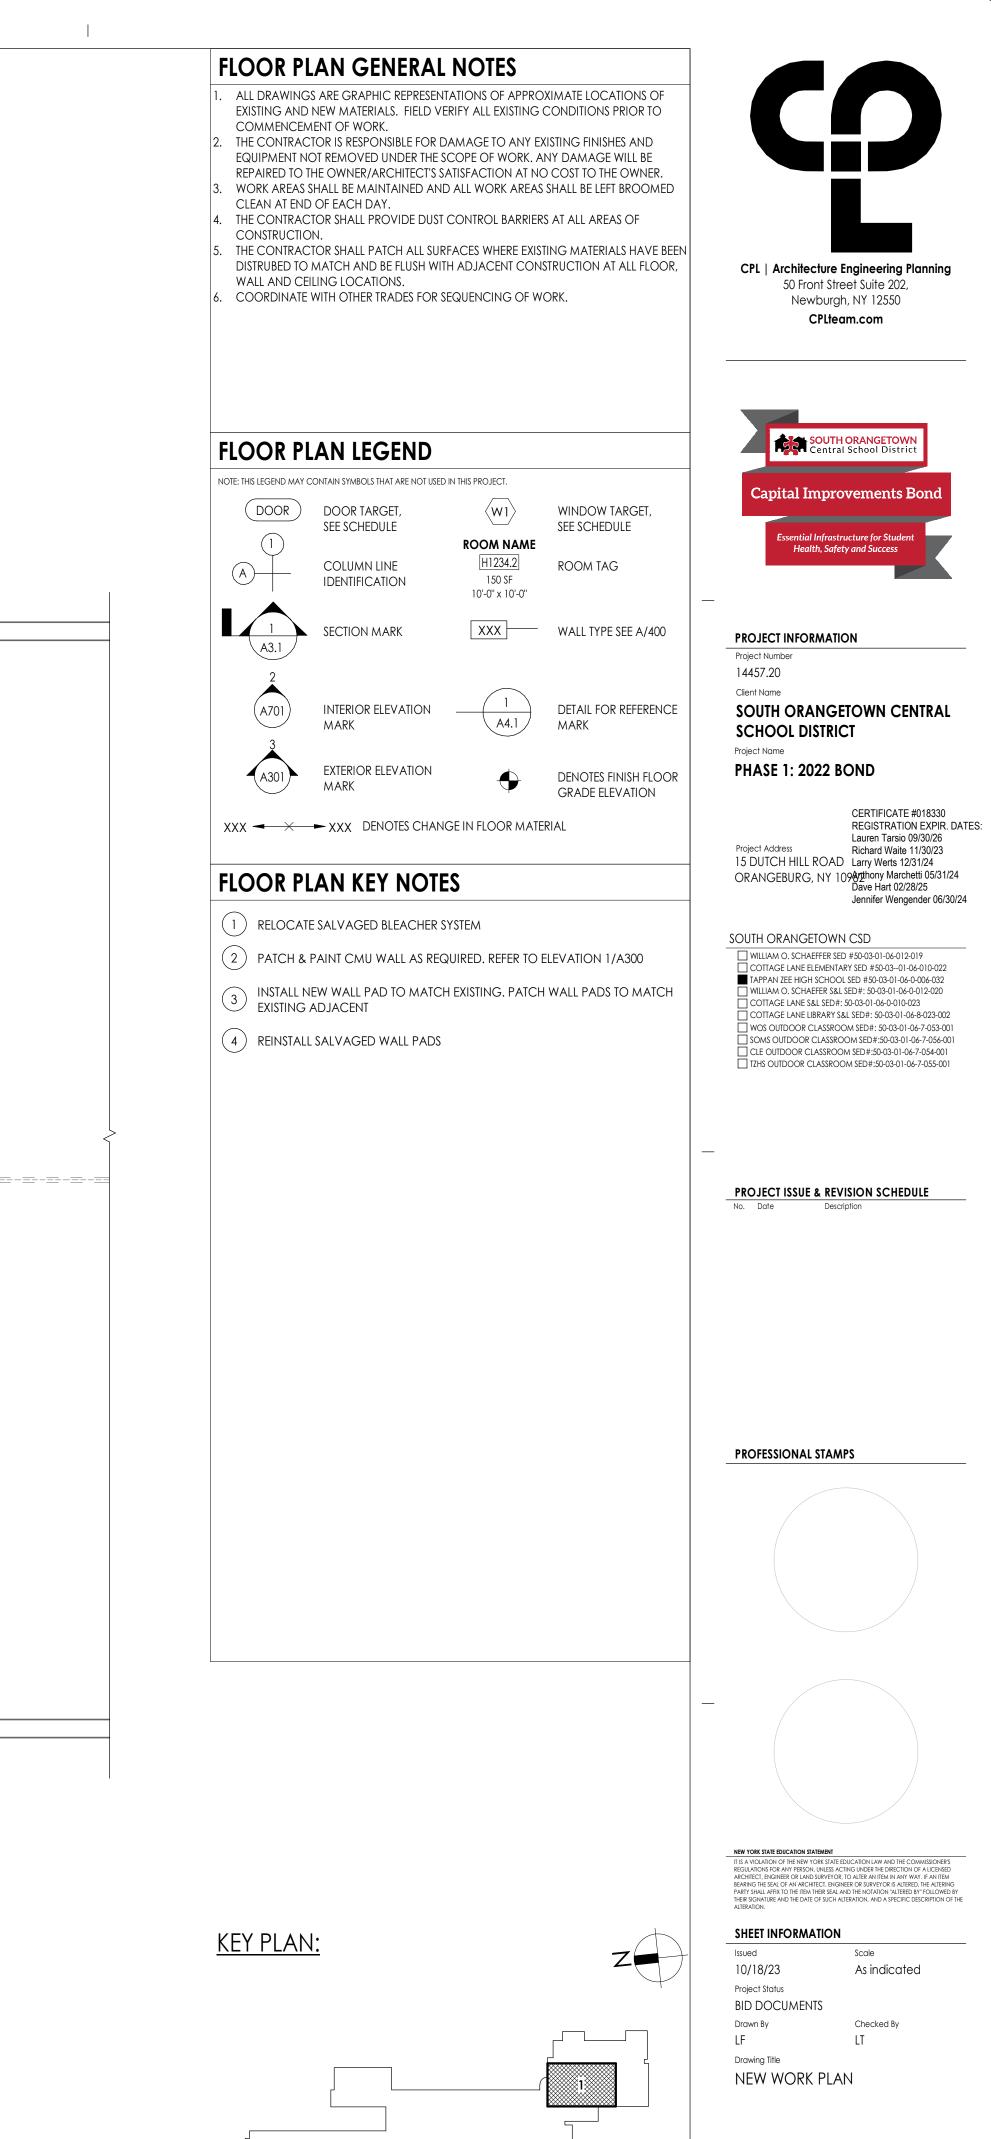
SHEET INFORMATION

Issued Scale
10/18/23 As indicated
Project Status
BID DOCUMENTS
Drawn By Checked By
LF LT
Drawing Title
DEMOLITION PLAN

Drawing Number TZHS A100




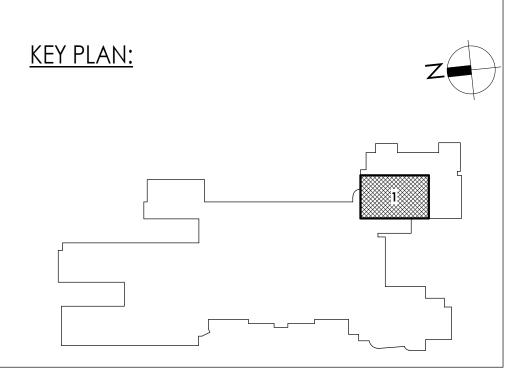

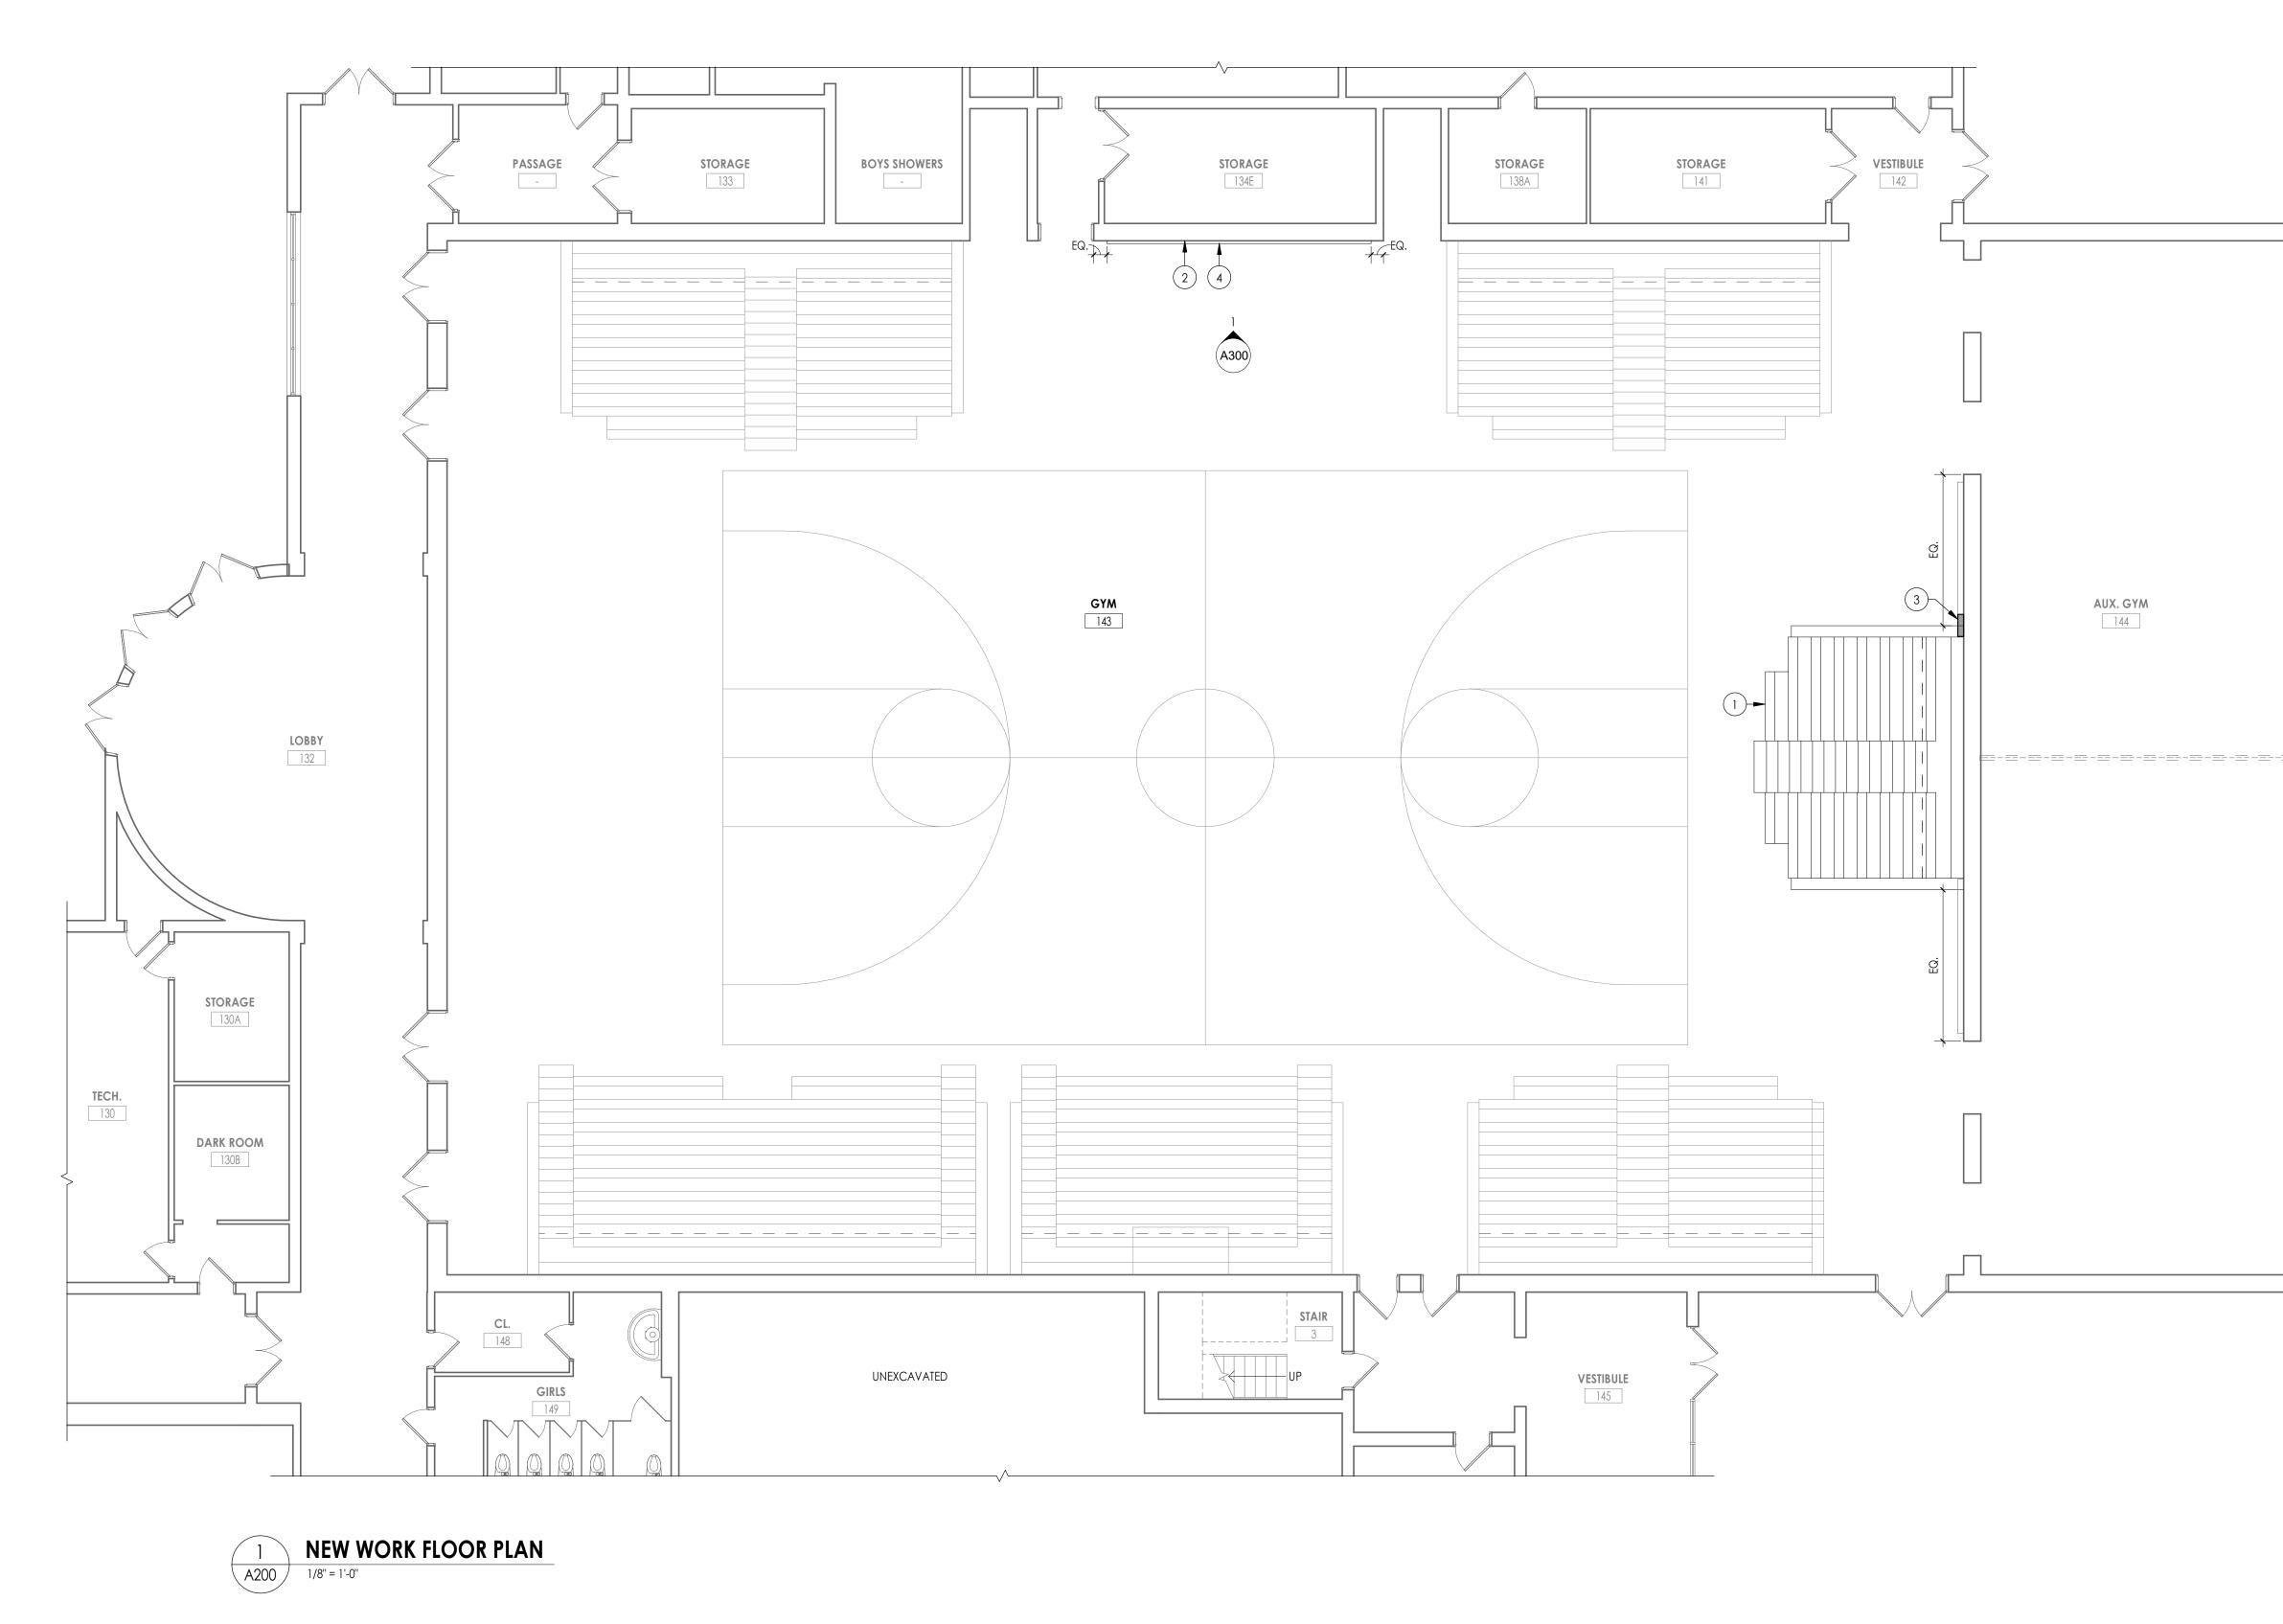

Drawing Number	TZHS
	A200



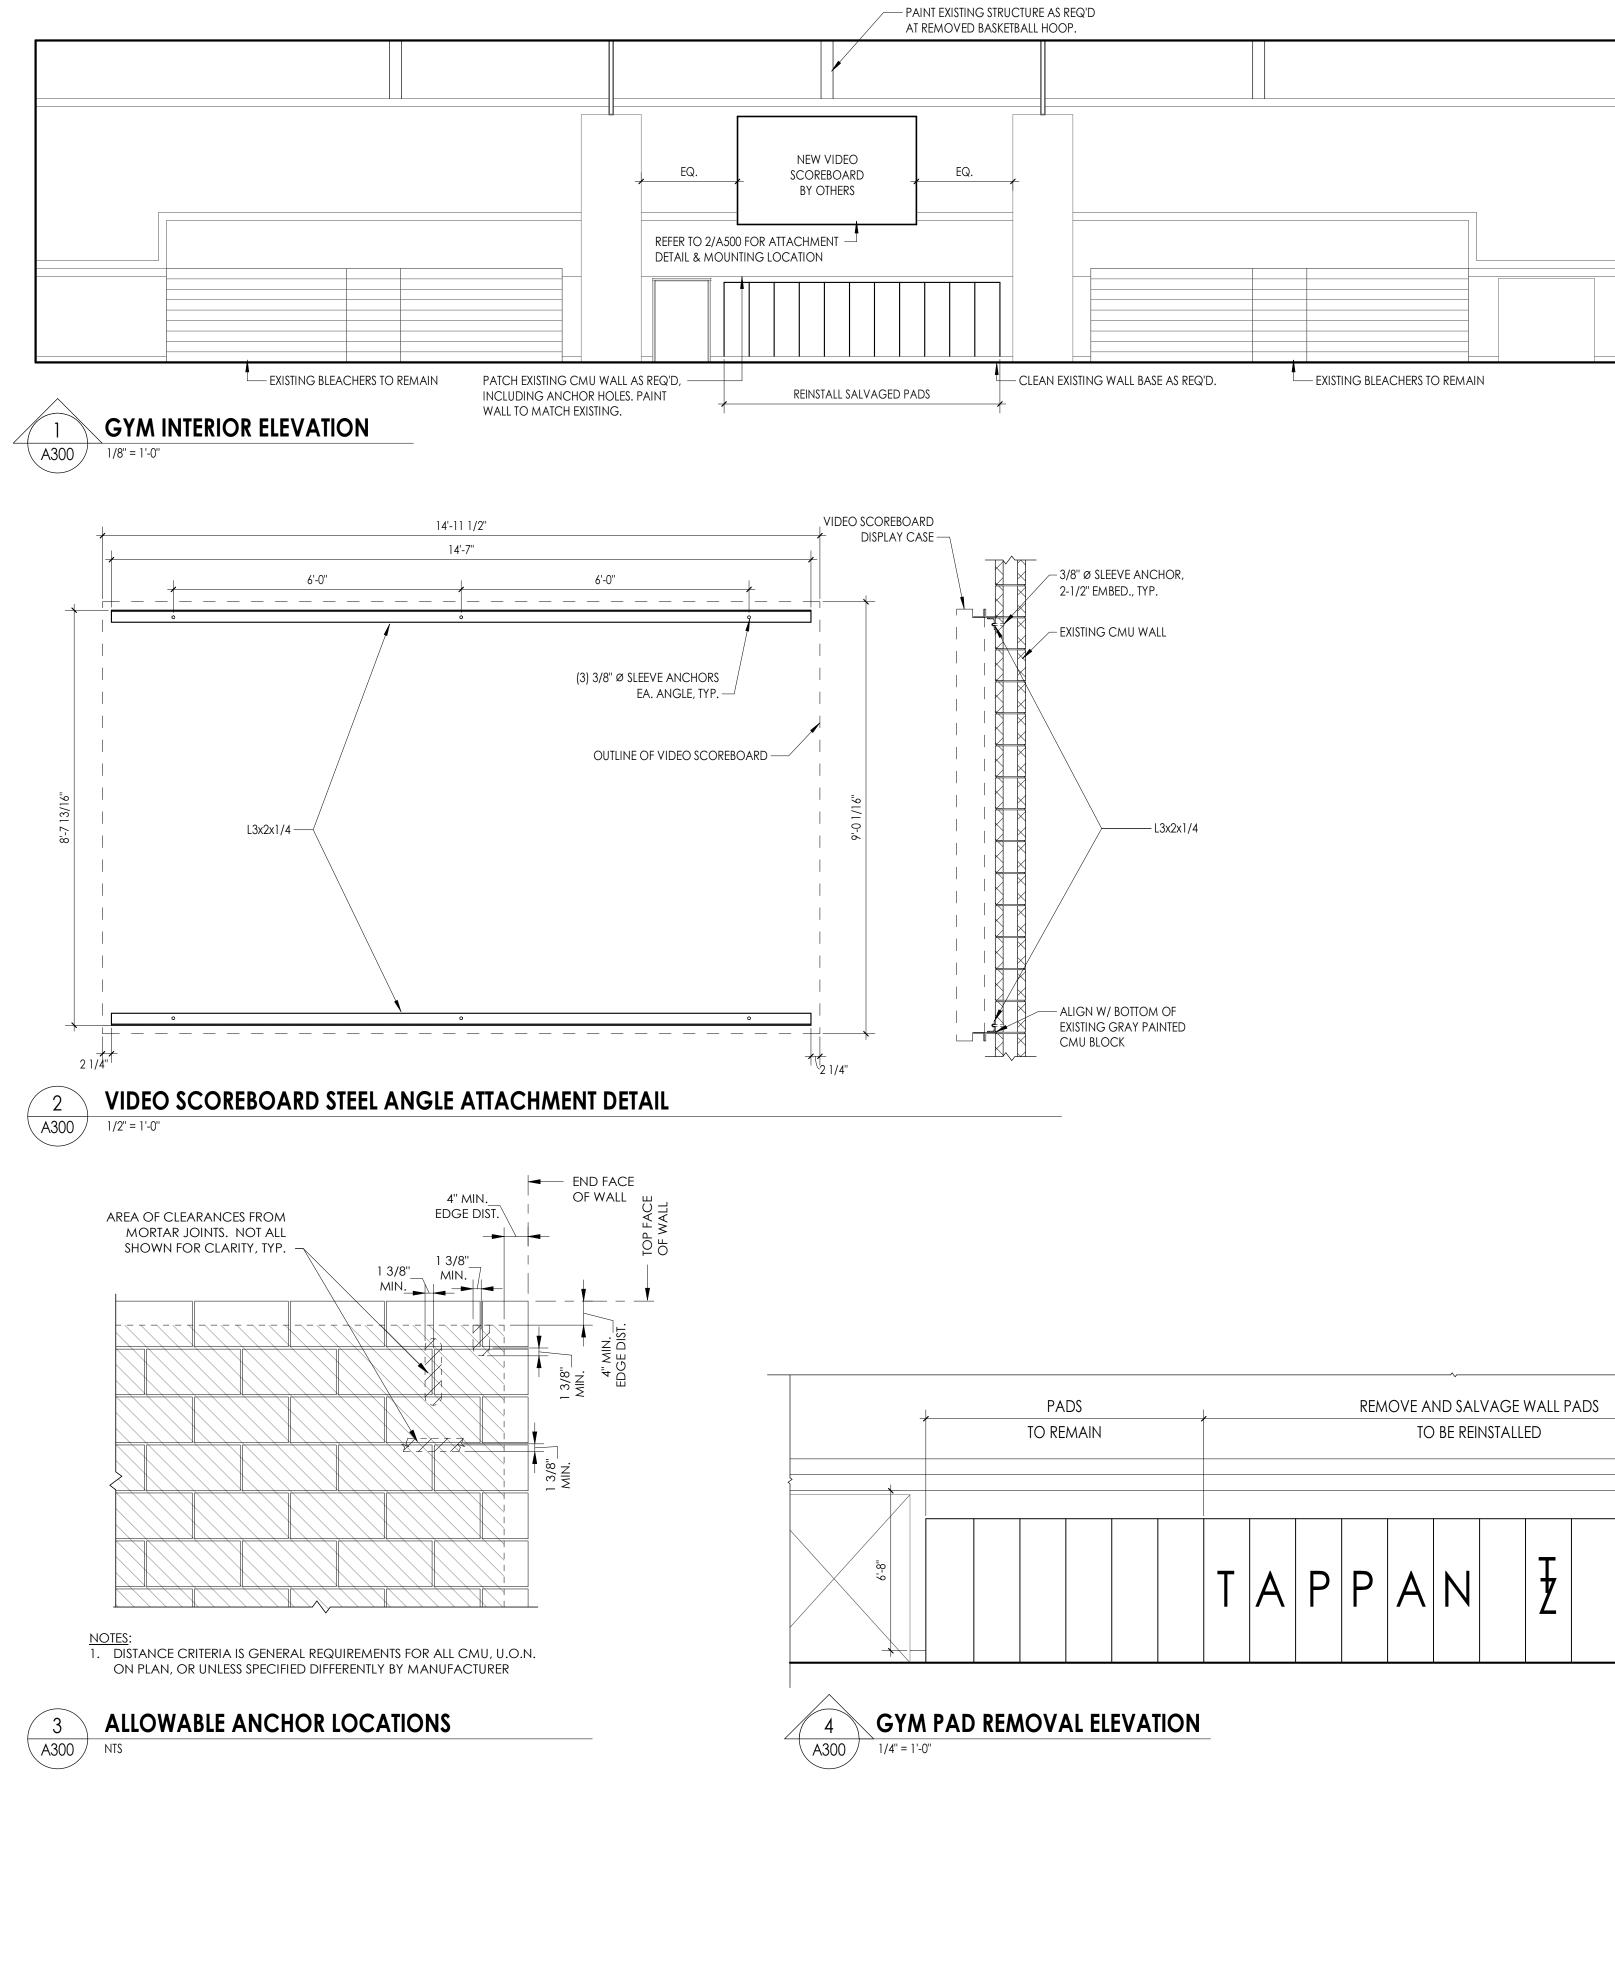


PADS	REMOVE AND SALVAGE WALL PADS	PADS	<u>-</u>
TO REMAIN	TO BE REINSTALLED	TO REMAIN	

POST-INSTALLED ANCHOR NOTES

- a. POST-INSTALLED ANCHORS SHALL ONLY BE USED WHERE SPECIFIED ON THE CONSTRUCTION DOCUMENTS. THE CONTRACTOR SHALL OBTAIN APPROVAL FROM THE DESIGN PROFESSIONAL PRIOR TO USING POST-INSTALLED ANCHORS FOR MISSING OR MISPLACED CAST-IN-PLACE ANCHORS.
- b. CARE SHOULD BE GIVEN TO AVOID CONFLICTS WITH EXISTING REINFORCING.
- c. HOLES SHALL BE DRILLED AND CLEANED PER THE MANUFACTURER'S INSTALLATION INSTRUCTIONS. ANCHORS SHALL BE INSTALLED IN ACCORDANCE WITH THE MANUFACTURER'S INSTALLATION INSTRUCTIONS.
- d. UNLESS NOTED OTHERWISE ON THE CONSTRUCTION DOCUMENTS, ACCEPTABLE PRODUCTS SHALL BE AS LISTED BELOW:
- A. EXPANSION ANCHORS/BOLTS INTO CONCRETE:
- a. HILTI KWIK BOLT TZ
- b. SIMPSON STRONG-BOLT 2 c. DEWALT/POWER POWER-STUD+ SD2
- B. EXPANSION ANCHORS/BOLTS INTO SOLID MASONRY:
- a. HILTI KWIK BOLT 3
- b. SIMPSON STRONG-BOLT 2
- c. DEWALT/POWER POWER-STUD+ SD1
- C. SCREW ANCHORS INTO CONCRETE OR MASONRY:
- a. HILTI HUS-EZ b. SIMPSON TITEN HD
- c. DEWALT/POWER SCREW-BOLT+
- D. ADHESIVE ANCHORS INTO MASONRY:
- a. HILTI HIT-HY270

- b. SIMPSON SET-XP c. DEWALT/POWER AC100+ GOLD
- E. SLEEVE ANCHORS/BOLTS INTO HOLLOW MASONRY:
- a. HILTI HLC SLEEVE ANCHOR
- b. SIMPSON SLEEVE-ALL c. DEWALT/POWER POWER-BOLT HEAVY-DUTY SLEEVE ANCHOR
- e. SUBSTITUTION REQUESTS, FOR PRODUCTS SHALL BE SUBMITTED TO THE DESIGN PROFESSIONAL FOR APPROVAL SHALL HAVE A VALID RESEARCH REPORT (EVALUATION REPORT), INDICATING COMPLIANCE WITH APPROPRIATE ACCEPTANCE CRITERIA REQUIRED FOR THE INTENDED LOAD TYPE AND USE.
- f. NUTS, WASHERS, AND OTHER HARDWARE USED WITH ANCHORS SHALL HAVE A MATERIAL OR AN ALLOY DESIGNATION THAT IS COMPATIBLE WITH THE ANCHOR.
- g. IN ADDITION TO THE MANUFACTURER'S INSTALLATION INSTRUCTIONS, THE FOLLOWING CRITERIA SHALL BE FOLLOWED FOR INSTALLATION OF ADHESIVE ANCHORS:
- A. ADHESIVE ANCHORS SHALL BE INSTALLED IN CONCRETE HAVING A MINIMUM AGE OF 21-DAYS AT TIME OF ANCHOR INSTALLATION.
- B. ADHESIVE ANCHORS SHALL BE INSTALLED IN DRY CONCRETE, AND DURING DRY CONDITIONS.
- . ADHESIVE ANCHORS SHALL BE INSTALLED IN HOLES PREDRILLED WITH A CARBIDE TIPPED DRILL BIT. D. ADHESIVE ANCHORS SHALL BE INSTALLED WITHIN THE TEMPERATURE RANGE SPECIFIED IN THE
- MANUFACTURER'S INSTALLATION INSTRUCTIONS. h. LOADS SHALL NOT BE APPLIED TO ADHESIVE ANCHORS UNTIL THE FULL CURING TIME HAS ELAPSED.
- i. INSTALLATION OF ADHESIVE ANCHORS SHALL BE PERFORMED BY CERTIFIED PERSONNEL. CERTIFICATION SHALL INCLUDE WRITTEN AND PERFORMANCE TESTS IN ACCORDANCE WITH THE ACI/CRSI ADHESIVE ANCHOR INSTALLER CERTIFICATION PROGRAM, OR EQUIVALENT.
- j. SPECIAL INSPECTIONS SHALL BE PROVIDED FOR POST-INSTALLED ANCHORS IN ACCORDANCE WITH THE ANCHOR MANUFACTURER'S INSTALLATION INSTRUCTIONS AND/OR EVALUATION REPORT, UNLESS MORE SPECIFIC REQUIREMENTS ARE SPECIFIED IN THE CONSTRUCTION DOCUMENTS.
- k. WHEN ANCHORING TO CONCRETE MASONRY WITH VOIDS, ALL MASONRY CELLS TO RECEIVE ANCHORS SHALL BE GROUTED SOLID OR THE APPROPRIATE SCREEN TUBE SHALL BE USED AS RECOMMENDED BY THE ADHESIVE MANUFACTURER.

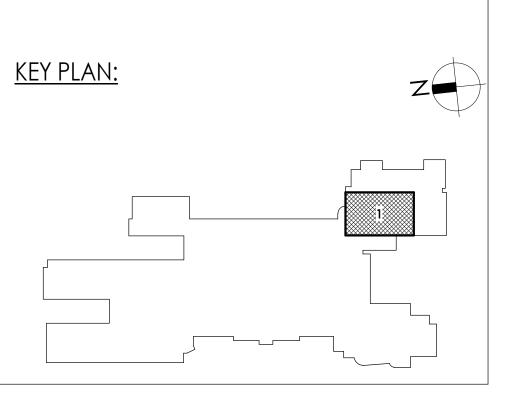



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CERTIFICATE #018330 REGISTRATION EXPIR. DATES: Lauren Tarsio 09/30/26 Richard Waite 11/30/23


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South orangetown CSD

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- COTTAGE LANE S&L SED#: 50-03-01-06-0-010-023 COTTAGE LANE LIBRARY S&L SED#: 50-03-01-06-8-023-002
- WOS OUTDOOR CLASSROOM SED#: 50-03-01-06-7-053-001 SOMS OUTDOOR CLASSROOM SED#:50-03-01-06-7-056-001
- CLE OUTDOOR CLASSROOM SED #:50-03-01-06-7-054-001 TZHS OUTDOOR CLASSROOM SED#:50-03-01-06-7-055-001

PROJECT ISSUE & REVISION SCHEDULE No. Date Description

PROFESSIONAL STAMPS

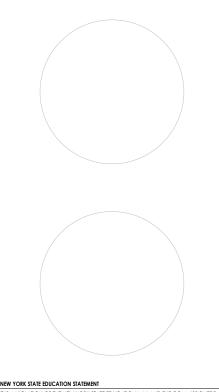

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SHEET INFORMATION

Issued Scale 10/18/23 As indicated Project Status BID DOCUMENTS Drawn By Checked By LF/SW LT Drawing Title


INTERIOR ELEVATION & STRUCTURAL DETAILS



ACOUSTIC WA AWP-1 AWP-2	LL PANELS (AWP)				
AWP-2	MDC OR EQUAL	ZINTRA WALL TILES	MALACHITE	9.8" X 9.8" X 1"	CLASS A; 100% POLYESTER; NRC 0.45 - 0.9
	MDC OR EQUAL	ZINTRA WALL TILES	CADET	9.75" X 19.5" X 1"	CLASS A; 100% POLYESTER; NRC 0.45 - 0.9
AWP-3 AWP-4	MDC OR EQUAL	ZINTRA WALL TILES ZINTRA WALL TILES	GREIGE OCHER	9.75" X 19.5" X 1" 19.5" X 19.5" X 1"	CLASS A; 100% POLYESTER; NRC 0.45 - 0.95 CLASS A; 100% POLYESTER; NRC 0.45 - 0.95
ACOUSTICAL (ACT-1	CEILING TILE (ACT)	AL SCHOOL ZONE FINE FISSURED 1820	WHITE	24" X 24" X 3/4"	CLASS A FIRE PERFORMANCE; NRC .70; C/
ACT-2		AL SCHOOL ZONE FINE FISSURED 1824	WHITE	24" X 48' X 3/4"	CLASS A FIRE PERFORMANCE; NRC .70; C.
CARPET (CPT)					
CPT-1	SHAW CONTRACT OR EQUAL	BISECT TILE 5T448	SEDIMENT 06555	24" X 24" X .219"	CLASS 1; MULTI-LEVEL PATTERN LOOP; 100
CPT-2	SHAW CONTRACT OR EQUAL	ENGAGE TILE 5T187	TRANSFORM RED 86585	24" X 24" X .226"	CLASS 1; MULTI-LEVEL PATTERN LOOP; 100
POXY PAINT (1	1
EPT-1	Sherwin Williams or Equal	PRO-INDUSTRIAL WATER BASED CATALYZED EPOXY	WESTHIGHLAND WHITE SW-7566	N/A	REFER TO SPECIFICATIONS
			·		•
<u>GROUT (GRT)</u> GRT-1	LATICRETE OR EQUAL	SPECTRLOCK PRO	BRIGHT WHITE 44	JOINT SIZE DETERMINED BY	HIGH PERFORMANCE EPOXY GROUT WITH
GRT-2	LATICRETE OR EQUAL	SPECTRLOCK PRO	NATURAL GREY 24	MANUFACTURER	HIGH PERFORMANCE EPOXY GROUT WITH
				MANUFACTURER	
HIGH PRESSURI	E PLASTIC LAMINATE (HPL)				
HPL-1	WILSONART OR EQUAL	AEON SCRATCH RESISTANT	PHANTOM CHARCOAL 8214K-28	N/A	GRAIN TO RUN VERTICALLY
HPL-2	WILSONART OR EQUAL	AEON SCRATCH RESISTANT	WHITE NEBULA 4621-60	N/A	
HPL-3 HPL-4	WILSONART OR EQUAL	AEON SCRATCH RESISTANT AEON SCRATCH RESISTANT	BEIGEWOOD 7850-60 PEARL SOAPSTONE 4886-38	N/A N/A	GRAIN TO RUN VERTICALLY
111 L-4	WILSONAKT OK EQUAL		1 LAKE SOAT STONE 4000-30		
				25CNA X 1NA X A 5NANA	
.VT-1 .VT-2	INTERFACE OR EQUAL INTERFACE OR EQUAL	STUDIO SET STUDIO SET	MUSHROOM A00706 PEWTER A00702	25CM X 1M X 4.5MM 25CM X 1M X 4.5MM	CLASS 1 RADIANT FLUX; <450 SMOKE DEN: CLASS 1 RADIANT FLUX; <450 SMOKE DEN:
LVT-3	SHAW CONTRACT OR EQUAL	COVE 0927V	CORNERSTONE 27585	9" X 48" X 5MM	CLASS 1 RADIANT FLUX; <450 SMOKE DENS
LVT-4	SHAW CONTRACT OR EQUAL	COVE 0927V	GESSO 27520	9" X 48" X 5MM	CLASS 1 RADIANT FLUX; <450 SMOKE DENS
					INSTALLATION METHOD
PAINT (PT)				1	1
PT-1 PT-2	SHERWIN WILLIAMS OR EQUAL	PRO MAR 200 PRO MAR 200	ALPACA SW-7022 STOP SW-6869	N/A N/A	REFER TO SPECIFICATIONS REFER TO SPECIFICATIONS
PT-3	SHERWIN WILLIAMS OR EQUAL	PRO MAR 200 PRO MAR 200	STOP SW-6869	N/A	REFER TO SPECIFICATIONS
PT-4	Sherwin Williams or Equal	PRO MAR 200	CEILING BRIGHT WHITE SW-7007	N/A	REFER TO SPECIFICATIONS
PT-5	Sherwin Williams or Equal	PRO MAR 200	DELFT SW9134	N/A	REFER TO SPECIFICATIONS
RESILIENT BASE					
RB-1	TARKETT OR EQUAL	TRADITIONAL WALL BASE 1/8"	BEDROCK TA6	4" HIGH	CLASS B <450 SMOKE DENSITY; CLASS 1 RA
RESILIENT STAIR					
RST-1	TARKETT OR EQUAL	TREAD & RISERS VISUALLY IMPAIRED -	FLAME TB6	N/A	SEE SPECS
		PATTERN: TBD			
RUBBER TILE (R	T)		1		
KODDER HEE [K		COLOR SPLASH HAMMERED HRTSP	GREENBLUFF VF3	24" X 24" X 1/8"	CLASS 1-B HOMOGENEOUS COMPOSITIO
	TARKETT OR EQUAL				WARRANIY.
RT-1	TARKETT OR EQUAL	COLOR SPLASH HAMMERED HRTSP	DUNGENESS CRAB VG2	24" X 24" X 1/8"	
RT-1 RT-2 RT-3			DUNGENESS CRAB VG2	24" X 24" X 1/8" 24" X 24" X 1/8"	CLASS 1-B HOMOGENEOUS COMPOSITION WARRANTY. CLASS 1-B HOMOGENEOUS COMPOSITION
RT-1	TARKETT OR EQUAL	COLOR SPLASH HAMMERED HRTSP			CLASS 1-B HOMOGENEOUS COMPOSITION WARRANTY.
RT-1 RT-2 RT-3 SHEET VINYL (S	TARKETT OR EQUAL TARKETT OR EQUAL V)	COLOR SPLASH HAMMERED HRTSP COLOR SPLASH HAMMERED HRTSP	LAKE CHELAN VH9	24" X 24" X 1/8"	CLASS 1-B HOMOGENEOUS COMPOSITION WARRANTY. CLASS 1-B HOMOGENEOUS COMPOSITION WARRANTY.
RT-1 RT-2 RT-3 HEET VINYL (S	TARKETT OR EQUAL	COLOR SPLASH HAMMERED HRTSP			CLASS 1-B HOMOGENEOUS COMPOSITION WARRANTY. CLASS 1-B HOMOGENEOUS COMPOSITION
RT-1 RT-2 RT-3 SHEET VINYL (S SV-1	TARKETT OR EQUAL TARKETT OR EQUAL V) TARKETT OR EQUAL	COLOR SPLASH HAMMERED HRTSP COLOR SPLASH HAMMERED HRTSP	LAKE CHELAN VH9	24" X 24" X 1/8"	CLASS 1-B HOMOGENEOUS COMPOSITION WARRANTY. CLASS 1-B HOMOGENEOUS COMPOSITION WARRANTY. CLASS 1 FIRE RESISTANCE, HOMOGENOUS
RT-1 RT-2 RT-3 SHEET VINYL (S SV-1 SOILD SURFAC	TARKETT OR EQUAL TARKETT OR EQUAL V)	COLOR SPLASH HAMMERED HRTSP COLOR SPLASH HAMMERED HRTSP	LAKE CHELAN VH9	24" X 24" X 1/8"	CLASS 1-B HOMOGENEOUS COMPOSITION WARRANTY. CLASS 1-B HOMOGENEOUS COMPOSITION WARRANTY. CLASS 1 FIRE RESISTANCE, HOMOGENOUS
RT-1 RT-2 RT-3 SHEET VINYL (S SV-1 SOILD SURFAC SSM-1	TARKETT OR EQUAL TARKETT OR EQUAL V) TARKETT OR EQUAL E MATERIAL (SSM) WILSONART OR EQUAL	COLOR SPLASH HAMMERED HRTSP COLOR SPLASH HAMMERED HRTSP ARIA 3.0	LAKE CHELAN VH9 DIORITE 0672	24" X 24" X 1/8" 6.5' X 75.5' ROLL X 0.080 THK	CLASS 1-B HOMOGENEOUS COMPOSITIO WARRANTY. CLASS 1-B HOMOGENEOUS COMPOSITIO WARRANTY. CLASS 1 FIRE RESISTANCE, HOMOGENOUS WARRANTY; INSTALL WITH 4" INTEGRAL BAS
RT-1 RT-2 RT-3 SHEET VINYL (S SV-1 SOILD SURFAC SSM-1 TACKABLE SUR	TARKETT OR EQUAL TARKETT OR EQUAL V) TARKETT OR EQUAL E MATERIAL (SSM) WILSONART OR EQUAL FACE (TAS)	COLOR SPLASH HAMMERED HRTSP COLOR SPLASH HAMMERED HRTSP ARIA 3.0 SOLID SURFACE MATERIAL	LAKE CHELAN VH9 DIORITE 0672 SILVER SMOKE 9226SS	24" X 24" X 1/8" 6.5' X 75.5' ROLL X 0.080 THK AS REQUIRED	CLASS 1-B HOMOGENEOUS COMPOSITION WARRANTY. CLASS 1-B HOMOGENEOUS COMPOSITION WARRANTY. CLASS 1 FIRE RESISTANCE, HOMOGENOUS WARRANTY; INSTALL WITH 4" INTEGRAL BAS REFER TO SPECIFICATIONS
RT-1 RT-2 RT-3 SHEET VINYL (S SV-1 SOILD SURFAC SSM-1 TACKABLE SUR	TARKETT OR EQUAL TARKETT OR EQUAL V) TARKETT OR EQUAL E MATERIAL (SSM) WILSONART OR EQUAL	COLOR SPLASH HAMMERED HRTSP COLOR SPLASH HAMMERED HRTSP ARIA 3.0	LAKE CHELAN VH9 DIORITE 0672	24" X 24" X 1/8" 6.5' X 75.5' ROLL X 0.080 THK AS REQUIRED	CLASS 1-B HOMOGENEOUS COMPOSITION WARRANTY. CLASS 1-B HOMOGENEOUS COMPOSITION WARRANTY. CLASS 1 FIRE RESISTANCE, HOMOGENOUS WARRANTY; INSTALL WITH 4" INTEGRAL BAS REFER TO SPECIFICATIONS
RT-1 RT-2 RT-3 SHEET VINYL (S SV-1 SOILD SURFAC	TARKETT OR EQUAL TARKETT OR EQUAL V) TARKETT OR EQUAL E MATERIAL (SSM) WILSONART OR EQUAL FACE (TAS) KOROSEAL OR EQUAL	COLOR SPLASH HAMMERED HRTSP COLOR SPLASH HAMMERED HRTSP ARIA 3.0 SOLID SURFACE MATERIAL	LAKE CHELAN VH9 DIORITE 0672 SILVER SMOKE 9226SS	24" X 24" X 1/8" 6.5' X 75.5' ROLL X 0.080 THK AS REQUIRED 48" HIGH; LENGTH AT INDICATED ON	CLASS 1-B HOMOGENEOUS COMPOSITIO WARRANTY. CLASS 1-B HOMOGENEOUS COMPOSITIO WARRANTY. CLASS 1 FIRE RESISTANCE, HOMOGENOUS WARRANTY; INSTALL WITH 4" INTEGRAL BA REFER TO SPECIFICATIONS
RT-1 RT-2 RT-3 <u>SHEET VINYL (S</u> SV-1 <u>SOILD SURFAC</u> <u>SSM-1</u> TACKABLE SUR TAS-1 TILE - BASE (TB)	TARKETT OR EQUAL TARKETT OR EQUAL V) TARKETT OR EQUAL E MATERIAL (SSM) WILSONART OR EQUAL FACE (TAS) KOROSEAL OR EQUAL	COLOR SPLASH HAMMERED HRTSP COLOR SPLASH HAMMERED HRTSP ARIA 3.0 SOLID SURFACE MATERIAL	LAKE CHELAN VH9 DIORITE 0672 SILVER SMOKE 9226SS	24" X 24" X 1/8" 6.5' X 75.5' ROLL X 0.080 THK AS REQUIRED 48" HIGH; LENGTH AT INDICATED ON	CLASS 1-B HOMOGENEOUS COMPOSITIO WARRANTY. CLASS 1-B HOMOGENEOUS COMPOSITIO WARRANTY. CLASS 1 FIRE RESISTANCE, HOMOGENOUS WARRANTY; INSTALL WITH 4" INTEGRAL BAS REFER TO SPECIFICATIONS CLASS B; BURLAP BACKING; SELF-HEALING FOOT ROLLS; PROVIDE CLEAR, ANODIZED
RT-1 RT-2 RT-3 <u>SHEET VINYL (S</u> SV-1 <u>SOILD SURFAC</u> <u>SSM-1</u> <u>TACKABLE SUR</u> TAS-1 <u>TILE - BASE (TB)</u> TB-1	TARKETT OR EQUAL TARKETT OR EQUAL V) TARKETT OR EQUAL E MATERIAL (SSM) WILSONART OR EQUAL FACE (TAS) KOROSEAL OR EQUAL CROSSVILLE OR EQUAL	COLOR SPLASH HAMMERED HRTSP COLOR SPLASH HAMMERED HRTSP ARIA 3.0 SOLID SURFACE MATERIAL WALL TALKERS TAC-WALL	LAKE CHELAN VH9 DIORITE 0672 SILVER SMOKE 9226SS	24" X 24" X 1/8" 6.5' X 75.5' ROLL X 0.080 THK AS REQUIRED 48" HIGH; LENGTH AT INDICATED ON DRAWINGS	CLASS 1-B HOMOGENEOUS COMPOSITION WARRANTY. CLASS 1-B HOMOGENEOUS COMPOSITION WARRANTY. CLASS 1 FIRE RESISTANCE, HOMOGENOUS WARRANTY; INSTALL WITH 4" INTEGRAL BAS
RT-1 RT-2 RT-3 SHEET VINYL (S SV-1 SOILD SURFAC SSM-1 TACKABLE SUR TAS-1 TILE - BASE (TB) TB-1 TILE - FLOOR (T	TARKETT OR EQUAL TARKETT OR EQUAL V) TARKETT OR EQUAL E MATERIAL (SSM) WILSONART OR EQUAL FACE (TAS) KOROSEAL OR EQUAL CROSSVILLE OR EQUAL	COLOR SPLASH HAMMERED HRTSP COLOR SPLASH HAMMERED HRTSP ARIA 3.0 SOLID SURFACE MATERIAL WALL TALKERS TAC-WALL	LAKE CHELAN VH9 DIORITE 0672 SILVER SMOKE 9226SS QUARRY 92 TEA FOR TWO GLOSS WT02 UPTOWN TAUPE SPECKLE	24" X 24" X 1/8" 6.5' X 75.5' ROLL X 0.080 THK AS REQUIRED 48" HIGH; LENGTH AT INDICATED ON DRAWINGS 4" X 8" X 1/4" 2" X 2" MOSIAC (12" X 24"	CLASS 1-B HOMOGENEOUS COMPOSITION WARRANTY. CLASS 1-B HOMOGENEOUS COMPOSITION WARRANTY. CLASS 1 FIRE RESISTANCE, HOMOGENOUS WARRANTY; INSTALL WITH 4" INTEGRAL BAS WARRANTY; INSTALL WITH 4" INTEGRAL BAS REFER TO SPECIFICATIONS CLASS B; BURLAP BACKING; SELF-HEALING FOOT ROLLS; PROVIDE CLEAR, ANODIZED C650 CHEMICAL RESISTANT; MOHS 7; INST.
RT-1 RT-2 RT-3 SHEET VINYL (S SV-1 SOILD SURFAC SSM-1 TACKABLE SUR TAS-1 TILE - BASE (TB) TB-1 TILE - FLOOR (T	TARKETT OR EQUAL TARKETT OR EQUAL V) TARKETT OR EQUAL E MATERIAL (SSM) WILSONART OR EQUAL FACE (TAS) KOROSEAL OR EQUAL CROSSVILLE OR EQUAL F)	COLOR SPLASH HAMMERED HRTSP COLOR SPLASH HAMMERED HRTSP ARIA 3.0 SOLID SURFACE MATERIAL WALL TALKERS TAC-WALL COLOR BY NUMBERS - COVE BASE	LAKE CHELAN VH9 DIORITE 0672 SILVER SMOKE 9226SS QUARRY 92 TEA FOR TWO GLOSS WT02	24" X 24" X 1/8" 6.5' X 75.5' ROLL X 0.080 THK AS REQUIRED 48" HIGH; LENGTH AT INDICATED ON DRAWINGS 4" X 8" X 1/4"	CLASS 1-B HOMOGENEOUS COMPOSITION WARRANTY. CLASS 1-B HOMOGENEOUS COMPOSITION WARRANTY. CLASS 1 FIRE RESISTANCE, HOMOGENOUS WARRANTY; INSTALL WITH 4" INTEGRAL BAS WARRANTY; INSTALL WITH 4" INTEGRAL BAS REFER TO SPECIFICATIONS CLASS B; BURLAP BACKING; SELF-HEALING FOOT ROLLS; PROVIDE CLEAR, ANODIZED C650 CHEMICAL RESISTANT; MOHS 7; INST.
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RT-1 RT-2 RT-3 SHEET VINYL (S SV-1 SOILD SURFAC SSM-1 TACKABLE SUR TAS-1 TILE - BASE (TB) TB-1 TILE - FLOOR (T TF-1 TILE - WALL (TW TW-1 TW-2 TRANSITION (TS TS-1 TS-2 TS-3 TS-4 TRIM (TR) TR-1 VINYL COMPC VCT-2 VCT-3 WALK OFF CAF WOC-1 WALL COVERIN WINDOW TREA	TARKETT OR EQUAL TARKETT OR EQUAL TARKETT OR EQUAL V) TARKETT OR EQUAL E MATERIAL (SSM) WILSONART OR EQUAL FACE (TAS) KOROSEAL OR EQUAL FACE (TAS) KOROSEAL OR EQUAL CROSSVILLE OR EQUAL F) DALTILE OR EQUAL CROSSVILLE OR EQUAL S) MARBLE THRESHOLD SCHLUTER SYSTEMS OR EQUAL TARKETT OR EQUAL SCHLUTER SYSTEMS SITION TILE (VCT) ARMSTRONG FLOORING OR EQUAL ARMSTRONG FLOORING OR EQUAL RPET (WOC) SHAW CONTRACT OR EQUAL NG (WC) SEE SHEDULE ON 1001 TMENT (WT)	COLOR SPLASH HAMMERED HRTSP COLOR SPLASH HAMMERED HRTSP ARIA 3.0 SOLID SURFACE MATERIAL WALL TALKERS TAC-WALL COLOR BY NUMBERS - COVE BASE COLOR BY NUMBERS - COVE BASE COLOR BY NUMBERS COLOR BY NUMBERS COLOR BY NUMBERS COLOR BY NUMBERS COLOR BY NUMBERS JULY STANDARD EXCELON IMPERIAL TEXTUR STANDARD EXCELON IMPERIAL TEXTUR	LAKE CHELAN VH9 LAKE CHELAN VH9 DIORITE 0672 SILVER SMOKE 9226SS QUARRY 92 TEA FOR TWO GLOSS WT02 UPTOWN TAUPE SPECKLE D202 TEA FOR TWO GLOSS WT02 CARBON 14 WT14 SATIN ANODIZED ALUMINUM (AE) SATIN ANODIZED ALUMINUM (AE) SILK 59234 FIELD GRAY 51927 RUBY RED 57534 SEE SCHEDULE ON 1001	24" X 24" X 1/8" 6.5' X 75.5' ROLL X 0.080 THK AS REQUIRED 48" HIGH; LENGTH AT INDICATED ON DRAWINGS 4" X 8" X 1/4" 2" X 2" MOSIAC (12" X 24" DOT-MOUNTED SHEET) 4" X 8" X 1/4" 4" X 8" X 1/4" 1/2" THICK AS REQUIRED TO MEET MATERIAL THICKNESS 1/4" TO 1/8" AS REQUIRED TO MEET MATERIAL THICKNESS 1/4" X 12" 1/8" 12" X 12" 1/8" 12" X 12" 1/8" 24" X 24" X .275" SEE SCHEDULE ON 1001	CLASS 1-B HOMOGENEOUS COMPOSITION WARRANTY. CLASS 1-B HOMOGENEOUS COMPOSITION WARRANTY. CLASS 1 FIRE RESISTANCE, HOMOGENOUS WARRANTY; INSTALL WITH 4" INTEGRAL BAS REFER TO SPECIFICATIONS CLASS B; BURLAP BACKING; SELF-HEALING FOOT ROLLS; PROVIDE CLEAR, ANODIZED C650 CHEMICAL RESISTANT; MOHS 7; INST. C650 CHEMICAL RESISTANT; C650 CHEMICAL RESISTANT; C650 CHEMICAL RESISTANT; TYPE II; C163 INSTALLATION. C1635 2 THROUGH PATTERN; TYPE II; C1635 INSTALLATION. C1635 2 THROUGH PATTERN; TYPE II; C1635 INSTALLATION. C1635 2 THROUGH PATTERN; TYPE II; C1635 INSTALLATION.
RT-1 RT-2 RT-3 SHEET VINYL (S SV-1 SOILD SURFAC SSM-1 TACKABLE SUR TAS-1 TILE - BASE (TB) TB-1 TILE - FLOOR (T TF-1 TILE - VALL (TW TW-1 TW-2 TRANSITION (TS TS-1 TS-2 TS-3 TS-4 TRIM (TR) TR-1 VINYL COMPC VCT-1 VCT-2 VCT-3 WALK OFF CAF WOC-1 WALL COVERIN WC-1 WINDOW TREA WT-1	TARKETT OR EQUAL TARKETT OR EQUAL TARKETT OR EQUAL V) TARKETT OR EQUAL E MATERIAL (SSM) WILSONART OR EQUAL FACE (TAS) KOROSEAL OR EQUAL CROSSVILLE OR EQUAL F) DALTILE OR EQUAL CROSSVILLE OR EQUAL S) MARBLE THRESHOLD SCHLUTER SYSTEMS OR EQUAL TARKETT OR EQUAL TARKETT OR EQUAL SS SCHLUTER SYSTEMS SITION TILE (VCT) ARMSTRONG FLOORING OR EQUAL ARMSTRONG FLOORING OR EQUAL RPET (WOC) SHAW CONTRACT OR EQUAL NG (WC) SEE SHEDULE ON 1001 TIMENT (WT) BLUESHADE BY DRAPERY INDUSTRIES OR EQUAL RFACE (WS)	COLOR SPLASH HAMMERED HRTSP COLOR SPLASH HAMMERED HRTSP ARIA 3.0 SOLID SURFACE MATERIAL WALL TALKERS TAC-WALL COLOR BY NUMBERS - COVE BASE COLOR BY NUMBERS - COVE BASE COLOR BY NUMBERS COLOR BY NUMBERS COLOR BY NUMBERS COLOR BY NUMBERS COLOR BY NUMBERS COLOR BY NUMBERS JUNPRO-T 1/4" TO 1/8" SLIMLINE REDUCER SLT-XX- THRESHOLD COVER PLATE JULLY STANDARD EXCELON IMPERIAL TEXTUR STANDARD EXCELON IMPERIAL TEXTUR	LAKE CHELAN VH9 DIORITE 0672 SILVER SMOKE 9226SS QUARRY 92 TEA FOR TWO GLOSS WT02 UPTOWN TAUPE SPECKLE D202 TEA FOR TWO GLOSS WT02 CARBON 14 WT14 SATIN ANODIZED ALUMINUM (AE) SATIN ANODIZED ALUMINUM (AE) SILK 59234 FIELD GRAY 51927 RUBY RED 57534 STRIDE 14505 SEE SCHEDULE ON 1001	24" X 24" X 1/8" 6.5' X 75.5' ROLL X 0.080 THK AS REQUIRED 48" HIGH; LENGTH AT INDICATED ON DRAWINGS 4" X 8" X 1/4" 2" X 2" MOSIAC (12" X 24" DOT-MOUNTED SHEET) 4" X 8" X 1/4" 4" X 8" X 1/4" 1/2" THICK AS REQUIRED TO MEET MATERIAL THICKNESS 1/4" TO 1/8" AS REQUIRED TO MEET MATERIAL THICKNESS 1/4" TO 1/8" AS REQUIRED TO MEET TILE THICKNESS 12" X 12" 1/8" 12" X 12" 1/8" 12" X 12" 1/8" 24" X 24" X .275" SEE SCHEDULE ON 1001 FILL RANGE; WIDTH VARIES; G.C. TO VERIFY IN FIELD	CLASS 1-B HOMOGENEOUS COMPOSITION WARRANTY. CLASS 1-B HOMOGENEOUS COMPOSITION WARRANTY. CLASS 1-BIRE RESISTANCE, HOMOGENOUS WARRANTY; INSTALL WITH 4" INTEGRAL BAS REFER TO SPECIFICATIONS CLASS B; BURLAP BACKING; SELF-HEALING FOOT ROLLS; PROVIDE CLEAR, ANODIZED C650 CHEMICAL RESISTANT; MOHS 7; INST. C650 CHEMICAL RESISTANT; MOHS 7; INST. C10 PROVIDE THRESHOLD THAT IS COM INSTALL AT ALL EXPOSED EDGES & OUTSID CLASS 2 THROUGH PATTERN; TYPE II; CLASS INSTALLATION. CLASS 2 THROUGH PATTERN; TYPE II; CLASS INSTALLATION. CLASS 1; MULTI-PATTERN LOOP; 100% SOLU REFER TO DIGITAL GRAPHICS SCHEDULE; N DESIGNED SEPARATELY WITH A UNIQUE DE BLUESHADE MANUAL CLUTCH WITH 4" SQL
RT-1 RT-2 RT-3 SHEET VINYL (S) SV-1 SOILD SURFAC SM-1 TACKABLE SUR TAS-1 TILE - BASE (TB) TB-1 TILE - FLOOR (T TF-1 TILE - WALL (TW TW-1 TW-2 TRANSITION (TS TS-1 TS-2 TS-3 TS-4 TRIM (TR) TR-1 VINYL COMPC VCT-1 VCT-2 VCT-3 WALK OFF CAF WOC-1 WALL COVERING WT-1	TARKETT OR EQUAL TARKETT OR EQUAL TARKETT OR EQUAL V) TARKETT OR EQUAL E MATERIAL (SSM) WILSONART OR EQUAL FACE (TAS) KOROSEAL OR EQUAL FACE (TAS) CROSSVILLE OR EQUAL CROSSVILLE OR EQUAL F) DALTILE OR EQUAL CROSSVILLE OR EQUAL S) MARBLE THRESHOLD SCHLUTER SYSTEMS OR EQUAL TARKETT OR EQUAL SSTITION TILE (VCT) ARMSTRONG FLOORING OR EQUAL ARMSTRONG F	COLOR SPLASH HAMMERED HRTSP COLOR SPLASH HAMMERED HRTSP ARIA 3.0 SOLID SURFACE MATERIAL WALL TALKERS TAC-WALL COLOR BY NUMBERS - COVE BASE COLOR BY NUMBERS - COVE BASE COLOR BY NUMBERS COLOR BY NUMBERS COLOR BY NUMBERS COLOR BY NUMBERS COLOR BY NUMBERS JULY STANDARD EXCELON IMPERIAL TEXTUR STANDARD EXCELON IMPERIAL TEXTUR	LAKE CHELAN VH9 LAKE CHELAN VH9 DIORITE 0672 SILVER SMOKE 9226SS QUARRY 92 TEA FOR TWO GLOSS WT02 UPTOWN TAUPE SPECKLE D202 TEA FOR TWO GLOSS WT02 CARBON 14 WT14 SATIN ANODIZED ALUMINUM (AE) SATIN ANODIZED ALUMINUM (AE) SILK 59234 FIELD GRAY 51927 RUBY RED 57534 SEE SCHEDULE ON 1001	24" X 24" X 1/8" 6.5' X 75.5' ROLL X 0.080 THK AS REQUIRED 48" HIGH; LENGTH AT INDICATED ON DRAWINGS 4" X 8" X 1/4" 2" X 2" MOSIAC (12" X 24" DOT-MOUNTED SHEET) 4" X 8" X 1/4" 1/2" THICK AS REQUIRED TO MEET MATERIAL THICKNESS 1/4" TO 1/8" AS REQUIRED TO MEET MATERIAL THICKNESS 1/4" TO 1/8" AS REQUIRED TO MEET TILE THICKNESS 12" X 12" 1/8" 12" X 12" 1/8" 24" X 24" X .275" SEE SCHEDULE ON 1001 FILL RANGE; WIDTH VARIES; G.C. TO	CLASS 1-B HOMOGENEOUS COMPOSITION WARRANTY. CLASS 1-B HOMOGENEOUS COMPOSITION WARRANTY. CLASS 1 FIRE RESISTANCE, HOMOGENOUS WARRANTY; INSTALL WITH 4" INTEGRAL BAS REFER TO SPECIFICATIONS CLASS B; BURLAP BACKING; SELF-HEALING FOOT ROLLS; PROVIDE CLEAR, ANODIZED C650 CHEMICAL RESISTANT; MOHS 7; INST. C650 CHEMICAL RESISTANT; C650 CHEMICAL RESISTANT; C650 CHEMICAL RESISTANT; TYPE II; C163 INSTALLATION. C1635 2 THROUGH PATTERN; TYPE II; C1635 INSTALLATION. C1635 2 THROUGH PATTERN; TYPE II; C1635 INSTALLATION. C1635 2 THROUGH PATTERN; TYPE II; C1635 INSTALLATION.

	1
INTERIOR FINISH SCHEDULE	
SPECIFICATIONS	NOTES
CLASS A; 100% POLYESTER; NRC 0.45 - 0.95 CLASS A; 100% POLYESTER; NRC 0.45 - 0.95	CLE - MUSIC CLASSROOM CLE - MUSIC CLASSROOM
CLASS A; 100% POLYESTER; NRC 0.45 - 0.95 CLASS A; 100% POLYESTER; NRC 0.45 - 0.95	CLE - MUSIC CLASSROOM CLE - MUSIC CLASSROOM
CLASS A FIRE PERFORMANCE; NRC .70; CAC 35; 85% LIGHT RREFLECTANCE; BIOBLOCK, MILDEW & MOLD RESISTANT; WITH 15/16" PRELUDE XL SUSPENSION SYSTEM; W CLASS A FIRE PERFORMANCE; NRC .70; CAC 35; 85% LIGHT RREFLECTANCE; BIOBLOCK, MILDEW & MOLD RESISTANT; WITH 15/16" PRELUDE XL SUSPENSION SYSTEM; W	
CLASS 1; MULTI-LEVEL PATTERN LOOP; 100% SOLUTION DYED; PASSES PILL TEST; SSP SHAW SOIL PROTECTION; QUARTER-TURN INSTALLATION. CLASS 1; MULTI-LEVEL PATTERN LOOP; 100% SOLUTION DYED; PASSES PILL TEST; SSP SHAW SOIL PROTECTION; QUARTER-TURN INSTALLATION.	CLE - MAIN OFFICE CLE - MUSIC CLASSROOM
REFER TO SPECIFICATIONS	TOILET ROOMS
HIGH PERFORMANCE EPOXY GROUT WITH MICROBAN ANTIMICROBIAL PROTECTION	WALL TILE GROUT
HIGH PERFORMANCE EPOXY GROUT WITH MICROBAN ANTIMICROBIAL PROTECTION	FLOOR TILE GROUT
GRAIN TO RUN VERTICALLY	WOS - VERTICAL; CASEWORK
GRAIN TO RUN VERTICALLY	WOS - HORIZONTAL; COUNTERTOPS CLE - VERTICAL; CASEWORK
	CLE - HORIZONTAL; COUNTERTOPS
CLASS 1 RADIANT FLUX; <450 SMOKE DENSITY; CLASS III PRINTED VINYL PLANK; 22 MIL WEAR LAYER; 1,500 PSI; 15 YEAR COMMERCIAL WARRANTY; ASHLAR INSTALLAT	ODLE - MAIN OFFICE
CLASS 1 RADIANT FLUX; <450 SMOKE DENSITY; CLASS III PRINTED VINYL PLANK; 22 MIL WEAR LAYER; 1,500 PSI; 15 YEAR COMMERCIAL WARRANTY; ASHLAR INSTALLATI CLASS 1 RADIANT FLUX; <450 SMOKE DENSITY; CLASS III PRINTED VINYL PLANK; 20 MIL WEAR LAYER; 1,200 PSI; 15 YEAR COMMERCIAL LIMITED WARRANTY; STAGGERE	ONE - MUSIC CLASSROOM
INSTALLATION METHOD CLASS 1 RADIANT FLUX; <450 SMOKE DENSITY; CLASS III PRINTED VINYL PLANK; 20 MIL WEAR LAYER; 1,200 PSI; 15 YEAR COMMERCIAL LIMITED WARRANTY; MONOLITH	
INSTALLATION METHOD	
REFER TO SPECIFICATIONS	FIELD COLOR, U.N.O.
REFER TO SPECIFICATIONS REFER TO SPECIFICATIONS	ACCENT COLOR HM DOOR & WINDOW FRAMES
REFER TO SPECIFICATIONS	GYP CEILING; U.N.O.
REFER TO SPECIFICATIONS	NURSE'S OFFICE ACCENT COLOR
	TYPICAL WALL BASE; U.N.O.
CLASS B <450 SMOKE DENSITY; CLASS 1 RADIANT PANEL; PROVIDE IN 120' ROLLS.	TIFICAL WALL BASE, U.N.O.
SEE SPECS	CLE - MUSIC CLASSROOM
CLASS 1-B HOMOGENEOUS COMPOSITION OF 100% SYNTHETIC RUBBER; CLASS 1 FIRE RESISTANCE; NOT LESS THAN 85 SHORE A HARDNESS; LIMITED 5-YEAR COMMER	CHAIERNATE BID GC-03 - FIELD TILE; U.N.O.
WARRANTY. CLASS 1-B HOMOGENEOUS COMPOSITION OF 100% SYNTHETIC RUBBER; CLASS 1 FIRE RESISTANCE; NOT LESS THAN 85 SHORE A HARDNESS; LIMITED 5-YEAR COMMER	CHALERNATE BID GC-03 - ACCENT COLOR
WARRANTY. CLASS 1-B HOMOGENEOUS COMPOSITION OF 100% SYNTHETIC RUBBER; CLASS 1 FIRE RESISTANCE; NOT LESS THAN 85 SHORE A HARDNESS; LIMITED 5-YEAR COMMER WARRANTY.	CHATERNATE BID GC-03 - ACCENT COLOR
CLASS 1 FIRE RESISTANCE, HOMOGENOUS VINYL CONSTRUCTION; 2MM WEAR LAYER; 2MM TOTAL THICKNESS; DIRECT GLUE-DOWN INSTALLATION; LIMITED 10-YEAR WARRANTY; INSTALL WITH 4" INTEGRAL BASE.	WOS - NURSE'S OFFICE
WARRANIT, INSTALL WITH 4 INTEGRAL DASE.	
REFER TO SPECIFICATIONS	TYPICAL WINDOW SILL
CLASS B; BURLAP BACKING; SELF-HEALING LINOLEUM RESILIENT HOMOGENEOUS TACKABLE MATERIAL; COLOR EXTENDS FULL THICKNESS OF MATERIAL; PROVIDE IN 9 FOOT ROLLS; PROVIDE CLEAR, ANODIZED TRIM AT ALL EDGES; LIMITED 5-YEAR WARRANTY	STYPICAL TACKABLE SURFACE
C650 CHEMICAL RESISTANT; MOHS 7; INSTALL WITH 1/16" GROUT JOINT	TOILET ROOMS
C650 CHEMICAL RESISTANT; DCOF > 0.42; INSTALL WITH 1/8" GROUT JOINT	TOILET ROOMS
C650 CHEMICAL RESISTANT; MOHS 7; INSTALL WITH 1/16" GROUT JOINT	TOILET ROOMS; FIELD TILE
C650 CHEMICAL RESISTANT; MOHS 7; INSTALL WITH 1/16" GROUT JOINT	TOILET ROOM; ACCENT TILE
TRANSITION MUST BE ADA COMPLAINT	ALL TOILET ROOM LOCATIONS; U.N.O.
	LVT/VCT/RT OR ETR FLOORING OR VCT
GC TO PROVIDE THRESHOLD THAT IS COMPATIABLE FOR ADJACENT FLOOR FINISHES	LVT TO CPT/WOC VCT TO ETR SPORTS FLOOR
s Install at all exposed edges & outside corners of tile installation	TOILET ROOMS
CLASS 2 THROUGH PATTERN; TYPE II; CLASS 1 RADIANT PANEL; 2000 PSI; FAST START FACTORY FINISH; 5-YEAR LIMITED COMMERICAL WARRANTY, QUARTER TURN	BASE BID - FIELD TILE; U.N.O.
INSTALLATION. CLASS 2 THROUGH PATTERN; TYPE II; CLASS 1 RADIANT PANEL; 2000 PSI; FAST START FACTORY FINISH; 5-YEAR LIMITED COMMERICAL WARRANTY, QUARTER TURN	BASE BID - ACCENT COLOR
INSTALLATION. CLASS 2 THROUGH PATTERN; TYPE II; CLASS 1 RADIANT PANEL; 2000 PSI; FAST START FACTORY FINISH; 5-YEAR LIMITED COMMERICAL WARRANTY, QUARTER TURN	BASE BID - ACCENT COLOR
INSTALLATION.	
CLASS 1; MULTI-PATTERN LOOP; 100% SOLUTION DYED; PASSES PILL TEST; SSP SHAW SOIL PROTECTION; QUARTER-TURN INSTALLATION	CLE - SECURE VESTIBULE
REFER TO DIGITAL GRAPHICS SCHEDULE; MANUFACTURER TO CREATE A GRAPHIC IMAGE & DESIGN IN COORDINATION WITH OWNER & ARCHITECCT. EACH AREA W DESIGNED SEPARATELY WITH A UNIQUE DESIGN. SIZE WILL VARY. GC TO PROVIDE FILEND MESUREMENTS. PAINT ALL WALLS FULL HEIGHT, AS SCHEDULED.	ISEBSCHEDULE ON 1001
BLUESHADE MANUAL CLUTCH WITH 4" SQUARE FASCIA; ANODIZED ALUMINUM.	TYPICAL WINDOW TREATMENT
CLASS A; TYPE II; WOVEN BACKING; MODERATE GLOSS FINISH; STRAIGHT MATCH PATTERN	TYPICAL WRITEABLE SURFACE


TYPICAL TRANSITION TYPES:

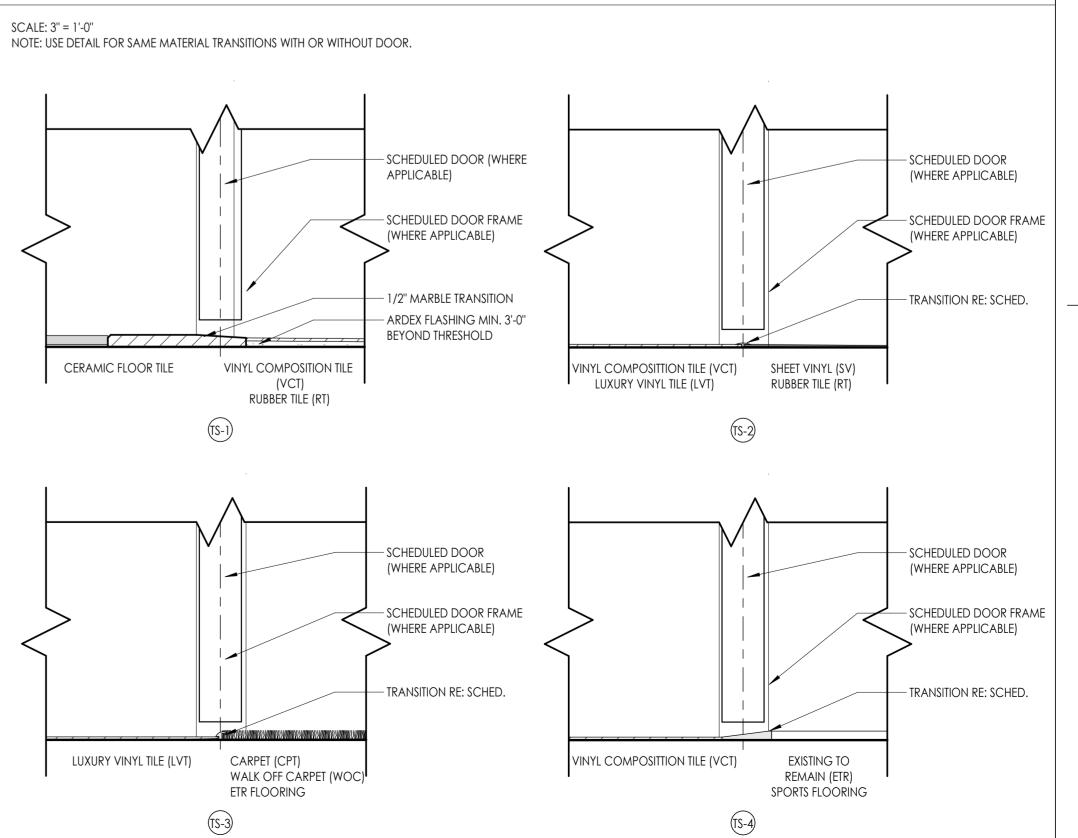

FINISH ABBREVIATIONS

NOTE: THIS LEGENE	D MAY CONTAIN ABBREVIATIONS THAT ARE NOT IN TH	IS PROJECT	
ACT AGL AWP CC CG CHR CPT CR DG DS DWC DWP EPT ERF ETR EXP FILM FRP GRT HPL HR INT LVT PT	ACOUSTICAL CEILING TILE ART GLASS ACOUSTICAL WALL PANEL CUBICLE CURTAIN CORNER GUARD CHAIR RAIL CARPET CRASH RAIL DIGITAL GRAPHIC DIVIDER STRIP DIGITAL WALL COVERING DIGITAL WALL COVERING DIGITAL WALL COVERING DIGITAL WALL COVERING DIGITAL WALL COVERING DIGITAL WALL COVERING EXISTING TO REMAIN EPOXY RESIN FLOOR EXISTING TO REMAIN EXPOSED FILM FIBER REINFORCED PANEL GROUT HIGH PRESSURE PLASTIC LAMINATE HAND RAIL INTEGRAL LUXURY VINYL TILE PAINT	RB RP RS RST RT SC SCON SN SSM ST SV SWP TB TER TF TR TAS TS TW UPH VCT VQT WC	STAIR NOSING & RISER SOLID SURFACE MATERIAL STONE VENEER SHEET VINYL SHEET WALL PROTECTION TILE BASE TERRAZZO TILE FLOOR TRIM TACKABLE SURACE TRANSITION STRIP TILE WALL UPHOLSTERY VINYL COMPOSITION TILE VINYL ENHANCED TILE VINYL ENHANCED TILE VINYL QUARTZ TILE WALL COVERING
2.1		WT	WINDOW TREATMENT

TYPICAL TILE PATTERN TYPES

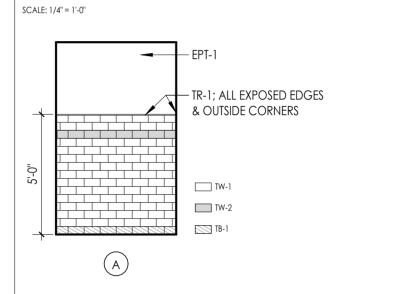



REGISTRATION EXPIR. DATES: Lauren Tarsio 09/30/26 District Office Address Richard Waite 11/30/23

160 VAN WYCK RD. Larry Werts 12/31/24 BLAUVELT, NY 10913 Anthony Marchetti 05/31/24


Dave Hart 02/28/25 Jennifer Wengender 06/30/24

south orangetown csd WILLIAM O. SCHAEFER SED#:50-03-01-06-0-012-019

- COTTAGE LANE ELEMENTARY SED#:50-03-01-06-0-010-022 TAPPAN ZEE HIGH SCHOOL SED#:50-03-01-06-0-006-032
- WILLIAM O. SCHAEFER S&L SED#:50-03-01-06-0-012-020
- COTTAGE LANE S&L SED#: 50-03-01-06-0-010-023 COTTAGE LANE LIBRARY S&L SED#: 50-03-01-06-8-023-002
- WOS OUTDOOR CLASSROOM SED#: 50-03-01-06-7-053-001 SOMS OUTDOOR CLASSROOM SED#:50-03-01-06-7-056-001
- CLE OUTDOOR CLASSROOM SED#:50-03-01-06-7-054-001 TZHS OUTDOOR CLASSROOM SED#:50-03-01-06-7-055-001

PROJECT ISSUE & REVISION SCHEDULE No. Date Description




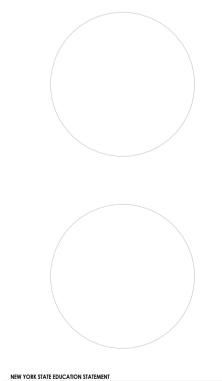


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SHEET INFORMATION Issued Scale 10/18/23 As indicated Project Status **BID DOCUMENTS** Drawn By Checked By ALS CPL Drawing Title

INTERIORS GENERAL



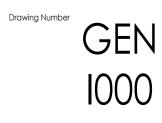

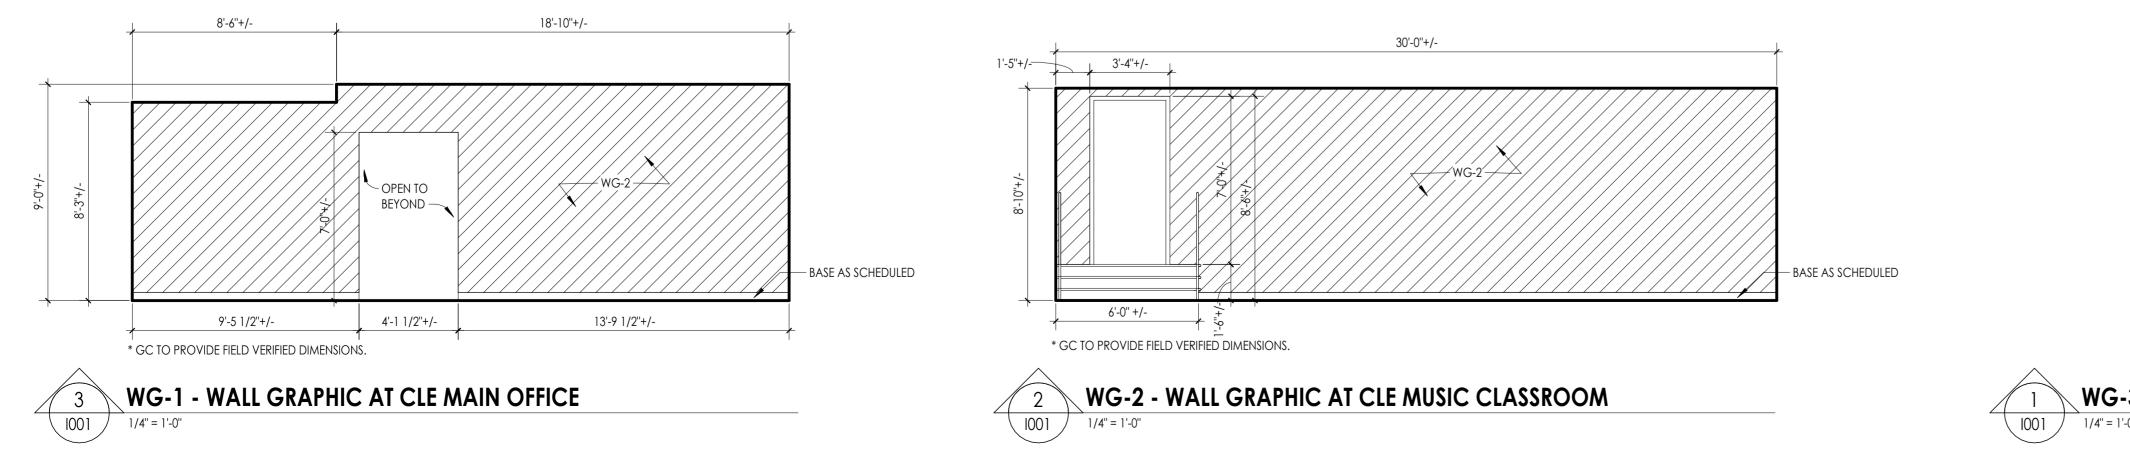	WALL GRAHIC SCHEDULE				
TAG	ROOM	APPLICATION	ТҮРЕ	DESCRIPTION	
WG-1		DIGITALLY PRINTED COLOR WALL COVERING ON GWB WALL. GRAPHIC TO EXTEND FULL HEIGHT & LENGTH OF WALL. GC TO PROVIDE VERIFIED DIMENSION IN FIELD.		IMAGE SUPPLIED AND APPROVED BY OWNER & ARCHITECT. PHYSICAL SAMPLE TO SCALE PROVIDED FOR OWNER & ARCHITECT APPROVAL. PLEASE CONSTACT EDNA CYZ (716) 432-1736 FOR SAMPLES AND SPEC INFO. REFER TO DRAWINGS FOR LOCATIONS & SIZES.	
WG-2		DIGITALLY PRINTED COLOR WALL COVERING ON GWB WALL. GRAPHIC TO EXTEND FULL HEIGHT & LENGTH OF WALL. GC TO PROVIDE VERIFIED DIMENSION IN FIELD.		IMAGE SUPPLIED AND APPROVED BY OWNER & ARCHITECT. PHYSICAL SAMPLE TO SCALE PROVIDED FOR OWNER & ARCHITECT APPROVAL. PLEASE CONSTACT EDNA CYZ (716) 432-1736 FOR SAMPLES AND SPEC INFO. REFER TO DRAWINGS FOR LOCATIONS & SIZES.	
WG-3		DIGITALLY PRINTED COLOR WINDOW FILM ON GLAZING. GRAPHIC TO EXTEND FULL HEIGHT AND NOT* LENGTH OF AREA INDICATED	VINYL FILM SUBSTRATE	IMAGE SUPPLIED AND APPROVED BY OWNER & ARCHITECT. PHYSICAL SAMPLE TO SCALE PROVIDED FOR OWNER & ARCHITECT APPROVAL. PLEASE CONSTACT EDNA CYZ (716) 432-1736 FOR SAMPLES AND SPEC INFO. REFER TO DRAWINGS FOR LOCATIONS & SIZES.	
WG-4		DIGITALLY PRINTED COLOR WINDOW FILM ON GLAZING. GRAPHIC TO EXTEND FULL HEIGHT AND NOT* LENGTH OF AREA INDICATED		IMAGE SUPPLIED AND APPROVED BY OWNER & ARCHITECT. PHYSICAL SAMPLE TO SCALE PROVIDED FOR OWNER & ARCHITECT APPROVAL. PLEASE CONSTACT EDNA CYZ (716) 432-1736 FOR SAMPLES AND SPEC INFO. REFER TO DRAWINGS FOR LOCATIONS & SIZES.	
WG-5		DIGITALLY PRINTED COLOR WINDOW FILM ON GLAZING. GRAPHIC TO EXTEND FULL HEIGHT AND NOT* LENGTH OF AREA INDICATED	VINYL FILM SUBSTRATE	IMAGE SUPPLIED AND APPROVED BY OWNER & ARCHITECT. PHYSICAL SAMPLE TO SCALE PROVIDED FOR OWNER & ARCHITECT APPROVAL. PLEASE CONSTACT EDNA CYZ (716) 432-1736 FOR SAMPLES AND SPEC INFO. REFER TO DRAWINGS FOR LOCATIONS & SIZES.	




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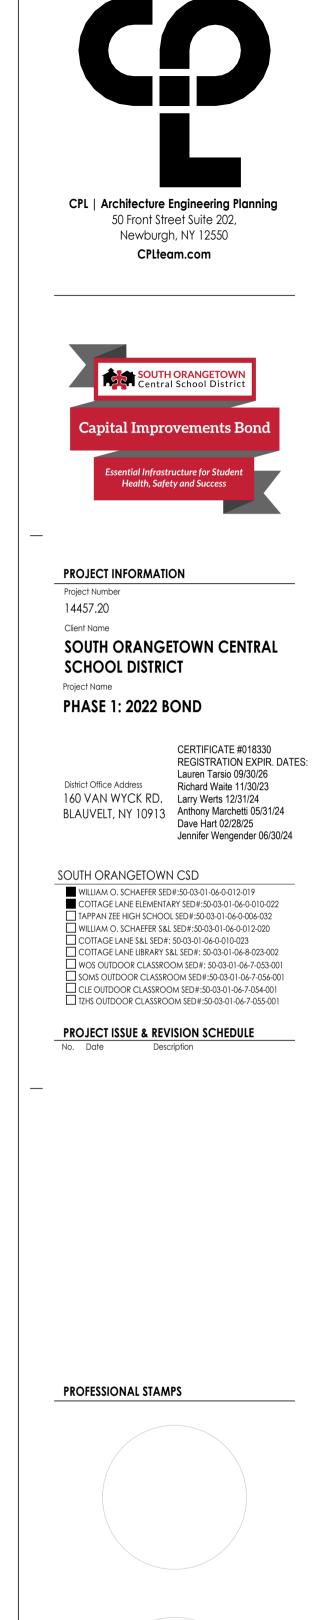


2'-4"+/-



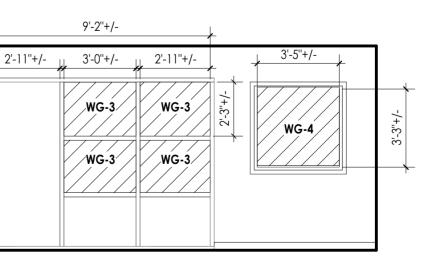

* GC TO PROVIDE FIELD VERIFIED DIMENSIONS.



HEY TORK STATE EDUCATION STATEMENT IT IS A VIOLATION OF THE NEW YORK STATE EDUCATION LAW AN REGULATIONS FOR ANY PERSON, UNLESS ACTING UNDER THE DI ARCHITECT, ENGINEER OR LAND SURVEYOR, TO ALTER AN ITEM BEARING THE SEAL OF AN ARCHITECT, ENGINEER OR SURVEYOR PARTY SHALL AFEX TO THE ITEM THER SEAL AND THE NOTATION ' HEIR SIGNATURE AND THE DATE OF SUCH ALTERATION, AND A SPECIFIC DESCRIPTION OF

SHEET INFORMATION	
Issued	Scale
10/18/23	1/4" = 1'-0"
Project Status	
BID DOCUMENTS	
Drawn By	Checked By
ALS	Checker
Drawing Title	

NEW YORK STATE EDUCATION STATEMENT

TYPICAL INTERIOR DETAILS





BASE BID: PROVIDE 3-COLOR PATTERN PATTERN: 60% VCT-1, 20% VCT-2, 20% VCT 2 ALTERNATE BID # GC-06: PROVIDE 3-CC BASE. RANDOM PATTERN: 60% RT-1, 20% 3 PROVIDE WINDOW TREATMENT (WT-1). F ADDITIONAL INFORMATION. 4 PROVIDE WRITEABLE/MAGNETIC SURFA 5 PROVIDE TACKABLE SURFACE (TAS-1) : INFORMATION. PROVIDE DIGITALLY PRINTED WINDOW 6 SCHEDULE & ADDITIONAL DETAIL. 7 PROVIDE 2-COLOR PATTERN CERAMIC EPOXY PAINT (EPT-1) ABOVE. REFER TO DETAIL. ROVIDE SCHEDULED LVT IN ASHLAR IN PROVIDE SCHEDULED CPT IN QUARTER- $\overline{(10)}$ PROVIDE WOC-1 IN QUARTER-TURN INS PROVIDE DIGITALLY PRINTED WALL GRA FOR GRAPHICS SCHEDULE & ADDITION PROVIDE INTEGRAL RESILIENT STAIR TREAD (RST-1) & RISERS AT STAIR LO PAINT STRINGERS & RAILING PT-2. PROVIDE LVT-2 & RB-1 AT LANDING. $\langle 13 \rangle$ PROVIDE VCT-1 IN ASHLAR INSTALLATION. PROVIDE 2 COLOR PAINT PATTERN WITH VINYL ADHERED SIGNAGE. SEE 2-1200 FOR ADDITIONAL DETAIL. 15 PROVIDE 4-COLOR PATTERN ACOUSTIC WALL PANELS (AWP). SEE A700 SERIES & FINISH SCHEDULE FOR ADDITIONAL INFORMATION.

FINISH PLAN KEY NOTES	F	INISH PLAN G
1 BASE BID: PROVIDE 3-COLOR PATTERN (VCT-1,2,3) WITH RESILIENT BASE. RANDOM PATTERN: 60% VCT-1, 20% VCT-2, 20% VCT-3.	1.	ALL NEW AND EXISTING HO FRAMES IN PROJECT SCOU ALL LOUVERS, VENTS, GRIL
2 <u>ALTERNATE BID # GC-06</u> : PROVIDE 3-COLOR PATTERN (RT-1,2,3) WITH RESILIENT BASE. RANDOM PATTERN: 60% RT-1, 20% RT-2, 20% RT-3.	2.	ELECTRICAL DEVICES ARE APPEAR, UNLESS NOTED C
3 PROVIDE WINDOW TREATMENT (WT-1). REFER TO INTERIOR FINISH SCHEDULE FOR ADDITIONAL INFORMATION.	3. 4.	REFER TO A600 SERIES DRA UNDERSIDE OF SOFFITS TO SPECIFICATIONS.
4 PROVIDE WRITEABLE/MAGNETIC SURFACE (WS-1) 2-6" AFF. SEE A700 SERIES FOR ADDITIONAL INFORMATION. WALL TO RECEIVE LEVEL 5 FINISH.	5. 6. 7.	PAINT GWB CEILINGS (PT- REFER TO A700 SERIES INTE ALL WINDOW SILLS SHALL
5 PROVIDE TACKABLE SURFACE (TAS-1) 2-6" AFF. SEE A700 SERIES FOR ADDITIONAL INFORMATION.	8. 9.	HIGH PRESSURE PLASTIC LA UNLESS NOTED OTHERWISE WHERE KICKSPACES OCC
6 PROVIDE DIGITALLY PRINTED WINDOW FILM. REFER TO 1001 FOR GRAPHICS SCHEDULE & ADDITIONAL DETAIL.	10.	RUN UNDERNEATH KICKSP REFER TO 1300 FOR FLOOR
PROVIDE 2-COLOR PATTERN CERAMIC WALL TILE WAINSCOT UP TO 5'-0" AFF WITH EPOXY PAINT (EPT-1) ABOVE. REFER TO TYPICAL TILE PATTERN "A" ON 1000 FOR DETAIL.		ALL FLOOR FINISHES SHALL NOTED OTHERWISE. INSTAL PROVIDE CONCRETE FLOO
8 PROVIDE SCHEDULED LVT IN ASHLAR INSTALLATION.	13.	MANUFACTURER SPECIFIC ALL NON-EPOXY GROUT T COMPLETION.
9 PROVIDE SCHEDULED CPT IN QUARTER-TURN INSTALLATION.	F	LOOR PATTERI
$\langle 10 \rangle$ PROVIDE WOC-1 IN QUARTER-TURN INSTALLATION.		ALL FLOOR FINISHES SHALL OTHERWISE NOTED. INSTA
$\langle 11 \rangle$ PROVIDE DIGITALLY PRINTED WALL GRAPHIC FULL HEIGHT OF WALL. REDER TO 1001 FOR GRAPHICS SCHEDULE & ADDITIONAL DETAIL.	2. 3.	PROVIDE ADA ACCESSIBL OTHERWISE NOTED. ALL AREAS WITH INTEGRAI
PROVIDE INTEGRAL RESILIENT STAIR TREAD (RST-1) & RISERS AT STAIR LOCATIONS.	4.	AS THE ADJACENT FLOOR WHERE KICKSPACES OCC

GENERAL NOTES HOLLOW METAL DOORS, DOOR FRAMES AND WINDOW

COPE SHALL BE PAINTED (PT-3), UNLESS NOTED OTHERWISE. RILLES AND OTHER MISCELLANEOUS MECHANICAL AND RE TO BE PAINTED TO MATCH THE SURFACE ON WHICH THEY OTHERWISE. RAWINGS FOR CEILING TYPES AND SOFFIT FINISHES.

O MATCH FACE OF SOFFIT. SEE A600 SERIES FOR PAINT ACCENT -4), UNLESS NOTED OTHERWISE.

- ITERIOR ELEVATIONS FOR MILLWORK FINISHES.
- L BE **SSM-1**, UNLESS OTHERWISE NOTED. LAMINATE ON VERTICAL SURFACES TO RUN VERTICALLY,
- CUR AT MILLWORK, FLOOR FINISH SHOWN ON PLANS SHALL SPACE AS WELL. OR PATTERN PLANS & DETAILS.
- ALL TRANSITION AT THE CENTERLINE OF THE DOOR, UNLESS TALL TRANSITION STRIPS PER DETAILS ON **1000**.
- OOR PREPARATION IN ACCORDANCE WITH FLOORING
- ICATION. IT TO BE SEALED A MINIMUM OF TWO TIMES PRIOR TO


RNING GENERAL NOTES


- ALL TRANSITION AT THE CENTERLINE OF THE DOOR, UNLESS TALL TRANSITION STRIPS PER DETAILS. IBLE MARBLE THRESHOLD AT ALL TOILET ROOM DOORS UNLESS
- RAL BASE SHALL BE AT 4" A.F.F. BASE SHALL BE THE SAME COLOR DRING MATERIAL, UNLESS OTHERWISE NOTED. CCUR AT MILLWORK, FLOOR FINISH SHOWN ON PLANS SHALL RUN UNDERNEATH KICKSPACE AS WELL.

FINISH ABBREVIATIONS

NOTE: THIS LEGEND MAY CONTAIN ABBREVIATIONS THAT ARE NOT IN THIS PROJECT				
AC1	Т	ACOUSTICAL CEILING TILE	RB	RESILIENT BASE
AGI	L	ART GLASS	RP	RESIN PANEL
AW	Έ	ACOUSTICAL WALL PANEL	RS	RESILIENT SHEET
CC		CUBICLE CURTAIN	RST	RESILIENT STAIR TREAD
CG		CORNER GUARD	RT	RUBBER TILE
CHF	R	CHAIR RAIL	SC	SPECIALTY CEILING
CPT	Γ	CARPET	SCON	SEALED CONCRETE
CR		CRASH RAIL	SN	STAIR NOSING & RISER
DG		DIGITAL GRAPHIC	SSM	SOLID SURFACE MATERIAL
DS		DIVIDER STRIP	ST	STONE VENEER
DW	C	DIGITAL WALL COVERING	SV	SHEET VINYL
DW	Ρ	DIGITAL WALL PANEL	SWP	SHEET WALL PROTECTION
EPT		EPOXY PAINT	TB	TILE BASE
ERF		EPOXY RESIN FLOOR	TER	TERRAZZO
ETR		EXISTING TO REMAIN	TF	TILE FLOOR
EXP)	EXPOSED	TR	TRIM
FILM	Λ	FILM	TAS	TACKABLE SURACE
FRP		FIBER REINFORCED PANEL	TS	TRANSITION STRIP
GRT	Г	GROUT	TW	TILE WALL
HPL	-	HIGH PRESSURE PLASTIC LAMINATE	UPH	UPHOLSTERY
HR		HAND RAIL	VCT	VINYL COMPOSITION TILE
INT		INTEGRAL	VET	VINYL ENHANCED TILE
LVT		LUXURY VINYL TILE	VQT	VINYL QUARTZ TILE
PT		PAINT	WC	WALL COVERING
PTM	1	PATCH TO MATCH	WD	WOOD
QB		QUARRY TILE BASE	WG	WALL GUARD
QT		QUARRY TILE	WOC	WALK OFF CARPET
QTZ	-	QUARTZ	WS	WRITEABLE SURFACE
			WT	WINDOW TREATMENT

FINISH PLAN SYMBOLS LEGEND

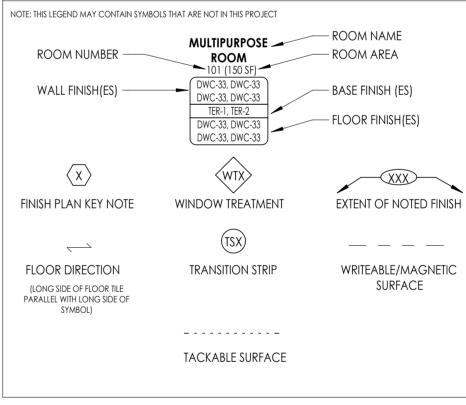

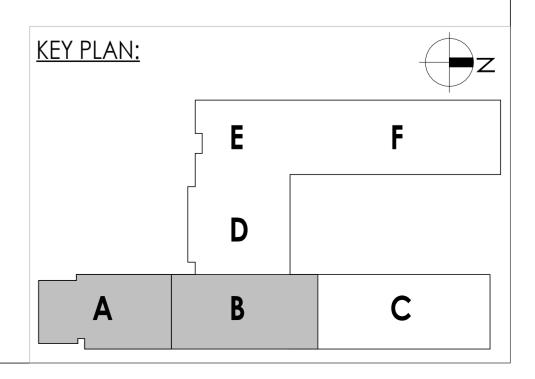

CPL | Architecture Engineering Planning 50 Front Street Suite 202, Newburgh, NY 12550 CPLteam.com SOUTH ORANG Capital Improvements Bon Health, Safety and Succes PROJECT INFORMATION Project Number 14457.20 Client Name SOUTH ORANGETOWN CENTRAL SCHOOL DISTRICT Proiect Name

PHASE 1: 2022 BOND

District Office Address

Lauren Tarsio 09/30/26 Richard Waite 11/30/23 160 VAN WYCK RD. Larry Werts 12/31/24

BLAUVELT, NY 10913 Anthony Marchetti 05/31/24 Dave Hart 02/28/25 Jennifer Wengender 06/30/24

- south orangetown CSD
- WILLIAM O. SCHAEFER SED#:50-03-01-06-0-012-019 COTTAGE LANE ELEMENTARY SED#:50-03-01-06-0-010-022


CERTIFICATE #018330 **REGISTRATION EXPIR. DATES:**

- TAPPAN ZEE HIGH SCHOOL SED#:50-03-01-06-0-006-032
- WILLIAM O. SCHAEFER S&L SED#:50-03-01-06-0-012-020 COTTAGE LANE S&L SED#: 50-03-01-06-0-010-023
- OTTAGE LANE LIBRARY S&L SED#: 50-03-01-06-8-023-002
- WOS OUTDOOR CLASSROOM SED#: 50-03-01-06-7-053-001 SOMS OUTDOOR CLASSROOM SED#:50-03-01-06-7-056-001 CLE OUTDOOR CLASSROOM SED#:50-03-01-06-7-054-001

TZHS OUTDOOR CLASSROOM SED#:50-03-01-06-7-055-001

PROJECT ISSUE & REVISION SCHEDULE

PROFESSIONAL STAMPS

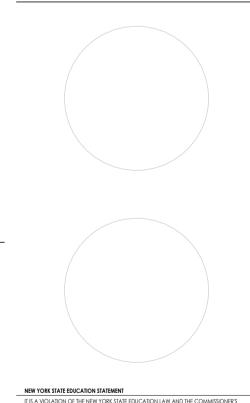


IT IS A VIOLATION OF THE NEW YORK STATE EDUCATION LAW AND THE COMMISSIONER'S REGULATIONS FOR ANY PERSON, UNLESS ACTING UNDER THE DIRECTION OF A LICENSED ARCHITECT, INGINEER OR LAND SURVEYOR, TO ALTER AN ITEM IN ANY WAY. IF AN ITEM BEARING THE SEAL OF AN ARCHITECT, BUGINEER OR SURVEYOR IS ALTERD, THE ALTERNO PARTY SHALL AFFIX TO THE ITEM THER SEAL AND THE NOTATION "ALTERED BY" FOLLOWED B THEIR SIGNATURE AND THE DATE OF SUCH ALTERATION, AND A SPECIFIC DESCRIPTIO


SHEET INFORMATION

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PARTIAL FIRST FLOOR FINISH PLAN - AREA A & AREA B






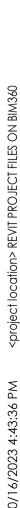
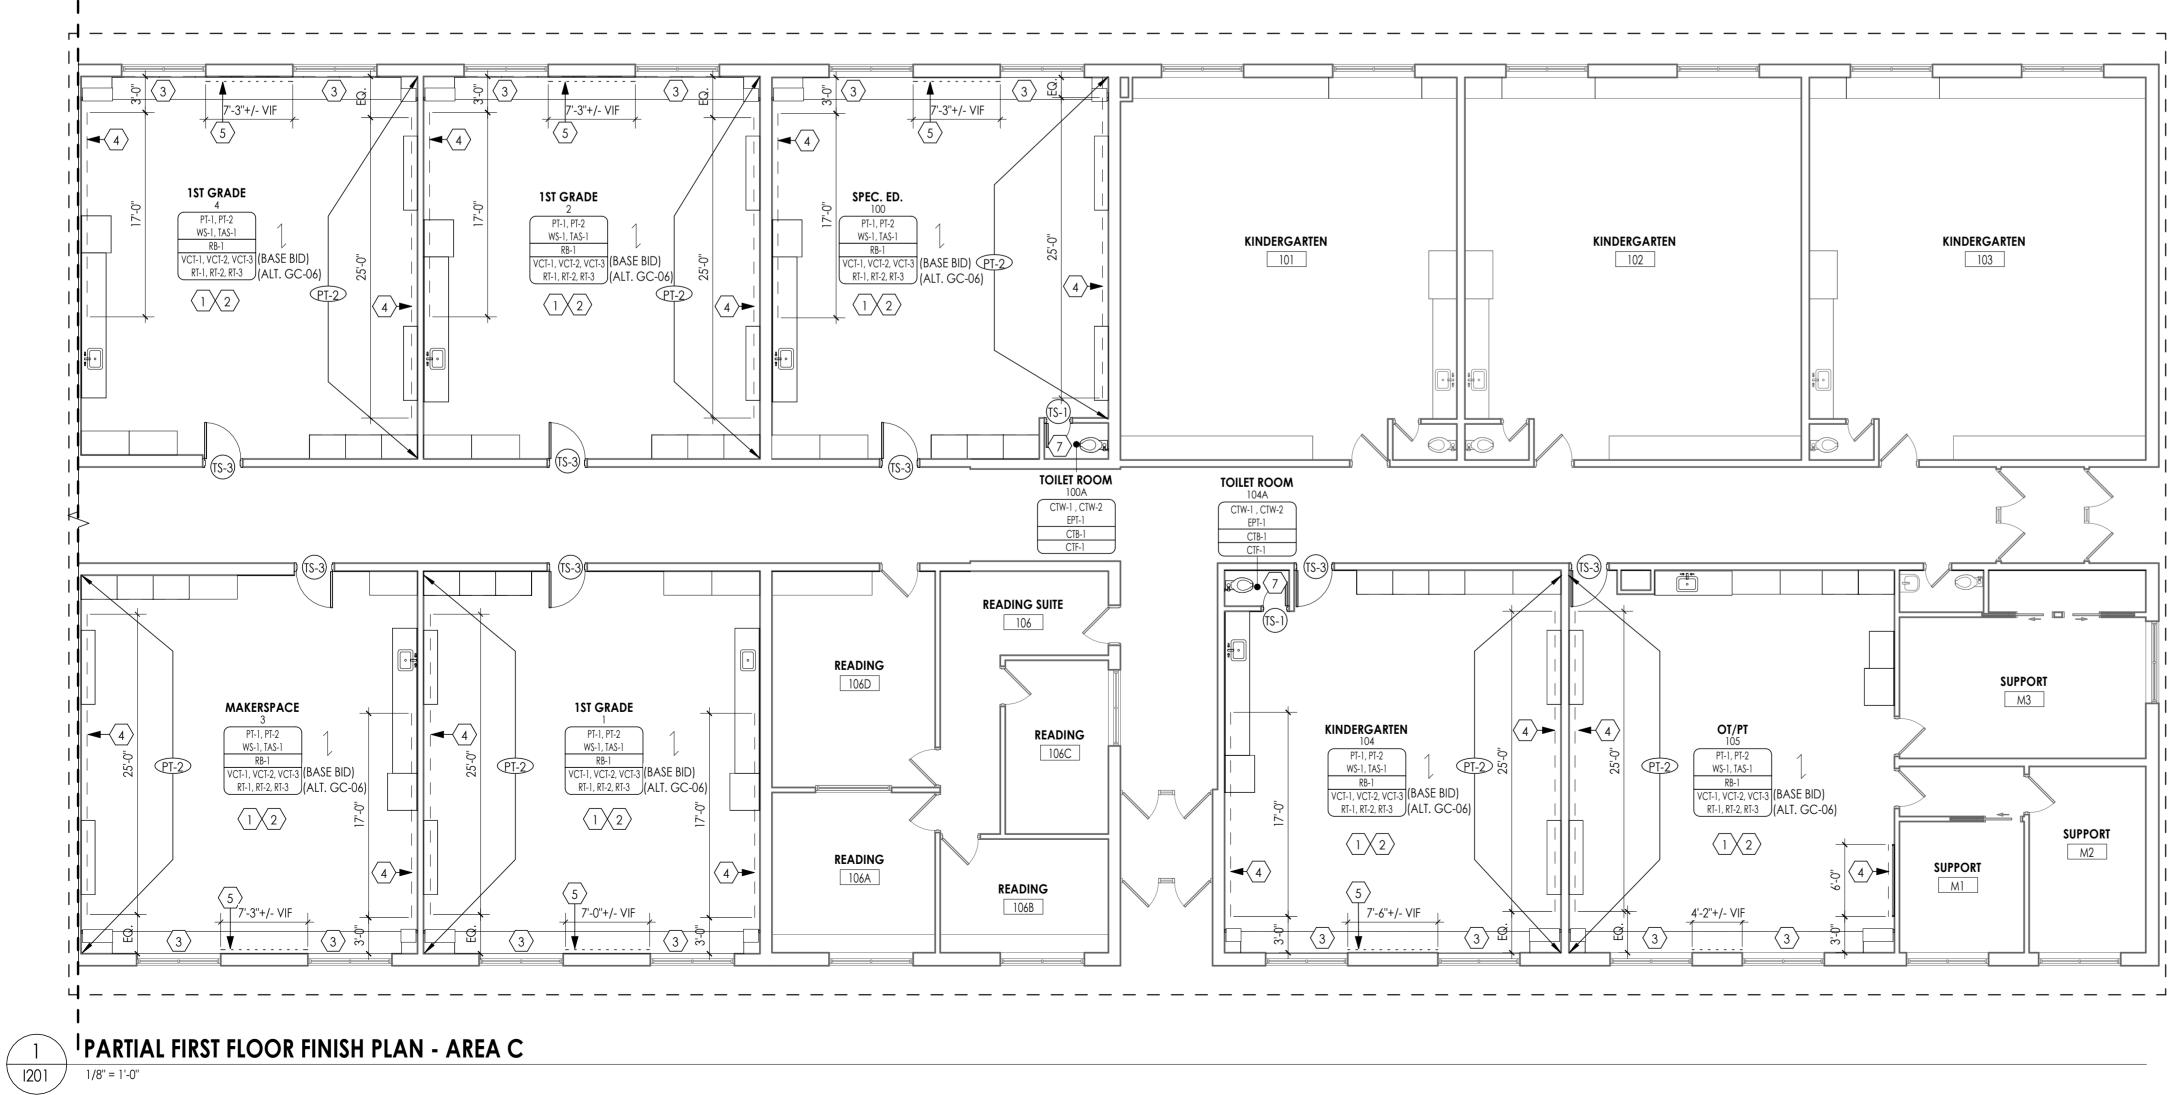
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FINISH PLAN KEY NOTES	FINISH PLAN GENERAL NOTES	
BASE BID: PROVIDE 3-COLOR PATTERN (VCT-1,2,3) WITH RESILIENT BASE. RANDOM PATTERN: 60% VCT-1, 20% VCT-2, 20% VCT-3.	1. ALL NEW AND EXISTING HOLLOW METAL DOORS, DOOR FRAMES AND WINDOW FRAMES IN PROJECT SCOPE SHALL BE PAINTED (PT-3), UNLESS NOTED OTHERWISE.	
ALTERNATE BID # GC-06: PROVIDE 3-COLOR PATTERN (RT-1,2,3) WITH RESILIENT	 ALL LOUVERS, VENTS, GRILLES AND OTHER MISCELLANEOUS MECHANICAL AND ELECTRICAL DEVICES ARE TO BE PAINTED TO MATCH THE SURFACE ON WHICH THEY 	
BASE. RANDOM PATTERN: 60% RT-1, 20% RT-2, 20% RT-3.	APPEAR, UNLESS NOTED OTHERWISE. 3. REFER TO A600 SERIES DRAWINGS FOR CEILING TYPES AND SOFFIT FINISHES.	
3 PROVIDE WINDOW TREATMENT (WT-1). REFER TO INTERIOR FINISH SCHEDULE FOR ADDITIONAL INFORMATION.	4. UNDERSIDE OF SOFFITS TO MATCH FACE OF SOFFIT. SEE A600 SERIES FOR PAINT ACCENT SPECIFICATIONS.	
4 PROVIDE WRITEABLE/MAGNETIC SURFACE (WS-1) 2-6" AFF. SEE A700 SERIES FOR ADDITIONAL INFORMATION. WALL TO RECEIVE LEVEL 5 FINISH.	 PAINT GWB CEILINGS (PT-4), UNLESS NOTED OTHERWISE. REFER TO A700 SERIES INTERIOR ELEVATIONS FOR MILLWORK FINISHES. ALL WINDOW SILLS SHALL BE SSM.1 JUNIESS OTHERWISE NOTED 	
PROVIDE TACKABLE SURFACE (TAS-1) 2-6" AFF. SEE A700 SERIES FOR ADDITIONAL	 ALL WINDOW SILLS SHALL BE SSM-1, UNLESS OTHERWISE NOTED. HIGH PRESSURE PLASTIC LAMINATE ON VERTICAL SURFACES TO RUN VERTICALLY, UNLESS NOTED OTHERWISE. 	CPL Architecture Engineering Planning
	 WHERE KICKSPACES OCCUR AT MILLWORK, FLOOR FINISH SHOWN ON PLANS SHALL RUN UNDERNEATH KICKSPACE AS WELL. 	50 Front Street Suite 202, Newburgh, NY 12550
SCHEDULE & ADDITIONAL DETAIL.	 REFER TO 1300 FOR FLOOR PATTERN PLANS & DETAILS. ALL FLOOR FINISHES SHALL TRANSITION AT THE CENTERLINE OF THE DOOR, UNLESS 	CPLteam.com
PROVIDE 2-COLOR PATTERN CERAMIC WALL TILE WAINSCOT UP TO 5'-0" AFF WITH EPOXY PAINT (EPT-1) ABOVE. REFER TO TYPICAL TILE PATTERN "A" ON 1000 FOR DETAIL.	NOTED OTHERWISE. INSTALL TRANSITION STRIPS PER DETAILS ON 1000 . 12. PROVIDE CONCRETE FLOOR PREPARATION IN ACCORDANCE WITH FLOORING	
8 PROVIDE SCHEDULED LVT IN ASHLAR INSTALLATION.	MANUFACTURER SPECIFICATION. 13. ALL NON-EPOXY GROUT TO BE SEALED A MINIMUM OF TWO TIMES PRIOR TO	
$\left< \frac{1}{9} \right>$ PROVIDE SCHEDULED CPT IN QUARTER-TURN INSTALLATION.	FLOOR PATTERNING GENERAL NOTES	SOUTH ORANGETOWN Central School District
	ALL FLOOR FINISHES SHALL TRANSITION AT THE CENTERLINE OF THE DOOR, UNLESS	
10 PROVIDE WOC-1 IN QUARTER-TURN INSTALLATION.	OTHERWISE NOTED. INSTALL TRANSITION STRIPS PER DETAILS. 2. PROVIDE ADA ACCESSIBLE MARBLE THRESHOLD AT ALL TOILET ROOM DOORS UNLESS	Capital Improvements Bond
PROVIDE DIGITALLY PRINTED WALL GRAPHIC FULL HEIGHT OF WALL. REDER TO 1001 FOR GRAPHICS SCHEDULE & ADDITIONAL DETAIL.	OTHERWISE NOTED. 3. ALL AREAS WITH INTEGRAL BASE SHALL BE AT 4" A.F.F. BASE SHALL BE THE SAME COLOR	Essential Infrastructure for Student Health, Safety and Success
PROVIDE INTEGRAL RESILIENT STAIR TREAD (RST-1) & RISERS AT STAIR LOCATIONS. PAINT STRINGERS & RAILING PT-2. PROVIDE LVT-2 & RB-1 AT LANDING.	 AS THE ADJACENT FLOORING MATERIAL, UNLESS OTHERWISE NOTED. 4. WHERE KICKSPACES OCCUR AT MILLWORK, FLOOR FINISH SHOWN ON PLANS SHALL RUN UNDERNEATH KICKSPACE AS WELL. 	
$\left< \frac{13}{13} \right> \text{PROVIDE VCT-1 IN ASHLAR INSTALLATION.}$	FINISH ABBREVIATIONS	_
	NOTE: THIS LEGEND MAY CONTAIN ABBREVIATIONS THAT ARE NOT IN THIS PROJECT	PROJECT INFORMATION
PROVIDE 2 COLOR PAINT PATTERN WITH VINYL ADHERED SIGNAGE. SEE 2-1200 FOR ADDITIONAL DETAIL.	ACT ACOUSTICAL CEILING TILE RB RESILIENT BASE AGL ART GLASS RP RESIN PANEL	Project Number 14457.20
PROVIDE 4-COLOR PATTERN ACOUSTIC WALL PANELS (AWP). SEE A700 SERIES & FINISH SCHEDULE FOR ADDITIONAL INFORMATION.	AGL ART GLASS RP RESIN PANEL AWP ACOUSTICAL WALL PANEL RS RESILIENT SHEET CC CUBICLE CURTAIN RST RESILIENT STAIR TREAD	Client Name SOUTH ORANGETOWN CENTRAL
	CG CORNER GUARD RT RUBBER TILE CHR CHAIR RAIL SC SPECIALTY CEILING	SCHOOL DISTRICT Project Name
	CPTCARPETSCONSEALED CONCRETECRCRASH RAILSNSTAIR NOSING & RISER	PHASE 1: 2022 BOND
	DGDIGITAL GRAPHICSSMSOLID SURFACE MATERIALDSDIVIDER STRIPSTSTONE VENEER	CERTIFICATE #018330
	DWC DIGITAL WALL COVERING SV SHEET VINYL DWP DIGITAL WALL PANEL SWP SHEET WALL PROTECTION	REGISTRATION EXPIR. DATES Lauren Tarsio 09/30/26 District Office Address Richard Waite 11/30/23
	EPT EPOXY PAINT TB TILE BASE ERF EPOXY RESIN FLOOR TER TERRAZZO	160 VAN WYCK RD. Larry Werts 12/31/24 BLAUVELT, NY 10913 Anthony Marchetti 05/31/24 Dave Hart 02/28/25
	ETR EXISTING TO REMAIN TF TILE FLOOR EXP EXPOSED TR TRIM FILM FILM TAS TACKABLE SURACE	Jennifer Wengender 06/30/24
	FRP FIBER REINFORCED PANEL TS TRANSITION STRIP GRT GROUT TW TILE WALL	SOUTH ORANGETOWN CSD
	HPL HIGH PRESSURE PLASTIC LAMINATE UPH UPHOLSTERY HR HAND RAIL VCT VINYL COMPOSITION TILE	WILLIAM O. SCHAEFER SED#:50-03-01-06-0-012-019 COTTAGE LANE ELEMENTARY SED#:50-03-01-06-0-010-022 TAPPAN ZEE HIGH SCHOOL SED#:50-03-01-06-0-006-032
	INT INTEGRAL VET VINYL ENHANCED TILE LVT LUXURY VINYL TILE VQT VINYL QUARTZ TILE	 WILLIAM O. SCHAEFER S&L SED#:50-03-01-06-0-012-020 COTTAGE LANE S&L SED#: 50-03-01-06-0-010-023 COTTAGE LANE LIBRARY S&L SED#: 50-03-01-06-8-023-002
	PTPAINTWCWALL COVERINGPTMPATCH TO MATCHWDWOOD	WOS OUTDOOR CLASSROOM SED#: 50-03-01-06-7-053-001
	QBQUARRY TILE BASEWGWALL GUARDQTQUARRY TILEWOCWALK OFF CARPET	CLE OUTDOOR CLASSROOM SED#:50-03-01-06-7-054-001 TZHS OUTDOOR CLASSROOM SED#:50-03-01-06-7-055-001
	QTZ QUARTZ WS WRITEABLE SURFACE WT WINDOW TREATMENT	PROJECT ISSUE & REVISION SCHEDULE No. Date Description
	FINISH PLAN SYMBOLS LEGEND	_
	NOTE: THIS LEGEND MAY CONTAIN SYMBOLS THAT ARE NOT IN THIS PROJECT	
	ROOM NUMBER ROOM NAME ROOM NUMBER ROOM AREA	
	101 (150 SF) DWC-33, DWC-33 DWC-33 DWC-33 DWC-33	
	DWC-33, DWC-33 TER-1, TER-2 DWC-33, DWC-33 FLOOR FINISH(ES)	
	DWC-33, DWC-33	
IO3	FINISH PLAN KEY NOTE WINDOW TREATMENT EXTENT OF NOTED FINISH	
	(TSX) — — — —	
	FLOOR DIRECTION TRANSITION STRIP WRITEABLE/MAGNETIC (LONG SIDE OF FLOOR TILE SURFACE	PROFESSIONAL STAMPS
	PÅRALLEL WITH LONG SIDE OF SYMBOL)	
	TACKABLE SURFACE	
		-
SUPPORT		
M3		NEW YORK STATE EDUCATION STATEMENT
		NEW YORK STATE EDUCATION STATEMENT IT IS A VIOLATION OF THE NEW YORK STATE EDUCATION LAW AND THE COMMISSIONER'S REGULATIONS FOR ANY PERSON, UNLESS ACTING UNDER THE DIRECTION OF A LICENSED ARCHITECT, BNGINEER OR LAND SURVEYOR, TO ALTER AN ITEM IN ANY WAY, IF AN ITEM BEARING THE SEAL OF AN ARCHITECT, BNGINEER OR SURVEYOR & ALTERD. THE ALTERING
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	KEY PLAN:	SHEET INFORMATION
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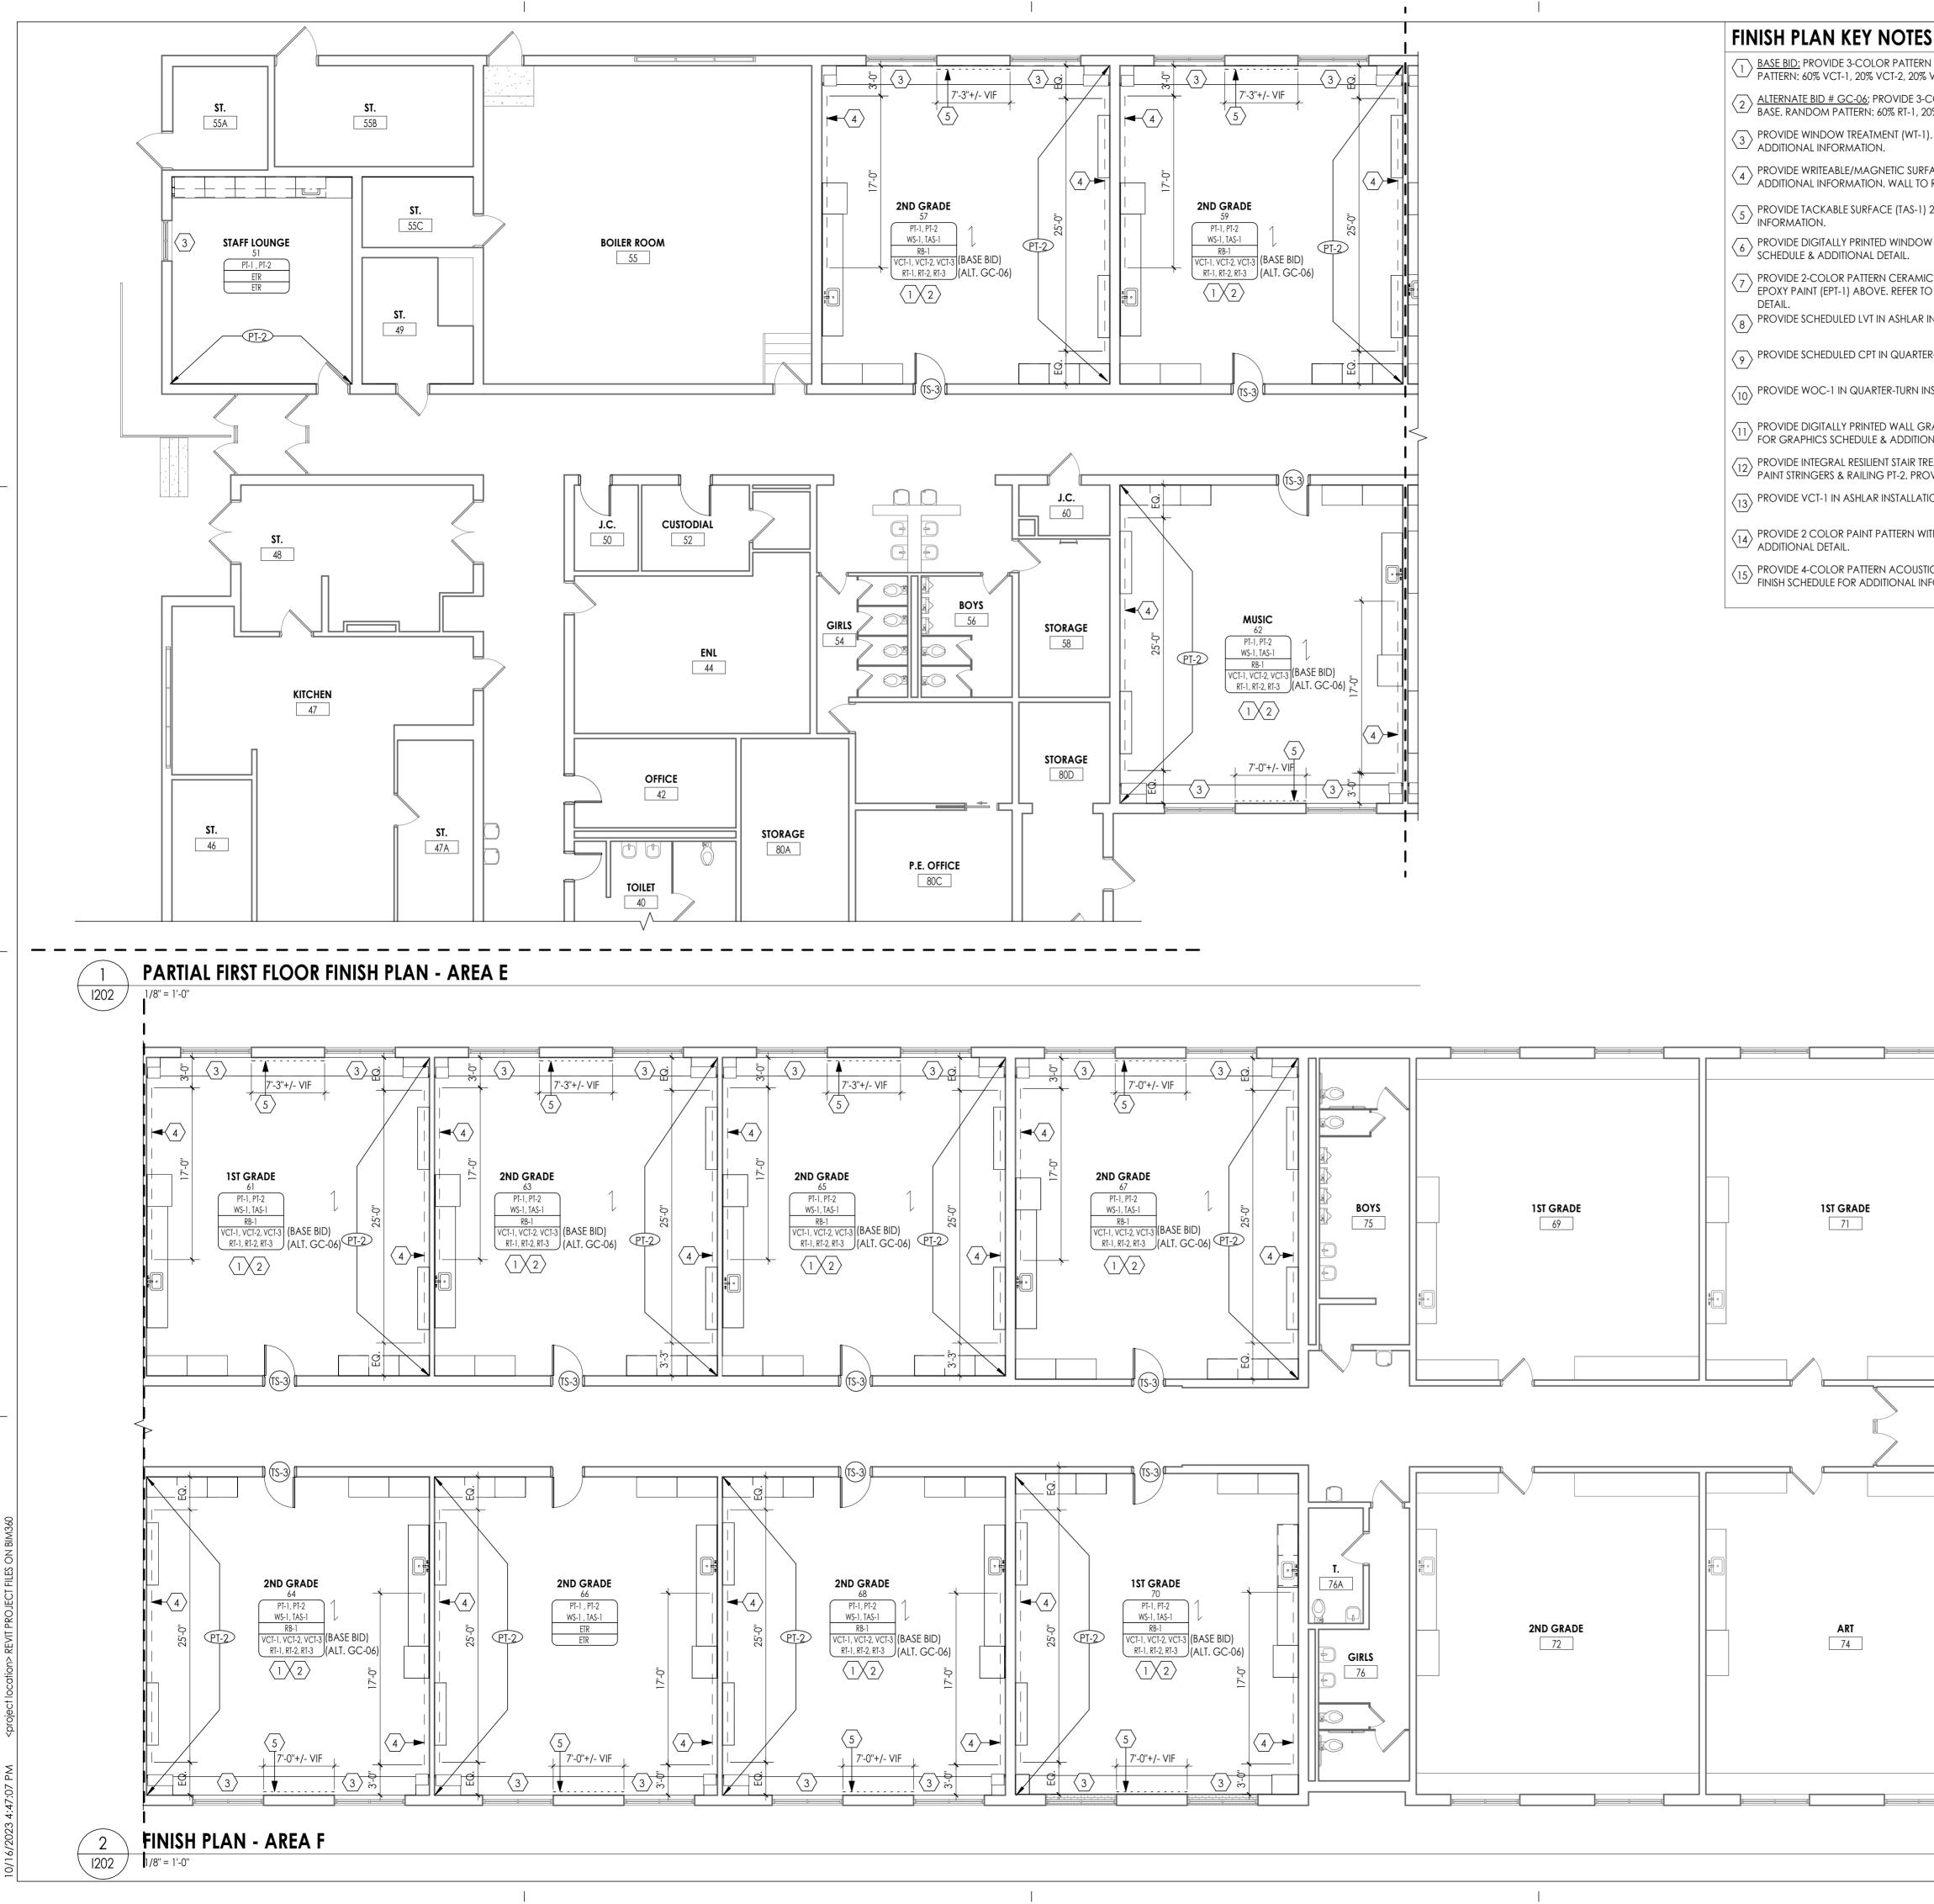
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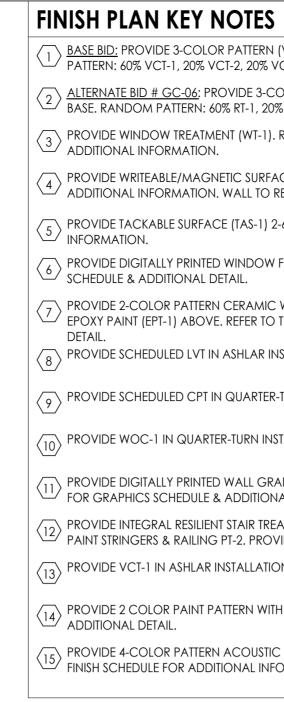
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PARTIAL FIRST FLOOR FINISH PLAN - AREA C

WOS

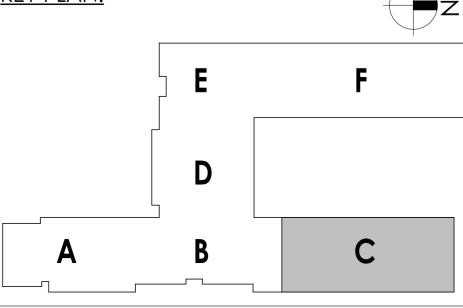




ES	FINISH PLAN GENERAL NOTES	
RN (VCT-1,2,3) WITH RESILIENT BASE. RANDOM % VCT-3.	1. ALL NEW AND EXISTING HOLLOW METAL DOORS, DOOR FRAMES AND WINDOW FRAMES IN PROJECT SCOPE SHALL BE PAINTED (PT-3), UNLESS NOTED OTHERWISE.	
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TER-TURN INSTALLATION.	FLOOR PATTERNING GENERAL NOTES	SOUTH ORANGETOWN Central School District
INSTALLATION.	ALL FLOOR FINISHES SHALL TRANSITION AT THE CENTERLINE OF THE DOOR, UNLESS OTHERWISE NOTED. INSTALL TRANSITION STRIPS PER DETAILS.	Capital Improvements Bond
GRAPHIC FULL HEIGHT OF WALL. REDER TO 1001	 PROVIDE ADA ACCESSIBLE MARBLE THRESHOLD AT ALL TOILET ROOM DOORS UNLESS OTHERWISE NOTED. 	
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WITH VINYL ADHERED SIGNAGE. SEE 2-1200 FOR	NOTE: THIS LEGEND MAY CONTAIN ABBREVIATIONS THAT ARE NOT IN THIS PROJECT ACT ACOUSTICAL CEILING TILE RB RESILIENT BASE	Project Number 14457.20
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	CC CUBICLE CURTAIN RST RESILIENT STAIR TREAD CG CORNER GUARD RT RUBBER TILE CHR CHAIR RAIL SC SPECIALTY CEILING	
	CPTCARPETSCONSEALED CONCRETECRCRASH RAILSNSTAIR NOSING & RISER	PHASE 1: 2022 BOND
	DG DIGITAL GRAPHIC SSM SOLID SURFACE MATERIAL DS DIVIDER STRIP ST STONE VENEER	CERTIFICATE #018330 REGISTRATION EXPIR. DATES:
	DWCDIGITAL WALL COVERINGSVSHEET VINYLDWPDIGITAL WALL PANELSWPSHEET WALL PROTECTIONEPTEPOXY PAINTTBTILE BASE	Lauren Tarsio 09/30/26 District Office Address Richard Waite 11/30/23
	ERFEPOXY RESIN FLOORTERTERRAZZOETREXISTING TO REMAINTFTILE FLOOR	160 VAN WYCK RD. Larry Werts 12/31/24 BLAUVELT, NY 10913 Anthony Marchetti 05/31/24 Dave Hart 02/28/25
	EXPEXPOSEDTRTRIMFILMFILMTASTACKABLE SURACE	Jennifer Wengender 06/30/24
	FRP FIBER REINFORCED PANEL TS TRANSITION STRIP GRT GROUT TW TILE WALL HPL HIGH PRESSURE PLASTIC LAMINATE UPH UPHOLSTERY	SOUTH ORANGETOWN CSD WILLIAM O. SCHAEFER SED#:50-03-01-06-0-012-019 COTTAGE LANE ELEMENTARY SED#:50-03-01-06-0-010-022
	HR HAND RAIL VCT VINYL COMPOSITION TILE INT INTEGRAL VET VINYL ENHANCED TILE	☐ COTTAGE LANE ELEMENTART SED#:50-03-01-06-0-006-032 ☐ TAPPAN ZEE HIGH SCHOOL SED#:50-03-01-06-0-006-032 ☐ WILLIAM O. SCHAFER \$&L SED#:50-03-01-06-0-012-020 ☐ COTTAGE LANE \$&L SED#: 50-03-01-06-0-010-023
	LVTLUXURY VINYL TILEVQTVINYL QUARTZ TILEPTPAINTWCWALL COVERING	COTTAGE LANE LIBRARY S&L SED#: 50-03-01-06-8-023-002
	PTM PATCH TO MATCH WD WOOD QB QUARRY TILE BASE WG WALL GUARD QT QUARRY TILE WOC WALK OFF CARPET	SOMS OUTDOOR CLASSROOM SED#:50-03-01-06-7-056-001 CLE OUTDOOR CLASSROOM SED#:50-03-01-06-7-054-001 TZHS OUTDOOR CLASSROOM SED#:50-03-01-06-7-055-001
	QT QUARRY TILE WOC WALK OFF CARPET QTZ QUARTZ WS WRITEABLE SURFACE WT WINDOW TREATMENT	PROJECT ISSUE & REVISION SCHEDULE
	FINISH PLAN SYMBOLS LEGEND	
	ROOM NUMBER ROOM ROOM AREA	
	WALL FINISH (ES)	
	TER-1, TER-2 DWC-33, DWC-33 DWC-33, DWC-33	
	$\langle \mathbf{x} \rangle$ $\langle \mathbf{w} \mathbf{x} \mathbf{x} \rangle$ $\langle \mathbf{x} \mathbf{x} \mathbf{x} \rangle$	
	FINISH PLAN KEY NOTE WINDOW TREATMENT EXTENT OF NOTED FINISH	
	(TSX)	
	FLOOR DIRECTION TRANSITION STRIP WRITEABLE/MAGNETIC	PROFESSIONAL STAMPS
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		NEW YORK STATE EDUCATION STATEMENT
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	· · · · ·	THER SIGNATURE AND THE DATE OF SUCH ALTERATION, AND A SPECIFIC DESCRIPTION OF THE ALTERATION.
	KEY PLAN:	SHEET INFORMATION Issued Scale
		10/18/23 As indicated Project Status
	E F	BID DOCUMENTS Drawn By Checked By
		PARTIAL FIRST FLOOR FINISH PLAN - AREA E & AREA F


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FINISH PLAN KEY NOTES

BASE BID: PROVIDE 3-COLOR PATTERN (VCT-1,2,3) W PATTERN: 60% VCT-1, 20% VCT-2, 20% VCT-3.
2 <u>ALTERNATE BID</u> # GC-06: PROVIDE 3-COLOR PATTER BASE. RANDOM PATTERN: 60% RT-1, 20% RT-2, 20% R
3 PROVIDE WINDOW TREATMENT (WT-1). REFER TO INT ADDITIONAL INFORMATION.
4 PROVIDE WRITEABLE/MAGNETIC SURFACE (WS-1) 2'- & A700 SERIES ELEVATIONS FOR SIZES & LOCATIONS. FINISH.
5 PROVIDE TACKABLE SURFACE (TAS-1) 2'-6" AFF. SEE A
6 PROVIDE DIGITALLY PRINTED WINDOW FILM. REFER T SCHEDULE AND ADDITIONAL DETAIL.
7 PROVIDE 2-COLOR PATTERN CERAMIC WALL TILE WARD POXY PAINT (EPT-1) ABOVE. REFER TO TYPICAL TILE DETAIL.
8 PROVIDE SCHEDULED LVT IN ASHLAR INSTALLATION.
9 PROVIDE SCHEDULED CPT IN QUARTER-TURN INSTAL
$\langle 10 \rangle$ PROVIDE WOC-1 IN QUARTER-TURN INSTALLATION.
11 PROVIDE DIGITALLY PRINTED WALL GRAPHIC, FULL H
12 PROVIDE INTEGRAL RESILIENT STAIR TREAD (RST-1) & PAINT STRINGERS & RAILING PT-2. PROVIDE LVT-2 & F
$\langle 13 \rangle$ PROVIDE VCT-1 IN ASHLAR INSTALLATION.
14 PROVIDE 2 COLOR PAINT PATTERN WITH VINYL ADHE ADDITIONAL DETAIL.
15 PROVIDE 4-COLOR PATTERN ACOUSTIC WALL PANE FINISH SCHEDULE FOR ADDITIONAL INFORMATION.

(VCT-1,2,3) WITH RESILIENT BASE. RANDOM CT-3.
DLOR PATTERN (RT-1,2,3) WITH RESILIENT

0% RT-2, 20% RT-3. . REFER TO INTERIOR FINISH SCHEDULE FOR

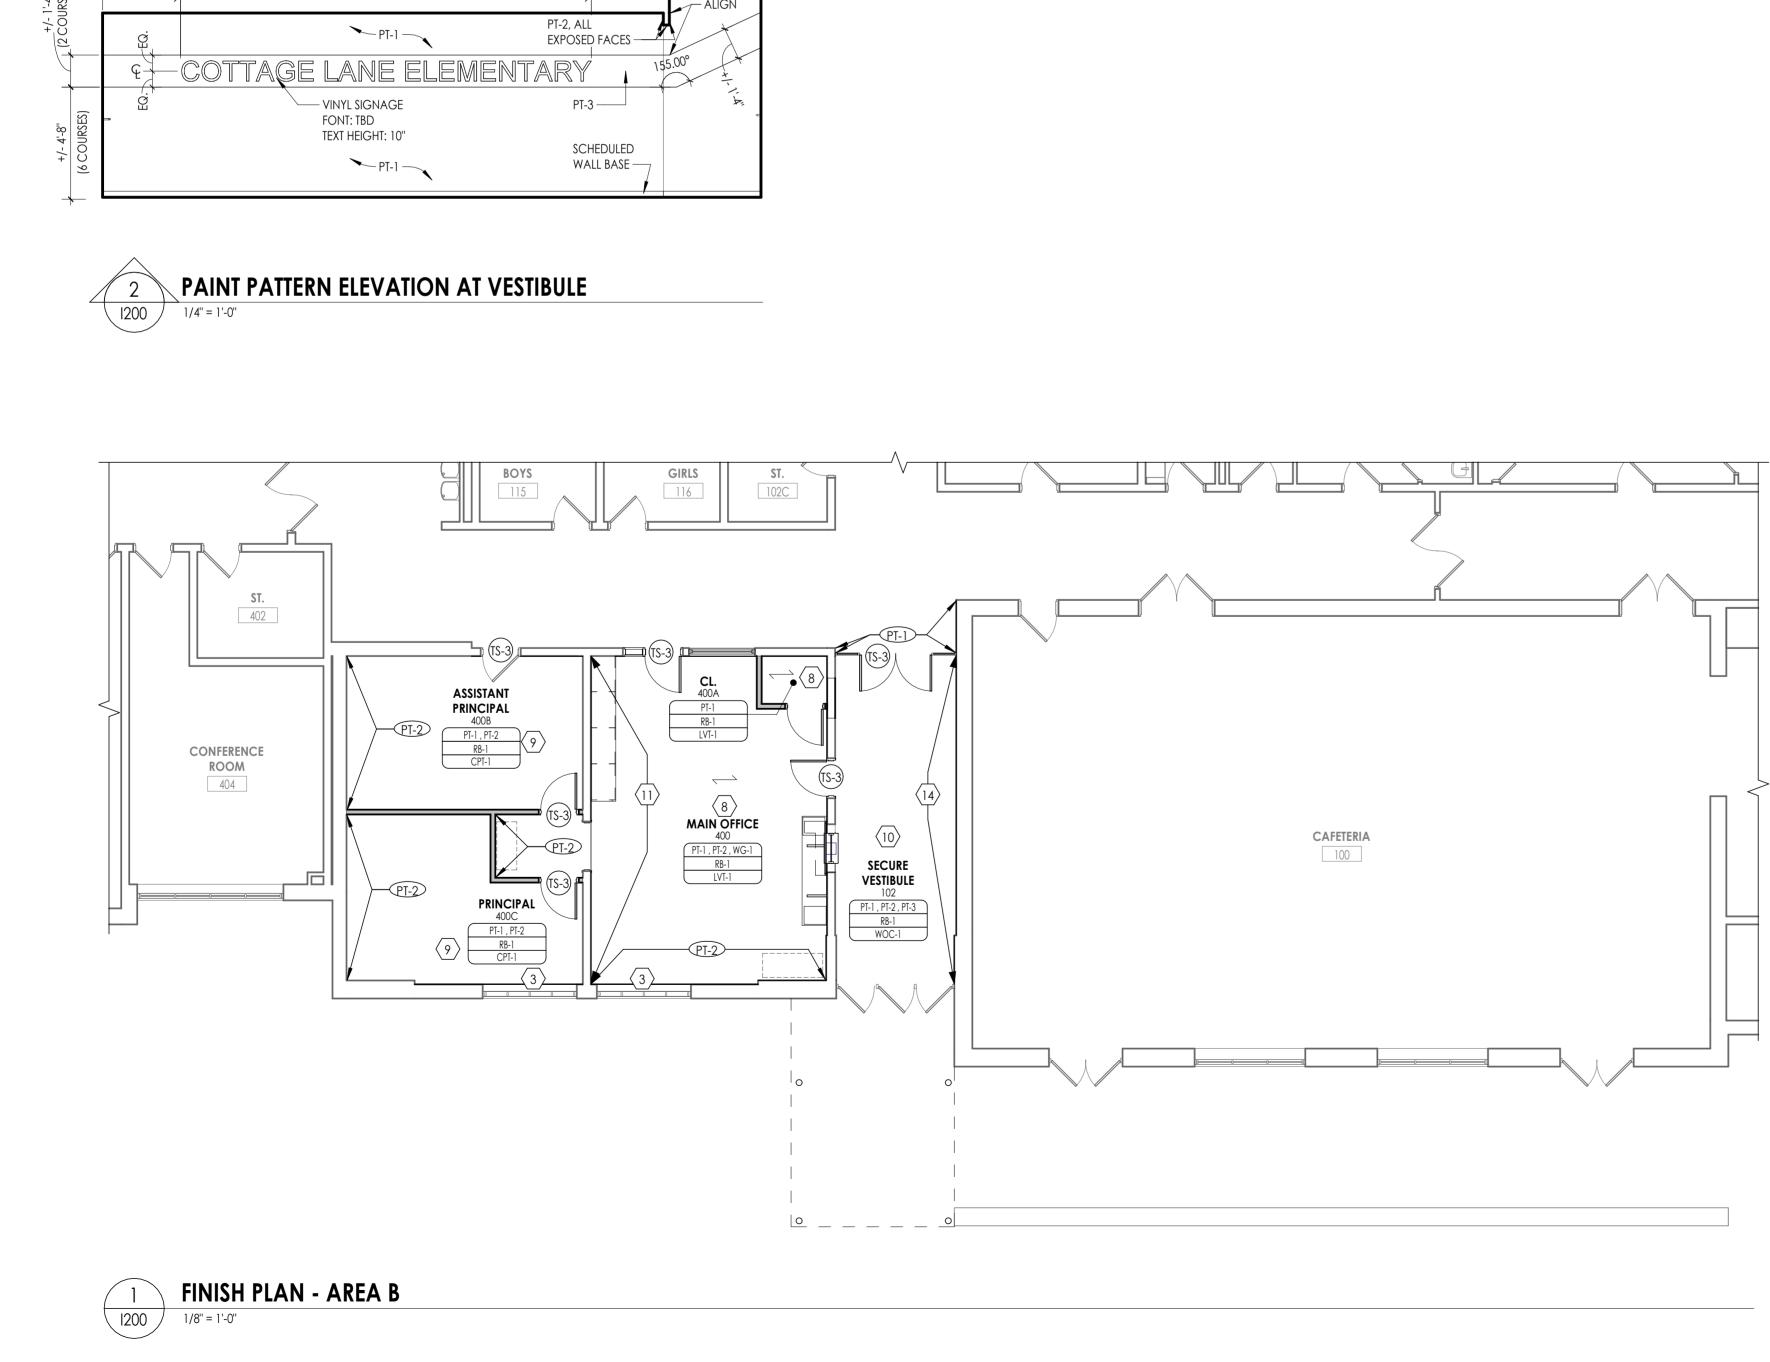ACE (WS-1) 2'-6" AFF. SEE I200 SERIES PLANS

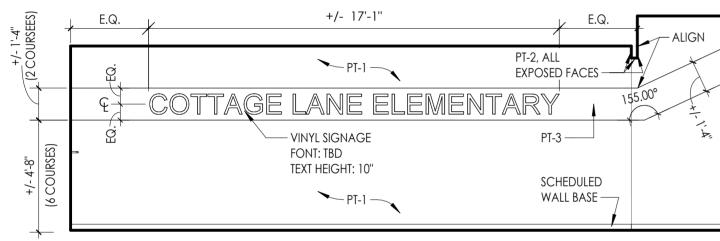& LOCATIONS. WALL TO RECIEVE LEVEL 5 2'-6" AFF. SEE A700 SERIES FOR ADDITIONAL

FILM. REFER TO 1001 FOR GRAPHICS

C WALL TILE WAINSCOT UP TO 5'-0" AFF WITH D TYPICAL TILE PATTERN "A" ON 1001 FOR

R-TURN INSTALLATION.

- RAPHIC, FULL HEIGHT OF WALL. REFER TO ADDITIONAL DETAIL.
- EAD (RST-1) & RISERS AT STAIR LOCATIONS. VIDE LVT-2 & RB-1 AT LANDING.

TH VINYL ADHERED SIGNAGE. SEE 2-1200 FOR

C WALL PANELS (AWP). SEE A700 SERIES &

FINISH PLAN GENERAL NOTES

ALL NEW AND EXISTING HOLLOW METAL DOORS, DOOR FRAMES AND WINDOW FRAMES IN PROJECT SCOPE SHALL BE PAINTED (PT-3), UNLESS NOTED OTHERWISE. ALL LOUVERS, VENTS, GRILLES AND OTHER MISCELLANEOUS MECHANICAL AND ELECTRICAL DEVICES ARE TO BE PAINTED TO MATCH THE SURFACE ON WHICH THEY APPEAR, UNLESS NOTED OTHERWISE. REFER TO A600 SERIES DRAWINGS FOR CEILING TYPES AND SOFFIT FINISHES.

UNDERSIDE OF SOFFITS TO MATCH FACE OF SOFFIT. SEE A600 SERIES FOR PAINT ACCENT SPECIFICATIONS. PAINT GWB CEILINGS (PT-4), UNLESS NOTED OTHERWISE.

- REFER TO A700 SERIES INTERIOR ELEVATIONS FOR MILLWORK FINISHES. ALL WINDOW SILLS SHALL BE **SSM-1**, UNLESS OTHERWISE NOTED.
- HIGH PRESSURE PLASTIC LAMINATE ON VERTICAL SURFACES TO RUN VERTICALLY, UNLESS NOTED OTHERWISE. WHERE KICKSPACES OCCUR AT MILLWORK, FLOOR FINISH SHOWN ON PLANS SHALL
- RUN UNDERNEATH KICKSPACE AS WELL. . REFER TO **1300** FOR FLOOR PATTERN PLANS & DETAILS.
- . ALL FLOOR FINISHES SHALL TRANSITION AT THE CENTERLINE OF THE DOOR, UNLESS NOTED OTHERWISE. INSTALL TRANSITION STRIPS PER DETAILS ON 1000.
- . PROVIDE CONCRETE FLOOR PREPARATION IN ACCORDANCE WITH FLOORING
- MANUFACTURER SPECIFICATION. 3. ALL NON-EPOXY GROUT TO BE SEALED A MINIMUM OF TWO TIMES PRIOR TO COMPLETION.

FLOOR PATTERNING GENERAL NOTES


- ALL FLOOR FINISHES SHALL TRANSITION AT THE CENTERLINE OF THE DOOR, UNLESS OTHERWISE NOTED. INSTALL TRANSITION STRIPS PER DETAILS. PROVIDE ADA ACCESSIBLE MARBLE THRESHOLD AT ALL TOILET ROOM DOORS UNLESS
- OTHERWISE NOTED. ALL AREAS WITH INTEGRAL BASE SHALL BE AT 4" A.F.F. BASE SHALL BE THE SAME COLOR AS THE ADJACENT FLOORING MATERIAL, UNLESS OTHERWISE NOTED. WHERE KICKSPACES OCCUR AT MILLWORK, FLOOR FINISH SHOWN ON PLANS SHALL RUN UNDERNEATH KICKSPACE AS WELL.

FINISH ABBREVIATIONS


ACTACOUSTICAL CEILING TILERBRESILIENT BASEAGLART GLASSRPRESIN PANELAWPACOUSTICAL WALL PANELRSRESILIENT SHEETCCCUBICLE CURTAINRSTRESILIENT STAIR TREADCGCORNER GUARDRTRUBBER TILECHRCHAIR RAILSCSPECIALTY CEILINGCPTCARPETSCONSEALED CONCRETECRCRASH RAILSNSTAIR NOSING & RISERDGDIGITAL GRAPHICSSMSOLID SURFACE MATERIALDSDIVIDER STRIPSTSTONE VENEERDWCDIGITAL WALL COVERINGSVSHEET VINYLDWPDIGITAL WALL PANELSWPSHEET WALL PROTECTIONEPTEPOXY PAINTTASTACKABLE SURFACE
AWPACOUSTICAL WALL PANELRSRESILIENT SHEETCCCUBICLE CURTAINRSTRESILIENT STAIR TREADCGCORNER GUARDRTRUBBER TILECHRCHAIR RAILSCSPECIALTY CEILINGCPTCARPETSCONSEALED CONCRETECRCRASH RAILSNSTAIR NOSING & RISERDGDIGITAL GRAPHICSSMSOLID SURFACE MATERIALDSDIVIDER STRIPSTSTONE VENEERDWCDIGITAL WALL COVERINGSVSHEET VINYLDWPDIGITAL WALL PANELSWPSHEET WALL PROTECTION
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DWCDIGITAL WALL COVERINGSVSHEET VINYLDWPDIGITAL WALL PANELSWPSHEET WALL PROTECTION
DWP DIGITAL WALL PANEL SWP SHEET WALL PROTECTION
EPT EPOXY PAINT TAS TACKABLE SURFACE
ERF EPOXY RESIN FLOOR TB TILE BASE
ETR EXISTING TO REMAIN TER TERRAZZO
EXP EXPOSED TF TILE FLOOR
FILM FILM TR TRIM
FRP FIBER REINFORCED PANEL TS TCKABLE SURFACE
GRT GROUT TW TILE WALL
HPL HIGH PRESSURE PLASTIC LAMINATE UPH UPHOLSTERY
HR HAND RAIL VCT VINYL COMPOSITION TILE
INT INTEGRAL VET VINYL ENHANCED TILE
LVT LUXURY VINYL TILE VQT VINYL QUARTZ TILE
PT PAINT WC WALL COVERING
PTM PATCH TO MATCH WD WOOD
QB QUARRY TILE BASE WG WALL GUARD
QT QUARRY TILE WOC WALK OFF CARPET
QTZ QUARTZ WS WRITEABLE SURFACE

FINISH PLAN SYMBOLS LEGEND

NOTE: THIS LEGEND MAY CONTAIN SYMBOLS THAT ARE NOT IN THIS PROJECT

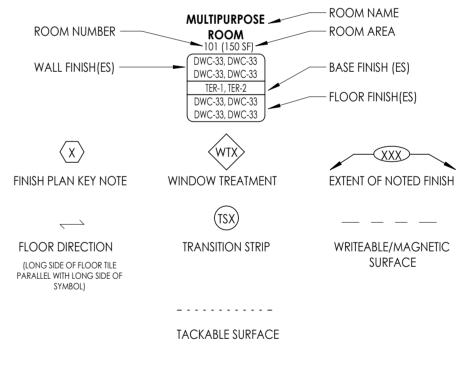

WT WINDOW TREATMENT

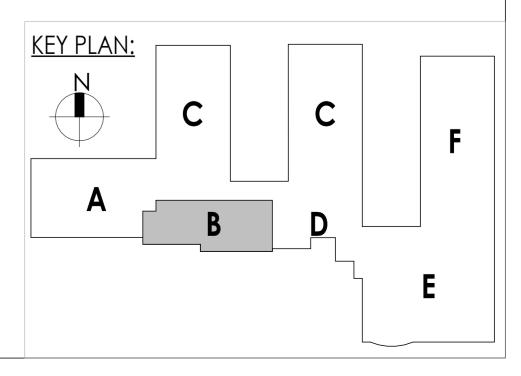



SOUTH ORANGETOWN CENTRAL SCHOOL DISTRICT Project Name

PHASE 1: 2022 BOND

District Office Address


Lauren Tarsio 09/30/26 Richard Waite 11/30/23 160 VAN WYCK RD. Larry Werts 12/31/24 BLAUVELT, NY 10913 Anthony Marchetti 05/31/24 Dave Hart 02/28/25 Jennifer Wengender 06/30/24

CERTIFICATE #018330 **REGISTRATION EXPIR. DATES:**

- south orangetown csd WILLIAM O. SCHAEFER SED#:50-03-01-06-0-012-019
- COTTAGE LANE ELEMENTARY SED#:50-03-01-06-0-010-022 TAPPAN ZEE HIGH SCHOOL SED#:50-03-01-06-0-006-032
- WILLIAM O. SCHAEFER S&L SED#: 50-03-01-06-0-012-020
- COTTAGE LANE S&L SED#: 50-03-01-06-0-010-023 COTTAGE LANE LIBRARY S&L SED#: 50-03-01-06-8-023-002
- WOS OUTDOOR CLASSROOM SED#:50-03-01-06-7-053-001 SOMS OUTDOOR CLASSROOM SED#:50-03-01-06-7-056-001
- CLE OUTDOOR CLASSROOM SED#:50-03-01-06-7-054-001 TZHS OUTDOOR CLASSROOM SED#:50-03-01-06-7-055-001

PROJECT ISSUE & REVISION SCHEDULE No. Date

PROFESSIONAL STAMPS

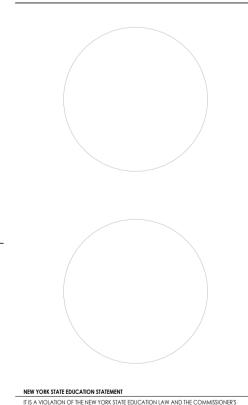


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SHEET INFORMATION

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10/18/23	As indicated
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ALS	CPL

Drawing Title PARTIAL FIRST FLOOR FINISH PLAN - AREA B



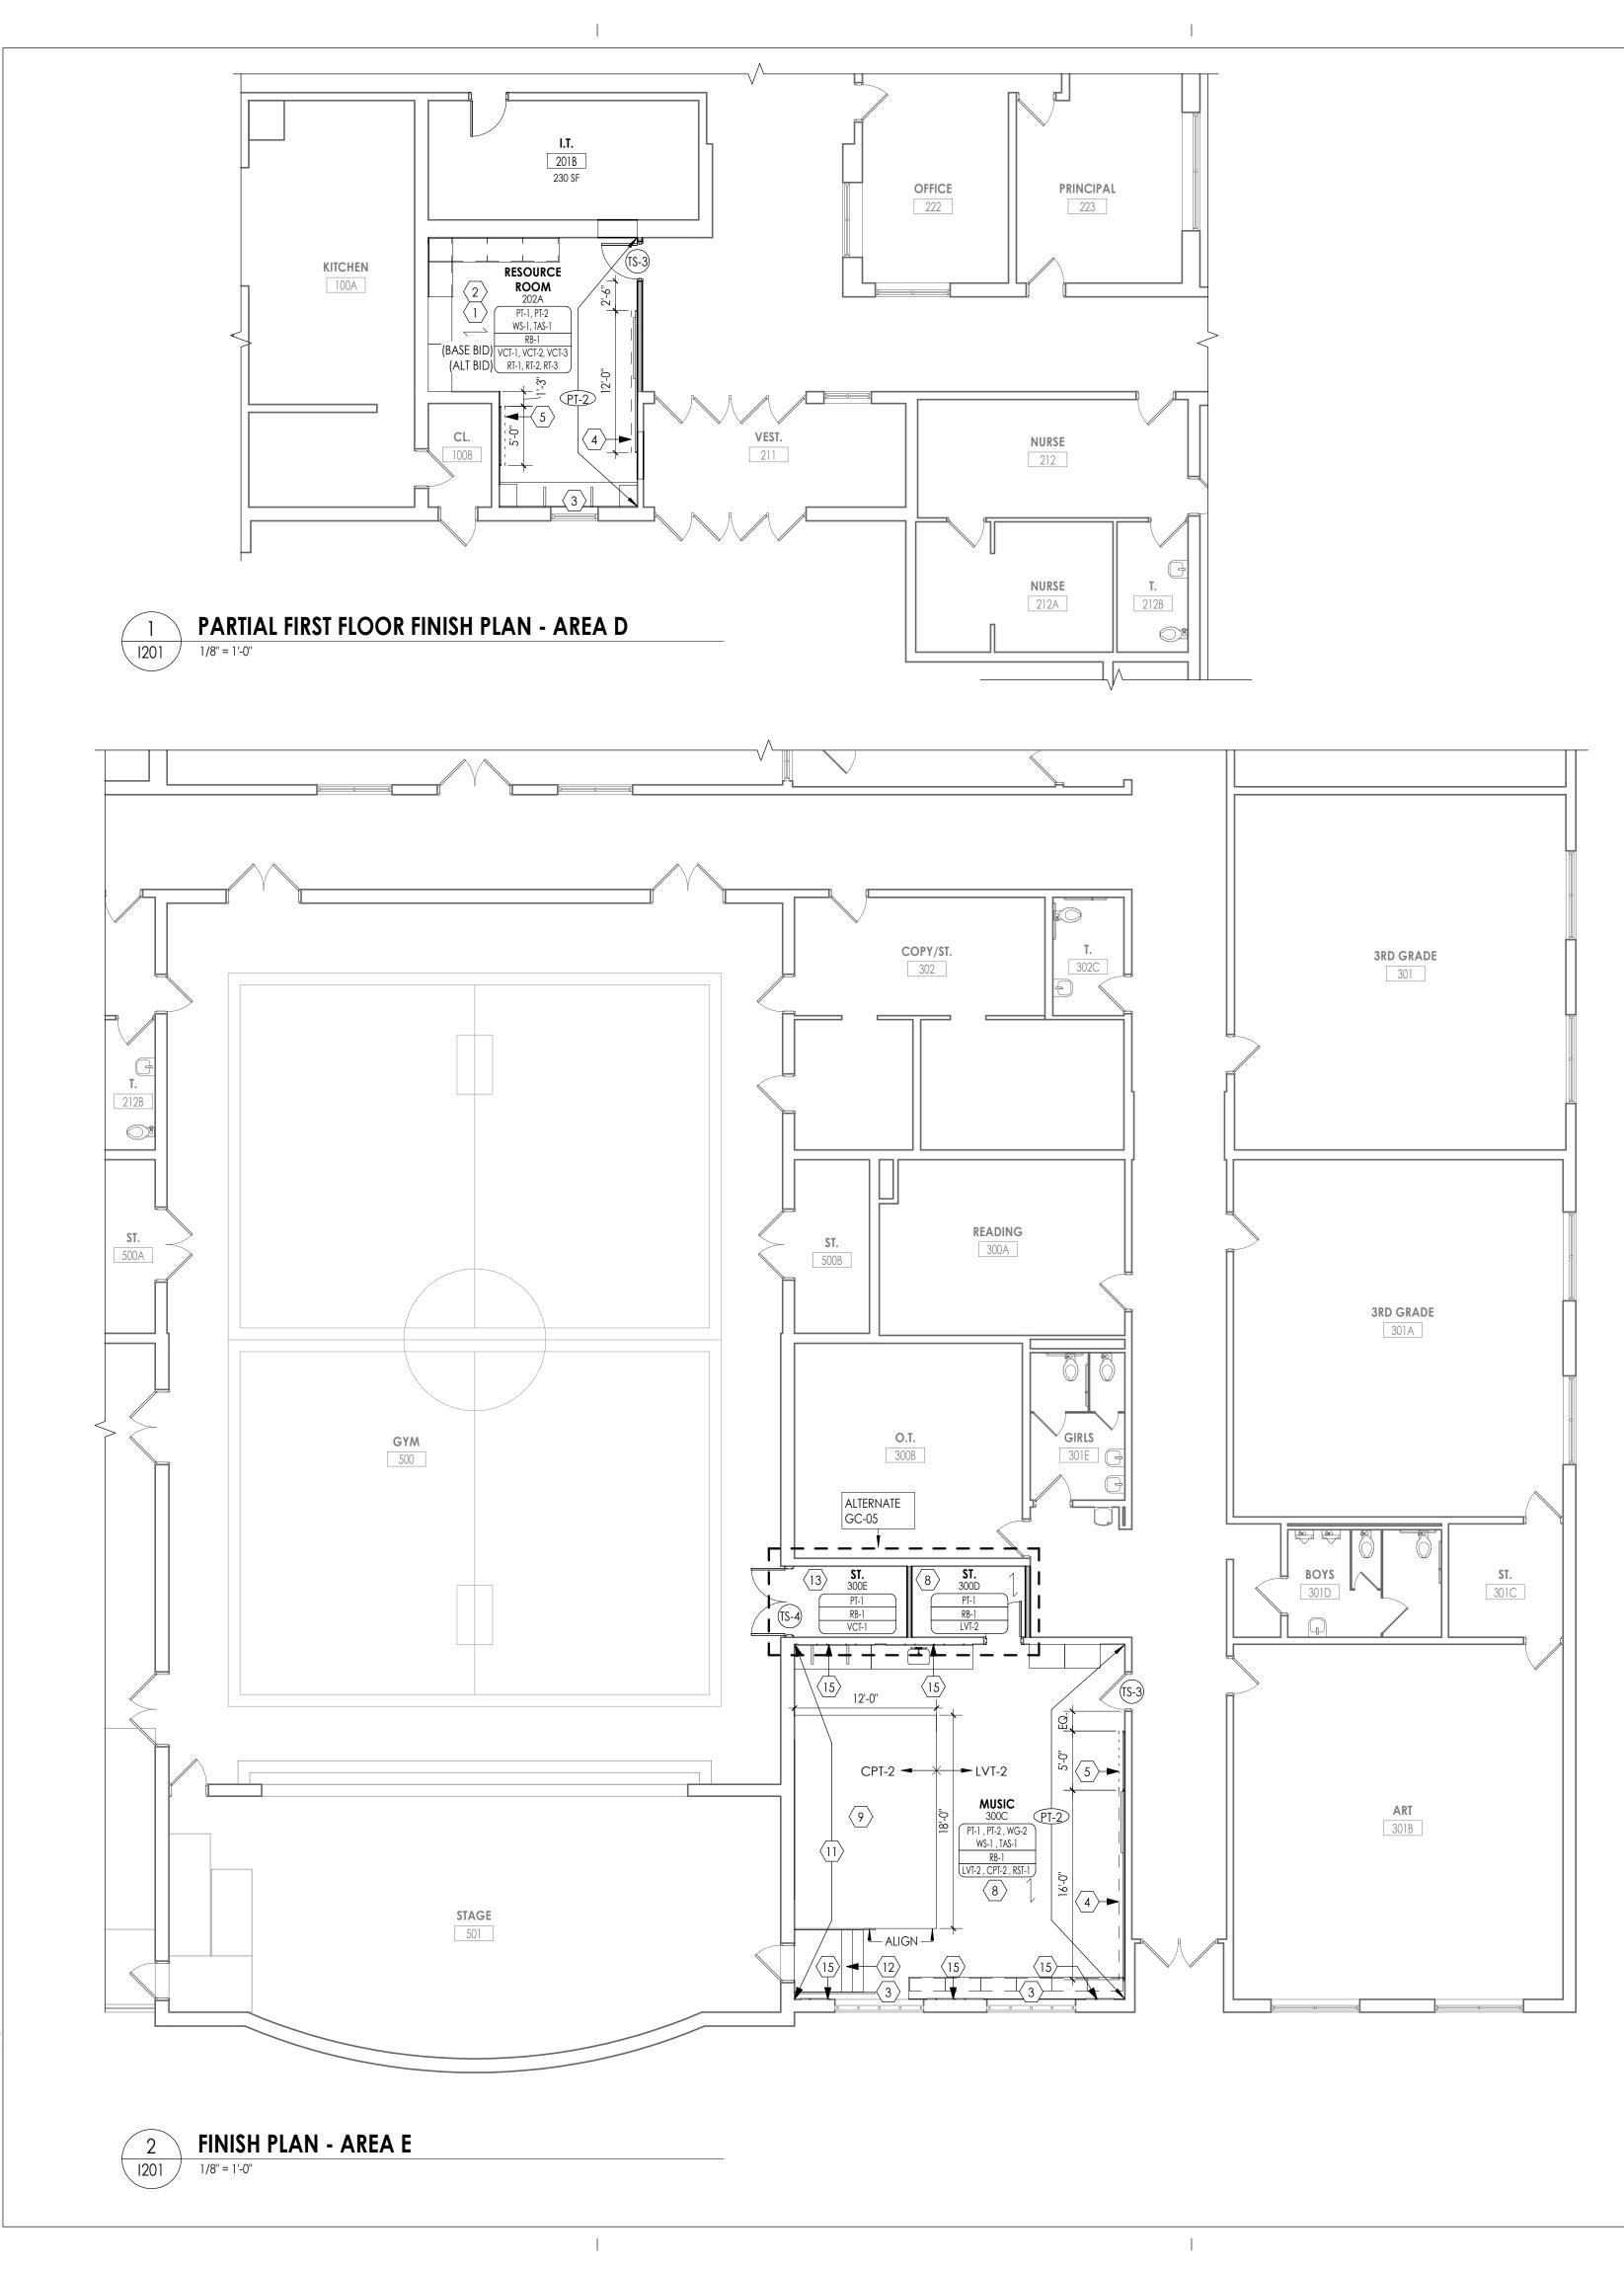

FINISH PLAN KEY NOTES

PATTERN: 60% VCT-1, 20% VCT-2, 20% VCT-3.
2 <u>ALTERNATE BID</u> # GC-06: PROVIDE 3-COLOR PATTER BASE. RANDOM PATTERN: 60% RT-1, 20% RT-2, 20% RT
3 PROVIDE WINDOW TREATMENT (WT-1). REFER TO INT ADDITIONAL INFORMATION.
4 PROVIDE WRITEABLE/MAGNETIC SURFACE (WS-1) 2'- & A700 SERIES ELEVATIONS FOR SIZES & LOCATIONS. FINISH.
 PROVIDE TACKABLE SURFACE (TAS-1) 2'-6" AFF. SEE A INFORMATION.
6 PROVIDE DIGITALLY PRINTED WINDOW FILM. REFER T SCHEDULE AND ADDITIONAL DETAIL.
7 PROVIDE 2-COLOR PATTERN CERAMIC WALL TILE WARD EPOXY PAINT (EPT-1) ABOVE. REFER TO TYPICAL TILE DETAIL.
8 PROVIDE SCHEDULED LVT IN ASHLAR INSTALLATION.
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14 PROVIDE 2 COLOR PAINT PATTERN WITH VINYL ADHI ADDITIONAL DETAIL.
(15) PROVIDE 4-COLOR PATTERN ACOUSTIC WALL PANEL FINISH SCHEDULE FOR ADDITIONAL INFORMATION.

- BASE BID: PROVIDE 3-COLOR PATTERN (VCT-1,2,3) WITH RESILIENT BASE. RANDOM

 PATTERN: 60% VCT-1, 20% VCT-2, 20% VCT-3.
 - COLOR PATTERN (RT-1,2,3) WITH RESILIENT % RT-2, 20% RT-3.
 - . REFER TO INTERIOR FINISH SCHEDULE FOR
 - ACE (WS-1) 2'-6" AFF. SEE I200 SERIES PLANS LOCATIONS. WALL TO RECIEVE LEVEL 5
 - 2'-6" AFF. SEE A700 SERIES FOR ADDITIONAL
 - V FILM. REFER TO 1001 FOR GRAPHICS
 - C WALL TILE WAINSCOT UP TO 5'-0" AFF WITH TYPICAL TILE PATTERN "A" ON 1001 FOR
 - NSTALLATION.
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 - RAPHIC, FULL HEIGHT OF WALL. REFER TO DDITIONAL DETAIL.
 - READ (RST-1) & RISERS AT STAIR LOCATIONS. OVIDE LVT-2 & RB-1 AT LANDING. ON.
 - TH VINYL ADHERED SIGNAGE. SEE 2-1200 FOR
 - C WALL PANELS (AWP). SEE A700 SERIES &

FINISH PLAN GENERAL NOTES

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- REFER TO A700 SERIES INTERIOR ELEVATIONS FOR MILLWORK FINISHES. ALL WINDOW SILLS SHALL BE **SSM-1**, UNLESS OTHERWISE NOTED.
- HIGH PRESSURE PLASTIC LAMINATE ON VERTICAL SURFACES TO RUN VERTICALLY, UNLESS NOTED OTHERWISE.
- WHERE KICKSPACES OCCUR AT MILLWORK, FLOOR FINISH SHOWN ON PLANS SHALL RUN UNDERNEATH KICKSPACE AS WELL.
- . REFER TO **I300** FOR FLOOR PATTERN PLANS & DETAILS. . ALL FLOOR FINISHES SHALL TRANSITION AT THE CENTERLINE OF THE DOOR, UNLESS NOTED OTHERWISE. INSTALL TRANSITION STRIPS PER DETAILS ON 1000.
- . PROVIDE CONCRETE FLOOR PREPARATION IN ACCORDANCE WITH FLOORING MANUFACTURER SPECIFICATION. ALL NON-EPOXY GROUT TO BE SEALED A MINIMUM OF TWO TIMES PRIOR TO
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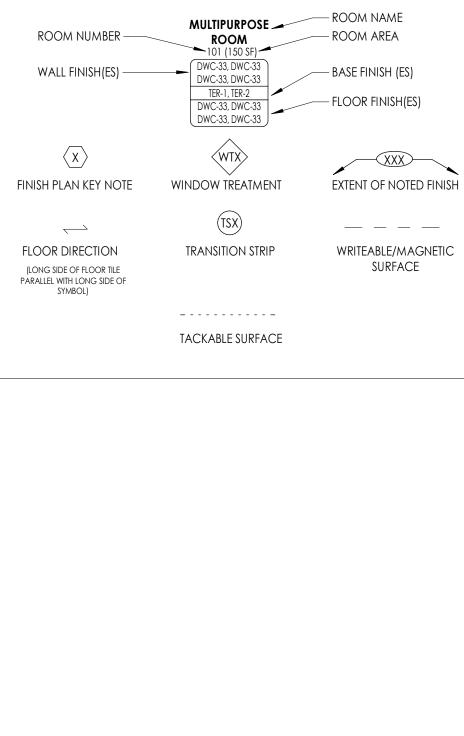
FINISH ABBREVIATIONS


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		ACT AGL AWP CC CG CHR CPT CR DG DWC DWP EPT ERF ETR FILM FRP GRT HPL HR INT PTM QB QTZ	ACOUSTICAL CEILING TILE ART GLASS ACOUSTICAL WALL PANEL CUBICLE CURTAIN CORNER GUARD CHAIR RAIL CARPET CRASH RAIL DIGITAL GRAPHIC DIVIDER STRIP DIGITAL WALL COVERING DIGITAL WALL COVERING DIGITAL WALL COVERING DIGITAL WALL PANEL EPOXY PAINT EPOXY RESIN FLOOR EXISTING TO REMAIN EXPOSED FILM FIBER REINFORCED PANEL GROUT HIGH PRESSURE PLASTIC LAMINATE HAND RAIL INTEGRAL LUXURY VINYL TILE PAINT PATCH TO MATCH QUARRY TILE BASE QUARRY TILE QUARTZ	RB RP RS RST RT SC SCON SN SSM ST SV SWP TAS TB TER TF TR TS TW UPH VCT VET VQT WC WD WG WOC WS	RESILIENT BASE RESIN PANEL RESILIENT SHEET RESILIENT STAIR TREAD RUBBER TILE SPECIALTY CEILING SEALED CONCRETE STAIR NOSING & RISER SOLID SURFACE MATERIAL STONE VENEER SHEET VINYL SHEET WALL PROTECTION TACKABLE SURFACE TILE BASE TERRAZZO TILE FLOOR TRIM TCKABLE SURFACE TILE WALL UPHOLSTERY VINYL COMPOSITION TILE VINYL ENHANCED TILE VINYL QUARTZ TILE WALL COVERING WOOD WALL GUARD WALK OFF CARPET WRITEABLE SURFACE
WT WINDOW TREATMENT		QTZ	QUARTZ	WS WT	WRITEABLE SURFACE WINDOW TREATMENT

FINISH PLAN SYMBOLS LEGEND

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PROJECT INFORMATION Project Number 14457.20 Client Name SOUTH ORANGETOWN CENTRAL

SCHOOL DISTRICT Project Name

CERTIFICATE #018330

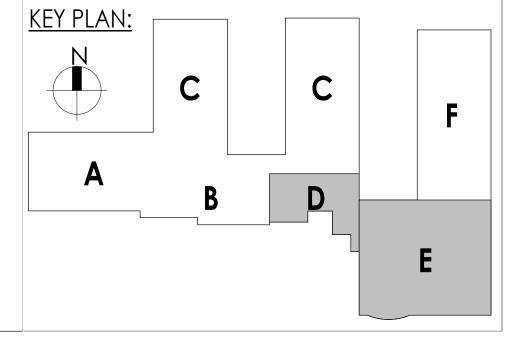PHASE 1: 2022 BOND

REGISTRATION EXPIR. DATES: District Office Address 160 VAN WYCK RD. Larry Werts 12/31/24 BLAUVELT, NY 10913 Anthony Marchetti 05/31/24


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- WOS OUTDOOR CLASSROOM SED#:50-03-01-06-7-053-001 SOMS OUTDOOR CLASSROOM SED#:50-03-01-06-7-056-001 CLE OUTDOOR CLASSROOM SED#:50-03-01-06-7-054-001 TZHS OUTDOOR CLASSROOM SED#:50-03-01-06-7-055-001

PROJECT ISSUE & REVISION SCHEDULE No. Date

PROFESSIONAL STAMPS



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Drawn By	Checked By
ALS	Checker
Drawing Title	
PARTIAL FIRST FLC	OR FINISH PLAN
- AREA D&E	

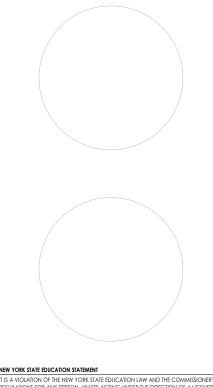Drawing Number

