VALLEY CENTRAL SCHOOL DISTRICT VALLEY CENTRAL HIGH SCHOOL ART ROOM AND WOODSHOP ALTERATIONS

BID SET - 10/31/23

CSARCH - ARCHITECTS

BLAKE ENGINEERING, PLLC - MEP ENGINEERS

STATE EDUCATION DEPARTMENT PROJECT CONTROL NUMBERS: 2021 CAPITAL PROJECT

THE MANUAL OF PLANNING STANDARDS OF THE NEW YORK STATE EDUCATION DEPARTMENT.


HIGH SCHOOL: 44-13-01-06-0-015-031



THE DESIGN OF THIS PROJECT CONFORMS TO APPLICABLE PROVISIONS OF THE NEW YORK STATE UNIFORM FIRE

PREVENTION AND BUILDING CODE, THE NEW YORK STATE ENERGY CONSERVATION CONSTRUCTION CODE, AND

CSArch PROJECT NO. 187-2103

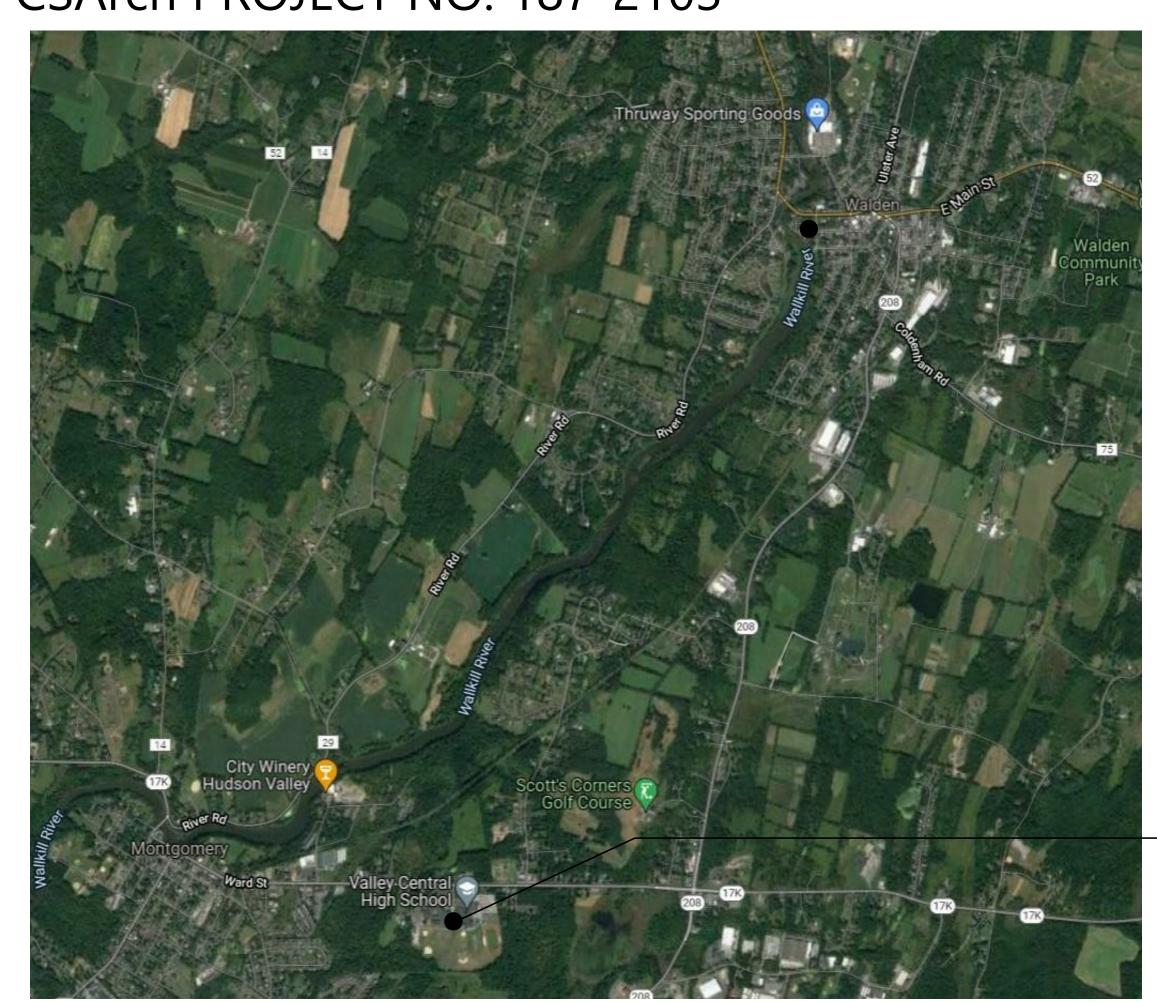

VALLEY CENTRAL HIGH SCHOOL MIDDLE SCHOOL 1175 NY-17K MONTGOMERY, NY 12549

NTS

VICINITY MAP




DRAWING LIST

GENERAL DRAWINGS SYMBOLS, ABBREVIATIONS, AND MISC ASBESTOS ABATEMENT ASBESTOS ABATEMENT ACTIVITIES ARCHITECTURAL DEMOLITION DRAWINGS FIRST FLOOR PARTIAL DEMOLITION PLANS ART ROOM DEMOLITION PLAN & ELEVATIONS WORK SHOP ROOM DEMOLITION PLANS & ELEVATIONS ARCHITECTURAL DRAWINGS FIRST FLOOR PARTIAL PLAN - ARTS / INDUSTRIAL ARTS ENLARGED PLANS AND INTERIOR DETAILS - ART CLASSROOM ENLARGED PLANS & AXONOMETRIC - IND. ARTS INTERIOR ELEVATIONS - INDUSTRIAL ARTS TYPICAL EQUIPMENT PLANS, ELEVATIONS AND DETAILS CASEWORK DETAILS DOOR SCHEDULE, ELEVATIONS, AND DETAILS

PLUMBING NOTES, SCHEDULE, LEGEND & DETAILS ART CLASSROOM PLUMBING PLANS INDUSTRIAL ARTS PLUMBING PLANS MECHANICAL GENERAL MECHANICAL NOTES, LEGEND, SCHEDULE & DETAILS MECHANICAL DRAWINGS INDUSTRIAL ARTS MECHANICAL PLANS

ELECTRICAL NOTES, LEGEND, DETAILS & SCHEDULES

ART CLASSROOM ELECTRICAL PLANS INDUSTRIAL ARTS ELECTRICAL PLANS

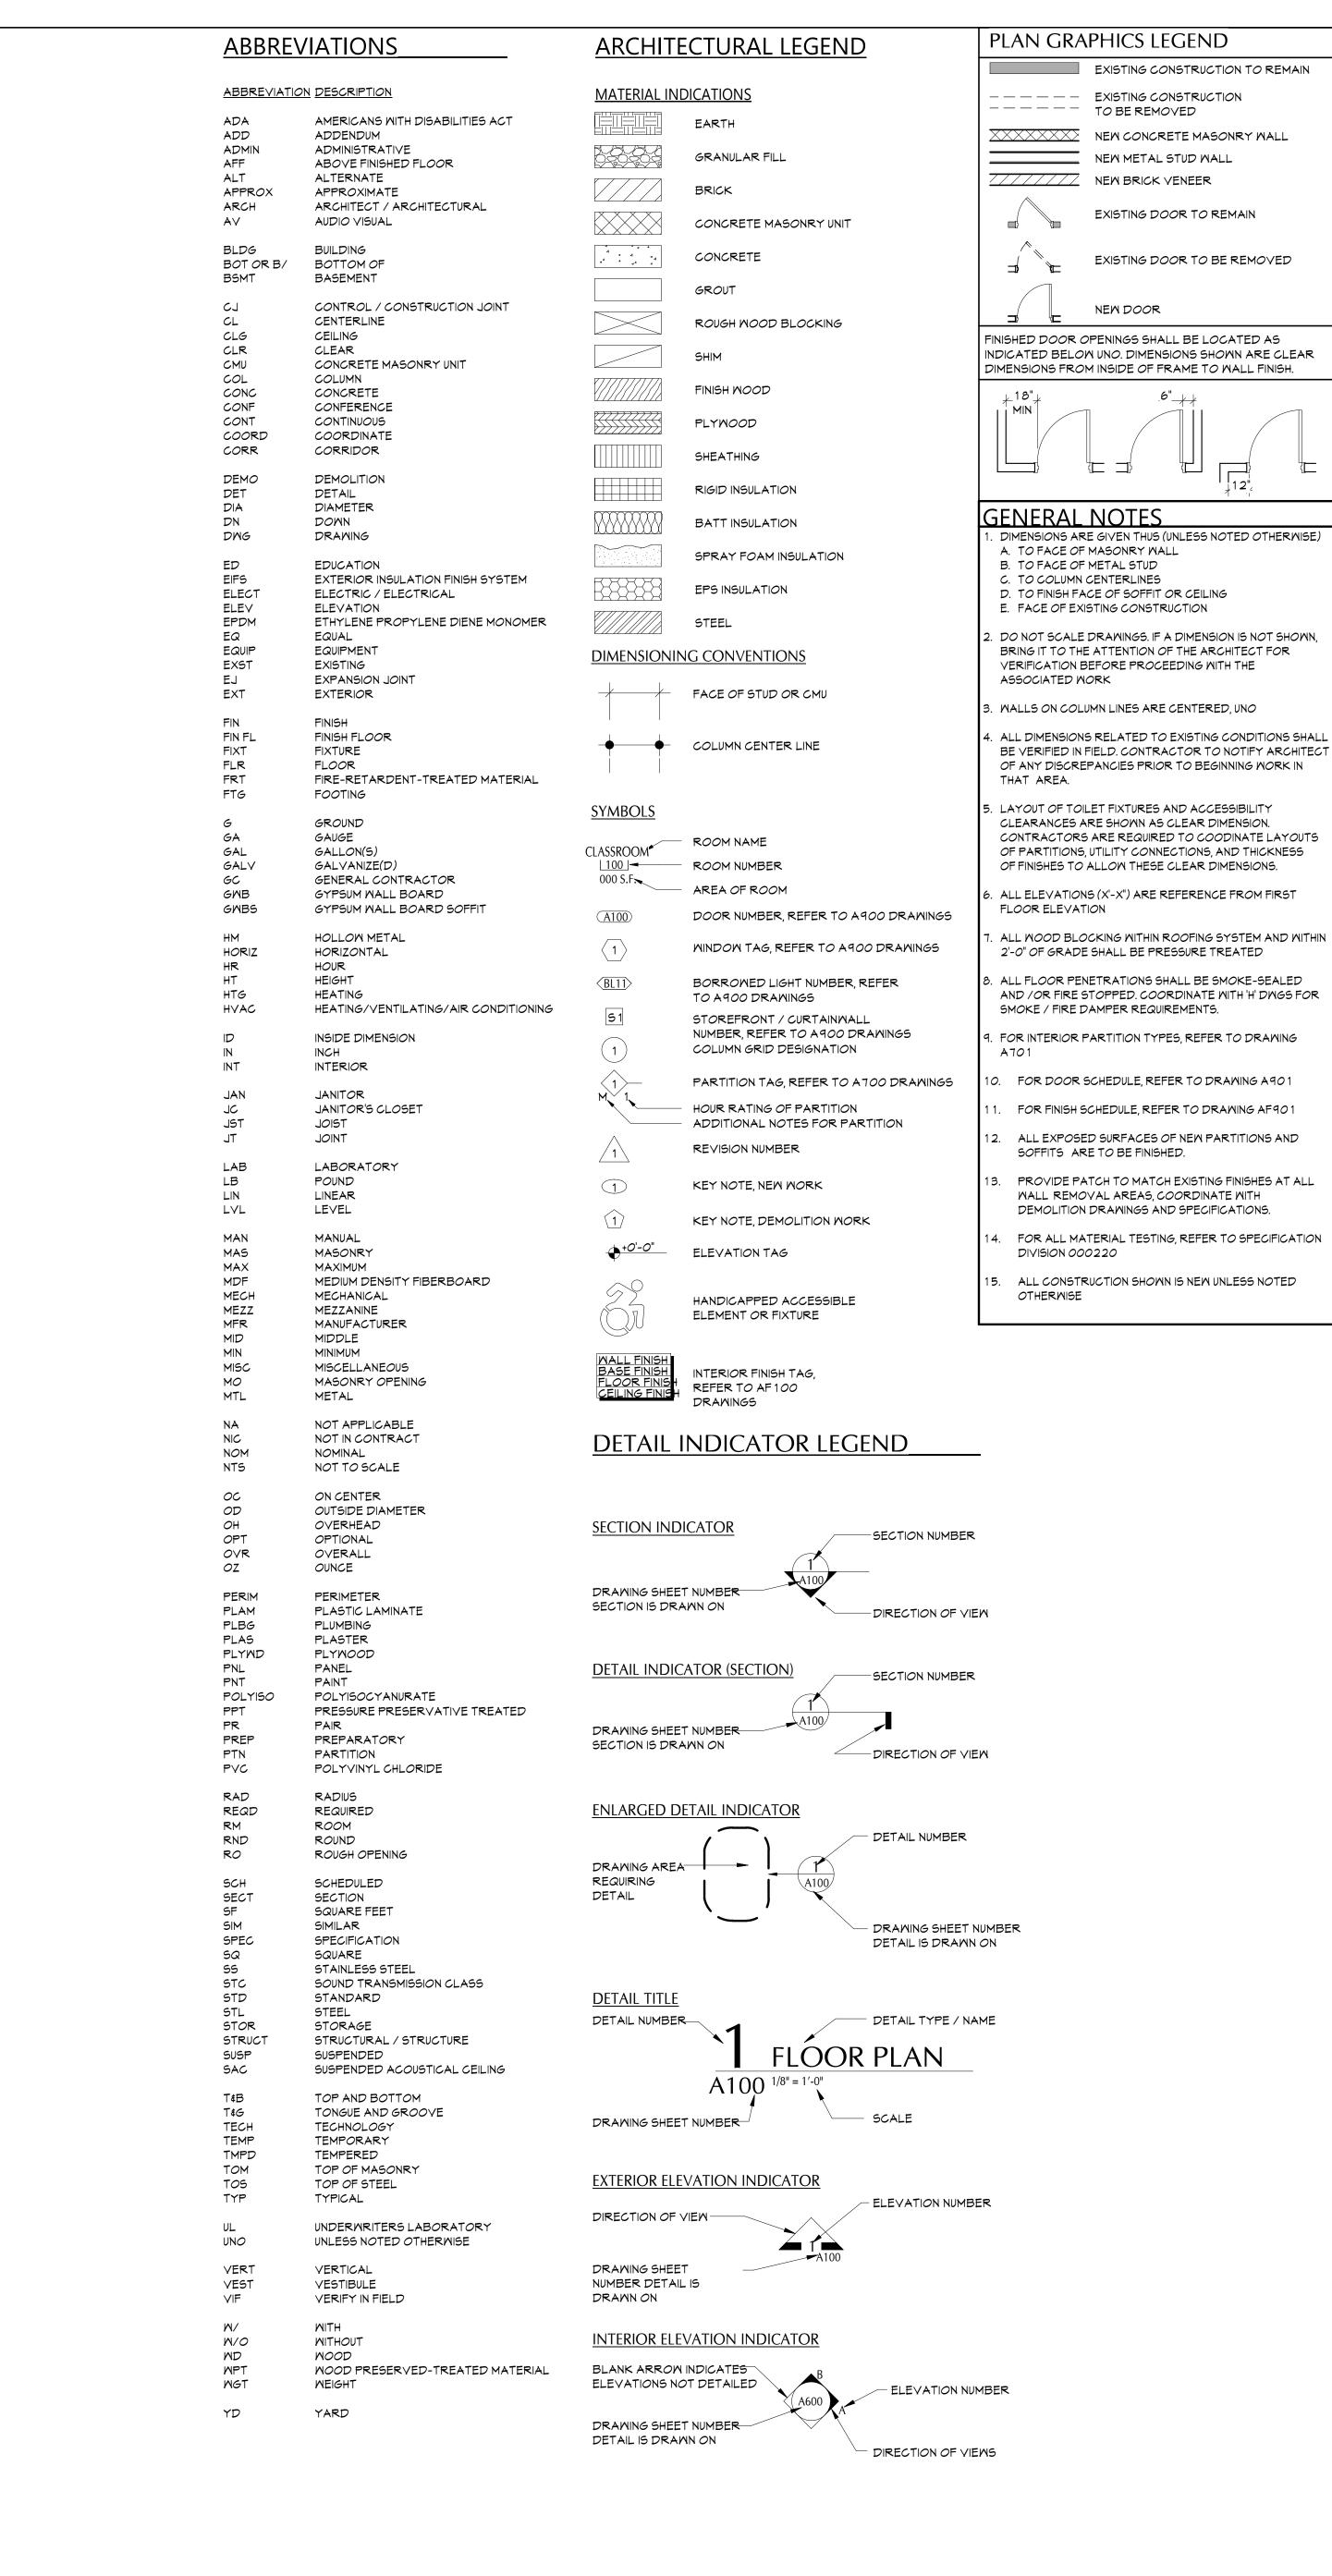

VALLEY CENTRAL SCHOOL DISTRICT
VALLEY CENTRAL HIGH SCHOOL
ART ROOM AND WOODSHOP ALTERATIONS

Project Title

DATE DESCRIPTION

Drawn By:
Checked By:
Proj. #: 44-13-01-06-0-015-03

CSArch Proj. #: 187-210

CSArch Proj. #: 44-13-0
Issued for Bid:
Sheet Title

SYMBOLS, ABBREVIATIONS

AND MISC

HSMS G001

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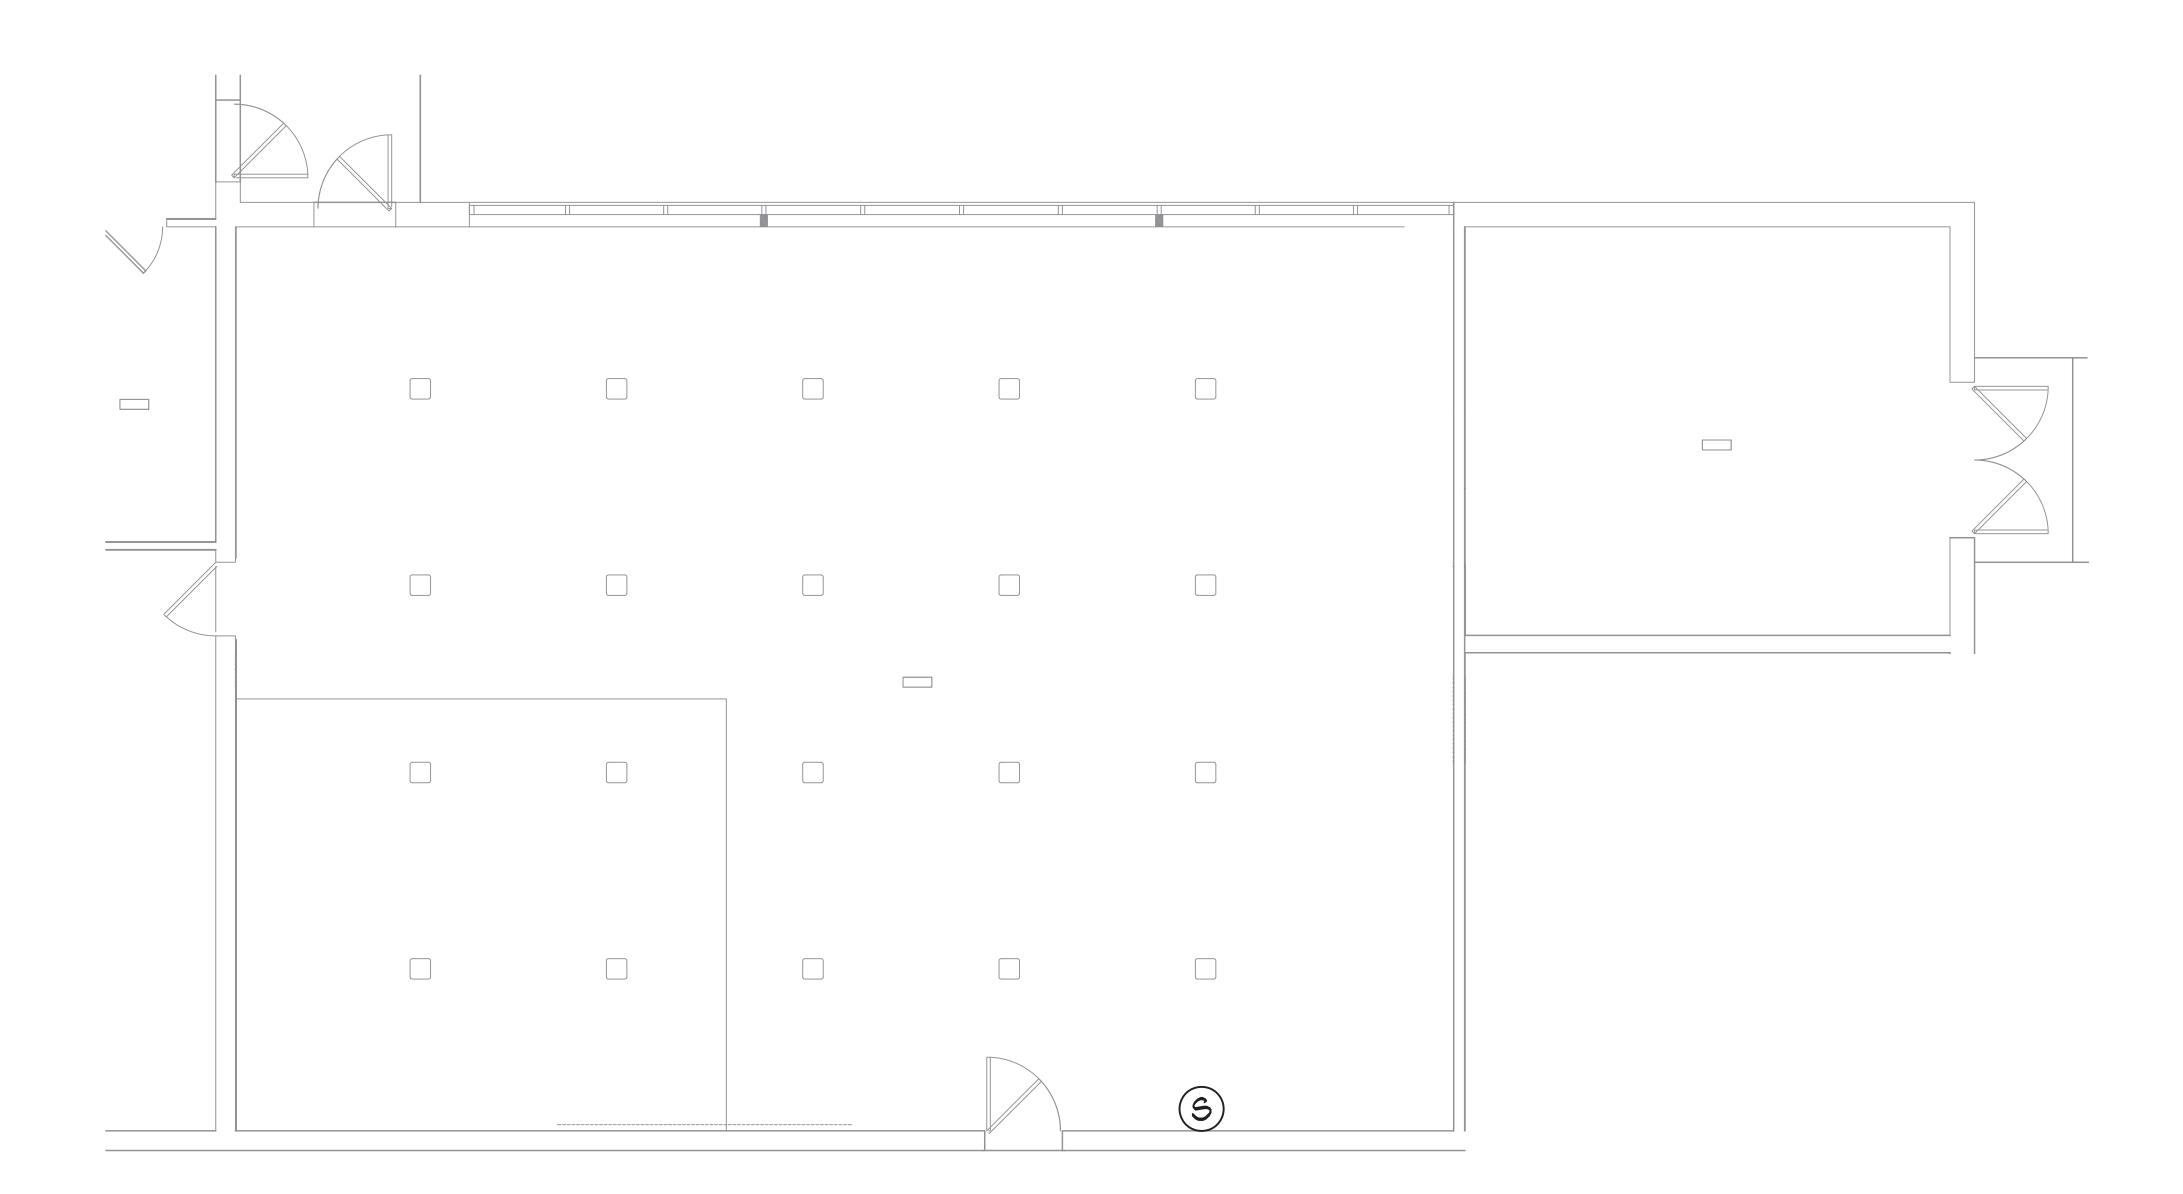
CONSTRUCTION DOCUMENTS

GENERAL NOTES

- 1. CONTRACTOR TO PROTECT THEIR EMPLOYEES WITH ADEQUATE PERSONAL PROTECTIVE EQUIPMENT AT ALL TIMES, WHEN
- PERFORMING WORK ON THIS PROJECT. 2. DISTRICT TO PROVIDE WATER SUPPLY AND ELECTRICAL POWER SOURCE ON THIS PROJECT TO CONDUCT WORK ACTIVITIES. CONTRACTOR TO PROVIDE ALL INTERCONNECTS FOR WATER/POWER AND TO ENSURE THAT ALL TEMPORARY WATER/POWER SOURCES ARE PROPERLY INSTALLED BY A LICENSED PLUMBER/ELECTRICIAN.
- 3. CONTRACTOR'S EMPLOYEES SHALL WEAR PROTECTIVE SUITS AND HALF-FACE RESPIRATORS (AT A MINIMUM) AT ALL TIMES, WHILE PERFORMING ASBESTOS ABATEMENT REGARDLESS OF ANY NEGATIVE EXPOSURE ASSESSMENT REPORTS/DATA.

ASBESTOS ABATEMENT NOTES

- 1. CONTRACTOR SHALL OBSERVE ALL FEDERAL, STATE, AND LOCAL REGULATIONS GOVERNING ASBESTOS ABATEMENT.
- 2. THE SCOPE OF ABATEMENT WORK INVOLVES THE REMOVAL OF ASBESTOS-CONTAINING MATERIAL FROM THE AREA INDICATED ON
- HM-100. 3. THE CONTRACTOR ASSUMES THE RESPONSIBILITY FOR THE MEANS AND METHODS UTILIZED TO COMPLETE THE PROJECT IN A TIMELY, PROFESSIONAL, LEGAL, AND SAFE MANNER.
- 4. THE CONTRACTOR ACKNOWLEDGES THAT THE PROVIDED DRAWING MAY NOT BE TO SCALE. IT IS THE RESPONSIBILITY OF THE CONTRACTOR TO ATTEND A PRE-BID WALKTHROUGH AND SATISFY THEMSELVES OF THE QUANTITY OF ASBESTOS-CONTAINING MATERIAL THAT THEY SHALL BE CONTRACTUALLY OBLIGATED TO HANDLE AND DISPOSE OF ON THIS PROJECT.
- 5. DECONTAMINATION ENCLOSURES SHALL BE CONSTRUCTED ACCORDANCE WITH THE REQUIREMENTS OF NYSDOL ICR 56. THE LOCATIONS OF THESE ENCLOSURES, STAGING AREAS, WASTE DUMPSTERS / TRAILERS / VEHICLES, POWER AND WATER SOURCES SHALL BE IDENTIFIED TO DISTRICT REPRESENTATIVES AND PROJECT DESIGNER SEVENTY-TWO (72) HOURS PRIOR TO THE COMMENCEMENT OF ANY ACTIVITIES ON-SITE. THE CONTRACTOR ACCEPTS THAT DISTRICT REPRESENTATIVES AND THE PROJECT DESIGNER MAY MODIFY THIS PLAN FOR ANY REASON DEEMED NECESSARY. THE CONTRACTOR MAY NOT PROCEED WITH ABATEMENT ACTIVITIES UNTIL THEY HAVE THE APPROVAL OF DISTRICT REPRESENTATIVES AND PROJECT DESIGNER.
- 6. THE DISTRICT (OR THEIR DESIGNATED PERSONNEL) SHALL BE RESPONSIBLE FOR HIRING THE PROJECT MONITORING FIRM ON THIS PROJECT. THE CONTRACTOR SHALL RECOGNIZE THE SELECTED FIRM'S PERSONNEL AS THE DISTRICT'S REPRESENTATIVE. THE CONTRACTOR SHALL BE RESPONSIBLE FOR THE COLLECTION OF PERSONAL AIR SAMPLES FOR THEIR EMPLOYEES DURING THIS PROJECT.
- 1. CONTRACTOR SHALL COORDINATE/SCHEDULE ALL WORK WITH THE



FIRST FLOOR PARTIAL FIRST FLOOR PLAN — ASBESTOS ABATEMENT ACTIVITIES $\frac{1}{1} = 1'-0$

KEY PLAN

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<u>LEGEND</u>:

ASBESTOS-CONTAINING SINK BASIN MASTIC TO BE REMOVED (APPROX. 6 SF)

Asbestos & Environmental Consulting Corporation 6308 Fly Road East Syracuse, NY 13057 Phone: (315) 432-9400 Fax: (315) 432-9405 www.aeccgroup.com


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CSArch Proj. #: 187-2103
Construction Documents: 04-15-2022


Sheet Title FIRST FLOOR PARTIAL PLAN - ARTS / INDUSTRIAL ARTS

HM-100

CONSTRUCTION DOCUMENTS

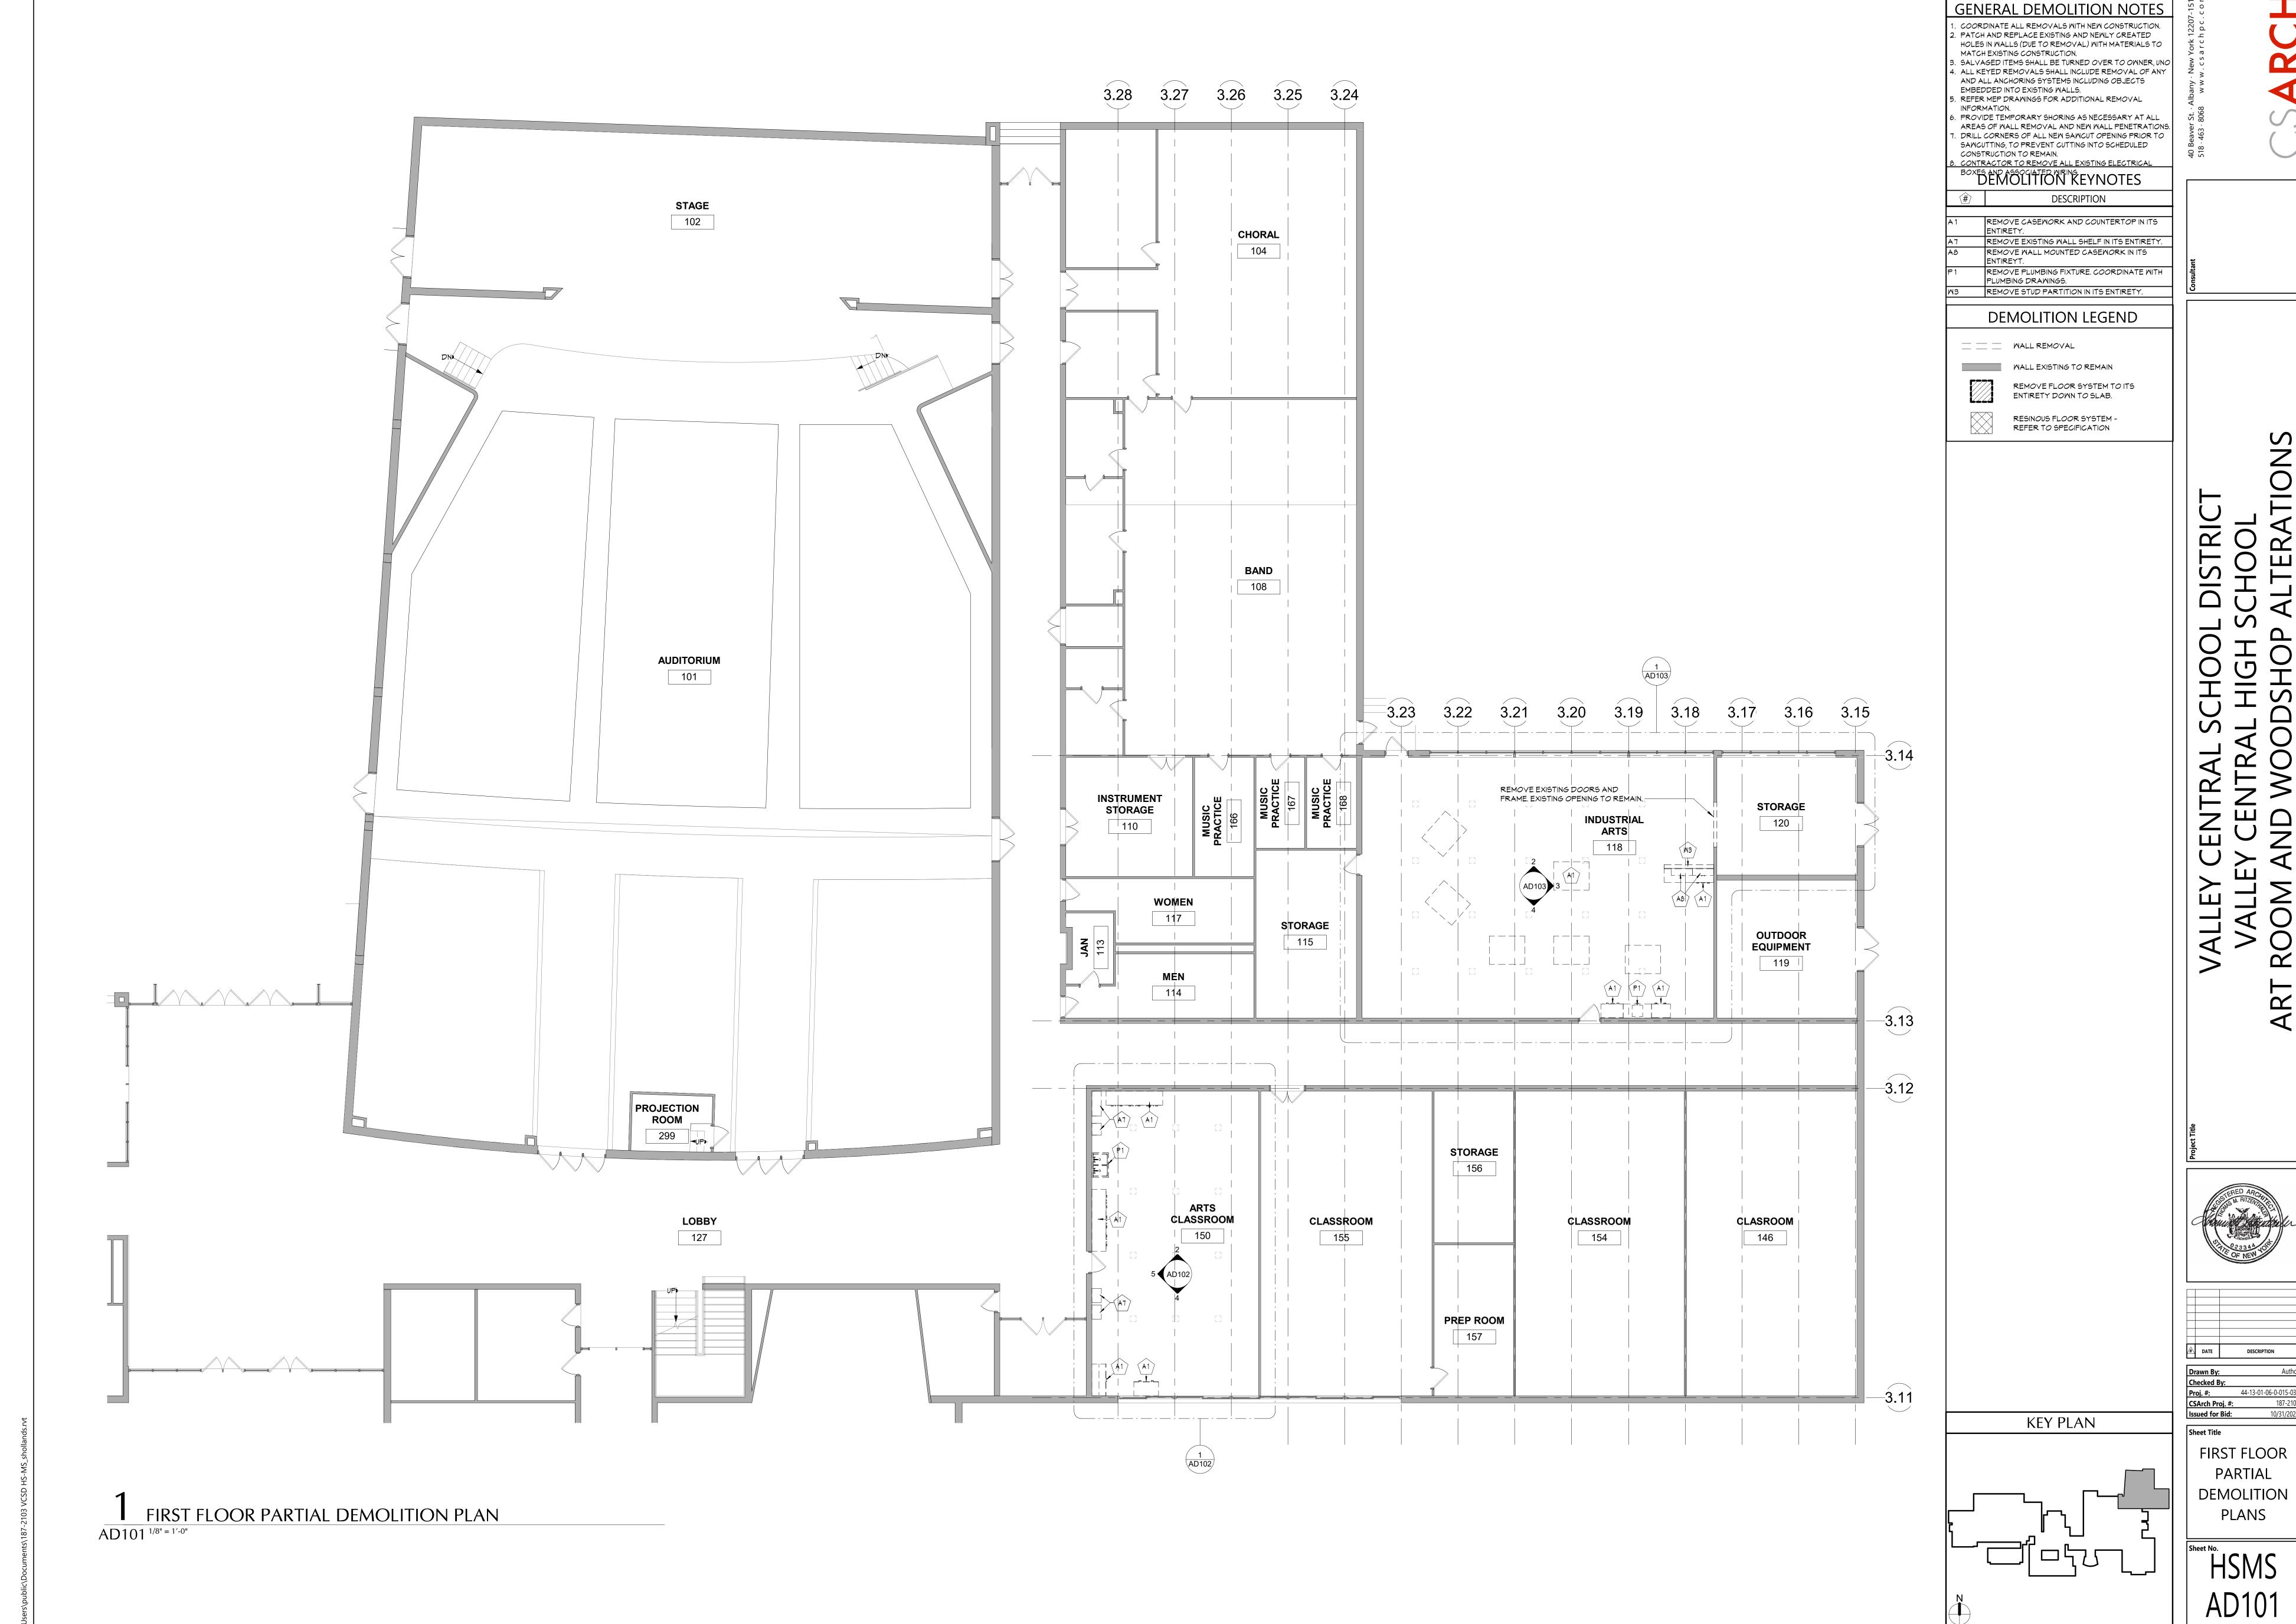

CONSTRUCTION DOCUMENTS

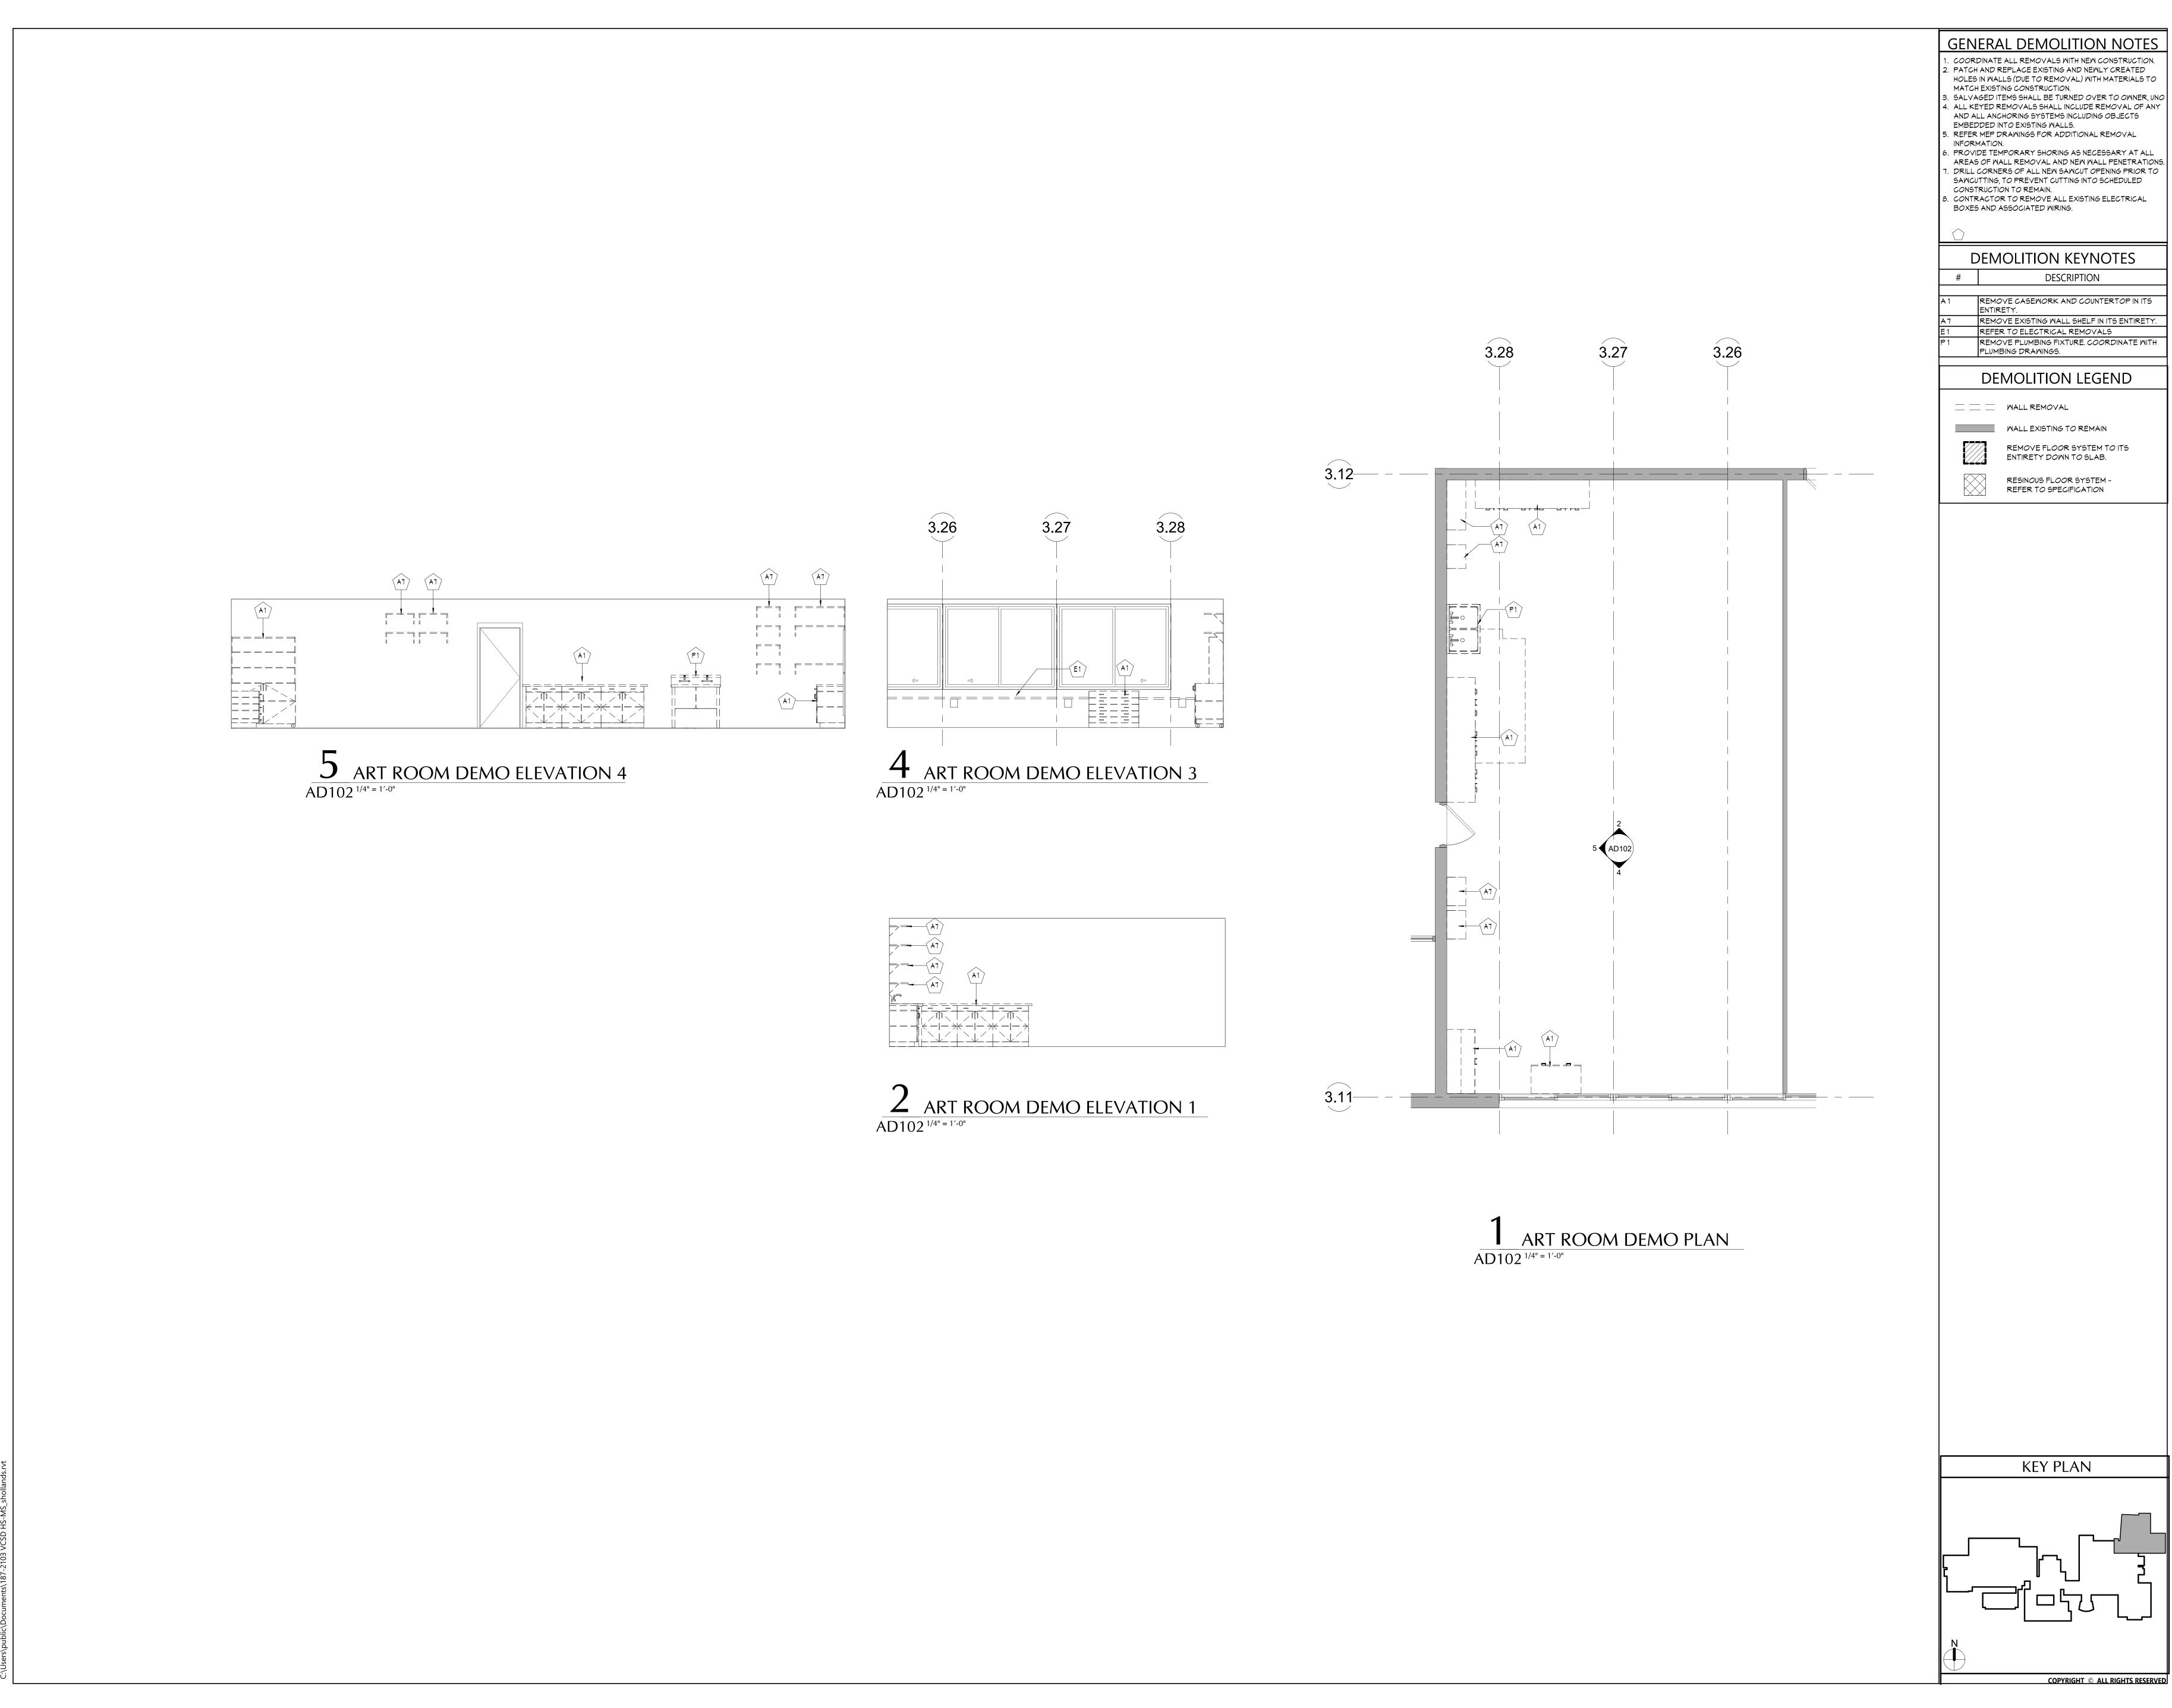

VALLEY CENTRAL SCHOOL DISTRICT
VALLEY CENTRAL HIGH SCHOOL
ART ROOM AND WOODSHOP ALTERATIONS

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CSArch Proj. #: 187-210
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Sheet Title

ART ROOM
DEMOLITION
PLAN &
ELEVATIONS

HSMS AD102

GENERAL DEMOLITION NOTES


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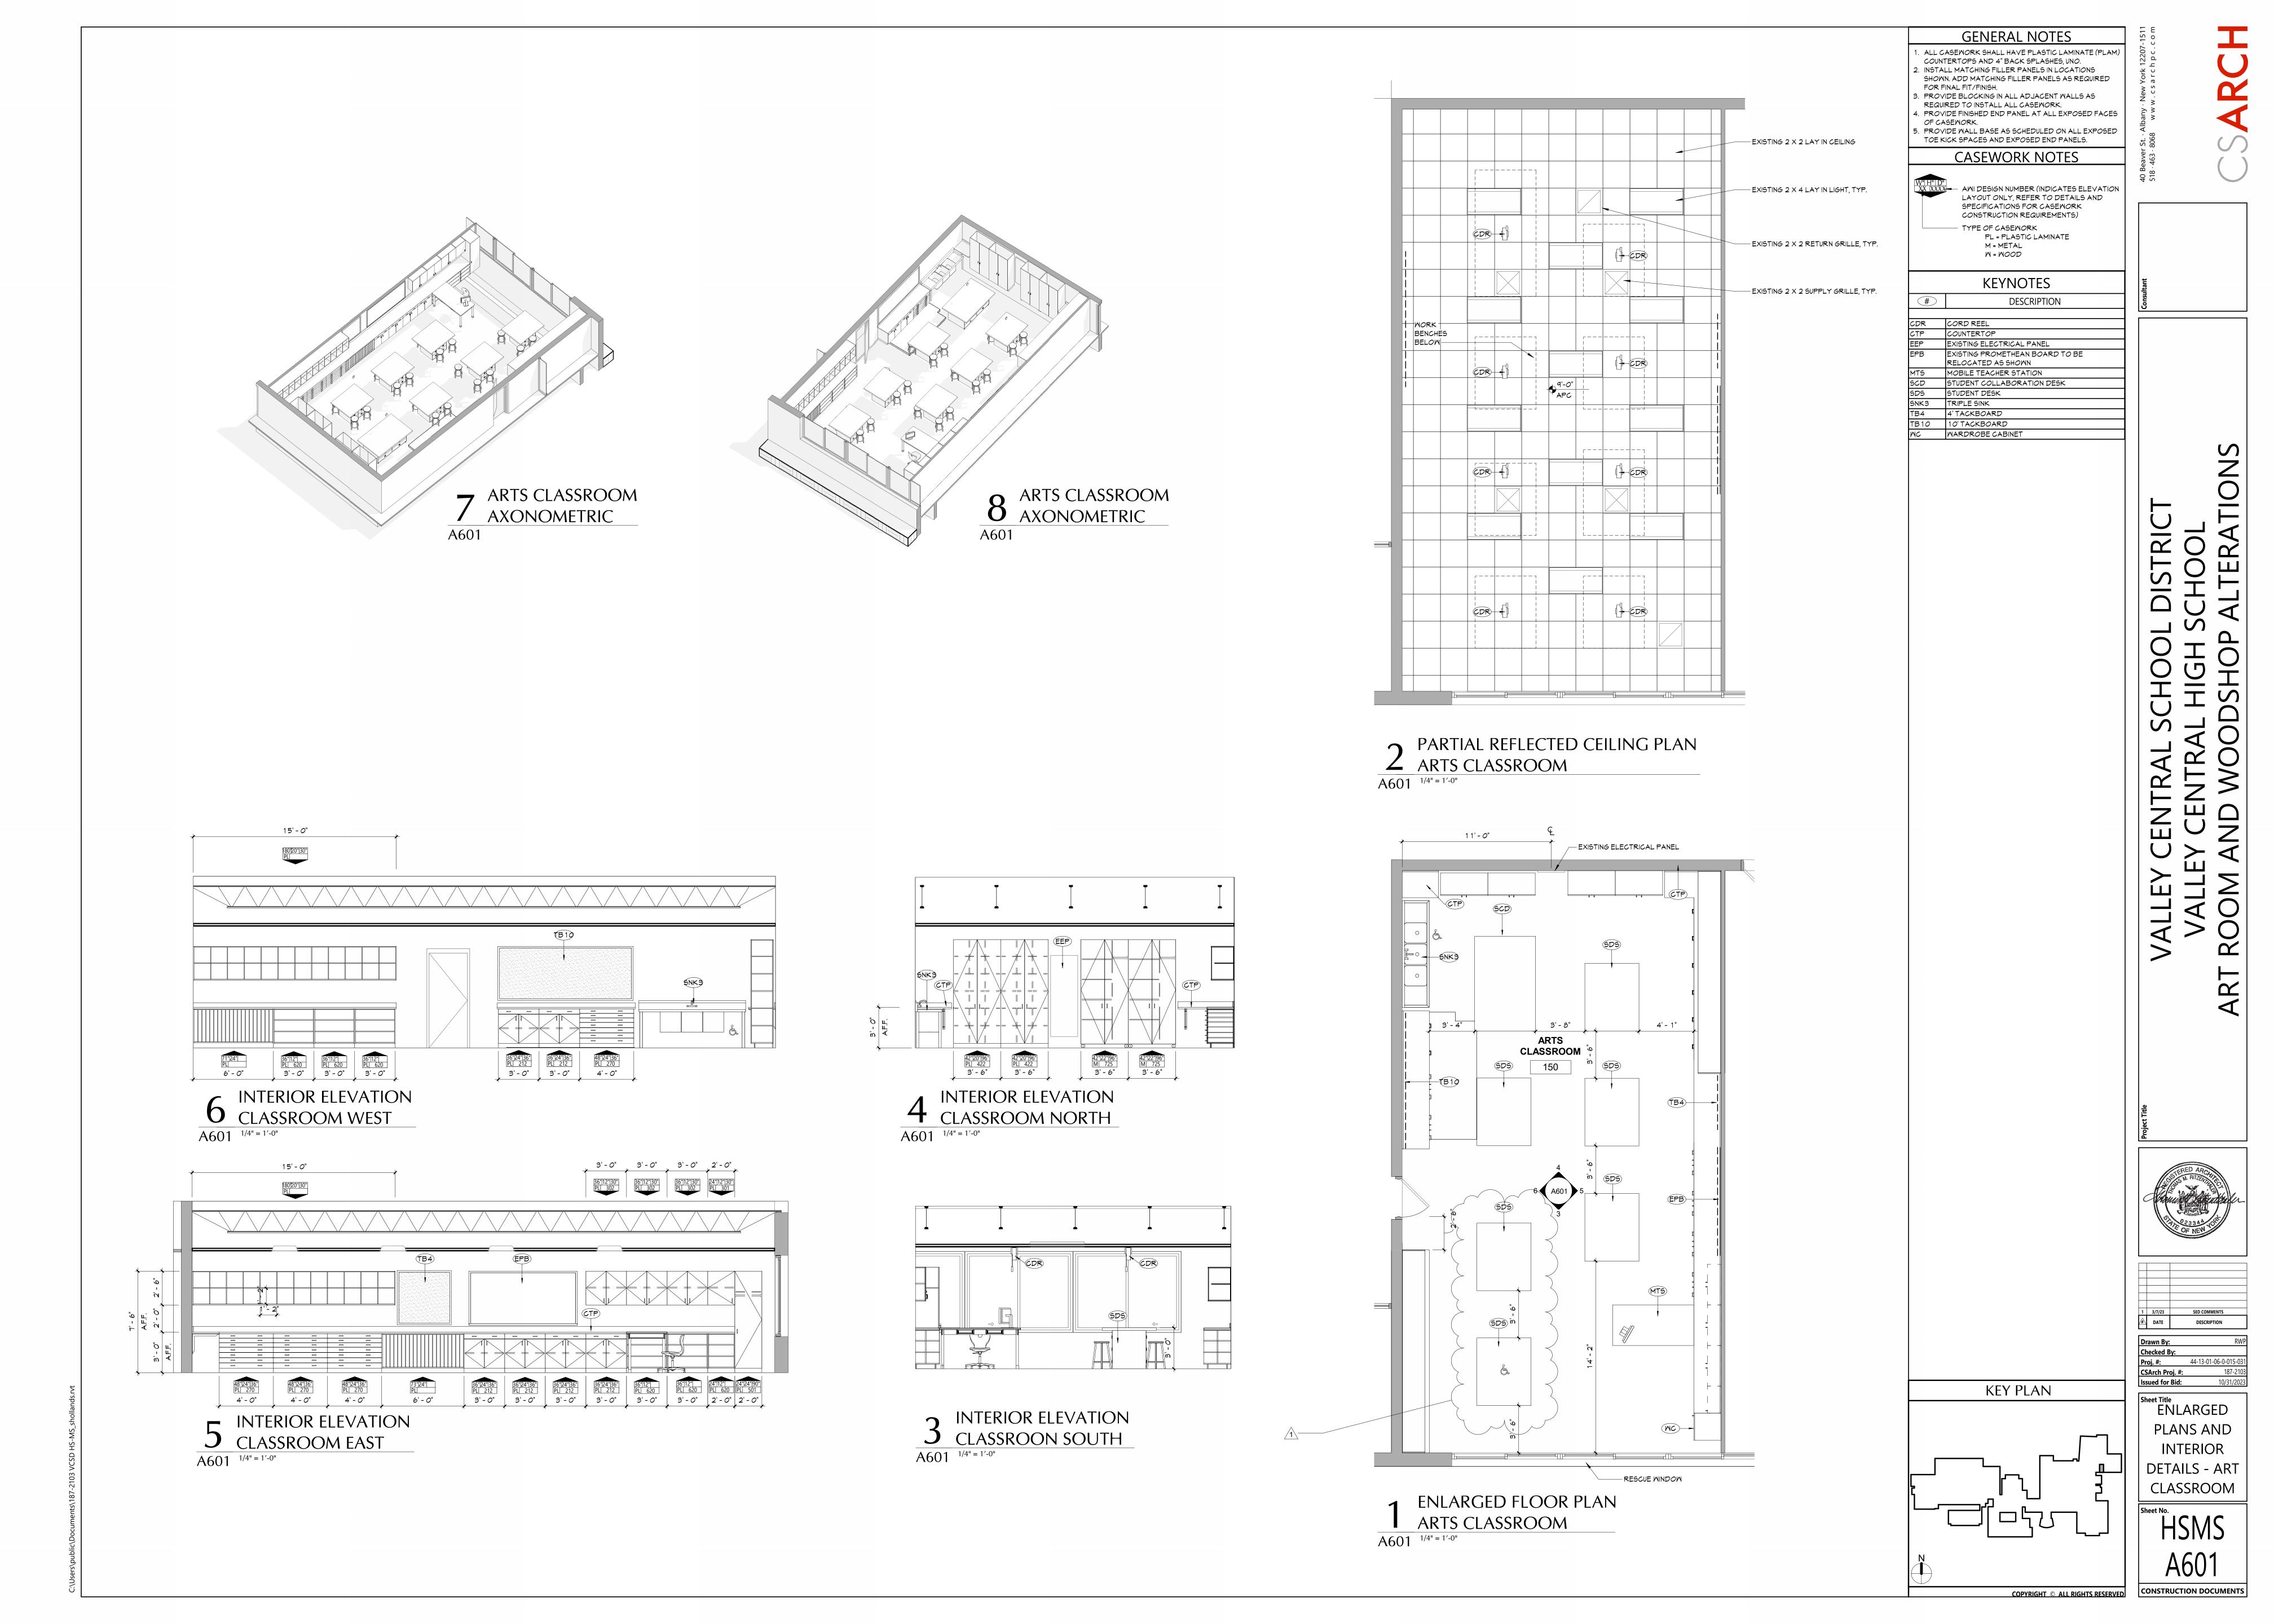
Sheet Title WORK SHOP ROOM DEMOLITION


ELEVATIONS


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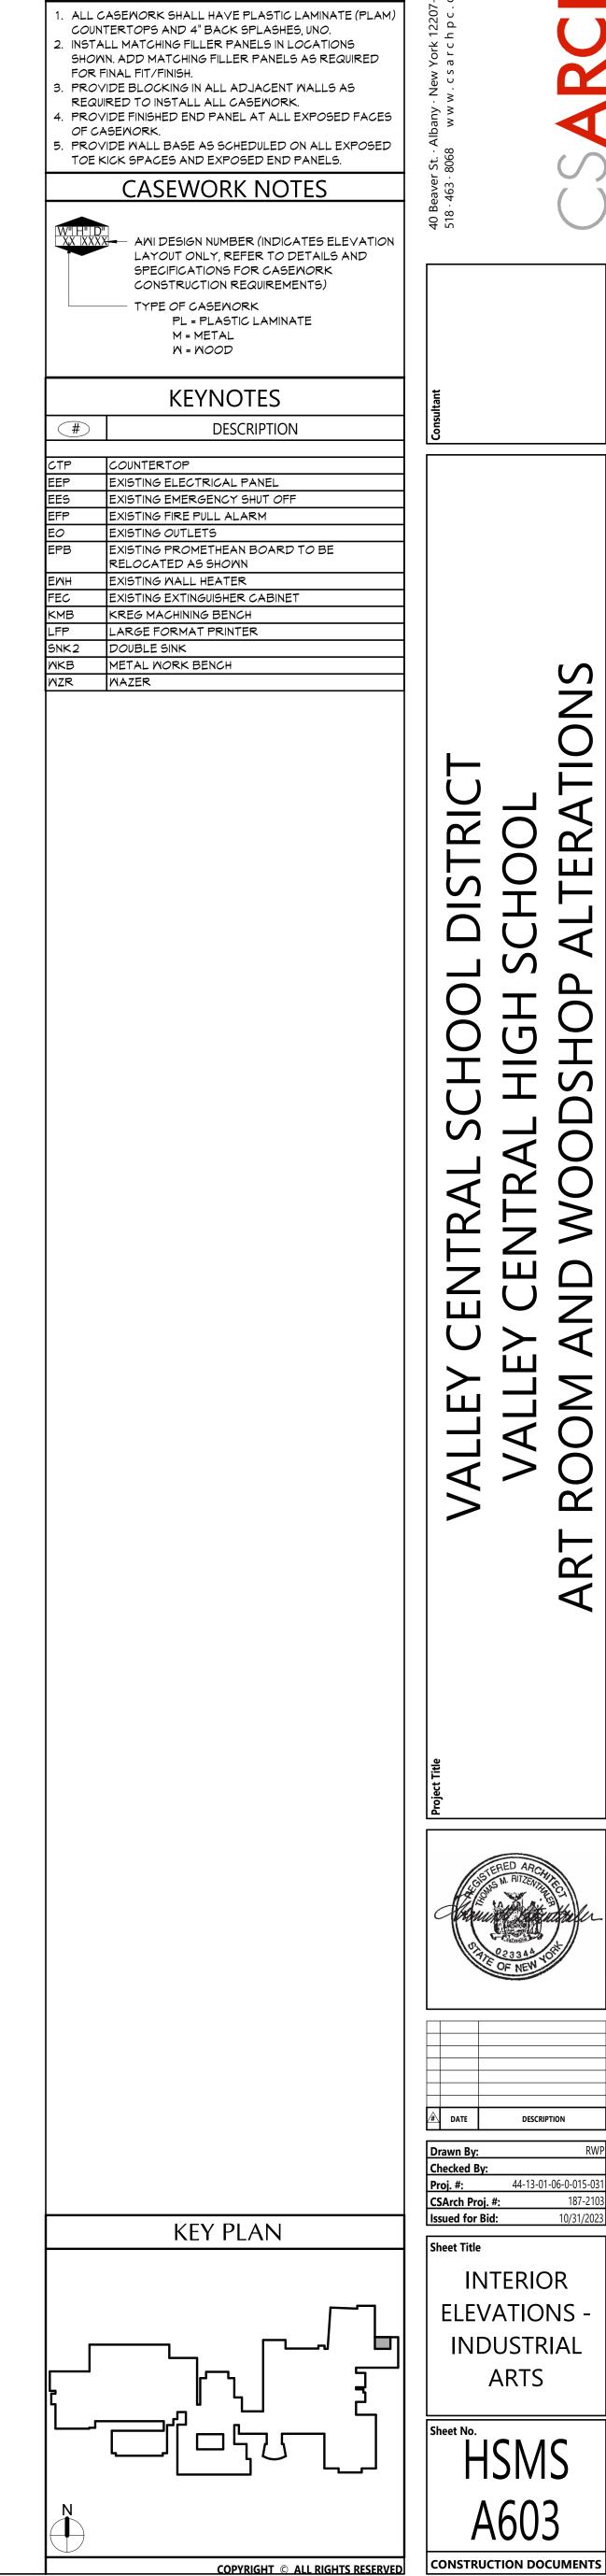
PLANS &





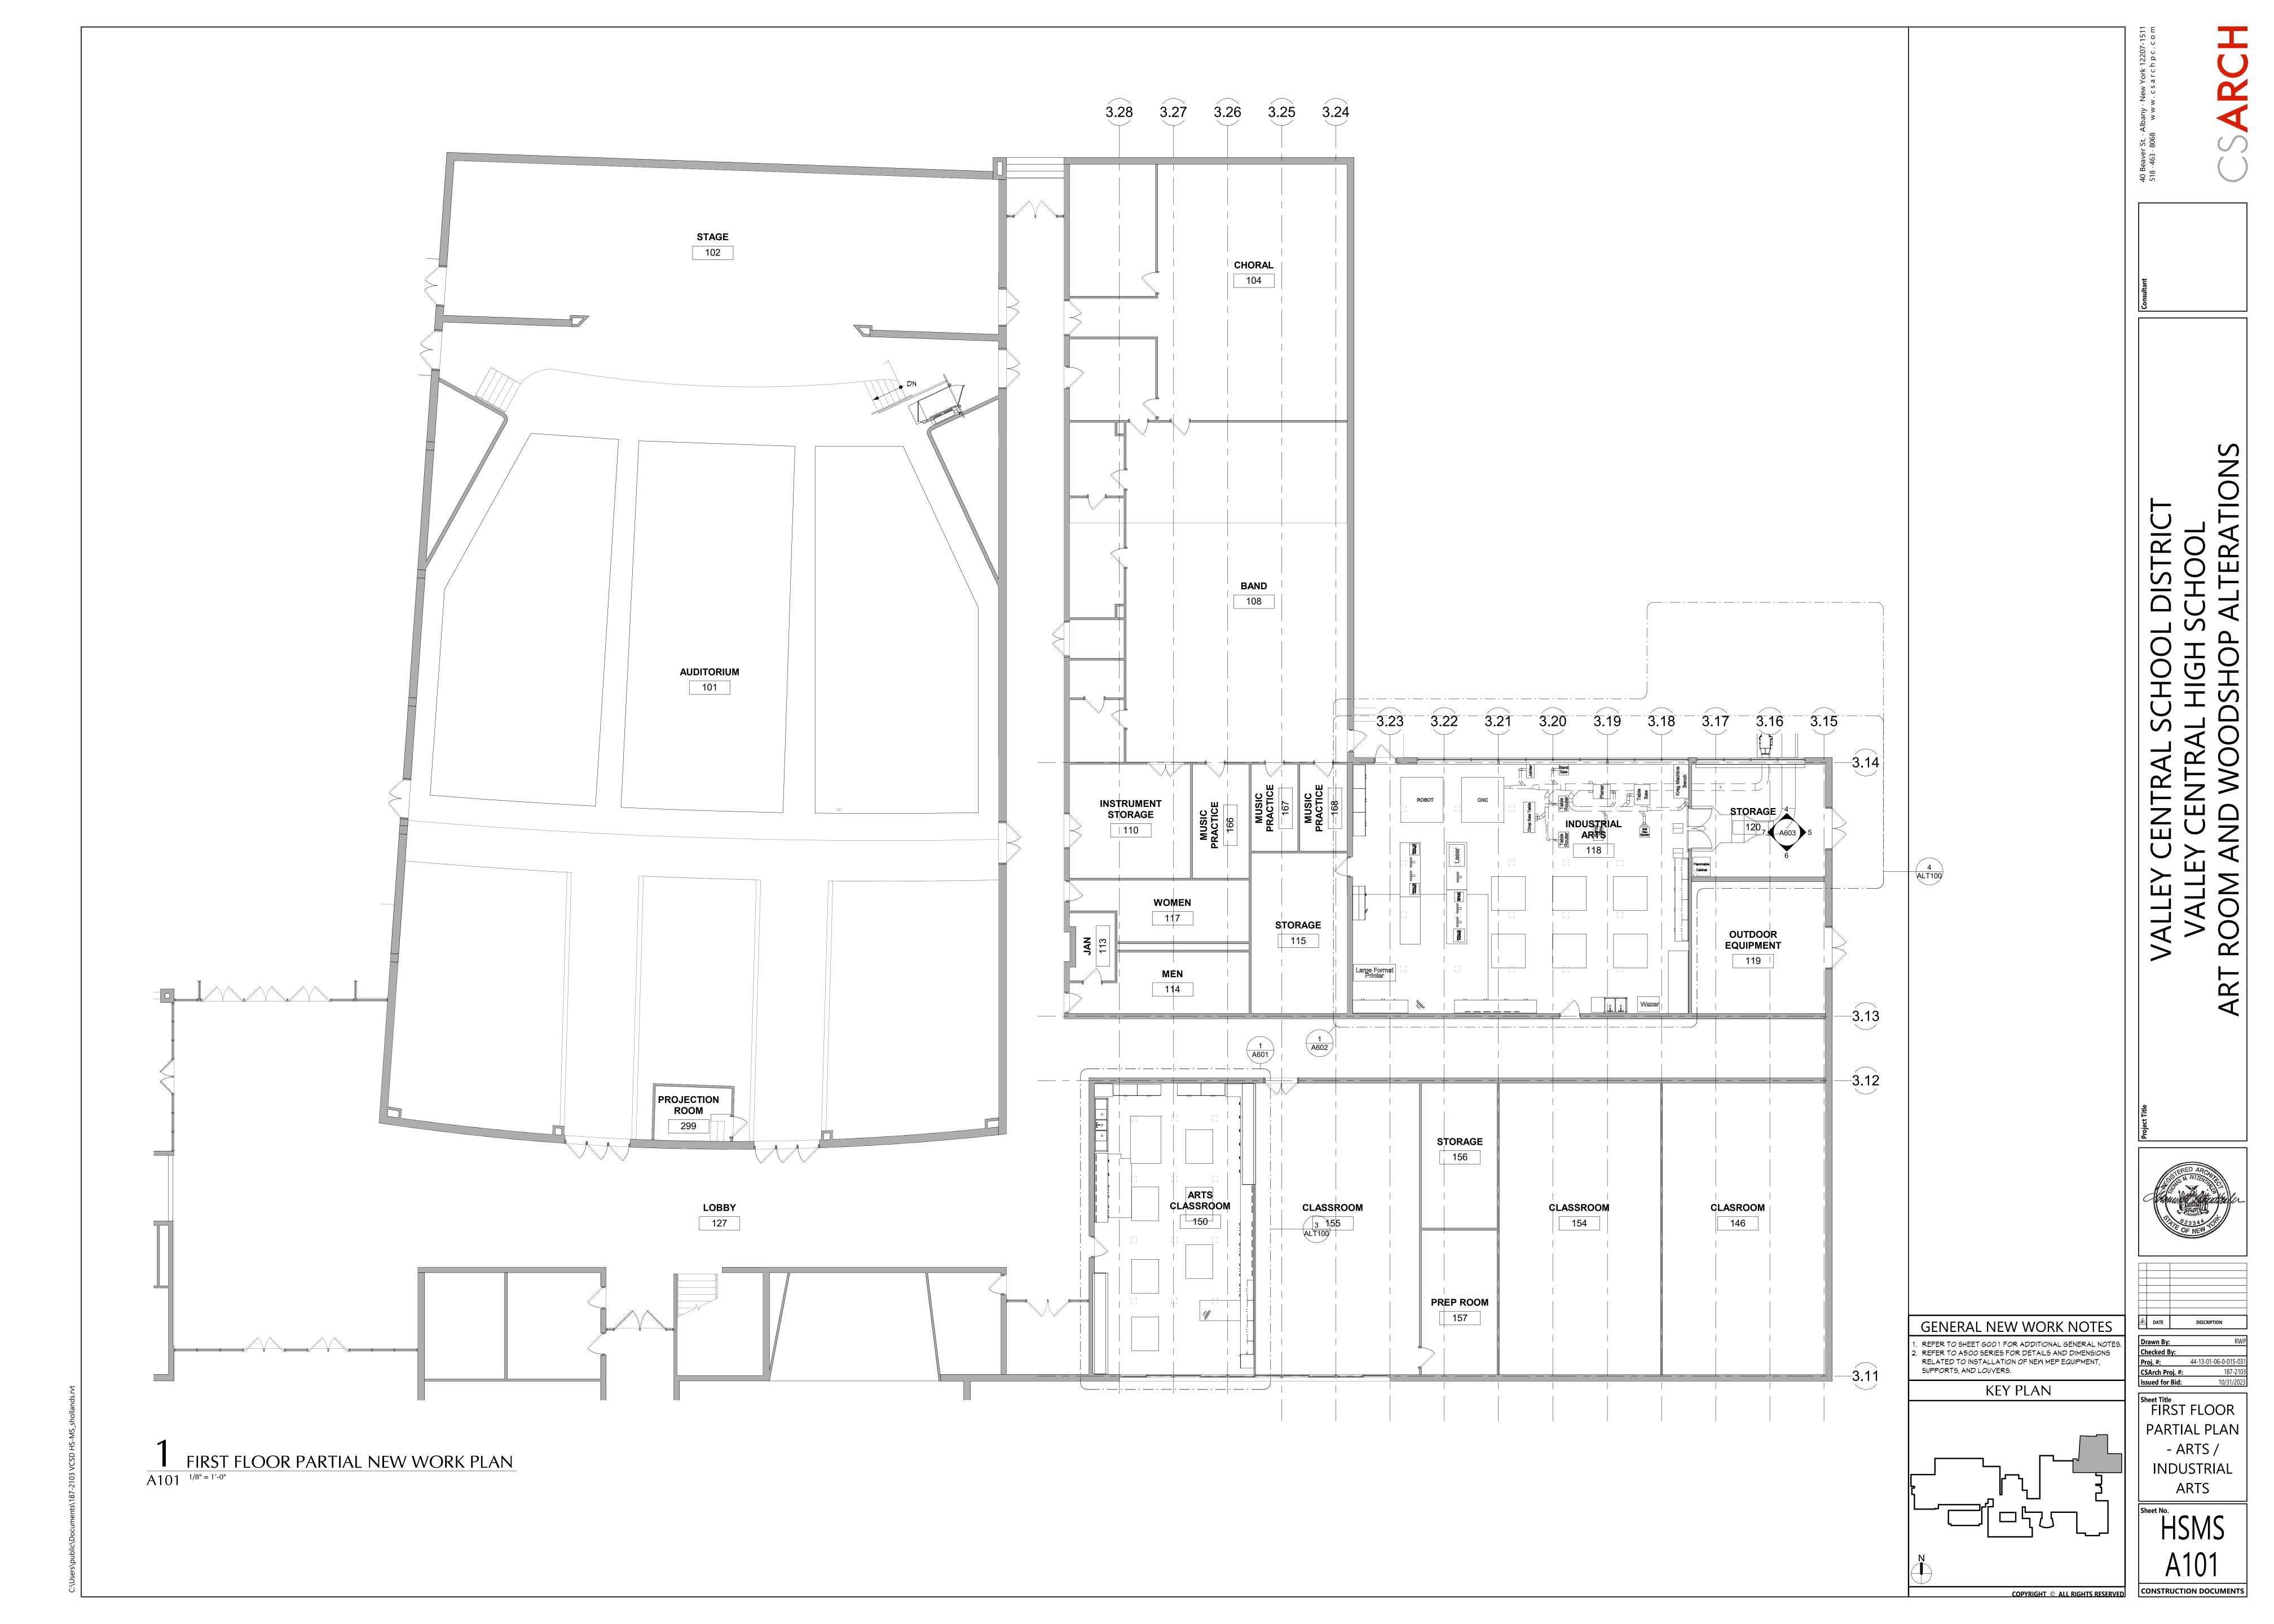

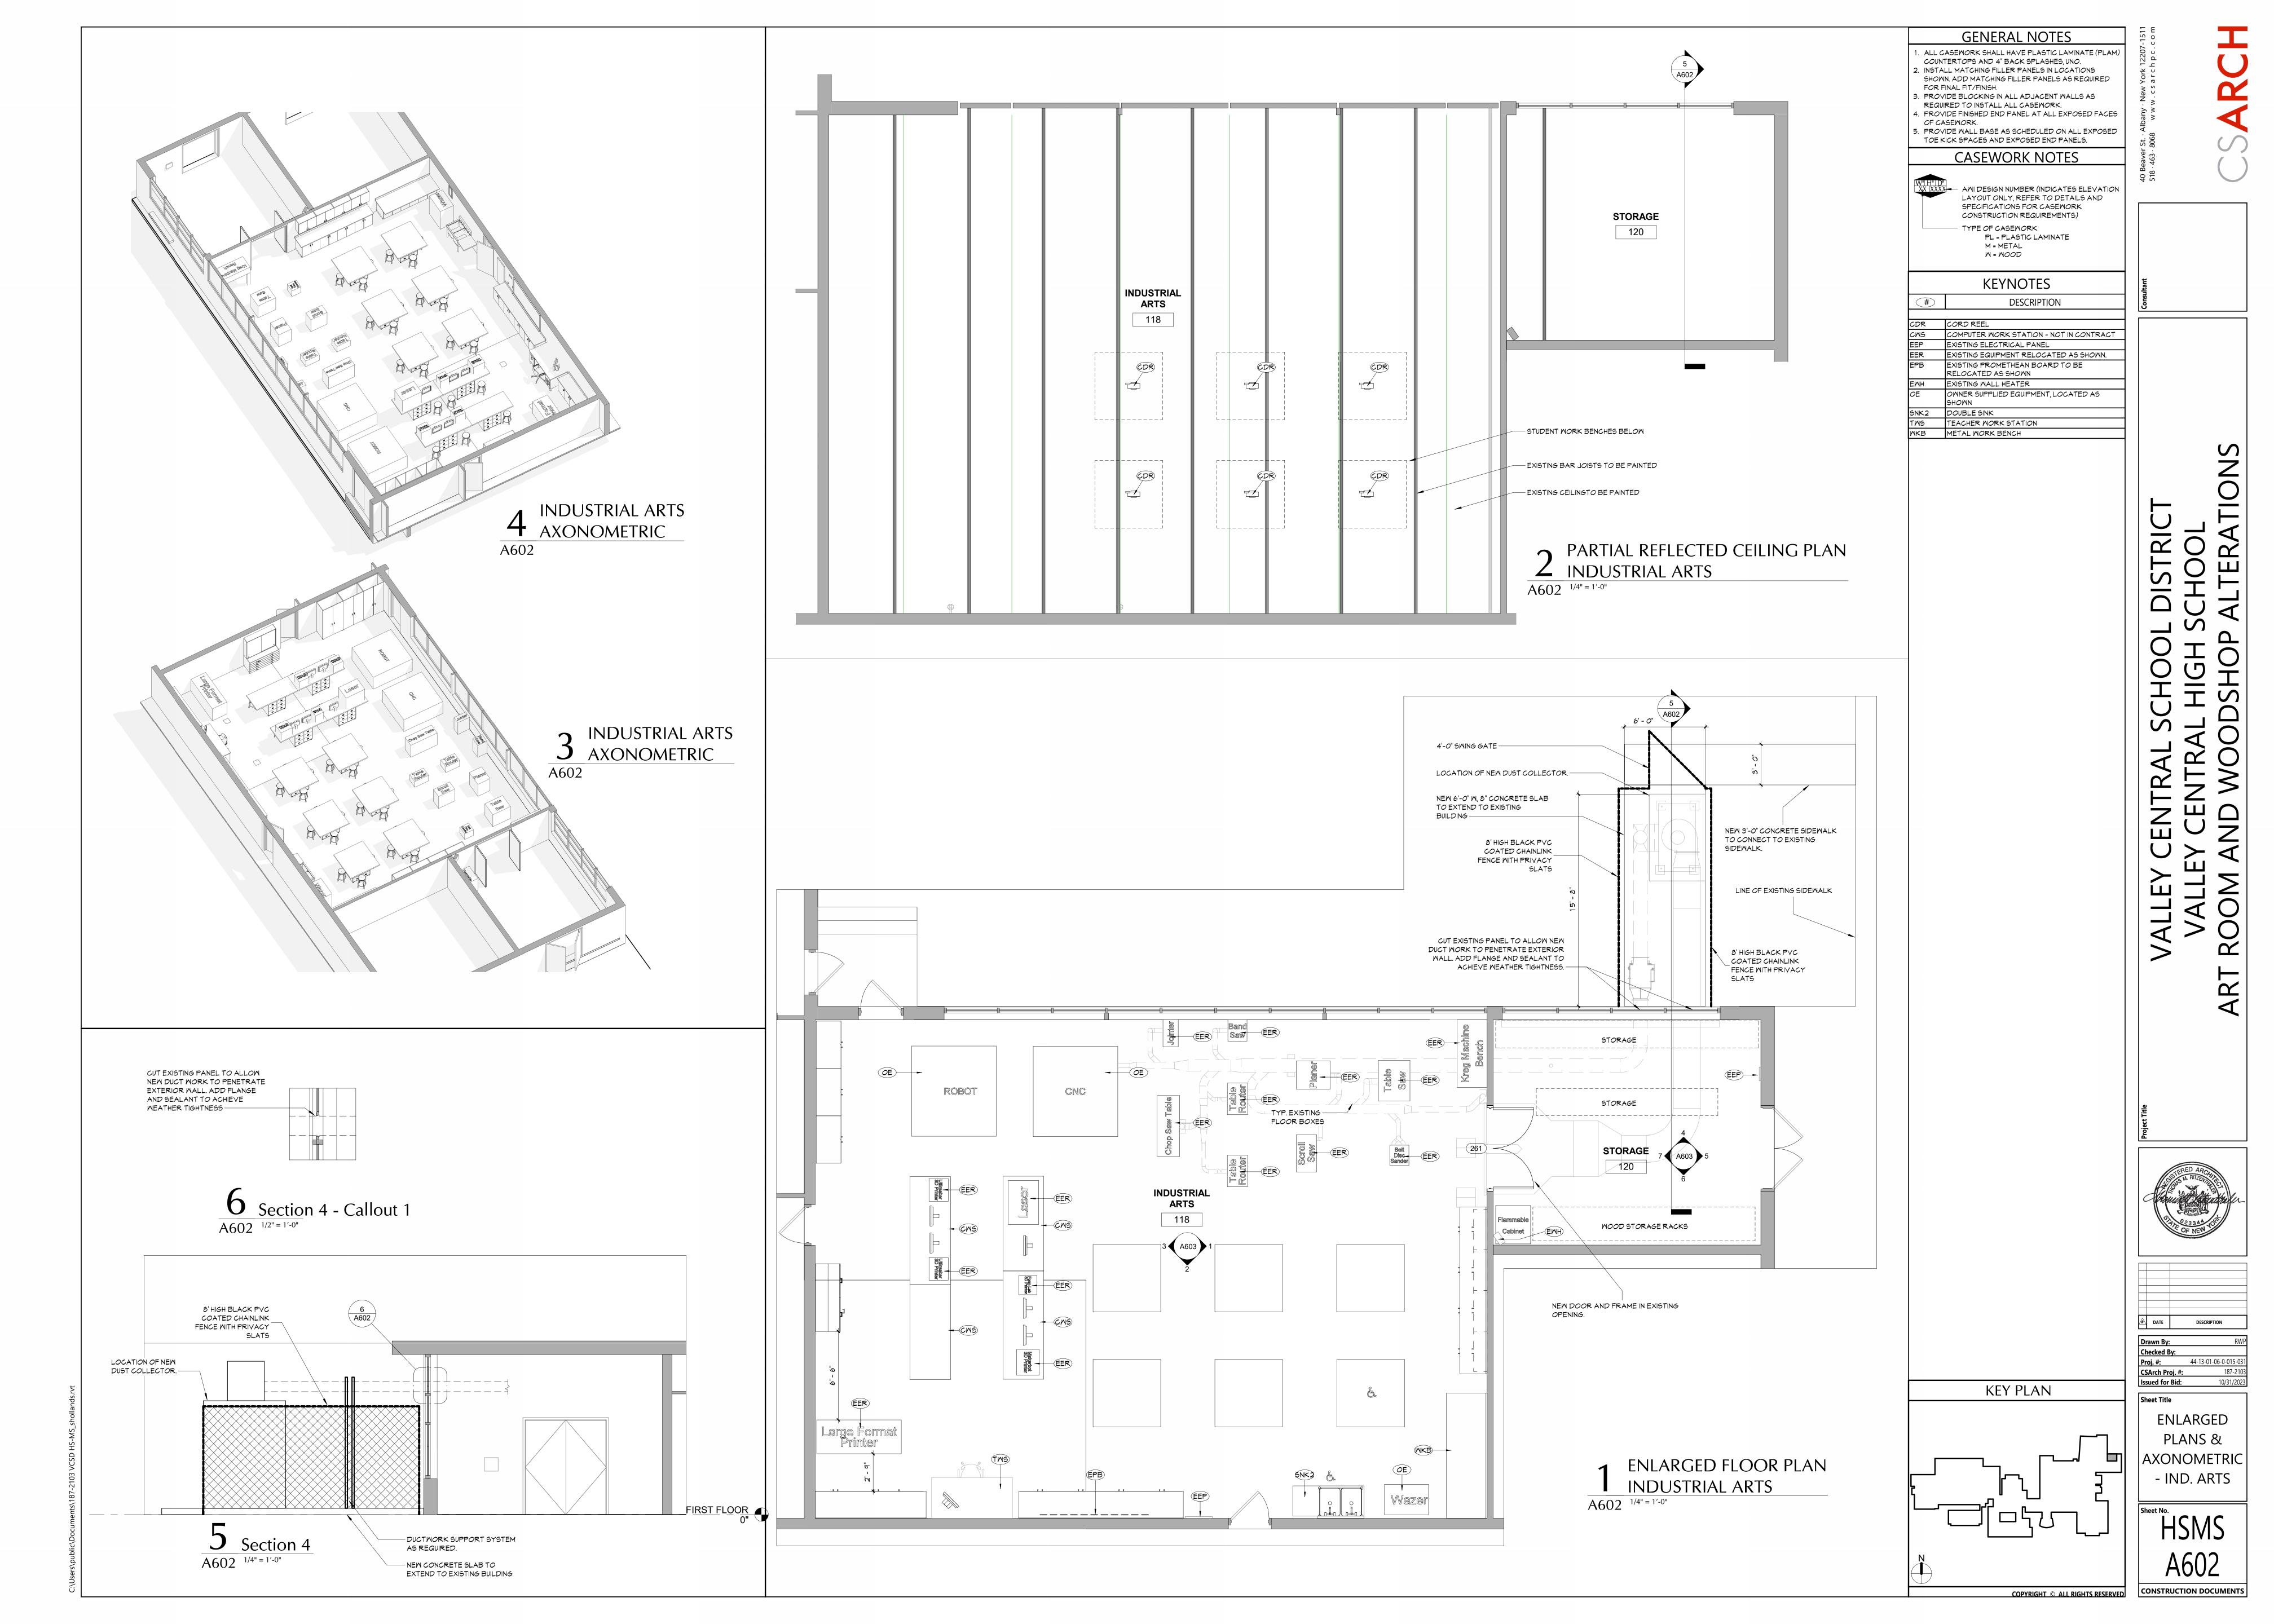

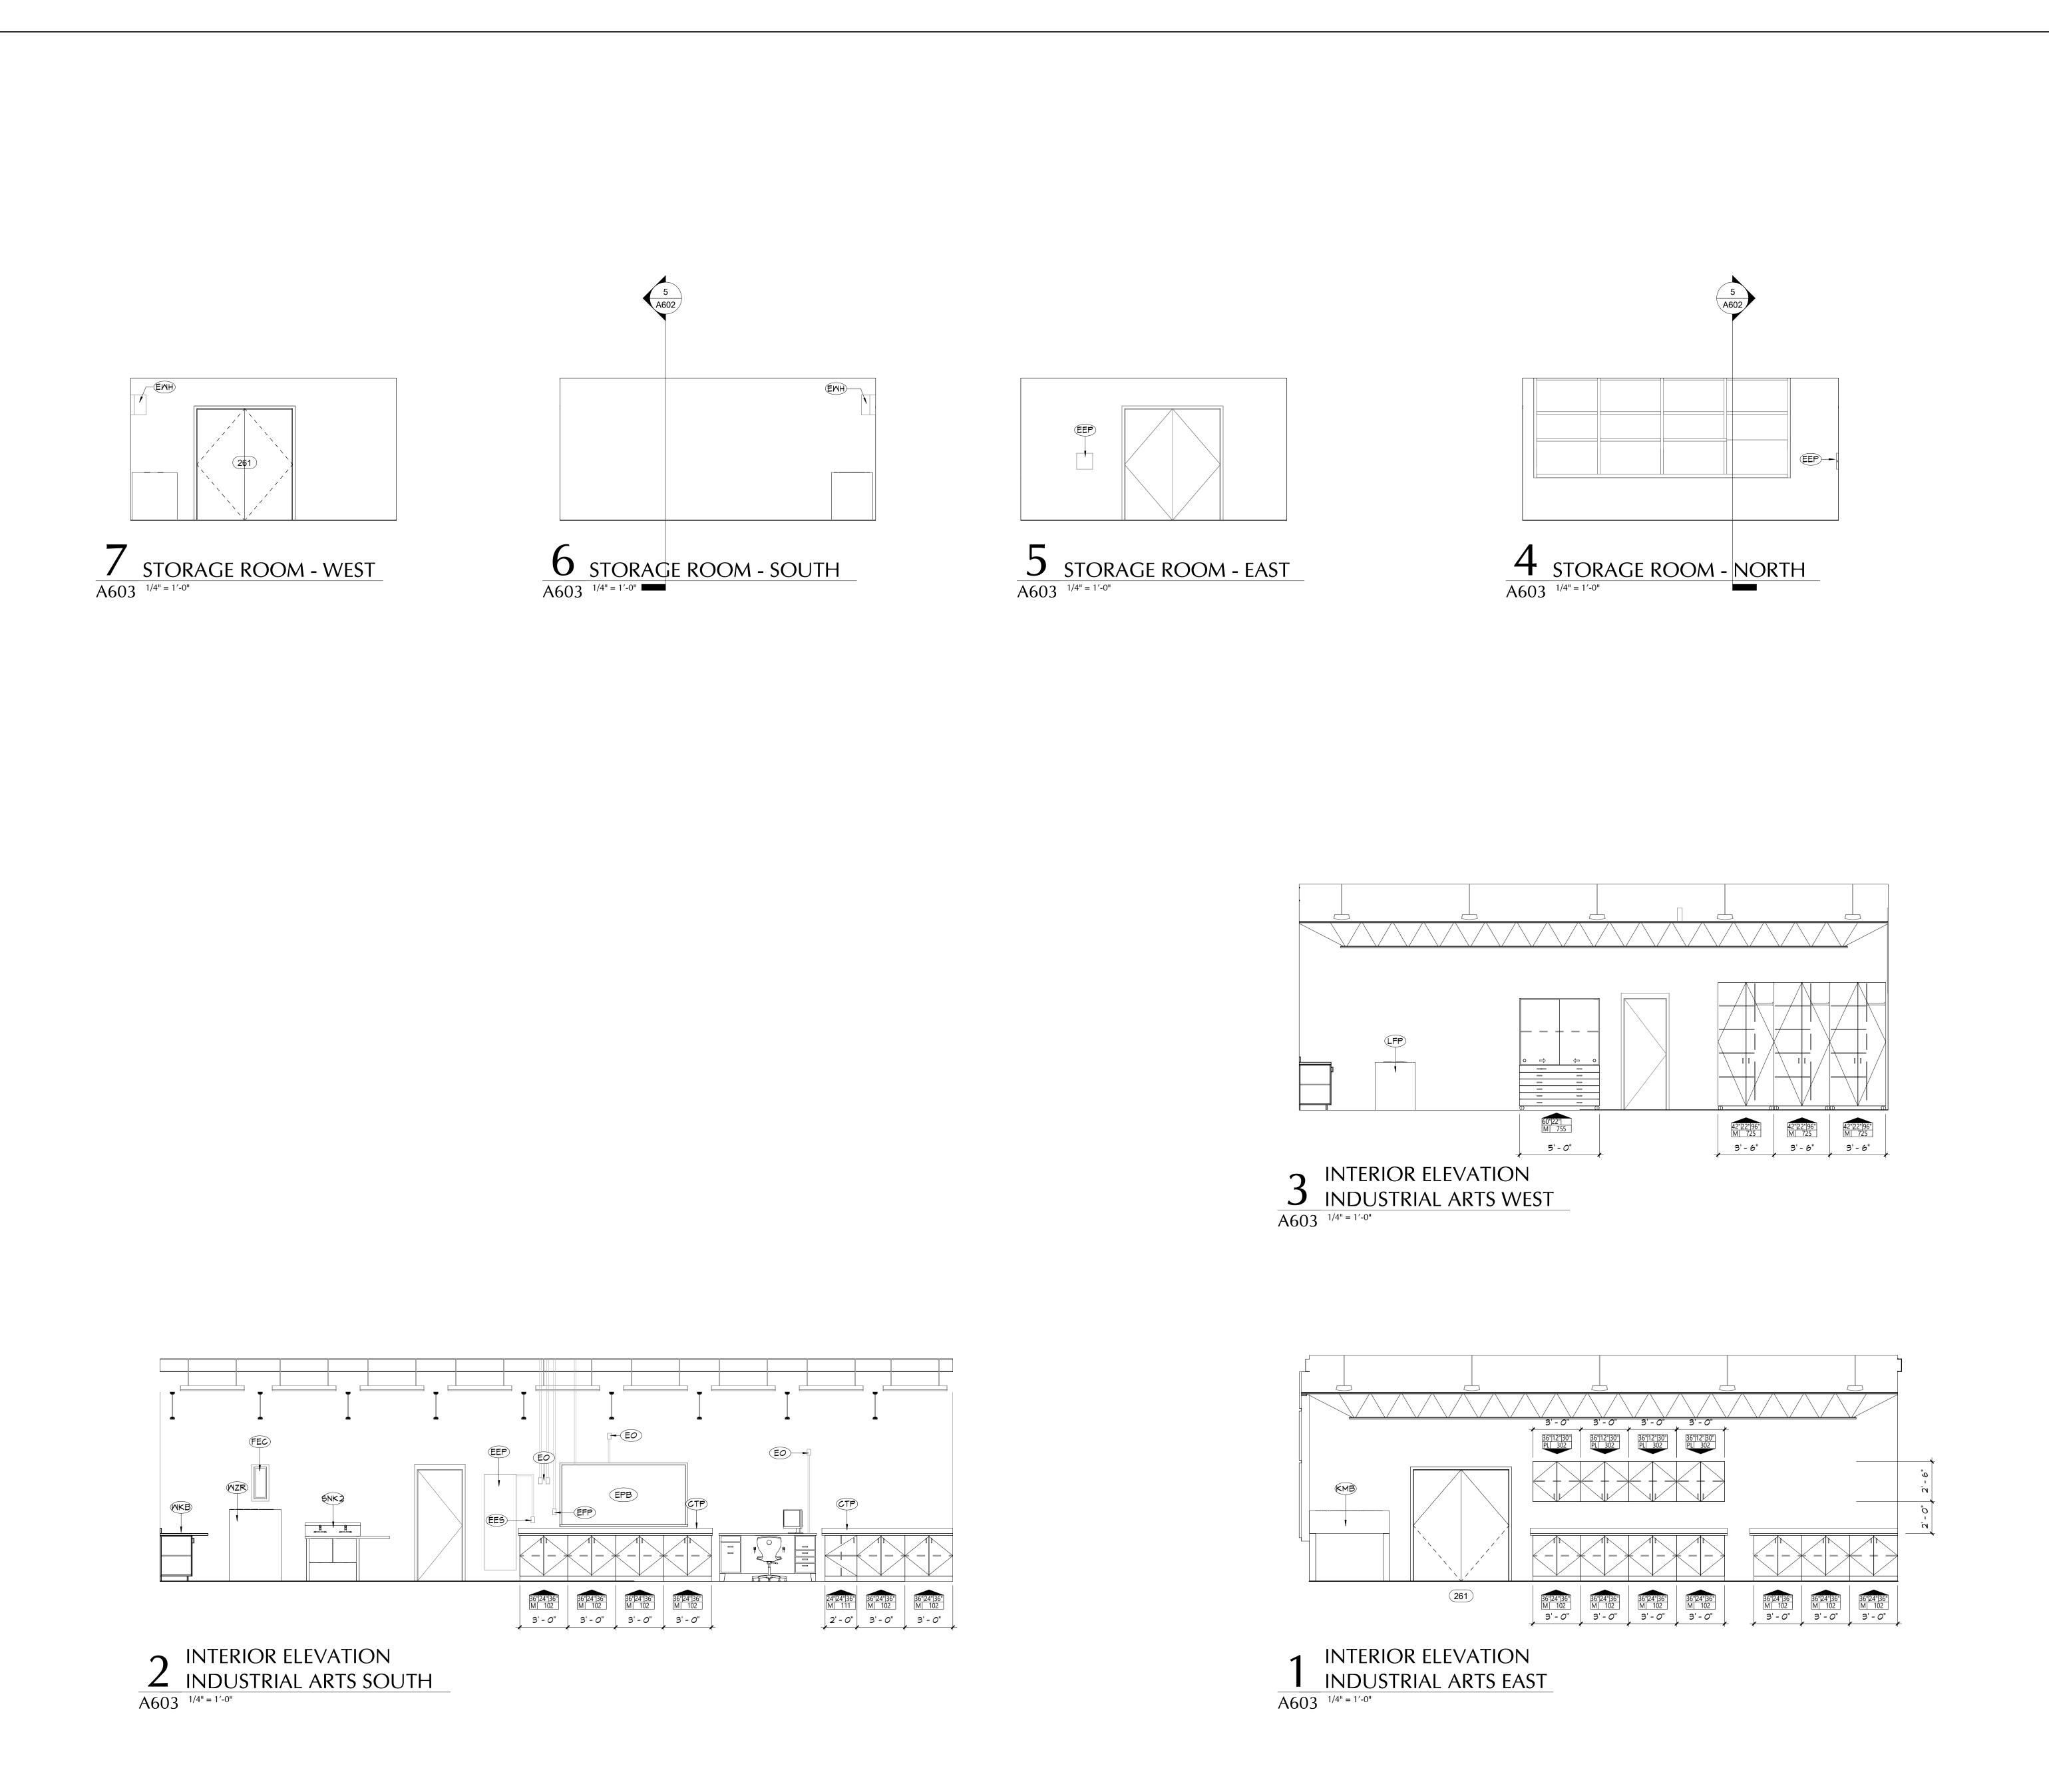

GENERAL NOTES

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GENERAL NOTES

- 1. ALL CASEWORK SHALL HAVE PLASTIC LAMINATE (PLAM) COUNTERTOPS AND 4" BACK SPLASHES, UNO.
- 2. INSTALL MATCHING FILLER PANELS IN LOCATIONS SHOWN. ADD MATCHING FILLER PANELS AS REQUIRED
- FOR FINAL FIT/FINISH. 3. PROVIDE BLOCKING IN ALL ADJACENT WALLS AS REQUIRED TO INSTALL ALL CASEMORK.
- 4. PROVIDE FINISHED END PANEL AT ALL EXPOSED FACES OF CASEMORK.
- 5. PROVIDE WALL BASE AS SCHEDULED ON ALL EXPOSED TOE KICK SPACES AND EXPOSED END PANELS.

CASEWORK NOTES



XX XXXX AWI DESIGN NUMBER (INDICATES ELEVATION LAYOUT ONLY, REFER TO DETAILS AND SPECIFICATIONS FOR CASEWORK CONSTRUCTION REQUIREMENTS) TYPE OF CASEMORK PL = PLASTIC LAMINATE M = METAL M = MOOD

TOILET ROOM NOTES

- 1. THE HEIGHTS SHOWN ARE TYPICAL AND DO NOT NECESSARILY SHOW ALL EQUIPMENT THAT ARE TO BE LOCATED ON WALLS.
- 2. THESE GUIDELINES ESTABLISH LOCATION OF FIXTURES AND EQUIPMENT VERTICALLY AT THE WALL GENERALLY THROUGHOUT THE PROJECT. 3. THE DIMENSIONS CALLED OUT ARE TO THE TOP OR
- BOTTOM OF FIXTURES AND EQUIPMENT FACE PLATES/TRIM AS SHOWN, UNO. 4. THE DIMENSIONS CALLED OUT ARE TO THE CENTERLINE
- OF FIXTURES AND EQUIPMENT AS SHOWN, UNO. 5. ALL ACCESSORIES TO BE SURFACE MOUNTED, UNO. 6. INSTALL PRESSURE TREATED WOOD BLOCKING IN STUD PARTITIONS AT ALL LOCATIONS WHERE TOILET ACCESSORIES ARE MOUNTED TO THE WALL.


TOILET ROOM KEY NOTES

EMO ELECTRIC WATER COOLER, COORDINATE WITH PLUMBING DRAWINGS 6B) 36" GRAB BAR

6B2 42" GRAB BAR

6B3 18" VERTICAL GRAB BAR

- (L1) SINGLE STATION LAVATORY, COORDINATE MITH PLUMBING DRAINGS
- L2 DOUBLE STATION LAVATORY, COORDINATE WITH PLUMBING DRAWINGS
- (L3) THREE STATION LAVATORY, COORDINATE WITH PLUMBING DRAWINGS
- MR) 18"x30" CHANNEL FRAMED GLASS MIRROR MR2 30"x60" CHANNEL FRAMED GLASS MIRROR
- PD PAPER TOWEL DISPENSER (PROVIDED BY OWNER) (5D) SOAP DISPENSER (PROVIDED BY OWNER)
- 6NR SANITARY NAPKIN WASTE RECEPTACLE
- 6ND SANITARY NAPKIN AND TAMPON DISPENSER
- TD TOILET TISSUE DISPENSER (PROVIDED BY OWNER) TP TOILET PARTITION
- UP URINAL PARTITION
- UR URINAL, COORDINATE WITH PLUMBING DRAWINGS
- MCM WATER CLOSET, WALL MOUNTED, COORDINATE WITH PLUMBING DRAWINGS

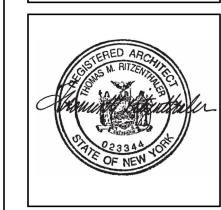


DATE DESCRIPTION **Proj. #:** 44-13-01-06-0-015-0 CSArch Proj. #:

TYPICAL **EQUIPMENT** PLANS, **ELEVATIONS** AND DETAILS

A604

CONSTRUCTION DOCUMENTS

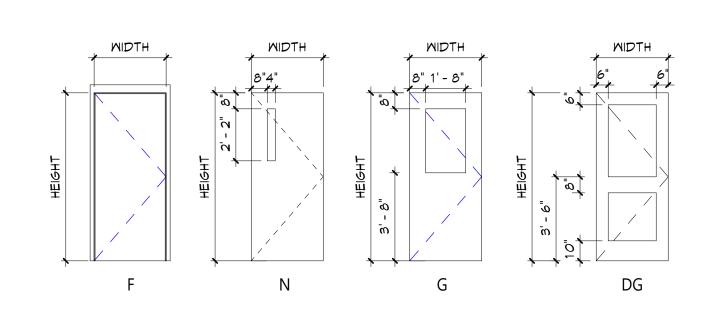


GLAZING TYPES

- CCL LOW-E COATED, INSULATED GLASS
- CI CLEAR INSULATED GLASS
- FR FIRE RATED GLASS
 FT FULLY TEMPERED GLASS
- LM LAMINATED GLASS
- SP SPANDREL GLASS

VALLEY CENTRAL SCHOOL DIS VALLEY CENTRAL HIGH SCH ART ROOM AND WOODSHOP ALT

Project Titl

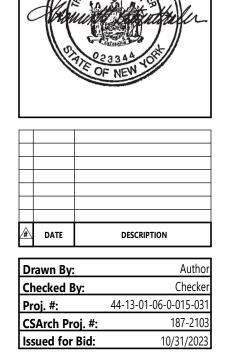

Sheet Title


DOOR

SCHEDULE,

ELEVATIONS,

AND DETAILS

Sheet No.
HSMS
A901
CONSTRUCTION DOCUMENTS

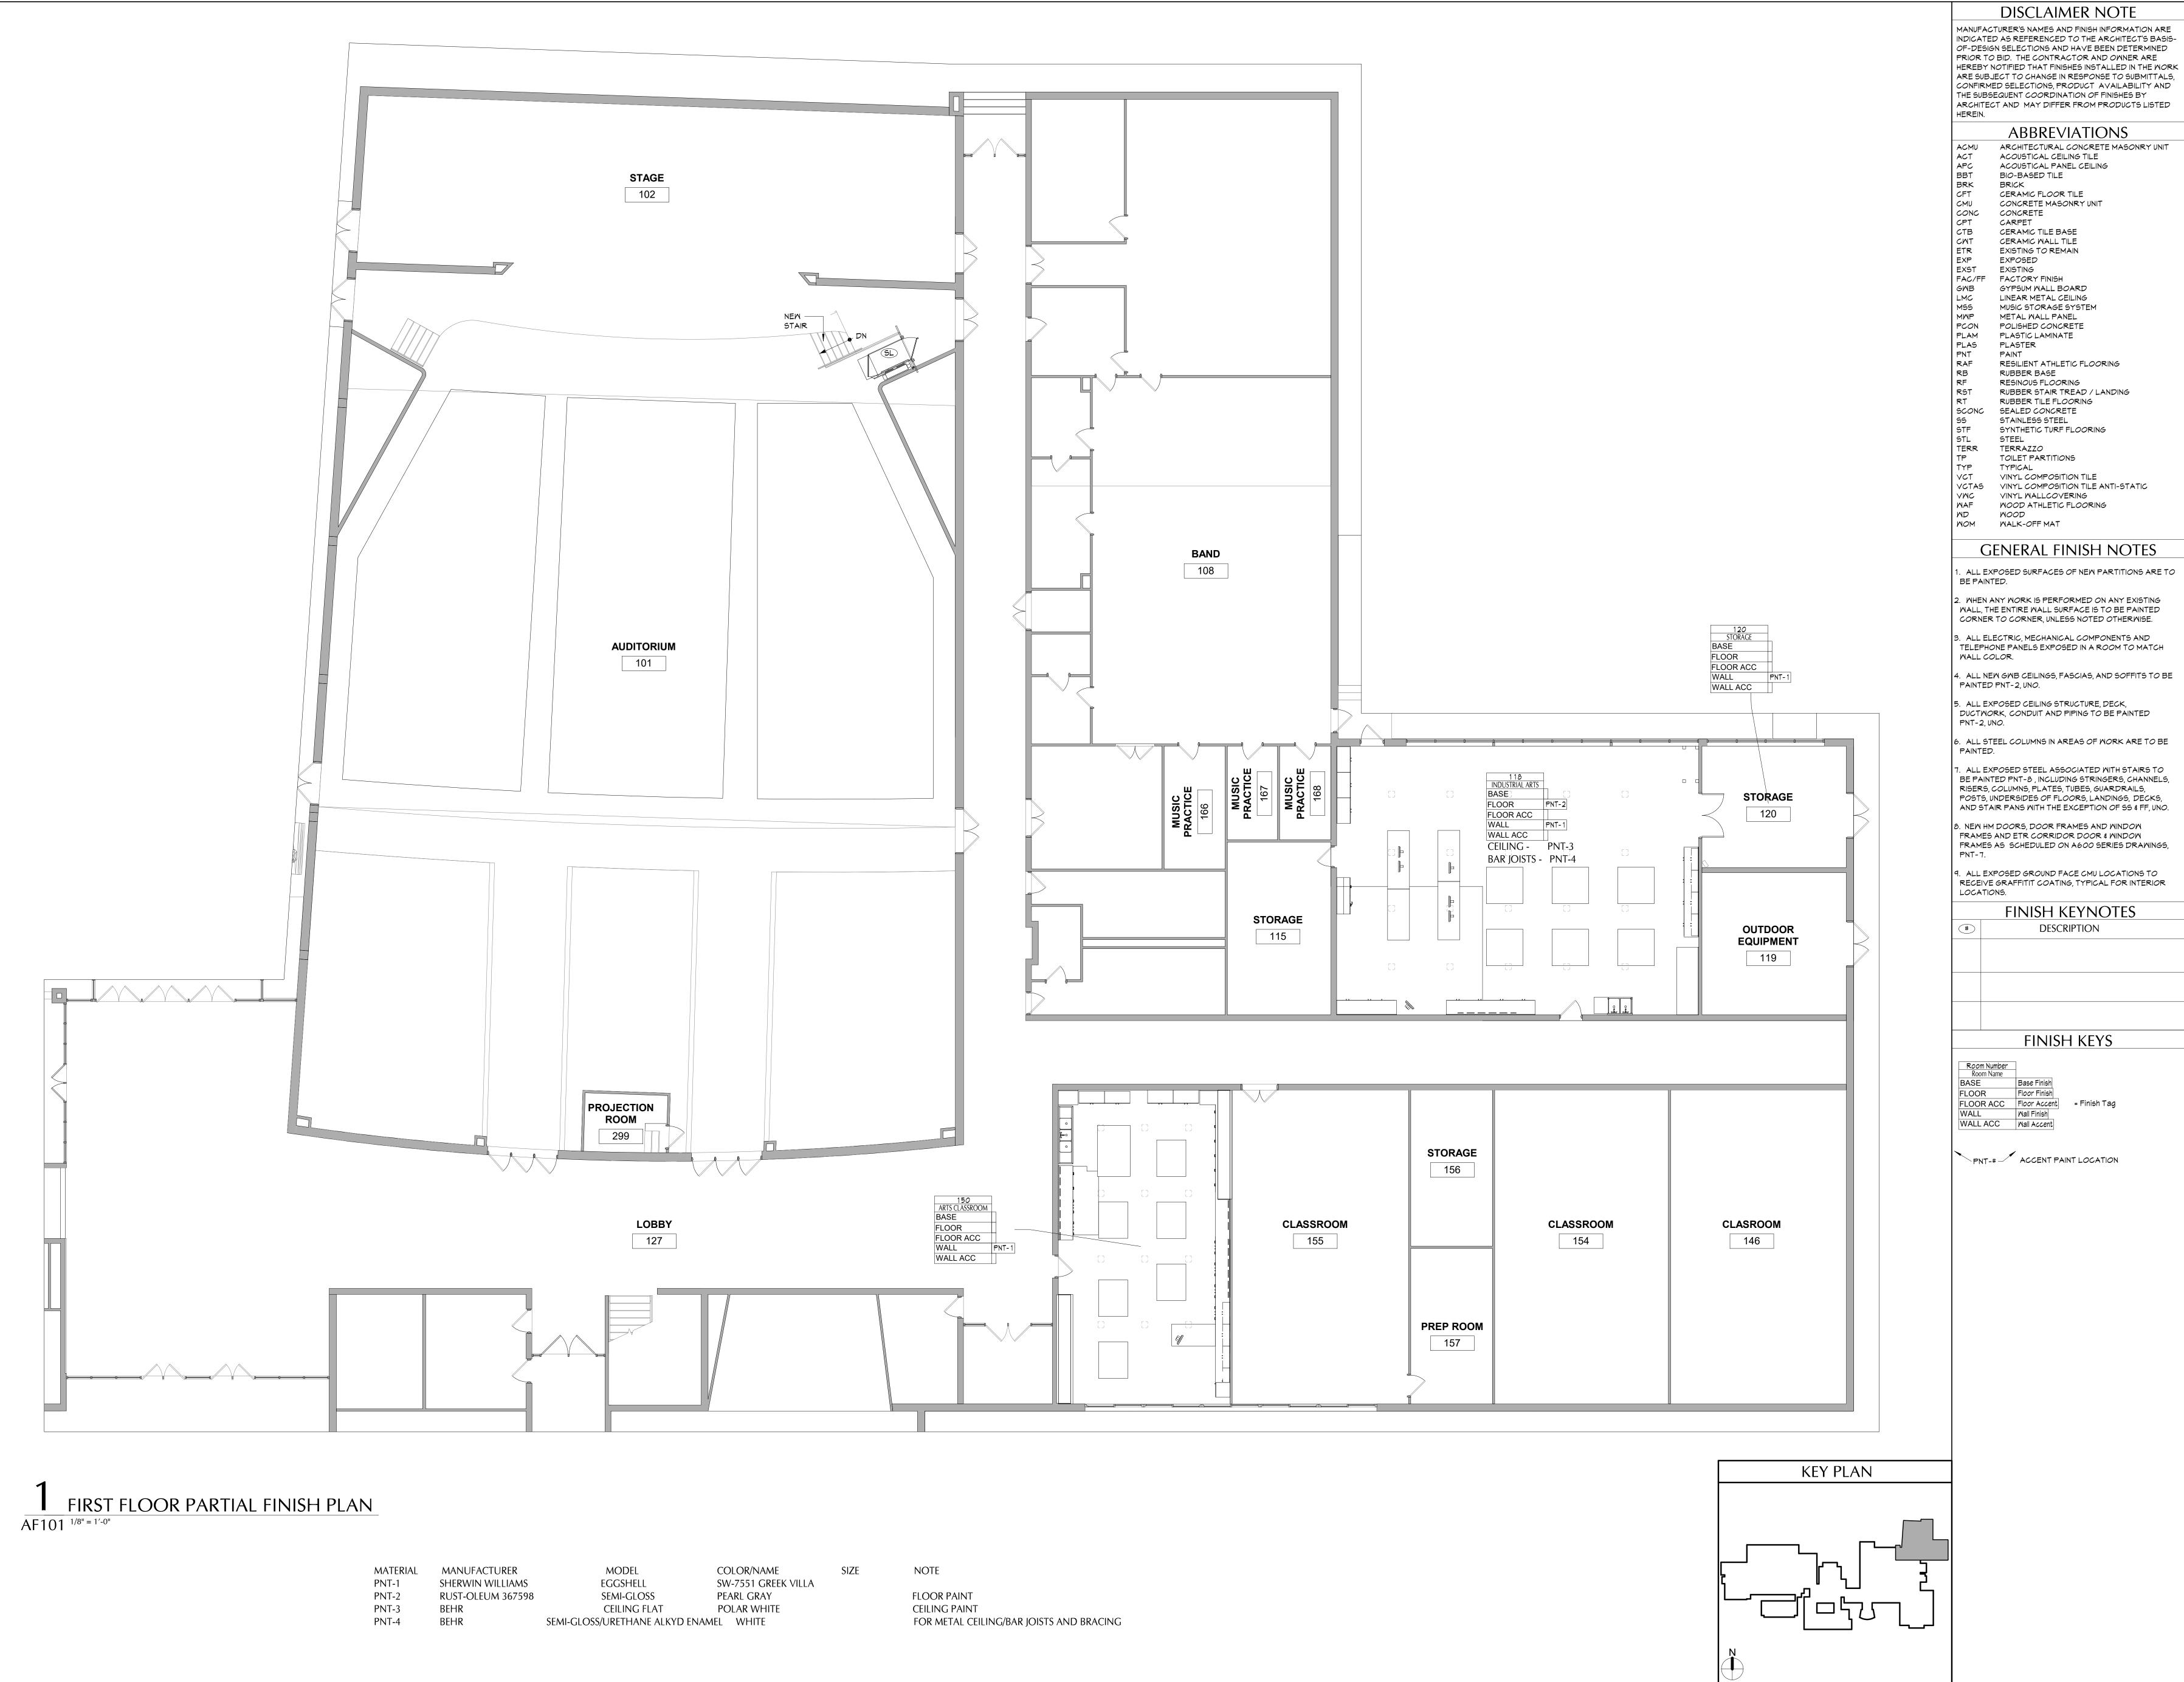

RESILIENT ATHLETIC FLOORING

RUBBER TILE FLOORING SYNTHETIC TURF FLOORING

VCTAS VINYL COMPOSITION TILE ANTI-STATIC VINYL WALLCOVERING WOOD ATHLETIC FLOORING

GENERAL FINISH NOTES

. ALL EXPOSED SURFACES OF NEW PARTITIONS ARE TO

2. WHEN ANY WORK IS PERFORMED ON ANY EXISTING WALL, THE ENTIRE WALL SURFACE IS TO BE PAINTED CORNER TO CORNER, UNLESS NOTED OTHERWISE.

5. ALL EXPOSED CEILING STRUCTURE, DECK, DUCTWORK, CONDUIT AND PIPING TO BE PAINTED

RISERS, COLUMNS, PLATES, TUBES, GUARDRAILS, POSTS, UNDERSIDES OF FLOORS, LANDINGS, DECKS, AND STAIR PANS WITH THE EXCEPTION OF SS & FF, UNO.


FRAMES AND ETR CORRIDOR DOOR & WINDOW FRAMES AS SCHEDULED ON A600 SERIES DRAWINGS,

9. ALL EXPOSED GROUND FACE CMU LOCATIONS TO RECEIVE GRAFFITIT COATING, TYPICAL FOR INTERIOR

FINISH KEYNOTES DESCRIPTION

FINISH KEYS

FLOOR ACC Floor Accent = Finish Tag

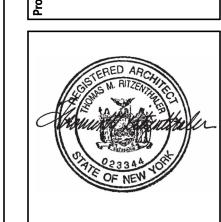

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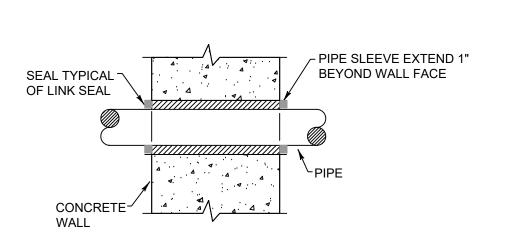
FIRST FLOOR PARTIAL FINISH PLAN

HSMS AF101


CONSTRUCTION DOCUMENTS



	Plumbing Fixture Schedule											
FIXTURE	DESCRIPTION		PIPING CONNECTION				DRAINAGE FIXTURE	ADA	ELECTRONIC CONTROL	MANUFACTURER/MODEL	REMARKS	
MARK	DESCRIPTION	H.W.	C.W.	WASTE	VENT	FIXTURE UNITS	UNITS	(Y/N)	(Y/N)	(OR ACCEPTABLE EQUAL)	KEWAIKO	
1	THREE COMPARTMENT SCULLERY SINK	1/2	1/2	2	1-1/2	2.0	2	N	N	3 COMPARTMENT SINK TYPICAL OF ADVANCE TABCO REGALINE 93 SERIES; 16 GAUGE TYPE 304 STAINLESS STEEL, 16"x20" BOWLS, 18" DRAINBOARDS; FURNISH W/ SPLASH MOUNT PRERINSE FAUCET MODEL #DTA-53	INSTALL PER ADA & MANUFACTURER'S REQUIREMENTS	
2	TWO COMPARTMENT SCULLERY SINK	1/2	1/2	2	1-1/2	2.0	2	N	N	2 COMPARTMENT SINK TYPICAL OF ADVANCE TABCO REGALINE 93 SERIES; 16 GAUGE TYPE 304 STAINLESS STEEL, 16"x20" BOWLS, 24" DRAINBOARD; FURNISH W/ SPLASH MOUNT PRERINSE FAUCET MODEL #DTA-53	INSTALL PER ADA & MANUFACTURER'S REQUIREMENTS	






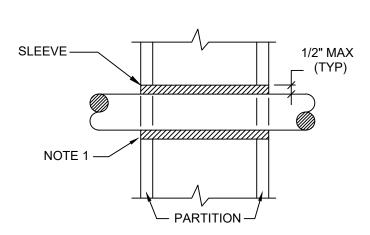

1. AT FIRE RATED PARTITIONS, ADD ADDITIONAL LAYER OF FIRE SAFING INSULATION AROUND PENETRATION SO AS TO FILL CAVITY. 2. DUCT AND PIPE PENETRATIONS THRU CORRIDOR WALLS ABOVE THE

CEILING ARE TO BE FIRE STOPPED AROUND THE PENETRATION.



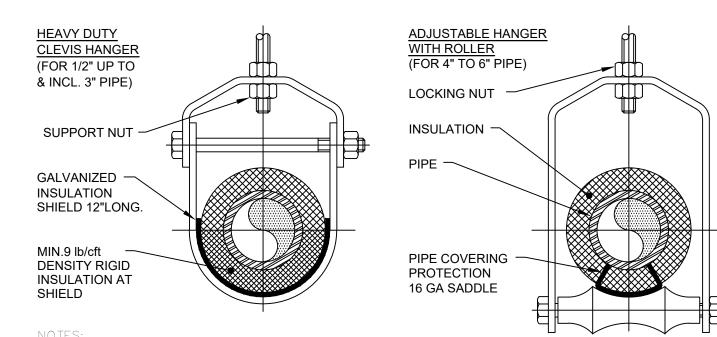

1. PIPE 8" AND LARGER SHALL HAVE ROLLER SUPPORTED WITH DUAL RODS. INSULATION BETWEEN PIPE AND SHIELD.



Plumbing Legend:

DOMESTIC COLD WATER SUPPLY

110 °F DOMESTIC HOT WATER SUPPLY

140 °F DOMESTIC HOT WATER SUPPLY

SANITARY SEWER, ABOVE GRADE

SANITARY SEWER, BELOW GRADE

GREASE WASTE, BELOW GRADE

STORM WATER, ABOVE GRADE

STORM WATER, BELOW GRADE

DIRECTION OF PIPE SLOPE (DOWN)

NATURAL GAS PIPING

ECCENTRIC REDUCER

SIDE CONNECTION

RISE OR DROP IN PIPE

AND EXISTING WORK

CAPPED OUTLET

PIPE UP

PIPE DOWN

HOSE BIB

SOLENOID VALVE

CHECK VALVE

BUTTERFLY VALVE

PRESSURE GAUGE

DRAIN VALVE

CLEANOUT

WALL CLEANOUT

FLOOR CLEANOUT

CLEANOUT TO GRADE

DOUBLE CLEANOUT TO GRADE

PLUMBING FIXTURE MARK

C.O.

W.C.O.

F.C.O.

C.O.T.G.

D.C.O.T.G.

P-X

FULL PORT BALL VALVE

PRESSURE REDUCING VALVE (PRV)

FLEXIBLE PIPING CONNECTION

TOP CONNECTION, 45° OR 90°

BOTTOM CONNECTION, 45° OR 90°

POINT OF CONNECTION BETWEEN NEW

HOT WATER RETURN

PLUMBING VENT

ADJUSTABLE HANGER WITH ROLLER (FOR 4" TO 6" PIPE)
LOCKING NUT
INSULATION
PIPE
PIPE COVERING PROTECTION 16 GA SADDLE

2. FOR CHW SERVICE OVER 3" REPLACE SADDLE WITH 12" LONG 14 GA SHIELD WITH RIGID

		SPACING BETWE ANGERS (FT.)	EN	MIN. ROD
PIPE Ø (IN.)	Н	SIZE		
	STEEL PIPE	COPPER PIPE	CPVC	(IN.)
1/2 THRU 1	7	5	5	3/8
1-1/2 THRU 2	9	8	6	3/8
2-1/2	11	9	7.5	1/2
3	12	10	7.5	1/2
4	14	12	8.5	5/8
6	17	14	9	3/4
8	19	16	10	7/8
10	22	18	10.5	7/8



Plumbing Notes:

1. ALL MATERIALS AND EQUIPMENT ARE TO BE NEW, UNUSED, AND FREE FROM DEFECTS OF ANY KIND. THE BASIS OF QUALITY SHALL BE THE LATEST REVISION OF ASTM, ANSI, OR OTHER ACCEPTABLE STANDARDS.

2. THESE DRAWINGS ARE DIAGRAMMATIC, AND INDICATE GENERAL ARRANGEMENT OF WORK. THE CONTRACTOR SHALL BE RESPONSIBLE TO HAVE REVIEWED THE SITE FOR HIS WORK PRIOR TO HAVING SUBMITTED HIS PROPOSAL. NO ADDITIONAL COMPENSATION WILL BE ALLOWED FOR CONDITIONS FOUND DURING THE COURSE OF THE CONTRACT.

3. THE CONTRACTOR SHALL COORDINATE HIS WORK WITH THAT OF ALL OTHER TRADES.

4. ALL CUTTING, PATCHING, FIRE-STOPPING, AND SURFACE RESTORATION IN CONNECTION WITH THIS TRADE SHALL BE COMPLETED BY THIS CONTRACTOR.

5. THIS CONTRACTOR SHALL PAY ALL FEES, GIVE ALL NOTICES, FILE ALL NECESSARY DRAWINGS, AND OBTAIN ALL PERMITS, INSPECTIONS AND CERTIFICATES OF APPROVAL REQUIRED IN CONNECTION WITH WORK UNDER THIS CONTRACT.

6. ALL WORK IN ASSOCIATION WITH THIS CONTRACT SHALL BE COMPLETED IN STRICT COMPLIANCE WITH THE 2020 BUILDING CODE OF NEW YORK STATE, 2020 PLUMBING CODE OF NEW YORK STATE, 2020 FUEL GAS CODE OF NEW YORK STATE & 2020 ENERGY CONSERVATION CONSTRUCTION CODE OF NEW YORK STATE.

WHERE THE PROJECT INVOLVES A GAS SERVICE, THIS CONTRACTOR SHALL BE CONCENTRIC REDUCER OR INCREASER RESPONSIBLE FOR ALL COORDINATION, APPLICATIONS AND FEES OF ALL WORK ASSOCIATED WITH THE LOCAL GAS UTILITY COMPANY. ALL WORK INVOLVING THE GAS UTILITY COMPANY SHALL BE COMPLETED IN ACCORDANCE WITH THEIR REGULATIONS AND GUIDELINES.

> 8. ALL DOMESTIC COLD AND HOT WATER PIPING AND FITTINGS ARE TO BE INSULATED WITH 1" THICK RIGID ONE-PIECE MOLDED SECTIONAL FIBERGLASS PIPE COVERING WITH UNIVERSAL JACKET. ALL JOINTS ARE TO BE COMPLETELY SEALED A MINIMUM OF

> 9. ALL PIPING SHALL BE PROPERLY SUPPORTED AND ROUTED PARALLEL OR PERPENDICULAR TO BUILDING WALLS. THE CONTRACTOR SHALL FURNISH AND INSTALL ALL SUPPORT HANGERS AND MISCELLANEOUS METALS REQUIRED FOR PROPER INSTALLATION OF WORK.

> 10. ALL EXPOSED PIPING, FITTINGS, TRAPS, ESCUTCHEONS, VALVES, ETC. SHALL BE CHROME PLATED.

> 11. SLOPE SANITARY DRAINAGE PIPING 2" DIAMETER AND SMALLER NOT LESS THAN 1/4" PER FOOT. SLOPE SANITARY DRAINAGE PIPING OVER 2" DIAMETER NOT LESS THAN 1/8" PER FOOT.

12. INSTALL A CLEANOUT AT THE BASE OF EACH SOIL STACK, AT EACH CHANGE IN DIRECTION, AT INTERVALS NOT OVER 50 FEET AND ELSEWHERE AS SHOWN ON DRAWINGS OR REQUIRED BY CODE.

13. PROVIDE EXPOSED PIPING WITH CHROME PLATED CAST BRASS ESCUTCHEON WITH SET SCREW WHERE PENETRATING FLOORS, CEILINGS, WALLS OR PARTITIONS.

14. TEST PIPING AND PROVE TIGHT FOR AT LEAST TWO HOURS IN ACCORDANCE WITH REQUIREMENTS OF AUTHORITIES HAVING JURISDICTION AND/OR AS SPECIFIED. TEST SHALL BE PERFORMED IN THE PRESENCE OF THE ENGINEER AND LOCAL INSPECTOR. TEST SHALL BE REPEATED IF NECESSARY UNTIL FINAL APPROVAL OF SYSTEM IS OBTAINED.

14.1. WATER & GAS PIPING TO BE AIR-PRESSURE TESTED TO 1-1/2 TIMES MAXIMUM WORKING PRESSURE.

14.2. DRAINAGE, WASTE & VENT PIPING TO BE TESTED BY FILLING THE SYSTEM WITH WATER TO 10-FEET ABOVE HIGHEST POINT.

16. INSTALL VALVES ON THE ENTIRE DISTRIBUTION SYSTEM. SO LOCATED AS TO GIVE

15. SUPPORT HORIZONTAL PIPING UTILIZING A SPACING PER PIPING MANUFACTURER'S REQUIREMENTS.

COMPLETE CONTROL TO ALL FIXTURES AND EQUIPMENT.

17. INSTALL DRAIN VALVES AT BASE OF ALL RISERS AND AT LOW POINTS OF PIPING

18. THE CONTRACTOR IS RESPONSIBLE TO TEST ALL EQUIPMENT, PIPING, FIXTURES, AND SYSTEMS INSTALLED UNDER THIS CONTRACT TO ENSURE PROPER OPERATION PRIOR TO FINAL ACCEPTANCE BY THE OWNER AND ENGINEER.

19. THE CONTRACTOR IS RESPONSIBLE TO DETERMINE WHETHER SPECIAL LICENSING IS REQUIRED IN ORDER TO PERFORM THE REQUIRED WORK IN THE MUNICIPALITY WHERE THE PROJECT IS LOCATED. IF THE CONTRACTOR CANNOT OBTAIN THE REQUIRED LICENSING TO COMPLETE THE WORK WITHIN THE PROJECT SCHEDULE, THEN THE CONTRACTOR SHALL NOT BE PERMITTED TO BID ON THIS PROJECT.

20. CONTRACTOR IS RESPONSIBLE TO CREATE AND SUBMIT RED-LINE "AS-BUILT" PLANS TO THE ENGINEER AT THE END OF THE PROJECT. AS-BUILT PLANS SHALL ACCURATELY REPRESENT THE SYSTEMS AS THEY WERE INSTALLED.







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44-13-01-06-0-015-031 Proj. #: CSArch Proj. #:

PLUMBING NOTES, SCHEDULE, LEGEND & **DETAILS**


VCHS




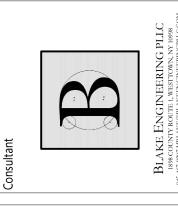

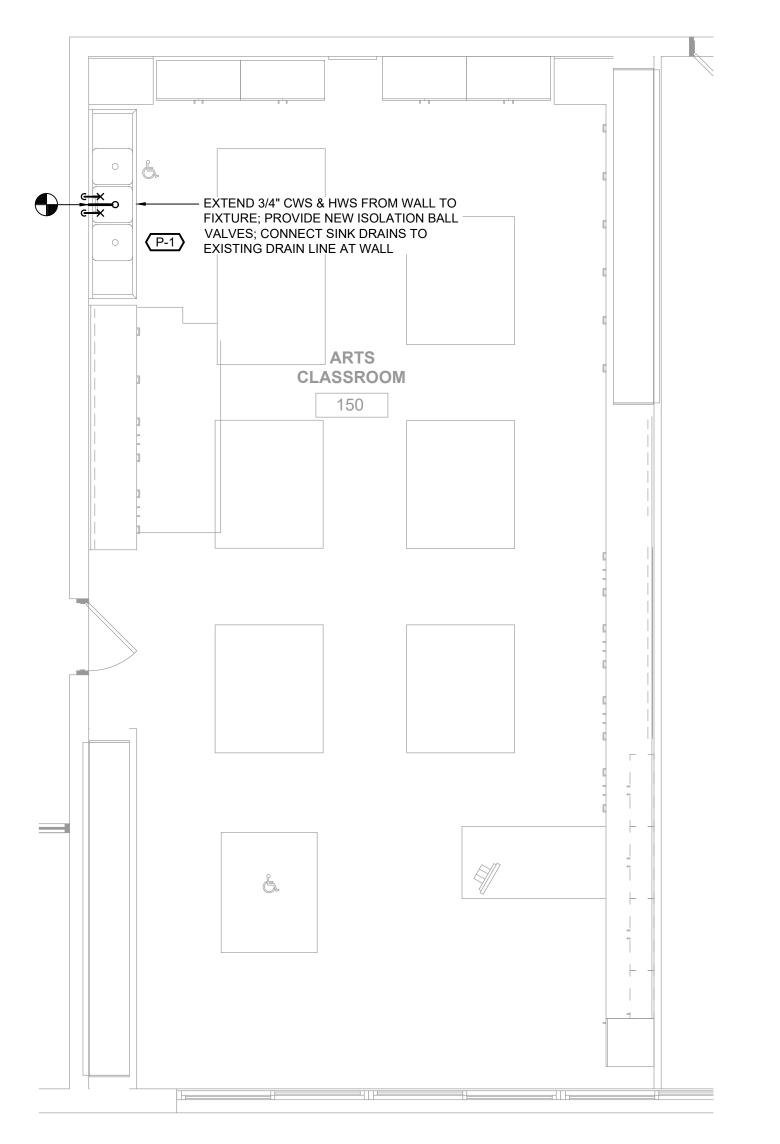Plumbing Demolition Plan
Scale: 1/4" = 1'-0"

DISCONNECT, REMOVE & PROPERLY
DISPOSE OF EXISTING SINK & EYEWASH
STATION; REMOVE DOMESTIC WATER
PIPING AND SANITARY DRAIN BACK TO
WALL AND TEMPORARILY CAP

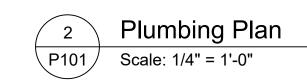

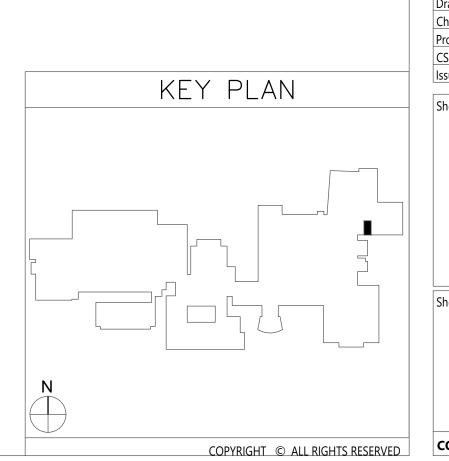


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 BJK

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 187-2103

 Issue Date:
 10/31/2023
 CLASSROOM PLUMBING PLANS

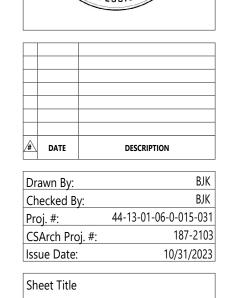

Issue Date: 187-2
Issue Date: 10/31/2

Sheet Title

INDUSTRIAL

ARTS

PLUMBING

PLANS


KEY PLAN

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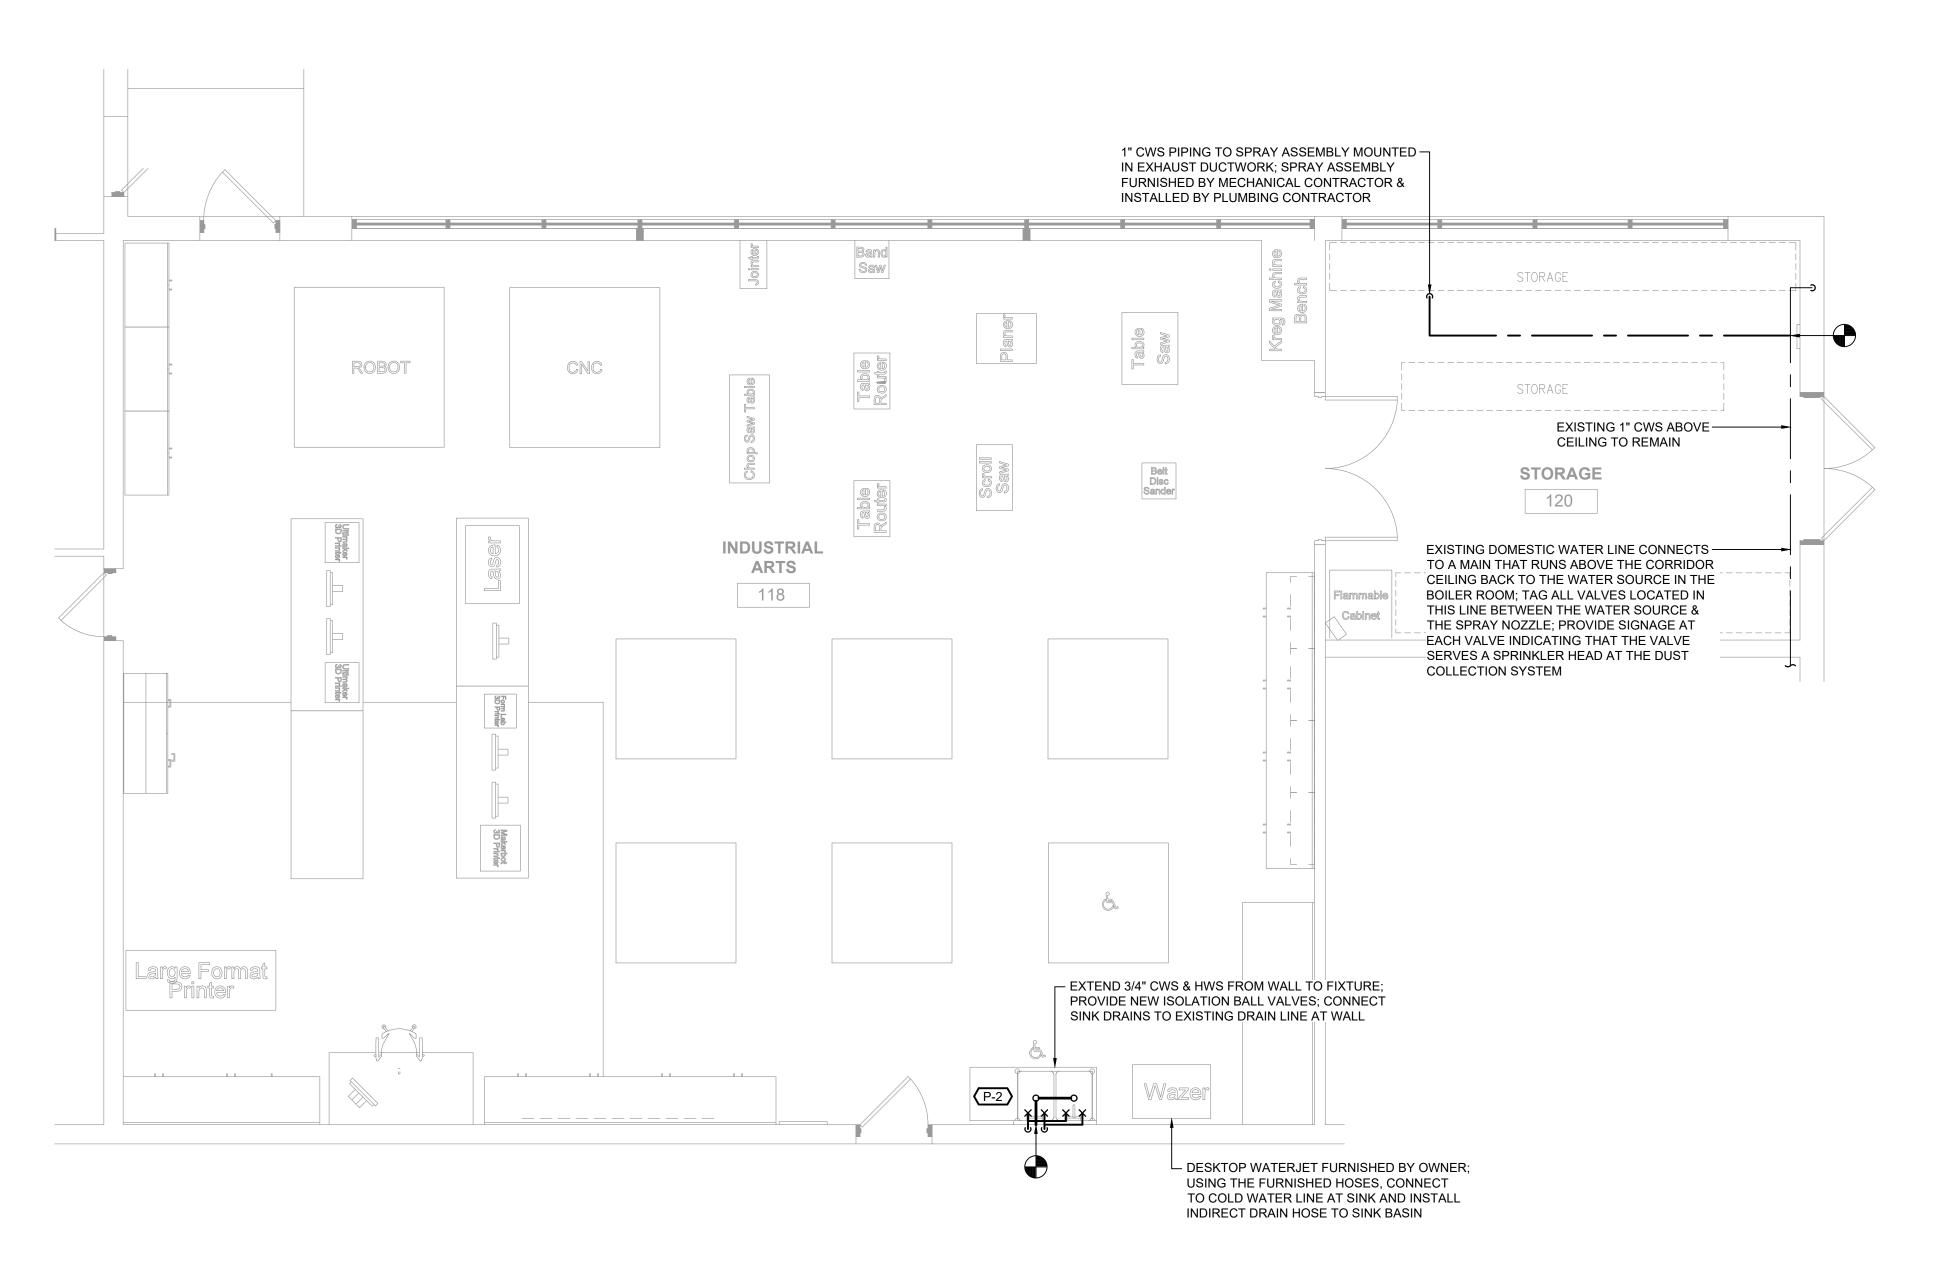
Sheet No.

VCHS
P102

CONSTRUCTION DOCUMENTS

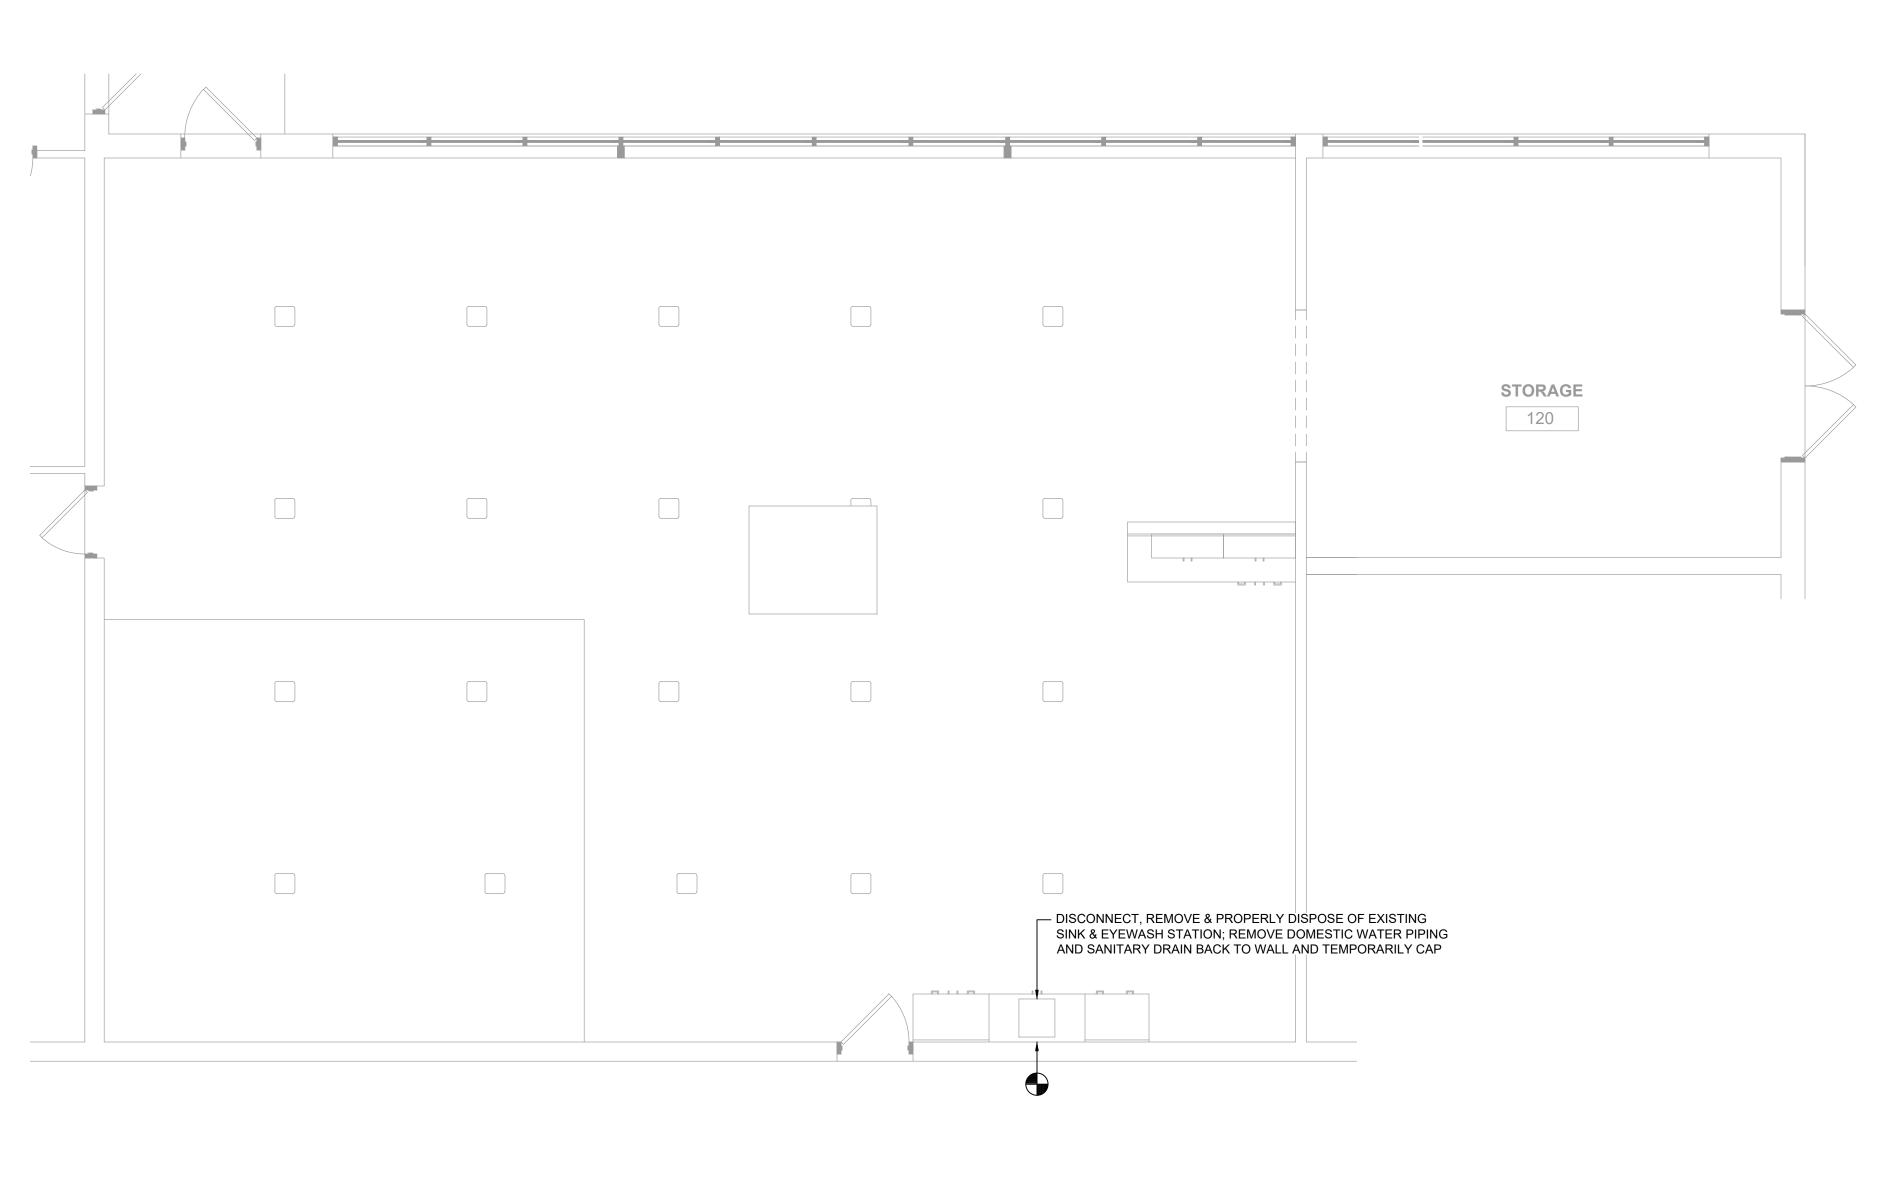

Plumbing Demolition Plan
Scale: 1/4" = 1'-0"



				AII	R GR	ILLE/DII	FFUSER S	SCHEDULE	E				
EQUIPMEN TAG	MANUFACTURER (OR ACCEPT. EQUAL)	MODEL	AIR DEVICE TYPE	AIRFLOV MIN.	V (CFM) MAX.	MAX AIR PRESS. DROP (IN. W.C.)		PANEL/FRAME SIZE (IN.)	NECK SIZE (IN.)	MAX NC	DAMPER	FINISH	NOTES
D-1	TITUS	300RL	DOUBLE DEFLECTION SUPPLY GRILLE	0	2000	0.10	SURFACE MTD.	38"x18"	36"x16"	25	-	WHITE	-

PLAIN "S" SLIP


STANDING SEAM

ANGLE REINFORCED

STANDING SEAM

	DUST COLLECTOR SCHEDULE										
EQUIPMENT TAG	MANUFACTURER	MODEL	SERVICE	FAN C.F.M.	R.P.M.	EXTERNAL STATIC PRESSURE INCH H ₂ O	POWER	MOTOR POWER VOLT. PHASE HZ.			- REMARKS
DC-1	STERNVENT	VIBRACLEAN DKPD 36007	WOODSHOP DUST COLLECTION	3,500	3,450	7.8	7-1/2 HP	208	3	60	W/ FACTORY WIRED NEMA 4 CONTROLLER W/ MAGNETIC STARTERS FOR BLOWER & SHAKER; W/ (2) 55 GALLON DRUMS: W/ 1/3 HP SHAKER MOTOR

COMPANION ANGLES

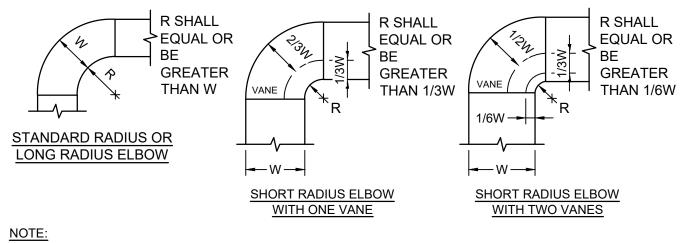


1. THE INTERIOR SURFACE OF ALL RADIUS ELBOWS SHALL BE MADE ROUND.

2. ALL STANDARD RADIUS ELBOWS CAN BE SUBSTITUTED WITH SHORT RADIUS ELBOWS. ALL SHORT RADIUS ELBOWS SHALL HAVE VANES. VANES SHALL BE CONSTRUCTED, SUPPORTED AND FASTENED AS RECOMMENDED BY SMACNA.

ANGLE REINFORCED POCKET LOCK

Ductwork Radius Elbow Detail

ALTERNATE BAR SLIP

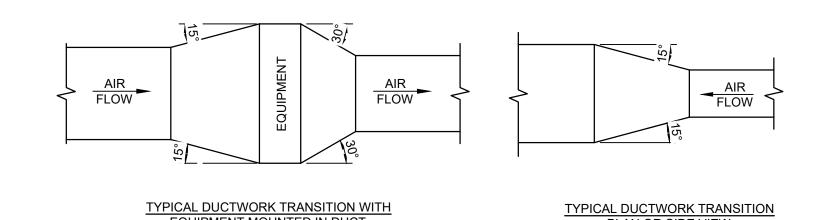

PLAN OR SIDE VIEW

NOTE:
UNLESS OTHERWISE INDICATED ON PLANS, MAXIMUM ANGLES SHOWN SHALL APPLY.

Ductwork Transition Detail

EQUIPMENT MOUNTED IN DUCT

PLAN OR SIDE VIEW

Mechanical Legend:

SUPPLY DUCT (UP & DOWN) EXHAUST DUCT (UP & DOWN) RETURN DUCT (UP & DOWN) ROUND AND SQUARE 4-WAY CEILING DIFFUSERS SQUARE 3-WAY CEILING DIFFUSERS SQUARE 2-WAY CEILING DIFFUSERS SQUARE 1-WAY CEILING DIFFUSERS

LINEAR SLOT DIFFUSER SUPPLY TOP REGISTER OR GRILLE (WALL TYPE)

EXHAUST OR RETURN CEILING REGISTER OR GRILLE EXHAUST OR RETURN BOTTOM REGISTER OR GRILLE (WALL TYPE)


EXHAUST OR RETURN REGISTER OR TOP GRILLE (WALL TYPE)

VANED ELBOW & AIR SPLIT TYPE DUCT TAKE-OFF

MANUAL SPLITTER DAMPER


STANDARD BRANCH SUPPLY OR RETURN, NO SPLITTER (45° TAP)

VANED ELBOW (PROVIDE ALL SQUARE OR

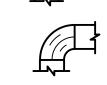


RECTANGULAR ELBOWS WITH VANES EVEN IF SYMBOL IS MISSING)

VANED ELBOW (SHORT RADIUS)

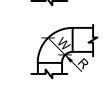


STANDARD RADIUS ELBOW (LONG RADIUS); INSIDE RADIUS R TO BE EQUAL TO OR GREATER THAN W



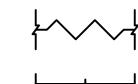


FLEXIBLE DUCTWORK (INSULATED)


MANUAL VOLUME DAMPER

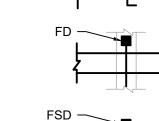

FIRE DAMPER

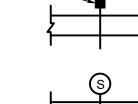

COMBINATION FIRE SMOKE DAMPER

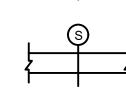

DUCT SMOKE DETECTOR

X TERMINAL UNIT TAG
X AIRFLOW (CUBIC FEET PER MINUTE)

Mechanical Notes:

- 1. ALL MATERIALS AND EQUIPMENT ARE TO BE NEW, UNUSED, AND FREE FROM DEFECTS OF ANY KIND. THE BASIS OF QUALITY SHALL BE THE LATEST REVISION OF ASTM, ANSI, OR OTHER ACCEPTABLE STANDARDS.
- 2. THESE DRAWINGS ARE DIAGRAMMATIC, AND INDICATE GENERAL ARRANGEMENT OF WORK. THE CONTRACTOR SHALL BE RESPONSIBLE TO HAVE REVIEWED THE SITE FOR HIS WORK PRIOR TO HAVING SUBMITTED HIS PROPOSAL. NO ADDITIONAL COMPENSATION WILL BE ALLOWED FOR CONDITIONS FOUND DURING THE COURSE OF
- 3. THE CONTRACTOR SHALL COORDINATE HIS WORK WITH THAT OF ALL OTHER TRADES. 4. ALL WORK INCLUDING LABOR AND MATERIALS SHALL BE FULLY GUARANTEED FOR ONE (1) YEAR FROM THE DATE OF PAYMENT AND FINAL ACCEPTANCE BY THE OWNER
- 5. ALL CUTTING, PATCHING, FIRE-STOPPING, AND SURFACE RESTORATION IN CONNECTION WITH THIS TRADE SHALL BE COMPLETED BY THIS CONTRACTOR.
- 6. A MINIMUM OF FOUR (4) COPIES OF SHOP DRAWINGS SHALL BE SUBMITTED TO THE ENGINEER FOR APPROVAL PRIOR TO ORDERING AND INSTALLATION OF THE EQUIPMENT AND/OR MATERIALS. BY SUBMITTING SHOP DRAWINGS, THE CONTRACTOR REPRESENTS THAT ACTUAL FIELD CONDITIONS ARE VERIFIED BY HIM AND ARE REFLECTED ON HIS SUBMITTALS.
- 7. THIS CONTRACTOR SHALL PAY ALL FEES, GIVE ALL NOTICES, FILE ALL NECESSARY DRAWINGS, AND OBTAIN ALL PERMITS, INSPECTIONS AND CERTIFICATES OF APPROVAL REQUIRED IN CONNECTION WITH WORK UNDER THIS CONTRACT.
- 8. ALL WORK IN ASSOCIATION WITH THIS CONTRACT SHALL BE COMPLETED IN STRICT COMPLIANCE WITH THE 2020 BUILDING CODE OF NEW YORK STATE, 2020 MECHANICAL CODE OF NEW YORK STATE & 2020 ENERGY CONSERVATION CONSTRUCTION CODE OF NEW YORK STATE.
- 9. ALL HYDRONIC HOT WATER PIPING AND FITTINGS ARE TO BE INSULATED WITH A MINIMUM OF R-3 INSULATION. ALL JOINTS ARE TO BE COMPLETELY SEALED A MINIMUM OF 6" BEYOND JOINT ENDS.
- 10. ALL PIPING SHALL BE PROPERLY SUPPORTED AND ROUTED PARALLEL OR PERPENDICULAR TO BUILDING WALLS. THE CONTRACTOR SHALL FURNISH AND INSTALL ALL SUPPORT HANGERS AND MISCELLANEOUS METALS REQUIRED FOR PROPER INSTALLATION OF WORK.
- 11. ALL PIPING SHALL BE PITCHED SUCH THAT AIR IN THE SYSTEM CAN BE VENTED THROUGH MANUAL AIR VENTS.
- 12. TEST PIPING AND PROVE TIGHT FOR AT LEAST TWO HOURS TO TWICE THE SYSTEM WORKING PRESSURE. TEST SHALL BE PERFORMED IN THE PRESENCE OF THE ENGINEER AND LOCAL INSPECTOR. TEST SHALL BE REPEATED IF NECESSARY UNTIL FINAL APPROVAL OF SYSTEM IS OBTAINED.
- 13. SUPPORT HORIZONTAL PIPING UTILIZING A SPACING PER PIPING MANUFACTURER'S REQUIREMENTS.
- 14. INSTALL VALVES ON THE ENTIRE DISTRIBUTION SYSTEM, SO LOCATED AS TO GIVE COMPLETE CONTROL TO ALL FIXTURES AND EQUIPMENT.
- 15. INSTALL DRAIN VALVES AT BASE OF ALL RISERS AND AT LOW POINTS OF PIPING SYSTEM. INSTALL MANUAL AIR VENT VALVE FACILITIES AT THE TOP OF ALL RISERS AND AT HIGH POINTS OF THE PIPING SYSTEM.

16. INSTALL ALL HYDRONIC PIPING AS HIGH AS POSSIBLE PROVIDING RISERS, DROPS AND

- OFFSETS TO CLEAR STRUCTURAL MEMBERS, LIGHT FIXTURES, OTHER PIPING, AND OTHER OBSTRUCTIONS. WHERE CONFLICTS ARISE, IT SHALL BE BROUGHT TO THE ENGINEER'S ATTENTION PRIOR TO PROCEEDING. 17. THE ENTIRE HYDRONIC SYSTEM IS TO BE BALANCED TO WITHIN 10% OF THE
- SPECIFIED WATER FLOWRATE REQUIREMENTS. A CERTIFIED BALANCING REPORT AND VERIFICATION IS TO BE SUBMITTED TO THE ENGINEER PRIOR TO FINAL ACCEPTANCE.
- 18. ALL DUCTWORK IS TO BE CONSTRUCTED OF GALVANIZED SHEET STEEL (EXCEPT WHERE OTHERWISE SPECIFIED) WITH GAUGES, BRACING AND CONSTRUCTION IN ACCORDANCE WITH THE LATEST SMACNA DUCT MANUAL STANDARDS AND ALL OTHER AUTHORITIES HAVING JURISDICTION.
- 19. PROVIDE MANUAL DAMPERS AT EACH SPLIT OR TAP CONNECTION TO TRUNK DUCTS FOR BALANCING PURPOSES WHETHER OR NOT SPECIFICALLY SHOWN ON DRAWINGS. EACH DAMPER SHALL BE OF THE OPPOSED BLADE DAMPER TYPE INSTALLED WITH AN OPERATOR AND LOCKING DEVICE. ALL DAMPERS LOCATED ABOVE HARD OR INACCESSIBLE CEILINGS SHALL BE INSTALLED WITH REMOTE GEAR OPERATORS.
- 20. FURNISH & INSTALL FUSIBLE LINK FIRE DAMPERS AT ALL LOCATIONS WHERE DUCT PENETRATES FIRE-RATED FLOOR OR CEILING ASSEMBLY WHETHER OR NOT SPECIFICALLY SHOWN. INSTALL DUCTWORK CASING ACCESS DOORS AND FRAMES AHEAD OF EACH FIRE DAMPER FOR INSPECTION AND MAINTENANCE. DOORS SHALL BE A MINIMUM OF 20 GA. DOUBLE PANEL INSULATED TYPE.
- 21. INSTALL TURNING VANES ON ALL RECTANGULAR TURNS. TURNING VANES SHALL BE DOUBLE THICKNESS TYPE CONSTRUCTED IN ACCORDANCE WITH SMACNA MANUAL.
- 22. ROUND SHEET STEEL ELBOWS ARE TO BE INSTALLED AT THE DUCT CONNECTION TO ALL SUPPLY AIR DIFFUSERS. SHEET STEEL PLENUM BOXES ARE TO BE INSTALLED AT THE DUCT CONNECTION TO ALL RETURN AND EXHAUST AIR GRILLES. THE CONTRACTOR IS TO PAINT THE INSIDE OF THE SHEET STEEL PLENUM BOXES FLAT
- 23. ALL SUPPLY AND RETURN DUCTWORK LOCATED IN UNCONDITIONED SPACES OR ABOVE CEILINGS SHALL BE INSULATED WITH A MINIMUM OF R-5 INSULATION. ALL DUCTWORK LOCATED OUTSIDE THE BUILDING ENVELOPE SHALL BE INSULATED WITH A MINIMUM OF R-8 INSULATION. INSULATION SHALL BE FIBERGLASS DUCT WRAP WITH VAPOR SEAL SECURELY TAPED AROUND DUCT. IF DUCT LINING IS TO BE USED, ALL DUCT SIZES SHOWN SHALL BE CONSIDERED TO BE INSIDE CLEAR DIMENSIONS.
- 24. INSTALL ALL DUCTWORK AS HIGH AS POSSIBLE PROVIDING RISERS, DROPS AND OFFSETS TO CLEAR STRUCTURAL MEMBERS, LIGHT FIXTURES, OTHER PIPING, AND OTHER OBSTRUCTIONS. WHERE CONFLICTS ARISE, IT SHALL BE BROUGHT TO THE ENGINEER'S ATTENTION PRIOR TO PROCEEDING.
- 25. THE ENTIRE AIR DISTRIBUTION SYSTEM IS TO BE BALANCED TO WITHIN 10% OF THE SPECIFIED AIRFLOW REQUIREMENTS.
- 26. THE CONTRACTOR IS RESPONSIBLE TO TEST ALL EQUIPMENT, PIPING, FIXTURES, AND SYSTEMS INSTALLED UNDER THIS CONTRACT TO ENSURE PROPER OPERATION PRIOR TO FINAL ACCEPTANCE BY THE OWNER AND ENGINEER.
- 27. THE CONTRACTOR IS RESPONSIBLE TO DETERMINE WHETHER SPECIAL LICENSING IS REQUIRED IN ORDER TO PERFORM THE REQUIRED WORK IN THE MUNICIPALITY WHERE THE PROJECT IS LOCATED. IF THE CONTRACTOR CANNOT OBTAIN THE REQUIRED LICENSING TO COMPLETE THE WORK WITHIN THE PROJECT SCHEDULE, THEN THE CONTRACTOR SHALL NOT BE PERMITTED TO BID ON THIS PROJECT.
- 28. CONTRACTOR IS RESPONSIBLE TO CREATE AND SUBMIT RED-LINE "AS-BUILT" PLANS TO THE ENGINEER AT THE END OF THE PROJECT. AS-BUILT PLANS SHALL ACCURATELY REPRESENT THE SYSTEMS AS THEY WERE INSTALLED.







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44-13-01-06-0-015-031 Proj. #: CSArch Proj. #: Issue Date: Sheet Title

> **MECHANICAL** NOTES, LEGEND, SCHEDULE & **DETAILS**


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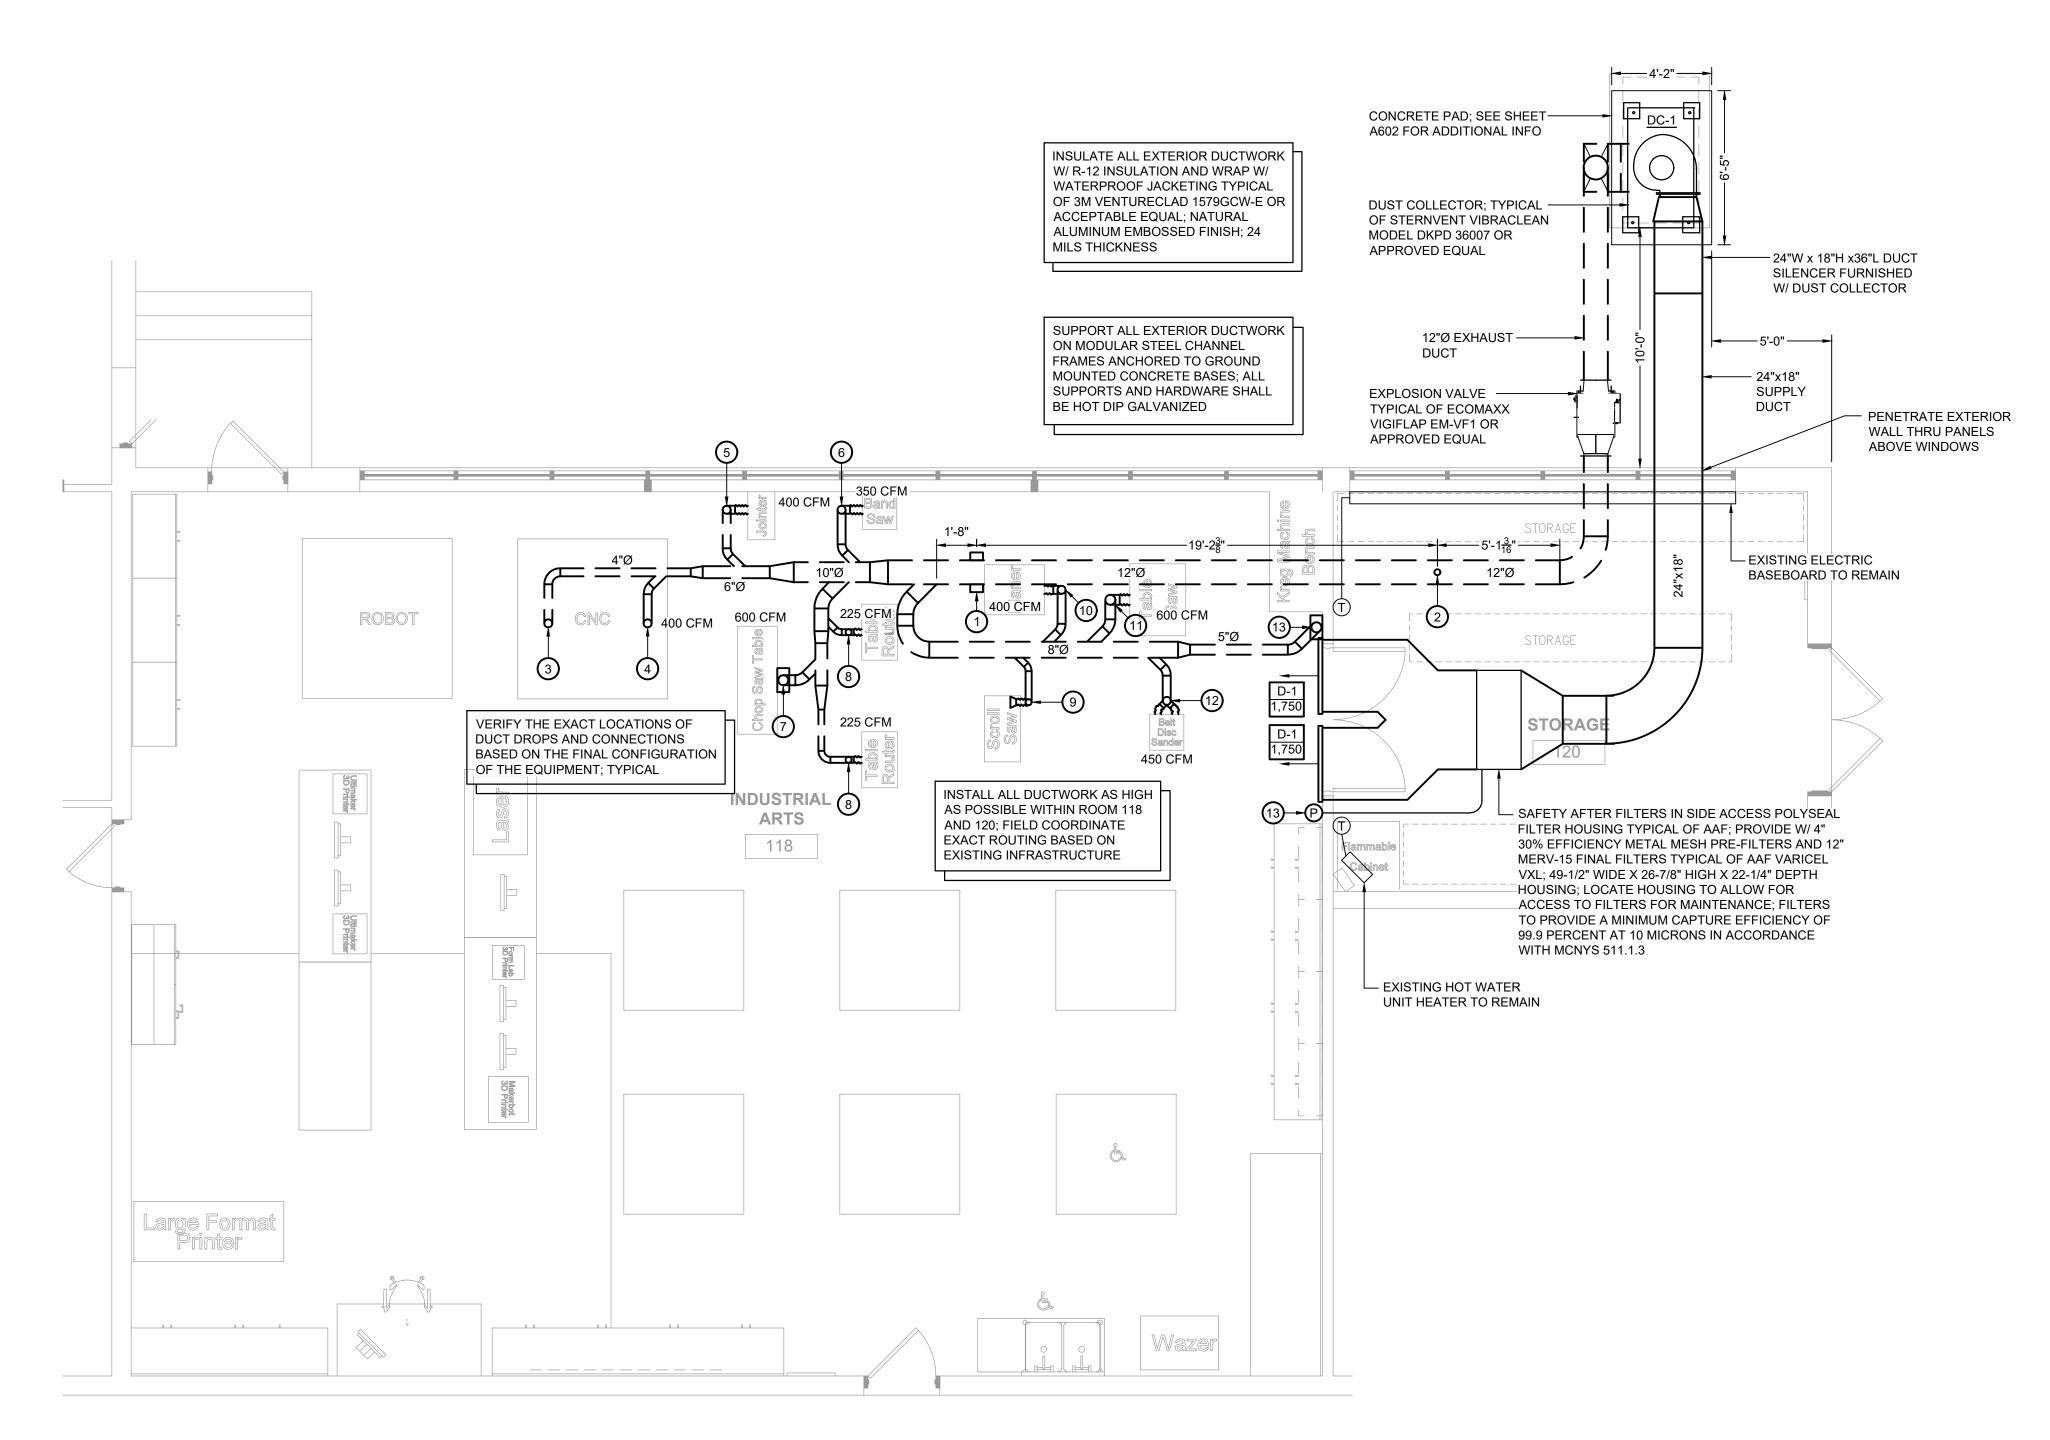



INDUSTRIAL ARTS

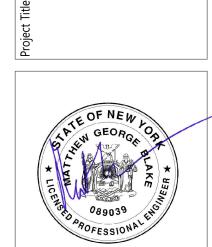MECHANICAL PLANS

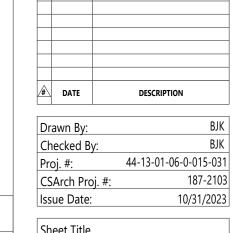

Mechanical Demolition Plan

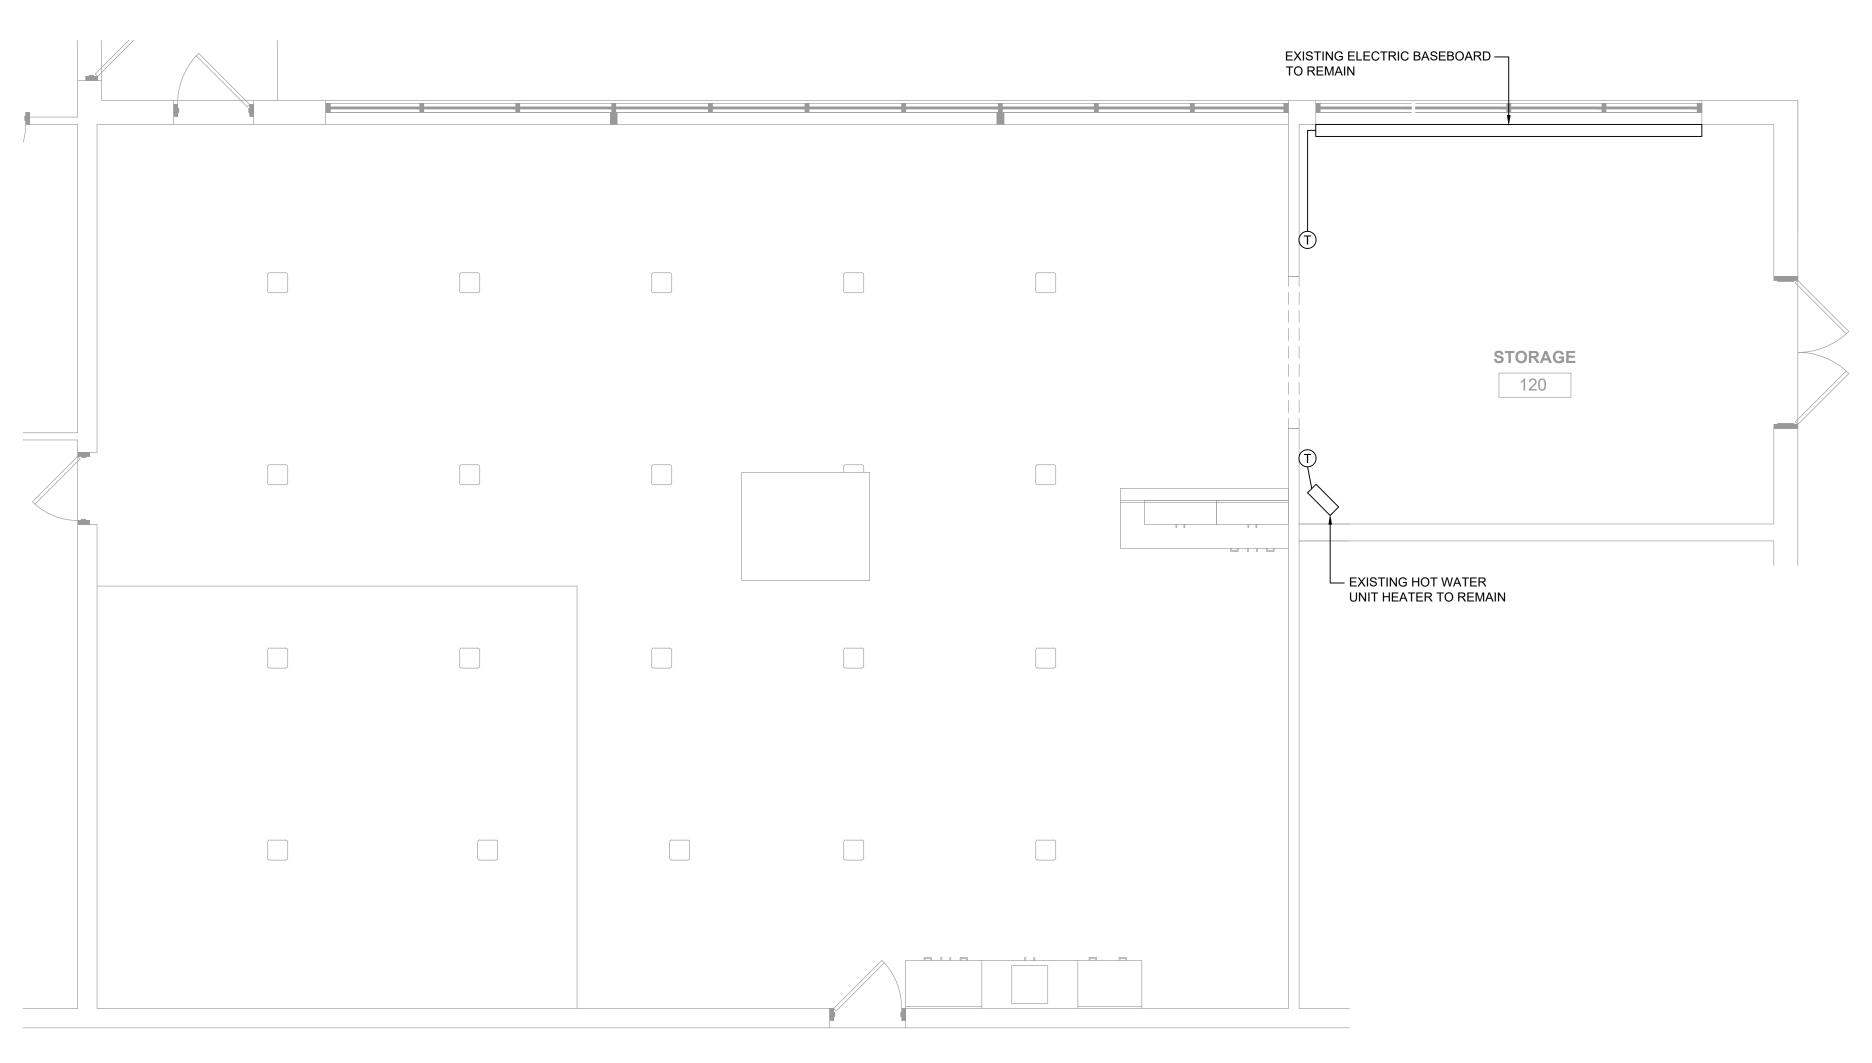

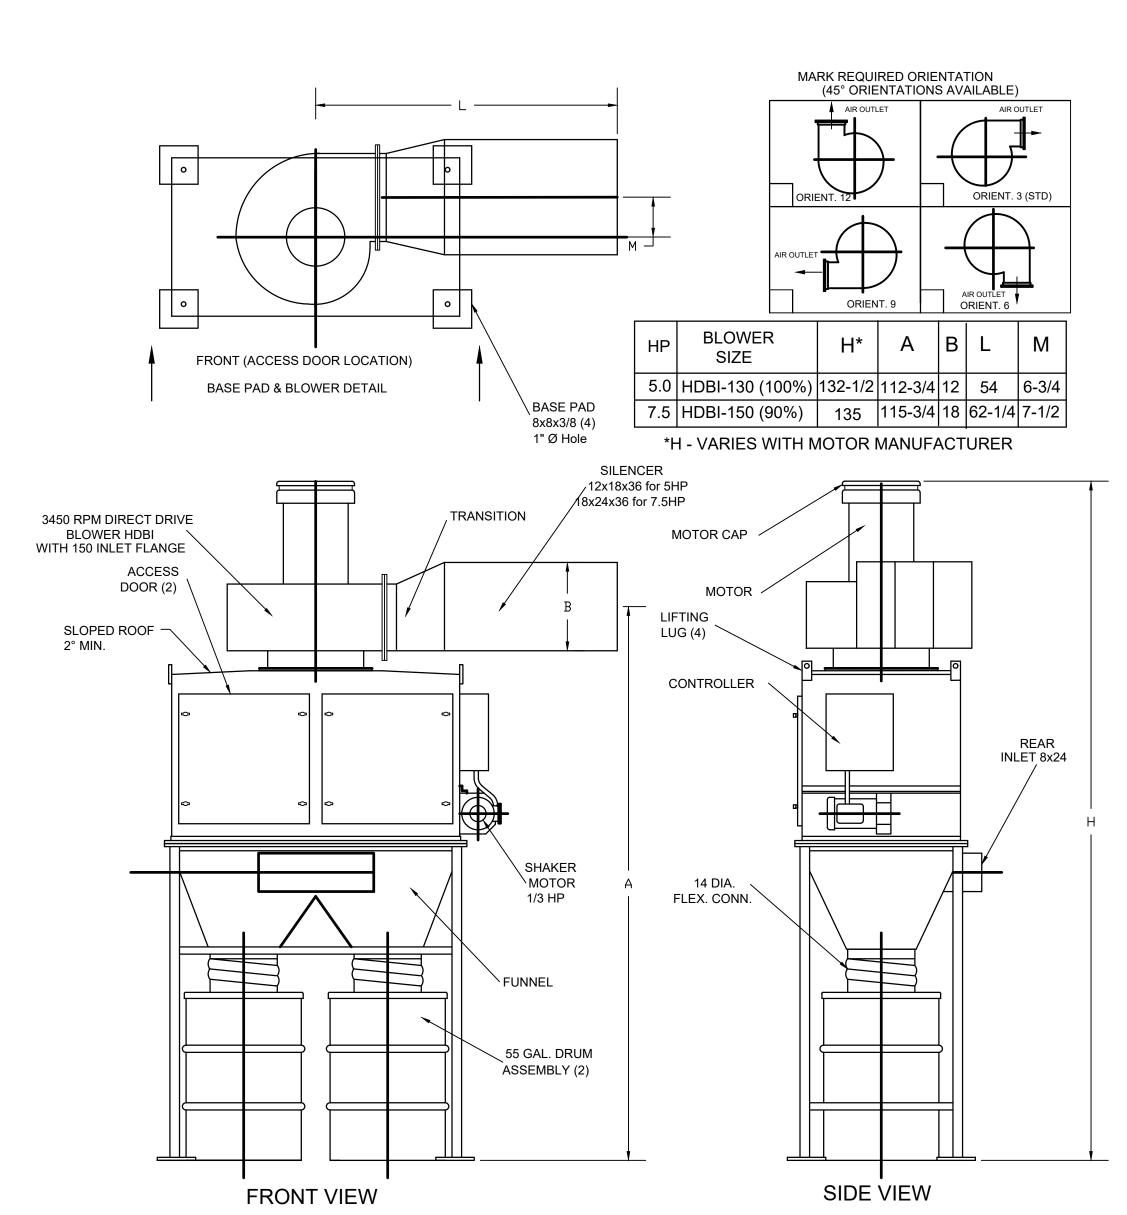

Key Notes:

MOVEMENT

BALANCE TO 400 CFM

BALANCE TO 450 CFM

AT FILTER HOUSING

5"Ø DUCT DROP TO FLOOR SWEEP

INFRARED SPARK DETECTORS TYPICAL OF HANSENTEK MODEL 120-1 OR APPROVED EQUAL; INSTALL ON BOTH SIDES OF THE

NOZZLE/VALVE SPRAY ASSEMBLY TYPICAL OF HANSENTEK MODEL 901-1S OR APPROVED EQUAL; INSTALL ON TOP OF DUCTWORK PER

4"Ø DUCT DROP TO CNC MACHINE VACUUM CONNECTION; PROVIDE 4"Ø FLEXIBLE HOSE TO ALLOW FOR FULL RANGE OF MOVEMENT;

4"Ø DUCT DROP TO CNC MACHINE VACUUM CLEANING HEAD; PROVIDE 4"Ø FLEXIBLE HOSE TO ALLOW FOR FULL RANGE OF

4"Ø DUCT DROP TO JOINTER; PROVIDE 4"Ø FLEXIBLE HOSE TO CONNECTION ON THE SIDE OF THE UNIT; BALANCE TO 400 CFM

4"Ø DUCT DROP TO BAND SAW; PROVIDE 4"Ø FLEXIBLE HOSE TO CONNECTION ON THE SIDE OF THE UNIT; BALANCE TO 350 CFM

3"Ø DUCT DROP TO ROUTER; PROVIDE 2.5"Ø FLEXIBLE HOSE TO CONNECTION ON THE REAR OF THE CABINET; BALANCE TO 225 CFM

3"Ø DUCT DROP TO SCROLL SAW; PROVIDE 3"Ø FLEX ARM FOR

4"Ø DUCT DROP TO PLANER; PROVIDE 4"Ø FLEXIBLE HOSE TO CONNECTION ON THE SIDE OF THE UNIT; BALANCE TO 400 CFM

5"Ø DUCT DROP TO TABLE SAW; PROVIDE 5"Ø FLEXIBLE HOSE TO CONNECTION ON THE SIDE OF THE UNIT; BALANCE TO 600 CFM

PROVIDE WALL MOUNT PRESSURE GAUGE TO MONITOR PRESSURE DROP ACROSS FILTERS; PROVIDE PNEUMATIC TUBING TO FITTINGS

4"Ø DUCT DROP TO COMBINATION SANDER; PROVIDE (2) 3"Ø FLEXIBLE HOSE TO CONNECTIONS ON THE SIDE OF THE UNIT;

MANUAL SAWDUST REMOVAL AT SAW

5"Ø DUCT DROP TO CHOP SAW; PROVIDE DUCTED HOOD AT SAWDUST DISCHARGE LOCATION ON SAW; BALANCE TO 600 CFM

DUCTWORK PER MANUFACTURER REQUIREMENTS

MANUFACTURER REQUIREMENTS

Dust Collector Details

M102 / Scale: 1/4" = 1'-0"

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KEY PLAN

Mechanical Plan

	LIGHTING FIXTURE SCHEDULE									
TAG SYMBOL MANUFACTURER & MODEL TYPE VOLTAGE # OF LAMP WATTS FIXTURE WATTS MOUNTING SIZE								NOTES		
А	A	LITHONIA LIGHTING LED SURFACE WRAP LBL4 3000LM 80CRI 35K MIN1 ZT MVOLT	LED	120	1	25.6	25.6	SURFACE/ PENDANT MTD.	48"x10"	PROVIDE ALL MOUNTING HARDWARE TO HANG/SUPPORT LIGHT FIXTURES FROM EXISTING STRUCTURE

PROVIDE NEW CIRCUIT BREAKERS FOR ALL NEW OR MODIFIED

CIRCUITS; BREAKERS SHALL MATCH EXISTING TYPE AND

CONTRACTOR SHALL VERIFY IN FIELD & ADJUST CIRCUIT

PANEL SCHEDULE SHOWN BASED ON EXISTING DIRECTORY

LAYOUT AS NEEDED BASED ON AVAILABLE POSITIONS

120/208V 3Ø 4W+G				BUS	RATING	: 225A				MLO
CONNECTED LOAD	CONDUCTORS	CKT. BREAKER AMPACITY	POSITION	L1 KVA	L2 KVA	L3 KVA	POSITION	CKT. BREAKER AMPACITY	CONDUCTORS	CONNECTED LOAD
EXISTING	EXISTING	20	1	<i>-</i> /-			2	20	(2) #12 CU & (1) #12 GND.	RECEPTACLES
EXISTING	EXISTING	20	3		·/.		4	20	(2) #12 CU & (1) #12 GND.	RECEPTACLES
EXISTING	EXISTING	20	5			·/.	6	20	EXISTING	EXISTING
RECEPTACLES	(2) #12 CU & (1) #12 GND.	20	7	·/.			8	20	EXISTING	LAISTING
CORD REELS	(2) #12 CU & (1) #12 GND.	20	9		·/.		10			EXISTING
CORD REELS	(2) #12 CU & (1) #12 GND.	20	11			·/.	12	40	EXISTING	
CORD REELS	(2) #12 CU & (1) #12 GND.	20	13	·/.			14			
CORD REELS	(2) #12 CU & (1) #12 GND.	20	15		-/-		16	50	EXISTING	EXISTING
SPARE	-	20	17			-/-	18	50	LAISTING	EXIOTING
EXISTING	EVICTING	50	19	·/.	- /		20	E0	FVICTING	EXISTING
EXISTING	EXISTING	50	21		<u> </u>	-/	22	50	EXISTING	
			25	<u>-</u> /_			26			
EXISTING	EXISTING	50	27		-/-		28	50	EXISTING	EXISTING
			29			<u>'</u>	30			
EXISTING	EXISTING	50	31	<u>'</u> .	- /		32	50	EXISTING	EVICTING
EXISTING	EXISTING	30	35		<u> </u>	-/	36	50	EXISTING	EXISTING
			37	-/-			38	40	EVICTIMO	EVICTING
EXISTING	EXISTING	50	39		·/.		40	40	EXISTING	EXISTING
			41			-/-	42	20	EXISTING	EXISTING

RATING

Existing Panelboard PP-Y

120/208V 3Ø 4W+G				BUS	RATING	: 100A				
CONNECTED LOAD	CONDUCTORS	CKT. BREAKER AMPACITY	POSITION	L1 KVA	L2 KVA	L3 KVA	POSITION	CKT. BREAKER AMPACITY	CONDUCTORS	CONNECTED L
RECEPTACLES	(2) #12 CU & (1) #12 GND.	20	1	·/.			2		EVICTING	EVI6.
RECEPTACLES	(2) #12 CU & (1) #12 GND.	20	3		-/-		4	50	EXISTING	EXISTIN
RECEPTACLES	(2) #12 CU & (1) #12 GND.	20	5			·/.	6	20	(2) #12 CU & (1) #12 GND.	TABLE ROL
CORD REELS	(2) #12 CU & (1) #12 GND.	20	7	·/.			8	20	(2) #12 CU & (1) #12 GND.	TABLE ROL
EXISTING	EVICTING	50	9		-/-		10	20	(2) #12 CU & (1) #12 GND.	PLA
EXISTING	EXISTING	50	11			·/.	12	20	(2) #12 CU & (1) #12 GND.	CORD R
EVICTING	EVICTING	50	13	·/.			14	20	(2) #12 CU & (1) #12 GND.	SCROLL
EXISTING	EXISTING		15		-/-		16	20	(2) #12 CU & (1) #12 GND.	TABLE
CORD REELS	(2) #12 CU & (1) #12 GND.	20	17			·/.	18	20	(2) #12 CU & (1) #12 GND.	BELT DISC SAN
			19	·/.			20			
EXISTING	EXISTING	50	21		·/.		22	50	EXISTING	EXIS
			23			·/.	24			
EXISTING	EXISTING	50	25	·/.			26	20	(2) #12 CU & (1) #12 GND.	RECEPTA
LAISTING	EXISTING	30	27		·/.		28	20	(2) #12 CU & (1) #12 GND.	RECEPTA
RECEPTACLES	(2) #12 CU & (1) #12 GND.	20	29			·/.	30	20	(2) #12 CU & (1) #12 GND.	SPARK DETEC
ROBOT	(2) #12 CU & (1) #12 GND.	20	31	·/.			32	20	EXISTING	EXIS
EXISTING	EXISTING	20	33		·/.		34	20	EXISTING	EXIS
EXISTING	EXISTING	20	35			·/.	36	20	(2) #12 CU & (1) #12 GND.	
JOINTER	(2) #12 CU & (1) #12 GND.	20	37				38			
BAND SAW	(2) #12 CU & (1) #12 GND.	20	39		-/-		40	40	(3) #8 CU & (1) #10 GND.	DUST COLLEC
CHOP SAW	(2) #12 CU & (1) #12 GND.	20	41			·/	42			


 PROVIDE NEW CIRCUIT BREAKERS FOR ALL NEW OR MODIFIED CIRCUITS; BREAKERS SHALL MATCH EXISTING TYPE AND

 PANEL SCHEDULE SHOWN BASED ON EXISTING DIRECTORY CONTRACTOR SHALL VERIFY IN FIELD & ADJUST CIRCUIT

LAYOUT AS NEEDED BASED ON AVAILABLE POSITIONS


Scale: None

Existing Panelboard PP-Z

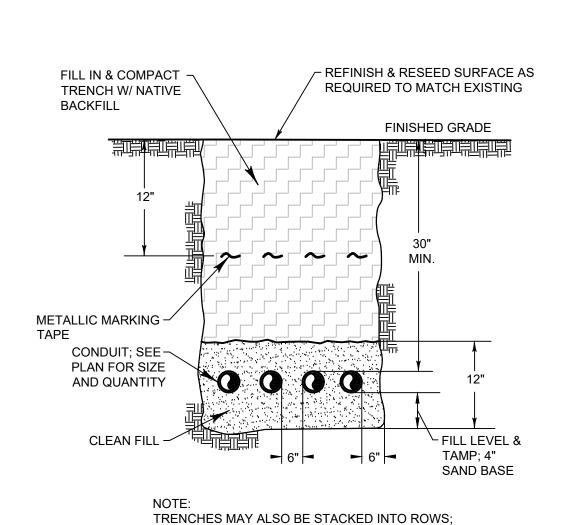

MAINTAIN 6" CLEARANCE BETWEEN CONDUITS.

Typical Conduit Trench Detail

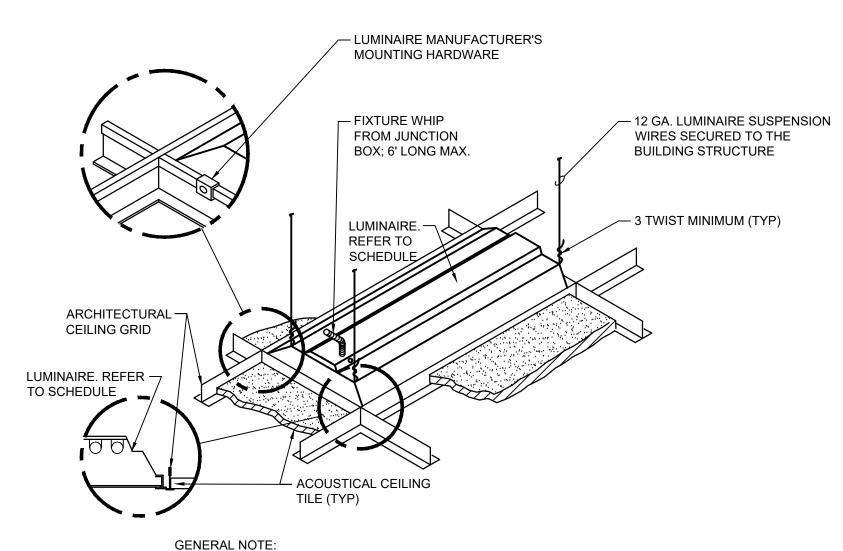

1. INSTALL IN ACCORDANCE WITH MANUFACTURER'S MOUNTING INSTRUCTIONS AND USING THE RECOMMENDED MOUNTING HARDWARE.

Luminaire Mounting Detail - Lay-In Ceiling E101 / Scale: None

ELECTRICAL LEGEND:

MOTOR

EARTH GROUND

JUNCTION BOX

EMERGENCY POWER OFF BUTTON

PULL BOX

CORD REEL

FUSE WITH RATING

MOLDED CASE CIRCUIT BREAKER

DISCONNECT SWITCH, FUSED

DISCONNECT SWITCH, UNFUSED STARTER, COMBINATION WITH DISCONNECT SWITCH

STARTER OR MOTOR CONTROLLER

METER

20A 120V DUPLEX CEILING MOUNTED RECEPTACLE

20A 120V DUPLEX WALL MOUNTED RECEPTACLE; 18" A.F.F. UNLESS OTHERWISE NOTED

20A 120V DUPLEX WALL MOUNTED RECEPTACLE WITH GROUND FAULT CIRCUIT INTERRUPTER

20A 120V QUADRAPLEX RECEPTACLE

WALL MOUNTED SPECIAL PURPOSE RECEPTACLE

⇒ 20A 120V WALL MOUNTED USB CHARGER RECEPTACLE TYPICAL OF HUBBELL USB20X OR ACCEPTABLE EQUAL

FLOOR BOX WITH STAINLESS COVER TYPICAL OF LEW EECTRIC #OB-1-SP OR ACCEPTABLE EQUAL; PUSH BUTTON OPEN; FULLY IP66 RATED WATER PROOF (WHEN IN CLOSED POSITION); W/ 20A 125V E60120 GFCI RECEPTACLE (UNLESS OTHERWISE NOTED)

WALL PHONE OUTLET MTD. 48" A.F.F.; 3/4" EMT CDT. IN WALL TO ABOVE CEILING W/ PULL CORD

WALL BOX FOR TELEVISION CONNECTION; 1-1/4" EMT CDT. IN WALL TO ABOVE CEILING W/ PULL CORD

TELEPHONE/DATA COMMUNICATION BOX W/ (2) 3/4" EMT CDT. IN WALL TO ABOVE CEILING W/ PULL CORD; NO FACE PLATE

BRANCH CIRCUIT HOMERUN; LINES INDICATE NUMBER OF CIRCUITS, NEUTRAL, AND SWITCH LEG CONDUCTORS; ONE SEPARATE GROUNDING CONDUCTOR SHALL BE PROVIDED FOR EACH

HOMERUN; NOT SHOWN BLANK = SINGLE POLE 2 = DOUBLE POLE 3 = THREE-WAY 4 = FOUR-WAY D = DIMMERK = KEY OPERATED P = WITH PILOT LIGHT PB= PUSH BUTTON T = TIMER OPERATED WP= WEATHER PROOF X = EXPLOSION PROOF OC= OCCUPANCY SENSOR

DUAL TECHNOLOGY OCCUPANCY SENSOR

DAYLIGHT SENSOR

HORN/STROBE DEVICE, ONE ASSEMBLY; MTD. 80" A.F.F. UNLESS OTHERWISE NOTED; 15 CANDELA UNLESS OTHERWISE NOTED

STROBE DEVICE; MTD. 80" A.F.F. UNLESS OTHERWISE NOTED; 15 CANDELA UNLESS OTHERWISE NOTED

MANUAL PULL STATION; MTD. 48" A.F.F.

WATER FLOW SWITCH

VALVE TAMPER SWITCH

DETECTOR; LETTER INDICATES AS FOLLOWS: BLANK = SMOKE DETECTOR P = PHOTOELECTRIC SMOKE M = MULTIPLE STATION SMOKE ALARM D = PHOTOELECTRIC DUCT SMOKE DETECTOR FSD = DUCT SMOKE DETECTOR FOR FIRE SMOKE DAMPER

RATE OF RISE HEAT DETECTOR, 135°F

CARBON MONOXIDE DETECTOR; MTD. 60" A.F.F.

ADDRESSABLE FIRE ALARM CONTROL PANEL

FIRE ALARM ANNUNCIATOR PANEL

REMOTE TEST SWITCH & LED FOR DUCT SMOKE DETECTORS

FIRE ALARM RELAY

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2. THESE DRAWINGS ARE DIAGRAMMATIC, AND INDICATE GENERAL ARRANGEMENT OF WORK. THE CONTRACTOR SHALL BE RESPONSIBLE TO HAVE REVIEWED THE SITE FOR HIS WORK PRIOR TO HAVING SUBMITTED HIS PROPOSAL. NO ADDITIONAL COMPENSATION WILL BE ALLOWED FOR CONDITIONS FOUND DURING THE COURSE OF THE CONTRACT.

3. THE CONTRACTOR SHALL COORDINATE HIS WORK WITH THAT OF ALL OTHER

4. ALL WORK INCLUDING LABOR AND MATERIALS SHALL BE FULLY GUARANTEED FOR ONE (1) YEAR FROM THE DATE OF PAYMENT AND FINAL ACCEPTANCE BY THE OWNER AND ENGINEER.

5. ALL CUTTING, PATCHING, FIRE-STOPPING, AND SURFACE RESTORATION IN CONNECTION WITH THIS TRADE SHALL BE COMPLETED BY THIS CONTRACTOR.

6. A MINIMUM OF FOUR (4) COPIES OF SHOP DRAWINGS SHALL BE SUBMITTED TO THE ARCHITECT FOR APPROVAL PRIOR TO ORDERING AND INSTALLATION OF THE EQUIPMENT AND/OR MATERIALS. BY SUBMITTING SHOP DRAWINGS, THE CONTRACTOR REPRESENTS THAT ACTUAL FIELD CONDITIONS ARE VERIFIED BY HIM AND ARE REFLECTED ON HIS SUBMITTALS.

7. THIS CONTRACTOR SHALL PAY ALL FEES, GIVE ALL NOTICES, FILE ALL NECESSARY DRAWINGS, AND OBTAIN ALL PERMITS, INSPECTIONS AND CERTIFICATES OF APPROVAL REQUIRED IN CONNECTION WITH WORK UNDER THIS CONTRACT.

EQUIPMENT AND MATERIALS FOR WHICH UNDERWRITERS LABORATORIES INC. (UL) PROVIDES PRODUCT LISTING SERVICE SHALL BE LISTED AND BEAR THE LISTING MARK.

9. ALL WORK IN ASSOCIATION WITH THIS CONTRACT SHALL BE COMPLETED IN STRICT COMPLIANCE WITH THE 2017 NATIONAL ELECTRIC CODE, 2020 BUILDING CODE OF NEW YORK STATE, 2020 FIRE CODE OF NEW YORK STATE & 2020 ENERGY CONSERVATION CONSTRUCTION CODE OF NEW YORK STATE.

10. ALL NEW LIGHTING FIXTURES SHALL BE INSTALLED FULLY LAMPED AND OPERABLE. THE CONTRACTOR SHALL TURN OVER TO THE OWNER SPARE LAMPS OF EVERY TYPE ON THE PROJECT IN AN AMOUNT NOT LESS THAN 20% OF THE TOTAL NUMBER OF EACH TYPE (MINIMUM 1 PER TYPE).

11. THIS CONTRACTOR SHALL BE RESPONSIBLE FOR ALL COORDINATION, APPLICATIONS AND FEES OF ALL WORK ASSOCIATED WITH THE LOCAL UTILITY COMPANY AND/OR THE TELEPHONE COMPANY. ALL WORK INVOLVING THE UTILITY COMPANY SHALL BE COMPLETED IN ACCORDANCE WITH THEIR REGULATIONS AND GUIDELINES.

12. ALL CONDUCTORS SHALL BE COPPER, SHALL NOT BE LESS THAN #12 AWG, AND SHALL NOT EXCEED 70 FEET FROM PANEL BOARD TO FURTHEST CONNECTION UNLESS OTHERWISE NOTED ON PLANS.

13. LIGHTING LOADS SHALL NOT BE COMBINED ON THE SAME CIRCUIT AS ANY OTHER ELECTRICAL LOADS.

14. CONTRACTOR SHALL BE RESPONSIBLE TO FURNISH & INSTALL ALL SMALL DETAILS AND INCIDENTAL WORK NOT SHOWN OR SPECIFIED, BUT WHICH CAN BE REASONABLY INFERRED AS REQUIRED FOR A COMPLETE AND OPERATING SYSTEM OF HIGH QUALITY MEETING ALL APPLICABLE CODES AND REGULATIONS.

15. FOR EACH NEW OR MODIFIED ELECTRICAL PANEL, THE CONTRACTOR SHALL PROVIDE A TYPE WRITTEN DIRECTORY CARD TO REFLECT ALL CIRCUITING. ADDITIONALLY, THE CONTRACTOR SHALL LABEL (WITH A PERMANENT MARKER OR LABEL) EACH RECEPTACLE ON THE INSIDE OF EACH FACE PLATE WITH PANEL AND CIRCUIT NUMBER DESIGNATION.

16. MINIMUM REQUIREMENT FOR EQUIPMENT GROUNDING SHALL BE GOVERNED BY THE NEC. ALL GROUNDS, BONDING, ETC. SHALL MEET THESE REQUIREMENTS. THE CONTRACTOR SHALL FURNISH AND INSTALL ANY AND ALL ITEMS NECESSARY TO MEET THESE REQUIREMENTS AT NO EXTRA COST, EVEN IF SUCH ITEMS ARE NOT DETAILED ON THE DRAWINGS.

17. ALL CONDUIT AND CABLE SHALL BE PROPERLY SUPPORTED AND ROUTED PARALLEL OR PERPENDICULAR TO BUILDING WALLS. THE CONTRACTOR SHALL FURNISH AND INSTALL ALL SUPPORT HANGERS AND MISCELLANEOUS METALS REQUIRED FOR PROPER INSTALLATION OF WORK.

18. THE CONTRACTOR IS RESPONSIBLE TO TEST ALL EQUIPMENT, WIRING, DEVICES, AND SYSTEMS INSTALLED UNDER THIS CONTRACT TO ENSURE PROPER OPERATION PRIOR TO FINAL ACCEPTANCE BY THE OWNER AND ENGINEER.

19. THE CONTRACTOR IS RESPONSIBLE TO DETERMINE WHETHER SPECIAL LICENSING IS REQUIRED IN ORDER TO PERFORM THE REQUIRED WORK IN THE MUNICIPALITY WHERE THE PROJECT IS LOCATED. IF THE CONTRACTOR CANNOT OBTAIN THE REQUIRED LICENSING TO COMPLETE THE WORK WITHIN THE PROJECT SCHEDULE, THEN THE CONTRACTOR SHALL NOT BE PERMITTED TO BID ON THIS PROJECT.

	WIRE COLOR CODING TABLE										
PHASE	WIRES	VOLTAGE	L1	L2	L3	NEUTRAL	GROUND				
1	2 (1)	120	BLACK	-	-	WHITE	-				
1	2 (1)	208	BLACK	RED	-	-	-				
1	3	120	BLACK	-	-	WHITE	GREEN (2)				
1	3	208	BLACK	RED	-	-	GREEN (2)				
3	4	208	BLACK	RED	BLUE	-	GREEN (2)				
3	5	208	BLACK	RED	BLUE	WHITE	GREEN (2)				
1	3	277	BROWN	-	-	GRAY	GREEN (2)				
1	3	277	BROWN	ORANGE	-	-	GREEN (2)				
3	4	480	BROWN	ORANGE	YELLOW	-	GREEN (2)				
3	5	480	BROWN	ORANGE	YELLOW	GRAY	GREEN (2)				
NOTES:											

FOR DOUBLE INSULATED EQUIPMENT ONLY. GREEN/YELLOW MAY BE USED:

CONDUCTORS.

TV & A/V OUTLETS

- GREEN/YELLOW SHALL BE GREEN WITH ONE OR MORE YELLOW STRIPES - GREEN = 50 TO 70%, YELLOW = 50 TO 30%. - GREEN/YELLOW IS THE ONLY COLOR INTERNATIONALLY ACCEPTED FOR USE AS AN EQUIPMENT GROUNDING CONDUCTOR. - GREEN OR GREEN/YELLOW <u>MUST</u> ONLY BE USED FOR GROUNDING

DEVICE MOUNTING	G HEIGHTS
POWER RECEPTACLES (INTERIOR)	18" A.F.F.
POWER RECEPTACLES (EXTERIOR)	36" A.F.G.
POWER RECEPTACLES (@ COUNTER)	44" A.F.F.
LIGHT SWITCHES	44" A.F.F. TO TOP OF DEVICE
DISCONNECT SWITCHES	SEE NEC 404.8(A)
TELEPHONE/DATA RECEPTACLES	18" A.F.F.
TELEPHONE/DATA RECEPTACLES (@ COUNTER)	44" A.F.F.
WALL TELEPHONE RECEPTACLES	48" A.F.F. TO TOP OF DEVICE
FIRE ALARM PULL STATIONS	42" A.F.F. MIN./44" A.F.F. MAX.
FIRE ALARM AUDIO/VISUAL DEVICES	80" A.F.F. MIN./96" A.F.F. MAX.
EXIT LIGHTS (WALL MOUNTED)	12" ABOVE DOOR
EMERGENCY LIGHTS (WALL MOUNTED)	90" A.F.F.

NOTE: ALL DIMENSIONS ARE TO CENTER OF DEVICE UNLESS OTHERWISE NOTED

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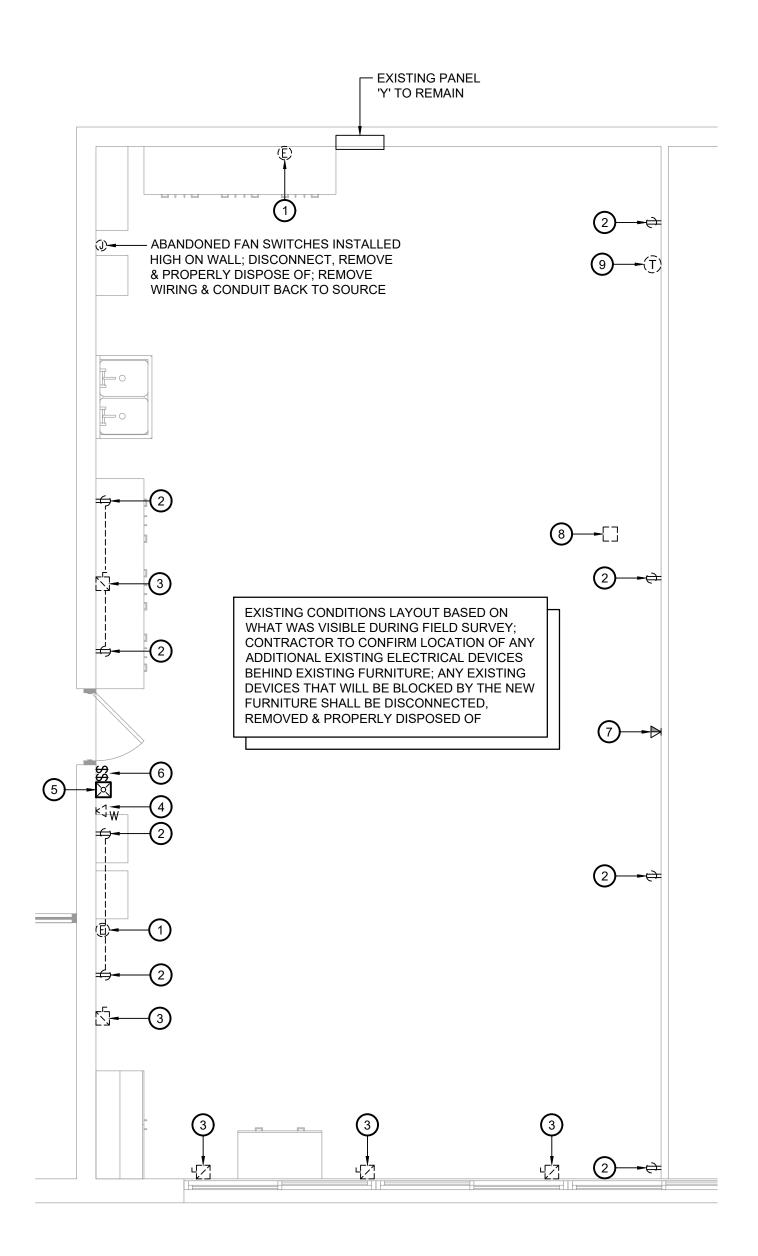
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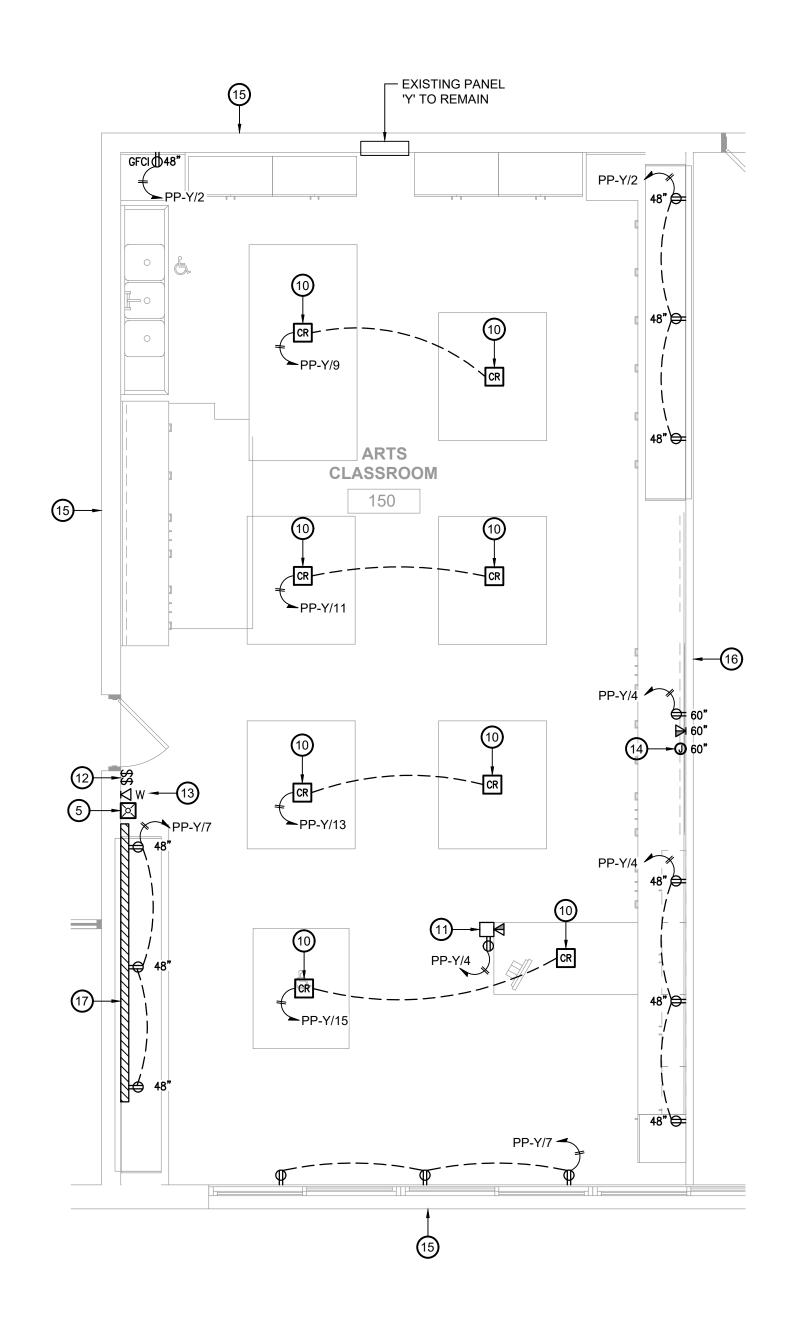
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ELECTRICAL NOTES, LEGEND, DETAILS & SCHEDULES



Electrical Demolition Plan

E101 Scale: 1/4" = 1'-0"



Electrical Plan E101 Scale: 1/4" = 1'-0"

Key Notes:

- ABANDONED EPO SWITCH TO BE DISCONNECTED, REMOVED & PROPERLY DISPOSED OF, REMOVE ALL EXISTING WIRING & CONDUIT BACK TO SOURCE
- RECEPTACLE TO BE DISCONNECTED, REMOVED & PROPERLY DISPOSED OF INCLUDING DEVICE BOX; REMOVE ALL EXISTING WIRING & CONDUIT BACK TO SOURCE
- DISCONNECT SWITCH TO BE DISCONNECTED, REMOVED & PROPERLY DISPOSED OF; REMOVE ALL EXISTING WIRING & CONDUIT BACK TO SOURCE
- WALL MOUNTED PHONE TO BE DISCONNECTED & REMOVED TO ALLOW FOR NEW FURNITURE; MAINTAIN EXISTING PHONE & CABLING FOR NEW LOCATION
- EXISTING WALL MOUNTED FIRE ALARM STROBE TO REMAIN
- EXISTING LIGHT SWITCHES TO REMAIN; REMOVE EXISTING SURFACE MOUNTED CONDUIT TO MAKE ROOM FOR NEW FURNITURE; MAINTAIN CIRCUIT FOR RECONNECTION TO SWITCHES
- EXISTING WALL MOUNTED DATA RECEPTACLE FOR PROMETHEAN BOARD TO BE DISCONNECTED & REMOVED; MAINTAIN CABLING FOR RECONNECTION
- EXISTING DUAL CHANNEL POWER POLE TO BE DISCONNECTED, REMOVED & PROPERLY DISPOSED OF; REMOVE ELECTRICAL WIRING & CONDUIT BACK TO SOURCE; MAINTAIN EXISTING DATA CABLING FOR RECONNECTION
- ABANDONED THERMOSTAT TO BE DISCONNECTED, REMOVED & PROPERLY DISPOSED OF; REMOVE ALL EXISTING WIRING & CONDUIT BACK TO SOURCE
- PROVIDE CORD REEL TYPICAL OF HUBBELL INREACH WHITE INDUSTRIAL REEL; 25 FT CORD LENGTH W/ 15A PLUG; PROVIDE W/ PLENUM RATED ENCLOSURE FOR MOUNTING ABOVE ACOUSTIC CEILING GRID; PROVIDE RECEPTACLE FOR CORD REEL POWER INSIDE PLENUM ENCLOSURE;
- PROVIDE DUAL CHANNEL POWER POLE TYPICAL OF LEGRAND WIREMOLD 30TC AND DUAL CHANNEL SURFACE MOUNTED STEEL RACEWAY TYPICAL OF LEGRAND WIREMOLD 4000 SERIES. COORDINATE EXACT LAYOUT AND MOUNTING REQUIREMENTS WITH OWNER BASED ON FURNITURE SELECTION. PROVIDE WITH ALL REQUIRED FITTINGS AND ACCESSORIES FOR A COMPLETE INSTALLATION. ALL CORNERS AND TRANSITIONS SHALL INCLUDE RADIUS/SWEEP FITTINGS. PROVIDE ALL COVER PLATES, JACKS AND CABLING FOR DATA OUTLETS.
- PROVIDE NEW SURFACE MOUNTED RACEWAY TO EXISTING SWITCHES; MAINTAIN EXISTING LIGHTING CIRCUIT
- REINSTALL EXISTING PHONE IN NEW LOCATION; COORDINATE W/ NEW FURNITURE LAYOUT
- PROVIDE JUNCTION BOX IN WALL W/ 1-1/4" CONDUITS W/ PULL CORDS STUBBED TO ABOVE CEILING; TO BE USED FOR CABLING TO BE PULLED BETWEEN JUNCTION BOX AND POWER POLE AT TEACHER'S DESK FOR PROMETHEAN BOARD COMMUNICATIONS (HDMI, USB, ETC.)
- EXISTING MASONRY WALL; ALL RACEWAYS AND DEVICE BOXES SHALL BE SURFACE MOUNTED;
- EXISTING FRAMED WALL; ALL RACEWAYS AND DEVICE BOXES SHALL BE RECESS MOUNTED AND CONCEALED WITHIN THE WALL
- PROVIDE SINGLE CHANNEL SURFACE MOUNTED STEEL RACEWAY TYPICAL OF LEGRAND WIREMOLD 4000 SERIES. PROVIDE WITH ALL REQUIRED FITTINGS AND ACCESSORIES FOR A COMPLETE INSTALLATION. ALL CORNERS AND TRANSITIONS SHALL INCLUDE RADIUS/SWEEP FITTINGS. RUN RACEWAY UP WALL TO ABOVE CEILING PRIOR TO TRANSITIONING TO CONDUIT.




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CLASSROOM ELECTRICAL

KEY PLAN



CEILING PRIOR TO TRANSITIONING TO CONDUIT. PROVIDE CORD REEL TYPICAL OF HUBBELL INREACH WHITE INDUSTRIAL REEL. 25 FT CORD LENGTH W/ 15A PLUG. PROVIDE W/ MOUNTING BRACKET AND PIVOT BASE. PROVIDE CEILING RECEPTACLE FOR CORD REEL POWER. PROVIDE DUAL CHANNEL POWER POLE TYPICAL OF LEGRAND

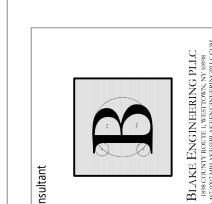REQUIRED FITTINGS AND ACCESSORIES FOR A COMPLETE

EXISTING WALL MOUNTED FIRE ALARM STROBE TO BE RELOCATED

EXISTING DUAL CHANNEL POWER POLE TO BE DISCONNECTED, REMOVED & PROPERLY DISPOSED OF; REMOVE ELECTRICAL WIRING & CONDUIT BACK TO SOURCE; MAINTAIN EXISTING DATA

EXISTING TWIST LOCK RECEPTACLES (CEILING MOUNTED ON UNISTRUT) TO BE DISCONNECTED, REMOVED & PROPERLY

PROVIDE JUNCTION BOX IN WALL W/ 1-1/4" CONDUITS W/ PULL

TEACHER'S DESK FOR PROMETHEAN BOARD COMMUNICATIONS

EXISTING MASONRY WALL; ALL RACEWAYS AND DEVICE BOXES

EXISTING FRAMED WALL; ALL RACEWAYS AND DEVICE BOXES SHALL BE RECESS MOUNTED AND CONCEALED WITHIN THE WALL

PROVIDE SINGLE CHANNEL SURFACE MOUNTED STEEL RACEWAY

INSTALLATION. ALL CORNERS AND TRANSITIONS SHALL INCLUDE

RADIUS/SWEEP FITTINGS. RUN RACEWAY UP WALL TO ABOVE

TYPICAL OF LEGRAND WIREMOLD 4000 SERIES. PROVIDE WITH ALL

BE PULLED BETWEEN JUNCTION BOX AND POWER POLE AT

CORDS STUBBED TO ABOVE CEILING; TO BE USED FOR CABLING TO

EXISTING FIRE ALARM PULL STATION TO REMAIN

EXISTING EMERGENCY LIGHT TO REMAIN

EXISTING WALL MOUNTED PHONE TO REMAIN

DISPOSED OF; REMOVE ALL EXISTING WIRING & CONDUIT BACK TO

EXISTING LIGHT SWITCHES TO REMAIN

CABLING FOR RECONNECTION

EXISTING EXIT SIGN TO REMAIN

SHALL BE SURFACE MOUNTED;

(HDMI, USB, ETC.)

SOURCE

EXISTING WALL MOUNTED DATA RECEPTACLE TO BE DISCONNECTED & REMOVED; MAINTAIN CABLING FOR

WIREMOLD 30TC AND DUAL CHANNEL SURFACE MOUNTED STEEL RACEWAY TYPICAL OF LEGRAND WIREMOLD 4000 SERIES. COORDINATE EXACT LAYOUT AND MOUNTING REQUIREMENTS WITH OWNER BASED ON FURNITURE SELECTION. PROVIDE WITH ALL REQUIRED FITTINGS AND ACCESSORIES FOR A COMPLETE INSTALLATION. ALL CORNERS AND TRANSITIONS SHALL INCLUDE RADIUS/SWEEP FITTINGS. PROVIDE ALL COVER PLATES, JACKS AND CABLING FOR DATA OUTLETS.

SPRAY ASSEMBLY FURNISHED BY MECHANICAL CONTRACTOR; PROVIDE 24 VOLT WIRING (14 AWG) IN 3/4" CONDUIT FROM CONTROL PANEL TO SOLENOID VALVE SPARK DETECTORS FURNISHED BY MECHANICAL CONTRACTOR;

CONTROL PANEL TO SPARK DETECTORS SPARK DETECTION SYSTEM FURNISHED BY MECHANICAL CONTRACTOR; ELECTRICAL CONTRACTOR TO MOUNT CONTROL


PROVIDE 24 VOLT WIRING (18 AWG) IN 3/4" CONDUIT FROM

PANEL AND PROVIDE DEDICATED 120V CIRCUIT TO PANEL


DUST COLLECTOR INTERLOCK SYSTEM FURNISHED BY MECHANICAL CONTRACTOR; TYPICAL OF STERNVENT DUST SWITCH OR EQUAL; ELECTRICAL CONTRACTOR TO MOUNT CONTROL PANEL AND PROVIDE ALL WIRING AND CONDUIT; INSTALL PER MANUFACTURER REQUIREMENTS

RELOCATED FIRE ALARM HORN STROBE


PROVIDE TWIST LOCK PLUG HUNG FROM STRUCTURE AT 7'-0" AFF; PLUG MOUNTED ON CORD W/ STRAIN RELIEF SUPPORTED FROM JUNCTION BOX MOUNTED TO STRUCTURE; TYPICAL AT EACH PIECE OF EQUIPMENT; FIELD VERIFY EXACT PLUG TYPE AND FINAL LOCATION OF PLUG

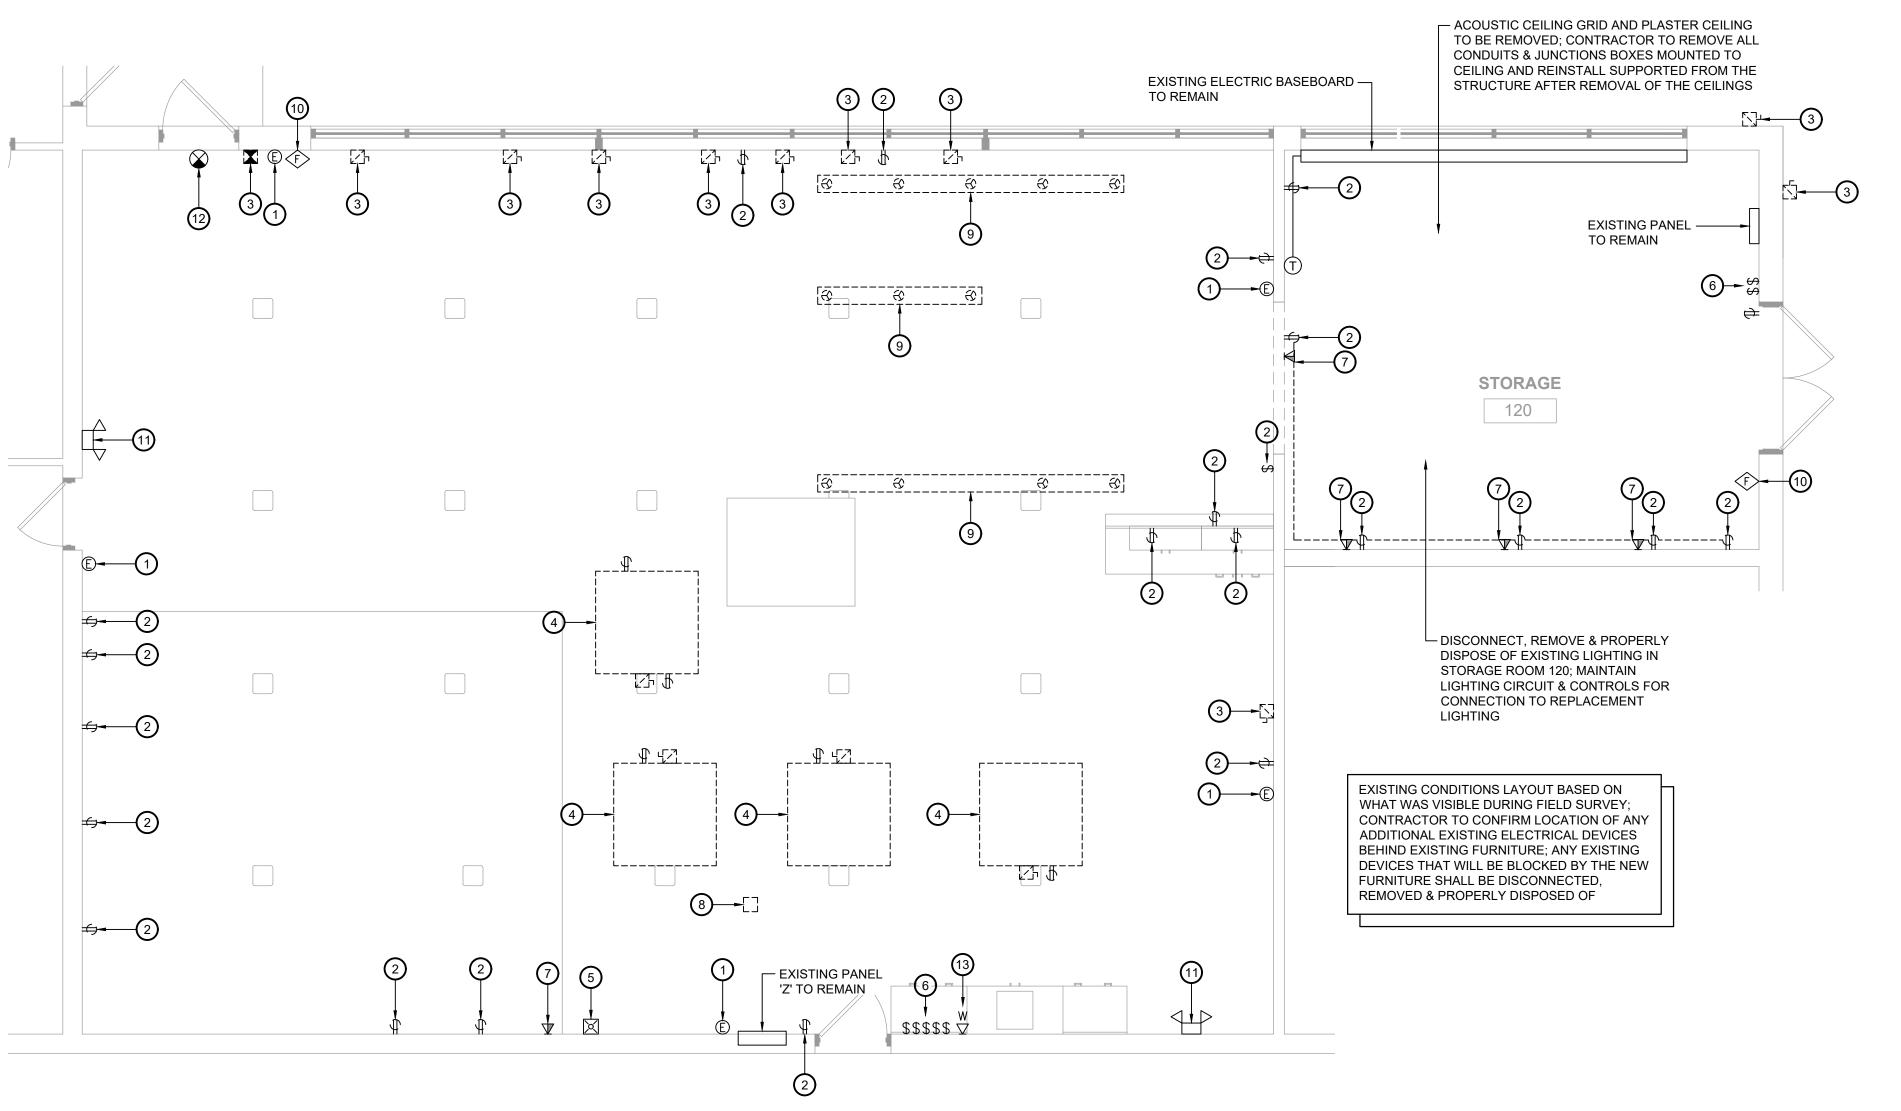


Electrical Demolition Plan E102 Scale: 1/4" = 1'-0"

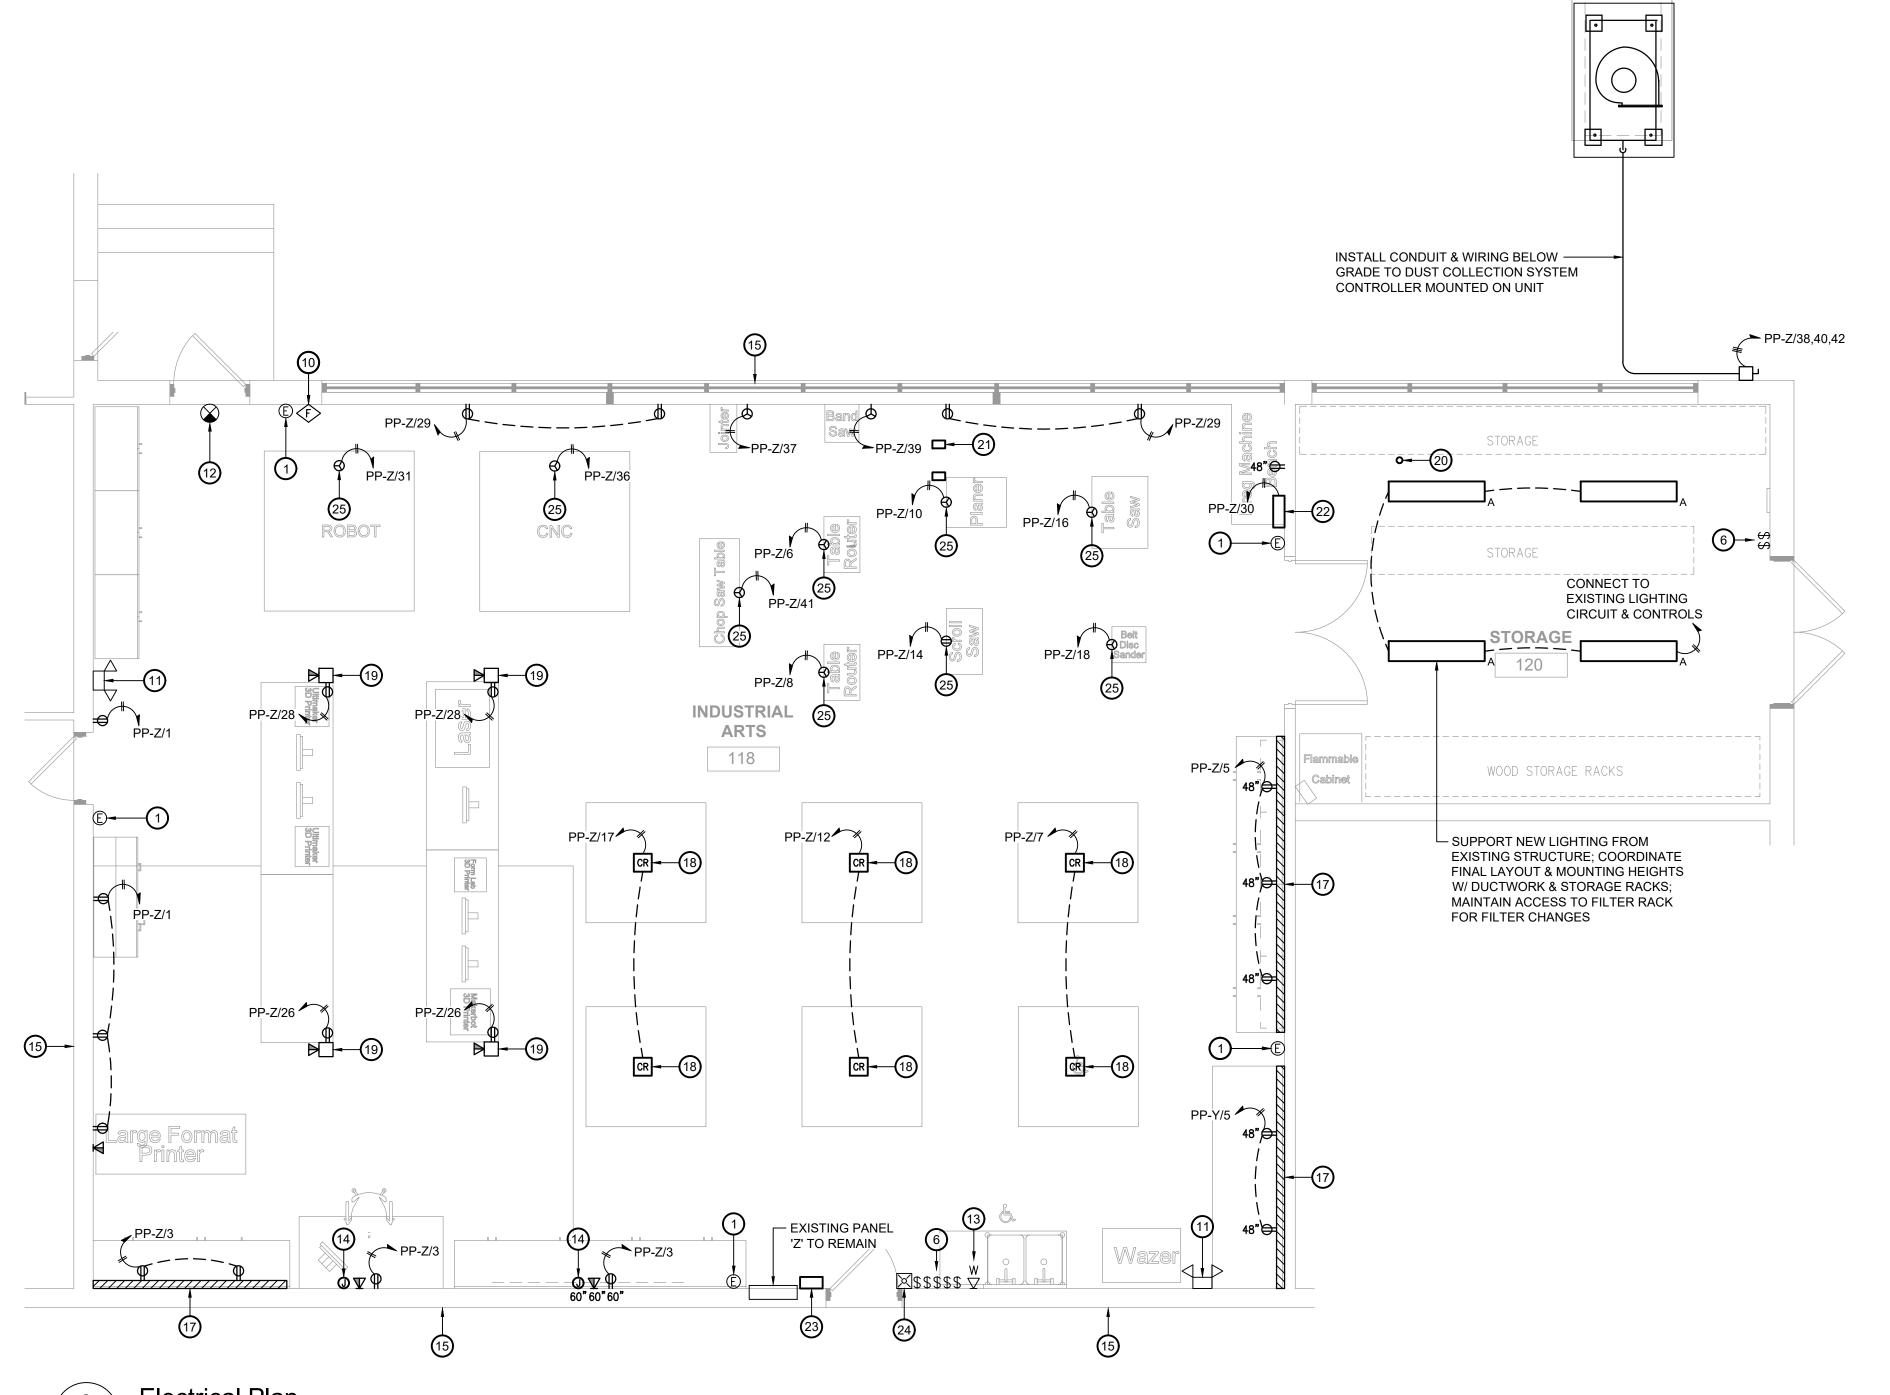



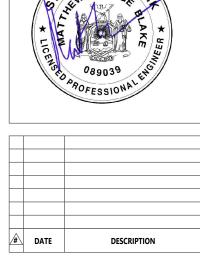

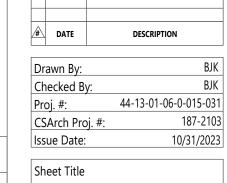

INDUSTRIAL **ARTS** ELECTRICAL PLANS

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KEY PLAN

Electrical Plan Scale: 1/4" = 1'-0"