

	Plumbing Fixture Schedule										
FIXTURE MARK	DESCRIPTION	PIPING CONNECTION			WATER SUPPLY	IV DRAINAGE	ADA	ELECTRONIC CONTROL	MANUFACTURER/MODEL	REMARKS	
		H.W.	C.W.	WASTE	VENT	FIXTURE UNITS	FIXTURE UNITS	(Y/N)	(Y/N)	(OR ACCEPTABLE EQUAL)	KLIMAKKS
1	THREE COMPARTMENT SCULLERY SINK	1/2	1/2	2	1-1/2	2.0	2	N	N	3 COMPARTMENT SINK TYPICAL OF ADVANCE TABCO REGALINE 93 SERIES; 16 GAUGE TYPE 304 STAINLESS STEEL, 16"x20" BOWLS, 18" DRAINBOARDS; FURNISH W/ SPLASH MOUNT PRERINSE FAUCET MODEL #DTA-53	INSTALL PER ADA & MANUFACTURER'S REQUIREMENTS
2	TWO COMPARTMENT SCULLERY SINK	1/2	1/2	2	1-1/2	2.0	2	N	N	2 COMPARTMENT SINK TYPICAL OF ADVANCE TABCO REGALINE 93 SERIES; 16 GAUGE TYPE 304 STAINLESS STEEL, 16"x20" BOWLS, 24" DRAINBOARD; FURNISH W/ SPLASH MOUNT PRERINSE FAUCET MODEL #DTA-53	INSTALL PER ADA & MANUFACTURER'S REQUIREMENTS




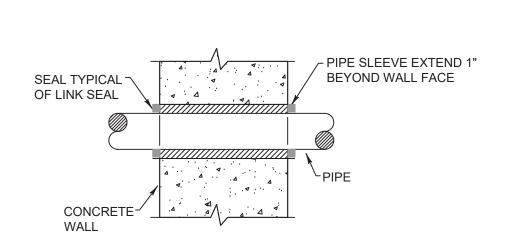

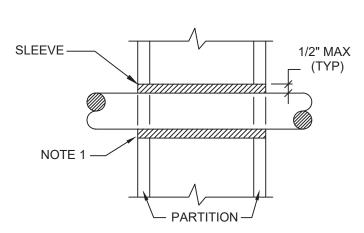

1. AT FIRE RATED PARTITIONS, ADD ADDITIONAL LAYER OF FIRE SAFING INSULATION AROUND PENETRATION SO AS TO FILL CAVITY. 2. DUCT AND PIPE PENETRATIONS THRU CORRIDOR WALLS ABOVE THE CEILING ARE TO BE FIRE STOPPED AROUND THE PENETRATION.

2	Pipe Penetrations Detail
PG001/	N.T.S.

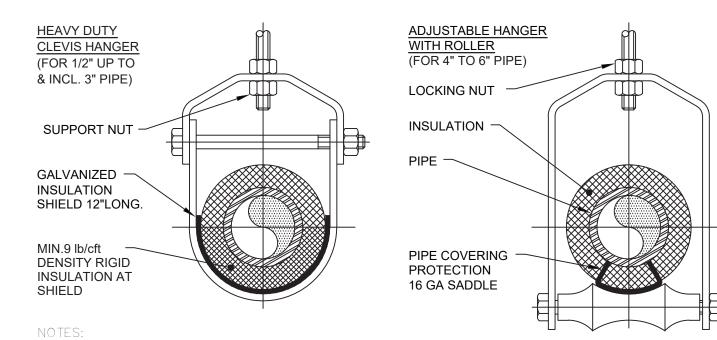

1. PIPE 8" AND LARGER SHALL HAVE ROLLER SUPPORTED WITH DUAL RODS.
2. FOR CHW SERVICE OVER 3" REPLACE SADDLE WITH 12" LONG 14 GA SHIELD WITH RIGID
INSULATION BETWEEN PIPE AND SHIELD.

PIPE Ø (IN.)	MAX. S	MIN. ROD SIZE		
FIFL & (IIV.)		(IN.)		
	STEEL PIPE	COPPER PIPE	CPVC	(114.)
1/2 THRU 1	7	5	5	3/8
1-1/2 THRU 2	9	8	6	3/8
2-1/2	11	9	7.5	1/2
3	12	10	7.5	1/2
4	14	12	8.5	5/8
6	17	14	9	3/4
8	19	16	10	7/8
10	22	18	10.5	7/8



Plumbing Legend:	

— DOMESTIC COLD WATER SUPPLY

CAPPED OUTLET

PIPE UP

PIPE DOWN

HOSE BIB

RISE OR DROP IN PIPE

AND EXISTING WORK

SOLENOID VALVE

CHECK VALVE

BUTTERFLY VALVE

PRESSURE GAUGE

DRAIN VALVE

CLEANOUT

WALL CLEANOUT

FLOOR CLEANOUT

CLEANOUT TO GRADE

DOUBLE CLEANOUT TO GRADE

PLUMBING FIXTURE MARK

C.O.

W.C.O.

F.C.O.

C.O.T.G.

D.C.O.T.G.

P-X

FULL PORT BALL VALVE

PRESSURE REDUCING VALVE (PRV)

FLEXIBLE PIPING CONNECTION

POINT OF CONNECTION BETWEEN NEW

		110 °F DOMESTIC HOT WATER SUPPLY
		140 °F DOMESTIC HOT WATER SUPPLY
		HOT WATER RETURN
		SANITARY SEWER, ABOVE GRADE
<u>INGER</u>		SANITARY SEWER, BELOW GRADE
PE)	—— GV ——— GV ——	GREASE WASTE, BELOW GRADE
		PLUMBING VENT
	SD-SD-	STORM WATER, ABOVE GRADE
	sp	STORM WATER, BELOW GRADE
		NATURAL GAS PIPING
		DIRECTION OF PIPE SLOPE (DOWN)
		CONCENTRIC REDUCER OR INCREASER
		ECCENTRIC REDUCER
		TOP CONNECTION, 45° OR 90°
		BOTTOM CONNECTION, 45° OR 90°
DDS. HIELD WITH RIGID		SIDE CONNECTION

 SERVICE OVER 3" RE ON BETWEEN PIPE A	EPLACE SADDLE WITH 12" LONG 14 GA S ND SHIELD.	HIELD WITH	RIGID
	MAX. SPACING BETWEEN	MIN. ROD	

PIPE Ø (IN.)	MAX. S	MIN. ROD SIZE		
	STEEL PIPE	COPPER PIPE	CPVC	(IN.)
1/2 THRU 1	7	5	5	3/8
1-1/2 THRU 2	9	8	6	3/8
2-1/2	11	9	7.5	1/2
3	12	10	7.5	1/2
4	14	12	8.5	5/8
6	17	14	9	3/4
8	19	16	10	7/8
10	22	18	10.5	7/8




Plumbing Notes:

1.	ALL MATERIALS AND EQUIPMENT ARE TO BE NEW, UNUSED, AND FREE FROM DEFECTS OF ANY KIND. THE BASIS OF QUALITY SHALL BE THE LATEST REVISION OF ASTM, ANSI, OR OTHER ACCEPTABLE STANDARDS.
2.	THESE DRAWINGS ARE DIAGRAMMATIC, AND INDICATE GENERAL ARRANGEMENT OF WORK. THE CONTRACTOR SHALL BE RESPONSIBLE TO HAVE REVIEWED THE SITE FOR

- HIS WORK PRIOR TO HAVING SUBMITTED HIS PROPOSAL. NO ADDITIONAL COMPENSATION WILL BE ALLOWED FOR CONDITIONS FOUND DURING THE COURSE OF THE CONTRACT.
- 3. THE CONTRACTOR SHALL COORDINATE HIS WORK WITH THAT OF ALL OTHER TRADES. 4. ALL CUTTING, PATCHING, FIRE-STOPPING, AND SURFACE RESTORATION IN
- CONNECTION WITH THIS TRADE SHALL BE COMPLETED BY THIS CONTRACTOR. 5. THIS CONTRACTOR SHALL PAY ALL FEES, GIVE ALL NOTICES, FILE ALL NECESSARY DRAWINGS, AND OBTAIN ALL PERMITS, INSPECTIONS AND CERTIFICATES OF APPROVAL REQUIRED IN CONNECTION WITH WORK UNDER THIS CONTRACT.
- 6. ALL WORK IN ASSOCIATION WITH THIS CONTRACT SHALL BE COMPLETED IN STRICT COMPLIANCE WITH THE 2020 BUILDING CODE OF NEW YORK STATE, 2020 PLUMBING CODE OF NEW YORK STATE, 2020 FUEL GAS CODE OF NEW YORK STATE & 2020 ENERGY CONSERVATION CONSTRUCTION CODE OF NEW YORK STATE.
- 7. WHERE THE PROJECT INVOLVES A GAS SERVICE, THIS CONTRACTOR SHALL BE OR INCREASER RESPONSIBLE FOR ALL COORDINATION, APPLICATIONS AND FEES OF ALL WORK ASSOCIATED WITH THE LOCAL GAS UTILITY COMPANY. ALL WORK INVOLVING THE GAS UTILITY COMPANY SHALL BE COMPLETED IN ACCORDANCE WITH THEIR REGULATIONS AND GUIDELINES.
 - 8. ALL DOMESTIC COLD AND HOT WATER PIPING AND FITTINGS ARE TO BE INSULATED WITH 1" THICK RIGID ONE-PIECE MOLDED SECTIONAL FIBERGLASS PIPE COVERING WITH UNIVERSAL JACKET. ALL JOINTS ARE TO BE COMPLETELY SEALED A MINIMUM OF 6" BEYOND JOINT ENDS.
 - 9. ALL PIPING SHALL BE PROPERLY SUPPORTED AND ROUTED PARALLEL OR PERPENDICULAR TO BUILDING WALLS. THE CONTRACTOR SHALL FURNISH AND INSTALL ALL SUPPORT HANGERS AND MISCELLANEOUS METALS REQUIRED FOR PROPER INSTALLATION OF WORK.
 - 10. ALL EXPOSED PIPING, FITTINGS, TRAPS, ESCUTCHEONS, VALVES, ETC. SHALL BE CHROME PLATED.
 - 11. SLOPE SANITARY DRAINAGE PIPING 2" DIAMETER AND SMALLER NOT LESS THAN 1/4" PER FOOT. SLOPE SANITARY DRAINAGE PIPING OVER 2" DIAMETER NOT LESS THAN 1/8" PER FOOT.
 - 12. INSTALL A CLEANOUT AT THE BASE OF EACH SOIL STACK, AT EACH CHANGE IN DIRECTION, AT INTERVALS NOT OVER 50 FEET AND ELSEWHERE AS SHOWN ON DRAWINGS OR REQUIRED BY CODE.
 - 13. PROVIDE EXPOSED PIPING WITH CHROME PLATED CAST BRASS ESCUTCHEON WITH SET SCREW WHERE PENETRATING FLOORS, CEILINGS, WALLS OR PARTITIONS.
 - 14. TEST PIPING AND PROVE TIGHT FOR AT LEAST TWO HOURS IN ACCORDANCE WITH REQUIREMENTS OF AUTHORITIES HAVING JURISDICTION AND/OR AS SPECIFIED. TEST SHALL BE PERFORMED IN THE PRESENCE OF THE ENGINEER AND LOCAL INSPECTOR. TEST SHALL BE REPEATED IF NECESSARY UNTIL FINAL APPROVAL OF SYSTEM IS OBTAINED.
 - 14.1. WATER & GAS PIPING TO BE AIR-PRESSURE TESTED TO 1-1/2 TIMES MAXIMUM WORKING PRESSURE.
 - 14.2. DRAINAGE, WASTE & VENT PIPING TO BE TESTED BY FILLING THE SYSTEM WITH WATER TO 10-FEET ABOVE HIGHEST POINT.
 - 15. SUPPORT HORIZONTAL PIPING UTILIZING A SPACING PER PIPING MANUFACTURER'S REQUIREMENTS.
 - 16. INSTALL VALVES ON THE ENTIRE DISTRIBUTION SYSTEM, SO LOCATED AS TO GIVE COMPLETE CONTROL TO ALL FIXTURES AND EQUIPMENT.
 - 17. INSTALL DRAIN VALVES AT BASE OF ALL RISERS AND AT LOW POINTS OF PIPING

 - 18. THE CONTRACTOR IS RESPONSIBLE TO TEST ALL EQUIPMENT, PIPING, FIXTURES, AND SYSTEMS INSTALLED UNDER THIS CONTRACT TO ENSURE PROPER OPERATION PRIOR TO FINAL ACCEPTANCE BY THE OWNER AND ENGINEER.
 - 19. THE CONTRACTOR IS RESPONSIBLE TO DETERMINE WHETHER SPECIAL LICENSING IS REQUIRED IN ORDER TO PERFORM THE REQUIRED WORK IN THE MUNICIPALITY WHERE THE PROJECT IS LOCATED. IF THE CONTRACTOR CANNOT OBTAIN THE REQUIRED LICENSING TO COMPLETE THE WORK WITHIN THE PROJECT SCHEDULE, THEN THE CONTRACTOR SHALL NOT BE PERMITTED TO BID ON THIS PROJECT.
 - 20. CONTRACTOR IS RESPONSIBLE TO CREATE AND SUBMIT RED-LINE "AS-BUILT" PLANS TO THE ENGINEER AT THE END OF THE PROJECT. AS-BUILT PLANS SHALL ACCURATELY REPRESENT THE SYSTEMS AS THEY WERE INSTALLED.

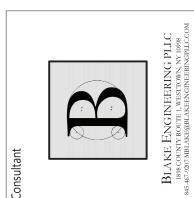




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PLUMBING NOTES, SCHEDULE, LEGEND & **DETAILS**







KEY PLAN
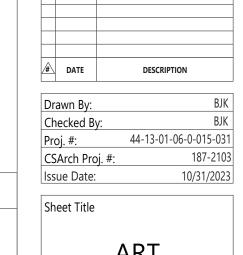
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CLASSROOM PLUMBING PLANS


DISCONNECT, REMOVE & PROPERLY
DISPOSE OF EXISTING SINK & EYEWASH
STATION; REMOVE DOMESTIC WATER
PIPING AND SANITARY DRAIN BACK TO
WALL AND TEMPORARILY CAP

Plumbing Demolition Plan
Scale: 1/4" = 1'-0"


EXTEND 3/4" CWS & HWS FROM WALL TO FIXTURE; PROVIDE NEW ISOLATION BALL VALVES; CONNECT SINK DRAINS TO EXISTING DRAIN LINE AT WALL

CLASSROOM

150

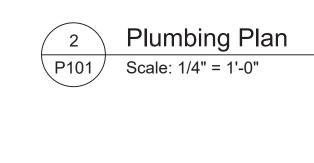



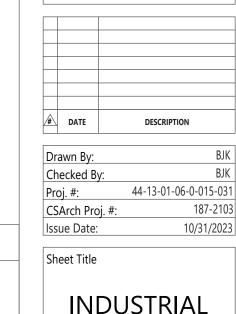

KEY PLAN

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Sheet Title

INDUSTRIAL

ARTS


PLUMBING

PLANS

Sheet No.

VCHS
P102

CONSTRUCTION DOCUMENTS

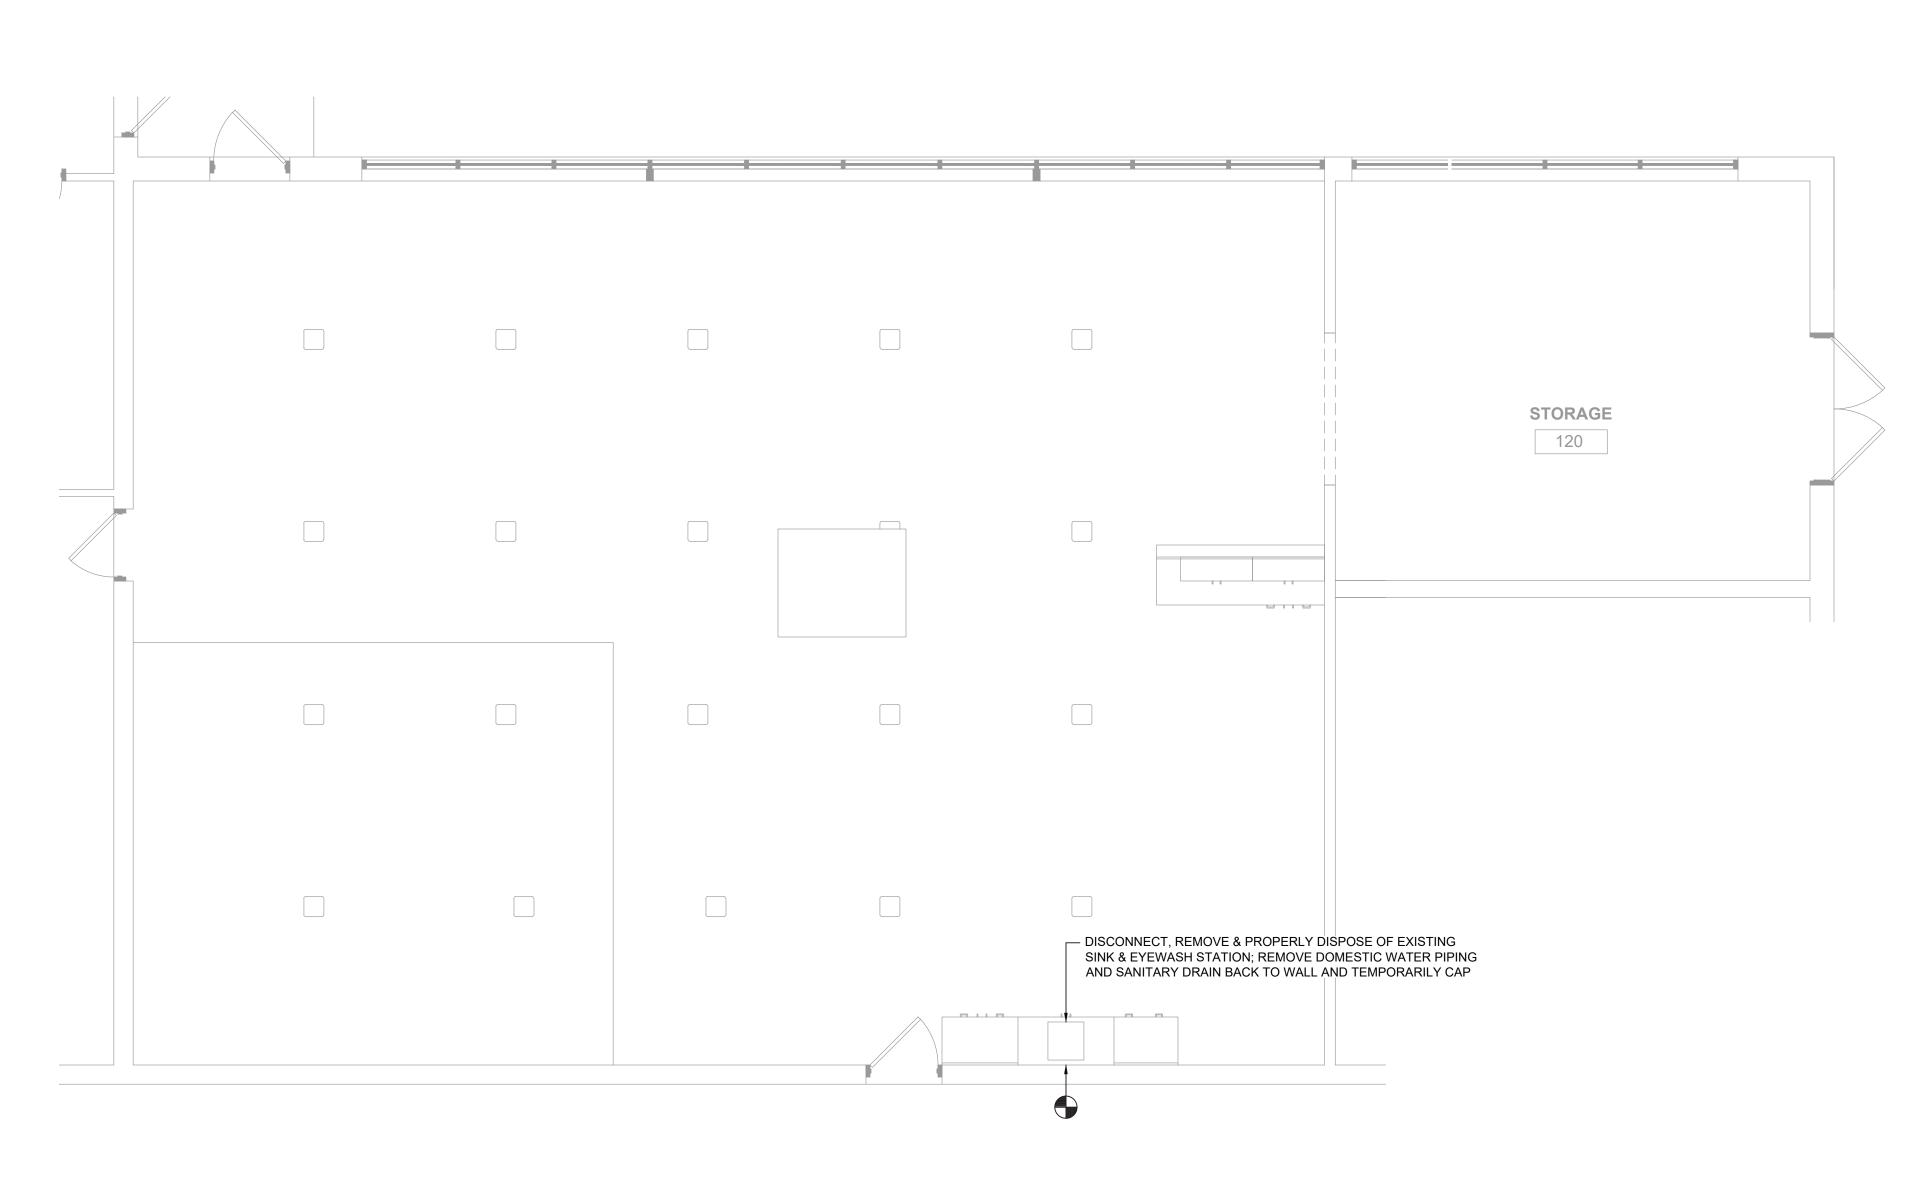

Plumbing Demolition Plan
Scale: 1/4" = 1'-0"

