

SYMBOLS	AND ABBI	REVIATIONS	
SYMBOL	ABBREVIATION	DESCRIPTION	
	EX.	EXISTING TO REMAIN	
	NEW	NEW WORK	
	DEM.	EXISTING TO BE REMOVED	
	CW	COLD WATER	
_	AFF	ABOVE FINISHED FLOOR	
_	BFP	BACK FLOW PREVENTER	
_	DCV	DOUBLE CHECK VALVE ELBOW DOWN	
_	DN.		
_	MAX.	MAXIMUM	
_	MIN.	MINIMUM	
_	PC	PLUMBING CONTRACTOR	
_	RPZ	REDUCED PRESSURE ZONE	
_	TYP	TYPICAL	
>	-	DIRECTION OF FLOW	
_	WCA	WESTCHESTER COUNTY AIRPORT	
	WJWW	WESTCHESTER JOINT WATER WORKS	

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EQUIPMENT NOTES:

1. 10" BACKFLOW PREVENTER ASSEMBLY (TYPICAL FOR 4 BACKFLOW PREVENTER DEVICES - PRIMARY & SECONDARY): SHALL BE WATTS MODEL LF909M1 REDUCED PRESSURE ZONE ASSEMBLY LEAD FREE. ASSEMBLY SHALL BE SUITABLE FOR PRESSURES UP TO 175 PSI AND TEMPERATURES UP TO 110°F. THE ASSEMBLY SHALL CONSIST OF A PRESSURE DIFFERENTIAL RELIEF VALVE LOCATED IN A ZONE BETWEEN TWO POSITIVE SEATING CHECK VALVES AND CAPTURED SPRINGS. BACKSIPHONAGE PROTECTION SHALL INCLUDE PROVISION TO ADMIT AIR DIRECTLY INTO THE REDUCED PRESSURE ZONE VIA A SEPARATE CHANNEL FROM THE WATER DISCHARGE CHANNEL. THE ASSEMBLY SHALL INCLUDE TWO TIGHTLY CLOSING SHUTOFF VALVES BEFORE AND AFTER THE VALVE AND TEST COCKS. THE ASSEMBLY SHALL INCLUDE TWO RESILIENT OS&Y SEATED SHUTOFF VALVES & FOUR BALL TYPE TEST COCKS. UL, FM APPROVED BACKFLOW PREVENTERS SHALL INCLUDE UL/FM APPROVED OSY GATE VALVES.

2. 10" WATER METER_SHALL BE SENSUS OMNI+FIRELINE F2

- NSF/ANSI STANDARD 61,
 STRAINER: UL LISTED/FM APPROVED, FIRE RATED, SENSUS V SHAPED
- STRAINER: UL LISTED/FM APPROVED, FIRE RATED, SENSUS V
 UNIT OF MEASURE SHALL BE HUNDREDS OF CUBIC FEET
- REMOTE READING SYSTEM.
- CONTRACTOR SHALL PROVIDE ALL ASSOCIATED COMPONENTS FOR REMOTE READING SYSTEM INCLUDING EXTERIOR WALL MOUNTED RADIO TRANSMITTER SENSUS SMARTPOINT 510M, 3-WRIE, DUAL PORT AND ALL ASSOCIATED WIRING.
- NOTE: FINAL WATER METER SIZE, MODEL, AND DIMENSIONS SHALL BE REVIEWED AND APPROVED BY THE WESTCHESTER JOINT WATER WORKS PRIOR TO INSTALLATION. THE PLUMBING CONTRACTOR IS RESPONSIBLE FOR COORDINATION AND INSTALLATION AND ALL RELATED WATER DEPARTMENT FEES.
- 3. <u>LEAK DETECTION</u>: SHALL BE SIMILAR TO LIEBERT LIQUI-TECT POINT LEAK-DETECTION SENSOR MODEL #: LT410 MOUNTED ON FLOOR OF ROOM. EXTERNAL POWER AND CONTROL WIRING ON FLOOR SHALL BE PROTECTED WITH CABLE PROTECTOR SYSTEM. PROVIDE OUTPUT TO REMOTE MONITORING SYSTEM.

PROPOSED PHASING NOTES

- 1. EXISTING BFP BUILDING AT TOWER ROAD TO REMAIN ACTIVE AS WESTCHESTER COUNTY AIRPORT'S PRIMARY WATER SUPPLY.
- 2. CONSTRUCT NEW BFP BUILDING AT TOWER ROAD & AIRPORT ROAD. VALVE & CAP NEW 12" UNDERGROUND PIPING UNTIL NEW 12" UNDERGROUND WATER MAIN IS INSTALLED. CONNECTION TO NEW 12' UNDERGROUND WATER MAIN SHALL NOT BE COMPLETED UNTIL CERTIFICATE OF COMPLETION IS PROVIDED BY WC DOH.
- 3. PRESSURE TEST AND DISINFECT THE NEW PIPING.
- 4. ENERGIZE THE NEW 12" WATER SERVICE PIPING.
- 5. DEMOLISH EXISTING BACKFLOW PREVENTER BUILDING AT TOWER RD.

NOTE: REFER TO CIVIL DRAWINGS FOR ADDITIONAL PHASING INFORMATION AND CONSTRUCTION SEQUENCE.

DATE

BUILDING INFORMATION

ADDRESS: 240 AIRPORT RD.

WHITE PLAINS NY, 10604

COUNTY: WESTCHESTER

GENERAL NOTES:

- ADEQUATE HEAT AND LIGHT SHALL BE PROVIDED IN LOCATIONS WHERE BACKFLOW PREVENTERS ARE TO BE INSTALLED.
- 2. THE CONTRACTOR SHALL USE ONLY AMERICAN MADE, UL/FM APPROVED VALVES.
- 3. NO WORK SHALL PROCEED WITHOUT WESTCHESTER JOINT WATER WORKS (WJWW) AND WESTCHESTER COUNTY DEPARTMENT OF HEALTH APPROVAL.
- BACKFLOW PREVENTER ARRANGEMENT SHALL NOT BE ALTERED WITHOUT PRIOR APPROVAL BY WESTCHESTER COUNTY DEPARTMENT OF HEALTH.
- 5. BACKFLOW PREVENTION SHALL BE PROTECTED FROM THE HIGHEST FLOOD
- 6. BY-PASSES AROUND BACKFLOW PREVENTER ASSEMBLY SHALL NOT BE PERMITIED.
- 7. BACKFLOW PREVENTER DEVICE SHALL BE TESTED INITIALLY AND ANNUALLY BY A CERTIFIED AND LICENSED TESTER. AT THE TIME OF INITIAL TESTING PART A AND B OF DOH 1013 FORM MUST BE COMPLETED, TEST RESULTS (FORM DOH 1013) SHALL BE FORWARDED TO THE WJWW, WESTCHESTER COUNTY DEPARTMENT OF HEALTH, OWNER AND ENGINEER.
- THE BACKFLOW PREVENTER SHALL BE REBUILT EVERY FIVE YEARS.
 ALL PLUMBING WORK SHALL BE PERFORMED BY A LICENSED PLUMBER AND ACCORDING TO DEPARTMENT OF PUBLIC WORKS REGULATIONS.
- 10. CONTRACTOR SHALL DISINFECT AND PRESSURE TEST BACKFLOW PREVENTER ASSEMBLY BEFORE PLACING IN SERVICE. DISINFECTION SHALL BE IN ACCORDANCE WITH AWWA STANDARD C651-05 WITH THE EXCEPTION OF SECTION 4.4.2.
- CONTRACTOR SHALL ADEQUATELY SUPPORT ALL PIPING AND DEVICES.
 WHERE THE DISTANCE BETWEEN THE WATER METER AND THE BACKFLOW PREVENTER ASSEMBLY IS GREATER THAN 10'-0", ALL EXPOSED PIPING SHALL BE STENCILED "FEED LINE TO BACKFLOW PREVENTER DO NOT TAP" AT 5'-0" INTERVALS.

INSTALLATION NOTES:

- A. STRAINERS ARE RECOMMENDED PRIOR TO EACH BACKFLOW DEVICE ON NON-FIRE FIGHTING LINES <u>ONLY</u>. NO STRAINER IS TO BE USED ON A FIRE LINE WITHOUT INSURANCE UNDERWRITER APPROVAL.
- B. ASSEMBLIES SHOULD BE SPECIFIED AND INSTALLED WITH MANUFACTURER SUPPLIED VALVES.
- C. WATER LINES SHOULD BE THOROUGHLY FLUSHED BEFORE INSTALLATION OF DEVICE TO PREVENT DEBRIS FOULING THE DEVICE CHECK VALVES.
- D. DEVICES MUST BE MOUNTED HORIZONTALLY UNLESS APPROVED FOR VERTICAL INSTALLATION.
- E. ASSEMBLIES SHOULD NOT BE INSTALLED IN AREAS CONTAINING CORROSIVE OR TOXIC GASES WHICH COULD RENDER THE DEVICE INOPERABLE.

NOTE: INSTALLATION SHALL BE IN ACCORDANCE WITH WESTCHESTER COUNTY DEPARTMENT OF HEALTH REQUIREMENTS.

SITE PLAN NOTES:

- 1. BACKFLOW PREVENTERS ARE MINIMUM 1 FOOT ABOVE THE 100 YEAR FLOOD ELEVATION.
- 2. CATASTROPHIC DISCHARGE FLOWS TO NON-PEDESTRIAN TRAFFIC AREAS. REFER TO DRAWINGS & ENGINEER'S REPORT FOR CALCULATIONS.
- 3. PIPING MATERIALS:

BOLTS.

COMPLY WITH REQUIREMENTS FOR PIPING & FITTING MATERIALS AND JOINING METHODS FOR SERVICE PIPING.
POTABLE-WATER PIPING AND COMPONENTS SHALL COMPLY WITH

NSF 61 ANNEX G.

COMPLY WITH NSF STANDARD 372 FOR LOW LEAD.
DUCTILE-IRON SERVICE PIPE AND FITTINGS

MECHANICAL-JOINT, DUCTILE-IRON PIPE:
AWWA C151/A21.51, WITH MECHANICAL-JOINT FLANGED ENDS.
GASKETS, AND BOLTS: AWWA C111/A21.11, RUBBER GASKETS, AND STEEL

PIPE JOINING MATERIALS

PIPE-FLANGE GASKET MATERIALS: AWWA C110, RUBBER, FLAT FACE, 1/8 INCH THICK OR ASME B16.21, NONMETALLIC AND ASBESTOS FREE, UNLESS OTHERWISE INDICATED; FULL-FACE OR RING TYPE UNLESS OTHERWISE INDICATED.

METAL, PIPE-FLANGE BOLTS AND NUTS: ASME B18.2.1, CARBON STEEL UNLESS OTHERWISE INDICATED.

IRON GATE VALVES

<u>CLASS 150, OS&Y, IRON GATE VALVES</u> (LEAD FREE): STANDARD: MSS SP-70, TYPE I.

CWP RATING: 200 PSIG.

BODY MATERIAL: ASTM A 126, GRAY IRON WITH BOLTED BONNET.

ENDS: FLANGED. TRIM: BRONZE.

DISC: SOLID WEDGE.
PACKING AND GASKET: ASBESTOS FREE.

4. PIPING INSULATION FOR COLD WATER FOR NPS 1-1/2 AND LARGER SHALL BE ONE OF THE FOLLOWING FOR FLUID OPERATING TEMPERATURE 40-60

DEG F: CELLULAR GLASS: 1 INCH THICK

FLEXIBLE ELASTOMERIC: 1 INCH THICK
MINERAL-FIBER, PREFORMED PIPE INSULATION, TYPE I: 1 INCH THICK



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RECORD DRAWING CERTIFICATION

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AS BUILT — NO CHANGES

CONTRACTOR PROJE

DATE

NAME

SIGNATURE ____

NO CHANGES

TRACTOR

PROJECT COORDINATOR

NAME

SIGNATURE

SIGNATURE

DEPARTMENT OF PUBLIC WORKS & TRANSPORTATION

DIVISION OF ENGINEERING

DOMESTIC WATER SYSTEM IMPROVEMENTS, WESTCHESTER COUNTY AIRPORT TOWNS OF HARRISON, NORTH CASTLE & VILLAGE OF RYE BROOK

PLUMBING

PLUMBING

WESTCHESTER COUNTY, NEW YORK

SYMBOLS, ABBREVIATIONS, & GENERAL NOTES

SHEET NO. 42 OF 61

RPORT SCALE: AS SHOWN DATE: 12/09/2022


DPW FILE NO. R

48-17-P-167

NUMBER

NUMBER

P-001

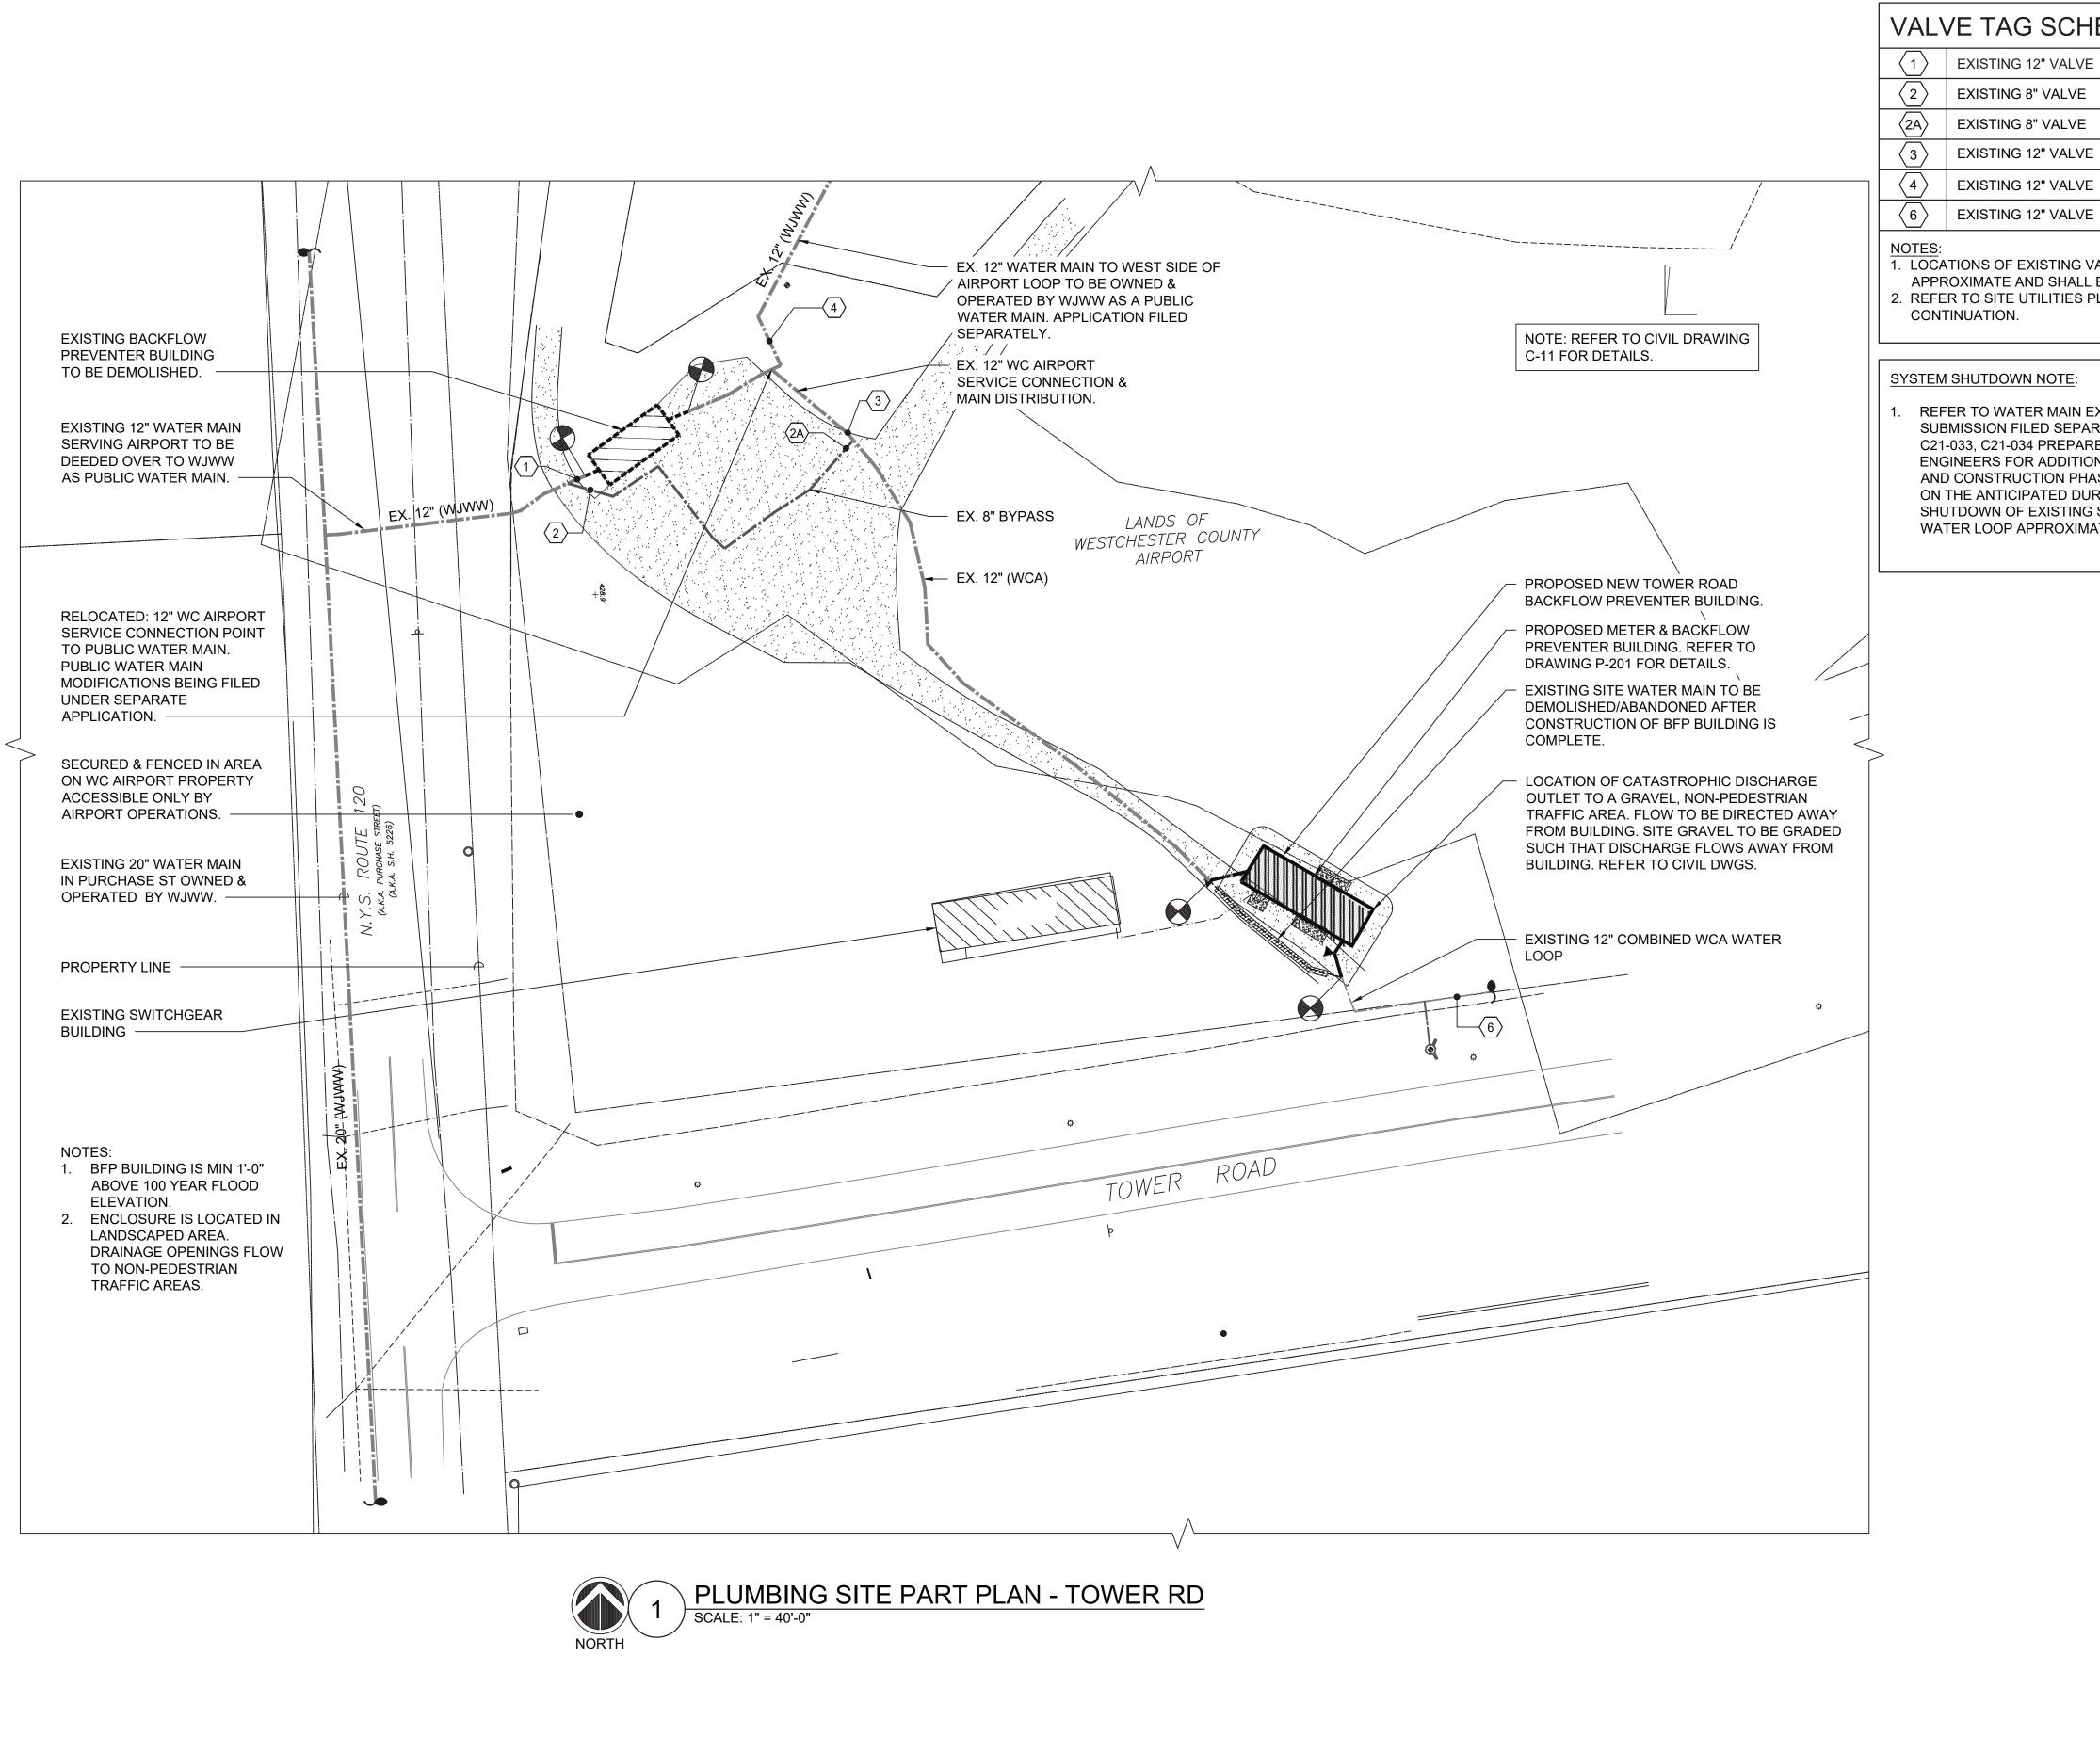

VALVE TAG SCHEDULE EXISTING 12" VALVE **EXISTING 8" VALVE EXISTING 8" VALVE** EXISTING 12" VALVE EXISTING 12" VALVE

1. LOCATIONS OF EXISTING VALVES ARE

APPROXIMATE AND SHALL BE VERIFIED IN FIELD. 2. REFER TO SITE UTILITIES PLAN FOR

SYSTEM SHUTDOWN NOTE:

REFER TO WATER MAIN EXTENSION SUBMISSION FILED SEPARATELY: FILE ID: C21-033, C21-034 PREPARED BY D&B ENGINEERS FOR ADDITIONAL SEQUENCING AND CONSTRUCTION PHASING INFORMATION ON THE ANTICIPATED DURATION OF SHUTDOWN OF EXISTING SEGMENT OF WCA WATER LOOP APPROXIMATELY 6,000 LF.

CONSTRUCTION SEQUENCE

PHASE 1A (REFER TO CIVIL DRAWING G-01 FOR ADDITIONAL DETAILS):

1. CONSTRUCT NEW AIRPORT ROAD BACKFLOW PREVENTER BUILDING IN ACCORDANCE WITH WCDOH APPROVED DOCUMENTS, REFER TO DRAWING P-003.

CONSTRUCT NEW WATER MAIN EXTENSION TO NEW KING STREET. REFER TO CIVIL DRAWINGS FOR

PHASE 1B: CONSTRUCTION AND ACTIVATION OF NEW TOWER RD BACKFLOW PREVENTER BUILDING:

CONSTRUCT NEW TOWER ROAD BACKFLOW PREVENTER BUILDING. BACKFLOW PREVENTION DEVICES SHALL BE INSTALLED ACCORDANCE WITH WCDOH APPROVED DOCUMENTS. PRESSURE TEST, DISINFECT, INSPECT AND SIGN OFF BFP INSTALLATION

SHUTDOWN THE SOUTH SERVICE CONNECTION AND CONSTRUCT 12" CONNECTIONS TO THE NEW TOWER ROAD BACKFLOW PREVENTER BUILDING TO TIE IN TO THE EXISTING WATER MAIN. THIS WORK SHALL BE COORDINATED WITH WC AIRPORT OPERATIONS AND WJWW TO MINIMIZE DOWNTIME.

CLOSE VALVE #3 AND VALVE #6.

VALVE #4 REMAINS OPEN TO SUPPLY WCA SERVICE LOOP.

PRESSURE TEST, DISINFECT, INSPECT AND SIGN OFF BFP INSTALLATION IN NEW TOWER ROAD BUILDING. FILE ALL FORMS AND RESULTS WITH WC DOH FOR APPROVAL

ISOLATE EXISTING TOWER ROAD BACKFLOW PREVENTER BUIDLING FOR DEMOLITION & RESTORE SOUTH SERVICE CONNECTION TO OPERATION:

OPEN NORMALLY CLOSED BYPASS VALVES #2 AND #2A. VALVE #3 REMAINS CLOSED

• CLOSE VALVE #1 AND #4 TO ISOLATE EXISTING WATERMAIN FOR BUILDING DEMOLITION.

 OPEN VALVE #6. • RESTORE WCA SOUTH SERVICE CONNECTION. WEST SIDE OF SERVICE LOOP IS ISOLATED.

PHASE 2: DEMOLISH EXISTING TOWER RD BACKFLOW PREVENTER BUILDING. 1. BUILDING DEMOLITION SHALL OCCUR UPON COMPLETION OF CONSTRUCTION OF THE WORK LISTED

ABOVE. DEMOLISH EXISTING STRUCTURE, EQUIPMENT AND PIPING COMPLETE. CONSTRUCT THE UNDERGROUND 12" WATER MAIN BETWEEN THE INLET AND OUTLET PIPING OF THE

DEMOLISHED BUILDING. TEST AND DISINFECT ALL NEW WATER MAINS IN ACCORDANCE WITH AWWA STANDARDS. FILE ALL FORMS AND RESULTS WITH WC DOH FOR APPROVAL.

3. PRESSURE TEST AND DISINFECT NEW PIPING AND FILE WITH WC DOH FOR APPROVAL.

REFER TO CIVIL DRAWINGS AND SEQUENCE NOTES ON G-01 FOR INFORMATION ON SUBSEQUENT PHASES:


PHASE 3: CONSTRUCTION OF EXISTING WATER SERVICE IMPROVEMENTS

PHASE 4: ABANDON BY-PASS WATER MAIN PIPING AT TOWER ROAD

PHASE 5: TESTING OF WATER MAIN

PHASE 6: OPERATION OF ALL DOMESTIC WATER LINE IMPROVEMENTS

- 1. REFER TO CIVIL DRAWING G-01 FOR CONSTRUCTION SEQUENCE COORDINATION. 2. EXISTING TOWER ROAD BACKFLOW PREVENTER BUILDING TO REMAIN ACTIVE AS WESTCHESTER COUNTY AIRPORT'S PRIMARY WATER SUPPLY UNTIL PROJECT COMPLETION INCLUDING CONSTRUCTION OF THE NEW TOWER ROAD AND AIRPORT ROAD BACKFLOW PREVENTER BUILDING AND WATER MAIN EXTENSION. REFER TO CIVIL DRAWINGS FOR WATER MAIN WORK AND WC DOH FILE ID: 13502-21-RPZ (2) AND C21-033, C21-034
- 3. EXISTING BFP BUILDING AT TOWER ROAD TO REMAIN ACTIVE CONSTRUCTION SHALL NOT PROCEED WITHOUT APPROVAL FROM WESTCHESTER COUNTY DEPARTMENT OF HEALTH.
- 4. SHUTDOWNS OF WATER MAIN SHALL BE SCHEDULED AND FULLY COORDINATED WITH WC AIRPORT, WESTCHESTER COUNTY DPW&T AND WESTCHESTER COUNTY DEPARTMENT OF HEALTH. NOTIFICATION FOR SHUTDOWN SHALL BE PROVIDED A MINIMUM OF SEVEN DAYS IN
- 5. INTENT OF CONSTRUCTION PHASING/SEQUENCE IS TO MINIMIZE SHUTDOWNS WC AIRPORT WATER SERVICE.

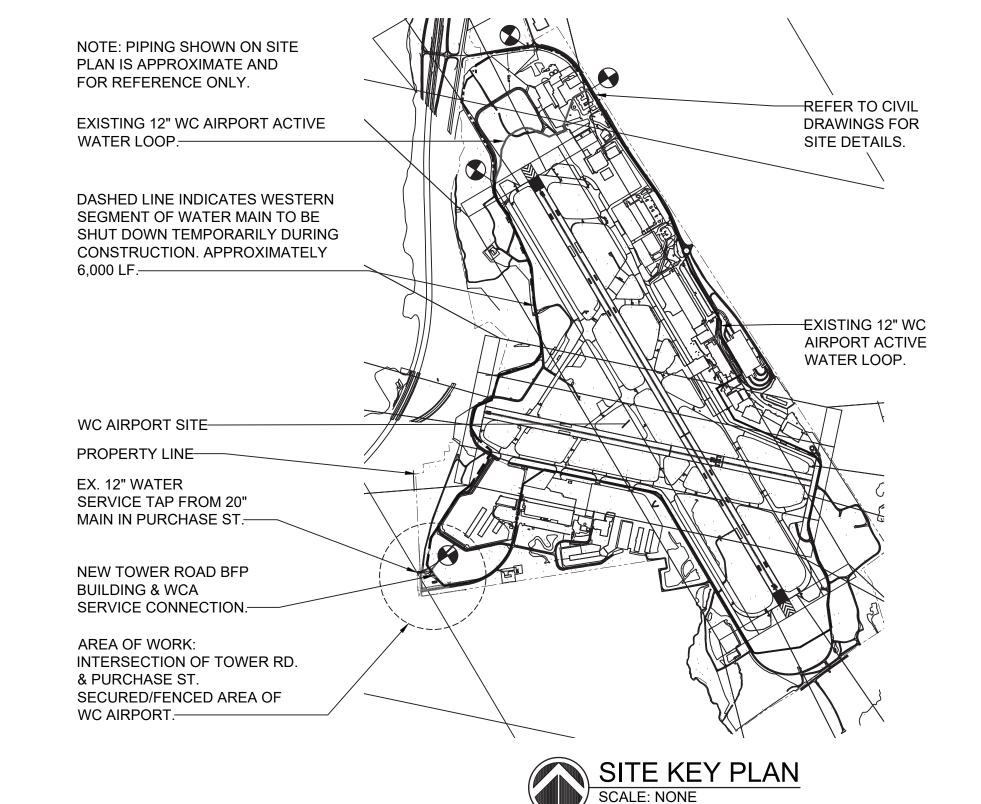

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DATE


DATE

WESTCHESTER COUNTY, NEW YORK DEPARTMENT OF PUBLIC WORKS & TRANSPORTATION DIVISION OF ENGINEERING OMESTIC WATER SYSTEM IMPROVEMENTS, WESTCHESTER COUNTY AIRPOR TOWNS OF HARRISON, NORTH CASTLE & VILLAGE OF RYE BROOK PLUMBING SITE PLAN - TOWER ROAD

NORTH

NUMBER NUMBER 22-522 SHEET NO. 43 OF 61 SCALE: AS SHOWN DATE: 12/09/2022

48-17-P-168

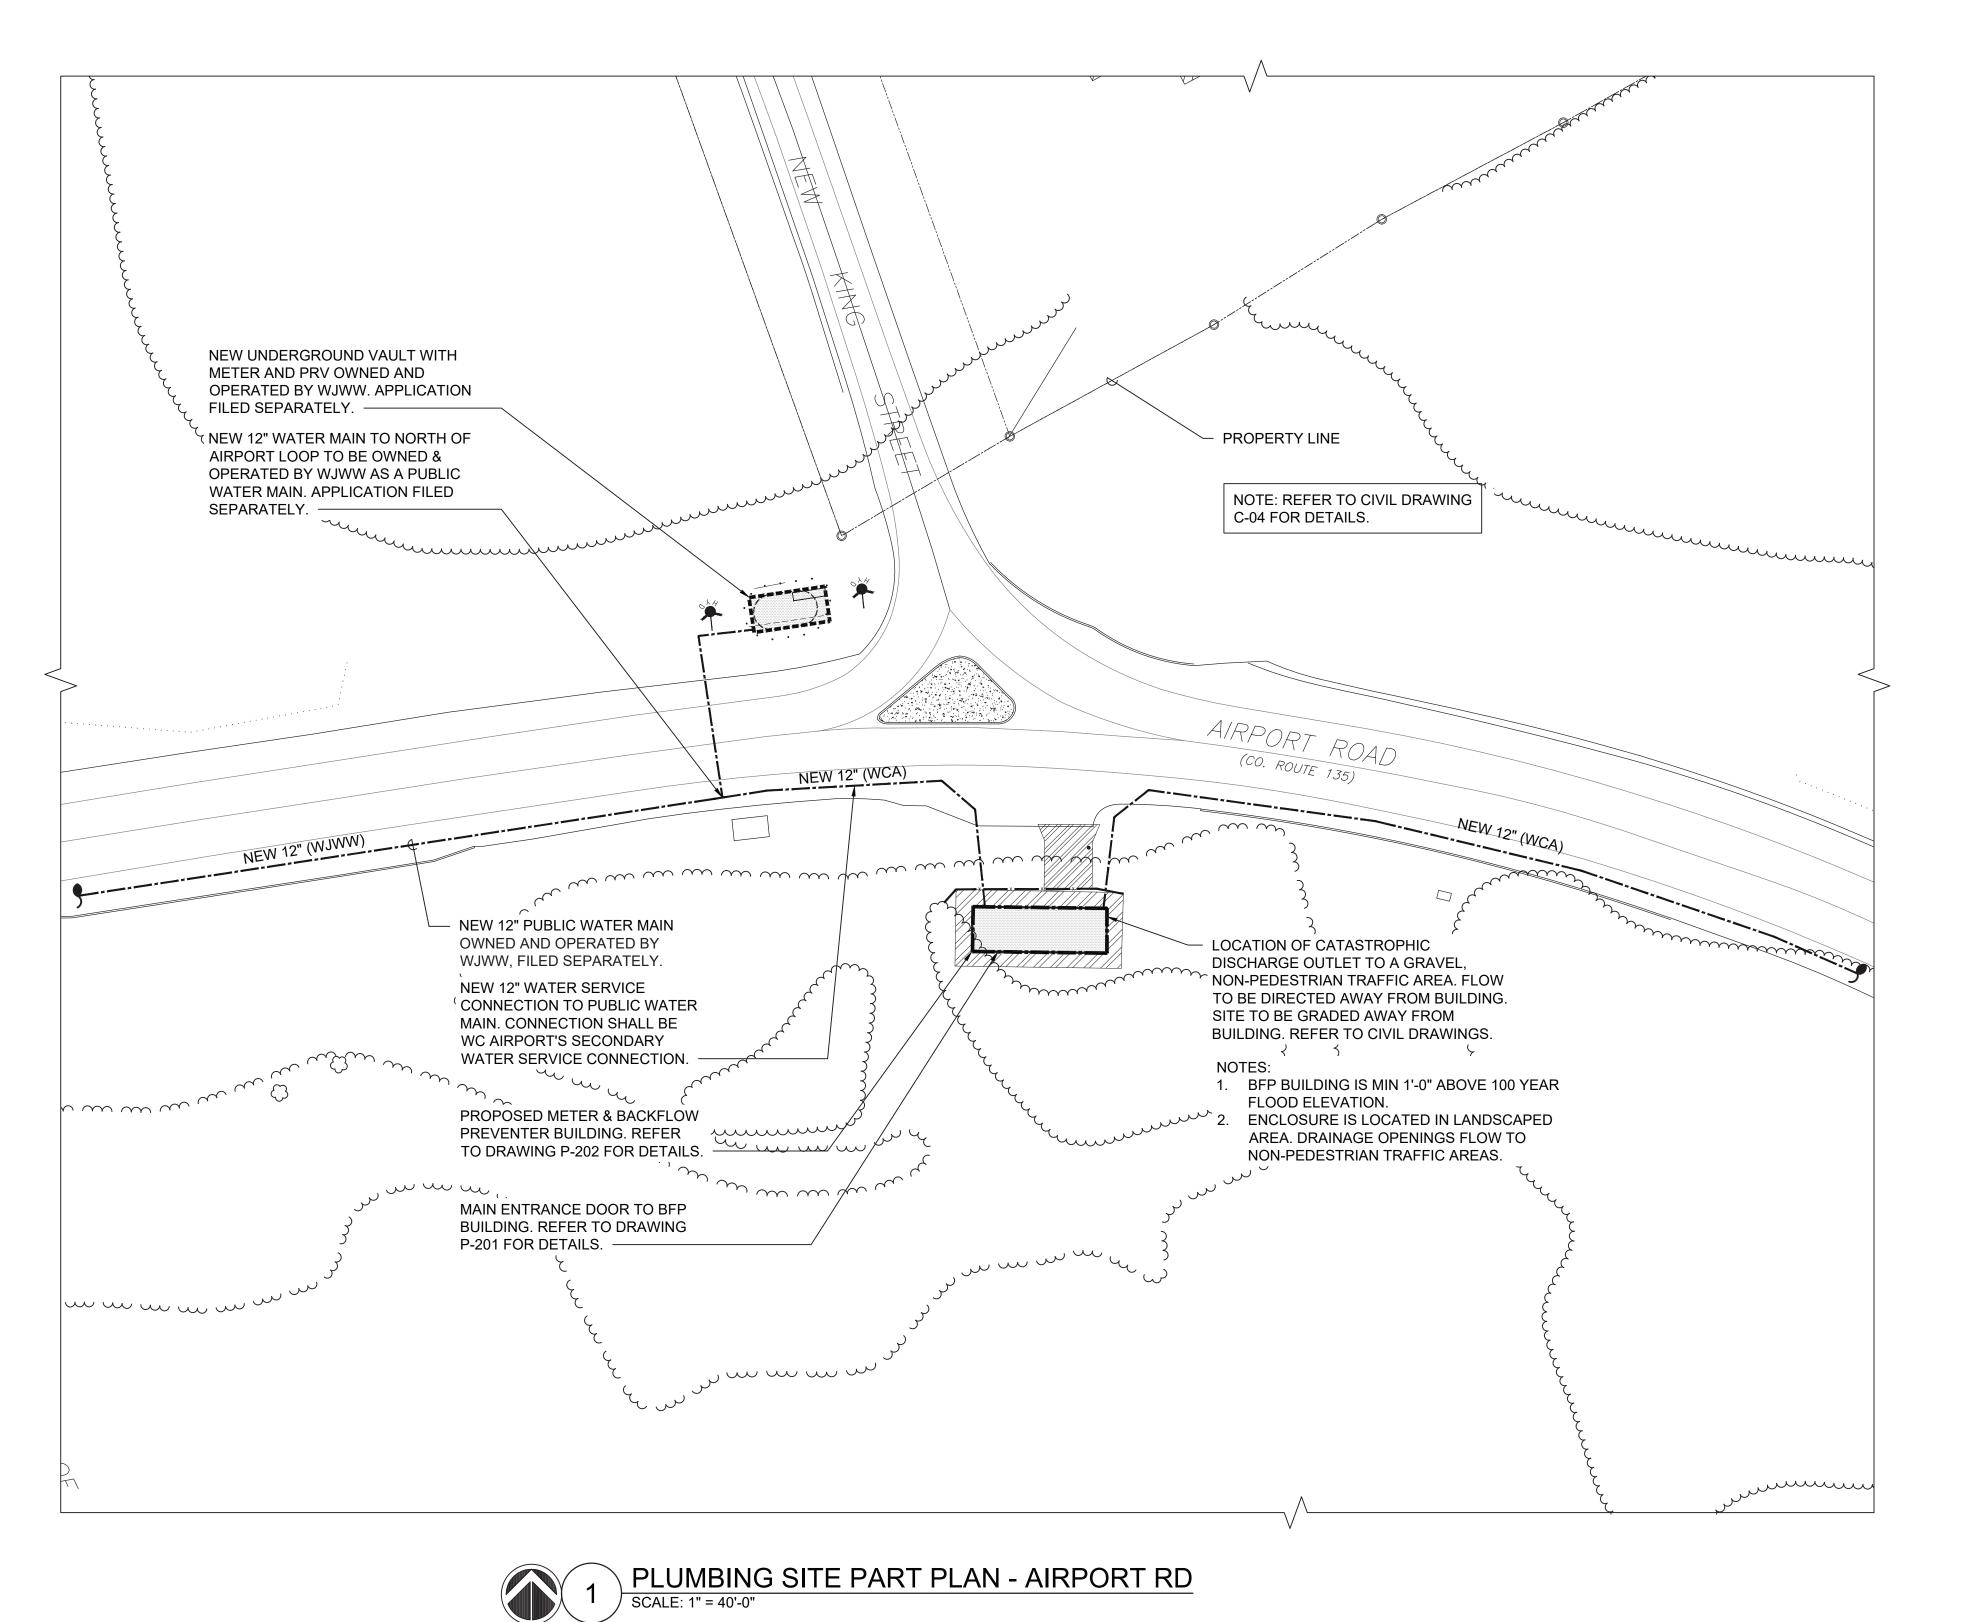

CONSTRUCTION SEQUENCE


PHASE 1A: CONSTRUCTION OF NEW FACILITIES AT NORTH END OF PROJECT. REFER TO CIVIL DRAWING G-01 FOR ADDITIONAL INFORMATION.

- 1. CONSTRUCT NEW AIRPORT ROAD BACKFLOW PREVENTER BUILDING IN ACCORDANCE WITH WCDOH APPROVED DOCUMENTS.
- 2. AIRPORT ROAD SERVICE CONNECTION SHALL NOT BE ENERGIZED UNTIL FINAL APPROVAL OF PUBLIC WATER MAIN. REFER TO FILE ID: C21-033, C21-034.
- 3. CONSTRUCT 12" CONNECTIONS TO EXISTING 12" WATER MAIN TO THE NEW AIRPORT ROAD BFP BUILDING.
- 4. PRESSURE TEST, DISINFECT, INSPECT AND SIGN OFF BFP INSTALLATION. FILE ALL FORMS AND RESULTS WITH WC DOH.
- 5. ENERGIZE THE NEW 12" WATER SERVICE PIPING TO THE NEW AIRPORT ROAD BFP BUILDING.

- EXISTING TOWER RD BFP BUILDING SHALL BE MAINTAINED ACTIVE AS WESTCHESTER COUNTY AIRPORT'S PRIMARY WATER SUPPLY UNTIL CONSTRUCTION IS COMPLETED. TOWER ROAD BUILDING DEMOLITION SHALL OCCUR UPON COMPLETION OF CONSTRUCTION OF THE AIRPORT ROAD BACKFLOW PREVENTER BUILDING AND WATER MAIN EXTENSION IS COMPLETE. REFER TO FILE ID: 13503-21-RPZ (2) & C21-033, C21-034. CONSTRUCTION SHALL NOT PROCEED WITHOUT APPROVAL FROM
- WESTCHESTER COUNTY DEPARTMENT OF HEALTH. 3. SHUTDOWNS OF WATER MAIN SHALL BE SCHEDULED AND FULLY COORDINATED WITH WC AIRPORT, WESTCHESTER COUNTY DPW&T AND
- WESTCHESTER COUNTY DEPARTMENT OF HEALTH. NOTIFICATION FOR SHUTDOWN SHALL BE PROVIDED A MINIMUM OF SEVEN DAYS IN ADVANCE.
- 4. INTENT OF CONSTRUCTION PHASING/SEQUENCE IS TO MINIMIZE SHUTDOWNS WC AIRPORT WATER SERVICE.

SYSTEM SHUTDOWN NOTE:

REFER TO WATER MAIN EXTENSION SUBMISSION FILED SEPARATELY: FILE ID: C21-033, C21-034 PREPARED BY D&B ENGINEERS FOR ADDITIONAL SEQUENCING AND CONSTRUCTION PHASING INFORMATION ON THE ANTICIPATED DURATION OF SHUTDOWN OF EXISTING SEGMENT OF WCA WATER LOOP APPROXIMATELY 6,000 LF.

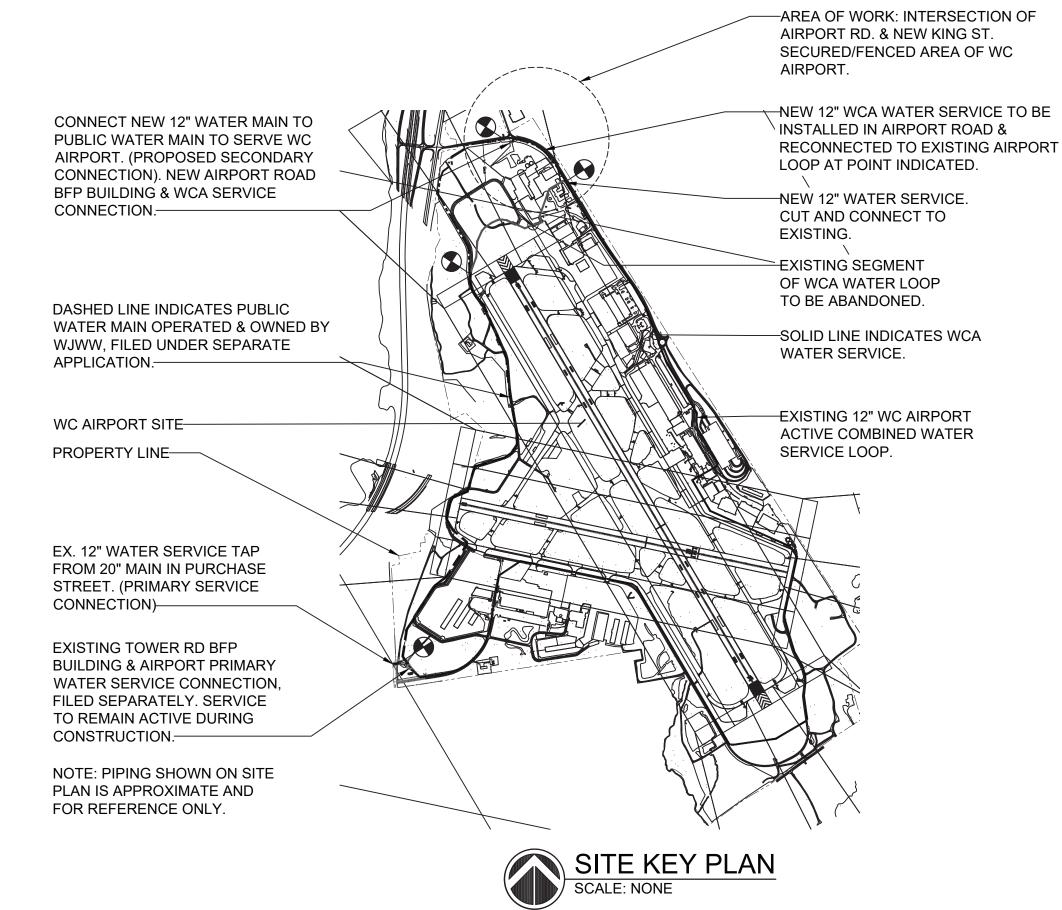

NORTH

PROJECT COORDINATOR

DATE

DATE __

OLA Consulting Engineers 50 Broadway, Hawthorne, NY 10532 914.747.2800 8 West 38th Street, Suite 501 New York, NY 10018 646.849.4110

olace.com

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D&B Engineers ARCHITECTS, P.C. 4 WEST RED OAK LANE WHITE PLAINS, NY, (914)467-5300

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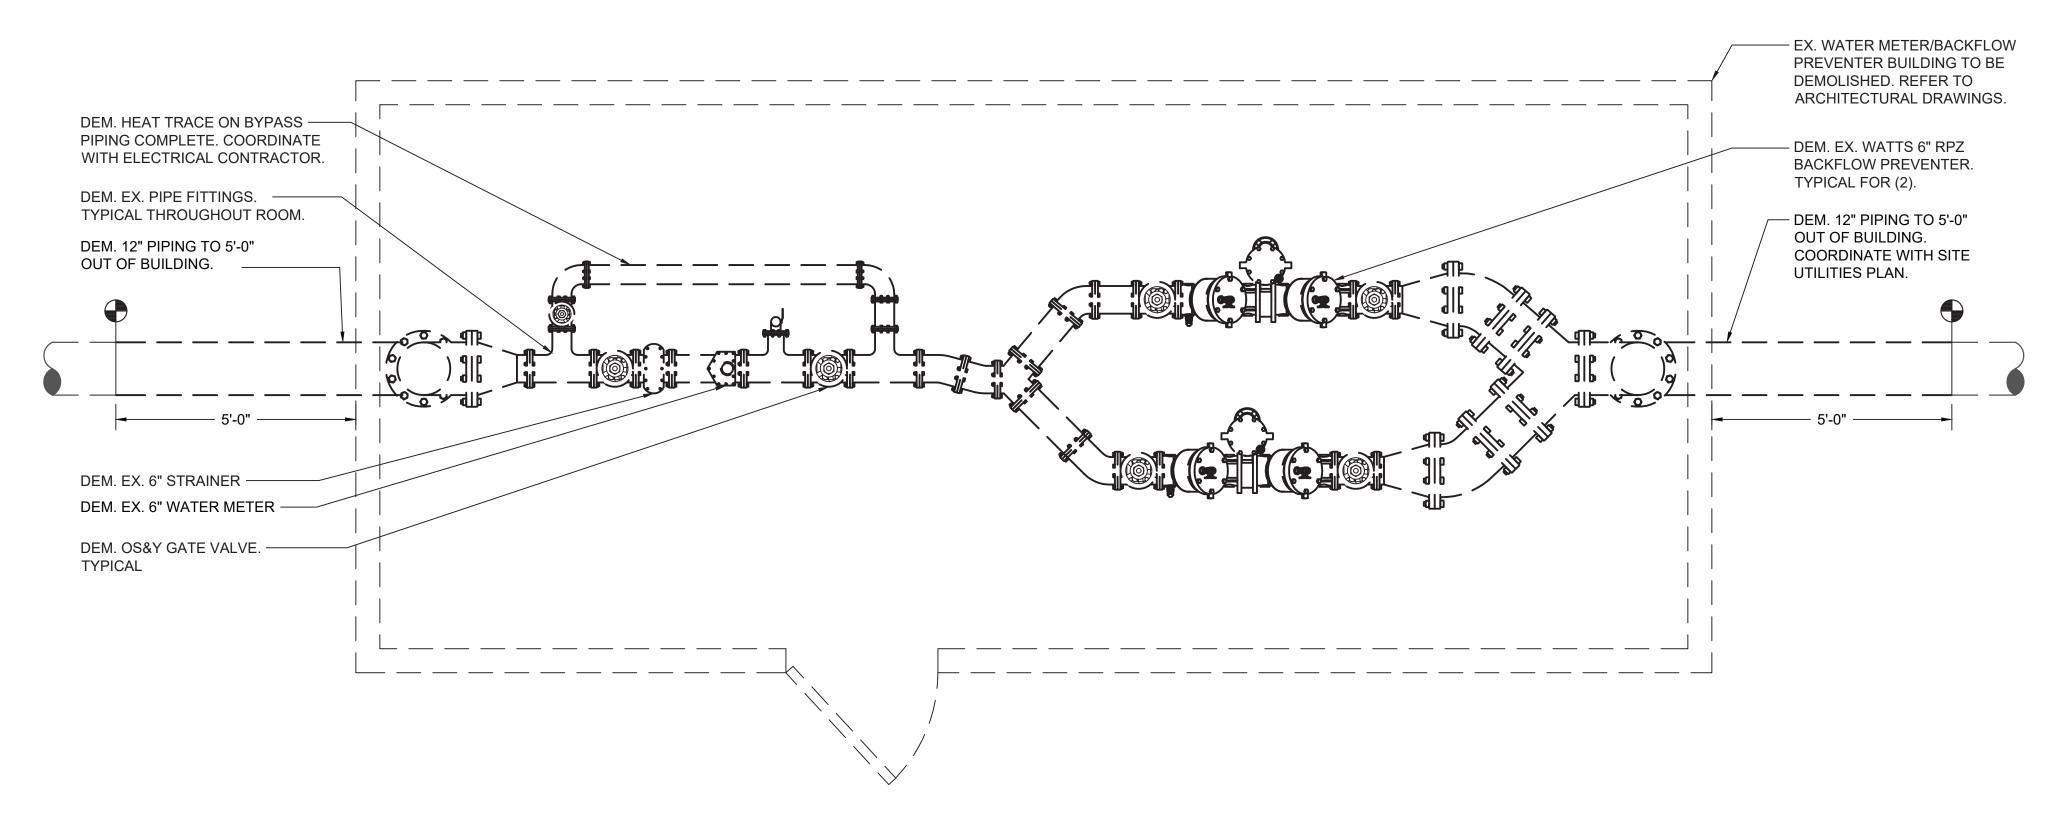
REVISION

WESTCHESTER COUNTY, NEW YORK NUMBER DEPARTMENT OF PUBLIC WORKS & TRANSPORTATION 22-522 DIVISION OF ENGINEERING SHEET NO. 44 OF 61 SCALE: AS SHOWN DOMESTIC WATER SYSTEM IMPROVEMENTS, WESTCHESTER COUNTY AIRPORT TOWNS OF HARRISON, NORTH CASTLE & VILLAGE OF RYE BROOK

DATE: 12/09/2022 DPW FILE NO. PLUMBING SITE PLAN - AIRPORT ROAD 48-17-P-169

SHEET NUMBER

P-003





PLUMBING DEMOLITION PLAN - TOWER RD

1. DEMOLISH ALL DOMESTIC COLD WATER PIPING, PIPE FITTINGS, VALVES, PIPING SUPPORTS COMPLETE. COORDINATE SHUTDOWN OF WATER SERVICE WITH

- WESTCHESTER COUNTY AIRPORT AND WESTCHESTER JOINT WATER WORKS. 2. CONTRACTOR SHALL BE RESPONSIBLE FOR WATER METER READINGS PRIOR TO REMOVAL AND SHALL COORDINATE WITH WESTCHESTER JOINT WATER WORKS AS
- 3. CONTRACTOR SHALL BE RESPONSIBLE TO REMOVE EXISTING WATER METER AND RETURN TO WESTCHESTER JOINT WATER WORKS AS REQUIRED.
- 4. EXISTING TOWER ROAD BACKFLOW PREVENTER BUILDING TO REMAIN ACTIVE UNTIL CONSTRUCTION OF THE NEW TOWER ROAD BFP BUILDING, AIRPORT ROAD BFP BUILDING AND WATER MAIN EXTENSION IS COMPLETE.
- 5. EXISTING BFP BUILDING AT TOWER ROAD TO REMAIN ACTIVE AS WESTCHESTER
- COUNTY AIRPORT'S PRIMARY WATER SUPPLY UNTIL PROJECT COMPLETION. 6. SHUTDOWNS OF WATER MAIN SHALL BE SCHEDULED AND FULLY COORDINATED WITH WC AIRPORT, WESTCHESTER COUNTY DPW&T AND WESTCHESTER COUNTY DEPARTMENT OF HEALTH. NOTIFICATION FOR SHUTDOWN SHALL BE PROVIDED A MINIMUM OF SEVEN DAYS IN ADVANCE.




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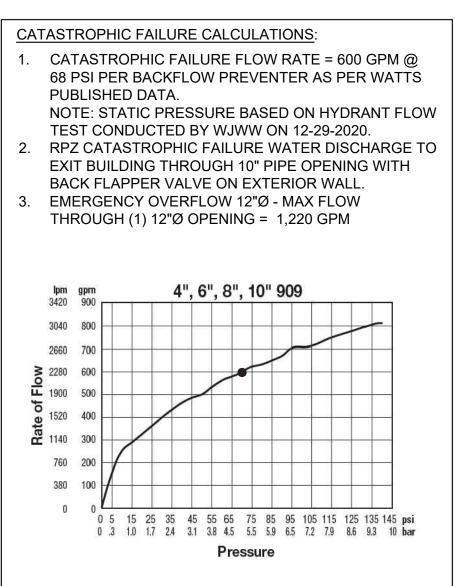
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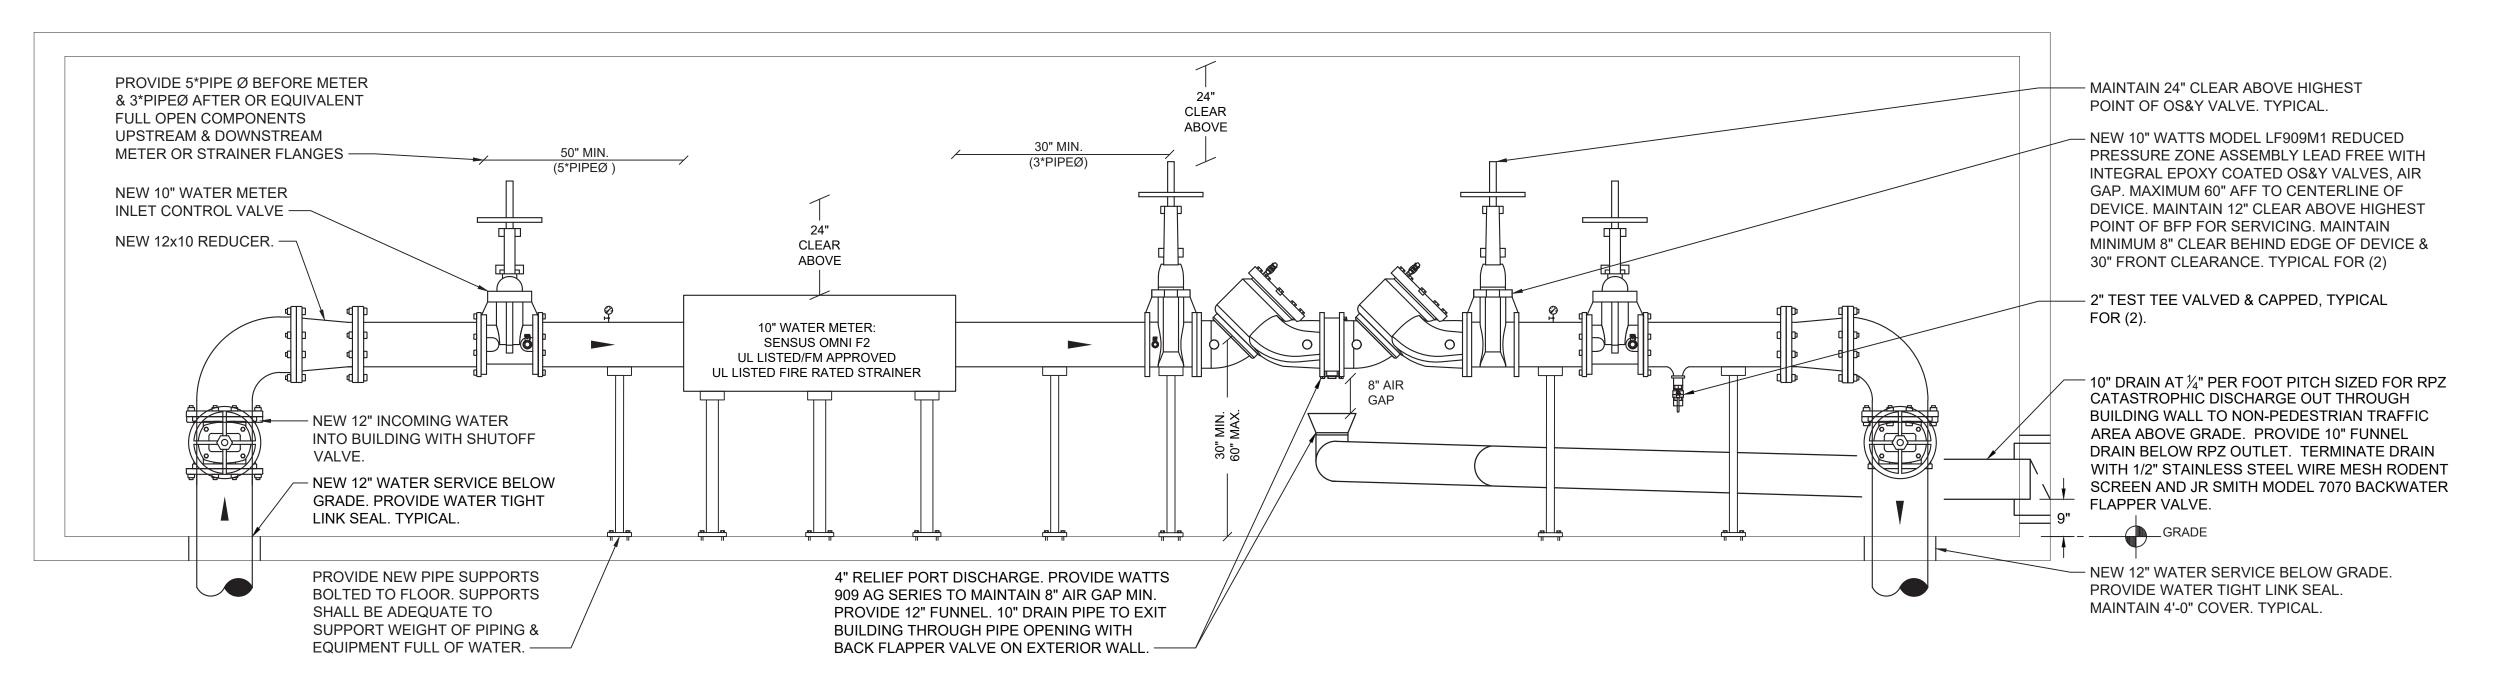
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NEW YORK STATE EDUCATION LAW.					AS BUILT — NO CHANGES		DIVISION OF ENGINEERING	SHEET NO. 45	
N CHARGE OF					CONTRACTOR		DOMESTIC WATER SYSTEM IMPROVEMENTS, WESTCHESTER COUNTY AIRPORT TOWNS OF HARRISON, NORTH CASTLE & VILLAGE OF RYE BROOK	SCALE: AS SHO DATE: 12/09/	OWN /2022
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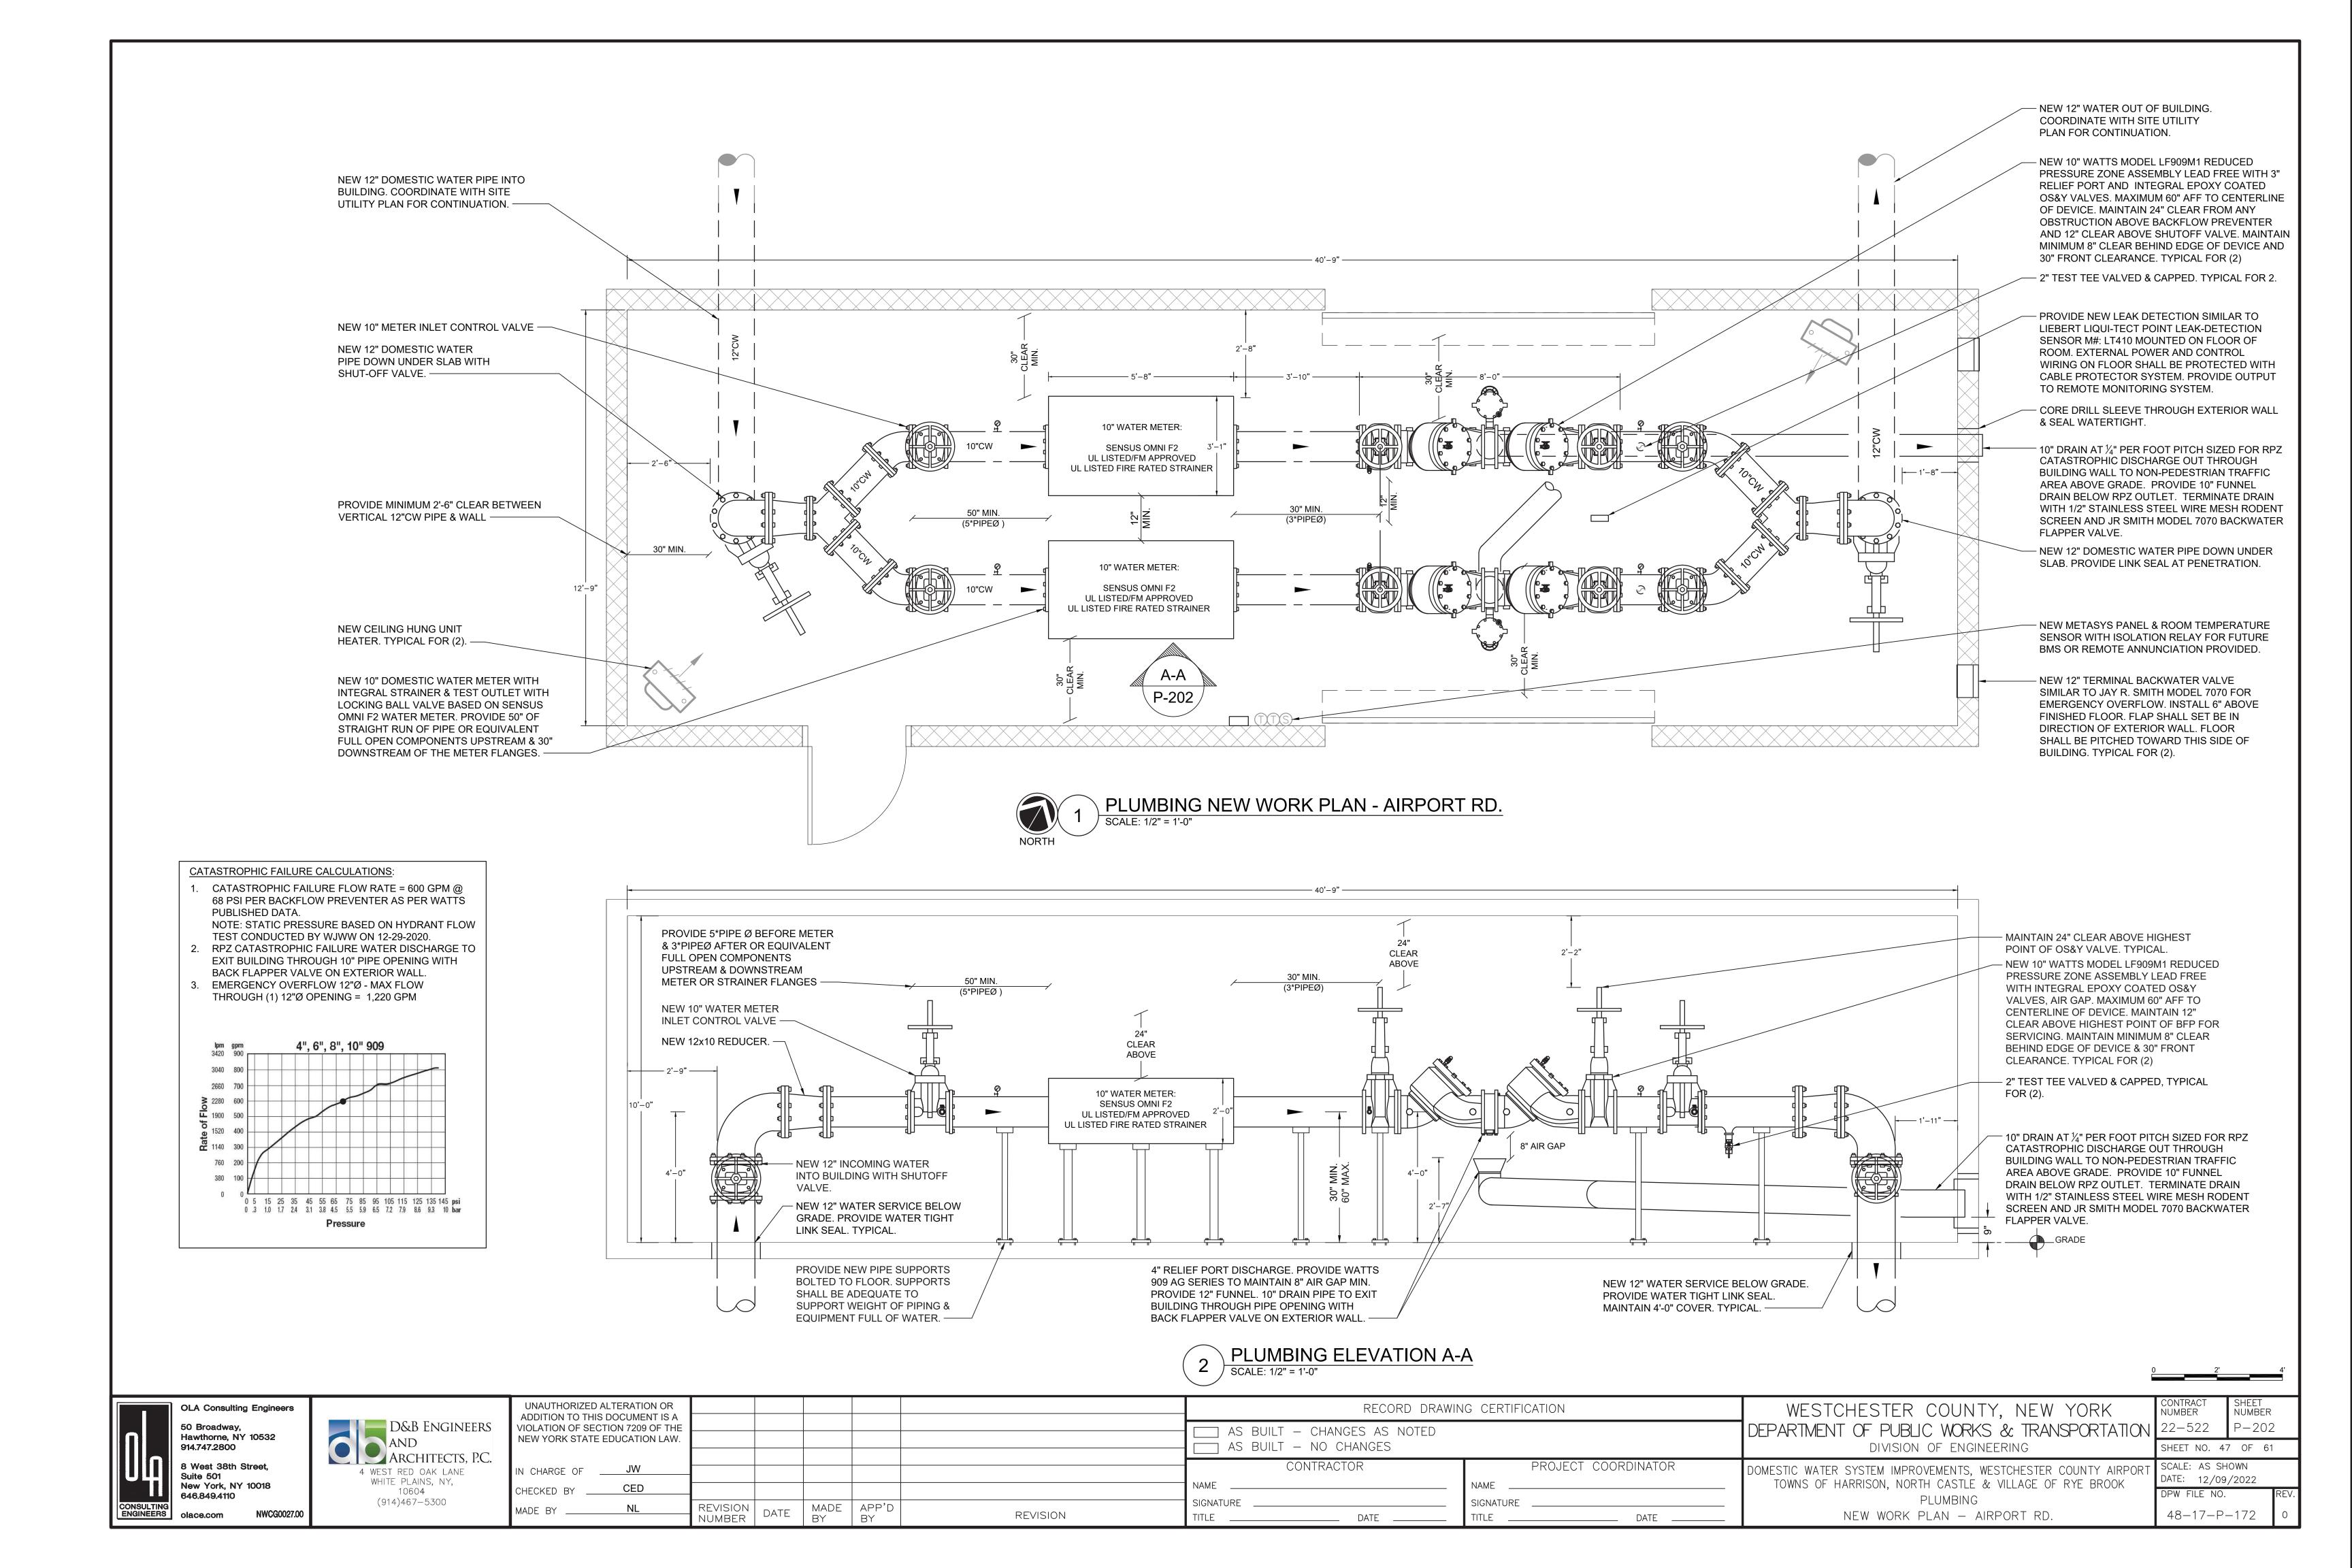
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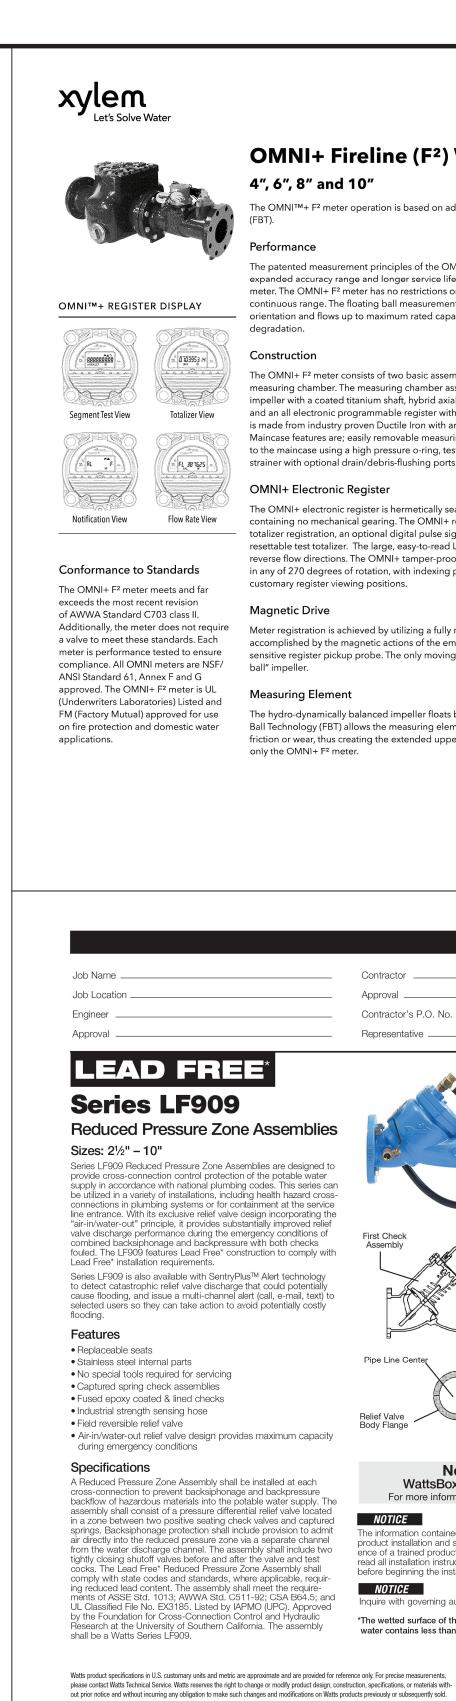
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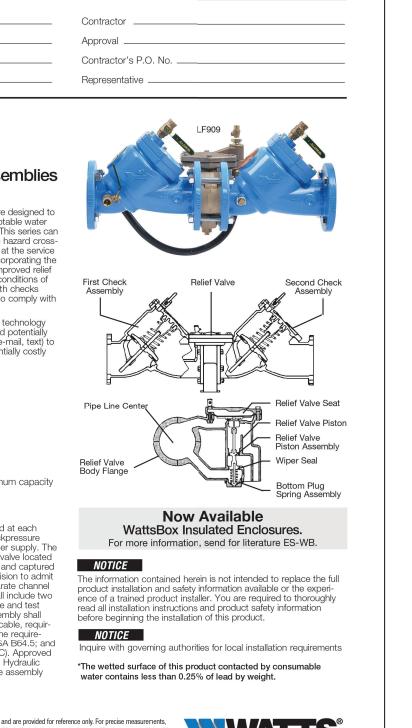
CONTRACT NUMBER WESTCHESTER COUNTY, NEW YORK NUMBER DEPARTMENT OF PUBLIC WORKS & TRANSPORTATION 22-522 DIVISION OF ENGINEERING SHEET NO. 46 OF 61 SCALE: AS SHOWN DOMESTIC WATER SYSTEM IMPROVEMENTS, WESTCHESTER COUNTY AIRPORT DATE: 12/09/2022 TOWNS OF HARRISON, NORTH CASTLE & VILLAGE OF RYE BROOK DPW FILE NO.

PLUMBING NEW WORK PLAN - TOWER RD. 48-17-P-171







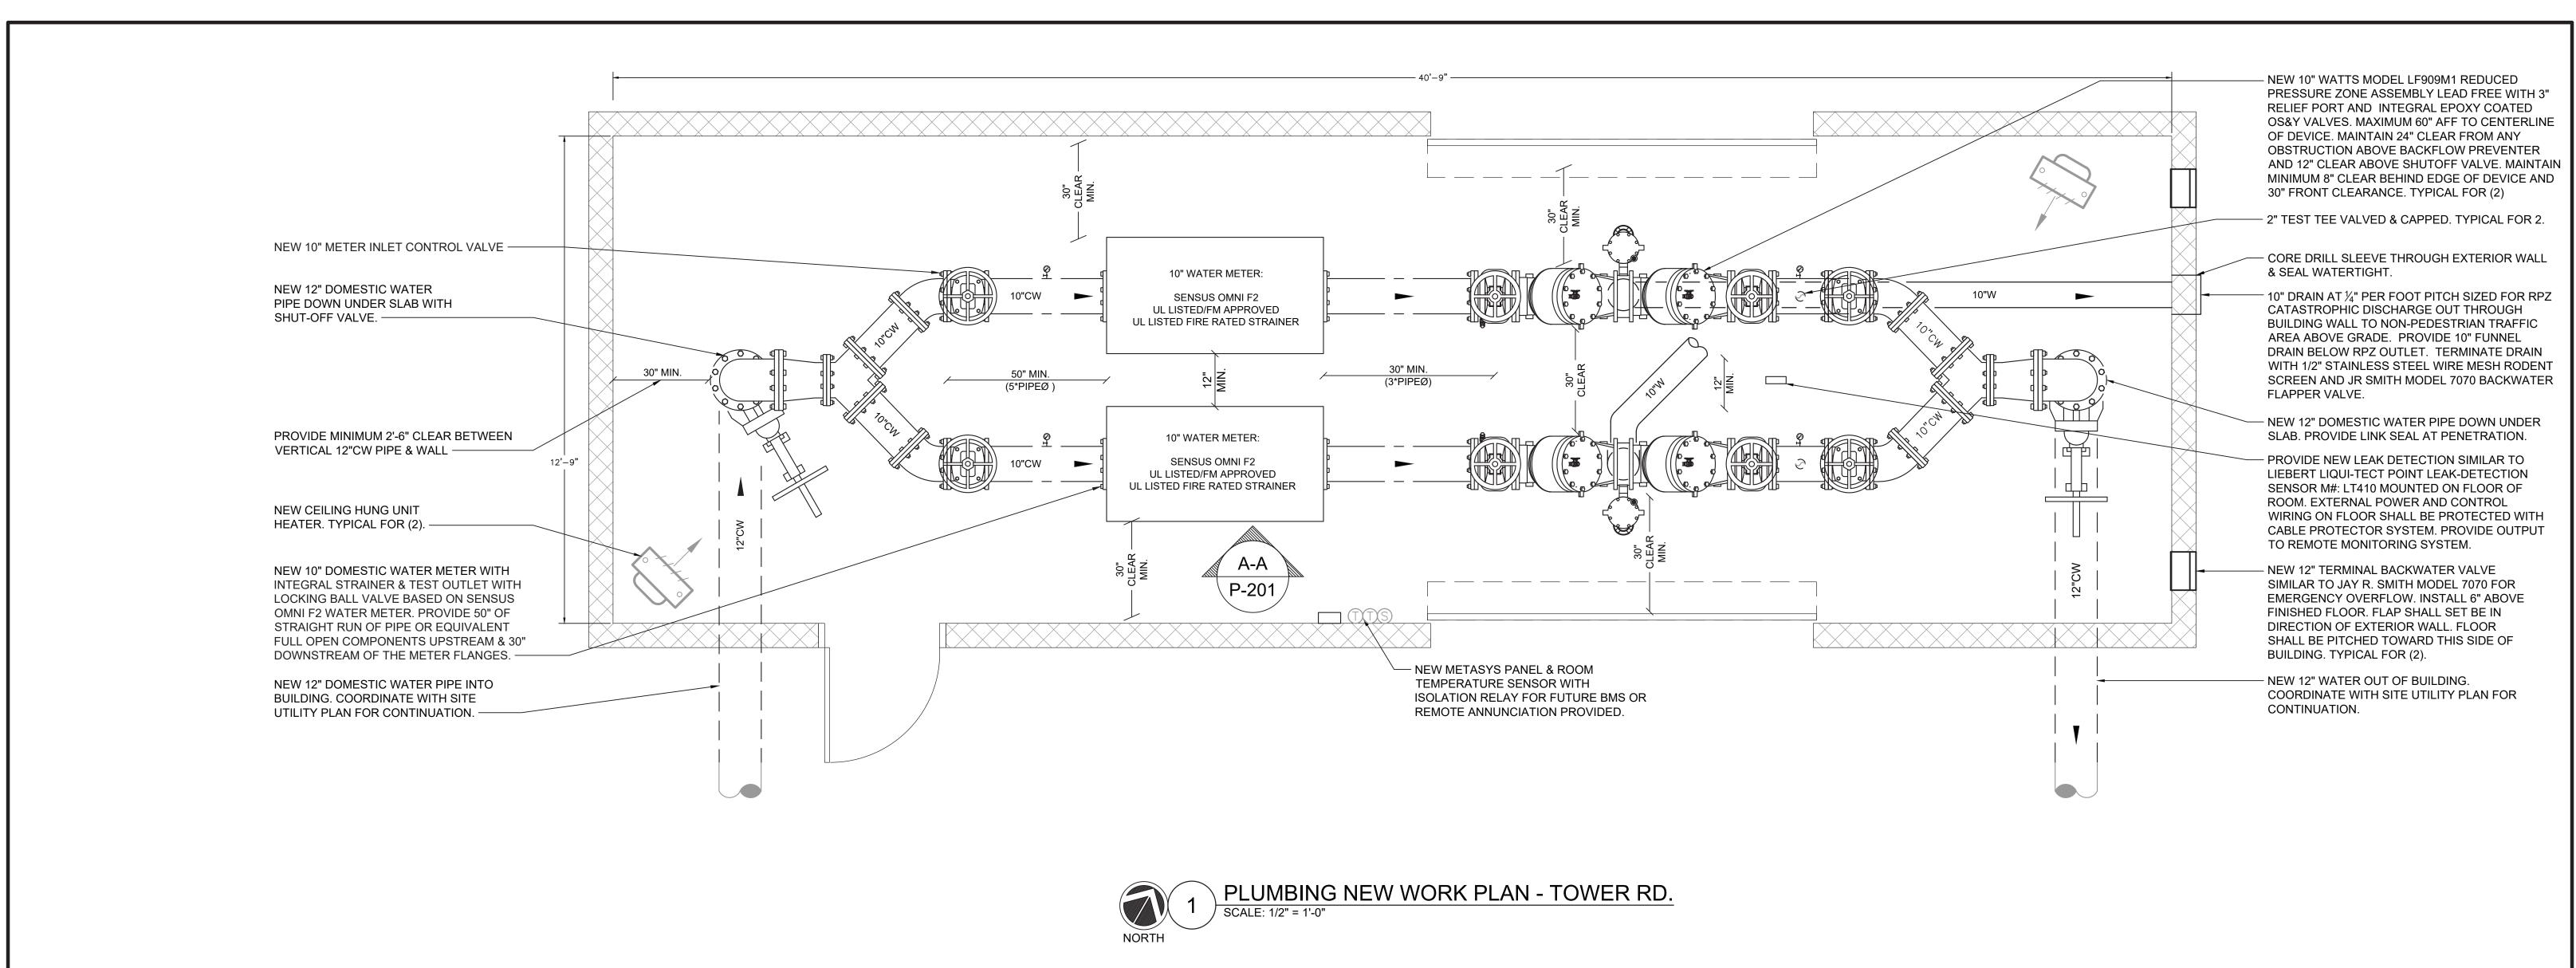

DATA SHEET

SENSUS a **xylem** brand

ES-LF909L

Dimensions — Weights

NOTE: Valve may be furnished with (2) OSY or (2) NRS Shutoffs.

Air Gap Dimensions

horizontally, use 909 AG series air gaps.


*UL, FM approved backflow preventers must include UL/FM approved OSY gate valves.


909AG-F 881378 11/4" - 3" 009/909 4% 111 6¾ 171 2 51 3.25 1.47

For flange size backflow preventers installed vertically (flow down), a fabricated air gap is recommended.


11/4" - 2" 009 M1


WDS-10019-05

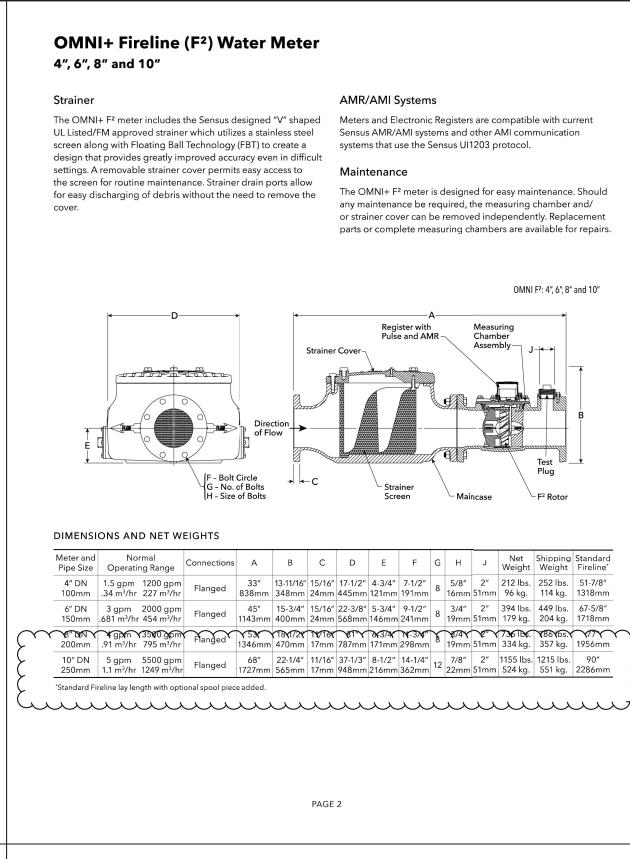

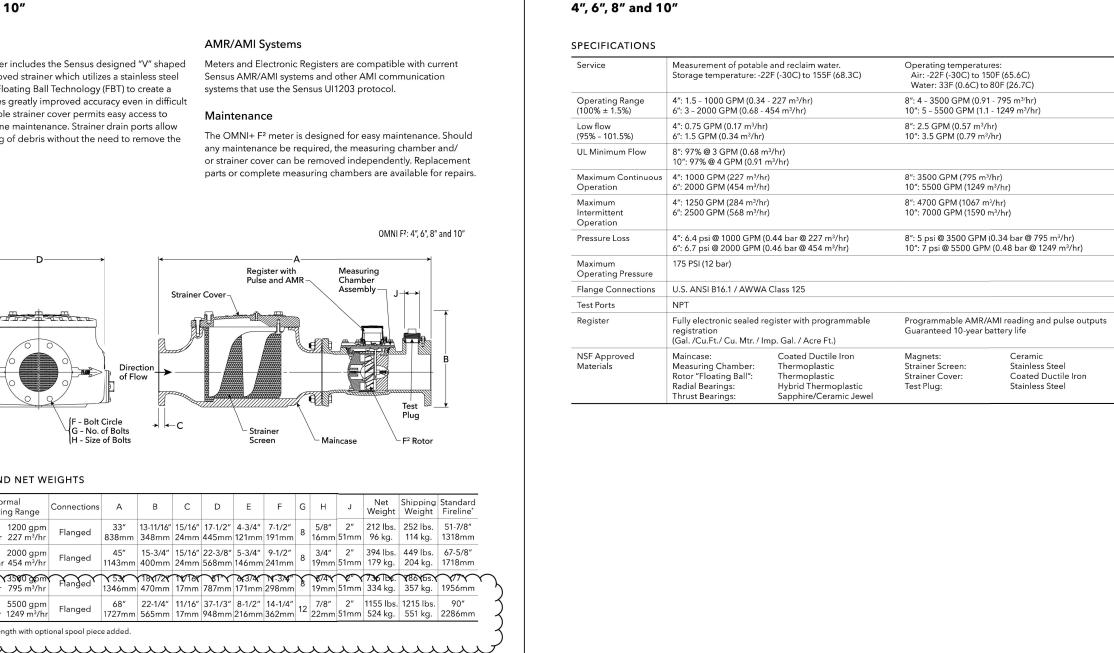

OMNI+ Fireline (F2) Water Meter

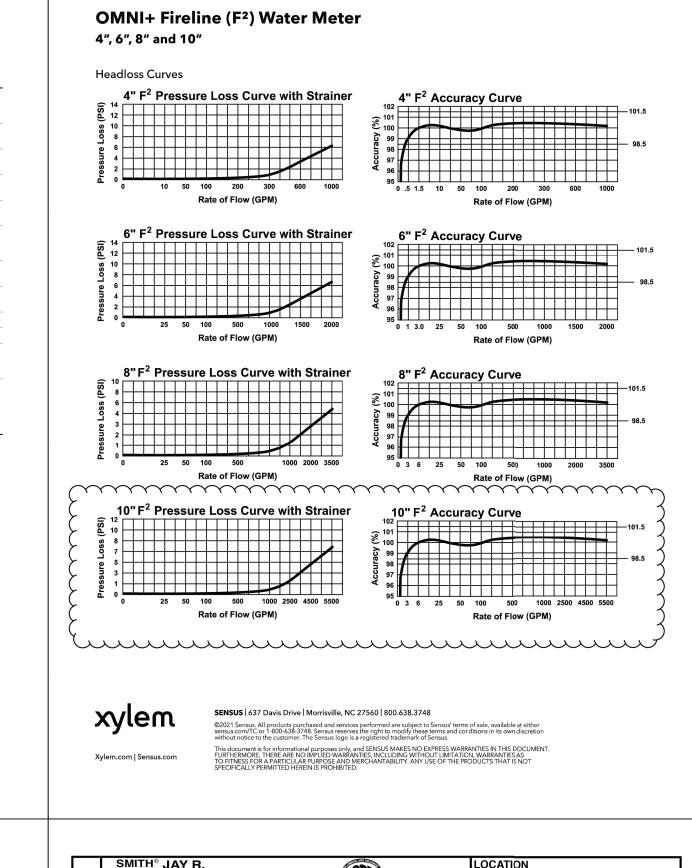


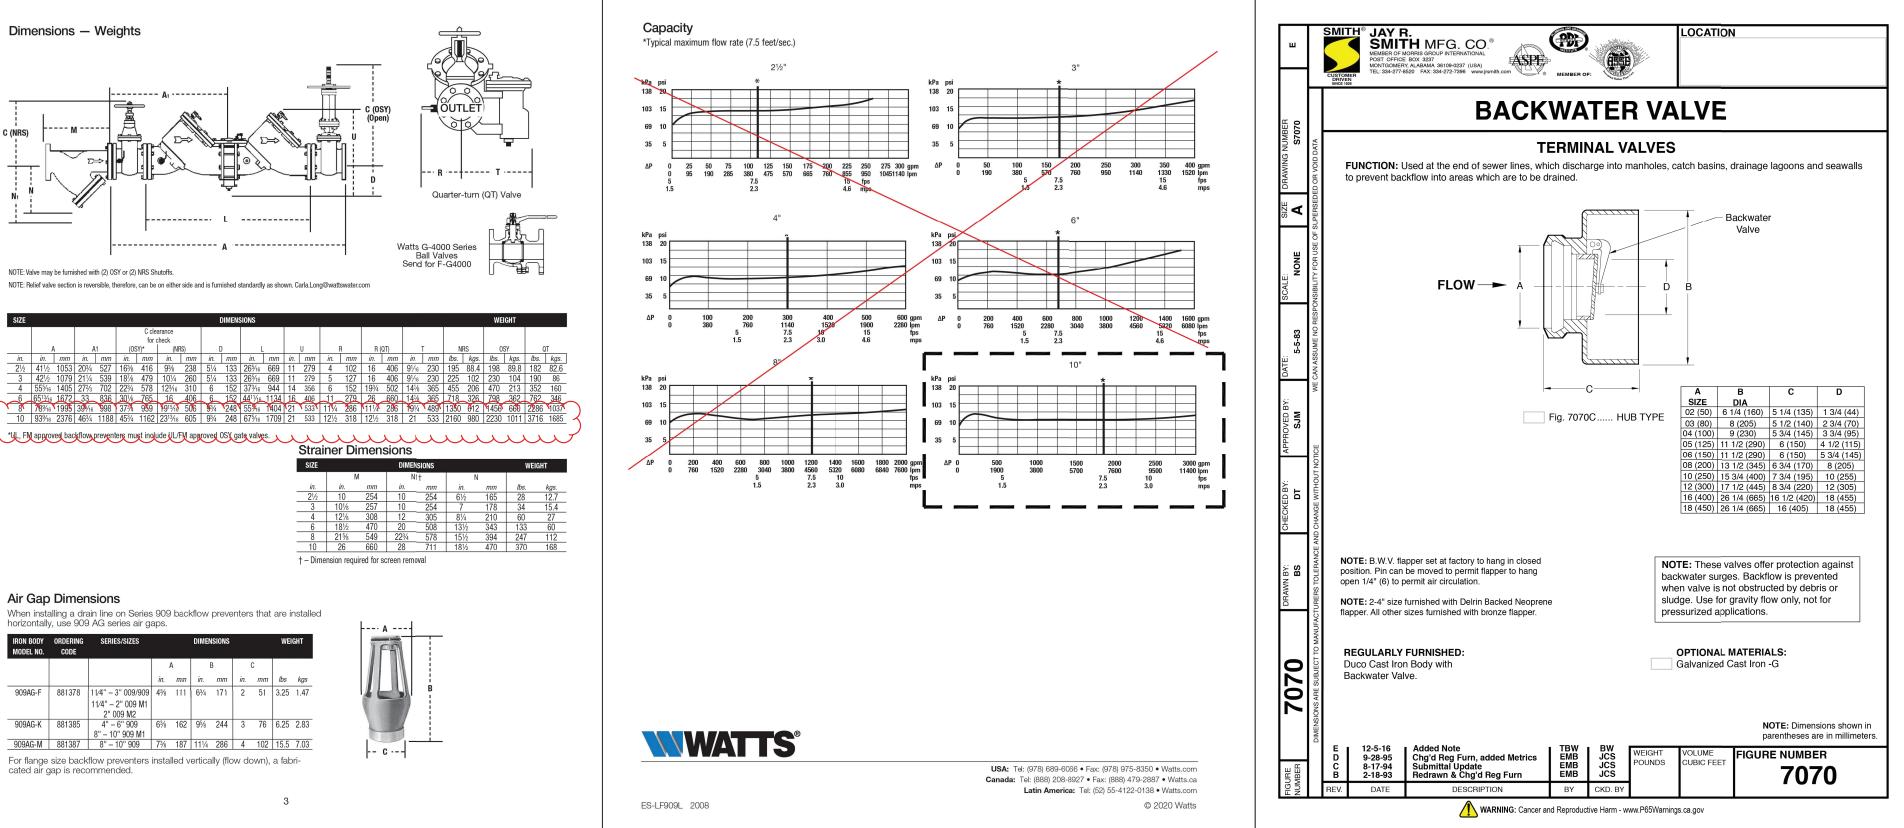


PAGE 3






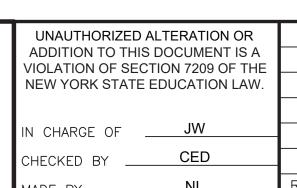

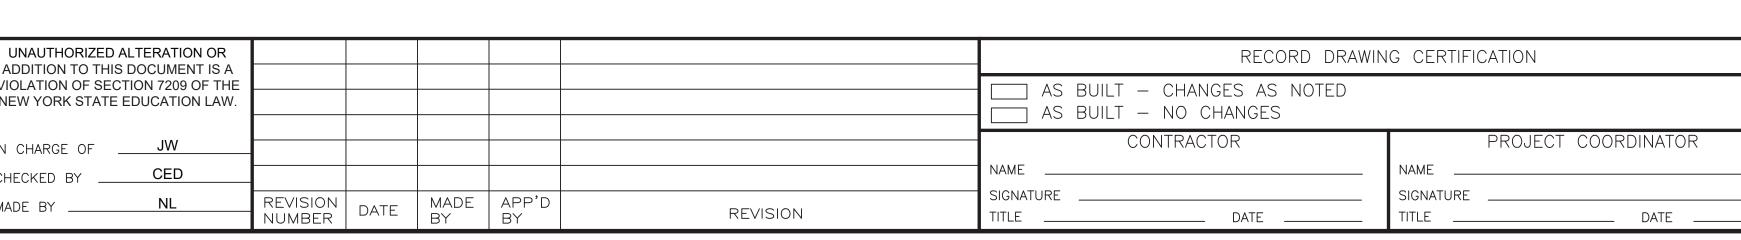

RECORD DRAWIN	G CERTIFICATION			SHEET NUMBER
AS BUILT — CHANGES AS NOTED		DEPARTMENT OF PUBLIC WORKS & TRANSPORTATION	22-522	P-301
AS BUILT — NO CHANGES		DIVISION OF ENGINEERING	SHEET NO. 48 OF 61	
CONTRACTOR	PROJECT COORDINATOR	■	SCALE: AS SHOWN DATE: 12/09/2022	
NATURE	SIGNATURE	PLUMBING	DPW FILE NO.	R
	TITLE DATE	EQUIPMENT SPECIFICATIONS	48-17-P-	-173

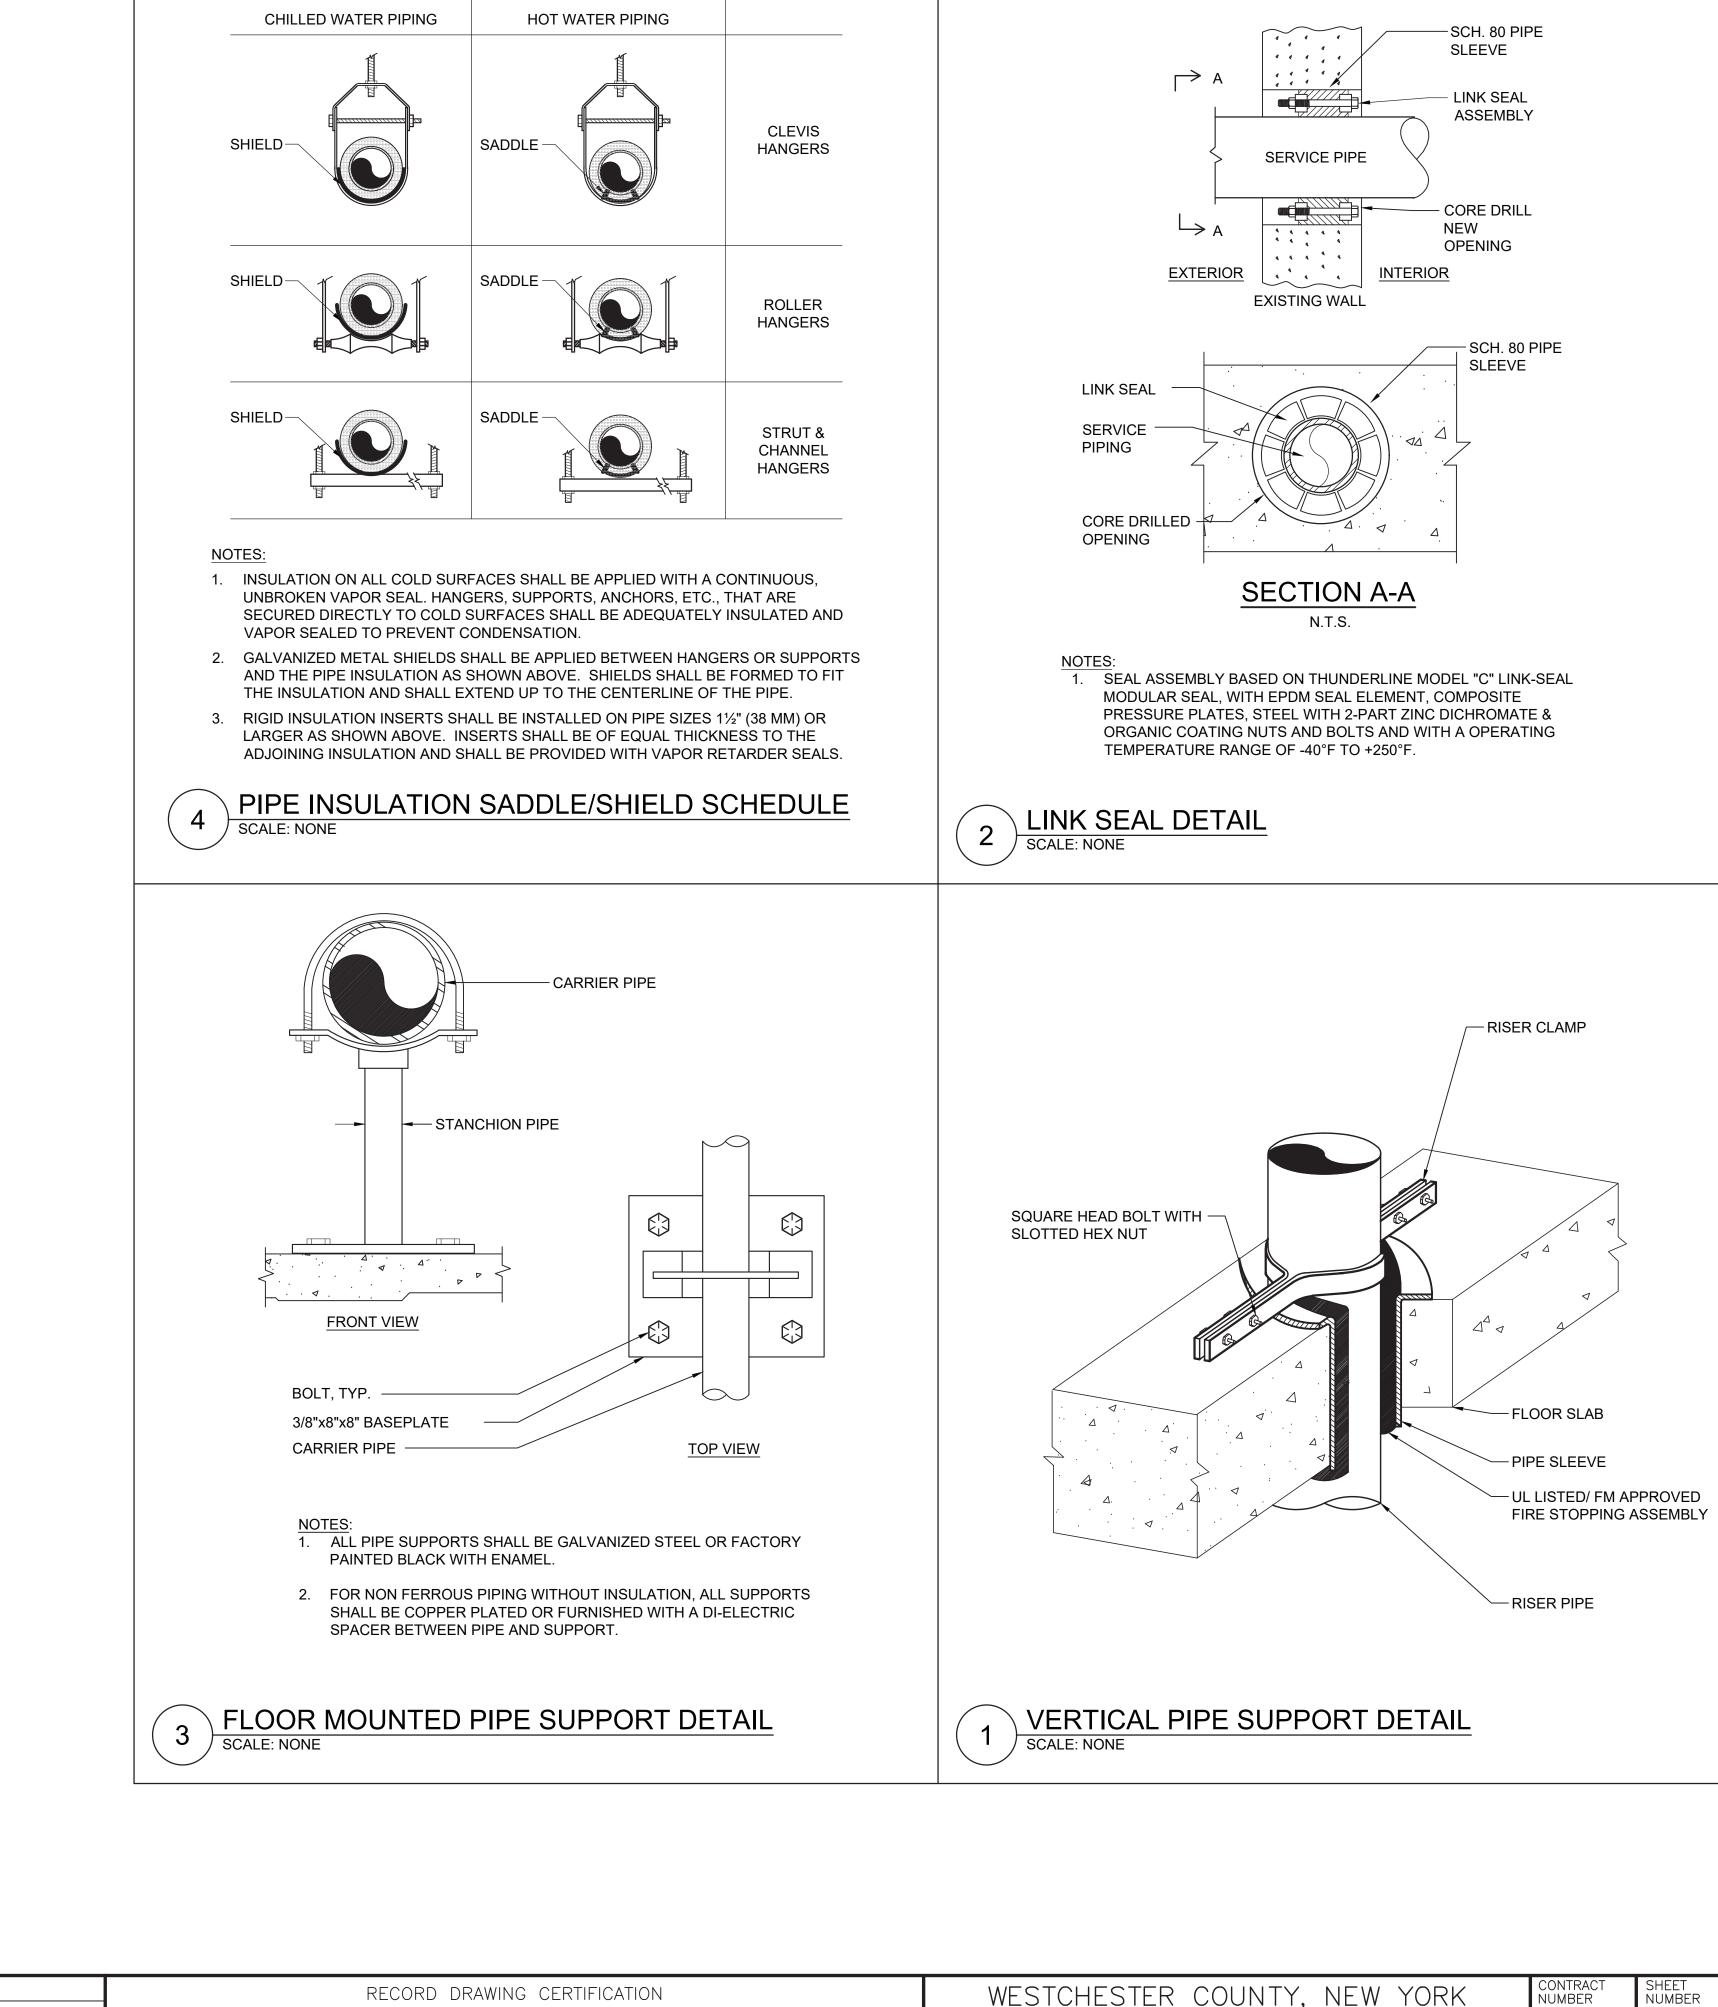





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NEW YORK STATE EDUCATION LAW.					
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RECORD DRAWIN	G CERTIFICATION	WESTCHESTER COUNTY, NEW YORK
AS BUILT — CHANGES AS NOTED AS BUILT — NO CHANGES		DEPARTMENT OF PUBLIC WORKS & TRANSPORTATION OF ENGINEERING
CONTRACTOR	PROJECT COORDINATOR	DOMESTIC WATER SYSTEM IMPROVEMENTS, WESTCHESTER COUNTY AIRF
NAME	NAME	TOWNS OF HARRISON, NORTH CASTLE & VILLAGE OF RYE BROOK
SIGNATURE	SIGNATURE	PLUMBING

DATE ___

DATE ____

SHEET NO. 49 OF 61

SCALE: AS SHOWN

DETAILS

DATE: 12/09/2022

48-17-P-174