

X:\PPSD\White Plains Central School District - 1001\PPSD 2205 - AC & Ventilation at Mamaroneck Elem. School\02-BM-CADD\Contractor\hvac\M001.DWG HVAC General Notes and Legends.dwg, Nov 01, 2023, 4:38pm, Plotted on: Nov 01, 2023, 4:38pm By: M001.dwg

ABBREVIATIONS	
AFF	ABOVE FINISHED FLOOR
BCU	BUILDING CONTROL UNIT
BTU	BRITISH THERMAL UNIT
CFH	CUBIC FEET PER HOUR
CFM	CUBIC FEET PER MINUTE
CLG	CEILING
COMM.	COMMUNICATION
CV	CONTROL VALVE
(D)	DEMOLISH
DB	DRY BULB
DCV	DEMAND CONTROLLED VENTILATION
DEG. F	DEGREES FAHRENHEIT
DIA	DIAMETER
DX	DIRECT EXPANSION
'E'	ELECTRICAL CONTRACTOR
(E)	EXISTING
EA	EACH
EAT	ENTERING AIR TEMPERATURE
EER	ENERGY EFFICIENCY RATING
ESP	EXTERNAL STATIC PRESSURE
FAI	FRESH AIR INTAKE
FD	FLOOR DRAIN
FLA	FULL LOAD AMPS
FT. H2O	FEET OF WATER
FTR	FIN TUBE RADIATOR
'G'	GENERAL CONSTRUCTION CONTRACTOR
GPM	GALLONS PER MINUTE
GPH	GALLONS PER HOUR
H	HEIGHT
'H'	HVAC CONTRACTOR
HP	HORSEPOWER
IN.	INCHES
IN. W.C. (W.G.)	INCHES WATER COLUMN (WATER GAUGE)
KW	KILOWATTS
L	LENGTH
LAT	LEAVING AIR TEMPERATURE
LBS	POUNDS
LCD	LIQUID CRYSTAL DISPLAY
LDB	LEAVING DRY BULB TEMPERATURE
LWB	LEAVING WET BULB TEMPERATURE
LWT	LEAVING WATER TEMPERATURE
M	METER
MAX	MAXIMUM
MBH	1,000 BTU PER HOUR
MCA	MINIMUM CIRCUIT AMPACITY
MIN	MINIMUM
MNF	MANUFACTURER
N.C.	NORMALLY CLOSED
N.O.	NORMALLY OPEN
NFPA	NATIONAL FIRE PROTECTION ASSOCIATION
NPT	NATIONAL PIPE THREAD
NTS	NOT TO SCALE
OAI	OUTDOOR AIR INTAKE
OD	OUTER DIAMETER
OED	OPEN ENDED DUCT
'P'	PLUMBING CONTRACTOR
PD	PRESSURE DROP
PSIG	LBS / SQUARE INCH (GAUGE PRESSURE)
RA	RETURN AIR
RD	ROOF DRAIN
RPM	REVOLUTIONS PER MINUTE
RPZ	REDUCED PRESSURE ZONE
SA	SUPPLY AIR
SAT	SUPPLY AIR TEMPERATURE
SEER	SEASONAL ENERGY EFFICIENCY RATING
TEMP	TEMPERATURE
TG	TRANSFER GRILLE
TYP	TYPICAL
VFD	VARIABLE FREQUENCY DRIVE
W	WIDTH
WB	WET BULB
WMS	WIRE MESH SCREEN

SYMBOL	ABBREV	DESCRIPTION
		DUCTWORK BRANCH CONNECTION
	VD	VOLUME DAMPER
	CD	ROUND FACE SUPPLY DIFFUSER
	SEE AIR DEVICE SCHEDULE	SIDEWALL SUPPLY, RETURN OR EXHAUST GRILLE/REGISTER
	SEE AIR DEVICE SCHEDULE	SQUARE FACE SUPPLY DIFFUSER
	SEE AIR DEVICE SCHEDULE	BOTTOM RETURN OR EXHAUST GRILLE/REGISTER
	FC	FLEXIBLE CONNECTION
		TURNING VANES
		RECTANGULAR TO ROUND TRANSITION
	AL	ACOUSTICAL LINING
		END CAP
	SEE AIR DEVICE SCHEDULE	SUPPLY DIFFUSER WITH DIRECTIONAL FLOW (SOLID HATCH INDICATES BLANK OFF PANEL)
		SUPPLY DUCT DROP (TURN DOWN)
		RETURN/EXHAUST DUCT DROP (TURN DOWN)
		SUPPLY DUCT RISE
		RETURN/EXHAUST DUCT RISE
	DSD	DUCT SMOKE DETECTOR
	MD	MOTORIZED DAMPER WITH ACTUATOR
	AD	ACCESS DOOR
	FD/AD	FIRE DAMPER WITH ACCESS DOOR
	FSD/AD	FIRE SMOKE DAMPER WITH ACCESS DOOR
	FAN	FAN
		WORK TO BE REMOVED
		POINT OF DISCONNECTION FROM EXISTING
		POINT OF CONNECTION TO EXISTING

SYMBOL	ABBREV	DESCRIPTION
	C	CARBON MONOXIDE SENSOR
	T	THERMOSTAT
	S	DIGITAL TEMPERATURE SENSOR
	H	HUMIDITY SENSOR
	CO2	CARBON DIOXIDE SENSOR
	P	PRESSURE SENSOR

SYMBOL	ABBREV	DESCRIPTION
		NEW WORK
		PIPING DOWN/ PIPING UP
		BALL VALVE WITH HOSE END CONNECTION
	TH	THERMOMETER
	U	UNION
	FPC	FLEXIBLE PIPE CONNECTION
		DIRECTION OF FLOW
	PSR	PRESSURE SAFETY AND RELIEF VALVE
	PRV	PRESSURE REDUCING VALVE
	BV	BALL VALVE
	BA	BALANCING VALVE
	BFV	BUTTERFLY VALVE
		TEMPERATURE SENSOR WITH THERMOWELL
	GA	GATE VALVE
	GB	GLOBE VALVE
	AV	AUTOMATIC AIR VENT
	CV	2-WAY ELECTRONIC CONTROL VALVE
	CV	3-WAY ELECTRONIC CONTROL VALVE
	CV	2-WAY PNEUMATIC CONTROL VALVE
	CV	3-WAY PNEUMATIC CONTROL VALVE
	STR	STRAINER WITH BLOW OFF VALVE WITH HOSE END CONNECTION
	FD	FLOOR DRAIN
		AIR SEPARATOR
	F&T	STEAM TRAPS (INDICATE TYPE)
	CH	CHECK VALVE
	PG	PRESSURE GAUGE WITH GAUGE COCK
	RED	REDUCER
	CO	CLEANOUT END CAP
		PIPE GUIDE
		PIPE ANCHOR
		CAPPED PIPE
		PUMP
		WORK TO BE REMOVED
		POINT OF DISCONNECTION FROM EXISTING
		POINT OF CONNECTION TO EXISTING
	TDV	TRIPLE DUTY VALVE

SYSTEM COMMISSIONING NOTES (NYS):

- COMMISSION ALL NEW BUILDING MECHANICAL SYSTEMS IN ACCORDANCE WITH THE REQUIREMENTS OF THE 2020 NEW YORK STATE (NYS) ENERGY CONSERVATION CODE (ECC) SECTION C408. COMMISSIONING SHALL BE PERFORMED BY AN APPROVED THIRD-PARTY COMMISSIONING AGENCY HIRED BY THE OWNER. REFER TO SPECIFICATION SECTION 230800 - COMMISSIONING OF MECHANICAL SYSTEMS FOR MORE INFORMATION.
- PROVIDE DRAWINGS, OPERATION & MAINTENANCE (O&M) MANUALS, AND SYSTEM BALANCING REPORTS TO BUILDING OWNER OR OWNER'S AUTHORIZED AGENT WITHIN 90 DAYS OF THE DATE OF RECEIPT OF THE CERTIFICATE OF OCCUPANCY OR LETTER OF COMPLETION IN ACCORDANCE WITH THE 2020 NYS ECC SECTION C408.2.5.
- PROVIDE FINAL COMMISSIONING REPORT TO THE BUILDING OWNER OR OWNER'S AUTHORIZED AGENT WITHIN 90 DAYS OF THE RECEIPT OF THE CERTIFICATE OF OCCUPANCY OR LETTER OF COMPLETION IN ACCORDANCE WITH THE REQUIREMENTS OF THE 2020 NYS ECC SECTION C408.2.5.4.

GENERAL NOTES

- PROVIDE ALL MATERIALS AND EQUIPMENT AND PERFORM ALL LABOR REQUIRED TO INSTALL COMPLETE AND OPERABLE MECHANICAL SYSTEMS AS INDICATED ON THE DRAWINGS, AS SPECIFIED AND AS REQUIRED BY CODE.
- THE CONTRACTOR, BY PRESENTING THEIR BID FOR THE WORK, REPRESENTS THAT HE/SHE HAS INSPECTED THE SITE AND IS COMPLETELY FAMILIAR WITH THE SCOPE OF WORK AND ALL FIELD CONDITIONS RELATED TO, AND AFFECTING THE WORK AND ITS PERFORMANCE. EXCEPTIONS AFFECTING THE WORK AND ITS PERFORMANCE, OR CONFLICTS BETWEEN FIELD CONDITIONS, SHALL BE BROUGHT TO THE ATTENTION OF THE ARCHITECT PRIOR TO THE SUBMISSION OF BIDS.
- PERFORM ALL WORK IN ACCORDANCE WITH THE PLUMBING CODE, FIRE CODE, MECHANICAL CODE, ENERGY CONSERVATION CONSTRUCTION CODE, AND FUEL GAS CODE OF NEW YORK STATE AND THE REQUIREMENTS OF THE LOCAL AUTHORITIES HAVING JURISDICTION.
- COMPLY WITH THE NATIONAL ELECTRIC CODE AND THE REQUIREMENTS OF DIVISION 26 FOR ALL ELECTRICAL INSTALLATIONS.
- FIRE STOP ALL OPENINGS IN FIRE RATED CONSTRUCTION FOR PIPING, DUCTWORK, CONDUIT, ETC. PROVIDE FIRE DAMPERS AND ACCESS DOORS IN ALL OPENINGS IN FIRE RATED FLOORS, PARTITIONS, AND WALLS FOR DUCTWORK AS PER THE MECHANICAL CODE OF NEW YORK STATE. (SEE ARCHITECTURAL DRAWINGS FOR LOCATIONS OF FIRE RATED CONSTRUCTION.)
- DO NOT SCALE DRAWINGS. DRAWINGS FOR HVAC WORK ARE DIAGRAMMATIC AND ARE INTENDED TO CONVEY SCOPE AND GENERAL ARRANGEMENT ONLY. THE LOCATIONS OF ALL ITEMS SHOWN ON THE DRAWINGS OR CALLED FOR IN THE SPECIFICATIONS THAT ARE NOT DEFINITELY FIXED BY DIMENSIONS ARE APPROXIMATE. COORDINATE CONTRACT DOCUMENTS, PROJECT REQUIREMENTS, WORK OF OTHERS, AND EQUIPMENT AND MATERIALS PURCHASED WITH FIELD DIMENSIONS. INSTALL ALL EQUIPMENT AS PER MANUFACTURER'S REQUIREMENTS TO PROVIDE PROPER CLEARANCE FOR INSTALLATION, OPERATION, AND MAINTENANCE. CONTRACTOR'S INTENDED MEANS AND METHODS OF INSTALLATION AND CONTRACTOR'S FABRICATED ITEMS SHALL ENSURE A PROPER 'FIT' AND INSTALLATION. BRING ANY CONFLICTS TO THE ATTENTION OF THE ARCHITECT/ENGINEER DURING THE SUBMITTAL PHASE FOR RESOLUTION PRIOR TO PURCHASING ANY EQUIPMENT.
- MAINTAIN MAXIMUM HEADROOM AND SPACE CONDITIONS AT ALL POINTS. WHERE HEADROOM AND SPACE CONDITIONS APPEAR INADEQUATE, NOTIFY THE ARCHITECT/ENGINEER PRIOR TO PROCEEDING WITH INSTALLATION. MAINTAIN A MINIMUM OF 6'-8" CLEARANCE FROM FINISHED FLOOR TO UNDERSIDE OF PIPES, DUCTS, CONDUITS, SUSPENDED EQUIPMENT, ETC., THROUGHOUT ACCESS ROUTES IN MECHANICAL ROOMS.
- FIELD VERIFY AND COORDINATE ALL DUCT AND PIPING DIMENSIONS BEFORE FABRICATION. MAKE MODIFICATIONS IN THE LAYOUT AS NEEDED TO PREVENT CONFLICT WITH WORK OF OTHER TRADES OR FOR PROPER EXECUTION OF THE WORK. OBTAIN THE APPROVAL OF THE ARCHITECT/ENGINEER FOR MODIFICATIONS.
- PROVIDE PRODUCTS OF ONE MANUFACTURER WHERE TWO OR MORE ITEMS OF THE SAME TYPE OF MATERIAL OR EQUIPMENT IS REQUIRED.
- INSTALL ALL EQUIPMENT AND APPURTENANCES IN ACCORDANCE WITH MANUFACTURER'S RECOMMENDATIONS, CONTRACT DOCUMENTS, AND APPLICABLE CODES AND REGULATIONS. REFER TO DETAILS FOR ADDITIONAL PIPING AND EQUIPMENT INSTALLATION REQUIREMENTS.
- LOCATE ALL TEMPERATURE, PRESSURE, AND FLOW MEASURING DEVICES IN ACCESSIBLE LOCATIONS WITH STRAIGHT SECTION OF PIPE OR DUCT UP- AND DOWNSTREAM AS RECOMMENDED BY THE MANUFACTURER TO ENSURE MANUFACTURER CERTIFIED ACCURACY.
- COORDINATE ALL EQUIPMENT CONNECTIONS WITH MANUFACTURER'S CERTIFIED DRAWINGS. COORDINATE AND PROVIDE ALL PIPING AND DUCT TRANSITIONS REQUIRED FOR FINAL CONNECTIONS TO EQUIPMENT.
- COORDINATE LOCATIONS AND SIZES OF ALL FLOOR, WALL, AND ROOF OPENINGS WITH ALL OTHER TRADES. COORDINATE ALL PIPING AND EQUIPMENT SUPPORTED FROM STRUCTURE WITH GENERAL CONSTRUCTION WORK.
- COORDINATE INSTALLATION OF SUPPLY AND RETURN GRILLES WITH INSTALLATION OF FINISHED CEILINGS.
- COMPLETE ALL PRESSURE TESTS BEFORE ANY MECHANICAL EQUIPMENT, DUCTWORK, OR PIPING INSULATION IS APPLIED.
- TESTING, ADJUSTING, AND BALANCING AGENCY SHALL BE A MEMBER OF THE ASSOCIATED AIR BALANCE COUNCIL (AABC) OR THE NATIONAL ENVIRONMENTAL BALANCING BUREAU (NEBB). PERFORM ALL TESTING, ADJUSTING, AND BALANCING IN ACCORDANCE WITH THE SPECIFICATIONS.
- MAKE ALL ATTACHMENTS TO JOISTS, TRUSSES, OR JOIST GIRDERS AT PANEL POINTS. PROVIDE BEAM CLAMPS MEETING MSS STANDARDS. THE USE OF C-CLAMPS IS NOT PERMITTED.
- PROVIDE CONCRETE PADS A MINIMUM OF 6 INCHES HIGH FOR ALL FLOOR MOUNTED EQUIPMENT. EXTEND PAD 4 INCHES BEYOND THE EQUIPMENT ON ALL SIDES.
- INTERNALLY LINE ALL SUPPLY AND RETURN DUCTWORK WITHIN 20 FEET UPSTREAM AND DOWNSTREAM OF FANS WITH 1" THICK INSULATION. INTERNALLY LINED DUCTWORK MEETING THIS REQUIREMENT SHALL ALSO BE PROVIDED WITH EXTERNALLY APPLIED INSULATION AS REQUIRED BY THE SPECIFICATIONS. SEE SPECIFICATION SECTION 230719 FOR ADDITIONAL REQUIREMENTS.
- PROVIDE TRAPPED DRAIN PIPING FROM DRAIN PANS OF ALL COOLING COILS, FANS, AND OTHER ACTIVE DRAINS EXPOSED TO SYSTEM AIR STREAM. PROVIDE TRAP AT CONNECTION. WATER SEAL DEPTH 1 INCH GREATER THAN UNIT OPERATING PRESSURE. DIRECT DRAINS TO NEAREST FLOOR DRAIN, MOP SINK, OR OTHER LOCATION APPROVED BY THE ARCHITECT/ENGINEER.
- INSTALL PIPING, DUCTWORK, AND CONDUIT CONCEALED IN AREAS HAVING HUNG CEILINGS AND/OR FURRED SPACES UNLESS OTHERWISE INDICATED ON THE DRAWINGS.

WORK IN EXISTING AREAS

- EXISTING CONDITIONS, INCLUDING EQUIPMENT, DUCT AND PIPE SIZES AND LOCATIONS, INDICATED ON THE DRAWINGS ARE DIAGRAMMATIC. CONFIRM ALL EXISTING CONDITIONS PRIOR TO PROCEEDING WITH THE WORK.
- CUT AND ROUGH PATCH EXISTING CONSTRUCTION AS REQUIRED FOR THE PERFORMANCE OF THE WORK. FINISH PATCHING AND FLASHING REQUIREMENTS ARE SHOWN ON THE ARCHITECTURAL DRAWINGS. PERFORM ALL CUTTING AND PATCHING WORK IN A MANNER SUCH THAT ANY EXISTING WARRANTIES/GUARANTEES ARE NOT VOIDED. USE QUALIFIED PERSONNEL IN PERFORMANCE OF THE WORK.

SCOPE NOTES

- PROVIDE ALL LOUVERS FOR INSTALLATION. SUBMIT LOUVER COLOR AND CONFIGURATION TO THE ARCHITECT/ENGINEER FOR APPROVAL.
- INSTALL SMOKE DETECTORS IN DUCTWORK FOR AIR HANDLING UNITS RATED AT 2,000 CFM OR GREATER AND AT FSD/SD. SMOKE DETECTOR SUPPLY AND WIRING IS PART OF CONTRACT 'E'.
- FURNISH AND INSTALL ALL NECESSARY CONTROL WIRING, CONDUIT, AND ACCESSORIES AS REQUIRED TO PROVIDE FULLY FUNCTIONING SYSTEMS AND SEQUENCES OF OPERATION.
- FURNISH ALL LINTELS FOR DUCT AND PIPE PENETRATIONS IN MASONRY WALLS FOR INSTALLATION.
- FURNISH ALL SLEEVES FOR PIPE AND CONDUIT FLOOR, WALL, PARTITION, AND ROOF PENETRATIONS FOR INSTALLATION.
- FURNISH ALL CURBS FOR ALL ROOF MOUNTED EQUIPMENT AND DUCT PENETRATIONS FOR INSTALLATION.
- REMOVE CHASE ENCLOSURE COVER WHEN PERFORMING WORK IN ANY CHASE, AND REINSTALL THE CHASE ENCLOSURE COVER WHEN WORK IS COMPLETE.
- PERFORM ALL CUTTING, ROUGH PATCHING, FINISH PATCHING, AND FLASHING AS REQUIRED IN THE EXECUTION OF THE WORK.
- ALL NEW EQUIPMENT TO BE INTEGRATED WITH EXISTING SCHNEIDER ELECTRIC EMF BMS.

LEGENDS/ABBREVIATIONS NOTES

- ABBREVIATIONS AND SYMBOLS ON THIS SHEET DO NOT DEFINE THE SCOPE OF WORK.

ADD ALTERNATE 1

- PROVIDE PRICING FOR REMOVAL OF PNEUMATIC RADIATOR CONTROL VALVES AND ASSOCIATED THERMOSTATS. SEE MD DRAWINGS FOR FURTHER INFORMATION.
- PROVIDE PRICING FOR FURNISH AND INSTALL OF NEW DDC RADIATOR CONTROL VALVES (CV-1) SEE DRAWINGS FOR FURTHER INFORMATION.
- PROVIDE NEW TWO STAGE THERMOSTATS IN PLACE OF NEW SINGLE STAGE THERMOSTATS ON PLAN. STAGE ONE: HEAT PUMP HEATING, STAGE TWO: HOT WATER RADIATOR HEATING. INTEGRATE WITH EXISTING BUILDING MANAGEMENT SYSTEM.

H

2

M

architects
+
engineers

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CONSULTANTS:

MARK	DATE	DESCRIPTION
	10-16-23	FINAL BID DOCUMENT
1	11-01-23	ADDENDUM #1

STATE OF NEW YORK
JOHN LARAY
LICENSED PROFESSIONAL ENGINEER
101303

DESIGNED BY: MJV
PROJECT NO.: WPSD 2205

DRAWN BY: KCM
DATE: OCTOBER 2023

CHECKED BY: MJV
SCALE:

REVIEWED BY: QAQC

CLIENT

White Plains City
School District

AC and Ventilation Upgrades
at Mamaroneck
Elementary School

White Plains Public Schools
WP
REAL LIFE LEARNING

7 Nosband Ave.
White Plains, NY 10605

SED PROJECT CONTROL
NO. 66-22-00-01-0-010-017

CONTRACT

CONTRACT H
HEATING VENTILATION AND AIR
CONDITIONING

STATUS

FINAL BID DOCUMENT

SHEET TITLE

HVAC LEGENDS, SYMBOLS,
ABBREVIATIONS, AND
GENERAL NOTES



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M001.00

X:\WPSP\White Plains Central School District - 10811\WPSP 2205 - AC & Ventilation at Mamaroneck Elem School\02-BIM\CADD\Construction\MD100.00 Mechanical Ground Floor Plan Part A.dwg Last Modified: Nov 01, 2023 - 3:20pm Printed on Nov 01, 2023 - 3:34pm By: Mataroneck

- GENERAL NOTES:
- EXISTING CONDITIONS ARE BASED ON A LIMITED FIELD SURVEY. CONTRACT IS RESPONSIBLE FOR VERIFICATION OF EXISTING CONDITIONS FOR ALL CONFLICTS AND SHALL ALERT ENGINEER PRIOR TO COMMENCEMENT OF NEW WORK AND PURCHASE OF EQUIPMENT.
 - DO NOT SCALE DRAWINGS. LINE WORK SHOWN IS SCHEMATIC. CONTRACTOR SHALL PROVIDE SHOP DRAWINGS BASED ON DESIGN INTENT, SURVEY OF EXISTING CONDITIONS, AND COORDINATION WITH OTHER TRADES.
 - INSTALL ALL EQUIPMENT IN ACCORDANCE WITH MANUFACTURER'S REQUIRED MAINTENANCE CLEARANCES AND PREVAILING CODE.
 - CONTRACTOR SHALL DEMOLISH AND REMOVE WINDOW ACs IN AREAS WHERE UNIT VENTILATORS ARE BEING REMOVED / REPLACED.
 - PATCH/SEAL ALL OPENINGS AND PENETRATIONS TO MATCH SURROUNDING FINISH(ES).
 - ALL EXISTING EXHAUST DUCTWORK, GRILLES, ETC TO REMAIN.

- KEYED NOTES:
- THERMOSTAT TO BE DEMOLISHED AS PART OF ADD ALT 1. SEE SHEET M001.
 - THERMOSTAT TO REMAIN AS PART OF BASE SCOPE

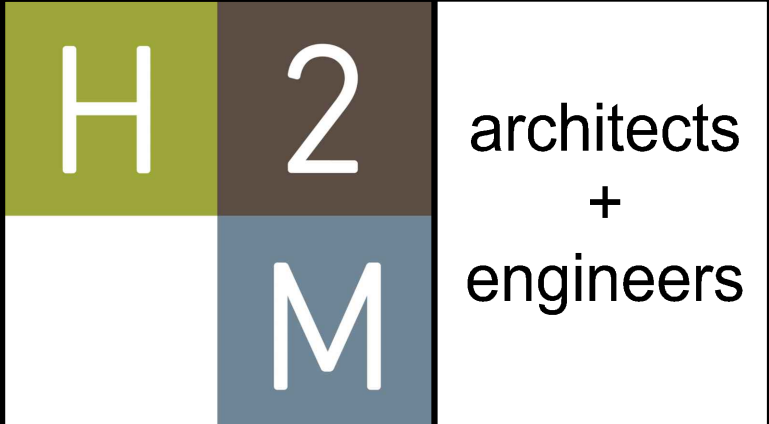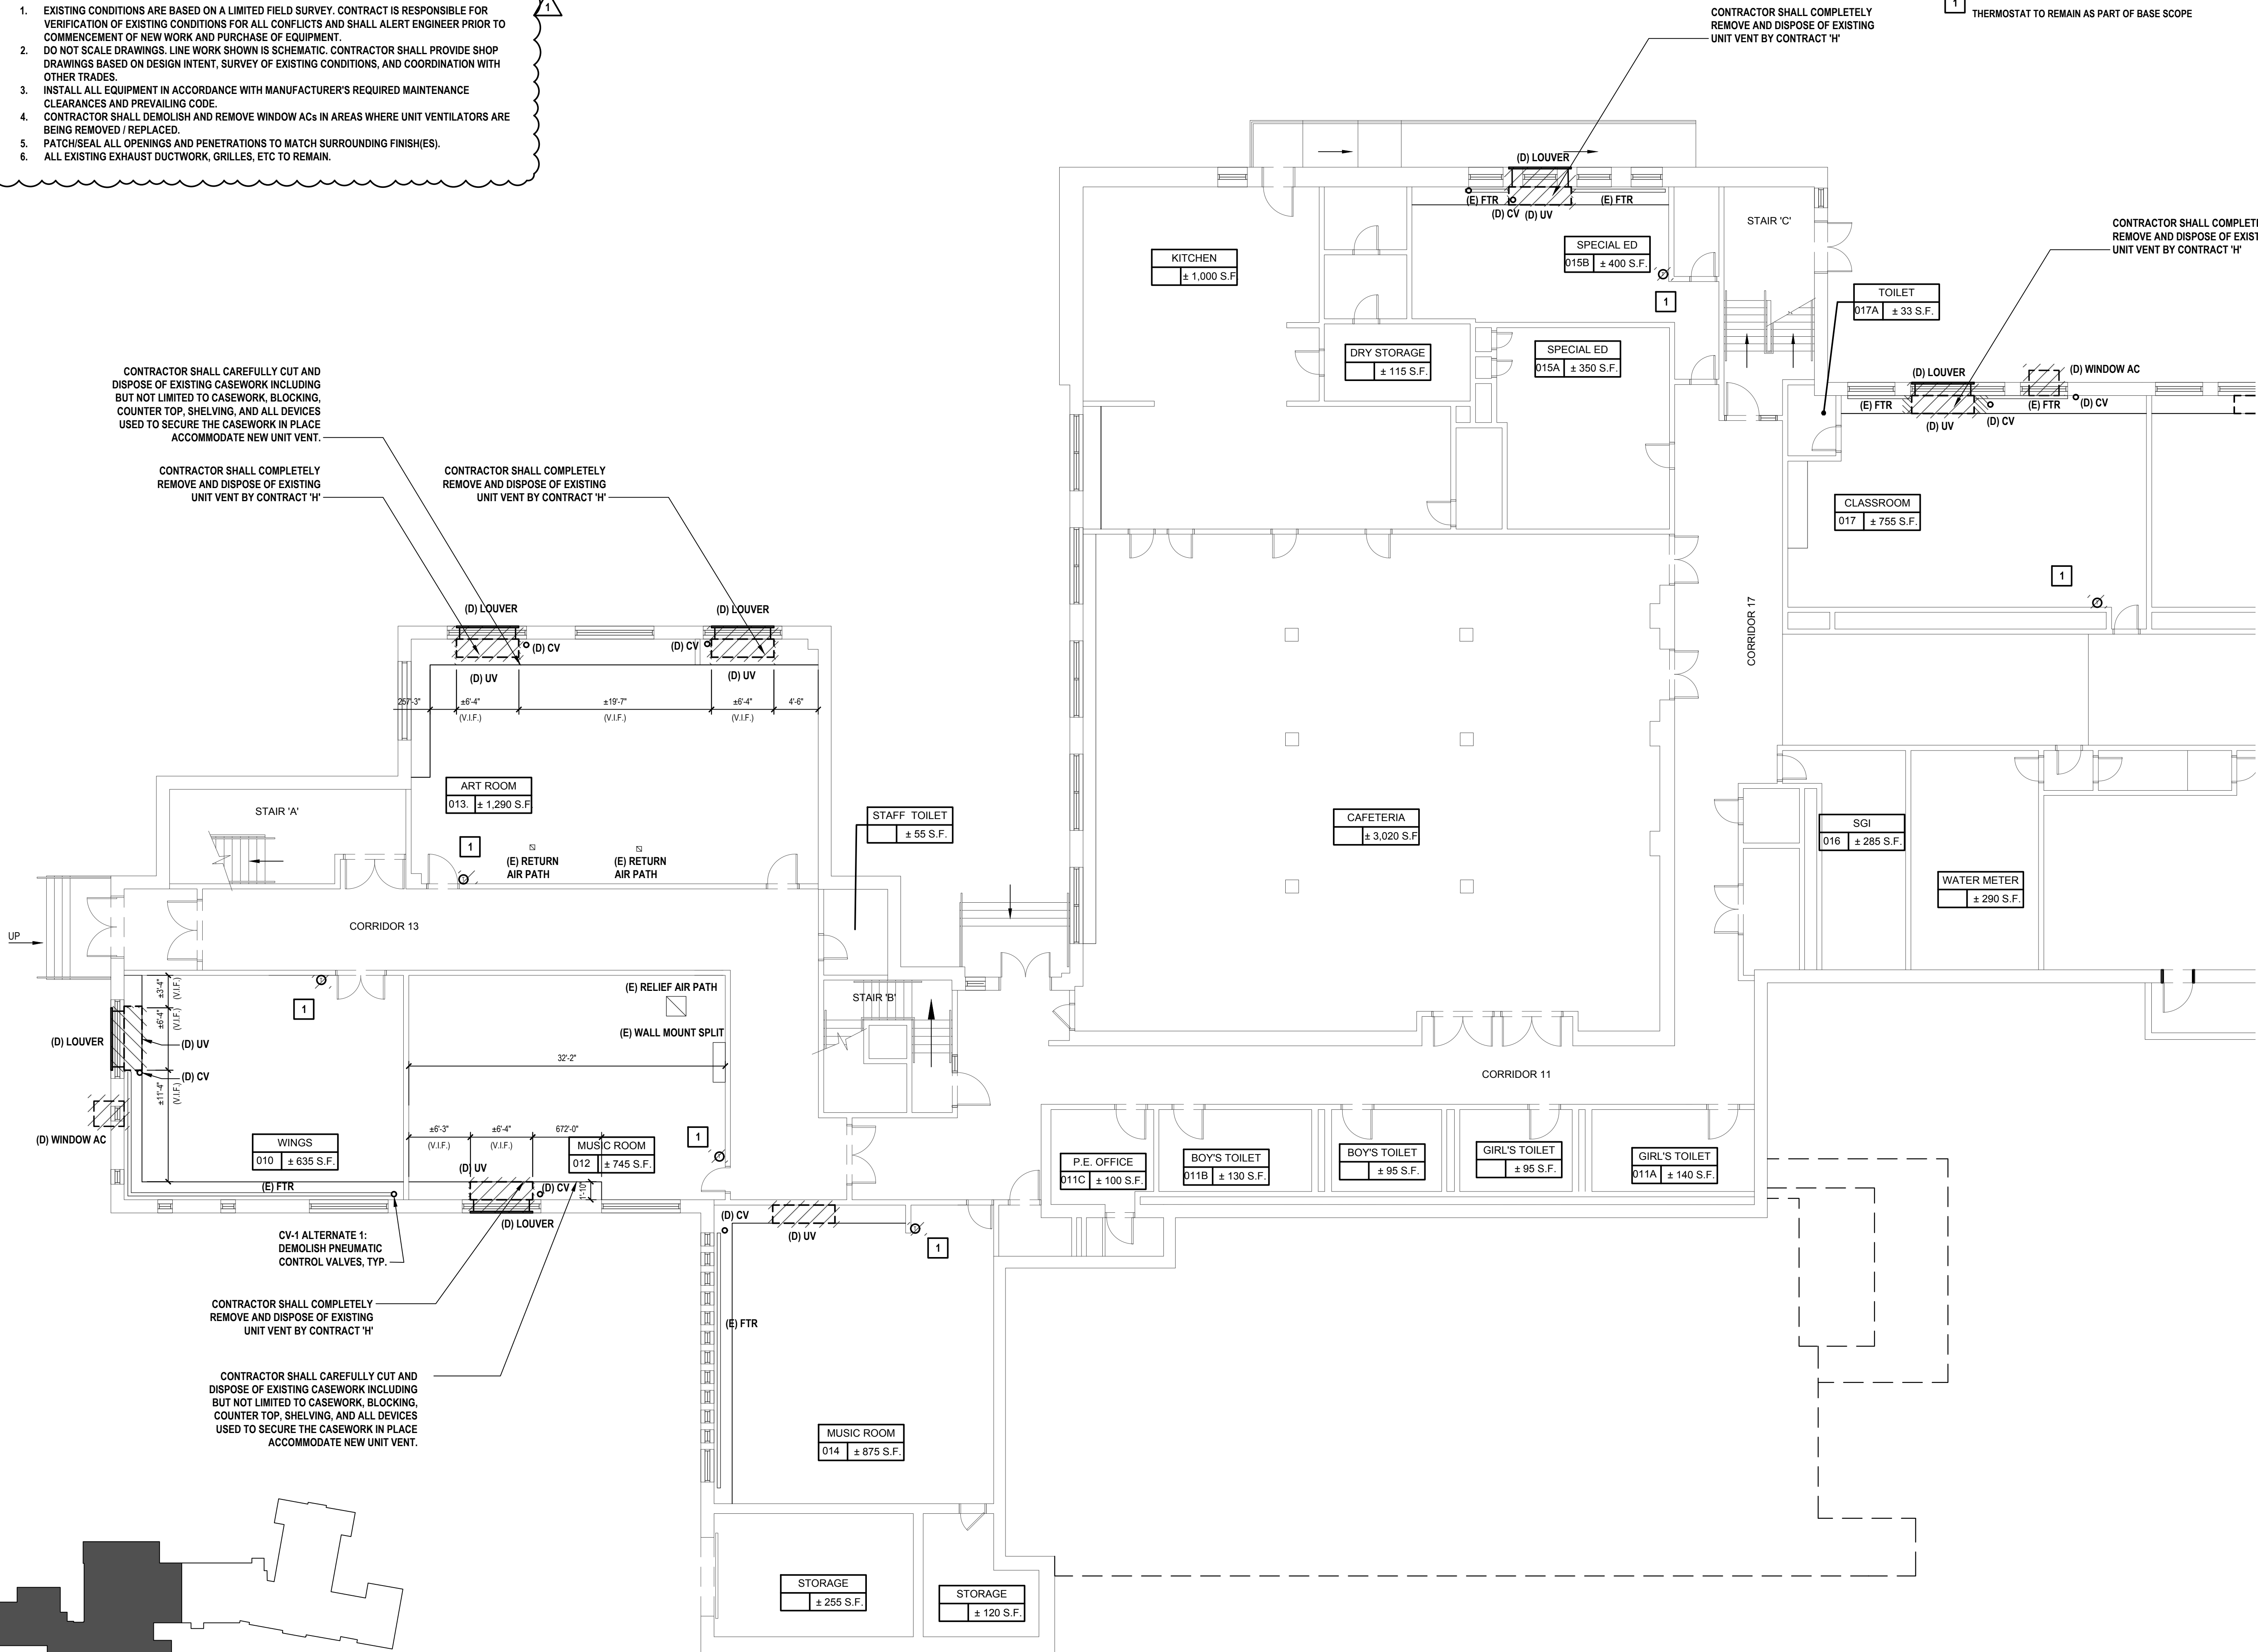


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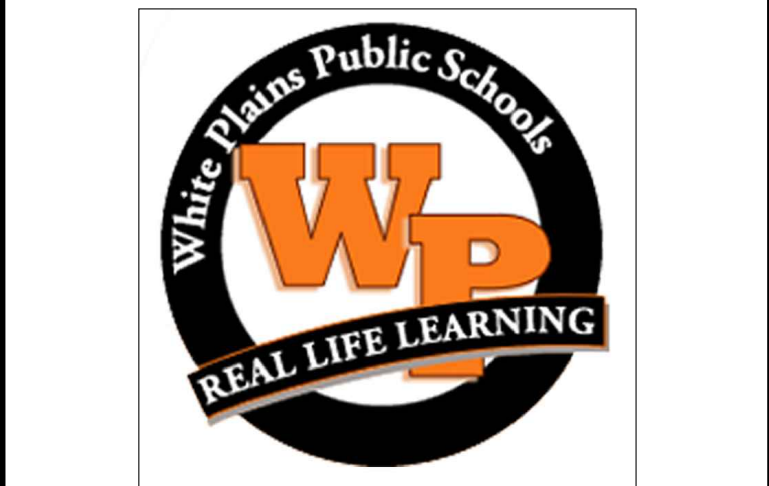
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MARK	DATE	DESCRIPTION
	10-16-23	FINAL BID DOCUMENT
1	11-01-23	ADDENDUM #1



White Plains City
School District

AC and Ventilation Upgrades
at Mamaroneck
Elementary School

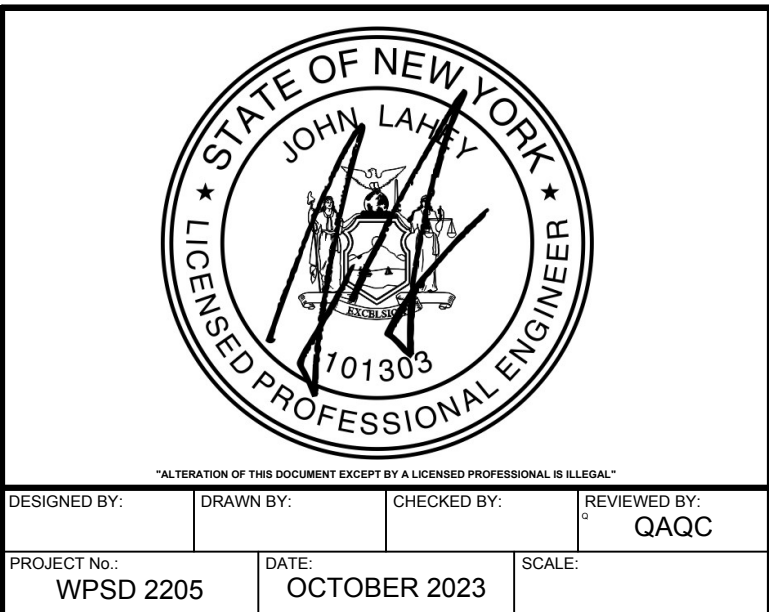

7 Nosband Ave.
White Plains, NY 10605

SED PROJECT CONTROL
NO. 66-22-00-01-0-010-017

CONTRACT
CONTRACT H
HEATING VENTILATION AND AIR
CONDITIONING

STATUS
FINAL BID DOCUMENT

SHEET TITLE
MECHANICAL GROUND
FLOOR PLAN PART A


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KEYED NOTES:

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THERMOSTAT TO REMAIN AS PART OF BASE SCOPE



Ground Floor Plan Part B

SCALE: 1/8"=1'-0"

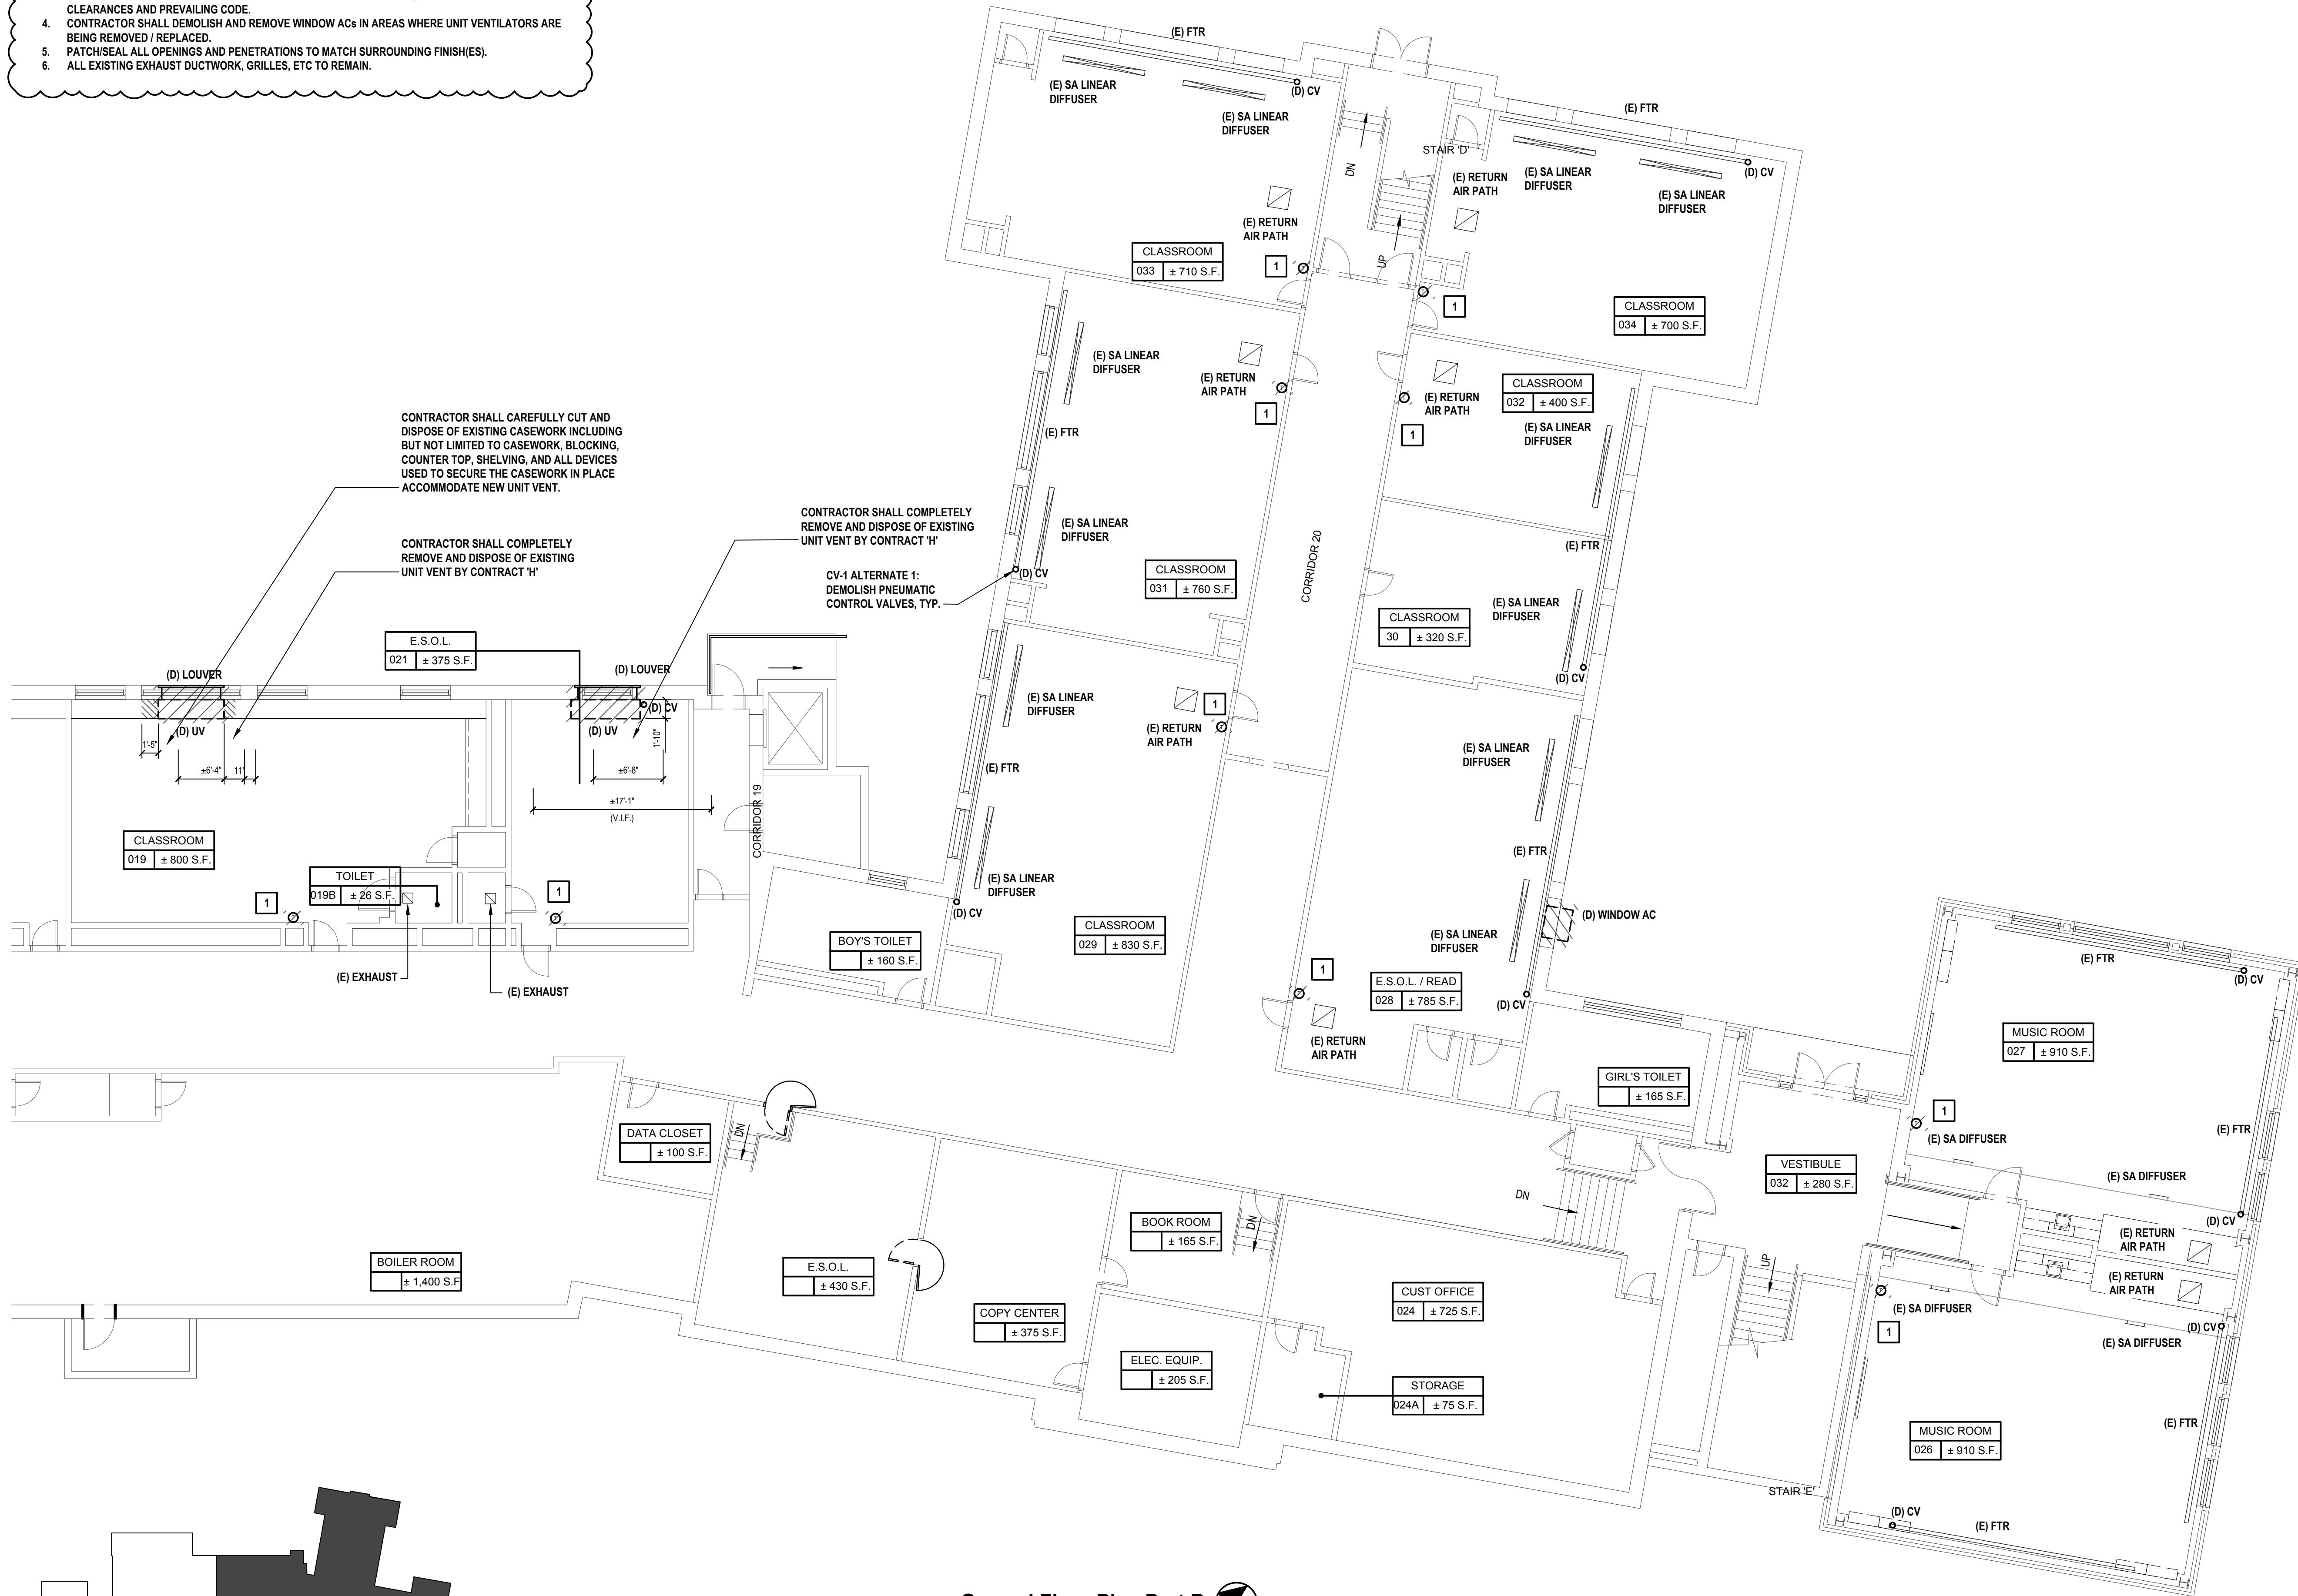Key Plan



DESIGNED BY:	DRAWN BY:	CHECKED BY:	REVIEWED BY:
MJV	KCM	MJV	QAQC
PROJECT NO:	DATE:	SCALE:	
WPSD 2205	OCTOBER 2023		

CLIENT
White Plains City School District

**AC and Ventilation Upgrades
at Mamaroneck
Elementary School**



**7 Nosband Ave.
White Plains, NY 10605**

**SED PROJECT CONTROL
NO. 66-22-00-01-0-010-017**

CONTRACT
**CONTRACT H
HEATING VENTILATION AND AIR
CONDITIONING**

STATUS
FINAL BID DOCUMENT



SHEET TITLE
**MECHANICAL GROUND FLOOR
PLAN PART B**

DRAWING No.
MD101.00

X:\PSPD\White Plains Central School District - 1081\WPSD 2205 - AC & Ventilation at Mamaroneck Elem. School\02-BIM\CADD\Construction\MD110.00 Mechanical First Floor Plan Part A.dwg Last Modified: No 01, 2023, 2:23pm Plotted on: No 01, 2023, 3:46pm By: Matarand

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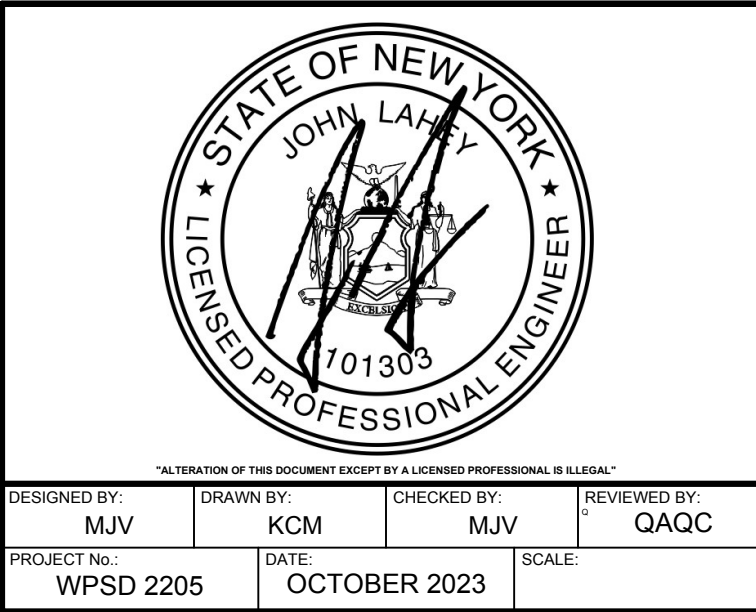
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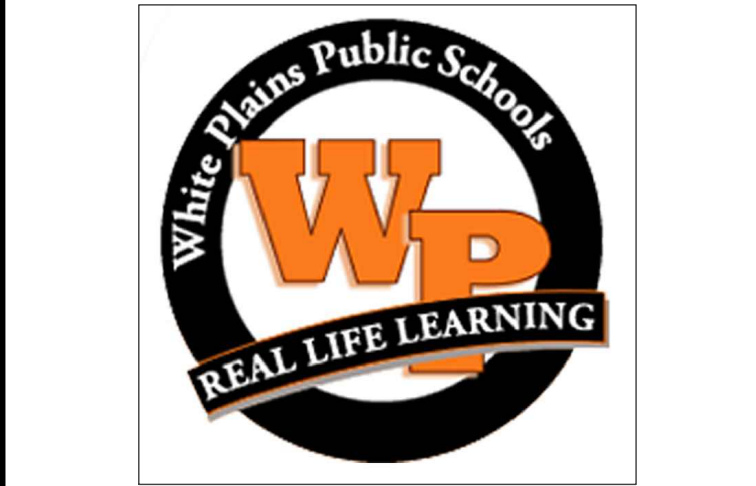
CONSULTANTS:

MARK	DATE	DESCRIPTION
	10-16-23	FINAL BID DOCUMENT
1	11-01-23	ADDENDUM #1

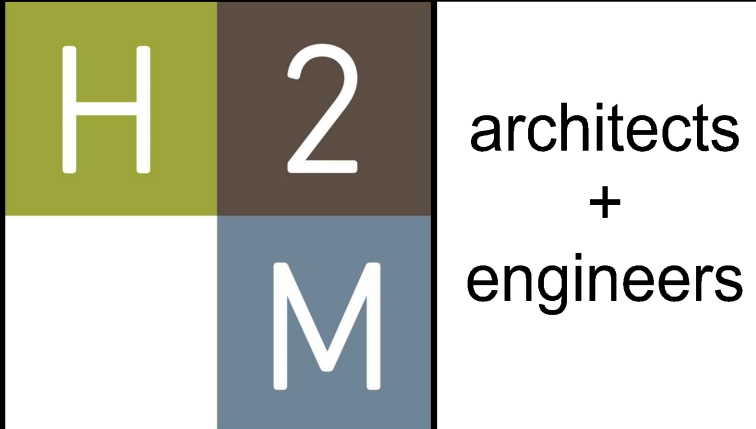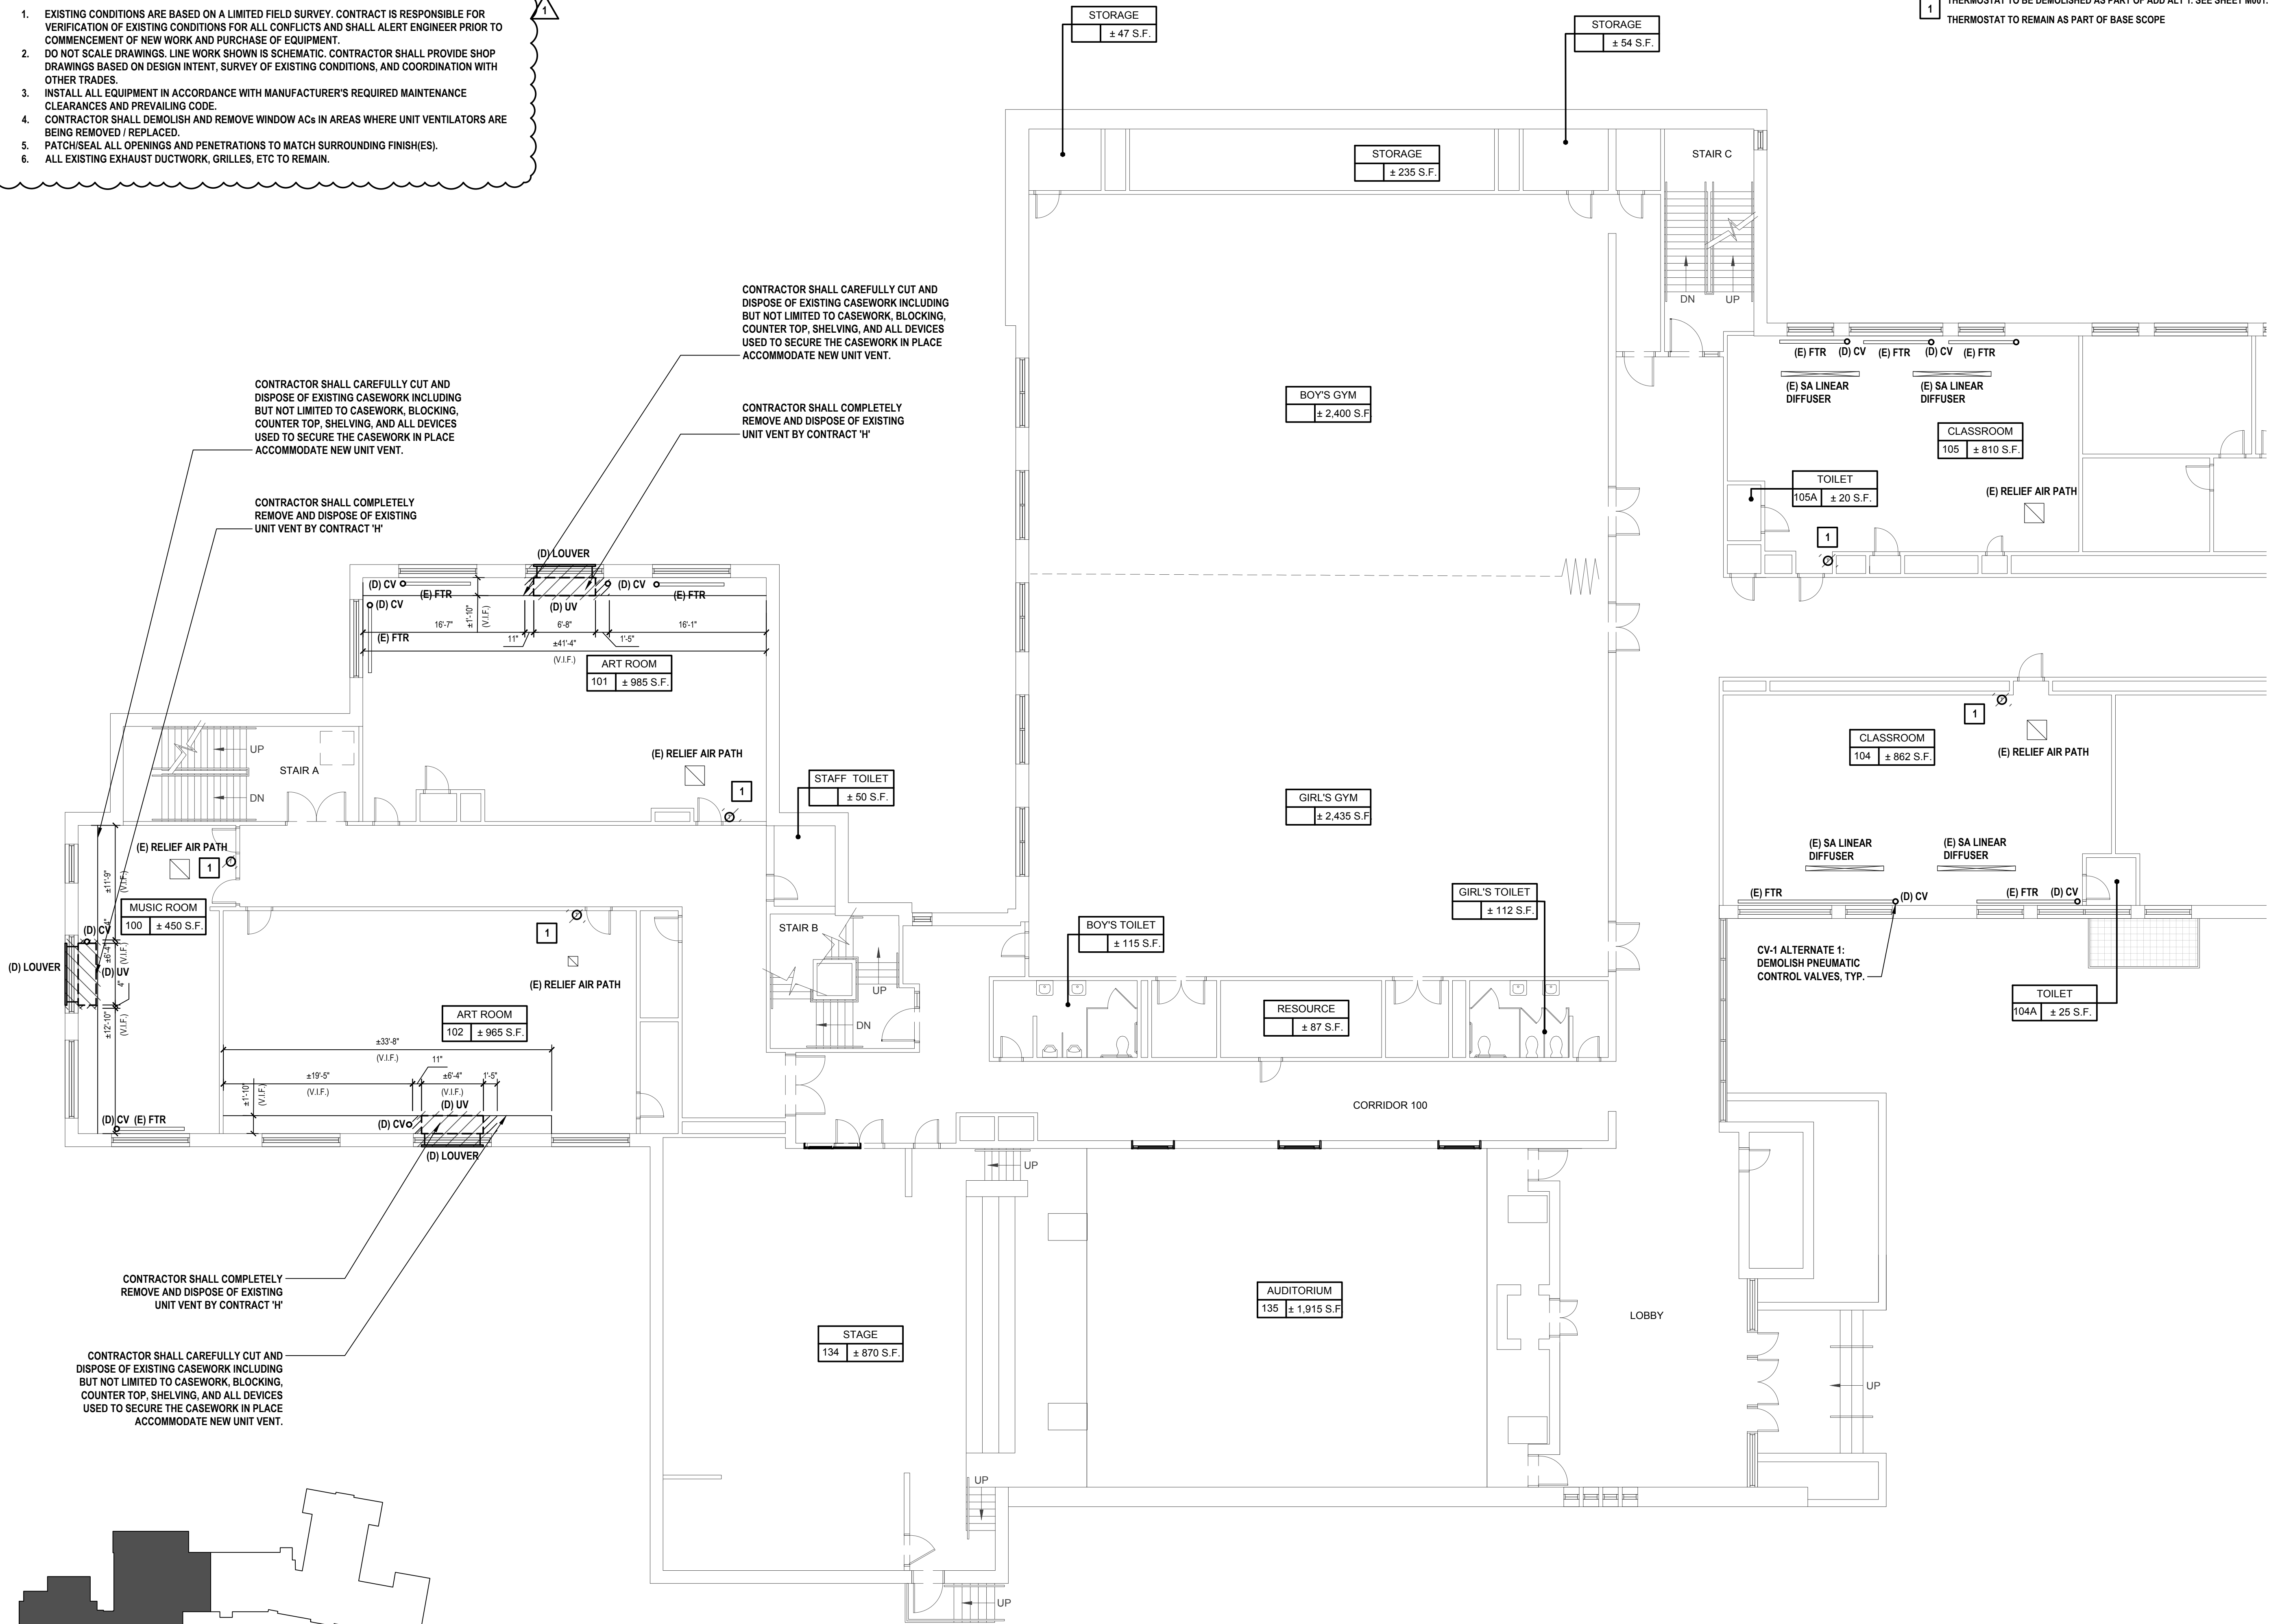

CLIENT
White Plains City School District

**AC and Ventilation Upgrades
at Mamaroneck
Elementary School**



7 Nosband Ave.
White Plains, NY 10605

SED PROJECT CONTROL
NO. 66-22-00-01-0-010-017

CONTRACT
**CONTRACT H
HEATING VENTILATION AND AIR
CONDITIONING**

STATUS
FINAL BID DOCUMENT

SHEET TITLE
**MECHANICAL FIRST FLOOR
PLAN PART A**

DRAWING No.
MD110.00



First Floor Plan Part A
SCALE: 1/8"=1'-0"


X:\WPSP\White Plains Central School District - 1081\WPSP 2205 - AC & Ventilation at Mamaroneck Elem School\02-BIM\CADD\Con.docx (w/MD111.00 Mechanical First Floor Plan Part B.rvt) Last Modified: Nov 01, 2023, 3:20pm Plotted on Nov 01, 2023, 3:24pm By: Matarand

GENERAL NOTES:


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4. CONTRACTOR SHALL DEMOLISH AND REMOVE WINDOW ACs IN AREAS WHERE UNIT VENTILATORS ARE BEING REMOVED / REPLACED.
5. PATCH/SEAL ALL OPENINGS AND PENETRATIONS TO MATCH SURROUNDING FINISHES).
6. ALL EXISTING EXHAUST DUCTWORK, GRILLES, ETC TO REMAIN.

KEYED NOTES:

- 1 THERMOSTAT TO BE DEMOLISHED AS PART OF ADD ALT 1. SEE SHEET M001.
THERMOSTAT TO REMAIN AS PART OF BASE SCOPE

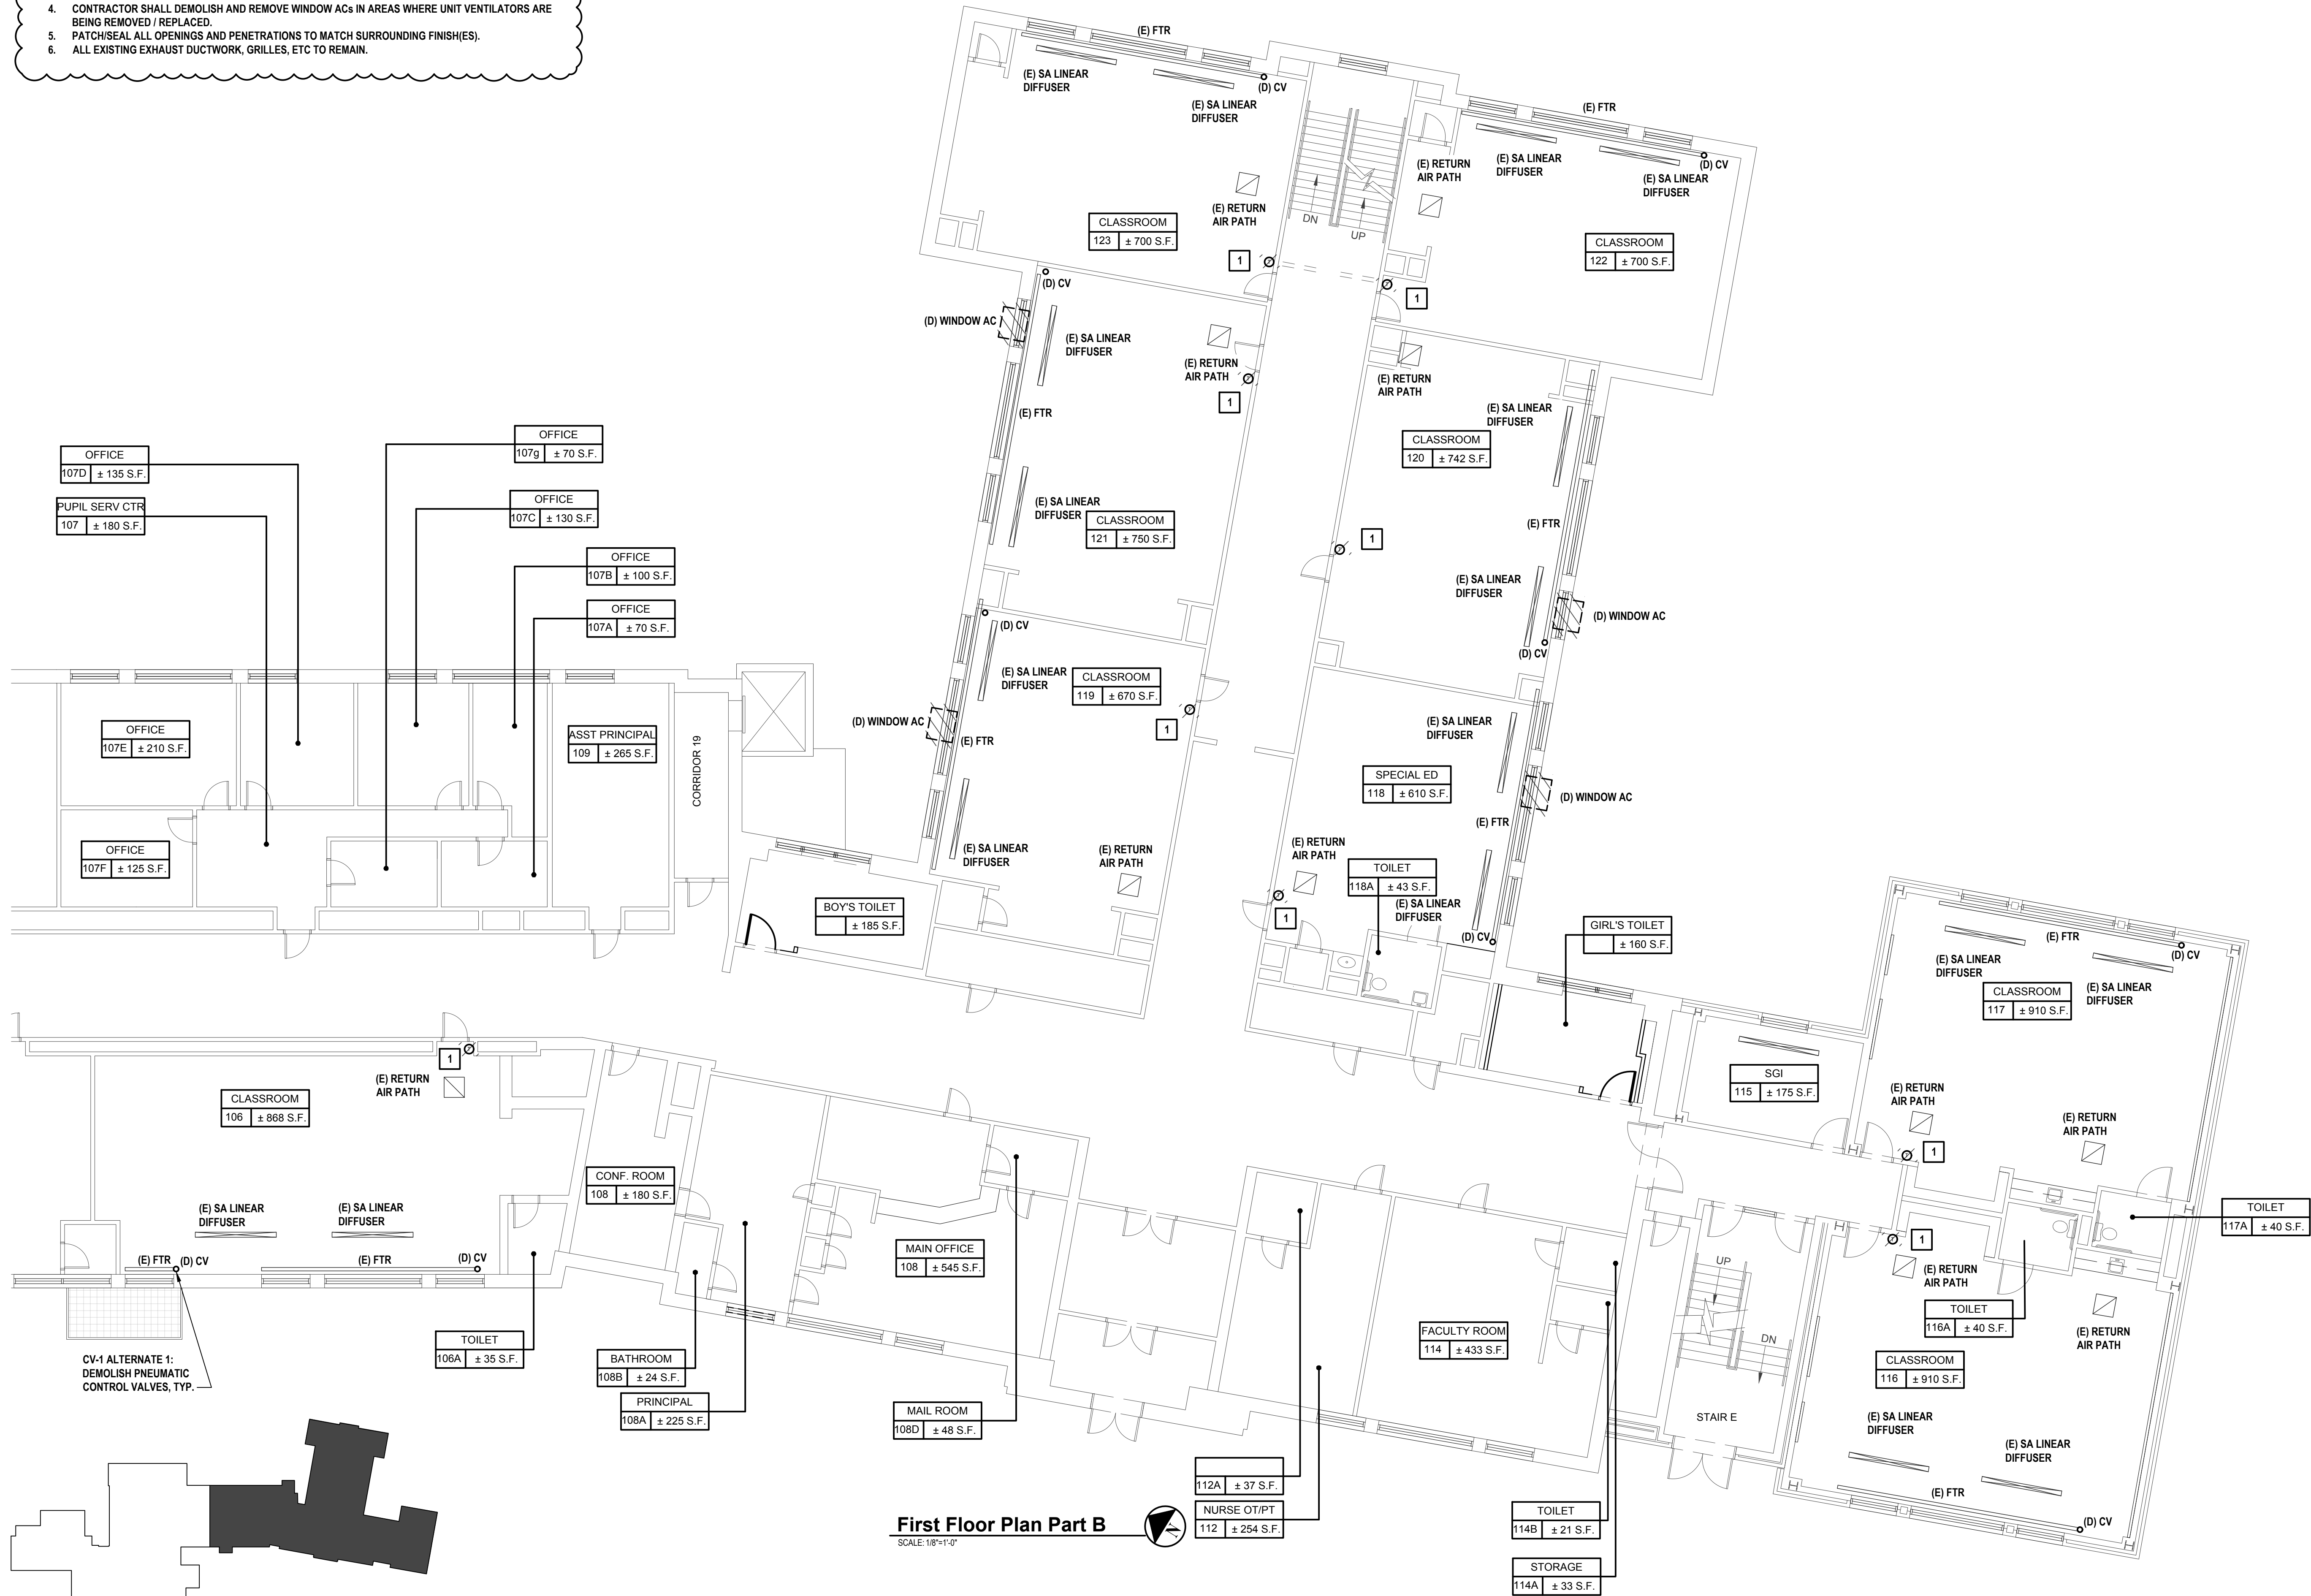

Key Plan

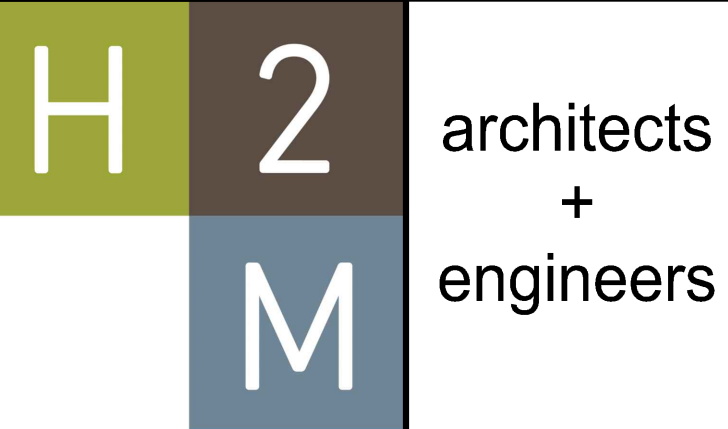

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CONSULTANTS:


MARK	DATE	DESCRIPTION
	10-16-23	FINAL BID DOCUMENT
1	11-01-23	ADDENDUM #1



DESIGNED BY:	DRAWN BY:	CHECKED BY:	REVIEWED BY:
MJV	KCM	MJV	QAQC
PROJECT No.:	DATE:	SCALE:	
WPSP 2205	OCTOBER 2023		

CLIENT
White Plains City School District

**AC and Ventilation Upgrades
at Mamaroneck
Elementary School**

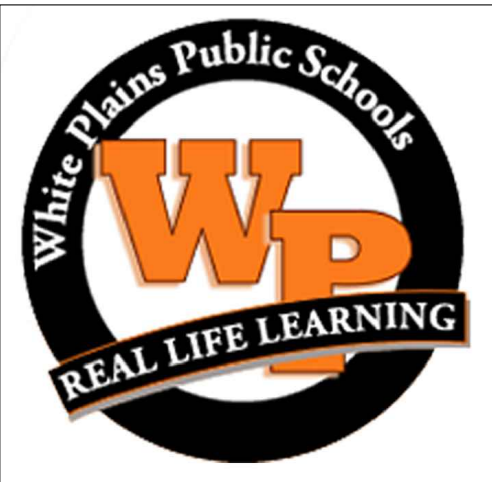

7 Nosband Ave.
White Plains, NY 10605

SED PROJECT CONTROL
NO. 66-22-00-01-0-010-017

CONTRACT
**CONTRACT H
HEATING VENTILATION AND AIR
CONDITIONING**

STATUS
FINAL BID DOCUMENT

SHEET TITLE
**MECHANICAL FIRST FLOOR
PLAN PART B**


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MD111.00

X:\PSD\White Plains Central School District - 1081\WPSD 2205 - AC & Ventilation at Mamaroneck Elem School\102-BM-CADD\Condsch\wmd120.00 Mechanical Second Floor Plan Part A.dwg Last Modified: Nov 01, 2023 3:20pm Plotted on Nov 01, 2023 3:34pm By: Mdelaney

- GENERAL NOTES:
- EXISTING CONDITIONS ARE BASED ON A LIMITED FIELD SURVEY. CONTRACT IS RESPONSIBLE FOR VERIFICATION OF EXISTING CONDITIONS FOR ALL CONFLICTS AND SHALL ALERT ENGINEER PRIOR TO COMMENCEMENT OF NEW WORK AND PURCHASE OF EQUIPMENT.
 - DO NOT SCALE DRAWINGS. LINE WORK SHOWN IS SCHEMATIC. CONTRACTOR SHALL PROVIDE SHOP DRAWINGS BASED ON DESIGN INTENT, SURVEY OF EXISTING CONDITIONS, AND COORDINATION WITH OTHER TRADES.
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THERMOSTAT TO REMAIN AS PART OF BASE SCOPE



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CONSULTANTS:

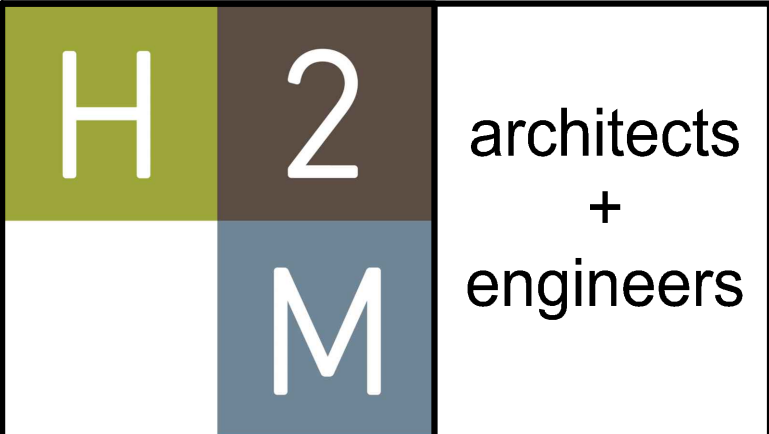MARK	DATE	DESCRIPTION
	10-16-23	FINAL BID DOCUMENT
1	11-01-23	ADDENDUM #1




DESIGNED BY:	DRAWN BY:	CHECKED BY:	REVIEWED BY:
MJV	KCM	MJV	QAQC
PROJECT NO:	DATE:	OCTOBER 2023	SCALE:
WPSD 2205			

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White Plains City School District

AC and Ventilation Upgrades
at Mamaroneck Elementary School

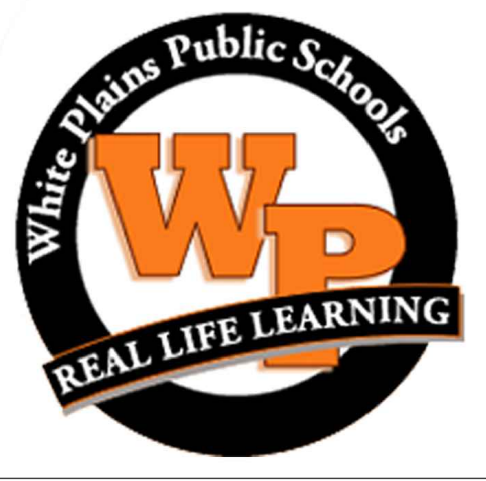

7 Nosband Ave.
White Plains, NY 10605

SED PROJECT CONTROL
NO. 66-22-00-01-0-010-017

CONTRACT

CONTRACT H
HEATING VENTILATION AND AIR
CONDITIONING

STATUS


FINAL BID DOCUMENT

SHEET TITLE

MECHANICAL SECOND FLOOR
PART A

DRAWING No.

MD120.00

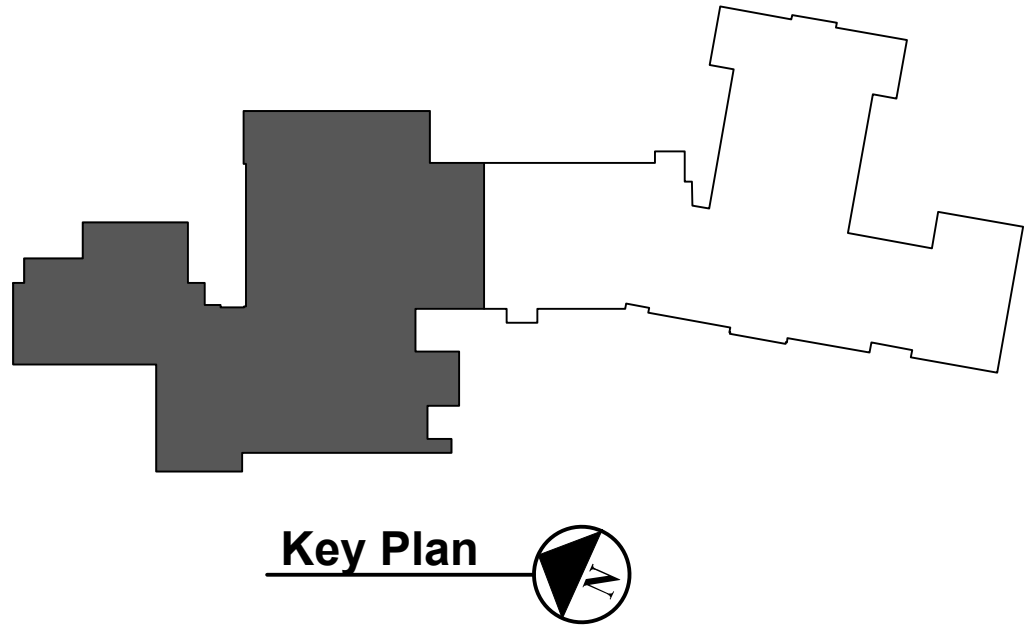

Second Floor Plan Part A


SCALE: 1/8"=1'-0"

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THERMOSTAT TO REMAIN AS PART OF BASE SCOPE




Second Floor Plan Part B

SCALE: 1/8"=1'-0"

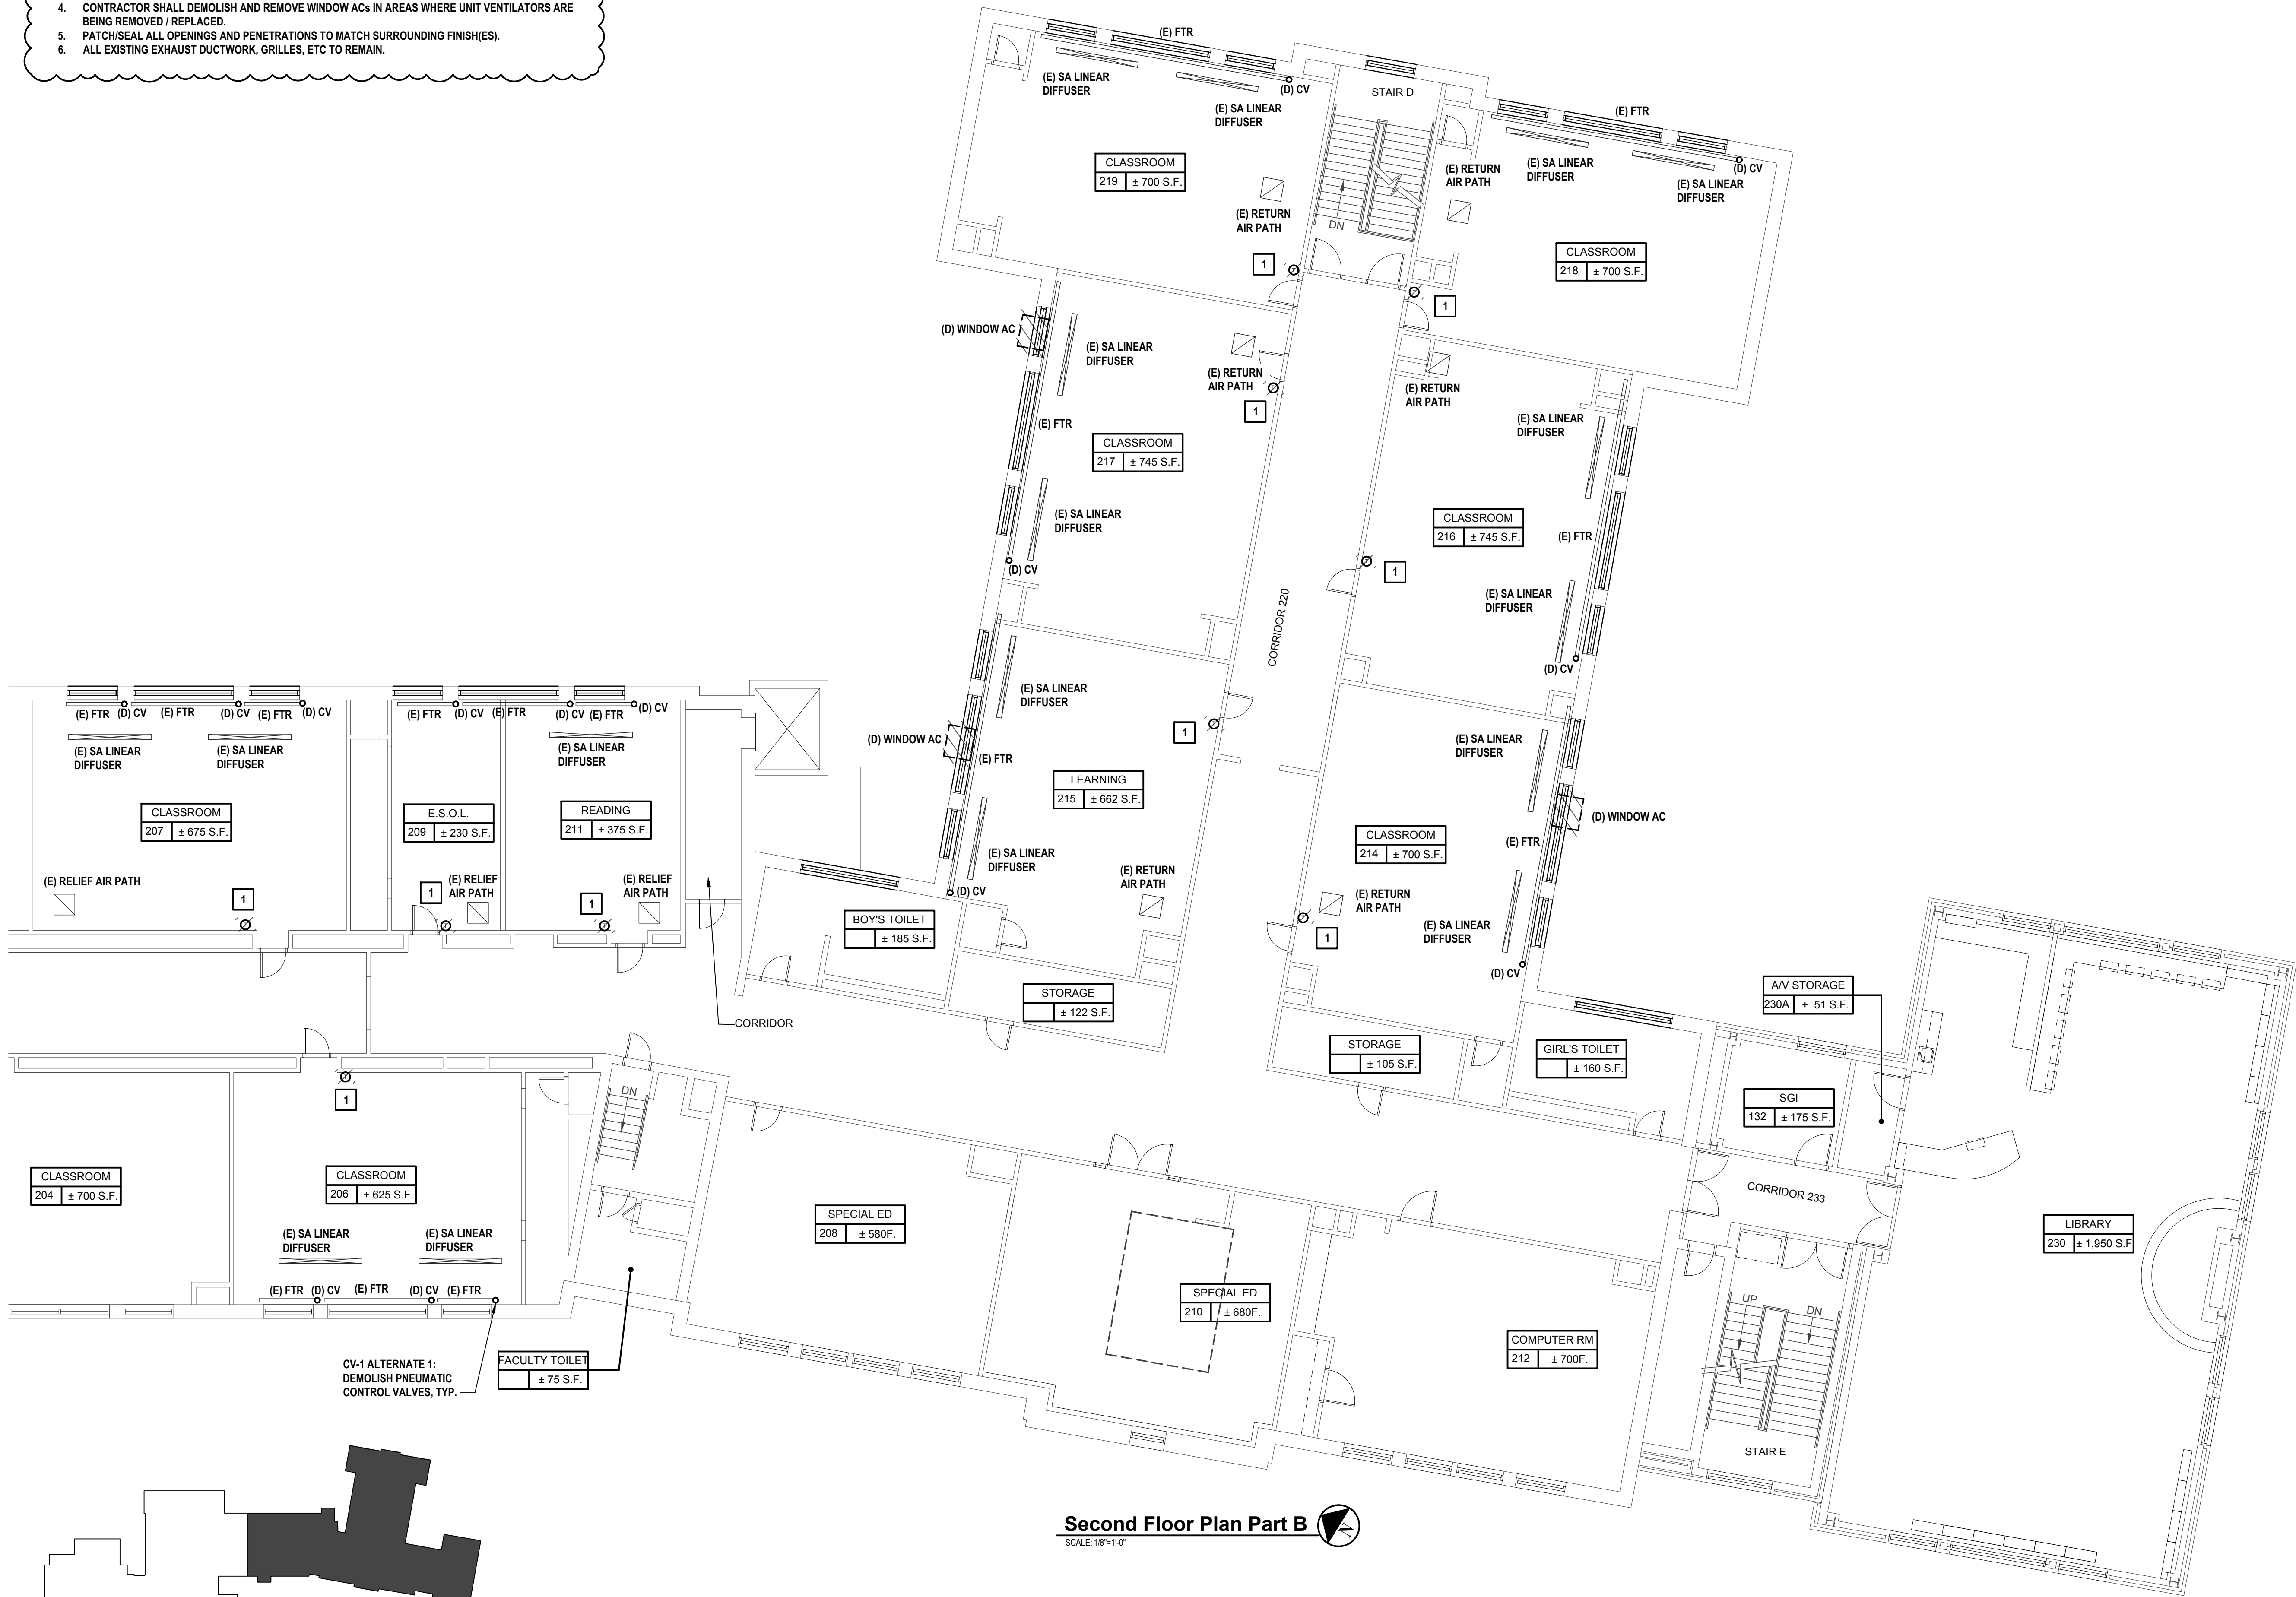

Key Plan

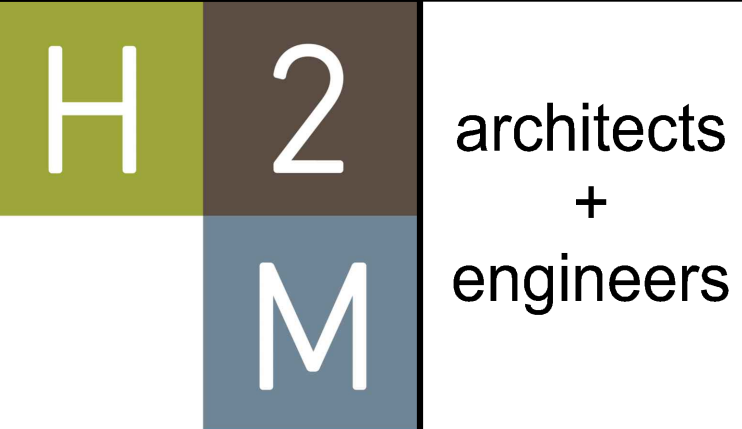

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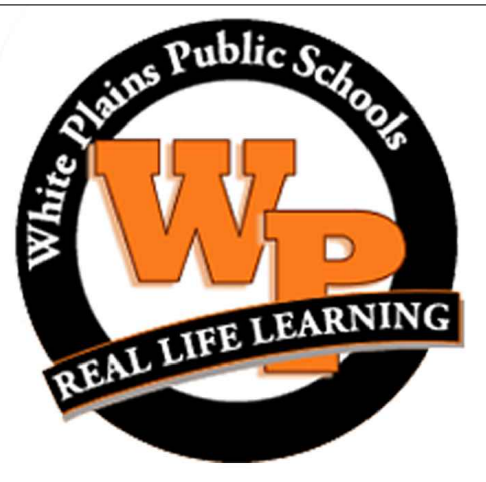
MARK	DATE	DESCRIPTION
	10-16-23	FINAL BID DOCUMENT
1	11-01-23	ADDENDUM #1



DESIGNED BY:	DRAWN BY:	CHECKED BY:	REVIEWED BY:
MJV	KCM	MJV	QAQC
PROJECT No:	DATE:	SCALE:	
WPSD 2205	OCTOBER 2023		

White Plains City School District

AC and Ventilation Upgrades
at Mamaroneck
Elementary School



7 Nosband Ave.
White Plains, NY 10605

SED PROJECT CONTROL
NO. 66-22-00-01-0-010-017

CONTRACT
CONTRACT H
HEATING VENTILATION AND AIR
CONDITIONING



STATUS
FINAL BID DOCUMENT

SHEET TITLE
MECHANICAL SECOND FLOOR
PLAN PART B

DRAWING No.
MD121.00

X:\PSD\White Plains Central School District - 10811\PSD 2205 - AC & Ventilation at Mamaroneck Elem School\02-BIM\CADD\Construction\MD 140.00 Mechanical Roof Plan Part A.dwg Last Modified: Nov 01, 2023 - 3:24pm Plotted on: Nov 01, 2023 - 3:24pm By: Mazarand

- GENERAL NOTES:
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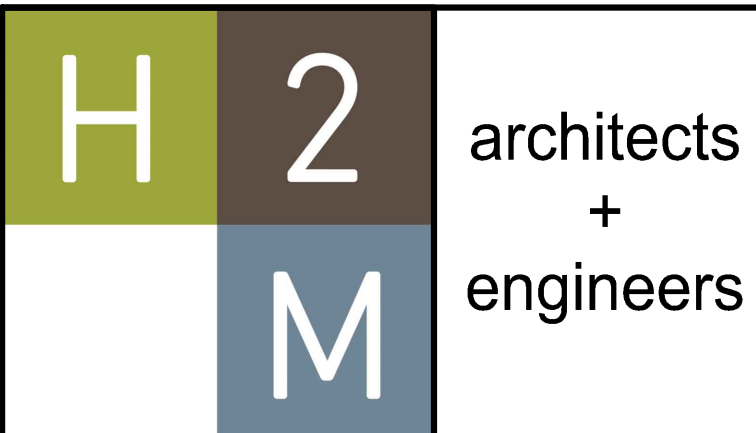


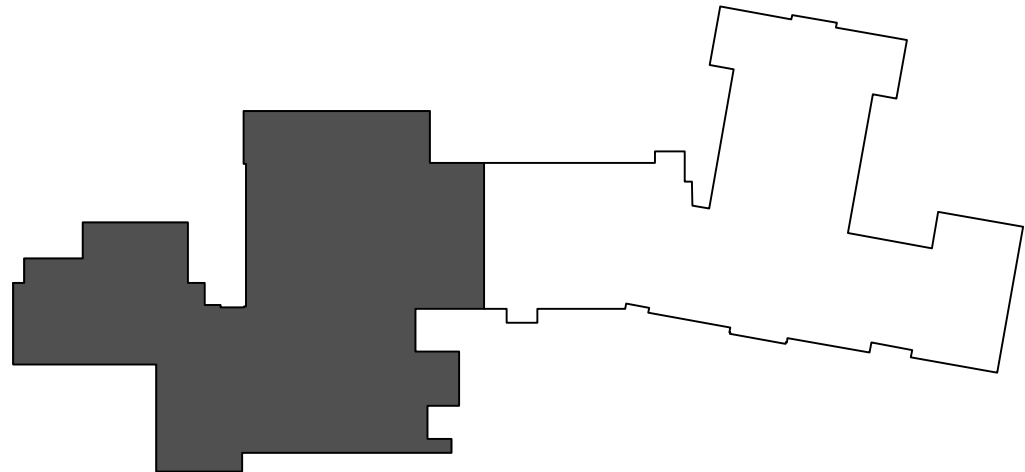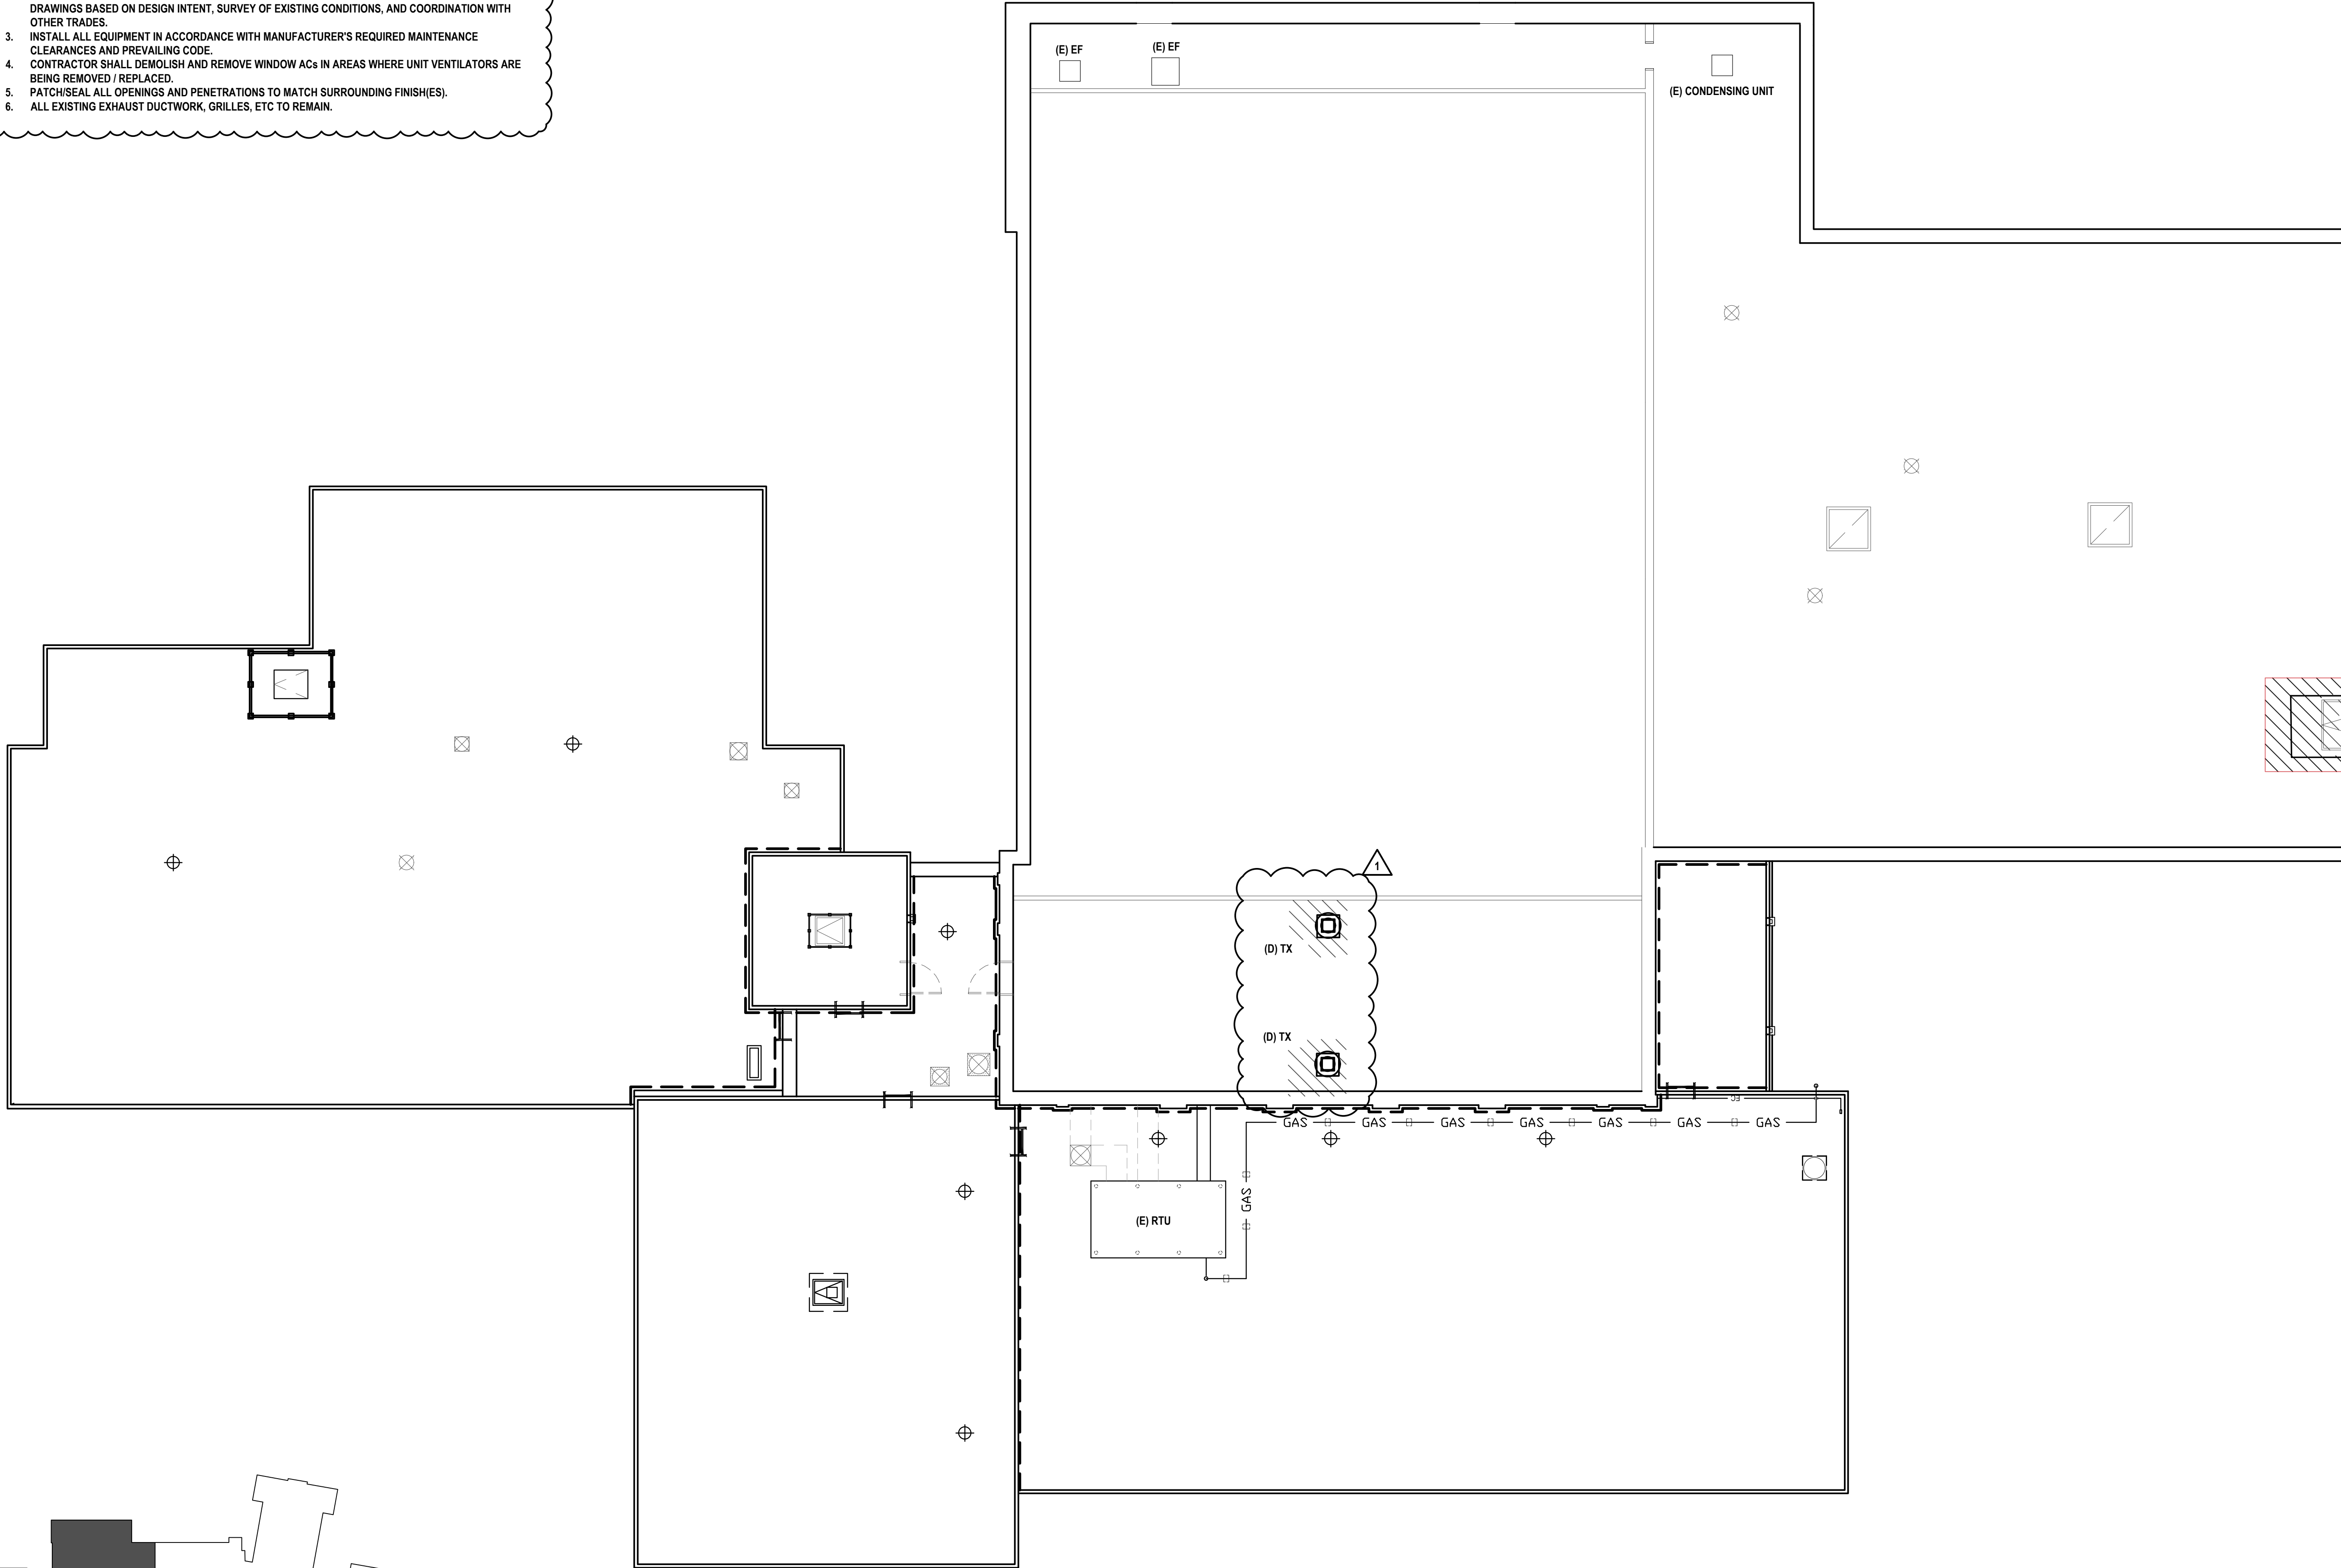Key Plan



Roof Plan Part A

SCALE: 1/8"=1'-0"



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1	11-01-23	ADDENDUM #1




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DESIGNED BY: MJV	DRAWN BY: KCM	CHECKED BY: MJV	REVIEWED BY: QAQC
PROJECT No.: WPSD 2205	DATE: OCTOBER 2023	SCALE:	

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White Plains City School District

**AC and Ventilation Upgrades
at Mamaroneck
Elementary School**



**7 Nosband Ave.
White Plains, NY 10605**

**SED PROJECT CONTROL
NO. 66-22-00-01-0-010-017**

CONTRACT

**CONTRACT H
HEATING VENTILATION AND AIR
CONDITIONING**

STATUS

FINAL BID DOCUMENT

SHEET TITLE


**MECHANICAL ROOF PLAN
PART A**

DRAWING No.

MD140.00


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- GENERAL NOTES:
1. EXISTING CONDITIONS ARE BASED ON A LIMITED FIELD SURVEY. CONTRACT IS RESPONSIBLE FOR VERIFICATION OF EXISTING CONDITIONS FOR ALL CONFLICTS AND SHALL ALERT ENGINEER PRIOR TO COMMENCEMENT OF NEW WORK AND PURCHASE OF EQUIPMENT.
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Roof Plan Part B
SCALE: 1/8"=1'-0"

Key Plan

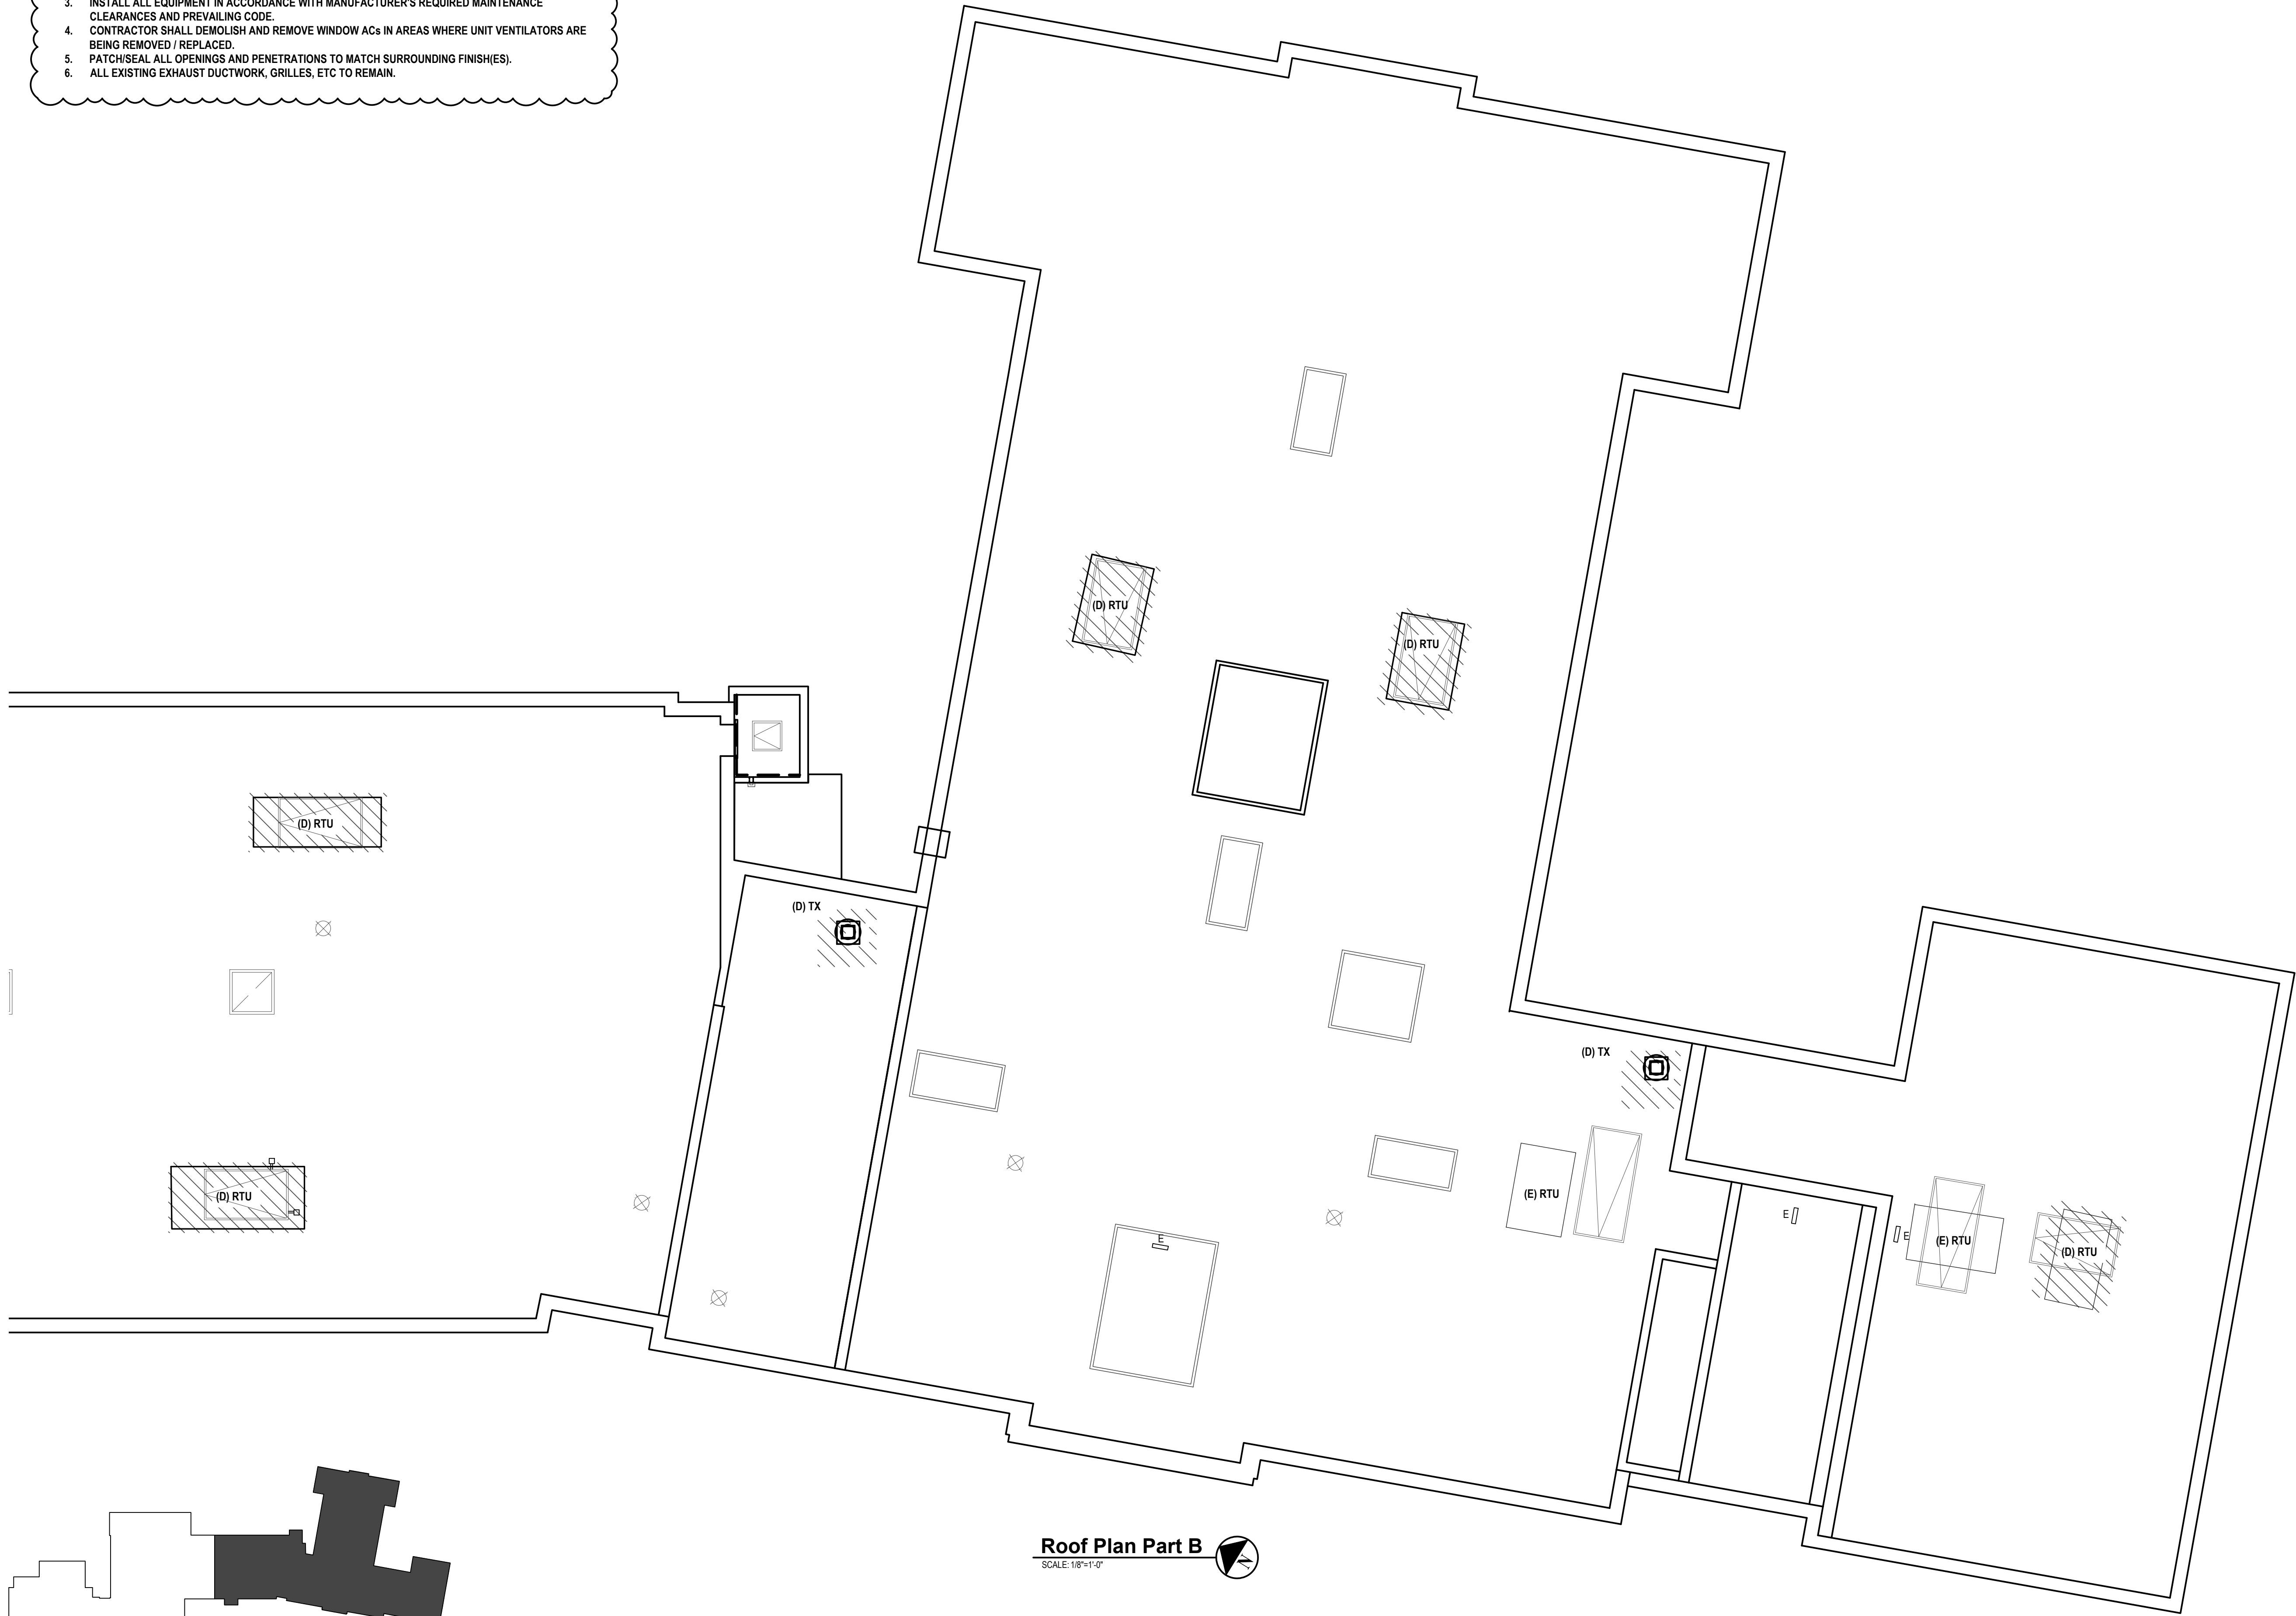

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CONSULTANTS:

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1	11-01-23	ADDENDUM #1

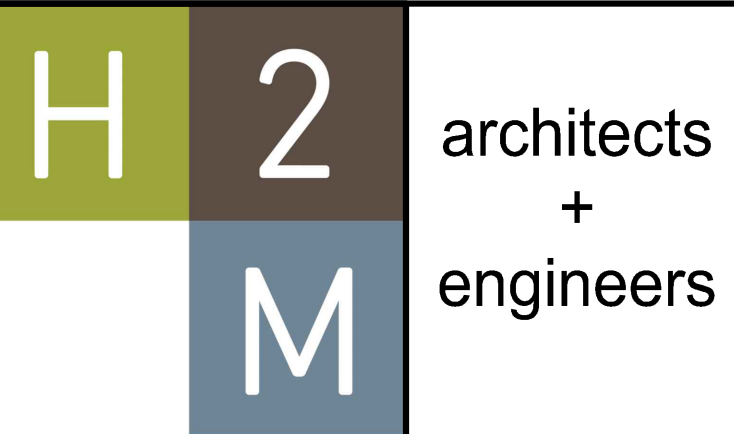


DESIGNED BY:	DRAWN BY:	CHECKED BY:	REVIEWED BY:
MJV	KCM	MJV	QAQC
PROJECT No:	DATE:	SCALE:	
WPSD 2205	OCTOBER 2023		

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White Plains City School District

**AC and Ventilation Upgrades
at Mamaroneck
Elementary School**



**7 Nosband Ave.
White Plains, NY 10605**

**SED PROJECT CONTROL
NO. 66-22-00-01-0-010-017**

CONTRACT
**CONTRACT H
HEATING VENTILATION AND AIR
CONDITIONING**

STATUS
FINAL BID DOCUMENT

SHEET TITLE
**MECHANICAL ROOF PLAN
PART B**

DRAWING No.
MD141.00

GENERAL NOTES:

1. REFRIGERANT PIPING IS SCHEMATIC FINAL PIPE LAYOUT AND SIZING TO BE PROVIDED AND VERIFIED THROUGH MANUFACTURER SOFTWARE AND SUBMITTED FOR ENGINEER APPROVAL.
2. RETURN AIR PATHS ARE EXISTING TO REMAIN.
3. ALL CONDENSATE PIPES TO BE PITCHED 1/8" PER FOOT. DRAIN INDIRECTLY IN LOCATIONS SHOWN
4. COORDINATE WITH STRUCTURE AND EXISTING DUCTWORK, OFFSET AS REQUIRED.
5. ALL DUCT SIZES ARE CLEAR INSIDE DIMENSIONS. REFER TO SPECIFICATIONS FOR ALL DUCT CONSTRUCTION REQUIREMENTS.
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7. NEW REFRIGERANT PIPING SHALL BE ROUTED DOWN FROM CONDENSING UNIT ON ROOFTOP TO THE ASSOCIATED FLOOR MOUNTED UNIT VENTILATOR(S), SIZED PIPING TAKE-OFF(S) AS PER MANUFACTURER'S SPECIFICATIONS FOR EACH FLOOR MOUNTED VENTILATOR. PIPING SHALL ROUTE DOWN FROM CEILING ABOVE FOR CONNECTION TO NEW UNIT VENTILATOR(S). CONTRACTOR IS RESPONSIBLE FOR COORDINATING ALTERATIONS TO EXISTING CASEWORK TO PROPERLY HIDE REFRIGERANT PIPING, EXPANSION VALVES, AND MAINTAIN EXISTING AESTHETIC.
8. SEE M502 FOR ALTERNATE #1.
9. THE CONTRACTOR SHALL REMOVE, PROTECT AND REINSTALL ALL CEILING SYSTEMS AS REQUIRED TO ACCOMMODATE NEW WORK. ANY DAMAGED CEILING SYSTEMS, WALLS OR FLOORS SHALL BE REPLACED IN-KIND AT NO ADDITIONAL COST TO THE OWNER.
10. EXISTING WALL, FLOOR AND CEILING FINISHES SHALL REMAIN IN PLACE U.O.N.. THE CONTRACTOR SHALL PATCH AND REPAIR ALL WALLS, FLOORING AND CEILINGS IN AREA OF WORK TO MATCH ADJACENT FINISHES AND PREPARE NEW CONSTRUCTION.

KEYED NOTES:

- 1 PROVIDE NEW MANUFACTURER LOUVER FOR UNIT VENTILATOR
- 2 UNIT VENTILATOR 3/4" CONDENSATE DRAIN THROUGH WALL TURN DOWN. TERMINATE +/- 24" ABOVE FINISHED GRADE
- 3 EXISTING VENTILATION TO REMAIN
- 4 EXISTING EXHAUST TO REMAIN
- 5 EXISTING RELIEF TO REMAIN
- 6 PROVIDE AND INSTALL NEW UNIT VENTILATOR (UV) WITH NEW DDC CONTROLS, NEW DDC THERMOSTAT
- 7 PROVIDE AND INSTALL NEW CEILING-MOUNTED CASSETTE VRF FAN COIL UNIT (AC) WITH NEW DDC CONTROLS, NEW DDC THERMOSTAT. FOR LAY-IN CEILING APPLICATIONS, MODIFY CEILING AS REQUIRED AND PROVIDE TRIM/FLANGE KIT.

EXISTING LAMINATE CASE WORK TO BE MODIFIED AS NECESSARY TO ACCOMMODATE NEW UNIT VENT.

EXISTING LAMINATE CASE WORK TO BE MODIFIED AS NECESSARY TO ACCOMMODATE NEW UNIT VENT.

NEW UNIT VENT BY CONTRACT 'H'

NEW UNIT VENT BY CONTRACT 'H'

REF. PIPING (TYP.)

CV-1 ALTERNATE 1: NEW ELECTRONIC CONTROL VALVE - INTEGRATE INTO LOCAL THERMOSTAT AND EXISTING BMS. TYP.

NEW UNIT VENT BY CONTRACT 'H'



EXISTING LAMINATE CASE WORK TO BE MODIFIED AS NECESSARY TO ACCOMMODATE NEW UNIT VENT.

Key Plan



Ground Floor Plan Part A

SCALE: 1/8"=1'-0"

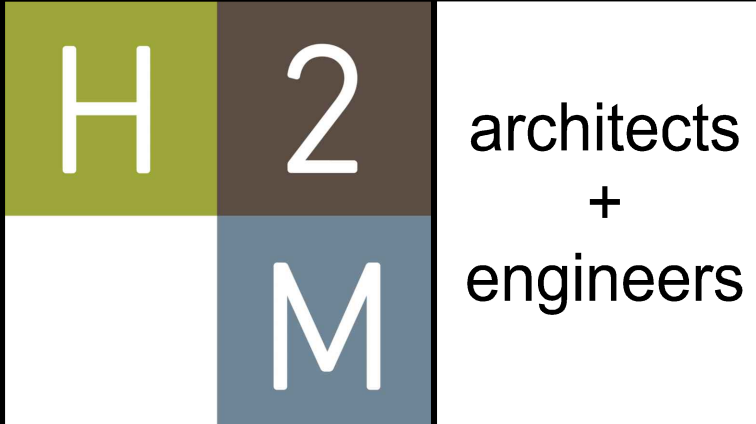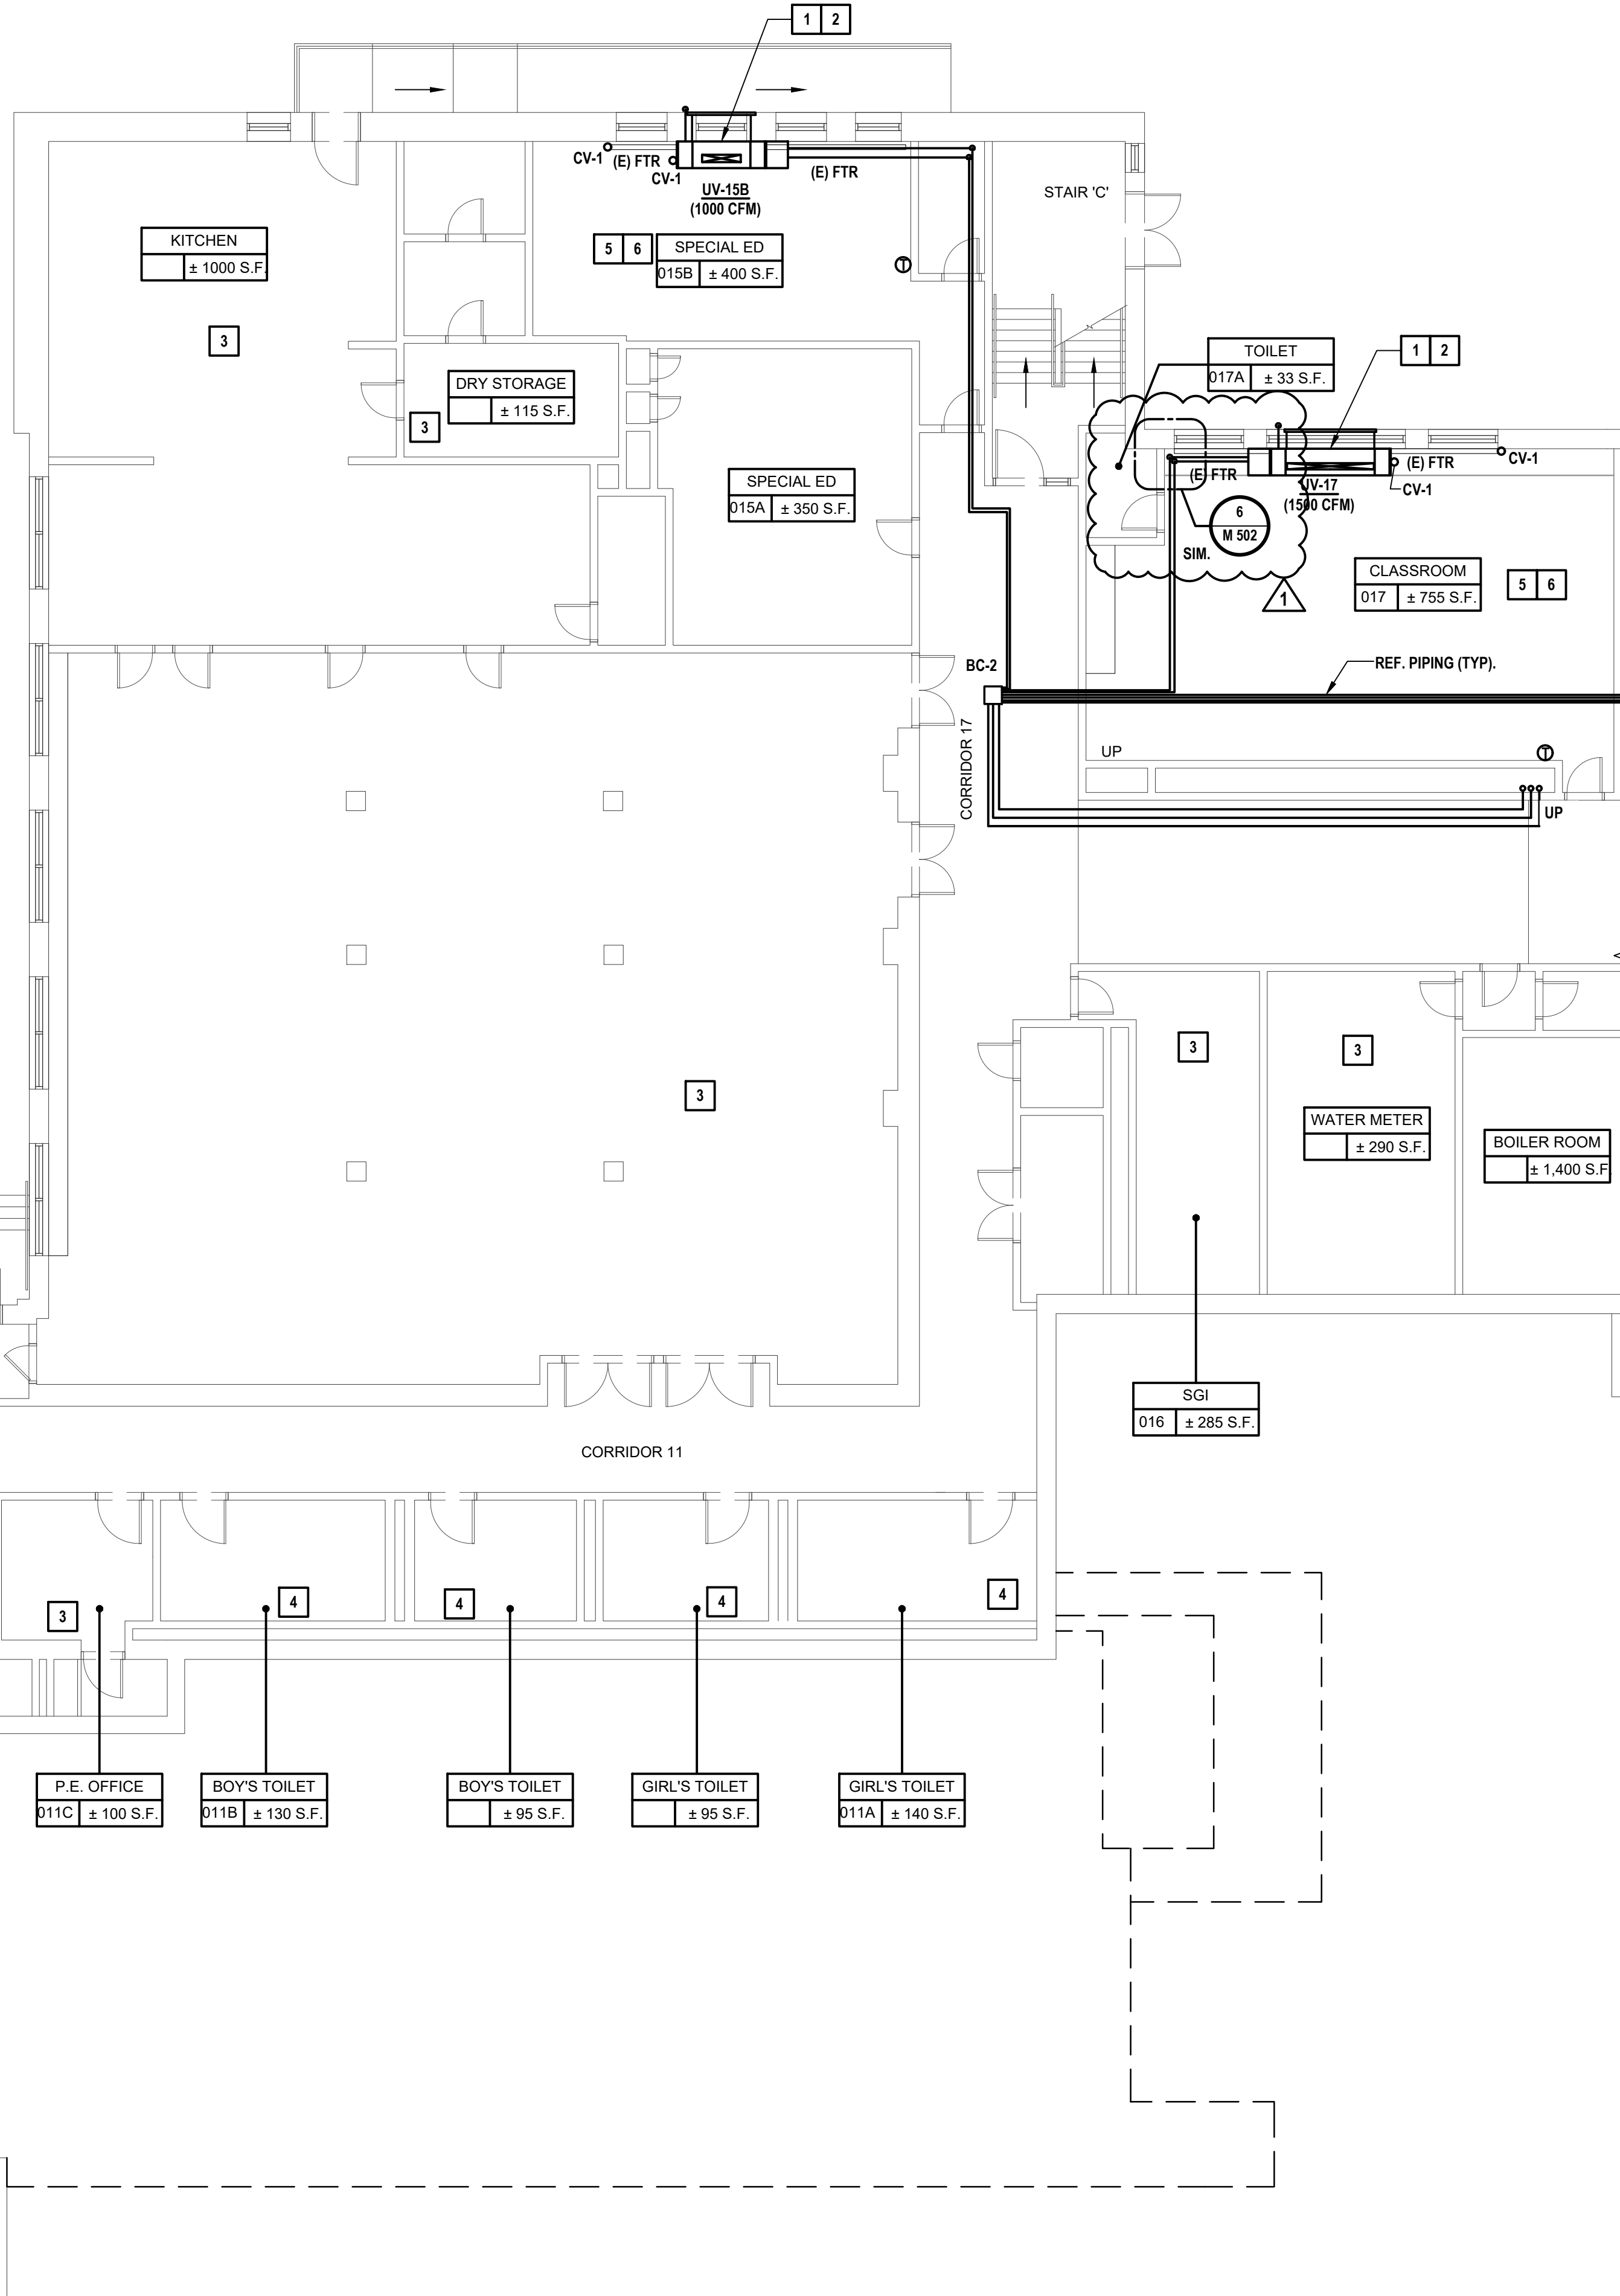

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CONSULTANTS:

MARK	DATE	DESCRIPTION
	10-16-23	FINAL BID DOCUMENT
1	11-01-23	ADDENDUM #1



DESIGNED BY:	DRAWN BY:	CHECKED BY:	REVIEWED BY:
PROJECT NO:	DATE:	SCALE:	QA/QC
WPSD 2205	OCTOBER 2023		

CLIENT
White Plains City School District

**AC and Ventilation Upgrades
at Mamaroneck
Elementary School**



7 Nosband Ave.
White Plains, NY 10605

**SED PROJECT CONTROL
NO. 66-22-00-01-0-010-017**

CONTRACT
**CONTRACT H
HEATING VENTILATION AND AIR
CONDITIONING**


STATUS
FINAL BID DOCUMENT

SHEET TITLE
**MECHANICAL GROUND
FLOOR PLAN PART A**

DRAWING No.
M100.00

X:\WPSD\White Plains City School District\1081\WPSD 2205 - AC & Ventilation at Mamaroneck Elem School\02-BIM-CADD\Construction\100-00 Mechanical Ground Floor Plan.dwg Last Modified: Nov 01, 2023, 3:51pm Plotted on: Nov 01, 2023, 3:52pm By: dlovas

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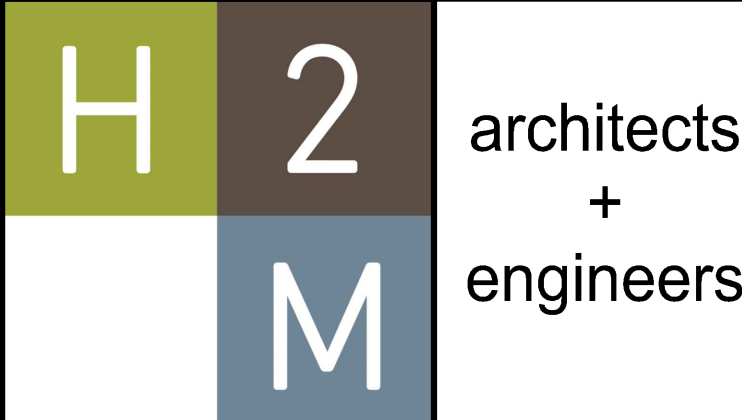

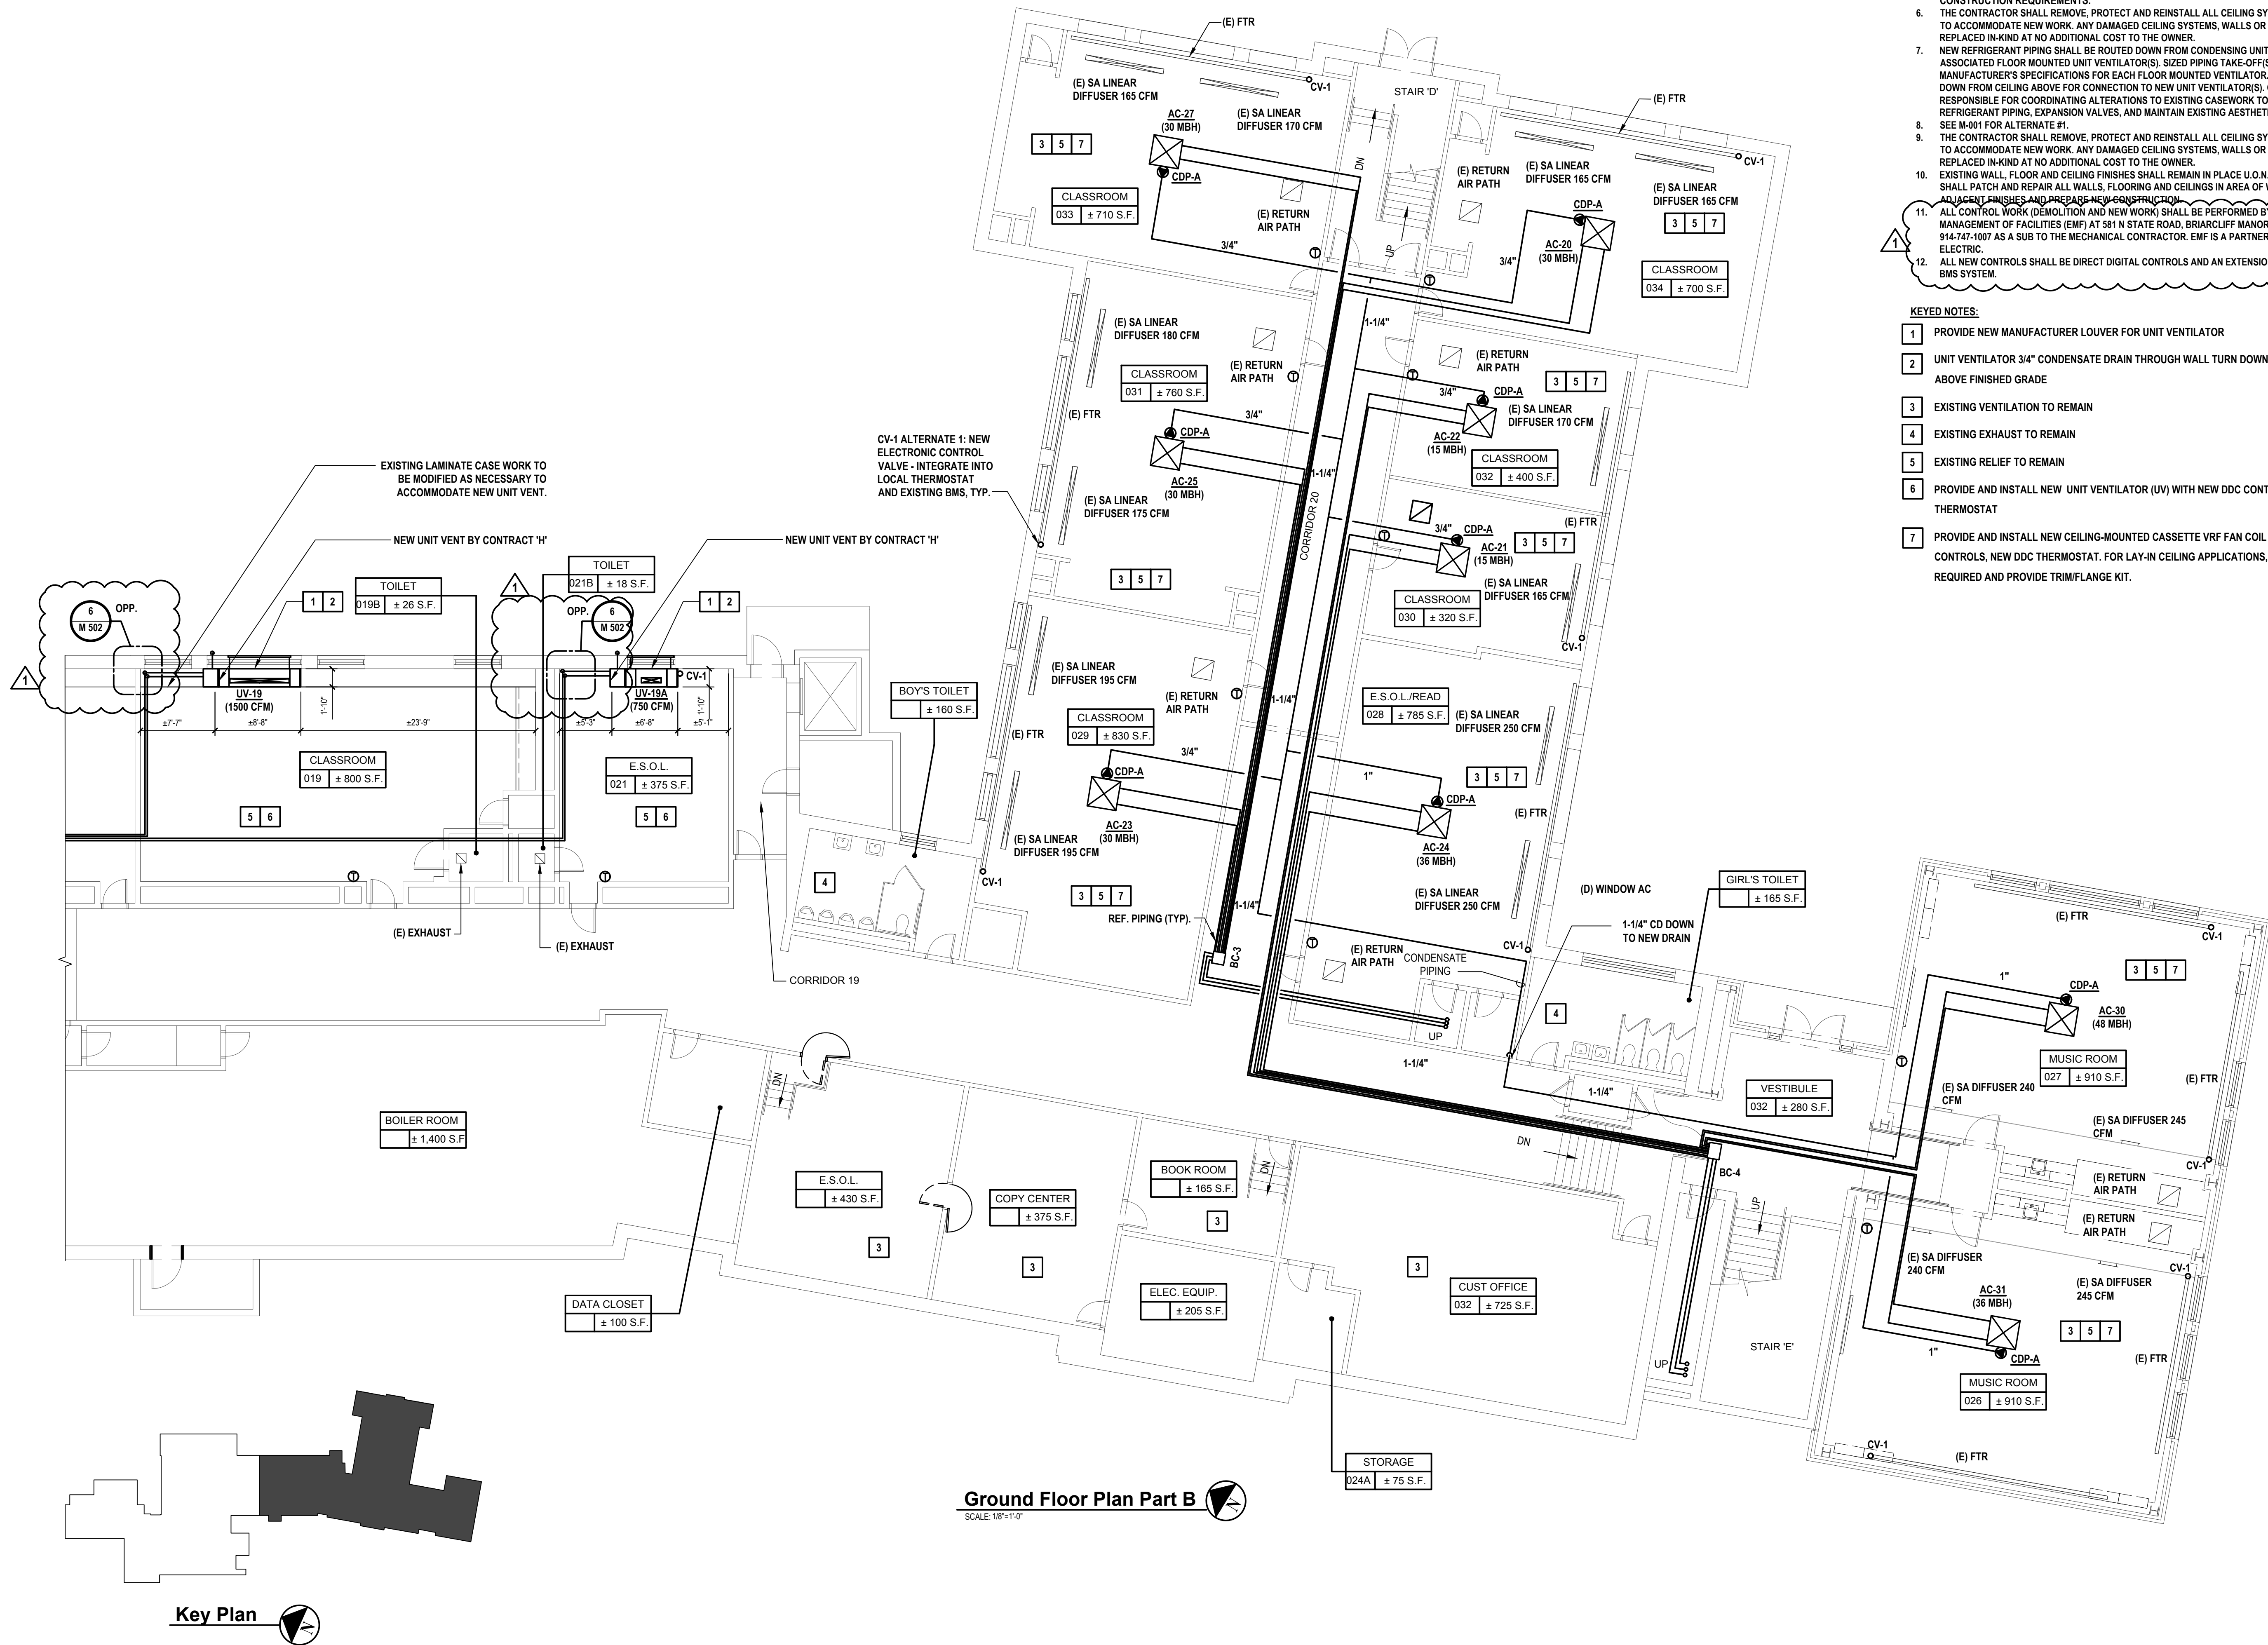
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- SEE M-401 FOR ALTERNATE #1.
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- ALL CONTROL WORK (DEMOLITION AND NEW WORK) SHALL BE PERFORMED BY ENERGY MANAGEMENT OF FACILITIES (EMF) AT 581 N STATE ROAD, BRIARCLIFF MANOR, NY 10510 - PHONE 914-747-1007 AS A SUB TO THE MECHANICAL CONTRACTOR. EMF IS A PARTNER OF SCHNEIDER ELECTRIC.
- ALL NEW CONTROLS SHALL BE DIRECT DIGITAL CONTROLS AND AN EXTENSION OF EMP'S EXISTING BMS SYSTEM.

KEYED NOTES:

- PROVIDE NEW MANUFACTURER LOUVER FOR UNIT VENTILATOR
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CONSULTANTS:

MARK	DATE	DESCRIPTION
	10-16-23	FINAL BID DOCUMENT
1	11-01-23	ADDENDUM #1



DESIGNED BY: MJV	DRAWN BY: KCM	CHECKED BY: MJV	REVIEWED BY: QAQC
PROJECT NO: WP5D 2205	DATE: OCTOBER 2023	SCALE:	

White Plains City School District

AC and Ventilation Upgrades
at Mamaroneck
Elementary School



7 Nosband Ave.
White Plains, NY 10605

SED PROJECT CONTROL
NO. 66-22-00-01-0-010-017

CONTRACT H
HEATING VENTILATION AND AIR
CONDITIONING

FINAL BID DOCUMENT

MECHANICAL GROUND FLOOR
PLAN PART B


DRAWING No. **M101.00**

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KEYED NOTES:


- PROVIDE NEW MANUFACTURER LOUVER FOR UNIT VENTILATOR
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- EXISTING RELIEF TO REMAIN
- PROVIDE AND INSTALL NEW UNIT VENTILATOR (UV) WITH NEW DDC CONTROLS, NEW DDC THERMOSTAT
- PROVIDE AND INSTALL NEW CEILING-MOUNTED CASSETTE VRF FAN COIL UNIT (AC) WITH NEW DDC CONTROLS, NEW DDC THERMOSTAT. FOR LAY-IN CEILING APPLICATIONS, MODIFY CEILING AS REQUIRED AND PROVIDE TRIM/FLANGE KIT.
- REFRIGERANT PIPING FROM FLOOR BELOW TO UV



Key Plan

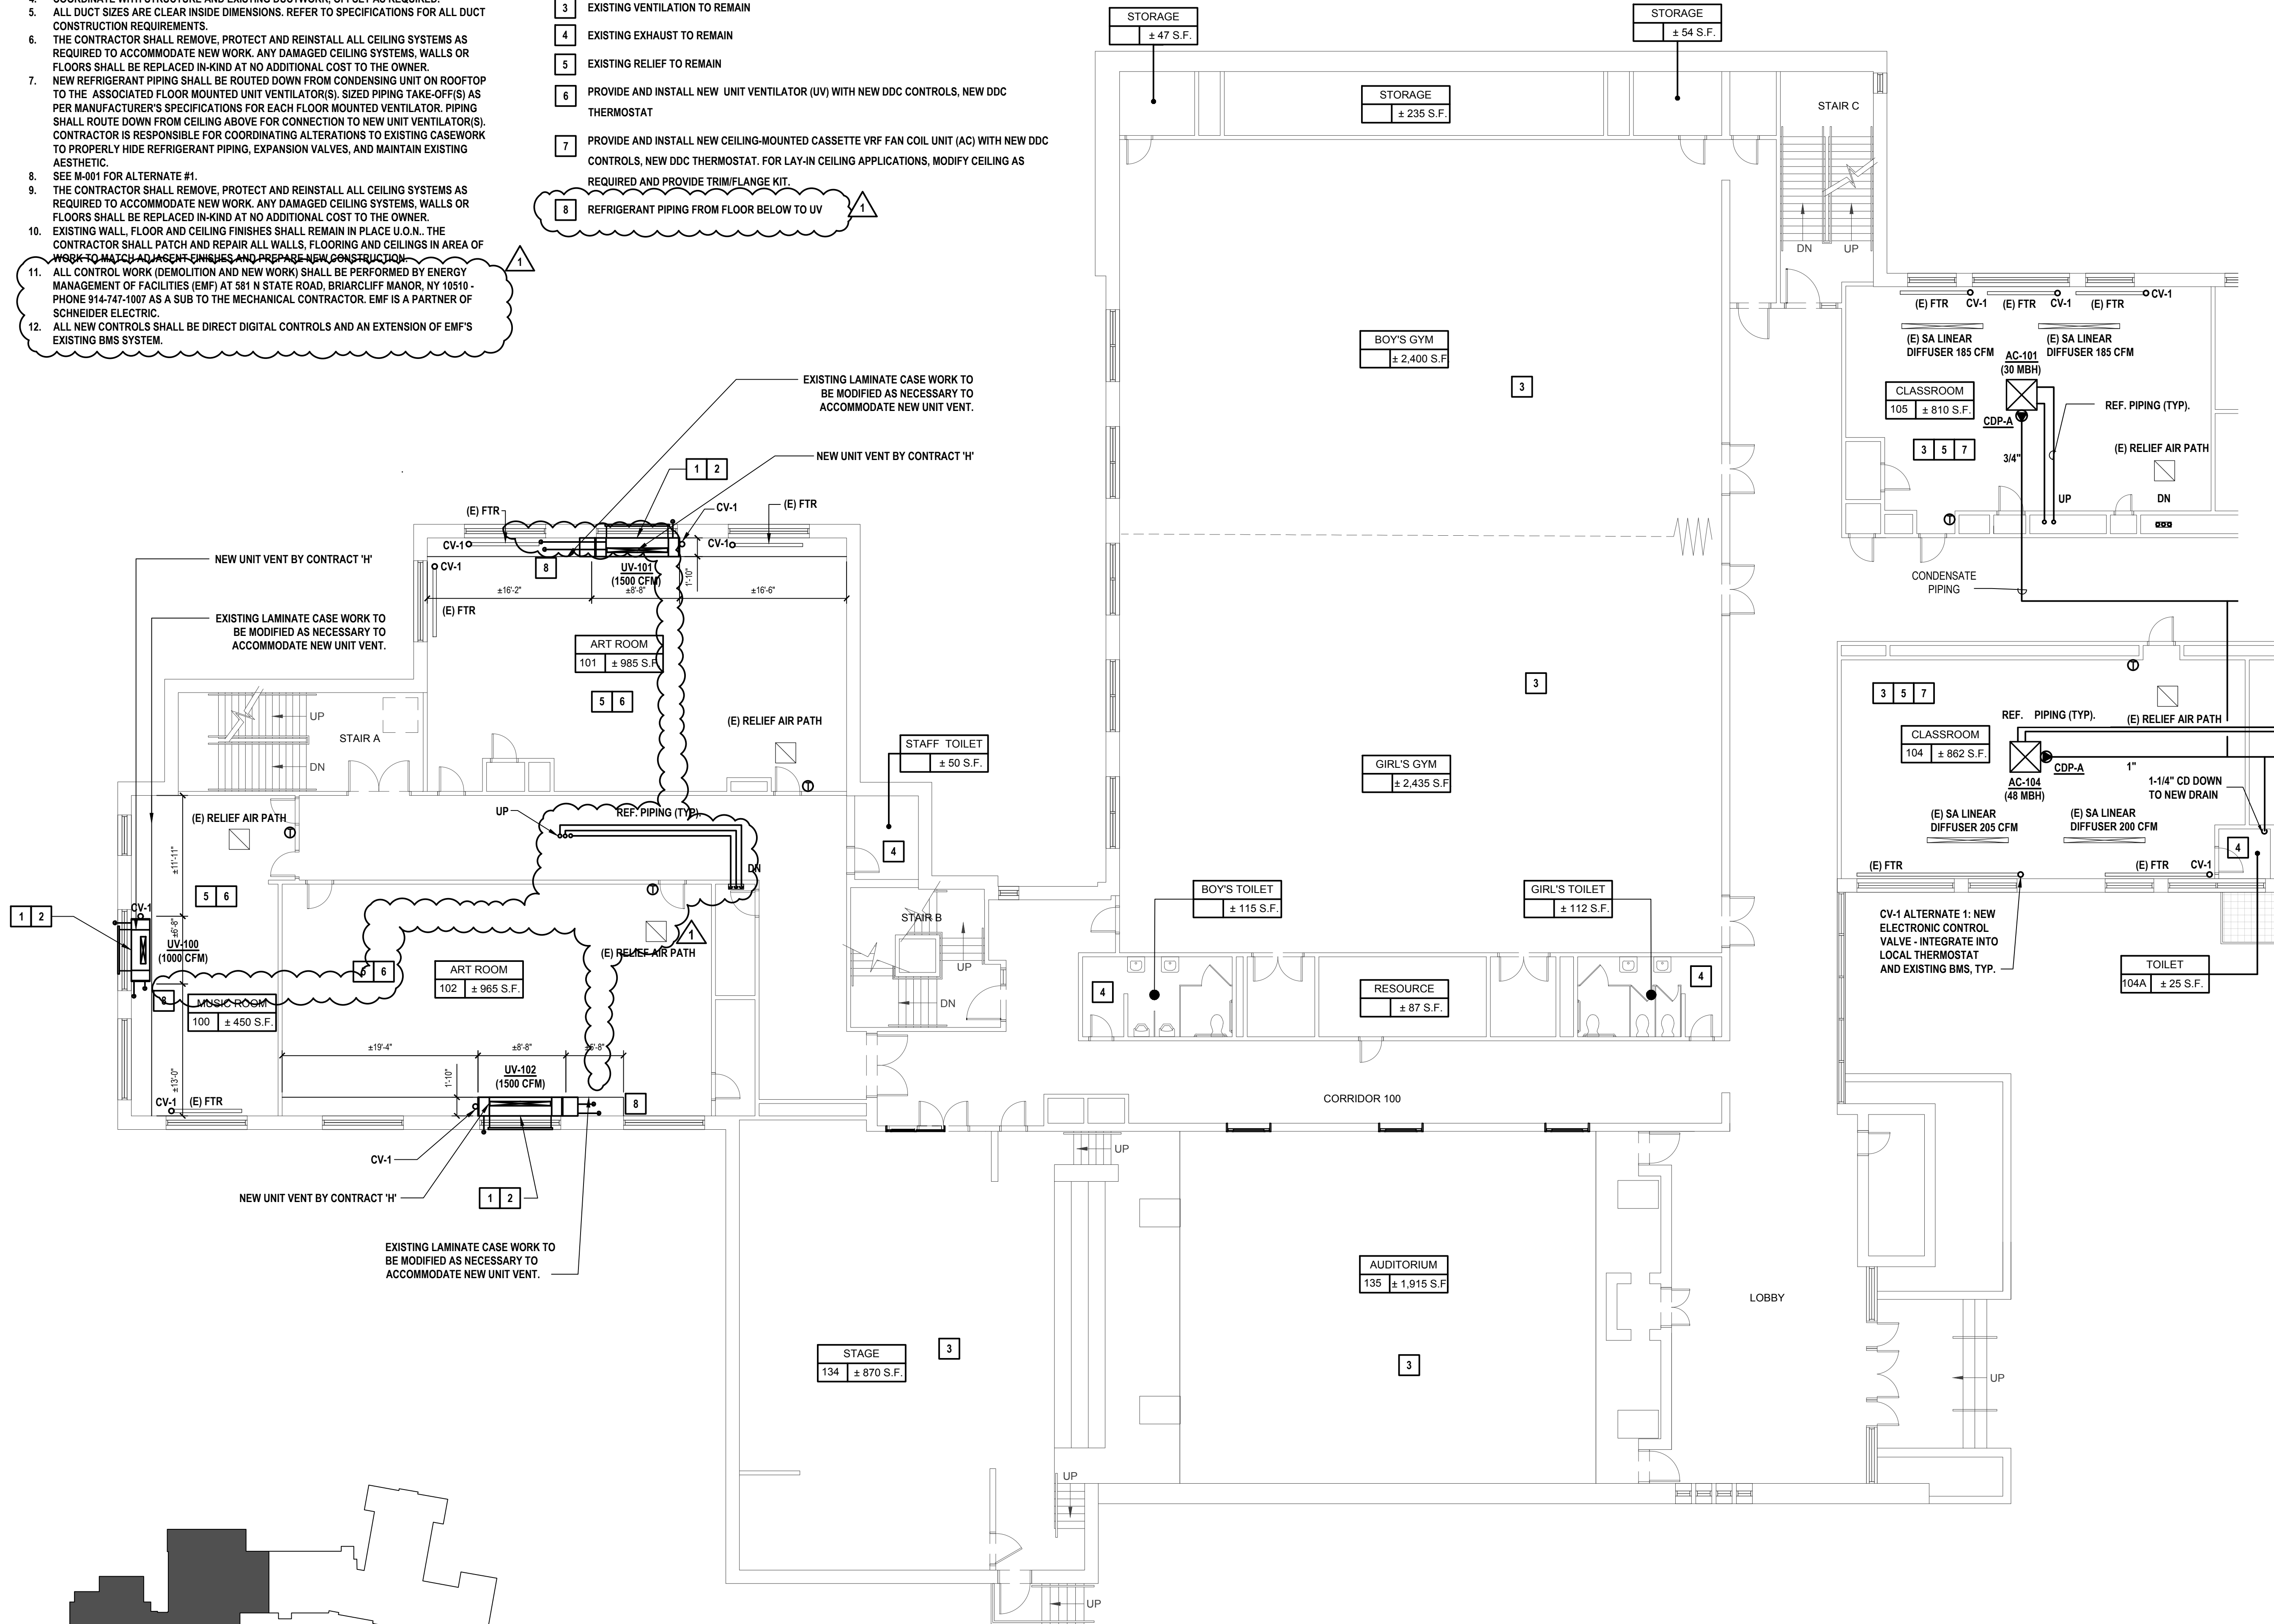First Floor Plan Part A

SCALE: 1/8"=1'-0"

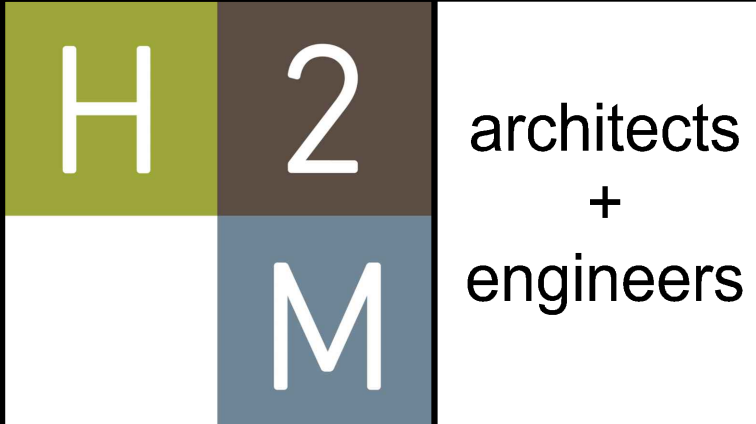

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Purchase, NY 10577
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CONSULTANTS:


MARK	DATE	DESCRIPTION
	10-16-23	FINAL BID DOCUMENT
1	11-01-23	ADDENDUM #1



DESIGNED BY:	DRAWN BY:	CHECKED BY:	REVIEWED BY:
MJV	KCM	MJV	QAQC
PROJECT NO:	DATE:	SCALE:	
WPSPD 2205	OCTOBER 2023		

CLIENT
White Plains City School District

**AC and Ventilation Upgrades
at Mamaroneck
Elementary School**

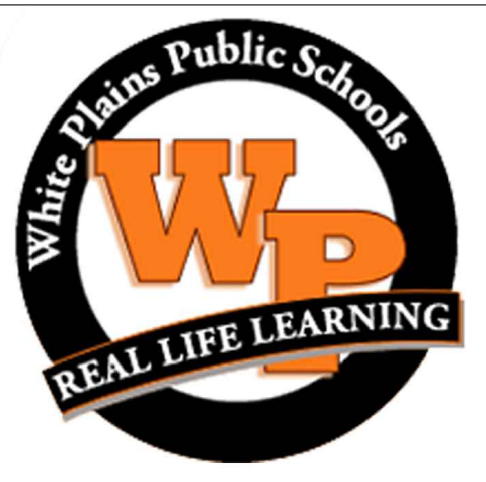

7 Nosband Ave.
White Plains, NY 10605

SED PROJECT CONTROL
NO. 66-22-00-01-0-010-017

CONTRACT
**CONTRACT H
HEATING VENTILATION AND AIR
CONDITIONING**

STATUS
FINAL BID DOCUMENT

SHEET TITLE
**MECHANICAL FIRST FLOOR
PLAN PART A**


DRAWING No.
M110.00

GENERAL NOTES:

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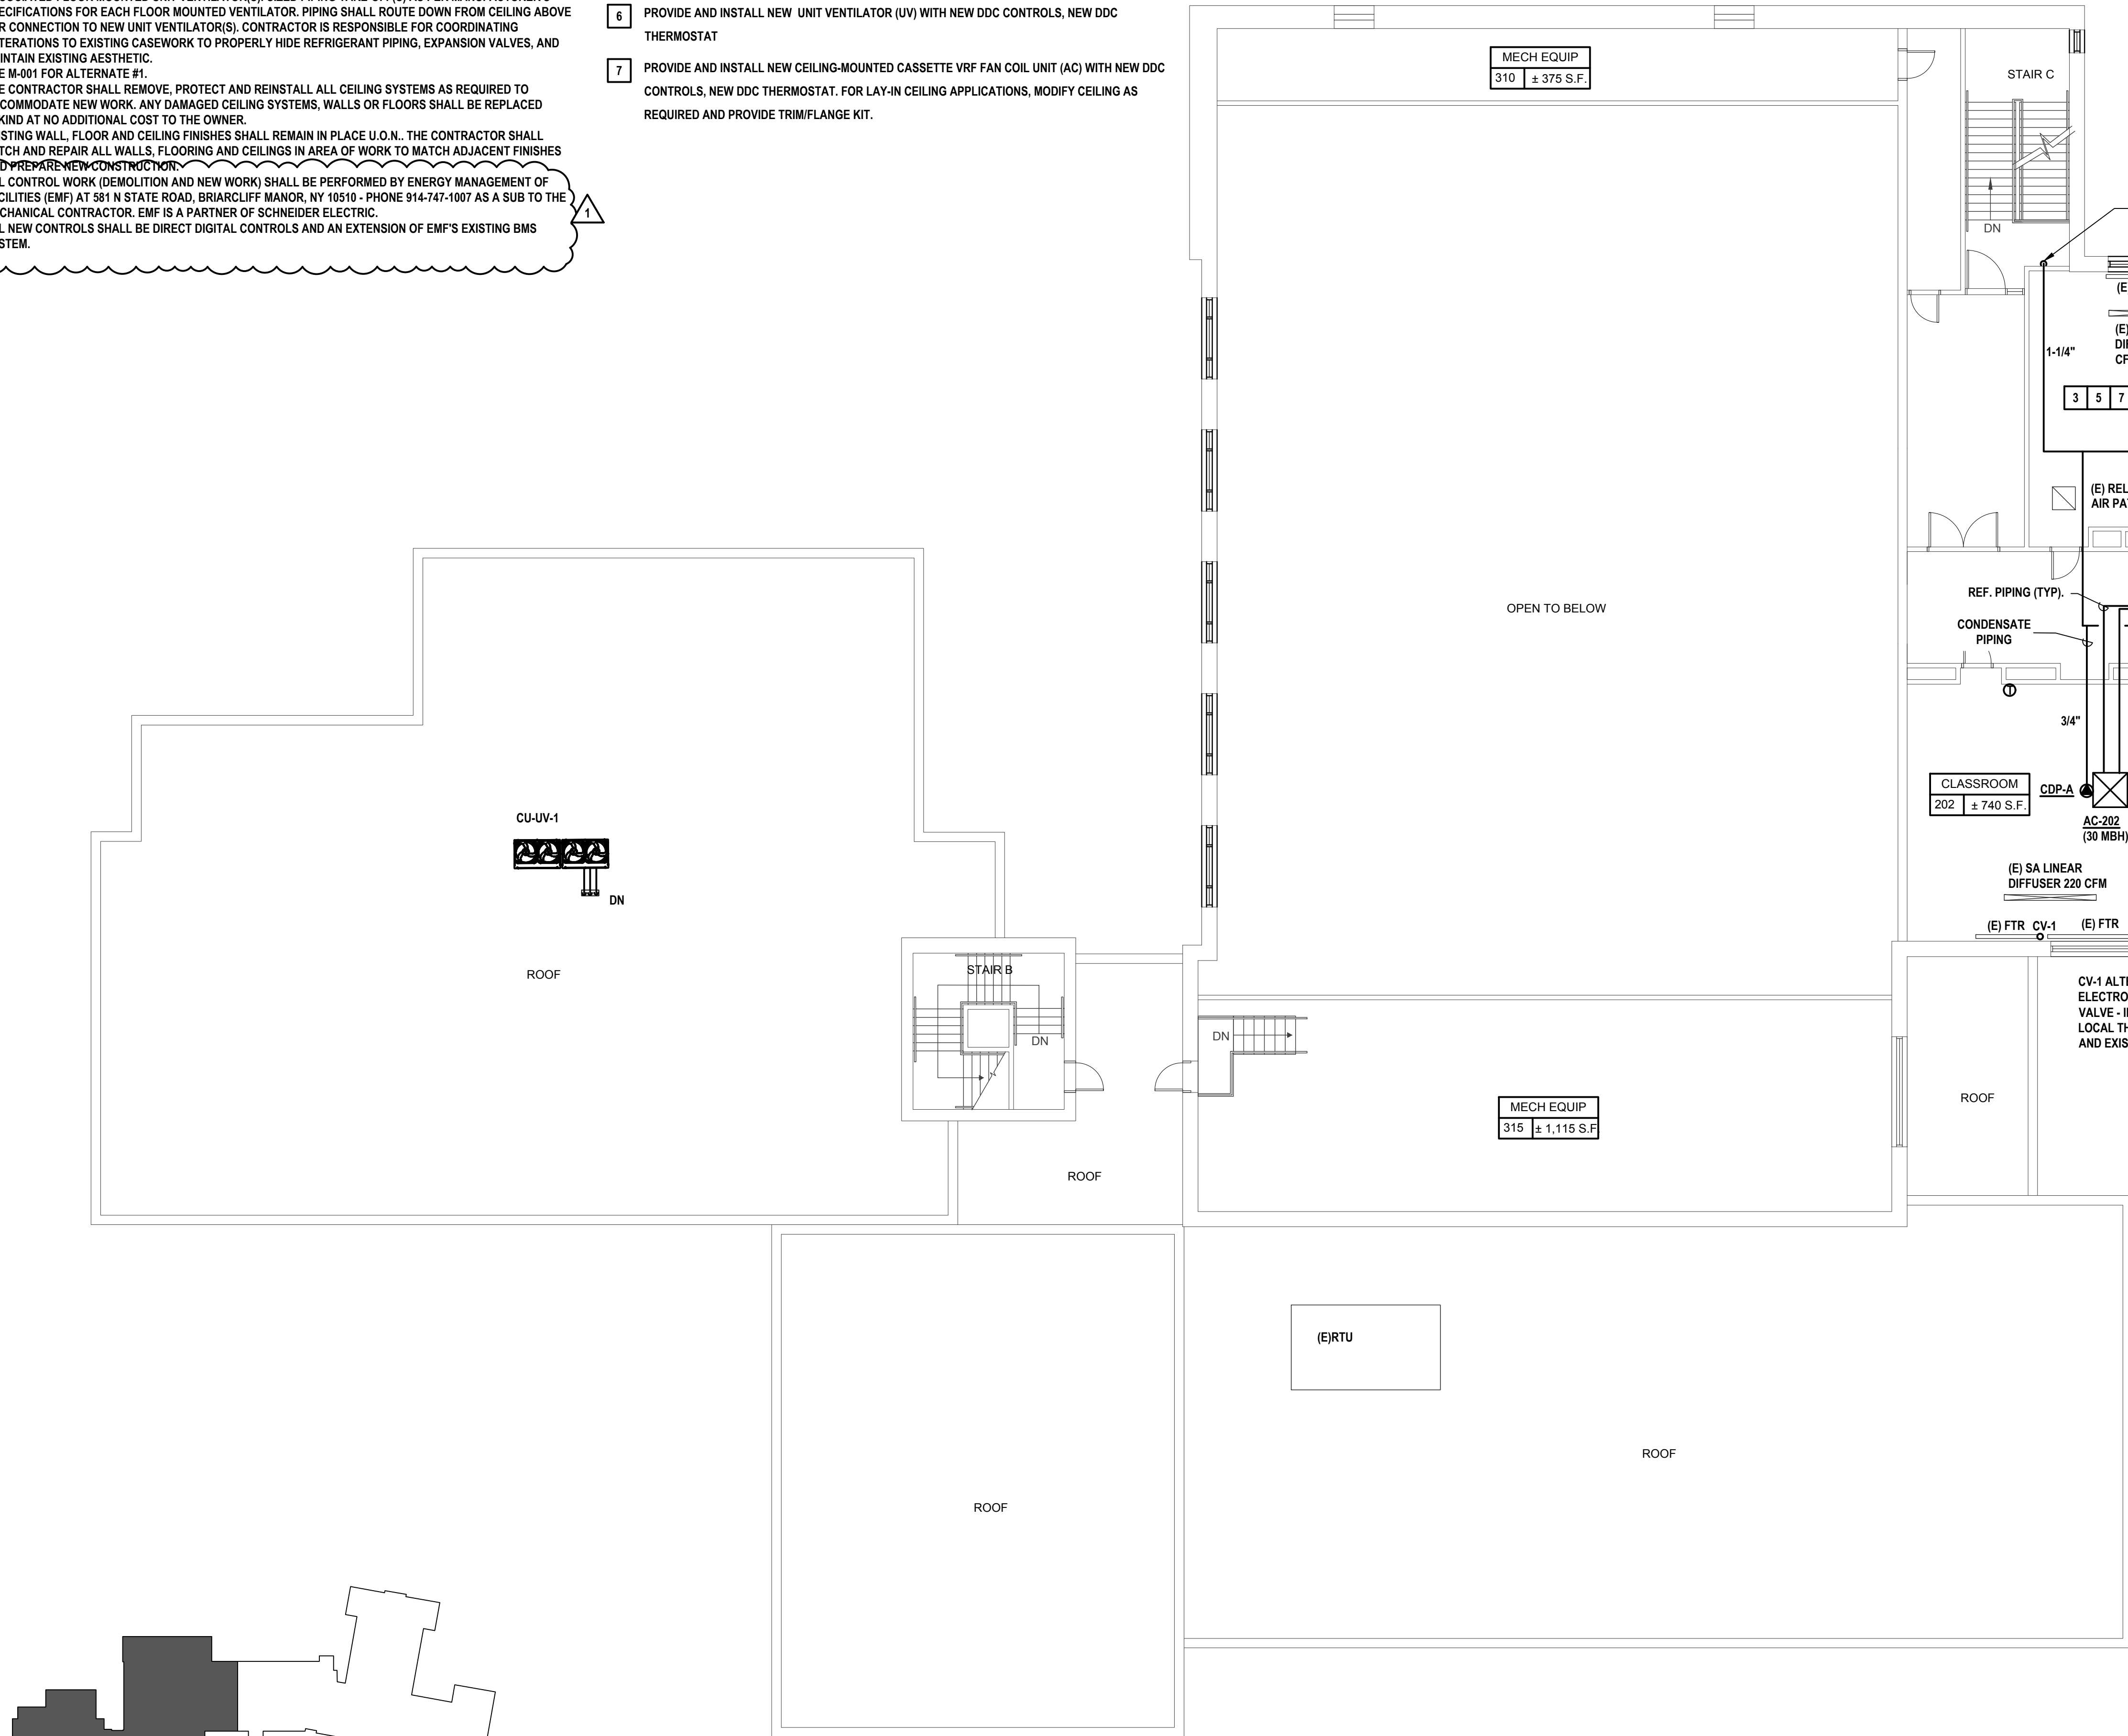
X:\WPSP\White Plains Central School District - 10851\WPSP 2205 - AC & Ventilation at Mamaroneck Elem School\02-BIM\CADD\Construction\120.00 Mechanical Second Floor Plan Part A.dwg, Last Modified: Nov 01, 2023 - 3:34pm By KMcDonald

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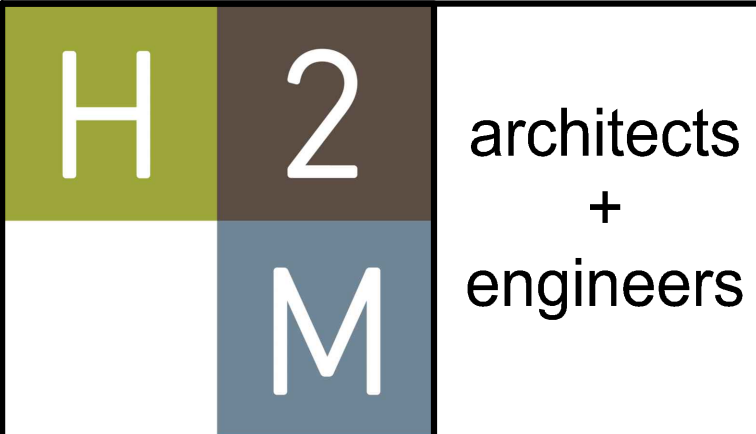
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Second Floor Plan Part A

SCALE: 1/8"=1'-0"

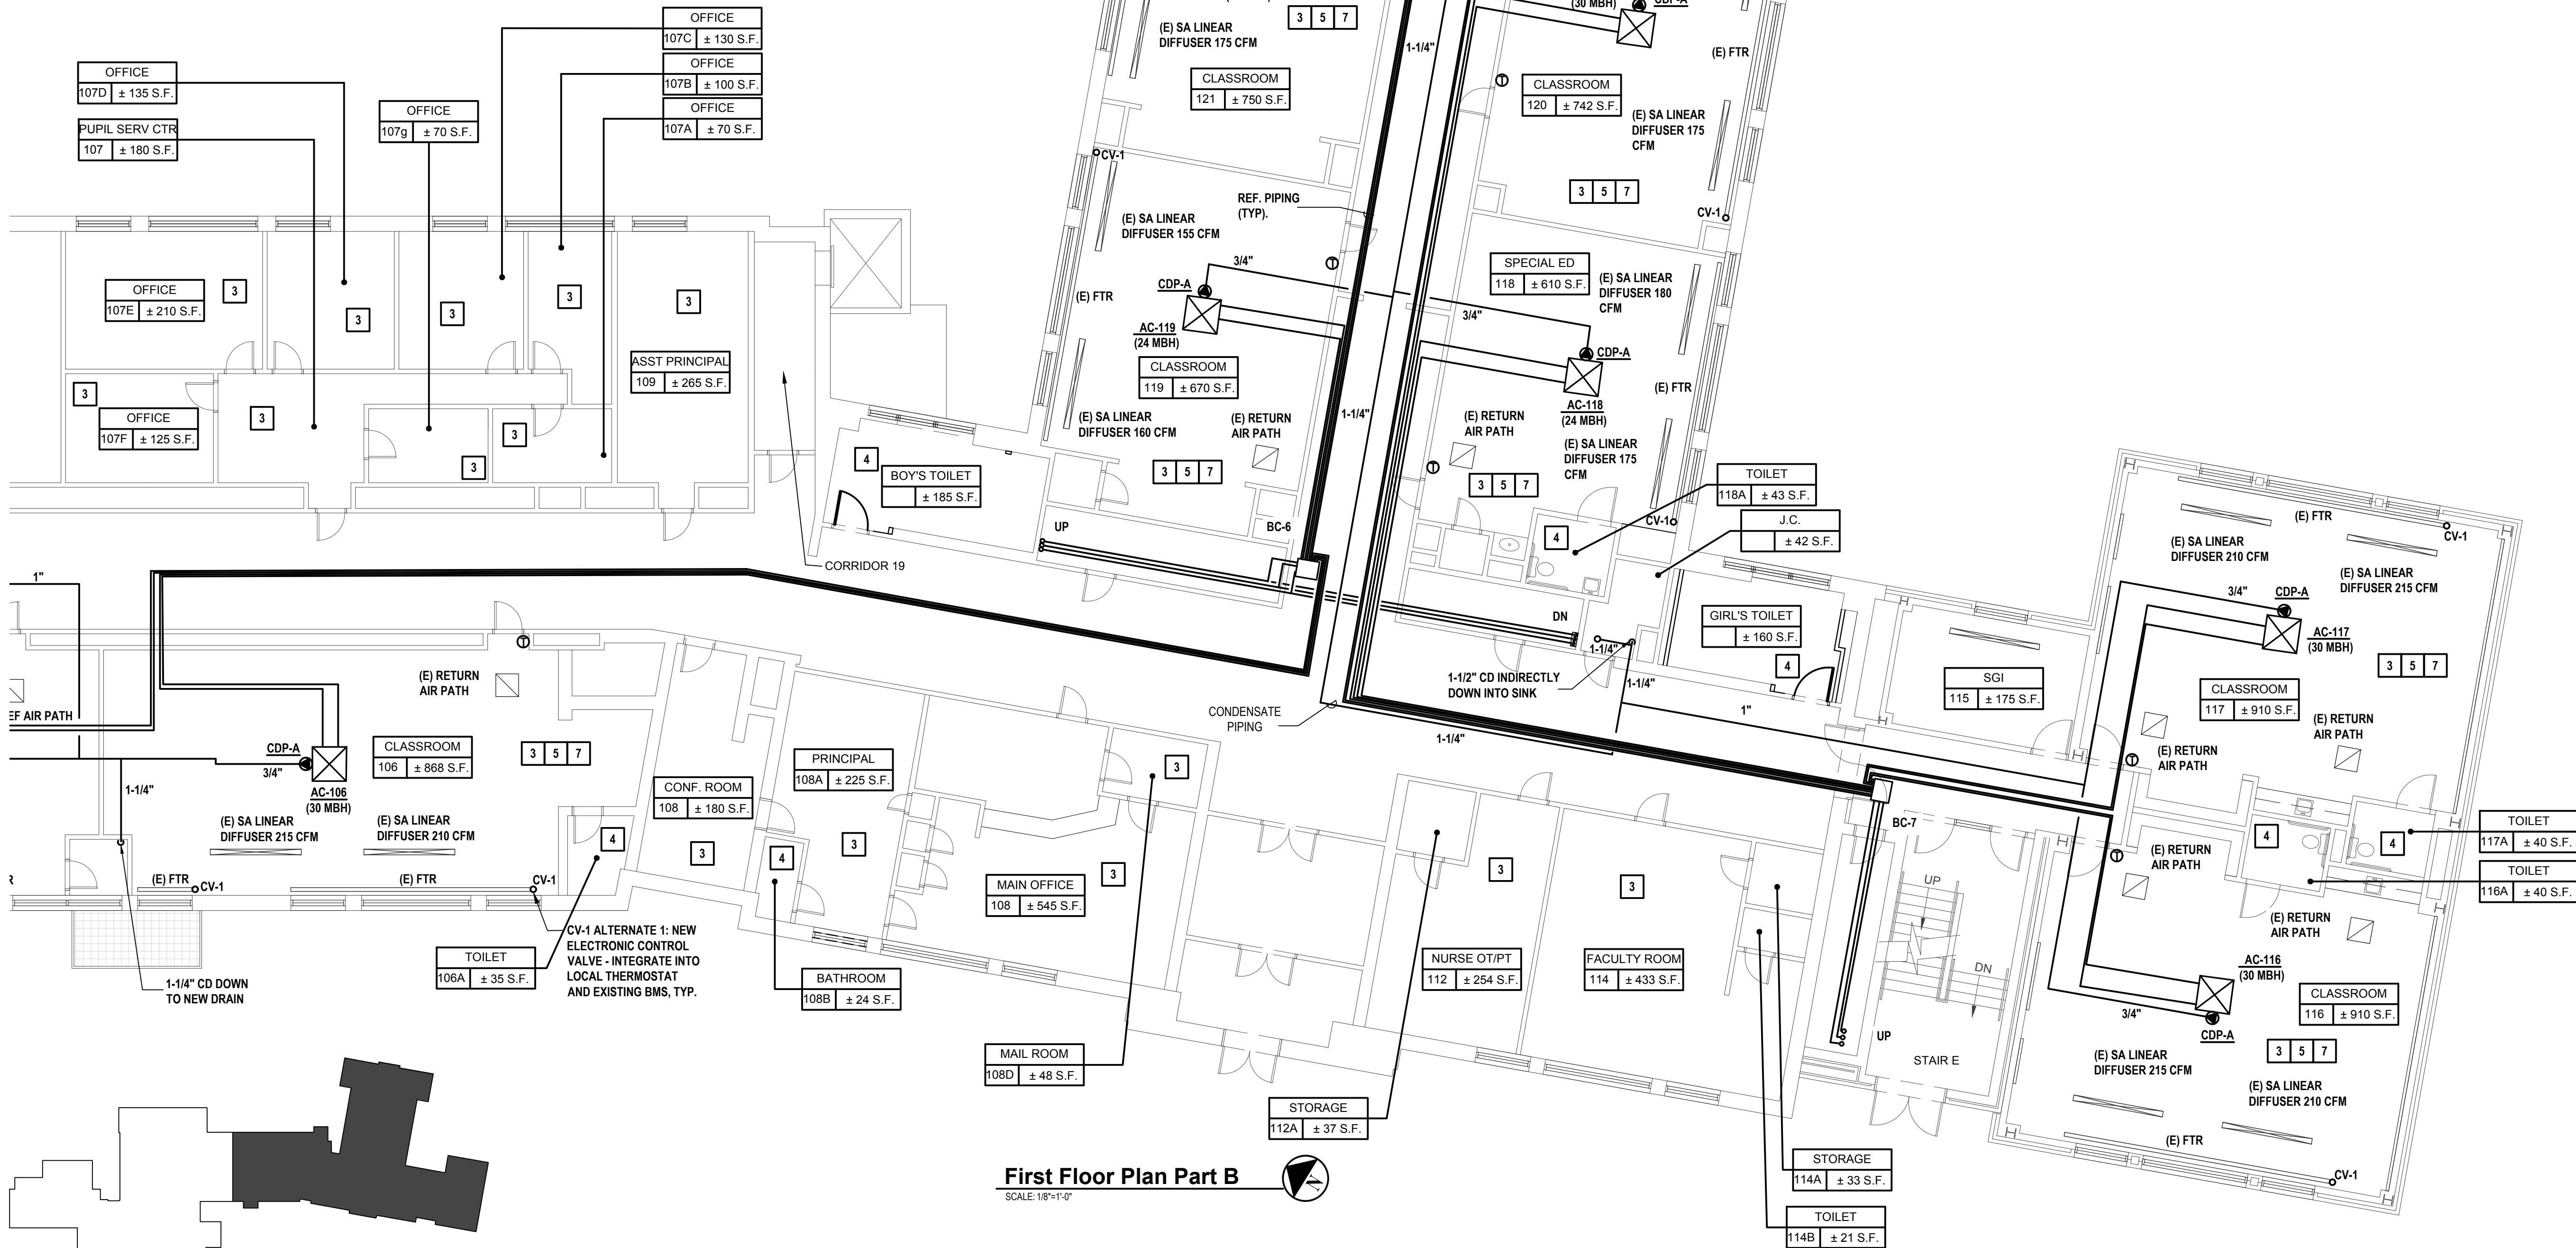

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CONSULTANTS:

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1	11-01-23	ADDENDUM #1




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DESIGNED BY: MJV	DRAWN BY: KCM	CHECKED BY: MJV	REVIEWED BY: QAQC
PROJECT No.: WPSPD 2205	DATE: OCTOBER 2023	SCALE:	

CLIENT

White Plains City School District

AC and Ventilation Upgrades
at Mamaroneck
Elementary School

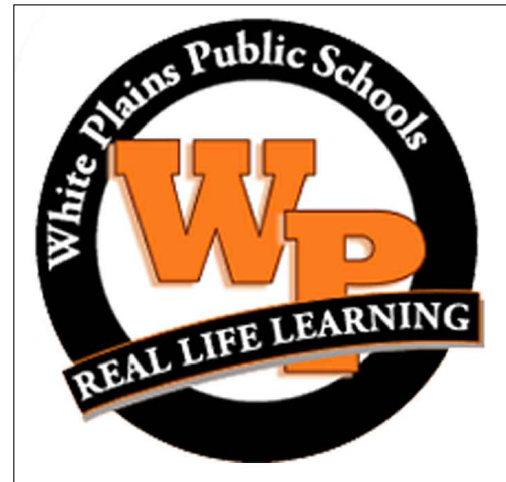

7 Nosband Ave.
White Plains, NY 10605

SED PROJECT CONTROL
NO. 66-22-00-01-0-010-017

CONTRACT

CONTRACT H
HEATING VENTILATION AND AIR
CONDITIONING

STATUS

FINAL BID DOCUMENT


SHEET TITLE

MECHANICAL SECOND FLOOR
PART A

DRAWING No.

M120.00

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Second Floor Plan Part B

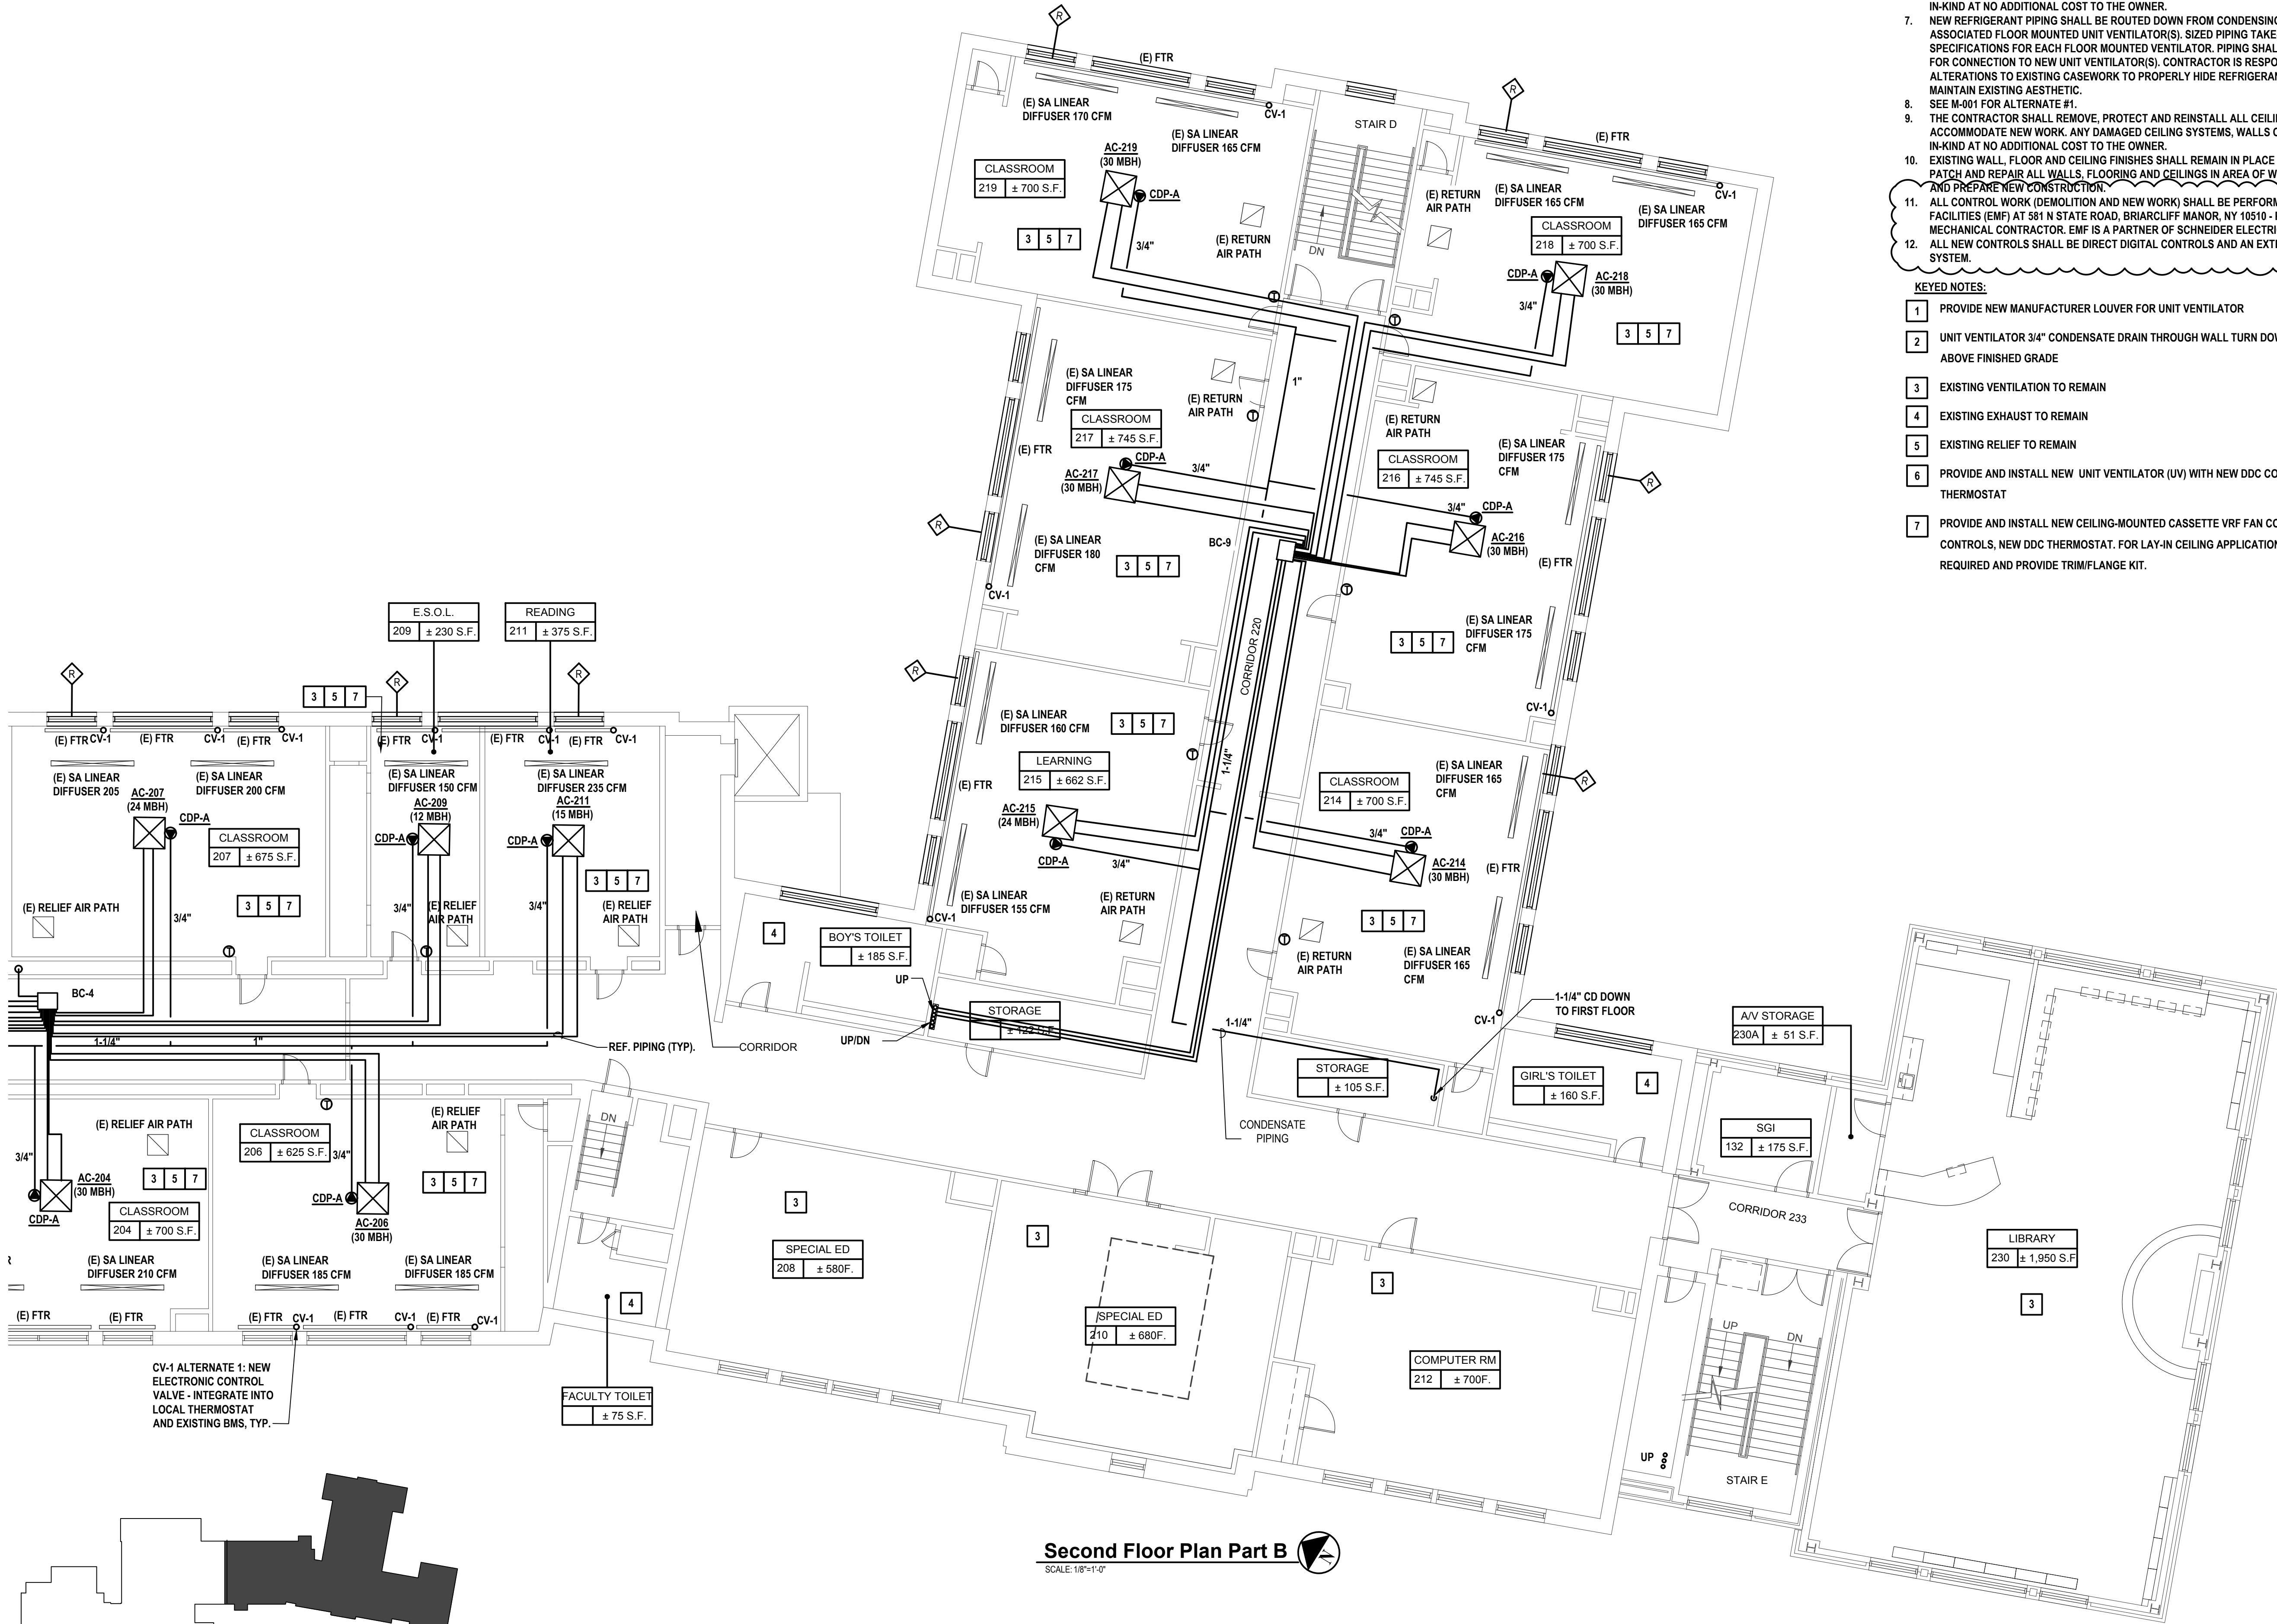
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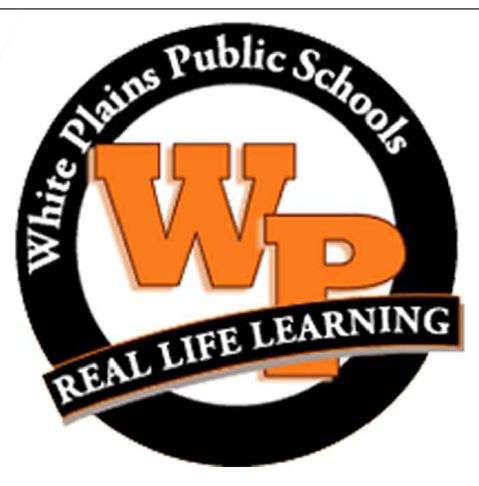
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1	11-01-23	ADDENDUM #1



DESIGNED BY:	DRAWN BY:	CHECKED BY:	REVIEWED BY:
MJV	KCM	MJV	QAQC
PROJECT NO:	DATE:	SCALE:	
WPSP 2205	OCTOBER 2023		

White Plains City School District

AC and Ventilation Upgrades
at Mamaroneck
Elementary School

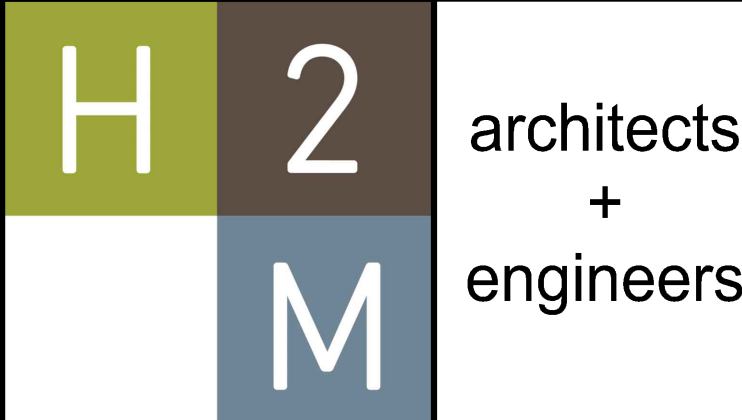

7 Nosband Ave.
White Plains, NY 10605

SED PROJECT CONTROL
NO. 66-22-00-01-0-010-017

CONTRACT H
HEATING VENTILATION AND AIR
CONDITIONING

STATUS
FINAL BID DOCUMENT



SHEET TITLE
MECHANICAL SECOND FLOOR
PLAN PART B

DRAWING No.
M121.00

GENERAL NOTES:

- ALL DUCT SIZES ARE CLEAR INSIDE DIMENSIONS. REFER TO SPECIFICATIONS FOR ALL DUCT CONSTRUCTION REQUIREMENTS.
- ALL SUPPLY, RETURN AND EXHAUST BRANCH DUCTWORK SHALL BE PROVIDED WITH VOLUME DAMPERS.
- COORDINATE WITH STRUCTURE AND EXISTING DUCTWORK. OFFSET AS REQUIRED.
- PROVIDE NEW THERMOSTAT LINKED TO RTUS IN ASSOCIATED SPACE.
- DOAS UNITS SHALL BE PROVIDED WITH DISCHARGE AIR TEMP SENSORS.
- ALL CONDENSATE PIPES TO BE PITCHED 1/8" PER FOOT. DRAIN INDIRECTLY TO ROOF DRAINS.
- CONTRACTOR TO PROVIDE SEISMIC/WIND RATED ROOF CURB MANUFACTURED THYBAR OR APPROVED EQUAL.
- CONTRACTOR TO PROVIDE PROJECT SPECIFIC ROOF CURB DESIGNED IN ACCORDANCE WITH WIND LOADS PROVIDED ON DRAWINGS, SIGNED AND SEAL BY A LICENSED PROFESSIONAL ENGINEER REPRESENTING THE ROOF CURB MANUFACTURER.
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WIND LOADS (MC 301.15 & BC 1609)		
ZONE ID	POSITIVE WIND PRESSURE (PSF)	NEGATIVE WIND PRESSURE (PSF)
ROOF (INT. ZONE)	13.0	-57.0
ROOF (END ZONE)	13.0	-67.3
ROOF (CORNER ZONE)	13.0	-91.8
WALLS (INT. ZONE)	32.0	-34.7
WALLS (END ZONE)	32.0	-42.9

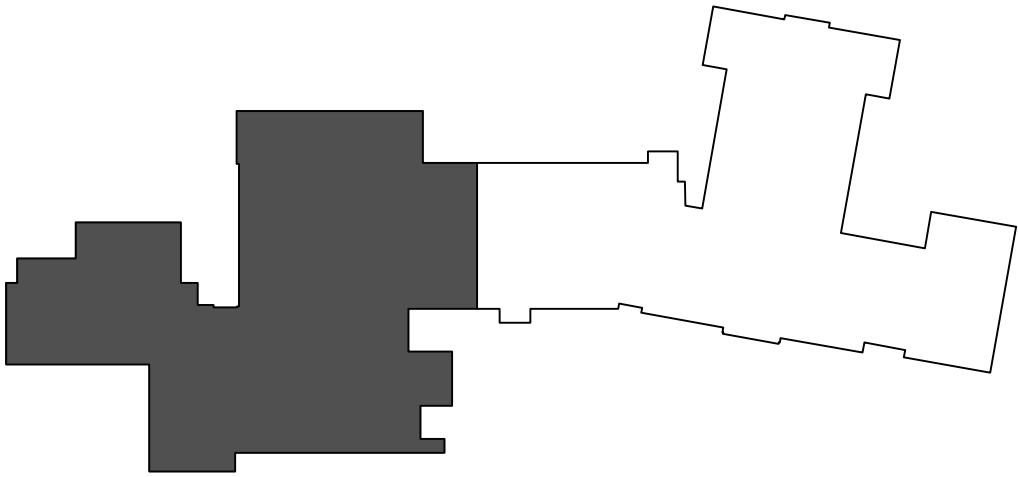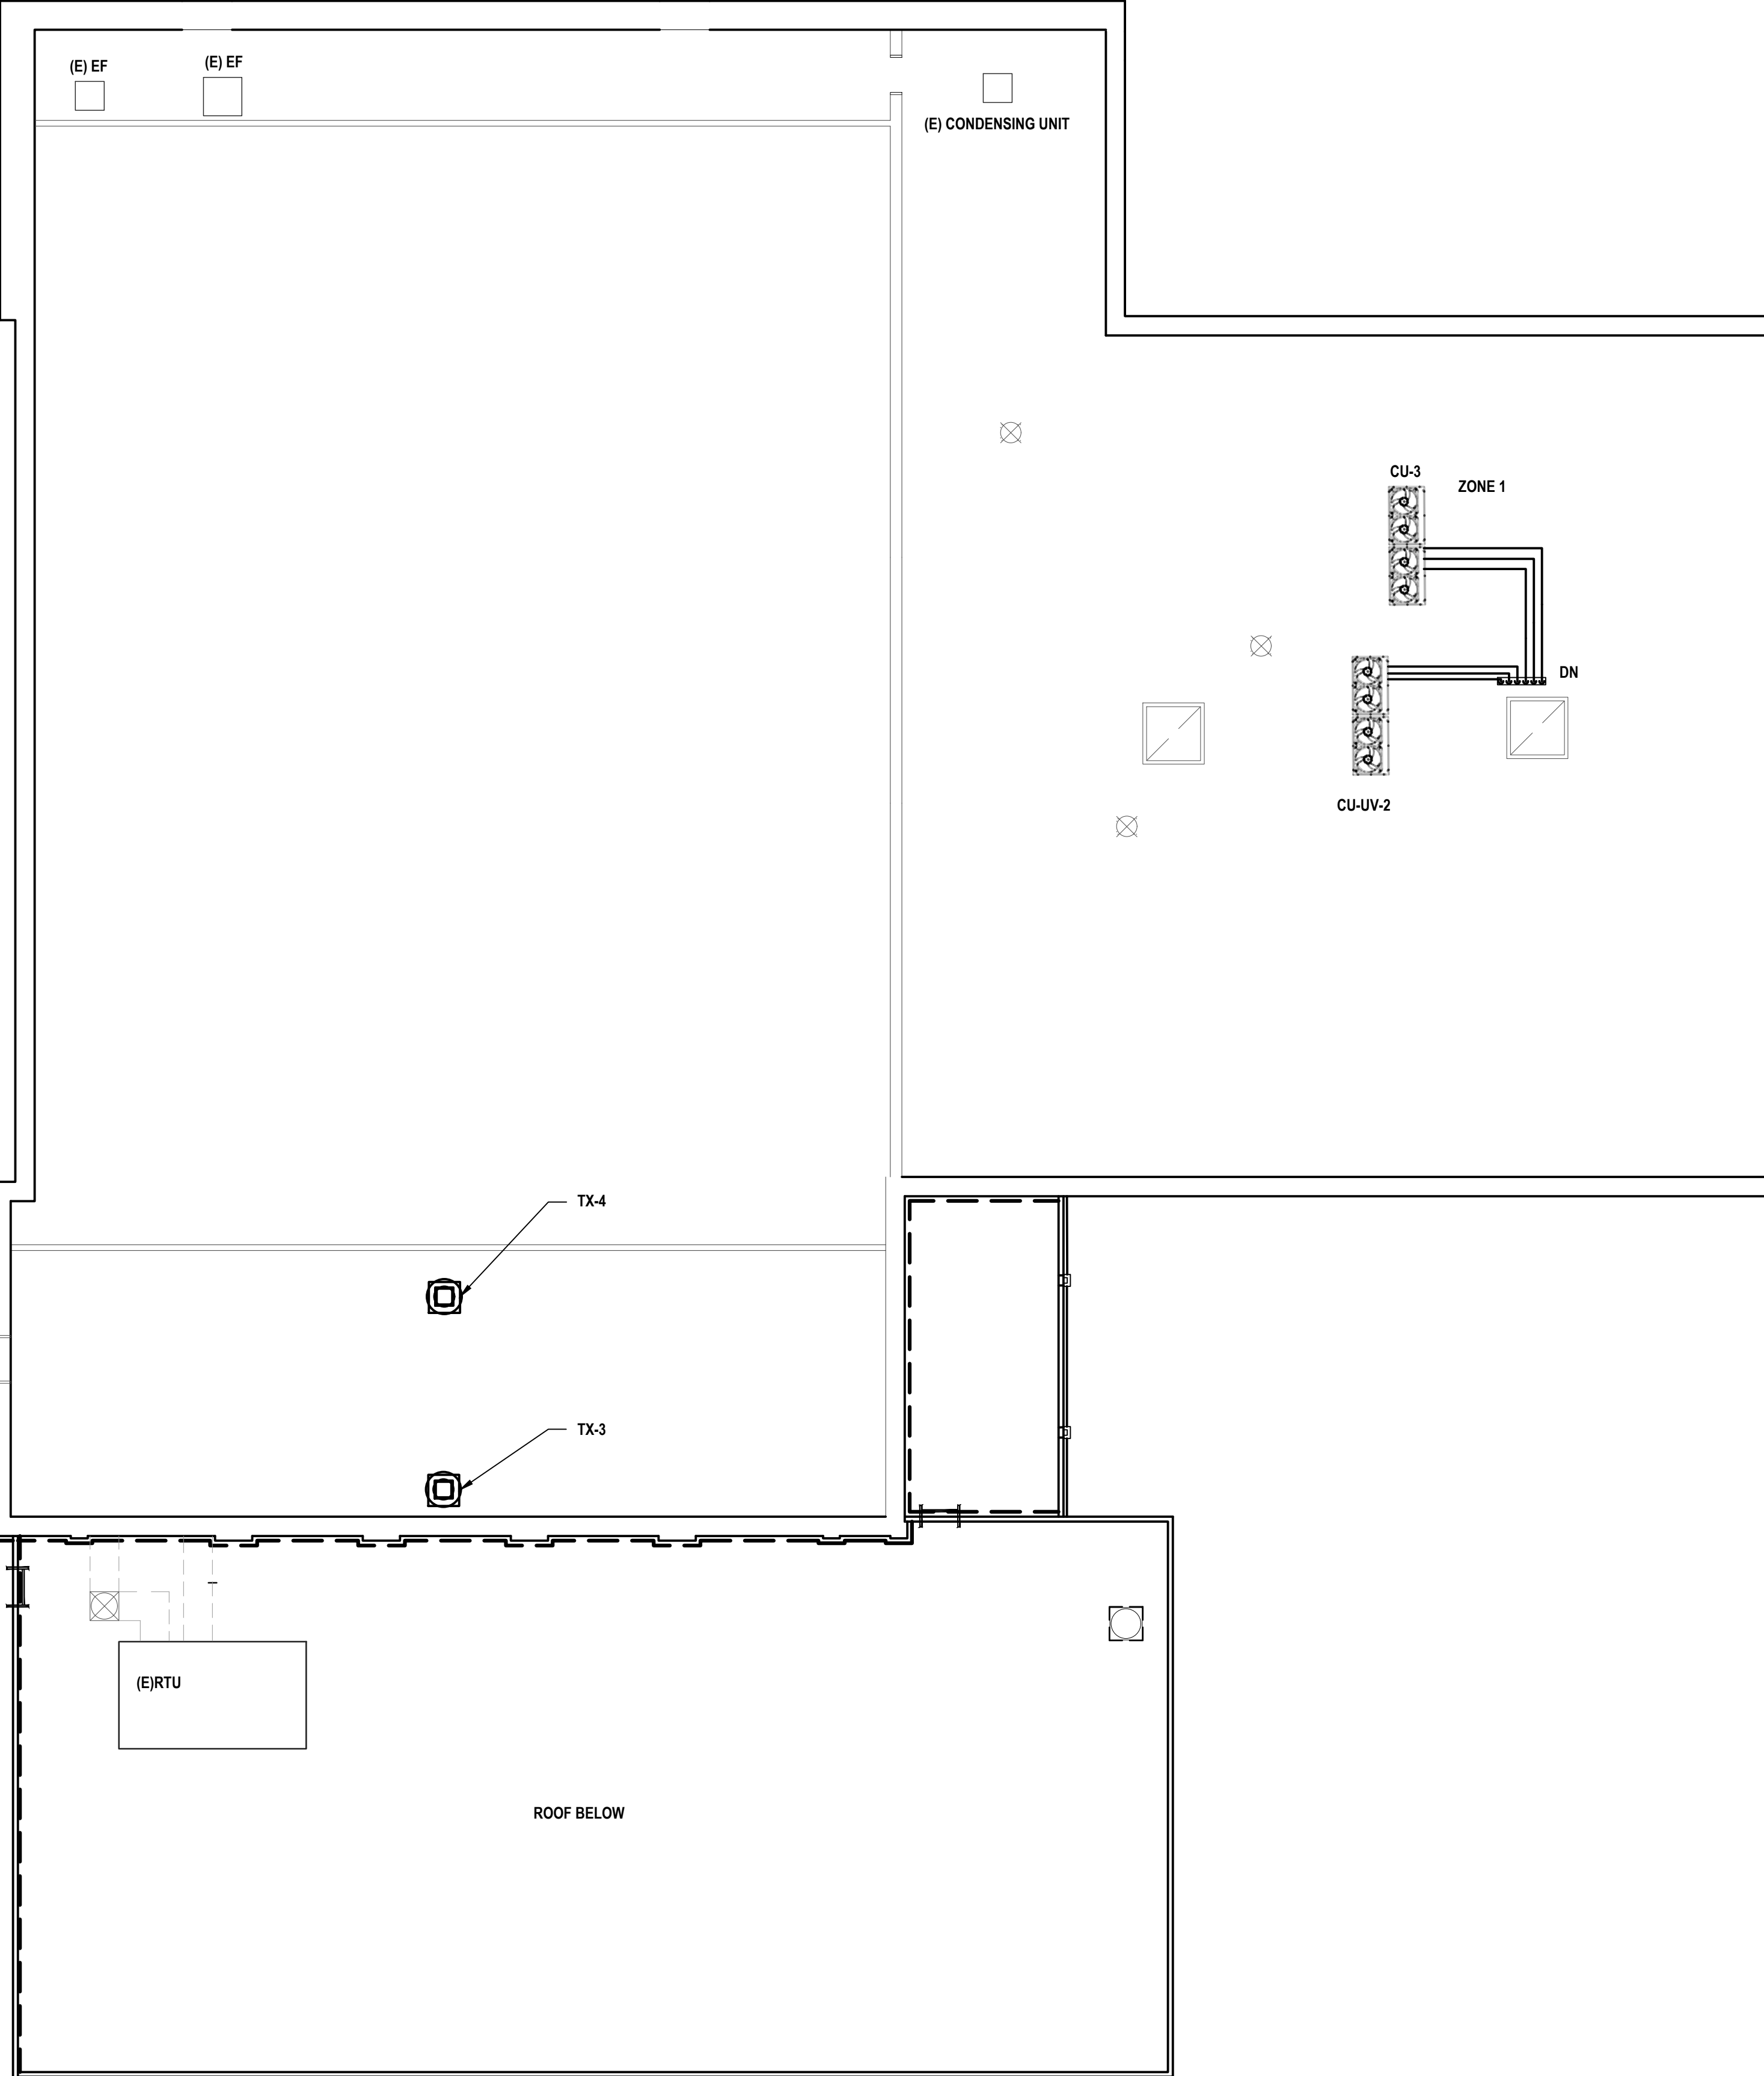

Key Plan

Roof Plan Part A

SCALE: 1/8"=1'-0"



H2M

architects
+
engineers

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CONSULTANTS:

MARK	DATE	DESCRIPTION
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DESIGNED BY:	DRAWN BY:	CHECKED BY:	REVIEWED BY:
MJV	KCM	MJV	QAQC
PROJECT No:	DATE:	SCALE:	
WPSD 2205	OCTOBER 2023		

CLIENT

White Plains City School District

AC and Ventilation Upgrades
at Mamaroneck Elementary School

7 Nosband Ave.
White Plains, NY 10605

SED PROJECT CONTROL
NO. 66-22-00-01-0-010-017

CONTRACT

CONTRACT H
HEATING VENTILATION AND AIR
CONDITIONING

STATUS

FINAL BID DOCUMENT

SHEET TITLE

MECHANICAL ROOF PLAN
PART A

DRAWING No.


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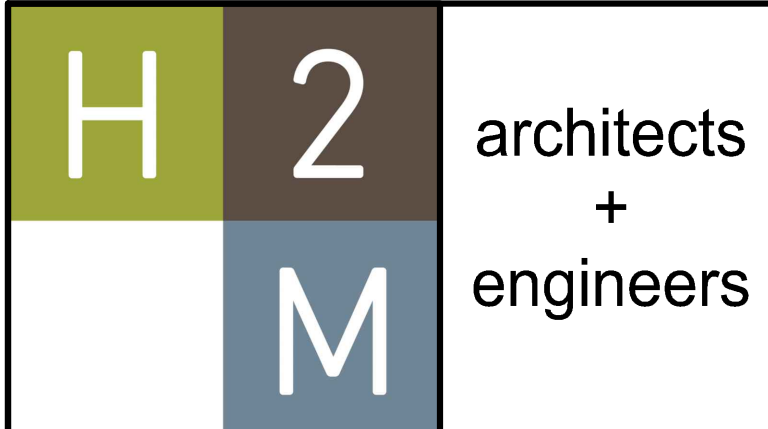
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Key Plan

Roof Plan Part B

SCALE: 1/8"=1'-0"



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CONSULTANTS:

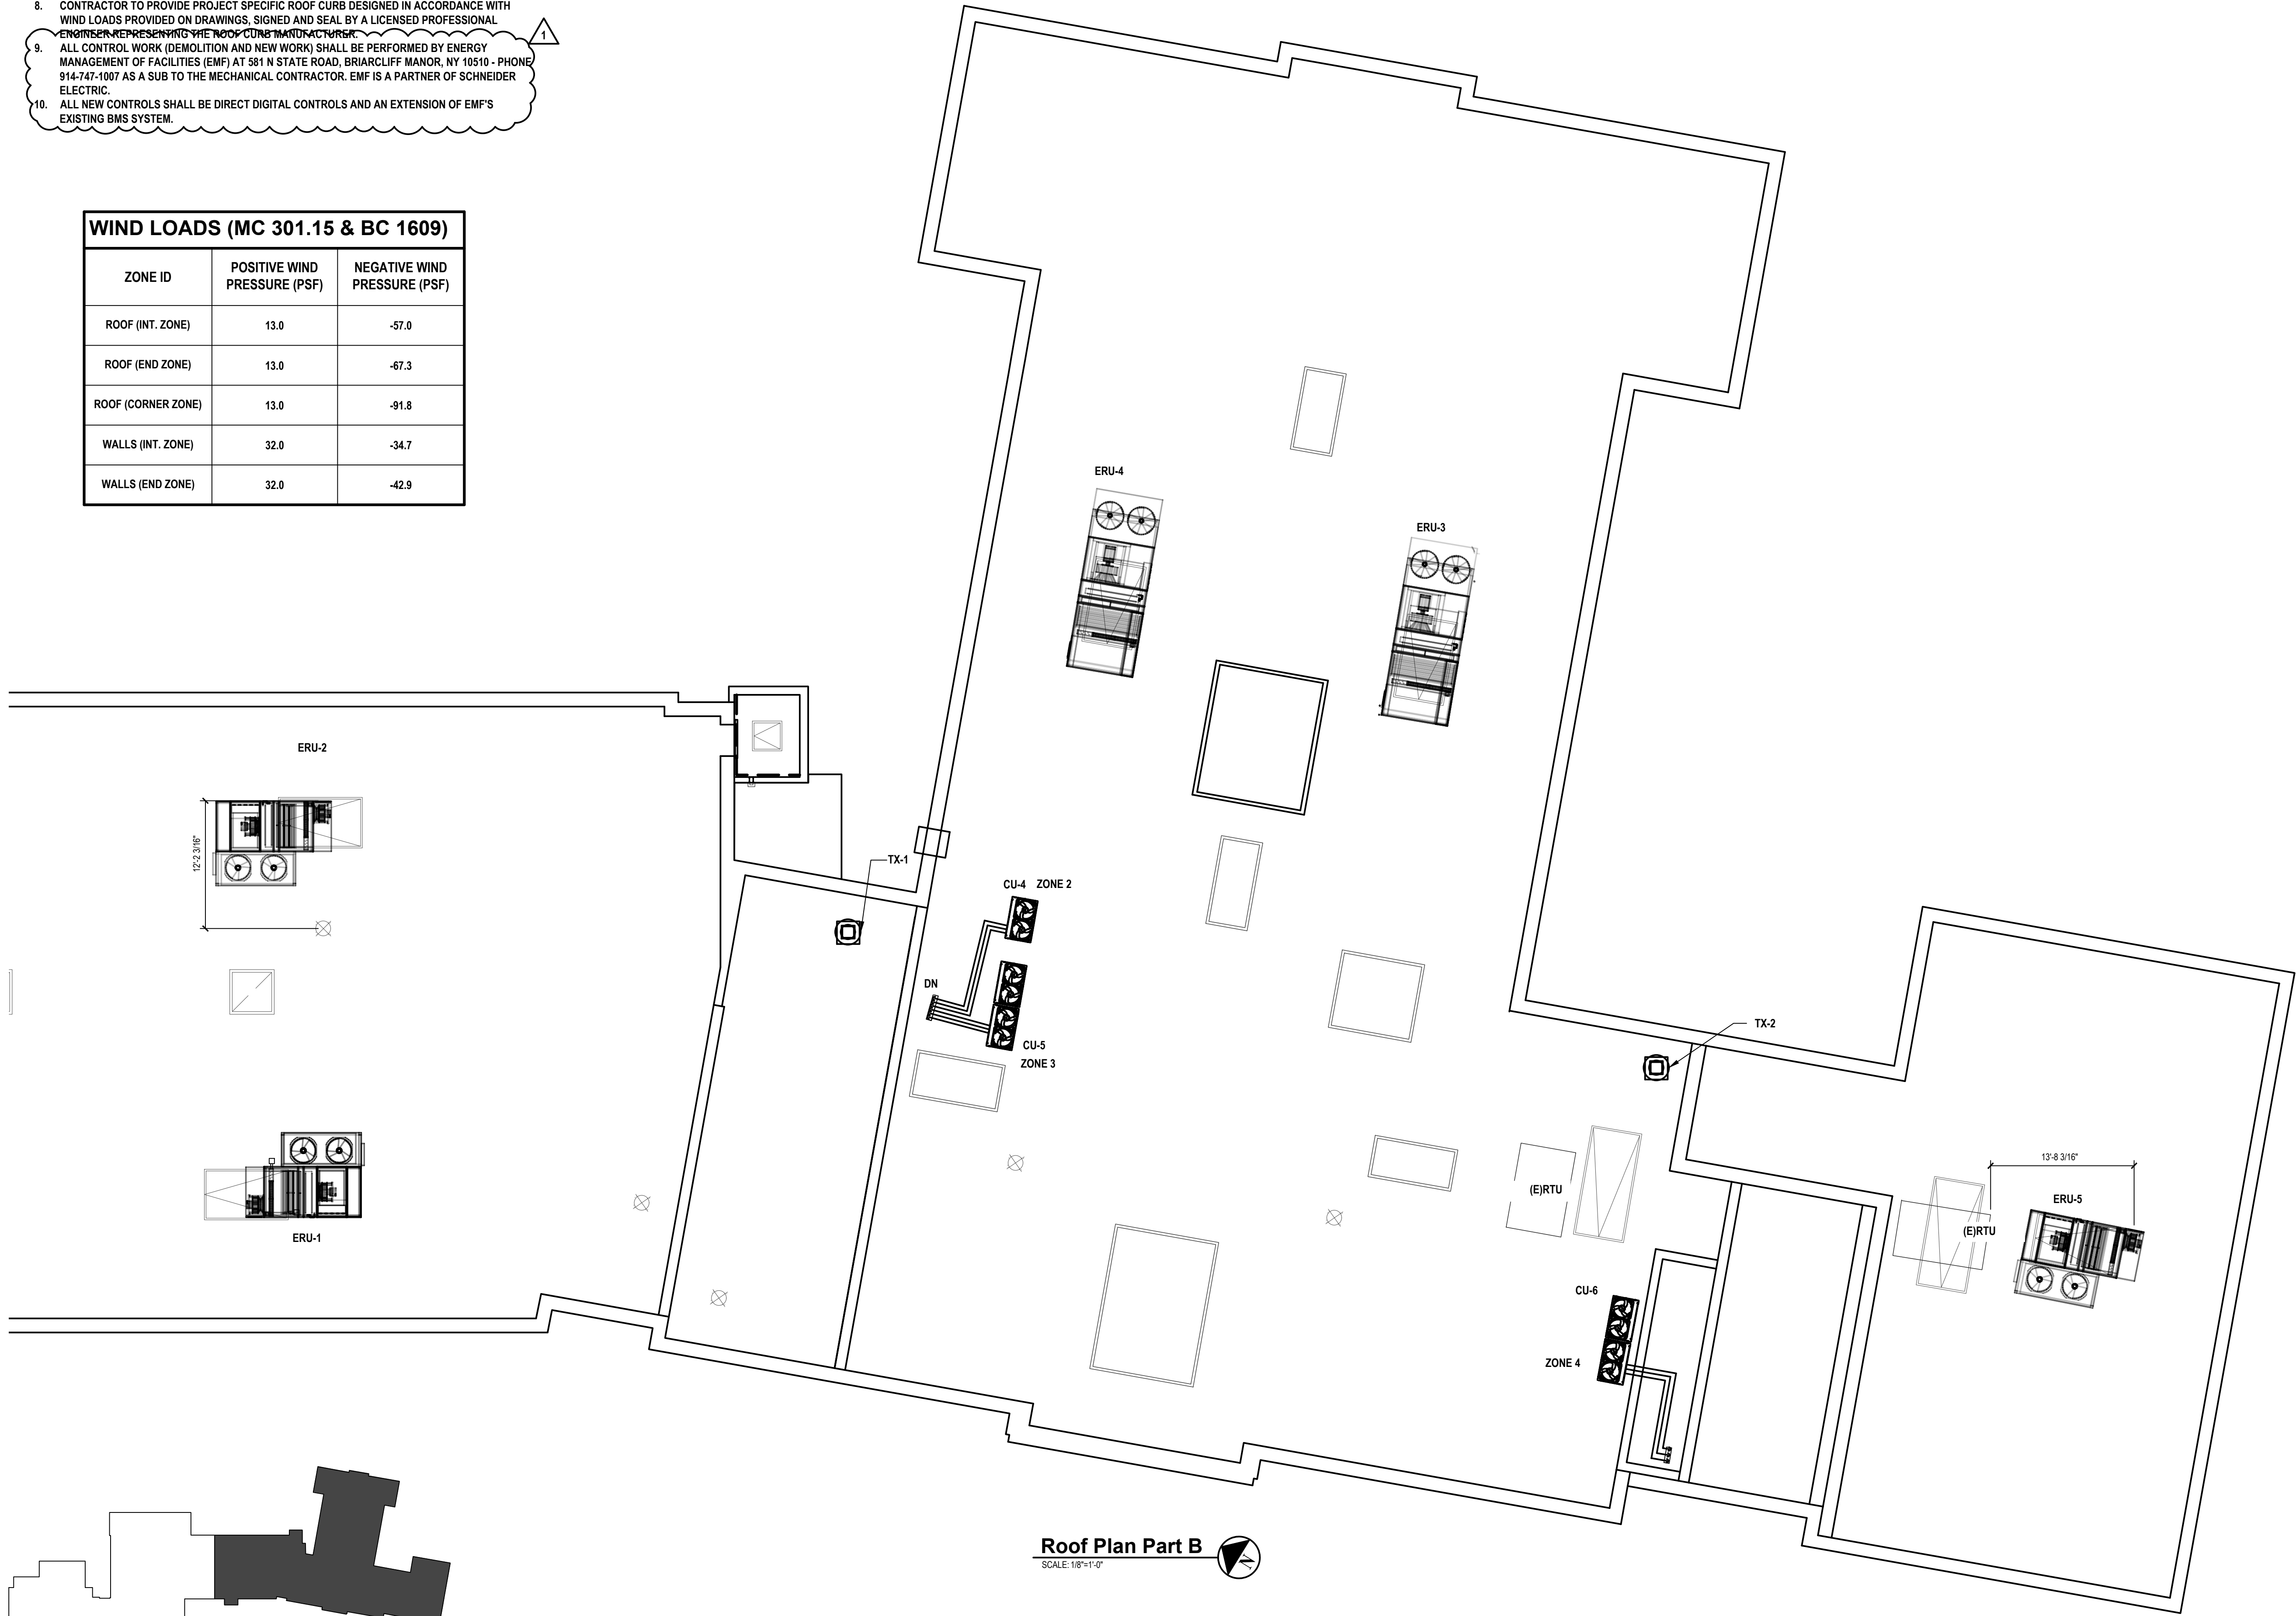
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MJV	KCM	MJV	QAQC
PROJECT No.:	DATE:	SCALE:	
WPSD 2205	OCTOBER 2023		

CLIENT
White Plains City School District

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White Plains, NY 10605


**SED PROJECT CONTROL
NO. 66-22-00-01-0-010-017**

CONTRACT
**CONTRACT H
HEATING VENTILATION AND AIR
CONDITIONING**

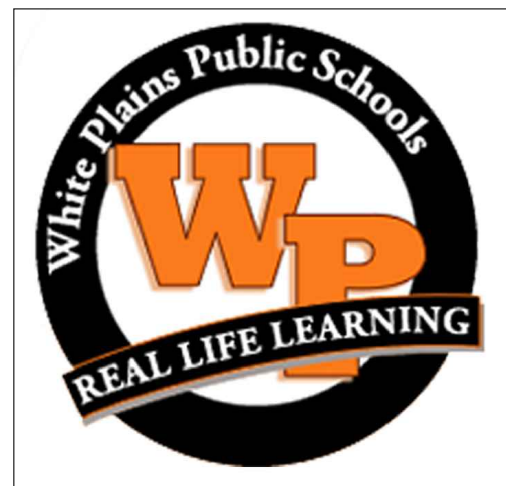STATUS
FINAL BID DOCUMENT

SHEET TITLE
**MECHANICAL ROOF PLAN
PART B**

DRAWING No.
M141.00

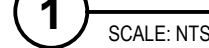

1. PIPE SUPPORTS SHALL BE INSTALLED A MINIMUM OF 6'-0" O.C. & AT EACH CHANGE OF DIRECTION OF PIPING.
2. PROVIDE PIPE SUPPORTS IN SERIES (WIDTHS) AS REQUIRED TO SUPPORT ALL NEW PIPING.
3. HEIGHT OF PIPE SUPPORT TO VARY AS REQUIRED BASED ON HEIGHT OF EXISTING PIPING & ROOF PITCH.



KEYED CONSTRUCTION NOTES:

- | | |
|---|--|
| 1 | PROVIDE AND INSTALL NEW VERTICAL FLOOR-MOUNTED UNIT VENTILATOR (UV) WITH NEW DDC CONTROLS, NEW DDC THERMOSTAT, LOWER, AND WALL SLEEVE. RECONNECT WITH NEW PIPING (SEE UNIT VENTILATOR PIPING DETAIL) INCLUDING NEW DDC CONTROL VALVE, ETC. RECONNECT ANY FIN-TUBE RADIATION (FT) PIPING BRANCHES OR CONTROL INTERLOCKS (FT CONTROL VALVE AND SHARED UV THERMOSTAT). SEE DETAIL 3 AND 4 ON THIS SHEET FOR ADDITIONAL INFORMATION. |
| 2 | PROVIDE AND INSTALL NEW MANUFACTURER SPECIFIED LOW VOLTAGE THERMOSTAT/CONTROLLER. |




1. ARRANGE PIPING TO ALLOW FOR FIN TUBE RADIATOR REMOVAL.
2. USE THIS DETAIL WHEN COIL FIN TUBE RADIATOR IS NOT AN ISSUE.

5 **Contr**
SCALE: NTS

SCALE: NTS

(Detail #)

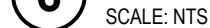

1. ALL DEMOLITION WORK SHALL BE IN COMPLIANCE WITH ALL FEDERAL AND NEW YORK STATE APPLICABLE BUILDING AND LIFE AND SAFETY REGULATIONS.
2. THE CONTRACTOR SHALL PROTECT ALL PORTIONS OF THE EXISTING BUILDING WHERE NEW WORK IS TO BE COMPLETED FROM DUST, WEATHER INCONVENIENCE AND FREEZING. PROVIDE DUST FREE BARRIER PARTITIONS DURING DEMOLITION TO PREVENT DEBRIS FROM ENTERING NON-WORK AREAS. THE CONTRACTOR WILL BE HELD RESPONSIBLE FOR ANY DAMAGE TO THE EXISTING STRUCTURE OR BUILDING CONTENTS.
3. THE CONTRACTOR ACCESS SHALL BE AS CALLED OUT ON SHEET G0.0. THE CONTRACTOR SHALL ADEQUATELY PROTECT ALL EXISTING FINISHES SCHEDULED TO REMAIN ALONG THE ACCESS ROUTE AND ADJOINING SURFACES OUTSIDE THE CONTRACT AREA OR SCOPE OF WORK FROM DAMAGE DUE TO PROJECT ACTIVITIES. THE CONTRACTOR SHALL BE RESPONSIBLE TO RESTORE AND/OR REPAIR EXISTING ADJACENT SURFACES DAMAGED DURING CONSTRUCTION INCLUDING PATCHING AND PAINTING AS REQUIRED AND DEEMED NECESSARY BY THE ARCHITECT AT NO ADDITIONAL COST TO THE OWNER.
4. THE CONTRACTOR SHALL REMOVE AND DISPOSE OF ALL CONSTRUCTION DEBRIS AND UNWANTED MATERIAL OFF SITE IN ACCORDANCE WITH ALL FEDERAL AND NEW YORK STATE APPLICABLE BUILDING AND LIFE AND SAFETY REGULATIONS.
5. THE CONTRACTOR SHALL TAKE CARE NOT TO DAMAGE ADJOINING SURFACES AND FINISHES DURING DEMOLITION. THE CONTRACTOR SHALL PATCH AND REPAIR ALL ADJACENT SURFACES DAMAGED DURING DEMOLITION. CONTRACTOR SHALL MATCH ALL ADJACENT FINISHES.
6. OVER-DEMOLITION SHALL BE ALLOWED PROVIDED THAT ALL SURFACES SHALL BE RESULT TO MATCH MATERIALS, STRUCTURAL INTEGRITY AND APPEARANCE OF THOSE WHICH WERE REMOVED AND IN CONFORMANCE WITH CONTRACT DOCUMENTS AND AT NO ADDITIONAL COST TO THE OWNER.
7. REMOVE ALL ITEMS THAT WILL BE ABANDONED AS A RESULT OF THE WORK BEING PERFORMED.
8. THE CONTRACTOR SHALL FIELD VERIFY ALL EXISTING CONDITIONS, DIMENSIONS AND QUANTITIES OF ALL ITEMS PRIOR TO BID.
9. COORDINATE THE WORK OF THE DEMOLITION DRAWING WITH ALL CONSTRUCTION DRAWINGS AND DOCUMENTS.
10. THIS DRAWING IS A GENERAL LIST OF DEMOLITION ITEMS AND IS NOT EVERY ITEM REQUIRED FOR DEMOLITION. CONTRACTOR SHALL PROVIDE ALL DEMOLITION REQUIRED TO PERFORM ALL WORK INDICATED WITHIN THE PROJECT DRAWINGS AND SPECIFICATIONS AND TO PREPARE ALL AREAS FOR THE CONSTRUCTION WORK.

1 EXISTING WALL FINISHES SHALL REMAIN IN PLACE U.N.O. THE CONTRACTOR SHALL PATCH AND REPAIR ALL WALLS, FLOORING AND CEILINGS IN AREA OF WORK TO MATCH ADJACENT FINISHES AND PREPARE NEW CONSTRUCTION.

2 EXISTING FLOORING SHALL REMAIN IN PLACE U.N.O.. EXISTING WALL BASE SHALL BE REMOVED AND LEGALLY DISPOSED OF. PATCH AND PREPARE EXISTING SURFACES FOR NEW CONSTRUCTION AND FINISHES.

3 THE CONTRACTOR SHALL PROVIDE AND INSTALL ~~3/8"~~ IMPACT RESISTANT GYPSUM WALL BOARD ON 3-5/8" GALVANIZED METAL STUD FRAMING @ 16" O.C. TO UNDERSIDE OF DECK TO FINISHED FLOOR PER PARTITION TYPE 1 ON THIS SHEET. THE CONTRACTOR SHALL ALIGN AND PREPARE NEW AND EXISTING WALL TO PLUMB AS REQUIRED FOR COMPLETE AND PROPER INSTALLATION OF NEW TILE AND FINISHES.

NOTES:

- CONTRACTOR SHALL COORDINATE WITH 'E' DRAWINGS REGARDING INSTALLATION OF NEW ITEMS THROUGHOUT SPACE.
- CONTRACTOR SHALL PATCH AND PREPARE EXISTING AND NEW SLAB/FLOORING, WALL AND CEILING OPENINGS.
- SEE THIS SHEET FOR DETAILS



WALL TYPE	OVERALL DIMENSIONS	STUD SIZE	FIRE RATING	UL No.	STC RATING	COMMENTS
1	4 1/4"	3 5/8"	-	-	-	GYPSUM BOARD ON ONE SIDE. FLOOR TO CEILING

H2M Ref #MI-131

UNIT VENTILATORS - STEAM HEAT


EQUIPMENT NO.	QUANTITY	PERFORMANCE/ CONSTRUCTION REQUIREMENTS											BASIS OF DESIGN INFORMATION							MECHANICAL NOTES	ELECTRICAL NOTES	
		SUPPLY FAN		OUTSIDE AIRFLOW (CFM)	COOLING COIL				HEATING COIL			MNF	MODEL NO.	NOMINAL DIMENSIONS L" x W" x H" (EXCLUDING LEV KIT)	NOMINAL OPERATING WEIGHT (LBS.)	ELECTRICAL DATA						
		AIRFLOW (CFM)	HP		REFRIGERANT TYPE	TOTAL CAPACITY (MBH)	SENSIBLE CAPACITY (MBH)	AIR DATA		TOTAL CAPACITY (MBH)	AIR DATA					STEAM COIL DATA	VOLTS/PHASE	MCA	MOCP			
								ENT. DB/WB (°F)	LVG. DB/WB (°F)		ENT. DB (°F)											LVG. DB (°F)
UV-15B	1	999	1 / 3	221	R-410A	33.2	24.9	80 / 67	57.1 / 56.3	58.5	51	105	3.0	DAIKIN	UAVS9H10	74"x16.63"x30.13"	425	115 / 1	6.3	15	1-18	6.7,10,12,14
UV-17	1	1474	1 / 3	401	R-410A	53.7	40.3	80 / 67	54.8 / 54.8	85.5	51	104.4	3.0	DAIKIN	UAVS9H15	98"x16.63"x30.13"	570	115 / 1	6.3	15	1-18	6.7,10,12,14
UV-19	1	1474	1 / 3	441	R-410A	53.7	40.3	80 / 67	54.8 / 54.8	85.5	51	104.4	3.0	DAIKIN	UAVS9H15	98"x16.63"x30.13"	570	115 / 1	6.3	15	1-18	6.7,10,12,14
UV-21	1	999	1 / 3	205	R-410A	33.2	24.9	80 / 67	57.1 / 56.3	58.5	51	105	3.0	DAIKIN	UAVS9H10	74"x16.63"x30.13"	425	115 / 1	6.3	15	1-18	6.7,10,12,14
<div><div>MECHANICAL NOTES:</div><div><div>1. PROVIDE PNEUMATIC CONTROLS TO TIE INTO EXISTING GALVANIZED DRAIN PAN</div><div>3. COLD WEATHER DAMPER ASSEMBLY</div><div>4. REAR OUTSIDE AIR, BOTTOM RETURN AIR</div><div>5. HIGH EFFICIENCY ECM MOTOR</div><div>6. STEAM 2 WAY MODULATING VALVE/ACTUATOR</div><div>7. 2" MERV 13 FILTER</div><div>8. TOP DISCHARGE BAR STOCK STEEL GRILLE</div></div><div><div>9. FALSE BACK</div><div>10. SINGLE ROW STEAM COIL</div><div>11. PROVIDE WITH FREEZE STAT</div><div>12. CONTRACTOR RESPONSIBILITY TO CONFIRM QUANTITIES</div><div>13. PROVIDE NEW WALL MOUNTED PNEUMATIC THERMOSTAT</div><div>14. PROVIDE ECONOMIZER</div><div>15. REUSE EXISTING PNEUMATIC LINES</div><div>16. PROVIDE SUBBASE, MATCH HEIGHT OF EXISTING CASEWORK.</div><div>17. OUTSIDE AIR VALUES IN THIS SCHEDULE ARE MAXIMUM VALUES.</div><div>18. BALANCER TO BALANCE UNIT VENTILATOR OUTSIDE AIR TO</div></div><div><div>ELECTRICAL NOTES:</div><div><div>1. INTEGRAL DISCONNECT SWITCH (FIELD WIRED)</div><div>2. INTEGRAL DISCONNECT SWITCH (FACTORY WIRED)</div><div>3. INTEGRAL UNPOWERED RECEPTACLES (FIELD WIRED)</div><div>4. INTEGRAL POWERED RECEPTACLES (FACTORY WIRED)</div><div>5. INTEGRAL CONDENSATE PUMP (UNPOWERED)</div><div>6. INTEGRAL CONDENSATE PUMP (POWERED)</div><div>7. LOW VOLTAGE CONTROLS</div></div><div><div>8. LINE VOLTAGE CONTROLS</div><div>9. INTEGRAL STARTERS</div><div>10. MOTORIZED DAMPERS (24VAC)</div><div>11. MOTORIZED DAMPERS (120VAC)</div><div>12. SINGLE POINT POWER FEED</div><div>13. INDOOR UNIT POWERED FROM OUTDOOR UNIT</div><div>14. ELECTRICAL CONTRACTOR TO PROVIDE DISCONNECT SWITCH ON SAME POWER FEED AS ASSOCIATED INDOOR UNIT</div><div>15.</div></div></div></div>																						

UNIT VENTILATORS - HOT WATER HEAT

EQUIPMENT NO.	QUANTITY	PERFORMANCE/ CONSTRUCTION REQUIREMENTS															BASIS OF DESIGN INFORMATION						MECHANICAL NOTES	ELECTRICAL NOTES	
		SUPPLY FAN		OUTSIDE AIRFLOW (CFM)	COOLING COIL				HEATING COIL							MNF	MODEL NO.	NOMINAL DIMENSIONS L" x W" x H" (EXCLUDING LEV KIT)	NOMINAL OPERATING WEIGHT (LBS.)	ELECTRICAL DATA					
		AIRFLOW (CFM)	HP		REFRIGERANT TYPE	TOTAL CAPACITY (MBH)	SENSIBLE CAPACITY (MBH)	AIR DATA		TOTAL CAPACITY (MBH)	AIR DATA		HOT WATER							VOLTS/PHASE	MCA	MOCP			
								ENT. DB/WB (°F)	LVG. DB/WB (°F)		ENT. DB (°F)	LVG. DB (°F)	ENT. TEMP (°F)	LVG. TEMP (°F)	FLOW RATE (GPM)										PRESSURE DROP (FT H2O)
UV-10	1	979	1 / 3	342	R-410A	33.2	24.9	80 / 67	56.6 / 56	46	70	113.4	180	133.9	2.0	.85	DAIKIN	UAVS9H10	74"x16.63"x30.13"	425	115 / 1	6.3	15	1-17	6.7,10,12,14
UV-12	1	979	1 / 3	387	R-410A	33.2	24.9	80 / 67	56.6 / 56	46	70	113.4	180	133.9	2.0	.85	DAIKIN	UAVS9H10	74"x16.63"x30.13"	425	115 / 1	6.3	15	1-17	6.7,10,12,14
UV-13A	1	979	1 / 3	281	R-410A	33.2	24.9	80 / 67	56.6 / 56	46	70	113.4	180	133.9	2.0	.85	DAIKIN	UAVS9H10	74"x16.63"x30.13"	425	115 / 1	6.3	15	1-17	6.7,10,12,14
UV-13B	1	979	1 / 3	281	R-410A	33.2	24.9	80 / 67	56.6 / 56	46	70	113.4	180	133.9	2.0	.85	DAIKIN	UAVS9H10	74"x16.63"x30.13"	425	115 / 1	6.3	15	1-17	6.7,10,12,14
UV-100	1	979	1 / 3	220	R-410A	33.2	24.9	80 / 67	56	46	70	113.4	180	133.9	2.0	.85	DAIKIN	UAVS9H10	74"x16.63"x30.13"	425	115 / 1	6.3	15	1-17	6.7,10,12,14
UV-101	1	1444	1 / 3	434	R-410A	53.7	40.3	80 / 67	54.3 / 54.3	62.9	70	110.1	180	117.1	2.0	.65	DAIKIN	UAVS9H15	98"x16.63"x30.13"	570	115 / 1	6.3	15	1-17	6.7,10,12,14
UV-102	1	1444	1 / 3	415	R-410A	53.7	40.3	80 / 67	54.3 / 54.3	62.9	70	110.1	180	117.1	2.0	.65	DAIKIN	UAVS9H15	98"x16.63"x30.13"	570	115 / 1	6.3	15	1-17	6.7,10,12,14
<div><div>MECHANICAL NOTES:</div><div><div>1. PROVIDE PNEUMATIC CONTROLS TO TIE INTO EXISTING GALVANIZED DRAIN PAN</div><div>2. COLD WEATHER DAMPER ASSEMBLY</div><div>3. REAR OUTSIDE AIR, BOTTOM RETURN AIR</div><div>4. HIGH EFFICIENCY ECM MOTOR</div></div><div><div>6. 2" MERV 13 FILTER</div><div>7. TOP DISCHARGE BAR STOCK STEEL GRILLE</div><div>8. FALSE BACK</div><div>9. SINGLE ROW HOT WATER COIL</div><div>10. PROVIDE WITH FREEZE STAT</div><div>11. CONTRACTOR RESPONSIBILITY TO CONFIRM QUANTITIES</div><div>12. PROVIDE WALL MOUNTED PNEUMATIC THERMOSTAT</div><div>13. PROVIDE ECONOMIZER</div></div><div><div>14. REUSE EXISTING PNEUMATICS</div><div>15. PROVIDE SUBBASE, MATCH HEIGHT OF EXISTING CASEWORK.</div><div>16. OUTSIDE AIR VALUES IN SCHEDULE ARE MAXIMUM VALUES.</div><div>17. BALANCE TO BALANCE UNIT VENTILATOR OUTSIDE AIR TO VALUES ON PLAN/VENTILATION SCHEDULE.</div><div>18. FACE AND BYPASS CONTROL</div></div></div> <div><div>ELECTRICAL NOTES:</div><div><div>1. INTEGRAL DISCONNECT SWITCH [FIELD WIRED]</div><div>2. INTEGRAL DISCONNECT SWITCH [FACTORY WIRED]</div><div>3. INTEGRAL UNPOWERED RECEPTACLES [FIELD WIRED]</div><div>4. INTEGRAL POWERED RECEPTACLES [FACTORY WIRED]</div><div>5. INTEGRAL CONDENSATE PUMP [UNPOWERED]</div><div>6. INTEGRAL CONDENSATE PUMP [POWERED]</div><div>7. LOW VOLTAGE CONTROLS</div></div><div><div>8. LINE VOLTAGE CONTROLS</div><div>9. INTEGRAL STARTERS</div><div>10. MOTORIZED DAMPERS [24VAC]</div><div>11. MOTORIZED DAMPERS [120VAC]</div><div>12. SINGLE POINT POWER FEED</div><div>13. INDOOR UNIT POWERED FROM OUTDOOR UNIT</div><div>14. ELECTRICAL CONTRACTOR TO PROVIDE DISCONNECT SWITCH ON SAME POWER FEED AS ASSOCIATED INDOOR UNIT</div><div>15.</div></div></div>																									

PACKAGED ROOFTOP SYSTEM WITH ENERGY RECOVERY WHEEL

EQUIPMENT NO.	LOCATION	PERFORMANCE/ CONSTRUCTION REQUIREMENTS																				BASIS OF DESIGN INFORMATION										MECHANICAL NOTES	ELECTRICAL NOTES										
		SUPPLY FAN				EXHAUST FAN				ERV		OUTSIDE AIR FLOW (CFM)	NOMINAL TONNAGE	COOLING COIL								HEATING								UNIT LVG TEMP (°F)	MNF			MODEL NO.	NOMINAL DIMENSIONS LxWxH (IN.)	NOMINAL OPERATION WEIGHT (LBS)	ELECTRICAL DATA						
		SUPPLY AIR (CFM)	BHP	MOTOR HP	EXT. S.P. (IN W.G)	EXHAUST AIR (CFM) [ECONOMIZER]	BHP	MOTOR HP	EXT. S.P. (IN W.G)	MOTOR HP	REFR. TYPE			TOTAL CAPACITY (MBH)	SENSIBLE CAPACITY (MBH)	EER	SEER / IEER	AIR DATA					UNIT LVG TEMP (°F)	HEAT PUMP					ELECTRIC COIL								VOLTS/ PHASE	FLA	MCA	MOCP			
																		OA DB/WB (°F)	RA DB/WB (°F)	ENT. DB (°F)	LVG. DB/WB (°F)	HGRH DB/WB (°F)		OA DB/WB (°F)	RA DB/WB (°F)	ENT. DB (°F)	LVG. DB (°F)	COP @47 F	ELECTRIC HEAT COIL SIZE (KW)												HEAT CAPACITY (MBH)	COIL ΔT (°F)	
ERU-1	SEE PLANS	2200	2.08	4	2	1482	.91	4	1.5	0.17	2200	7	R-410A	86.1	63.8	12.6	18.8	88 / 72	75 / 62	79.7/66.1	53.2/53.1	70 / 59.5	53.2	44.8	10 / 70	70 / 50	46.7	65.4	3.58	18	61.4	25.8	72.5	DAIKIN	DPS007A	111x96.5x56.8	2424	208 / 3	94.6	110.1	125	1-9, 11-17, 19	2,4,7,10,11
ERU-2	SEE PLANS	1800	1.76	4	2	1404	.81	4	1.5	0.17	1800	7	R-410A	81.0	56.7	12.6	18.8	88 / 72	75 / 62	78.7/65.3	49.8/49.8	70/57.8	49.8	43.8	10 / 70	70 / 50	51.7	73.9	3.58	18	61.4	31.4	83.1	DAIKIN	DPS007A	111x96.5x56.8	2424	208 / 3	94.6	110.1	125	1-9, 11-17, 19	2,4,7,10,11
ERU-3	SEE PLANS	3200	4.12	5	2	3000	1.95	4	1.5	0.17	3200	16	R-410A	162	108.5	11.5	20.5	88 / 72	75 / 62	79.3/65.8	48.3/48.2	70/57.1	48.3	95.7	10 / 70	70 / 50	48.7	76.1	3.55	30	102.4	29.5	78.2	DAIKIN	DPS016A	182.3x76.5x82.5	4139	208 / 3	167.7	200.3	225	1-9, 11-17, 19	2,4,7,10,11
ERU-4	SEE PLANS	3200	4.13	5	2	2496	1.47	4	1.5	0.17	3200	16	R-410A	167.2	106.3	11.5	20.5	88 / 72	75 / 62	80.4/67.5	50.0/50.0	70/58.0	50	95.7	10 / 70	70 / 50	47.0	74.4	3.55	30	102.4	29.5	76.5	DAIKIN	DPS016A	182.3x76.5x82.5	4139	208 / 3	167.7	200.3	225	1-9, 11-17, 19	2,4,7,10,11
ERU-5	SEE PLANS	1900	1.83	4	2	1482	.86	4	1.5	0.17	1900	7	R-410A	82.1	58.4	12.6	18.8	88 / 72	75 / 62	78.7/65.4	50.6/50.6	70/58.2	50.6	44.0	10 / 70	70 / 50	51.2	72.4	3.58	18	61.4	29.8	81.0	DAIKIN	DPS007A	111x96.5x56.8	2424	208 / 3	94.6	110.1	125	1-10, 12-18	2,4,7,10,11
MECHANICAL NOTES: 1. 4" PLEATED MERV-8 FILTERS. 2. HINGED ACCESS DOORS 3. DIRTY FILTER INDICATOR SWITCH. 4. SUPPLY FAN STATUS SWITCH 5. HOT GAS REHEAT COIL. 6. PROVIDE NEW PROGRAMMABLE THERMOSTAT. 7. MANUFACTURER TO PROVIDE BACNET INTERFACE CARD 8. STAINLESS STEEL DRAIN PAN AND CONDENSATE OVERFLOW SWITCH, INTERLOCK TO TURN OFF UNIT. 9. PHASE LOSS PROTECTION 10. VERTICAL SUPPLY/RETURN DUCTWORK CONFIGURATION.												11. HORIZONTAL SUPPLY/RETURN DUCTWORK CONFIGURATION. 12. CONDENSER PAIL GUARD 13. ENERGY RECOVERY WHEEL 14. SCROLL COMPRESSOR FOR ALL CIRCUITS 15. MANUFACTURER TO PROVIDE FACTORY INSTALLED UNIT CONTROLLER 16. SUPPLY AIR FLOW MONITORING 17. SUPPLY AND EXHAUST FAN VFD 18. PROVIDE CURB ADAPTER 19. MOUNT ON EXISTING DUNNAGE.												ELECTRICAL NOTES: 1. INTEGRAL DISCONNECT SWITCH [FIELD WIRED] 2. INTEGRAL DISCONNECT SWITCH [FACTORY WIRED] 3. INTEGRAL UNPOWERED RECEPTACLES [FIELD WIRED] 4. INTEGRAL POWERED RECEPTACLES [FACTORY WIRED] 5. INTEGRAL CONDENSATE PUMP [UNPOWERED] 6. INTEGRAL CONDENSATE PUMP [POWERED] 7. LOW VOLTAGE CONTROLS										8. LINE VOLTAGE CONTROLS 9. INTEGRAL STARTERS 10. MOTORIZED DAMPERS [120VAC] 11. SINGLE POINT POWER FEED 12. INDOOR UNIT POWERED FROM OUTDOOR UNIT 13. ELECTRICAL CONTRACTOR TO PROVIDE DISCONNECT SWITCH ON SAME POWER FEED AS ASSOCIATED INDOOR UNIT									

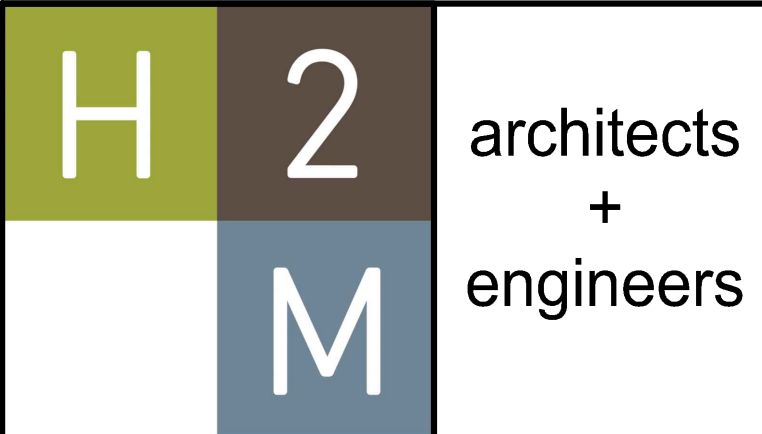

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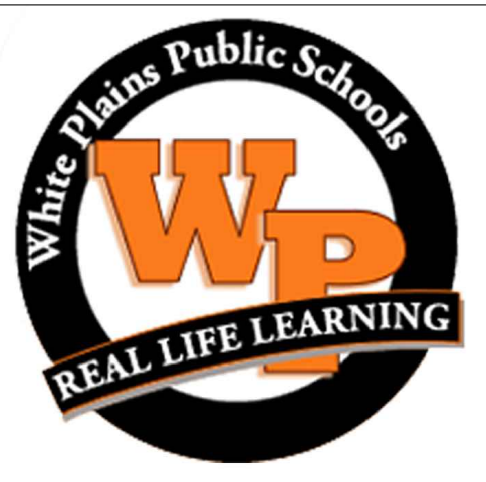
CONSULTANTS:

[illegible]

DESIGNED BY: JML				DRAWN BY: BFB/DKR		CHECKED BY: JML		REVIEWED BY: QAQC	
PROJECT No.: WPSD 2205			DATE: OCTOBER 2023			SCALE:			

CLIENT **White Plains City
School District**

AC and Ventilation Upgrades at Mamaroneck Elementary School



**7 Nosband Ave.
White Plains, NY 10605**

SED PROJECT CONTROL
NO. 66-22-00-01-0-010-017

CONTRACT

CONTRACT H
HEATING VENTILATION AND AIR
CONDITIONING

STATUS

FINAL BID DOCUMENT

SHEET TITLE

MECHANICAL SCHEDULES

DRAWING No.

M602.00