


RECORD OF SUBSURFACE EXPLORATION 19662_Blogs 11/2/2022

roject:		White I	Plains High Schoo	l Impro	vements	1				WAI Project No.:	GJ2219662.Y00	
ocation:		550 No	orth Street; White F	Plains,	Westche	ester Co	unty, NY			Client:	H2M Architects 8	& Engineers
urface E	levatio	n:	± NS fee	et			Date Started:		10/10/2022	Water Depth Elevation	Cave-I	n Depth Elevation
erminatio	on Dep	th:	27.0fee	t bgs			Date Complete	ed:	10/10/2022	(feet bgs) (feet)	(fe	eet bgs) (feet)
roposed	Locati	on:	Building				Logged By:	МО		During: 9.0 (P) NS y		
rill / Test	Metho	od:	HSA / SPT				Contractor:	ECG		At Completion:	At Completion:	<u> </u>
							Equipment:	AMS-	9580	24 Hours:	24 Hours:	<u>\</u>
	SA	MPLE	INFORMATION	1		DEPTH	4					
Depth (feet)	No	Туре	Blows Per 6"	Rec. (in.)	N	(feet)	STRAT	Ά		DESCRIPTION OF MATERIALS (Classification)	3	REMARKS
(icci)	140	Турс	Blows I el o	(,	- "	25.0		14141		(Cruscinicalieri)		
25 - 25.4	S-9	X	50/4"	-	50/4"	_	GLACIAL	[+]+[Light Brown Poor	y Graded Sand, Wet, Very Dense (SP)		1
						_	DEPOSITS					
							1					
				-		27.0		-;-;-	Poring Log P 1 T	erminated at a Depth of 27.0 Feet Below Grou	ad Surface Due to	Auger Refusal @
							4		Auger Refusal	eminated at a Depth of 27.0 Feet Below Groun	id Surface Due to	27.0 fbgs
						_	1					
						•	1					
						_	1					
						30.0	1					
]					
						_	1					
							4					
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						35.0]					
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]					
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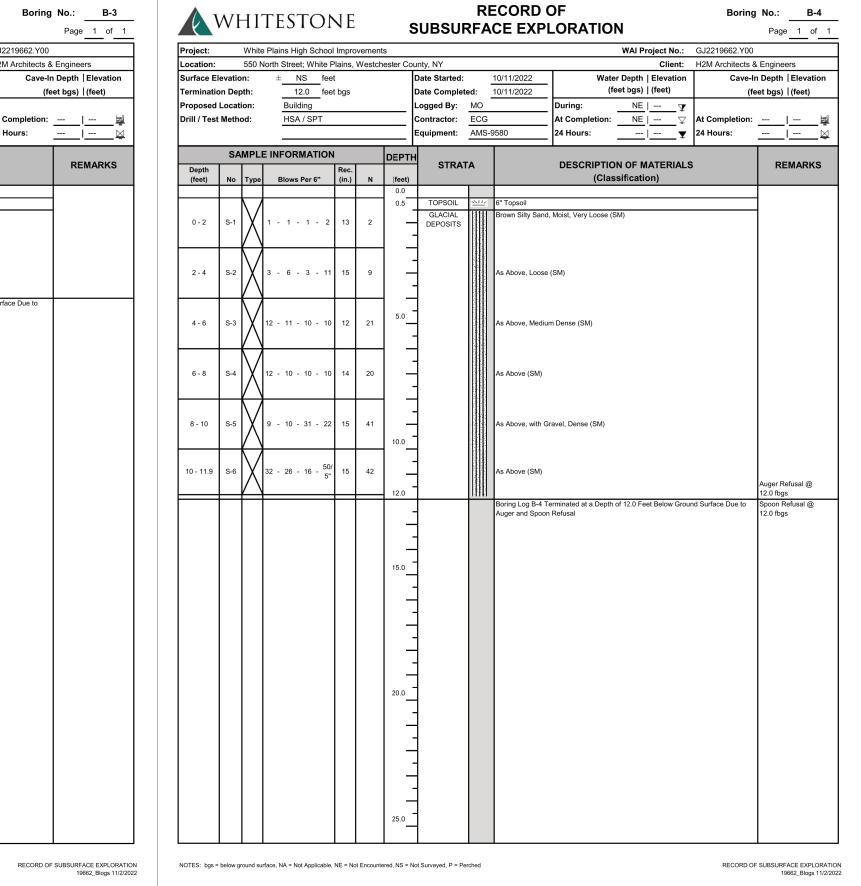
RECORD OF SUBSURFACE EXPLORATION 19662_Blogs 11/2/2022


Project: Location:			Plains High School orth Street; White F	_			unty, NY			WAI Project No.: Client:	GJ2219662.Y00 H2M Architects 8	& Engineers
Surface E	levatio		± NS fee	_			Date Started:			r Depth Elevation		n Depth Elevation
Terminati	on Dep	th:	28.4 fee	t bgs		ļ	Date Complete	ed:	0/10/2022 (fe	et bgs) (feet)	(fe	eet bgs) (feet)
Proposed			Building					МО	During:	10.0 (P) NS Y		
Orill / Tes	t Metho	od:	HSA / SPT			_	Contractor:	ECG	At Completion:			<u> </u> <u> </u>
						ˈ	Equipment:	AMS-9	580 24 Hours :	<u></u>	24 Hours:	💆
	SA	MPLE	INFORMATION			DEPTH						
Depth (feet)	No	Туре	Blows Per 6"	Rec. (in.)	N	feet)	STRAT	Α		N OF MATERIALS sification)	5	REMARKS
	-	\vdash		┢	-	0.0	TOPSOIL	<u> </u>	6" Topsoil			-
0 - 2	S-1	X	1 - 1 - 1 - 2	15	2	- " -	GLACIAL DEPOSITS		Brown Silt, Moist, Soft (ML)			Qu = 0.5 tsf
2 - 4	S-2	X	3 - 2 - 1 - 3	14	3	4.0			As Above, Light Brown (ML)			Qu = 0.5 tsf
4 - 6	S-3	M	6 - 11 - 13 - 16	17	24	5.0			Brown Silty Sand with Gravel, Moist, Me	edium Dense (SM)		
6 - 8	S-4	X	12 - 13 - 17 - 16	18	30	- - -			As Above, Dense (SM)			
8 - 10	S-5	\bigvee	11 - 15 - 11 - 13	24	26				As Above, Very Moist, Medium Dense (SM)		
10 - 12	S-6	M	8 - 10 - 13 - 18	22	23	10.0 5			As Above, Wet (SM)			
						15.0						
15 - 17	S-7	X	32 - 37 - 43 - 50	24	60	- - -			Gray Poorly Graded Sand with Gravel,	Moist, Very Dense (SP)		
						20.0						
20 - 22	S-8	X	14 - 15 - 21 - 21	16	36	- - -			Gray/Brown Silty Sand, Wet, Dense (Sf	VI)		
							†	1111				1

Project: Location: Surface E Termination Proposed Drill / Test	levatio on Dep Locati t Metho	550 No n: oth: oon: od:	Plains High School	Plains, et et bgs		ester Coul	Date Started: Date Complete Date By:		Client: H 10/10/2022 Water Depth Elevation 10/10/2022 (feet bgs) (feet) During: 100 (P) NS		& Engineers n Depth Elevatio eet bgs) (feet)
Depth (feet)	No	Туре	Blows Per 6"	Rec. (in.)	N	(feet)	STRAT	Ά	DESCRIPTION OF MATERIALS (Classification)		REMARKS
						25.0	GLACIAL	ИИ			
25 - 25.8	S-9	\prec	27 - 50/3"	3	50/3"		DEPOSITS		Gray Sand with Gravel, Wet, Very Dense (SP)		
						-					
						▎ᇽ					
28 - 28.4	S-10	\forall	50/5"	4	50/5"	28.5			Gray Sand with Gravel, Wet, Very Dense (SP)		Auger Refusal @ 28.0 fbgs
									Boring Log B-2 Terminated at a Depth of 23.4 Feet Below Ground S Auger and Spoon Refusal	Surface Due to	Spoon Refusal @ 28.4 fbgs
						30.0					
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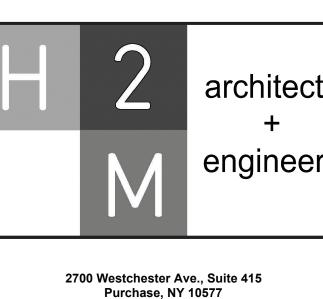
NOTES: bgs = below ground surface, NA = Not Applicable, NE = Not Encountered, NS = Not Surveyed, P = Perched



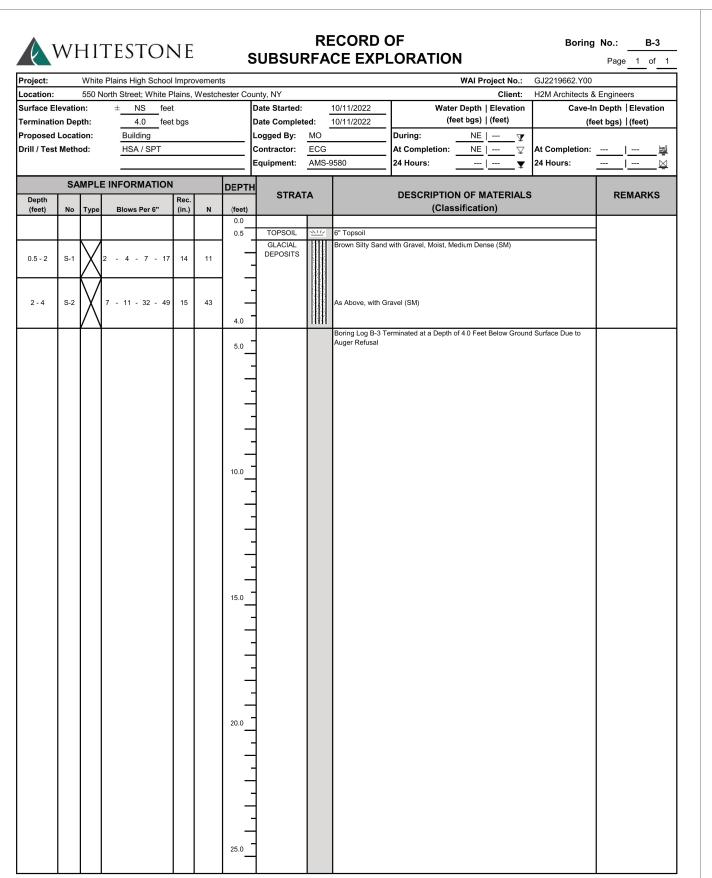

SUBSURFACE EXPLORATION DATA

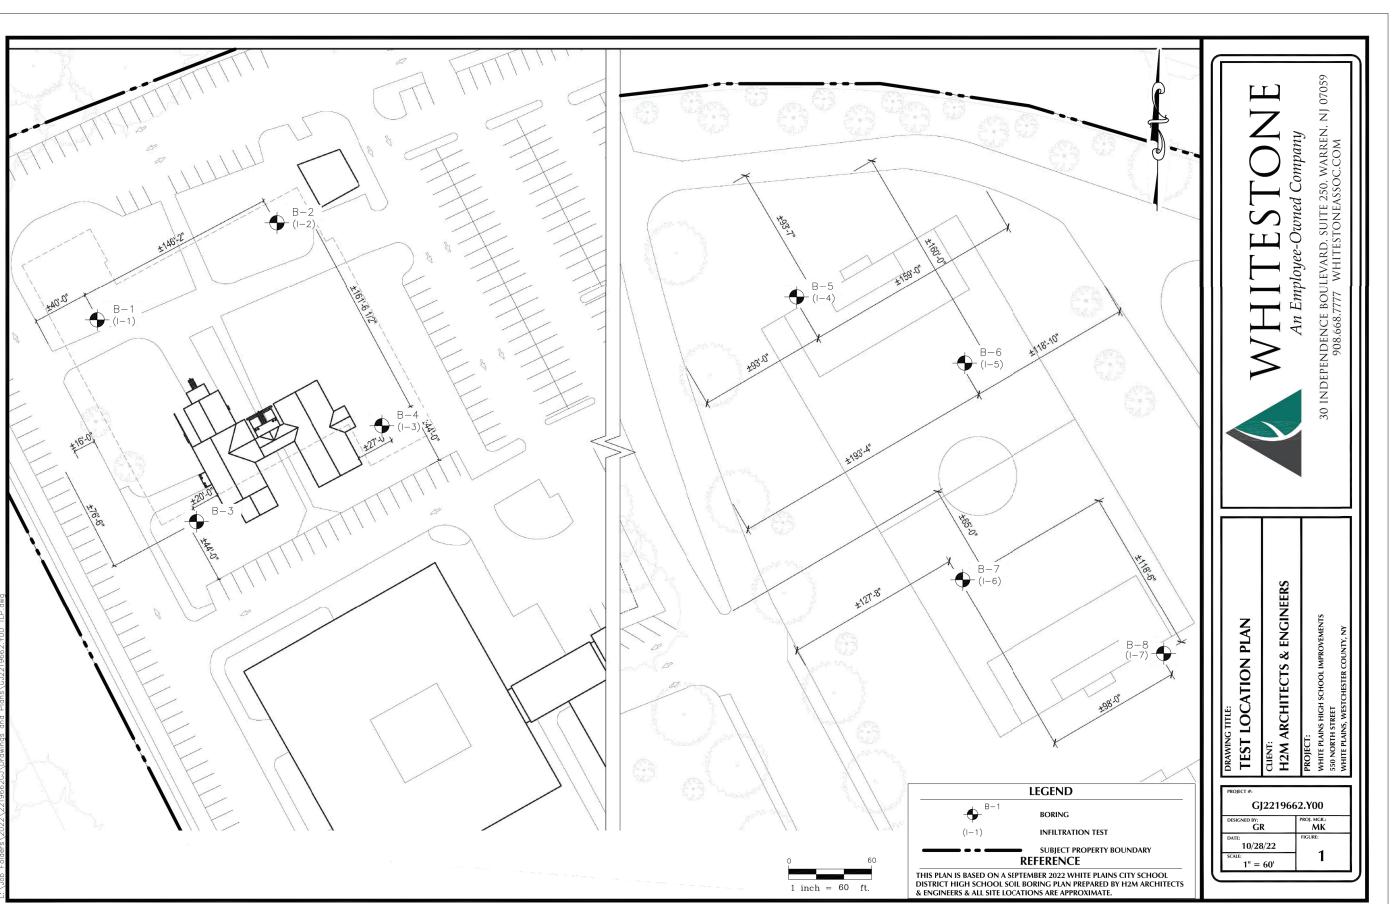FOR INFORMATION ONLY - NOT PART OF CONTRACT DOCUMENTS THE FOLLOWING DATA IS OFFERED SOLELY FOR THE PURPOSE OF PLACING BIDDERS IN RECEIPT OF INFORMATION AVAILABLE, AND IN NO EVENT IS TO BE CONSIDERED A PART OF CONTRACT BIDDER FURTHER ACKNOWLEDGES THAT HE/SHE ASSUMES ALL RISK CONTINGENT UPON THE NATURE OF THE SUBSURFACE CONDITIONS TO BE ACTUALLY ENCOUNTERED BY HIM/HER IN PERFORMING THE WORK OF THE CONTRACT, EVEN THOUGH SUCH ACTUAL CONDITIONS MAY RESULT IN THE BIDDER PERFORMING MORE OR LESS WORK THAN HE/SHE ORIGINALLY ANTICIPATED.



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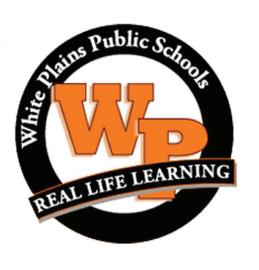
CONSULTANTS.

- 1	MARK	DATE	DESCRIPTION
- 1	-	07-24-2023	FINAL BID SET
	1	08-07-2023	ADDENDUM NO. 1
- 1			
- 1			
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"ALTER	RATION OF T	HIS DOCUMENT EXCEPT	BY A LICENSED PROFESS	SIONAL IS ILI	LEGAL"
DESIGNED BY:	DRAWN	I BY:	CHECKED BY:		REVIEWED BY:
CWP	D	OD/NPO	CWP		° KMM
PROJECT No.: WPSD 2200	6	AUGUS	ST 2023	SCALE:	AS SHOWN

White Plains City School District

WHITE PLAINS HIGH SCHOOL **UPGRADES AND TURF FIELD**



550 North Street White Plains, NY 10605

SED No. 66-22-00-01-0-16-029


19662_Blogs 11/2/2022

CONTRACT G GENERAL CONSTRUCTION

FINAL BID SET

RECORD OF SUBSURFACE **EXPLORATION AND SOIL BORING INFORMATION**

SB100.00

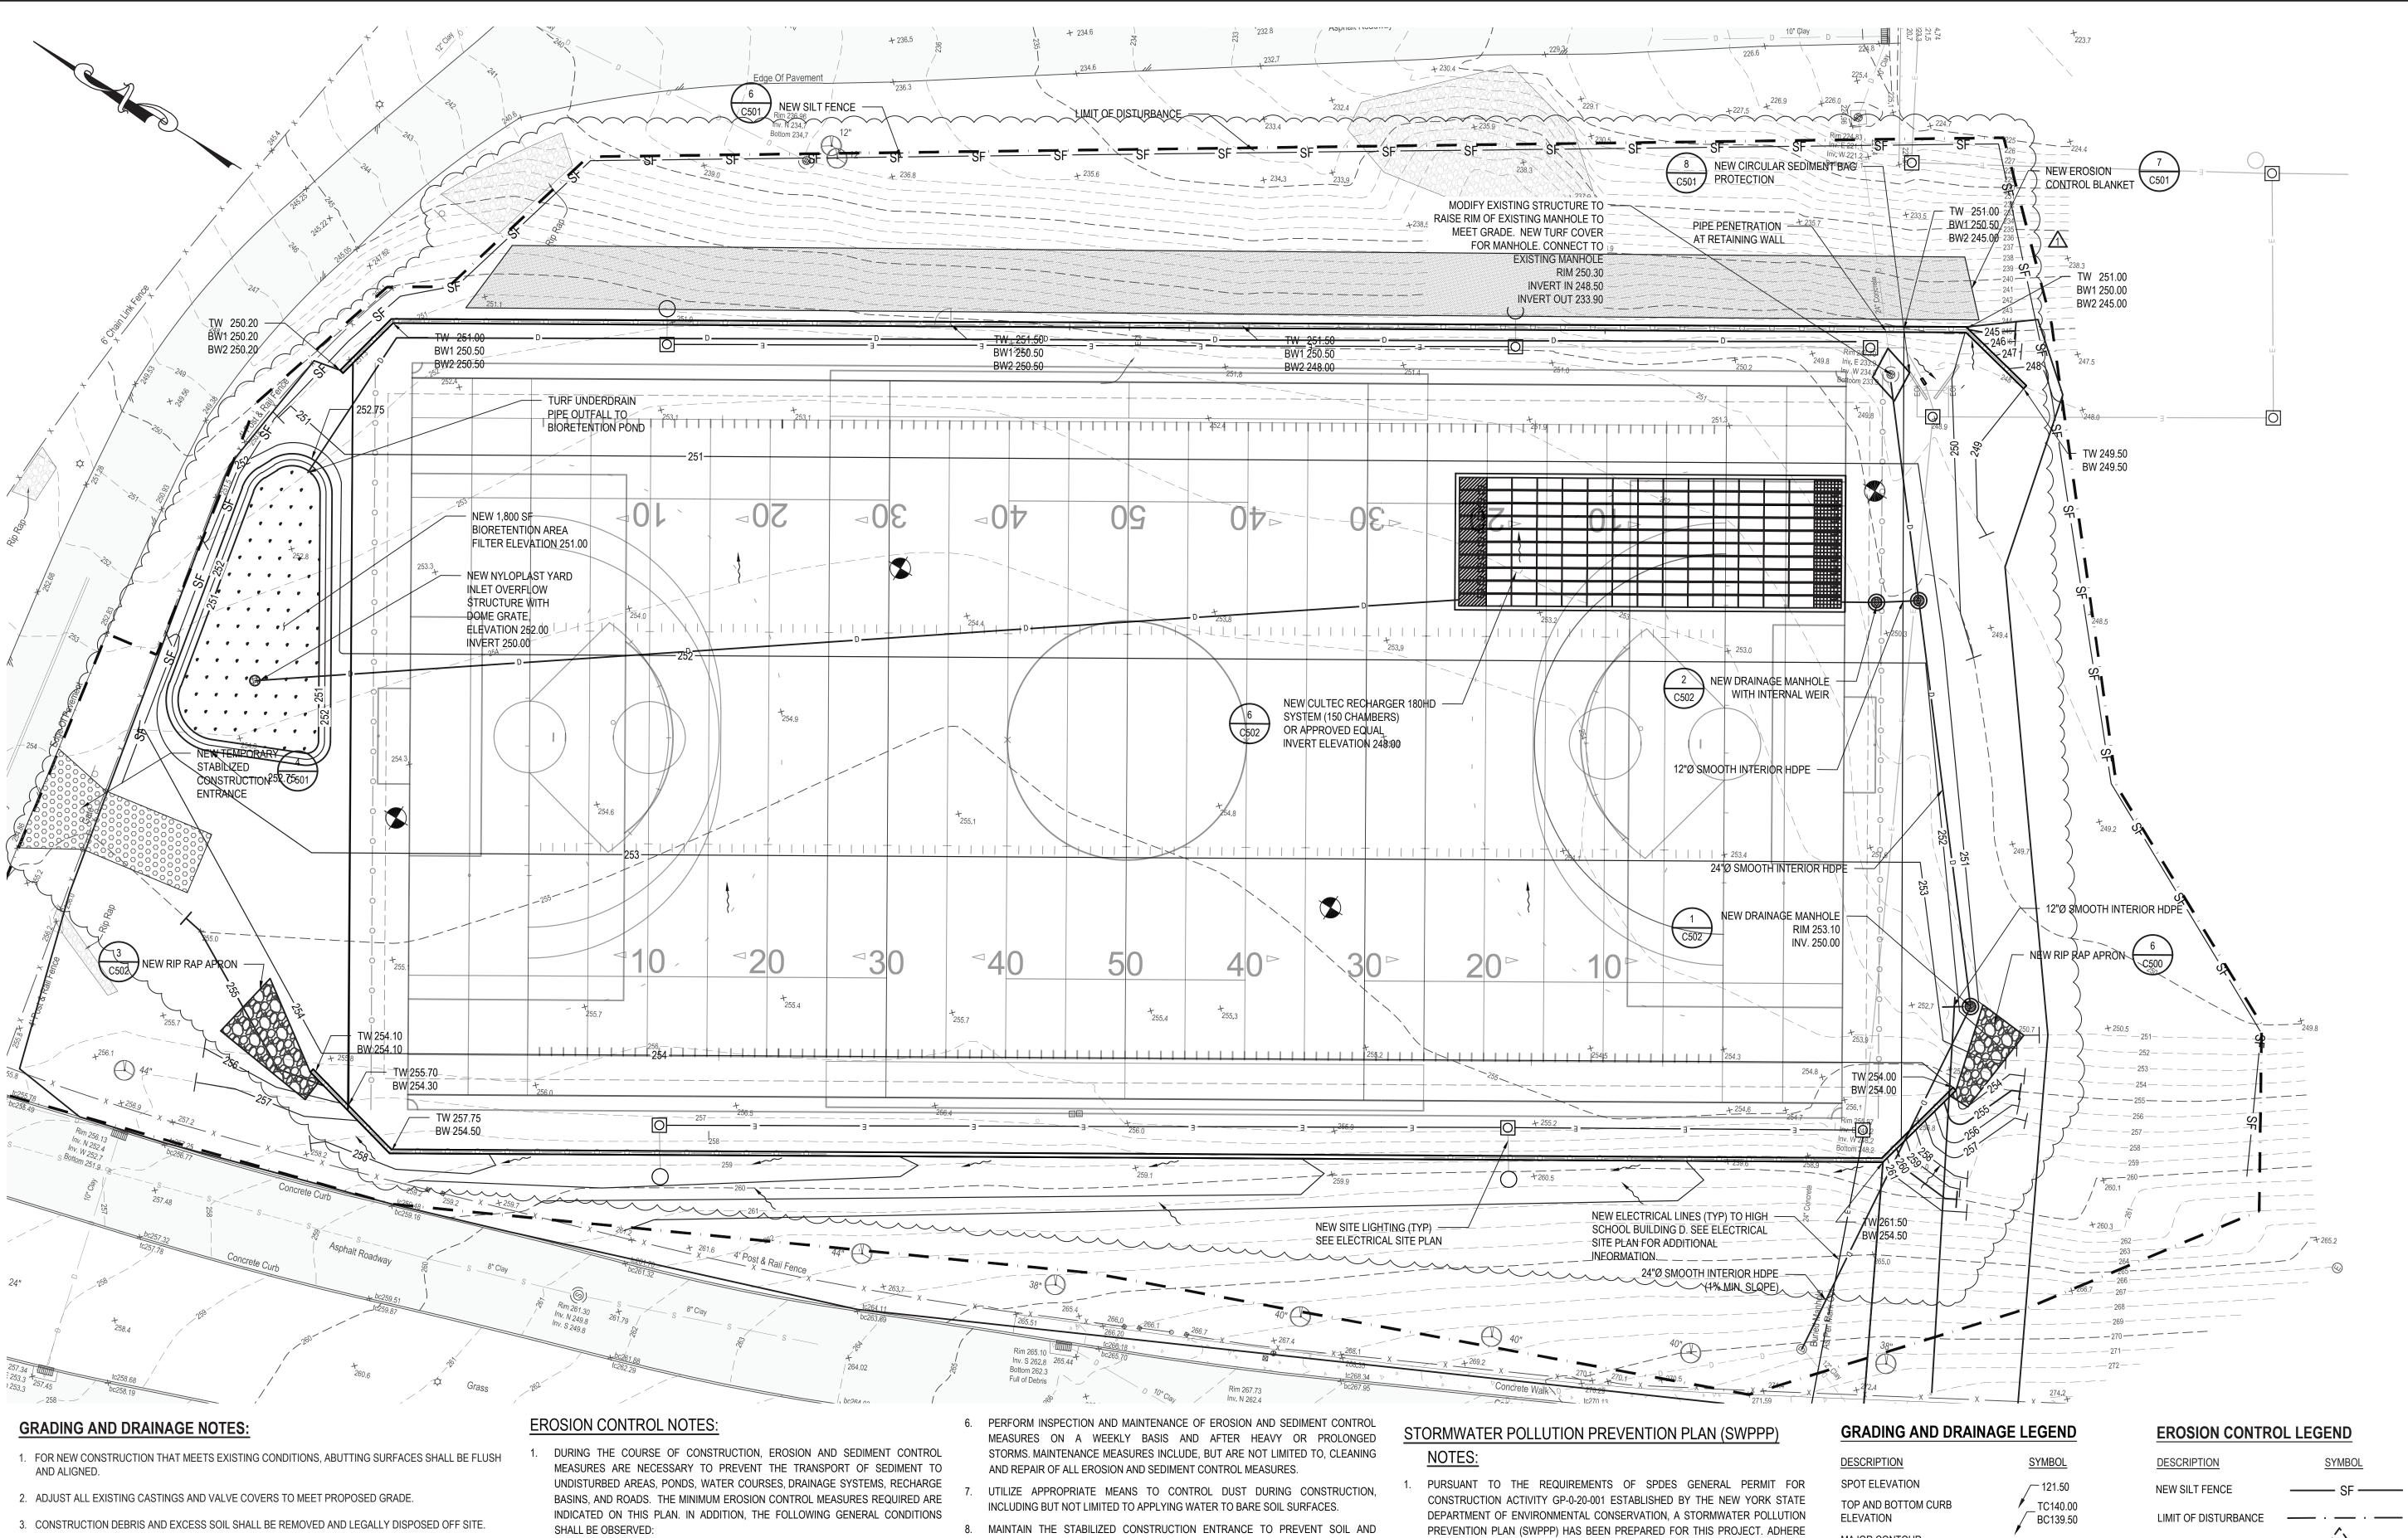

4. UNSUITABLE SOILS ENCOUNTERED DURING CONSTRUCTION SHALL BE BROUGHT TO THE ATTENTION OF THE OWNER AND ENGINEER IMMEDIATELY IN WRITING BEFORE REMOVAL OR DISTURBANCE.

PIPE MATERIAL SPECIFICATIONS:


- LINEAR LEACHING CHAMBERS TO MANHOLE CONNECTION: 12" Ø SMOOTH INTERIOR HDPE
- MANHOLE TO HYDRODYNAMIC SEPARATOR CONNECTION: 12" Ø SMOOTH INTERIOR HDPE
- MANHOLE TO MANHOLE CONNECTION: 24" Ø SMOOTH INTERIOR HDPE




- a. EXISTING VEGETATION SCHEDULED TO REMAIN SHALL BE PROTECTED AND REMAIN UNDISTURBED.
- b. INSTALL ADDITIONAL EROSION AND SEDIMENT CONTROL MEASURES AS REQUIRED TO PREVENT THE INCIDENTAL DISCHARGE OF SEDIMENT FROM THE SITE.
- SPECIFIC METHODS AND MATERIALS EMPLOYED IN THE INSTALLATION AND MAINTENANCE OF EROSION CONTROL MEASURES MUST CONFORM TO THE LATEST EDITION OF THE "NEW YORK STATE STANDARDS AND SPECIFICATIONS FOR EROSION AND SEDIMENT CONTROL".
- 3. INSTALL PROPRIETARY EROSION AND SEDIMENT CONTROL PRODUCTS IN ACCORDANCE WITH MANUFACTURERS INSTRUCTIONS.
- ADJUST EROSION AND SEDIMENT CONTROL MEASURES TO ACCOMMODATE CONSTRUCTION PHASING TO MAINTAIN EFFECTIVENESS OF EROSION AND SEDIMENT CONTROL MEASURES.
- PROTECT EXISTING DRAINAGE INLETS WITHIN THE PROJECT LIMITS AND NEW DRAINAGE INLETS INSTALLED AS PART OF THIS PROJECT FROM SEDIMENT

- LOOSE DEBRIS FROM BEING TRACKED ONTO LOCAL ROADS. MAINTAIN THE CONSTRUCTION ENTRANCE WEEKLY UNTIL THE SITE IS PERMANENTLY STABILIZED.
- ALL EROSION AND SEDIMENT CONTROL MEASURES SHALL REMAIN IN PLACE UNTIL DISTURBED AREAS ARE PERMANENTLY STABILIZED. AFTER PERMANENT STABILIZATION, REMOVE ALL TEMPORARY EROSION AND SEDIMENT CONTROL MEASURES AND ALL ACCUMULATED SEDIMENT AND DEBRIS FROM THE SITE AND DRAINAGE STRUCTURES.

TOTAL LAND DISTURBANCE = 3.18 ACRES

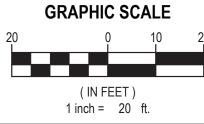

- TO AND IMPLEMENT ALL REQUIREMENTS OF THE SWPPP AND EROSION AND SEDIMENT CONTROL PLAN.
- REVIEW THE SWPPP AND SIGN IN THE LOCATION SHOWN STATING THAT ALL WORK PERTAINING TO EROSION AND SEDIMENT CONTROL WILL BE PERFORMED WITHIN REQUIREMENTS OF THE SWPPP AND EROSION AND SEDIMENT CONTROL PLAN.
- THE OWNER SHALL PROVIDE A QUALIFIED INSPECTOR WHO WILL PERFORM WEEKLY INSPECTIONS AT THE CONSTRUCTION SITE. THE QUALIFIED INSPECTOR SHALL MEET THE REQUIREMENTS OUTLINED IN SPDES GENERAL PERMIT FOR STORMWATER DISCHARGE FROM CONSTRUCTION ACTIVITY (GP-0-20-001). IF THE INSPECTIONS FIND ANY DEVIATIONS FROM THE SWPPP OR THE EROSION AND SEDIMENT CONTROL PLAN IT WILL BE NOTED. THE CONTRACTOR WILL HAVE 7 DAYS TO CORRECT ANY DEVIATIONS SO THAT IT COMPLIES WITH THE REQUIREMENTS OF THE SWPPP AND OR EROSION AND SEDIMENT CONTROL PLAN. IN THE EVENT THAT MORE THAN 5 ACRES OF SOIL IS DISTURBED AT ANY TIME, 2 WEEKLY INSPECTIONS WILL BE PERFORMED.

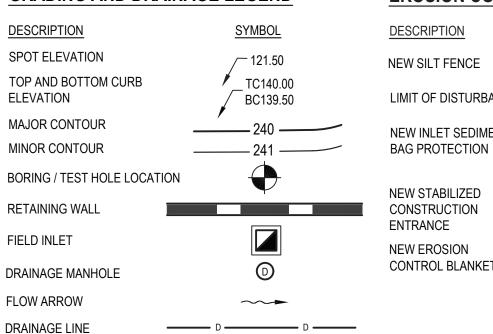


ELECTRIC LINE

WATER SERVICE LINE

WATER LINE

NEW RIP RAP


APRON

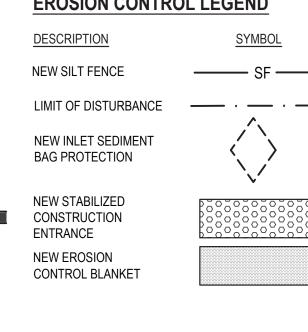

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engineers

_		
MADIC	DATE	DECODIDEION
MARK	DATE	DESCRIPTION
-	07-24-2023	FINAL BID SET
1	08-07-2023	ADDENDUM NO. 1

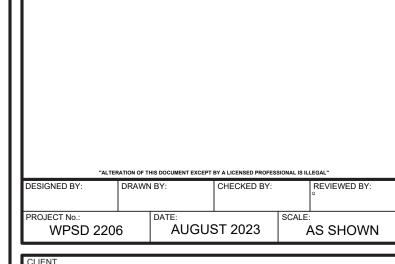

White Plains City School District

WHITE PLAINS HIGH SCHOOL **UPGRADES AND TURF FIELD**



550 North Street White Plains, NY 10605


SED No. 66-22-00-01-0-16-029


CONTRACT C **CIVIL AND SITE WORK**

FINAL BID SET

GRADING & DRAINAGE AND EROSION & SEDIMENT CONTROL PLAN UPPER FIELD

C 100.00

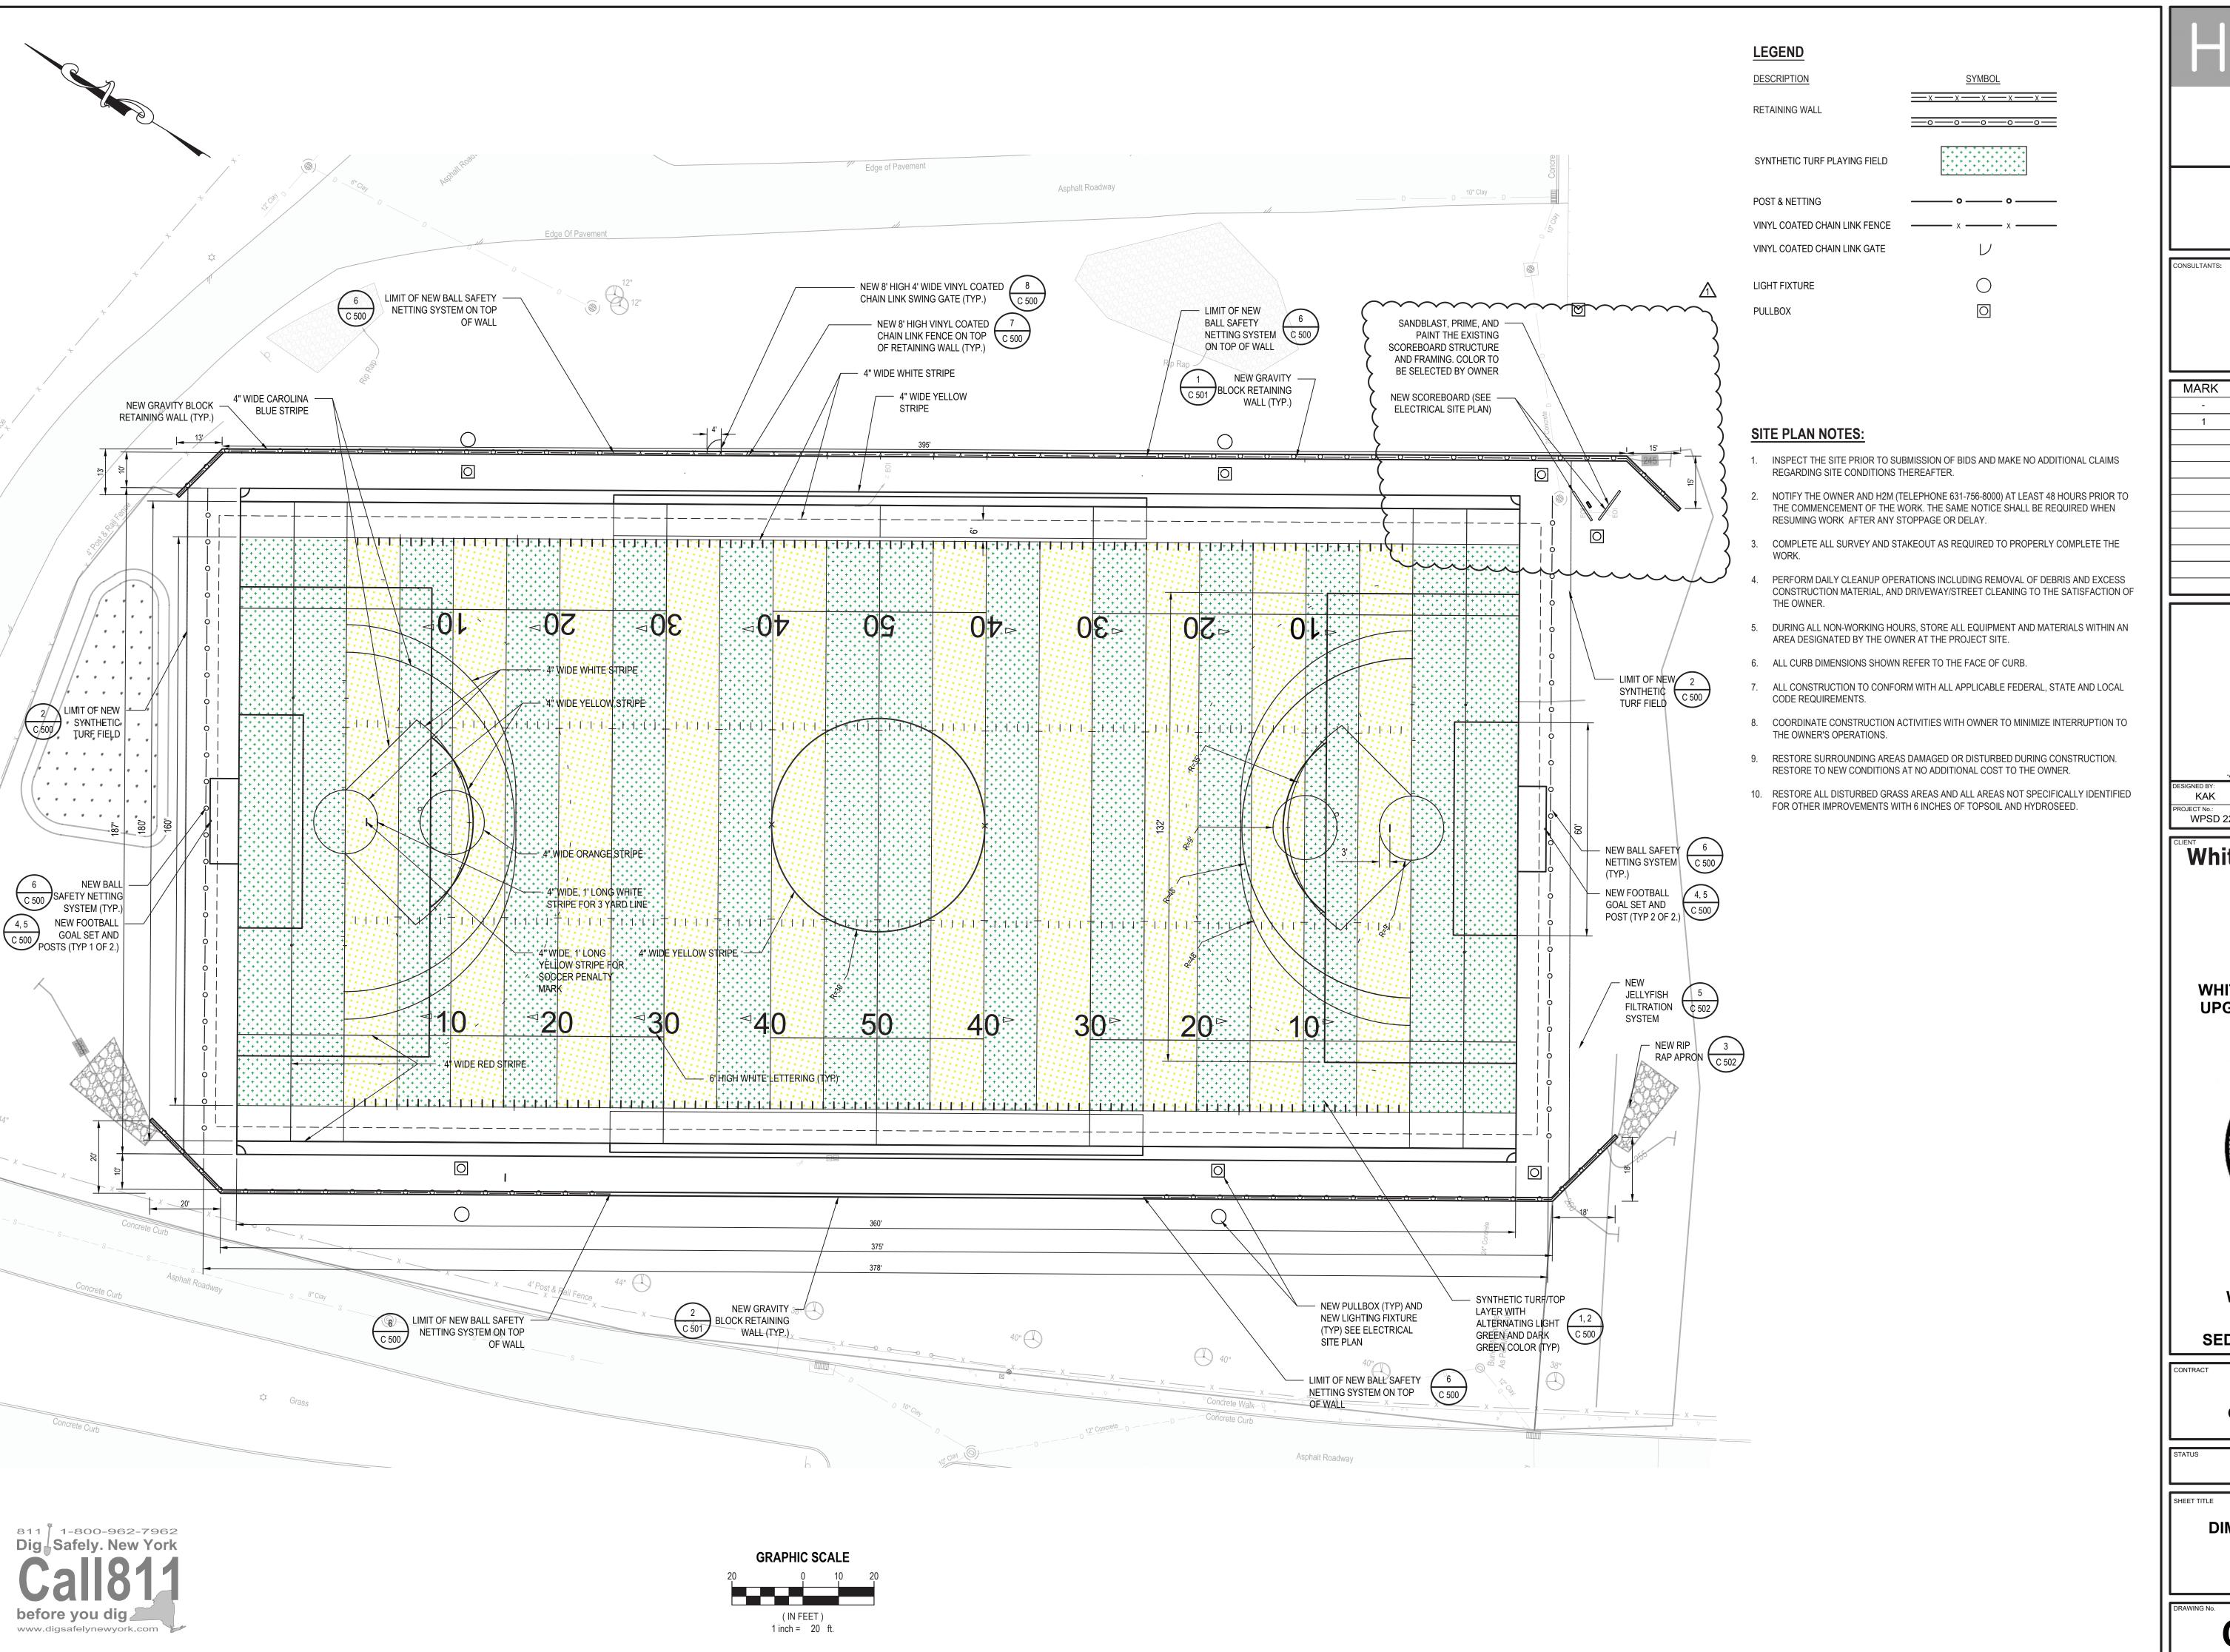

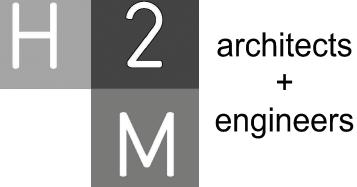

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MARK	DATE	DESCRIPTION
-	07-24-2023	FINAL BID SET
1	08-07-2023	ADDENDUM NO. 1

"ALTEF	RATION OF TH	HIS DOCUMENT EXCEPT	BY A LICENSED PROFES:	SIONAL IS ILI	LEGAL"
DESIGNED BY:	DRAWN	BY:	CHECKED BY:		REVIEWED BY:
KAK		NR	KAK		Q
PROJECT No.: WPSD 2206		AUGUS	ST 2023	SCALE:	AS SHOWN

White Plains City School District

WHITE PLAINS HIGH SCHOOL **UPGRADES AND TURF FIELD**



550 North Street White Plains, NY 10605


SED No. 66-22-00-01-0-16-029


CONTRACT C **CIVIL AND SITE WORK**


FINAL BID SET

DIMENSIONAL SITE PLAN UPPER FIELD

CS 100.00

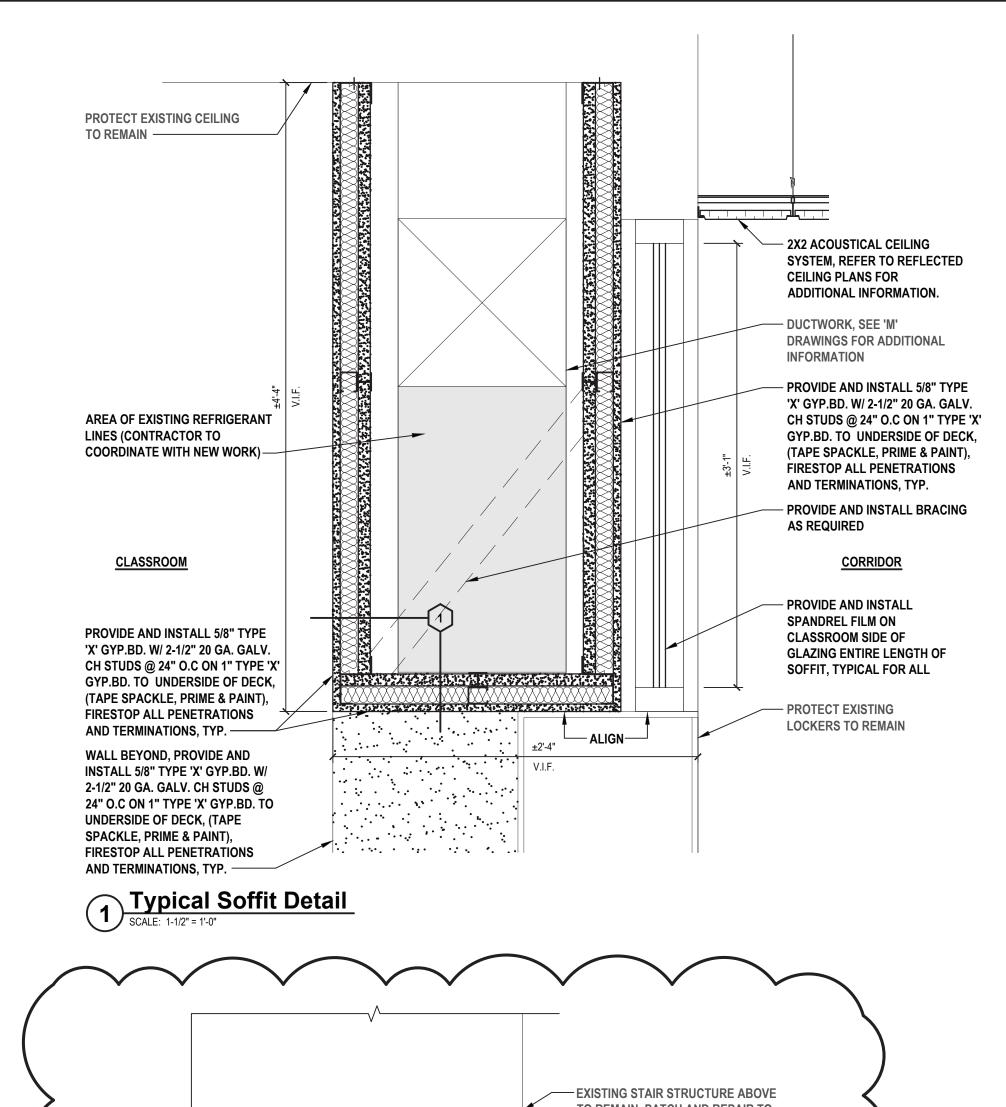


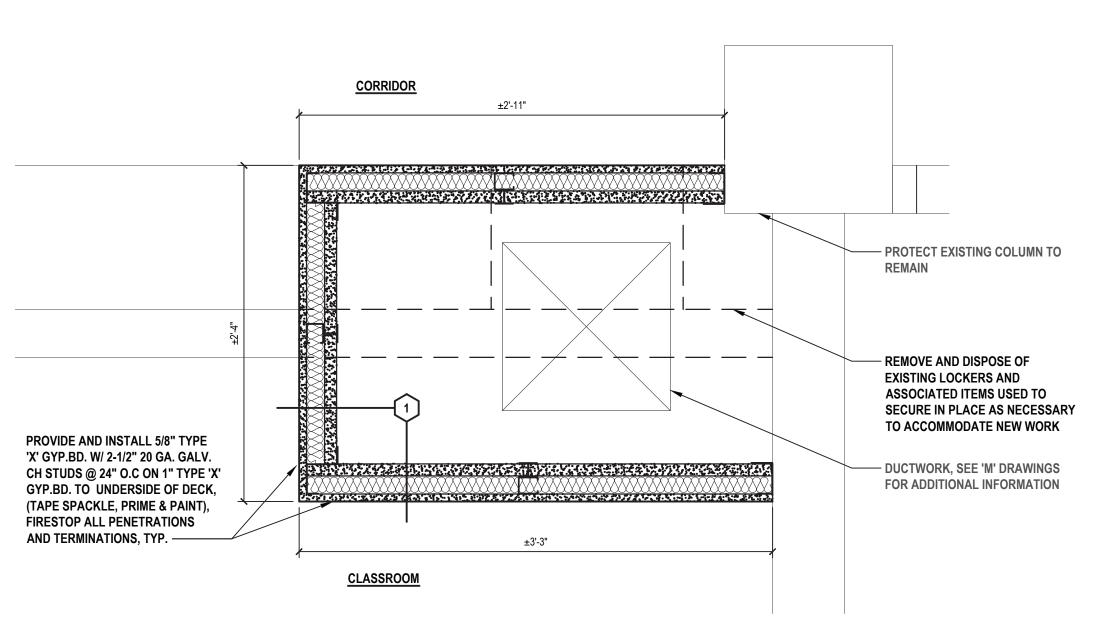

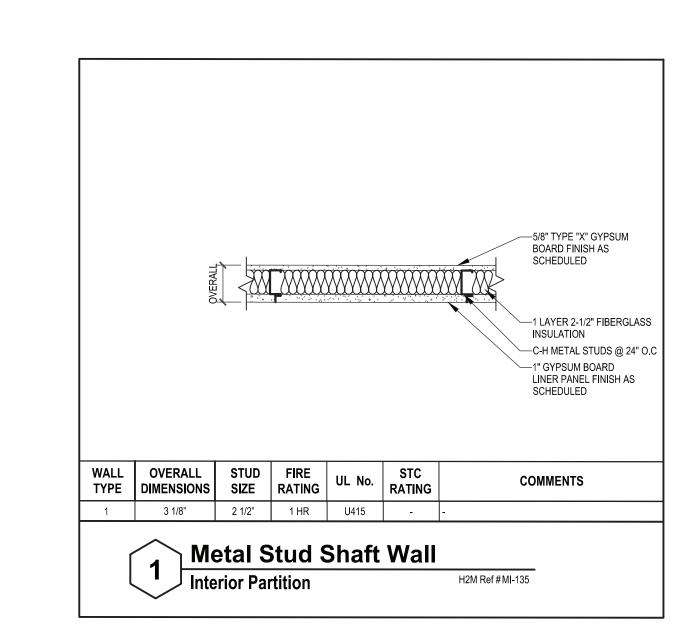

Typical Chase Detail

SCALE: 1-1/2" = 1'-0"

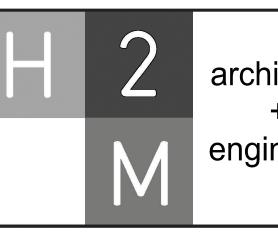

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ONSULTANTS:

MARK	DATE	DESCRIPTION
-	07-24-2023	FINAL BID SET
1	08-07-2023	ADDENDUM NO. 1

_			SIONAL IS ILI	
DRAWN	N BY:	CHECKED BY:		REVIEWED BY:
	DATE:		SCALE:	
:		DRAWN BY:	DRAWN BY: CHECKED BY:	

White Plains City School District

WHITE PLAINS HIGH SCHOOL UPGRADES AND TURF FIELD



550 North Street White Plains, NY 10605

SED No. 66-22-00-01-0-16-029

CONTRACT G
GENERAL CONSTRUCTION


FINAL BID SET


SHEET TITLE

DETAILS

No.

A500.00

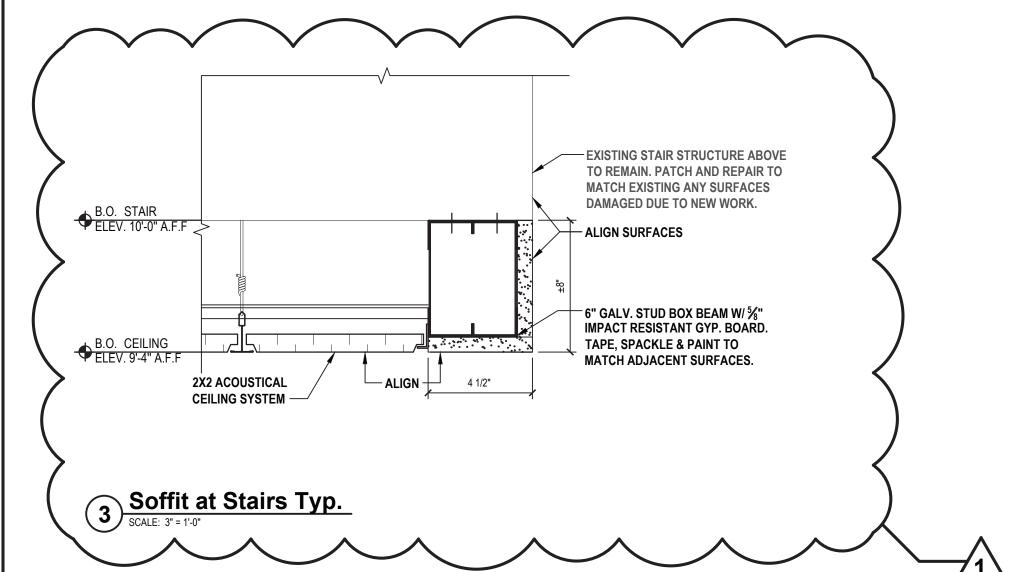


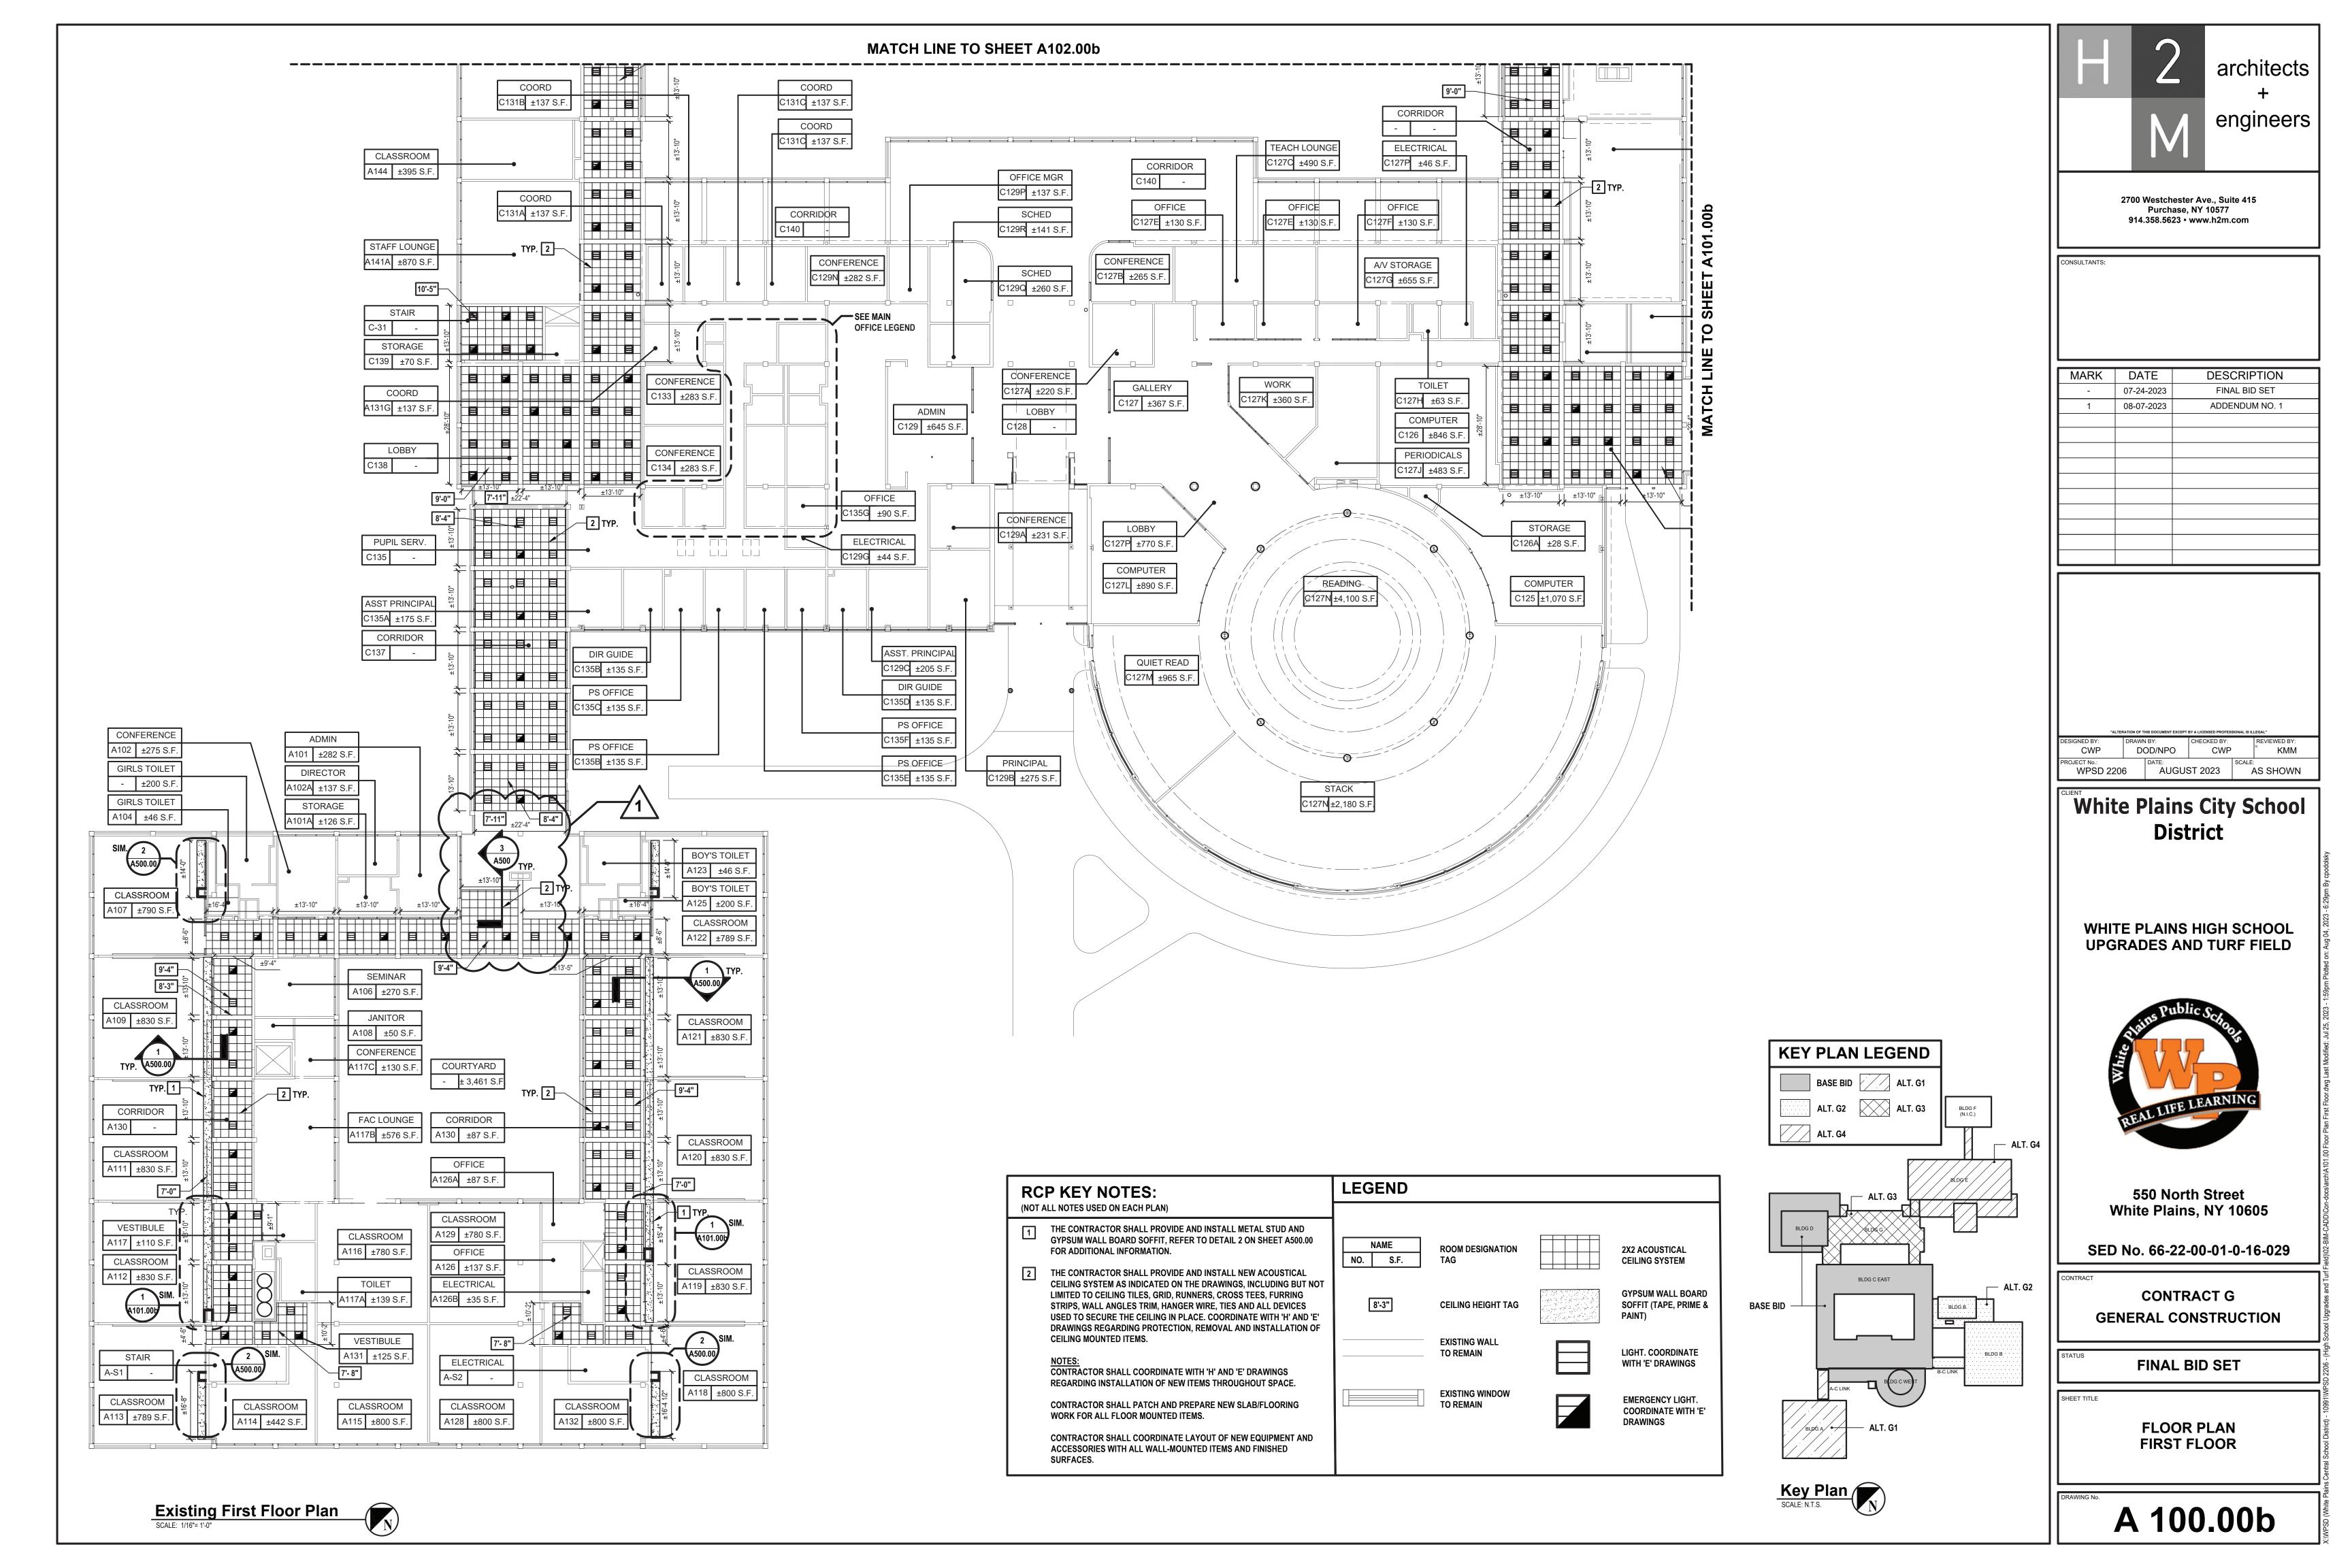

				1
SYMBOL	DESCRIPTION	COMMENTS	ABBREVIATION	
S ₃	THREE - WAY SWITCH	46" AFF TO CL UON	AFF	ABOVE FINI
S ₄	FOUR - WAY SWITCH	46" AFF TO CL UON	AFC	ABOVE FINI
Sı G ^A	ILLUMINATED SWITCH	46" AFF TO CL UON	AFCI	ARC FAULT
S ^A	SINGLE POLE SWITCH; "A" INDICATES SWITCH CONTROL SINGLE POLE DIMMER SWITCH	46" AFF TO CL UON 46" AFF TO CL UON	AFG AHJ	ABOVE FINI AUTHORITY
S3D	THREE - WAY DIMMER SWITCH	46" AFF TO CL UON	AMP, A	AMPERE
Sk	SINGLE POLE KEYED SWITCH	46" AFF TO CL UON	ATS	AUTOMATIC
Sk3	KEYED THREE - WAY SWITCH	46" AFF TO CL UON		SCHEDULE
Sk4	KEYED FOUR - WAY SWITCH	46" AFF TO CL UON	AWG	AMERICAN
Sp	SWITCH AND PILOT LIGHT		BFC CL	BELOW FIN
St	SWITCH WITH THERMAL OVERLOAD PROTECTION (CONTRACTOR SHALL COORDINATE VOLTAGE AND PHASE WITH EQUIPMENT)		CT	COUNTER 1
Sosivs	OCCUPANCY/VACANCY SENSOR WITH MANUAL OVERRIDE, WALL MOUNT		E.C.	ELECTRICA
TC	TIME CLOCK		EM	EMERGENC
E,G	EMERGENCY SHUT OFF SWITCH; 'E' INDICATES ELECTRICAL; 'G' INDICATES GAS		GFCI	GROUND F
	2 #12 AWG + #12 AWG GND IN 3/4" E.C. CONCEALED IN WALL OR CEILING		GFI	GROUND FA
			GND	GROUND
	3 #12 AWG + #12 AWG GND IN 3/4" E.C. CONCEALED IN OR BELOW SLAB		CON-ED	CONSOLIDA
LP1-35	DEDICATED HOME RUN TO PANEL LP1 FOR CIRCUIT NO. 35 ONLY. 2 #12 AWG + #12 AWG GND IN 3/4" E.C. CONCEALED IN WALL OR CEILING		MCB	MAIN CIRCU
-	SIMPLEX RECEPTACLE: 120V, 20A. COORDINATE MOUNTING HEIGHT WITH MECHANICAL CONTRACTOR TO CLEAR	FLUSH	MLO	MAIN LUGS
	BASEBOARDS. DUPLEX RECEPTACLE: 120V, 20A. COORDINATE MOUNTING HEIGHT WITH MECHANICAL CONTRACTOR TO CLEAR		NTS	NOT TO SC
⊕	BASEBOARDS.	FLUSH	TYP	TYPICAL
#	QUAD RECEPTACLE, DOUBLE DUPLEX RECEPTACLE: 120V, 20A. COORDINATE MOUNTING HEIGHT WITH MECHANICAL CONTRACTOR TO CLEAR BASEBOARDS.	FLUSH	UON	UNLESS OT
⊕ ^c	DUPLEX RECEPTACLE: 120V, 20A; SUBSCRIPT "C" INDICATES CEILING MOUNT.	FLUSH	UC	UNDER COL
	DUPLEX RECEPTACLE: 120V, 20A; FLOOR MOUNTED.	FLUSH	V	VOLTOALT
<u>₩</u>		1 20011	VAC VDC	VOLTS ALT
	QUAD RECEPTACLE: 120V, 20A; FLOOR MOUNTED.		X-FMR	TRANSFOR
⊕ ▼ _{D/T}	DUPLEX RECEPTACLE AND DATA JACK: 120V, 20A; FLOOR MOUNTED.		WP	WEATHERF
▼ _{D/T}	DATA JACK; FLOOR MOUNTED.			
⊖IG	ISOLATED GROUND DUPLEX RECEPTACLE. COORDINATE MOUNTING HEIGHT WITH MECHANICAL CONTRACTOR TO CLEAR BASEBOARDS.	FLUSH		
GFI ⊕	DUPLEX RECEPTACLE: 120V, 20A; WITH GROUND FAULT INDICATOR. COORDINATE MOUNTING HEIGHT WITH MECHANICAL CONTRACTOR TO CLEAR BASEBOARDS.	FLUSH		
⊕uc	DUPLEX RECEPTACLE: 120V, 20A; SUBSCRIPT "UC" INDICATES UNDER COUNTER	AS PER ENGINEER		
€СТ	DUPLEX RECEPTACLE: 120V, 20A; SUBSCRIPT "CT" INDICATES COUNTER TOP.	AS PER ENGINEER		
⊕ WP	DUPLEX RECEPTACLE: 120V, 20A; SUBSCRIPT "WP" INDICATED WEATHER PROOF.	AS PER ENGINEER		
USB	DUPLEX RECEPTACLE: 120V, 20A; SUBSCRIPT "USB" INDICATES INTEGRAL USB.	FLUSH		
♥ 40 240	SPECIAL PURPOSE OUTLET: 240V, 40A. VERIFY NEMA CONFIGURATION WITH EQUIPMENT MANUFACTURER.	AS PER ENGINEER		
⊕ _TL	TWISTED LOCK RECEPTACLE: 125V, 20A, 3 WIRE; UNLESS OTHERWISE NOTED.	AS PER ENGINEER		
	SURFACE RACEWAY WITH 2 GROUNDED AND ISOLATED TYPE DUPLEX RECEPTACLES AND 1 DATA OUTLET PER POSITION, 18" AFF UNLESS OTHERWISE NOTED.			
⊠' _{S1}	MAGNETIC STARTER "S1"; SEE STARTER SCHEDULE			
	DISCONNECTION SWITCH "DS1"; SEE DISCONNECT SWITCH SCHEDULE.			
0	JUNCTION BOX.			
O _{4X}	NEMA 4X STAINLESS STEEL JUNCTION BOX WITH GASKET COVER.			
O _s	JUNCTION BOX RECESSED IN WALL WITH BLANK COVER. PROVIDE 3/4" E.C. AND DRAG LINE TO ABOVE FINISHED CEILING. MOUNT 18" AFF, UNLESS OTHERWISE NOTED.			
\bigcirc^{M}	FOR MONITOR, JUNCTION BOX RECESSED IN WALL WITH BLANK COVER. PROVIDE 3/4" E.C. AND DRAG LINE TO ABOVE FINISHED CEILING.			
O _{HD}	FOR HAND DRYER, JUNCTION BOX RECESSED IN WALL WITH BLANK COVER. PROVIDE 3/4" E.C. AND DRAG LINE TO ABOVE FINISHED CEILING. COORDINATE MOUNTING HEIGHT WITH ARCHITECT.			
T _{T1}	TRANSFORMER "T1"; SEE TRANSFORMER SCHEDULE.			
///P1	ELECTRICAL PANEL "P1", RECESSED; SEE PANEL SCHEDULE.			
P1	ELECTRICAL PANEL "P1", SURFACE MOUNT; SEE PANEL SCHEDULE.			
<u> </u>	CONDUIT GOING UP.			
<u> </u>	CONDUIT GOING DOWN.			
<u> </u>	TELEPHONE. PROVIDE 3/4" E.C. WITH DRAG LINE TO AFC AND EMPTY J. BOX RECESSED IN WALL WITH BLANK COVER.			
I A	CABLE TELEVISION. PROVIDE 3/4" E.C. WITH DRAG LINE TO AFC AND EMPTY J. BOX RECESSED IN WALL WITH BLANK			
TV	COVER. DATA, PROVIDE 3/4" E.C. WITH DRAG LINE TO AFC AND EMPTY J. BOX RECESSED IN WALL WITH BLANK COVER.			
D A	COMBINED DATA AND TV. PROVIDE 3/4" E.C. WITH DRAG LINE TO AFC AND EMPTY J. BOX RECESSED IN WALL WITH BLANK			
D/T	COVER.			
I	SECURITY CAMERA. PROVIDE 3/4" E.C. WITH DRAG LINE TO AFC AND EMPTY J. BOX RECESSED IN WALL WITH BLANK	1		

S				SINGLE LINE DIAGRAM LEGEND		LIST OF D	RAWINGS
S	ABBREVIATION	DESCRIPTION COMMENTS	SYMBOL	DESCRIPTION COMM	NTS E 001	ELECTRICAL LEGENDS, SCHE	EDULES AND DETAILS
UON	AFF	ABOVE FINISHED FLOOR	(T)	LINE VOLTAGE THERMOSTAT, 120V, 10A.	ED 100	ELECTRICAL PARTIAL BASEM	MENT DEMOLITION PLAN
UON	AFC	ABOVE FINISHED CEILING			ED 110	ELECTRICAL PARTIAL GROUP	ND FLOOR DEMOLITION PLANS
UON	AFCI	ARC FAULT CIRCUIT INTERRUPTER	100AF	CIRCUIT BREAKER WITH TRIP AND POLES AS NOTED; 100 AMP FRAME, 100 AMP TRIP.	ED 111		ND FLOOR DEMOLITION PLANS
UON	AFG	ABOVE FINISHED GRADE	100AT	CIRCUIT BREAKER WITH TRIP AND POLES AS NOTED, 100 AWIP FRANCE, 100 AWIP TRIP.	ED 120	ELECTRICAL PARTIAL FIRST I	
JON	AHJ	AUTHORITY HAVING JURISDICTION			ED 121 ED 122		
UON	AMP, A	AMPERE	• /	TRANSFER SWITCH 'TS1'; SEE TRANSFER SWITCH SCHEDULE.	ED 122 ED 130		ND FLOOR DEMOLITION PLANS
UON	ATS	AUTOMATIC TRANSFER SWITCH; SEE TRANSFER SWITCH SCHEDULE	ATS1		ES 100		NOT LOOK DEWICETTON'T EANG
UON UON	AWG	AMERICAN WIRE GAUGE)M.C.B 30A/2P		E 100	ELECTRICAL PARTIAL BASEM	MENT PLANS
OON	BFC	BELOW FINISHED CEILING	PANEL	DISTRIBUTION PANEL P1 WITH 30A, 2 POLE M.C.B.; SEE DISTRIBUTION PANEL SCHEDULE.	E 110	ELECTRICAL PARTIAL GROUN	ND FLOOR PLANS
	CL	CENTERLINE	"P1"		E 111	ELECTRICAL PARTIAL GROUN	ND FLOOR PLANS
	CT	COUNTER TOP	100AS	UNFUSED DISCONNECT SWITCH DS1, 100 AMP; SEE DISCONNECT SWITCH SCHEDULE.	E 120	ELECTRICAL PARTIAL FIRST I	FLOOR PLANS
	E.C.	ELECTRICAL CONDUIT EMERGENCY	•/		E 121	ELECTRICAL PARTIAL FIRST I	
	GFCI	GROUND FAULT CIRCUIT INTERRUPTER	H 100AS	FUSED DISCONNECT SWITCH 'DSI', FUSED AT 100 AMP SIZE, 100 AMP FUSED, 3 POLES; SEE	E 122	ELECTRICAL PARTIAL FIRST I	
	GFI	GROUND FAULT INDICATOR	DS1 100AS 100AF	DISCONNECT SWITCH SCHEDULE.	F 130	ELECTRICAL PARTIAL SECON ELECTRICAL PARTIAL ROOF I	DI AN DUIL DING A
	GND	GROUND	•		E 140 E 141	ELECTRICAL PARTIAL ROOF I	R.
	CON-ED	CONSOLIDATED EDISON INC. (LOCAL ELECTRIC UTILITY)	G	GENERATOR SET 'G'	E 142	ELECTRICAL PARTIAL ROOF I	D
	MCB	MAIN CIRCUIT BREAKER	M	ELECTRIC METER AND METER PAN AS PER PSEG REQUIREMENTS.			S SINGLE LINE DIAGRAMS, FIRE ALARM
	MLO	MAIN CIRCUIT BREAKER MAIN LUGS ONLY		ELECTRIC WETER AND WETERT AN AST ERT SEGREGOTILIMENTS.	E 200	LEGEND, RISER AND NOTES	h .
	NTS	NOT TO SCALE	(5HP)	MOTOR, NUMBER INDICATES HORSEPOWER.	E 201	ELECTRICAL PANEL SCHEDU	DLES .
	TYP	TYPICAL	(CURRENT TRANSFORMERS	E 300		
	UON	UNLESS OTHERWISE NOTED	стѕ	CURRENT TRANSFORMERS.	E 400	ELECTRICAL FIELD LIGHTING	POLE AND FOUNDATION DETAILS
	UC	UNDER COUNTER	⊢}{- pts	VOLTAGE TRANSFORMERS.		CITE DI AN	LL ECEND
	V	VOLT	UPS	UNINTERRUPTIBLE POWER SUPPLY		SHEPLAN	N LEGEND
	VAC	VOLTS ALTERNATING CURRENT		CHINTERICO FIBEL FOWER GOLFET			CLIDD
	VDC	VOLTS DIRECT CURRENT	120/208V T2				CURB
	X-FMR	TRANSFORMER	277/480	TRANSFORMER 'T2' WITH SIZE, PRIMARY AND SECONDARY VOLTAGES AS NOTED.		<u>₽</u>	UTILITY POWER/TELEPHONE POLE
	WP	WEATHERPROOF	<u> </u>		_	G	EXISTING NATURAL GAS SERVICE
			<u></u>				EXISTING SEWER SERVICE
	-		100AF	RACK OUT CIRCUIT BREAKER	_	W	EXISTING WATER SERVICE
			100AT	RACK OUT GIRCUIT BREAKER	_	Т	EXISTING TELEPHONE SERVICE
EER			*			T	NEW TELEPHONE SERVICE
EER			RVRM	REDUCED VOLTAGE SOLID STATE RAMPING MODULE, SIZED FOR 10 H.P.	_	E	EXISTING ELECTRICAL LINES
EER			RVSS	DEDUCED VOLTAGE COLUD OTATE OTADED. CIZED FOR 450 U.D.		E	NEW ELECTRICAL LINES
			150	REDUCED VOLTAGE SOLID STATE STARTER, SIZED FOR 150 H.P.			EXISTING PRIMARY ELECTRIC SERVICE
	ļ		VFD	VARIABLE FREQUENCY DRIVE, RATED FOR 25 H.P.		pr	NEW PRIMARY ELECTRIC SERVICE
EER			25			011/5	
EER			TVNR 6	FULL VOLTAGE NON-REVERSING STARTER, NEMA SIZE 6		OH/E	EXISTING OVERHEAD ELECTRIC LINES
				FULL VOLTAGE REVERSING STARTER, NEMA SIZE 5		-x-x-x-x-	EXISTING FENCE ELECTRIC PULL BOX
			าาร	FAST ACTING SOLID STATE FUSES AS PER MANUFACTURER.		HH	HANDHOLE
				MULTIPLE BRANCH CIRCUITS AS REQUIRED.		T	TRANSFORMER
				CONTROL CIRCUIT; MIN 2 #12 AWG IN ¾" E.C.		SYMBOLS	S LEGEND
	ļ					100	ROOM DESIGNATION
						5 A22	BUILDING SECTION CUT
						5 A22	WALL SECTION CUT
						5 A22	DETAIL KEY
						5 A22	ELEVATION KEY
						(H)	COLUMN GRID
							ELEVATION LINE

LIGHTING	FIXTURI	E SCHEDULI	<u> </u>									
DESIGNATION	SYMBOL	MANUFACTURER	MODEL NUMBER	TYPE	WATTS	COLOR TEMP	VOLT	LUMENS	MOUNTING	REMARKS	MOUNTING HEIGHT	DETAIL
F1		COLUMBIA LIGHTING	LCAT22-40LWG-G-EDU	LED	23	4000K	UNV	2782	RECESSED	-	CEILING	
F1E		COLUMBIA LIGHTING	LCAT22-40LW-G-EDU-ELL14	LED	23	4000K	UNV	2782	RECESSED	EMERGENCY BATTERY BACKUP WITH 90 MINUTES OF BACK-UP CAPACITY	CEILING	1 E 001
F2		COLUMBIA LIGHTING	LCAT22-40MLG-G-EDU	LED	28	4000K	UNV	3431	RECESSED	-	CEILING	
F2E		COLUMBIA LIGHTING	LCAT22-40ML-G-EDU-ELL14	LED	28	4000K	UNV	3431	RECESSED	EMERGENCY BATTERY BACKUP WITH 90 MINUTES OF BACK-UP CAPACITY	CEILING	1 E 001

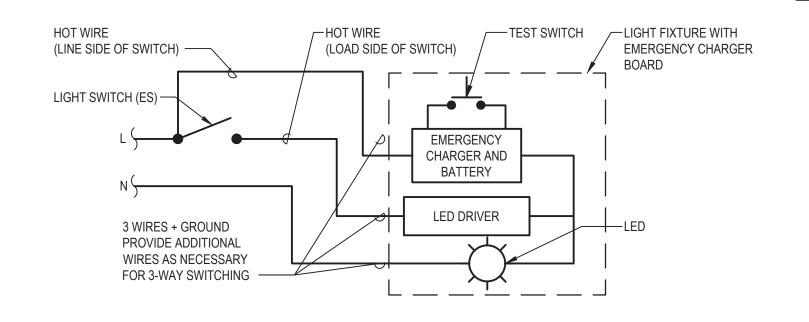

Title
SCALE:


DRAWING TITLE

SEE NOTE # ON DWG #

INTERIOR ELEVATION REFERENCE

Typical Detail of Light Fixture with <u>Emergency Battery Backup</u>


SCALE:NTS

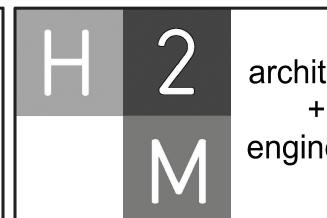

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White Plains City School District

WHITE PLAINS HIGH SCHOOL UPGRADES AND TURF FIELD

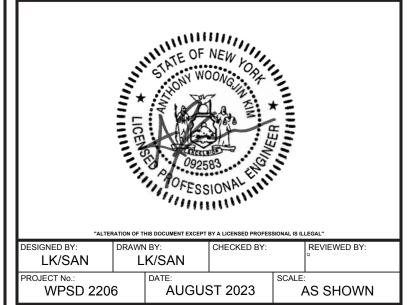

550 North Street White Plains, NY 10605

SED No. 66-22-00-01-0-16-029

CONTRACT E
ELECTRICAL CONSTRUCTION


FINAL BID SET

HEET TITLE

ELECTRICAL LEGENDS, SCHEDULES, AND DETAILS

NG No.

E 001.00

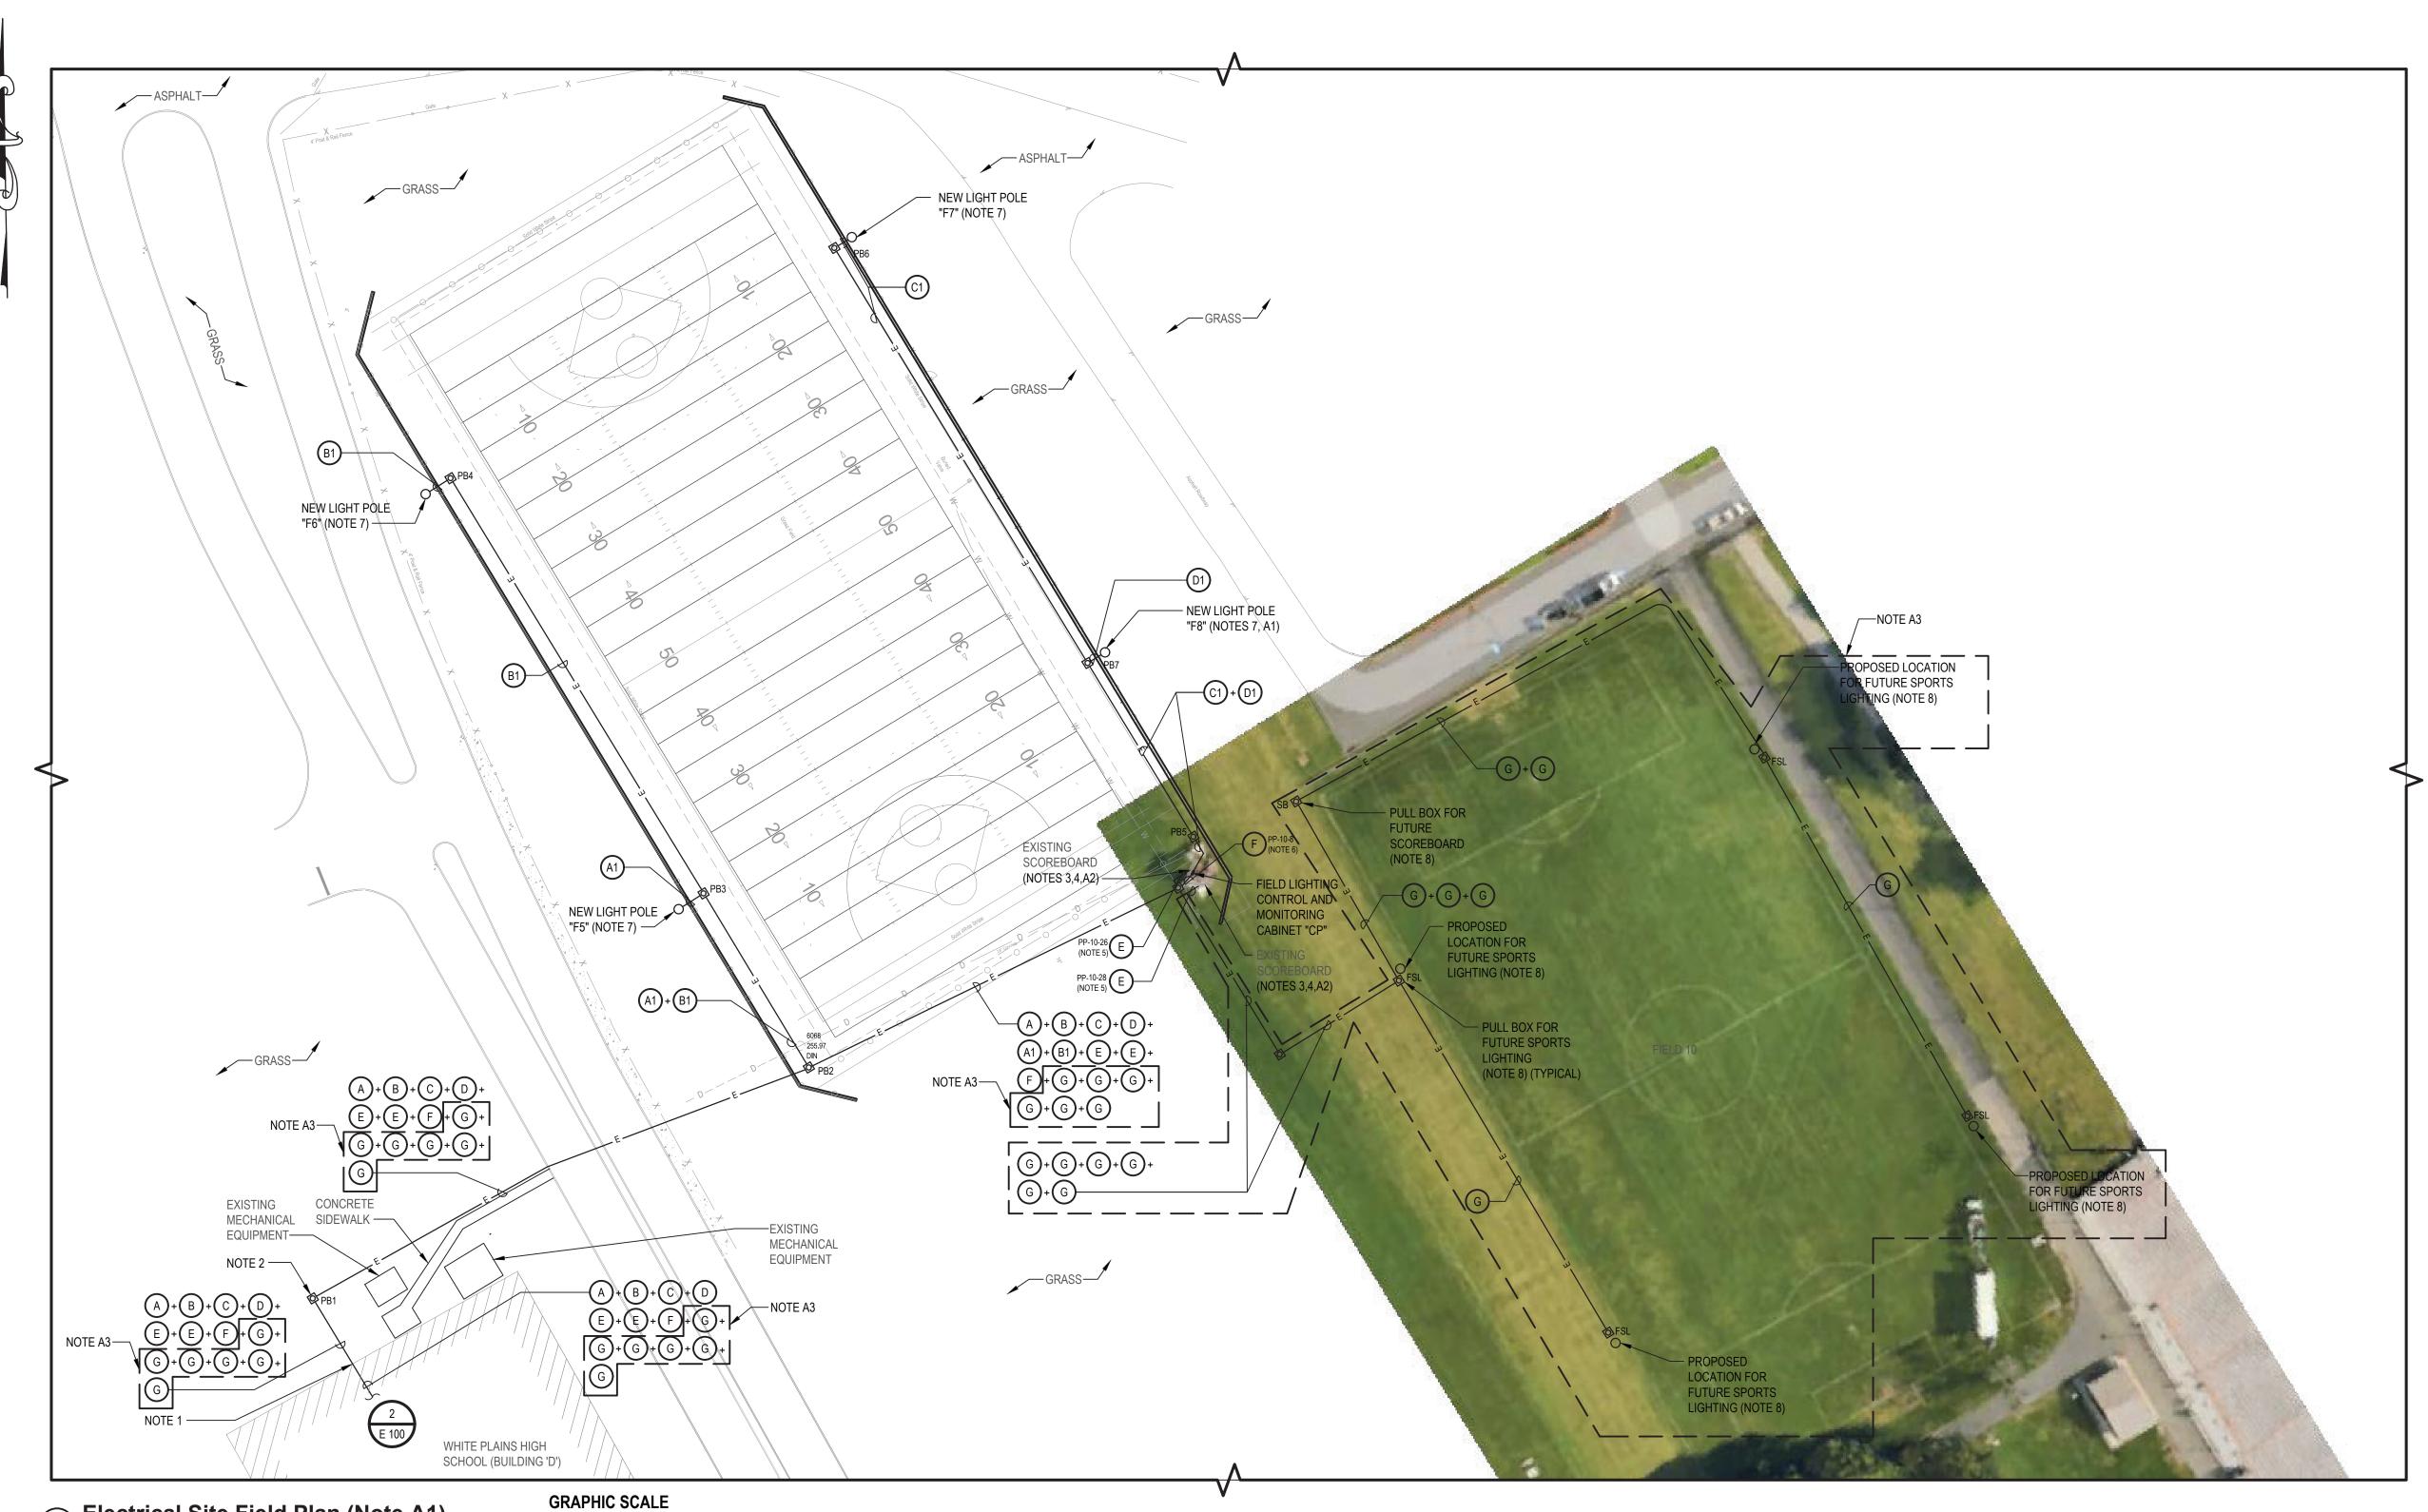

1 Electrical Site Field Plan (Note A1) SCALE: 1"=40'

ELECTRICAL GENERAL SITE PLAN NOTES:

- GS1. CONTRACTOR SHALL INSPECT CONSTRUCTION SITE PRIOR TO SUBMISSION OF BIDS AND SHALL MAKE NO ADDITIONAL CLAIMS REGARDING SITE CONDITIONS THEREAFTER.
- GS2. LOCATION OF ALL UNDERGROUND UTILITIES BOTH PUBLIC AND CUSTOMER OWNED, WERE OBTAINED FROM EITHER MAPS, SURVEYS, DRAWINGS AND RECORDS SUPPLIED BY OTHERS. THE OWNER AND ENGINEER DO NOT GUARANTEE OR ACCEPT RESPONSIBILITY FOR ANY DAMAGE TO SUCH FACILITIES DUE TO DISCREPANCIES GS10. CONTRACTOR SHALL PROVIDE AND TEMPORARILY INSTALL TRAFFIC RATED STEEL PLATES OVER ALL IN LOCATION AND SIZE SHOWN ON THE PLANS OR THOSE UTILITIES NOT SHOWN. THE CONTRACTOR IS RESPONSIBLE FOR OBTAINING A PRIVATE MARKOUT COMPANY FOR DETERMINING THE LOCATION OF ALL UNDERGROUND UTILITIES PRIOR TO BEGINNING WORK. CONTRACTOR SHALL LOCATE ALL UTILITIES WITHIN PROXIMITY OF CONSTRUCTION LIMITS.
- GS3. CONTRACTOR SHALL COMPLETELY RESTORE ALL AREAS DISTURBED DURING CONSTRUCTION, INCLUDING BUT NOT LIMITED TO GRASS AREAS, LANDSCAPING, PAVEMENTS, SIDEWALKS, CURBING AND IN-GROUND SPRINKLER SYSTEMS.
- GS4. THE CONTRACTOR SHALL PERFORM DAILY CLEAN-UP OPERATIONS WHICH INCLUDE REMOVAL OF DEBRIS AND EXCESS CONSTRUCTION MATERIAL TO THE SATISFACTION OF THE OWNER AND THE ENGINEER.
- GS5. DURING ALL NON-WORKING HOURS, THE CONTRACTOR WILL BE REQUIRED TO STORE ALL EQUIPMENT AND MATERIALS WITHIN THE AREA DESIGNATED BY THE ENGINEER AT THE PROJECT SITE.
- GS6. PROVIDE TEMPORARY FENCING TO PROTECT WORK AREAS.
- GS7. CONTRACTOR SHALL MINIMIZE REMOVAL OF EXISTING TREES. CONTRACTOR SHALL BE RESPONSIBLE FOR SITE LAYOUT, TAGGING AND REMOVAL OF TREES REQUIRED TO COMPLETE ALL WORK. OWNER SHALL APPROVE TREES TO BE REMOVED PRIOR TO ACTUAL REMOVALS. REMOVALS SHALL INCLUDE REMOVAL OF COMPLETE STUMP AND ROOT SYSTEM. CONTRACTOR NOT PERMITTED TO GRIND STUMPS.

1 inch = 40 ft.

- GS8. CONTRACTOR SHALL BE RESPONSIBLE FOR ALL LAYOUT SURVEY, ETC. AS REQUIRED TO COMPLETE THE
- GS9. CONCRETE SIDEWALKS SHALL BE SAWCUT BACK TO EXPANSION/ CONTROL JOINTS.
- TRENCHES SUCH THAT TRAFFIC AND WALKING PATTERNS ARE MINIMALLY DISTURBED. PROVIDE AND INSTALL TRAFFIC SIGNS AND SIDEWALK SIGNS AS REQUIRED TO DIRECT TRAFFIC OF PEDESTRIANS AND AUTOMOBILES.
- GS11. SAW-CUT EXISTING PAVEMENT/SIDEWALK/CURBING FOR INSTALLATION OF NEW CONDUITS. REMOVE AND DISPOSE OF ALL DEBRIS.
- GS12. CONTRACTOR SHALL PROVIDE NYLON PULL STRING IN ALL SPARE CONDUIT FOR ENTIRE PROJECT.

ELECTRICAL SITE PLAN KEY NOTES:

- 1. CONTRACTOR SHALL STUB ALL CONDUITS INTO BUILDINGS BELOW GRADE. NO EXTERIOR CONDUITS PERMITTED TO RUN EXPOSED ON EXTERIOR WALLS. CORE DRILL AS REQUIRED. RESTORE ALL FINISHES TO MATCH EXISTING. CONTRACTOR SHALL PROVIDE AND INSTALL LINK SEALS ON ALL CONDUITS ENTERING/EXITING THE BUILDING. CONTRACTOR SHALL PROVIDE AND INSTALL DUCT SEAL IN ALL CONDUITS ENTERING/EXITING THE BUILDING AND ALL PULLBOXES.
- NEW PULL BOX. SITE PLAN SHOWS MINIMUM REQUIRED PULL BOXES. PROVIDE ADDITIONAL PULL BOXES AS REQUIRED BY NEC AND UTILITY REQUIREMENTS.

- SCOREBOARDS SCHEDULED FOR DEMOLITION INCLUDING WIRE AND CONDUIT BACK TO SOURCE.
- 4. CONTRACTOR SHALL PROVIDE AND INSTALL NEW WIRE AND CONDUIT FROM PANEL "PP-11" TO NEW SCOREBOARDS.
- CONTRACTOR SHALL PROVIDE AND INSTALL A NEW 15A/1P CIRCUIT BREAKER IN EXISTING PANEL. PROVIDE AND INSTALL ALL MOUNTING HARDWARE AS REQUIRED. NEW CIRCUIT BREAKER SHALL BE LISTED/LABELED FOR USE IN EXISTING PANEL. AMPERE INTERRUPTING CAPACITY (AIC) RATING ON NEW CIRCUIT BREAKER SHALL MATCH OR EXCEED EXISTING PANEL RATING.
- CONTRACTOR SHALL BE PERMITTED TO USE EXISTING 20A/1P SPARE CIRCUIT BREAKER IN EXISTING
- 7. CONTRACTOR SHALL REMOVE AND CLEAN EXISTING 20A/3P SPARE CIRCUIT BREAKER IN EXISTING PANEL AND TURN OVER TO SCHOOL DISTRICT. CONTRACTOR SHALL PROVIDE AND INSTALL A NEW 30A/3P CIRCUIT BREAKER IN EXISTING PANEL. PROVIDE AND INSTALL ALL MOUNTING HARDWARE AS REQUIRED. NEW CIRCUIT BREAKER SHALL BE LISTED/LABELED FOR USE IN EXISTING PANEL. AMPERE INTERRUPTING CAPACITY (AIC) RATING ON NEW CIRCUIT BREAKER SHALL MATCH OR EXCEED EXISTING PANEL RATING.
- PROPOSED AREA FOR FUTURE SPORTS FIELD LIGHTING. THIS IS AREA SHALL BE KEPT CLEAR OF ALL EQUIPMENT, CONDUIT, FENCES, PULL BOXES, AND ANY OTHER OBSTRUCTION THAT WOULD NOT ALLOW FOR INSTALLATION OF FUTURE LIGHTING.

ADD/ALTERNATE NOTES:

- CONTRACTOR SHALL REMOVE AND DISPOSE OF ALL ELECTRICAL EQUIPMENT ASSOCIATED WITH THE EXISTING A1. CONTRACTOR SHALL PROVIDE ALL LABOR AND MATERIAL COST ASSOCIATED WITH PROVIDING AND INSTALL THE FIELD SPORTS LIGHTING AND ASSOCIATED CONTROL PANEL, ACCESSORIES, CONCRETE BASE AND HARDWARE IN ADD/ALTERNATE E5, ONLY. BASE BID WILL ONLY INCLUDE EMPTY CONDUIT AND ASSOCIATE PULLBOXES WITH NYLON PULL STRING.
 - A2. CONTRACTOR SHALL INCLUDE ALL LABOR AND MATERIAL COST ASSOCIATED WITH PROVIDING AND INSTALL NEW SCOREBOARD IN ADD/ALTERNATE E6, ONLY. BASE BID WILL ONLY INCLUDE EMPTY CONDUIT AND ASSOCIATED PULLBOXES WITH NYLON PULL STRING.
 - A3. CONTRACTOR SHALL INCLUDE ALL LABOR AND MATERIAL COST ASSOCIATED WITH NEW SPARE CONDUIT AND ASSOCIATED PULL BOX ASSOCIATED WITH FIELD 10 IN ADD/ALTERNATE E7, ONLY.




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White Plains City School District

WHITE PLAINS HIGH SCHOOL **UPGRADES AND TURF FIELD**



550 North Street White Plains, NY 10605
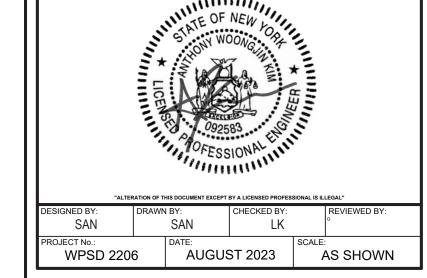
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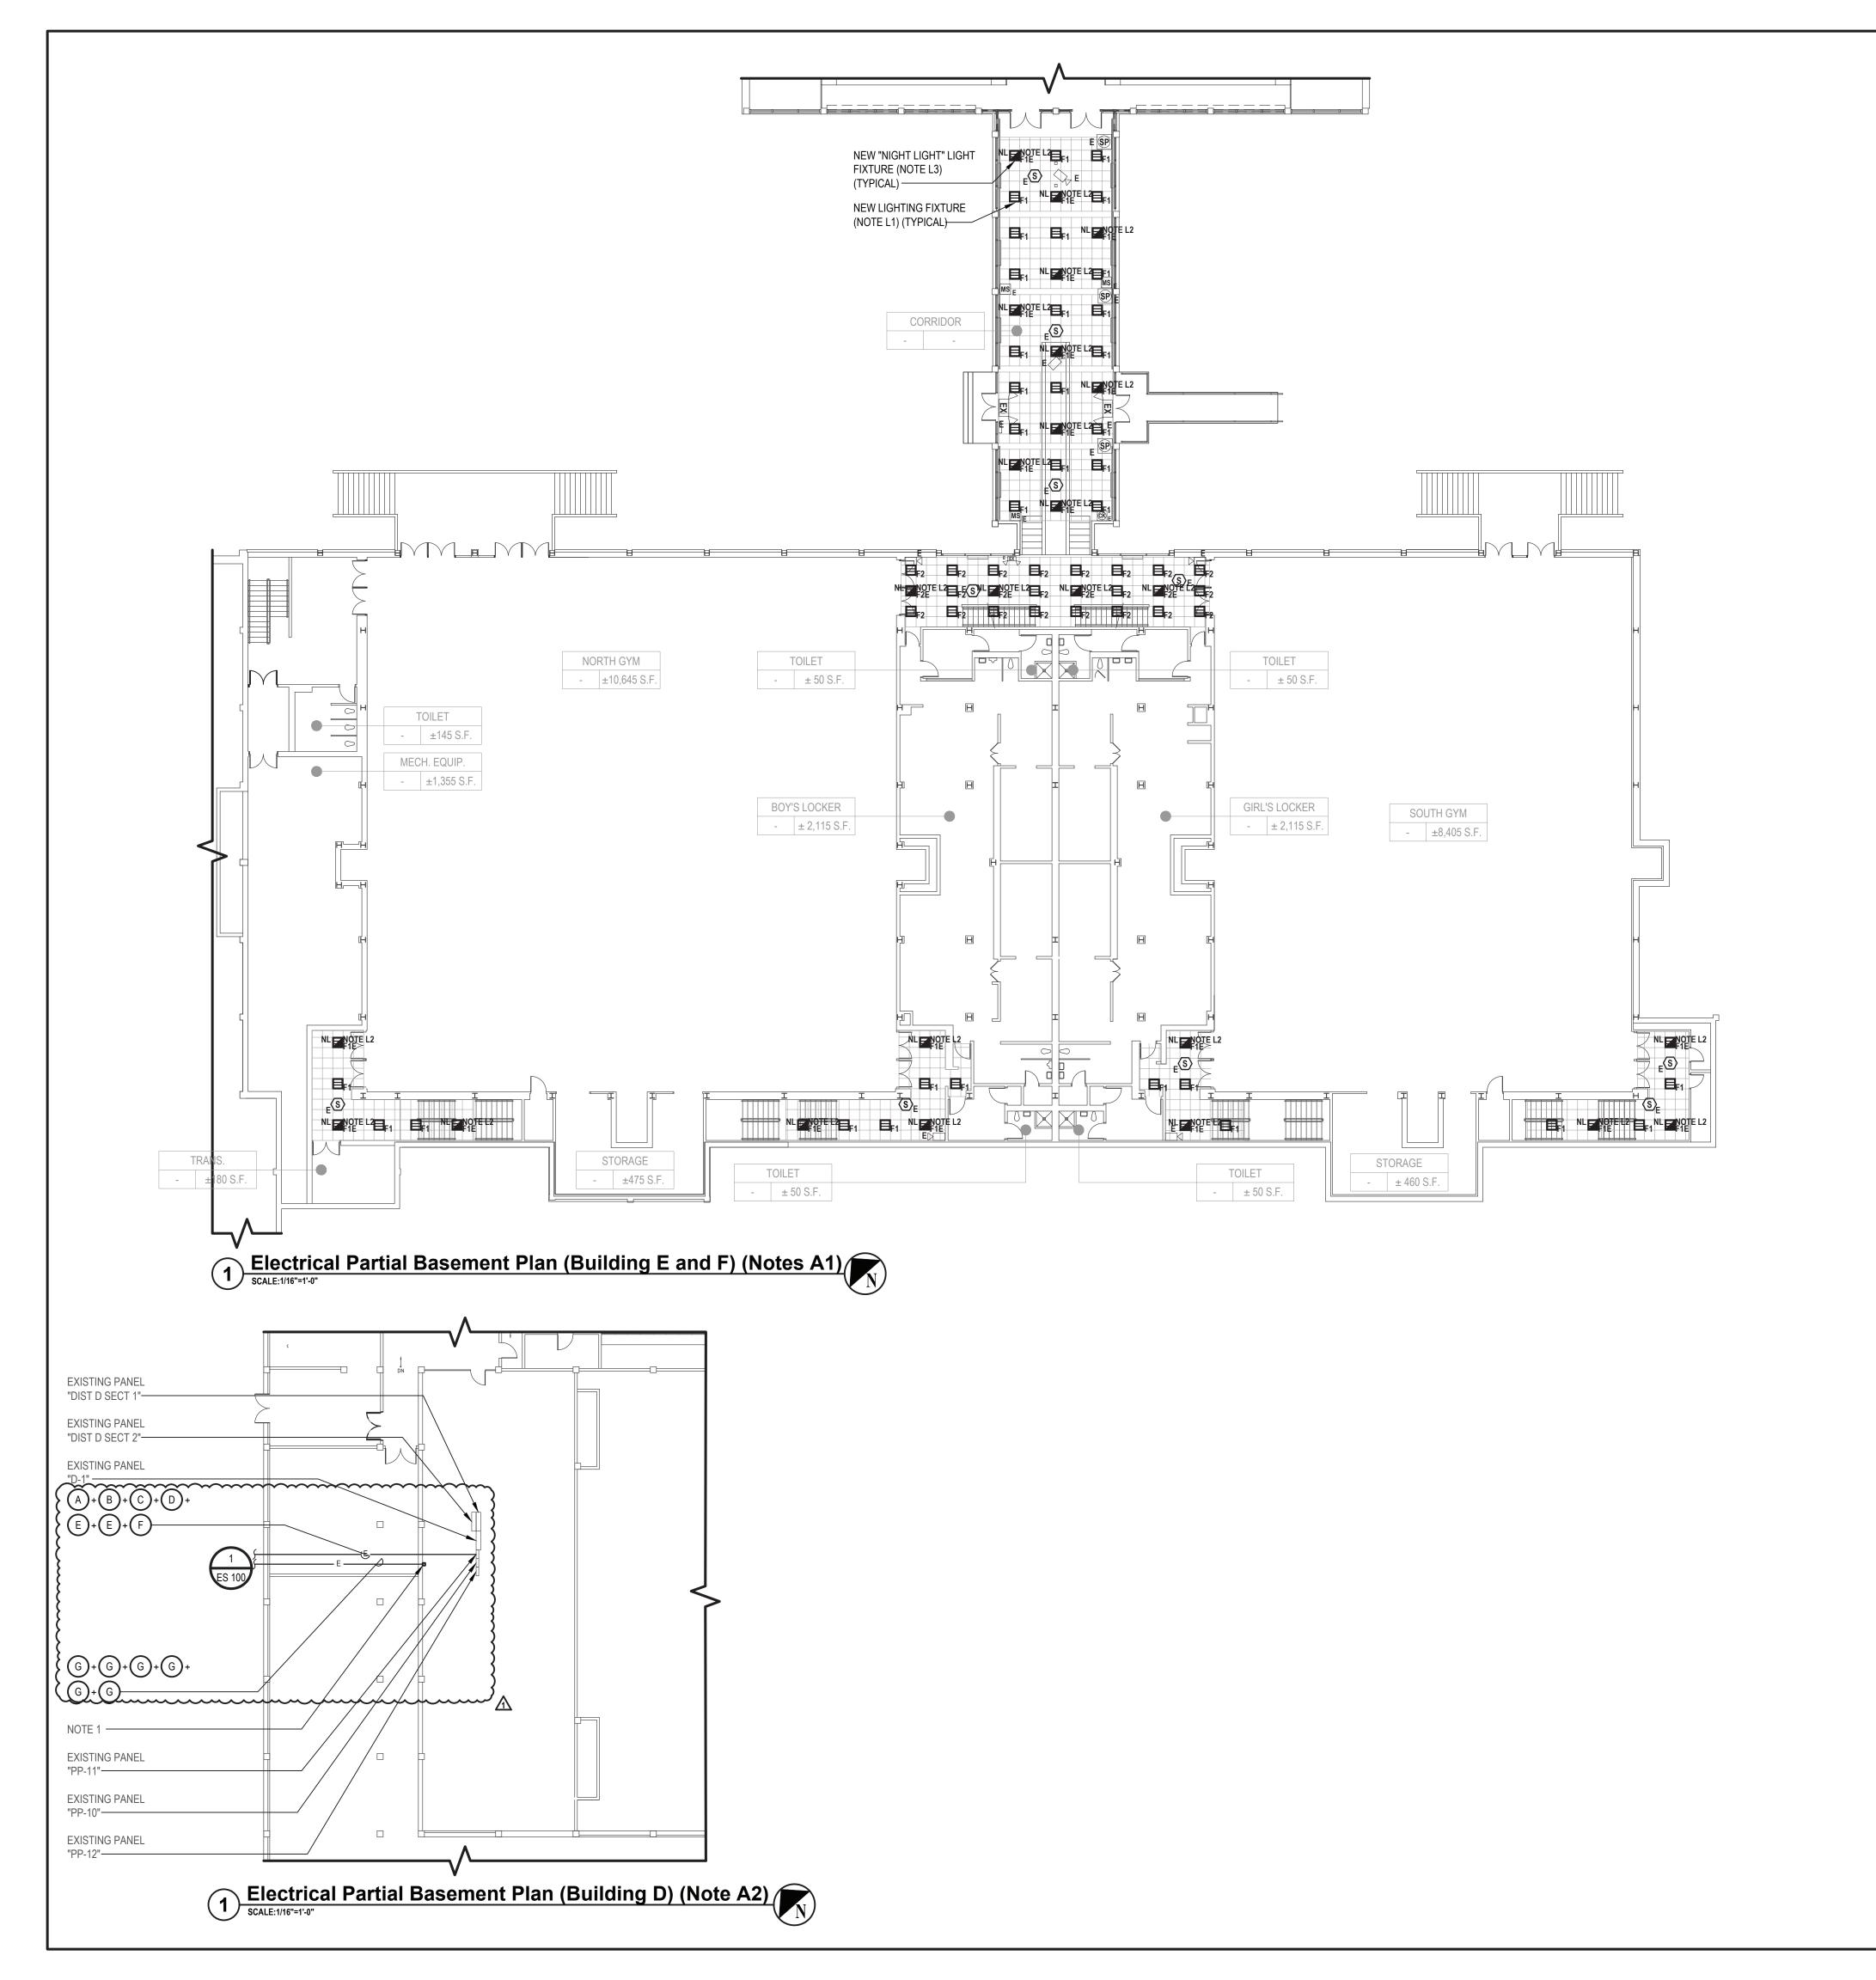
CONTRACT E ELECTRICAL CONSTRUCTION

FINAL BID SET

ELECTRICAL SITE PLAN

ES 100.00





ELECTRICAL GENERAL LIGHTING NOTES:

- GL1. PROVIDE ALL REQUIRED WIRING NECESSARY BETWEEN SWITCHES & CONTROLLERS. WHERE 3 OR 4 WAY SWITCHES ARE USED, PROVIDE ALL REQUIRED WIRING BETWEEN SWITCHES. WIRE SIZE SHALL EQUAL POWER FEED SIZE
- GL2. FIXTURES SHALL BE CONNECTED TO LINE SIDE OF CIRCUIT.
- GL3. PROVIDE AND INSTALL A DEDICATED NEUTRAL FOR EACH CIRCUIT. CONTRACTOR IS NOT PERMITTED TO USE COMMON NEUTRALS.
- GL4. PROVIDE BOX AND ACCESSORIES AS PER MANUFACTURER'S RECOMMENDATION FOR ALL SWITCHES.
- GL5. VERIFY EXACT LOCATIONS AND MOUNTING HEIGHTS WITH ARCHITECT/ENGINEER IN FIELD.
- GL6. ALL CEILING MOUNTED FIXTURES WITH EMERGENCY DRIVERS AND ALL FIXTURES THAT ARE PART OF AN EMERGENCY LIGHTING SYSTEM, FED FROM AN EMERGENCY BATTERY BACKUP SHALL BE LABELED. THESE LABELS SHALL BE EASILY READ FROM THE FLOOR LEVEL AND STATE THAT THE FIXTURE IS AN EMERGENCY FIXTURE AND CONTAIN THE PANEL NAME AND CIRCUIT NUMBER THAT IT IS FEED FROM.
- GL7. WIRING FOR EMERGENCY DRIVER IS NOT SHOWN ON PLANS. FIXTURES WITH EMERGENCY DRIVERS SHALL BE PROVIDED WITH AN UNSWITCHED POWER FEED FROM CIRCUIT FEEDING LIGHT FIXTURE.

ELECTRICAL LIGHTING KEY NOTES:


- L1. CONTRACTOR SHALL PROVIDE AND EXTEND WIRE AND CONDUIT FROM THE EXISTING LIGHTING CIRCUIT SERVING THIS ROOM TO TERMINATE AT NEW LIGHT FIXTURE AND SWITCH. WIRE AND CONDUIT SHALL BE 2 #12 AWG + #12 AWG GND IN 3/4" E.C.
- L2. CONTRACTOR SHALL PROVIDE AND INSTALL AN UNSWITCHED POWER FEED FROM THE LINE SIDE OF THE LIGHT SWITCH SERVING THE LIGHT FIXTURES IN THE ROOM WHERE THE NEW EMERGENCY LIGHT FIXTURE IS SCHEDULED TO BE INSTALLED. UNSWITCHED FEED SHALL ORIGINATE FROM THE SAME CIRCUIT FEEDING LIGHT FIXTURES IN THE ROOM WHERE THE EMERGENCY LIGHT FIXTURE IS SCHEDULED TO BE INSTALLED. PROVIDE AND INSTALL WIRE AND CONDUIT AS REQUIRED. CONTRACTOR SHALL PATCH, REPAIR, RESTORE, PRIME, PAINT AND REFINISH TO MATCH ORIGINAL APPEARANCE OF ALL WALLS, CEILINGS, AND ALL BUILDING FINISHES THAT ARE DISTURBED DURING INSTALLATION OF THE UNSWITCHED POWER FEED. WIRE AND CONDUIT SHALL BE 2 #12 AWG + #12 AWG GND IN 3/4" E.C.
- L3. LIGHT FIXTURE WITH SUBSCRIPT "NL" SHALL BE NIGHT LIGHT. LIGHT FIXTURES SHALL BE ON 24 HOURS AND EMERGENCY BATTERY BACKUP. FIXTURE SHALL NOT BE CONTROLLED BY SWITCH. PROVIDE AN UNSWITCHED POWER FEED FROM CIRCUIT SERVING LIGHT IN THIS AREA. TERMINATE UNSWITCHED POWER FEED TO EMERGENCY DRIVE/BATTERY AND NORMAL UTILITY DRIVER.

ADD/ALTERNATE NOTES:

- A1. CONTRACTOR SHALL PROVIDE ALL LABOR AND MATERIAL COST ASSOCIATED WITH WORK SHOWN ON THIS DETAIL IN ADD/ALTERNATE E4, ONLY.
- A2. CONTRACTOR SHALL PROVIDE ALL LABOR AND MATERIAL COST ASSOCIATED WITH PROVIDING AND INSTALL THE FIELD SPORTS LIGHTING AND ASSOCIATED CONTROL PANEL, ACCESSORIES, CONCRETE BASE AND HARDWARE IN ADD/ALTERNATE E5, ONLY. BASE BID WILL ONLY INCLUDE EMPTY CONDUIT AND ASSOCIATE PULLBOXES WITH NYLON PULL STRING.

ELECTRICAL KEY NOTE:

1. CONTRACTOR SHALL TERMINATE SPARE CONDUITS TO NEW NEMA 1 JUNCTION BOX FOR FUTURE SPORTS LIGHTING ON FIELD 10. PROVIDE AND INSTALL A LABEL ON THE JUNCTION BOX STATING "FUTURE USE FOR SPORTS LIGHTING ON FIELD 10". JUNCTION BOX SHALL BE SIZED IN ACCORDANCE WITH NEC REQUIREMENTS.

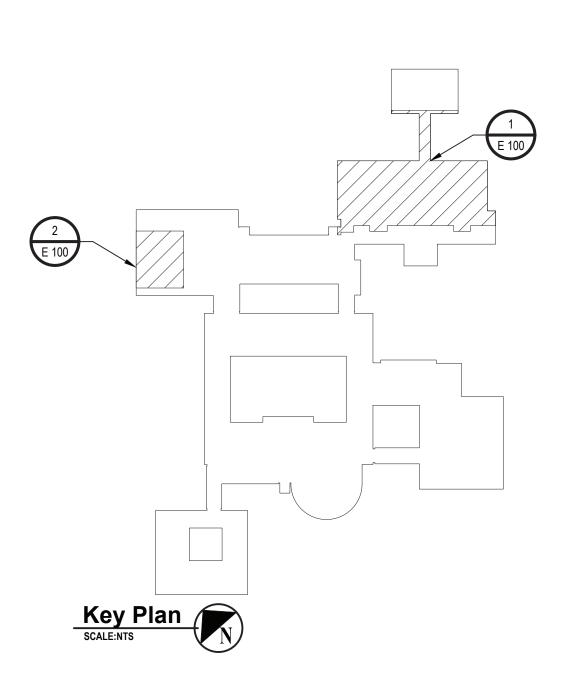



engineer

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1	08-07-2023	ADDENDUM NO. 1



DESIGNED BY: SAN	DRAWN BY: SAN	CHECKED BY:		REVIEWED BY:
PROJECT No.: WPSD 2206	DATE: AUGU	ST 2023	SCALE:	AS SHOWN

White Plains City School District

WHITE PLAINS HIGH SCHOOL UPGRADES AND TURF FIELD



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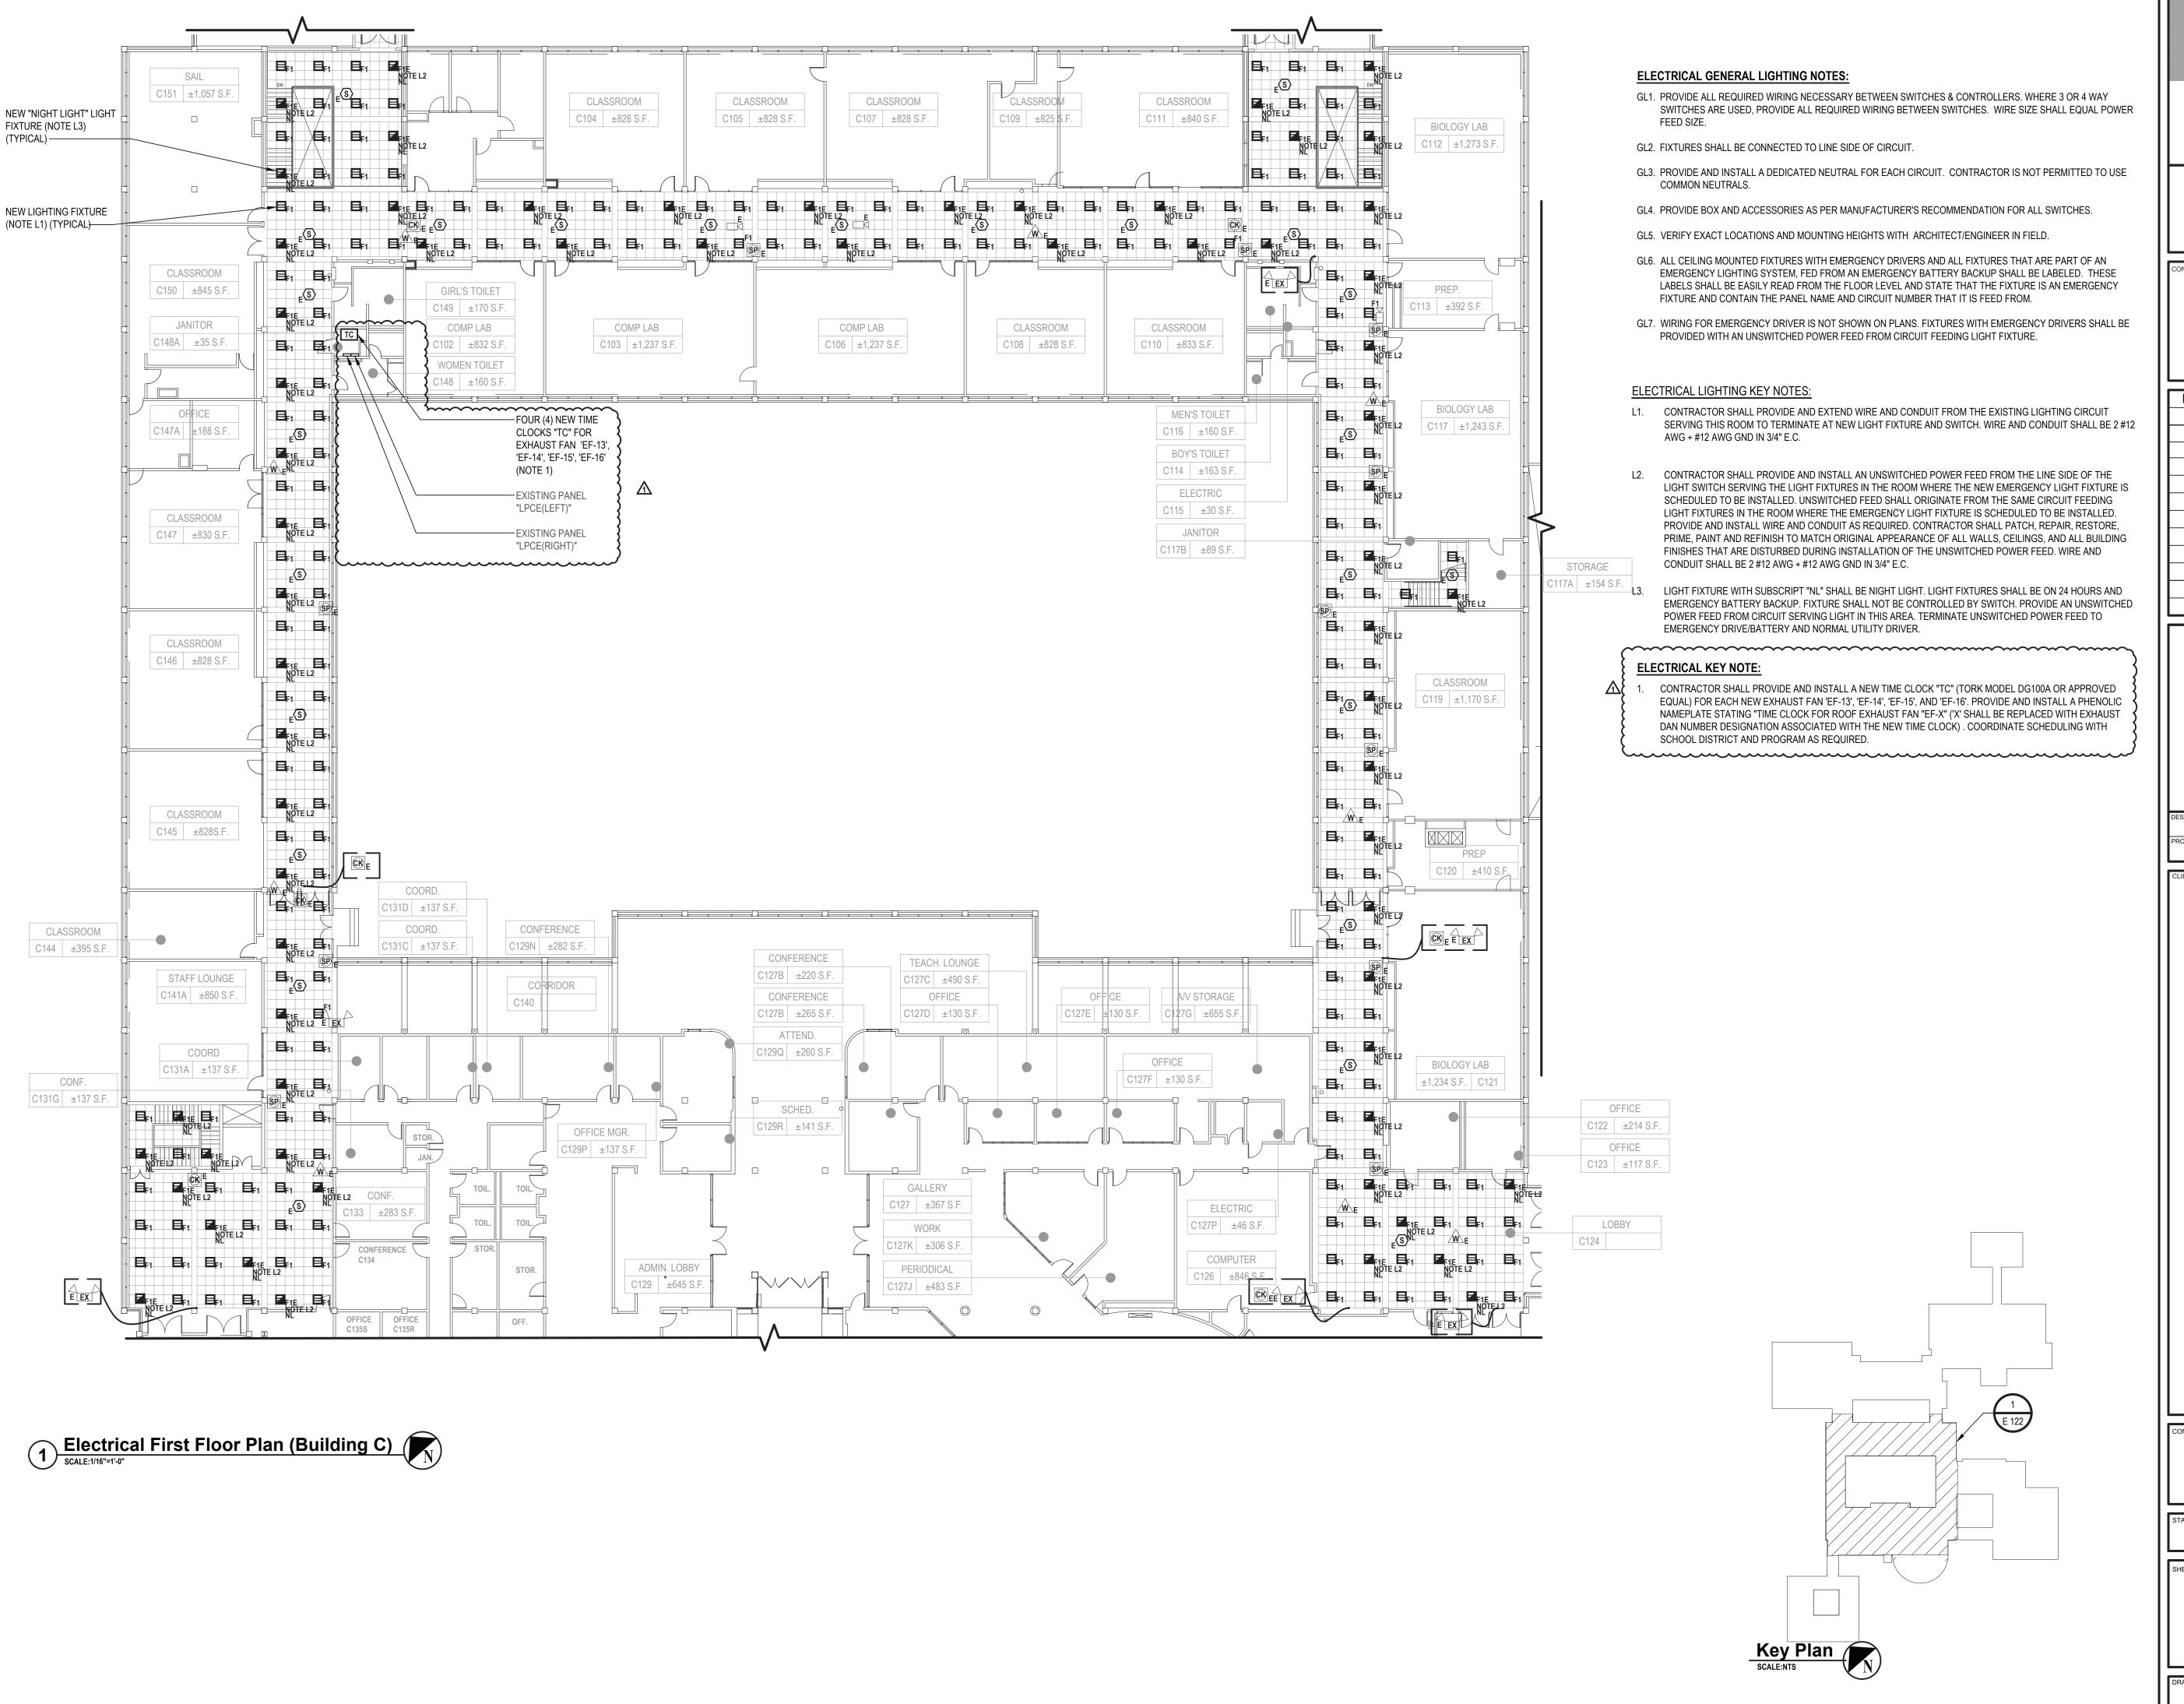
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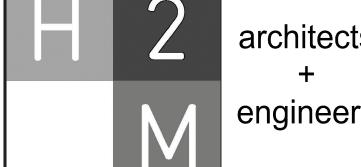
HEET TITLE

ELECTRICAL PARTIAL BASEMENT PLANS

DRAWING No.

E 100.00





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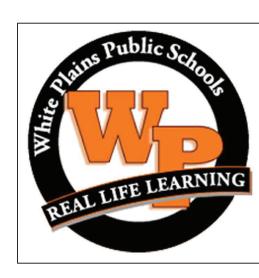
MARK	DATE	DESCRIPTION
-	07-24-2023	FINAL BID SET
1	08-07-2023	ADDENDUM NO. 1



DESIGNED BY:
SAN
SAN
PROJECT No.:
WPSD 2206
DRAWN BY:
SAN
CHECKED BY:
PROJECT No.:
AUGUST 2023
SCALE:
AS SHOWN

White Plains City School District

WHITE PLAINS HIGH SCHOOL UPGRADES AND TURF FIELD



550 North Street White Plains, NY 10605

SED No. 66-22-00-01-0-16-029

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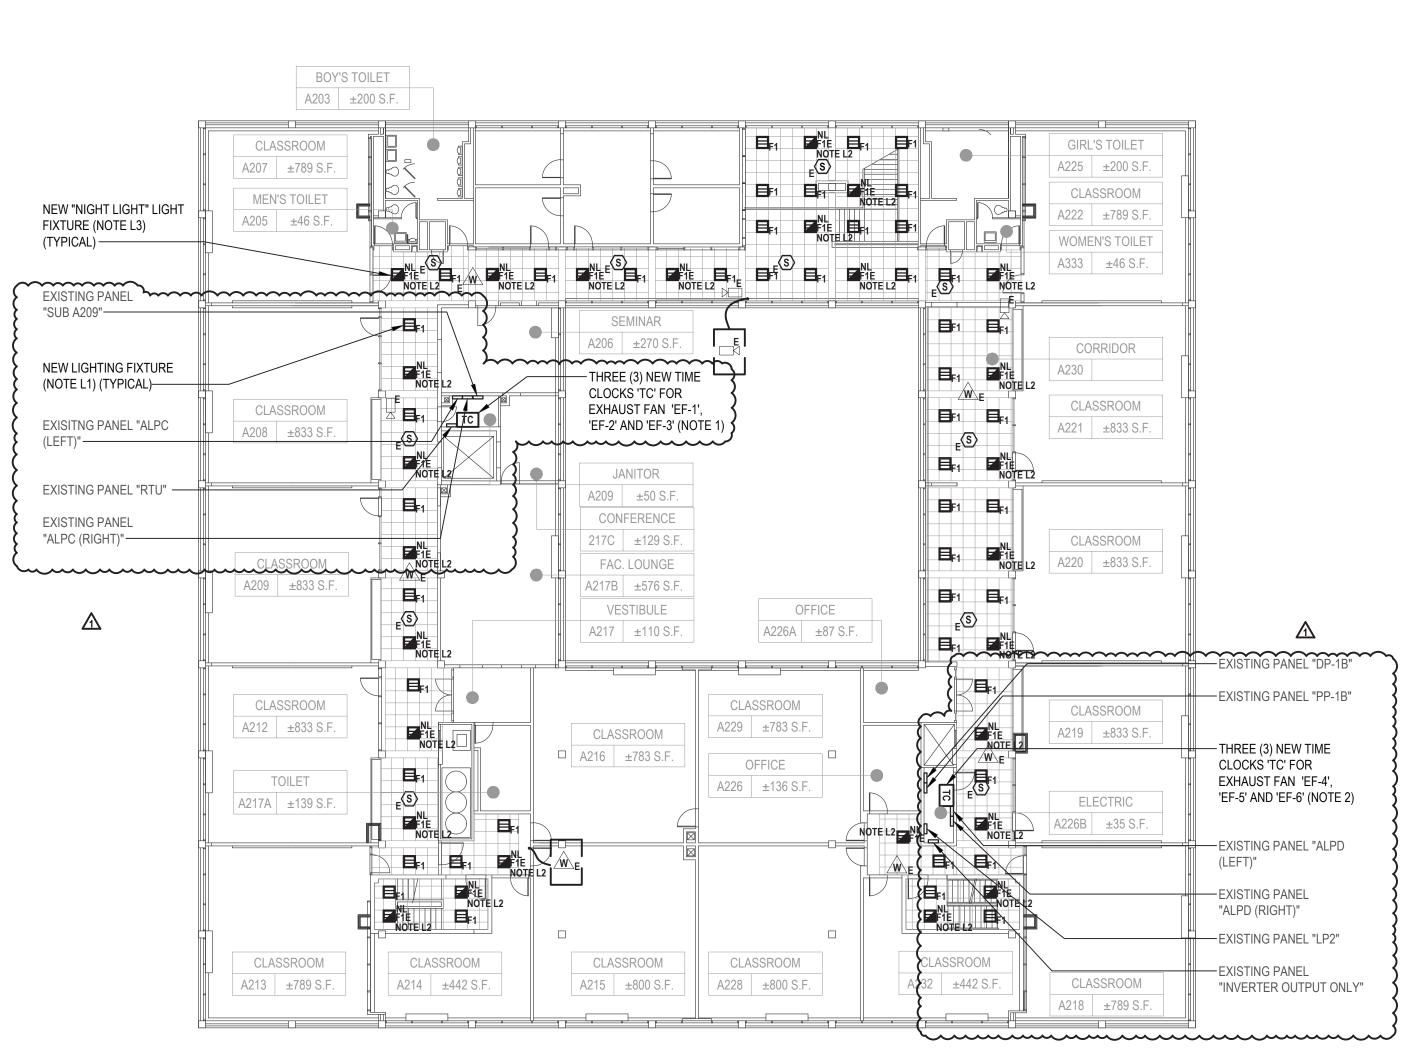
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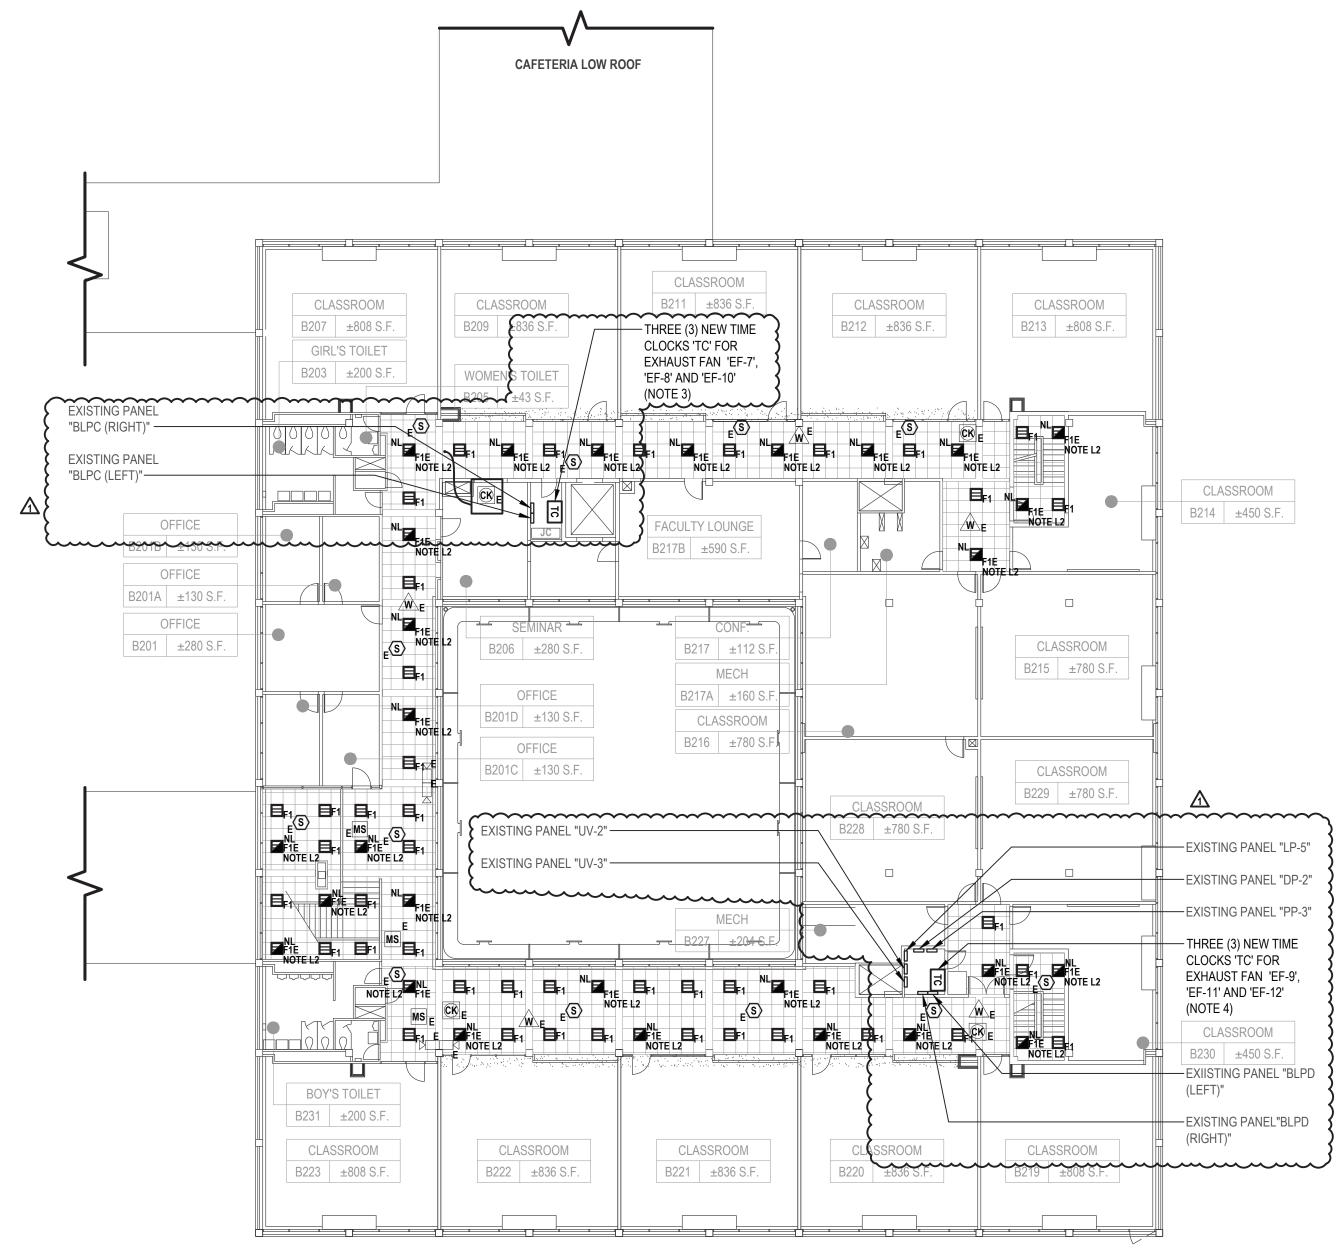
EET TITLE

ELECTRICAL PARTIAL FIRST FLOOR PLANS

DRAWING No.

E 122.00





1 Electrical Second Floor Plan (Building A) (Note A1) SCALE: 1/16"=1'-0"

ELECTRICAL GENERAL LIGHTING NOTES:

- GL1. PROVIDE ALL REQUIRED WIRING NECESSARY BETWEEN SWITCHES & CONTROLLERS. WHERE 3 OR 4 WAY SWITCHES ARE USED, PROVIDE ALL REQUIRED WIRING BETWEEN SWITCHES. WIRE SIZE SHALL EQUAL POWER
- GL2. FIXTURES SHALL BE CONNECTED TO LINE SIDE OF CIRCUIT.
- GL3. PROVIDE AND INSTALL A DEDICATED NEUTRAL FOR EACH CIRCUIT. CONTRACTOR IS NOT PERMITTED TO USE COMMON NEUTRALS.
- GL4. PROVIDE BOX AND ACCESSORIES AS PER MANUFACTURER'S RECOMMENDATION FOR ALL SWITCHES.
- GL5. VERIFY EXACT LOCATIONS AND MOUNTING HEIGHTS WITH ARCHITECT/ENGINEER IN FIELD.
- GL6. ALL CEILING MOUNTED FIXTURES WITH EMERGENCY DRIVERS AND ALL FIXTURES THAT ARE PART OF AN EMERGENCY LIGHTING SYSTEM, FED FROM AN EMERGENCY BATTERY BACKUP SHALL BE LABELED. THESE LABELS SHALL BE EASILY READ FROM THE FLOOR LEVEL AND STATE THAT THE FIXTURE IS AN EMERGENCY FIXTURE AND CONTAIN THE PANEL NAME AND CIRCUIT NUMBER THAT IT IS FEED FROM.
- GL7. WIRING FOR EMERGENCY DRIVER IS NOT SHOWN ON PLANS. FIXTURES WITH EMERGENCY DRIVERS SHALL BE PROVIDED WITH AN UNSWITCHED POWER FEED FROM CIRCUIT FEEDING LIGHT FIXTURE.

ELECTRICAL LIGHTING KEY NOTES:

- CONTRACTOR SHALL PROVIDE AND EXTEND WIRE AND CONDUIT FROM THE EXISTING LIGHTING CIRCUIT SERVING THIS ROOM TO TERMINATE AT NEW LIGHT FIXTURE AND SWITCH. WIRE AND CONDUIT SHALL BE 2 #12 AWG + #12 AWG GND IN 3/4" E.C.
- CONTRACTOR SHALL PROVIDE AND INSTALL AN UNSWITCHED POWER FEED FROM THE LINE SIDE OF THE LIGHT SWITCH SERVING THE LIGHT FIXTURES IN THE ROOM WHERE THE NEW EMERGENCY LIGHT FIXTURE IS SCHEDULED TO BE INSTALLED. UNSWITCHED FEED SHALL ORIGINATE FROM THE SAME CIRCUIT FEEDING LIGHT FIXTURES IN THE ROOM WHERE THE EMERGENCY LIGHT FIXTURE IS SCHEDULED TO BE INSTALLED. PROVIDE AND INSTALL WIRE AND CONDUIT AS REQUIRED. CONTRACTOR SHALL PATCH, REPAIR, RESTORE, PRIME, PAINT AND REFINISH TO MATCH ORIGINAL APPEARANCE OF ALL WALLS, CEILINGS, AND ALL BUILDING FINISHES THAT ARE DISTURBED DURING INSTALLATION OF THE UNSWITCHED POWER FEED. WIRE AND CONDUIT SHALL BE 2 #12 AWG + #12 AWG GND IN 3/4" E.C.
- LIGHT FIXTURE WITH SUBSCRIPT "NL" SHALL BE NIGHT LIGHT. LIGHT FIXTURES SHALL BE ON 24 HOURS AND EMERGENCY BATTERY BACKUP. FIXTURE SHALL NOT BE CONTROLLED BY SWITCH. PROVIDE AN UNSWITCHED POWER FEED FROM CIRCUIT SERVING LIGHT IN THIS AREA. TERMINATE UNSWITCHED POWER FEED TO EMERGENCY DRIVE/BATTERY AND NORMAL UTILITY DRIVER.


2 Electrical Second Floor Plan (Building B) (Note A2) SCALE:1/16"=1'-0"


ADD/ALTERNATE NOTES:

- CONTRACTOR SHALL PROVIDE ALL LABOR AND MATERIAL COST ASSOCIATED WITH WORK SHOWN ON THIS DETAIL IN ADD/ALTERNATE E1 ONLY.
- A2. CONTRACTOR SHALL PROVIDE ALL LABOR AND MATERIAL COST ASSOCIATED WITH WORK SHOWN ON THIS DETAIL IN ADD/ALTERNATE E2 ONLY.

ELECTRICAL KEY NOTES:


- 1. CONTRACTOR SHALL PROVIDE AND INSTALL A NEW TIME CLOCK "TC" (TORK MODEL DG100A OR APPROVED EQUAL) FOR EACH NEW EXHAUST FAN 'EF-1', 'EF-2', AND 'EF-3'. PROVIDE AND INSTALL A PHENOLIC NAMEPLATE STATING "TIME CLOCK FOR ROOF EXHAUST FAN "EF-X" ('X' SHALL BE REPLACED WITH EXHAUST DAN NUMBER DESIGNATION ASSOCIATED WITH THE NEW TIME CLOCK). COORDINATE SCHEDULING WITH SCHOOL DISTRICT AND PROGRAM AS REQUIRED.
- CONTRACTOR SHALL PROVIDE AND INSTALL A NEW TIME CLOCK "TC" (TORK MODEL DG100A OR APPROVED EQUAL) FOR EACH NEW EXHAUST FAN 'EF-4', 'EF-5', AND 'EF-6'. PROVIDE AND INSTALL A PHENOLIC NAMEPLATE STATING "TIME CLOCK FOR ROOF EXHAUST FAN "EF-X" ('X' SHALL BE REPLACED WITH EXHAUST DAN NUMBER DESIGNATION ASSOCIATED WITH THE NEW TIME CLOCK). COORDINATE SCHEDULING WITH SCHOOL DISTRICT AND PROGRAM AS REQUIRED.
- CONTRACTOR SHALL PROVIDE AND INSTALL A NEW TIME CLOCK "TC" (TORK MODEL DG100A OR APPROVED EQUAL) FOR EACH NEW EXHAUST FAN 'EF-7', 'EF-8', AND 'EF-10'. PROVIDE AND INSTALL A PHENOLIC NAMEPLATE STATING "TIME CLOCK FOR ROOF EXHAUST FAN "EF-X" ('X' SHALL BE REPLACED WITH EXHAUST DAN NUMBER DESIGNATION ASSOCIATED WITH THE NEW TIME CLOCK). COORDINATE SCHEDULING WITH SCHOOL DISTRICT AND PROGRAM AS REQUIRED.
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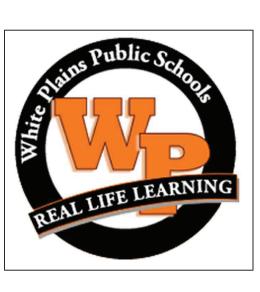
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MARK	DATE	DESCRIPTION
-	07-24-2023	FINAL BID SET
1	08-07-2023	ADDENDUM NO. 1

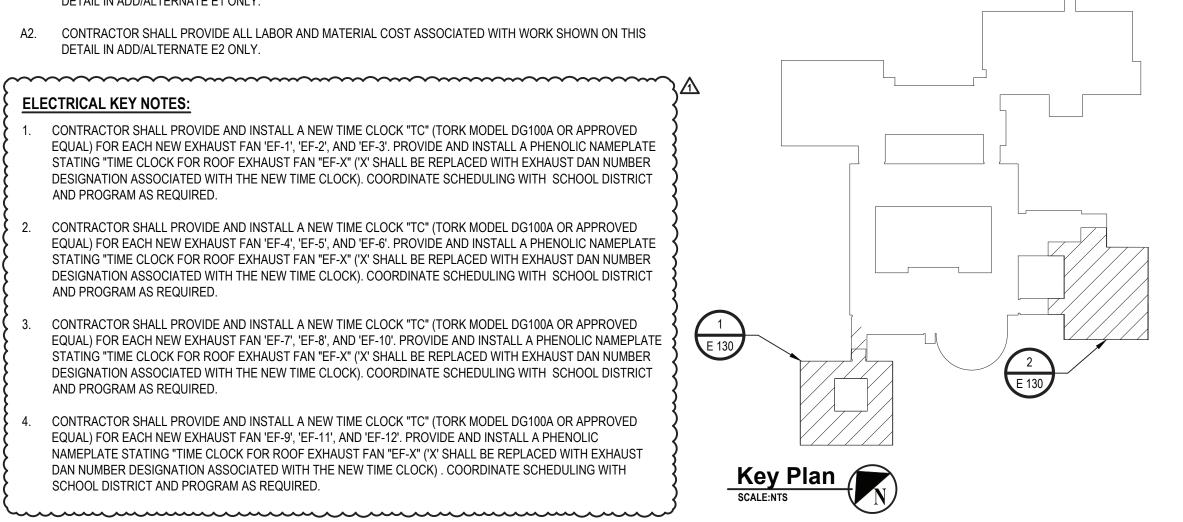

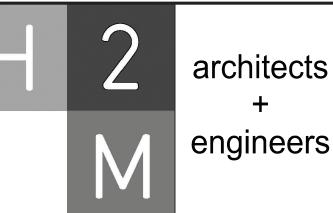White Plains City School District

WHITE PLAINS HIGH SCHOOL **UPGRADES AND TURF FIELD**

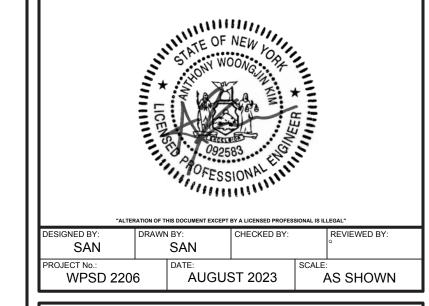

550 North Street White Plains, NY 10605


SED No. 66-22-00-01-0-16-029

CONTRACT E ELECTRICAL CONSTRUCTION

FINAL BID SET

ELECTRICAL PARTIAL SECOND FLOOR PLANS

E 130.00

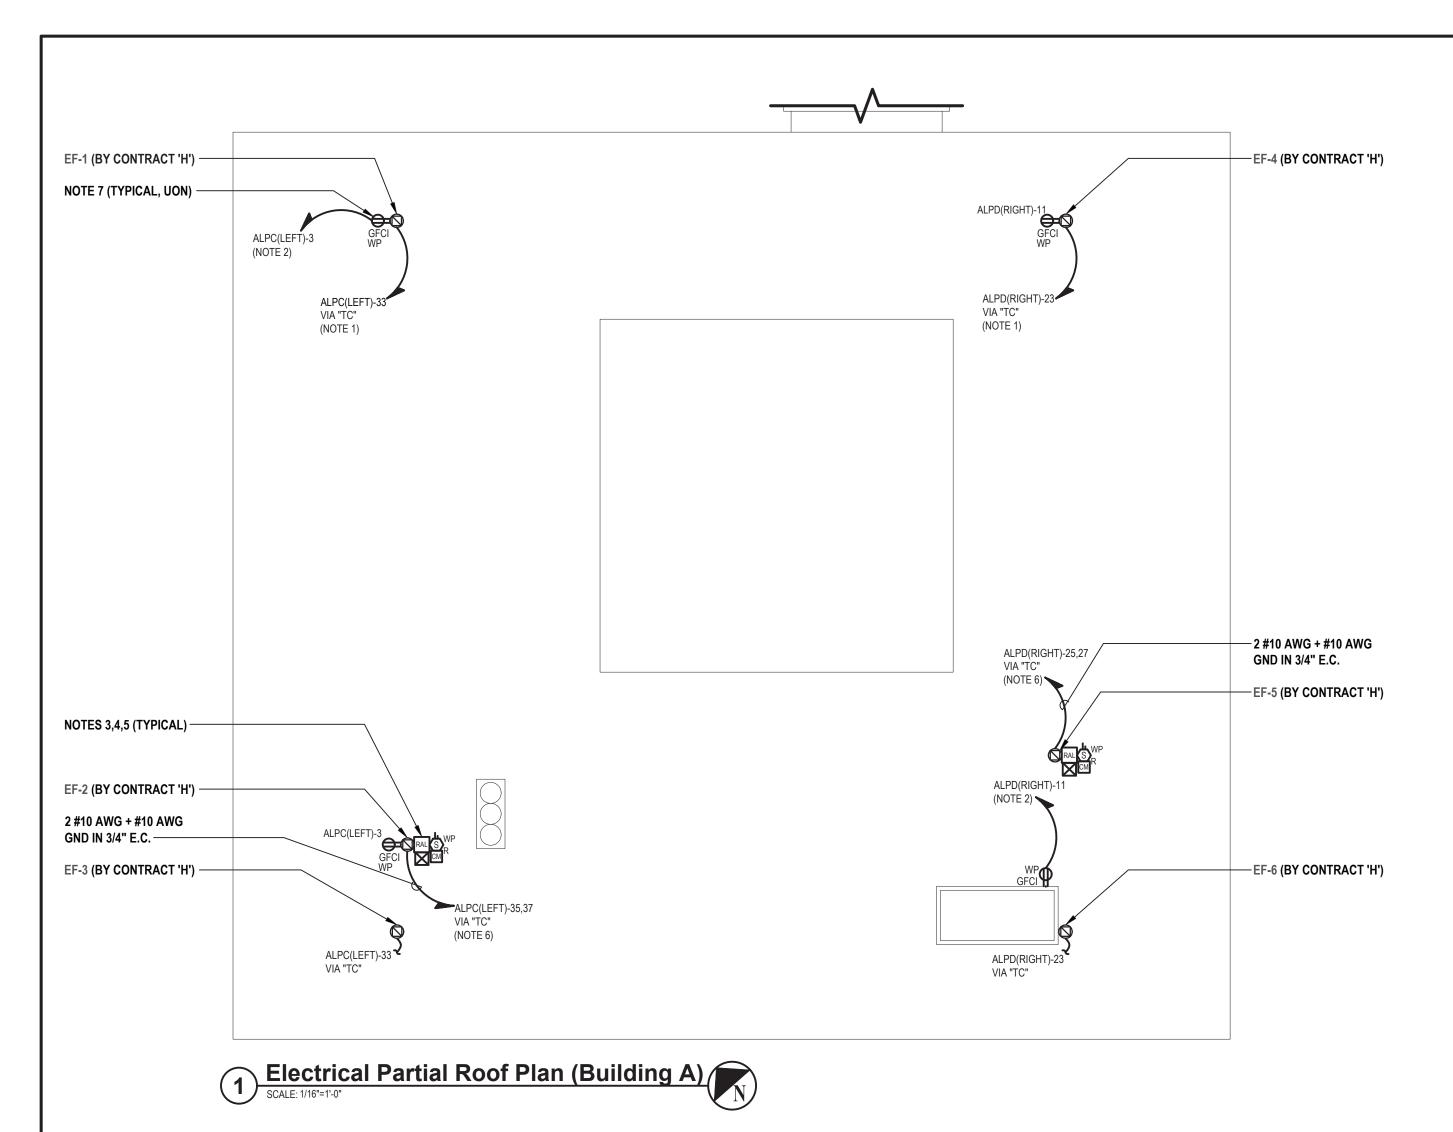



ELECTRICAL GENERAL NOTES:

- G1. REFER TO DRAWING E 130 FOR APPROXIMATE LOCATION OF EXISTING PANELS, NEW TIME CLOCKS AND ADDITIONAL INFORMATION.
- G2. CONTRACTOR SHALL PROVIDE AND INSTALL ALL WIRE AND CONDUIT AS REQUIRED TO TERMINATE TO FACTORY PROVIDED DISCONNECT SWITCH.

ELECTRICAL KEY NOTES:

- 1. CONTRACTOR SHALL BE PERMITTED TO USE EXISTING 15A/1P SPARE CIRCUIT BREAKER IN EXISTING PANEL. PROVIDE AND INSTALL MOUNTING HARDWARE AS REQUIRED.
- 2. CONTRACTOR SHALL BE PERMITTED TO USE EXISTING 20A/1P SPARE CIRCUIT BREAKER IN EXISTING PANEL. PROVIDE AND INSTALL MOUNTING HARDWARE AS REQUIRED.
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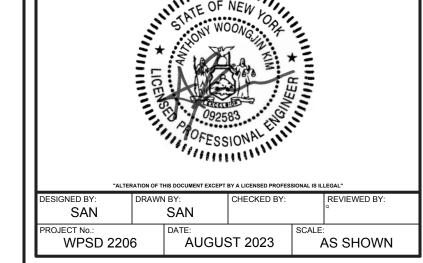


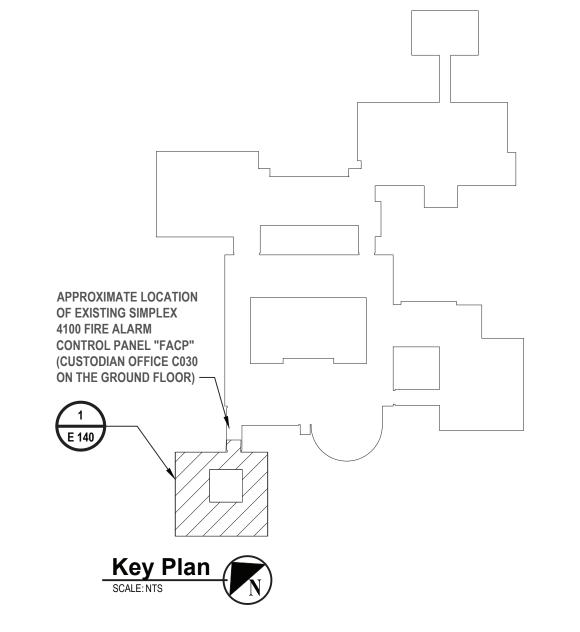
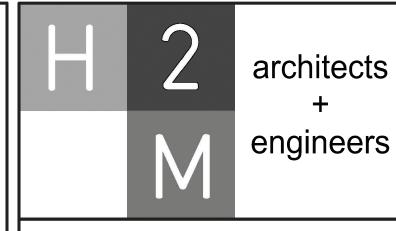
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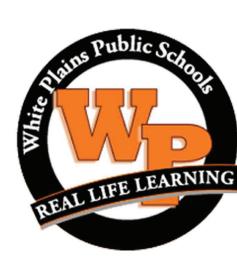
CONSULTANTS:		

MARK	DATE	DESCRIPTION
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White Plains City School District

WHITE PLAINS HIGH SCHOOL UPGRADES AND TURF FIELD



550 North Street White Plains, NY 10605

SED No. 66-22-00-01-0-16-029


CONTRACT E
ELECTRICAL CONSTRUCTION

FINAL BID SET

SHEET TITLE

ELECTRICAL PARTIAL ROOF PLAN BUILDING A

E 140.00

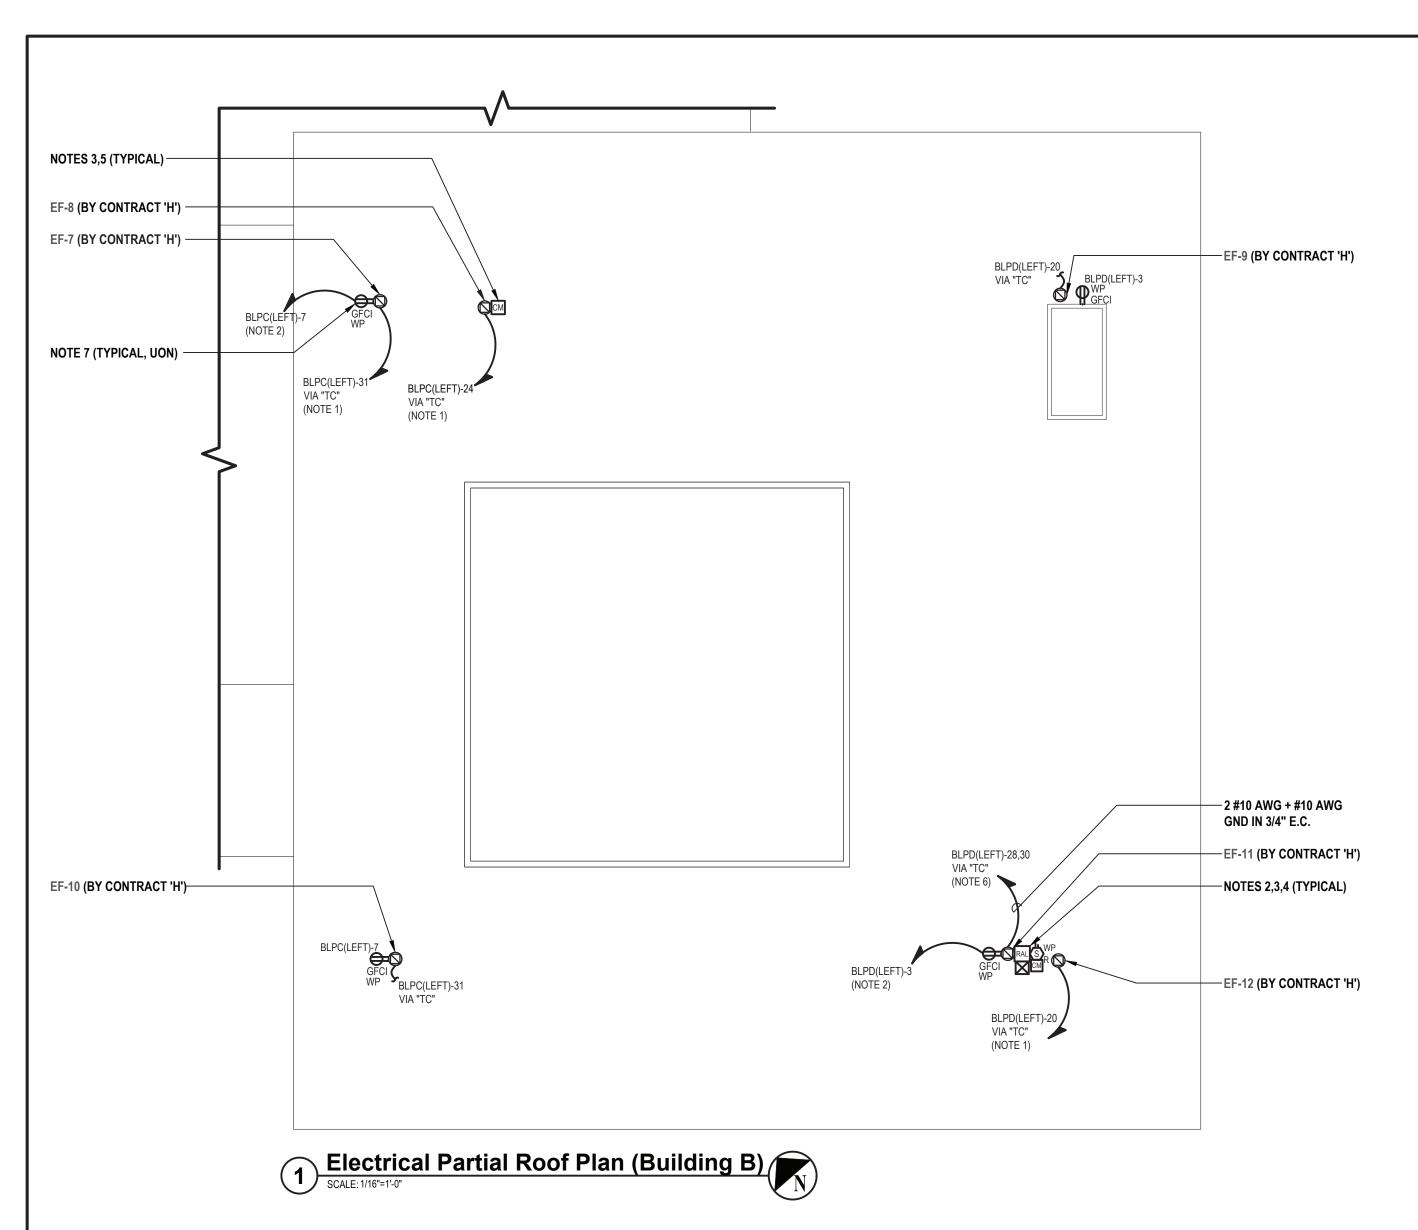



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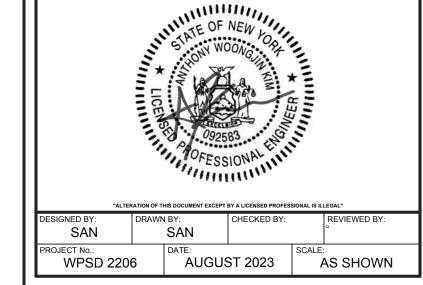




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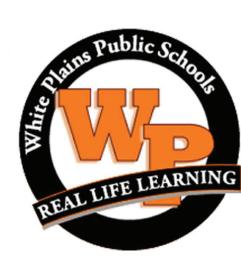
CONSULTANTS:

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1	08-07-2023	ADDENDUM NO. 1
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White Plains City School District

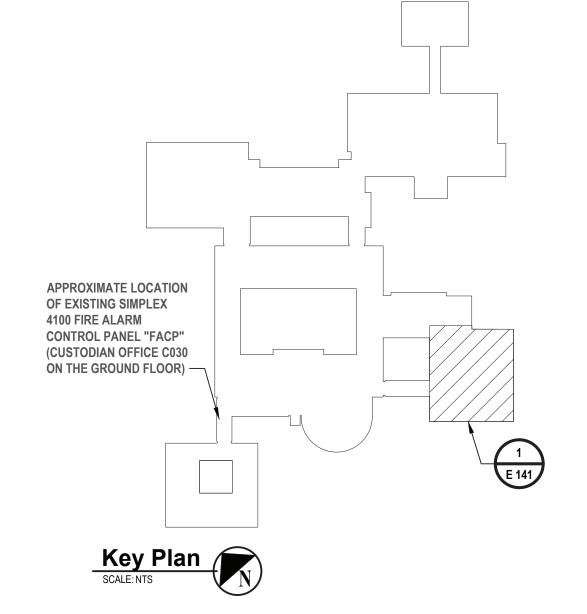WHITE PLAINS HIGH SCHOOL UPGRADES AND TURF FIELD

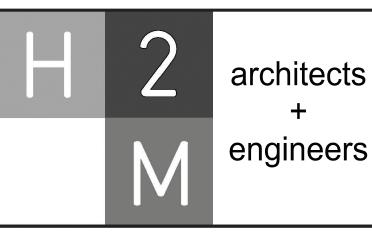

550 North Street White Plains, NY 10605

SED No. 66-22-00-01-0-16-029


CONTRACT E
ELECTRICAL CONSTRUCTION

FINAL BID SET

IEET TITLE

ELECTRICAL PARTIAL ROOF PLAN BUILDING B

E 141.00

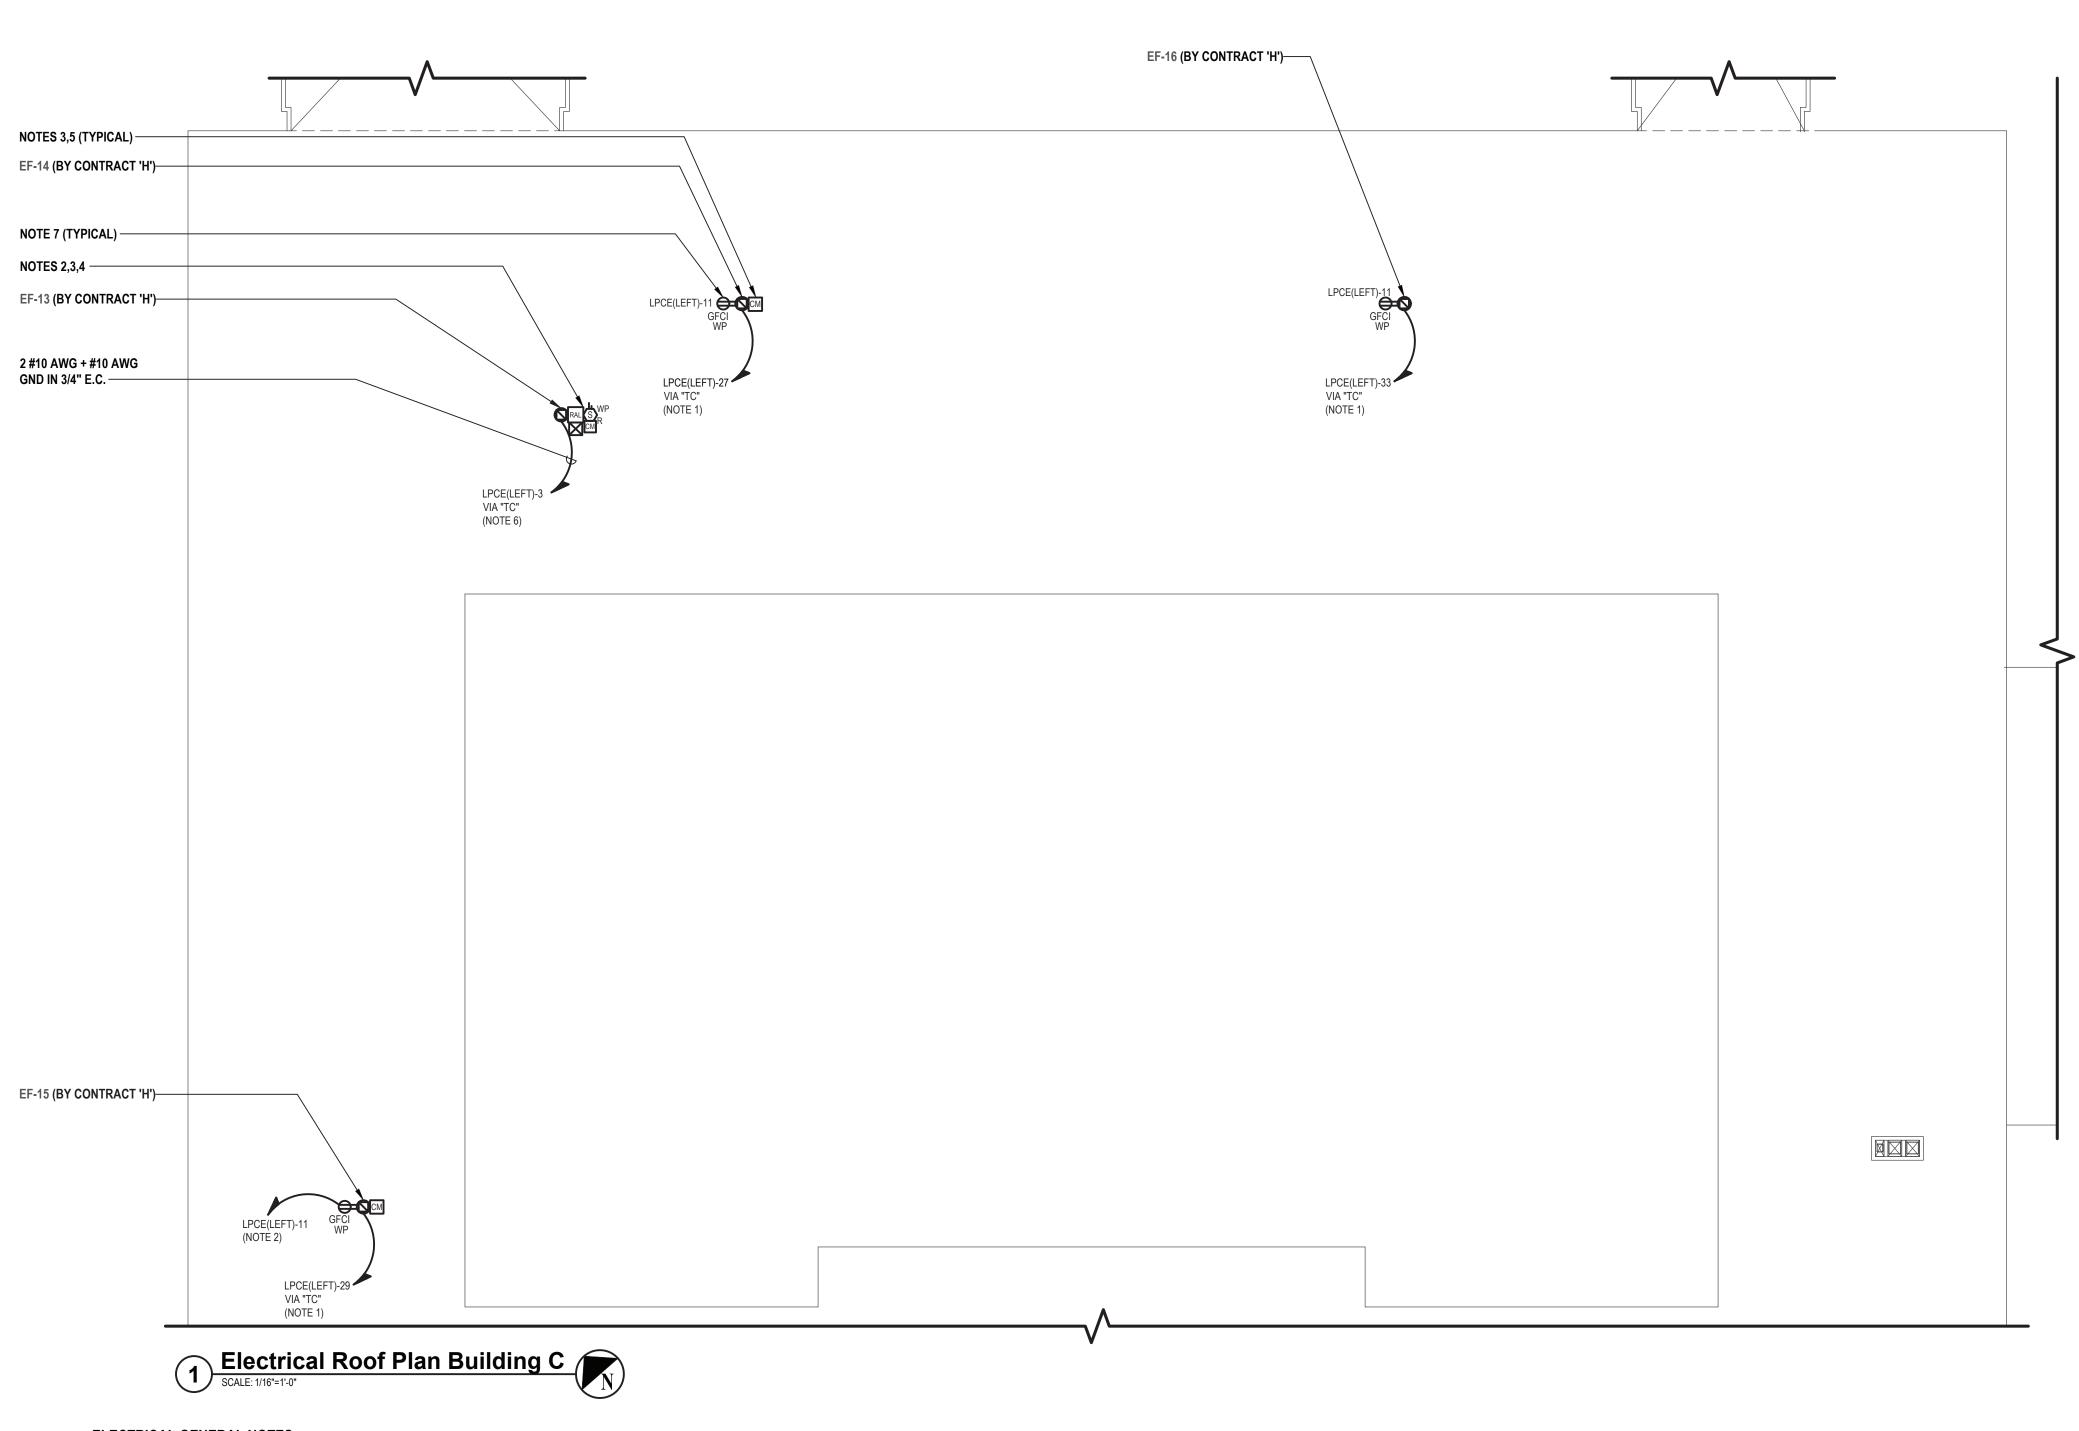



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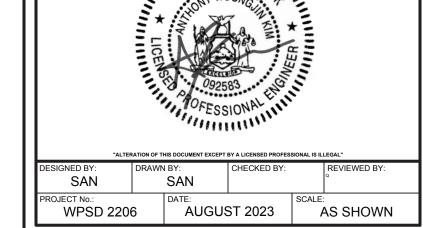




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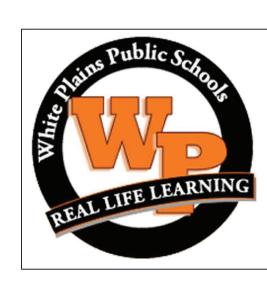
CONSULTANTS:		

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White Plains City School District

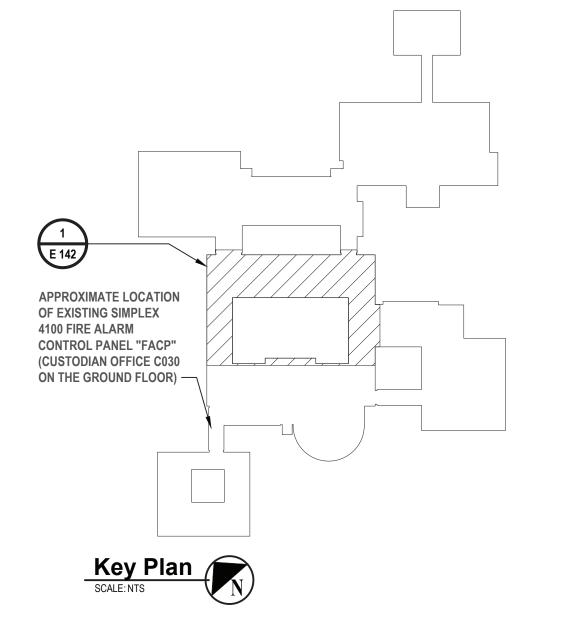WHITE PLAINS HIGH SCHOOL UPGRADES AND TURF FIELD

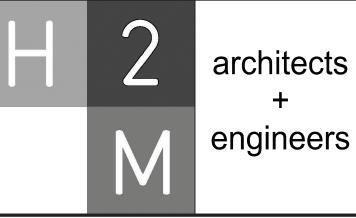

550 North Street White Plains, NY 10605

SED No. 66-22-00-01-0-16-029


CONTRACT E
ELECTRICAL CONSTRUCTION

FINAL BID SET

SHEET TITLE

ELECTRICAL PARTIAL ROOF PLAN
BUILDING C

E 142.00

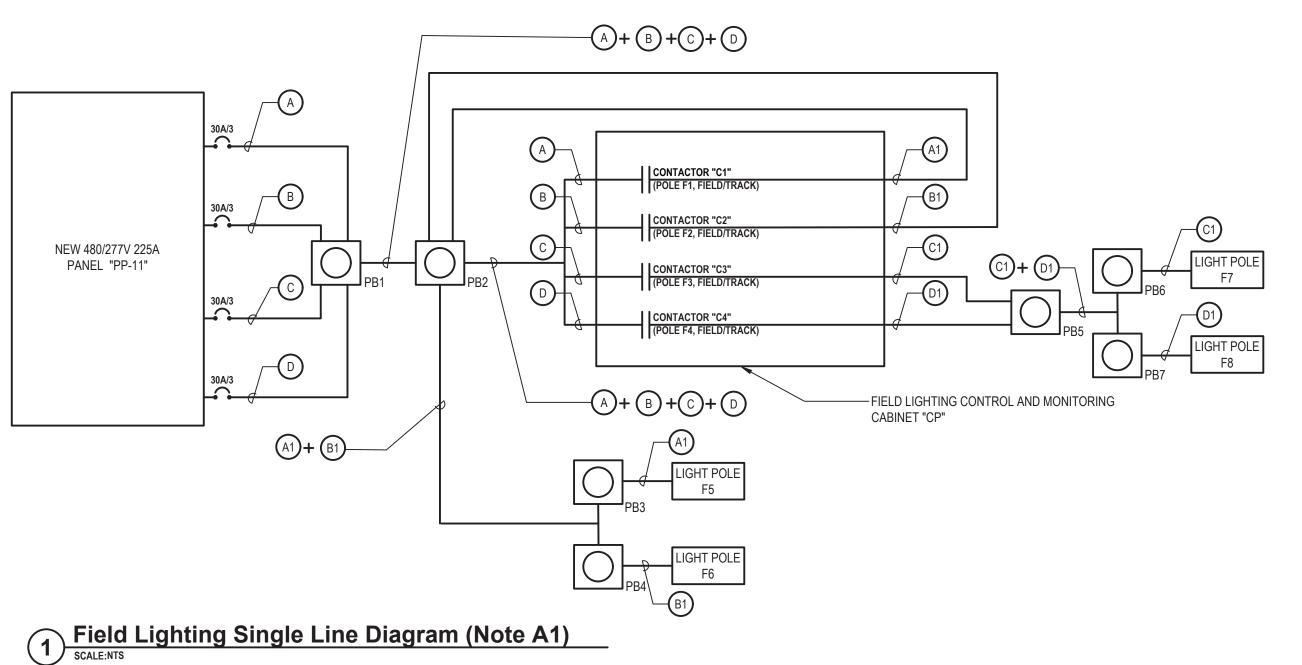

FIRE ALARM LEGEND

DESCRIPTION

DUCT DETECTOR WITH REMOTE ALARM LAMP; "S" DENOTES SUPPLY, "R" DENOTES RETURN.

NOTES

SYMBOL

CONTROL MODULE.

SIMPLEX 4100

F.A.C.P.

CUSTODIAN OFFICE C030 (ON THE GROUND

FLOOR)

F1 Fire Alarm Riser Diagram (Note 15)
SCALE:NTS

WIRE LEGEND

WIRE DESCRIPTION


1 PAIR #18 AWG. NON SHIELDED

1 PAIR #14 AWG. NON SHIELDED


#14 AWG. NON SHIELDED

TO EXISTING

DEVICES

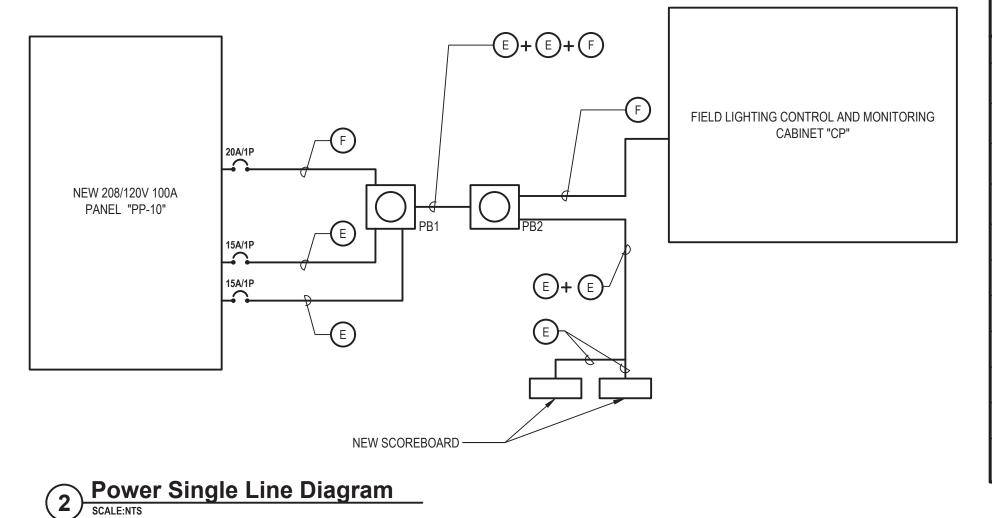


SINGLE LINE DIAGRAM AND SITE PLAN FEEDER SCHEDULE **FEEDER** CONDUTOR AND CONDUITS FEEDER SCHEDULE 3 #6 AWG + #6 AWG GND IN 1" E.C. (FROM PANEL "PP-11" TO FOR CONTACTOR C1 IN CONTROL PANEL) 3 #4 AWG + #4 AWG GND IN 1-1/4" E.C. (FROM PANEL "PP-11" TO FOR CONTACTOR C2 IN CONTROL PANEL 3 #3 AWG + #3 AWG GND IN 1-1/2" E.C. (FROM PANEL "PP-11" TO FOR CONTACTOR C3 IN CONTROL PANEL) 3 #2 AWG + #2 AWG GND IN 1-1/2" E.C. (FROM PANEL "PP-11" TO FOR CONTACTOR C4 IN CONTROL PANEL) 3 #6 AWG + #6 AWG GND IN 1" E.C. 3 #4 AWG + #4 AWG GND IN 1-1/4" E.C. 3 #3 AWG + #3 AWG GND IN 1-1/2" E.C. 3 #2 AWG + #2 AWG GND IN 1-1/2" E.C. 3 #2 AWG + #2 AWG GND IN 1-1/2" E.C. 3 #1/0 AWG + #1/0 AWG GND IN 2" E.C. 2" SPARE E.C. WITH NYLON PULL STRING

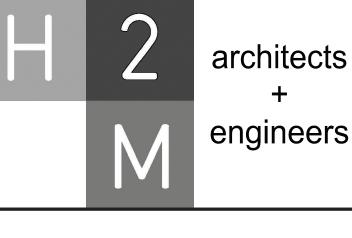

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Ш	MARK	DATE	DESCRIPTION
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| White Plains City School **District**

WHITE PLAINS HIGH SCHOOL **UPGRADES AND TURF FIELD**

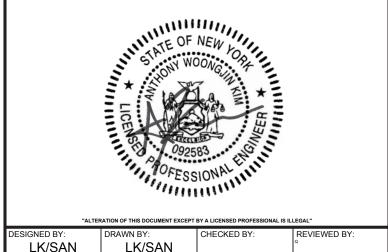

550 North Street White Plains, NY 10605

SED No. 66-22-00-01-0-16-029

CONTRACT E ELECTRICAL CONSTRUCTION

FINAL BID SET

ELECTRICAL FIELD LIGHTING SINGLE LINE DIAGRAMS, FIRE **ALARM LEGEND, RISER AND NOTES**

E 200.00

CONTRACTOR

COMMENTS

FIRE ALARM GENERAL NOTES: ALL WIRING TO BE INSTALLED ACCORDING TO THE LATEST REVISION OF THE NATIONAL ELECTRIC CODE AND N.F.P.A 72 AS REQUIRED BY LOCAL ORDINANCE.

ELECTRICAL ADD/ALT NOTE:

DETAIL IN ADD/ALTERNATE E5, ONLY.

A1. CONTRACTOR SHALL PROVIDE ALL LABOR AND MATERIAL COST ASSOCIATED WITH WORK SHOWN ON THIS

2. ALL CONDUCTORS MUST BE TEST FREE OF OPENS, SHORTS AND GROUNDS.

3. GROUNDING MUST COMPLY WITH THE NATIONAL ELECTRIC CODE. GROUNDING MUST BE No.

4. ALL PANEL TERMINATIONS TO BE SUPERVISED BY A FACTORY AUTHORIZED TECHNICIAN PRIOR TO POWERING EQUIPMENT.

5. FOR COMPONENT WIRING AND INSTALLATION INFORMATION REFER TO MANUFACTURERS REQUIREMENTS.

6. REFER TO CONTRACT DRAWINGS FOR APPROXIMATE DEVICE LOCATIONS. DRAWINGS REPRESENT DEVICE QUANTITIES. SHOP DRAWINGS SHALL BE SUBMITTED SHOWING SCALED LOCATIONS. CONTRACTOR TO SUBMIT PLANS STAMPED BY LICENSED NEW YORK PROFESSIONAL ENGINEER ONLY. SHOP DRAWINGS WITHOUT P.E STAMP WILL BE AUTOMATICALLY REJECTED.

7. CONTRACTOR RESPONSIBLE TO PATCH & PAINT ALL OPENINGS AS A RESULT OF REMOVAL OF EXISTING EQUIPMENT.

INSTALL DETECTORS A MINIMUM OF 3'-0" FROM ANY SUPPLY OR RETURN AIR REGISTERS. COORDINATE EXACT LOCATIONS OF SUPPLY/RETURNS REGISTERS WITH MECHANICAL

9. WHEN INSTALLING SHIELDED CABLE THE FOLLOWING MUST BE OBSERVED:

A. METALLIC CONTINUITY MUST BE MAINTAINED THROUGHOUT THE CABLE RUN.

B. THE CABLE SHIELD MUST BE ISOLATED FROM GROUND AND TERMINATED ONLY IN THE ASSOCIATED CONTROL PANEL AT THE TERMINAL INDICATED ON THE CONTROL PANEL DRAWINGS. THE REMOTE END OF THE SHIELD (AT LAST DEVICE) MUST BE TAPED AND ISOLATED FROM GROUND.

10. AFTER ALARM INDICATION, ALL FANS SHALL BE MANUALLY RESET INDEPENDENT FROM F.A.C.P. SYSTEM RESET. PROVIDE ALL REQUIRED HARDWARE ACCESSORIES, MOTOR STARTERS, CONTROLS, POWER AND CONTROL WIRING AND CONDUITS TO PROVIDE INDEPENDENT RESET OF ALL FANS AFTER ALARM INDICATION.

11. INSTALL ALL DEVICES IN ACCORDANCE WITH A.D.A REQUIREMENTS. ALL DEVICES SHALL BE MOUNTED AS FOLLOWS:

A. MANUAL PULL STATIONS 48" O.C.

B. ALARM INDICATING APPLIANCE 80" A.F.F.

C. VERIFY WITH CONTRACT SPECIFICATIONS FOR ANY DEVIATIONS.

12. ALL EQUIPMENT TO BE RECESSED MOUNTED AND ALL WIRING AND CONDUIT TO BE RUN CONCEALED

13. PROVIDE AND INSTALL ALL NECESSARY CONTROL MODULES, SYNCHRONIZATION MODULES, STARTERS AND MONITOR MODULES AS REQUIRED BY MANUFACTURER.

14. PROVIDE ALL REQUIRED DUCT SMOKE DETECTORS. CONTRACTOR TO INSTALL DUCT SMOKE

15. FIRE ALARM RISER DIAGRAM IS SCHEMATIC. REFER TO FLOOR PLANS FOR DEVICE TYPES AND QUANTITIES.

AND RETURN DUCT SMOKE DETECTORS WITH REMOTE LED'S FOR ALL HVAC UNITS WITH A COST FOR INTERCONNECTING TWO (2) ADDITIONAL HVAC UNITS TO SHUTDOWN UPON ALARM ACTIVATION AND ALL COSTS FOR PROVIDING AND INSTALLING TWO (2) DUCT SMOKE DETECTORS WITH REMOTE LEDS INCLUDING ALL ASSOCIATED CONTROL MODULES AND

DETECTORS. CONTRACTOR TO INTERFACE ALL DUCT DETECTORS WITH FACP.

16. ALL HVAC EQUIPMENT WITH A CFM RATING OF 1000 CFM OR GREATER SHALL BE INTERCONNECTED TO THE FIRE ALARM SYSTEM AND SHUT DOWN UPON FIRE ALARM SYSTEM ALARM ACTIVATION. CONTRACTOR SHALL ALSO PROVIDE AND INSTALL NEW SUPPLY CFM RATING OF 2000 CFM OR GREATER. CONTRACTOR SHALL PROVIDE IN BASE BID PRICE A WIRING/CONDUIT. CONTRACTOR SHALL INTERFACE WITH ALL EXISTING STARTERS AND PROVIDE NEW STARTERS WHERE REQUIRED.

NOTIFICATIONSUPPLEMENTARY **MANUAL PULL STATION** SMOKE DETECTOR **HEAT DETECTOR DUCT DETECTOR** CARBON MONOXIDE DETECTOR FIRE PANEL AC POWER FAILURE FA SYSTEM LOW BATTERY OPEN CIRCUIT **GROUND FAULT**

F3 Fire Alarm Sequence of Operation SCALE:NTS

NOTIFICATION APPLIANCE

CIRCUIT SHORT


/STROBE-STROBE PULL STATIONS -

TYPICAL DEVICE LOCATIONS

SMOKE DETECTOR -


Typical Fire Alarm Device Location

SCALE:NTS

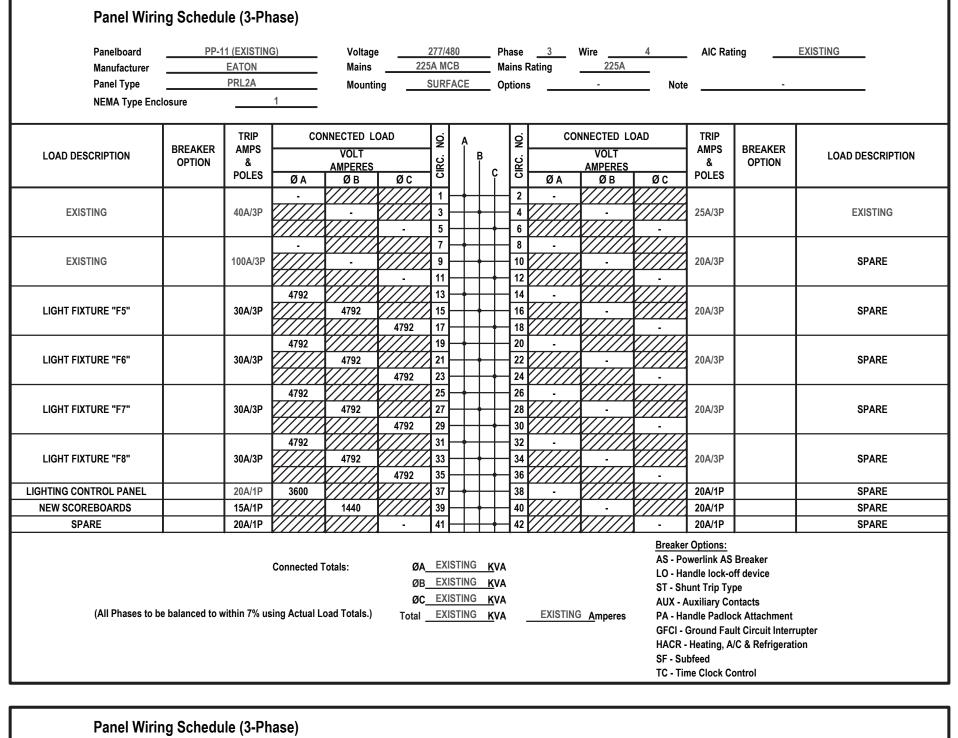

Panel Wirir	ıg Schedu	le (3-Ph	ase)										
Panelboard	ALPC (L	.EFT) (EXIS	TING)	Voltage	ı	120/20	08	Ph	ase	3 Wire 4_	AIC Rat	tina l	EXISTING
Manufacturer		EATON		Mains	-)A MC		_		Rating 225A			
Panel Type		PRL2a		Mountir	ng	SURF	ACE	Op	tions	· -	Note	-	
NEMA Type Encl	osure		1										_
LOAD DESCRIPTION	BREAKER OPTION	TRIP AMPS & POLES	© A	VOLT AMPERES ØB	Ø C	CIRC. NO.	A E	3 C	CIRC. NO.	CONNECTED LOAD VOLT AMPERES Ø A Ø B Ø	TRIP AMPS & POLES	BREAKER OPTION	LOAD DESCRIPTION
EXISTING SPARE		30A/1P	<u> </u>			11	+	+	2	· ////////////////////////////////////	20A/1P		EXISTING
CONVENIENCE RECEPTACLES		20A/1P				3	$\dashv \dashv$	+	4	///// - ///	20A/1P		EXISTING
EXISTING SPARE		20A/1P			-	5	+	+	6		- 20A/1P		EXISTING
EXISTING SPARE		20A/1P	-			7	\dashv	+	8	· ////////////////////////////////////	20A/1P		EXISTING SPARE
EXISTING SPARE		20A/1P		- 1		9	\dashv	+	10	///// - ///	20A/1P		EXISTING SPARE
EXISTING SPARE		20A/1P			-	11	+	_	12		- 20A/1P		EXISTING SPARE
EXISTING		20A/1P	· ·			13	\dashv	+	14	- /////////////////////////////////////	20A/1P		EXISTING SPARE
EXISTING		20A/1P				15	\dashv	+	16	///// - ///	30A/1P		EXISTING SPARE
EXISTING		20A/1P			-	17	+	_	18		- 20A/1P		EXISTING
EXISTING		20A/1P	· ·			19	\dashv	+	20	- /////////////////////////////////////	15A/1P		EXISTING
EXISTING		15A/1P				21	\dashv	\vdash	22	///// - ///	15A/1P		EXISTING
EXISTING		15A/1P			•	23	+	\rightarrow	24		- 15A/1P		EXISTING SPARE
EXISTING		15A/1P				25	\dashv	+	26	- <i>\\\\\\\\\\\\\\\\\\\\\\\\\\\\\\\\\\\\</i>	15A/1P		EXISTING SPARE
EXISTING		15A/1P	/////	-		27	\dashv	-	28	///// - ///	15A/1P	1	EXISTING SPARE
EXISTING		15A/1P				29	\dashv	\rightarrow	30		- 15A/1P		EXISTING SPARE
EXISTING		15A/1P				31	\dashv	+	32	· ////////////////////////////////////	15A/1P		EXISTING SPARE
EF-1,3	HACR	15A/1P	//////	684		33	\dashv	\vdash	34	///// - ///	15A/1P		EXISTING SPARE
					1300	35	\dashv	\rightarrow	36		- 15A/1P		EXISTING SPARE
EF-2	HACR	25A/1P	1300		/////	37	\dashv	\perp	38	• (////////////////////////////////////	/// 15A/1P		EXISTING SPARE
EXISTING SPARE		15A/1P	//////			39	\dashv	-	40	///// - ///	15A/1P		EXISTING SPARE
EXISTING SPARE		15A/1P				41	\dashv	\rightarrow	42		- 15A/1P		EXISTING SPARE
(All Phases to be	e balanced to v	vithin 7% us	Connected 1		ØA_ ØB_ ØC_ Total_		-	KVA KVA KVA KVA	-	- <u>A</u> mperes	Breaker Options: AS - Powerlink AS LO - Handle lock-c ST - Shunt Trip Ty AUX - Auxiliary Co PA - Handle Padlo GFCI - Ground Fau HACR - Heating, A SF - Subfeed TC - Time Clock C	off device pe ontacts ck Attachment alt Circuit Interru /C & Refrigeratio	

Panelboard	BLPD (L	EFT) (EXIS	TING)	Voltage	e	120/20)8	Р	hase	3	Wire	4	AIC Rat	ting	EXISTING
Manufacturer		EATON		Mains	150	OA MC	В	M	lains R		225A				
Panel Type		PRL2a		Mounti	ng	SURF	ACE	_ 0	ptions			Note			
NEMA Type Encl	osure		1												
LOAD DESCRIPTION	BREAKER OPTION	TRIP AMPS &	COI	NNECTED L	OAD	NO.	A E	 В	S. NO.	CC	ONNECTED L	OAD	TRIP AMPS &	BREAKER OPTION	LOAD DESCR
	OPTION	POLES	Ø A	AMPERES Ø B	ØС	CIRC.		Ç	CIRC.	ØΑ	AMPERES Ø B	ØС	POLES	OPTION	
EXISTING		15A/1P			/////	11	\dashv	₩	2	-			20A/1P		EXISTING S
CONVENIENCE RECEPTACLES		20A/1P	/////			3	\dashv	-	4	/////	.		20A/1P	1	EXISTING S
EXISTING		15A/1P		/////		5	+	\vdash	- 6		X/////		20A/1P	1	EXISTING S
EXISTING		15A/1P			/////	7	+	₩	- 8	•			20A/1P	1	EXISTING S
EXISTING		15A/1P				9	\dashv	₩	10	/////			20A/1P	1	EXISTIN
EXISTING		15A/1P				11	+	\vdash	12		X/////		20A/1P	1	EXISTIN
EXISTING		15A/1P			/////	13	+	₩	14	-			15A/1P		EXISTIN
EXISTING		15A/1P	/////			15	\dashv	\vdash	16	/////	.		15A/1P		EXISTIN
EXISTING		15A/1P		/////		17	+	\vdash	18		X/////		20A/1P	1	EXISTIN
EXISTING		15A/1P			/////	19	\dashv	\vdash	20	684	1////		15A/1P	HACR	EF-9, EF
EXISTING		15A/1P	/////			21	\dashv	\vdash	22	/////	/ · · · · · · · · · · · · · · · · · · ·		15A/1P		EXISTIN
EXISTING		15A/1P		/////	-	23	+	\vdash	24		X/////		15A/1P		EXISTIN
EXISTING		15A/1P			/////	25	+	₩	26	-			20A/1P		EXISTIN
EXISTING		15A/1P	/////			27	\dashv	\vdash	28	/////	1300		054/00	UACD	FF 44
EXISTING		15A/1P		/////	-	29	+	\vdash	30		X/////	1300	25A/2P	HACR	EF-11
EXISTING		15A/1P			/////	31	\dashv	\vdash	32	-			15A/1P		EXISTING S
EXISTING SPARE		15A/1P	/////			33	\dashv	\vdash	34	/////	1 .		15A/1P		EXISTING S
EXISTING		15A/1P		/////	-	35	+	\vdash	36		X/////		20A/1P		EXISTING S
EXISTING		15A/1P			/////	37	\dashv	\vdash	38	-			20A/1P		EXISTING S
EXISTING		15A/1P	/////			39	\dashv	\vdash	40	/////	.		15A/1P	1	EXISTING S
EXISTING SPARE		20A/1P		/////	-	41	+	\vdash	42		X/////		20A/1P		EXISTING S
(All Phases to be	balanced to w		Connected 1		•			KVA KVA KVA	\ \	-	<u>A</u> mperes	AS - Po LO - Ha ST - Sh AUX - A PA - Ha GFCI - (Ground Fau Heating, A	off device pe	

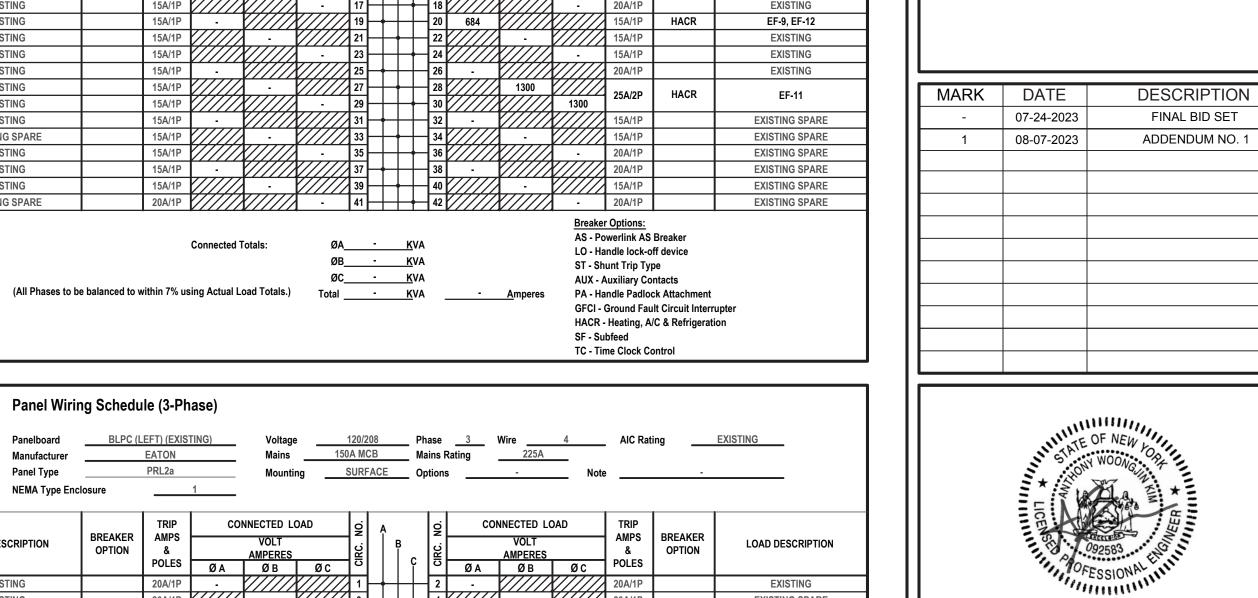

GFCI - Ground Fault Circuit Interrupter

HACR - Heating, A/C & Refrigeration

SF - Subfeed TC - Time Clock Control

Panelboard		10 (EXISTING)		Voltage		277/4	80	_	Phase			4	AIC Rat	ing	EXISTING
Manufacturer		EATON		Mains		MLO				Rating	100A				
Panel Type		PRL1A		Mounti	ng	SURF	ACE	— '	Option	·	-	Note	• ——		
NEMA Type End	closure		1												
LOAD DESCRIPTION	BREAKER OPTION	TRIP AMPS & POLES	COI Ø A	NNECTED LO VOLT AMPERES Ø B	OAD Ø C	CIRC. NO.	Ā	B C	CIRC. NO.	CON Ø A	VOLT AMPERES Ø B	OAD Ø C	TRIP AMPS & POLES	BREAKER OPTION	LOAD DESCRIPTION
EXISTING		20A/1P	-	177777	17777	11	\rightarrow	++	_ 2	-	177777	17777	20A/1P		EXISTING
EXISTING	1	20A/1P	/////			3	+	+	4				20A/1P		EXISTING
EXISTING		20A/1P		/////		5	+	+	 6		/////		20A/1P		EXISTING
EXISTING		20A/1P				7	\rightarrow	++	- 8	3600			20A/1P		LIGHTING CONTROL PANI
SPARE		20A/1P		· ·		9	+	+	10		· ·		20A/1P		SPARE
SPARE		20A/1P				11	+	+	12				20A/1P		SPARE
EXISTING		20A/1P	· ·			13	+	++	14	· ·			20A/1P		SPARE
EXISTING		20A/1P		-		15	+	+	16		-		20A/1P		SPARE
EXISTING		20A/1P			-	17	+	+	18				20A/1P		SPARE
SPARE		20A/1P				19	\dashv	++	20	-			20A/1P		SPARE
SPARE		20A/1P				21	+	+	22				20A/1P		SPARE
SPARE		20A/1P			-	23	+	++	24			-	20A/1P		SPARE
SPACE		-	-			25	+	++	26	360			15A/1P		SCOREBOARD 1
SPACE		-		-		27	+	+	28		360		15A/1P		SCOREBOARD 2
SPACE		-			-	29	\pm	++	30			-	-		SPACE
(All Phases to b	pe balanced to w	vithin 7% us	Connected 1		ØB	EXI:	STING STING	3 KV 3 KV 3 KV	A	EXISTING	<u>A</u> mperes	AS - Po LO - Ha ST - Sh AUX - A PA - Ha GFCI - 6	Ground Fau Heating, A	ff device pe intacts ck Attachment ilt Circuit Interru /C & Refrigerati	

LOAD DESCRIPTION	BREAKER OPTION	TRIP AMPS &	со	NNECTED L	OAD	S.	A	B		ا ج		NECTED LO	DAD	TRIP AMPS &	BREAKER OPTION	LOAD DESCRIPT
		POLES	ØA	AMPERES Ø B	ØС	CIRC.		9	; E	┋┝	ØA	AMPERES Ø B	ØС	POLES		
EXISTING		15A/1P		/////	/////	1	Ή	+		2	- 1	/////		40A/1P		EXISTING SPAF
EXISTING		15A/1P	/////			3	⊣	+		4	/////	-		20A/1P		EXISTING SPAF
EXISTING		15A/1P		/////		5	₩	┵	⊢ [•	6	////	//////		20A/1P		EXISTING
EXISTING SPARE		20A/2P	/////	/////		7			_ ⊢	8		//////		20A/2P		EXISTING SPAR
CONVENIENCE RECEPTACLES		20A/1P		1/////		11	₩	\dashv	<u> </u>	12		//////		20A/1P		EXISTING SPAR
EXISTING SPARE		20A/1P			/////	13	₩	+	<u> </u>	4	- 1			20A/1P		EXISTING SPAR
EXISTING SPARE		20A/1P	/////			15	⊣	+	— 1	16	/////	-		20A/1P		EXISTING SPAF
EXISTING SPARE		20A/1P		//////		17	₩	┵	<u> </u>	18	/////	//////		20A/1P		EXISTING SPAR
EXISTING		20A/1P			/////	19	₩	+	<u> </u>	20	· ·			20A/1P		EXISTING SPAR
EXISTING SPARE		20A/1P				21	₩	+	<u> </u>	22		-		20A/1P		EXISTING
EF-4,6	HACR	15A/1P		<i>\\\\\\</i>	684	23	₩	╫	<u> </u>	24	/////	/////	-	15A/1P		EXISTING
FF F	HACR	05 A /0D	1300	V/////		25	₩	+	<u> </u>	26	· ·			15A/1P		EXISTING
EF-5	HACK	25A/2P		1300		27	\vdash	+	<u> </u>	28		•		15A/1P		EXISTING SPAR
EXISTING SPARE		15A/1P		<i>\\\\\\</i>	-	29	₩	┦┦	<u> </u>	30	/////	/////		15A/1P		EXISTING SPAF
EXISTING		15A/1P		V/////	<i>\\\\\\\</i>	31	₩	+	<u> </u>	32	· ·			15A/1P		EXISTING SPAF
EXISTING		15A/1P		<u> </u>		33	\vdash	+	 3	34				15A/1P		EXISTING SPAR
EXISTING SPARE		15A/1P		<i>\/////</i>		35	${\mathbb H}$	+	<u> </u>	36	/////		-	15A/1P		EXISTING SPAF
						37	\vdash	+	— [3	38				15A/1P		EXISTING SPAF
EXISTING		40A/3P		1		39	\vdash	+	— [4	10		-		15A/1P		EXISTING SPAF
				<i>X/////</i>	-	41	\vdash	╫	4	12	/////		-	15A/1P		EXISTING SPAR
			Connected -	Totals:	- ØA	41	<u>⊢</u>	H K	⊢ 4 VA	12	/////	//////	AS - Po	15A/1P Options: werlink AS ndle lock-o		EXISTI

HACR - Heating, A/C & Refrigeration

SF - Subfeed TC - Time Clock Control

Panel Type NEMA Type Enc	1	Mount	ing	SURFA	CE	Options		-	Note		-			
LOAD DESCRIPTION	BREAKER OPTION	TRIP AMPS & POLES	Ø A	VOLT AMPERES Ø Ø Ø Ø B		CIRC. NO.	А в р	CIRC. NO.	Ø A	VOLT AMPERES Ø B	AD Ø C	TRIP AMPS & POLES	BREAKER OPTION	LOAD DESCRIPTION
EXISTING		20A/1P	-	1/////	X/////	11	+	_ 2		1/////	77777	20A/1P		EXISTING
EXISTING		20A/1P	/////	/////	1/////	3	+++	4	/////	1		20A/1P		EXISTING SPARE
EXISTING		20A/1P		X/////		5	+++	6		X////X		20A/1P		EXISTING
CONVENIENCE RECEPTACLES		20A/1P	.	1////	X/////	7	+ + +	8	· · · · · · ·	1////	/////	20A/1P		EXISTING
EXISTING SPARE		20A/1P	/////	/////	1/////	9	+++	10	/////	******		20A/1P		EXISTING
EXISTING SPARE		20A/1P		X/////		111-	+++	12		X////X	•	20A/1P		EXISTING
EXISTING		20A/1P			X/////	13	+	14	<u> </u>	1////	/////	20A/1P		EXISTING
EXISTING		15A/1P	/////	1 .	1////	15	++	16	/////	/////////////////////////////////////		15A/1P		EXISTING
EXISTING		15A/1P		X/////		17	+++	18		X////X				
EXISTING		15A/1P	<i> </i>	1////	X/////	19	+	20	<u> </u>	1////	/////	15A/2P		EXISTING
EXISTING		15A/1P	/////	/////	1////	21	+++	22	/////	1		15A/1P		EXISTING
EXISTING		15A/1P		X/////		23	+++	24		X////X	768	15A/1P	HACR	EF-8
EXISTING		15A/1P		1////	X/////	25	+ + +	26	 	1////	/////	15A/1P		EXISTING SPARE
EXISTING		15A/1P	/////	/////	1/////	27	+++	28	/////			15A/1P		EXISTING SPARE
EXISTING		15A/1P		X/////		29	+++	30		X////X	· ·	15A/1P		EXISTING SPARE
EF-7,10	HACR	15A/1P	684	1////	X/////	31	+ + +	32	.	1////	/////	15A/1P		EXISTING SPARE
EXISTING		15A/1P	/////	/////	1/////	33	+++	34	/////	1		15A/1P		EXISTING SPARE
EXISTING		15A/1P		X/////	1 .	35 –	+++	36		X////X		15A/1P		EXISTING SPARE
EXISTING		15A/1P	-	V////	X/////	37	+	38	<u>.</u>	1////	/////	15A/1P		EXISTING SPARE
EXISTING		15A/1P	/////	7	1/////	39	+++	40	/////	7		15A/1P		EXISTING SPARE
EXISTING		15A/1P		X////	7	41	+++	42		X////X		15A/1P		EXISTING SPARE
			Connected	Totals:	_						AS - Po LO - Ha	Options: werlink AS ndle lock-o unt Trip Ty	ff device	



LK/SAN

WPSD 2206 AUGUST 2023 AS SHOWN

White Plains City School

District

WHITE PLAINS HIGH SCHOOL **UPGRADES AND TURF FIELD**

LK/SAN

engineers

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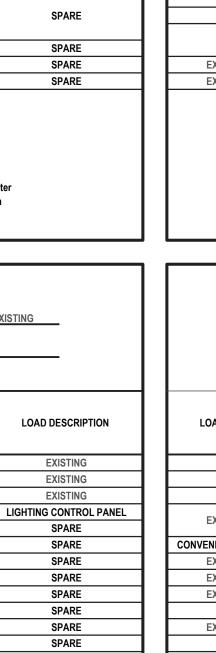
SED No. 66-22-00-01-0-16-029

CONTRACT E ELECTRICAL CONSTRUCTION

FINAL BID SET

ELECTRICAL PANEL SCHEDULES

E 201.00



Panel Wiring Schedule (3-Phase)

Manufacturer		EATON		Mains		OA MO				Rating	125A		AIC Rat		
Panel Type		PRL2a			ng	SURF	ACE	— º	ptions	·	•	Note	·	•	
NEMA Type End	losure		1												
LOAD DESCRIPTION	BREAKER OPTION	TRIP AMPS & POLES		NECTED LO VOLT AMPERES Ø B	OAD Ø C	CIRC. NO.	A	в ç	CIRC. NO.	CO Ø A	NNECTED VOLT AMPERES		TRIP AMPS & POLES	BREAKER OPTION	LOAD DESCRIPTION
EXISTING		20A/1P	1 .	/////		1	\vdash	₩	2	-		X/////	20A/1P		EXISTING
EF-13	HACR	25A/1P	/////	1380		3	\vdash	+	4	/////	1 .		20A/1P		EXISTING
EXISTING		20A/1P	1////	/////		5	\vdash	\vdash	- 6		1////	/////////////////////////////////////	20A/1P		EXISTING
EXISTING		20A/1P	1		/////	7	\vdash	-	8	-		X/////	20A/1P		EXISTING
EXISTING		20A/1P	1////	-		9	\vdash	++	10	/////	1	1/////	20A/1P		EXISTING
CONVENIENCE RECEPTACLES		20A/1P	V////X	//////		11		\vdash	12		1////	1 .	20A/1P		EXISTING
EXISTING		20A/1P	1 . 1		/////	13	\vdash	-	14			X/////	001/00		=======================================
EXISTING		20A/1P	/////	-		15	\vdash	+	16	/////	1 .	1/////	20A/2P		EXISTING
EXISTING		15A/1P	V////X	//////		17	\vdash	\vdash	18		1////	1 .	15A/1P		EXISTING
EXISTING		15A/1P	1		/////	19	\vdash	-	20	•		X/////	15A/1P		EXISTING
EXISTING		15A/1P	/////	-		21	\vdash	₩.	22	/////	1 .		15A/1P		EXISTING
EXISTING		15A/1P	V////X	/////		23	\vdash	\vdash	24		1////	1 .	15A/1P		EXISTING
EXISTING		15A/1P	1		/////	25	\vdash	-	26	-		X/////	15A/1P		EXISTING
EF-14	HACR	15A/1P	/////	768		27	\vdash	\vdash	28	/////	1 .		15A/1P		EXISTING
EF-15	HACR	15A/1P	V////X	/////	768	29	\vdash	\vdash	30		1////	7 .	15A/1P		EXISTING SPARE
EXISTING		15A/1P	T			31	\vdash	₩	32	-		X/////	15A/1P		EXISTING
EF-16	HACR	15A/1P		342		33	\vdash	┿	34	//////	1		15A/1P		EXISTING SPARE
EXISTING SPARE		15A/1P	V////X	/////		35	$\vdash\vdash$	\vdash	36		X////	7	15A/1P		EXISTING SPARE
EXISTING SPARE		15A/1P	T			37	\vdash	\vdash	38	-	V////	X/////	15A/1P		EXISTING SPARE
EXISTING		15A/1P	V/////	-		39	\vdash	+	40	/////	1 .	V/////	15A/1P		EXISTING SPARE
EXISTING SPARE		15A/1P	V/////	//////		41	\vdash	\vdash	42		X/////	7	15A/1P		EXISTING SPARE

ST - Shunt Trip Type AUX - Auxiliary Contacts

SF - Subfeed TC - Time Clock Control

PA - Handle Padlock Attachment GFCI - Ground Fault Circuit Interrupter HACR - Heating, A/C & Refrigeration

Panel Wiring Schedule (3-Phase)

(All Phases to be balanced to within 7% using Actual Load Totals.)