

**SB100.00**

RECORD OF SURFACE EXPLORATION  
1962, Bogs 11/202RECORD OF SURFACE EXPLORATION  
1962, Bogs 11/2/20RECORD OF SURFACE EXPLORATION  
1962 Logs 11/2/20RECORD OF SUBSURFACE EXPLORATION  
10462\_logs 11/2/20RECORD OF SUBSURFACE EXPLORATION  
19852, Block 11/2/20RECORD OF SUBSURFACE EXPLORATION  
19952, Bore 11/2/05

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+  
engineers

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CONSULTANTS:

[illegible]


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DESIGNED BY:	DRAWN BY:	CHECKED BY:	REVIEWED BY:
PROJECT No.: WPSD 2206		DATE: AUGUST 2023	SCALE: AS SHOWN

#### CLIENT

CLIENT **White Plains City School District**

## WHITE PLAINS HIGH SCHOOL UPGRADES AND TURF FIELD

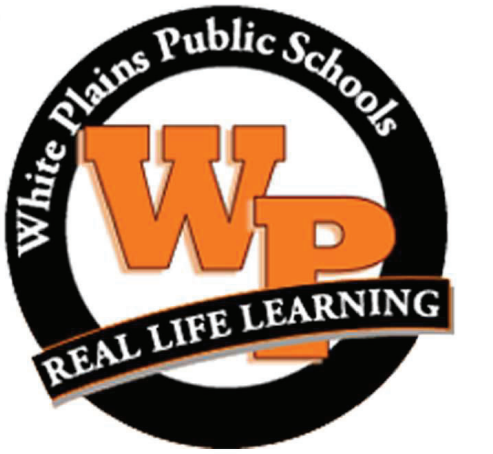

**550 North Street  
White Plains, NY 10605**

**SED No. 66-22-00-01-0-16-029**

CONTRACT

**CONTRACT C**  
**CIVIL AND SITE WORK**

STATUS


**FINAL BID SET**

SHEET TITLE

**GRADING & DRAINAGE AND  
EROSION & SEDIMENT CONTROL  
PLAN  
UPPER FIELD**

DRAWING No.

**C 100.00**

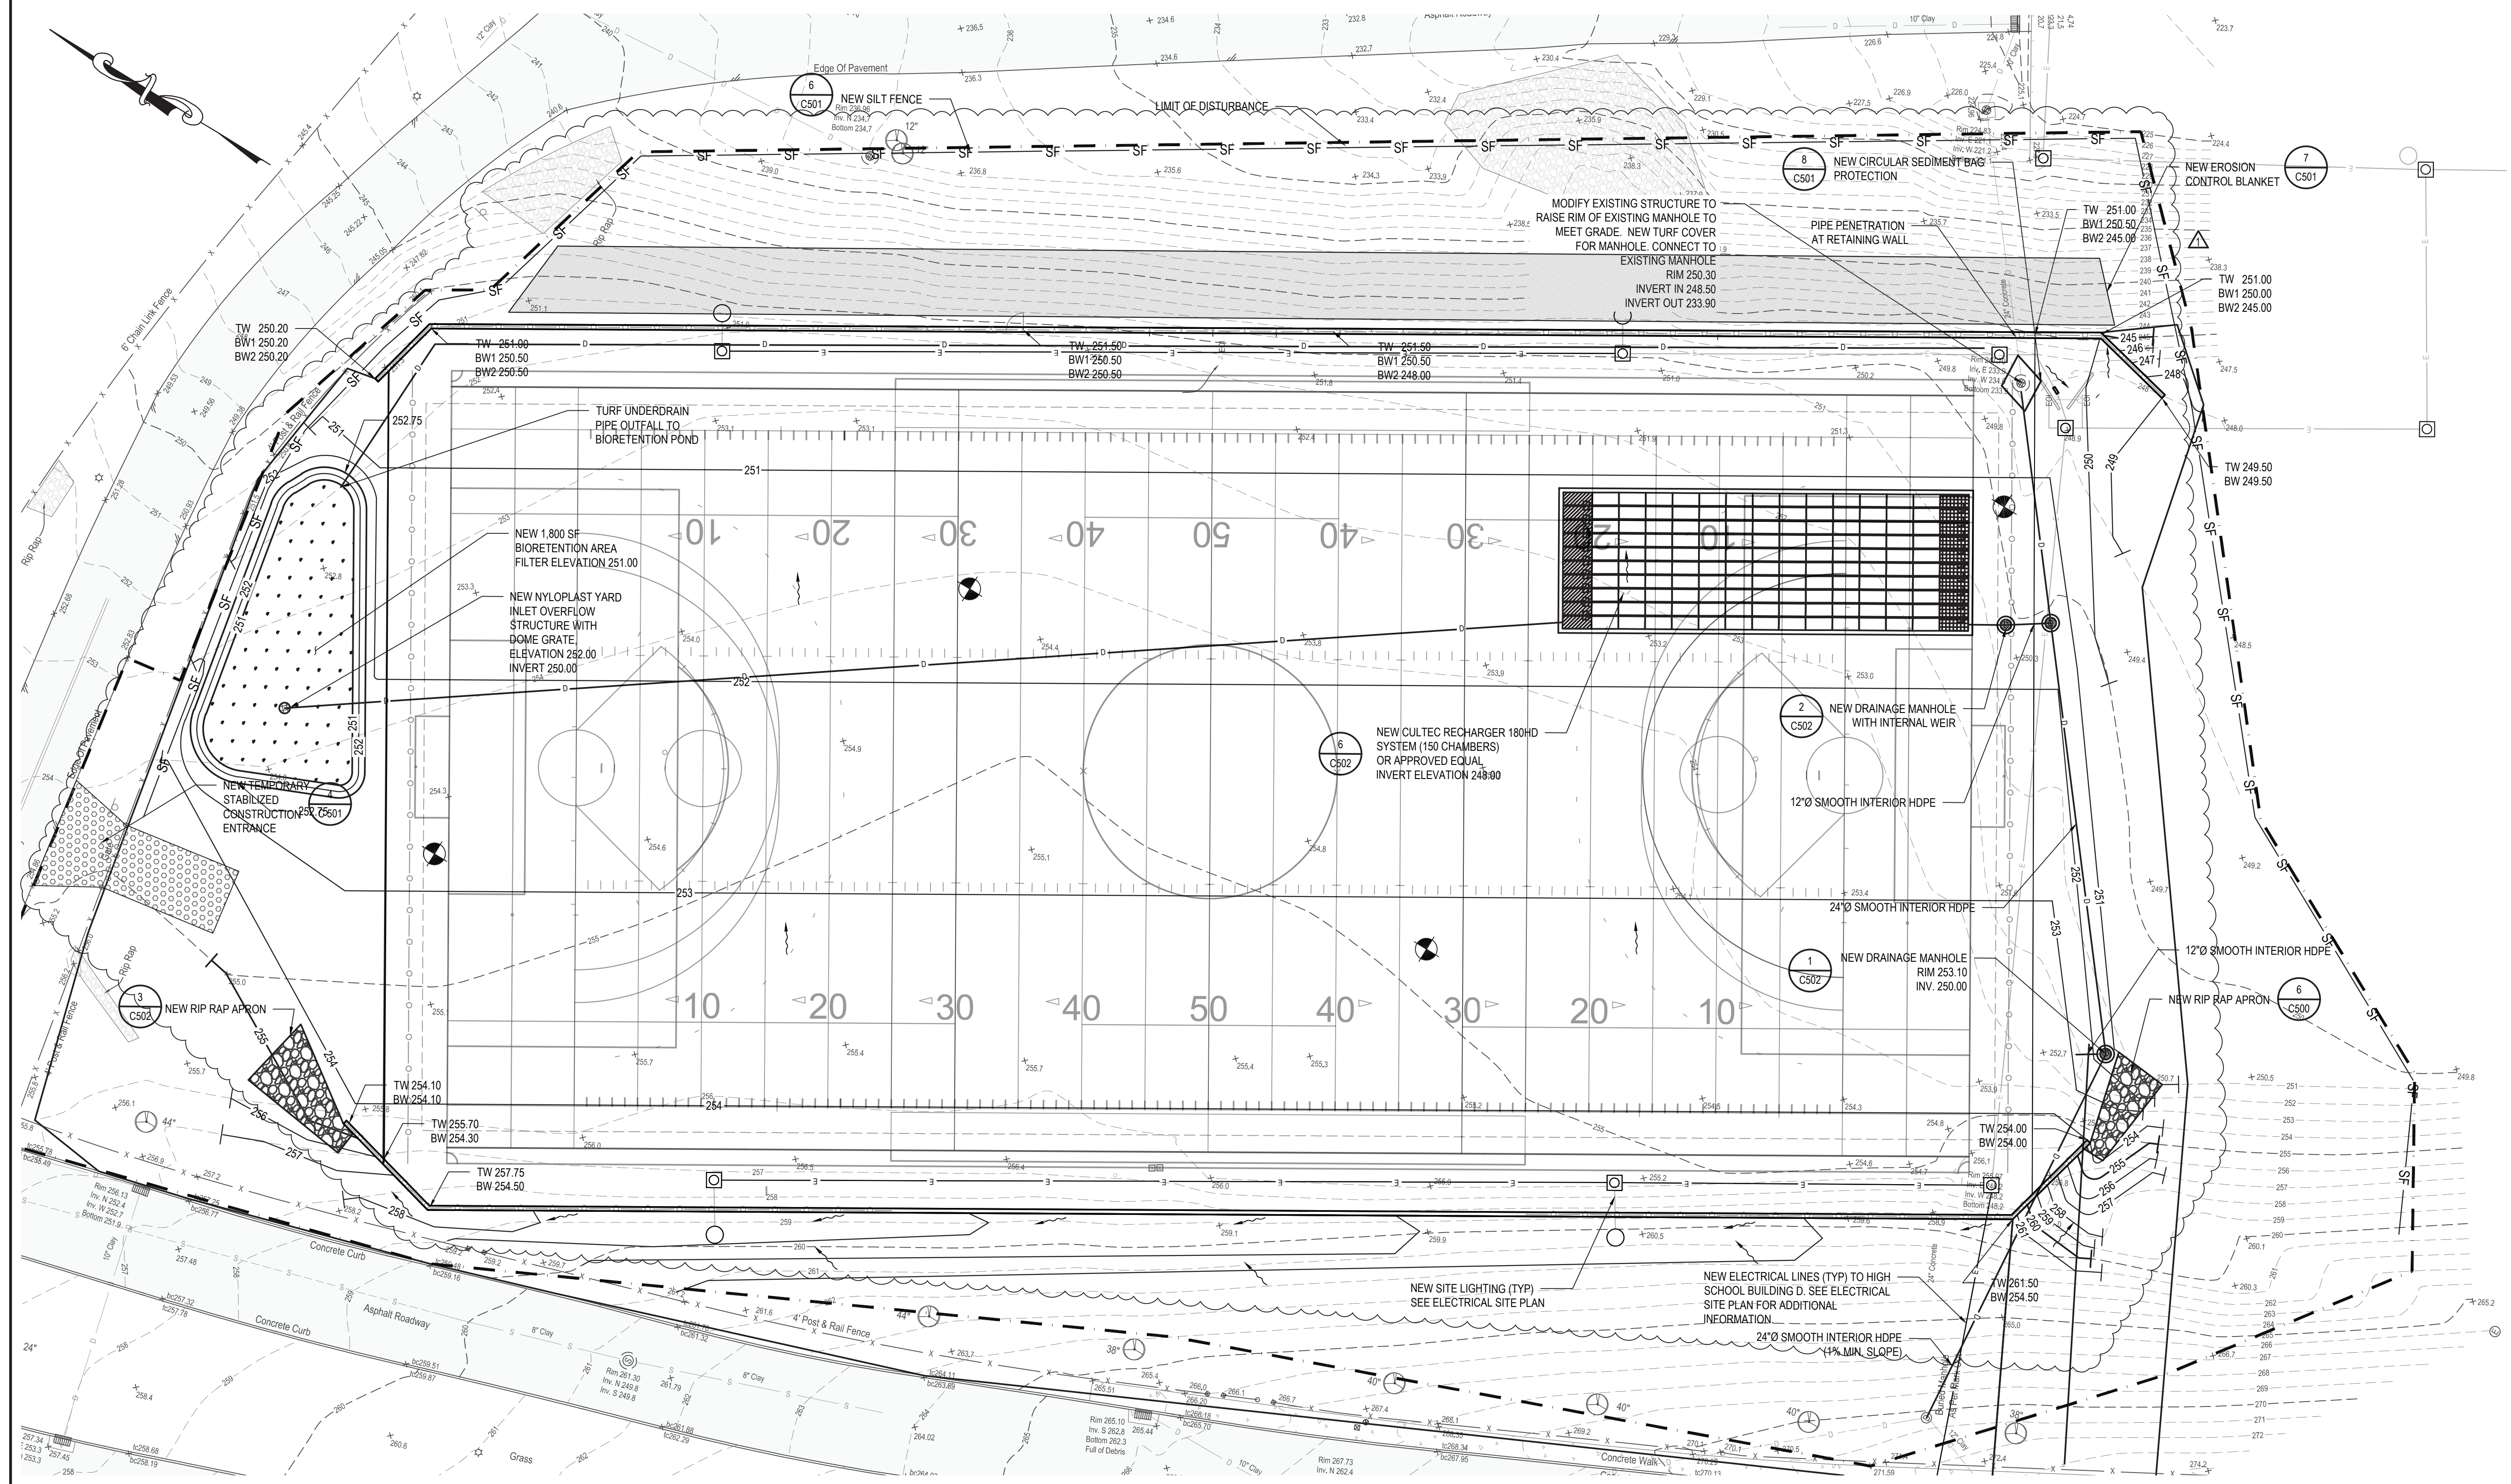

**GRADING AND DRAINAGE NOTES:**

1. FOR NEW CONSTRUCTION THAT MEETS EXISTING CONDITIONS, ABUTTING SURFACES SHALL BE FLUSH AND ALIGNED.
2. ADJUST ALL EXISTING CASTINGS AND VALVE COVERS TO MEET PROPOSED GRADE.
3. CONSTRUCTION DEBRIS AND EXCESS SOIL SHALL BE REMOVED AND LEGALLY DISPOSED OFF SITE.
4. UNSUITABLE SOILS ENCOUNTERED DURING CONSTRUCTION SHALL BE BROUGHT TO THE ATTENTION OF THE OWNER AND ENGINEER IMMEDIATELY IN WRITING BEFORE REMOVAL OR DISTURBANCE.

**PIPE MATERIAL SPECIFICATIONS:**

- LINEAR LEACHING CHAMBERS TO MANHOLE CONNECTION: 12" Ø SMOOTH INTERIOR HDPE
- MANHOLE TO HYDRODYNAMIC SEPARATOR CONNECTION: 12" Ø SMOOTH INTERIOR HDPE
- MANHOLE TO MANHOLE CONNECTION: 24" Ø SMOOTH INTERIOR HDPE


811 1-800-962-7962  
Dig Safely. New York  
**Call 811**  
before you dig  
[www.digsafelynewyork.com](http://www.digsafelynewyork.com)

EROSION CONTROL NOTES:

1. DURING THE COURSE OF CONSTRUCTION, EROSION AND SEDIMENT CONTROL MEASURES ARE NECESSARY TO PREVENT THE TRANSPORT OF SEDIMENT TO UNDISTURBED AREAS, PONDS, WATER COURSES, DRAINAGE SYSTEMS, RECHARGE BASINS, AND ROADS. THE MINIMUM EROSION CONTROL MEASURES REQUIRED ARE INDICATED ON THIS PLAN. IN ADDITION, THE FOLLOWING GENERAL CONDITIONS SHALL BE OBSERVED:
  - a. EXISTING VEGETATION SCHEDULED TO REMAIN SHALL BE PROTECTED AND REMAIN UNDISTURBED.
  - b. INSTALL ADDITIONAL EROSION AND SEDIMENT CONTROL MEASURES AS REQUIRED TO PREVENT THE INCIDENTAL DISCHARGE OF SEDIMENT FROM THE SITE.
2. SPECIFIC METHODS AND MATERIALS EMPLOYED IN THE INSTALLATION AND MAINTENANCE OF EROSION CONTROL MEASURES MUST CONFORM TO THE LATEST EDITION OF THE "NEW YORK STATE STANDARDS AND SPECIFICATIONS FOR EROSION AND SEDIMENT CONTROL".
3. INSTALL PROPRIETARY EROSION AND SEDIMENT CONTROL PRODUCTS IN ACCORDANCE WITH MANUFACTURERS INSTRUCTIONS.
4. ADJUST EROSION AND SEDIMENT CONTROL MEASURES TO ACCOMMODATE CONSTRUCTION PHASING TO MAINTAIN EFFECTIVENESS OF EROSION AND SEDIMENT CONTROL MEASURES.
5. PROTECT EXISTING DRAINAGE INLETS WITHIN THE PROJECT LIMITS AND NEW DRAINAGE INLETS INSTALLED AS PART OF THIS PROJECT FROM SEDIMENT INTRUSION.

6. PERFORM INSPECTION AND MAINTENANCE OF EROSION AND SEDIMENT CONTROL MEASURES ON A WEEKLY BASIS AND AFTER HEAVY OR PROLONGED STORMS. MAINTENANCE MEASURES INCLUDE, BUT ARE NOT LIMITED TO, CLEANING AND REPAIR OF ALL EROSION AND SEDIMENT CONTROL MEASURES.
7. UTILIZE APPROPRIATE MEANS TO CONTROL DUST DURING CONSTRUCTION, INCLUDING BUT NOT LIMITED TO APPLYING WATER TO BARE SOIL SURFACES.
8. MAINTAIN THE STABILIZED CONSTRUCTION ENTRANCE TO PREVENT SOIL AND LOOSE DEBRIS FROM BEING TRACKED ONTO LOCAL ROADS. MAINTAIN THE CONSTRUCTION ENTRANCE WEEKLY UNTIL THE SITE IS PERMANENTLY STABILIZED.
9. ALL EROSION AND SEDIMENT CONTROL MEASURES SHALL REMAIN IN PLACE UNTIL DISTURBED AREAS ARE PERMANENTLY STABILIZED. AFTER PERMANENT STABILIZATION, REMOVE ALL TEMPORARY EROSION AND SEDIMENT CONTROL MEASURES AND ALL ACCUMULATED SEDIMENT AND DEBRIS FROM THE SITE AND DRAINAGE STRUCTURES.

**TOTAL LAND DISTURBANCE = 3.18 ACRES**

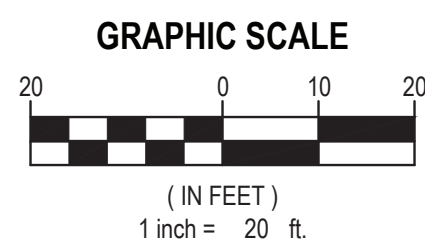

## STORMWATER POLLUTION PREVENTION PLAN (SWPPP)






NOTES:

1. PURSUANT TO THE REQUIREMENTS OF SPODES GENERAL PERMIT FOR CONSTRUCTION ACTIVITY (GP-02-001) ESTABLISHED BY THE NEW YORK STATE DEPARTMENT OF ENVIRONMENTAL CONSERVATION, A STORMWATER POLLUTION PREVENTION PLAN (SWPPP) HAS BEEN PREPARED FOR THIS PROJECT. ADHERE TO AND IMPLEMENT ALL REQUIREMENTS OF THE SWPPP AND EROSION AND SEDIMENT CONTROL PLAN.
2. REVIEW THE SWPPP AND SIGN IN THE LOCATION SHOWN STATING THAT ALL WORK PERTAINING TO EROSION AND SEDIMENT CONTROL, WILL BE PERFORMED WITH REQUIREMENTS OF THE SWPPP AND EROSION AND SEDIMENT CONTROL PLAN.
3. THE OWNER SHALL PROVIDE A QUALIFIED INSPECTOR WHO WILL PERFORM WEEKLY INSPECTIONS AT THE CONSTRUCTION SITE. THE QUALIFIED INSPECTOR SHALL MEET THE REQUIREMENTS OUTLINED IN SPODES GENERAL PERMIT FOR STORMWATER DISCHARGE FROM CONSTRUCTION ACTIVITY (GP-02-001). IF THE INSPECTIONS FIND ANY DEVIATIONS FROM THE SWPPP OR THE EROSION AND SEDIMENT CONTROL PLAN IT WILL BE NOTED. THE CONTRACTOR WILL HAVE 7 DAYS TO CORRECT ANY DEVIATIONS SO THAT IT COMPLIES WITH THE REQUIREMENTS OF THE SWPPP AND OR EROSION AND SEDIMENT CONTROL PLAN. IN THE EVENT THAT MORE THAN 5 ACRES OF SOIL IS DISTURBED AT ANY TIME, 2 WEEKLY INSPECTIONS WILL BE PERFORMED.


### GRADING AND DRAINAGE LEGEND

DESCRIPTION	SYMBOL
SPOT ELEVATION	121.50
TOP AND BOTTOM CURB ELEVATION	TC140.00 BC139.50
MAJOR CONTOUR	240
MINOR CONTOUR	241
BORING / TEST HOLE LOCATION	
RETAINING WALL	
FIELD INLET	
DRAINAGE MANHOLE	
FLOW ARROW	
DRAINAGE LINE	D ————— D
ELECTRIC LINE	E ————— E
WATER LINE	W ————— W
WATER SERVICE LINE	WS ————— WS
NEW RIP RAP	

### EROSION CONTROL LEGEND


DESCRIPTION	SYMBOL
NEW SILT FENCE	
LIMIT OF DISTURBANCE	
NEW INLET SEDIMENT BAG PROTECTION	
NEW STABILIZED CONSTRUCTION ENTRANCE	
NEW EROSION CONTROL BLANKET	



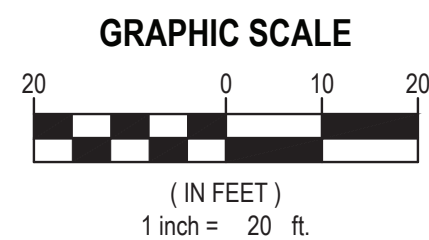

### **SITE PLAN NOTES:**

1. INSPECT THE SITE PRIOR TO SUBMISSION OF BIDS AND MAKE NO ADDITIONAL CLAIMS REGARDING SITE CONDITIONS THEREAFTER.
2. NOTIFY THE OWNER AND H2M (TELEPHONE 631-756-8000) AT LEAST 48 HOURS PRIOR TO THE COMMENCEMENT OF THE WORK. THE SAME NOTICE SHALL BE REQUIRED WHEN RESUMING WORK AFTER ANY STOPPAGE OR DELAY.
3. COMPLETE ALL SURVEY AND STAKEOUT AS REQUIRED TO PROPERLY COMPLETE THE WORK.
4. PERFORM DAILY CLEANUP OPERATIONS INCLUDING REMOVAL OF DEBRIS AND EXCESS CONSTRUCTION MATERIAL, AND DRIVEWAY/STREET CLEANING TO THE SATISFACTION OF THE OWNER.
5. DURING ALL NON-WORKING HOURS, STORE ALL EQUIPMENT AND MATERIALS WITHIN AN AREA DESIGNATED BY THE OWNER AT THE PROJECT SITE.
6. ALL CURB DIMENSIONS SHOWN REFER TO THE FACE OF CURB.
7. ALL CONSTRUCTION TO CONFORM WITH ALL APPLICABLE FEDERAL, STATE AND LOCAL CODE REQUIREMENTS.
8. COORDINATE CONSTRUCTION ACTIVITIES WITH OWNER TO MINIMIZE INTERRUPTION TO THE OWNER'S OPERATIONS.
9. RESTORE SURROUNDING AREAS DAMAGED OR DISTURBED DURING CONSTRUCTION. RESTORE TO NEW CONDITIONS AT NO ADDITIONAL COST TO THE OWNER.
10. RESTORE ALL DISTURBED GRASS AREAS AND ALL AREAS NOT SPECIFICALLY IDENTIFIED FOR OTHER IMPROVEMENTS WITH 6 INCHES OF TOPSOIL AND HYDROSEED.



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CONSULTANTS:

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DESIGNED BY: <b>KAK</b>	DRAWN BY: <b>NR</b>	CHECKED BY: <b>KAK</b>	REVIEWED BY:
PROJECT NO: <b>WPSD 2206</b>	DATE: <b>AUGUST 2023</b>	SCALE: <b>AS SHOWN</b>	

CLIENT

**White Plains City School District**

## WHITE PLAINS HIGH SCHOOL UPGRADES AND TURF FIELD



**550 North Street  
White Plains, NY 10605**

**SED No. 66-22-00-01-0-16-029**

CONTRACT

**CONTRACT C**

**CIVIL AND SITE WORK**

STATUS	FINAL BID SET
--------	---------------

SHEET TITLE


**DIMENSIONAL SITE PLAN  
UPPER FIELD**

DRAWING No.


**CS 100.00**

X:\WPSD (White Plains Central School District) - 10691\WPSD 2206 - (High School Upgrades and Turf Field)\02-BIM-CADD\Con-docs\to\ICS 100 Dimensional Site Plandwg Last Modified: Aug 04, 2023 - 4:10pm Plotted on: Aug 04, 2023 - 4:11pm By: wackermann




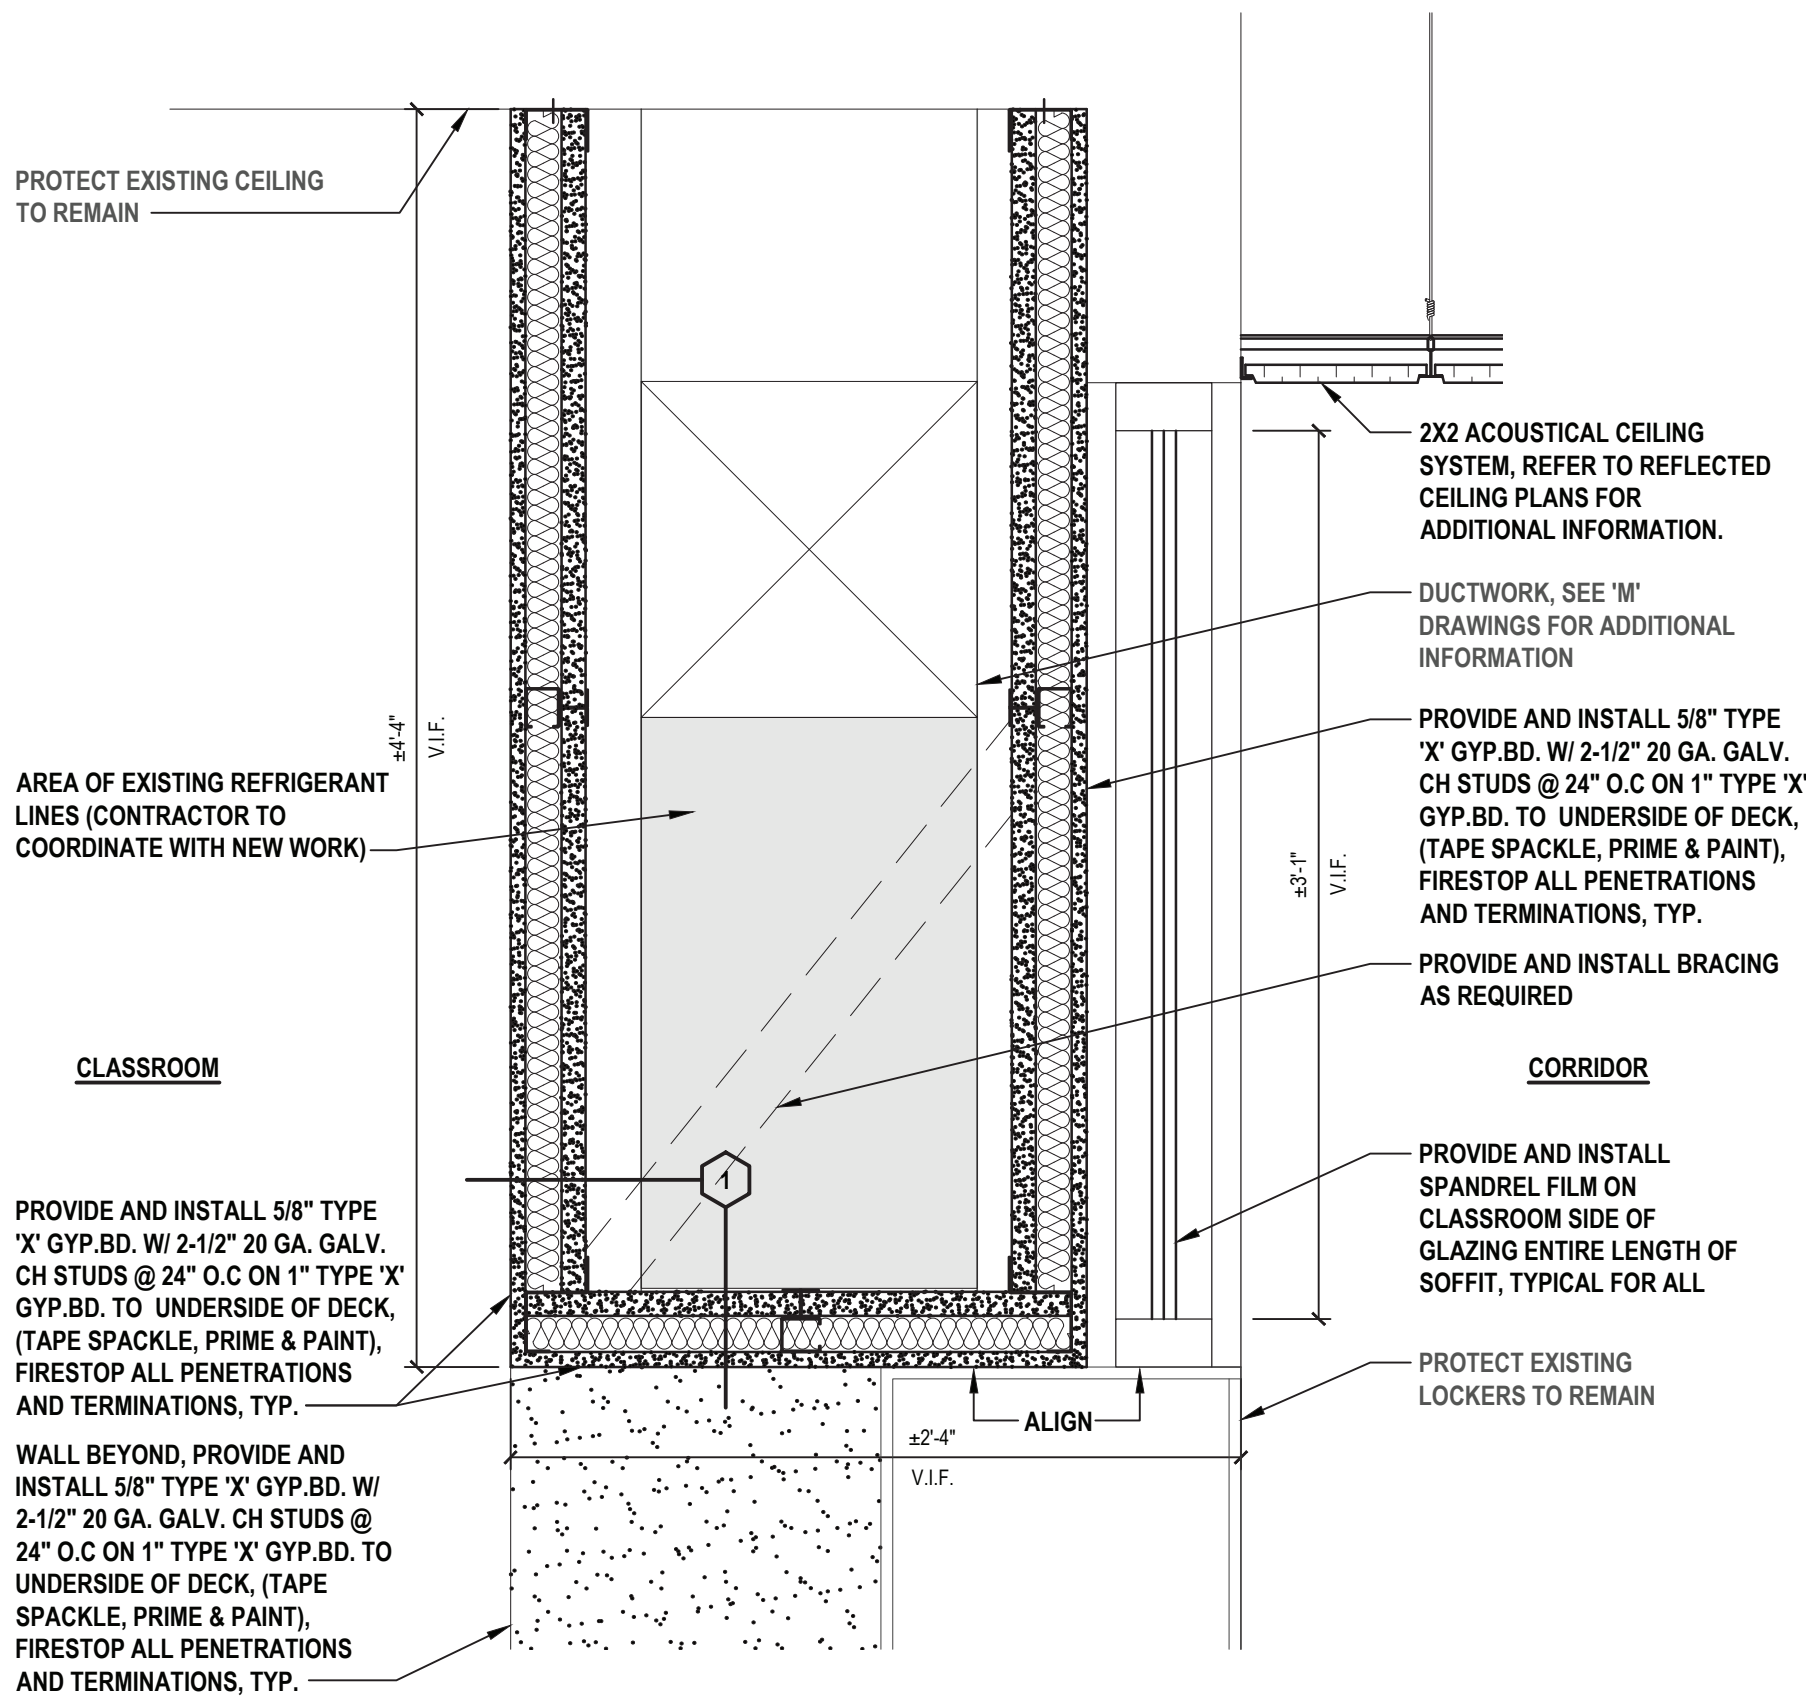


1 Typical Soffit Detail  
SCALE: 1-1/2" = 1'-0"

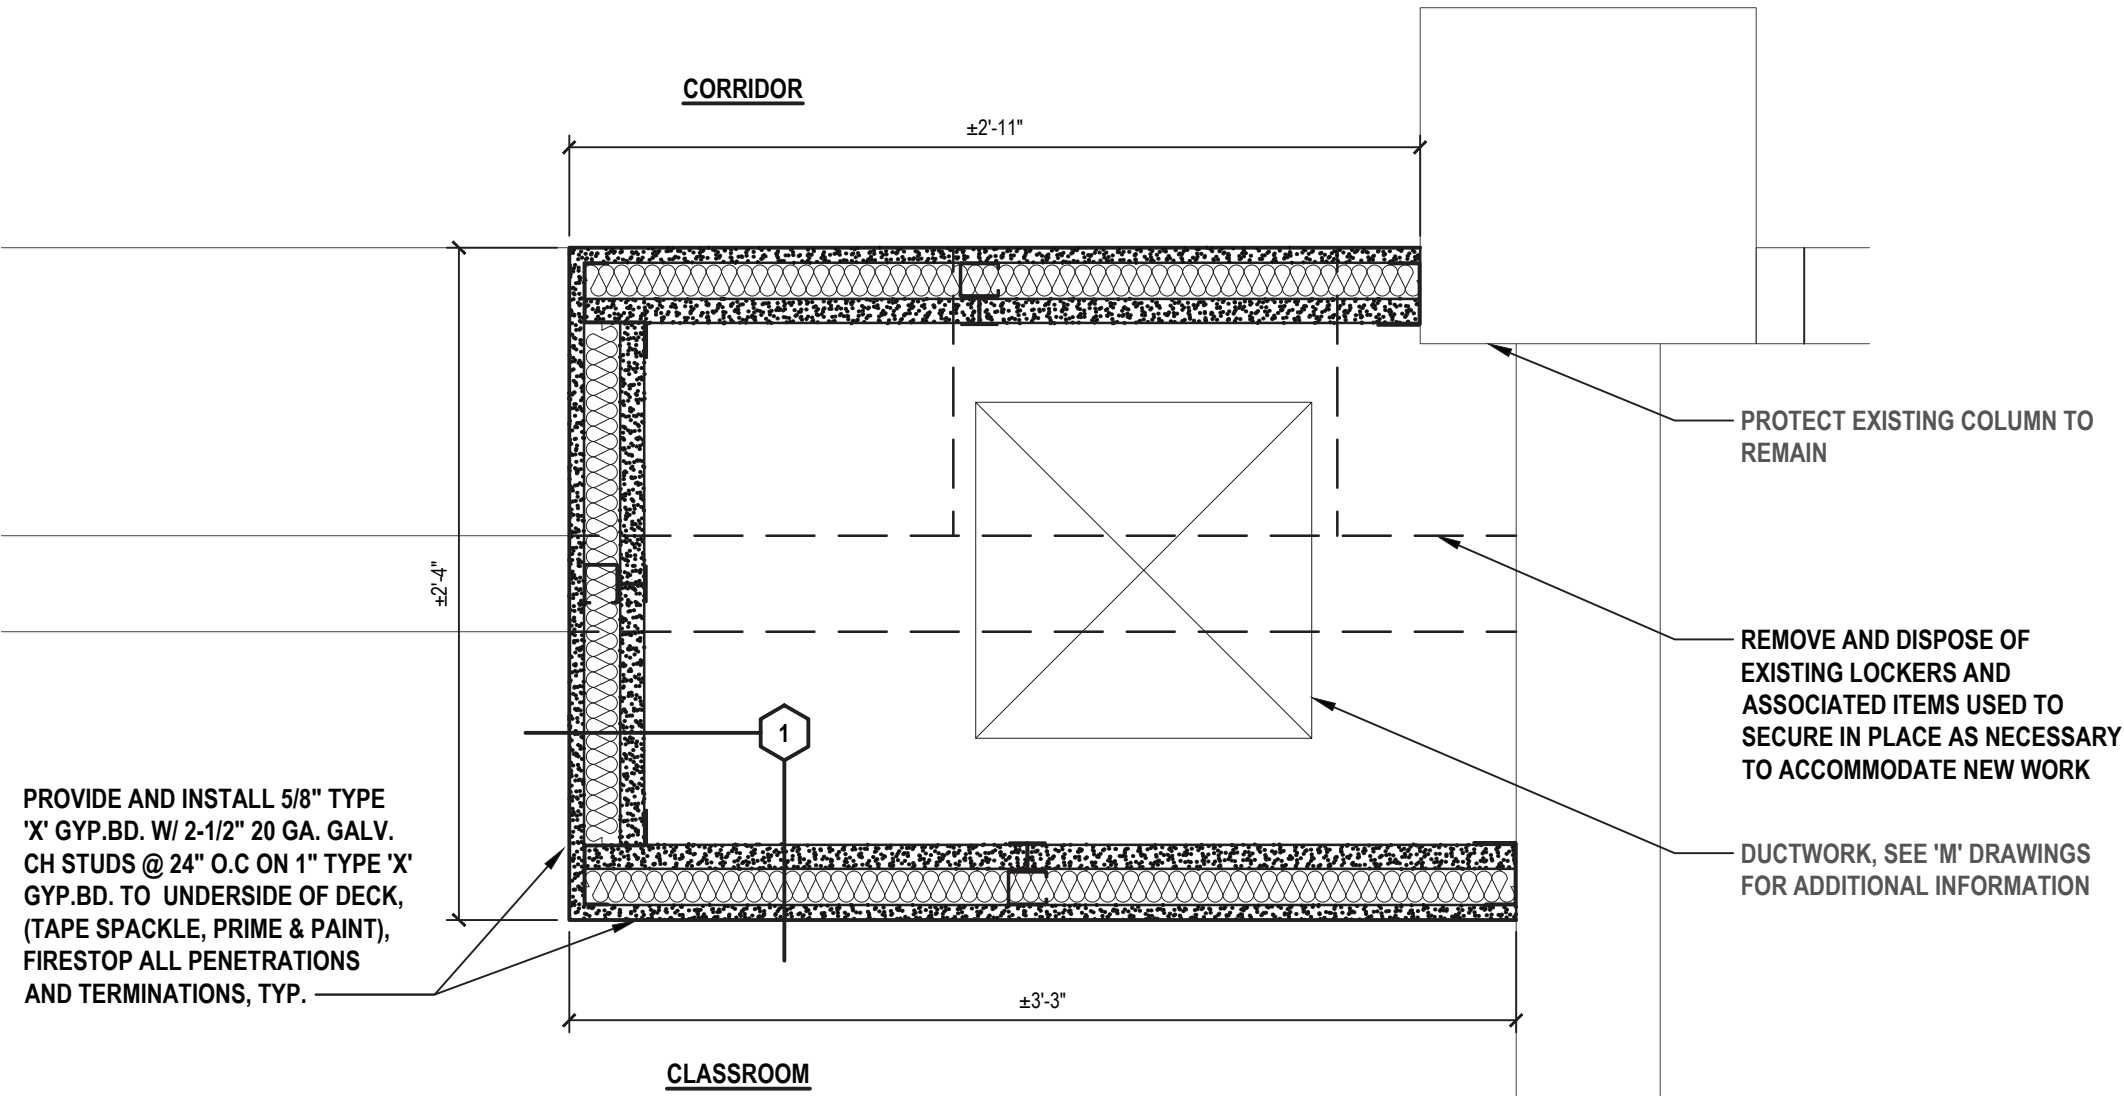

2 Typical Chase Detail  
SCALE: 1-1/2" = 1'-0"

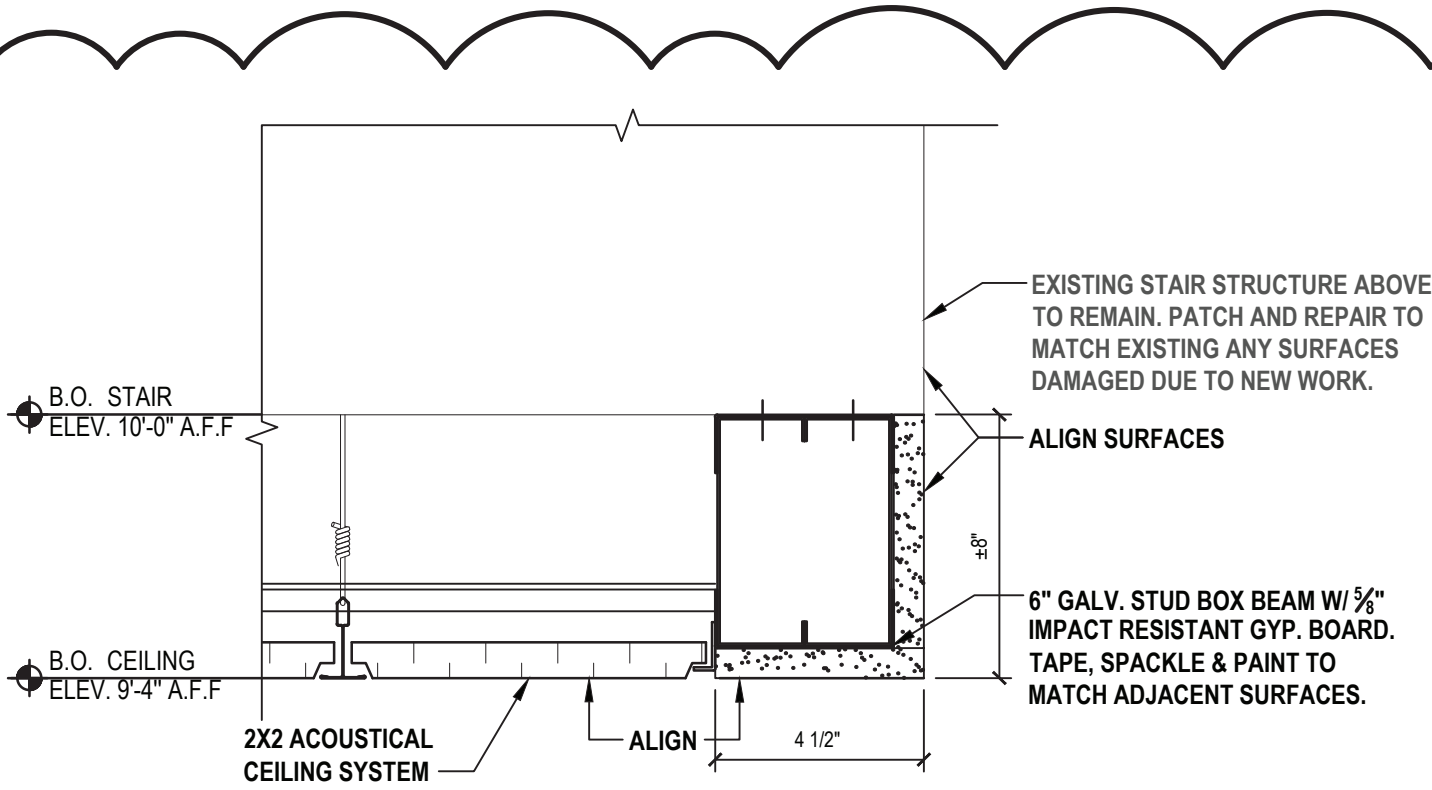

3 Soffit at Stairs Typ.  
SCALE: 3" = 1'-0"

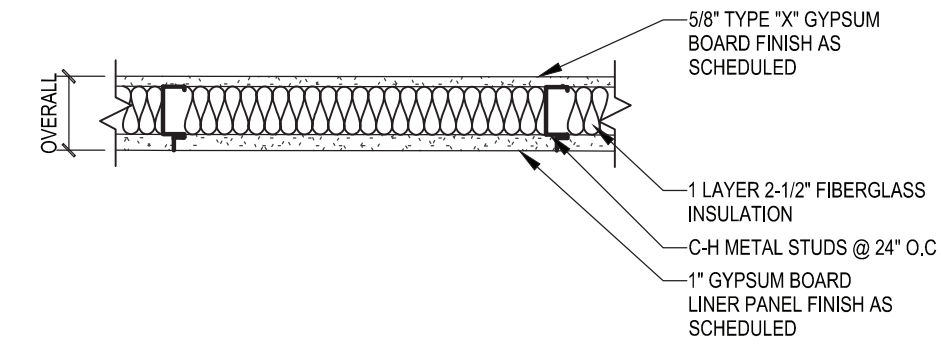

WALL TYPE	OVERALL DIMENSIONS	STUD SIZE	FIRE RATING	UL No.	STC RATING	COMMENTS
1	3 1/8"	2 1/2"	1 HR	U415	-	-

1 Metal Stud Shaft Wall  
Interior Partition

H2M Ref # MH-135

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CONSULTANTS:

MARK	DATE	DESCRIPTION
-	07-24-2023	FINAL BID SET
1	08-07-2023	ADDENDUM NO. 1

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DESIGNED BY:	DRAWN BY:	CHECKED BY:	REVIEWED BY:
PROJECT NO: WPSD 2206	DATE: AUGUST 2023	SCALE: AS SHOWN	

CLIENT  
**White Plains City School District**

**WHITE PLAINS HIGH SCHOOL  
UPGRADES AND TURF FIELD**



**550 North Street  
White Plains, NY 10605**

**SED No. 66-22-00-01-0-16-029**

CONTRACT  
**CONTRACT G  
GENERAL CONSTRUCTION**


STATUS  
**FINAL BID SET**

SHEET TITLE  
**DETAILS**

DRAWING No.  
**A500.00**



MATCH LINE TO SHEET A102.00b

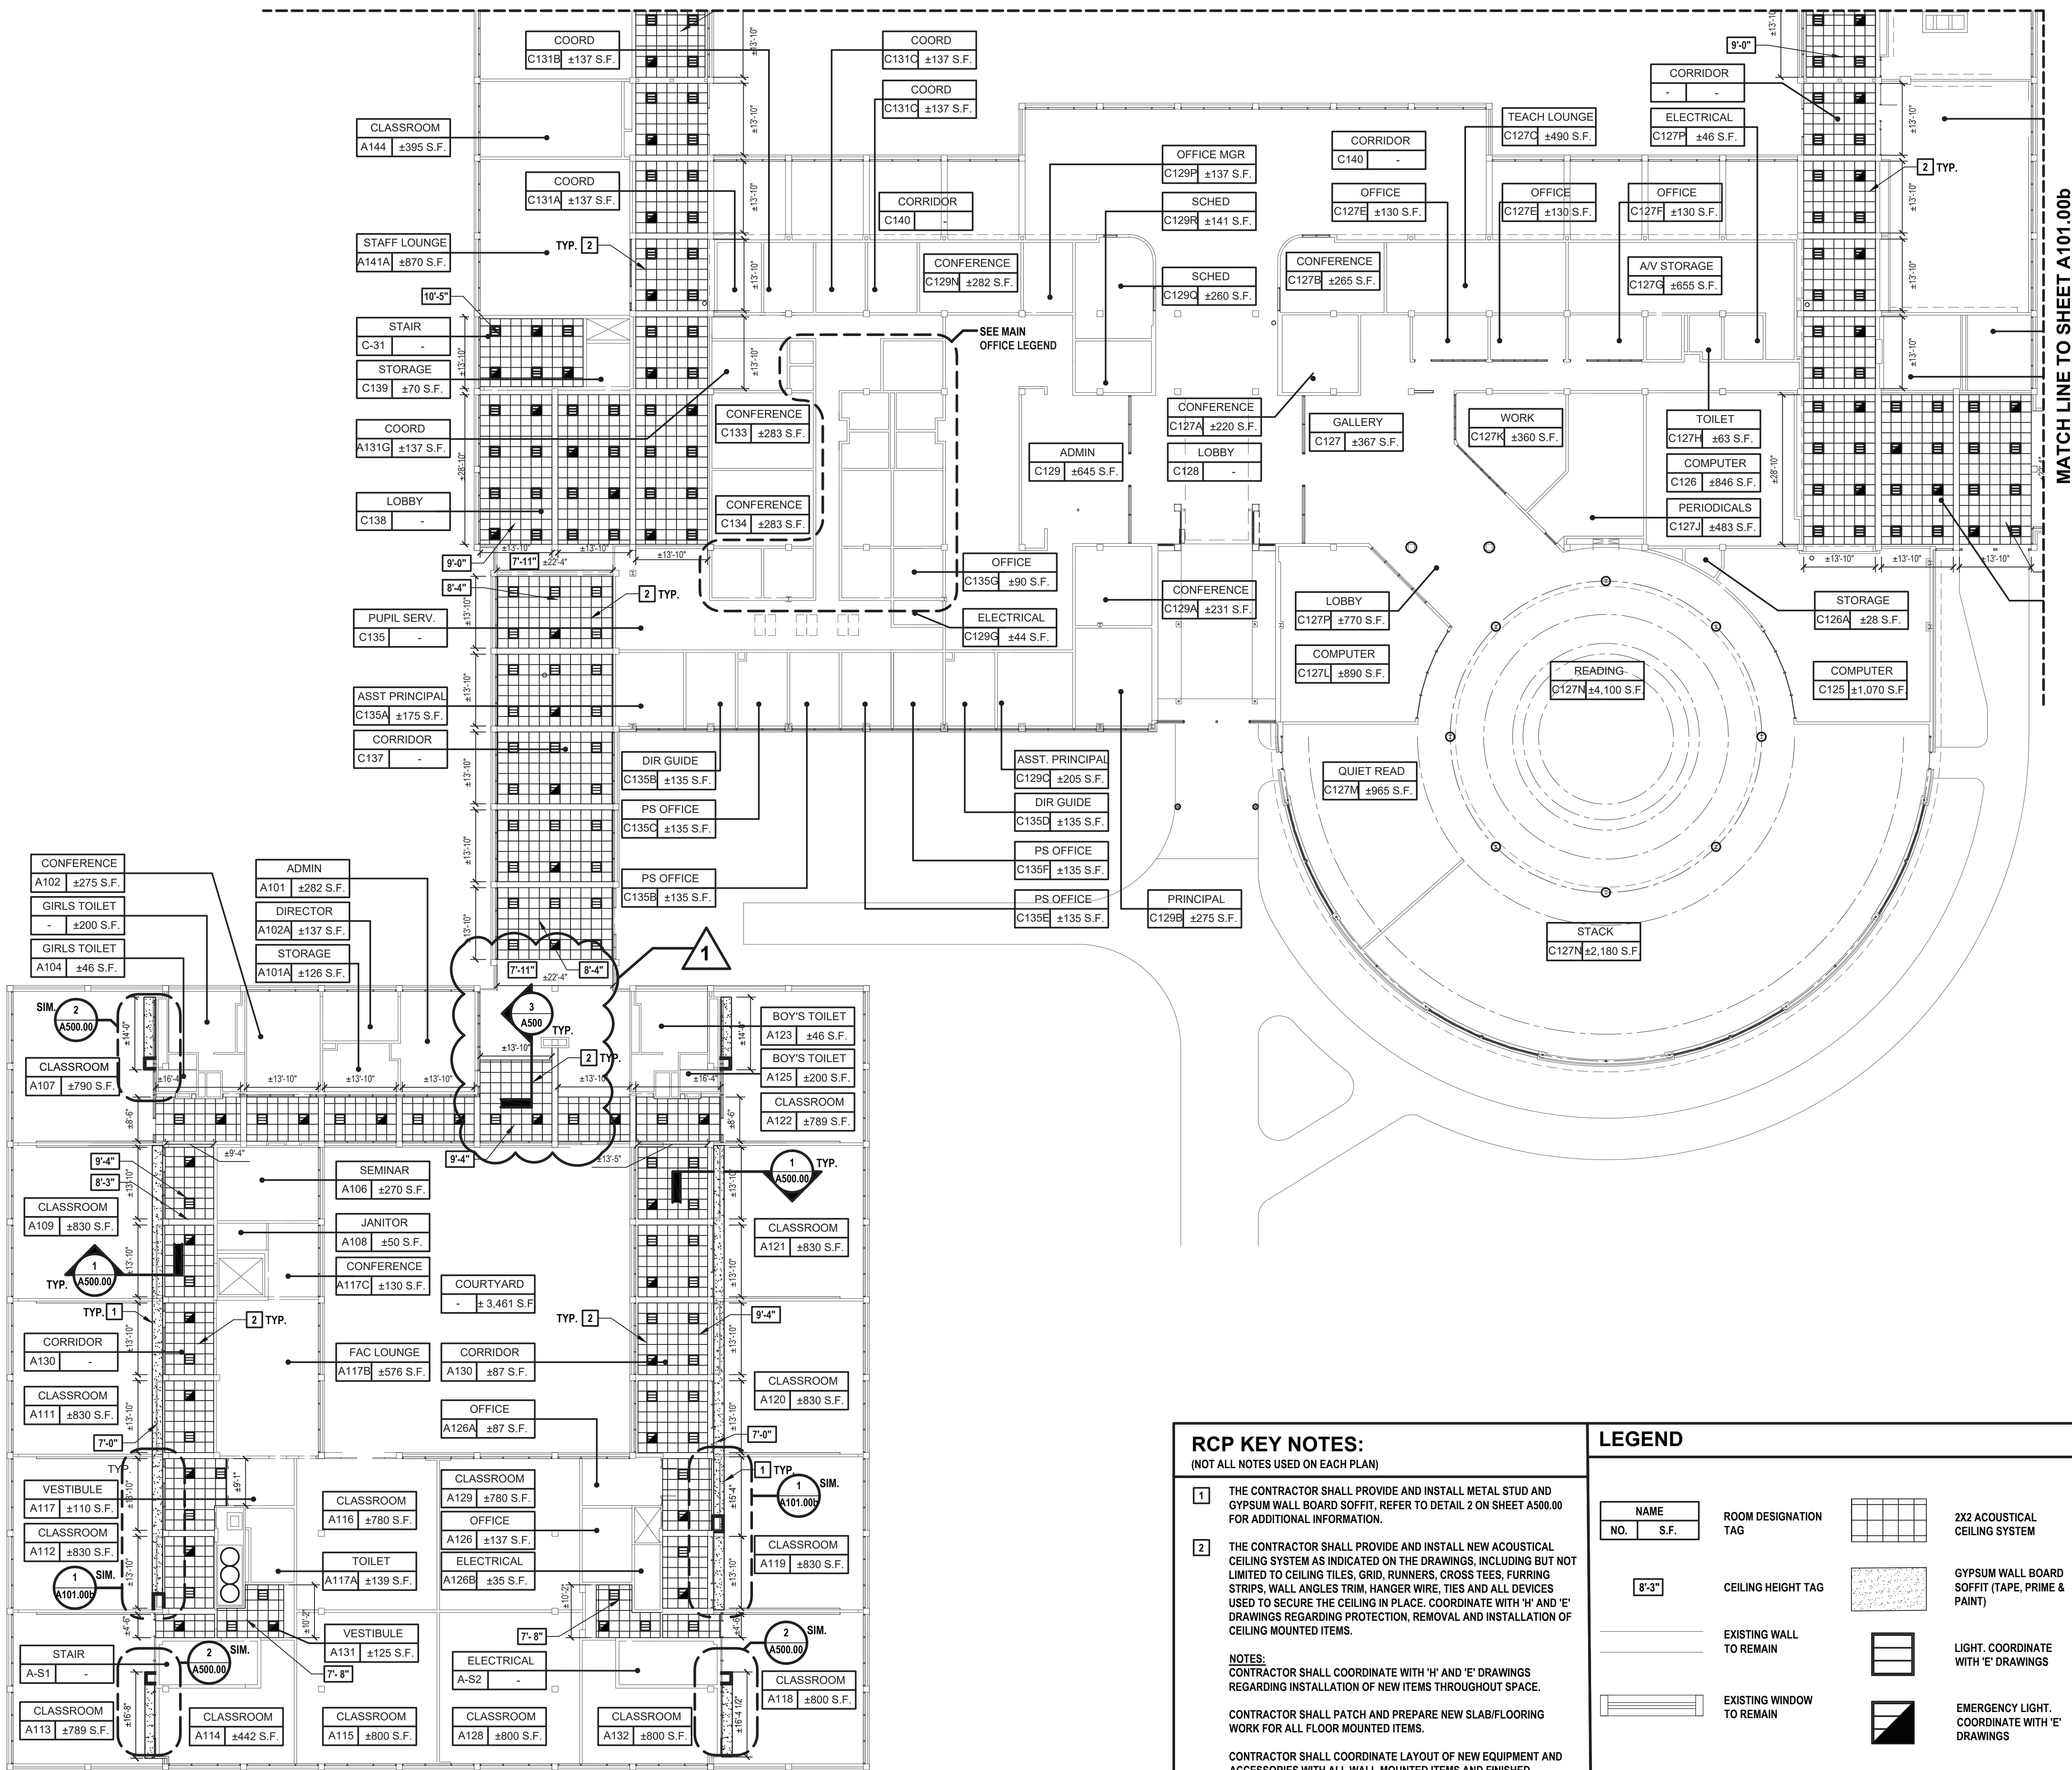

MATCH LINE TO SHEET A101.00b

#### RCP KEY NOTES:

(NOT ALL NOTES USED ON EACH PLAN)

- THE CONTRACTOR SHALL PROVIDE AND INSTALL METAL STUD AND GYPSUM WALL BOARD SOFFIT, REFER TO DETAIL 2 ON SHEET A500.00 FOR ADDITIONAL INFORMATION.
- THE CONTRACTOR SHALL PROVIDE AND INSTALL NEW ACOUSTICAL CEILING SYSTEM AS INDICATED ON THE DRAWINGS, INCLUDING BUT NOT LIMITED TO CEILING TILES, GRID, RUNNERS, CROSS TEES, FURRING STRIPS, WALL ANGLES TRIM, HANGER WIRE, TIES AND ALL DEVICES USED TO SECURE THE CEILING IN PLACE. COORDINATE WITH 'H' AND 'E' DRAWINGS REGARDING PROTECTION, REMOVAL AND INSTALLATION OF CEILING MOUNTED ITEMS.

NOTES:  
CONTRACTOR SHALL COORDINATE WITH 'H' AND 'E' DRAWINGS REGARDING INSTALLATION OF NEW ITEMS THROUGHOUT SPACE.

CONTRACTOR SHALL PATCH AND PREPARE NEW SLAB/FLOORING WORK FOR ALL FLOOR MOUNTED ITEMS.


CONTRACTOR SHALL COORDINATE LAYOUT OF NEW EQUIPMENT AND ACCESSORIES WITH ALL WALL-MOUNTED ITEMS AND FINISHED SURFACES.

#### LEGEND

NAME	ROOM DESIGNATION		
NO.	S.F.	TAG	
			2X2 ACOUSTICAL CEILING SYSTEM
			GYPSUM WALL BOARD SOFFIT (TAPE, PRIME & PAINT)
			LIGHT. COORDINATE WITH 'E' DRAWINGS
			EMERGENCY LIGHT. COORDINATE WITH 'E' DRAWINGS


#### KEY PLAN LEGEND

BASE BID	ALT. G1
ALT. G2	ALT. G3
ALT. G4	

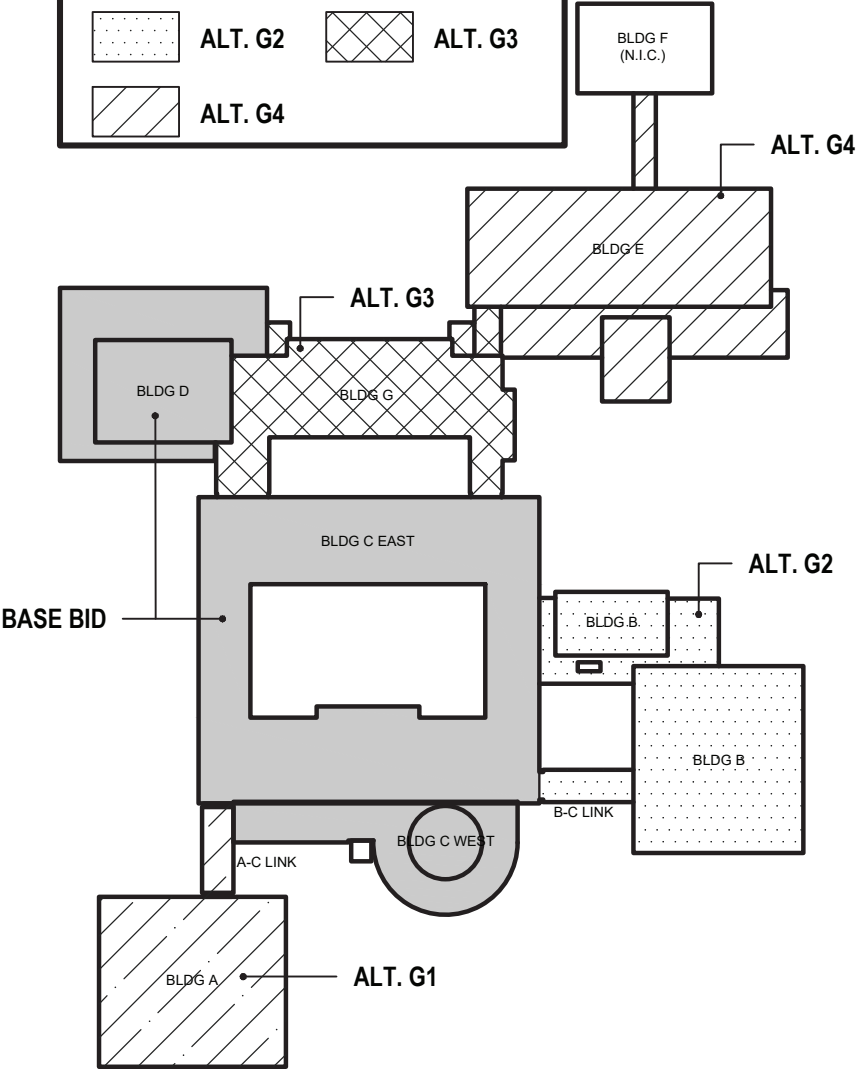

Key Plan  
SCALE: N.T.S.

Existing First Floor Plan  
SCALE: 1/16" = 1'-0"

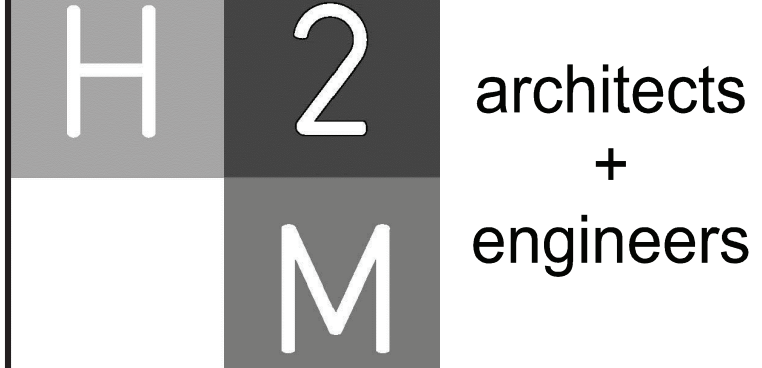

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CONSULTANTS:

MARK	DATE	DESCRIPTION
-	07-24-2023	FINAL BID SET
1	08-07-2023	ADDENDUM NO. 1

DESIGNED BY:	DRAWN BY:	CHECKED BY:	REVIEWED BY:
CWP	DOD/NPO	CWP	KMM
PROJECT NO:	DATE:	SCALE:	AS SHOWN
WPSD 2206	AUGUST 2023		

White Plains City School District

WHITE PLAINS HIGH SCHOOL  
UPGRADES AND TURF FIELD



550 North Street  
White Plains, NY 10605

SED No. 66-22-00-01-0-16-029






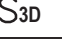

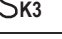
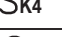
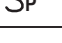






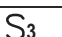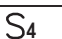


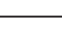








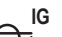

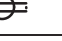

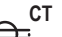
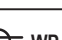
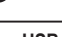

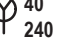



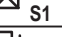
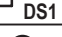
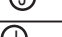
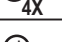
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



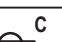

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



















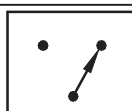

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




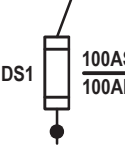

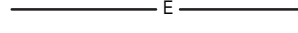
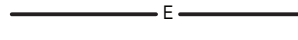





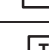


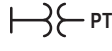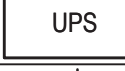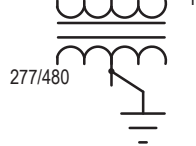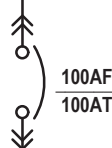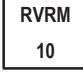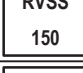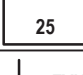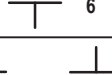
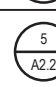
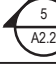
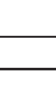






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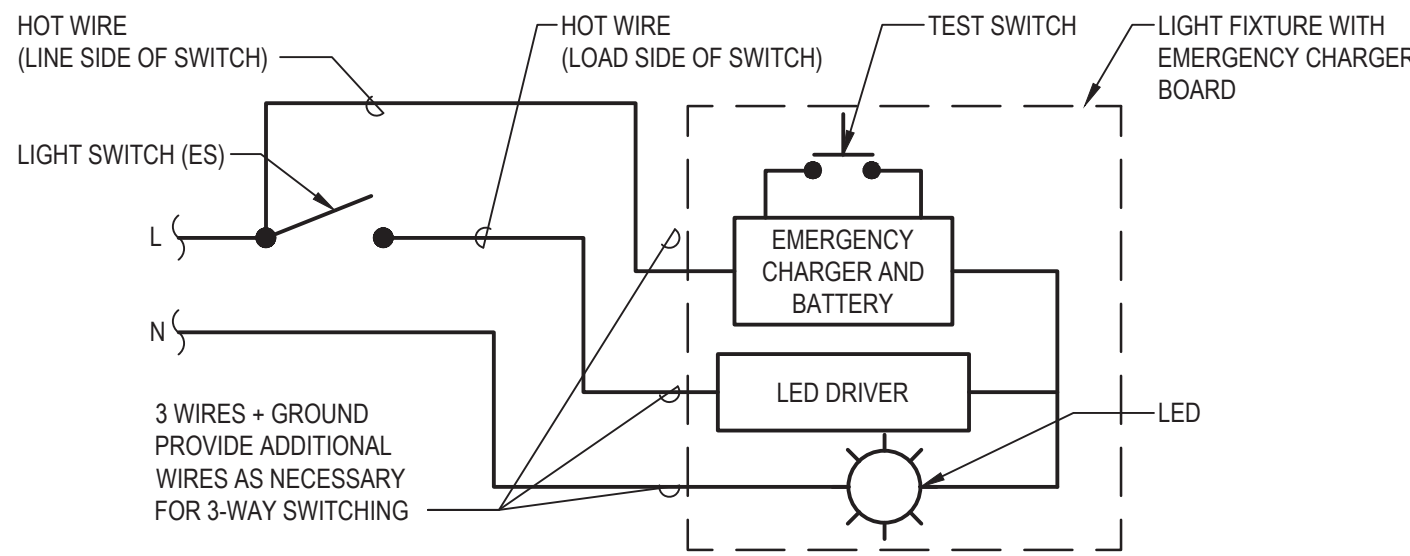


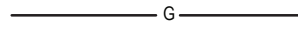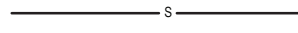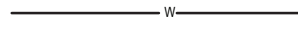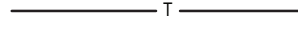ELECTRICAL LEGENDS					
SYMBOL	DESCRIPTION	COMMENTS	ABBREVIATION	DESCRIPTION	COMMENTS
	THREE - WAY SWITCH	46" AFF TO CL UON	AFF	ABOVE FINISHED FLOOR	
	FOUR - WAY SWITCH	46" AFF TO CL UON	AFC	ABOVE FINISHED CEILING	
	ILLUMINATED SWITCH	46" AFF TO CL UON	AFCI	ARC FAULT CIRCUIT INTERRUPTER	
	SINGLE POLE SWITCH; "A" INDICATES SWITCH CONTROL	46" AFF TO CL UON	AFG	ABOVE FINISHED GRADE	
	SINGLE POLE DIMMER SWITCH	46" AFF TO CL UON	AHJ	AUTHORITY HAVING JURISDICTION	
	THREE - WAY DIMMER SWITCH	46" AFF TO CL UON	AMP, A	AMPERE	
	SINGLE POLE KEYED SWITCH	46" AFF TO CL UON	ATS	AUTOMATIC TRANSFER SWITCH; SEE TRANSFER SWITCH SCHEDULE	
	KEYED THREE - WAY SWITCH	46" AFF TO CL UON	AWG	AMERICAN WIRE GAUGE	
	KEYED FOUR - WAY SWITCH	46" AFF TO CL UON	BFC	BELOW FINISHED CEILING	
	SWITCH AND PILOT LIGHT		CL	CENTERLINE	
	SWITCH WITH THERMAL OVERLOAD PROTECTION (CONTRACTOR SHALL COORDINATE VOLTAGE AND PHASE WITH EQUIPMENT)		CT	COUNTER TOP	
	OCCUPANCY/VACANCY SENSOR WITH MANUAL OVERRIDE, WALL MOUNT		E.C.	ELECTRICAL CONDUIT	
	TIME CLOCK		EM	EMERGENCY	
	EMERGENCY SHUT OFF SWITCH; 'E' INDICATES ELECTRICAL; 'G' INDICATES GAS		GFCI	GROUND FAULT CIRCUIT INTERRUPTER	
	2 #12 AWG + #12 AWG GND IN 3/4" E.C. CONCEALED IN WALL OR CEILING		GF1	GROUND FAULT INDICATOR	
	3 #12 AWG + #12 AWG GND IN 3/4" E.C. CONCEALED IN OR BELOW SLAB		GND	GROUND	
	DEDICATED HOME RUN TO PANEL LP1 FOR CIRCUIT NO. 35 ONLY. 2 #12 AWG + #12 AWG GND IN 3/4" E.C. CONCEALED IN WALL OR CEILING		CON-ED	CONSOLIDATED EDISON INC. (LOCAL ELECTRIC UTILITY)	
	SIMPLEX RECEPTACLE: 120V, 20A. COORDINATE MOUNTING HEIGHT WITH MECHANICAL CONTRACTOR TO CLEAR BASEBOARDS.	FLUSH	MCB	MAIN CIRCUIT BREAKER	
	DUPLEX RECEPTACLE: 120V, 20A. COORDINATE MOUNTING HEIGHT WITH MECHANICAL CONTRACTOR TO CLEAR BASEBOARDS.	FLUSH	MLO	MAIN LUGS ONLY	
	QUAD RECEPTACLE, DOUBLE DUPLEX RECEPTACLE: 120V, 20A. COORDINATE MOUNTING HEIGHT WITH MECHANICAL CONTRACTOR TO CLEAR BASEBOARDS.	FLUSH	NTS	NOT TO SCALE	
	DUPLEX RECEPTACLE: 120V, 20A; SUBSCRIPT "C" INDICATES CEILING MOUNT.	FLUSH	TYP	TYPICAL	
	DUPLEX RECEPTACLE: 120V, 20A; FLOOR MOUNTED.	FLUSH	UON	UNLESS OTHERWISE NOTED	
	QUAD RECEPTACLE: 120V, 20A; FLOOR MOUNTED.		UC	UNDER COUNTER	
	DUPLEX RECEPTACLE AND DATA JACK: 120V, 20A; FLOOR MOUNTED.		v	VOLT	
	DATA JACK; FLOOR MOUNTED.		VAC	VOLTS ALTERNATING CURRENT	
	ISOLATED GROUND DUPLEX RECEPTACLE. COORDINATE MOUNTING HEIGHT WITH MECHANICAL CONTRACTOR TO CLEAR BASEBOARDS.	FLUSH	VDC	VOLTS DIRECT CURRENT	
	DUPLEX RECEPTACLE: 120V, 20A; WITH GROUND FAULT INDICATOR. COORDINATE MOUNTING HEIGHT WITH MECHANICAL CONTRACTOR TO CLEAR BASEBOARDS.	FLUSH	X-FMR	TRANSFORMER	
	DUPLEX RECEPTACLE: 120V, 20A; SUBSCRIPT "UC" INDICATES UNDER COUNTER	AS PER ENGINEER	WP	WEATHERPROOF	
	DUPLEX RECEPTACLE: 120V, 20A; SUBSCRIPT "CT" INDICATES COUNTER TOP.	AS PER ENGINEER			
	DUPLEX RECEPTACLE: 120V, 20A; SUBSCRIPT "WP" INDICATED WEATHER PROOF.	AS PER ENGINEER			
	DUPLEX RECEPTACLE: 120V, 20A; SUBSCRIPT "USB" INDICATES INTEGRAL USB.	FLUSH			
	SPECIAL PURPOSE OUTLET: 240V, 40A. VERIFY NEMA CONFIGURATION WITH EQUIPMENT MANUFACTURER.	AS PER ENGINEER			
	TWISTED LOCK RECEPTACLE: 125V, 20A, 3 WIRE, UNLESS OTHERWISE NOTED.	AS PER ENGINEER			
	SURFACE RACEWAY WITH 2 GROUNDED AND ISOLATED TYPE DUPLEX RECEPTACLES AND 1 DATA OUTLET PER POSITION, 18" AFF UNLESS OTHERWISE NOTED.				
	MAGNETIC STARTER "S1"; SEE STARTER SCHEDULE				
	DISCONNECTION SWITCH "DS1"; SEE DISCONNECT SWITCH SCHEDULE.				
	JUNCTION BOX.				
	NEMA 4X STAINLESS STEEL JUNCTION BOX WITH GASKET COVER.				
	JUNCTION BOX RECESSED IN WALL WITH BLANK COVER. PROVIDE 3/4" E.C. AND DRAG LINE TO ABOVE FINISHED CEILING. MOUNT 18" AFF, UNLESS OTHERWISE NOTED.				
	FOR MONITOR, JUNCTION BOX RECESSED IN WALL WITH BLANK COVER. PROVIDE 3/4" E.C. AND DRAG LINE TO ABOVE FINISHED CEILING.				
	FOR HAND DRYER, JUNCTION BOX RECESSED IN WALL WITH BLANK COVER. PROVIDE 3/4" E.C. AND DRAG LINE TO ABOVE FINISHED CEILING. COORDINATE MOUNTING HEIGHT WITH ARCHITECT.				
	TRANSFORMER "T1"; SEE TRANSFORMER SCHEDULE.				
	ELECTRICAL PANEL "P1", RECESSED; SEE PANEL SCHEDULE.				
	ELECTRICAL PANEL "P1", SURFACE MOUNT; SEE PANEL SCHEDULE.				

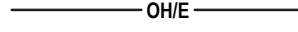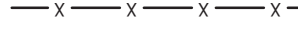
Lighting Fixture Schedule												
Designation	Symbol	Manufacturer	Model Number	Type	Watts	Color Temp	Volt	Lumens	Mounting	Remarks	Mounting Height	Detail
F1		COLUMBIA LIGHTING	LCAT22-40LWG-G-EDU	LED	23	4000K	UNV	2782	RECESSED	-	CEILING	
F1E		COLUMBIA LIGHTING	LCAT22-40LW-G-EDU-ELL14	LED	23	4000K	UNV	2782	RECESSED	EMERGENCY BATTERY BACKUP WITH 90 MINUTES OF BACK-UP CAPACITY	CEILING	
F2		COLUMBIA LIGHTING	LCAT22-40MLG-G-EDU	LED	28	4000K	UNV	3431	RECESSED	-	CEILING	
F2E		COLUMBIA LIGHTING	LCAT22-40ML-G-EDU-ELL14	LED	28	4000K	UNV	3431	RECESSED	EMERGENCY BATTERY BACKUP WITH 90 MINUTES OF BACK-UP CAPACITY	CEILING	

SINGLE LINE DIAGRAM LEGEND		
SYMBOL	DESCRIPTION	COMMENTS
	LINE VOLTAGE THERMOSTAT, 120V, 10A.	
	CIRCUIT BREAKER WITH TRIP AND POLES AS NOTED; 100 AMP FRAME, 100 AMP TRIP.	
	TRANSFER SWITCH 'TS1'; SEE TRANSFER SWITCH SCHEDULE.	
	DISTRIBUTION PANEL P1 WITH 30A, 2 POLE M.C.B.; SEE DISTRIBUTION PANEL SCHEDULE.	
	UNFUSED DISCONNECT SWITCH DS1, 100 AMP; SEE DISCONNECT SWITCH SCHEDULE.	
	FUSED DISCONNECT SWITCH 'DS', FUSED AT 100 AMP SIZE, 100 AMP FUSED, 3 POLES; SEE DISCONNECT SWITCH SCHEDULE.	
	GENERATOR SET 'G'	
	ELECTRIC METER AND METER PAN AS PER PSEG REQUIREMENTS.	
	MOTOR, NUMBER INDICATES HORSEPOWER.	
	CURRENT TRANSFORMERS.	
	VOLTAGE TRANSFORMERS.	
	UNINTERRUPTIBLE POWER SUPPLY	
	TRANSFORMER 'T2' WITH SIZE, PRIMARY AND SECONDARY VOLTAGES AS NOTED.	
	RACK OUT CIRCUIT BREAKER	
	REDUCED VOLTAGE SOLID STATE RAMPING MODULE, SIZED FOR 10 H.P.	
	REDUCED VOLTAGE SOLID STATE STARTER, SIZED FOR 150 H.P.	
	VARIABLE FREQUENCY DRIVE, RATED FOR 25 H.P.	
	FULL VOLTAGE NON-REVERSING STARTER, NEMA SIZE 6	
	FULL VOLTAGE REVERSING STARTER, NEMA SIZE 5	
	FAST ACTING SOLID STATE FUSES AS PER MANUFACTURER.	
	MULTIPLE BRANCH CIRCUITS AS REQUIRED.	
	CONTROL CIRCUIT; MIN 2 #12 AWG IN 3/4" E.C.	

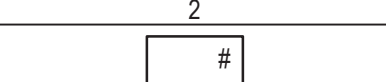LIST OF DRAWINGS	
E 001	ELECTRICAL LEGENDS, SCHEDULES AND DETAILS
ED 100	ELECTRICAL PARTIAL BASEMENT DEMOLITION PLAN
ED 110	ELECTRICAL PARTIAL GROUND FLOOR DEMOLITION PLANS
ED 111	ELECTRICAL PARTIAL GROUND FLOOR DEMOLITION PLANS
ED 120	ELECTRICAL PARTIAL FIRST FLOOR DEMOLITION PLANS
ED 121	ELECTRICAL PARTIAL FIRST FLOOR DEMOLITION PLANS
ED 122	ELECTRICAL PARTIAL FIRST FLOOR DEMOLITION PLANS
ED 130	ELECTRICAL PARTIAL SECOND FLOOR DEMOLITION PLANS
ES 100	ELECTRICAL SITE PLAN
E 100	ELECTRICAL PARTIAL BASEMENT PLANS
E 110	ELECTRICAL PARTIAL GROUND FLOOR PLANS
E 111	ELECTRICAL PARTIAL GROUND FLOOR PLANS
E 120	ELECTRICAL PARTIAL FIRST FLOOR PLANS
E 121	ELECTRICAL PARTIAL FIRST FLOOR PLANS
E 122	ELECTRICAL PARTIAL FIRST FLOOR PLANS
F 130	ELECTRICAL PARTIAL SECOND FLOOR PLANS
E 140	ELECTRICAL PARTIAL ROOF PLAN BUILDING A
E 141	ELECTRICAL PARTIAL ROOF PLAN BUILDING B
E 142	ELECTRICAL PARTIAL ROOF PLAN BUILDING C
E 200	ELECTRICAL FIELD LIGHTING SINGLE LINE DIAGRAMS, FIRE ALARM LEGEND, RISER AND NOTES
E 201	ELECTRICAL PANEL SCHEDULES
E 300	ELECTRICAL DETAILS
E 400	ELECTRICAL FIELD LIGHTING POLE AND FOUNDATION DETAILS
SITE PLAN LEGEND	
	CURB
	UTILITY POWER/TELEPHONE POLE
	EXISTING NATURAL GAS SERVICE
	EXISTING SEWER SERVICE
	EXISTING WATER SERVICE
	EXISTING TELEPHONE SERVICE
	NEW TELEPHONE SERVICE
	EXISTING ELECTRICAL LINES
	NEW ELECTRICAL LINES
	EXISTING PRIMARY ELECTRIC SERVICE
	NEW PRIMARY ELECTRIC SERVICE
	EXISTING OVERHEAD ELECTRIC LINES
	EXISTING FENCE
	ELECTRIC PULL BOX
	HANDHOLE
	TRANSFORMER
SYMBOLS LEGEND	
	ROOM DESIGNATION
	BUILDING SECTION CUT
	WALL SECTION CUT
	DETAIL KEY
	ELEVATION KEY
	COLUMN GRID
	ELEVATION LINE
	DRAWING TITLE
	INTERIOR ELEVATION REFERENCE
	SEE NOTE #
	ON DWG #



**1 Typical Detail of Light Fixture with  
Emergency Battery Backup**  
SCALE: NTS



architects  
+  
engineers

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# White Plains City School District

WHITE PLAINS HIGH SCHOOL  
UPGRADES AND TURF FIELD

White Plains Public Schools  
**WP**  
REAL LIFE LEARNING

550 North Street  
White Plains, NY 10605

SED No. 66-22-00-01-0-16-029

CONTRACT	<b>CONTRACT E ELECTRICAL CONSTRUCTION</b>
STATUS	<b>FINAL BID SET</b>
SHEET TITLE	<b>ELECTRICAL LEGENDS, SCHEDULES, AND DETAILS</b>
DRAWING No.	<b>E 001.00</b>



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-	07-24-2023	FINAL BID SET
1	08-07-2023	ADDENDUM NO. 1



DESIGNED BY: SAN	DRAWN BY: SAN	CHECKED BY: LK	REVIEWED BY:
PROJECT NO: WPSD 2206	DATE: AUGUST 2023	SCALE: AS SHOWN	

CLIENT  
**White Plains City School District**

**WHITE PLAINS HIGH SCHOOL  
UPGRADES AND TURF FIELD**



**550 North Street  
White Plains, NY 10605**

**SED No. 66-22-00-01-0-16-029**

CONTRACT  
**CONTRACT E  
ELECTRICAL CONSTRUCTION**


STATUS  
**FINAL BID SET**

SHEET TITLE  
**ELECTRICAL SITE PLAN**

DRAWING No.  
**ES 100.00**



**1 Electrical Site Field Plan (Note A1)**  
SCALE: 1"=40'

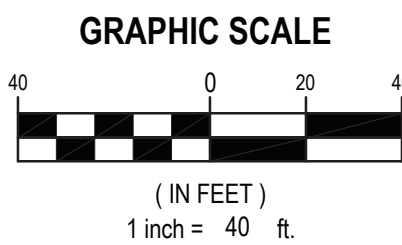

**ELECTRICAL GENERAL SITE PLAN NOTES:**

- CONTRACTOR SHALL INSPECT CONSTRUCTION SITE PRIOR TO SUBMISSION OF BIDS AND SHALL MAKE NO ADDITIONAL CLAIMS REGARDING SITE CONDITIONS THEREAFTER.
- LOCATION OF ALL UNDERGROUND UTILITIES BOTH PUBLIC AND CUSTOMER OWNED, WERE OBTAINED FROM EITHER MAPS, SURVEYS, DRAWINGS AND RECORDS SUPPLIED BY OTHERS. THE OWNER AND ENGINEER DO NOT GUARANTEE OR ACCEPT RESPONSIBILITY FOR ANY DAMAGE TO SUCH FACILITIES DUE TO DISCREPANCIES IN LOCATION AND SIZE SHOWN ON THE PLANS OR THOSE UTILITIES NOT SHOWN. THE CONTRACTOR IS RESPONSIBLE FOR OBTAINING A PRIVATE MARKOUT COMPANY FOR DETERMINING THE LOCATION OF ALL UNDERGROUND UTILITIES PRIOR TO BEGINNING WORK. CONTRACTOR SHALL LOCATE ALL UTILITIES WITHIN PROXIMITY OF CONSTRUCTION LIMITS.
- CONTRACTOR SHALL COMPLETELY RESTORE ALL AREAS DISTURBED DURING CONSTRUCTION, INCLUDING BUT NOT LIMITED TO GRASS AREAS, LANDSCAPING, PAVEMENTS, SIDEWALKS, CURBING AND IN-GROUND SPRINKLER SYSTEMS.
- THE CONTRACTOR SHALL PERFORM DAILY CLEAN-UP OPERATIONS WHICH INCLUDE REMOVAL OF DEBRIS AND EXCESS CONSTRUCTION MATERIAL TO THE SATISFACTION OF THE OWNER AND THE ENGINEER.
- DURING ALL NON-WORKING HOURS, THE CONTRACTOR WILL BE REQUIRED TO STORE ALL EQUIPMENT AND MATERIALS WITHIN THE AREA DESIGNATED BY THE ENGINEER AT THE PROJECT SITE.
- PROVIDE TEMPORARY FENCING TO PROTECT WORK AREAS.
- CONTRACTOR SHALL MINIMIZE REMOVAL OF EXISTING TREES. CONTRACTOR SHALL BE RESPONSIBLE FOR SITE LAYOUT, TAGGING AND REMOVAL OF TREES REQUIRED TO COMPLETE ALL WORK. OWNER SHALL APPROVE TREES TO BE REMOVED PRIOR TO ACTUAL REMOVALS. REMOVALS SHALL INCLUDE REMOVAL OF COMPLETE STUMP AND ROOT SYSTEM. CONTRACTOR NOT PERMITTED TO GRIND STUMPS.

- CONTRACTOR SHALL BE RESPONSIBLE FOR ALL LAYOUT SURVEY, ETC. AS REQUIRED TO COMPLETE THE WORK.
- CONCRETE SIDEWALKS SHALL BE SAWCUT BACK TO EXPANSION/ CONTROL JOINTS.
- CONTRACTOR SHALL PROVIDE AND TEMPORARILY INSTALL TRAFFIC RATED STEEL PLATES OVER ALL TRENCHES SUCH THAT TRAFFIC AND WALKING PATTERNS ARE MINIMALLY DISTURBED. PROVIDE AND INSTALL TRAFFIC SIGNS AND SIDEWALK SIGNS AS REQUIRED TO DIRECT TRAFFIC OF PEDESTRIANS AND AUTOMOBILES.
- SAW-CUT EXISTING PAVEMENT/SIDEWALK/CURBING FOR INSTALLATION OF NEW CONDUITS. REMOVE AND DISPOSE OF ALL DEBRIS.
- CONTRACTOR SHALL PROVIDE NYLON PULL STRING IN ALL SPARE CONDUIT FOR ENTIRE PROJECT.

**ELECTRICAL SITE PLAN KEY NOTES:**

- CONTRACTOR SHALL STUB ALL CONDUITS INTO BUILDINGS BELOW GRADE. NO EXTERIOR CONDUITS PERMITTED TO RUN EXPOSED ON EXTERIOR WALLS. CORE DRILL AS REQUIRED. RESTORE ALL FINISHES TO MATCH EXISTING. CONTRACTOR SHALL PROVIDE AND INSTALL LINK SEALS ON ALL CONDUITS ENTERING/EXITING THE BUILDING. CONTRACTOR SHALL PROVIDE AND INSTALL DUCT SEAL IN ALL CONDUITS ENTERING/EXITING THE BUILDING AND ALL PULLBOXES.
- NEW PULL BOX. SITE PLAN SHOWS MINIMUM REQUIRED PULL BOXES. PROVIDE ADDITIONAL PULL BOXES AS REQUIRED BY NEC AND UTILITY REQUIREMENTS.

- CONTRACTOR SHALL REMOVE AND DISPOSE OF ALL ELECTRICAL EQUIPMENT ASSOCIATED WITH THE EXISTING SCOREBOARDS SCHEDULED FOR DEMOLITION INCLUDING WIRE AND CONDUIT BACK TO SOURCE.
- CONTRACTOR SHALL PROVIDE AND INSTALL NEW WIRE AND CONDUIT FROM PANEL "PP-11" TO NEW SCOREBOARDS.
- CONTRACTOR SHALL PROVIDE AND INSTALL A NEW 15A/1P CIRCUIT BREAKER IN EXISTING PANEL. PROVIDE AND INSTALL ALL MOUNTING HARDWARE AS REQUIRED. NEW CIRCUIT BREAKER SHALL BE LISTED/LABELED FOR USE IN EXISTING PANEL. AMPERE INTERRUPTING CAPACITY (AIC) RATING ON NEW CIRCUIT BREAKER SHALL MATCH OR EXCEED EXISTING PANEL RATING.
- CONTRACTOR SHALL BE PERMITTED TO USE EXISTING 20A/1P SPARE CIRCUIT BREAKER IN EXISTING PANEL.
- CONTRACTOR SHALL REMOVE AND CLEAN EXISTING 20A/3P SPARE CIRCUIT BREAKER IN EXISTING PANEL AND TURN OVER TO SCHOOL DISTRICT. CONTRACTOR SHALL PROVIDE AND INSTALL A NEW 30A/3P CIRCUIT BREAKER IN EXISTING PANEL. PROVIDE AND INSTALL ALL MOUNTING HARDWARE AS REQUIRED. NEW CIRCUIT BREAKER SHALL BE LISTED/LABELED FOR USE IN EXISTING PANEL. AMPERE INTERRUPTING CAPACITY (AIC) RATING ON NEW CIRCUIT BREAKER SHALL MATCH OR EXCEED EXISTING PANEL RATING.
- PROPOSED AREA FOR FUTURE SPORTS FIELD LIGHTING. THIS IS AREA SHALL BE KEPT CLEAR OF ALL EQUIPMENT, CONDUIT, FENCES, PULL BOXES, AND ANY OTHER OBSTRUCTION THAT WOULD NOT ALLOW FOR INSTALLATION OF FUTURE LIGHTING.

**ADD/ALTERNATE NOTES:**

- CONTRACTOR SHALL PROVIDE ALL LABOR AND MATERIAL COST ASSOCIATED WITH PROVIDING AND INSTALL THE FIELD SPORTS LIGHTING AND ASSOCIATED CONTROL PANEL, ACCESSORIES, CONCRETE BASE AND HARDWARE IN ADD/ALTERNATE E5, ONLY. BASE BID WILL ONLY INCLUDE EMPTY CONDUIT AND ASSOCIATE PULLBOXES WITH NYLON PULL STRING.
- CONTRACTOR SHALL INCLUDE ALL LABOR AND MATERIAL COST ASSOCIATED WITH PROVIDING AND INSTALL NEW SCOREBOARD IN ADD/ALTERNATE E6, ONLY. BASE BID WILL ONLY INCLUDE EMPTY CONDUIT AND ASSOCIATED PULLBOXES WITH NYLON PULL STRING.
- CONTRACTOR SHALL INCLUDE ALL LABOR AND MATERIAL COST ASSOCIATED WITH NEW SPARE CONDUIT AND ASSOCIATED PULL BOX ASSOCIATED WITH FIELD 10 IN ADD/ALTERNATE E7, ONLY.

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-	07-24-2023	FINAL BID SET
1	08-07-2023	ADDENDUM NO. 1



DESIGNED BY: SAN	DRAWN BY: SAN	CHECKED BY:	REVIEWED BY:
PROJECT NO: WPSD 2206	DATE: AUGUST 2023	SCALE:	AS SHOWN

CLIENT  
**White Plains City School District**

**WHITE PLAINS HIGH SCHOOL  
UPGRADES AND TURF FIELD**



**550 North Street  
White Plains, NY 10605**

**SED No. 66-22-00-01-0-16-029**

CONTRACT  
**CONTRACT E  
ELECTRICAL CONSTRUCTION**

STATUS  
**FINAL BID SET**

SHEET TITLE  
**ELECTRICAL PARTIAL BASEMENT  
PLANS**

DRAWING No.  
**E 100.00**

**ELECTRICAL GENERAL LIGHTING NOTES:**

- GL1. PROVIDE ALL REQUIRED WIRING NECESSARY BETWEEN SWITCHES & CONTROLLERS. WHERE 3 OR 4 WAY SWITCHES ARE USED, PROVIDE ALL REQUIRED WIRING BETWEEN SWITCHES. WIRE SIZE SHALL EQUAL POWER FEED SIZE.
- GL2. FIXTURES SHALL BE CONNECTED TO LINE SIDE OF CIRCUIT.
- GL3. PROVIDE AND INSTALL A DEDICATED NEUTRAL FOR EACH CIRCUIT. CONTRACTOR IS NOT PERMITTED TO USE COMMON NEUTRALS.
- GL4. PROVIDE BOX AND ACCESSORIES AS PER MANUFACTURER'S RECOMMENDATION FOR ALL SWITCHES.
- GL5. VERIFY EXACT LOCATIONS AND MOUNTING HEIGHTS WITH ARCHITECT/ENGINEER IN FIELD.
- GL6. ALL CEILING MOUNTED FIXTURES WITH EMERGENCY DRIVERS AND ALL FIXTURES THAT ARE PART OF AN EMERGENCY LIGHTING SYSTEM, FED FROM AN EMERGENCY BATTERY BACKUP SHALL BE LABELED. THESE LABELS SHALL BE EASILY READ FROM THE FLOOR LEVEL AND STATE THAT THE FIXTURE IS AN EMERGENCY FIXTURE AND CONTAIN THE PANEL NAME AND CIRCUIT NUMBER THAT IT IS FEED FROM.
- GL7. WIRING FOR EMERGENCY DRIVER IS NOT SHOWN ON PLANS. FIXTURES WITH EMERGENCY DRIVERS SHALL BE PROVIDED WITH AN UNSWITCHED POWER FEED FROM CIRCUIT FEEDING LIGHT FIXTURE.

**ELECTRICAL LIGHTING KEY NOTES:**


- L1. CONTRACTOR SHALL PROVIDE AND EXTEND WIRE AND CONDUIT FROM THE EXISTING LIGHTING CIRCUIT SERVING THIS ROOM TO TERMINATE AT NEW LIGHT FIXTURE AND SWITCH. WIRE AND CONDUIT SHALL BE 2 #12 AWG + #12 AWG GND IN 3/4" E.C.
- L2. CONTRACTOR SHALL PROVIDE AND INSTALL AN UNSWITCHED POWER FEED FROM THE LINE SIDE OF THE LIGHT SWITCH SERVING THE LIGHT FIXTURES IN THE ROOM WHERE THE NEW EMERGENCY LIGHT FIXTURE IS SCHEDULED TO BE INSTALLED. UNSWITCHED FEED SHALL ORIGINATE FROM THE SAME CIRCUIT FEEDING LIGHT FIXTURES IN THE ROOM WHERE THE EMERGENCY LIGHT FIXTURE IS SCHEDULED TO BE INSTALLED. PROVIDE AND INSTALL WIRE AND CONDUIT AS REQUIRED. CONTRACTOR SHALL PATCH, REPAIR, RESTORE, PRIME, PAINT AND REFINISH TO MATCH ORIGINAL APPEARANCE OF ALL WALLS, CEILINGS, AND ALL BUILDING FINISHES THAT ARE DISTURBED DURING INSTALLATION OF THE UNSWITCHED POWER FEED. WIRE AND CONDUIT SHALL BE 2 #12 AWG + #12 AWG GND IN 3/4" E.C.
- L3. LIGHT FIXTURE WITH SUBSCRIPT "NL" SHALL BE NIGHT LIGHT. LIGHT FIXTURES SHALL BE ON 24 HOURS AND EMERGENCY BATTERY BACKUP. FIXTURE SHALL NOT BE CONTROLLED BY SWITCH. PROVIDE AN UNSWITCHED POWER FEED FROM CIRCUIT SERVING LIGHT IN THIS AREA. TERMINATE UNSWITCHED POWER FEED TO EMERGENCY DRIVEBATTERY AND NORMAL UTILITY DRIVER.

**ADD/ALTERNATE NOTES:**


- A1. CONTRACTOR SHALL PROVIDE ALL LABOR AND MATERIAL COST ASSOCIATED WITH WORK SHOWN ON THIS DETAIL IN ADD/ALTERNATE E4, ONLY.
- A2. CONTRACTOR SHALL PROVIDE ALL LABOR AND MATERIAL COST ASSOCIATED WITH PROVIDING AND INSTALL THE FIELD SPORTS LIGHTING AND ASSOCIATED CONTROL PANEL, ACCESSORIES, CONCRETE BASE AND HARDWARE IN ADD/ALTERNATE E5, ONLY. BASE BID WILL ONLY INCLUDE EMPTY CONDUIT AND ASSOCIATE PULLBOXES WITH NYLON PULL STRING.

**ELECTRICAL KEY NOTE:**


1. CONTRACTOR SHALL TERMINATE SPARE CONDUITS TO NEW NEMA 1 JUNCTION BOX FOR FUTURE SPORTS LIGHTING ON FIELD 10. PROVIDE AND INSTALL A LABEL ON THE JUNCTION BOX STATING "FUTURE USE FOR SPORTS LIGHTING ON FIELD 10". JUNCTION BOX SHALL BE SIZED IN ACCORDANCE WITH NEC REQUIREMENTS.

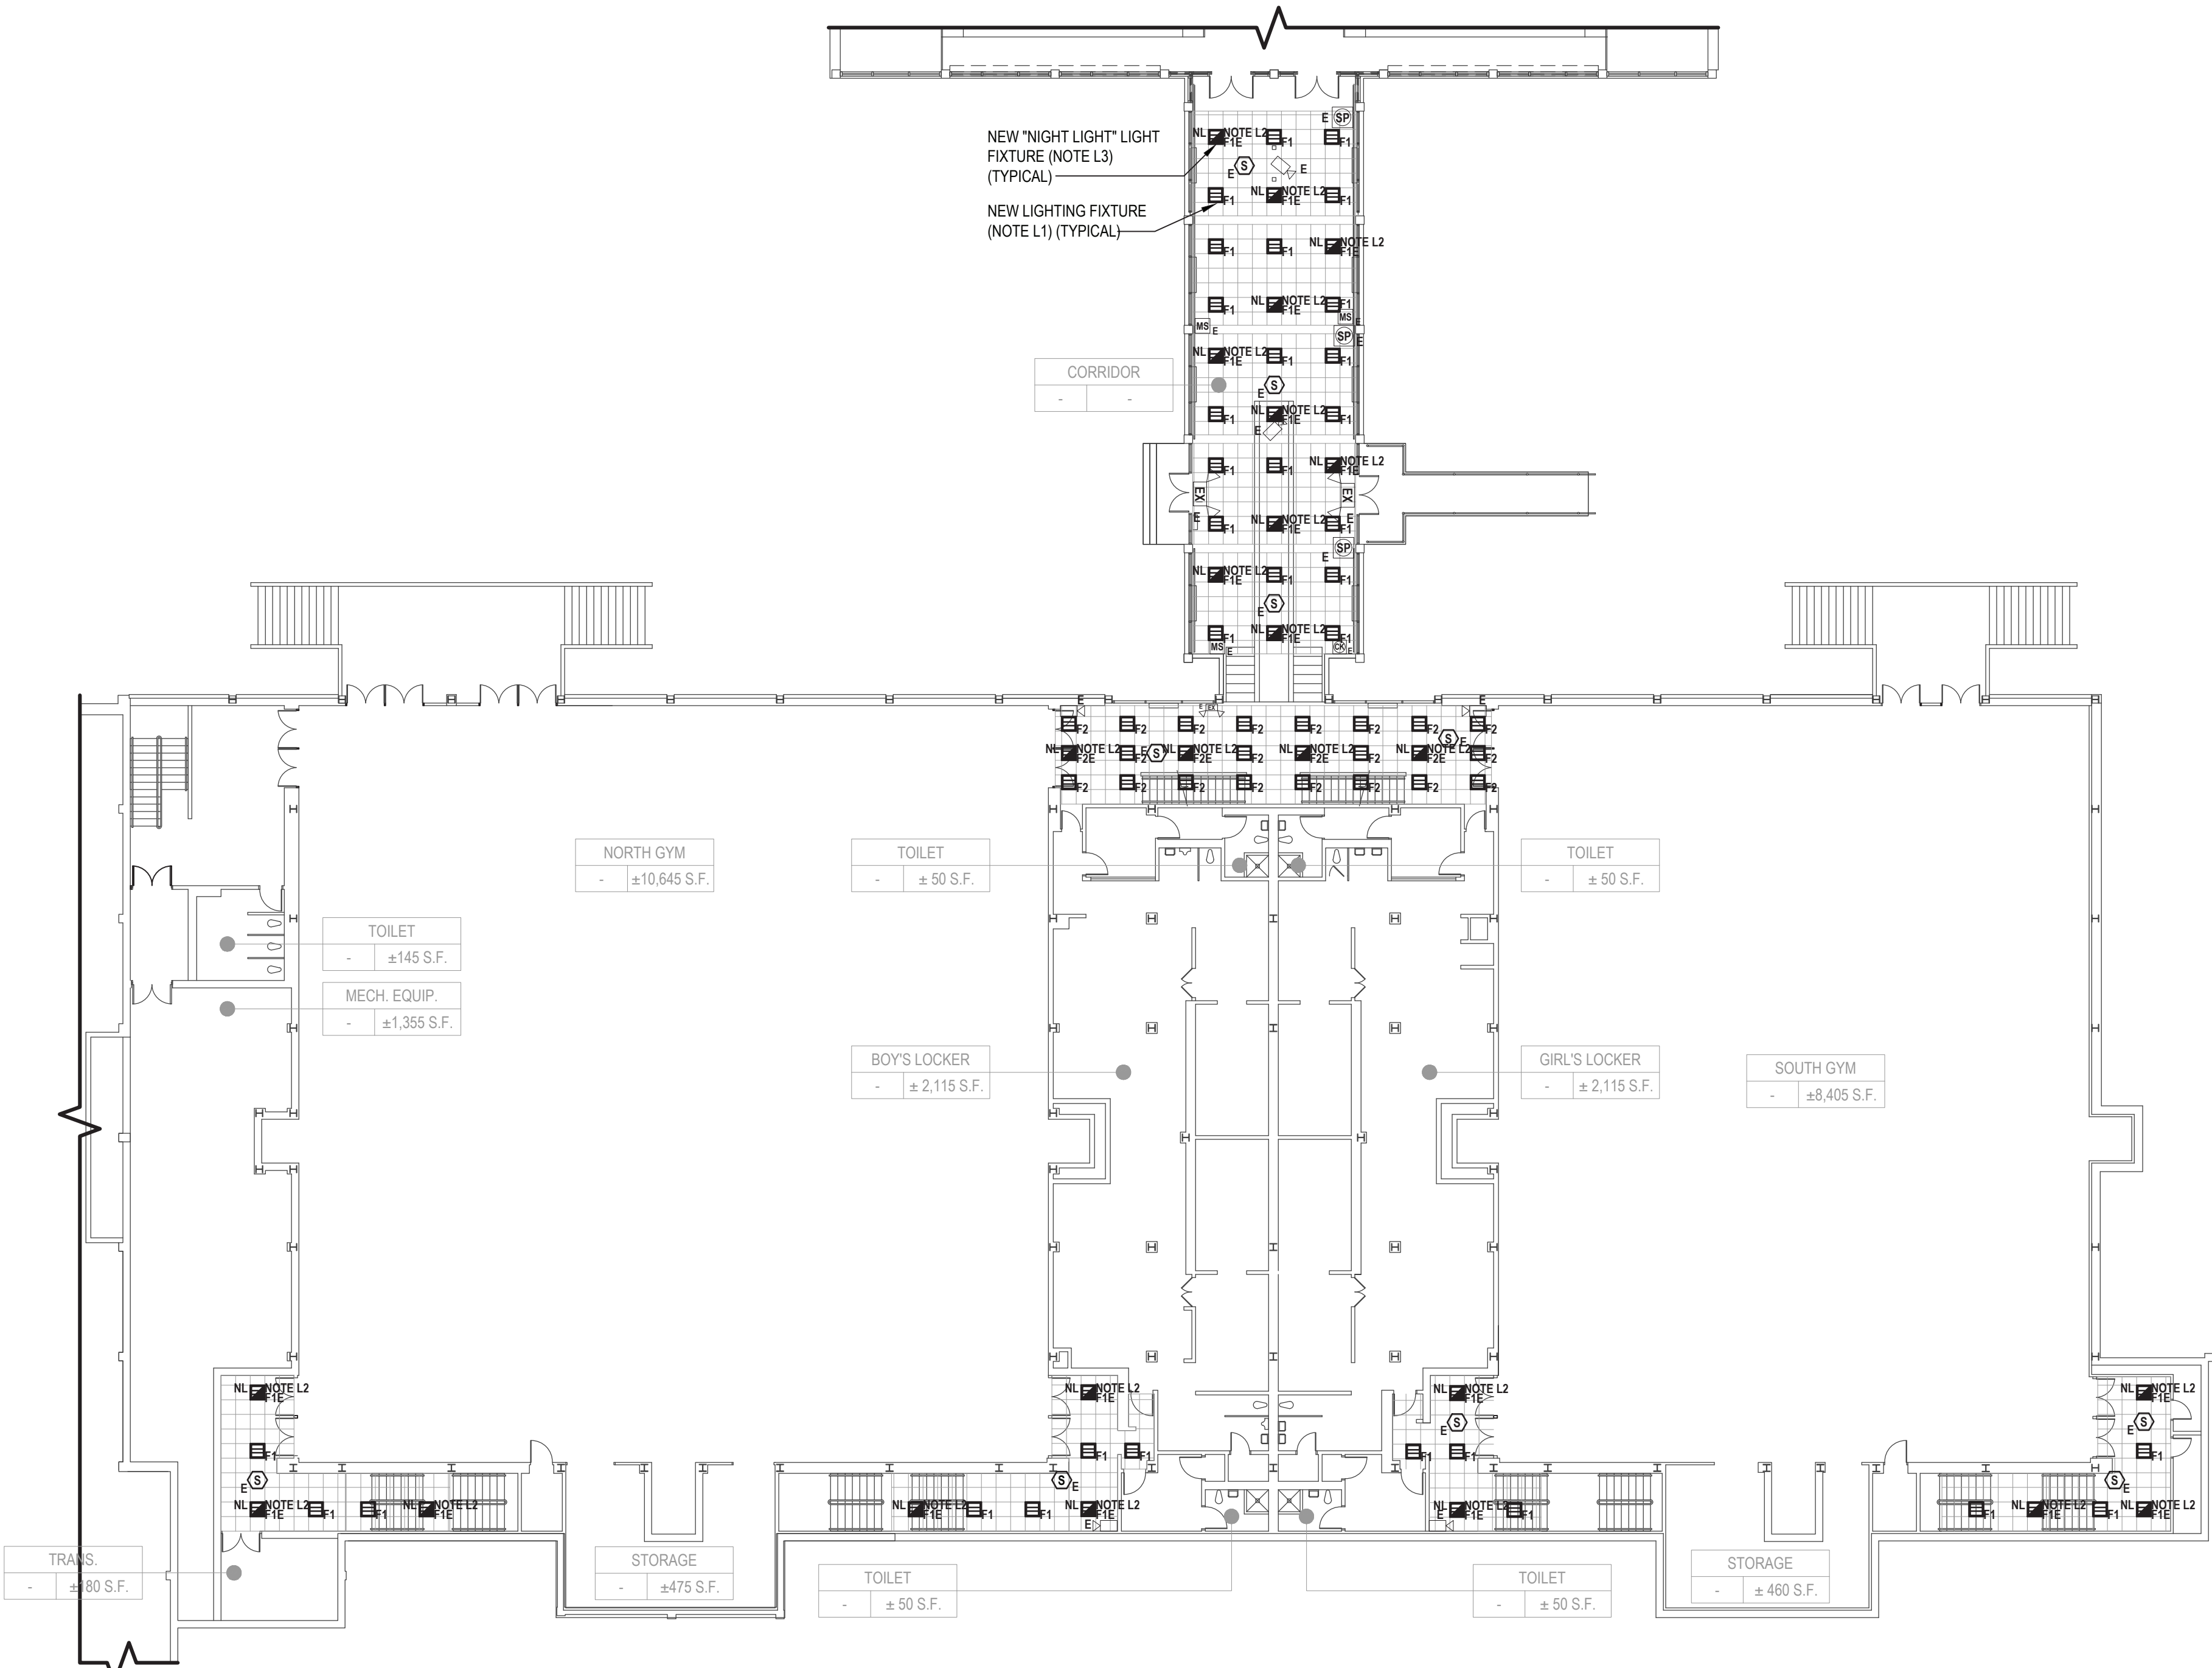

**1 Electrical Partial Basement Plan (Building E and F) (Notes A1)**  
SCALE:1/16"=1'-0"

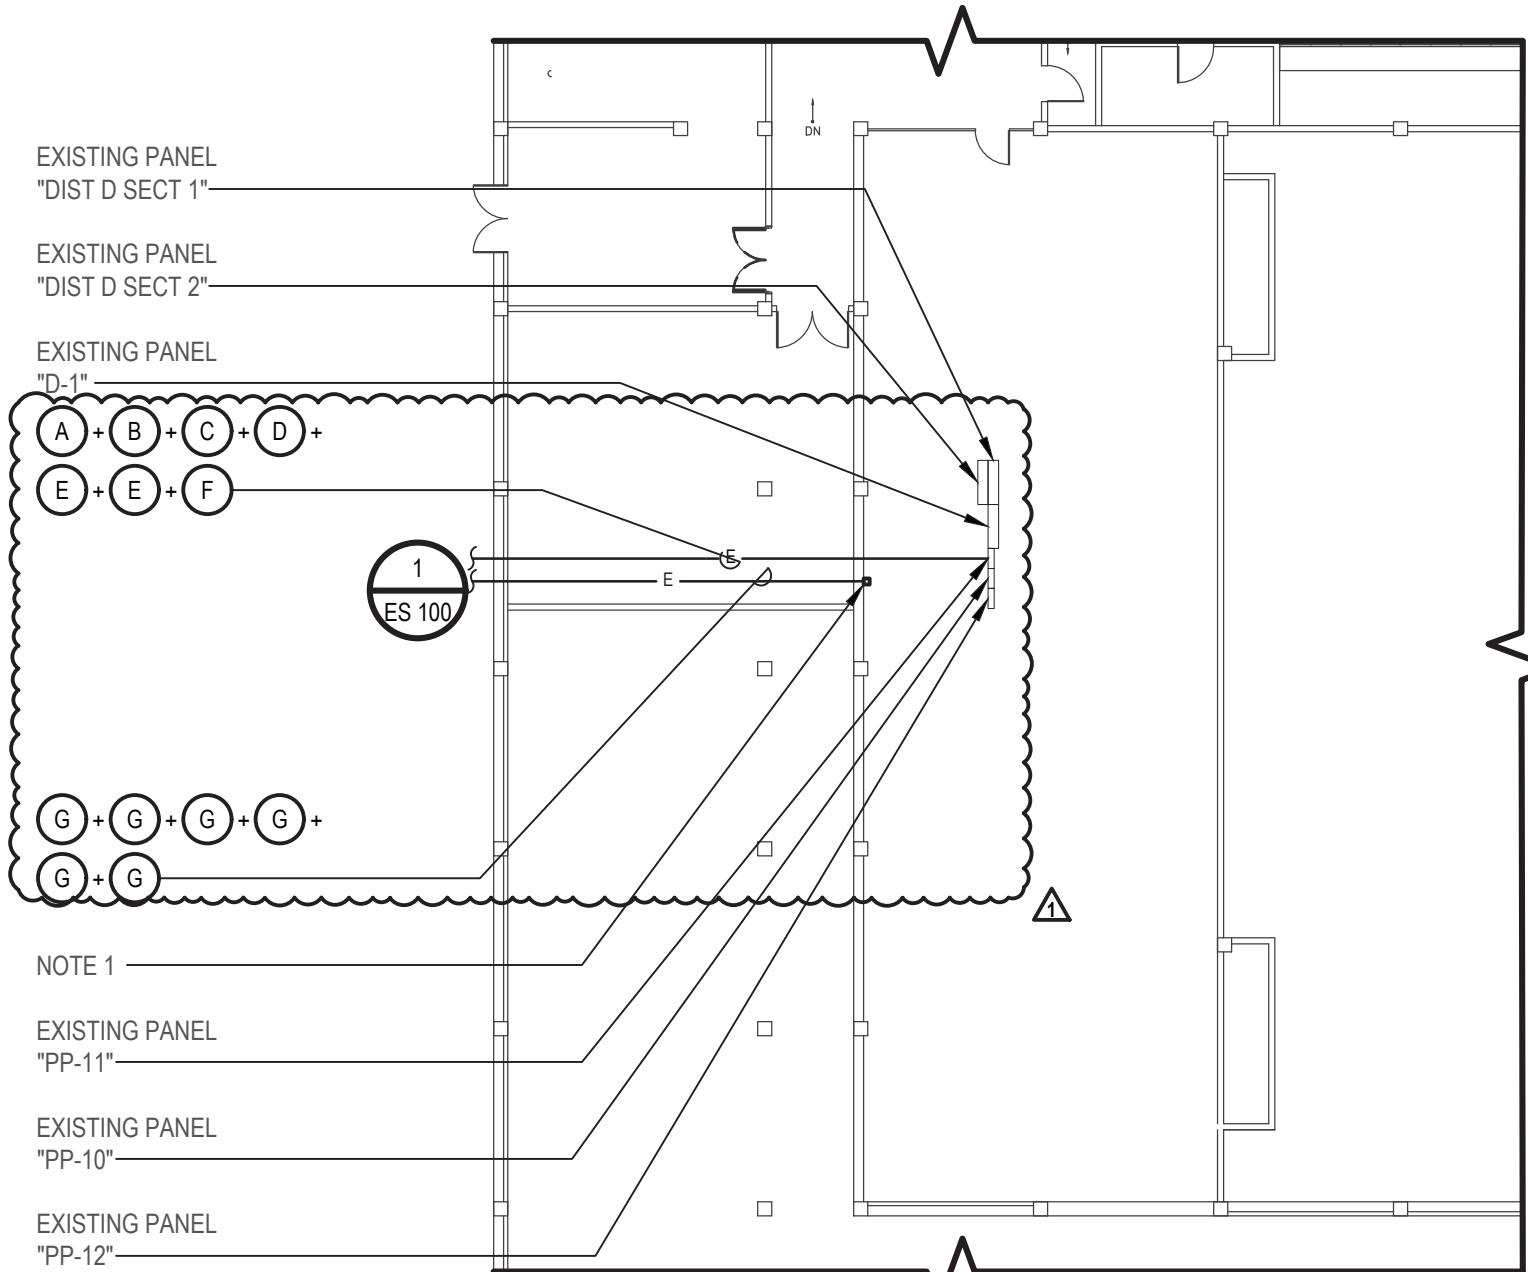

**1 Electrical Partial Basement Plan (Building D) (Note A2)**  
SCALE:1/16"=1'-0"

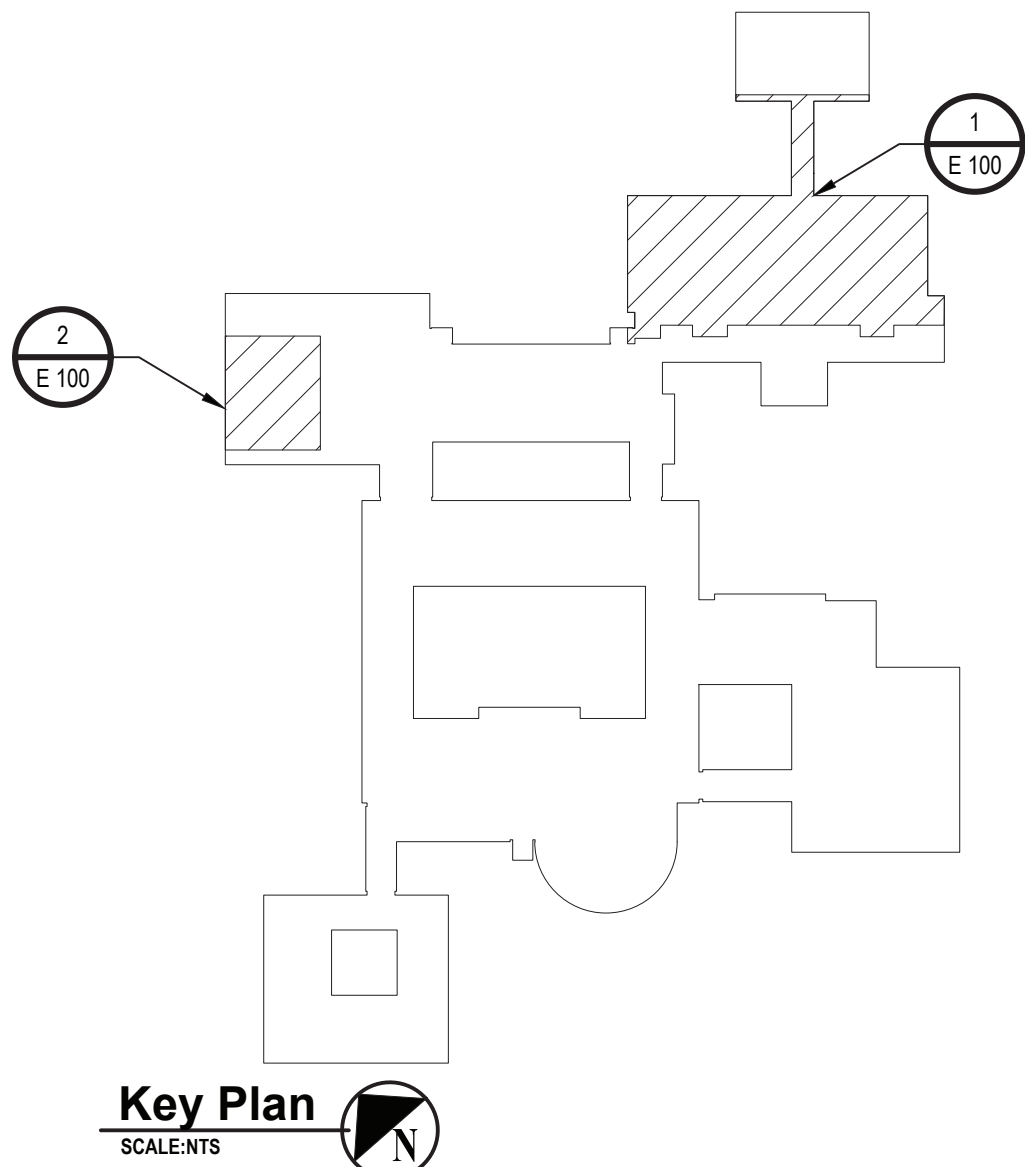

**Key Plan**  
SCALE:1/16"=1'-0"



CONSULTANTS:

MARK	DATE	DESCRIPTION
-	07-24-2023	FINAL BID SET
1	08-07-2023	ADDENDUM NO. 1




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PROJECT NO: WPSD 2206	DATE: AUGUST 2023	SCALE:	AS SHOWN

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**White Plains City School  
District**

**WHITE PLAINS HIGH SCHOOL  
UPGRADES AND TURF FIELD**



550 North Street  
White Plains, NY 10605

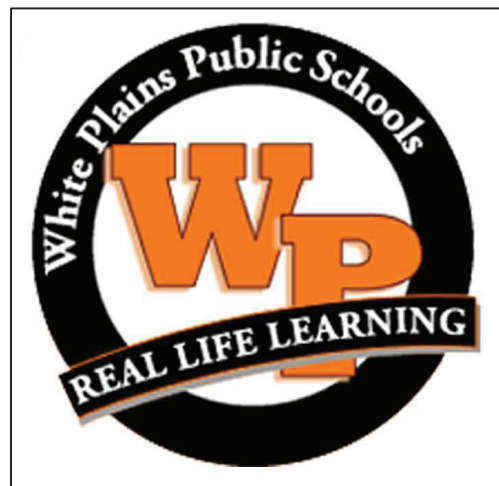SED No. 66-22-00-01-0-16-029

CONTRACT

**CONTRACT E  
ELECTRICAL CONSTRUCTION**

STATUS

**FINAL BID SET**

SHEET TITLE

**ELECTRICAL PARTIAL FIRST  
FLOOR PLANS**

DRAWING No.

**E 122.00**

**ELECTRICAL GENERAL LIGHTING NOTES:**


- GL1. PROVIDE ALL REQUIRED WIRING NECESSARY BETWEEN SWITCHES & CONTROLLERS. WHERE 3 OR 4 WAY SWITCHES ARE USED, PROVIDE ALL REQUIRED WIRING BETWEEN SWITCHES. WIRE SIZE SHALL EQUAL POWER FEED SIZE.
- GL2. FIXTURES SHALL BE CONNECTED TO LINE SIDE OF CIRCUIT.
- GL3. PROVIDE AND INSTALL A DEDICATED NEUTRAL FOR EACH CIRCUIT. CONTRACTOR IS NOT PERMITTED TO USE COMMON NEUTRALS.
- GL4. PROVIDE BOX AND ACCESSORIES AS PER MANUFACTURER'S RECOMMENDATION FOR ALL SWITCHES.
- GL5. VERIFY EXACT LOCATIONS AND MOUNTING HEIGHTS WITH ARCHITECT/ENGINEER IN FIELD.
- GL6. ALL CEILING MOUNTED FIXTURES WITH EMERGENCY DRIVERS AND ALL FIXTURES THAT ARE PART OF AN EMERGENCY LIGHTING SYSTEM, FED FROM AN EMERGENCY BATTERY BACKUP SHALL BE LABELED. THESE LABELS SHALL BE EASILY READ FROM THE FLOOR LEVEL AND STATE THAT THE FIXTURE IS AN EMERGENCY FIXTURE AND CONTAIN THE PANEL NAME AND CIRCUIT NUMBER THAT IT IS FEED FROM.
- GL7. WIRING FOR EMERGENCY DRIVER IS NOT SHOWN ON PLANS. FIXTURES WITH EMERGENCY DRIVERS SHALL BE PROVIDED WITH AN UNSWITCHED POWER FEED FROM CIRCUIT FEEDING LIGHT FIXTURE.

**ELECTRICAL LIGHTING KEY NOTES:**

- L1. CONTRACTOR SHALL PROVIDE AND EXTEND WIRE AND CONDUIT FROM THE EXISTING LIGHTING CIRCUIT SERVING THIS ROOM TO TERMINATE AT NEW LIGHT FIXTURE AND SWITCH. WIRE AND CONDUIT SHALL BE 2 #12 AWG + #12 AWG GND IN 3/4" E.C.
- L2. CONTRACTOR SHALL PROVIDE AND INSTALL AN UNSWITCHED POWER FEED FROM THE LINE SIDE OF THE LIGHT SWITCH SERVING THE LIGHT FIXTURES IN THE ROOM WHERE THE NEW EMERGENCY LIGHT FIXTURE IS SCHEDULED TO BE INSTALLED. UNSWITCHED FEED SHALL ORIGINATE FROM THE SAME CIRCUIT FEEDING LIGHT FIXTURES IN THE ROOM WHERE THE EMERGENCY LIGHT FIXTURE IS SCHEDULED TO BE INSTALLED. PROVIDE AND INSTALL WIRE AND CONDUIT AS REQUIRED. CONTRACTOR SHALL PATCH, REPAIR, RESTORE, PRIME, PAINT AND REFINISH TO MATCH ORIGINAL APPEARANCE OF ALL WALLS, CEILINGS, AND ALL BUILDING FINISHES THAT ARE DISTURBED DURING INSTALLATION OF THE UNSWITCHED POWER FEED. WIRE AND CONDUIT SHALL BE 2 #12 AWG + #12 AWG GND IN 3/4" E.C.
- L3. LIGHT FIXTURE WITH SUBSCRIPT "NL" SHALL BE NIGHT LIGHT. LIGHT FIXTURES SHALL BE ON 24 HOURS AND EMERGENCY BATTERY BACKUP. FIXTURE SHALL NOT BE CONTROLLED BY SWITCH. PROVIDE AN UNSWITCHED POWER FEED FROM CIRCUIT SERVING LIGHT IN THIS AREA. TERMINATE UNSWITCHED POWER FEED TO EMERGENCY DRIVE/BATTERY AND NORMAL UTILITY DRIVER.

**ELECTRICAL KEY NOTE:**

1. CONTRACTOR SHALL PROVIDE AND INSTALL A NEW TIME CLOCK "TC" (TORK MODEL DG100A OR APPROVED EQUAL) FOR EACH NEW EXHAUST FAN 'EF-13', 'EF-14', 'EF-15', AND 'EF-16'. PROVIDE AND INSTALL A PHENOLIC NAMEPLATE STATING "TIME CLOCK FOR ROOF EXHAUST FAN 'EF-X'" (X SHALL BE REPLACED WITH EXHAUST DAN NUMBER DESIGNATION ASSOCIATED WITH THE NEW TIME CLOCK). COORDINATE SCHEDULING WITH SCHOOL DISTRICT AND PROGRAM AS REQUIRED.

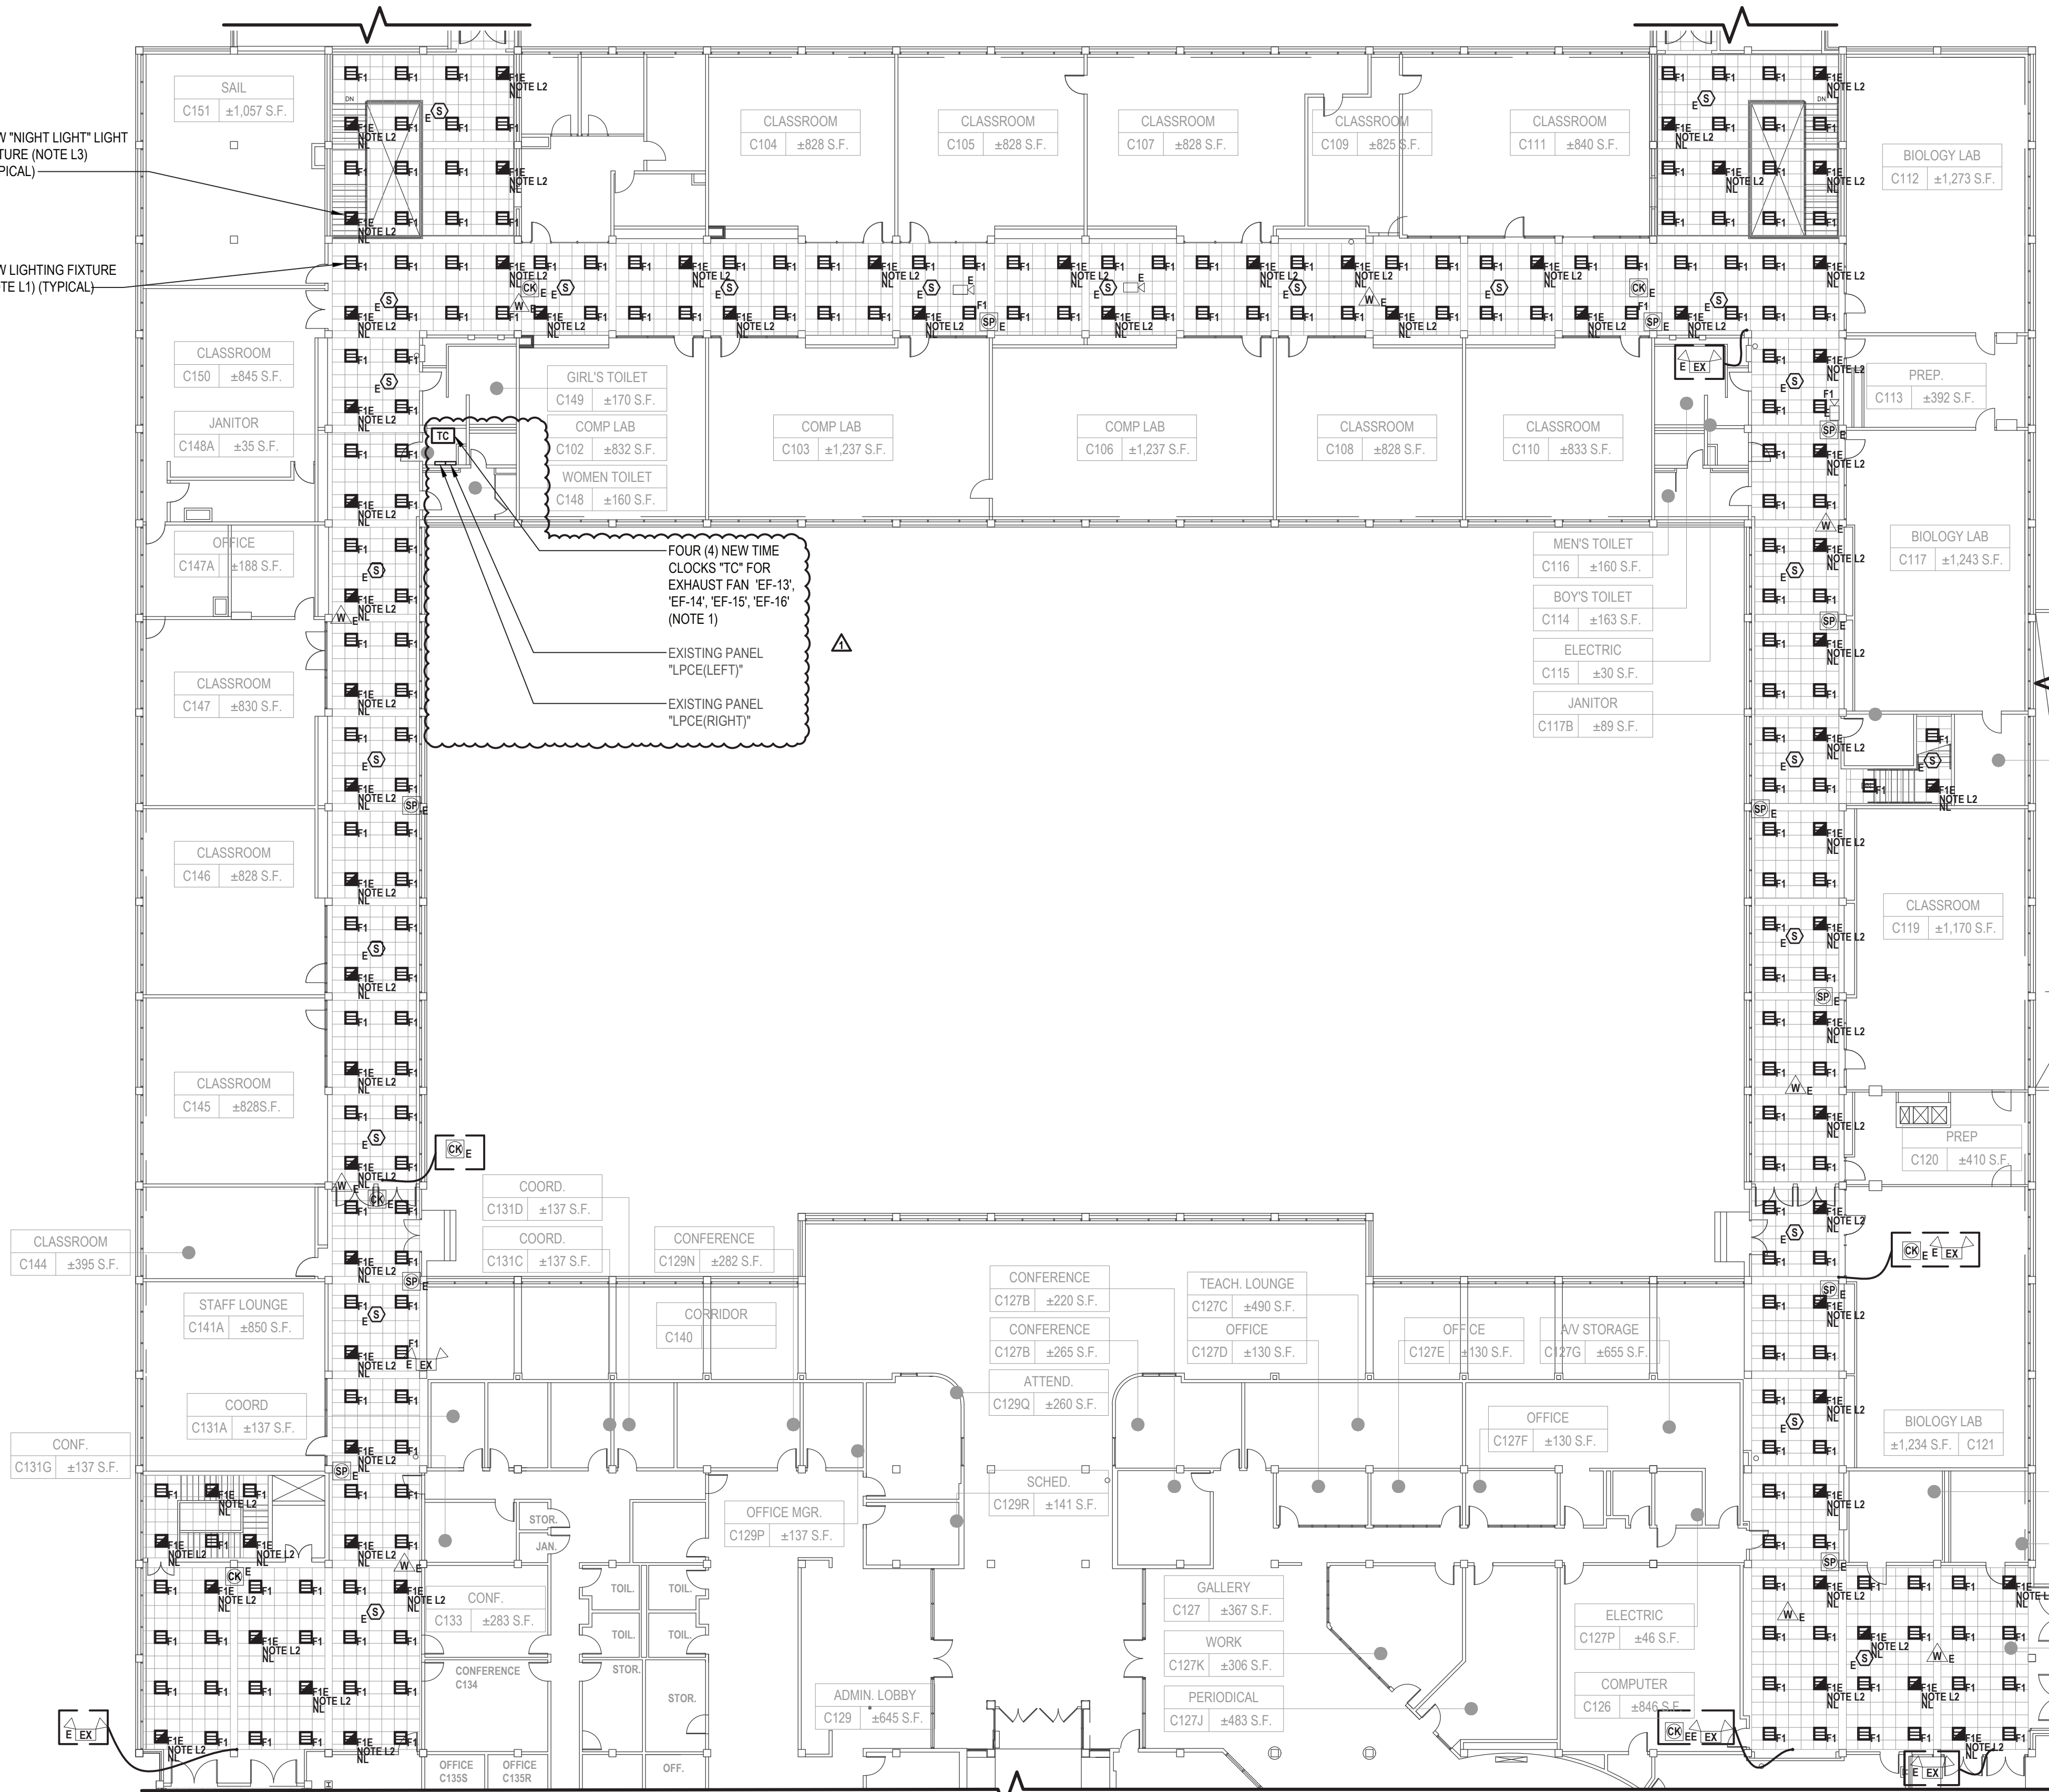

**1 Electrical First Floor Plan (Building C)**  
SCALE: 1/16"=1'-0"





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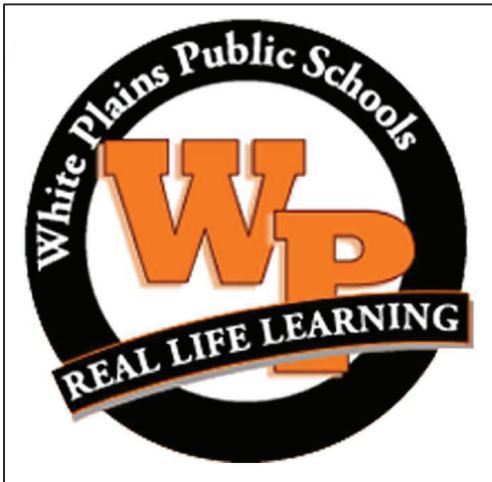
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1	08-07-2023	ADDENDUM NO. 1



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SAN	SAN		
PROJECT NO:	DATE:	SCALE:	
WPSD 2206	AUGUST 2023	AS SHOWN	

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**White Plains City School District**

**WHITE PLAINS HIGH SCHOOL  
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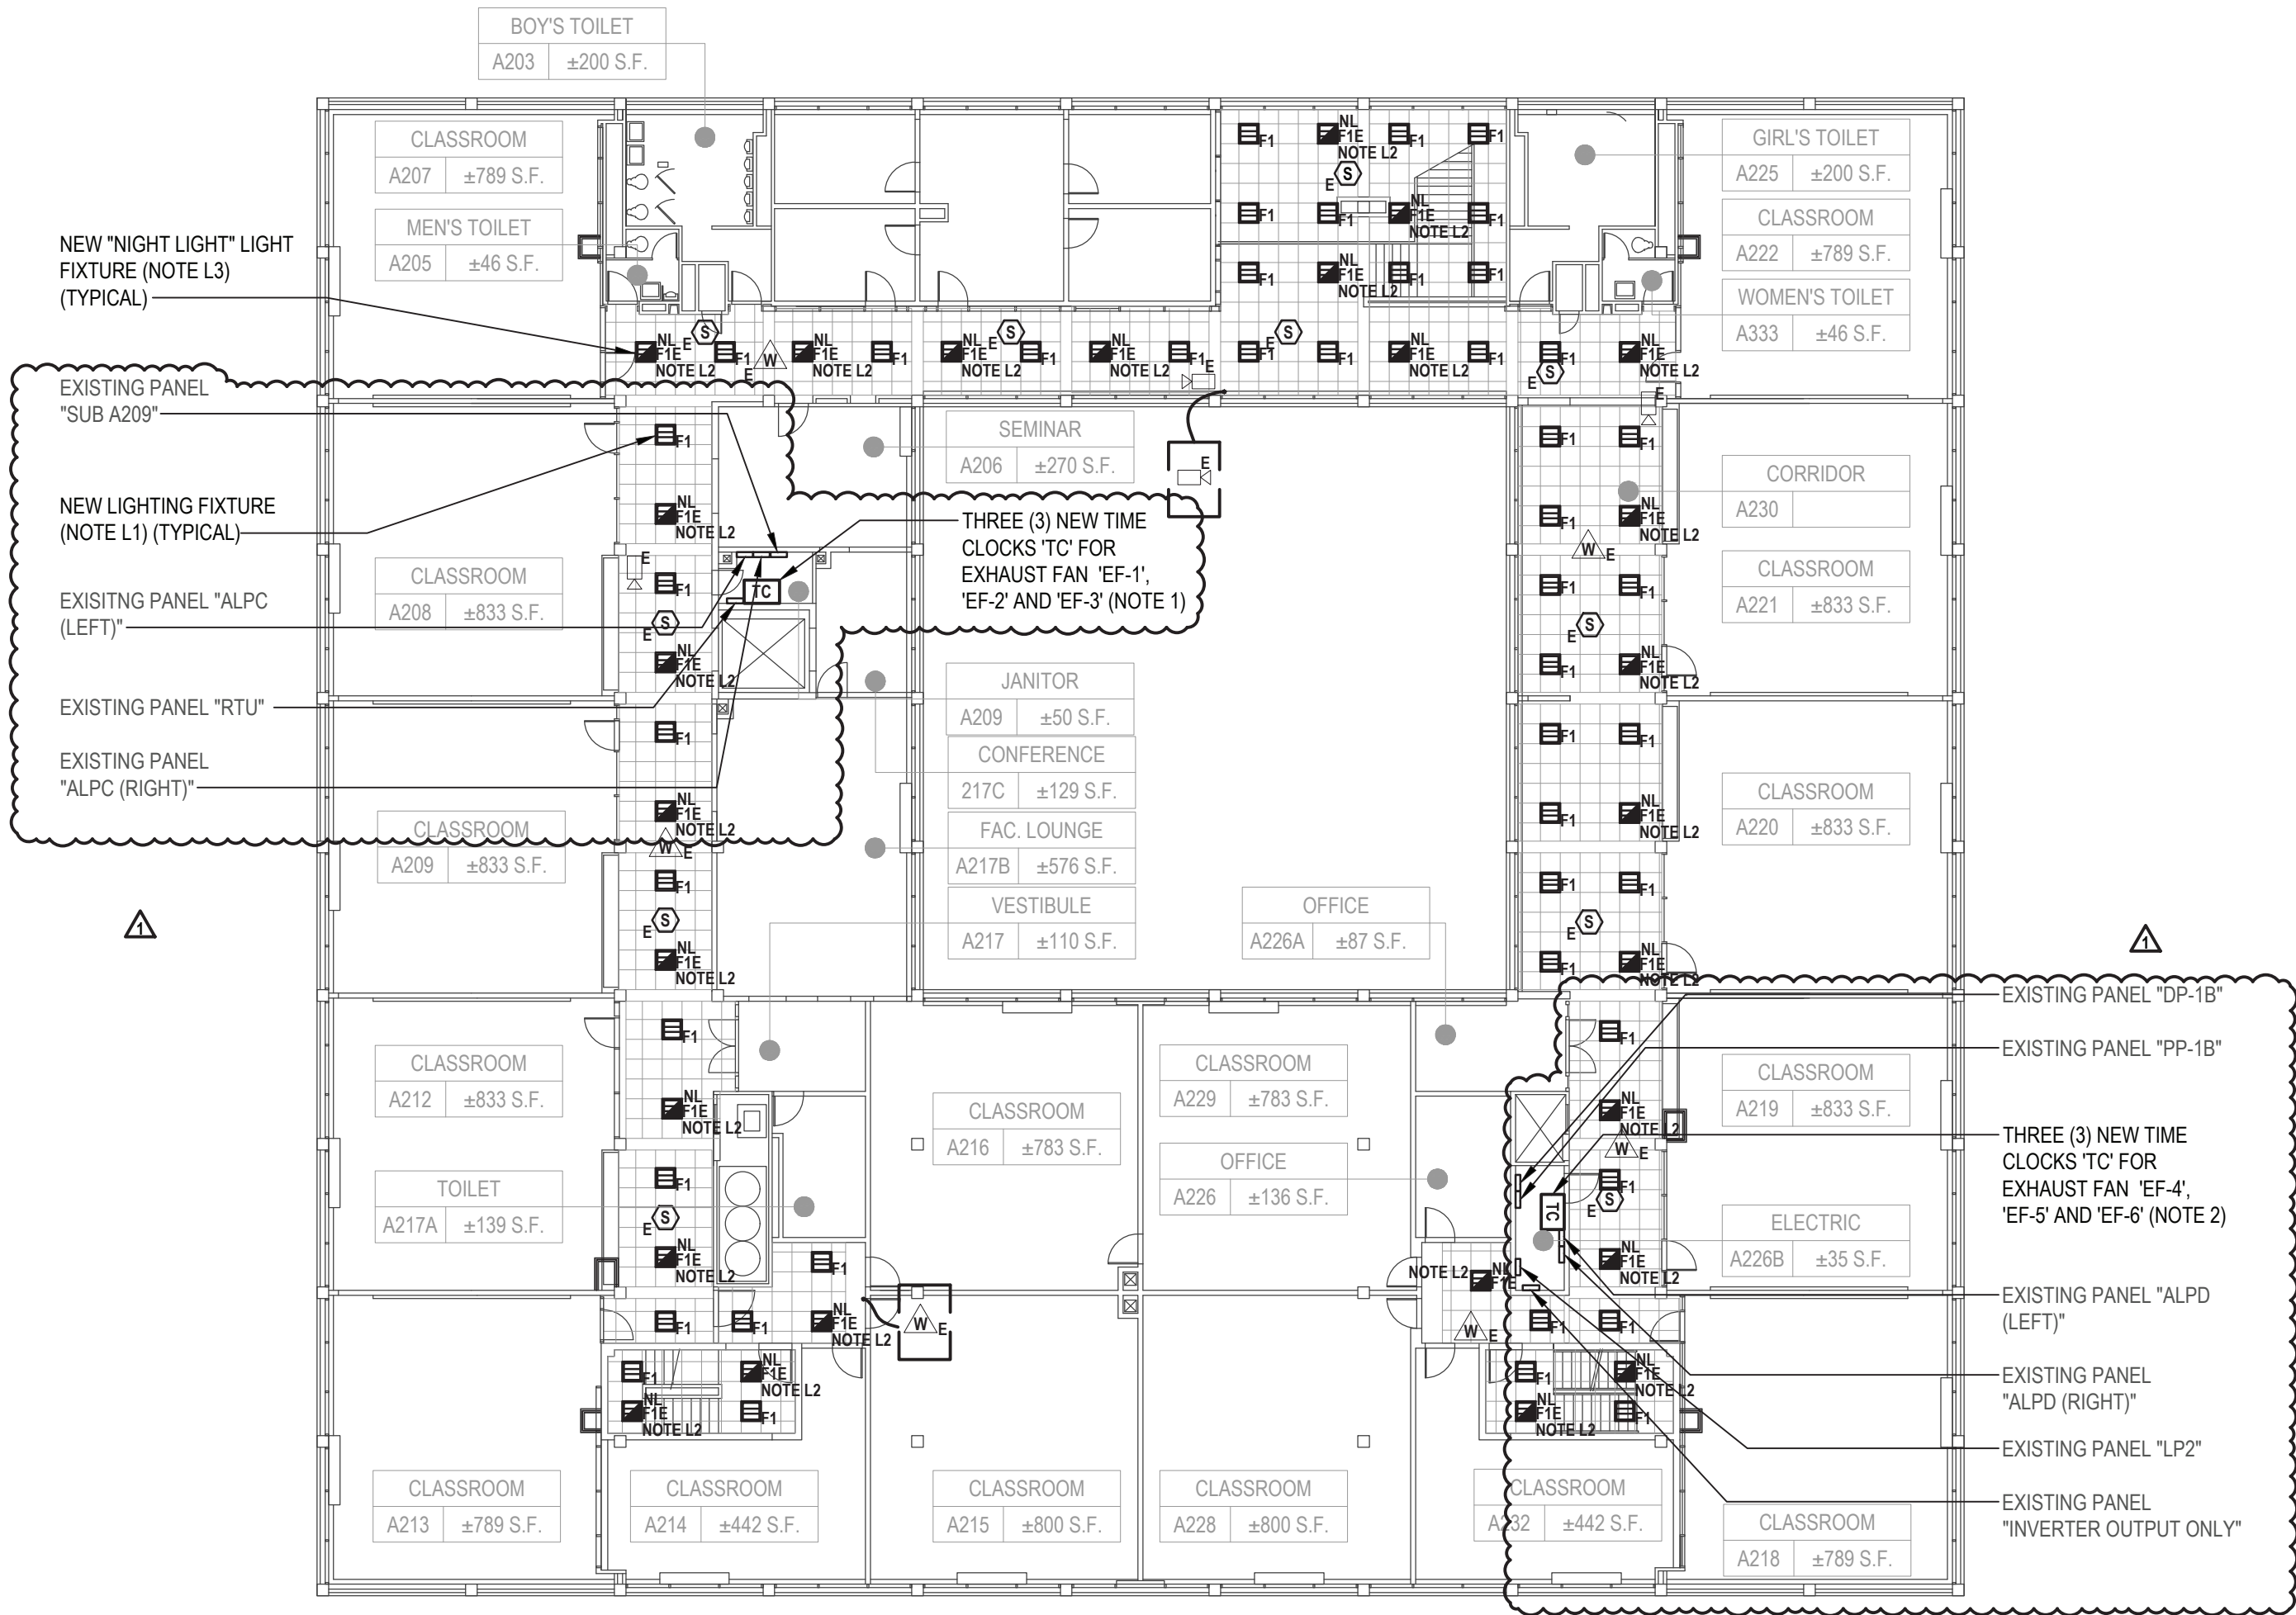


**550 North Street  
White Plains, NY 10605**

**SED No. 66-22-00-01-0-16-029**

CONTRACT	<b>CONTRACT E ELECTRICAL CONSTRUCTION</b>
STATUS	<b>FINAL BID SET</b>
SHEET TITLE	<b>ELECTRICAL PARTIAL SECOND FLOOR PLANS</b>

DRAWING No.  
**E 130.00**



**1 Electrical Second Floor Plan (Building A) (Note A1)**  
SCALE: 1/16"=1'-0"

**ELECTRICAL GENERAL LIGHTING NOTES:**

- GL1. PROVIDE ALL REQUIRED WIRING NECESSARY BETWEEN SWITCHES & CONTROLLERS. WHERE 3 OR 4 WAY SWITCHES ARE USED, PROVIDE ALL REQUIRED WIRING BETWEEN SWITCHES. WIRE SIZE SHALL EQUAL POWER FEED SIZE.
- GL2. FIXTURES SHALL BE CONNECTED TO LINE SIDE OF CIRCUIT.
- GL3. PROVIDE AND INSTALL A DEDICATED NEUTRAL FOR EACH CIRCUIT. CONTRACTOR IS NOT PERMITTED TO USE COMMON NEUTRALS.
- GL4. PROVIDE BOX AND ACCESSORIES AS PER MANUFACTURER'S RECOMMENDATION FOR ALL SWITCHES.
- GL5. VERIFY EXACT LOCATIONS AND MOUNTING HEIGHTS WITH ARCHITECT/ENGINEER IN FIELD.
- GL6. ALL CEILING MOUNTED FIXTURES WITH EMERGENCY DRIVERS AND ALL FIXTURES THAT ARE PART OF AN EMERGENCY LIGHTING SYSTEM, FED FROM AN EMERGENCY BATTERY BACKUP SHALL BE LABELED. THESE LABELS SHALL BE EASILY READ FROM THE FLOOR LEVEL AND STATE THAT THE FIXTURE IS AN EMERGENCY FIXTURE AND CONTAIN THE PANEL NAME AND CIRCUIT NUMBER THAT IT IS FEED FROM.
- GL7. WIRING FOR EMERGENCY DRIVER IS NOT SHOWN ON PLANS. FIXTURES WITH EMERGENCY DRIVERS SHALL BE PROVIDED WITH AN UNSWITCHED POWER FEED FROM CIRCUIT FEEDING LIGHT FIXTURE.

**ELECTRICAL LIGHTING KEY NOTES:**


- L1. CONTRACTOR SHALL PROVIDE AND EXTEND WIRE AND CONDUIT FROM THE EXISTING LIGHTING CIRCUIT SERVING THIS ROOM TO TERMINATE AT NEW LIGHT FIXTURE AND SWITCH. WIRE AND CONDUIT SHALL BE 2 #12 AWG + #12 AWG GND IN 3/4" E.C.
- L2. CONTRACTOR SHALL PROVIDE AND INSTALL AN UNSWITCHED POWER FEED FROM THE LINE SIDE OF THE LIGHT SWITCH SERVING THE LIGHT FIXTURES IN THE ROOM WHERE THE NEW EMERGENCY LIGHT FIXTURE IS SCHEDULED TO BE INSTALLED. UNSWITCHED FEED SHALL ORIGINATE FROM THE SAME CIRCUIT FEEDING LIGHT FIXTURES IN THE ROOM WHERE THE EMERGENCY LIGHT FIXTURE IS SCHEDULED TO BE INSTALLED. PROVIDE AND INSTALL WIRE AND CONDUIT AS REQUIRED. CONTRACTOR SHALL PATCH, REPAIR, RESTORE, PRIME, PAINT AND REFINISH TO MATCH ORIGINAL APPEARANCE OF ALL WALLS, CEILINGS, AND ALL BUILDING FINISHES THAT ARE DISTURBED DURING INSTALLATION OF THE UNSWITCHED POWER FEED. WIRE AND CONDUIT SHALL BE 2 #12 AWG + #12 AWG GND IN 3/4" E.C.
- L3. LIGHT FIXTURE WITH SUBSCRIPT "NL" SHALL BE NIGHT LIGHT. LIGHT FIXTURES SHALL BE ON 24 HOURS AND EMERGENCY BATTERY BACKUP. FIXTURE SHALL NOT BE CONTROLLED BY SWITCH. PROVIDE AN UNSWITCHED POWER FEED FROM CIRCUIT SERVING LIGHT IN THIS AREA. TERMINATE UNSWITCHED POWER FEED TO EMERGENCY DRIVE/BATTERY AND NORMAL UTILITY DRIVER.

**ADD/ALTERNATE NOTES:**


- A1. CONTRACTOR SHALL PROVIDE ALL LABOR AND MATERIAL COST ASSOCIATED WITH WORK SHOWN ON THIS DETAIL IN ADD/ALTERNATE E1 ONLY.
- A2. CONTRACTOR SHALL PROVIDE ALL LABOR AND MATERIAL COST ASSOCIATED WITH WORK SHOWN ON THIS DETAIL IN ADD/ALTERNATE E2 ONLY.

**ELECTRICAL KEY NOTES:**

1. CONTRACTOR SHALL PROVIDE AND INSTALL A NEW TIME CLOCK "TC" (TORK MODEL DG100A OR APPROVED EQUAL) FOR EACH NEW EXHAUST FAN "EF-1", "EF-2", AND "EF-3". PROVIDE AND INSTALL A PHENOLIC NAMEPLATE STATING "TIME CLOCK FOR ROOF EXHAUST FAN "EF-X" ("X" SHALL BE REPLACED WITH EXHAUST DAN NUMBER DESIGNATION ASSOCIATED WITH THE NEW TIME CLOCK). COORDINATE SCHEDULING WITH SCHOOL DISTRICT AND PROGRAM AS REQUIRED.
2. CONTRACTOR SHALL PROVIDE AND INSTALL A NEW TIME CLOCK "TC" (TORK MODEL DG100A OR APPROVED EQUAL) FOR EACH NEW EXHAUST FAN "EF-4", "EF-5", AND "EF-6". PROVIDE AND INSTALL A PHENOLIC NAMEPLATE STATING "TIME CLOCK FOR ROOF EXHAUST FAN "EF-X" ("X" SHALL BE REPLACED WITH EXHAUST DAN NUMBER DESIGNATION ASSOCIATED WITH THE NEW TIME CLOCK). COORDINATE SCHEDULING WITH SCHOOL DISTRICT AND PROGRAM AS REQUIRED.
3. CONTRACTOR SHALL PROVIDE AND INSTALL A NEW TIME CLOCK "TC" (TORK MODEL DG100A OR APPROVED EQUAL) FOR EACH NEW EXHAUST FAN "EF-7", "EF-8", AND "EF-10". PROVIDE AND INSTALL A PHENOLIC NAMEPLATE STATING "TIME CLOCK FOR ROOF EXHAUST FAN "EF-X" ("X" SHALL BE REPLACED WITH EXHAUST DAN NUMBER DESIGNATION ASSOCIATED WITH THE NEW TIME CLOCK). COORDINATE SCHEDULING WITH SCHOOL DISTRICT AND PROGRAM AS REQUIRED.
4. CONTRACTOR SHALL PROVIDE AND INSTALL A NEW TIME CLOCK "TC" (TORK MODEL DG100A OR APPROVED EQUAL) FOR EACH NEW EXHAUST FAN "EF-9", "EF-11", AND "EF-12". PROVIDE AND INSTALL A PHENOLIC NAMEPLATE STATING "TIME CLOCK FOR ROOF EXHAUST FAN "EF-X" ("X" SHALL BE REPLACED WITH EXHAUST DAN NUMBER DESIGNATION ASSOCIATED WITH THE NEW TIME CLOCK). COORDINATE SCHEDULING WITH SCHOOL DISTRICT AND PROGRAM AS REQUIRED.

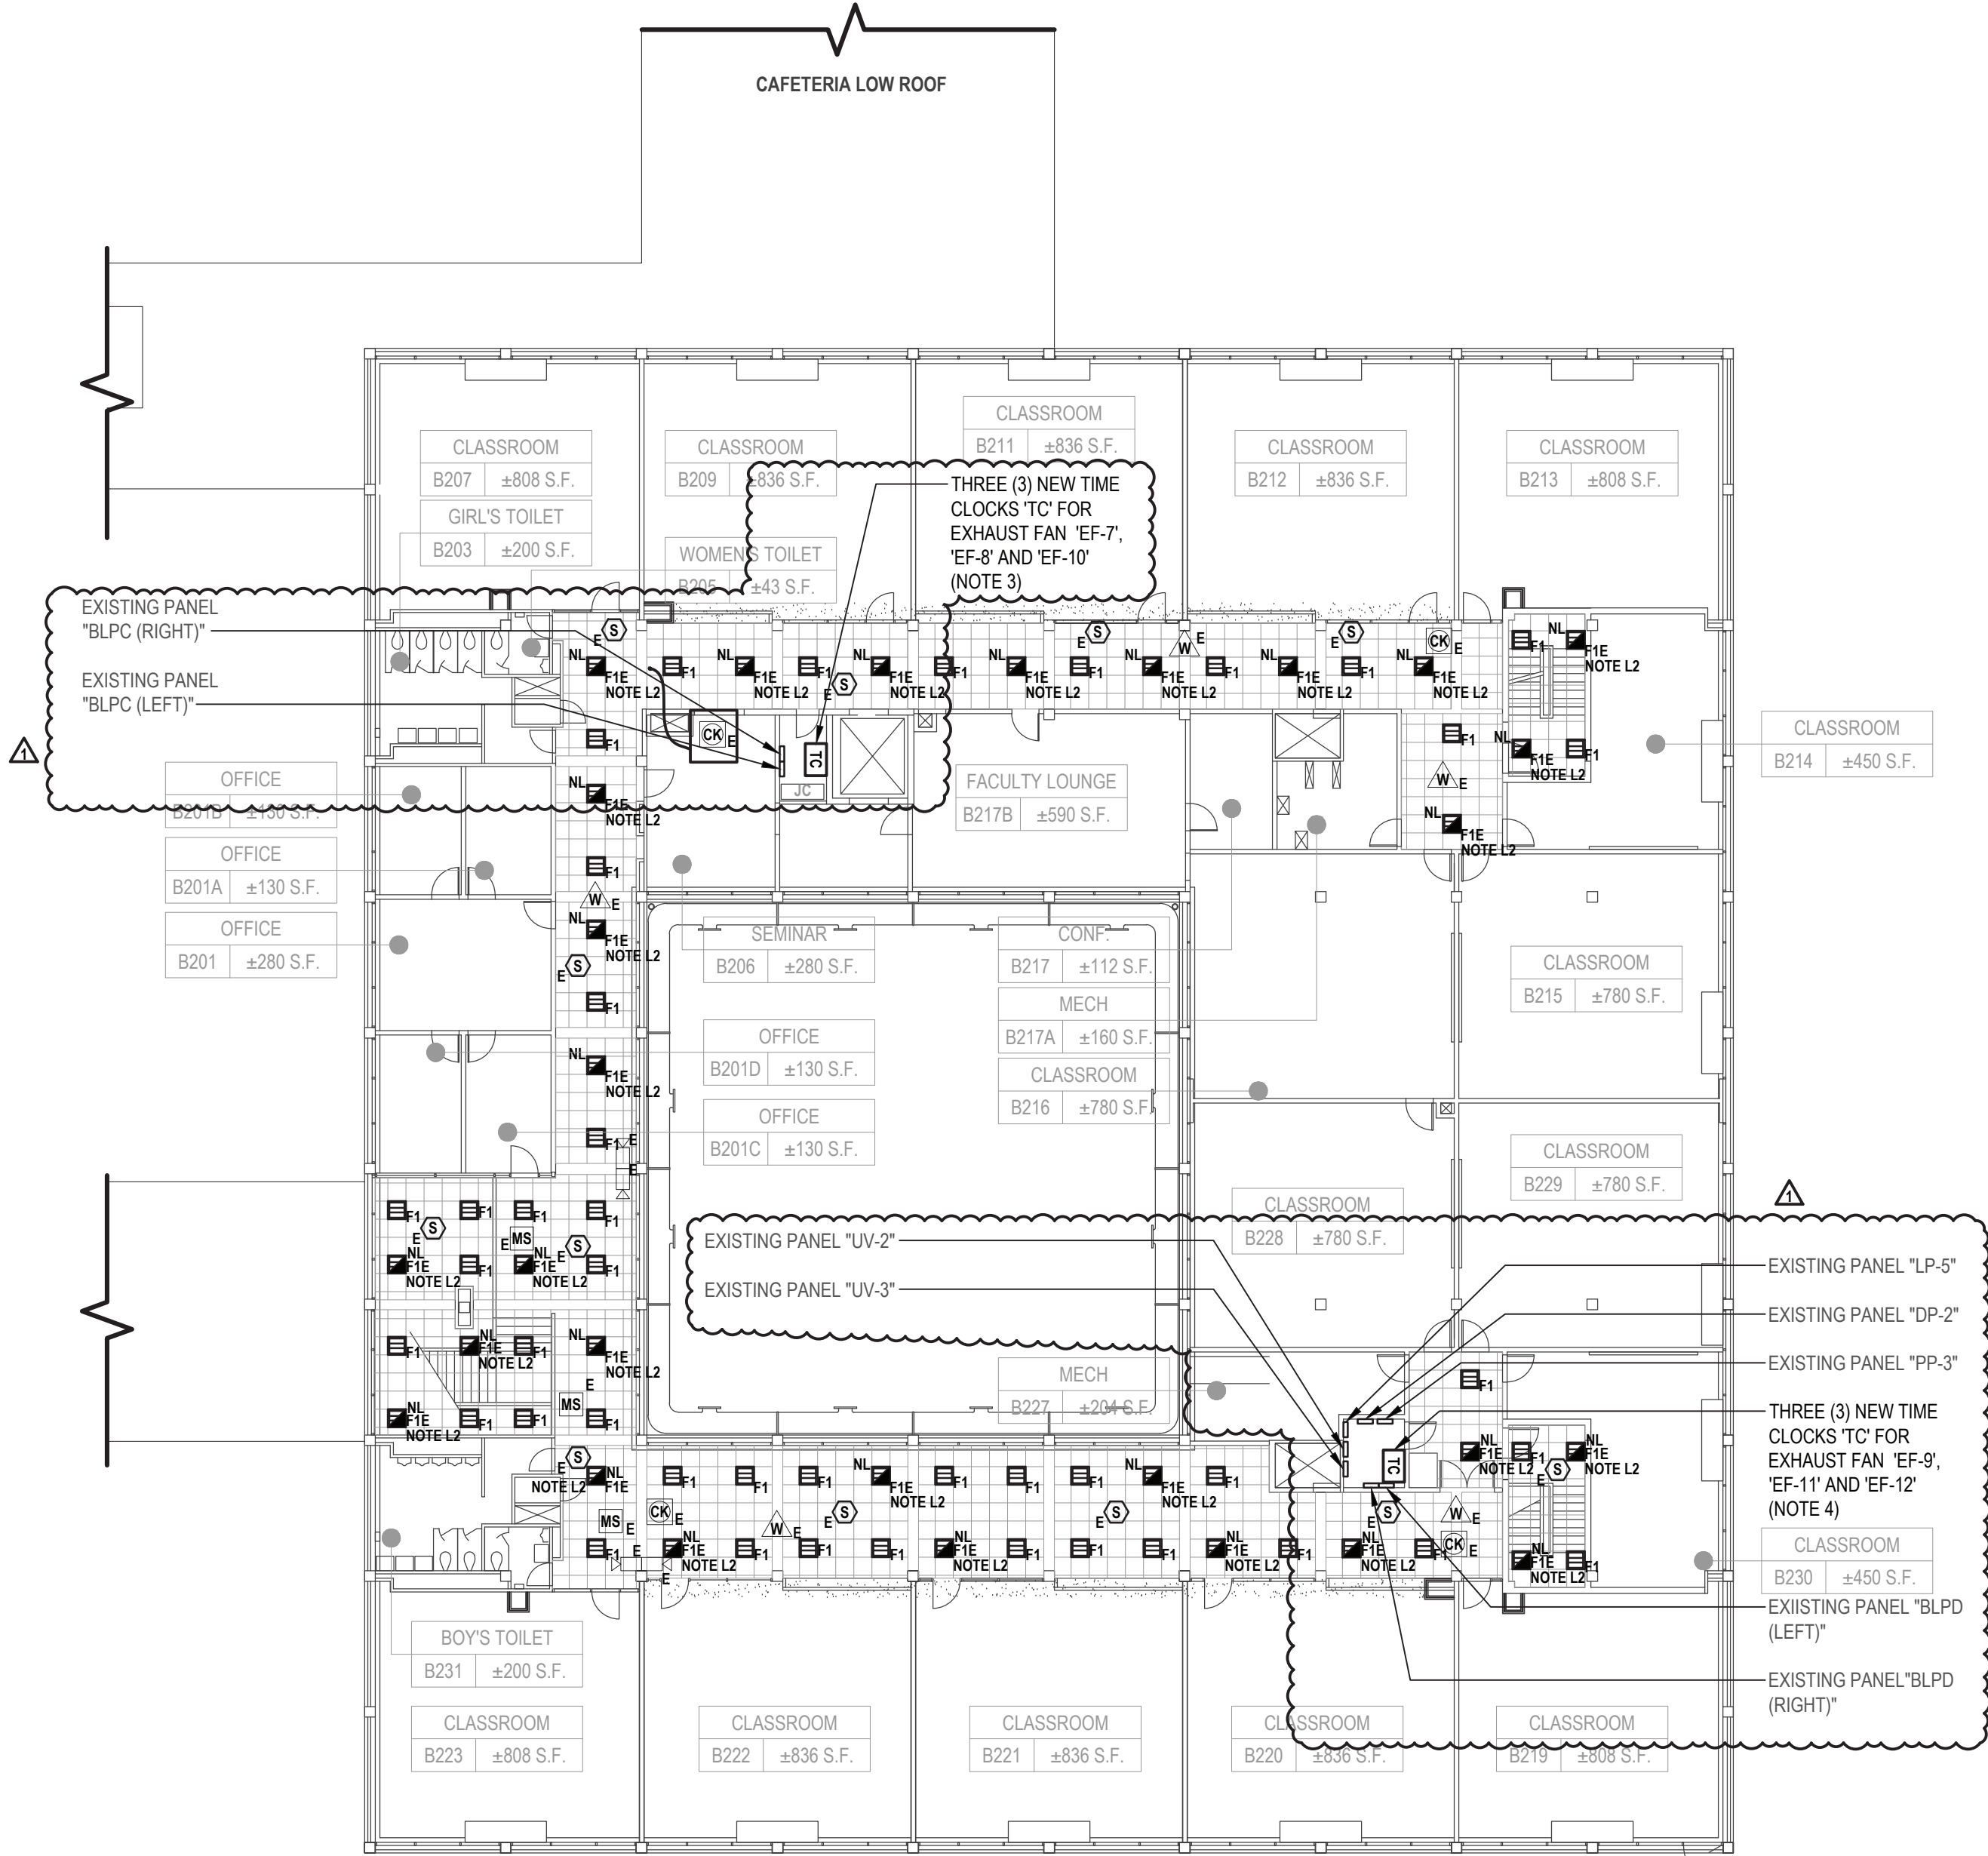


**2 Electrical Second Floor Plan (Building B) (Note A2)**  
SCALE: 1/16"=1'-0"

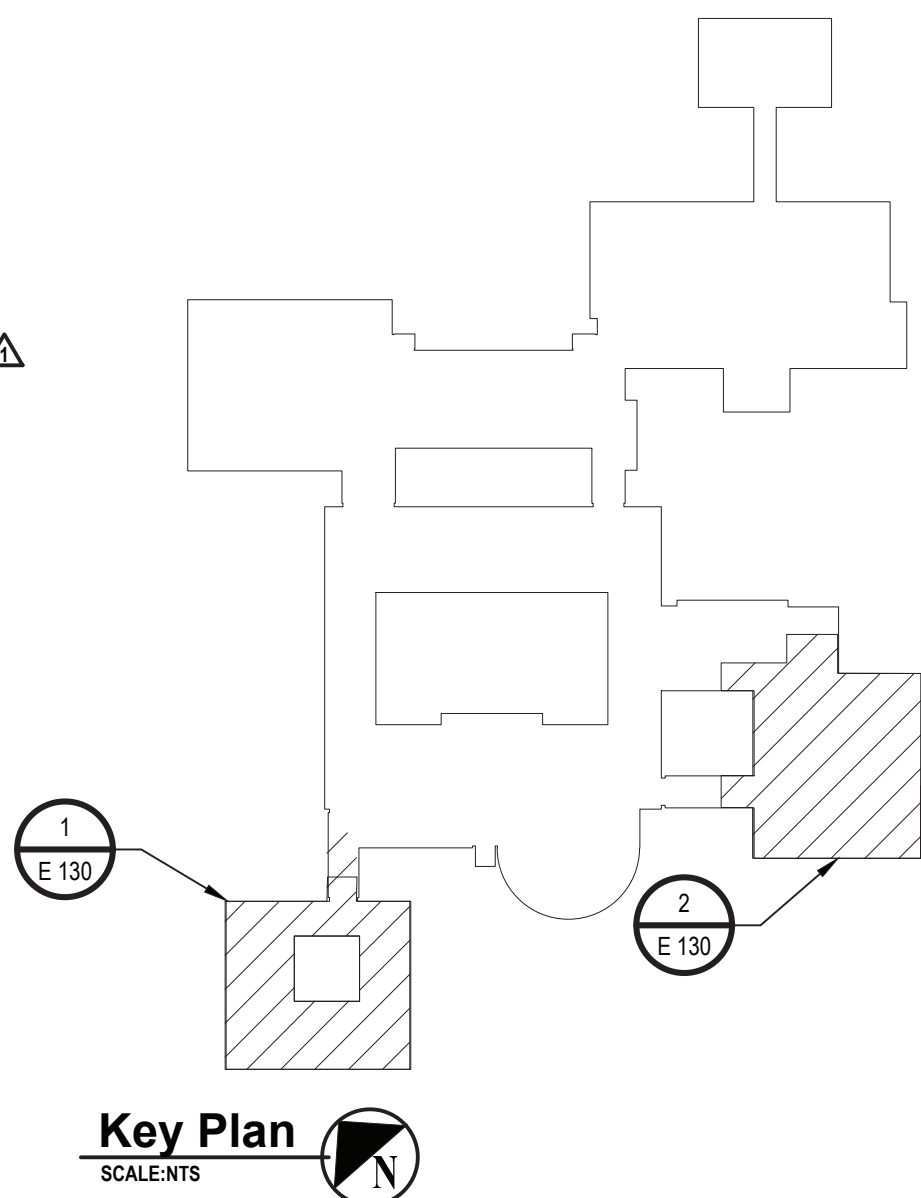

**Key Plan**  
SCALE: 1/16"=1'-0"



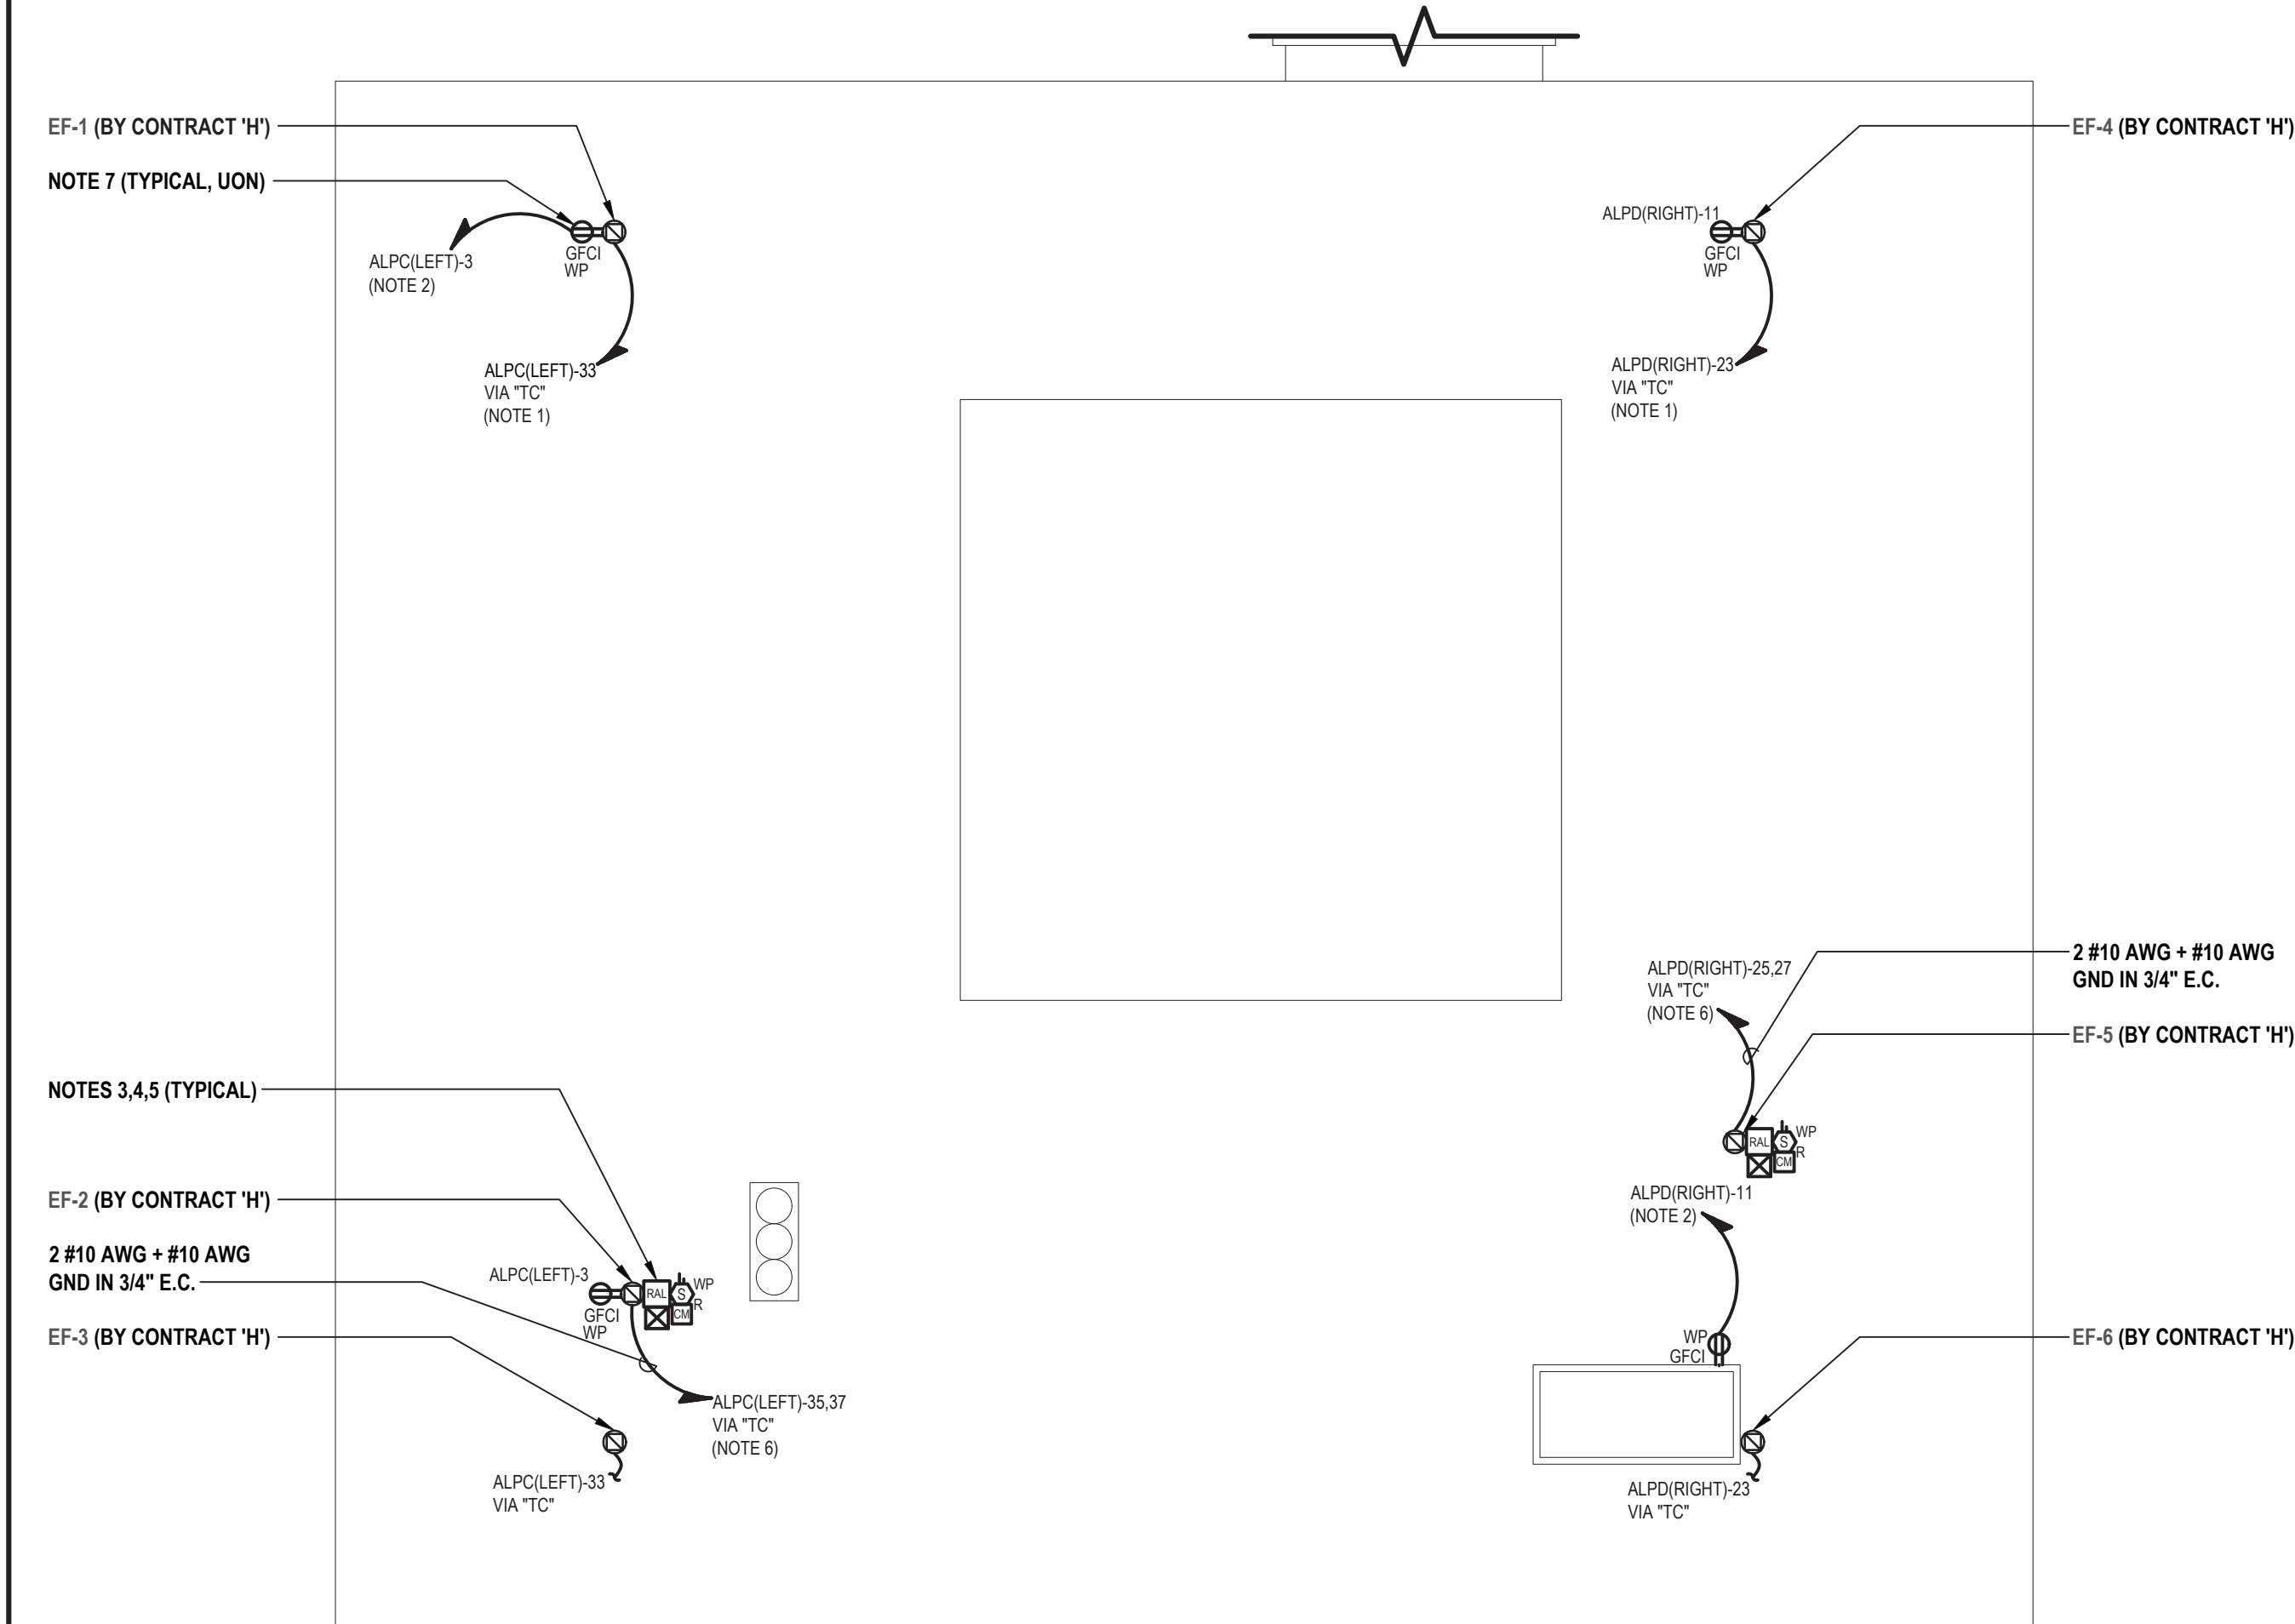



1 Electrical Partial Roof Plan (Building A)  
SCALE: 1/16"=1'-0"

**ELECTRICAL GENERAL NOTES:**

- G1. REFER TO DRAWING E 130 FOR APPROXIMATE LOCATION OF EXISTING PANELS, NEW TIME CLOCKS AND ADDITIONAL INFORMATION.
- G2. CONTRACTOR SHALL PROVIDE AND INSTALL ALL WIRE AND CONDUIT AS REQUIRED TO TERMINATE TO FACTORY PROVIDED DISCONNECT SWITCH.

**ELECTRICAL KEY NOTES:**

- CONTRACTOR SHALL BE PERMITTED TO USE EXISTING 15A/1P SPARE CIRCUIT BREAKER IN EXISTING PANEL. PROVIDE AND INSTALL MOUNTING HARDWARE AS REQUIRED.
- CONTRACTOR SHALL BE PERMITTED TO USE EXISTING 20A/1P SPARE CIRCUIT BREAKER IN EXISTING PANEL. PROVIDE AND INSTALL MOUNTING HARDWARE AS REQUIRED.
- CONTRACTOR SHALL PROVIDE AND INSTALL NEW FIRE ALARM DEVICES AND ALL NECESSARY EQUIPMENT TO MAKE A PROPER CONNECTION TO EXISTING FIRE ALARM CONTROL PANEL "FACP" LOCATED IN THE CUSTODIAN OFFICE C030 IN THE GROUND FLOOR USING MANUFACTURERS RECOMMENDED WIRING IN 3/4" E.C. CONTRACTOR SHALL PROVIDE AND EXTEND POWER/DATA FEEDS TO NEW FIRE ALARM DEVICE LOCATION. PROVIDE AND INSTALL ALL EXPANSION CARDS, WIRE, CONDUIT, RELAYS, POWER SUPPLIES, BATTERIES, EXTENDERS, PROGRAMMING, MOUNTING HARDWARE, AND JUNCTION BOXES AS REQUIRED. COORDINATE EXACT MOUNTING LOCATION AND HEIGHT WITH ARCHITECT PRIOR TO INSTALLATION. TYPICAL OF ALL FIRE ALARM DEVICES.
- CONTRACTOR SHALL INSTALL DUCT SMOKE DETECTOR UPSTREAM OF ANY FILTERS. EXHAUST AIR CONNECTIONS, OUTDOOR AIR CONNECTIONS, OR DECONTAMINATION EQUIPMENT. PROVIDE AND INSTALL REMOTE ALARM LAMP ON FINISHED CEILING BELOW FOR ALL DUCT SMOKE DETECTORS INSTALLED ABOVE CEILINGS OR ON ROOFS.
- CONTRACTOR SHALL PROVIDE AND INSTALL NEW ADDRESSABLE SHUTDOWN CONTROL MODULES, ASSOCIATED RELAYS, STARTERS, WIRE AND CONDUIT AS REQUIRED TO INTEGRATE NEW HVAC EQUIPMENT WITH FIRE ALARM SYSTEM. NEW HVAC EQUIPMENT TO BE INTERCONNECTED TO THE FIRE ALARM SYSTEM AND SHUT DOWN UPON FIRE ALARM SYSTEM ACTIVATION. INTERFACE WITH DESIGNATED UNITS.
- CONTRACTOR SHALL REMOVE AND TURN OVER TO SCHOOL DISTRICT TWO (2) EXISTING 15A/1P CIRCUIT BREAKERS IN EXISTING PANEL. CONTRACTOR SHALL PROVIDE AND INSTALL A NEW 25A/2P CIRCUIT BREAKER IN EXISTING PANEL. PROVIDE AND INSTALL ALL MOUNTING HARDWARE AS REQUIRED. NEW CIRCUIT BREAKER SHALL BE LISTED/LABELED FOR USE IN EXISTING PANEL. AMPERE INTERRUPTING CAPACITY (AIC) SHALL MATCH OR EXCEED EXISTING PANEL RATING. REFER TO PANEL SCHEDULE FOR ADDITIONAL INFORMATION.
- CONTRACTOR SHALL PROVIDE AND INSTALL A CHANNEL SUPPORT SYSTEM AS REQUIRED TO MOUNT RECEPTACLE FROM THE ROOF CURBS SUPPORTING THE HVAC UNIT SUCH THAT THE UNITS MANUFACTURER'S WARRANTY IS NOT VOIDED. PROVIDE AND INSTALL ALL MOUNTING HARDWARE AND ACCESSORIES AS REQUIRED TO MAINTAIN WORKING CLEARANCE AS PER NEC 110.26. MAINTAIN ALL CLEARANCES FROM THE HVAC UNIT AS REQUIRED BY THE IMC.

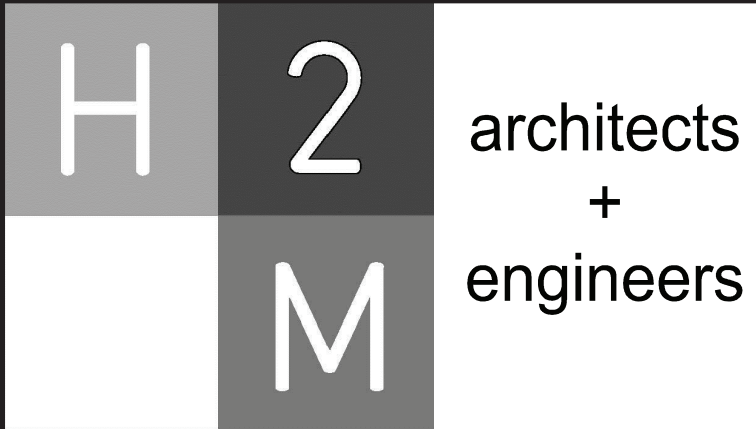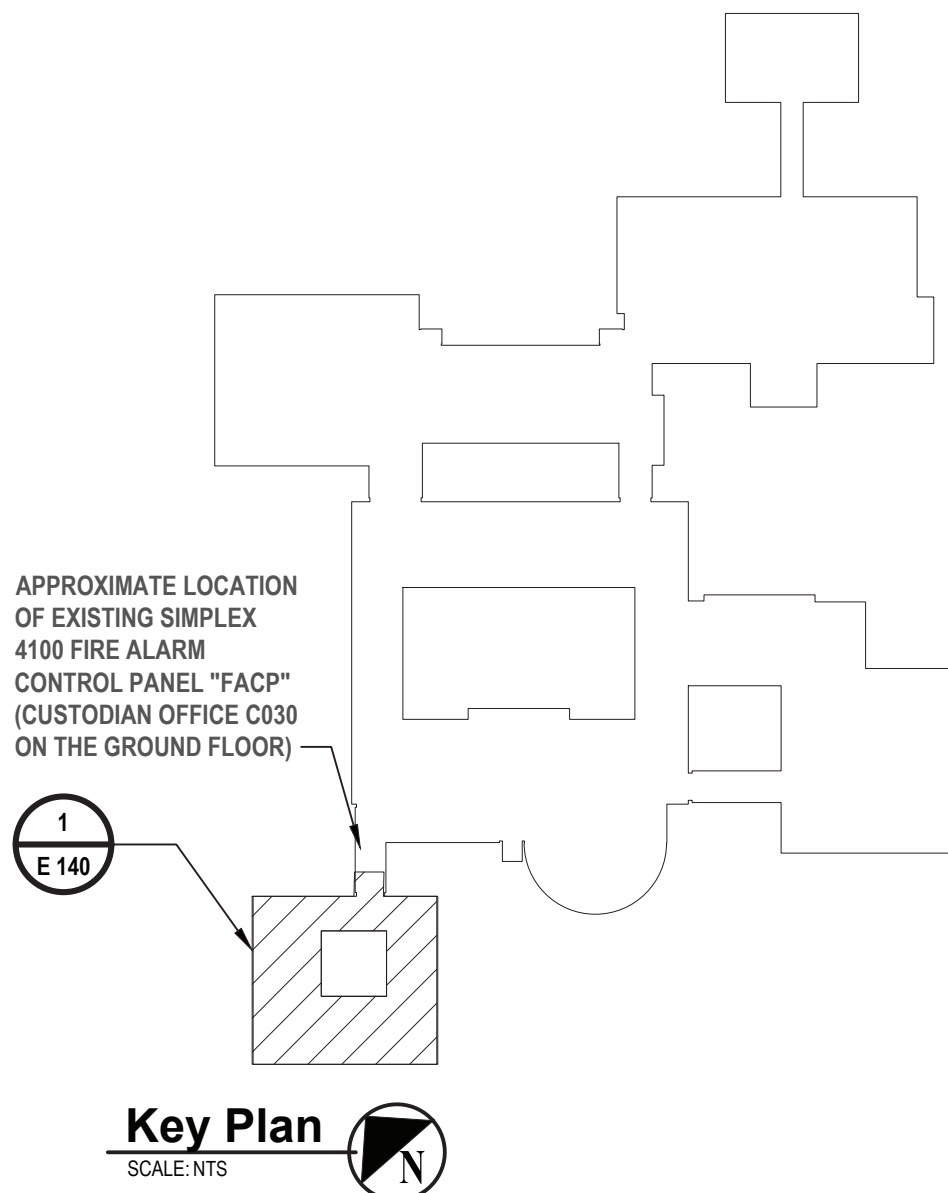

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Purchase, NY 10577  
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CONSULTANTS:

MARK	DATE	DESCRIPTION
-	07-24-2023	FINAL BID SET
1	08-07-2023	ADDENDUM NO. 1



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PROJECT NO: WPSD 2206	DATE: AUGUST 2023	SCALE:	AS SHOWN

CLIENT  
**White Plains City School District**

**WHITE PLAINS HIGH SCHOOL  
UPGRADES AND TURF FIELD**



**550 North Street  
White Plains, NY 10605**

**SED No. 66-22-00-01-0-16-029**

CONTRACT  
**CONTRACT E  
ELECTRICAL CONSTRUCTION**


STATUS  
**FINAL BID SET**

SHEET TITLE  
**ELECTRICAL PARTIAL ROOF  
PLAN BUILDING A**

DRAWING No.  
**E 140.00**

WPSD (White Plains City School District) 2206 (High School Upgrades and Turf Field) 16-E-140-Electrical Partial Roof Plan Building A.dwg, last Modified: Aug 04, 2023, 11:12am, Printed on: Aug 04, 2023, 4:49pm By: ksh



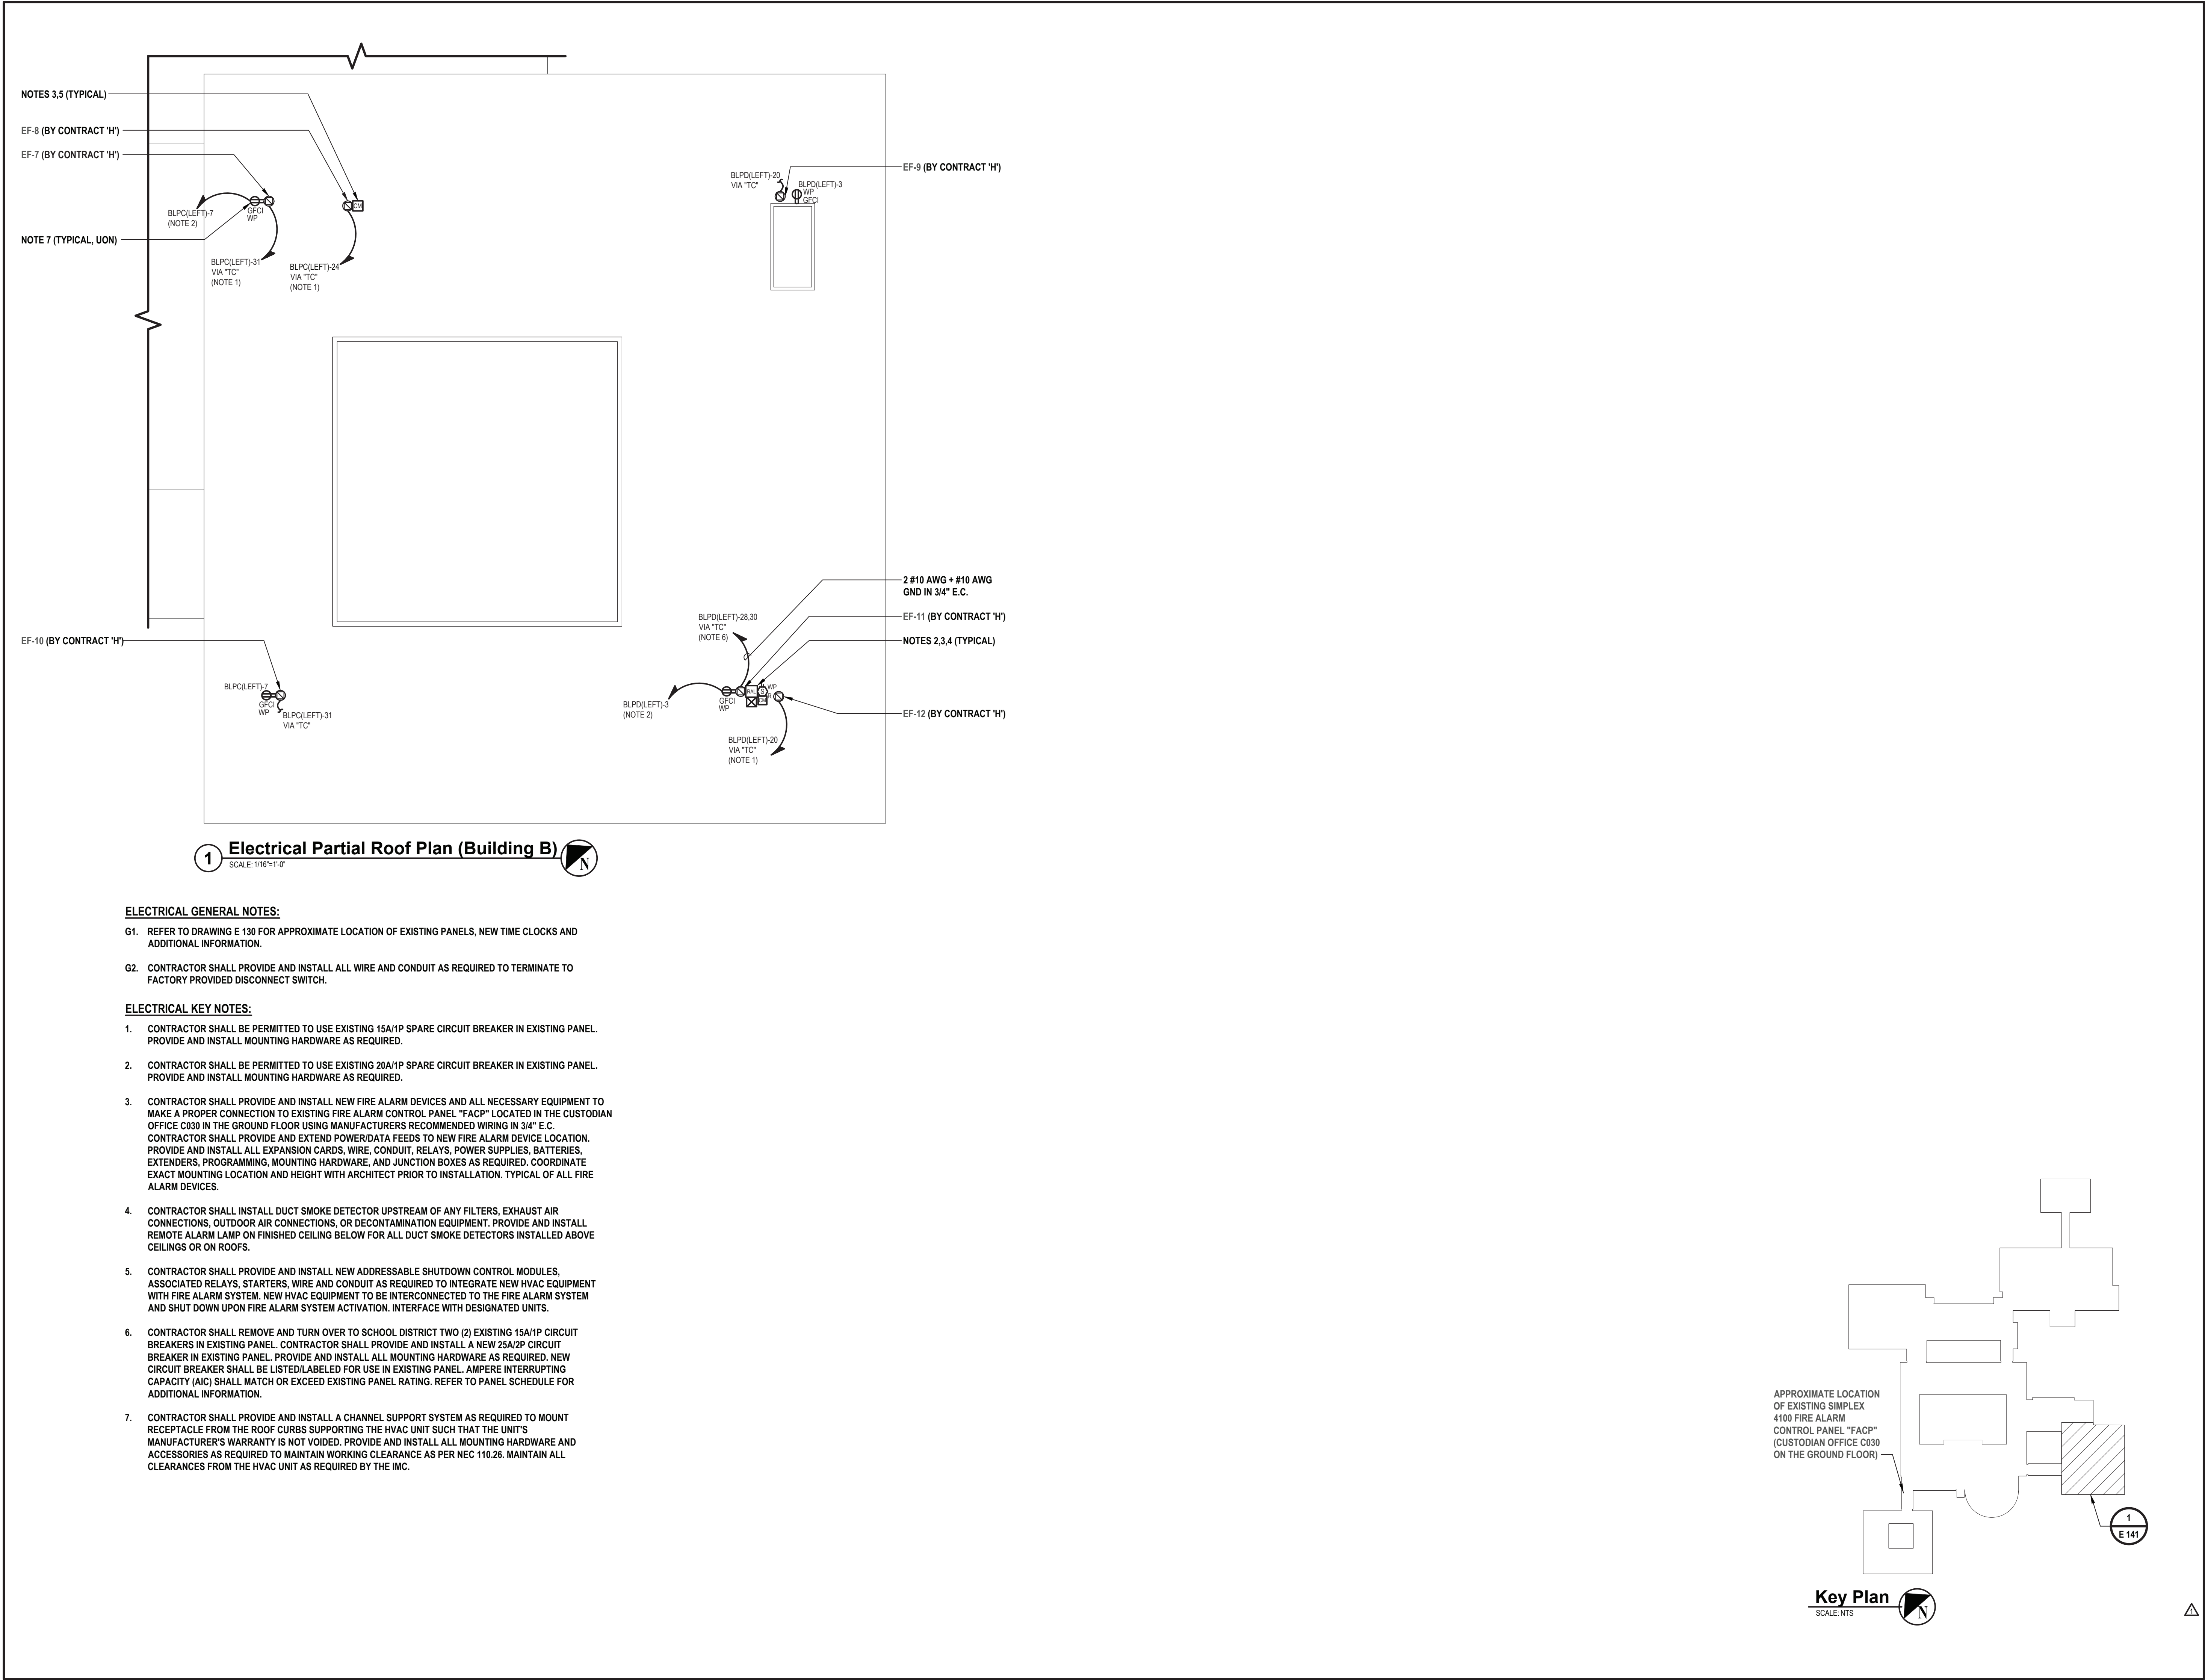


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engineers

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
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-	07-24-2023	FINAL BID SET
1	08-07-2023	ADDENDUM NO. 1



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PROJECT NO: WPSD 2206	DATE: AUGUST 2023	SCALE: AS SHOWN	

CLIENT  
**White Plains City School District**  
  
**WHITE PLAINS HIGH SCHOOL UPGRADES AND TURF FIELD**  
  
  
**550 North Street  
White Plains, NY 10605**  
  
**SED No. 66-22-00-01-0-16-029**

CONTRACT  
**CONTRACT E  
ELECTRICAL CONSTRUCTION**


STATUS  
**FINAL BID SET**

SHEET TITLE  
**ELECTRICAL PARTIAL ROOF  
PLAN BUILDING B**

DRAWING No.  
**E 141.00**

W:\PSD\White Plains City School District\2022\WPSD 2206 - High School Upgrades and Turf Field\02-00-01-0-16-029 Electrical Partial Roof Plan Building B.dwg, last Modified: Aug 04, 2023 - 11:16am Printed on: Aug 04, 2023 - 4:25pm By: ksh



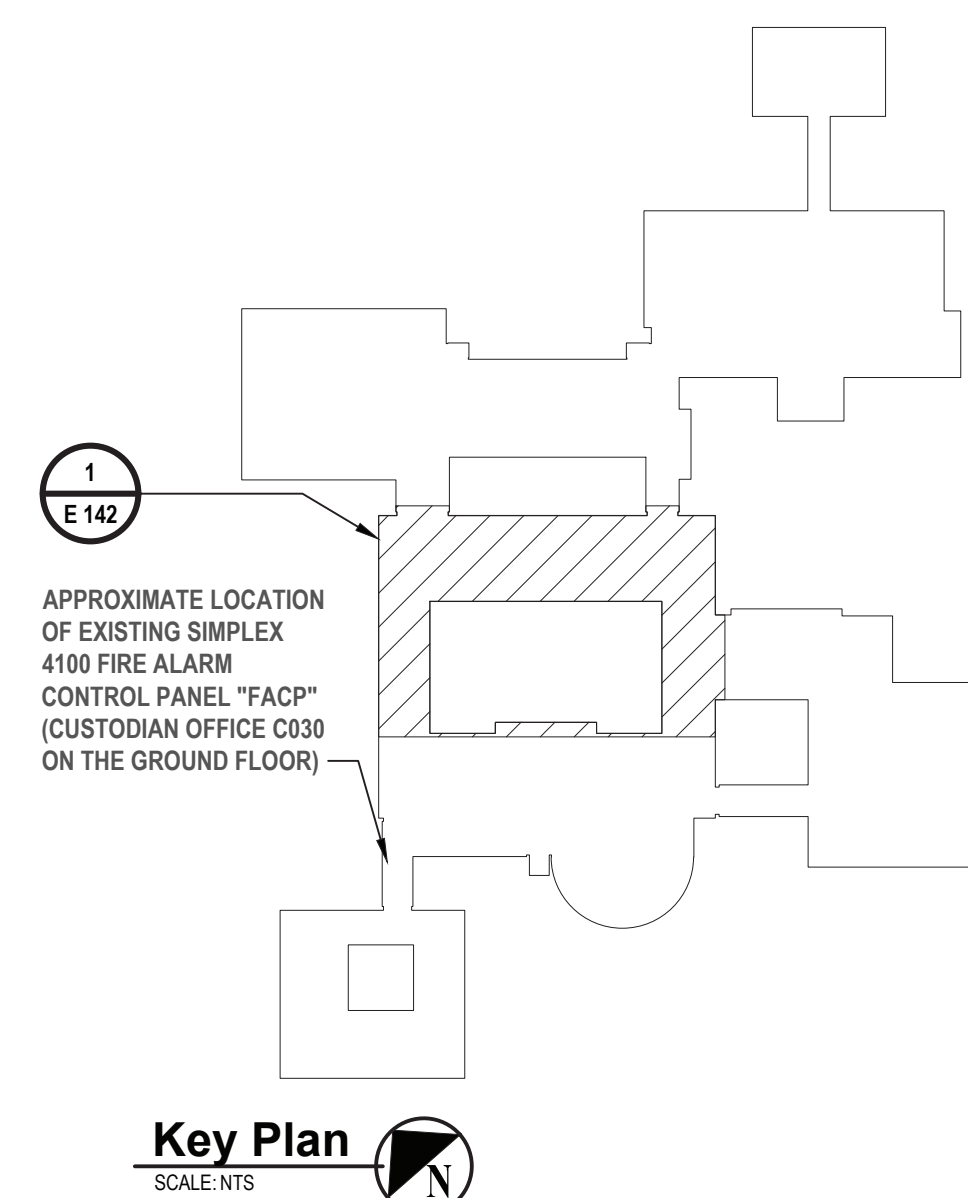

1. CONTRACTOR SHALL BE PERMITTED TO USE EXISTING 15A/P SPARE CIRCUIT BREAKER IN EXISTING PANEL. PROVIDE AND INSTALL MOUNTING HARDWARE AS REQUIRED.
2. CONTRACTOR SHALL BE PERMITTED TO USE EXISTING 20A/P SPARE CIRCUIT BREAKER IN EXISTING PANEL. PROVIDE AND INSTALL MOUNTING HARDWARE AS REQUIRED.
3. CONTRACTOR SHALL PROVIDE AND INSTALL NEW FIRE ALARM DEVICES AND ALL NECESSARY EQUIPMENT TO MAKE A PROPER CONNECTION TO EXISTING FIRE ALARM CONTROL PANEL "FACP" LOCATED IN THE CUSTODIAN OFFICE C309 IN THE GROUND FLOOR USING MANUFACTURERS RECOMMENDED WIRING IN 3/4" E.C. CONTRACTOR SHALL PROVIDE AND EXTEND POWER/DATA FEEDS TO NEW FIRE ALARM DEVICE LOCATION. PROVIDE AND INSTALL ALL EXPANSION CARDS, WIRE, CONDUIT, RELAYS, POWER SUPPLIES, BATTERIES, EXTENDERS, PROGRAMMING, MOUNTING HARDWARE, AND JUNCTION BOXES AS REQUIRED. COORDINATE EXACT MOUNTING LOCATION AND HEIGHT WITH ARCHITECT PRIOR TO INSTALLATION. TYPICAL OF ALL FIRE ALARM DEVICES.
4. CONTRACTOR SHALL INSTALL DUCT SMOKE DETECTOR UPSTREAM OF ANY FILTERS, EXHAUST AIR CONNECTIONS, OUTDOOR AIR CONNECTIONS, OR DECONTAMINATION EQUIPMENT. PROVIDE AND INSTALL REMOTE ALARM LAMP ON FINISHED CEILING BELOW FOR ALL DUCT SMOKE DETECTORS INSTALLED ABOVE CEILINGS OR ON ROOFS.
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6. CONTRACTOR SHALL REMOVE AND TURN OVER TO SCHOOL DISTRICT ONE (1) EXISTING 15A/P CIRCUIT BREAKERS IN EXISTING PANEL. CONTRACTOR SHALL PROVIDE AND INSTALL A NEW 25A/P CIRCUIT BREAKER IN EXISTING PANEL. PROVIDE AND INSTALL ALL MOUNTING HARDWARE AS REQUIRED. NEW CIRCUIT BREAKER SHALL BE LISTED/LABELED FOR USE IN EXISTING PANEL. AMPERE INTERRUPTING CAPACITY (AIC) SHALL MATCH OR EXCEED EXISTING PANEL RATING. REFER TO PANEL SCHEDULE FOR ADDITIONAL INFORMATION.
7. CONTRACTOR SHALL PROVIDE AND INSTALL A CHANNEL SUPPORT SYSTEM AS REQUIRED TO MOUNT RECEPTACLE FROM THE ROOF CURBS SUPPORTING THE HVAC UNIT SUCH THAT THE UNITS MANUFACTURER'S WARRANTY IS NOT VOIDED. PROVIDE AND INSTALL ALL MOUNTING HARDWARE AND ACCESSORIES AS REQUIRED TO MAINTAIN WORKING CLEARANCE AS PER NEC 110.26. MAINTAIN ALL CLEARANCES FROM THE HVAC UNIT AS REQUIRED BY THE IMC.

DESIGNED BY: <b>SAN</b>				DRAWN BY: <b>SAN</b>		CHECKED BY:		REVIEWED BY: <b>G</b>	
PROJECT No.: <b>WPSD 2206</b>				DATE: <b>AUGUST 2023</b>				SCALE: <b>AS SHOWN</b>	

**SED No. 66-22-00-01-0-16-029**


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PROJECT NO: <b>WPSD 2206</b>	DATE: <b>AUGUST 2023</b>	SCALE:	<b>AS SHOWN</b>

## WHITE PLAINS HIGH SCHOOL UPGRADES AND TURF FIELD



CONTRACT	<h2 style="margin: 0;">CONTRACT E</h2> <h3 style="margin: 0;">ELECTRICAL CONSTRUCTION</h3>
----------	--

SHEET TITLE

# ELECTRICAL PANEL SCHEDULES

1

Panel Wiring Schedule (3-Phase)

Panelboard

LPCE (LEFT) (EXISTING)

Manufacturer

EATON

Panel Type

PRL2a

NEMA Type Enclosure

1

Voltage

120/208

Mains

150A MCB

Mounting

SURFACE

Phase

3

Wire

4

Mains Rating

125A

Options

A/C Rating

EXISTING

Note

LOAD DESCRIPTION	BREAKER OPTION	TRIP AMPS & POLES	CONNECTED LOAD			CIRC. NO.	A	B	C	CIRC. NO.	CONNECTED LOAD			TRIP AMPS & POLES	BREAKER OPTION	LOAD DESCRIPTION
			VOLT AMPERES								VOLT AMPERES					
			Ø A	Ø B	Ø C						Ø A	Ø B	Ø C			
EXISTING	HACR	20A/1P	-	-	-	1				2	-	-	-	20A/1P	EXISTING	
EF-15		25A/1P	-	1300	-	3				4	-	-	-	20A/1P	EXISTING	
EXISTING		20A/1P	-	-	-	5				6	-	-	-	20A/1P	EXISTING	
EXISTING		20A/1P	-	-	-	7				8	-	-	-	20A/1P	EXISTING	
EXISTING	HACR	20A/1P	-	-	-	9				10	-	-	-	20A/1P	EXISTING	
CONVENIENCE RECEPTACLES		20A/1P	-	-	-	11				12	-	-	-	20A/1P	EXISTING	
EXISTING		20A/1P	-	-	-	13				14	-	-	-	20A/2P	EXISTING	
EXISTING		20A/1P	-	-	-	15				16	-	-	-	15A/1P	EXISTING	
EXISTING	HACR	15A/1P	-	-	-	17				18	-	-	-	15A/1P	EXISTING	
EXISTING		15A/1P	-	-	-	19				20	-	-	-	15A/1P	EXISTING	
EXISTING		15A/1P	-	-	-	21				22	-	-	-	15A/1P	EXISTING	
EXISTING		15A/1P	-	-	-	23				24	-	-	-	15A/1P	EXISTING	
EF-41	HACR	15A/1P	-	-	-	25				26	-	-	-	15A/1P	EXISTING	
EF-41		15A/1P	-	768	-	27				28	-	-	-	15A/1P	EXISTING	
EF-15		15A/1P	-	-	-	29				30	-	-	-	15A/1P	EXISTING SPARE	
EXISTING		15A/1P	-	-	-	31				32	-	-	-	15A/1P	EXISTING	
EF-16	HACR	15A/1P	-	342	-	33				34	-	-	-	15A/1P	EXISTING SPARE	
EXISTING SPARE		15A/1P	-	-	-	35				36	-	-	-	15A/1P	EXISTING SPARE	
EXISTING SPARE		15A/1P	-	-	-	37				38	-	-	-	15A/1P	EXISTING SPARE	
EXISTING		15A/1P	-	-	-	39				40	-	-	-	15A/1P	EXISTING SPARE	
EXISTING SPARE	15A/1P	-	-	-	41				42	-	-	-	15A/1P	EXISTING SPARE		

Connected Totals:

ØA

-

KVA

ØB

-

KVA

ØC

-

KVA

Total

-

KVA

-

Amperes

(All Phases to be balanced to within 7% using Actual Load Totals.)

Breaker Options:

AS - Powerlink AS Breaker

LO - Handle lock-off device

ST - Shunt Trip Trip Type

AUX - Auxiliary Contacts

PA - Handle Padlock Attachment

GFCR - Ground Fault Circuit Interrupter

HACR - Heating, A/C & Refrigeration

Subfeed

TC - Time Clock Control

Panel Wiring Schedule (3-Phase)

Panelboard

ALPD (RIGHT) (EXISTING)

Manufacturer

EATON

Panel Type

PRL2a

Voltage

120/208

Maine

150A MCB

Mounting

SURFACE

Phase

3

Wire

4

Mains Rating

225A

AIC Rating

EXISTING

Note

NEMA Type Enclosure

1

LOAD DESCRIPTION	BREAKER OPTION	TRIP AMPS & POLES	CONNECTED LOAD			CIRC. NO.	A	B	C	CIRC. NO.	CONNECTED LOAD			TRIP AMPS & POLES	BREAKER OPTION	LOAD DESCRIPTION
			VOLT. AMPERES								VOLT. AMPERES					
			Ø A	Ø B	Ø C						Ø A	Ø B	Ø C			
EXISTING			15A/1P	/	-	1				2	40A/1P				EXISTING SPARE	
EXISTING			15A/1P	/	-	3				4	20A/1P				EXISTING SPARE	
EXISTING			15A/1P	/	-	5				6	20A/1P				EXISTING	
EXISTING SPARE			20A/2P	/	-	7				8	20A/1P				EXISTING SPARE	
CONVENIENCE RECEPTACLES			20A/2P	/	-	9				10	20A/2P				EXISTING SPARE	
EXISTING SPARE			20A/1P	/	-	11				12	20A/1P				EXISTING SPARE	
EXISTING SPARE			20A/1P	/	-	13				14	20A/1P				EXISTING SPARE	
EXISTING SPARE			20A/1P	/	-	15				16	20A/1P				EXISTING SPARE	
EXISTING SPARE			20A/1P	/	-	17				18	20A/1P				EXISTING SPARE	
EXISTING			20A/1P	/	-	19				20	20A/1P				EXISTING SPARE	
EXISTING SPARE			20A/1P	/	-	21				22	20A/1P				EXISTING	
EF-4,6	HACR		15A/1P	/	684	23				24	15A/1P				EXISTING	
EF-5	HACR		25A/2P	/	1300	25				26	15A/1P				EXISTING	
EXISTING SPARE			15A/1P	/	1300	26				27	15A/1P				EXISTING SPARE	
EXISTING			15A/1P	/	-	29				30	15A/1P				EXISTING SPARE	
EXISTING			15A/1P	/	-	31				32	15A/1P				EXISTING SPARE	
EXISTING			15A/1P	/	-	33				34	15A/1P				EXISTING SPARE	
EXISTING SPARE			15A/1P	/	-	35				36	15A/1P				EXISTING SPARE	
EXISTING			40A/3P	/	-	37				38	15A/1P				EXISTING SPARE	
				/	-	39				40	15A/1P				EXISTING SPARE	
				/	-	41				42	15A/1P				EXISTING SPARE	

Connected Totals:

ØA - KVA

ØB - KVA

ØC - KVA

Total - KVA

- Amperes

(All Phases to be balanced to within 7% using Actual Load Totals.)

Breaker Options:

AS - Powerlink AS Breaker

LO - Handle lock-off device

ST - Shunt Trip Type

AUX - Auxiliary Contacts

PA - Handle Padlock Attachment

GFCI - Ground Fault Circuit Interrupter

HACR - Heating, A/C & Refrigeration

SF - Subfeed

TC - Time Clock Control

# Panel Wiring Schedule (3-Phase)

Panelboard

BLPC (LEFT) (EXISTING)

Manufacturer

EATON

Panel Type

PRL2a

NEMA Type Enclosure

1

Voltage

420/208

Mains

150A MCP

Mounting

SURFACE

Phase

3

Wiring

4

Mains Rating

225A

A/C Rating

EXISTING

Note

-

LOAD DESCRIPTION	BREAKER OPTION	TRIP AMPS & POLES	CONNECTED LOAD			CIRC. NO.	A	B	C	CIRC. NO.	CONNECTED LOAD			TRIP AMPS & POLES	BREAKER OPTION	LOAD DESCRIPTION
			VOLT AMPERES								VOLT AMPERES					
			Ø A	Ø B	Ø C						Ø A	Ø B	Ø C			
EXISTING		20A/1P	-	-	-	1				2	-	-	-			EXISTING
EXISTING		20A/1P	-	-	-	2				4	-	-	-			EXISTING SPARE
EXISTING		20A/1P	-	-	-	3				6	-	-	-			EXISTING
CONVENIENCE RECEPTACLES		20A/1P	-	-	-	7				8	-	-	-			EXISTING
EXISTING SPARE		20A/1P	-	-	-	9				10	-	-	-			EXISTING
EXISTING SPARE		20A/1P	-	-	-	11				12	-	-	-			EXISTING
EXISTING		20A/1P	-	-	-	13				14	-	-	-			EXISTING
EXISTING		15A/1P	-	-	-	15				16	-	-	-			EXISTING
EXISTING		15A/1P	-	-	-	17				18	-	-	-			EXISTING
EXISTING		15A/1P	-	-	-	19				20	-	-	-			EXISTING
EXISTING		15A/1P	-	-	-	21				22	-	-	-			EXISTING
EXISTING		15A/1P	-	-	-	23				24	-	-	-			EXISTING
EXISTING		15A/1P	-	-	-	25				26	-	-	-			EXISTING SPARE
EXISTING		15A/1P	-	-	-	27				28	-	-	-			EXISTING SPARE
EXISTING		15A/1P	-	-	-	29				30	-	-	-			EXISTING SPARE
EF-7,10	HACR	15A/1P	684	-	-	31				32	-	-	-			EXISTING SPARE
EXISTING		15A/1P	-	-	-	33				34	-	-	-			EXISTING SPARE
EXISTING		15A/1P	-	-	-	35				36	-	-	-			EXISTING SPARE
EXISTING		15A/1P	-	-	-	37				38	-	-	-			EXISTING SPARE
EXISTING		15A/1P	-	-	-	39				40	-	-	-			EXISTING SPARE
EXISTING		15A/1P	-	-	-	41				42	-	-	-			EXISTING SPARE

Connected Totals:

ØA

-

KVA

ØB

-

KVA

ØC

-

KVA

Total

-

KVA

-

Amperes

Breaker Options:

AS - Powerlink AS Breaker

LO - Handle lock-off device

ST - Shunt Trip Type

AUX - Auxiliary Contacts

PA - Handle Padlock Attachment

GFCC - Ground Fault Circuit Interrupter

HACR - Heating, A/C & Refrigeration

SF - Subfeed

TC - Time Clock Control

(All Phases to be balanced to within 7% using Actual Load Totals.)