



# DPW ADMIN BUILDING


DISBROW PARK RYE, NY 10580


ISSUE FOR BID


09.12.2024
ADDENDUM 3 11.13.2024
Stanton Project Numbers


Stantec Project Number: 192311093


#### **DRAWING LIST** NO. DRAWING NAME M-502 MECHANICAL DETAILS DRAWING NAME DRAWING NAME **GENERAL** A-401 **ENLARGED PLAN AND ELEVATIONS ENLARGED PLANS AND ELEVATIONS** MECHANICAL DETAILS COVERSHEET **MECHANICAL DETAILS** LIFE SAFETY PLAN ENLARGED BREAKROOM PLANS A-404 **ENLARGED BREAKROOM ELEVATIONS** STAIR PLANS & SECTIONS **EXISTING CONDITIONS** STAGING PLANS A-406 STAIR DETAILS MECHANICAL SCHEDULES C-101B STAGING PLAN A-407 **ELEVATOR PLAN, SECTION, & DETAILS** PIPING SCHEMATICS MECHANICAL ARCHITECTURE, CONTROL ZONES AND NOTES SITE PLANS TYPICAL ROOF DETAILS A-502 TYPICAL MILLWORK DETAILS MECHANICAL CONTROLS SCHEMATICS TYPICAL MILLWORK DETAILS MECHANICAL CONTROLS SCHEMATICS TYPICAL MILLWORK DETAILS MECHANICAL CONTROLS SCHEMATICS SOIL REMOVAL PLAN SITE DETAILS A-505 ARCHITECTURAL & CEILING DETAILS **ELECTRICAL** C-105B SITE DETAILS DOOR SCHEDULE AND DETAILS **ELECTRICAL LEAD SHEET** STOREFRONT ELEVATIONS AND DETAILS ELECTRICAL SITE PLAN A-800 FINISH TRANSITION DETAILS FIRST FLOOR POWER PLAN FIRE PROTECTION SECOND FLOOR POWER PLAN NOTES AND SPECIAL INSPECTIONS FIRE PROTECTION LEAD SHEET **ROOF POWER PLAN** S-001 FP-000 FIRST FLOOR LIGHTING PLAN NOTES AND SPECIAL INSPECTIONS FIRE PROTECTION FIRST FLOOR COVERAGE PLAN FOUNDATION / SLAB PLAN FIRE PROTECTION SECOND FLOOR COVERAGE PLAN SECOND FLOOR LIGHTING PLAN SECOND FLOOR FRAMING PLAN FP-201 FIRE PROTECTION FIRST FLOOR PIPING PLAN FIRST FLOOR SYSTEMS PLAN FIRE PROTECTION SECOND FLOOR PIPING PLAN ROOF FRAMING PLAN FP-202 SECOND FLOOR SYSTEMS PLAN TYPICAL CONCRETE DETAILS FIRE PROTECTION DETAILS SHEET 1 ELECTRICAL DETAILS 1 OF 2 TYPICAL CONCRETE DETAILS FIRE PROTECTION DETAILS SHEET 2 ELECTRICAL DETAILS 2 OF 2 TYPICAL MASONRY DETAILS FIRE PROTECTION DETAILS SHEET 3 **ELECTRICAL ONE-LINE DIAGRAM AND SCHEDULES** TYPICAL MASONRY DETAILS FP-503 FIRE PROTECTION DETAILS SHEET 4 ELECTRICAL SCHEDULES FOUNDATION SECTIONS & DETAILS FP-600 FIRE PROTECTION SCHEDULES ELECTRICAL SCHEDULES TYPICAL STEEL DETAILS PLUMBING ELECTRICAL LEGEND, NOTES **ELECTRICAL SPECIFICATIONS** FRAMING SECTIONS AND DETAILS P-000 PLUMBING LEAD SHEET SOLAR PV SITE PLAN S-411 FRAMING SECTIONS AND DETAILS PLUMBING UNDERSLAB PLAN **ELECTRICAL DETAILS ARCHITECTURE** PLUMBING FIRST FLOOR PLAN **ELECTRICAL DETAILS** ARCHITECTURAL LEGEND, SYMBOLS, ABBREVIATIONS, & GENERAL NOTES P-102 PLUMBING SECOND FLOOR PLAN TYPICAL ELECTRICAL EQUIPMENT LABELS FIRST FLOOR PLAN PLUMBING ROOF PLAN TYPICAL ELECTRICAL EQUIPMENT LABELS SECOND FLOOR PLAN PLUMBING DETAILS SHEET 1 WIRING DIAGRAM PV CONDUIT & CABLE SCHEDULE FIRST FLOOR FINISH PLAN PLUMBING DETAILS SHEET 2 PV ELECTRICAL DESIGN CALCULATIONS PLUMBING DETAILS SHEET 3 SECOND FLOOR FINISH PLAN FIRST FLOOR FURNITURE PLAN FOR REFERENCE ONLY P-503 PLUMBING DETAILS SHEET 4 SECOND FLOOR FURNITURE PLAN\_ FOR REFERENCE ONLY P-600 PLUMBING SCHEDULES SHEET PLUMBING SCHEDULES SHEET 2 **ROOF PLAN** P-601 FIRST FLOOR REFLECTED CEILING PLAN P-602 PLUMBING RISER DIAGRAMS SECOND FLOOR REFLECTED CEILING PLAN **MECHANICAL BUILDING ELEVATIONS** MECHANICAL LEAD SHEET **BUILDING SECTIONS** MECHANICAL FIRST FLOOR PLAN WALL SECTIONS MECHANICAL SECOND FLOOR PLAN WALL SECTIONS SECTION DETAILS MILOLINIA DE IAILO

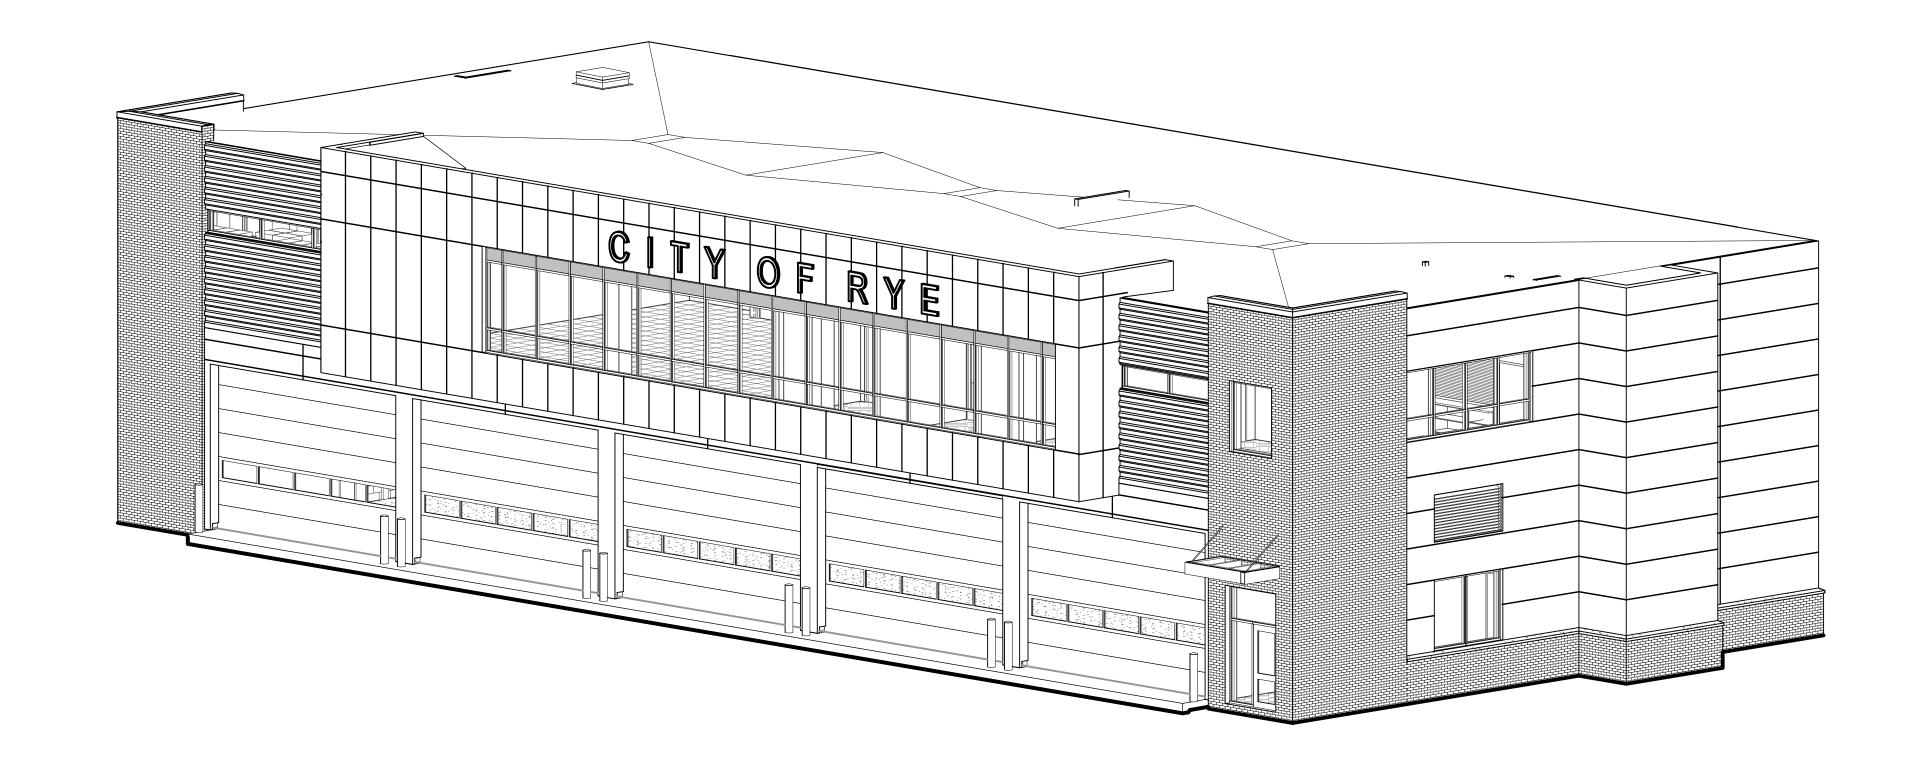


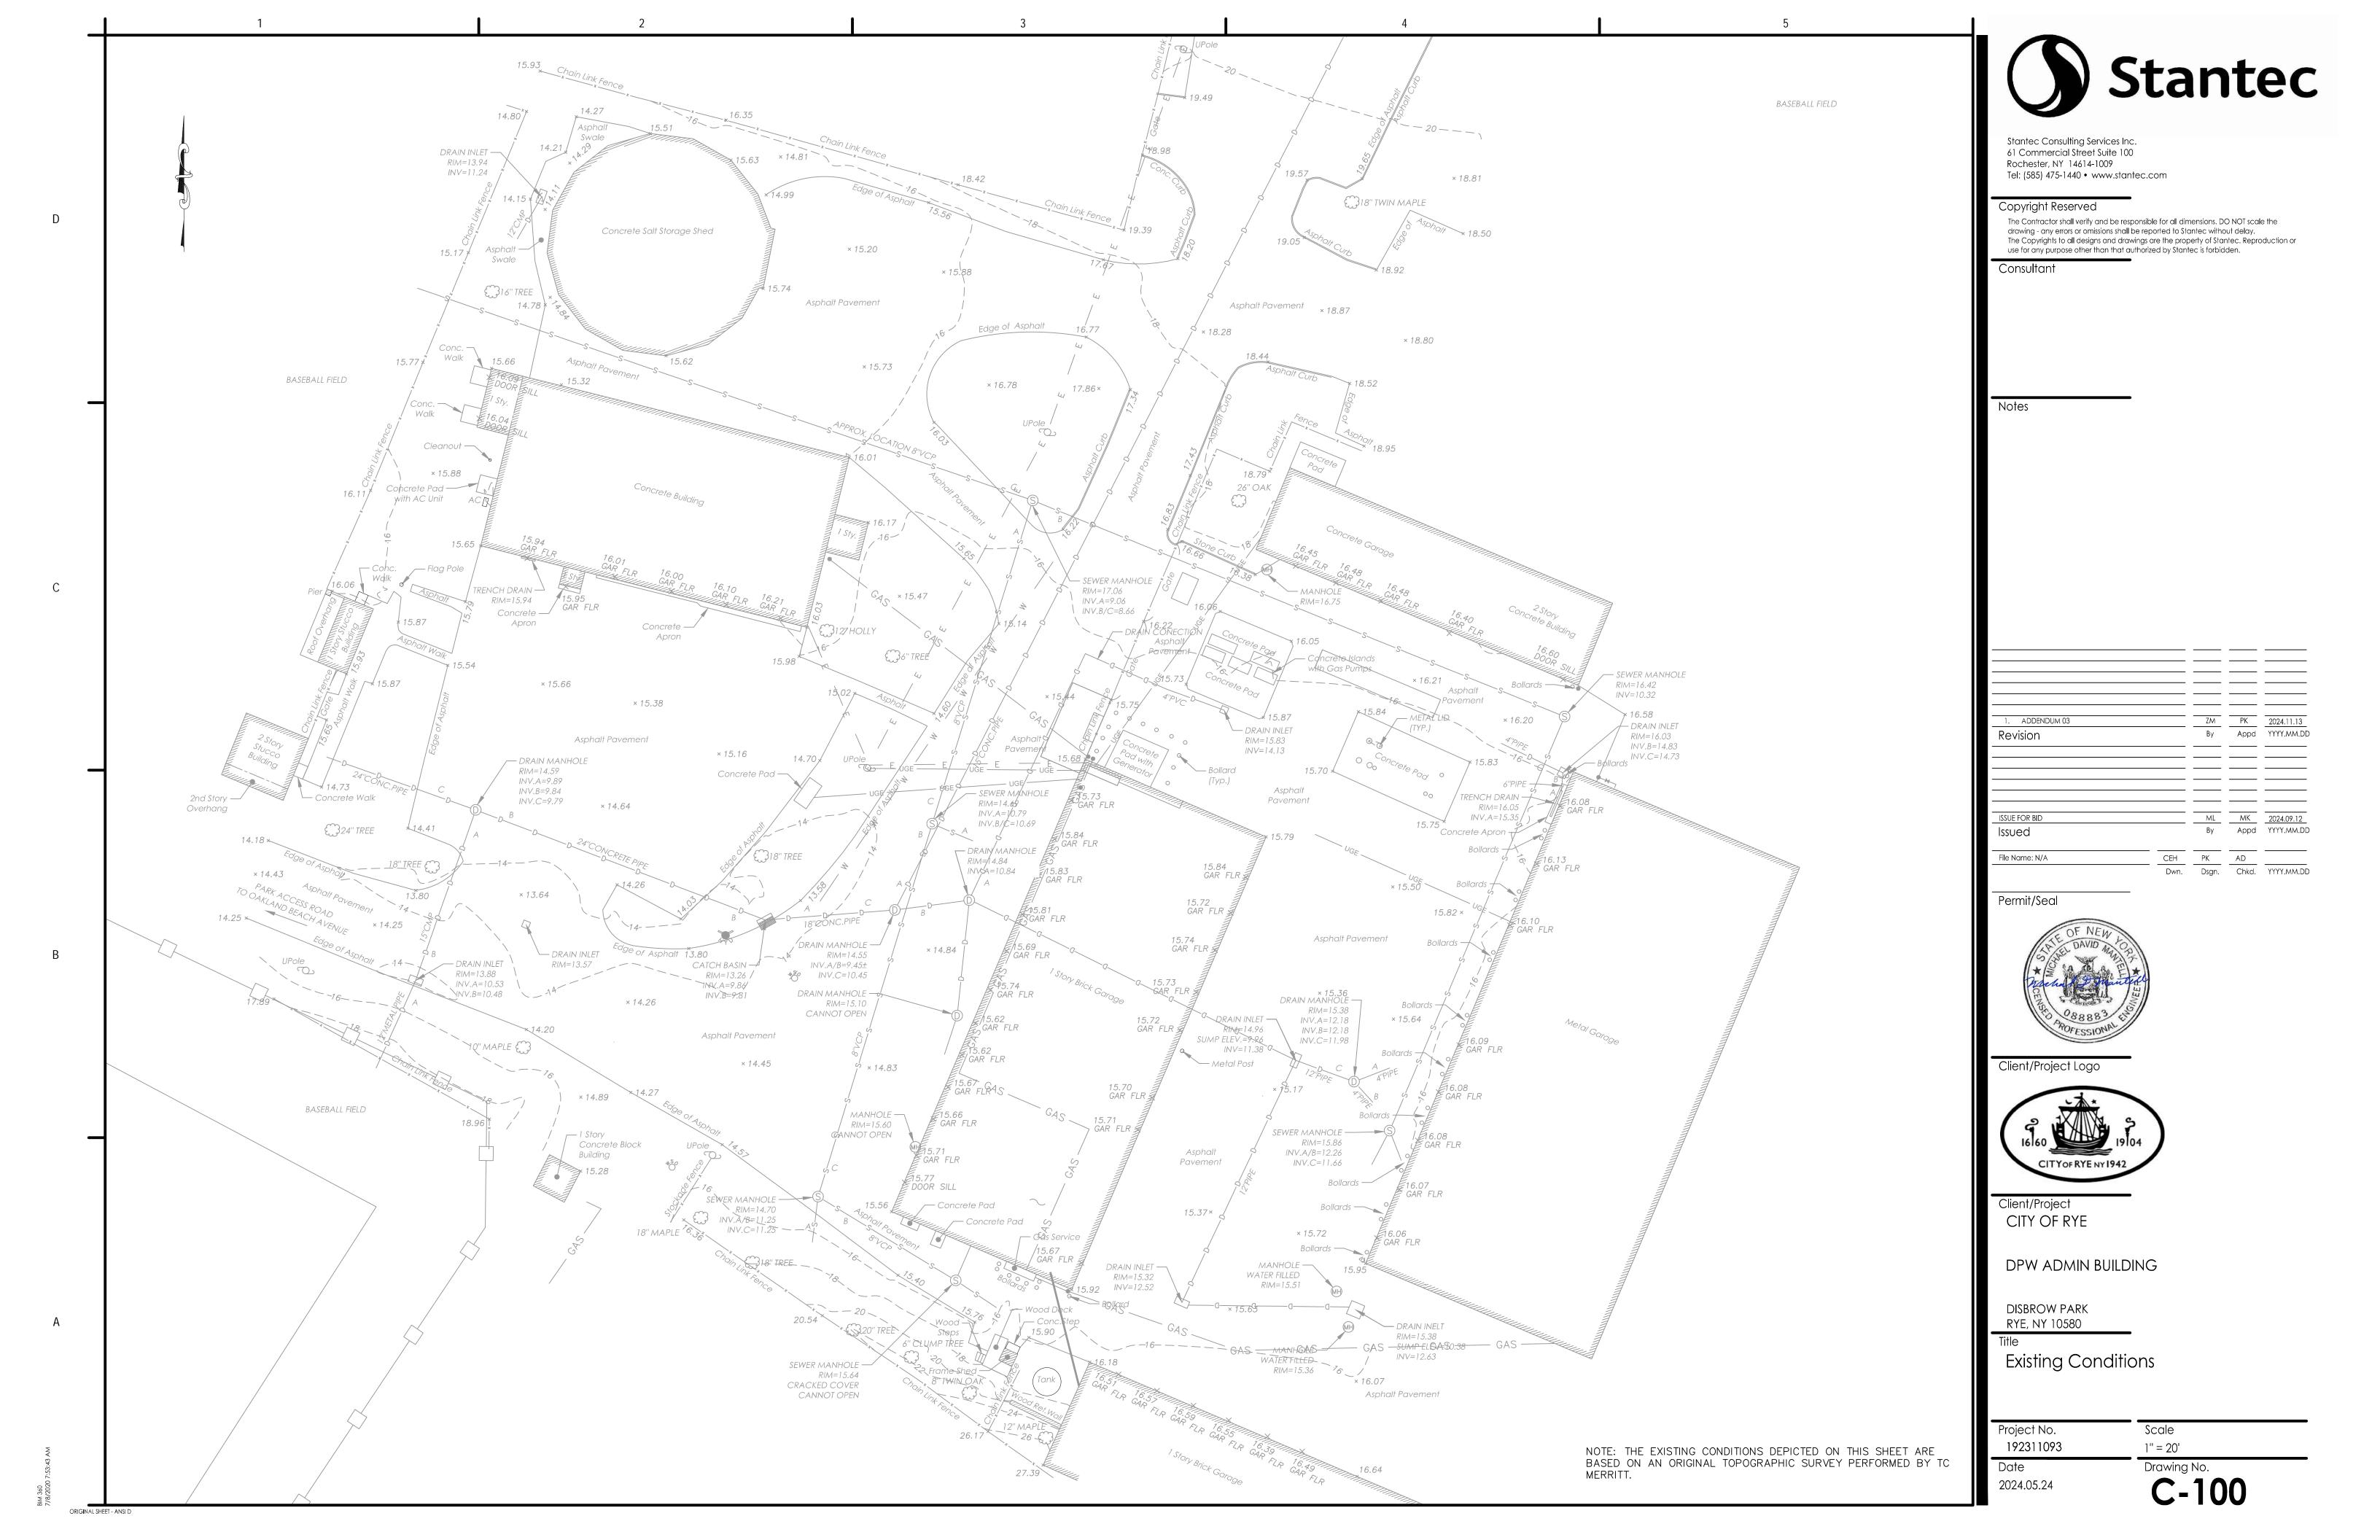


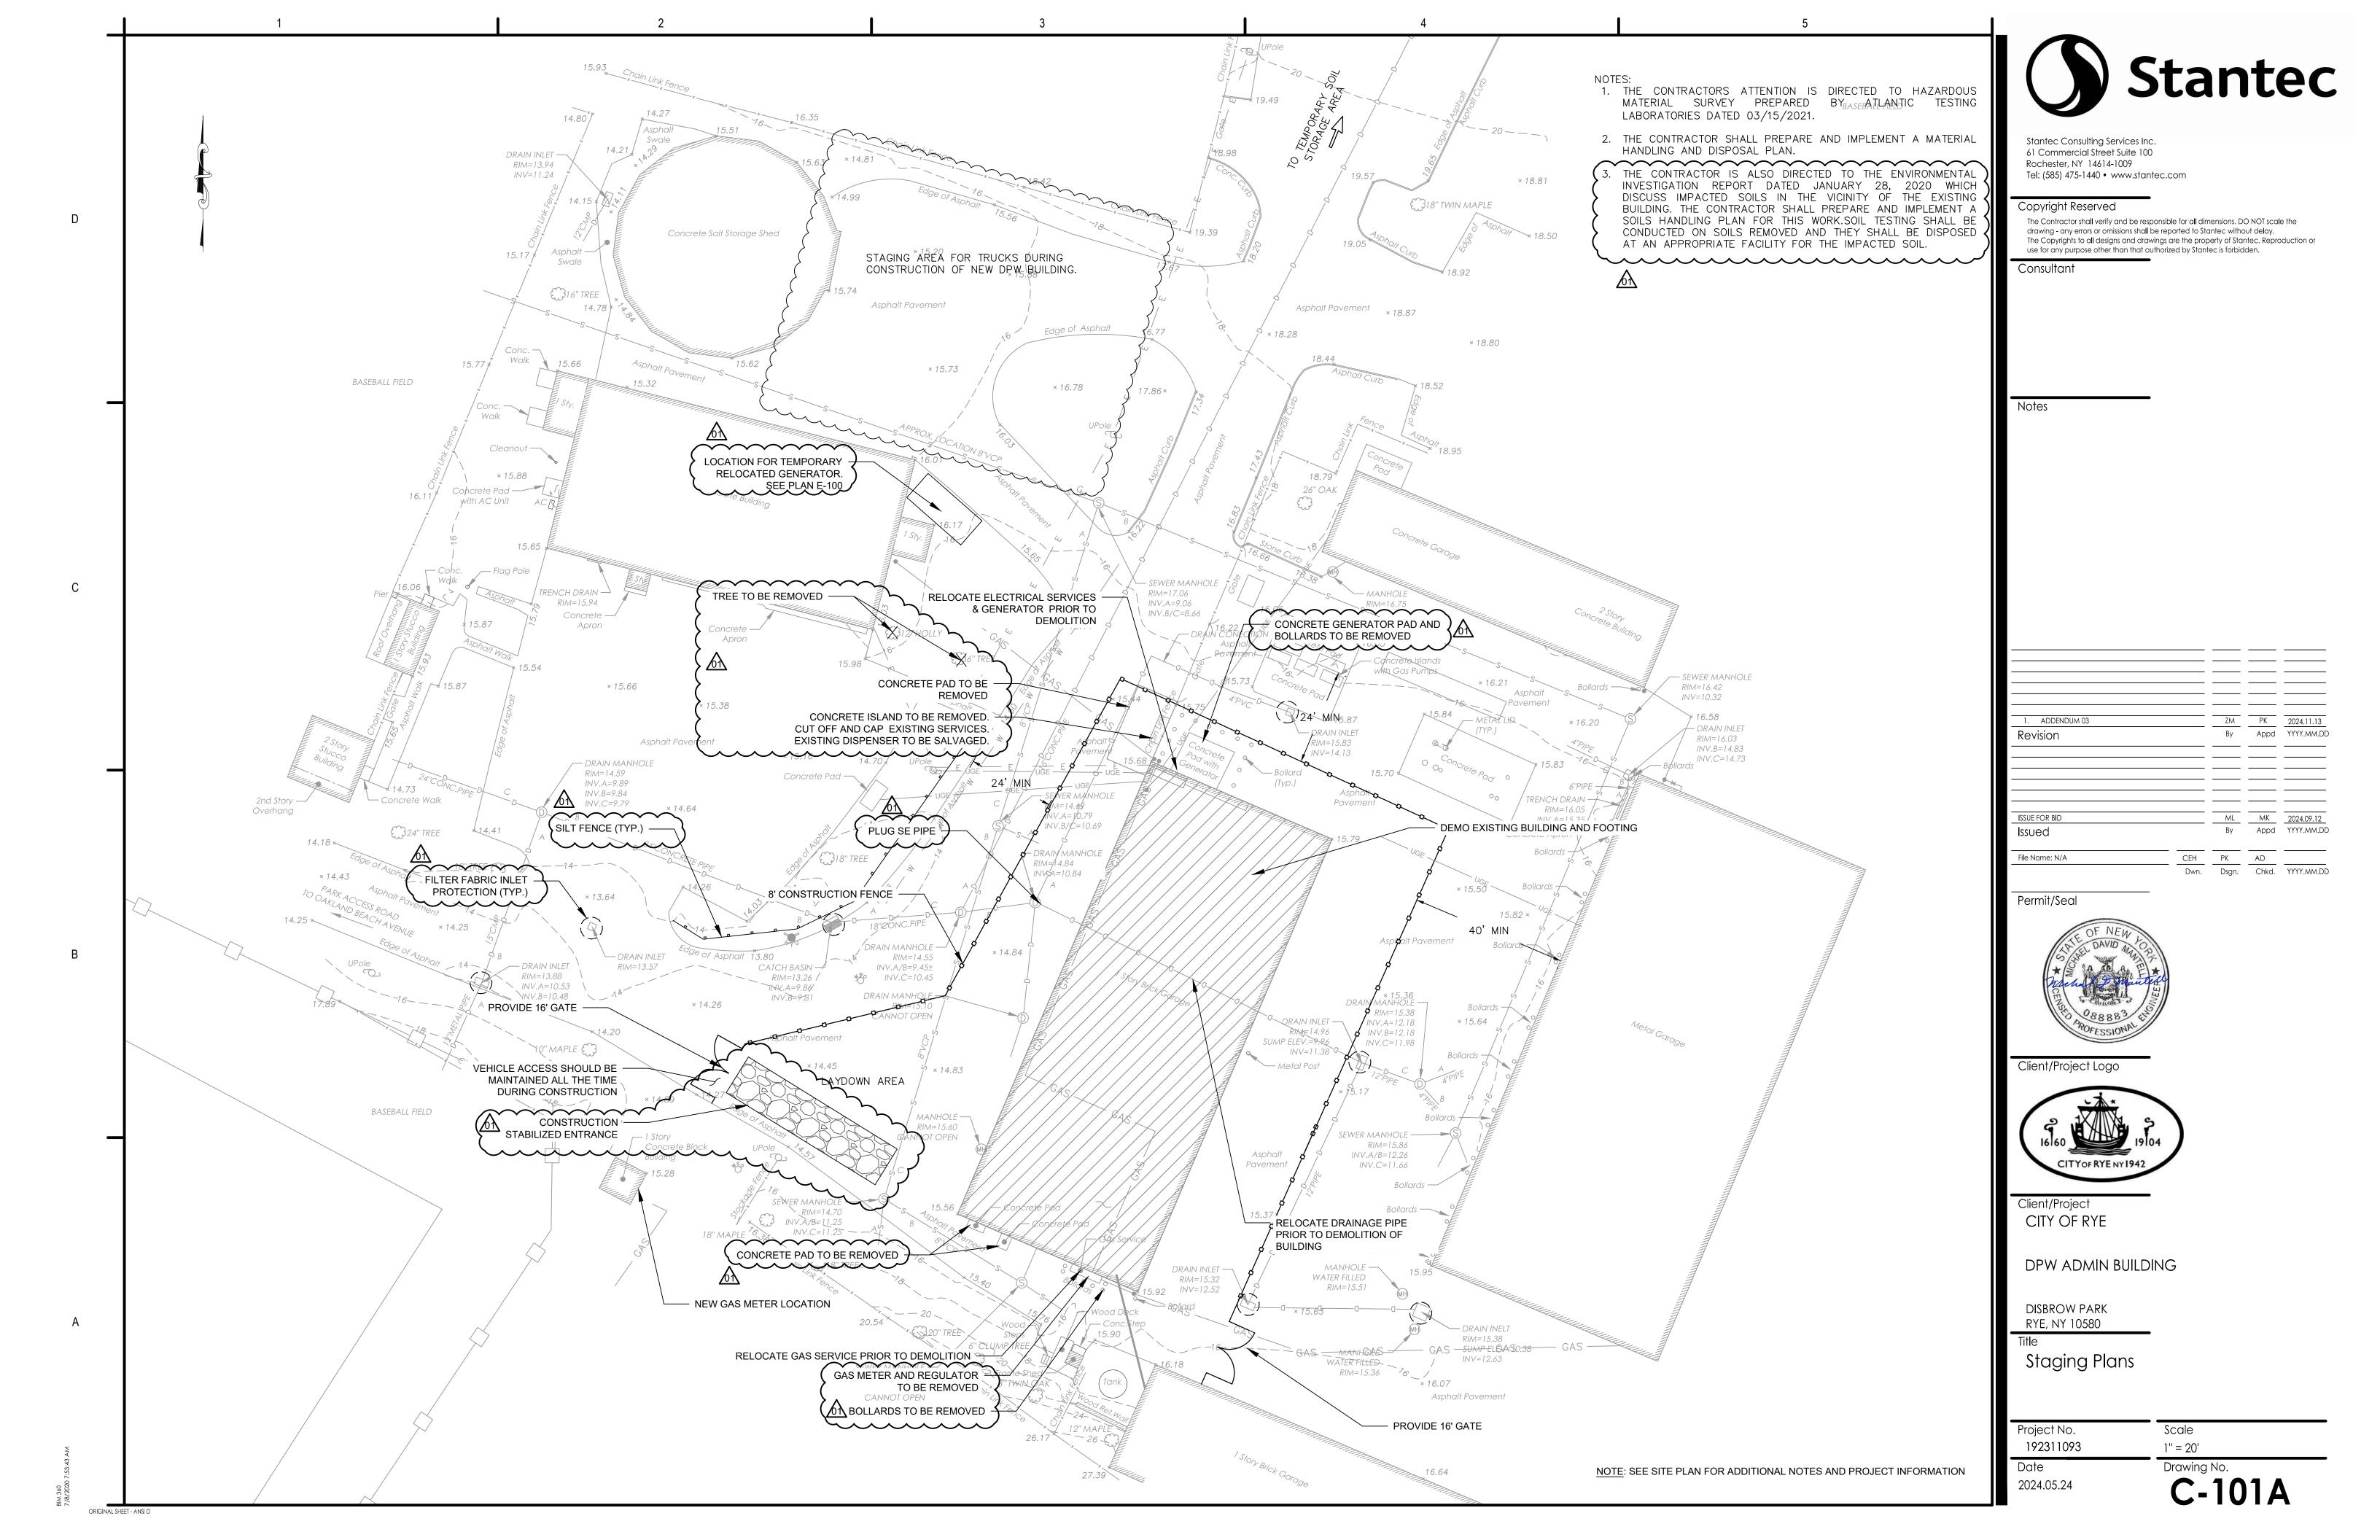

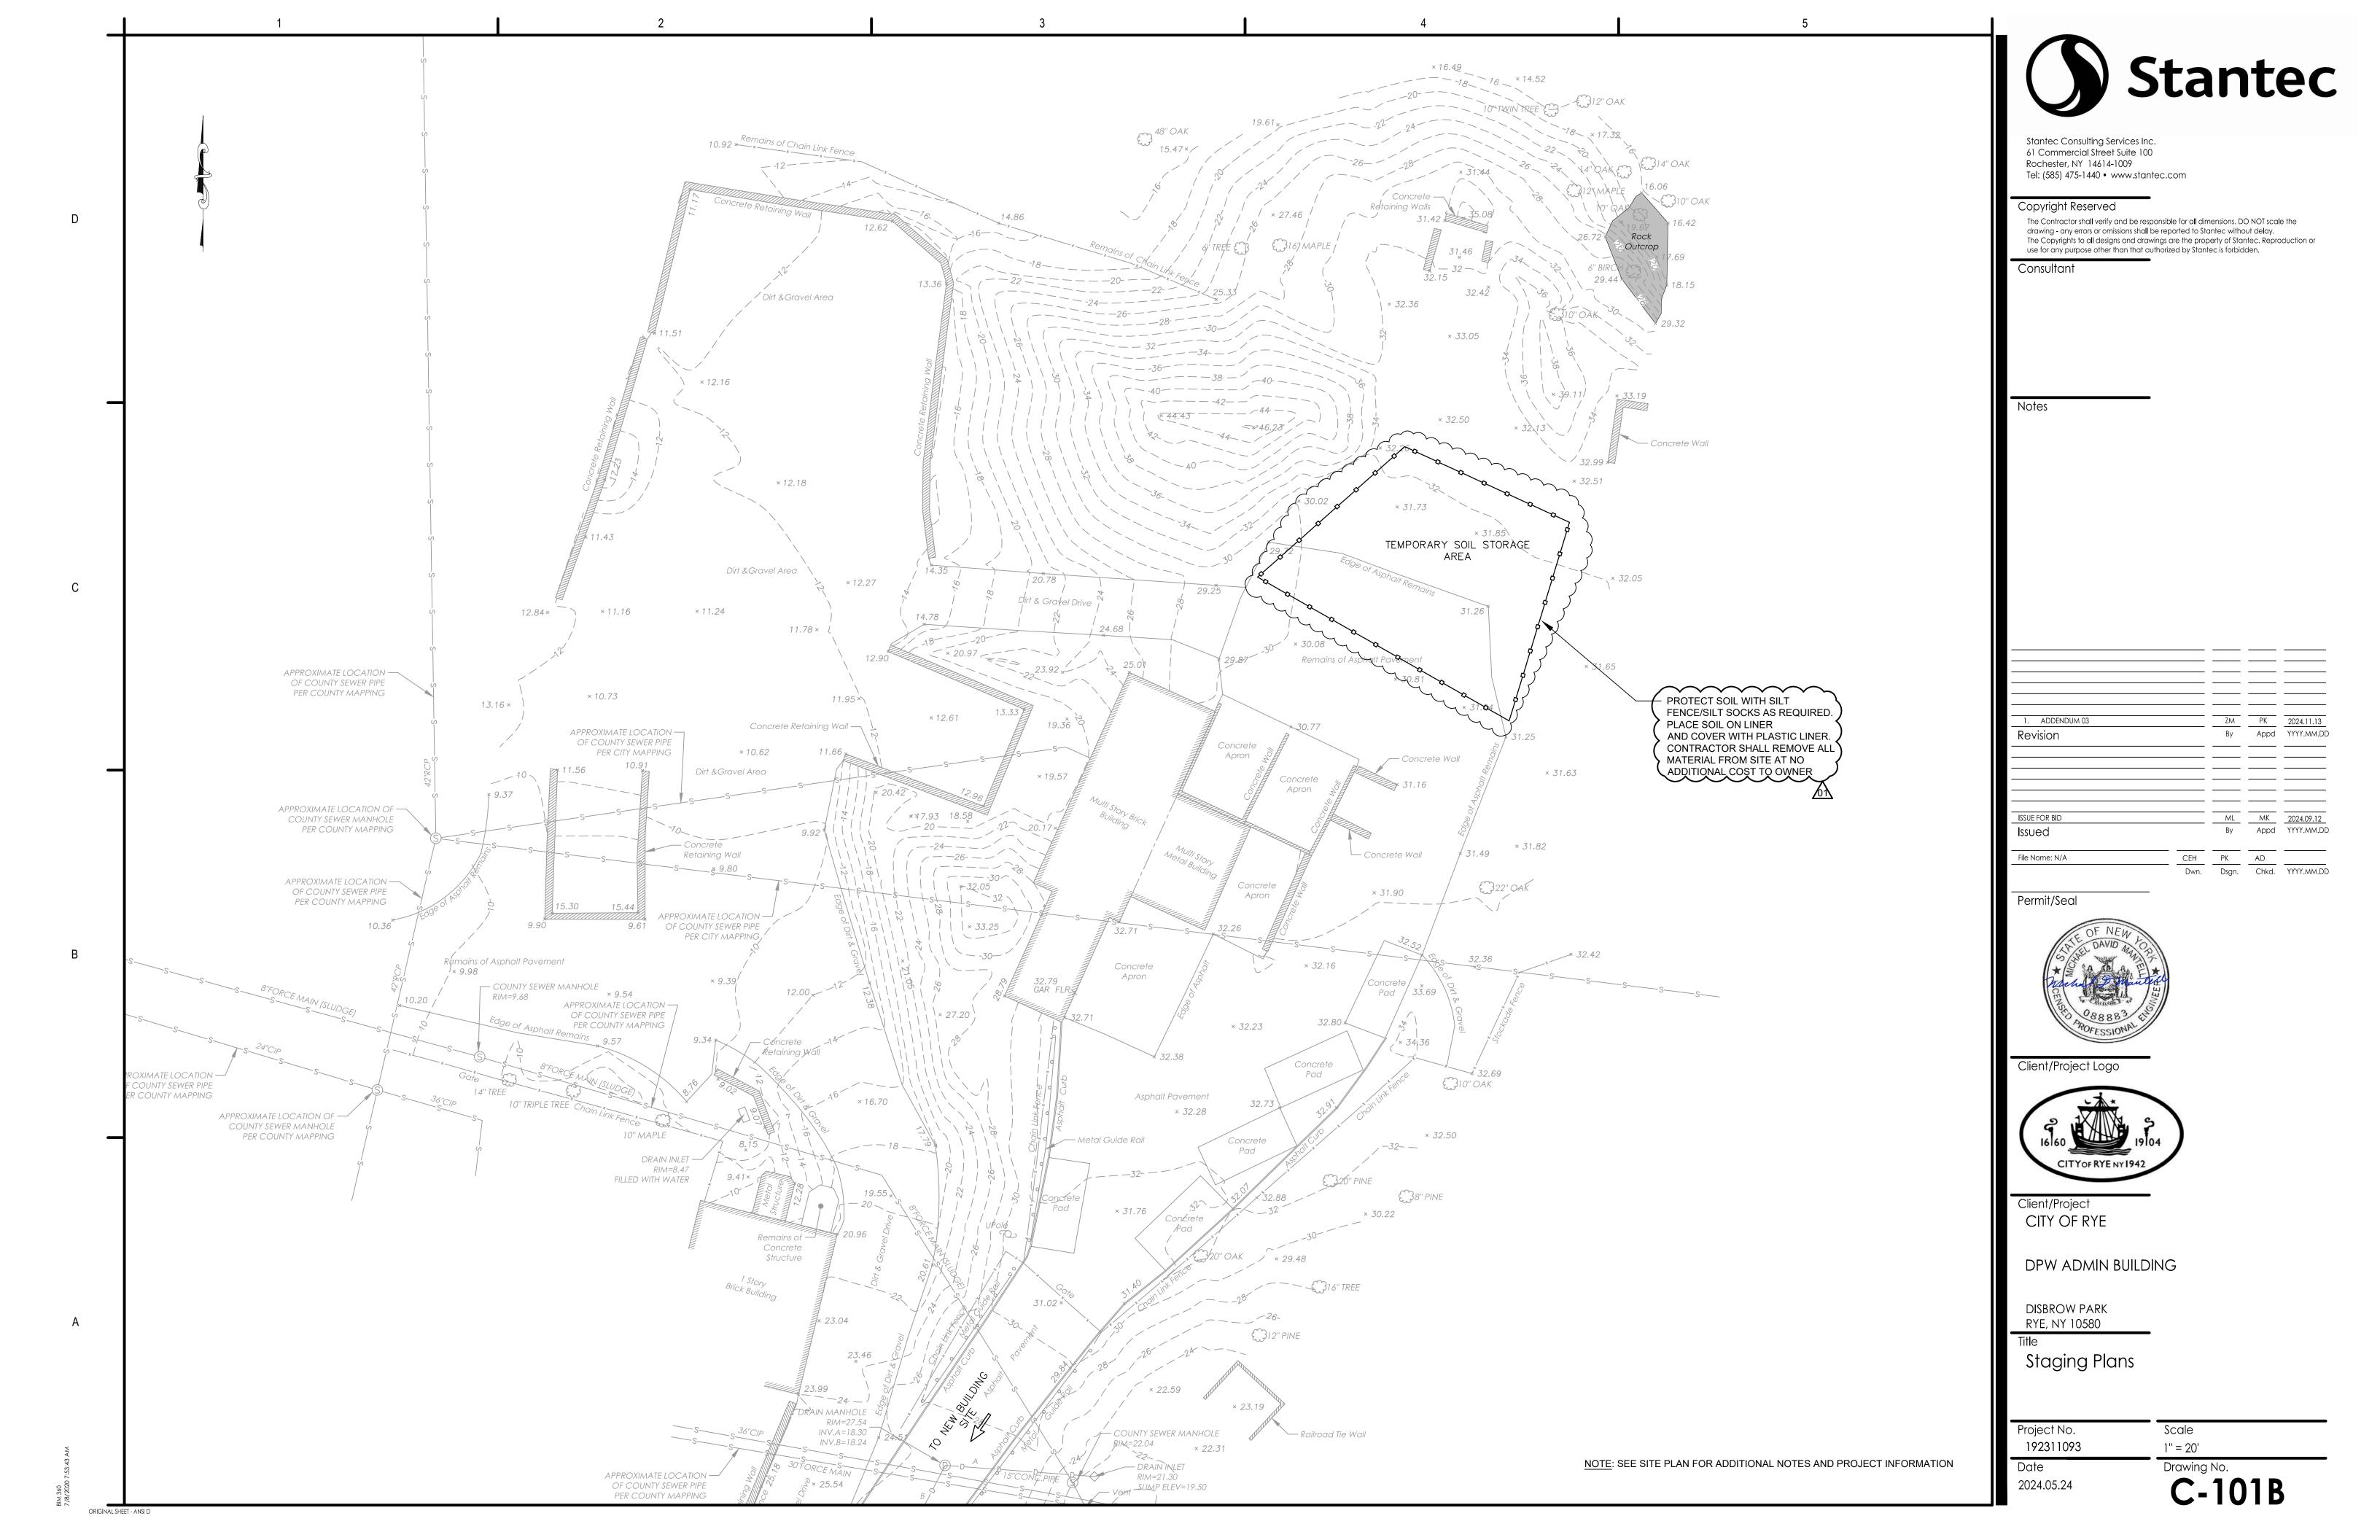

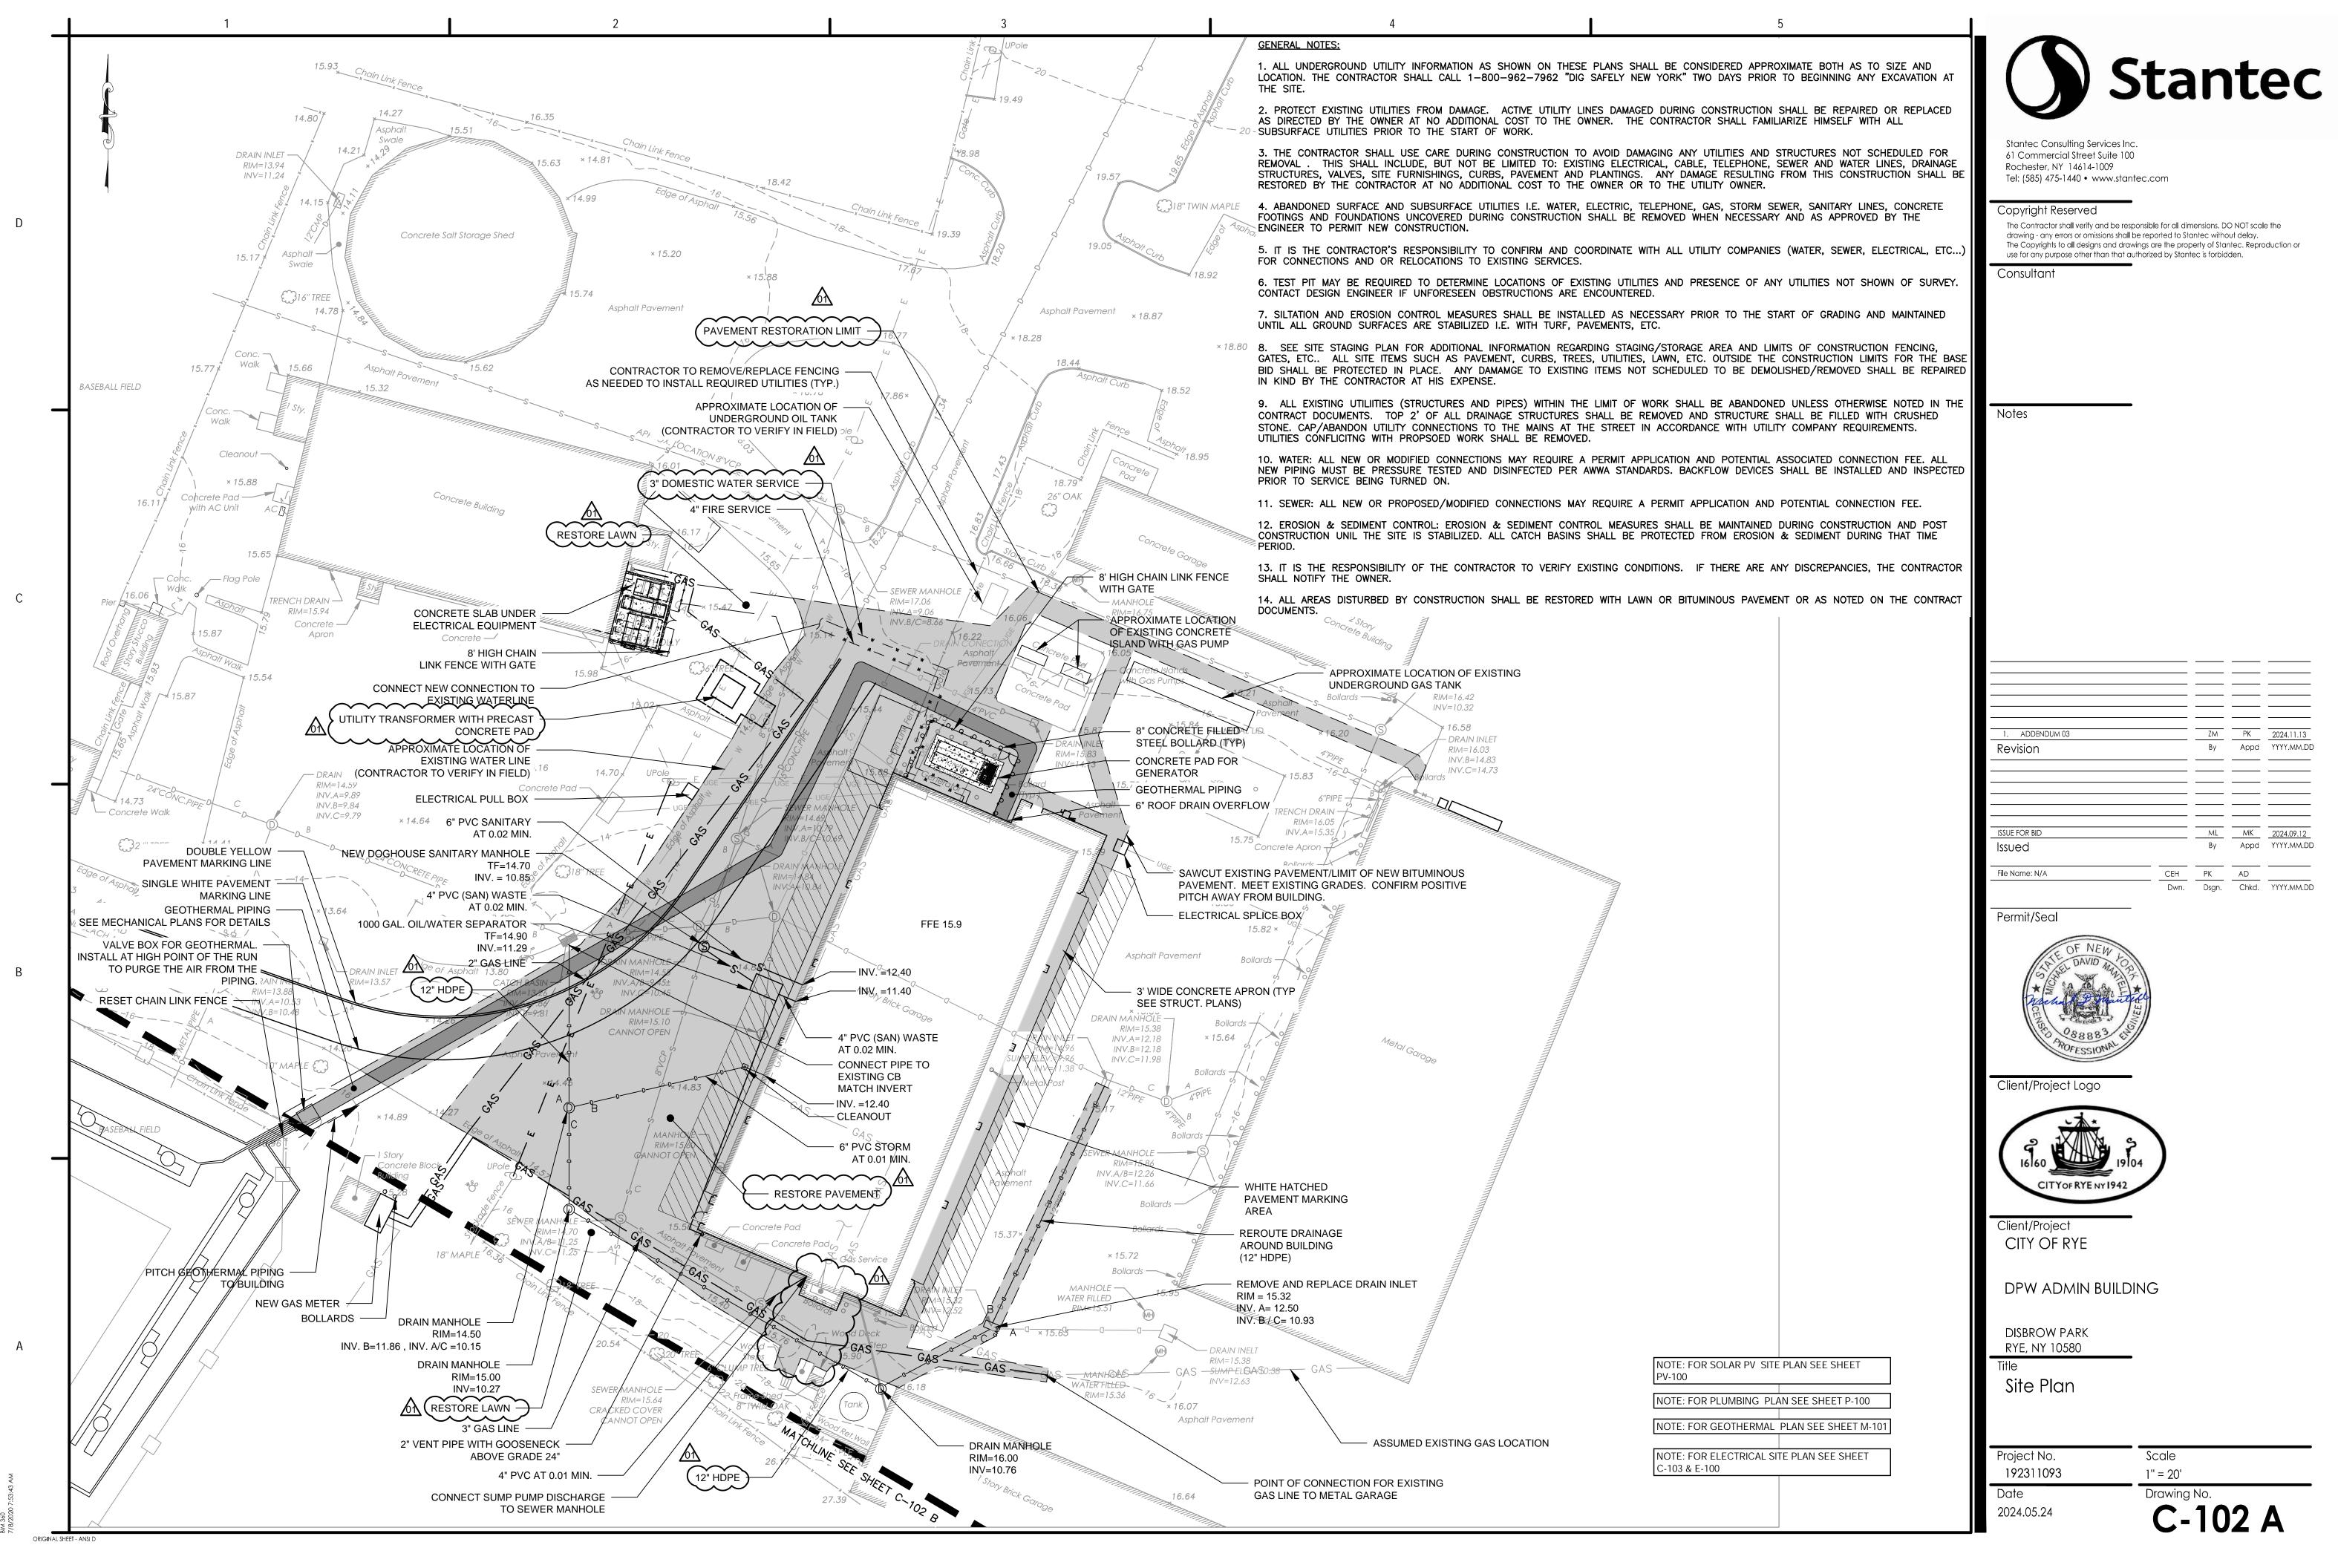

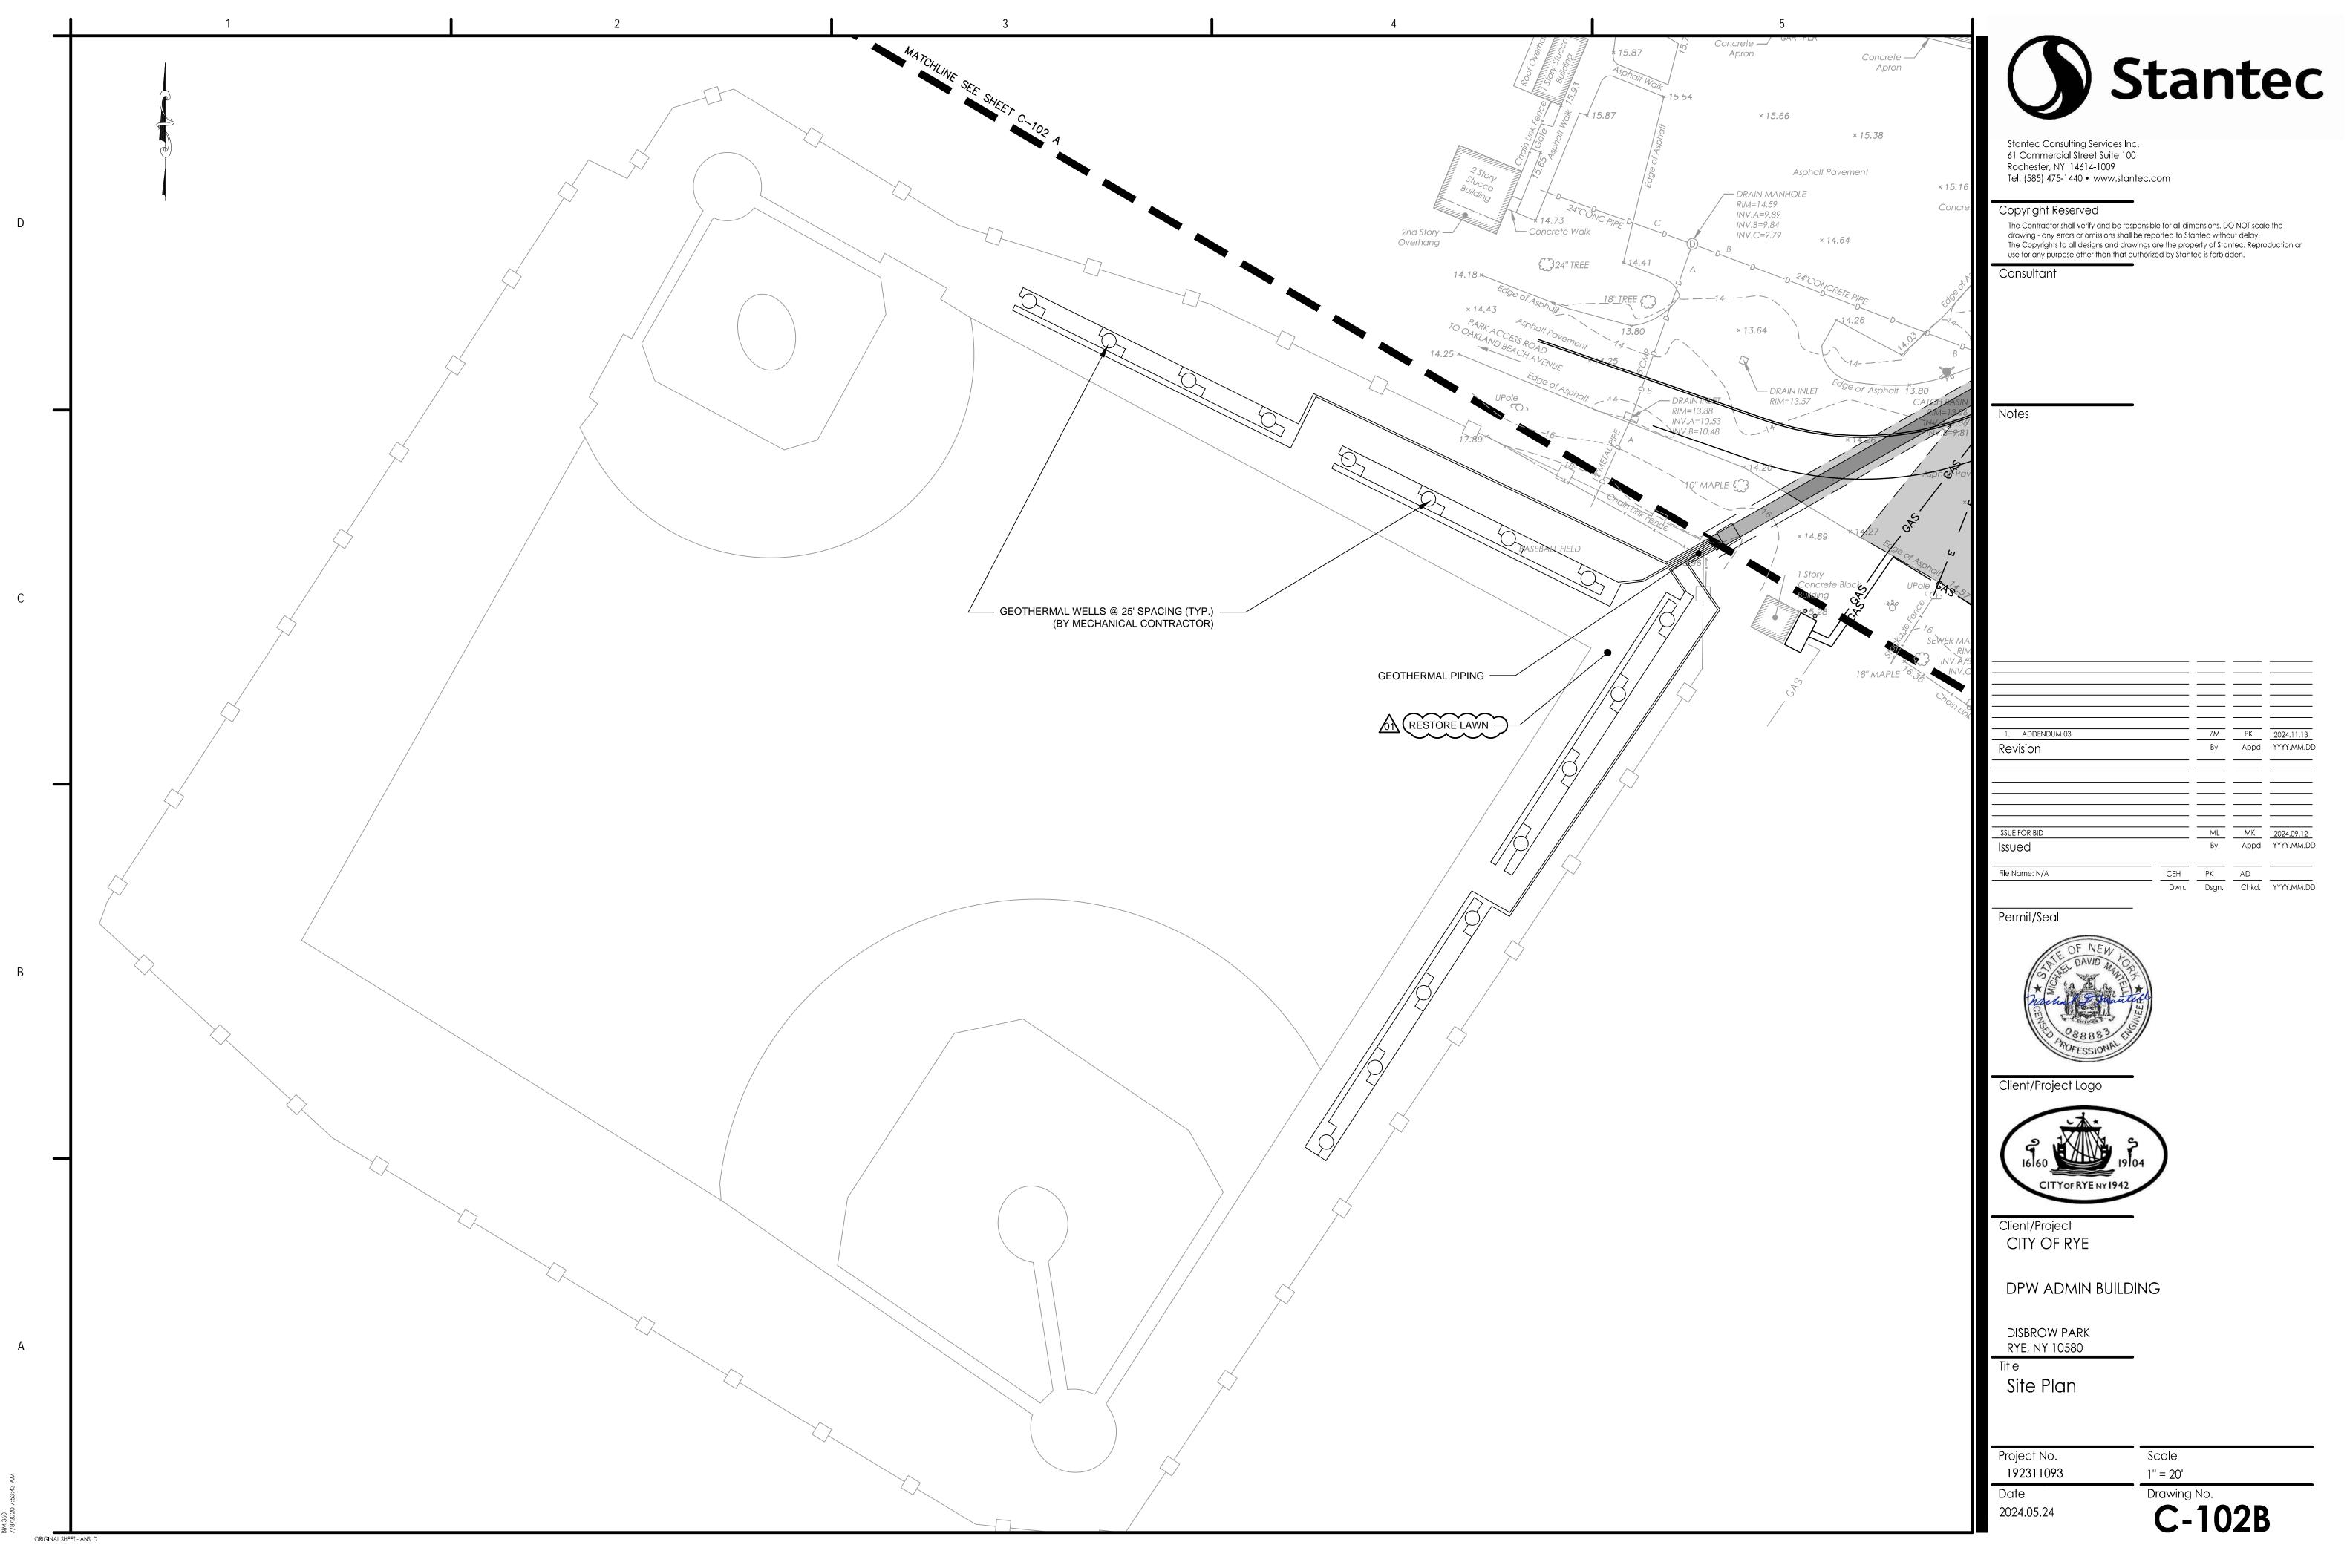

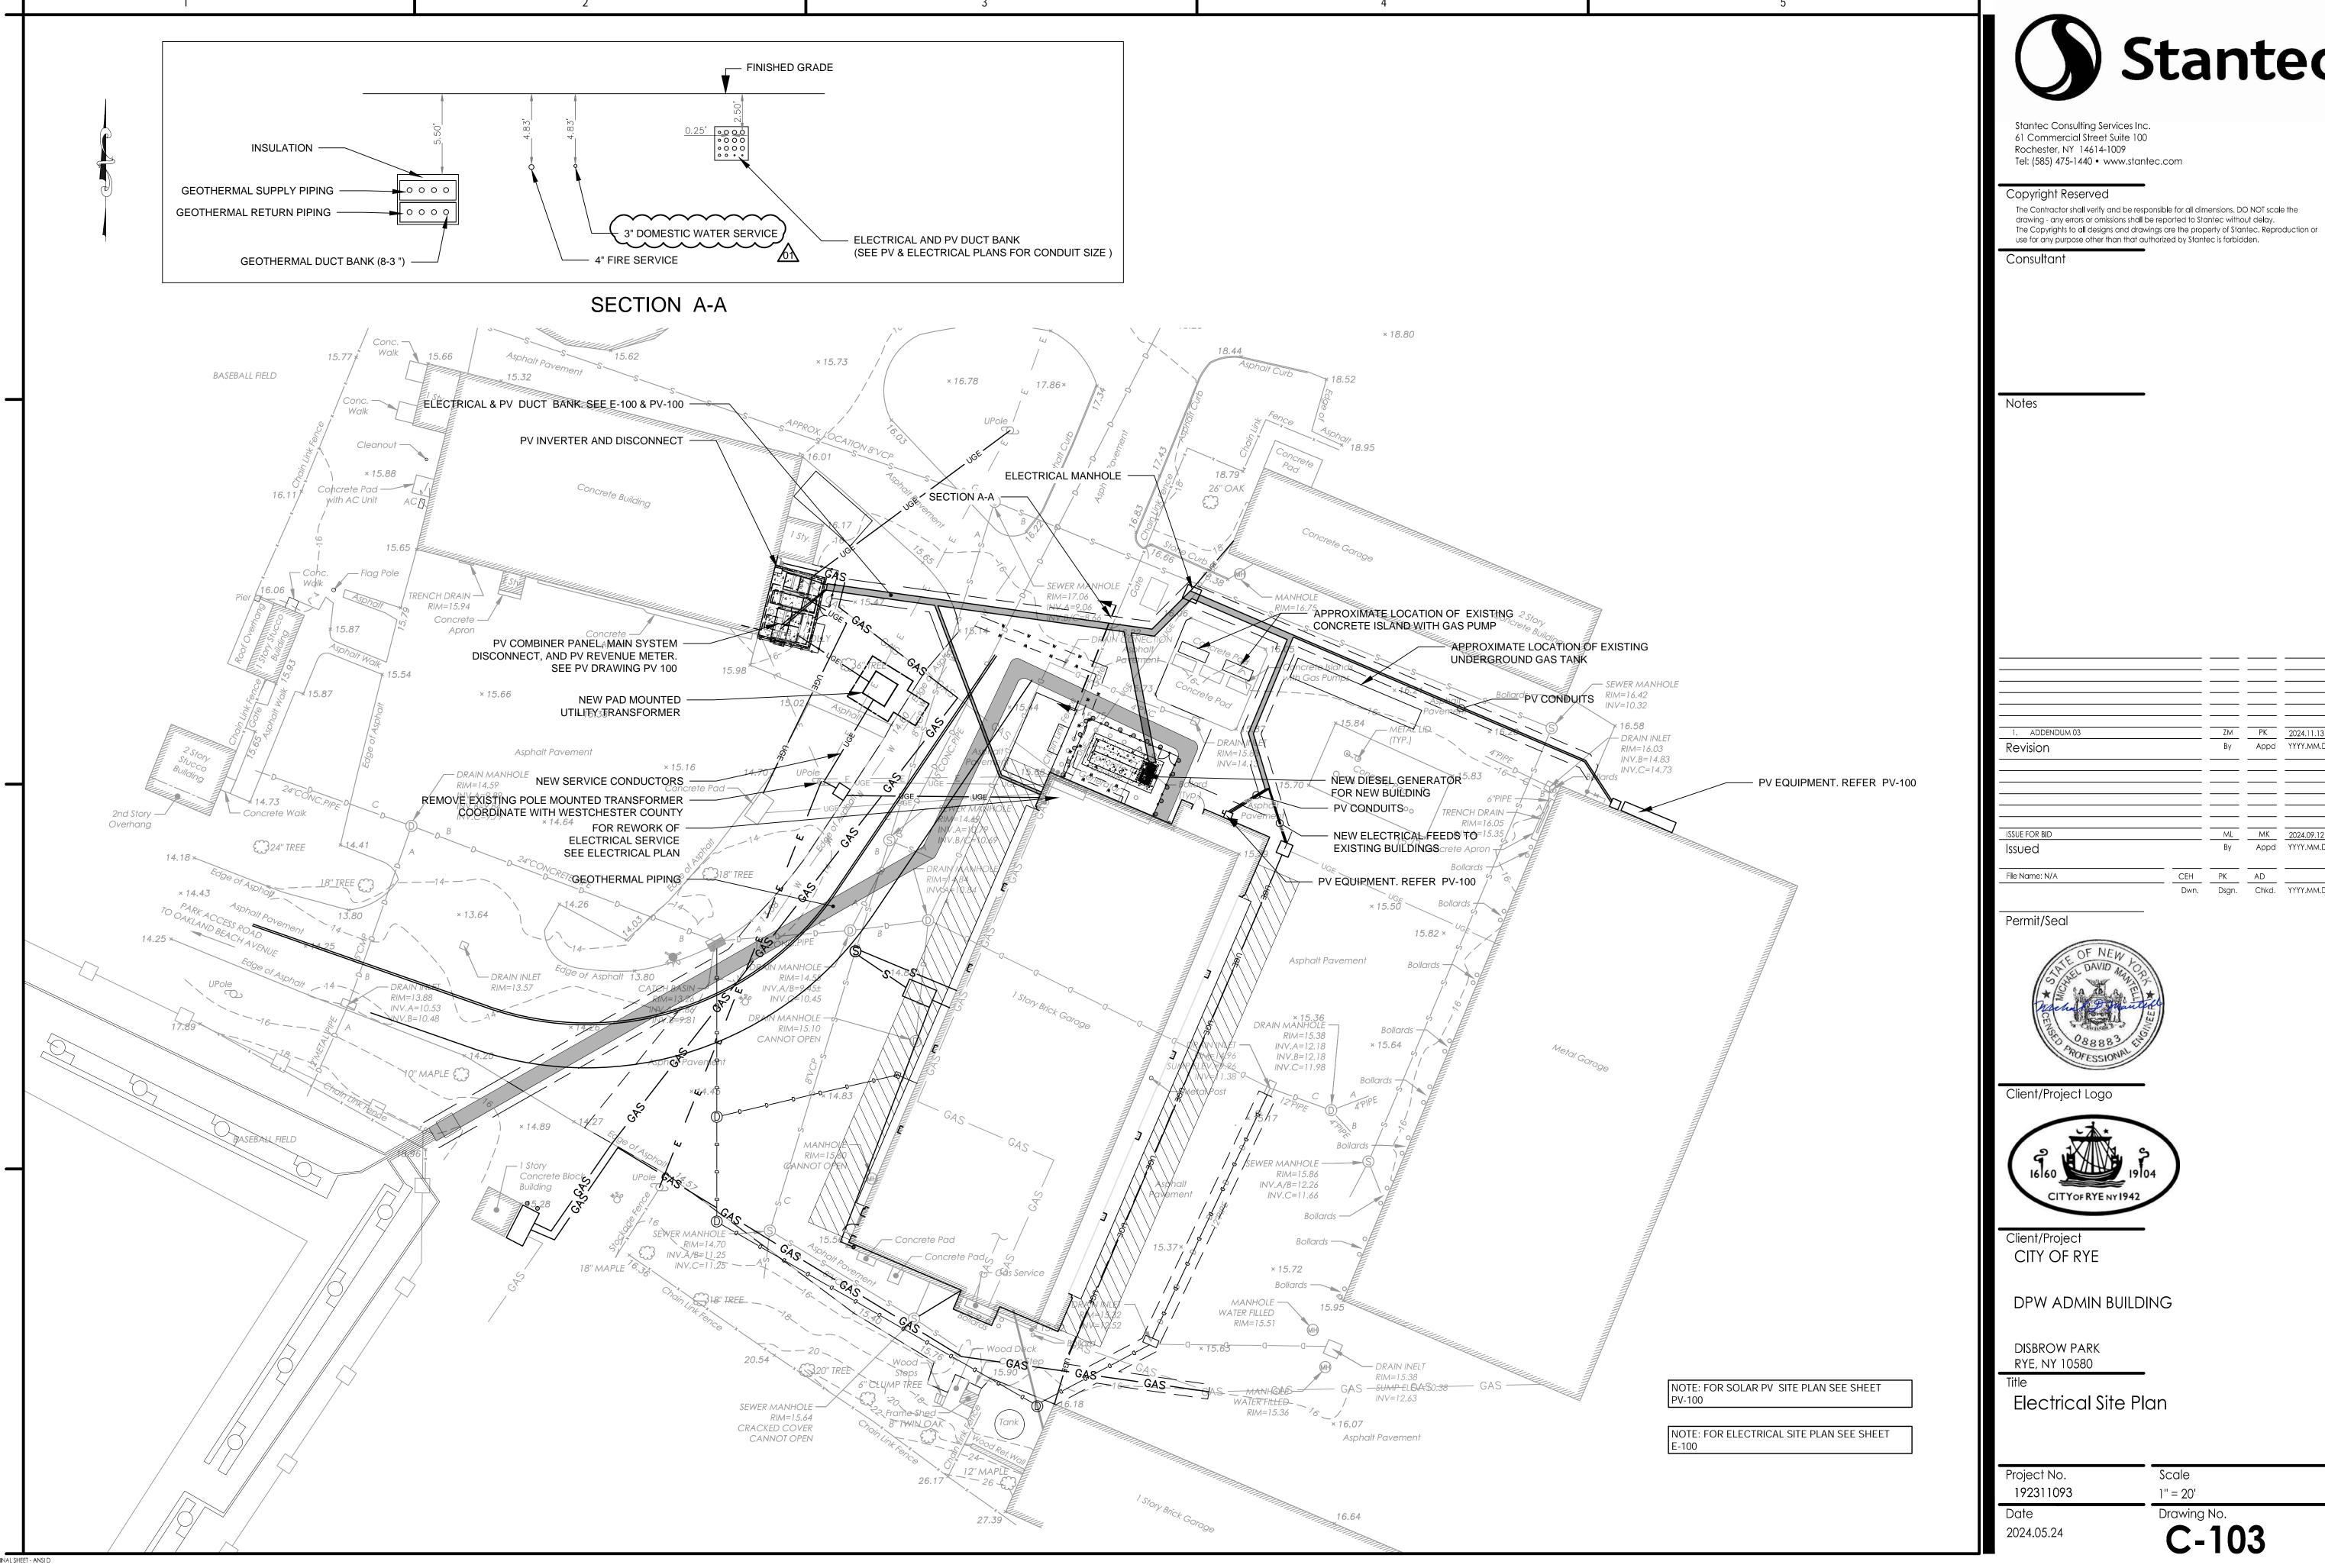




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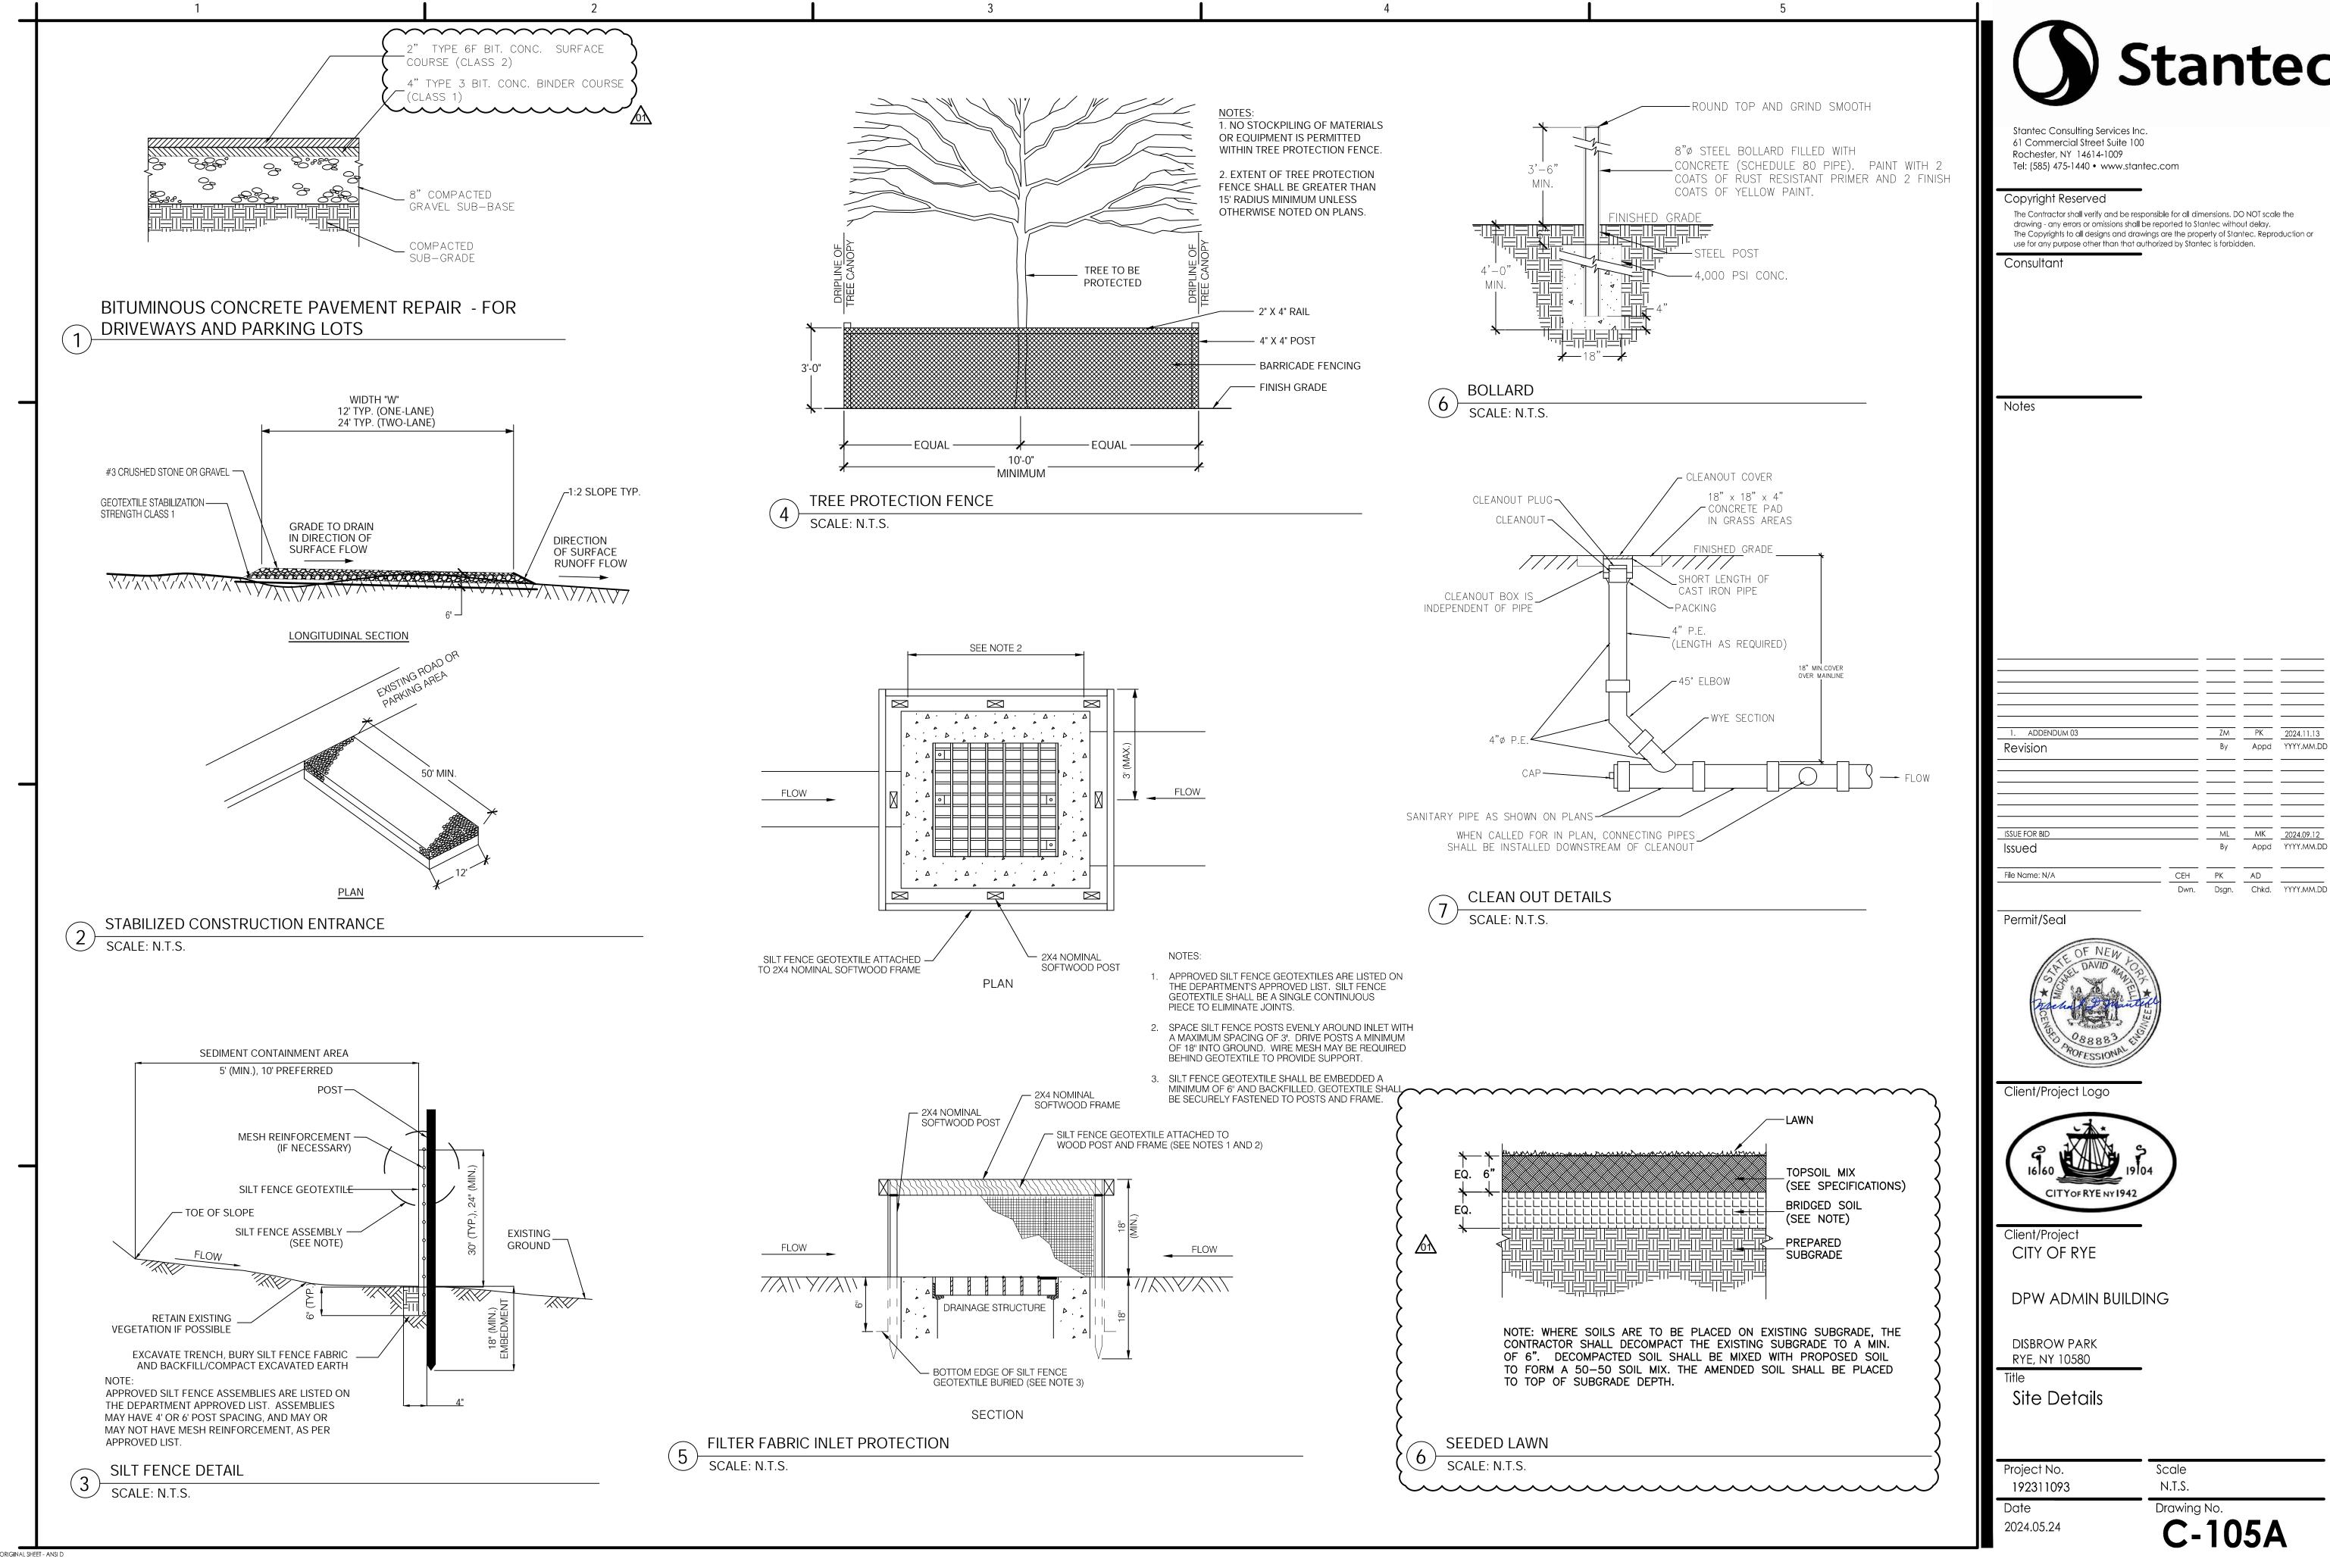
1. ADDENDUM 03		ZM		2024.11.
Revision		Ву	Appd	YYYY.MM
ISSUE FOR BID		ML	<u>MK</u>	2024.09.
Issued		Ву	Appd	YYYY.MM
File Name: N/A	CEH	PK	AD	

Scale 1" = 20'

Drawing No.


C-103



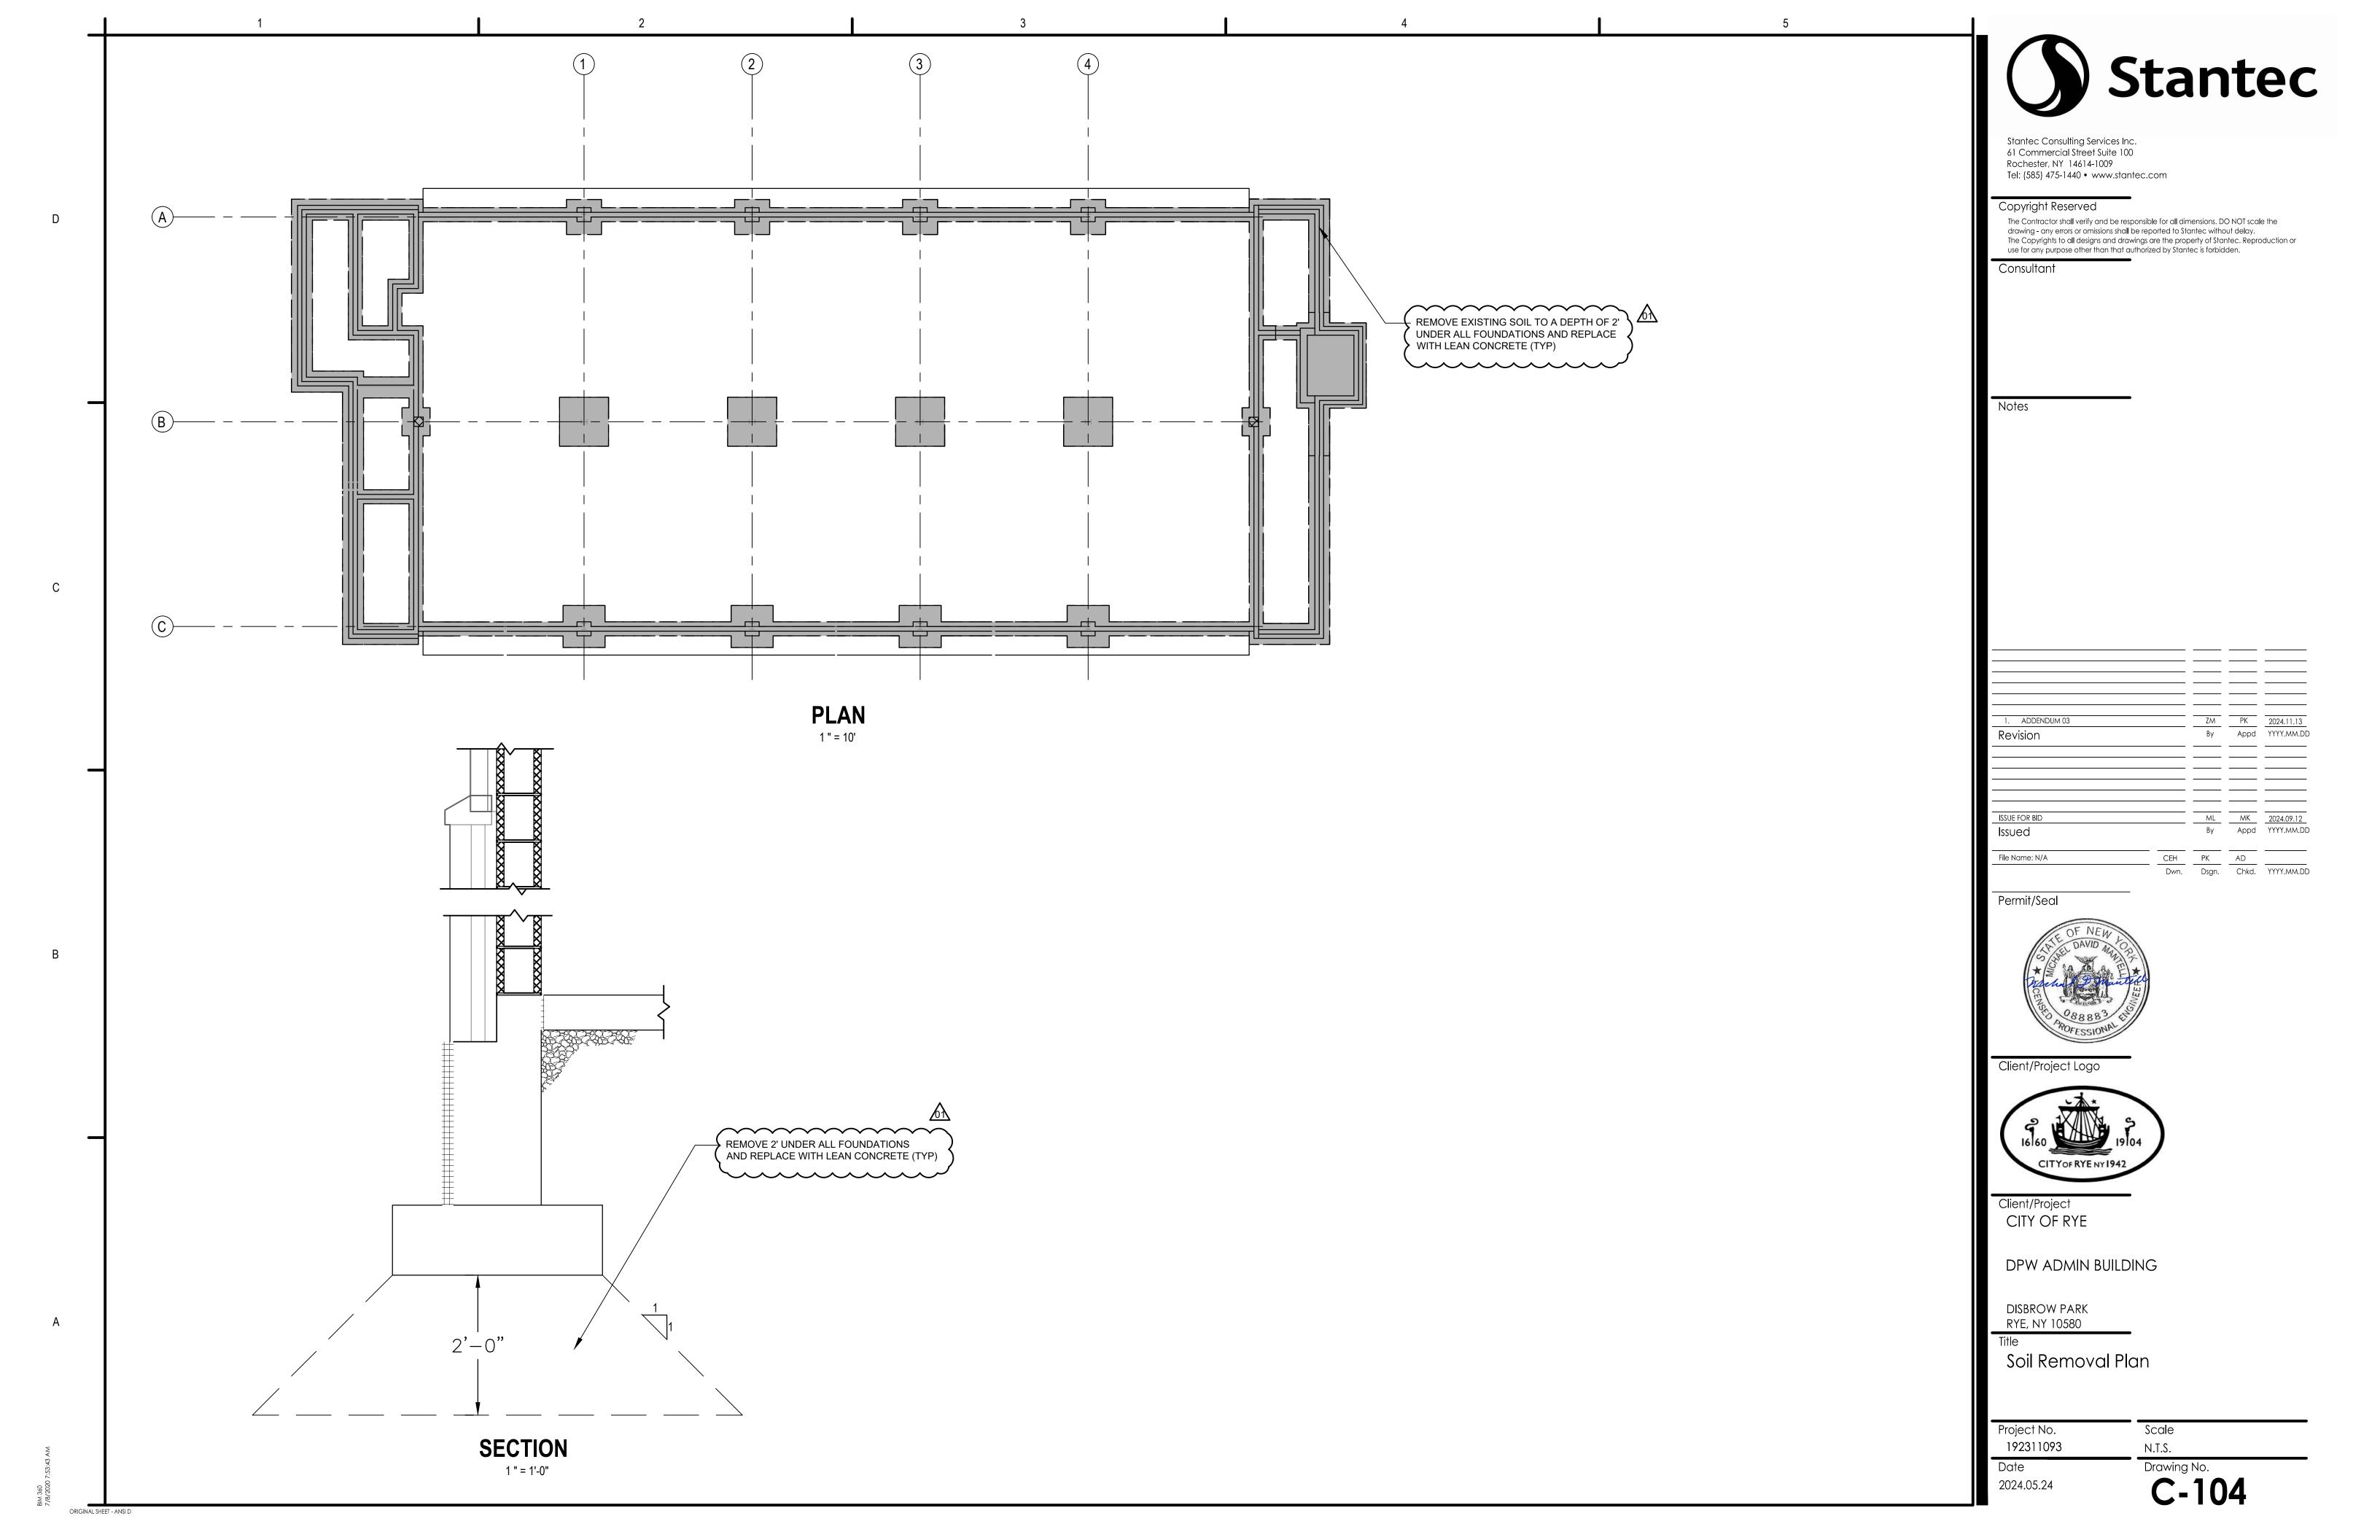


### TYPICAL TRENCH SECTION (STORM/SANITARY)

ノ SCALE: N.T.S

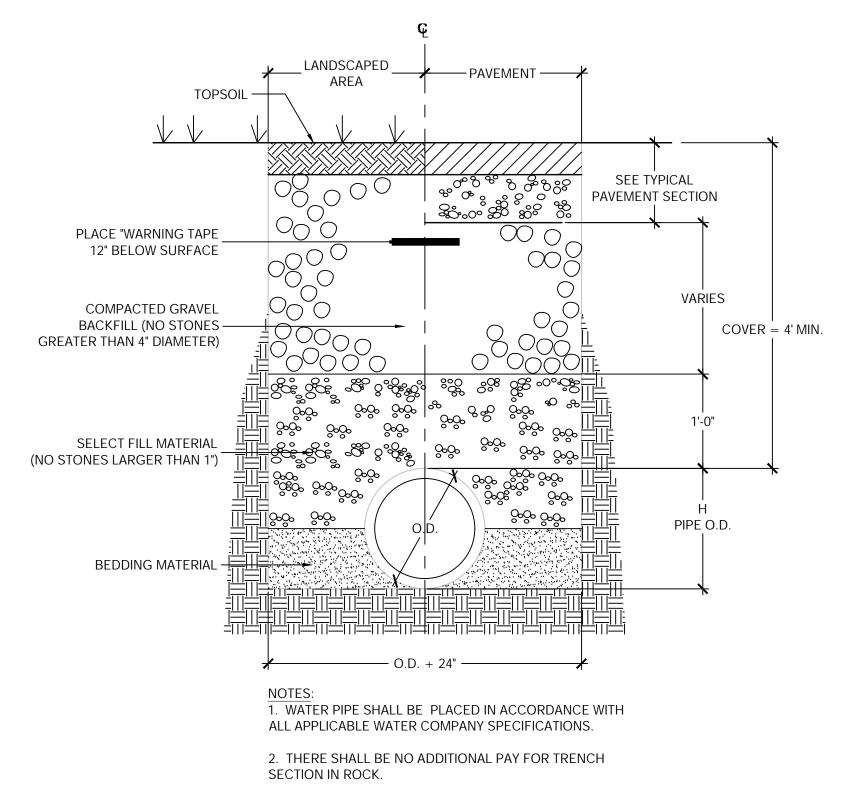


### TYPICAL TRENCH SECTION (WATER PIPE)

SCALE: N.T.S.

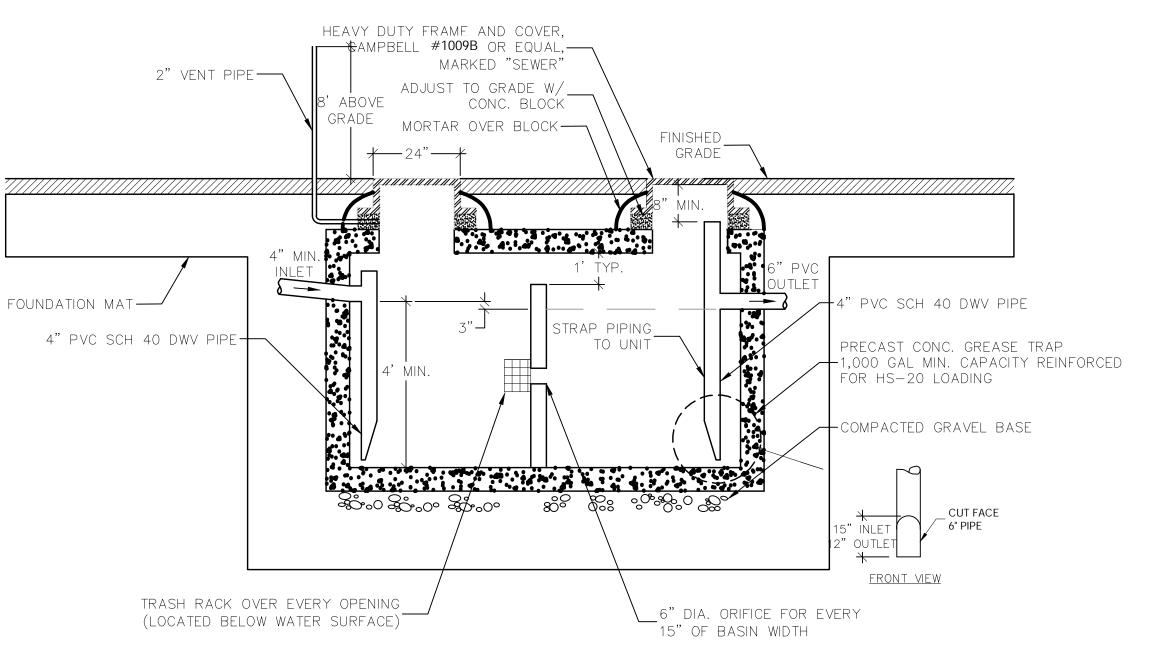

### OIL/WATER SEDIMENT SEPARATOR

SCALE: N.T.S.

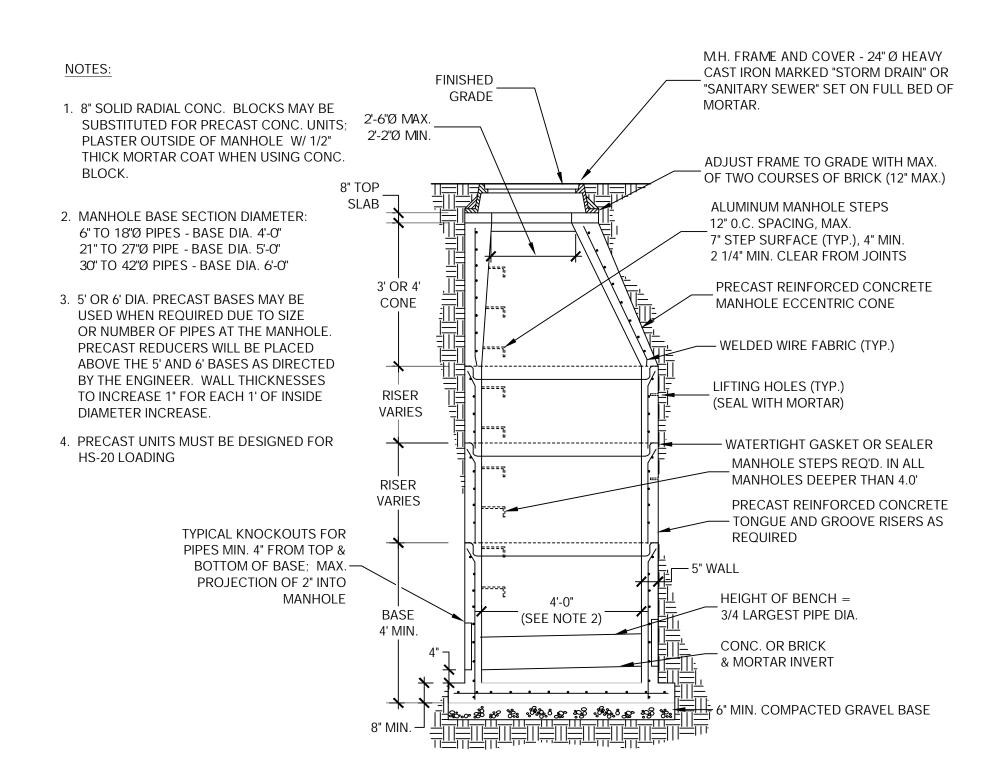

## TYPICAL SANITARY OR STORM MANHOLE

SCALE: N.T.S.



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Notes

	<u> </u>		
	ZM	PK_	2024.11.1
	By	Appd	YYYY.MM
	ML	MK	2024.09.1
	Ву	Appd	MM.YYYY
CEH	PK	AD	
Dwn.	Dsgn.	Chkd.	MM.YYYY
		ML By	By Appd  ML MK By Appd  CEH PK AD

### Permit/Seal



Client/Project Logo



Client/Project
CITY OF RYE

DPW ADMIN BUILDING

DISBROW PARK RYE, NY 10580 Title Site Details

Project No.
192311093


Date
2024.05.24

Scale

Drawing No.

C-105B


M 360

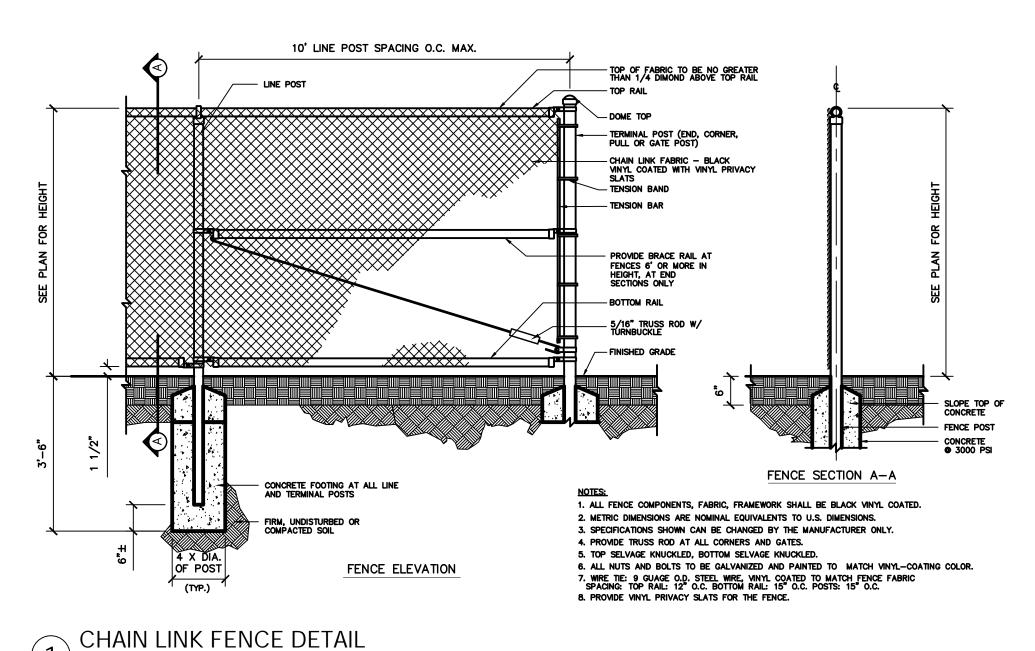

# SCALE: N.T.S.

### SIZING SCHEDULE FOR GATE FRAMEWORK

HEIGHT OF FENCE	OF	POST SPACING MAXIMUM	GATE POST Ø	HORIZ. BRACE AT GATE POST	SIZE OF GATE MEMBERS	HORIZ. BRACE ON GATES	SINGLE GATE HEIGHT	SINGLE GATE WIDTH	DIAG. TRUSS ON GATE	DIAG. TRUSS- FENCE PANEL	PORTAL	HEAD RAIL	FOOTING TYPE
8'-0"	2 1/2"	8'-0"	3"	1 –1 5 <i>/</i> 8"	2"	1 5/8"	7'-7"	VARIES	1/2" ø	1/2" ø	NO	0	30"ø

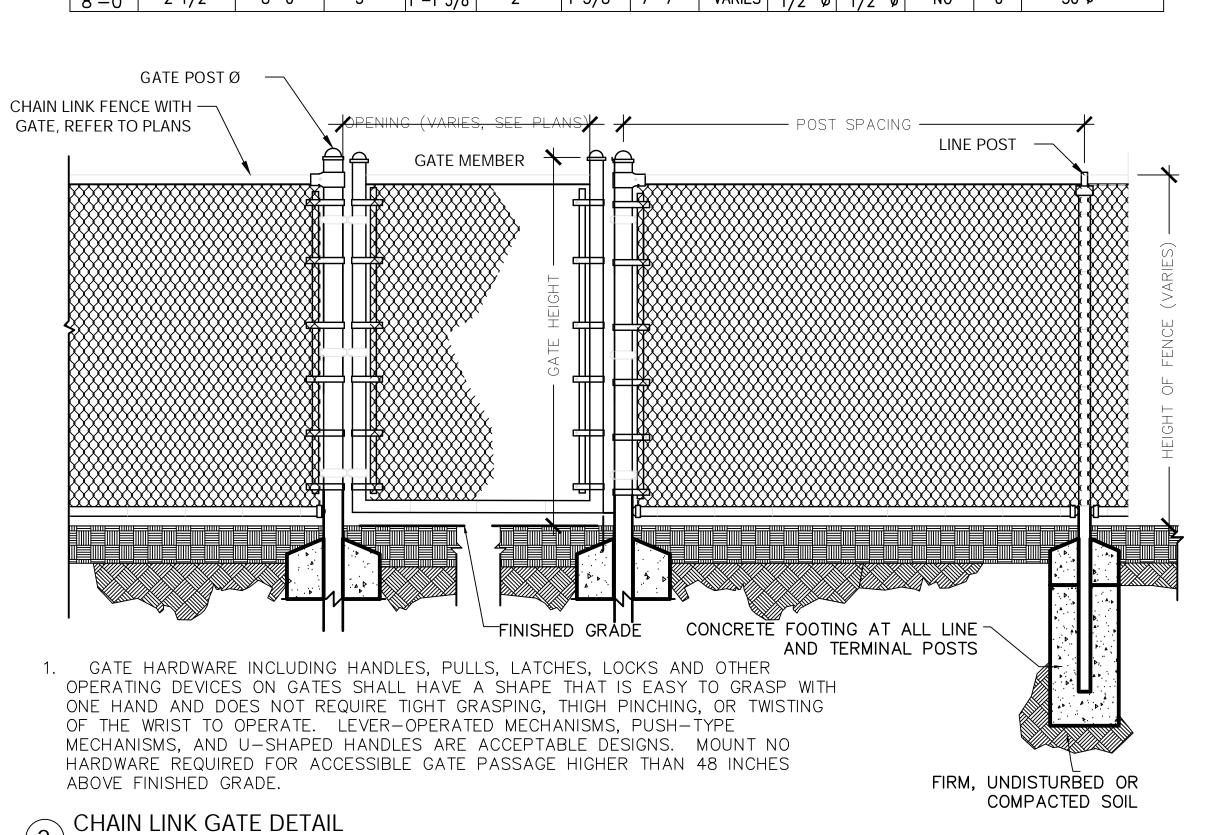

4KSI CONCRETE

#4 @12" O.C. EACHWAY

CRUSHED STONE ALL AROUND PAD, TYP.

FINISHED GRADE


COMPACTED (95% MDD)

NO. 4 PROCESSED

AGGREGATE


COMPACTED SUBGRADE

COMPACTED SUBGRADE

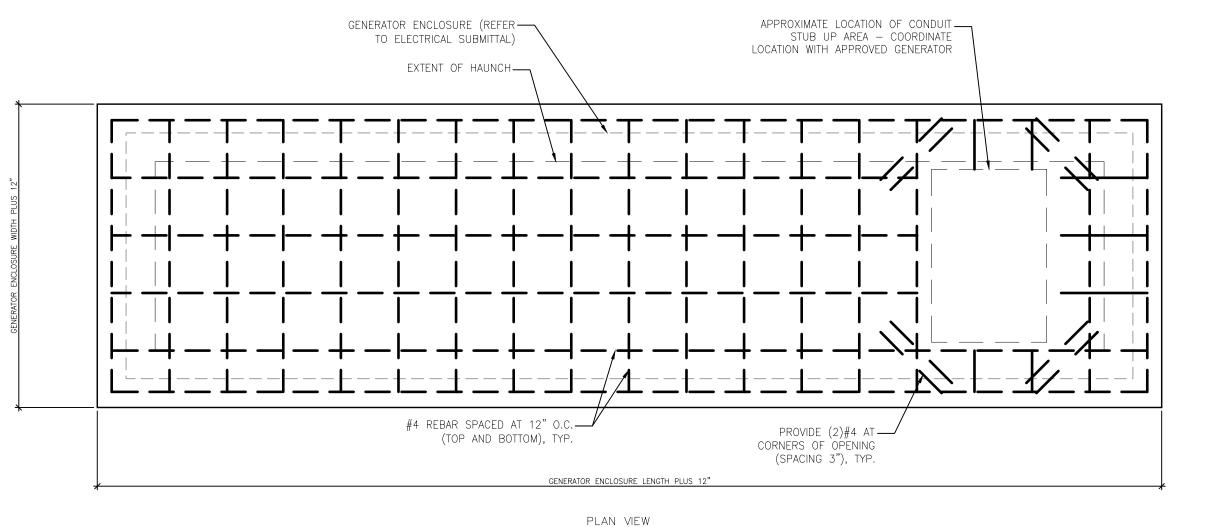

SECTION VIEW

GENERATOR CONCRETE PAD

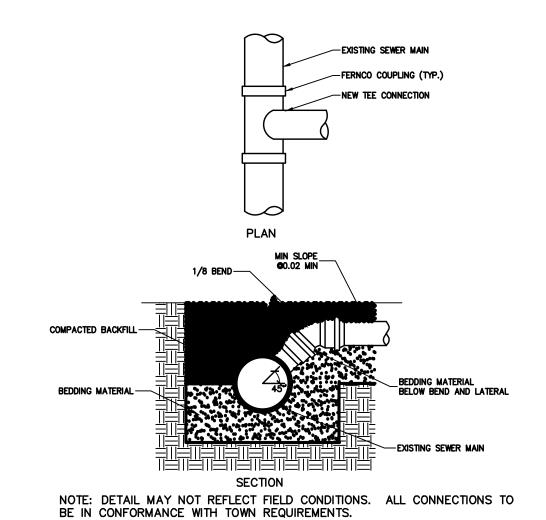

SEWER LATERAL CONNECTION

SCALE: N.T.S.



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CITY OF RYE

DPW ADMIN BUILDING

DISBROW PARK RYE, NY 10580

Site Details

Project No.
192311093

Date
2024.05.24

Scale


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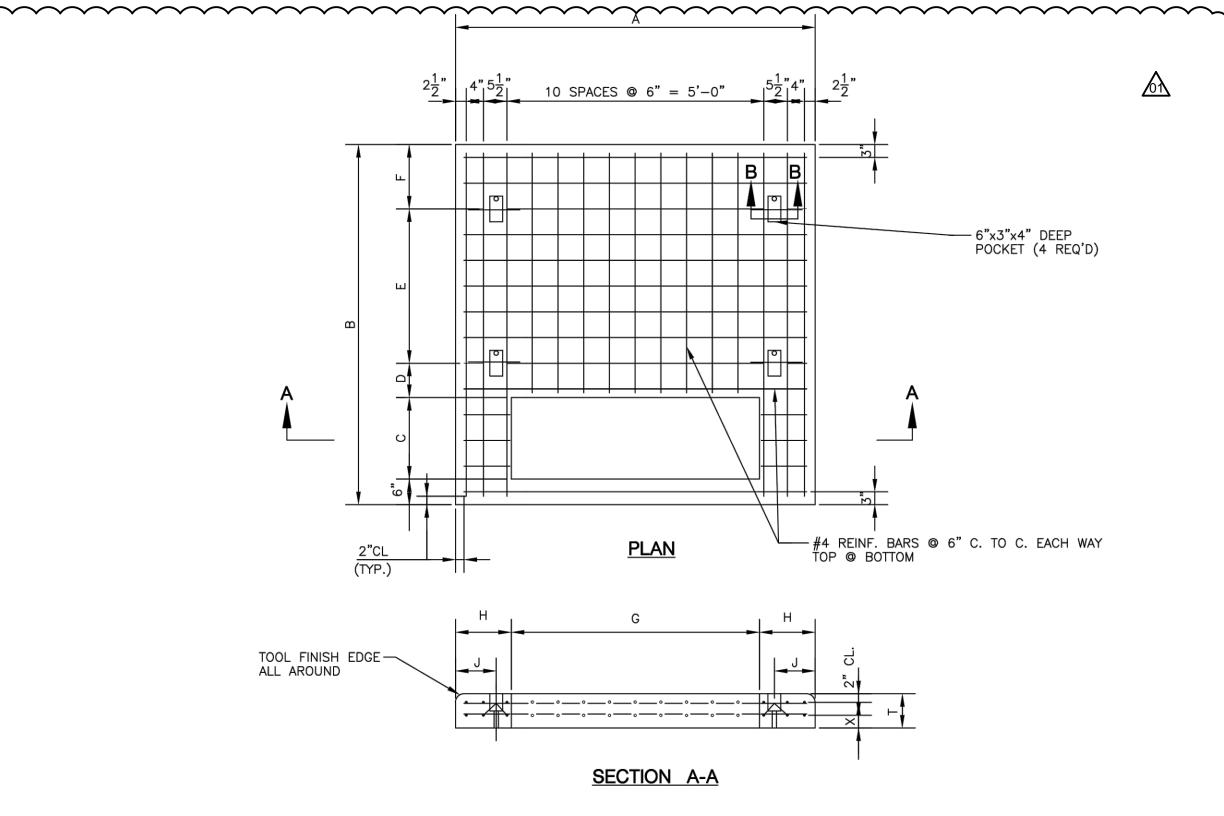
C-105C

M 360

ORIGINAL SHEET - AN

SCALE: N.T.S.



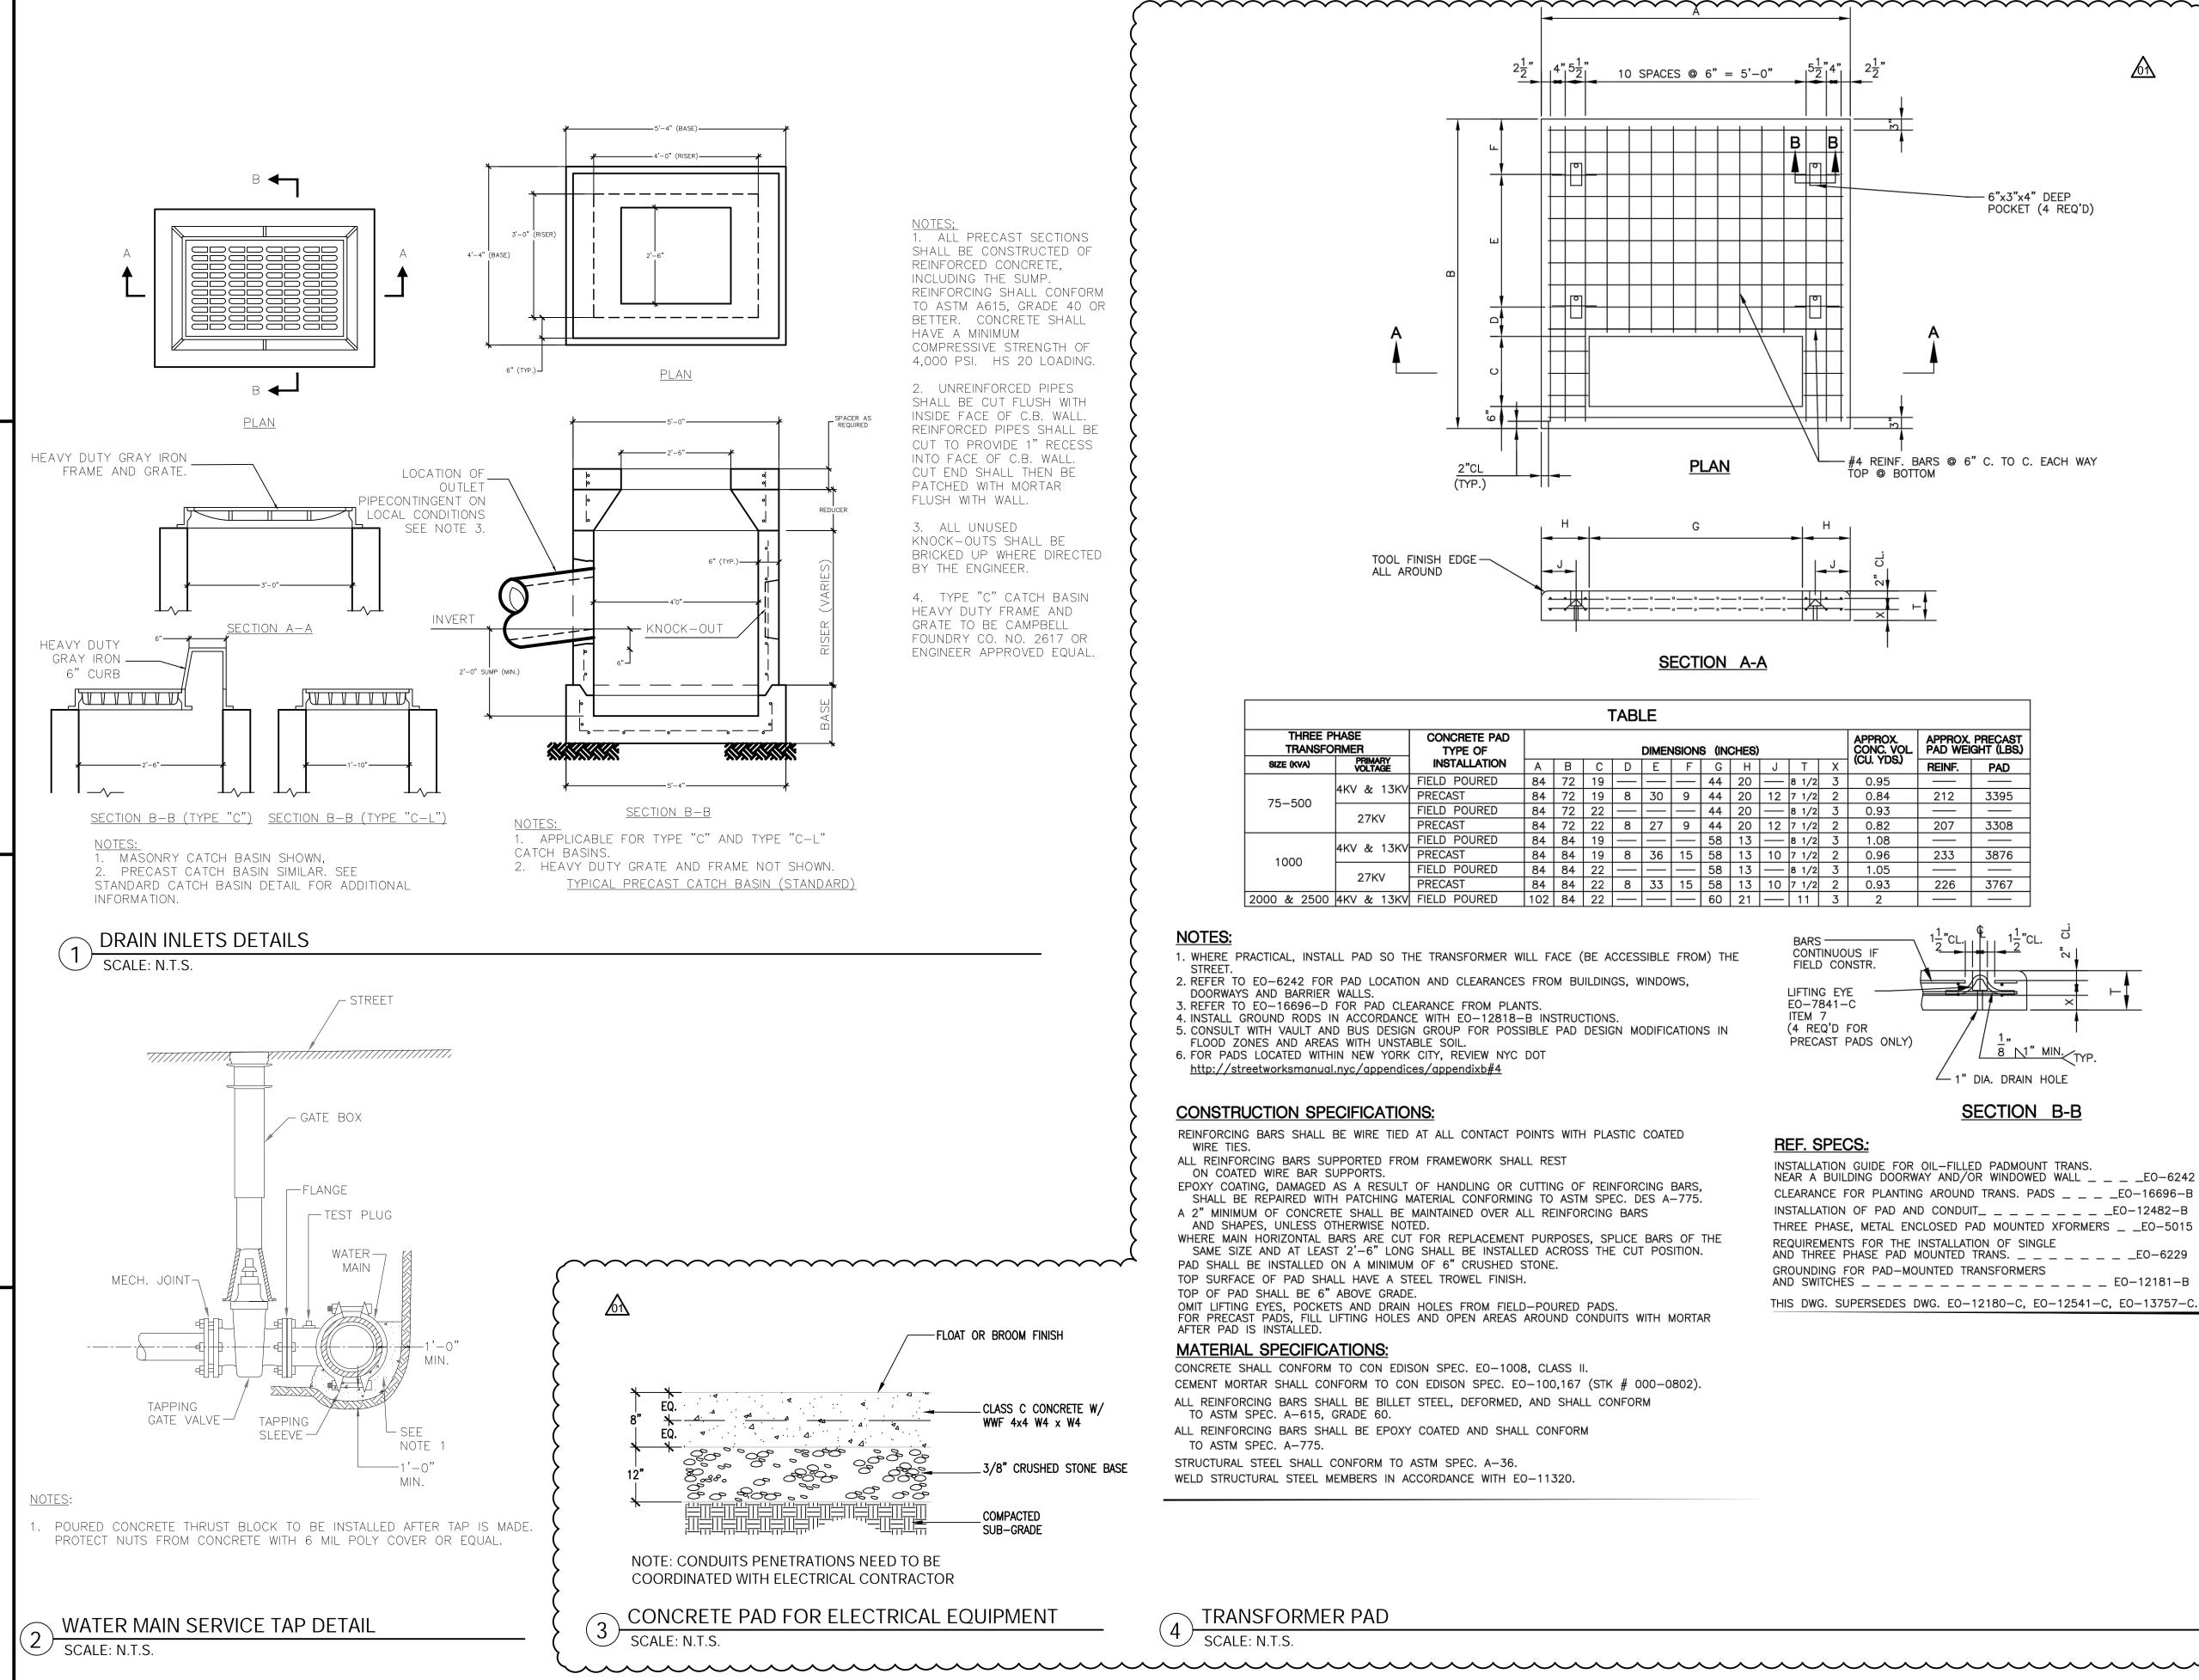

CONTINUOUS IF

FIELD CONSTR.

PRECAST PADS ONLY)

8 N" MIN.

— 1" DIA. DRAIN HOLE

NEAR A BUILDING DOORWAY AND/OR WINDOWED WALL \_ \_ \_ E0-6242

CLEARANCE FOR PLANTING AROUND TRANS. PADS \_ \_ \_ \_ EO-16696-B

THREE PHASE, METAL ENCLOSED PAD MOUNTED XFORMERS \_ \_EO-5015

INSTALLATION OF PAD AND CONDUIT\_ \_ \_ \_ \_ \_ \_ \_ \_ \_ \_ \_ \_ EO-12482-B

AND SWITCHES \_ \_ \_ \_ \_ \_ \_ E0-12181-B

THIS DWG. SUPERSEDES DWG. E0-12180-C, E0-12541-C, E0-13757-C

INSTALLATION GUIDE FOR OIL-FILLED PADMOUNT TRANS.

REQUIREMENTS FOR THE INSTALLATION OF SINGLE

GROUNDING FOR PAD-MOUNTED TRANSFORMERS

SECTION B-B

LIFTING EYE

EO-7841-C

REF. SPECS.:

ITEM 7 (4 REQ'D FOR

	TABLE																
THREE PHASE TRANSFORMER		CONCRETE PAD TYPE OF		DIMENSIONS (INCHES) CONC. VOL   F								APPROX. PAD WEI	APPROX. PRECAST PAD WEIGHT (LBS.)				
SIZE (KVA)	PRIMARY VOLTAGE	INSTALLATION	Α	В	С	D	E	F	G	Н	J	Т	Χ	(CU. YDS.)	REINF.	PAD	
75–500	4KV & 13KV 27KV	FIELD POURED	84	72	19	_	_		44	20	_	8 1/2	3	0.95			
		PRECAST	84	72	19	8	30	9	44	20	12	7 1/2	2	0.84	212	3395	
75-500		FIELD POURED	84	72	22	_	_	_	44	20	_	8 1/2	3	0.93			
		PRECAST	84	72	22	8	27	9	44	20	12	7 1/2	2	0.82	207	3308	
	4KV & 13KV	4107 0- 4710	FIELD POURED	84	84	19	_	_	_	58	13		8 1/2	3	1.08		
1000		PRECAST	84	84	19	8	36	15	58	13	10	7 1/2	2	0.96	233	3876	
	07107	FIELD POURED	84	84	22	—	_	_	58	13		8 1/2	3	1.05			
	27KV	PRECAST	84	84	22	8	33	15	58	13	10	7 1/2	2	0.93	226	3767	
2000 & 2500	4KV & 13KV	FIELD POURED	102	84	22				60	21		11	3	2			

- 1. WHERE PRACTICAL, INSTALL PAD SO THE TRANSFORMER WILL FACE (BE ACCESSIBLE FROM) THE
- 2. REFER TO EO-6242 FOR PAD LOCATION AND CLEARANCES FROM BUILDINGS, WINDOWS,
- DOORWAYS AND BARRIER WALLS.
- 3. REFER TO EO-16696-D FOR PAD CLEARANCE FROM PLANTS. 4. INSTALL GROUND RODS IN ACCORDANCE WITH EO-12818-B INSTRUCTIONS.
- 5. CONSULT WITH VAULT AND BUS DESIGN GROUP FOR POSSIBLE PAD DESIGN MODIFICATIONS IN FLOOD ZONES AND AREAS WITH UNSTABLE SOIL.
- 6. FOR PADS LOCATED WITHIN NEW YORK CITY, REVIEW NYC DOT
- http://streetworksmanual.nyc/appendices/appendixb#4

### CONSTRUCTION SPECIFICATIONS:

- REINFORCING BARS SHALL BE WIRE TIED AT ALL CONTACT POINTS WITH PLASTIC COATED
- ALL REINFORCING BARS SUPPORTED FROM FRAMEWORK SHALL REST ON COATED WIRE BAR SUPPORTS.
- EPOXY COATING, DAMAGED AS A RESULT OF HANDLING OR CUTTING OF REINFORCING BARS, SHALL BE REPAIRED WITH PATCHING MATERIAL CONFORMING TO ASTM SPEC. DES A-775. A 2" MINIMUM OF CONCRETE SHALL BE MAINTAINED OVER ALL REINFORCING BARS
- AND SHAPES, UNLESS OTHERWISE NOTED. WHERE MAIN HORIZONTAL BARS ARE CUT FOR REPLACEMENT PURPOSES, SPLICE BARS OF THE SAME SIZE AND AT LEAST 2'-6" LONG SHALL BE INSTALLED ACROSS THE CUT POSITION.
- PAD SHALL BE INSTALLED ON A MINIMUM OF 6" CRUSHED STONE. TOP SURFACE OF PAD SHALL HAVE A STEEL TROWEL FINISH.
- TOP OF PAD SHALL BE 6" ABOVE GRADE.
- OMIT LIFTING EYES, POCKETS AND DRAIN HOLES FROM FIELD-POURED PADS. FOR PRECAST PADS, FILL LIFTING HOLES AND OPEN AREAS AROUND CONDUITS WITH MORTAR AFTER PAD IS INSTÁLLED.

### MATERIAL SPECIFICATIONS:

- CONCRETE SHALL CONFORM TO CON EDISON SPEC. EO-1008, CLASS II. CEMENT MORTAR SHALL CONFORM TO CON EDISON SPEC. E0-100,167 (STK # 000-0802).
- ALL REINFORCING BARS SHALL BE BILLET STEEL, DEFORMED, AND SHALL CONFORM TO ASTM SPEC. A-615, GRADE 60.
- ALL REINFORCING BARS SHALL BE EPOXY COATED AND SHALL CONFORM
- TO ASTM SPEC. A-775.
- STRUCTURAL STEEL SHALL CONFORM TO ASTM SPEC. A-36.
- WELD STRUCTURAL STEEL MEMBERS IN ACCORDANCE WITH E0-11320.

TRANSFORMER PAD

SCALE: N.T.S.




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Client/Project Logo



CITY OF RYE

DPW ADMIN BUILDING


**DISBROW PARK** RYE, NY 10580

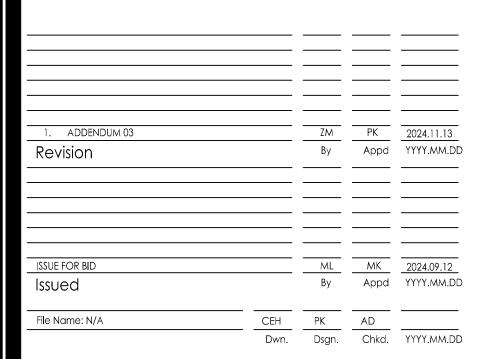
Site Details

Project No. Scale 192311093

Drawing No. 2024.05.24

ORIGINAL SHEET - ANSI D

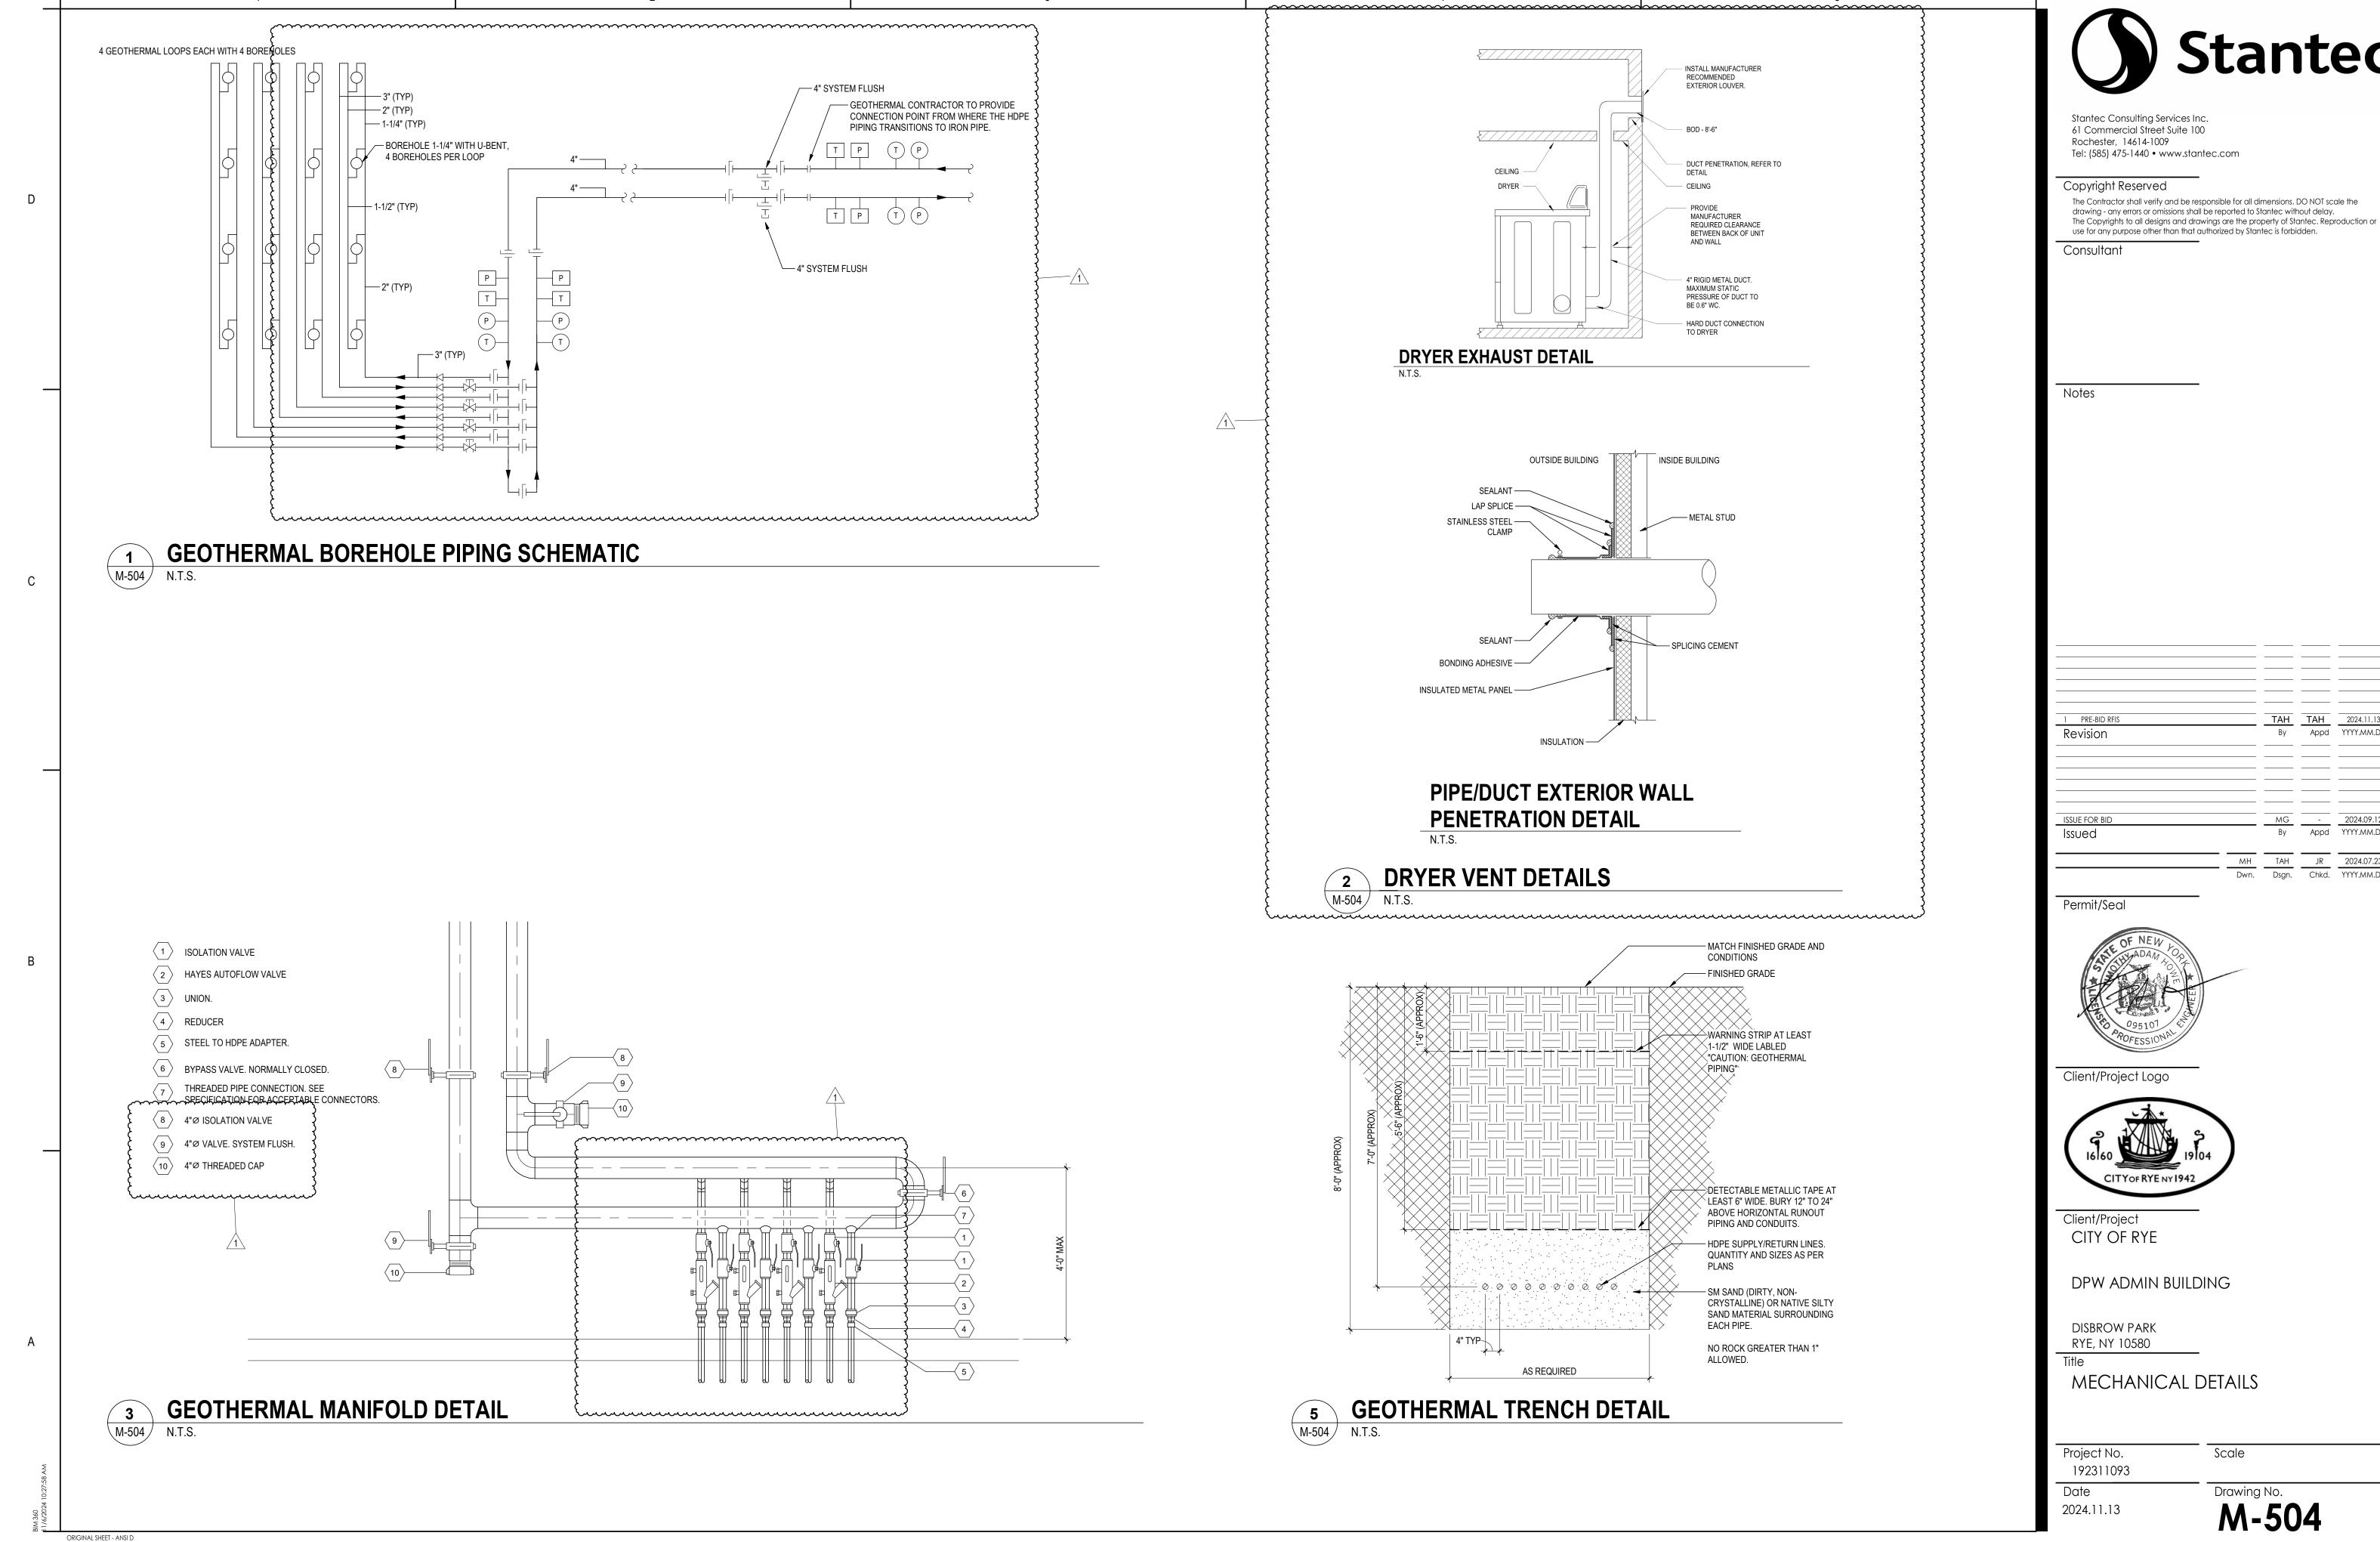

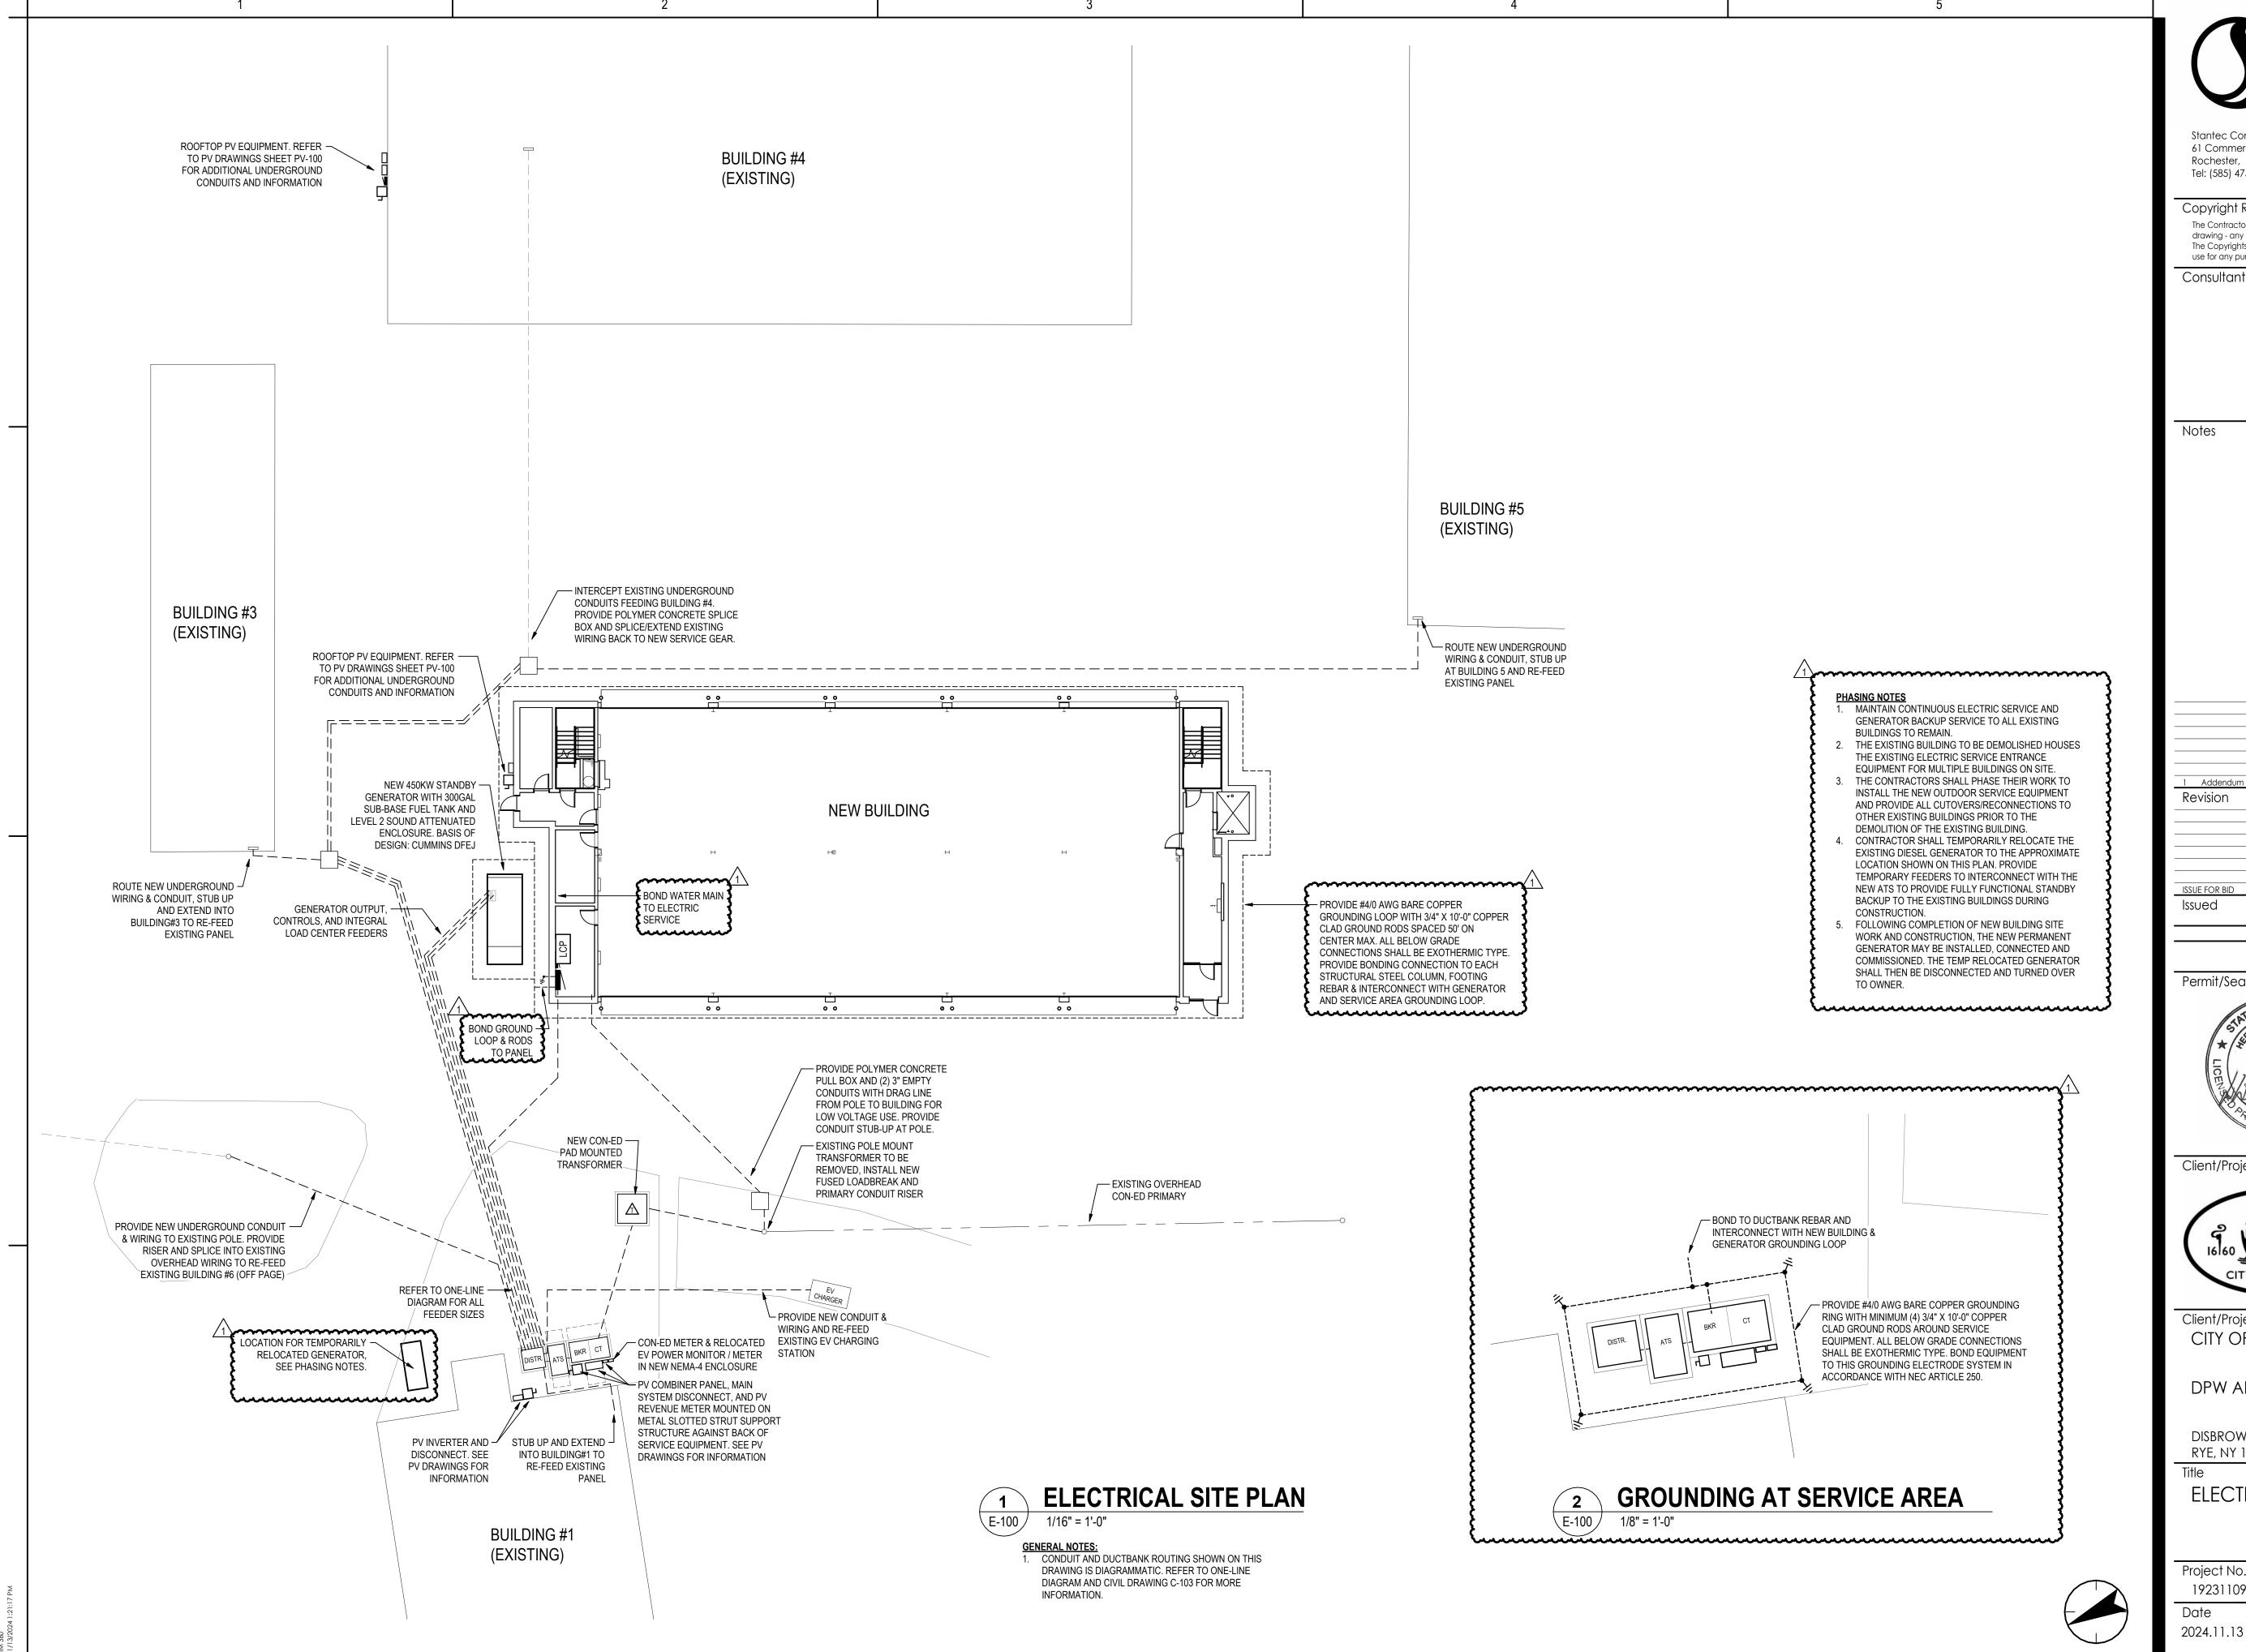

ORIGINAL SHEET - ANSI D



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Revision Appd YYYY.MM.DD ISSUE FOR BID Appd YYYY.MM.DD Issued

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Client/Project CITY OF RYE

DPW ADMIN BUILDING

DISBROW PARK RYE, NY 10580

ELECTRICAL SITE PLAN

Project No. 192311093

Scale As indicated

Drawing No.

+43" +43" AP1-67,69\_\_AP1-39,41\_\(\Phi\) WP 14-30R 14-30R +43" +43" 0 **O V** OHD-7 OHD-6 OHD-10 OHD-9 OHD-8 AP1-16 OUTER WEAR PV ARRAY DISCONNECT AND EQUIPMENT. REFER TO PV DRAWINGS FOR INFORMATION GARAGE 103 106 **ELEVATOR** AP1-10 G +43" FOR ELEVATOR PIT SUMP LOBBY AP1-2 G - GENERATOR PUMP CONTROLLER 102 AP1-18 GEF-1 AP1-12 LOAD CENTER WATER SERVICES EUH-1 MOUNTING HEIGHTS ADDED OR CLARIFIED IN MULTIPLE LOCATIONS 8 AP1-29 WP 😝 450KW GSF-1 GENERATOR OVERHEAD DOOR — MOTORIZED OPERATOR 1 (TYP.) VESTIBULE OHD-1 OHD-2 OHD-3 OHD-4 OHD-5 101 Ø  $\Rightarrow$ AP1-20 +43" +43" +43" 0 0 0 0 0 0 **GENERAL NOTES:** OPEN/CLOSE/STOP 1. REFER TO DRAWING E-001 FOR ELECTRICAL DRAWING PUSHBUTTONS FOR LIST, SYMBOLS LEGEND, AND GENERAL NOTES. DOOR OPERATOR (TYP). 2. REFER TO DRAWING E-601 FOR FEEDER & BRANCH

# FIRST FLOOR POWER PLAN

TAG	PANEL	CIRCUIT NO.	VOLTAGE	NUMBER OF POLES	LOAD	DISCONNECTING MEANS PROVIDED BY E.C.	CIRCUIT RATING
DH-1	DP1	2	208 V	3	18000 VA	250V/3P/SN/100A NEMA-1 DISCONNECT SW.	70A
DV-1	AP1	31,33	208 V	2	478 VA	250V/3P/SN/30A FUSIBLE NEMA-1 DISCONNECT SW.	15A
ECUH-1	AP1	43,45,47	208 V	3	3000 VA	(PROVIDED BY VENDOR INTERNAL TO UNIT)	20A
ECUH-2	AP1	49,51,53	208 V	3	3000 VA	(PROVIDED BY VENDOR INTERNAL TO UNIT)	20A
ECUH-3	AP1	55,57,59	208 V	3	3000 VA	(PROVIDED BY VENDOR INTERNAL TO UNIT)	20A
ECUH-4	AP1	61,63,65	208 V	3	3000 VA	(PROVIDED BY VENDOR INTERNAL TO UNIT)	20A
EUH-1	AP1	36,38,40	208 V	3	3300 VA	250V/3P/SN/30A NEMA-1 DISCONNECT SW.	20A
EUH-2	AP1	42,44,46	208 V	3	3300 VA	250V/3P/SN/30A NEMA-1 DISCONNECT SW.	20A
WH-2	DP1	1	208 V	3	12300 VA	250V/3P/SN/60A NEMA-1 DISCONNECT SW.	45A
CU-1	AP1	35,37	208 V	2	133 VA	MOTOR RATED 2-POLE SNAP SWITCH WITH COVERPLATE PADLOCK ATTACHMENT	15A
-CU-2	AP1	35,37	208 V	2	266 VA	MOTOR RATED 2-POLE SNAP SWITCH WITH COVERPLATE PADLOCK ATTACHMENT	15A
GEF-1	AP1	48,50,52	208 V	3	3963 VA	250V/3P/SN/30A NEMA-1 DISCONNECT SW.	20A
GSF-1	AP1	54,56,58	208 V	3	3963 VA	250V/3P/SN/30A NEMA-1 DISCONNECT SW.	20A
OHD-1	AP1	3	120 V	1	1176 VA	MOTOR RATED SNAP SWITCH, 120V/1P/20A	20A
OHD-2	AP1	5	120 V	1	1176 VA	MOTOR RATED SNAP SWITCH, 120V/1P/20A	20A
OHD-3	AP1	7	120 V	1	1176 VA	MOTOR RATED SNAP SWITCH, 120V/1P/20A	20A
OHD-4	AP1	9	120 V	1	1176 VA	MOTOR RATED SNAP SWITCH, 120V/1P/20A	20A
OHD-5	AP1	11	120 V	1	1176 VA	MOTOR RATED SNAP SWITCH, 120V/1P/20A	20A
OHD-6	AP1	13	120 V	1	1176 VA	MOTOR RATED SNAP SWITCH, 120V/1P/20A	20A
DHD-7	AP1	15	120 V	1	1176 VA	MOTOR RATED SNAP SWITCH, 120V/1P/20A	20A
OHD-8	AP1	17	120 V	1	1176 VA	MOTOR RATED SNAP SWITCH, 120V/1P/20A	20A
OHD-9	AP1	19	120 V	1	1176 VA	MOTOR RATED SNAP SWITCH, 120V/1P/20A	20A
OHD-10	AP1	21	120 V	222222	1176 VA	MOTOR RATED SNAP SWITCH, 120V/1P/20A	20A
SP-1	AP1	18	120 V	1	1000 VA	RECEPTACLE & PLUG	20A

CIRCUIT RATINGS LISTED IN THE TABLE ABOVE DO NOT INCLUDE ADJUSTMENT FACTORS FOR CONDUIT FILL, VOLTAGE DROP, OR OTHER FACTORS. CONTRACTOR TO PERFORM VOLTAGE DROP CALCULATIONS AND ADJUSTMENTS BASED ON ACTUAL CIRCUIT LENGTHS AND FIELD CONDITIONS AND SHALL MAKE ADJUSTMENTS AS REQUIRED TO COMPLY WITH NEC REQUIREMENTS.

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Revision TR 2024.09.12 Appd YYYY.MM.DD Issued 
 WM
 HSB
 TR
 2024.11.13

 Dwn.
 Dsgn.
 Chkd.
 YYYY.MM.DD



Client/Project Logo



Client/Project CITY OF RYE

DPW ADMIN BUILDING

DISBROW PARK RYE, NY 10580

FIRST FLOOR POWER PLAN

Project No. 192311093 Date

2024.11.13

1/8" = 1'-0" Drawing No.

Scale

CIRCUIT SIZING SCHEDULE, AND ONE-LINE DIAGRAMS. 3. REFER TO DIVISION 26 BOOK SPECIFICATIONS FOR

ADDITIONAL MATERIALS AND INSTALLATION

4. REFER TO CIVIL DRAWINGS FOR SITE PLAN AND SITE WORK PERTAINING TO THE ELECTRIC SERVICE

5. ALL OUTDOOR EXPOSED CONDUITS SHALL BE RIGID

PROVIDE AND INSTALL ALL INTERCONNECTING WIRING FOR GARAGE DOOR OPERATOR,

ACCORDANCE WITH MANUFACTURERS LITERATURE.

WIRING AND TERMINATIONS. REFER TO SUMP PUMP CONTROLLER MANUFACTURERS LITERATURE FOR

PUSHBUTTONS, SAFETY DEVICES ETC. IN

2. FURNISH AND INSTALL ALL INTERCONNECTING

INTERCONNECTING WIRING REQUIREMENTS BETWEEN PUMP CONTROLLER AND PUMP, OIL SENSING PROBE, LEVEL SENSOR FLOATS, AND REMOTE MONITORING CONNECTIONS. COORDINATE

LOCATION OF POWER CONNECTION AND COMPONENTS IN FIELD WITH PLUMBING

3. PROVIDE MATCHING RECEPTACLE FOR OWNER

CONNECTIONS FOR OWNER FURNISHED CLOTHES DRYERS.

S. IN GARAGE AREA, RECEPTACLES AND DEVICES

MOUNTED ON MASONRY WALLS SHALL BE RECESSED INTO WALL CONSTRUCTION. DEVICES MOUNTED ON COLUMNS SHALL BE SURFACE MOUNTED WITH

FURNISHED PRESSURE WASHER.

4. PROVIDE MATCHING CORDSET AND ALL

SURFACE MOUNTED RGS CONDUIT.

GALVANIZED STEEL WITH THREADED FITTINGS. ALL OUTDOOR BELOW GRADE CONDUITS SHALL BE SCHEDULE 80 PVC.

6. UNLESS OTHERWISE NOTED, RECEPTACLE MOUNTING. HEIGHTS SHALL BE 1'-6" AFF TO CENTERLINE OF BOX.

REQUIREMENTS.

INSTALLATIONS.

CONTRACTOR.

# KEYED NOTES:

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— DEADFRONT GFCI MODULE IN ACCESSIBLE LOCATION FOR REFRIGERATOR RECEPTACLE STAIR ST-1 AP2-41 AP2-6 KITCHENETTE STAIR ST-2 203 \_AP2-18 OFFICE WTWHP-2-211 SHELL SPACE AP2-18 AP2-18 RESTROOM **ELEVATOR** ₩ AP2-17 EL-1 FCU-8 - CONNECT ELEVATOR FOR MIXING -POWER AND LIGHTING 214 AP2-20 OPEN OFFICE VESTIBULE CIRCUITS TO ELEVATOR CONTROL PANEL LOCATED 213 201 IN JAMB AP2-11 AP2-23 AP2-23 AP2-21 DEADFRONT GFCI MODULE **ELEVATOR** ELECTRIC ₩ AP2-20 223 4 SF G +44" AP2-11 WOMEN'S FOR PROTECTION OF AP2-32 AP2-30 MEN'S MEN'S G +44" RESTROOM FRIDGE RECEPTACLE. AP2-25 **←** — ELEVATOR POWER AND RESTROOM FCU-10 LIGHTING DISCONNECTS, LOCKER ROOM SEE ONE-LINE FOR ADDITIONAL INFORMATION — FURNITURE FEED FURNITURE FEED — AP2-11 AP2-23 4 MULTIPURPOSE **AP2-37** MEETING ROOM 4 AP2-25 ← 215 AP2-25 € 1538 SF CONFERENCE ROOM FCU-5 LOCKER ROOM 217 SECOND FLOOR POWER PLAN - ADDED MOUNTING HEIGHTS AT VARIOUS \E-102 \sqrt{1/8" = 1'-0" LOCATIONS GENERAL NOTES:

1. REFER TO DRAWING E-001 FOR ELECTRICAL DRAWING

35A

	EQUIPMENT CONNECTIONS SCHEDULE - SECOND FLOOR												
TAG	PANEL	CIRCUIT NO.	VOLTAGE	NUMBER OF POLES	LOAD	DISCONNECTING MEANS PROVIDED BY E.C.	CIRCUIT RATING						
EL-1 (ELEVATOR)	DP1	6	208 V	3	28172 VA	ENCLOSED C.B. WITH SHUNT TRIP AND AUX CONTACTS. SEE ONE-LINE	100A						
ERV-1	DP2	7	208 V	3	4760 VA	250V/3P/SN/30A NEMA-1 DISCONNECT SW.	20A						
EUH-3	DP2	15	208 V	3	3300 VA	250V/3P/SN/30A NEMA-1 DISCONNECT SW.	20A						
EWH-1	DP2	13	208 V	3	15000 VA	250V/3P/SN/60A NEMA-1 DISCONNECT SW.	60A						
FCU-3	DP2	14	208 V	2	133 VA	MOTOR RATED 2-POLE SNAP SWITCH WITH COVERPLATE PADLOCK ATTACHMENT	15A						
FCU-4	DP2	14	208 V	2	266 VA	MOTOR RATED 2-POLE SNAP SWITCH WITH COVERPLATE PADLOCK ATTACHMENT	15A						
FCU-5	DP2	16	208 V	2	233 VA	MOTOR RATED 2-POLE SNAP SWITCH WITH COVERPLATE PADLOCK ATTACHMENT	15A						
FCU-6	DP2	14	208 V	2	533 VA	MOTOR RATED 2-POLE SNAP SWITCH WITH COVERPLATE PADLOCK ATTACHMENT	15A						
FCU-7	DP2	14	208 V	2	133 VA	MOTOR RATED 2-POLE SNAP SWITCH WITH COVERPLATE PADLOCK ATTACHMENT	15A						
FCU-8	DP2	16	208 V	2	133 VA	MOTOR RATED 2-POLE SNAP SWITCH WITH COVERPLATE PADLOCK ATTACHMENT	15A						
FCU-9	DP2	14	208 V	2	266 VA	MOTOR RATED 2-POLE SNAP SWITCH WITH COVERPLATE PADLOCK ATTACHMENT	15A						
FCU-10	DP2	14	208 V	2	533 VA	MOTOR RATED 2-POLE SNAP SWITCH WITH COVERPLATE PADLOCK ATTACHMENT	15A						
FCU-11	DP2	16	208 V	2	533 VA	MOTOR RATED 2-POLE SNAP SWITCH WITH COVERPLATE PADLOCK ATTACHMENT	15A						
FCU-12	DP2	14	208 V	2	266 VA	MOTOR RATED 2-POLE SNAP SWITCH WITH COVERPLATE PADLOCK ATTACHMENT	15A						
FCU-13	DP2	16	208 V	2	815 VA	MOTOR RATED 2-POLE SNAP SWITCH WITH COVERPLATE PADLOCK ATTACHMENT	15A						
GWP-1	DP2	8	208 V	3	6304 VA	PACKAGED VFD WITH INTEGRAL DISCONNECT & BYPASS SWITCH, LCD HMI. SQUARE-D S-FLEX #SFD212FG2YA07D07 OR EQUAL	35A						
GWP-2	DP2	11	208 V	3	6304 VA	PACKAGED VFD WITH INTEGRAL DISCONNECT & BYPASS SWITCH, LCD HMI. SQUARE-D S-FLEX #SFD212FG2YA07D07 OR EQUAL	35A						
RP-1	DP2	10	120 V	1	528 VA	MOTOR RATED SNAP SWITCH, 120V/1P/20A	15A						
RWP-1	DP2	9	208 V	3	2810 VA	250V/3P/SN/30A NEMA-1 DISCONNECT SW.	15A						
RWP-2	DP2	12	208 V	3	2810 VA	250V/3P/SN/30A NEMA-1 DISCONNECT SW.	15A						
WCVRF-1	DP2	3	208 V	3	7926 VA	250V/3P/SN/60A NEMA-1 DISCONNECT SW.	40A						
WCVRF-1(B)	DP2	5	208 V	3	7926 VA	250V/3P/SN/60A NEMA-1 DISCONNECT SW.	40A						
WCVRF-2	DP2	4	208 V	3	7926 VA	250V/3P/SN/60A NEMA-1 DISCONNECT SW.	40A						
WCVRF-2(B)	DP2	6	208 V	3	7926 VA	250V/3P/SN/60A NEMA-1 DISCONNECT SW.	40A						
WTWHP-1	DP2	1	208 V	3	18730 VA	250V/3P/SN/100A NEMA-1 DISCONNECT SW.	80A						
WTWHP-2	DP2	2	208 V	3	18730 VA	250V/3P/SN/100A NEMA-1 DISCONNECT SW.	80A						
WTWHP-3	DP2	17	208 V	2	4306 VA	250V/3P/SN/60A NEMA-1 DISCONNECT SW.	35A						
							T						

250V/3P/SN/60A NEMA-1 DISCONNECT SW.

CALCULATIONS AND ADJUSTMENTS BASED ON ACTUAL CIRCUIT LENGTHS AND FIELD CONDITIONS AND SHALL MAKE ADJUSTMENTS AS REQUIRED TO COMPLY WITH NEC REQUIREMENTS.

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LIST, SYMBOLS LEGEND, AND GENERAL NOTES. 2. REFER TO DRAWING E-601 FOR FEEDER & BRANCH

CIRCUIT SIZING SCHEDULE, AND ONE-LINE DIAGRAMS. 3. REFER TO DIVISION 26 BOOK SPECIFICATIONS FOR ADDITIONAL MATERIALS AND INSTALLATION

HEIGHTS SHALL BE 1'-6" AFF TO CENTERLINE OF BOX.

INSTALL FLOOR POKE THRU AND ASSOCIATED WIRING & CONDUIT RUNS FOR FLOOR FURNITURE FEED IN ADDITION TO WALL FEED. COORIDNATE LOCATION IN

2. COORDINATE ROUGH-IN LOCATION WITH APPROVED

4. COORDINATE RECEPTACLE MOUNTING HEIGHT AND LOCATION FOR TV WITH OWNERS AV INSTALLER.

WATER FOUNTAIN SHOP DRAWINGS / LITERATURE. 3. DEDICATED RECEPTACLE FOR COPIER / PRINTER. COORDINATE ACTUAL LOCATION IN FIELD WITH

# KEYED NOTES:

1. INCLUDE IN BID AN ALLOWANCE TO FURNISH AND

FIELD WITH FURNITURE VENDOR.



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SECOND FLOOR POWER PLAN


Project No. 192311093 Date

2024.11.13

Scale 1/8" = 1'-0" Drawing No.

NOTES: CIRCUIT RATINGS LISTED IN THE TABLE ABOVE DO NOT INCLUDE ADJUSTMENT FACTORS FOR CONDUIT FILL, VOLTAGE DROP, OR OTHER FACTORS. CONTRACTOR TO PERFORM VOLTAGE DROP

WTWHP-4 DP2

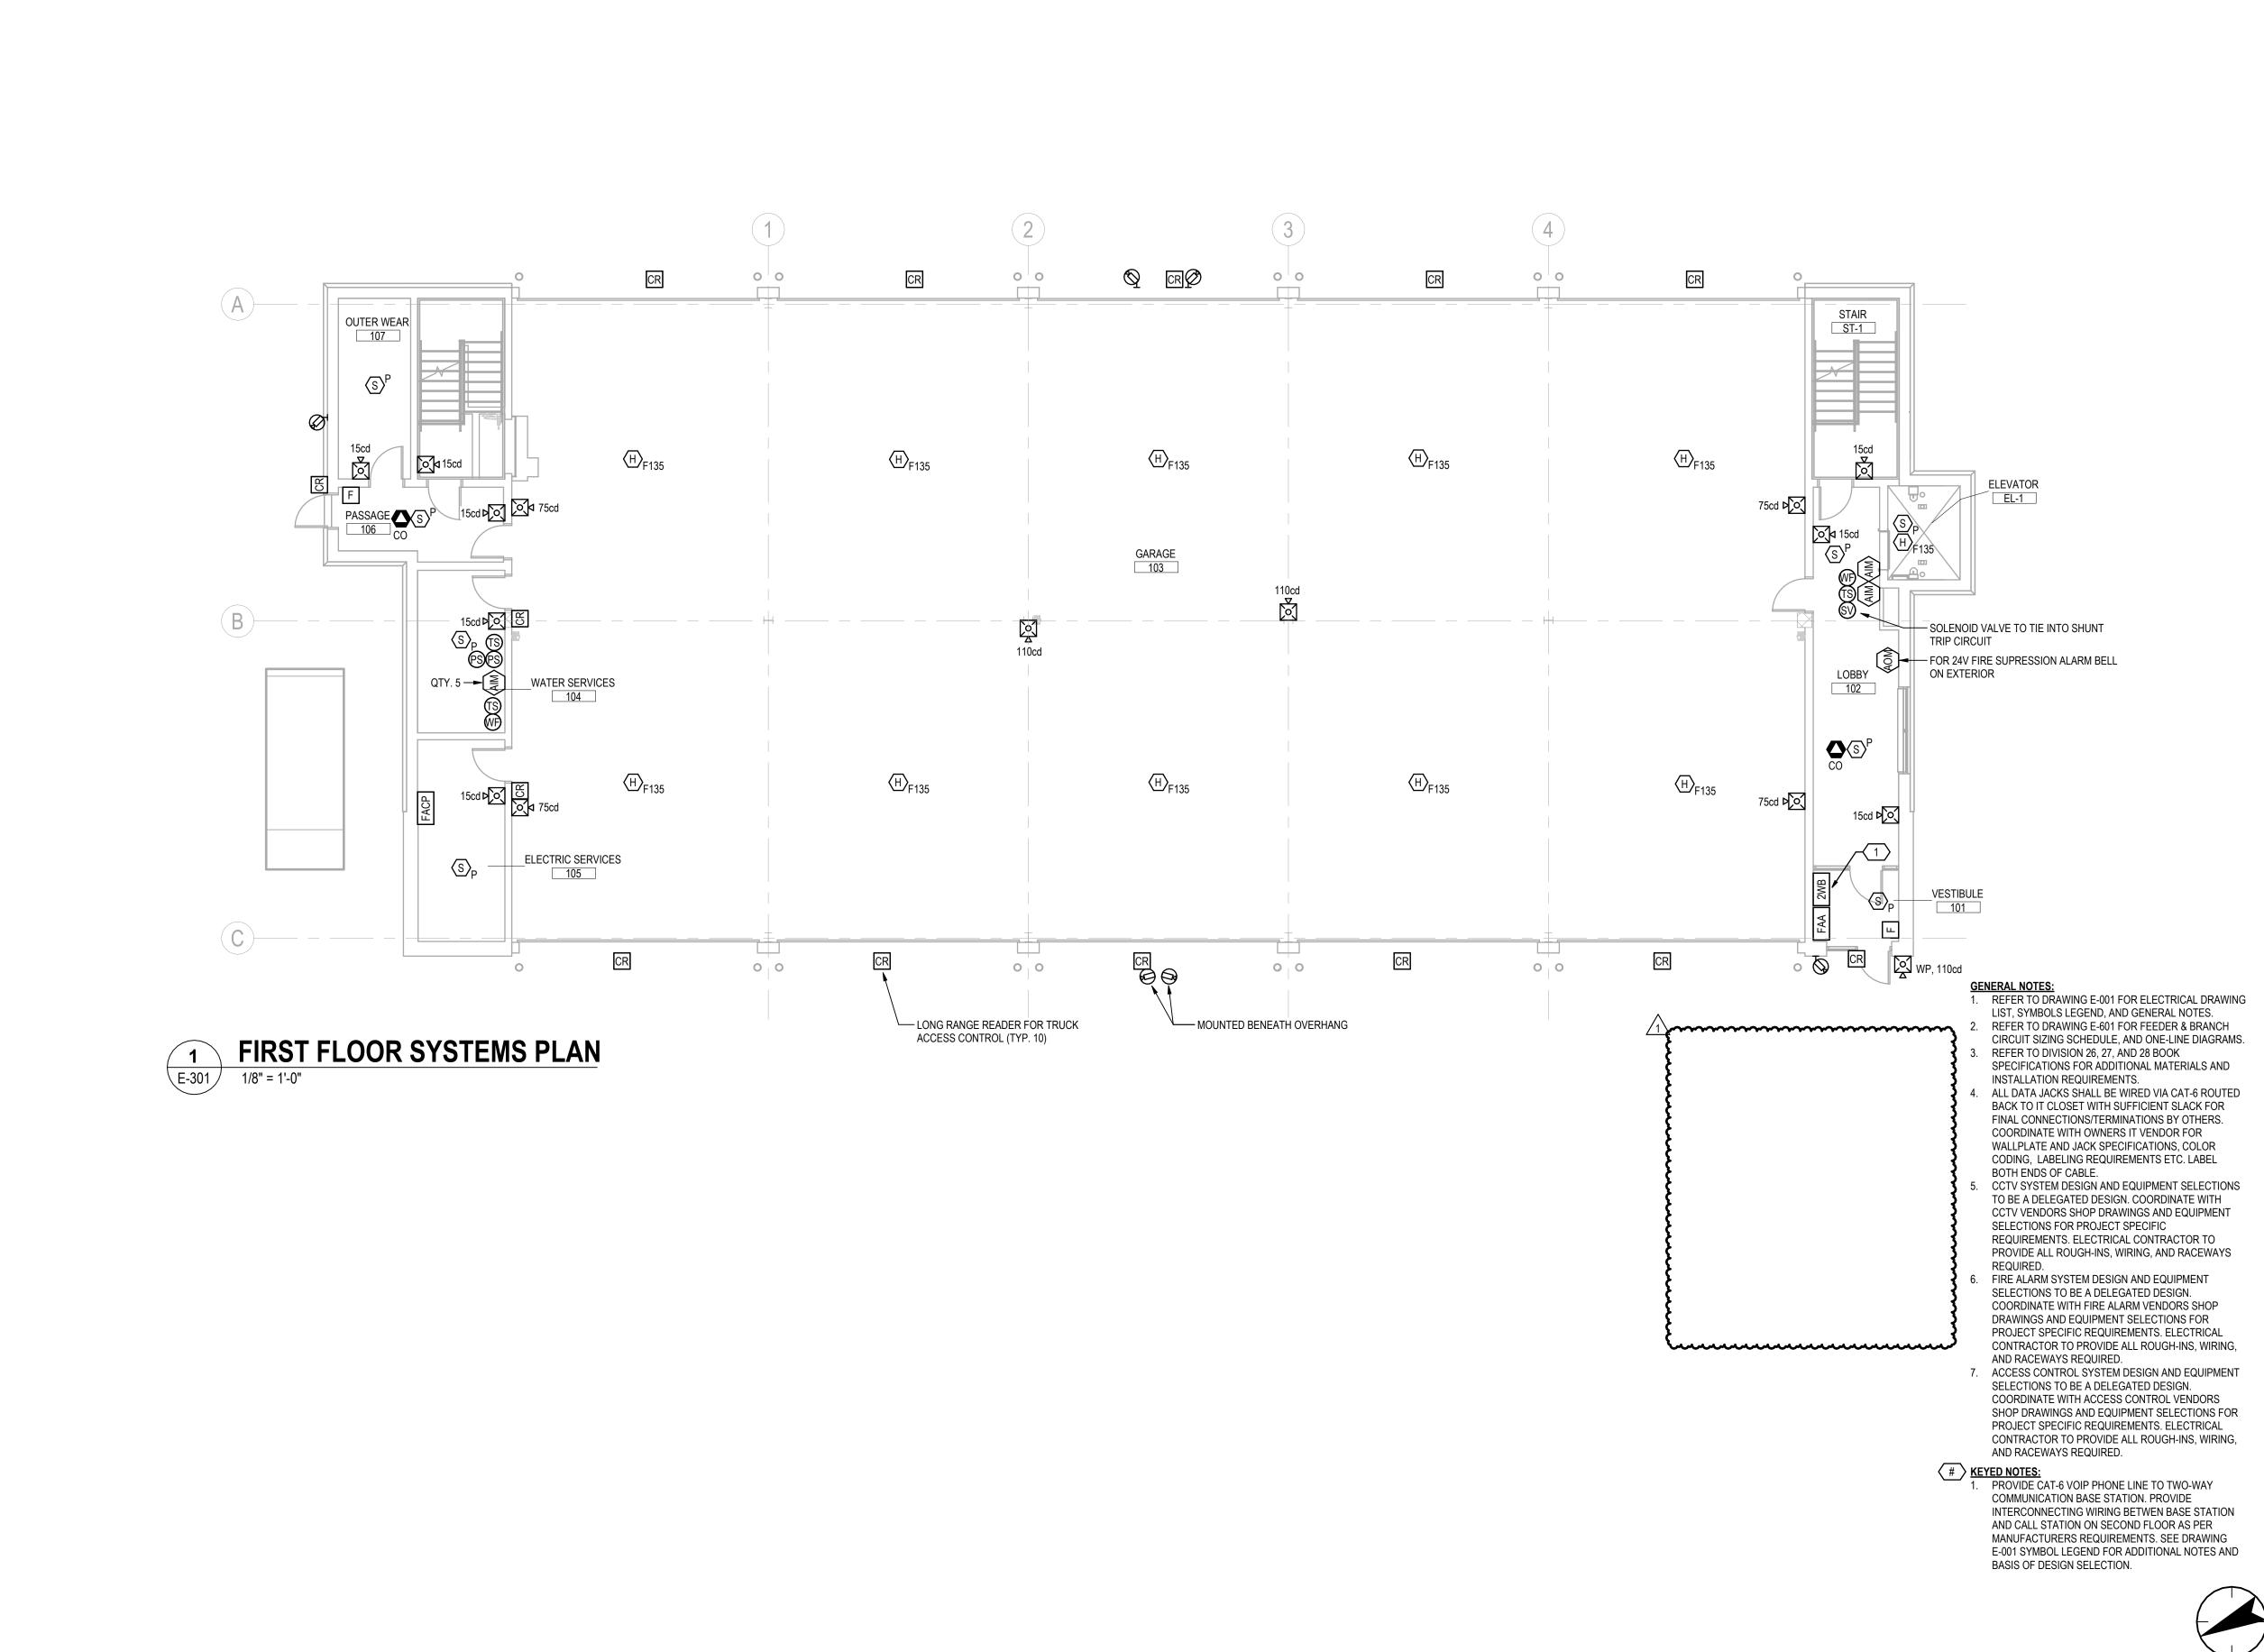



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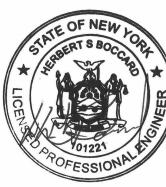
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FIRST FLOOR SYSTEMS PLAN

Project No. 192311093 Date

2024.11.13

Scale 1/8" = 1'-0"

Drawing No.

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RESTROOM 203 58 SF STAIR KITCHENETTE OFFICE 212 205 132 SF S ST-1 ST-2 134 SF UTILITY RM SHELL SPACE 221 216 517 SF 1057 SF 116 SF OUTPUT MODULES FOR RECALL, ELEVATOR - PROVIDE MULLION MOUNTED WARNING / FIREMANS READERS WHERE GLAZING HAT, AND ALTERNATE IS LOCATED ADJACENT TO 223 LEVEL RECALL 14 SF 4 RESTROOM 🗔 **ELEVATOR** EL-1 CR ELEVATOR DISCONNECTS WITH SHUNT TRIP AND INTERFACES WITH FIRE ALARM AND ELEVATOR OPEN OFFICE CONTROLS, SEE POWER PLANS WOMEN'S 213 AOM (AIM) RESTROOM 1311 SF 218 FURNITURE FEED 219 (TEL/DATA) VERIFY OPEN OFFICE 181 SF LOCKER ROOM - FIRE SPRINKLER SOLENOID VALVE LOCATION IN FIELD 206 217 WITH TIE IN TO SHUNT TRIP CIRCUIT 568 SF 536 SF 30cd — FURNITURE FEED (TEL/DATA) VERIFY CONFERENCE ROOM LOCATION IN FIELD MULTIPURPOSE 207 MEETING ROOM 75cd 🔎 311 SF 215 1538 SF OFFICE (S)P **GENERAL NOTES:** 1. REFER TO DRAWING E-001 FOR ELECTRICAL DRAWING LIST, SYMBOLS LEGEND, AND GENERAL NOTES. REFER TO DRAWING E-601 FOR FEEDER & BRANCH CIRCUIT SIZING SCHEDULE, AND ONE-LINE DIAGRAMS. 222 3. REFER TO DIVISION 26, 27, AND 28 BOOK 24 SF SPECIFICATIONS FOR ADDITIONAL MATERIALS AND INSTALLATION REQUIREMENTS. 4. ALL DATA JACKS SHALL BE WIRED VIA CAT-6 ROUTED BACK TO IT CLOSET WITH SUFFICIENT SLACK FOR ackslashSECOND FLOOR SYSTEMS PLAN FINAL CONNECTIONS/TERMINATIONS BY OTHERS. COORDINATE WITH OWNERS IT VENDOR FOR E-302 WALLPLATE AND JACK SPECIFICATIONS, COLOR CODING, LABELING REQUIREMENTS ETC. LABEL BOTH ENDS OF CABLE. 5. CCTV SYSTEM DESIGN AND EQUIPMENT SELECTIONS TO BE A DELEGATED DESIGN. COORDINATE WITH CCTV VENDORS SHOP DRAWINGS AND EQUIPMENT SELECTIONS FOR PROJECT SPECIFIC REQUIREMENTS. ELECTRICAL CONTRACTOR TO PROVIDE ALL ROUGH-INS, WIRING, AND RACEWAYS REQUIRED. 6. FIRE ALARM SYSTEM DESIGN AND EQUIPMENT SELECTIONS TO BE A DELEGATED DESIGN. COORDINATE WITH FIRE ALARM VENDORS SHOP DRAWINGS AND EQUIPMENT SELECTIONS FOR PROJECT SPECIFIC REQUIREMENTS. ELECTRICAL CONTRACTOR TO PROVIDE ALL ROUGH-INS, WIRING, AND RACEWAYS REQUIRED. ACCESS CONTROL SYSTEM DESIGN AND EQUIPMENT SELECTIONS TO BE A DELEGATED DESIGN. COORDINATE WITH ACCESS CONTROL VENDORS SHOP DRAWINGS AND EQUIPMENT SELECTIONS FOR PROJECT SPECIFIC REQUIREMENTS. ELECTRICAL CONTRACTOR TO PROVIDE ALL ROUGH-INS, WIRING,

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SECOND FLOOR SYSTEMS PLAN

Project No. 192311093 Date 2024.11.13 Scale 1/8" = 1'-0" Drawing No. **E-302** 

AND RACEWAYS REQUIRED.

FIELD WITH FURNITURE VENDOR.

LOCATION IN FIELD WITH OWNER.

VOLTAGE USE.

INCLUDE IN BID AN ALLOWANCE TO FURNISH AND


INSTALL FLOOR POKE THRU AND ASSOCIATED WIRING

& CONDUIT RUNS FOR FLOOR FURNITURE FEED IN ADDITION TO WALL FEED. COORIDNATE LOCATION IN

2. DATA FOR COPIER / PRINTER. COORDINATE ACTUAL

 COORDINATE DATA JACK MOUNTING HEIGHT AND LOCATION FOR TV WITH OWNERS AV INSTALLER.
 PROVIDE (2) 3" EMPTY CONDUITS WITH DRAG LINE DOWN TO ELECTRICAL SERVICES ROOM FOR LOW

# KEYED NOTES:

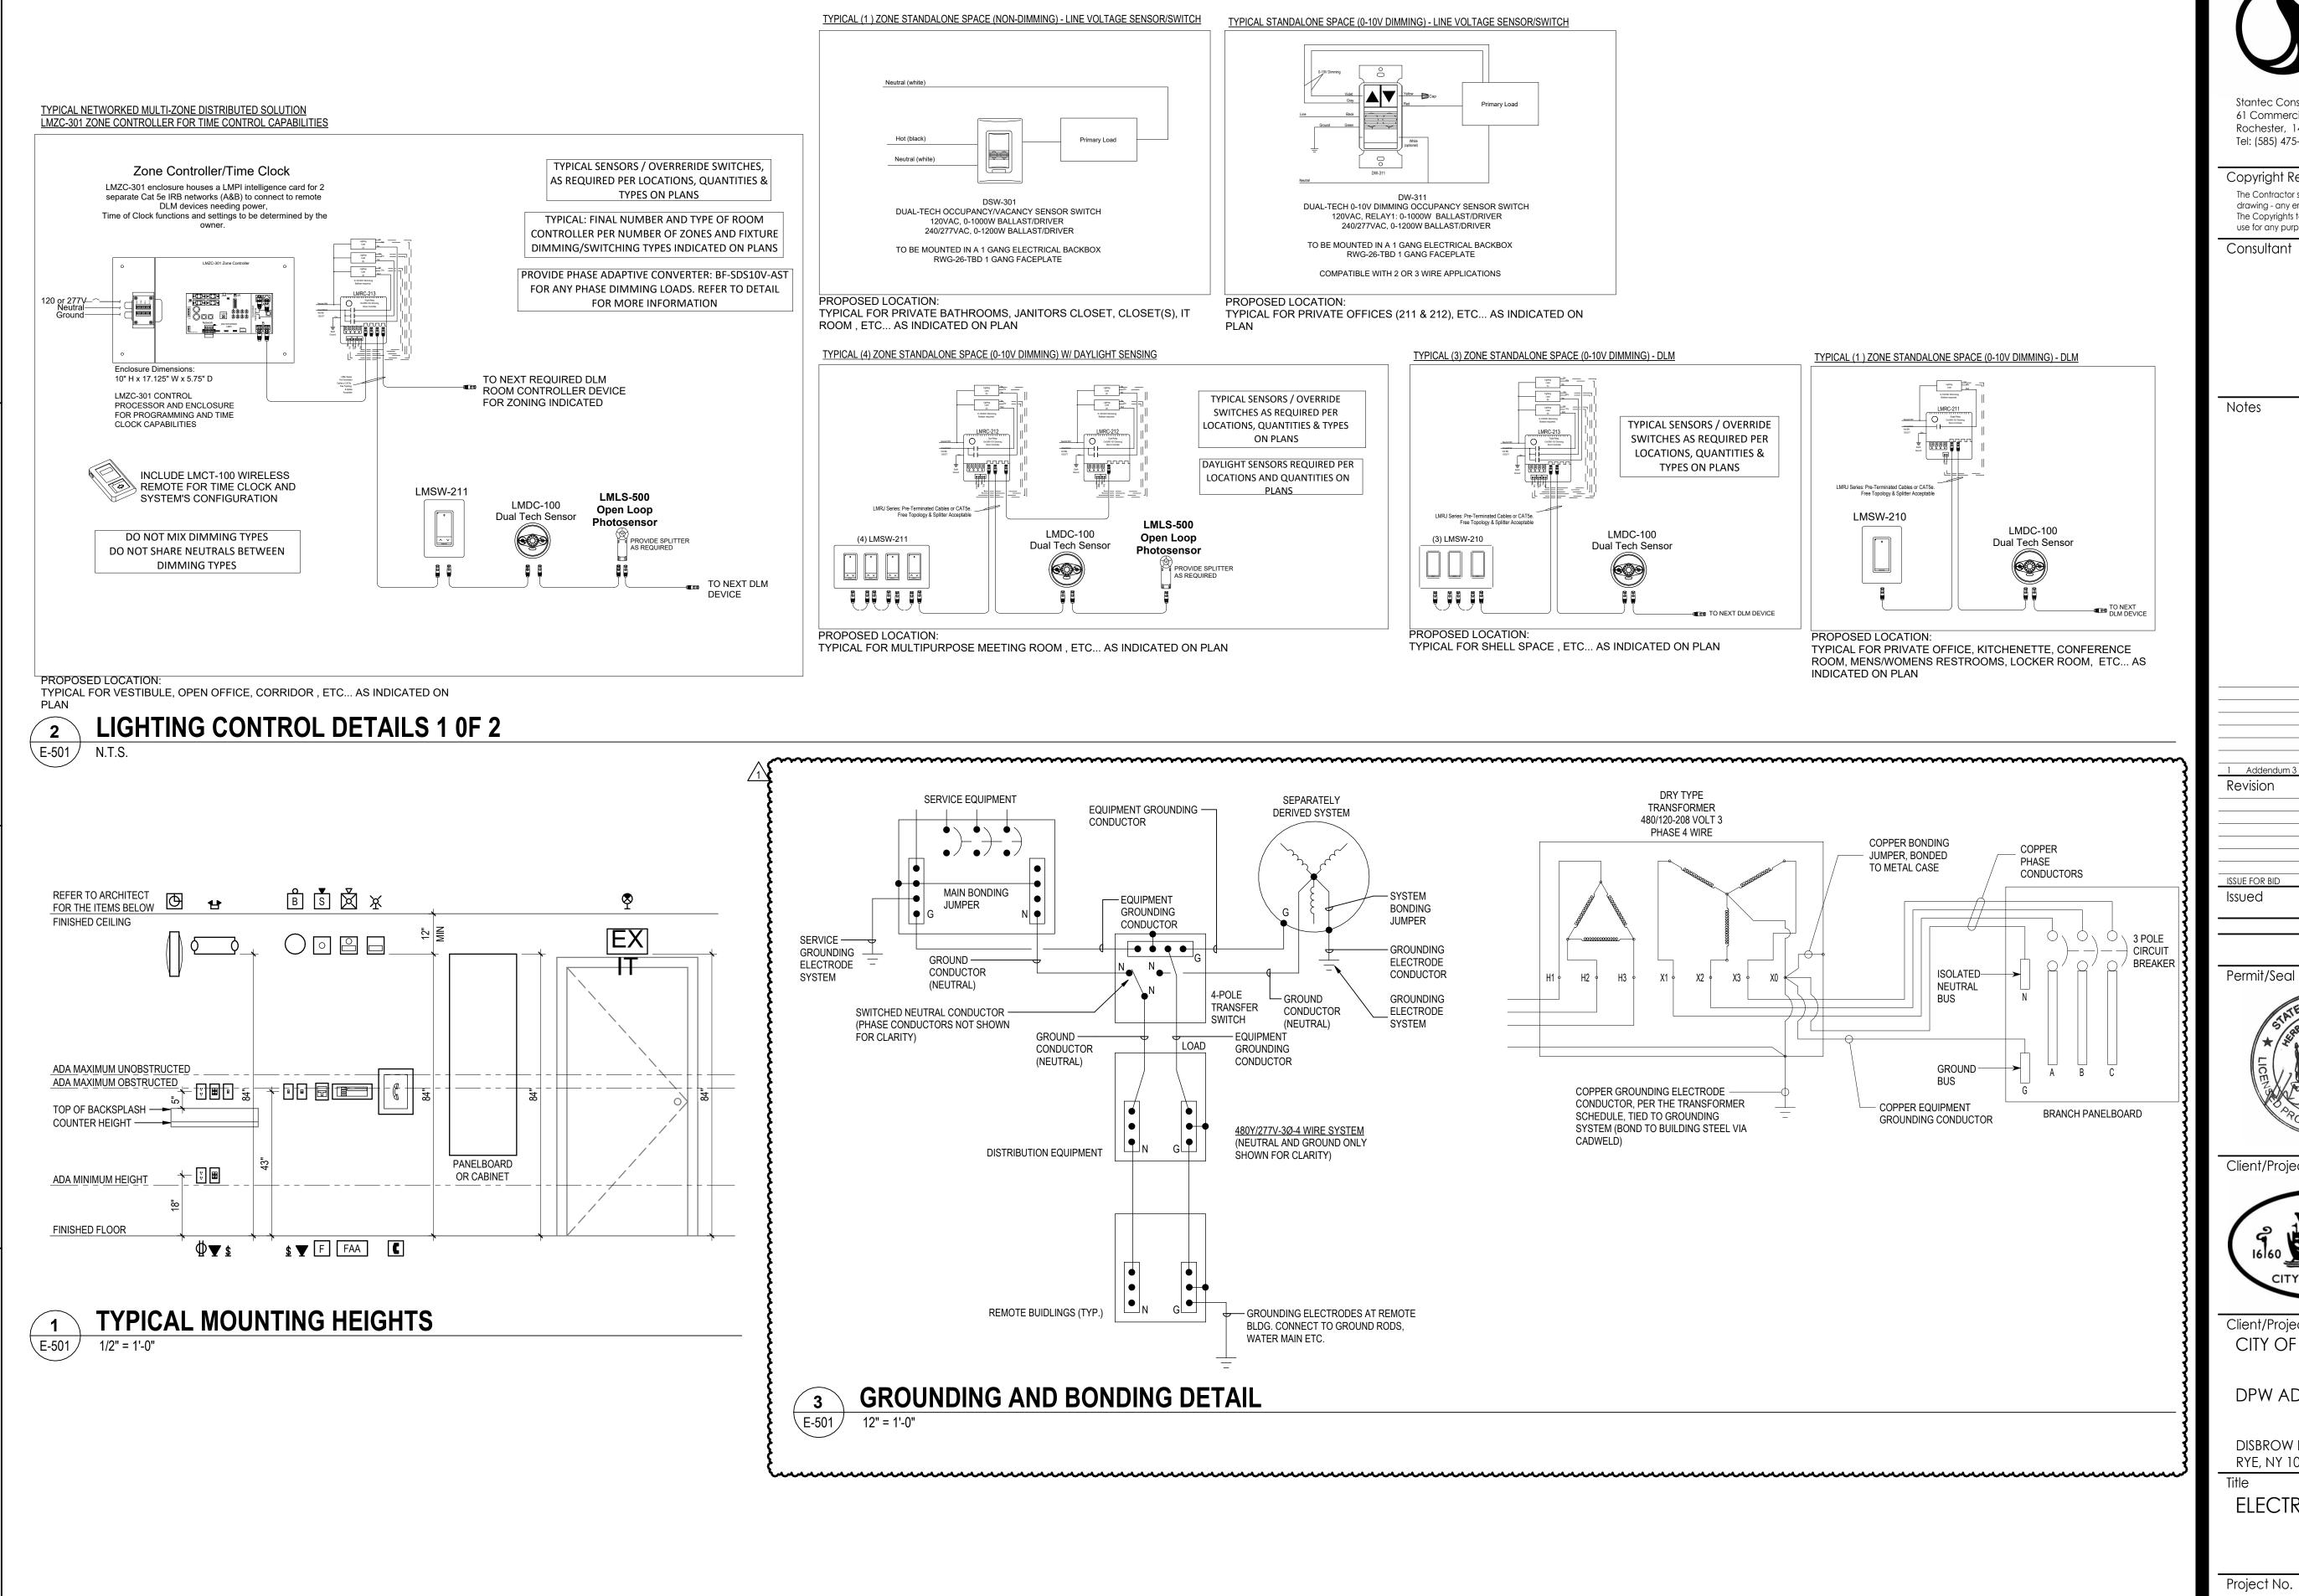

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ELECTRICAL DETAILS 1 OF 2


Project No. 192311093

Drawing No.

As indicated

Scale

E-501

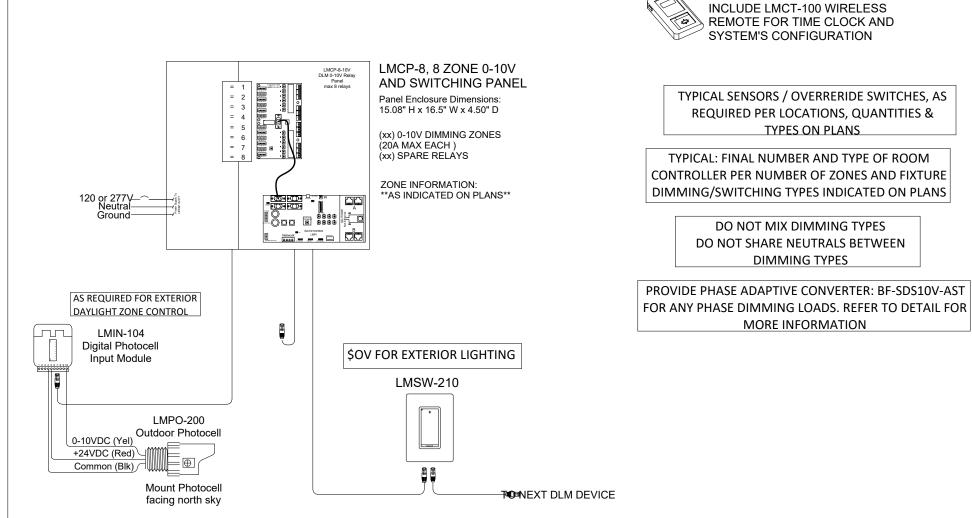

TYPICAL (1) ZONE STANDALONE SPACE (0-10V DIMMING) - DLM LMSW-210 LMDC-100 **Dual Tech Sensor** TO NEXT DLM DEVICE

TYPICAL FOR GARAGE, LOBBY, VESTIBULE, ETC... AS INDICATED ON PLAN

TYPICAL (1) ZONE STANDALONE SPACE (NON-DIMMING) - LINE VOLTAGE SENSOR/SWITCH Neutral (white) DUAL-TECH OCCUPANCY/VACANCY SENSOR SWITCH 120VAC, 0-1000W BALLAST/DRIVER 240/277VAC, 0-1200W BALLAST/DRIVER TO BE MOUNTED IN A 1 GANG ELECTRICAL BACKBOX RWG-26-TBD 1 GANG FACEPLATE PROPOSED LOCATION:

TYPICAL FOR OUTER-WEAR, VESTIBULE, ETC... AS INDICATED ON PLAN

TYPICAL FOR EXTERIOR LIGHTING, ETC... AS INDICATED ON

### **DLM RULES & BEST PRACTICES**

DLM INSIDE THE ROOM

Always power Room Controllers with a constant hot (unswitched) circuit

Use WS LMRJ-xx Cat 5e cables for reliable communication.

• No more than 4 total 100 series room controllers (RCs) LMRC-10x / LMPL-101 / LMPB-100 on a DLM Cat 5e Room Network (aka IRB "In Room Bus"). Other DLM RCs and LMCPs have smart power supplies, so you can have a DLM max of 64 loads or 48 devices. (IRBs with only 100 series RCs have a max of 24 devices and 8 loads.) Check total mA consumption of DLM devices against total current available from all LMRCs, LMCPs & LMZCs on the Cat 5e network to a max of 800mA. LMRC-10x / LMPL-100 / LMPB-100 will not limit their 150mA current which is why their 4 unit max. Other LMRCs, LMCPs & LMZCs will limit their current on Cat 5e room netwsolloman. • Don't overload rooms: DLM allows 150' Cat 5e (free topology) per intelligent DLM device, to a max of 1,000' per

IRB. Suggest rooms have < 32 loads (and never more than 4 total 100 series RCs and < 24 DLM devices unless

- 2 & 3 Relay Room Controllers are for <u>multi-level lighting</u> or <u>multiple zones</u> inside a room, not multiple rooms. Rooms ideally should have only one "occupancy state". Multiple occupancy zones in a room are possible, but
- makes setup more challenging. • LMLS units require another DLM device (LMCP, OS, etc...) to set initial On state, else set Load to "Auto On" in
- Pay attention to all LMRC-22x warnings: 1) Don't share neutrals; 2) Don't mix dimming loads types on LMRC-222s; 3) Every dimming load type should be on separate circuits.

DLM NETWORKING (via MS/TP or "Segment Wire")

reviewed by Project Management.

ONLY USE WS LM-MSTP CABLE for DLM Networking.

- Only one Network Bridge per room. LMCPs and LMZCs have this device on their LMPI intelligence card. • Do not run LM-MSTP to multiple floors (except for LMCP panel only runs). Locate LMSM-3E or a NB-ROUTER at start of all LM-MSTP runs on a network project, and ONLY ground shield there. MS/TP wire cannot exceed 4,000' and must be run in daisy chain topology to all rooms/panels. Pay close attention on how LM-MSTP connects to DLM networking devices and where terminating resistors are required (see device installation instructions and TB-179.2).
- WS Networks are defined and limited as follows: BASIC: LMSM-3E with up to 3 LM-MSTP segment runs. Each segment limited to max 40 Rooms / 250 DLM devices. Integration only via LMSM Export Table. ADVANCED: LMSM-6E with NB-ROUTERs and an NB-SWITCH (can connect to max 250 Rooms / 1000 DLM

devices). Integration other than via Export Table is Advanced. Advanced requires WS PM review!

DLM LMCP RELAY PANEL

- Panels are basically large RCs, but DO NOT connect multiple panels with Cat 5e wire use Network Bridges. Each LMCP Panel provides 2 separate Cat 5e IRB networks, each allowing max 47 DLM devices. Max loads for
- all relays in panel and in RCs stays max 64. • Panels use below equivalency table when connecting to a LMSM (to calculate allowed segment room/device


LMZC-301 panel 1 rooms / 10 devices LMCP-8 panel 3 rooms / 20 devices LMCP-24 panel 5 rooms / 30 devices LMCP-48 panel 7 rooms / 40 devices

DIMMING COMPATIBILITY:


Contractor shall coordinate and confirm dimming compatibility of all lighting controls devices with final approved lighting fixture submittal documents.


Prior to purchase and install, contractor shall coordinate and confirm an exact match between the led array, driver and controls devices.


Prior to purchase and install, coordinate with system manufacturer for confirmation of compatibility and any required testing that may be required.a testing request with system manufacturer may be required.

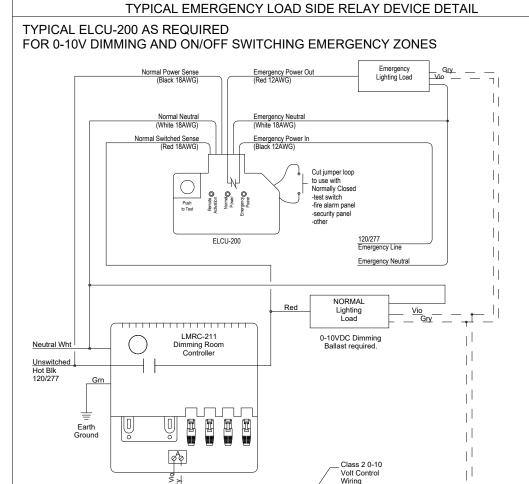

PROPOSED LOCATION:

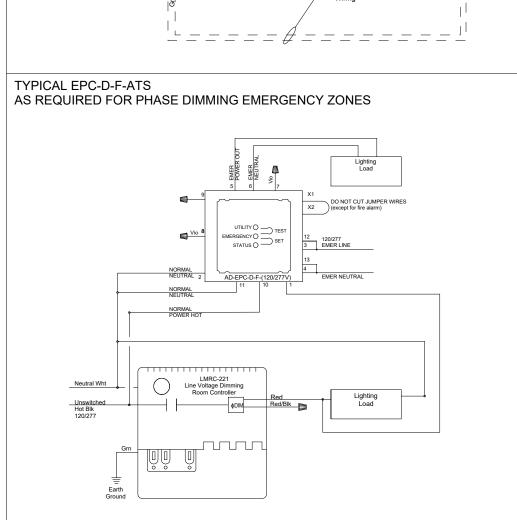

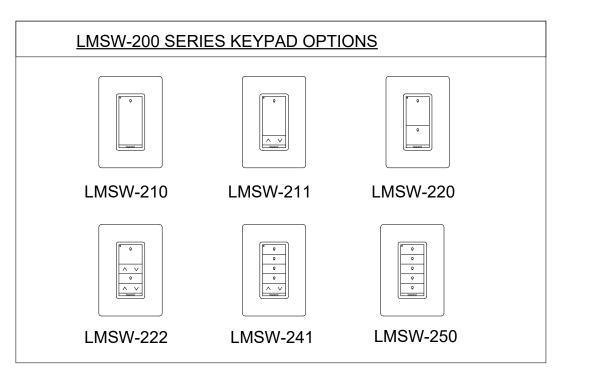

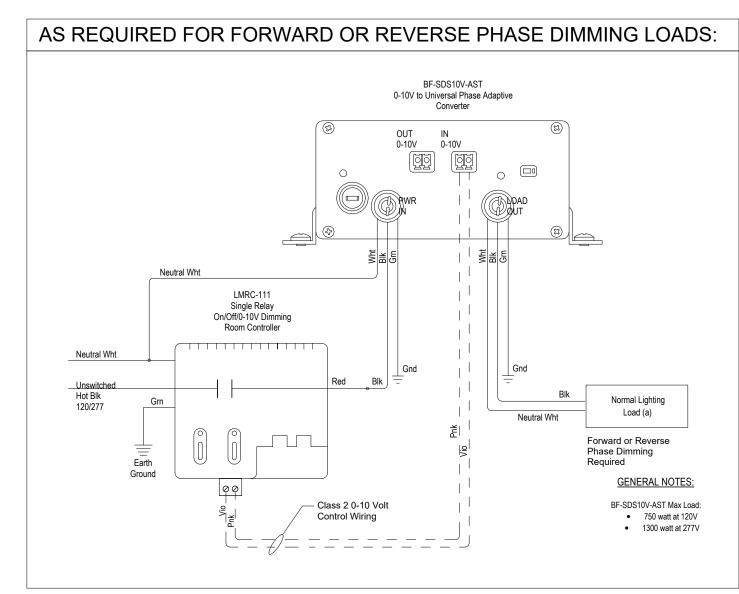



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ELECTRICAL DETAILS 2 OF 2

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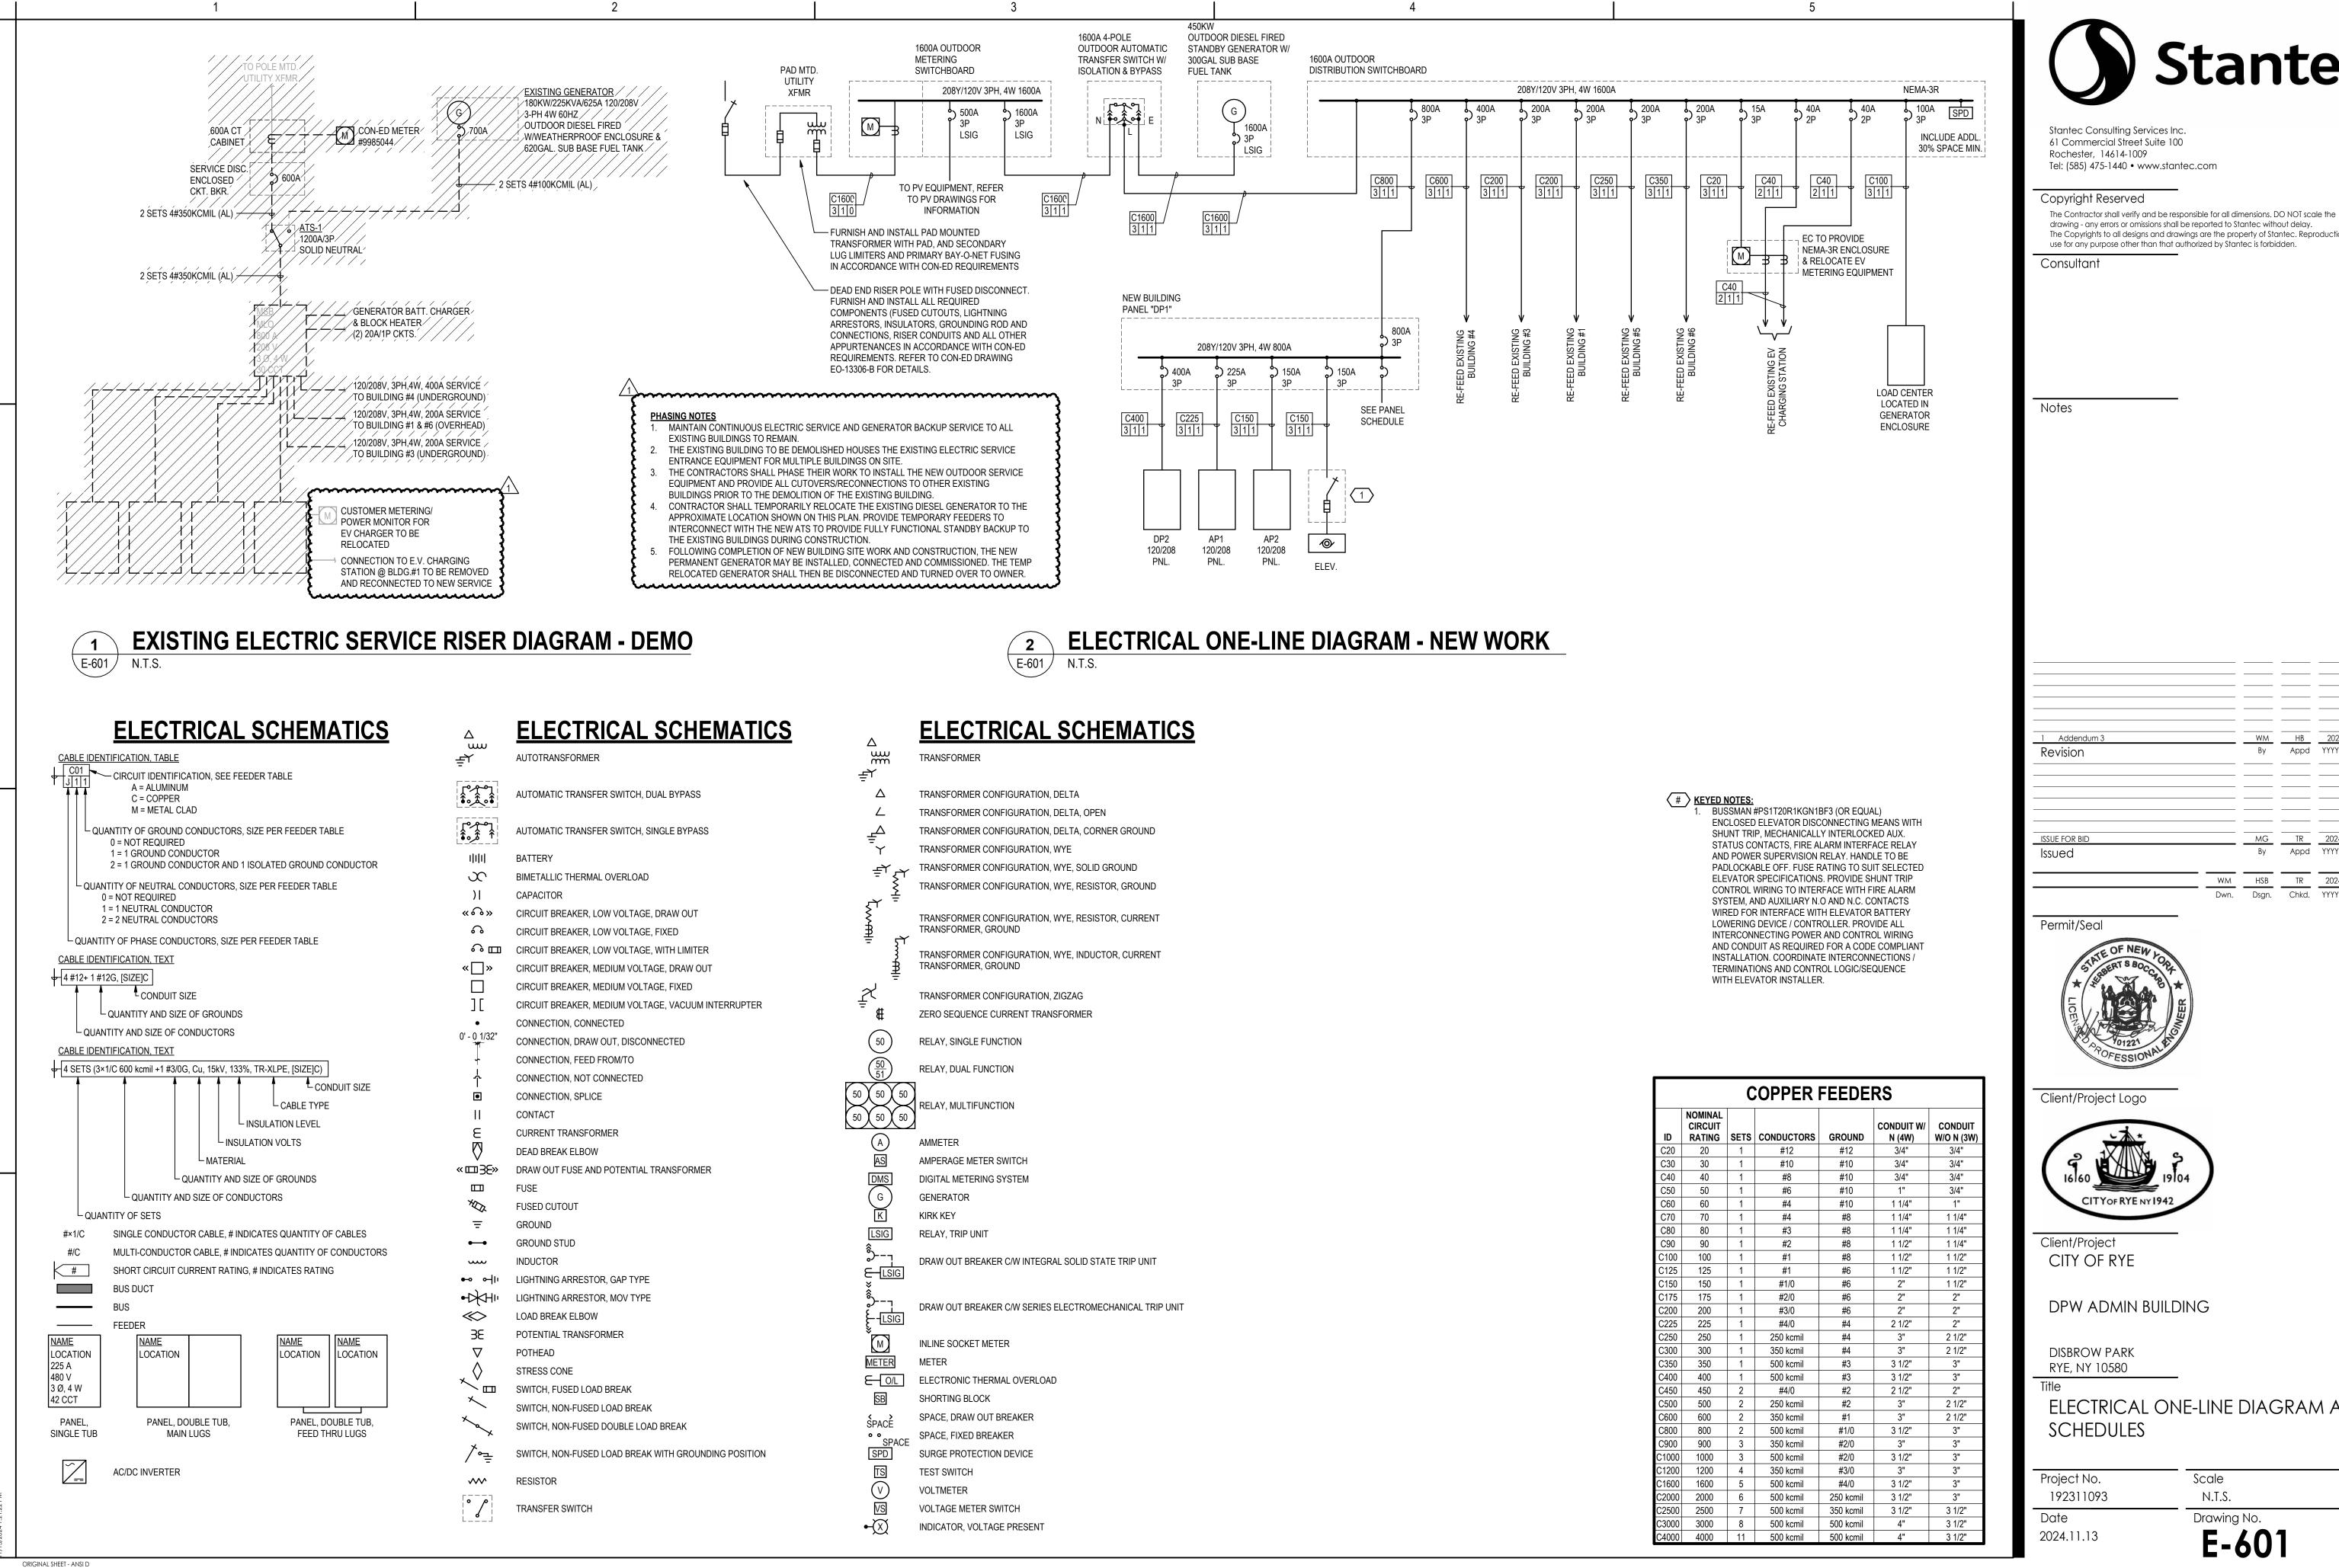
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**LIGHTING CONTROL DETAILS 2 0F 2** 

E-502

Scale

N.T.S.




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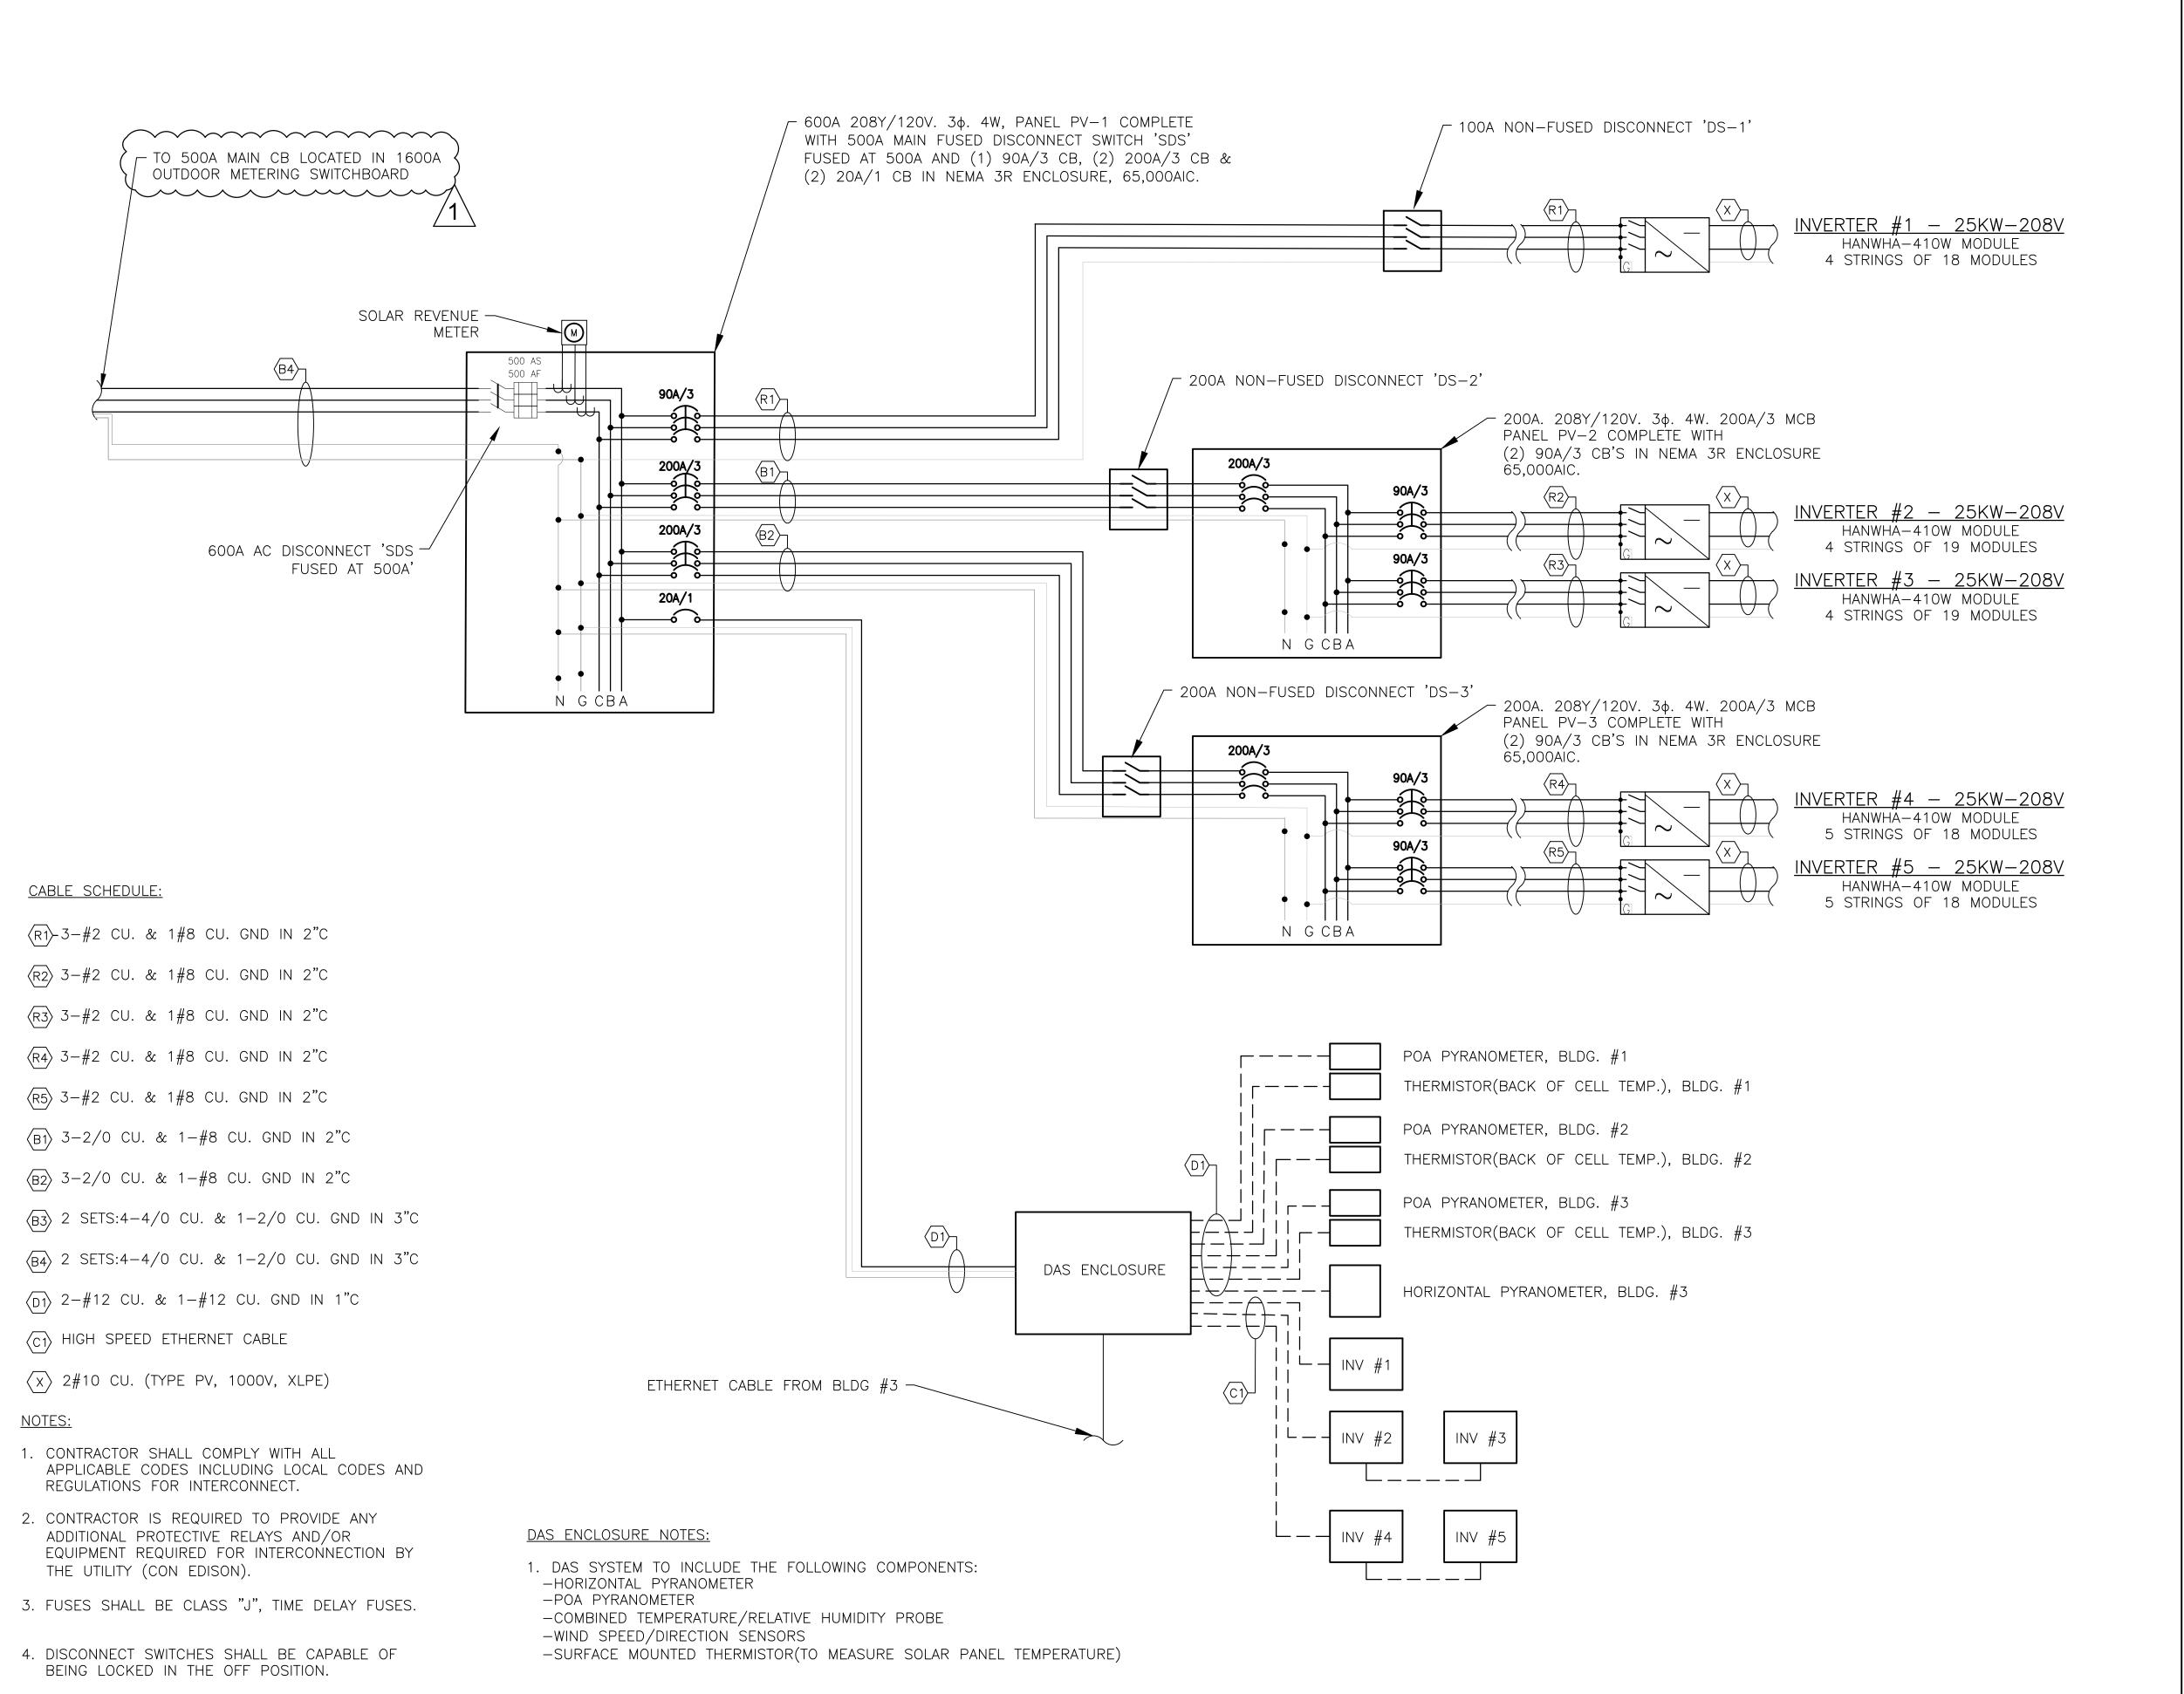
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ELECTRICAL ONE-LINE DIAGRAM AND

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| 1. ADDENDUM 03 | Z/M | PK | 2024.11.13 | Revision | By | Appd | YYYY.MM.DI | SSUE FOR BID | ML | MK | 2024.09.12 | ISSUEd | By | Appd | YYYY.MM.DI | File Name: N/A | CEH | PK | AD

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Wiring Diagram

Project No. Scale
192311093 AS SHOWN

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PV-600

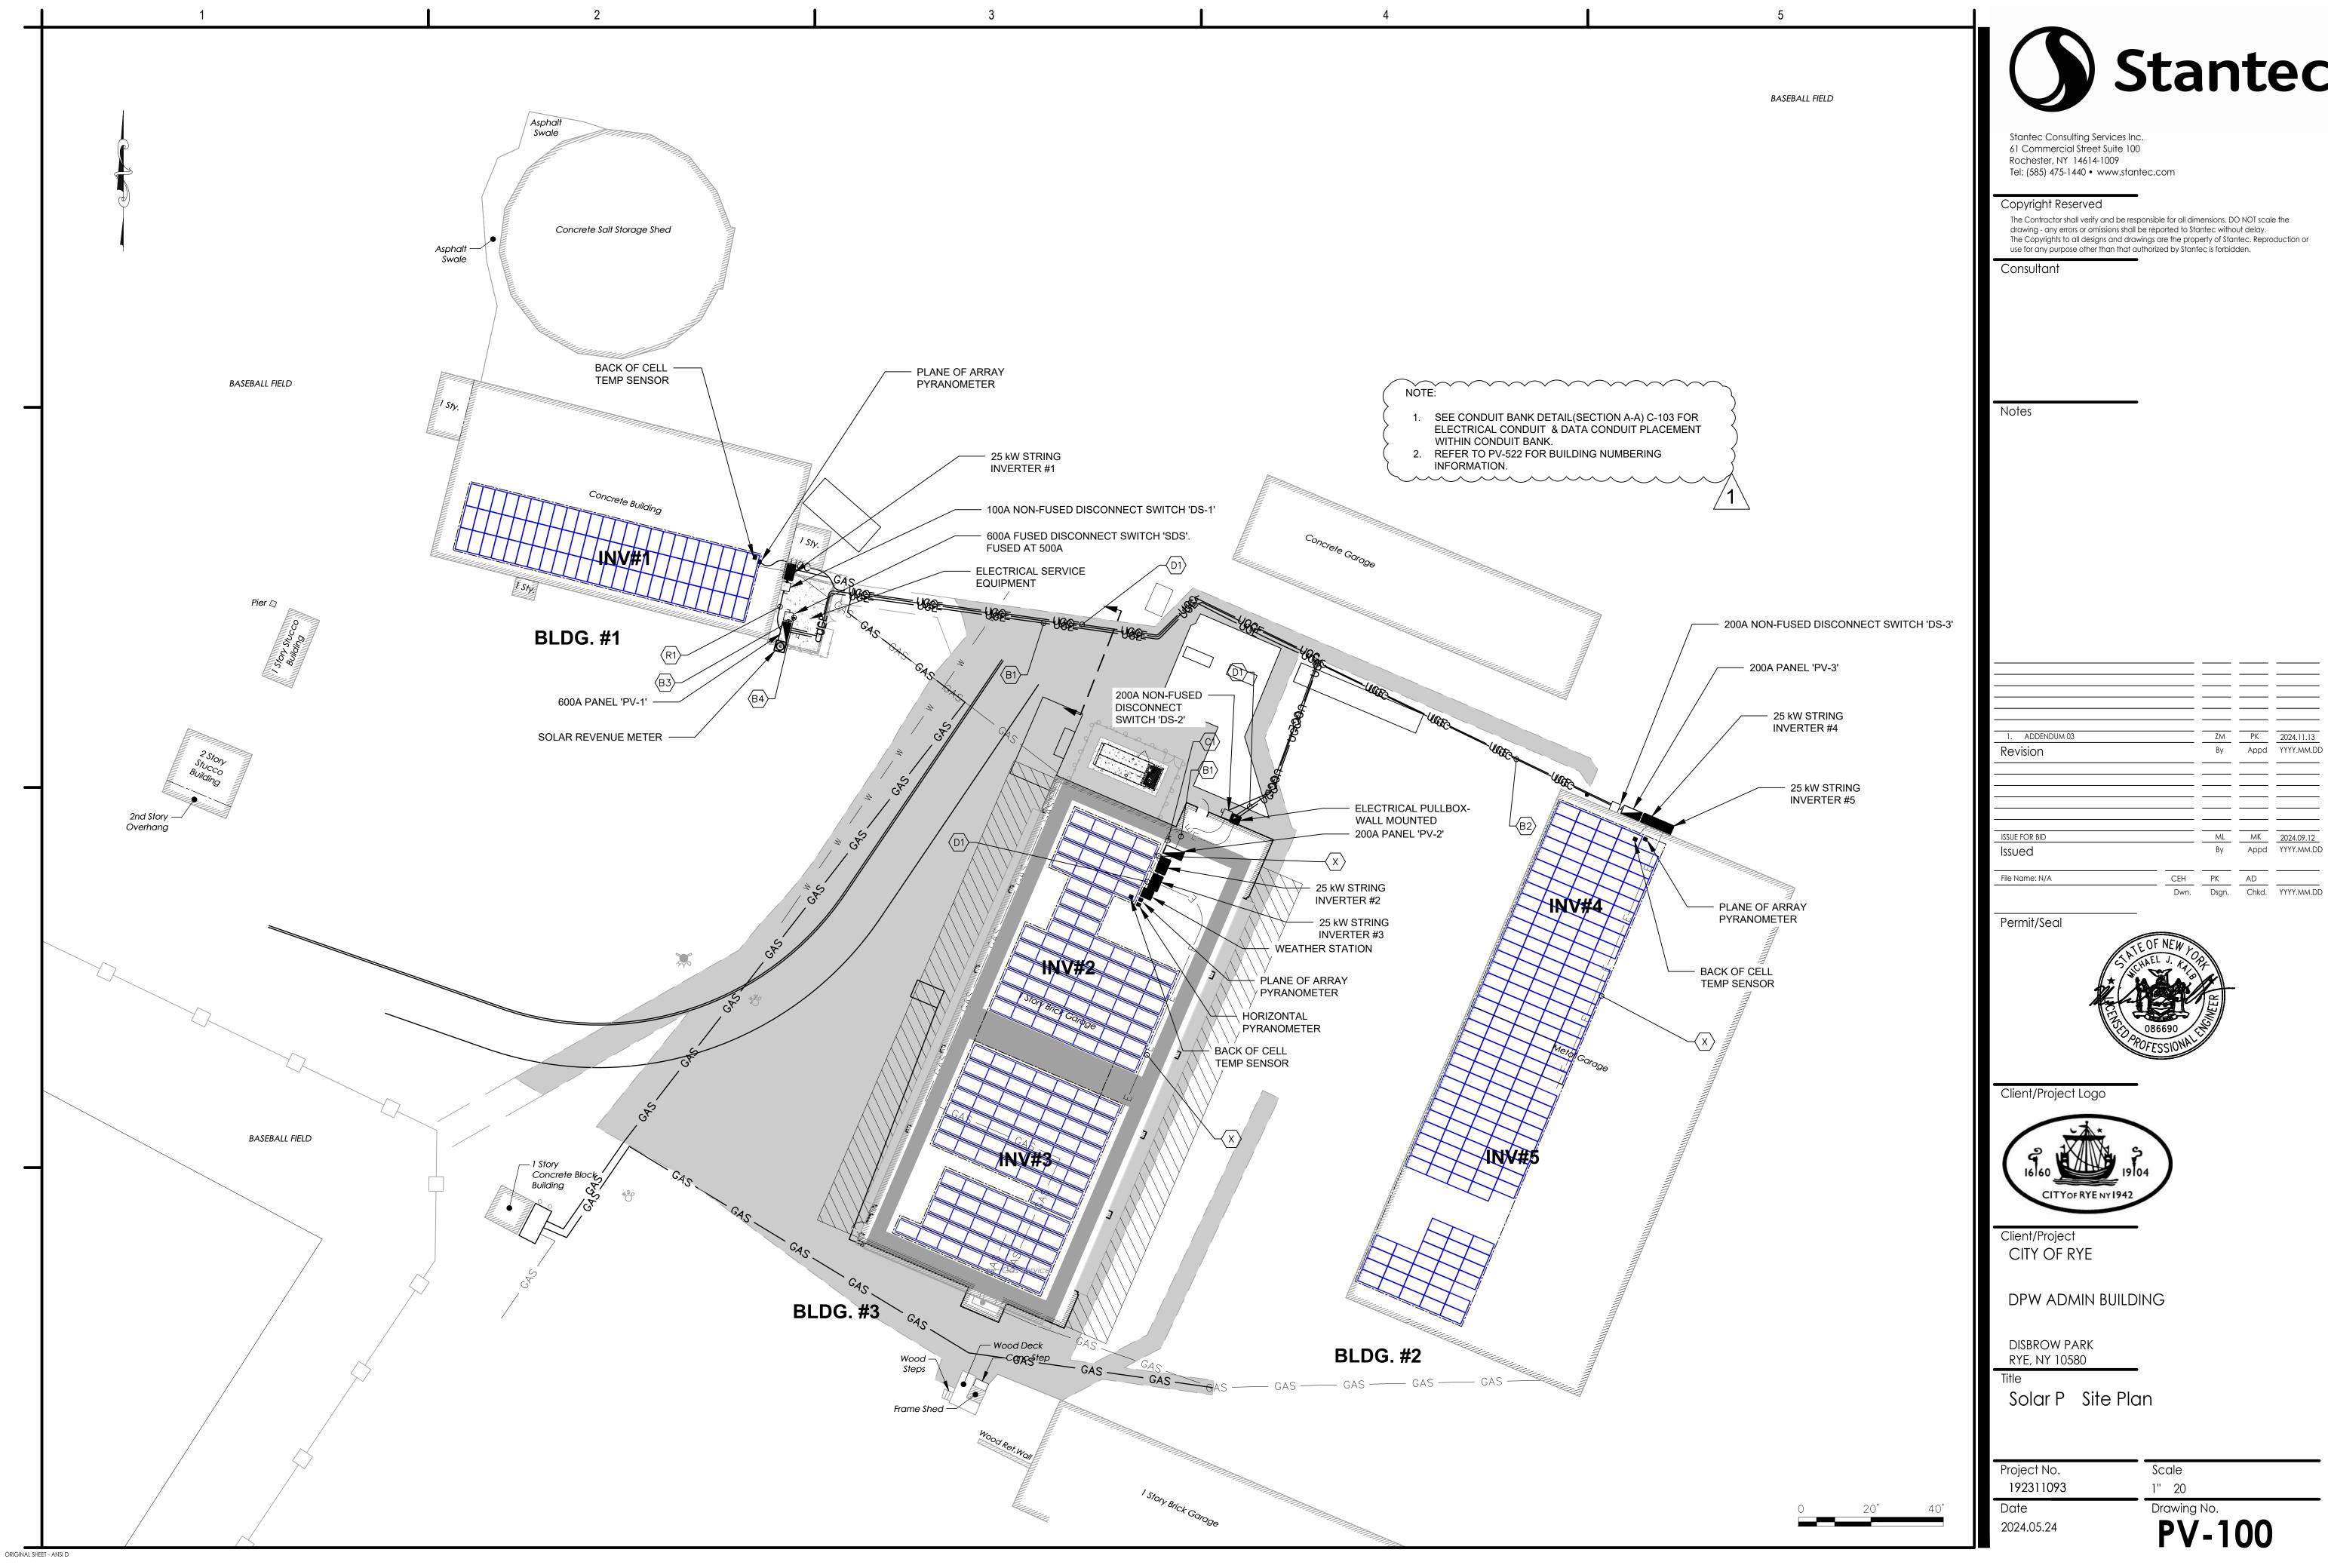M 340