



FACILITIES MANAGEMENT

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ROBERT H. GRUFFI, P.E. LEED AP  
DIRECTOR, FACILITIES MANAGEMENT

CAPITAL PROJECT 2098  
HEALTH CENTER BUILDING IMPROVEMENTS  
BUILDING A DOMESTIC WATER BOOSTER PUMP  
REPLACEMENT


50 SANATORIUM ROAD  
POMONA, NY 10970

DRAWING INDEX	
DWG #	DRAWING TITLE
COVER	
T0.1	COVER SHEET
PLUMBING	
P0.1	PLUMBING ABBREVIATIONS, SYMBOLS, AND GENERAL NOTES
P1.2	PLUMBING DEMOLITION AND NEW WORK PLANS
P7.1	PLUMBING DETAILS
ELECTRICAL	
E0.1	ELECTRICAL ABBREVIATIONS, SYMBOLS AND NOTES
E1.1	ELECTRICAL DEMOLITION PLAN
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E7.1	ELECTRICAL DETAILS
TOTAL: 8	




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PROJECT


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BUILDING IMPROVEMENTS BUILDING A  
DOMESTIC WATER BOOSTER PUMP  
REPLACEMENT  
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DRAWING TITLE


COVER SHEET

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	DRAWN BY JC	DRAWING NO.
	CHECKED BY RS	T0.1
	DATE 2024.04.05	

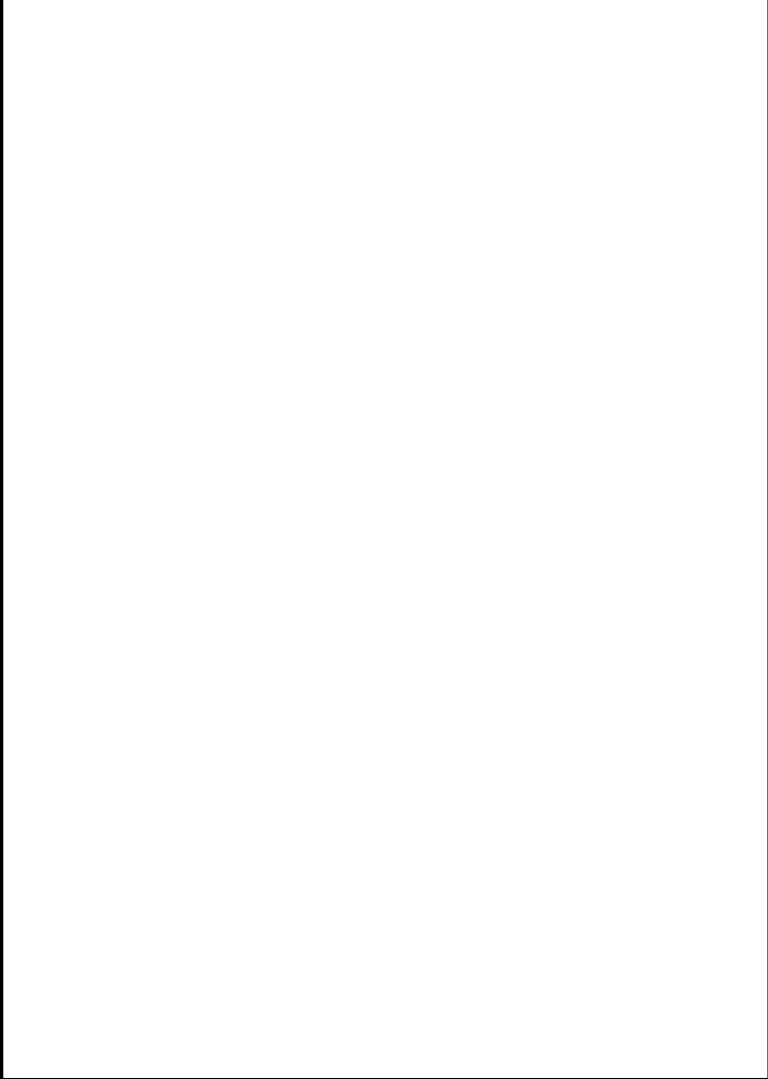


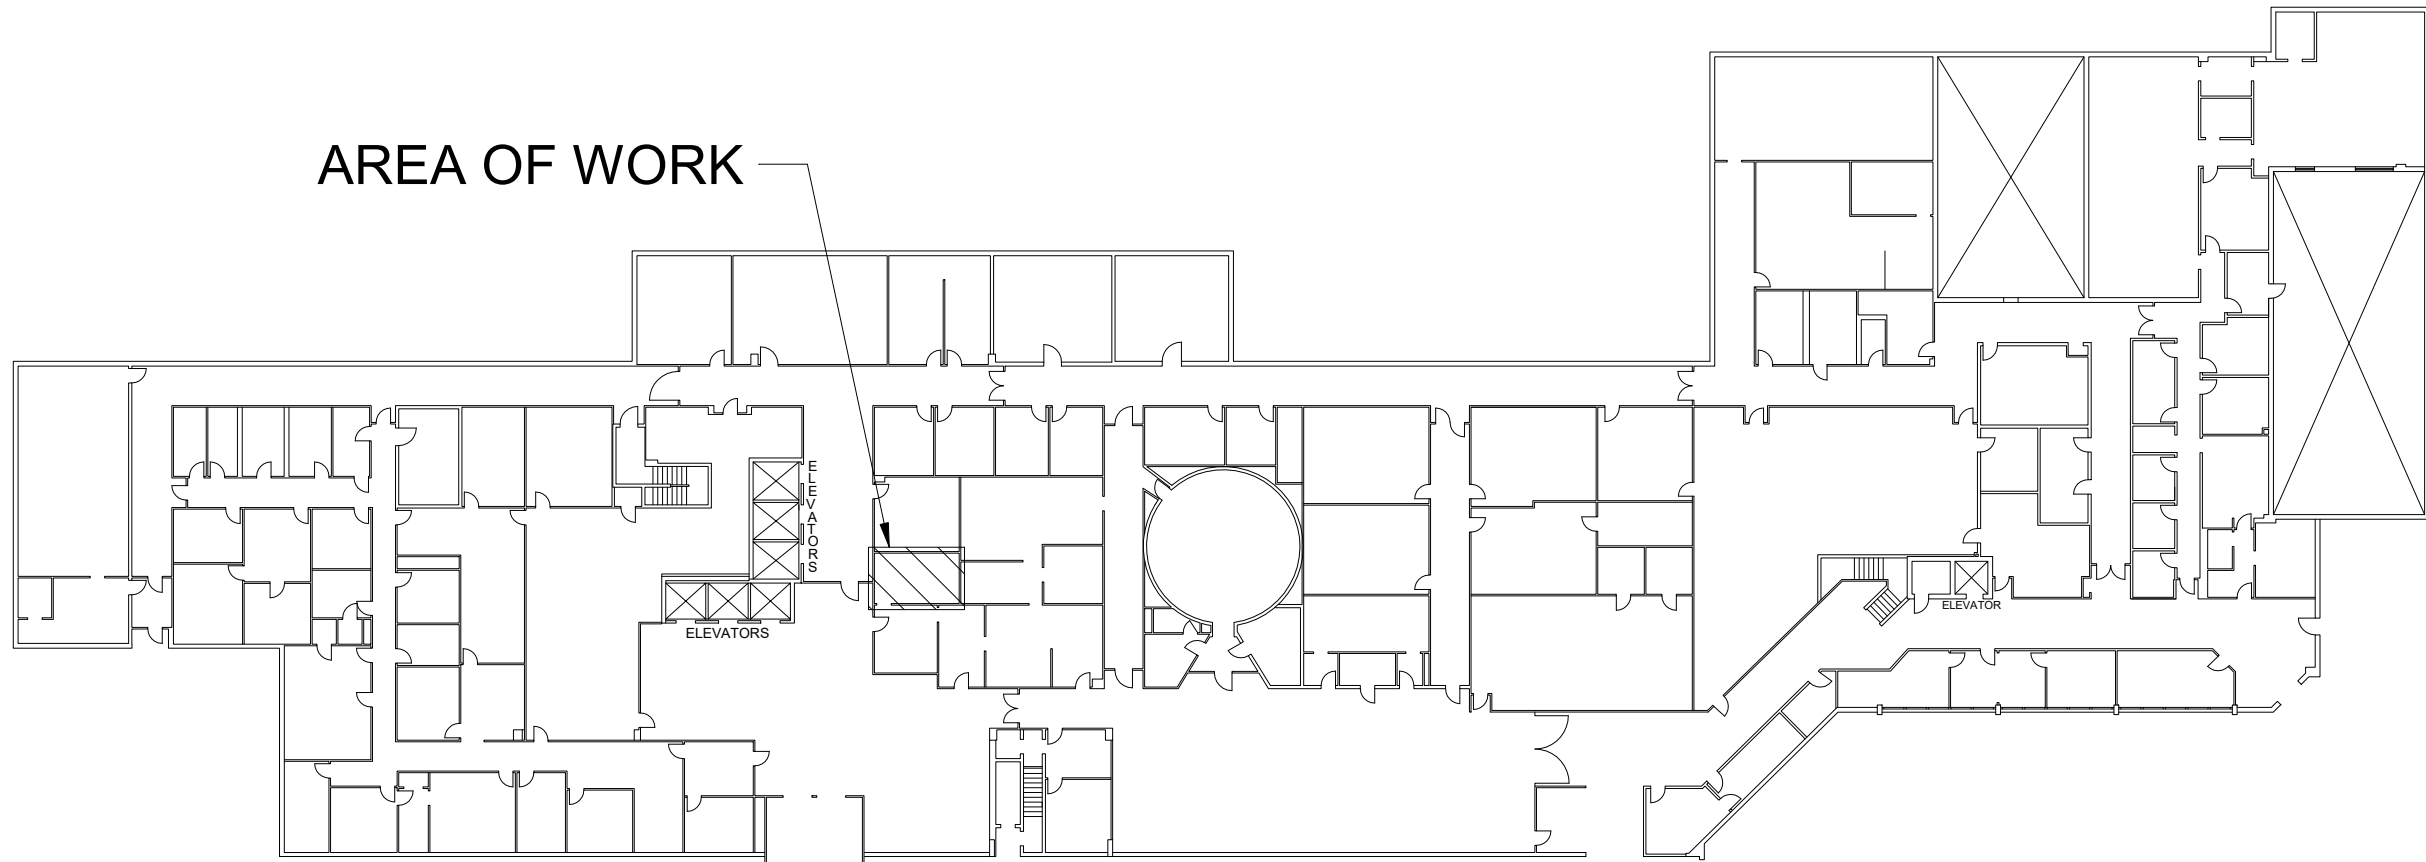


**5 LEVEL 01 KEY PLAN**  
SCALE: 1" = 40'-0"

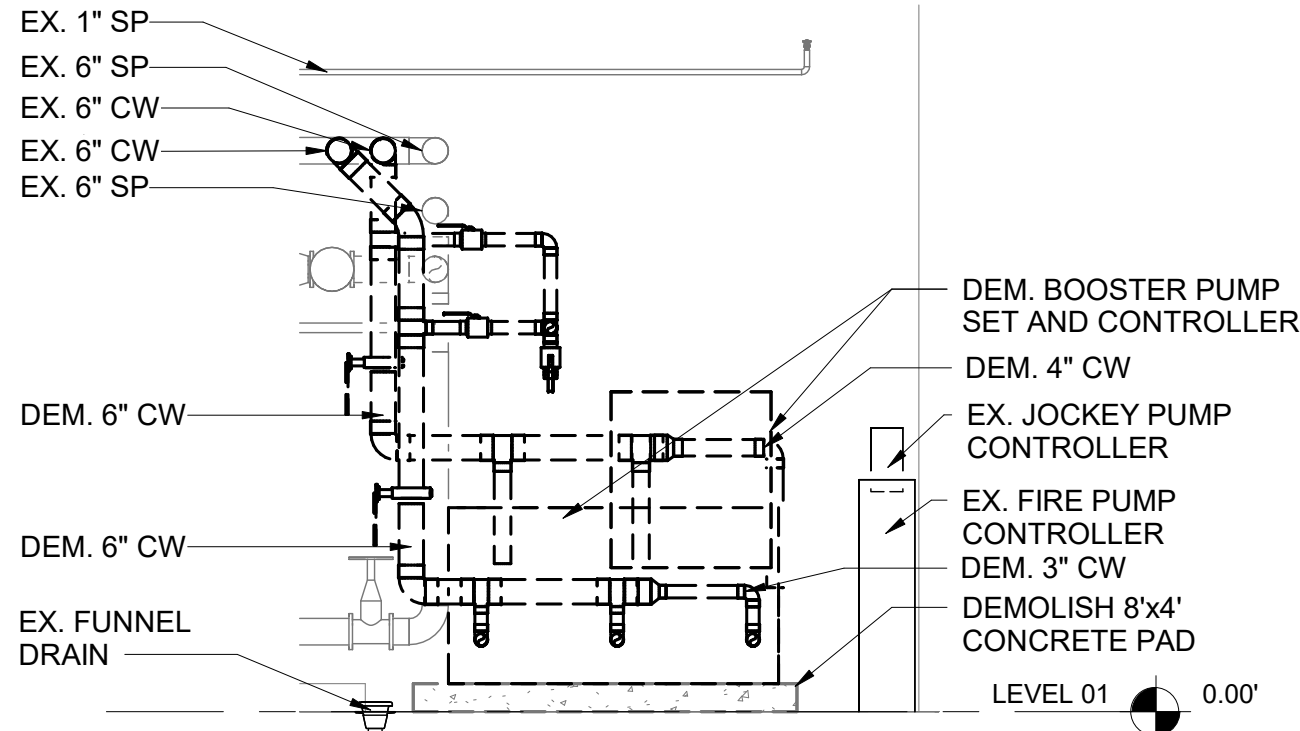


**4 LEVEL 01 PLUMBING DEMOLITION ELEVATION**  
SCALE: 1/4" = 1'-0"

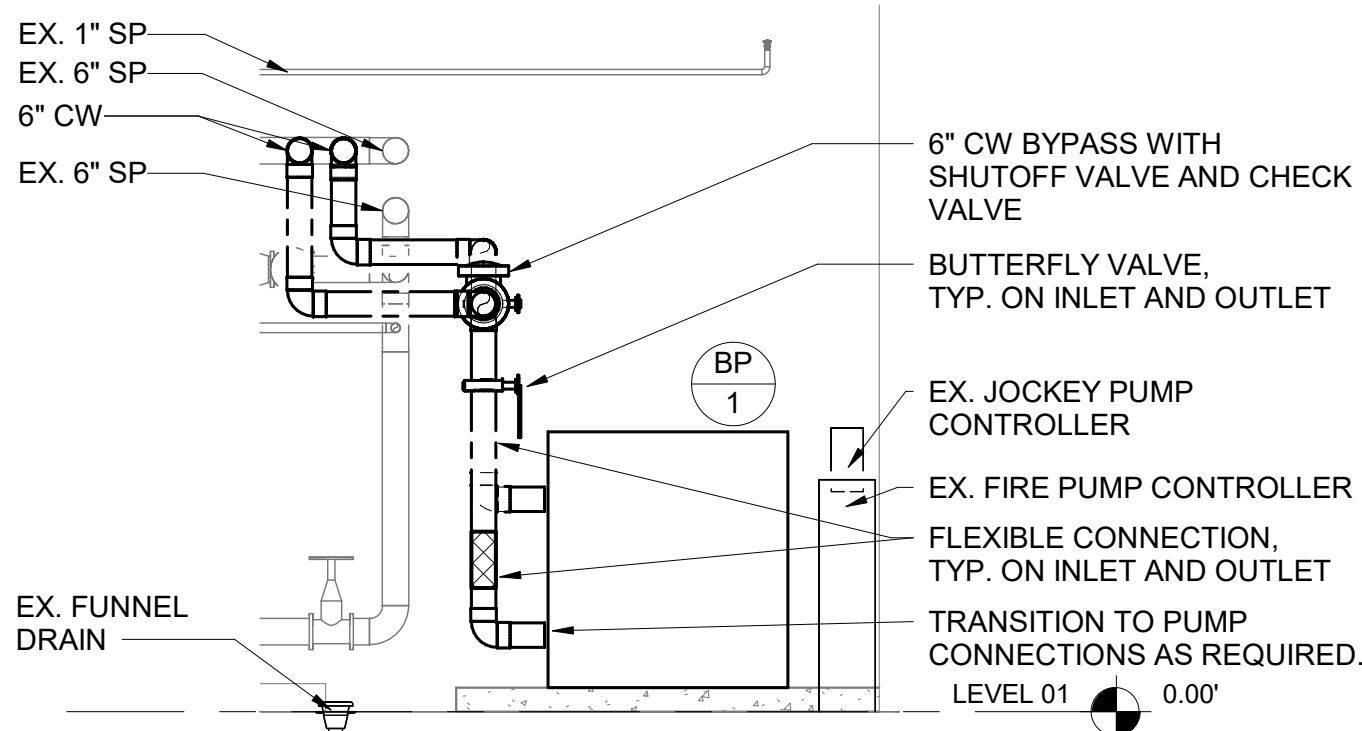

**2 LEVEL 01 PLUMBING NEW WORK ELEVATION**  
SCALE: 1/4" = 1'-0"

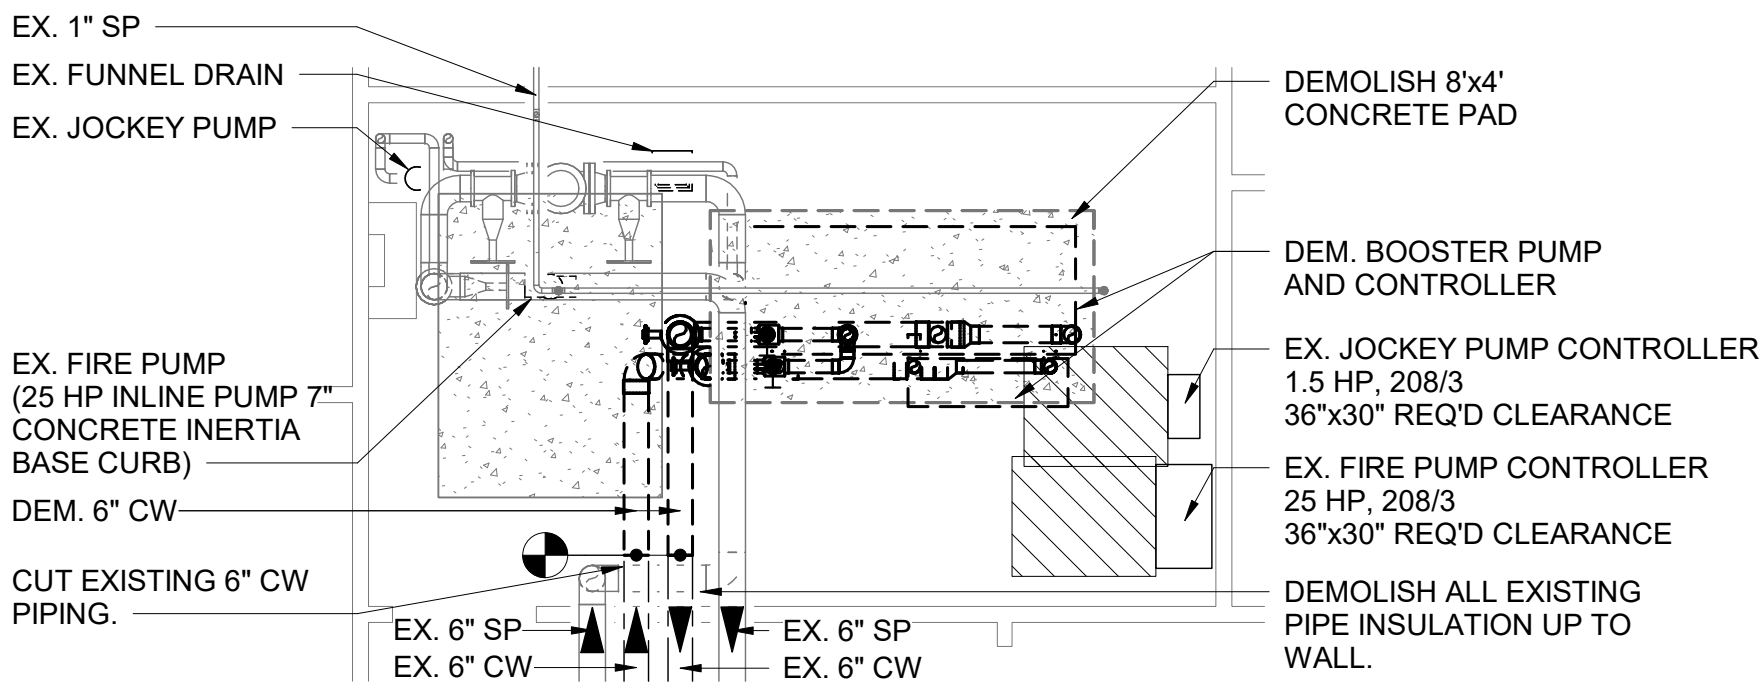

**3 LEVEL 01 PLUMBING DEMOLITION PLAN**  
SCALE: 1/4" = 1'-0"

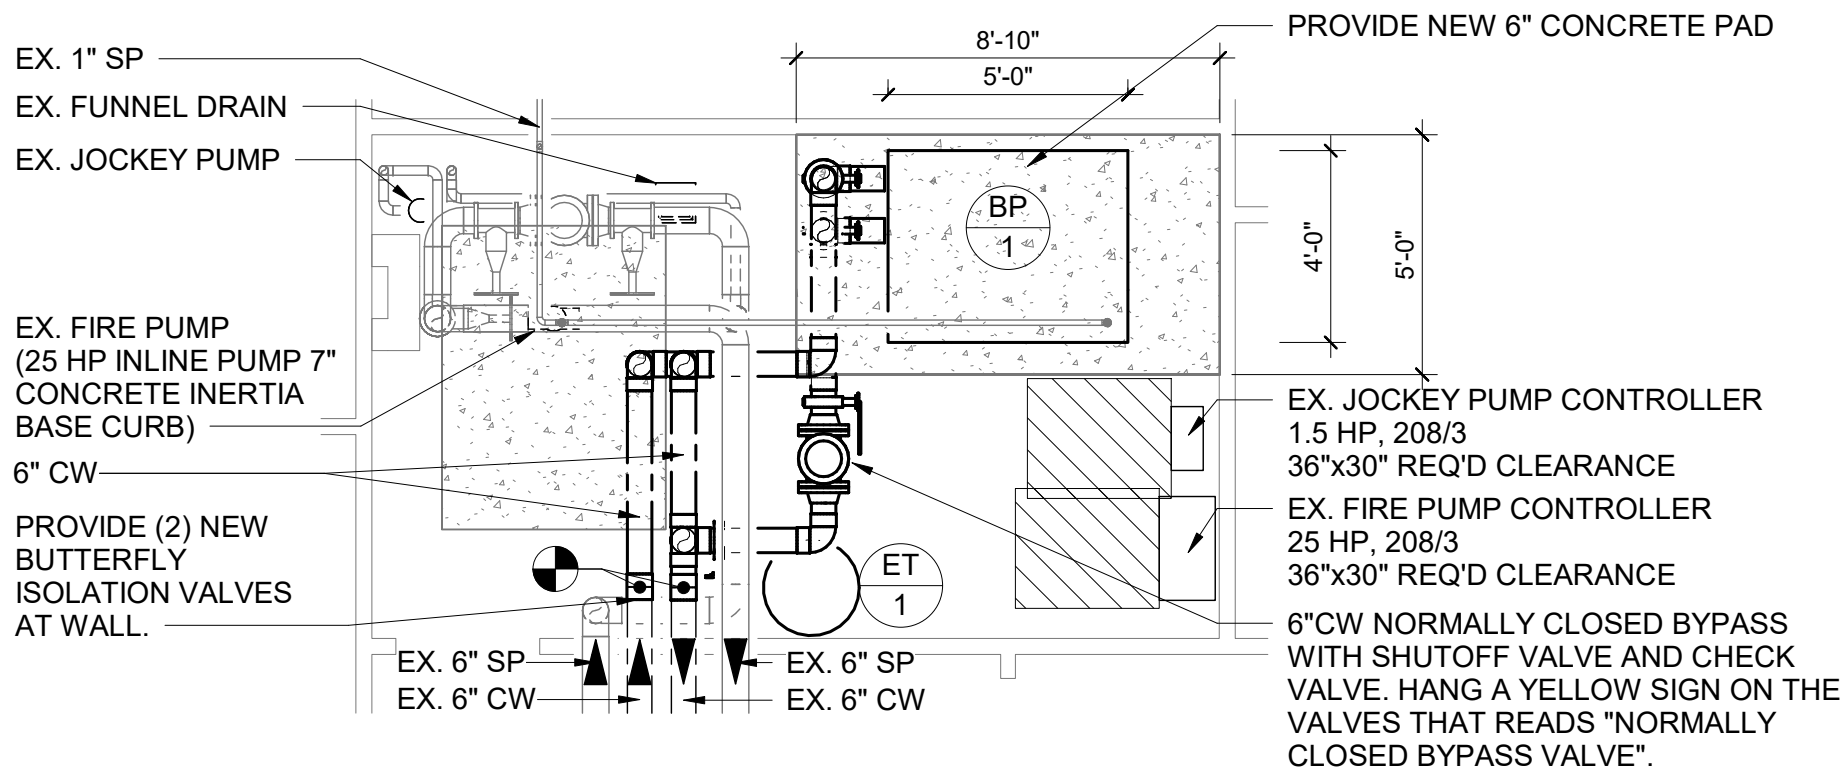

**1 LEVEL 01 PLUMBING NEW WORK PLAN**  
SCALE: 1/4" = 1'-0"

GENERAL NOTES

- CONDITIONS MAY NOT BE EXACTLY AS INDICATED ON THIS DRAWING. CONTRACTORS SHALL VISIT THE SITE TO UNDERSTAND THE EXISTING FIELD CONDITIONS AND TO VERIFY SCOPE OF WORK PRIOR TO SUBMITTING BID. NO ALLOWANCE WILL BE MADE AFTER THE CONTRACT IS APPROVED.
- ALL ABANDONED AND UNUSED EQUIPMENT SHALL BE REMOVED.
- COORDINATE ALL SHUTDOWNS WITH BUILDING FACILITIES, OWNER, AND TENANTS.
- INSULATE ALL NEW AND EXISTING COLD WATER PIPING. SEE PIPE INSULATION SCHEDULE.
- JACKET AND LABEL ALL PIPING INSULATION, INCLUDING FLOW ARROWS.
- POWER WASH AND DEGREASE ALL SURFACES IN THE MECHANICAL ROOM, INCLUDING THE WALLS AND FLOORS. MECHANICALLY CLEAN THE FLOOR OF ALL LOOSE PAINT AND DEBRIS. PAINT THE FLOORS WITH GRAY ARMORSEAL REXTHANE FLOOR PLAIN BY SHERWIN-WILLIAMS OR EQUAL. PAINT NEW AND EXISTING PADS YELLOW.
- DEMOLISH EXISTING CONCRETE PADS TO FACILITATE THE INSTALLATION OF NEW WORK. PATCH THE CONCRETE FLOOR TO MATCH EXISTING.

EQUIPMENT NOTES

- CW PIPE MATERIAL:** FOR DOMESTIC WATER SYSTEMS, SHALL BE SEAMLESS COPPER TUBING, TYPE L, DRAWN TEMPER, ASTM B88. FITTINGS SHALL BE WROUGHT COPPER, SOULDER-JOINT, ANSI B16.22 OR CAST BRONZE ANSI B16.23, ANSI B16.18.
- HYDRO-PNEUMATIC TANK (ET-1):** SHALL BE WESSELS MODEL FXA-300 WITH 79 GALLON VOLUME, 24" DIAMETER X 55" HIGH, CARBON STEEL SHELL, HEAVY DUTY BUTYL BLADDER, WITH INTEGRAL PRESSURE GAUGE AND BLADDER INTEGRITY MONITOR.

DOMESTIC WATER BOOSTER PUMP SCHEDULE

DESIGNATION	BP-1
LOCATION	LEVEL 01
MANUFACTURER	CANARIIS CORPORATION
MODEL	TM-300-48-3VS
FLOW RATE (GPM)	300
MIN SUCTION PRESSURE (PSIG)	35
SYSTEM PRESSURE (PSIG)	78
<b>PUMPS:</b>	
NUMBER OF PUMPS	3
FLOW RATE PER PUMP (GPM)	150
TDH (FT HEAD)	110
HORSEPOWER PER PUMP (HP)	7.5
<b>CONNECTION SIZES:</b>	
INLET (IN.)	4
OUTLET (IN.)	4
<b>EXPANSION TANK</b>	
CAPACITY (GALLONS)	79
PRESSURE (PSIG)	125
<b>ELECTRICAL DATA:</b>	
VOLTAGE / PH / FREQ.	208/3/60
FLA / MCA / MOCOP (A)	95 / 102.75 / -

- NOTES:
- PROVIDE THREE SKID-MOUNTED VARIABLE FREQUENCY DRIVES SUITABLE FOR VARIABLE TORQUE APPLICATIONS.
  - VARIABLE FREQUENCY DRIVES SHALL BE SIZED FOR THE MAXIMUM POSSIBLE AMP DRAW THROUGHOUT THE PROGRAMMED SEQUENCE OF PUMP OPERATION.
  - PROVIDE SKID-MOUNTED CONTROL PANEL. PROVIDE BMS CONNECTION.
  - ALL MOTORS USING VARIABLE FREQUENCY DRIVES SHALL BE PREMIUM EFFICIENCY AND RATED FOR "INVERTER DUTY".
  - PUMP STATUS AND ALL ALARM CONDITIONS SHALL BE CONNECTED TO THE BMS THROUGH THE PUMP CONTROL PANEL AUXILIARY CONTACTS.



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PROJECT  
**CAPITAL PROJECT 2098 HEALTH CENTER**  
**BUILDING IMPROVEMENTS BUILDING A**  
**DOMESTIC WATER BOOSTER PUMP**  
**REPLACEMENT**  
**50 SANATORIUM ROAD**  
**POMONA, NY 10970**

DRAWING TITLE  
**PLUMBING DEMOLITION AND**  
**NEW WORK PLANS**

SEAL	SCALE AS NOTED	PROJECT NO. RCK0019.00
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	DATE 04/23/24	


## DOMESTIC WATER BOOSTER PUMP NOTES

THE COMPLETE PACKAGED PUMPING SYSTEM, INCLUDING PUMPS, MOTORS, CONTROL EQUIPMENT, VARIABLE FREQUENCY DRIVES, TANK, VALVES, FITTINGS AND MANIFOLDS MUST BE UL LISTED UNDER CATEGORY QCCJ (PACKAGED PUMPING SYSTEMS). IN ADDITION TO THE UL LISTING FOR THE COMPLETE SYSTEM THE CONTROL PANEL ASSEMBLY MUST BE SEPARATELY LISTED UNDER UL 508A (INDUSTRIAL CONTROL PANELS). ALL WELDING SHALL BE PERFORMED BY CERTIFIED WELDERS IN ACCORDANCE WITH ASME SECTION IX.

INDIVIDUAL PUMPS, MOTORS AND PRESSURE REGULATING OR CHECK VALVES MAY BE SERVICED WITH THE BOOSTER SYSTEM IN OPERATION AND ALL COMPONENTS SHALL BE SUITABLE FOR THE MAXIMUM WORKING PRESSURE AND TEMPERATURE IN THE SYSTEM.

THE LEAD PUMP SHALL RUN ONLY AS NECESSARY TO MAINTAIN SYSTEM PRESSURE AND WILL BE CONTROLLED AUTOMATICALLY BY MEANS OF A PRESSURE SENSOR/TRANSMITTER AND PROGRAMMABLE LOGIC CONTROLLER (PLC) PROGRAMMED TO PREVENT SHUTTING OFF. IF THE LEAD PUMP IS UNABLE TO MAINTAIN SYSTEM PRESSURE THE LAG PUMP(S) WILL BE CALLED ON AFTER A TIME DELAY AND WILL OPERATE IN PARALLEL WITH THE LEAD PUMP IN ACCORDANCE WITH THE PLC PROGRAM. WHEN ONE PUMP CAN HANDLE THE SYSTEM DEMAND THE CONTROLS WILL SHUT DOWN THE LAG PUMP(S). WHEN A LOW OR NO FLOW CONDITION IS REACHED, THE PUMP(S) WILL BE SHUT DOWN TO PREVENT DRY RUNNING OF THE SYSTEM AND HYDRO-PNEUMATIC TANK THEN SHUT THE LEAD PUMP DOWN AND ALTERNATE.

THE SERVICE OF A FACTORY-TRAINED REPRESENTATIVE SHALL BE MADE AVAILABLE ON THE JOBSITE FOR START-UP AND INSTRUCTING OPERATING PERSONNEL.

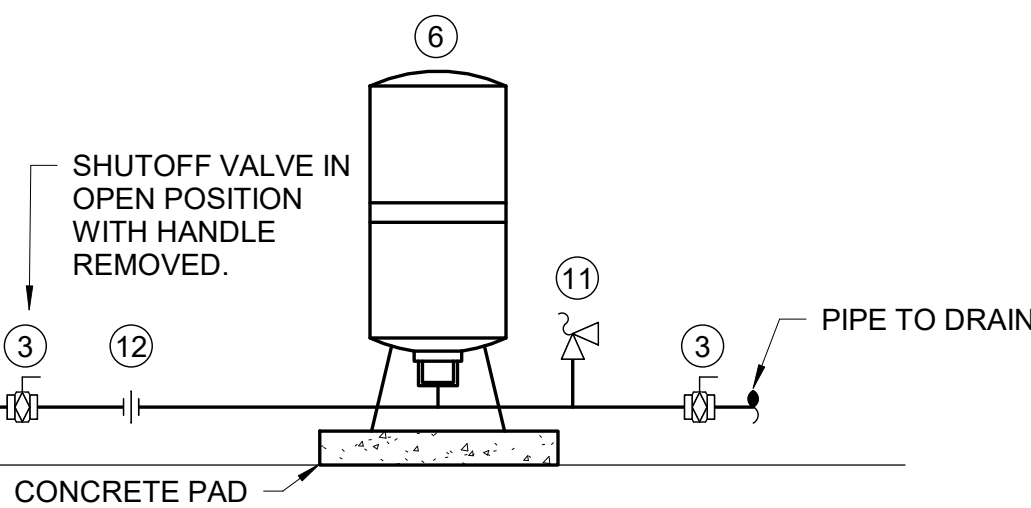


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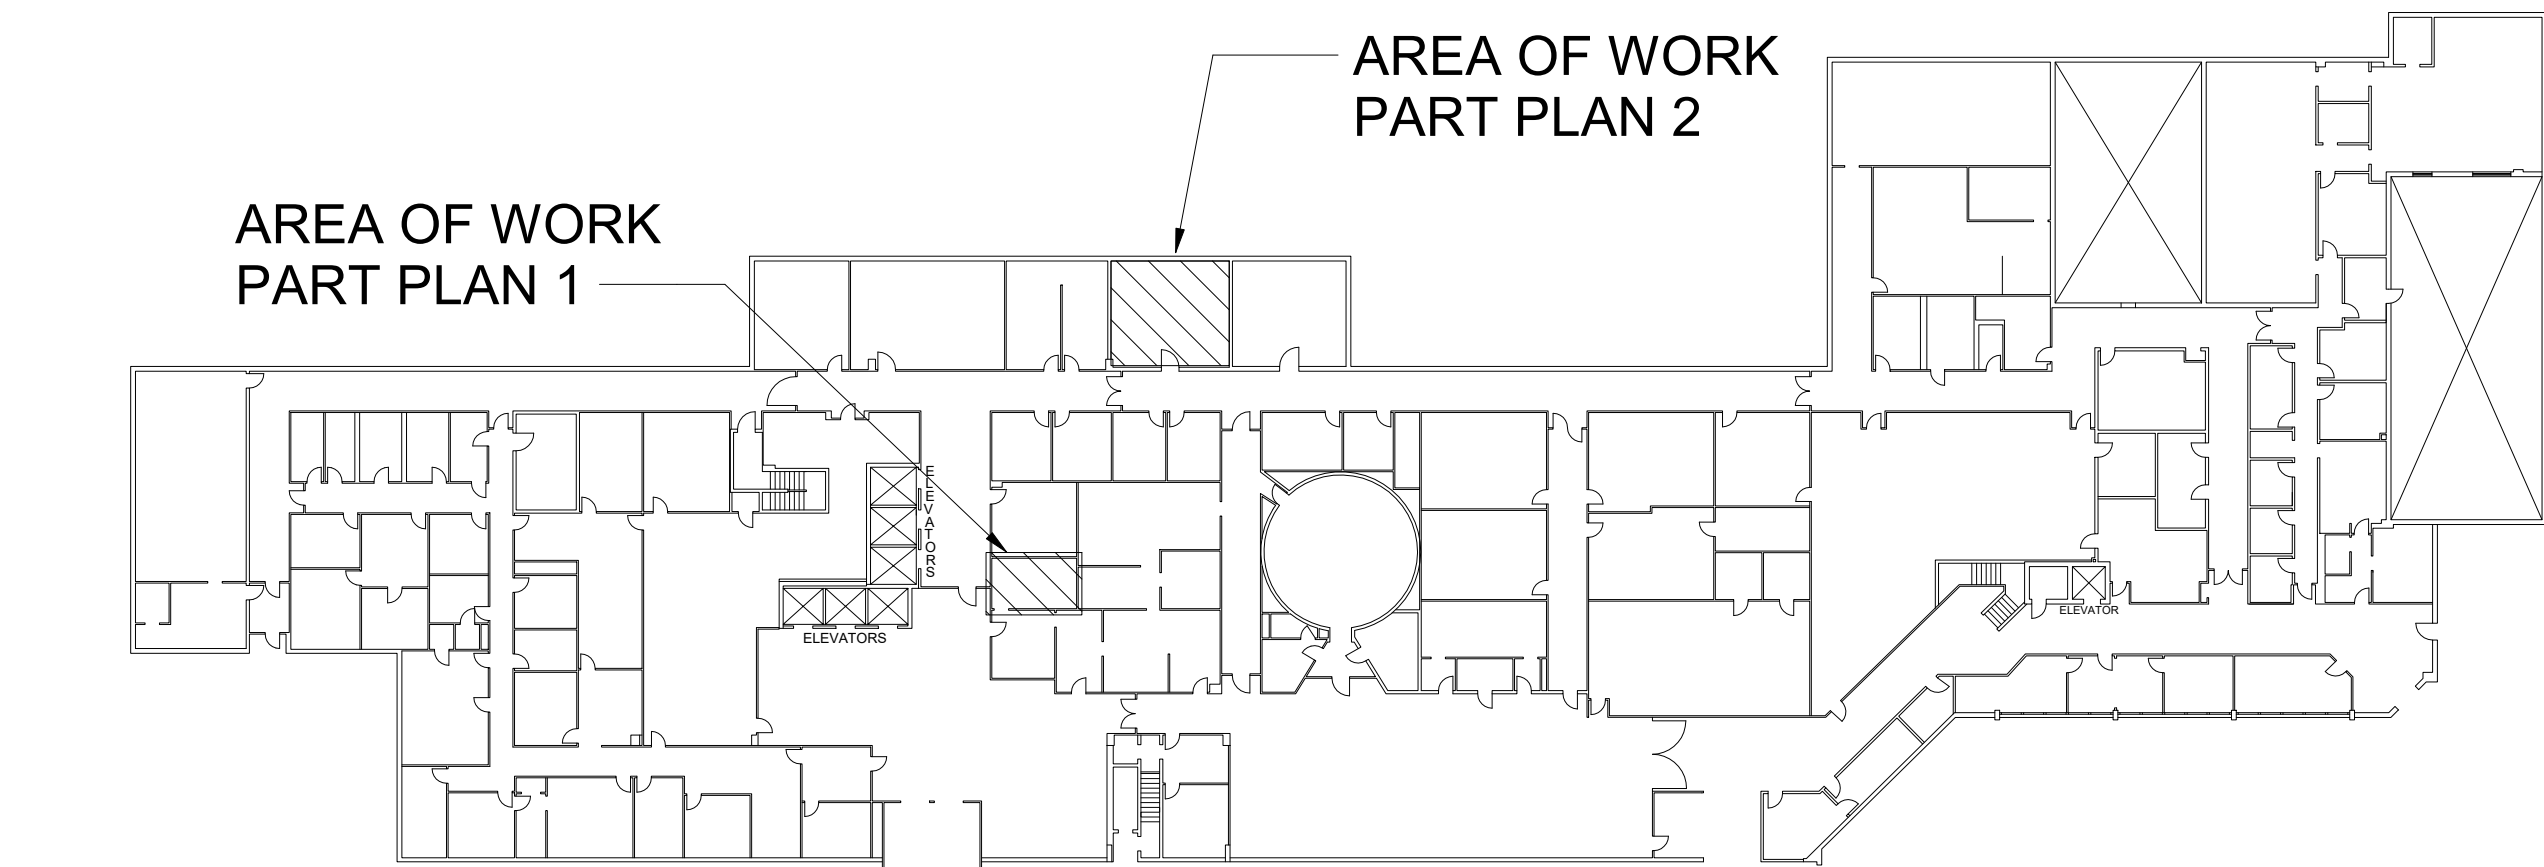
SYMBOLS AND ABBREVIATIONS			SYMBOL			TYPICAL BRANCH CIRCUIT WIRING LEGEND		
SYMBOL	ABBREVIATION	DESCRIPTION	SYMBOL	ABBREVIATION	DESCRIPTION			
	-	CONDUIT AND WIRING		A	AMPERE(S)			
	-	CONDUIT & WIRING TO BE REMOVED UON		AC	AIR CONDITIONER			
	-	BURIED CONDUIT		ACC	AIR CONDITIONER CONDENSER			
	-	OVERHEAD CONDUCTORS		AFF	ABOVE FINISHED FLOOR			
	-	HOMERUN TO PANEL, ARROWS INDICATE # 1P		AF	AMPERAGE OF FUSE	NOTES: 1. EACH 120V AND 277V CIRCUIT SHALL HAVE A DEDICATED NEUTRAL CONDUCTOR. SHARED NEUTRAL HOMERUNS ARE NOT PERMITTED.		
	-	MULTI-POLE HOMERUN		AGL	ABOVE GRADE LEVEL	2. CONDUCTORS SHALL BE INCREASED FOR VOLTAGE DROP AND DERATING AS PER APPLICABLE ELECTRICAL CODE. FOR CIRCUITS THAT ARE BETWEEN 100' AND 150' IN LENGTH, PHASE AND NEUTRAL CONDUCTORS SHALL BE #10 AWG. FOR CIRCUITS THAT ARE BETWEEN 150' AND 225' IN LENGTH, PHASE AND NEUTRAL CONDUCTORS SHALL BE #8 AWG. FOR LENGTHS GREATER THAN 225' IN LENGTH, VERIFY CONDUCTOR SIZES WITH ENGINEER.		
	-	ELECTRICAL EQUIPMENT AS INDICATED		AHU	AIR HANDLING UNIT			
	-	ELECTRICAL EQUIPMENT TO BE REMOVED UON		AL	ALUMINIUM			
	-	ELECTRIC METER		ARC	ARC FAULT INTERRUPTER			
	-	JUNCTION BOX		AS	AMPERAGE OF SWITCH			
	-	FUSED DISCONNECT SWITCH		AWG	AMERICAN WIRE GAUGE			
	-	UNFUSED DISCONNECT SWITCH		BCW	BARE COPPER WIRE			
	-	COMBINATION MOTOR STARTER/FUSED DISC.		BLDG	BUILDING			
	-	MOTOR STARTER		BMS	BUILDING MANAGEMENT SYSTEM			
	-	MOTOR		C	CONDUIT			
	-	BATTERY PACK EMERGENCY LIGHT FIXTURE		CP	CONTROL PANEL			
	-	EXIT LIGHT, FACES-SHADED, CHEVRON-ARROW		CKT	CIRCUIT			
	-	SINGLE POLE SWITCH (x - INDICATES FIXTURE BEING CONTROLLED)		CLG	CEILING			
	-	THREE WAY SWITCH (x - INDICATES FIXTURE BEING CONTROLLED)		COL	COLUMN			
	-	FOUR WAY SWITCH (x - INDICATES FIXTURE BEING CONTROLLED)		CU	COPPER			
	-	DIMMER SWITCH (x - INDICATES FIXTURE BEING CONTROLLED)		CUH	CABINET UNIT HEATER			
	-	MOTOR RATED TOGGLE SWITCH		DEM.	DEMOLISH AND REMOVE			
	-	KEY OPERATED SINGLE POLE SWITCH		DISC	DISCONNECT			
	-	SPEED CONTROLLER (FBO)		DIM	DIMMER			
	-	DUPLEX RECEPTACLE		DWG	DRAWING			
	-	DOUBLE DUPLEX RECEPTACLE		EMT	ELECTRICAL METALLIC TUBING			
	-	SPECIAL RECEPTACLE		EM	EMERGENCY			
	-	SECURITY MOTION DETECTOR		EX.	EXISTING TO REMAIN			
	-	KEY PAD		F	FLOOR			
	-	PANIC ALARM		FBO	FURNISHED BY OTHERS			
	CB	CIRCUIT BREAKER		FC	FAN COIL UNIT			
	-	ENCLOSED CIRCUIT BREAKER		GEN	GENERATOR			
	-	FUSED SWITCH		GFI	GROUND FAULT INTERRUPTER			
	GND	GROUND AS PER LOCAL CODE		HP	HORSEPOWER			
	-	GROUND BAR		HVAC	HEATING VENTILATION AIR CONDITIONING			
	-	GROUND ROD		IMC	INTERMEDIATE METAL CONDUIT			
	-	TRANSFER SWITCH		KVA	KILO-VOLT-AMPERE			
	XFMR	TRANSFORMER		KW	KILO-WATT			
	CT	CURRENT TRANSFORMER		MAX	MAXIMUM			
	-	UTILITY POLE		MCB	MAIN CIRCUIT BREAKER			
	WM	WATER MAIN		MIN	MINIMUM			
	-	BOILER BREAK GLASS STATION		MLO	MAIN LUG ONLY			
	NC	NORMALLY CLOSED CONTACTS		NIC	NOT IN CONTRACT			
	NO	NORMALLY OPEN CONTACTS		NL	NIGHT LIGHT			
	CV	CONTROL VALVE		NTS	NOT TO SCALE			
	MD	MOTORIZED DAMPER		OH	OVERHEAD			
	SD OR CFSD	SMOKE DAMPER		P	POLE			
	UH	UNIT HEATER		PBO	PROVIDED BY OTHERS			
	CL	CLOCK		PNL	PANEL			
	A	AIR TERMINAL		PVC	POLY VINYL CHLORIDE			
				REL.	REMOVE AND RELOCATE			
				REM.	REMOVE AND REINSTALL.			
				RTU	ROOF TOP UNIT			
				SCH	SCHEDULE			
				SPD	SURGE PROTECTION DEVICE			
				SW	SWITCH(ES)			
				TELCO	TELEPHONE COMPANY			

[illegible]


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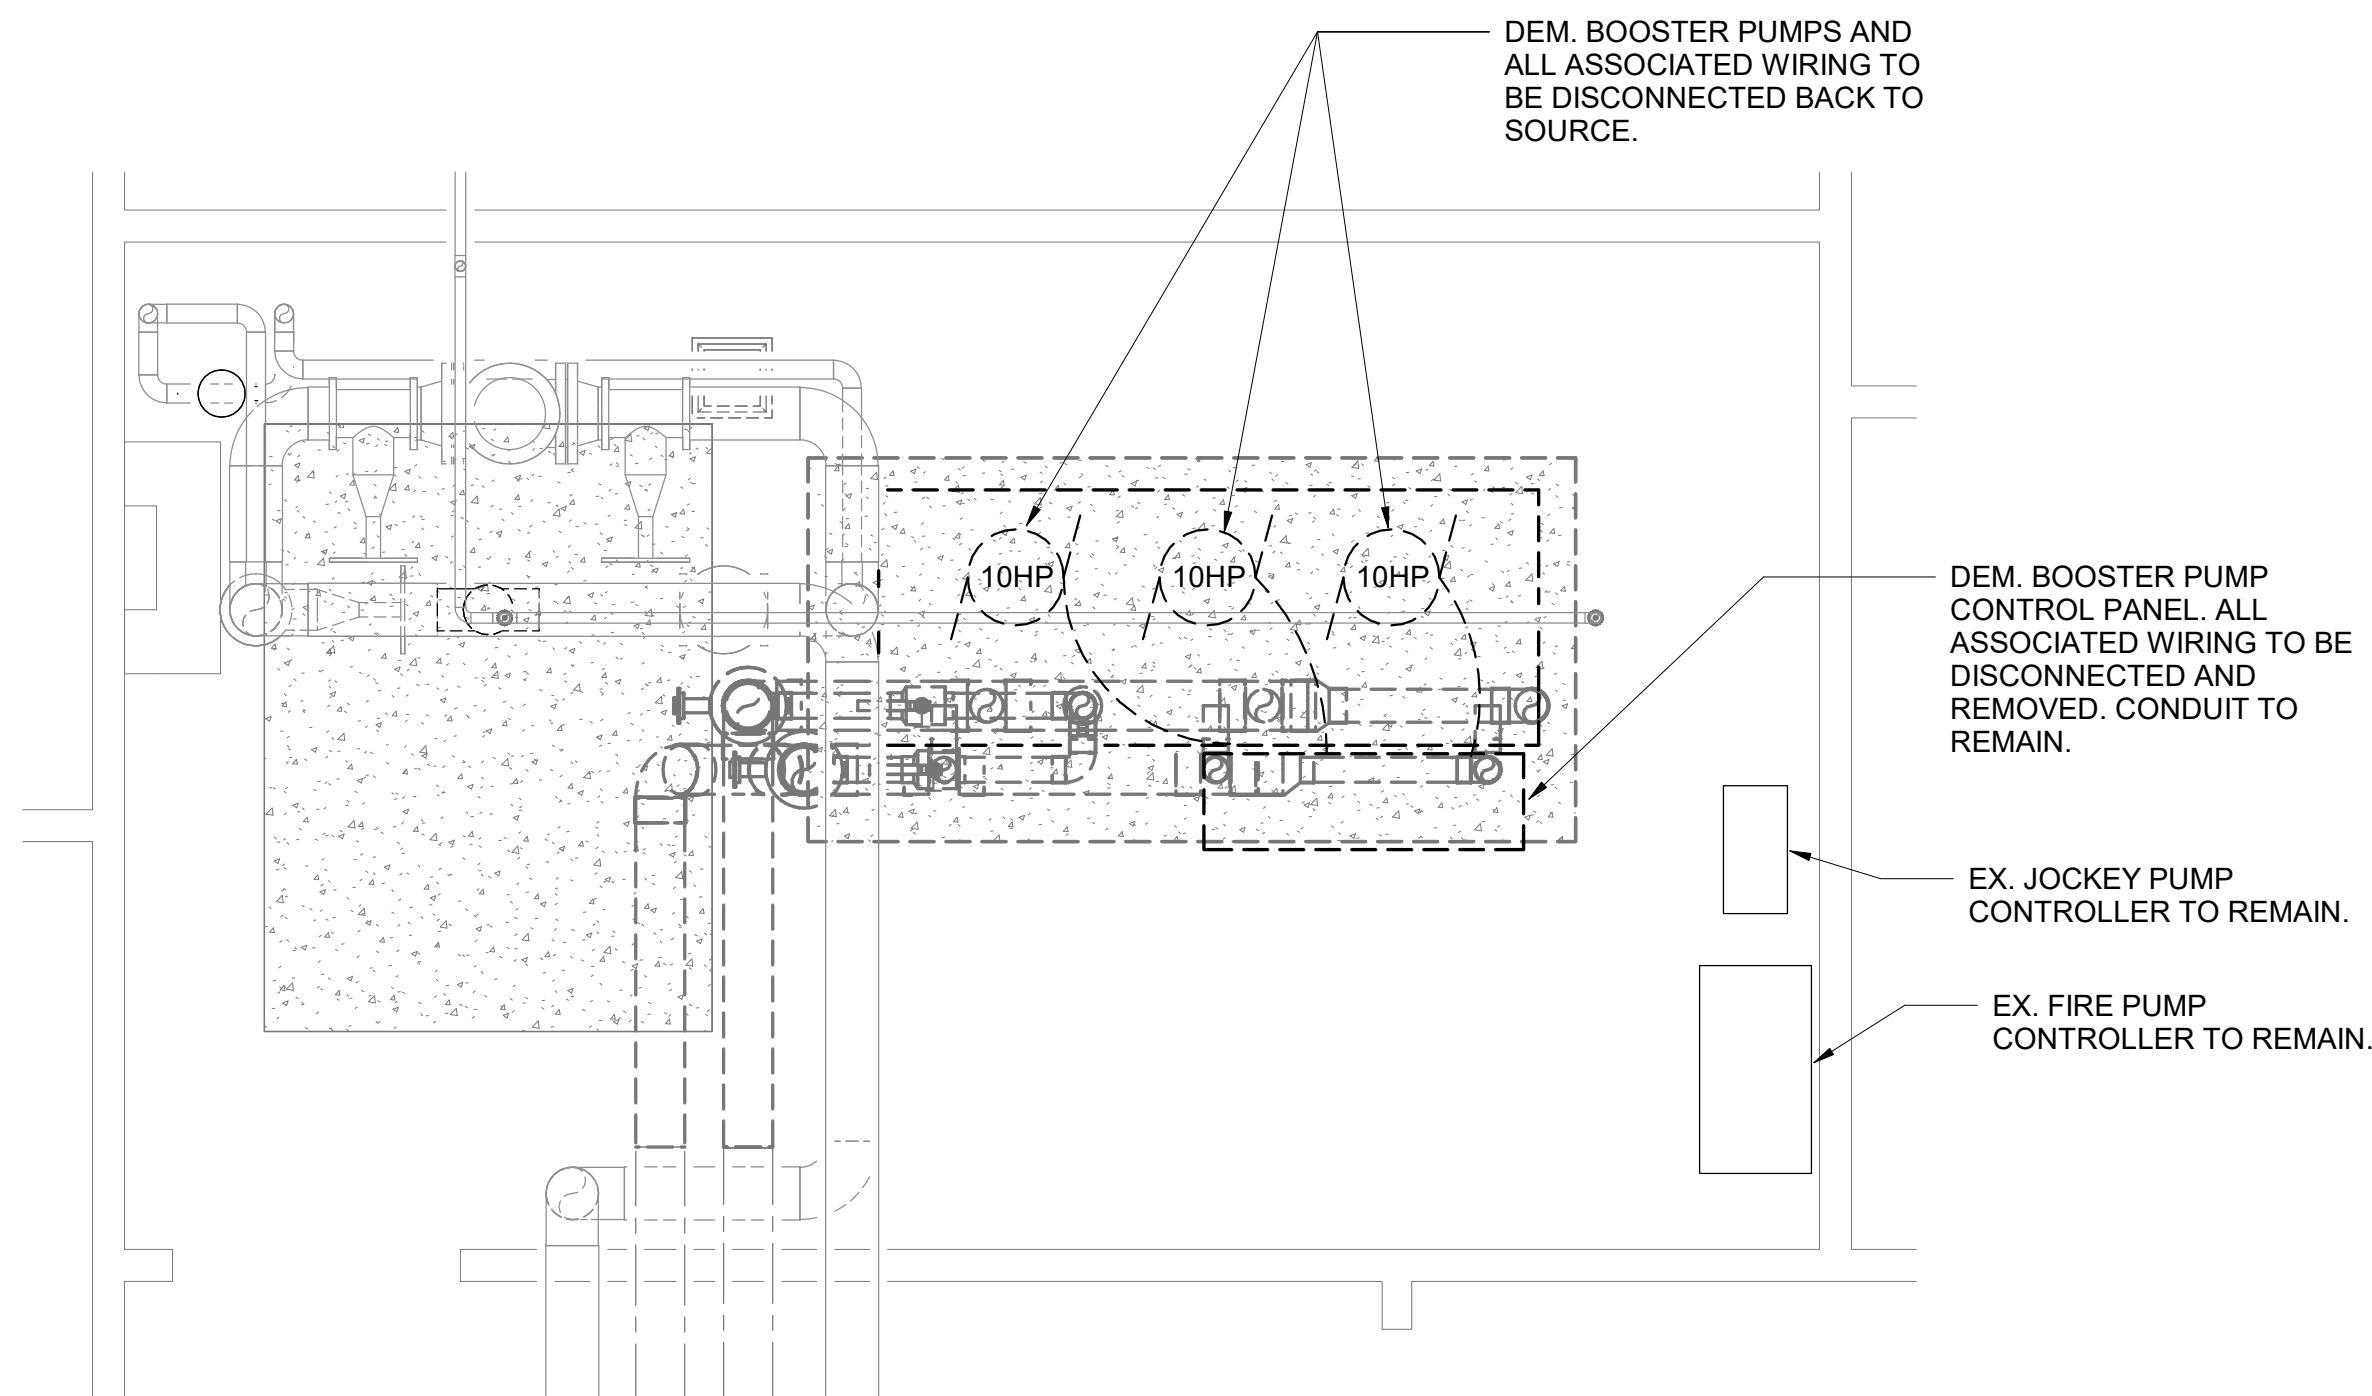
4 PP-1 SINGLE LINE DEMOLITION  
SCALE:NONE

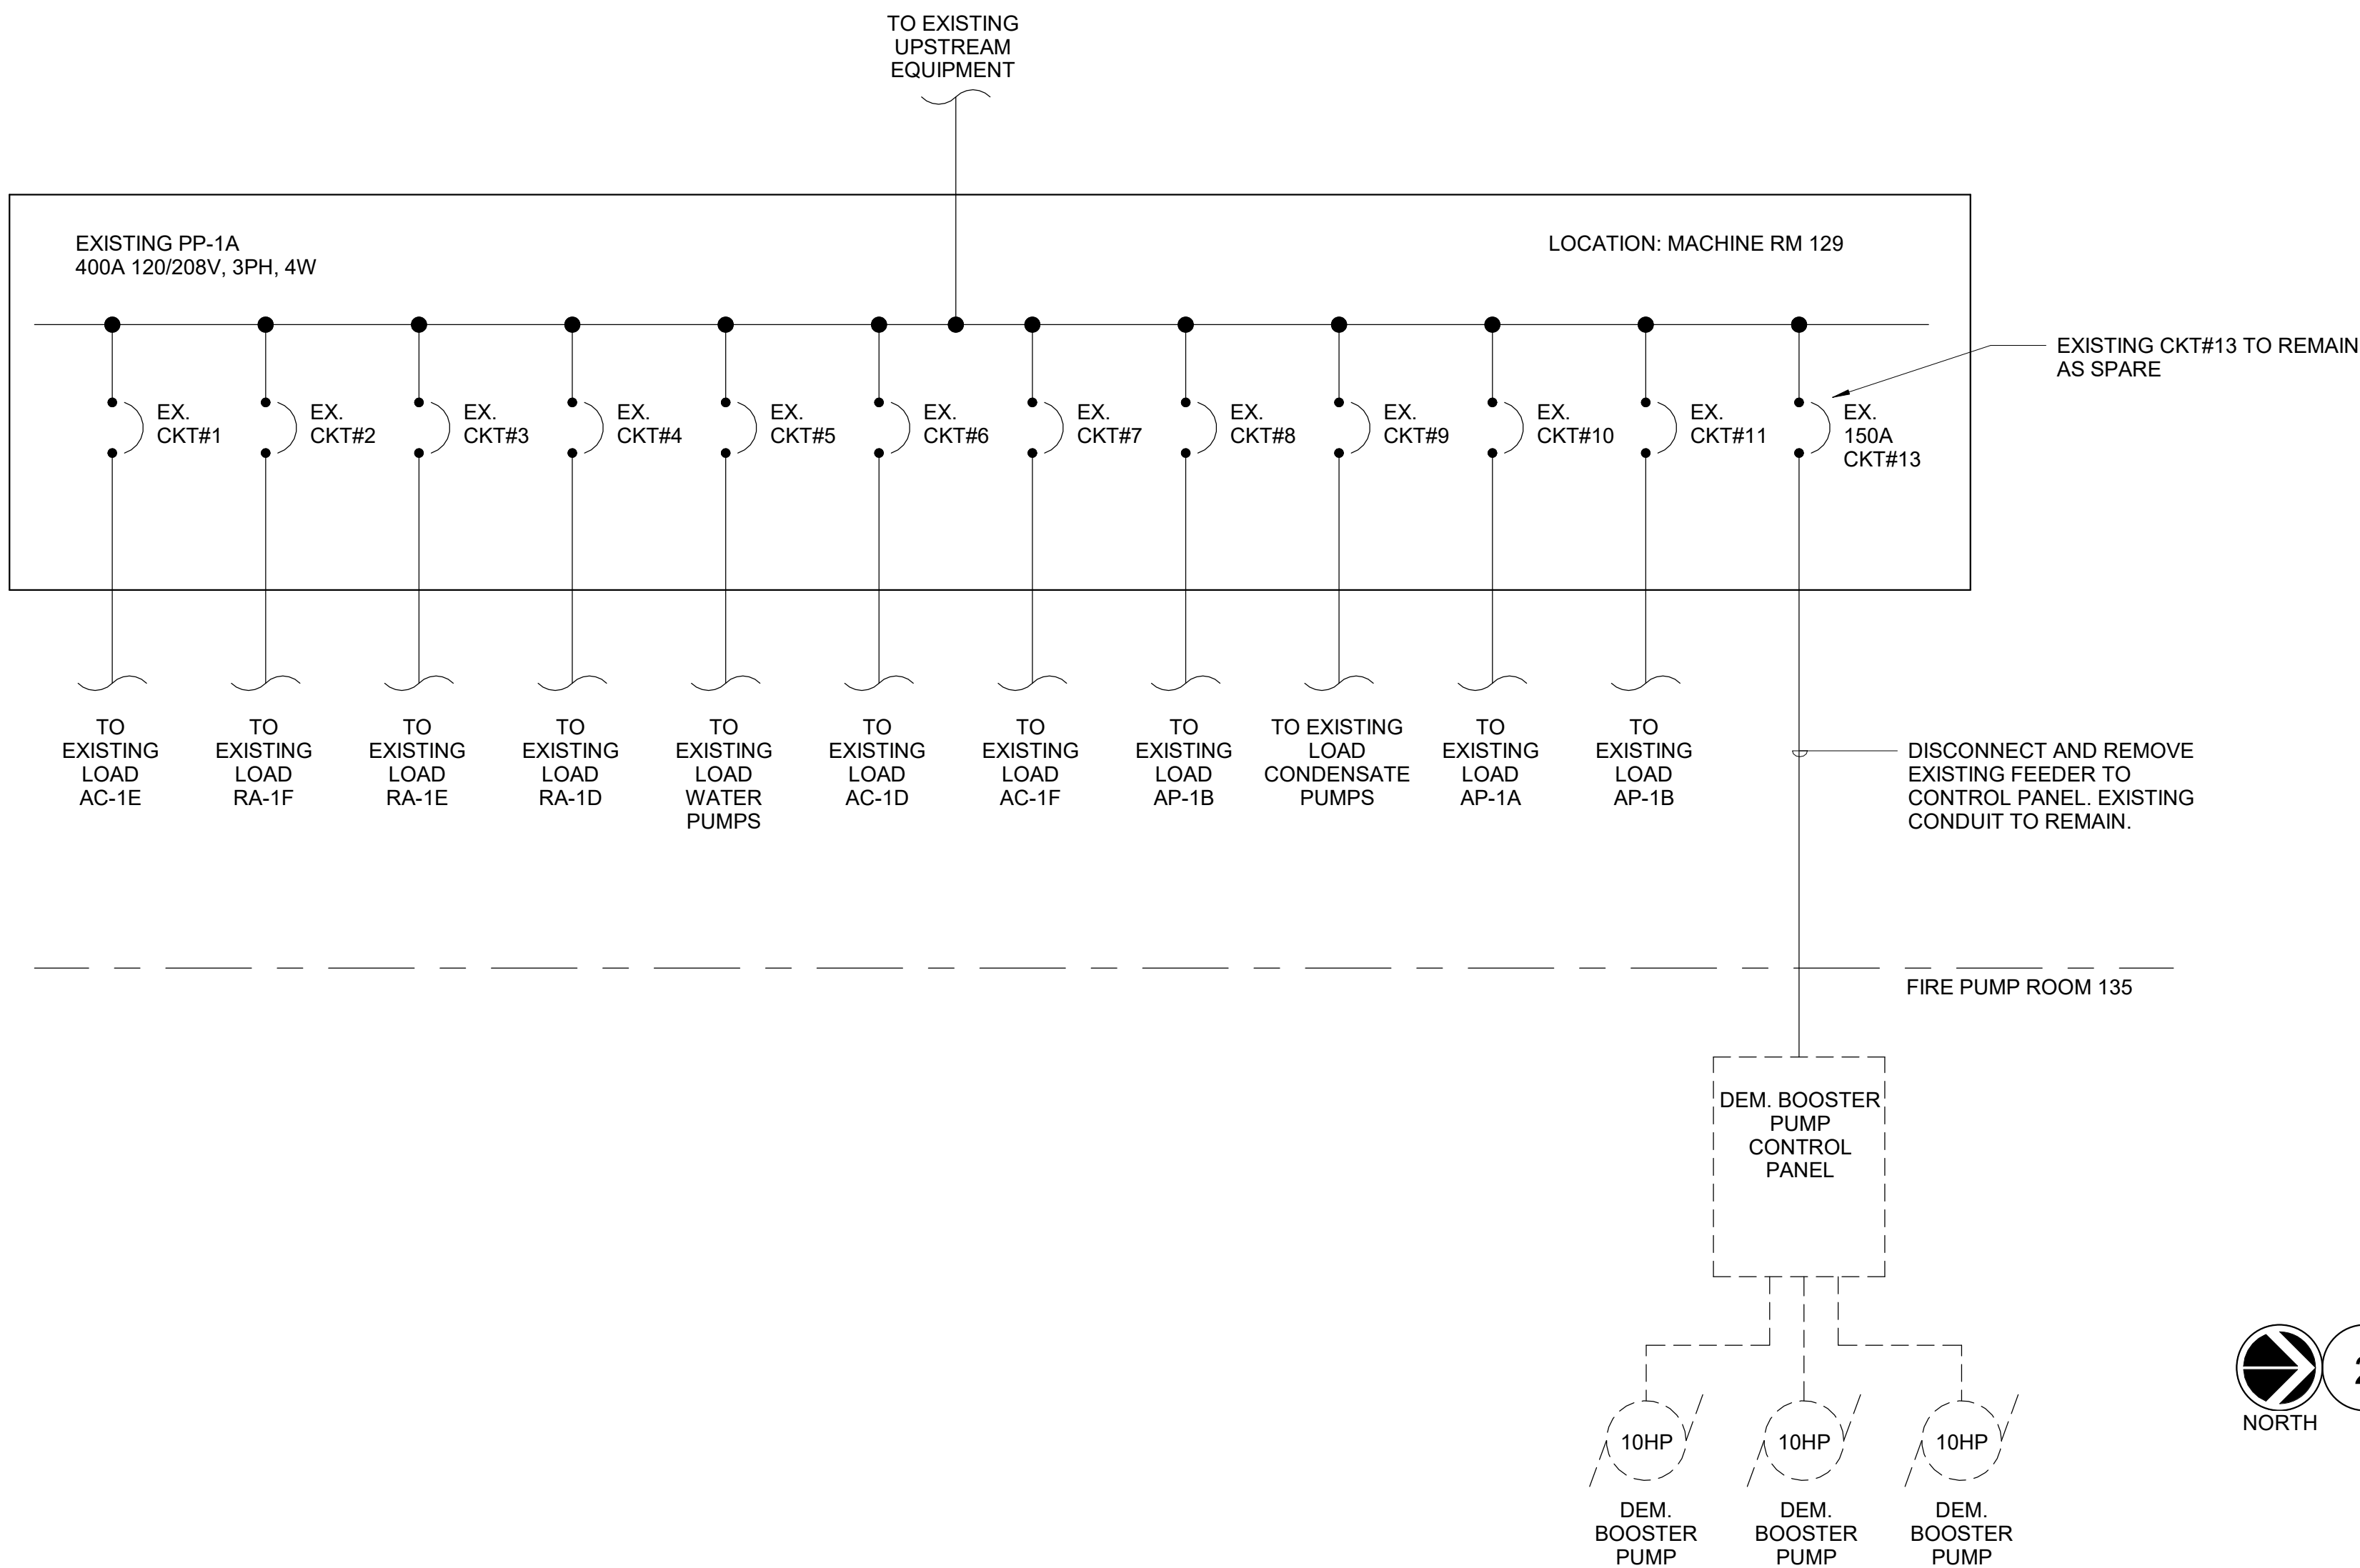

3 LEVEL 01 KEY PLAN  
SCALE: 1" = 40'-0"



2 LEVEL 01 EXISTING ELECTRICAL PLAN MACHINE ROOM-129  
SCALE: 1/4" = 1'-0" NOTE: NOT ALL EXISTING EQUIPMENT IS SHOWN IN THE ROOM.

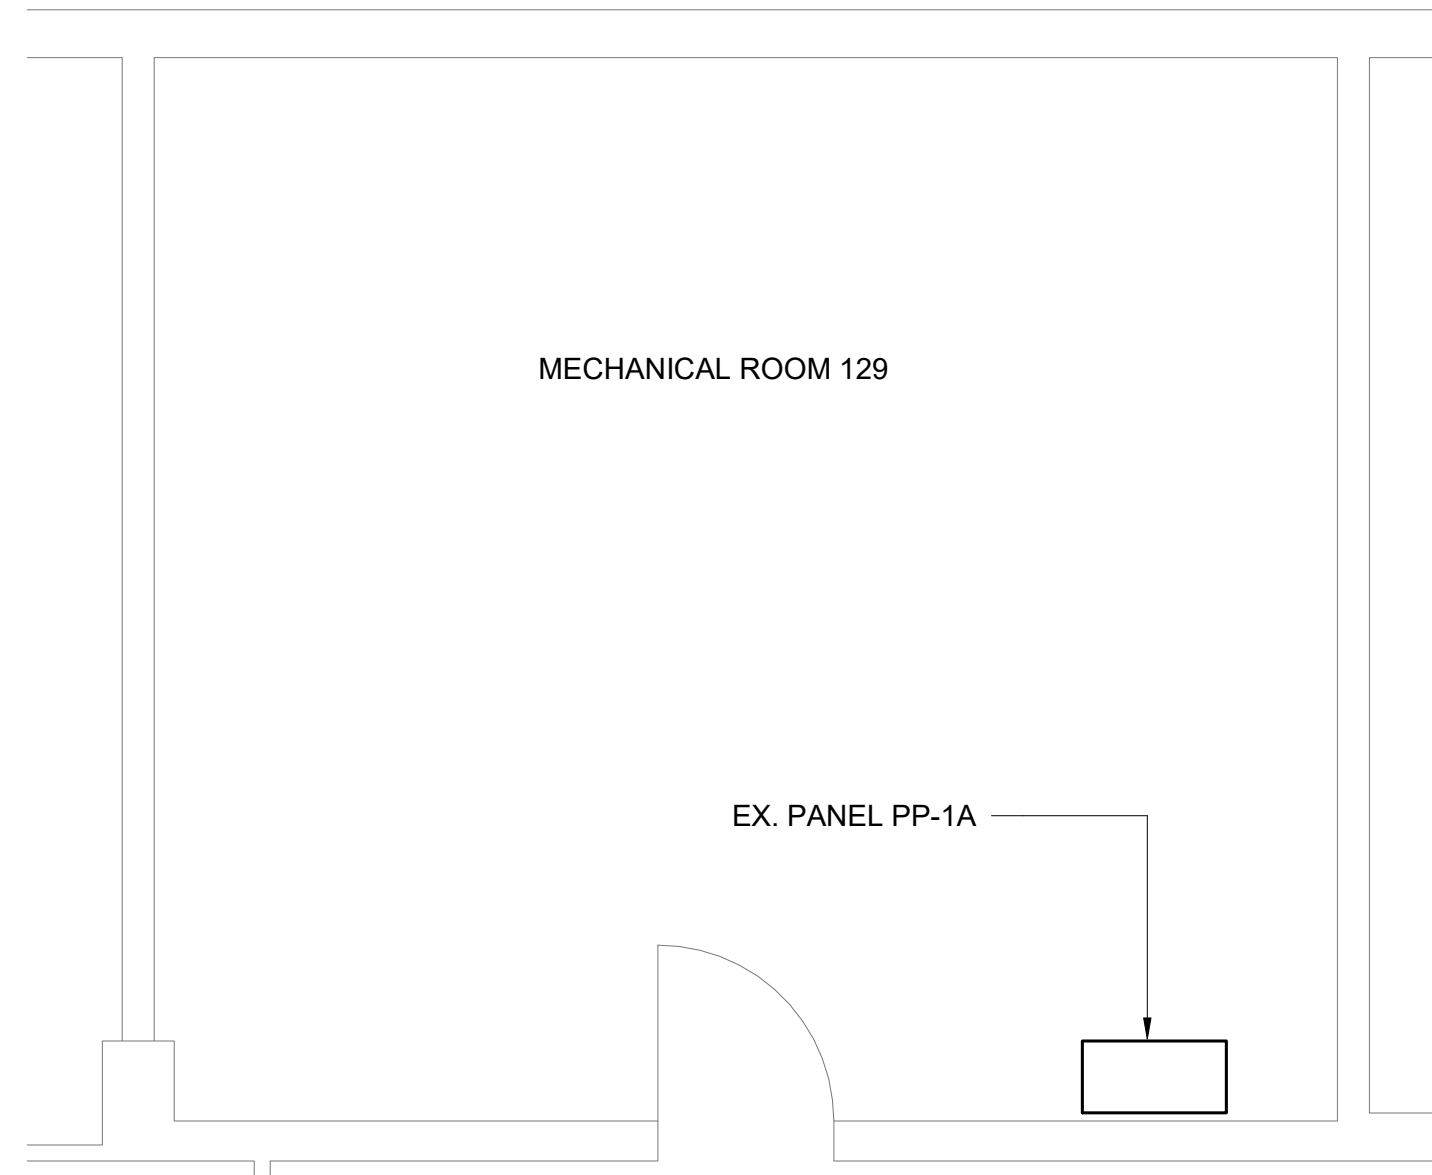

1 LEVEL 01 EXISTING ELECTRICAL PLAN FIRE PUMP ROOM 135  
SCALE: 1/2" = 1'-0"



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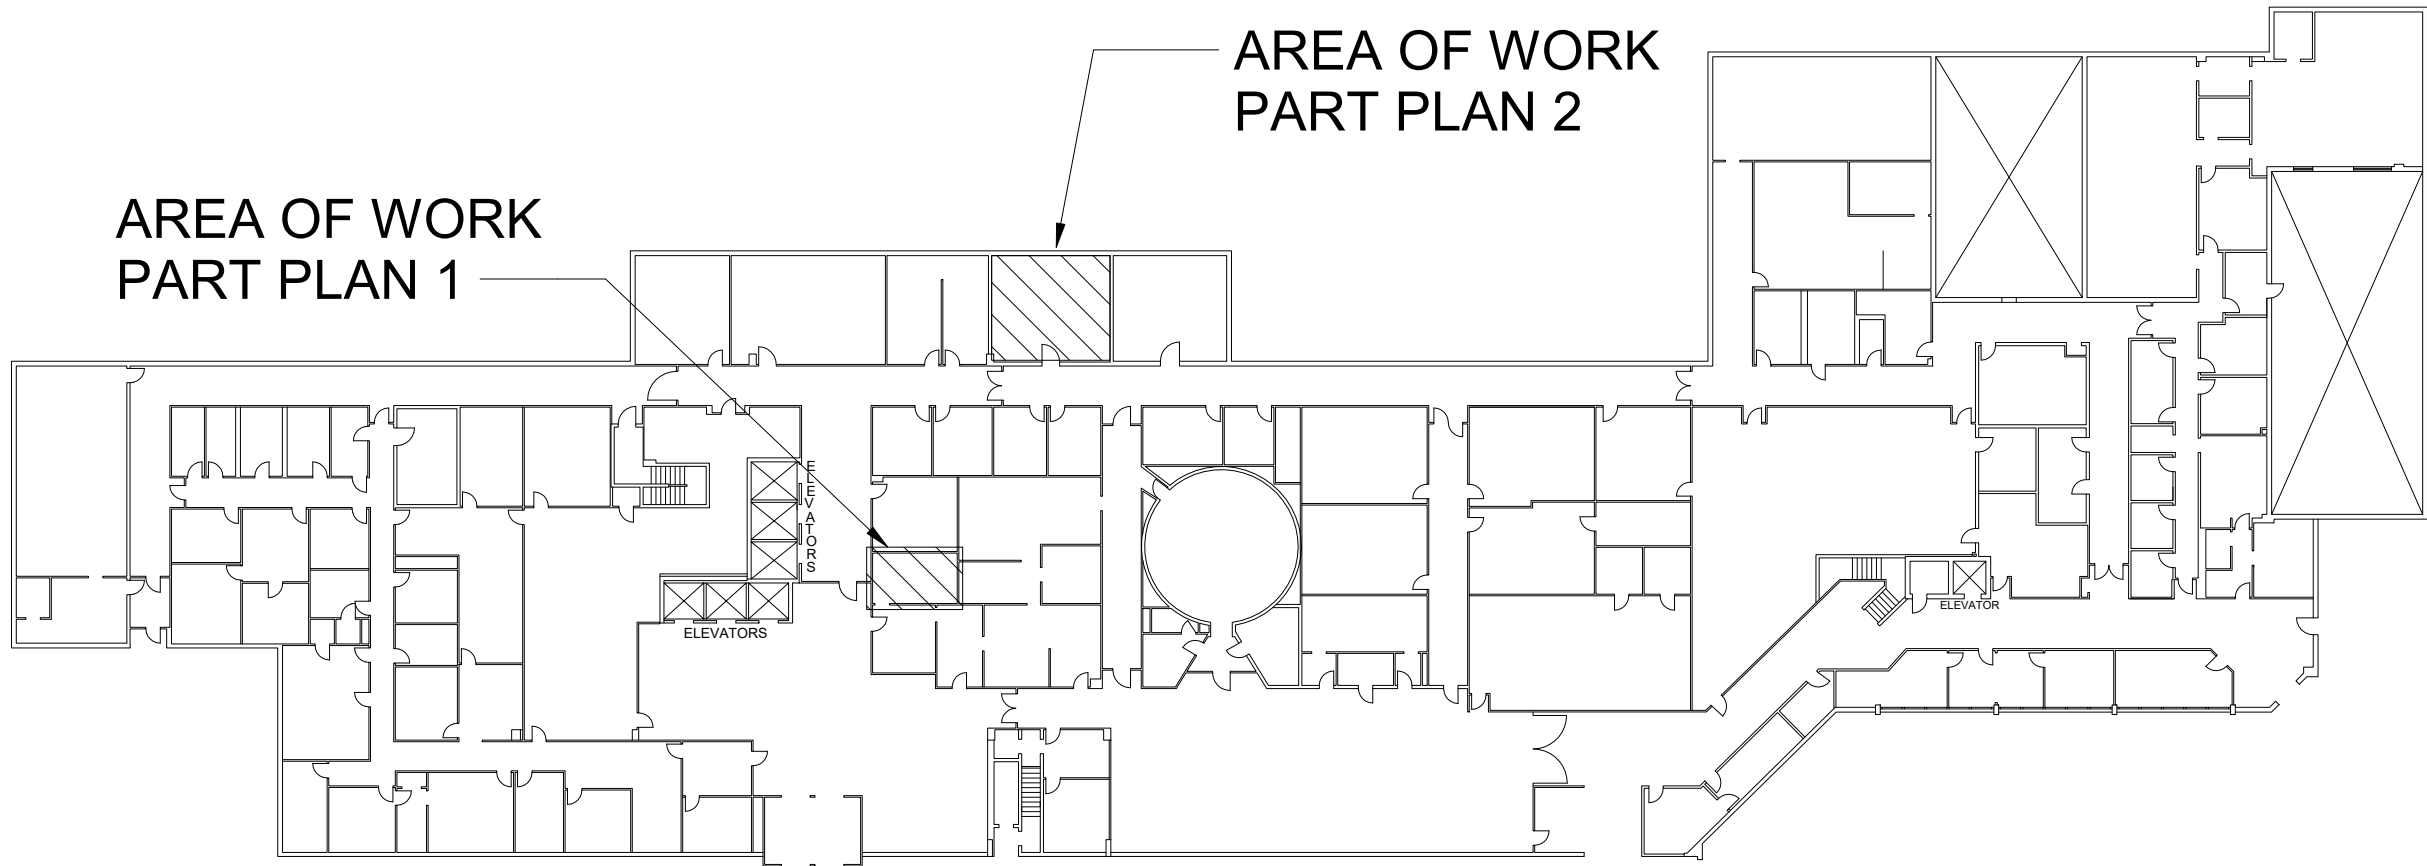
DRAWING TITLE  
**ELECTRICAL DEMOLITION  
PLAN**

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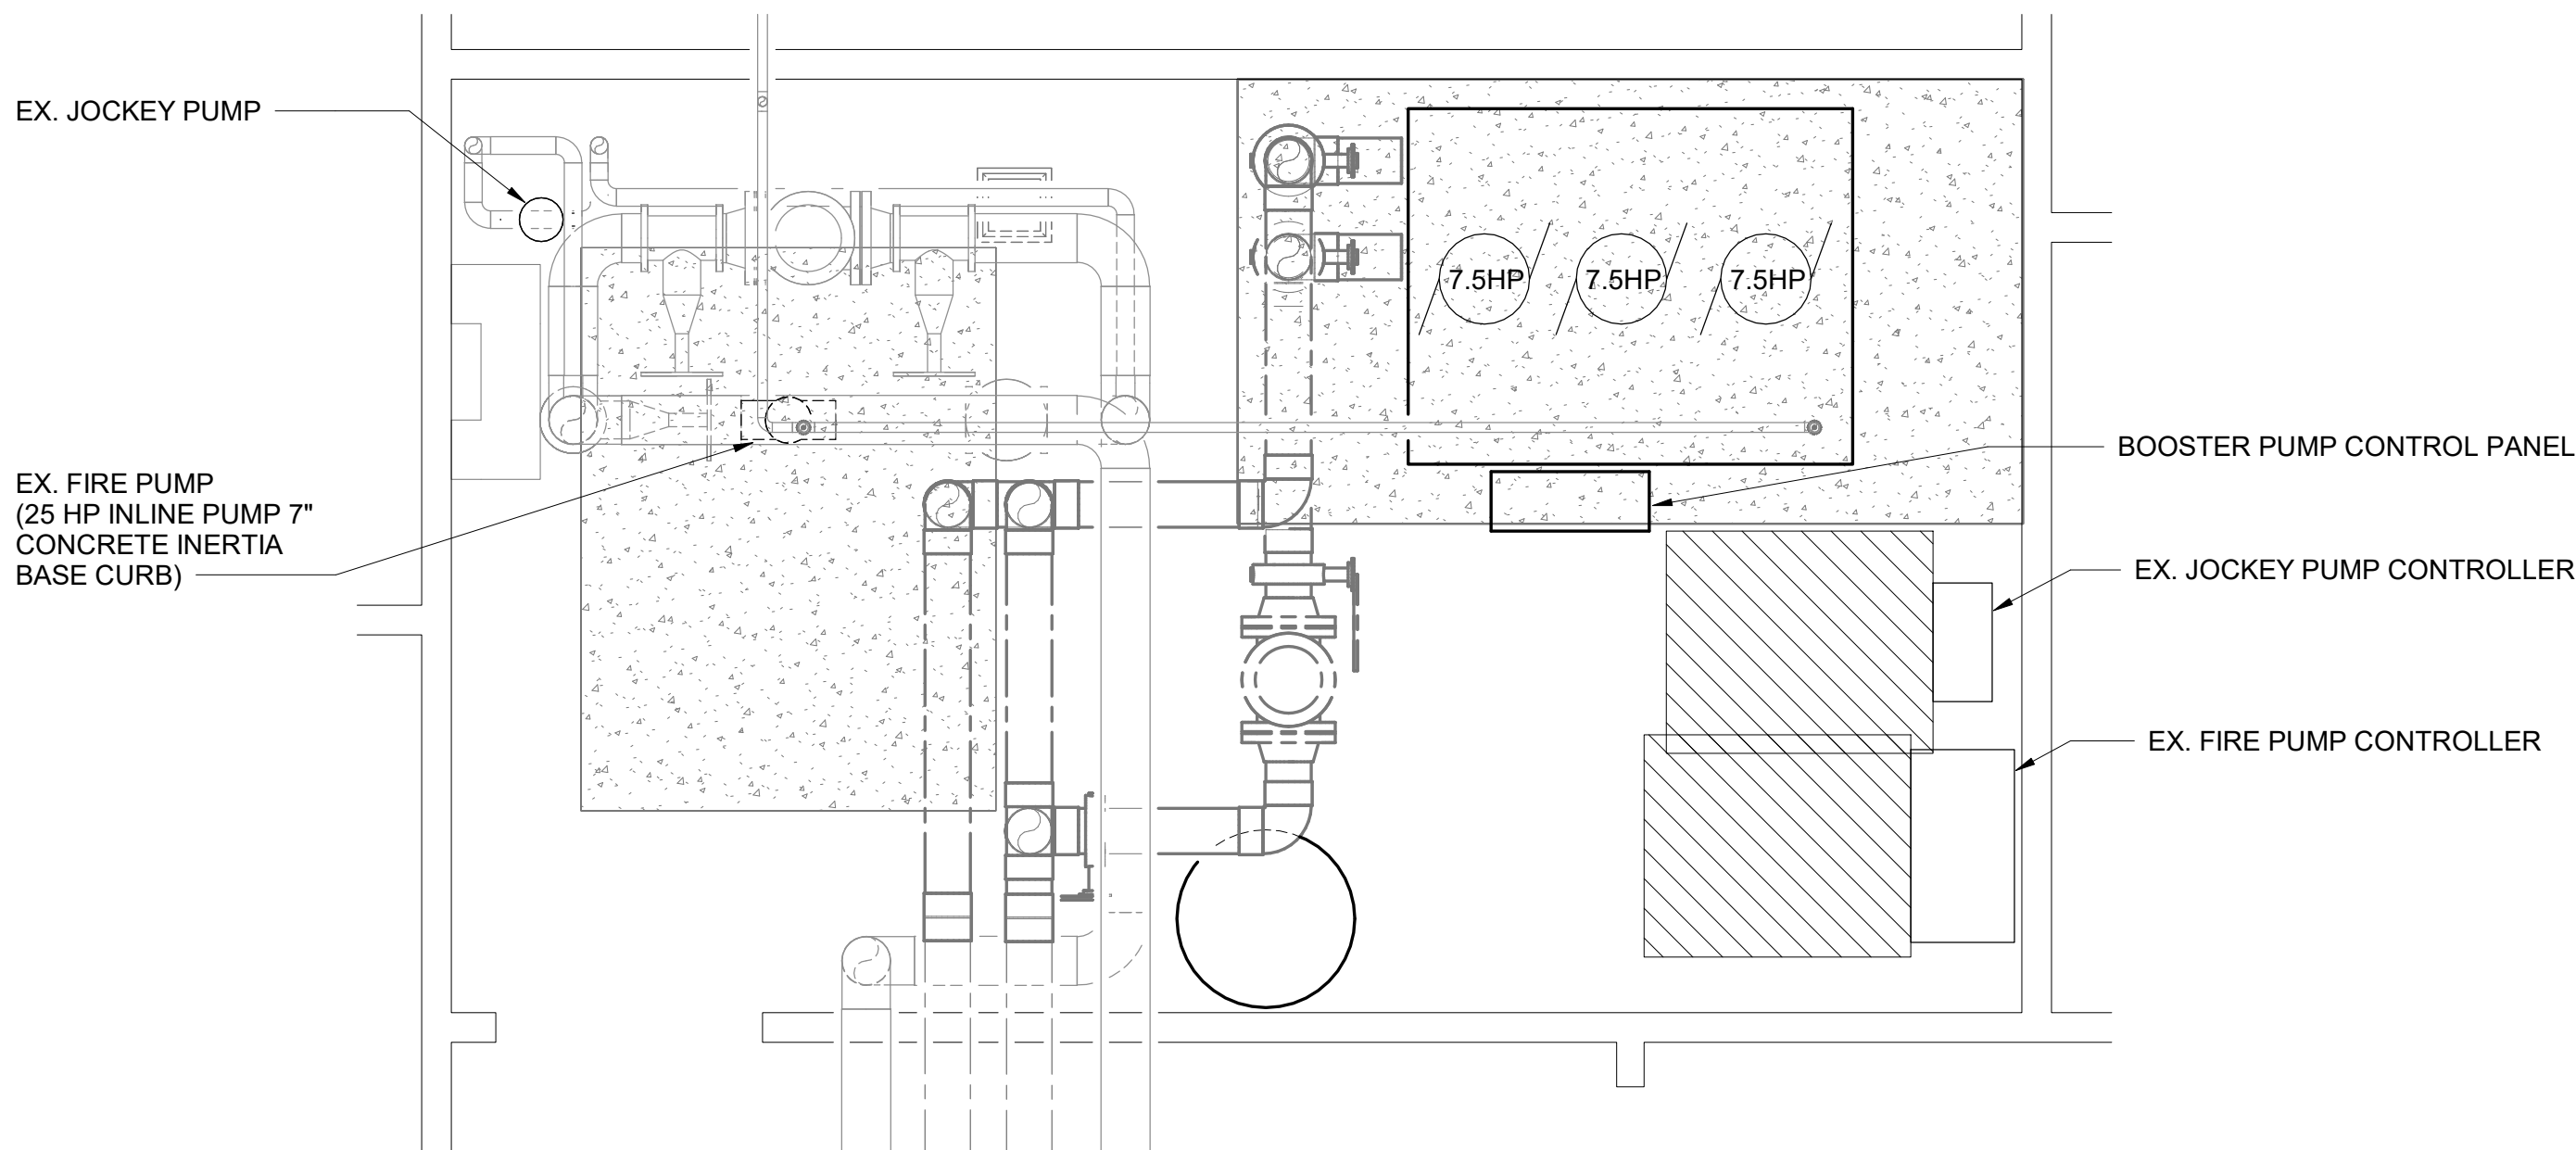


2 LEVEL 01 EXISTING ELECTRICAL PLAN MACHINE ROOM 129  
SCALE: 1/4" = 1'-0" NOTE: NOT ALL EXISTING EQUIPMENT IS SHOWN IN THE ROOM.

4 PP-1 SINGLE LINE NEW WORK  
SCALE: NONE

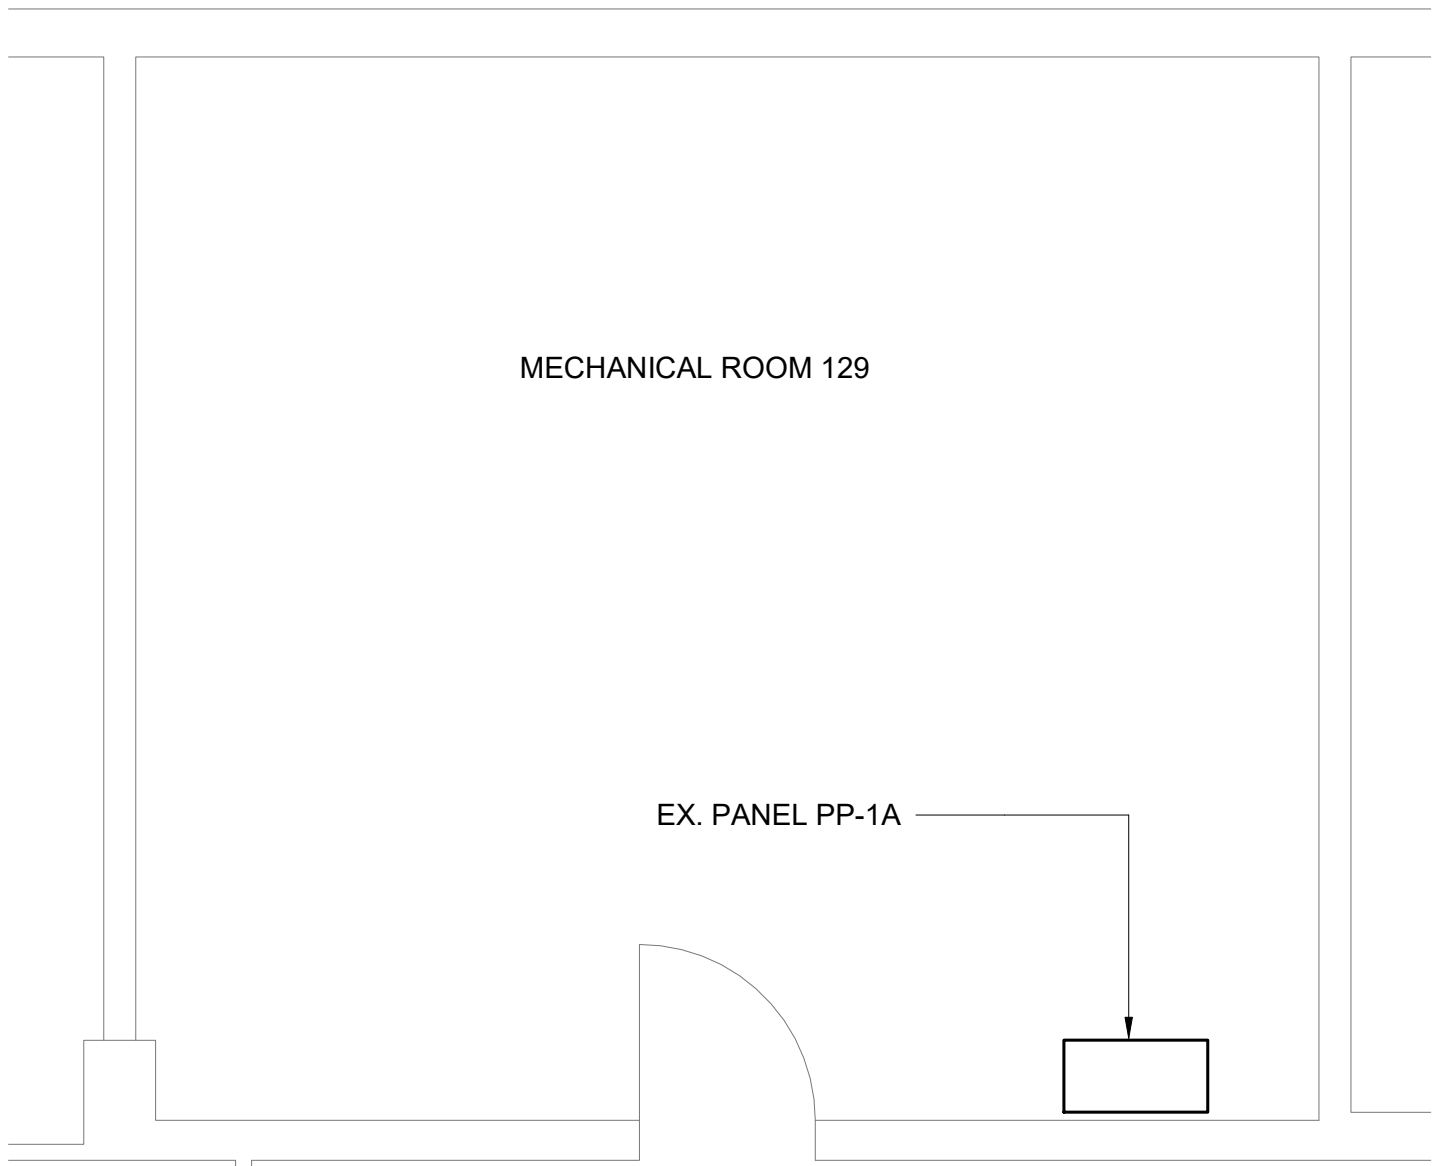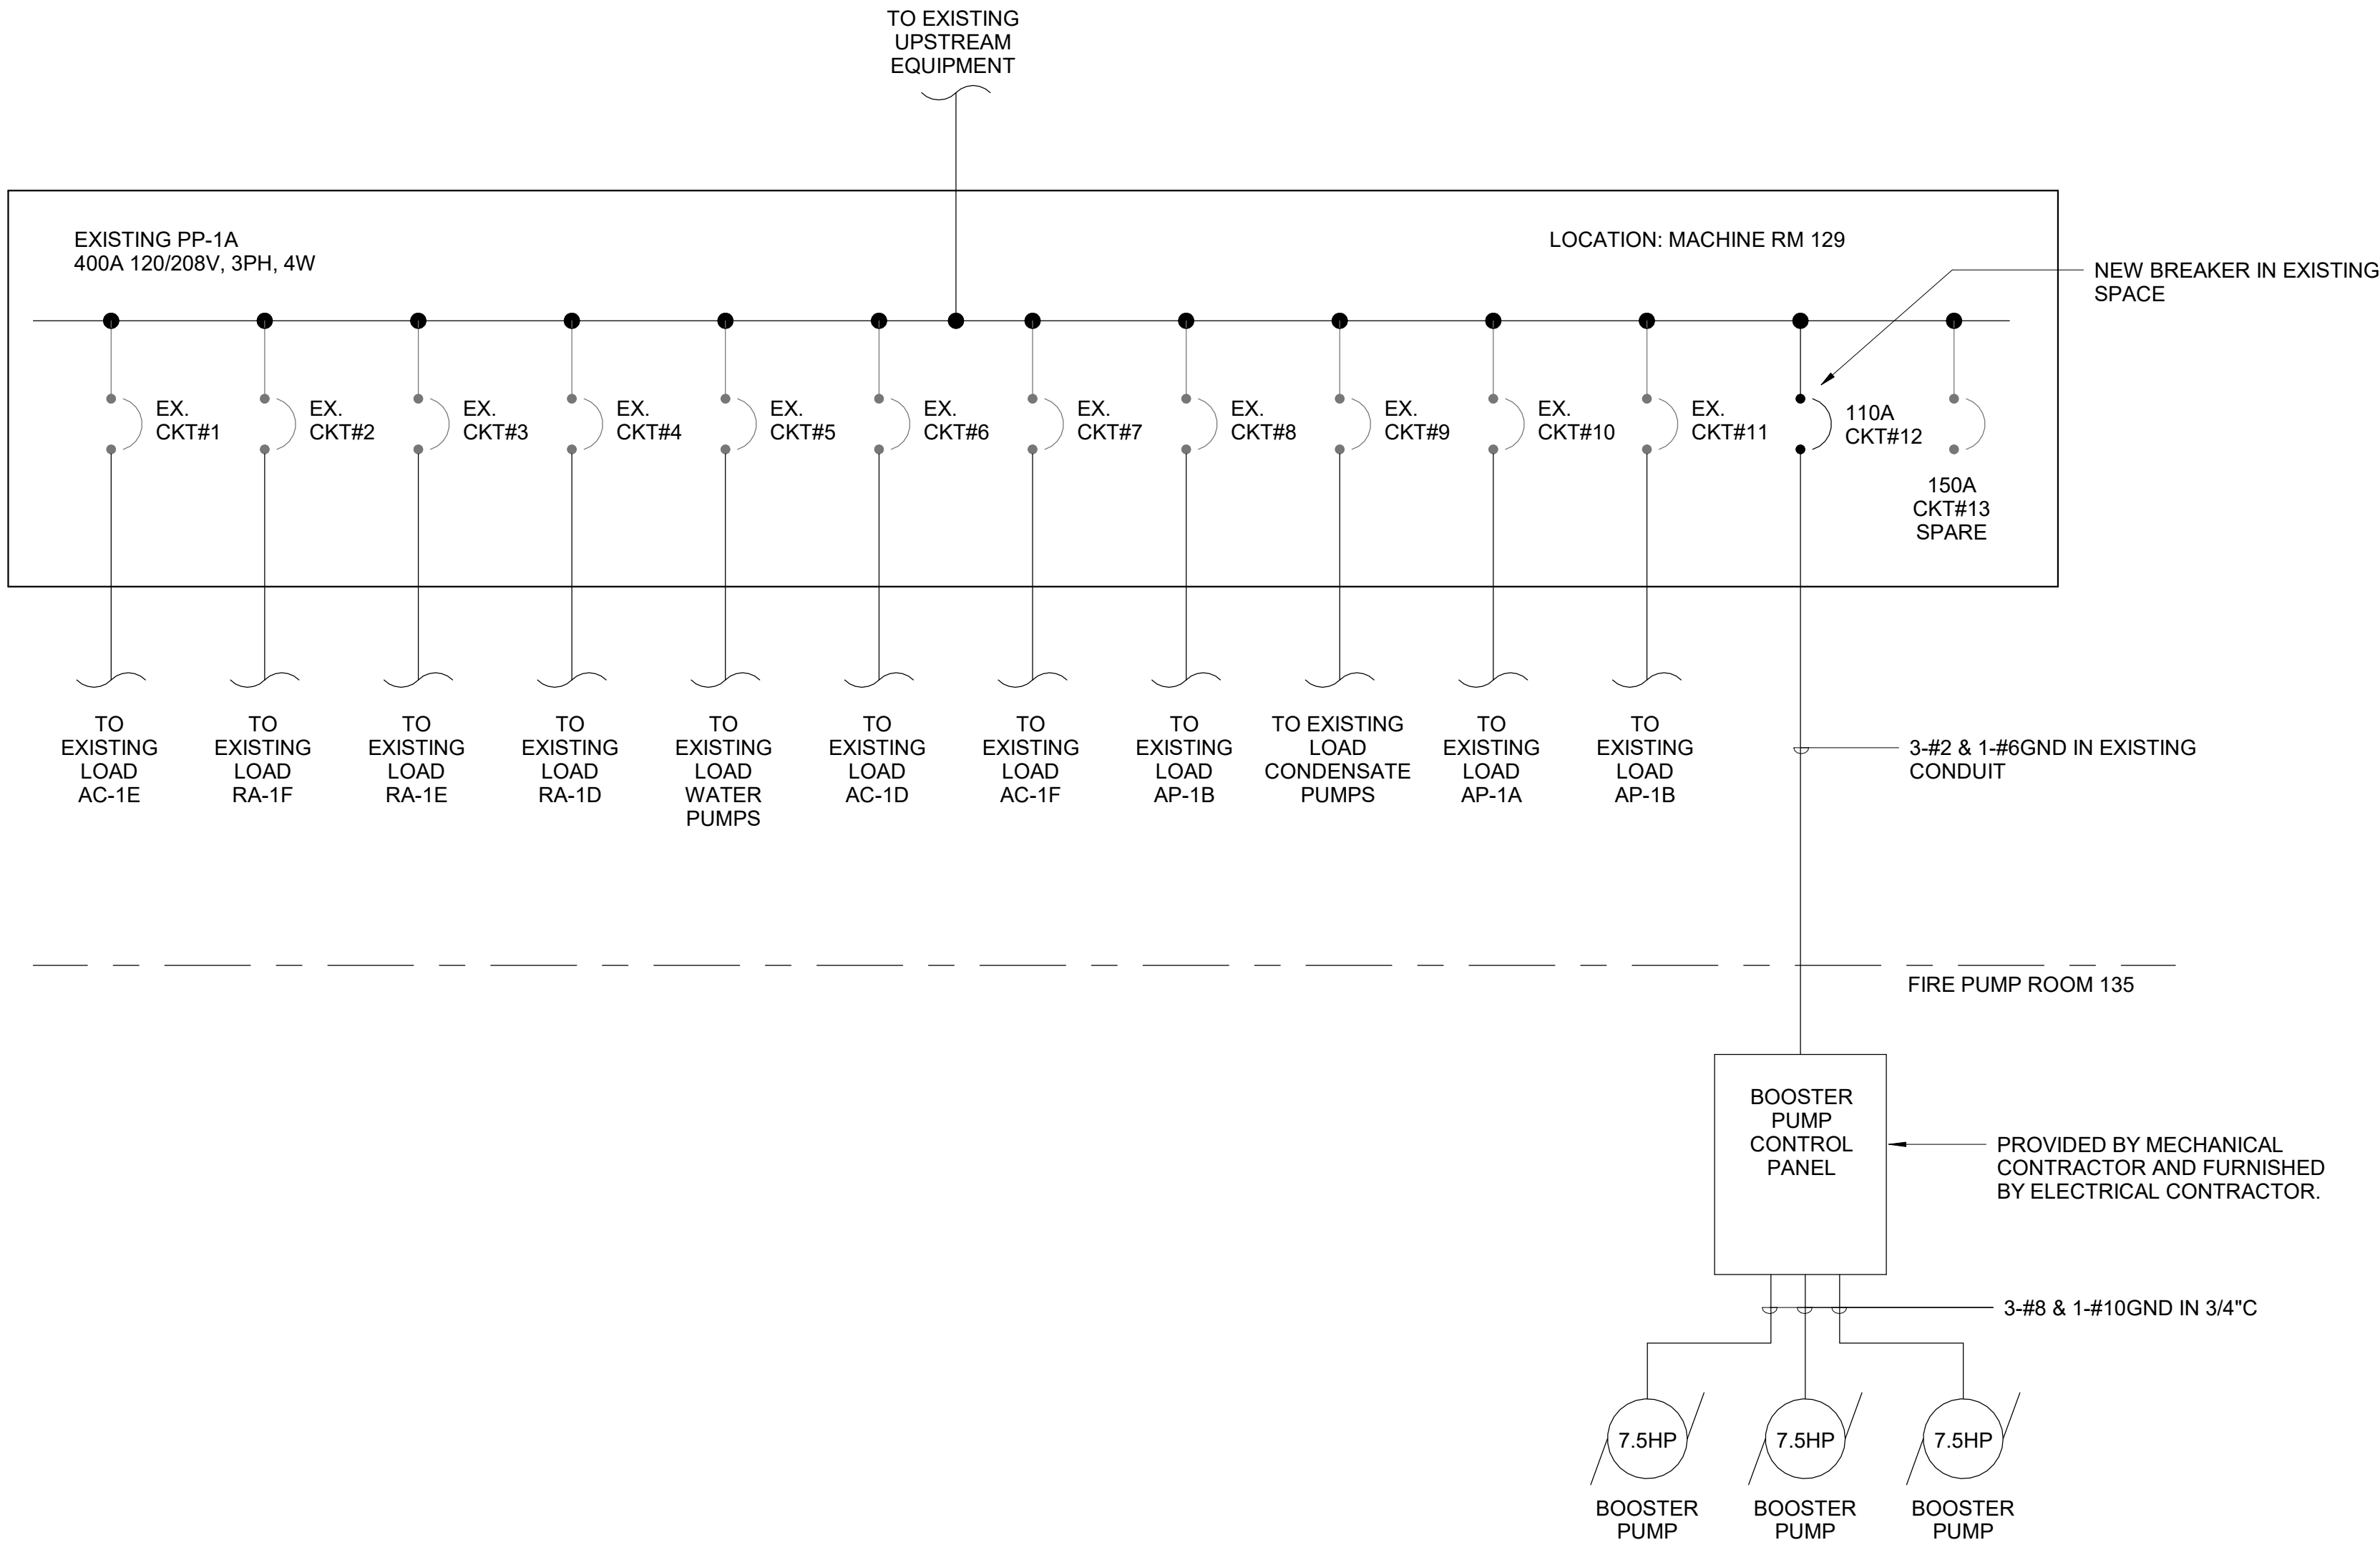

3 LEVEL 01 KEY PLAN  
SCALE: 1" = 40'-0"



1 LEVEL 01 ELECTRICAL PLAN NEW WORK  
SCALE: 1/2" = 1'-0"

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DRAWING TITLE  
**ELECTRICAL NEW WORK  
PLAN**


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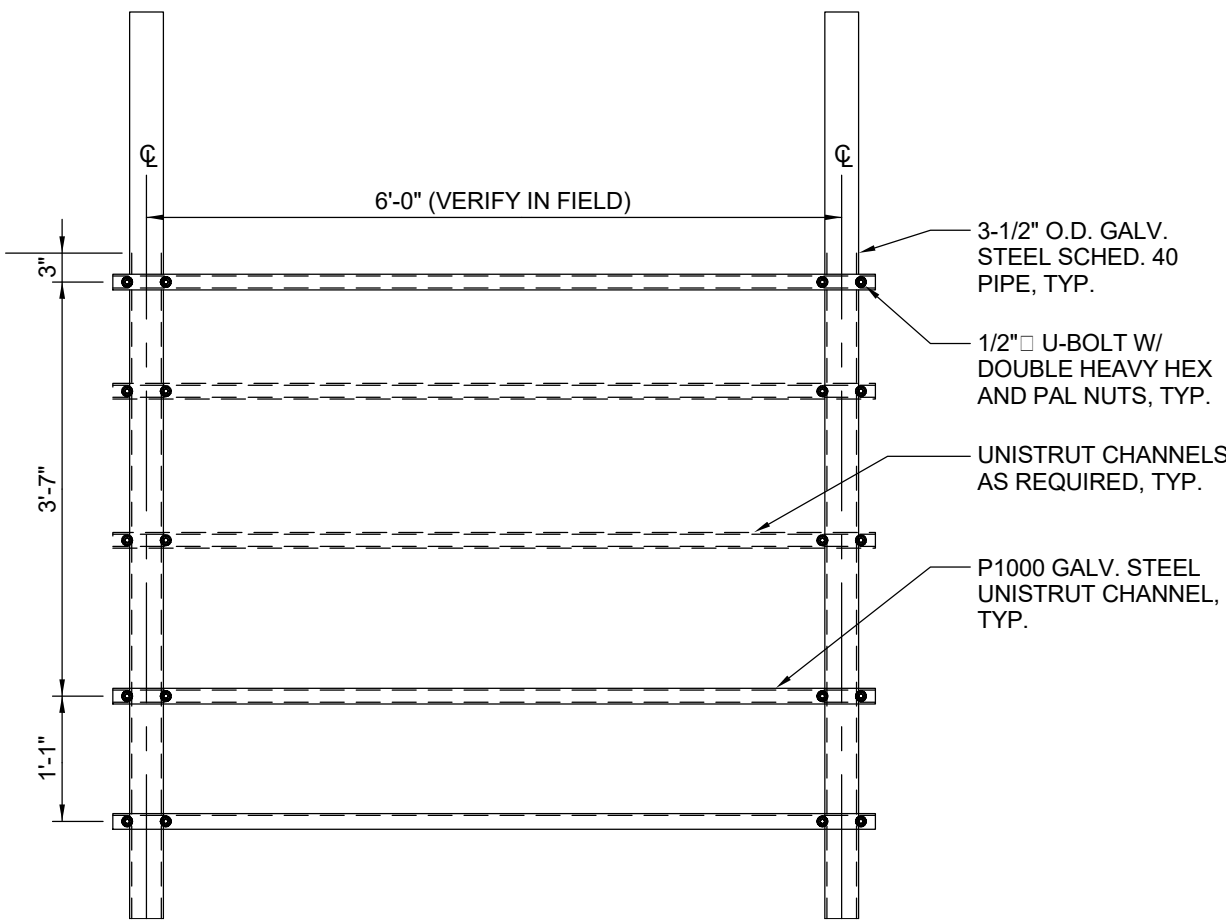
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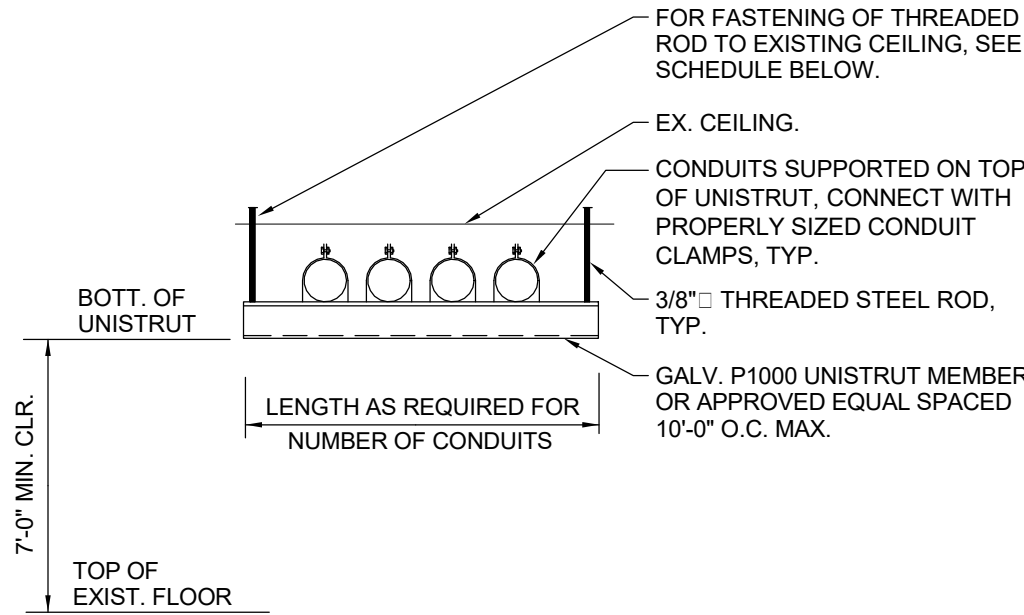
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**9** **STRUCTURAL STEEL**  
**CONDUIT SUPPORTED FROM**  
SCALE: NONE




**8** **EQUIPMENT SUPPORT FRAME DETAIL**  
SCALE: NONE  
NOTE:  
1.) DESIGN TYPICAL FOR MOUNTING ALL WALL MOUNTED POWER EQUIPMENT.




CEILING CONSTRUCTION	ANCHOR TYPE	EMBEDMENT
NORMAL WT. CONC	HILTI HDI DROP-IN ANCHOR	1" MIN.
CINDER CONCRETE	HILTI KWIK BOLT II	3" MIN.
HOLLOW CONSTRUCTION	TOGGLE BOLTS	NA

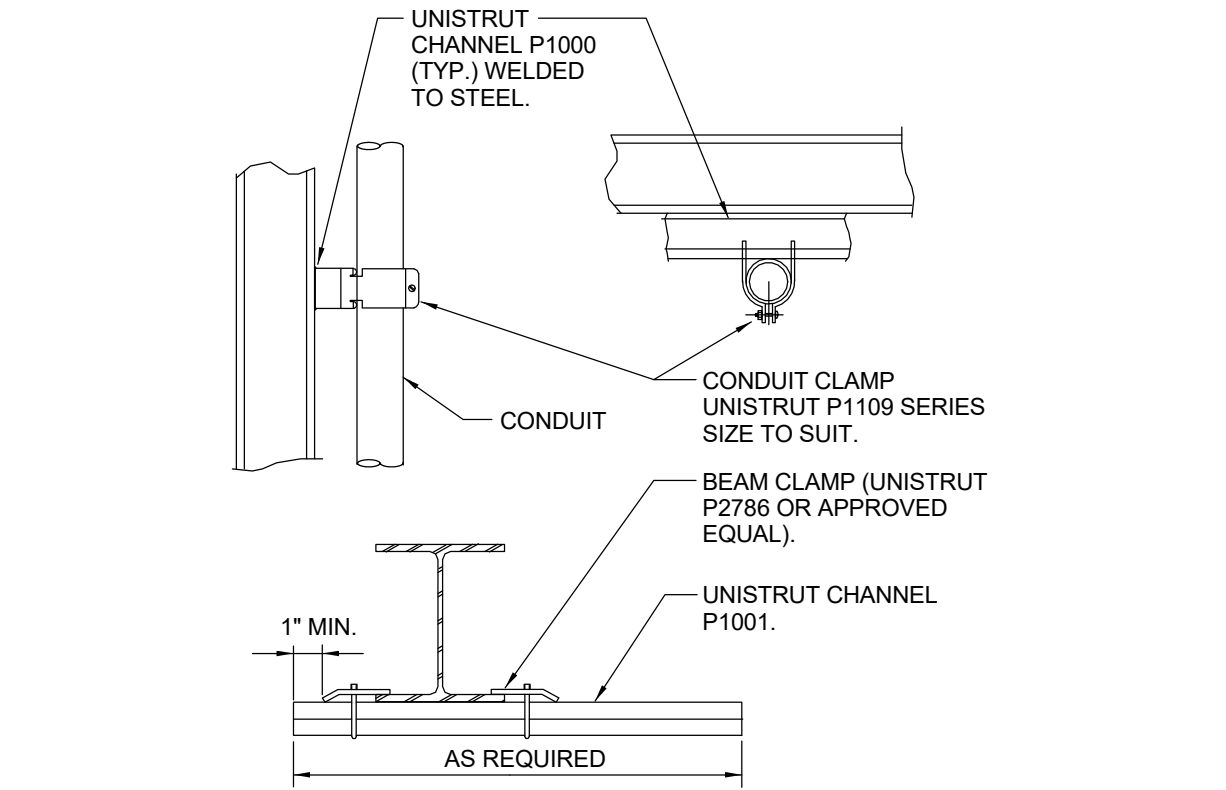
**7** **TRAPEZE SUPPORT DETAIL**  
SCALE: NONE

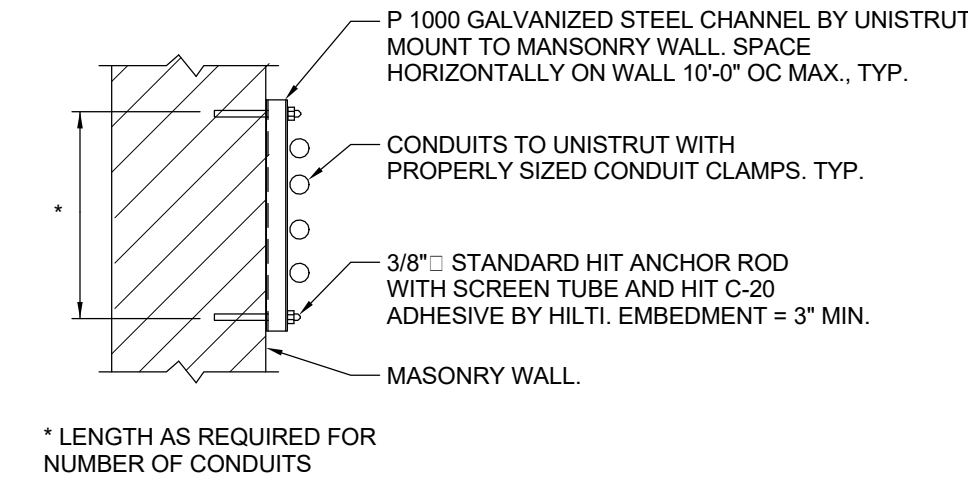


**6** **TYPICAL CONDUIT SUPPORT**  
**ON MASONRY DETAIL**  
SCALE: NONE

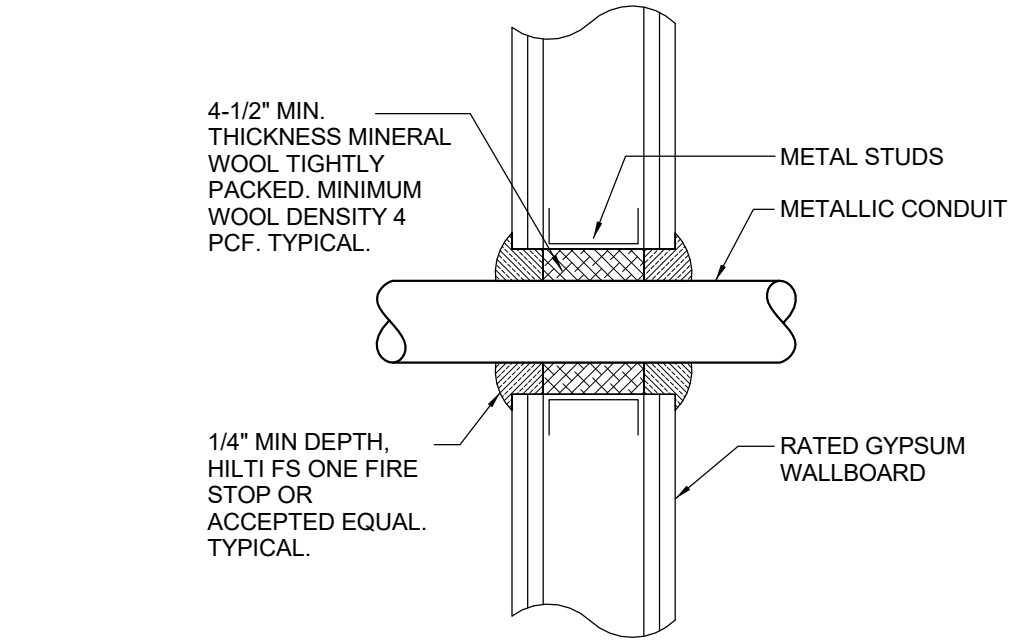


**5** **WALL PENETRATION DETAIL**  
SCALE: NONE

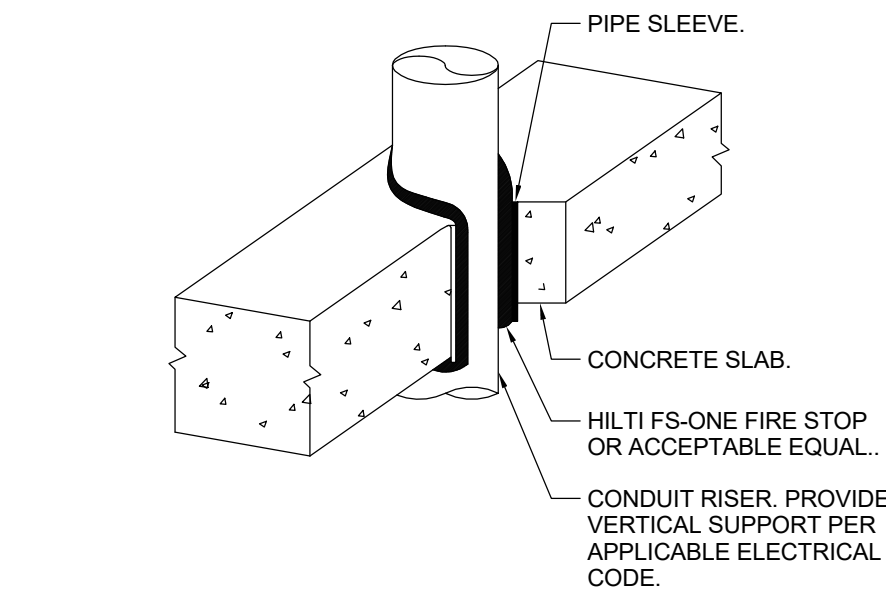


**4** **TYPICAL VERTICAL CONDUIT**  
**PENETRATION DETAIL**  
SCALE: NONE

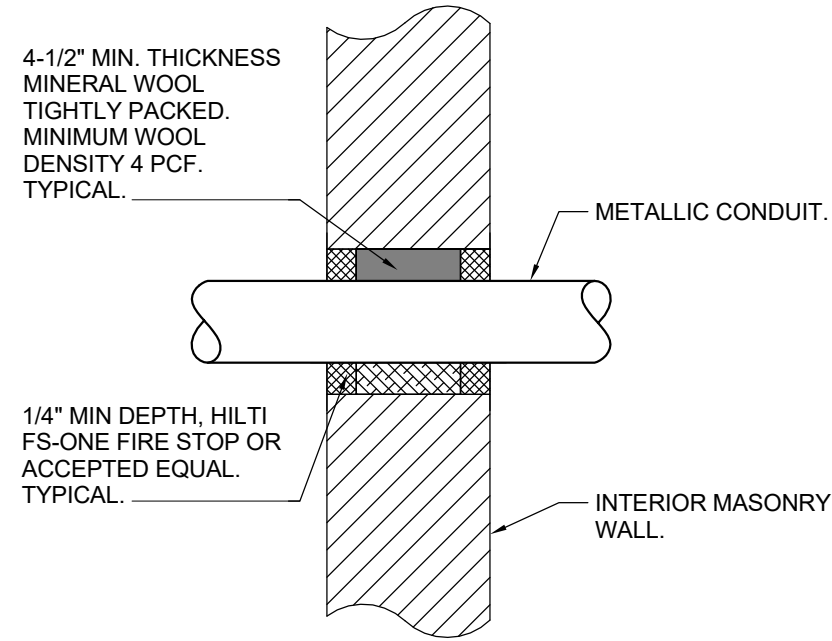

**3** **TYPICAL INTERIOR MASONRY WALL**  
**CONDUIT PENETRATION DETAIL**  
SCALE: NONE

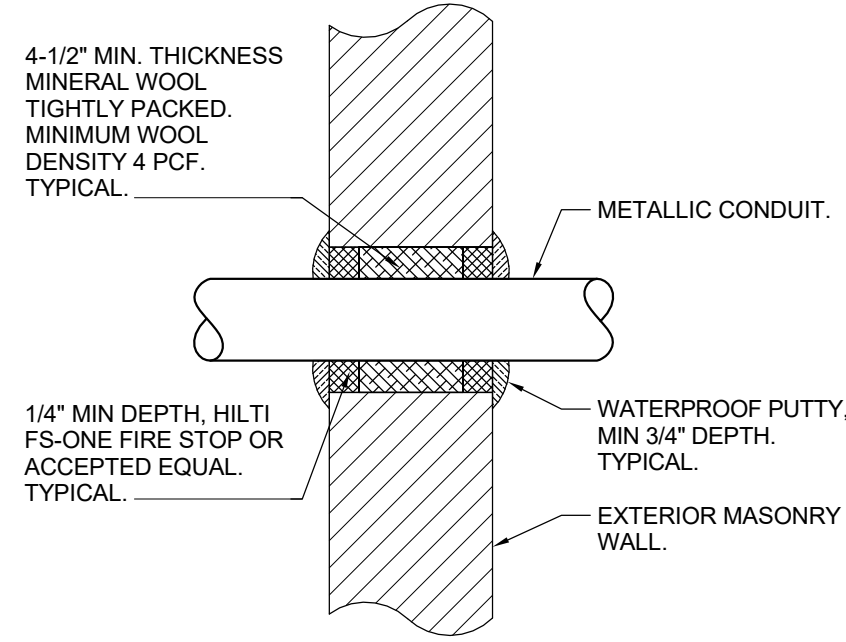

**2** **TYPICAL EXTERIOR MASONRY WALL ABOVE**  
**GRADE CONDUIT PENETRATION DETAIL**  
SCALE: NONE

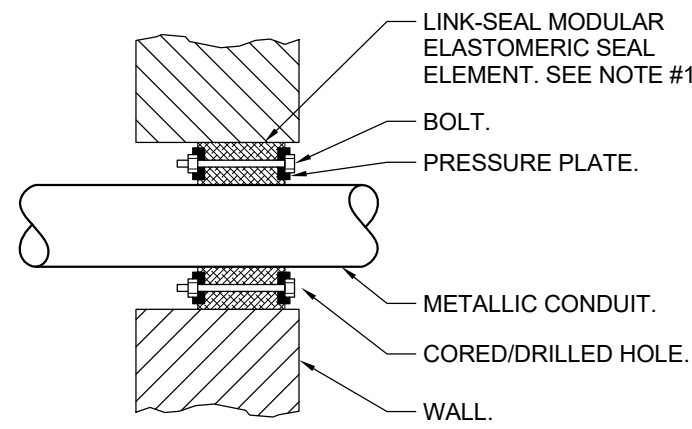

- NOTES:
1. SEAL ASSEMBLY BASED ON MODEL "C" LINK-SEAL MODULAR SEAL, WITH EPDM SEAL ELEMENT, REINFORCED NYLON POLYMER PRESSURE PLATES, STEEL WITH 2-PART ZINC DICHROMATE & CORROSION INHIBITING COATING NUTS AND BOLTS AND WITH A OPERATING TEMPERATURE RANGE OF -40°F TO +250°F.
  2. PROVIDE AND INSTALL TWO SEALS WHEN PENETRATED WALL THICKNESS IS GREATER THAN 12".
  3. PROVIDE SCHEDULE 80 WALL SLEEVE FOR NEW WALL CONSTRUCTION PER MANUFACTURER'S REQUIREMENTS.

**1** **TYPICAL EXTERIOR MASONRY WALL BELOW**  
**GRADE CONDUIT PENETRATION DETAIL**  
SCALE: NONE

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