CD	SPRINKLER PIPING					
DR	DRAIN PIPING					
	PIPING BELOW SLAB					
~~~~~~~~~~~~~~~~~~~~~~~~~~~~~~~~~~~~~~	PIPING W/FREEZE PROTECTION CABLE & INSULATION					
	SLOPED CHANGE IN PIPE ELEVATION					
+	WATER PROOF SLEEVE					
=	SLEEVE					
ÂC	ALARM CHECK VALVE W/ALL RELATED APPURTENANCES					
	CONNECT TO EXISTING					
FIRE DEPARTMENT SIAMESE CONNECTION (WALL MOUNTED)						
	MIXING VALVE					
<b>\$</b> <b>↓</b> <b>↓</b>	RELIEF VALVE					
б 🖣	BALL VALVE					
$\bowtie$	GATE VALVE					
	GLOBE VALVE					
$\mathbf{A}$	OUTSIDE SCREW & YOKE (OS & Y) VALVE					
	CHECK VALVE					
	PRESSURE REDUCING VALVE (PRV)					
	SOLENOID VALVE					
	FLOAT VALVE					
	BACKWATER VALVE					
	Y STRAINER W/BLOW-OFF VALVE					
	REDUCED PRESSURE ZONE BACKFLOW PREVENTER ASSEMBLY					
	DETECTOR CHECK VALVE ASSEMBLY					
	HYDRAULIC REF. POINTS 🛛 HELEMENT (H) NODE					
Ţ	TAMPER SWITCH					
P	WATER FLOW SWITCH					
Ŷ	PRESSURE GAUGE W/GAUGE COCK					
	TEMPERATURE GAUGE					
F	RISER DESIGNATION					

SPRINI	(LER DRAWING LIST	
SP001.00	PRINKLER COVER SHEET	
SP211.00	PRINKLER LOWER LEVEL CONSTRUCTION REFLECTED CEILING PLAN	
SP212.00	PRINKLER UPPER LEVEL CONSTRUCTION REFLECTED CEILING PLAN	
SP213.00	PRINKLER GARAGE LEVEL CONSTRUCTION REFLECTED CEILING PLAN	
SP214.00	PRINKLER GARAGE LEVEL CONSTRUCTION REFLECTED CEILING PLAN (REA	CT)
SP215.00	PRINKLER MEZZANINE LEVEL CONSTRUCTION REFLECTED CEILING PLAN	
SP400.00	PRINKLER RISER DIAGRAMS	
SP600.00	PRINKLER DETAILS	

	<u>SPRINKLER HEAD SCHEDULE</u>															
		MANUFACTURER/MODEL				T١	(PE					OPER	ATION			
DESIGINATION	REQUIRED	TYCO RELIABLE VIKING	CONCEALED	PENDANT	UPRIGHT	SIDEWALL	EXTENDED COVERAGE	FLUSH	DRY	DELUGE	K–FACTOR	ORIFICE SIZE (INCH)	TEMPERATURE (°F)	MINIMUM PRESSURE (PSI)	LISTINGS	REMAR
8	۲	G5-56	۲								5.6	1/2	165	7.0	cULus, FM	
•		F1FR56									5.6	1/2	155	7.0	cULus, FM	
		F1FR56				۲					5.6	1/2	155	7.0	cULus, FM	



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#### GENERAL NOTES

- 1. ALL WORK SHALL CONFORM TO THE REQUIREMENTS OF THE NEW YORK STATE BUILDING CODE, FIRE DEPARTMENT RULES AND REGULATIONS, UTILITY COMPANY REQUIREMENTS, AND THE BEST TRADE PRACTICES.
- 2. BEFORE COMMENCING WORK, THE CONTRACTOR SHALL FILE ALL REQUIRED INSURANCE CERTIFICATES WITH THE DEPARTMENT OF BUILDINGS, OBTAIN ALL REQUIRED PERMITS, AND PAY ALL FEES REQUIRED BY THE GOVERNING AGENCIES OF ROCKLAND COUNTY. CONTRACTOR SHALL PRESENT PACKAGE OF ALL PERMITS, INSURANCE CERTIFICATES, AND FEES PAID TO OWNER PRIOR TO START OF PROJECT.
- 3. MINOR DETAILS NOT USUALLY SHOWN OR SPECIFIED, BUT REQUIRED FOR PROPER CONSTRUCTION OF ANY PART OF THE WORK SHALL BE INCLUDED AS IF THEY WERE INDICATED IN THE DRAWINGS.
- 4. THE CONTRACTOR SHALL COORDINATE ALL WORK PROCEDURES WITH THE STIPULATIONS OF LOCAL AUTHORITIES, SITE MANAGEMENT OR BOARD OF DIRECTORS.
- 5. THE CONTRACTOR SHALL BE RESPONSIBLE FOR THE PROTECTION OF ALL CONDITIONS AND MATERIALS WITHIN THE PROPOSED CONSTRUCTION AREA. THE CONTRACTOR SHALL DESIGN AND INSTALL ADEQUATE SHORING AND BRACING FOR ALL STRUCTURAL OR REMOVAL TASKS. THE CONTRACTOR SHALL HAVE SOLE RESPONSIBILITY FOR ANY DAMAGE OR INJURIES CAUSED BY OR DURING THE EXECUTION OF THE WORK.
- 6. THE CONTRACTOR SHALL LAY OUT HIS OWN WORK, AND SHALL PROVIDE ALL DIMENSIONS REQUIRED FOR OTHER TRADES: PLUMBING, ELECTRICALS, ETC.
- 7. PLUMBING WORK SHALL BE PERFORMED BY PERSONS LICENSED IN THEIR TRADES, WHO SHALL ARRANGE FOR AND OBTAIN THROUGH THE DEPARTMENT OF BUILDINGS ALL REQUIRED PERMITS, INSPECTIONS AND REQUIRED SIGN OFFS.
- 8. ELECTRICAL WORK SHALL BE PERFORMED BY PERSONS LICENSED IN THEIR TRADES, WHO SHALL ARRANGE FOR AND OBTAIN THROUGH THE BUREAU OF ELECTRICAL CONTROL ALL REQUIRED PERMITS, INSPECTIONS AND REQUIRED SIGN OFFS.
- 9. THE CONTRACTOR SHALL DO ALL CUTTING, PATCHING, REPARING AS REQUIRED TO PERFORM ALL OF THE WORK INDICATED ON THE DRAWINGS, AND ALL OTHER WORK THAT MAY BE REQUIRED TO COMPLETE THE JOB.

#### SPRINKLER DESIGN CRITERIA

- NFPA 13-16.
- 2. SPRINKLERS ARE QUICK RESPONSE.
- 3. OCCUPANCY CRITERIA
  - A. <u>LIGHT HAZARD</u>
  - B. ORDINARY HAZARD GROUP 1

A. EXACT LOCATION OF SPRINKLER HEADS IN FINISHED AREAS WITH SUSPENDED CEILINGS SHALL BE AS INDICATED ON ARCHITECTURAL REFLECTED CEILING PLANS WITH HEADS IN CENTER OF TILES.

- EQUIVALENT FEET OF PIPE.
- BY 30%
- 5. FLOW TEST DATA:

**I**ARKS

1. THE SPRINKLER SYSTEM IN THIS BUILDING SHALL BE IN ACCORDANCE WITH 2020 NYS BUILDING CODE AND

OFFICE SPACE, RESTROOMS, LOBBYS, DENSITY 0.10 GPM/SQ.FT. @900 SQ.FT.

MECHANICAL AND STORAGE ROOMS, GARAGES DENSITY 0.15 GPM PER SQ. FT OVER MOST HYDRAULICALLY REMOTE 1500 SQ. FT. MAXIMUM COVERAGE PER SPRINKLER HEAD 130 SQ. FT. 2,000 SQ. FT. MAXIMUM AREA LIMITATION.

4. HYDRAULICALLY CALCULATED SYSTEMS SHALL MEET THE FOLLOWING CRITERIA:

B. WHENEVER ROLLED GROOVED CONNECTIONS ARE USED, ALLOWANCE FOR ADDITIONAL PRESSURE LOSS AT GROOVES SHALL BE MADE AS FOLLOWS:

B.1. FOR EACH COUPLING ON STRAIGHT RUN INCLUDING STRAIGHT FLOW THROUGH TEE OR CROSS: ADD 1 EQUIVALENT FOOT OF PIPE. B.2. FOR EACH COUPLING AT ELBOW, TEE OR CROSS WHERE DIRECTION OF FLOW CHANGES: ADD 2

C. EQUIVALENT FITTING LENGTHS USED IN HYDRAULIC CALCULATIONS SHALL BE IN ACCORDANCE WITH NFPA STANDARD NO. 13 AS REFERENCED BY THE NYC BC. WHEREVER FITTINGS ARE USED IN CONJUNCTION WITH SCHEDULE 40 PIPE, EQUIVALENT FITTING LENGTHS INDICATED IN NFPA 13 SHALL BE INCREASED

D. DISCHARGE FROM EACH SPRINKLER HEAD SHALL NOT BE LESS THAN REQUIRED FOR AREA COVERED BY THE HEAD. AREA COVERAGE PER HEAD SHALL BE DETERMINED IN ACCORDANCE WITH NFPA STANDARD NO. 13, PARAGRAPH 23.4.4.7.1, AS REFERENCED BY NYS BC.

E. HYDRAULIC CALCULATIONS SHALL BE BROUGHT BACK TO CONNECTION TO WATER SUPPLY.

A. CONTRACTOR SHALL OBTAIN FLOW DATA INDICATING RESIDUAL PRESSURES ASSOCIATED WITH BUILDING SYSTEM AND SUBMIT DATA WITH HYDRAULIC CALCULATIONS.

B. THESE HYDRAULIC CALCULATIONS ALONG WITH PUMP OR WATER FLOW TEST ARE TO BE SUBMITTED FOR APPROVAL TO THE ENGINEER AND TO THE INSURANCE UNDERWRITER HYDRAULIC CALCULATIONS SHALL BE BROUGHT BACK TO THE LOCATION OF THE PUMP OR WATER FLOW TEST.

C. CONSTRUCTION MAY ONLY BEGIN WHEN APPROVALS ARE GRANTED.

D. RESULT OF HYDRAULIC CALCULATIONS SHALL INDICATE MINIMUM 10% PRESSURE SAFETY MARGIN, I.E., EXCESS OF PRESSURE AVAILABLE OVER PRESSURE REQUIRED.

E. PRELIMINARY WATER SUPPLY INFORMATION.



Robert H. Gruffi, P.E., LEED AP Director Facilities Management

Dr. Robert L. Yeager Health Center 50 Sanatorium Road Building A, 2nd Floor Pomona, NY 10970




#### Associates Architects D.P.C.

#### **333 Westchester Avenue** White Plains, New York 10604 914-741-1115



445 HAMILTON AVE, SUITE 608 White Plains, NY 10601 (914) 332-7658

ISSUE NO.5	09/03/2024	ISSUED FOR BID
ISSUE NO.4	07/10/2024	UPDATED 100% CONSTRUCTION DOCUMENT SUBMISSION
ISSUE NO.3	06/06/2024	100% CD SUBMISSION
ISSUE NO.2	03/29/2024	90% CD SUBMISSION
ISSUE NO.1	12/14/2023	60% SUBMISSION
ISSUE NO.	ISSUE DATE	DESCRIPTION

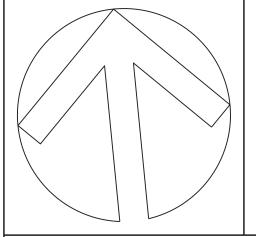



## **CAPITAL PROJECT #1521**

## **SHERIFF'S OPERATIONS** BUILDING

23 NEW HEMPSTEAD RD NEW CITY, NY 10956

#### SPRINKLER COVER SHEET


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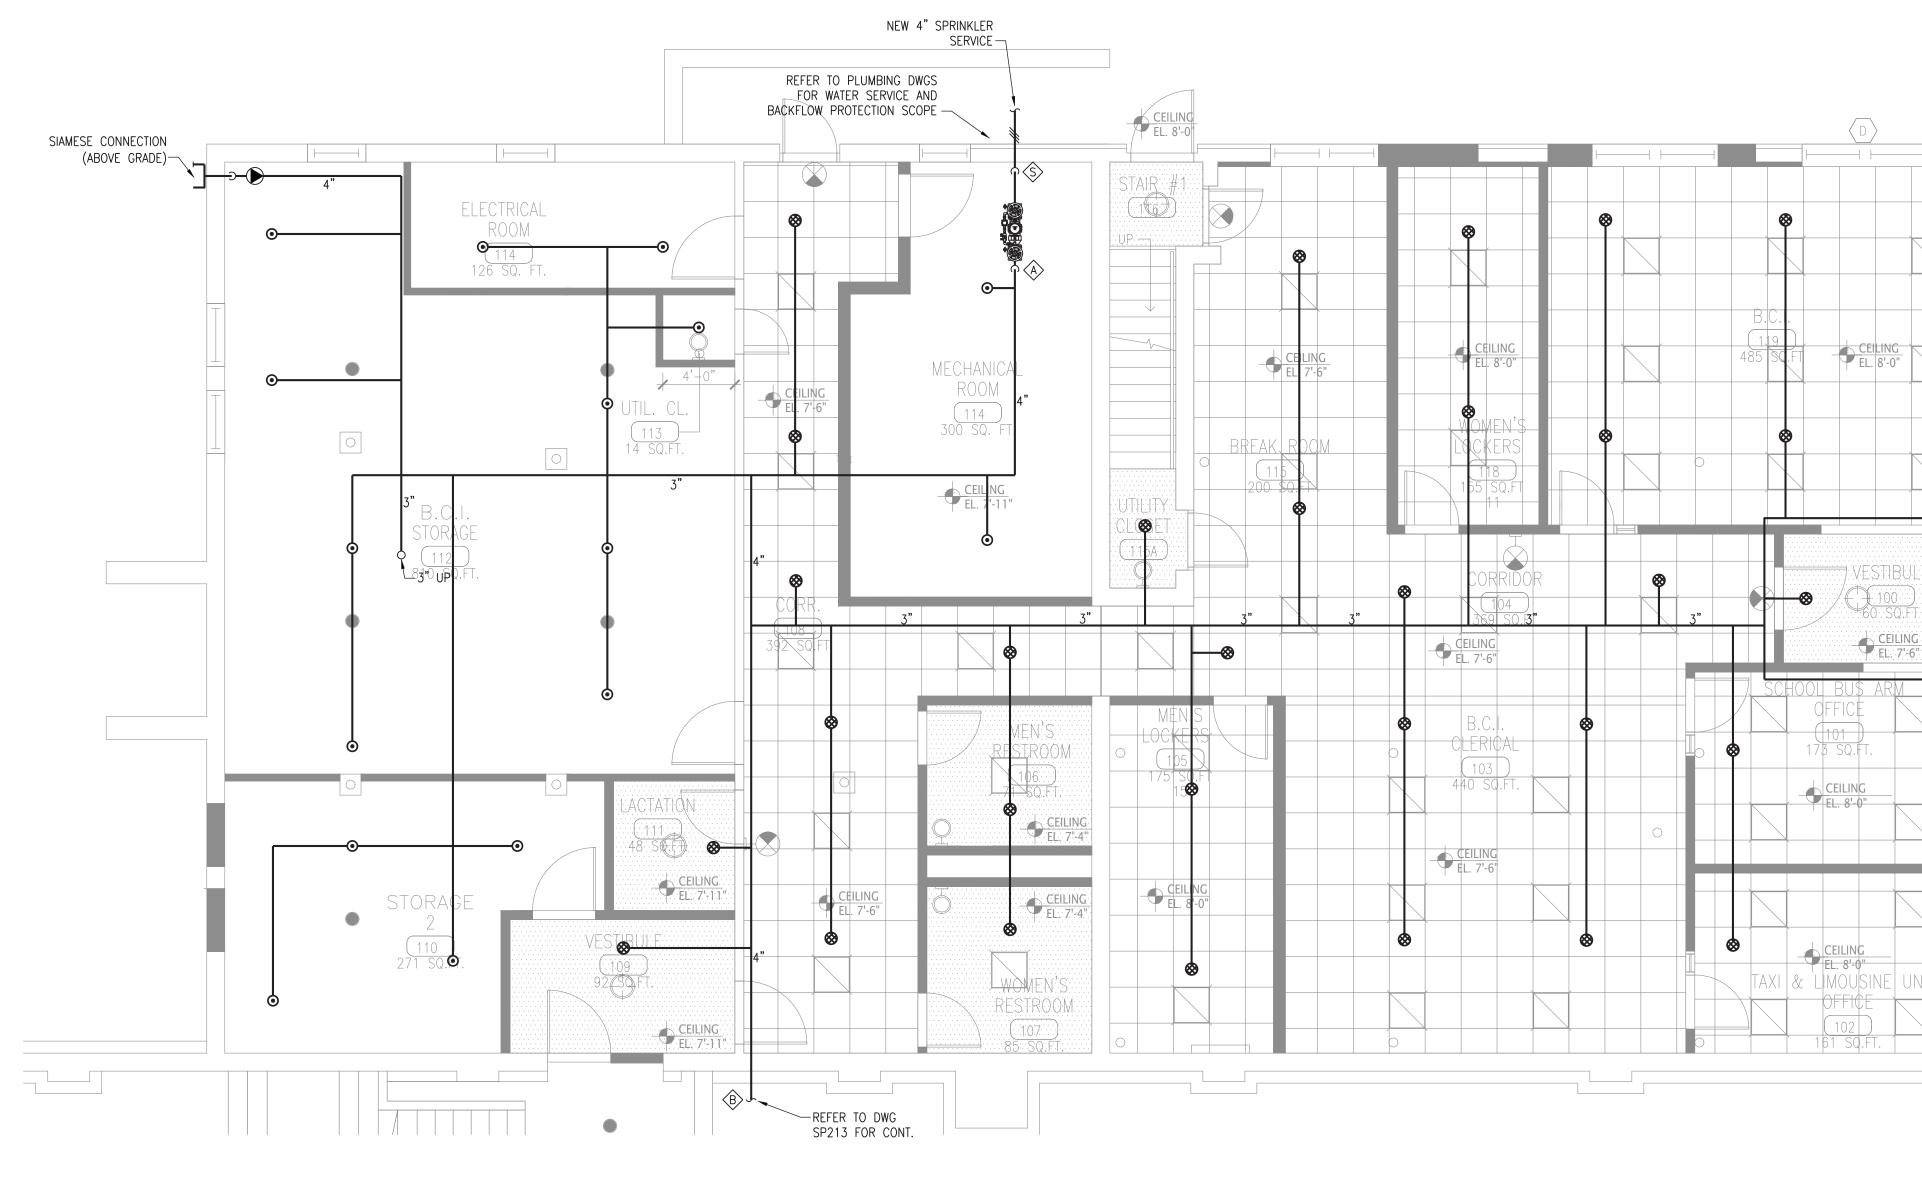
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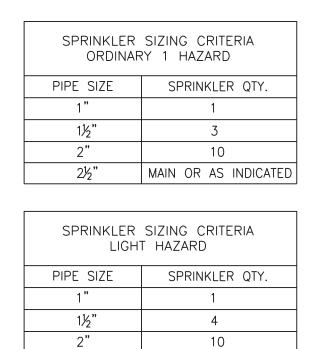
25097 SCALE:

AS NOTED

# SP001.00






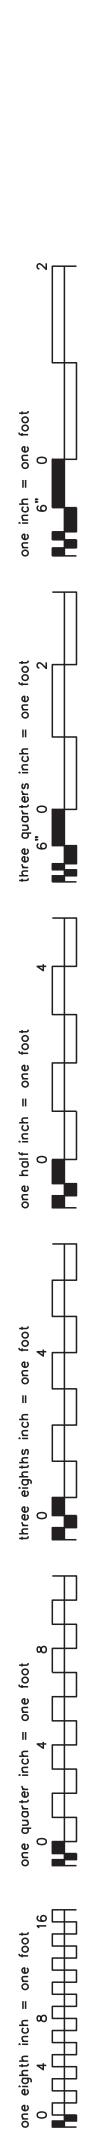


2½"

MAIN OR AS INDICATED



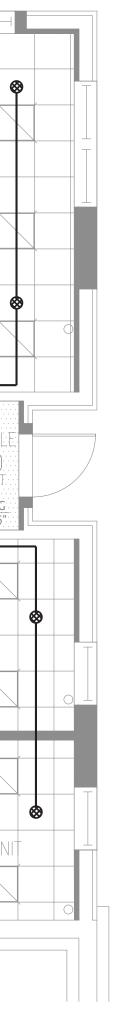


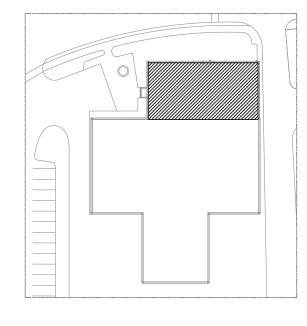





ISSUE NO.5 09/03/2024 ISSUED FOR BID UPDATED 100% CONSTRUCTION DOCUMENT SUBMISSION ISSUE NO.4 07/10/2024 06/06/2024 100% CD SUBMISSION ISSUE NO.3 90% CD SUBMISSION 03/29/2024 ISSUE NO.2 60% SUBMISSION ISSUE NO.1 12/14/2023 ISSUE DATE DESCRIPTION ISSUE NO.

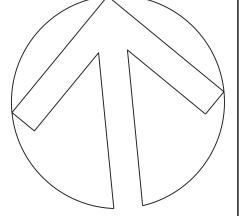



## CAPITAL PROJECT #1521

# SHERIFF'S OPERATIONS BUILDING

23 NEW HEMPSTEAD RD NEW CITY, NY 10956

### SPRINKLER LOWER LEVEL CONSTRUCTION REFLECTED CEILING PLAN


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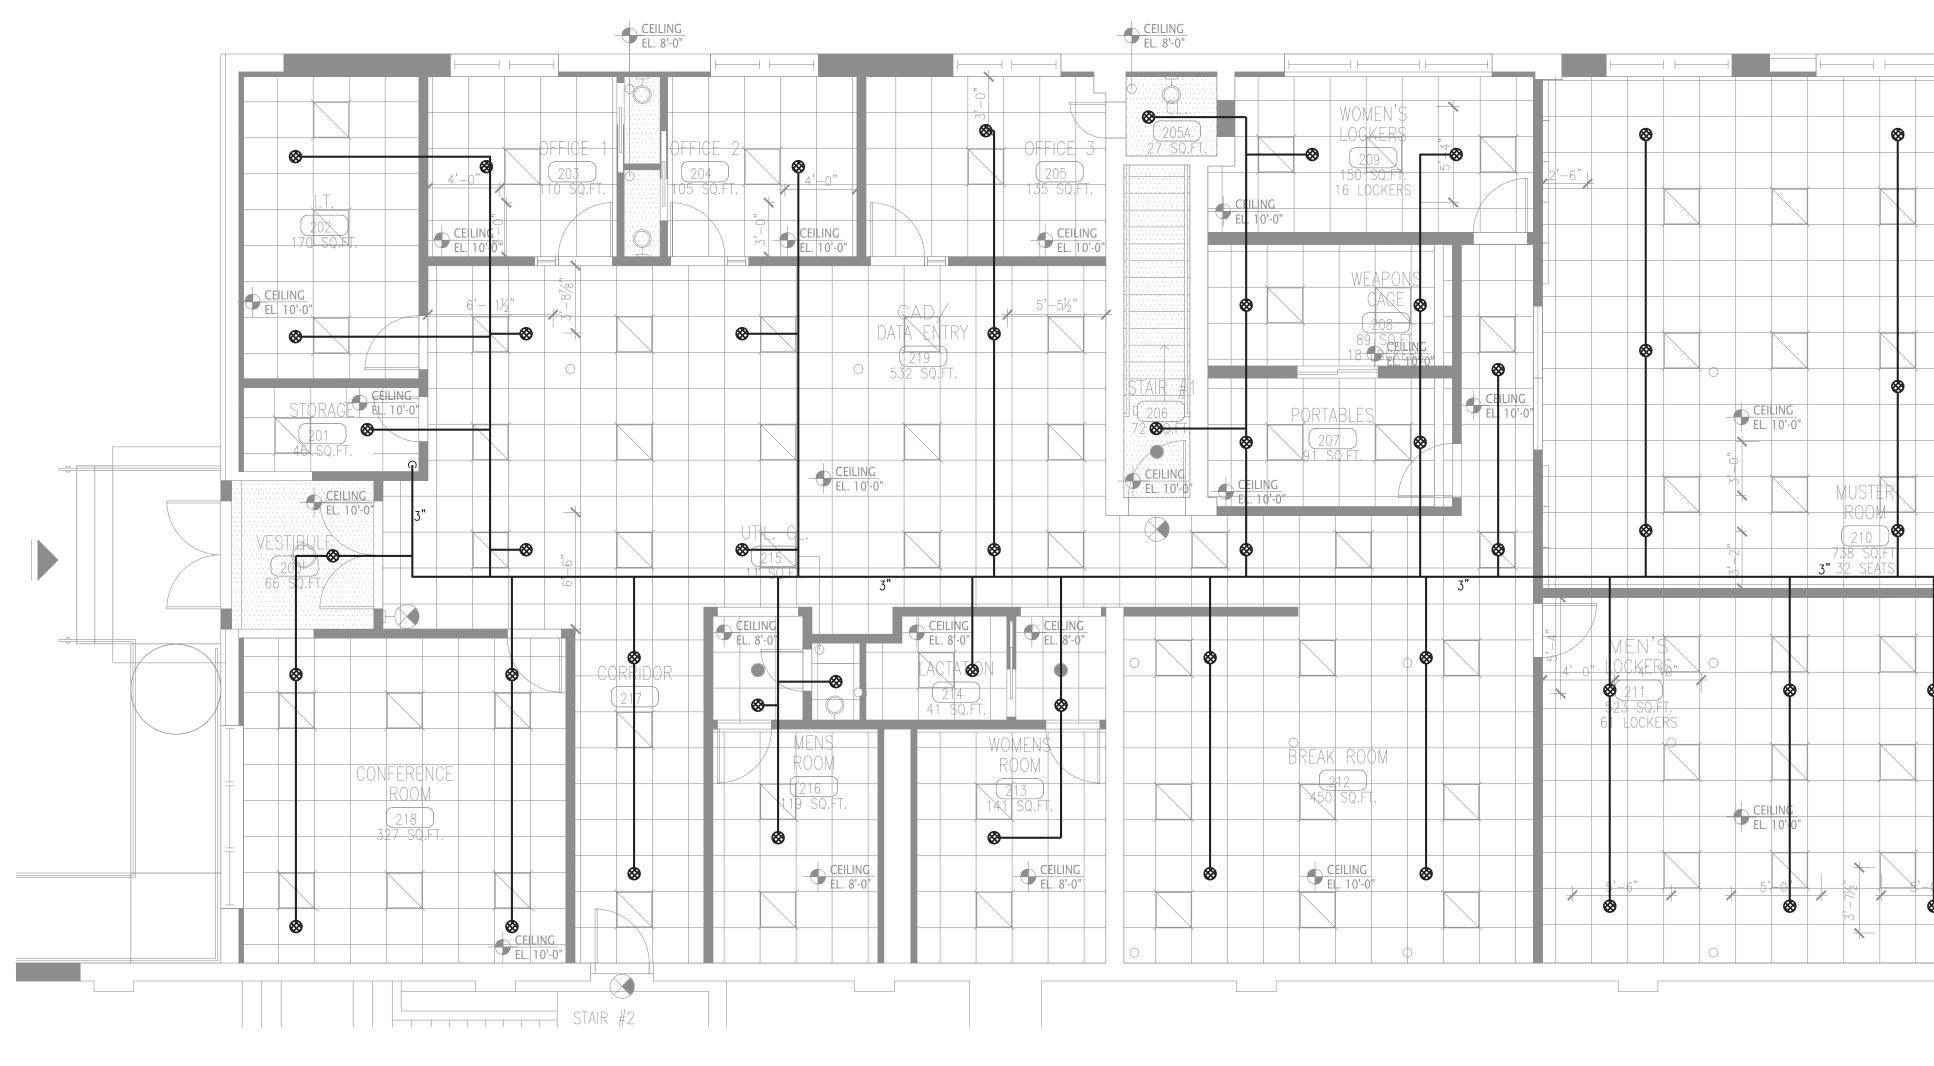
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25097 SCALE:

AS NOTED






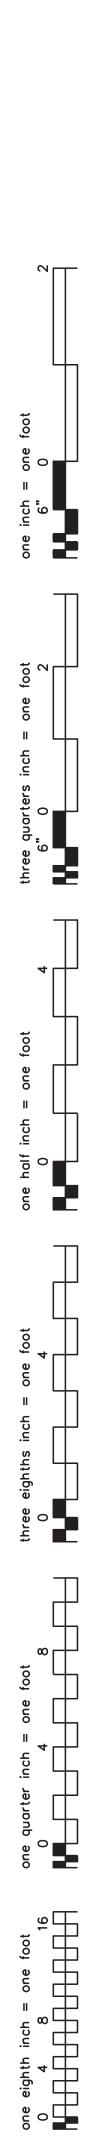


ORDINA	RY 1 HAZARD
PIPE SIZE	SPRINKLER QTY.
1 "	1
11/2"	3
2"	10
21/2"	MAIN OR AS INDICATED

SPRINKLER SIZING CRITERIA LIGHT HAZARD					
PIPE SIZE	SPRINKLER QTY.				
1"	1				
1½"	4				
2"	10				
21/2"	MAIN OR AS INDICATED				

) UPPER LEVEL CONSTRUCTION REFLECTED CEILING PLAN SCALE: 3/16"=1'-0"

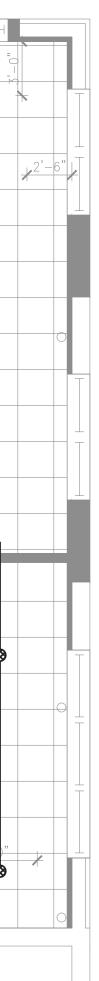

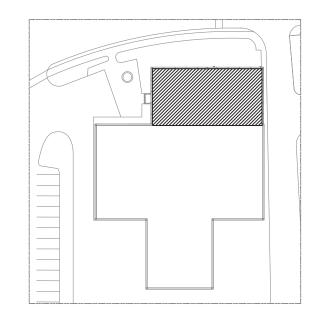





CAPITAL PROJECT #1521

90% CD SUBMISSION

60% SUBMISSION

DESCRIPTION

03/29/2024

12/14/2023

ISSUE DATE

ISSUE NO.2

ISSUE NO.1

ISSUE NO.

# SHERIFF'S OPERATIONS BUILDING

23 NEW HEMPSTEAD RD NEW CITY, NY 10956

### SPRINKLER UPPER LEVEL CONSTRUCTION REFLECTED CEILING PLAN

PROJECT NO.:

DRAWING NO .:


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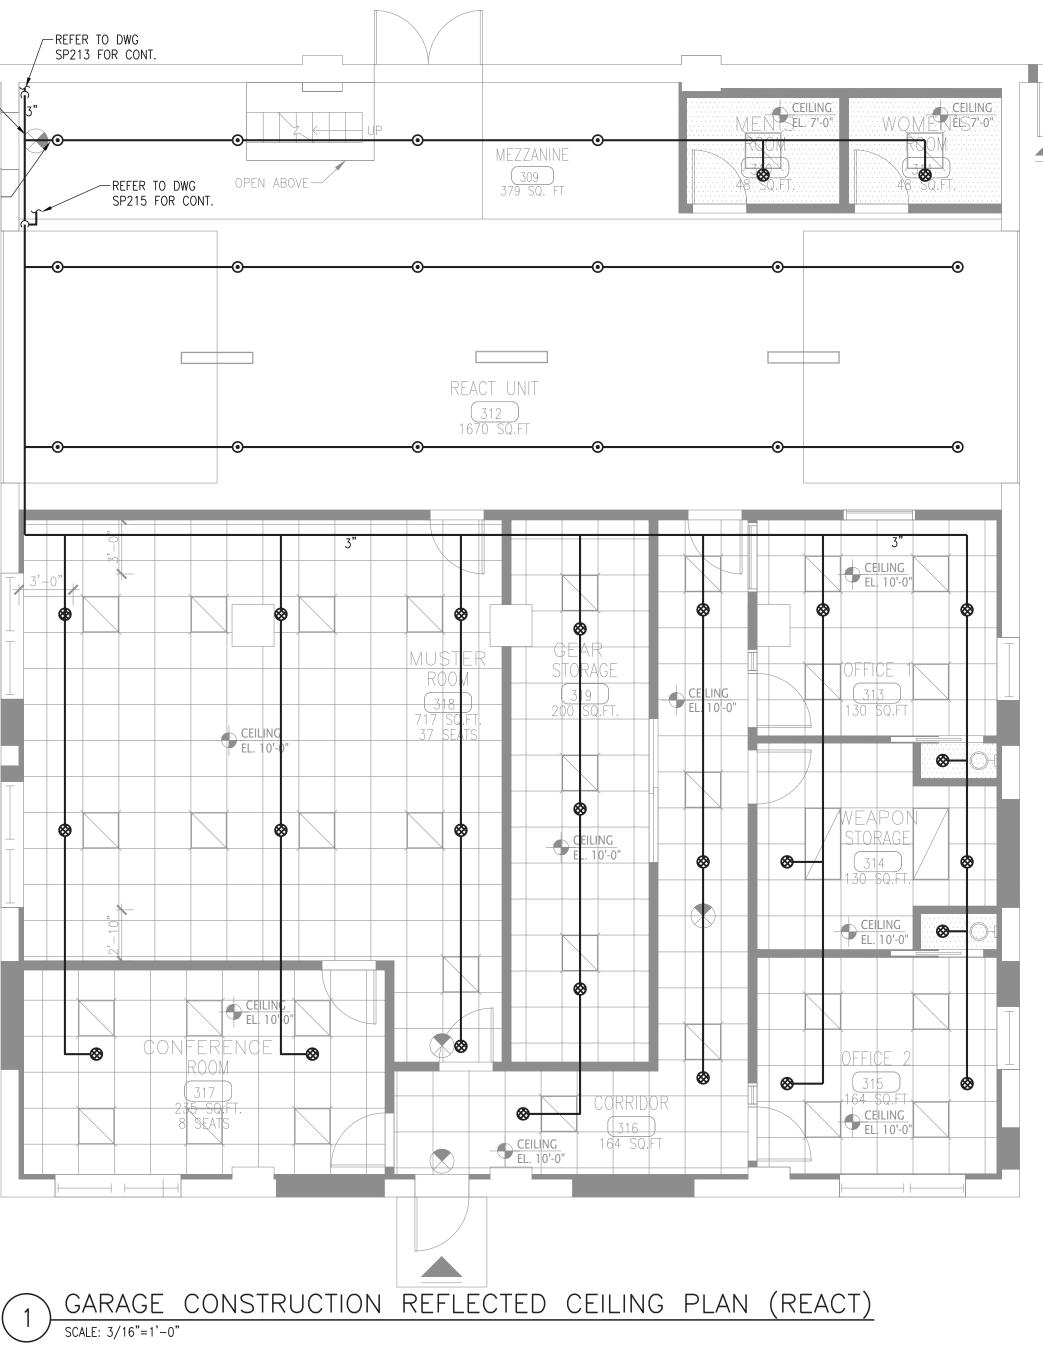
AS NOTED

## SP212.00

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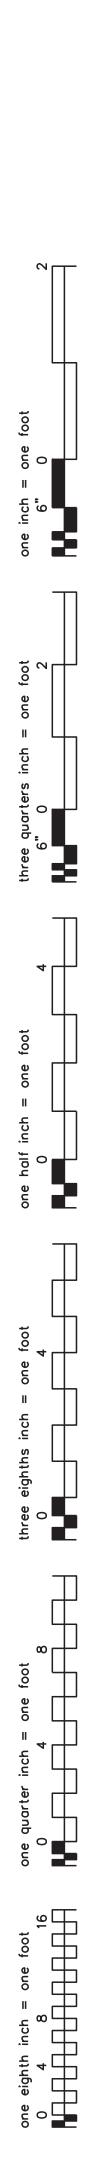




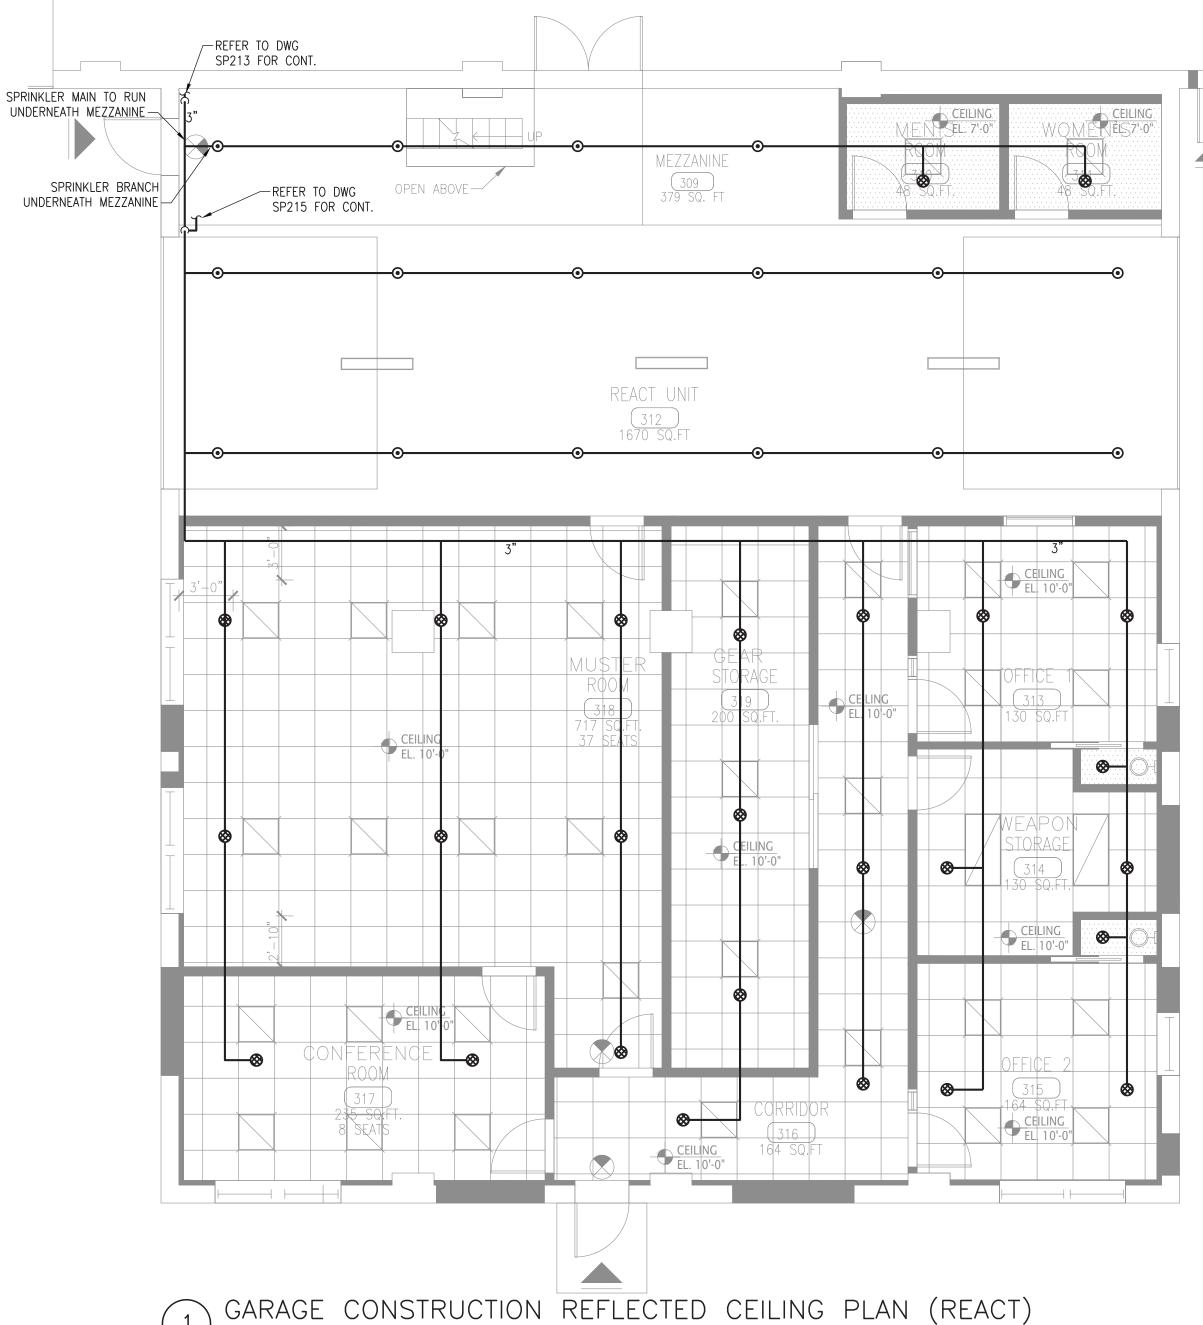


SPRINKLER SIZING CRITERIA ORDINARY 1 HAZARD				
PIPE SIZE	SPRINKLER QTY.			
1"	1			
1½"	3			
2"	10			
21/2"	MAIN OR AS INDICATED			

	SIZING CRITERIA T HAZARD
PIPE SIZE	SPRINKLER QTY.
1 "	1
11/2"	4
2"	10
21/2"	MAIN OR AS INDICATED





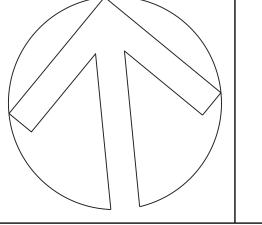



## **CAPITAL PROJECT #1521**

# **SHERIFF'S OPERATIONS** BUILDING

23 NEW HEMPSTEAD RD NEW CITY, NY 10956

### SPRINKLER GARAGE LEVEL CONSTRUCTION REFLECTED CEILING PLAN (REACT)

PROJECT NO.:


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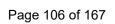
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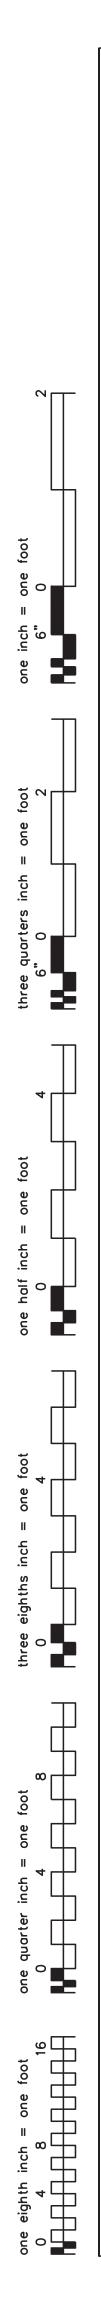
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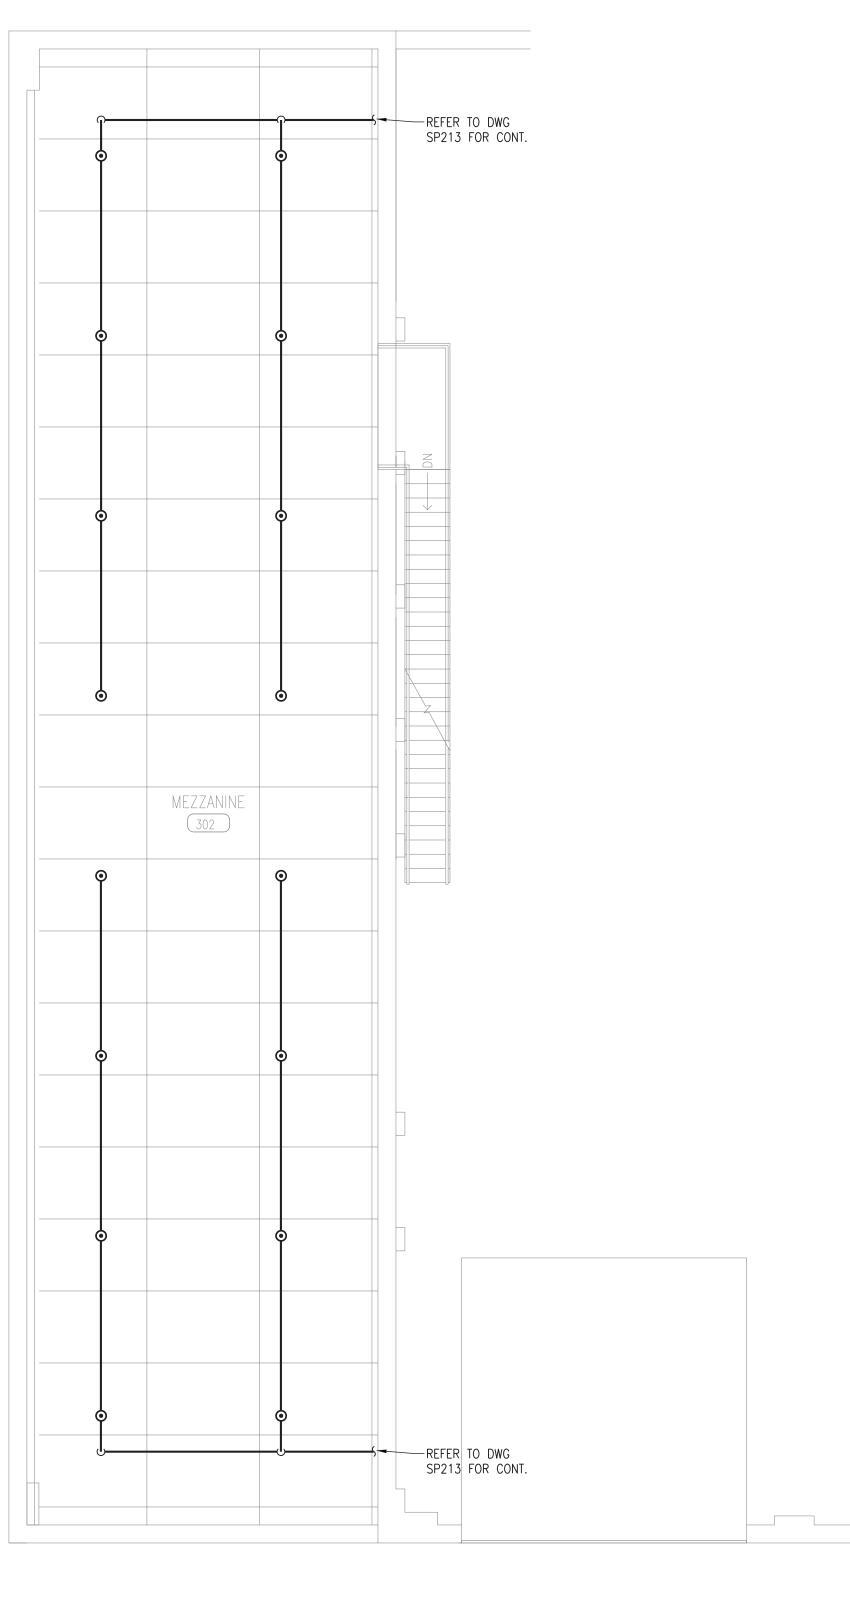
A KEY PLAN SCALE: NTS









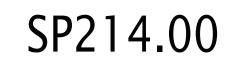





MEZZANINE CONSTRUCTION REFLECTED CEILING PLAN SCALE: 3/16"=1'-0"

	SIZING CRITERIA RY 1 HAZARD
PIPE SIZE	SPRINKLER QTY.
1"	1
1½"	3
2"	10
21/2"	MAIN OR AS INDICATED

	SIZING CRITERIA T HAZARD
PIPE SIZE	SPRINKLER QTY.
1"	1
1½"	4
2"	10
2½"	MAIN OR AS INDICATED

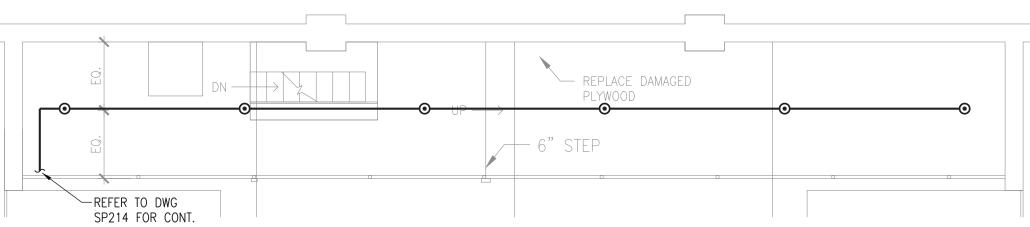



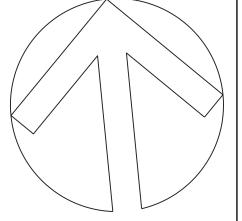



## **CAPITAL PROJECT #1521**

## **SHERIFF'S OPERATIONS** BUILDING

23 NEW HEMPSTEAD RD NEW CITY, NY 10956

#### SPRINKLER MEZZANINE LEVEL CONSTRUCTION REFLECTED CEILING PLAN

PROJECT NO.:


25097 SCALE:

AS NOTED

DRAWING NO .:




SP215.00

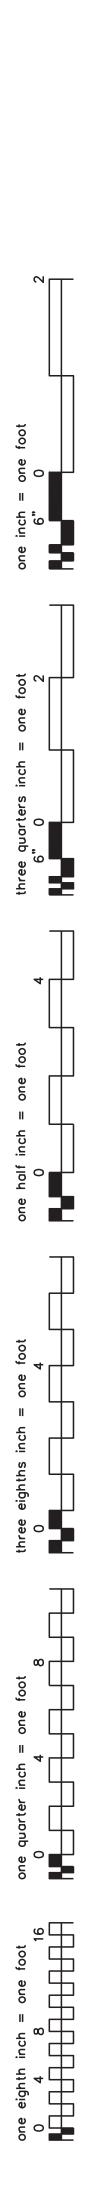


SIAMESE CONNECTION ----

GRADE

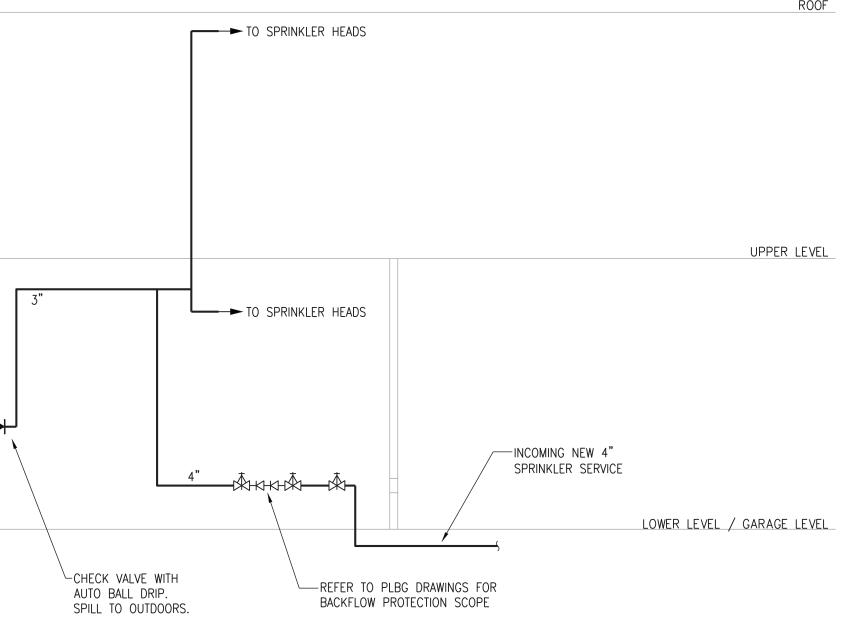

ROOF

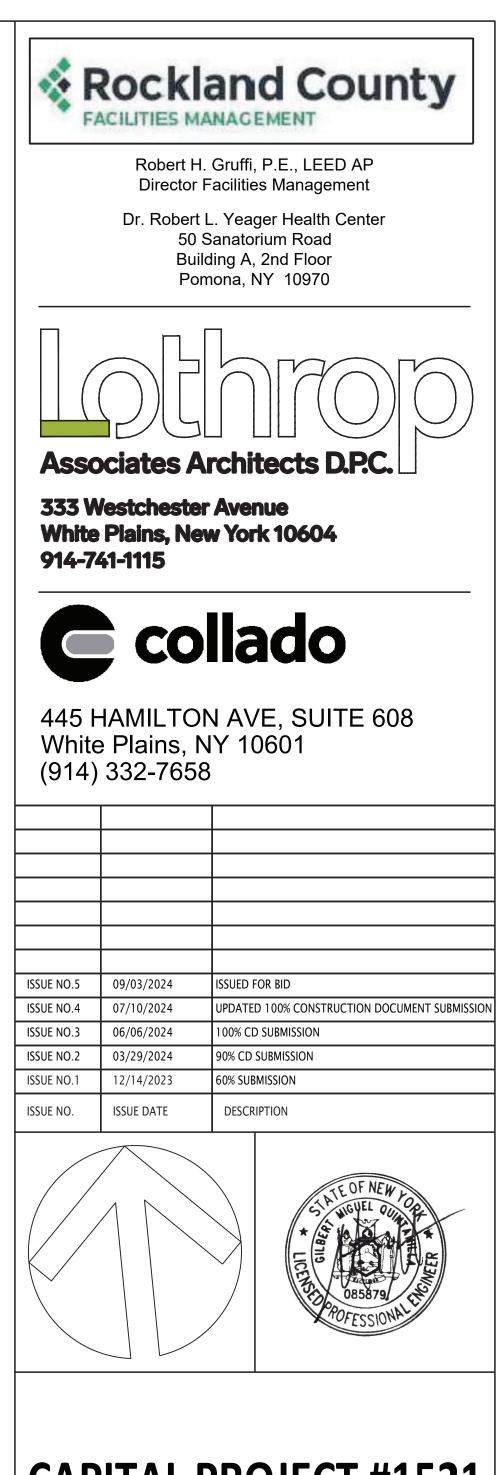

## **CAPITAL PROJECT #1521 SHERIFF'S OPERATIONS** BUILDING

23 NEW HEMPSTEAD RD NEW CITY, NY 10956

### SPRINKLER RISER DIAGRAM

PROJECT NO.:

DRAWING NO .:

25097 SCALE:

AS NOTED

SP400.00

