

COLA COMMUNITY CENTER UNTERMYER PARK AND GARDENS 945 NORTH BROADWAY YONKERS, NY 10701

CONSTRUCTION DOCUMENTS MAY 6, 2024

	SHEET LIST BKSK	PF	ROPERT
NUMBER	NAME		
T-000	COVER	1.	PROPERTY C
G-001	ABBREVIATION AND DRAWING SYMBOLS		
A-101	SITE PLAN	2.	SITE: COM 1
A-201	1ST FLOOR REMOVALS AND CONSTRUCTION PLAN	3.	ZONING COD
A-301	ELECTRICAL / MECHANICAL PLAN	0.	2011110 000
A-401	EXTERIOR ELEVATION	4.	NEIGHBORHO
A-501	INTERIOR ELEVATIONS		
A-700	PARTITION AND DOOR TYPES, SCHEDULES	5.	TAX MAP ID #
A-800	DETAILS	6.	BLOCK 3535
	DE CONSERVATION STATEMENT	7.	WORK DESCR
IUDGEMENT COMPLIANCE	F OF MY KNOWLEDGE, BELIEF AND PROFESSIONAL THESE PLANS AND SPECIFICATIONS ARE IN WITH THE 2020 ENERGY CONSERVATION CODE OF	8.	CONSTRUCTI REQUIRED IN
NEW YORK S	STATE.	9.	NO PLUMBIN
	Julia Ja. Relay	10.	EXISTING SPI
		11.	NO FIRE ALAI
	\bigvee	12.	APPLICABLE CODE 2020

RTY INFORMATION

RTY CLASS: 682- REC FACILITY

DM 1

CODE: S-50- DET- 1 FAM 50 FT

ORHOOD CODE: 00017- NEPARA PARK

P ID #: 3.-3535-56

3535 LOT 56

ESCRIPTION: CONVERSION OF GARAGE SPACE TO A MULTIPURPOSE ROOM, INCLUDING INDOWS IN EXISTING GARAGE DOOR OPENINGS AND A NEW INTERIOR ENTRANCE DOOR.

RUCTION CLASSIFICATION: TYPE VB, FIRE SEPARATION > 30 FEET: NO FIRE RATING ED IN WALLS OR ROOF PER TABLE 602..

MBING IN SCOPE OF WORK

IG SPRINKLER SYSTEM TO REMAIN UNCHANGED

E ALARM IN BUILDING

ABLE CODE: NYS EXISTING BUILDING CODE 2020 AND THE NYS ENERGY CONSERVATION

13. CHANGE OF OCCUPANCY: FROM LOW HAZARD STORAGE S2 TO BUSINESS GROUP B

LOCATION PLAN

14. ENERGY CODE ANALYSIS: SEE A-401





ABBREVIATIONS


MATERIAL SYMBOL


AB	ANCHOR BOLT	CEM	CEMENT	DMPR	DAMPER	FRT	FIRE RETARDANT TREATED	INSTL	INSTALLATION	MOV	MOVABLE	PTD	PAINTED	SPD
ABV	ABOVE	CER	CERAMIC	DMT	DEMOUNTABLE	FSH	FIRE SPRINKLER HEAD	INSTR	INSTRUCTION(S)	MP	METAL PANEL	PCSP	PORTLAND CEMENT	SPE
AC	AIR CONDITIONING	CG	CORNER GUARD	DN	DOWN	FSP	FIRE STANDPIPE	INSUL	INSULATION	MJ	MASONRY EXPANSION JOINT		STRUCTURAL PANELS	SPK
ACM	ASBESTOS-CONTAINING	CHAN	CHANNEL	DO	DOOR OPENING	FTG	FOOTING	INT	INTERIOR	MT	MASS TIMBER/MARBLE TILE	PKG	PARKING	SPH
	MATERIAL	CHAM	CHAMFER	DOM	DOMESTIC	FURN	FURNITURE	INTER	INTERSECTION	MTD	MOUNTED	PTN	PARTITION	SPK
ACOUS	ACOUSTICAL	CI	CONTINUOUS INSULATION	DR	DINING ROOM	FURR	FURRING		1 INTERCOMMUNICATION	MRT	MORTAR	PVR	PAVER	SQ
ACP	ACOUSTICAL CEILING PANEL	CIP	CAST IN PLACE	DSP	DRY STANDPIPE	FUT	FUTURE	INV	INVERT	MS	MUD SET	PVG	PAVING	SS
ACT	ACOUSTIC CEILING TILE	CJ	CONTROL/CONSTRUCTION JOINT	DU	DWELLING UNIT	FVC	FIRE VALVE CABINET	IMP	INSULATED METAL PANEL	MTL	METAL	PVMT	PAVEMENT	ST
ACT INSU		CSTIR	CAST IRON	DW	DISHWASHER	FXD	FIXED	IPS	INSIDE PIPE SIZE	MULL	MULLION	PWR	POWER	STN
AD	ACCESS DOOR	CL	CENTER LINE	DWG	DRAWING					MULT	MULTIPLE			STA
ADDM	ADDENDUM	CLG	CEILING	DWR	DRAWER	GA	GAUGE	JAN	JANITOR			RA	RETURN AIR	STC
ADDL	ADDITIONAL	CLO	CLOSET			GAL	GALLON	JB	JUNCTION BOX	NA	NOT APPLICABLE	RAD	RADIATOR	STD
ADH	ADHESIVE	CLL	CONTRACT LIMIT TIME	EA	EACH	GALV	GALVANIZED	JC	JANITOR'S CLOSET	NIC	NOT IN CONTRACT	RAG	RETURN AIR GRILLE	STL
ADJ	ADJUSTABLE	CO	CLEANOUT	EB	EXPANSION BOLT	GB	GRAB BAR	JCT	JUNCTION	NSV	NATURAL STONE VENEER	RC	RESILIENT CHANNEL	STO
AFF	ABOVE FINISH FLOOR	COORD	COORDINATE	EF	EACH FACE	GEN	GENERATOR	JST	JOIST	NO	NUMBER	RCWY	RACEWAY	STR
AFCI	ARC FAULT CIRCUIT	COL	COLUMN	EFS	EXTERIOR FINISH SYSTEM	GENL	GENERAL	JT	JOINT	NOM	NOMINAL	RD	ROOF DRAIN	STR
	INTERRUPTER	COMB	COMBUSTIBLE	EG	END GUARD	GF	GROUND FACE			NS	NONSLIP	RECT	RECTANGLE	SUR
AGG	AGGREGATE	COMP	COMPOSITE	EHG	ELECTRIC HAND DRYER	GFI	GROUND FAULT INTERRUPTER	KD	KNOCK DOWN	NRC	NOISE REDUCTION	REF	REFRIGERATOR	SUS
ALUM	ALUMINUM	CONC	CONCRETE	ELEC	ELECTRIC	GLM	GLUE GLAMINATED	KITCH	KITCHEN		COEFFICIENT	REG	REGISTER	SWF
ALT	ALTERNATE	CONF	CONFERENCE	EIFS	EXTERIOR INSULATION FINISH	GLZ	GLAZING	KO	KNOCK OUT	NTS	NOT TO SCALE	REINF	REINFORCEMENT	SYM
ANOD	ANODIZED, ANODIC COATING	CMDT	CARBON MONOXIDE DETECTOR		SYSTEM	GMU	GLASS MASONRY UNIT	KOP	KNOCK OUT PANEL			REQ'D	REQUIRED	SYM
AP	ACCESS PANEL	CMU	CONCRETE MASONRY UNIT	EL	ELEVATION	GND	GROUND	KPL	KICK PLATE	OA	OUTSIDE AIR	RESIL	RESILIENT	SYS
APPX	APPROXIMATE(LY)	CSMU	CALCIUM SILICATE MASONRY	EJ	EXPANSION JOINT	GR	GRADE/GRADING			000	OCCUPANCY	RET	RETURN	
APT	APARTMENT		UNIT	EMGCY	EMERGENCY	GRT	GRATING	LAB	LABORATORY	OCCSR	OCCUPANCY SENSOR	REV	REVISION	T&G
ARCH	ARCHITECT(URAL)	CWS	CURTAIN WALL SYSTEM	EMR	ELEVATOR MACHINE ROOM	GSKT	GASKET	LAD	LADDER	OD	OVERFLOW DRAIN	RFG	ROOFING	TB
ASC	ABOVE SUSPENDED CEILING	CONT	CONTINUOUS	ENCL	ENCLOSURE	GT	GROUT	LAM	LAMINATE	OFO	OUTSIDE FACE OF	RFH	ROOF HATCH	TBB
ASPH	ASPHALT(IC)	CORR	CORRIDOR	ENAM	ENAMEL	GWB	GYPSUM WALLBOARD	LAV	LAVATORY	OFF	OFFICE	RHB	RECESSED HOSE BIBB	TB-X
ASTRG	ASTRAGAL	CPT	CARPET	ENGR	ENGINEER	GWT	GLAZED WALL TILE	LB	POUND	OC	ON CENTER	RHRB	RIGHT HAND REVERSE BEVEL	TD
AUTO	AUTOMATIC	CMD	CORRUGATED METAL DECK	ELEV	ELEVATOR	GYP	GYPSUM	LBL	LABEL	OPP	OPPOSITE	RLG	RAILING	TEL
AUX	AUXILARY	CSK	COUNTERSUNK	EP	ELECTRICAL PANEL	011		LBR	LUMBER	OPNG	OPENING	RM	ROOM	TEM
AV	AUDIO/VISUAL	CT	CERAMIC TILE	EPS	EXPANDED POLYSTYRENE	HB	HOSE BIBB	LCD	LINEAR CEILING DIFFUSER	ORIG	ORIGINAL	RND	ROUND	TER
AVG	AVERAGE	CTR	CENTER	EQUIP	EQUIPMENT	HC	HAT CHANNEL / HOLLOW CORE	LD	LINEAR DIFFUSER	OVHD	OVERHEAD	RO	ROUGH OPENING	TER
///0		CTV	CABLE TELEVISION	EQ	EQUAL	HCW	HOT & COLD WATER	LINO	LINOLEUM	OVIND				TG
BOC	BOTTOM OF CURB	CU	CUBIC	EST	ESTIMATE(D)	HD	HEAD	LT	LIGHT	PB	PANIC BAR	SAB	SOUND ATTENUATION BATT	THE
BIT	BITUMINOUS	CBCL	CUBICLE	EXDF	EXHAUST DIFFUSER	HDBD	HARDBOARD	LW	LIGHTWEIGHT	PED	PEDESTAL	SALV	SALVAGE	THR
BLK	BLOCK	CW	COLD WATER	EXT	EXTERIOR	HDR	HEADER	LVL	LEVEL	PERF	PERFORATED	SAN	SANITARY	THK
BLKG	BLOCKING	000	OOED WATER	EX'G	EXISTING	HGR	HANGER	LVR	LOUVER	PERIM	PERIMETER	SCHED	SCHEDULE	THR
BLDG	BUILDING	DBL	DOUBLE	LXO	EXICTING	HM	HOLLOW METAL		EGOVER	PFB	PREFABRICATED	SCN	SCREEN	THR
BLKHD	BULKHEAD	DEG	DEGREE	FA	FIRE ALARM	HO	HOLD-OPEN	MAINT	MAINTENANCE	PG	PLATE GLASS	SDL	SADDLE	TM
BLW	BELOW	DEMO	DEMOLISHED, DEMOLITION	FB	FACE BRICK	HTSB	LARGE FORMAT AND HEAVY	MFR	MANUFACTURER	PF	FENESTRATION PROJECTION	SECT	SECTION	TMP
BM	BEAM	DEP	DEPRESSED	FBO	FURNISH BY OTHER	IIIOD	TILE SETTING BED	MAS	MASONRY	FACTOR	TENESTRATIONTROJECTION	SECT	SQUARE FEET	TO
BO	BOTTOM OF	DEPT	DEPARTMENT	FC	FOOTCANDLE	HT	HEIGHT	MATL	MATERIAL	PLAS	PLASTER	SFS	STOREFRONT SYSTEM	TOC
BD BP	BASE PLATE	DEFT	DETAIL	FCU	FAN COIL UNIT	HTG	HEATING	MAX	MATERIAL	PLYWD	PLYWOOD	SHGC	SOLAR HEAT GAIN COEFFICIENT	TOF
BR	BEDROOM	DETL		FDC	FIRE DEPARTMENT CONNECTION	HTDT	HEAT DETECTOR	MBR	MAXIMOM MASTER BEDROOM		PANEL	SHUC	SHOWER	TOF
							HEATER		MASTER BEDROOM MEDICINE CABINET	PNL	PANEL PORCELAIN TILE			
BRG	BEARING	DH	DOUBLE HUNG	FO		HTR		MC		PCTL		SHTHG	SHEATHING	TOIL
BRNZ	BRONZE	DIA	DIAMETER	FD	FLOOR DRAIN	HORIZ	HORIZONTAL	MDF	MEDIUM DENSITY FIBERBOARD	POLYISO		SHV	SHELVES	TOS
BS	BOTH SIDES	DIAG	DIAGONAL	FDN	FOUNDATION	HW	HOT WATER	MEMB		DDOOT	INSULATION	SK	SINK	TOW
BSBD	BASEBOARD	DISP	DISPENSER	FDPR				MER	MECHANICAL EQUIPMENT ROOM	PRCST	PRECAST	SIM	SIMILAR	TPD
BSMT	BASEMENT	DS	DOWNSPOUT		FINISHED FLOOR	IG	INSULATED GLASS	MFR	MANUFACTURER	PREP	PREPARATION	SMKDT	SMOKE DETECTOR	TPH
BTWN	BETWEEN	DKG	DECKING	FIN	FINISHED	IGU	INSULATED GLASS UNIT	MIR	MIRROR	PROD	PRODUCT	SMHDT	SMOKE + HEAT DETECTOR	TR
		DIM	DIMENSION	FIXT	FIXTURE	INCL	INCLUDE & INCLUDING	ML	METAL LATH	PROJ	PROJECT/PROJECTION	SLB	SLAB	TS
C/C	CENTER TO CENTER	DIST	DISTANCE	FLR	FLOOR	INCIN	INCINERATOR	MLWK	MILLWORK	PSI	POUND PER SQUARE INCH	SLV	SLEEVE	TYP
CAB CCTV	CABINET CLOSED CIRCUIT TELEVISION	DIV DMPFG	DIVISION/DIVIDER	FPSC	FIREPROOF SELF-CLOSING	INFO	INFORMATION	MO	MASONRY OPENING	PSF	POUND PER SQUARE FOOT	SNT SP	SEALANT	
			DAMPPROOFING							PRTD	PRESSURE TREATED		STANDPIPE	

DRAFTING SYMBOL


			Room name	2	LOW VOLTAG	<u>)E</u>	<u>SENSORS</u>		SPRINKLERS	
STONE ELEVATION	1 (A101) 1	ELEVATION TAG	150 SF	ROOM TAG	Y	LOW VOLTAGE WALL OUTLET (S) SHADE SWITCH	OS	CEILING OCCUPANCY SENSOR		SIDE WALL
STONE SECTION	SIM		<u>Area name</u> 150 SF	AREA TAG		(TÉL)	Ō	WALL OCCUPANCY SENSOR		CEILING CONCE
CONCRETE BLOCK SECTION	1 A101	SECTION TAG		REVISION TAG		LOW VOLTAGE FLOOR OUTLET	VS	CEILING VACANCY SENSOR	•	CEILING EXPOSE
	SIM		POWER		<u>SWITCHES</u>				•	
EARTH	A101	CALLOUT TAG	φ	SIMPLEX / DEDICATED OUTLET (DW) DISHWASHER	\$	SINGLE WALL SWITCH FOR (J) JAMB SWITCH	<u>V</u> S	WALL VACANCY SENSOR		UPRIGHT SPRIN
CONCRETE SECTION				(GD) GARBAGE DISPOSAL (MW) MICROWAVE		(#) # LIGHT CIRCUIT (E) BATHROOM EXHAUST (S) SCONCES	©\$	CEILING SMOKE/CO DETECTOR	EXIT SIGNS	
GYPSUM PLASTER	x	GRID HEAD		(OV) OVEN (CT) COOKTOP (RF) REFRIGERATOR / FREEZER		(C) COVE LIGHTS (R) RECESSED LIGHTS	<u>OS</u>	WALL SMOKE/CO DETECTOR	⊗	CEILING MOUNT
ALUMINUM	• • • • • • • • • • • • • • • • • • •	SPOT ELEVATION		(HD) HOOD (WM) WARMING DRAWER (WA) WASHER	\$\$	DOUBEL SWITCH GANG	LIFE SAFETY	DEVICE LEGEND	⊻	WALL MOUNTED
GRAVEL 1		SI OT ELEVATION	\oplus	(DR) DRYER	\$\$\$	TRIPLE SWITCH GANG				WITH EMERGEN
GRAVEL 2		TOS Elevation Level	Н	DUPLEX OUTLET (#) # SWITCHED OUTLET (S) DUPLEX 1/2 SWITCHED TO OUTLET	\$\$\$\$	QUAD SWITCH GANG	P	PULL STATION		EMERGENCY LIG
STEEL SECTION	(2001A) (T-44)	DOOR TAG BY MARK/TYPE MARK		(WP) WATERPROOF (GFI) GROUND FAULT INTERRUPTER	<u>AUDIO VISUA</u>	L, IT, SECURITY	F	FA HORN & STROBE WALL		
WOOD SECTION		PARTITION TAG	ŧ	QUAD OUTLET	TP	TOUCH PANEL	F	FA HORN & STROBE CEILING	LIGHTING	
	4202 (4407)	WINDOW TAG BY MARK/TYPE MARK		JUNCTION BOX WALL	Ţ	INTERCOM	FEC	FULLY RECESED FIRE EXTINGUISHER & CABINET	- ⊕ - I	CEILING R
WOOD ELEVATION 1	(1202) (W9B)		Ū	JUNCTION BOX FLOOR						CEILING S
WOOD ELEVATION 2	L1	LIGHTING TAG			<u>SP</u>	WALL SPEAKER			I	
PLASTIC SECTION		CEILING TAG		FLOOR DUPLEX	SP	CEILING SPEAKER	<u>PLUMBING</u>			CEILING F
MDF	PB-01	PLUMBING TAG		FLOOR QUAD	SW	CEILING SUBWOOFER	M FD	FLOOR DRAIN	Ŷ	WALL FIXT
	EQ-01	EQUIPMENT TAG	P	SWITCH OUTLET	Ĭ	CEILING CAMERA	RD	ROOF DRAIN	E = = = = =	LINEAR TA
INSULATION			LV	LV PANEL		WALL CAMERA				PENDANT
	WD-01	MATERIAL TAG	ELEC	ELECTRICAL PANEL						
		ACCESSORY TAG			WAP	CEILING WIFI				


SPDF SPEC SPKLR SPHD SPKR SQ SS ST STN STAG STC STD STL STOR STR STRCT SUSP SWR SYMB SYMB SYMB SYMB SYMB SYMB SYMB SYMB	SUPPLY DIFFUSER SPECIFICATIONS SPRINKLER SPRINKLER SPRINKLER SPRINKLER HEAD SPEAKER SQUARE STAINLESS STEEL STREET STONE STAGGERED SOUND TRANSMISSION STANDARD STEEL STORAGE STRAIGHT STRUCTURE & STRUCT SURFACE SUSPENDED SEWER SYMBOL SYMMETRY SYSTEM TONGUE AND GROOVE TOWEL BAR TILE BACKER BOARD TEST BORING - XX TRENCH DRAIN TELEPHONE TEMPORARY TERRAZZO TERMINAL TEMPORARY TERRAZZO TERMINAL TEMPORARY TERRAZZO TERMINAL TEMPORARY TERRAZIO TERMOSTAT THICKNESS THRESHOLD THROUGH TRANSITION MEMBRAI TEMPERED GLASS THERMAL THERMOSTAT THICKNESS THRESHOLD THROUGH TRANSITION MEMBRAI TEMPERED TOP OF FOOTING TOP OF FINISH FLOOR TOP OF FINISH FLOOR TOP OF STRUCTURE/S TOP OF WALL TOILET PAPER DISPON TOILET PAPER HOLDE TRANSOM THIN SET TYPICAL	UTIL UV UWS TURAL VAR VB VCT VEN VEN VEN VEN VEN VEN VEN VEN VEN VEN	UNDERCUT UNDERGROUND UNIT HEATER UNDERSIDE OF DECK UNDERSIDE OF SLAB UNLESS OTHERWISE NOTED UNIFORM UNIVERSAL URINAL UTILITY ULTRA-VIOLET UUTRA-VIOLET UHOSTERERED WALL SYST VARIES VAPOR BARRIER VINYL COMPOSITION TILE VENEER VEHICLE TVENTILATOR TVERTICAL TVESTIBULE BVAPOR IMPERMEABLE WEAT BARRIER VENEER VENEER VAPOR PERMEABLE WEATH BARRIER VERTICAL GRAIN WINDOW WATER CLOSET WATER HYDRANT WEIGHT WITH UTHOUT WOOD CTWAINSCOT WEATHER STRIPPING FWELDED WIRE FABRIC	TEM 6 BID SET 05.06.2024 5 ISSUED FOR FILING 02.21.2024 4 REVISED PER PARKS 02.16.2024
		MECHANICAL		
WALL		T	THERMOSTAT	APPLICANT
NG CONCEALI	ED		TOILET EXHAUST FAN	UNTERMYER GARDENS CONSERVANCY 945 N BROADWAY YONKERS,NY 10701
NG EXPOSED		AP	ACCESS PANEL	T: 917-974-9713
GHT SPRINKLE	ER	FIRE WALL RAT	ING AND EGRESS	BKSK
NG MOUNTED			- PROPERTY LINE	BKSK ARCHITECTS LLP
MOUNTED			1HR RATED WALL	230 W 38TH STREET NEW YORK, NEW YORK 10018 T: 212.807.9600 WWW.BKSK.COM
EMERGENCY	LIGHT		2HR RATED WALL3HR RATED WALL	
GENCY LIGH	T W BATTERY		FIRE SERVICE ACCESS ELEVA	TOR Untermyer Multipurpose Room 945 N BROADWAY YONKERS, NY 10701
		MISCELLANEOU	<u>JS</u>	DOB JOB #: 00000000
CEILING ROU	JND FIXTURE	EI.	ADA SIGNAGE	DRAWING TITLE
CEILING SQU	JARE FIXTURE			ABBREVIATION AND DRAWING
CEILING FIXT	URE LINEAR		EXISTING TREE TO REMAIN	SYMBOLS
WALL FIXTUR	RE	XDa bo		
LINEAR TAPE	E		PROPOSED NEW TREE	STAMP & SIGNATURE PROJECT NO. 2210 DATE: 03/17/23
PENDANT		Los of		SCALE: As indicated SHEET NO. 2 OF 9

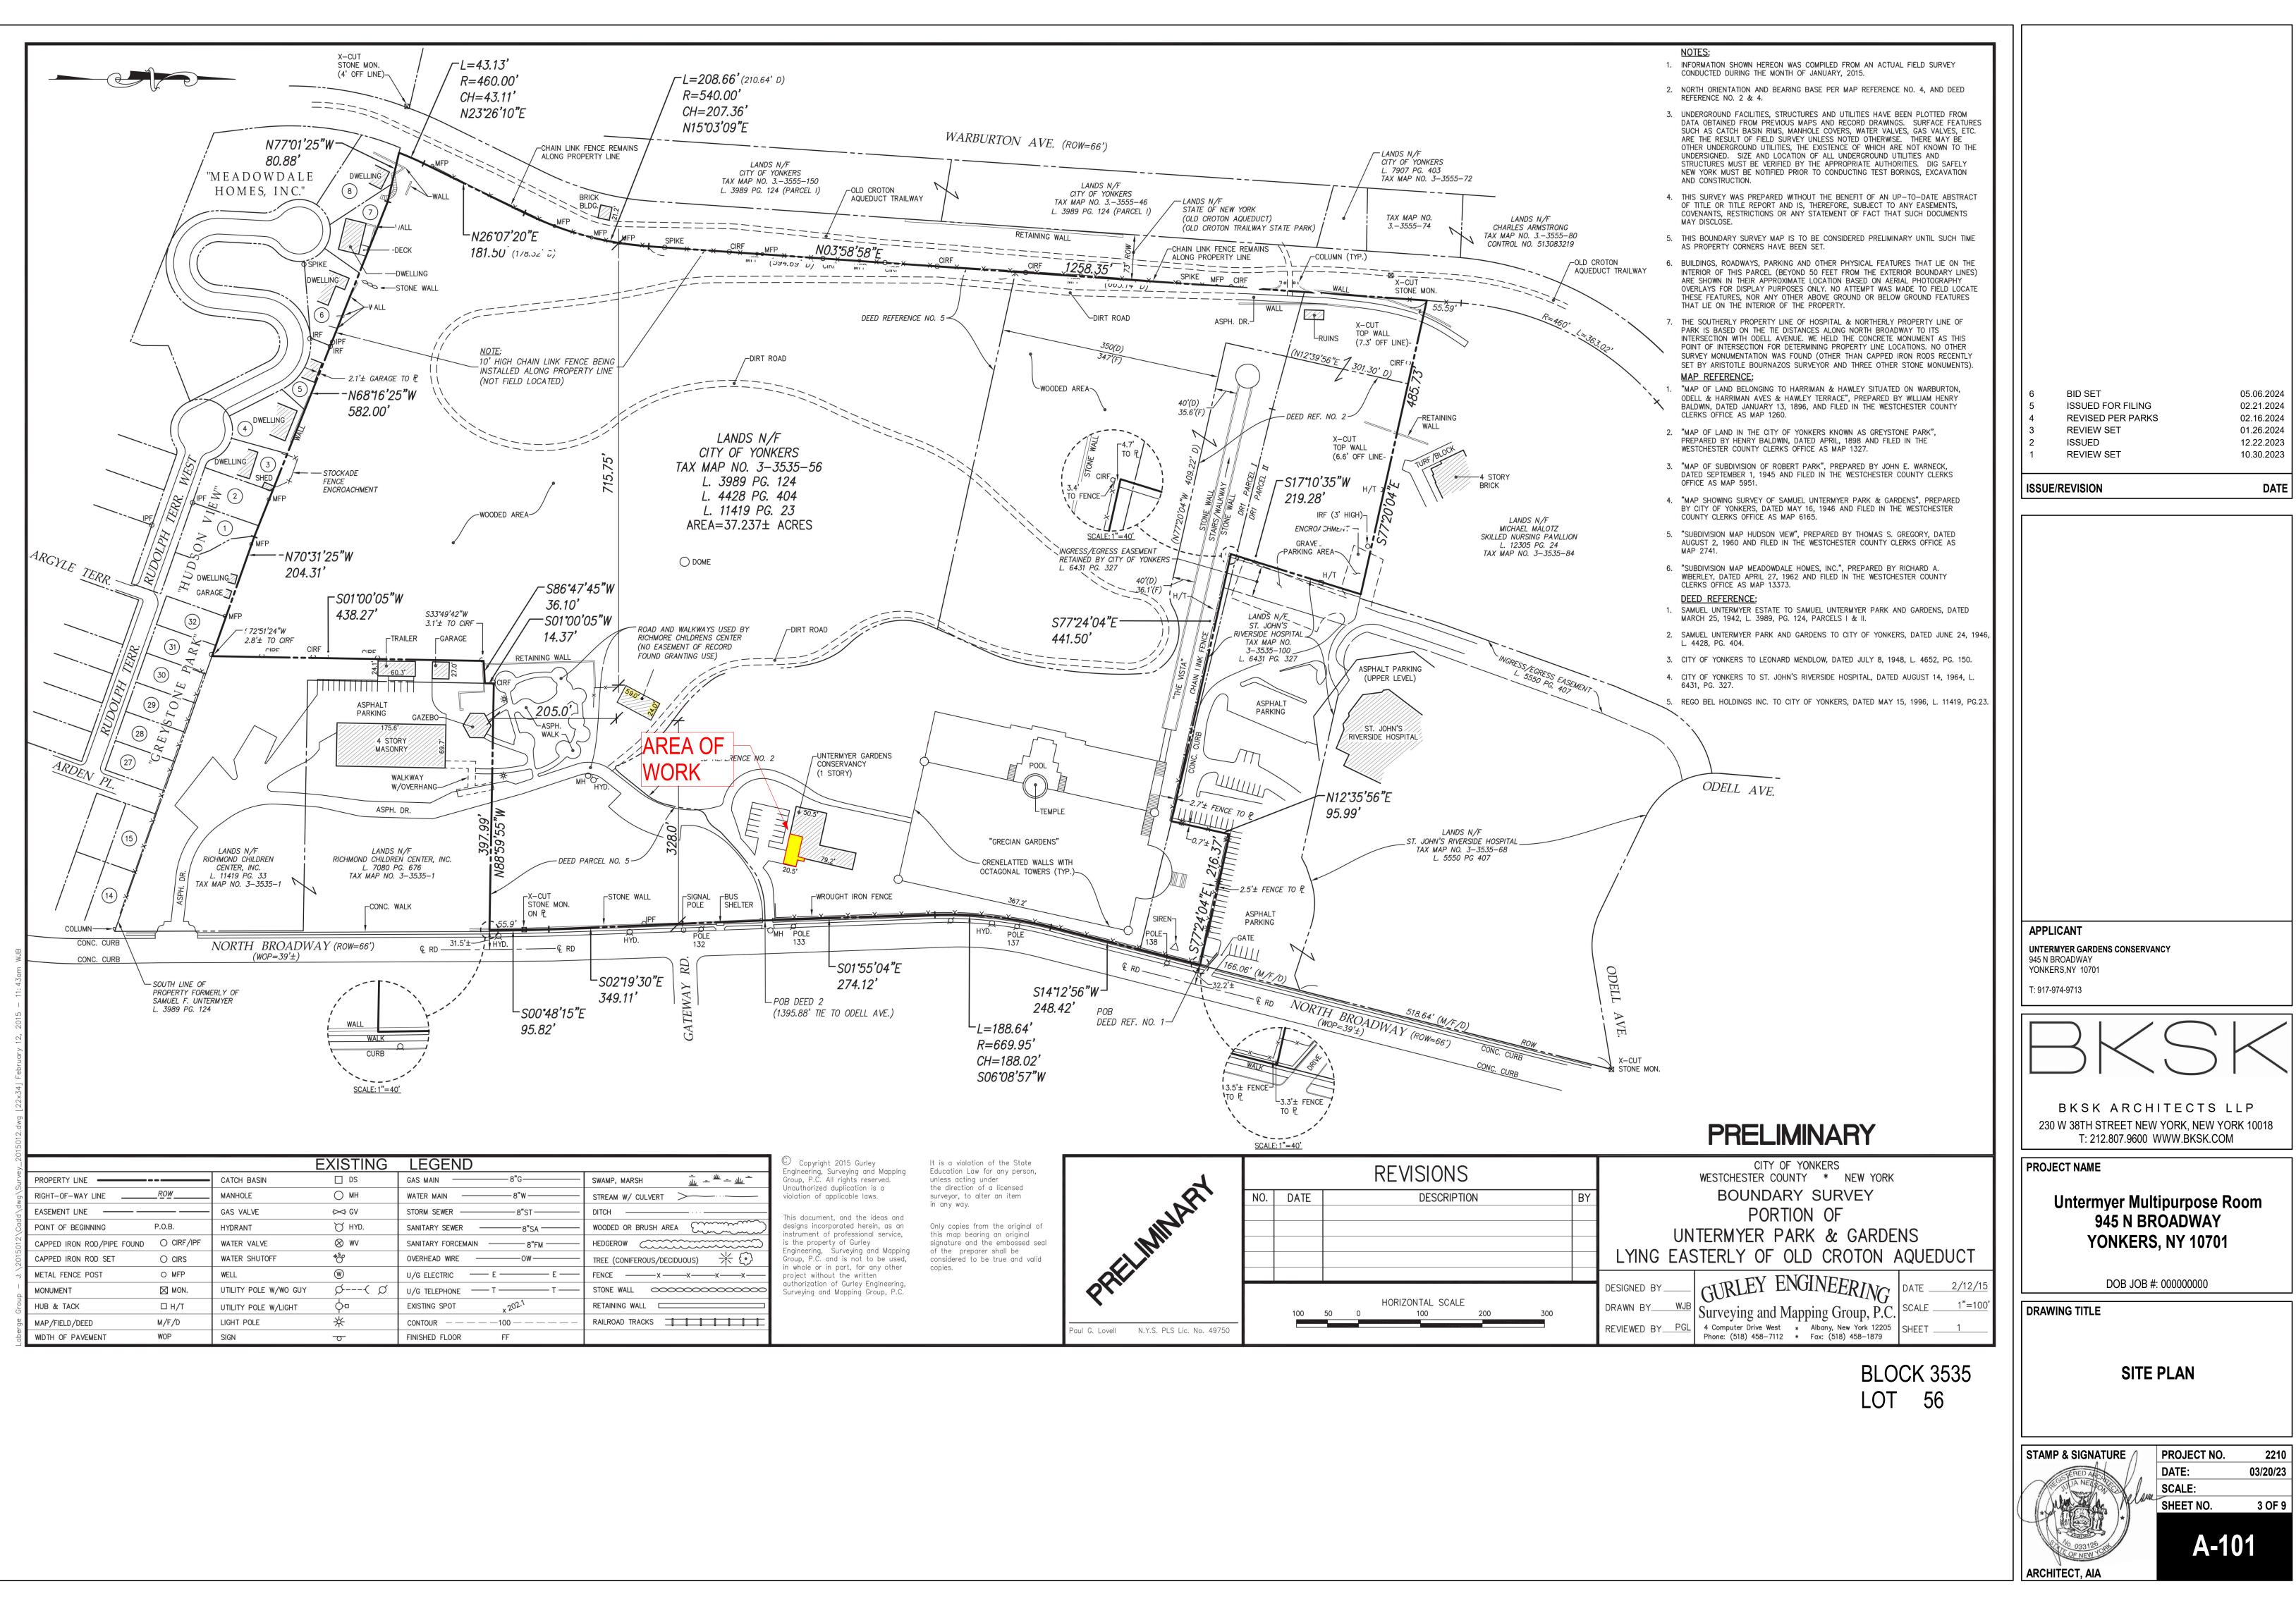

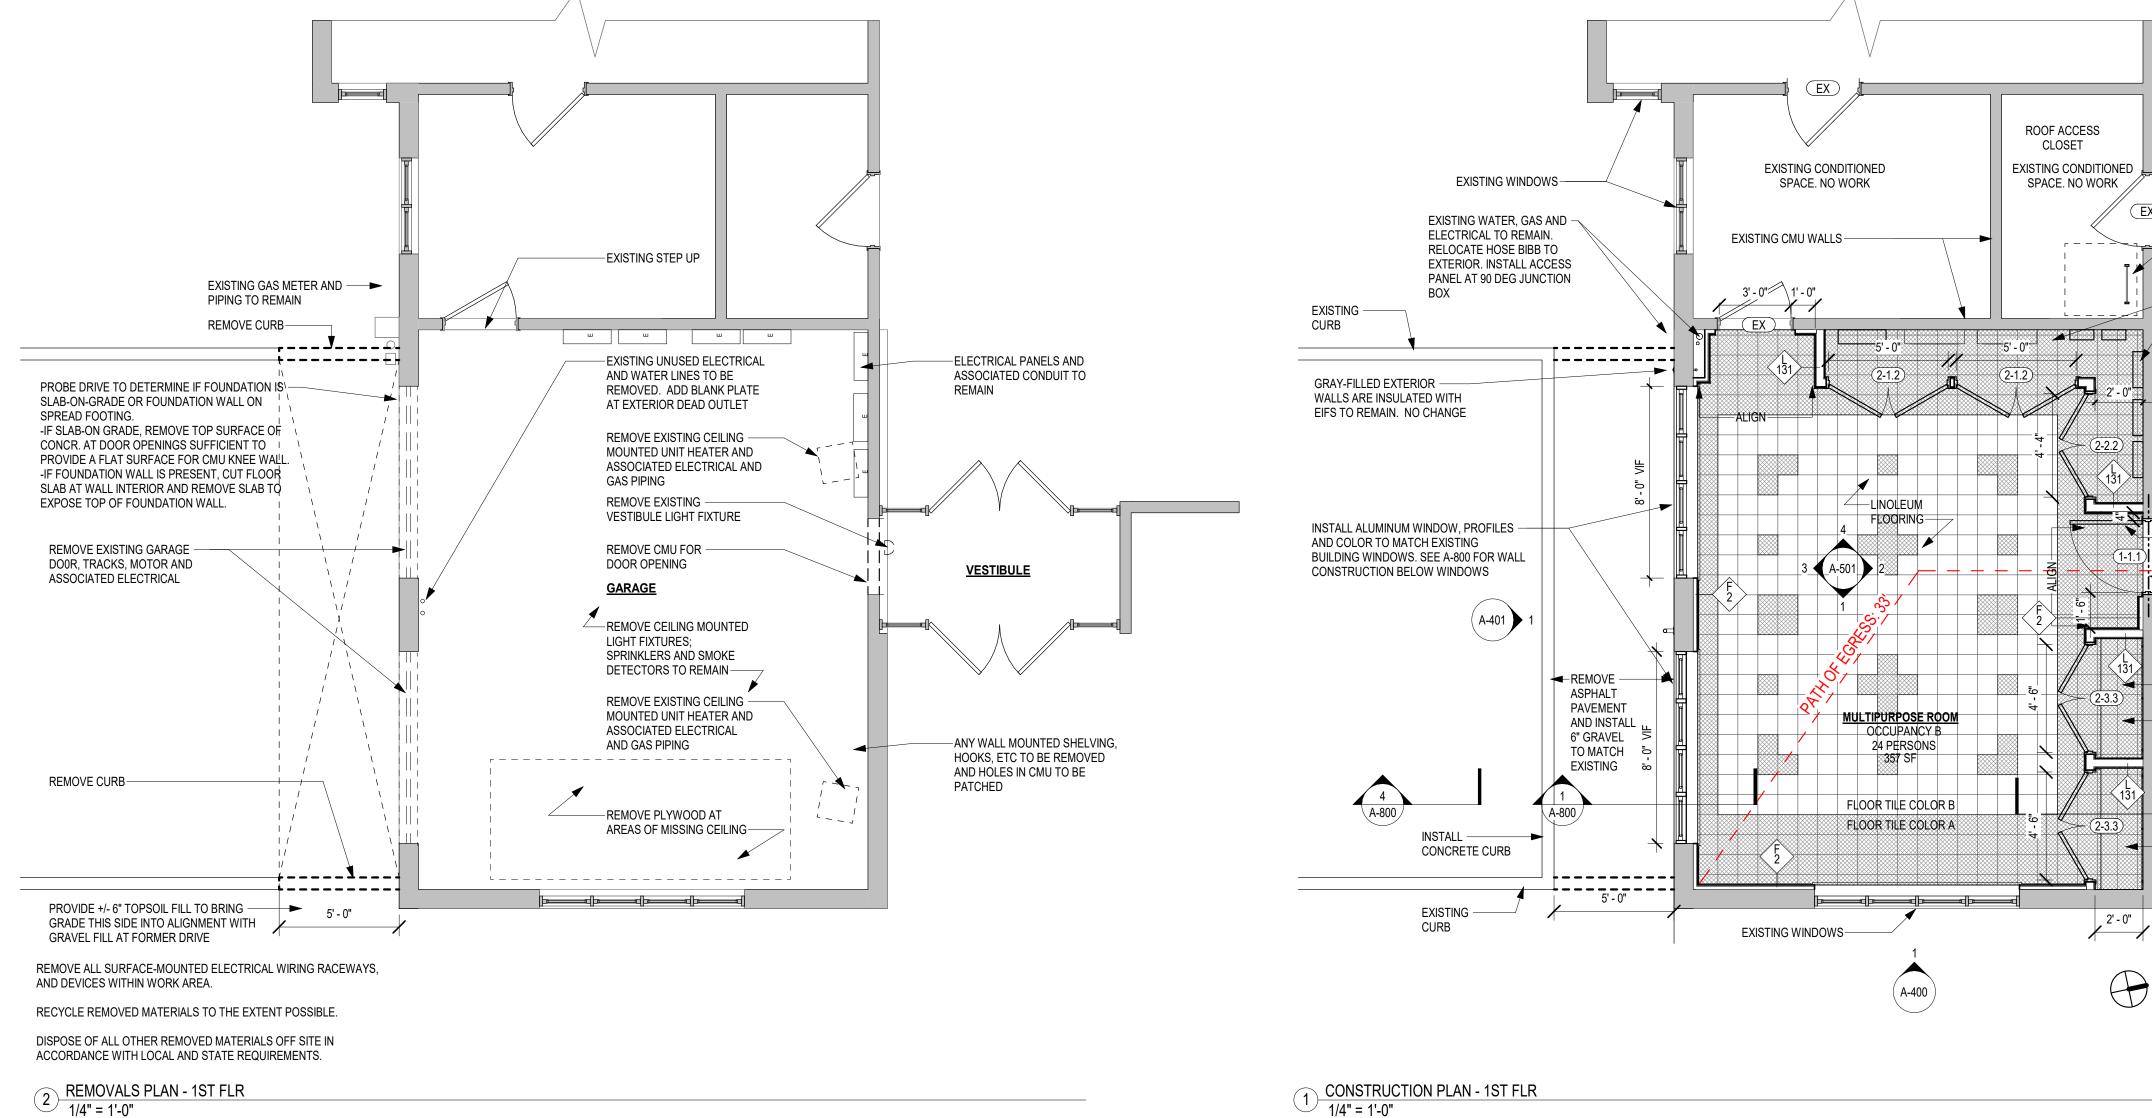

DOOR ACCESSIBILITY DIAGRAMS

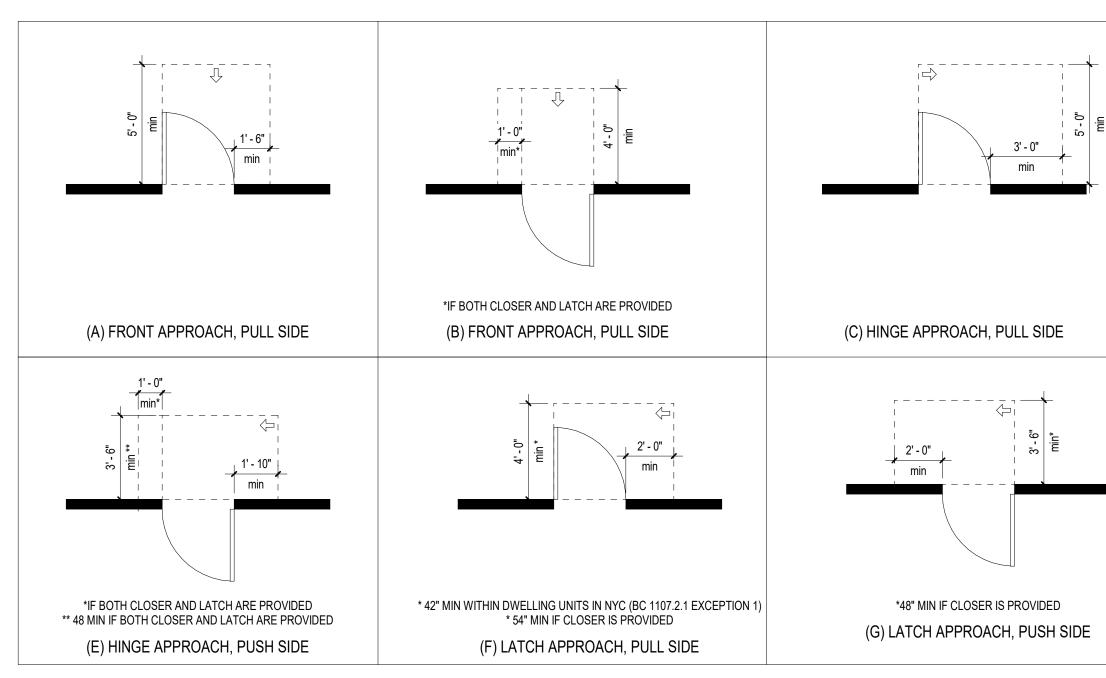

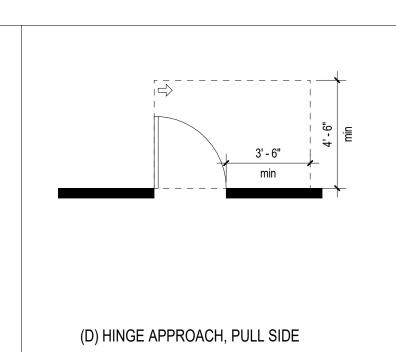

FINISH MA	TERIA	LS
FLOOR VAPOR RETARDER:	LAITICRETE	VAP
CONCRETE DEGREASER:	LAITICRETE	L+N
DASH PATCH:	LAITICRETE	L+N
FINSH FLOOR ADHESIVE:	FORBO	SUS
FINISH FLOOR:	FORBO	MAI
BASE:	JOHNSONITE	BL
CEILING PAINT:	BENJ MOORE	FL CC
WALL PAINT:	BENJ MOORE	PE CC
DOORS + TRIM PAINT:	BENJ MOORE	SEN COI

FLOOR FINISH INSTALLATION

FLOOR FINISH WILL CONSIST OF LINOLEUM SHEET GOODS GLUED TO EXISTING CONCRETE SLAB, OVER A LIQUID-API

- REMOVE ALL LOOSE AND UNSOUND M
- EXISTING CONCRETE SLAB-ON GRADE PREPARE ENTIRE SURFACE TO RECEIN ACCORDANCE WITH VAPOR RETARDER INSTRUCTIONS: REMOVE ALL DIRT, OIL AND OTHER CONTAMINANTS BY MECH. (INTERNATIONAL CONCRETE REPAIR IN
- TO MEDIUM SHOTBLAST TEXTURE). SI https://www.tccmaterials.com/wpcontent/uploads/2020/06/ConcreteSurfaceP
- CLEAN ANY REMAINING OIL OR GREASE CITREX DEGREASING AGENT AND THOROUGHLY RINSE USING 3000 PSI PRESSURE WASH.



ARMOLEUM 10 X 10 TILE: COLOR A: DONKEY ISLAND COLOR B: STARDUST BLACK VINYL 6"

LAT LATEX OLOR SELECTED BY OWNER EARLESCENT LATEX

COLOR SELECTED BY OWNER EMIGLOSS LATEX

COLOR SELECTED BY OWNER

HEET GOODS GLUED TO PPLIED VAPOR RETARDER:		
MATERIAL FROM SURFACE OF E.	4.	REPAIR ANY CRACKS OR OTHER DEFECTS IN SLAB SURFACE IN ACCORDANCE WITH VAPOR RETARDER MANUFACTURER'S INSTRUCTIONS.
IVED FLOOR FINISH IN		
ER MANUFACTURER'S IL, PAINT, LAITANCE, SEALERS HANICAL MEANS TO AN ICRI INSTITUTE) CSP-3 TO 5 (LIGHT SEE	5.	MIX AND APPLY VAPOR RETARDER USING BRUSH, ROLLER, RESIN BROOM, OR NOTCHED SQUEEGEE PER MANUFACTURER'S INSTRUCTIONS. ALLOW TO CURE 3-5 HOURS BEFORE INSTALLING FLOOR FINISH.
Profiles.pdf	6.	DASH PATCH SURFACE FLAT AND LEVEL TO A TOLERANCE OF NOT MORE THAN 1/8" IN 10 FEET.
SE CONTAMINATION USING L+M	7.	GLUE DOWN FINISH FLOOR PER MANUFACTURER'S INSTRUCTIONS.

3.

5.

)	-EXISTING LADDER TO ATTIC FOR ACCESS TO EXISTING ROOF HATCH
	-EXISTING ELECTRICAL PANELS AND METERS TO REMAIN, TYP. MAINTAIN 3' CLEAR IN FRONT OF ALL PANELS WHEN CLOSETS DOORS ARE OPEN. LEAVE CMU EXPOSED ON BACK WALL OF CLOSETS
	ADJUSTABLE SHELVING LEAVE CMU EXPOSED ON BACK WALL OF CLOSETS
	6 A-700 -ADJUSTABLE SHELVING -GRAY-FILLED EXTERIOR WALLS ARE INSULATED WITH EIFS TO REMAIN. NO CHANGE

GENERAL NOTES DIMENSION MEASURED FROM WALL FINISH TO 1.

WALL FINISH UNLESS OTHERWISE NOTED. 2.

ALL EXISTING AND NEW WALL AND CEILIING SURFACES TO RECEIVE PAINT UNDER THIS CONTRACT SHALL BE FINISHED TO A LEVEL 4 FINISH. APPLY 1 COAT PRIMER + 2 COATS FINISH.

ALL FRAMING SHALL BE LIGHT GAGE STEEL, SIZE AND GAGE SELECTED TO LIMIT DEFLECTION TO 1/360.

4. ALL DRYWALL SHALL BE 5/8", TYPE C AT RATED CONSTRUCTION.

ALL WIRING AND PIPING INSTALLED WITHIN WORK AREA SHALL BE CONCEALED. REMOVE EXISTING FINISHES AS REQUIRED FOR INSTALLATION. REPAIR TO LIKE-NEW CONDTION.

> EXISTING CONSTRUCTION NEW CONSTRUCTION

ISSUE/REVISION

APPLICANT UNTERMYER GARDENS CONSERVANCY 945 N BROADWAY YONKERS,NY 10701

T: 917-974-9713



BKSK ARCHITECTS LLP 230 W 38TH STREET NEW YORK, NEW YORK 10018 T: 212.807.9600 WWW.BKSK.COM


PROJECT NAME


Untermyer Multipurpose Room 945 N BROADWAY YONKERS, NY 10701

DOB JOB #: 000000000


DRAWING TITLE

1ST FLOOR REMOVALS AND CONSTRUCTION PLAN

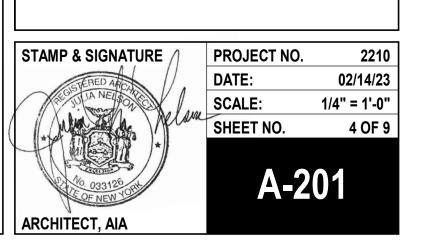

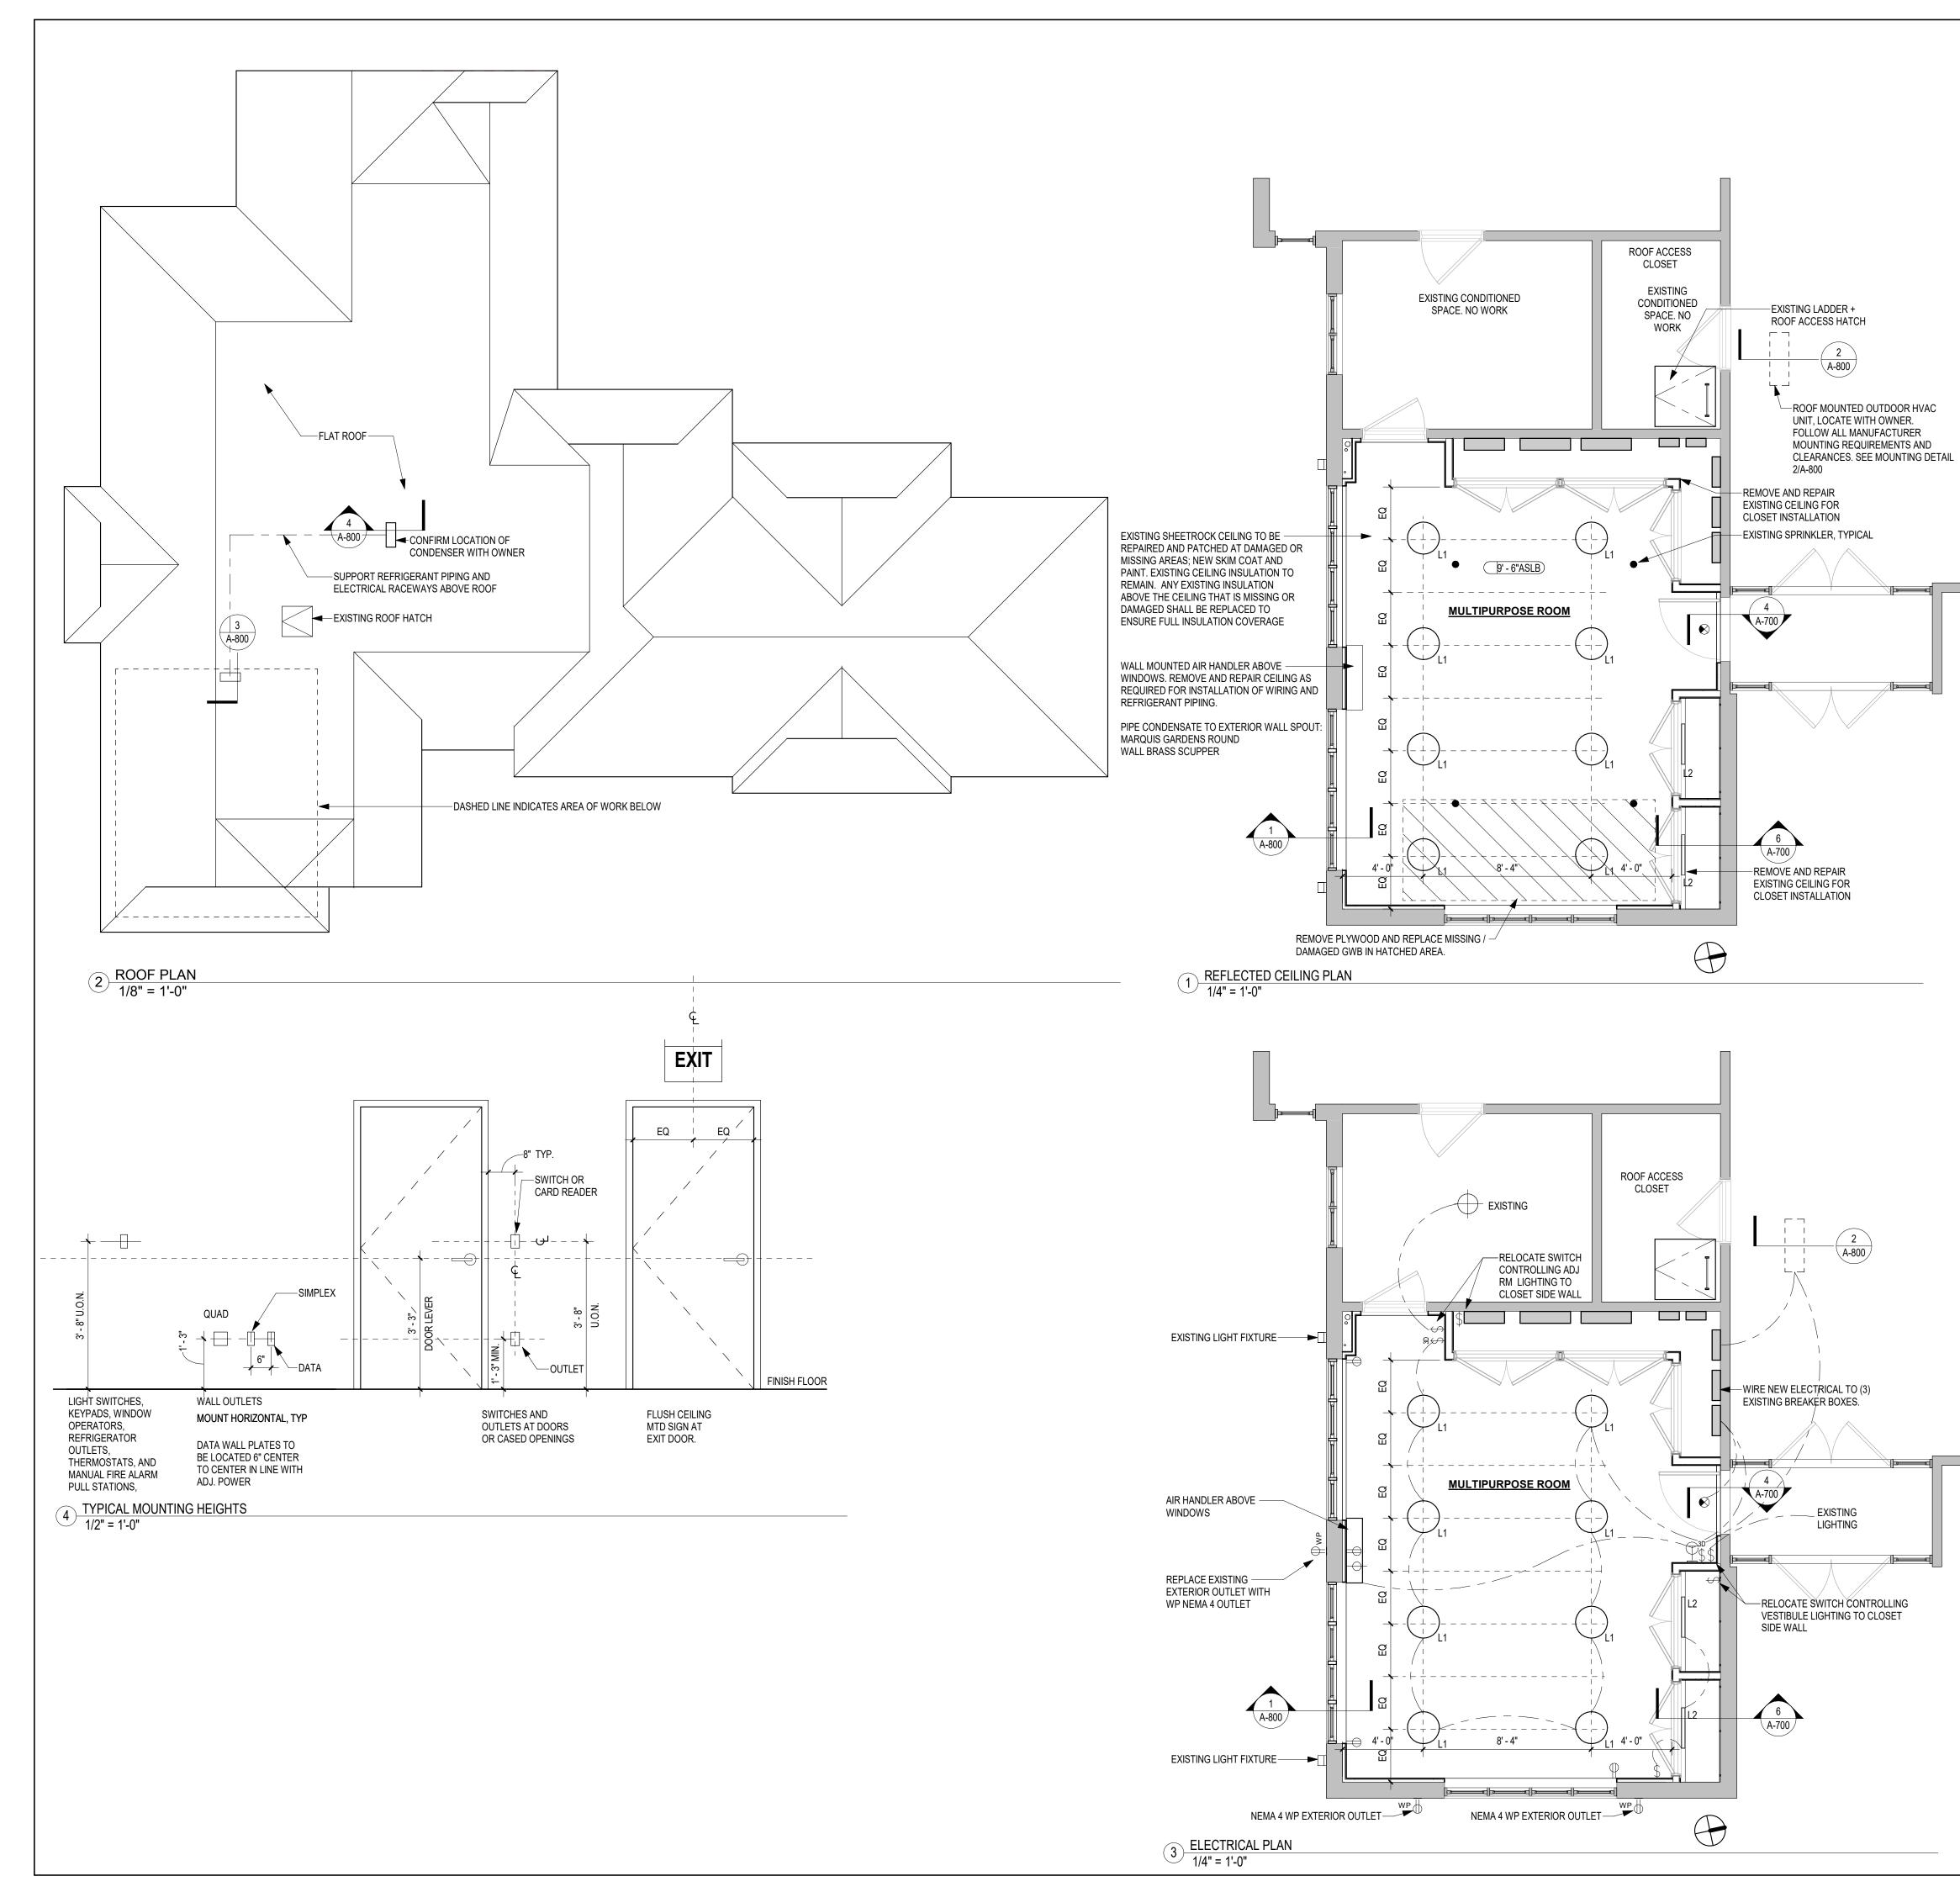


	-1 [
MECHANICAL NOTES	
1. WRAP REFRIGERANT PIPING WITH CLOSED-CELL INSULATION AND WITH BUILT-IN VAPOR RETARDER. SEAL ALL SEAMS. INSTALL PIPING ABOVE CEILING AND WITHIN FURRED CONSTRUCTION. SUPPORT AS REQUIRED AT	
 ROOF LEVEL, AND PROVIDE WEATHER-PROOF JACKET. WALL MOUNTED TYPE HVAC UNIT WITH INDOOR AND OUTDOOR UNITS FOR 	
HEATING AND COOLING: MITSUBISHI 12,000 BTU MSZ GS12 / HYPER HEAT MUZ-GS12HZ DUCTLESS	
MINI-SPLIT HEAT PUMP SYSTEM OR EQUAL. PROVIDE POWER AS REQUIRED. PROVIDE PT CURB ON EXISTING ROOF- REMOVE EXISTING ROOF AND	
SECURE CURB DIRECTLY TO ROOF SHEATHING AND FRAMING. FLASH CURB INTO EXISTING ROOF USING MATERIALS COMPATIBLE WITH EXISTING ROOF.	
3. PIPE CONDENSATE TO EXTERIOR WALL SPOUT: MARQUIS GARDENS ROUND WALL BRASS SCUPPER.	
 REQUIRED SUBMITTALS A. SPLIT SYSTEM PRODUCT INFORMATION, INCLUDING PIPING, INSULATION, CONTROL SYSTEM, INSTALLATION AND MAINTENANCE MANUALS. 	
B. ROOF CURB AND PENETRATION PRODUCT INFORMATION FOR FLASHING AND COPINGS COMPATIBLE WITH EXISTING ROOF SYSTEM. SHOP DRAWINGS OF PROPOSED CURBS AND PENETRATIONS IF THEY DIFFER FROM CONTRACT DRAWINGS.	
ELECTRICAL NOTES	8 BID SET 05.06.2024
1. OUTLETS AND OTHER DEVICES SHALL BE FLUSH MOUNTED. ALL WIRING	7 FILING REVISIONS 04.09.2024 6 ISSUED FOR FILING 02.21.2024
CONCEALED.	5 REVISED PER PARKS 02.16.2024 4 REVIEW SET 01.26.2024
2. LIGHT SWITCHES SHALL BE WHITE TOGGLE TYPE	3 REVIEW SET 01.19.2024 2 ISSUED 12.22.2023
3. DEVICES AND COVER PLATES SHALL BE WHITE	1 REVIEW SET 10.30.2023
 INTERIOR ELECTRICAL WIRING SHALL BE IN GREENFIELD ALL EXPOSED WIRING SHALL BE PLENUM-RATED 	
 ALL EXPOSED WIRING SHALL BE PLENUM-RATED ALL EXTERIOR WIRING SHALL BE INSTALLED IN WEATHER-TIGHT IMC. 	ISSUE/REVISION DATE
7. ALL ELECTRICAL WORK SHALL BE PERFORMED BY A LICENSED	
ELECTRICIAN, WHO WILL EVALUATE THE CAPACITY OF THE EXISTING PANELS TO ACCOMMODATE NEW ELECTRICAL LOADS. ASSIGN WIRING TO CIRCUITS IN ACCORDANCE WITH ELECTRICAL CODE AND BREAKER CAPACITY.	
ELECTRICAL LEGEND	
\oplus DUPLEX OUTLET ϕ HARD-WIRED CONNECTION	1
\$ WALL SWITCH	
3D \$ 3-WAY SWITCH WITH DIMMER	
J	
EXIT SIGN	
LIGHT FIXTURE SCHEDULE	
L1, CEILING ROUND FIXTURE: NUVO LIGHTING BLINK PLUS SINGLE LIGHT 19" INTEGRATED LED FLUSH MOUNT CEILING FIXTURE- WITH WHITE TRIM. 3000K 120 V DIMMABLE	
L2, CLOSET LIGHT: GM LIGHTING CL18-TUN-WH 3000K	APPLICANT UNTERMYER GARDENS CONSERVANCY
ELECTRICAL SUBMITTALS:	945 N BROADWAY YONKERS,NY 10701
A. LIGHT FIXTURE PRODUCT INFORMATION, WITH FINISH OPTIONS FOR SELECTION BY OWNER.	T: 917-974-9713
B. WIRING AND ACCESSORIES	
C. ELECTRICAL DEVICES (SWITCHES, OUTLETS, ETC. WITH COLOR	
D. ANY ADDITIONAL PANELBOARDS OR SUB-PANELS REQUIRED TO	
ACCOMMODATE LOADS.	
PLUMBING NON-FREEZE HOSE BIBB: ZURN Z1321-C KEYED NON-FREEZE ANTI-SIPHON	BKSK ARCHITECTS LLP 230 W 38TH STREET NEW YORK, NEW YORK 10018 T: 212.807.9600 WWW.BKSK.COM
L	PROJECT NAME
	Untermyer Multipurpose Room
	945 N BROADWAY
	YONKERS, NY 10701
	DOB JOB #: 00000000
	DRAWING TITLE
	ELECTRICAL / MECHANICAL PLAN
	STAMP & SIGNATURE PROJECT NO. 2210
	DATE: 02/14/23
	SHEET NO. 5 OF 9
	A-301
	ARCHITECT, AIA

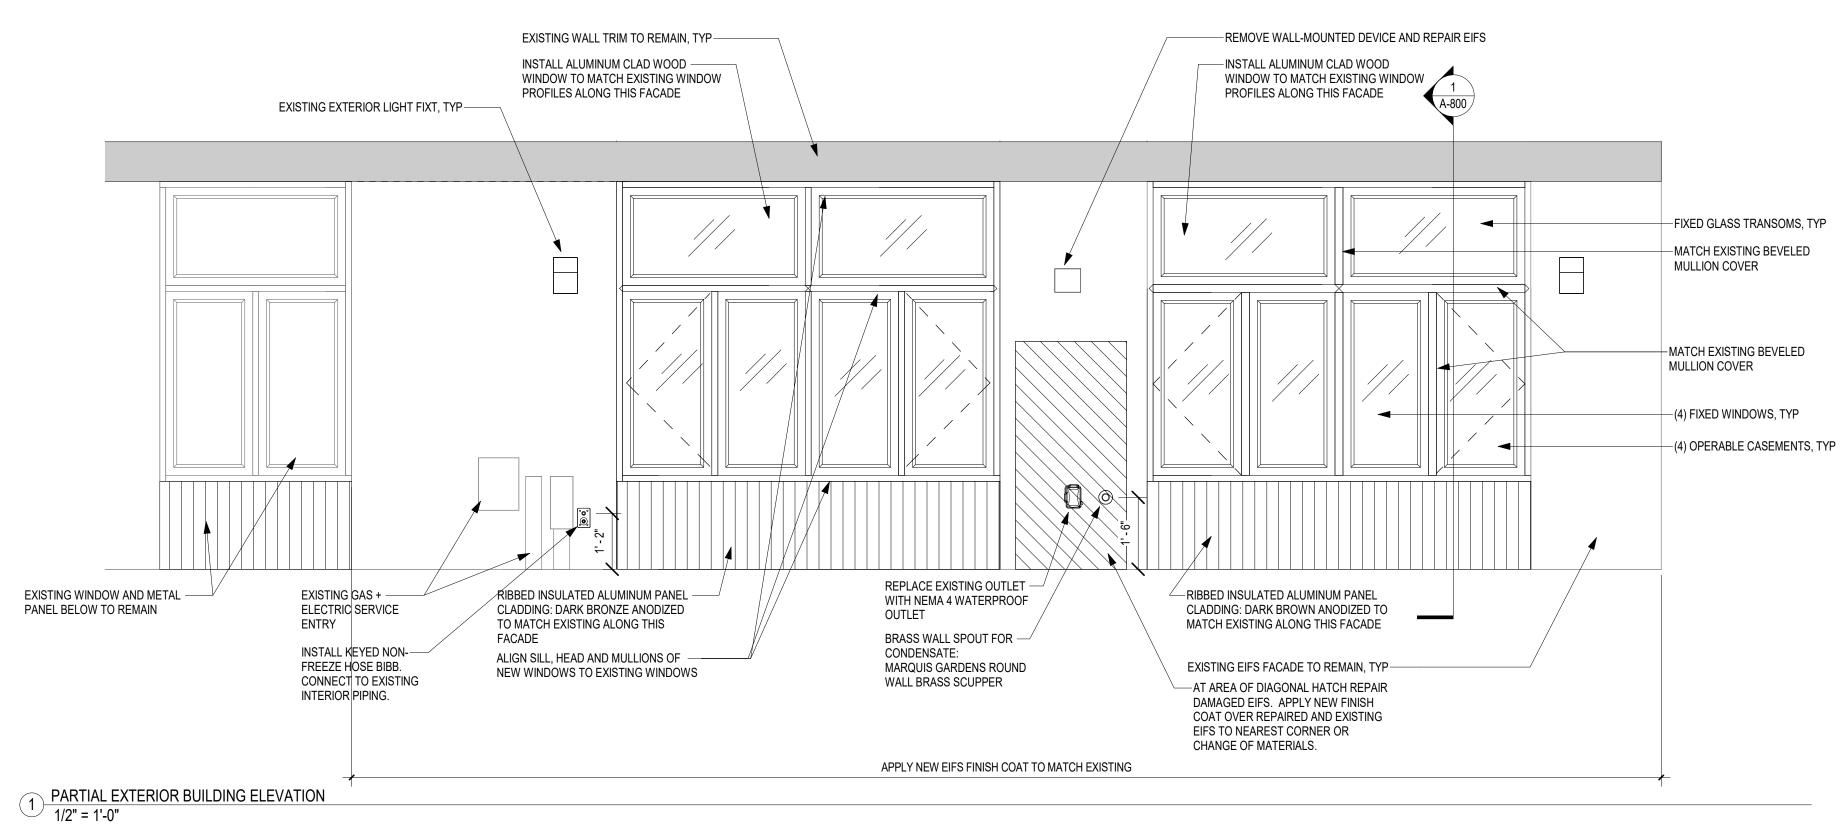





EXISTING CONDITIONS

	EXTERIOR GENERAL NOTES		
	1 NEW WINDOW SPECIFICATIONS: MATERIAL: HIGH PERFORMANCE PAINTED ALUMINUM EXTERIOR FRAME TO MATCH COLOR OF EXISTING WINDOWS. WOOD INTERIOR FRAMES PAINTED TO MATCH INTERIOR WALLS. PRODUCT: MARVIN ULTIMATE OUTSWING CASEMENTS WITH SCREENS AND		
	FIXED TRANSOMS 2. PROVIDE EXTERIOR WALL SUBMITTALS: A. WINDOW JAMB SILL + HEAD DETAILS SHOWING ADJACENT CONSTRUCTION, SEALANT JOINTS, AND CONNECTION TO		
	WEATHER BARRIER, MATCH TO EXISTING PROFILES.B. WINDOW AND GLAZING PRODUCT INFORMATION DEMONSTRATING		
	COMPLIANCE WITH ENERGY CODE REQUIREMENTS. C. ALUMINIUM CLADDING TO MATCH EXISTING, SHOWING SHEATHING, INSULATION AND ATTACHMENTS BACKUP MASONRY.		
	D. ALUMINUM CLADDING SAMPLE TO MATCH EXISTING.		
	E. CONDENSATE SPOUT ENERGY CODE NOTES PER 2020 EBCNYS		
	PROJECTION FACTOR= HORIZONTAL FROM GLAZING / OVERHANG TO BOTTOM OF GLAZING=		
	36" / 71" = 0.51 1. NEW WINDOW PERFORMANCE REQUIREMENTS C402.4:		
Ρ	FIXED WINDOW:38 U-FACTOR MAXIMUM OPERABLE WINDOW: .45 U-FACTOR MAXIMUM ALL WINDOWS: .36 SHGC MAXIMUM	7 BID SET 05.06.2024 6 ISSUED FOR FILING 02.21.2024 5 REVISED PER PARKS 02.16.2024	4
	2. NEW INSULATED ALUMINUM PANEL PERFORMANCE REQUIREMENTS C402.1.3: CONTINUOUS INSULATION: 9.5 R- VALUE MINIMUM	4 REVIEW SET 01.26.2024 3 REVIEW SET 01.19.2024 2 ISSUED 12.22.2023	4
	3. EXISTING EIFS EXTERIOR WALL: NO CHANGE 4. EXISTING CEILING INSULATION: NO CHANGE	1 REVIEW SET 10.30.2023	
		ISSUE/REVISION DAT	Έ
		APPLICANT UNTERMYER GARDENS CONSERVANCY	
		945 N BROADWAY YONKERS,NY 10701	
		T: 917-974-9713	
		BKSK	
		BKSK ARCHITECTS LLP 230 W 38TH STREET NEW YORK, NEW YORK 10018	
		T: 212.807.9600 WWW.BKSK.COM	
		Untermyer Multipurpose Room	
		945 N BROADWAY	
		YONKERS, NY 10701	
		DOB JOB #: 00000000	
		DRAWING TITLE	
		EXTERIOR ELEVATION	
		STAMP & SIGNATURE PROJECT NO. 221 DATE: 02/14/2 SCALE: As indicated	3
		SHEET NO. 6 OF	
		ARCHITECT, AIA	

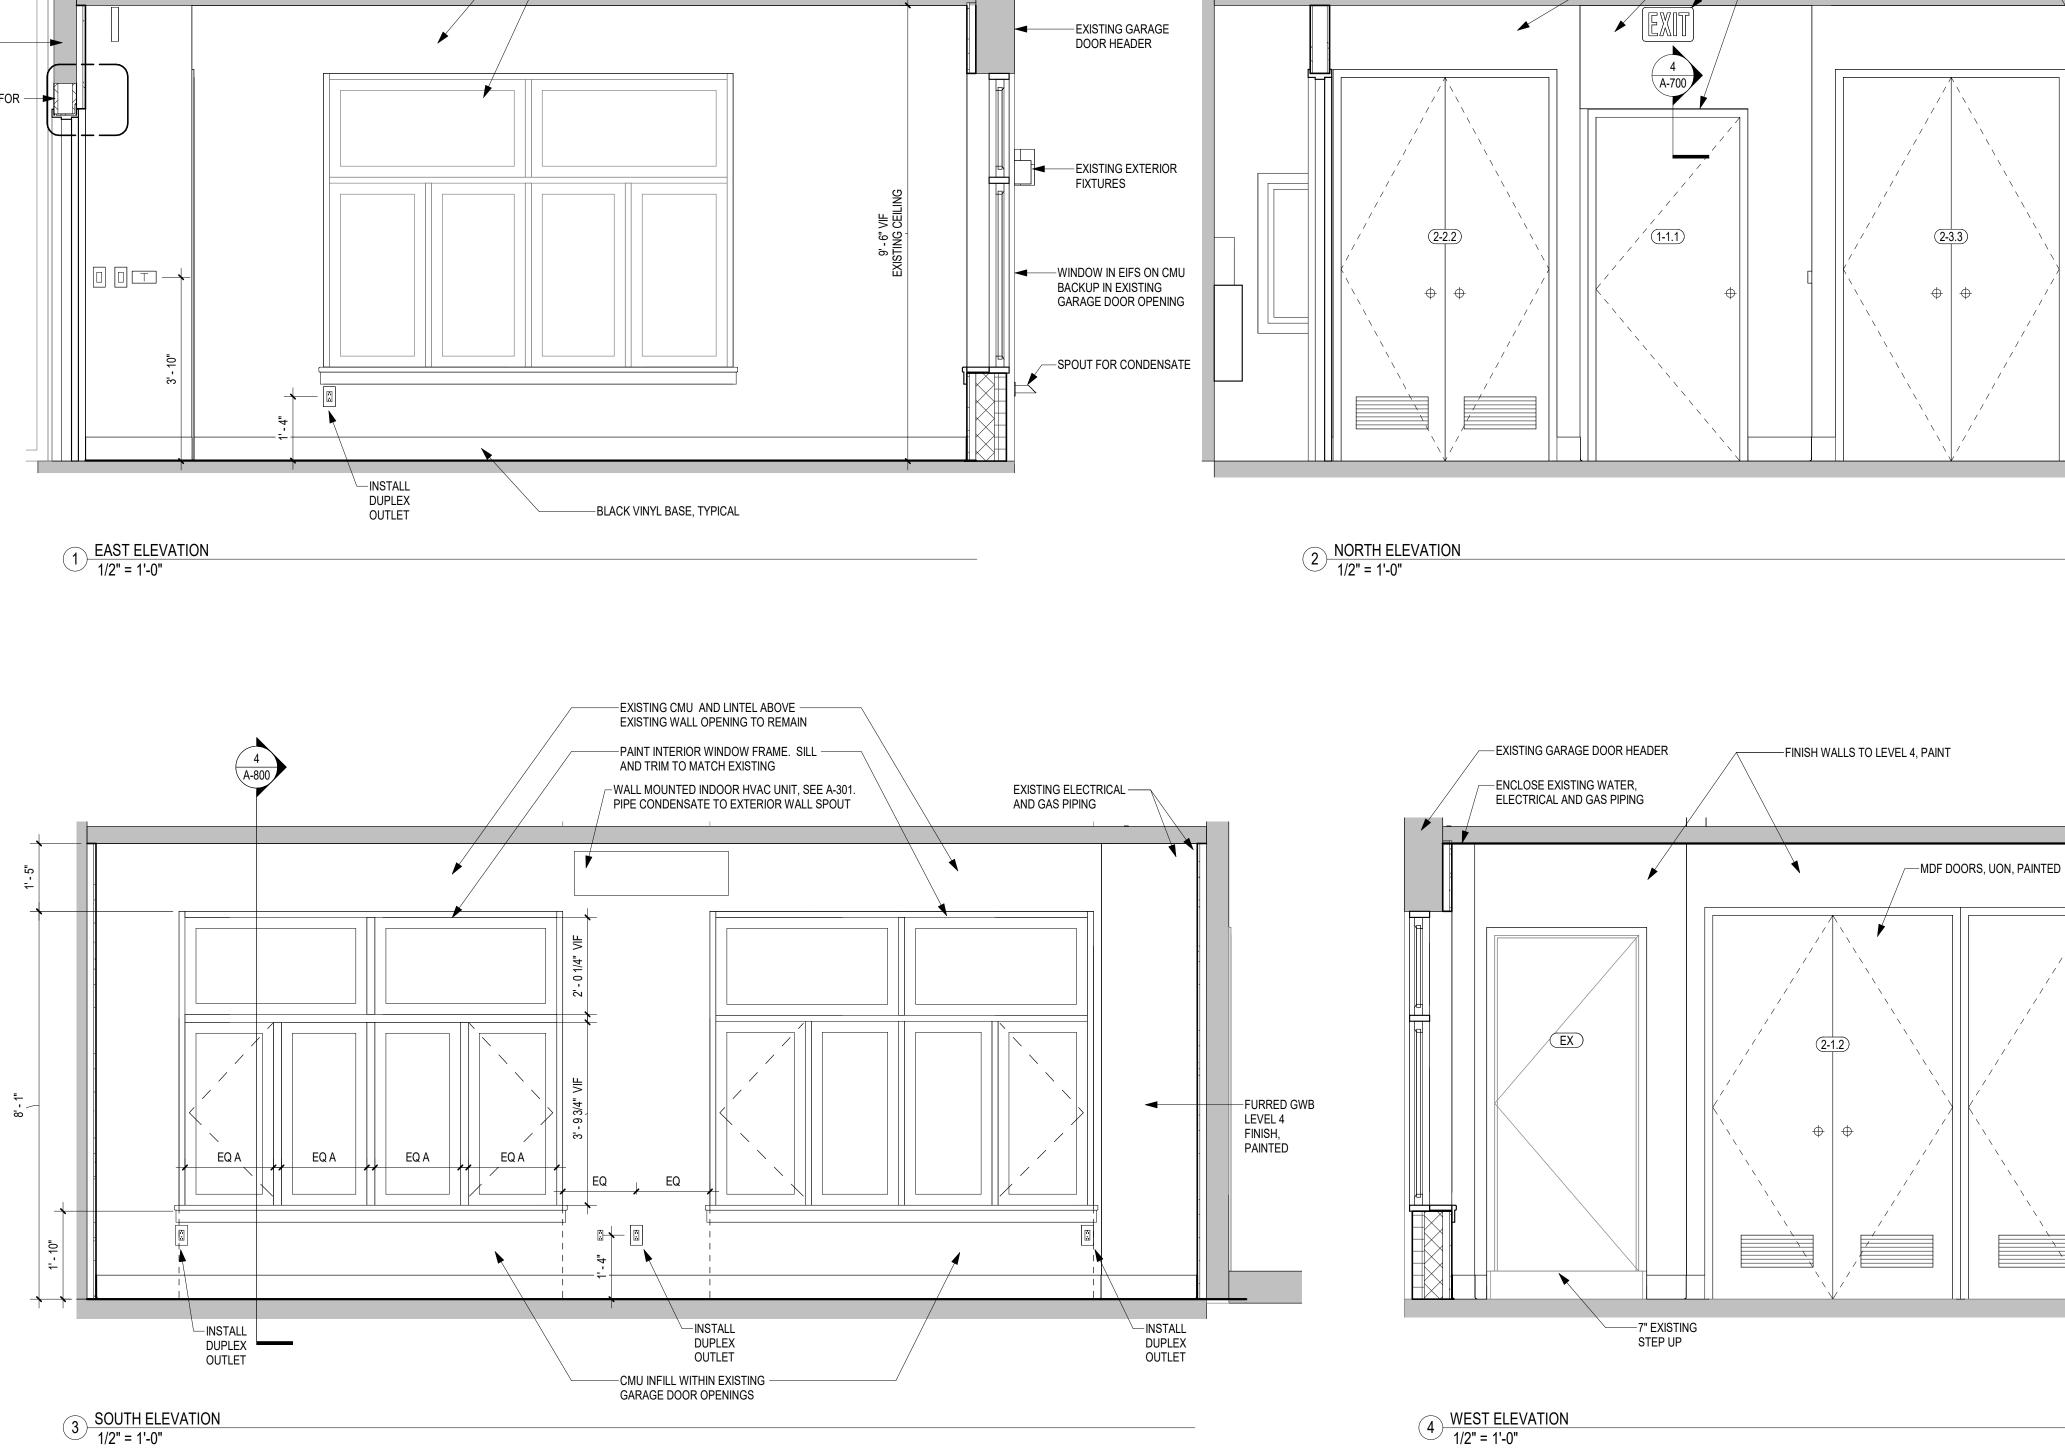


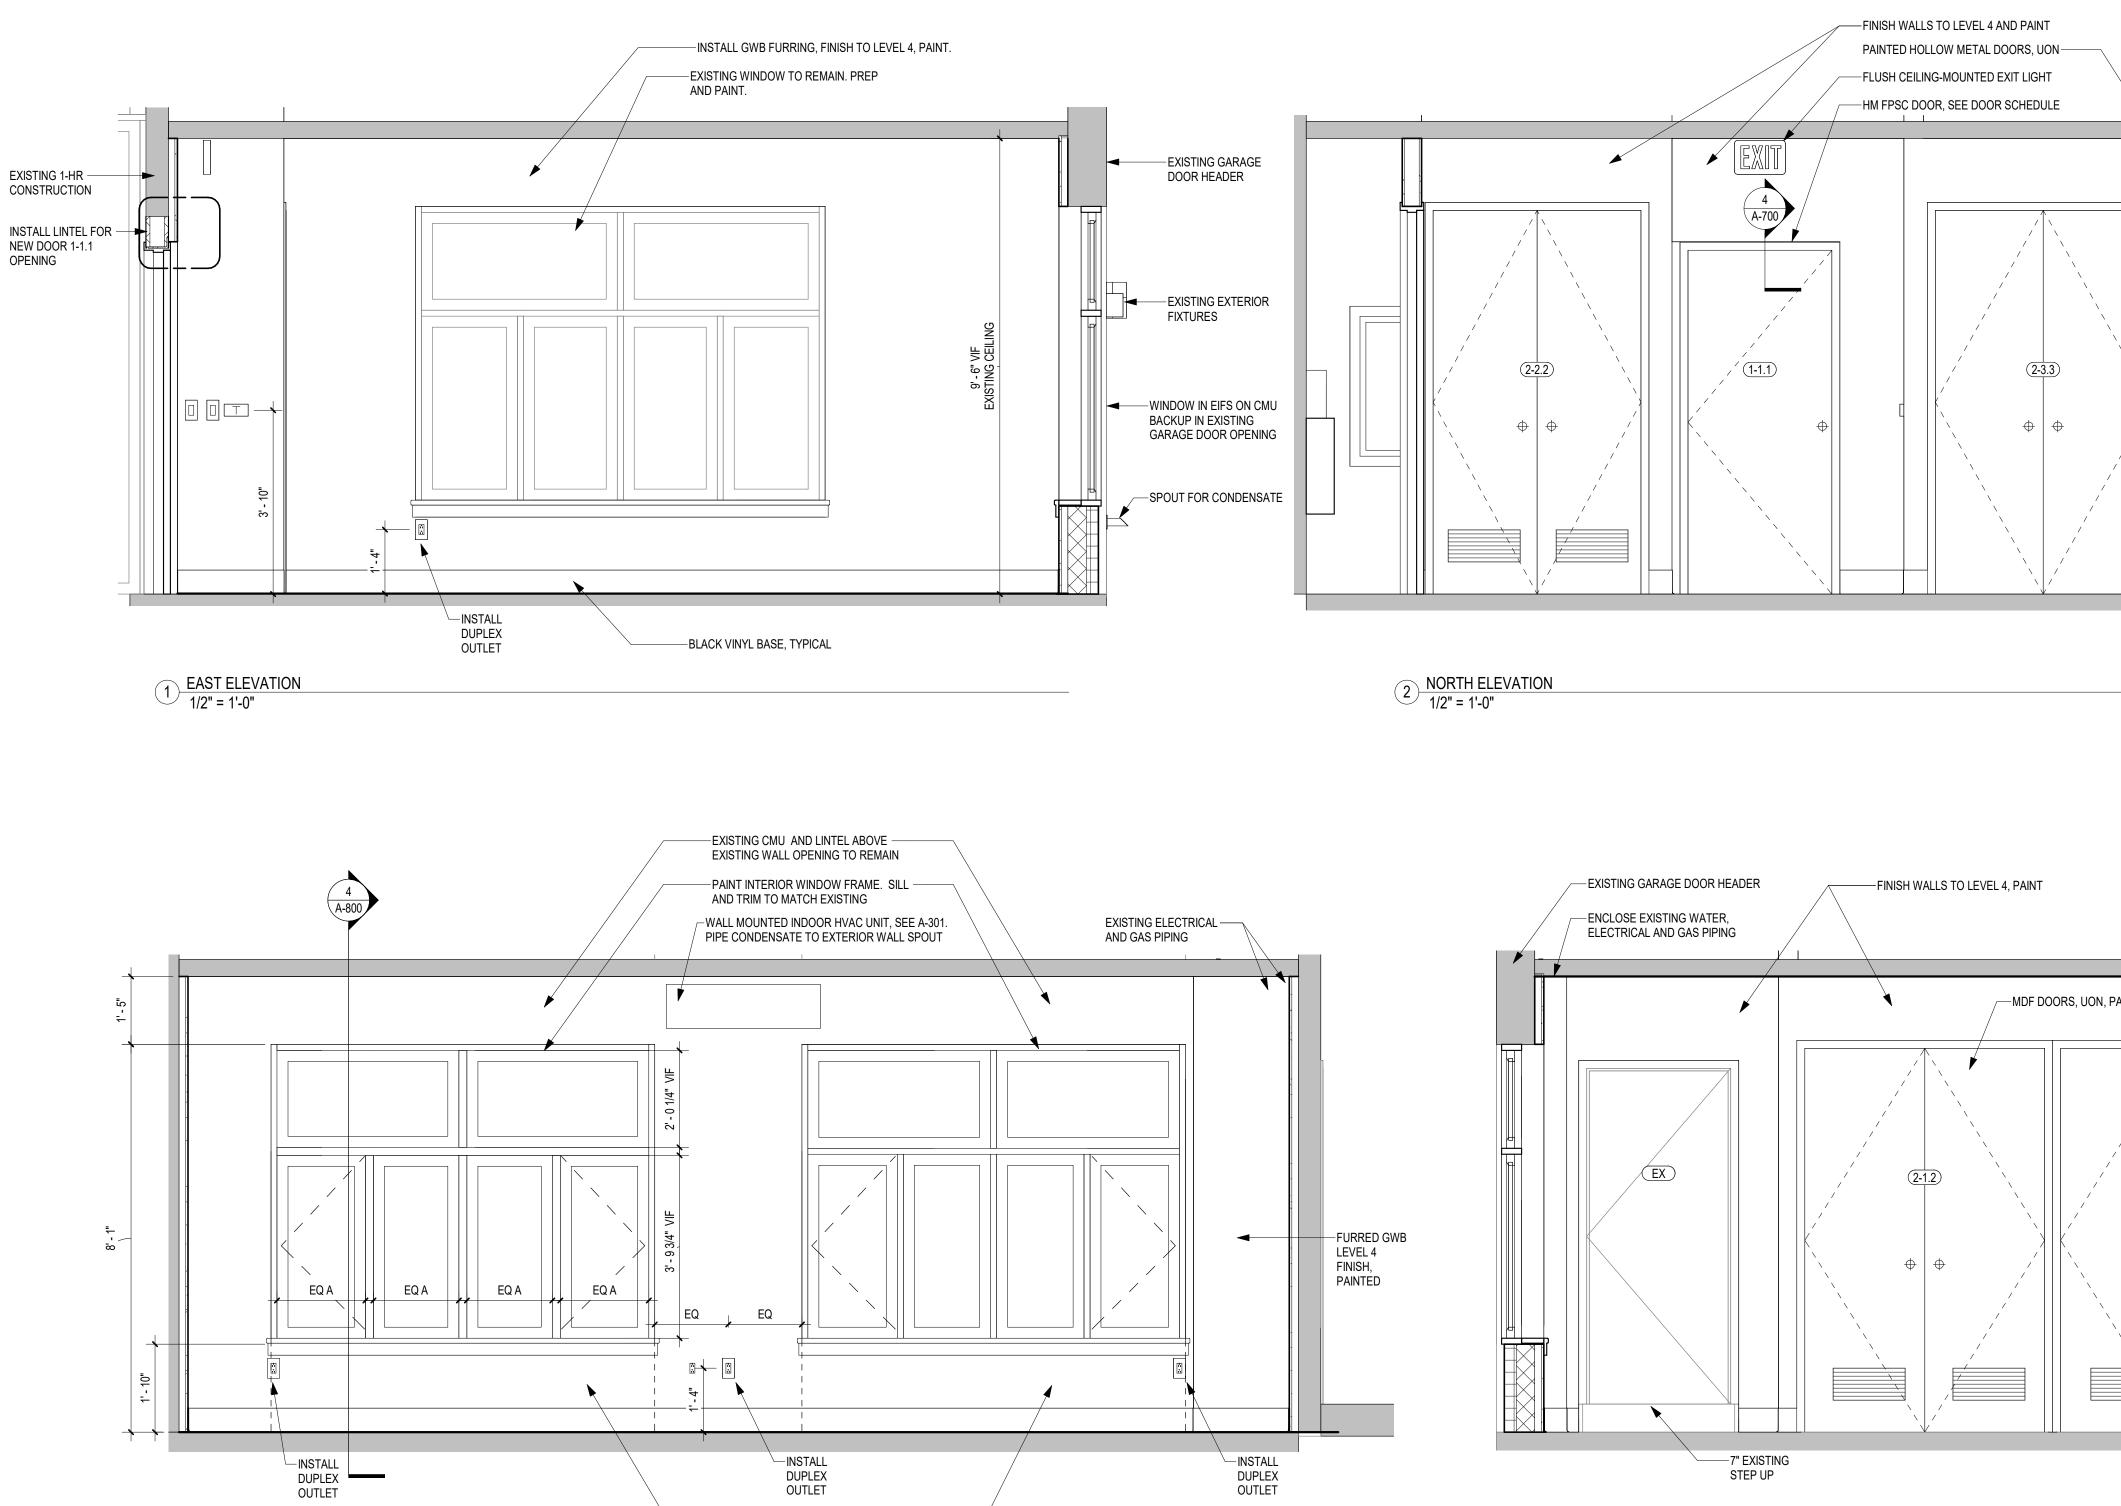



(4) WEST ELEVATION 1/2" = 1'-0"

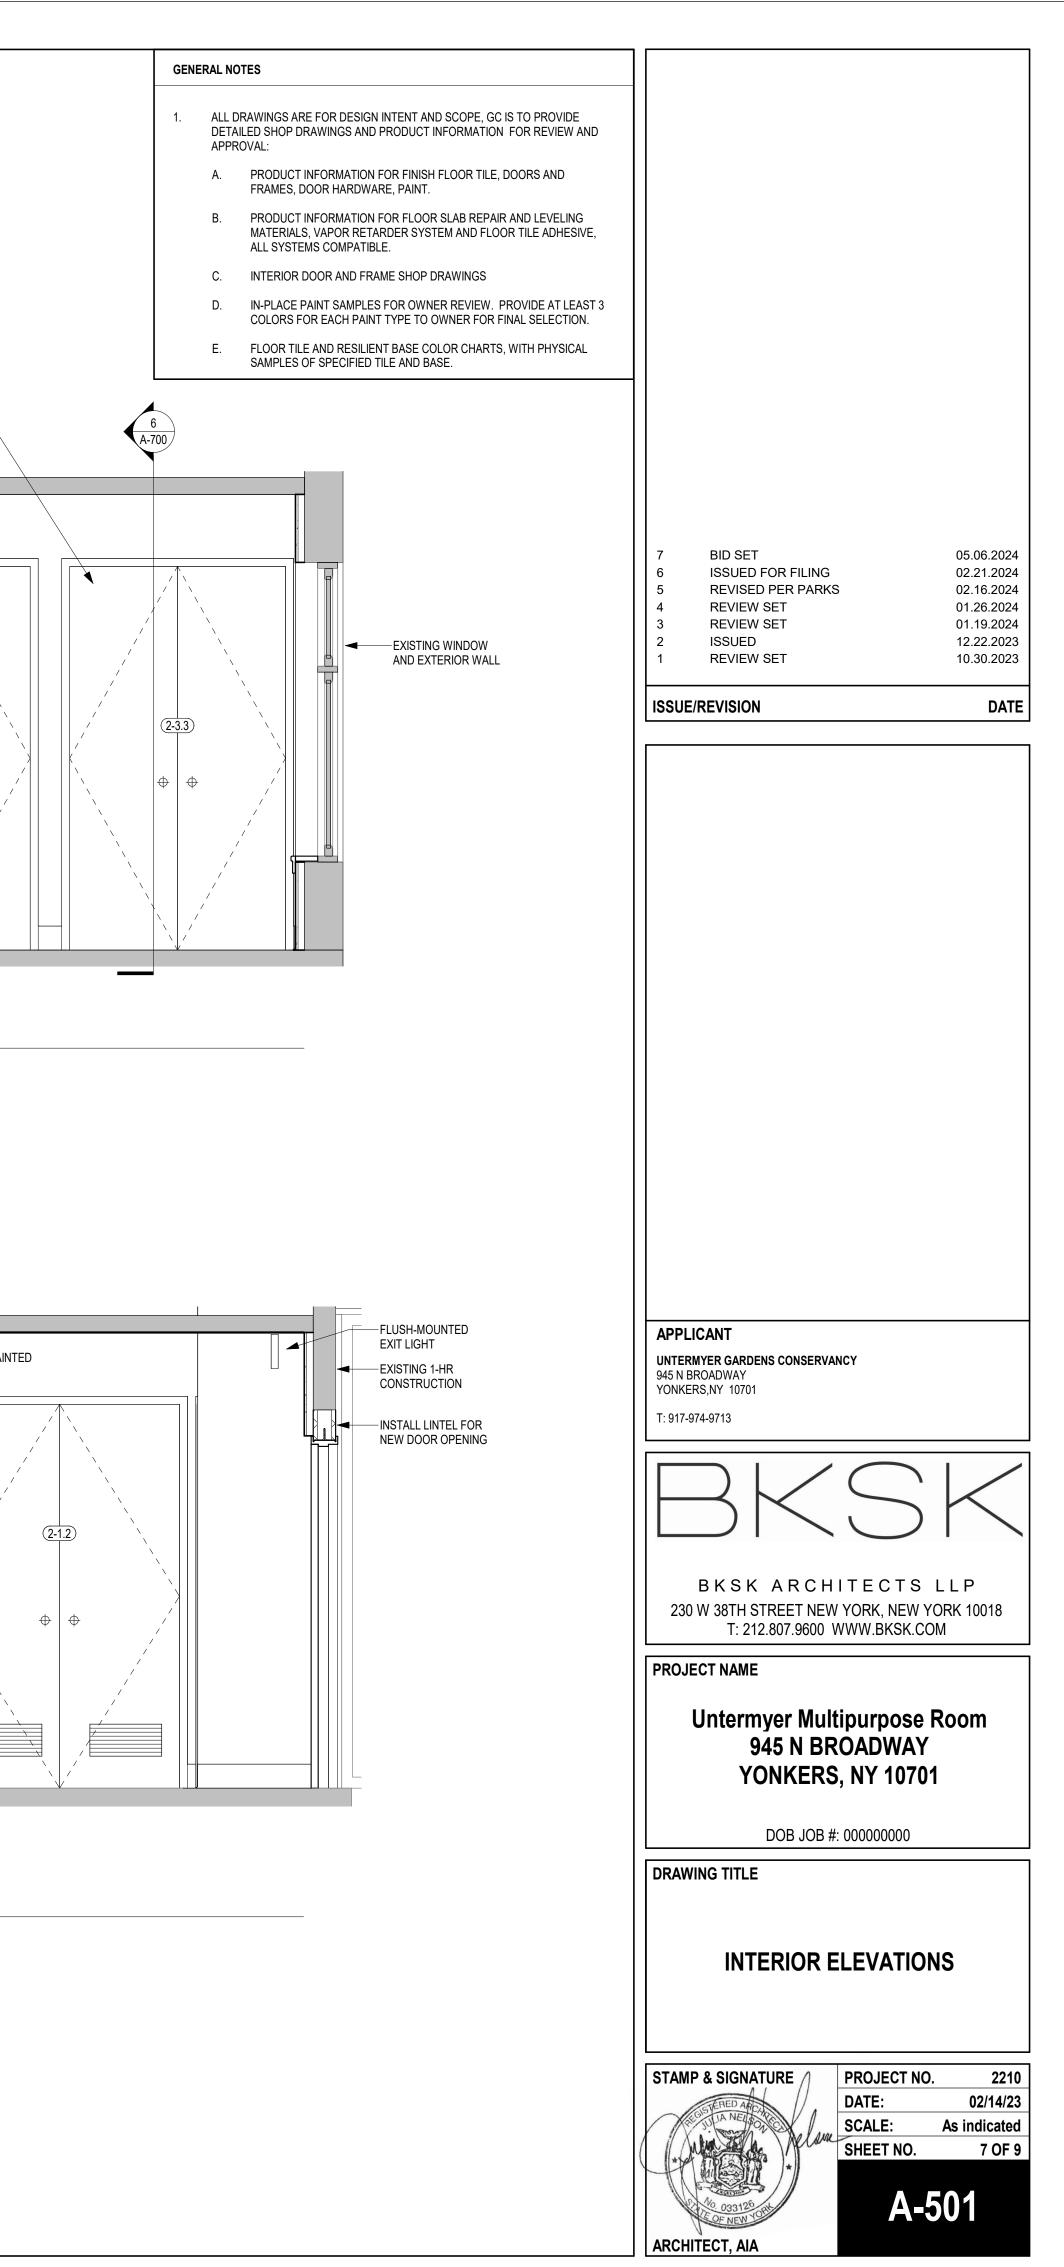



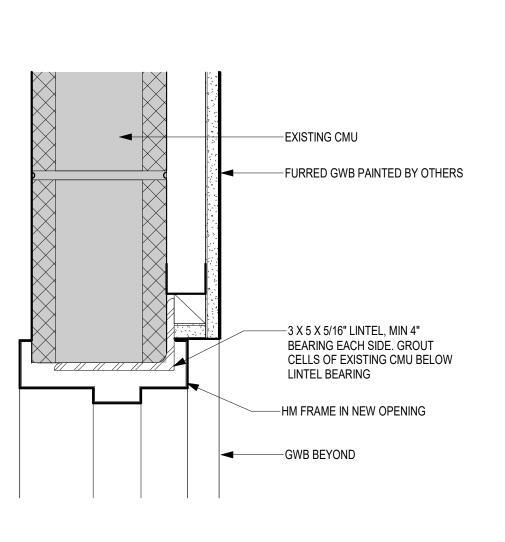


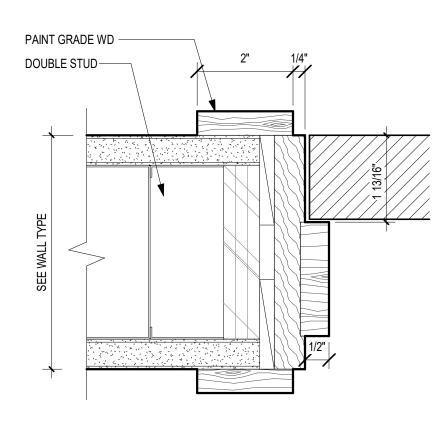


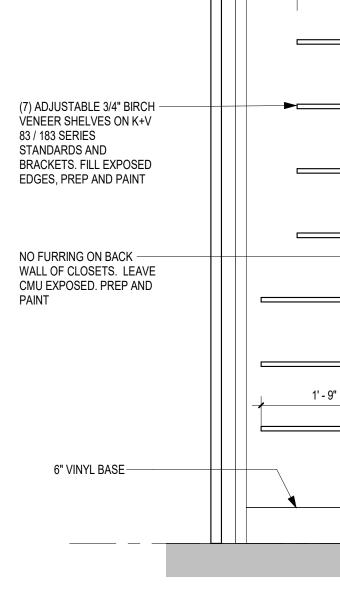

REPAIR / REPLACE ----EXISTING CEILING AT CLOSET. PAINT

6 CLOSET SECTION 3/4" = 1'-0"

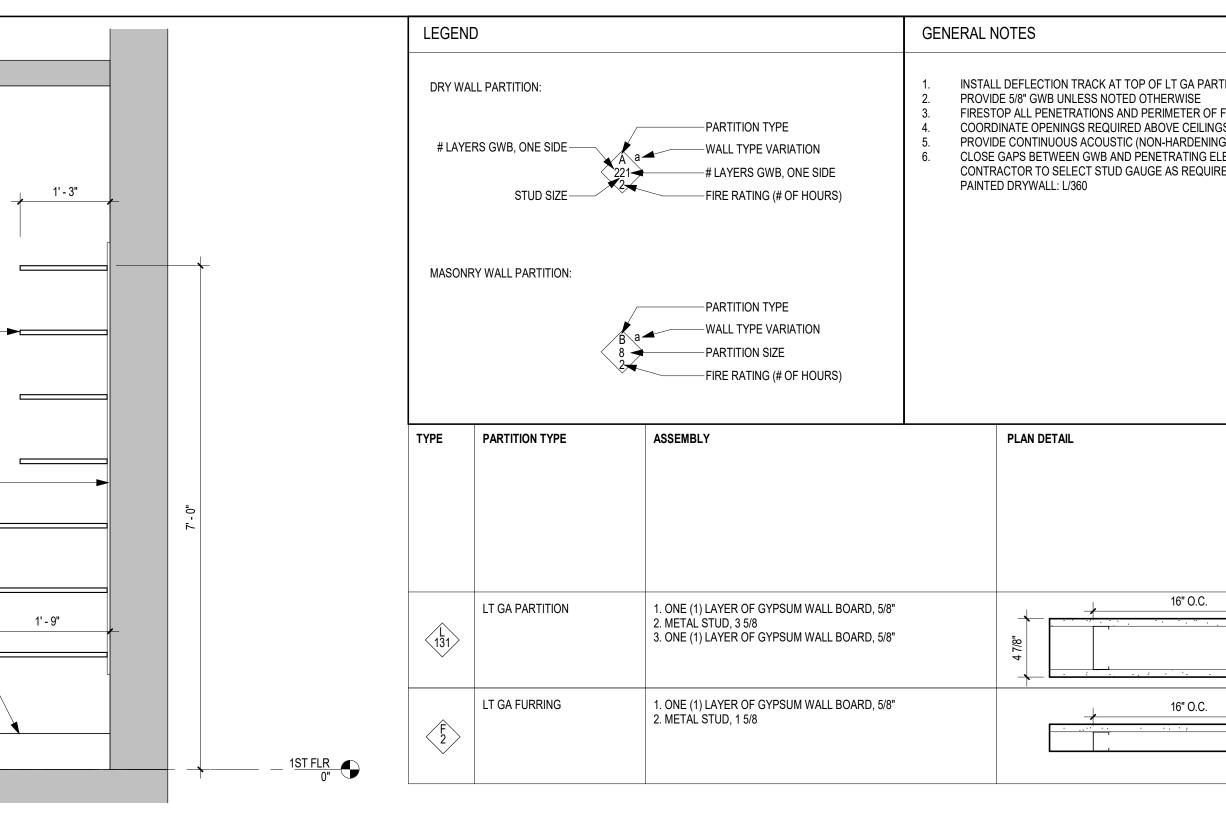


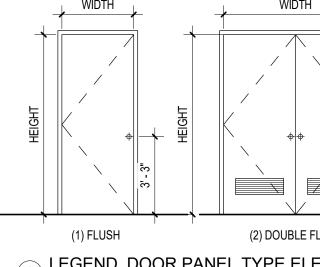



GENERAL NOTES 1. INSTALL DEFLECTION TRACK AT TOP OF LT GA PARTITIONS TO PERMIT MOVEMENT 2. PROVIDE 5/8" GWB UNLESS NOTED OTHERWISE 3. FIRESTOP ALL PENETRATIONS AND PERIMETER OF FIRE-RATED PARTITIONS 4. COORDINATE OPENINGS REQUIRED ADOVE CELLINGS REQUIRED OF MECHANICAL 5. PROVIDE CONTINUOUS ACOUSTIC (NON-HARDENING) SEALANT ON EACH SIDE OF T 6. CLOSG GAPS BETWEEN GWB AND PENETRATING ELEMENTS WITH ACOUSTIC SEAL CONTRACTOR TO SELECT STUD GAUGE AS REQUIRED BY STUD SPACING AND LEND PAINTED DRYWALL: L/360 PROVIDE DRYWALL: L/360	. RETURN AIR, IF A THE BOTTOM STUD ANT	NY.) RUNNER	BETWEEN THE GWB AND FLOOR.	7 BID SET 05.06.2024 6 ISSUED FOR FILING 02.21.2024 5 REVISED PER PARKS 02.16.2024 4 REVIEW SET 01.26.2024
5/8" 5/8" 5/8"	YES	49	U419 TAPE AND COMPOUND ALL DRYWALL. PROVIDE LEVEL 4 FINISH READY FOR PAINT BY OTHERS.	- 3 REVIEW SET 01.19.2024 2 ISSUED 12.22.2023 1 REVIEW SET 10.30.2023
5/8"	NO	-	- TAPE AND COMPOUND ALL DRYWALL. PROVIDE LEVEL 4 FINISH READY FOR PAINT	ISSUE/REVISION DATE
			BY OTHERS.	
	5 C GENERAL NOTE	E PARTITION SWB CO 12" = 1'- ES (DOOR S COORDINAT		
	3. DOOR S	UBMITALLS	S TO DOCUMENT FRAME INSTALLATION HEIGHTS AND RESPONDING UNDERCUT DIMENSIONS FOR ALL DOOR	APPLICANT UNTERMYER GARDENS CONSERVANCY 945 N BROADWAY YONKERS,NY 10701
WIDTH WIDTH WIDTH H H H H H H H H H H H H H	DOOR # LEAVE ILITY D DOOR SUE IT TO HARDWAF	2-2.	3)	T: 917-974-9713 BKSKARCHITECTSLLP 230 W 38TH STREET NEW YORK, NEW YORK 10018 T: 212.807.9600 WWW.BKSK.COM
Image: 1 LEGEND_DOOR PANEL TYPE ELEVATIONS 1 1/4" = 1'-0" DOOR SCHEDULE TYPE MATERIAL PANEL TYPE WIDTH HEIGHT DR THIC 1-1.1 MDF + MINERAL CORE FLUSH 3'-0" 7'-2" 1 3/4" 2-1.2 MDF DOUBLE FLUSH 5'-0" 8'-0" 1 3/4" 2-2.2 MDF DOUBLE FLUSH 4'-4" 8'-0" 1 3/4" 2-3.3 MDF DOUBLE FLUSH 4'-6" 8'-0" 1 3/4"	CKNESS FRAME HM WD WD WD WD	E HEA HEAD/J/ HEAD/J/ HEAD/J/ HEAD/J/	AMB 12WITH LOUVERSAMB 12WITH LOUVERS	PROJECT NAME Untermyer Multipurpose Room 945 N BROADWAY YONKERS, NY 10701 DOB JOB #: 00000000
PREP AND PAINT ALL DOORS AND FRAMES HARDWARE SET SCHEDULE HW SET HARDWARE TYPE ARCHITECTURAL TRIM HINGES/SLIDER 1 ENTRY MANUF/MODEL: CORBIN RUSSWIN CITATION LEVER WITH ROUND ROSE FINISH: STAINLESS STEEL (32D) MANUF/MODEL: MCKIN TA714 OR EQUAL FINISH: STAINLESS STEEL (32D) 2 UTILITY CLOSET MANUF/MODEL: CORBIN RUSSWIN CITATION LEVER WITH ROUND ROSE MANUF/MODEL: MCKIN TA714 OR EQUAL	EEL	TUBULAR PRIVACY CLOSET LOCKSET	R YES PEMKO N/A (3) SET EV2320BL VINYL 608 OR SADDLE EQUAL	DRAWING TITLE PARTITION AND DOOR TYPES, SCHEDULES
Image: Storage closet MANUF/MODEL:CORBIN RUSSWIN CITATION MANUF/MODEL: MCKIN 3 STORAGE CLOSET MANUF/MODEL:CORBIN RUSSWIN CITATION MANUF/MODEL: MCKIN		DUMMY	N/A N/A N/A (2)	STAMP & SIGNATURE PROJECT NO. 2210 DATE: 03/20/23 SCALE: As indicated
ALL DOOR HARDWARE BRUSHED STAINLESS STEEL COORDINATE KEYING AND KEYWAYS WITH OWNER	EEL	ROLLER CATCH	ITH ROCKWOOD 608 OR EQUAL	SHEET NO. 8 OF 9 ADCHITECT AIA

GENERAL NOTES 1. INSTALL DEFLECTION TRACK AT TOP OF LT GA PARTITIONS TO PERMIT MOVEMENT 2. PROVIDE 5/8" GWB UNLESS NOTED OTHERWISE 3. FIRESTOP ALL PENETRATIONS AND PERIMETER OF FIRE-RATED PARTITIONS 4. COORDINATE OPENINGS REQUIRED ABOVE CEILINGS REQUIRED FOR MECHANICAL 5. PROVIDE CONTINUOUS ACOUSTIC (NON-HARDENING) SEALANT ON EACH SIDE OF T 6. CLOSE GAPS BETWEEN GWB AND PENETRATING ELEMENTS WITH ACOUSTIC SEALAR CONTRACTOR TO SELECT STUD GAUGE AS REQUIRED BY STUD SPACING AND LENC PAINTED DRYWALL: L/360	. RETURN THE BOTT ANT	I AIR, IF AN OM STUD I	Y. RUNNER	BETWEEN TI	HE GWB AND FLOOR.	
PLAN DETAIL	FIRE RATING	ACOUSTIC INSULATION	STC RATING	UL LISTING (OR OTHER)	NOTES	7 BID SET 05.06.2024 6 ISSUED FOR FILING 02.21.2024
5/8" 5/8"		YES	49	U419	TAPE AND COMPOUND ALL DRYWALL. PROVIDE LEVEL 4 FINISH READY FOR PAINT BY OTHERS.	5 REVISED PER PARKS 02.16.2024 4 REVIEW SET 01.26.2024 3 REVIEW SET 01.19.2024 2 ISSUED 12.22.2023 1 REVIEW SET 10.30.2023
5/8"		NO	-	-	TAPE AND COMPOUND ALL DRYWALL. PROVIDE LEVEL 4 FINISH READY FOR PAINT BY OTHERS.	
	1.	GC TO CC	WB CC 2" = 1'-	CHEDULE)	HEIGHTS WITH SADDLE DETAILS	
	2. 3.	DOOR SU	BMITALLS	S TO DOCUM	O BE FULLY WELDED, UON ENT FRAME INSTALLATION HEIGHTS AND G UNDERCUT DIMENSIONS FOR ALL DOOR	APPLICANT UNTERMYER GARDENS CONSERVANCY 945 N BROADWAY YONKERS,NY 10701 T: 917-974-9713
Image: Second state sta	D C IT TO I	EXISTING DOOR # LEAVES DOOR SUBT HARDWARE 3) KEY TO I	2-2.: YPE E SET	3)		BKSKARCHITECTSLLP 230 W 38TH STREET NEW YORK, NEW YORK 10018 T: 212.807.9600 WWW.BKSK.COM
Type MATERIAL PANEL TYPE WIDTH HEIGHT DR THIC 1-1.1 MDF + MINERAL CORE FLUSH 3'-0" 7'-2" 1 3/4" 2-1.2 MDF DOUBLE FLUSH 5'-0" 8'-0" 1 3/4" 2-2.2 MDF DOUBLE FLUSH 4'-4" 8'-0" 1 3/4" 2-3.3 MDF DOUBLE FLUSH 4'-6" 8'-0" 1 3/4"	CKNESS	FRAME HM WD WD WD	HEAD/J/ HEAD/J/ HEAD/J/ HEAD/J/	AMB 1 AMB 1	HARDWARE SET NOTES 1 45 MIN FPSC 2 WITH LOUVERS 2 WITH LOUVERS 3	Untermyer Multipurpose Room 945 N BROADWAY YONKERS, NY 10701 DOB JOB #: 00000000
HARDWARE SET SCHEDULE HW SET HARDWARE TYPE ARCHITECTURAL TRIM HINGES/SLIDER 1 ENTRY MANUF/MODEL: CORBIN RUSSWIN CITATION LEVER WITH ROUND ROSE FINISH: STAINLESS STEEL (32D) MANUF/MODEL: MCKIN TA714 OR EQUAL FINISH: STAINLESS STEEL (32D) 2 UTILITY CLOSET MANUF/MODEL: CORBIN RUSSWIN CITATION LEVER WITH ROUND ROSE MANUF/MODEL: MCKIN TA714 OR EQUAL	INEY WA IVE EEL	ES 61A	LOCKSE TUBULAR PRIVACY CLOSET	SET YES	R GASKETING DOOR BOTTOM SILENCER PEMKO N/A (3) EV2320BL ROCKWOOD VINYL 608 OR SADDLE EQUAL N/A N/A	PARTITION AND DOOR TYPES, SCHEDULES
LEVER WITH ROUND ROSE TA714 OR EQUAL FINISH: STAINLESS STEEL (32D) AT FINISH: STAINLESS STEEL (32D) AT INACTIVE DOOR DUMMY LEVER AND FLUSH BOLT TOP AND BOTTOM 3 STORAGE CLOSET MANUF/MODEL:CORBIN RUSSWIN CITATION LEVER WITH ROUND ROSE FINISH: STAINLESS STEEL (32D) MANUF/MODEL: MCKIN ALL DOOR HARDWARE BRUSHED STAINLESS STEEL COORDINATE KEYING AND KEYWAYS WITH OWNER	INEY N/A	A	LOCKSET DUMMY LEVER WI ROLLER CATCH	N/A	ROCKWOOD 608 OR EQUALN/AN/AN/A(2) ROCKWOOD 608 OR EQUAL	STAMP & SIGNATURE PROJECT NO. 2210 DATE: 03/20/23 SCALE: As indicated SHEET NO. 8 OF 9 A-700

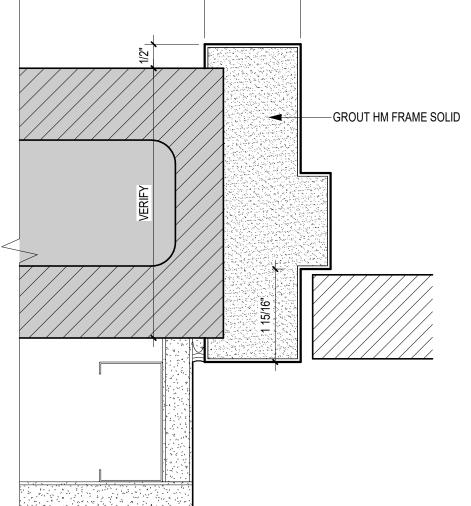

2"



2 HEAD/JAMB 2 - DOUBLE RABBET METAL FRAME MASONRY W/ FURRING 6" = 1'-0"

ARCHITECT, AIA

