

	i					JRE SCHEDULE	SYMBOLS AND ABBREVIATIONS	
S EVATION FIXTURES	RES V		VENT		HOT	DESCRIPTION	SYMBOL ABBREVIATION DESCRIPTION	
				WATER	WATER	MANUFACTURER: AMERICAN STANDARD MODEL: AFWALL ELONGATED TOILET LESS EVERCLEAN		
WATER CLOS		4"	2"	11⁄4"	-	1.6 GPF FLUSH VALVE, WALL MOUNTED TOILET, WITH ELONGATED BOWL, VITREOUS CHINA, WITH EVERCLEAN. 1½" INLET SPUD, 2½" TRAPWAY, 10"x12" WATER SURFACE AREA.	– AHC ABOVE HUNG CE – BFP BACK FLOW PRE	
WALLINGON						FLUSH VALVE: AMERICAN STANDARD SELECTRONIC #6065.161.002 BATTERY POWER (TOP SPUD) RECESSED WALL MOUNT TYPE PROVIDE WALL CARRIER	- BALL VALVE	
						MANUFACTURER: SLOAN SOLID SURFACE 1-STATION WALL MOUNTED SINK	BASKET STRAINE	ER
LAVATORY WALL HUNG		2"	2"	³ ⁄4"	³ ⁄4"	MODEL: ELGR-81000 SLOANSTONE SOLID SURFACE. DOUBLE HOLE FAUCET; MODEL: REFER TO ARCHITECTURAL PLANS	BUTTERFLY VALV	VE
							CHECK VALVE	
LAVATORY						MANUFACTURER: SLOAN SOLID SURFACE 2-STATION WALL MOUNTED SINK MODEL: ELGR-82000		
WALL HUNG		2"	2"	3⁄4"	3⁄4"	SLOANSTONE SOLID SURFACE. DOUBLE HOLE FAUCET; MODEL: REFER TO ARCHITECTURAL PLANS	T CODP CLEAN OUT DECI - - - -	K PLATE
							COLD WATER	
LAVATORY WALL HUNG		2"	2"	3⁄4"	3⁄4"	MANUFACTURER: SLOAN MODEL: ELGR-83000 SLOANSTONE SOLID SURFACE. TRIPLE HOLE	- DCV DOUBLE CHECK	
						FAUCET; MODEL: REFER TO ARCHITECTURAL PLANS	ECCENTRIC RED	UCER
						MANUFACTURER: AMERICAN STANDARD MODEL: 6002.001 TOP SPUD HIGH EFFICIENCY URINAL 0.125 GPF, VITREOUS CHINA, ³ / ₄ " INLET SPUD, OUTLET CONNECTION 2" THREADED INSIDE.	C _ ELBOW DOWN	
URINAL	AL	3"	2"	3⁄4"	-	FLUSH VALVE: MODEL 6063013.002, 0.125 GPF EXPOSED TOP SPUD RECESSED WALL MOUNT TYPE S ELECTRONIC URINAL FLUSH VALVE. 20 PSI (FLOWING), 80 PSI (STATIC) OPERATING PRESSURE. 10 GPM FLOW	O – ELBOW UP	
~						REQUIREMENT PROVIDE WALL CARRIER	– DEM. EXISTING TO BE	REMOVE
		0"	0"	374	374	MANUFACTURER: BEST BATH SYSTEMS MODEL: 4LSS24038A75FTB.V3* 38.25"x40.5"x80.5" SHOWER, FIBERGLASS	EX. EXISTING TO REM	
SHOWER (AE	(ADA)	3"	2"	³ ⁄4"	³ /4"	NOTES: INSTALL IN ACCORDANCE WITH MANUFACTURER'S SPECIFICATIONS AND ADA GUIDELINES. PROVIDE MOEN HANDHELD KIT KACXMOAN1001 OR APPROVED EQUIVALENT.		
							- FCO FLOOR CLEAN OF - FS FLOOR SINK	
SHOWER (AD	R (ADA)	3"	2"	³ ⁄4"	³ ⁄4"	MANUFACTURER: BEST BATH SYSTEMS MODEL: 4LSS26337A75FTB.V3* 38.5"x63"x80.5" SHOWER, FIBERGLASS	- FLOW ARROW	
					7 4	NOTES: INSTALL IN ACCORDANCE WITH MANUFACTURER'S SPECIFICATIONS AND ADA GUIDELINES. PROVIDE MOEN HANDHELD KIT KACXMOAN1001 OR APPROVED EQUIVALENT.	– FAI FRESH AIR INTAK	KE
							GATE VALVE	
ART ROOM		2"	2"	³ ⁄4"	³ ⁄4"	MANUFACTURER: ELKAY MODEL: EWMA4820C 304 STAINLESS STEEL WALL HUNG MULTIPLE STATION HAND WASH SINK. INCLUDE SOLIDS INTERCEPTOR AT	GLOBE VALVE	
	rx					DRAIN.	- HW HOT WATER	
						MANUFACTURER: ELKAY	- HW HTR HOT WATER HEA	\TER
SINK (ADA)	ADA)	2"	2"	³ ⁄4"	³ ⁄4"	MODEL: LRAD221955 FAUCET; MAKE: ELKAY MODEL: LK406GN05T4	- HWC HOT WATER REC	IRCULAT
						304 STAINLESS STEEL DROP IN ADA SINK. FAUCET SHALL BE BRASS MATERIAL, & DOUBLE HOLE WITH A FLOW RATE OF 1.5 GPM. INCLUDE SOLIDS INTERCEPTOR AT DRAIN.	– LDR LEADER	
						MANUFACTURER: ZURN		11
JANITOR'S SI	S SINK	3"	2"	³ ⁄4"	³ ⁄4"	MODEL: Z5850 FAUCET: ZURN SINK FAUCET Z843M1-XL ENAMELED CAST IRON CORNER FLOOR SINK WITH 28x28x8 BOWL, 3" DRAIN WITH DRAIN GRID	ー NEW NEW WORK	
						ENAIVELED CAST IKON CORNER FLOOR SINK WITH 2022020 BOWL, 3' DRAIN WITH DRAIN GRID		V E
						MANUFACTURER: CURTIS	· · · · · · · · · · · · · · · · · · ·	
COFFEE MAK	MAKER	-	-	3⁄4"	-	MODEL: ALPHA G3 AUTOMATIC COFFEE BREWING SYSTEM SHALL BE ABLE TO BREW 12 GAL/HR ELECTRICAL: 120/1/60, 1800 WATTS, 15 AMPS	PRESSURE GAGE	
							PRESSURE REDU	UCING VA
						MANUFACTURER: KEURIG	© – PUMP	
	MAKER	-	-	3⁄4"	-	MODEL: KEURIG K-2500 PLUMBED COMMERCIAL COFFEE MAKER ELECTRICAL: 120/1/60, 1800 WATTS, 12 AMPS	PD PUMP DISCHARG	Æ
							- RPZ REDUCED PRESS	SURE ZOI
ICE ICE MACHIN				3⁄4"		MANUFACTURER: AVANTCO ICE MACHINES MODEL: KMC-H-530-A 30" AIR COOLED MODULAR HALF CUBE ICE MACHINE WITH BIN - 500LB.	- REL. REMOVE AND RE	ELOCATE
		-	-	74	-	ICE MAKER WITH BIN. SHALL BE ABLE TO PRODUCE 500 LBS/DAY AT 90°F. 350 LB BIN STORAGE CAPACITY. ELECTRICAL: 115/1/60, 9.4 AMPS	S SANITARY	
							SOLENOID VALVE	E
ICE ICE MACHIN	CHINE	_	_	³ ⁄4"	_	MANUFACTURER: AVANTCO ICE MACHINES MODEL:UC-F-120-A-19" AIR COOLED UNDERCOUNTER FULL CUBE ICE MACHINE - 129LB. ICE MAKER WITH BIN. SHALL BE ABLE TO PRODUCE 129 LBS/DAY AT 90°F. 40 LB BIN STORAGE CAPACITY.	- STRAINER	
						ELECTRICAL: 115/1/60, 5 AMPS	C – TEE DOWN	JC
						MANUFACTURER: JACKSON WAREWASHING SYSTEMS	O – TEE UP	
DISHWASHE	SHER	1-3⁄8"	-	-	¹ /2"	MODEL: DISHSTAR HT-E UNDERCOUNTER DISHWASHER, HIGH TEMPERATURE SANITIZING. 27 RACKS PER HOUR CAPACITY, 100 SECOND	L - THERMOMETER	
						CYCLE, BOTTOM MOUNTED CONTROLS WITH STAINLESS STEEL TOP AND SIDE PANELS, AND BUILT IN BOOSTER HEATER. 180°F FINAL RINSE WATER. ELECTRICAL: 208/60/1	- TYP. TYPICAL	
						MANUFACTURER: ELKAY	T&P RELIEF VALV	VE
DRINKING FOUNTAIN		2"	2"	3⁄4"	-	MODEL: LZSTL8WSLK ezH20 BOTTLE FILLING STATION AND BI-LEVEL ADA COOLER FILTERED REFRIGERATED LIGHT GRAY. 8.0 GPH OF 50°F DRINKING WATER BASED ON 80°F INLET WATER AND 90°F AMBIENT		
						MODEM: V/P/Hz: 115/1/60, FLA=6	- V VENT	
							- VTR VENT THROUGH	
DRINKING FOUNTAIN		2"	2"	³ ⁄4"	-	MODEL: LZS8WSLK exH20 BOTTLE FILLING STATION WITH SINGLE ADA COOLER FILTERED REFRIGERATED LIGHT GRAY. 8.0 GPH OF 50°F DRINKING WATER BASED ON 80°F INLET WATER AND 90°F AMBIENT MODEM: V/P/Hz: 115/1/60, FLA=6	- WCO WALL CLEAN OUT - W WASTE LINE	I
							W WASTE LINE NOTE: FOR REFERENCE ONLY. NOT ALL SYMBOLS OR ABBREV	
						FLOOR DRAIN; MAKE: JR SMITH	PROJECT.	
FLOOR DRA	DRAIN	3"	2"	-	-	MODEL: 2110 MEDIUM DUTY DRAIN, 8.5" ROUND TOP, STRAINER. PROVIDE TRAP SEAL	PLUMBING MATERIALS	
							1. ALL PIPING BURIED BELOW THE GARAGE SLAB SHALL WEIGHT CAST IRON CHARLOTTE PIPE "EDGE HP IRON"	
PARKING		0"	0"			WADE #W-1210-27 WITH CAST IRON BODY, CAST IRON DRAINAGE FLANGE, SEDIMENT BUCKET, FLASHING	GASKETS ASTM C564 OR LEAD & OAKUM. REFER TO SI	
GARAGE FLOOR DRA		3"	2"	-	-	COLLAR, 12" ROUND HEAVY DUTY CAST IRON GRATE. PROVIDE <u>TG-1</u> FOR EACH FD.		
							GENERAL NOTES	
			_	_	_	HOSE BIB; MAKE: WOODFORD MODEL: 65	1. THE CONTRACT DRAWINGS INDICATE THE EXTENT SYSTEMS. IF ANY DEPARTURES FROM THE DRAW	
HOSE-BIB	-BIB					ANTI-SIPHON PROTECTED AUTOMATIC DRAINING FREEZELESS WALL HYDRANT WITH INTEGRAL VACUUM BREAKER	CONTRACTOR, DETAILS OF SUCH DEPARTURES AND TH OWNER AND ENGINEER FOR APPROVAL. NO SUCH DE	IE REASO
							APPROVAL OF THE OWNER AND ENGINEER. EQUIP ADEQUATE AND ACCEPTABLE CLEARANCES FOR ENTR	MENT AN
		-	-	-		FLOOR CLEANOUT WITH ADJUSTABLE HEAD, ANCHOR FLANGE, CUT-OF SECTIONS AND ROUND SCORIATED NICKEL-BRONZE TOP: WADE #W-6000 OR APPROVED EQUAL. PROVIDE HEAVY DUTY CAST IRON TOP FOR	PIPING AND EQUIPMENT LOCATIONS NECESSARY TO A MADE AT NO EXTRA COST.	VOID INT
DECK PLAT						MECHANICAL ROOMS. CODP IN GARBAGE ROOM TO BE RATED FOR VEHICULAR TRAFFIC.	2. THE PLUMBING WORK SHALL BE PERFORMED IN STRI	
WALL		_	_	-	_	WALL CLEANOUT WITH CLEANOUT TEE AND CHROME PLATED BRONZE SQUARE ACCESS COVER AND FRAME.	PREVAILING NEW YORK STATE PLUMBING AND BUILI CONTRACT DOCUMENTS AND A GOVERNING CODE OR APPLY.	
CLEANOUT	OUT				-	WADE #W-8480 OR APPROVED EQUAL.	3. THE PLUMBING CONTRACTOR SHALL BE RESPONSIBLE	E FOR OF
	RAIN	4"	2"	2	-	JOSAM 21500 4" SERIES COATED CAST IRON ROOF DRAIN. LARGE POLYPROPYLENE LOCKING DOME, WEJOC NON-PUNCTURING CLAMP RING WITH INTEGRAL GRAVEL STOP, LARGE SUMP WITH WIDE ROOF FLANGE AND BOTTOM OUTLET.	PAYING RELATED FEES.	
						JOSAM 21500 4" 16 SERIES COATED CAST IRON ROOF DRAIN. LARGE POLYPROPYLENE LOCKING DOME, WEJOC	4. CONNECTIONS TO EXISTING UTILITIES AND SERVICES AVAILABLE. THE CONTRACTOR SHALL VERIFY THE EX	XACT LOC
	RAIN	4"	2"	2	-	NON-PUNCTURING CLAMP RING WITH INTEGRAL GRAVEL STOP, INTERNAL WATER GUARD FOR OVERFLOW,	EXISTING PLUMBING SERVICES IN FIELD, AND SHALL C DRAWINGS.	ONNECT
	רועדיי= -						5. PRIOR TO FABRICATION, THIS CONTRACTOR SHALL VE SITE, AND COORDINATE THIS WORK WITH THE WORK OF	
KAL UKAWINGS FOR FIX	K FIX I URE	QUAN LITY,		אור, & MOL	IN LING HEIC	סוחמ.	6. ALL ACCESS PANELS SHALL BE BY GENERAL CON	
							RESPONSIBLE FOR THEIR LOCATION.	
IRAL		ROOF DRAIN						ROOF DRAIN 4" 2" 2 - JOSAM 21500 4" 16 SERIES COATED CAST IRON ROOF DRAIN. LARGE POLYPROPYLENE LOCKING DOME, WEJOC NON-PUNCTURING CLAMP RING WITH INTEGRAL GRAVEL STOP, INTERNAL WATER GUARD FOR OVERFLOW, LARGE SUMP WITH WIDE ROOF FLANGE AND BOTTOM OUTLET. AVAILABLE. THE CONTRACTOR SHALL VERIFY THE EX EXISTING PLUMBING SERVICES IN FIELD, AND SHALL C DRAWINGS. DRAWINGS FOR FIXTURE QUANTITY, LOCATIONS, & MOUNTING HEIGHTS. - JOSAM 21500 4" 16 SERIES COATED CAST IRON ROOF DRAIN. LARGE POLYPROPYLENE LOCKING DOME, WEJOC NON-PUNCTURING CLAMP RING WITH INTEGRAL GRAVEL STOP, INTERNAL WATER GUARD FOR OVERFLOW, LARGE SUMP WITH WIDE ROOF FLANGE AND BOTTOM OUTLET. 5. PRIOR TO FABRICATION, THIS CONTRACTOR SHALL VE SITE, AND COORDINATE THIS WORK WITH THE WORK OF SITE, AND COORDINATE THIS WORK WITH THE WORK OF 6. ALL ACCESS PANELS SHALL BE BY GENERAL CON -


	GENERAL NOTES
	7. PROVIDE ALL PLUMBING FIXTURES, PIPING, VALVES AND ACCESSORY ITEMS AS SPECIFIED AND AS REG FOR A COMPLETE INSTALLATION. ROUGHING DIMENSIONS OF FIXTURES MUST BE COORDINATED WIT
LOOR NG	GENERAL CONTRACTOR.
NTOR	 PITCH ALL WASTE, SANITARY, AND STORM DRAIN PIPING AT MAXIMUM SLOPE POSSIBLE, BUT NOT LESS 1/8" PER FOOT FOR PIPING ≥ 3" AND 1/4" PER FOOT FOR PIPING ≤ 2¹/₂". NO PIPING SHALL RUN EXPOSED IN FINISHED AREAS.
	10. PROVIDE DIELECTRIC FITTINGS OR COUPLINGS WHEREVER DISSIMILAR METALS ARE JOINED.
	 PROVIDE SHUTOFF VALVES AT ALL FIXTURES AND EQUIPMENT ON COLD WATER, AND HOT WATER PIPES ALL WORK SHALL BE PROPERLY TESTED, BALANCED, AND CLEANED AND DISINFECTED. PROVIDE A ONE YEAR WARRANTY FROM DATE OF FINAL INSPECTION ON ALL PARTS AND LABOR.
PLATE	13. PROVIDE ALL PIPE OPENINGS THROUGH PARTITIONS WITH PIPE SLEEVES. FOR PIPES PENETRATING RATED PARTITIONS, THE SPACE BETWEEN THE PIPE AND THE SLEEVE SHALL BE SEALED WITH FIRE STOPPING MATERIAL. PENETRATIONS FOR PIPING SHALL BE MADE BY CORE DRILLING WHENEVER POS
JCER	14. PROVIDE TRAP SEAL PRIMERS FOR FLOOR DRAINS AS REQUIRED. INSTALL THE PRIMER VALVE IN THE WATER SERVICE, WITH THE TRAP CONNECTION PIPED TO THE FLOOR DRAIN TRAP. LOCATE THE VALVE ACCESSIBLE LOCATION.
LVE - BFP	15. THE PLUMBING CONTRACTOR SHALL PROVIDE ALL CUTTING, PATCHING, CORE DRILLING, PAINTING, A
ER	PANELS, AND FINAL RESTORATION REQUIRED TO FACILITATE THE INSTALLATION OF PLUMBING PIPING, INCLUDING ABOVE CEILINGS AND IN SHAFTS THAT WILL NOT BE REPLACED OR OPENED UNDER ANY (SCOPE OF WORK RELATED TO THIS PROJECT. CONTRACTOR TO REMOVE AND REPLACE CEILINGS, AND OPEN AND PATCH SHAFTS AND WALLS, AS REQUIRED TO EXECUTE THE PLUMBING WORK.
MOVED	16. SEE THE ARCHITECTURAL DRAWINGS FOR EXACT PHASING AND TIME SCHEDULE FOR CONSTRUCTION. 17. ALL MOTOR STARTERS AND DISCONNECT SWITCHES FOR PLUMBING EQUIPMENT SHALL BE FURNISH
IN ΓΙΟΝ	THE PLUMBING CONTRACTOR AND INSTALLED BY THE ELECTRICAL CONTRACTOR, UNLESS OTHERWISE NOTED. DISCONNECT SWITCHES FURNISHED BY THE PLUMBING CONTRACTOR FOR PLUMBING EQUI SHALL BE HEAVY DUTY TYPE.
	18. THE CONTRACTOR SHALL BE RESPONSIBLE FOR PROVIDING TEMPORARY VENTILATION AND EXHAUS WHEN WELDING OR SOLDERING OPERATIONS ARE PERFORMED, AS REQUIRED BY OSHA. EQUIPMENT NOTES
	1. NATURAL GAS-FIRED DOMESTIC HOT WATER HEATER, (HWH-1): SHALL BE BASED ON AO SMITH MODEL
	BTH-120 MXI, RATED FOR 138 GPH @ 100° RISE, GAS FIRED. 120,000 BTUH INPUT CAPACITY. THERMAL EFFICIENCY = 95.8%
	BTH-150 MXI, RATED FOR 178 GPH @ 100° RISE, GAS FIRED. 150,000 BTUH INPUT CAPACITY. THERMAL EFFICIENCY = 98.8%
R CULATION	 <u>NATURAL GAS-FIRED DOMESTIC HOT WATER HEATER, (HWH-3)</u>: SHALL BE BASED ON AO SMITH MODEL BTH-120 MXI, RATED FOR 138 GPH @ 100° RISE, GAS FIRED. 120,000 BTUH INPUT CAPACITY. THERMAL EFFICIENCY = 95.8%
	4. <u>ELEVATOR SUMP PUMP</u> , (<u>ESP-1</u>), TO BE BASED ON STANCOR MODEL SE50 PUMP, 0.5 HP, 115V-1 PHASE- HERTZ, 8 FLA, 55 GPM @ 20 FEET HEAD AND 3450 RPM, 40A LOCKED ROTOR AMPS, 33 FEET MAX. SUBMERGENCE. PROVIDE STANCOR CHECK VALVE WITH EACH PUMP. PROVIDE OIL MINDER CONTROL SYSTEM FOR EACH PUMP WITH BUILT IN AUDIBLE AND VISUAL ALARM WHEN PUMP DOES NOT RUN DUE OIL IN PIT OR HIGH LIQUID ALARM. PROVIDE SILENCING BUTTON FOR AUDIBLE ALARM BUILT INTO PANI
	PANEL SHALL HAVE ADDITIONAL CONTACT FOR A REMOTE ALARM LOCATION. PROVIDE JUNCTION BOX MULTI PIN CONNECTOR AND CORD LENGTHS AS REQUIRED. PANEL TO HAVE INDICATOR LIGHTS FOR O SPILL, HIGH LIQUID LEVEL, OVERLOAD AND PUMP RUN. CONTROL PANEL ENCLOSURE TO BE NEMA4X WATERTIGHT CORROSION RESISTANT FIBERGLASS.
	5. <u>SUMP PUMP</u> , (<u>SP-1) AND (SP-2)</u> , TO BE BASED ON STANCOR MODEL SV500 PUMP, 5 HP, 208V-3 PHASE-60 HERTZ, 16.6 FLA, 210 GPM @ 35 FEET HEAD AND 3450 RPM, 83A LOCKED ROTOR AMPS, 33 FEET MAX.
	SUBMERGENCE. PROVIDE STANCOR CHECK VALVE WITH EACH PUMP. PROVIDE OIL MINDER CONTROL SYSTEM FOR EACH PUMP WITH BUILT IN AUDIBLE AND VISUAL ALARM WHEN PUMP DOES NOT RUN DUE OIL IN PIT OR HIGH LIQUID ALARM. PROVIDE SILENCING BUTTON FOR AUDIBLE ALARM BUILT INTO PAN
NG VALVE	PANEL SHALL HAVE ADDITIONAL CONTACT FOR A REMOTE ALARM LOCATION. PROVIDE JUNCTION BOX MULTI PIN CONNECTOR AND CORD LENGTHS AS REQUIRED. PANEL TO HAVE INDICATOR LIGHTS FOR C SPILL, HIGH LIQUID LEVEL, OVERLOAD AND PUMP RUN. CONTROL PANEL ENCLOSURE TO BE NEMA4X WATERTIGHT CORROSION RESISTANT FIBERGLASS.
RE ZONE - BFP	6. <u>LD-1</u> SPOT TYPE LEAK DETECTORS SHALL BE LIEBERT MODEL LT-410. PROVIDE 100 WATT LOW-VOLTAG TRANSFORMER. PROVIDE CONNECTION TO BMS FOR LD ALARM.
DCATE	 <u>DOMESTIC HOT WATER HEATER RECIRCULATION PUMP</u>, (HWCP-1): SHALL BE BASED ON BELL AND GOS MODEL PL-55 RATED FOR 1- GPM AT 40' TDH, 2/5 HP, 120V/1Ø/60HZ. MOTOR STARTERS AND DISCONNEC SWITCHES SHALL BE FURNISHED BY THE PLUMBING CONTRACTOR AND INSTALLED BY THE ELECTRICA CONTRACTOR.
	8. <u>3" DOMESTIC WATER BACKFLOW PREVENTION ASSEMBLY</u> : SHALL BE WATTS MODEL LF009 LEAD FREE REDUCED PRESSURE ZONE BACKFLOW PREVENTER. ASSEMBLY SHALL BE SUITABLE FOR PRESSURES TO 175 PSI AND TEMPERATURES UP TO 110°F. THE ASSEMBLY SHALL INCLUDE TWO RESILIENT OS&Y S SHUTOFF VALVES AND FOUR BALL TYPE TEST COCKS. THE 3" DOMESTIC WATER BACKFLOW PREVENT SHALL BE PROVIDED WITH WATTS AIR GAP / SPLASH GUARD.
	 <u>6" FIRE PROTECTION BACKFLOW PREVENTION ASSEMBLY</u>: SHALL BE WATTS SERIES 709DCDA DOUBLE CHECK DETECTOR ASSEMBLY BACKFLOW PREVENTER. ASSEMBLY SHALL BE SUITABLE FOR PRESSUR TO 175 PSI AND TEMPERATURES UP TO 110°F. THE ASSEMBLY SHALL INCLUDE TWO RESILIENT OS&Y S SHUTOFF VALVES AND TWO BALL TYPE TEST COCKS.
	10. <u>WATER METER</u> : SHALL BE BASED ON ELSTER EVOQ4 METER, 3" SIZE. FINAL WATER METER AND SIZE, M AND DIMENSIONS SHALL BE DETERMINED AND APPROVED BY THE WATER UTILITY. THE PLUMBING CONTRACTOR IS RESPONSIBLE FOR COORDINATION AND INSTALLATION, AND ALL RELATED WATER DEPARTMENT FEES.
	11. ALL DOMESTIC, SANITARY, AND STORM PIPING ROUTED EXPOSED WITHIN GARAGE SHALL BE HEAT TRA COMPLETE, INCLUDING A MINIMUM OF 5'-0" INTO THE TEMPERED SPACES. PIPING SHALL BE INSULATED COMPLETE AND WRAPPED WITH PVC JACKETING .
DOF	12. COORDINATE WITH ARCHITECTURAL DRAWINGS FOR FINAL LOCATION, TYPE, AND QUANTITY OF FIXTU AND ROOF DRAINS THROUGHOUT THE BUILDING.
	13. COORDINATE WITH SITE ENGINEER DRAWINGS FOR FINAL LOCATION, TYPE, AND QUANTITY OF ROADW DRAINS.
TIONS ARE USED IN THIS	14. ALL PIPING INCLUDING HANGERS/SUPPORTS WITHIN THE GARAGE SHALL BE ROUTED AS HIGH AS POS TO MAINTAIN VEHICLE CLEARANCE THROUGHOUT. REFER TO ARCHITECTURAL DRAWINGS FOR MINIMU ELEVATIONS.
E HIGH PERFORMANCE HUB & SPIGOT SERVICE TSM A74, CISPI TM/NSF, EN 877 COMPRESSION	15. THE PLUMBING CONTRACTOR SHALL SUBMIT FOR REVIEW A COMPOSITE SHOP DRAWING, FULLY COORDINATED WITH ALL OTHER TRADES, INDICATING EQUIPMENT, DUCTWORK, PLUMBING AND SPRIN PIPING, SMOKE DETECTORS, LIGHTS, CONDUITS, SMOKE DETECTORS, DIFFUSERS, GRILLES, AND ALL F ELEMENTS, ETC.
CIFICATIONS 221316	16. PROVIDE TRAP AND VALVE GUARDS AT ALL LAVATORIES WITH EXPOSED PIPING SIMILAR TO TRUEBRO P-TRAP AND TWO (2) VALVE COVERS WITH VINYL COVER.
ID GENERAL ARRANGEMENTS OF THE PLUMBING BS ARE DEEMED NECESSARY BY THE PLUMBING REASONS THEREFORE SHALL BE SUBMITTED TO THE RTURES SHALL BE MADE WITHOUT PRIOR WRITTEN INT AND PIPING ARRANGEMENTS SHALL PROVIDE SERVICING, AND MAINTENANCE. ANY CHANGES TO DID INTERFERENCE WITH OTHER TRADES SHALL BE	17. <u>GAS BOOSTER PUMP (GMP-1)</u> : SHALL BE ACCARDI COMPAC HB4615-1. SYSTEM SHALL BE A PACKAGE HERMETICALLY SEALED SYSTEM THAT INCLUDES AUTO FLOW CONTROL, INTEGRAL VFD, NEMA 4 PANE NEMA 4 LOW PRESSURE SWITCH, INLET AND OUTLET ISOLATION VALVES, FLEXIBLE CONNECTIONS, INL AND OUTLET PRESSURE GAUGES, AND CHECK VALVE. SYSTEM SHALL BE CAPABLE OF OF DELIVERING VARIABLE VOLUME OF NATURAL GAS OF 1,370 CFH WHILE PROVIDING A CONSTANT ELEVATED DIFFERE GAS PRESSURE OF 11" WC.
ACCORDANCE WITH THE LATEST EDITION OF THE IG CODES. IN CASE OF CONFLICT BETWEEN THE RDINANCE, THE MORE STRINGENT STANDARD SHALL	
OR OBTAINING ALL NECESSARY PERMITS AND FOR	
E SHOWN ACCORDING TO THE BEST INFORMATION CT LOCATIONS, INVERT ELEVATIONS, AND SIZES OF INECT NEW PLUMBING SERVICES AS INDICATED ON	
FY ALL MEASUREMENTS AND CONDITIONS ON JOB	
ACTOR. THE PLUMBING CONTRACTOR SHALL BE	

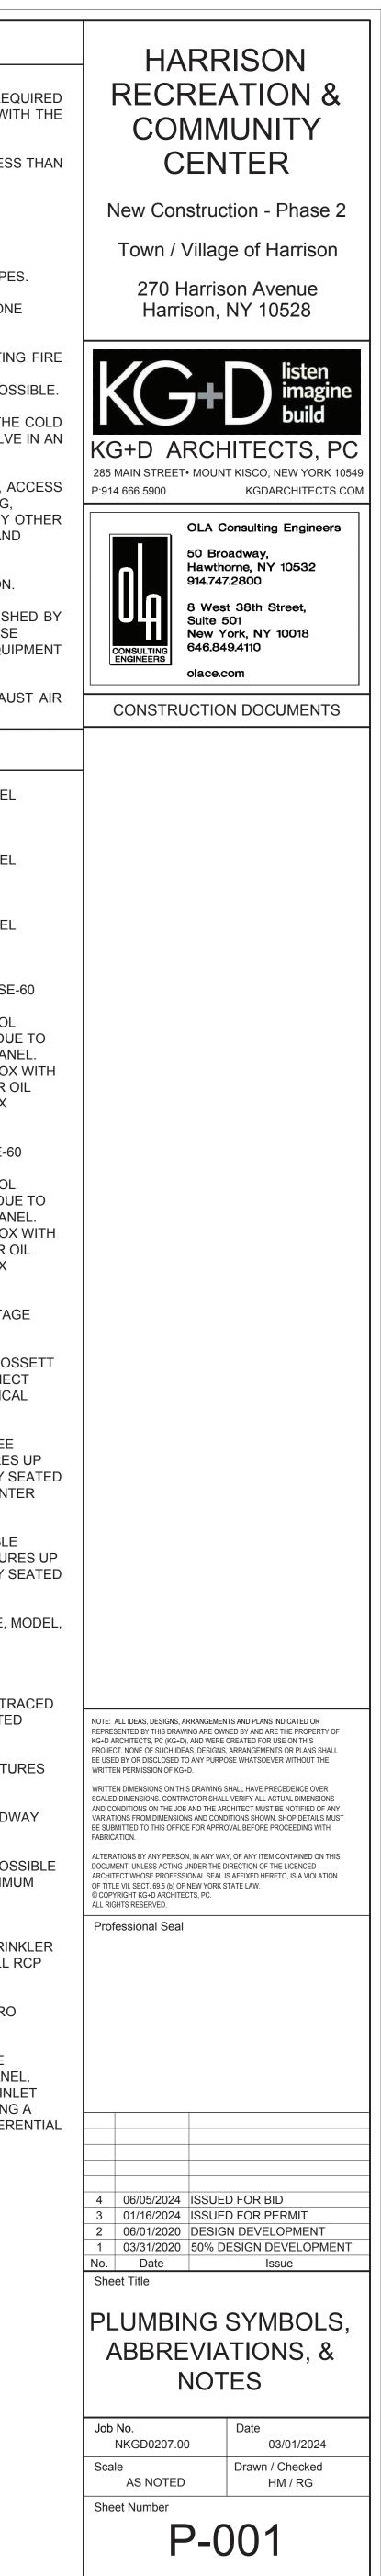

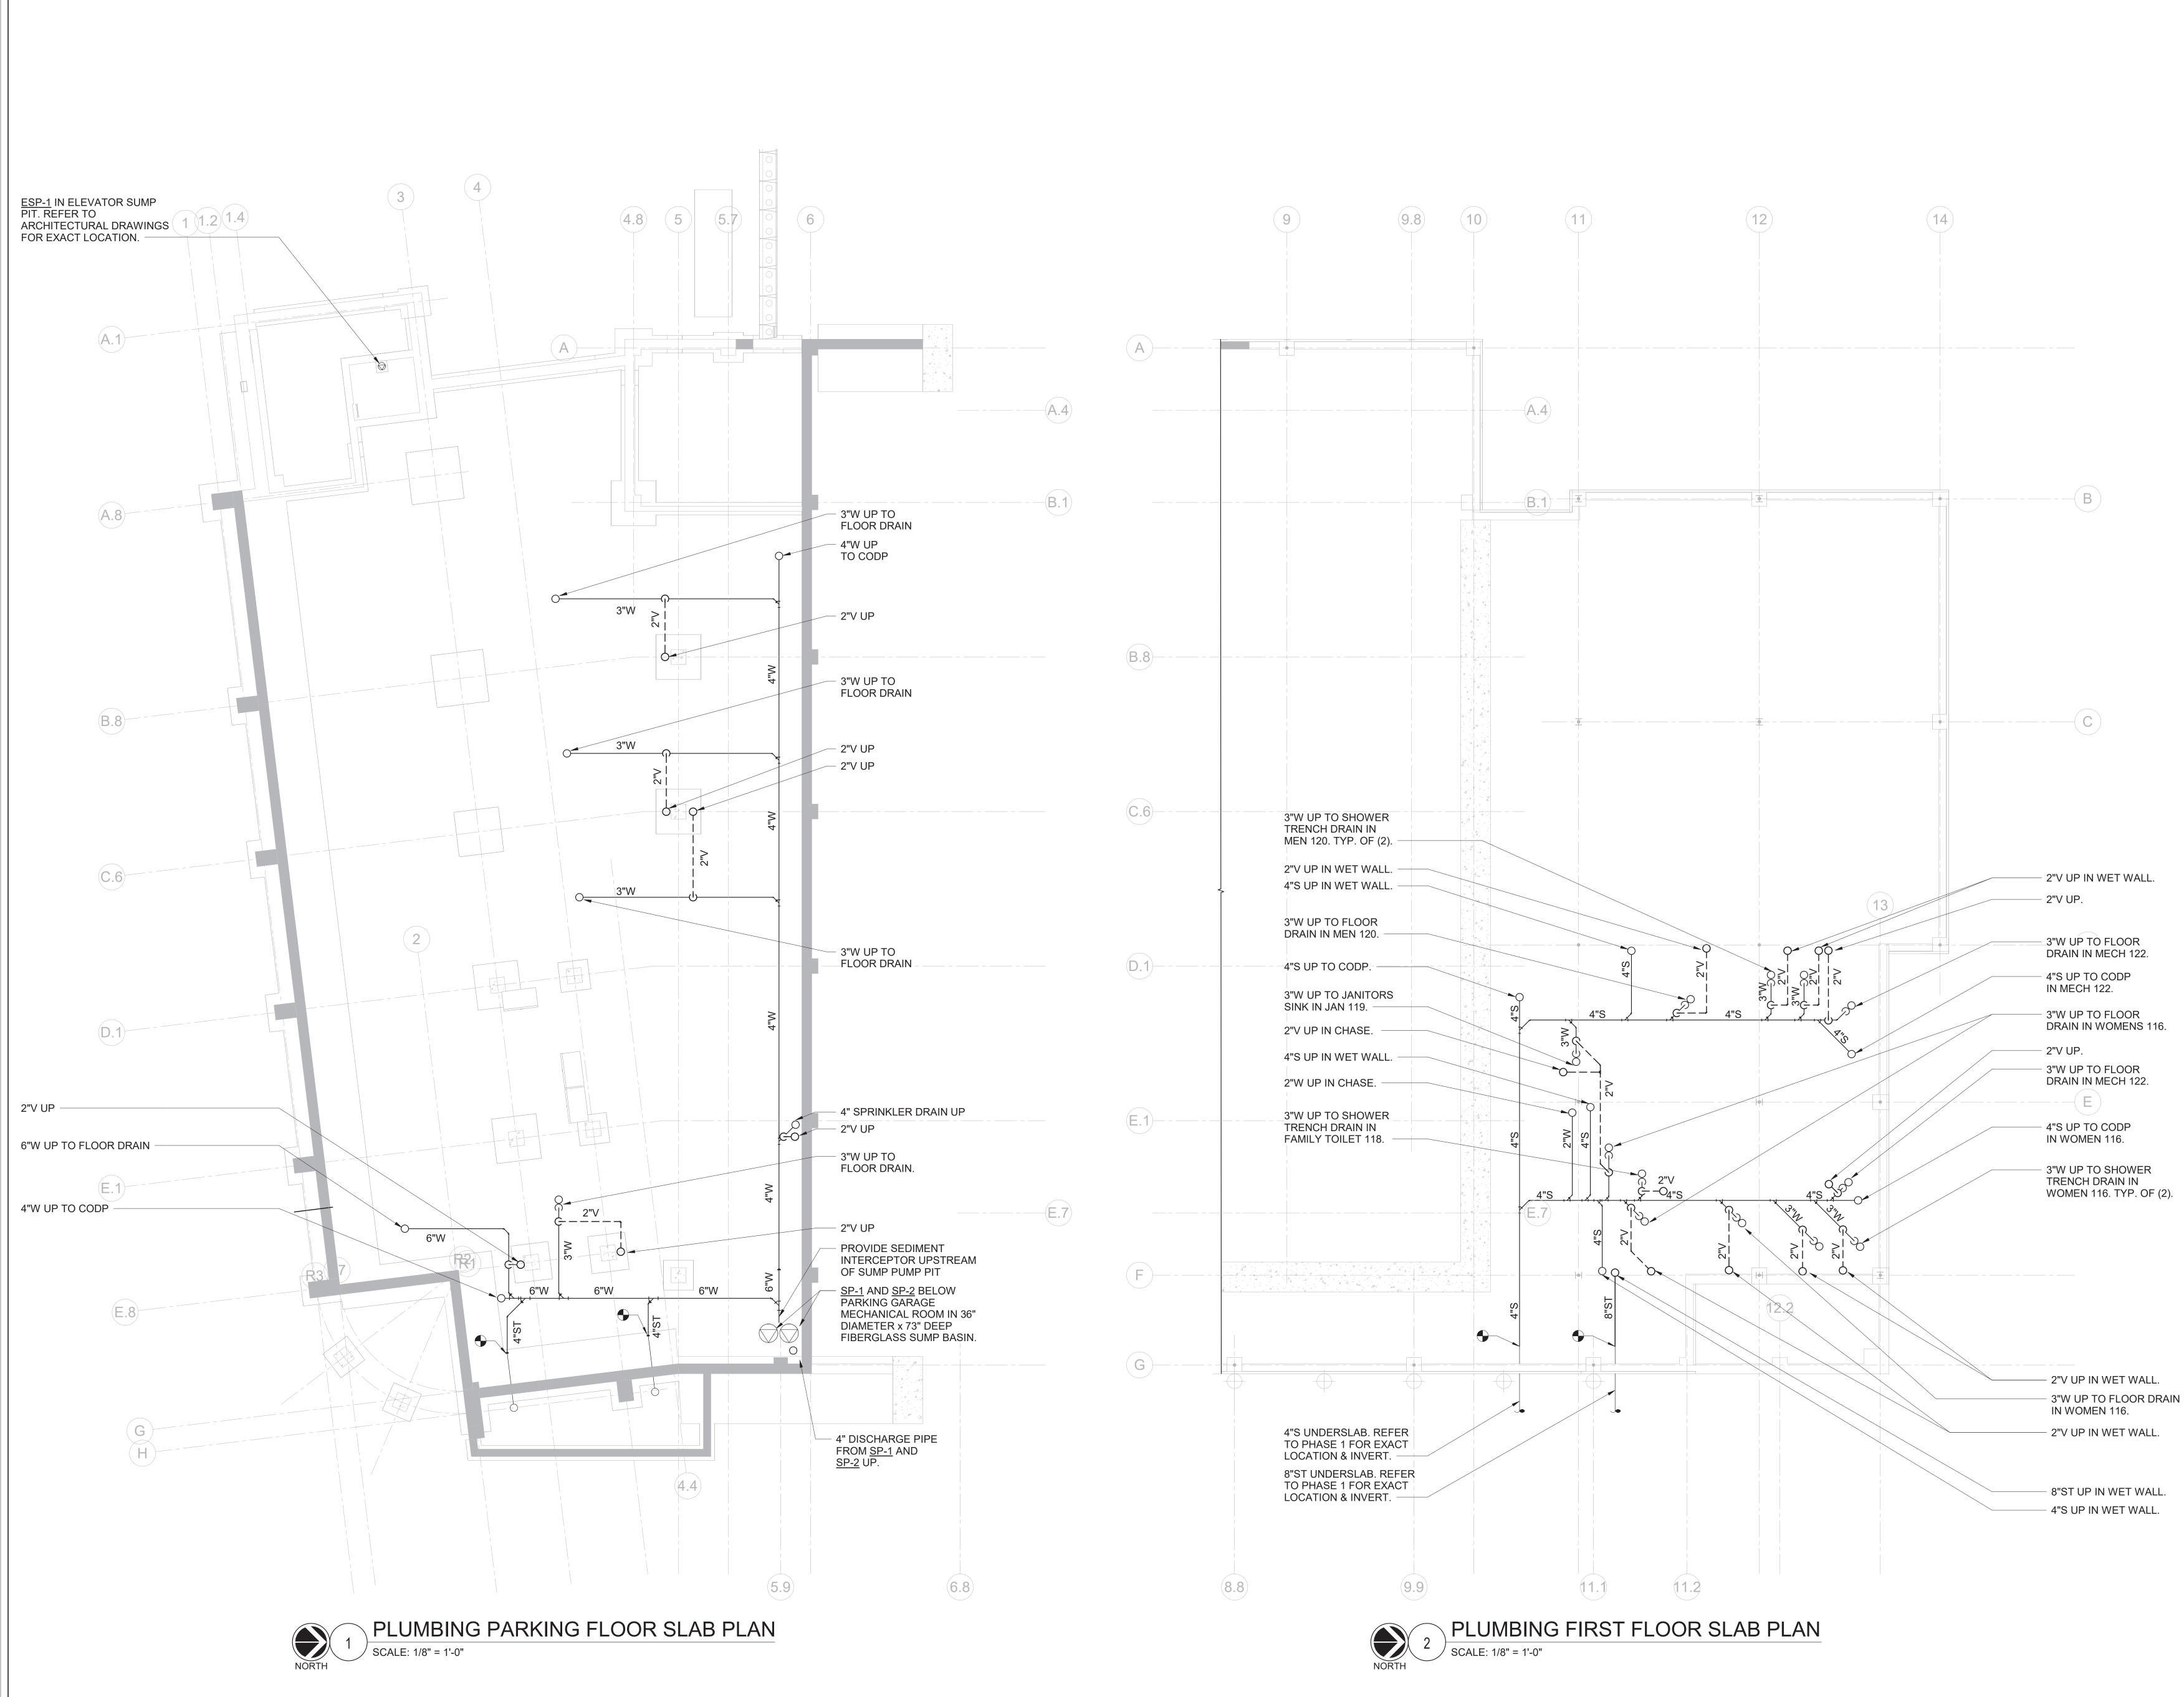

HARRISON **RECREATION &** COMMUNITY CENTER New Construction - Phase 2 Town / Village of Harrison 270 Harrison Avenue Harrison, NY 10528 KG+D ARCHITECTS, PC 285 MAIN STREET • MOUNT KISCO, NEW YORK 10549 P:914.666.5900 KGDARCHITECTS.COM OLA Consulting Engineers 50 Broadway, Hawthorne, NY 10532 914.747.2800 8 West 38th Street, Suite 501 New York, NY 10018 CONSULTING ENGINEERS 646.849.4110 olace.com CONSTRUCTION DOCUMENTS Key Plan NOTE: ALL IDEAS, DESIGNS, ARRANGEMENTS AND PLANS INDICATED OR REPRESENTED BY THIS DRAWING ARE OWNED BY AND ARE THE PROPERTY OF KAEYER, GARMENT, & DAVIDSON ARCHITECTS, PC (KG-D), AND WERE CREATED FOR USE ON THIS PROJECT. NONE OF SUCH IDEAS, DESIGNS, ARRANGEMENTS OR PLANS SHALL BE USED BY OR DISCLOSED TO ANY PURPOSE WHATSOEVER WITHOUT THE WRITTEN PERMISSION OF (KG+D). WRITTEN DIMENSIONS ON THIS DRAWING SHALL HAVE PRECEDENCE OVER SCALED DIMENSIONS. CONTRACTOR SHALL VERIFY ALL ACTUAL DIMENSIONS AND CONDITIONS ON THE JOB AND THE ARCHITECT MUST BE NOTIFIED OF ANY VARIATIONS FROM DIMENSIONS AND CONDITIONS SHOWN. SHOP DETAILS MUST BE SUBMITTED TO THIS OFFICE FOR APPROVAL BEFORE PROCEEDING WITH FABRICATION. ALTERATIONS BY ANY PERSON, IN ANY WAY, OF ANY ITEM CONTAINED ON THIS DOCUMENT, UNLESS ACTING UNDER THE DIRECTION OF THE LICENCED ARCHITECT WHOSE PROFESSIONAL SEAL IS AFFIXED HERETO, IS A VIOLATION OF TITLE VII, SECT. 69.5 (b) OF NEW YORK STATE LAW. COPYRIGHT KAEYER, GARMENT + DAVIDSON ARCHITECTS & ENGINEERS, PC ALL RIGHTS RESERVED. Professional Seal 06/05/2024 ISSUED FOR BID 01/16/2024 ISSUED FOR PERMIT 06/01/2020 DESIGN DEVELOPMENT 03/31/2020 50% DESIGN DEVELOPMENT Date PARKING FLOOR & FIRST FLOOR SLAB PLAN Job No. Date 02/16/2024 NKGD0207.00 Drawn / Checked Scale AS NOTED HM / RG Sheet Number P-200A


NON-FREEZE HOSE BIB	1 1.2 1.4	3	(4)
2"PD DOWN TO <u>ESP-1</u> . REFER TO P-200A FOR EXACT LOCATION.		•	
A.1			DN
3"W UP TO FLOOR DRAIN IN MEN 110. PROVIDE HEAT TRACE FOR P-TRAP.	STAIR A BSA	DPEN VEST	• 0
2"PD. INDIRECTLY SPILL 2"PD INTO FUNNEL.	2"V		
2"V UP 4"S UP		3"W 	
3"W UP TO FLOOR DRAIN IN WOMEN 109. PROVIDE HEAT TRACE FOR P-TRAP.	SW		
3/4"CW ROUTED TO NON- FREEZE HOSE BIB. PROVIDE HEAT TRACE IN UNHEATED GARAGE AREA.	3		
2"V UP	4" S		
3"CW & 4"G UP TO JAN 104. SEE P-401 FOR CONTINUATION C.6 4"S DN. CONNECT TO EXISTING 4"S FROM PHASE 1 WORK		3"V	
CONNECT 4"PD WITH WYE FITTING CONNECTION EXISTING 4"S. REFER TO PHASE 1		2	3(4"CW
FOR ADDITIONAL INFORMATION 3" DOMESTIC WATER RPZ BFP, WATTS MODEL LF009- QTS. MAINTAIN 8" CLEAR BEHIND DEVICE AND & 30" CLEAR IN FRONT OF DEVICE.		St 4"S	
PROVIDE CATASTROPHIC FLOOR DRAIN BENEATH RPZ . 3" ELSTER EVOQ4 WATER METER. INSTALL PER MANUFACTURERS SPECIFICATIONS.			504"S 0-
3" WATTS LF777S Y STRAINER 3" HDPE PIPE GAS SERVICE TO PROPERTY LINE ON CALVERT STREET. CONTRACTOR SHALL COORDINATE WITH CON EDISON FOR EXACT LOCATION.		4"PI	3.CM
GAS METER. COORDINATE WITH CON EDISON FOR EXACT LOCATION OF METER AND METER RIG ASSEMBLY.	EX. <u>3</u> "CM		
WORK ASSOCIATED WITH THE DOMESTIC AND FIRE PROTECTION BFP'S SHOWN FOR GENERAL ARRANGEMENT AND SCOPE OF WORK. THE FINAL ARRANGEMENT AND LAYOUT OF THE DOMESTIC E.8 AND FIRE PROTECTION BACKELOW PREVENTEERS		TS (TS)	
BACKFLOW PREVENTERS, VALVES, SPECIALTIES, ETC; SHALL BE PER THE APPROVED DOH SET OF DRAWINGS.			
6" FIRE WATER SERVICE TO BUILDING FROM MUNICIPAL			
WATER MAIN IN CALVERT STREET 6" FIRE PROTECTION DCDA BFP,			
WATER MAIN IN CALVERT STREET		BY PLU CONTR	UMBING I BY SPE RACTOR CONTE

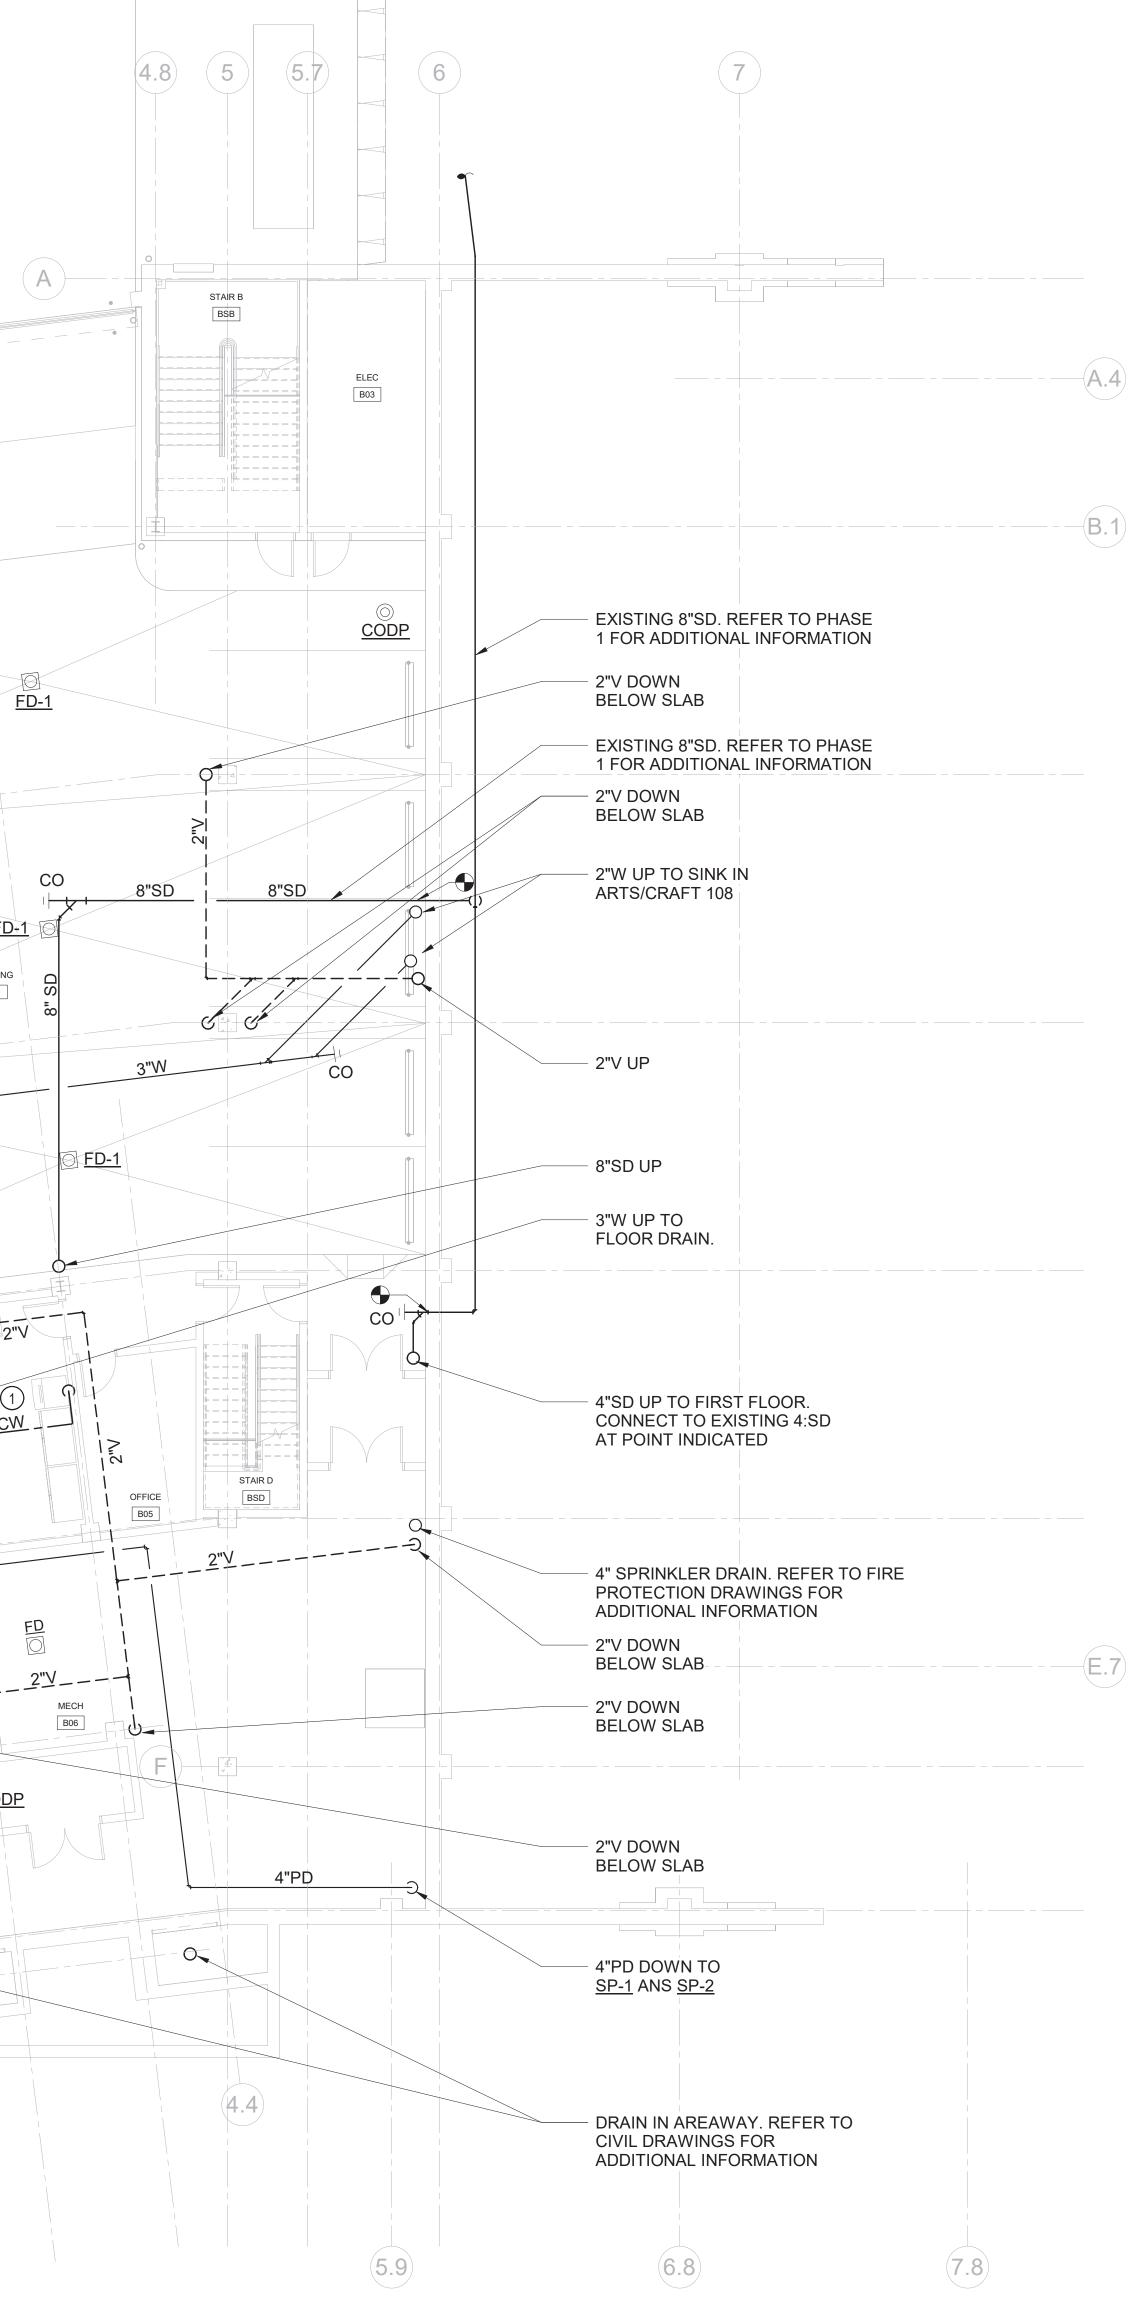


KING FLOOR PLAN

NEW WORK KEY NOTES


1 ICE MACHINE IM. PROVIDE 3/4"CW. PROVIDE SHUT-OFF VALVE.

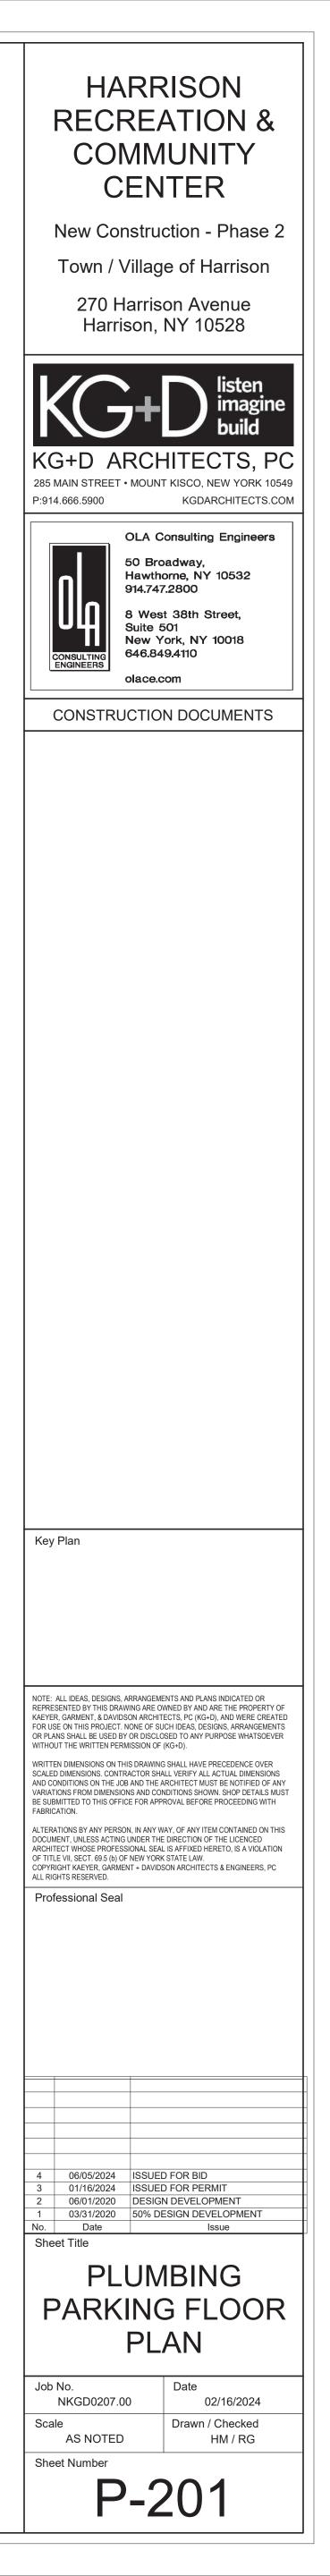


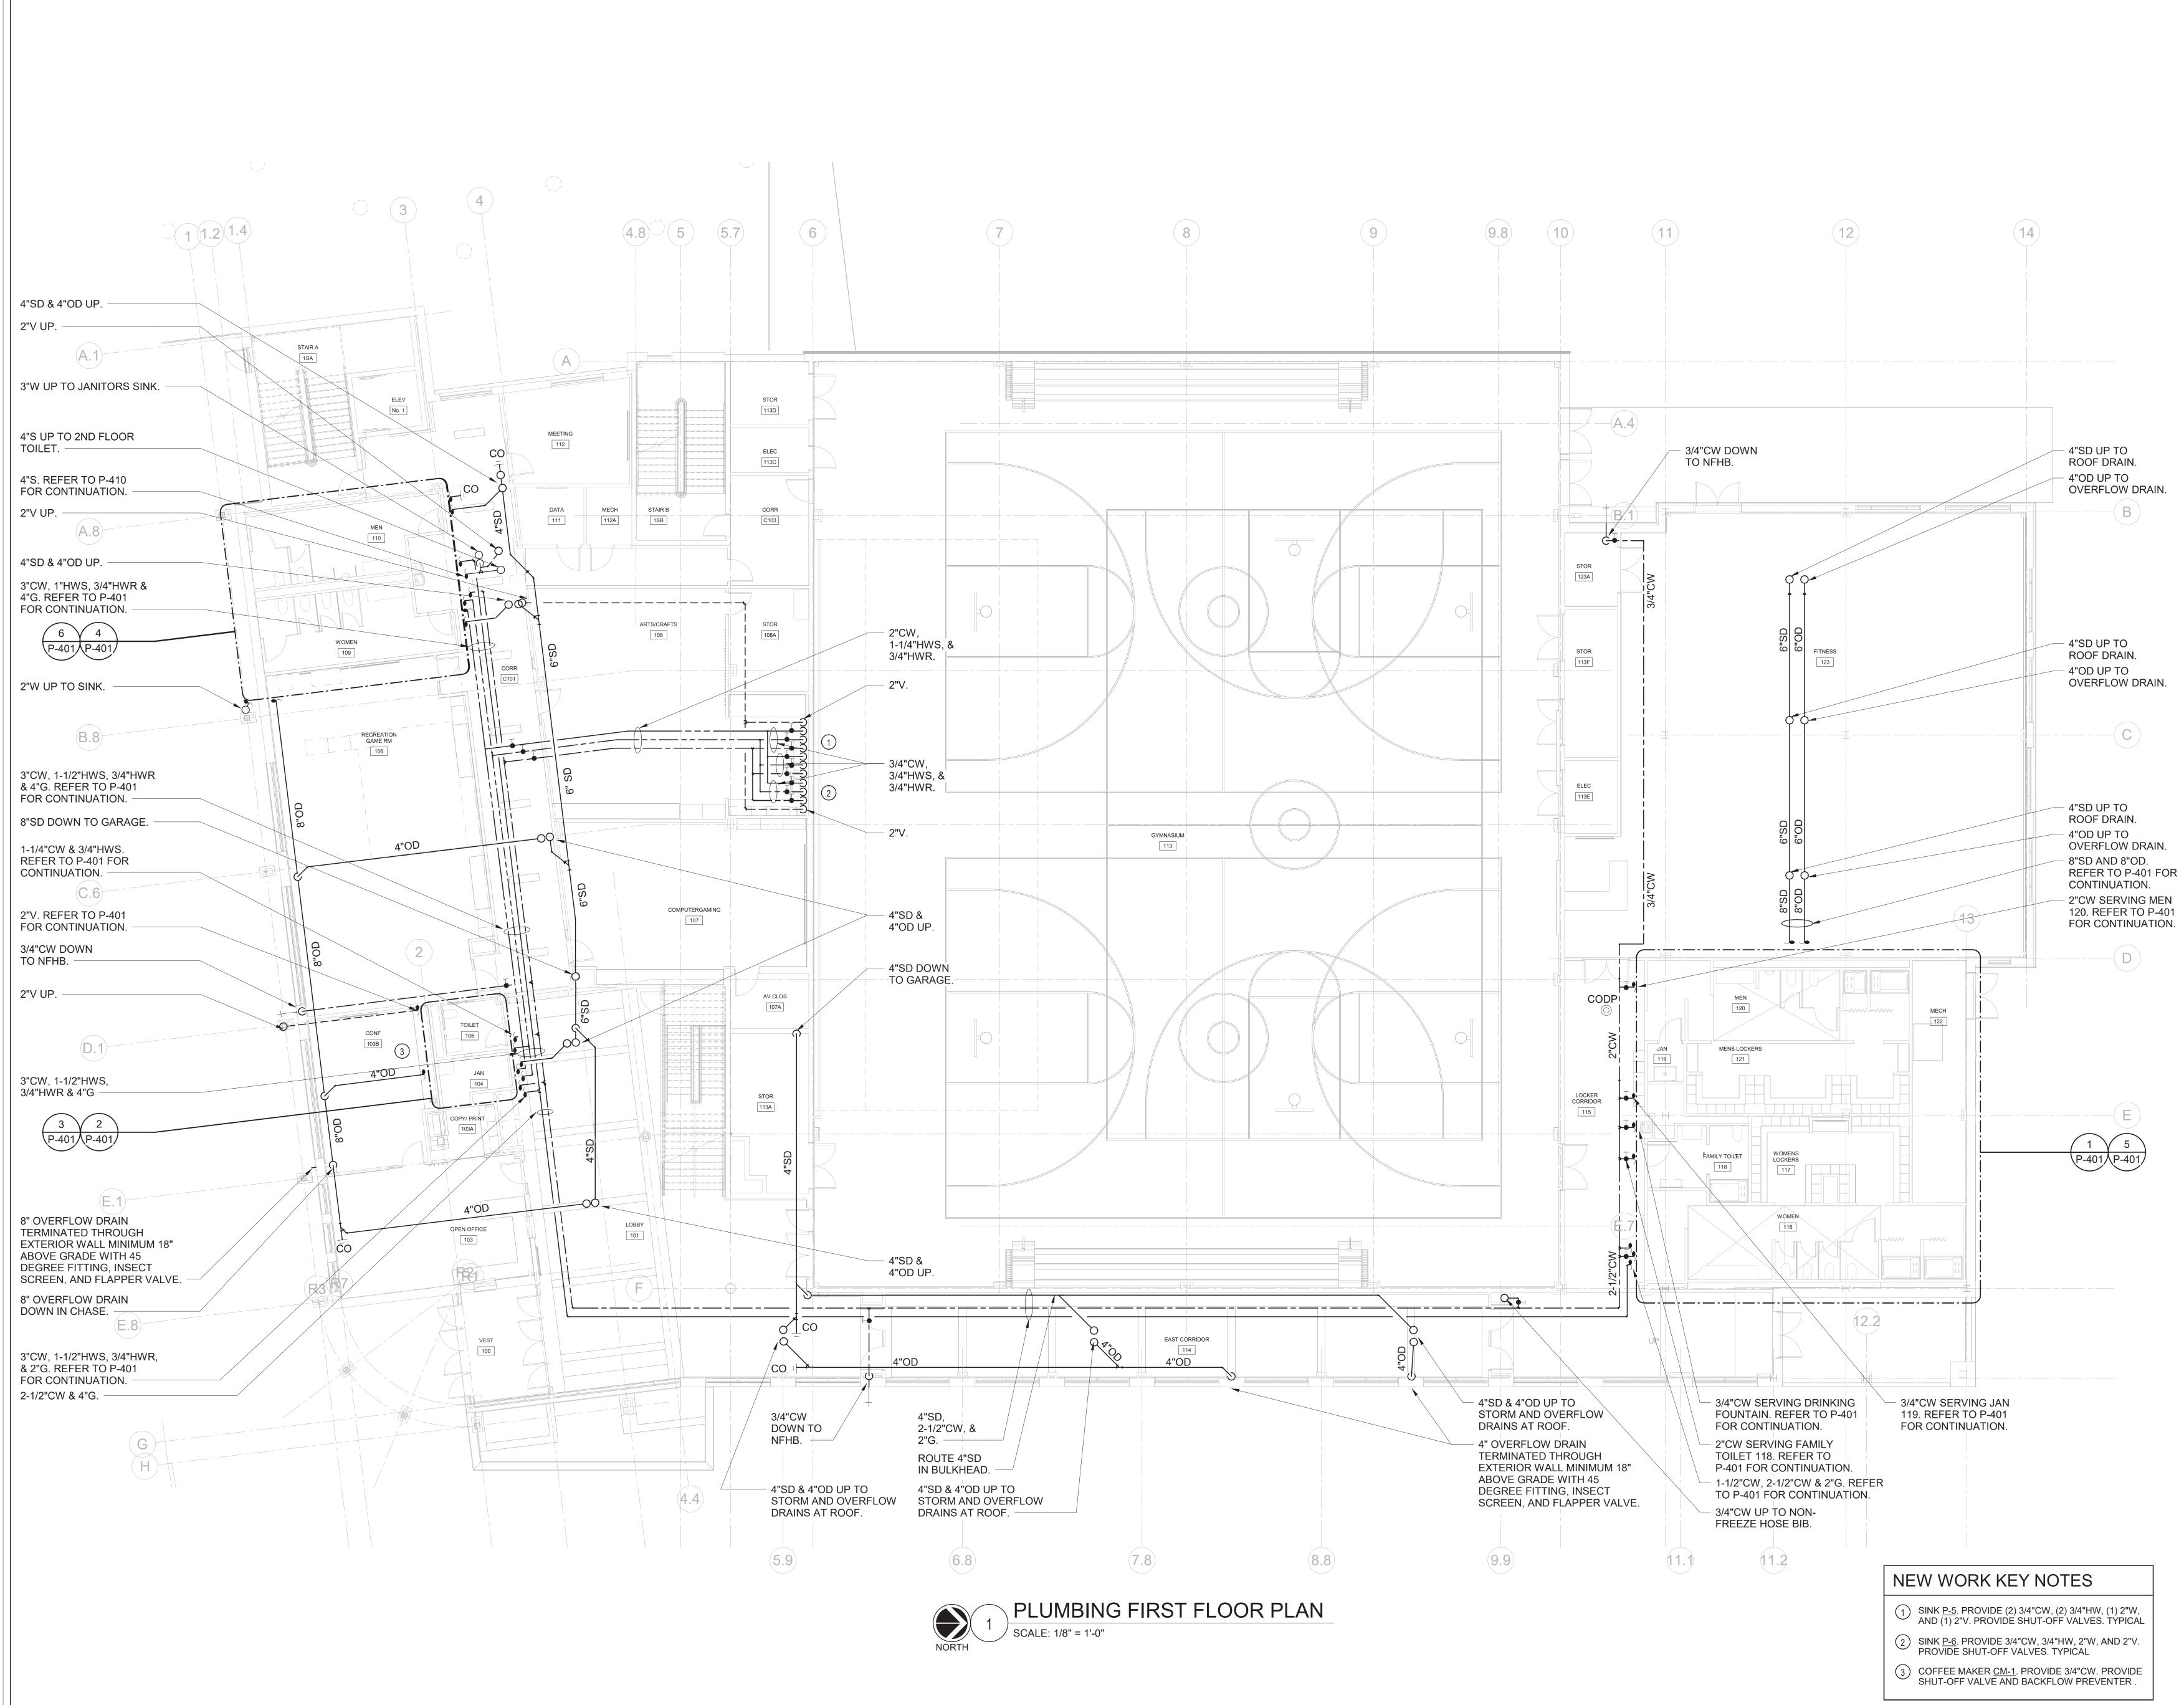


HARRISON **RECREATION &** COMMUNITY CENTER New Construction - Phase 2 Town / Village of Harrison 270 Harrison Avenue Harrison, NY 10528 KG+D ARCHITECTS, PC 285 MAIN STREET • MOUNT KISCO, NEW YORK 10549 KGDARCHITECTS.COM P:914.666.5900 OLA Consulting Engineers 50 Broadway, Hawthorne, NY 10532 914.747.2800 8 West 38th Street, Suite 501 New York, NY 10018 646.849.4110 CONSULTING ENGINEERS olace.com CONSTRUCTION DOCUMENTS Key Plan NOTE: ALL IDEAS, DESIGNS, ARRANGEMENTS AND PLANS INDICATED OR REPRESENTED BY THIS DRAWING ARE OWNED BY AND ARE THE PROPERTY OF KAEYER, GARMENT, & DAVIDSON ARCHITECTS, PC (KG+D), AND WERE CREATED FOR USE ON THIS PROJECT. NONE OF SUCH IDEAS, DESIGNS, ARRANGEMENTS OR PLANS SHALL BE USED BY OR DISCLOSED TO ANY PURPOSE WHATSOEVER WITHOUT THE WRITTEN PERMISSION OF (KG+D). WRITTEN DIMENSIONS ON THIS DRAWING SHALL HAVE PRECEDENCE OVER SCALED DIMENSIONS. CONTRACTOR SHALL VERIFY ALL ACTUAL DIMENSIONS AND CONDITIONS ON THE JOB AND THE ARCHITECT MUST BE NOTIFIED OF ANY VARIATIONS FROM DIMENSIONS AND CONDITIONS SHOWN. SHOP DETAILS MUST BE SUBMITTED TO THIS OFFICE FOR APPROVAL BEFORE PROCEEDING WITH FABRICATION. ALTERATIONS BY ANY PERSON, IN ANY WAY, OF ANY ITEM CONTAINED ON THIS DOCUMENT, UNLESS ACTING UNDER THE DIRECTION OF THE LICENCED ARCHITECT WHOSE PROFESSIONAL SEAL IS AFFIXED HERETO, IS A VIOLATION OF TITLE VII, SECT. 69.5 (b) OF NEW YORK STATE LAW. COPYRIGHT KAEYER, GARMENT + DAVIDSON ARCHITECTS & ENGINEERS, PC ALL RIGHTS RESERVED. Professional Seal 06/05/2024 ISSUED FOR BID 01/16/2024 ISSUED FOR PERMIT 06/01/2020 DESIGN DEVELOPMENT
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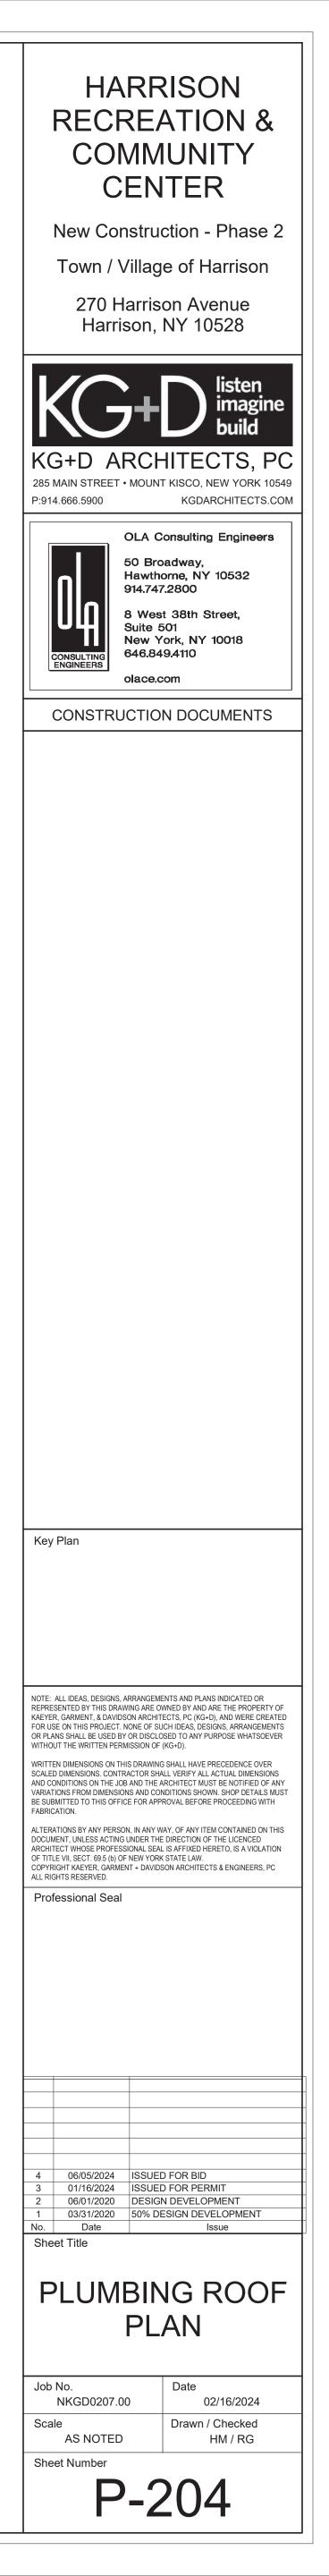
 o.
 Date
 Issue
 Sheet Title PLUMBING FIRST FLOOR PLAN Job No. Date 02/16/2024 NKGD0207.00 Drawn / Checked Scale AS NOTED HM / RG Sheet Number P-202




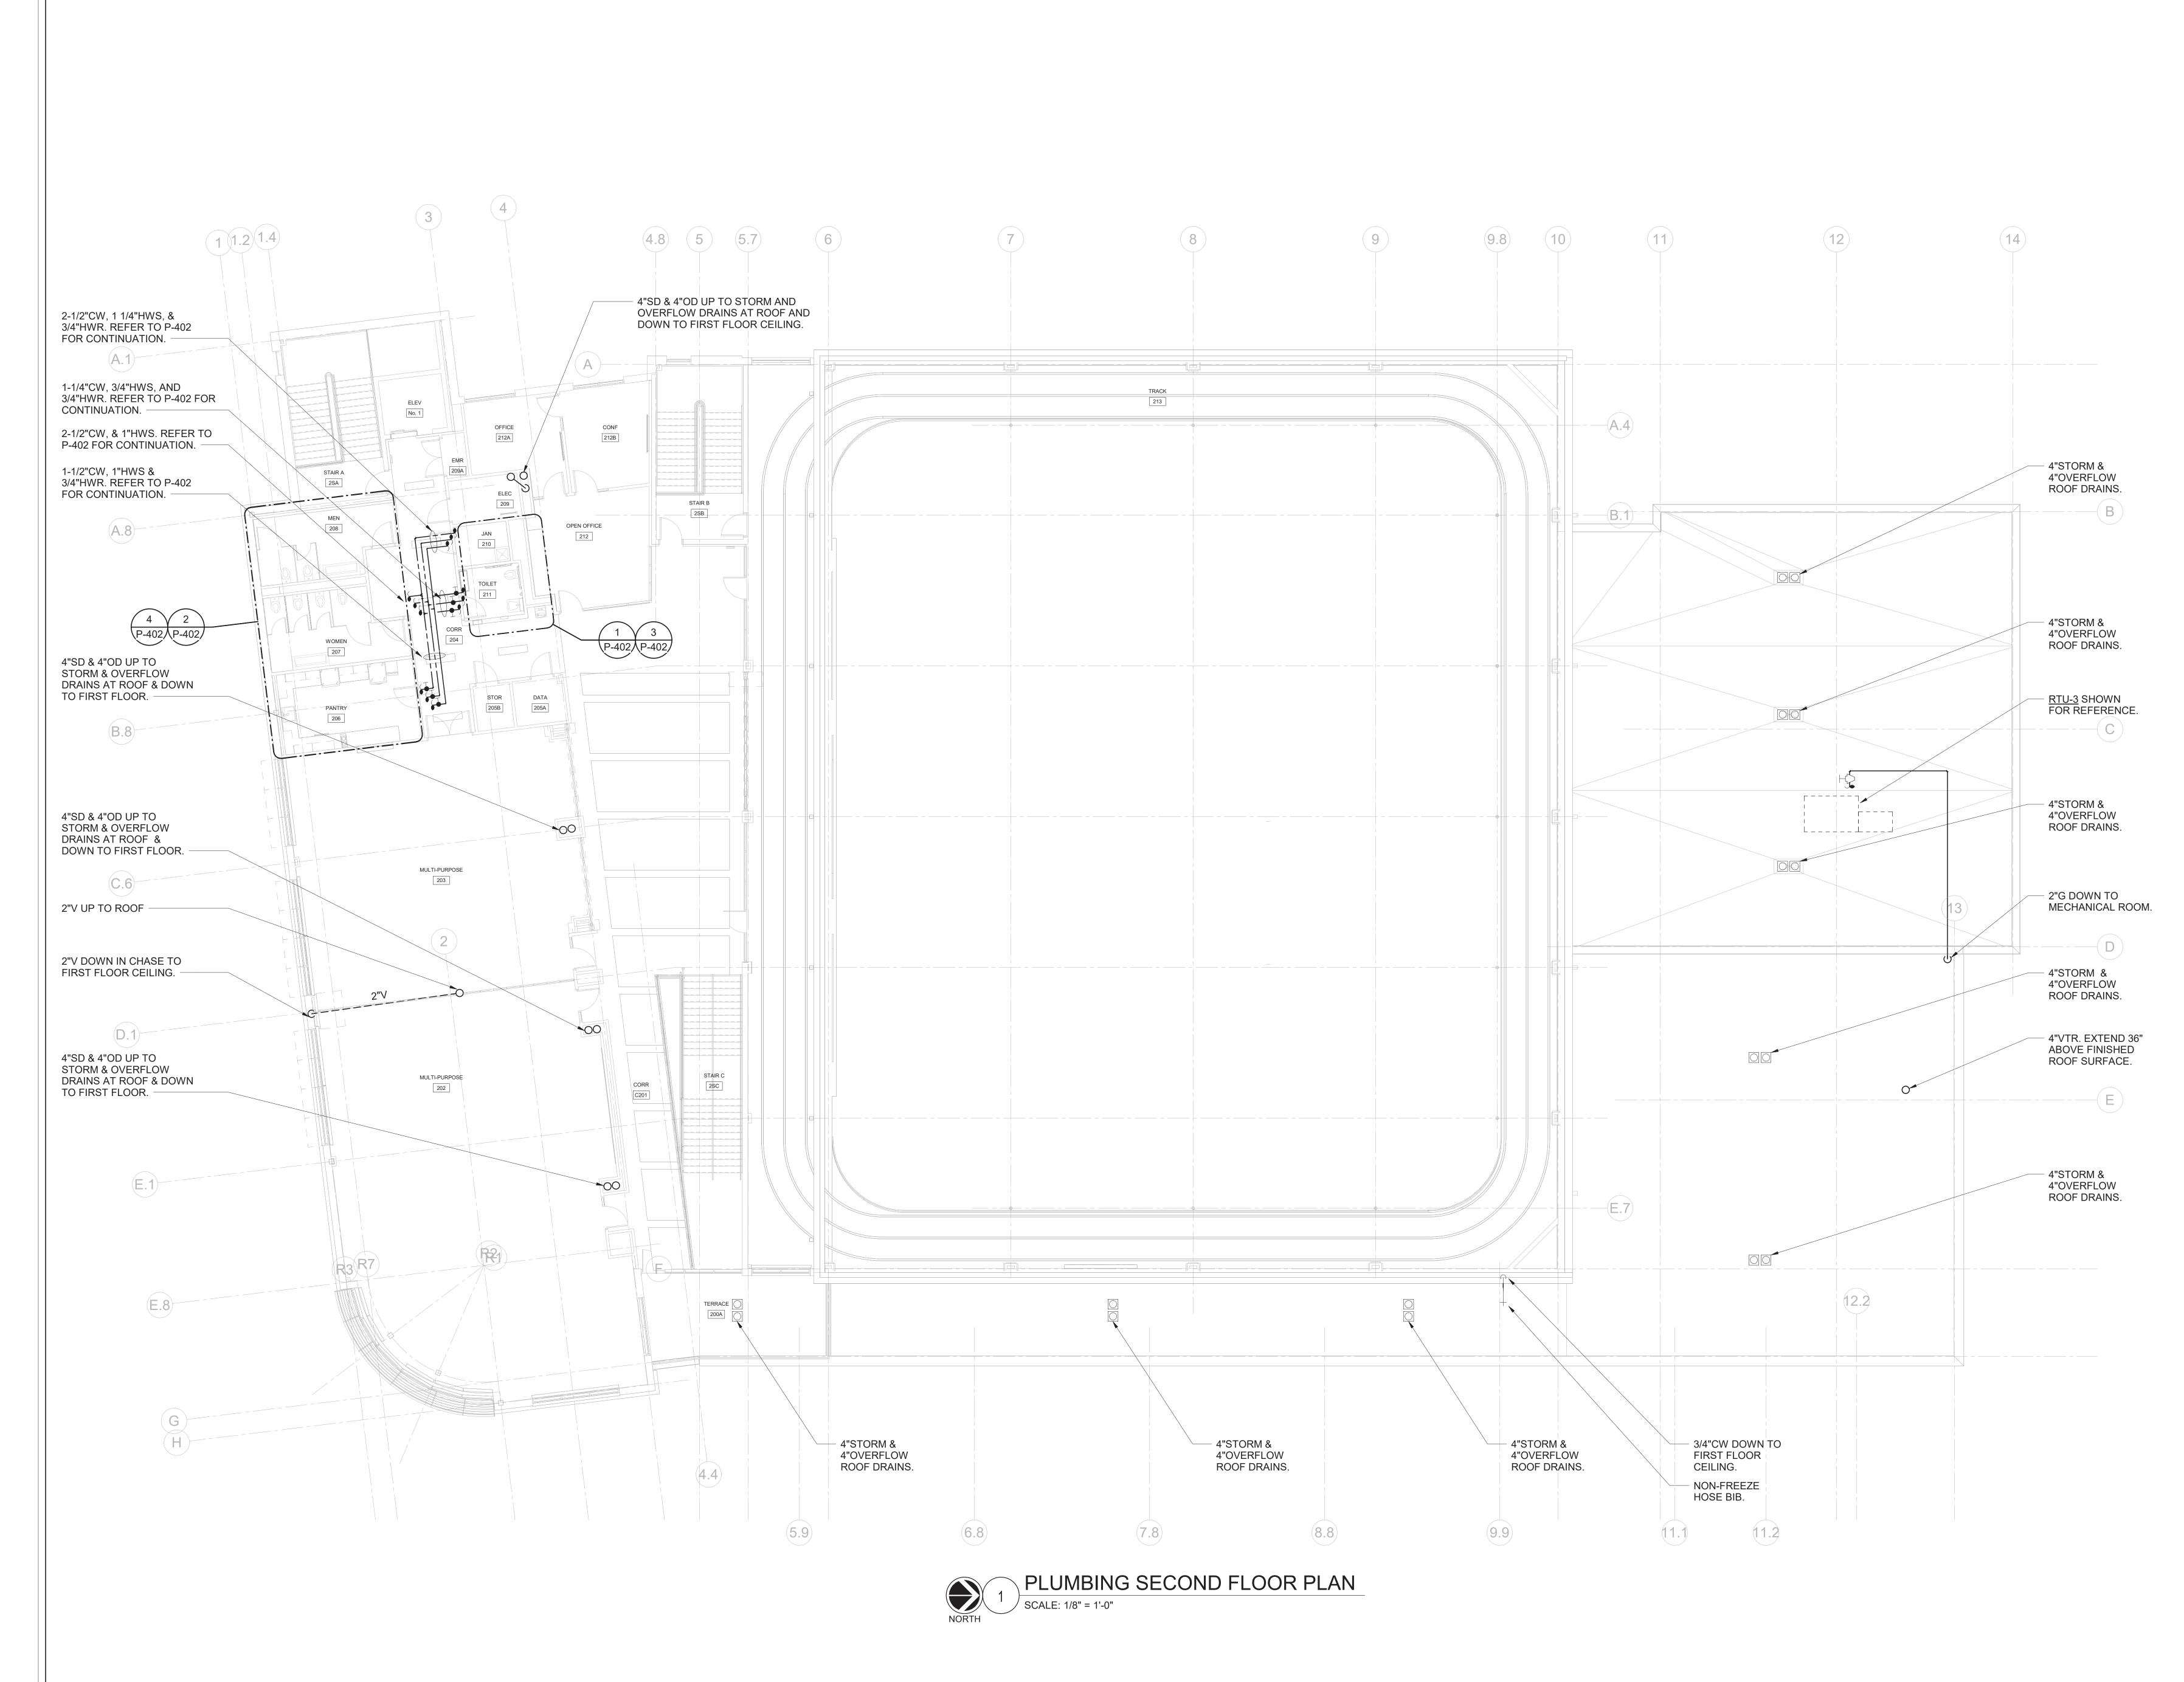


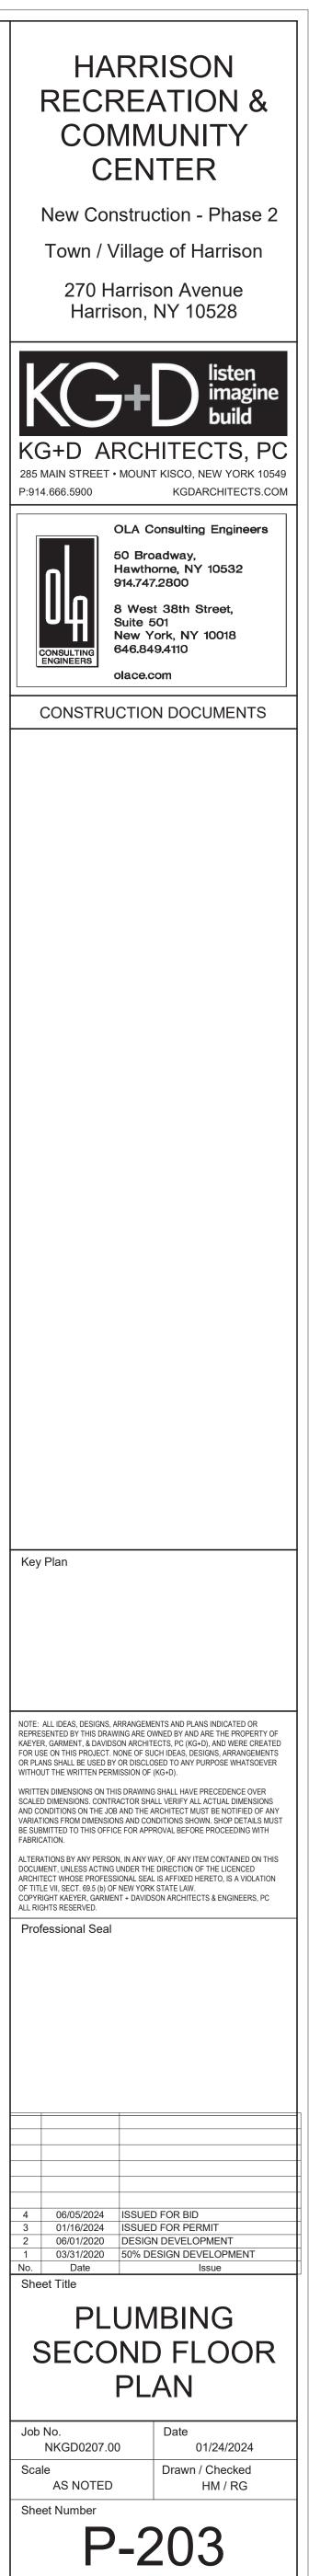

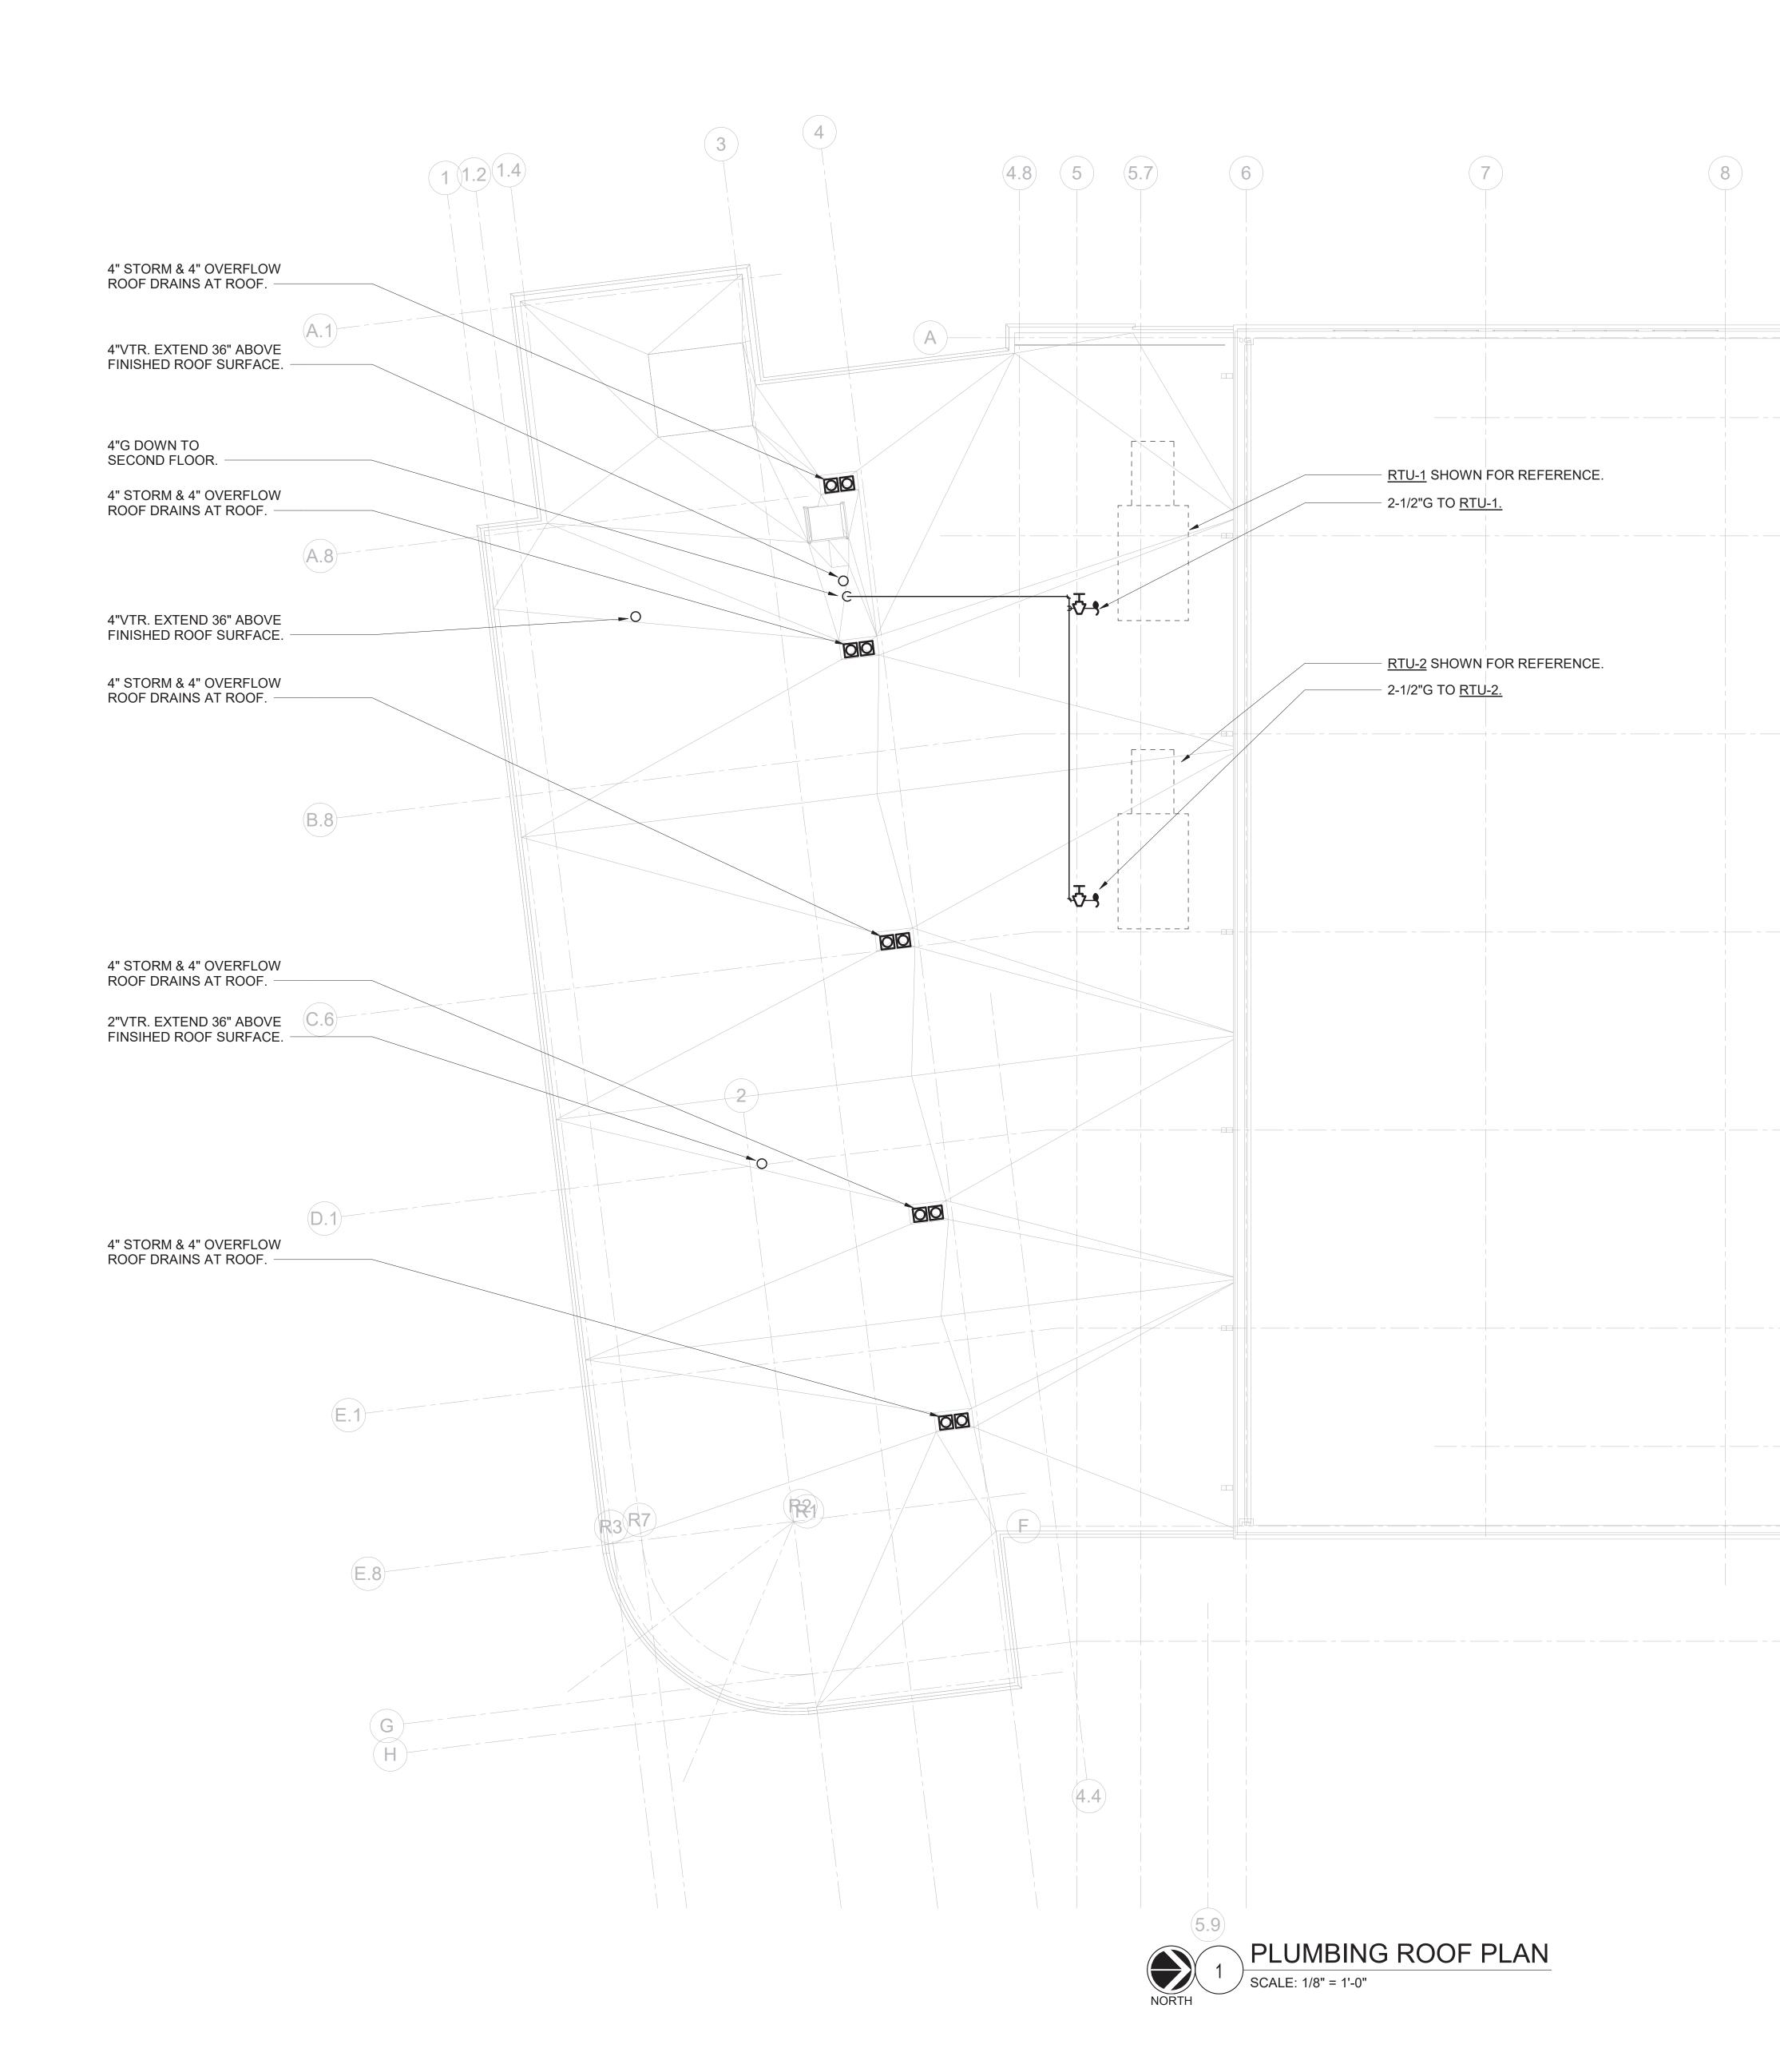



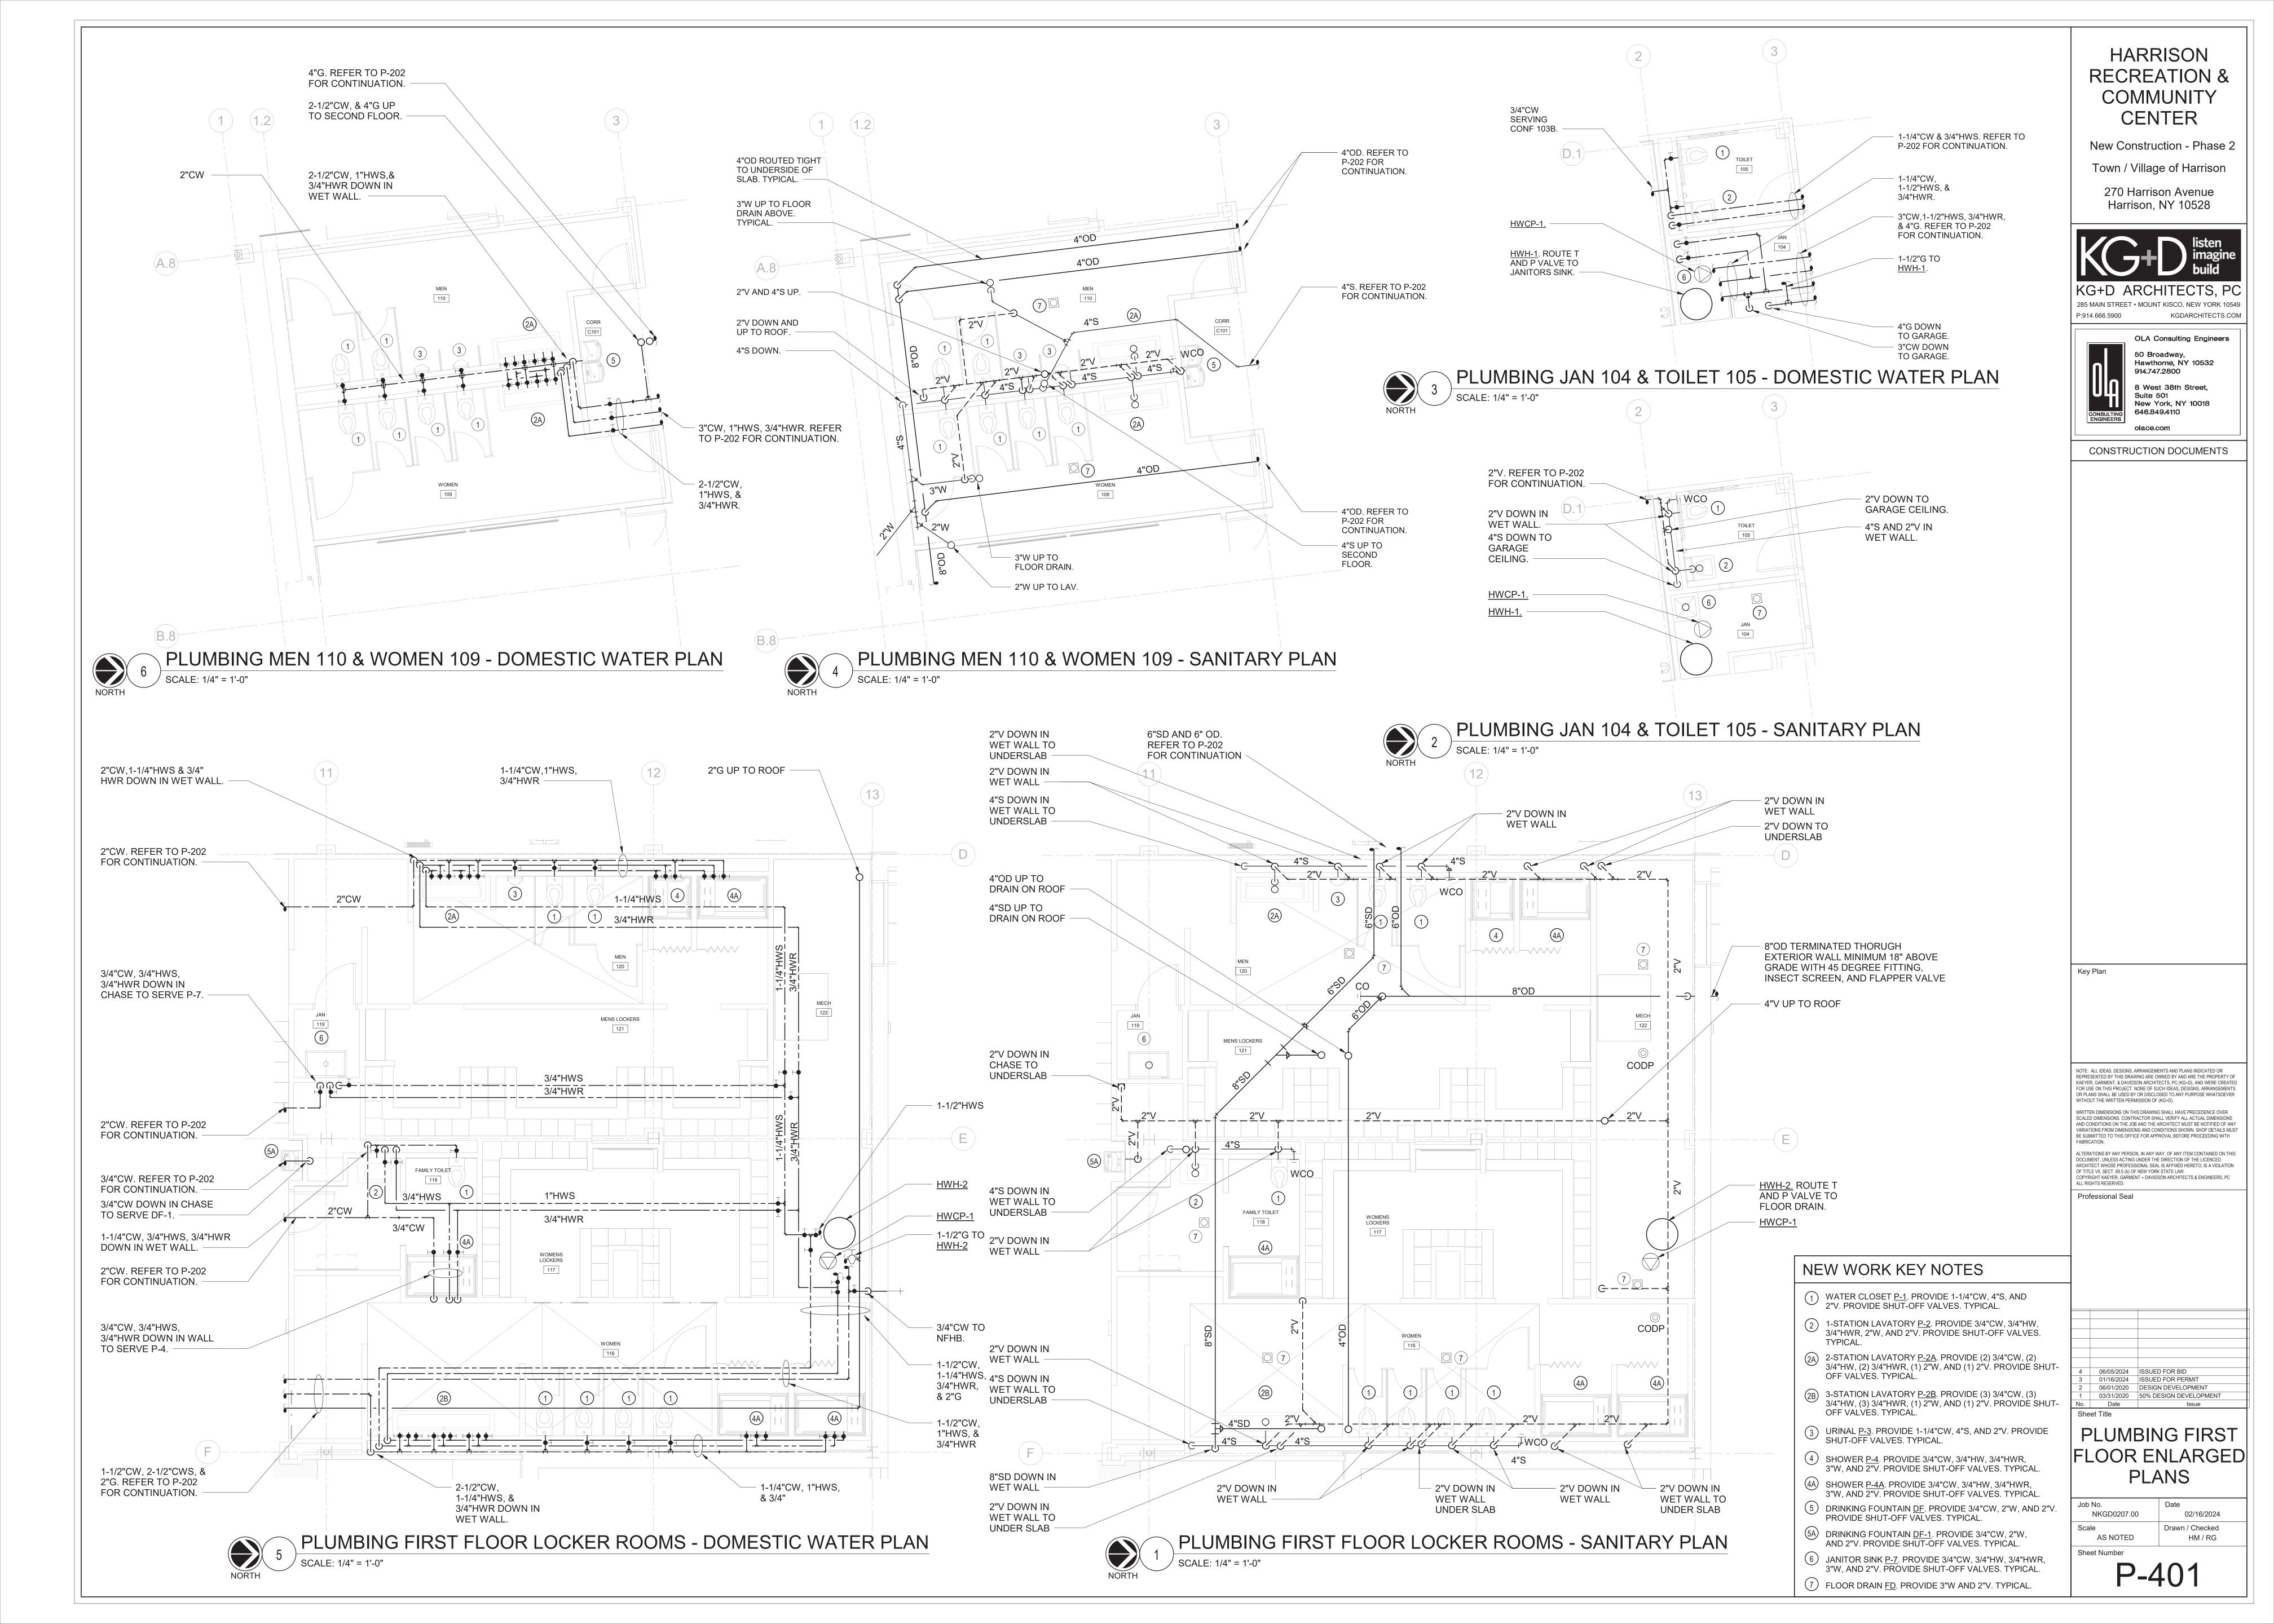

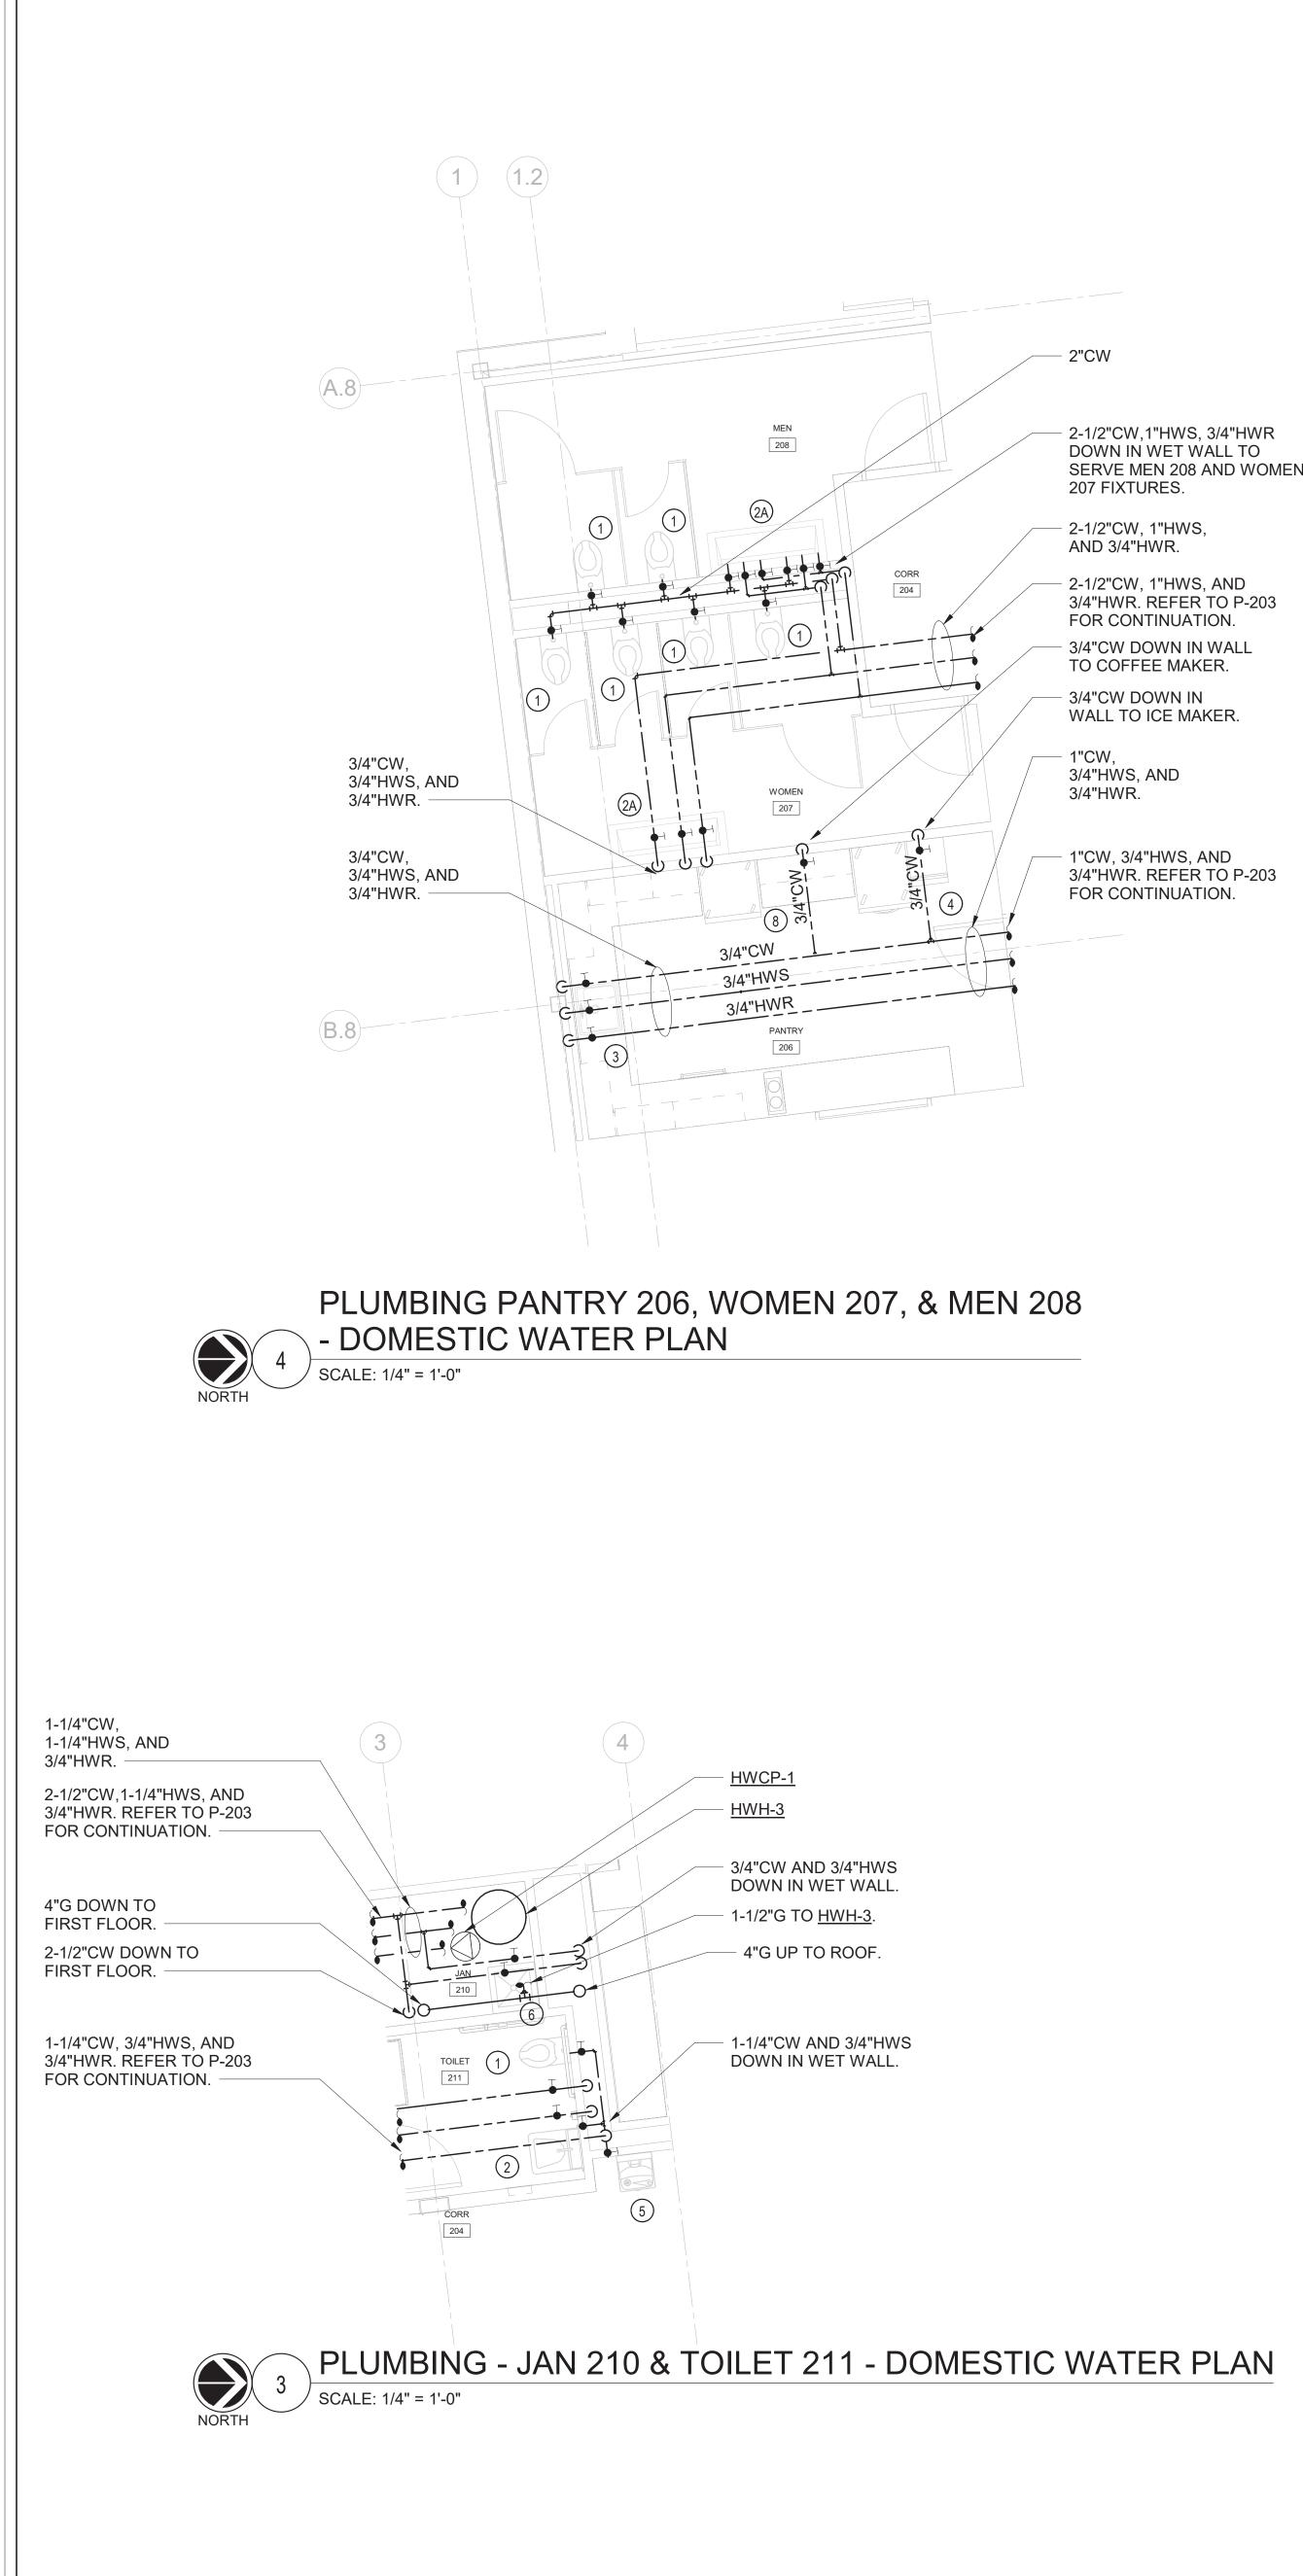

2-1/2"CW,1"HWS, 3/4"HWR DOWN IN WET WALL TO SERVE MEN 208 AND WOMEN 207 FIXTURES.

2-1/2"CW, 1"HWS, AND 3/4"HWR.


2-1/2"CW, 1"HWS, AND 3/4"HWR. REFER TO P-203 FOR CONTINUATION. 3/4"CW DOWN IN WALL TO COFFEE MAKER.


3/4"CW DOWN IN WALL TO ICE MAKER.

1"CW, 3/4"HWS, AND 3/4"HWR.

1"CW, 3/4"HWS, AND 3/4"HWR. REFER TO P-203 FOR CONTINUATION.

(1) (1.2) (A.8) MEN 208 (1)(1)1 1 $\overline{7}$ (2A 2"W DOWN PANTRY 206 (**B.8**) PLUMBING PANTRY 206, WOMEN 207, & MEN 208

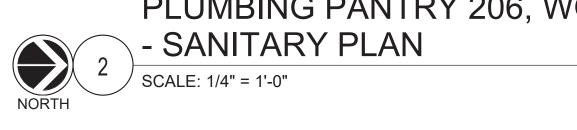

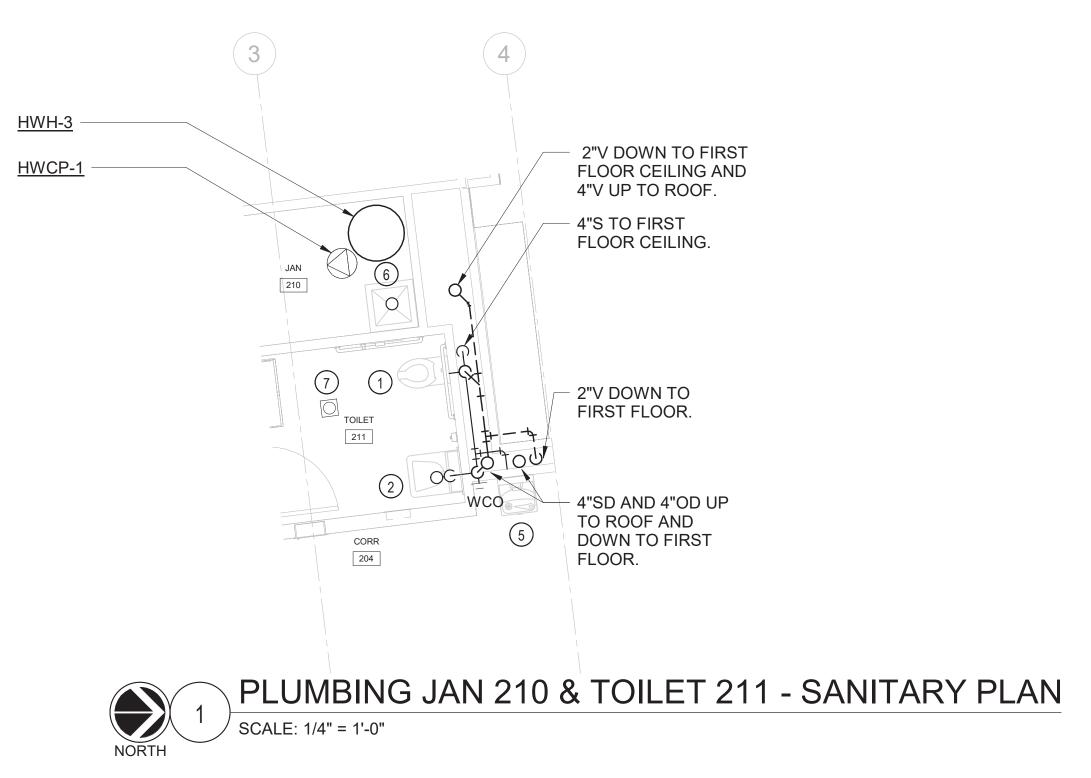






() WATER CLOSET <u>P-1</u>. PROVIDE 1-1/4"CW, 4"S, AND 2"V. PROVIDE SHUT-OFF VALVES. TYPICAL. 2 1-STATION LAVATORY <u>P-2</u>. PROVIDE 3/4"CW, 3/4"HW, 3/4"HWR, 2"W, AND 2"V. PROVIDE SHUT-OFF VALVES. TYPICAL.


NEW WORK KEY NOTES

- 2-STATION LAVATORY <u>P-2A</u>. PROVIDE (2) 3/4"CW, (2) 3/4"HW, (2) 3/4"HWR, (1) 2"W, AND (1) 2"V. PROVIDE SHUT-OFF VALVES. TYPICAL.
- (3) PANTRY SINK <u>P-6</u>. PROVIDE 3/4"CW, 3/4"HW, 3/4"HWR, 2"W, AND 2"V. PROVIDE SHUT-OFF VALVES. TYPICAL.
- (4) ICE MAKER <u>IM-1</u>. PROVIDE 3/4"CW. PROVIDE SHUT-OFF VALVES. TYPICAL.
- 5 DRINKING FOUNTAIN <u>DF-1</u>. PROVIDE 3/4"CW, 2"W, AND 2"V. PROVIDE SHUT-OFF VALVES. TYPICAL.
- 6 JANITOR SINK <u>P-7</u>. PROVIDE 3/4"CW, 3/4"HW, 3/4"HWR, 3"W, AND 2"V. PROVIDE SHUT-OFF VALVES. TYPICAL.
- (7) FLOOR DRAIN <u>FD</u>. PROVIDE 3"W AND 2"V. TYPICAL. 8 COFFEE MAKER <u>CM</u>. PROVIDE 3/4"CW. PROVIDE SHUT-OFF VALVE AND BACKFLOW PREVENTER.

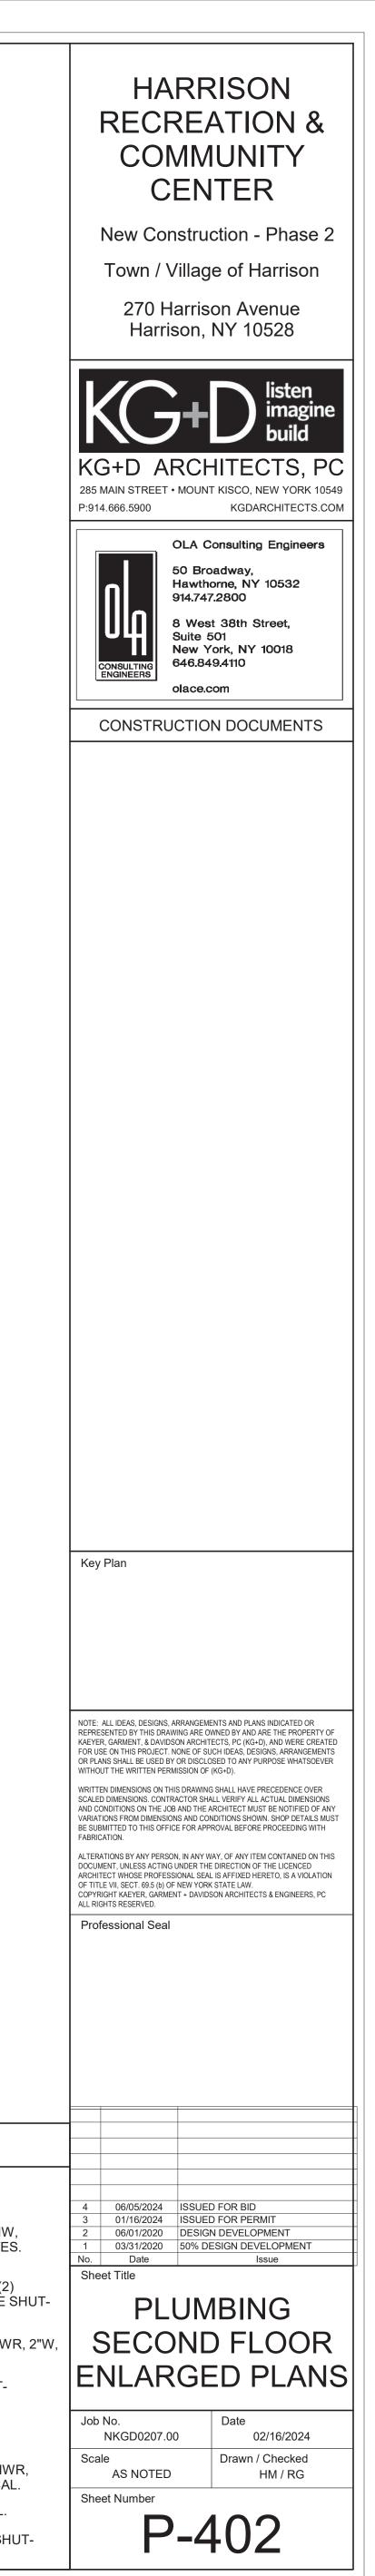

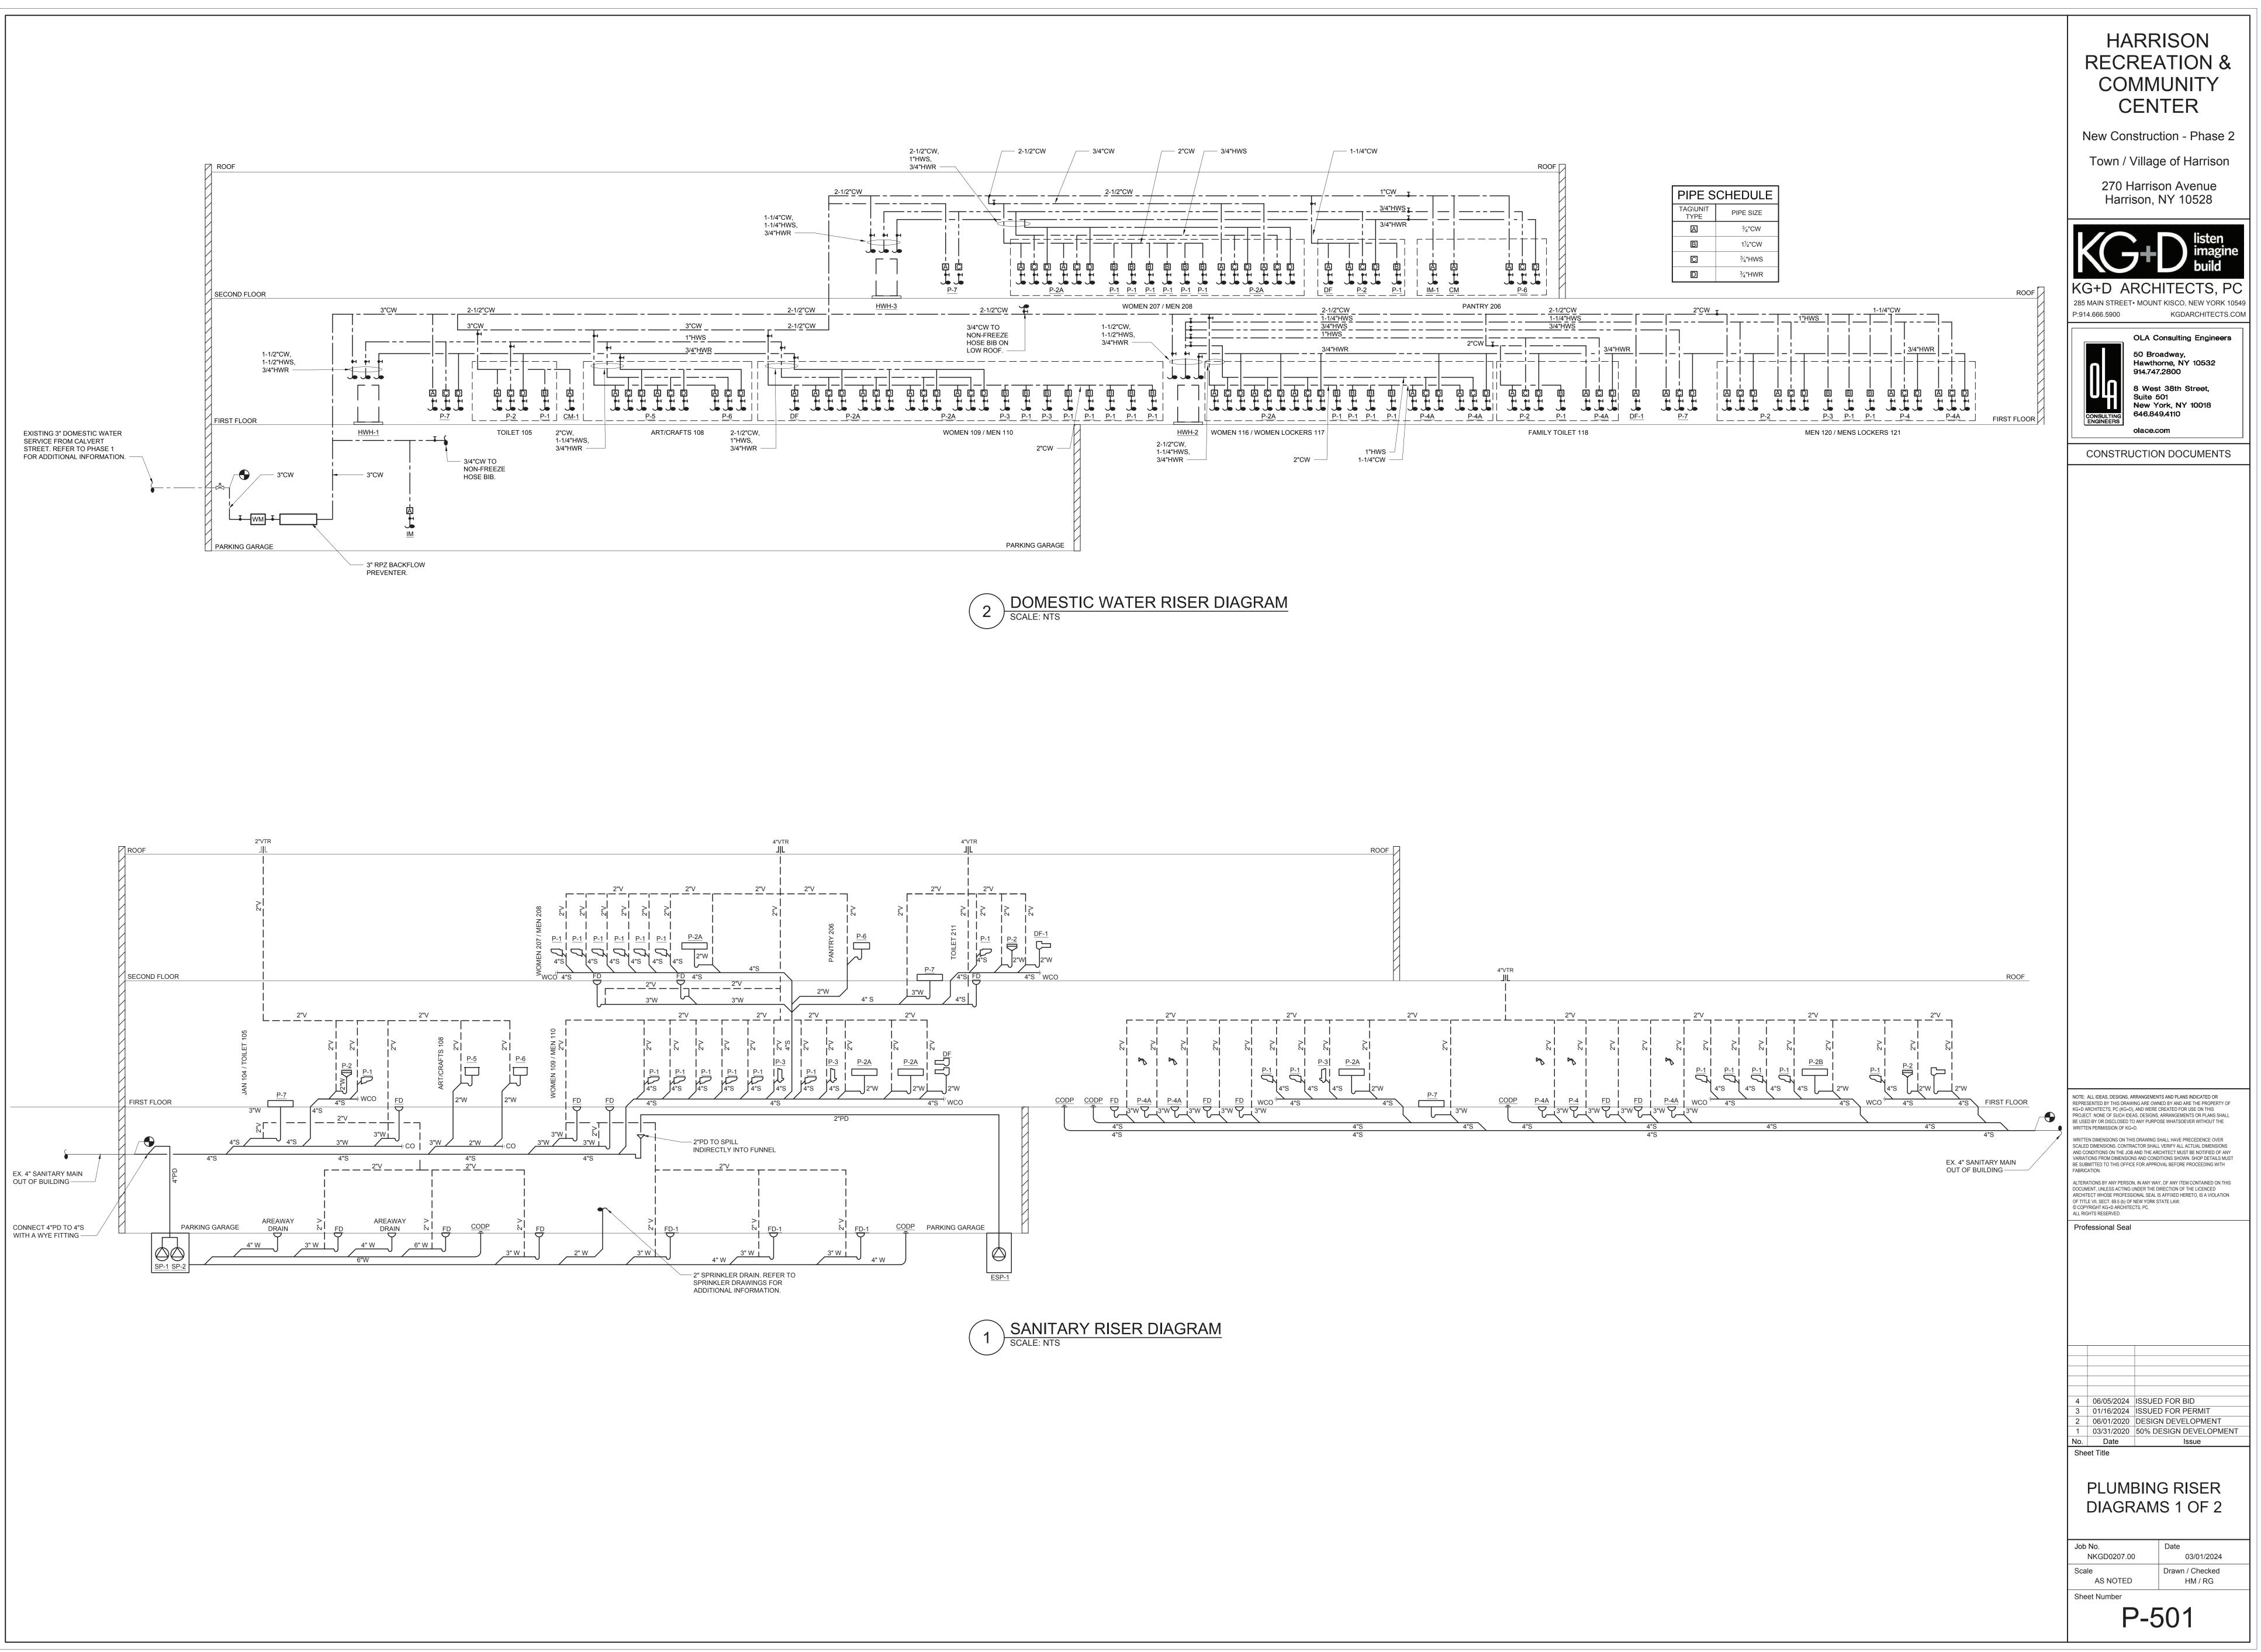

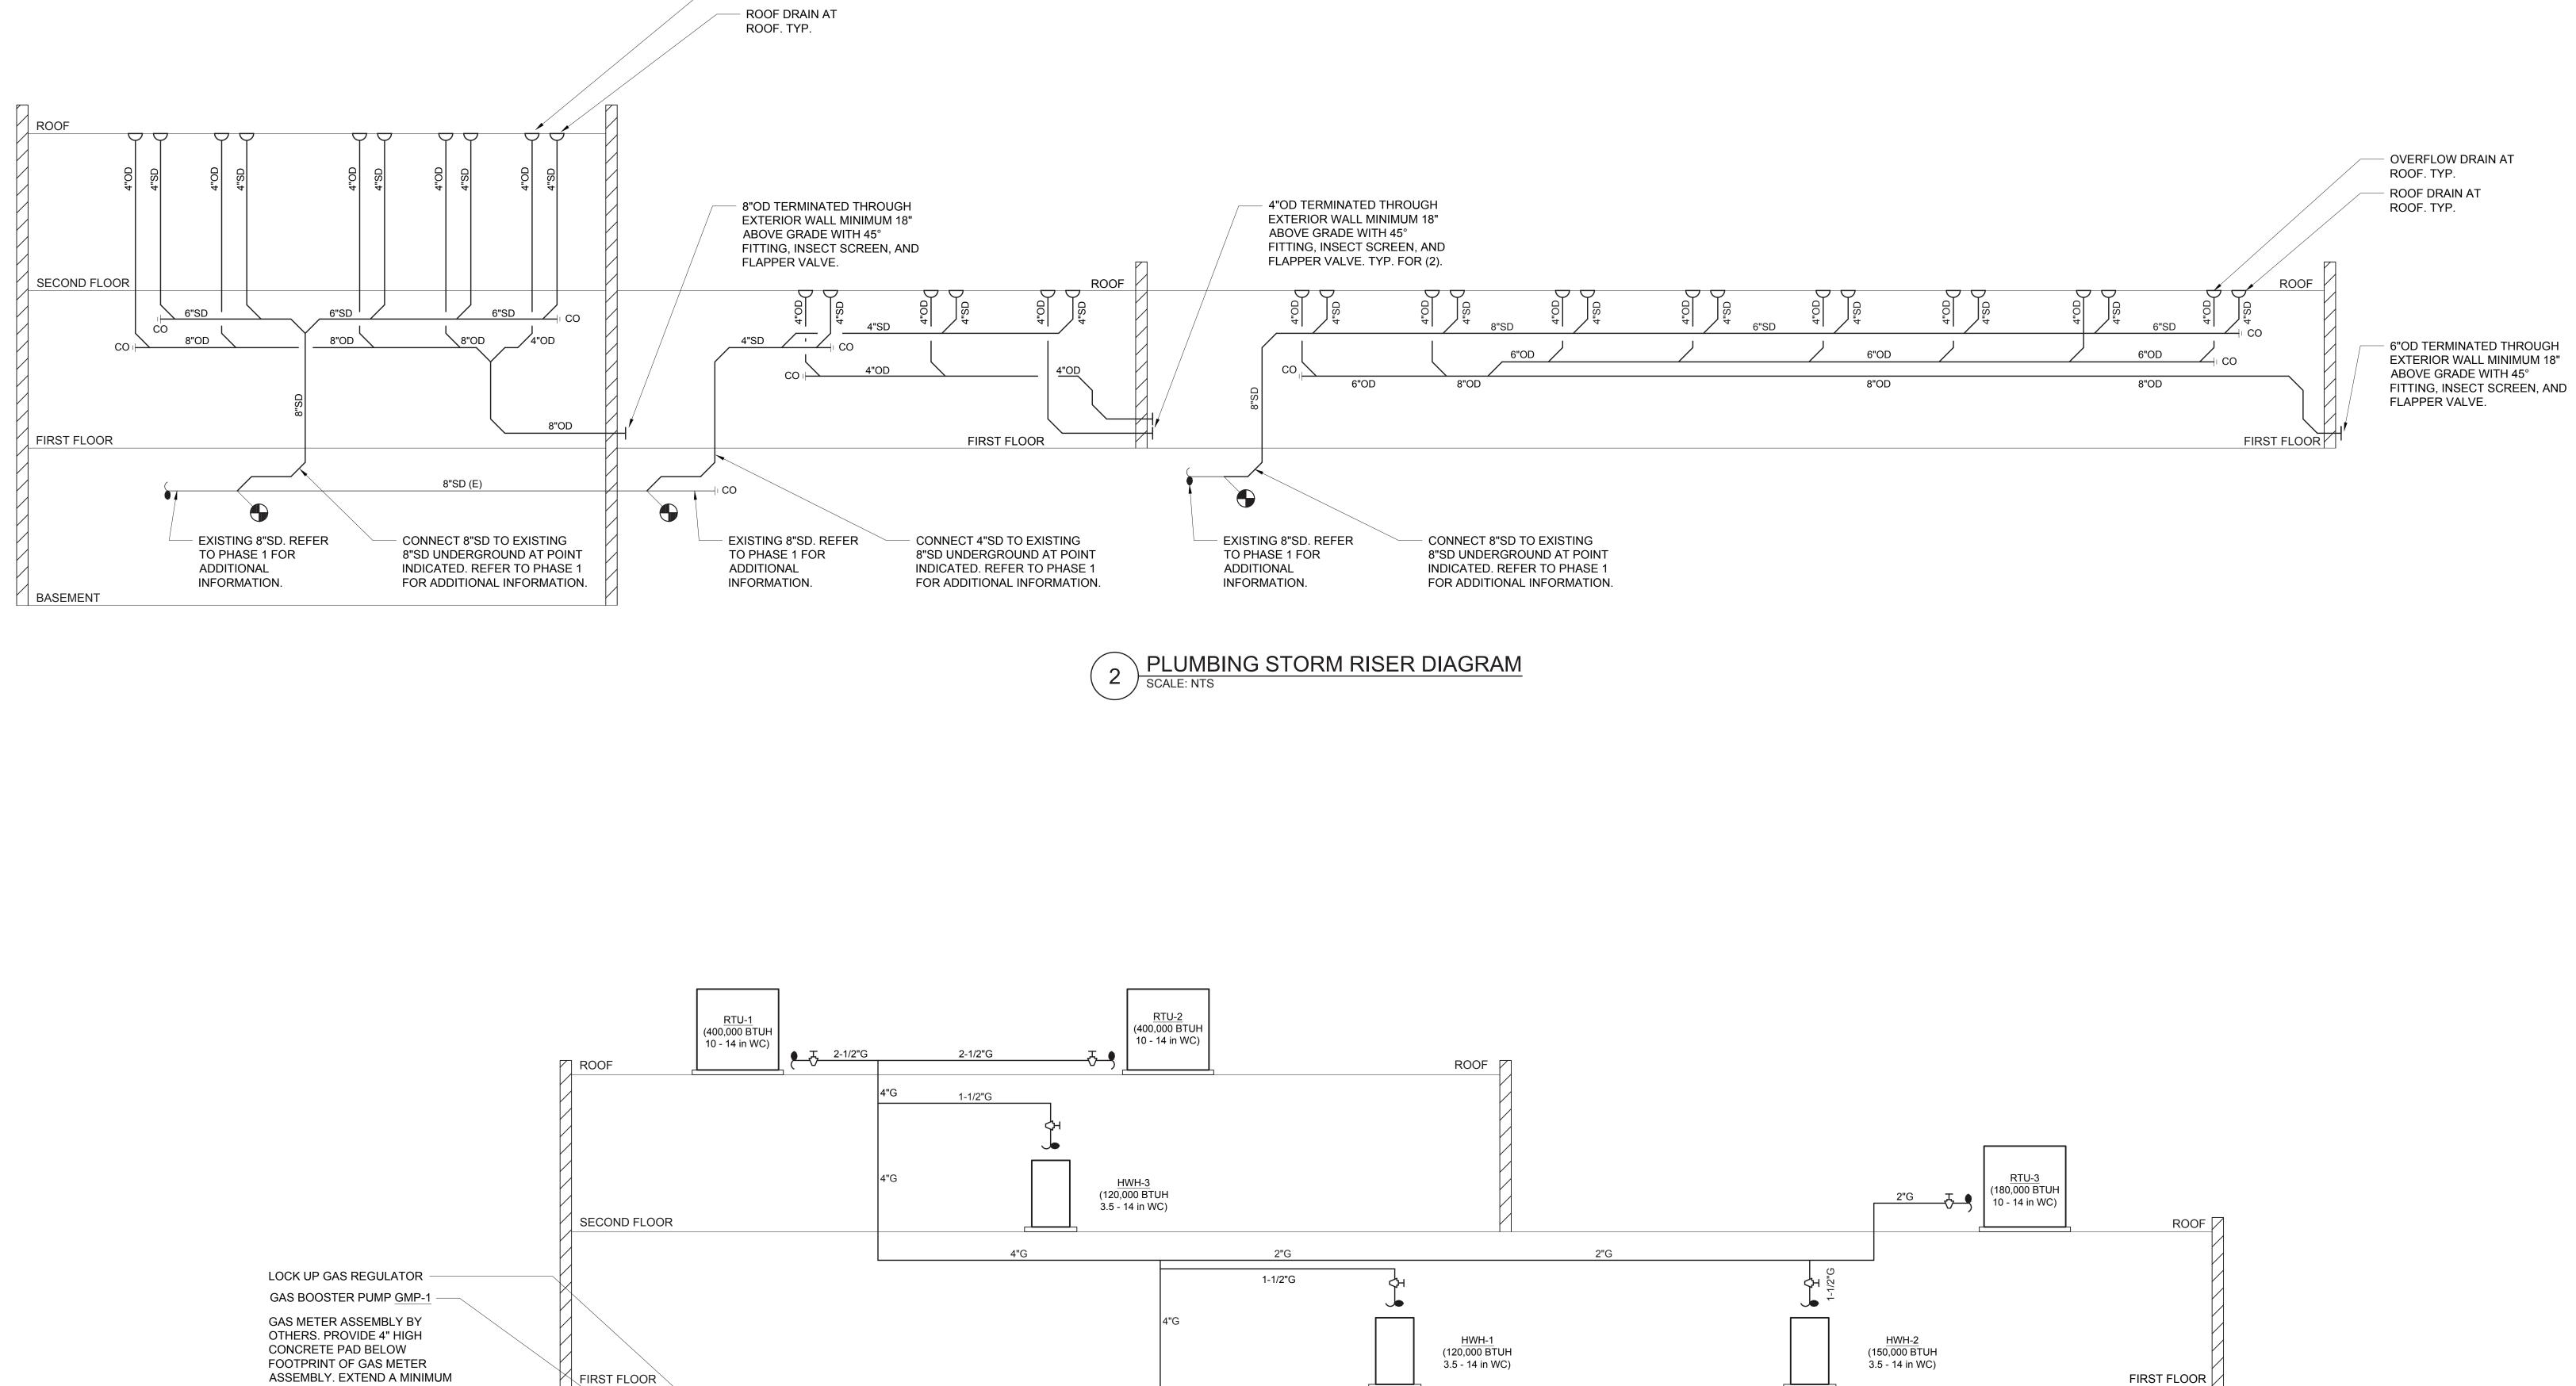

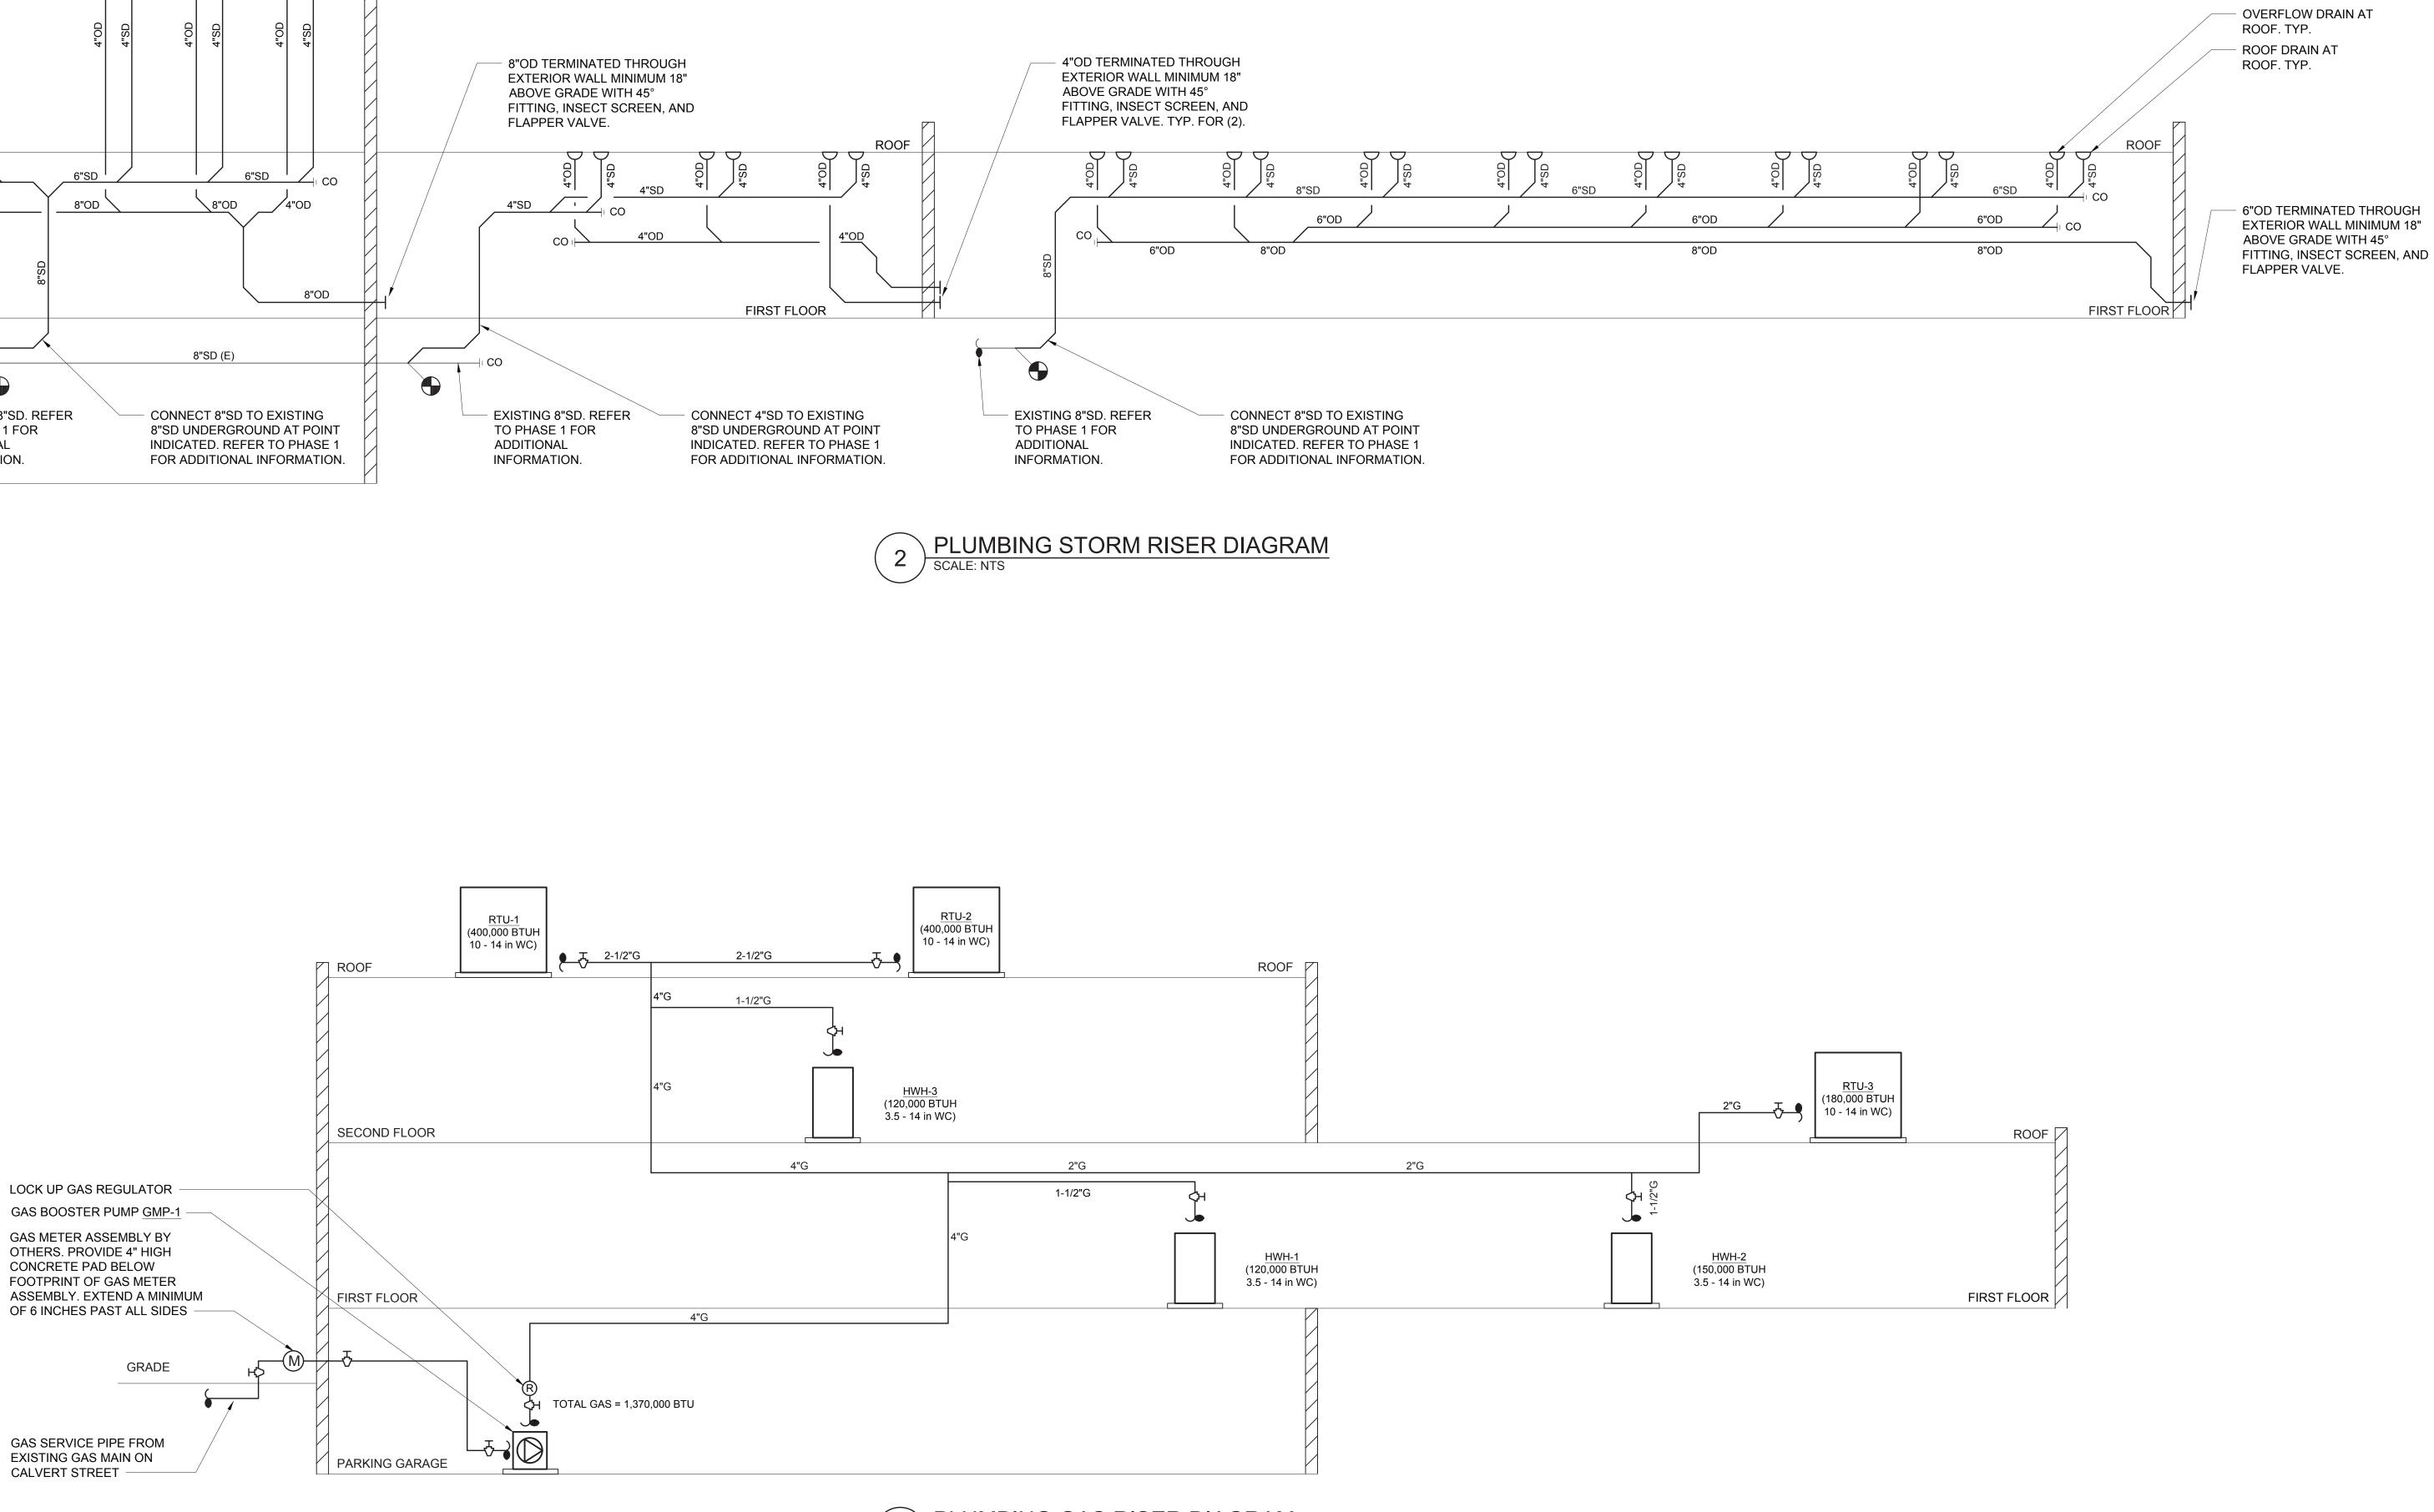

OVERFLOW DRAIN AT ROOF. TYP.

1 PLUMBING GAS RISER DIAGRAM SCALE: NTS

