CITY OF MIDDLETOWN NEW COURTHOUSE FACILITY

CONTRACT 1A - GENERAL CONSTRUCTION CONTRACT 1B - MECHANICAL CONSTRUCTION CONTRACT 1C - PLUMBING/FIRE PROTECTION CONSTRUCTION **CONTRACT 1D - ELECTRICAL CONSTRUCTION**

25 SOUTH STREET MIDDLETOWN, NEW YORK, 10940 ORANGE COUNTY, NEW YORK



CITY COUNCIL

JOSEPH M. DESTEFANO MAYOR

COMMON COUNCIL PRESIDENT J. MIGUEL RODRIGUES **JOSEPH G. MASI COUNCIL MEMBER KEVIN WITT COUNCIL MEMBER COUNCIL MEMBER** ANDREW GREEN **GERALD P. KLEINER COUNCIL MEMBER KATE WRAY COUNCIL MEMBER PAUL JOHNSON COUNCIL MEMBER JUDE A. JEAN-FRANCOIS COUNCIL MEMBER SPARROW TOBIN COUNCIL MEMBER**

JACOB TAWIL, P.E.

COMMISSIONER OF PUBLIC WORKS



PROJECT LOCATION

PROJECT LOCATION PLAN

NOT TO SCALE

AUGUST, 2024 CONTRACT DOCUMENTS



Sheet Number G001

1753.008.001

T IS A VIOLATION OF THE NEW YORK STATE EDUCATION LAW, ARTICLE 145 §7209 SPECIAL PROVISIONS, FOR ANY PERSON UNLESS THEY ARE ACTING UNDER THE **DIRECTION OF A LICENSED PROFESSIONAL** ENGINEER, ARCHITECT, LANDSCAP ARCHITECT, OR LAND SURVEYOR, TO ALTER AN ITEM IN ANY WAY. IF AN ITEM BEARIN THE STAMP OF A LICENSED PROFESSIONA IS ALTERED, THE ALTERING PROFESSIONAL SHALL STAMP THE DOCUMENT AND INCLUDE THE NOTATION "ALTERED BY FOLLOWED BY THEIR SIGNATURE, THE DATE

OF SUCH ALTERATION, AND A SPECIFIC

DESCRIPTION OF THE ALTERATION.

A406 FIRST FLOOR ENLARGED BATHROOM PLANS AND INTERIOR ELEVATIONS

A407 FIRST FLOOR ENLARGED BATHROOM PLANS AND INTERIOR ELEVATIONS

A408 SECOND FLOOR COURTOOM ENLARGEMENT PLAN

INDEX

SHEET TITLE

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SHEET TITLE

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E601 ONE-LINE DIAGRAM DEMO

E602 ONE LINE DIAGRAM NORMAL POWER INSTALL

E604 FIRE ALARM RISER DIAGRAM DEMO

E605 FIRE ALARM RISER DIAGRAM INSTALL

E603 ONE LINE DIAGRAM EMERGENCY POWER INSTALL

POO1 SYMBOLS AND ABBREVIATIONS


P102 FIRST FLOOR PLUMBING DEMOLITION PLAN

P101 BASEMENT PLUMBING PLAN

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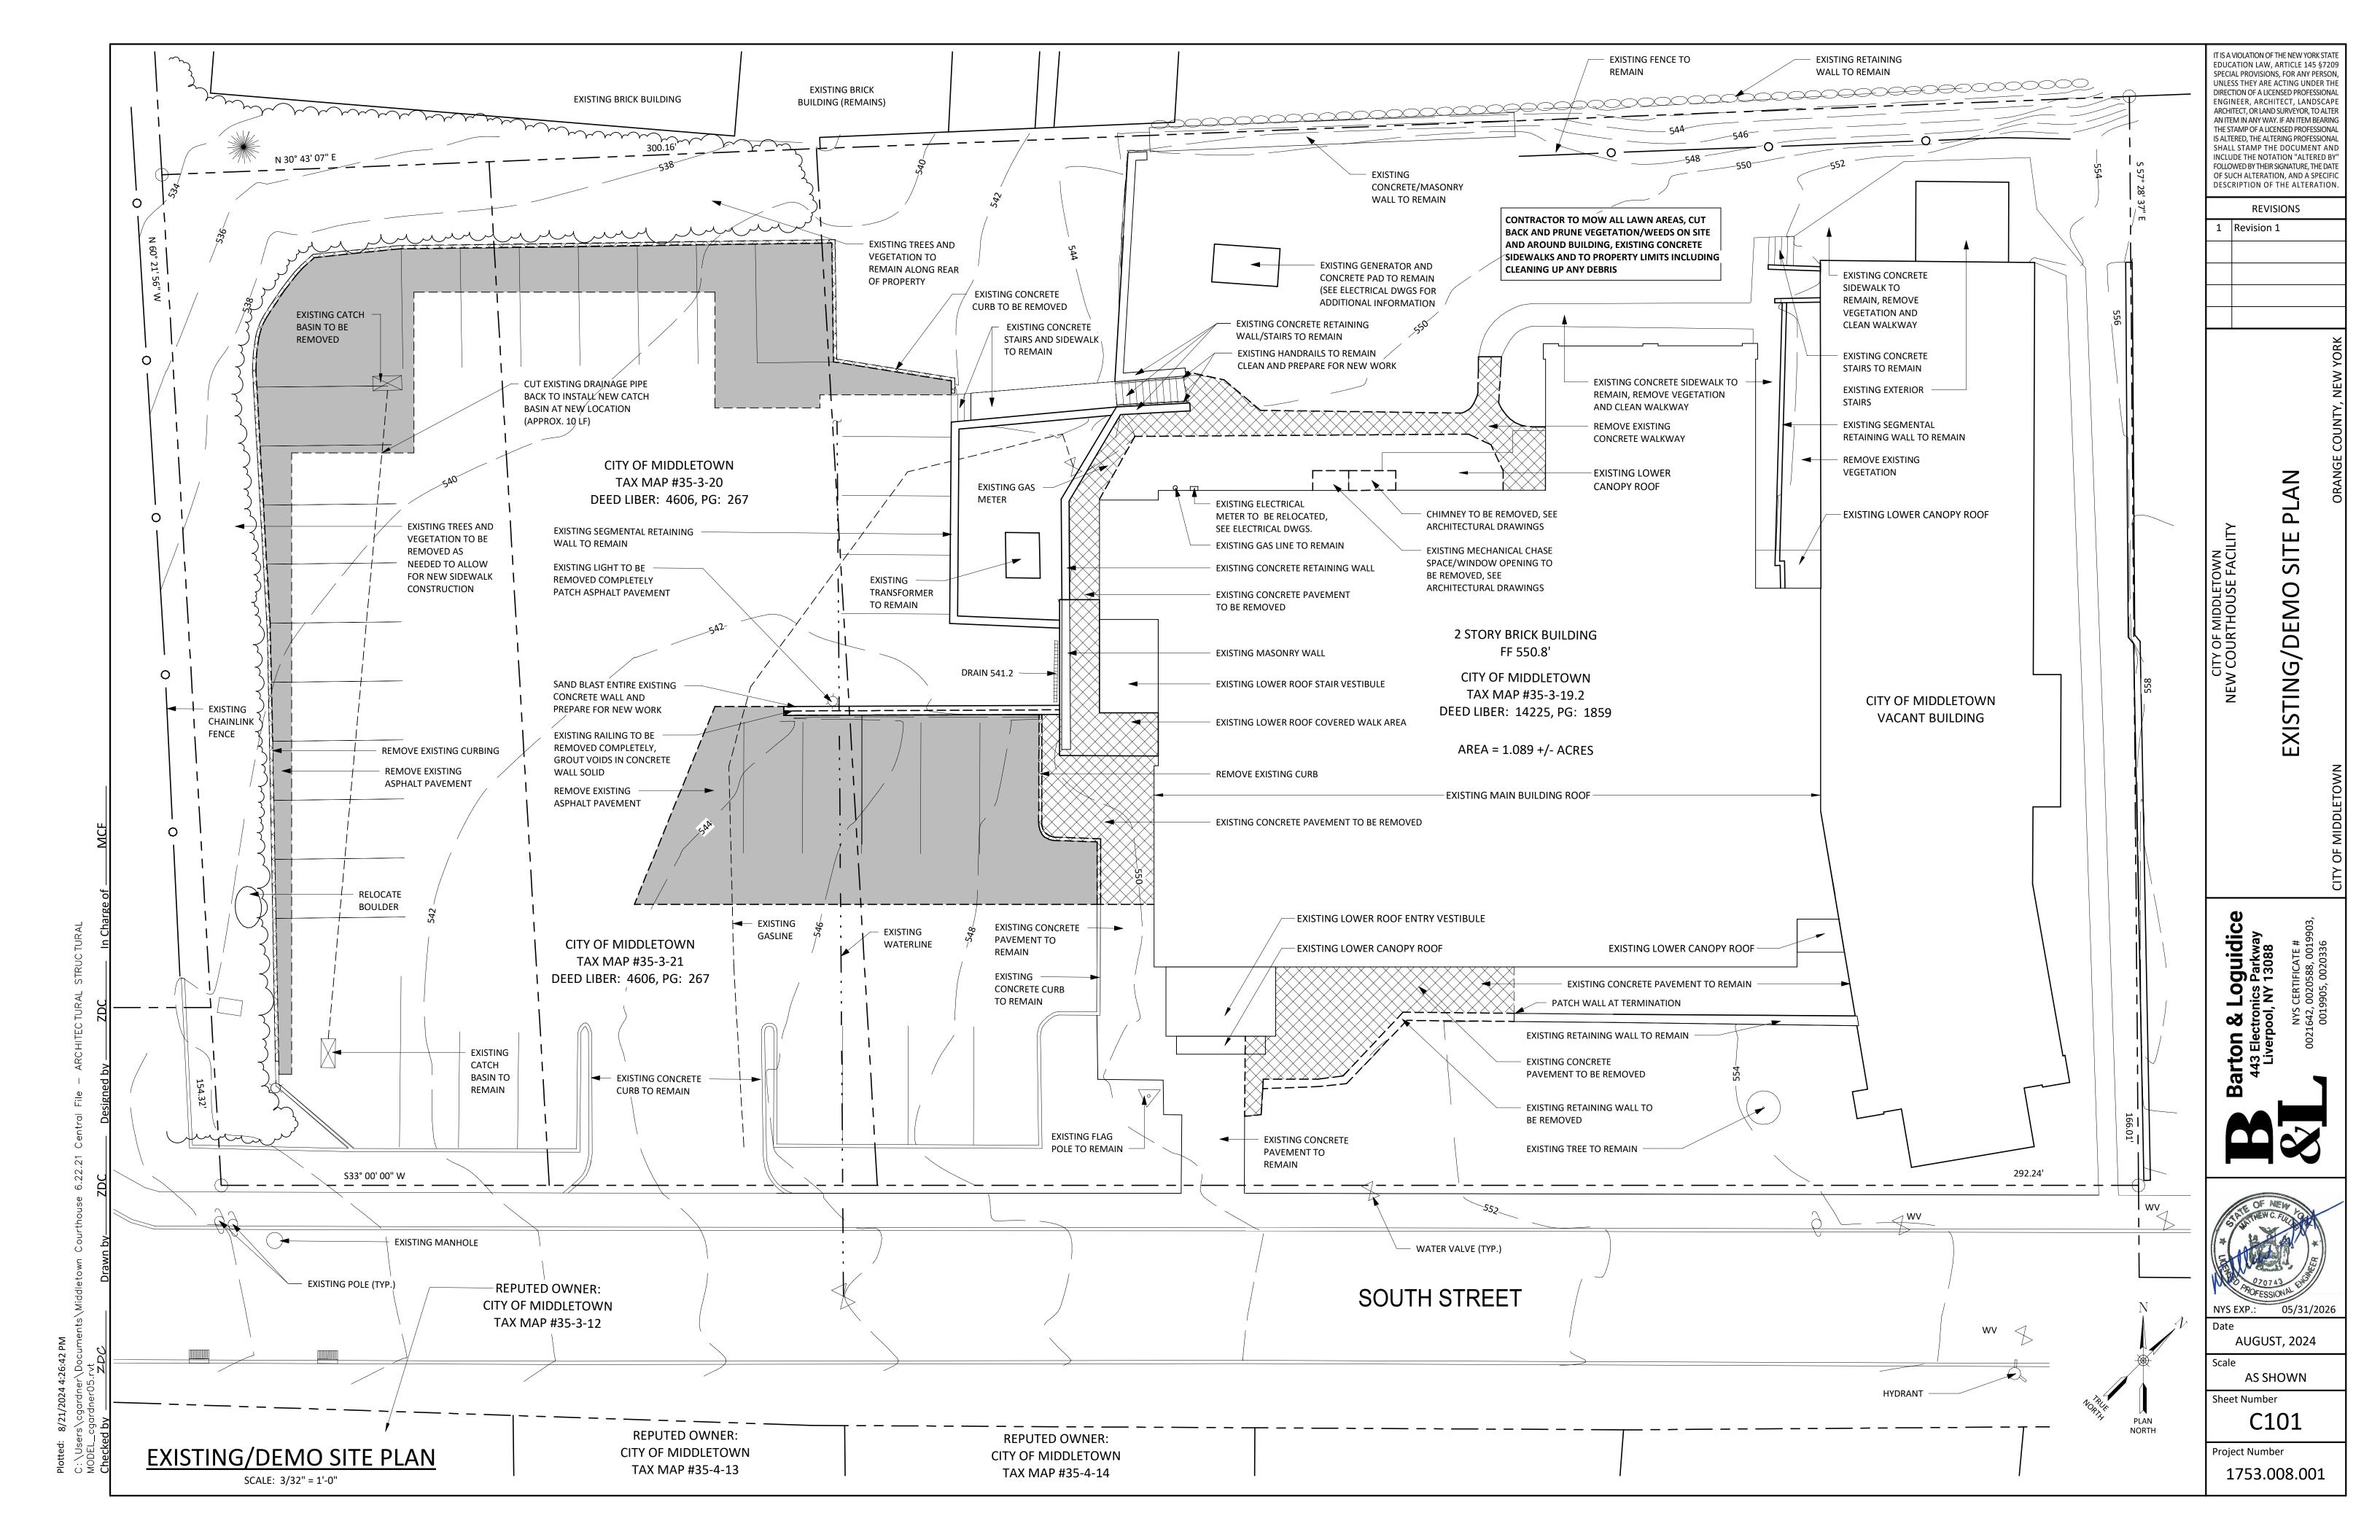
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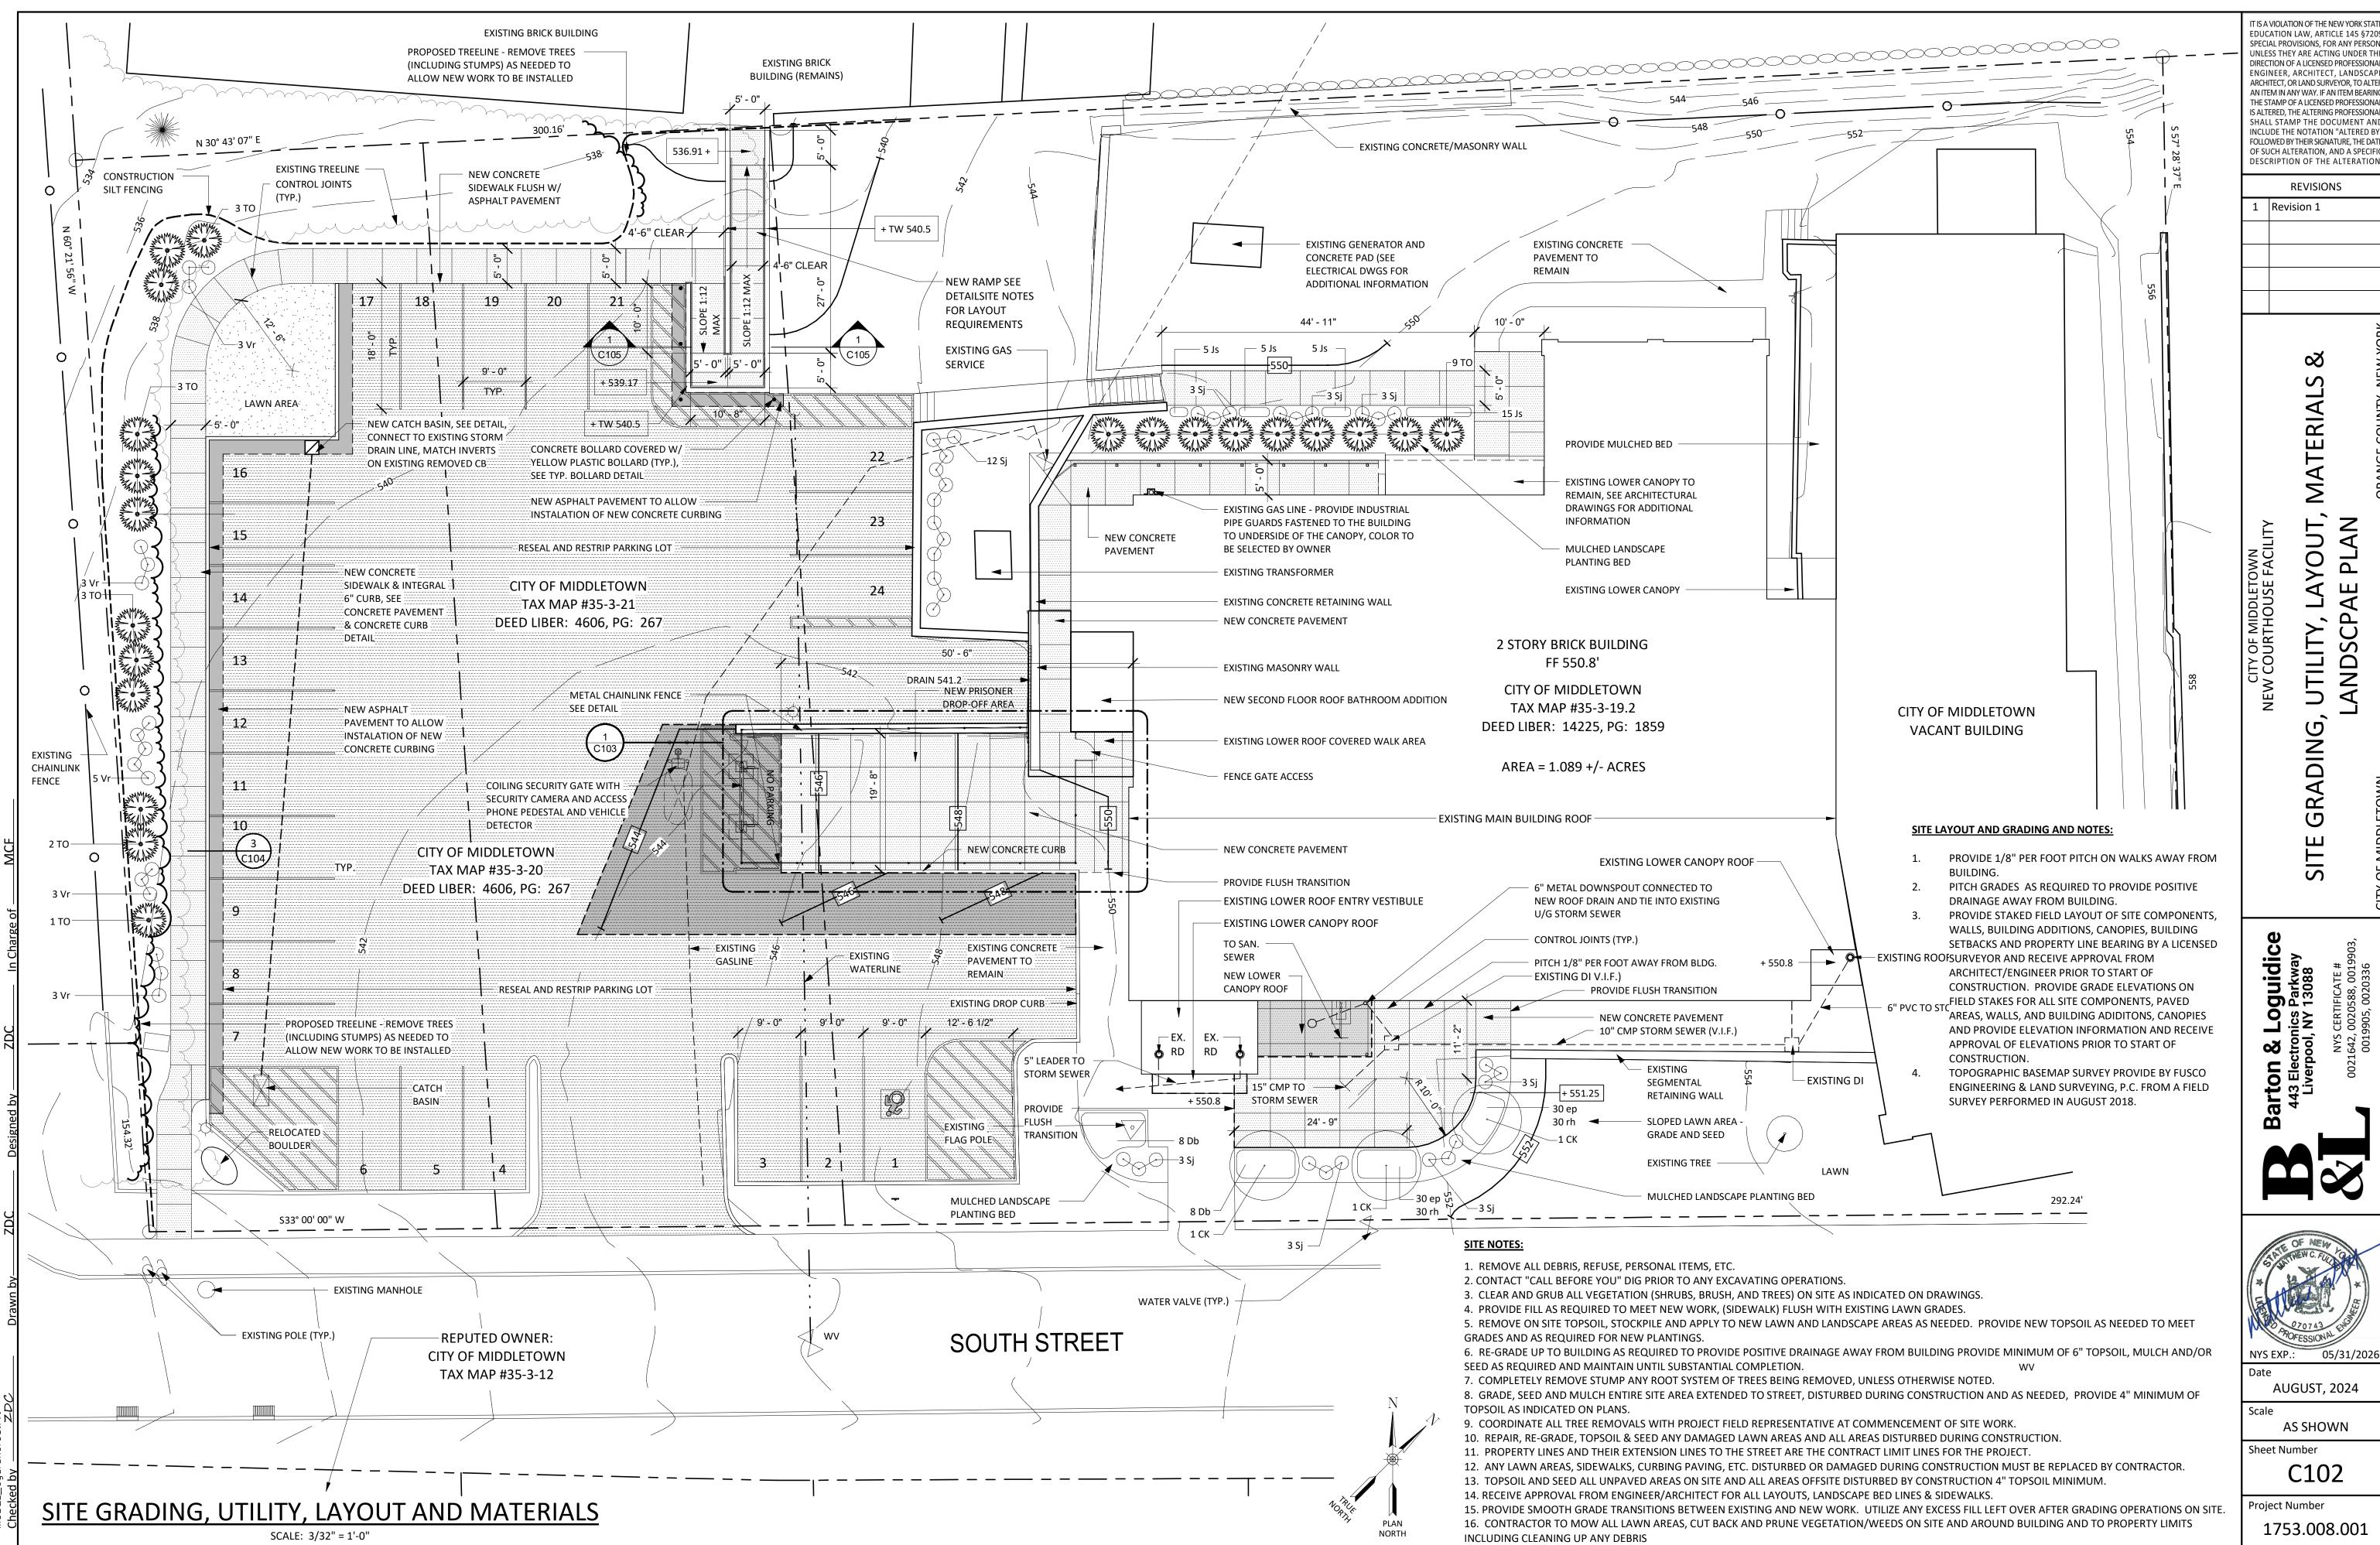
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Project Number 1753.008.001

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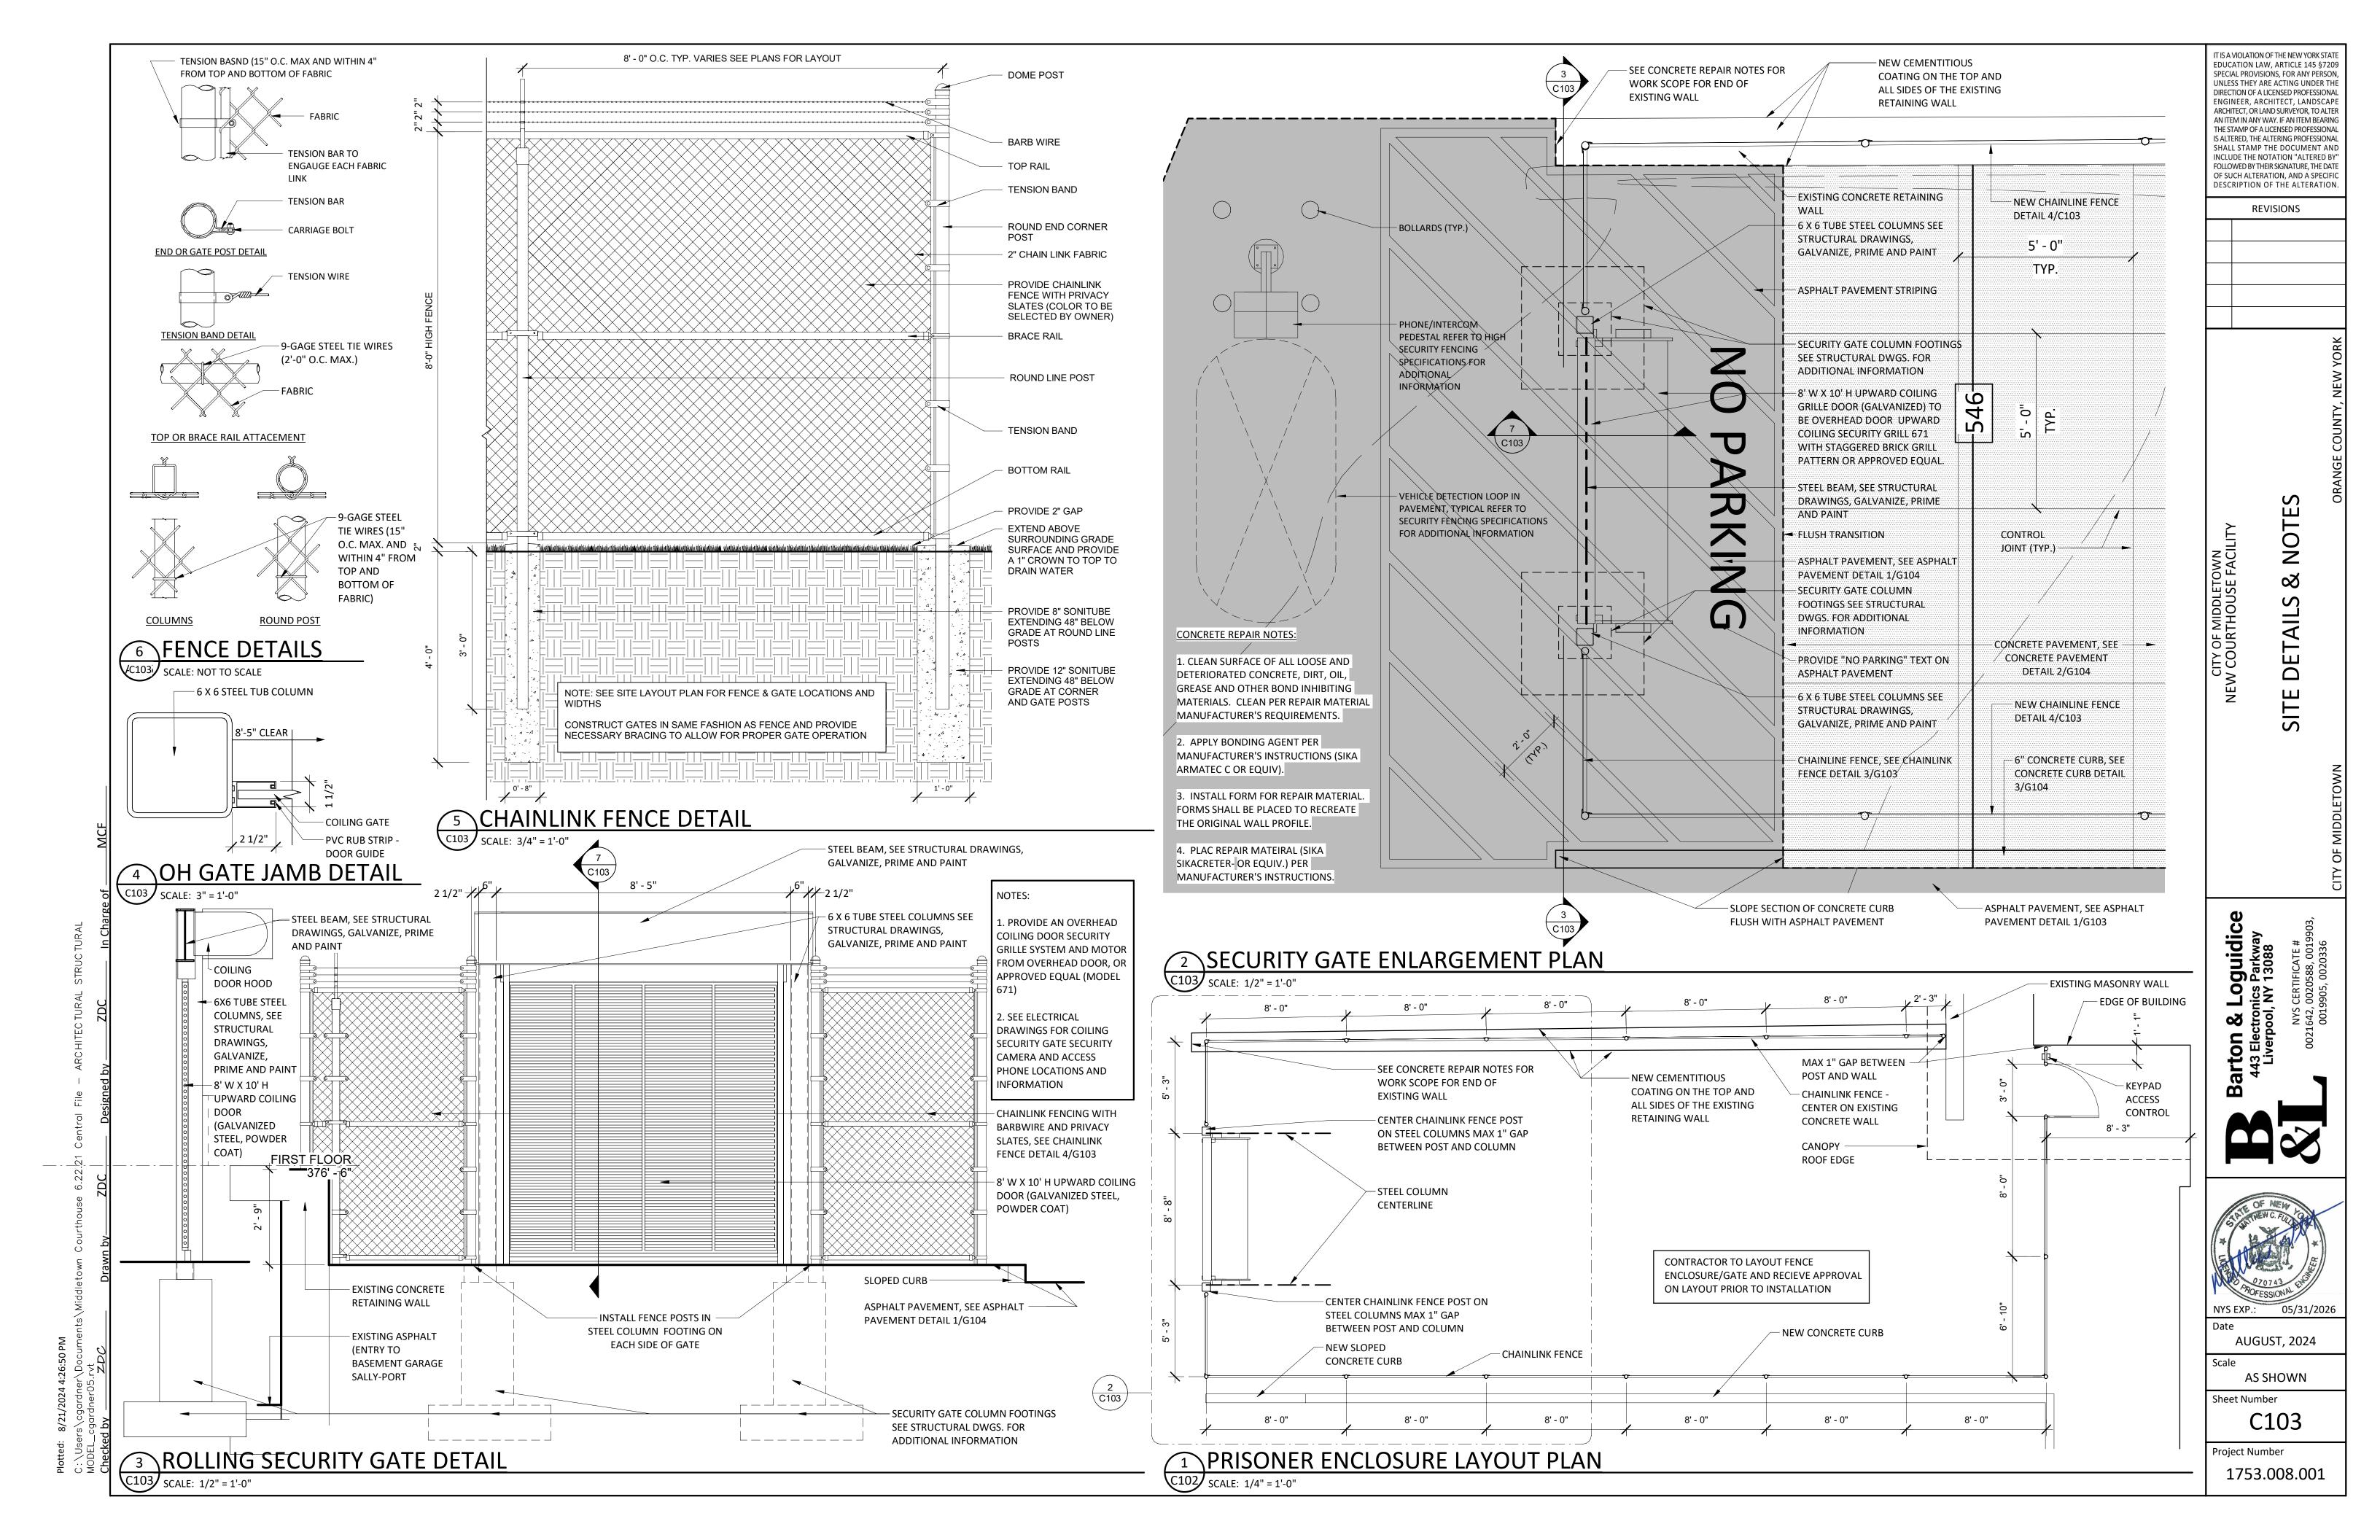
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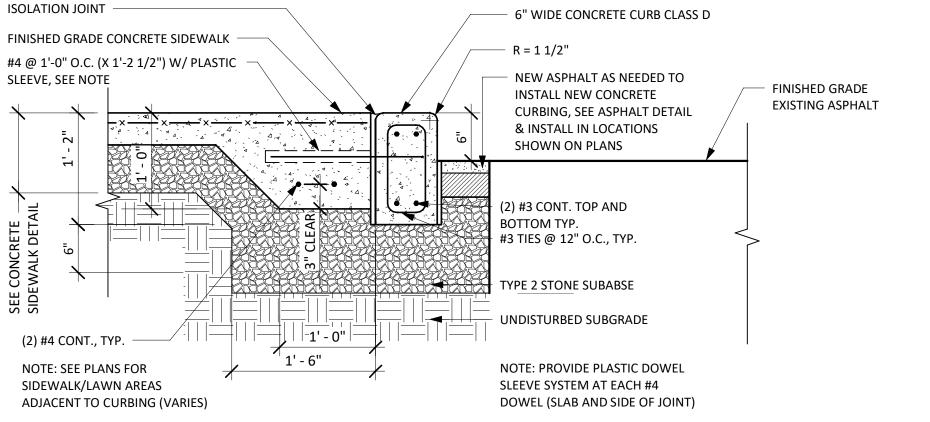
- MAXIMUM CROSS SLOPE OF CONCRETE SIDEWALK IS 1.5%.
- PROVIDE 1/2 INCH WIDE ISOLATION JOINT EVERY 20' IN LENGTH IN SIDEWALKS, BETWEEN NEW CONCRETE CONSTRUCTION AND BACK EDGE CURB, CONCRETE GUTTER, OTHER PAVED AREAS, BUILDINGS, WALLS, POLE BASES AND OTHER

UNDISTURBED SUBGRADE

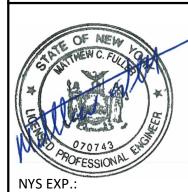- STRUCTURES/APPURTENANCES. SIDEWALKS WITH AREAS GREATER THAN 36 SQUARE FEET ARE TO BE SCORED WITH JOINTS. PROVIDE A FINE BROOMED SURFACE FREE OF HOLES, TEARS, POCK MARKS, BROKEN CORNERS, AND OTHER DEFECTS. JOINTS ARE TO BE CLEAR OF EXCESS CONCRETE AND MORTAR MATERIAL RESULTING FROM BROOMING OR FINISHING OF ADJACENT CONCRETE.
- AT ISOLATION JOINTS BETWEEN CONCRETE SLABS, PROVIDE DOWEL (SEE DETAIL TYP. SLAB-ON-GRADE ISOLATION JOINT
- 5. SEE STRUCTURAL DRAWINGS FOR CONSTRUCTION AND CONTROL JOINT DETAILING


2 CONCRETE PAVEMENT

SCALE: NOT TO SCALE




3 CONCRETE CURB DETAIL

SCALE: 1" = 1'-0"

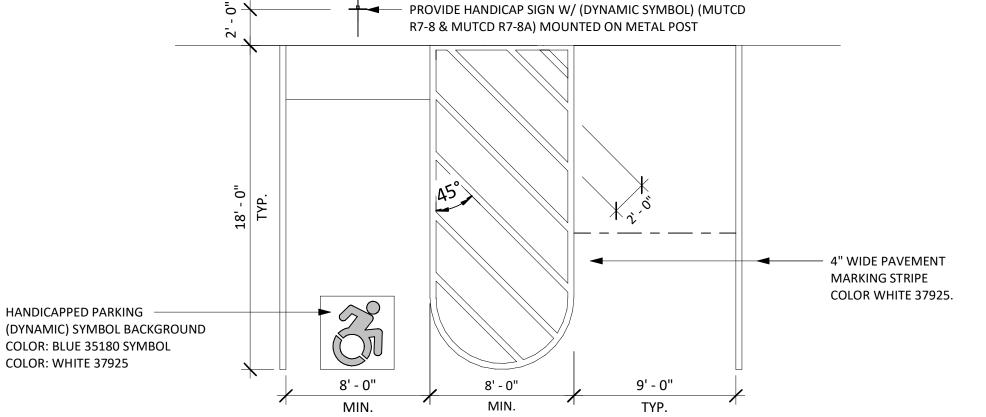


TYPICAL ADA PARKING AND STRIPING LAYOUT PLAN

SCALE: NOT TO SCALE

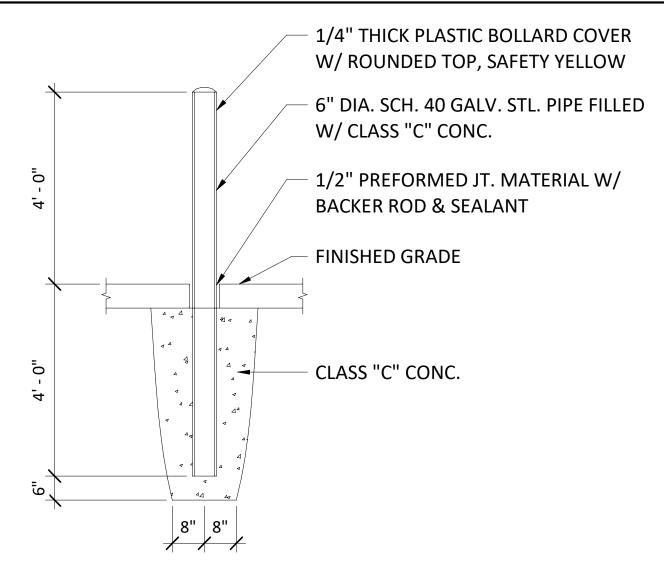


TYP. BOLLARD DETAIL

SCALE: NOT TO SCALE

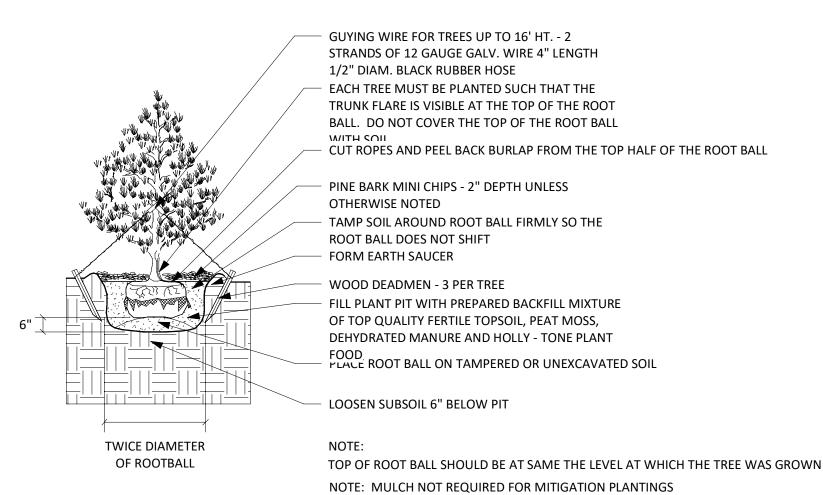

EVERGREEN PLANTING


SCALE: NOT TO SCALE

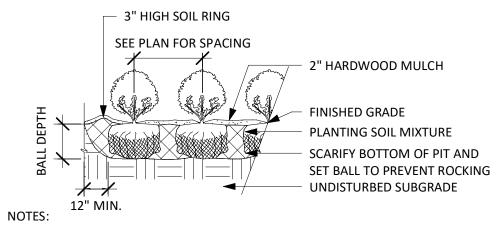

1. REMOVE BURLAP, ROPE, OR WIRE BASKET FROM TOP 1/3 OF BALL MINIMUM, CUT REMAINING PORTIONS OF ROPE OR WIRE BASKET ONCE PLANT IS IN THE FINAL POSITION IN PIT OR REMOVE FROM GROWING CONTAINER.

SHRUB PLANTING

SCALE: NOT TO SCALE

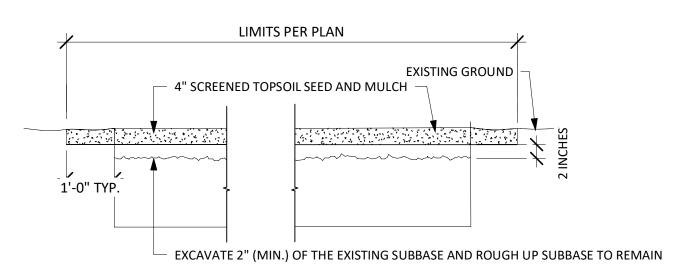

LAWN RESTORATION DETAIL

SCALE: NOT TO SCALE SET TRUNK PLUMB 1" - 2" DIA. RUBBER STRAP OR HOSE **GALVANIZED WIRE** — (3) 2"X2"X6' WOOD STAKES 3" SOIL RING - 3" HARDWOOD MULCH DO NOT BLACE MULCH IN CONTACT WITH TREE TRUNK FINISHED GRADE PLANTING SOIL MIXTURE SCARIFY BOTTOM OF PIT AND SET BALL TO PREVENT ROCKING UNDISTURBED SUBGRADE 18" MIN.

1. REMOVE BURLAP, ROPE, OR WIRE BASKET FROM TOP 1/3 OF BALL MINIMUM, CUT REMAINING PORTIONS OF ROPE OR WIRE BASKET ONE PLANT IS IN THE FINAL POSITION IN PIT.

2. TOP OF ROOT BALL SHALL BE SET FLUSH WITH SURROUNDING FINISHED GRADE. EACH TREE MUST BE PLANTED SUCH THAT THE TRUNK FLRE IS VISIBLE AT THE TOP OF THE ROOT BALL. DO NOT COVER TOP OF ROOT BALL WITH SOIL


3. MARK THE NORTH SIDE OF THE TREE IN NURSERY AND ROTATE TREE TO FACE NORTH AT THE SITE WHERE POSSIBLE.

18" MIN.

NOTES:

DECIDUOUS TREE PLANTING

SCALE: 1/4" = 1'-0"

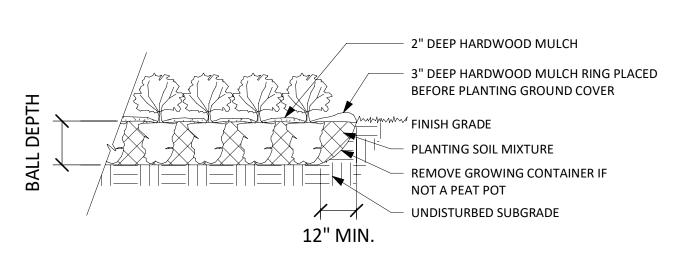

PERENNIAL PLANTING

SCALE: NOT TO SCALE

PLANTING SCHEDULE						
SYMBOL	QTY.	LATIN NAME	COMMON NAME	SIZE	REMARKS	BLOOM TIME/COLOR
EVERGREEN TREE						
PP	12	PICEA PUNGENS GLAUCA	COLORADO BLUE SPRUCE	6 - 8 FT.	B & B	EVERGREEN/BLUE/GREEN
ТО	9	THUJA OCCIDENTALIS	COMMON ARBORVITAE	6 - 8 FT.	B & B	EVERGREEN/BLUE/GREEN
DECIDUOUS TREE						
CK	3	CORNUS KOUSA	KOUSA DOGWOOD	8-10 FT.	B & B	WHITE FLOWERS
EVERGREEN SHRUB						
Vr	17	VIBURNUM RHYTIDOPHYLLUM	LEATHERLEAF VIBURNUM	3 GALLON	CONTAINER, FULL	YELLOWISH-WHITE FLOWERS
SHRUB/PERENNIAL						
Db	16	DAPHNE BURKWOODI	CAROLE MACKIE DAPHNE	3 GALLON	CONTAINER, FULL	PINK FLOWERS
ер	60	ECHINACEA PURPUREA	PURPLE CONEFLOWER	1 GALLON	12" O.C.	PURPLE FLOWERS
Js	30	JUNIPERUS SQUAMATA	'BLUE STAR' JUNIPER	3 GALLON	CONTAINER, FULL	EVERGREEN/BLUE/GREEN
rh	60	RUDBECKIA HIRTA	BLACK-EYED SUSAN	1 GALLON	12" O.C.	YELLOW FLOWERS
Sj	30	SPIREA JAPONICA	JAPANESE SPIREA	3 GALLON	CONTAINER, FULL	PINK FLOWERS

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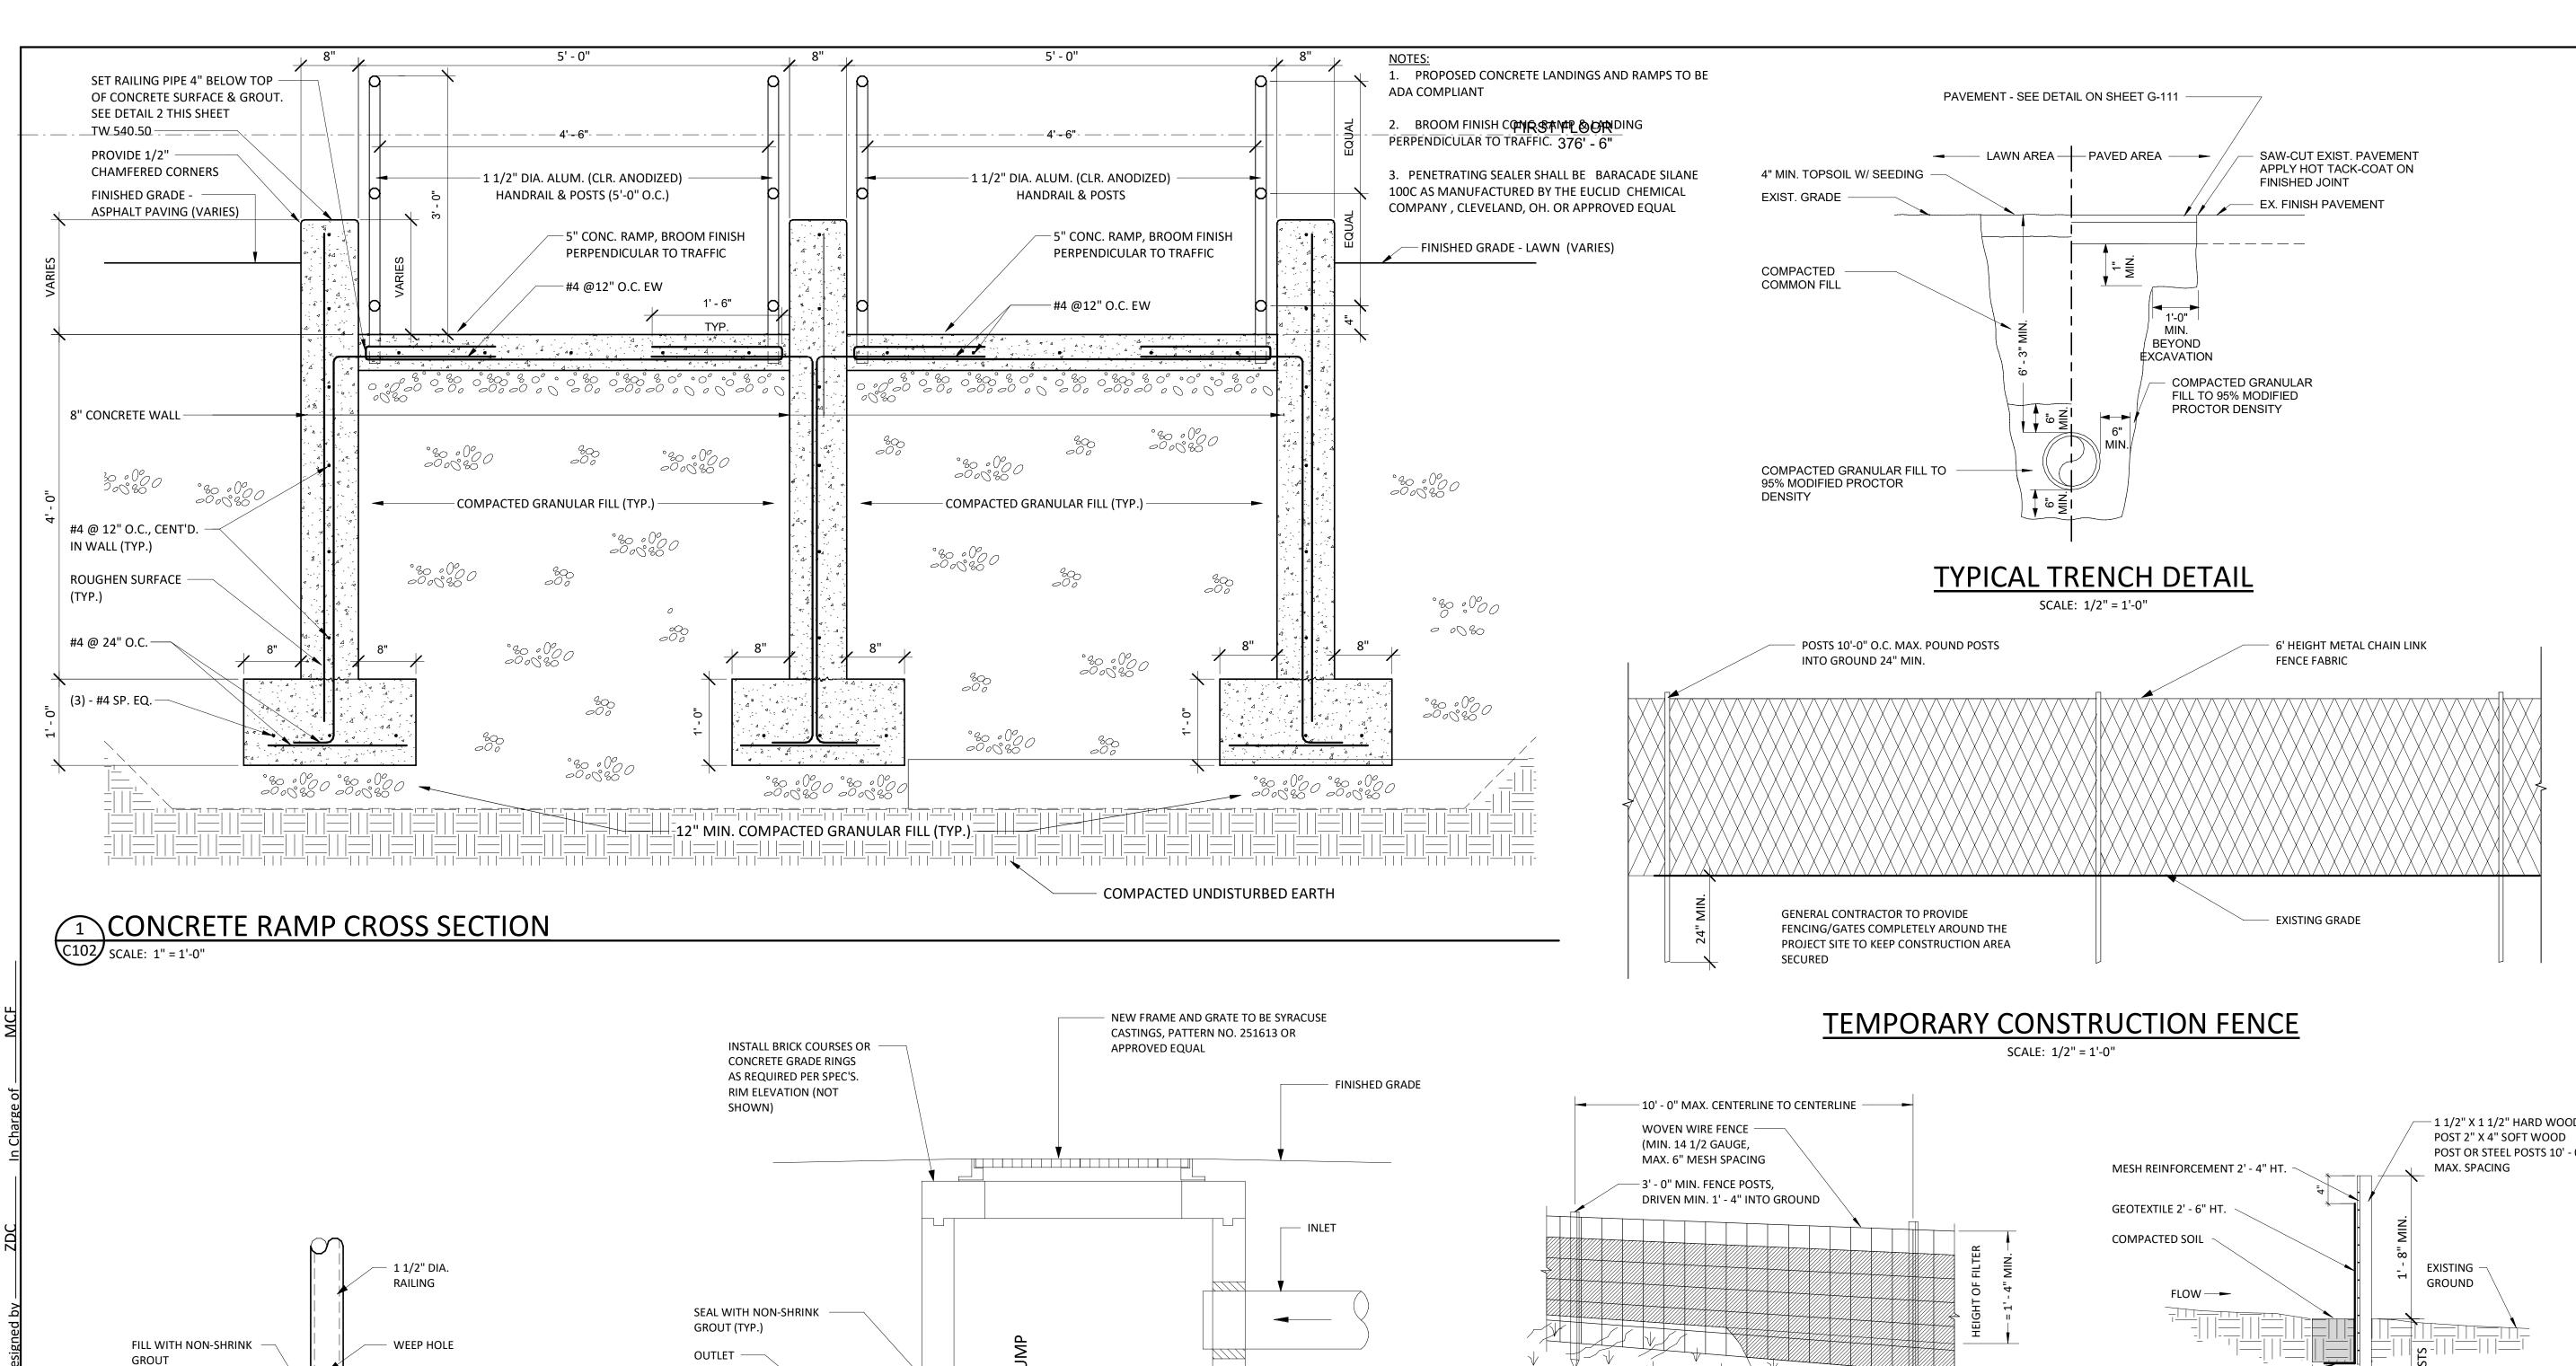





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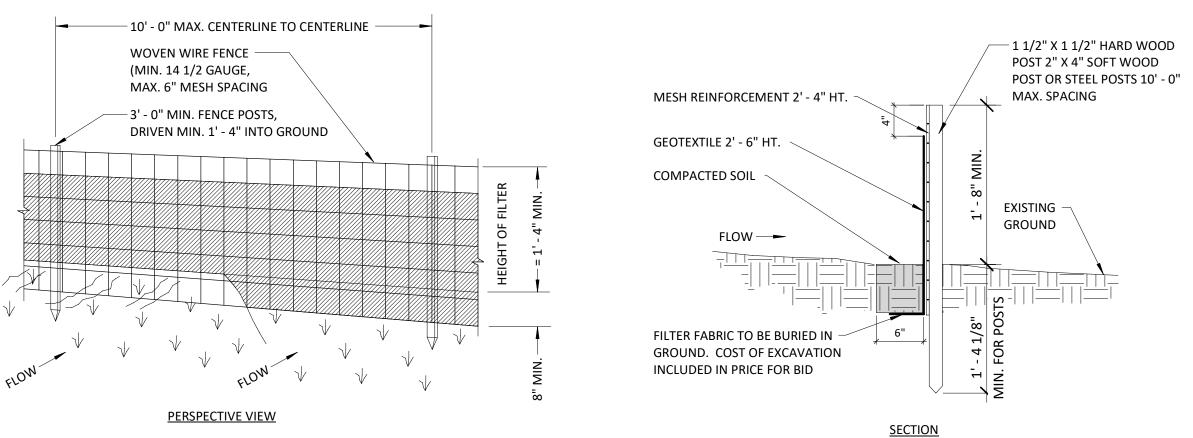
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TYPICAL CATCH BASIN DETAIL SCALE: 1 1/2" = 1'-0"



CONSTRUCTION NOTES FOR FABRICATED SILT FENCE

- 1. WOVEN WIRE FENCE TO BE FASTENED SECURELY TO FENCE POSTS WITH WIRE TIES OR STAPLES.
- 2. FILTER CLOTH TO BE FASTENED SECURELY TO WOVEN WIRE FENCE WITH TIES SPACED EVERY 2' 0" AT TOP AND MID SECTION.
- 3. WHEN TWO SECTIONS OF FILTER CLOTH ADJOIN EACH OTHER THEY SHALL BE OVERLAPPED BY SIX INCHES AND FOLDED.
- 4. MAINTENANCE SHALL BE PERFORMED AS NEEDED AND MATERIAL REMOVED WHEN "BULGES" DEVELOP IN THE SILT FENCE.

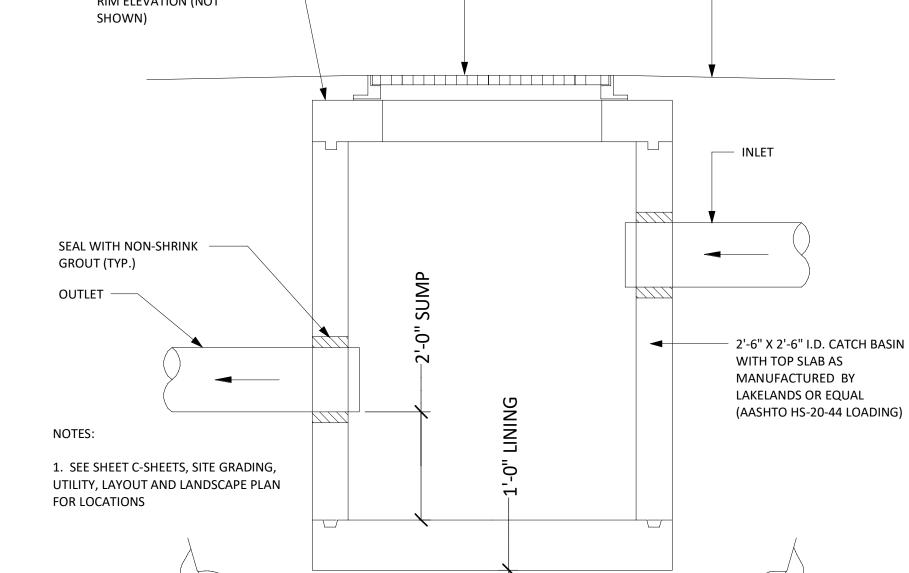POSTS: STEEL EITHER "T" OR "U" TYPE OR 2" HARDWARE

FENCE: WOVEN WIRE, 14 1/2 GA. 6" MAX. MESH OPENING

FILTER CLOTH: FILTER X, MIRAFI 100X, STABILINKA T140N OR APPROVED EQUAL

PREFABRICATED UNIT: GEOFAB, EVIROFENCE, OR APPROVED EQUAL.

CONSTRUCTION SILT FENCING

SCALE: NOT TO SCALE

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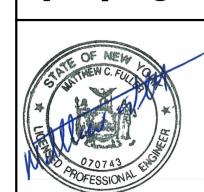
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APPLY HEAVY COATING OF

BITUMINOUS PAINT OR

ASPHALTIC VARNISH

2 CORE DRILL DETAIL

SCALE: 3" = 1'-0"

CJ - CONTROL JOINT CL - CENTER LINE CLG - CEILING CLR - CLEAR CMU - CONCRETE MASONRY UNITS COL - COLUMN CONC - CONCRETE **CONST - CONSTRUCTION**

CONT - CONTINUOUS CPP - CORRUGATED POLYETHYLENE PIPE CPT - CARPET CT - CERAMIC TILE DEMO - DEMOLISH, DEMOLITION

DN - DOWN DS - DOWNSPOUT DTL - DETAIL DWG - DRAWING E.F. - EACH FACE E.W. - EACH WAY EA - EACH ELEC - ELECTRICAL

ELEV - ELEVATION **EMBED - EMBEDMENT** EPS - EXPANDED POLYSTYRENE **EQUIP - EQUIPMENT** EW - EACH WAY EXP - EXPOSED EXP ANCHOR - EXPANSION ANCHOR EXT - EXTERIOR EX, EXIST - EXISTING

FND - FOUNDATION FRP - FIBER REINFORCED PLASTIC FT - FIRE TREATED FTG - FOOTING FV - FIELD VERIFY GA - GAUGE GALV - GALVANIZED GC - GENERAL CONTRACTOR GL BLK - GLASS BLOCK GWB - GYPSUM WALL BOARD GWT - GLAZED WALL TILE HBD - HARDBOARD

HC - HANDICAP

FIN FLR - FINISHED FLOOR

ABBREVIATIONS (CONT.):

MANUF - MANUFACTURER

MR - MOISTURE RESISTANT

MO - MASONRY OPENING

NIC - NOT IN CONTRACT

OD - OUTSIDE DIAMETER

NTS - NOT TO SCALE

PERF - PERFORATED

PLYWD - PLYWOOD

PVMT - PAVEMENT

QT - QUARRY TILE

RD - ROOF DRAIN

REQ'D - REQUIRED

SC - SOLID CORE

SAN - SANITARY

SHT - SHEET

SIM - SIMILAR

SQ - SQUARE

STL - STEEL

T - TREAD

T/ - TOP OF

TYP - TYPICAL

W/ - WITH

WD - WOOD

WDO - WINDOW

SS - STAINLESS STEEL

T&B - TOP AND BOTTOM

VCT - VINYL COMPOSITION TILE

UNO - UNLESS NOTED OTHERWISE

WWF - WELDED WIRE FABRIC

XPS - EXTRUDED POLYSTYRENE

SUS - SUSPENDED

TEMP - TEMPERED

UG - UNDERGROUND

VB - VAPOR BARRIER

SV - SHEET VINYL

RO - ROUGH OPENING

RAD - RADIUS

R - RISER

PT - PRESSURE TREATED

PPT - PRESSURE PRESERVATIVE TREATED

PLAS - PLASTIC

PNT - PAINT

O/C - ON CENTER

PL - PLATE

HM - HOLLOW METAL

INSUL - INSULATION

LAM - LAMINATE

MAS - MASONRY

MIN - MINIMUM

MTL - METAL

MAX - MAXIMUM

IGU - INSULATED GLASS UNIT **GENERAL NOTES:** INV - INVERT 1. ALL DIMENSIONS TO, OF, AND IN EXISTING BUILDING SHALL BE VERIFIED IN FIELD BY JT - JOINT CONTRACTOR.

> CONTRACTOR SHALL COORDINATE ALL WORK WITH ALL OTHER CONTRACTORS ON SITE. CONTRACTOR SHALL PROVIDE ALL MATERIALS AND LABOR FOR A COMPLETE

ALL WORK SHALL COMPLY WITH NYS FIRE PREVENTION AND BUILDING CODE. LOCAL

BUILDING CODES, AS WELL AS NATIONAL PLUMBING AND ELECTRICAL CODES. ALL WORK SHALL BE IN STRICT ACCORDANCE WITH MANUFACTURER'S WRITTEN INSTRUCTIONS FOR PREPARATIONS AND INSTALLATION OF MATERIALS.

DO NOT CHANGE SIZE NOR SPACING OF STRUCTURAL ELEMENTS.

DETAILS SHOWN ARE TYPICAL; SIMILAR DETAILS APPLY TO SIMILAR CONDITIONS UNLESS OTHERWISE INDICATED.

THE CONTRACTOR AND/OR SUBCONTRACTORS ARE SOLELY RESPONSIBLE FOR EXECUTING THE WORK AND MAINTAINING THE WORK SITE IN ACCORDANCE WITH ALL APPLICABLE SAFETY CODES AND STANDARDS.

CONTRACTOR SHALL PROVIDE PROTECTIVE BARRICADES, SIGNS AND LIGHTING TO PREVENT ANY UNAUTHORIZED PASSAGE INTO WORK AREA.

PROTECT ALL EXISTING AND NEW BUILDING ELEMENTS INSTALLED BY OTHER CONTRACTS FROM DAMAGE. CONTRACTOR SHALL RESTORE ALL DAMAGED ELEMENTS TO ORIGINAL OR BETTER CONDITION.

11. BRACE BUILDING UNTIL ALL STRUCTURAL ELEMENTS NEED FOR STABILITY ARE INSTALLED. THESE ELEMENTS ARE AS FOLLOWS: FLOOR DECK, ROOF DECK, BRACING MEMBERS, SHEAR WALLS.

12. CONTRACTOR SHALL DETERMINE EXACT LOCATION OF EXISTING UTILITIES BEFORE COMMENCING WORK, HE AGREES TO BE FULLY RESPONSIBLE FOR ANY AND ALL DAMAGES WHICH MIGHT BE OCCASIONED BY HIS FAILURE TO EXACTLY LOCATE AND PRESERVE UNDERGROUND UTILITIES.

13. CONTRACTOR SHALL NOTIFY THE ARCHITECT/ENGINEER IN WRITING OF ALL PROPOSED DEVIATIONS OR SUBSTITUTIONS FROM DIMENSIONS, MATERIALS, OR EQUIPMENT SHOWN ON THE DRAWINGS AND MAKE ONLY THOSE DEVIATIONS OR SUBSTITUTIONS ACCEPTABLE TO THE ARCHITECT/ENGINEER. NO CHANGES SHALL BE MADE WITH APPROVAL BY THE ARCHITECT/ENGINEER.


14. CONTRACTOR SHALL VERIFY ALL DIMENSIONS PRIOR TO ORDER AND/OR INSTALLATION OF MATERIAL

DO NOT SCALE DRAWINGS. CONTRACTOR SHALL NOTIFY ARCHITECT/ENGINEER OF ANY DISCREPANCIES IN DIMENSIONS BETWEEN EXISTING CONDITIONS AND/OR ARCHITECTURAL DRAWINGS AND THE STRUCTURAL DRAWINGS.

16. PROVIDE ALL DEMO REQUIRED FOR NEW INSTALLATIONS SHOWN, AND PATCH EXISTING MATERIALS BACK TO ORIGINAL CONDITION, OR TO A CONDITION TO RECEIVE NEW WORK AS APPLICABLE.

17. EXAMINE ALL MECHANICAL, ELECTRICAL, PLUMBING & OTHER TRADE DRAWINGS FOR ADDITIONAL AND INCIDENTAL WORK RELATED TO OPENINGS, PENETRATIONS, EQUIPMENT PADS, EQUIPMENT ITEM OR TAG NUMBERS, AND OTHER ADDITIONAL WORK. COORDINATE WITH ALL OTHER TRADES & PROVIDE ALL LABOR & MATERIALS FOR A COMPLETE INSTALLATION.

18. SUBMISSION AND COSTS ASSOCIATED WITH OBTAINING A BUILDING PERMIT ARE THE GENERAL CONTRACTORS RESPONSIBILITY.

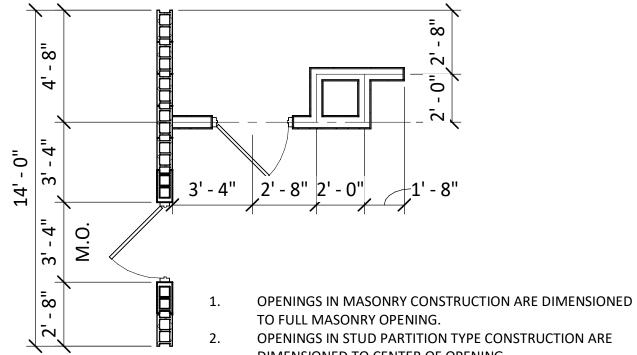

OPENINGS IN STUD PARTITION TYPE CONSTRUCTION ARE

DIMENSIONED TO CENTER OF OPENING. STUD PARTITION TYPE WALLS ARE DIMENSIONED TO

CENTERLINE OF WALL. SEE WALL TYPE FOR WALL THICKNESS. AT INTERSECTIONS OF DIFFERENT PARTITION TYPES THE PARTITION WITH THE GREATEST FIRE RATING SHALL BE CONTINUED THROUGH THE INTERSECTION (UNO)

DIMENSIONING CONVENTIONS


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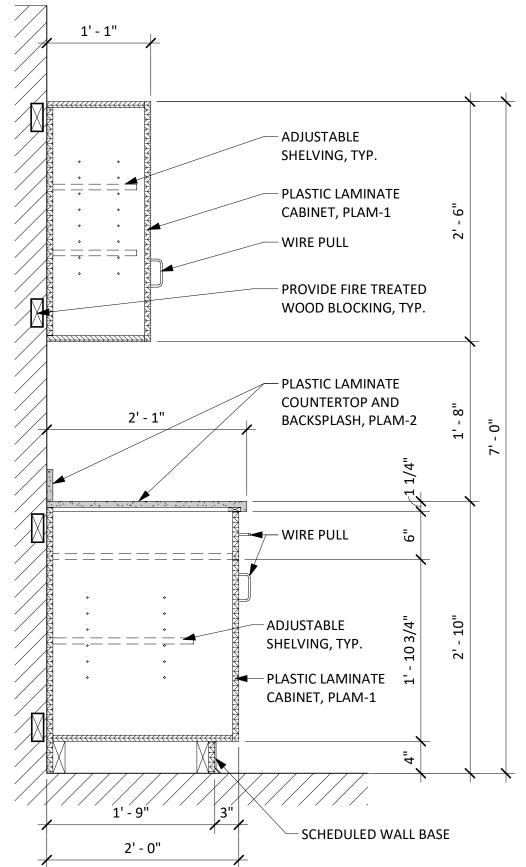
TAG LEGEND


? DOOR TAG

? WINDOW TAG

PARTITION TAG



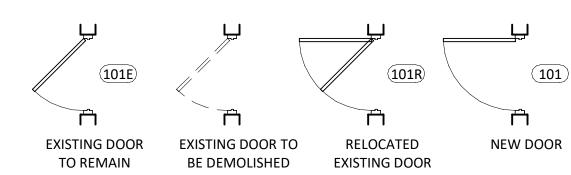

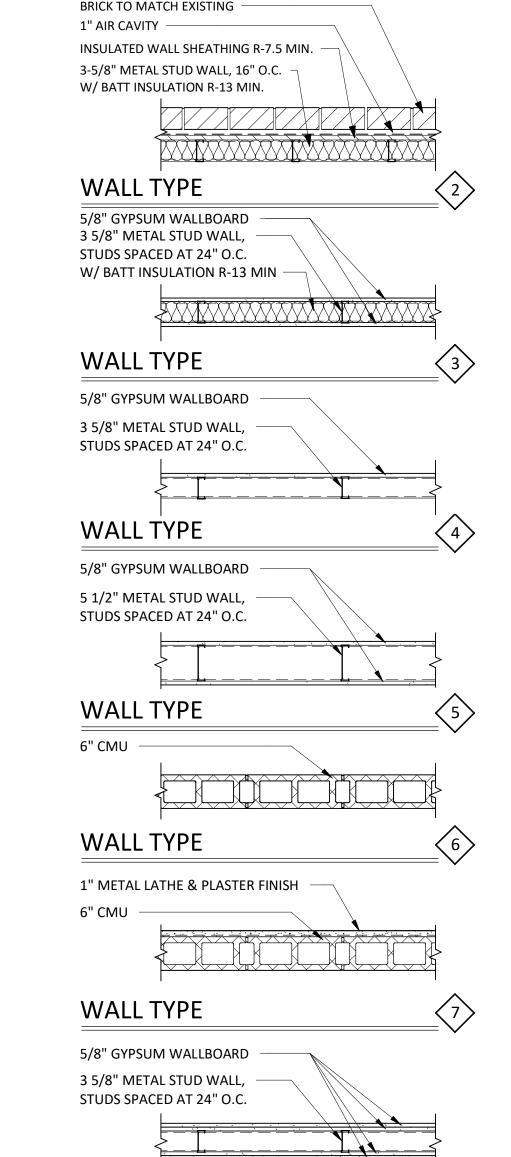

WALL TYPE

WALL TYPE

WALL TYPE

(2) LAYERS 5/8" GYPSUM

3 5/8" METAL STUD WALL,

STUDS SPACED AT 24" O.C. W/

SOUND ATTENUATION BATTS

WALL TYPES

NOT TO SCALE

WALLBOARD EACH SIDE

5/8" GYPSUM WALLBOARD

5 1/2" METAL STUD WALL,

STUDS SPACED AT 24" O.C.

NEW BRICK VENEER CAVITY WALL,

INSULATED WALL SHEATHING R-7.5 MIN.

3-5/8" METAL STUD WALL, 16" O.C.

W/ BATT INSULATION R-13 MIN.

5/8" GYPSUM WALLBOARD

NEW BRICK VENEER CAVITY WALL,

WALL TYPE

BRICK TO MATCH EXISTING

1" AIR CAVITY

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PROVIDE 5-1/2" BATT

INSULATION IN WALLS OF

THE EXTERIOR OF THE

BUILDING




AUGUST, 2024

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DOOR SIGN DETAIL

NOT TO SCALE

LAYOUT, SIZE AND COLOR TO BE SELECTED BY OWNER **RAISED SYMBOLS** RAISED CHARACTERS TO MATCH SPECIFIC ALL GENDER **ROOM NAMES** RESTROOM PROVIDE (1) RESTROOM oran kana arbat ADA COMPLIANT SIGN IN LOCATION SHOWN ON PLANS 60" MAX. 48" MIN.

ADA SIGNAGE DETAIL

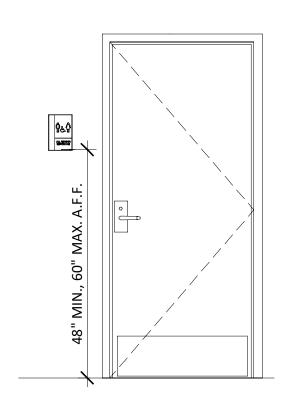


SEE FLOOR PLANS AND SPECIFICATIONS FOR

ROOM NAMES AND

SIGNAGE

NUMBERS FOR ROOM

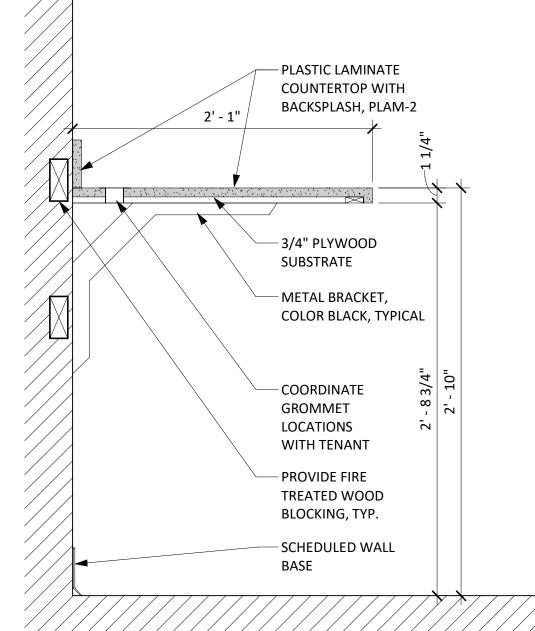


TYPICAL DESK DETAIL

SCALE: 1 1/2" = 1'-0"



TYPICAL CABINETRY DETAIL

SCALE: 1" = 1'-0"

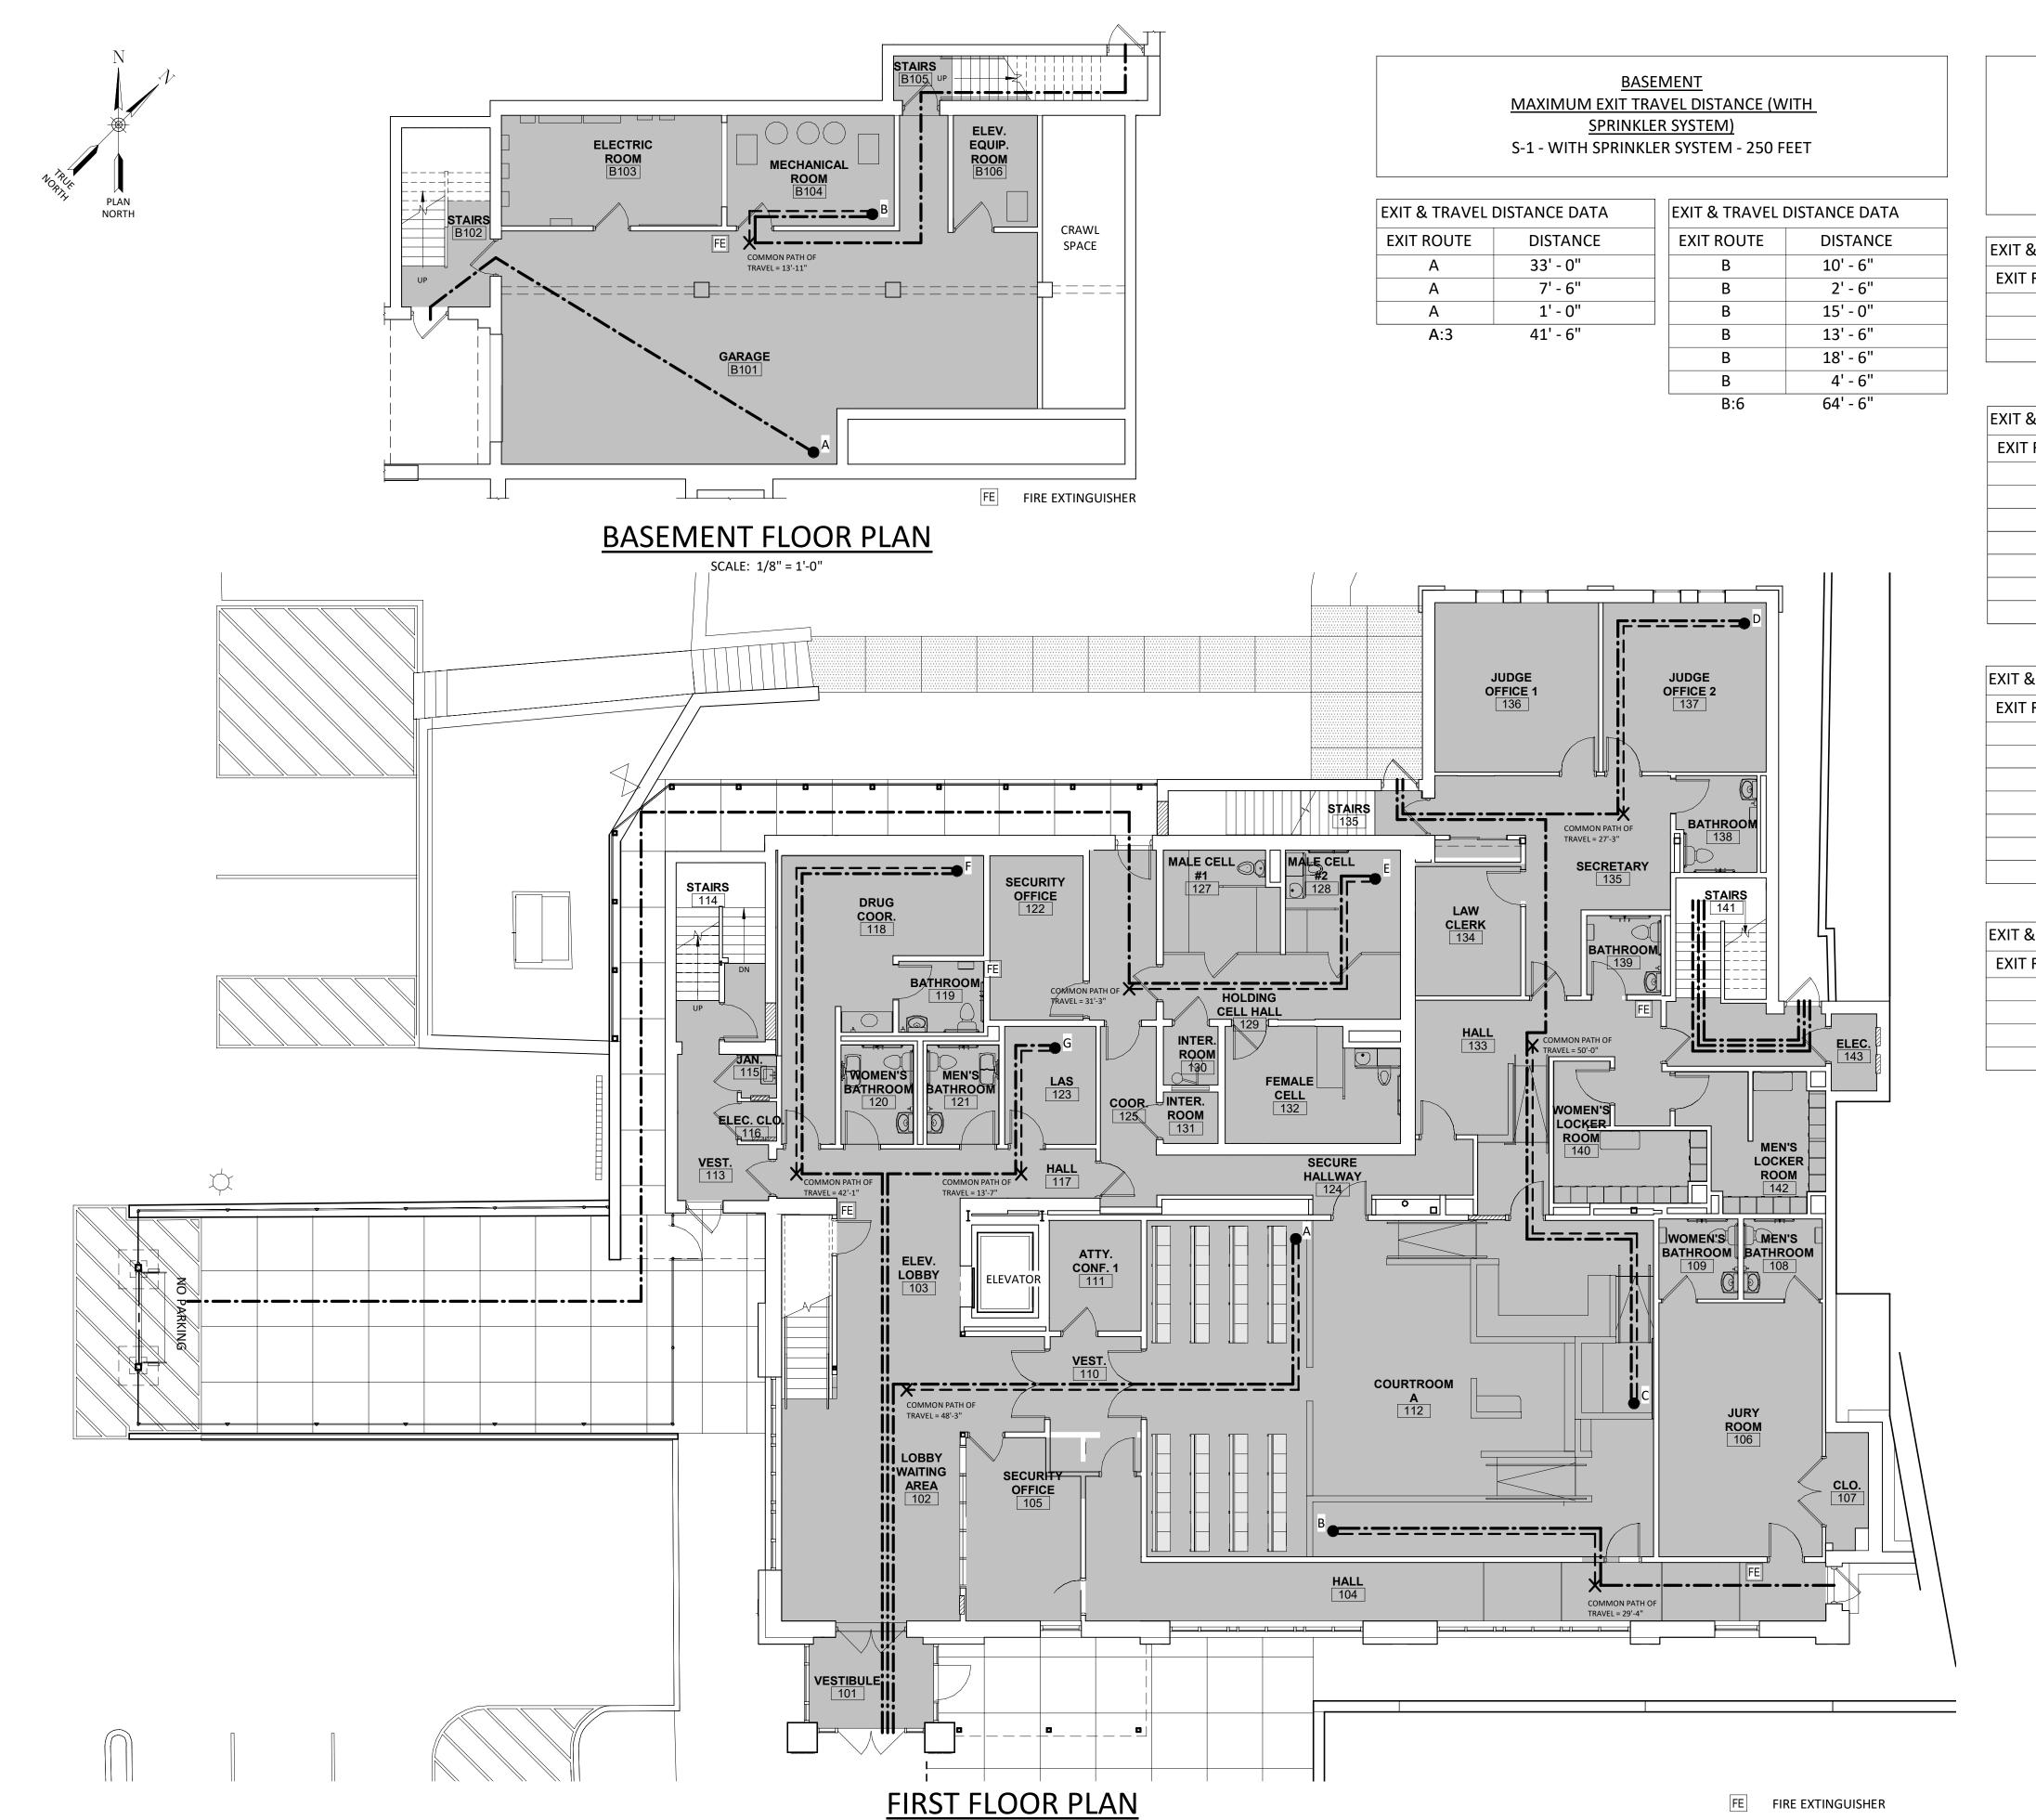

SCALE: 1/8" = 1'-0"

FIRST FLOOR

MAXIMUM EXIT TRAVEL DISTANCE (WITH **SPRINKLER SYSTEM)**

A-3 - WITH SPRINKLER SYSTEM - 250 FEET B - WITH SPRINKLER SYSTEM - 300 FEET I-3 - WITH SPRINKLER SYSTEM - 200 FEET

EXIT & TRAVEL	DISTANCE DATA	EXIT & TRAVEL DISTANCE DATA		
EXIT ROUTE	DISTANCE	EXIT ROUTE	DISTANCE	
Α	12' - 6"	В	23' - 6"	
Α	37' - 6"	В	5' - 0"	
Α	31' - 6"	В	21' - 6"	
A:3	81' - 6"	B:3	50' - 0"	


EXIT & TRAVEL DISTANCE DATA			
EXIT ROUTE	DISTANCE		
С	14' - 3"		
С	9' - 4"		
С	18' - 6"		
С	1' - 8"		
С	19' - 4"		
С	13' - 1"		
С	3' - 4"		
C:7	79' - 6"		

EXIT & TRAVEL DISTANCE DATA		
EXIT ROUTE	DISTANCE	
D	10' - 4"	
D	16' - 10"	
D	19' - 9"	
D	3' - 1"	
D:4	50' - 0"	

EXIT & TRAVEL DISTANCE DATA				
EXIT ROUTE	DISTANCE			
E	2' - 6"			
E	9' - 8"			
Е	19' - 0"			
Е	15' - 4"			
Е	43' - 10"			
Е	41' - 0"			
Е	39' - 6"			
E:7	170' - 10"			

EXIT & TRAVEL DISTANCE DATA		
EXIT ROUTE	DISTANCE	
F	13' - 4"	
F	27' - 0"	
F	6' - 0"	
F	50' - 2"	
F:4	96' - 6"	

XIT & TRAVEL DISTANCE DATA				
EXIT ROUTE	DISTANCE			
G	4' - 0"			
G	11' - 0"			
G	12' - 0"			
G	50' - 2"			
G:4	77' - 2"			

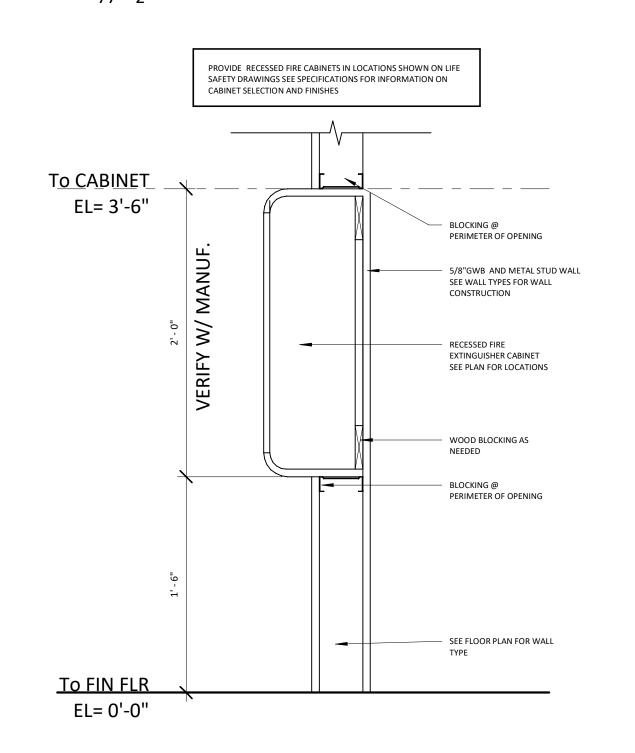

FIRE EXTINGUISHER CABINET DETAIL

UNLESS THEY ARE ACTING UNDER THE DIRECTION OF A LICENSED PROFESSIONAL ENGINEER, ARCHITECT, LANDSCAPE ARCHITECT, OR LAND SURVEYOR, TO ALTER AN ITEM IN ANY WAY. IF AN ITEM BEARIN THE STAMP OF A LICENSED PROFESSIONAL IS ALTERED, THE ALTERING PROFESSIONAL SHALL STAMP THE DOCUMENT AND INCLUDE THE NOTATION "ALTERED BY FOLLOWED BY THEIR SIGNATURE, THE DATE

IT IS A VIOLATION OF THE NEW YORK STATE **EDUCATION LAW, ARTICLE 145 §7209** SPECIAL PROVISIONS, FOR ANY PERSON

OF SUCH ALTERATION, AND A SPECIFIC DESCRIPTION OF THE ALTERATION REVISIONS

ANS PL **EXITING**

FLOOR

FIRST Ø SEMENT

R Loguidice ectronics Parkway pool, NY 13088

Barton 443 Elector





AUGUST, 2024

AS SHOWN

Sheet Number A002

Project Number 1753.008.001

SCALE: 1 1/2" = 1'-0"

SECOND FLOOR PLAN SCALE: 1/8" = 1'-0"

SECOND FLOOR MAXIMUM EXIT TRAVEL DISTANCE (WITH SPRINKLER SYSTEM)

A-3 - WITH SPRINKLER SYSTEM - 250 FEET B - WITH SPRINKLER SYSTEM - 300 FEET

EXIT & TRAVEL DISTANCE DATA		
EXIT ROUTE	DISTANCE	
Α	3' - 9"	
А	65' - 1"	
А	6' - 4"	
А	12' - 4"	
A:4	87' - 6"	

EXIT & TRAVEL DISTANCE DATA		
EXIT ROUTE	DISTANCE	
В	7' - 2"	
В	9' - 6"	
В	24' - 6"	
В	55' - 4"	
В	6' - 4"	
В	12' - 4"	
B:6	115' - 2"	

EXIT & TRAVEL	DISTANCE DATA
EXIT ROUTE	DISTANCE
С	11' - 10"
С	4' - 1"
С	12' - 6"
С	4' - 0"
С	6' - 9"
С	44' - 8"
С	13' - 0"
С	4' - 6"
С	13' - 0"
С	9' - 6"
С	4' - 0"
C:11	127' - 10"

EXIT & TRAVEL	DISTANCE DATA
EXIT ROUTE	DISTANCE
D	7' - 2"
D	15' - 2"
D	40' - 0"
D	13' - 0"
D	4' - 6"
D	13' - 0"
D	9' - 6"
D	4' - 0"
D:8	106' - 4"

XIT & TRAVEL DISTANCE DATA			
EXIT ROUTE	DISTANCE		
Е	10' - 4"		
Е	36' - 10"		
Е	10' - 10"		
E	13' - 0"		
E	4' - 6"		
E	13' - 0"		
E	9' - 6"		
Е	4' - 0"		
E:8	102' - 0"		

IT IS A VIOLATION OF THE NEW YORK STATE EDUCATION LAW, ARTICLE 145 §7209 SPECIAL PROVISIONS, FOR ANY PERSON, UNLESS THEY ARE ACTING UNDER THE DIRECTION OF A LICENSED PROFESSIONAL ENGINEER, ARCHITECT, LANDSCAPE ARCHITECT, OR LAND SURVEYOR, TO ALTER AN ITEM IN ANY WAY. IF AN ITEM BEARING THE STAMP OF A LICENSED PROFESSIONAL IS ALTERED, THE ALTERING PROFESSIONAL SHALL STAMP THE DOCUMENT AND


INCLUDE THE NOTATION "ALTERED BY FOLLOWED BY THEIR SIGNATURE, THE DATE OF SUCH ALTERATION, AND A SPECIFIC DESCRIPTION OF THE ALTERATION REVISIONS

PL

EXITING

FLOOR SECOND



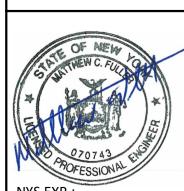

AUGUST, 2024

AS SHOWN **Sheet Number**

A003

<u>602.1 SCOPE.</u> LEVEL 1 ALTERATIONS INCLUDE THE REMOVAL AND REPLACEMENT OR THE COVERING OF EXISTING MATERIALS, ELEMENTS, EQUIPMENT, OR FIXTURES USING NEW MATERIALS, ELEMENTS, EQUIPMENT, OR FIXTURES THAT SERVE THE SAME PURPOSE.

602.2 APPLICATION. LEVEL 1 ALTERATIONS SHALL COMPLY WITH THE PROVISIONS OF CHAPTER 7.

<u>603.1 SCOPE.</u> LEVEL 2 ALTERATIONS INCLUDE THE RECONFIGURATION OF SPACE, THE ADDITION OR ELIMINATION OF ANY DOOR OR WINDOW, THE RECONFIGURATION OR EXTENSION OF ANY SYSTEM, OR THE INSTALLATION OF ANY ADDITIONAL EQUIPMENT.

603.2 APPLICATION. LEVEL 2 ALTERATIONS SHALL COMPLY WITH THE PROVISIONS OF CHAPTER 7 FOR LEVEL 1 ALTERATIONS AS WELL AS THE PROVISIONS OF CHAPTER 8.

604.1 SCOPE. LEVEL 3 ALTERATIONS APPLY WHERE THE WORK AREA EXCEEDS 50 PERCENT OF THE BUILDING

604.2 APPLICATION. LEVEL 3 ALTERATIONS SHALL COMPLY WITH THE PROVISIONS OF CHAPTER 7 AND 8 FOR LEVEL 1 AND 2 ALTERATIONS, RESPECTIVELY, AS WELL AS THE PROVISIONS OF CHAPTER 9.

605.1 SCOPE. CHANGE OF OCCUPANCY PROVISIONS APPLY WHERE THE ACTIVITY IS CLASSIFIED AS A CHANGE OF OCCUPANCY AS DEFINED IN CHAPTER 2.

605.2 APPLICATION. CHANGES OF OCCUPANCY SHALL COMPLY WITH THE PROVISION OF CHAPTER 10.

606.1 SCOPE. PROVISIONS FOR ADDITIONS SHALL APPLY WHERE WORK IS CLASSIFIED AS AN ADDITION AS DEFINED IN CHAPTER 2.

606.2 APPLICATION. ADDITIONS TO EXISTING BUILDINGS SHALL COMPLY WITH THE PROVISIONS OF CHAPTER

EBC NYS CHAPTER 7 - ALTERATIONS LEVEL 1

701.1 SCOPE. LEVEL 1 ALTERATIONS AS DESCRIBED IN SECTION 602 SHALL COMPLY WITH THE REQUIREMENTS OF THIS CHAPTER. LEVEL 1 ALTERATIONS TO HISTORIC BUILDINGS SHALL COMPLY WITH THIS CHAPTER, EXCEPT AS MODIFIED IN CHAPTER 12.

701.2 CONFORMANCE. AN EXISTING BUILDING OR PORTION THEREOF SHALL NOT BE ALTERED SUCH THAT THE BUILDING BECOMES LESS SAFE THAN ITS EXISTING CONDITION.

702.1 INTERIOR FINISHES. NEWLY INSTALLED INTERIOR WALL AND CEILING FINISHES SHALL COMPLY WITH CHAPTER 8 OF THE BUILDING CODE OF NEW YORK STATE.

702.2 INTERIOR FLOOR FINISH. NEW INTERIOR FLOOR FINISH, INCLUDING NEW CARPETING USED AS AN INTERIOR FLOOR FINISH MATERIAL, SHALL COMPLY WITH SECTION 804 OF THE BUILDING CODE OF NEW YORK

702.3 INTERIOR TRIM. NEWLY INSTALLED INTERIOR TRIM MATERIALS SHALL COMPLY WITH SECTION 806 OF THE BUILDING CODE OF NEW YORK STATE.

702.6 MATERIALS AND METHODS. NEW WORK SHALL COMPLY WITH THE MATERIALS AND METHODS REQUIREMENTS IN THE BUILDING CODE OF NEW YORK STATE, ENERGY CONSERVATION CONSTRUCTION CODE OF NEW YORK STATE, MECHANICAL CODE OF NEW YORK STATE, AND PLUMBING CODE OF NEW YORK STATE, AS APPLICABLE, THAT SPECIFY MATERIAL STANDARDS, DETAIL OF INSTALLATION AND CONNECTION, JOINTS. PENETRATIONS, AND CONTINUITY OF ANY ELEMENT, COMPONENT, OR SYSTEM IN THE BUILDING.

703.1 GENERAL. ALTERATIONS SHALL BE DONE IN A MANNER THAT MAINTAINS THE LEVEL OF FIRE PROTECTION

704.1 GENERAL. ALTERATIONS SHALL BE DONE IN A MANNER THAT MAINTAINS THE LEVEL OF PROTECTION PROVIDED FOR THE MEANS OF EGRESS.

705.1 GENERAL. MATERIALS AND METHODS OF APPLICATION USED FOR RECOVERING OR REPLACING AN EXISTING ROOF COVERING SHALL COMPLY WITH THE REQUIREMENTS OF CHAPTER 15 OF THE BUILDING CODE OF NEW YORK STATE.

705.2 STRUCTURAL AND CONSTRUCTION LOADS. STRUCTURAL ROOF COMPONENTS SHALL BE CAPABLE OF SUPPORTING THE ROOF-COVERING SYSTEM AND THE MATERIAL AND EQUIPMENT LOADS THAT WILL BE ENCOUNTERED DURING INSTALLATION OF THE SYSTEM.

705.3 ROOF REPLACEMENT. ROOF REPLACEMENT SHALL INCLUDE THE REMOVAL OF ALL EXISTING LAYERS OF ROOF COVERINGS DOWN TO THE ROOF DECK.

705.6 FLASHINGS. FLASHINGS SHALL BE RECONSTRUCTED IN ACCORDANCE WITH APPROVED MANUFACTURER'S INSTALLATION INSTRUCTIONS. METAL FLASHING TO WHICH BITUMINOUS MATERIALS ARE TO BE ADHERED SHALL BE PRIMED PRIOR TO INSTALLATION.

706.2 ADDITION OR REPLACEMENT OF ROOFING OR REPLACEMENT OF EQUIPMENT. ANY EXISTING GRAVITY LOAD-CARRYING STRUCTURAL ELEMENT FOR WHICH AN ALTERATION CAUSES AN INCREASE IN DESIGN DEAD, LIVE OR SNOW LOAD, INCLUDING SNOW DRIFT EFFECTS, OF MORE THAN 5PERCENT SHALL BE REPLACED OR ALTERED AS NEEDED TO CARRY THE GRAVITY LOADS REQUIRED BY THE BUILDING CODE OF NEW YORK STATE FOR NEW STRUCTURES.

707.1 MINIMUM REQUIREMENTS. LEVEL 1 ALTERATIONS TO EXISTING BUILDINGS OR STRUCTURES DO NOT REQUIRE THE ENTIRE BUILDING OR STRUCTURE TO COMPLY WITH THE ENERGY REQUIREMENTS OF THE ENERGY CONSERVATION CONSTRUCTION CODE OF NEW YORK STATE OR RESIDENTIAL CODE OF NEW YORK STATE. THE ALTERATIONS SHALL CONFORM TO THE ENERGY REQUIREMENTS OF THE ENERGY CONSERVATION CONSTRUCTION CODE OF NEW YORK STATE OR RESIDENTIAL CODE OF NEW YORK STATE AS THEY RELATE TO

708.1 WATER CLOSET REPLACEMENT. WHEN ANY WATER CLOSET IS REPLACED, THE REPLACEMENT WATER CLOSET SHALL COMPLY WITH SECTION 604.4 OF THE PLUMBING CODE OF NEW YORK STATE.

EBC NYS CHAPTER 8 - ALTERATIONS LEVEL 2

801.1 SCOPE. LEVEL 2 ALTERATIONS AS DESCRIBED IN SECTION 603 SHALL COMPLY WITH THE REQUIREMENTS OF THIS CHAPTER.

801.2 ALTERATION LEVEL 1 COMPLIANCE. IN ADDITION TO THE REQUIREMENTS OF THIS CHAPTER, ALL WORK SHALL COMPLY WITH THE REQUIREMENTS OF CHAPTER 7.

801.3 COMPLIANCE. NEW CONSTRUCTION ELEMENTS, COMPONENTS, SYSTEMS, AND SPACES SHALL COMPLY WITH THE REQUIREMENTS OF THE BUILDING CODE OF NEW YORK STATE.

802.2.1 EXISTING VERTICAL OPENINGS. EXISTING INTERIOR VERTICAL OPENINGS CONNECTING TWO OR MORE FLOORS SHALL BE ENCLOSED WITH APPROVED ASSEMBLIES HAVING A FIRE-RESISTANCE RATING OF NOT LESS THAN 1 HOUR WITH APPROVED OPENING PROTECTIVES.

802.5.1 MINIMUM REQUIREMENT. EVERY PORTION OF A FLOOR, SUCH AS A BALCONY OR A LOADING DOCK, THAT IS MORE THAN 30 INCHES ABOVE THE FLOOR OR GRADE BELOW AND IS NOT PROVIDED WITH GUARDS, OR THOSE IN WHICH THE EXISTING GUARDS ARE JUDGED TO BE IN DANGER OF COLLAPSING, SHALL BE PROVIDED WITH GUARDS.

802.5.2 DESIGN. WHERE THERE ARE NO GUARDS OR WHERE EXISTING GUARDS MUST BE REPLACED, THE GUARDS SHALL BE DESIGNED AND INSTALLED IN ACCORDANCE WITH THE BUILDING CODE OF NEW YORK STATE.

803.1.1 CORRIDOR RATINGS. WHERE AN APPROVED AUTOMATIC SPRINKLER SYSTEM IS INSTALLED THROUGHOUT THE STORY, THE REQUIRED FIRE-RESISTANCE RATING FOR ANY CORRIDOR LOCATED ON THE STORY SHALL BE PERMITTED TO BE REDUCED IN ACCORDANCE WITH THE BUILDING CODE OF NEW YORK STATE. IN ORDER TO BE CONSIDERED FOR A CORRIDOR RATING REDUCTION, SUCH SYSTEM SHALL PROVIDE COVERAGE FOR THE STAIRWAY LANDINGS SERVING THE FLOOR AND THE INTERMEDIATE LANDINGS IMMEDIATELY BELOW.

803.2.2.1 MIXED USES. IN WORK AREAS CONTAINING MIXED USES, ONE OR MORE OF WHICH REQUIRES AUTOMATIC SPRINKLER PROTECTION IN ACCORDANCE WITH SECTION 803.2.2, SUCH PROTECTION SHALL NOT BE REQUIRED THROUGHOUT THE WORK AREA PROVIDED THAT THE USES REQUIRING SUCH PROTECTION ARE SEPARATED FROM THOSE NOT REQUIRING PROTECTION BY FIRE-RESISTANCE-RATED CONSTRUCTION HAVING A MINIMUM 2-HOUR RATING FOR GROUP H AND A MINIMUM 1-HOUR RATING FOR ALL OTHER OCCUPANCY GROUPS.

803.2.4 SUPERVISION. FIRE SPRINKLER SYSTEMS REQUIRED BY THIS SECTION SHALL BE SUPERVISED BY ONE OF THE FOLLOWING METHODS:

1. APPROVED CENTRAL STATION SYSTEM IN ACCORDANCE WITH NFPA 72.

2. APPROVED PROPRIETARY SYSTEM IN ACCORDANCE WITH NFPA 72. 3. APPROVED REMOTE STATION SYSTEM OF THE JURISDICTION IN ACCORDANCE WITH NFPA 72.

4. WHERE APPROVED BY THE BUILDING OFFICIAL, APPROVED LOCAL ALARM SERVICE THAT WILL CAUSE THE SOUNDING OF AN ALARM IN ACCORDANCE WITH NFPA 72.

804.1 CARBON MONOXIDE DETECTION AND NOTIFICATION. CARBON MONOXIDE DETECTION AND NOTIFICATION SHALL BE

PROVIDED IN ACCORDANCE WITH SECTIONS 503.15 THROUGH 503.15.1 FOR BUILDINGS THAT UNDERGO AN ALTERATION.

805.3.1 MINIMUM NUMBER. EVERY STORY UTILIZED FOR HUMAN OCCUPANCY ON WHICH THERE IS A WORK AREA THAT INCLUDES EXITS OR CORRIDORS SHARED BY MORE THAN ONE TENANT WITHIN THE WORK AREA SHALL BE PROVIDED WITH THE MINIMUM NUMBER OF EXITS BASED ON THE OCCUPANCY AND THE OCCUPANT LOAD IN ACCORDANCE WITH THE BUILDING CODE OF NEW YORK STATE. IN ADDITION, THE EXITS SHALL COMPLY WITH SECTIONS 805.3.1.1 AND 805.3.1.2.

805.4.1.1 OCCUPANT LOAD AND TRAVEL DISTANCE. IN ANY WORK AREA, ALL ROOMS AND SPACES HAVING AN OCCUPANT LOAD GREATER THAN 50 OR IN WHICH THE TRAVEL DISTANCE TO AN EXIT EXCEEDS 75 FEET SHALL HAVE NOT FEWER THAN TWO EGRESS DOORWAYS.

805.4.2 DOOR SWING. IN THE WORK AREA AND IN THE EGRESS PATH FROM ANY WORK AREA TO THE EXIT DISCHARGE, ALL EGRESS DOORS SERVING AN OCCUPANT LOAD GREATER THAN 50 SHALL SWING IN THE DIRECTION OF EXIT TRAVEL.

805.4.3 DOOR CLOSING. IN ANY WORK AREA, ALL DOORS OPENING ONTO AN EXIT PASSAGEWAY AT GRADE OR AN EXIT STAIRWAY SHALL BE SELF-CLOSING OR AUTOMATIC-CLOSING BY LISTED CLOSING DEVICES.

805.4.4 PANIC HARDWARE. IN ANY WORK AREA, AND IN THE EGRESS PATH FROM ANY WORK AREA TO THE EXIT DISCHARGE, IN BUILDINGS OR PORTIONS THEREOF OF GROUP A ASSEMBLY OCCUPANCIES WITH AN OCCUPANT LOAD GREATER THAN 100, ALL REQUIRED EXIT DOORS EQUIPPED WITH LATCHING DEVICES SHALL BE EQUIPPED WITH APPROVED PANIC HARDWARE.

805.5.1 CORRIDOR DOORS. CORRIDOR DOORS IN THE WORK AREA SHALL NOT BE CONSTRUCTED OF HOLLOW CORE WOOD AND SHALL NOT CONTAIN LOUVERS. DWELLING UNIT OR SLEEPING UNIT CORRIDOR DOORS IN WORK AREAS IN BUILDINGS OF GROUPS R-1, R-2, AND I-1 SHALL BE NOT LESS THAN 1 3/8 INCH SOLID CORE WOOD OR APPROVED EQUIVALENT AND SHALL NOT HAVE ANY GLASS PANELS, OTHER THAN APPROVED WIRED GLASS OR OTHER APPROVED GLAZING MATERIAL IN METAL FRAMES. DWELLING UNIT OR SLEEPING UNIT CORRIDOR DOORS IN WORK AREAS IN BUILDINGS OF GROUPS R-1, R-2, AND I-1 SHALL BE EQUIPPED WITH APPROVED DOOR CLOSERS. REPLACEMENT DOORS SHALL BE 1 3/4 INCH SOLID BONDED WOOD CORE OR APPROVED EQUIVALENT, UNLESS THE EXISTING FRAME WILL ACCOMMODATE ONLY A 1 3/8 INCH DOOR.

805.6 DEAD-END CORRIDORS. DEAD-END CORRIDORS IN ANY WORK AREA SHALL NOT EXCEED 35 FEET.

805.7.1 ARTIFICIAL LIGHTING REQUIRED. MEANS OF EGRESS IN ALL WORK AREAS SHALL BE PROVIDED WITH ARTIFICIAL LIGHTING IN ACCORDANCE WITH THE REQUIREMENTS OF THE BUILDING CODE OF NEW YORK STATE.

805.8.1 WORK AREAS. MEANS OF EGRESS IN ALL WORK AREAS SHALL BE PROVIDED WITH EXIT SIGNS IN ACCORDANCE WITH THE REQUIREMENTS OF THE BUILDING CODE OF NEW YORK STATE.

805.9.1 MINIMUM REQUIREMENT. EVERY REQUIRED EXIT STAIRWAY THAT IS PART OF THE MEANS OF EGRESS FOR ANY WORK AREA AND THAT HAS THREE OR MORE RISERS AND IS NOT PROVIDED WITH NOT FEWER THAN ONE HANDRAIL, OR IN WHICH THE EXISTING HANDRAILS ARE JUDGED TO BE IN DANGER OF COLLAPSING, SHALL BE PROVIDED WITH HANDRAILS FOR THE FULL LENGTH OF THE STAIRWAY ON NOT FEWER THAN ONE SIDE. EXIT STAIRWAYS WITH A REQUIRED EGRESS WIDTH OF MORE THAN 66 INCHES SHALL HAVE HANDRAILS ON BOTH SIDES.

805.9.2 DESIGN. HANDRAILS REQUIRED IN ACCORDANCE WITH SECTION 805.9.1 SHALL BE DESIGNED AND INSTALLED IN ACCORDANCE WITH THE PROVISIONS OF THE BUILDING CODE OF NEW YORK STATE.

806.2 EXISTING STRUCTURAL ELEMENTS CARRYING GRAVITY LOADS. ANY EXISTING GRAVITY LOAD-CARRYING STRUCTURAL ELEMENT FOR WHICH AN ALTERATION CAUSES AN INCREASE IN DESIGN DEAD, LIVE OR SNOW LOAD, INCLUDING SNOW DRIFT EFFECTS, OF MORE THAN 5 PERCENT SHALL BE REPLACED OR ALTERED AS NEEDED TO CARRY THE GRAVITY LOADS REQUIRED BY THE BUILDING CODE OF NEW YORK STATE FOR NEW STRUCTURES. ANY EXISTING GRAVITY LOAD-CARRYING STRUCTURAL ELEMENT WHOSE GRAVITY LOAD-CARRYING CAPACITY IS DECREASED AS PART OF THE ALTERATION SHALL BE SHOWN TO HAVE THE CAPACITY TO RESIST THE APPLICABLE DESIGN DEAD, LIVE AND SNOW LOADS, INCLUDING SNOW DRIFT EFFECTS, REQUIRED BY THE BUILDING CODE OF NEW YORK STATE FOR NEW STRUCTURES.

806.3 EXISTING STRUCTURAL ELEMENTS RESISTING LATERAL LOADS. EXCEPT AS PERMITTED BY SECTION 806.4, WHERE THE ALTERATION INCREASES DESIGN LATERAL LOADS, OR WHERE THE ALTERATION RESULTS IN PROHIBITED STRUCTURAL IRREGULARITY AS DEFINED IN ASCE 7, OR WHERE THE ALTERATION DECREASES THE CAPACITY OF ANY EXISTING LATERAL LOAD-CARRYING STRUCTURAL ELEMENT, THE STRUCTURE OF THE ALTERED BUILDING OR STRUCTURE SHALL MEET THE REQUIREMENTS OF SECTIONS 1609 AND 1613 OF THE BUILDING CODE OF NEW YORK STATE. REDUCED SEISMIC FORCES SHALL BE PERMITTED.

807.1 NEW INSTALLATIONS. NEWLY INSTALLED ELECTRICAL EQUIPMENT AND WIRING RELATING TO WORK DONE IN ANY WORK AREA SHALL COMPLY WITH ALL APPLICABLE REQUIREMENTS OF NFPA 70 EXCEPT AS PROVIDED FOR IN SECTION 807.3.

808.1 RECONFIGURED OR CONVERTED SPACES. RECONFIGURED SPACES INTENDED FOR OCCUPANCY AND SPACES CONVERTED TO HABITABLE OR OCCUPIABLE SPACE IN ANY WORK AREA SHALL BE PROVIDED WITH NATURAL OR MECHANICAL VENTILATION IN ACCORDANCE WITH THE MECHANICAL CODE OF NEW YORK STATE.

808.2 ALTERED EXISTING SYSTEMS. IN MECHANICALLY VENTILATED SPACES, EXISTING MECHANICAL VENTILATION SYSTEMS THAT ARE ALTERED, RECONFIGURED, OR EXTENDED SHALL PROVIDE NOT LESS THAN 5 CUBIC FEET PER MINUTE PER PERSON OF OUTDOOR AIR AND NOT LESS THAN 15 CFM OF VENTILATION AIR PER PERSON; OR NOT LESS THAN THE AMOUNT OF VENTILATION AIR DETERMINED BY THE INDOOR AIR QUALITY PROCEDURE OF ASHRAE 62.1.

809.1 MINIMUM FIXTURES. WHERE THE OCCUPANT LOAD OF THE STORY IS INCREASED BY MORE THAN 20 PERCENT, PLUMBING FIXTURES FOR THE STORY SHALL BE PROVIDED IN QUANTITIES SPECIFIED IN THE PLUMBING CODE OF NEW YORK STATE BASED ON THE INCREASED OCCUPANT LOAD.

EBC NYS CHAPTER 9 - ALTERATIONS LEVEL 3

901.1 SCOPE. LEVEL 3 ALTERATIONS AS DESCRIBED IN SECTION 604 SHALL COMPLY WITH THE REQUIREMENTS OF THIS CHAPTER.

901.2 COMPLIANCE. IN ADDITION TO THE PROVISIONS OF THIS CHAPTER, WORK SHALL COMPLY WITH ALL OF THE REQUIREMENTS OF CHAPTER 7 AND 8. THE REQUIREMENTS OF SECTION 802, 803, 804, AND 805 SHALL APPLY WITHIN ALL WORK AREAS WHETHER OR NOT THEY INCLUDE EXITS AND CORRIDORS SHARED BY MORE THAN ONE TENANT AND REGARDLESS OF THE OCCUPANT LOAD.

904.2.1 MANUAL FIRE ALARM SYSTEMS. WHERE REQUIRED BY THE BUILDING CODE OF NEW YORK STATE, A MANUAL FIRE ALARM SYSTEM SHALL BE PROVIDED THROUGH THE WORK AREA. ALARM NOTIFICATION APPLIANCES SHALL BE PROVIDED ON SUCH FLOORS AND SHALL BE AUTOMATICALLY ACTIVATED AS REQUIRED BY THE BUILDING CODE OF NEW YORK STATE.

904.2.2 AUTOMATIC FIRE DETECTION. WHERE REQUIRED BY THE BUILDING CODE OF NEW YORK STATE FOR NEW BUILDINGS, AUTOMATIC FIRE DETECTION SYSTEMS SHALL BE PROVIDED THROUGHOUT THE WORK AREA.

905.2 MEANS-OF-EGRESS LIGHTING. MEANS OF EGRESS FROM THE HIGHEST WORK AREA FLOOR TO THE FLOOR OF EXIT DISCHARGE SHALL BE PROVIDED WITH ARTIFICIAL LIGHTING WITHIN THE EXIT ENCLOSURE IN ACCORDANCE WITH THE REQUIREMENTS OF THE BUILDING CODE OF NEW YORK STATE.

905.3 EXIT SIGNS. MEANS OF EGRESS FROM THE HIGHEST WORK AREA FLOOR TO THE FLOOR OF EXIT DISCHARGE SHALL BE PROVIDED WITH EXIT SIGNS IN ACCORDANCE WITH THE REQUIREMENTS OF THE BUILDING CODE OF NEW YORK STATE.

EBC NYS CHAPTER 10 - CHANGE OF OCCUPANCY

1001.2.2 CHANGE OF OCCUPANCY CLASSIFICATION OR GROUP. WHERE THE OCCUPANCY CLASSIFICATION OF A BUILDING CHANGES, THE PROVISIONS OF SECTION 1002 THROUGH 1011 SHALL APPLY. THIS INCLUDES A CHANGE OF OCCUPANCY CLASSIFICATION AND A CHANGE TO ANOTHER GROUP WITHIN AN OCCUPANCY

1001.2.2.1 PARTIAL CHANGE OF OCCUPANCY. WHERE THE OCCUPANCY CLASSIFICATION OR GROUP OF A PORTION OF AN EXISTING BUILDING IS CHANGED, SECTION 1011 SHALL APPLY.

1007.1 SPECIAL OCCUPANCIES. WHERE THE OCCUPANCY OF AN EXISTING BUILDING OR PART OF AN EXISTING BUILDING IS CHANGED TO ONE OF THE FOLLOWING SPECIAL OCCUPANCIES AS DESCRIBED IN NFPA 70, THE ELECTRICAL WIRING AND EQUIPMENT OF THE BUILDING OR PORTION THEREOF THAT CONTAINS THE PROPOSED OCCUPANCY SHALL COMPLY WITH THE APPLICABLE REQUIREMENTS OF NFPA 70 WHETHER OR NOT A CHANGE OF OCCUPANCY GROUP IS INVOLVED: 8. PLACES OF ASSEMBLY.

1007.2 UNSAFE CONDITIONS. WHERE THE OCCUPANCY OF AN EXISTING BUILDING OR PART OF AN EXISTING BUILDING IS CHANGED, ALL UNSAFE CONDITIONS SHALL BE CORRECTED WITHOUT REQUIRING THAT ALL PARTS OF THE ELECTRICAL SYSTEM COMPLY WITH NFPA 70.

1007.3 SERVICE UPGRADE. WHERE THE OCCUPANCY OF AN EXISTING BUILDING OR PART OF AN EXISTING BUILDING IS CHANGED, ELECTRICAL SERVICE SHALL BE UPGRADED TO MEET THE REQUIREMENTS OF NFPA 70 FOR THE NEW OCCUPANCY.

1007.4 NUMBER OF ELECTRICAL OUTLETS. WHERE THE OCCUPANCY OF AN EXISTING BUILDING OR PART OF AN EXISTING BUILDING IS CHANGED, THE NUMBER OF ELECTRICAL OUTLETS SHALL COMPLY WITH NFPA 70 FOR THE NEW OCCUPANCY.

1008.1 MECHANICAL REQUIREMENTS. WHERE THE OCCUPANCY OF AN EXISTING BUILDING OR PART OF AN EXISTING BUILDING IS CHANGED SUCH THAT THE NEW OCCUPANCY IS SUBJECT TO DIFFERENT KITCHEN EXHAUST REQUIREMENTS OR TO INCREASED MECHANICAL VENTILATION REQUIREMENTS IN ACCORDANCE WITH THE MECHANICAL CODE OF NEW YORK STATE, THE NEW OCCUPANCY SHALL COMPLY WITH THE RESPECTIVE MECHANICAL CODE OF NEW YORK STATE PROVISIONS.

1009.1 INCREASED DEMAND. WHERE THE OCCUPANCY OF AN EXISTING BUILDING OR PART OF AN EXISTING BUILDING IS CHANGED SUCH THAT THE NEW OCCUPANCY IS SUBJECT TO INCREASED OR DIFFERENT PLUMBING FIXTURE REQUIREMENTS OR TO INCREASED WATER SUPPLY REQUIREMENTS IN ACCORDANCE WITH THE PLUMBING CODE OF NEW YORK STATE, THE NEW OCCUPANCY SHALL COMPLY WITH THE INTENT OF THE RESPECTIVE PLUMBING CODE OF NEW YORK STATE PROVISIONS.

1010.1 LIGHT AND VENTILATION. LIGHT AND VENTILATION SHALL COMPLY WITH THE REQUIREMENTS OF THE BUILDING CODE OF NEW YORK STATE FOR THE NEW OCCUPANCY.

1011.1 GENERAL. THE PROVISIONS OF THIS SECTION SHALL APPLY TO BUILDINGS OR PORTIONS THEREOF UNDERGOING A CHANGE OF OCCUPANCY CLASSIFICATION. THIS INCLUDES A CHANGE OF OCCUPANCY CLASSIFICATION WITHIN A GROUP AS WELL AS A CHANGE OF OCCUPANCY CLASSIFICATION FROM ONE GROUP TO A DIFFERENT GROUP OR WHERE THERE IS A CHANGE OF OCCUPANCY WITHIN A SPACE WHERE THERE IS A DIFFERENT FIRE PROTECTION SYSTEM THRESHOLD REQUIREMENT IN CHAPTER 9 OF THE BUILDING CODE OF NEW YORK STATE. SUCH BUILDINGS SHALL ALSO COMPLY WITH SECTIONS 1002 THROUGH 1010 OF THIS CODE. THE APPLICATION OF REQUIREMENTS FOR THE CHANGE OF OCCUPANCY SHALL BE AS SET FORTH IN SECTIONS 1011.1.1 THROUGH 1011.1.3. A CHANGE OF OCCUPANCY, AS DEFINED IN SECTION 202, WITHOUT A CORRESPONDING CHANGE OF OCCUPANCY CLASSIFICATION SHALL COMPLY WITH SECTION 1001.2.

1011.1.1.2 CHANGE OF OCCUPANCY CLASSIFICATION WITH SEPARATION. WHERE A PORTION OF AN EXISTING BUILDING IS CHANGED TO A NEW OCCUPANCY CLASSIFICATION OR WHERE THERE IS A CHANGE OF OCCUPANCY WITHIN A SPACE WHERE THERE IS A DIFFERENT FIRE PROTECTION SYSTEM THRESHOLD REQUIREMENT IN CHAPTER 9 OF THE BUILDING CODE OF NEW YORK STATE, AND THAT PORTION IS SEPARATED FROM THE REMAINDER OF THE BUILDING WITH FIRE BARRIERS HAVING A FIRE-RESISTANCE RATING AS REQUIRED IN THE BUILDING CODE OF NEW YORK STATE FOR THE SEPARATE OCCUPANCY, THAT PORTION SHALL COMPLY WITH ALL OF THE REQUIREMENTS OF CHAPTER 9 OF THIS CODE FOR THE NEW OCCUPANCY CLASSIFICATION AND WITH THE REQUIREMENTS OF THIS CHAPTER.

1011.3 INTERIOR FINISH. IN AREAS OF THE BUILDING UNDERGOING THE CHANGE OF OCCUPANCY CLASSIFICATION, THE INTERIOR FINISH OF WALLS AND CEILINGS SHALL COMPLY WITH THE REQUIREMENTS OF THE BUILDING CODE OF NEW YORK STATE FOR THE NEW OCCUPANCY CLASSIFICATION.

1011.4.1 MEANS OF EGRESS FOR CHANGE TO A HIGHER-HAZARD CATEGORY. WHERE A CHANGE OF OCCUPANCY CLASSIFICATION IS MADE TO A HIGHER-HAZARD CATEGORY AS SHOWN IN TABLE 1011.4, THE MEANS OF EGRESS SHALL COMPLY WITH THE REQUIREMENTS OF CHAPTER 10 OF THE BUILDING CODE OF NEW

1011.5.1 HEIGHT AND AREA FOR CHANGE TO A HIGHER-HAZARD CATEGORY. WHERE A CHANGE OF OCCUPANCY CLASSIFICATION IS MADE TO A HIGHER-HAZARD CATEGORY AS SHOWN IN TABLE 1011.5, HEIGHTS AND AREAS OF BUILDINGS AND STRUCTURES SHALL COMPLY WITH THE REQUIREMENTS OF CHAPTER 5 OF THE BUILDING CODE OF NEW YORK STATE FOR THE NEW OCCUPANCY CLASSIFICATION.

1011.5.3 FIRE BARRIERS. WHERE A CHANGE OF OCCUPANCY CLASSIFICATION IS MADE TO A HIGHER-HAZARD CATEGORY AS SHOWN IN TABLE 1011.5, FIRE BARRIERS IN SEPARATED MIXED USE BUILDINGS SHALL COMPLY WITH THE FIRE-RESISTANCE REQUIREMENTS OF THE BUILDING CODE OF NEW YORK STATE.

1011.6.2 EXTERIOR WALL RATING FOR CHANGE OF OCCUPANCY CLASSIFICATION TO AN EQUAL OR LESSER-HAZARD CATEGORY. WHERE A CHANGE OF OCCUPANCY CLASSIFICATION IS MADE TO AN EQUAL OR LESSER-HAZARD CATEGORY AS SHOWN IN TABLE 1011.6, EXISTING EXTERIOR WALLS, INCLUDING OPENINGS, SHALL BE ACCEPTED.

1011.7.1 MINIMUM REQUIREMENTS. VERTICAL SHAFTS SHALL BE DESIGNED TO MEET THE BUILDING CODE OF NEW YORK STATE REQUIREMENTS FOR ATRIUMS OR THE REQUIREMENTS OF THIS SECTION.

1011.7.2 STAIRWAYS. WHERE A CHANGE OF OCCUPANCY CLASSIFICATION IS MADE TO A HIGHER-HAZARD CATEGORY AS SHOWN IN TABLE 1011.4, INTERIOR STAIRWAYS SHALL BE ENCLOSED AS REQUIRED BY THE BUILDING CODE OF NEW YORK STATE. EXCEPTIONS: 1. IN OTHER THAN GROUP I OCCUPANCIES, AN ENCLOSURE SHALL NOT BE REQUIRED FOR

OPENINGS SERVING ONLY ONE ADJACENT FLOOR AND THAT ARE NOT CONNECTED WITH CORRIDORS OR STAIRWAYS SERVING OTHER FLOORS.

1101.1 SCOPE. AN ADDITION TO A BUILDING OR STRUCTURE SHALL COMPLY WITH THE UNIFORM CODE AS ADOPTED FOR NEW CONSTRUCTION WITHOUT REQUIRING THE EXISTING BUILDING OR STRUCTURE TO COMPLY WITH ANY REQUIREMENTS OF THOSE CODES OR OF THESE PROVISIONS, EXCEPT AS REQUIRED BY THIS CHAPTER. WHERE AN ADDITION IMPACTS THE EXISTING BUILDING OR STRUCTURE, THAT PORTION SHALL COMPLY WITH THIS CODE.

1102.1 HEIGHT LIMITATIONS. AN ADDITION SHALL NOT INCREASE THE HEIGHT OF AN EXISTING BUILDING BEYOND THAT PERMITTED UNDER THE APPLICABLE PROVISIONS OF CHAPTER 5 OF THE BUILDING CODE OF NEW YORK STATE FOR NEW BUILDINGS.

1102.2 AREA LIMITATIONS. AN ADDITION SHALL NOT INCREASE THE AREA OF AN EXISTING BUILDING BEYOND THAT PERMITTED UNDER THE APPLICABLE PROVISIONS OF CHAPTER 5 OF THE BUILDING CODE OF NEW YORK STATE FOR NEW BUILDINGS UNLESS FIRE SEPARATION AS REQUIRED BY THE BUILDING CODE OF NEW YORK STATE IS

1102.3 FIRE PROTECTION SYSTEMS. EXISTING FIRE AREAS INCREASED BY THE ADDITION SHALL COMPLY WITH CHAPTER 9 OF THE BUILDING CODE OF NEW YORK STATE.

1107.1 MINIMUM REQUIREMENTS. ADDITIONS TO EXISTING BUILDINGS SHALL CONFORM TO THE ENERGY REQUIREMENTS OF THE ENERGY CONSERVATION CONSTRUCTION CODE OF NEW YORK STATE OR RESIDENTIAL CODE OF NEW YORK STATE AS THEY RELATE TO NEW CONSTRUCTION.

2020 BUILDING CODE OF NEW YORK STATE (BC NYS) REVIEW:

BC NYS CHAPTER 3 - OCCUPANCY CLASSIFICATION AND USE

303.4 ASSEMBLY GROUP A-3. GROUP A-3 OCCUPANCY INCLUDES ASSEMBLY USES INTENDED FOR WORSHIP, RECREATION OR AMUSEMENT AND OTHER ASSEMBLY USES NOT CLASSIFIED ELSEWHERE IN GROUP A INCLUDING, BUT NOT LIMITED TO: COURTROOMS.

304.1 BUSINESS GROUP B. BUSINESS GROUP B OCCUPANCY INCLUDES, AMONG OTHERS, THE USE OF A BUILDING OR STRUCTURE, OR A PORTION THEREOF, FOR OFFICE, PROFESSIONAL OR SERVICE-TYPE TRANSACTIONS, INCLUDING STORAGE OF RECORDS AND ACCOUNTS. BUSINESS OCCUPANCIES SHALL INCLUDE, BUT NOT BE LIMITED TO, THE FOLLOWING: CIVIC ADMINISTRATION.

308.4 INSTITUTIONAL GROUP I-3. INSTITUTIONAL GROUP I-3 OCCUPANCY SHALL INCLUDE BUILDINGS AND STRUCTURES THAT ARE INHABITED BY MORE THAN FIVE PERSONS WHO ARE UNDER RESTRAINT OR SECURITY. A GROUP I-3 FACILITY IS OCCUPIED BY PERSONS WHO ARE GENERALLY INCAPABLE OF SELF-PRESERVATION DUE TO SECURITY MEASURES NOT UNDER THE OCCUPANTS' CONTROL. THIS GROUP SHALL INCLUDE, BUT NOT BE LIMITED TO, THE FOLLOWING: JAILS. BUILDINGS OF GROUP I-3 SHALL BE CLASSIFIED AS ONE OF THE OCCUPANCY CONDITIONS SPECIFIED IN SECTIONS 308.4.1 THROUGH 308.4.5 (SEE SECTION 408.1).

308.4.5 CONDITION 5. THIS OCCUPANCY CONDITION SHALL INCLUDE BUILDINGS IN WHICH FREE MOVEMENT IS RESTRICTED FROM AN OCCUPIED SPACE. STAFF-CONTROLLED MANUAL RELEASE IS PROVIDED TO PERMIT MOVEMENT FROM SLEEPING UNITS, ACTIVITY SPACES AND OTHER OCCUPIED AREAS WITHIN THE SMOKE COMPARTMENT TO OTHER SMOKE COMPARTMENTS.

BC NYS CHAPTER 4 - SPECIAL DETAILED REQUIREMENTS BASED ON OCCUPANCY AND USE

404.1 GENERAL. IN OTHER THAN GROUP H OCCUPANCIES, AND WHERE PERMITTED BY SECTION 712.1.7, THE PROVISIONS OF SECTIONS 404.1 THROUGH 404.10 SHALL APPLY TO BUILDINGS OR STRUCTURES CONTAINING VERTICAL OPENINGS DEFINED AS "ATRIUMS".

404.2 USE. THE FLOOR OF THE ATRIUM SHALL NOT BE USED FOR OTHER THAN LOW FIRE HAZARD USES AND ONLY APPROVED MATERIALS AND DECORATIONS IN ACCORDANCE WITH THE FIRE CODE OF NEW YORK STATE SHALL BE USED IN THE ATRIUM SPACE.

EXCEPTION: THE ATRIUM FLOOR AREA IS PERMITTED TO BE USED FOR ANY APPROVED USE WHERE THE INDIVIDUAL SPACE IS PROVIDED WITH AN AUTOMATIC SPRINKLER SYSTEM IN ACCORDANCE WITH SECTION

404.3 AUTOMATIC SPRINKLER PROTECTION. AN APPROVED AUTOMATIC SPRINKLER SYSTEM SHALL BE INSTALLED THROUGHOUT THE ENTIRE BUILDING.

404.4 FIRE ALARM SYSTEM. A FIRE ALARM SYSTEM SHALL BE PROVIDED IN ACCORDANCE WITH SECTION 907.2.13.

404.5 SMOKE CONTROL. A SMOKE CONTROL SYSTEM SHALL BE INSTALLED IN ACCORDANCE WITH SECTION 909. EXCEPTION: IN OTHER THAN GROUP I-2, AND GROUP I-1, CONDITION 2, SMOKE CONTROL IS NOT REQUIRED FOR ATRIUMS THAT CONNECT ONLY TWO STORIES.

404.6 ENCLOSURE OF ATRIUMS. ATRIUM SPACES SHALL BE SEPARATED FROM ADJACENT SPACES BY A 1-HOUR FIRE BARRIER CONSTRUCTED IN ACCORDANCE WITH SECTION 707 OR A HORIZONTAL ASSEMBLY CONSTRUCTED IN ACCORDANCE WITH SECTION 711, OR BOTH.

404.8 INTERIOR FINISH. THE INTERIOR FINISH OF WALLS AND CEILINGS OF THE ATRIUM SHALL BE NOT LESS THAN CLASS B. SPRINKLER PROTECTION SHALL NOT RESULT IN A REDUCTION IN CLASS.

404.9.1 EGRESS NOT THROUGH THE ATRIUM. WHERE REQUIRED ACCESS TO THE EXITS IS NOT THROUGH THE ATRIUM, EXIT ACCESS TRAVEL DISTANCE SHALL COMPLY WITH SECTION 1017.

404.9.2 EXIT ACCESS TRAVEL DISTANCE AT THE LEVEL OF EXIT DISCHARGE. WHERE THE PATH OF EGRESS TRAVEL IS THROUGH AN ATRIUM SPACE, EXIT ACCESS TRAVEL DISTANCE AT THE LEVEL OF EXIT DISCHARGE SHALL BE DETERMINED IN ACCORDANCE WITH SECTION 1017.

404.9.3 EXIT ACCESS TRAVEL DISTANCE AT OTHER THAN THE LEVEL OF EXIT DISCHARGE. WHERE THE PATH OF EGRESS TRAVEL IS NOT AT THE LEVEL OF EXIT DISCHARGE FROM THE ATRIUM, THAT PORTION OF THE TOTAL PERMITTED EXIT ACCESS TRAVEL DISTANCE THAT OCCURS WITHIN THE ATRIUM SHALL BE NOT GREATER THAN 200

404.10 INTERIOR EXIT STAIRWAYS. NOT GREATER THAN 50 PERCENT OF INTERIOR EXIT STAIRWAYS ARE PERMITTED TO EGRESS THROUGH AN ATRIUM ON THE LEVEL OF EXIT DISCHARGE IN ACCORDANCE WITH SECTION 1028.

408.1 GENERAL. OCCUPANCIES IN GROUP I-3 SHALL COMPLY WITH THE PROVISIONS OF SECTIONS 408.1 THROUGH 408.11 AND OTHER APPLICABLE PROVISIONS OF THIS CODE.

408.2 OTHER OCCUPANCIES. BUILDINGS OR PORTIONS OF BUILDINGS IN GROUP I-3 OCCUPANCIES WHERE SECURITY OPERATIONS NECESSITATE THE LOCKING OF REQUIRED MEANS OF EGRESS SHALL BE PERMITTED TO BE CLASSIFIED AS A DIFFERENT OCCUPANCY. OCCUPANCIES CLASSIFIED AS OTHER THAN GROUP I-3 SHALL MEET THE APPLICABLE REQUIREMENTS OF THIS CODE FOR THAT OCCUPANCY WHERE PROVISIONS ARE MADE FOR THE RELEASE OF OCCUPANTS AT ALL TIMES.

MEANS OF EGRESS FROM DETENTION AND CORRECTIONAL OCCUPANCIES THAT TRAVERSE OTHER USE ARES SHALL, AS A MINIMUM, CONFORM TO REQUIREMENTS FOR DETENTION AND CORRECTIONAL OCCUPANCIES.

408.3.6 EXIT DISCHARGE. EXITS ARE PERMITTED TO DISCHARGE INTO A FENCED OR WALLED COURTYARD. ENCLOSED YARDS OR COURTS SHALL BE OF A SIZE TO ACCOMMODATE ALL OCCUPANTS, BE LOCATED NOT LESS

THAN 50 FEET FROM THE BUILDING AND HAVE AN AREA OF NOT LESS THAN 15 SQUARE FEET PER PERSON. 408.4 LOCKS. EGRESS DOORS ARE PERMITTED TO BE LOCKED IN ACCORDANCE WITH THE APPLICABLE USE CONDITION. DOORS FROM A REFUGE AREA TO THE OUTSIDE ARE PERMITTED TO BE LOCKED WITH A KEY IN LIEU

OF LOCKING METHODS DESCRIBED IN SECTION 408.4.1. THE KEYS TO UNLOCK THE EXTERIOR DOORS SHALL BE AVAILABLE AT ALL TIMES AND THE LOCKS SHALL BE OPERABLE FROM BOTH SIDES OF THE DOOR. 408.4.2 POWER-OPERATED DOORS AND LOCKS. POWER-OPERATED SLIDING DOORS OR POWER-OPERATED LOCKS


FOR SWINGING DOORS SHALL BE OPERABLE BY A MANUAL RELEASE MECHANISM AT THE DOOR. EMERGENCY POWER SHALL BE PROVIDED FOR THE DOORS AND LOCKS IN ACCORDANCE WITH SECTION 2702.

IT IS A VIOLATION OF THE NEW YORK STATE EDUCATION LAW, ARTICLE 145 §7209 SPECIAL PROVISIONS. FOR ANY PERSON UNLESS THEY ARE ACTING UNDER THI DIRECTION OF A LICENSED PROFESSIONAL ENGINEER, ARCHITECT, LANDSCAPE ARCHITECT, OR LAND SURVEYOR, TO ALTER AN ITEM IN ANY WAY. IF AN ITEM BEARING THE STAMP OF A LICENSED PROFESSIONAL IS ALTERED, THE ALTERING PROFESSIONAL SHALL STAMP THE DOCUMENT AND INCLUDE THE NOTATION "ALTERED BY' FOLLOWED BY THEIR SIGNATURE, THE DATE OF SUCH ALTERATION, AND A SPECIFIC DESCRIPTION OF THE ALTERATION

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408.6 SMOKE BARRIER. OCCUPANCIES IN GROUP I-3 SHALL HAVE SMOKE BARRIERS COMPLYING WITH SECTIONS 408.6 AND 709 TO DIVIDE EVERY STORY OCCUPIED BY RESIDENTS FOR SLEEPING, OR ANY OTHER STORY HAVING AN OCCUPANT LOAD OF 50 OR MORE PERSONS, INTO NOT FEWER THAN TWO SMOKE COMPARTMENTS.

408.6.1 SMOKE COMPARTMENTS. THE NUMBER OF RESIDENTS IN ANY SMOKE COMPARTMENT SHALL BE NOT MORE THAN 200. THE DISTANCE OF TRAVEL TO A DOOR IN A SMOKE BARRIER FROM ANY ROOM DOOR REQUIRED AS EXIT ACCESS SHALL BE NOT GREATER THAN 150 FEET. THE DISTANCE OF TRAVEL TO A DOOR IN A SMOKE BARRIER FROM ANY POINT IN A ROOM SHALL BE NOT GREATER THAN 200 FEET.

408.6.2 REFUGE AREA. NOT LESS THAN 6 NET SQUARE FEET PER OCCUPANT SHALL BE PROVIDED ON EACH SIDE OF EACH SMOKE BARRIER FOR THE TOTAL NUMBER OF OCCUPANTS IN ADJOINING SMOKE COMPARTMENTS. THIS SPACE SHALL BE READILY AVAILABLE WHEREVER THE OCCUPANTS ARE MOVED ACROSS THE SMOKE BARRIER IN A FIRE EMERGENCY.

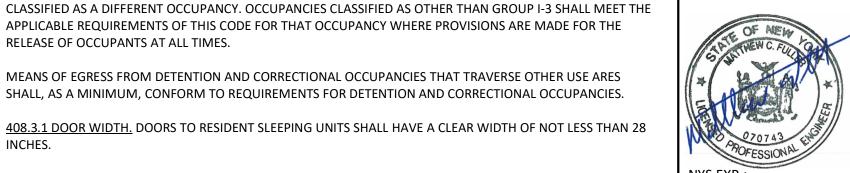408.7 SECURITY GLAZING. IN OCCUPANCIES IN GROUP I-3, WINDOWS AND DOORS IN 1-HOUR FIRE BARRIERS CONSTRUCTED IN ACCORDANCE WITH SECTION 707, FIRE PARTITIONS CONSTRUCTED IN ACCORDANCE WITH SECTION 708 AND SMOKE BARRIERS CONSTRUCTED IN ACCORDANCE WITH SECTION 709 SHALL BE PERMITTED TO HAVE SECURITY GLAZING INSTALLED PROVIDED THAT THE FOLLOWING CONDITIONS ARE MET.

1. INDIVIDUAL PANELS OF GLAZING SHALL NOT EXCEED 1,296 SQUARE INCHES. 2. THE GLAZING SHALL BE PROTECTED ON BOTH SIDES BY AN AUTOMATIC SPRINKLER SYSTEM. THE SPRINKLER SYSTEM SHALL BE DESIGNED TO, WHEN ACTUATED, WET COMPLETELY THE ENTIRE SURFACE OF ANY GLAZING AFFECTED BY FIRE.

3. THE GLAZING SHALL BE IN A GASKETED FRAME AND INSTALLED IN SUCH A MANNER THAT THE FRAMING SYSTEM WILL DEFLECT WITHOUT BREAKING (LOADING) THE GLASS BEFORE THE SPRINKLER SYSTEM OPERATES. 4. OBSTRUCTIONS, SUCH AS CURTAIN RODS, DRAPERY TRAVERSE RODS, CURTAINS, DRAPES OR SIMILAR MATERIALS SHALL NOT BE INSTALLED BETWEEN THE AUTOMATIC SPRINKLERS AND THE GLAZING.

408.8.2 OCCUPANCY CONDITION 5. EACH SLEEPING AREA IN OCCUPANCY CONDITION 5 SHALL BE SEPARATED FROM ADJACENT SLEEPING AREAS, CORRIDORS AND COMMON SPACES BY A SMOKE-TIGHT PARTITION. ADDITIONALLY, COMMON SPACES SHALL BE SEPARATED FROM THE CORRIDOR BY A SMOKE-TIGHT PARTITION.

408.8.4 SMOKE-TIGHT DOORS. DOORS IN OPENINGS IN PARTITIONS REQUIRED TO BE SMOKE TIGHT BY SECTION 408.8 SHALL BE SUBSTANTIAL DOORS, OF CONSTRUCTION THAT WILL RESIST THE PASSAGE OF SMOKE. LATCHES AND DOOR CLOSURES ARE NOT REQUIRED ON CELL DOORS.

408.10 FIRE ALARM SYSTEM. A FIRE ALARM SYSTEM SHALL BE PROVIDED IN ACCORDANCE WITH SECTION

408.11 AUTOMATIC SPRINKLER SYSTEM. GROUP I-3 OCCUPANCIES SHALL BE EQUIPPED THROUGHOUT WITH AN AUTOMATIC SPRINKLER SYSTEM IN ACCORDANCE WITH SECTION 903.2.6.

BC NYS CHAPTER 5 - GENERAL BUILDING HEIGHTS AND AREAS

504.2 MIXED OCCUPANCY. IN A BUILDING CONTAINING MIXED OCCUPANCIES IN ACCORDANCE WITH SECTION 508, NO INDIVIDUAL OCCUPANCY SHALL EXCEED THE HEIGHT AND NUMBER OF STORY LIMITS SPECIFIED IN THIS SECTION FOR THE APPLICABLE OCCUPANCIES.

504.3 HEIGHT IN FEET. THE MAXIMUM HEIGHT, IN FEET, OF A BUILDING SHALL NOT EXCEED THE LIMITS SPECIFIED IN TABLE 504.3.

TABLE 504.3 ALLOWABLE BUILDING HEIGHT IN FEET ABOVE GRADE PLANE A & B - S - TYPE II B - 75 FEET

I-3 - S - TYPE II B - 75 FEET

504.4 NUMBER OF STORIES. THE MAXIMUM NUMBER OF STORIES OF A BUILDING SHALL NOT EXCEED THE LIMITS SPECIFIED IN TABLE 504.4.

TABLE 504.4 ALLOWABLE NUMBER OF STORIES ABOVE GRADE PLANE

A-3 - S - TYPE II B - 3 STORIES B - S - TYPE II B - 4 STORIES

I-3 - S - TYPE II B - 2 STORIES

506.2 ALLOWABLE AREA DETERMINATION. THE ALLOWABLE AREA OF A BUILDING SHALL BE DETERMINED IN ACCORDANCE WITH THE APPLICABLE PROVISIONS OF SECTION 506.2.1 THROUGH 506.2.4 AND SECTION 506.3.

TABLE 506.2 ALLOWABLE AREA FACTOR IN SQUARE FEET

A-3 - SM - TYPE II B - 28,500 SQUARE FEET

B - SM - TYPE II B - 69,000 SQUARE FEET I-3 - SM - TYPE II B - 30,000 SQUARE FEET

506.2.4 MIXED-OCCUPANCY, MULTISTORY BUILDINGS. EACH STORY OF A MIXED-OCCUPANCY BUILDING WITH MORE THAN ONE STORY ABOVE GRADE PLANE SHALL INDIVIDUALLY COMPLY WITH THE APPLICABLE REQUIREMENTS OF SECTION 508.1. FOR BUILDINGS WITH MORE THAN THREE STORIES ABOVE GRADE PLANE, THE TOTAL BUILDING AREA SHALL BE SUCH THAT THE AGGREGATE SUM OF THE RATIOS OF THE ACTUAL AREA OF EACH STORY DIVIDED BY THE ALLOWABLE AREA OF SUCH STORIES, DETERMINED IN ACCORDANCE WITH EQUATION 5-3 BASED ON THE APPLICABLE PROVISIONS OF SECTION 508.1, SHALL NOT EXCEED THREE.

508.1 GENERAL. EACH PORTION OF A BUILDING SHALL BE INDIVIDUALLY CLASSIFIED IN ACCORDANCE WITH SECTION 302.1. WHERE A BUILDING CONTAINS MORE THAN ONE OCCUPANCY GROUP, THE BUILDING OR PORTION THEREOF SHALL COMPLY WITH THE APPLICABLE PROVISIONS OF SECTION 508.2, 508.3 OR 508.4, OR A COMBINATION OF THESE SECTIONS.

508.2 ACCESSORY OCCUPANCIES. ACCESSORY OCCUPANCIES ARE THOSE OCCUPANCIES THAT ARE ANCILLARY TO THE MAIN OCCUPANCY OF THE BUILDING OR PORTION THEREOF. ACCESSORY OCCUPANCIES SHALL COMPLY WITH THE PROVISIONS OF SECTION 508.2.1 THROUGH 508.2.4.

508.2.1 OCCUPANCY CLASSIFICATION. ACCESSORY OCCUPANCIES SHALL BE INDIVIDUALLY CLASSIFIED IN ACCORDANCE WITH SECTION 302.1. THE REQUIREMENTS OF THIS CODE SHALL APPLY TO EACH PORTION OF THE BUILDING BASED ON THE OCCUPANCY CLASSIFICATION OF THAT SPACE.

508.2.3 ALLOWABLE BUILDING AREA. THE ALLOWABLE AREA OF THE BUILDING SHALL BE BASED ON THE APPLICABLE PROVISIONS OF SECTION 506 FOR THE MAIN OCCUPANCY OF THE BUILDING. AGGREGATE ACCESSORY OCCUPANCIES SHALL NOT OCCUPY MORE THAN 10 PERCENT OF THE FLOOR AREA OF THE STORY IN WHICH THEY ARE LOCATED AND SHALL NOT EXCEED THE TABULAR VALUES FOR NONSPRINKLERED BUILDINGS IN TABLE 506.2 FOR EACH SUCH ACCESSORY OCCUPANCY.

508.2.4 SEPARATION OF OCCUPANCIES. NO SEPARATION IS REQUIRED BETWEEN ACCESSORY OCCUPANCIES AND THE MAIN OCCUPANCY.

508.4 SEPARATED OCCUPANCIES. BUILDINGS OR PORTIONS OF BUILDINGS THAT COMPLY WITH THE PROVISIONS OF THIS SECTION SHALL BE CONSIDERED AS SEPARATED OCCUPANCIES.

TABLE 508.4 REQUIRED SEPARATION OF OCCUPANCIES A, B & I-3 - S - 1 HOUR REQUIRED SEPARATION

508.4.2 ALLOWABLE BUILDING AREA. IN EACH STORY, THE BUILDING AREA SHALL BE SUCH THAT THE SUM OF THE RATIOS OF THE ACTUAL BUILDING AREA OF EACH SEPARATE OCCUPANCY DIVIDED BY THE ALLOWABLE BUILDING AREA OF EACH SEPARATED OCCUPANCY SHALL NOT EXCEED 1.

FIRST FLOOR AREA= ((XXX/28,500)+(XXX/69,000)+(XXX/30,000)) = SECOND FLOOR AREA= ((XXX/28,500)+(XXX/69,000)) =

508.4.4.1 CONSTRUCTION. REQUIRED SEPARATIONS SHALL BE FIRE BARRIERS CONSTRUCTED IN ACCORDANCE WITH SECTION 707 OR HORIZONTAL ASSEMBLIES CONSTRUCTED IN ACCORDANCE WITH SECTION 711, OR BOTH, SO AS TO COMPLETELY SEPARATE ADJACENT OCCUPANCIES.

BC NYS CHAPTER 6 - TYPES OF CONSTRUCTION

601.1 SCOPE. THE PROVISIONS OF THIS CHAPTER SHALL CONTROL THE CLASSIFICATION OF BUILDINGS AS TO TYPE OF

TABLE 601 FIRE-RESISTANCE RATING REQUIREMENTS FOR BUILDING ELEMENTS

PRIMARY STRUCTURAL FRAME - TYPE II B - 0 HOURS BEARING WALLS - TYPE II B - O HOURS

NONBEARING WALLS AND PARTITIONS - TYPE II B - 0 HOURS

FLOOR CONSTRUCTION AND ASSOCIATED SECONDARY MEMBERS - TYPE II B - 0 HOURS ROOF CONSTRUCTION AND ASSOCIATED SECONDARY MEMBERS - TYPE II B - 0 HOURS

602.1 GENERAL. BUILDINGS AND STRUCTURES ERECTED OR TO BE ERECTED, ALTERED OR EXTENDED IN HEIGHT OR AREA SHALL BE CLASSIFIED IN ONE OF THE FIVE CONSTRUCTION TYPES DEFINED IN SECTIONS 602.2 THROUGH 602.5. THE BUILDING ELEMENTS SHALL HAVE A FIRE-RESISTANCE RATING NOT LESS THAN THAT SPECIFIED IN TABLE 601 AND EXTERIOR WALLS SHALL HAVE A FIRE-RESISTANCE RATING NOT LESS THAN THAT SPECIFIED IN TABLE 602. WHERE REQUIRED TO HAVE A FIRE-RESISTANCE RATING BY TABLE 601, BUILDING ELEMENTS SHALL COMPLY WITH THE APPLICABLE PROVISIONS OF SECTION 703.2. THE PROTECTION OF OPENINGS, DUCTS AND AIR TRANSFER OPENINGS IN BUILDING ELEMENTS SHALL NOT BE REQUIRED UNLESS REQUIRED BY OTHER PROVISIONS OF THIS CODE.

TABLE 602 FIRE-RESISTANCE RATING REQUIREMENTS FOR EXTERIOR WALLS BASED ON FIRE SEPARATION DISTANCE DISTANCE GREATER THAN 10 FEET - TYPE II B - A, B & I OCCUPANCIES - 0 HOURS

BC NYS CHAPTER 7 - FIRE AND SMOKE PROTECTION FEATURES

THE OCCUPANCIES BEING SEPARATED.

703.2 FIRE-RESISTANCE RATING. THE FIRE-RESISTANCE RATING OF BUILDING ELEMENTS, COMPONENTS OR ASSEMBLIES SHALL BE DETERMINED IN ACCORDANCE WITH THE TEST PROCEDURES SET FORTH IN ASTM E119 OR UL 263 OR IN ACCORDANCE WITH SECTION 703.3. THE FIRE-RESISTANCE RATING OF PENETRATIONS AND FIRE-RESISTANT JOINT SYSTEMS SHALL BE DETERMINED IN ACCORDANCE WITH SECTIONS 714 AND 715, RESPECTIVELY.

707.3.1 SHAFT ENCLOSURES. THE FIRE-RESISTANCE RATING OF THE FIRE BARRIER SEPARATING BUILDING AREAS FROM A SHAFT SHALL COMPLY WITH SECTION 713.4.

707.3.2 INTERIOR EXIT STAIRWAY AND RAMP CONSTRUCTION. THE FIRE-RESISTANCE RATING OF THE FIRE BARRIER SEPARATING BUILDING AREAS FROM AN INTERIOR EXIT STAIRWAY OR RAMP SHALL COMPLY WITH SECTION 1023.1.

707.3.3 ENCLOSURES FOR EXIT ACCESS STAIRWAYS. THE FIRE-RESISTANCE RATING OF THE FIRE BARRIER SEPARATING BUILDING AREAS FROM AN EXIT ACCESS STAIRWAY OR RAMP SHALL COMPLY WITH SECTION 713.4.

707.3.4 EXIT PASSAGEWAY. THE FIRE-RESISTANCE RATING OF THE FIRE BARRIER SEPARATING BUILDING AREAS FROM AN EXIT PASSAGEWAY SHALL COMPLY WITH SECTION 1024.3.

707.3.5 HORIZONTAL EXIT. THE FIRE-RESISTANCE RATING OF THE SEPARATION BETWEEN BUILDING AREAS CONNECTED BY A HORIZONTAL EXIT SHALL COMPLY WITH SECTION 1026.1.

707.3.6 ATRIUMS. THE FIRE-RESISTANCE RATING OF THE FIRE BARRIER SEPARATING ATRIUMS SHALL COMPLY WITH SECTION

707.3.9 SEPARATED OCCUPANCIES. WHERE THE PROVISIONS OF SECTION 508.4 ARE APPLICABLE, THE FIRE BARRIER SEPARATING MIXED OCCUPANCIES SHALL HAVE A FIRE-RESISTANCE RATING OF NOT LESS THAN THAT INDICATED IN TABLE 508.4 BASED ON

707.5 CONTINUITY. FIRE BARRIERS SHALL EXTEND FROM THE TOP OF THE FOUNDATION OR FLOOR/CEILING ASSEMBLY BELOW TO THE UNDERSIDE OF THE FLOOR OR ROOF SHEATHING, SLAB OR DECK ABOVE AND SHALL BE SECURELY ATTACHED THERETO. SUCH FIRE BARRIERS SHALL BE CONTINUOUS THROUGH CONCEALED SPACE, SUCH AS THE SPACE ABOVE A SUSPENDED CEILING. JOINTS AND VOIDS AT INTERSECTIONS SHALL COMPLY WITH SECTIONS 707.8 AND 707.9.

707.5.1 SUPPORTING CONSTRUCTION. THE SUPPORTING CONSTRUCTION FOR A FIRE BARRIER SHALL BE PROTECTED TO AFFORD THE REQUIRED FIRE-RESISTANCE RATING OF THE FIRE BARRIER SUPPORTED. HOLLOW VERTICAL SPACES WITHIN A FIRE BARRIER SHALL BE FIREBLOCKED IN ACCORDANCE WITH SECTION 718.2 AT EVERY FLOOR LEVEL.

707.6 OPENINGS. OPENINGS IN A FIRE BARRIER SHALL BE PROTECTED IN ACCORDANCE WITH SECTION 716. OPENINGS SHALL BE LIMITED TO A MAXIMUM AGGREGATE WIDTH OF 25 PERCENT OF THE LENGTH OF THE WALL, AND THE MAXIMUM AREA OF ANY SINGLE OPENING SHALL NOT EXCEED 156 SQUARE FEET. OPENINGS IN ENCLOSURES FOR EXIT ACCESS STAIRWAYS AND RAMPS, INTERIOR EXIT STAIRWAYS AND RAMPS AND EXIT PASSAGEWAYS SHALL ALSO COMPLY WITH SECTIONS 1019, 1023.4 AND

EXCEPTIONS: 1. OPENINGS SHALL NOT BE LIMITED TO 156 SQUARE FEET WHERE ADJOINING FLOOR AREAS ARE EQUIPPED THROUGHOUT WITH AN AUTOMATIC SPRINKLER SYSTEM IN ACCORDANCE WITH SECTION 903.3.1.1.

707.7 PENETRATIONS. PENETRATIONS OF FIRE BARRIERS SHALL COMPLY WITH SECTION 714.

707.8 JOINTS MADE IN OR BETWEEN FIRE BARRIERS, AND JOINTS MADE AT THE INTERSECTION OF FIRE BARRIERS WITH UNDERSIDE OF A FIRE-RESISTANCE-RATED FLOOR OR ROOF SHEATHING, SLAB OR DECK ABOVE, AND THE EXTERIOR VERTICAL WALL INTERSECTION SHALL COMPLY WITH SECTION 715.

707.9 VOIDS AT INTERSECTIONS. THE VOIDS CREATED AT THE INTERSECTION OF A FIRE BARRIER AND A NONFIRE-RESISTANCE-RATED ROOF ASSEMBLY OR A NONFIRE-RESISTANCE-RATED EXTERIOR WALL ASSEMBLY SHALL BE FILLED. AN APPROVED MATERIAL OR SYSTEM SHALL BE USED TO FILL THE VOID, AND SHALL BE SECURELY INSTALLED IN OR ON THE INTERSECTION FOR ITS ENTIRE LENGTH SO AS NOT TO DISLODGE, LOOSEN OR OTHERWISE IMPAIR ITS ABILITY TO ACCOMMODATE EXPECTED BUILDING MOVEMENTS AND TO RETARD THE PASSAGE OF FIRE AND HOT GASES.

707.10 DUCTS AND AIR TRANSFER OPENINGS. PENETRATIONS IN A FIRE BARRIER BY DUCTS AND AIR TRANSFER OPENINGS SHALL COMPLY WITH SECTION 717.

708.3 FIRE-RESISTANCE RATING. FIRE PARTITIONS SHALL HAVE A FIRE-RESISTANCE RATING OF NOT LESS THAN 1 HOUR.

708.4 CONTINUITY. FIRE PARTITIONS SHALL EXTEND FROM THE TOP OF THE FOUNDATION OR FLOOR/CEILING ASSEMBLY BELOW AND BE SECURELY ATTACHED TO ONE OF THE FOLLOWING:

1. THE UNDERSIDE OF THE FLOOR OR ROOF SHEATHING, DECK OR SLAB ABOVE. 2. THE UNDERSIDE OF A FLOOR/CEILING OR ROOF/CEILING ASSEMBLY HAVING A FIRE-RESISTANCE RATING THAT IS NOT LESS THAN THE FIRE-RESISTANCE RATING OF THE FIRE PARTITION.

711.2.4.1 SEPARATING MIXED OCCUPANCIES. WHERE THE HORIZONTAL ASSEMBLY SEPARATES MIXED OCCUPANCIES, THE ASSEMBLY SHALL HAVE A FIRE-RESISTANCE RATING OF NOT LESS THAN THAT REQUIRED BY SECTION 508.4 BASED ON THE OCCUPANCIES BEING SEPARATED.

713.4 FIRE-RESISTANCE RATING. SHAFT ENCLOSURES SHALL HAVE A FIRE-RESISTANCE RATING OF NOT LESS THAN 2 HOURS WHERE CONNECTING FOUR STORIES OR MORE, AND NOT LESS THAN 1 HOUR WHERE CONNECTING LESS THAN FOUR STORIES. THE NUMBER OF STORIES CONNECTED BY THE SHAFT ENCLOSURE SHALL INCLUDE ANY BASEMENTS BUT NOT ANY MEZZANINES. SHAFT ENCLOSURES SHALL HAVE A FIRE-RESISTANCE RATING NOT LESS THAN THE FLOOR ASSEMBLY PENETRATED, BUT NEED NOT EXCEED 2 HOURS. SHAFT ENCLOSURES SHALL MEET THE REQUIREMENTS OF SECTION 703.2.1.

713.5 CONTINUITY. SHAFT ENCLOSURES SHALL BE CONSTRUCTED AS FIRE BARRIERS IN ACCORDANCE WITH SECTION 707 OR HORIZONTAL ASSEMBLIES CONSTRUCTED IN ACCORDANCE WITH SECTION 711, OR BOTH, AND SHALL HAVE CONTINUITY IN ACCORDANCE WITH SECTION 707.5 FOR FIRE BARRIERS OR SECTION 711.2.2 FOR HORIZONTAL ASSEMBLIES, AS APPLICABLE.

714.2 INSTALLATION. A LISTED PENETRATION FIRESTOP SYSTEM SHALL BE INSTALLED IN ACCORDANCE WITH THE MANUFACTURER'S INSTALLATION INSTRUCTIONS AND THE LISTING CRITERIA.

714.3 INSTALLATION DETAILS. WHERE SLEEVES ARE USED, THEY SHALL BE SECURELY FASTENED TO THE ASSEMBLY PENETRATED. THE SPACE BETWEEN THE ITEM CONTAINED IN THE SLEEVE AND THE SLEEVE ITSELF AND ANY SPACE BETWEEN THE SLEEVE AND THE ASSEMBLY PENETRATED SHALL BE PROTECTED IN ACCORDANCE WITH THIS SECTION. INSULATION AND COVERINGS ON OR IN THE PENETRATING ITEM SHALL NOT PENETRATE THE ASSEMBLY UNLESS THE SPECIFIC MATERIAL USED HAS BEEN TESTED AS PART OF THE ASSEMBLY IN ACCORDANCE WITH THIS SECTION.

714.4.1.1 FIRE-RESISTANCE-RATED ASSEMBLIES. THROUGH PENETRATIONS SHALL BE PROTECTED USING SYSTEMS INSTALLED AS TESTED IN THE APPROVED FIRE-RESISTANCE-RATED ASSEMBLY.

714.4.1.2 THROUGH-PENETRATION FIRESTOP SYSTEM. THROUGH PENETRATIONS SHALL BE PROTECTED BY AN APPROVED PENETRATION FIRESTOP SYSTEM INSTALLED AS TESTED IN ACCORDANCE WITH ASTM E814 OR UL 1479, WITH A MINIMUM POSITIVE PRESSURE DIFFERENTIAL OF 0.01 INCH OF WATER AND SHALL HAVE AN F RATING OF NOT LESS THAN THE REQUIRED FIRE-RESISTANCE RATING OF THE WALL PENETRATED.

714.4.3 DISSIMILAR MATERIALS. NONCOMBUSTIBLE PENETRATING ITEMS SHALL NOT CONNECT TO COMBUSTIBLE ITEMS BEYOND THE POINT OF FIRESTOPPING UNLESS IT CAN BE DEMONSTRATED THAT THE FIRE-RESISTANCE INTEGRITY OF THE WALL IS MAINTAINED.

714.5.1.1 FIRE-RESISTANCE-RATED ASSEMBLIES. THROUGH PENETRATIONS SHALL BE PROTECTED USING SYSTEMS INSTALLED AS TESTED IN THE APPROVED FIRE-RESISTANCE-RATED ASSEMBLY.

714.5.1.2 THROUGH-PENETRATION FIRESTOP SYSTEM. THROUGH PENETRATIONS SHALL BE PROTECTED BY AN APPROVED THROUGH-PENETRATION FIRESTOP SYSTEM INSTALLED AND TESTED IN ACCORDANCE WITH ASTM E814 OR UL 1479, WITH A MINIMUM POSITIVE PRESSURE DIFFERENTIAL OF 0.01 INCH OF WATER. THE SYSTEM SHALL HAVE AN F RATING/T RATING OF NOT LESS THAN 1 HOUR BUT NOT LESS THAN THE REQUIRED RATING OF THE FLOOR PENETRATED.

714.5.3 DISSIMILAR MATERIALS. NONCOMBUSTIBLE PENETRATING ITEMS SHALL NOT CONNECT TO COMBUSTIBLE MATERIALS BEYOND THE POINT OF FIRESTOPPING UNLESS IT CAN BE DEMONSTRATED THAT THE FIRE-RESISTANCE INTEGRITY OF THE HORIZONTAL ASSEMBLY IS MAINTAINED.

714.6.1 NONCOMBUSTIBLE PENETRATING ITEMS. NONCOMBUSTIBLE PENETRATING ITEMS THAT CONNECT NOT MORE THAN FIVE STORIES ARE PERMITTED, PROVIDED THAT THE ANNULAR SPACE IS FILLED TO RESIST THE FREE PASSAGE OF FLAME AND THE PRODUCTS OF COMBUSTION WITH AN APPROVED NONCOMBUSTIBLE MATERIAL OR WITH A FILL, VOID OR CAVITY MATERIAL THAT IS TESTED AND CLASSIFIED FOR USE IN THROUGH-PENETRATION FIRESTOP SYSTEMS.

714.6.2 PENETRATING ITEMS. PENETRATING ITEMS THAT CONNECT NOT MORE THAN TWO STORIES ARE PERMITTED, PROVIDED THAT THE ANNULAR SPACE IS FILLED WITH AN APPROVED MATERIAL TO RESIST THE FREE PASSAGE OF FLAME AND THE PRODUCTS OF COMBUSTION.

715.1 GENERAL. JOINTS INSTALLED IN OR BETWEEN FIRE-RESISTANCE-RATED WALLS, FLOOR OR FLOOR/CEILING ASSEMBLIES AND ROOFS OR ROOF/CEILING ASSEMBLIES SHALL BE PROTECTED BY AN APPROVED FIRE-RESISTANT JOINT SYSTEM DESIGNED TO RESIST THE PASSAGE OF FIRE FOR A TIME PERIOD NOT LESS THAN THE REQUIRED FIRE-RESISTANCE RATING OF THE WALL, FLOOR OR ROOF IN OR BETWEEN WHICH THE SYSTEM IS INSTALLED. FIRE-RESISTANT JOINT SYSTEMS SHALL BE TESTED IN ACCORDANCE WITH SECTION 715.3.

715.3 FIRE TEST CRITERIA. FIRE-RESISTANT JOINT SYSTEMS SHALL BE TESTED IN ACCORDANCE WITH THE REQUIREMENTS OF EITHER ASTM E1996 OR UL 2079. NONSYMMETRICAL WALL JOINT SYSTEMS SHALL BE TESTED WITH BOTH FACES EXPOSED TO THE FURNACE, AND THE ASSIGNED FIRE-RESISTANCE RATING SHALL BE THE SHORTEST DURATION OBTAINED FROM THE TWO TESTS. WHERE EVIDENCE IS FURNISHED TO SHOW THAT THE WALL WAS TESTED WITH THE LEAST FIRE-RESISTANT SIDE EXPOSED TO THE FURNACE, SUBJECT TO ACCEPTANCE OF THE BUILDING OFFICIAL, THE WALL NEED NOT BE SUBJECTED TO TESTS FROM THE OPPOSITE

TABLE 716.1(2) OPENING FIRE PROTECTION ASSEMBLIES, RATINGS AND MARKINGS FIRE BARRIERS - 1 HOUR WALL ASSEMBLY - 1 HOUR FIRE DOOR W/ 100 SQ. IN. MAX VISION PANEL (D-H-60)

TABLE 716.1(3) FIRE WINDOW ASSEMBLY FIRE PROTECTION RATINGS

ATRIUM SEPARATIONS - 1 HOUR WALL ASSEMBLY - 3/4 HOUR WINDOW ASSEMBLY W/ OH-45 OR W-60

716.2.6.1 DOOR CLOSING. FIRE DOORS SHALL BE LATCHING AND SELF OR AUTOMATIC CLOSING IN ACCORDANCE WITH THIS SECTION.

716.2.6.2 LATCH REQUIRED. UNLESS OTHERWISE SPECIFICALLY PERMITTED, SINGLE SIDE-HINGED SWINGING FIRE DOORS AND BOTH LEAVES OF PAIRS OF SIDE-HINGED SWINGING FIRE DOORS SHALL BE PROVIDED WITH AN ACTIVE LATCH BOLT THAT WILL SECURE THE DOOR WHEN IT IS CLOSED.

716.2.6.4 AUTOMATIC-CLOSING FIRE DOOR ASSEMBLIES. AUTOMATIC-CLOSING FIRE DOOR ASSEMBLIES SHALL BE SELF-CLOSING IN ACCORDANCE WITH NFPA 80.

716.2.6.5 DELAYED-ACTION CLOSERS. DOORS REQUIRED TO BE SELF-CLOSING AND NOT REQUIRED TO BE AUTOMATIC CLOSING SHALL BE PERMITTED TO BE EQUIPPED WITH DELAYED-ACTION CLOSERS.

716.2.9 LABELED PROTECTIVE ASSEMBLIES. FIRE DOOR ASSEMBLIES SHALL BE LABELED BY AN APPROVED AGENCY. THE LABEL SHALL COMPLY WITH NFPA 80, AND SHALL BE PERMANENTLY AFFIXED TO THE DOOR OR FRAME.

716.3.1 TESTING REQUIREMENTS. FIRE WINDOW ASSEMBLIES SHALL BE CONSTRUCTED OF ANY MATERIAL OR ASSEMBLY OF COMPONENT MATERIALS THAT CONFORMS TO THE TEST REQUIREMENTS OF SECTIONS 716.3.1.1 AND 716.1.2 AND THE FIRE PROTECTION RATING INDICATED IN TABLE 716.1(3).

716.3.2 PERFORMANCE REQUIREMENTS. FIRE WINDOW ASSEMBLIES SHALL BE INSTALLED IN THE ASSEMBLIES AND COMPLY WITH THE FIRE PROTECTION RATING SPECIFIED IN TABLE 716.1(3).

716.3.5 LABELED PROTECTIVE ASSEMBLIES. GLAZING IN FIRE WINDOW ASSEMBLIES SHALL BE LABELED BY AN APPROVED AGENCY. THE LABELS SHALL COMPLY WITH NFPA 80 AND SECTION 716.3.5.2.

716.3.5.2 LABELING REQUIREMENTS. FIRE-PROTECTION-RATED GLAZING SHALL BEAR A LABEL OR OTHER IDENTIFICATION SHOWING THE NAME OF THE MANUFACTURER, THE TEST STANDARD AND INFORMATION REQUIRED IN SECTION 716.1.2.2.2 AND TABLE 716.1(3) THAT SHALL BE ISSUED BY AN APPROVED AGENCY AND PERMANENTLY IDENTIFIED ON THE GLAZING.

717.5.2 FIRE BARRIERS. DUCTS AND AIR TRANSFER OPENINGS OF FIRE BARRIERS SHALL BE PROTECTED WITH LISTED FIRE DAMPERS INSTALLED IN ACCORDANCE WITH THEIR LISTING. DUCTS AND AIR TRANSFER OPENINGS SHALL NOT PENETRATE ENCLOSURES FOR INTERIOR EXIT STAIRWAYS AND RAMPS AND EXIT PASSAGEWAYS, EXCEPT AS PERMITTED BY SECTIONS 1023.5 AND 1024.6, RESPECTIVELY.

717.5.3 SHAFT ENCLOSURES. SHAFT ENCLOSURES THAT ARE PERMITTED TO BE PENETRATED BY DUCTS AND AIR TRANSFER OPENINGS SHALL BE PROTECTED WITH LISTED FIRE AND SMOKE DAMPERS INSTALLED IN ACCORDANCE WITH THEIR LISTING.

BC NYS CHAPTER 8 - INTERIOR FINISHES

B - SPRINKLERED

I-3 - SPRINKLERED

TABLE 803.13 INTERIOR WALL AND CEILING FINISH REQUIREMENTS BY OCCUPANCY

- INTERIOR EXIT STAIRWAYS - B

- CORRIDORS AND ENCLOSURE FOR EXIT ACCESS STAIRWAYS - B

- ROOMS AND ENCLOSED SPACES - C - INTERIOR EXIT STAIRWAYS - B

- CORRIDORS AND ENCLOSURE FOR EXIT ACCESS STAIRWAYS - C - ROOMS AND ENCLOSED SPACES - C

- INTERIOR EXIT STAIRWAYS - A - CORRIDORS AND ENCLOSURE FOR EXIT ACCESS STAIRWAYS - A

- ROOMS AND ENCLOSED SPACES - C

804.4.2 MINIMUM CRITICAL RADIANT FLUX. IN ALL OCCUPANCIES, INTERIOR FLOOR FINISH AND FLOOR COVERING MATERIALS IN ENCLOSURES FOR STAIRWAYS AND RAMPS, EXIT PASSAGEWAYS, CORRIDORS AND ROOMS OR SPACES NOT SEPARATED FROM CORRIDORS BY PARTITIONS EXTENDING FROM THE FLOOR TO THE UNDERSIDE OF THE CEILING SHALL WITHSTAND A MINIMUM CRITICAL RADIANT FLUX. THE MINIMUM CRITICAL RADIANT FLUX SHALL BE NOT LESS THAN CLASS I IN GROUPS I-1, I-2 AND I-3 AND NOT LESS THAN CLASS II IN GROUPS A, B, E, H, I-4, M, R-1, R-2 AND S.

EXCEPTION: WHERE A BUILDING IS EQUIPPED THROUGHOUT WITH AN AUTOMATIC SPRINKLER SYSTEM IN ACCORDANCE WITH SECTION 903.3.1.1 OR 903.3.1.2, CLASS II MATERIALS ARE PERMITTED IN ANY AREA WHERE CLASS I MATERIALS ARE REQUIRED, AND MATERIALS COMPLYING WITH DOC FF-1 "PILL TEST" OR WITH ASTM D2859 ARE PERMITTED IN ANY AREA WHERE CLASS II MATERIALS ARE REQUIRED.

808.1.1 MATERIALS AND INSTALLATION. ACOUSTICAL MATERIALS COMPLYING WITH THE INTERIOR FINISH REQUIREMENTS OF SECTION 803 SHALL BE INSTALLED IN ACCORDANCE WITH THE MANUFACTURER'S RECOMMENDATIONS AND APPLICABLE PROVISIONS FOR APPLYING INTERIOR FINISH.

808.1.1.1 SUSPENDED ACOUSTICAL CEILINGS. SUSPENDED ACOUSTICAL CEILING SYSTEMS SHALL BE INSTALLED IN ACCORDANCE WITH THE PROVISIONS OF ASTM C635 AND ASTM C636.

808.1.1.2 FIRE-RESISTANCE-RATED CONSTRUCTION. ACOUSTICAL CEILING SYSTEMS THAT ARE PART OF FIRE-RESISTANCE-RATED CONSTRUCTION SHALL BE INSTALLED IN THE SAME MANNER USED IN THE ASSEMBLY TESTED AND SHALL COMPLY WITH THE PROVISIONS OF CHAPTER 7.

BC NYS CHAPTER 9 - FIRE PROTECTION AND LIFE SAFETY SYSTEMS

903.2.1.3 GROUP A-3. AN AUTOMATIC SPRINKLER SYSTEM SHALL BE PROVIDED THROUGHOUT STORIES CONTAINING GROUP A-3 OCCUPANCIES AND THROUGHOUT ALL STORIES FROM THE GROUP A-3 OCCUPANCY TO AND INCLUDING THE LEVELS OF EXIT DISCHARGE SERVING THAT OCCUPANCY WHERE ONE OF THE FOLLOWING **CONDITIONS EXISTS:**

1. THE FIRE AREA EXCEEDS 12,000 SQUARE FEET.

2. THE FIRE AREA HAS AN OCCUPANT LOAD OF 300 OR MORE.

3. THE FIRE AREA IS LOCATED ON A FLOOR OTHER THAN A LEVEL OF EXIT DISCHARGE SERVING SUCH

903.2.6 GROUP I. AN AUTOMATIC SPRINKLER SYSTEM SHALL BE PROVIDED THROUGHOUT BUILDINGS WITH A GROUP I FIRE AREA.

903.3.1.1 NFPA 13 SPRINKLER SYSTEMS. WHERE THE PROVISIONS OF THIS CODE REQUIRE THAT A BUILDING OR PORTION THEREOF BE EQUIPPED THROUGHOUT WITH AN AUTOMATIC SPRINKLER SYSTEM IN ACCORDANCE WITH THIS SECTION, SPRINKLERS SHALL BE INSTALLED THROUGHOUT IN ACCORDANCE WITH NFPA 13 EXCEPT AS PROVIDED IN SECTIONS 903.3.1.1.1 AND 903.3.1.1.2.

906.1 WHERE REQUIRED. PORTABLE FIRE EXTINGUISHERS SHALL BE INSTALLED IN ALL OF THE FOLLOWING

1. IN GROUP A, B, E, F, H, I, M, R-1, R-2, R-4 AND S OCCUPANCIES. 4. ON EACH FLOOR OF STRUCTURES UNDER CONSTRUCTION, EXCEPT GROUP R-3 OCCUPANCIES, IN ACCORDANCE WITH SECTION 3315.1 OF THE FIRE CODE OF NEW YORK STATE.

5. WHERE REQUIRED BY THE FIRE CODE OF NEW YORK STATE SECTIONS INDICATED IN TABLE 906.1.

906.2 GENERAL REQUIREMENTS. PORTABLE FIRE EXTINGUISHERS SHALL BE SELECTED AND INSTALLED IN ACCORDANCE WITH THIS SECTION AND NFPA 10.

906.3 SIZE AND DISTRIBUTION. THE SIZE AND DISTRIBUTION OF PORTABLE FIRE EXTINGUISHERS SHALL BE IN ACCORDANCE WITH SECTIONS 906.3.1 THROUGH 906.3.4.

TABLE 906.3(1) FIRE EXTINGUISHERS FOR CLASS A FIRE HAZARDS (ORDINARY HAZARD OCCUPANCY) MINIMUM-RATED SINGLE EXTINGUISHER

MAXIMUM FLOOR AREA PER UNIT OF A - 1,500 SQUARE FEET MAXIMUM FLOOR AREA FOR EXTINGUISHER - 11,250 SQUARE FEET MAXIMUM DISTANCE OF TRAVEL TO EXTINGUISHER - 75 FEET

907.2 WHERE REQUIRED - NEW BUILDINGS AND STRUCTURES. AN APPROVED FIRE ALARM SYSTEM INSTALLED IN ACCORDANCE WITH THE PROVISIONS OF THIS CODE AND NFPA 72 SHALL BE PROVIDED IN NEW BUILDINGS AND STRUCTURES IN ACCORDANCE WITH SECTIONS 907.2.1 THROUGH 907.2.23 AND PROVIDE OCCUPANT NOTIFICATION IN ACCORDANCE WITH SECTION 907.5, UNLESS OTHER REQUIREMENTS ARE PROVIDED BY

NOT FEWER THAN ONE MANUAL FIRE ALARM BOX SHALL BE PROVIDED IN AN APPROVED LOCATION TO INITIATE A FIRE ALARM SIGNAL FOR FIRE ALARM SYSTEMS EMPLOYING AUTOMATIC FIRE DETECTORS OR WATERFLOW DETECTION DEVICES. WHERE OTHER SECTIONS OF THIS CODE ALLOW ELIMINATION OF FIRE ALARM BOXES DUE TO SPRINKLERS, A SINGLE FIRE ALARM BOX SHALL BE INSTALLED.

907.2.1 GROUP A. A MANUAL FIRE ALARM SYSTEM THAT ACTIVATES THE OCCUPANT NOTIFICATION SYSTEM IN ACCORDANCE WITH SECTION 907.5 SHALL BE INSTALLED IN GROUP A OCCUPANCIES WHERE THE OCCUPANT LOAD DUE TO THE ASSEMBLY OCCUPANCY IS 300 OR MORE, OR WHERE THE GROUP A OCCUPANT LOAD IS MORE THAN 100 PERSONS ABOVE OR BELOW THE LOWEST LEVEL OF EXIT DISCHARGE. GROUP A OCCUPANCIES NOT SEPARATED FROM ONE ANOTHER IN ACCORDANCE WITH SECTION 707.3.10 SHALL BE CONSIDERED AS A SINGLE OCCUPANCY FOR THE PURPOSES OF APPLYING THIS SECTION. PORTIONS OF GROUP E OCCUPANCIES OCCUPIED FOR ASSEMBLY PURPOSES SHALL BE PROVIDED WITH A FIRE ALARM SYSTEM AS REQUIRED FOR THE GROUP E OCCUPANCY.

907.2.1.3 AUTOMATIC SMOKE DETECTION SYSTEM. A SMOKE DETECTION SYSTEM THAT ACTIVATES THE OCCUPANT NOTIFICATION SYSTEM IN ACCORDANCE WITH SECTION 907.5 SHALL BE INSTALLED IN GROUP A OCCUPANCIES UNLESS THE FIRE AREA IS PROTECTED WITH AN AUTOMATIC FIRE SPRINKLER SYSTEM, THAT ACTIVATES THE OCCUPANT NOTIFICATION SYSTEM, INSTALLED IN ACCORDANCE WITH SECTION 903.3.1.1.

907.2.6.3 GROUP I-3 OCCUPANCIES. GROUP I-3 OCCUPANCIES SHALL BE EQUIPPED WITH A MANUAL FIRE ALARM SYSTEM AND AUTOMATIC SMOKE DETECTION SYSTEM INSTALLED FOR ALERTING STAFF.

907.2.6.3.1 SYSTEM INITIATION. ACTUATION OF AN AUTOMATIC FIRE-EXTINGUISHING SYSTEM, AUTOMATIC SPRINKLER SYSTEM, A MANUAL FIRE ALARM BOX OR A FIRE DETECTOR SHALL INITIATE AN APPROVED FIRE ALARM SIGNAL THAT AUTOMATICALLY NOTIFIES STAFF.

907.2.6.3.2 MANUAL FIRE ALARM BOXES. MANUAL FIRE ALARM BOXES ARE NOT REQUIRED TO BE LOCATED IN ACCORDANCE WITH SECTION 907.4.2 WHERE THE FIRE ALARM BOXES ARE PROVIDED AT STAFF-ATTENDED LOCATIONS HAVING DIRECT SUPERVISION OVER AREAS WHERE MANUAL FIRE ALARM BOXES HAVE BEEN OMITTED.

907.2.6.3.2.1 MANUAL FIRE ALARM BOXES IN DETAINEE AREAS. MANUAL FIRE ALARM BOXES ARE ALLOWED TO BE LOCKED IN AREAS OCCUPIED BY DETAINEES, PROVIDED THAT STAFF MEMBERS ARE PRESENT WITHIN THE SUBJECT AREA AND HAVE KEYS READILY AVAILABLE TO OPERATE THE MANUAL FIRE ALARM BOXES.

IT IS A VIOLATION OF THE NEW YORK STATI EDUCATION LAW, ARTICLE 145 §7209 SPECIAL PROVISIONS. FOR ANY PERSON UNLESS THEY ARE ACTING UNDER THI DIRECTION OF A LICENSED PROFESSIONAL ENGINEER, ARCHITECT, LANDSCAPE ARCHITECT, OR LAND SURVEYOR, TO ALTER AN ITEM IN ANY WAY. IF AN ITEM BEARING THE STAMP OF A LICENSED PROFESSIONAL IS ALTERED, THE ALTERING PROFESSIONAL SHALL STAMP THE DOCUMENT AND INCLUDE THE NOTATION "ALTERED BY FOLLOWED BY THEIR SIGNATURE, THE DATE OF SUCH ALTERATION, AND A SPECIFIC

DESCRIPTION OF THE ALTERATION REVISIONS

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907.3.1 DUCT SMOKE DETECTORS. SMOKE DETECTORS INSTALLED IN DUCTS SHALL BE LISTED FOR THE AIR VELOCITY, TEMPERATURE AND HUMIDITY PRESENT IN THE DUCT. DUCT SMOKE DETECTORS SHALL BE CONNECTED TO THE BUILDING'S FIRE ALARM CONTROL UNIT WHERE A FIRE ALARM SYSTEM IS REQUIRED BY SECTION 907.2. ACTIVATION OF A DUCT SMOKE DETECTOR SHALL INITIATE A VISIBLE AND AUDIBLE SUPERVISORY SIGNAL AT A CONSTANTLY ATTENDED LOCATION AND SHALL PERFORM THE INTENDED FIRE SAFETY FUNCTION IN ACCORDANCE WITH THIS CODE AND THE MECHANICAL CODE OF NEW YORK STATE. IN FACILITIES THAT ARE REQUIRED TO BE MONITORED BY A SUPERVISING STATION, DUCT SMOKE DETECTORS SHALL REPORT ONLY AS A SUPERVISORY SIGNAL AND NOT AS A FIRE ALARM. THEY SHALL NOT BE USED AS A SUBSTITUTE FOR REQUIRED OPEN AREA DETECTION.

907.3.2 SPECIAL LOCKING SYSTEMS. WHERE SPECIAL LOCKING SYSTEMS ARE INSTALLED ON MEANS OF EGRESS DOORS IN ACCORDANCE WITH SECTIONS 1010.1.9.7 OR 1010.1.9.8, AN AUTOMATIC DETECTION SYSTEM SHALL BE INSTALLED AS REQUIRED BY THAT SECTION.

907.3.3 ELEVATOR EMERGENCY OPERATION. AUTOMATIC FIRE DETECTORS INSTALLED FOR ELEVATOR EMERGENCY OPERATION SHALL BE INSTALLED IN ACCORDANCE WITH THE PROVISIONS OF ASME A17.1/CSA B44 AND NFPA 72.

907.3.4 WIRING. THE WIRING TO THE AUXILIARY DEVICES AND EQUIPMENT USED TO ACCOMPLISH THE FIRE SAFETY FUNCTIONS SHALL BE MONITORED FOR INTEGRITY IN ACCORDANCE WITH NFPA 72.

907.4.1 PROTECTION OF FIRE ALARM CONTROL UNIT. IN AREAS THAT ARE NOT CONTINUOUSLY OCCUPIED, A SINGLE SMOKE DETECTOR SHALL BE PROVIDED AT THE LOCATION OF EACH FIRE ALARM CONTROL UNIT, NOTIFICATION APPLIANCE CIRCUIT POWER EXTENDERS, AND SUPERVISING STATION TRANSMITTING

907.4.2.1 LOCATION. MANUAL FIRE ALARM BOXES SHALL BE LOCATED NOT MORE THAN 5 FEET FROM THE ENTRANCE TO EACH EXIT. IN BUILDINGS NOT PROTECTED BY AN AUTOMATIC SPRINKLER SYSTEM IN ACCORDANCE WITH SECTION 903.3.1.1 OR 903.3.1.2, ADDITIONAL MANUAL FIRE ALARM BOXES SHALL BE LOCATED SO THAT THE DISTANCE OF TRAVEL TO THE NEAREST BOX DOES NOT EXCEED 200 FEET.

907.4.2.2 HEIGHT. THE HEIGHT OF THE MANUAL FIRE ALARM BOXES SHALL BE NOT LESS THAN 42 INCHES AND NOT MORE THAN 48 INCHES MEASURED VERTICALLY, FROM THE FLOOR LEVEL TO THE ACTIVATING HANDLE OR LEVER OF THE BOX.

907.4.3 AUTOMATIC SMOKE DETECTION. WHERE AN AUTOMATIC SMOKE DETECTION SYSTEM IS REQUIRED IT SHALL UTILIZE SMOKE DETECTORS UNLESS AMBIENT CONDITIONS PROHIBIT SUCH AN INSTALLATION. IN SPACES WHERE SMOKE DETECTORS CANNOT BE UTILIZED DUE TO AMBIENT CONDITIONS, APPROVED AUTOMATIC HEAT DETECTORS SHALL BE PERMITTED.

907.5 OCCUPANT NOTIFICATION SYSTEMS. A FIRE ALARM SYSTEM SHALL ANNUNCIATE AT THE FIRE ALARM CONTROL UNIT AND SHALL INITIATE OCCUPANT NOTIFICATION UPON ACTIVATION, IN ACCORDANCE WITH SECTIONS 907.5.1 THROUGH 907.5.2.3.3. WHERE A FIRE ALARM SYSTEM IS REQUIRED BY ANOTHER SECTION OF THIS CODE, IT SHALL BE ACTIVATED BY:

- 1. AUTOMATIC FIRE DETECTORS.
- 2. AUTOMATIC SPRINKLER SYSTEM WATERFLOW DEVICES.
- 3. MANUAL FIRE ALARM BOXES.

907.5.2.1 AUDIBLE ALARMS. AUDIBLE ALARM NOTIFICATION APPLIANCES SHALL BE PROVIDED AND EMIT A DISTINCTIVE SOUND THAT IS NOT TO BE USED FOR ANY PURPOSE OTHER THAN THAT OF A FIRE ALARM.

907.5.2.2 EMERGENCY VOICE/ALARM COMMUNICATION SYSTEMS. EMERGENCY VOICE/ALARM COMMUNICATION SYSTEMS REQUIRED BY THIS CODE SHALL BE DESIGNED AND INSTALLED IN ACCORDANCE WITH NFPA 72. THE OPERATION OF ANY AUTOMATIC FIRE DETECTOR, SPRINKLER WATERFLOW DEVICE OR MANUAL FIRE ALARM BOX SHALL AUTOMATICALLY SOUND AN ALERT TONE FOLLOWED BY VOICE INSTRUCTIONS GIVING APPROVED INFORMATION AND DIRECTIONS FOR A GENERAL OR STAGED EVACUATION IN ACCORDANCE WITH THE BUILDING'S FIRE SAFETY AND EVACUATION PLANS REQUIRED BY SECTION 404 OF THE FIRE CODE OF NEW YORK STATE. IN HIGH-RISE BUILDINGS, THE SYSTEM SHALL OPERATE ON AT LEAST THE ALARMING FLOOR, THE FLOOR ABOVE AND THE FLOOR BELOW. SPEAKERS SHALL BE PROVIDED THROUGHOUT

- THE BUILDING BY PAGING ZONES. AT A MINIMUM, PAGING ZONES SHALL BE PROVIDED AS FOLLOWS: 1. ELEVATOR GROUPS.
- 2. INTERIOR EXIT STAIRWAYS.
- EACH FLOOR.
- 4. AREAS OF REFUGE AS DEFINED IN CHAPTER 2.

907.5.2.2.5 EMERGENCY POWER. EMERGENCY VOICE/ALARM COMMUNICATIONS SYSTEMS SHALL BE PROVIDED WITH EMERGENCY POWER IN ACCORDANCE WITH SECTION 2702. THE SYSTEM SHALL BE CAPABLE OF POWERING THE REQUIRED LOAD FOR A DURATION OF NOT LESS THAN 24 HOURS, AS REQUIRED IN NFPA 72.

907.5.2.3.1 PUBLIC USE AREAS AND COMMON USE AREAS. VISIBLE ALARM NOTIFICATION APPLIANCES SHALL BE PROVIDED IN PUBLIC USE AREAS AND COMMON USE AREAS.

907.6.1 WIRING. WIRING SHALL COMPLY WITH THE REQUIREMENTS OF NFPA 70 AND NFPA 72. WIRELESS PROTECTION SYSTEMS UTILIZING RADIO-FREQUENCY TRANSMITTING DEVICES SHALL COMPLY WITH THE SPECIAL REQUIREMENTS FOR SUPERVISION OF LOW-POWER WIRELESS SYSTEMS IN NFPA 72.

907.6.2 POWER SUPPLY. THE PRIMARY AND SECONDARY POWER SUPPLY FOR THE FIRE ALARM SYSTEM SHALL BE PROVIDED IN ACCORDANCE WITH NFPA 72.

907.6.3 INITIATING DEVICE IDENTIFICATION. THE FIRE ALARM SYSTEM SHALL IDENTIFY THE SPECIFIC INITIATING DEVICE ADDRESS, LOCATION, DEVICE TYPE, FLOOR LEVEL WHERE APPLICABLE AND STATUS INCLUDING INDICATION OF NORMAL, ALARM, TROUBLE AND SUPERVISORY STATUS, AS APPROPRIATE.

907.6.3.1 ANNUNCIATION. THE INITIATING DEVICE STATUS SHALL BE ANNUNCIATED AT AN APPROVED ON-SITE

907.6.4 ZONES. EACH FLOOR SHALL BE ZONED SEPARATELY AND A ZONE SHALL NOT EXCEED 22,500 SQUARE FEET. THE LENGTH OF ANY ZONE SHALL NOT EXCEED 300 FEET IN ANY DIRECTION.

907.6.4.1 ZONING INDICATOR PANEL. A ZONING INDICATOR PANEL AND THE ASSOCIATED CONTROLS SHALL BE PROVIDED IN AN APPROVED LOCATION. THE VISUAL ZONE INDICATION SHALL LOCK IN UNTIL THE SYSTEM IS RESET AND SHALL NOT BE CANCELED BY THE OPERATION OF AN AUDIBLE-ALARM SILENCING SWITCH.

907.6.5 ACCESS. ACCESS SHALL BE PROVIDED TO EACH FIRE ALARM DEVICE AND NOTIFICATION APPLIANCE FOR PERIODIC INSPECTION, MAINTENANCE AND TESTING.

907.6.6 MONITORING. FIRE ALARM SYSTEMS REQUIRED BY THIS CHAPTER OR BY THE FIRE CODE OF NEW YORK STATE SHALL BE MONITORED BY AN APPROVED SUPERVISING STATION IN ACCORDANCE WITH NFPA 72.

907.6.6.1 AUTOMATIC TELEPHONE-DIALING DEVICES. AUTOMATIC TELEPHONE-DIALING DEVICES USED TO TRANSMIT AN EMERGENCY ALARM SHALL NOT BE CONNECTED TO ANY FIRE DEPARTMENT TELEPHONE NUMBER UNLESS APPROVED BY THE FIRE CHIEF.

907.6.6.2 TERMINATION OF MONITORING SERVICE. TERMINATION OF FIRE ALARM MONITORING SERVICES SHALL BE IN ACCORDANCE WITH SECTION 901.9 OF THE FIRE CODE OF NEW YORK STATE.

907.7 ACCEPTANCE TESTS AND COMPLETION. UPON COMPLETION OF THE INSTALLATION, THE FIRE ALARM SYSTEM AND ALL FIRE ALARM COMPONENTS SHALL BE TESTED IN ACCORDANCE WITH NFPA 72.

907.8 INSPECTION, TESTING AND MAINTENANCE. THE MAINTENANCE AND TESTING SCHEDULES AND PROCEDURES FOR FIRE ALARM AND FIRE DETECTION SYSTEMS SHALL BE IN ACCORDANCE WITH SECTION 907.8 OF THE FIRE CODE OF NEW YORK STATE AND NFPA 72.

912.2 LOCATION. WITH RESPECT TO HYDRANTS, DRIVEWAYS, BUILDINGS AND LANDSCAPING, FIRE DEPARTMENT CONNECTIONS SHALL BE SO LOCATED THAT FIRE APPARATUS AND HOSE CONNECTED TO SUPPLY THE SYSTEM WILL NOT OBSTRUCT ACCESS TO THE BUILDINGS FOR OTHER FIRE APPARATUS. THE LOCATION OF FIRE DEPARTMENT CONNECTIONS SHALL BE APPROVED BY THE FIRE CODE OFFICIAL.

912.2.2 EXISTING BUILDINGS. ON EXISTING BUILDINGS, WHEREVER THE FIRE DEPARTMENT CONNECTION IS NOT VISIBLE TO APPROACHING FIRE APPARATUS, THE FIRE DEPARTMENT CONNECTION SHALL BE INDICATED BY AN APPROVED SIGN MOUNTED ON THE STREET FRONT OR ON THE SIDE OF THE BUILDING. SUCH SIGN SHALL HAVE THE LETTERS "FDC" NOT LESS THAN 6 INCHES HIGH AND WORDS IN LETTERS NOT LESS THAN 2 INCHES HIGH OR AN ARROW TO INDICATE THE LOCATION. SUCH SIGNS SHALL BE SUBJECT TO THE APPROVAL OF THE FIRE CODE OFFICIAL.

912.3 FIRE HOSE THREADS. FIRE HOSE THREADS USED IN CONNECTION WITH STANDPIPE SYSTEMS SHALL BE APPROVED AND SHALL BE COMPATIBLE WITH FIRE DEPARTMENT HOSE THREADS.

912.4 ACCESS. IMMEDIATE ACCESS TO FIRE DEPARTMENT CONNECTIONS SHALL BE MAINTAINED AT ALL TIMES AND WITHOUT OBSTRUCTION BY FENCES, BUSHES, TREES, WALLS OR ANY OTHER FIXED OR MOVEABLE OBJECT. ACCESS TO FIRE DEPARTMENT CONNECTIONS SHALL BE APPROVED BY THE FIRE CODE OFFICIAL.

912.5 SIGNS. A METAL SIGN WITH RAISED LETTERS NOT LESS THAN 1 INCH IN SIZE SHALL BE MOUNTED ON ALL FIRE DEPARTMENT CONNECTIONS SERVING AUTOMATIC SPRINKLERS, STANDPIPES OR FIRE PUMP CONNECTIONS. SUCH SIGNS SHALL READ: AUTOMATIC SPRINKLERS OR STANDPIPES OR TEST CONNECTION OR A COMBINATION THEREOF AS APPLICABLE. WHERE THE FIRE DEPARTMENT CONNECTION DOES NOT SERVE THE ENTIRE BUILDING, A SIGN SHALL BE PROVIDED INDICATING THE PORTIONS OF THE BUILDING SERVED.

912.6 BACKFLOW PROTECTION. THE POTABLE WATER SUPPLY TO AUTOMATIC SPRINKLER AND STANDPIPE SYSTEMS SHALL BE PROTECTED AGAINST BACKFLOW AS REQUIRED BY THE PLUMBING CODE OF NEW YORK STATE.

914.2 EQUIPMENT ROOM IDENTIFICATION. FIRE PROTECTION EQUIPMENT SHALL BE IDENTIFIED IN AN APPROVED MANNER. ROOMS CONTAINING CONTROLS FOR AIR-CONDITIONING SYSTEMS, SPRINKLER RISERS AND VALVES OR OTHER FIRE DETECTION, SUPPRESSION OR CONTROL ELEMENTS SHALL BE IDENTIFIED FOR THE USE OF THE FIRE DEPARTMENT. APPROVED SIGNS REQUIRED TO IDENTIFY FIRE PROTECTION EQUIPMENT AND EQUIPMENT LOCATION SHALL BE CONSTRUCTED OF DURABLE MATERIALS, PERMANENTLY INSTALLED AND READILY VISIBLE.

915.1 GENERAL. CARBON MONOXIDE ALARMS AND CARBON MONOXIDE DETECTION SHALL BE INSTALLED IN NEW AND EXISTING BUILDINGS IN ACCORDANCE WITH SECTION 915 OF THE FIRE CODE OF NEW YORK STATE.

BC NYS CHAPTER 10 - MEANS OF EGRESS

1003.2 CEILING HEIGHT. THE MEANS OF EGRESS SHALL HAVE A CEILING HEIGHT OF NOT LESS THAN 7 FEET 6 INCHES ABOVE THE

1004.1 DESIGN OCCUPANT LOAD. IN DETERMINING MEANS OF EGRESS REQUIREMENTS, THE NUMBER OF OCCUPANTS FOR WHOM MEANS OF EGRESS FACILITIES ARE PROVIDED SHALL BE DETERMINED IN ACCORDANCE WITH THIS SECTION.

OCCUPANT LOAD CALCULATIONS

TOTAL BUILDING OCCUPANCY

<u>FIRST FLOOR</u>		
A-3 OCCUPANCY	= (800 NET SF/40 SF/OCCUPANT) + 56 OCCUPANTS (FIXED SEATING)	= 76 OCCUPANT
B OCCUPANCY	= 5,390 GROSS SF/150 SF/OCCUPANT	= 36 OCCUPANT
I-3 OCCUPANCY	= 20 SF/OCCUPANT IN HOLDING FACILITIES (MCKINNEY)	= 17 OCCUPANT
SECOND FLOOR		

B OCCUPANCY = 28 OCCUPANTS = 4,116 GROSS SF/150 SF/OCCUPANT

= (372 NET SF/40 SF/OCCUPANT) + 27 OCCUPANTS (FIXED SEATING)

1005.3.1 STAIRWAYS. THE CAPACITY, IN INCHES, OF MEANS OF EGRESS STAIRWAYS SHALL BE CALCULATED BY MULTIPLYING THE OCCUPANT LOAD SERVED BY SUCH STAIRWAYS BY A MEANS OF EGRESS CAPACITY FACTOR OF 0.3 INCH PER OCCUPANT. WHERE STAIRWAYS SERVE MORE THAN ONE STORY, ONLY THE OCCUPANT LOAD OF EACH STORY CONSIDERED INDIVIDUALLY SHALL BE USED IN CALCULATING THE REQUIRED CAPACITY OF THE STAIRWAYS SERVING THAT STORY.

EXCEPTIONS:

A-3 OCCUPANCY

FOR OTHER THAN GROUP H AND I-2 OCCUPANCIES, THE CAPACITY, IN INCHES, OF MEANS OF EGRESS STAIRWAYS SHALL BE CALCULATED BY MULTIPLYING THE OCCUPANT LOAD SERVED BY SUCH STAIRWAYS BY A MEANS OF EGRESS CAPACITY FACTOR OF 0.2 INCH PER OCCUPANT IN BUILDINGS EQUIPPED THROUGHOUT WITH AN AUTOMATIC SPRINKLER SYSTEM INSTALLED IN ACCORDANCE WITH SECTION 903.3.1.1 OR 903.3.1.2 AND AN EMERGENCY VOICE/ALARM COMMUNICATION SYSTEM IN ACCORDANCE WITH SECTION 907.5.2.2.

1005.3.2 OTHER EGRESS COMPONENTS. THE CAPACITY, IN INCHES, OF MEANS OF EGRESS COMPONENTS OTHER THAN STAIRWAYS SHALL BE CALCULATED BY MULTIPLYING THE OCCUPANT LOAD SERVED BY SUCH COMPONENT BY A MEANS OF EGRESS CAPACITY FACTOR OF 0.2 INCH PER OCCUPANT.

FOR OTHER THAN GROUP H AND I-2 OCCUPANCIES, THE CAPACITY, IN INCHES, OF MEANS OF EGRESS COMPONENTS OTHER THAN STAIRWAYS SHALL BE CALCULATED BY MULTIPLYING THE OCCUPANT LOAD SERVED BY SUCH COMPONENT BY A MEANS OF EGRESS CAPACITY FACTOR OF 0.15 INCH PER OCCUPANT IN BUILDINGS EQUIPPED THROUGHOUT WITH AN AUTOMATIC SPRINKLER SYSTEM INSTALLED IN ACCORDANCE WITH SECTION 903.3.1.1 OR 903.3.1.2 AND AN EMERGENCY VOICE/ALARM COMMUNICATION SYSTEM IN ACCORDANCE WITH SECTION 907.5.2.2.

TABLE 1006.2.1 SPACES WITH ONE EXIT OR EXIT ACCESS DOORWAY

A - MAX. OCCUPANT LOAD OF 49 - MAX. COMMON PATH OF EGRESS TRAVEL DISTANCE - 75 FEET B - MAX OCCUPANT LOAD OF 49 - MAX. COMMON PATH OF EGRESS TRAVEL DISTANCE - 100 FEET I-3 - MAX OCCUPANT LOAD OF 10 - MAX. COMMON PATH OF EGRESS TRAVEL DISTANCE - 100 FEET

TABLE 1006.3.2 MINIMUM NUMBER OF EXITS OR ACCESS TO EXITS PER STORY 1-500 OCCUPANTS - 2 EXITS OR ACCESS TO EXITS FROM STORY

1008.2 ILLUMINATION REQUIRED: THE MEANS OF EGRESS SERVING A ROOM OR SPACE SHALL BE ILLUMINATED AT ALL TIMES THAT THE ROOM OR SPACE IS OCCUPIED.

1008.3.1 GENERAL. IN THE EVENT OF POWER SUPPLY FAILURE IN ROOMS AND SPACES THAT REQUIRE TWO OR MORE MEANS OF EGRESS, AN EMERGENCY ELECTRICAL SYSTEM SHALL AUTOMATICALLY ILLUMINATE ALL OF THE FOLLOWING AREAS: AISLES.

2. CORRIDORS. 3. EXIT ACCESS STAIRWAYS AND RAMPS.

1008.3.2 BUILDINGS. IN THE EVENT OF POWER SUPPLY FAILURE IN BUILDINGS THAT REQUIRE TWO OR MORE MEANS OF EGRESS, AN EMERGENCY ELECTRICAL SYSTEM SHALL AUTOMATICALLY ILLUMINATE ALL OF THE FOLLOWING AREAS: 1. INTERIOR EXIT ACCESS STAIRWAYS AND RAMPS.

2. INTERIOR AND EXTERIOR EXIT STAIRWAYS AND RAMPS.

3. EXIT PASSAGEWAYS.

4. VESTIBULES AND AREAS ON THE LEVEL OF DISCHARGE USED FOR EXIT DISCHARGE IN ACCORDANCE WITH SECTION 1028.1. 5. EXTERIOR LANDINGS AS REQUIRED BY SECTION 1010.1.6 FOR EXIT DOORWAYS THAT LEAD DIRECTLY TO THE EXIT DISCHARGE. 1008.3.3 ROOMS AND SPACES. IN THE EVENT OF POWER SUPPLY FAILURE, AN EMERGENCY ELECTRICAL

SYSTEM SHALL AUTOMATICALLY ILLUMINATE ALL OF THE FOLLOWING AREAS:

1. ELECTRICAL EQUIPMENT ROOMS.

2. FIRE COMMAND CENTERS.

3. FIRE PUMP ROOMS.

4. GENERATOR ROOMS.

5. PUBLIC RESTROOMS WITH AN AREA GREATER THAN 300 SQUARE FEET.

1008.3.5 ILLUMINATION LEVEL UNDER EMERGENCY POWER: EMERGENCY LIGHTING FACILITIES SHALL BE ARRANGED TO PROVIDE INITIAL ILLUMINATION THAT IS NOT LESS THAN AN AVERAGE OF 1 FOOTCANDLE AND A MINIMUM AT ANY POINT OF 0.1 FOOTCANDLE MEASURED ALONG THE PATH OF EGRESS AT FLOOR LEVEL. ILLUMINATION LEVELS SHALL BE PERMITTED TO DECLINE TO 0.6 FOOTCANDLE AVERAGE AND A MINIMUM AT ANY POINT OF 0.06 FOOTCANDLE AT THE END OF THE EMERGENCY LIGHTING TIME DURATION. A MAXIMUM-TO-MINIMUM ILLUMINATION UNIFORMITY RATIO OF 40 TO 1 SHALL NOT BE EXCEEDED. IN GROUP I-2 OCCUPANCIES, FAILURE OF A SINGLE LAMP IN A LUMINAIRE SHALL NOT REDUCE THE ILLUMINATION LEVEL TO LESS THAN 0.2 FOOTCANDLE.

1012.2 SLOPE. RAMPS USED AS PART OF A MEANS OF EGRESS SHALL HAVE A RUNNING SLOPE NOT STEEPER THAN ONE UNIT VERTICAL IN 12 UNITS HORIZONTAL (8-PERCENT SLOPE). THE SLOPE OF OTHER PEDESTRIAN RAMPS SHALL NOT BE STEEPER THAN ONE UNIT VERTICAL IN EIGHT UNITS HORIZONTAL (12.5-PERCENT SLOPE).

1012.5.1 WIDTH AND CAPACITY. THE MINIMUM WIDTH AND REQUIRED CAPACITY OF A MEANS OF EGRESS RAMP SHALL BE NOT LESS THAN THAT REQUIRED FOR CORRIDORS BY SECTION 1020.2. THE CLEAR WIDTH OF A RAMP BETWEEN HANDRAILS, IF PROVIDED, OR OTHER PERMISSIBLE PROJECTIONS SHALL BE 36 INCHES

1012.6.2 WIDTH. THE LANDING WIDTH SHALL BE NOT LESS THAN THE WIDTH OF THE WIDEST RAMP RUN ADJOINING THE LANDING.

1012.6.3 LENGTH. THE LANDING LENGTH SHALL BE 60 INCHES MINIMUM.

1012.6.4 CHANGE IN DIRECTION. WHERE CHANGES IN DIRECTION OF TRAVEL OCCUR AT LANDINGS PROVIDED BETWEEN RAMP RUNS, THE LANDING SHALL BE 60 INCHES BY 60 INCHES MINIMUM.

1012.6.5 DOORWAYS. WHERE DOORWAYS ARE LOCATED ADJACENT TO A RAMP LANDING, MANEUVERING CLEARANCES REQUIRED BY ICC A117.1 ARE PERMITTED TO OVERLAP THE REQUIRED LANDING AREA.

1012.8 HANDRAILS. RAMPS WITH A RISE GREATER THAN 6 INCHES (152 MM) SHALL HAVE HANDRAILS ON BOTH SIDES. HANDRAILS SHALL COMPLY WITH SECTION 1014.

1013.1 WHERE REQUIRED: EXITS AND EXIT ACCESS DOORS SHALL BE MARKED BY AN APPROVED EXIT SIGN READILY VISIBLE FROM ANY DIRECTION OF EGRESS TRAVEL. THE PATH OF EGRESS TRAVEL TO EXITS AND WITHIN EXITS SHALL BE MARKED BY READILY VISIBLE EXIT SIGNS TO CLEARLY INDICATE THE DIRECTION OF EGRESS TRAVEL IN CASES WHERE THE EXIT OR THE PATH OF EGRESS TRAVEL IS NOT IMMEDIATELY VISIBLE TO THE OCCUPANTS. INTERVENING MEANS OF EGRESS DOORS WITHIN EXITS SHALL BE MARKED BY EXIT SIGNS. EXIT SIGN PLACEMENT SHALL BE SUCH THAT ANY POINT IN AN EXIT ACCESS CORRIDOR OR EXIT PASSAGEWAY IS WITHIN 100 FEET OR THE LISTED VIEWING DISTANCE OF THE SIGN, WHICHEVER IS LESS, FROM THE NEAREST VISIBLE EXIT SIGN.

1013.6.3 POWER SOURCE: EXIT SIGNS SHALL BE ILLUMINATED AT ALL TIMES. TO ENSURE CONTINUED ILLUMINATION FOR A DURATION OF NOT LESS THAN 90 MINUTES IN CASE OF PRIMARY POWER LOSS, THE SIGN ILLUMINATION MEANS SHALL BE CONNECTED TO TO AN EMERGENCY POWER SYSTEM PROVIDED FROM STORAGE BATTERIES, UNIT EQUIPMENT OR AN ON-SITE GENERATOR. THE INSTALLATION OF THE EMERGENCY POWER SYSTEM SHALL BE IN ACCORDANCE WITH CHAPTER 27. GROUP I-2, CONDITION 2 EXIT SIGN ILLUMINATION SHALL NOT BE PROVIDED BY UNIT EQUIPMENT BATTERIES ONLY.

1014.2 HEIGHT. HANDRAIL HEIGHT, MEASURED ABOVE STAIR TREAD NOSINGS, OR FINISH SURFACE OF RAMP SLOPE, SHALL BE UNIFORM, NOT LESS THAN 34 INCHES AND NOT MORE THAN 38 INCHES. HANDRAIL HEIGHT OF ALTERNATING TREAD DEVICES AND SHIP'S LADDERS, MEASURED ABOVE TREAD NOSINGS, SHALL BE UNIFORM, NOT LESS THAN 30 INCHES AND NOT MORE THAN 34 INCHES.

1014.6 HANDRAIL EXTENSIONS. HANDRAILS SHALL RETURN TO A WALL, GUARD OR THE WALKING SURFACE OR SHALL BE CONTINUOUS TO THE HANDRAIL OF AN ADJACENT FLIGHT OF STAIRS OR RAMP RUN. WHERE HANDRAILS ARE NOT CONTINUOUS BETWEEN FLIGHTS, THE HANDRAILS SHALL EXTEND HORIZONTALLY NOT LESS THAN 12 INCHES BEYOND THE TOP RISER AND CONTINUE TO SLOPE FOR THE DEPTH OF ONE TREAD BEYOND THE BOTTOM RISER. AT RAMPS WHERE HANDRAILS ARE NOT CONTINUOUS BETWEEN RUNS, THE HANDRAILS SHALL EXTEND HORIZONTALLY ABOVE THE LANDING 12 INCHES MINIMUM BEYOND THE TOP AND BOTTOM OF RAMP RUNS. THE EXTENSIONS OF HANDRAILS SHALL BE IN THE SAME DIRECTION OF THE FLIGHTS OF STAIRS AT STAIRWAYS AND THE RAMP RUNS AT RAMPS.

TABLE 1017.2 EXIT ACCESS TRAVEL DISTANCE

A - WITH SPRINKLER SYSTEM - 250 FEET B - WITH SPRINKLER SYSTEM - 300 FEET

= 37 OCCUPANTS

=194 OCCUPANTS

I-3 - WITH SPRINKLER SYSTEM - 200 FEET

BC NYS CHAPTER 11 - ACCESSIBILITY

1108.2.2 WHEELCHAIR SPACES. IN ROOMS AND SPACES USED FOR ASSEMBLY PURPOSES WITH FIXED SEATING, ACCESSIBLE WHEELCHAIR SPACES SHALL BE PROVIDED IN ACCORDANCE WITH SECTIONS 1108.2.2.1 THROUGH

TABLE 1108.2.2.1 ACCESSIBLE WHEELCHAIR SPACES 4 TO 25 CAPACITY OF SEATING - 1 WHEELCHAIR SPACE REQUIRED

26 TO 50 CAPACITY OF SEATING - 2 WHEELCHAIR SPACES REQUIRED

1108.2.3 COMPANION SEATS. AT LEAST ONE COMPANION SEAT SHALL BE PROVIDED FOR EACH WHEELCHAIR SPACE REQUIRED BY SECTIONS 1108.2.2.1 THROUGH 1108.2.2.3.

1108.2.7.1 RECEIVERS. THE NUMBER AND TYPE OF RECEIVERS SHALL BE PROVIDED FOR ASSISTIVE LISTENING SYSTEMS IN ACCORDANCE WITH TABLE 1108.2.7.1.

TABLE 1108.2.7.1 RECEIVERS FOR ASSISTIVE LISTENING SYSTEMS

50 OR LESS CAPACITY OF SEATING - 2 RECEIVERS MIN - 2 RECEIVERS TO BE HEARING-AID COMPATIBLE MIN 51 TO 200 CAPACITY OF SEATING - 3 RECEIVERS MIN - 2 RECEIVERS TO BE HEARING-AID COMPATIBLE MIN

1108.4.1.1 JURY BOX. A WHEELCHAIR SPACE SHALL BE PROVIDED WITHIN THE JURY BOX.

1108.4.1.2 GALLERY SEATING. WHEELCHAIR SPACES SHALL BE PROVIDED IN ACCORDANCE WITH TABLE 1108.2.2.1. DESIGNATED AISLE SEATS SHALL BE PROVIDED IN ACCORDANCE WITH SECTION 1108.2.5.

1108.4.1.3 ASSISTIVE LISTENING SYSTEMS. AN ASSISTIVE LISTENING SYSTEM MUST BE PROVIDED. RECEIVERS SHALL BE PROVIDED FOR THE ASSISTIVE LISTENING SYSTEM IN ACCORDANCE WITH SECTION 1108.2.7.1.

1108.4.1.4 EMPLOYEE WORK STATIONS. THE JUDGE'S BENCH, CLERK'S STATION, BAILIFF'S STATION, DEPUTY CLERK'S STATION AND COURT REPORTER'S STATION SHALL BE LOCATED ON AN ACCESSIBLE ROUTE. THE VERTICAL ACCESS TO ELEVATED EMPLOYEE WORK STATIONS WITHIN A COURTROOM IS NOT REQUIRED AT THE TIME OF INITIAL CONSTRUCTION, PROVIDED A RAMP, LIFT OR ELEVATOR CAN BE INSTALLED WITHOUT REQUIRING RECONFIGURATION OR EXTENSION OF THE COURTROOM OR EXTENSION OF THE ELECTRICAL SYSTEM.

1108.4.1.5 OTHER WORK STATIONS. THE LITIGANT'S AND COUNSEL STATIONS, INCLUDING THE LECTERN, SHALL

1108.4.2.1 CENTRAL HOLDING CELLS. WHERE SEPARATE CENTRAL HOLDING CELLS ARE PROVIDED FOR ADULT MALES, JUVENILE MALES, ADULT FEMALES OR JUVENILE FEMALES, ONE OF EACH TYPE SHALL BE ACCESSIBLE. WHERE CENTRAL HOLDING CELLS ARE PROVIDED AND ARE NOT SEPARATED BY AGE OR SEX, AT LEAST ONE ACCESSIBLE CELL SHALL BE PROVIDED.

1109.2 TOILET AND BATHING FACILITIES. EACH TOILET ROOM AND BATHING ROOM SHALL BE ACCESSIBLE. WHERE A FLOOR LEVEL IS NOT REQUIRED TO BE CONNECTED BY AN ACCESSIBLE ROUTE, THE ONLY TOILET ROOMS OR BATHING ROOMS PROVIDED WITHIN THE FACILITY SHALL NOT BE LOCATED ON THE INACCESSIBLE FLOOR. EXCEPT AS PROVIDED FOR IN SECTIONS 1109.2.2 AND 1109.2.3, AT LEAST ONE OF EACH TYPE OF FIXTURE, ELEMENT, CONTROL OR DISPENSER IN EACH ACCESSIBLE TOILET ROOM AND BATHING ROOM SHALL BE ACCESSIBLE.

1109.5.1 MINIMUM NUMBER. NOT FEWER THAN TWO DRINKING FOUNTAINS SHALL BE PROVIDED. ONE DRINKING FOUNTAIN SHALL COMPLY WITH THE REQUIREMENTS FOR PEOPLE WHO USE A WHEELCHAIR AND ONE DRINKING FOUNTAIN SHALL COMPLY WITH THE REQUIREMENTS FOR STANDING PERSONS.

1111.1 SIGNS. REQUIRED ACCESSIBLE ELEMENTS SHALL BE IDENTIFIED BY THE INTERNATIONAL SYMBOL OF ACCESSIBILITY AT THE FOLLOWING LOCATIONS.

1. ACCESSIBLE PARKING SPACES REQUIRED BY SECTION 1106.1.

3. ACCESSIBLE PASSENGER LOADING ZONES.

5. ACCESSIBLE ENTRANCES WHERE NOT ALL ENTRANCES ARE ACCESSIBLE.

BC NYS CHAPTER 12 - INTERIOR ENVIRONMENT

1202.1 GENERAL: BUILDINGS SHALL BE PROVIDED WITH NATURAL VENTILATION IN ACCORDANCE WITH SECTION 1202.5 OR MECHANICAL VENTILATION IN ACCORDANCE WITH THE MECHANICAL CODE OF NEW YORK STATE.

1203.1 EQUIPMENT AND SYSTEMS. INTERIOR SPACES INTENDED FOR HUMAN OCCUPANCY SHALL BE PROVIDED WITH ACTIVE OR PASSIVE SPACE HEATING SYSTEMS CAPABLE OF MAINTAINING AN INDOOR TEMPERATURE OF NOT LESS THAN 68°F AT A POINT 3 FEET ABOVE THE FLOOR ON THE DESIGN HEATING DAY.

1204.1 GENERAL. EVERY SPACE INTENDED FOR HUMAN OCCUPANCY SHALL BE PROVIDED WITH NATURAL LIGHT BY MEANS OF EXTERIOR GLAZED OPENINGS IN ACCORDANCE WITH SECTION 1204.2 OR SHALL BE PROVIDED WITH ARTIFICIAL LIGHT IN ACCORDANCE WITH SECTION 1204.3. EXTERIOR GLAZED OPENINGS SHALL OPEN DIRECTLY ONTO A PUBLIC WAY OR ONTO A YARD OR COURT IN ACCORDANCE WITH SECTION 1205.

1204.3 ARTIFICIAL LIGHT. ARTIFICIAL LIGHT SHALL BE PROVIDED THAT IS ADEQUATE TO PROVIDE AN AVERAGE ILLUMINATION OF 10 FOOTCANDLES OVER THE AREA OF THE ROOM AT A HEIGHT OF 30 INCHES ABOVE THE FLOOR LEVEL.

1204.4 STAIRWAY ILLUMINATION. STAIRWAYS WITHIN DWELLING UNITS AND EXTERIOR STAIRWAYS SERVING A DWELLING UNIT SHALL HAVE AN ILLUMINATION LEVEL ON TREAD RUNS OF NOT LESS THAN 1 FOOTCANDLE. STAIRWAYS IN OTHER OCCUPANCIES SHALL BE GOVERNED BY CHAPTER 10.

1204.4.1 CONTROLS. THE CONTROL FOR ACTIVATION OF THE REQUIRED STAIRWAY LIGHTING SHALL BE IN ACCORDANCE WITH NFPA 70.

1207.1 MINIMUM ROOM WIDTHS: HABITABLE SPACES, OTHER THAN A KITCHEN, SHALL BE NOT LESS THAN 7 FEET IN ANY PLAN DIMENSION. KITCHENS SHALL HAVE A CLEAR PASSAGEWAY OF NOT LESS THAN 3 FEET BETWEEN COUNTER FRONTS AND APPLIANCES OR COUNTER FRONTS AND WALLS.

1207.2 MINIMUM CEILING HEIGHTS: OCCUPIED SPACES, HABITABLE SPACES AND CORRIDORS SHALL HAVE A CEILING HEIGHT OF NOT LESS THAN 7 FEET 6 INCHES ABOVE THE FINISHED FLOOR. BATHROOMS, TOILET ROOMS, KITCHENS, STORAGE ROOMS AND LAUNDRY ROOMS SHALL HAVE A CEILING HEIGHT OF NOT LESS THAN 7 FEET ABOVE THE FINISHED FLOOR.

1207.3 ROOM AREA: EVERY DWELLING UNIT SHALL HAVE NOT LESS THAN ONE ROOM THAT SHALL HAVE NOT LESS THAN 120 SQUARE FEET OF NET FLOOR AREA. OTHER HABITABLE ROOMS SHALL HAVE A NET FLOOR AREA OF NOT LESS THAN 70 SQUARE FEET.

1209.2.1 FLOORS AND WALL BASES. IN OTHER THAN DWELLING UNITS, TOILET, BATHING AND SHOWER ROOM FLOOR FINISH MATERIALS SHALL HAVE A SMOOTH, HARD, NONABSORBENT SURFACE. THE INTERSECTIONS OF SUCH FLOORS WITH WALLS SHALL HAVE A SMOOTH, HARD, NONABSORBENT VERTICAL BASE THAT EXTENDS UPWARD ONTO THE WALLS NOT LESS THAN 4 INCHES.

<u>1209.2.2 WALLS AND PARTITIONS.</u> WALLS AND PARTITIONS WITHIN 2 FEET OF SERVICE SINKS, URINALS AND WATER CLOSETS SHALL HAVE A SMOOTH, HARD, NONABSORBENT SURFACE, TO A HEIGHT OF NOT LESS THAN 4 FEET ABOVE THE FLOOR, AND EXCEPT FOR STRUCTURAL ELEMENTS, THE MATERIALS USED IN SUCH WALLS SHALL BE OF A TYPE THAT IS NOT ADVERSELY AFFECTED BY MOISTURE.

NYS ENERGY CONSERVATION CONSTRUCTION CODE (ECCC) REVIEW SUMMARY

1. GENERAL REQUIREMENTS

TABLE C301.1 NEW YORK STATE CLIMATE ZONES BY COUNTY ZONE 5A - ORANGE COUNTY

TABLE C303.1.3(1) DEFAULT GLAZED WINDOW, GLASS DOOR AND SKYLIGHT U-FACTORS METAL FRAME TYPE WITH THERMAL BREAK - DOUBLE - 0.65 NONMETAL OR METAL CLAD FRAME - DOUBLE - 0.55

TABLE C303.1.3(2) DEFAULT OPAQUE DOOR U-FACTORS INSULATED METAL (OTHER) DOOR - 0.60 INSULATED, NONMETAL EDGE, MAX 45% GLAZING - 0.35

TABLE C303.1.3(3) DEFAULT GLAZED FENESTRATION SHGC AND VT SHGC - DOUBLE GLAZED - 0.7

2. COMMERCIAL ENERGY EFFICIENCY

VT - DOUBLE GLAZED - 0.6

TABLE C402.1.3 OPAQUE THERMAL ENVELOPE INSULATION COMPONENT MINIMUM REQUIREMENTS, R-

VALUE METHOD ROOFS - INSULATION ENTIRELY ABOVE ROOF DECK - R-30.0 CI WALLS ABOVE GRADE - MASS - 11.4 CI WALLS ABOVE GRADE - METAL FRAMED - R-13 + R-7.5 CI FLOORS - MASS - R-10 CI SLAB ON GRADE FLOORS - UNHEATED SLABS - R-10.0 FOR 24" BELOW OPAQUE DOORS - NONSWINGING - R-4.75

TABLE C402.1.4 OPAQUE THERMAL ENVELOPE ASSEMBLY MAXIMUM REQUIREMENTS, U-FACTOR METHOD OPAQUE DOORS - SWINGING DOOR - U-0.37

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DESCRIPTION OF THE ALTERATION REVISIONS




AUGUST, 2024

AS SHOWN

Sheet Number

Project Number

1753.008.001

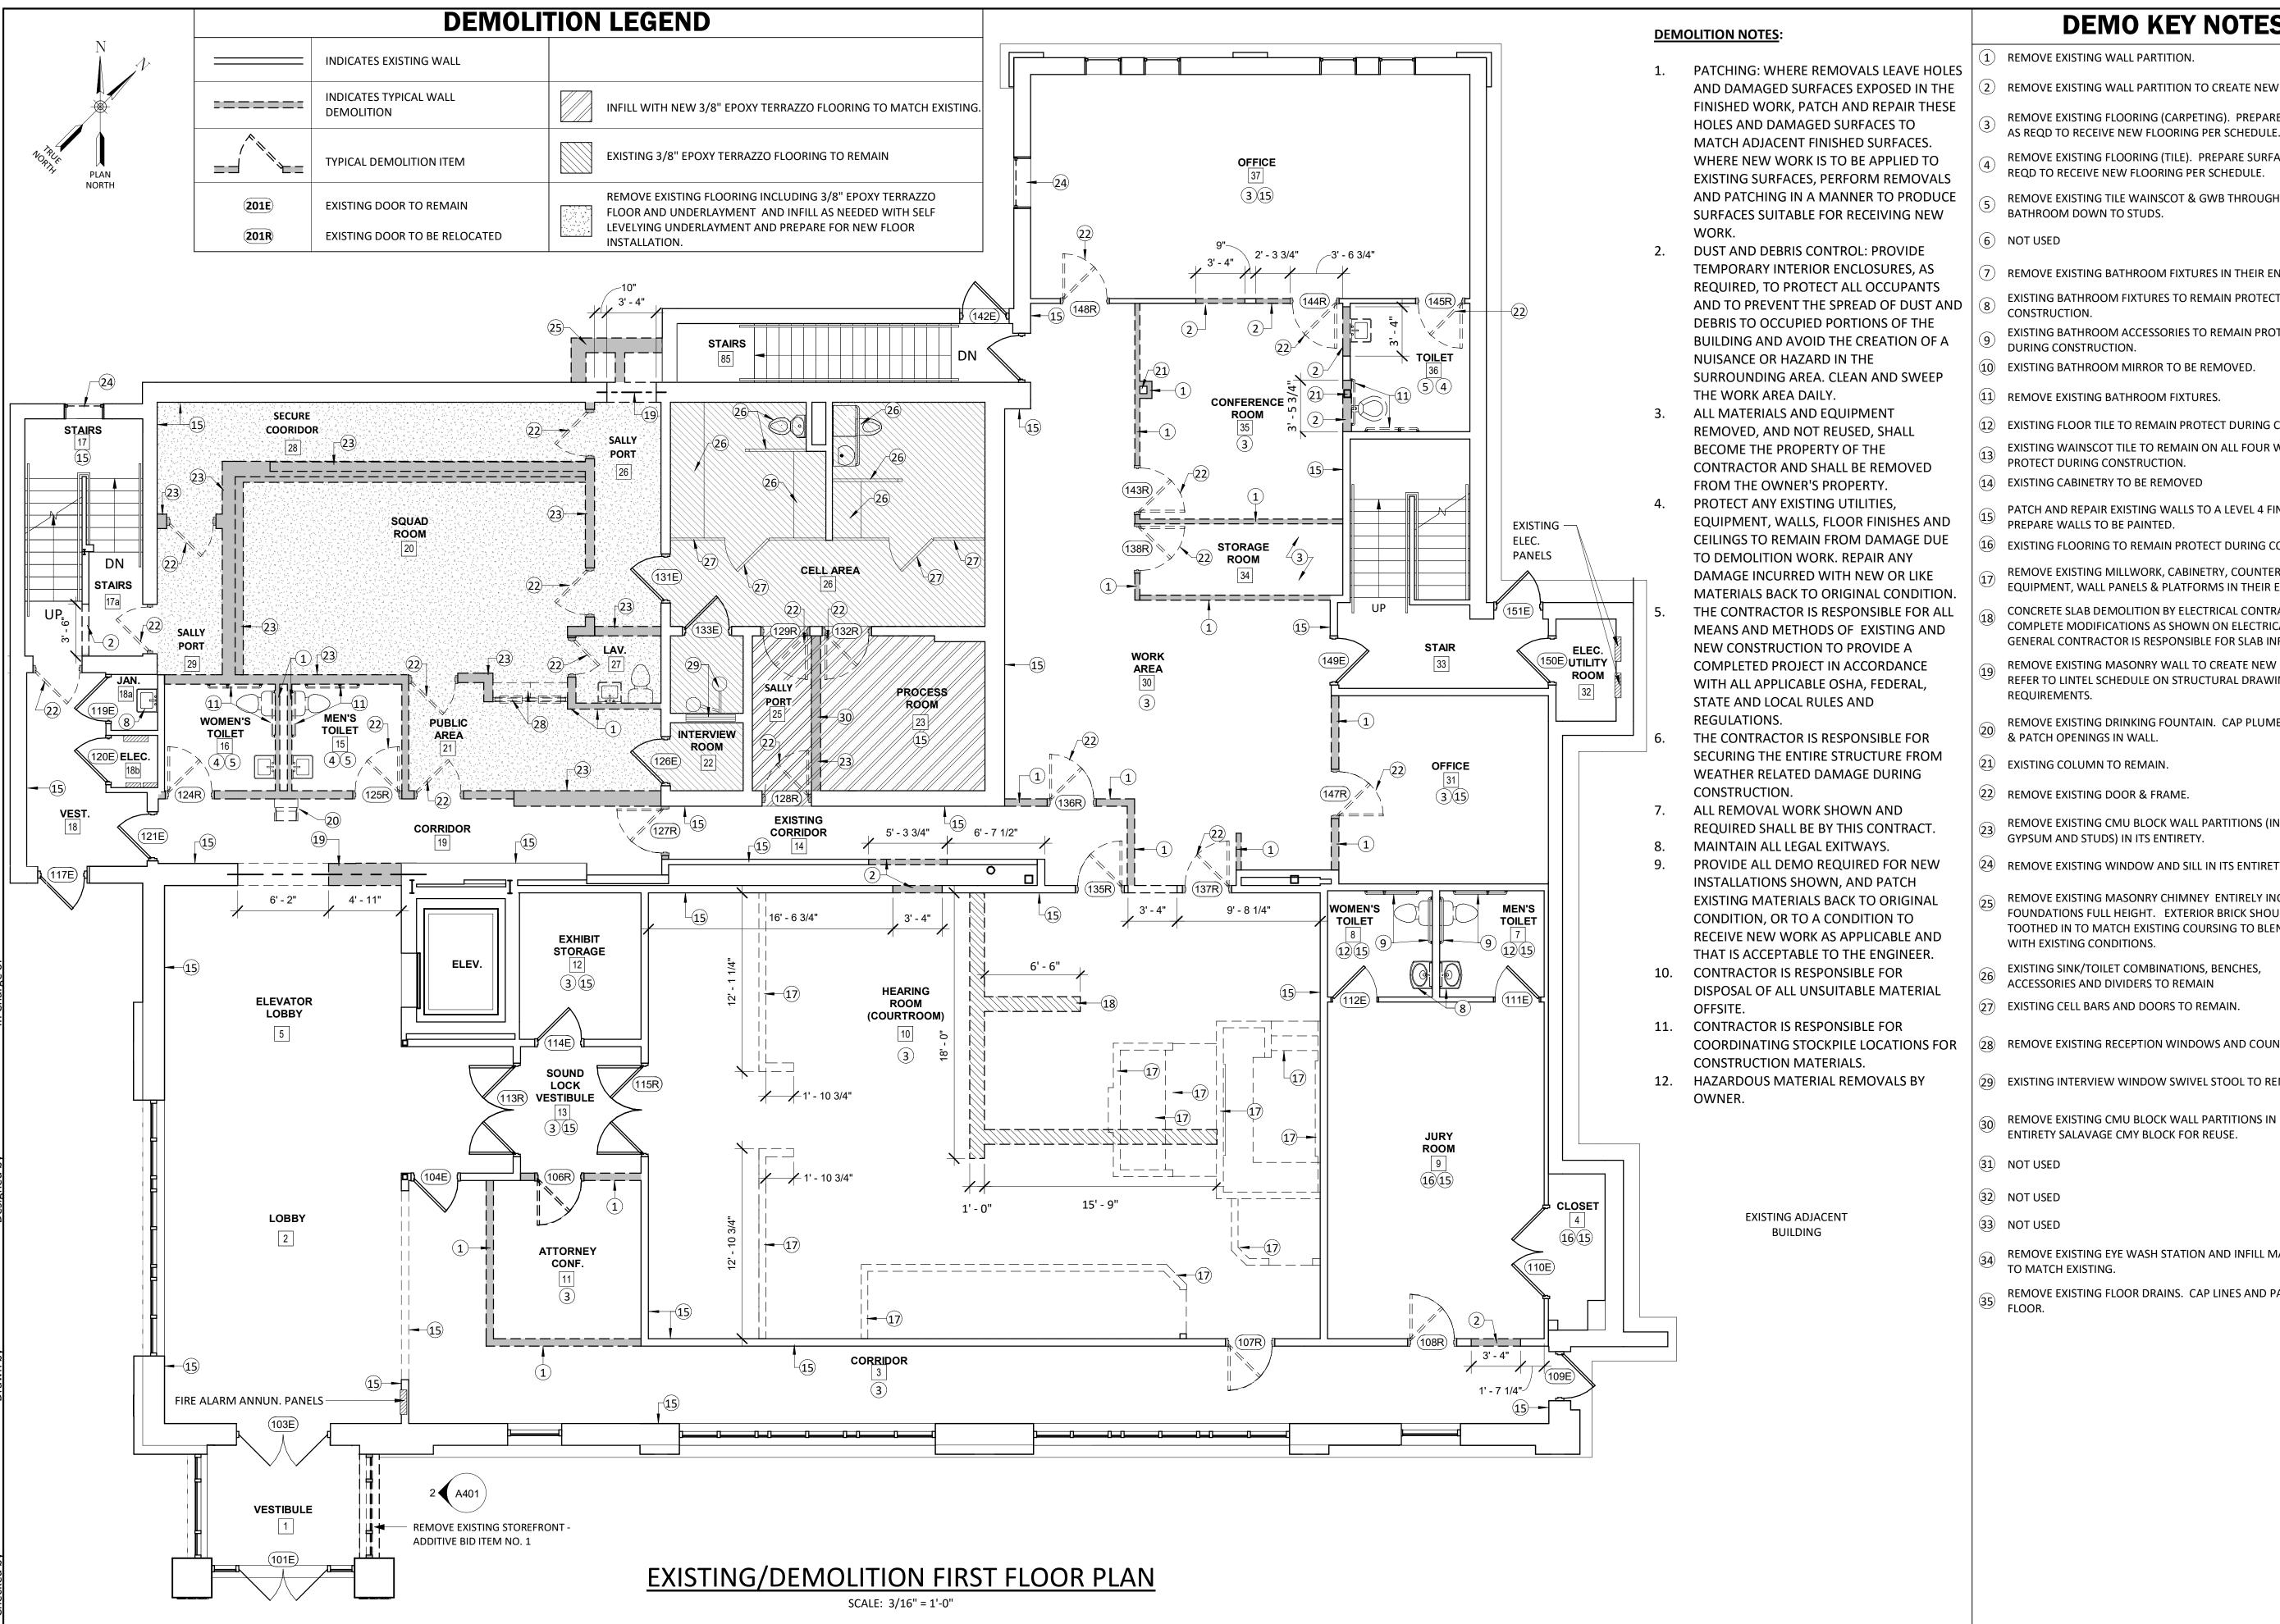

DEMO KEY NOTES

- REMOVE EXISTING WALL PARTITION.
- REMOVE EXISTING WALL PARTITION TO CREATE NEW OPENINGS.
- REMOVE EXISTING FLOORING (CARPETING). PREPARE SURFACE
- REMOVE EXISTING FLOORING (TILE). PREPARE SURFACE AS
- REMOVE EXISTING TILE WAINSCOT & GWB THROUGHOUT BATHROOM DOWN TO STUDS.
- REMOVE EXISTING BATHROOM FIXTURES IN THEIR ENTIRETY.
- EXISTING BATHROOM FIXTURES TO REMAIN PROTECT DURING
- EXISTING BATHROOM ACCESSORIES TO REMAIN PROTECT
- 9) DURING CONSTRUCTION.
- (12) EXISTING FLOOR TILE TO REMAIN PROTECT DURING CONSTRUCTION
- EXISTING WAINSCOT TILE TO REMAIN ON ALL FOUR WALLS
- (14) EXISTING CABINETRY TO BE REMOVED
- PATCH AND REPAIR EXISTING WALLS TO A LEVEL 4 FINISH AND
- PREPARE WALLS TO BE PAINTED. (16) EXISTING FLOORING TO REMAIN PROTECT DURING CONSTRUCTION.
- REMOVE EXISTING MILLWORK, CABINETRY, COUNTERTOPS &
- EQUIPMENT, WALL PANELS & PLATFORMS IN THEIR ENTIRETY
- CONCRETE SLAB DEMOLITION BY ELECTRICAL CONTRACTOR TO COMPLETE MODIFICATIONS AS SHOWN ON ELECTRICAL DRAWINGS. GENERAL CONTRACTOR IS RESPONSIBLE FOR SLAB INFILL.
- REMOVE EXISTING MASONRY WALL TO CREATE NEW OPENING. REFER TO LINTEL SCHEDULE ON STRUCTURAL DRAWINGS FOR REQUIREMENTS.
- REMOVE EXISTING DRINKING FOUNTAIN. CAP PLUMBING LINES & PATCH OPENINGS IN WALL.
- (21) EXISTING COLUMN TO REMAIN.
- 22 REMOVE EXISTING DOOR & FRAME.
- REMOVE EXISTING CMU BLOCK WALL PARTITIONS (INCL. GYPSUM AND STUDS) IN ITS ENTIRETY.
- 24) REMOVE EXISTING WINDOW AND SILL IN ITS ENTIRETY.
- REMOVE EXISTING MASONRY CHIMNEY ENTIRELY INCLUDING FOUNDATIONS FULL HEIGHT. EXTERIOR BRICK SHOULD BE TOOTHED IN TO MATCH EXISTING COURSING TO BLEND IN
 - EXISTING SINK/TOILET COMBINATIONS, BENCHES, ACCESSORIES AND DIVIDERS TO REMAIN
- (27) EXISTING CELL BARS AND DOORS TO REMAIN
- (28) REMOVE EXISTING RECEPTION WINDOWS AND COUNTERTOPS
- (29) EXISTING INTERVIEW WINDOW SWIVEL STOOL TO REMAIN
- 30 REMOVE EXISTING CMU BLOCK WALL PARTITIONS IN ITS
- (31) NOT USED
- (32) NOT USED
- (33) NOT USED
- REMOVE EXISTING EYE WASH STATION AND INFILL MASONRY TO MATCH EXISTING.
- REMOVE EXISTING FLOOR DRAINS. CAP LINES AND PATCH

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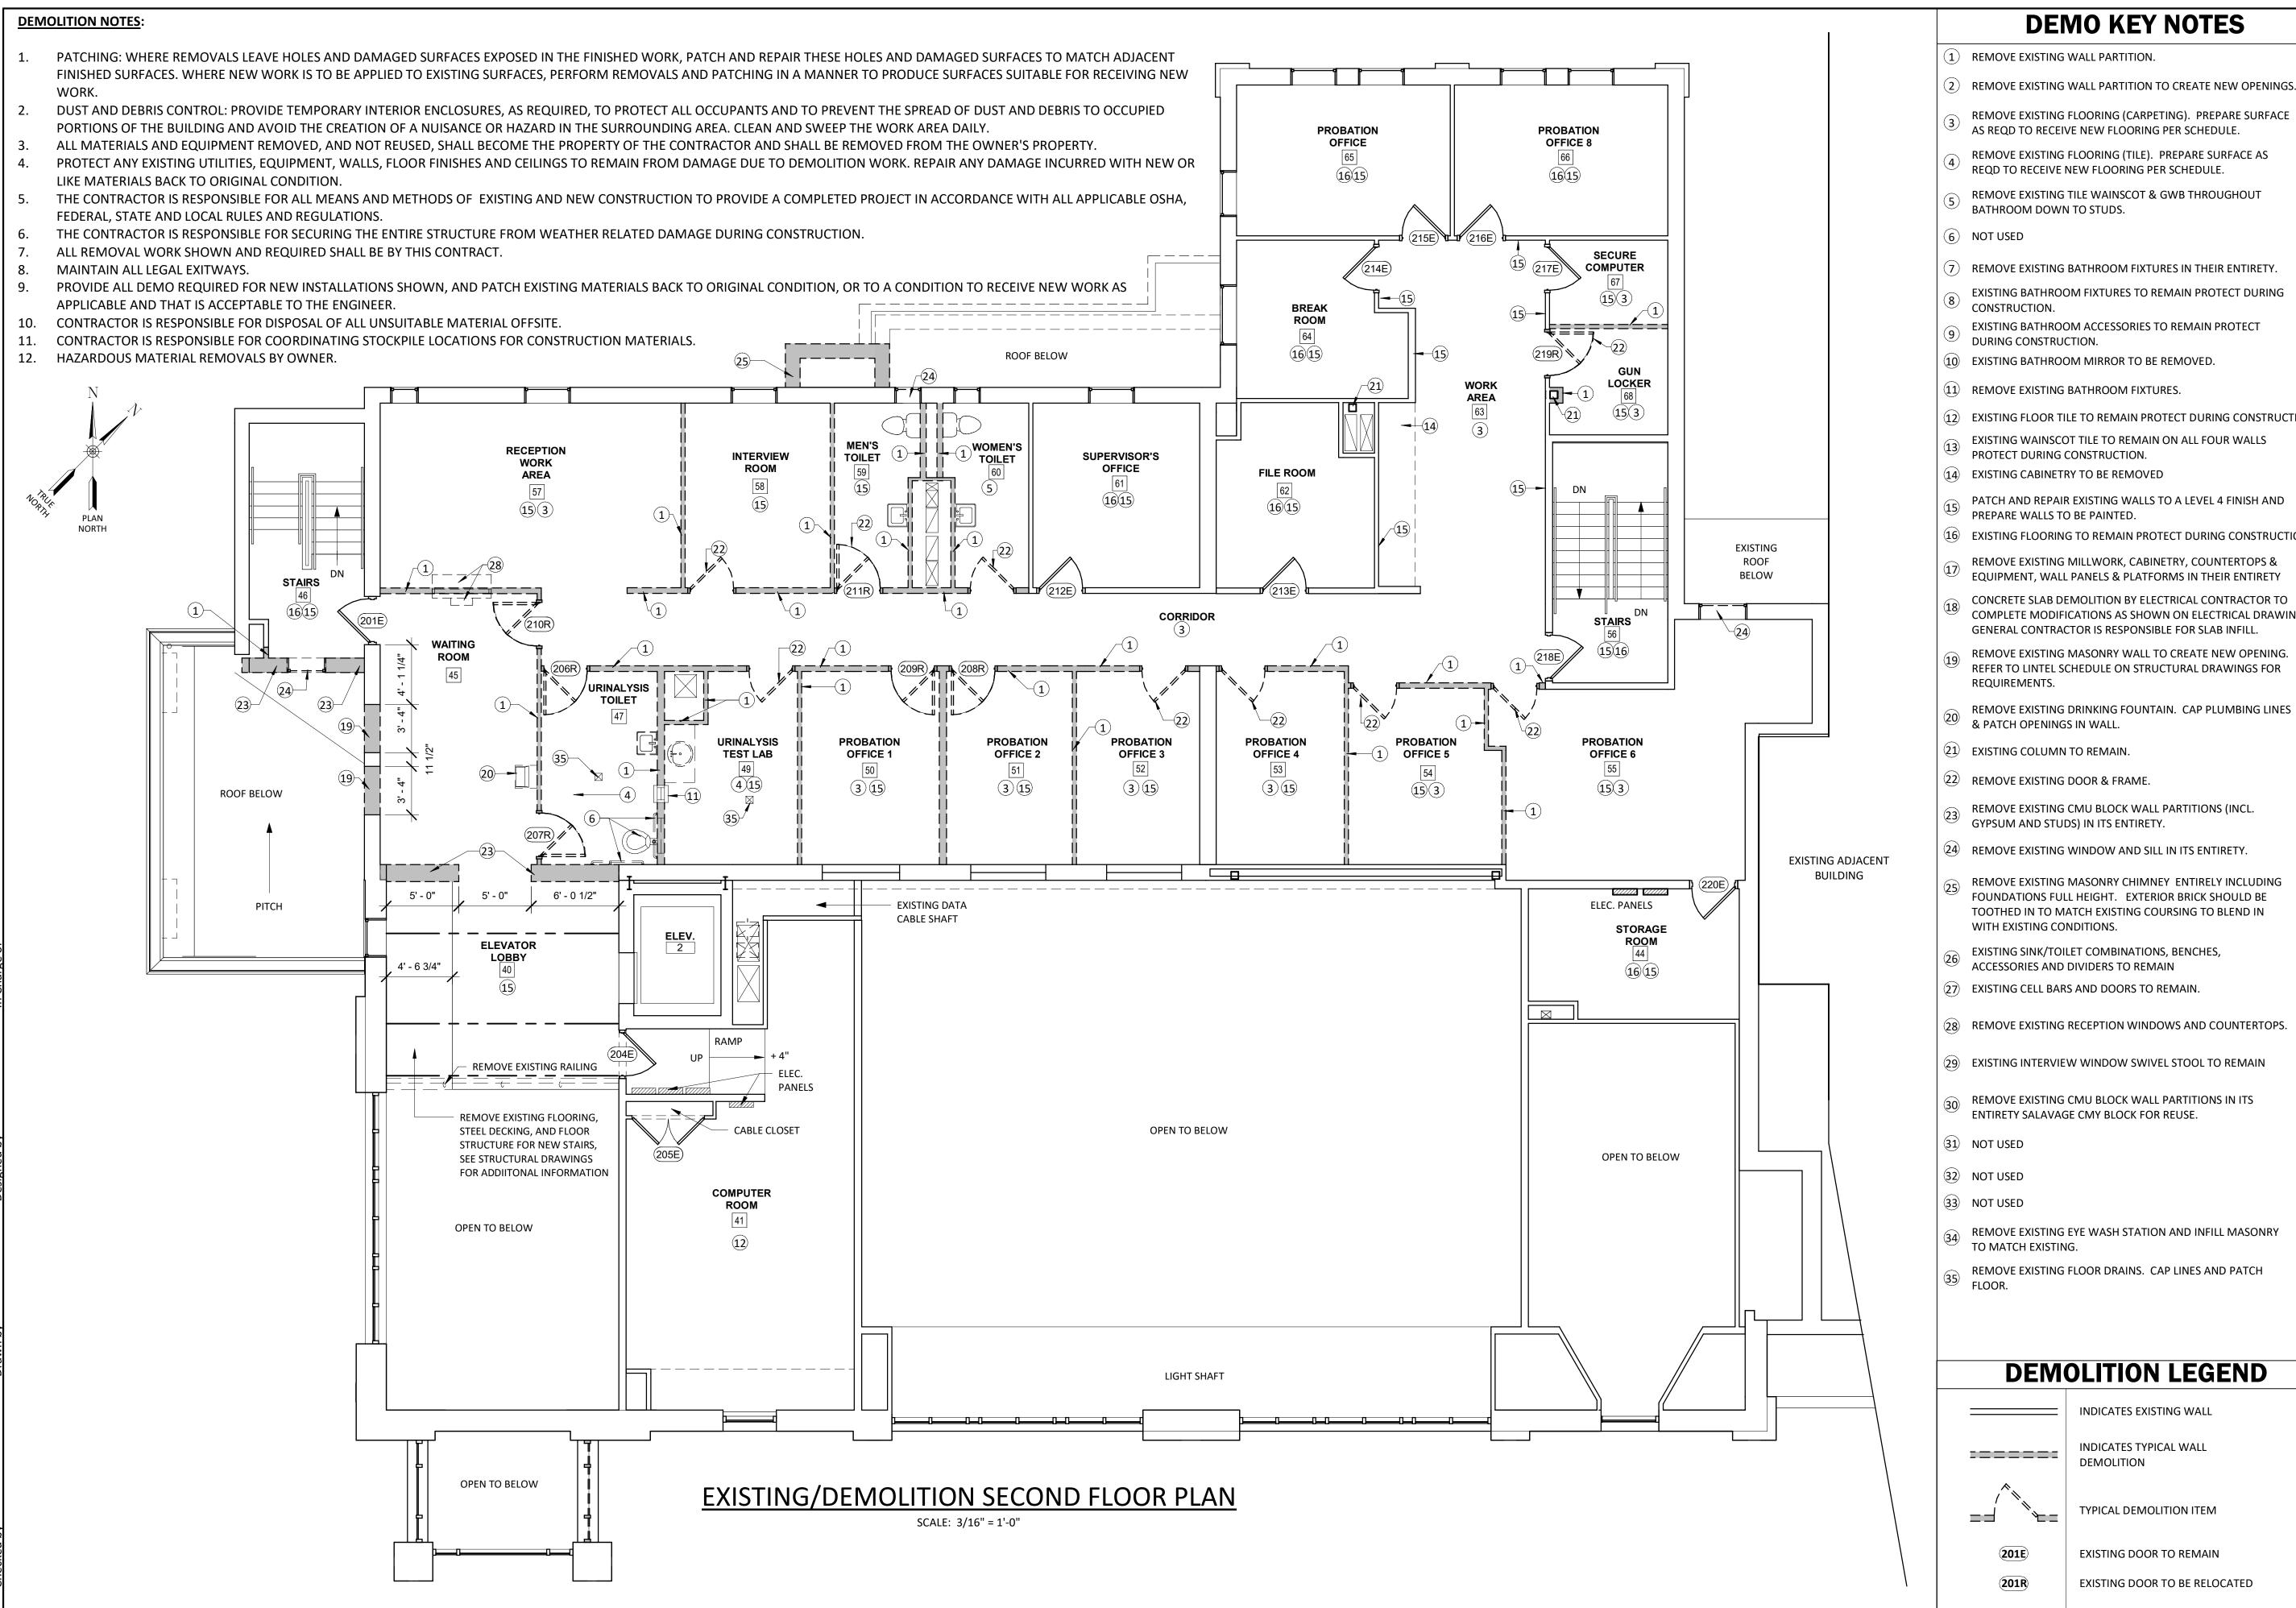




AUGUST, 2024

AS SHOWN

Sheet Number AD101



DEMO KEY NOTES

- (1) REMOVE EXISTING WALL PARTITION.
- REMOVE EXISTING WALL PARTITION TO CREATE NEW OPENINGS.
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- REMOVE EXISTING FLOORING (TILE). PREPARE SURFACE AS
- REQD TO RECEIVE NEW FLOORING PER SCHEDULE.
- REMOVE EXISTING TILE WAINSCOT & GWB THROUGHOUT BATHROOM DOWN TO STUDS.
- (7) REMOVE EXISTING BATHROOM FIXTURES IN THEIR ENTIRETY.
- EXISTING BATHROOM FIXTURES TO REMAIN PROTECT DURING
- EXISTING BATHROOM ACCESSORIES TO REMAIN PROTECT
- 9 DURING CONSTRUCTION.
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- (12) EXISTING FLOOR TILE TO REMAIN PROTECT DURING CONSTRUCTION
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- PATCH AND REPAIR EXISTING WALLS TO A LEVEL 4 FINISH AND
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- REMOVE EXISTING MILLWORK, CABINETRY, COUNTERTOPS &
- EQUIPMENT, WALL PANELS & PLATFORMS IN THEIR ENTIRETY
- COMPLETE MODIFICATIONS AS SHOWN ON ELECTRICAL DRAWINGS GENERAL CONTRACTOR IS RESPONSIBLE FOR SLAB INFILL.
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- (20) & PATCH OPENINGS IN WALL.
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- EXISTING SINK/TOILET COMBINATIONS, BENCHES, ACCESSORIES AND DIVIDERS TO REMAIN
- 28 REMOVE EXISTING RECEPTION WINDOWS AND COUNTERTOPS
- 29 EXISTING INTERVIEW WINDOW SWIVEL STOOL TO REMAIN
- 30 REMOVE EXISTING CMU BLOCK WALL PARTITIONS IN ITS ENTIRETY SALAVAGE CMY BLOCK FOR REUSE.
- REMOVE EXISTING EYE WASH STATION AND INFILL MASONRY TO MATCH EXISTING.
- REMOVE EXISTING FLOOR DRAINS. CAP LINES AND PATCH

DEMOLITION LEGEND

INDICATES EXISTING WALL INDICATES TYPICAL WALL **DEMOLITION**

TYPICAL DEMOLITION ITEM

EXISTING DOOR TO REMAIN EXISTING DOOR TO BE RELOCATED

EDUCATION LAW, ARTICLE 145 §720 SPECIAL PROVISIONS, FOR ANY PERSON UNLESS THEY ARE ACTING UNDER TH DIRECTION OF A LICENSED PROFESSION THE STAMP OF A LICENSED PROFESSIONA IS ALTERED. THE ALTERING PROFESSION. SHALL STAMP THE DOCUMENT AND INCLUDE THE NOTATION "ALTERED BY FOLLOWED BY THEIR SIGNATURE, THE DATI OF SUCH ALTERATION, AND A SPECIFIC DESCRIPTION OF THE ALTERATION

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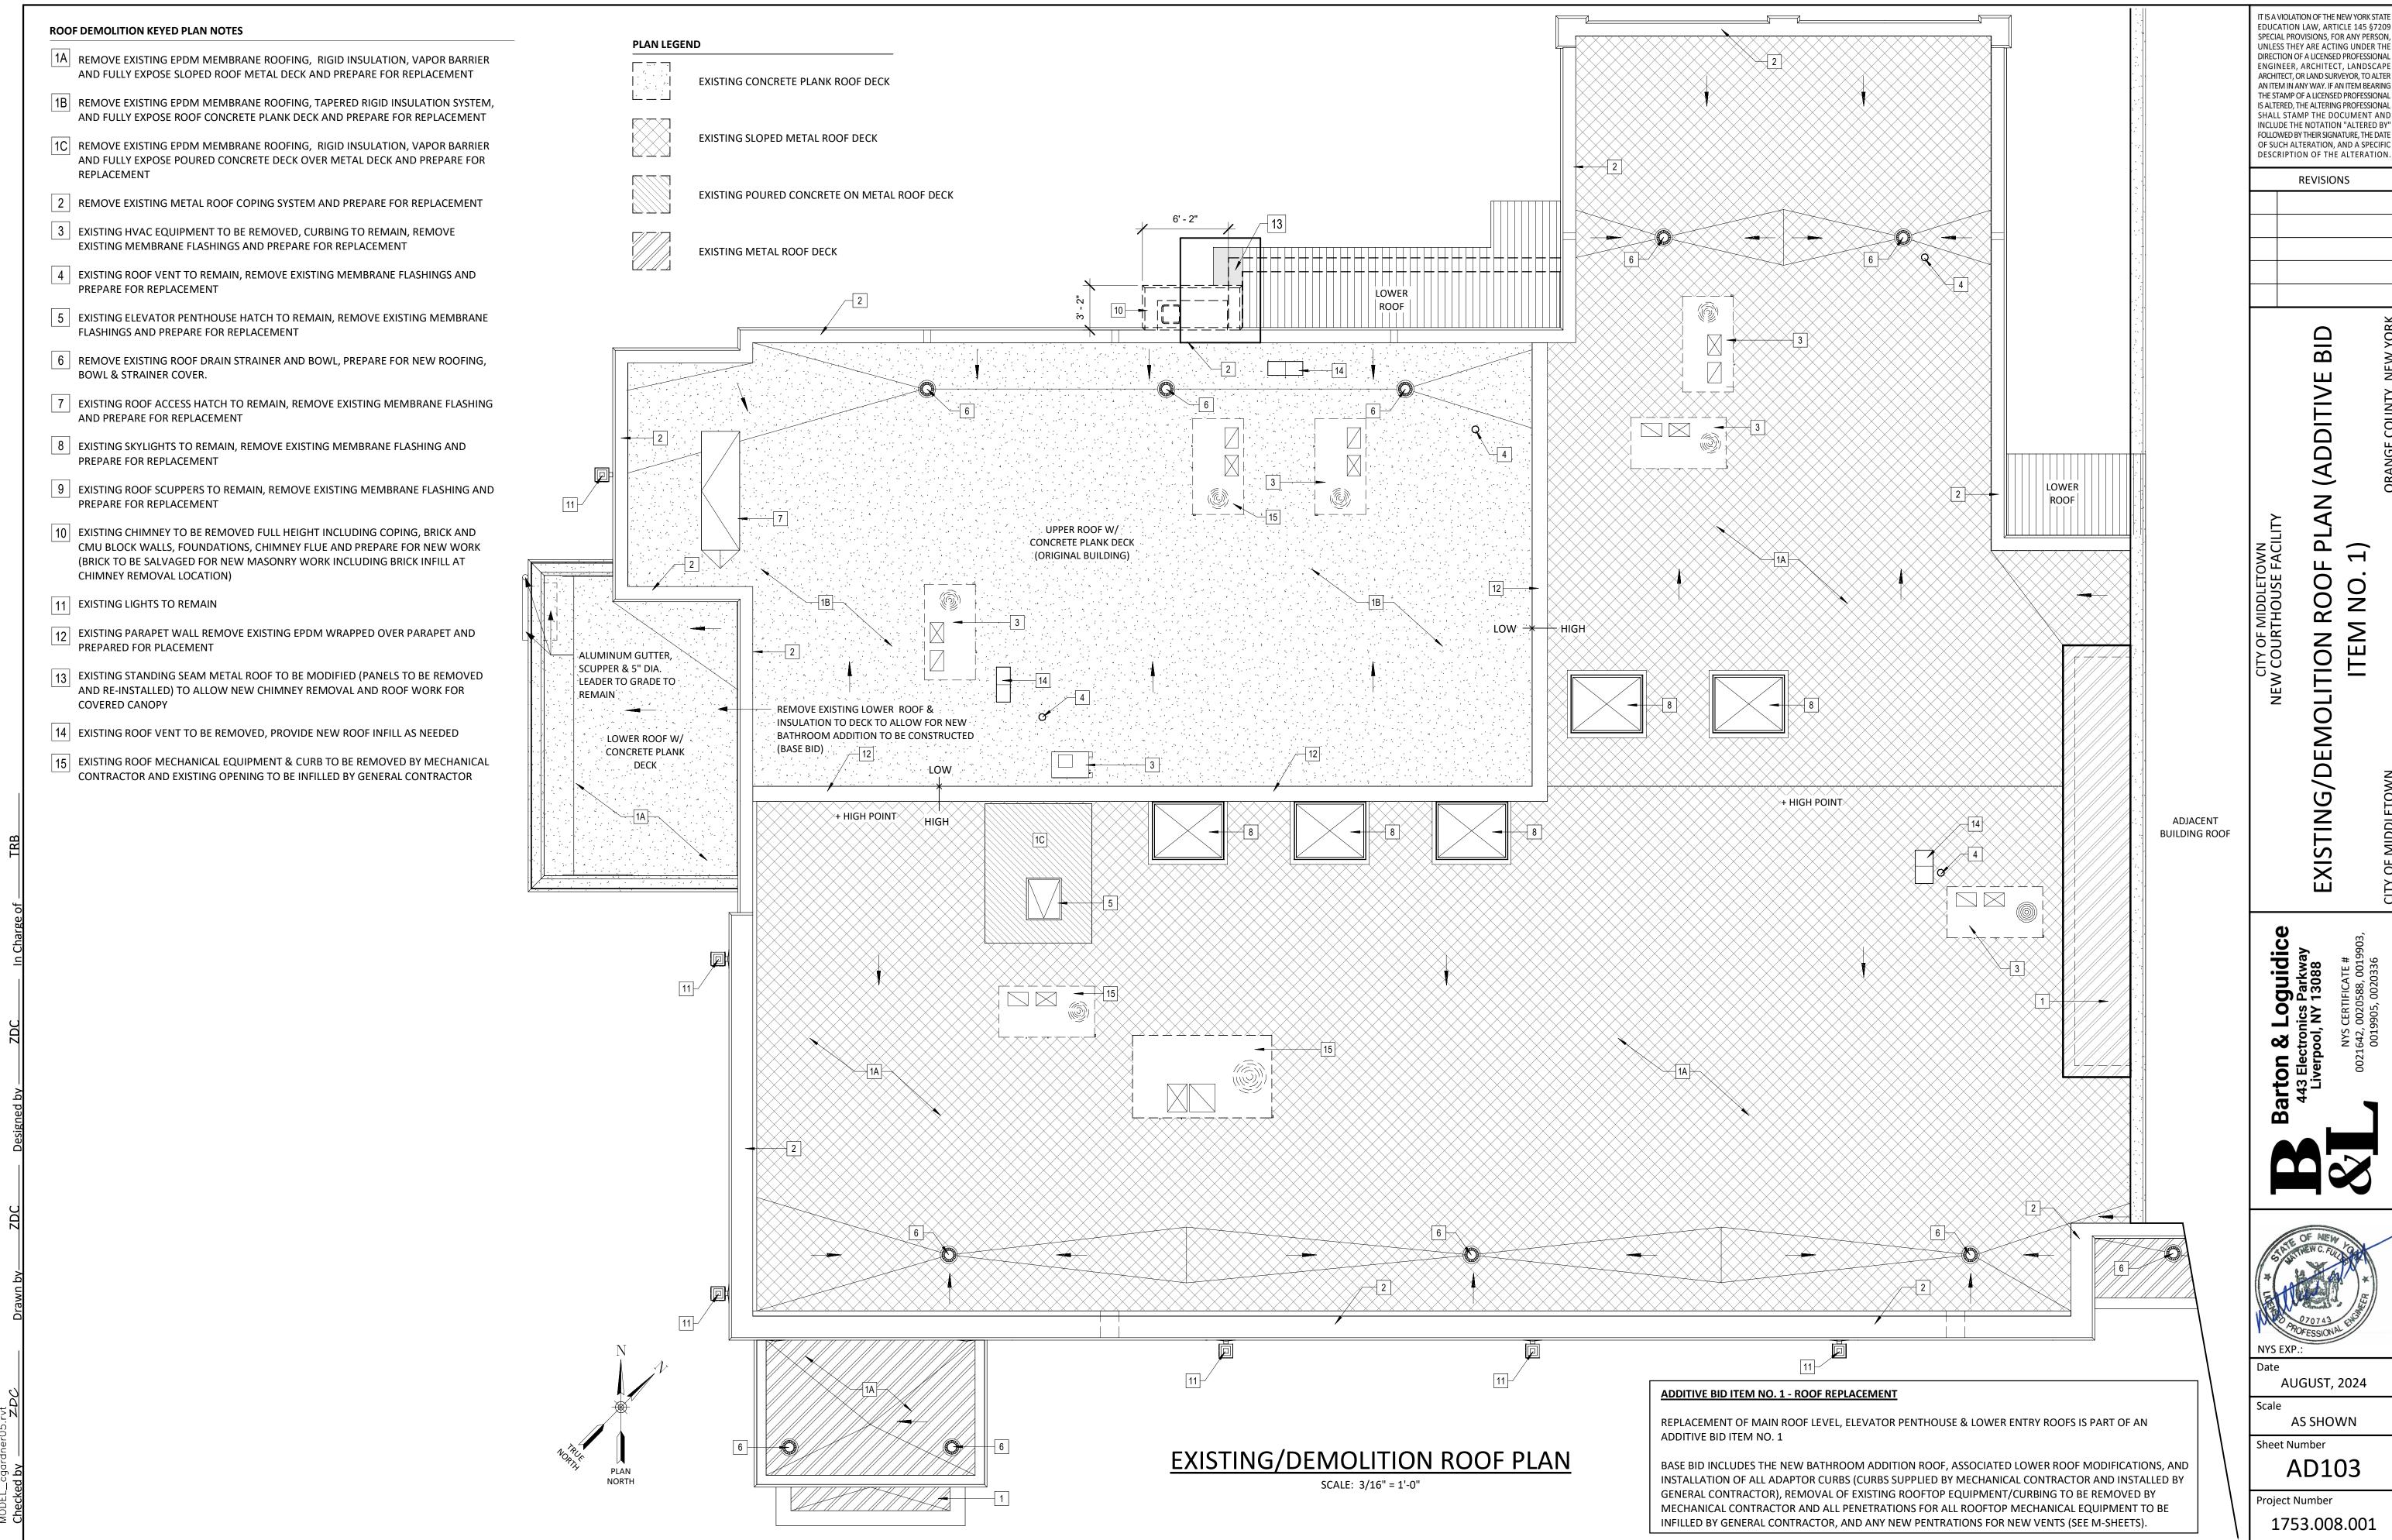


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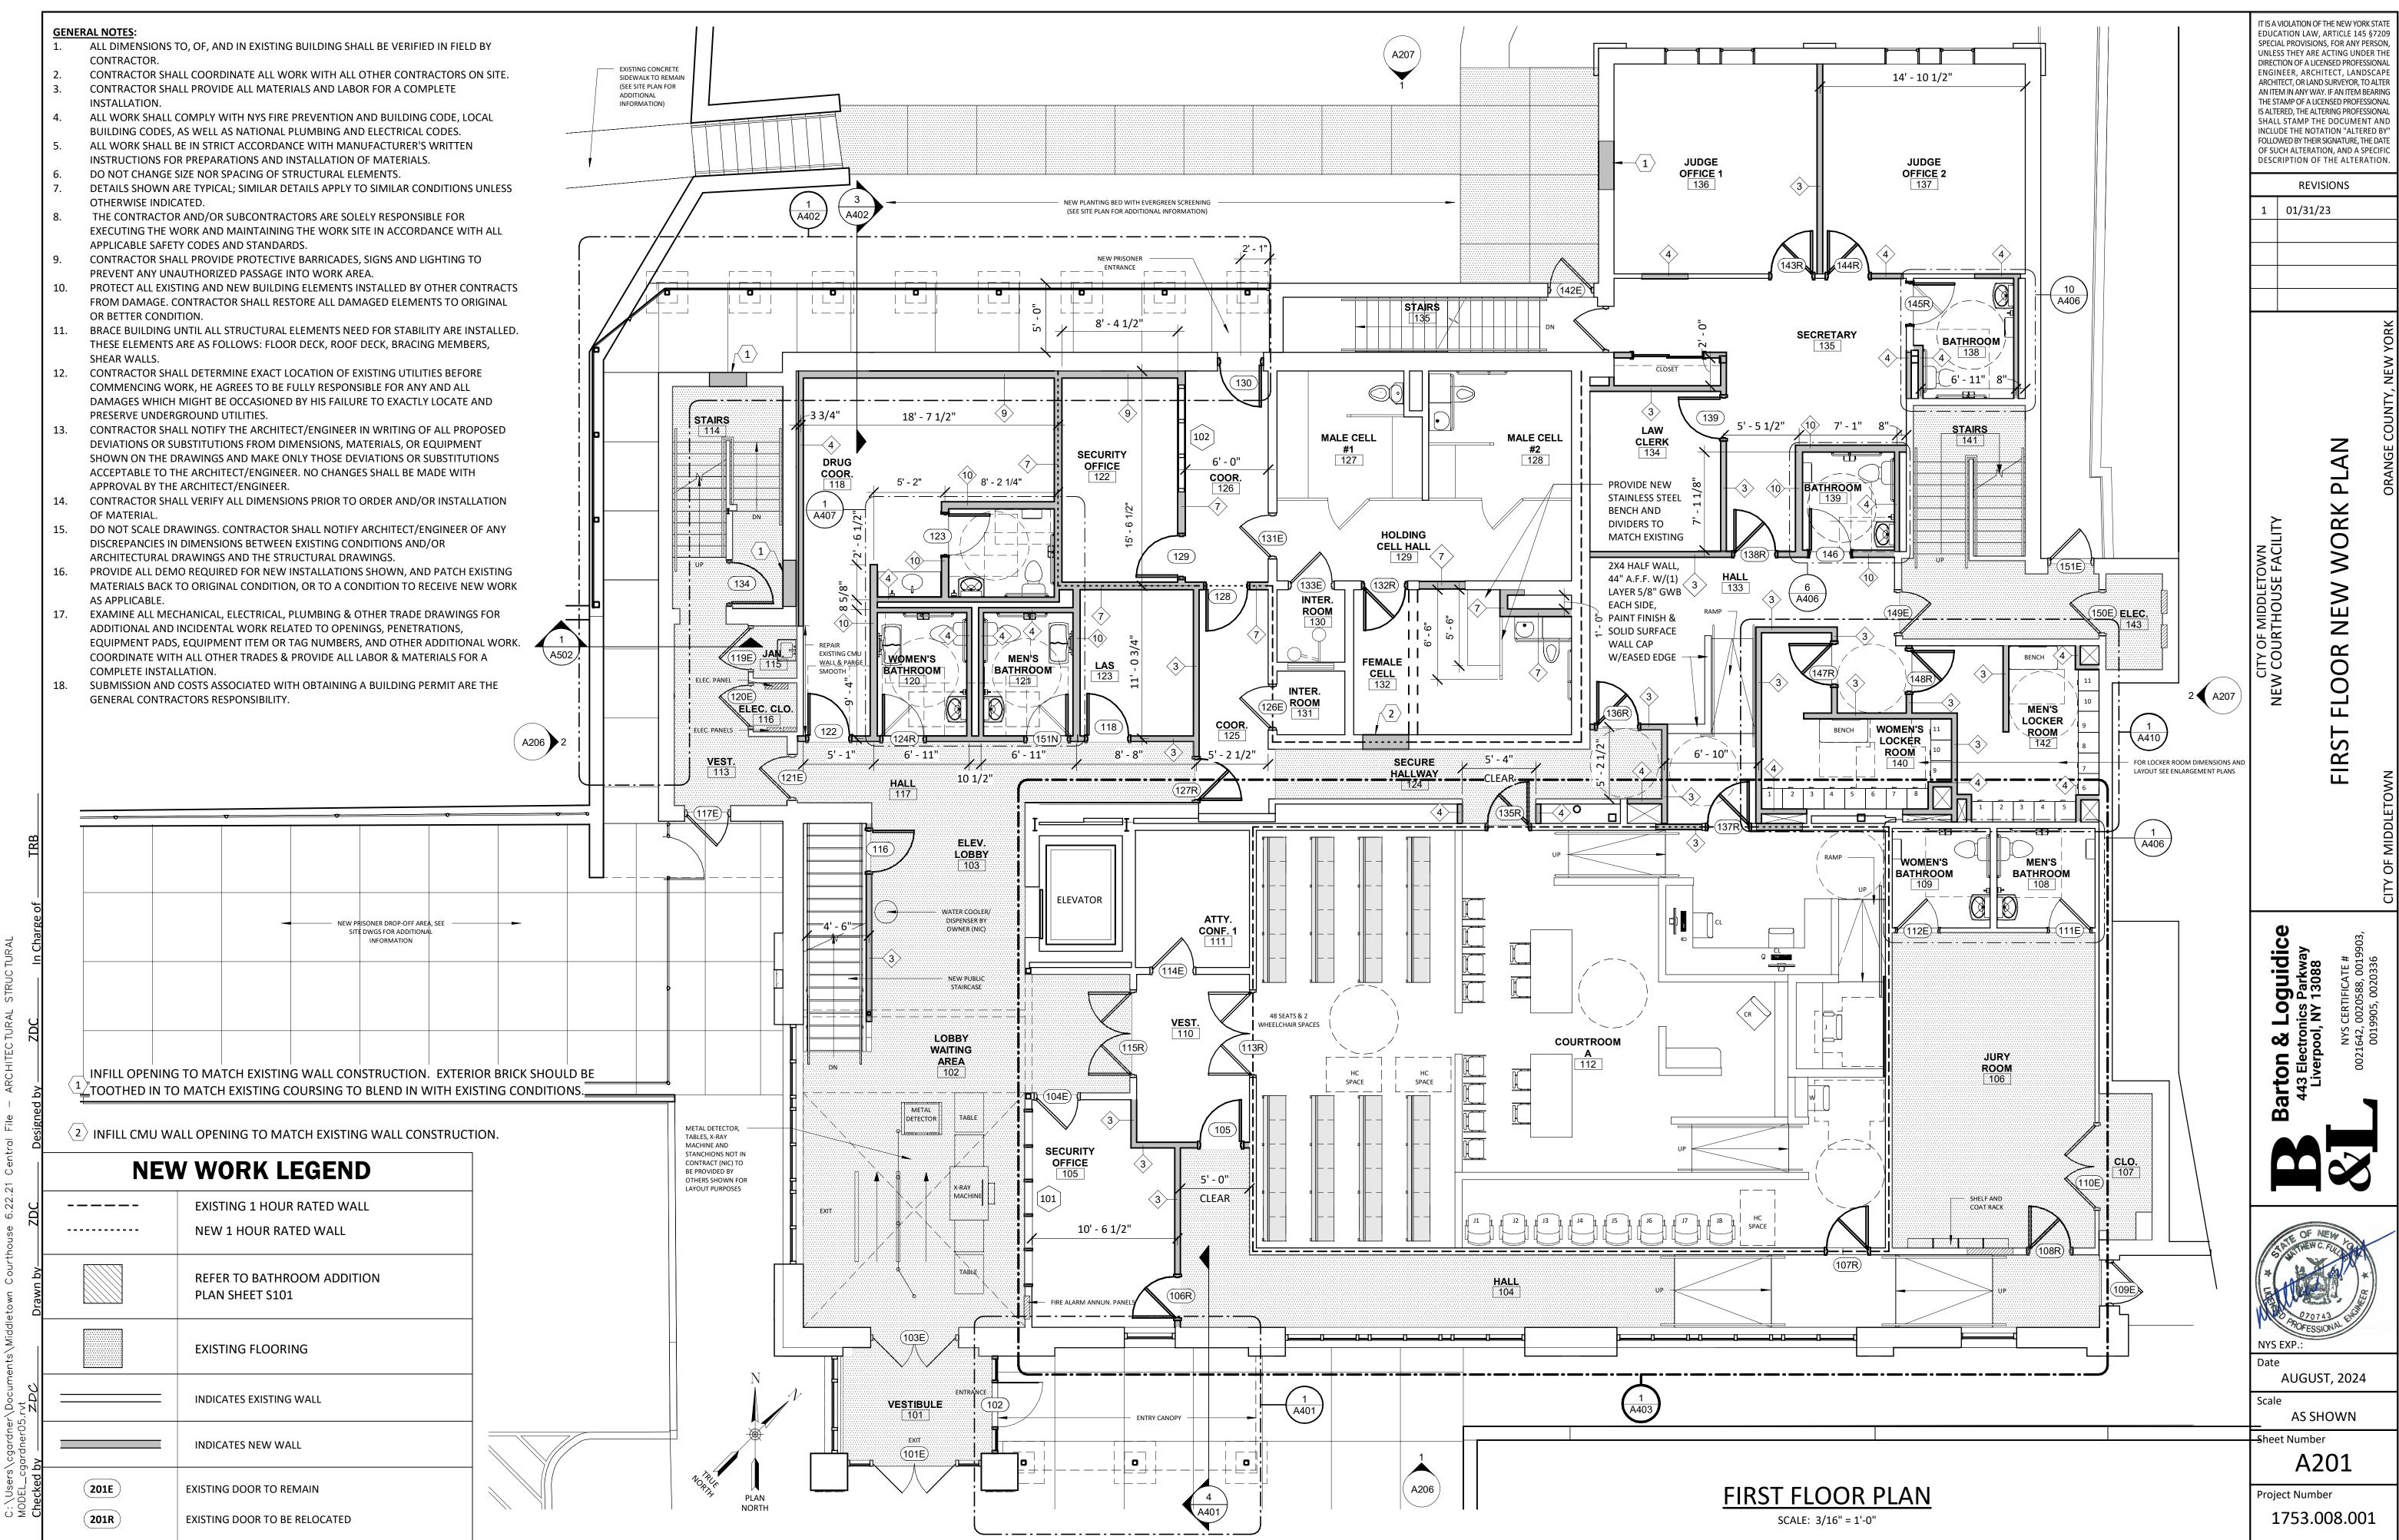


AN ITEM IN ANY WAY. IF AN ITEM BEARING THE STAMP OF A LICENSED PROFESSIONAL IS ALTERED, THE ALTERING PROFESSIONAL SHALL STAMP THE DOCUMENT AND INCLUDE THE NOTATION "ALTERED BY FOLLOWED BY THEIR SIGNATURE, THE DATE OF SUCH ALTERATION, AND A SPECIFIC DESCRIPTION OF THE ALTERATION REVISIONS


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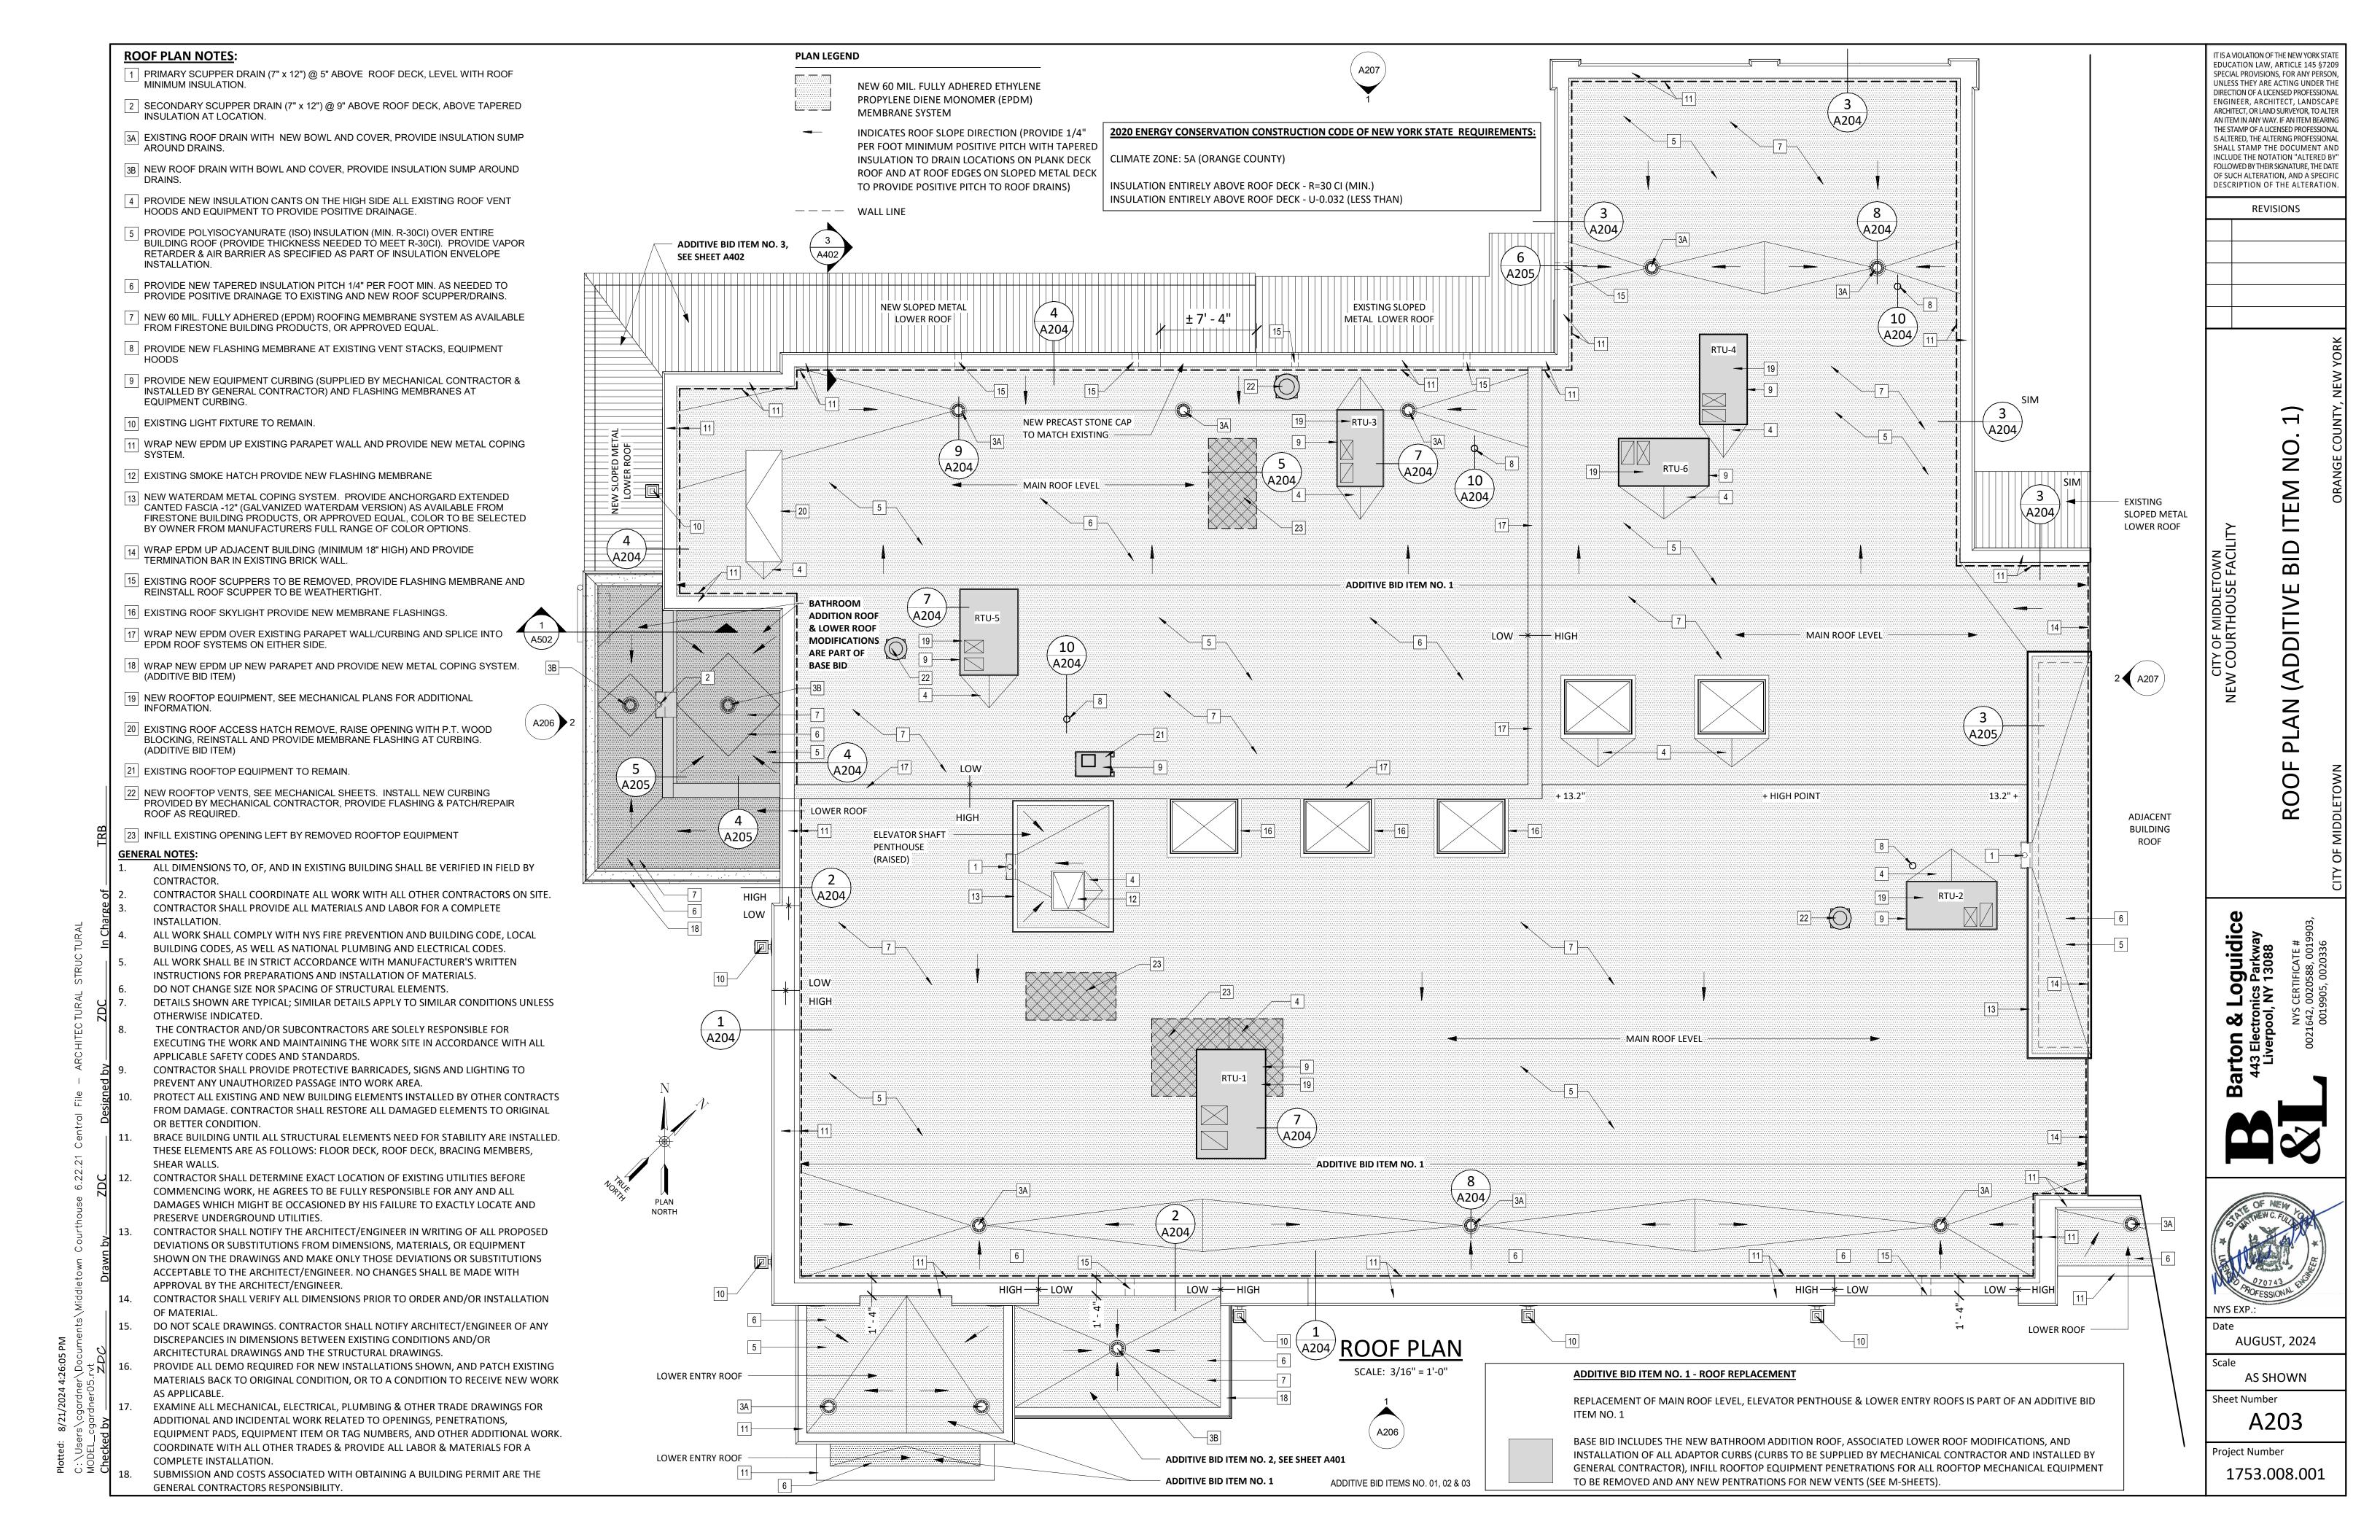



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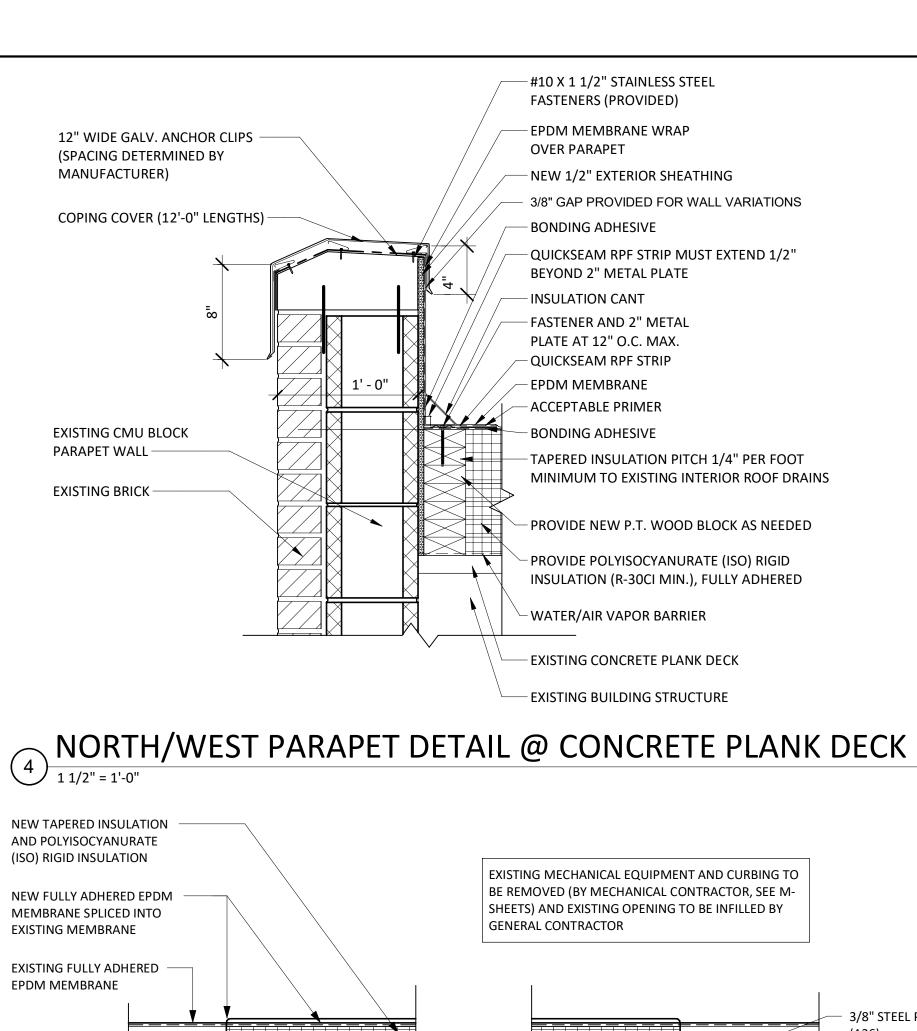





EXISTING BUILDING STRUCTURE

NORTH/EAST PARAPET DETAIL @ SLOPED METAL DECK

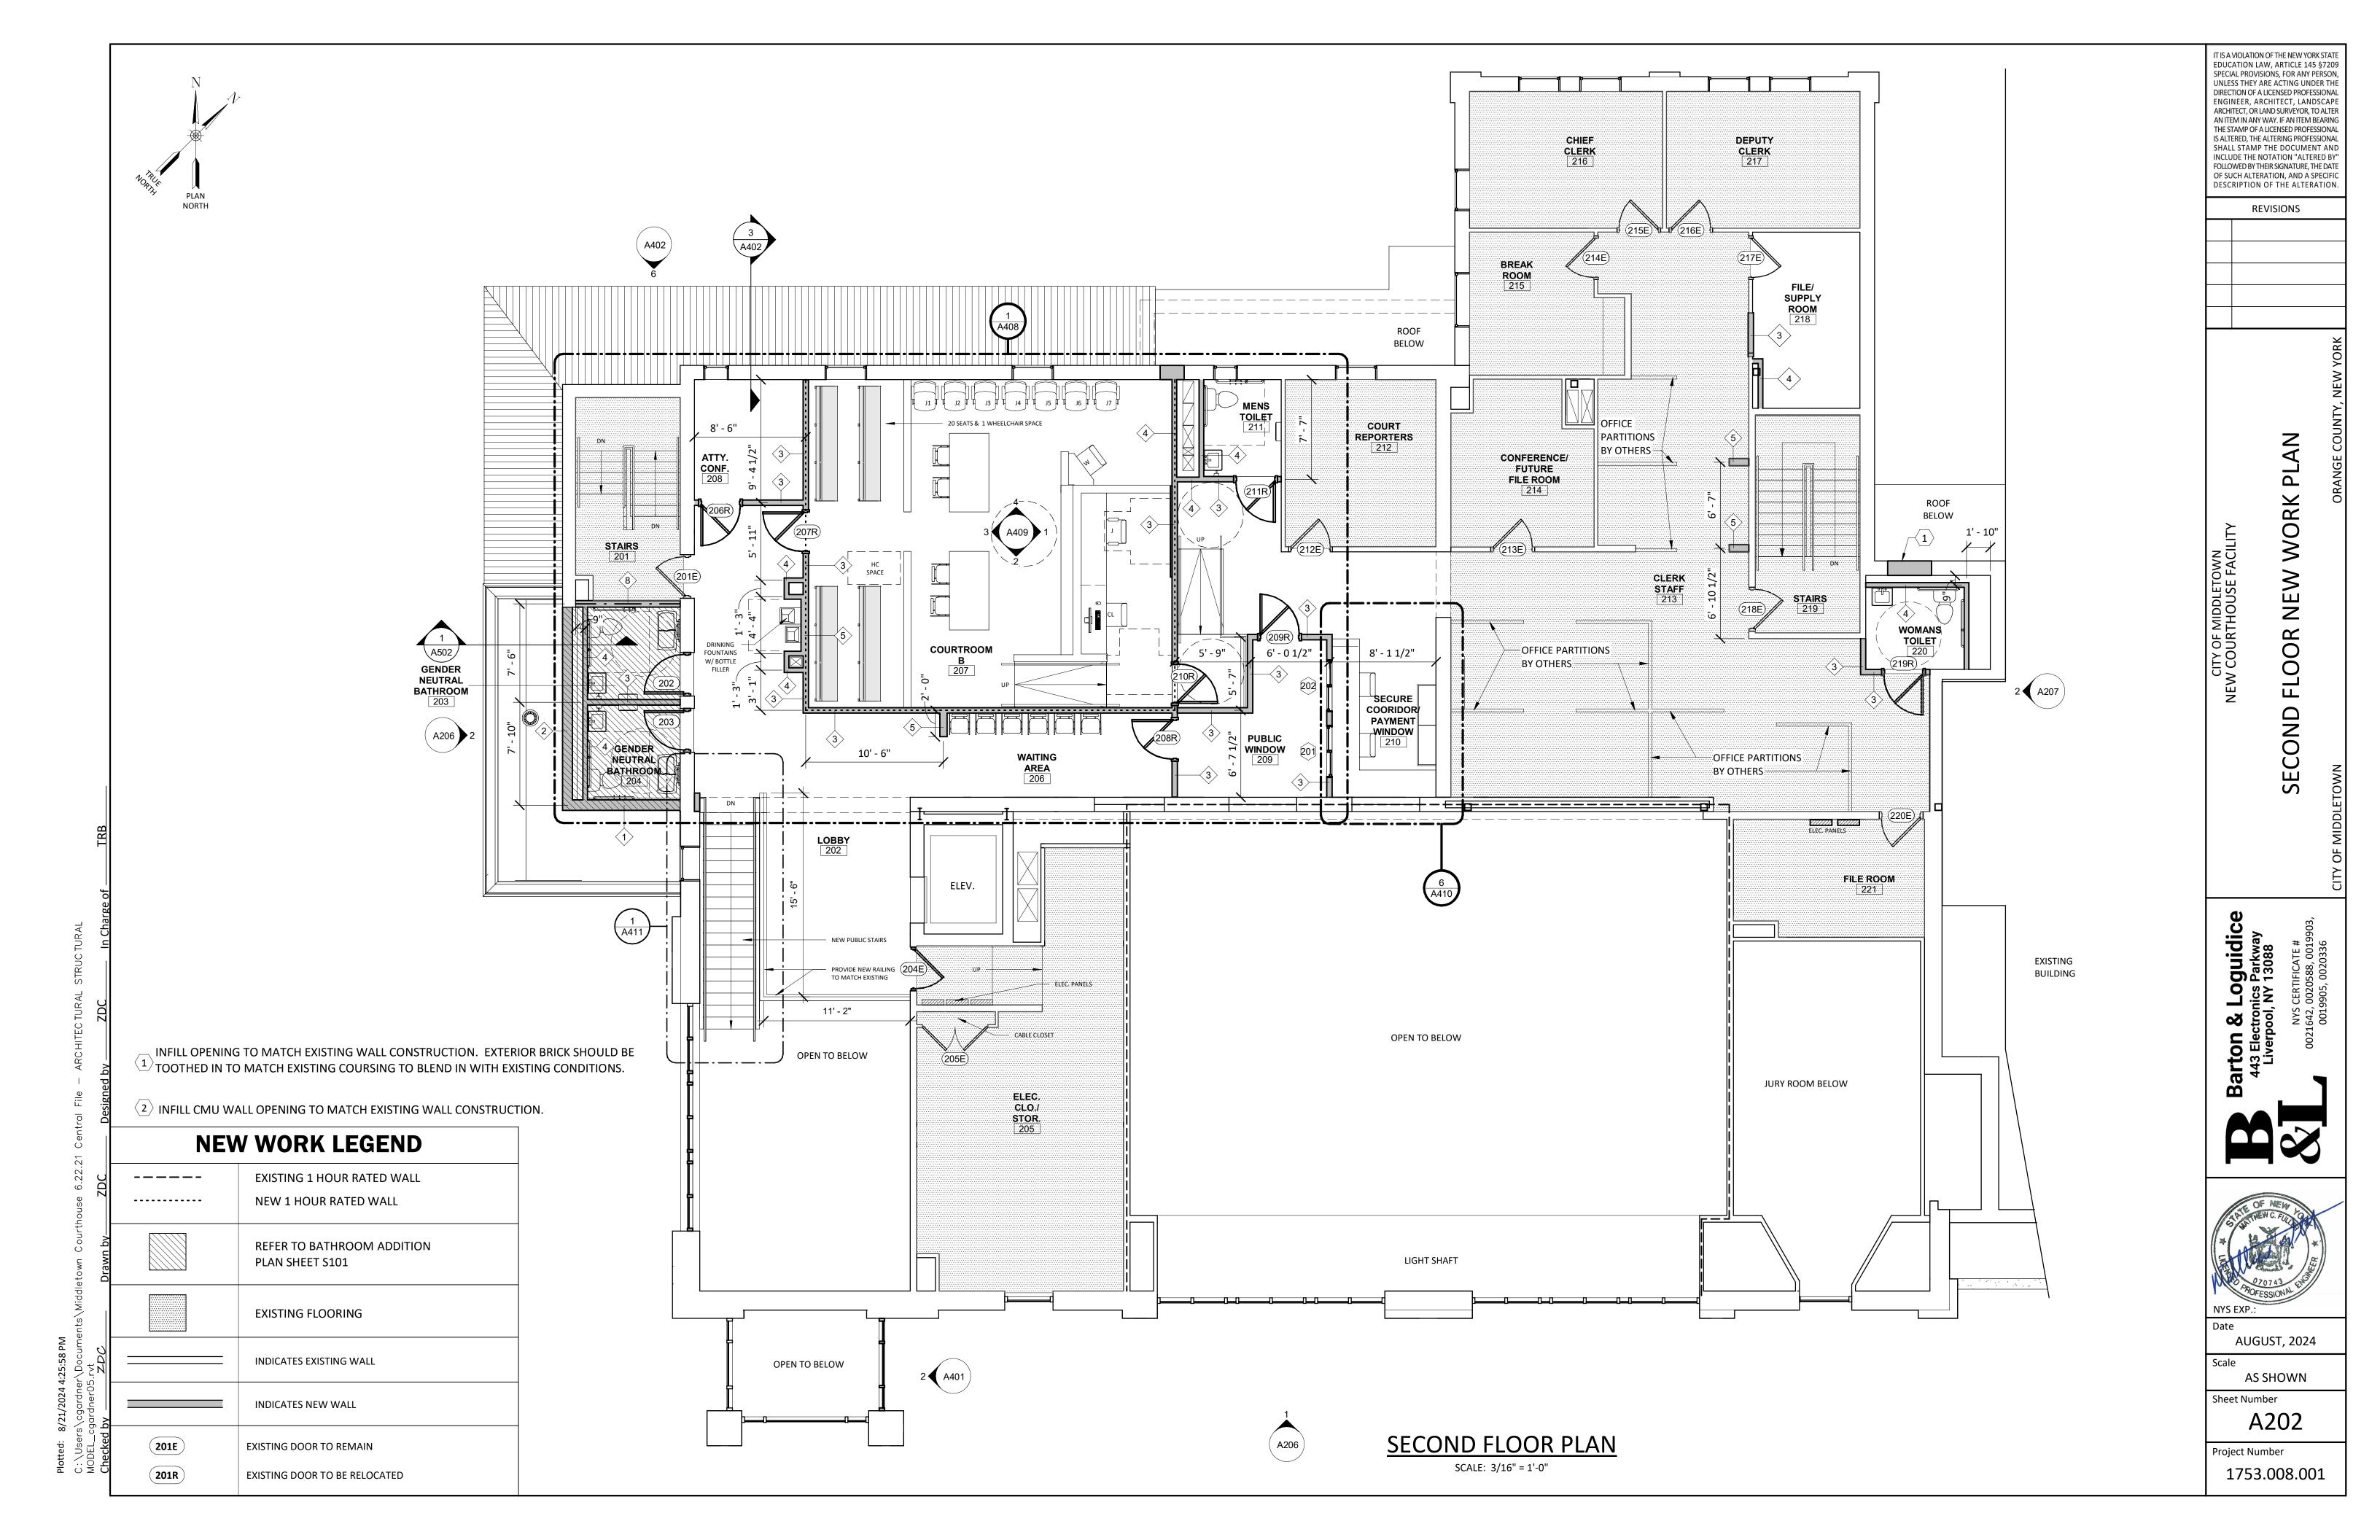
3 1 1/2" = 1'-0"

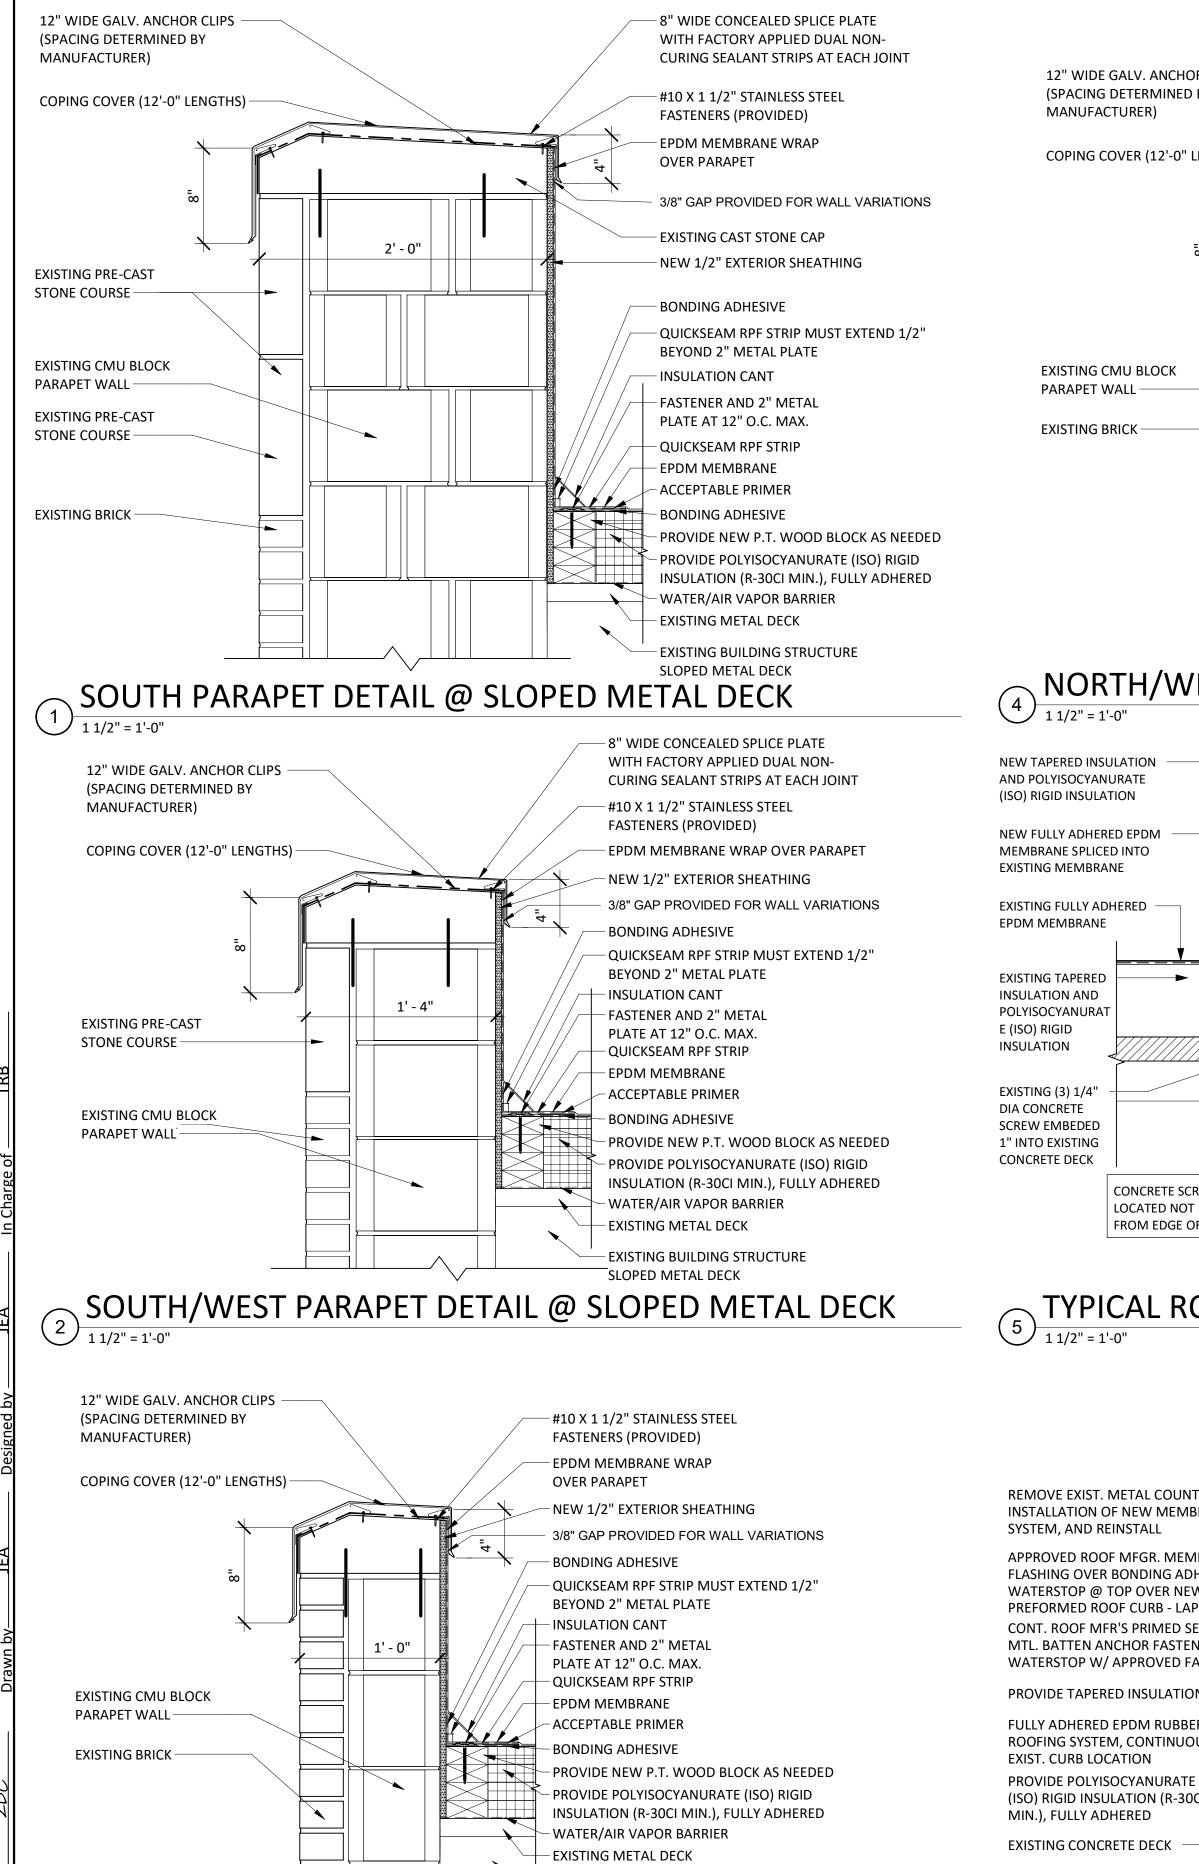

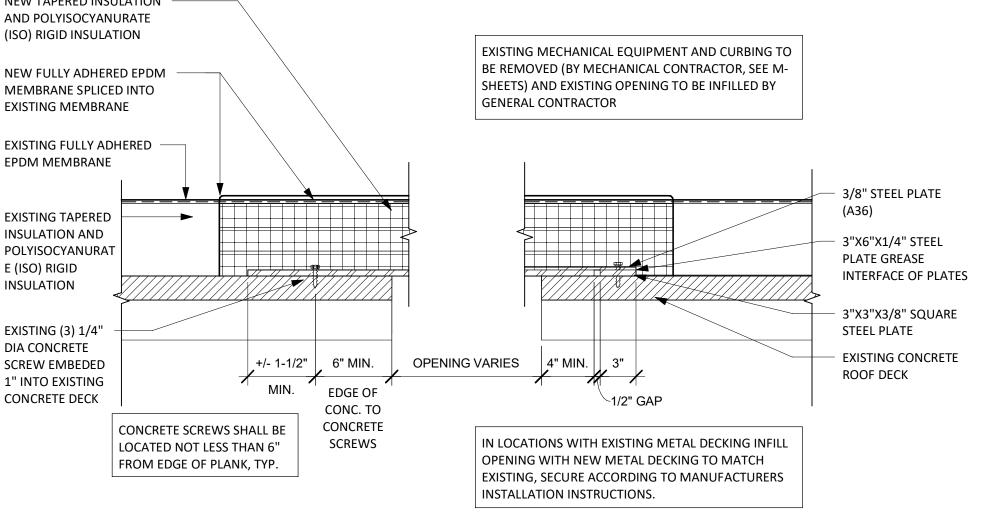


TYPICAL ROOF INFILL DETAIL

1 1/2" = 1'-0"

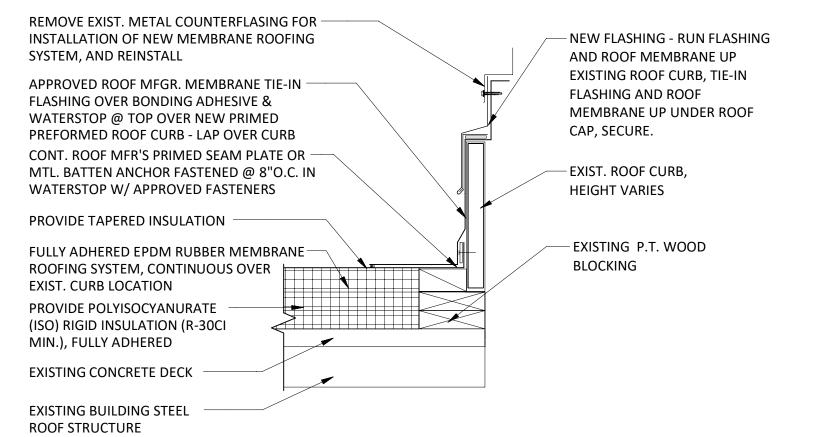

TYP. ROOF EQUIP./ CURB DETAIL

7 1 1/2" = 1'-0"

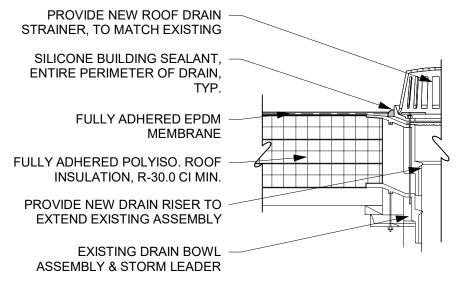

ROOF DRAIN DETAIL

PROVIDE NEW ROOF DRAIN STRAINER, TO MATCH EXISTING SILICONE BUILDING SEALANT, ENTIRE PERIMETER OF DRAIN, TYP. FULLY ADHERED EPDM MEMBRANE

FULLY ADHERED POLYISO. ROOF INSULATION, R-30.0 CI MIN.

PROVIDE NEW DRAIN RISER TO EXTEND EXISTING ASSEMBLY


TAPERED INSULATION PITCH TO

SCUPPER

DRAIN BOWL ASSEMBLY & STORM LEADER. COORDINATE WITH MECHANICAL CONTRACTOR

9 ROOF DRAIN DETAIL W/ TAPERED INSULATION

CLAMP RING

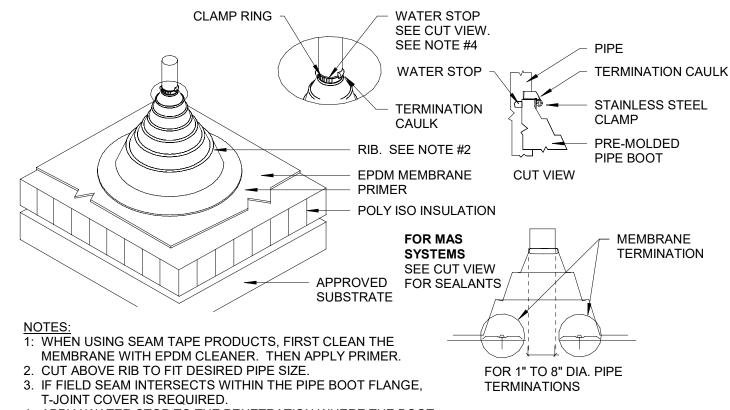

4. APPLY WATER STOP TO THE PENETRATION WHERE THE BOOT WILL BE COMPRESSED WITH THE CLAMPING RING

5. INSTALL MEMBRANE SECUREMENT, CONSISTING OF 4 FASTENERS AND SEAM PLATES PER PIPE FLASHING. WHEN POSSIBLE, INSTALL CLOSE ENOUGH TO BE COVERED BY BOOT FLANGE WITHOUT INTERFERING WITH THE BOOT TO DECK MEMBRANE SEAM AREA. 6. APPLY TERMINATION CAULK TO THE TOP OF THE PIPE BOOT

AS SHOWN ABOVE.

PREFAB BOOT DETAIL

1/8" TO 1/4" EXPOSED 3" SEAM TAPE ATTACHED **EPDM MEMBRANE** PRIMER TO THE BOTTOM MEMBRANE. SEE NOTE 1 PRIMER POLY ISO INSULATION EPDM MEMBRANE

NOTES:

1. WHEN USING SEAM TAPE AND BAR COVER TAPE, FIRST CLEAN THE MEMBRANE WITH THE MFR CLEANER. THEN APPLY THE MFR PRIMER

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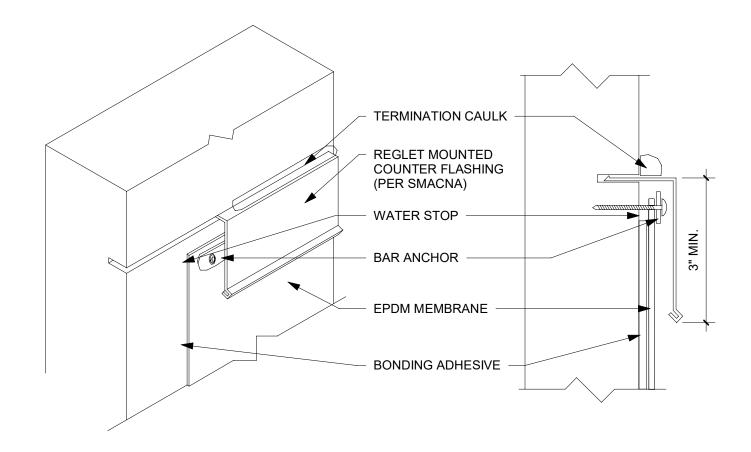
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6 SEAM TAPE APPLICATION DETAIL

 $\frac{\text{NOTES:}}{\text{1. METAL COPING CAP, EXPANSION JOINT AND EDGE DETAILS ARE TYPICAL ONLY. ALL METAL WORK}$ SHOULD BE INSTALLED TO SHEET METAL CODES (SMACNA). CLEAN ALL METAL PRIOR TO INSTALLATION

- OF ROOF MATERIALS. 2. ALL WOOD NAILERS TO BE APPROVED MATERIAL. ATTACHMENT OF WOOD NAILER TO BE ACCOMPLISHED BY USING FASTENERS PROVIDED NO LESS THAT 125 LB OF PULLOUT RESISTANCE PER LINEAR FOOT, WITH FASTENER SPACING NO GREATER THAN 24" BETWEEN FASTENERS.
- 3. ALL PARAPET WALLS AND ROOF CURBS MUST BE SUITABLE FOR FLASHING, I.E. CLEAN, TIGHT SMOOTH. NO CRACKS, ETC.
- 4. WHEN FIELD MEMBRANE IN USED AS WALL OR CURB FLASHING, VERTICAL SEAMS MUST BE STRIPPED IN AT BASE OF ANGLE CHANGE WITH A 7" WIDE STRIP OF PEEL AND STICK FLASHING. SEE DETAIL 9/A504.

1 EPDM MEMBRANE COPING TERMINATION DETAIL 12" = 1'-0"



REGLET MOUNTED COUNTER FLASHING TERMINATION DETAIL 6" = 1'-0"

FASCIA COVER (12'-0" LENGTHS) -- WOOD NAILER FULLY ADHERED EPDM RUBBER MEMBRANE ROOFING SYSTEM (EPDM) WRAP OVER PARAPET AND SECURE TO WOOD BLOCKING #10 X 2" STAINLESS STEEL TAPERED INSULATION PITCH 1/4" PER FOOT MINIMUM TO EXISTING INTERIOR ROOF DRAINS OR ROOF EDGE ANCHOR BAR EXTRUDED SCUPPER IN WATERDAM COPING SYSTEM NEW WOOD BLOCKING AT PROVIDE POLYISOCYANURATE (ISO) RIGID INSULATION ROOF EDGE AS NEEDED FOR (R-30CI MIN.), FULLY ADHERED INSTALLATION OF NEW - WATER/AIR VAPOR BARRIER EXISTING DECK 1/4" X 1 1/4" MASONRY/WOOD 20 GA. GALV. CONTINUOUS CLEAT EXTERIOR WALL (BRICK)

1. PROVIDE ANCHORGARD EXTENDED CANTED FASCIA - 12" (GALVANIZED WATERDAM VERSION) AS AVAILABLE FROM FIRESTONE BUILDING PRODUCTS, OR APPROVED EQUAL, COLOR TO BE SELECTED BY OWNER FROM MANUFACTURERS FULL RANGE OF COLOR OPTIONS.

- 2. PROVIDE DOWNSPOUT SCUPPER IN LOCATION SHOWN ON ROOF PLAN.
- 3. INSTALL WATERDAM FASCIA COPINGS AND SCUPPERS PER MANUFACTURERS REQUIREMENTS.

ROOF METAL COPING DETAIL AT EXISTING ROOF 1 1/2" = 1'-0"


FASCIA COVER (12'-0" LENGTHS) -WOOD NAILER - WOOD BLOCKING #10 X 2" STAINLESS STEEL FASTENERS 12" O.C. ANCHOR BAR EXTRUDED NEW WOOD BLOCKING AT ROOF EDGE AS NEEDED FOR **INSTALLATION OF NEW ROOF SYSTEM -**1/4" X 1 1/4" MASONRY/WOOD FASTENERS 24" O.C. 20 GA. GALV. CONTINUOUS CLEAT EXTERIOR WALL (BRICK)

NOTES:

1. PROVIDE ANCHORGARD EXTENDED CANTED FASCIA - 12" (GALVANIZED WATERDAM VERSION) AS AVAILABLE FROM FIRESTONE BUILDING PRODUCTS, OR APPROVED EQUAL, COLOR TO BE SELECTED BY OWNER FROM MANUFACTURERS FULL RANGE OF COLOR OPTIONS.

- 2. PROVIDE DOWNSPOUT SCUPPER IN LOCATION SHOWN ON ROOF PLAN.
- 3. INSTALL WATERDAM FASCIA COPINGS AND SCUPPERS PER MANUFACTURERS REQUIREMENTS.

NEW PARAPET METAL COPING DETAIL AT NEW ADDITION

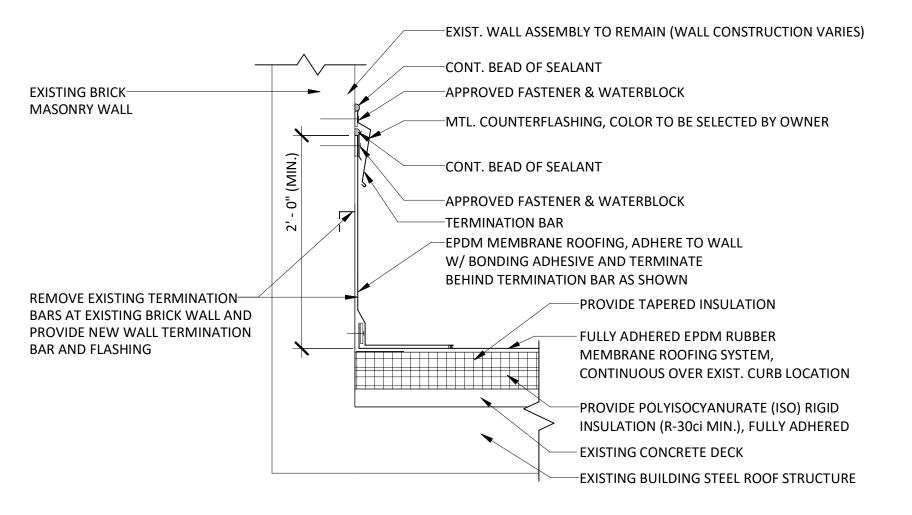

TYPICAL WALL TERMINATION DETAIL AT NEW ADDITION

12" WIDE GALV. ANCHOR CLIPS (SPACING DETERMINED BY MANUFACTURER) COPING COVER (12'-0" LENGTHS) - END OF SCUPPER FASCIA CLOSURE PIECE WRAP EPDM MEMBRANE INTO EXISTING SCUPPER OPENING EXISTING SCUPPER OPENING -THERMOPLASTIC POLYOLEFIN (TPO) FULLY ADHERED ROOFING MEMBRANE SYSTEM AND SECURE TO WOOD BLOCKING AND **EXISTING BRICK** WRAP OVER PARAPET AND UNDER SCUPPER EXISTING CMU BLOCK PARAPET WALL

NOTES:

1. PROVIDE ANCHORGARD EXTENDED CANTED FASCIA - 12" (GALVANIZED WATERDAM VERSION) AS AVAILABLE FROM FIRESTONE BUILDING PRODUCTS, OR APPROVED EQUAL, COLOR TO BE SELECTED BY OWNER FROM MANUFACTURERS FULL RANGE OF COLOR OPTIONS.


2. INSTALL WATERDAM FASCIA COPINGS AND SCUPPERS PER MANUFACTURERS REQUIREMENTS.

6 ROOF METAL SCUPPER DETAIL

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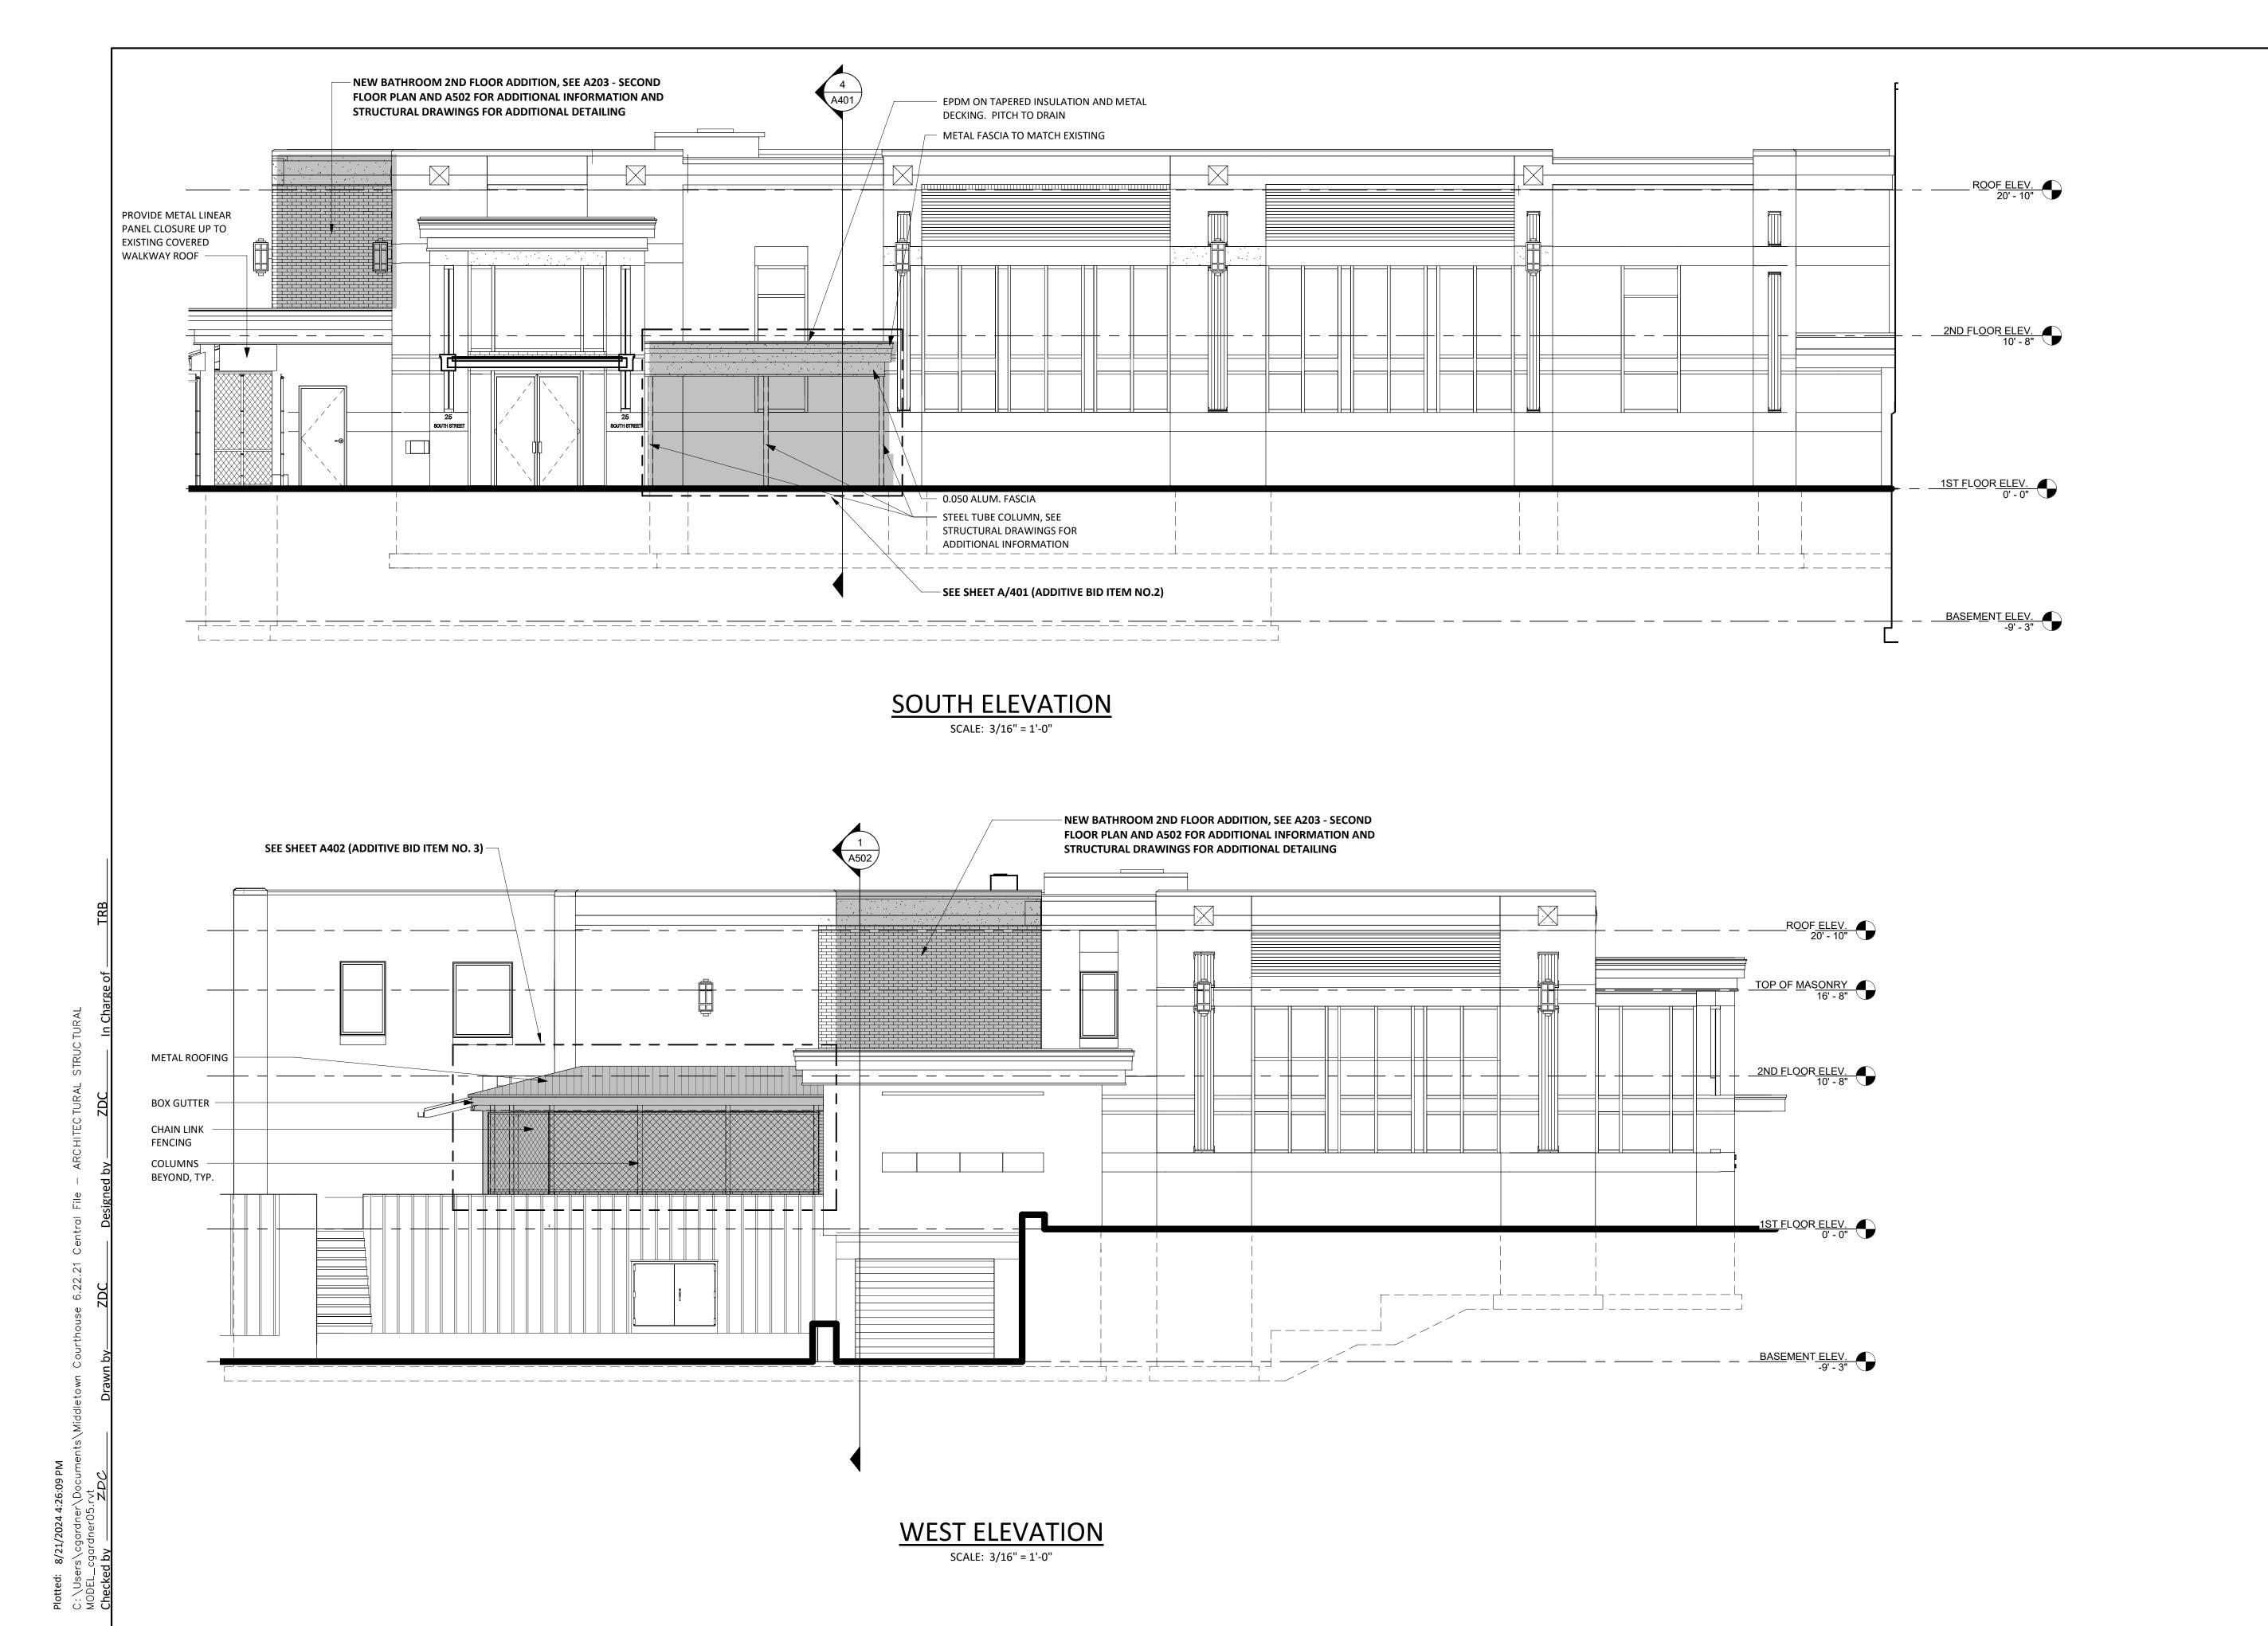
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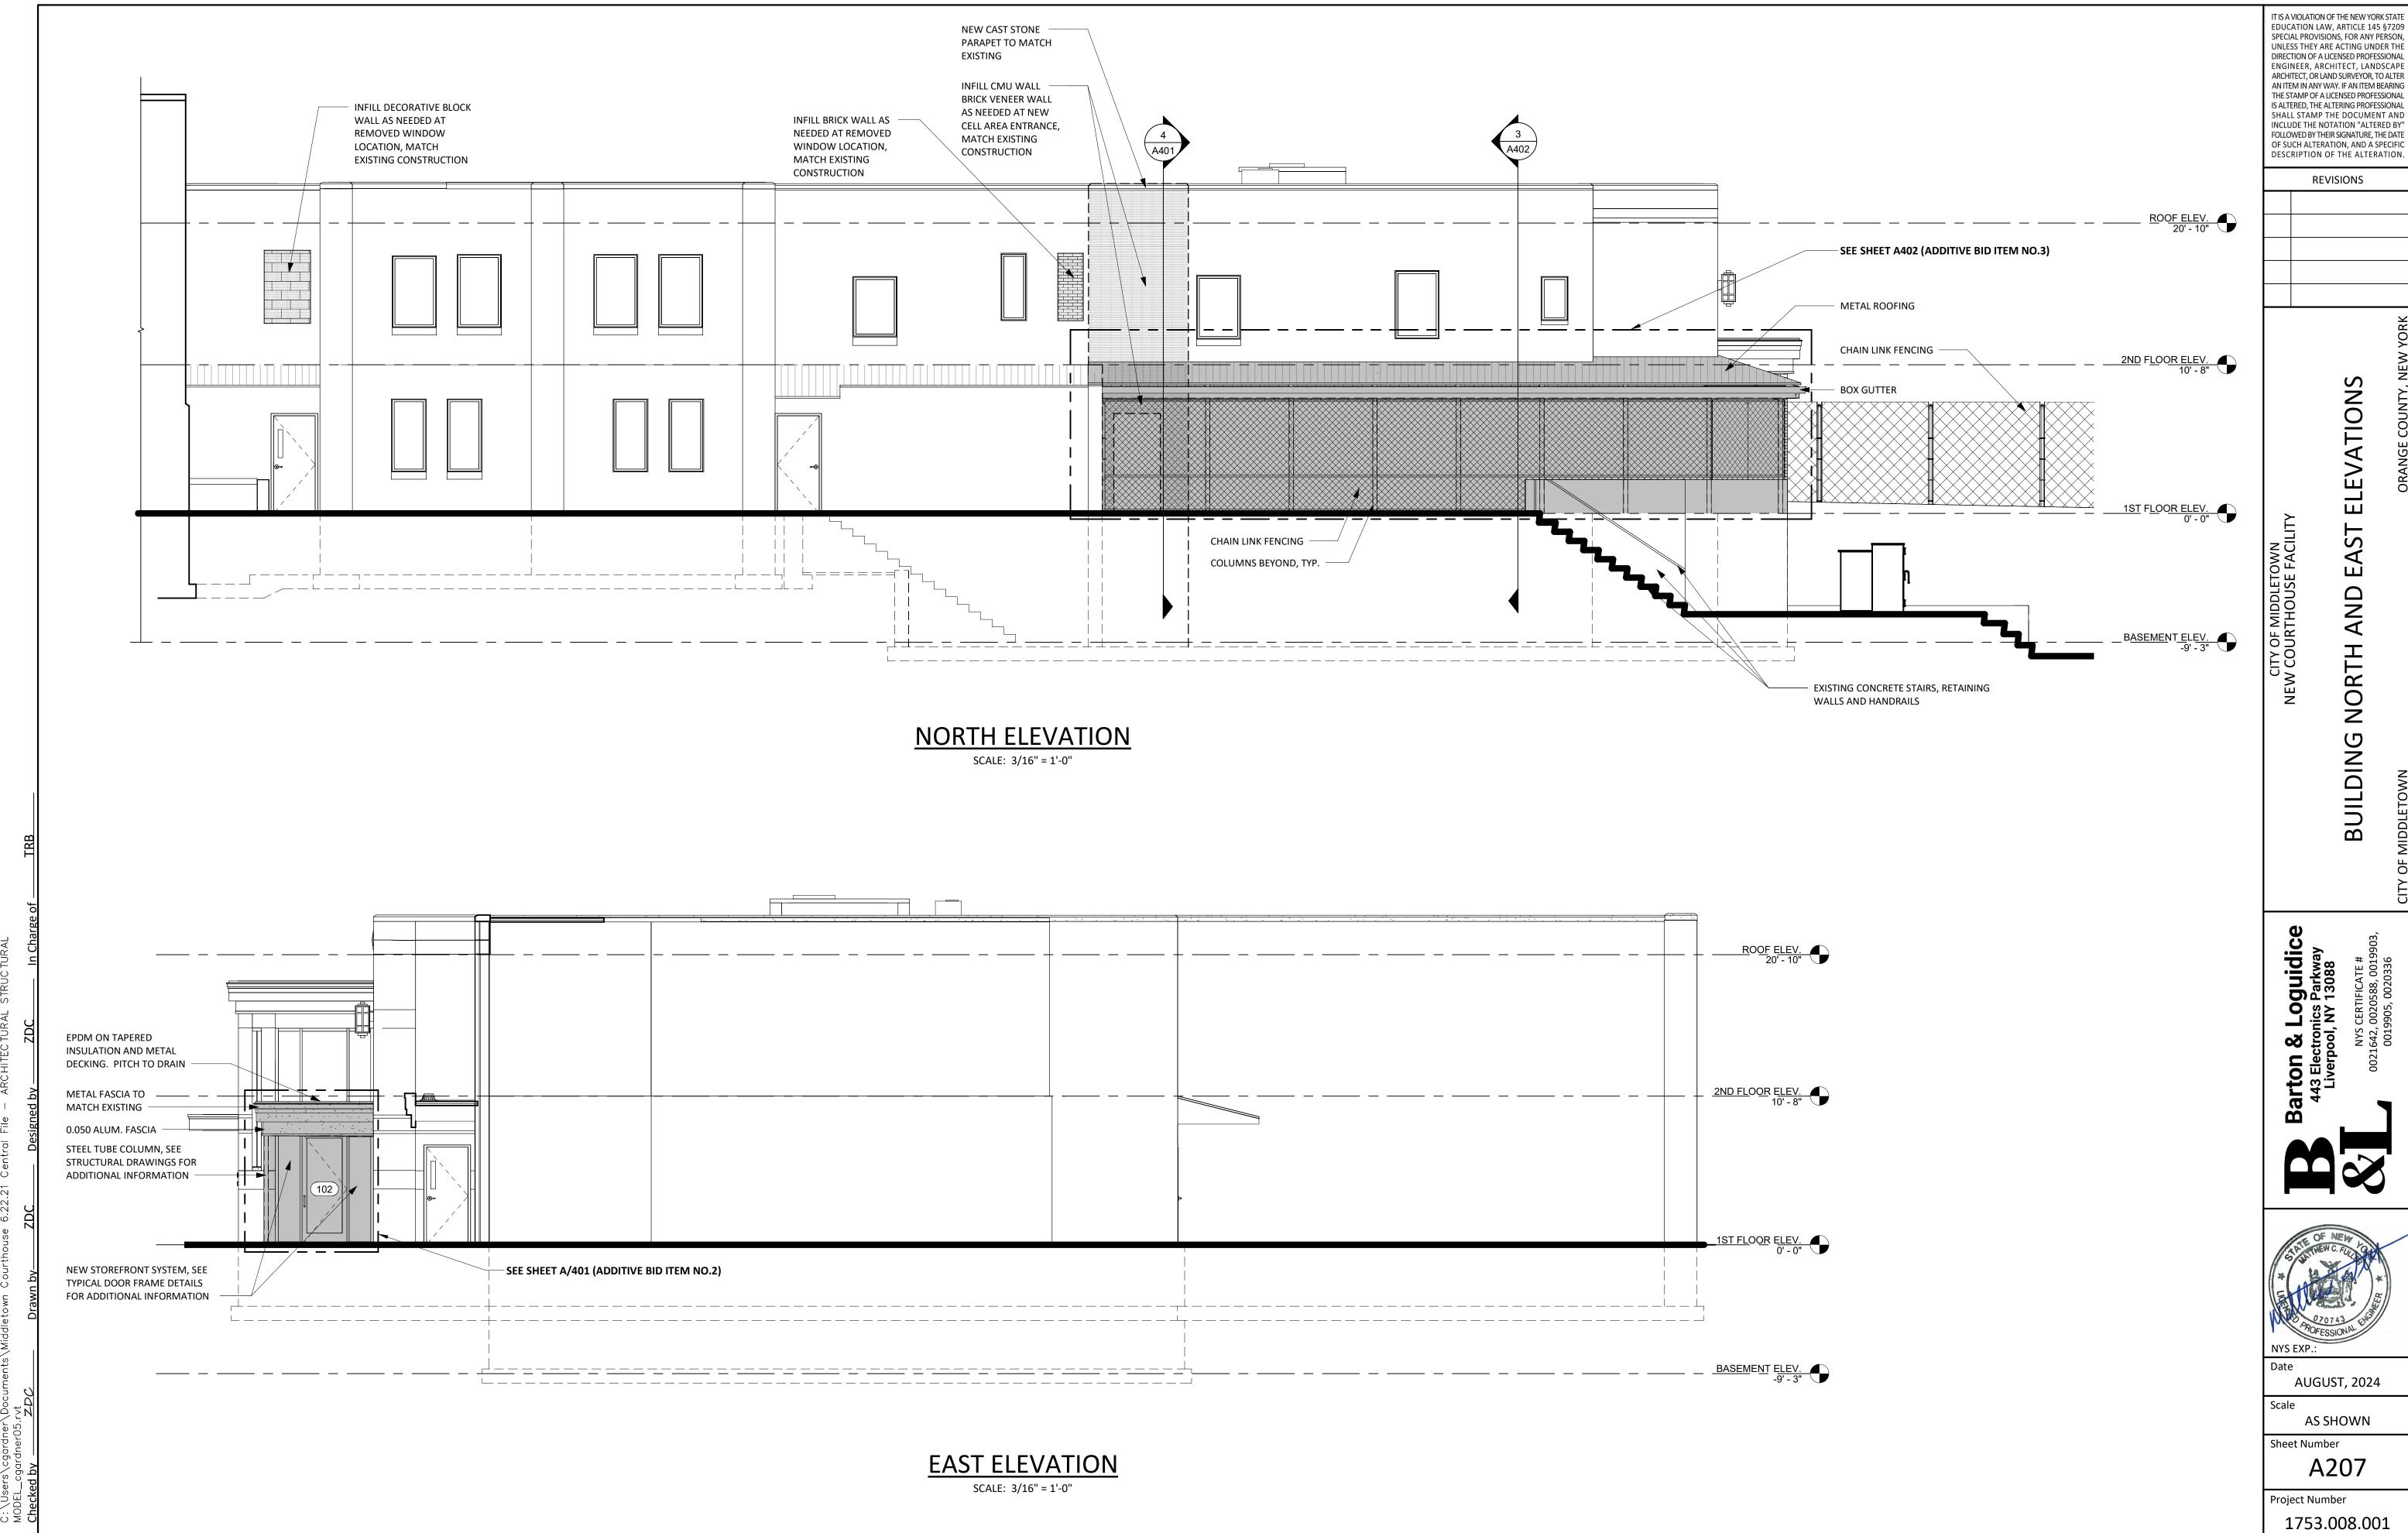
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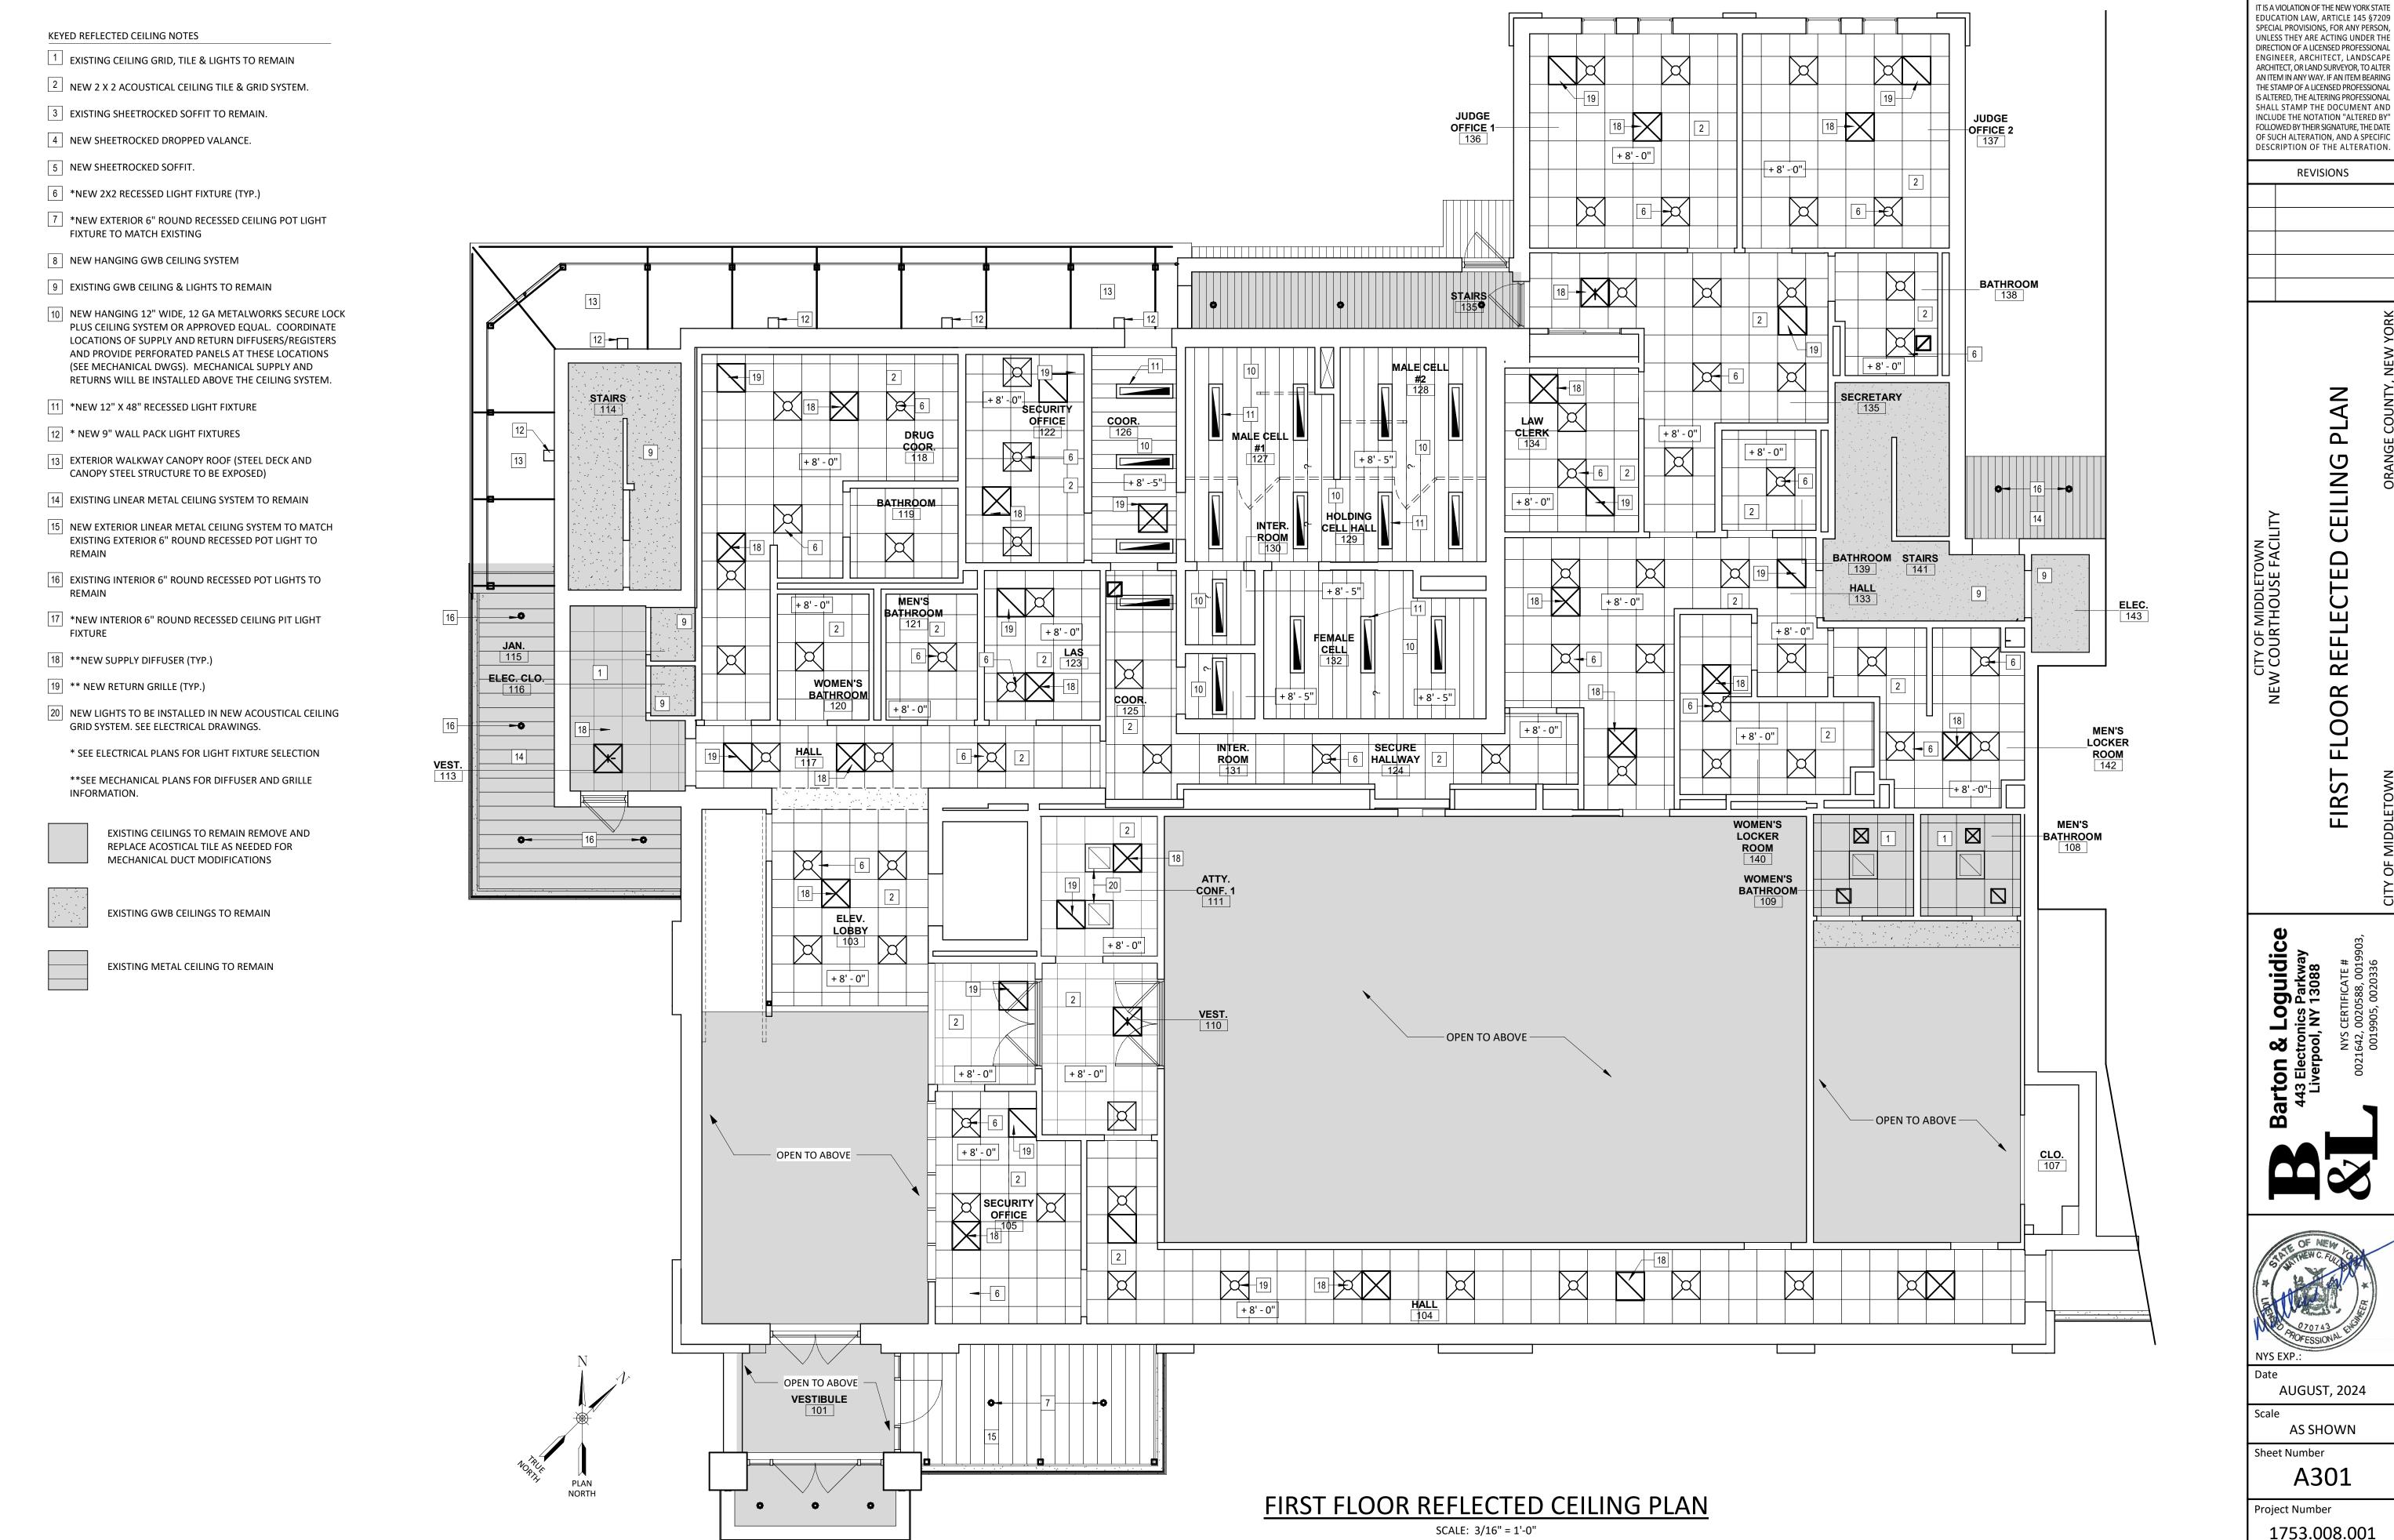
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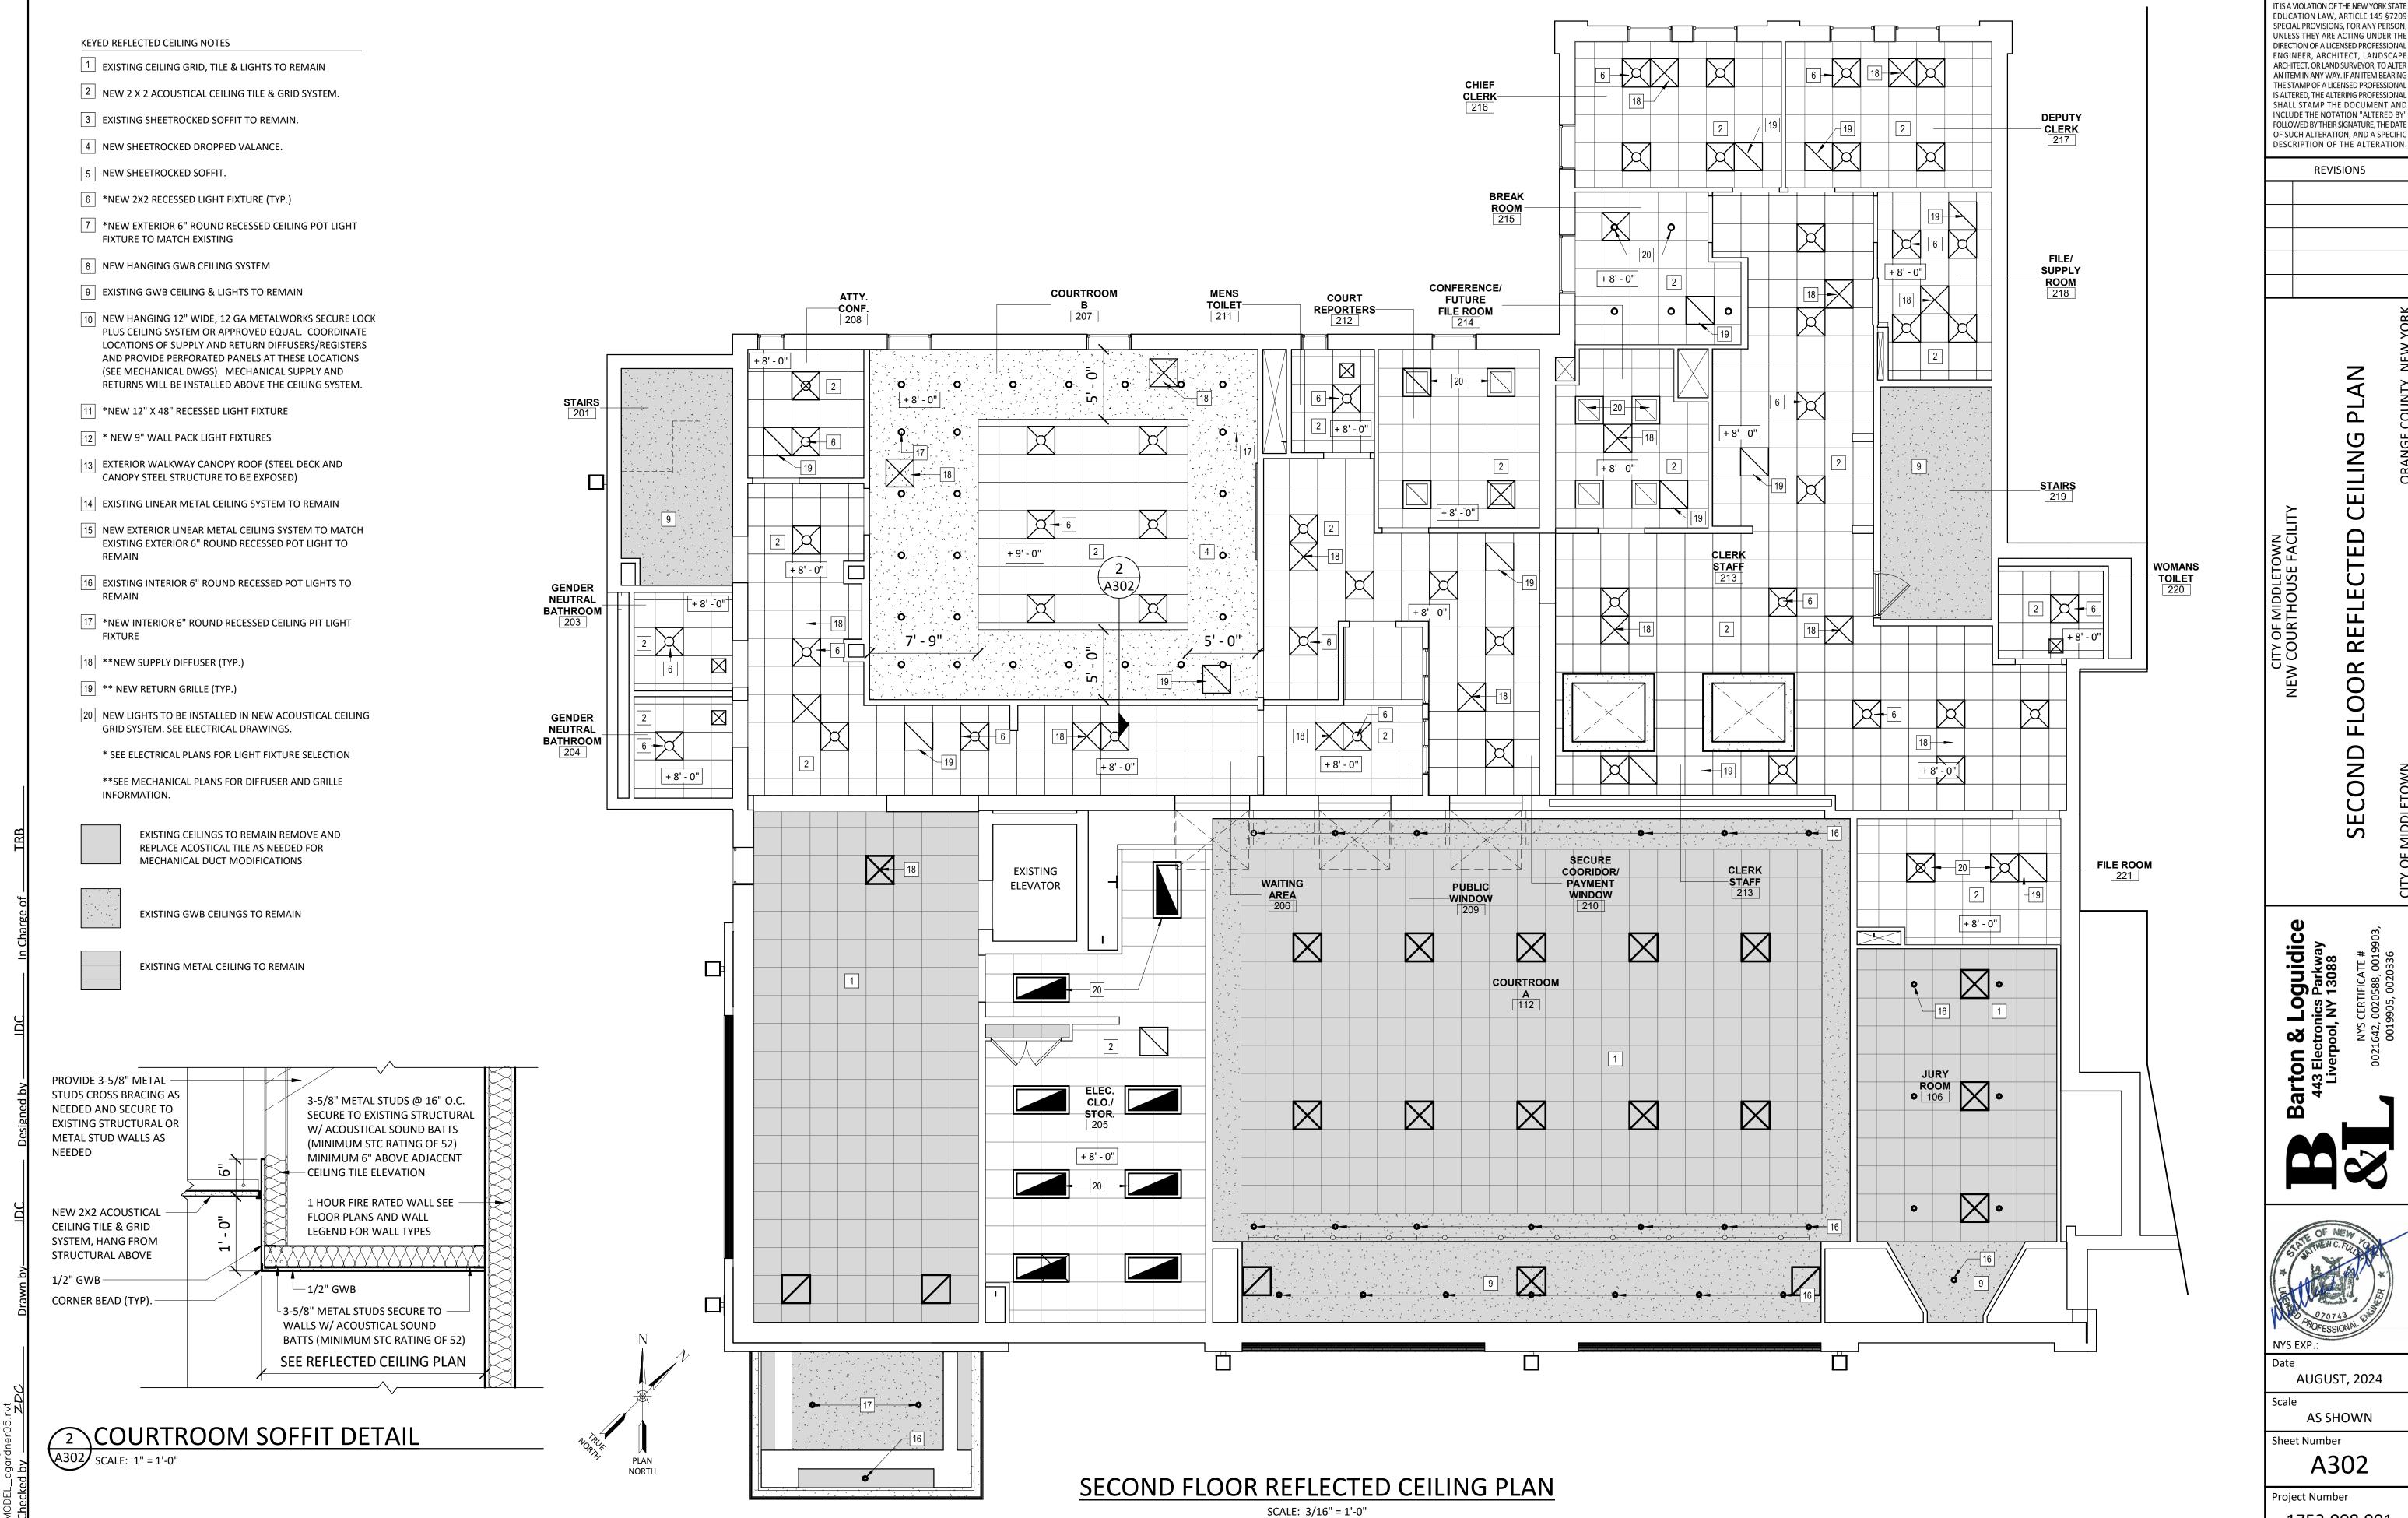


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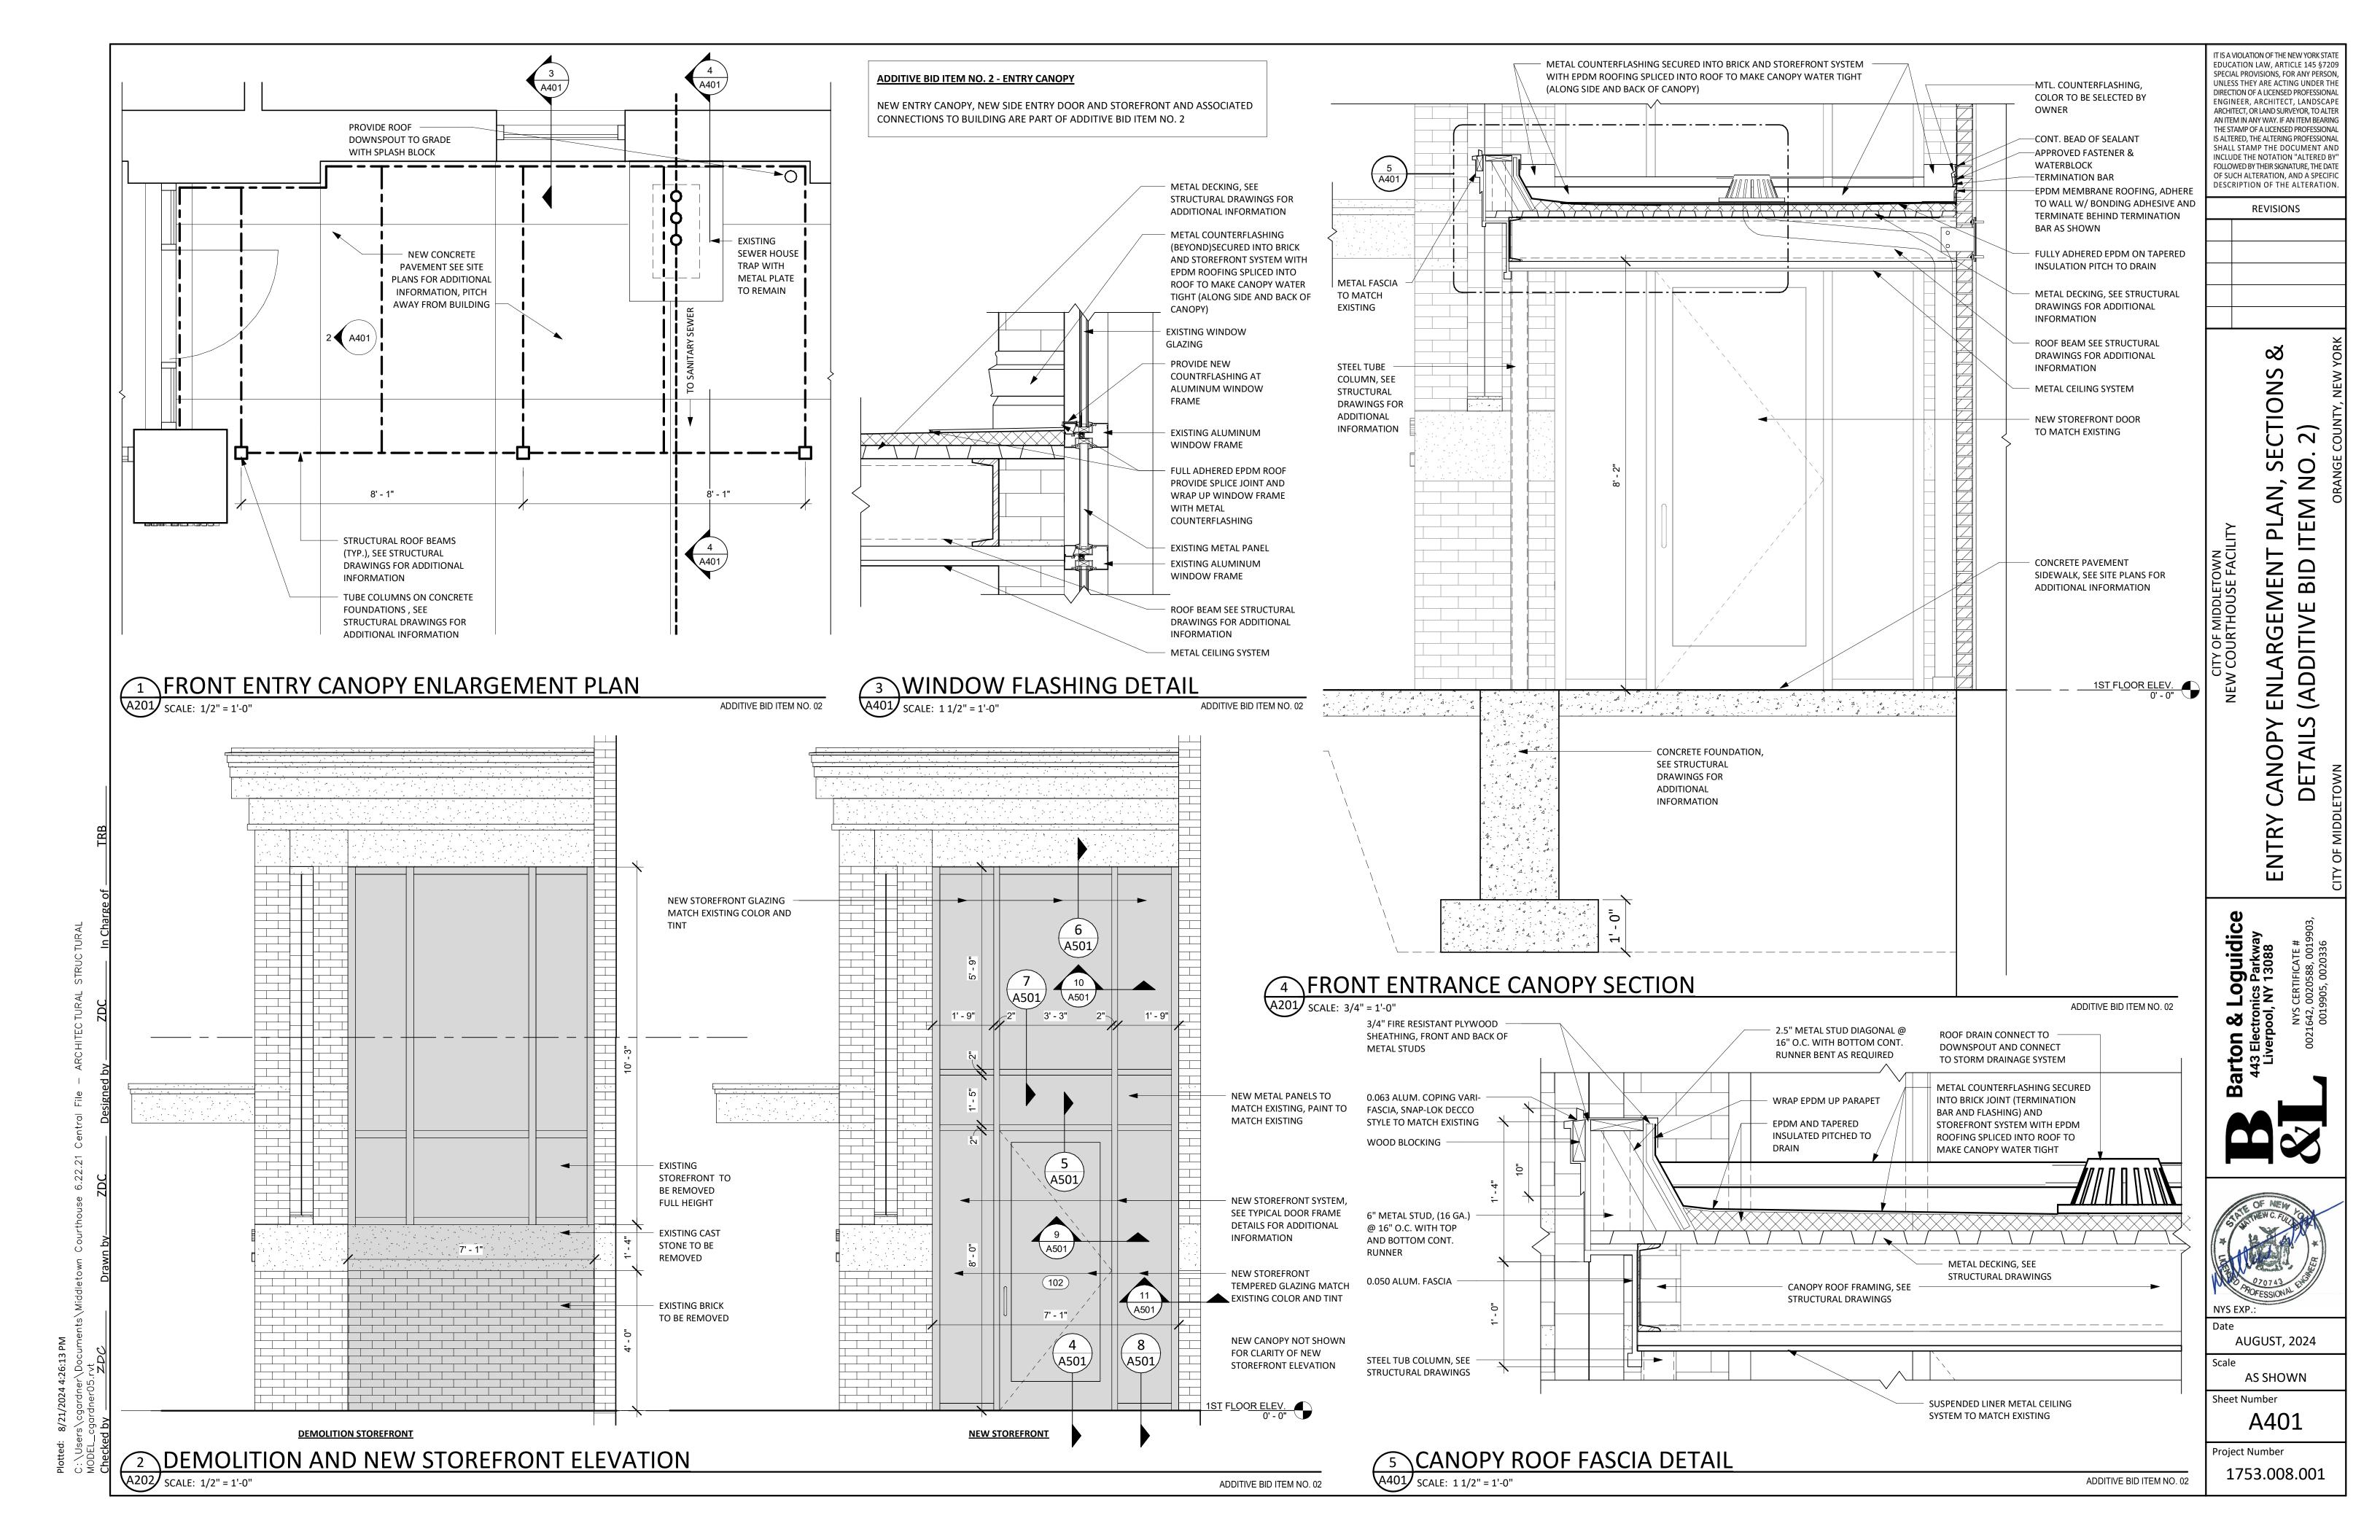
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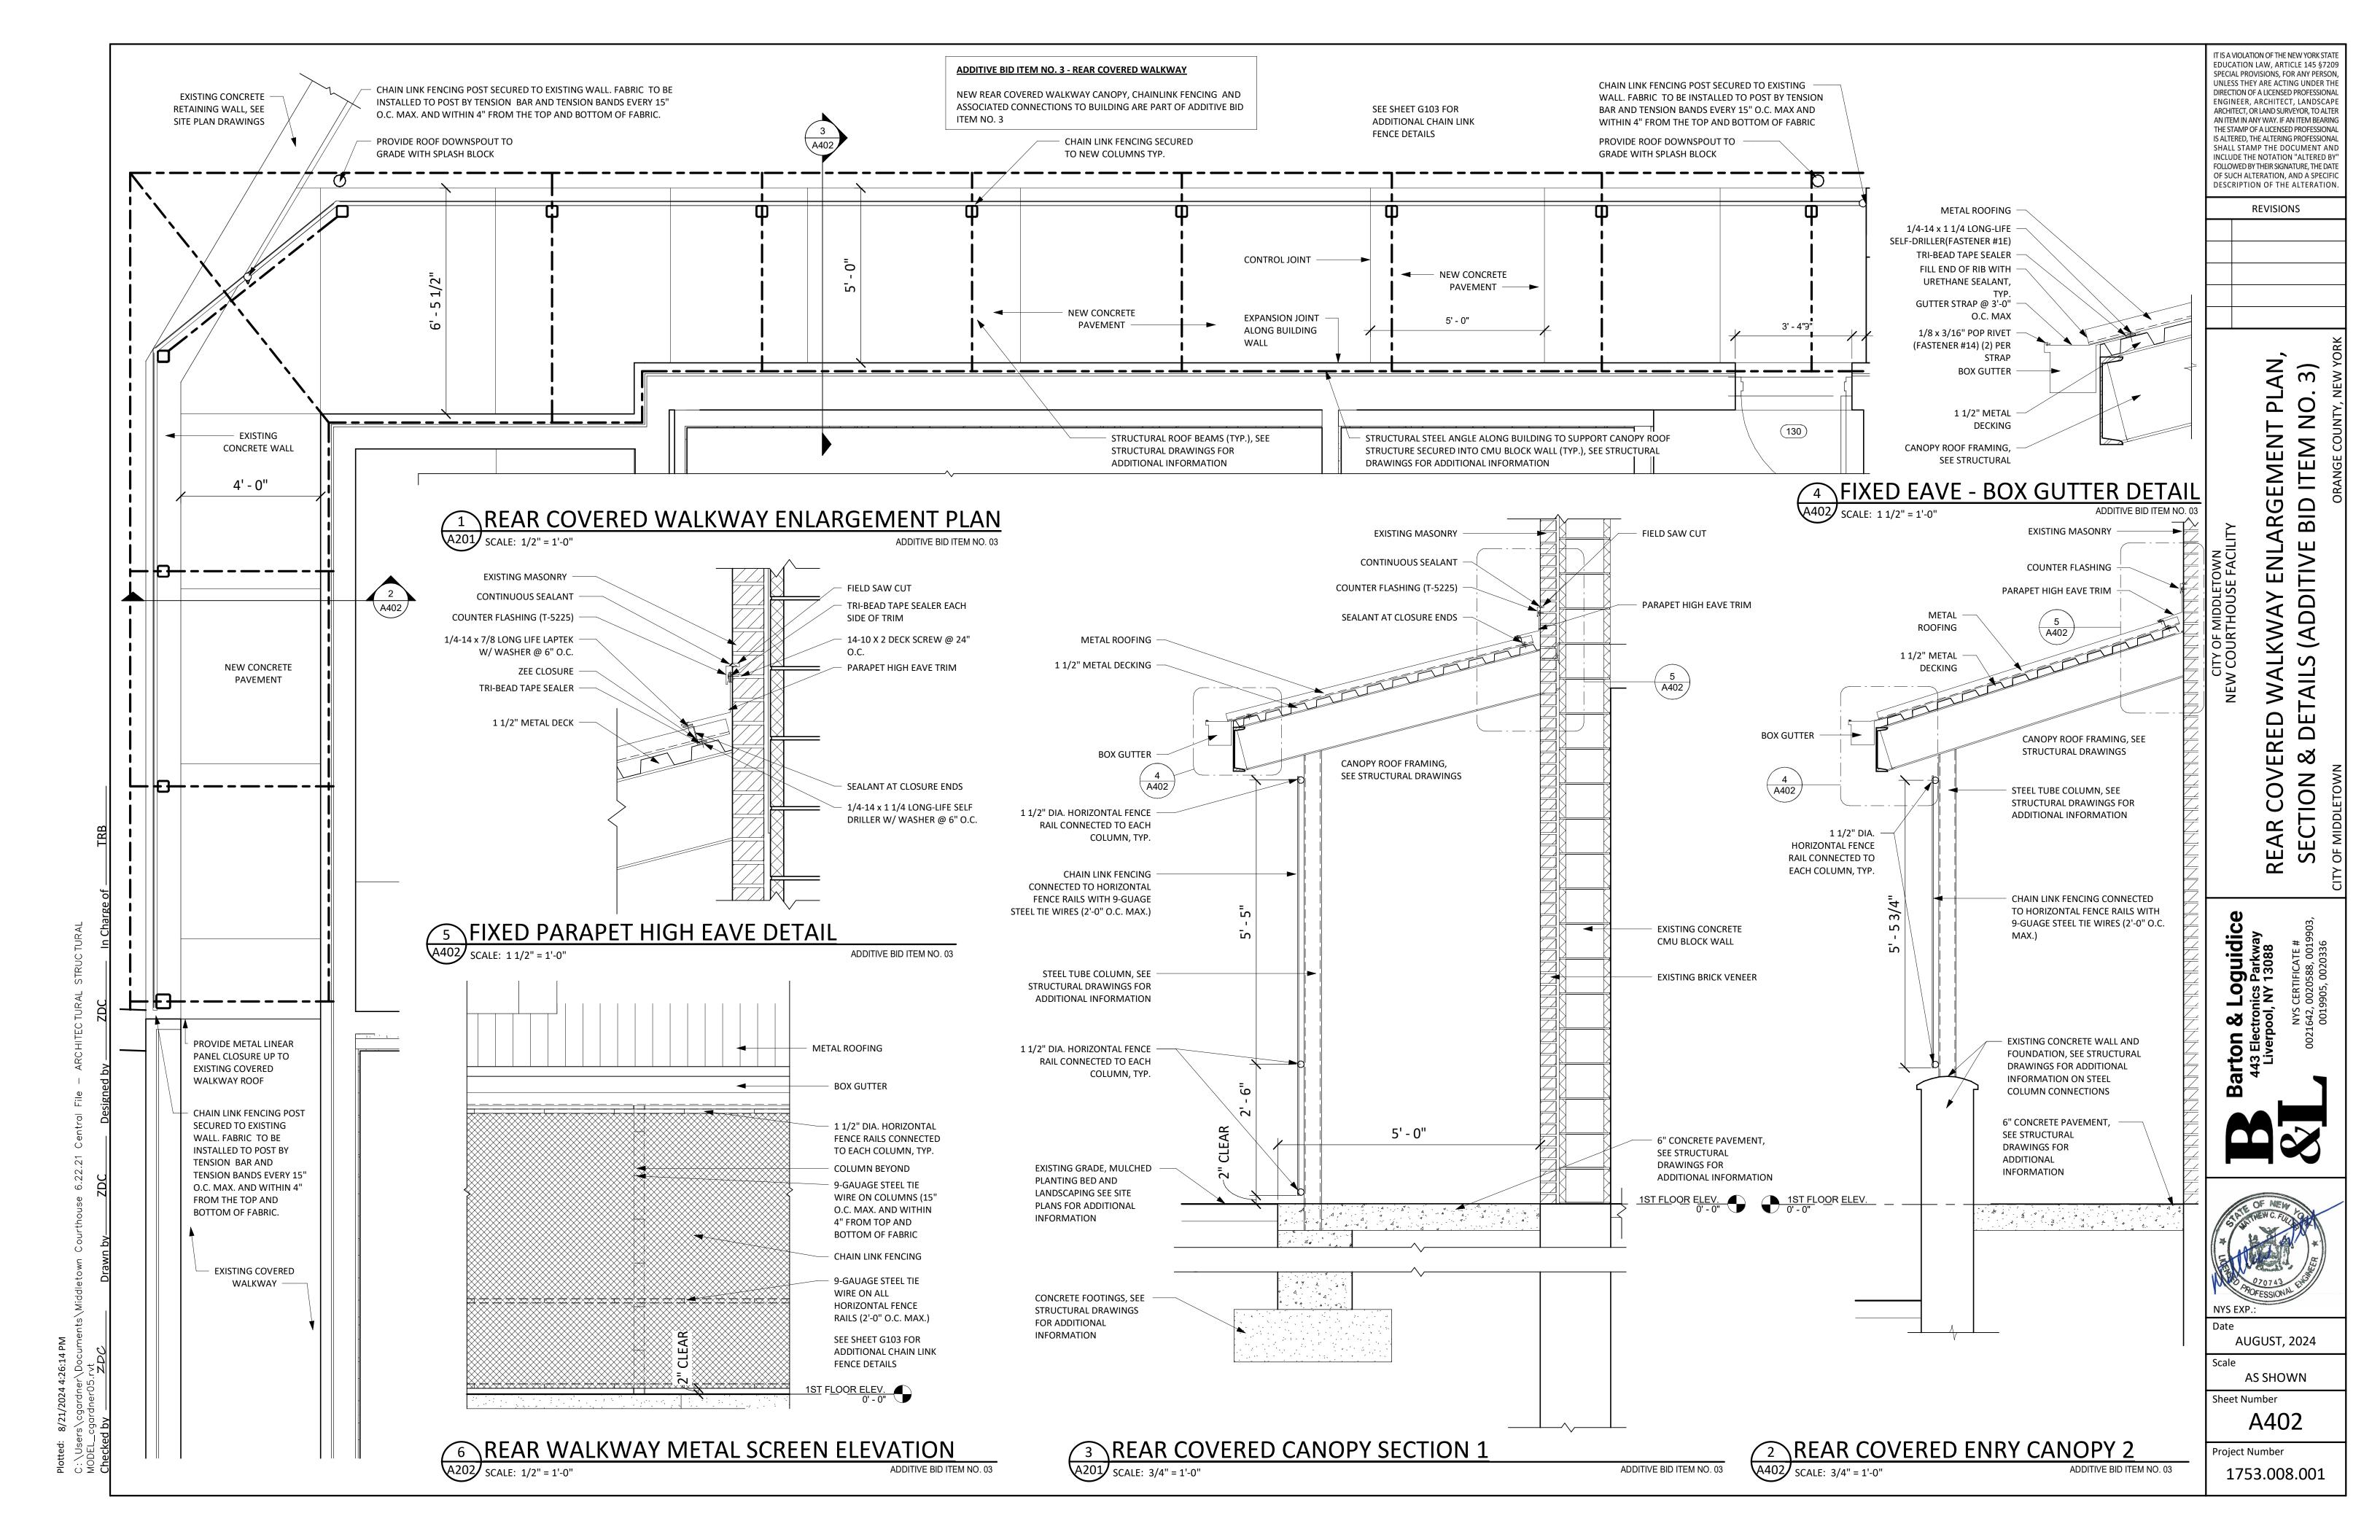
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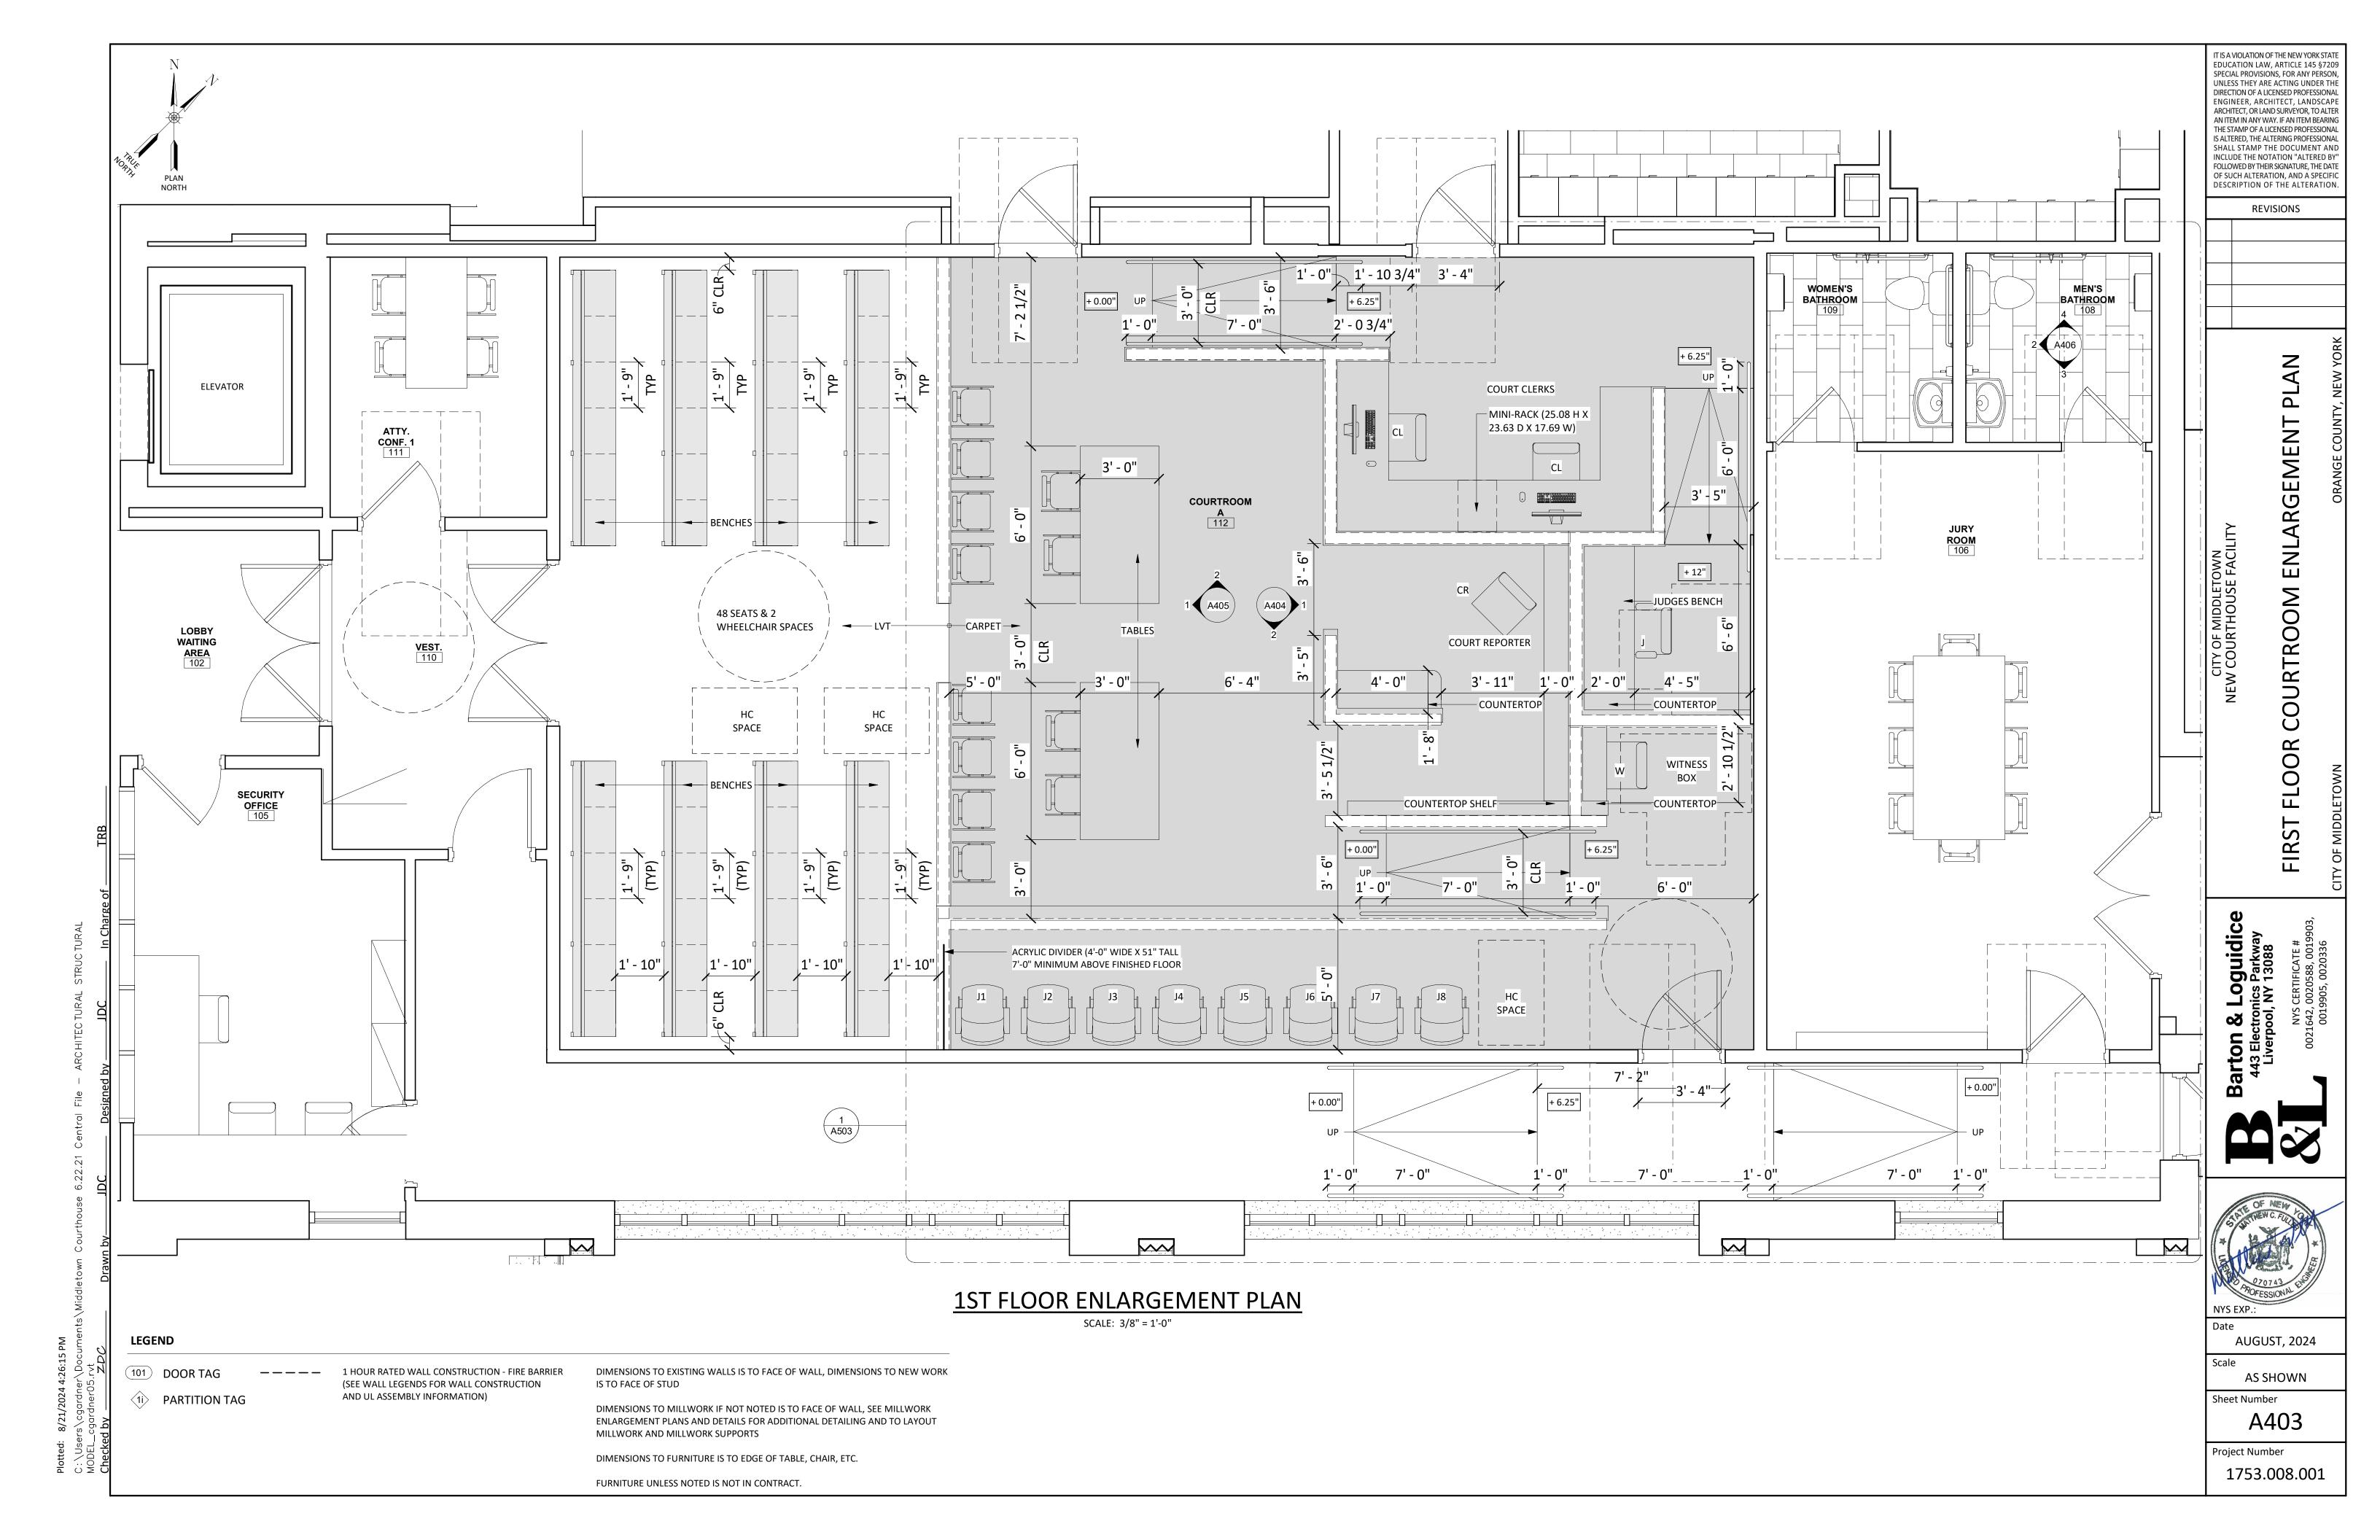
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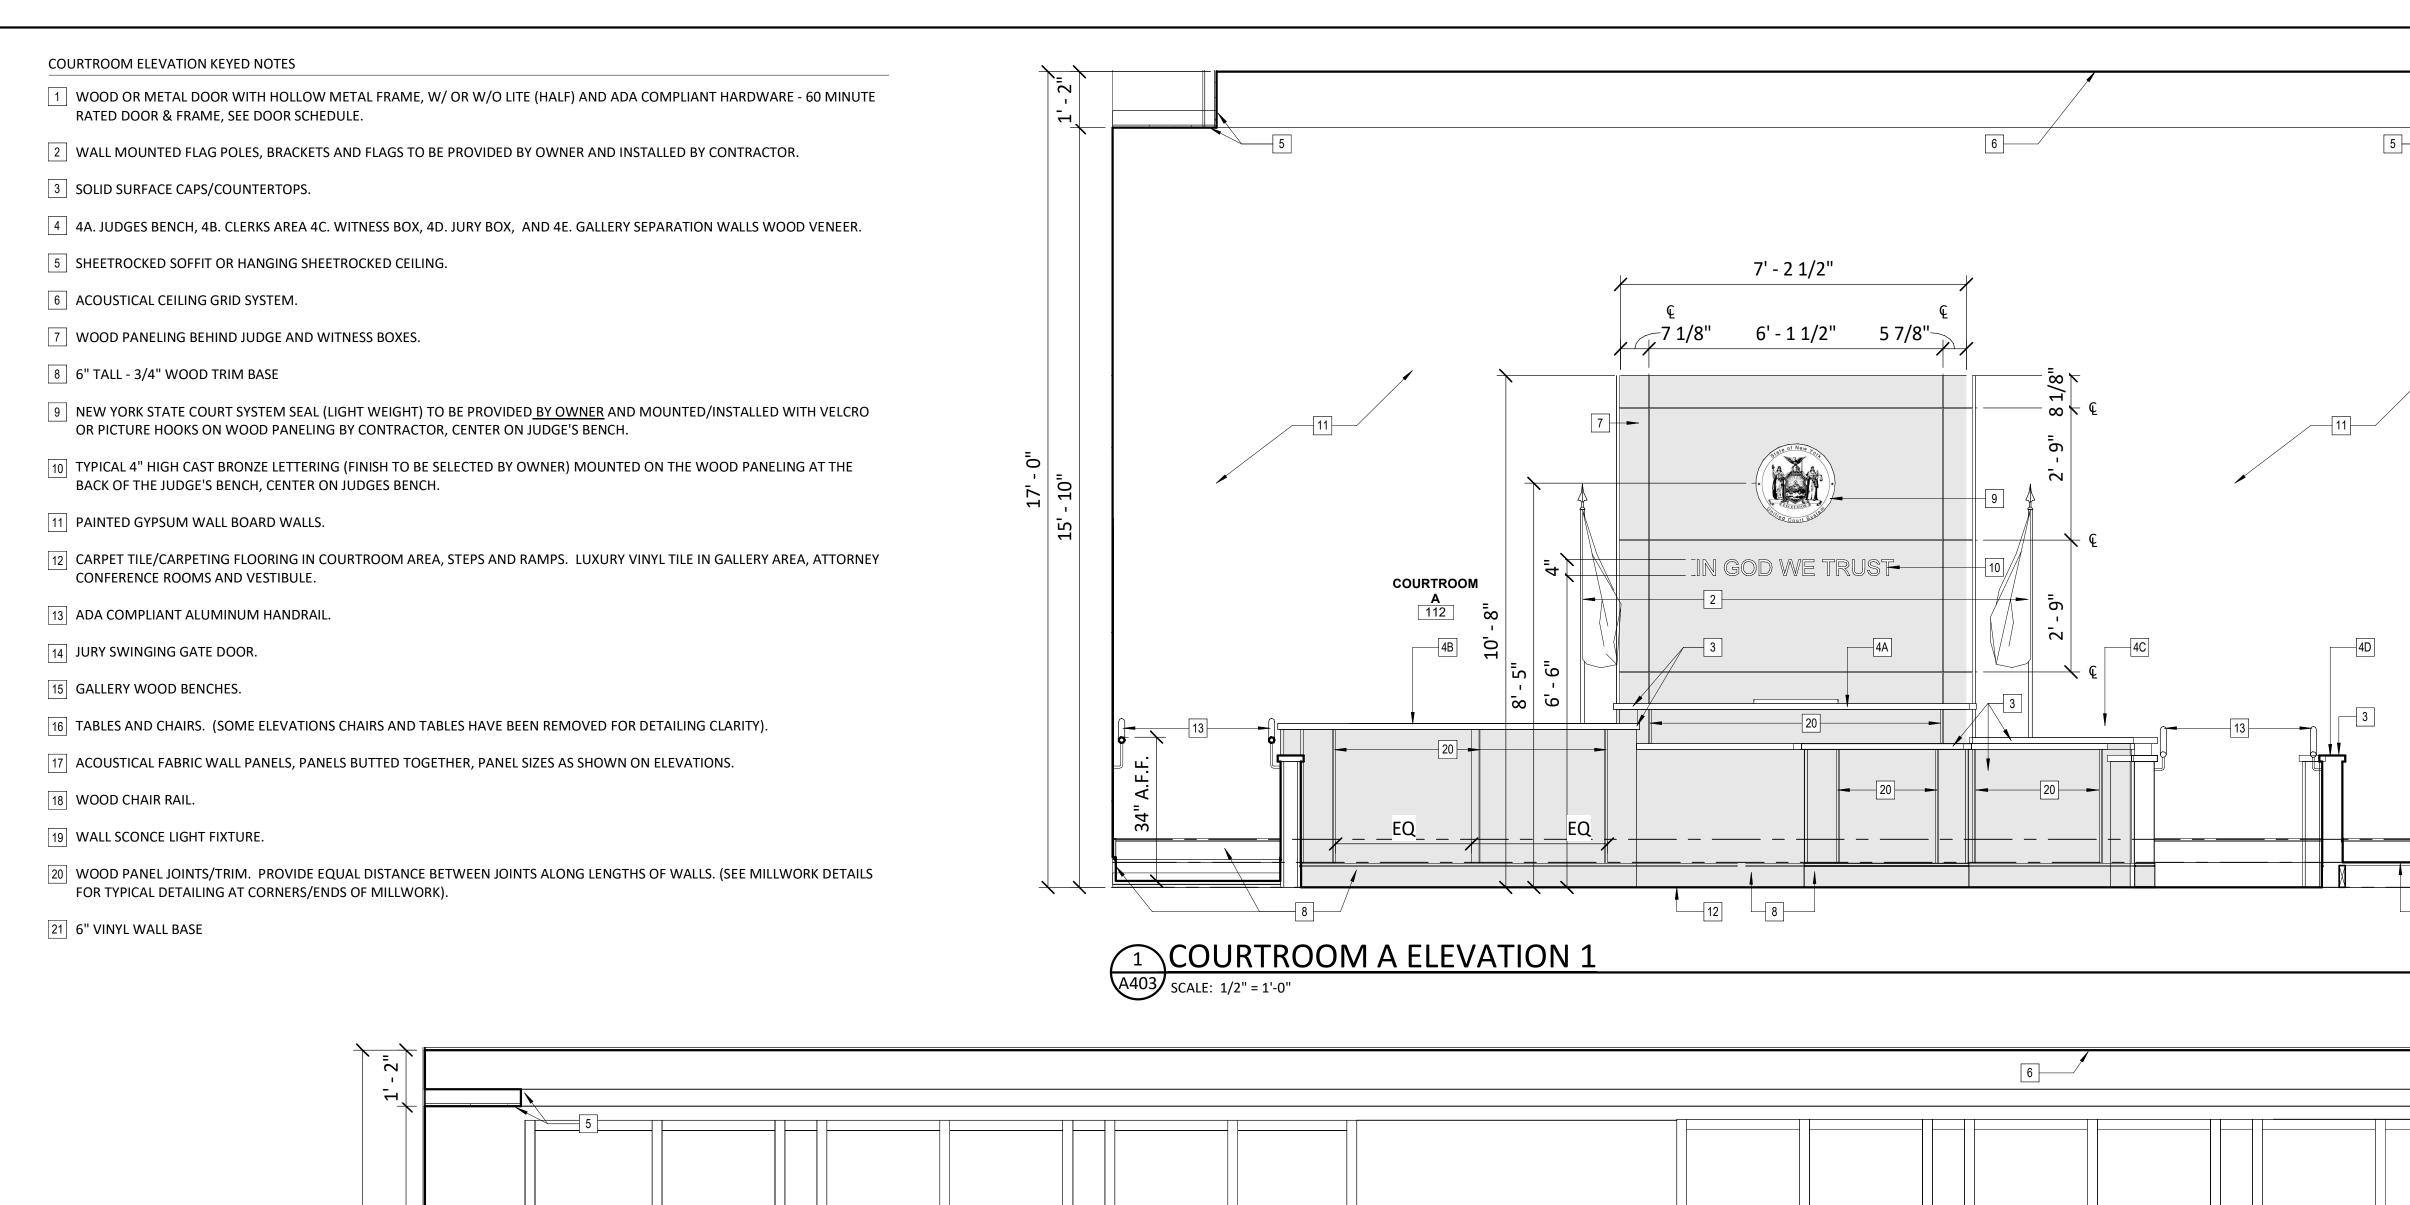



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COURTROOM FLOOR S

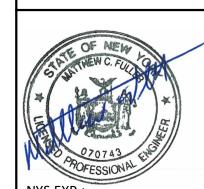

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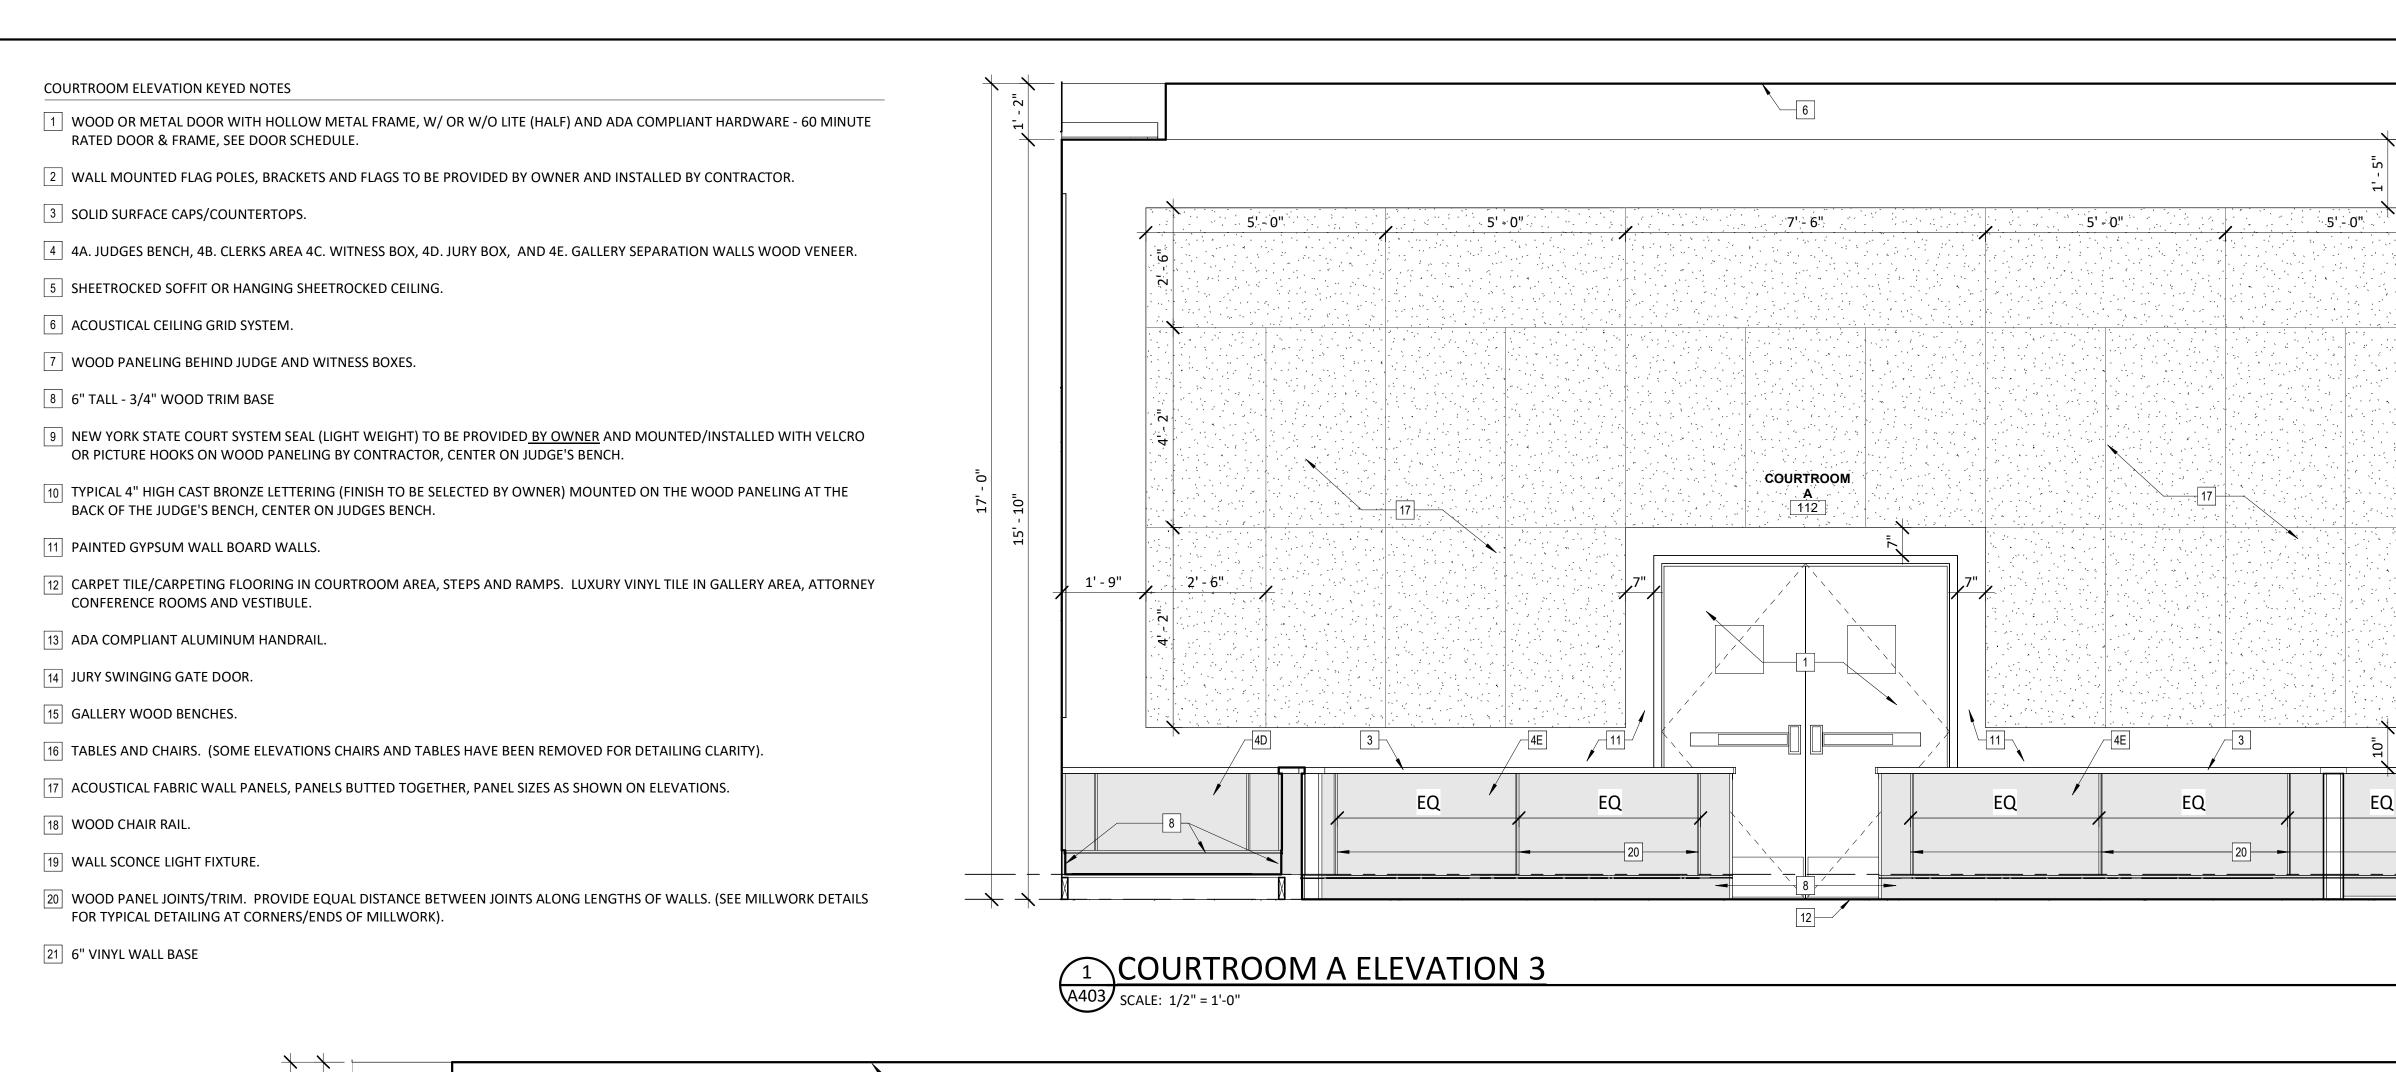
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COURTROOM A ELEVATION 2

A403 SCALE: 1/2" = 1'-0"

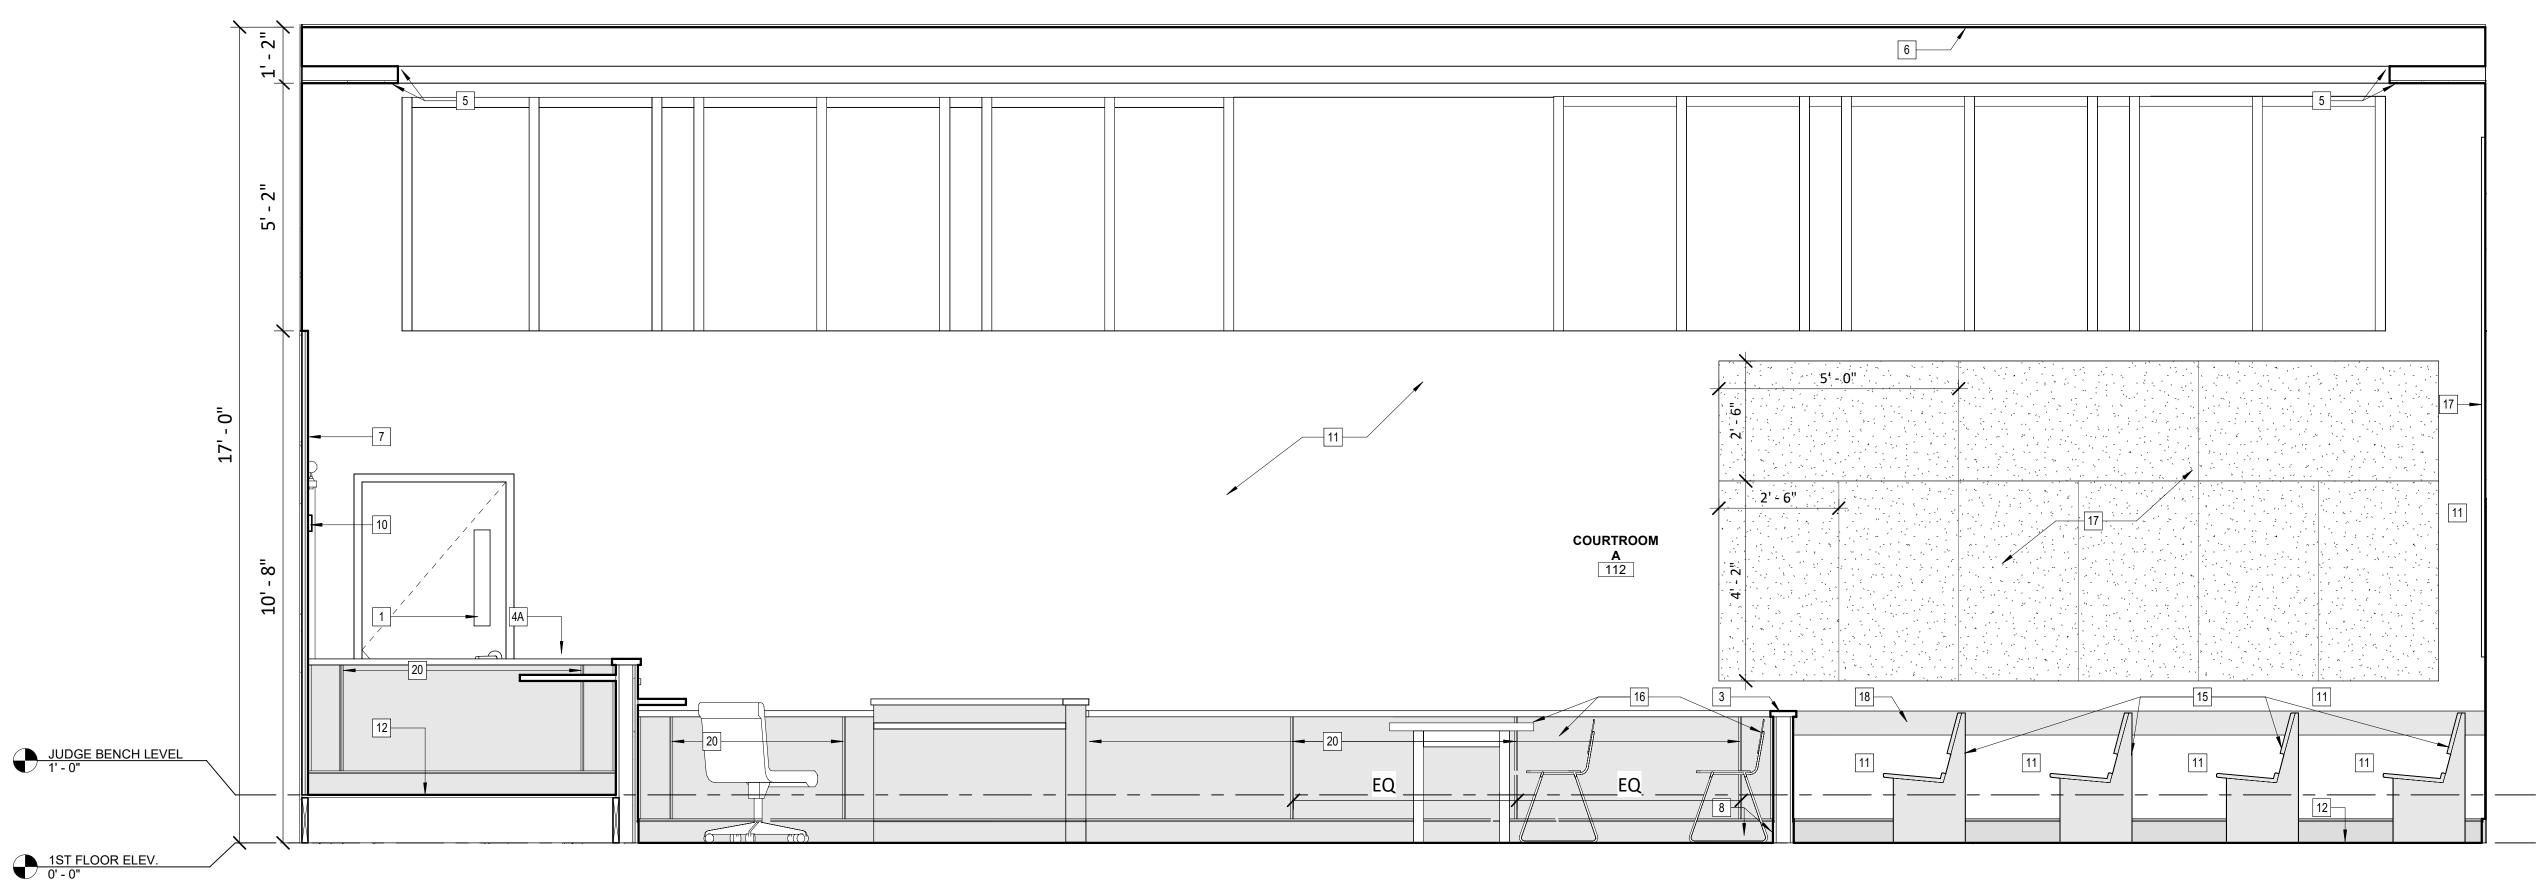

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COURTROOM


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Project Number 1753.008.001



COURTROOM A ELEVATION 4

SCALE: 1/2" = 1'-0"

6 ENLARGED BATHROOM 139 PLAN SCALE: 1/2" = 1'-0"

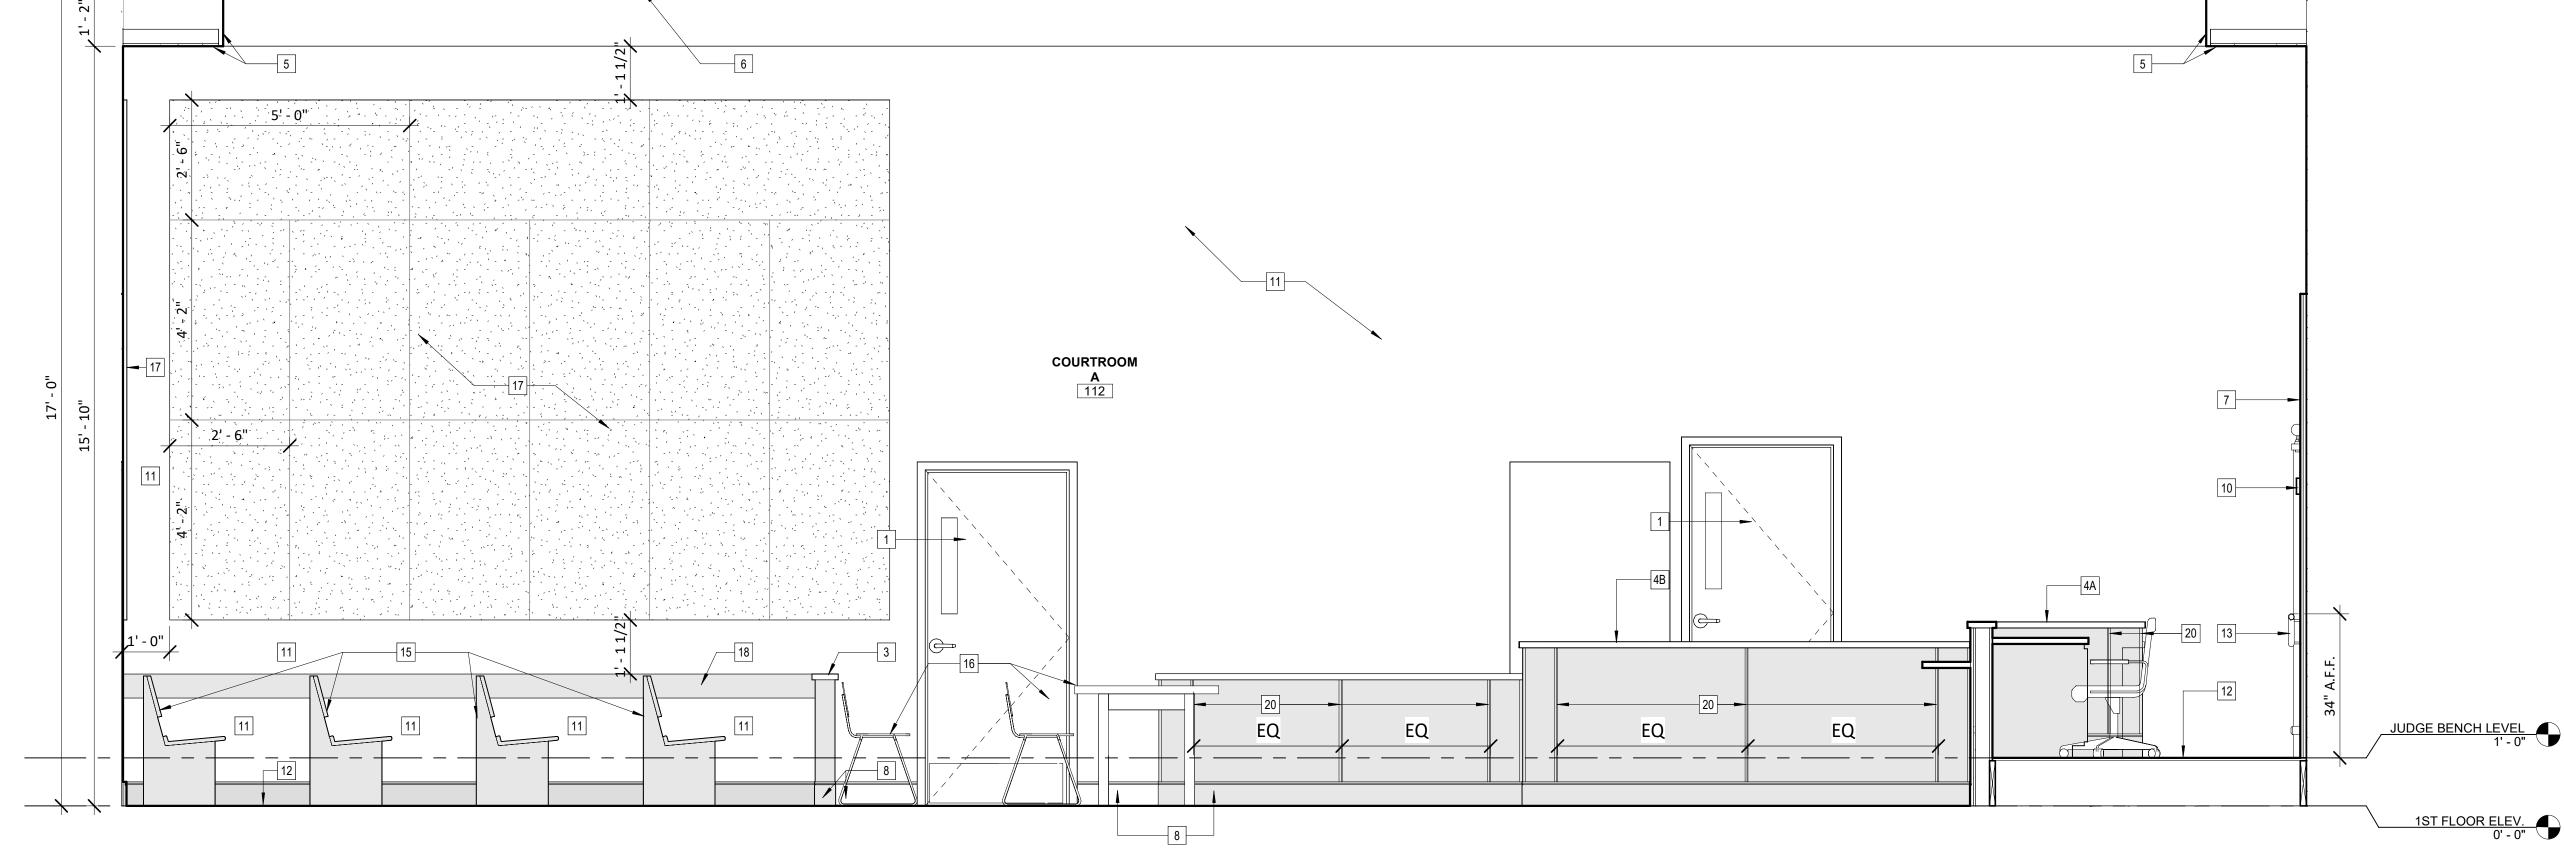A406

7' - 1 3/8"

BATHROOM


7 BATH. 139 ELEVATION 1
A406 SCALE: 1/2" = 1'-0"

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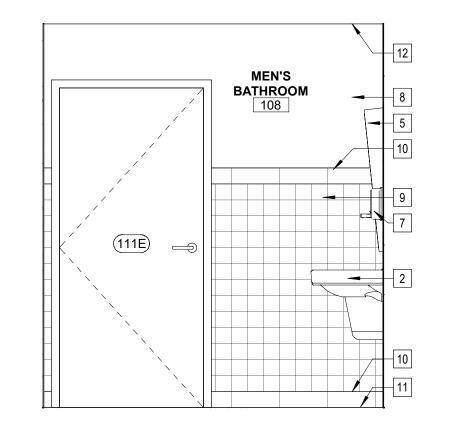
8 BATH. 139 ELEVATION 2
SCALE: 1/2" = 1'-0"

1 ENLARGED BATHROOM 108 & 109 PLAN


A201 SCALE: 1/2" = 1'-0"

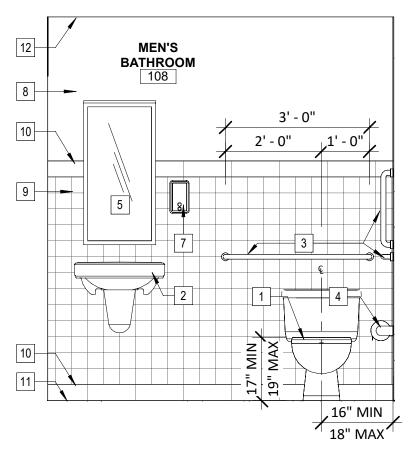


2 BATH. 108 ELEVATION 1 A403 SCALE: 1/2" = 1'-0"



3 BATH. 108 ELEVATION 2
A403 SCALE: 1/2" = 1'-0"

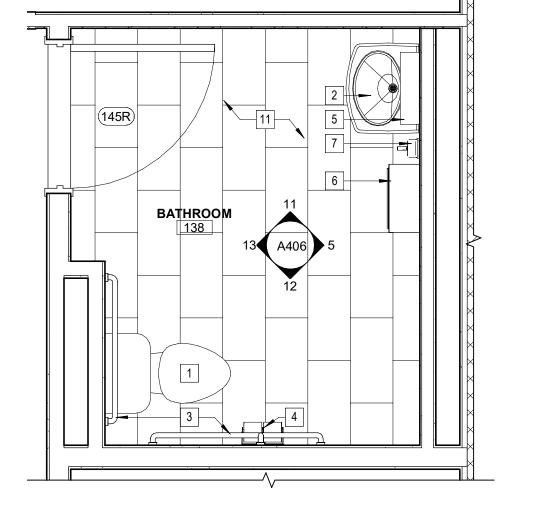


ENLARGED BATHROOM 138 PLAN
SCALE: 1/2" = 1'-0"

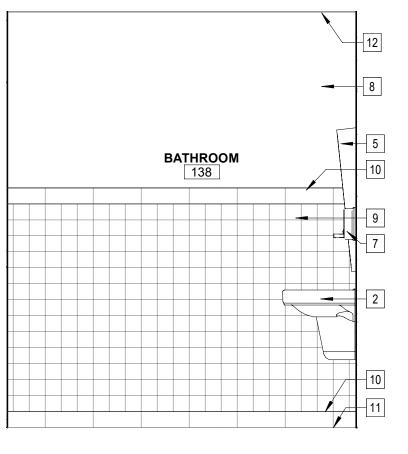


BATHROOM 138 ELEVATION 1


SCALE: 1/2" = 1'-0"

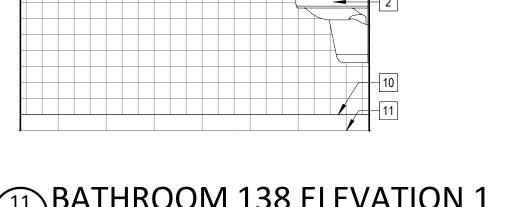

BATHROOM 54" MIN 39" MIN 41" MAX -12" MAX 42" MIN

4 BATH. 108 ELEVATION 3
SCALE: 1/2" = 1'-0"

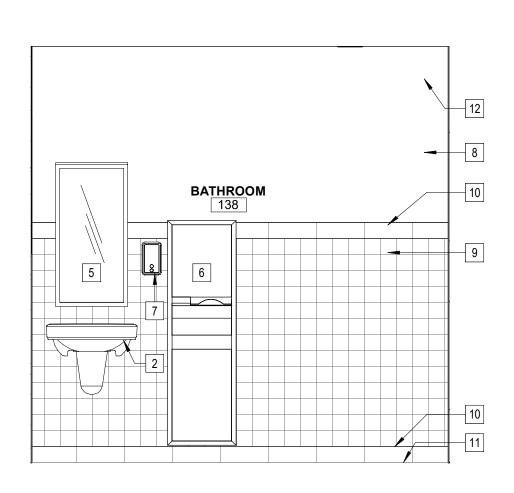

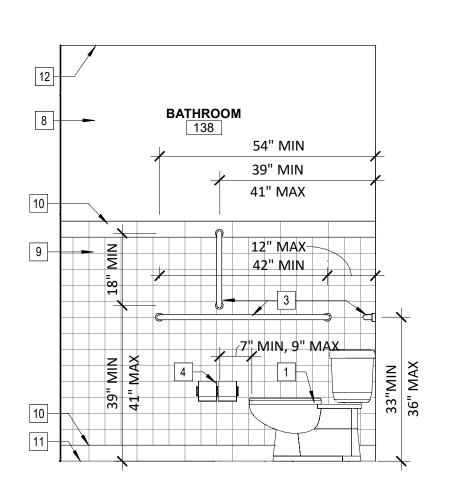


5 BATHROOM 138 ELEVATION 2

SCALE: 1/2" = 1'-0"

BATHROOM 138 ELEVATION 3

SCALE: 1/2" = 1'-0"

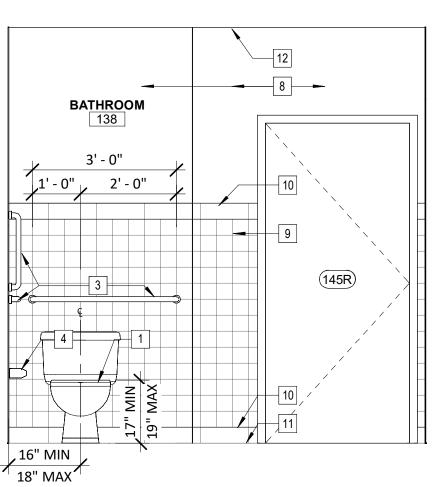

BATHROOM 138 ELEVATION 4

BATHROOM KEY NOTES

- 1 | SEE PLUMBING SHEETS FOR ADA COMPLIANT WATER CLOSET TOILET (SEAT 17 MIN. AND 19" MAX. OFF OF THE FLOOR) IN LOCATIONS SHOWN, SEE PLUMBING DRAWINGS FOR FIXTURE SELECTION, COLOR TO BE SELECTED BY OWNER.
- 2 | SEE PLUMPING SHEETS FOR ADA COMPLIANT WALL MOUNTED SINKS AND FAUCETS (THE FRONT OF THE SINK SHALL BE A MAXIMUM OF 34" ABOVE THE FLOOR) IN LOCATIONS SHOWN, SEE PLUMBING DRAWINGS FOR FIXTURE SELECTION, COLOR TO BE SELECTED BY OWNER. PROVIDE PIPE PROTECTION FOR WATER SUPPLY LINES AND DRAINPIPES UNDER THE SINKS. MAINTAIN PROPER ADA KNEE AND TOE CLEARANCE AT ALL FIXTURES.
- 3 PROVIDE GRAB BARS IN LOCATIONS SHOWN AND AS FOLLOWS. FIXED SIDEWALL GRAB BAR 42" MINIMUM IN LENGTH, LOCATED 12" MAXIMUM FROM REAR WALL AND EXTENDING 54" MINIMUM FROM THE REAR WALL (33" MINIMUM AND 36" MAXIMUM TO TOP OF GRAB BAR OFF OF THE FLOOR). PROVIDE VERTICAL GRAB BAR 18" MINIMUM LENGTH AND SHALL BE MOUNTED WITH THE BOTTOM OF THE BAR LOCATED 39" MINIMUM AND 41" MAXIMUM OFF OF THE FLOOR AND 39" TO 41" TO THE CENTER OF THE BAR FROM THE BACK WALL. THE REAR GRAB BAR SHALL BE 36" MINIMUM IN LENGTH AND EXTEND FROM THE CENTERLINE OF THE WATER CLOSET (TOILET) 12" MINIMUM ON THE SIDE CLOSEST TO THE WALL, AND 24" MINIMUM ON THE TRANSFER SIDE. PROVIDE ALL WOOD BLOCKING IN WALL AS NEEDED FOR THE INSTALLATION OF GRAB BARS.
- 4 PROVIDE ADA COMPLIANT WALL MOUNTED JUMBO BATH TISSUE DOUBLE ROLL DISPENSER TO BE INSTALLED BY CONTRACTOR, 18" MINIMUM FROM THE FLOOR TO THE BOTTOM OF THE UNIT OR 48" MAXIMUM TO THE TOP OF THE UNIT FROM THE FLOOR AND 24" FROM THE BACK WALL TO THE BACK EDGE OF THE UNIT IN LOCATIONS SHOWN ON PLANS. COORDINATE LOCATION WITH GRAB BAR INSTALLATION.
- 5 PROVIDE ADA COMPLIANT 24" W x 36" H MIRROR, WHICH SHALL BE MOUNTED WITH THE BOTTOM EDGE OF THE REFLECTING SURFACE NO HIGHER THAN 40" ABOVE THE FLOOR.
- 6 PROVIDE ADA COMPLIANT WALL MOUNTED PAPER TOWEL DISPENSER AND WASTE DISPOSAL COMBINATION UNIT TO BE INSTALLED BY CONTRACTOR (MOUNT WITH THEIR 'OPERABLE PART" DISPENSING MECHANISM NO MORE THAN 48" ABOVE THE FLOOR) IN LOCATIONS SHOWN.
- 7 PROVIDE ADA COMPLIANT WALL MOUNTED LIQUID SOAP DISPENSER TO BE INSTALLED BY CONTRACTOR (MOUNT WITH THEIR 'OPERABLE PART" DISPENSING MECHANISM NO MORE THAN 48" ABOVE THE FLOOR) IN LOCATIONS SHOWN.
- 8 PRIME AND PAINTED GWB WALLS, COLOR TO BE SELECTED BY OWNER.
- 9 4" X 4" CERAMIC WALL TILE MAIN FIELD, COLOR TO BE SELECTED BY OWNER
- 10 4" X 12" CERAMIC WALL BULL NOSE & COVE BASE, SUBWAY TILE LAYOUT, COLOR TO BE SELECTED BY OWNER.
- 11 12" X 24" PORCELAIN TILE FLOOR, COLOR TO BE SELECTED BY OWNER.
- 12 ACOUSTICAL CEILING TILES AND GRID SYSTEM.
- PROVIDE FIRE EXTINGUISHER CABINET, REFER TO DETAIL FOR MORE INFORMATION.
- 14 PROVIDE ADA COMPLIANT TACTILE SIGNAGE (SYMBOL AT THE TOP, RAISED CHARACTERS AND BRAILLE AT THE BOTTOM) IN LOCATIONS SHOWN. BRAILLE SHALL BE 48 INCHES MINIMUM, AND 60 INCHES MAXIMUM ABOVE THE FLOOR, MEASURED TO THE BASELINE OF THE BRAILLE CELLS. SEE ADA COMPLIANT SIGNAGE DETAIL.
- | 15 | PROVIDE BABY/DIAPER CHANGING STATION, WHICH SHALL BE MOUNTED TO THE HIGHEST PART OF THE WORK SURFACE AT 34" ABOVE THE FLOOR
- | 16 | PROVIDE ADA COMPLIANT FULLY RECESSED PAPER TOWEL DISPENSER AND WASTE DISPOSAL COMBINATION UNIT TO BE INSTALLED BY CONTRACTOR (MOUNT WITH THEIR 'OPERABLE PART" DISPENSING MECHANISM NO MORE THAN 48" ABOVE THE FLOOR) IN LOCATIONS SHOWN.
- 17 PROVIDE ADA COMPLIANT WALL MOUNTED SOLID SURFACE SEAMLESS ONE (1) BASIN SINK, BACKSPLASHES AND FAUCETS (THE FRONT OF THE SINK SHALL BE A MAXIMUM OF 34" ABOVE THE FLOOR) IN LOCATIONS SHOWN, SEE PLUMBING DRAWINGS FOR FIXTURE SELECTION, COLOR/STYLE TO BE SELECTED BY OWNER. PROVIDE PIPE PROTECTION FOR WATER SUPPLY LINES AND DRAINPIPES UNDER THE SINKS. MAINTAIN PROPER ADA KNEE AND TOE CLEARANCE AT ALL FIXTURES. TYPE: "OMNIDECK 3010 SERIES BY AS MFGR.'D BY BRADLEY (OR APPROVED EQUAL)".

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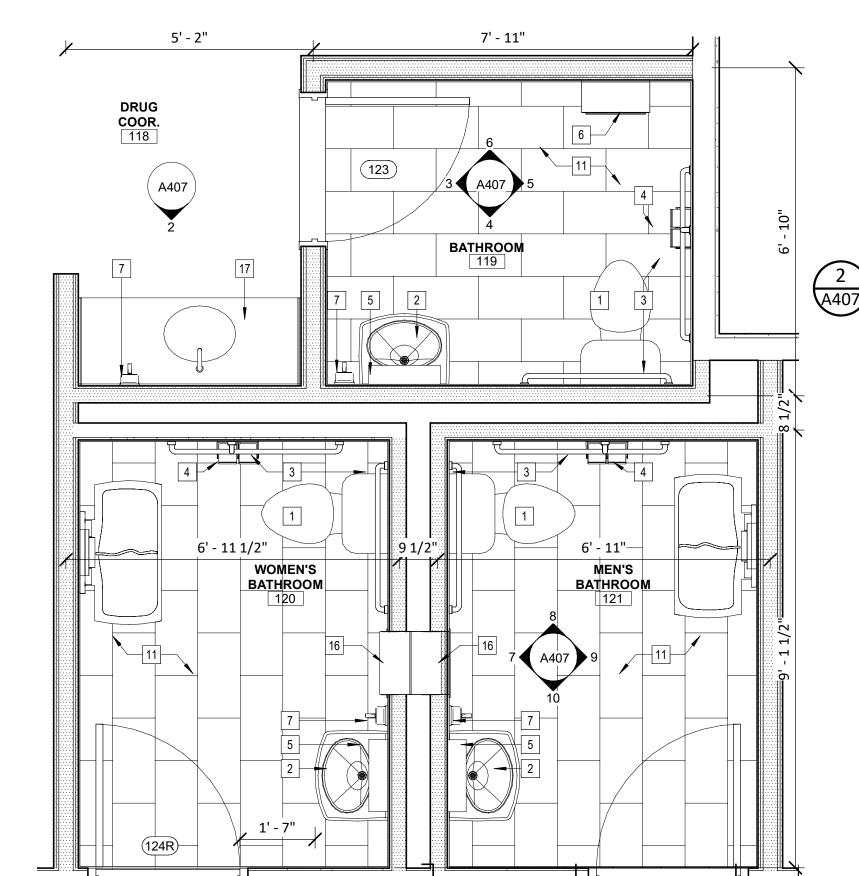
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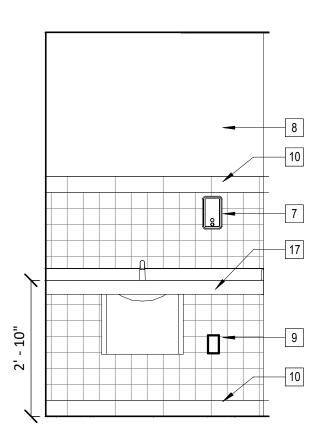
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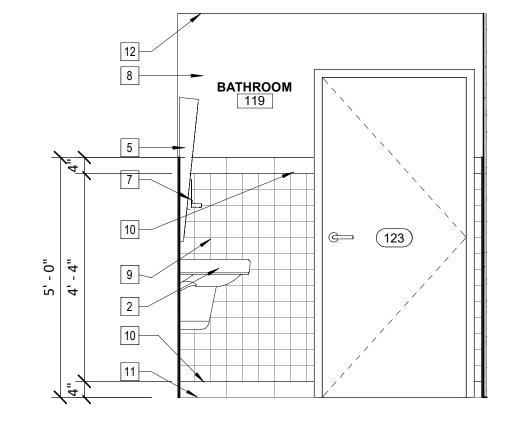


ENLARGED DRUG COOR. BATHROOM PLANS

SCALE: 1/2" = 1'-0"




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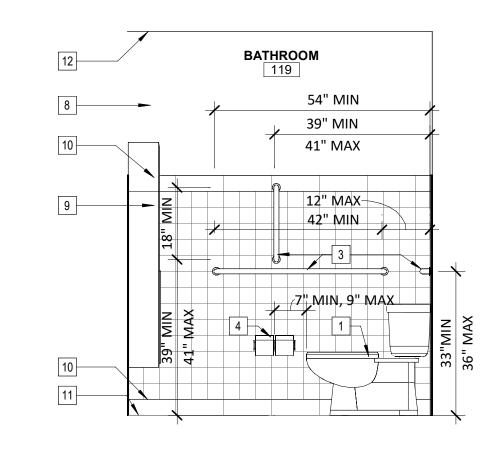
3 BATH. 119 ELEVATION 1
A407 SCALE: 1/2" = 1'-0" DRUG COOR. ELEVATION

SCALE: 1/2" = 1'-0"



4 BATH. 119 ELEVATION 2

A407 SCALE: 1/2" = 1'-0"

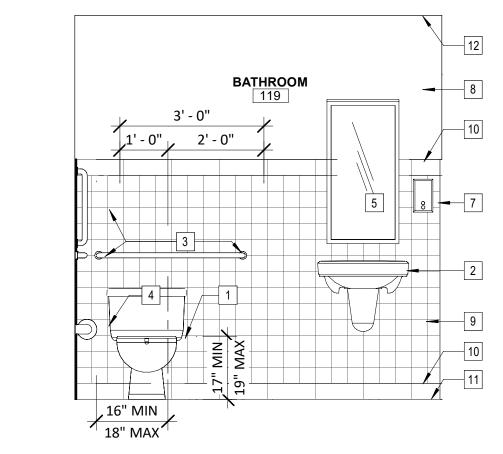

5 BATH. 119 ELEVATION 3
SCALE: 1/2" = 1'-0"

1 SEE PLUMBING SHEETS FOR ADA COMPLIANT WATER CLOSET TOILET (SEAT 17 MIN. AND 19" MAX. OFF

2 SEE PLUMPING SHEETS FOR ADA COMPLIANT WALL MOUNTED SINKS AND FAUCETS (THE FRONT OF THE SINK SHALL BE A MAXIMUM OF 34" ABOVE THE FLOOR) IN LOCATIONS SHOWN, SEE PLUMBING DRAWINGS FOR FIXTURE SELECTION, COLOR TO BE SELECTED BY OWNER. PROVIDE PIPE PROTECTION FOR WATER SUPPLY LINES AND DRAINPIPES UNDER THE SINKS. MAINTAIN PROPER ADA KNEE AND TOE

3 PROVIDE GRAB BARS IN LOCATIONS SHOWN AND AS FOLLOWS. FIXED SIDEWALL GRAB BAR 42" MINIMUM IN LENGTH, LOCATED 12" MAXIMUM FROM REAR WALL AND EXTENDING 54" MINIMUM FROM THE REAR WALL (33" MINIMUM AND 36" MAXIMUM TO TOP OF GRAB BAR OFF OF THE FLOOR). PROVIDE VERTICAL GRAB BAR 18" MINIMUM LENGTH AND SHALL BE MOUNTED WITH THE BOTTOM OF THE BAR LOCATED 39" MINIMUM AND 41" MAXIMUM OFF OF THE FLOOR AND 39" TO 41" TO THE CENTER OF THE BAR FROM THE BACK WALL. THE REAR GRAB BAR SHALL BE 36" MINIMUM IN LENGTH, AND EXTEND FROM THE CENTERLINE OF THE WATER CLOSET (TOILET) 12" MINIMUM ON THE SIDE CLOSEST TO THE WALL, AND 24" MINIMUM ON THE TRANSFER SIDE. PROVIDE ALL WOOD BLOCKING IN

4 PROVIDE ADA COMPLIANT WALL MOUNTED JUMBO BATH TISSUE DOUBLE ROLL DISPENSER TO BE INSTALLED BY CONTRACTOR, 18" MINIMUM FROM THE FLOOR TO THE BOTTOM OF THE UNIT OR 48" MAXIMUM TO THE TOP OF THE UNIT FROM THE FLOOR AND 24" FROM THE BACK WALL TO THE BACK EDGE OF THE UNIT IN LOCATIONS SHOWN ON PLANS. COORDINATE LOCATION WITH GRAB BAR

5 PROVIDE ADA COMPLIANT 24" W x 36" H MIRROR, WHICH SHALL BE MOUNTED WITH THE BOTTOM

6 PROVIDE ADA COMPLIANT WALL MOUNTED PAPER TOWEL DISPENSER AND WASTE DISPOSAL COMBINATION UNIT TO BE INSTALLED BY CONTRACTOR (MOUNT WITH THEIR 'OPERABLE PART"

(MOUNT WITH THEIR 'OPERABLE PART" DISPENSING MECHANISM NO MORE THAN 48" ABOVE THE FLOOR) IN LOCATIONS SHOWN.

8 PRIME AND PAINTED GWB WALLS, COLOR TO BE SELECTED BY OWNER.

11 12" X 24" PORCELAIN TILE FLOOR, COLOR TO BE SELECTED BY OWNER.

13 PROVIDE FIRE EXTINGUISHER CABINET, REFER TO DETAIL FOR MORE INFORMATION.

14 PROVIDE ADA COMPLIANT TACTILE SIGNAGE (SYMBOL AT THE TOP, RAISED CHARACTERS AND BRAILLE AT THE BOTTOM) IN LOCATIONS SHOWN. BRAILLE SHALL BE 48 INCHES MINIMUM, AND 60 INCHES MAXIMUM ABOVE THE FLOOR, MEASURED TO THE BASELINE OF THE BRAILLE CELLS. SEE ADA COMPLIANT SIGNAGE DETAIL.

| 15 | PROVIDE BABY/DIAPER CHANGING STATION, WHICH SHALL BE MOUNTED TO THE HIGHEST PART OF THE WORK SURFACE AT 34" ABOVE THE FLOOR

| 16 | PROVIDE ADA COMPLIANT FULLY RECESSED PAPER TOWEL DISPENSER AND WASTE DISPOSAL COMBINATION UNIT TO BE INSTALLED BY CONTRACTOR (MOUNT WITH THEIR 'OPERABLE PART" DISPENSING MECHANISM NO MORE THAN 48" ABOVE THE FLOOR) IN LOCATIONS SHOWN.

| 17 | PROVIDE ADA COMPLIANT WALL MOUNTED SOLID SURFACE SEAMLESS ONE (1) - BASIN SINK, BACKSPLASHES AND FAUCETS (THE FRONT OF THE SINK SHALL BE A MAXIMUM OF 34" ABOVE THE FLOOR) IN LOCATIONS SHOWN, SEE PLUMBING DRAWINGS FOR FIXTURE SELECTION, COLOR/STYLE TO BE SELECTED BY OWNER. PROVIDE PIPE PROTECTION FOR WATER SUPPLY LINES AND DRAINPIPES UNDER THE SINKS. MAINTAIN PROPER ADA KNEE AND TOE CLEARANCE AT ALL FIXTURES. TYPE: "OMNIDECK 3010 SERIES BY AS MFGR.'D BY BRADLEY (OR APPROVED EQUAL)"

BATHROOM KEY NOTES

OF THE FLOOR) IN LOCATIONS SHOWN, SEE PLUMBING DRAWINGS FOR FIXTURE SELECTION, COLOR TO BE SELECTED BY OWNER.

CLEARANCE AT ALL FIXTURES.

WALL AS NEEDED FOR THE INSTALLATION OF GRAB BARS.

INSTALLATION.

EDGE OF THE REFLECTING SURFACE NO HIGHER THAN 40" ABOVE THE FLOOR.

DISPENSING MECHANISM NO MORE THAN 48" ABOVE THE FLOOR) IN LOCATIONS SHOWN.


7 PROVIDE ADA COMPLIANT WALL MOUNTED LIQUID SOAP DISPENSER TO BE INSTALLED BY CONTRACTOR


9 4" X 4" CERAMIC WALL TILE MAIN FIELD, COLOR TO BE SELECTED BY OWNER

10 4" X 12" CERAMIC WALL BULL NOSE & COVE BASE, SUBWAY TILE LAYOUT, COLOR TO BE SELECTED BY

12 ACOUSTICAL CEILING TILES AND GRID SYSTEM.


BATHROOM 121 54" MIN 39" MIN 41" MAX -12" MAX 42" MIN

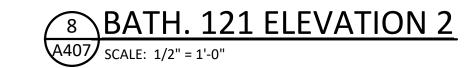


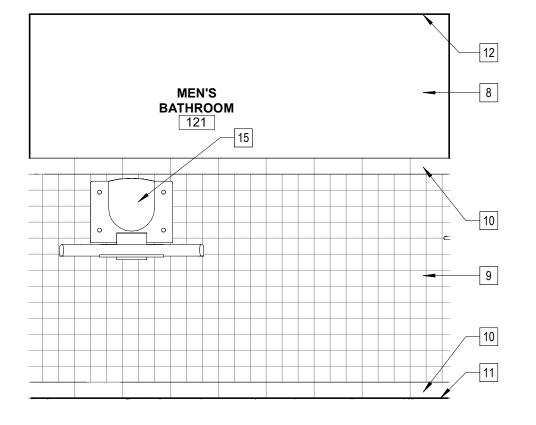

6 BATH. 119 ELEVATION 4

SCALE: 1/2" = 1'-0"

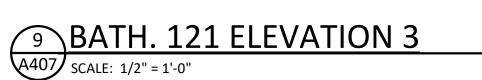

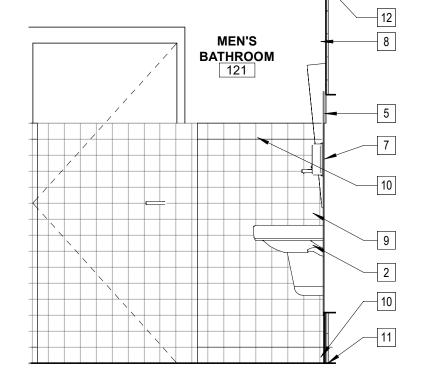

7 BATH. 121 ELEVATION 1

A407 SCALE: 1/2" = 1'-0"

MEN'S

BATHROOM 121

16" MIN 18" MAX



Project Number 1753.008.001

AUGUST, 2024

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A407

Sheet Number

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OF SUCH ALTERATION, AND A SPECIFIC DESCRIPTION OF THE ALTERATION

REVISIONS

ATHROOM

LEVATION

INTERIOR

6 PROVIDE ADA COMPLIANT WALL MOUNTED PAPER TOWEL DISPENSER AND WASTE DISPOSAL COMBINATION UNIT TO

ABOVE THE FLOOR) IN LOCATIONS SHOWN.

8 12" X 24" PORCELAIN TILE FLOOR, COLOR TO BE SELECTED BY OWNER.

BE INSTALLED BY CONTRACTOR (MOUNT WITH THEIR 'OPERABLE PART" DISPENSING MECHANISM NO MORE THAN 48"

PROVIDE ADA COMPLIANT WALL MOUNTED LIQUID SOAP DISPENSER TO BE INSTALLED BY CONTRACTOR (MOUNT WITH

THEIR 'OPERABLE PART" DISPENSING MECHANISM NO MORE THAN 48" ABOVE THE FLOOR) IN LOCATIONS SHOWN.

AND UL ASSEMBLY INFORMATION)

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Sheet Number

Project Number

A408

1753.008.001

DIMENSIONS TO MILLWORK IF NOT NOTED IS TO FACE OF WALL, SEE MILLWORK

DIMENSIONS TO FURNITURE IS TO EDGE OF TABLE, CHAIR, ETC.

MILLWORK AND MILLWORK SUPPORTS

FURNITURE UNLESS NOTED IS NOT IN CONTRACT.

ENLARGEMENT PLANS AND DETAILS FOR ADDITIONAL DETAILING AND TO LAYOUT

PROVIDE GRAB BARS IN LOCATIONS SHOWN AND AS FOLLOWS. FIXED SIDEWALL GRAB BAR 42" MINIMUM IN LENGTH, LOCATED

OF GRAB BAR OFF OF THE FLOOR). PROVIDE VERTICAL GRAB BAR 18" MINIMUM LENGTH AND SHALL BE MOUNTED WITH THE

WATER CLOSET (TOILET) 12" MINIMUM ON THE SIDE CLOSEST TO THE WALL, AND 24" MINIMUM ON THE TRANSFER SIDE.

PROVIDE ALL WOOD BLOCKING IN WALL AS NEEDED FOR THE INSTALLATION OF GRAB BARS.

12" MAXIMUM FROM REAR WALL AND EXTENDING 54" MINIMUM FROM THE REAR WALL (33" MINIMUM AND 36" MAXIMUM TO TOP

BOTTOM OF THE BAR LOCATED 39" MINIMUM AND 41" MAXIMUM OFF OF THE FLOOR AND 39" TO 41" TO THE CENTER OF THE BAR FROM THE BACK WALL. THE REAR GRAB BAR SHALL BE 36" MINIMUM IN LENGTH, AND EXTEND FROM THE CENTERLINE OF THE

COURTROOM

COURTROOM

COURTROOM B ELEVATION 2

0 6 COURTROOM EQ

4 COURTROOM B ELEVATION 4

A202 SCALE: 1/2" = 1'-0"

1' - 8 1/2" BENCH SEAT & **BACKREST** 5 1/2"

SEE COURTROOM ENLARGEMENT LENGTHS LAYOUT AND SPACING IN

PROVIDE WOOD GALLERY BENCHES AS AVAILABLE FROM AGATI, COMMUNITY FURNITURE FROM THE JASPER GROUP, **GUNLOCKE OR APPROVED EQUAL** MANUFACTURER

AS NEEDED TO SECURE FLAG MOUNTING **BRACKETS INTO WALL**

EQUAL, CONTRACTOR TO RECEIVE FINAL

APPROVAL OF FLAG POLE COMPONENTS

WITH OWNER

FLAGPOLE TOP WALL MOUNTING -PROVIDE WOOD BLOCKING **BRACKET PROVIDED BOTTOM WALL** MOUNTING BRACKET

SIDE VIEW

AUGUST, 2024

FRONT VIEW

AS SHOWN

A409

Project Number 1753.008.001

3 COURTROOM B ELEVATION 3

A202 SCALE: 1/2" = 1'-0"

EQ

COURTROOM ELEVATION KEYED NOTES

EQ

A202 | SCALE: 1/2" = 1'-0"

1 WOOD OR METAL DOOR WITH HOLLOW METAL FRAME, W/ OR W/O LITE (HALF) AND ADA COMPLIANT HARDWARE - 60 MINUTE RATED DOOR & FRAME, SEE DOOR SCHEDULE.

2 WALL MOUNTED FLAG POLES, BRACKETS AND FLAGS TO BE PROVIDED BY OWNER AND INSTALLED BY CONTRACTOR.

3 SOLID SURFACE CAPS/COUNTERTOPS.

4 4A. JUDGES BENCH, 4B. CLERKS AREA 4C. WITNESS BOX, 4D. JURY BOX, AND 4E. GALLERY SEPARATION WALLS WOOD VENEER.

| 5 | SHEETROCKED SOFFIT OR HANGING SHEETROCKED CEILING.

6 ACOUSTICAL CEILING GRID SYSTEM.

7 WOOD PANELING BEHIND JUDGE AND WITNESS BOXES.

8 6" TALL - 3/4" WOOD TRIM BASE

9 NEW YORK STATE COURT SYSTEM SEAL (LIGHT WEIGHT) TO BE PROVIDED BY OWNER AND MOUNTED/INSTALLED WITH VELCRO OR PICTURE HOOKS ON WOOD PANELING BY CONTRACTOR, CENTER ON JUDGE'S BENCH.

10 TYPICAL 4" HIGH CAST BRONZE LETTERING (FINISH TO BE SELECTED BY OWNER) MOUNTED ON THE WOOD PANELING AT THE BACK OF THE JUDGE'S BENCH, CENTER ON JUDGES BENCH.

11 PAINTED GYPSUM WALL BOARD WALLS.

| 12 | CARPET TILE/CARPETING FLOORING IN COURTROOM AREA, STEPS AND RAMPS. LUXURY VINYL TILE IN GALLERY AREA, ATTORNEY CONFERENCE ROOMS AND VESTIBULE.

| 13 | ADA COMPLIANT ALUMINUM HANDRAIL.

14 JURY SWINGING GATE DOOR.

15 GALLERY WOOD BENCHES.

16 TABLES AND CHAIRS. (SOME ELEVATIONS CHAIRS AND TABLES HAVE BEEN REMOVED FOR DETAILING CLARITY).

ACOUSTICAL FABRIC WALL PANELS, PANELS BUTTED TOGETHER, PANEL SIZES AS SHOWN ON ELEVATIONS.


EQ

18 WOOD CHAIR RAIL.

19 WALL SCONCE LIGHT FIXTURE.

[20] WOOD PANEL JOINTS/TRIM. PROVIDE EQUAL DISTANCE BETWEEN JOINTS ALONG LENGTHS OF WALLS. (SEE MILLWORK DETAILS FOR TYPICAL DETAILING AT CORNERS/ENDS OF MILLWORK).

21 6" VINYL WALL BASE

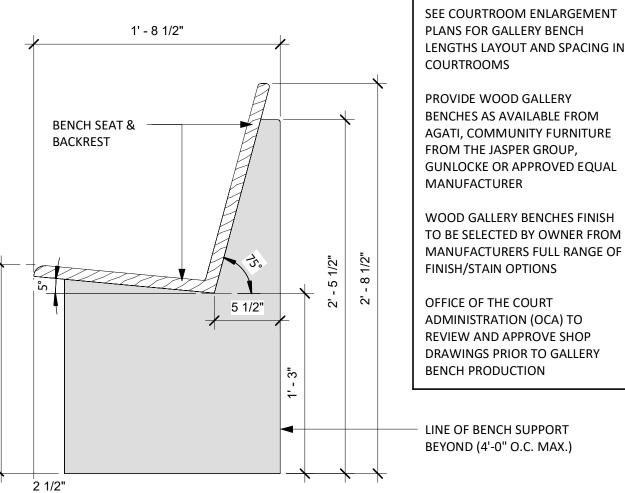

GALLERY BENCH ELEVATION DETAIL SCALE: 1 1/2" = 1'-0"

FLAG POLE DETAIL SCALE: 1" = 1'-0"

CONTRACTOR TO PROVIDE AND INSTALL 2 FLAG ACCESSORIES FLAG POLES, FLAGS, FLAG ACCESSORIES (FINIAL) OWNER TO AND WALL MOUNTING BRACKETS PER SELECT FINIAL TYPE COURTROOM IN LOCATIONS SHOWN. CONTRACTOR TO PROVIDE FLAG POLE, FLAGS, FLAG ACCESSORIES AND WALL MOUNTING BRACKETS AND INSTALL CONTRACTOR TO PROVIDE (2) UNITED STATES FLAGS AND (2) NEW YORK STATE FLAGS, CONTRACTOR TO INSTALL UNITED STATES FLAGS TO THE LEFT OF THE JUDGE'S BENCH AND INSTALL THE NEW YORK STATE FLAGS TO THE RIGHT OF THE JUDGE'S BENCH. PROVIDE FLAG POLE COMPONENTS AS AVAILABLE FROM EDER FLAG, OR APPROVED

70" TALL 1 INCH

DIAMETER WOODEN

NYS EXP.:

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THE STAMP OF A LICENSED PROFESSIONAL IS ALTERED, THE ALTERING PROFESSIONAL SHALL STAMP THE DOCUMENT AND

OF SUCH ALTERATION, AND A SPECIFIC DESCRIPTION OF THE ALTERATION


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OR COURTROC ELEVATIONS

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EDUCATION LAW, ARTICLE 145 §720 SPECIAL PROVISIONS, FOR ANY PERSON UNLESS THEY ARE ACTING UNDER TH THE STAMP OF A LICENSED PROFESSIONA OF SUCH ALTERATION, AND A SPECIFIC DESCRIPTION OF THE ALTERATION

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ELEVATION

INTERIOR

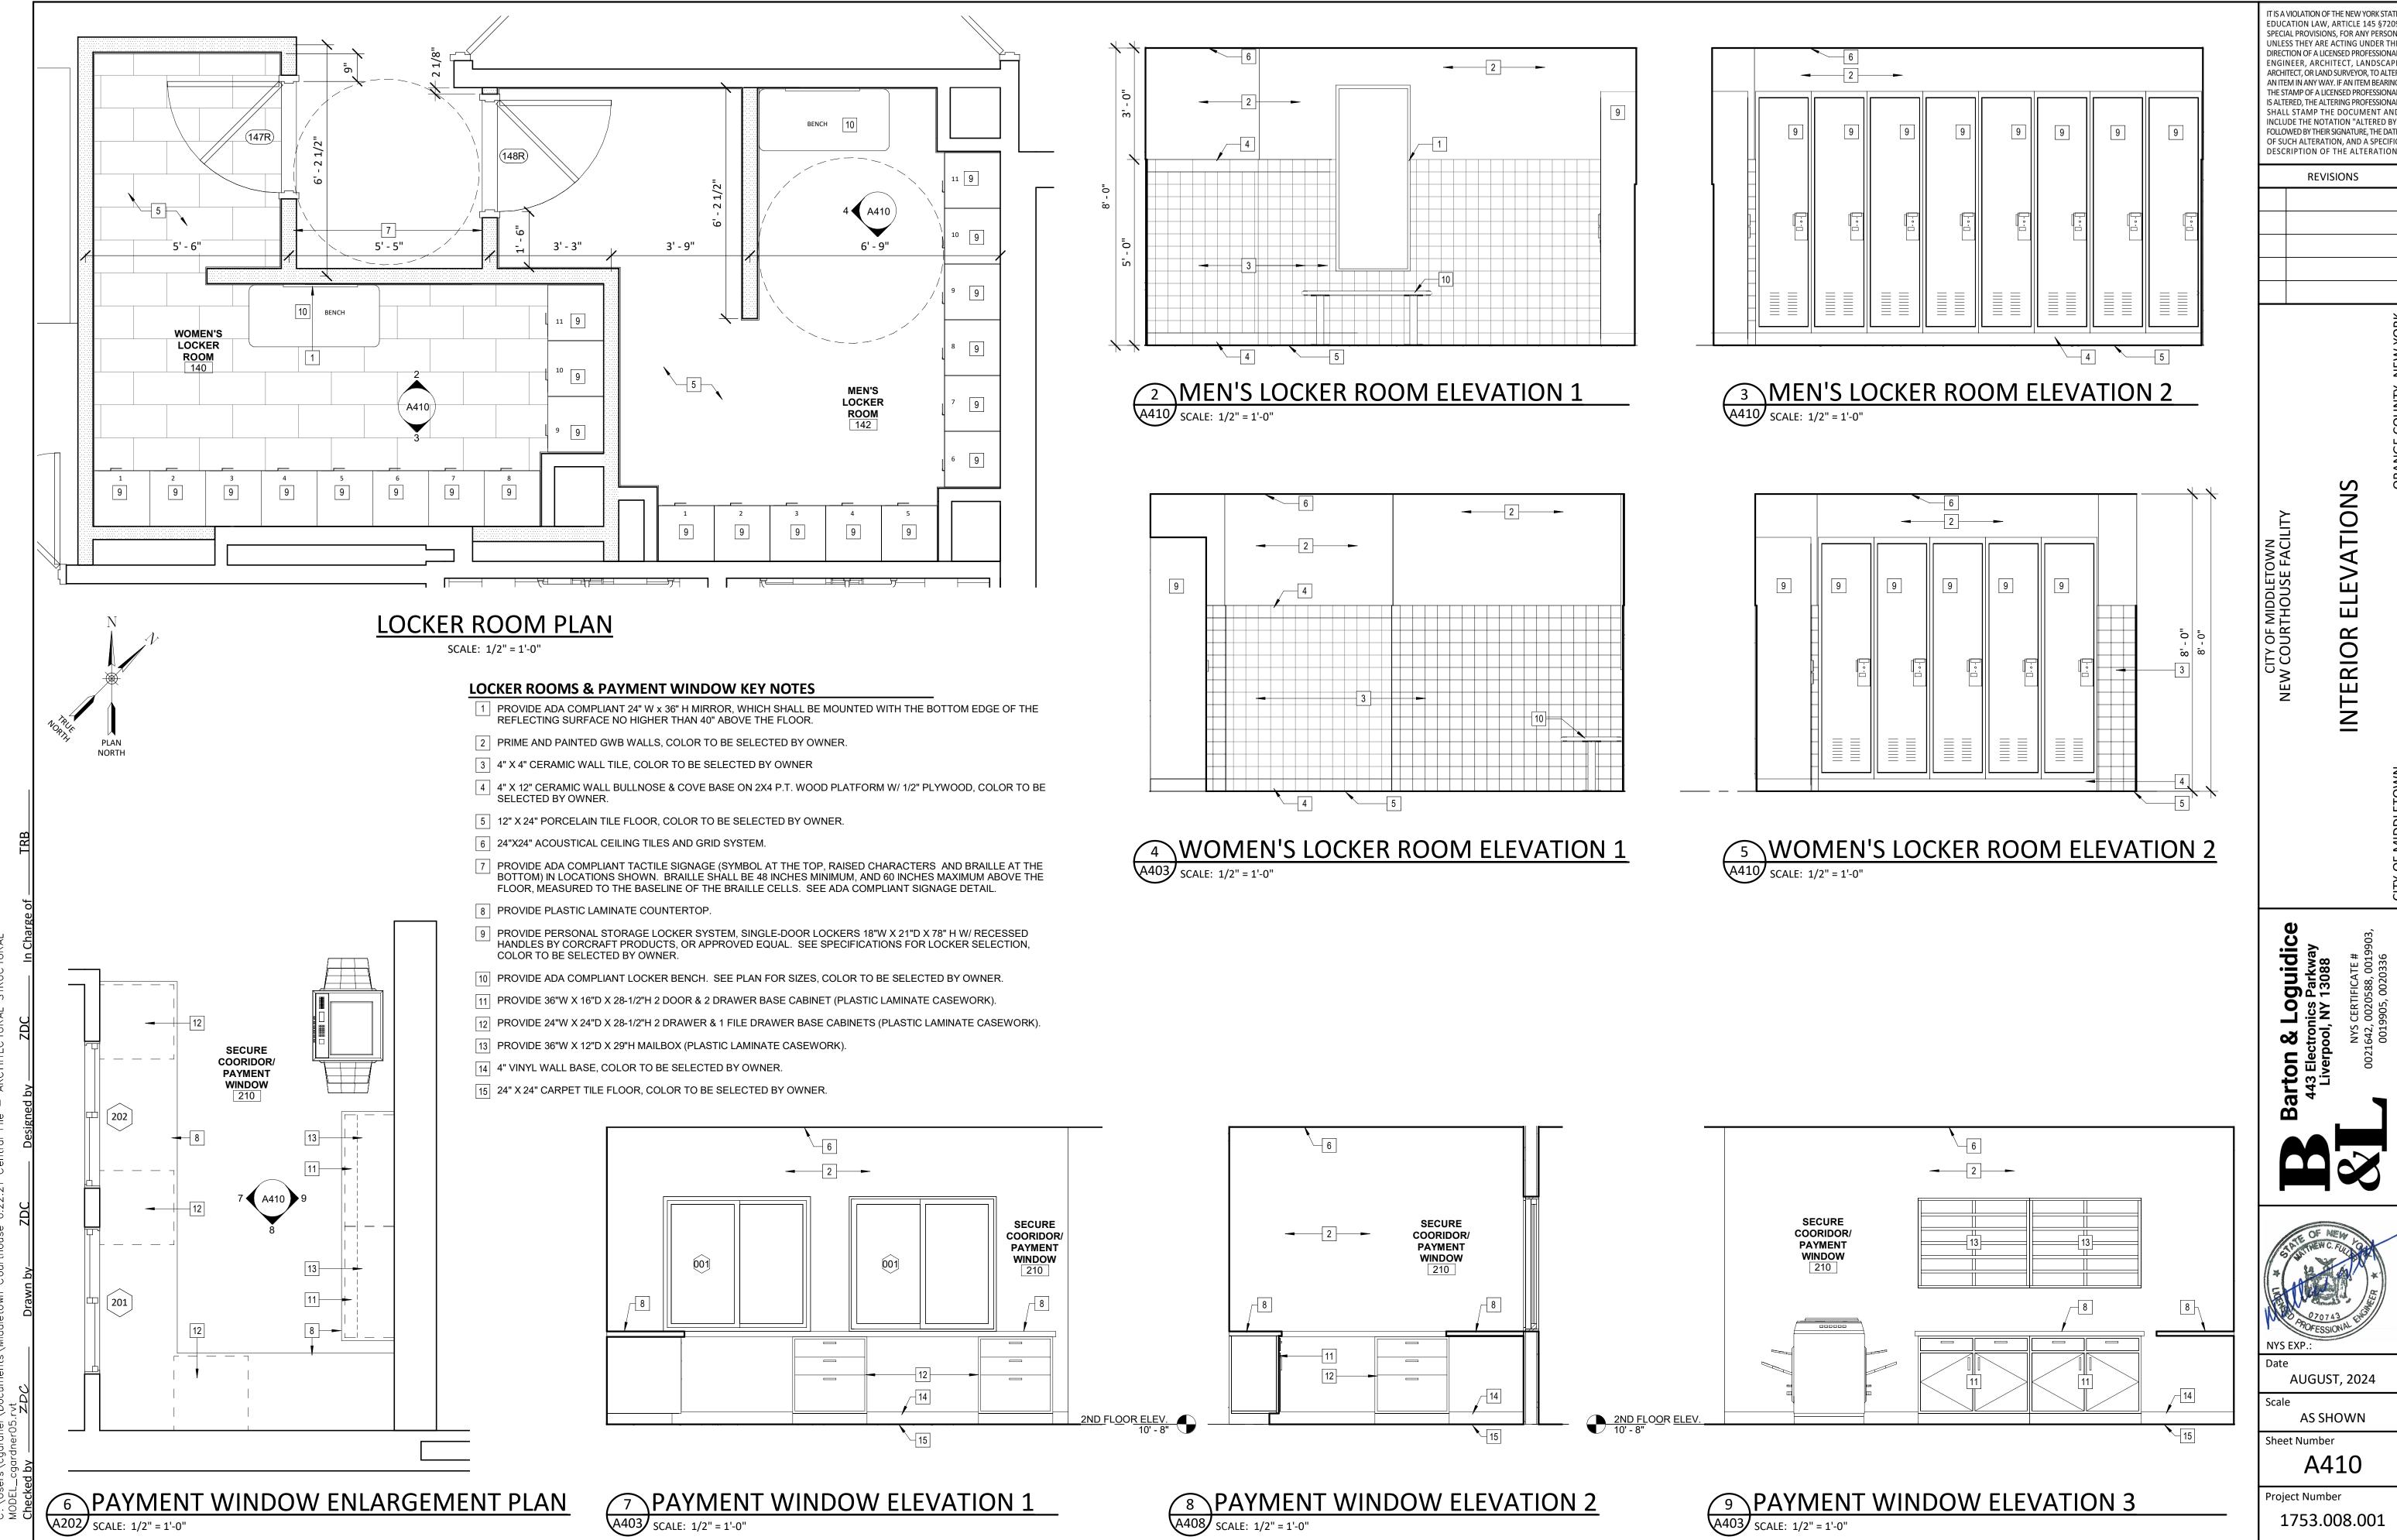



AUGUST, 2024

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Sheet Number

A410 Project Number




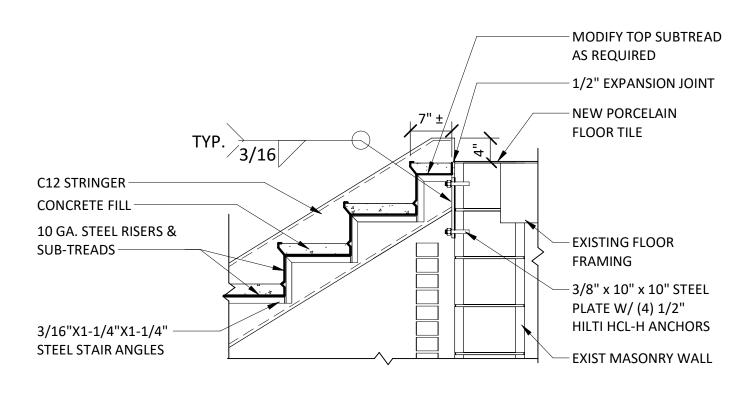


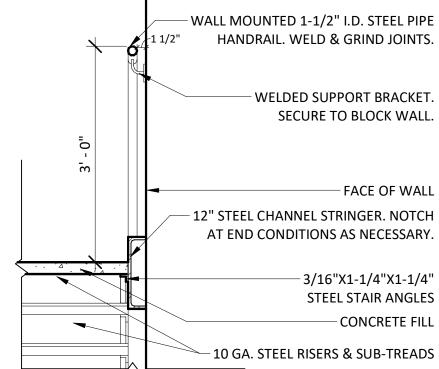2 CONCRETE PAN DETAIL AT FLOOR
A411 SCALE: 3/4" = 1'-0"

3 SECTION AT LANDING A411 SCALE: 3/4" = 1'-0"

4 STAIR CROSS SECTION A411 SCALE: 3/4" = 1'-0"

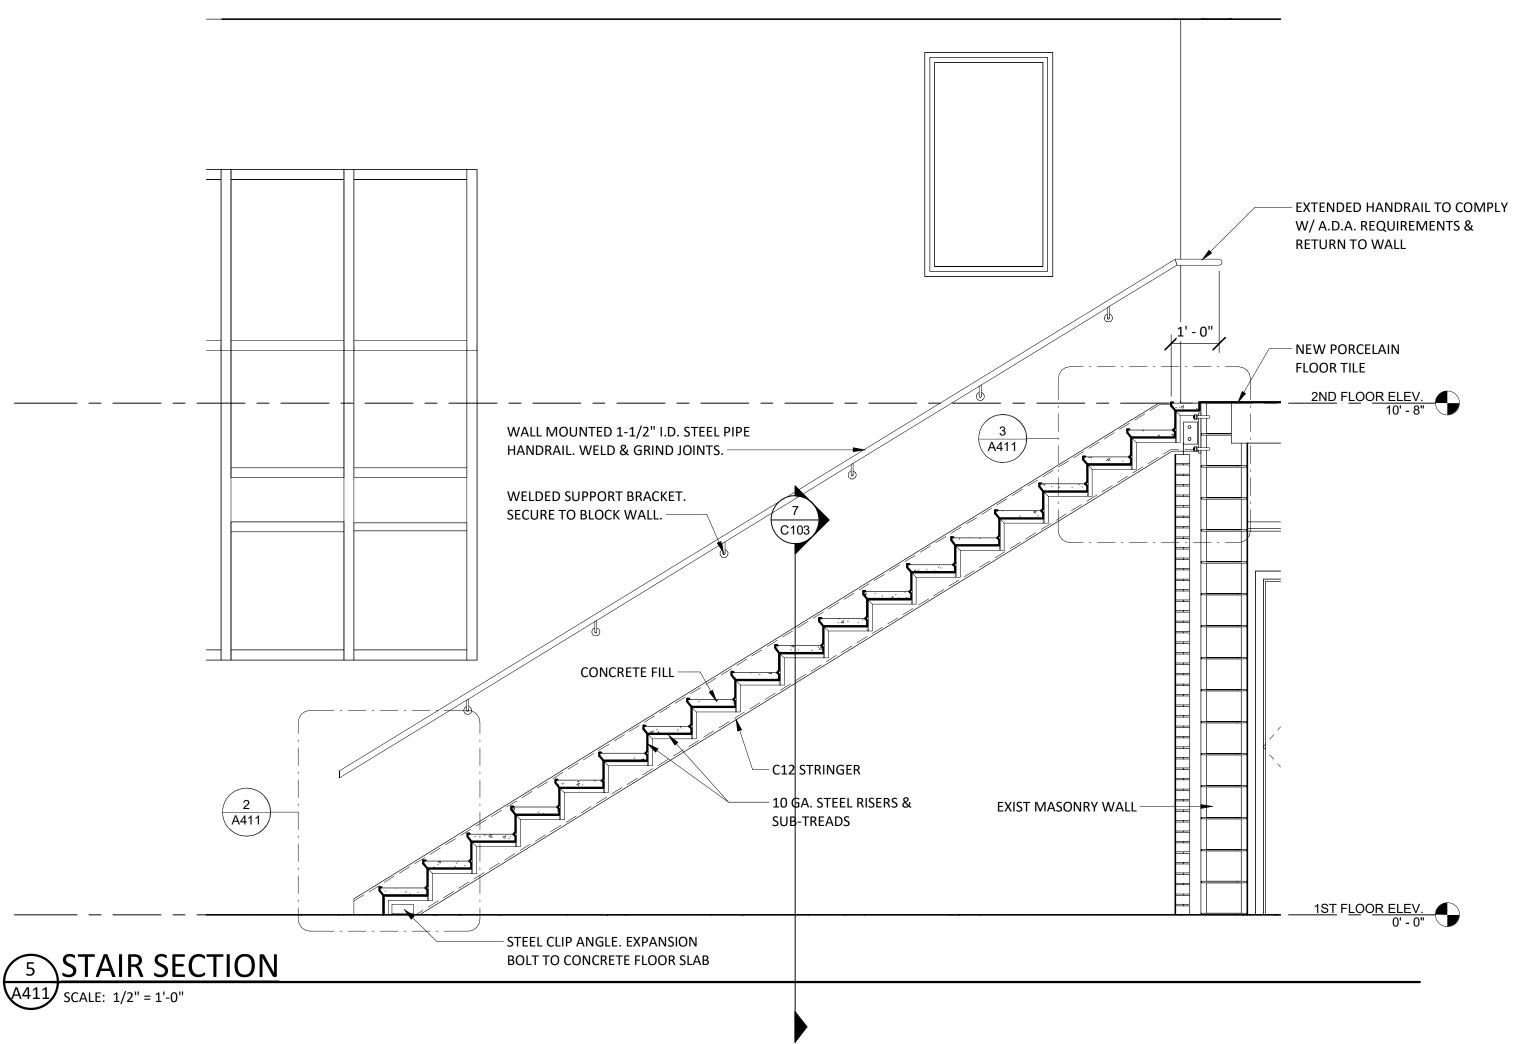

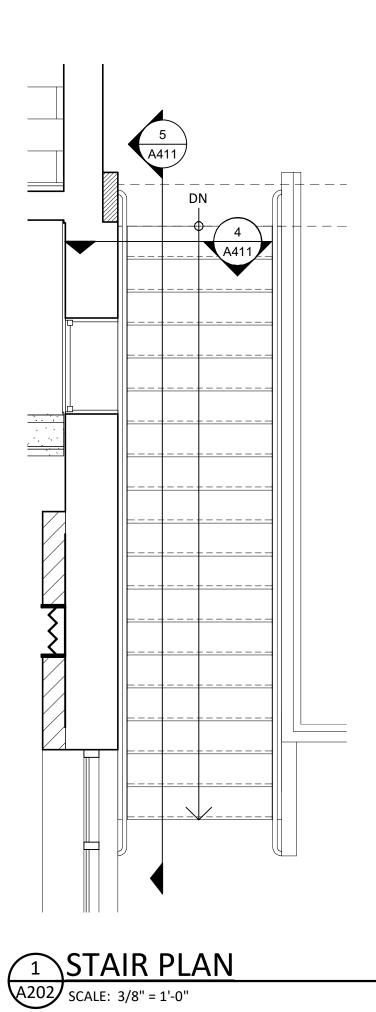

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Sheet Number A411

Project Number 1753.008.001

5 STAIR SECTION

SCALE: 1/2" = 1'-0"

FACE OF WALL AT END CONDITIONS AS NECESSARY. - 3/16"X1-1/4"X1-1/4" STEEL STAIR ANGLES CONCRETE FILL - 10 GA. STEEL RISERS & SUB-TREADS

STAIR

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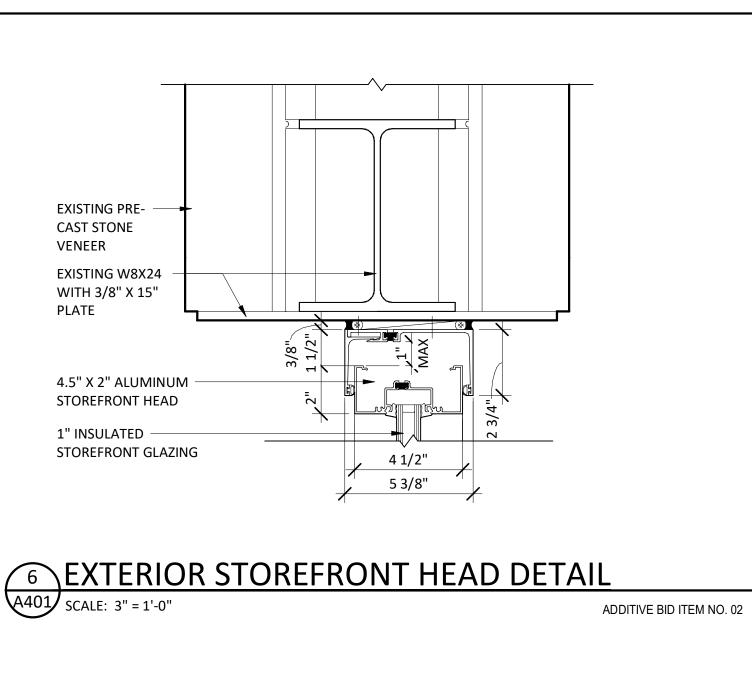
DETAIL


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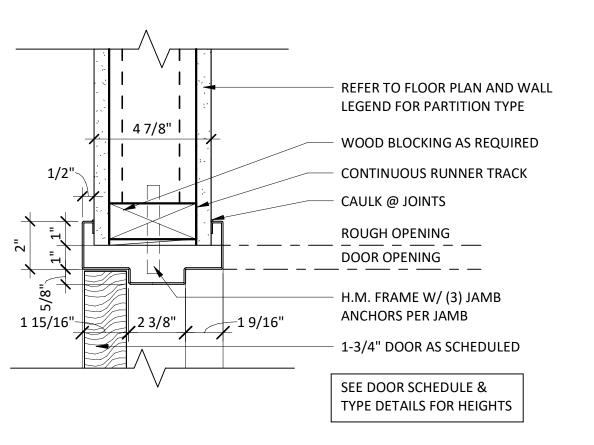
SECTION


PLAN,

CITY OF MIDDLETOWN
NEW COURTHOUSE FACILITY





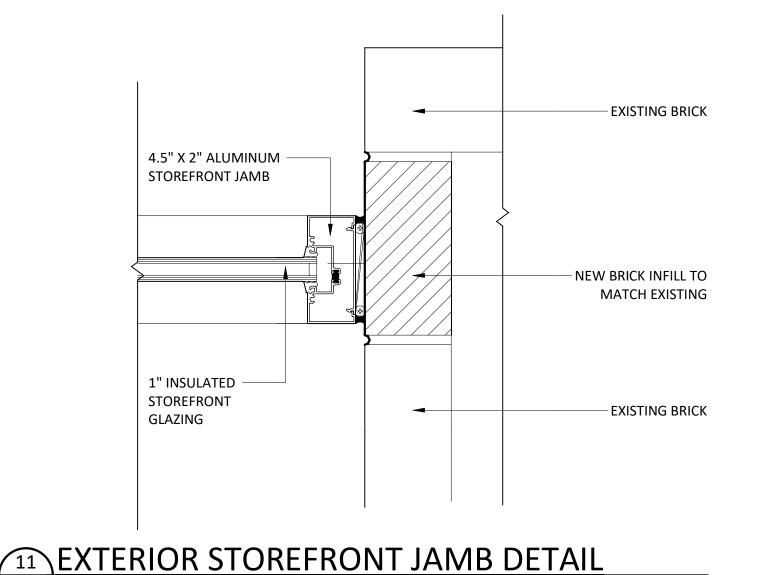

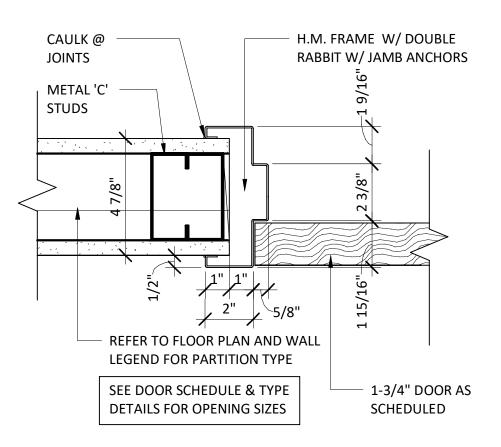



1 DOOR HEAD DETAIL 1 SCALE: 3" = 1'-0"

2 DOOR JAMB DETAIL 1


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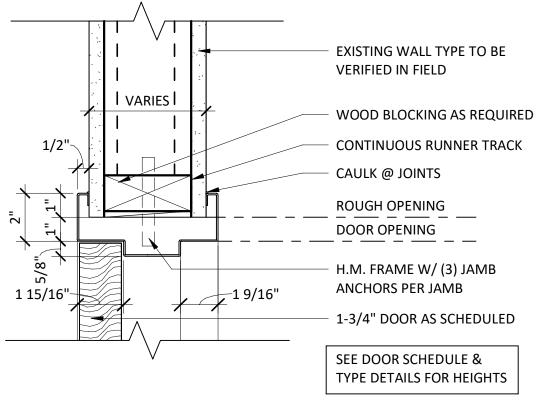
A401 SCALE: 3" = 1'-0"

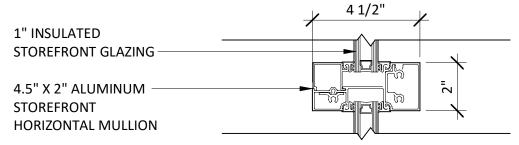


ADDITIVE BID ITEM NO. 02

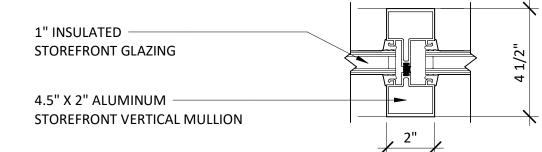ADDITIVE BID ITEM NO. 02




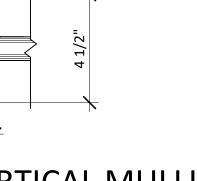

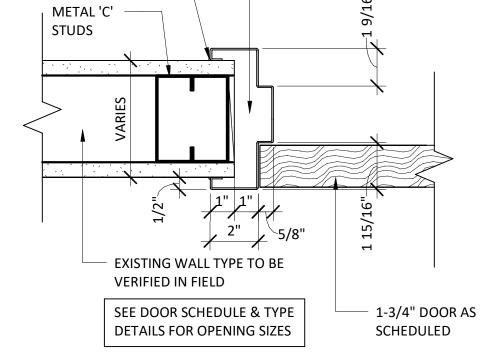


H.M. FRAME W/ DOUBLE

RABBIT W/JAMB ANCHORS

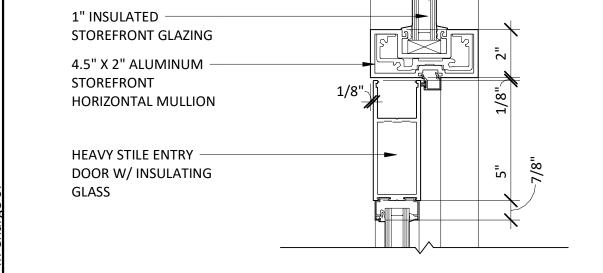

A401 SCALE: 3" = 1'-0"

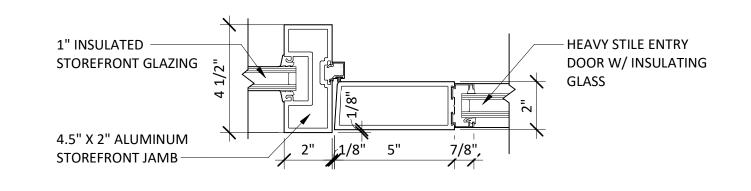

9 EXTERIOR STOREFRONT DOOR JAMB DETAIL



13 DOOR JAMB DETAIL 2 SCALE: 3" = 1'-0"





> EXTERIOR STOREFRONT HORIZONTAL MULLION





ADDITIVE BID ITEM NO. 02

ADDITIVE BID ITEM NO. 02

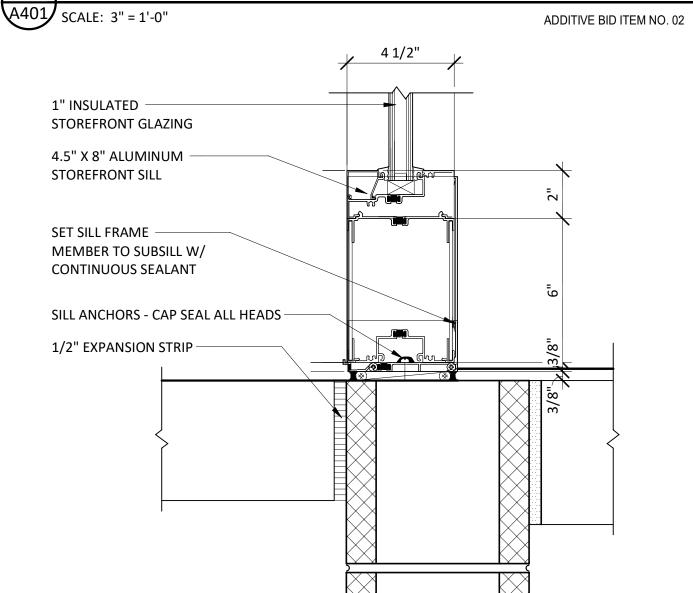

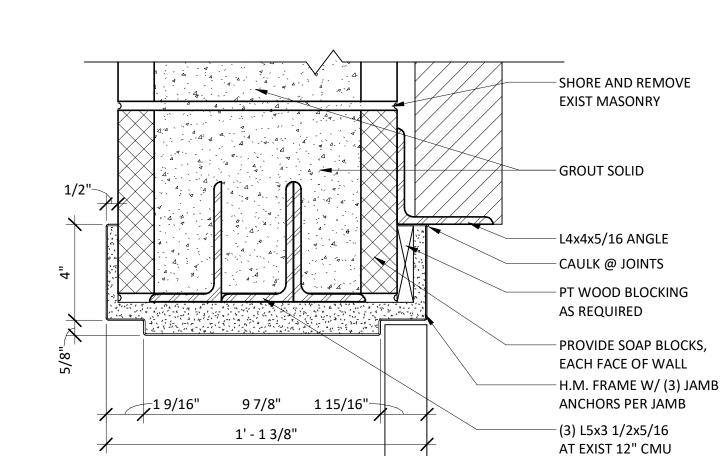

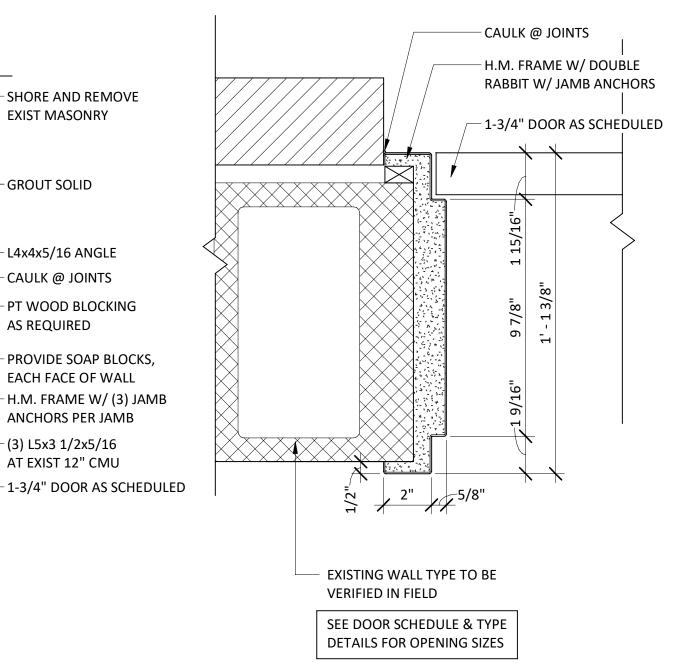

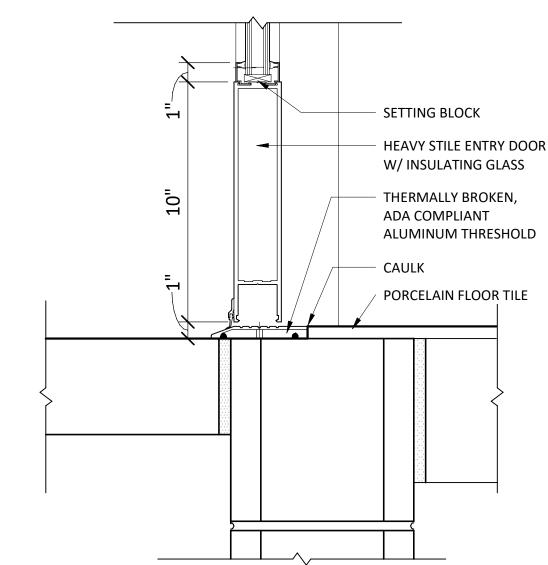

4 EXTERIOR STOREFRONT THRESHOLD DETAIL





EXISTING WALL TYPE TO BE

VERIFIED IN FIELD



A401 SCALE: 3" = 1'-0"

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A501

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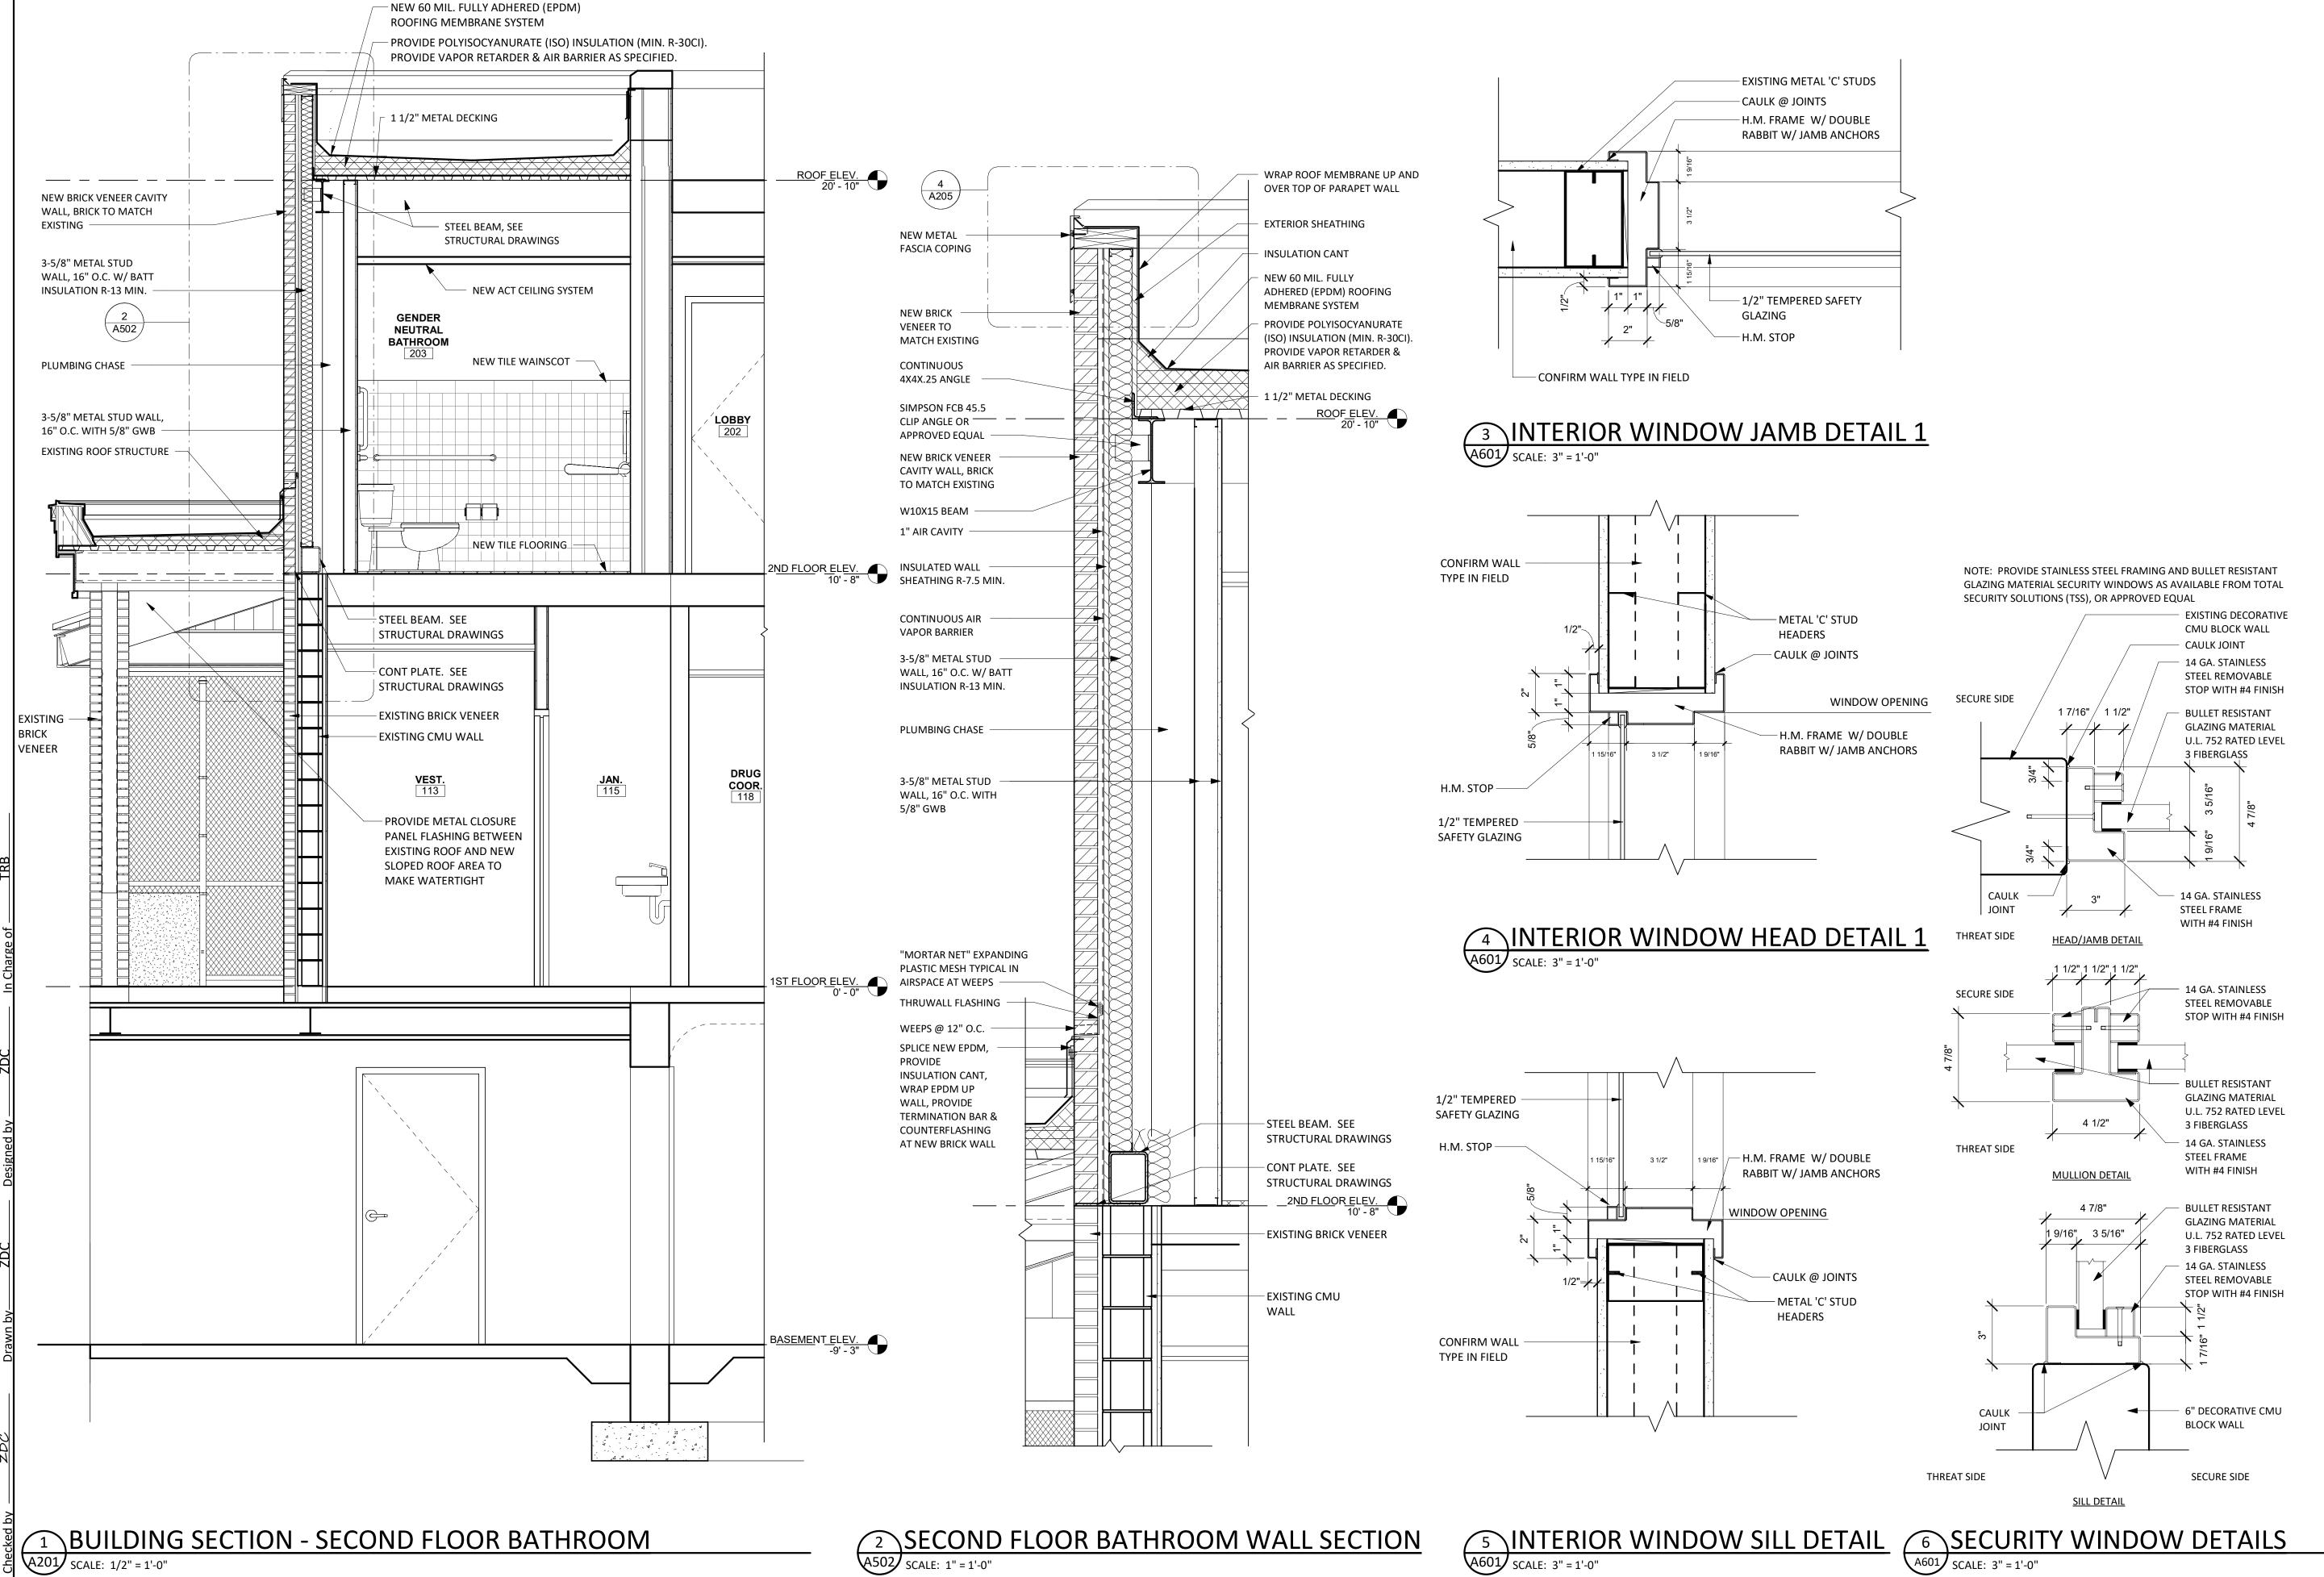
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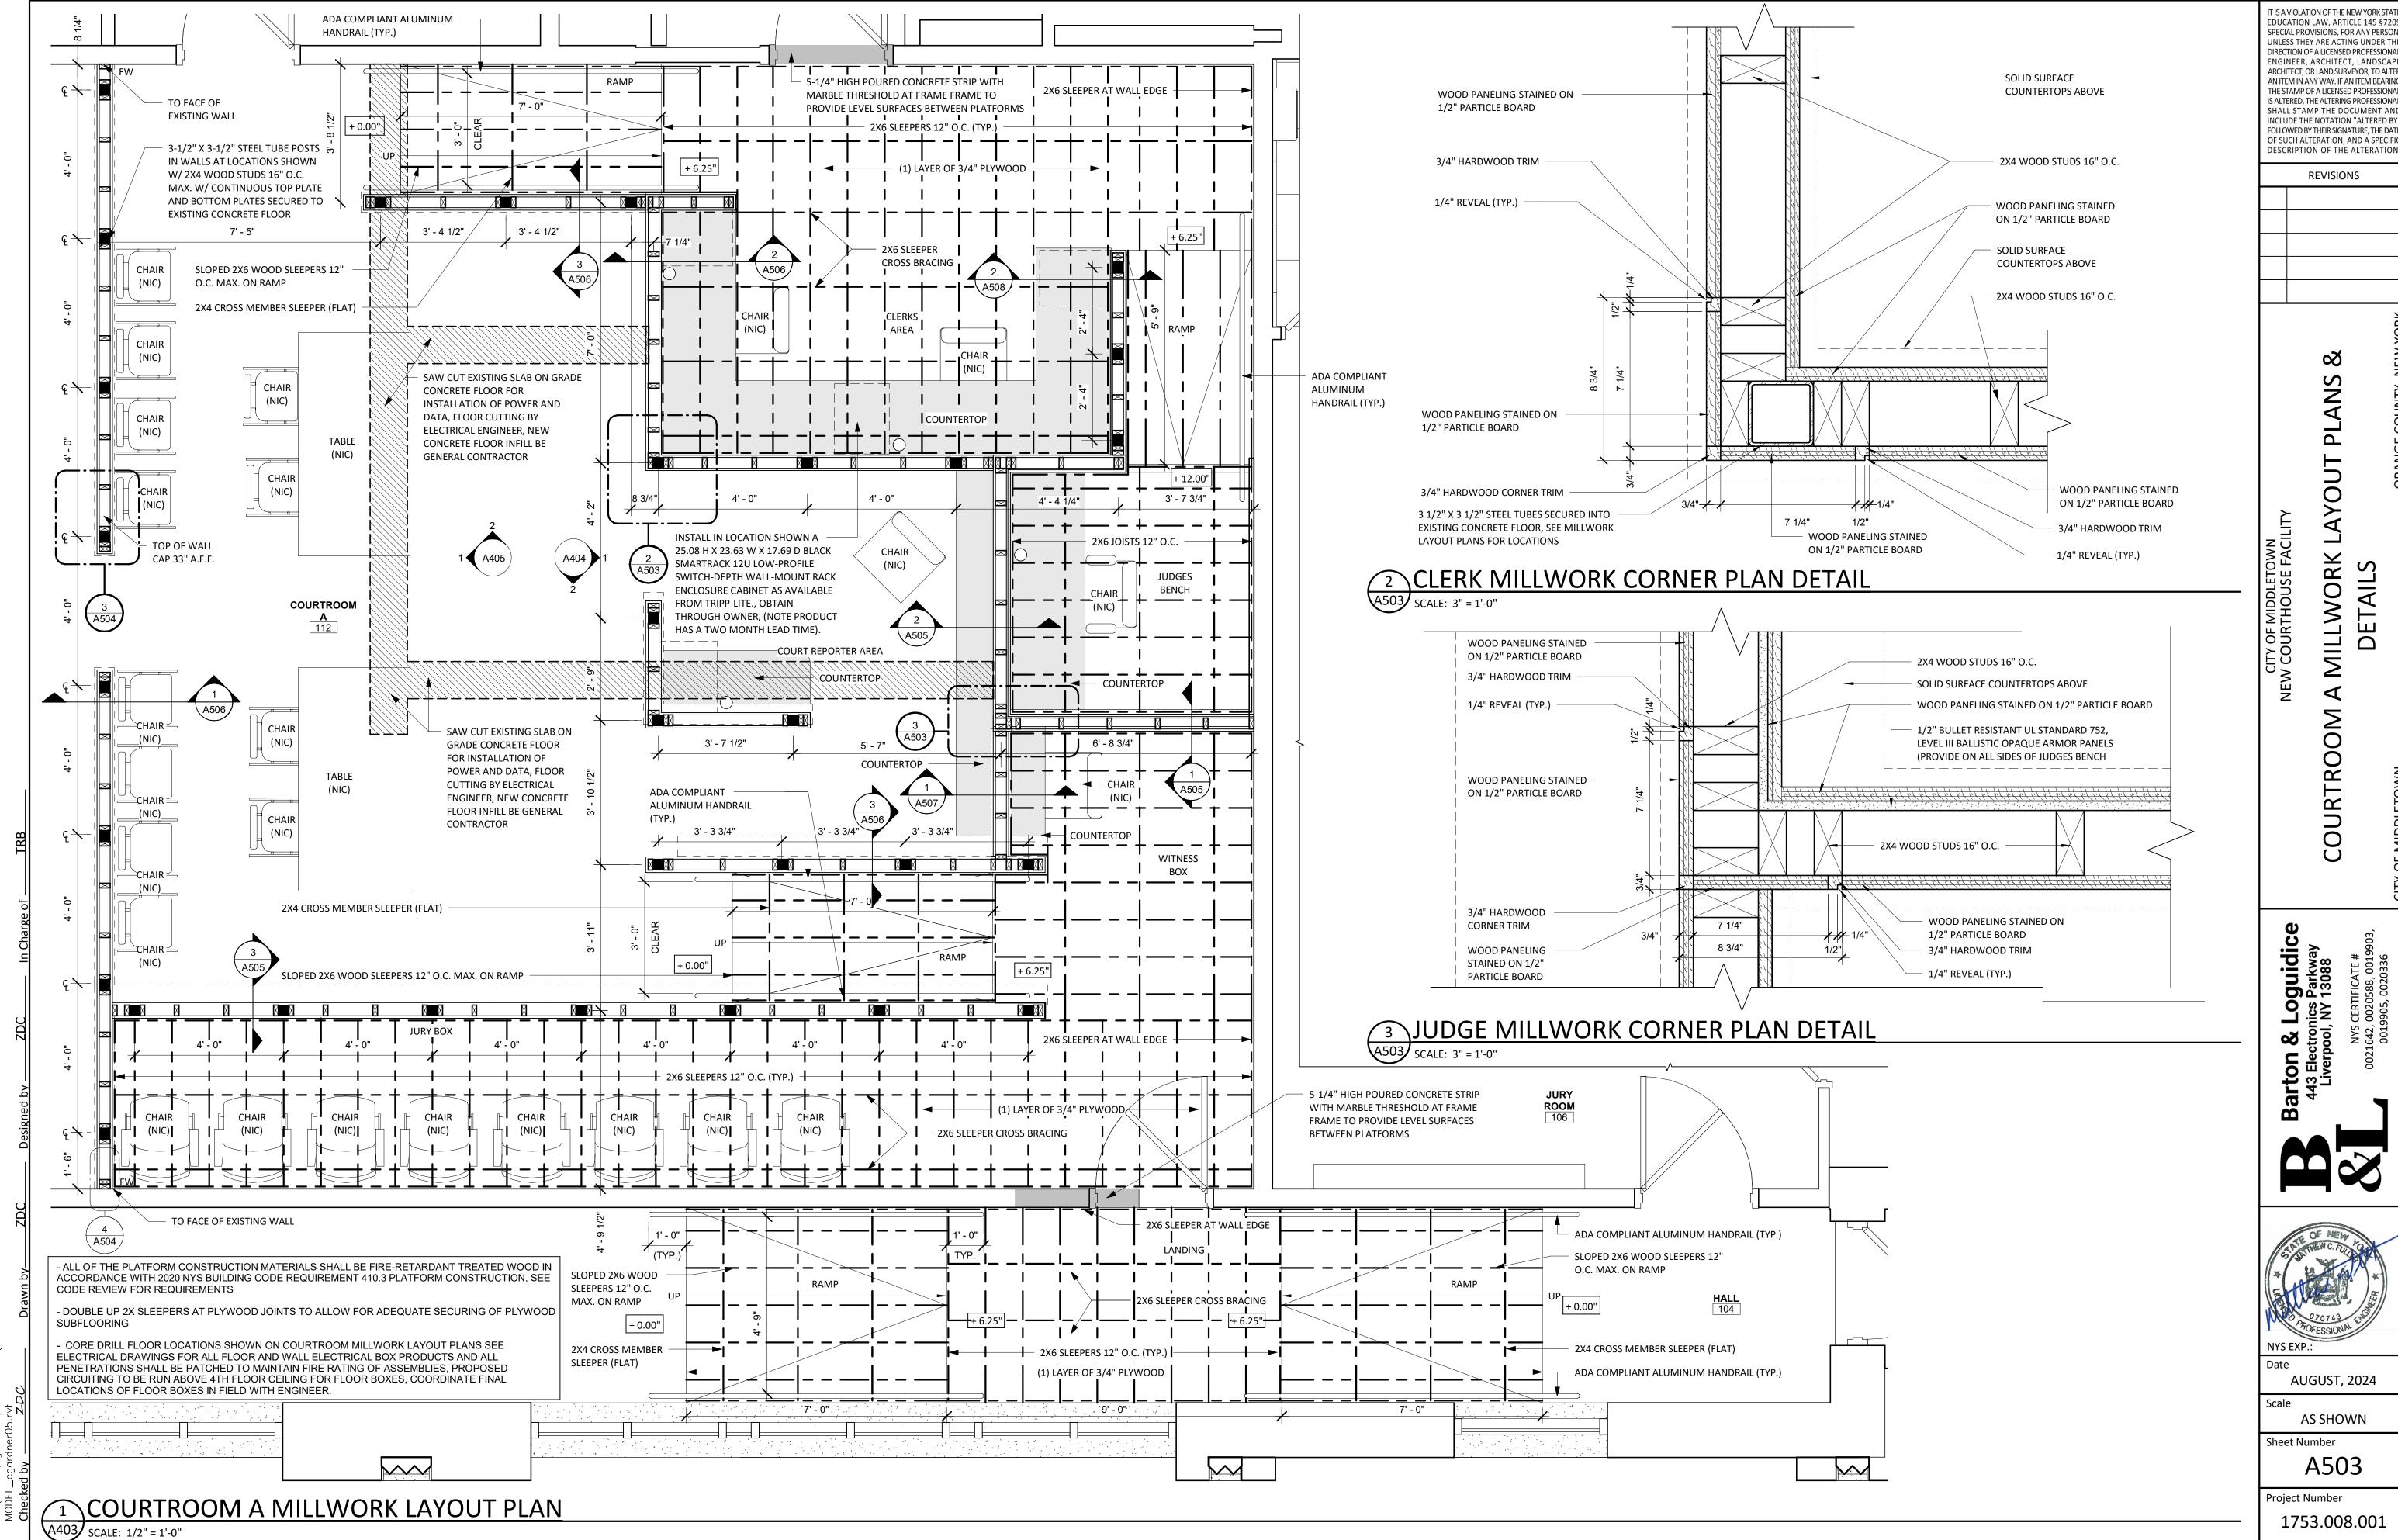
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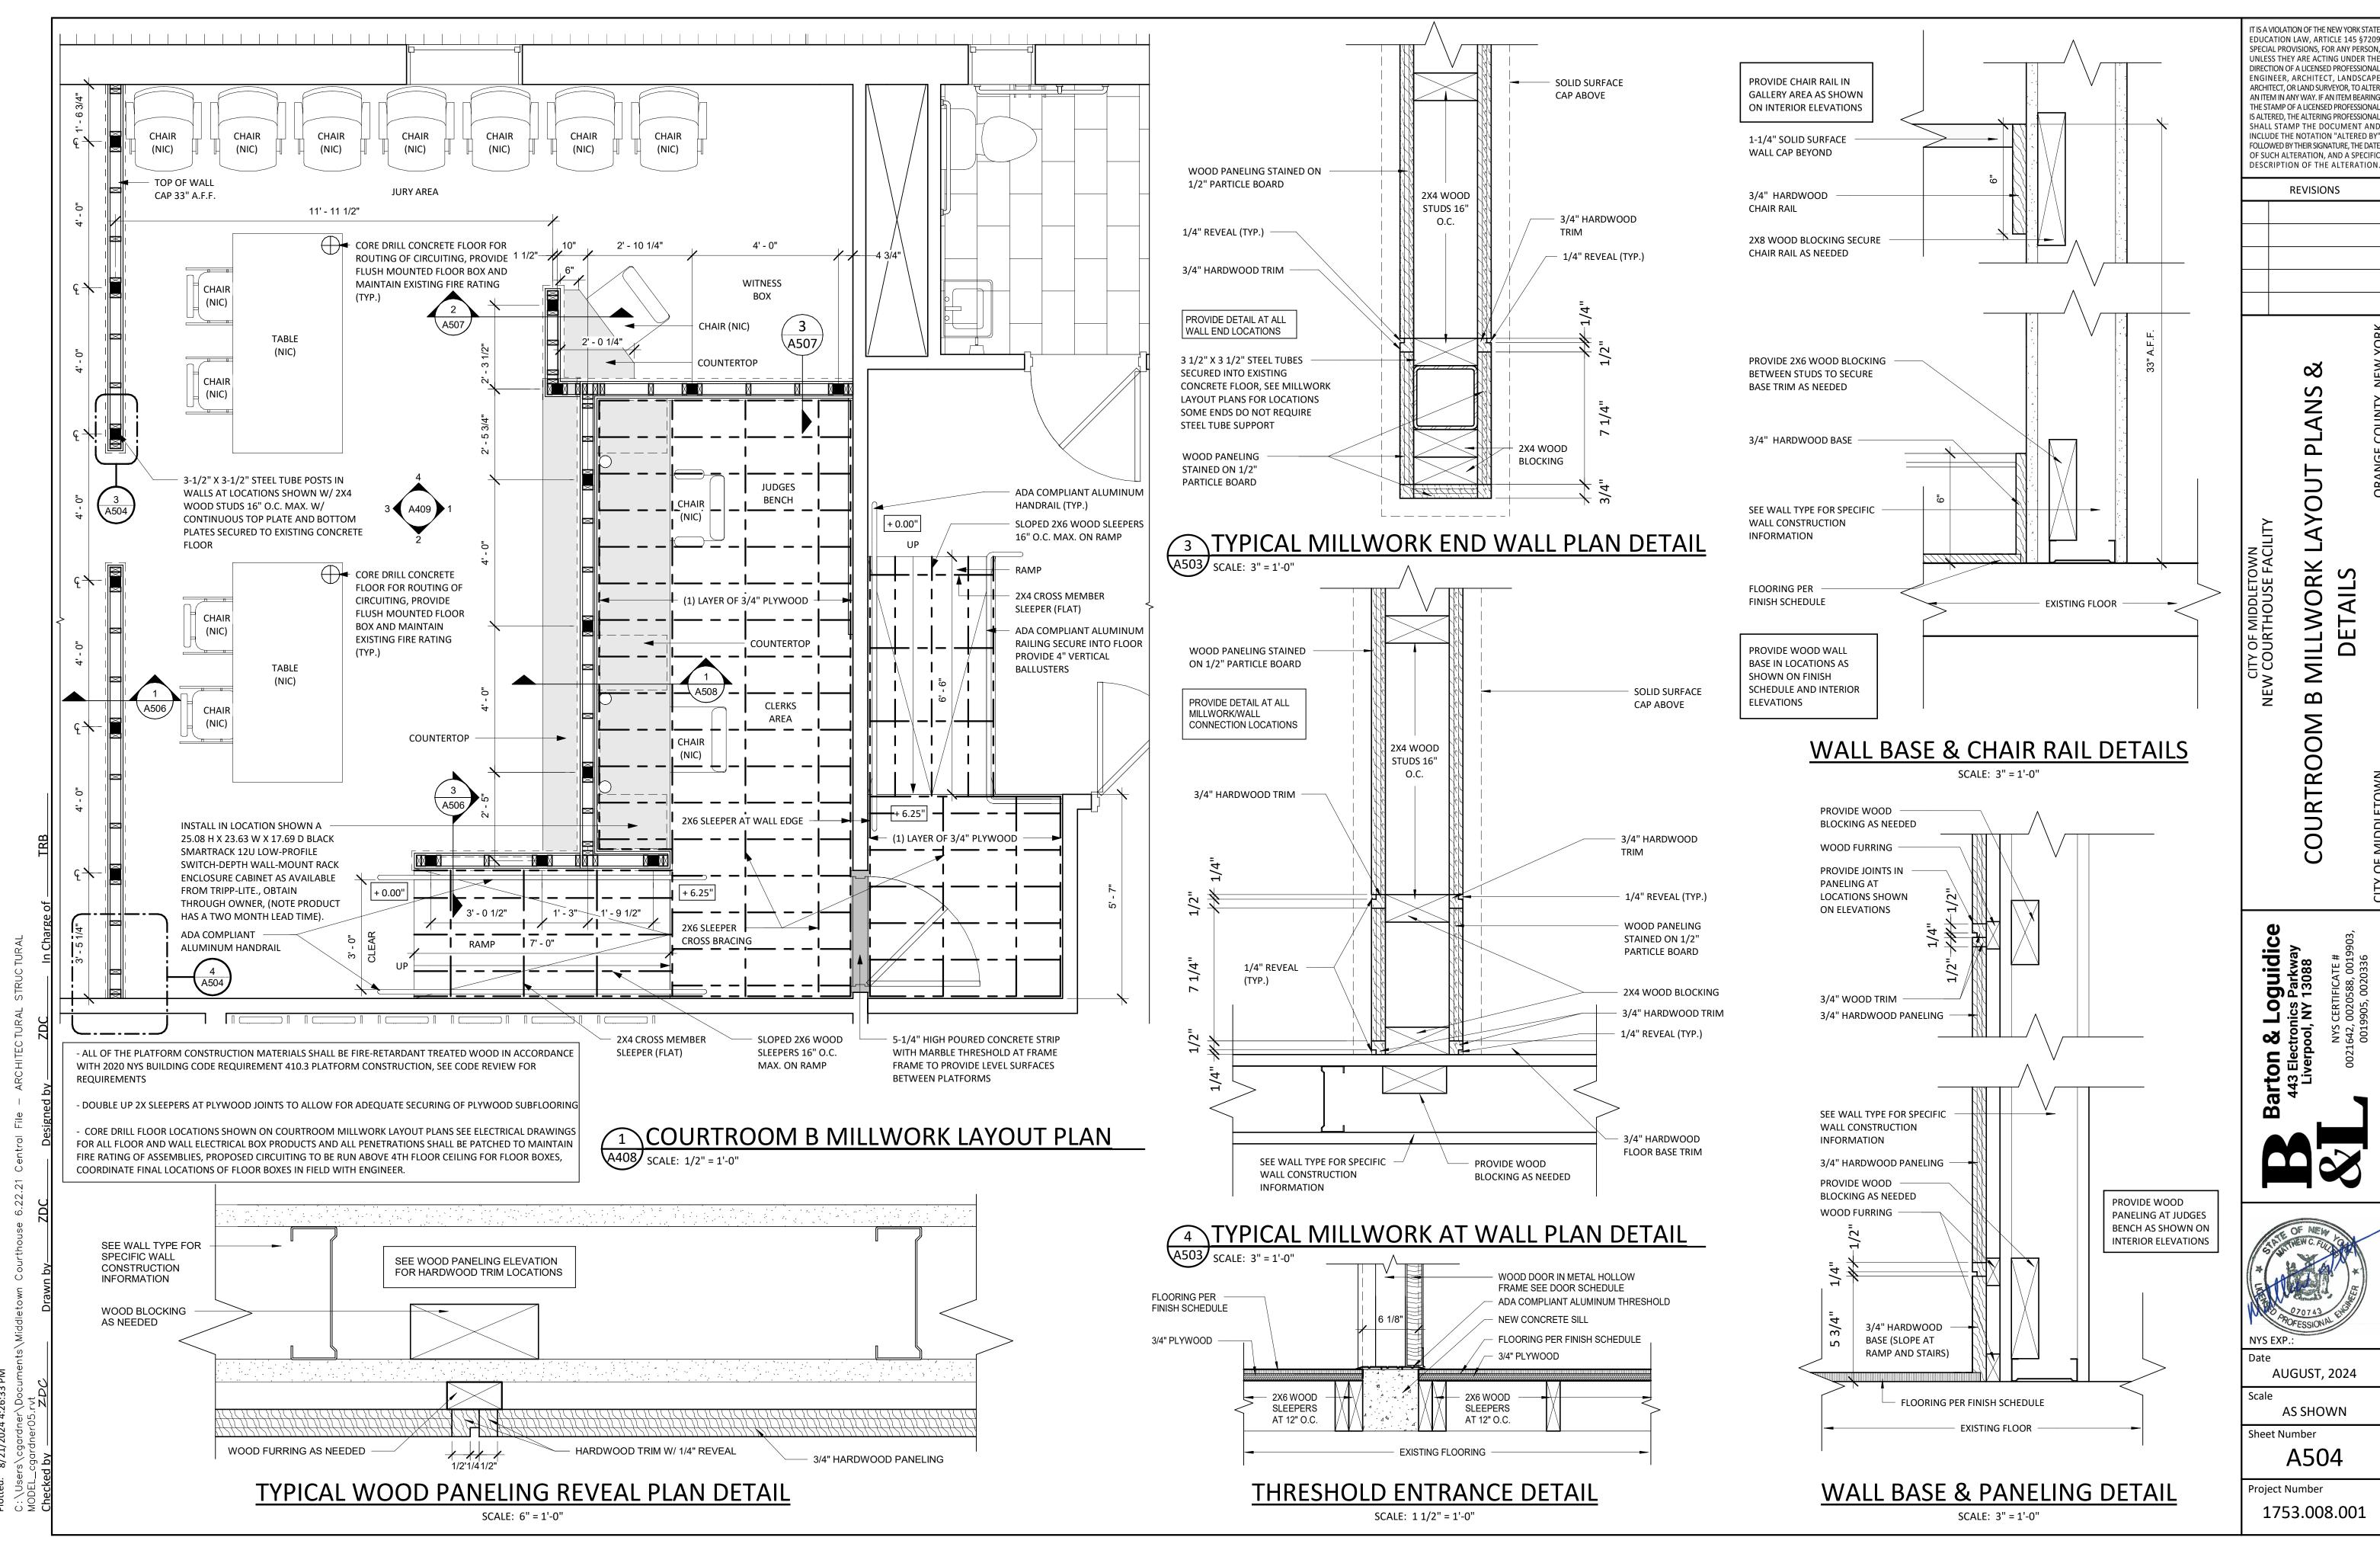



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AUGUST, 2024


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Sheet Number A505


SOLID SURFACE WALL CAP W/ EASED EDGE 2X4 WOOD STUD WALL TOP PLATE WOOD PANELING STAINED ON 1/2" PARTICLE BOARD - 3 1/2" X 3 1/2" STEEL TUBES SECURED INTO EXISTING CONCRETE FLOOR, SEE MILLWORK LAYOUT PLANS FOR LOCATIONS WITH 2X4 STUDS 16" O.C. IN BETWEEN - WOOD BLOCKING (TYP.) - 3/4" WOOD TRIM BASE LVT ON EXISTING FLOOR CARPET TILE - 12" X 3 1/2" X 1/4" STEEL BASE PLATE WELDED TO POST SECURE INTO EXISTING CONCRETE FLOOR W/ 1/2" EXPANSION ANCHORS EXISTING FLOORING

GALLERY WALL DETAIL

A503 SCALE: 3" = 1'-0"

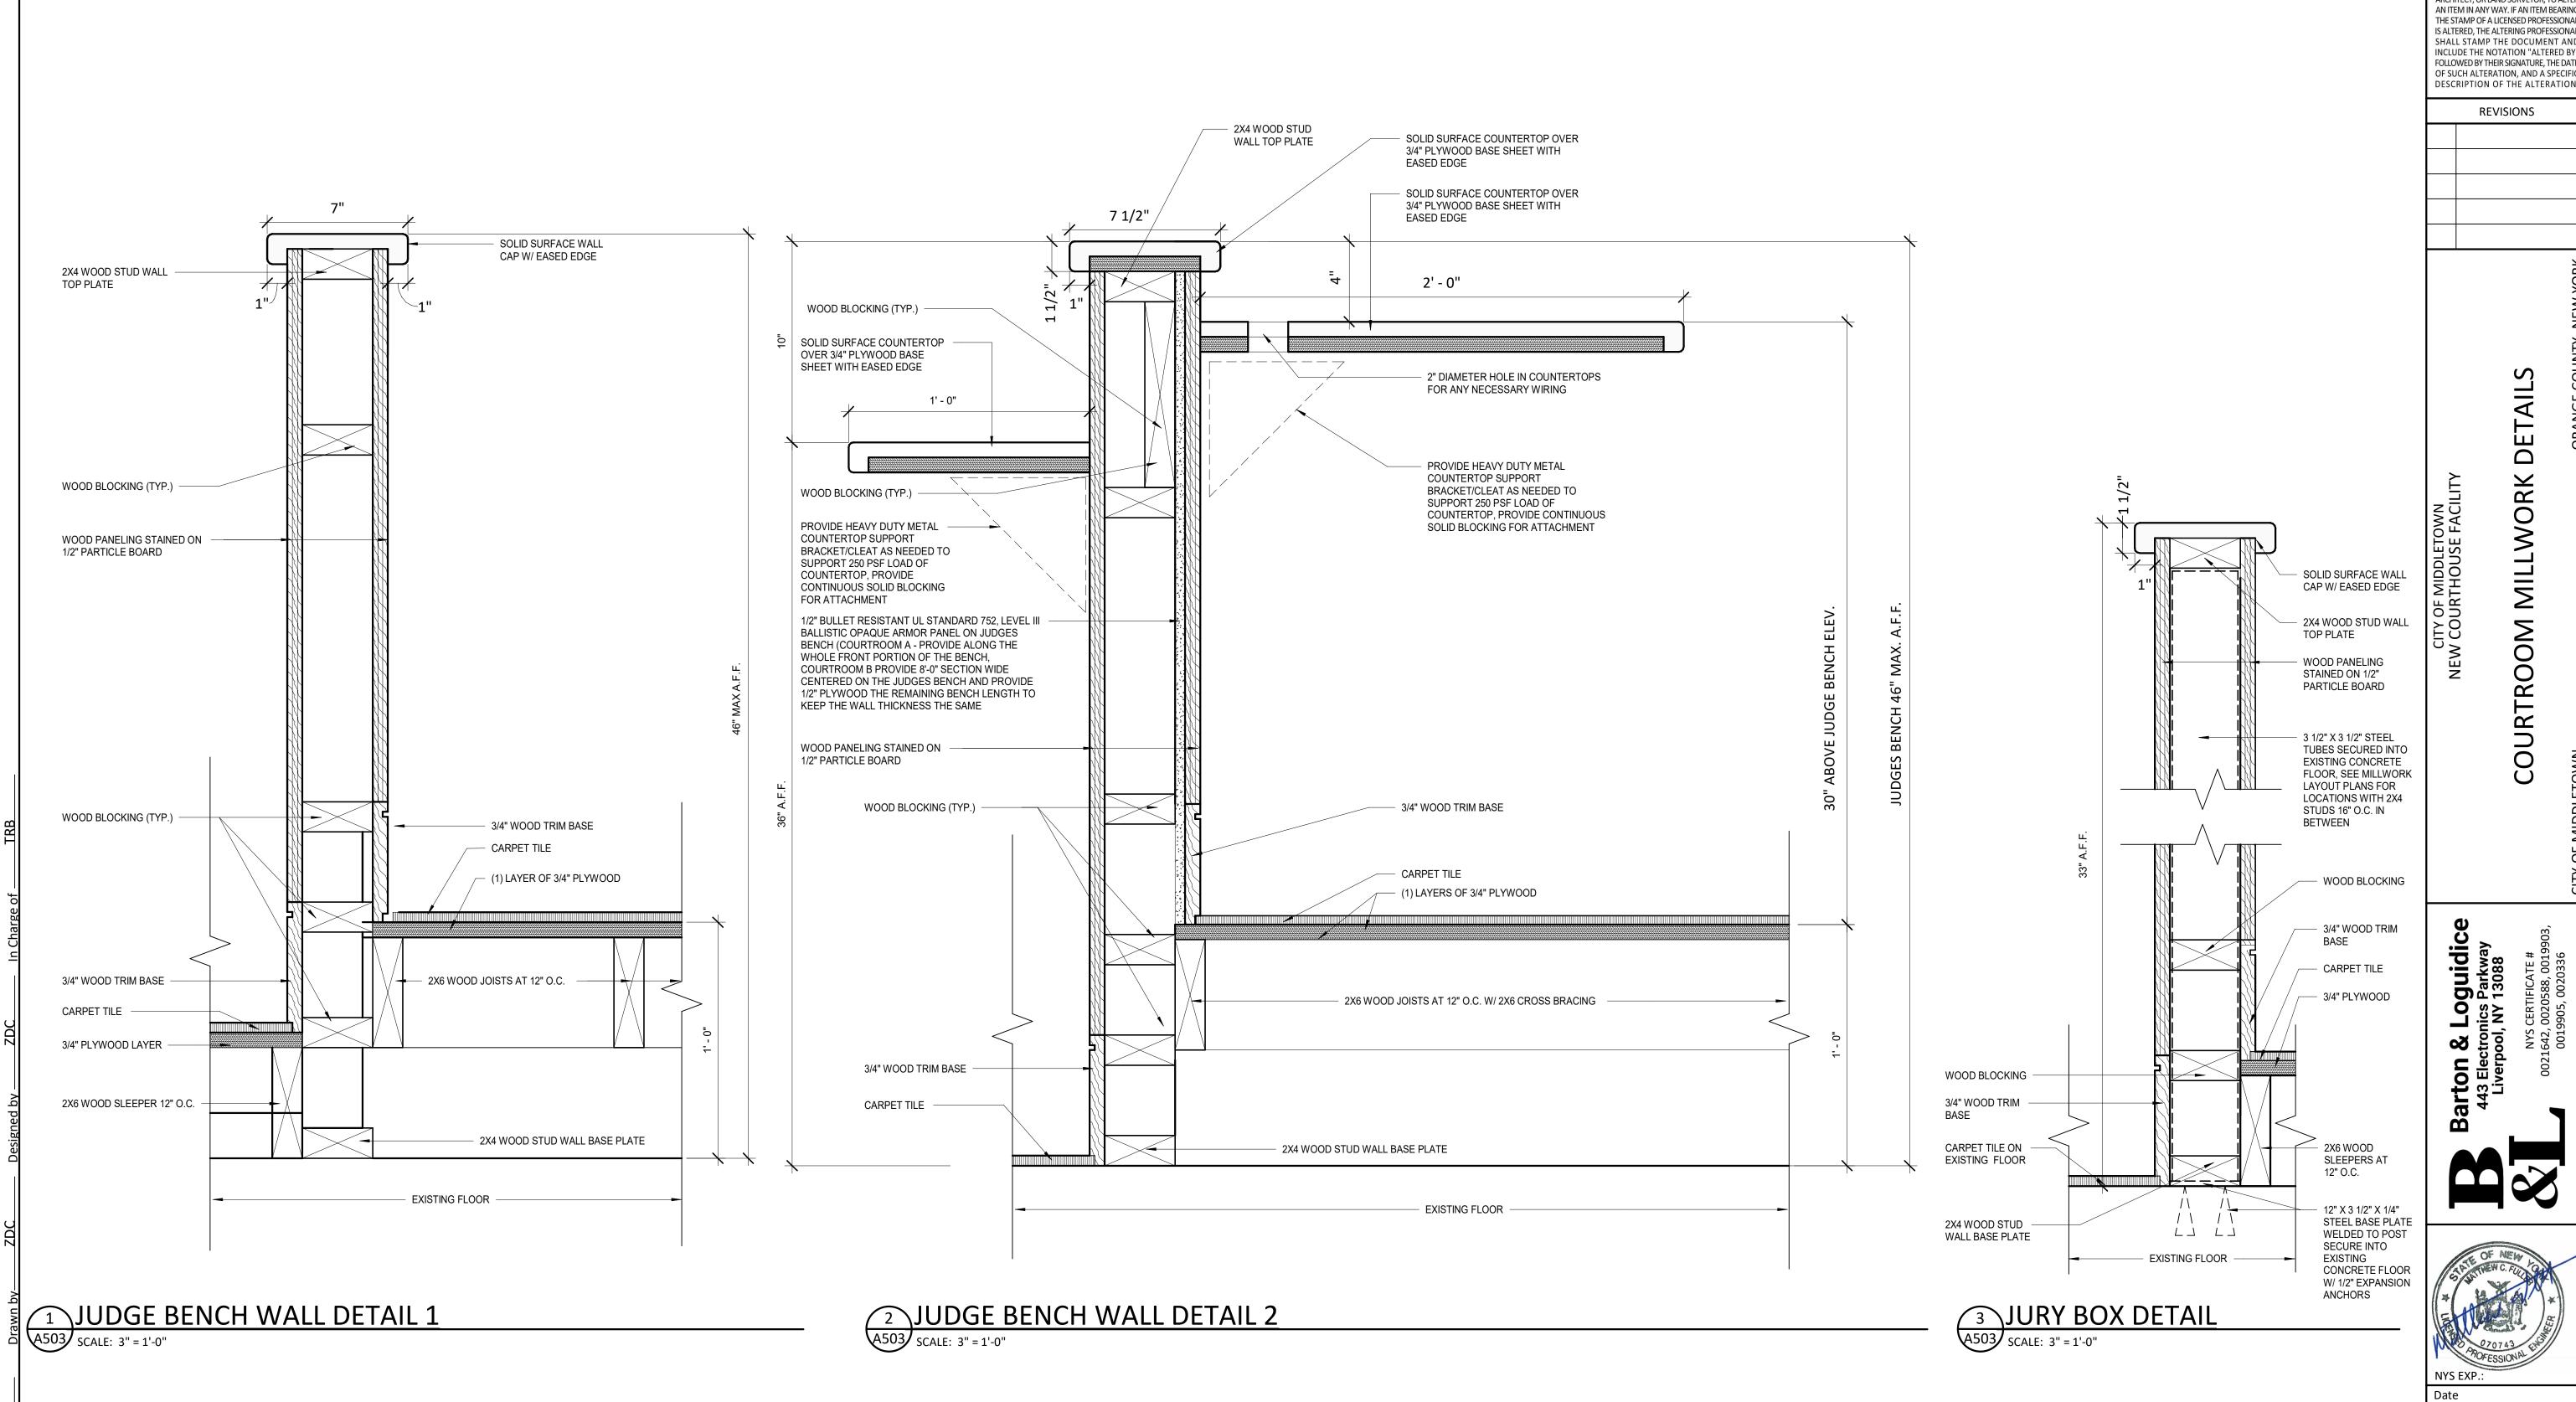

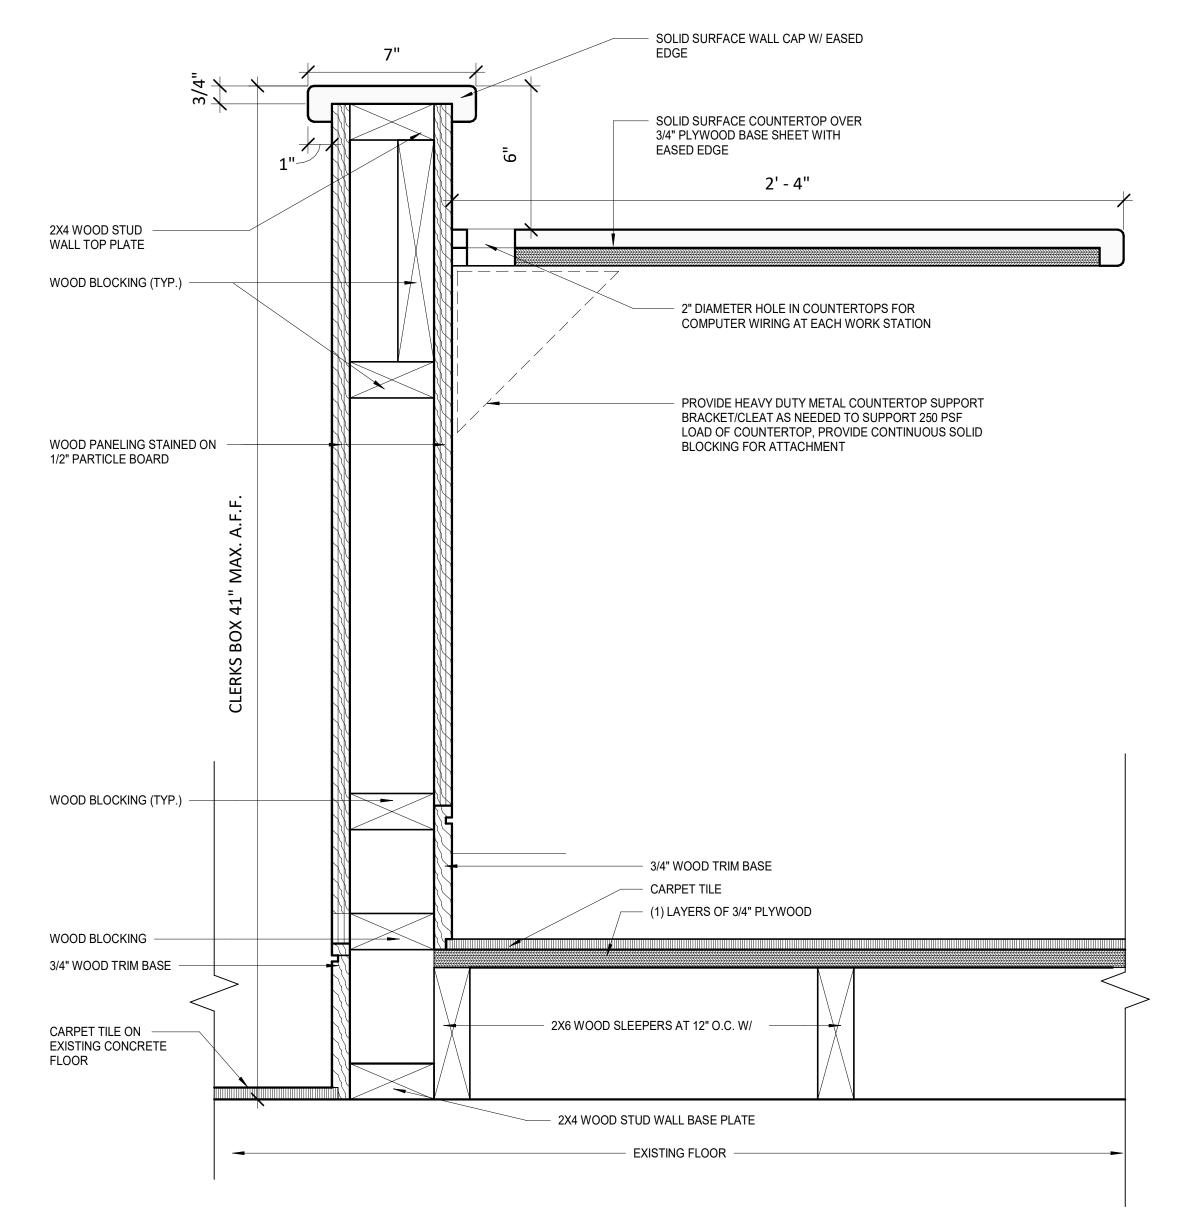2 CLERKS AREA WALL DETAIL
A503 SCALE: 3" = 1'-0"

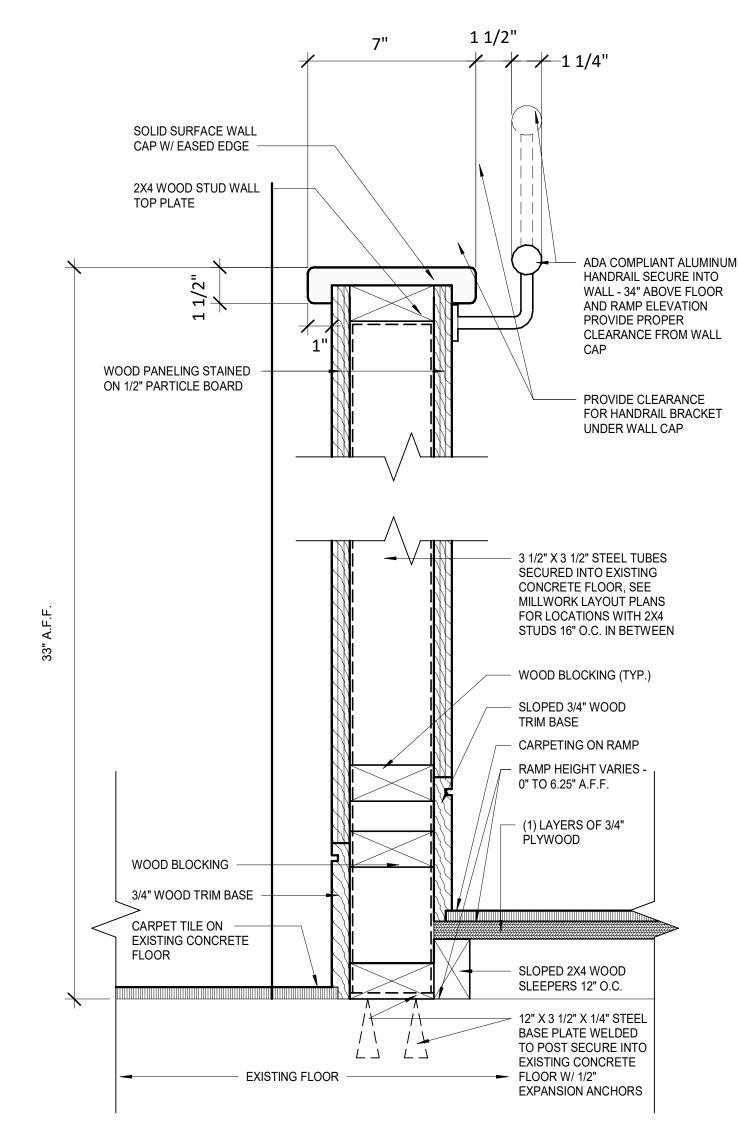

3 RAMP DETAIL 1
A503 SCALE: 3" = 1'-0"

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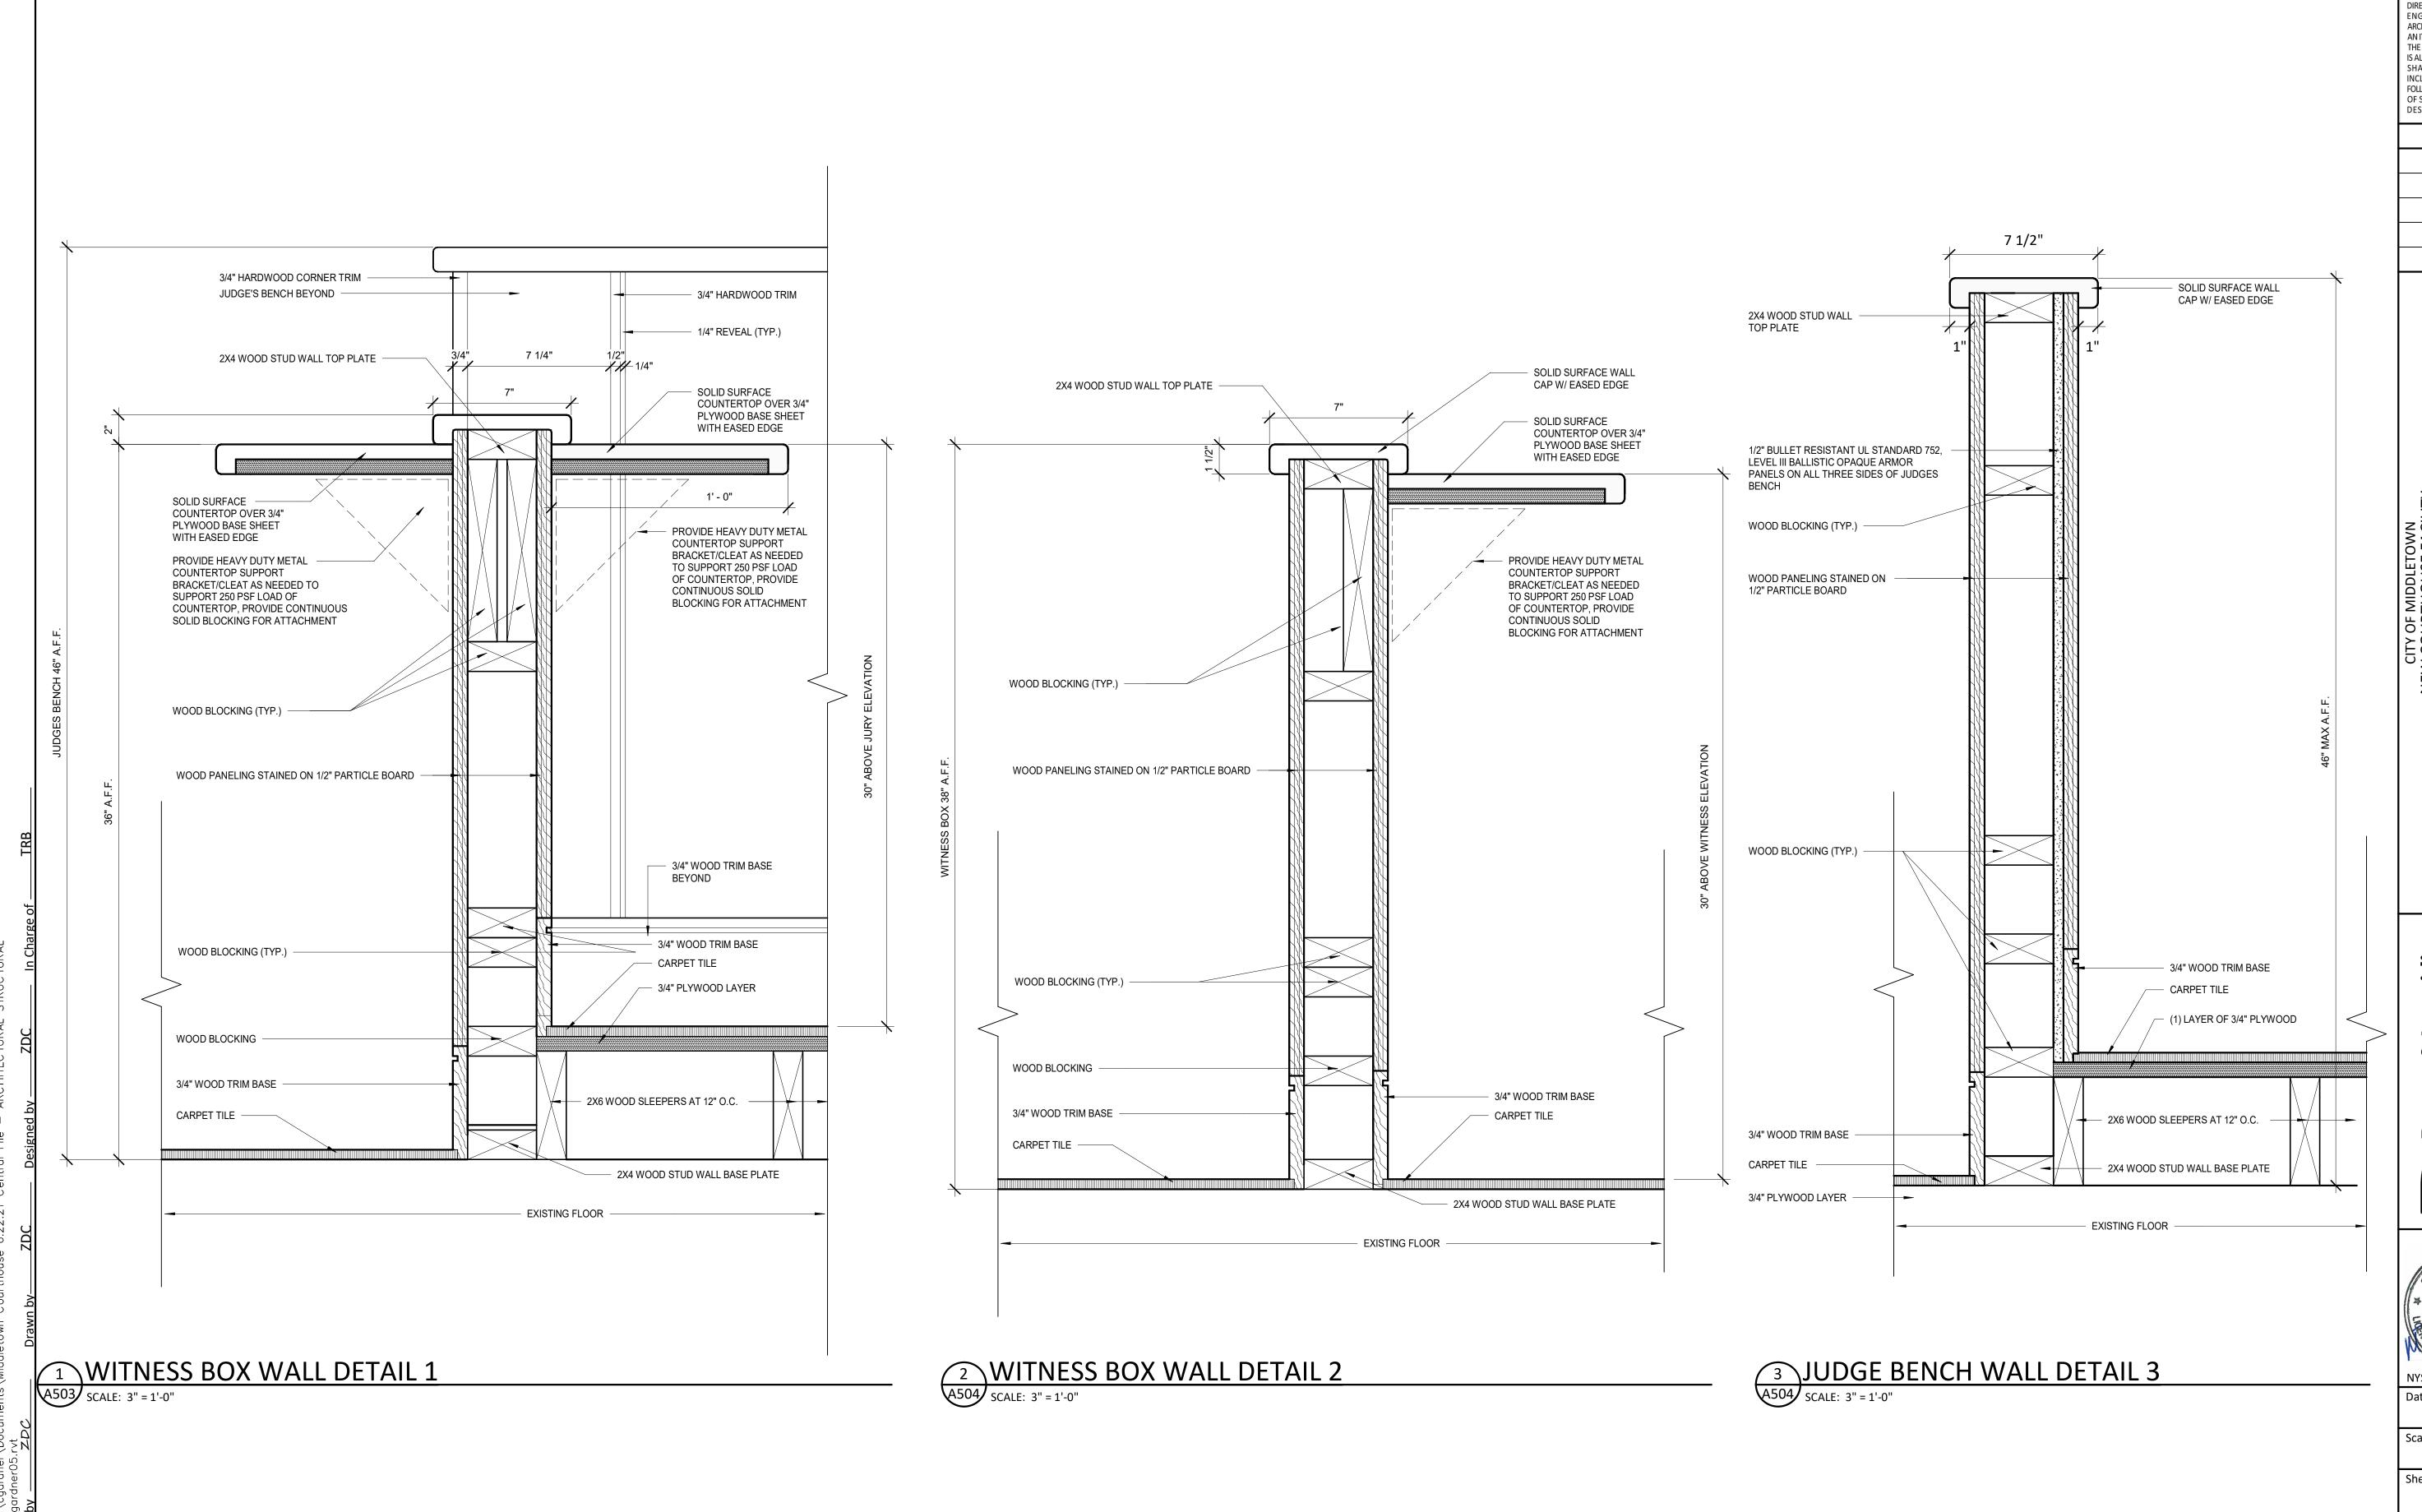
Barton & Loguidice 443 Electronics Parkway Liverpool, NY 13088



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AS SHOWN

Sheet Number A506



IT IS A VIOLATION OF THE NEW YORK STATE EDUCATION LAW, ARTICLE 145 §7209 SPECIAL PROVISIONS, FOR ANY PERSON, UNLESS THEY ARE ACTING UNDER THE DIRECTION OF A LICENSED PROFESSIONAL ENGINEER, ARCHITECT, LANDSCAPE ARCHITECT, OR LAND SURVEYOR, TO ALTER AN ITEM IN ANY WAY. IF AN ITEM BEARING THE STAMP OF A LICENSED PROFESSIONAL IS ALTERED, THE ALTERING PROFESSIONAL SHALL STAMP THE DOCUMENT AND INCLUDE THE NOTATION "ALTERED BY' FOLLOWED BY THEIR SIGNATURE, THE DATE OF SUCH ALTERATION, AND A SPECIFIC DESCRIPTION OF THE ALTERATION

REVISIONS

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Barton & Loguidice 443 Electronics Parkway Liverpool, NY 13088



AUGUST, 2024

AS SHOWN

Sheet Number

A507 Project Number

1753.008.001

1' - 0" 2" DIAMETER HOLE IN COUNTERTOPS FOR ANY NECESSARY WIRING PROVIDE HEAVY DUTY METAL COUNTERTOP SUPPORT BRACKET/CLEAT AS NEEDED TO SUPPORT 250 PSF LOAD OF COUNTERTOP, PROVIDE CONTINUOUS SOLID BLOCKING FOR ATTACHMENT PROVIDE HEAVY DUTY METAL COUNTERTOP SUPPORT BRACKET/CLEAT AS NEEDED TO WOOD BLOCKING (TYP.) SUPPORT 250 PSF LOAD OF COUNTERTOP, PROVIDE CONTINUOUS SOLID BLOCKING FOR ATTACHMENT 1/2" BULLET RESISTANT UL STANDARD 752, LEVEL III BALLISTIC OPAQUE ARMOR PANEL ON JUDGES BENCH (COURTROOM A -PROVIDE ALONG THE WHOLE FRONT PORTION OF THE BENCH, COURTROOM B PROVIDE 8'-0" SECTION WIDE CENTERED ON THE JUDGES BENCH AND PROVIDE 1/2" PLYWOOD THE REMAINING BENCH LENGTH TO KEEP THE WALL THICKNESS THE SAME WOOD PANELING STAINED ON 1/2" PARTICLE BOARD 3/4" WOOD TRIM BASE WOOD BLOCKING (TYP.) CARPET TILE - (1) LAYERS OF 3/4" PLYWOOD 3/4" WOOD TRIM BASE CARPET TILE 2X6 WOOD SLEEPERS AT 12" O.C. W/ 2X6 CROSS BRACING 2X4 WOOD STUD WALL BASE PLATE EXISTING FLOOR CLERK/JUDGE BENCH WALL DETAIL

SCALE: 3" = 1'-0"

7 1/2"

SOLID SURFACE COUNTERTOP OVER 3/4" PLYWOOD BASE

SHEET WITH EASED EDGE

2X4 WOOD STUD WALL TOP PLATE

EASED EDGE

EASED EDGE

2' - 0"

SOLID SURFACE COUNTERTOP OVER 3/4" PLYWOOD BASE SHEET WITH

SOLID SURFACE COUNTERTOP OVER

3/4" PLYWOOD BASE SHEET WITH

2X4 WOOD STUD -WALL TOP PLATE SOLID SURFACE WALL CAP -W/ EASED EDGE SOLID SURFACE COUNTERTOP OVER 3/4" PLYWOOD BASE SHEET WITH EASED EDGE ADA COMPLIANT ALUMINUM 2' - 4" HANDRAIL SECURE INTO WALL - 34" ABOVE FLOOR AND RAMP ELEVATION PROVIDE PROPER CLEARANCE FROM WALL 2" DIAMETER HOLE IN COUNTERTOPS FOR PROVIDE CLEARANCE COMPUTER WIRING AT EACH WORK STATION FOR HANDRAIL BRACKET UNDER WALL CAP WOOD BLOCKING (TYP.) -PROVIDE HEAVY DUTY METAL COUNTERTOP SUPPORT BRACKET/CLEAT AS NEEDED TO SUPPORT 250 PSF LOAD OF COUNTERTOP, PROVIDE CONTINUOUS SOLID BLOCKING FOR ATTACHMENT WOOD PANELING STAINED ON 1/2" PARTICLE BOARD SLOPED 3/4" WOOD TRIM BASE RAMP HEIGHT VARIES -6.25" TO 12" A.F.F. (1) LAYERS OF 3/4" PLYWOOD CARPETING ON RAMP WOOD BLOCKING (TYP.) 3/4" WOOD TRIM BASE CARPET TILE (1) LAYERS OF 3/4" PLYWOOD - SLOPED 2X6 WOOD JOISTS 12" O.C. WOOD BLOCKING 2X6 WOOD SLEEPERS AT 12" O.C. W/ SLOPED 2X6 WOOD SLEEPERS 12" O.C. 2X4 WOOD STUD WALL BASE PLATE - EXISTING FLOOR

2 CLERKS AREA AND RAMP DETAIL
A503 SCALE: 3" = 1'-0"

30"


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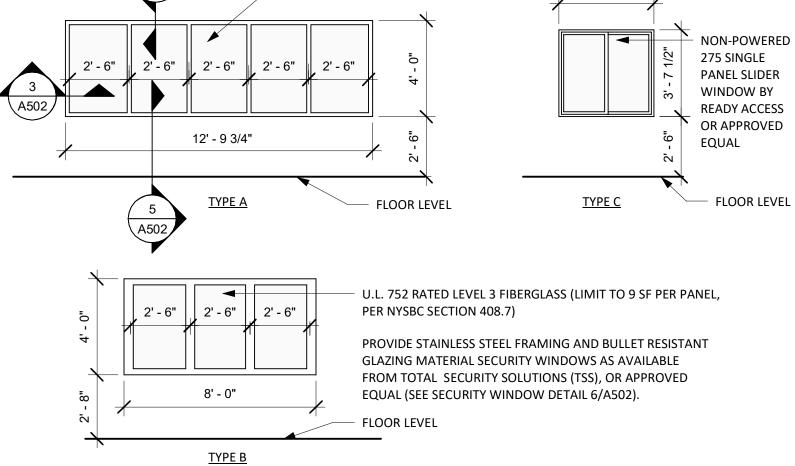
Sheet Number A508

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					ROOM FINISH SO	CHEDULE					
ROOM NUMBER	ROOM NAME	FLOOR FINISH	BASE FINISH	WALL FINISH - NORTH	WALL FINISH - EAST	WALL FINISH - SOUTH	WALL FINISH - WEST	CEILING FINISH	CEILING HEIGHT	COMMENTS	
101	VESTIBULE	EXIST	EXIST	EXIST	EXIST	EXIST	EXIST	EXIST			
102	LOBBY WAITING AREA	EXIST	EXIST	PNT	PNT	PNT	PNT	EXIST			
103	ELEV. LOBBY	EXIST	EXIST	PNT	PNT	PNT	PNT	ACT-1	8' - 0"		
104	HALL	EXIST/C/PFT	VB	PNT	PNT	PNT	PNT	ACT-1	8' - 0"		
105	SECURITY OFFICE	LVT	VB	PNT	PNT	PNT	PNT	ACT-1	8' - 0"		
106	JURY ROOM	EXIST	EXIST	PNT	PNT	PNT	PNT	EXIST			
107	CLO.	EXIST	EXIST	PNT	PNT	PNT	PNT	EXIST			_ "
108	MEN'S BATHROOM	EXIST	EXIST	EXIST GWT/PNT	EXIST GWT/PNT	EXIST GWT/PNT	EXIST GWT/PNT	EXIST			
109	WOMEN'S BATHROOM	EXIST	EXIST	EXIST GWT/PNT	EXIST GWT/PNT	EXIST GWT/PNT	EXIST GWT/PNT	EXIST			
110	VEST.	LVT	VB	PNT	PNT	PNT	PNT	EXIST			_
111	ATTY. CONF. 1	LVT	VB		PNT	PNT	PNT	EXIST			
112	COURTROOM A	C/LVT	WD	PNT/AWT	PNT	PNT/AWT	PNT/AWT	EXIST			_
113	VEST.	EXIST	EXIST	PNT	PNT	PNT	PNT	EXIST			-
114 115	STAIRS JAN.	EXIST	EXIST	PNT EXIST	PNT EXIST	PNT EXIST	PNT EXIST	EXIST			- \
116	ELEC. CLO.	EXIST	EXIST	EXIST	EXIST	EXIST	EXIST	EXIST			-
117	HALL	EXIST	VB	PNT	PNT	PNT	PNT	ACT-1	8' - 0"		-
118	DRUG COOR.	C	VB		PNT	PNT	PNT	ACT-1		PARGE EXIST CMU WALL SMOOTH	
119	BATHROOM	PFT	GWT	GWT/PNT	GWT/PNT	GWT/PNT	GWT/PNT	ACT-1	8' - 0"	ANGE EXIST CIVIO WALE SIVIOUTTI	
120	WOMEN'S BATHROOM	PFT	GWT	GWT/PNT	GWT/PNT	GWT/PNT	GWT/PNT	ACT-1	8' - 0"		
121	MEN'S BATHROOM	PFT	GWT	GWT/PNT	GWT/PNT	GWT/PNT	GWT/PNT	ACT-1	8' - 0"		
122	SECURITY OFFICE	EXIST/T	-	D/CMU	D/CMU	D/CMU	D/CMU	ACT-1	8' - 0"		
123	LAS	C	VB	PNT	PNT	PNT	PNT	ACT-1	8' - 0"		
124	SECURE HALLWAY	EXIST	EXIST		PNT	PNT	PNT	ACT-1	8' - 0"		
125	COOR.	LVT	VB	PNT	PNT	PNT	PNT	ACT-1	8' - 0"		
126	COOR.	EXIST/T	-	D/CMU	D/CMU	PNT	PNT	LINEAR METAL	8' - 5"		
127	MALE CELL #1	EXIST/T	-	D/CMU	D/CMU	D/CMU	D.CMU	LINEAR METAL	8' - 5"		
128	MALE CELL #2	EXIST/T	-	D/CMU	D/CMU	D/CMU	D/CMU	LINEAR METAL	8' - 5"		
129	HOLDING CELL HALL	EXIST/T	-	D/CMU	D/CMU	D/CMU	D/CMU	LINEAR METAL	8' - 5"		
130	INTER. ROOM	EXIST/T	-	PNT	PNT	PNT	PNT	EXIST			
131	INTER. ROOM	EXIST/T	_	PNT	PNT	PNT	PNT	EXIST			
132	FEMALE CELL	EXIST/T	_	D/CMU	D/CMU	D/CMU	D/CMU	LINEAR METAL	8' - 5"		
133	HALL	LVT	VB	PNT	PNT	PNT	PNT	ACT-1	8' - 0"		
134	LAW CLERK	С	VB	PNT	PNT	PNT	PNT	ACT-1	8' - 0"		
135	SECRETARY	С	VB	PNT	PNT	PNT	PNT	ACT-1	8' - 0"		
135	STAIRS	EXIST	EXIST	PNT	PNT	PNT	PNT	EXIST			
136	JUDGE OFFICE 1	С	WB		PNT	PNT	PNT	ACT-1	8' - 0"		
137	JUDGE OFFICE 2	С	WB	PNT	PNT	PNT	PNT	ACT-1	8' - 0"		
138	BATHROOM	PFT	GWT	GWT/PNT	GWT/PNT	GWT/PNT	GWT/PNT	ACT-1	8' - 0"		
139	BATHROOM	PFT	GWT	GWT/PNT	GWT/PNT	GWT/PNT	GWT/PNT	ACT-1	8' - 0"		
140	WOMEN'S LOCKER ROOM	LVT	VB		PNT	PNT	PNT	ACT-1	8' - 0"		_
141	STAIRS	EXIST	EXIST	PNT	PNT	PNT	PNT	EXIST			_
142	MEN'S LOCKER ROOM	LVT	VB		PNT	PNT	PNT	ACT-1	8' - 0"		
143	ELEC.	EXIST	EXIST	EXIST	EXIST	EXIST	EXIST	EXIST			_
201	STAIRS	EXIST	EXIST	PNT	PNT	PNT	PNT	EXIST			_
202	CENDED NEUTRAL DATHBOOM	PFT	VB GWT		PNT CWT/DNT	PNT CWT/DNT	PNT CWT/DNT	EXIST	8' - 0"		
203	GENDER NEUTRAL BATHROOM GENDER NEUTRAL BATHROOM	PFT	GWT	GWT/PNT GWT/PNT	GWT/PNT GWT/PNT	GWT/PNT GWT/PNT	GWT/PNT GWT/PNT	ACT-1	8' - 0"		
204	ELEC. CLO./ STOR.	EXIST	EXIST	EXIST	EXIST	EXIST	EXIST	EXIST	8 - 0		_
206	WAITING AREA	PFT	VB		PNT	PNT	PNT	ACT-1	8' - 0"		-
207	COURTROOM B	C/LVT	WB	PNT/AWT	PNT	PNT/AWT	PNT/AWT	ACT-2, GWB PT	0 0		$\overline{}$
208	ATTY. CONF.	C	VB	•	PNT	PNT	PNT	ACT-1	8' - 0"		
209	PUBLIC WINDOW	PFT	VB		PNT	PNT	PNT	ACT-1	8' - 0"		
210	SECURE COORIDOR/ PAYMENT WINDOW		VB	PNT	PNT	PNT	PNT	ACT-1	8' - 0"		\dashv
211	MENS TOILET	PFT	GWT	GWT/PNT	GWT/PNT	GWT/PNT	GWT/PNT	ACT-1	8' - 0"		
212	COURT REPORTERS	EXIST	EXIST	•	PNT	PNT	PNT	EXIST			\dashv
213	CLERK STAFF	C	VB	PNT	PNT	PNT	PNT	ACT-1	8' - 0"		\dashv
214	CONFERENCE/ FUTURE FILE ROOM	EXIST	EXIST		PNT	PNT	PNT	EXIST			\dashv
215	BREAK ROOM	EXIST	EXIST		PNT	PNT	PNT	EXIST			\dashv
216	CHIEF CLERK	EXIST	EXIST		PNT	PNT	PNT	EXIST			\dashv
217	DEPUTY CLERK	EXIST	EXIST		PNT	PNT	PNT	EXIST			\dashv
218	FILE/ SUPPLY ROOM	С	VB		PNT	PNT	PNT	ACT-1	8' - 0"		$\overline{}$
219	STAIRS	EXIST	EXIST		PNT		PNT	EXIST			\neg
220	WOMANS TOILET	PFT	GWT		GWT/PNT	GWT/PNT		ACT-1	8' - 0"		\dashv
221	FILE ROOM	EXIST		•	PNT	PNT	PNT	EXIST			
		1	T		1	1	1	1	,		

WINDOW SCHEDULE WINDOW NUMBER | TYPE | WIDTH HEIGHT MATERIAL COMMENTS | HOLLOW METAL | TWO-WAY MIRROR GLASS A | 12' - 9 3/4" 4' - 0" B 7' - 8 3/4" STAINLESS STEEL | SECURITY WINDOW AS AVAILABLE FROM TOTAL 4' - 2" SECURITY SOLUTIONS OR APPROVED EQUAL HOLLOW METAL | NON-POWERED 275 SINGLE PANEL SLIDER C 3' - 11 1/2" 3' - 7 1/2" WINDOW BY READY ACCESS OR APPROVED EQUAL C 3' - 11 1/2" 3' - 7 1/2" HOLLOW METAL | NON-POWERED 275 SINGLE PANEL SLIDER WINDOW BY READY ACCESS OR APPROVED EQUAL 1/2" SAFETY GLAZING (LIMIT TO 9 SF PER PANEL, PER NYSBC SECTION 408.7), PROVIDE TWO-WAY MIRROR GLASS FOR

SECURITY OFFICE PRIVACY FROM LOBBY/WAITING AREA

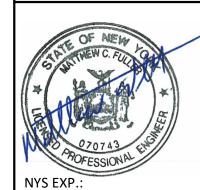

INTERIOR WINDOW TYPES

SCALE: 1/4" = 1'-0"

*ROOM FINISH LEGEND

FLOOR FINISHES

 $\underline{\mathsf{C}}$ - PROVIDE CARPET TILE/CARPET AS AVAILABLE FROM SHAW INDUSTRIES OR APPROVED EQUAL, SIZE TO BE 24 X 24, COLOR TO BE SELECTED BY OWNER FROM MANUFACTURERS FULL RANGE OF COLORS.

<u>LVT</u> - PROVIDE LUXURY VINYL TILE AS AVAILABLE FROM ARMSTRONG FLOORING COMMERCIAL OR APPROVED EQUAL, SIZE TO BE 18X36 AND 18X18, COLOR TO BE SELECTED BY OWNER FROM MANUFACTURERS FULL RANGE OF COLORS.

PFT - PROVIDE PORCELAIN FLOOR TILE AS AVAILABLE FROM MARAZZI, OR APPROVED EQUAL, SIZE TO BE 12 x 24, COLOR TO BE SELECTED BY OWNER FROM MANUFACTURERS FULL RANGE OF COLORS.

EXIST/T - EXISTING TERRAZZO FLOORING, PROVIDE INFILL OF TERRAZZO FLOORING TO MATCH EXISTING

WALL BASE FINISH

<u>VB</u> - PROVIDE VINYL WALL BASE AS AVAILABLE FROM JOHNSONITE OR APPROVED EQUAL, SIZE TO BE 6", COLOR TO BE SELECTED BY OWNER FROM MANUFACTURERS FULL RANGE OF COLORS.

<u>WB</u> - WOOD WALL BASE, SEE DRAWINGS FOR SIZE, STAIN FINISH TO BE SELECTED BY OWNER FROM AVAILABLE OPTIONS.

WALL FINISHES

PNT - PROVIDE PAINT AS AVAILABLE FROM SHERWIN WILLIAMS OR APPROVED EQUAL, COLOR TO BE SELECTED BY OWNER FROM MANUFACTURERS FULL RANGE OF COLORS.

<u>GWT</u> - PROVIDE WAINSCOT GLAZED CERAMIC WALL TILE AS AVAILABLE FROM CROSSVILLE OR APPROVED EQUAL, SIZE TO BE 4X12, TILE COLOR TO BE SELECTED BY OWNER FROM MANUFACTURERS FULL RANGE OF

<u>AWT</u> - PROVIDE ACOUSTICAL WALL TILE AS AVAILABLE FROM XOREL ARTFORM (SHAPE - PLANK - FABRIC WRAPPED ACOUSTICAL SUBSTRATE) OR APPROVED EQUAL, SIZE TO BE 10" H X 20" W X 1" D INSTALLED WITH MANUFACTURER'S RECOMMENDED ADHESIVE. WALL TILE COLOR AND FABRIC TO BE SELECTED BY OWNER FROM MANUFACTURERS FULL RANGE OF COLORS.

D/CMU - EXISTING DECORATIVE CONCRETE MASONRY UNIT BLOCK, PROVIDE INFILL OF CMU BLOCK TO MATCH EXISTING.

CEILING FINISHES

ACT-1 - PROVIDE 5/8" 2 X 2 ACOUSTICAL CEILING GRID SYSTEM AS AVAILABLE FROM ARMSTRONG OR APPROVED EQUAL. SEE REFLECTED CEILING PLAN FOR LAYOUT.

ACT-2 - PROVIDE 7/8" HIGH-NRC (.85/35) (MIN. STC RATING OF 52) 2 X 2 ACOUSTICAL CEILING GRID SYSTEM AS AVAILABLE FROM ARMSTRONG OR APPROVED EQUAL. SEE REFLECTED CEILING PLAN FOR LAYOUT.

GWB PT - PROVIDE PAINT (SOFFITS) AS AVAILABLE FROM SHERWIN WILLIAMS OR APPROVED EQUAL, COLOR TO BE SELECTED BY OWNER FROM MANUFACTURERS FULL RANGE OF COLORS.

LINEAR METAL - PROVIDE NEW HANGING 12" WIDE LINEAR METAL CEILING SYSTEM, METALWORKS SECURELOCK PLUS, AS AVAILABLE FROM ARMSTRONG OR APPROVED EQUAL. SEE REFLECTED CEILING PLAN FOR LAYOUT, COLOR TO BE SELECTED BY OWNER FROM MANUFACTURERS FULL RANGE OF COLORS.

* RECEIVE LAYOUT PATTERN APPROVAL PRIOR TO THE INSTALLATION OF ROOM FINISH MATERIALS FROM OWNER.

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DESCRIPTION OF THE ALTERATION REVISIONS

WINDOW SC TES REVISION N

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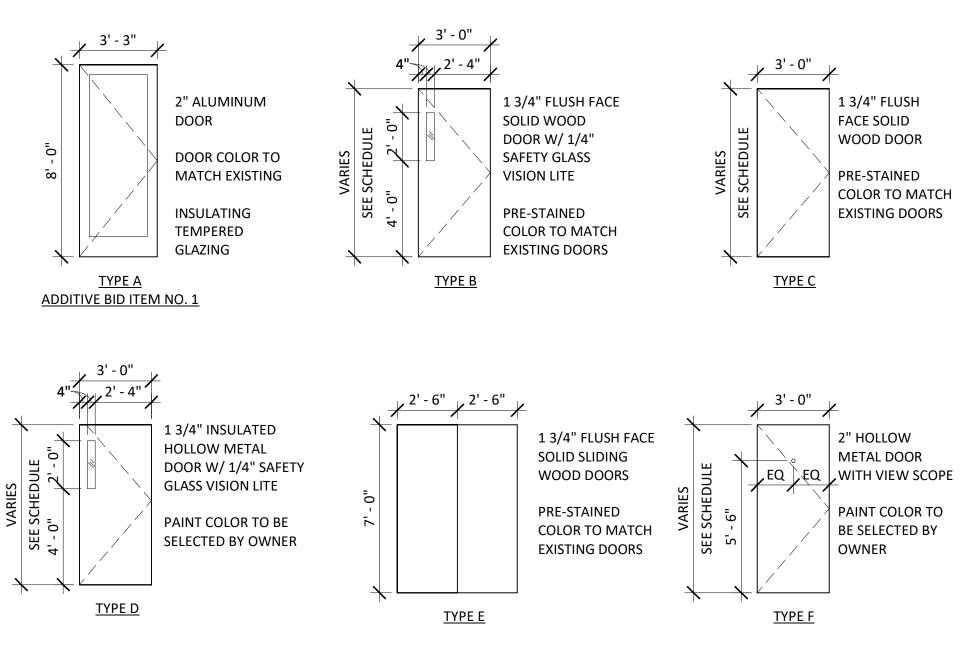
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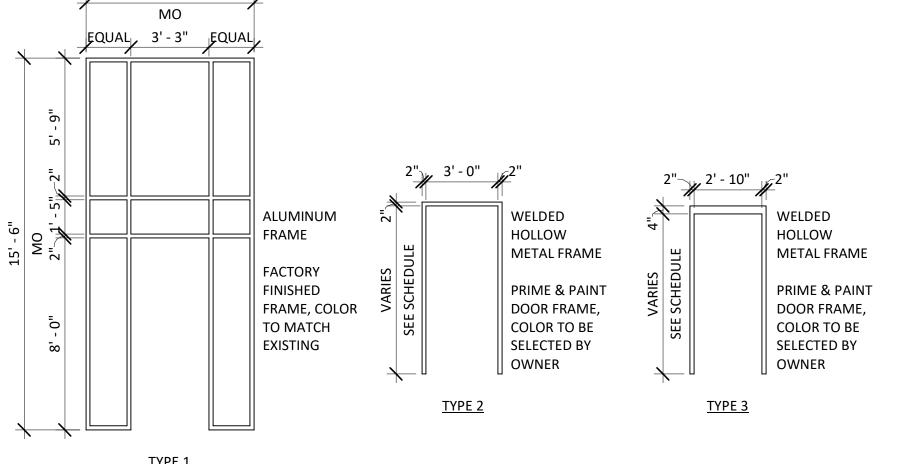
A601

DOOR			DOC	DR			FIRE		DOOR SCH FRAME	TEDULE	HEAD	10040		ELECTRIC	
DOOR NUMBER	TYPE	WIDTH	HEIGHT	THICKNESS	MATERIAL	FINISH	RATING	TYPE	MATERIAL	FINISH	DETAIL	JAMB DETAIL	HARDWARE	STRIKE	COMMENTS
101E	EXIST	6' - 0"	8' - 0"	2"	EXIST	EXIST	-	EXIST	EXIST	EXIST	-	-	1	YES	
102	A	3' - 2 1/2"	8' - 0"	2"	ALUM	FACT	-	1 EVICE	ALUM	FACT	5/A501	9/A501	2	YES	
103E 104E	EXIST EXIST	6' - 0" 3' - 0"	8' - 0" 7' - 0"	2"	EXIST EXIST	EXIST EXIST	45 MINUTE	EXIST	EXIST EXIST	EXIST EXIST	-	-	5	- YES	
105	В	3' - 0"	7' - 0"	1 3/4"	WD	STAIN	-	2	HM	PNT	1/A501	2/A501	7	YES	
106R	RELOCATE	3' - 0"	7' - 0"	1 3/4"	EXIST	EXIST	-	2	HM	PNT	11/A501	2/A501	7	YES	
107R	RELOCATE	3' - 0"	7' - 0"	1 3/4"	EXIST	EXIST	45 MINUTE	2	НМ	PNT	12/A501	13/A501	5	YES	INSTALL VISION PANEL
108R	RELOCATE	3' - 0"	7' - 0"	1 3/4"	EXIST	EXIST	45 MINUTE	2	HM	PNT	12/A501	13/A501		-	
109E	EXIST EXIST	3' - 0" 6' - 0"	7' - 0" 7' - 0"	1 3/4"	EXIST EXIST	PNT EXIST	90 MINUTE	EXIST	EXIST EXIST	PNT EXIST	-	-	9	YES	
110E 111E	EXIST	3' - 0"	7 - 0"	1 3/4"	EXIST	EXIST	-	EXIST	EXIST	EXIST	-	-	15	-	
112E	EXIST	3' - 0"	7' - 0"	1 3/4"	EXIST	EXIST	-	EXIST	EXIST	EXIST	-	-	15	-	
113R	RELOCATE	6' - 0"	7' - 0"	1 3/4"	EXIST	EXIST	45 MINUTE	4	HM	PNT	12/A501	13/A501	10	-	
114E	EXIST	3' - 0"	7' - 0"	1 3/4"	EXIST	EXIST	-	EXIST	EXIST	EXIST	-	-	5	-	
115R	RELOCATE	6' - 0"	7' - 0"	1 3/4"	EXIST	EXIST	-	4	HM	PNT	12/A501	13/A501		-	
116 117E	EXIST	3' - 0" 3' - 0"	6' - 8" 6' - 8"	1 3/4"	WD EXIST	STAIN	45 MINUTE	2 EXIST	HM EXIST	PNT PNT	1/A501	2/A501	3	-	
1172	В	3' - 0"	6' - 8"	1 3/4"	WD	STAIN	-	2	HM	PNT	12/A501	13/A501	6	_	
119E	EXIST	3' - 0"	6' - 8"	1 3/4"	EXIST		45 MINUTE			EXIST	-	-	5	-	
120E	EXIST	3' - 0"	6' - 8"	1 3/4"	EXIST	EXIST	45 MINUTE	EXIST	EXIST	EXIST	-	-	5	-	
121E	EXIST	3' - 0"	7' - 0"	1 3/4"	EXIST	EXIST	90 MINUTE		EXIST	EXIST	-	-	14	YES	
122	В	3' - 0"	6' - 8"	1 3/4"	WD	STAIN	-	2	HM	PNT	12/A501	13/A501	6		
123	C RELOCATE	3' - 0" 3' - 0"	6' - 8" 6' - 8"	1 3/4"	WD EXIST	STAIN	45 MINUTE	2	HM HM	PNT PNT	1/A501	2/A501	11 15	-	PROVIDE MARBLE THRESHOLD
124R 126E	EXIST	3' - 0"	6' - 8"	1 3/4"	EXIST	EXIST	45 MINUTE		EXIST	EXIST	12/A501 -	13/A501 -	5	- YES	I NOVIDE WIANDLE HINESHULD
127R	RELOCATE	3' - 0"	6' - 8"	1 3/4"	EXIST	EXIST	-	2	HM	PNT	1/A501	2/A501	5	YES	
128	F	3' - 0"	6' - 8"	1 3/4"	НМ	PNT	45 MINUTE	5	HM	PNT	1/A501	2/A501	12	YES	
129	F	3' - 0"	6' - 8"	1 3/4"	НМ	PNT	60 MINUTE	5	HM	PNT	12/A501	13/A501	12	YES	
130	D	3' - 0"	7' - 0"	1 3/4"	HM	PNT	60 MINUTE	3	HM	PNT	14/A501	15/A501		YES	INSULATED EXTERIOR DOOR
131E	EXIST RELOCATE	3' - 0" 3' - 0"	6' - 8" 6' - 8"	1 3/4"	EXIST EXIST	PNT	-	EXIST 5	EXIST	PNT PNT	12/4501	12/4501	13 16	YES	
132R 133E	EXIST	3' - 0"	6' - 8"	1 3/4"	EXIST	PNT	-	EXIST	EXIST	PNT	12/A501 -	13/A501 -	16	YES	
134	D	3' - 0"	7' - 0"	1 3/4"	HM	PNT	-	3	HM	PNT	12/A501	13/A501	+	-	STAIRS 114 TO BE SECURE TO BASEMENT STAIRS
135R	RELOCATE	3' - 0"	7' - 0"	1 3/4"	EXIST	EXIST	60 MINUTE	2	HM	PNT	12/A501	13/A501	5	YES	INSTALL VISION PANEL
136R	RELOCATE	3' - 0"	7' - 0"	1 3/4"	EXIST	EXIST	45 MINUTE	2	HM	PNT	1/A501	2/A501	5	YES	
137R	RELOCATE	3' - 0"	7' - 0"	1 3/4"	EXIST	EXIST	45 MINUTE	2	HM	PNT	12/A501	13/A501		YES	INSTALL VISION PANEL
138R 139	RELOCATE B	3' - 0" 3' - 0"	7' - 0" 7' - 0"	1 3/4"	EXIST WD	EXIST STAIN	45 MINUTE	2	HM HM	PNT PNT	12/A501 1/A501	13/A501 2/A501	5	YES -	INSTALL VISION PANEL
140	E	5' - 0"	7' - 0"	1 3/4"	WD	STAIN	_	6	HM	PNT	1/A301 -	- -	8	_	
141E	EXIST	3' - 0"	7' - 0"	1 3/4"	EXIST	EXIST	-	EXIST	EXIST	PNT	-	-	14	YES	
142E	EXIST	3' - 0"	7' - 0"	1 3/4"	EXIST	PNT	45 MINUTE	EXIST	EXIST	PNT	-	-	3	-	
143R	RELOCATE	3' - 0"	7' - 0"	1 3/4"	EXIST	EXIST	45 MINUTE	2	HM	PNT	12/A501	13/A501	5	-	
144R	RELOCATE	3' - 0"	7' - 0"	1 3/4"	EXIST	EXIST	-	2	HM	PNT	12/A501	13/A501		-	DDOV/IDE MANDRIE TURECUOLD
145R 146	RELOCATE	3' - 0" 3' - 0"	7' - 0" 6' - 8"	1 3/4"	EXIST WD	EXIST PNT	-	2	HM HM	PNT PNT	12/A501 1/A501	13/A501 2/A501	15 11	-	PROVIDE MARBLE THRESHOLD
147R	RELOCATE	3' - 0"	7' - 0"	1 3/4"	EXIST	EXIST	_	2	HM	PNT	1/A501	2/A501	5	_	
148R	RELOCATE	3' - 0"	7' - 0"	1 3/4"	EXIST	EXIST	-	2	HM	PNT	1/A501	2/A501	5	-	
149E	EXIST	3' - 0"	7' - 0"	1 3/4"	EXIST	EXIST	-	EXIST	EXIST	PNT	-	-	14	YES	
150E	EXIST	3' - 0"	7' - 0"	1 3/4"	EXIST	EXIST	60 MINUTE		EXIST	PNT	-	-	5	-	
151E	EXIST	3' - 0"	7' - 0"	1 3/4"	EXIST	PNT	90 MINUTE		EXIST	PNT	- 12/4501	12/252	3	YES	DDOVIDE MANDELE TURESURES
151N 201E	RELOCATE EXIST	3' - 0" 3' - 0"	6' - 8" 6' - 8"	1 3/4"	EXIST EXIST	EXIST	90 MINUTE		HM EXIST	PNT PNT	12/A501	13/A501	15 14	- YES	PROVIDE MARBLE THRESHOLD
2012	C	3' - 0"	7' - 0"	1 3/4"	WD	STAIN	-	3	HM	PNT	12/A501	13/A501	+	-	
203	C	3' - 0"	7' - 0"	1 3/4"	WD	STAIN	-	3	HM	PNT	12/A501	13/A501		-	
204E	EXIST	3' - 0"	6' - 8"	1 3/4"	EXIST	EXIST	45 MINUTE	EXIST	EXIST	PNT	-	-	5	-	
205E	EXIST	5' - 0"	6' - 8"	1 3/4"	EXIST	EXIST	45 MINUTE		EXIST	PNT	-	-	9	-	
206R	RELOCATE	3' - 0"	6' - 8"	1 3/4"	EXIST	EXIST	45 MINUTE	2	HM	PNT	1/A501	2/A501	5	-	
207R 208R	RELOCATE RELOCATE	3' - 0" 3' - 0"	6' - 8" 6' - 8"	1 3/4"	EXIST EXIST	EXIST	45 MINUTE	2	HM HM	PNT PNT	1/A501 1/A501	2/A501	14 5	-	
208R 209R	RELOCATE	3' - 0"	6' - 8"	1 3/4"	EXIST	EXIST	-	2	HM	PNT	1/A501 1/A501	2/A501 2/A501	7	YES	
210R	RELOCATE	3' - 0"	6' - 8"	1 3/4"	EXIST	EXIST	45 MINUTE	2	HM	PNT	1/A501 1/A501	2/A501 2/A501	5	YES	
211R	RELOCATE	3' - 0"	6' - 8"	1 3/4"	EXIST	EXIST		2	НМ	PNT	1/A501	2/A501	15	-	
212E	EXIST	3' - 0"	6' - 8"	1 3/4"	EXIST	EXIST	-	EXIST	EXIST	PNT	-	-	5	-	
213E	EXIST	3' - 0"	6' - 8"	1 3/4"	EXIST	EXIST	-	EXIST	EXIST	PNT	-	-	5	-	
214E	EXIST	3' - 0"	6' - 8"	1 3/4"	EXIST	EXIST	-	EXIST	EXIST	PNT	-	-	5	-	DEDI ACE VICIONI BANISI CLASS
215E 216E	EXIST EXIST	3' - 0" 3' - 0"	6' - 8" 6' - 8"	1 3/4"	EXIST EXIST	EXIST	-	EXIST	EXIST EXIST	PNT PNT	-	-	5	-	REPLACE VISION PANEL GLASS
210E 217E	EXIST	3' - 0"	6' - 8"	1 3/4"	EXIST	EXIST	_	EXIST	EXIST	PNT	-	-	5	-	
217E	EXIST	3' - 0"	6' - 8"	1 3/4"	EXIST	EXIST	60 MINUTE		EXIST	PNT	_	-	14	YES	
219R	RELOCATE	3' - 0"	6' - 8"	1 3/4"	EXIST		90 MINUTE		НМ	PNT	1/A501	2/A501	15	-	PROVIDE MARBLE THRESHOLD
220E	EVICT	ט טי	6' 0"	1 2 / 4 "	EVICT		45 MINITE		EVICT	DNT			_		


EXIST 3' - 0" 6' - 8" 1 3/4" EXIST EXIST 45 MINUTE EXIST PNT



DOOR TYPES SCALE: 1/4" = 1'-0"



<u>TYPE 1</u> ADDITIVE BID ITEM NO. 02

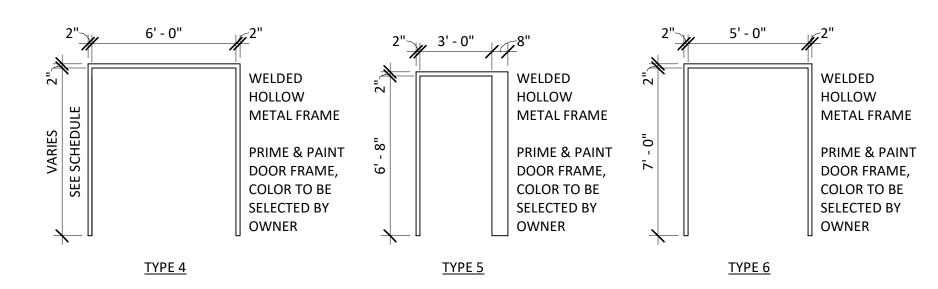

DOOR FRAMES TYPES

SCALE: 1/4" = 1'-0"

DOOR NUMBERS WITH "E" REFER TO EXISTING DOORS AND FRAMES REMAINING IN PLACE.

DOOR NUMBERS WITH "R" REFER TO EXISTING DOORS WHICH ARE RELOCATED. SEE EXISTING/DEMOLITION DRAWINGS FOR LOCATIONS OF RELOCATED DOORS. CERTAIN RELOCATED DOORS HAVE ELECTRIC STRIKES (SEE DOOR SCHEDULE) WHICH ARE TO BE RELOCATED. COORDINATE WITH ELECTRICAL CONTRACTORS.

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DESCRIPTION OF THE ALTERATION REVISIONS

NOTES

AND SCHEDULE DOOR

CITY OF MIDDLETOWN
NEW COURTHOUSE FACILITY



AUGUST, 2024

AS SHOWN

Sheet Number A602

NEW YORK STATE.

DESIGN LOADS: DEAD LOADS:

> **ROOF DEAD LOAD** 18 PSF FLOOR DEAD LOAD 50 PSF

LIVE LOADS:

ROOF LIVE LOAD 20 PSF FLOOR LIVE LOAD 100 PSF

SNOW LOAD: GROUND SNOW LOAD, Pg = 40 PSF SNOW EXPOSURE FACTOR, Ce = 1.0 THERMAL FACTOR, Ct = 1.0 (AT ADDITION) Ct = 1.2 (AT CANOPY)SNOW LOAD IMPORTANCE FACTOR, Is = 1.1

WIND LOAD: BASIC WIND SPEED (3-SECOND GUST) = 120 MPH WIND EXPOSURE B VELOCITY PRESSURE, Kz = 0.57 TOPOGRAPHIC FACTOR, Kzt = 1.0 WIND DIRECTIONALITY FACTOR, Kd = 0.85 GROUND ELEVATION FACTOR, Ke = 1.0

COMPONENTS AND CLADDING (CANOPY, NEGATIVE VALUE IS AWAY FROM SURFACE) ZONE 2: 12.2 PSF / -27.4 PSF

ZONE 3: 12.2 PSF / -27.4 PSF

SEISMIC CRITERIA: SEISMIC USE OCCUPANCY III SEISMIC IMPORTANCE FACTOR, le = 1.25 SITE CLASS D BASIC SEISMIC-FORCE-RESISTING SYSTEM: N.A. DESIGN SPECTRAL RESPONSE ACCELERATION FOR SHORT PERIODS, Sds = 0.222 AT 1-SECOND PERIOD, Sd1 = 0.087 SEISMIC DESIGN CATEGORY B

4. THE CONTRACTOR SHALL CHECK THE ARCHITECTURAL, PLUMBING, HVAC, AND ELECTRICAL DRAWINGS AND SPECIFICATIONS FOR ADDITIONAL INFORMATION NOT INDICATED ON THE STRUCTURAL DRAWINGS, SUCH INFORMATION INCLUDES, AS A MINIMUM, EMBEDDED SLEEVES AND INSERTS, MISCELLANEOUS DETAILS, SPECIAL FLOOR FINISHES, DOOR THRESHOLDS, SLOPES TO DRAINS, NAILERS, OPENINGS IN STRUCTURAL ELEMENTS, ETC.

EXCAVATION AND FILL:

- . THE BOTTOM OF ALL CONCRETE FOUNDATIONS AND SLABS SHALL REST ON UNDISTURBED SOIL AND/OR APPROVED COMPACTED MATERIAL, AS DEFINED IN THE CONTRACT SPECIFICATIONS. ALL GRANULAR FILL MATERIALS BELOW SLABS SHALL BE OF THE THICKNESS SHOWN AND SHALL BE COMPACTED TO MINIMUM 95% MODIFIED PROCTOR DENSITY. SEE SPECIFICATIONS FOR COMPACTION AND FIELD TESTS.
- 2. THE CONTRACTOR SHALL NOT COMMENCE FOUNDATION CONSTRUCTION WORK PRIOR TO INSPECTION AND APPROVAL OF THE BEARING SOIL BY AN INDEPENDENT TESTING LAB. SOILS TO BE TESTED BY SOIL PENTROMETER OR EQUAL TO VERIFY A MINIMUM BEARING PRESSURE OF 2,000 PSF.
- 3. ALL EXCAVATIONS INTO UNDISTURBED SOILS SHALL BE COMPACTED TO MINIMUM 95% MODIFIED PROCTOR DENSITY
- 4. ALL EXCAVATIONS SHALL BE DEWATERED AS NECESSARY TO MAINTAIN GROUNDWATER AT LEAST 24" BELOW FOOTING BEFORE PLACING OF CONCRETE.

CONCRETE:

DESIGN STRENGTH -STRUCTURAL CONCRETE AND SLAB ON GRADE - 4,000 PSI @ 28 DAYS

STANDARDS -

DESIGN ACI 318 - LATEST EDITION DETAILS ACI 315 - LATEST EDITION

REINFORCING -

MESH - ASTM A-185 (FLAT SHEETS) BARS - ASTM A-615 GRADE 60

4. AIR CONTENT - ALL SLAB ON GRADE AND EXTERIOR CONCRETE SHALL BE AIR ENTRAINED IN ACCORDANCE WITH SPECIFICATION SECTION 03300.

CONCRETE COVER OVER BARS:

CONCRETE DEPOSITED ON GROUND - 3" FORMED CONCRETE EXPOSED TO GROUND, WEATHER OR WATER - 2" WALLS & SLABS NOT DIRECTLY EXPOSED TO GROUND, WATER OR WEATHER - 1"

6. SPLICES IN REINFORCEMENT: UNLESS OTHERWISE NOTED, ALL SPLICES AND ANCHORAGES SHALL BE IN ACCORDANCE WITH ACI 318 CHAPTER 12. STAGGER SPLICES WHEREVER POSSIBLE AND LOCATE SO AS NOT TO IMPAIR STRENGTH OF MEMBERS.

- 7. ALL EXPOSED EDGES OF CONCRETE SHALL HAVE A CHAMFER AS SHOWN ON DRAWINGS.
- 8. THE CONTRACTOR SHALL NOT POUR ANY CONCRETE PRIOR TO INSPECTION OF THE REINFORCING STEEL AND AUTHORIZATION BY THE ENGINEER.

STRUCTURAL STEEL:

1. STRUCTURAL STEEL:

W: ASTM A992 (FY = 50 KSI) M, S, HP, C, MC, L, & PLATES: ASTM A36 (FY = 36 KSI) HSS: ASTM A500 GR. B (FY = 46 KSI) STEEL PIPE: ASTM A53 GR. B (FY = 35 KSI) HIGH STRENGTH BOLTS: ASTM A325-N, 3/4" Ø MIN NUTS: ASTM A563 WASHERS: ASTM F436 DIRECT TENSION INDICATORS: ASTM F959 THREADED ROD: ASTM A36 ANCHOR RODS: ASTM F1554 GR. 36 SHEAR STUD CONNECTORS: ASTM A108

- 2. WELDING ELECTRODES SHALL BE AWS E-70XX. ALL SHOP CONNECTIONS SHALL BE WELDED UNLESS OTHERWISE SHOWN, ALL FIELD CONNECTIONS SHALL BE BOLTED.
- 3. PROVIDE FRAMED OR SEATED BEAM CONNECTIONS IN ACCORDANCE WITH THE AISC MANUAL OF STEEL CONSTRUCTION. UNLESS OTHERWISE NOTED, BEAM CONNECTIONS SHALL BE DETAILED TO HAVE A CAPACITY OF NOT LESS THAN ONE-HALF THE TOTAL ALLOWABLE UNIFORM LOAD DETERMINED IN ACCORDANCE WITH AISC MANUAL OF STEEL CONSTRUCTION TABLE FOR "ALLOWABLE UNIFORM LOADS IN KIPS FOR BEAMS LATERALLY SUPPORTED", FOR BEAMS AND SPANS IN QUESTION, HOLES FOR SHOP AND FIELD CONNECTIONS SHALL BE DRILLED OR PUNCHED. NO BURNT HOLES WILL BE ALLOWED.
- 4. CONTRACTOR SHALL SUPPLY AND USE ALL NECESSARY BRACING AND OTHER MEANS TO MAINTAIN STABILITY AND LOCATION OF STEEL FRAMING DURING CONSTRUCTION.

MASONRY NOTES:

- STANDARDS:
 - BUILDING CODE REQUIREMENTS FOR MASONRY STRUCTURES (ACI 530.1-02/ASCE 5-02/TMS 402-02) - SPECIFICATION FOR MASONRY STRUCTURES (ACI 530.1-02/ASCE 6-02/TMS 602-02)
- MINIMUM NET AREA COMPRESSIVE STRENGTH OF MASONRY (f'm) = 1,500 PSI
- HOLLOW LOAD BEARING UNITS: ASTM C90, GRADE N-I OR N-II.
- HOLLOW NON-LOAD BEARING UNITS: ASTM C129, TYPE 1 OR II.
- 5. SOLID LOAD BEARING UNITS: ASTM C145, GRADE S-I OR S-II.
- 6. REINFORCEMENT: DEFORMED REINFORCING BARS THAT CONFORM TO ASTM A615 (FY = 60,000 PSI)
- 7. JOINT REINFORCEMENT: HOT-DIP GALVANIZED MASONRY JOINT REINF. THAT CONFORMS TO ASTM A153, AND ASTM A951.
- 8. PROVIDE MORTAR OF TYPE AND COLOR SPECIFIED THAT CONFORMS TO ASTM C270.
- 9. GROUT SHALL BE PROPORTIONED AND MIXED IN ACCORDANCE WITH ASTM C476 AND SHALL ATTAIN A MINIMUM ULTIMATE COMPRESSIVE STRENGTH OF 3,000 PSI AT 28 DAYS IN ACCORDANCE WITH ASTM C1019. PROVIDE COARSE OR FINE GROUT IN ACCORDANCE WITH THE SPECIFICATIONS.
- 10. GROUT SHALL BE PLACED IN A CONTINUOUS LIFT, WITH A MAXIMUM LIFT HEIGHT NOT EXCEED 5 FT. BETWEEN LIFTS, A HORIZONTAL CONSTRUCTION JOINT SHALL BE FORMED BY STOPPING GROUT 1 1/2" BELOW A HORIZONTAL MORTAR JOIN EXCEPT AT TOP OF WALLS.
- 11. MAXIMUM GROUT PLACEMENT HEIGHT SHALL BE IN ACCORDANCE WITH ACI 530.1-02 SPECIFICATION FOR MASONRY STRUCTURES TABLE 7.
- 12. CONSOLIDATE GROUT AT TIME OF PLACEMENT. CONSOLIDATE GROUT LIFTS 12" OR LESS IN HEIGHT BY MECHANICAL VIBRATION OR BY PUDDLING. CONSOLIDATE GROUT LIFTS MORE THAN 12" IN HEIGHT BY MECHANICAL VIBRATION AND RECONSOLIDATE BY MECHANICAL VIBRATION AFTER INITIAL WATER LOSS AND SETTLEMENT HAS OCCURRED.
- 13. DO NOT USE GROUT OR MORTAR ADMIXTURES CONTAINING CALCIUM CHLORIDES, AIR-ENTRAINMENT OR ANTIFREEZE COMPOUNDS.
- 14. REINFORCEMENT SHALL BE SECURELY PLACED USING APPROVED PREFABRICATED CORROSION RESISTANT METAL BAR POSITIONERS AND INSPECTED BY THE ENGINEER PRIOR TO GROUT PLACEMENT.
- 15. VERTICAL REINFORCEMENT SHALL BE PROVIDED WITHIN 16" OF EACH SIDE OF OPENINGS, WITHIN 8" OF EACH SIDE OF MOVEMENT JOINTS, AND WITHIN 8" OF THE END OF WALLS.
- 16. HORIZONTAL REINFORCEMENT SHALL BE PROVIDED AT THE BOTTOM AND TOP OF WALL OPENINGS AND SHALL EXTEND NOT LESS THAN 24" PAST OPENINGS. CONTINUOUSLY AT STRUCTURALLY CONNECTED ROOF AND FLOOR LEVELS, AND WITHIN 16" OF THE TOP OF WALLS.

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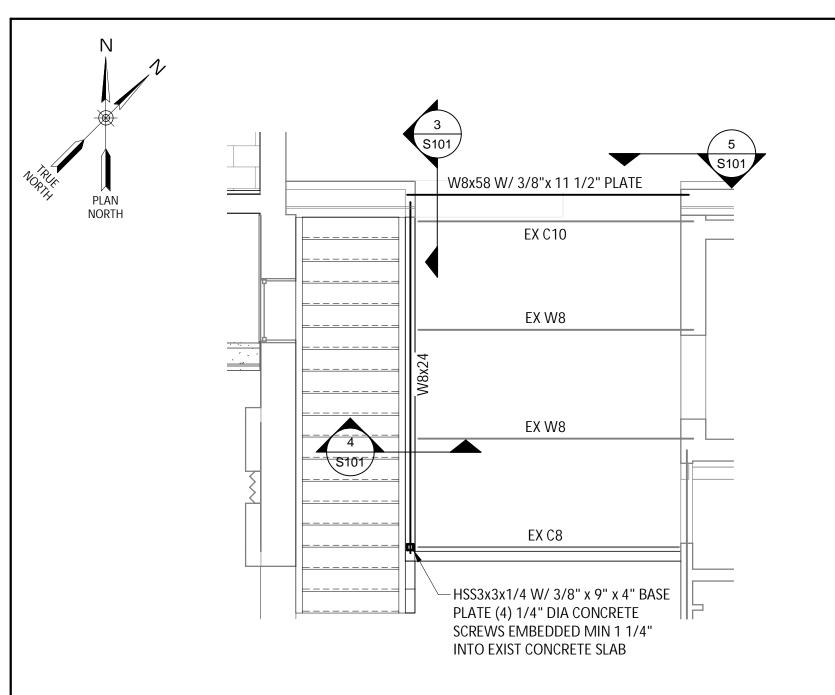



NYS EXP.: May 31, 2026


AUGUST, 2024

AS SHOWN

Sheet Number S001



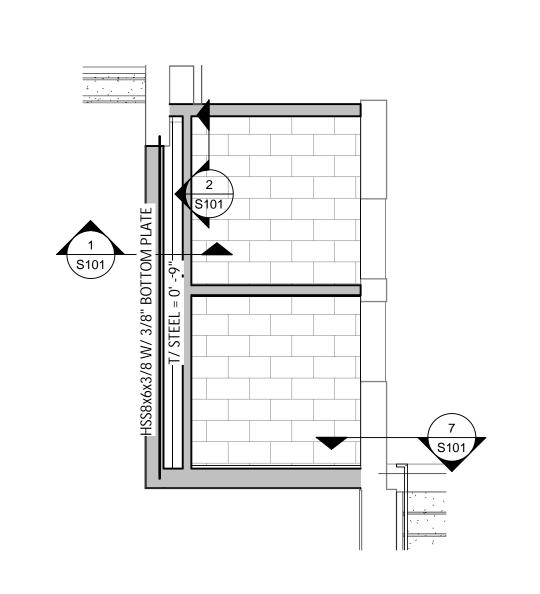

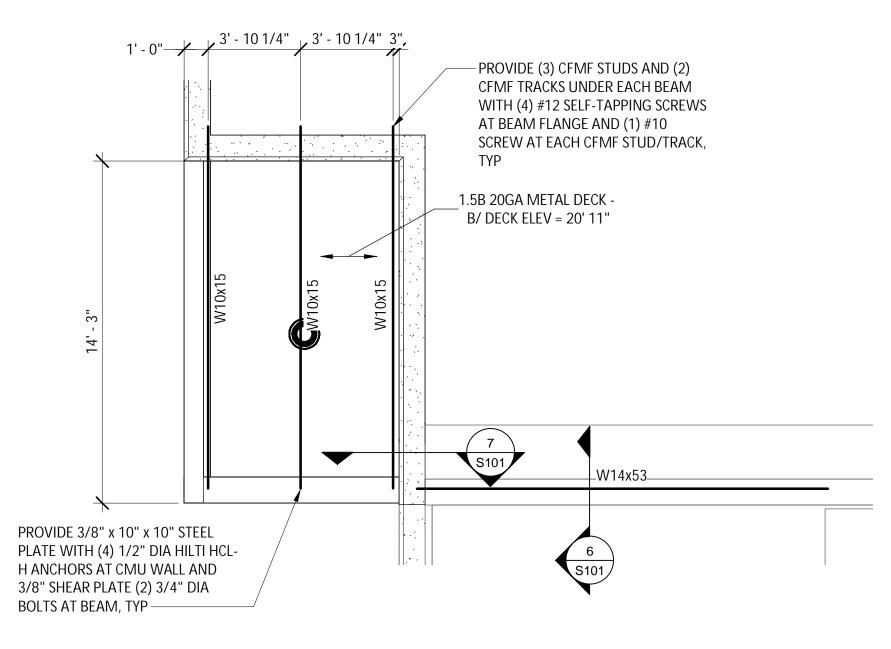



STAIR FRAMING PLAN SCALE: 1/4" = 1'-0"


BATHROOM ADDITION FLOOR PLAN SCALE: 1/4" = 1'-0"

PARTIAL ROOF FRAMING PLAN

SCALE: 1/4" = 1'-0"

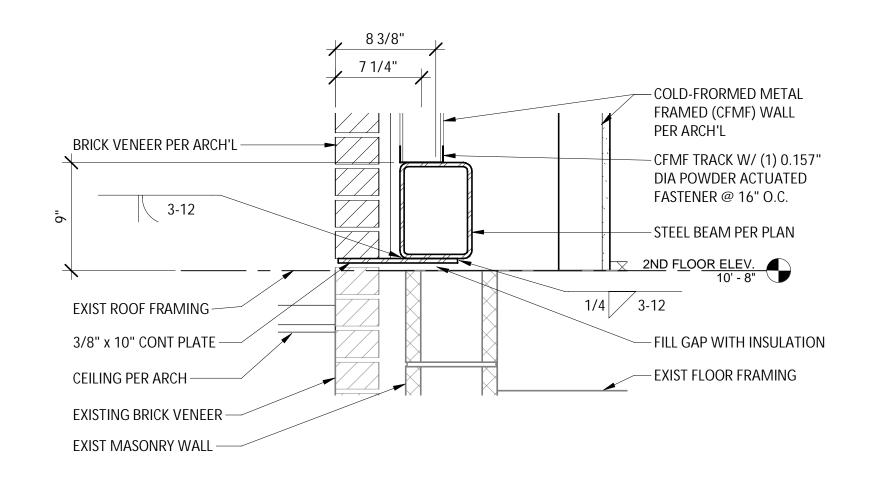

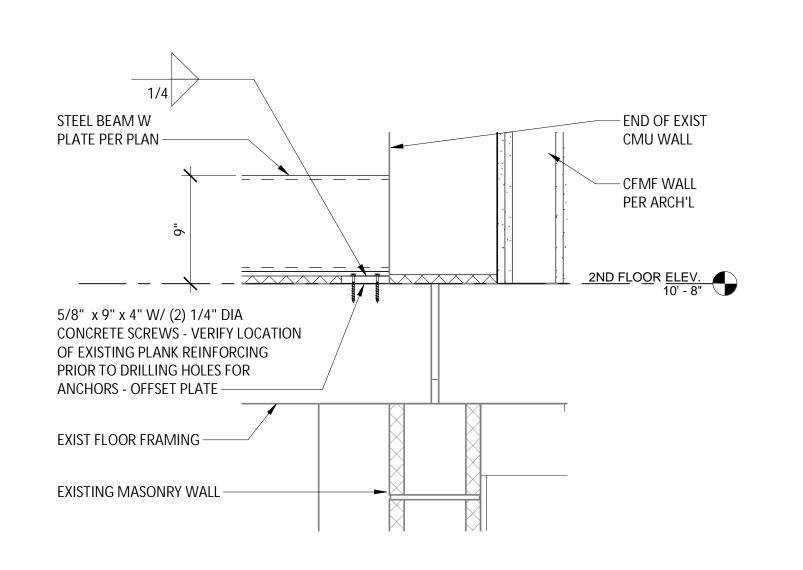


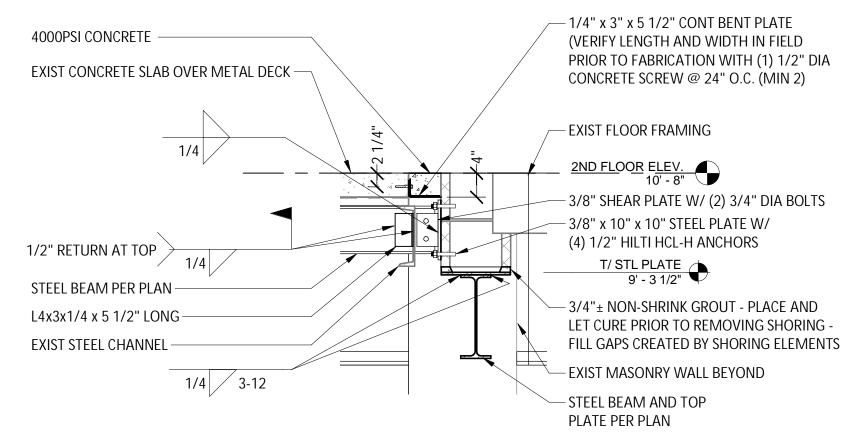



3 INTERIOR BEAM AT EXIST MASONRY WALL S101/ SCALE: 3/4" = 1'-0"


1 WALL SUPPORT BEAM S101 SCALE: 1 1/2" = 1'-0"

2 WALL SUPPORT BEAM CONNECTION

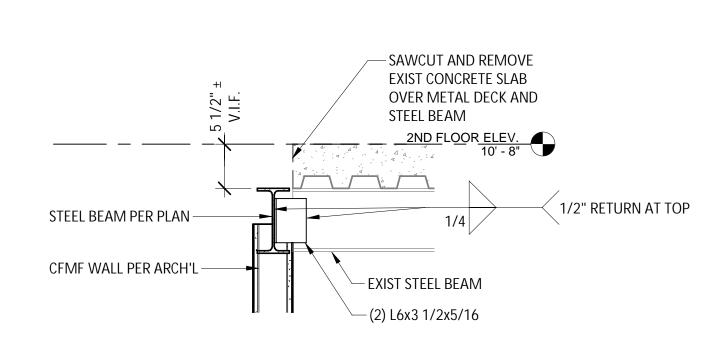

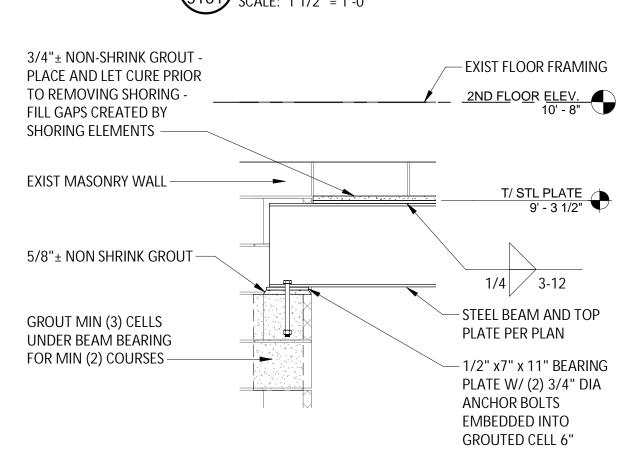

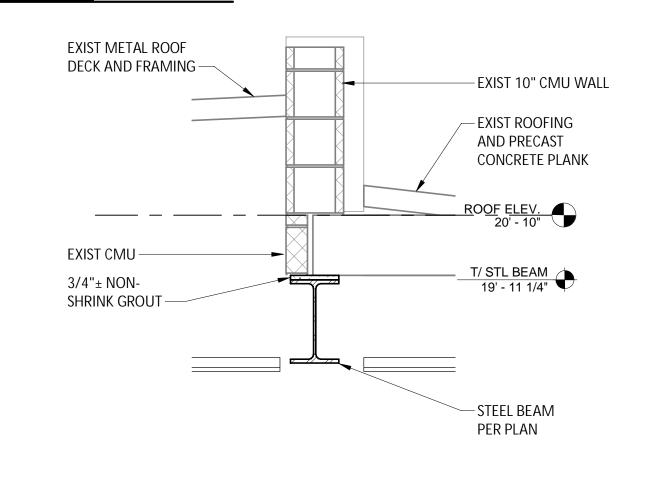

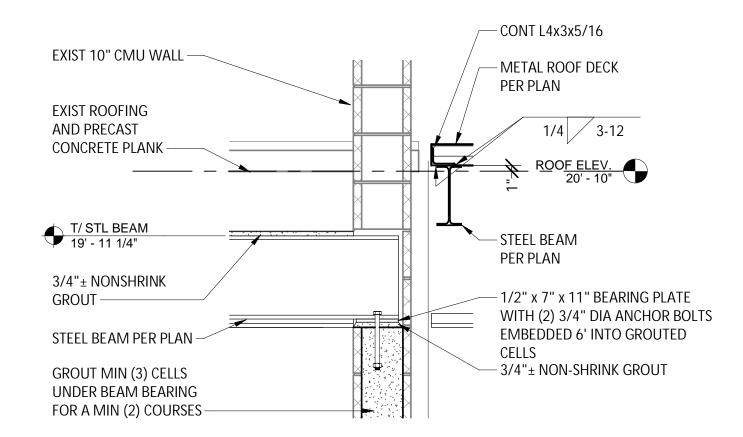

4 EXIST STEEL BEAM AT STEEL BEAM S101 SCALE: 1" = 1'-0"

5 STEEL BEAM AT EXIST CMU WALL S101 | SCALE: 3/4" = 1'-0"

6 STEEL BEAM AT EXIST ROOF S101 SCALE: 3/4" = 1'-0"

\$101 SCALE: 3/4" = 1'-0"

7\STEEL BEAM AT EXIST CMU WALL

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REVISIONS

FRAMING STAIR AILS ADDITION AND STA

CITY OF MIDDLETOWN
NEW COURTHOUSE FACILITY

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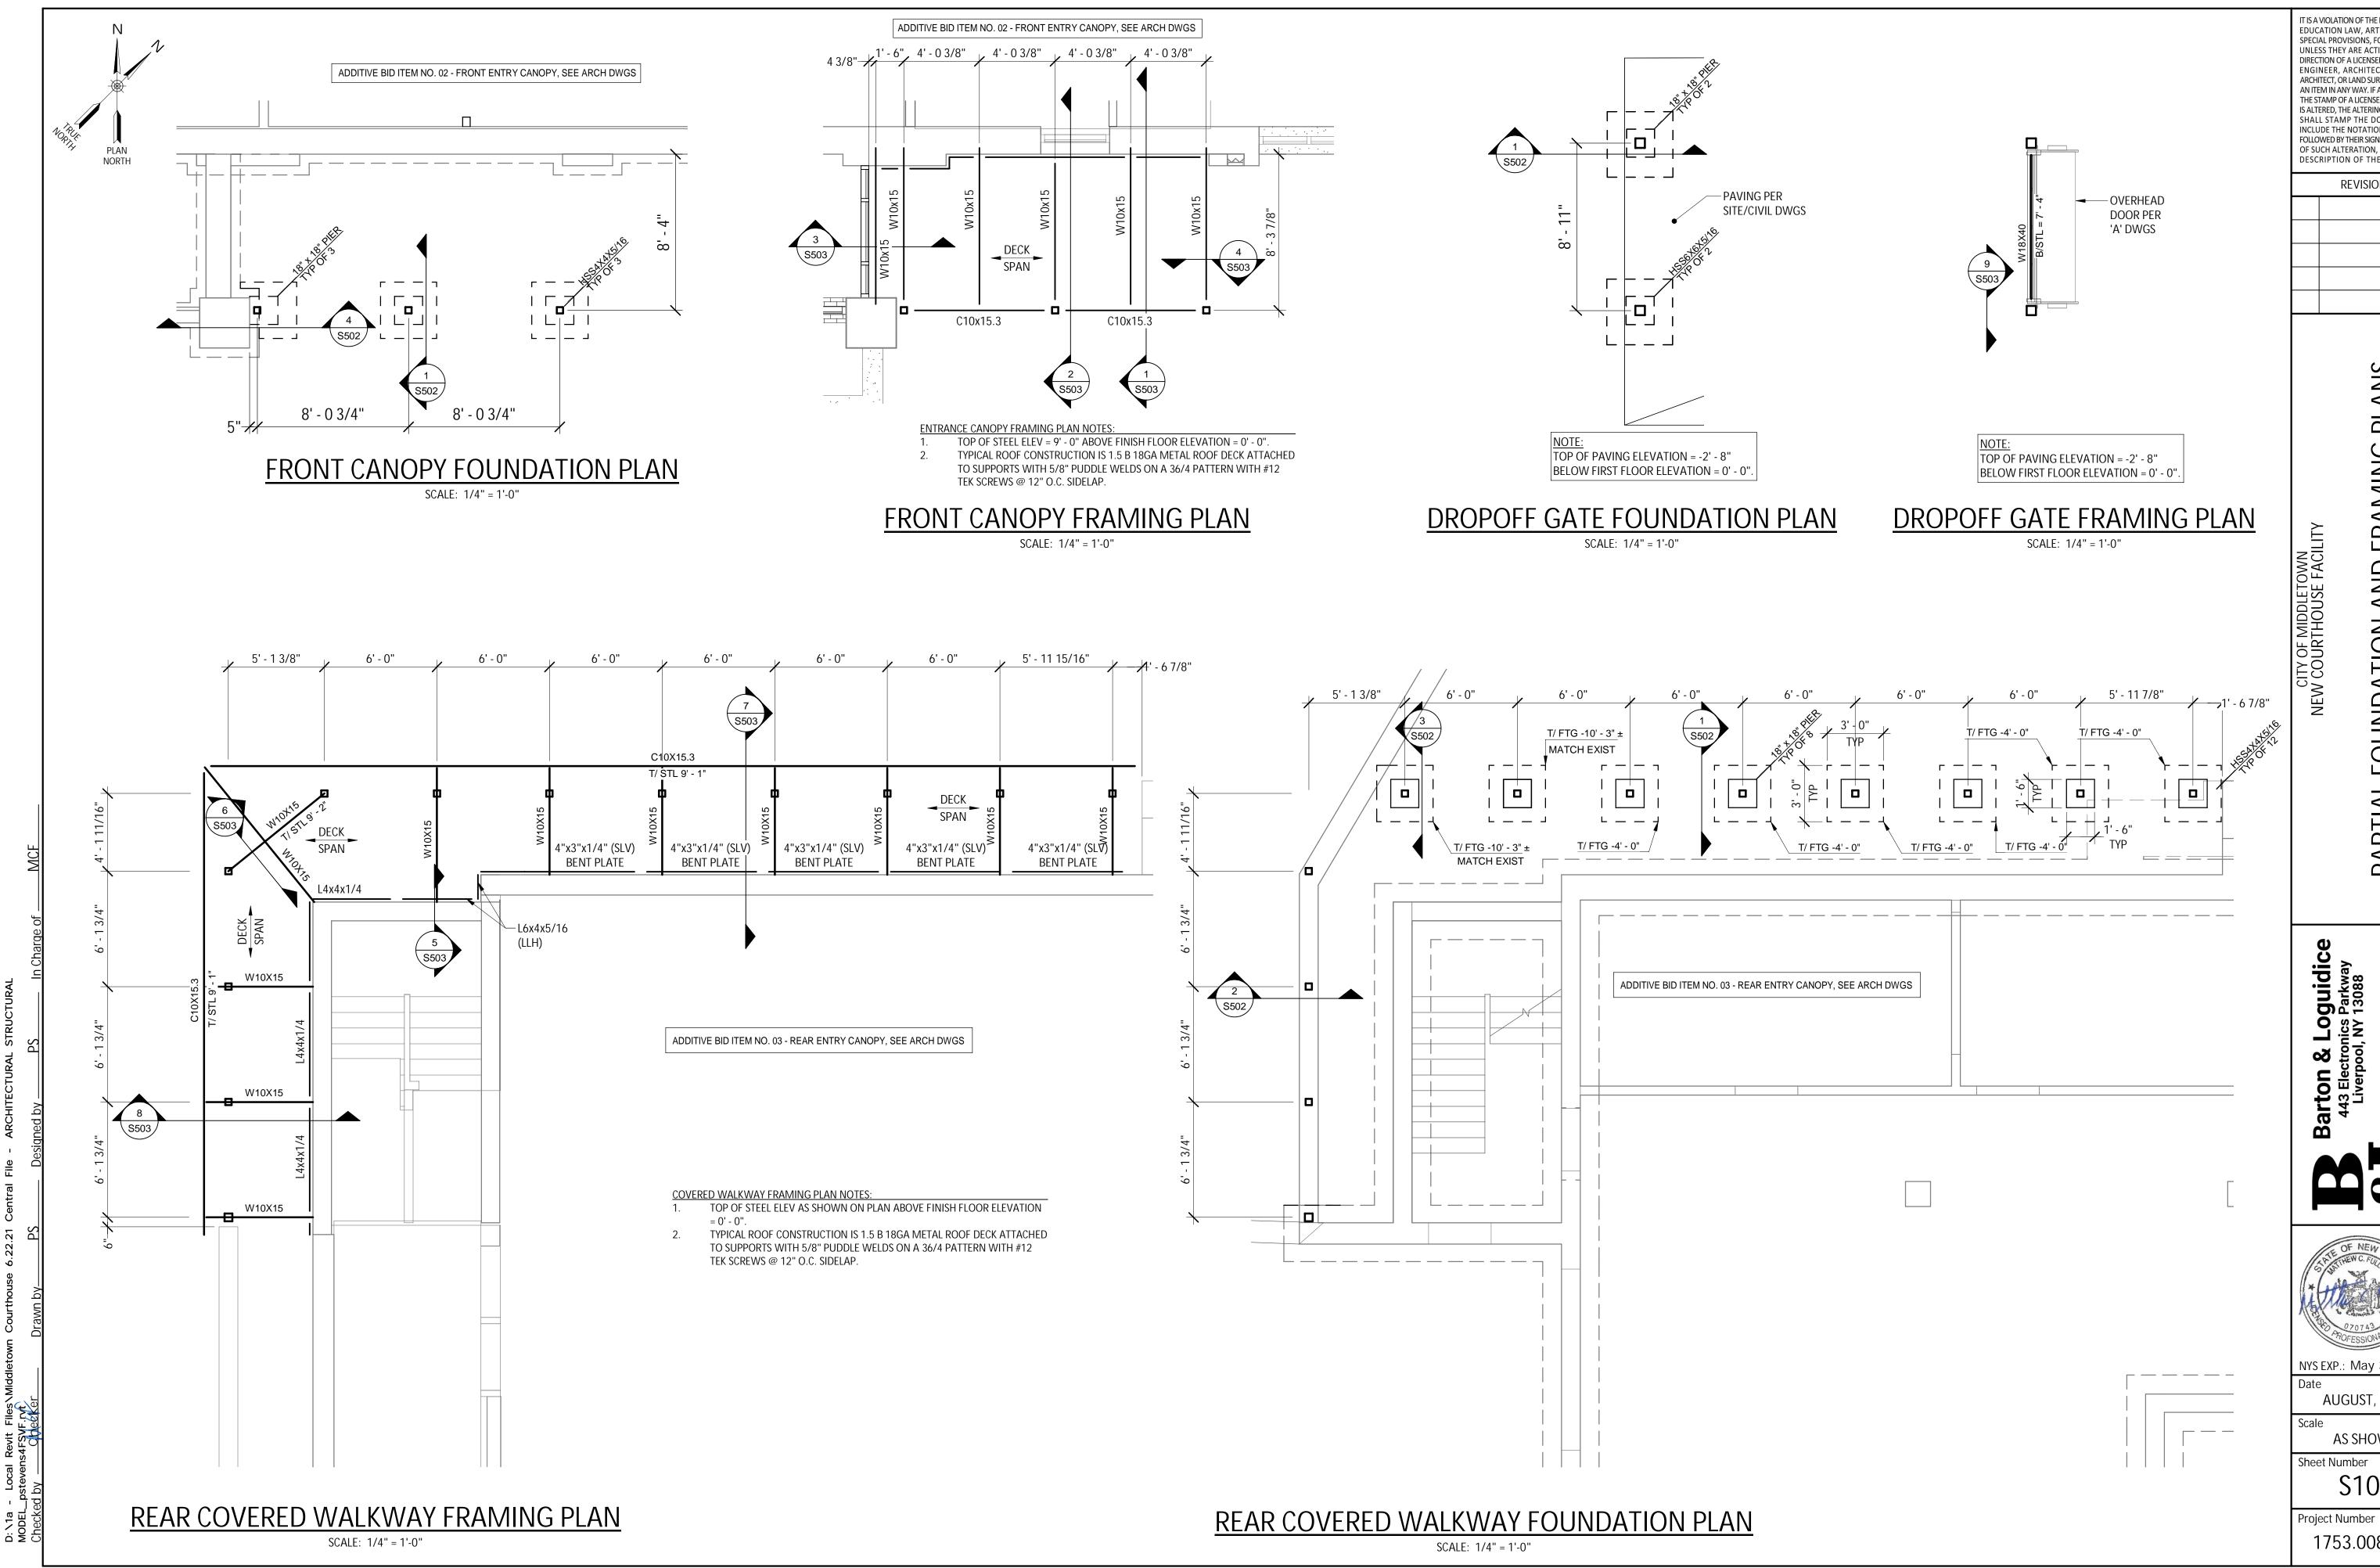
& Loguidice ctronics Parkway pool, NY 13088



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AS SHOWN Sheet Number S101



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REVISIONS

PARTIAL FOUNDATION AND FRAMING PLANS




AUGUST, 2024

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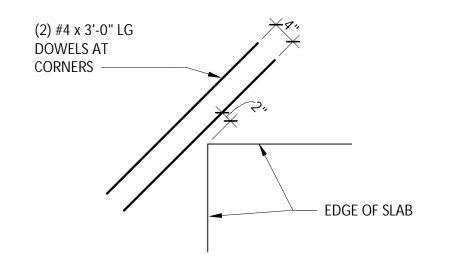


SECTION VIEW

SEE PLANS FOR EXISTING AND PROPOSED WALL THICKNESS AND

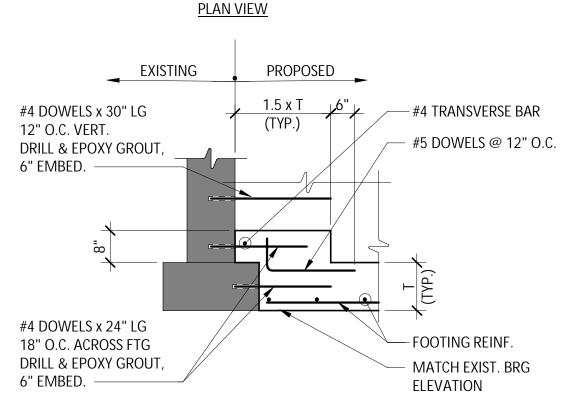DETAIL SHALL BE USED UNLESS NOTED OTHERWISE ON DRAWINGS.

NEW TO EXIST. FNDN WALL CONNECTION NOT TO SCALE



DETAIL NOTES:

- THIS DETAIL SHALL OCCUR AT DOOR OPENINGS.
- DOWELS SHALL BE LOCATED IN THE TOP OF THE SLAB, WHILE MAINTAINING PROPER COVER.

S.O.G. REINF. AT RE-ENTRANT CORNERS


NOT TO SCALE

PLACEMENT PLACEMENT SEE SCHEDULE FOR REINFORCEMENT 2X4 KEYWAY CLASS B LAP SPLICE TOP OF FOOTING

- LOCATE CONSTRUCTION JOINT AT A CONTROL JOINT (CJ) LOCATION AND STOP EVERY OTHER TOP AND BOTTOM
- LOCATIONS TO BE DETERMINED IN FIELD AT APPROXIMATELY 30' 0" O.C. (MAX) SPACING.
- PREPARE JOINT FACE PRIOR TO CONTINUING CONCRETE PLACEMENT IN ACCORDANCE WITH THE SPECIFICATIONS. CONTRACTOR SHALL WAIT 48 HOURS BETWEEN PLACEMENT OF ADJACENT SECTIONS OF CONCRETE.

TYP. FOOTING CONSTRUCTION JOINT

NOT TO SCALE

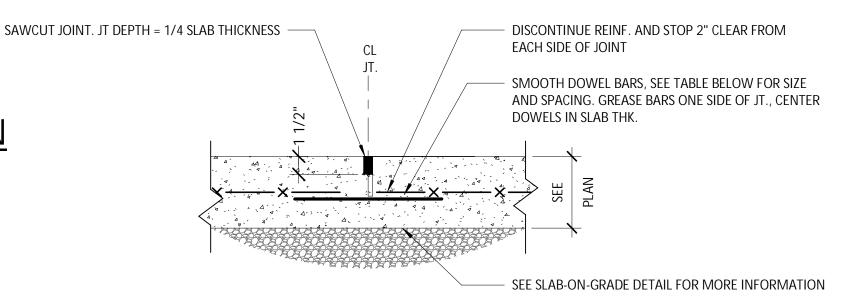

SLAB DEPTH		DOWEL DIMENSION:	S	DOWEL SPACING CENTER TO CENTER					
SLAB DEFIN	ROUND	SQUARE	RECTANGULAR	ROUND	SQUARE	RECTANGULAR			
5" - 6"	3/4" x 14"	3/4" x 14"	3/8" x 2" x 12"	12"	14"	19"			
7" - 8"	1" x 16"	1" x 16"	1/2" x 2-1/2" x 12"	12"	14"	18"			
9" -12"	1-1/4" x 18"	1-1/4" x 18"	3/4" x 2-1/2" x 12"	12"	12"	18"			

TOLERANCE, +0" -1/16" WITH CONCRETE SURFACE. ANY PROJECTION OF METAL ABOVE SURFACE MUST BE REMOVED BY GRINDING.


- PROVIDE CONTROL JOINTS AT LOCATIONS AS SHOWN ON PLANS.
- FILL JOINTS W/ JOINT SEALANT AND BACKER ROD, OR BOND BREAKER TAPE.

LONGITUDINAL BAR 2" CLR. FROM FACE OF JOINT.


- PROVIDE JOINT SIZE TO ACCOMMODATE INSTALLED SEALANT DIMENSIONS OF 2(W):1(D) AND AN APPROPRIATELY SIZED (DIA.)CLOSED CELL POLYETHYLENE FOAM BACKER ROD, OR
- PROVIDE APPR'D. MFGR'D. DOWEL/BASKET ASSEMBLIES W/ DOWELS WELDED AT ALTERNATING ENDS (GREASE OPPOSITE ENDS)
- SAWCUTTING SHALL BE COMPLETED WITHIN 18 HOURS OF CONCRETE POUR.

TYP. SLAB ON GRADE CONTROL JOINT

NOT TO SCALE

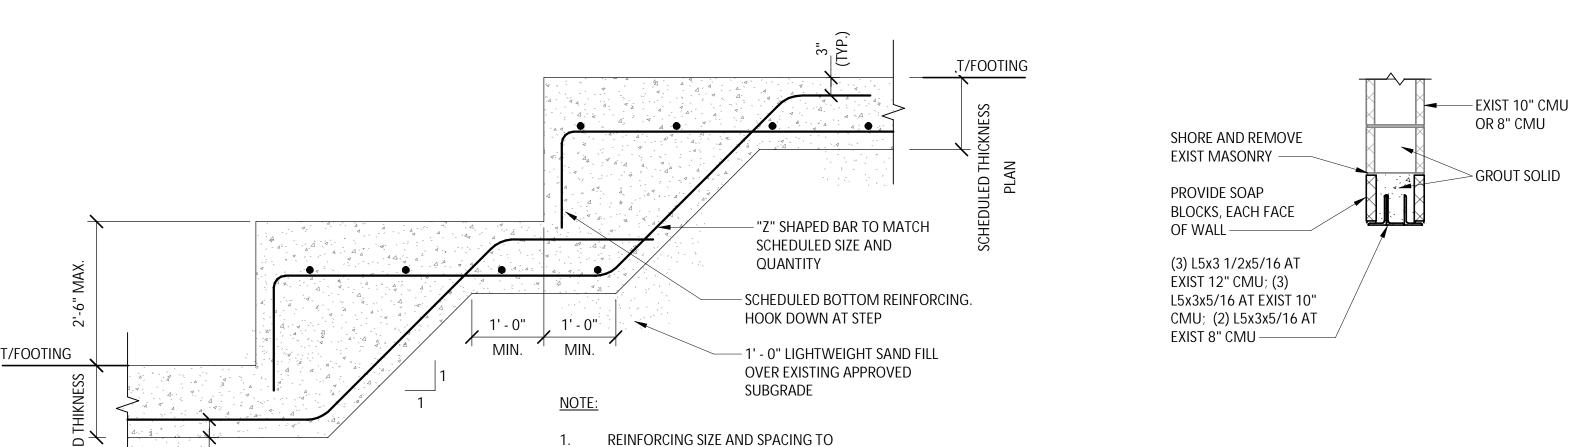

MATCH FOOTING REINFORCEMENT.

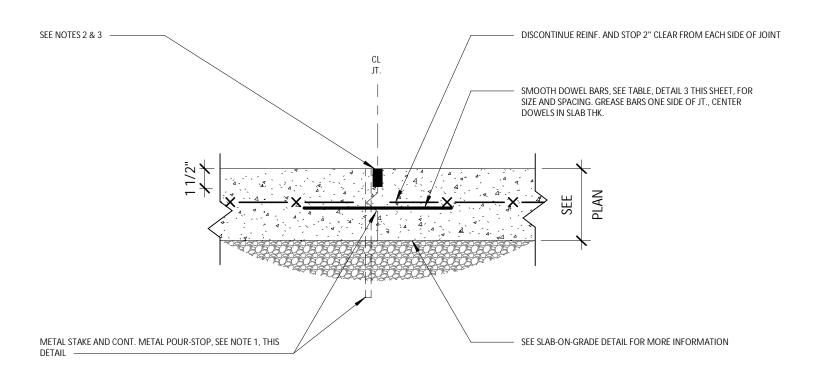


METAL CONSTRUCTION JOINT MUST BE CONTINUOUS FOR THE FULL WIDTH OF THE POUR. INDIVIDUAL SHORT SECTIONS ARE NOT PERMITTED. IN ORDER TO OBTAIN A CONTINUOUS STRIP, LAP AND FIELD WELD THE SECTIONS. METAL JOINT MATERIAL SHALL BE REMOVED PRIOR TO PLACING CONCRETE AT ADJACENT SLAB. TOP OF METAL STAKE SHALL BE LOCATED 1-INCH (MIN.) BELOW TOP OF FINAL CONC. SLAB ELEVATION.

- PROVIDE JOINT SIZE AT TOP OF SLAB TO ACCOMMODATE INSTALLED SEALANT DIMENSIONS OF 2(W):1(D) AND AN APPROPRIATELY SIZED (DIA.) CLOSED CELL POLYETHYLENE FOAM BACKER ROD, OR BOND BREAKER TAPE.
- FILL JOINTS W/ JOINT SEALANT AND BACKER ROD, OR BOND BREAKER TAPE.
- PROVIDE APPR'D. MFGR'D. DOWEL/BASKET ASSEMBLIES W/ DOWELS WELDED AT ALTERNATING ENDS (GREASE OPPOSITE ENDS).
- JOINTS TO BE LOCATED AT CONTROL JT. LOC'S. UNLESS NOTED OTHERWISE, OR DIRECTED BY THE ENGINEER. IF NOT LOCATED AT A SPECIFIED CONTROL JOINT LOCATION NOTIFY
- SEE "TYP. SLAB-ON-GRADE CONTROL JOINT (CJ)" FOR DOWEL SIZE REQ'S.

TYP. SLAB ON GRADE CONSTRUCTION JOINT

NOT TO SCALE

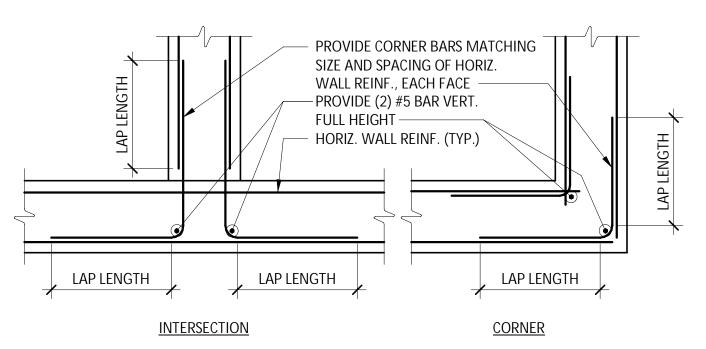


DETAIL NOTES:

- 1. VERTICAL WALL REINFORCING NOT SHOWN FOR CLARITY.
 - SEE "CONCRETE REINFORCING SPLICE AND EMBEDMENT" SCHEDULE FOR REQUIRED LAP LENGTHS.

CONCRETE WALL INTERSECTION AND CORNER

NOT TO SCALE

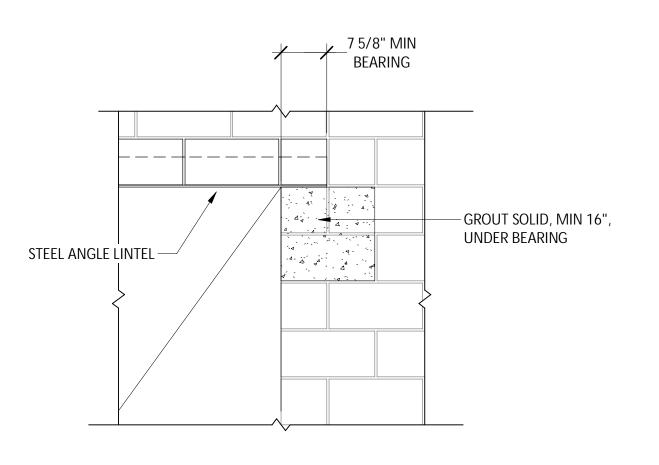

LINTEL AT EXIST CMU WALL


NOT TO SCALE

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REVISIONS

TYPICAL

CITY OF MIDDLETOWN
NEW COURTHOUSE FACILITY

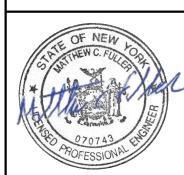

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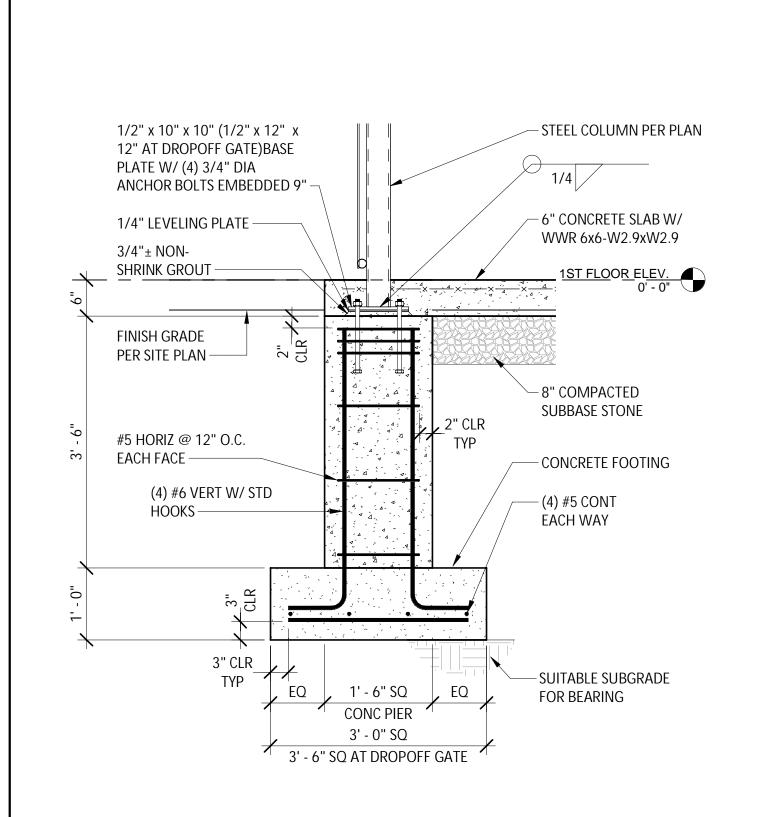
AS SHOWN


Sheet Number **S501**

Project Number 1753.008.001

STEP FOOTING DETAIL

NOT TO SCALE




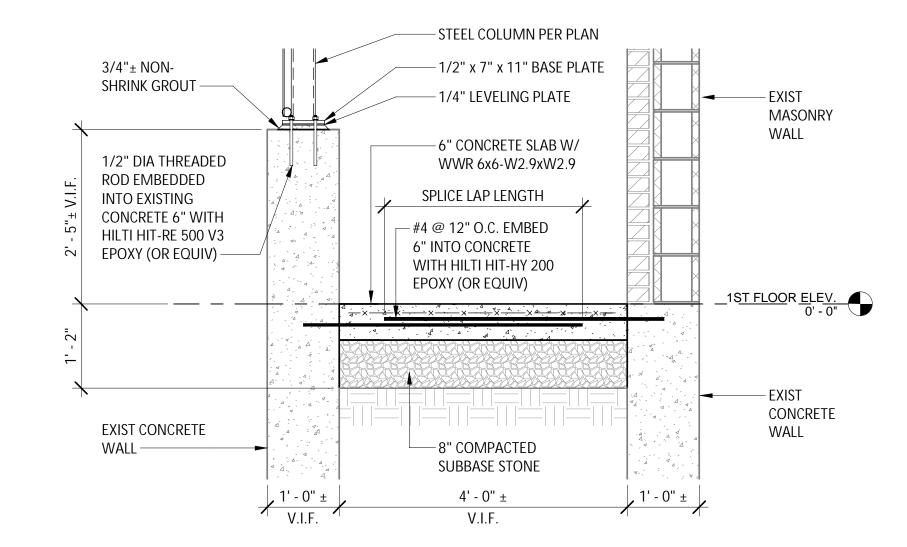


REAR COVERED WALKWAY COLUMN AT EXIST 2 RETAINING WALL

S102 | SCALE: 3/4" = 1'-0"

COVERED WALKWAY COLUMN FOOTING SCALE: 3/4" = 1'-0"

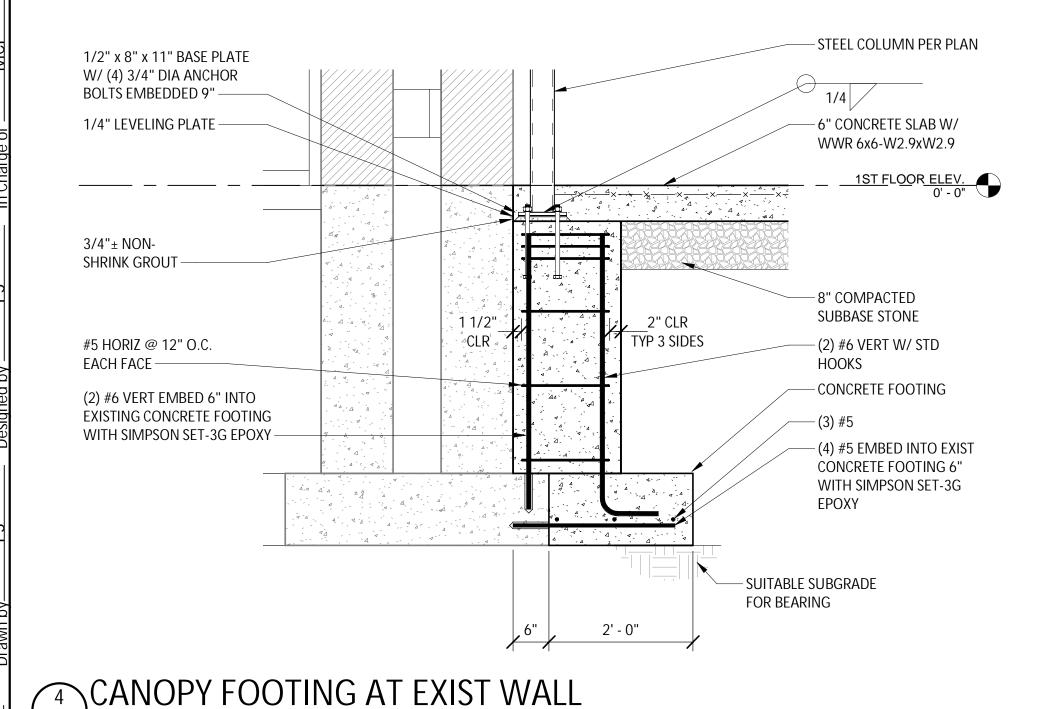

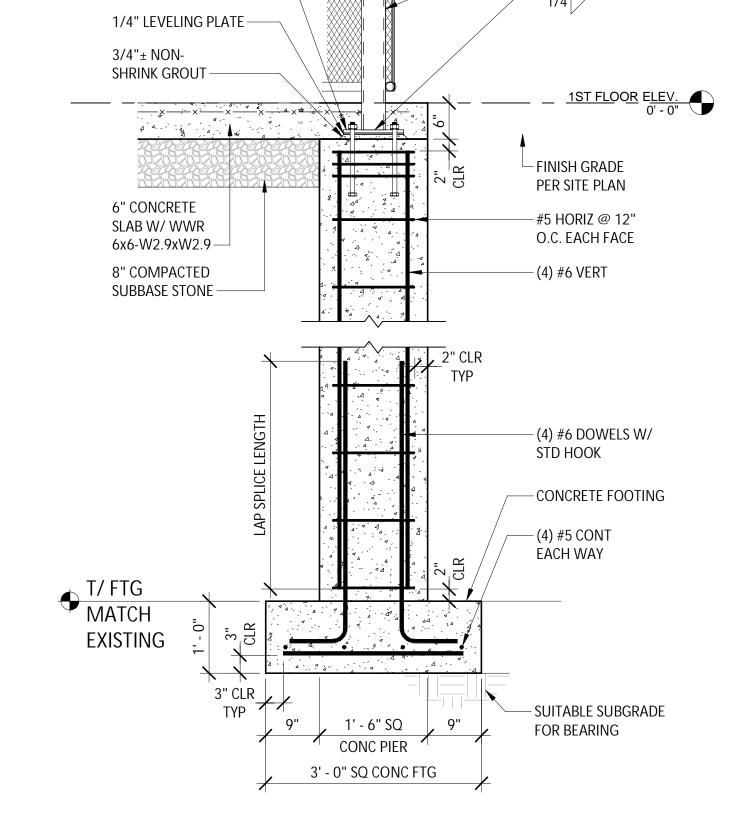

- STEEL COLUMN PER PLAN

1/2" x 10" x 10" BASE PLATE

W/ (4) 3/4" DIA ANCHOR

BOLTS EMBEDDED 9"

REAR COVERED WALKWAY COLUMN FOOTING S102 | SCALE: 3/4" = 1'-0"

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REVISIONS

REAR COVERED

DETAILS

E CANOPY AND I ENTRANCE

WALKWAY **FRONT**

Barton 443 Elec





NYS EXP.: May 31, 2026

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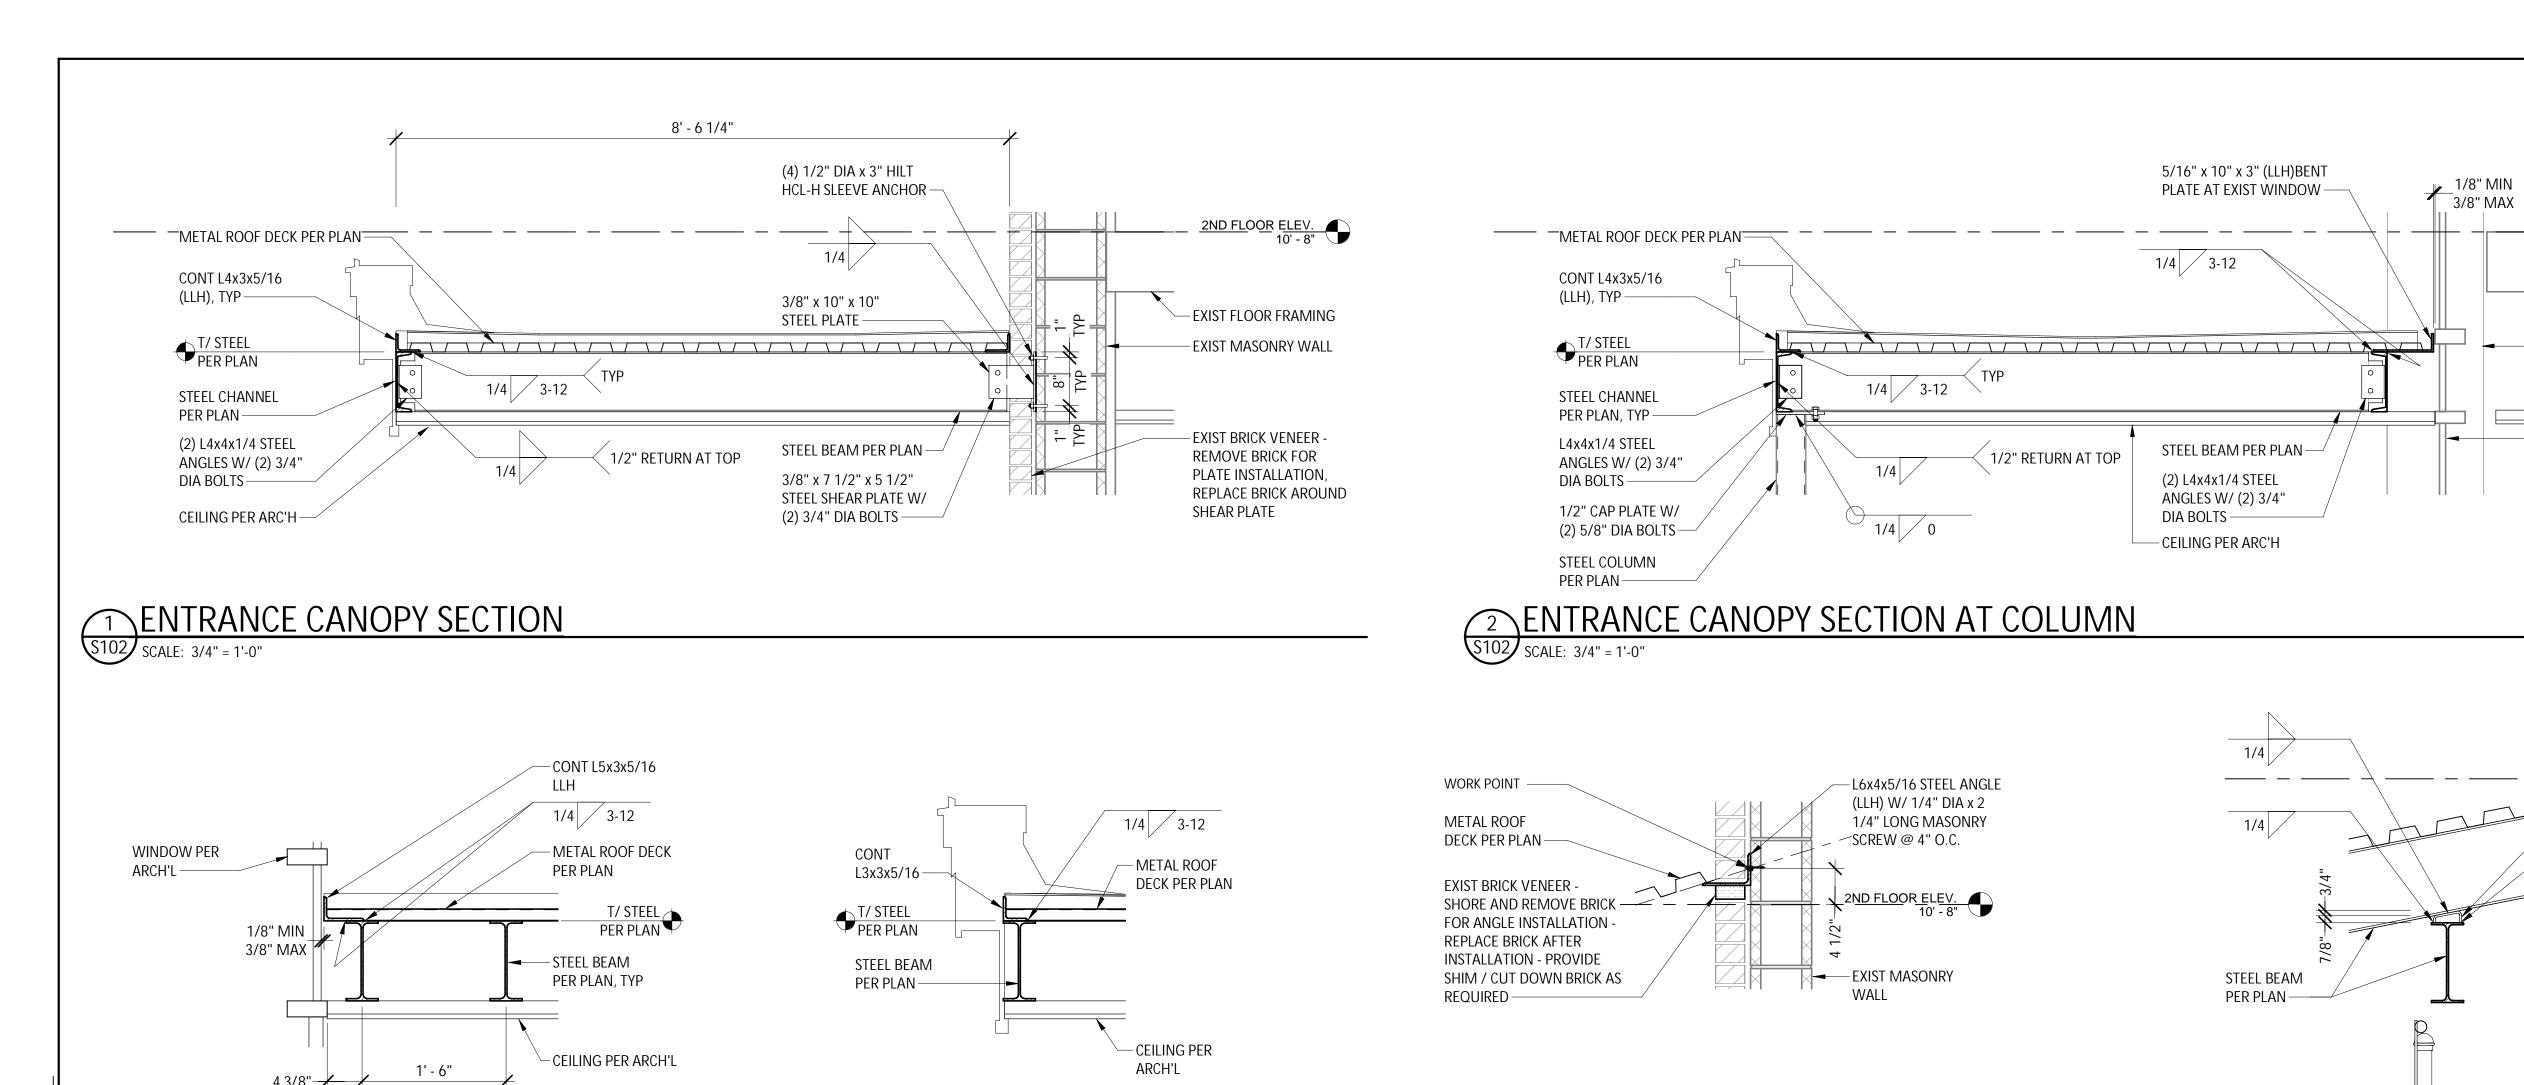
AS SHOWN

Sheet Number S502

Project Number 1753.008.001

ADDITIVE BID ITEM NO. 02 - FRONT ENTRY CANOPY, SEE ARCH DWGS ADDITIVE BID ITEM NO. 03 - REAR ENTRY CANOPY, SEE ARCH DWGS


\$102 SCALE: 3/4" = 1'-0"



4 METAL ROOF DECK AT STEEL BEAM




6 STEEL BEAM AT STEEL BEAM CONNECTION

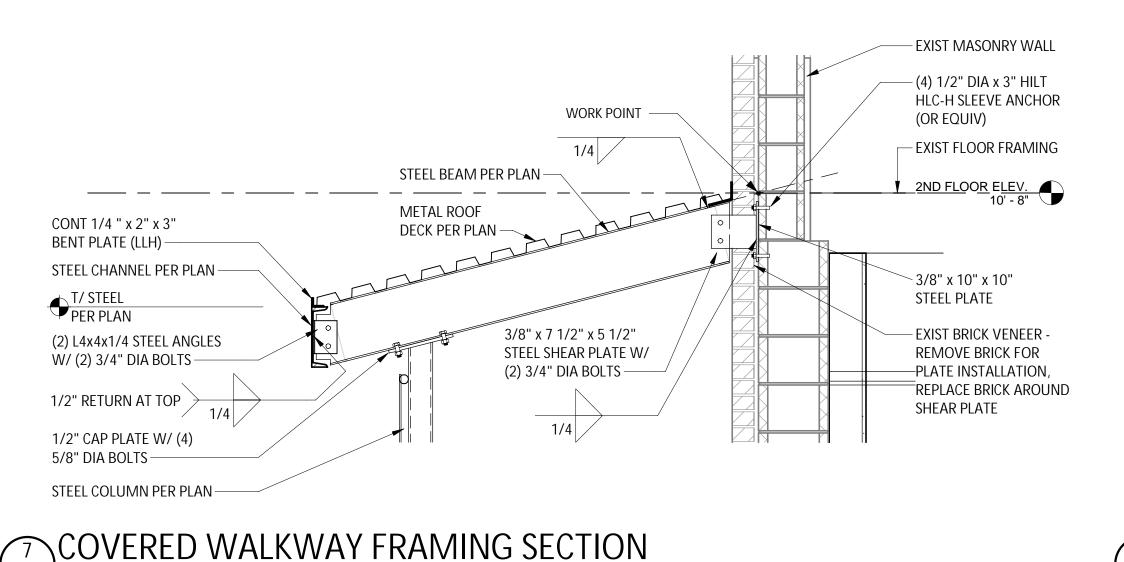


3 ENTRANCE CANOPY AT VESTIBULE

S102 | SCALE: 1" = 1'-0"

S102 | SCALE: 3/4" = 1'-0"

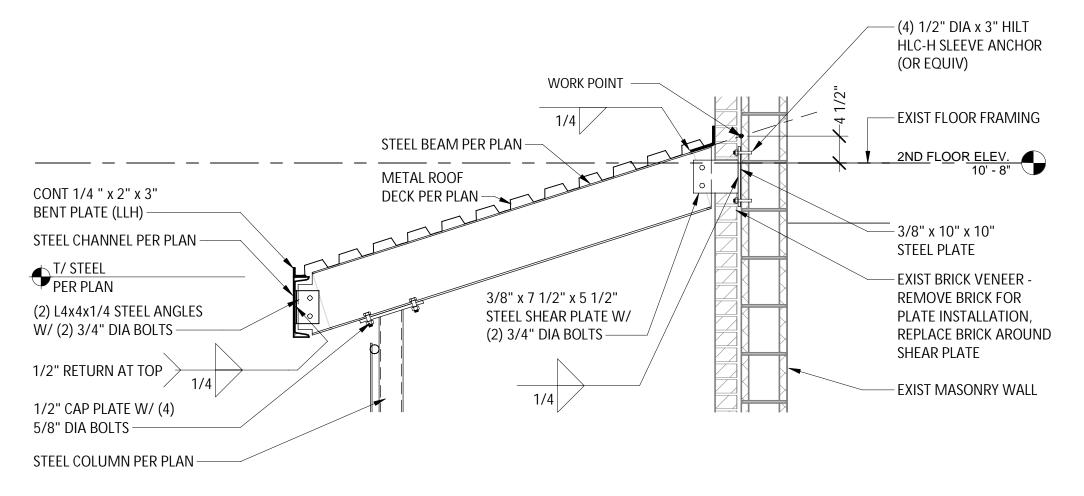

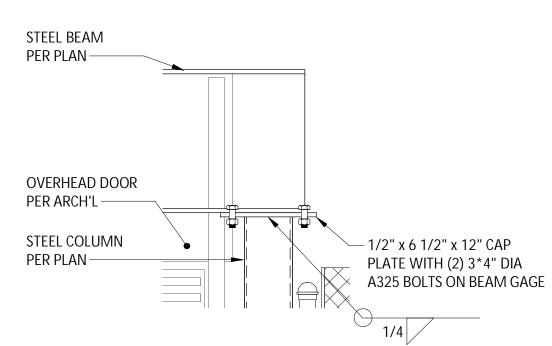

2ND FLOOR ELEV. 10' - 8"

EXIST FLOOR FRAMING

- EXIST MASONRY WALL BEYOND

- EXIST WINDOW

2ND FLOOR ELEV. 10' - 8"

- 1/4" BENT PLATE

x 5" LONG

1/4

9 DROPOFF GATE BEAM AT COLUMN

8 COVERED WALKWAY FRAMING SECTION S102 SCALE: 3/4" = 1'-0"

> ADDITIVE BID ITEM NO. 02 - FRONT ENTRY CANOPY, SEE ARCH DWGS ADDITIVE BID ITEM NO. 03 - REAR ENTRY CANOPY, SEE ARCH DWGS

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REVISIONS

WALKWAY

COVERED AND REAR COV SAMING DETAILS

FRAMING ENTRANCE

RONT

Barton 443 Elec



NYS EXP.: May 31, 2026

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AS SHOWN

Sheet Number S503

Project Number

1753.008.001

- DRAWINGS ARE DIAGRAMMATIC AND INDICATE GENERAL ARRANGEMENT OF SYSTEMS AND WORK INCLUDED IN THE CONTRACT. IT IS INTENDED THAT ALL COMPONENTS AND MATERIALS REQUIRED TO MAKE THE SYSTEMS COMPLETE, TESTED AND OPERATIONAL BE INSTALLED.
- CONTRACTOR SHALL FIELD VERIFY ALL LOCATIONS, DIMENSIONS AND ELEVATIONS BEFORE DEMOLITION AND CONSTRUCTION.
- ALL MATERIALS, EQUIPMENT, METHODS OF INSTALLATION, REMOVALS AND DISPOSAL SHALL BE IN ACCORDANCE WITH THE STANDARDS, REGULATIONS, CODES, ORDINANCES, AND LAWS OF AUTHORITIES THAT HAVE LAWFUL JURISDICTION.
- COMPLETELY COORDINATE WORK OF THIS CONTRACT WITH WORK OF OTHER CONTRACTORS AND OWNERS WORK.
- PROTECT ALL EXISTING BUILDING ELEMENTS AND SITE ELEMENTS TO REMAIN FROM ANY DAMAGE. CONTRACTOR SHALL RESTORE ALL EXISTING CONDITIONS AFFECTED BY DEMOLITION AND CONSTRUCTION TO ORIGINAL OR BETTER CONDITION.
- WORK SHALL BE EXECUTED IN A WORKMANLIKE MANNER AND SHALL PRESENT NEAT, RECTILINEAR APPEARANCE WHEN COMPLETED. MAINTAIN MAXIMUM HEAD ROOM AT ALL TIMES.
- MATERIALS AND EQUIPMENT SHALL BE NEW AND INSTALLED ACCORDING TO MANUFACTURER'S INSTRUCTIONS AND RECOMMENDATIONS. MAINTAIN MANUFACTURER'S EQUIPMENT CLEARANCES.
- ALL EQUIPMENT PIPING, WIRING, INSULATION AND ANCILLARY MATERIALS INSTALLED IN HVAC AIR PLENUM SPACES SHALL MEET CODE REQUIREMENTS FOR SMOKE AND COMBUSTIBILITY
- DO NOT SUPPORT EQUIPMENT FROM SUSPENDED CEILINGS. ALL SUPPORT SHALL COME FROM BUILDING STRUCTURE. SUPPORTS SHALL BE SELECTED AND INSTALLED TO PROVIDE A VIBRATION FREE INSTALLATION.
- DUCTWORK SHALL BE CONSTRUCTED AND INSTALLED IN ACCORDANCE WITH THE LATEST ISSUES OF SMACNA STANDARDS.
- PROVIDE PROPER ACCESS TO MATERIALS AND EQUIPMENT THAT REQUIRE INSPECTION, REPLACEMENT, REPAIR OR SERVICE SUCH AS COILS, DAMPERS, HEATERS, VALVES, ETC. IF PROPER ACCESS CANNOT BE PROVIDED, CONFER WITH THE ENGINEER AS TO THE BEST METHOD OF APPROACH TO MINIMIZE THE EFFECT OF THE REDUCED ACCESS WHICH MAY RESULT.
- RELOCATE EXISTING DUCTING, PIPING, CONDUIT AND OTHER INTERFERENCES TO INSTALL NEW EQUIPMENT AND MATERIALS. OFFSETS IN PIPING AND DUCTS, DIVIDED DUCTS AND TRANSITIONS AROUND OBSTRUCTIONS SHALL BE PROVIDED AT NO ADDITIONAL COST TO OWNER.
- THOROUGHLY CLEAN ALL NEW DUCTWORK AFTER INSTALLATION.
- 14. NOTES, SYMBOLS LIST AND DETAILS ARE APPLICABLE TO ALL
- 15. ALL WORK SHOWN IS TO BE COMPLETED BY THIS CONTRACT UNLESS SPECIFICALLY INDICATED OTHERWISE.
- 16. FIRE STOP ALL NEW AND EXISTING SLEEVES THROUGH CONCRETE FLOORS AND FIRE RATED WALLS OR PARTITIONS WITH UL RATED ASSEMBLIES WITH EQUAL FIRE RATING. SEE ARCHITECTURAL PLANS FOR LOCATIONS OF FIRE RATED FLOOR AND WALL ASEMBLIES.
- CONTRACTOR IS RESPONSIBLE FOR ALL OWNER COORDINATION AND PROCEDURES RELATED TO ISOLATING, SHUTTING DOWN, DRAINING, FILLING AND RESTARTING SYSTEMS, INCLUDING THOSE REQUIRED FOR RELOCATIONS, TO ALLOW FOR COMPLETION OF ALL DEMOLITION AND NEW WORK. INTERRUPTIONS TO EXISTING SERVICES AND SYSTEMS SHALL BE AS SHORT AS POSSIBLE AND AT A TIME AND DURATION APPROVED BY THE OWNER. INCLUDE ALL PREMIUM TIME ASSOCIATED WITH INTERRUPTIONS. ALL SYSTEM INTERRUPTIONS SHALL BE SCHEDULED WITH OWNER AND COORDINATED WITH OTHER CONTRACTORS. CONTRACTOR SHALL FURNISH ALL FLUIDS REQUIRED, INCLUDING GLYCOL FOR FILLING NEW SYSTEMS AND REFILLING EXISTING SYSTEMS.

ABBREVIATIONS:

∠ - ANGLE AAD - AUTOMATIC AIR DAMPER **ALUM - ALUMINUM** BLDG - BUILDING BSMT - BASEMENT BOT - BOTTOM CFM - CUBIC FEET PER MINUTE CJ - CONTROL JOINT CL - CENTER LINE CLG - CEILING CLR - CLEAR CMU - CONCRETE MASONRY UNITS CONC - CONCRETE **CONST - CONSTRUCTION** DEMO - DEMOLISH, DEMOLITION DN - DOWN EA - EACH EC - ELECTRICAL CONTRACTOR **ELEC - ELECTRICAL ELEV - ELEVATION EQUIP - EQUIPMENT** E.S.P - EXTERNAL STATIC PRESSURE EX. EXIST - EXISTING FIN FLR - FINISHED FLOOR FLA - FULL LOAD AMPS FPM - FEET PER MINUTE FTG - FOOTING GA - GAUGE GALV - GALVANIZED GC - GENERAL CONTRACTOR

BALL VALVE

(TYP) –

ABBREVIATIONS (CONT.) **HP - HORSE POWER** HZ - HERTZ **INSUL - INSULATION** INV - INVERT MANUF - MANUFACTURER MAX - MAXIMUM MC - MECHANICAL CONTRACTOR MIN - MINIMUM MTL - METAL NAT - NATURAL NTS - NOT TO SCALE OD - OUTSIDE DIAMETER PLAS - PLASTIC RD - ROOF DRAIN SAN - SANITARY SHT - SHEET

SIM - SIMILAR SS - STAINLESS STEEL STL - STEEL T/ - TOP OF T&B - TOP AND BOTTOM TEMP - TEMPERED TYP - TYPICAL VIF - VERIFY IN FIELD W.G - WATER GAUGE

S—S— SLOPE DN IN DIRECTION OF ARROW → BREAK ******** PIPING/EQUIPMENT TO BE REMOVED

LIMIT OF REMOVAL

CONNECTION POINT TO EXISTING ─── TEE RISE

○ PIPE RISE

LEGEND

PIPE DROP → DIRECTION OF FLOW CAP

UNION = CONCENTRIC REDUCER

—— FLANGED CONNECTION FLEXIBLE CONNECTION

BUTTERFLY VALVE PRESSURE GAUGE THERMOMETER

MANUAL AIR VENT

AUTOMATIC AIR VENT STRAINER

SWING CHECK VALVE BALL VALVE \triangleright

 \bowtie GATE VALVE **LEGEND**

□ GLOBE VALVE

TRIPLE DUTY VALVE

BALANCE VALVE

BALL VALVE W/ HOSE CONNECTION, CAP AND CHAIN

PRESSURE REDUCING VALVE

SAFETY RELIEF VALVE

TEMPERATURE SENSOR

CONTROL VALVE, 3-WAY, MODULATING

VOLUME DAMPER

→ FIRE DAMPER

SUPPLY DUCT SECTION UP

SUPPLY DUCT SECTION DOWN

RET/EXH DUT SECTION UP

RET/EXH DUT SECTION DOWN

45° BRANCH DUCT CONNECTION


NEW SUPPLY DIFFUSER, REGISTER OR GRILLE (WITH CFM)

NEW RETURN/EXHAUST REGISTER OR GRILLE (WITH CFM)

(ARROW INDICATES DEVICE)

—HWS— HOT WATER SUPPLY PIPING

—HWR— HOT WATER RETURN PIPING

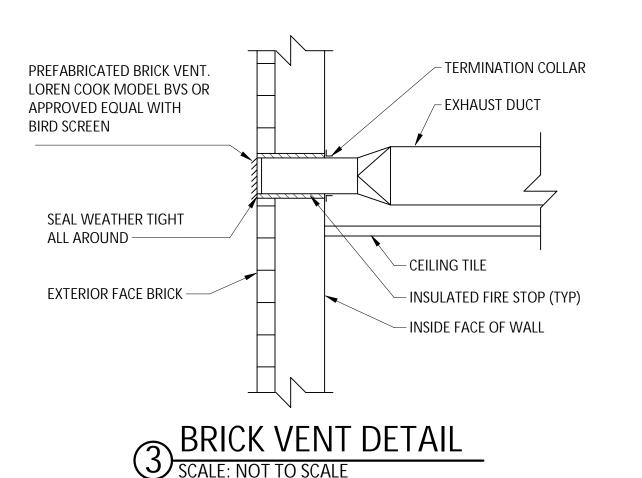

POWER VENT WITH

DISCONNECT SWITCH

- BACKDRAFT DAMPER

SUPPLY RETURN BALANCE VALVE ~STRAINER CONTROL VALVE, WITH 2-WAY, MODULATING — **BLOWDOWN** MANUAL BALL VALVE AIR VENT -COIL DRAIN REDUCER (TYP) – DIRT POCKET AND COIL DRAIN VALVE

1. REFER TO DRAWINGS FOR LINE SIZES.


HOT WATER REHEAT COIL DETAIL

SCALE: NOT TO SCALE


2. ALL ISOLATION VALVES AND ACCESSORIES SHALL BE LINE SIZE UNLESS OTHERWISE SHOWN.

BIRD SCREEN ALL AROUND -— ALUMINUM CURB CAP GASKET APPLIED PRE-FAB CURB WITH BLOCKING TO UNDERSIDE -_PROVIDED BY CONTRACT 1B, **INSTALLED BY CONTRACT 1A EXHAUST DUCTWORK-**


5 EXHAUST FAN DETAIL
SCALE: NOT TO SCALE

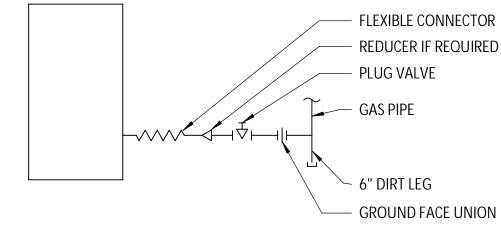

TYPICAL GAS FIRED APPLIANCE CONNECTION DETAIL

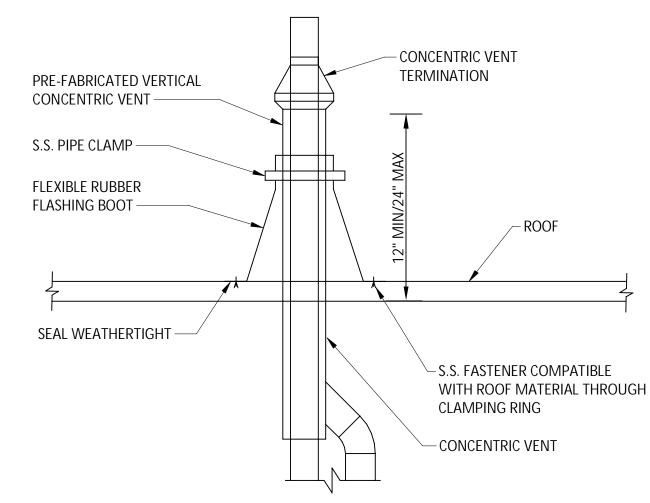

TYPICAL CONCENTRIC VENT DETAIL

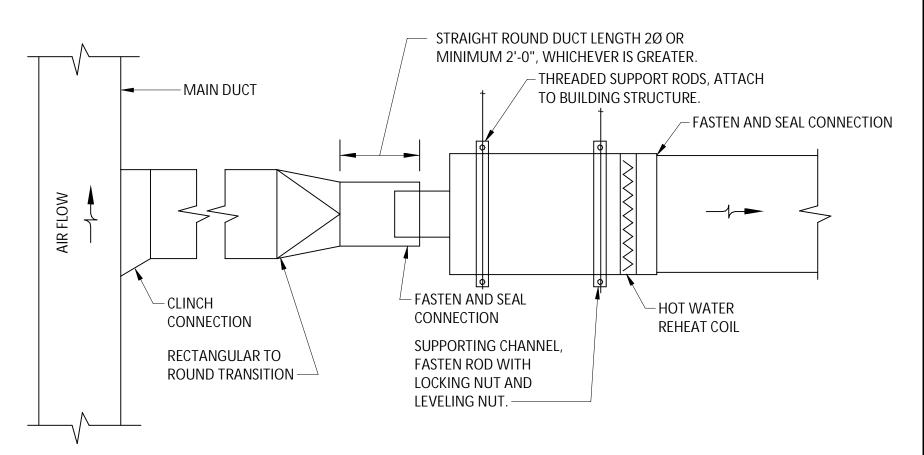

NOTES:

- 1. THE OPERATION OF VARIABLE AIR VOLUME TERMINAL BOX ARE AFFECTED BY EXCESSIVE TURBULENCE ON THE ENTERING SIDE OF EACH TERMINAL BOX. THEREFORE, TERMINAL BOX MUST NOT BE INSTALLED TOO CLOSE TO MAIN DUCTS, ELBOWS AND FITTINGS.
- 2. WHEN MINIMUM UPSTREAM STRAIGHT DUCT CONNECTION TO TERMINALS AS INDICATED ABOVE CANNOTBE MAINTAINED, PROVIDE ORIFICE PLATE, STRAIGHTENING VANES OR OTHER DEVICE AS RECOMMENDEDBY TERMINAL BOX MANUFACTURER AND SUBMIT TO ENGINEER FOR REVIEW PRIOR TO INSTALLATION.
- DDC PANELS & MOTORS FOR NEW VAV TERMINAL BOXES SHALL BE PROVIDED BY CONTROLS MANUFACTURER AND SHALL BE DELIVERED TO VAV BOX MANUFACTURER. DDC PANEL SHALL CONTAIN STEP DOWN TRANSFORMER (120V AC TO 24V AC) TO POWER CONTROL & MOTOR. BOX MANUFACTURER SHALL FACTORY MOUNT DDC CONTROLLER & MOTOR ON LEFT OR RIGHT HAND SIDE OF VAV BOXES TO SUIT FIELD CONDITIONS VAV BOX MANUFACTURER WILL PROVIDE ALL SENSORS & DAMPER WITH LINKAGES.
- 4. ARRANGE ACCESS TO PERMIT EASY FIELD BALANCE AND MAINTENANCE OF TERMINAL UNIT.

VAV BOX INSTALLATION DETAIL


SCALE: NOT TO SCALE

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REVISIONS

BBREVIATION \triangleleft N

NEW CT 1B YMBOI CONTRA



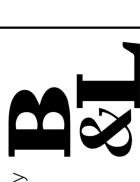


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Sheet Number M001



BASEMENT HVAC PIPING DEMOLITION PLAN SCALE: 3/16" = 1'-0"

GENERAL NOTES:

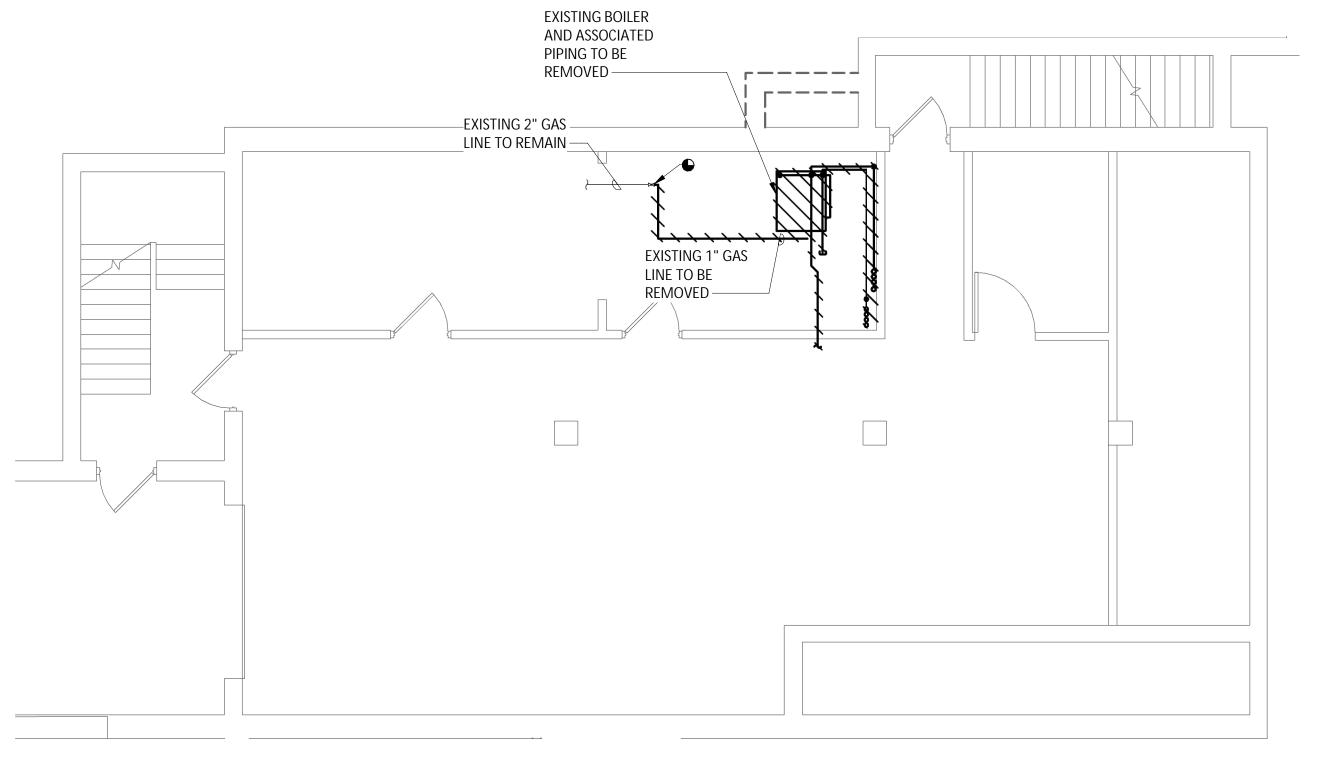- 1. REMOVE ALL EXISTING HOT WATER SUPPLY AND RETURN PIPING, VALVES AND INSULATION IN THE BASEMENT COMPLETE.
- 2. REMOVE EXISTING BOILER VENTING COMPLETE. EXISTING CHIMNEY BEING REMOVED IN CONTRACT 1A.

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THE STAMP OF A LICENSED PROFESSIONAL
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SHALL STAMP THE DOCUMENT AND
INCLUDE THE NOTATION "ALTERED BY"
FOLLOWED BY THEIR SIGNATURE, THE DATE
OF SUCH ALTERATION, AND A SPECIFIC
DESCRIPTION OF THE ALTERATION.

REVISIONS

DEMOLITION PLAN CITY OF MIDDLETOWN
NEW COURTHOUSE FACILITY
CONTRACT 1B - MECHANICAL CONSTRUCTION


BASEMENT


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M100





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REVISIONS

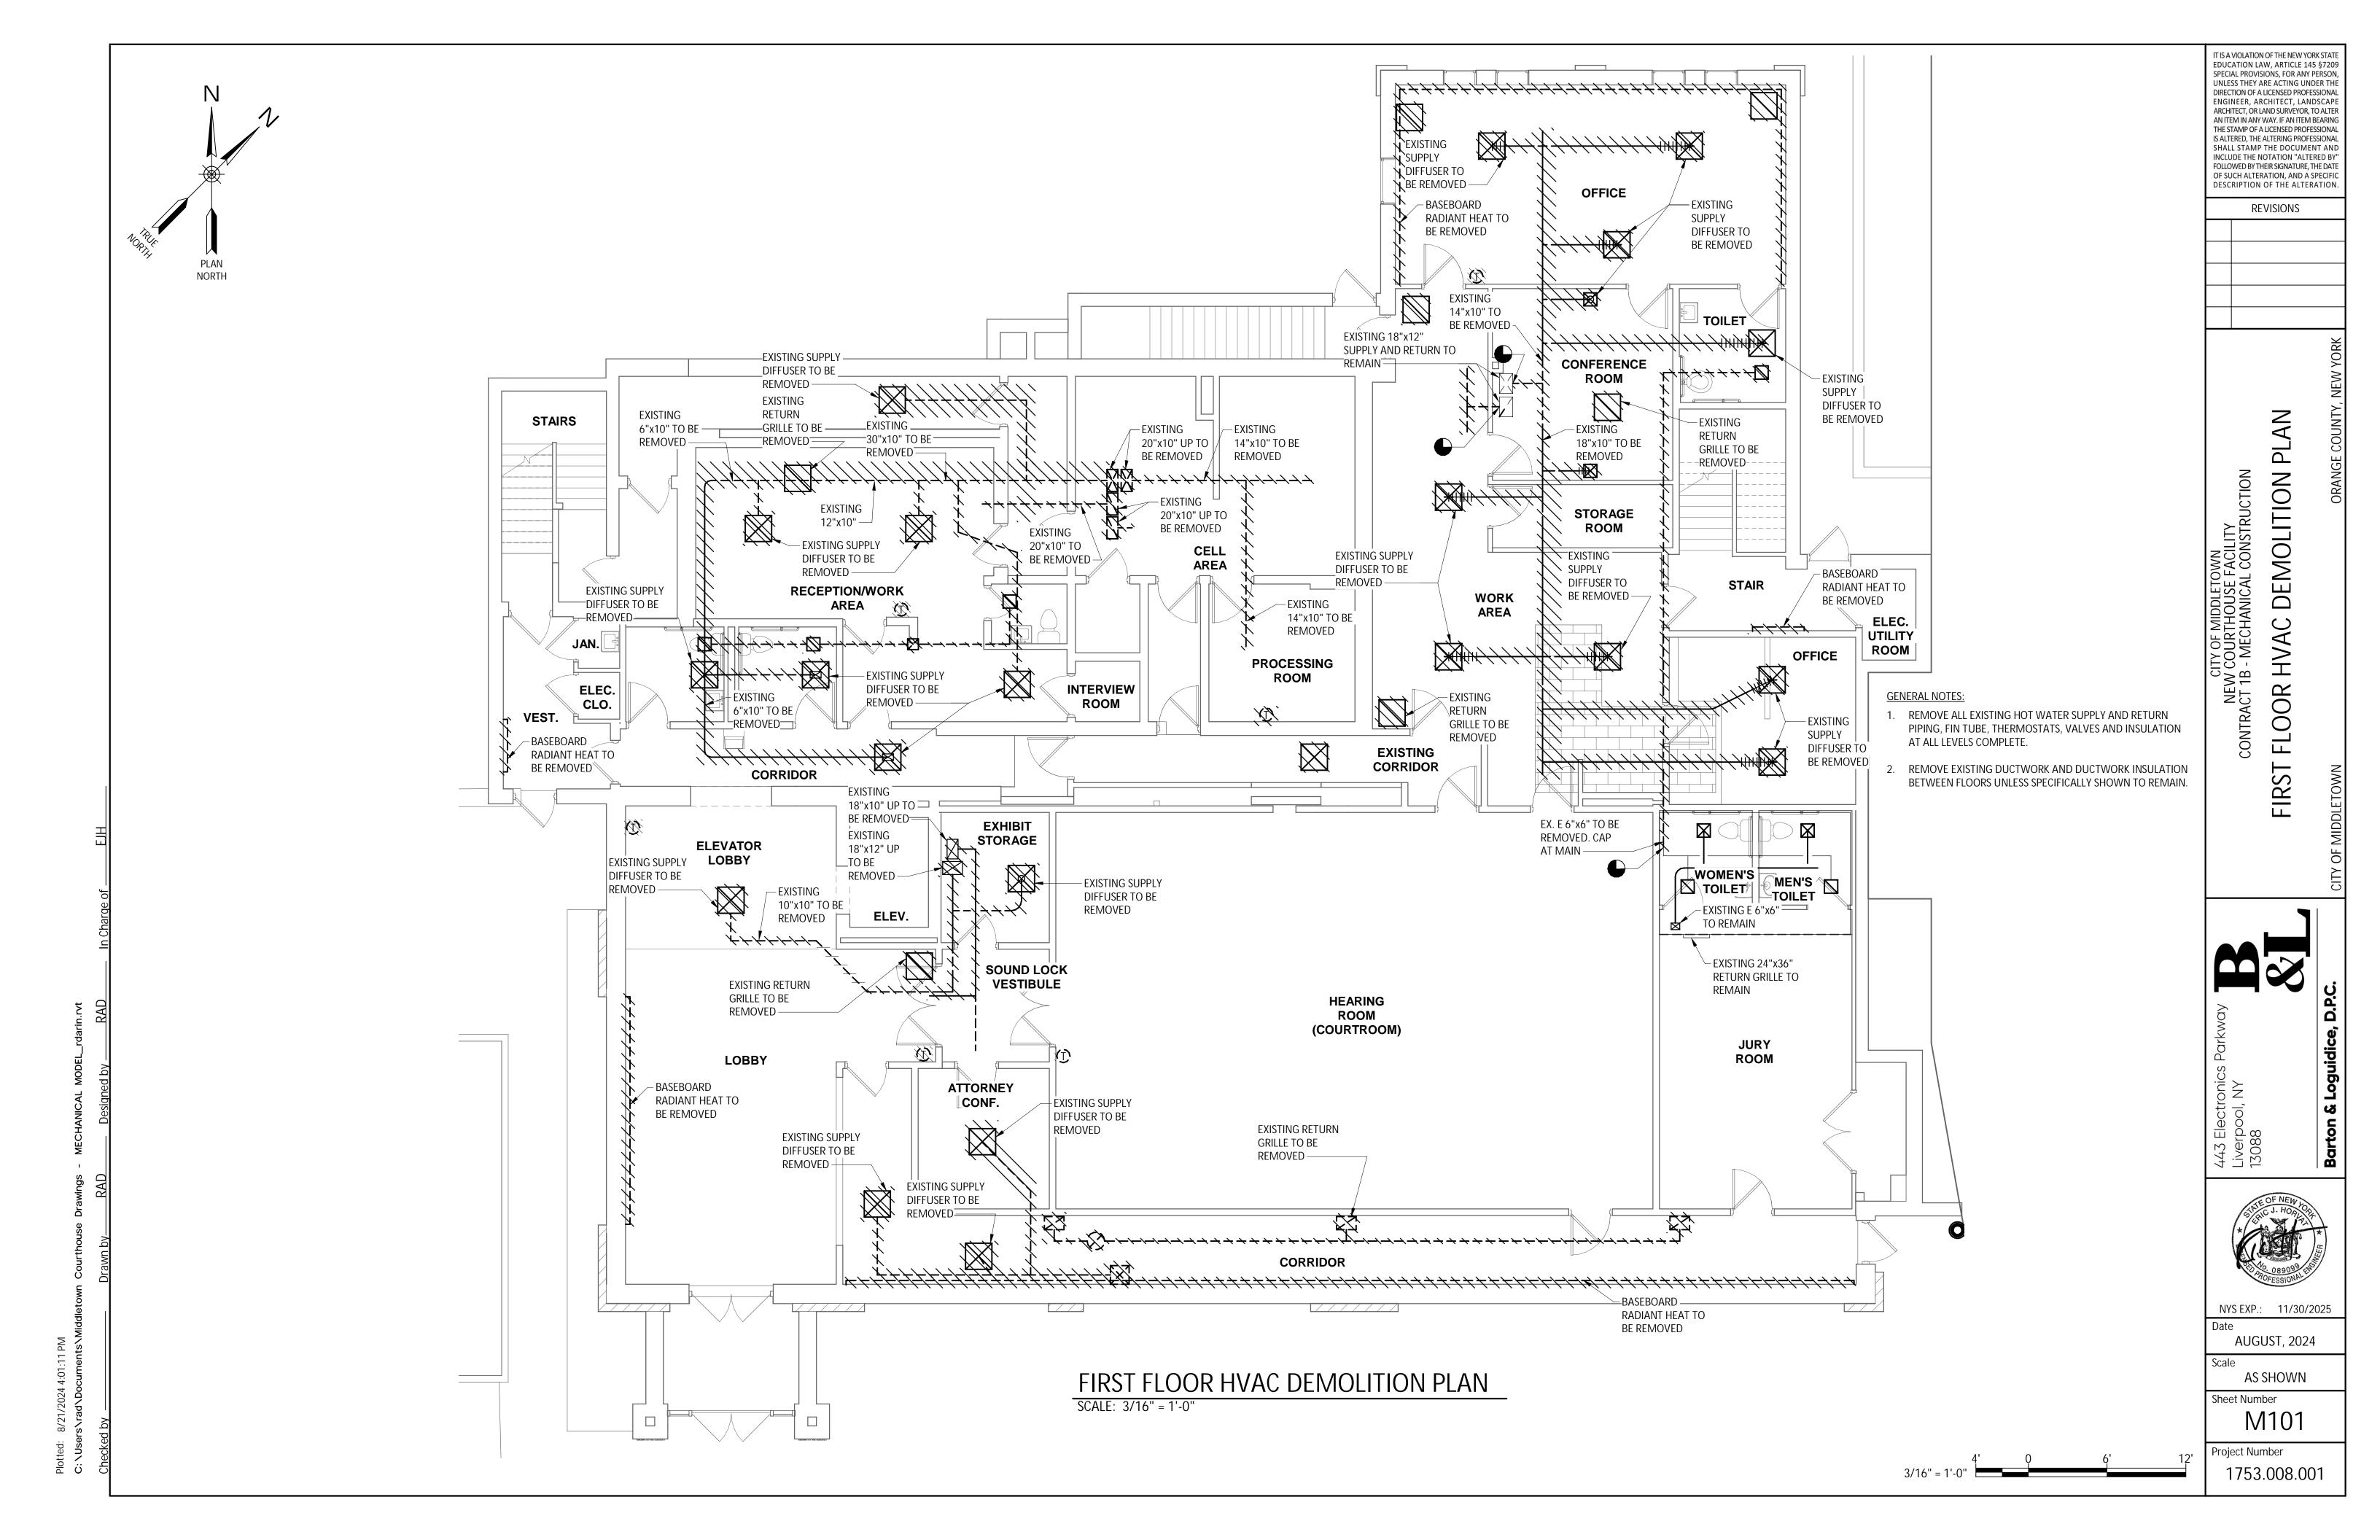1/31/23 ADD. 2

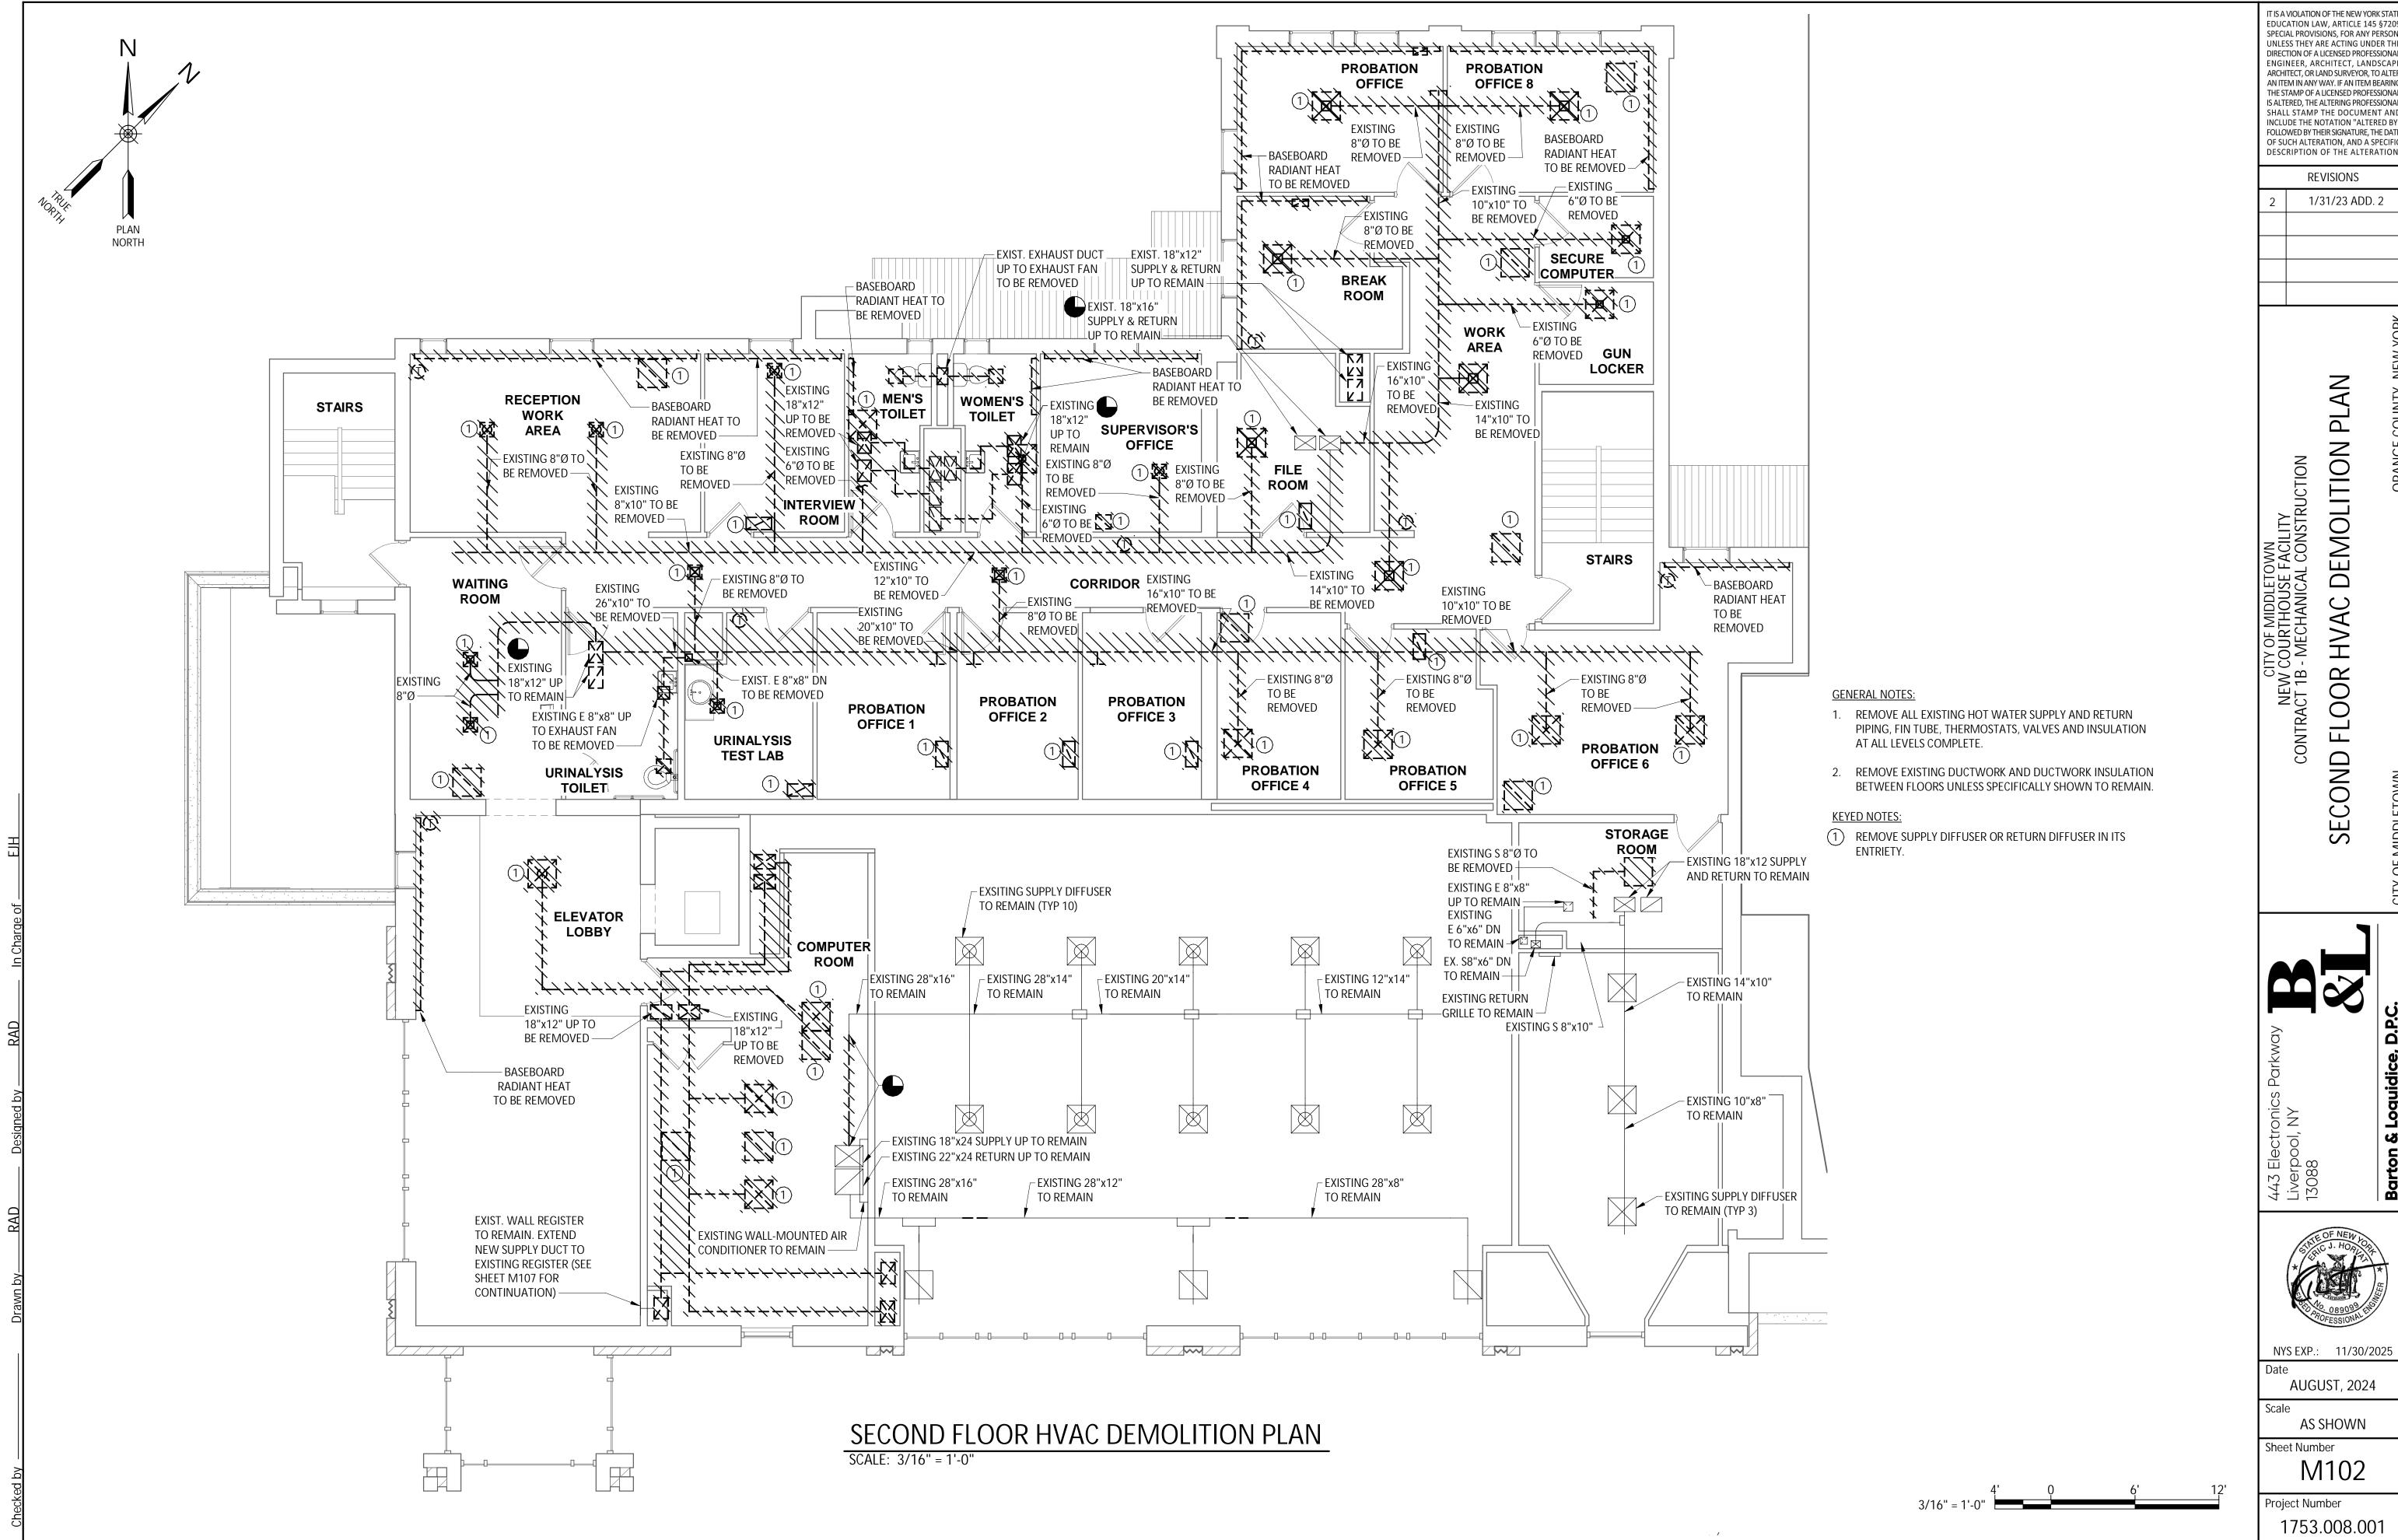DEMOLITION

HVAC FLOOR NEW C CONTRACT 1B -SECOND




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REVISIONS

DEMOLITION PLAN HVAC ROOF




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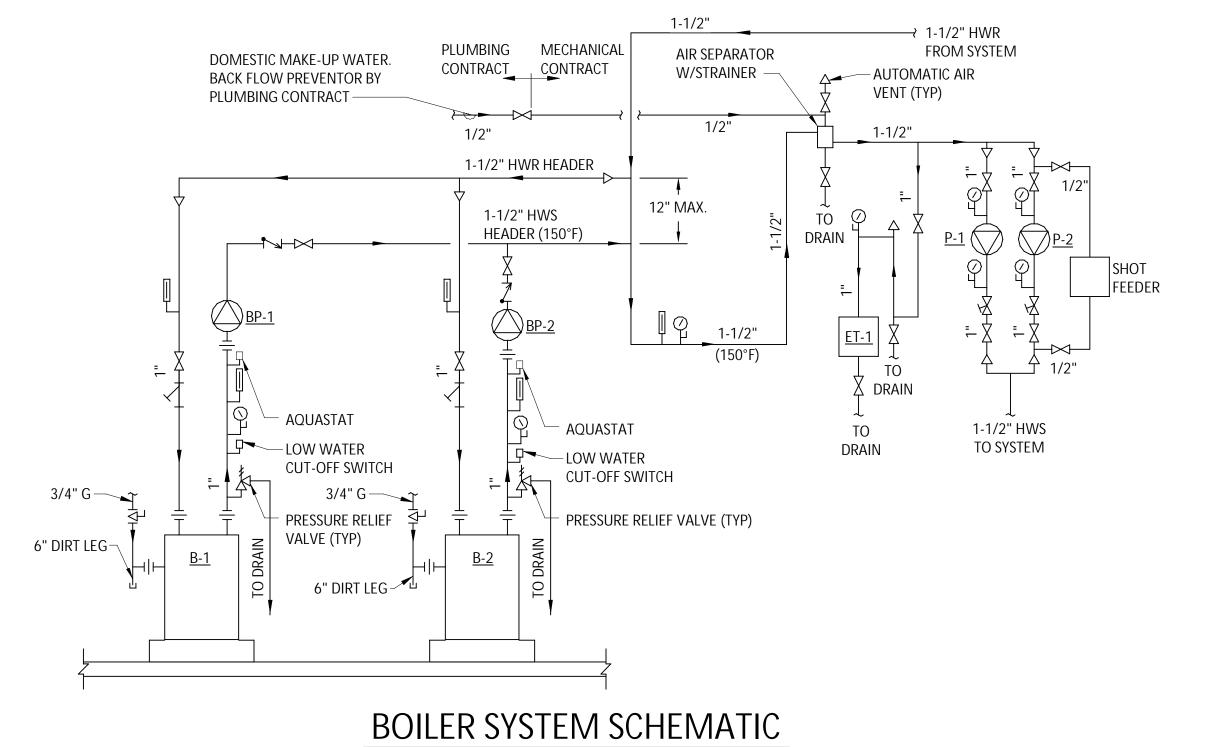
AS SHOWN

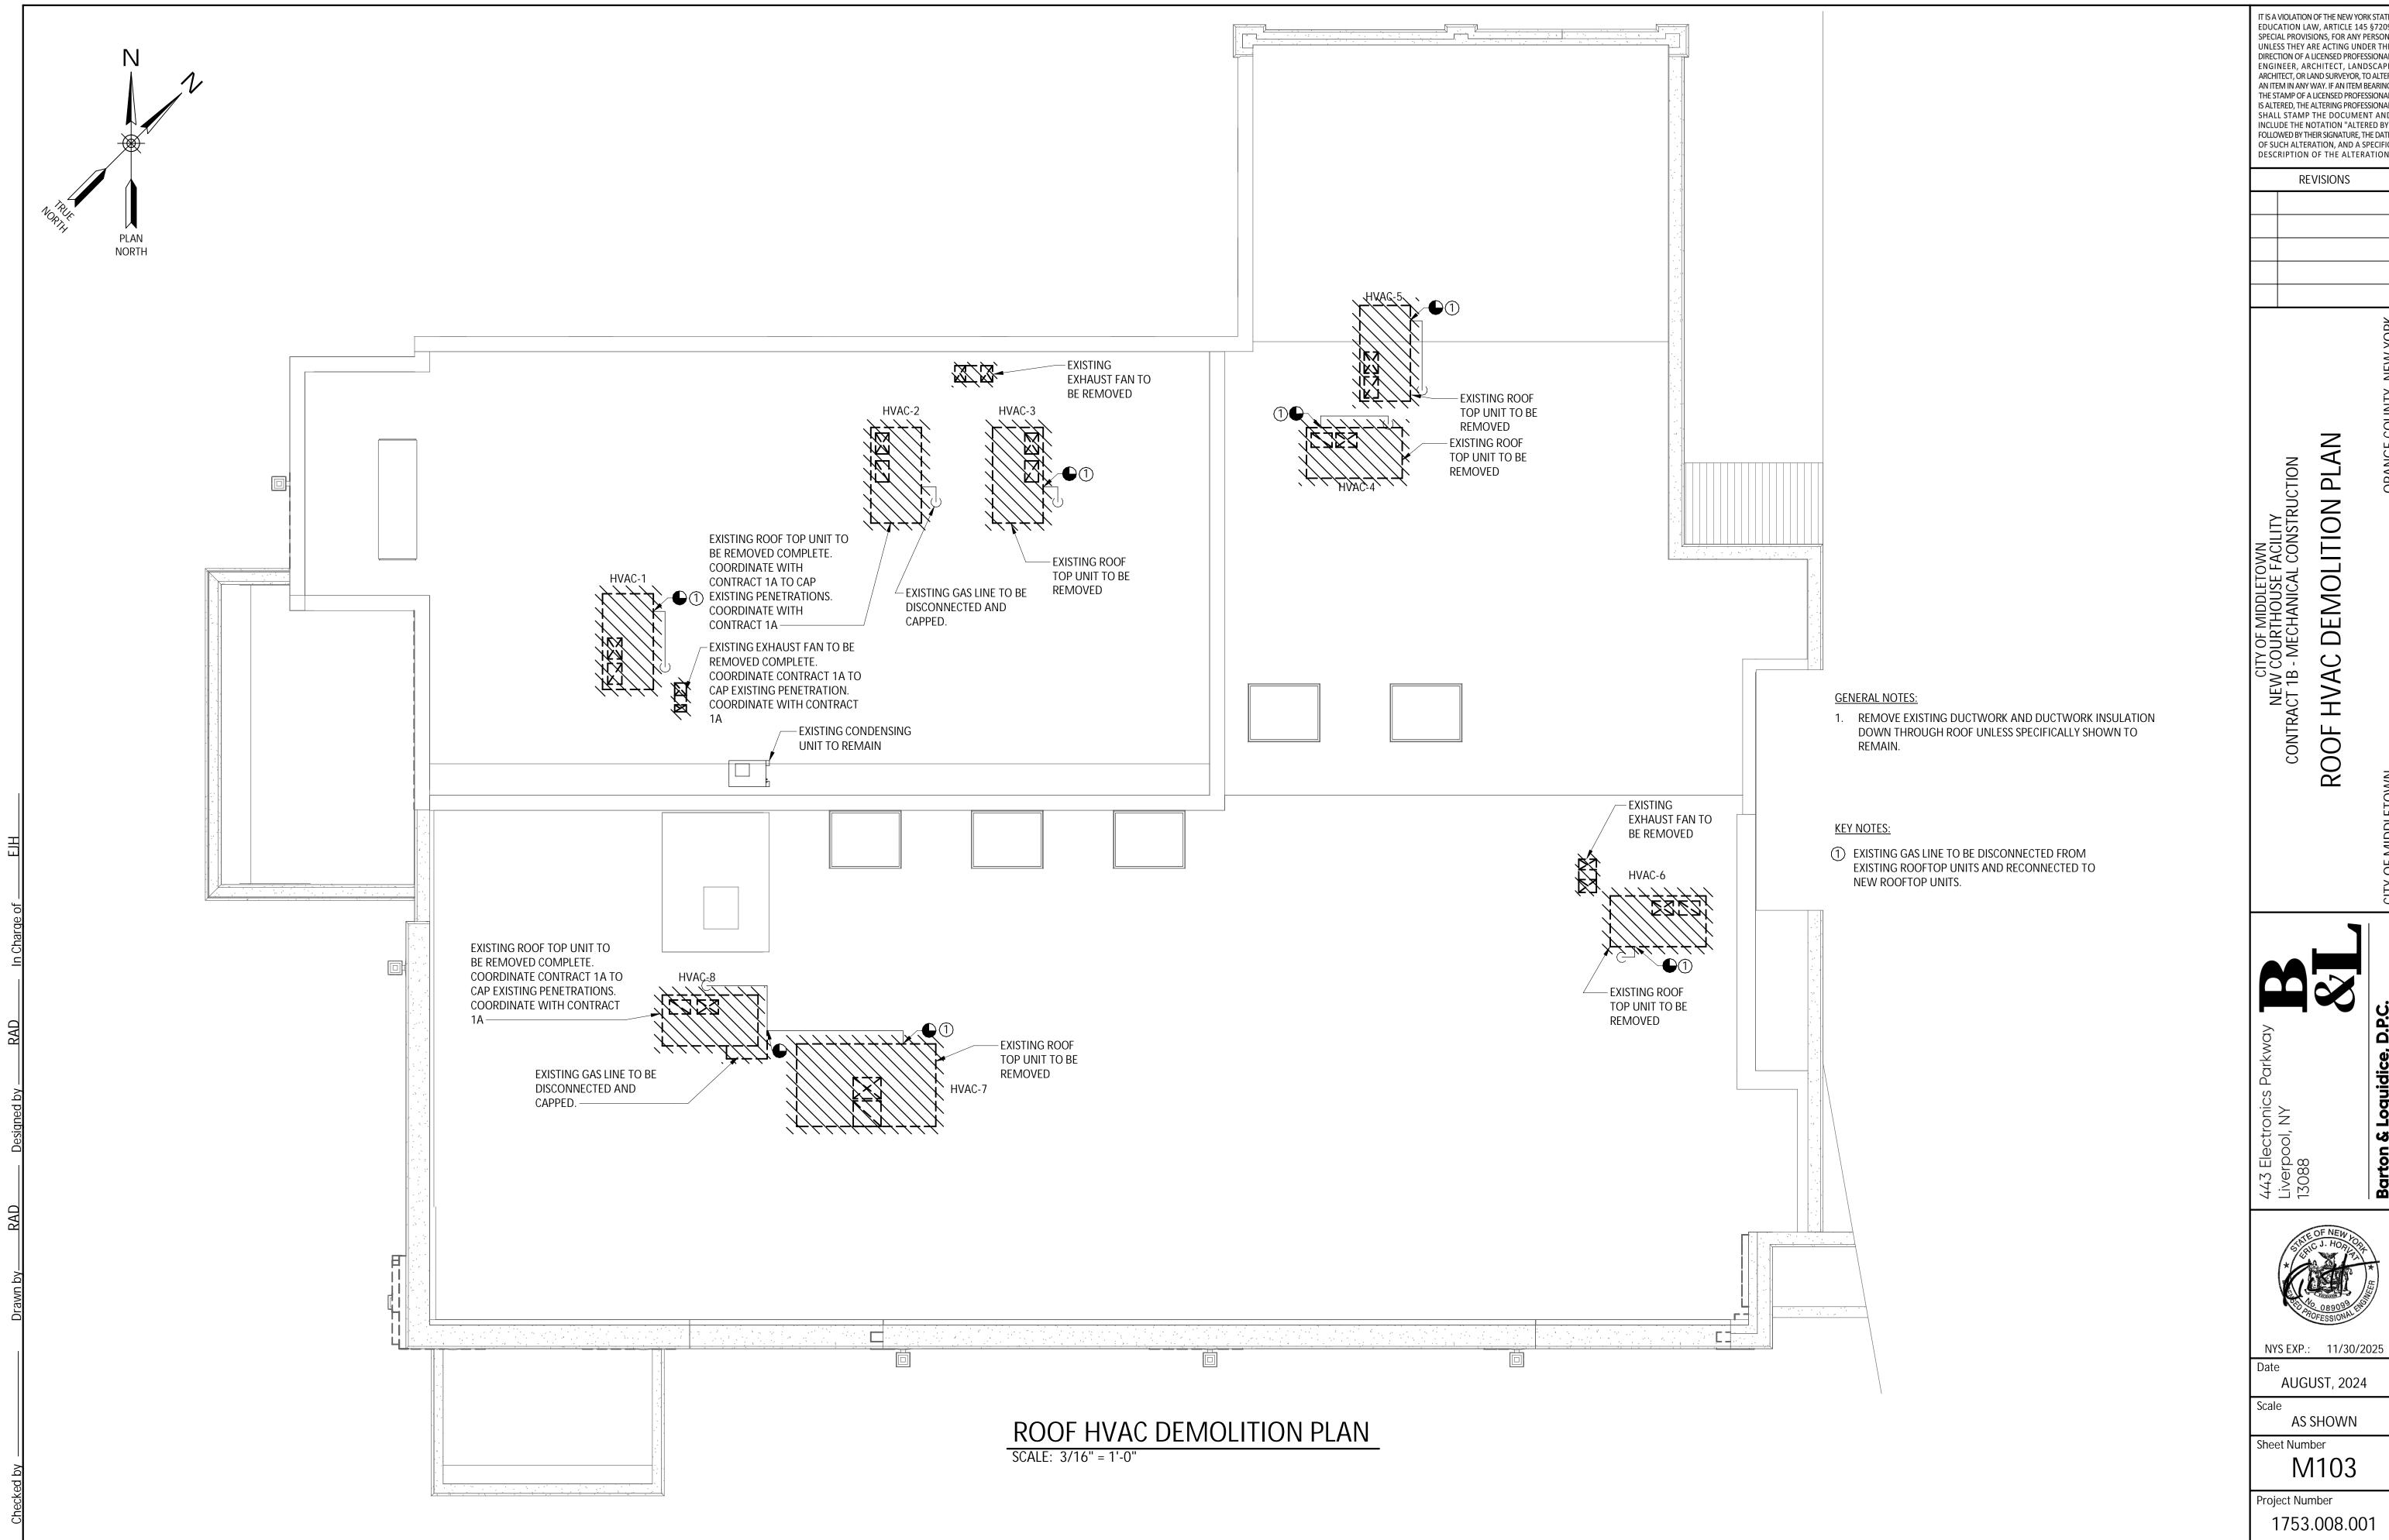Sheet Number M103



BASEMENT HVAC PIPING PLAN

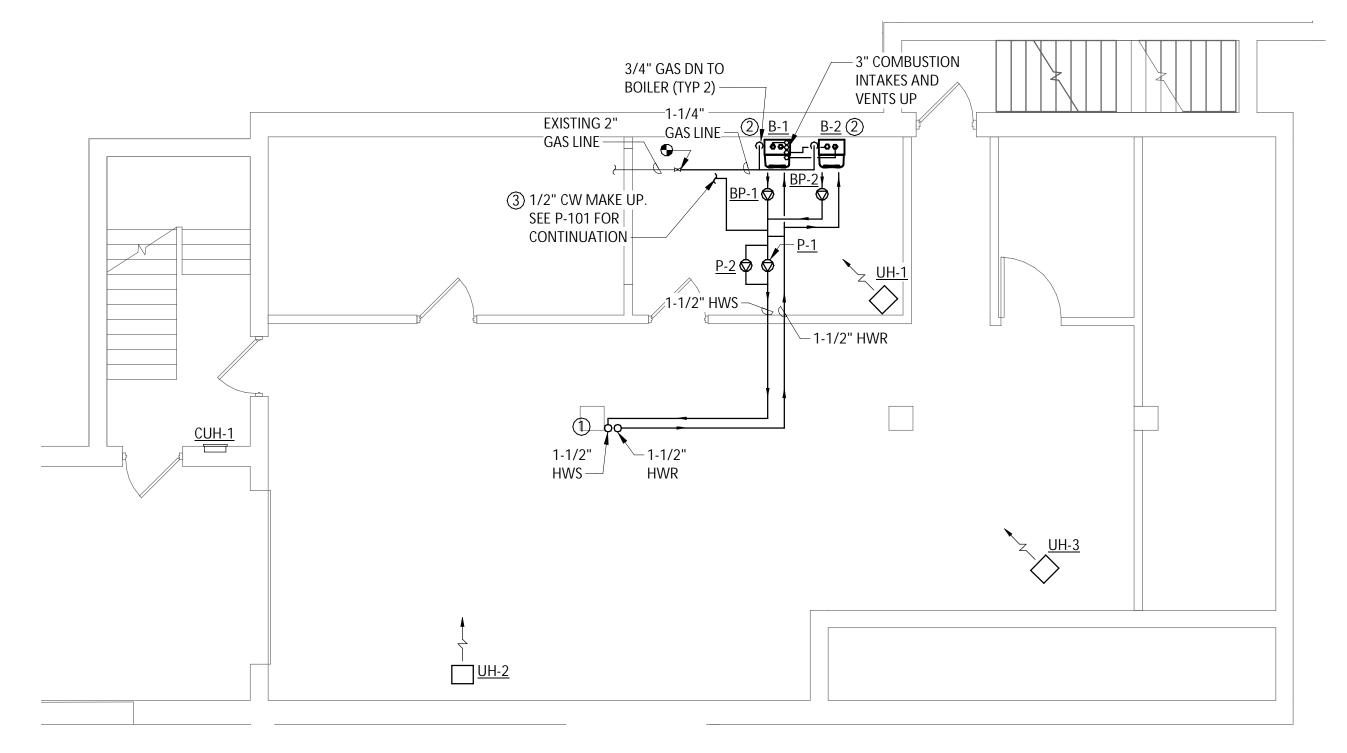SCALE: 3/16" = 1'-0"



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REVISIONS

PIPING PLAN CITY OF MIDDLETOWN NEW COURTHOUSE FACILITY CONTRACT 1B - MECHANICAL CONSTRUCTION **BASEMENT HVAC**

KEY NOTES:

(1) CORE DRILL THROUGH CEILING TO FLOOR

FIRE CAULK PENETRATIONS.

BELOW BOILERS.

WITH CONTRACT 1C.

② NEW BOILERS ARE FLOOR MOUTNED.

3 COORDINATE NEW COLD WATER MAKE-UP CONNECTION FOR BOILER SYSTEM

ABOVE TO ACCOMODATE NEW PIPING.

PROVIDE 6" CONCRETE EQUIPMENT PAD

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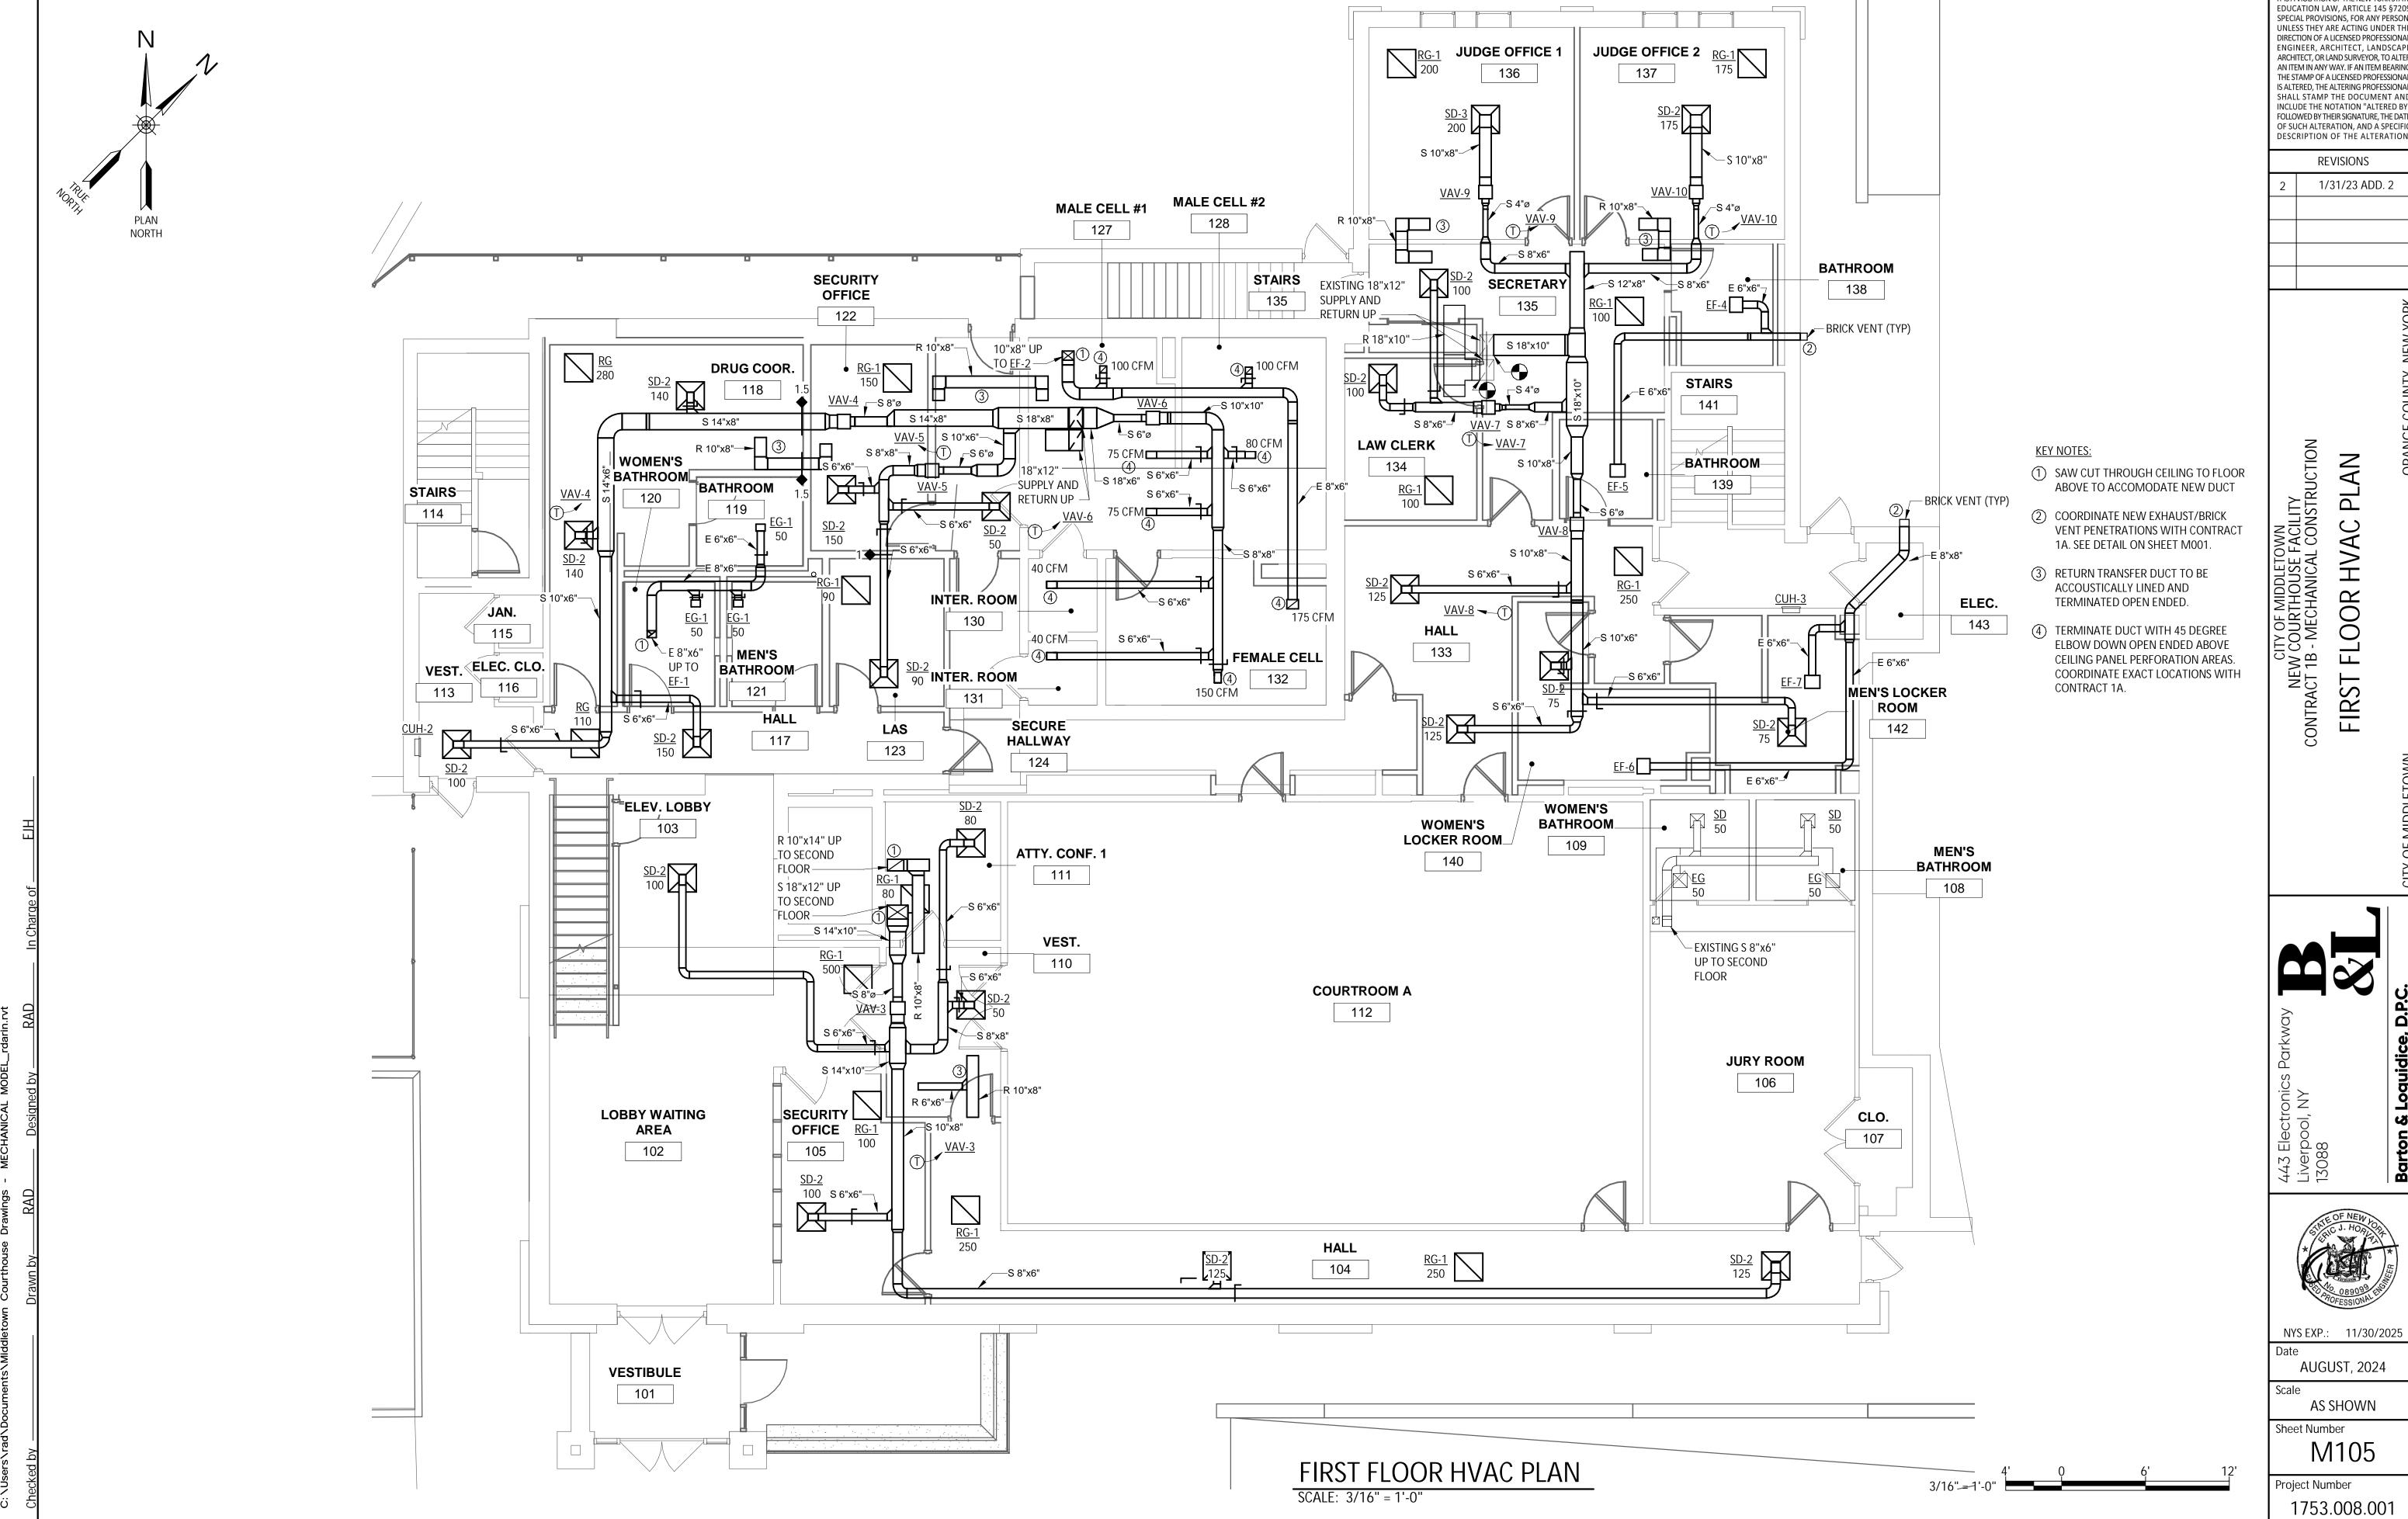
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Sheet Number M104

Project Number 1753.008.001

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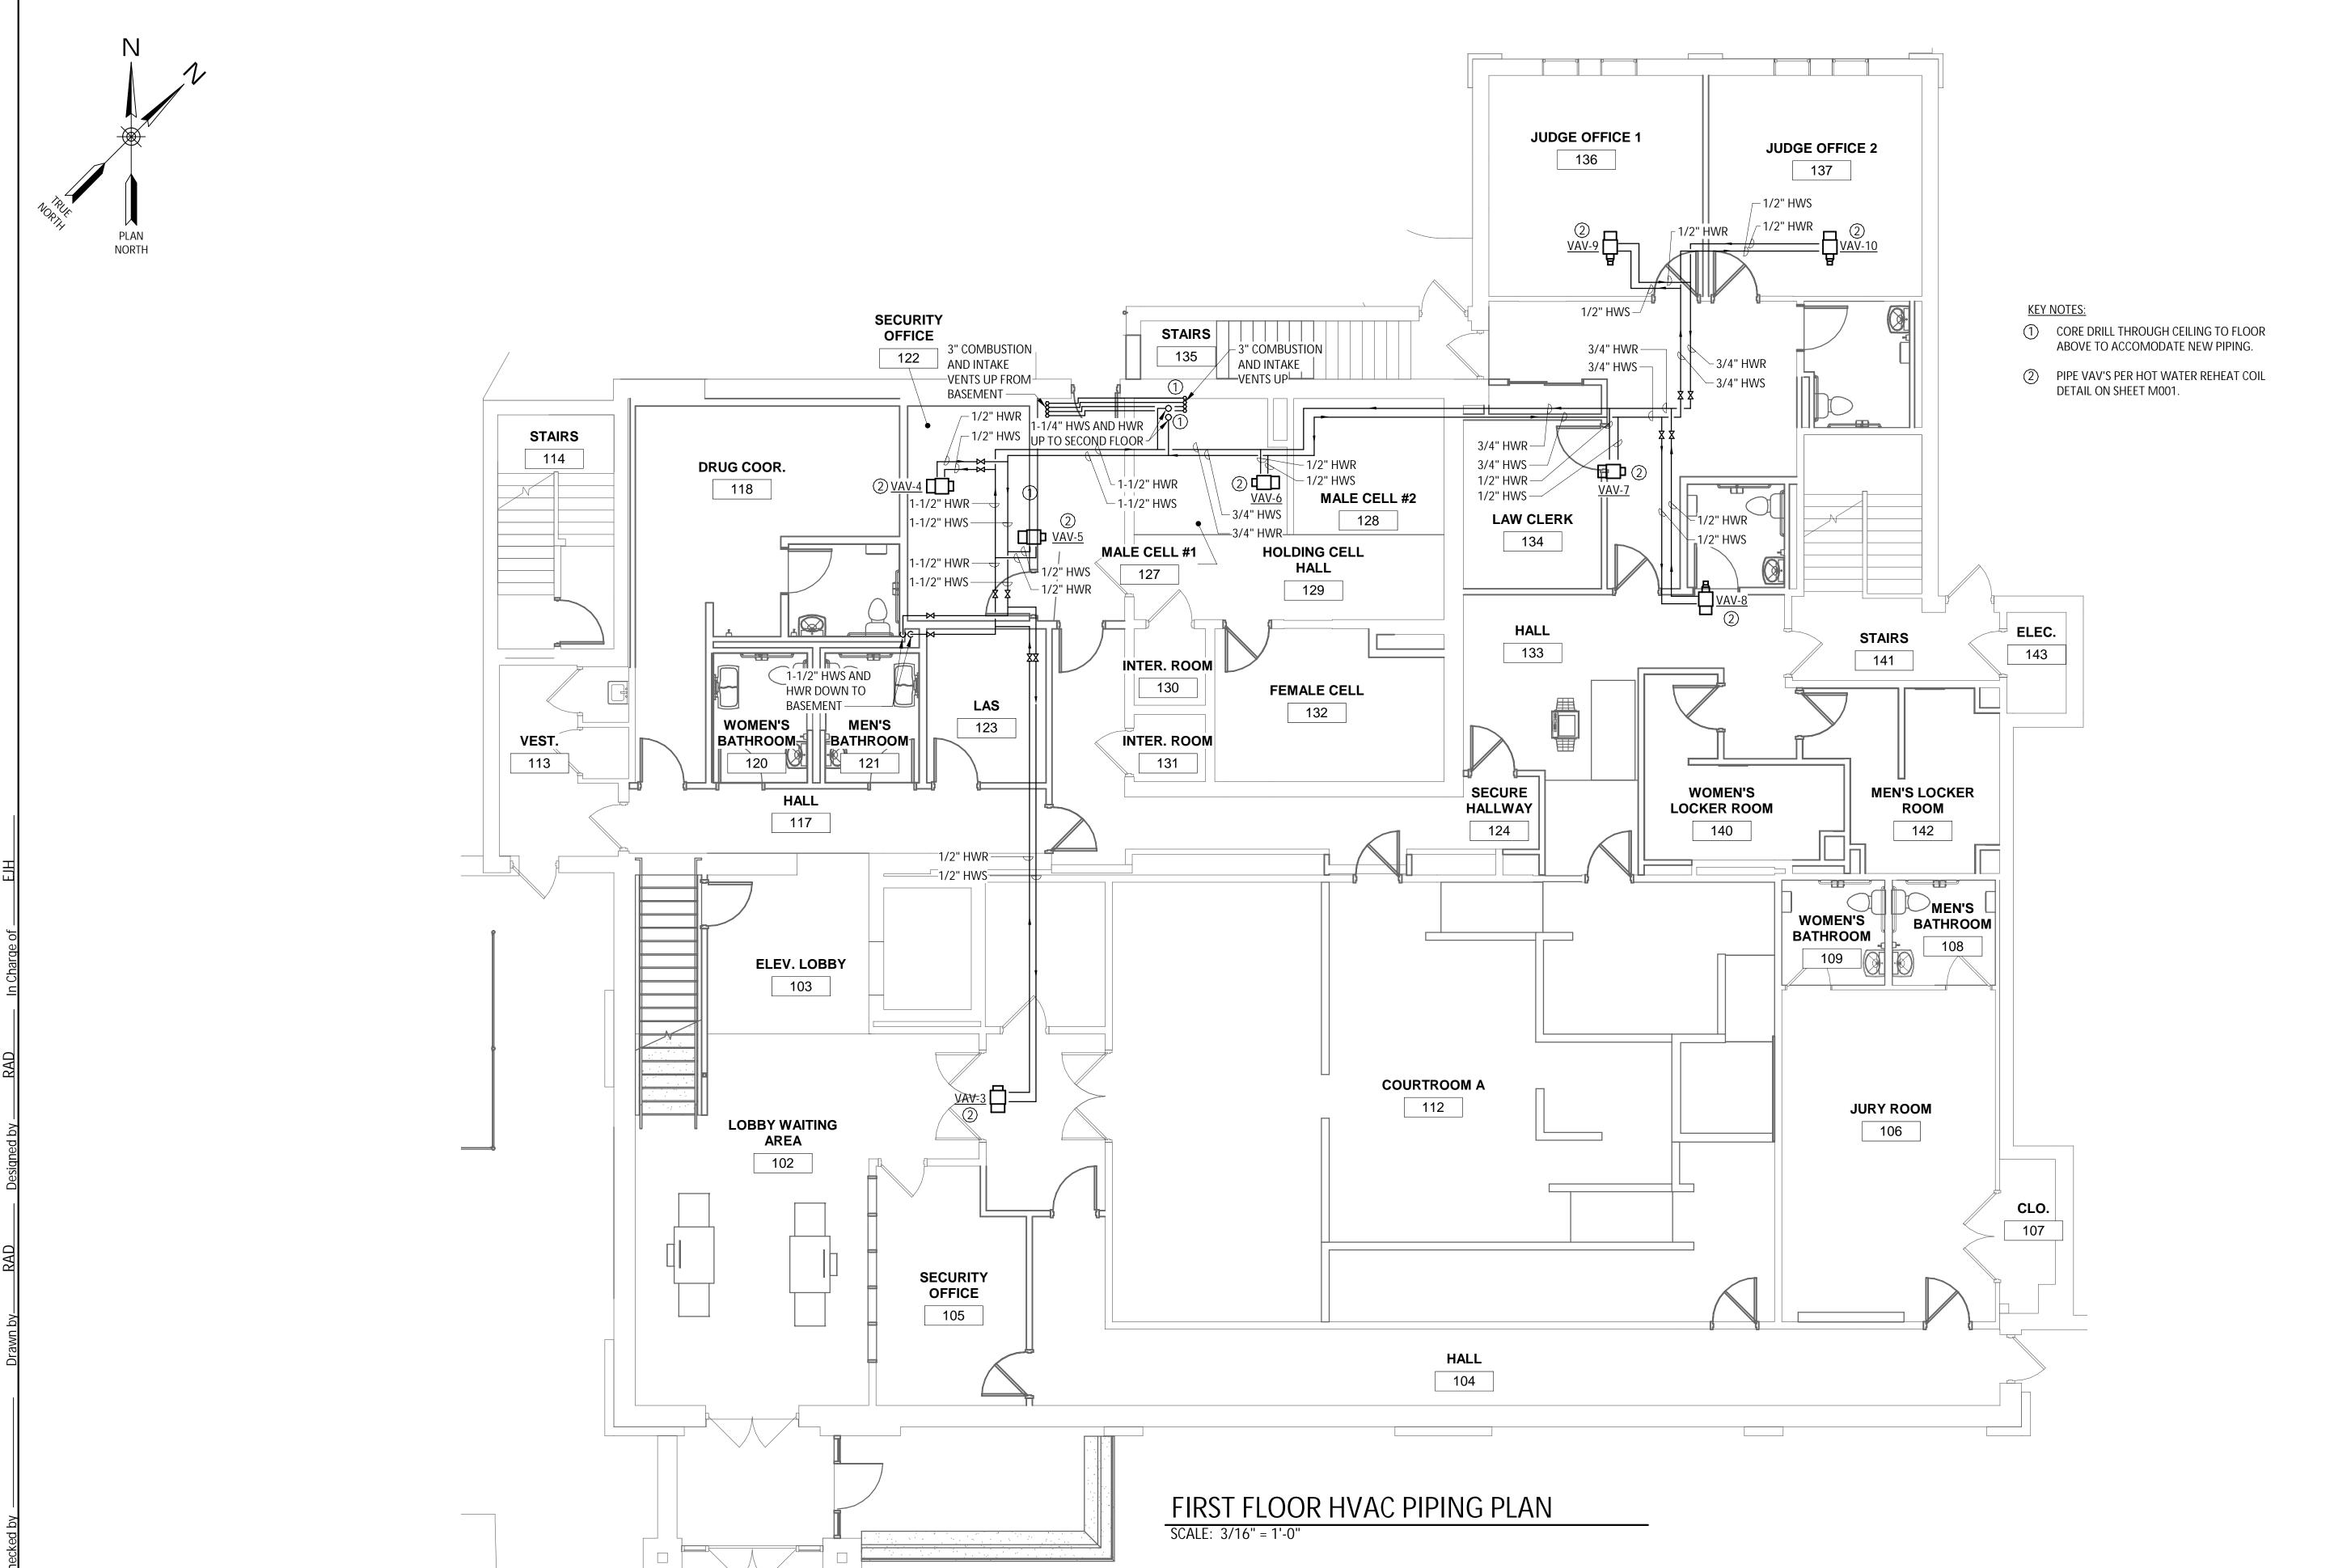
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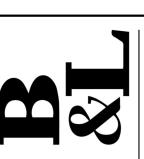
IT IS A VIOLATION OF THE NEW YORK STATE **EDUCATION LAW, ARTICLE 145 §7209** SPECIAL PROVISIONS, FOR ANY PERSON, UNLESS THEY ARE ACTING UNDER THE DIRECTION OF A LICENSED PROFESSIONAL ENGINEER, ARCHITECT, LANDSCAPE ARCHITECT, OR LAND SURVEYOR, TO ALTER AN ITEM IN ANY WAY. IF AN ITEM BEARING THE STAMP OF A LICENSED PROFESSIONAL IS ALTERED, THE ALTERING PROFESSIONAL SHALL STAMP THE DOCUMENT AND INCLUDE THE NOTATION "ALTERED BY FOLLOWED BY THEIR SIGNATURE, THE DATE OF SUCH ALTERATION, AND A SPECIFIC DESCRIPTION OF THE ALTERATION


REVISIONS

PLAN PIPING

FIRST FLOOR HVAC

CITY OF MIDDLETOWN NEW COURTHOUSE FACILITY CONTRACT 1B - MECHANICAL CONSTRUCTION



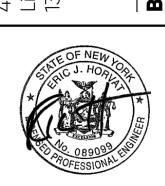


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M106



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DESCRIPTION OF THE ALTERATION REVISIONS

1/31/23 ADD. 2

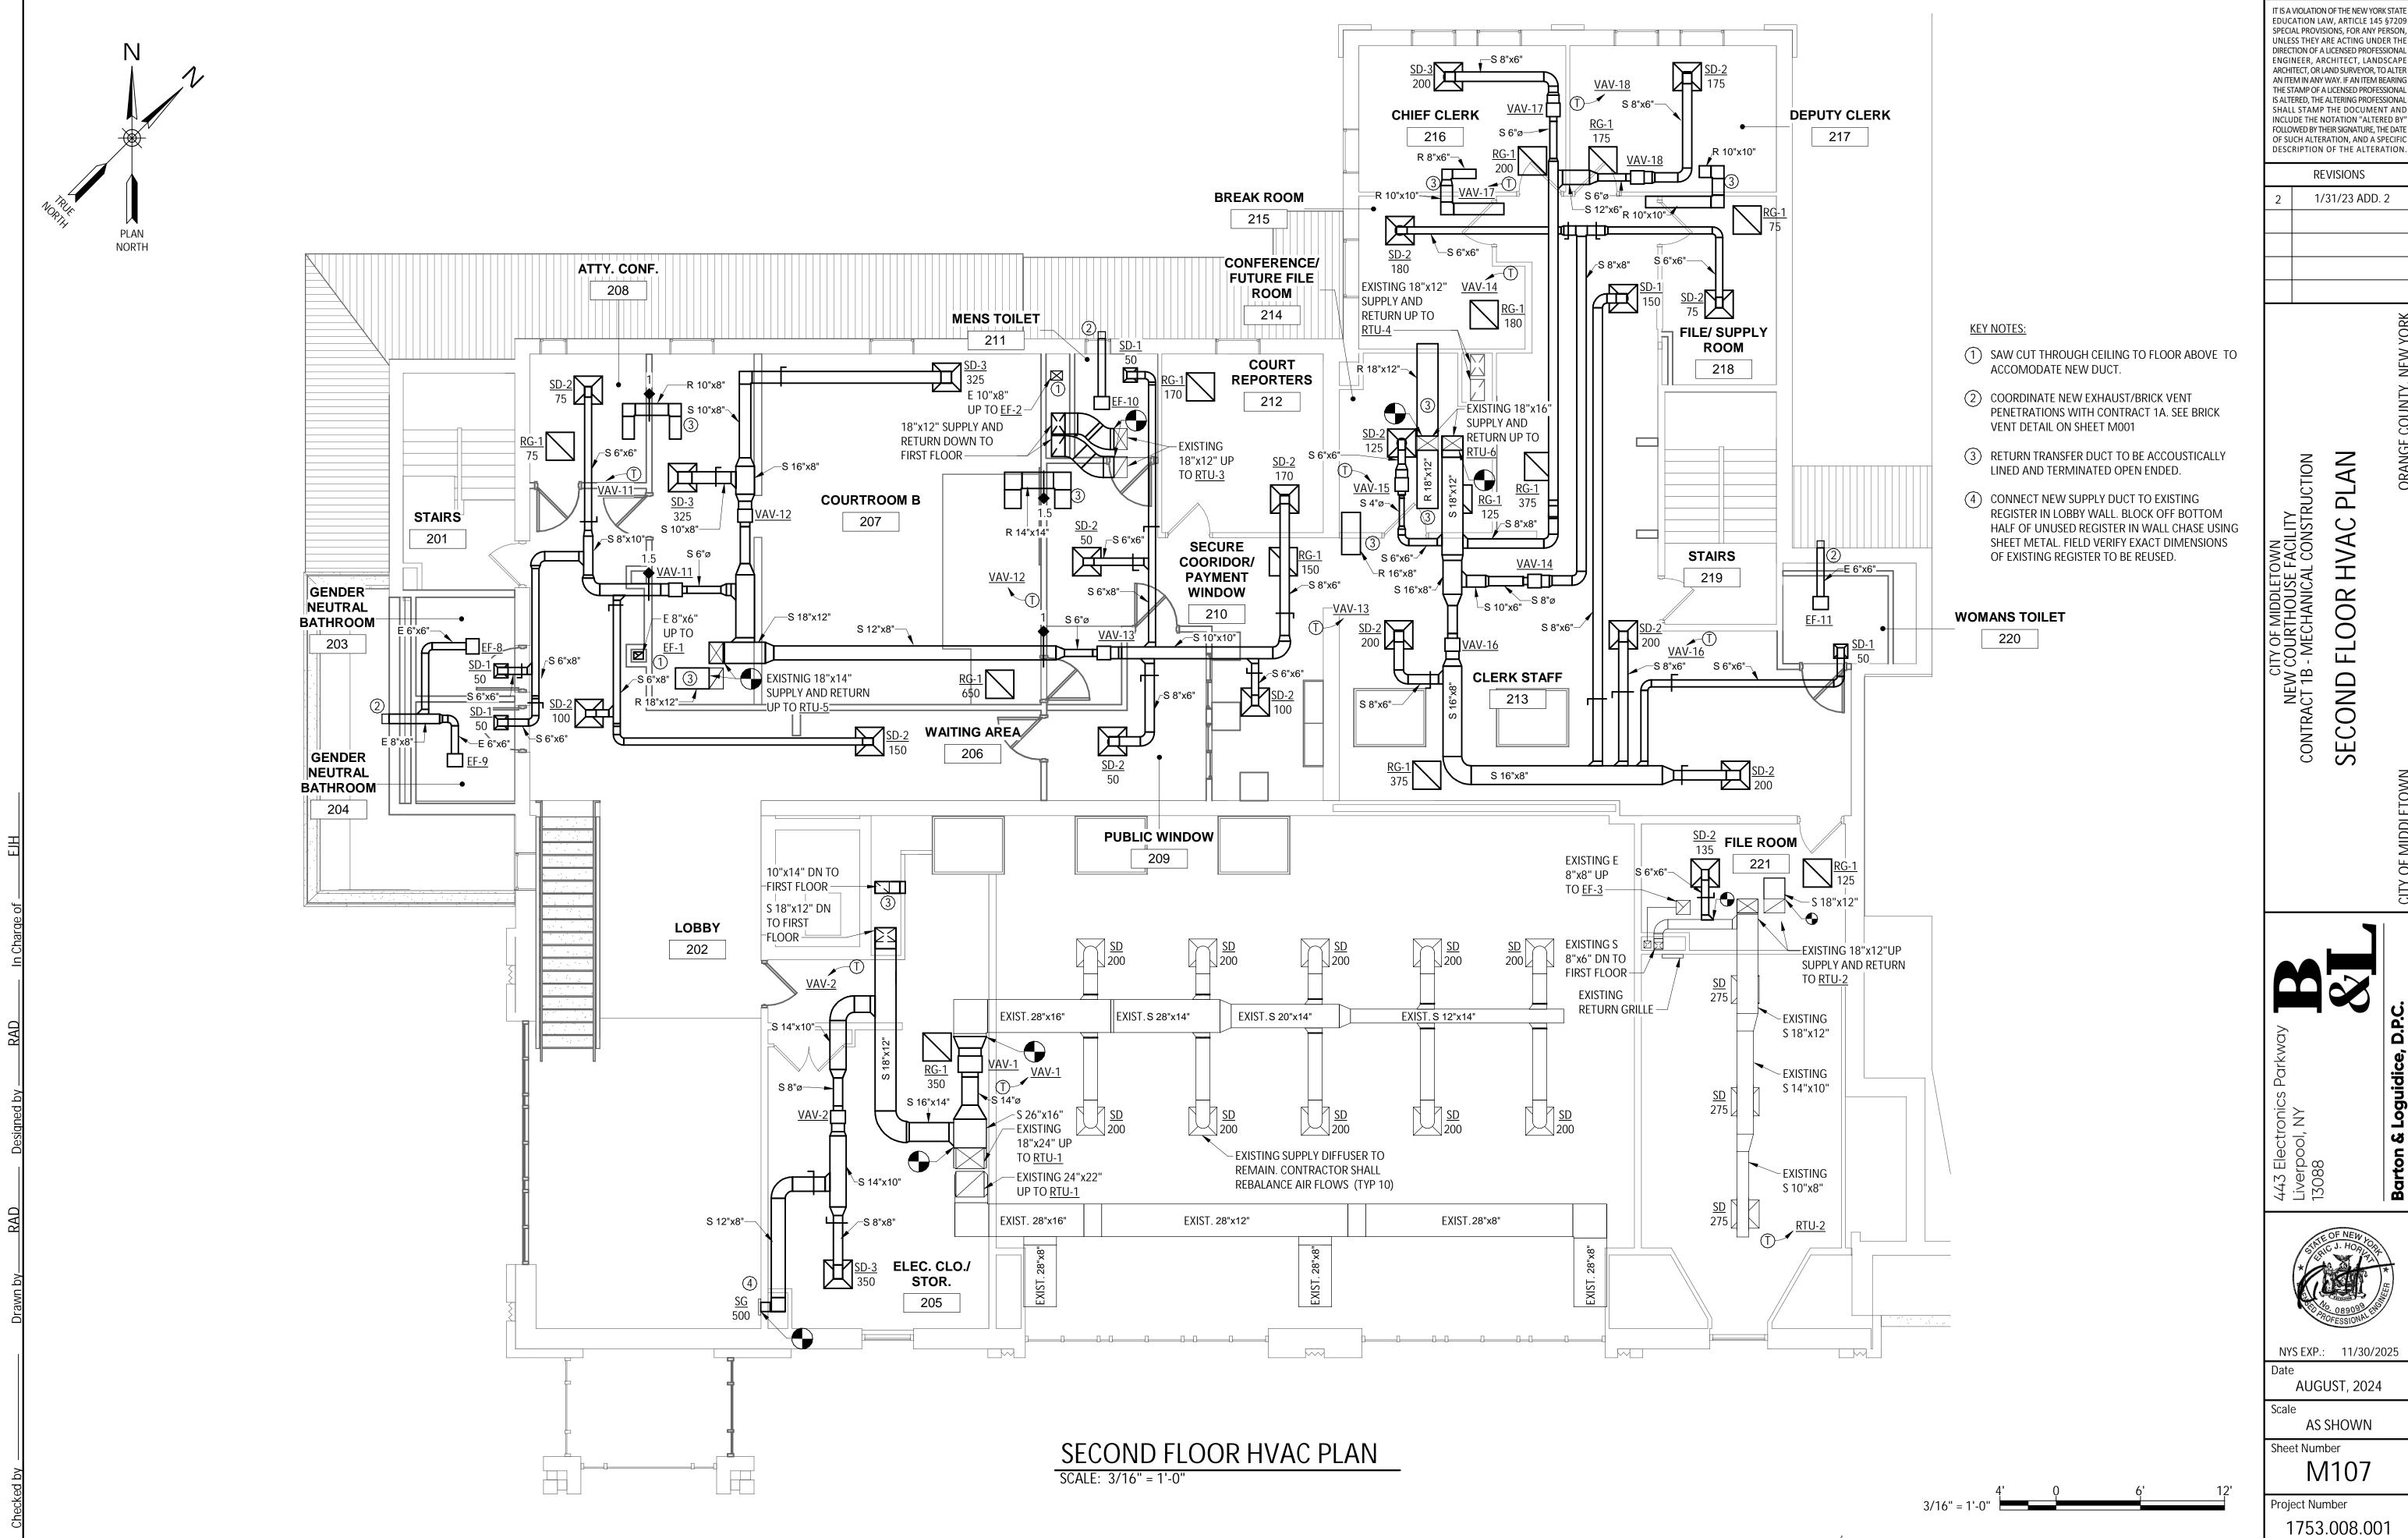PLAN

VAC 工 FLOOR SECOND


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Sheet Number M107

Project Number

1753.008.001



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REVISIONS
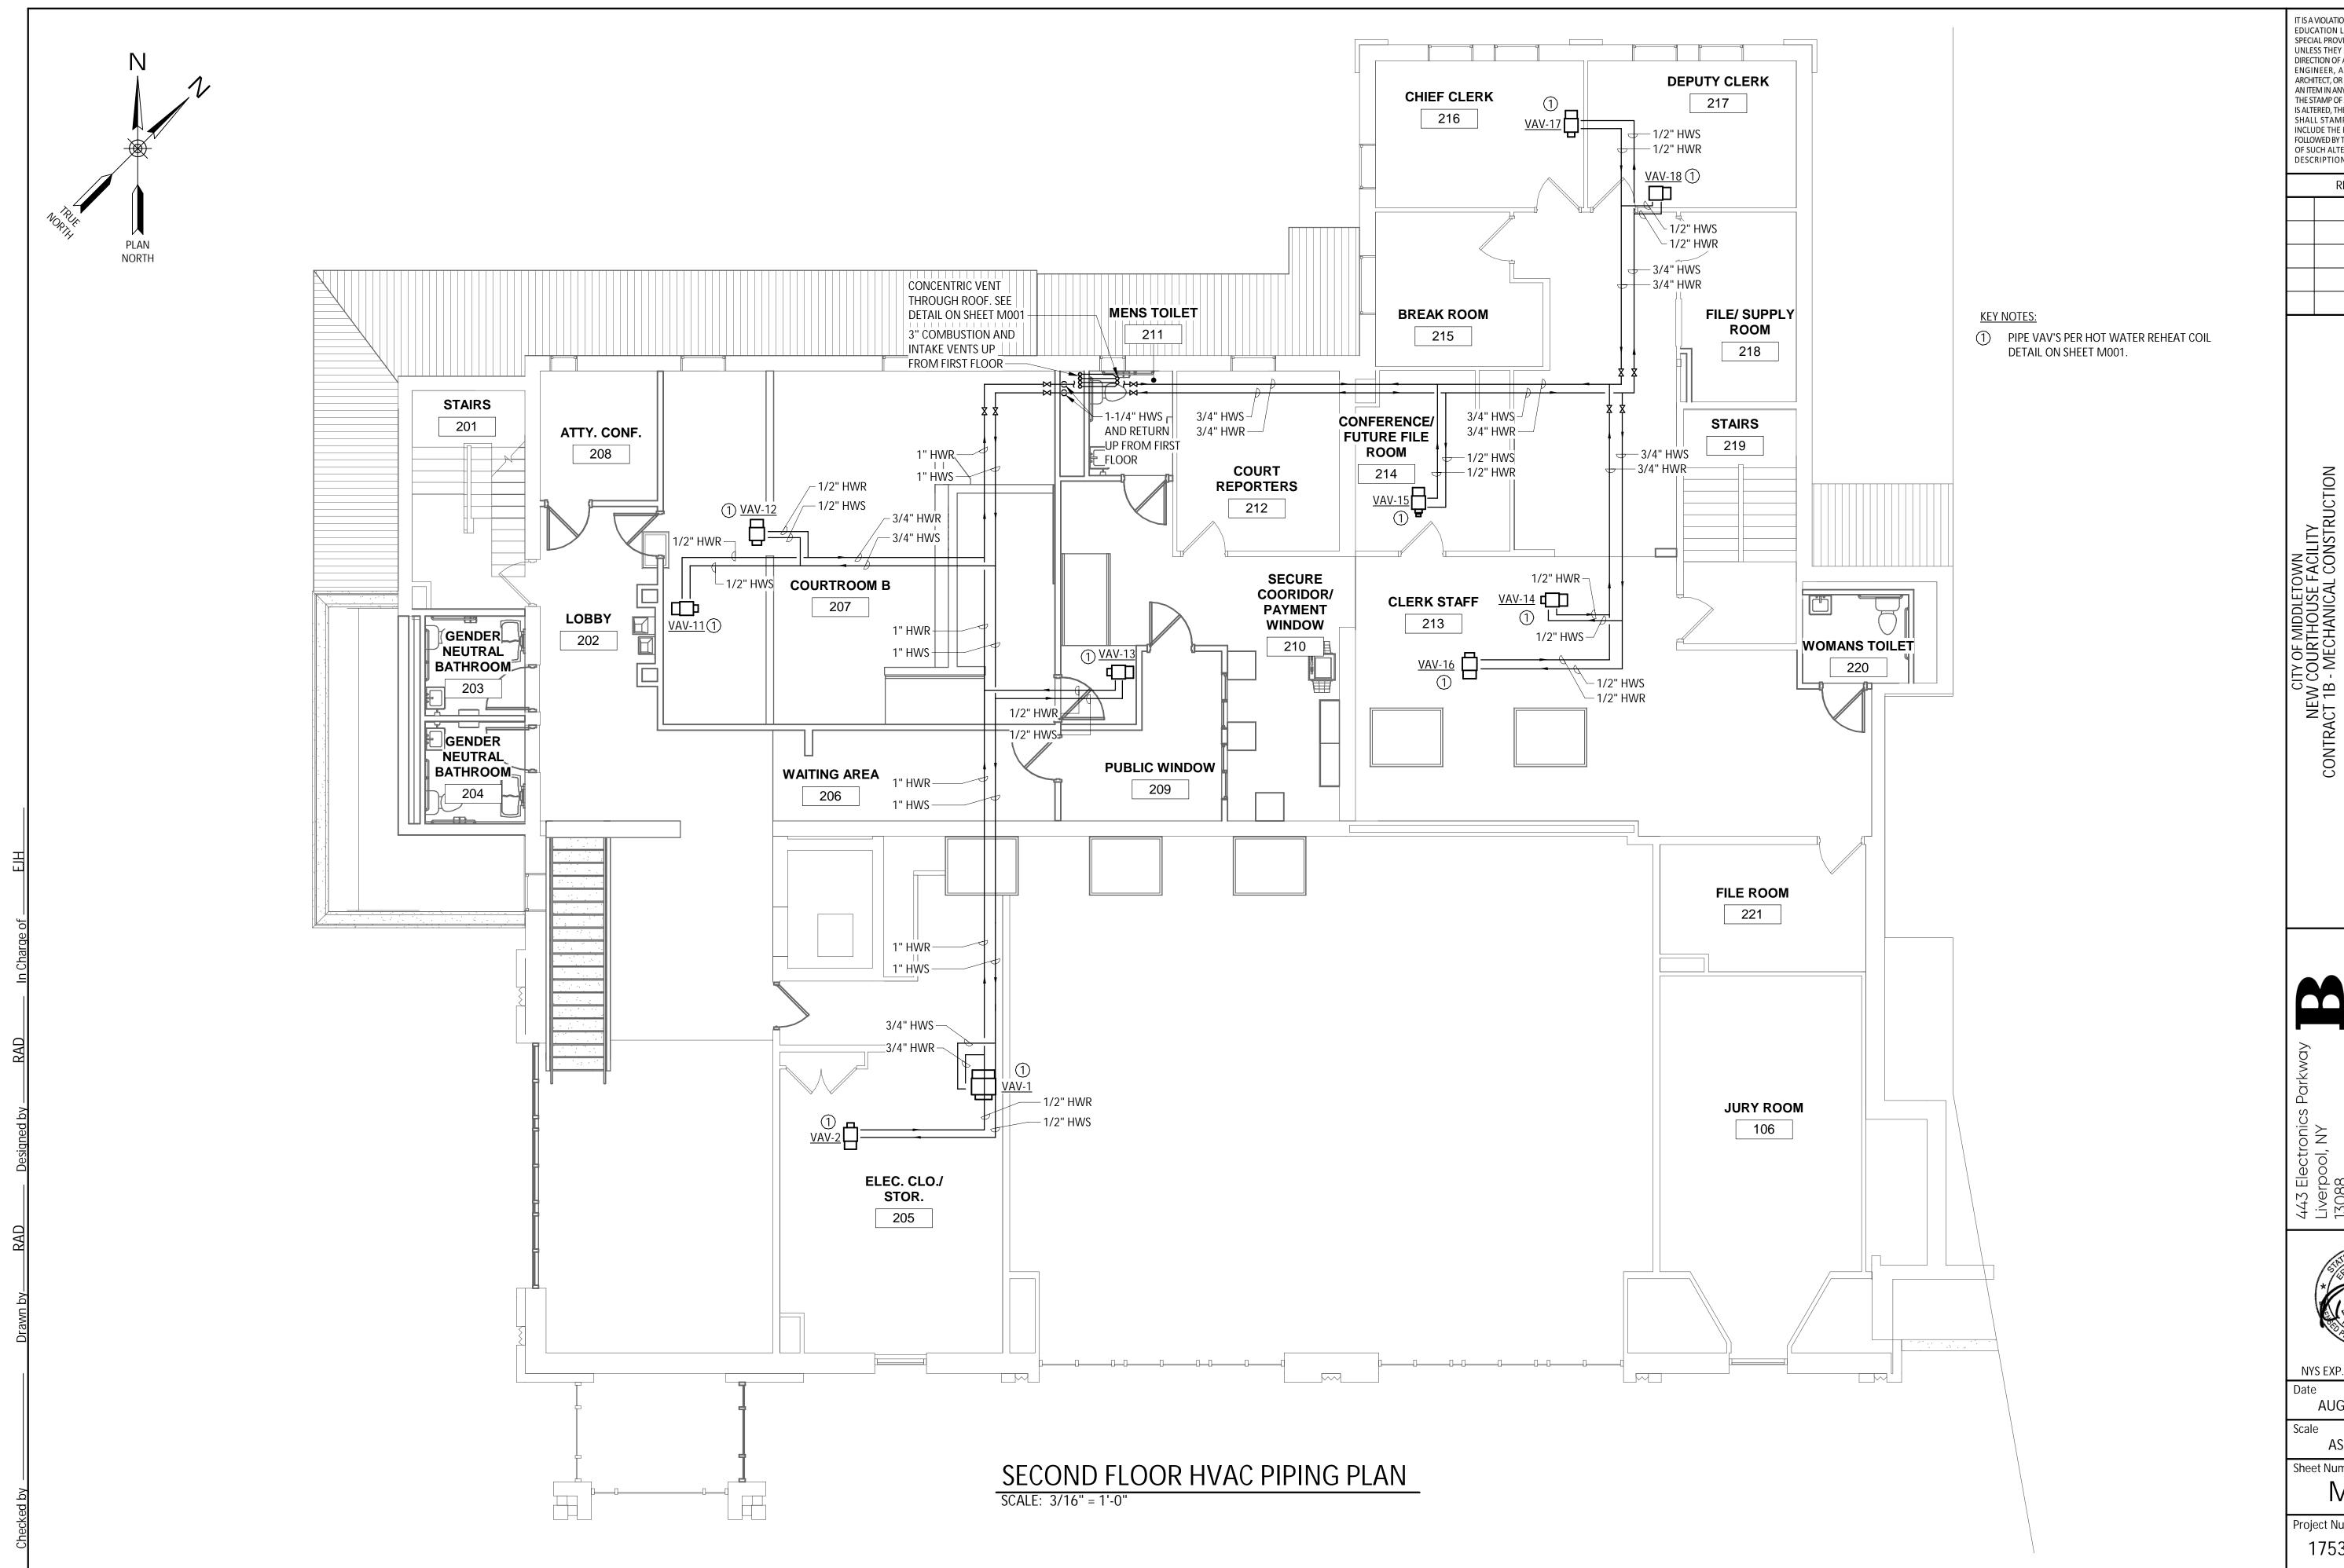
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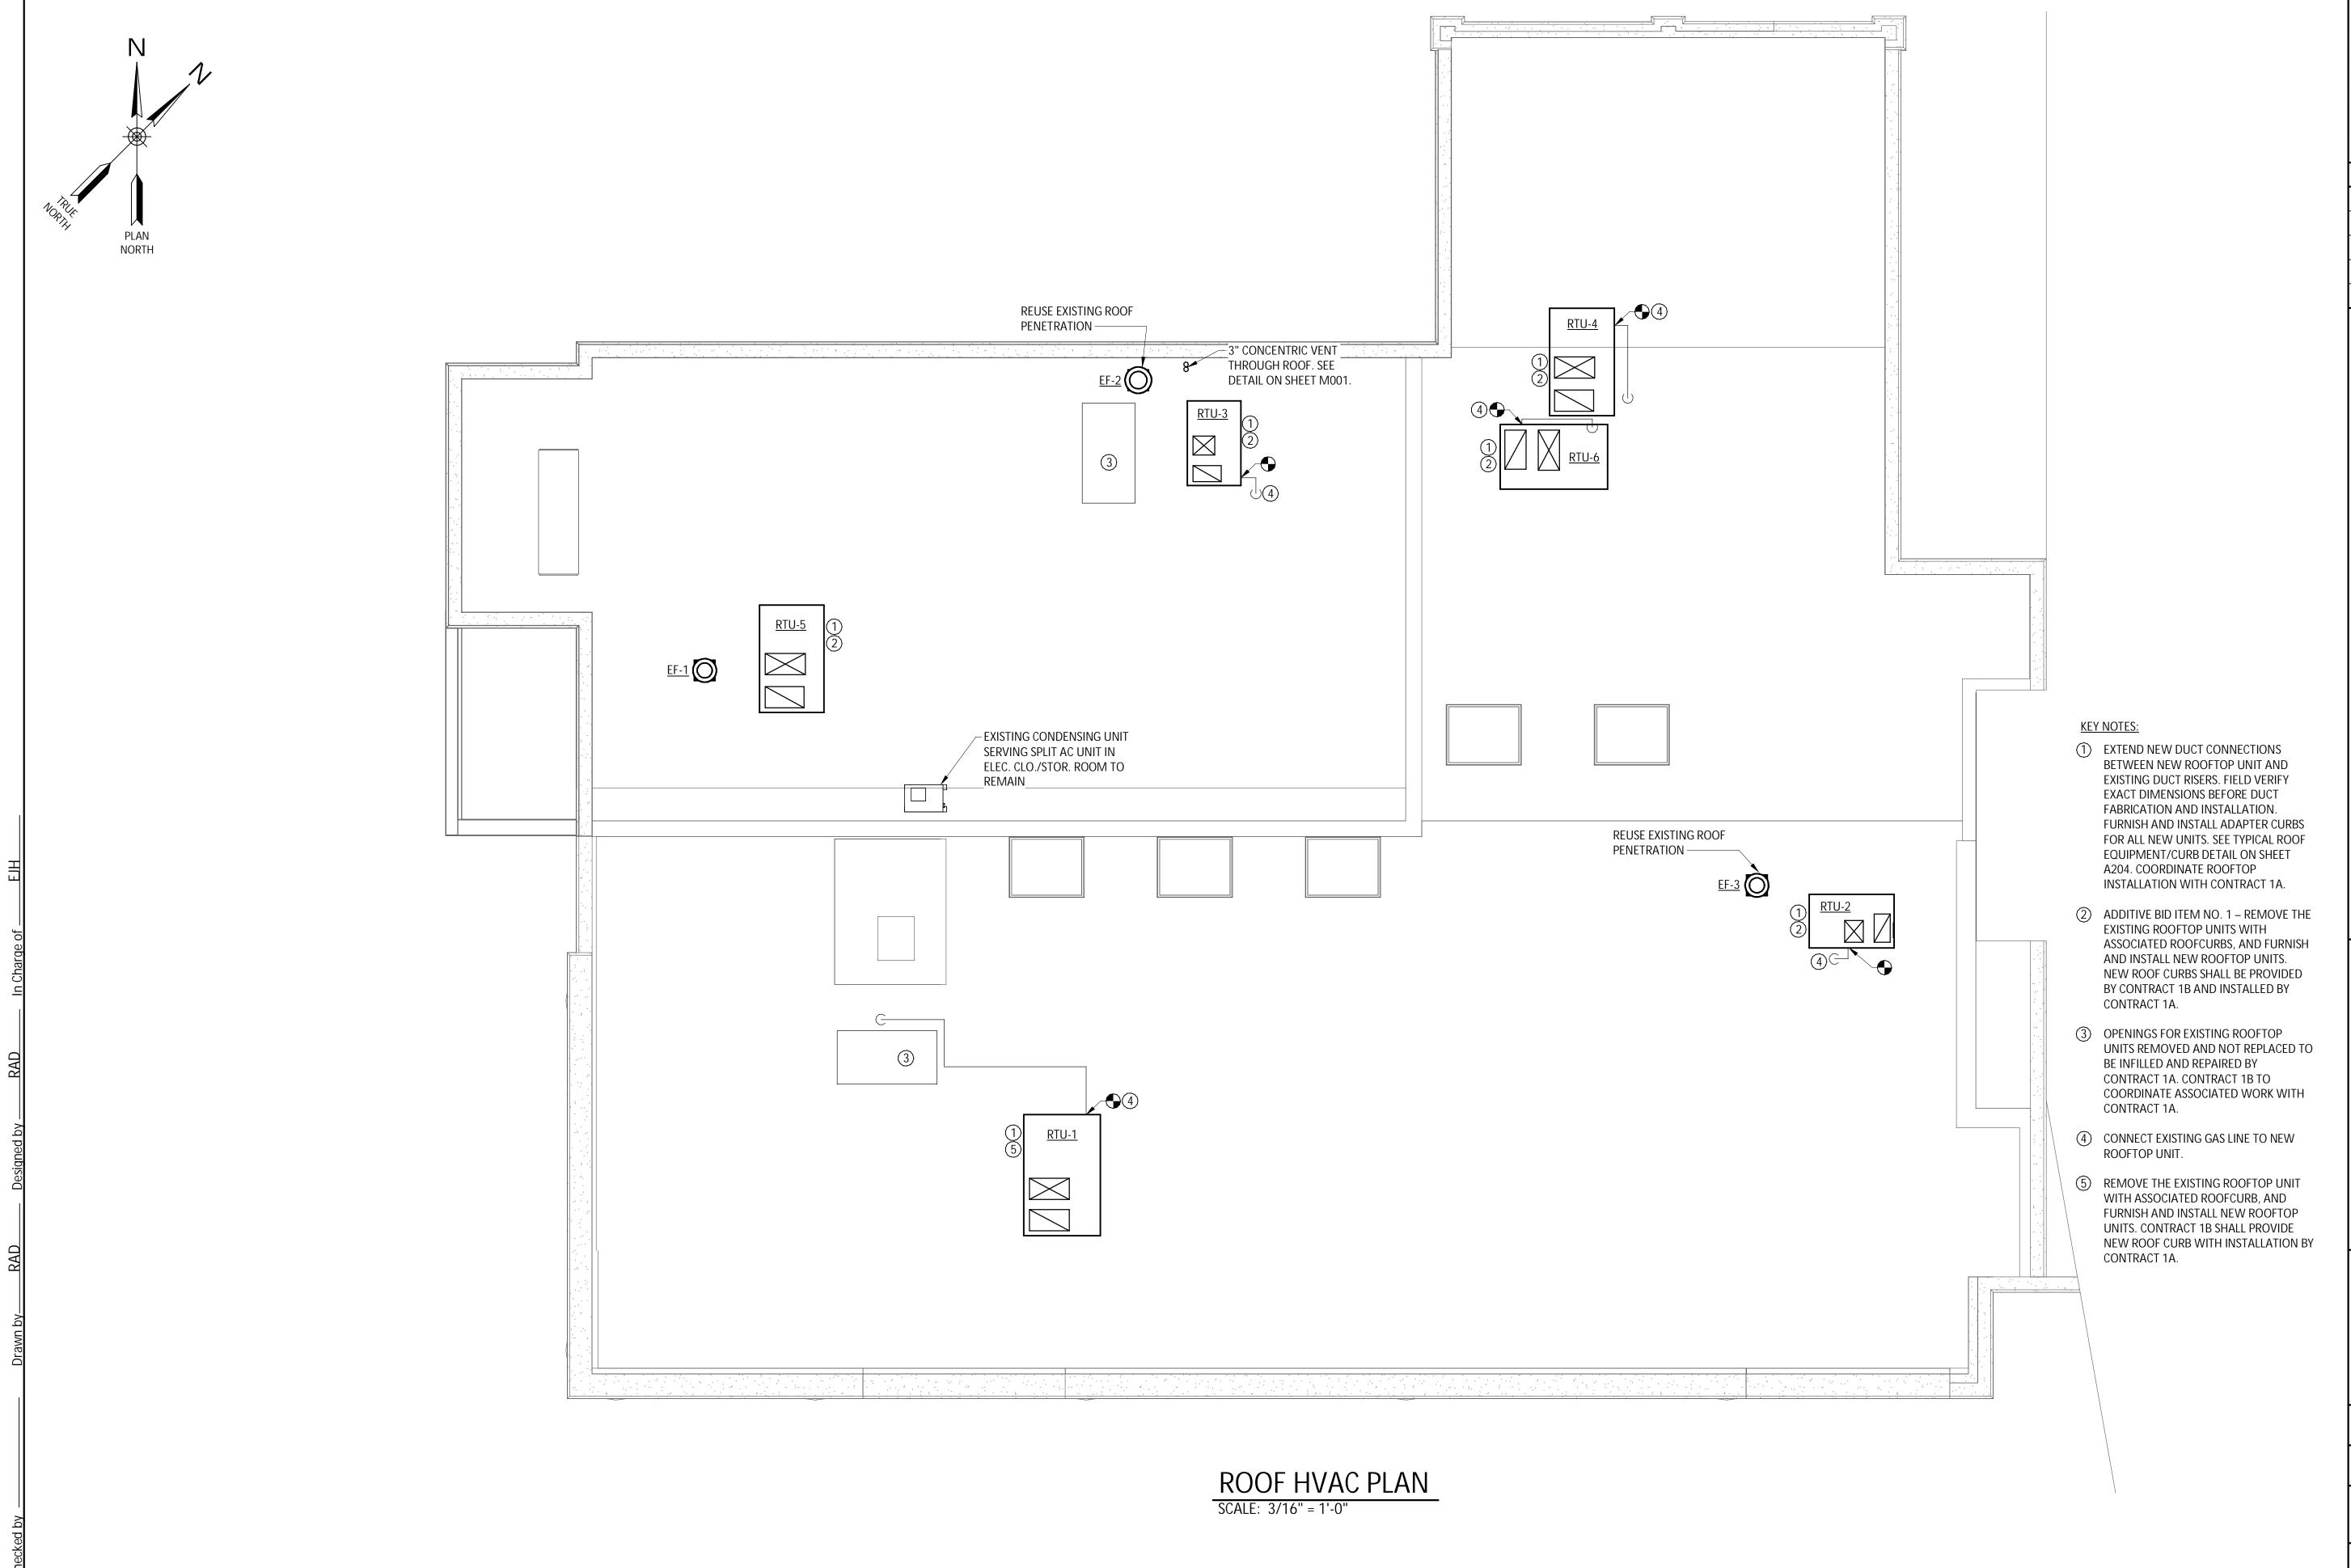
PIPING FLOOR HVAC SECOND

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AUGUST, 2024

AS SHOWN

M108



IT IS A VIOLATION OF THE NEW YORK STATE EDUCATION LAW, ARTICLE 145 §7209 SPECIAL PROVISIONS, FOR ANY PERSON, UNLESS THEY ARE ACTING UNDER THE DIRECTION OF A LICENSED PROFESSIONAL ENGINEER, ARCHITECT, LANDSCAPE ARCHITECT, OR LAND SURVEYOR, TO ALTER AN ITEM IN ANY WAY. IF AN ITEM BEARING THE STAMP OF A LICENSED PROFESSIONAL IS ALTERED, THE ALTERING PROFESSIONAL SHALL STAMP THE DOCUMENT AND INCLUDE THE NOTATION "ALTERED BY" FOLLOWED BY THEIR SIGNATURE, THE DATE OF SUCH ALTERATION, AND A SPECIFIC DESCRIPTION OF THE ALTERATION.

REVISIONS

CITY OF MIDDLETOWN NEW COURTHOUSE FACILITY CONTRACT 1B - MECHANICAL CONSTRUCTION **ROOF HVAC**



NYS EXP.: 11/30/2025

AUGUST, 2024

AS SHOWN

Sheet Number M109

NOTES:

1. PROVIDE SMOKE DETECTOR AND CO₂ SENSOR IN RETURN DUCT MAIN, WITH ASSOCIATED WIRING AND CONTROLS.

2. PROVIDE ECONOMIZER FOR 100% OUTSIDE AIR MODE WITH DIFFERENTIAL ENTHALPY CONTROL AND TRANSMITTER, AND POWER EXHAUST.

3. PROVIDE WITH R410A TYPE REFRIGERANT, CRANKCASE HEATER AND LOW AMBIENT CONTROL

4. PROVIDE MANUFACTURER SUPPLIED 24" ADAPTER CURB.

						VΛDIΛRI	E AIR VOLUM	F (\/\\\)	SCHEDIII							
					VAV		- AIR VOLOIVI	[(VAV)	JOHEDOE		HOT WA	ATER REHI	EAT COIL			
TAG	ASSOC. UNIT	AREA SERVED	ZONE	MAX CFM	MIN. CFM	NECK SIZE (IN)	MAX AIR PD (IN WC)	LOAD (MBH)	EWT (°F)	LWT (°F)	EAT (°F)	LAT (°F)	FLOW RATE (GPM)	MAX WATER PD (FT H2O)	COIL ROWS	DESIGN BASIS
VAV-1	RTU-1	112	1	2000	570	12	0.69	31.71	150	130	55	106.3	3.18	0.56	2	TRANE VCWF12
VAV-2	RTU-1	102, 202, 205	2	850	150	8	0.66	8.86	150	130	55	108.38	0.87	0.07	2	TRANE VCWF08
VAV-3	RTU-1	103, 104, 105, 110, 111	3	580	105	8	0.36	6.43	150	130	55	111.44	0.64	0.04	2	TRANE VCWF08
VAV-4	RTU-3	113, 117, 118	4	530	105	8	0.31	6.43	150	130	55	111.44	0.64	0.04	2	TRANE VCWF08
VAV-5	RTU-3	122, 123, 124, 126	5	290	75	5	0.19	5.38	150	130	55	121.14	0.54	0.20	2	TRANE VCWF05
VAV-6	RTU-3	127, 128, 129, 130, 131, 132	6	460	150	6	0.53	9.22	150	130	55	111.69	0.92	0.52	2	TRANE VCWF06
VAV-7	RTU-4	134, 135	7	200	50	4	0.10	3.98	150	134.06	55	128.39	0.50	0.18	2	TRANE VCWF04
VAV-8	RTU-4	133, 140, 142	8	400	225	6	0.43	12.2	150	130	55	104.99	1.22	0.86	2	TRANE VCWF06
VAV-9	RTU-4	136	9	200	50	4	0.10	3.98	150	134.06	55	128.39	0.50	0.18	2	TRANE VCWF04
VAV-10	RTU-4	137	10	175	50	4	0.09	3.98	150	134.06	55	128.39	0.50	0.18	2	TRANE VCWF04
VAV-11	RTU-5	203, 204, 206, 208	11	425	150	6	0.47	9.22	150	130	55	111.69	0.92	0.52	2	TRANE VCWF06
VAV-12	RTU-5	207	12	650	275	8	0.43	13.67	150	130	55	100.85	1.37	0.16	2	TRANE VCWF08
VAV-13	RTU-5	209, 210, 211, 212	13	420	75	6	0.46	5.38	150	130	55	121.14	0.54	0.20	2	TRANE VCWF08
VAV-14	RTU-6	215, 218	14	255	50	5	0.16	3.98	150	134.06	55	128.39	0.50	0.18	2	TRANE VCWF05
VAV-15	RTU-6	214	15	125	50	4	0.06	3.98	150	134.06	55	128.39	0.50	0.18	2	TRANE VCWF04
VAV-16	RTU-6	213, 220	16	800	125	8	0.60	7.47	150	130	55	110.10	0.75	0.05	2	TRANE VCWF08
VAV-17	RTU-6	216	17	200	50	4	0.10	3.98	150	134.06	55	128.39	0.50	0.18	2	TRANE VCWF04
VAV-18	RTU-6	217	18	175	50	4	0.09	3.98	150	134.06	55	128.39	0.50	0.18	2	TRANE VCWF04

1. PROVIDE INSULATED ACCESS DOOR WITHIN UNIT FOR INSPECTION AND SERVICE OF DAMPER

2.FURNISH AND INSTALL VAV UNIT, REHEAT COIL, PIPING, VALVES, ALL CONTROL EQUIPMENT (INCLUDING ACTUATOR, SENSORS & LOW VOLTAGE WIRING), AND SUPPORTS.

	DIFFUSER AND GRILLE SCHEDULE											
TYPE	DESCRIPTION	MAX SONES	BLOW PATTERN	FACE SIZE (IN)	NECK SIZE (IN)	AIR FLOW (CFM)	BASIS OF DESIGN					
SD-1	SUPPLY DIFFUSER	-	4-WAY	12 x 12	4Ø	0-70	TITUS TMS					
SD-2	SUPPLY DIFFUSER	19	4-WAY	24 x 24	6Ø	0-180	TITUS TMS					
SG-1	SUPPLY GRILLE	22	4-WAY	14 x 14	12 x 12	0-500	TITUS 300RL					
RG-1	EGGCRATE RETURN GRILLE	20	-	24 x 24	-	0-650	TITUS 50F					
EG-1	EXHAUST GRILLE	19	-	10 x 8	8 x 6	0-175	TITUS 350R					

REMARKS:

BALANCE ALL DUCT BRANCHES TO CFM VALUE SHOWN.

- REFER TO PLANS FOR QUANTITIES, AIR FLOW. ALL BRANCH DUCT CONNECTING DIFFUSER TO MAIN SHALL BE THE SAME SIZE AS THE DIFFUSER NECK. VERIFY MOUNTING FRAME. REFER TO REFLECTED CEILING PLAN FOR LOCATIONS AND CEILING TYPE. COORDINATE WITH OTHER CEILING MOUNTED EQUIPMENT.
- PROVIDE WITH OPPOSED BLADE DAMPER, ADJUSTABLE WITHOUT DISASSEMBLY.

PROVIDE FACTORY SUPPLIED PLENUM FOR LINEAR DIFFUSER.

	BOILER (B) SCHEDULE												
			MAXIMUM	OUTPUT AT		WATER			RELIEF	VOLTS/			
TAG	LOCATION	FUEL	INPUT (MBH)	MAX. CAPACITY (MBH)	FLOW RATE (GPM)	ENT./LVG. TEMP. (°F)	WATER CONTENT (GAL)	COMBUSTION EFFICIENCY	VALVE SETTING (PSI)	PHASE/ HZ	FULL LOAD AMPS	DESIGN EQUIPMENT	
B-1	BASEMENT	NG	110	101	7.5	120/150	2.5	95.1%	30	120/1	15	WEIL MCLAIN EVG-110	
B-2	BASEMENT	NG	110	101	7.5 120/150 2.5 95.1% 30 120/1 15 WEIL MCLAIN EVG-110								
NOTES	OTES:												

1. PROVIDE COMPLETE WITH LOW-WATER CUTOFF, MANUAL RESET HIGH LIMIT AQUASTAT, PRESSURE/TEMPERATURE GAUGE AND DRAIN VALVE.

2. PROVIDE COMPLETE WITH ASME COMPLIANT PRESSURE RELIEF VALVE DESIGNED FOR THE BOILER OUTPUT CAPACITY.

3. PROVIDE DISCONNECT WITH THERMAL OVERLOAD PROTECTION.

4. HVAC CONTRACT SHALL FURNISH AND INSTALL UNIT AND ALL CONTROL EQUIPMENT, INCLUDING SENSORS, LOW VOLTAGE WIRING AND CONDUIT. LINE VOLTAGE WIRING

PUMP SCHEDULE

TAG	SERVICE		MOTOR		PUMP	FLUID	FLOW	HEAD	TYPE	BASIS OF DESIGN	
TAG	SERVICE	HP	VOLTS	PHASE	RPM	FLOID	(GPM)	(FT WC)	TTPE	DASIS OF DESIGN	
BP-1	BOILER B-1	1/8	115	1	3250	WATER	7.2	10	INLINE	TACO ECM OO15e	
BP-2	BOILER B-2	1/8	115	1	3250	WATER	7.2	10	INLINE	TACO ECM OO15e	
P-1	HOT WATER LOOP	1/2	115	1	1725	WATER	18	20	INLINE (CLOSE COUPLED)	BELL & GOSSETT e-90 1.25AAB	
P-2	HOT WATER LOOP	1/2	115	1	1725	WATER	18	20	INLINE (CLOSE COUPLED)	BELL & GOSSETT e-90 1.25AAB	

VERTICAL, FLOOR MOUNTED | BELL & GOSSETT B-35

PROVIDE WITH COMBINATION MOTOR STARTER/DISCONNECT AND INTERLOCK OPERATION WITH ASSOCIATED BOILER.

FURNISH AND INSTALL UNIT AND ALL CONTROL EQUIPMENT, INCLUDING SENSORS, LOW VOLTAGE WIRING AND CONDUIT.

RATED FOR 125PSI MAXIMUM WORKING PRESSURE AND 225°F MAXIMUM OPERATING TEMPERATURE.

				EXPANSIO	N TANK (ET) SCHE	DULE		
TAG	CONN. SIZE (IN)	SYSTEM	TANK TYPE	TANK VOLUME (GAL)	TANK ACCEPTANCE (GAL)	CHARGE PRESSURE (PSIG)	ORIENTATION	BASIS OF DESIGN

NOTES:

1. TANK SHALL BE STEEL CONSTRUCTION WITH HEAVY DUTY BUTYL RUBBER DIAPHRAGM & FORGED STEEL CONNECTION FITTINGS.

2. EXPANSION TANK TO BE DESIGNED, CONSTRUCTED AND STAMPED PER ASME SECTION VIII, DIVISION 1

BLADDER

3. TANK SHALL BE RATED FOR MAXIMUM WORKING PRESSURE OF 125 PSIG AND MAXIMUM WORKING TEMPERATURE OF 240°F.

	EXHAUST FAN SCHEDULE													
TAG	AREA SERVED	LOCATION	CFM	E.S.P. (IN W.G.)	DRIVE	RPM	WATTS	MOTOR VOLTS	PHASE	DESIGN EQUIPMENT	NOTES			
EF-1	119, 120, 121	ROOF	150	.35	DIRECT	850	13	115	1	GREENHECK G-070-D	1,3,4			
EF-2	127, 128, 129	ROOF	375	.35	DIRECT	850	13	115	1	GREENHECK G-095-VG	1,3,4			
EF-3	108, 109	ROOF	100	.25	DIRECT	1,550	13	115	1	GREENHECK G-060-D	1,3,4			
EF-4	138	CEILING	50	.25	DIRECT	850	13	115	1	GREENHECK SP-A70	1,2,4			
EF-5	139	CEILING	90	.25	DIRECT	950	17	115	1	GREENHECK SP-A70	1,2,4			
EF-6	140	CEILING	50	.25	DIRECT	850	13	115	1	GREENHECK SP-A70	1,2,4			
EF-7	142	CEILING	50	.25	DIRECT	850	13	115	1	GREENHECK SP-A70	1,2,4			
EF-8	203	CEILING	110	.25	DIRECT	1,100	21	115	1	GREENHECK SP-A70	1,2,4			
EF-9	204	CEILING	170	.25	DIRECT	1,400	48	115	1	GREENHECK SP-A70	1,2,4			
EF-10	211	CEILING	50	.25	DIRECT	850	13	115	1	GREENHECK SP-A70	1,2,4			
EF-11	220	CEILING	50	.25	DIRECT	850	13	115	1	GREENHECK SP-A70	1,2,4			

1. PROVIDE COMBINATION STARTER/DISCONNECT SWITCH WITH THERMAL OVERLOAD PROTECTION.

2. PROVIDE BACKDRAFT DAMPER, ALUMINUM BIRD SCREEN, WALL COLLAR, MOTORIZED SHUTTER AND SHUTTER GAURD.

3. PROVIDE BACKDRAFT DAMPER, ALUMINUM BIRD SCREEN AND MANUFACTURERS ROOF CURB.

4. FAN SHALL RUN CONTINUOUSLY WHILE BUILDING IS OCCUPIED.

HOT WATER

	ELECTRIC UNIT HEATER (UH) SCHEDULE												
TAG LOCATION MOUNTING TYPE CAPACITY (KW) VOLTS PHASE FULL LOAD AIR FLOW (CFM) DESIGN EQUIPMENT													
UH-1	BASEMENT	CEILING	3	208	1	14.4	380	MODINE HER 30					
UH-2	BASEMENT	CEILING	5	208	1	24.5	380	MODINE HER 50					
UH-2	BASEMENT	CEILING	5	208	1	24.5	380	MODINE HER 50					

1. FURNISH WITH FUSED DISCONNECT SWITCH.

2. PROVIDE MOUNTING BRACKETS AND SUPPORTS AS NECESSARY, FINISH TO MATCH UNIT HOUSING.

3. PROVIDE UNIT MOUNTED THERMOSTAT.

CABINET UNIT HEATER (CUH) SCHEDULE											
TAG	AIR FLOW	IR FLOW CAP.		TEMP.	NO. OF	ELEC.		BASIS OF DESIGN			
TAG	(CFM)	(BTUH)	kW	RISE (°F)	FANS	VOLTS	PHASE	DASIS OF DESIGN			
CUH-1	100	6,820	4.8	50	1	208	1	QMARK LFK488F			
CUH-2	100	5,115	4.8	50	1	208	1	QMARK LFK488F			
CUH-2	100	5,115	4.8	50	1	208	1	QMARK LFK488F			

1. PROVIDE UNIT MOUNTED TAMPERPROOF THERMOSTAT AND DISCONNECT SWITCH.

2. PROVIDE WITH UNIT MOUNTED DAY/NIGHT RELAY AND SURFACE MOUNTING ADAPTER.


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DESCRIPTION OF THE ALTERATION

REVISIONS

SCHEDUL NEW C CONTRACT 1B -



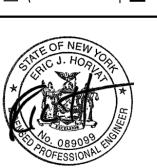

NYS EXP.: 11/30/2025

AUGUST, 2024

AS SHOWN

Sheet Number M501

Project Number

1753.008.001

(120V AND ABOVE) BY ELECTRICAL CONTRACT.

- 1. NOTES, SYMBOLS LIST AND DETAILS ARE APPLICABLE TO ALL DRAWINGS IN THIS CONTRACT.
- 2. ADDRESS QUESTIONS REGARDING DRAWINGS TO ENGINEER IN WRITING BEFORE COMMENCING WITH WORK. OTHERWISE, ENGINEER'S INTERPRETATION OF MEANING AND INTENT OF DRAWINGS SHALL BE FINAL.
- 3. DRAWINGS ARE DIAGRAMMATIC AND INDICATE GENERAL ARRANGEMENT OF SYSTEMS AND WORK INCLUDED IN THIS CONTRACT. IT IS INTENDED THAT ALL COMPONENTS AND MATERIALS REQUIRED TO MAKE THE SYSTEMS COMPLETE, TESTED AND OPERATIONAL BE INSTALLED.
- 4. CONTRACTOR SHALL FIELD VERIFY ALL LOCATIONS, DIMENSIONS AND ELEVATIONS BEFORE FABRICATION AND CONSTRUCTION.
- 5. ALL MATERIALS, EQUIPMENT AND METHODS OF INSTALLATION SHALL BE IN ACCORDANCE WITH THE STANDARDS, REGULATIONS, CODES, ORDINANCES, AND LAWS OF LOCAL, STATE, AND FEDERAL GOVERNMENTS, AND OTHER AUTHORITIES THAT HAVE LAWFUL JURISDICTION.
- 6. COMPLETELY COORDINATE WORK OF THIS CONTRACT WITH THE OPERATIONS AND THE WORK OF OTHER CONTRACTS.
- 7. WORK SHALL BE EXECUTED IN A WORKMANLIKE MANNER AND SHALL PRESENT NEAT, RECTILINEAR APPEARANCE WHEN COMPLETED. MAINTAIN MAXIMUM HEAD ROOM AT ALL TIMES.
- 8. MATERIALS AND EQUIPMENT SHALL BE NEW AND INSTALLED ACCORDING TO MANUFACTURER'S INSTRUCTIONS AND RECOMMENDATIONS. MAINTAIN MANUFACTURER'S EQUIPMENT CLEARANCES.
- 9. FIRE STOP ALL NEW AND EXISTING SLEEVES THROUGH CONCRETE FLOORS AND FIRE RATED WALLS OR PARTITIONS WITH UL RATED ASSEMBLIES WITH EQUAL FIRE RATING.
- 10. PROVIDE PROPER ACCESS TO EQUIPMENT THAT REQUIRES INSPECTION, REPLACEMENT OR REPAIR. ACCESS PANELS SHALL BE SIZED TO ALLOW THE REQUIRED ACCESS, BUT IN NO CASE LESS THAN 12"x12".
- 11. CONTRACTOR IS RESPONSIBLE FOR ALL OWNER COORDINATION AND PROCEDURES RELATED TO ISOLATING, SHUTTING DOWN, DRAINING, FILLING AND RESTARTING SYSTEMS, ALL SYSTEM INTERRUPTIONS SHALL BE SCHEDULED WITH OWNER AND COORDINATED WITH OTHER CONTRACTS

<u>LEGEND</u>		,	<u> </u>	ABBREVIATION ADA	<u>ONS</u> AMERICAN DISABILITIES ACT
 S	SLOPE DN IN DIRECTION OF ARROW	-cw-	DOMESTIC COLD WATER	AFF AHU	ABOVE FINISHED FLOOR AIR HANDLING UNIT
/	BREAK	-HW-	DOMESTIC HOT WATER	BTU	BRITISH THERMAL UNIT
	TEE RISE	-HWR-	DOMESTIC HOT WATER RECIRCULATED	CI	CAST IRON
	TEE DROP	-D-	DRAIN	CO CONC	CLEANOUT CONCRETE
O	PIPE RISE	—LPG—	PROPANE	CW	COLD WATER
Ç	PIPE DROP	—SAN—	SANITARY	D DCW	DRAIN DOMESTIC COLD WATER
	PIPE ABOVE SLAB OR GRADE	—-V——	SANITARY VENT	DHW DIA DN	DOMESTIC HOT WATER DIAMETER DOWN DECK DIATE CLEANOUT
	PIPE BELOW SLAB OR GRADE			DPCO DWV	DECK PLATE CLEANOUT DRAIN, WASTE AND VENT
	DIRECTION OF FLOW			EC ESP	ELECTRICAL CONTRACTOR EXTERNAL STATIC PRESSURE
Г	CAP			ET EX	EXPANSION TANK EXISTING
=	UNION			FD	FLOOR DRAIN
\triangleleft	CONCENTRIC REDUCER			FLR FT WC	FLOOR FEET OF WATER COLUMN
7	PRESSURE GAUGE			GA	GAUGE
Щ,	THERMOMETER			GAL GALV	GALLON GALVANIZED
X	STRAINER W/ BLOWDOWN VALVE			GC GPF	GENERAL CONTRACTOR GALLONS PER FLUSH
	SWING CHECK VALVE			GPH GPM	GALLONS PER HOUR GALLONS PER MINUTE
	BALL VALVE			HW HWR	HOT WATER HOT WATER RECIRCULATED
	GATE VALVE			IN WC	INCHES OF WATER COLUMN
Ā	TRIPLE DUTY VALVE			INV	INVERT
\otimes	BALANCE VALVE			LAV	LAVATORY
	BALL VALVE W/ HOSE CONNECTION, CAP AND CHAIN			MAX MBH MC	MAXIMUM 1,000 BTU/HR MECHANICAL CONTRACTOR
	PRESSURE REDUCING VALVE			MIN	MINIMUM
*	SAFETY RELIEF VALVE			SAN SCH	SANITARY SCHEDULE
T	TEMPERATURE SENSOR			SS	STAINLESS STEEL
	PUMP			T&B TYP	TOP & BOTTOM TYPICAL
	LPG REGULATOR			V VTR	VENT VENT THRU ROOF
141	PLUG VALVE			WC	WATER CLOSET
	FLOOR DRAIN			WH WPCO	WALL HYDRANT WALL PLATE CLEANOUT
ı,	NON-FREEZE WALL HYDRANT			•	
<u> </u>	CLEANOUT				
	DECK PLATE CLEANOUT				

//// PIPING/EQUIPMENT TO BE REMOVED

CONNECTION POINT TO EXISTING

LIMIT OF REMOVAL

PLUMBING FIXTURE CONNECTION SCHEDULE									
FIXTURE NO.	FIXTURE TYPE	HW	CW	SAN	VENT				
P-1	WATER CLOSET (FLOOR, ADA)	-	1/2"	3"	1-1/2"				
P-2	LAVATORY (WALL, ADA)	1/2"	1/2"	1-1/4"	1-1/4"				
P-3	COUNTERTOP SINK (MOLDED SINK TOP PROVIDED BY CONTRACT 1A)	1/2"	1/2"	1-1/4"	1-1/4"				
P-4	DRINKING FOUNTAIN	-	1/2"	1-1/2"	1-1/4"				
P-5	SECURITY COMBINATION WC/LAV.	1/2"	1"	3"	1-1/2"				

- 1. ADA HANDICAP ACCESSABLE (ADA) FIXTURE
- 2. FLOOR FLOOR MOUNT
- 3. WALL WALL MOUNT (PROVIDE CARRIER BY JOSAM, OR EQUAL)

	HOT WATER HEATER (HWH) SCHEDULE										
TAG	AREA SERVED	STORAGE (GAL)	FUEL	TEMP RISE (°F)	RECOVERY (GPH)	SUPPLY TEMP (°F)	ELECTRIC (VOLT/PH/HZ)	BASIS OF DESIGN			
WH-1	DHW SYSTEM	50	ELECTRIC	90	56	140	208/3/60	AO SMITH DVE-52-12.3			

- 1. PROVIDE COMPLETE WITH ASME SAFTEY RELIEF VALVE AND DRAIN VALVE.
- 2. INSTALL HOT WATER HEATER IN ACCORDANCE WITH THE MANUFACTURERS INSTRUCTIONS AND RECOMMENDATIONS.
- 3. FURNISH AND INSTALL UNIT AND ALL CONTROL EQUIPMENT, INCLUDING SENSORS, CONTROL WIRING AND CONDUIT.


PUMP SCHEDULE										
TAG	EQUIPMENT		MOTOR PUMP		FLOW	HEAD	TYPE	BASIS OF DESIGN		
TAG	SERVED	WATTS	VOLTS	PHASE	RPM	(GPM)	(FT WC)	ITPE	DASIS OF DESIGN	
DWCP-1	HWH-1	4-60	115	1	2253	2	12	INLINE	BELL AND GOSSET ECOCIRC 19-16	

NOTES:

- 1. FURNISH AND INSTALL DISCONNECT SWITCH WITH THERMAL OVERLOAD PROTECTION, TIMER AND AQUASTAT. UNIT SHALL BE
- FURNISHED WITH A PLUG-IN TYPE CORD AND BUILT-IN IMPEDIANCE PROTECTION.
- 2. UNIT SHALL BE BRONZE CONSTRUCTION SUTIABLE FOR POTABLE WATER.
- 3. FURNISH AND INSTALL UNIT AND ALL CONTROL EQUIPMENT, INCLUDING SENSORS, LOW VOLTAGE WIRING AND CONDUIT. LINE
- VOLTAGE POWER WIRING (120V AND ABOVE) SHALL BE BY THE ELECTRICAL CONTRACTOR.

EXPANSION TANK (ET) SCHEDULE										
TAG	CONN. SIZE (IN)	SYSTEM	TANK TYPE	TANK VOLUME (GAL)	TANK ACCEPTANCE (GAL)	ORIENTATION	BASIS OF DESIGN			
ET-1	3/4	HW	BLADDER	5.0	3.3	VERTICAL, FLOOR MOUNTED	BELL &GOSSET PTA-12			

- 1. TANK SHALL BE STEEL CONSTRUCTION WITH HEAVY DUTY BUTYL RUBBER DIAPHRAGM & FORGED STEEL CONNECTION FITTINGS.
- 2. EXPANSION TANK TO BE DESIGNED, CONSTRUCTED AND STAMPED PER ASME SECTION VII, DIVISION 1.
- 3. TANK SHALL BE RATED FOR MAXIMUM WORKING PRESSURE OF 125 PSIG AND MAXIMUM WORKING TEMPERATURE OF 240°F.

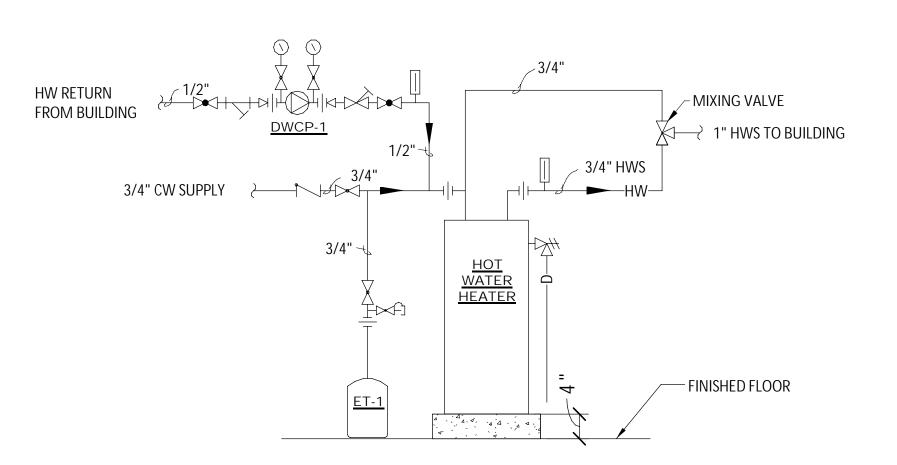


6 HOT WATER SYSTEM AND PIPING DIAGRAM SCALE: NTS

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DESCRIPTION OF THE ALTERATION REVISIONS

ABBREVIATION

 \forall NEW (CONTRACT NO. YMBOI

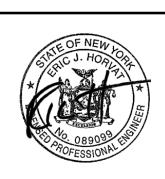

NYS EXP.: 11/30/2025

AUGUST, 2024

AS SHOWN Sheet Number

Project Number 1753.008.001

P001

BASEMENT PLUMBING PIPING DEMO PLAN

SCALE: 3/16" = 1'-0"

GENERAL NOTES:

1. FIELD VERIFY LOCATIONS AND SIZES OF EX. WATER LINES.

BASEMENT PLUMBING PIPING PLAN

— 1/2" HWR DN TO HWR PUMP <u>DWCP-1</u>

1" CW, 1/2" HW &

HWR UP TO 1ST FLOOR

1/2" CW MAKEUP TO BOILER

SYSTEM (SEE SHEET M104 FOR CONTINUATION)

EX. 1-1/2" WATER SERVICE

1-1/4" CW, 3/4" HW & 1/2" HWR UP TO 1ST FLOOR

-2" CW &

- 2" CW, 1/2" HW & 1/2" HWR UP TO 1ST FLOOR

SCALE: 3/16" = 1'-0"


KEY NOTES:

(1) CORE DRILL FLOOR SLAB ABOVE AS REQUIRED TO ACCOMODATE NEW PIPE RISERS AND FIRE CAULK PENETRATIONS.

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REVISIONS

BASEMENT PLUMBING PLAN CITY OF MIDDLETOWN NEW COURTHOUSE FACILITY CONTRACT NO. 1C - PLUMBING CONSTRUCTION

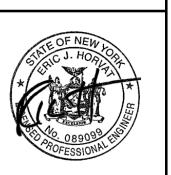

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AUGUST, 2024

AS SHOWN Sheet Number

EDUCATION LAW, ARTICLE 145 §7209 SPECIAL PROVISIONS, FOR ANY PERSON, UNLESS THEY ARE ACTING UNDER THE DIRECTION OF A LICENSED PROFESSIONAL ENGINEER, ARCHITECT, LANDSCAPE ARCHITECT, OR LAND SURVEYOR, TO ALTER AN ITEM IN ANY WAY. IF AN ITEM BEARING THE STAMP OF A LICENSED PROFESSIONAL IS ALTERED, THE ALTERING PROFESSIONAL SHALL STAMP THE DOCUMENT AND INCLUDE THE NOTATION "ALTERED BY FOLLOWED BY THEIR SIGNATURE, THE DATE OF SUCH ALTERATION, AND A SPECIFIC DESCRIPTION OF THE ALTERATION

IT IS A VIOLATION OF THE NEW YORK STATE

REVISIONS

PLAN

DEMOLITION

CITY OF MIDDLETOWN NEW COURTHOUSE FACILITY CONTRACT NO. 1C - PLUMBING CONSTRUCTION **PLUMBING** FLOOR **FIRST**

NYS EXP.: 11/30/2025

AUGUST, 2024

AS SHOWN

Sheet Number P102


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DEMOLITION CITY OF MIDDLETOWN NEW COURTHOUSE FACILITY CONTRACT NO. 1C - PLUMBING CONSTRUCTION

SANITARY FLOOR **FIRST**




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AUGUST, 2024

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Sheet Number P103

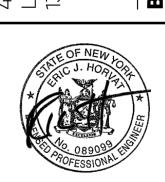

EDUCATION OF THE NEW TORK STATE
EDUCATION LAW, ARTICLE 145 §7209
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REVISIONS

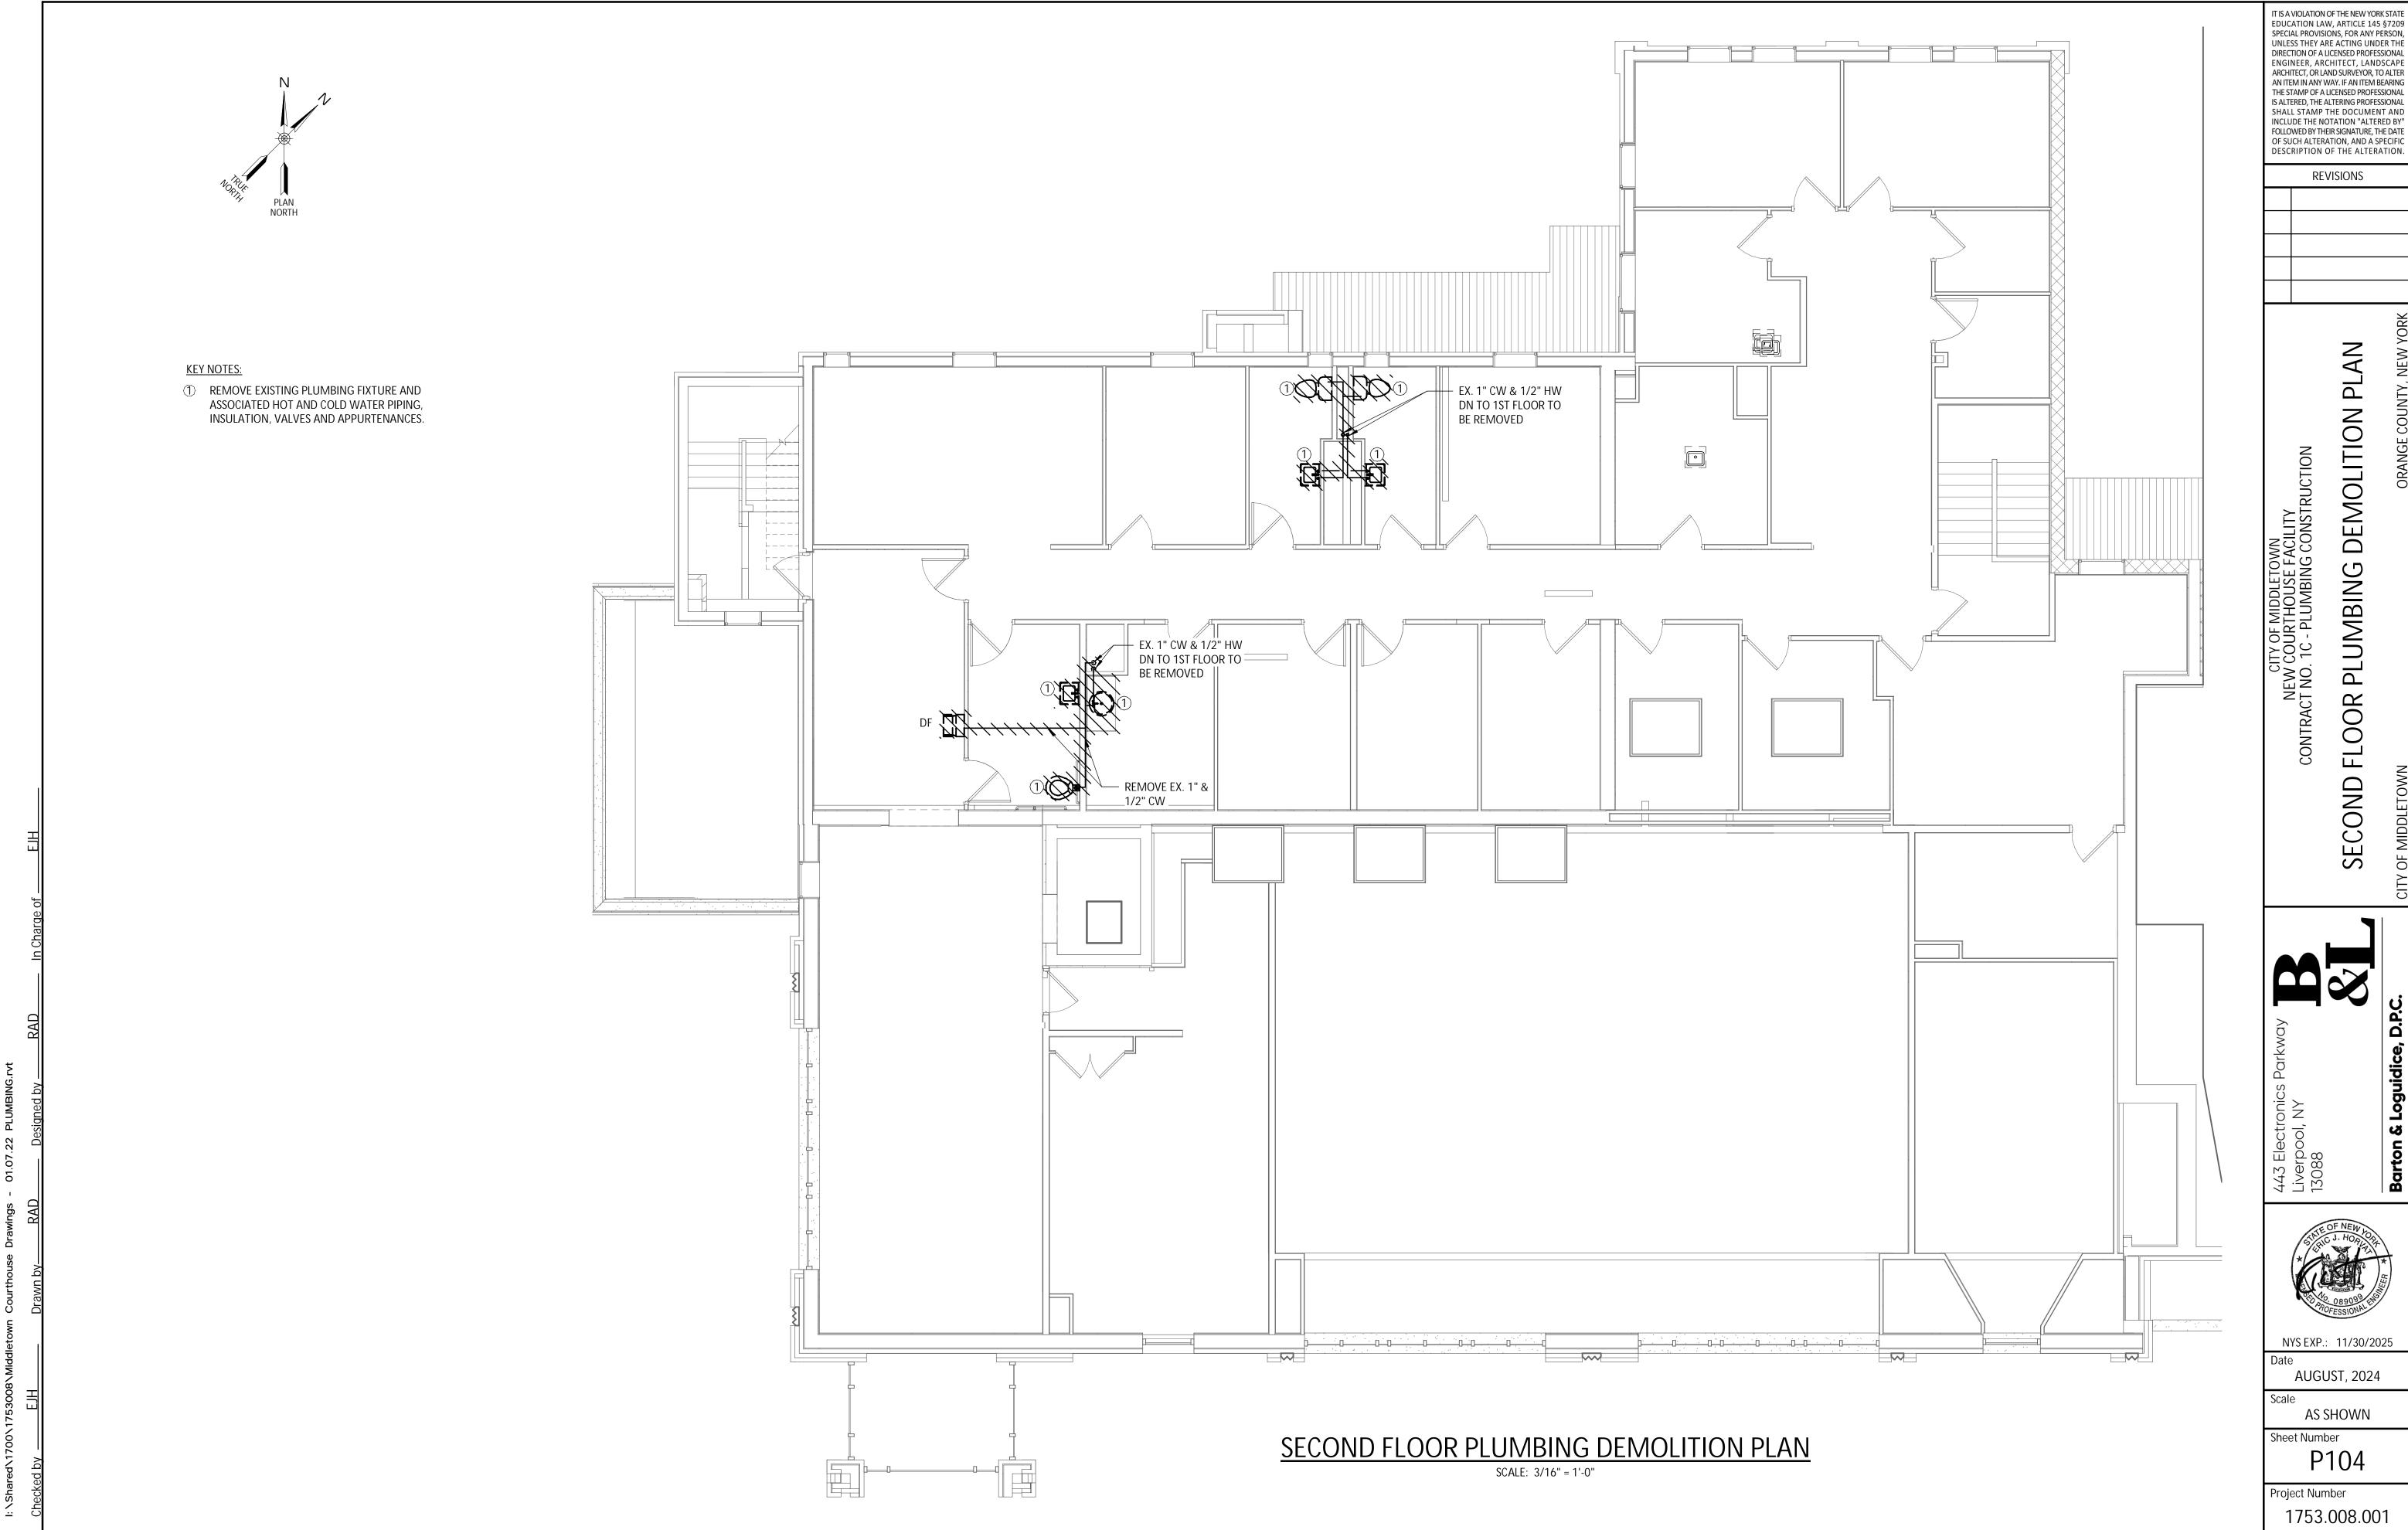FLOOR PLUMBING DEMOLITION PLAN SECOND




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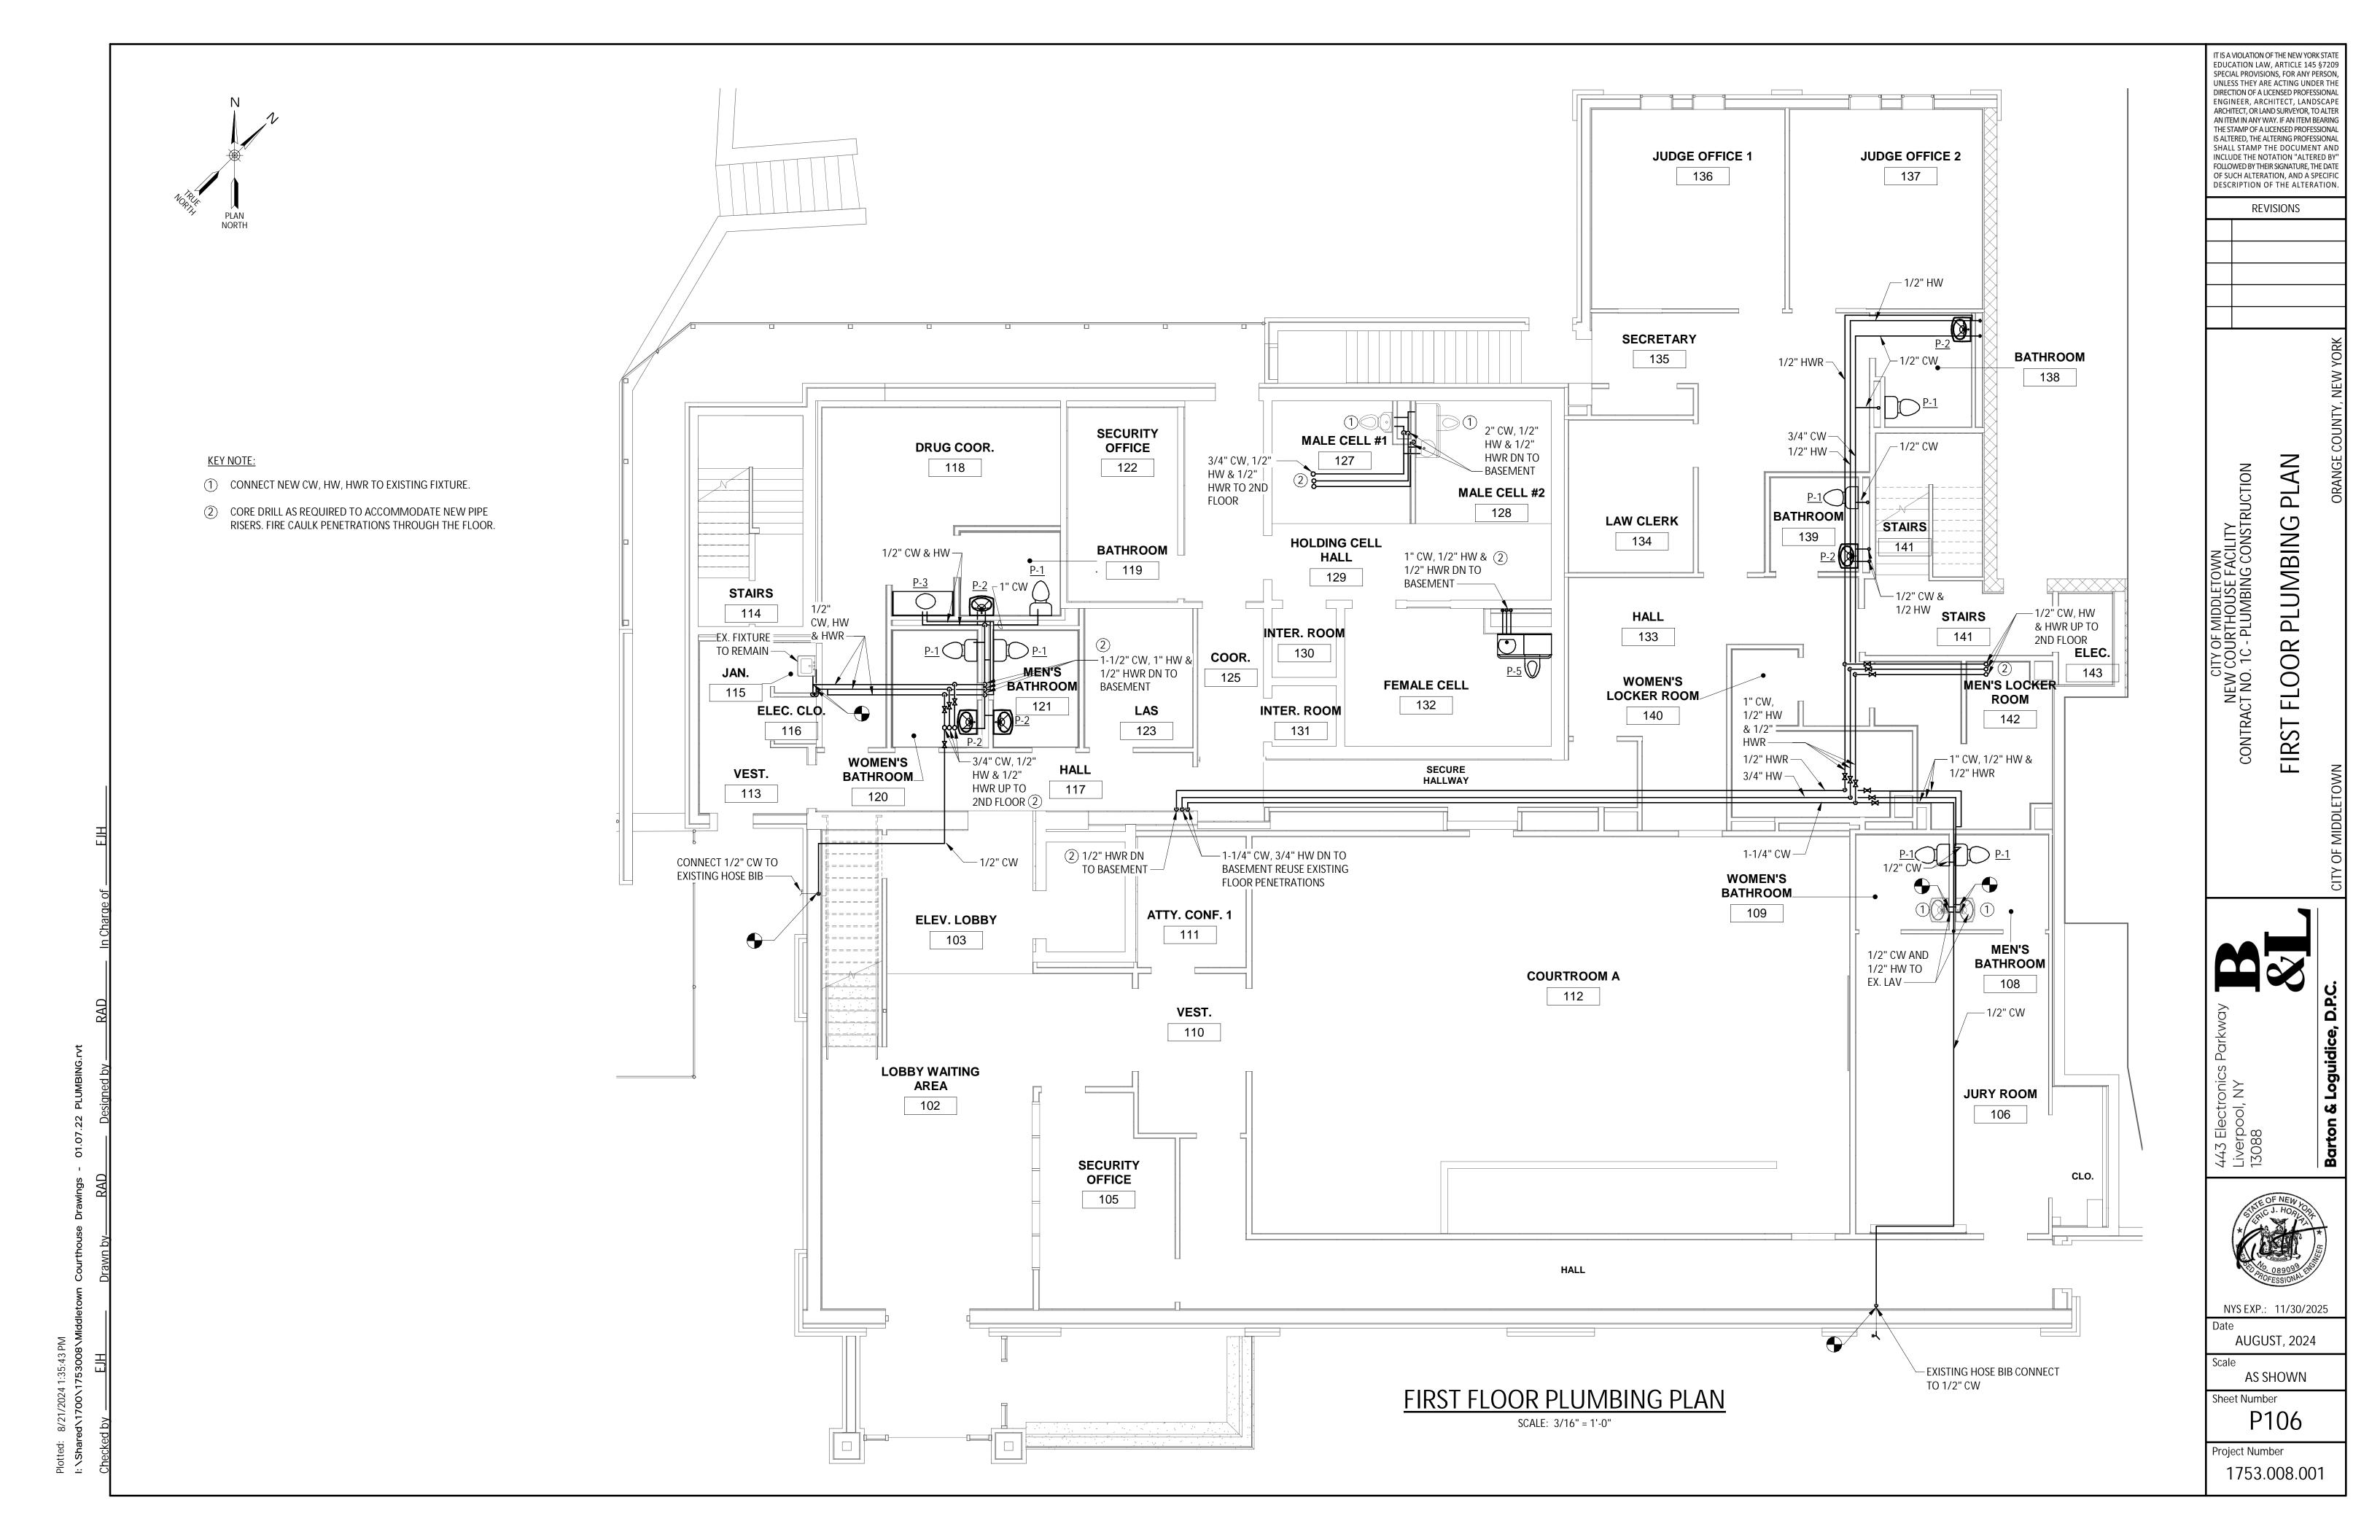
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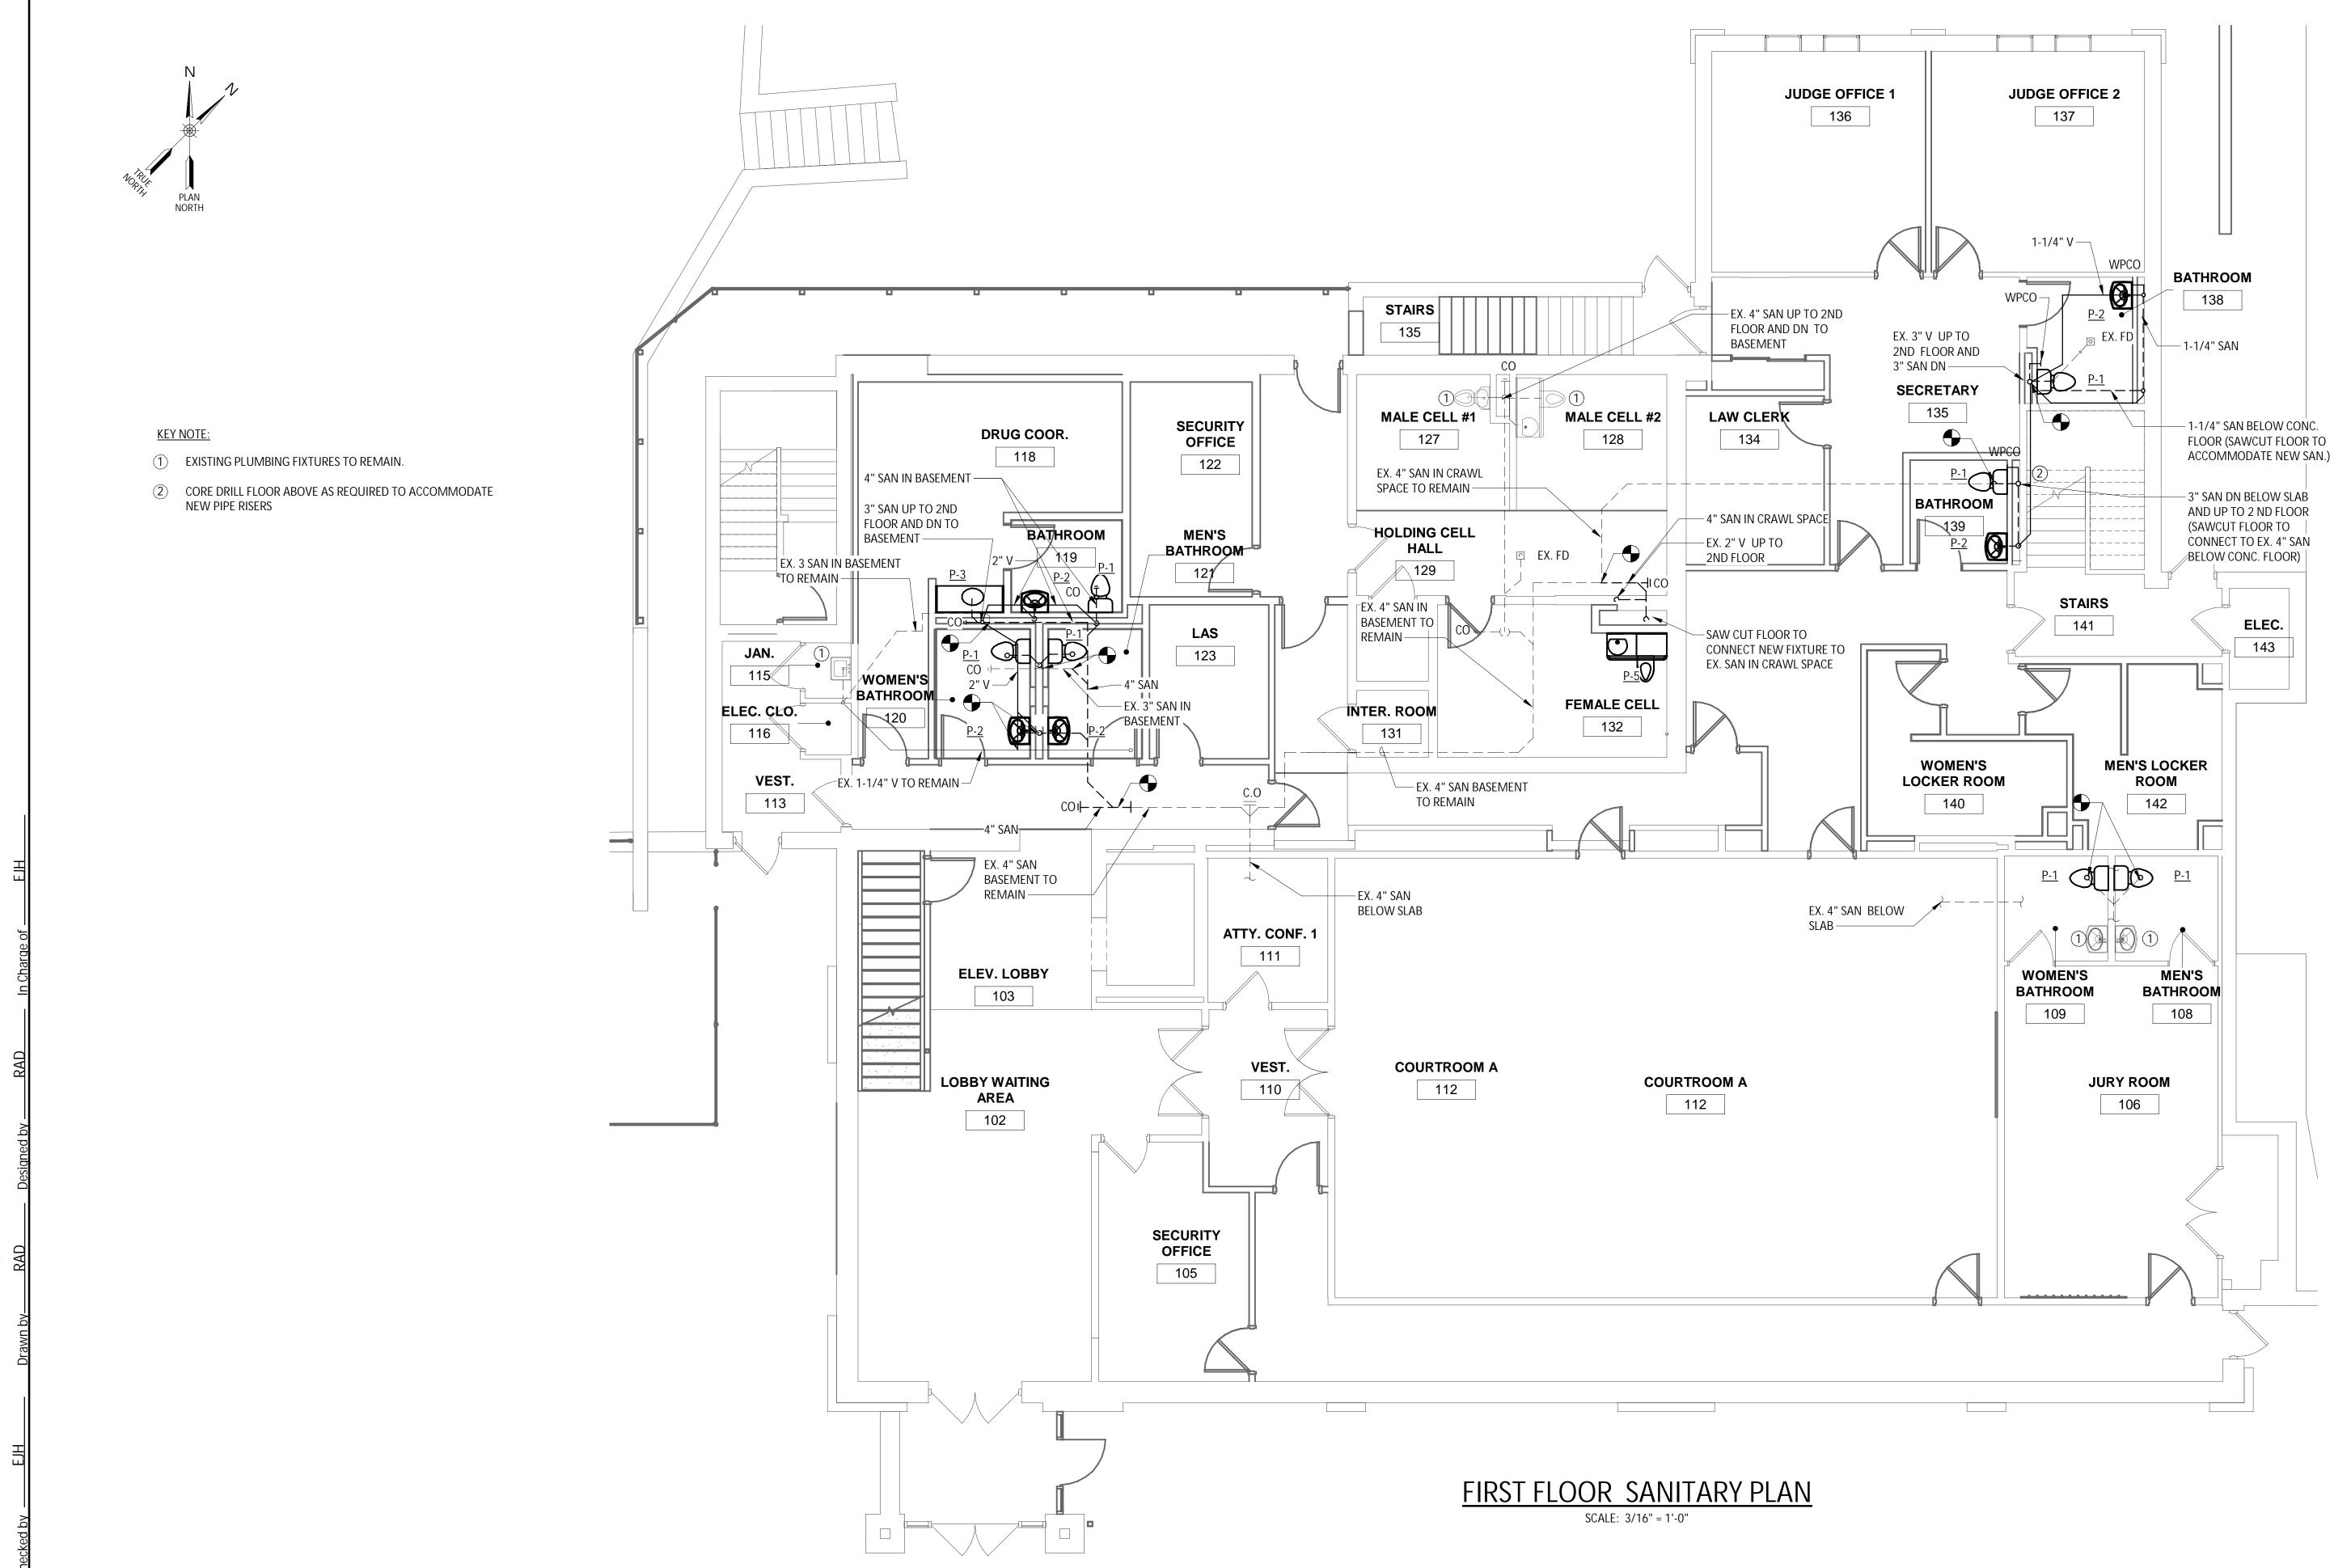
FLOOR SANITARY DEMOLITION PLAN SECOND

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Project Number



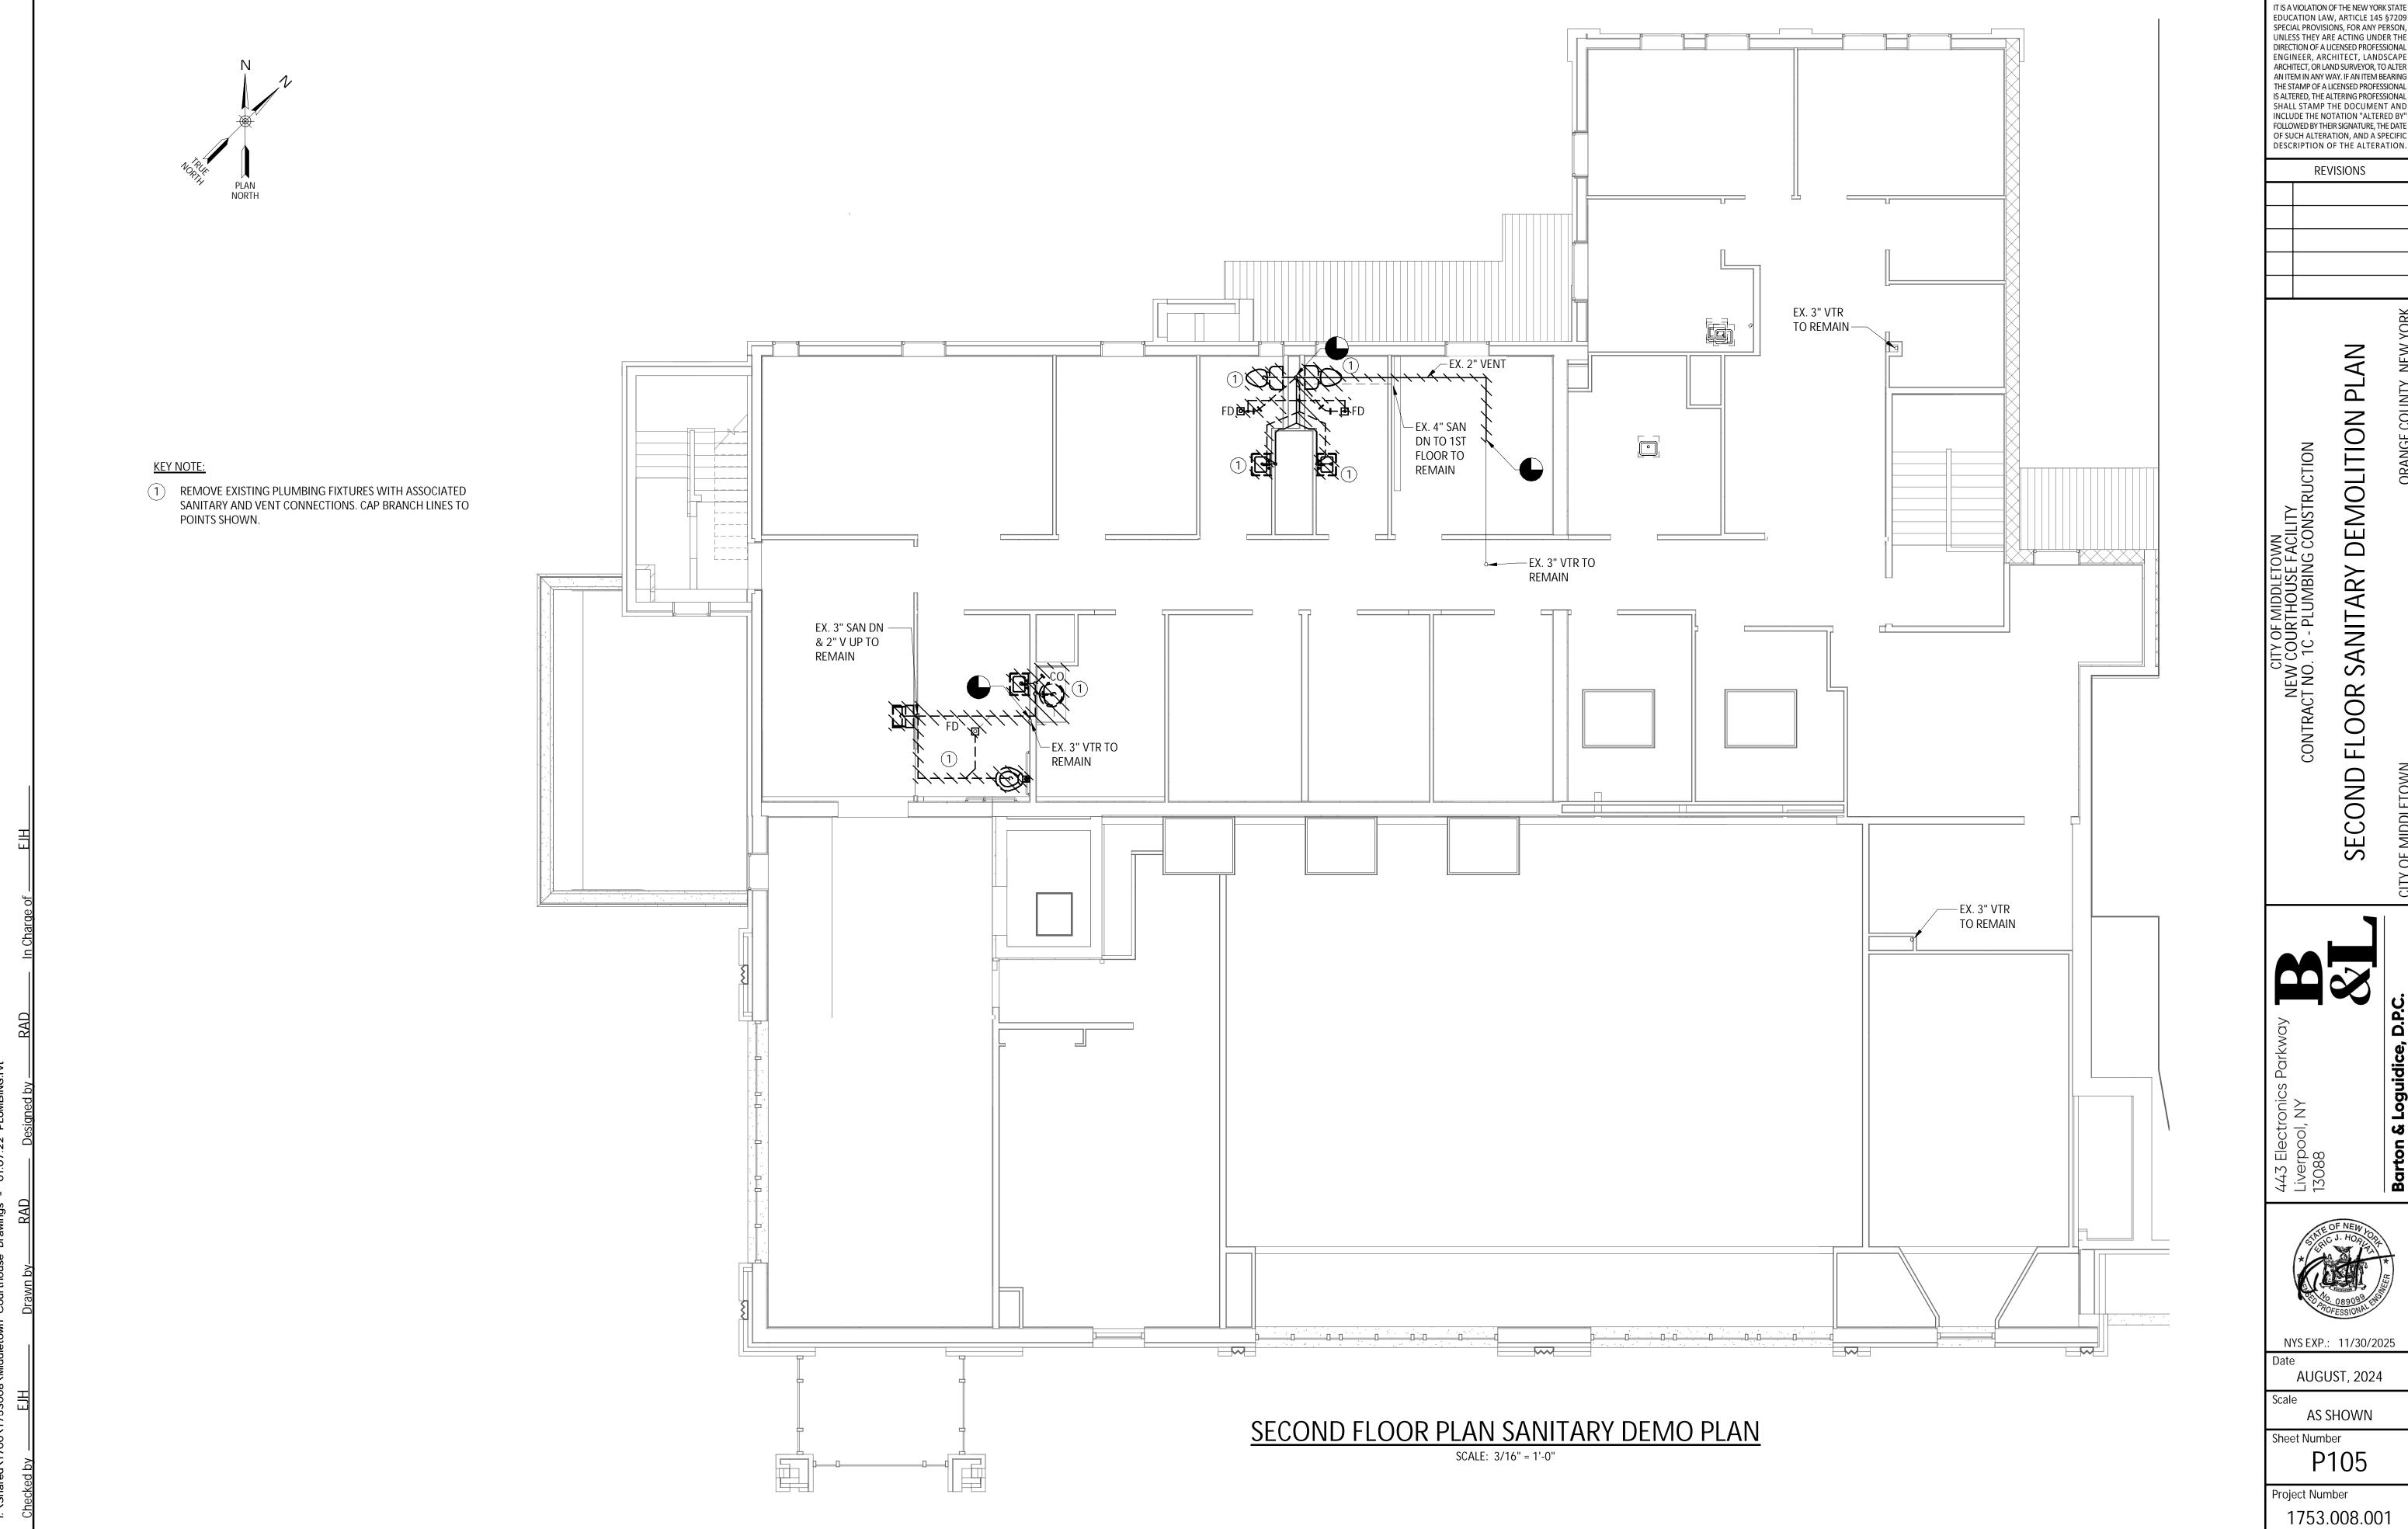

EDUCATION LAW, ARTICLE 145 §7209 SPECIAL PROVISIONS, FOR ANY PERSON, UNLESS THEY ARE ACTING UNDER THE DIRECTION OF A LICENSED PROFESSIONAL ENGINEER, ARCHITECT, LANDSCAPE ARCHITECT, OR LAND SURVEYOR, TO ALTER AN ITEM IN ANY WAY. IF AN ITEM BEARING THE STAMP OF A LICENSED PROFESSIONAL IS ALTERED, THE ALTERING PROFESSIONAL SHALL STAMP THE DOCUMENT AND INCLUDE THE NOTATION "ALTERED BY FOLLOWED BY THEIR SIGNATURE, THE DATE OF SUCH ALTERATION, AND A SPECIFIC

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DESCRIPTION OF THE ALTERATION

PLAN

CITY OF MIDDLETOWN NEW COURTHOUSE FACILITY CONTRACT NO. 1C - PLUMBING CONSTRUCTION SANITARY

FIRST FLOOR




NYS EXP.: 11/30/2025

AUGUST, 2024

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Sheet Number P107

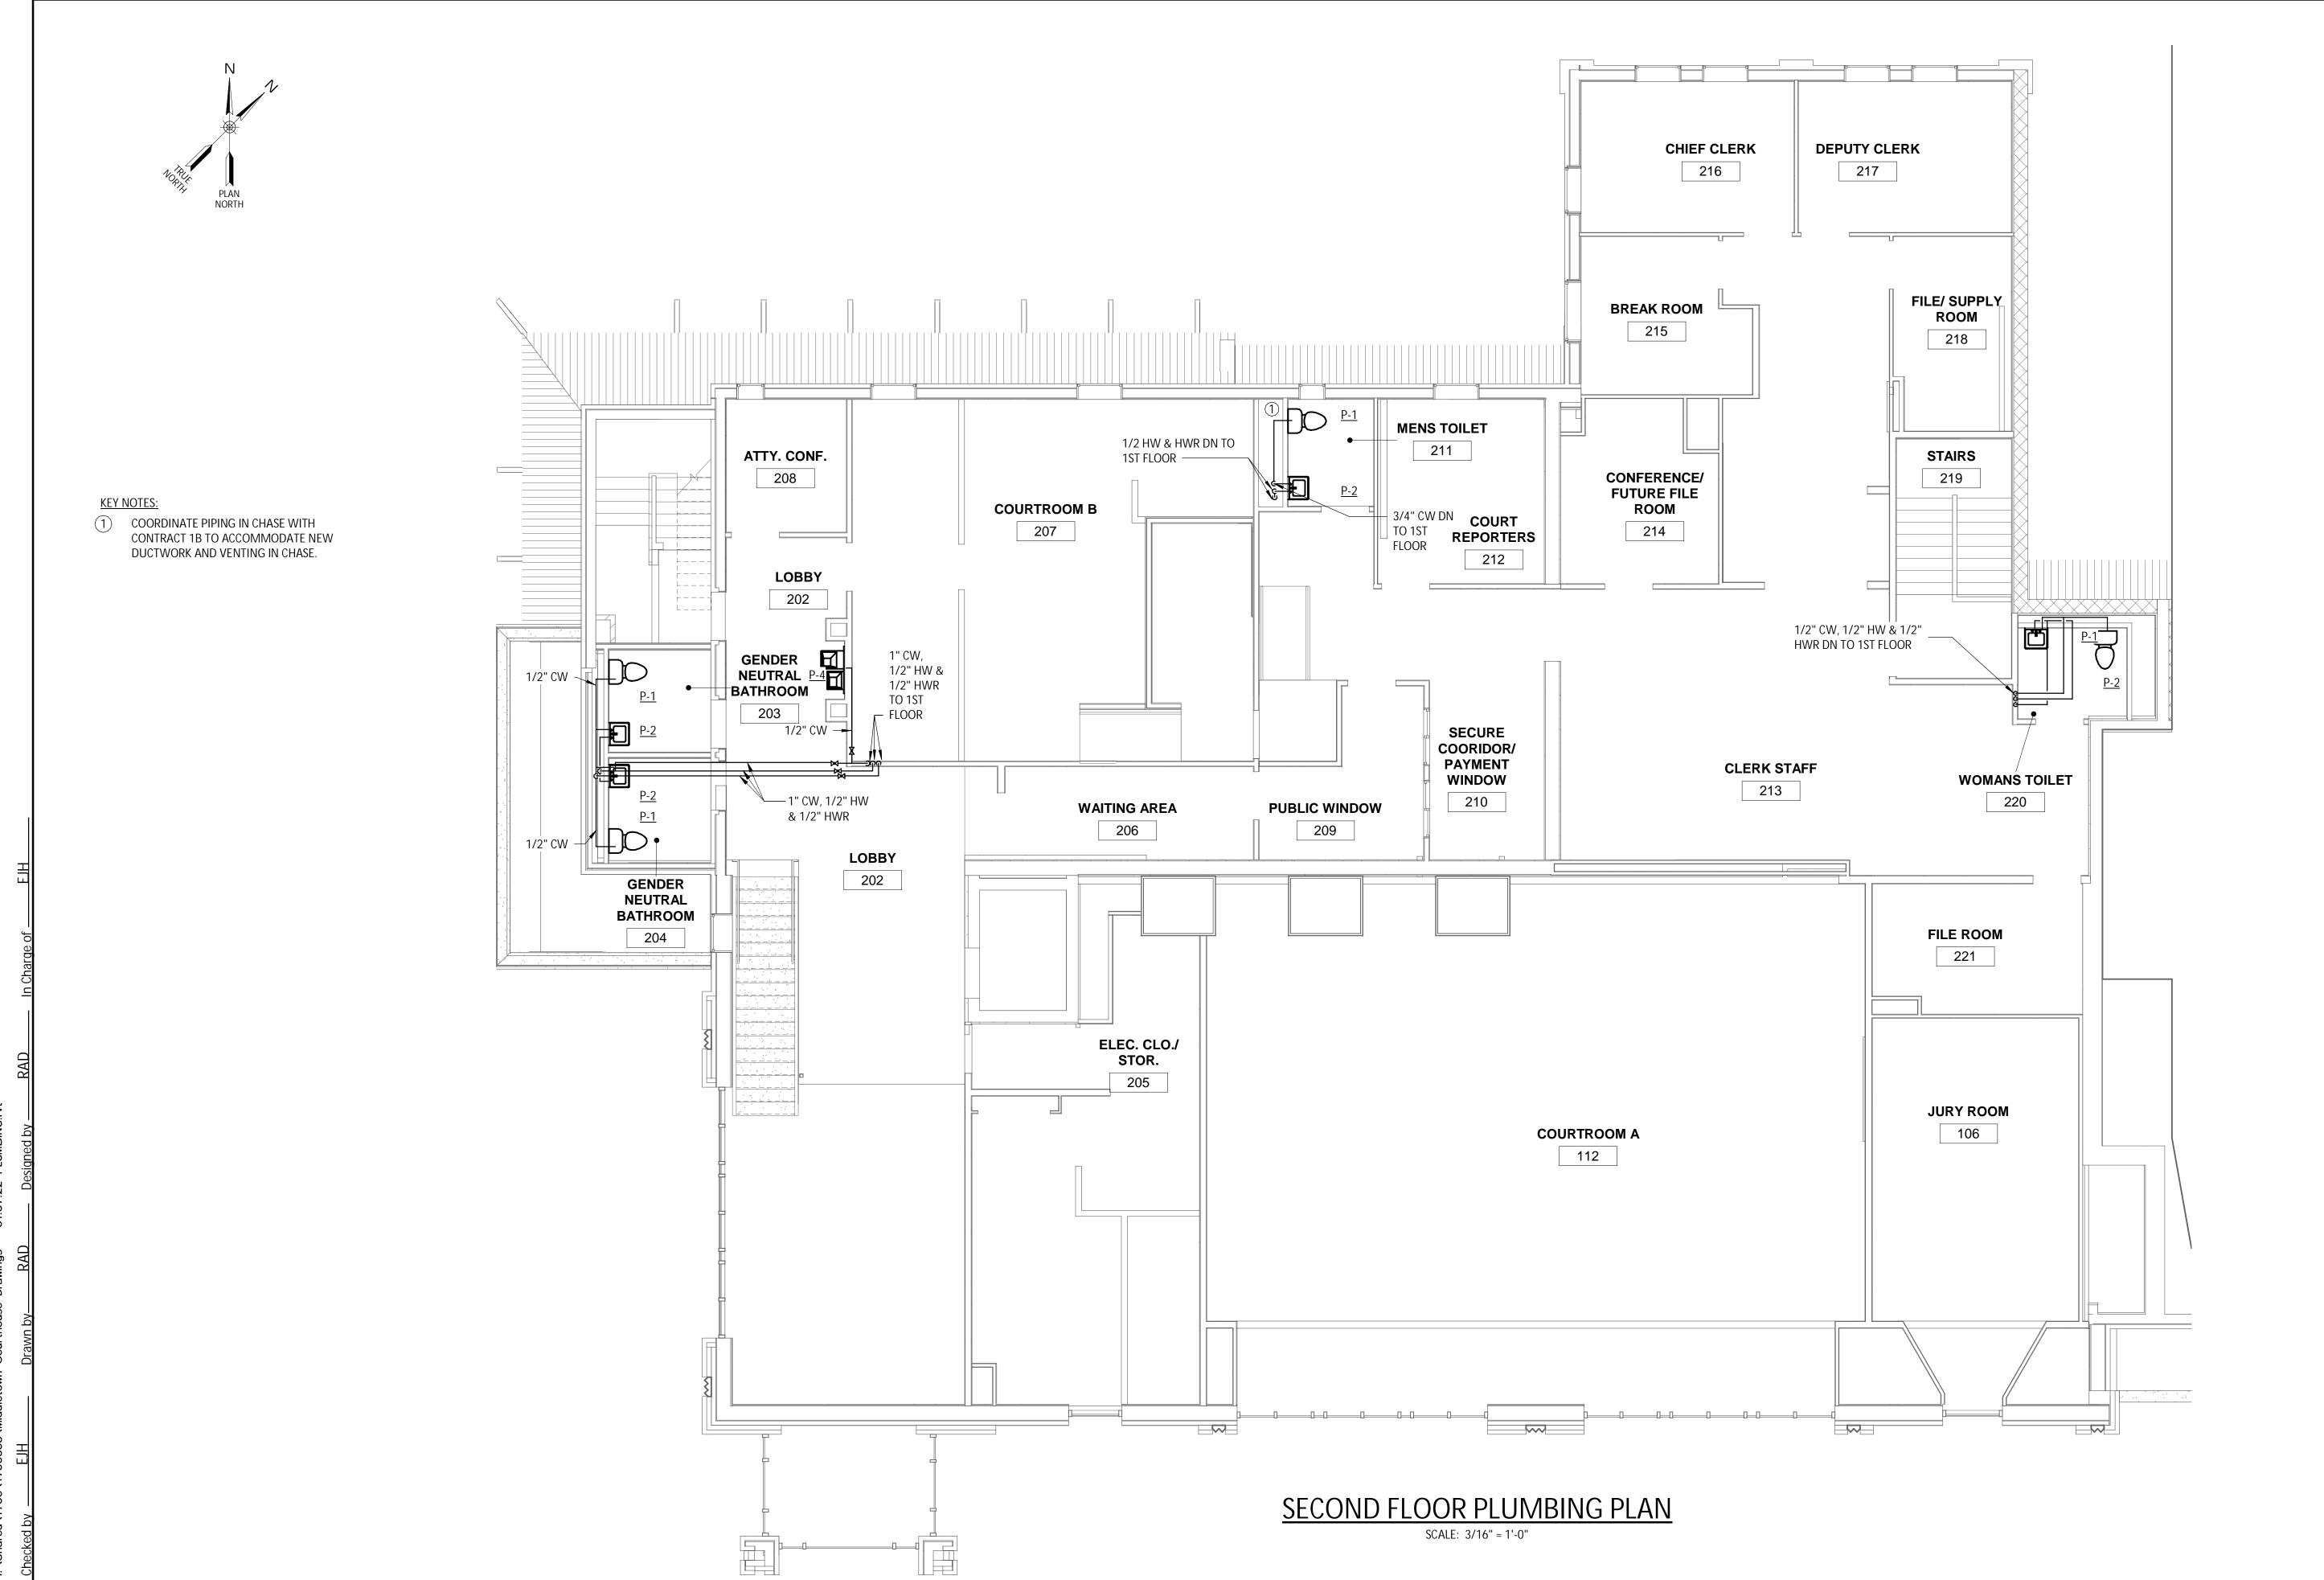

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REVISIONS

CITY OF MIDDLETOWN
NEW COURTHOUSE FACILITY
CONTRACT NO. 1C - PLUMBING CONSTRUCTION SECOND FLOOR PLUMBING




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Sheet Number P108



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REVISIONS

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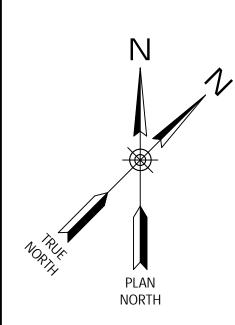
SANITARY

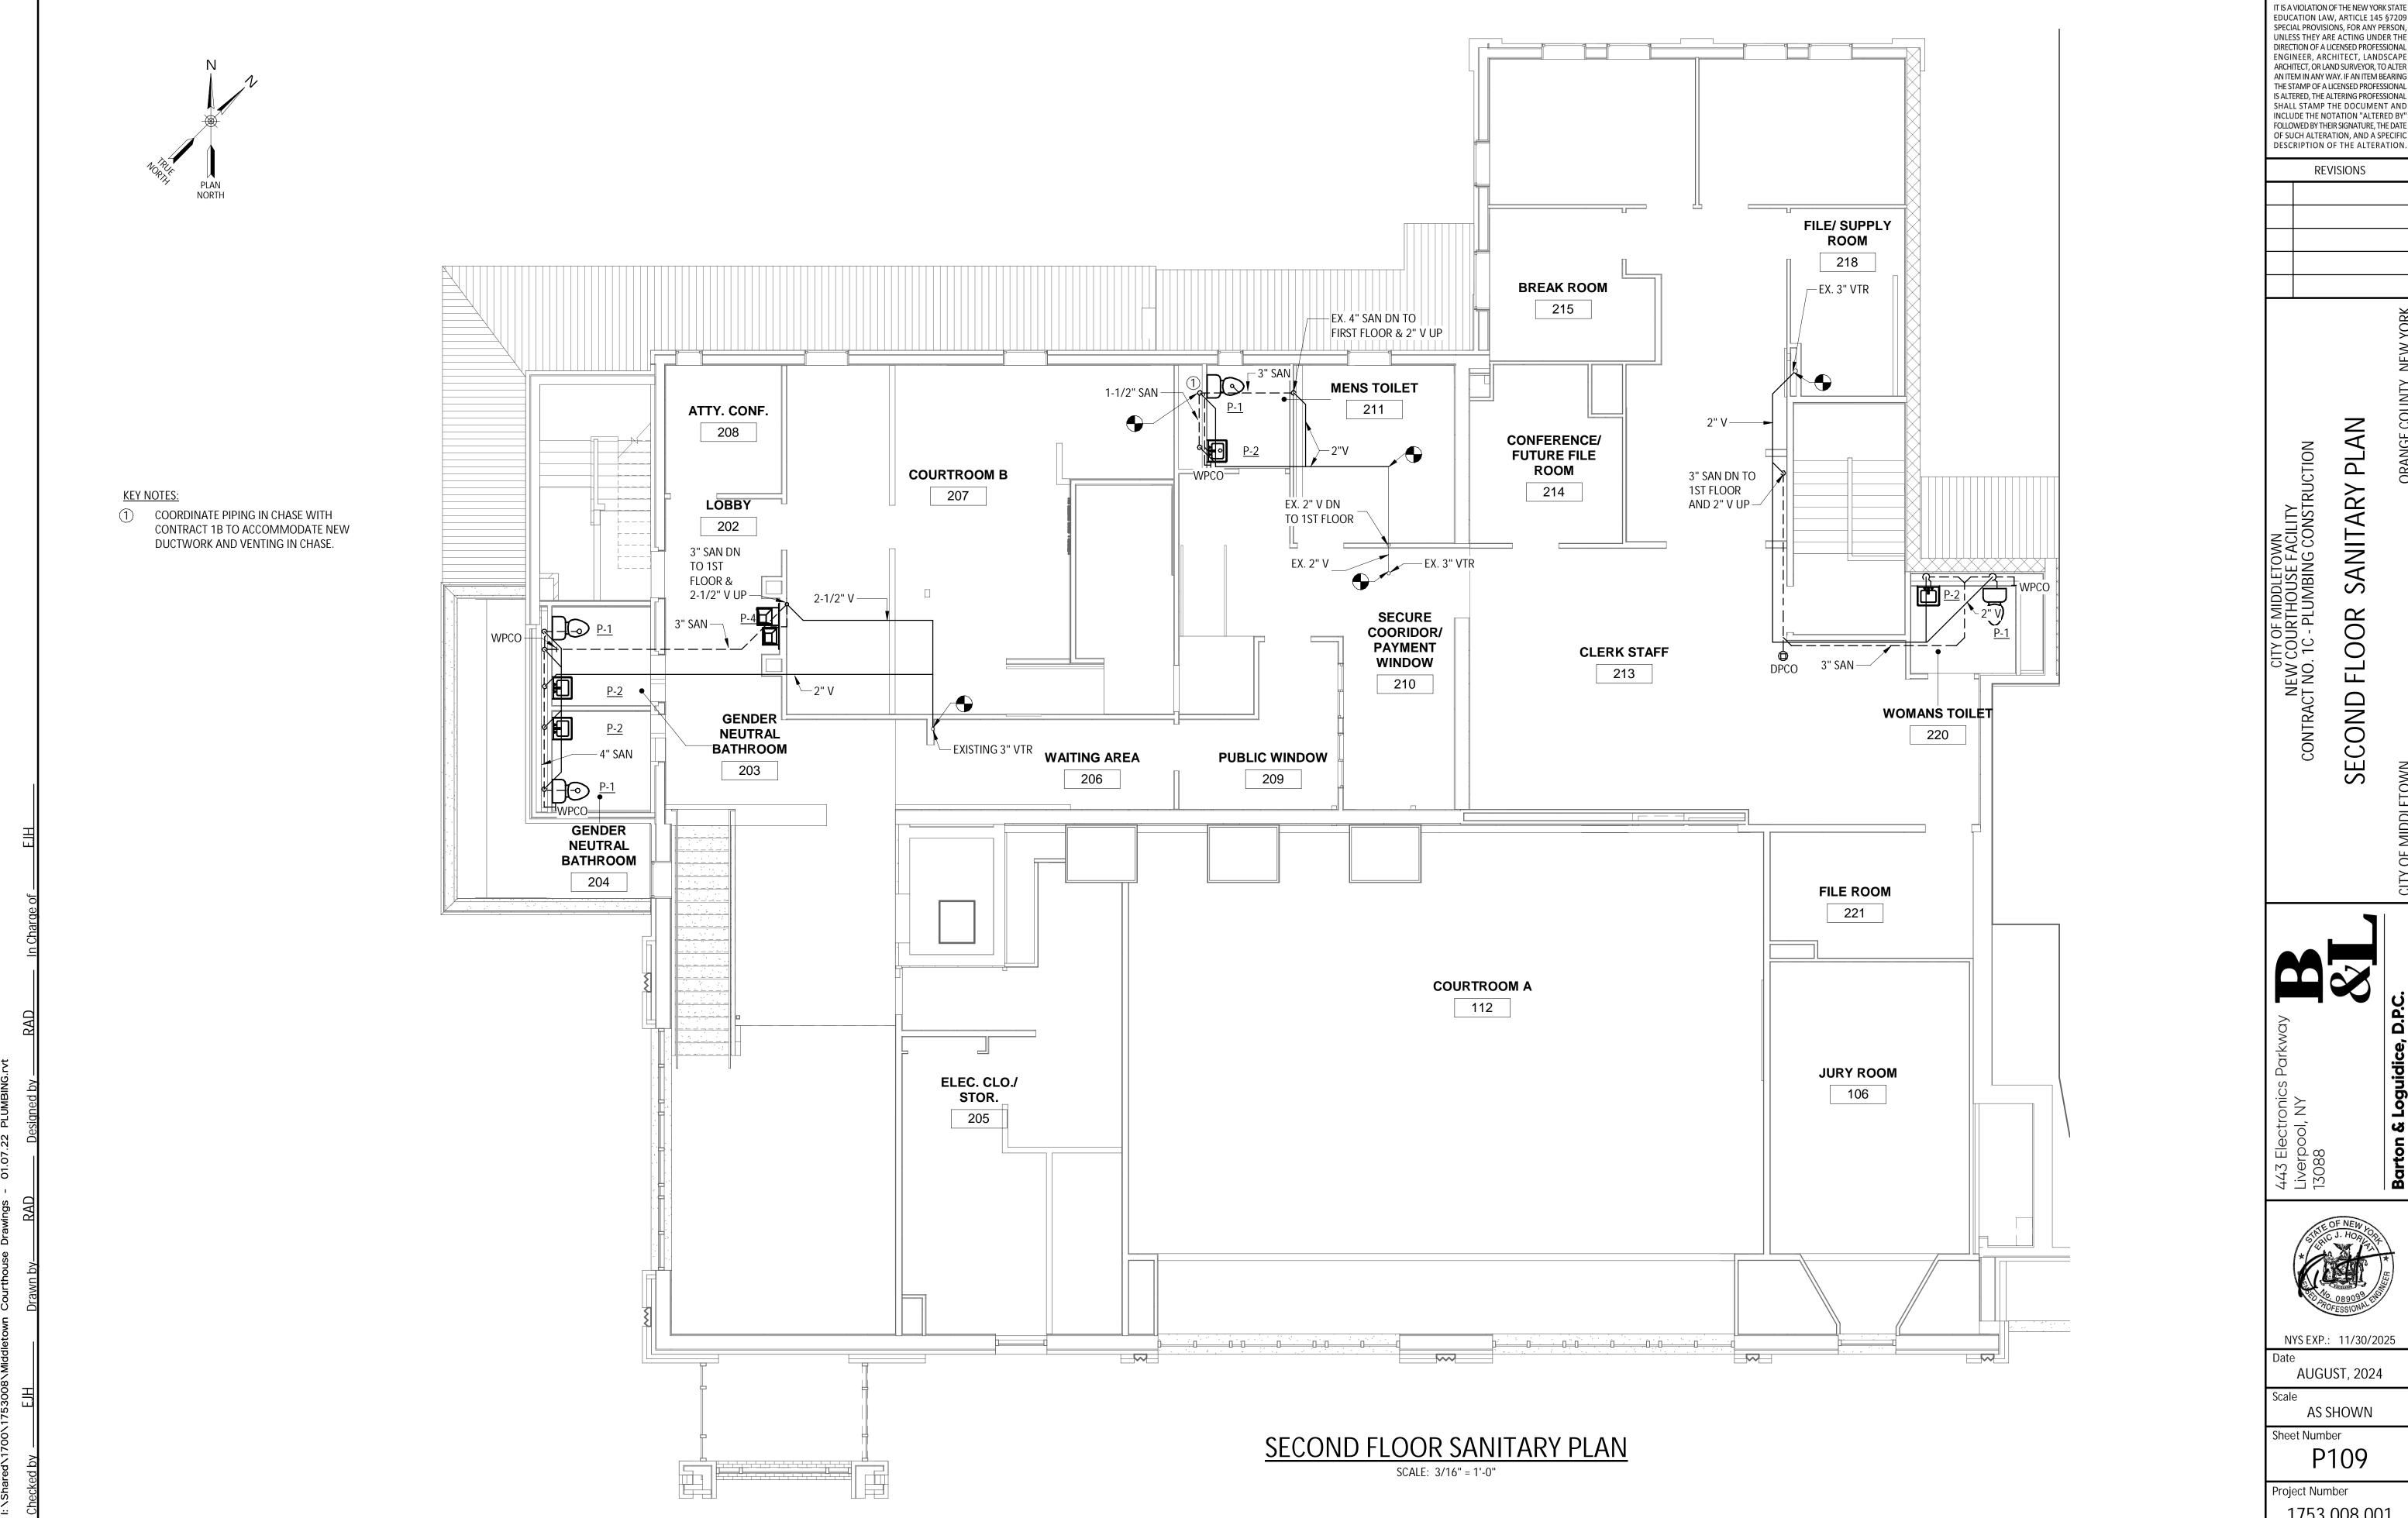SECOND FLOOR

NYS EXP.: 11/30/2025


AUGUST, 2024

AS SHOWN Sheet Number P109



PROVIDE ADDITIONAL HEAD(S) AND PIPING TO PROVIDE COVERAGE IN AREA AND EXTEND EXISTING SYSTEM.

FIRE PROTECTION LEGEND

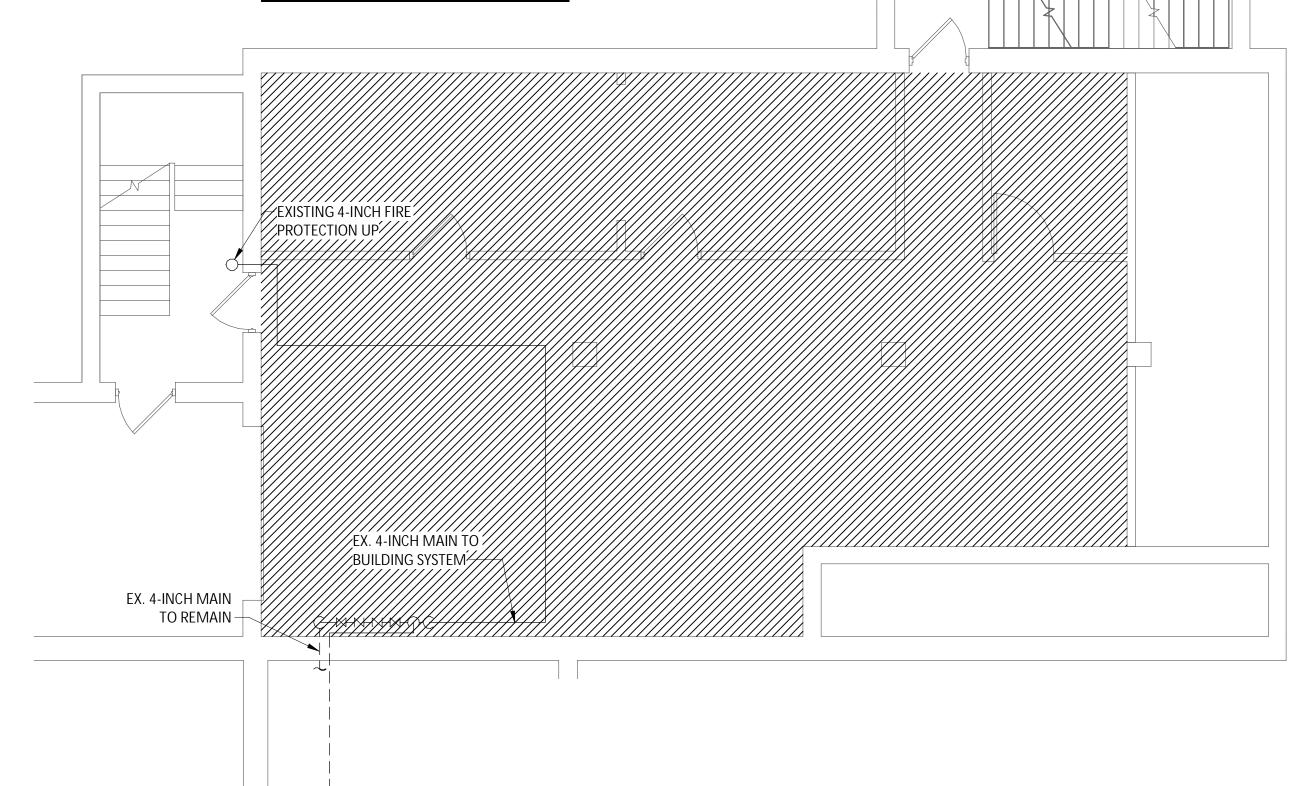

BASEMENT FIRE PROTECTION PLAN

EX. FIRE DEPARTMENT CONNECTION TO REMAIN -

GENERAL NOTES:

EXISTING FIRE PROTECTION SYSTEM TO REMAIN. CONTRACTOR SHALL COORDINATE WITH THE LOCAL UTILITY AND CONDUCT A FIRE FLOW TEST IN ACCORDANCE WITH NFPA 13 PRIOR TO PERFORMING ANY WORK. CONTRACTOR SHALL PAY FOR ANY/ALL FEES ASSOCIATED WITH THE

MODIFY EXISTING SPRINKLER HEAD LOCATIONS AND BRANCH PIPING AS REQUIRED TO PROVIDE SPRINKLER COVERAGE OF NEW OFFICE CONFIGURATIONS ON THE FIRST AND SECOND FLOORS IN ACCORDANCE WITH

THESE DRAWINGS ARE DIAGRAMMATIC AND APPROXIMATE; IT IS THE RESPONSIBILITY OF THE INSTALLING CONTRACTOR FOR VERIFICATION OF ALL DIMENSIONS, MEASUREMENTS, AND LOCATIONS OF EXISTING FACILITIES, UTILITIES, EQUIPMENT, AND OTHER EXISTING CONDITIONS WHICH MAY AFFECT CONSTRUCTION PRIOR TO SHOP DRAWINGS AND INSTALLATION. HOWEVER, IN THE EVENT OF DISCREPANCIES BETWEEN THE DRAWINGS AND ACTUAL FIELD CONDITIONS, CONTACT THE CONTRACTING OFFICER IMMEDIATELY.

- THE DESIGN AND INSTALLATION/MODIFICATION OF THE FIRE PROTECTION SYSTEMS SHALL BE IN STRICT ACCORDANCE WITH NFPA 13, 2016 EDITION; AND ANY APPLICABLE LOCAL, STATE, OR NATIONAL CODES AND STANDARDS.
- THE ENTIRE FACILITY IS BEING PROTECTED BY AN AUTOMATIC WET PIPE SPRINKLER SYSTEM. COORDINATE SHUTDOWNS AND INTERRUPTIONS IN SPRINKLER PROTECTION WITH THE BUILDING OWNER AND THE AUTHORITY HAVING JURISDICTION.
- THE SPRINKLER SYSTEM SHALL CONTINUE TO BE MONITORED BY THE FIRE ALARM SYSTEM.
- THE INTENT OF THE FIRE PROTECTION WORK IS TO MODIFY THE EXISTING SYTEMS TO ACCOMODATE THE NEW FLOOR PLAN.
- ALL HANGERS SHALL BE PROVIDED AND INSTALLED IN ACCORDANCE WITH NFPA 13.
- PROVIDE SLEEVES AND FIRESTOP SEALANTS WHERE PIPES PENETRATE FIRE RATED FLOORS AND WALLS. COMPLY WITH ASTM E-814 AND UL 1479. PROVIDE PIPE SLEEVES WITH FIRE STOP SEALANTS FOR ALL PIPING PENETRATING DRYWALL PARTITIONS, MASONRY PARTITIONS, AND FLOORS.
- A MAXIMUM OF ONE SPRINKLER MAY BE SUPPLIED BY A SINGLE 1" OUTLET WITHOUT PROVIDING HYDRAULIC CALCULATIONS TO VALIDATE ADEQUACY. NEW MECHANICAL OUTLETS FOR NEW PENDENT HEADS SHOULD BE INSTALLED ON NEARBY BRANCHLINES.
- FIRE PROTECTION PIPING IS TO BE LOCATED ABOVE THE CEILING UNLESS OTHERWISE NOTED.
- 12. COORDINATE WITH OTHERS THE FINAL LOCATIONS OF SPRINKLER HEADS, PIPING, AND ALL NEW WORK WITH EXISTING AND NEW LIGHT FIXTURES, DIFFUSERS, GRILLES, REGISTERS, SMOKE DETECTORS, SPEAKERS, AND OTHER CEILING MOUNTED DEVICES.
- CENTER HEADS IN ALL CEILING TILES UNLESS ARCHITECT APPROVES ALTERNATE LOCATION. PROVIDE ADDITIONAL HEADS WHERE REQUIRED TO MEET COVERAGE REQUIREMENTS.
- 14. RELOCATE EXISTING SPRINKLER HEADS OR ADD NEW SPRINKLER HEADS AS SHOWN TO PROVIDE A CODE COMPLIANT SYSTEM WHILE ADHERING TO ALL **OBSTUCTION RULES WITHIN NFPA 13.**
- 15. LIGHT HAZARD OCCUPANCY, MAXIMUM OF 225FT² PER HEAD, MAXIMUM SPACING IS 15', MINIMUM SPACING IS 6', MINIMUM DISTANCE FROM WALL IS
- 16. SEE ARCHITECTURAL PLANS FOR CEILING MATERIAL AND COORDINATE HEAD TYPE IN EACH LOCATION.
- 17. SEAL ALL PENETRATIONS IN ACCORDANCE WITH THE FIRE RATING OF WALLS, CEILINGS OR FLOORS. SEE ARCHITECTURAL PLANS FOR ADDITIONAL INFORMATION.
- 18. EACH CONTRACTOR SHALL BE RESPONSIBLE FOR ALL CUTTING AND PATCHING ASSOCIATED WITH THEIR WORK. WHERE EQUIPMENT IS COMPLETELY DEMOLISHED OR REMOVED AND REPLACED WITH NEW EQUIPMENT, ALL FINISHES, FLOORING, BASE AND WALL SHALL BE PATCHED TO MATCH SURROUNDING AREAS. FEATHER INTO EXISTING FINISHED CONDITIONS TO TRANSITION NEW PATCH WORK WITH EXISTING FINISHED CONDITIONS. ALL PATCHING AND PAINTING SHALL BE DONE IN A MANNER TO MATCH THE EXISTING SURFACE IN APPEARANCE AND FUNCTION. ALL PATCHING SHALL BE PERFORMED BY A CONTRACTOR SKILLED IN THE APPROPRIATE CRAFT AND FINAL PATCHING IS SUBJECT TO REVIEW AND APPROVAL BY THE ARCHITECT.
- 19. PIPING SHALL BE AS FOLLOWS:
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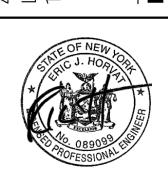
EDUCATION LAW, ARTICLE 145 §7209 SPECIAL PROVISIONS, FOR ANY PERSON

DESCRIPTION OF THE ALTERATION REVISIONS

AND

NOTE GENERAL FIRE **PROTECTION** NEW C CONTRACT 1B

SEMENT




NYS EXP.: 11/30/2025

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Sheet Number FP101

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GENERAL NOTES:

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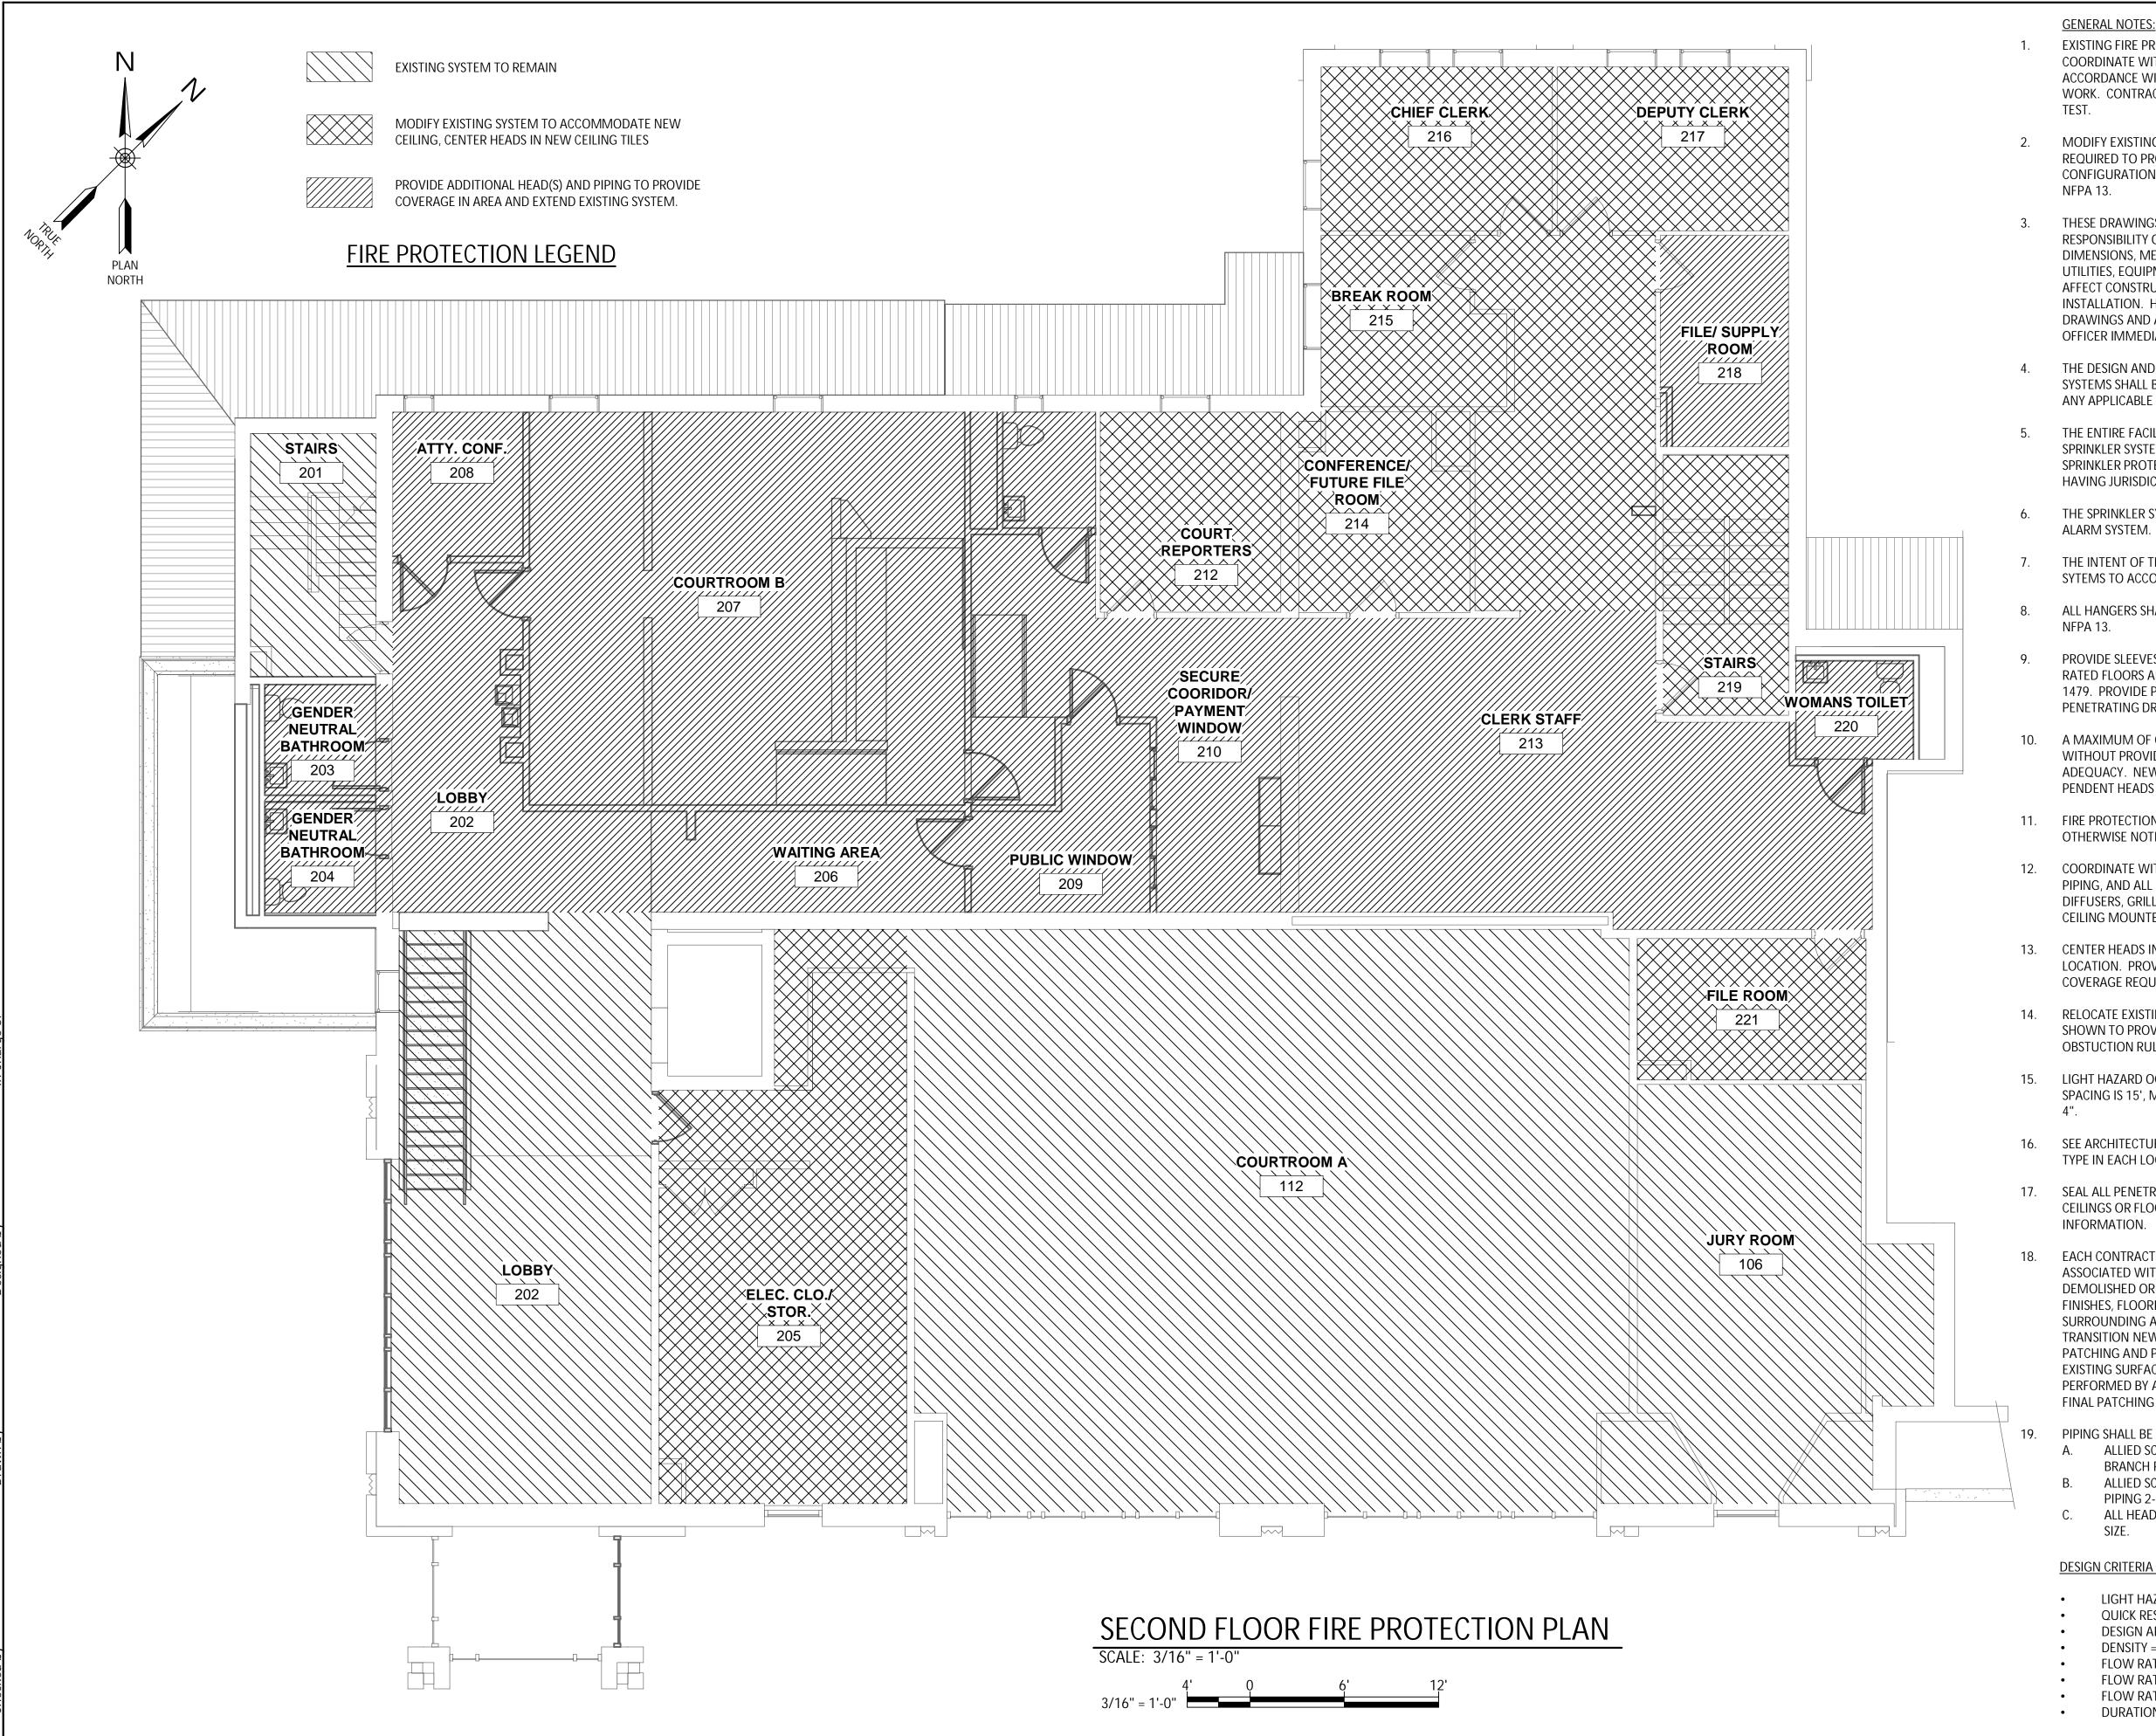
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FP102

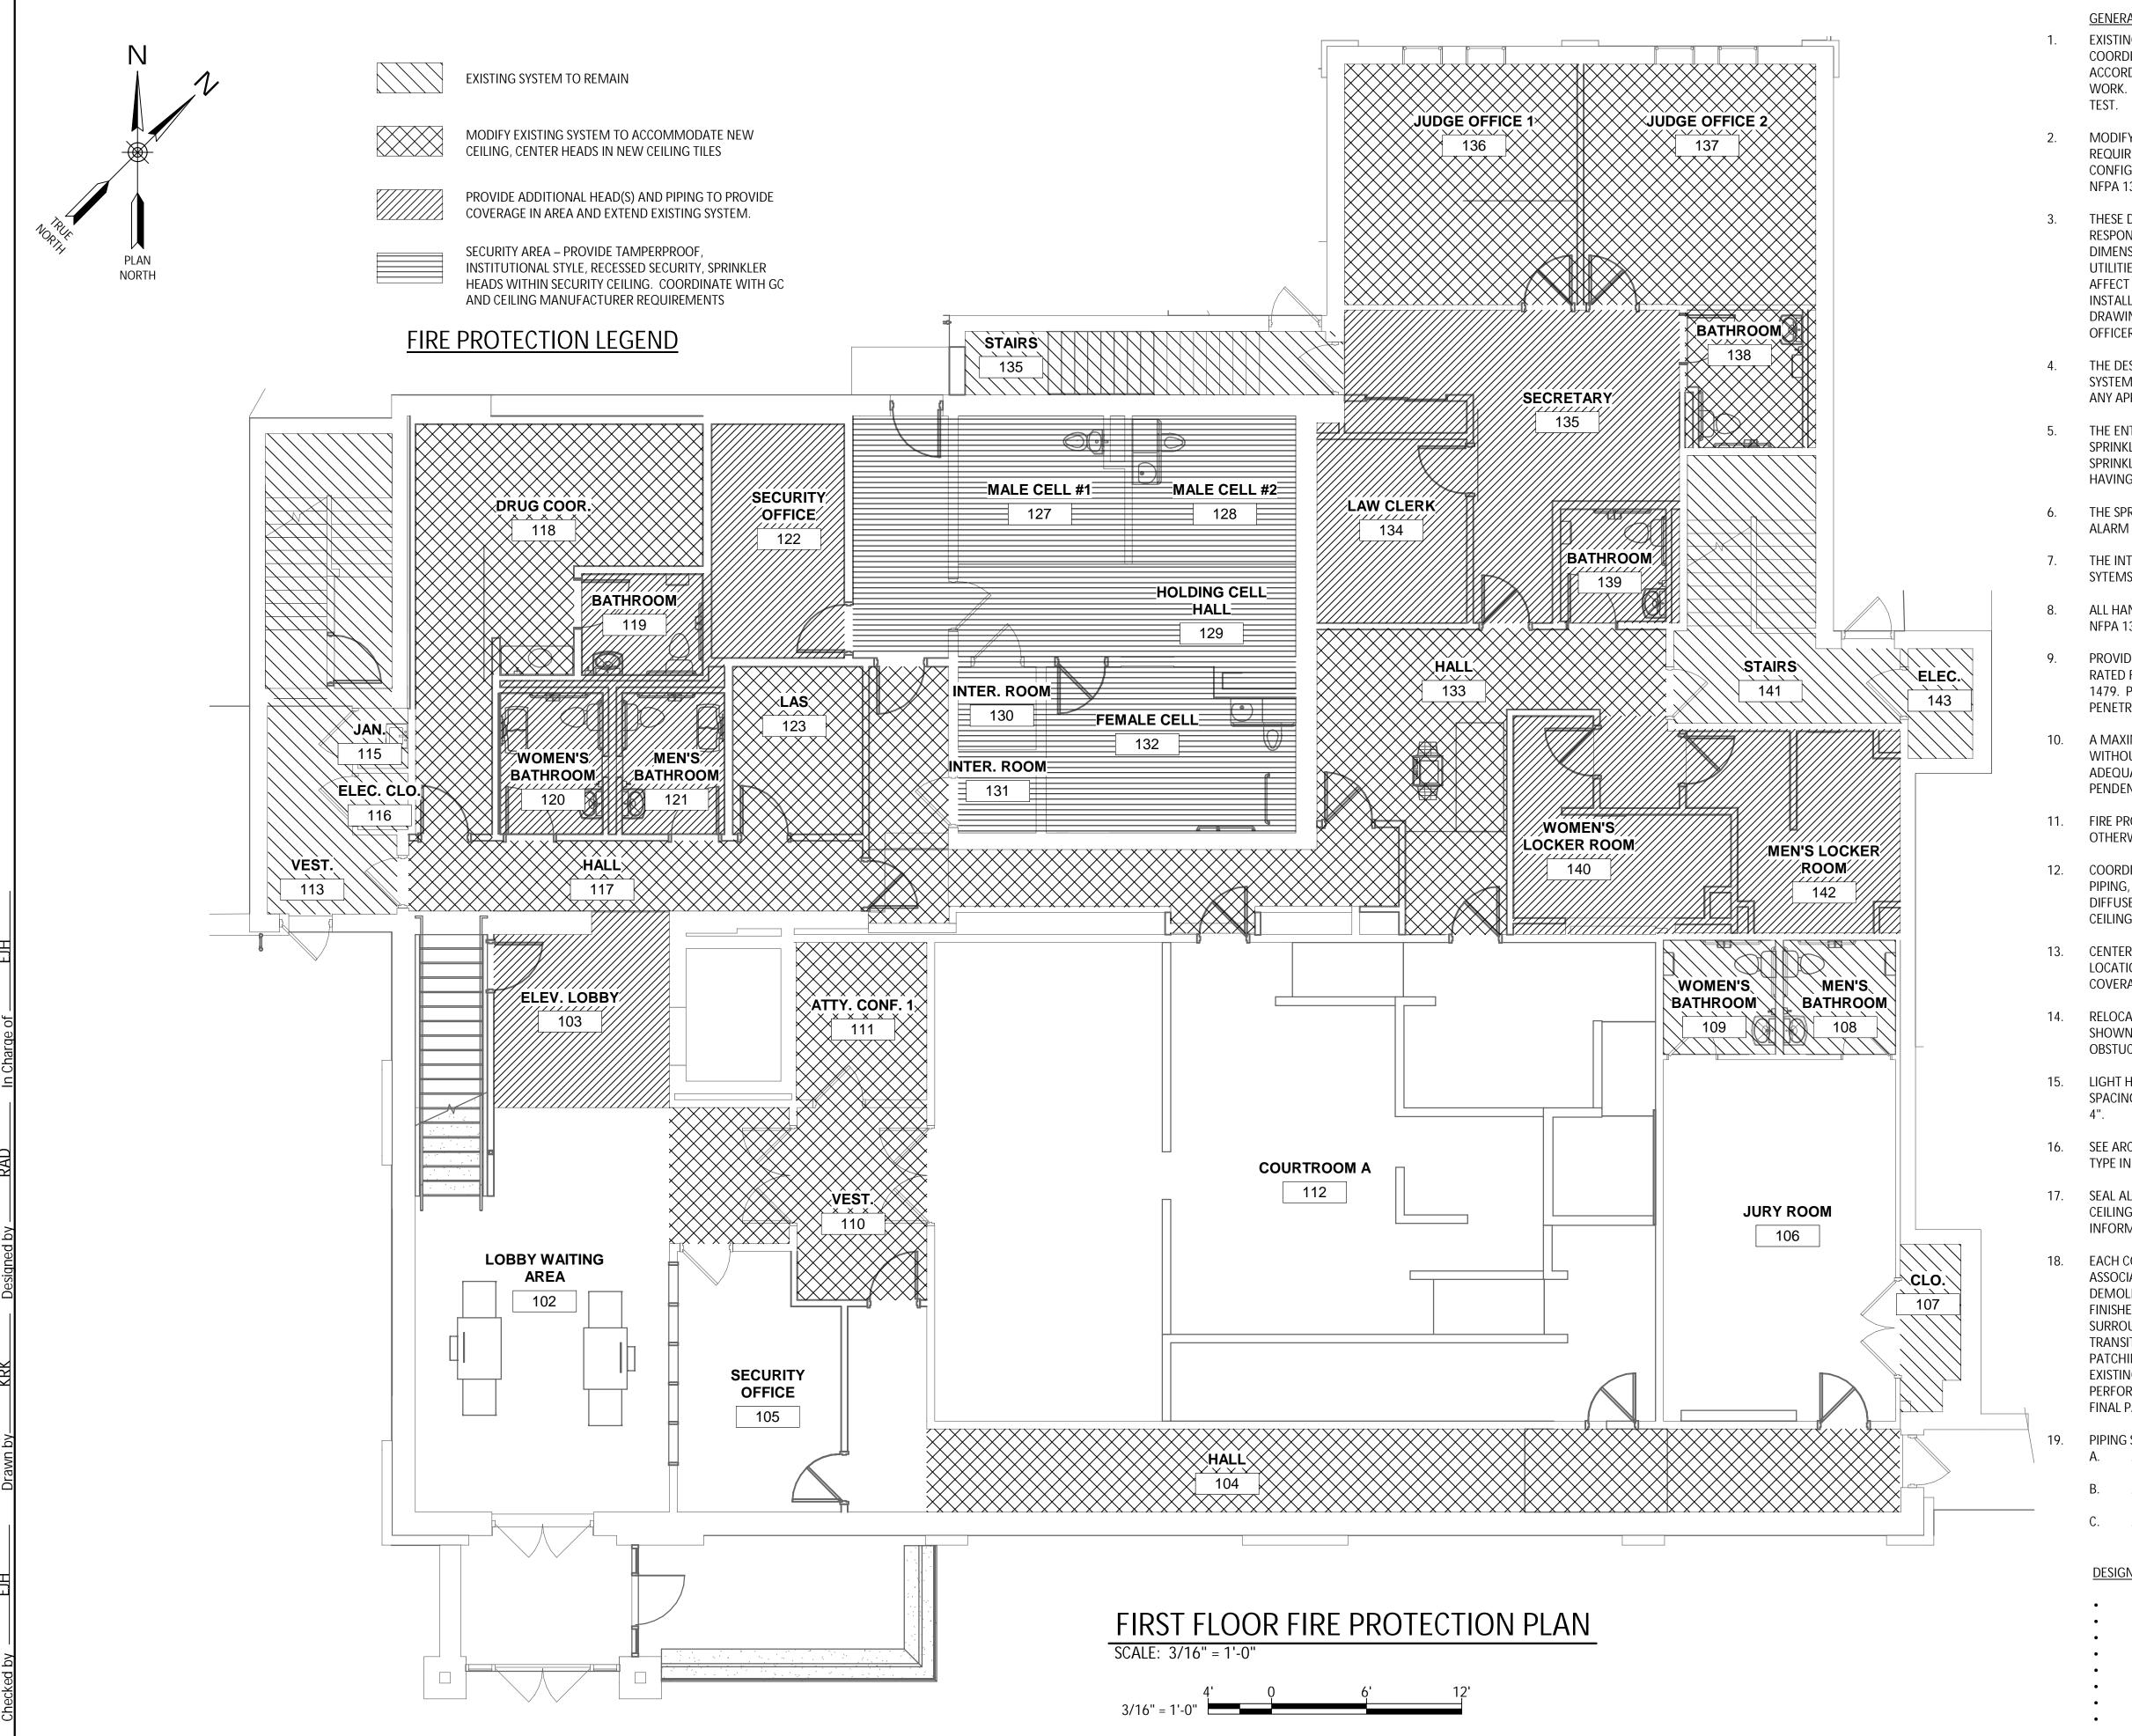

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OTECTION OWN FACILITY AL CONSTRUCTION PR FIRE OR NEW CONTRACT 1B

SECOND

NYS EXP.: 11/30/2025

AUGUST, 2024

AS SHOWN

Sheet Number FP103

Project Number

SYMBOLS AND ABBREVIATIONS

1. THIS SHEET CONTAINS SYMBOLS AND ABBREVIATIONS TYPICALLY SHOWN ON ELECTRICAL DRAWINGS AND SCHEMATICS. THIS CONTRACT DRAWING SET MAY NOT CONTAIN ALL SYMBOLS AND ABBREVIATIONS SHOWN ON THIS SHEET.

PERMITS AND INSPECTIONS

- 1. THE CONTRACTOR SHALL OBTAIN ALL REQUIRED PERMITS AND ARRANGE FOR ALL REQUIRED INSPECTIONS IN ACCORDANCE WITH STATE AND LOCAL GOVERNING AUTHORITIES.
- 2. ALL WORK SHALL BE DONE IN ACCORDANCE WITH NEC, AND STATE AND LOCAL GOVERNING REGULATIONS.

- 1. UNLESS OTHERWISE INDICATED, PROVIDE A COMPLETE AND OPERATIONAL ELECTRICAL SYSTEM INCLUDING ALL NECESSARY MATERIAL, LABOR, AND EQUIPMENT.
- 2. ALL DISCONNECTS REQUIRED BY CODE MAY NOT BE SHOWN. CONTRACTOR SHALL PROVIDE ALL NECESSARY DISCONNECTS AND OVERCURRENT PROTECTIVE DEVICES.
- 3. ALL EQUIPMENT AND MATERIAL SHALL BE LABELED AND LISTED, AND INSTALLED IN ACCORDANCE WITH THEIR LISTING.
- 4. PROVIDE ELECTRICAL POWER WIRING TO ALL MECHANICAL EQUIPMENT

COORDINATION OF WORK

- 1. THE CONTRACTOR SHALL COORDINATE AND VERIFY THAT WORKING AND DEDICATED EQUIPMENT SPACE REQUIREMENTS ARE MET PER NEC AND AHJ.
- 2. FIELD LOCATE ALL CORE DRILL LOCATIONS.
- 3. BEFORE CUTTING OR DRILLING INTO BUILDING ELEMENTS INSPECT AND LAYOUT WORK TO AVOID DAMAGING STRUCTURAL ELEMENTS AND BUILDING UTILITIES.
- 4. BEFORE SELECTING MATERIAL AND EQUIPMENT, AND PROCEEDING WITH WORK, INSPECT AREAS WHERE MATERIAL AND EQUIPMENT ARE TO BE INSTALLED TO INSURE SUITABILITY AND CHECK NEEDED SPACE FOR PLACEMENT, CLEARANCES AND INTERCONNECTIONS.
- 5. COORDINATION OF POSSIBLE SYSTEM SHUT-DOWNS AND WORK AREAS NEED TO BE COORDINATED WITH THE OWNER.
- 6. VERIFY RECEPTACLE, SWITCH, & COVER PLATE COLORS WITH OWNER.
- 7. TURN OVER TO THE OWNER ALL MANUFACTURER'S WARRANTIES FOR EQUIPMENT AND MATERIALS PROVIDED.

- 1. THE DEFINITION OF ELECTRICAL TERMS USED SHALL BE AS DEFINED IN THE EDITION OF THE NATIONAL ELECTRIC CODE (NEC) AS REFERENCED IN THE BUILDING CODE OF NEW YORK
- 2. THE TERM "INDICATED" SHALL MEAN "AS SHOWN ON CONTRACT DOCUMENTS (SPECIFICATIONS, DRAWINGS, AND RELATED ATTACHMENTS)'
- 3. THE TERM "PROVIDE" SHALL MEAN "TO FURNISH, INSTALL, AND CONNECT COMPLETELY"
- 4. THE TERM "SIZE" SHALL MEAN ONE OR MORE OF THE FOLLOWING: "LENGTH, CURRENT AND VOLTAGE RATING, NUMBER OF POLES, NEMA SIZE, AND OTHER SIMILAR ELECTRICAL CHARACTERISTICS".

- 1. ELECTRICAL PLANS, DETAILS, AND ONE LINE DIAGRAMS SHOW THE GENERAL LOCATION AND ARRANGEMENT OF THE ELECTRICAL SYSTEM. THEY ARE DIAGRAMMATIC AND DO NOT SHOW ALL CONDUIT BODIES, CONNECTORS, BENDS, FITTINGS, HANGERS, AND ADDITIONAL PULL BOXES WHICH THE CONTRACTOR MUST PROVIDE TO COMPLETE THE ELECTRICAL
- 2. ELECTRICAL PLANS AND DETAILS DO NOT SHOW ALL INTERFERENCES AND CONDITIONS VISIBLE AND/OR HIDDEN, THAT MAY EXIST; THUS REQUIRING THE CONTRACTOR TO INSPECT AND SURVEY THE SPACE BEFORE PERFORMING THE

METHODS

- 1. ALL EXTERIOR CONDUITS TO HAVE DUCT SEAL INSTALLED AT ALL ENDS, BOXES, WEATHERHEADS, PENETRATIONS TO INTERIOR SPACES, ETC.
- 2. DUCT BANKS SHALL NOT BE ROUTED DIRECTLY ABOVE OR BELOW EXISTING/PROPOSED UTILITIES EXCEPT WHEN CROSSING. WHERE CROSSING EXISTING OR PROPOSED UTILITIES DUCT BANKS SHALL CROSS AT 90 DEGREE ANGLES.
- 3. ALL CONDUIT SYSTEMS EXPOSED TO TEMPERATURE DIFFERENTIALS, IN POTENTIAL CONDENSING ATMOSPHERES, EXTERIOR INSTALLED, OR INSTALLED UNDERGROUND SHALL HAVE PROVISIONS FOR DRAINING WATER OUT OF CONDUIT SYSTEMS.

UNDERGROUND UTILITIES

- 1. UNDERGROUND UTILITY LOCATIONS ARE NOT GUARANTEED, NOR IS THERE ANY GUARANTEE THAT ALL EXISTING UTILITIES WHETHER FUNCTIONAL OR ABANDONED WITHIN THE PROJECT AREA ARE SHOWN ON THESE DRAWINGS.
- 2. THE CONTRACTOR SHALL DETERMINE THE EXACT LOCATION OF ALL UNDERGROUND UTILITIES BEFORE BEGINNING WORK & SHALL BE RESPONSIBLE FOR ALL DAMAGE RESULTING FROM HIS/HER WORK.
- 3. THE CONTRACTOR SHALL NOTIFY "DIG SAFELY NEW YORK" 1-800-962-7962 PRIOR TO ANY EXCAVATION.

SYMBOLS

LINEWEIGHT AND LINETYPE DESIGNATIONS

EXISTING U.O.I. PROPOSED TO BE PROVIDED U.O.I.

OVERHEAD ELECTRIC

UNDERGROUND ELECTRIC —UGE—

BASIC DRAWING SYMBOLS

UNDERGROUND DUCT BANK DESIGNATION

DRAWING SPECIFIC NOTE

FEEDER DESIGNATION



BRANCH CONTINUATION CIRCUIT (2#12, 1#12G IN 3/4"C TO INDICATED PANEL, PROVIDE 20A, 1P BREAKER)

DISTRIBUTION

\emptyset	UTILITY POLE
	CIRCUIT BREAKER PANELBOARD, SURFACE MTD., 72"AFF (TO TOP)
_	

CIRCUIT BREAKER PANELBOARD, FLUSH MTD., 72"AFF (TO TOP)

GENERATOR

SELF CONTAINED METER METER CONNECTION WITH CURRENT TRANSFORMERS

TRANSFORMER TRANSFORMER

AUTOMATIC TRANSFER SWITCH

SWITCHES AND OVER CURRENT PROTECTION

FUSIBLE/SAFETY DISCONNECT CIRCUIT BREAKER

FUSE DISCONNECT SWITCH

FUSED DISCONNECT SWITCH SWITCH (OPEN)

SWITCH (CLOSED) 0 _7/ **FUSE CUTOUT**

DRAW-OUT FRAME

GROUNDING

WIRING METHODS

GROUND

GROUND ROD

GAS/WATER TIGHT PENETRATION INSULATED BUSHING OR CONDUIT STUB

 \vdash SEAL OFF PULL BOX, ITEM NUMBER JUNCTION BOX

HAND HOLE, ITEM NUMBER

MOTORS AND MOTOR STARTERS

FIRE PROTECTION

FAN/BLOWER

MOTOR WITH HORSEPOWER VARIABLE FREQUENCY DRIVE (VFD)

MS MANUAL MOTOR STARTER

\bowtie COMBINATION MAG. MOTOR STARTER W/FUSIBLE SWITCH,

FIRE ALARM SYSTEM, SMOKE DETECTOR FIRE ALARM SYSTEM, PULLSTATION FACP FIRE ALARM SYSTEM, FIRE ALARM CONTROL PANEL

FIRE ALARM SYSTEM, HEAT DETECTOR

FIRE ALARM SYSTEM, CARBON MONOXIDE DETECTOR

FIRE ALARM SYSTEM, HORN/STROBE FIRE ALARM SYSTEM, HORN

FIRE ALARM SYSTEM, STROBE

SMOKE DETECTOR UNDER RAISED FLOOR

RECEPTACLES & DATA DEVICES

SINGLE RECEPTACLE DUPLEX RECEPTACLE, XXX-X INDICATES PANEL AND CIRCUIT NUMBER (2#12, 1#12G IN 3/4"C TO INDICATED PANEL, PROVIDE 20A, 1P BREAKER)

QUADPLEX RECEPTACLE SPECIAL RECEPTACLE, 4'AFF, NEMA CONFIGURATION AS NOTED

DOUBLE DUPLEX RECEPTACLE

SWITCHED DUPLEX RECEPTACLE OUTLET, SWITCH TOP HALF

DUPLEX DATA RECEPTACLE (2 CAT6A CABLES PER SYMBOL) QUAD DATA RECEPTACLE (4 CAT6A CABLES PER SYMBOL) 2 PORT TELEPHONE AND RJ-45 DATA OUTLET

FLUSH MOUNT FLOOR BOX

WALL SWITCH

FLOORBOX WITH DATA RECEPTACLE, DUPLEX RECEPTACLE AND MIC RECEPTACLE

FLOORBOX WITH DATA RECEPTACLE AND DUPLEX RECEPTACLE FLOORBOX WITH (2) DATA RECEPTACLE, DUPLEX RECEPTACLE AND MIC RECEPTACLE FLOORBOX WITH (2) DATA RECEPTACLE, DUPLEX RECEPTACLE, MIC RECEPTACLE AND MINI SPEAKER

FLOORBOX WITH (4) DATA RECEPTACLE, QUAD RECEPTACLE AND MIC RECEPTACLE FLOORBOX WITH (4) DATA RECEPTACLE, QUAD RECEPTACLE, MIC RECEPTACLE AND MINI SPEAKER

LIGHTING (REFER TO LIGHTING FIXTURE SCHEDULE FOR FIXTURE TYPES)

DIMMER WALL SWITCH 3-WAY WALL SWITCH CEILING MOUNTED OCCUPANCY/MOTION SENSOR 2'X2' LED LIGHT FIXTURE, X INDICATES FIXTURE TYPE

2'x4' LED LIGHT FIXTURE, X INDICATES FIXTURE TYPE WALL PACK, OUTDOOR LIGHTING FIXTURE, X INDICATES FIXTURE TYPE

EXIT LIGHT FIXTURE, CEILING MOUNTED SHADING INDICATES FACE EXIT LIGHT FIXTURE, WALL MOUNTED, ARROWS AS INDICATED

EMERGENCY LIGHTING UNIT, INTEGRAL BATTERY, X INDICATES FIXTURE TYPE

SITE LIGHTING FIXTURE, TWIN POLE MOUNTED

CONTROL DEVICES

CONTACTOR (NO) $\rightarrow \downarrow \leftarrow$ CONTACTOR (NC)

TEMPERATURE ACTUATED SWITCH (OPEN) TEMPERATURE ACTUATED SWITCH (CLOSED)

PUSH BUTTON (OPEN) T THERMOSTAT

SECURITY DEVICES

MASTER INTERCOM W/DOOR RELEASE MASTER INTERCOM W/DOOR RELEASE

REMOTE INTERCOM

INTERCOM WITH DURESS ALARM **DURESS ALARM ACTIVATION DEVICE**

 \overline{R} HEAT RISE DETECTOR MOTION DETECTOR

DIGITAL KEYPAD CARD READER

ALARM ANNUNCIATOR PANEL SECURITY CAMERA (CAMERAS PROVIDED BY OCA AND INSTALLED BY PROJECT

COORDINATOR) (J1)TEL/DATA FLUSH MOUNTED FLOOR BOX

WIFI WIRELESS ACCESS POINT

AIPHONE

KRONOS KRONOS (2 CAT6A CABLES PER SYMBOL) DEVICE

OVERHEAD DOOR KEYPAD OPERATOR BALANCED MAGNETIC DOOR CONTACT

MAGNETIC DOOR CONTACT IN CEILING SPEAKER

DOOR CLOSER WITH DOOR POSITION SWITCH

ABBREVIATIONS

CB

CONC

CP

CT

CU

DISC

EC

FS/S

FSR

FT

GC

CONCRETE

PHASE MAIN DISCONNECT WITH ITEM NUMBER **AMPERE** MAIN CIRCUIT BREAKER AMP FRAME MOTOR CONTROL CENTER MCP ABOVE FINISHED FLOOR MAIN CONTROL PANEL AMERICAN NATIONAL STANDARDS INSTITUTE MFR MANUFACTURER ANSI AMP TRIP MINIMUM MOTOR STARTER **AUTOMATIC TRANSFER SWITCH** MS CONDUIT MTS MANUAL TRANSFER SWITCH CIRCUIT BREAKER NEUTRAL CKT CIRCUIT NORMALLY CLOSED COMB COMBINATION STARTER NATIONAL ELECTRIC CODE **COMM** COMMUNICATIONS NON-FUSED DISCONNECT

NO

NORMALLY OPEN

SWITCH

SWBD

VFD

SWITCHBOARD

WEATHERPROOF

TRANSFORMER

VARIABLE FREQUENCY DRIVE

CONSTRUCTION POLE CONST CONTROL PANEL PULL BOX WITH ITEM NUMBER **CURRENT TRANSFORMER** PROVIDED (FURNISHED AND INSTALLED) COPPER PHOTO CELL DISCONNECT PHASE DISTRIBUTION PANEL WITH ITEM NUMBER PΝ PANEL

DWG DRAWING PRI ELECTRICAL CONTRACTOR POUNDS PER SQUARE INCH PSI **EMERGENCY** PRESSURE TRANSDUCER ELECTROMAGNETIC INTERFERENCE PWR POWER EMERGENCY POWER SUPPLY SYSTEM QTY QUANTITY

RCPT RECEPTACLE **EQUIP** EQUIPMENT **EXTERIOR** REQD REQUIRED EXT FIRE ALARM RGS RIGID GALVANIZED STEEL SEC FIRE ALARM ANNUNCIATION PANEL SECONDARY SPEC **FACP** FIRE ALARM CONTROL PANEL SPECIFICATION **FURNISHED BY** SQ SQUARE

SYMMETRICAL FAN SHUT-DOWN RELAY FEET TYPICAL **FURN FURNISHED** UG/E UNDERGROUND ELECTRIC UNINTERRUPTIBLE POWER SUPPLY GENERAL CONTRACTOR GFCI GROUND FAULT CIRCUIT INTERRUPTER VOLTAGE

GND HAND HOLE WITH ITEM NUMBER HIGH INTENSITY DISCHARGE HAND-OFF-AUTO SELECTOR SWITCH

BOX COVER FUSTAT W/ SWITCH

HORSEPOWER INCITES JUNCTION BOX

FULL LOAD AMPACITY

1000 AMPERE INTERRUPTING CAPACITY 1000 CIRCULAR MILS KILOWATT

LIGHT EMITTING DIODE LED LOCATION

LIGHTING PANEL WITH ITEM NUMBER LEVEL SENSOR LIGHTS LTS

MAN MANUAL STARTER MDP-1 MAIN DISTRIBUTION PANEL WITH ITEM NUMBER

UNIT ABBREVIATIONS

WP

AIR COOLED CONDENSING UNIT AIR HANDLING UNIT BOILER EXHAUST FAN UNIT HEATER ELECTRIC WATER COOLER FEED PUMP GREENSAND FILTER HOT WATER HEATER PUMP


PACKAGED TERMINAL AIR CONDITIONING REMOTE THERMAL UNIT RTU

> WELL PUMP VARIABLE FREQUENCY DRIVE

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SHALL STAMP THE DOCUMENT AND FOLLOWED BY THEIR SIGNATURE, THE DATE OF SUCH ALTERATION, AND A SPECIFIC DESCRIPTION OF THE ALTERATION REVISIONS


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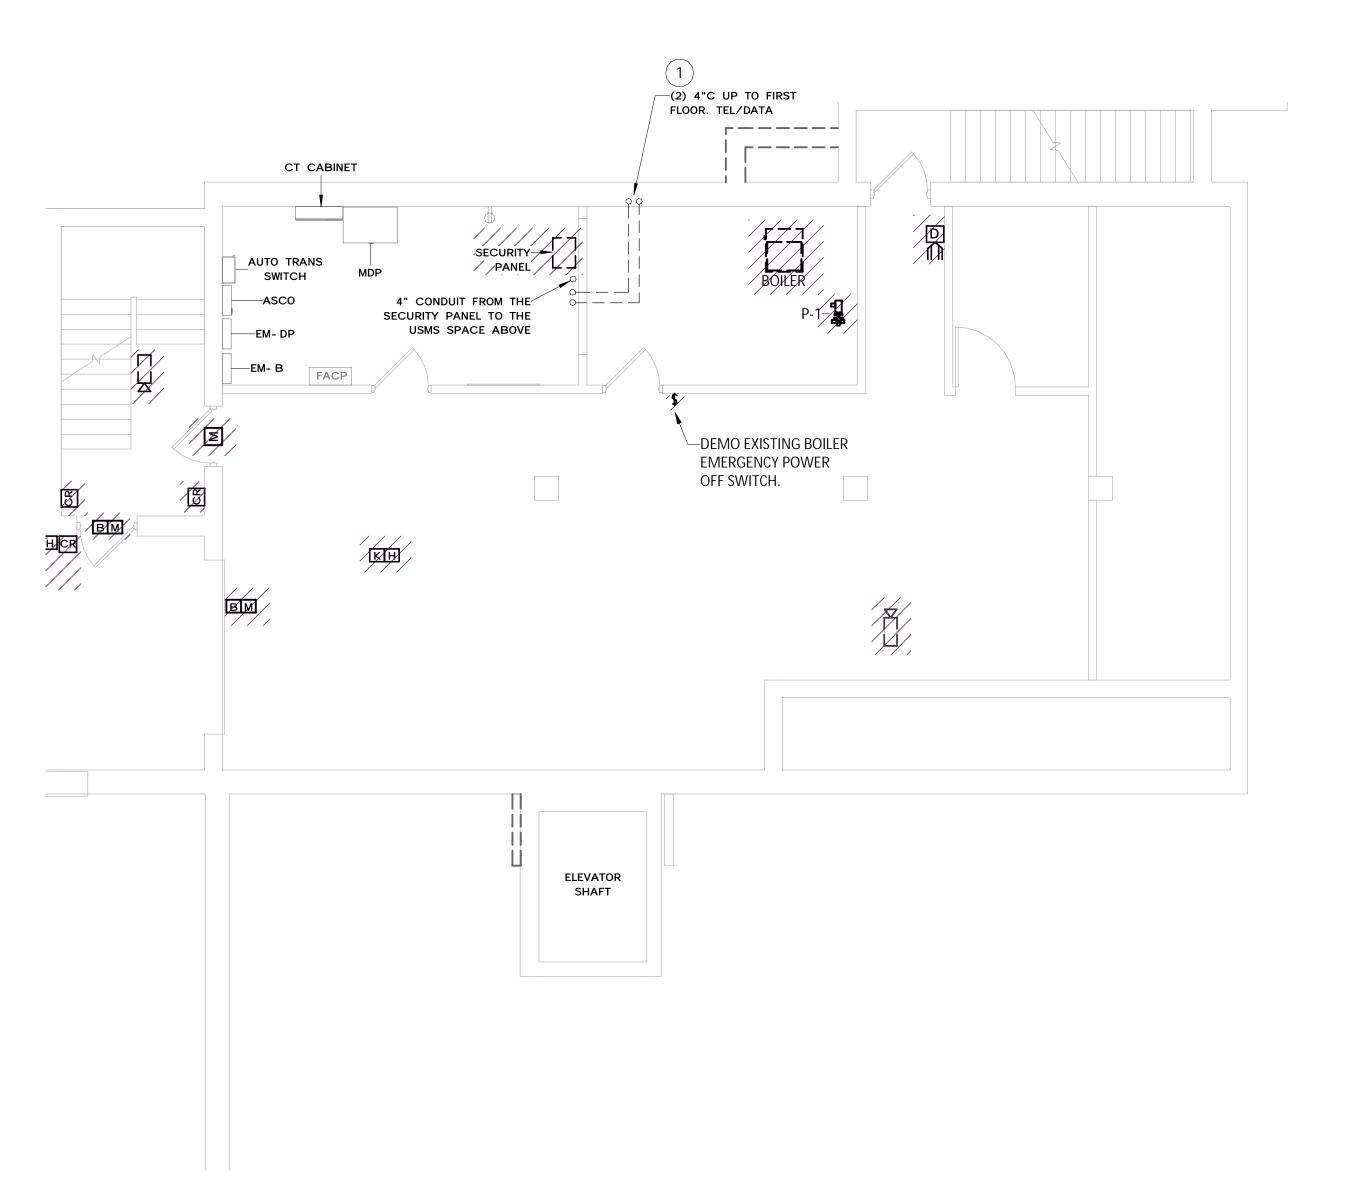


11/30/202 AUGUST, 2024

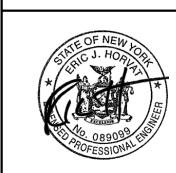AS SHOWN Sheet Number

Project Number



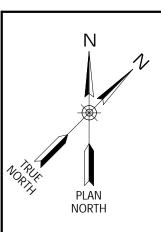

BASEMENT POWER & SYSTEMS PLAN DEMO

SCALE: 3/16" = 1'-0"

GENERAL NOTES - BASEMENT POWER & SYSTEMS PLAN DEMO

- 1 DEMO ALL EQUIPMENT SHOWN IN A HATCH PATTERN. DEMO ALL ASSOCIATED CONDUCTORS, RACEWAY, AND HARDWARE BACK TO ITS SOURCE.
- 2 BASEMENT POWER & SYSTEMS PLAN DEMO DRAWING CREATED FROM DRAWINGS E-1 TITLED BASEMENT PLAN AND SE1 TITLED BASEMENT FLOOR SECURITY PLAN DIAGRAM DATED FEBRUARY 1, 2005, AND CURSORY FIELD OBSERVATIONS. CONTRACTOR TO FIELD VERIFY ALL EXISTING INFORMATION REQUIRED.
- 3 MAINTAIN EXISTING CIRCUITS OTHER THAN THE ONES SHOWN TO BE DEMOED. UPDATE PANEL DIRECTORIES AS REQUIRED.
- 4 CONTRACTOR SHALL VERIFY NO EQUIPMENT TO REMAIN IS CONNECTED TO CIRCUITS THAT ARE BEING REMOVED. MAINTAIN CIRCUIT CONTINUITY TO ALL EQUIPMENT TO REMAIN. PROVIDE ALL REQUIRED CIRCUIT MODIFICATIONS INCLUDING, BUT NOT LIMITED TO, CONDUIT, WIRE, JUNCTION BOXES, AND SPLICES.

KEYED NOTES - BASEMENT POWER & SYSTEMS PLAN DEMO

1 EXISTING CONDUITS AND PULLBOXES SHALL REMAIN AND BE REUSED.

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REVISIONS

DESCRIPTION OF THE ALTERATION.

DEMO


PLA CITY OF MIDDLETOWN
NEW COURTHOUSE FACILITY
CONTRACT 1D - ELECTRICAL CONSTRUCTION SYSTEMS


POWER BASEMENT

AUGUST, 2024

AS SHOWN

Sheet Number E101

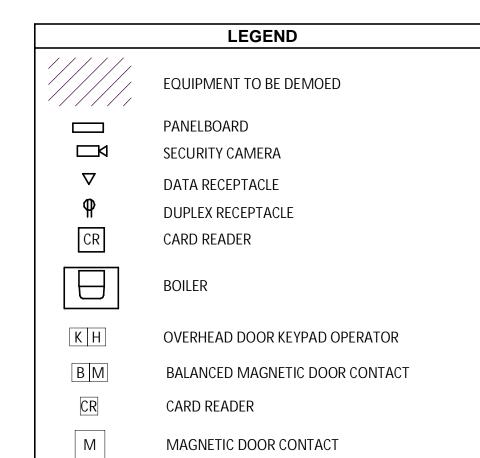

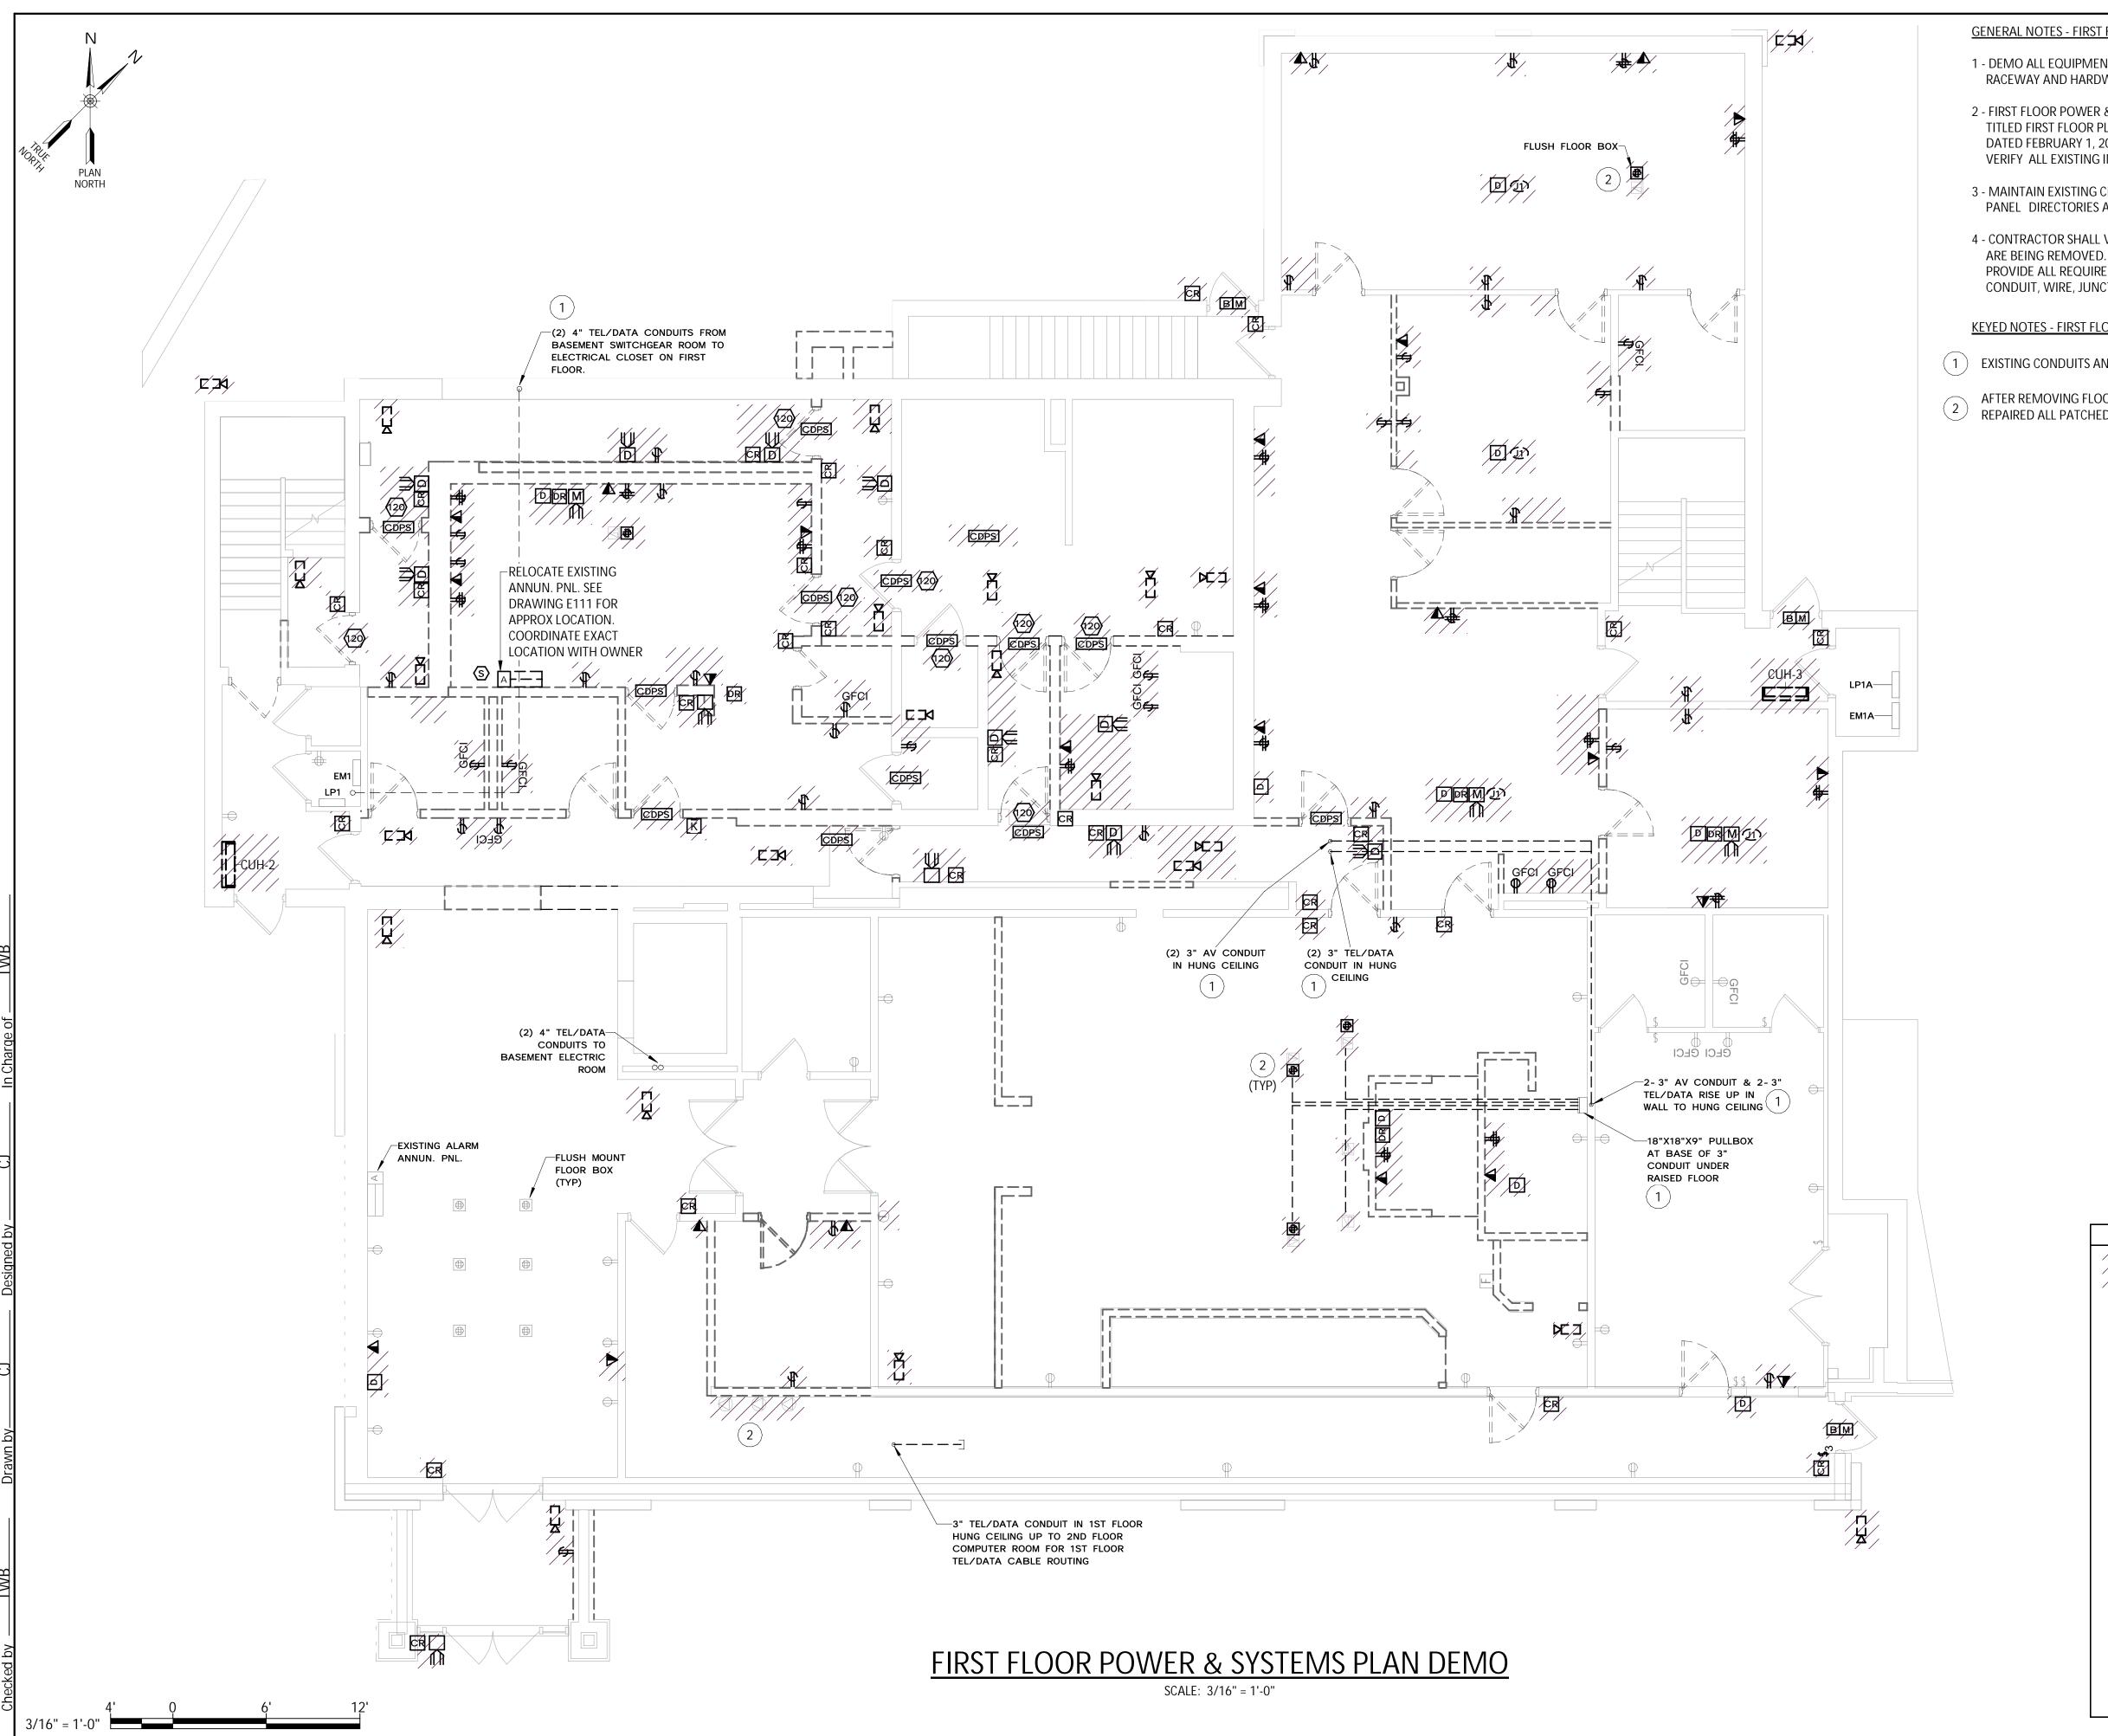

GENERAL NOTES - FIRST FLOOR POWER & SYSTEMS PLAN DEMO

- 1 DEMO ALL EQUIPMENT SHOWN IN HATCH PATTERN. DEMO ALL ASSOCIATED CONDUCTORS, RACEWAY AND HARDWARE BACK TO ITS SOURCE.
- 2 FIRST FLOOR POWER & SYSTEMS PLAN DEMO DRAWING CREATED FROM DRAWINGS E-2P TITLED FIRST FLOOR PLAN POWER AND SE2 TITLED FIRST FLOOR SECURITY PLAN DIAGRAM DATED FEBRUARY 1, 2005 AND CURSORY FIELD OBSERVATIONS. CONTRACTOR TO FIELD VERIFY ALL EXISTING INFORMATION REQUIRED.
- 3 MAINTAIN EXISTING CIRCUITS OTHER THAN THE ONES SHOWN TO BE DEMO'D. UPDATE PANEL DIRECTORIES AS REQUIRED.
- 4 CONTRACTOR SHALL VERIFY NO EQUIPMENT TO REMAIN IS CONNECTED TO CIRCUITS THAT ARE BEING REMOVED. MAINTAIN CIRCUIT CONTINUITY TO ALL EQUIPMENT TO REMAIN. PROVIDE ALL REQUIRED CIRCUIT MODIFICATIONS INCLUDING, BUT NOT LIMITED TO, CONDUIT, WIRE, JUNCTION BOXES, AND SPLICES.

KEYED NOTES - FIRST FLOOR POWER & SYSTEMS PLAN DEMO

- (1) EXISTING CONDUITS AND PULLBOXES SHALL REMAIN AND BE REUSED.
- AFTER REMOVING FLOUR BUXES FATOLIAND RELAIN. 2001. 2

 REPAIRED ALL PATCHED FLOOR PENETRATIONS MUST BE 2 HOUR FIRE RATED. AFTER REMOVING FLOOR BOXES PATCH AND REPAIR FLOOR TO ITS ORIGINAL STATE. WHEN

LEGEND

EQUIPMENT TO BE DEMOED

PANELBOARD

SECURITY CAMERA

DATA RECEPTACLE

CARD READER

М

CDPS

DUPLEX RECEPTACLE

OVERHEAD DOOR KEYPAD OPERATOR

BALANCED MAGNETIC DOOR CONTACT

MAGNETIC DOOR CONTACT

INTERCOM WITH DURESS ALARM

DURESS ALARM ACTIVATION DEVICE

MASTER INTERCOM W/DOOR RELEASE

TEL/DATA FLUSH MOUNTED FLOOR BOX

DOOR CLOSER WITH DOOR POSITION SWITCH

WALL MOUNTED HEATER

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OF SUCH ALTERATION, AND A SPECIFIC DESCRIPTION OF THE ALTERATION

REVISIONS


DEMO

AN CITY OF MIDDLETOWN NEW COURTHOUSE FACILITY CONTRACT 1D - ELECTRICAL CONSTRUCTION **L** SYSTEMS

POWER OR FLO **FIRST**

AUGUST, 2024 Scale AS SHOWN

Sheet Number E102

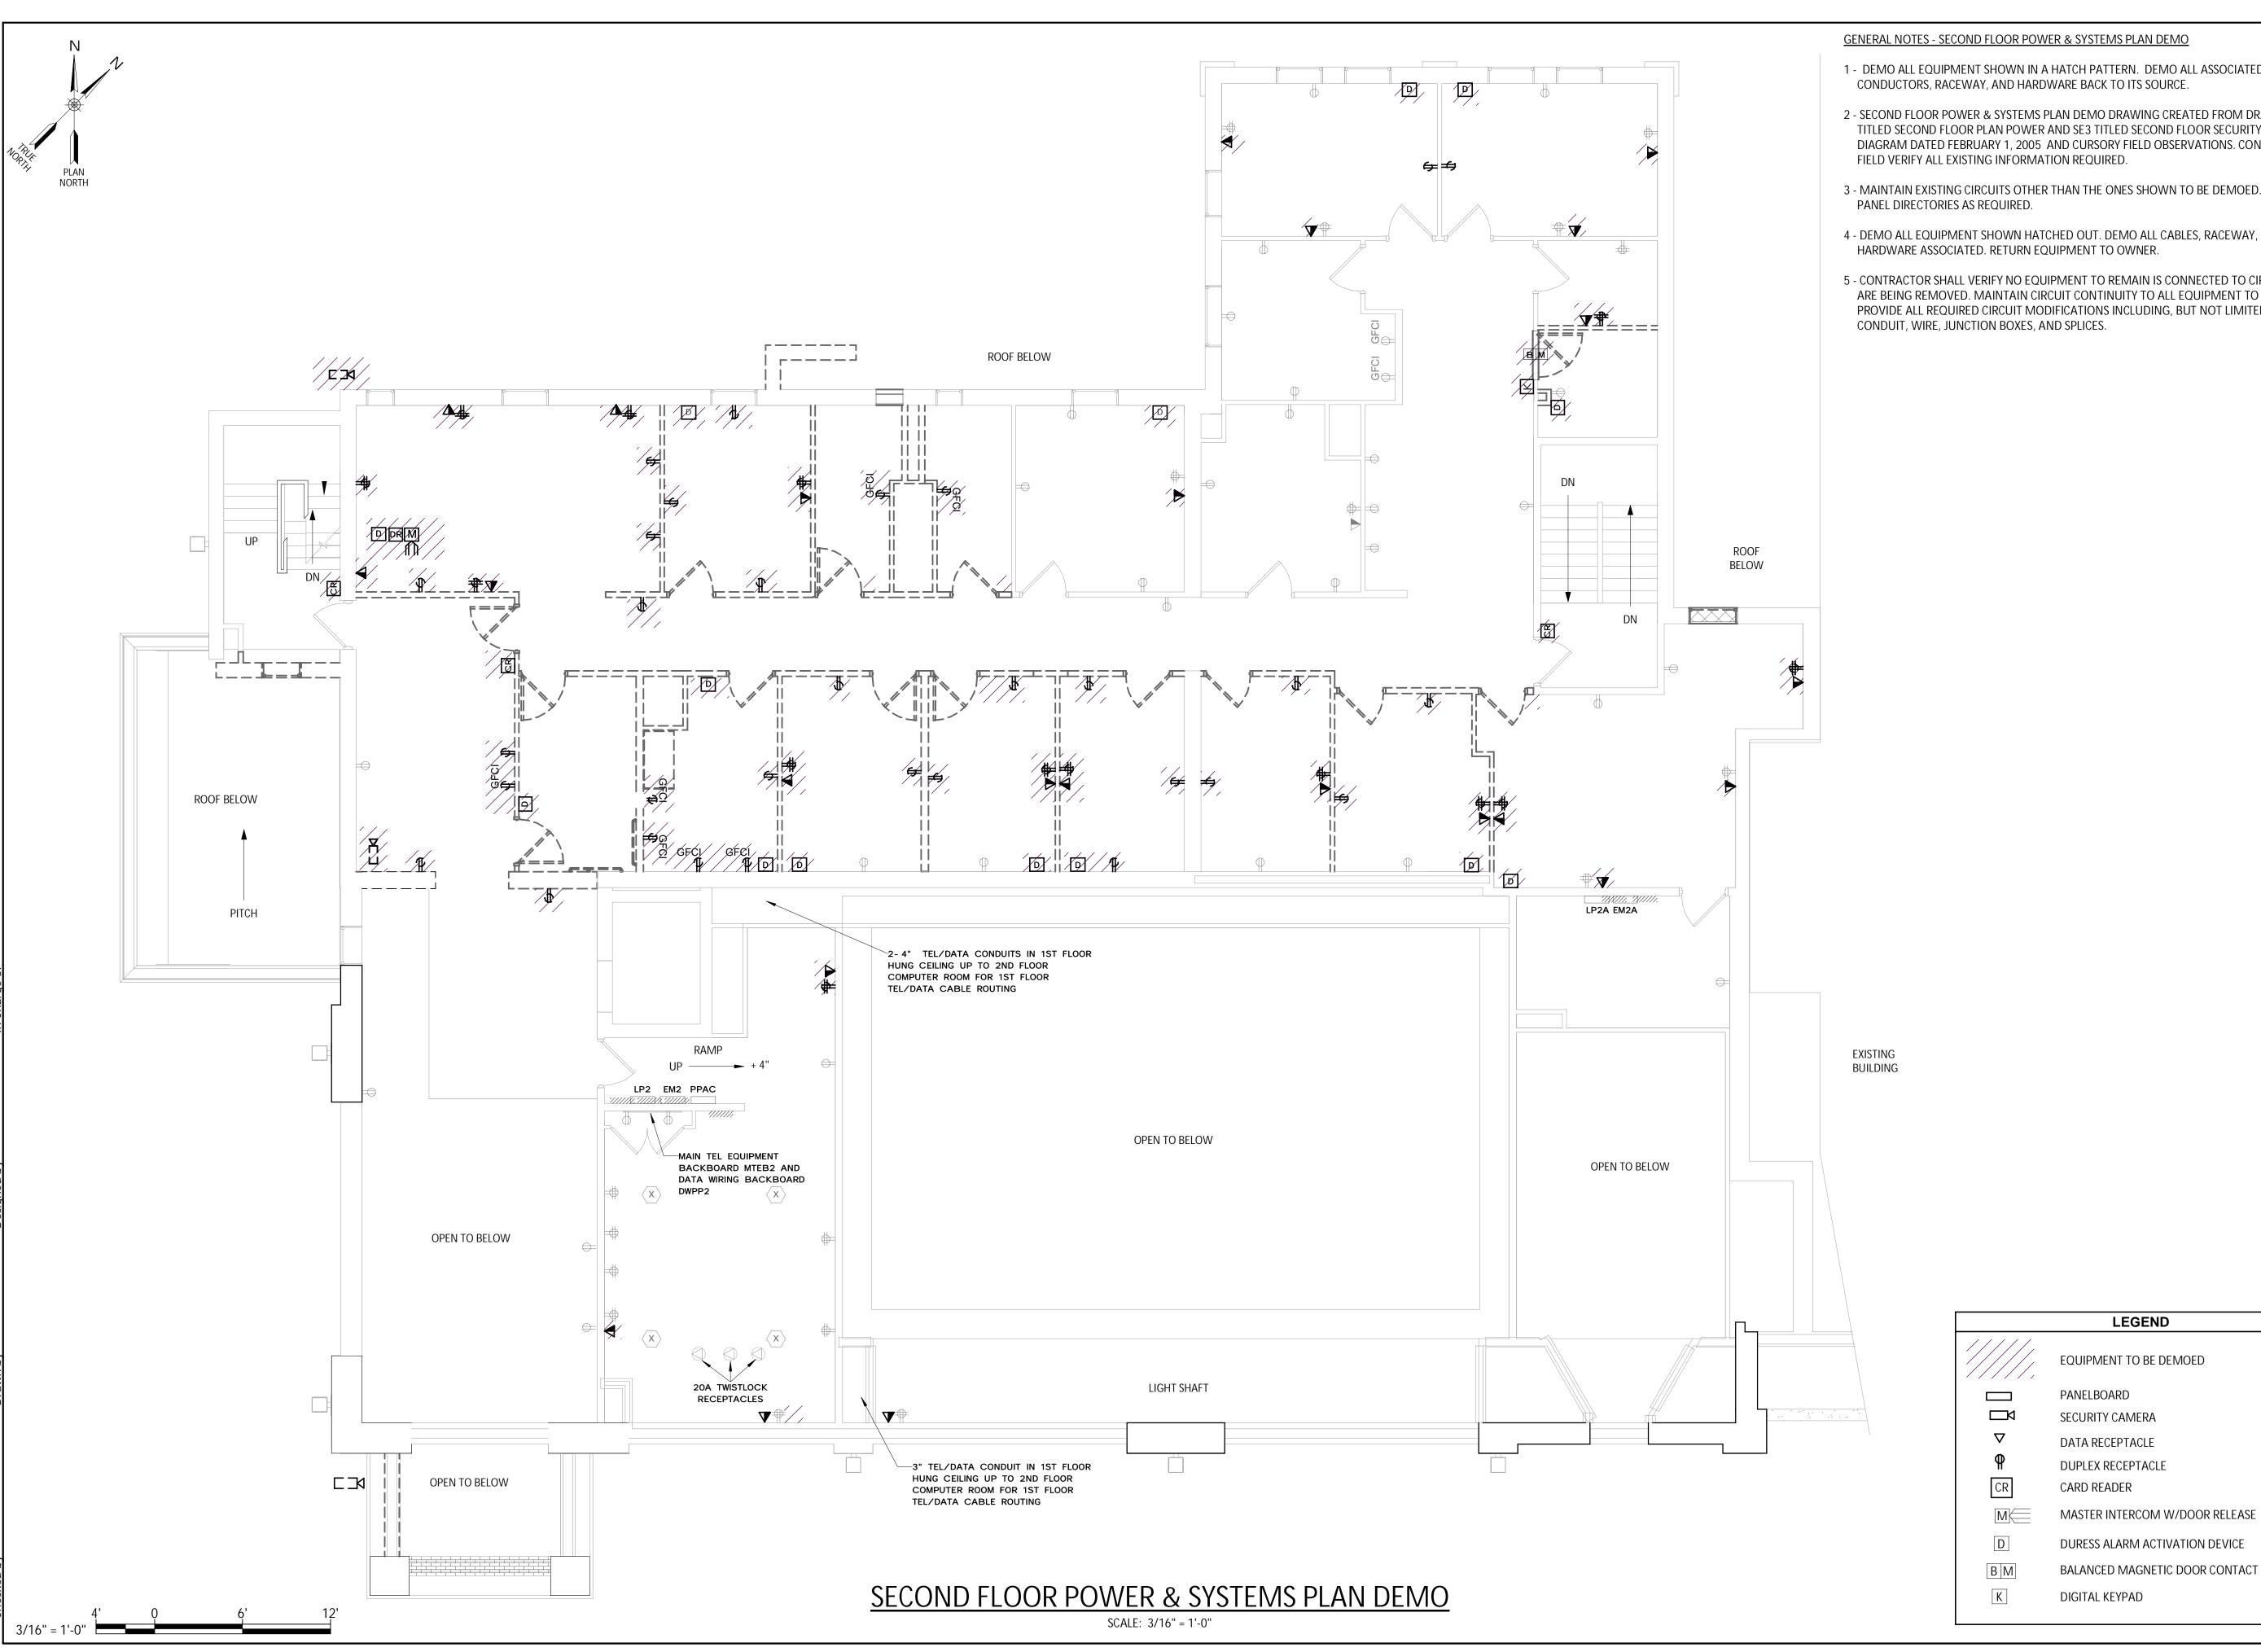

1 - DEMO ALL EQUIPMENT SHOWN IN A HATCH PATTERN. DEMO ALL ASSOCIATED

2 - SECOND FLOOR POWER & SYSTEMS PLAN DEMO DRAWING CREATED FROM DRAWINGS E-3P TITLED SECOND FLOOR PLAN POWER AND SE3 TITLED SECOND FLOOR SECURITY PLAN DIAGRAM DATED FEBRUARY 1, 2005 AND CURSORY FIELD OBSERVATIONS. CONTRACTOR TO

3 - MAINTAIN EXISTING CIRCUITS OTHER THAN THE ONES SHOWN TO BE DEMOED. UPDATE

4 - DEMO ALL EQUIPMENT SHOWN HATCHED OUT. DEMO ALL CABLES, RACEWAY, AND

5 - CONTRACTOR SHALL VERIFY NO EQUIPMENT TO REMAIN IS CONNECTED TO CIRCUITS THAT ARE BEING REMOVED. MAINTAIN CIRCUIT CONTINUITY TO ALL EQUIPMENT TO REMAIN. PROVIDE ALL REQUIRED CIRCUIT MODIFICATIONS INCLUDING, BUT NOT LIMITED TO,

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OF SUCH ALTERATION, AND A SPECIFIC DESCRIPTION OF THE ALTERATION

REVISIONS

DEMO AN

CITY OF MIDDLETOWN
NEW COURTHOUSE FACILITY
CONTRACT 1D - ELECTRICAL CONSTRUCTION SYSTEMS **POWER** OOR


SECOND

AUGUST, 2024

AS SHOWN

Sheet Number

E103

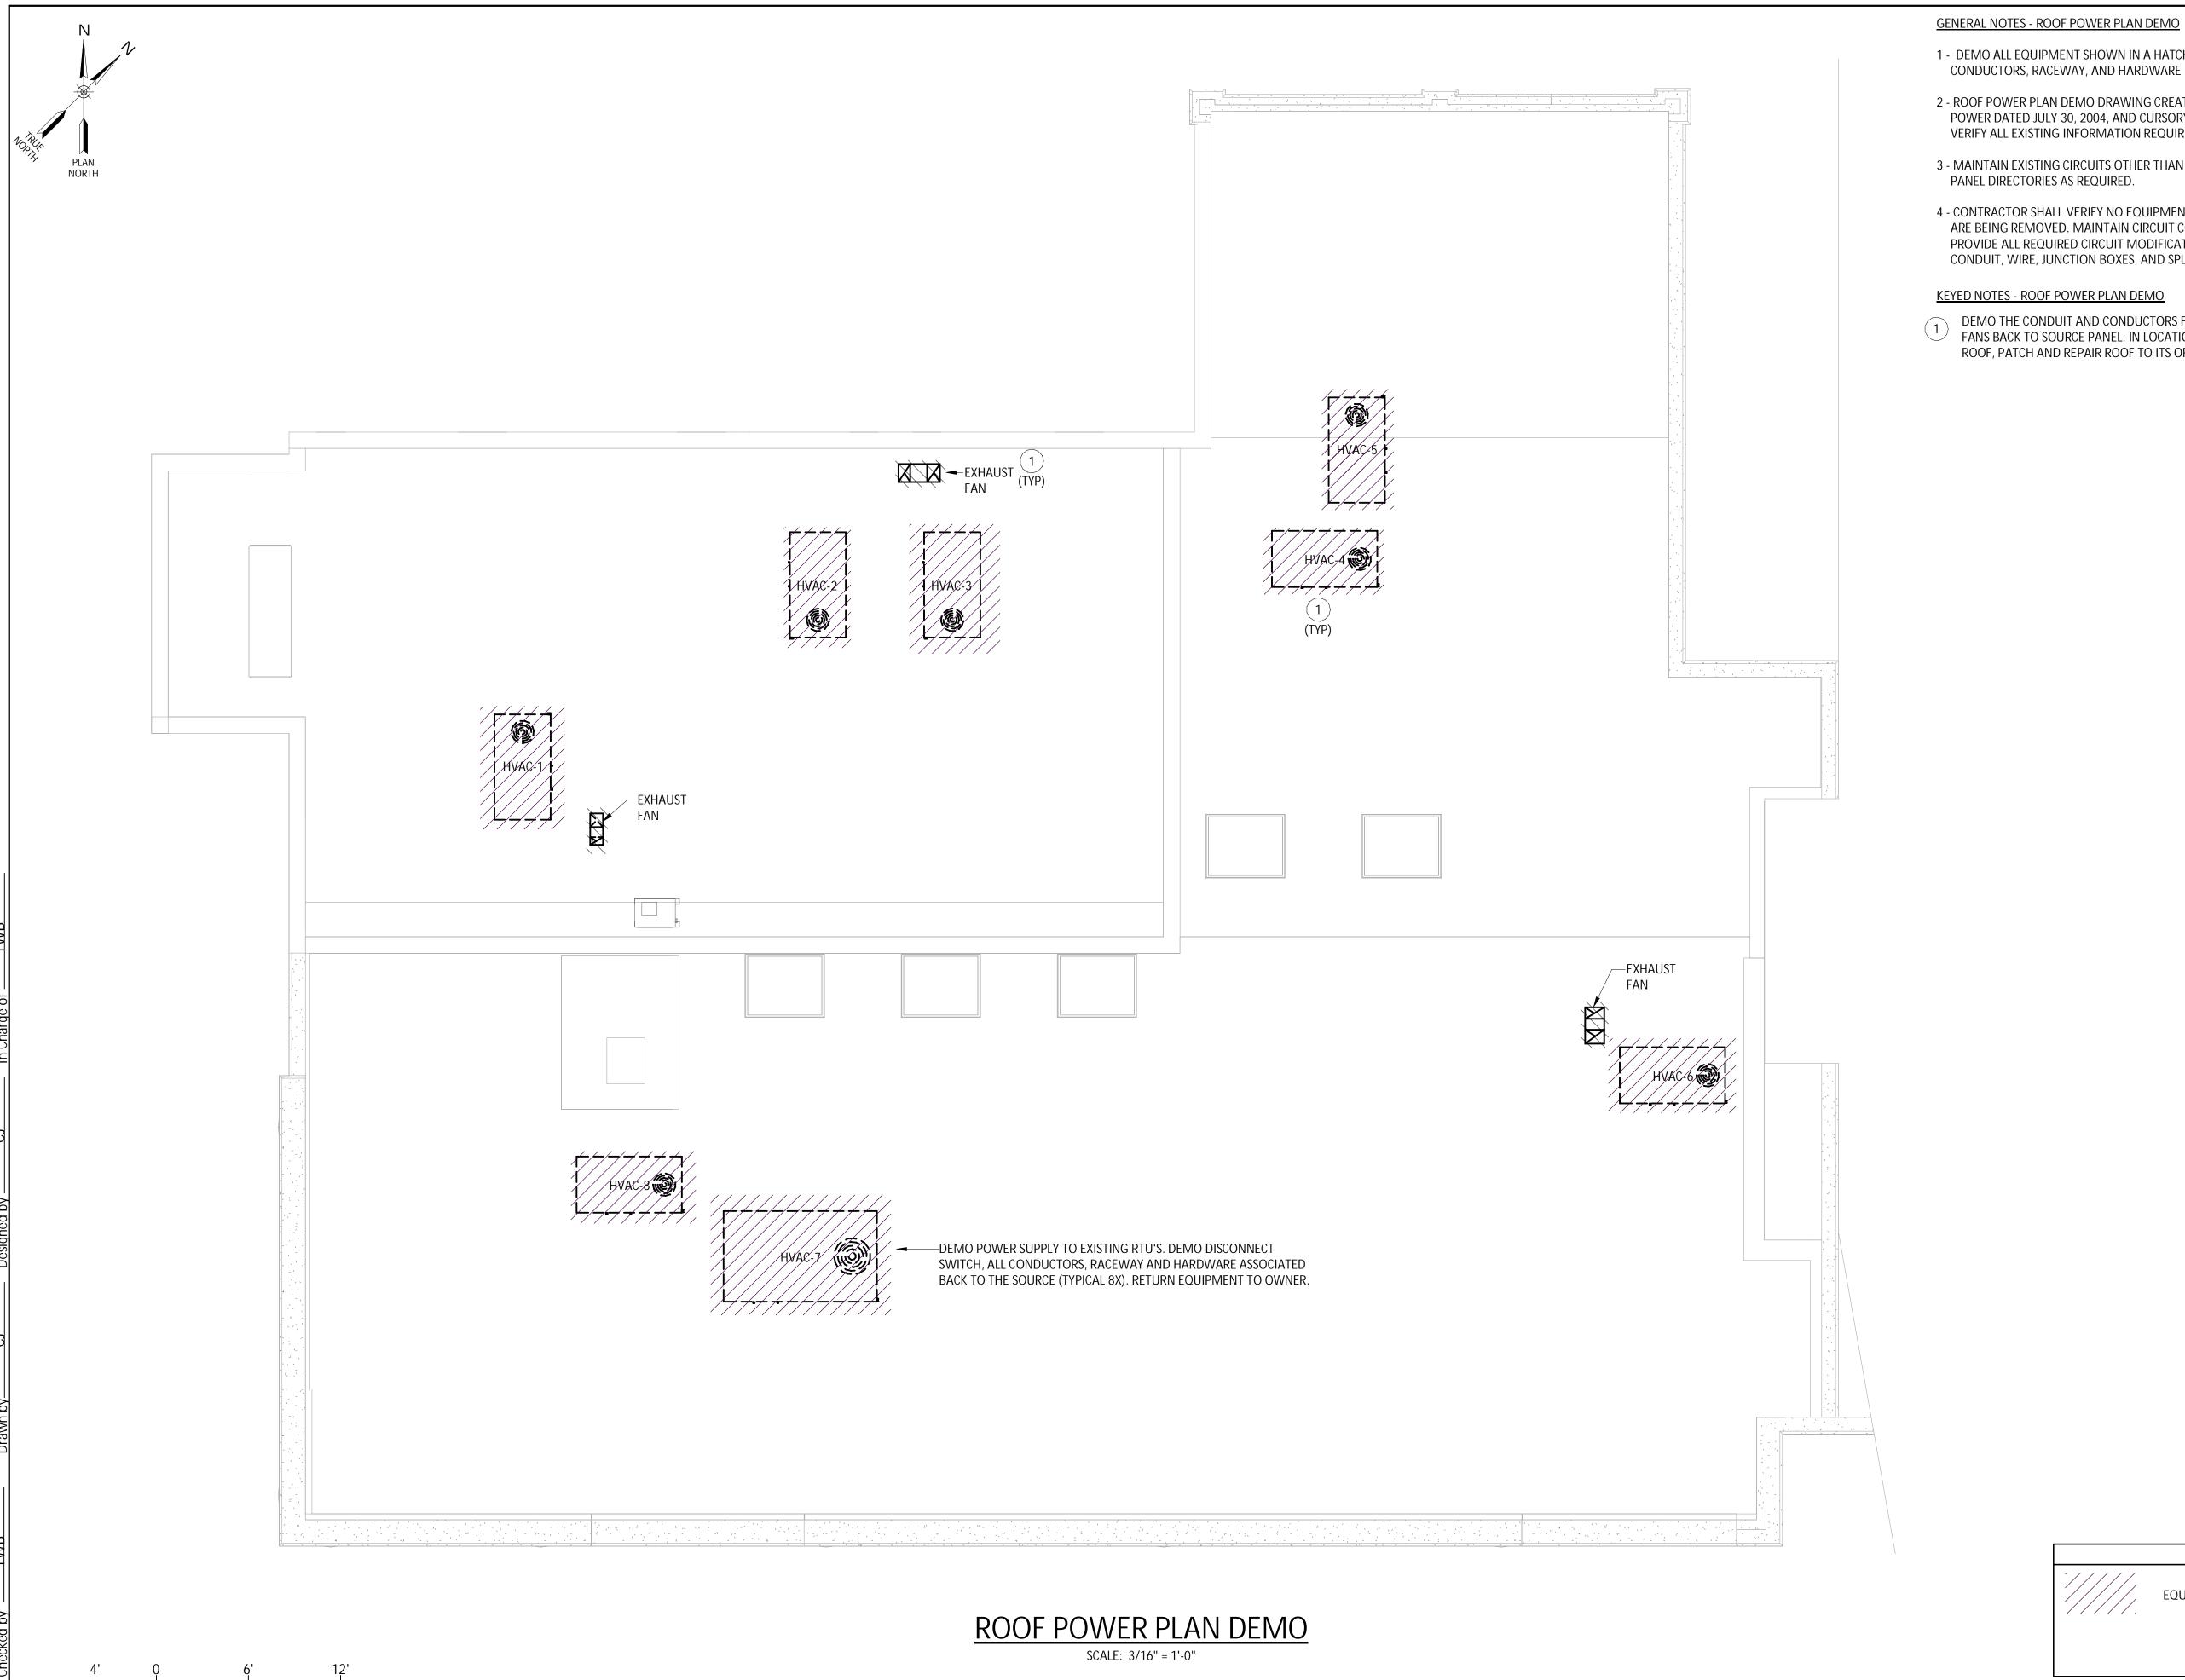

- 1 DEMO ALL EQUIPMENT SHOWN IN A HATCH PATTERN. DEMO ALL ASSOCIATED CONDUCTORS, RACEWAY, AND HARDWARE BACK TO ITS SOURCE.
- 2 ROOF POWER PLAN DEMO DRAWING CREATED FROM DRAWINGS E-4 TITLED ROOF PLAN POWER DATED JULY 30, 2004, AND CURSORY FIELD OBSERVATIONS. CONTRACTOR TO FIELD VERIFY ALL EXISTING INFORMATION REQUIRED.
- 3 MAINTAIN EXISTING CIRCUITS OTHER THAN THE ONES SHOWN TO BE DEMOED. UPDATE
- 4 CONTRACTOR SHALL VERIFY NO EQUIPMENT TO REMAIN IS CONNECTED TO CIRCUITS THAT ARE BEING REMOVED. MAINTAIN CIRCUIT CONTINUITY TO ALL EQUIPMENT TO REMAIN. PROVIDE ALL REQUIRED CIRCUIT MODIFICATIONS INCLUDING, BUT NOT LIMITED TO, CONDUIT, WIRE, JUNCTION BOXES, AND SPLICES.

DEMO THE CONDUIT AND CONDUCTORS FROM THE EXISTING HVAC UNITS AND EXHAUST FANS BACK TO SOURCE PANEL. IN LOCATIONS WHERE THE CONDUIT PENETRATED THE ROOF, PATCH AND REPAIR ROOF TO ITS ORIGINAL CONDITION.

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OF SUCH ALTERATION, AND A SPECIFIC DESCRIPTION OF THE ALTERATION

REVISIONS

DEMO CITY OF MIDDLETOWN
NEW COURTHOUSE FACILITY
CONTRACT 1D - ELECTRICAL CONSTRUCTION POWER ROOF





AUGUST, 2024


AS SHOWN

Sheet Number E104

Project Number 1753.008.001

LEGEND

EQUIPMENT TO BE DEMOED

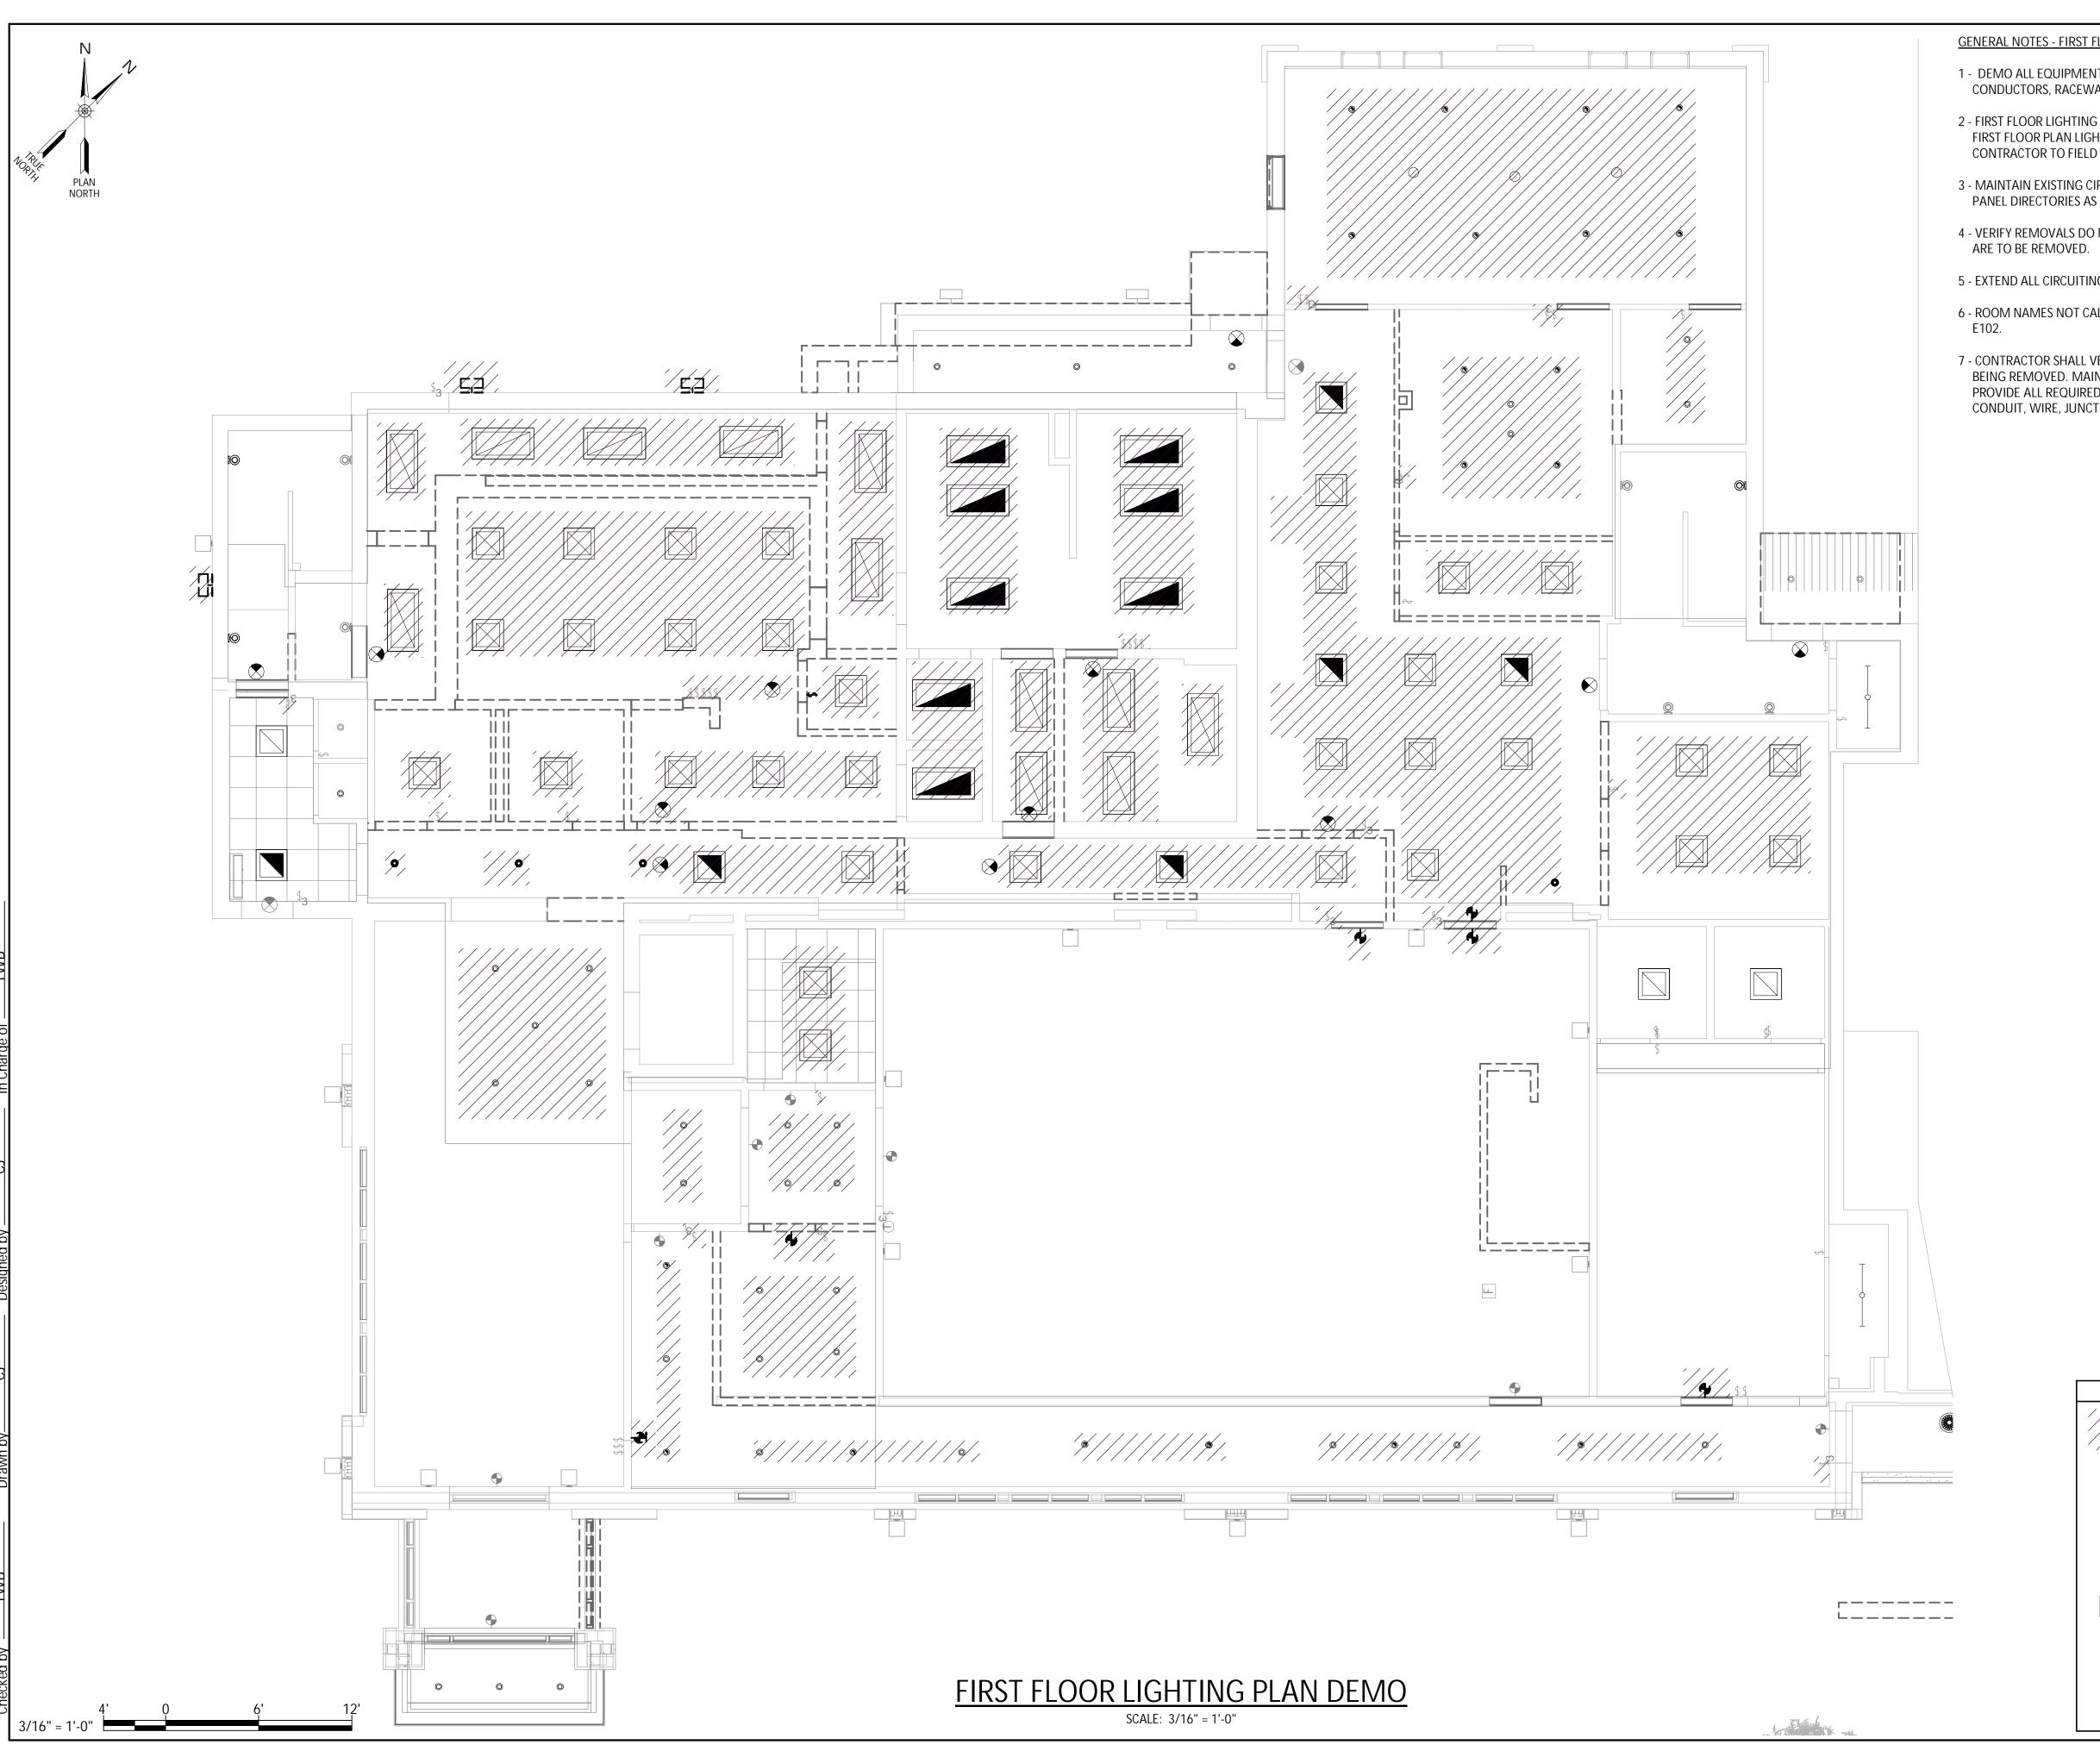

GENERAL NOTES - FIRST FLOOR LIGHTING PLAN DEMO

- 1 DEMO ALL EQUIPMENT SHOWN IN A HATCH PATTERN. DEMO ALL ASSOCIATED CONDUCTORS, RACEWAY, AND HARDWARE BACK TO ITS SOURCE.
- 2 FIRST FLOOR LIGHTING PLAN DEMO DRAWING CREATED FROM DRAWINGS E-2L TITLED FIRST FLOOR PLAN LIGHTING DATED JULY 30, 2004, AND CURSORY FIELD OBSERVATIONS. CONTRACTOR TO FIELD VERIFY ALL EXISTING INFORMATION REQUIRED.
- 3 MAINTAIN EXISTING CIRCUITS OTHER THAN THE ONES SHOWN TO BE DEMOED. UPDATE PANEL DIRECTORIES AS REQUIRED.
- 4 VERIFY REMOVALS DO NOT IMPACT EQUIPMENT AND DEVICES OTHER THAN THOSE THAT
- 5 EXTEND ALL CIRCUITING TO DEVICES AND EQUIPMENT TO REMAIN.
- 6 ROOM NAMES NOT CALLED OUT FOR DRAWING CLARITY. FOR ROOM NAMES SEE DRAWING
- 7 CONTRACTOR SHALL VERIFY EQUIPMENT TO REMAIN IS CONNECTED TO CIRCUITS THAT ARE BEING REMOVED. MAINTAIN CIRCUIT CONTINUITY TO ALL EQUIPMENT TO REMAIN. PROVIDE ALL REQUIRED CIRCUIT MODIFICATIONS INCLUDING, BUT NOT LIMITED TO, CONDUIT, WIRE, JUNCTION BOXES, AND SPLICES.

LEGEND

EQUIPMENT TO BE DEMOED

CEILING MOUNTED OCCUPANCY/MOTION SENSOR

2'X2' LED LIGHT FIXTURE, X INDICATES FIXTURE TYPE

2'x4' LED LIGHT FIXTURE, X INDICATES FIXTURE TYPE

EXIT LIGHT FIXTURE, CEILING MOUNTED

RECESSED LIGHT FIXTURE, CEILING MOUNTED

DIMMER WALL SWITCH

3-WAY WALL SWITCH

WALL SWITCH

WALL PACK

IT IS A VIOLATION OF THE NEW YORK STATE **EDUCATION LAW, ARTICLE 145 §7209** SPECIAL PROVISIONS, FOR ANY PERSON, UNLESS THEY ARE ACTING UNDER THE DIRECTION OF A LICENSED PROFESSIONAL ENGINEER, ARCHITECT, LANDSCAPE ARCHITECT, OR LAND SURVEYOR, TO ALTER AN ITEM IN ANY WAY. IF AN ITEM BEARING THE STAMP OF A LICENSED PROFESSIONAL IS ALTERED, THE ALTERING PROFESSIONAL SHALL STAMP THE DOCUMENT AND INCLUDE THE NOTATION "ALTERED BY' FOLLOWED BY THEIR SIGNATURE, THE DATE

DESCRIPTION OF THE ALTERATION REVISIONS

OF SUCH ALTERATION, AND A SPECIFIC

PLAN DEMO

CITY OF MIDDLETOWN
NEW COURTHOUSE FACILITY
CONTRACT 1D - ELECTRICAL CONSTRUCTION **LIGHTING** FLOOR


AUGUST, 2024

AS SHOWN

Sheet Number

Project Number 1753.008.001

E105

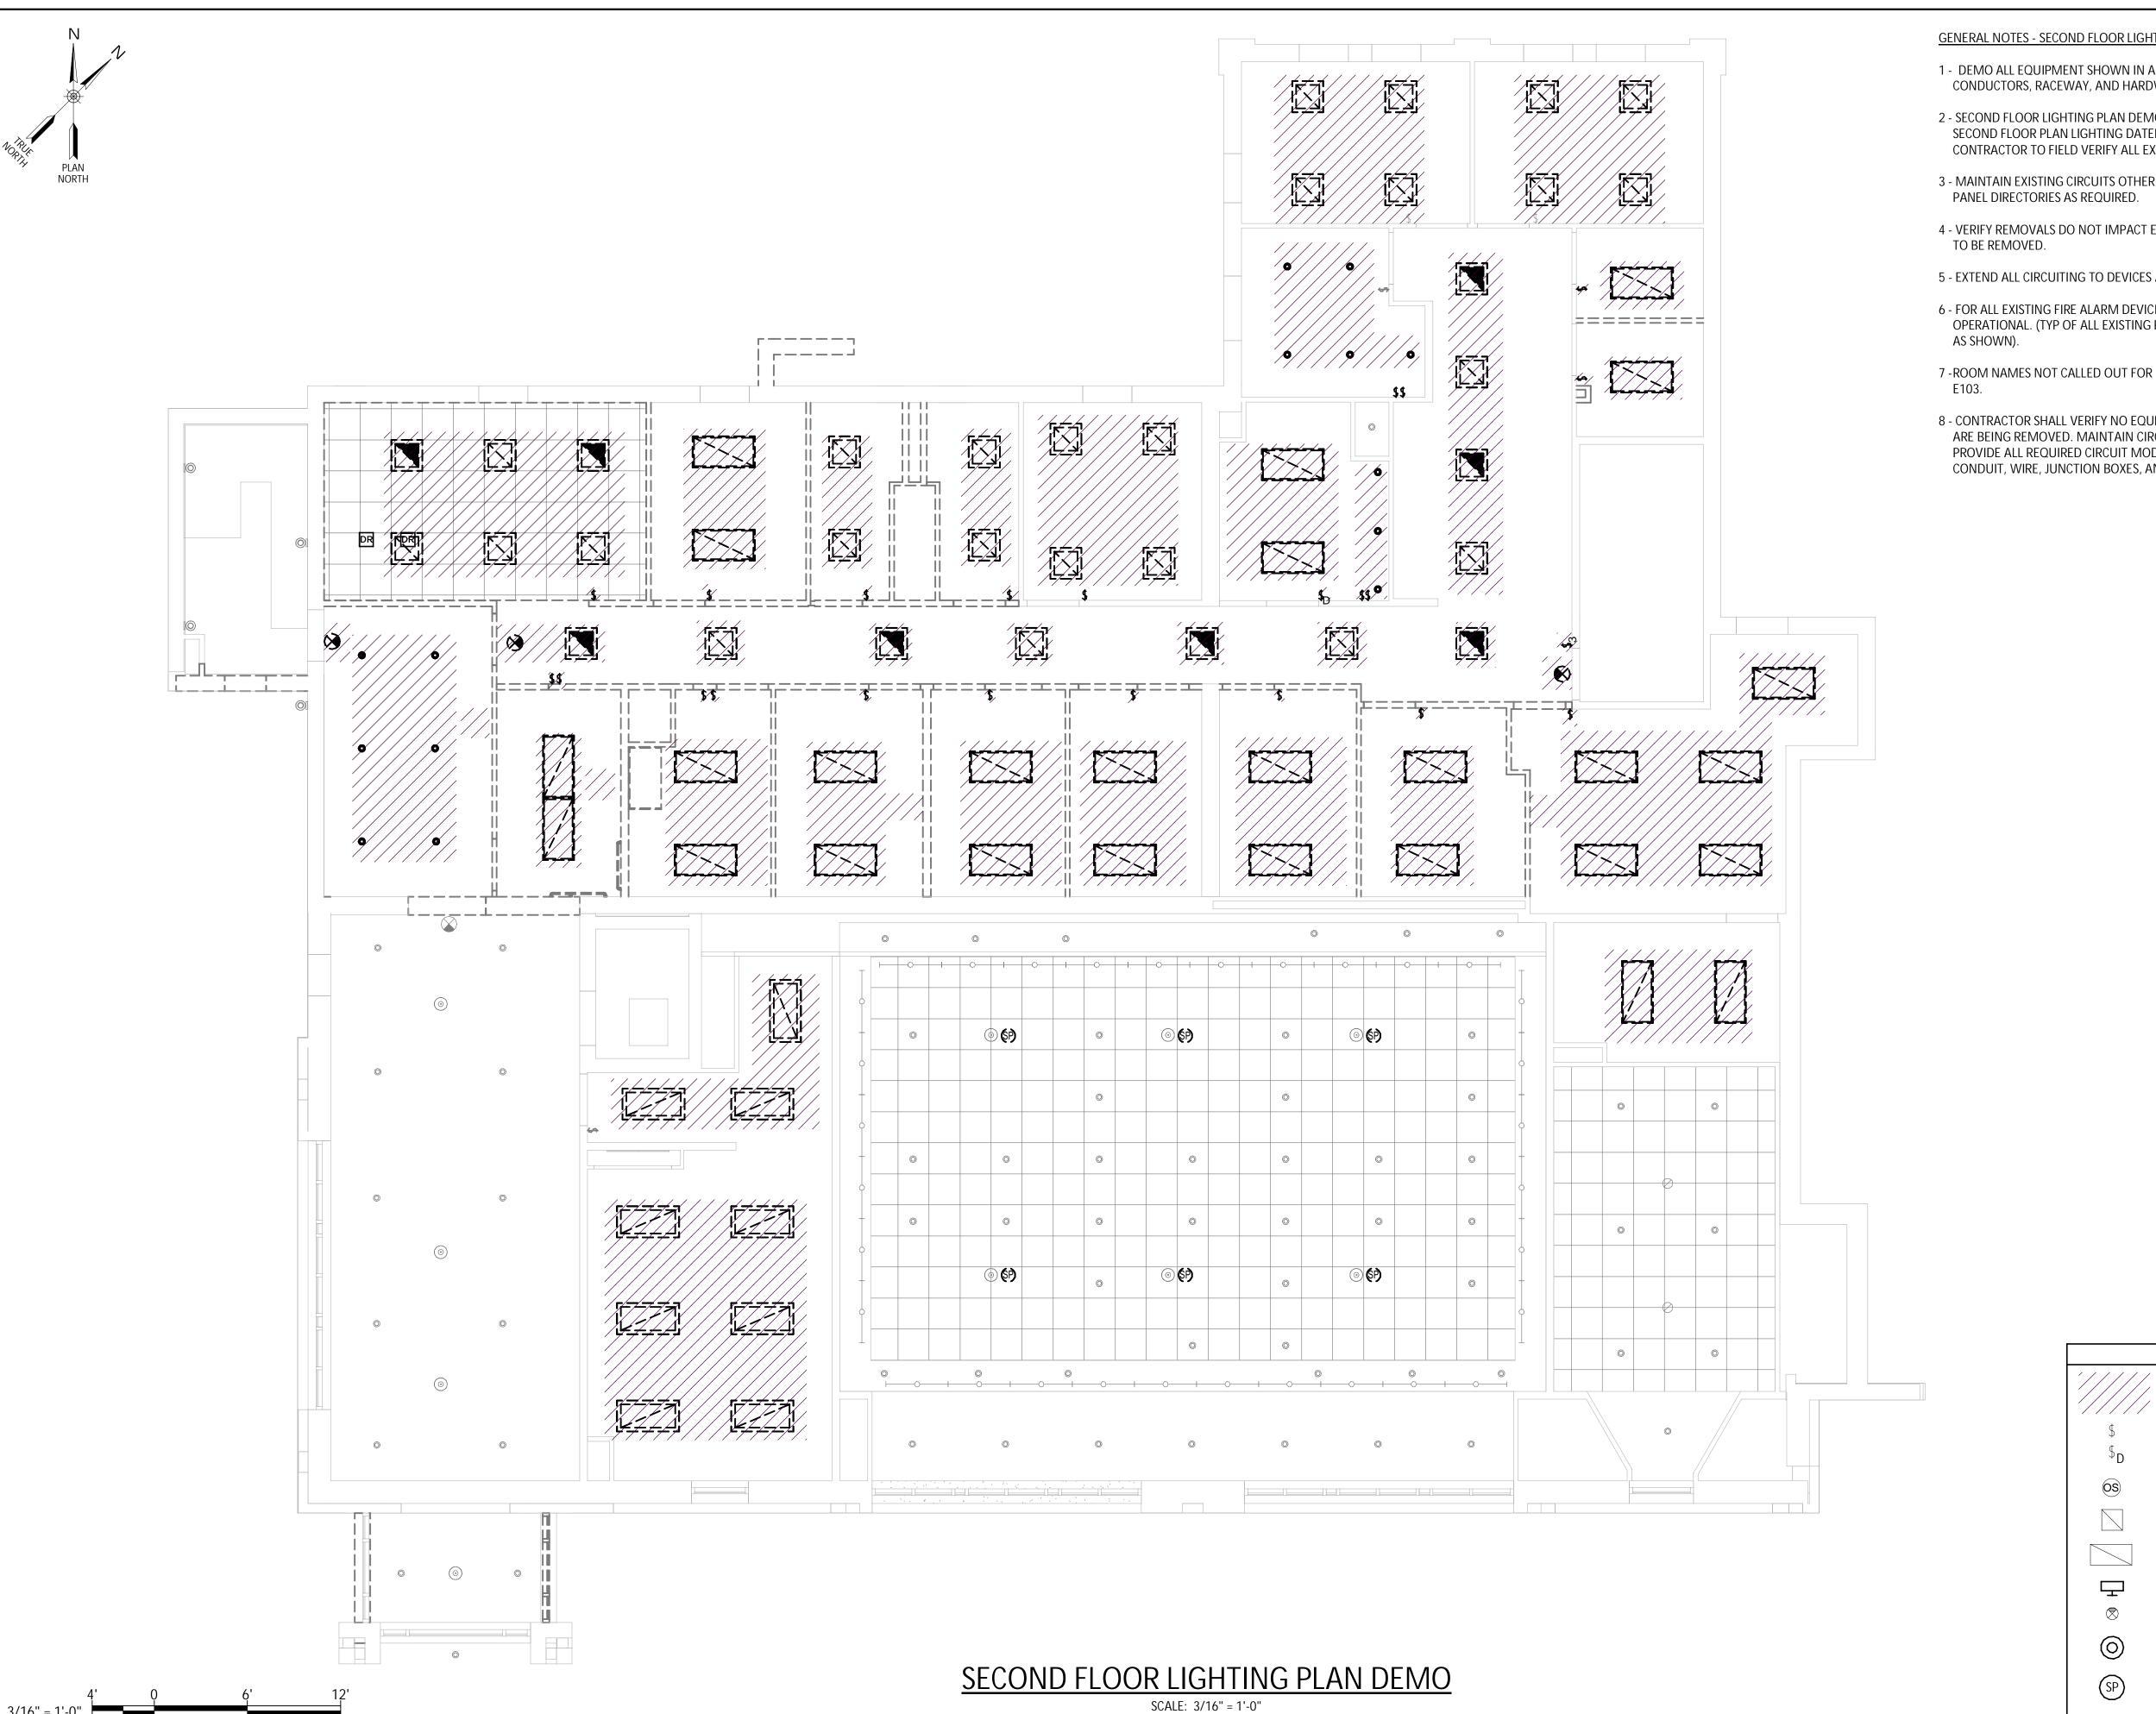

GENERAL NOTES - SECOND FLOOR LIGHTING PLAN DEMO

- 1 DEMO ALL EQUIPMENT SHOWN IN A HATCH PATTERN. DEMO ALL ASSOCIATED CONDUCTORS, RACEWAY, AND HARDWARE BACK TO ITS SOURCE.
- 2 SECOND FLOOR LIGHTING PLAN DEMO DRAWING CREATED FROM DRAWINGS E-3L TITLED SECOND FLOOR PLAN LIGHTING DATED JULY 30, 2004, AND CURSORY FIELD OBSERVATIONS. CONTRACTOR TO FIELD VERIFY ALL EXISTING INFORMATION REQUIRED.
- 3 MAINTAIN EXISTING CIRCUITS OTHER THAN THE ONES SHOWN TO BE DEMOED. UPDATE
- 4 VERIFY REMOVALS DO NOT IMPACT EQUIPMENT AND DEVICES OTHER THAN THOSE THAT ARE
- 5 EXTEND ALL CIRCUITING TO DEVICES AND EQUIPMENT TO REMAIN.
- 6 FOR ALL EXISTING FIRE ALARM DEVICES NOT DEMO'D VERIFY THEY ARE PRESENT AND OPERATIONAL. (TYP OF ALL EXISTING POWER AND DATA OUTLETS AND FIRE ALARM DEVICES
- 7 -ROOM NAMES NOT CALLED OUT FOR DRAWING CLARITY. FOR ROOM NAMES SEE DRAWING
- 8 CONTRACTOR SHALL VERIFY NO EQUIPMENT TO REMAIN IS CONNECTED TO CIRCUITS THAT ARE BEING REMOVED. MAINTAIN CIRCUIT CONTINUITY TO ALL EQUIPMENT TO REMAIN. PROVIDE ALL REQUIRED CIRCUIT MODIFICATIONS INCLUDING, BUT NOT LIMITED TO, CONDUIT, WIRE, JUNCTION BOXES, AND SPLICES.

LEGEND

CEILING MOUNTED OCCUPANCY/MOTION SENSOR

2'X2' LED LIGHT FIXTURE, X INDICATES FIXTURE TYPE

2'x4' LED LIGHT FIXTURE, X INDICATES FIXTURE TYPE

EXIT LIGHT FIXTURE, CEILING MOUNTED

RECESSED LIGHT FIXTURE, CEILING MOUNTED

EQUIPMENT TO BE DEMOED

DIMMER WALL SWITCH

WALL SWITCH

WALL PACK

SPEAKER

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REVISIONS

DEMO


CITY OF MIDDLETOWN NEW COURTHOUSE FACILITY CONTRACT 1D - ELECTRICAL CONSTRUCTION PLAN **LIGHTING** FLOOR SECOND



AUGUST, 2024

AS SHOWN

Sheet Number E106

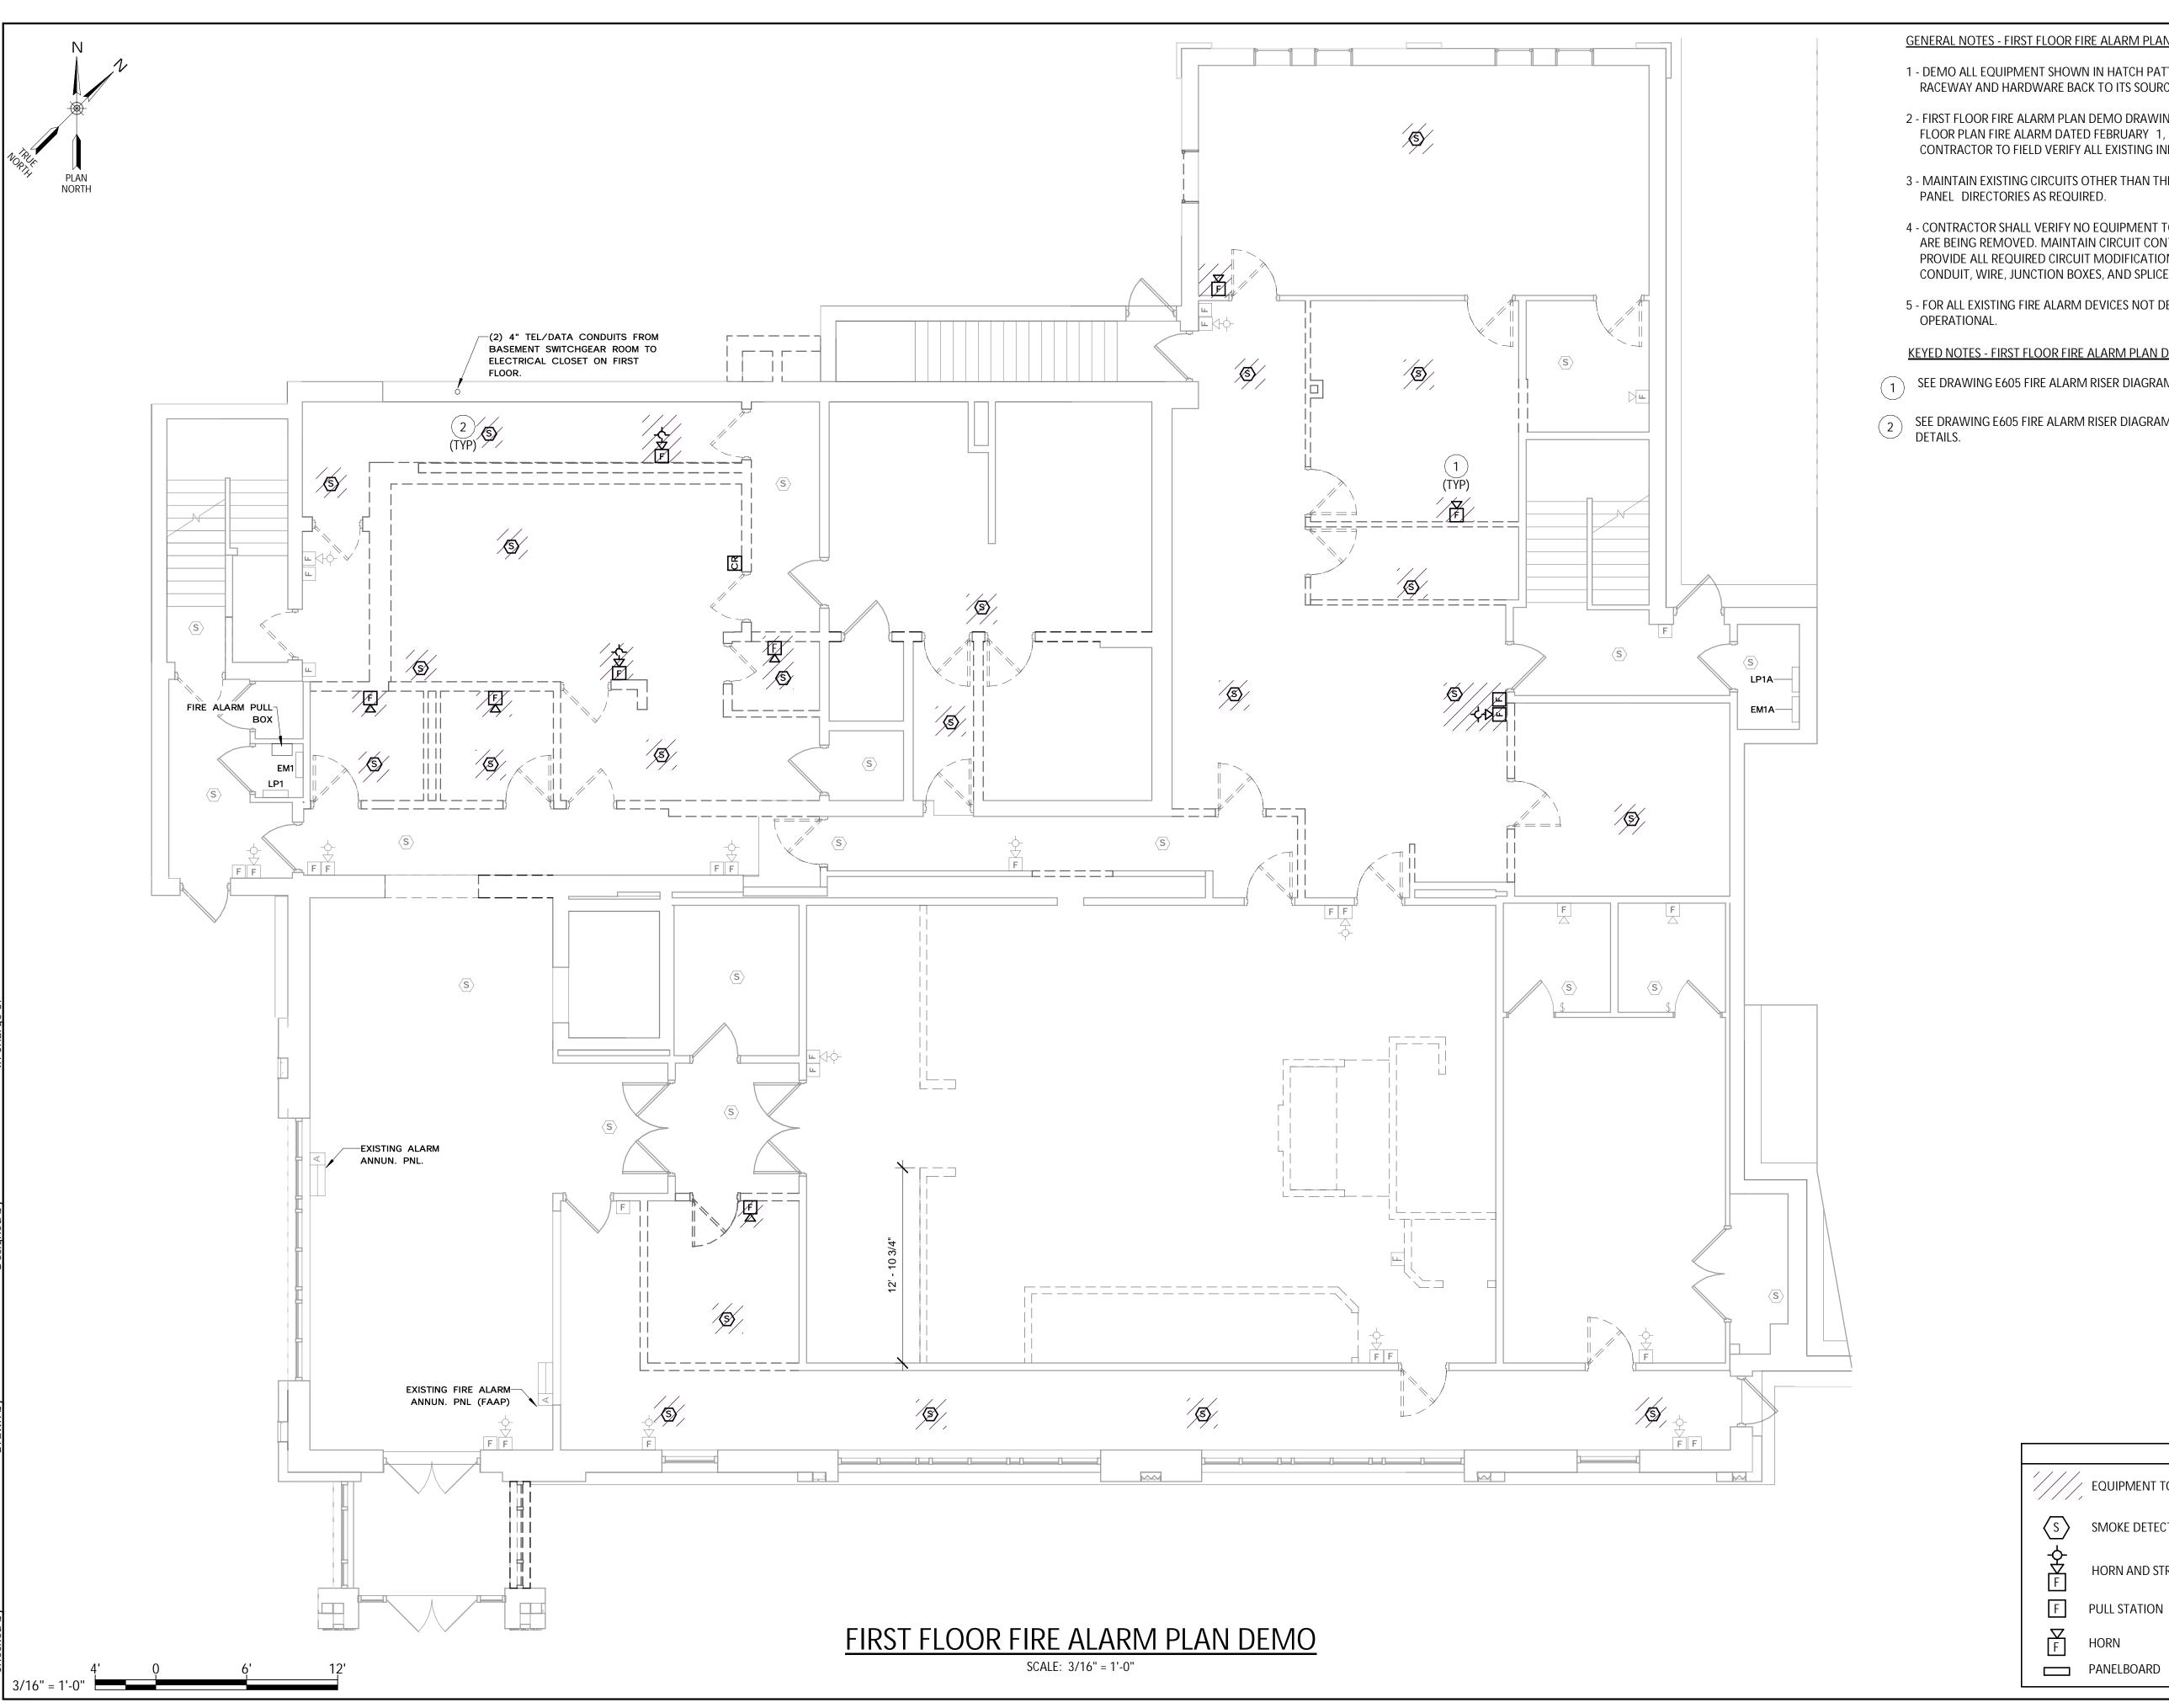

GENERAL NOTES - FIRST FLOOR FIRE ALARM PLAN DEMO

1 - DEMO ALL EQUIPMENT SHOWN IN HATCH PATTERN. DEMO ALL ASSOCIATED CONDUCTORS, RACEWAY AND HARDWARE BACK TO ITS SOURCE.

2 - FIRST FLOOR FIRE ALARM PLAN DEMO DRAWING CREATED FROM DRAWING FA-2 TITLED FIRST FLOOR PLAN FIRE ALARM DATED FEBRUARY 1, 2005 AND CURSORY FIELD OBSERVATIONS. CONTRACTOR TO FIELD VERIFY ALL EXISTING INFORMATION REQUIRED.

3 - MAINTAIN EXISTING CIRCUITS OTHER THAN THE ONES SHOWN TO BE DEMO'D. UPDATE PANEL DIRECTORIES AS REQUIRED.

4 - CONTRACTOR SHALL VERIFY NO EQUIPMENT TO REMAIN IS CONNECTED TO CIRCUITS THAT ARE BEING REMOVED. MAINTAIN CIRCUIT CONTINUITY TO ALL EQUIPMENT TO REMAIN. PROVIDE ALL REQUIRED CIRCUIT MODIFICATIONS INCLUDING, BUT NOT LIMITED TO, CONDUIT, WIRE, JUNCTION BOXES, AND SPLICES.

5 - FOR ALL EXISTING FIRE ALARM DEVICES NOT DEMO'D VERIFY THEY ARE PRESENT AND

KEYED NOTES - FIRST FLOOR FIRE ALARM PLAN DEMO

SEE DRAWING E605 FIRE ALARM RISER DIAGRAM DEMO FOR HORN/STROBE WIRING DETAILS.

SEE DRAWING E605 FIRE ALARM RISER DIAGRAM DEMO FOR SMOKE DETECTOR WIRING DETAILS.

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REVISIONS

DEMO CITY OF MIDDLETOWN
NEW COURTHOUSE FACILITY
CONTRACT 1D - ELECTRICAL CONSTRUCTION AN

ALARM FIRE FLOOR

LEGEND

EQUIPMENT TO BE DEMOED

SMOKE DETECTOR


HORN AND STROBE

PULL STATION

AUGUST, 2024

AS SHOWN

Sheet Number E107

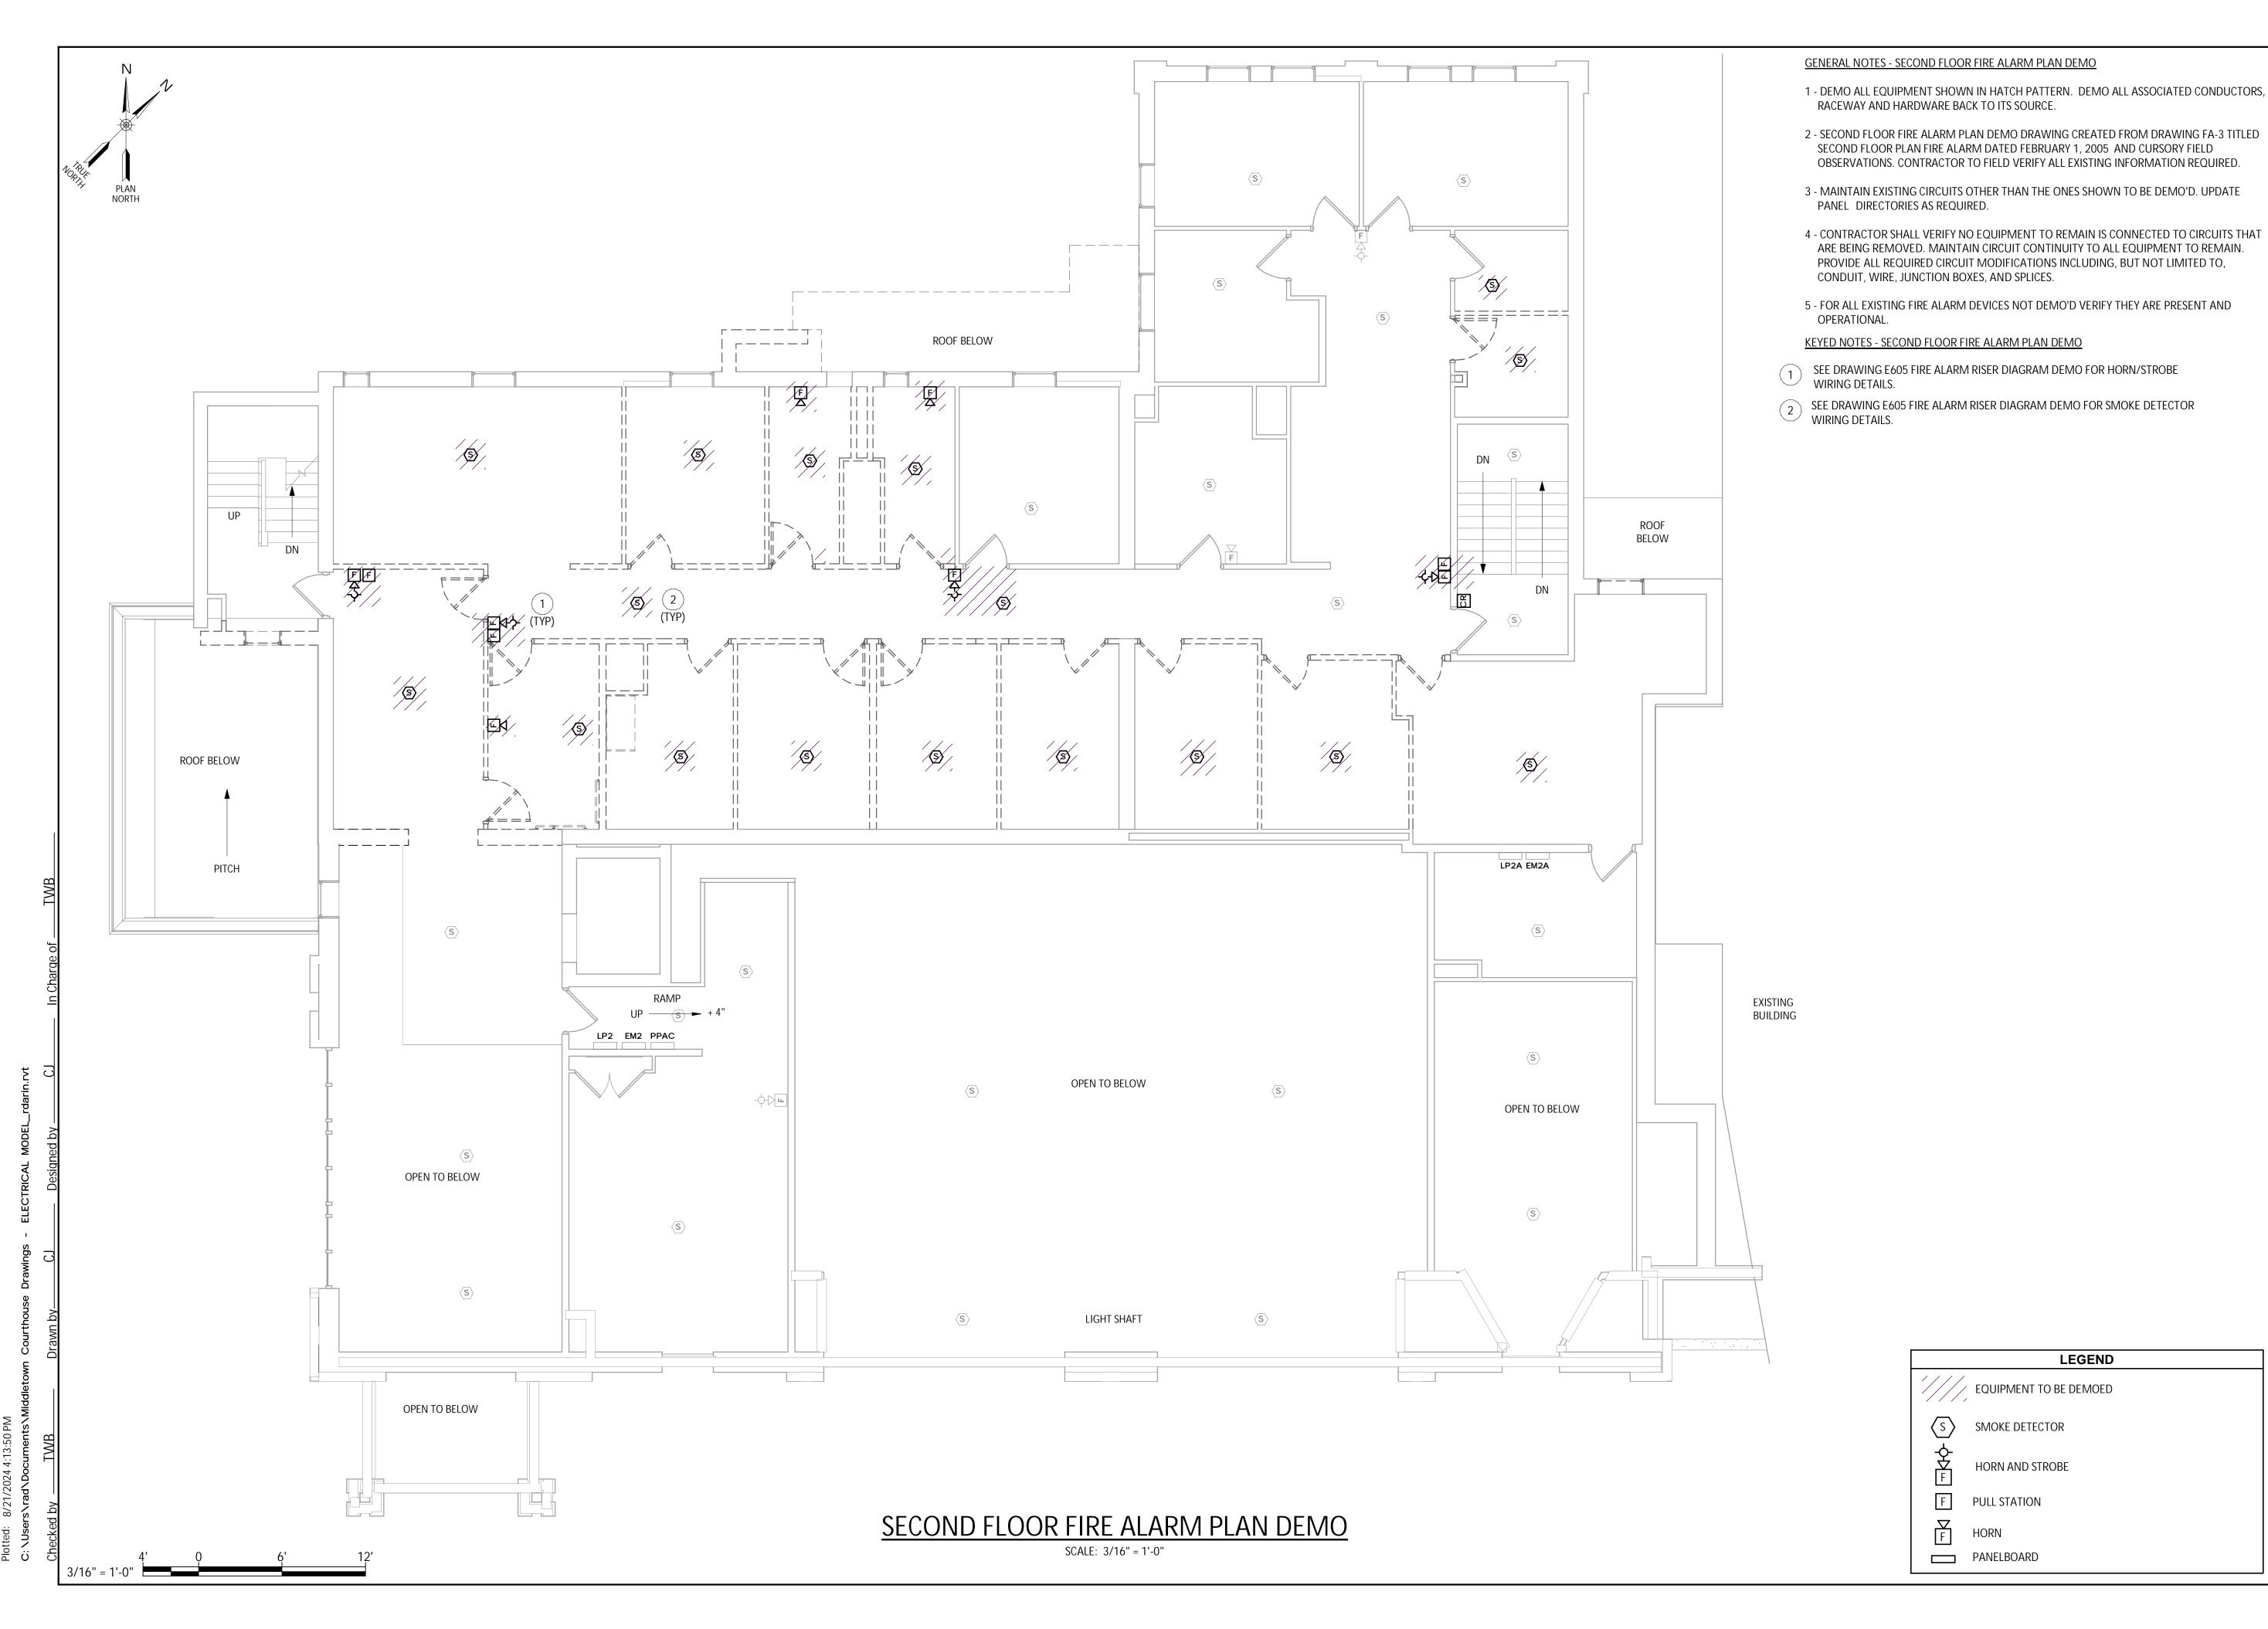

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DEMO

PLAN **ALARM**

CITY OF MIDDLETOWN
NEW COURTHOUSE FACILITY
CONTRACT 1D - ELECTRICAL CONSTRUCTION FIRE FLOOR SECOND

AUGUST, 2024

AS SHOWN

Sheet Number E108

BASEMENT POWER & SYSTEMS PLAN INSTALL

SCALE: 3/16" = 1'-0"

GENERAL NOTES - BASEMENT POWER & SYSTEMS PLAN INSTALL

- 1 ALL 120V RECEPTACLES SHALL BE TAMPER RESISTANT (TR).
- 2 ALL CIRCUITING IS NOT SHOWN FOR CLARITY.
- 3 HVAC AND MECHANICAL EQUIPMENT INSTALLED BY OTHERS. ELECTRICAL CONTRACTOR SHALL FURNISH AND INSTALL THE CONDUCTORS AND CONDUITS TO THE EQUIPMENT.
- 4 ELECTRICAL SWITCH AND OUTLET BOXES SHALL BE SEALED USING A MOLDABLE PUTTY PAD AND A SEALANT (SUCH AS FD-150+ CAULK OR FB 1000 NS SEALANT, AS AVAILABLE FROM 3M, OR APPROVED EQUAL) AROUND THE PERIMETER OF THE BOX AT THE GYPSUM/BOX INTERFACE TO MINIMIZE THE TRANSMISSION OF SMOKE (AND SOUND).


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DESCRIPTION OF THE ALTERATION. REVISIONS

INSTALL

PLAN CITY OF MIDDLETOWN
NEW COURTHOUSE FACILITY
CONTRACT 1D - ELECTRICAL CONSTRUCTION **SYSTEMS**

POWER BASEMENT

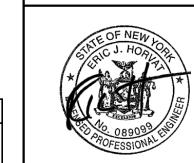


AUGUST, 2024

AS SHOWN

Sheet Number E109

Project Number 1753.008.001

LEGEND UNIT HEATER AUTO TRANSFER SWITCH PANELBOARD MAIN DISTRIBUTION PANEL HOT WATER HEATER

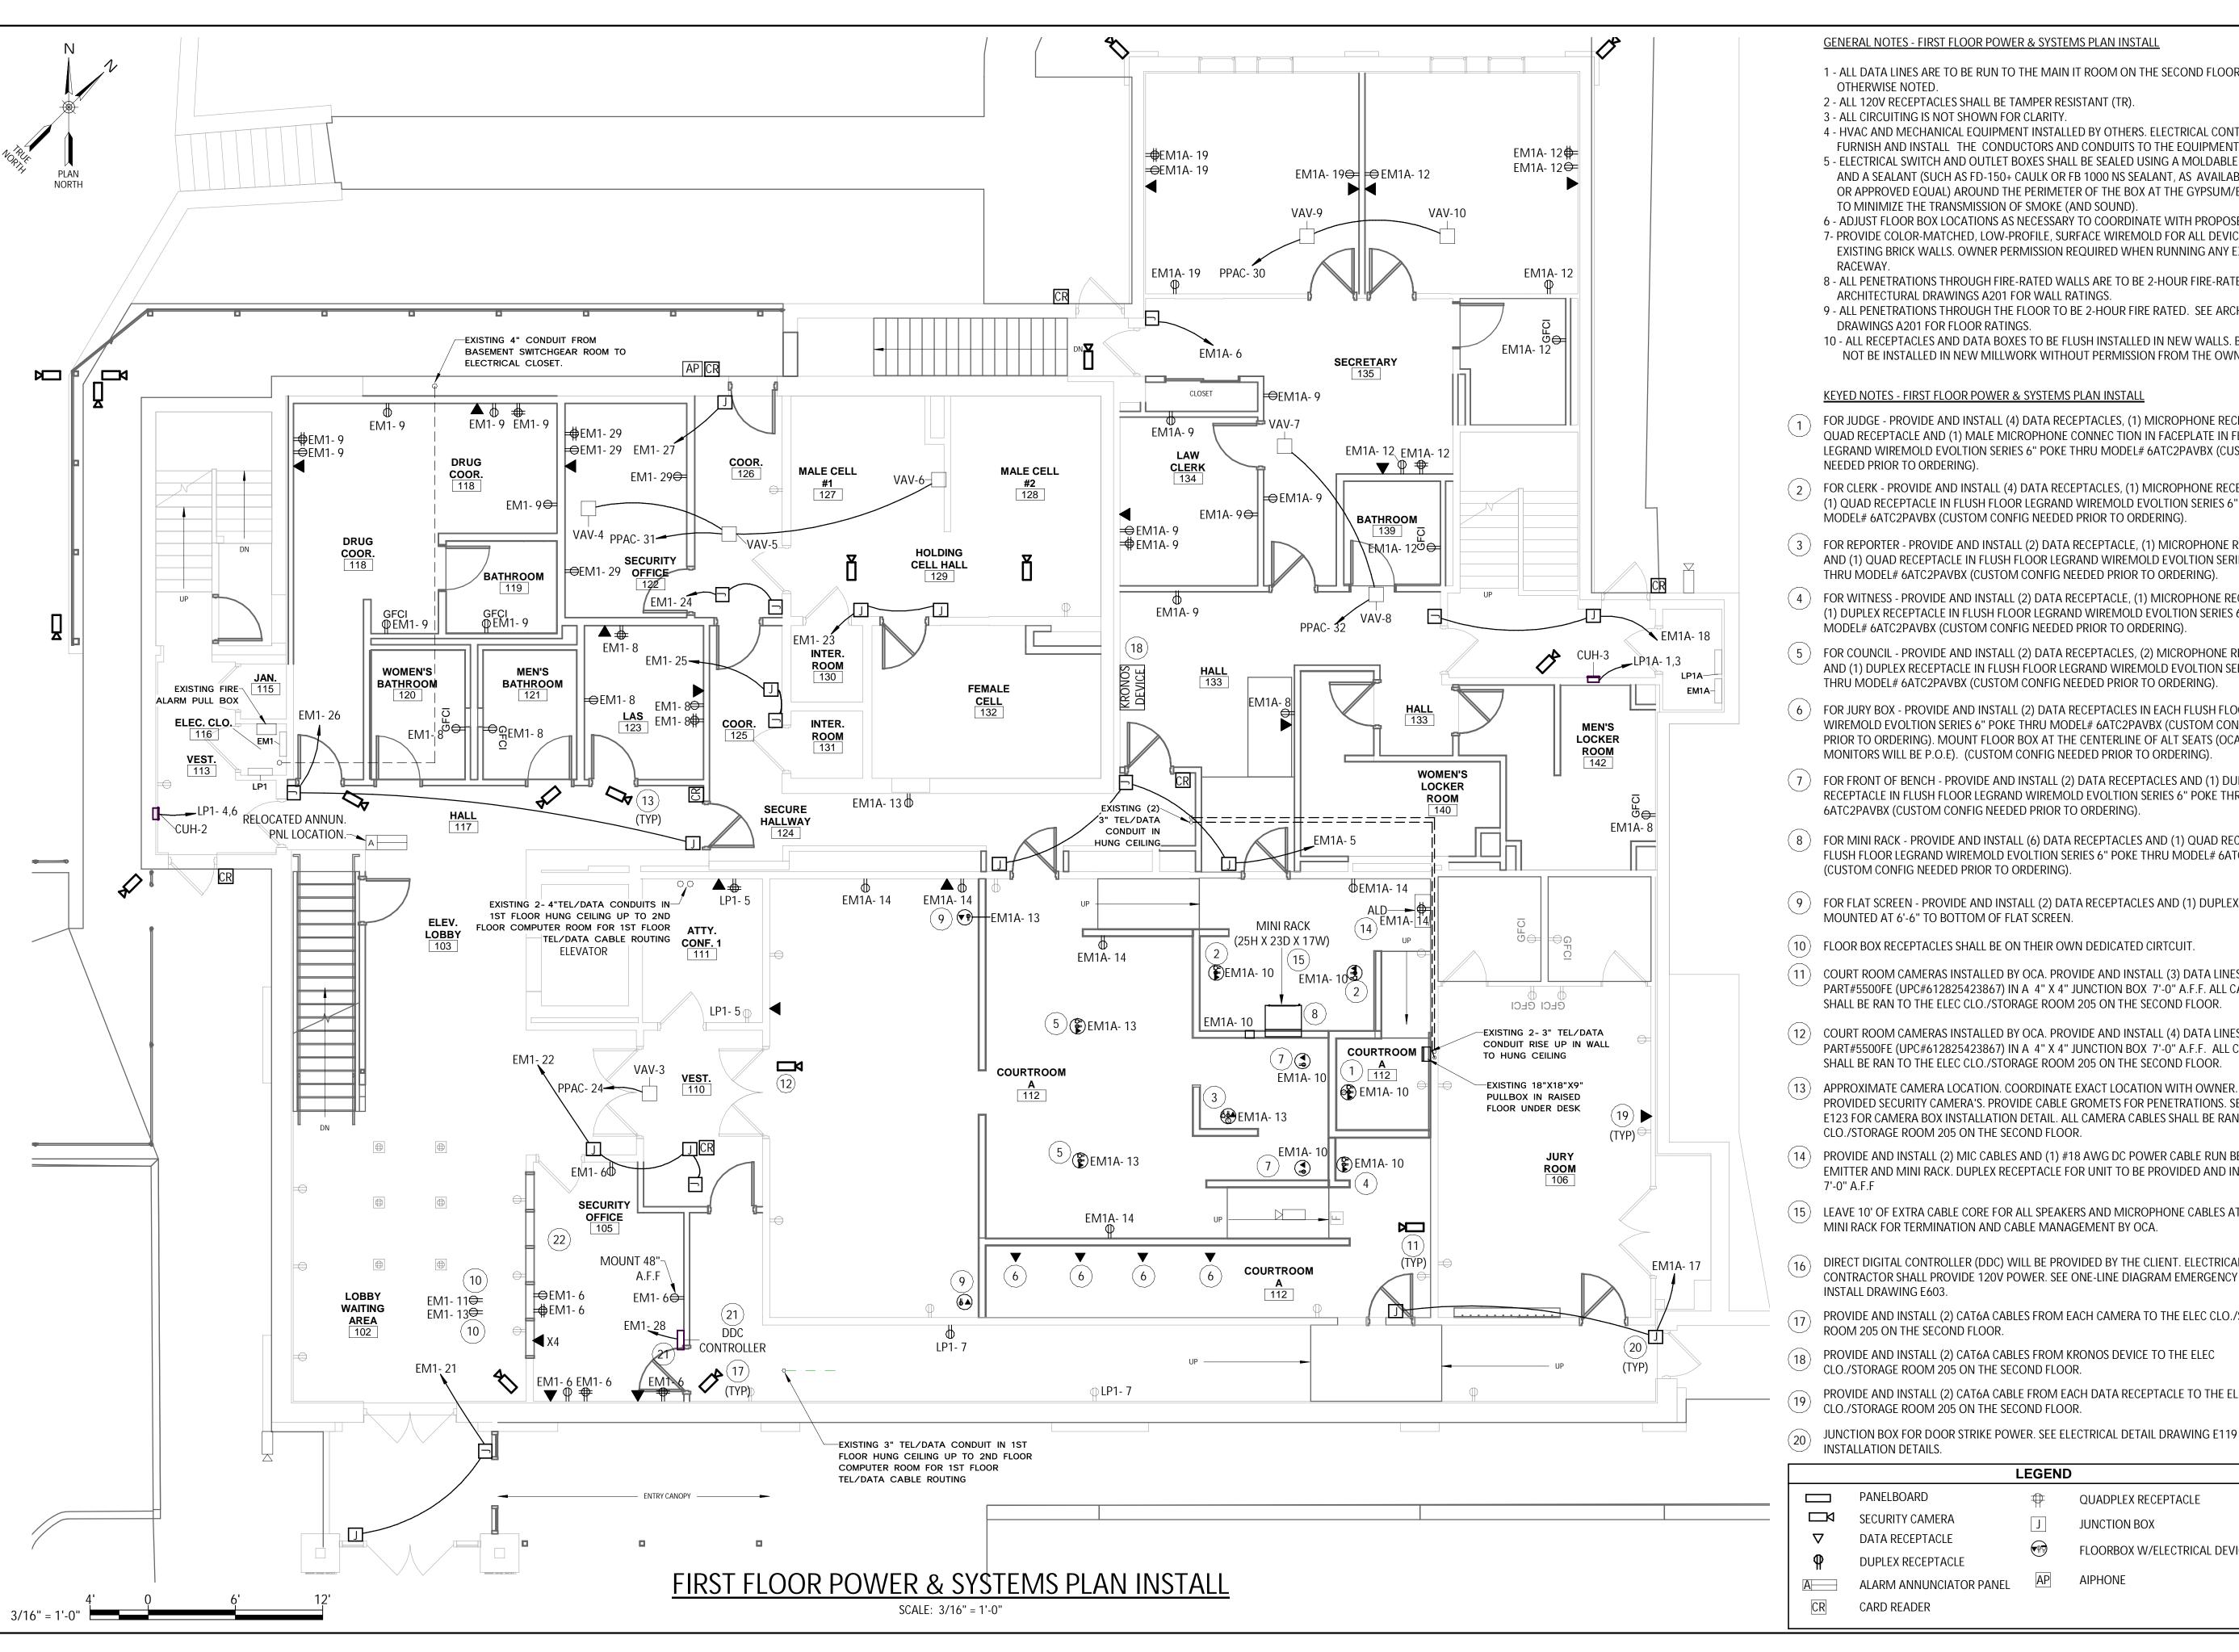

GENERAL NOTES - FIRST FLOOR POWER & SYSTEMS PLAN INSTALL

- 1 ALL DATA LINES ARE TO BE RUN TO THE MAIN IT ROOM ON THE SECOND FLOOR UNLESS
 - 2 ALL 120V RECEPTACLES SHALL BE TAMPER RESISTANT (TR).

 - 4 HVAC AND MECHANICAL EQUIPMENT INSTALLED BY OTHERS. ELECTRICAL CONTRACTOR SHALL
 - 5 ELECTRICAL SWITCH AND OUTLET BOXES SHALL BE SEALED USING A MOLDABLE PUTTY PAD AND A SEALANT (SUCH AS FD-150+ CAULK OR FB 1000 NS SEALANT, AS AVAILABLE FROM 3M OR APPROVED EQUAL) AROUND THE PERIMETER OF THE BOX AT THE GYPSUM/BOX INTERFACE
 - 6 ADJUST FLOOR BOX LOCATIONS AS NECESSARY TO COORDINATE WITH PROPOSED TABLES 7- PROVIDE COLOR-MATCHED, LOW-PROFILE, SURFACE WIREMOLD FOR ALL DEVICES LOCATED OF EXISTING BRICK WALLS. OWNER PERMISSION REQUIRED WHEN RUNNING ANY EXPOSED
 - 8 ALL PENETRATIONS THROUGH FIRE-RATED WALLS ARE TO BE 2-HOUR FIRE-RATED. SEE ARCHITECTURAL DRAWINGS A201 FOR WALL RATINGS.
 - 9 ALL PENETRATIONS THROUGH THE FLOOR TO BE 2-HOUR FIRE RATED. SEE ARCHITECTURAL DRAWINGS A201 FOR FLOOR RATINGS.
 - 10 ALL RECEPTACLES AND DATA BOXES TO BE FLUSH INSTALLED IN NEW WALLS. BOXES SHALL NOT BE INSTALLED IN NEW MILLWORK WITHOUT PERMISSION FROM THE OWNER.

KEYED NOTES - FIRST FLOOR POWER & SYSTEMS PLAN INSTALL

- FOR JUDGE PROVIDE AND INSTALL (4) DATA RECEPTACLES, (1) MICROPHONE RECEPTACLE, (1) QUAD RECEPTACLE AND (1) MALE MICROPHONE CONNECTION IN FACEPLATE IN FLOOR LEGRAND WIREMOLD EVOLTION SERIES 6" POKE THRU MODEL# 6ATC2PAVBX (CUSTOM CONFIG
- FOR CLERK PROVIDE AND INSTALL (4) DATA RECEPTACLES, (1) MICROPHONE RECEPTACLE AND (1) QUAD RECEPTACLE IN FLUSH FLOOR LEGRAND WIREMOLD EVOLTION SERIES 6" POKE THRU MODEL# 6ATC2PAVBX (CUSTOM CONFIG NEEDED PRIOR TO ORDERING).
- FOR REPORTER PROVIDE AND INSTALL (2) DATA RECEPTACLE, (1) MICROPHONE RECEPTACLE AND (1) QUAD RECEPTACLE IN FLUSH FLOOR LEGRAND WIREMOLD EVOLTION SERIES 6" POKE THRU MODEL# 6ATC2PAVBX (CUSTOM CONFIG NEEDED PRIOR TO ORDERING).
- (4) FOR WITNESS PROVIDE AND INSTALL (2) DATA RECEPTACLE, (1) MICROPHONE RECEPTACLE AND (1) DUPLEX RECEPTACLE IN FLUSH FLOOR LEGRAND WIREMOLD EVOLTION SERIES 6" POKE THRU MODEL# 6ATC2PAVBX (CUSTOM CONFIG NEEDED PRIOR TO ORDERING).
- (5) FOR COUNCIL PROVIDE AND INSTALL (2) DATA RECEPTACLES, (2) MICROPHONE RECEPTACLES AND (1) DUPLEX RECEPTACLE IN FLUSH FLOOR LEGRAND WIREMOLD EVOLTION SERIES 6" POKE THRU MODEL# 6ATC2PAVBX (CUSTOM CONFIG NEEDED PRIOR TO ORDERING).
- (6) FOR JURY BOX PROVIDE AND INSTALL (2) DATA RECEPTACLES IN EACH FLUSH FLOOR LEGRAND WIREMOLD EVOLTION SERIES 6" POKE THRU MODEL# 6ATC2PAVBX (CUSTOM CONFIG NEEDED PRIOR TO ORDERING). MOUNT FLOOR BOX AT THE CENTERLINE OF ALT SEATS (OCA PROVIDED MONITORS WILL BE P.O.E). (CUSTOM CONFIG NEEDED PRIOR TO ORDERING).
- FOR FRONT OF BENCH PROVIDE AND INSTALL (2) DATA RECEPTACLES AND (1) DUPLEX RECEPTACLE IN FLUSH FLOOR LEGRAND WIREMOLD EVOLTION SERIES 6" POKE THRU MODEL# 6ATC2PAVBX (CUSTOM CONFIG NEEDED PRIOR TO ORDERING).
- (8) FOR MINI RACK PROVIDE AND INSTALL (6) DATA RECEPTACLES AND (1) QUAD RECEPTACLE IN FLUSH FLOOR LEGRAND WIREMOLD EVOLTION SERIES 6" POKE THRU MODEL# 6ATC2PAVBX (CUSTOM CONFIG NEEDED PRIOR TO ORDERING).
- FOR FLAT SCREEN PROVIDE AND INSTALL (2) DATA RECEPTACLES AND (1) DUPLEX RECEPTACLE MOUNTED AT 6'-6" TO BOTTOM OF FLAT SCREEN.
- (10) FLOOR BOX RECEPTACLES SHALL BE ON THEIR OWN DEDICATED CIRTCUIT.
- (11) COURT ROOM CAMERAS INSTALLED BY OCA. PROVIDE AND INSTALL (3) DATA LINES BELDEN PART#5500FE (UPC#612825423867) IN A 4" X 4" JUNCTION BOX 7'-0" A.F.F. ALL CAMERA CABLES SHALL BE RAN TO THE ELEC CLO./STORAGE ROOM 205 ON THE SECOND FLOOR.
- (12) COURT ROOM CAMERAS INSTALLED BY OCA. PROVIDE AND INSTALL (4) DATA LINES BELDEN PART#5500FE (UPC#612825423867) IN A 4" X 4" JUNCTION BOX 7'-0" A.F.F. ALL CAMERA CABLE SHALL BE RAN TO THE ELEC CLO./STORAGE ROOM 205 ON THE SECOND FLOOR.
- (13) APPROXIMATE CAMERA LOCATION. COORDINATE EXACT LOCATION WITH OWNER. INSTALL OCS PROVIDED SECURITY CAMERA'S. PROVIDE CABLE GROMETS FOR PENETRATIONS. SEE DRAWING E123 FOR CAMERA BOX INSTALLATION DETAIL. ALL CAMERA CABLES SHALL BE RAN TO THE ELEC CLO./STORAGE ROOM 205 ON THE SECOND FLOOR.
- (14) PROVIDE AND INSTALL (2) MIC CABLES AND (1) #18 AWG DC POWER CABLE RUN BETWEEN THE EMITTER AND MINI RACK. DUPLEX RECEPTACLE FOR UNIT TO BE PROVIDED AND INSTALLED AT
- (15) LEAVE 10' OF EXTRA CABLE CORE FOR ALL SPEAKERS AND MICROPHONE CABLES AT THE MINI RACK FOR TERMINATION AND CABLE MANAGEMENT BY OCA.
- DIRECT DIGITAL CONTROLLER (DDC) WILL BE PROVIDED BY THE CLIENT. ELECTRICAL CONTRACTOR SHALL PROVIDE 120V POWER. SEE ONE-LINE DIAGRAM EMERGENCY POWER INSTALL DRAWING E603.
- PROVIDE AND INSTALL (2) CAT6A CABLES FROM EACH CAMERA TO THE ELEC CLO./STORAGE ROOM 205 ON THE SECOND FLOOR.
- PROVIDE AND INSTALL (2) CAT6A CABLES FROM KRONOS DEVICE TO THE ELEC CLO./STORAGE ROOM 205 ON THE SECOND FLOOR.
- PROVIDE AND INSTALL (2) CAT6A CABLE FROM EACH DATA RECEPTACLE TO THE ELEC CLO./STORAGE ROOM 205 ON THE SECOND FLOOR.

LEGEND					
	PANELBOARD		QUADPLEX RECEPTACLE		
	SECURITY CAMERA	J	JUNCTION BOX		
∇	DATA RECEPTACLE		FLOORBOX W/ELECTRICAL DEVICE		
P	DUPLEX RECEPTACLE	VIII)	FLOORBOX W/ELECTRICAL DEVICE		
A	ALARM ANNUNCIATOR PANEL	AP	AIPHONE		
CR	CARD READER				

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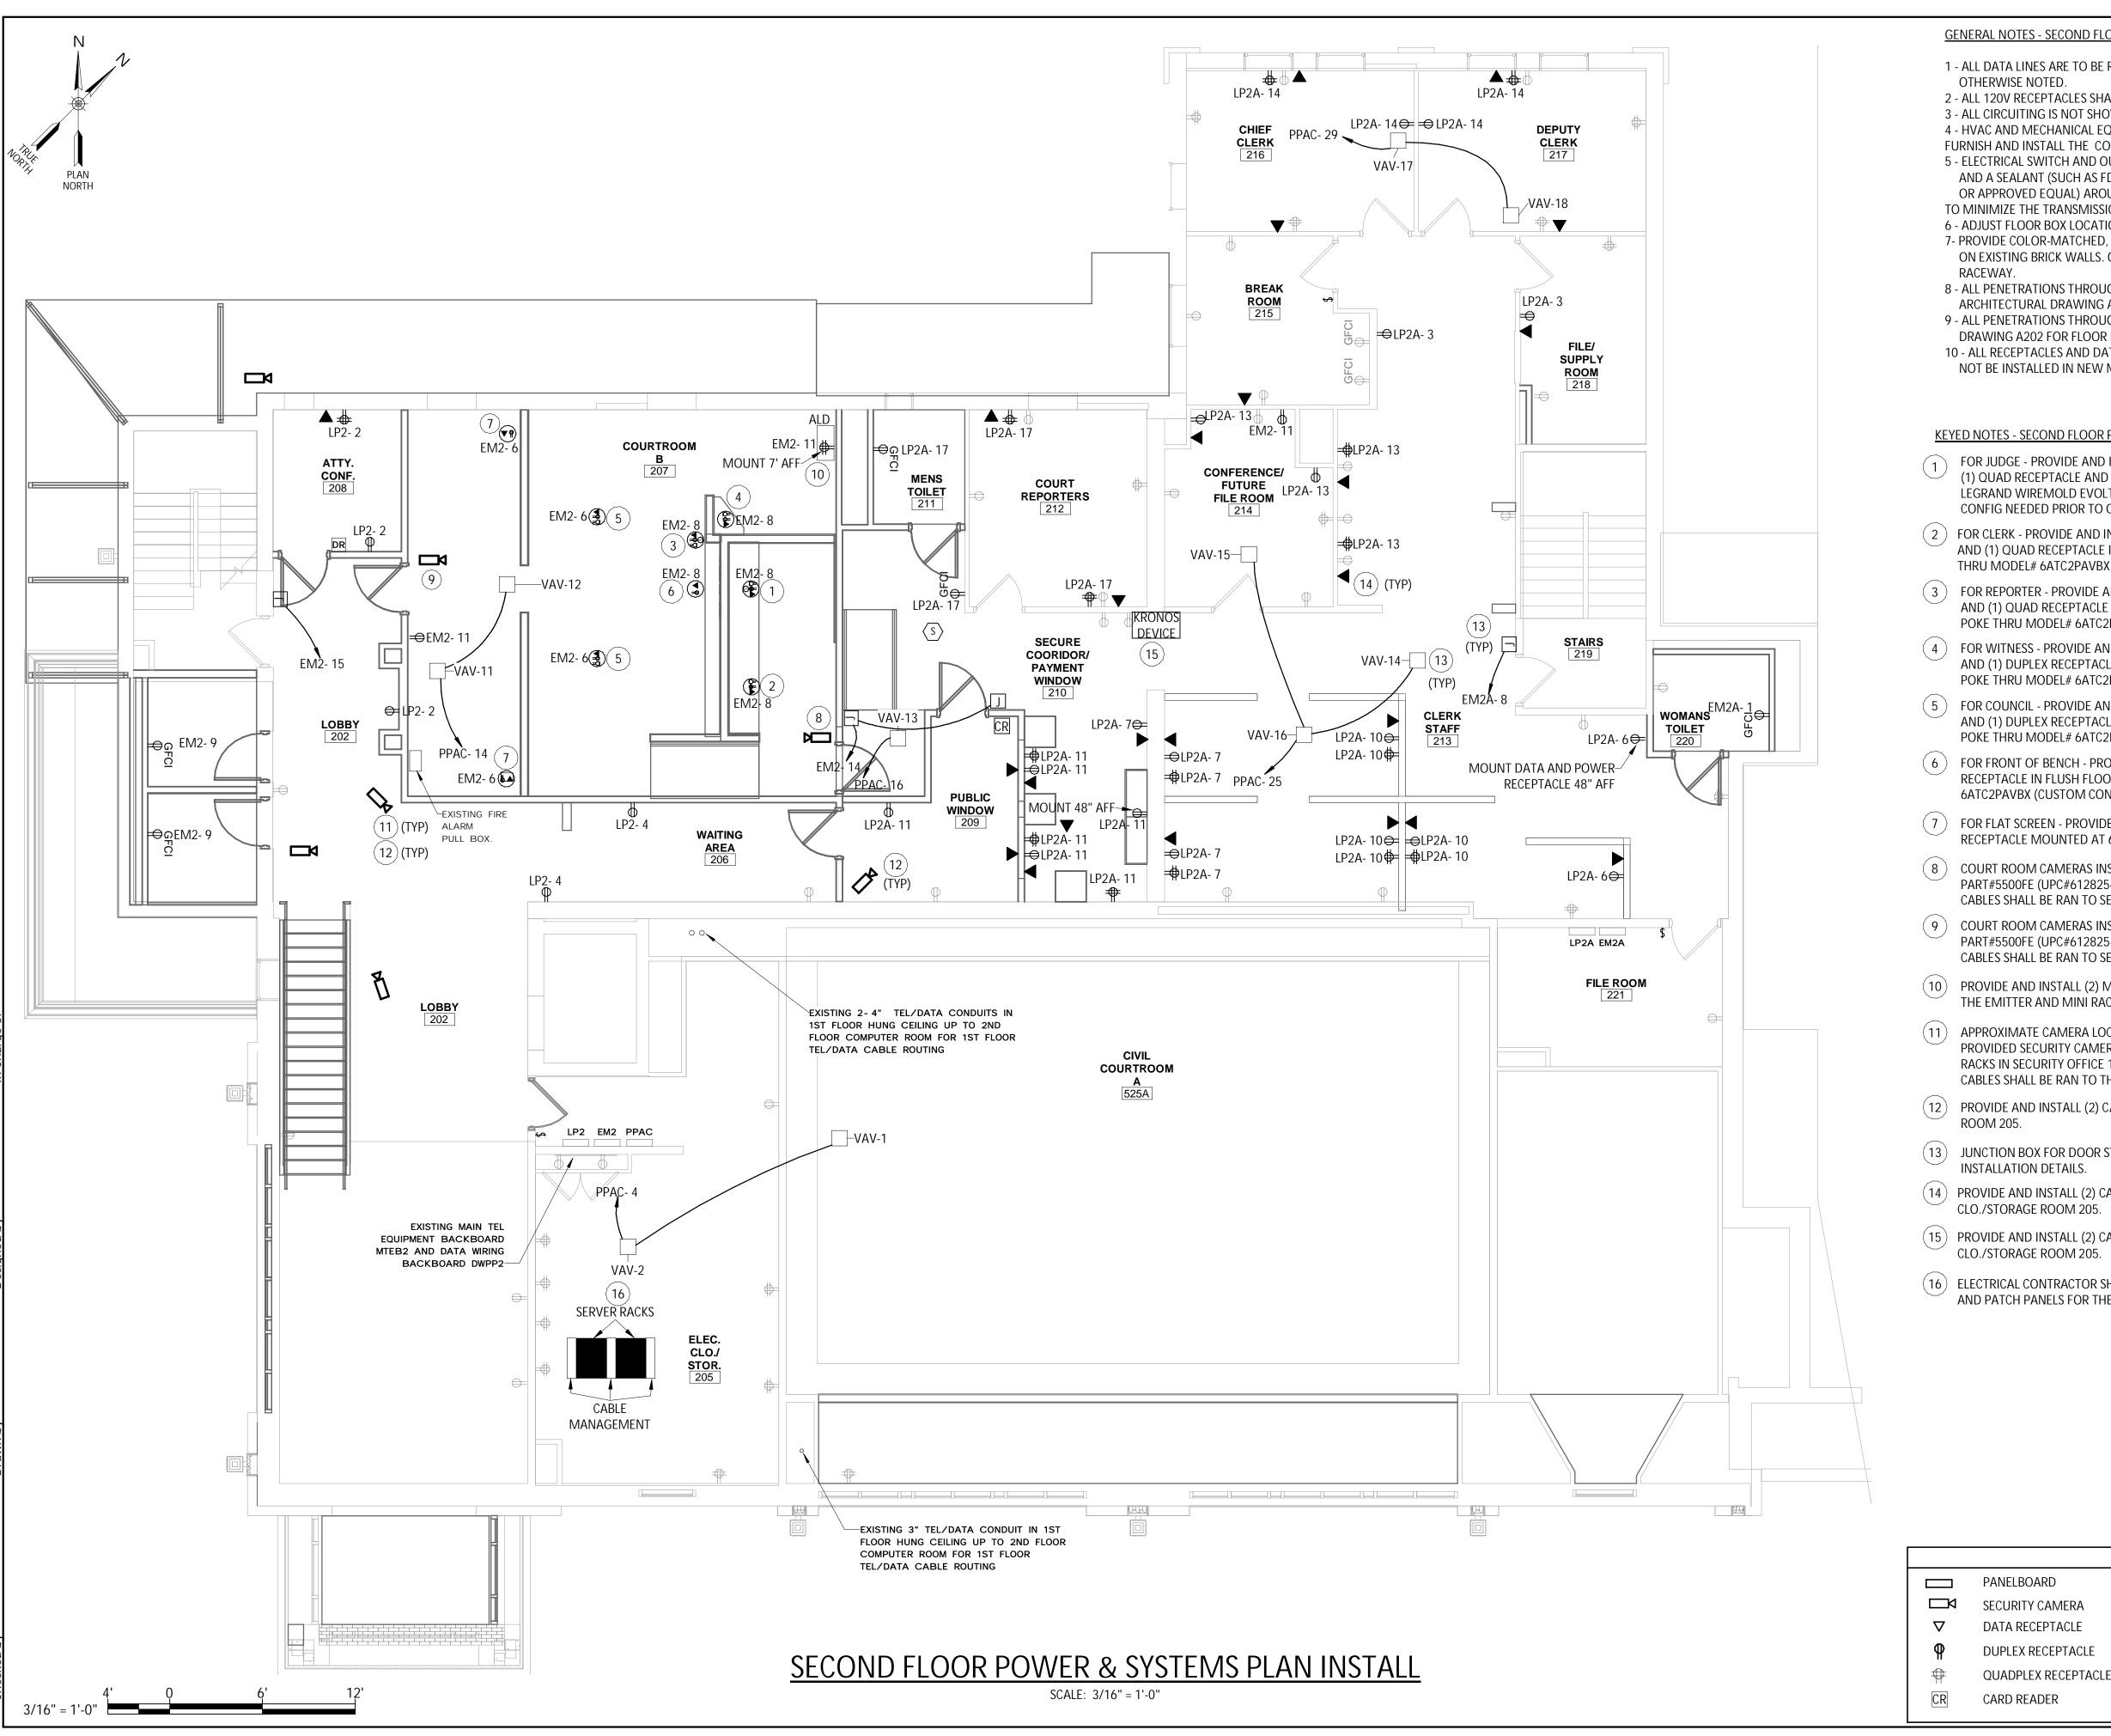
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AUGUST, 2024

AS SHOWN

Sheet Number E110



GENERAL NOTES - SECOND FLOOR POWER & SYSTEMS PLAN INSTALI

- 1 ALL DATA LINES ARE TO BE RUN TO THE MAIN IT ROOM ON THE SECOND FLOOR UNLESS
- 2 ALL 120V RECEPTACLES SHALL BE TAMPER RESISTANT (TR).
- 3 ALL CIRCUITING IS NOT SHOWN FOR CLARITY.
- 4 HVAC AND MECHANICAL EQUIPMENT INSTALLED BY OTHERS. ELECTRICAL CONTRACTOR SHA
- FURNISH AND INSTALL THE CONDUCTORS AND CONDUITS TO THE EQUIPMENT. 5 - ELECTRICAL SWITCH AND OUTLET BOXES SHALL BE SEALED USING A MOLDABLE PUTTY PAD AND A SEALANT (SUCH AS FD-150+ CAULK OR FB 1000 NS SEALANT, AS AVAILABLE FROM 3M OR APPROVED EQUAL) AROUND THE PERIMETER OF THE BOX AT THE GYPSUM/BOX INTERFACE
- TO MINIMIZE THE TRANSMISSION OF SMOKE (AND SOUND). 6 - ADJUST FLOOR BOX LOCATIONS AS NECESSARY TO COORDINATE WITH PROPOSED TABLES. 7- PROVIDE COLOR-MATCHED, LOW-PROFILE, SURFACE WIREMOLD FOR ALL DEVICES LOCATED
- ON EXISTING BRICK WALLS. OWNER PERMISSION REQUIRED WHEN RUNNING ANY EXPOSED
- 8 ALL PENETRATIONS THROUGH FIRE-RATED WALLS ARE TO BE 2-HOUR FIRE-RATED. SEE ARCHITECTURAL DRAWING A202 FOR WALL RATINGS.
- 9 ALL PENETRATIONS THROUGH THE FLOOR TO BE 2-HOUR FIRE RATED. SEE ARCHITECTURAL DRAWING A202 FOR FLOOR RATINGS.
- 10 ALL RECEPTACLES AND DATA BOXES TO BE FLUSH INSTALLED IN NEW WALLS. BOXES SHALL NOT BE INSTALLED IN NEW MILLWORK WITHOUT WRITTEN PERMISSION FROM THE OWNER.

KEYED NOTES - SECOND FLOOR POWER & SYSTEMS PLAN INSTALL

- FOR JUDGE PROVIDE AND INSTALL (4) DATA RECEPTACLES, (1) MICROPHONE RECEPTACLE (1) QUAD RECEPTACLE AND (1) MALE MICROPHONE CONNECTION IN FACEPLATE IN FLOOR LEGRAND WIREMOLD EVOLTION SERIES 6" POKE THRU MODEL# 6ATC2PAVBX (CUSTOM CONFIG NEEDED PRIOR TO ORDERING).
- (2) FOR CLERK PROVIDE AND INSTALL (4) DATA RECEPTACLES, (1) MICROPHONE RECEPTACLE AND (1) QUAD RECEPTACLE IN FLUSH FLOOR LEGRAND WIREMOLD EVOLUTION SERIES 6" POKE THRU MODEL# 6ATC2PAVBX (CUSTOM CONFIG NEEDED PRIOR TO ORDERING).
- (3) FOR REPORTER PROVIDE AND INSTALL (2) DATA RECEPTACLE, (1) MICROPHONE RECEPTACLE AND (1) QUAD RECEPTACLE IN FLUSH FLOOR LEGRAND WIREMOLD EVOLUTION SERIES 6" POKE THRU MODEL# 6ATC2PAVBX (CUSTOM CONFIG NEEDED PRIOR TO ORDERING).
- (4) FOR WITNESS PROVIDE AND INSTALL (2) DATA RECEPTACLE, (1) MICROPHONE RECEPTACLE AND (1) DUPLEX RECEPTACLE IN FLUSH FLOOR LEGRAND WIREMOLD EVOLTION SERIES 6" POKE THRU MODEL# 6ATC2PAVBX (CUSTOM CONFIG NEEDED PRIOR TO ORDERING).
- (5) FOR COUNCIL PROVIDE AND INSTALL (2) DATA RECEPTACLES, (2) MICROPHONE RECEPTACLES AND (1) DUPLEX RECEPTACLE IN FLUSH FLOOR LEGRAND WIREMOLD EVOLUTION SERIES 6" POKE THRU MODEL# 6ATC2PAVBX (CUSTOM CONFIG NEEDED PRIOR TO ORDERING).
- (6) FOR FRONT OF BENCH PROVIDE AND INSTALL (2) DATA RECEPTACLES AND (1) DUPLEX RECEPTACLE IN FLUSH FLOOR LEGRAND WIREMOLD EVOLTION SERIES 6" POKE THRU MODEL# 6ATC2PAVBX (CUSTOM CONFIG NEEDED PRIOR TO ORDERING).
- (7) FOR FLAT SCREEN PROVIDE AND INSTALL (2) DATA RECEPTACLES AND (1) DUPLEX RECEPTACLE MOUNTED AT 6'-6" TO BOTTOM OF FLAT SCREEN.
- (8) COURT ROOM CAMERAS INSTALLED BY OCA. PROVIDE AND INSTALL (3) DATA LINES BELDEN PART#5500FE (UPC#612825423867) IN A 4" X 4" JUNCTION BOX 7'-0" A.F.F. ALL CAMERA CABLES SHALL BE RAN TO SECURITY OFFICE 105 LOCATED ON THE FIRST FLOOR.
- (9) COURT ROOM CAMERAS INSTALLED BY OCA. PROVIDE AND INSTALL (4) DATA LINES BELDEN PART#5500FE (UPC#612825423867) IN A 4" X 4" JUNCTION BOX 7'-0" A.F.F. ALL CAMERA CABLES SHALL BE RAN TO SECURITY OFFICE 105 LOCATED ON THE FIRST FLOOR.
- (10) PROVIDE AND INSTALL (2) MIC CABLES AND (1) #18 AWG DC POWER CABLE RUN BETWEEN THE EMITTER AND MINI RACK. MOUNT UNIT AT 7'-0" A.F.F.
- (11) APPROXIMATE CAMERA LOCATION. COORDINATE EXACT LOCATION WITH OWNER. INSTALL PROVIDED SECURITY CAMERA'S. RUN (2) CAT6A CABLES FROM EACH CAMERA TO SERVER RACKS IN SECURITY OFFICE 105. PROVIDE CABLE GROMETS FOR PENETRATIONS. ALL CAMERA CABLES SHALL BE RAN TO THE ELEC CLO./STORAGE ROOM 205.
- (12) PROVIDE AND INSTALL (2) CAT6A CABLES FROM EACH CAMERA TO THE ELEC CLO./STORAGE
- (13) JUNCTION BOX FOR DOOR STRIKE POWER. SEE ELECTRICAL DETAIL DRAWING E119 FOR INSTALLATION DETAILS.
- (14) PROVIDE AND INSTALL (2) CAT6A CABLE FROM EACH DATA RECEPTACLE TO THE ELEC CLO./STORAGE ROOM 205.
- (15) PROVIDE AND INSTALL (2) CAT6A CABLES FROM EACH KRONOS DEVICE TO THE ELEC CLO./STORAGE ROOM 205.
- (16) ELECTRICAL CONTRACTOR SHALL PROVIDE (2) 19" 48U OPEN FRAME SERVER CABINETS AND PATCH PANELS FOR THE OCA PROVIDED SERVERS AND SWITCHES.

LEGEND

JUNCTION BOX

FLOORBOX W/ELECTRICAL DEVICE

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ST WE NEW CONTRACT 1 <u>Д</u> OR




AUGUST, 2024

AS SHOWN

E111

Project Number

Sheet Number

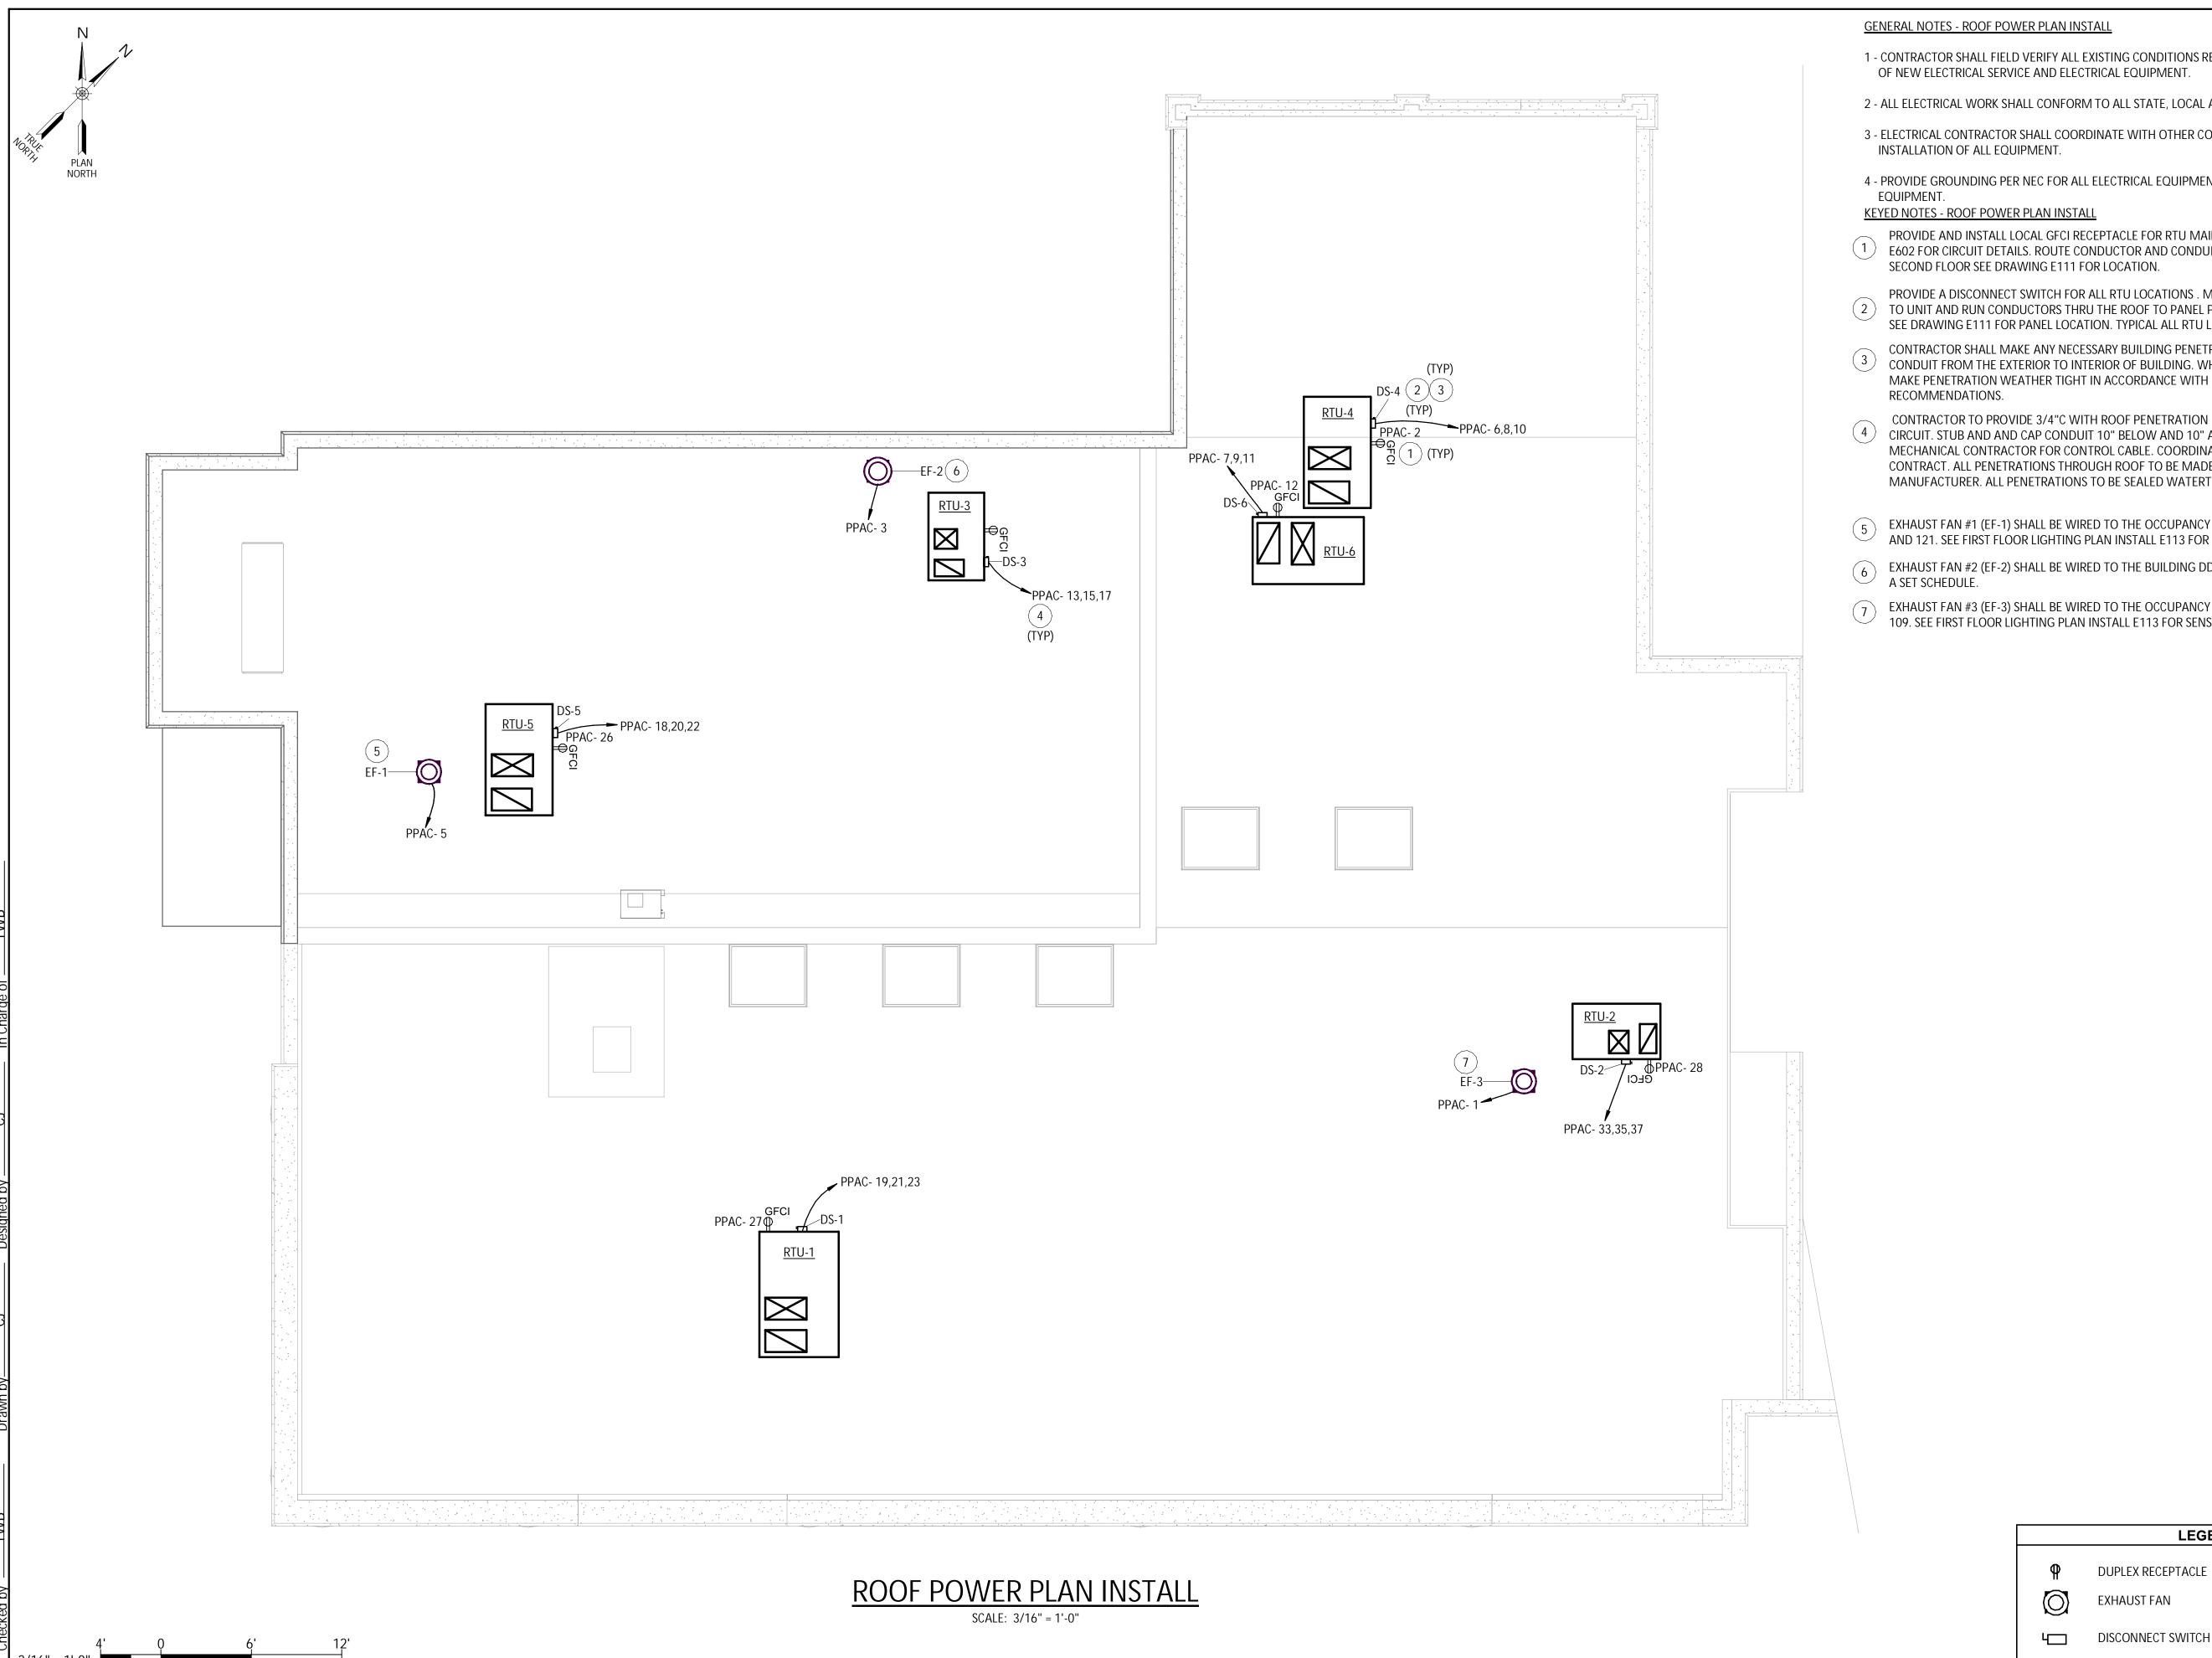


- 1 CONTRACTOR SHALL FIELD VERIFY ALL EXISTING CONDITIONS REQUIRED FOR INSTALLATION
- 2 ALL ELECTRICAL WORK SHALL CONFORM TO ALL STATE, LOCAL AND NATIONAL CODES.
- 3 ELECTRICAL CONTRACTOR SHALL COORDINATE WITH OTHER CONTRACTORS DURING THE
- 4 PROVIDE GROUNDING PER NEC FOR ALL ELECTRICAL EQUIPMENT AND ASSOCIATED
- PROVIDE AND INSTALL LOCAL GFCI RECEPTACLE FOR RTU MAINTENANCE PURPOSES. SEE DRAWING (1) E602 FOR CIRCUIT DETAILS. ROUTE CONDUCTOR AND CONDUITS TO PANEL PPAC LOCATED ON THE
- PROVIDE A DISCONNECT SWITCH FOR ALL RTU LOCATIONS. MOUNT DISCONNECT SWITCH (2) TO UNIT AND RUN CONDUCTORS THRU THE ROOF TO PANEL PPAC ON THE SECOND FLOOR SEE DRAWING E111 FOR PANEL LOCATION. TYPICAL ALL RTU LOCATIONS.
- CONTRACTOR SHALL MAKE ANY NECESSARY BUILDING PENETRATIONS TO ROUTE CABLE AND CONDUIT FROM THE EXTERIOR TO INTERIOR OF BUILDING. WHEN INSTALLATION IS COMPLETE MAKE PENETRATION WEATHER TIGHT IN ACCORDANCE WITH MANUFACTURER
- CONTRACTOR TO PROVIDE 3/4"C WITH ROOF PENETRATION NEAR PENETRATION FOR POWER (4) CIRCUIT. STUB AND AND CAP CONDUIT 10" BELOW AND 10" ABOVE ROOF FOR USE BY MECHANICAL CONTRACTOR FOR CONTROL CABLE. COORDINATE ALL WORK WITH MECHANICAL CONTRACT. ALL PENETRATIONS THROUGH ROOF TO BE MADE AS REQUIRED BY ROOF TYPE AND MANUFACTURER. ALL PENETRATIONS TO BE SEALED WATERTIGHT.
- EXHAUST FAN #1 (EF-1) SHALL BE WIRED TO THE OCCUPANCY SENSORS IN ROOMS 119,120 AND 121. SEE FIRST FLOOR LIGHTING DLAN INSTALL F113 FOR SENSOR LOCATION. AND 121. SEE FIRST FLOOR LIGHTING PLAN INSTALL E113 FOR SENSOR LOCATION.
- 6 EXHAUST FAN #2 (EF-2) SHALL BE WIRED TO THE BUILDING DDC SYSTEM AND CONTROLED BY A SET SCHEDULE.
- EXHAUST FAN #3 (EF-3) SHALL BE WIRED TO THE OCCUPANCY SENSORS IN ROOMS 108 AND 109. SEE FIRST FLOOR LIGHTING PLAN INSTALL E113 FOR SENSOR LOCATION.

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PLAN INSTALI

CITY OF MIDDLETOWN
NEW COURTHOUSE FACILITY
CONTRACT 1D - ELECTRICAL CONSTRUCTION POWER ROOF



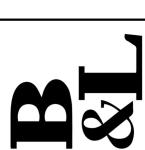


AS SHOWN

Project Number

AUGUST, 2024

LEGEND

E112

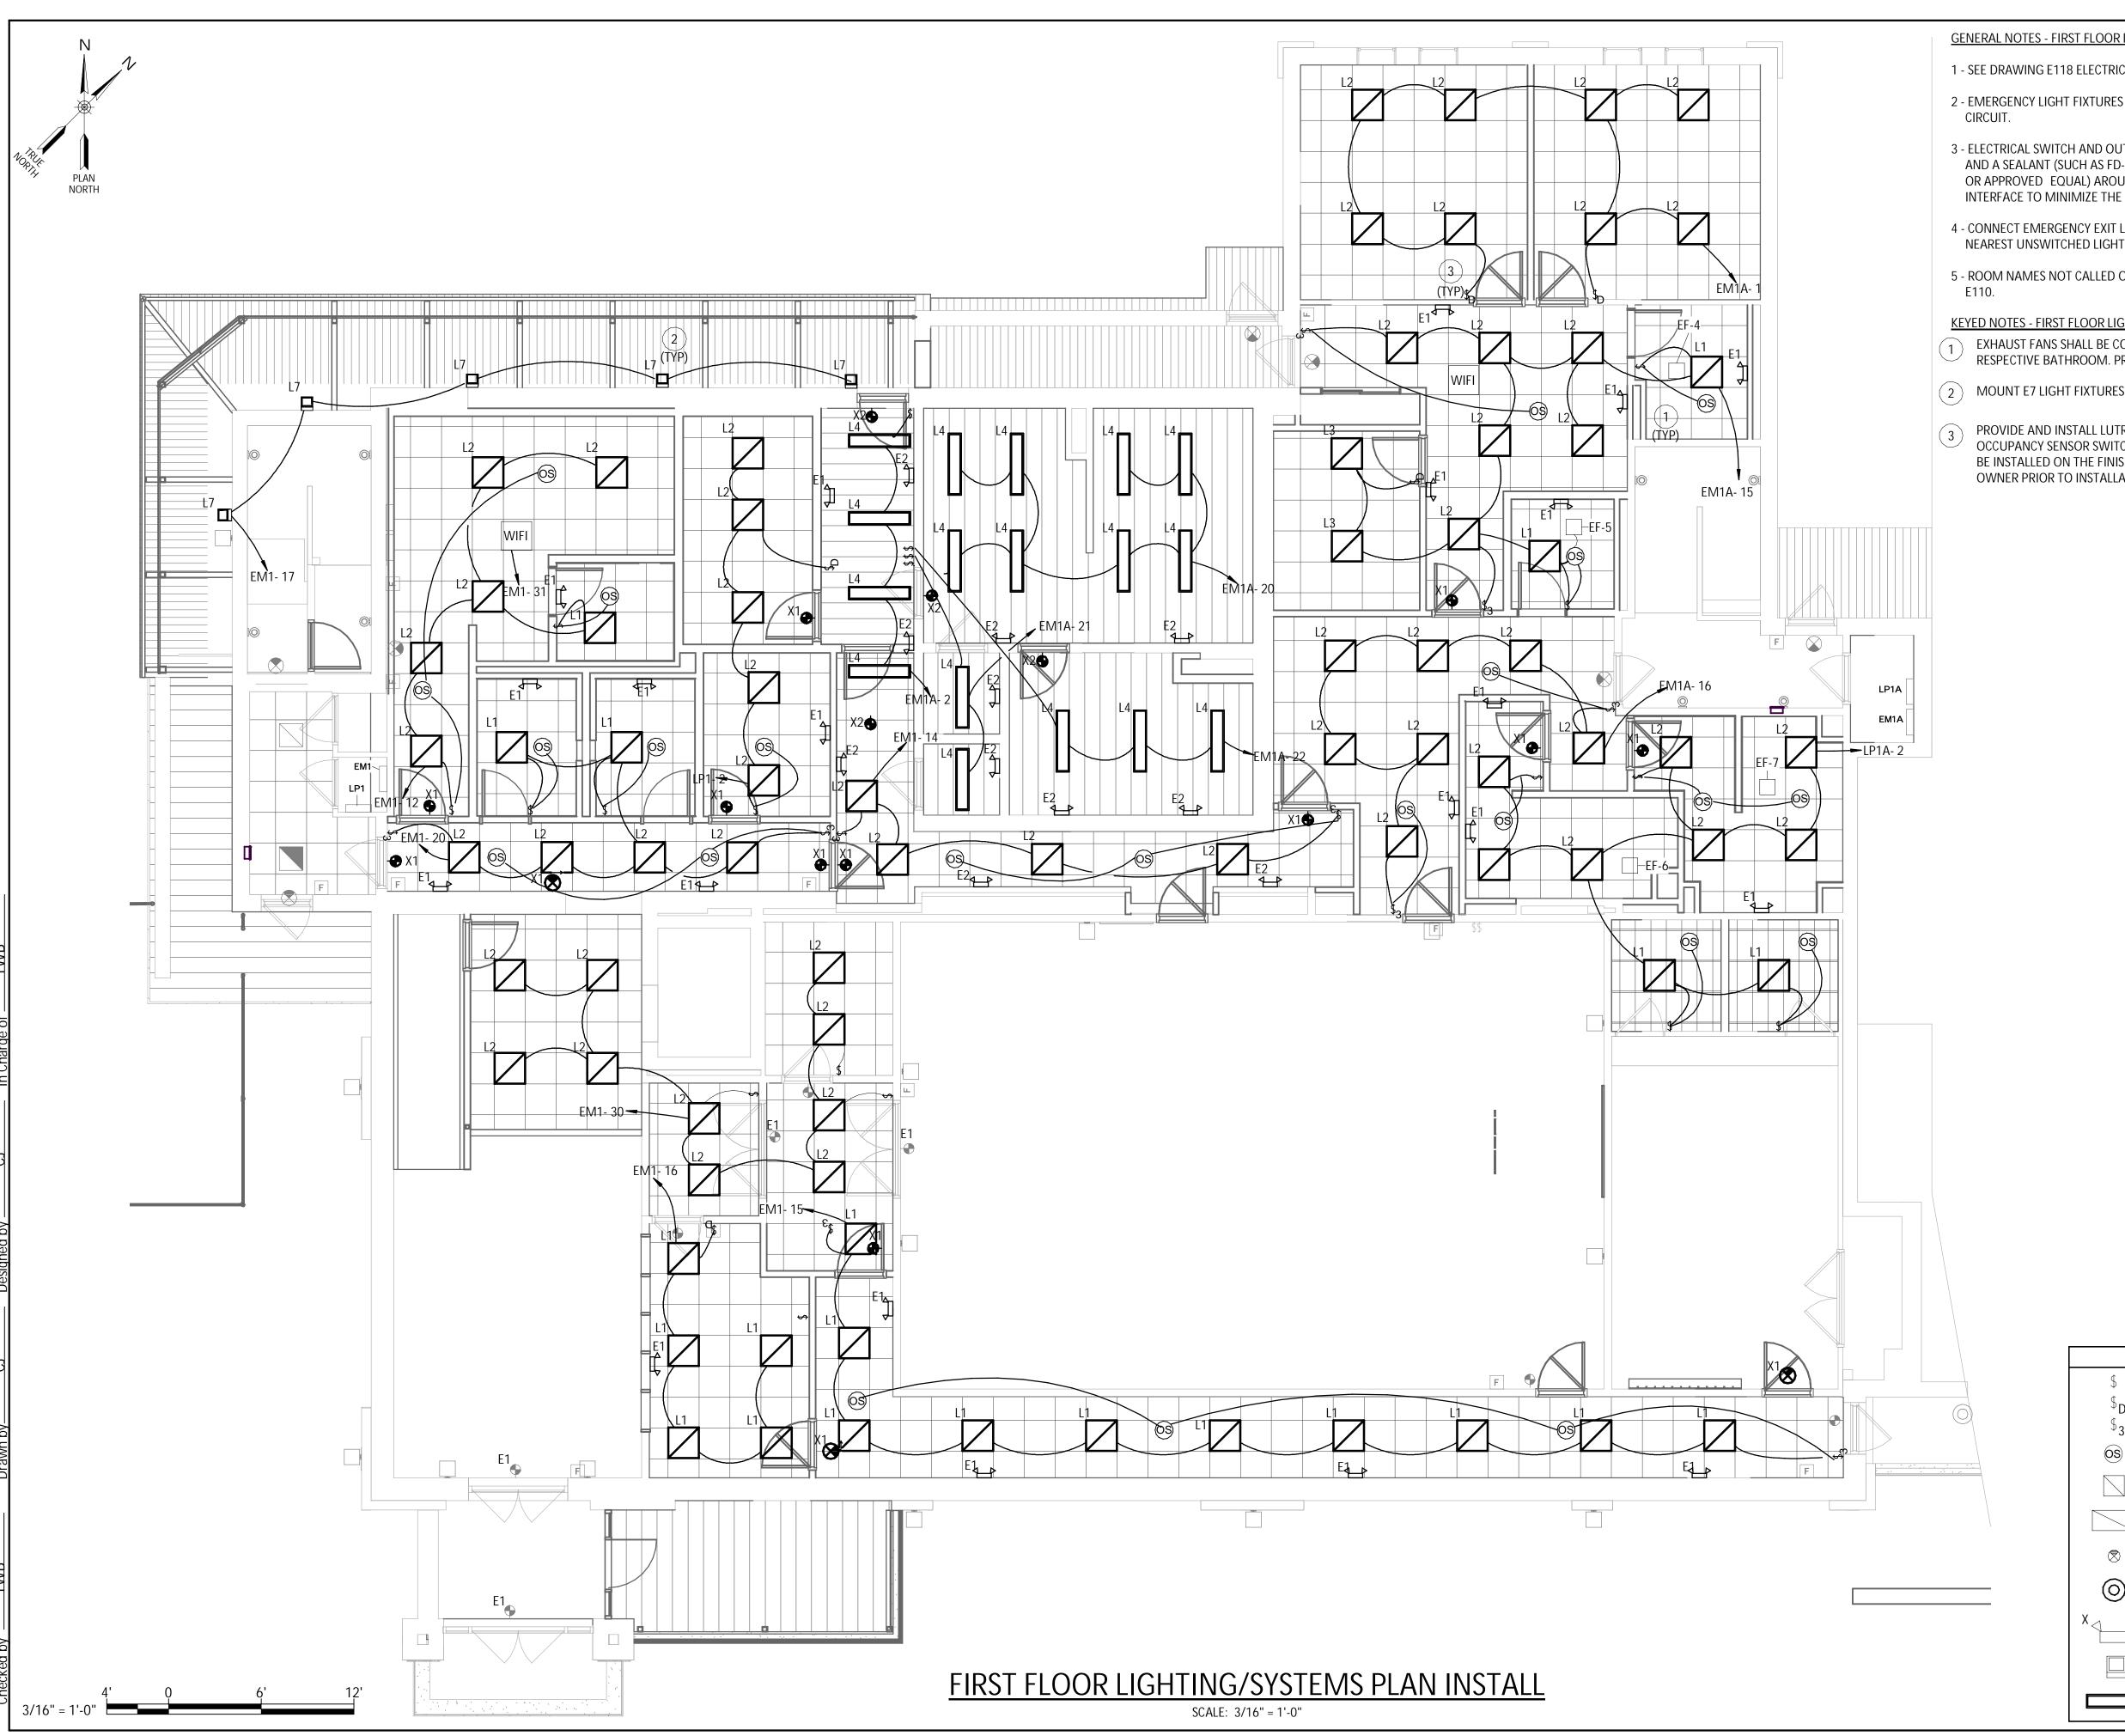

GENERAL NOTES - FIRST FLOOR LIGHTING/SYSTEMS PLAN INSTALL

1 - SEE DRAWING E118 ELECTRICAL SCHEDULES FOR LIGHT FIXTURE DETAILS.

2 - EMERGENCY LIGHT FIXTURES SHALL BE INSTALLED ON THE UNSWITCHED PORTION OF THE

3 - ELECTRICAL SWITCH AND OUTLET BOXES SHALL BE SEALED USING A MOLDABLE PUTTY PAD AND A SEALANT (SUCH AS FD-150+ CAULK OR FB 1000 NS SEALANT, AS AVAILABLE FROM 3M, OR APPROVED EQUAL) AROUND THE PERIMETER OF THE BOX AT THE GYPSUM/BOX INTERFACE TO MINIMIZE THE TRANSMISSION OF SMOKE (AND SOUND).

4 - CONNECT EMERGENCY EXIT LIGHTS SIGNS AND EMERGENCY EGRESS LIGHTING TO THE NEAREST UNSWITCHED LIGHTING CIRCUIT IN THE SAME ROOM OR AREA.

5 - ROOM NAMES NOT CALLED OUT FOR DRAWING CLARITY. FOR ROOM NAMES SEE DRAWING

KEYED NOTES - FIRST FLOOR LIGHTING/SYSTEMS PLAN INSTALL

EXHAUST FANS SHALL BE CONTROLED BY THE OCCUPANCY SENSOR INSTALLED IN EACH RESPECTIVE BATHROOM. PROVIDE AND INSTALL 2#12 - 1#12GND IN 3/4" CONDUIT.

(2) MOUNT E7 LIGHT FIXTURES 8'-0" ABOVE FINISH GRADE.

PROVIDE AND INSTALL LUTRON MAESTRO OR SIMULAR 0-10V DIMMER SINGLE POLE OCCUPANCY SENSOR SWITCHES OR EQUAL WHERE SHOWN. ALL NEW SWITCHES SHALL NOT BE INSTALLED ON THE FINISHED WOOD SURFACES. COORDINATE FINAL LOCATIONS WITH OWNER PRIOR TO INSTALLATION.

LEGEND

CEILING MOUNTED OCCUPANCY/MOTION SENSOR

2'X2' LED LIGHT FIXTURE, X INDICATES FIXTURE TYPE

2'x4' LED LIGHT FIXTURE, X INDICATES FIXTURE TYPE

EXIT LIGHT FIXTURE, CEILING MOUNTED

EMERGENCY LIGHTING UNIT

RECESSED LIGHT FIXTURE, CEILING MOUNTED

WALL PACK, OUTDOOR LIGHTING FIXTURE

CEILING RECESSED LIGHTING FIXTURE

WALL SWITCH

DIMMER WALL SWITCH 3-WAY WALL SWITCH

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REVISIONS

INSTALL

LIGHTING/SYSTEMS OR

FIRST

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Sheet Number


E113

1753.008.001

AUGUST, 2024

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Project Number

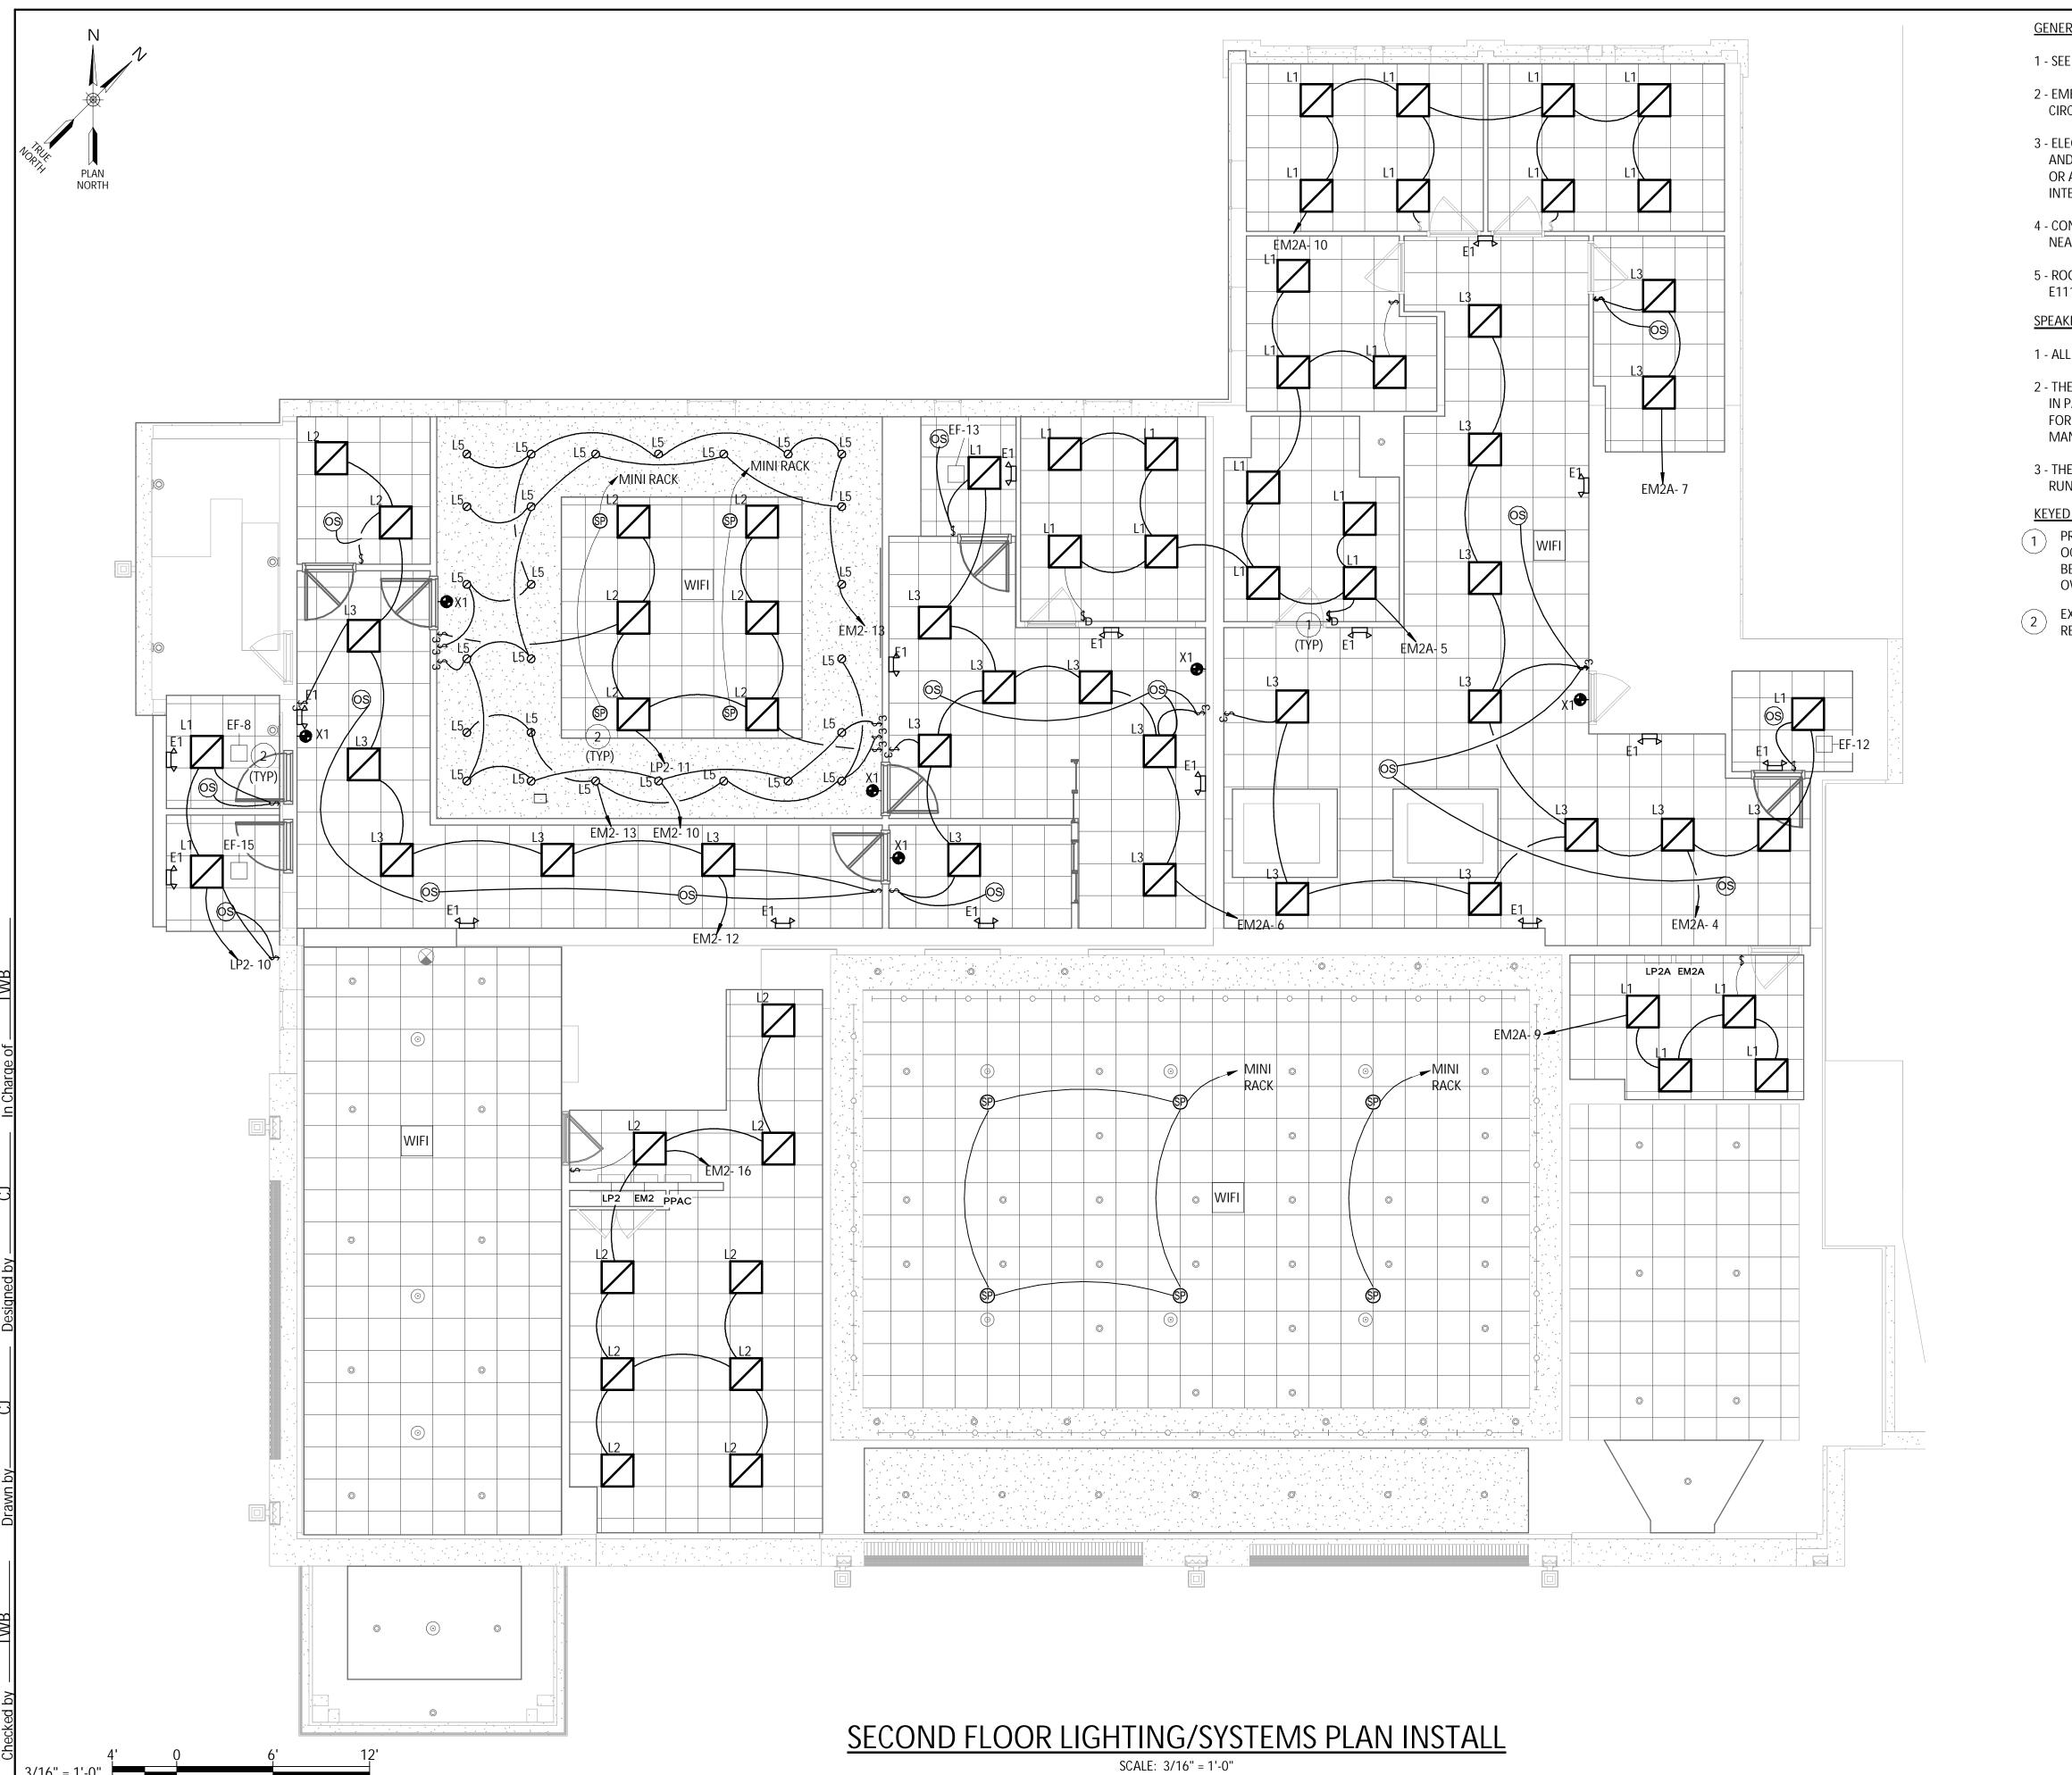

GENERAL NOTES - SECOND FLOOR LIGHTING/SYSTEMS PLAN INSTALL

- 1 SEE DRAWING E118 ELECTRICAL SCHEDULES FOR LIGHT FIXTURE DETAILS.
- 2 EMERGENCY LIGHT FIXTURES SHOULD BE INSTALLED ON THE UNSWITCHED PORTION OF THE
- 3 ELECTRICAL SWITCH AND OUTLET BOXES SHOULD BE SEALED USING A MOLDABLE PUTTY PAD AND A SEALANT (SUCH AS FD-150+ CAULK OR FB 1000 NS SEALANT, AS AVAILABLE FROM 3M, OR APPROVED EQUAL) AROUND THE PERIMETER OF THE BOX AT THE GYPSUM/BOX INTERFACE TO MINIMIZE THE TRANSMISSION OF SMOKE (AND SOUND).
- 4 CONNECT EMERGENCY EXIT LIGHTS SIGNS AND EMERGENCY EGRESS LIGHTING TO THE NEAREST UNSWITCHED LIGHTING CIRCUIT IN THE SAME ROOM OR AREA.
- 5 ROOM NAMES NOT CALLED OUT FOR DRAWING CLARITY. FOR ROOM NAMES SEE DRAWING

SPEAKER NOTES - SECOND FLOOR LIGHTING/SYSTEMS PLAN INSTALL

- 1 ALL SPEAKERS SHOULD BE SET TO 70 VOLTS, 15 WATTS.
- 2 THE TWO SPEAKERS OVER THE JUDGES BENCH AREA SHOULD BE DAISY CHAINED (CONNECTED IN PARALLEL) WITH A SINGLE HOME RUN TO THE MIDI RACK. LEAVE 10' OF EXTRA CABLE CORE FOR ALL SPEAKER & MICROPHONE CABLES AT THE MIDI RACK FOR TERMINATION & CABLE MANAGEMENT BY OCA.
- 3 THE REMAINING SPEAKERS IN THE ROOM CAN ALL BE DAISY CHAINED WITH ANOTHER HOME RUN TO THE MIDI RACK.

KEYED NOTES - SECOND FLOOR LIGHTING/SYSTEMS PLAN INSTALL

- PROVIDE AND INSTALL LUTRON MAESTRO OR SIMULAR 0-10V DIMMER SINGLE POLE OCCUPANCY SENSOR SWITCHES OR EQUAL WHERE SHOWN. ALL NEW SWITCHES SHALL NOT BE INSTALLED ON THE FINISHED WOOD SURFACES. COORDINATE FINAL LOCATIONS WITH OWNER PRIOR TO INSTALLATION.
- EXHAUST FANS SHALL BE CONTROLED BY THE OCCUPANCY SENSOR INSTALLED IN EACH REPECTIVE BATHROOM. PROVIDE AND INSTALL 2#12 - 1#12GND IN 3/4" CONDUIT.

LEGEND

CEILING MOUNTED OCCUPANCY/MOTION SENSOR

2'X2' LED LIGHT FIXTURE, X INDICATES FIXTURE TYPE

EXIT LIGHT FIXTURE, CEILING MOUNTED

EMERGENCY LIGHTING UNIT

WIRELESS ACCESS POINT

RECESSED LIGHT FIXTURE, CEILING MOUNTED

WALL SWITCH

SPEAKER

DIMMER WALL SWITCH 3-WAY WALL SWITCH

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REVISIONS

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ECOND


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KEYED NOTES - SALLY PORT & SECURITY PLAN INSTALL

PROVIDE AND INSTALL 30A DISCONNECT SWITCH SQUARE-D H361 OR EQUAL. RUN 3# 10 - 1#10G IN 1" CONDUIT FROM NEW AUTO GARAGE DOOR OPENER TO PANEL EM1.

2 SEE DETAIL ON SHEET E118 FOR OVERHEAD DOOR WIRING DETAIL.

MOUNT PROVIDED WIRELESS AIPHONE AND DURESS BUTTON TO FENCE POLE.

MOUNT PROVIDED SECURITY CAMERAS TO LIGHT POLES AT A HEIGHT OF 10' ABOVE FINISH GRADE. PROVIDE AND INSTALL (2) CAT6A CABLES FROM CAMERA TO THE ELEC CLO./STORAGE ROOM 205 ON THE SECOND FLOOR.

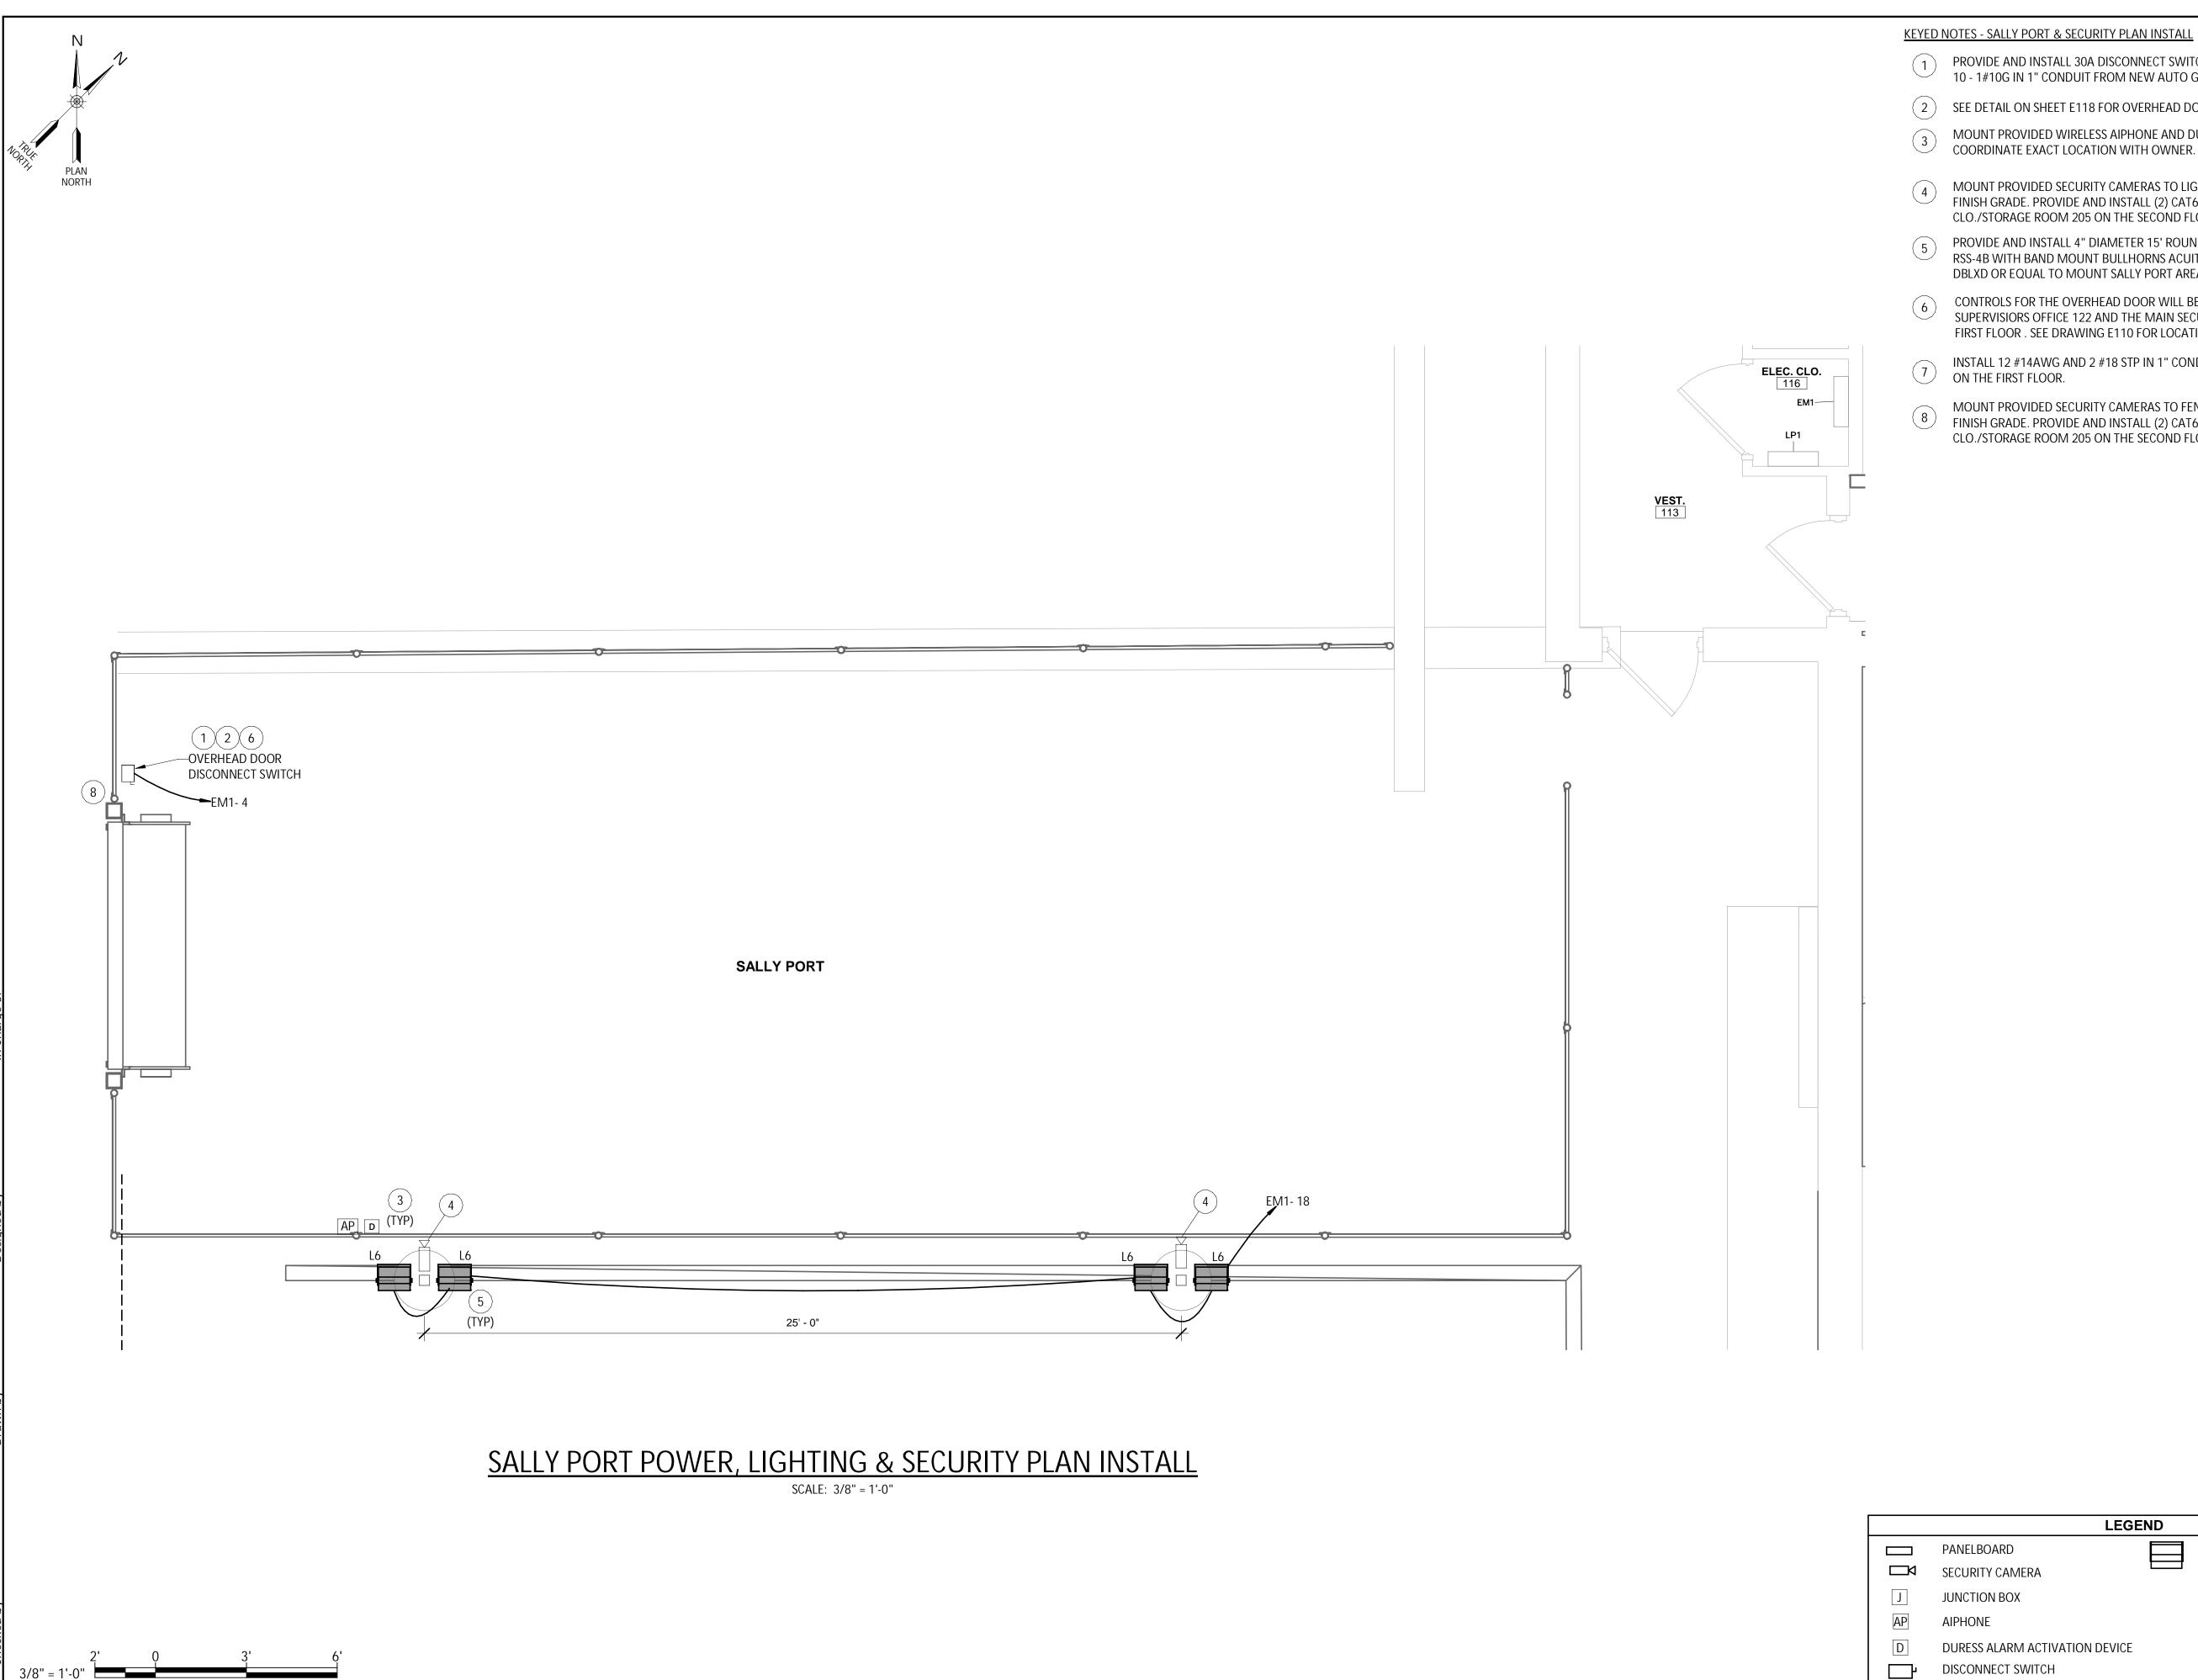PROVIDE AND INSTALL 4" DIAMETER 15' ROUND STEEL POLES ACUITY PART NUMBER RSS-4B WITH BAND MOUNT BULLHORNS ACUITY PART NUMBER SMACBT-14/8T-RND-DBLXD OR EQUAL TO MOUNT SALLY PORT AREA LIGHT FIXTURES. TYPICAL 2X

CONTROLS FOR THE OVERHEAD DOOR WILL BE LOCATED IN THE SECURITY SUPERVISIORS OFFICE 122 AND THE MAIN SECURITY OFFICE 105 LOCATED ON THE FIRST FLOOR . SEE DRAWING E110 FOR LOCATIONS.

INSTALL 12 #14AWG AND 2 #18 STP IN 1" CONDUIT TO THE MAIN SECURITY ROOM 105

MOUNT PROVIDED SECURITY CAMERAS TO FENCE POLE AT A HEIGHT OF 6' ABOVE FINISH GRADE. PROVIDE AND INSTALL (2) CAT6A CABLES FROM CAMERA TO THE ELEC CLO./STORAGE ROOM 205 ON THE SECOND FLOOR.

LEGEND

POLE MOUNTED FLOOD LIGHT

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FOLLOWED BY THEIR SIGNATURE, THE DATE OF SUCH ALTERATION, AND A SPECIFIC DESCRIPTION OF THE ALTERATION

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SECURITY

, LIGHTING INSTALL POWER,


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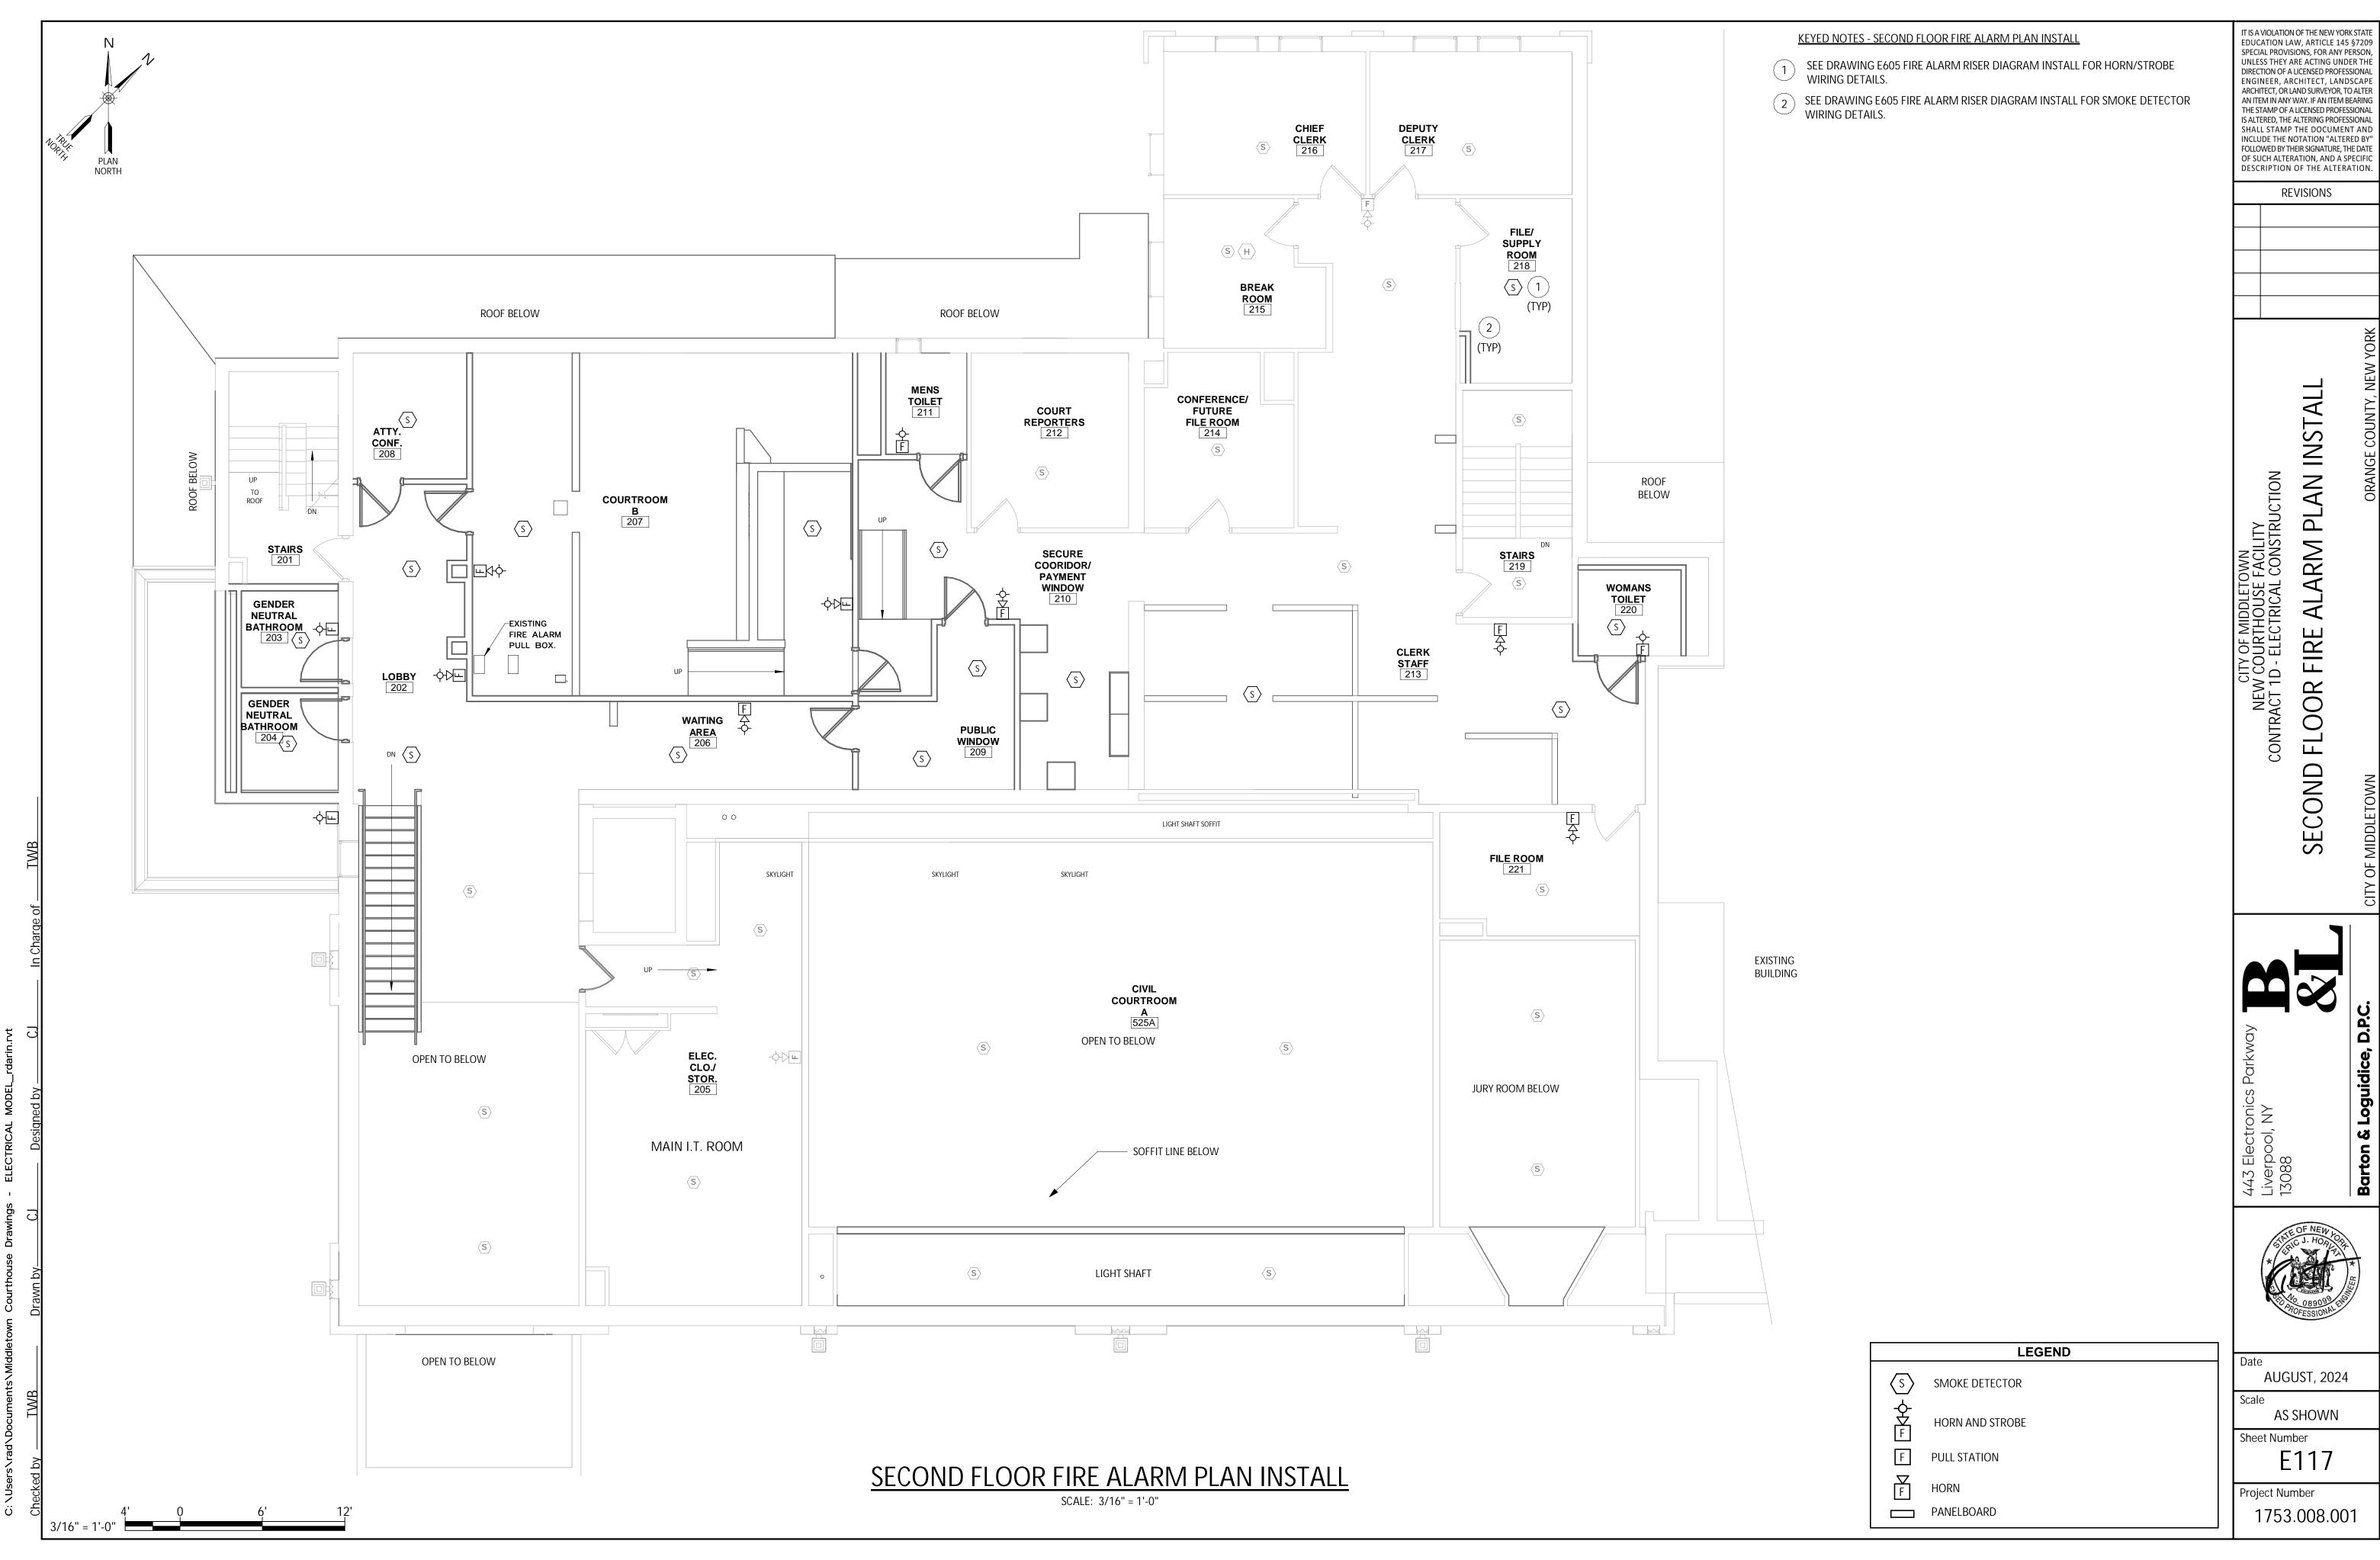
AUGUST, 2024

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E115




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KEYED NOTES, SOUND SYSTEM DIAGRAM

- 1 PROVIDE DEDICATED 120V, 20A OUTLET FOR EMITTER AT EMITTER LOCATION. OUTLET TO BE PROVIDED IN RECESSED WALL BOX. CIRCUIT TO NEW PANELBOARD WITH 2#12, 1#12G IN 3/4"C. PROVIDE 20A, 1P CIRCUIT BREAKER.
- 2 UTILIZE 120V OUTLETS SHOWN ON FLOOR PLAN.

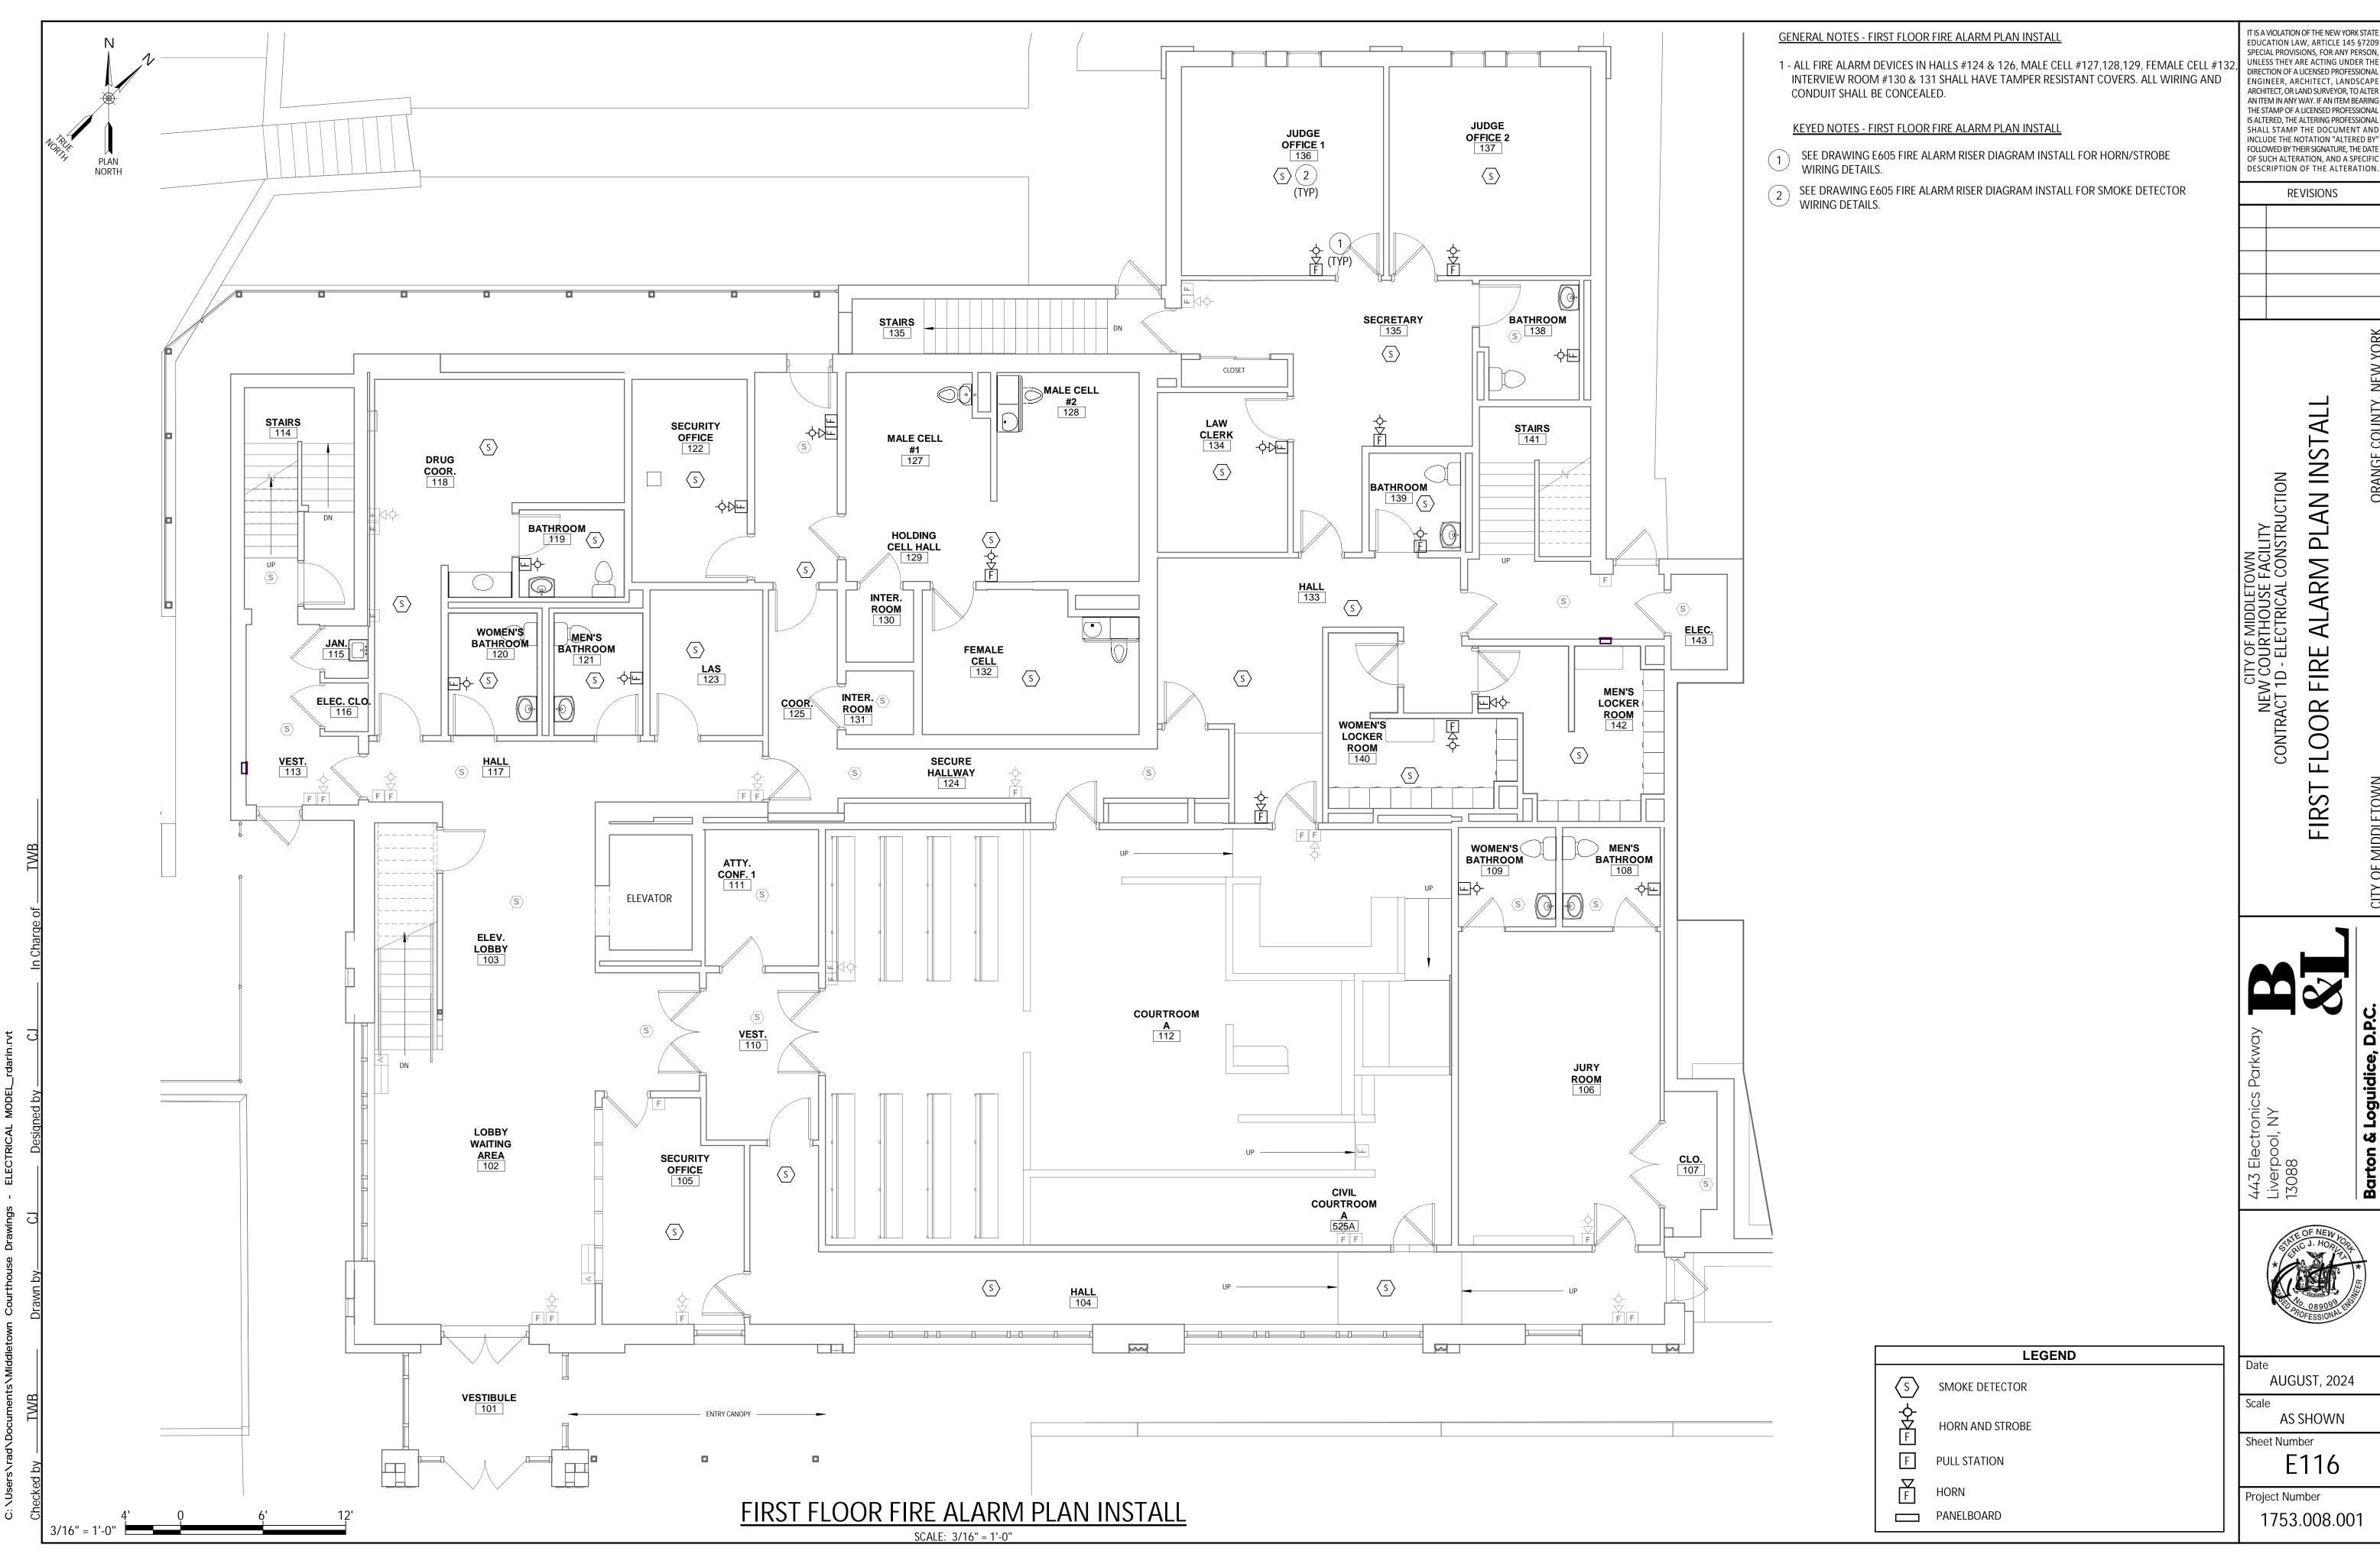

GENERAL NOTES, OVERHEAD DOOR - DIAGRAM

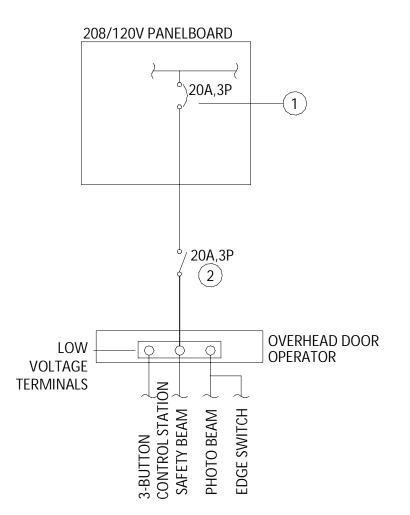- 1. CIRCUITING, CIRCUIT BREAKER, DISCONNECT, AND LOW VOLTAGE WIRING SHOWN AS THE BASIS OF DESIGN. COORDINATE REQUIREMENTS WITH GENERAL
- CONTRACT PRIOR TO INSTALLATION. 2. ALL CIRCUITING SHALL BE IN CONDUIT.

KEYED NOTES, OVERHEAD DOOR - DIAGRAM

- PROVIDE NEW CIRCUIT BREAKER IN EXISTING PANELBOARD. MATCH EXISTING KAIC RATINGS. (TYP)
- (2) SEE ONE-LINE DIAGRAM FOR CIRCUITING.

GARAGE DOOR WIRING DETAIL

SCALE: NOT TO SCALE

LIGHT FIXTURE SCHDULE										
DESIGNATION	TYPE	MANUFACTURER	CATALOG NUMBER	LUMENS	LIGHT COLOR	VOLTS	LIGHT DISTRIBUTION	INSTALLATION	FINISH / COLOR	REMARKS
L1	TROFFER	ACUITY	2BLT2 20L SDSM LP840	2000	4000K	120	N/A	CEILING/RECESSED	WHITE	
L2	TROFFER	ACUITY	2BLT2 33L SDSM LP840	3000	4000K	120	N/A	CEILING/RECESSED	WHITE	
L3	TROFFER	ACUITY	2BLT2 40L SDSM LP840	4000	4000K	120	N/A	CEILING/RECESSED	WHITE	
L4	TROFFER	KENALL	RMCA-4-TG-0-2-67L40K-IS-2-DV-0	5836	4000K	MULTI VOLT	N/A	CEILING RECESSED	WHITE	6
L5	RECESSED MOUNT	ACUITY	LDN6 40 15 L06 WR LSS MVOLT GZ10	1500	4000K	MULTI VOLT	N/A	CEILING	WHITE	
L6	FLOODLIGHT	ACUITY	RSXF1-P5-50K-AWFD-MVOLT-AAWSC-PE-DBLXD	N/A	5000K	MULTI VOLT	N/A	POLE MOUNT	BLACK	1
L7	WALL PACK	KENALL	FN9-2-7-MB-49L-40K8-120	N/A	5000K	MULTI VOLT	N/A	WALL MOUNT	BLACK	1,4
X1	EXIT LIGHT	ACUITY	LQM S W 3 R 120/277 M6	N/A	RED	120	N/A	SURFACE, WALL	WHITE	2,3
Х2	TAMPER RESISTANT EXIT LIGHT	KENALL	MMEX-1-0-R-DT-1-EL	N/A	RED	120	N/A	SURFACE, WALL	WHITE	2,3,4
E1	EMERGENCY LIGHT	ACUITY	ELM4L	N/A	STANDARD	120	N/A	WALL	WHITE	2,3
E1	TAMPER REISITANT EMERGENCY LIGHT	KENALL	METELHC-24W-MW-2-6.5L-120	N/A	STANDARD	120	N/A	WALL	WHITE	2,3,4

PD610ED10-PDM6A840-61VBB

SOUND. SYSTEM TO INCLUDE:

(1) WIR TX9 infrared emitter

(4) RX22-4N infrared receivers (4) HED 021 headphones

(8) BAT 001 AA alkaline batteries.

(1) MOD 232 modulator

(1) BKT 024 bracket

(2) NKL 001 neckloops (1) RPK 005 rack panel kit (1) IDP 008 ADA wall plaque

SOUND SYSTEM WIRING DETAIL

SCALE: NOT TO SCALE

GENERAL NOTES, LIGHT FIXTURE SCHEDULE

1. MODEL IS GIVEN FOR QUALITY ONLY. SUBSTITUTE LIGHT FIXTURES SHALL BE OF EQUAL OR GREATER QUALITY. 2. ALL FIXTURES TO BE PROVIDED WITH REQUIRED MOUNTING HARDWWARE FOR INSTALLATION TYPE SHOWN.

REMARK, LIGHT FIXTURE SCHEDULE

1. PROVIDE FIXTURE WITH INTEGRATED PHOTOCELL.

2. FIXTURE SHALL BE SELF DIAGNOSTIC. 3. PROVIDE WITH BATTERY PACK.

4. FIXTURE SHALL BE HIGH IMPACT AND VANDAL PROOF SUITABLE FOR HIGH SECURITY AREAS.

SPACERS AS_ GALVANIZED REQUIRED C-CHANNEL INSTALL AT 3'-0" OC. _ LOCKING **SQUARE WASHER & LOCKNUT** GALVANIZED REFER TO PLANS CONDUIT CLAMP WITH FOR QUANTITY & _ 3/8" MIN GALVANIZED CUSHION NUT AND BOLT. SIZE AS THREADED ROD, TYP. SIZE OF CONDUITS

REQUIRED

CONDUIT SUPPORT DETAIL

SCALE: NOT TO SCALE

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CITY OF MIDDLETOWN
NEW COURTHOUSE FACILITY
CONTRACT 1D - ELECTRICAL CONSTRUCTION SCHEDULES ELECTRICAL

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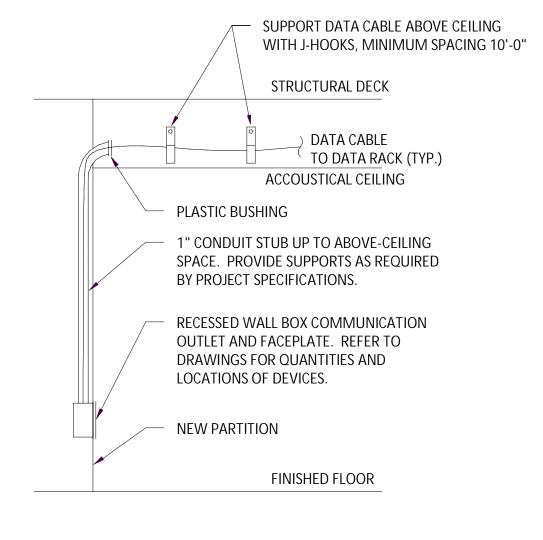
AS SHOWN Sheet Number

GENERAL NOTES, TYPICAL CEILING MOUNT OCCUPANCY SENSOR DETAIL - DIAGRAM


- 1 CONTRACTOR TO PROVIDE A COMPLETE AND OPERATIONAL SYSTEM.
- 2 PROVIDE ALL REQUIRED POWER/RELAY PACKS AND CIRCUITING.

TYPICAL CEILING MOUNT OCCUPANCY SENSOR DETAIL

SCALE: NOT TO SCALE



TYPICAL DATA CABLE ROUTING DETAIL SCALE: NOT TO SCALE

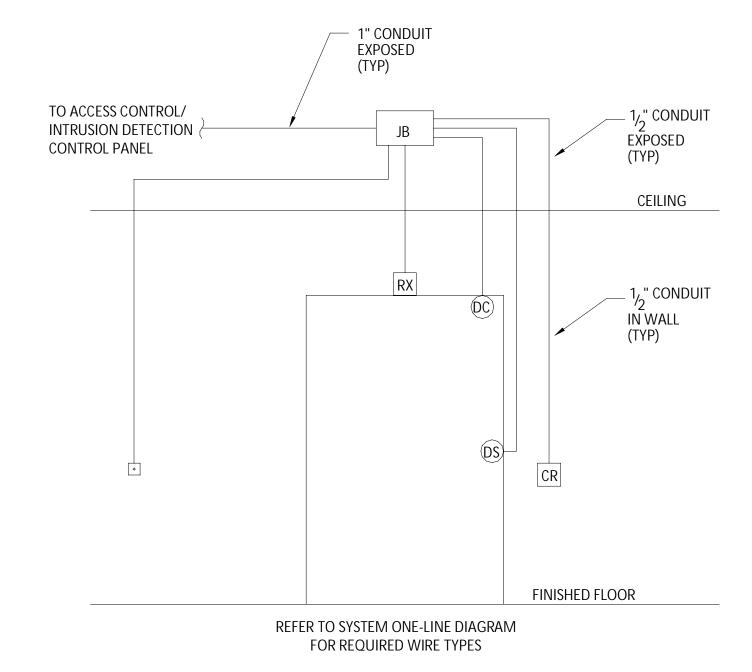


GENERAL NOTES, DOOR ACCESS CONTROL REQUIREMENTS - DIAGRAM

- 1 REFER TO ONE-LINE DIAGRAM FOR POWER CIRCUITING TO DOOR STRIKES.
- DOOR STRIKES PROVIDED BY ARCHITECURAL CONTRACT. 2 - COORDINATE INSTALLATION WITH ARCHITECTURAL CONTRACT AND OWNER.
- 3 OWNER TO PROVIDE CONTROL CIRCUITING, CARD READER, DOOR CONTROLLERS, REQUEST TO EXIT, AND DOOR CONTACTS. EQUIPMENT SHOWN FOR REFERANCE. ELECTRICAL CONTRACT TO PROVIDE ALL REQUIRED JUNCTIONS BOXES AND RACEWAY FOR OWNER PROVIDED EQUIPMENT.

TYPICAL DOORWAY ACCESS CONTROL REQUIREMENTS

SCALE: NOT TO SCALE

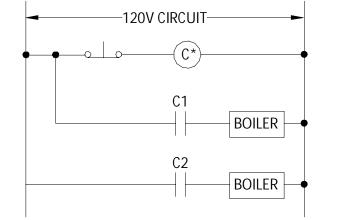



GENERAL NOTES, BOILER EMERGENCY SHUT OFF - DIAGRAM

- 1 PROVIDE MUSHROOM HEAD EMERGENCY STOP PUSH BUTTON SWITCH AT LOCATION
- OF EACH BOILER ROOM EXIT DOOR.
- 2 EMERGENCY STOP TO BE PUSH TO TRIP, PULL TO RESET.
- PROVIDE ALL REQUIRED CONTACTORS.
- 3 PUSHING THE MUSHROOM HEAD EMERGENCY PUSH BUTTON SHALL BREAK POWER TO THE
- COIL AND THE CONTACTS SHALL OPEN.

BOILER EMERGENCY SHUT-OFF DETAIL

SCALE: NOT TO SCALE

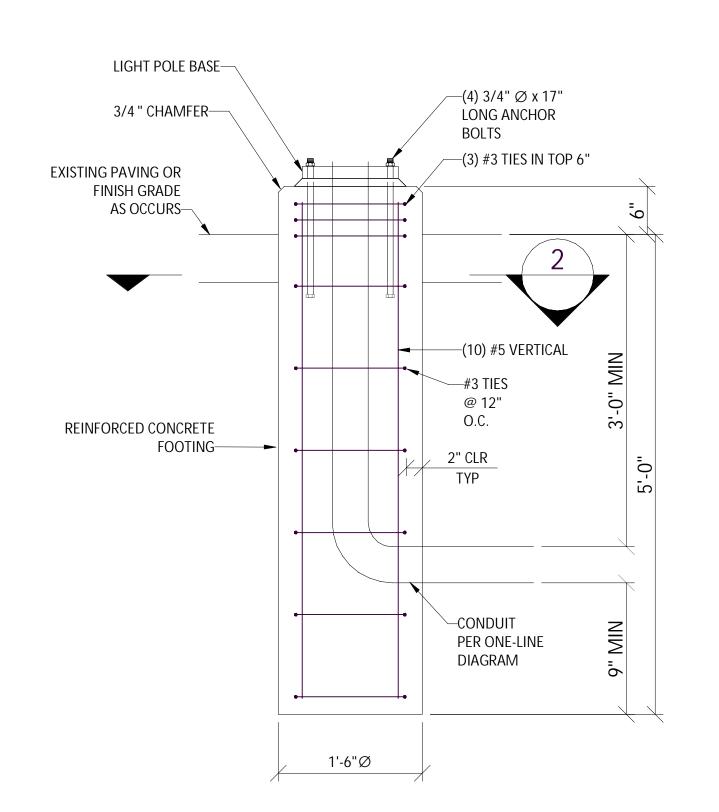

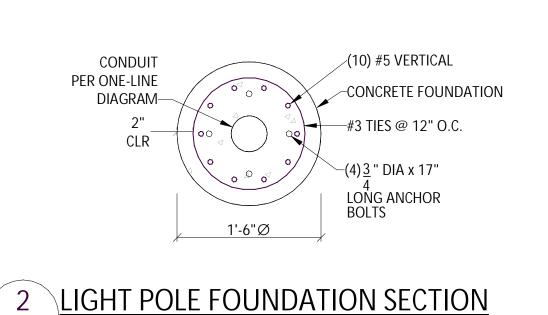

LIGHT POLE FOUNDATION DETAIL

SCALE: NOT TO SCALE

CITY OF MIDDLETOWN NEW COURTHOUSE FACILITY CONTRACT 1D - ELECTRICAL CONSTRUCTION DETAIL ELECTRICAL

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ARCHITECT, OR LAND SURVEYOR, TO ALTE AN ITEM IN ANY WAY. IF AN ITEM BEARIN THE STAMP OF A LICENSED PROFESSIONAL IS ALTERED, THE ALTERING PROFESSIONAL


SHALL STAMP THE DOCUMENT AND

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Sheet Number E119

CAMERA BOX INSTALLATION DETAIL

1 - THE EC SHALL PROVIDE BOXES IN THE WALLS, PROVIDE CONDUIT FROM THE

BOX TO ABOVE THE DROP CEILING OR GYPSUM WALLBOARD. 2 - CAMERAS, AND WIRING TO AND FROM BOXES BY OTHERS.

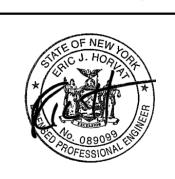SCALE: NOT TO SCALE


CONDUIT SCHEDULE							
BUILDING OR AREA	AREA DESCRIPTION	CONDUIT TYPE	REMARKS				
GENERAL (ALL	INTERIOR - CONCEALED	EMT	1, 2				
AREAS)	INTERIOR - EXPOSED	WIREMOLD	1, 3				
ELECTRICAL ROOMS	ALL	EMT					

1 - CONDUIT TYPES ARE UNLESS OTHERWISE INDICATED OR REQUIRED BY EQUIPMENT OR CABLE MANUFACTURER. PROVIDE AS REQUIRED.

REMARKS, CONDUIT SCHEDULE

- 1 EXPOSED SYSTEMS ONLY ACCEPTABLE WHERE DEVICES ARE INSTALLED ON EXISTING
- 2- METAL CLAD, MC CABLE, ALLOWED FOR RECEPTACLE AND LIGHTING CIRCUITS.
- 3 WIREMOLD TO BE COLOR MATCHED TO ADJACENT SURFACES.

CONDUIT SCHEDULE SCALE: NOT TO SCALE

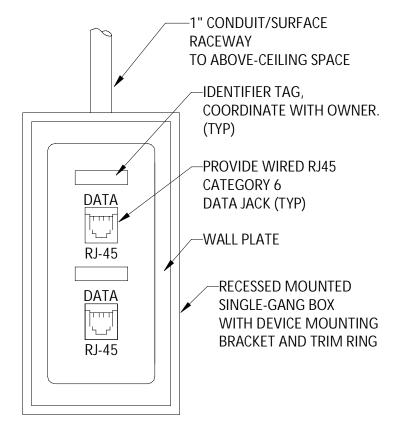

NON-SHRINK GROUT

STEEL WALL

SLEEVE (SCH. 40)

CORE DRILL HOLE

MECHANICAL SEAL


REQUIRED FOR

TYPICAL WALL.

TYPICAL WALL/FLOOR CONDUIT PENETRATION DETAIL

SCALE: NOT TO SCALE

TYPICAL DATA PORT SCALE: NOT TO SCALE

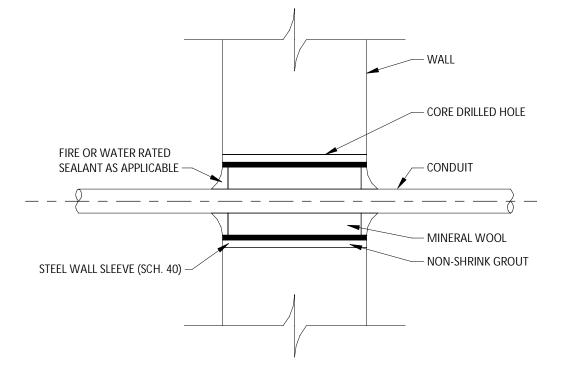


TYPICAL WALL/FLOOR CONDUIT PENETRATION DETAIL - FIRE RATED

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CITY OF MIDDLETOWN
NEW COURTHOUSE FACILITY
CONTRACT 1D - ELECTRICAL CONSTRUCTION DETAIL



AUGUST, 2024
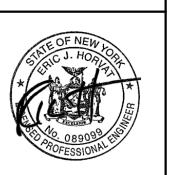
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E120



GENERAL NOTES – ONE-LINE DIAGRAM DEMO

1 - ONE LINE DIAGRAM DEMO DRAWING CREATED FROM DRAWINGS E-5 TITLED ONE LINE RISER DIAGRAM DATED JULY 30, 2004 AND CURSORY FIELD OBSERVATIONS. CONTRACTOR TO FIELD VERIFY ALL EXISTING INFORMATION REQUIRED.

2 - MAINTAIN EXISTING CIRCUITS OTHER THAN THE ONES SHOWN TO BE DEMOED. UPDATE

(1) DEMO CIRCUIT BREAKERS FOR ALL CIRCUITS BEING REMOVED.

DIRECTION OF A LICENSED PROFESSIONAL ENGINEER, ARCHITECT, LANDSCAPE ARCHITECT, OR LAND SURVEYOR, TO ALTER AN ITEM IN ANY WAY. IF AN ITEM BEARING THE STAMP OF A LICENSED PROFESSIONAL IS ALTERED, THE ALTERING PROFESSIONAL SHALL STAMP THE DOCUMENT AND INCLUDE THE NOTATION "ALTERED BY' FOLLOWED BY THEIR SIGNATURE, THE DATE

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DEMO CITY OF MIDDLETOWN
NEW COURTHOUSE FACILITY
CONTRACT 1D - ELECTRICAL CONSTRUCTION **DIAGRAM**

LINE ONE

AUGUST, 2024

LEGEND

EQUIPMENT TO BE DEMOED

Scale

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Sheet Number E601

Project Number 1753.008.001

ONE LINE DIAGRAM DEMO SCALE: NOT TO SCALE

ONE LINE DIAGRAM NORMAL POWER INSTALL

VAV-2

VAV-7

VAV-8

VAV-11

VAV-12

DIRECTION OF A LICENSED PROFESSIONAL ENGINEER, ARCHITECT, LANDSCAPE ARCHITECT, OR LAND SURVEYOR, TO ALTER AN ITEM IN ANY WAY. IF AN ITEM BEARING THE STAMP OF A LICENSED PROFESSIONAL IS ALTERED, THE ALTERING PROFESSIONAL SHALL STAMP THE DOCUMENT AND INCLUDE THE NOTATION "ALTERED BY FOLLOWED BY THEIR SIGNATURE, THE DATE OF SUCH ALTERATION, AND A SPECIFIC DESCRIPTION OF THE ALTERATION

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UNLESS THEY ARE ACTING UNDER THE

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POWER CITY OF MIDDLETOWN
NEW COURTHOUSE FACILITY
CONTRACT 1D - ELECTRICAL CONSTRUCTION NORMAL

DIAGRAM LINE ONE



AUGUST, 2024

VAV-15 VAV-16

VAV-14


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Sheet Number E602

Project Number 1753.008.001

SCALE: NOT TO SCALE

VAV-1

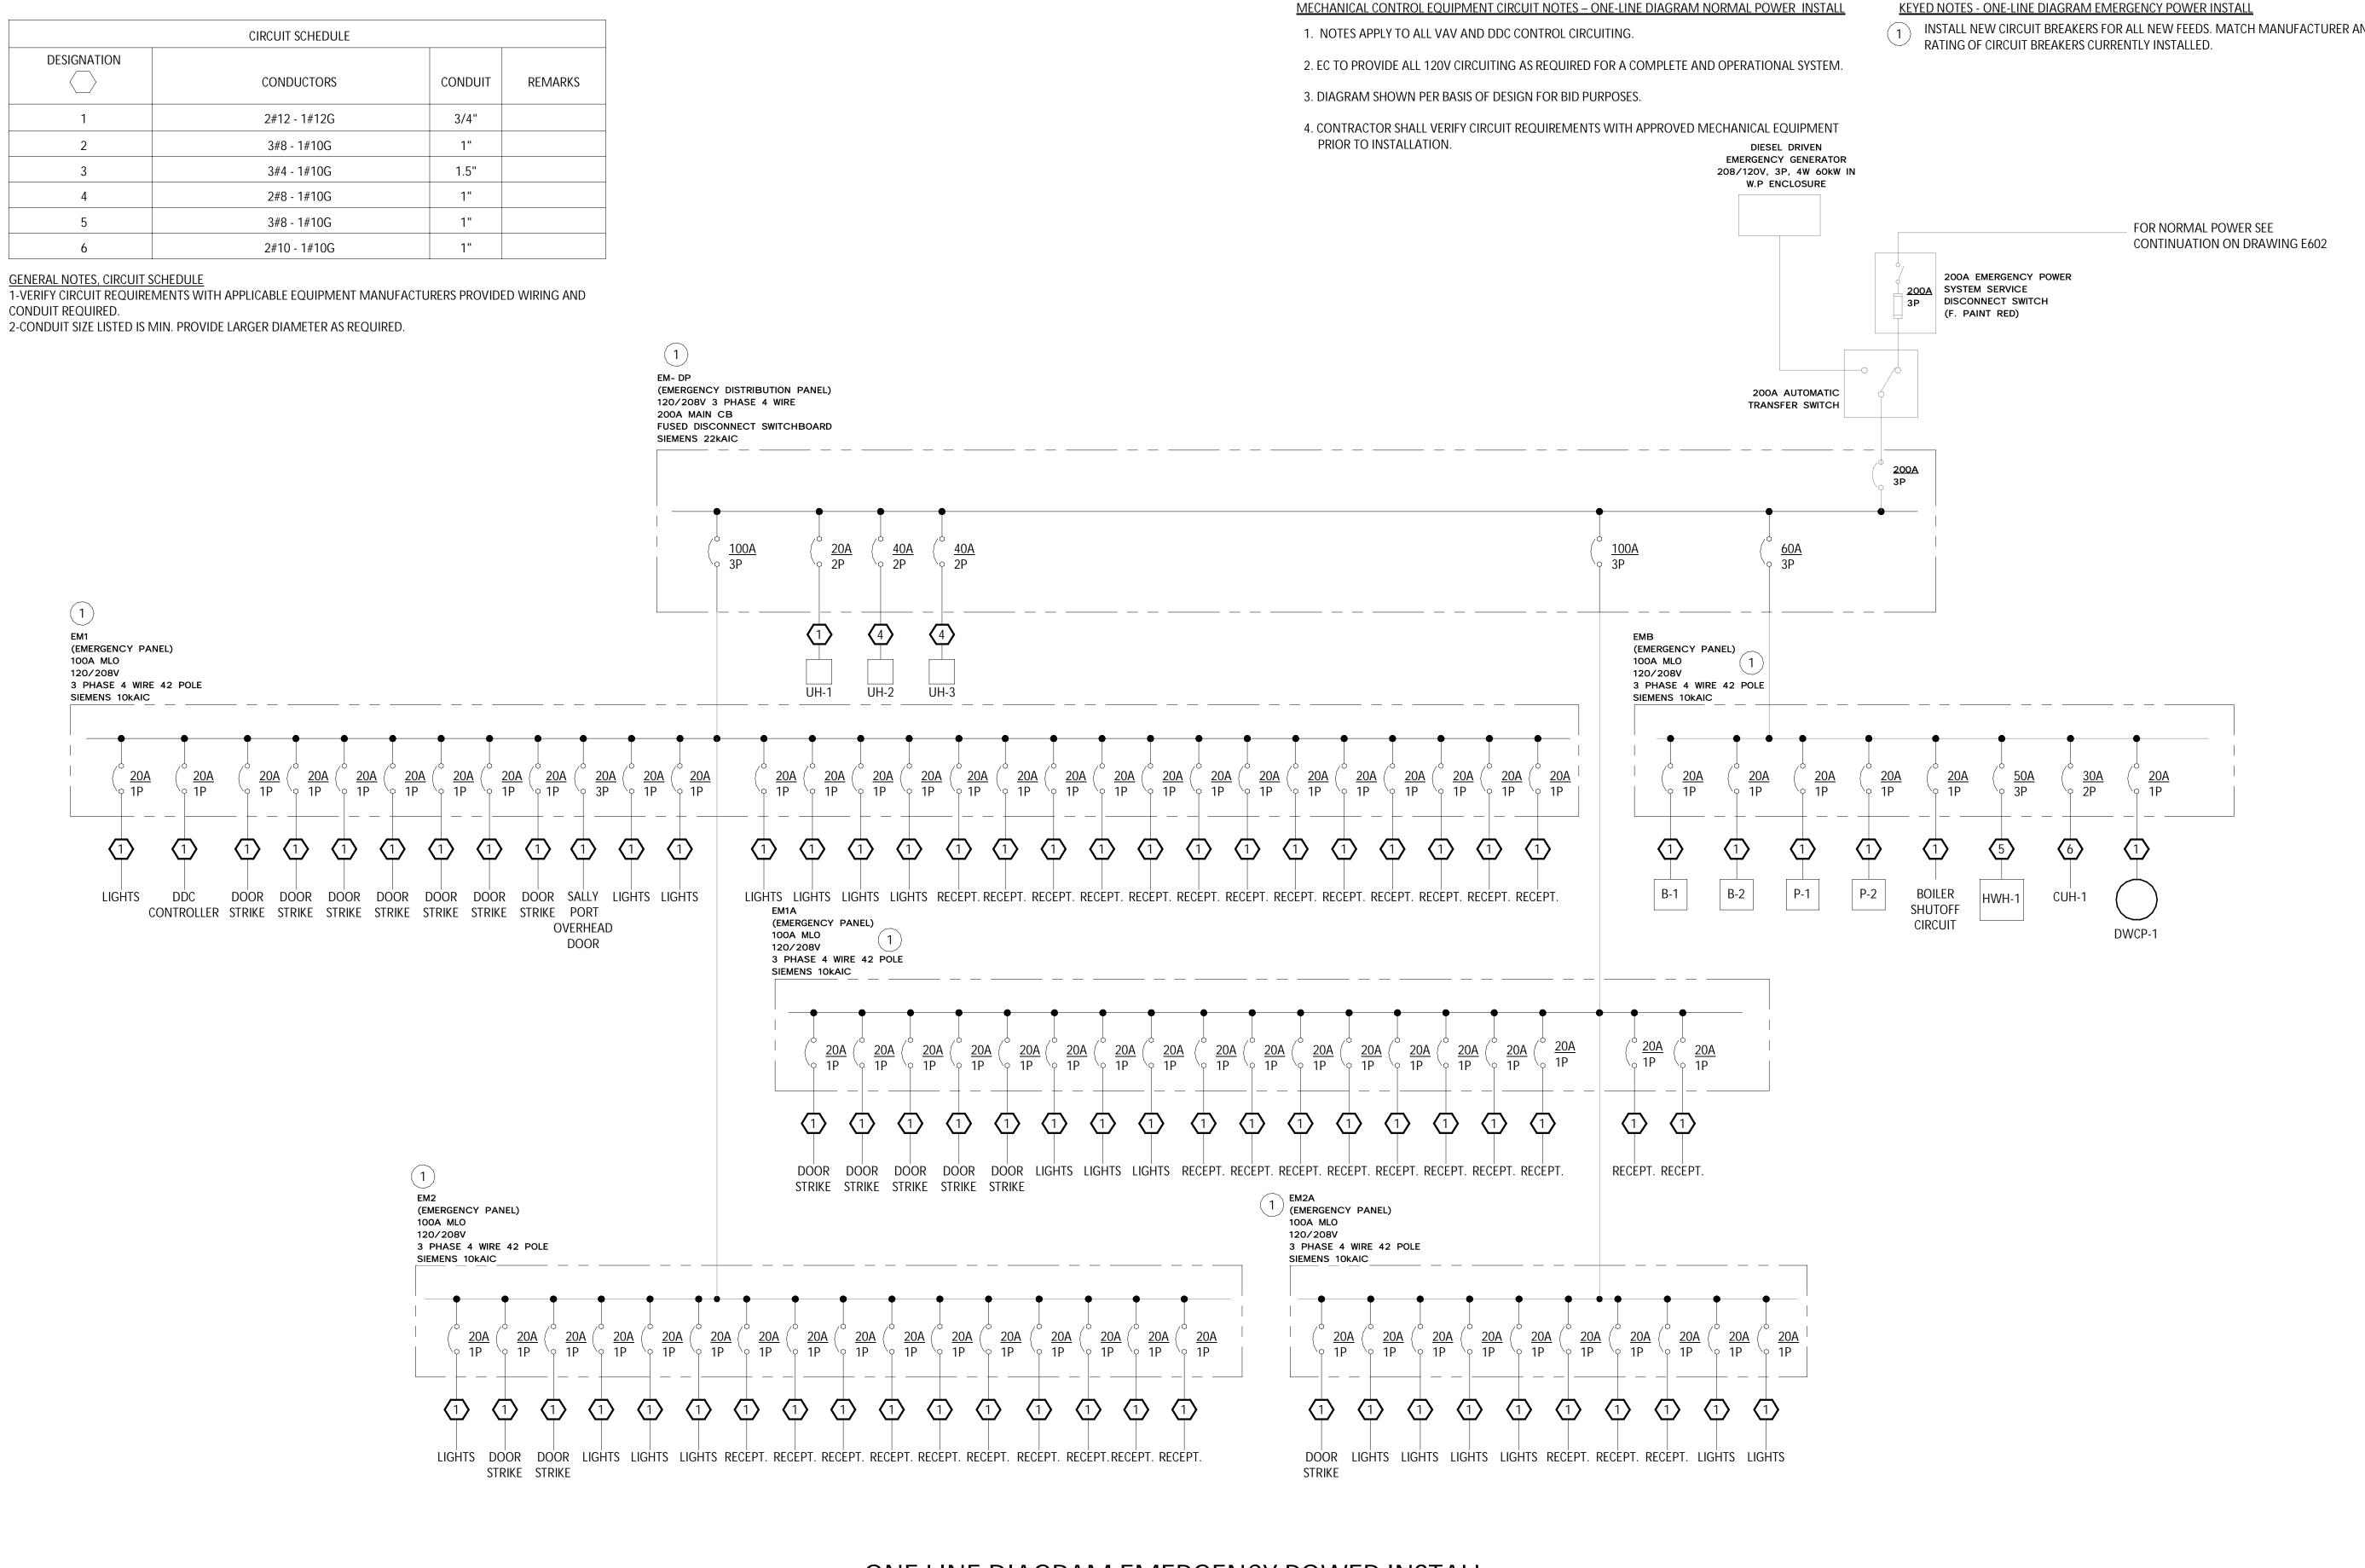

ONE LINE DIAGRAM EMERGENCY POWER INSTALL

SCALE: NOT TO SCALE

KEYED NOTES - ONE-LINE DIAGRAM EMERGENCY POWER INSTALL

INSTALL NEW CIRCUIT BREAKERS FOR ALL NEW FEEDS. MATCH MANUFACTURER AND KAIC

EDUCATION LAW, ARTICLE 145 §7209 SPECIAL PROVISIONS, FOR ANY PERSON, UNLESS THEY ARE ACTING UNDER THE DIRECTION OF A LICENSED PROFESSIONAL ENGINEER, ARCHITECT, LANDSCAPE ARCHITECT, OR LAND SURVEYOR, TO ALTER AN ITEM IN ANY WAY. IF AN ITEM BEARING THE STAMP OF A LICENSED PROFESSIONAL IS ALTERED. THE ALTERING PROFESSIONAL SHALL STAMP THE DOCUMENT AND INCLUDE THE NOTATION "ALTERED BY FOLLOWED BY THEIR SIGNATURE, THE DATE OF SUCH ALTERATION, AND A SPECIFIC DESCRIPTION OF THE ALTERATION

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LINE


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AUGUST, 2024

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Sheet Number E603



GENERAL NOTES - FIRE ALARM RISER DIAGRAM DEMO

1 - FIRE ALARM RISER DIAGRAM DEMO DRAWING CREATED FROM DRAWING FA-4 TITLED FIRE ALARM RISER DIAGRAM DATED JULY 30, 2004 AND CURSORY FIELD OBSERVATIONS. CONTRACTOR TO FIELD VERIFY ALL EXISTING INFORMATION REQUIRED.

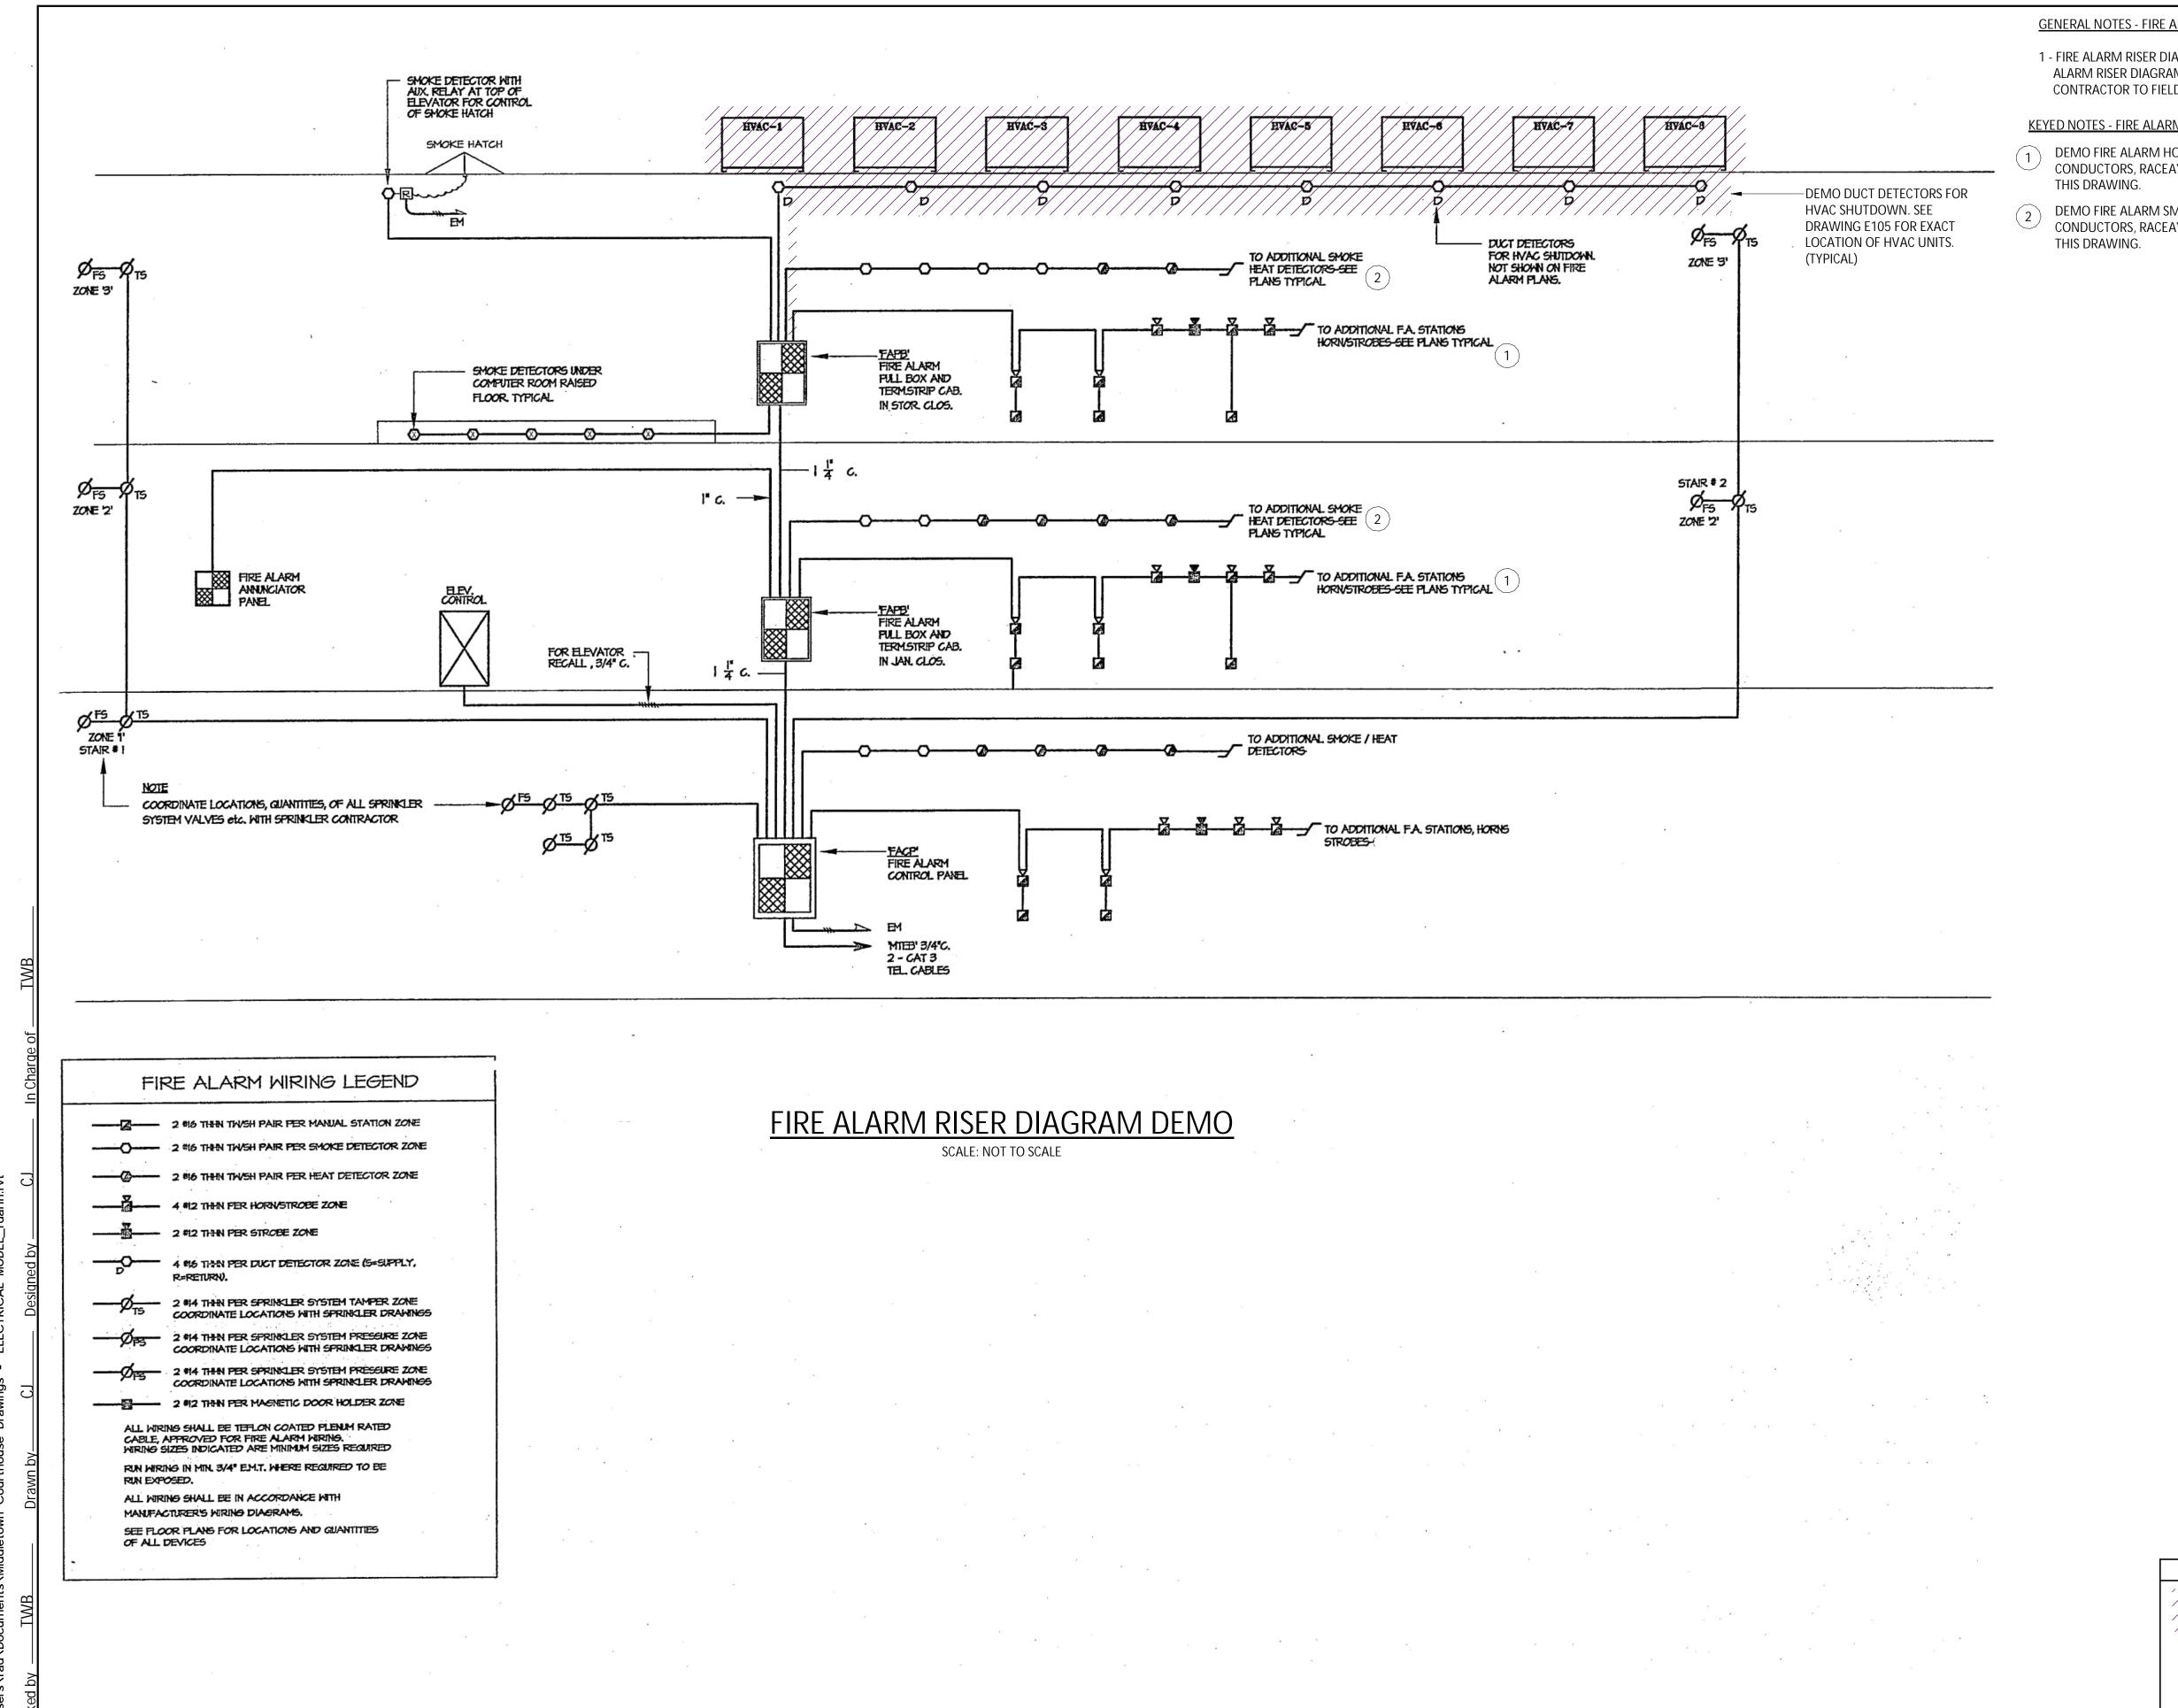KEYED NOTES - FIRE ALARM RISER DIAGRAM DEMO

- DEMO FIRE ALARM HORN/STROBES PER DRAWINGS E107 AND E108. DEMO ALL CONDUCTORS, RACEAY AND HARDWARE ASSOCIATED BACK TO SOURCE PANEL SHOWN ON
- DEMO FIRE ALARM SMOKE DETECTORS PER DRAWINGS E107 AND E108. DEMO ALL CONDUCTORS, RACEAY AND HARDWARE ASSOCIATED BACK TO SOURCE PANEL SHOWN ON

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DESCRIPTION OF THE ALTERATION

REVISIONS

DEMO CITY OF MIDDLETOWN
NEW COURTHOUSE FACILITY
CONTRACT 1D - ELECTRICAL CONSTRUCTION **DIAGRAM** RISER

ALARM

FIRE

LEGEND

EQUIPMENT TO BE DEMOED


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Project Number

Sheet Number

E604

AUGUST, 2024

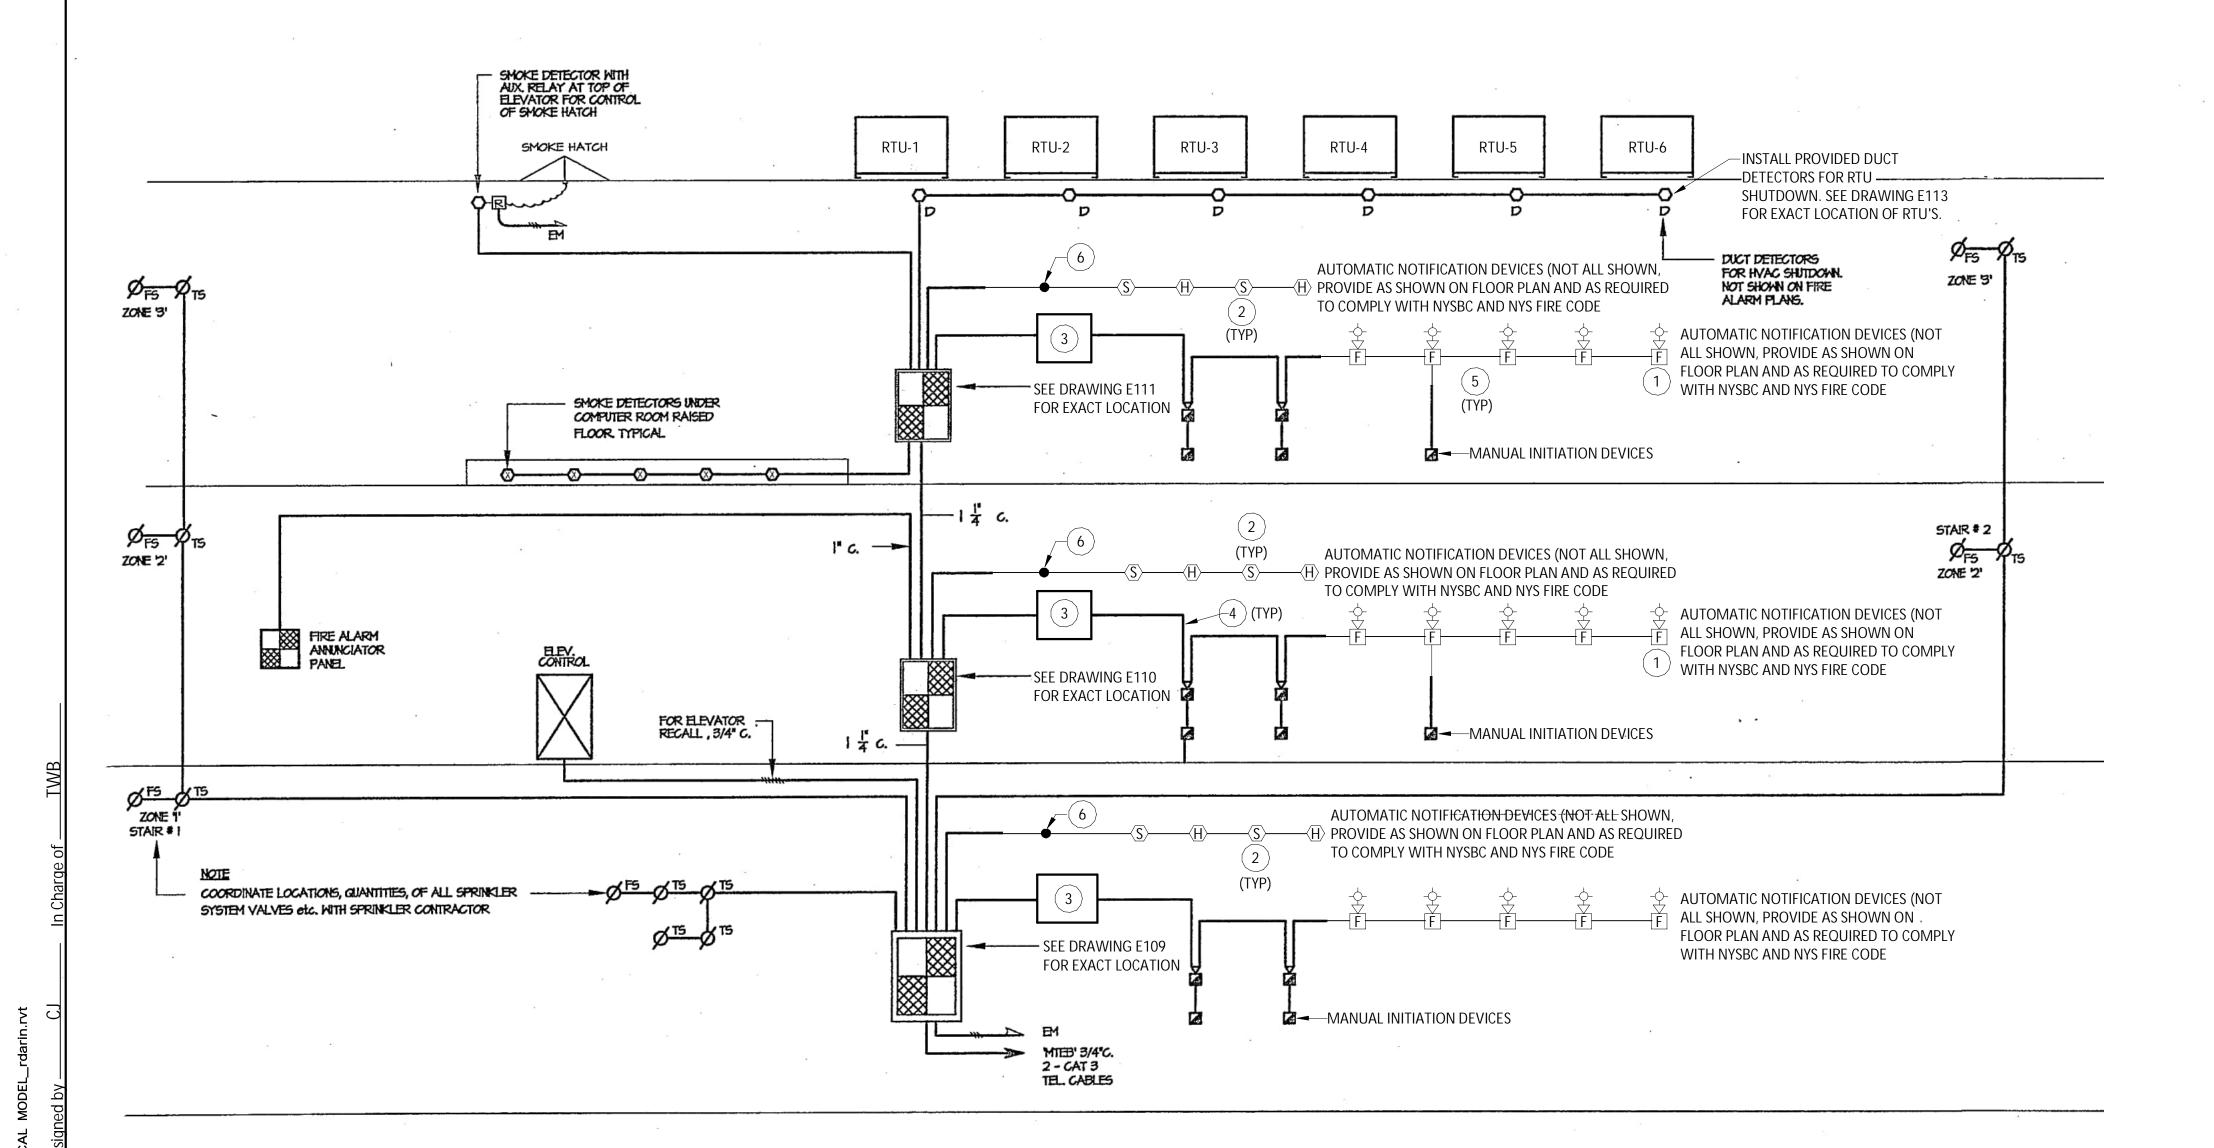

FIRE ALARM RISER DIAGRAM INSTALL

SCALE: NOT TO SCALE

GENERAL NOTES - FIRE ALARM RISER DIAGRAM INSTALL

- 1 PROVIDE ALL FIRE ALARM DEVICES AND CIRCUITING TO COMPLY WITH REQUIREMENTS OF NFPA 72 FOR ALTERATION WORK.
- 2 NO EXPOSED WIRE MOLD OR CONDUIT WILL BE ALLOWED EXCEPT WHERE INDICATED OR WITH PERMISSION OF THE OWNER.
- 3 RISER DIAGRAM IS DIAGRAMMATIC ONLY AND INTENDED TO ILLUSTRATE SCOPE OF WORK.
- 4 PROVIDE ALL ADDRESSABLE INTERFACE MODULES, RELAY EXPANSION MODULES, BOOSTER PANELS, AND HARDWARE TO ACCOMMODATE ALL DEVICES AS SHOWN.
- 5 COORDINATE EXACT FIRE ALARM SYSTEM WIRING INCLUDING TYPES, QUANTITIES, AND ROUTING WITH FIRE ALARM MANUFACTURER AND SITE CONDITIONS.
- 6 NOT ALL INTERCONNECTING WIRING IS INDICATED HERE. REFER TO SPECIFICATIONS FOR ADDITIONAL REQUIREMENTS.
- 7 PROVIDE 2-HOUR FIRE-RATED CAULK AROUND CONDUITS WHERE THEY PENETRATE FLOORS AND RATED WALLS.
- 8- ALL FIRE ALARM CIRCUITING TO BE IN CONDUIT.
- 9 PROVIDE NYLON BUSHINGS ON BOTH ENDS OF ALL CONDUITS.
- 10 PROVIDE 1/8" NYLON PULLROPE IN EACH CONDUIT.
- 11 PROVIDE ALL WORK IN ACCORDANCE TO TIA/EIA 569.
- 12 MINIMUM CONDUIT SIZE SHALL BE 1/2" ALL CONDUIT SHALL BE SIZED PER NEC REQUIREMENTS.
- 13 ALL CONDUITS SHALL BE AS INDICATED ON CONDUIT SCHEDULE, PAINT ALL CONDUITS RED
- 14 PROVIDE ALL WIRING PER MANUFACTURER REQUIREMENTS. ALL WIRE SIZES SHALL BE SIZED PER NEC AT A MINIMUM, AND ACCOMMODATE VOLTAGE
- 15 DROP DUE TO CIRCUIT LENGTHS. PROVIDE VENDOR VOLTAGE-DROP CALCULATIONS AND ASSOCIATED WIRE SIZING.
- 16 PROVIDE POWER BOOSTER/EXTENDER PANELS WHEREVER REQUIRED FOR A COMPLETE AND OPERATIONAL SYSTEM.
- 17 PROVIDE ALL WIRING, PROGRAMMING, CONTROL MODULES, MONITOR MODULES, AND OTHER SUCH DEVICES AS REQUIRED FOR A COMPLETE AND OPERATIONAL SYSTEM.

KEYED NOTES - FIRE ALARM RISER DIAGRAM INSTALL

- (1) PROVIDE AND INSTALL FIRE ALARM HORN/STROBES PER DRAWINGS E116 AND E117.
- 2 PROVIDE AND INSTALL FIRE ALARM SMOKE DETECTORS PER DRAWINGS E116 AND E117.
- PROVIDE BOOSTER PANEL WITH CODE REQUIRED BATTERY POWER, POWER CIRCUITING, CIRCUIT BREAKER, AND ALL REQUIRED INTEGRATION TO EXISTING FIRE ALARM CONTROL
- PROVIDE QUANTITY OF NOTIFICATION CIRCUITS AS REQUIRED TO COMPLY WITH POWER OUTPUT AND VOLTAGE DROP REQUIREMENTS.
- (5) PROVIDE DEVICES WITH ONE-WAY COMMUNICATION SPEAKERS AS COORDINATED WITH
- CONNECT TO EXISTING SNC CIRCUITING. CONTRACTOR TO FILED VERIFY LOCATION AND PROVIDE ALL REQUIRED WORK FOR A COMPLETE AND FUNCTIONAL FIRE ALARM SYSTEM.

IT IS A VIOLATION OF THE NEW YORK STATE EDUCATION LAW, ARTICLE 145 §7209 SPECIAL PROVISIONS, FOR ANY PERSON, UNLESS THEY ARE ACTING UNDER THE DIRECTION OF A LICENSED PROFESSIONAL ENGINEER, ARCHITECT, LANDSCAPE ARCHITECT, OR LAND SURVEYOR, TO ALTER AN ITEM IN ANY WAY. IF AN ITEM BEARING THE STAMP OF A LICENSED PROFESSIONAL IS ALTERED, THE ALTERING PROFESSIONAL SHALL STAMP THE DOCUMENT AND INCLUDE THE NOTATION "ALTERED BY FOLLOWED BY THEIR SIGNATURE, THE DATE

OF SUCH ALTERATION, AND A SPECIFIC DESCRIPTION OF THE ALTERATION

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NEW CC CONTRACT 1D -





AUGUST, 2024

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Sheet Number E605