

CITY OF MIDDLETOWN

NEW COURTHOUSE FACILITY

CONTRACT 1A - GENERAL CONSTRUCTION  
CONTRACT 1B - MECHANICAL CONSTRUCTION  
CONTRACT 1C - PLUMBING/FIRE PROTECTION CONSTRUCTION  
CONTRACT 1D - ELECTRICAL CONSTRUCTION

25 SOUTH STREET MIDDLETOWN, NEW YORK, 10940  
ORANGE COUNTY, NEW YORK



NYS CERTIFICATE # 0021642, 0020588, 0019903, 0019905, 0020336

CITY COUNCIL

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COUNCIL MEMBER  
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COUNCIL MEMBER  
COUNCIL MEMBER

JACOB TAWIL, P.E.

COMMISSIONER OF PUBLIC WORKS



PROJECT LOCATION

PROJECT LOCATION PLAN

NOT TO SCALE

AUGUST, 2024  
CONTRACT DOCUMENTS



IT IS A VIOLATION OF THE NEW YORK STATE EDUCATION LAW, ARTICLE 145 §7209 SPECIAL PROVISIONS, FOR ANY PERSON, UNLESS THEY ARE ACTING UNDER THE DIRECTION OF A LICENSED PROFESSIONAL ENGINEER, ARCHITECT, LANDSCAPE ARCHITECT, OR LAND SURVEYOR, TO ALTER AN ITEM IN ANY WAY. IF AN ITEM BEARING THE STAMP OF A LICENSED PROFESSIONAL IS ALTERED, THE ALTERING PROFESSIONAL SHALL STAMP THE DOCUMENT AND INCLUDE THE NOTATION "ALTERED BY" FOLLOWED BY THEIR SIGNATURE, THE DATE OF SUCH ALTERATION, AND A SPECIFIC DESCRIPTION OF THE ALTERATION.

Sheet Number

G001

Project Number

1753.008.001



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REVISIONS


CITY OF MIDDLETOWN  
NEW COURTHOUSE FACILITY

DRAWING INDEX

CITY OF MIDDLETOWN  
ORANGE COUNTY, NEW YORK

Barton & Loguidice

443 Electronics Parkway

Liverpool, NY 13088

NYS CERTIFICATE #  
0021642, 0020588, 0019903,  
0019905, 0020336



NYS EXP.:  
Date  
AUGUST, 2024

Scale  
AS SHOWN

Sheet Number  
G002


Project Number  
1753.008.001



REVISIONS	
1	Revision 1

CITY OF MIDDLETOWN  
NEW COURTHOUSE FACILITY  
BIDDING/DEMO SITE


**Barton & Loguidice**  
443 Electronics Parkway  
Liverpool, NY 13088

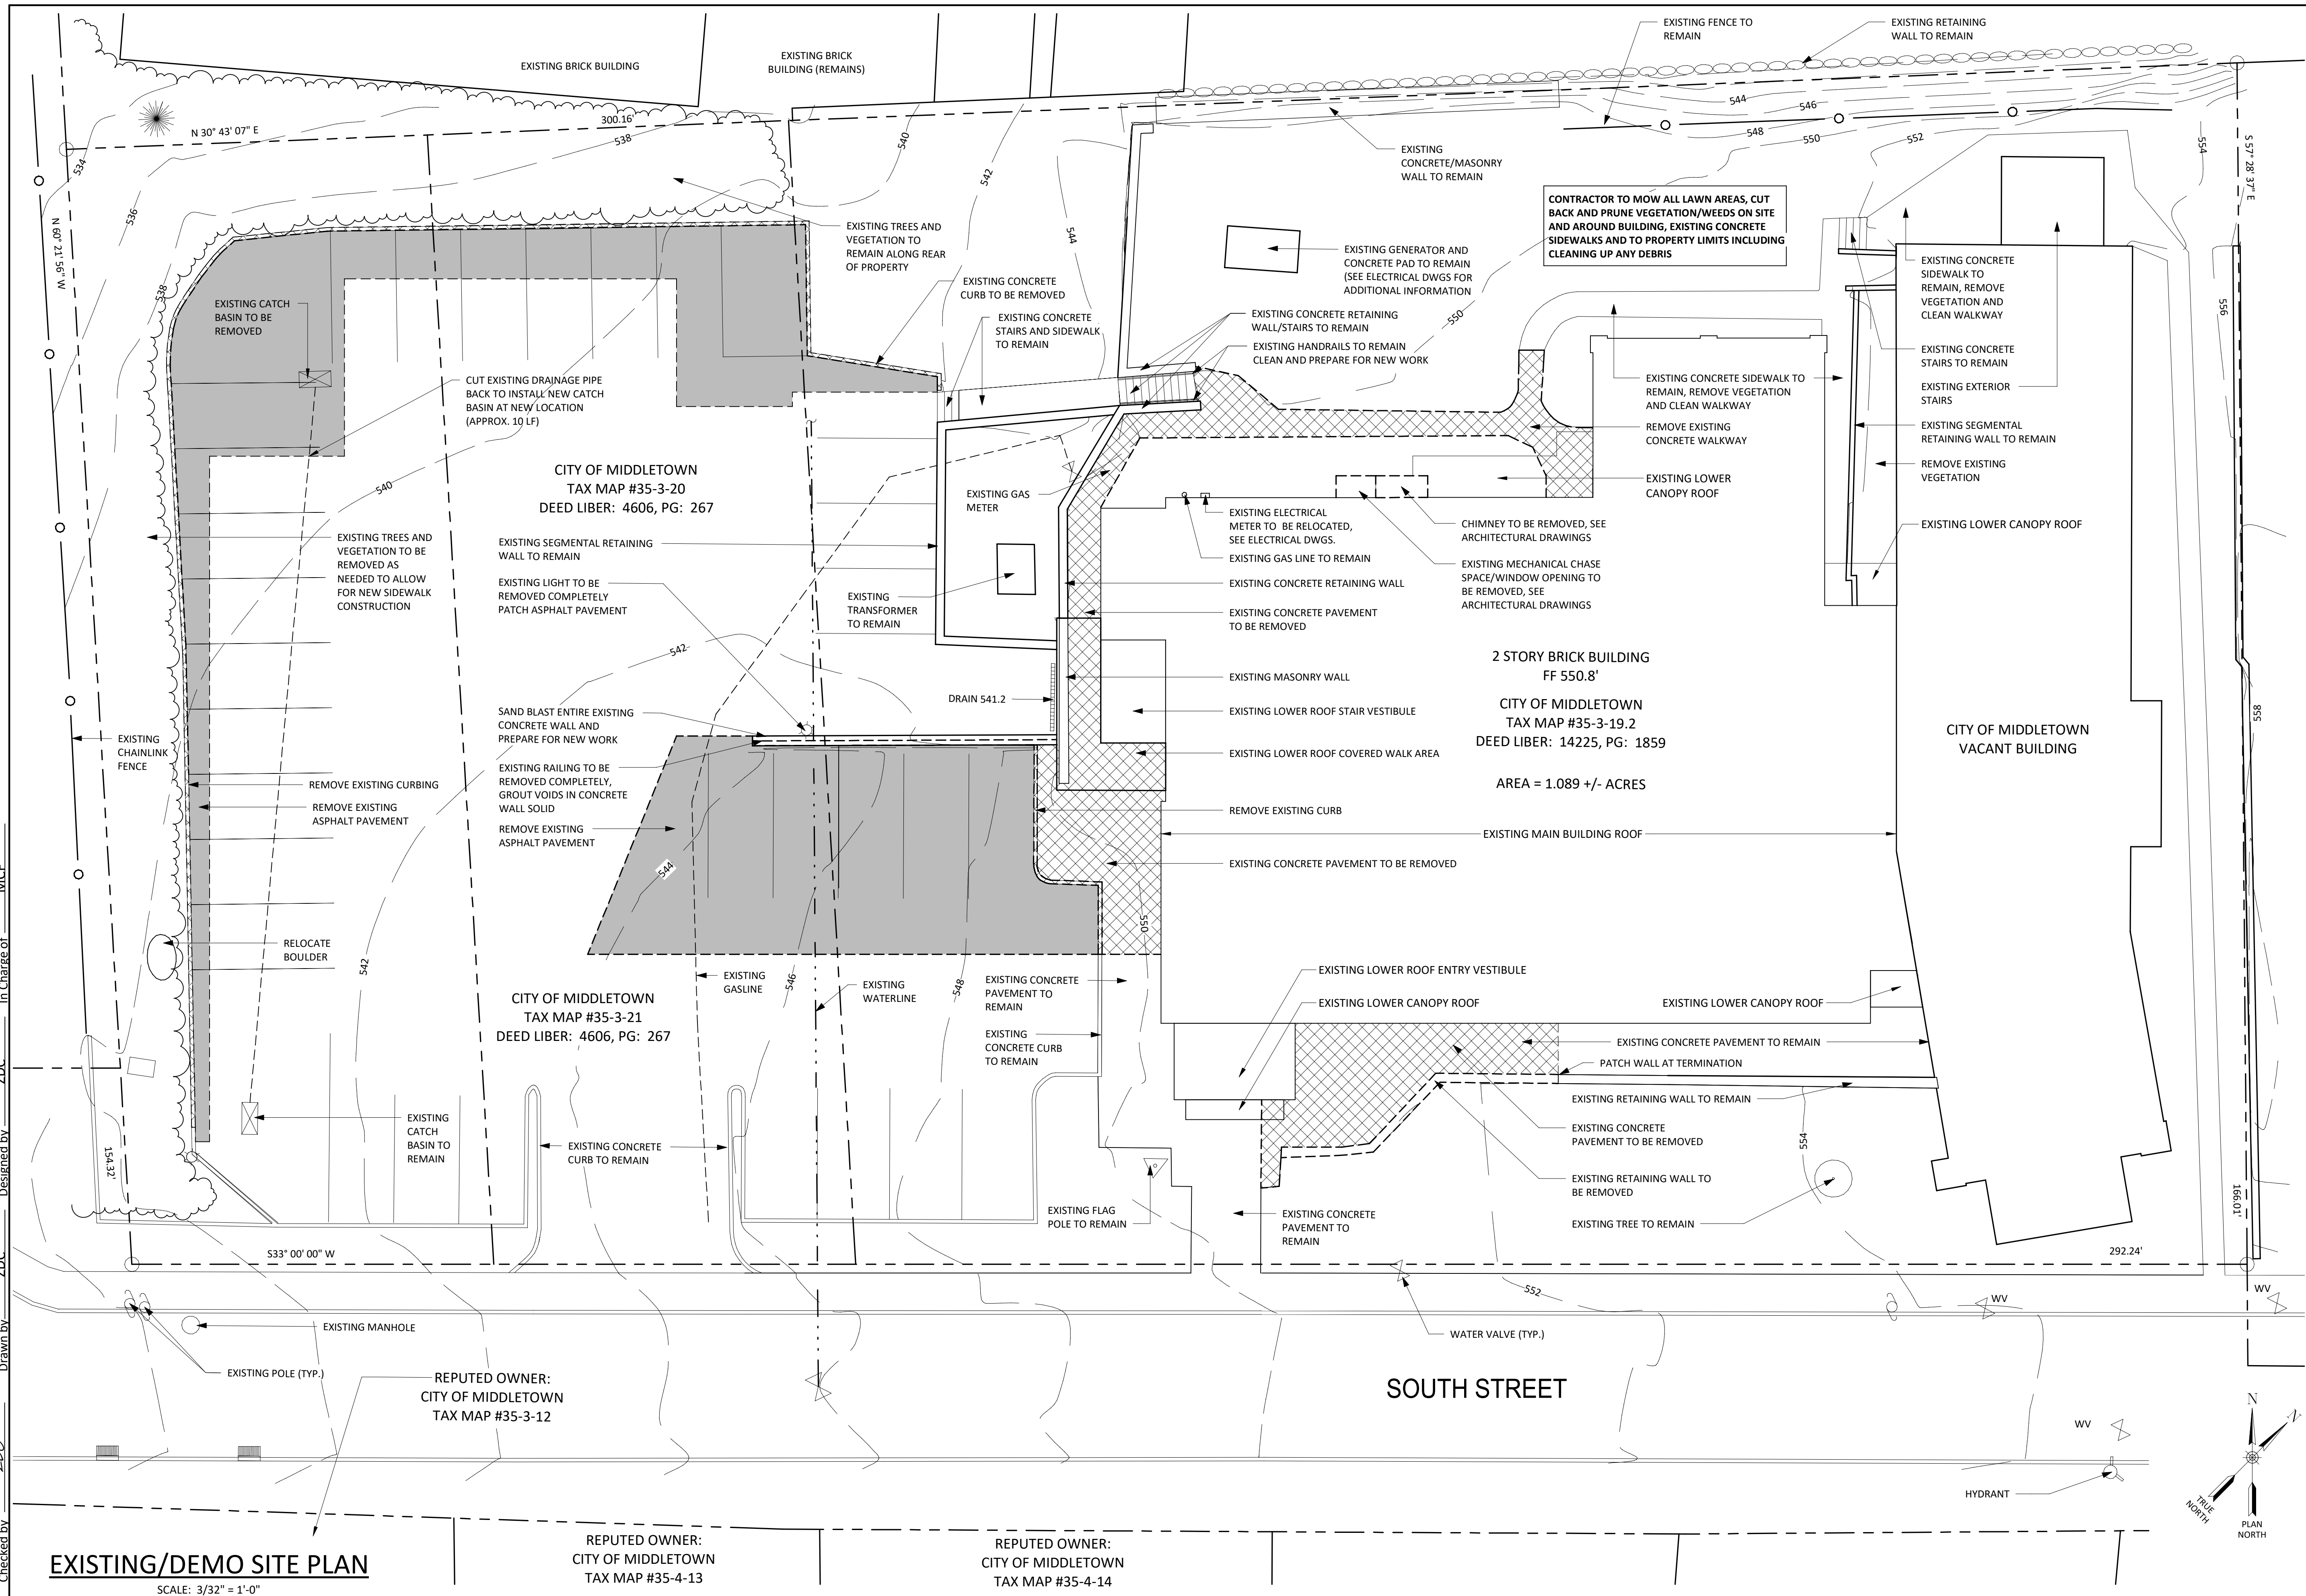








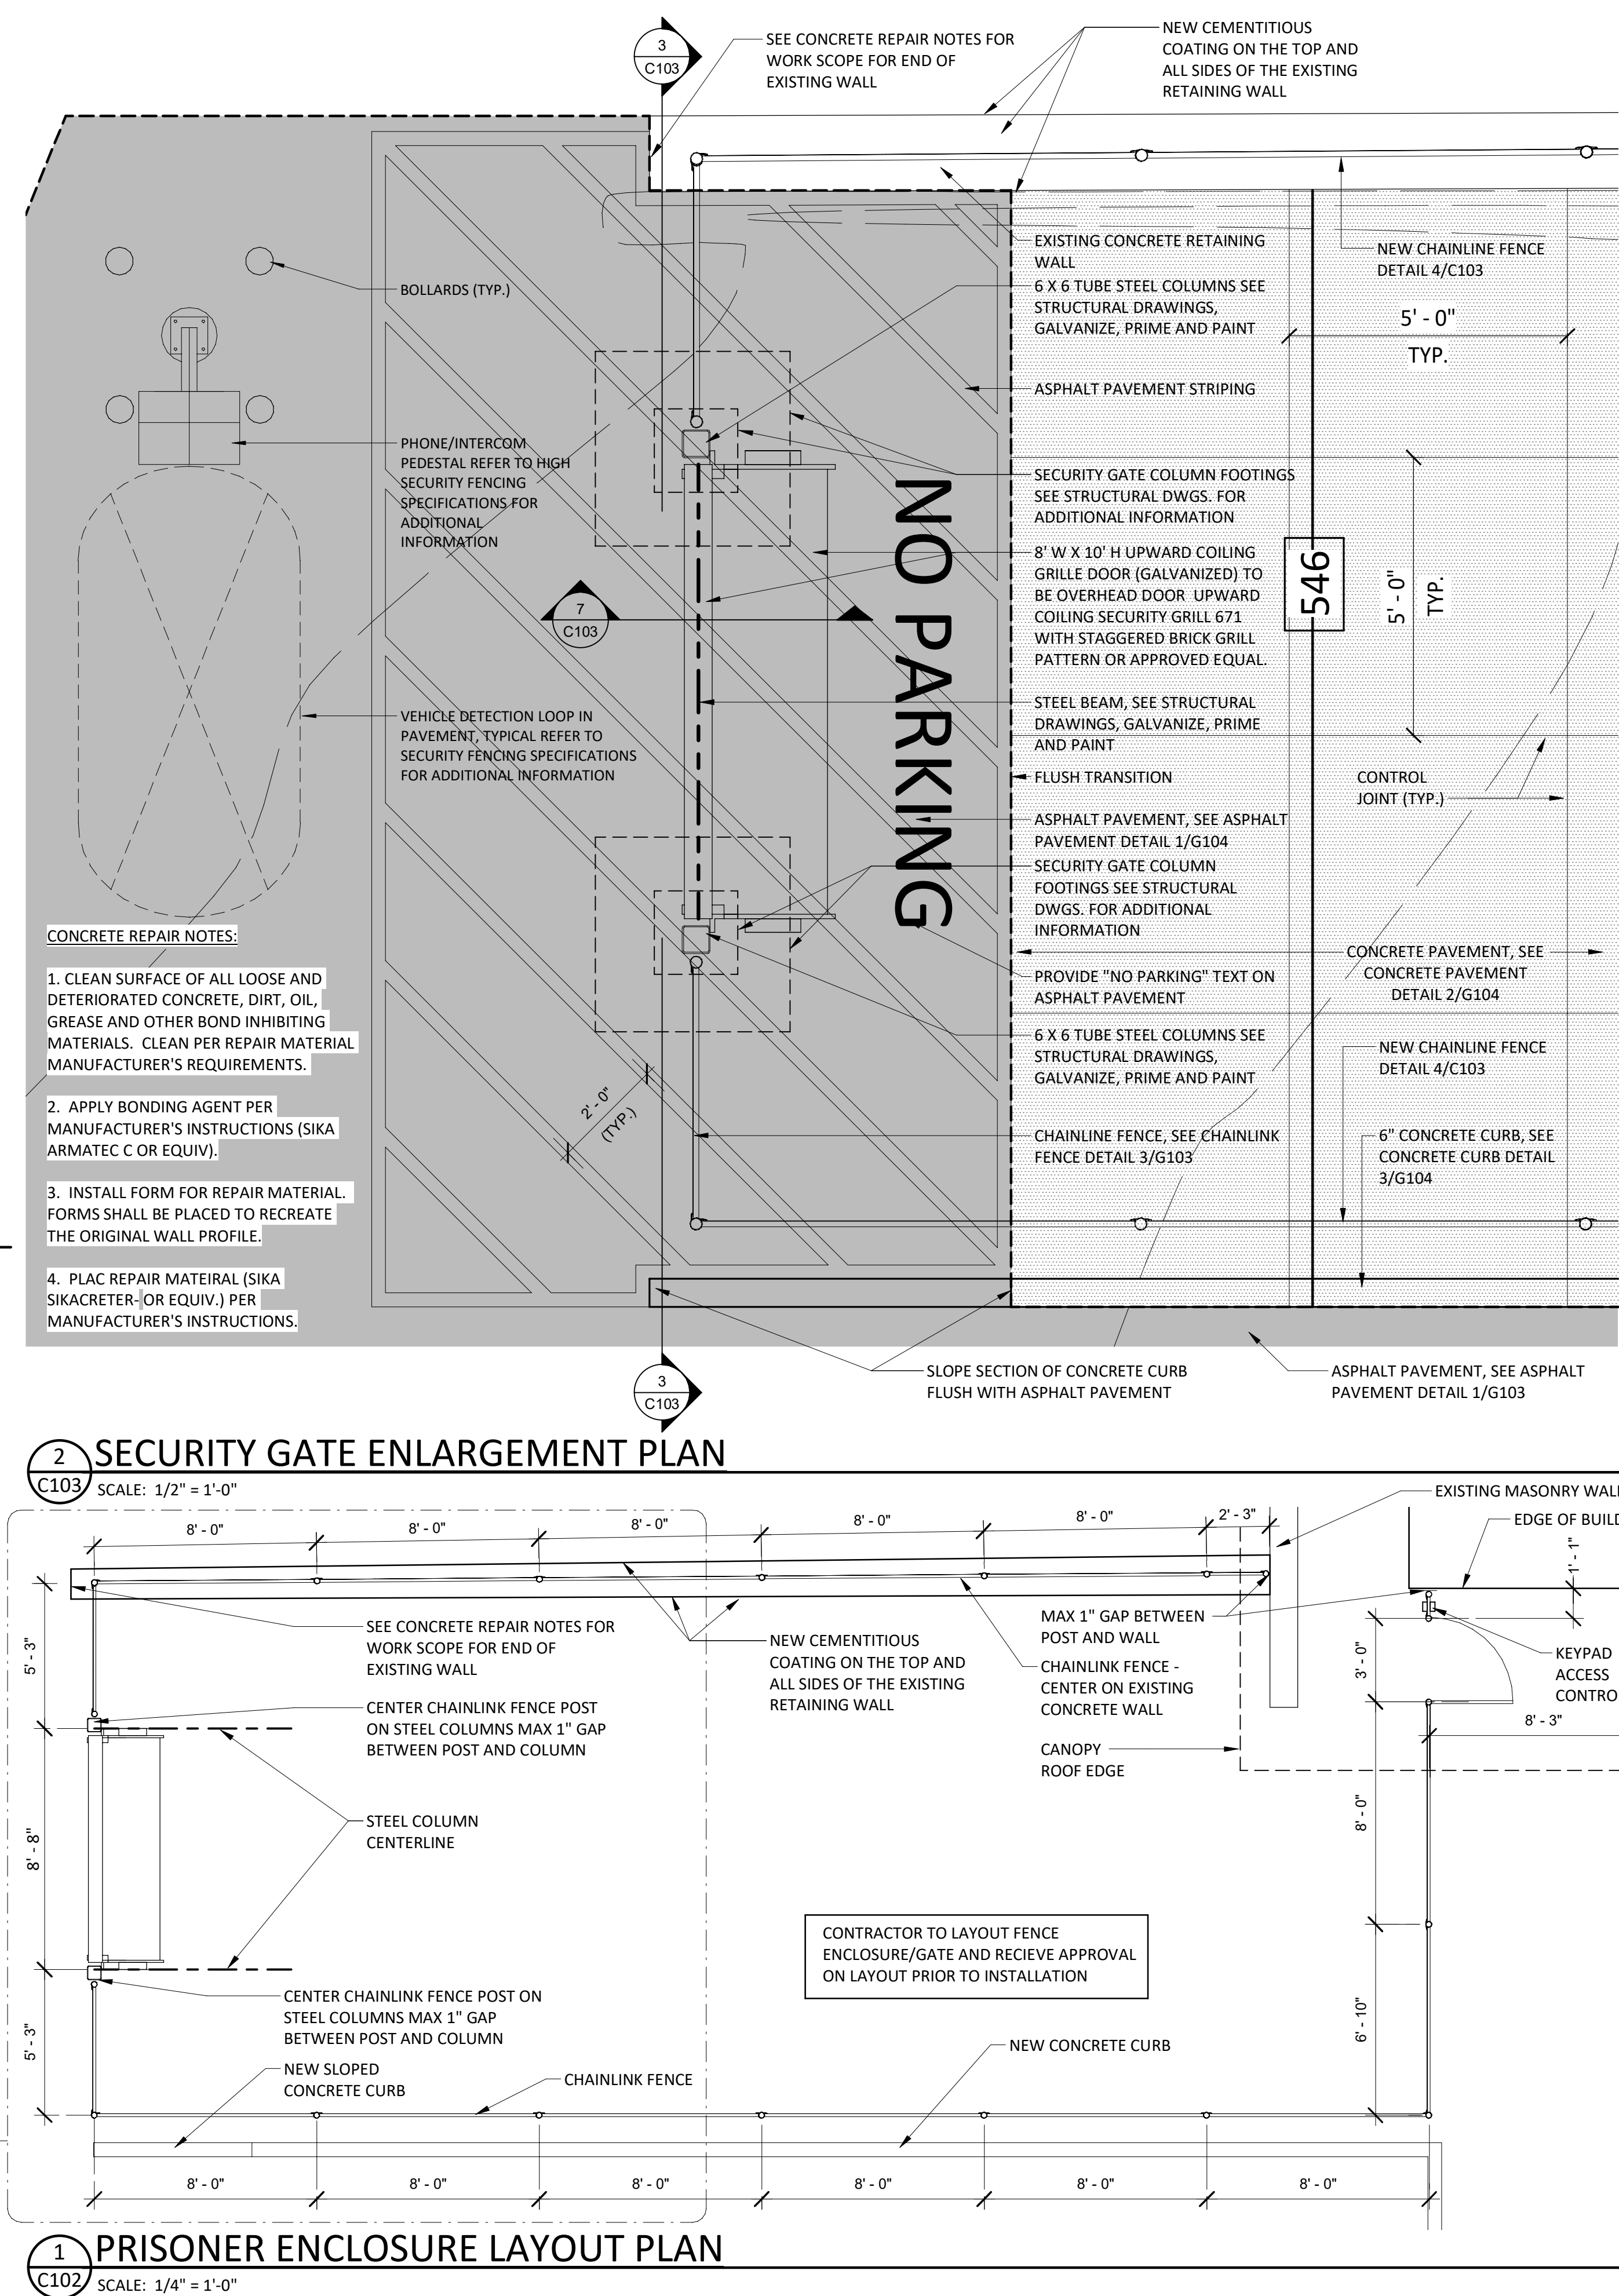

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<p>CITY OF MIDDLETOWN NEW COURTHOUSE FACILITY</p>		<p>CITY OF MIDDLETOWN ORANGE COUNTY, NEW YORK</p>	
<p><b>Barton &amp; Loguidice</b> 443 Electronics Parkway Liverpool, NY 13088</p>		<p>NYS CERTIFICATE # 0021642, 0020588, 0019903, 0019905, 0020336</p>	
<p><b>B&amp;L</b></p>		<p>NYS EXP.: 05/31/2026</p>	
<p>Date</p>		<p>AUGUST, 2024</p>	
<p>Scale</p>		<p>AS SHOWN</p>	
<p>Sheet Number</p>		<p>C103</p>	
<p>Project Number</p>		<p>1753.008.001</p>	




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## 1 ASPHALT PAVEMENT

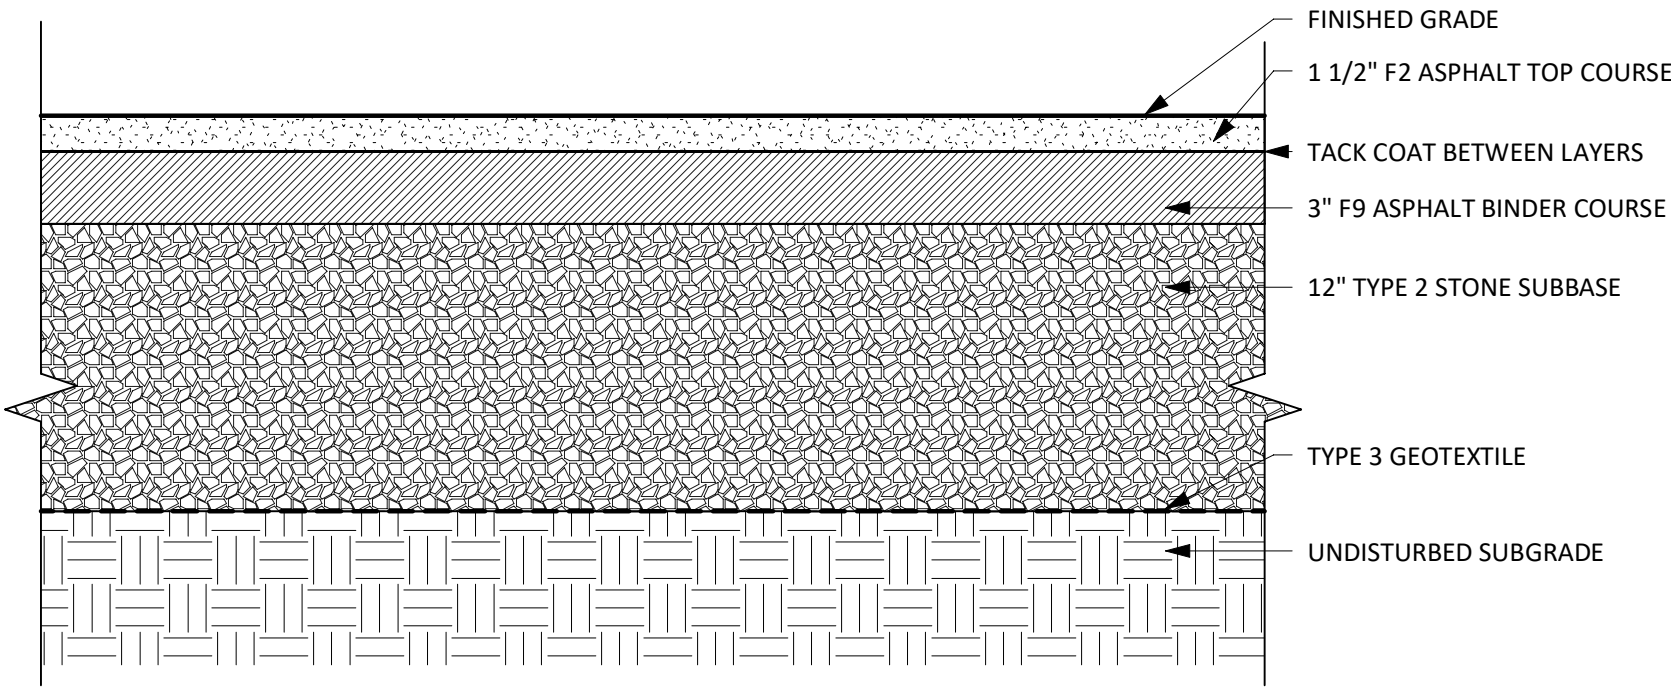SCALE: NOT TO SCALE




NOTES:

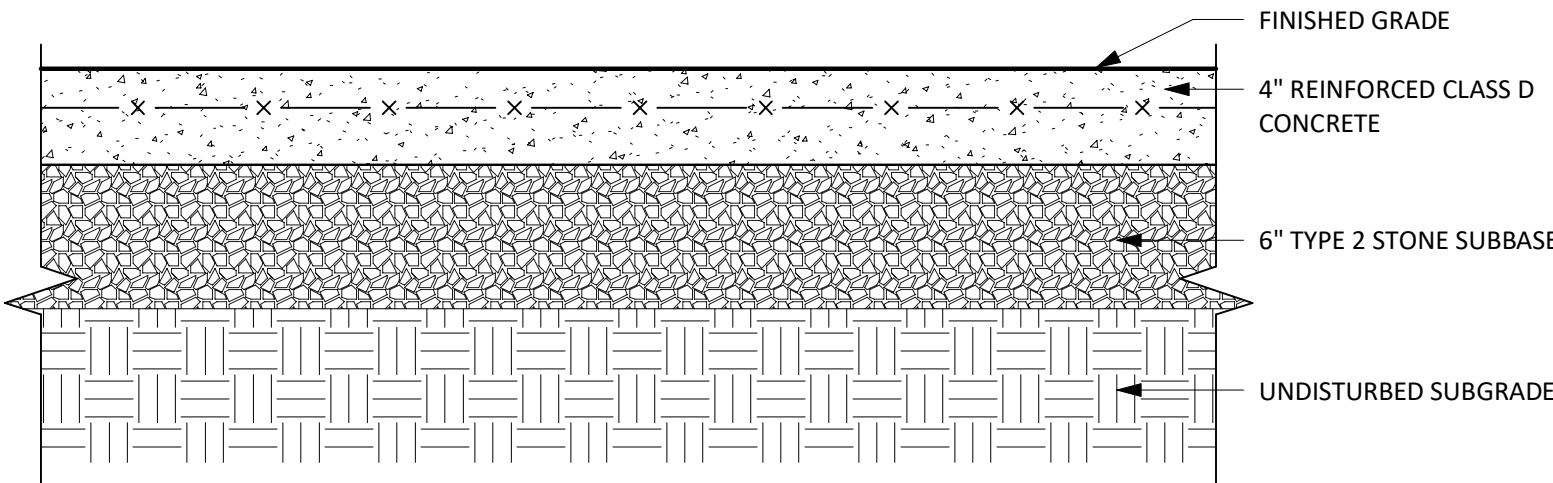- MAXIMUM CROSS SLOPE OF CONCRETE SIDEWALK IS 1.5%.
- PROVIDE 1/2 INCH WIDE ISOLATION JOINT EVERY 20' IN LENGTH IN SIDEWALKS, BETWEEN NEW CONCRETE CONSTRUCTION AND BACK EDGE CURB, CONCRETE GUTTER, OTHER PAVED AREAS, BUILDINGS, WALLS, POLE BASES AND OTHER STRUCTURES/APURTENANCES. SIDEWALKS WITH AREAS GREATER THAN 36 SQUARE FEET ARE TO BE SCORED WITH JOINTS. PROVIDE A FINE BROOMED SURFACE FREE OF HOLES, TEARS, POCK MARKS, BROKEN CORNERS, AND OTHER DEFECTS. JOINTS ARE TO BE CLEAR OF EXCESS CONCRETE AND MORTAR MATERIAL RESULTING FROM BROOMING OR FINISHING OF ADJACENT CONCRETE.
- AT ISOLATION JOINTS BETWEEN CONCRETE SLABS, PROVIDE DOWEL (SEE DETAIL TYP. SLAB-ON-GRADE ISOLATION JOINT DETAIL).
- SEE STRUCTURAL DRAWINGS FOR CONSTRUCTION AND CONTROL JOINT DETAILING


## 2 CONCRETE PAVEMENT

SCALE: NOT TO SCALE

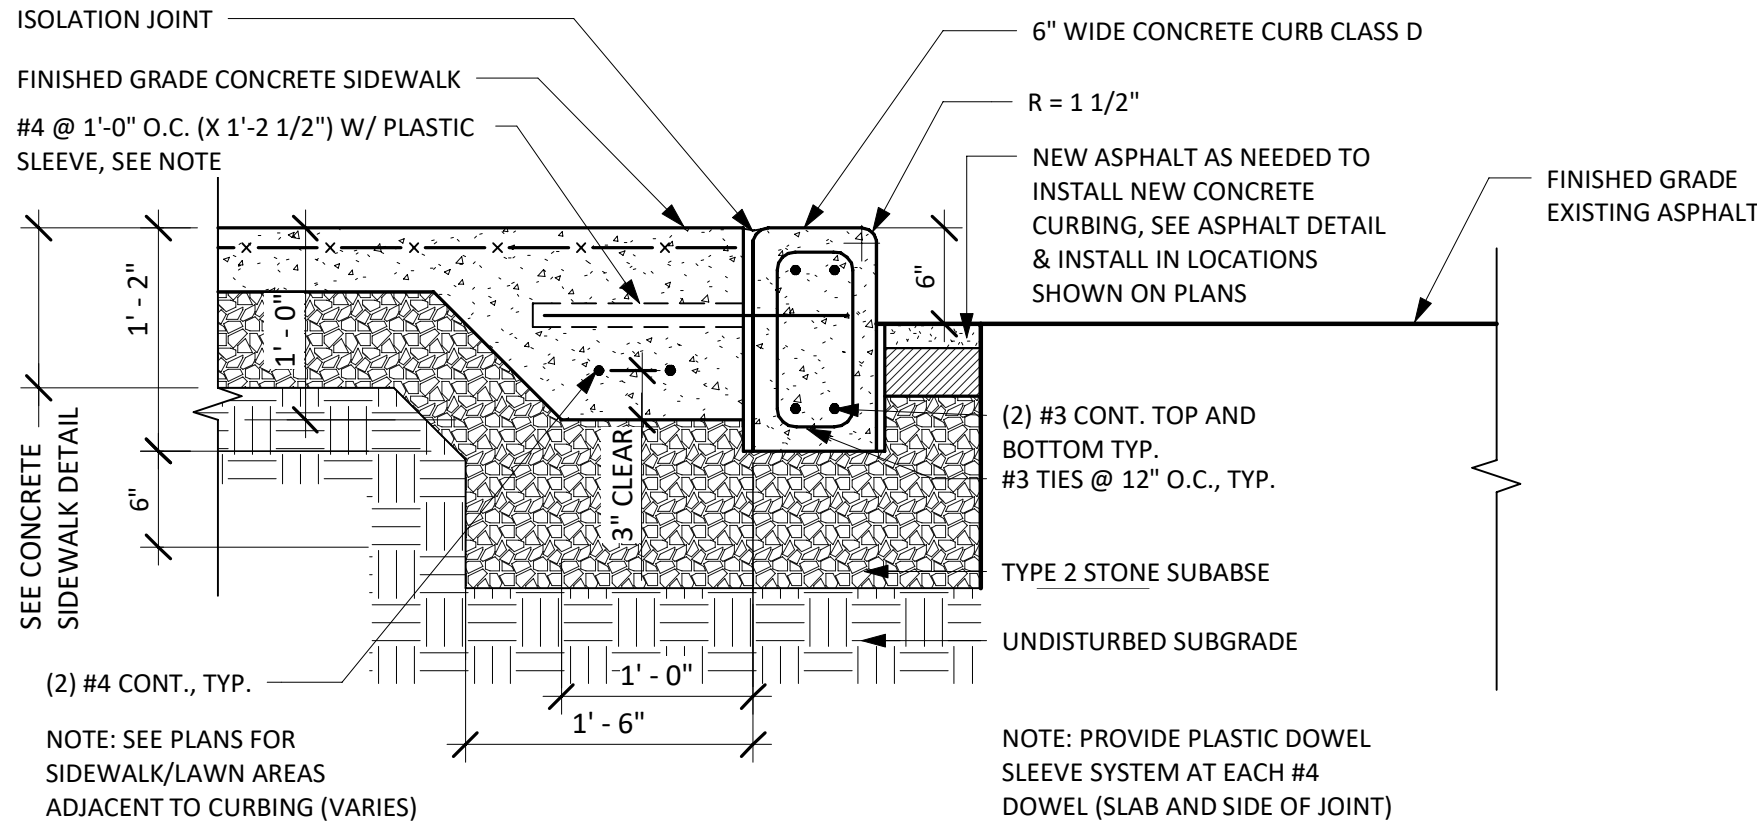


## 3 CONCRETE CURB DETAIL

SCALE: 1" = 1'-0"

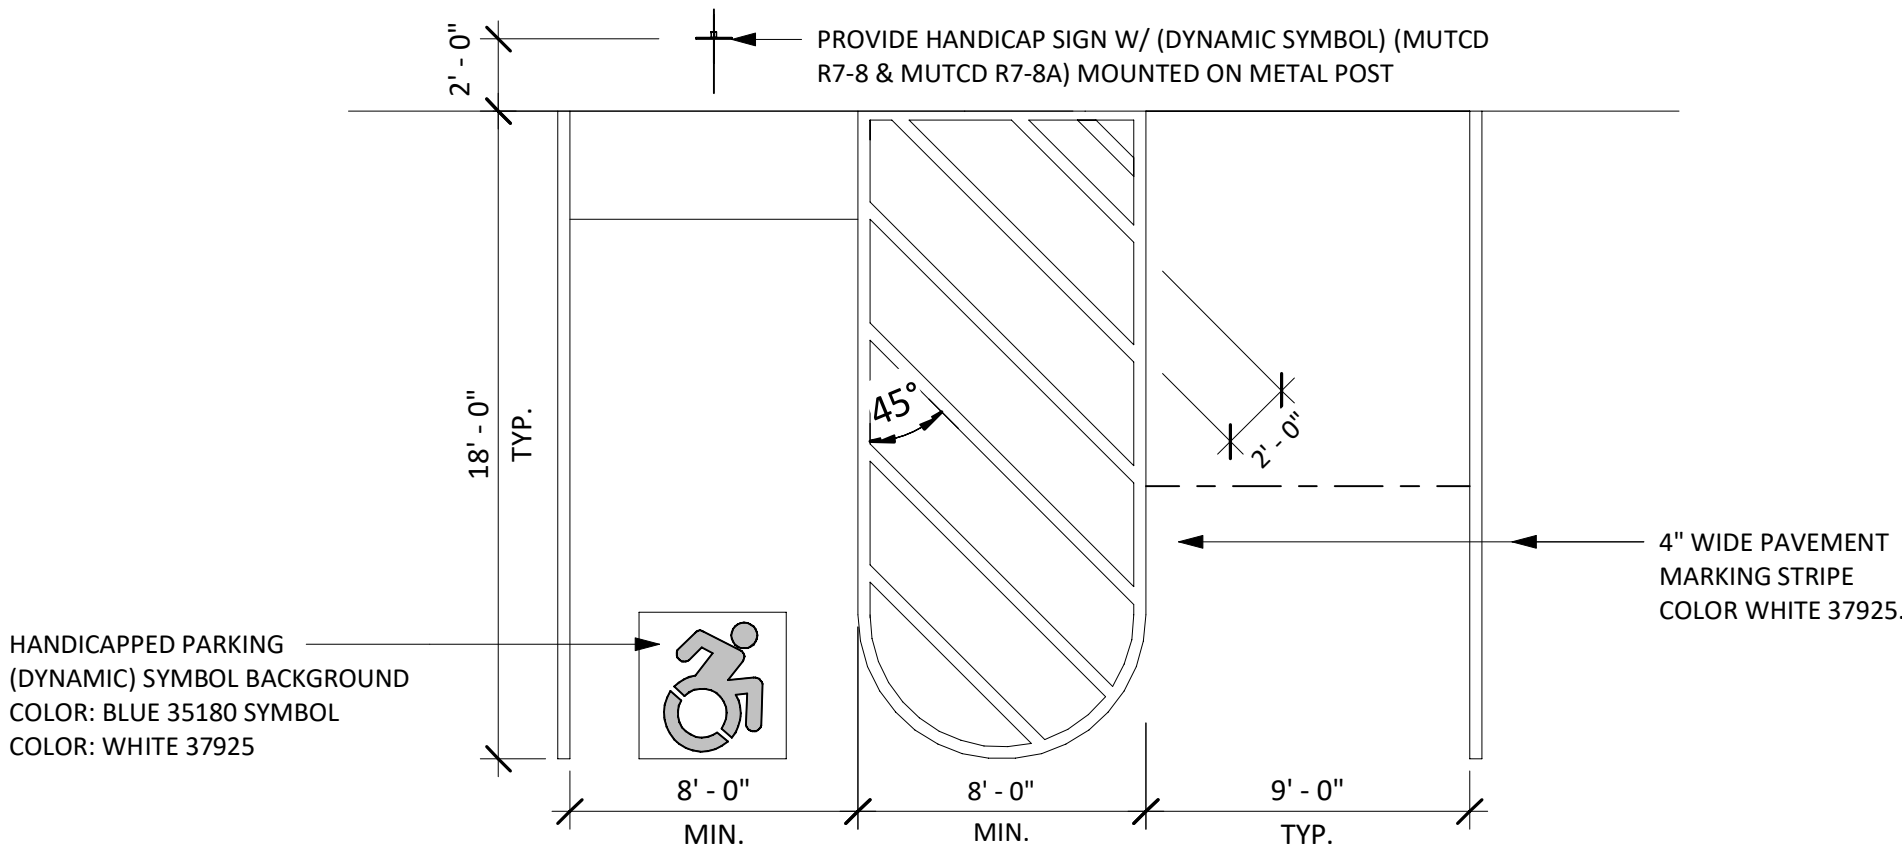


## TYPICAL ADA PARKING AND STRIPING LAYOUT PLAN

SCALE: NOT TO SCALE

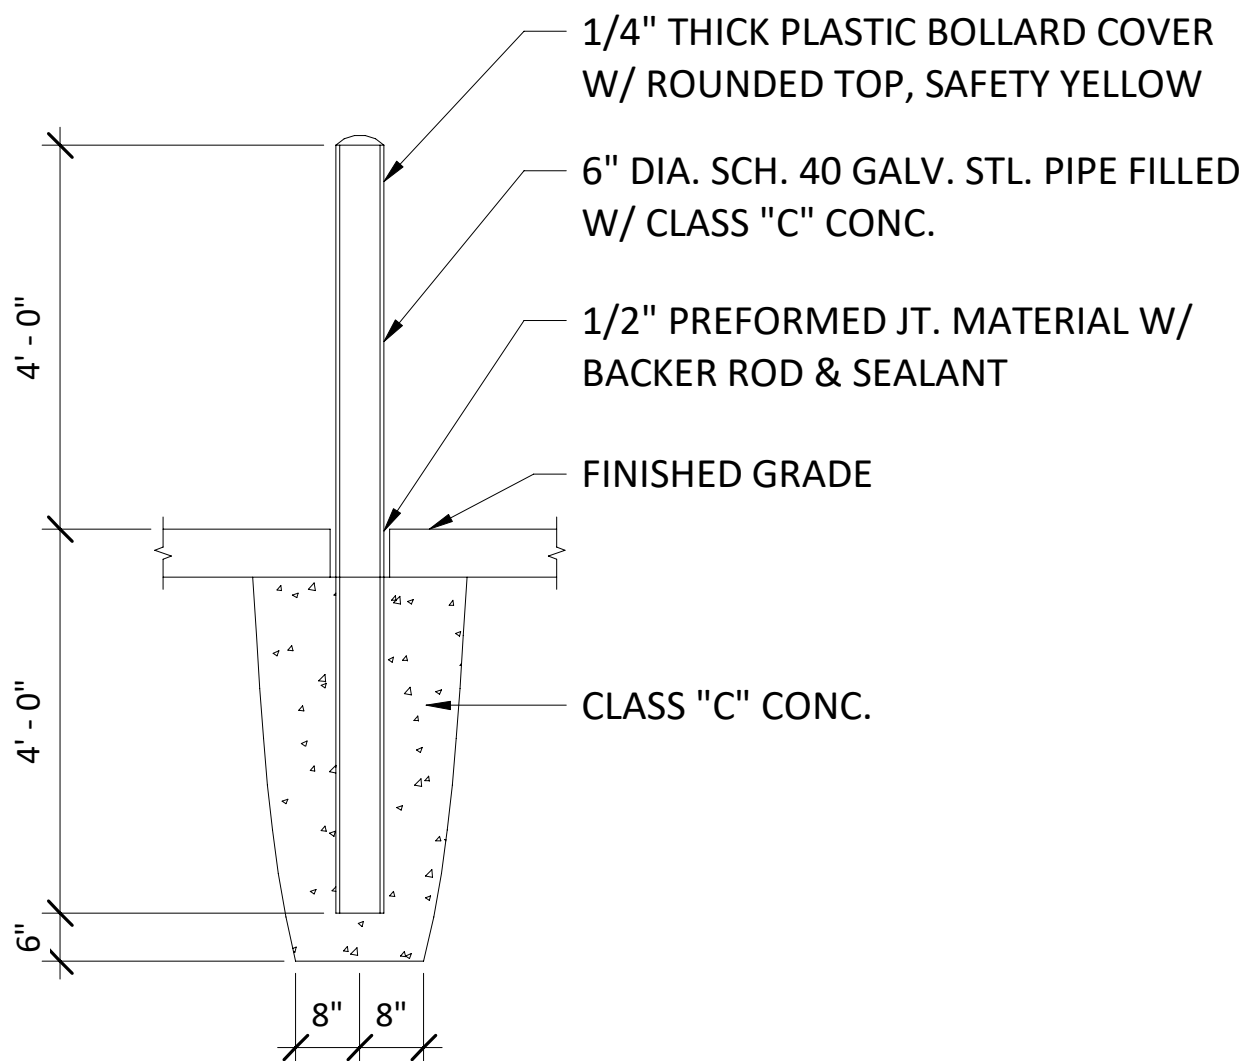


## TYP. BOLLARD DETAIL

SCALE: NOT TO SCALE

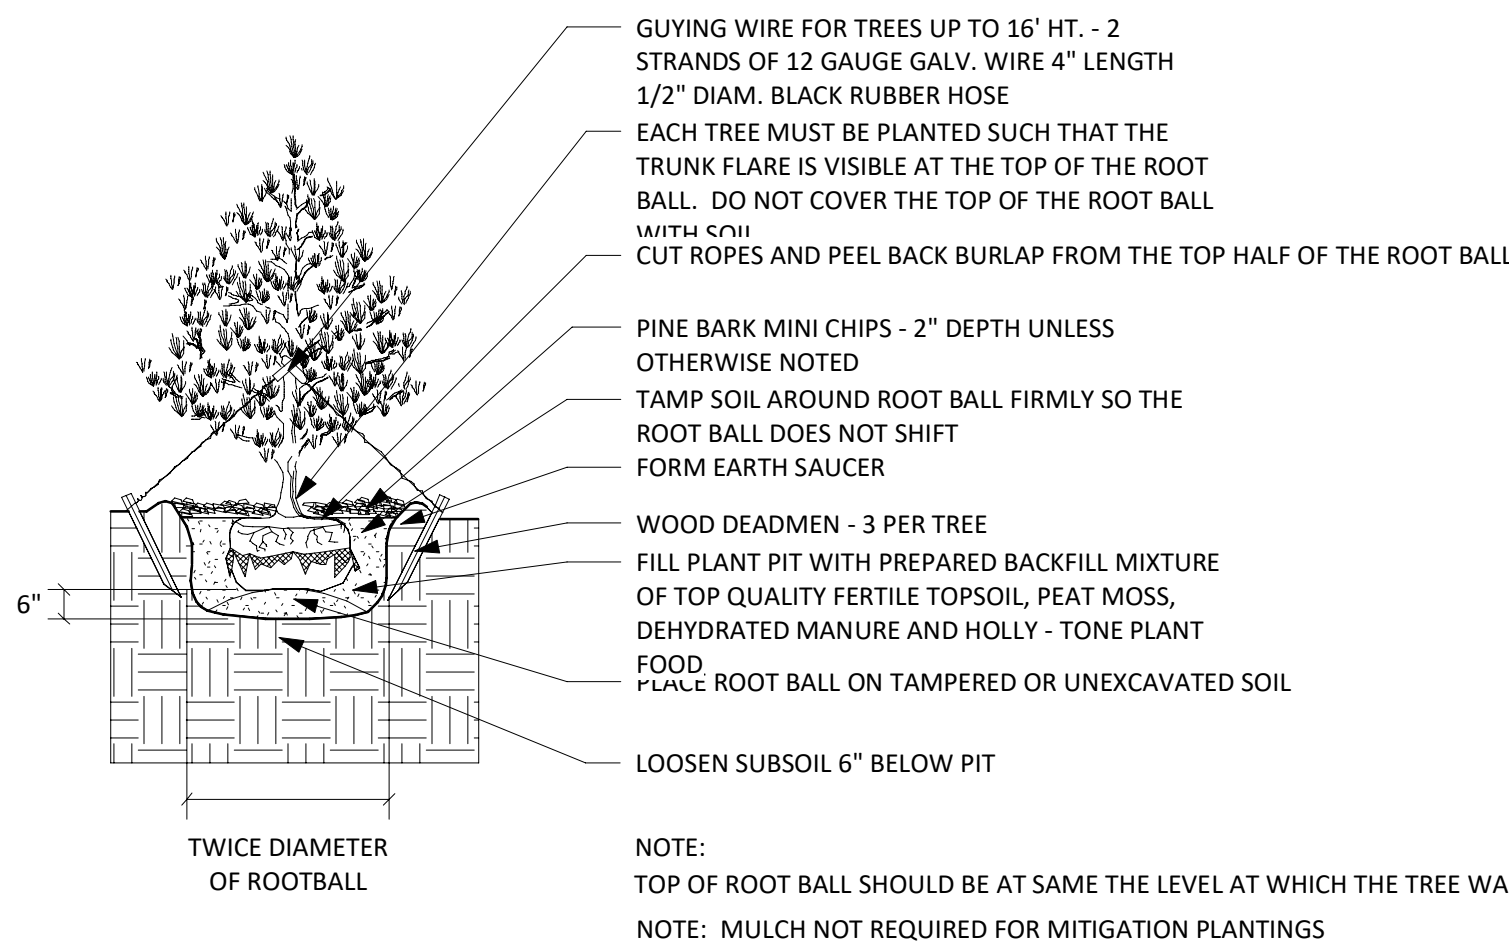


## EVERGREEN PLANTING

SCALE: NOT TO SCALE

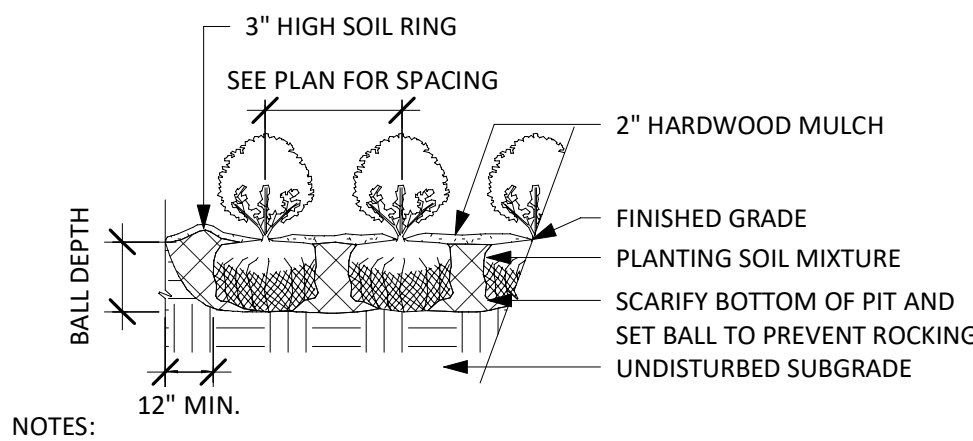


## SHRUB PLANTING

SCALE: NOT TO SCALE

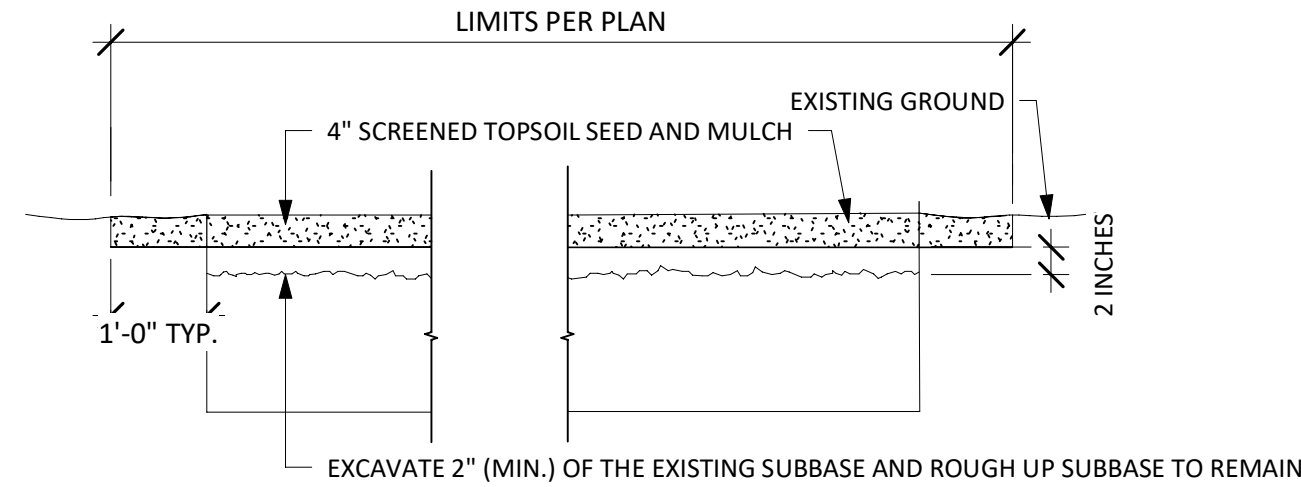

## LAWN RESTORATION DETAIL

SCALE: NOT TO SCALE

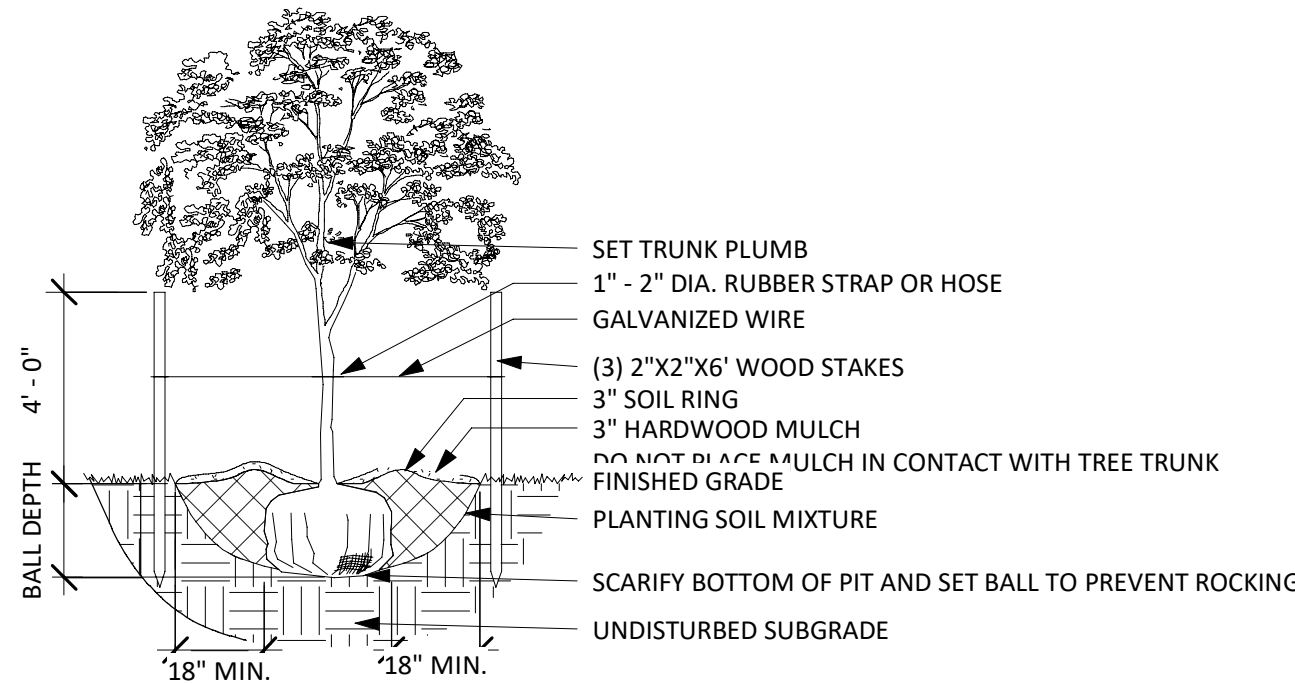


NOTES:

- REMOVE BURLAP, ROPE, OR WIRE BASKET FROM TOP 1/3 OF BALL MINIMUM, CUT REMAINING PORTIONS OF ROPE OR WIRE BASKET ONE PLANT IS IN THE FINAL POSITION IN PIT.
- TOP OF ROOT BALL SHALL BE SET FLUSH WITH SURROUNDING FINISHED GRADE. EACH TREE MUST BE PLANTED SUCH THAT THE TRUNK FLRE IS VISIBLE AT THE TOP OF THE ROOT BALL. DO NOT COVER TOP OF ROOT BALL WITH SOIL.
- MARK THE NORTH SIDE OF THE TREE IN NURSERY AND ROTATE TREE TO FACE NORTH AT THE SITE WHERE POSSIBLE.

## DECIDUOUS TREE PLANTING

SCALE: 1/4" = 1'-0"

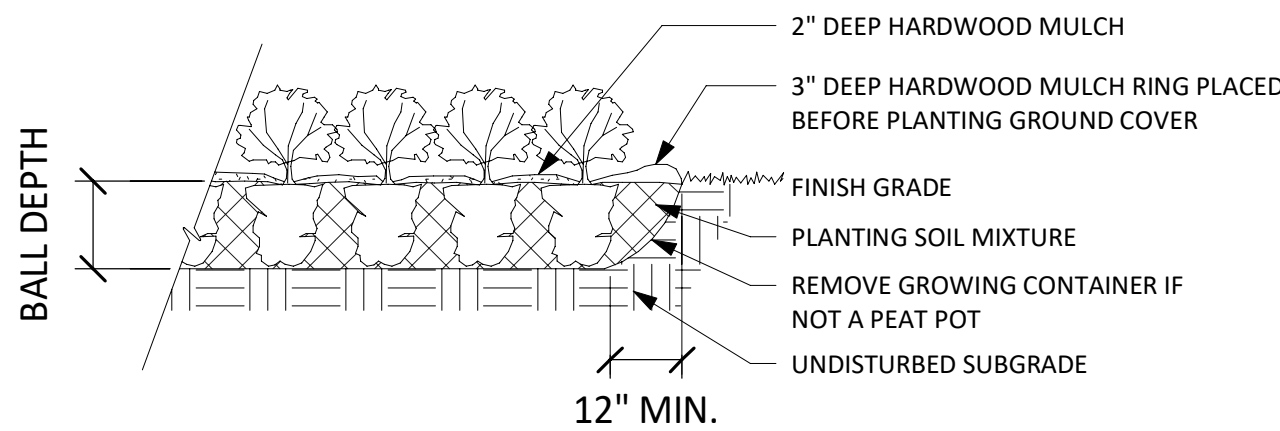

## PERENNIAL PLANTING

SCALE: NOT TO SCALE

PLANTING SCHEDULE						
SYMBOL	QTY.	LATIN NAME	COMMON NAME	SIZE	REMARKS	BLOOM TIME/COLOR
EVERGREEN TREE						
PP	12	PICEA PUNGENS GLAUCA	COLORADO BLUE SPRUCE	6 - 8 FT.	B & B	EVERGREEN/BUE/GREEN
TO	9	THUJA OCCIDENTALIS	COMMON ARBORVITAE	6 - 8 FT.	B & B	EVERGREEN/BUE/GREEN
DECIDUOUS TREE						
CK	3	CORNUS KOUSA	KOUSA DOGWOOD	8-10 FT.	B & B	WHITE FLOWERS
EVERGREEN SHRUB						
Vr	17	VIBURNUM RHYTIDOPHYLLUM	LEATHERLEAF VIBURNUM	3 GALLON	CONTAINER, FULL	YELLOWISH-WHITE FLOWERS
SHRUB/PERENNIAL						
Db	16	DAPHNE BURKWOODI	CAROLE MACKIE DAPHNE	3 GALLON	CONTAINER, FULL	PINK FLOWERS
ep	60	ECHINACEA PURPUREA	PURPLE CONEFLOWER	1 GALLON	12" O.C.	PURPLE FLOWERS
Js	30	JUNIPERUS SQUAMATA	'BLUE STAR' JUNIPER	3 GALLON	CONTAINER, FULL	EVERGREEN/BUE/GREEN
rh	60	RUDBECKIA HIRTA	BLACK-EYED SUSAN	1 GALLON	12" O.C.	YELLOW FLOWERS
Sj	30	SPIREA JAPONICA	JAPANESE SPIREA	3 GALLON	CONTAINER, FULL	PINK FLOWERS

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SITE DETAIL & NOTES

ORANGE COUNTY, NEW YORK

CITY OF MIDDLETOWN

Barton & Loguidice  
443 Electronics Parkway  
Liverpool, NY 13088

B&L



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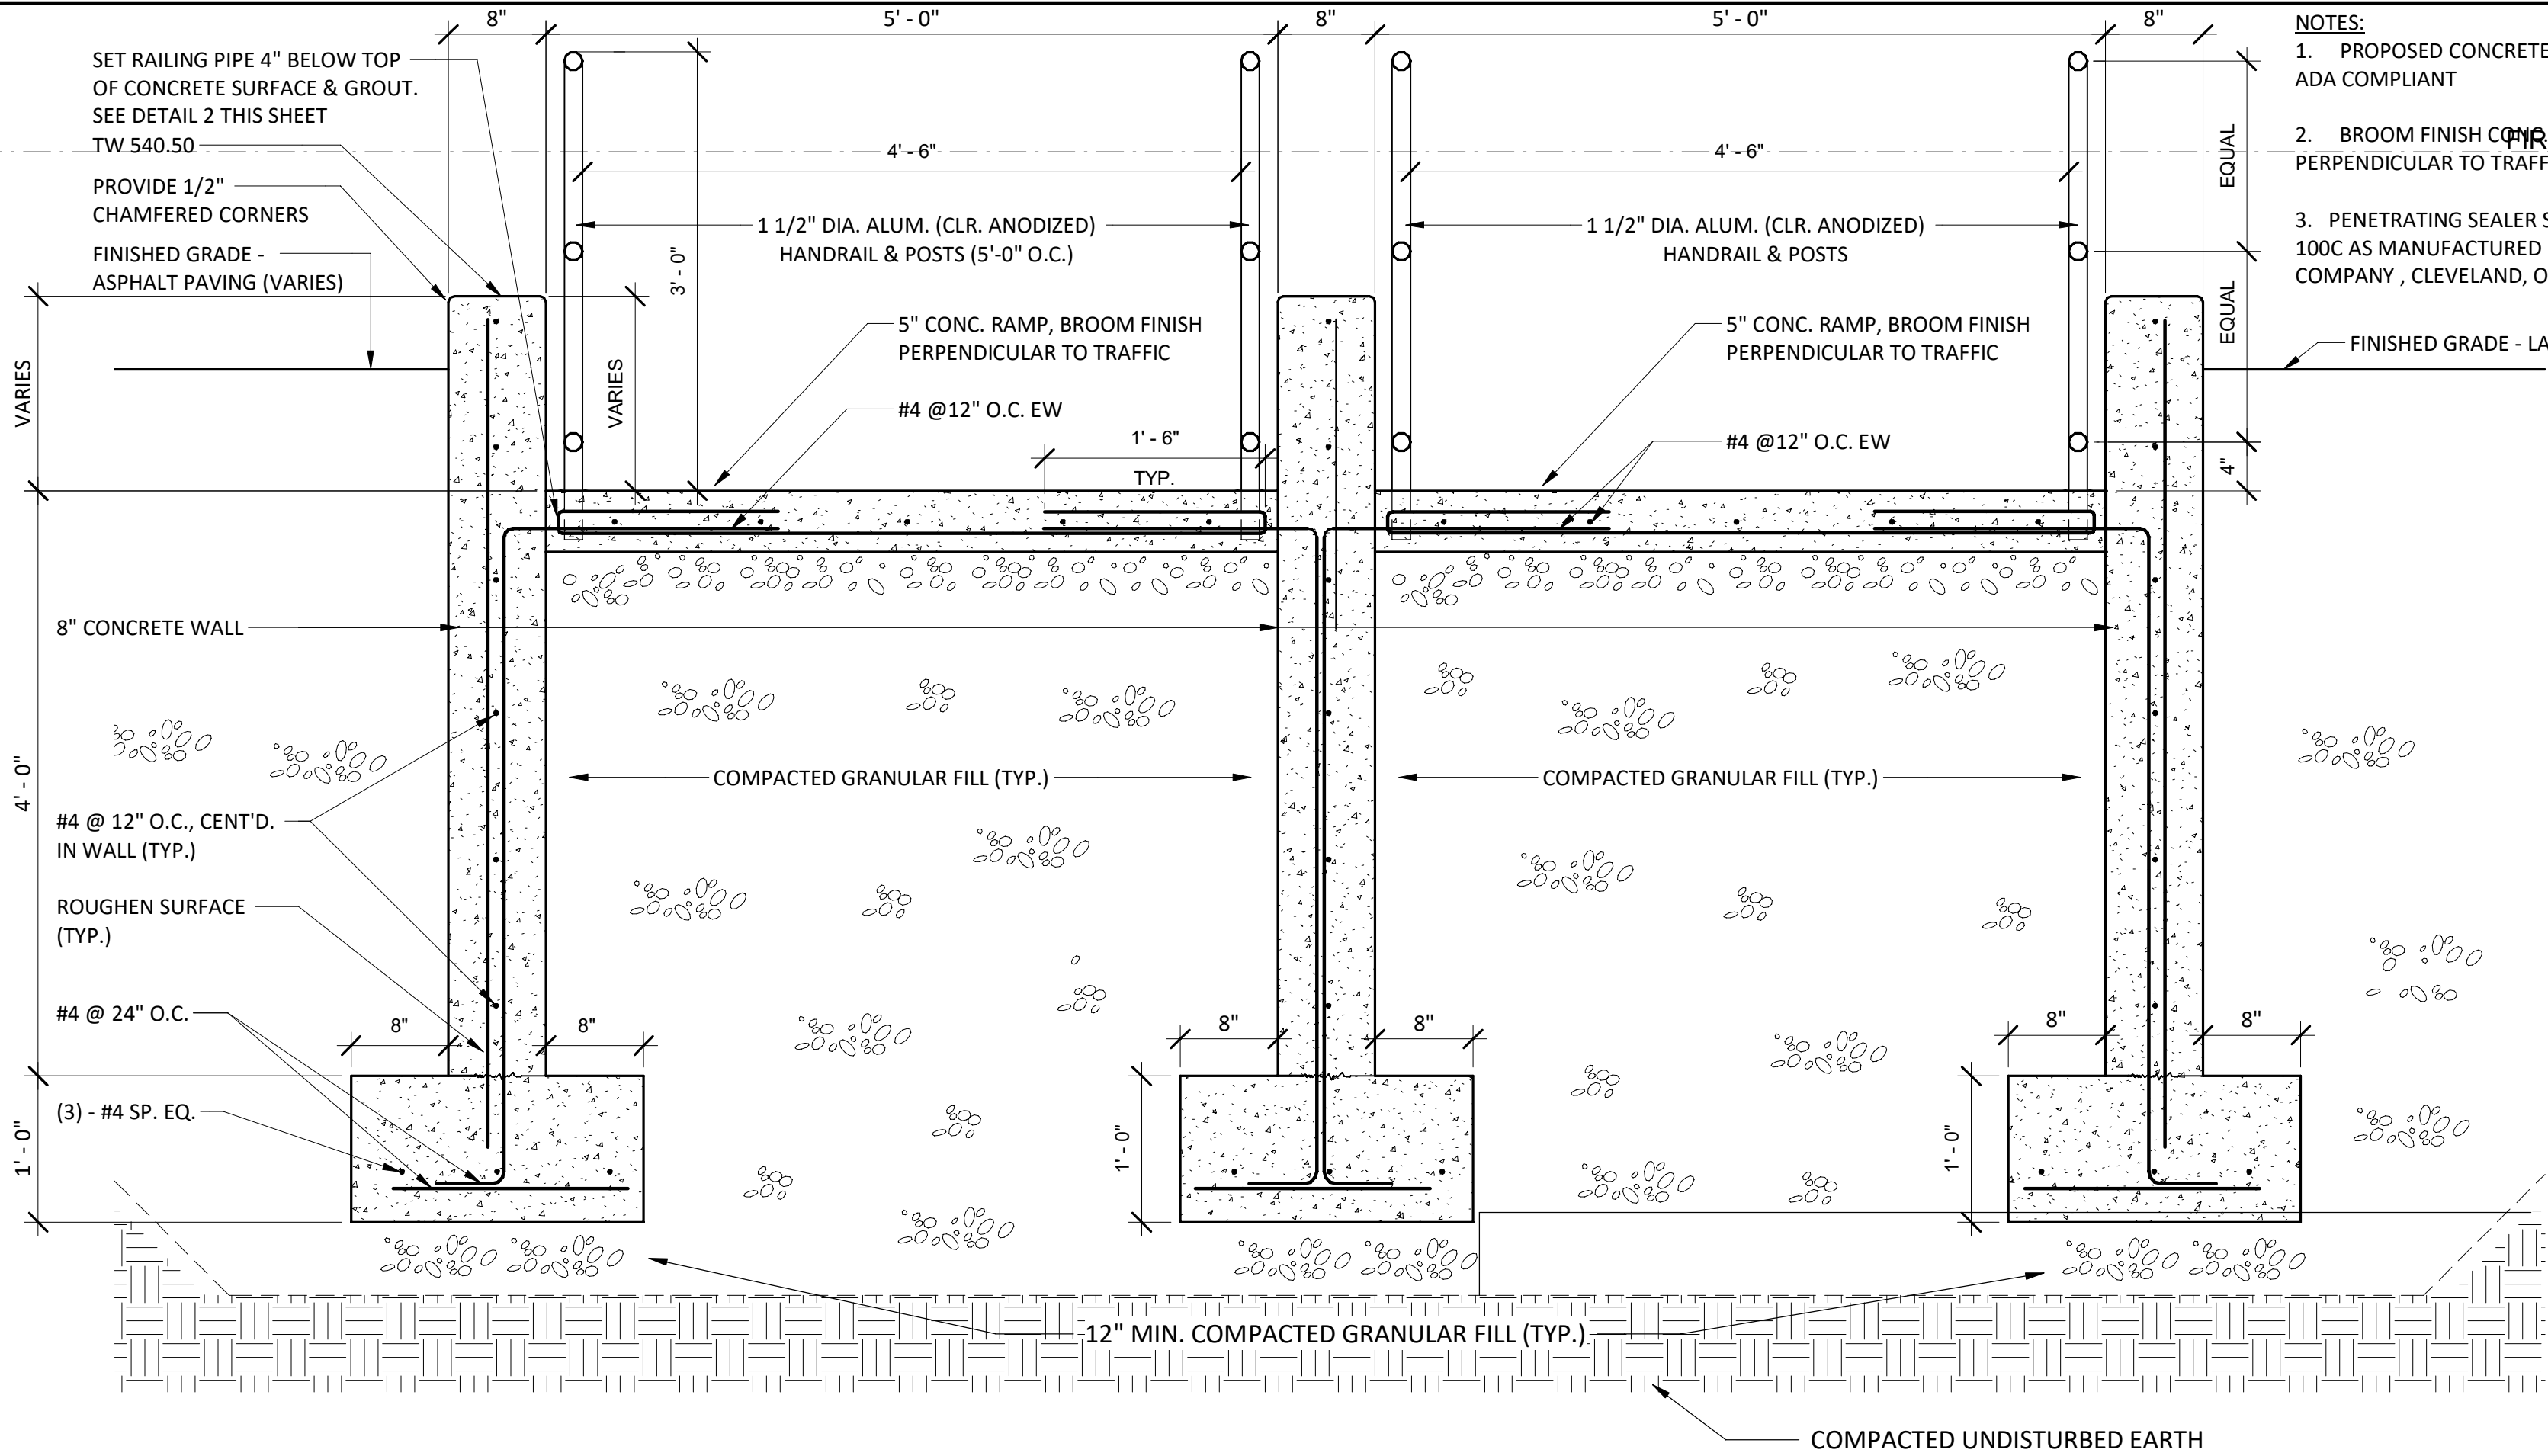
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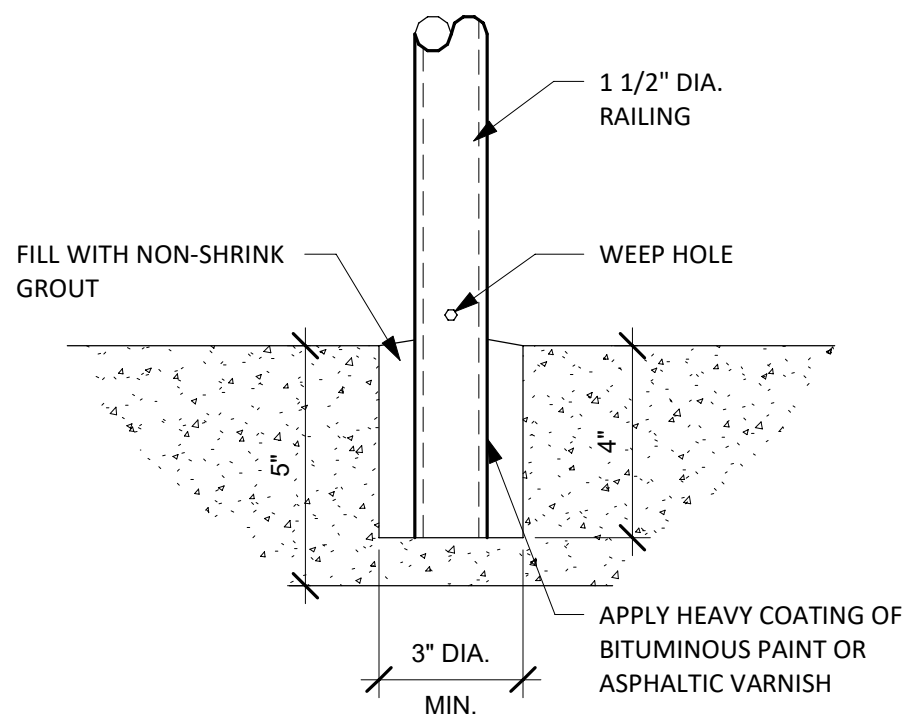
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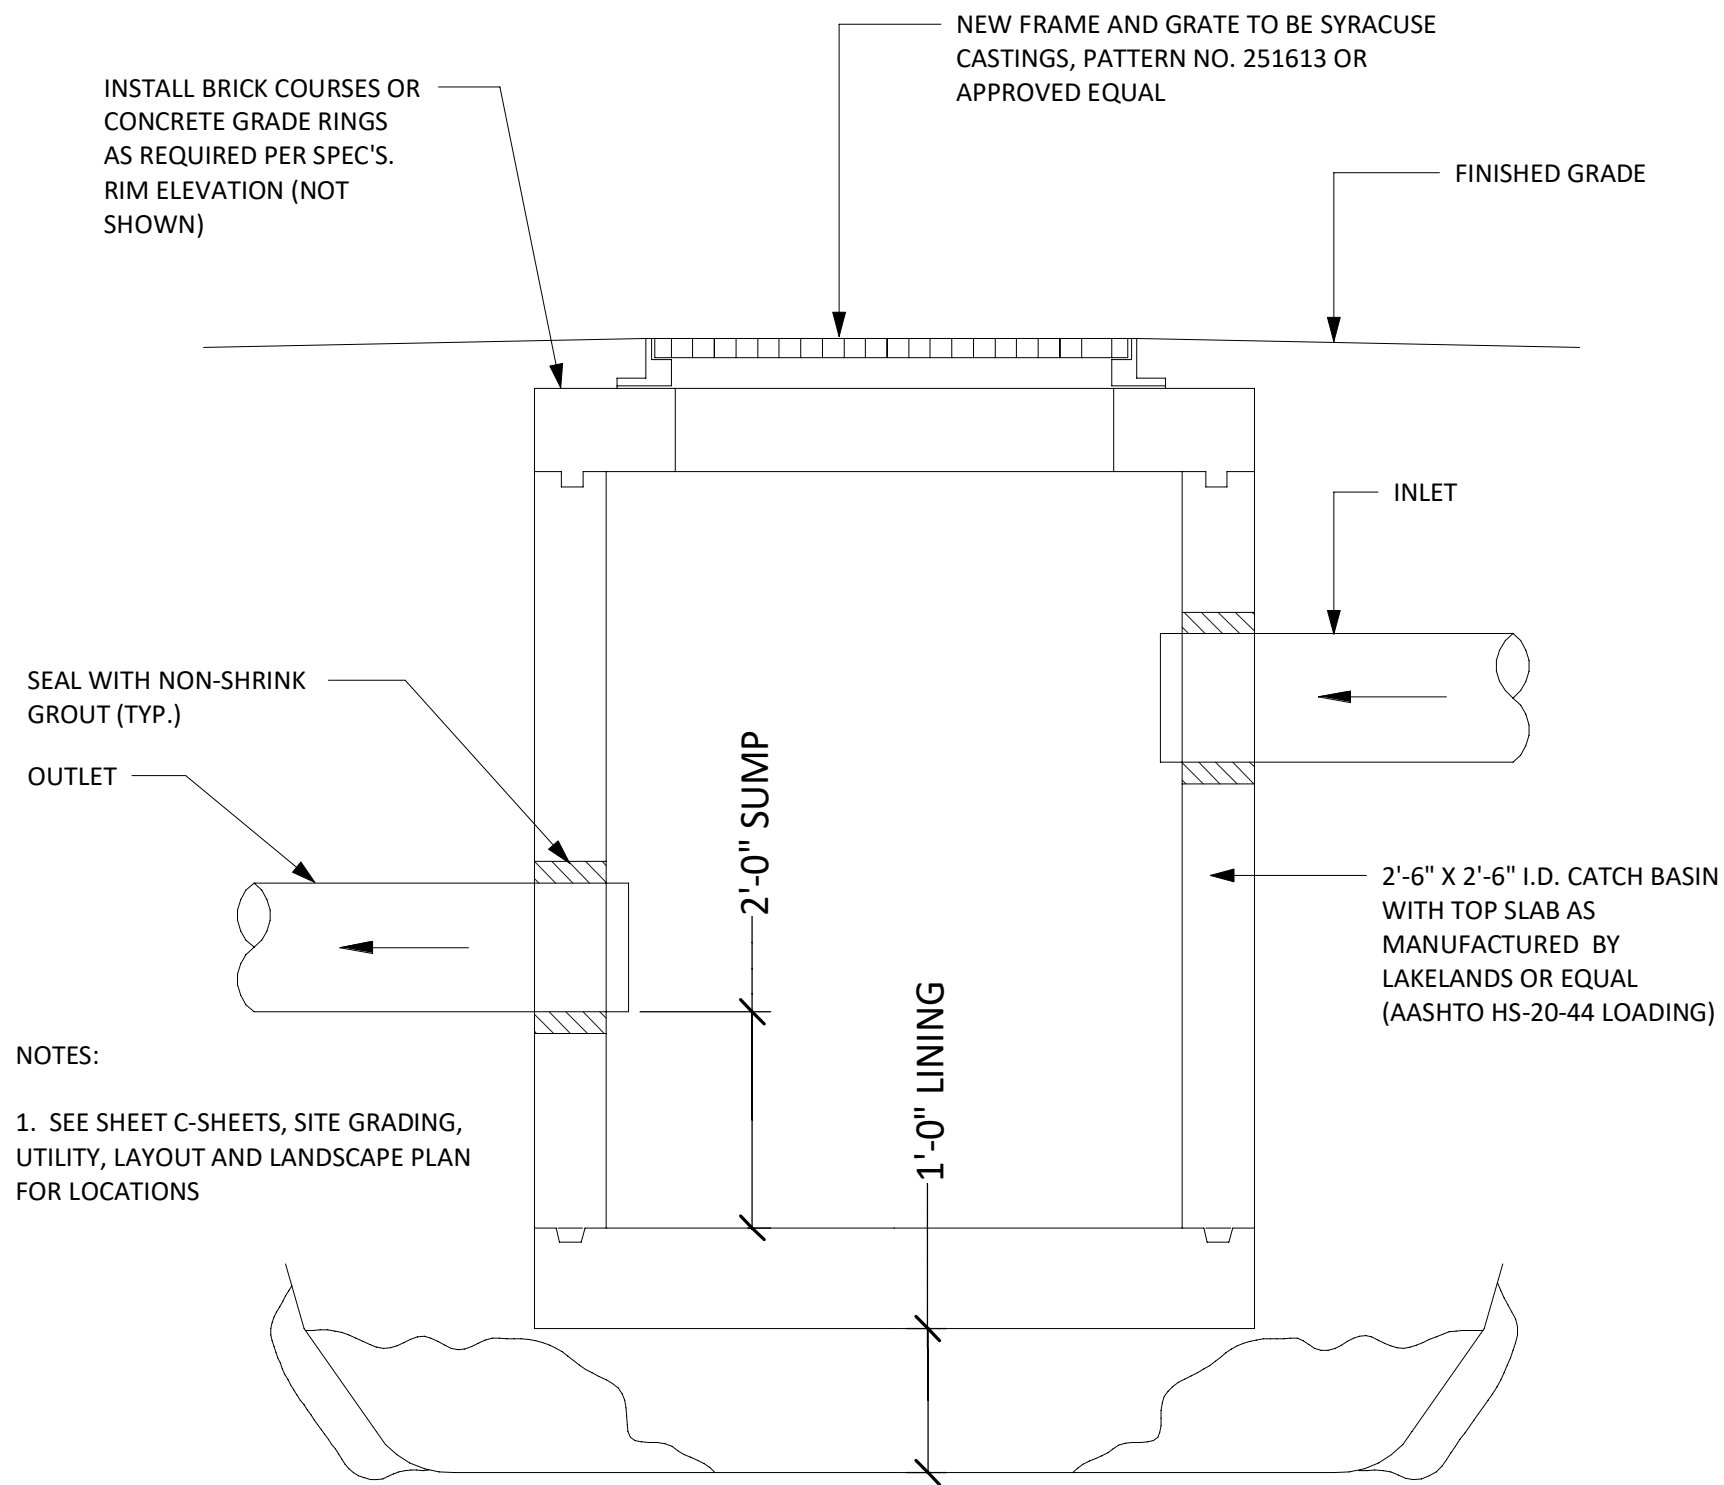





1 CONCRETE RAMP CROSS SECTION  
C102 SCALE: 1" = 1'-0"



2 CORE DRILL DETAIL  
A201 SCALE: 3" = 1'-0"






TYPICAL CATCH BASIN DETAIL  
SCALE: 1 1/2" = 1'-0"

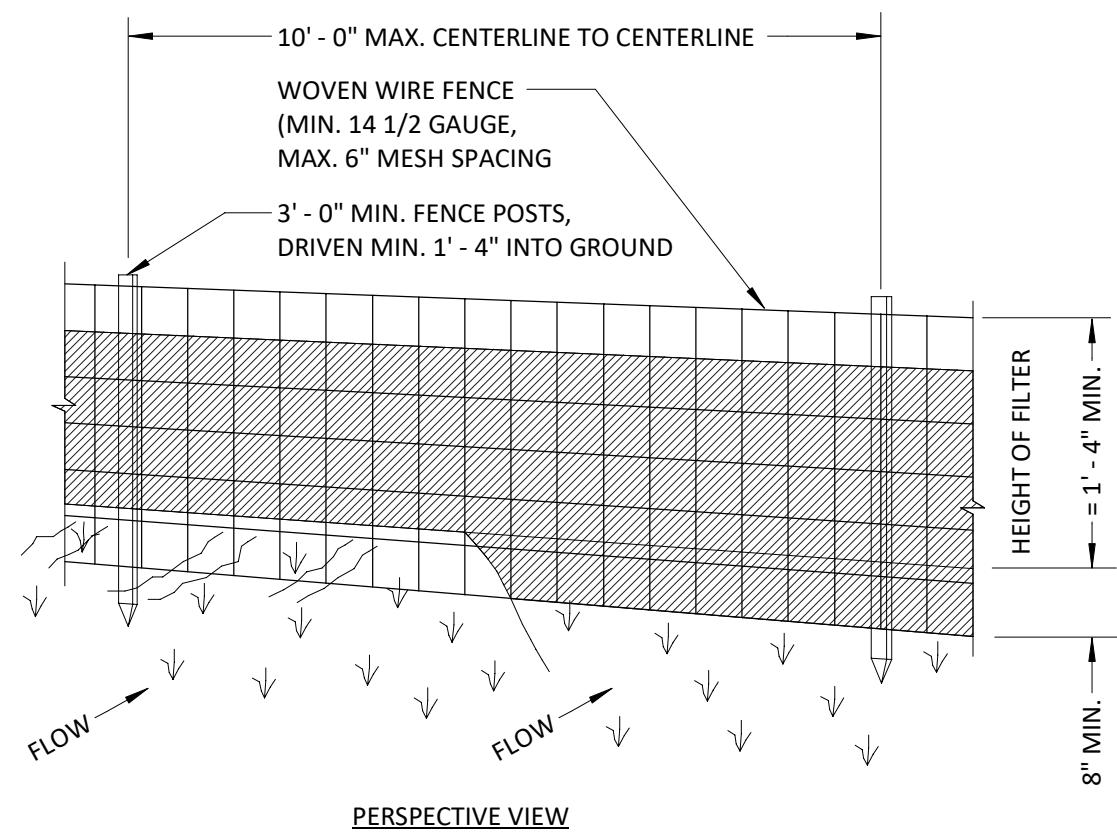

CONSTRUCTION NOTES FOR FABRICATED SILT FENCE

- WOVEN WIRE FENCE TO BE FASTENED SECURELY TO FENCE POSTS WITH WIRE TIES OR STAPLES.
  - FILTER CLOTH TO BE FASTENED SECURELY TO WOVEN WIRE FENCE WITH TIES SPACED EVERY 2' - 0" AT TOP AND MID SECTION.
  - WHEN TWO SECTIONS OF FILTER CLOTH ADJOIN EACH OTHER THEY SHALL BE OVERLAPPED BY SIX INCHES AND FOLDED.
  - MAINTENANCE SHALL BE PERFORMED AS NEEDED AND MATERIAL REMOVED WHEN "BULGES" DEVELOP IN THE SILT FENCE.
- POSTS: STEEL EITHER "T" OR "U" TYPE OR 2" HARDWARE
- FENCE: WOVEN WIRE, 14 1/2 GA. 6" MAX. MESH OPENING
- FILTER CLOTH: FILTER X, MIRAFI 100X, STABILINKA T140N OR APPROVED EQUAL.
- PREFABRICATED UNIT: GEOFAB, EVIOFENCE, OR APPROVED EQUAL.

CONSTRUCTION SILT FENCING  
SCALE: NOT TO SCALE

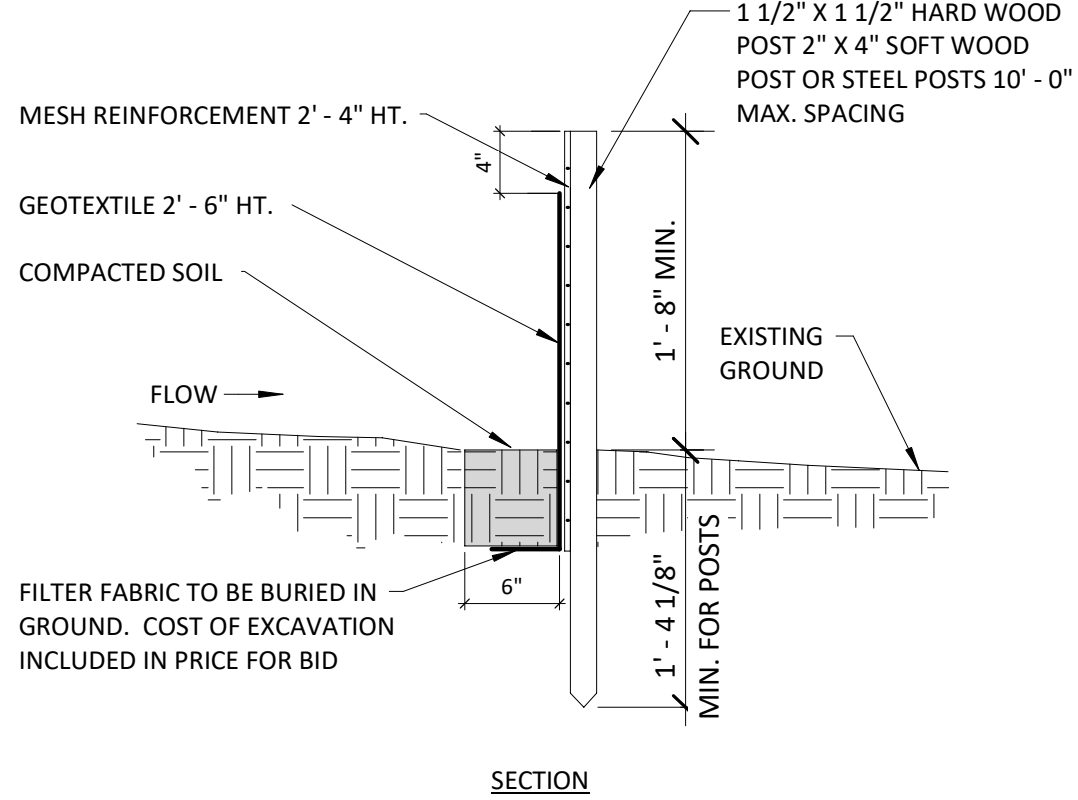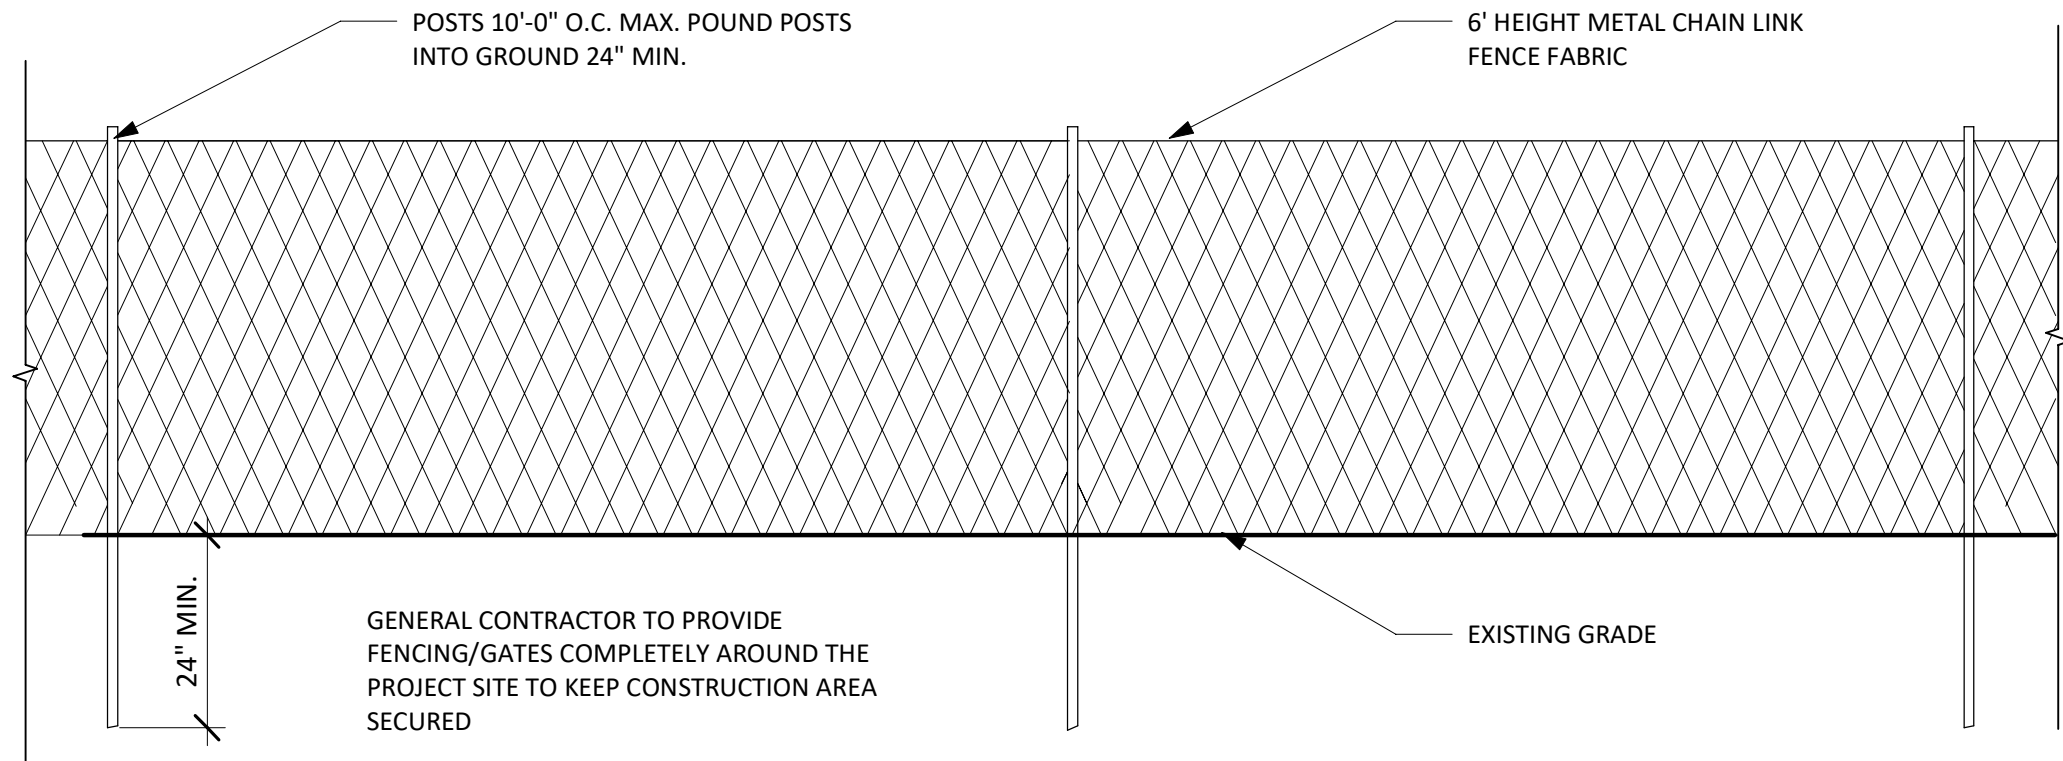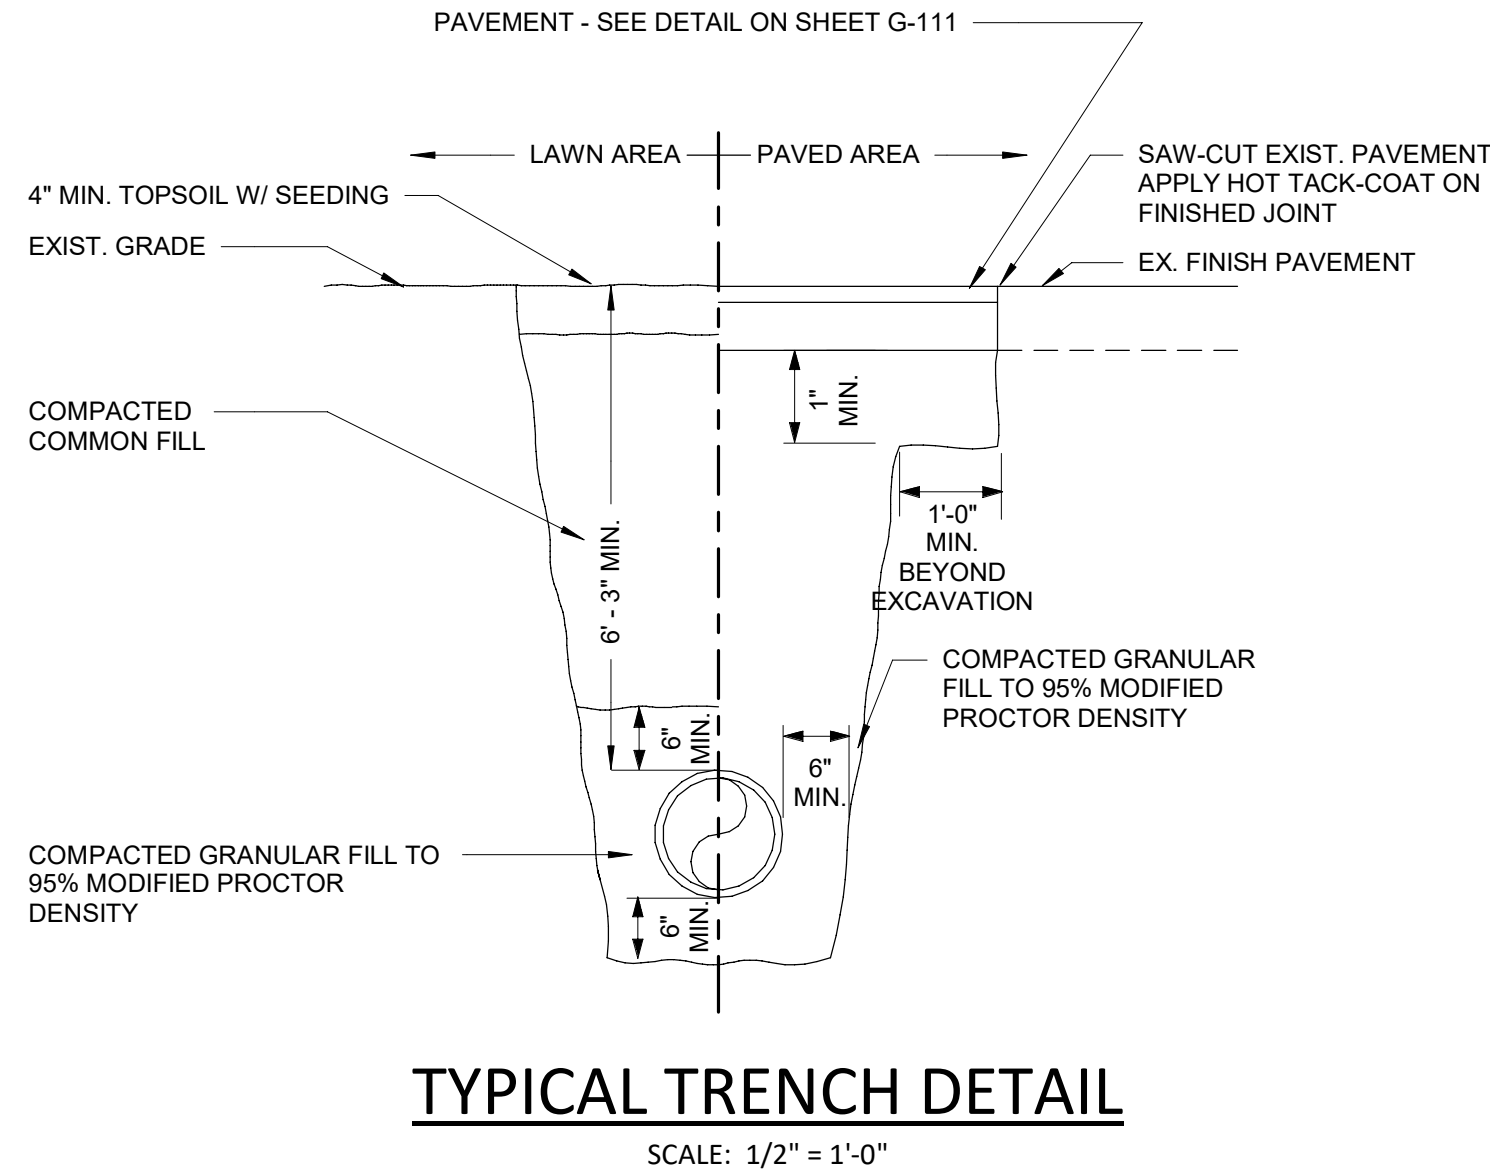

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SITE DETAILS & NOTES

CITY OF MIDDLETOWN

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ABBREVIATIONS:


∠ - ANGLE  
ACT - ACOUSTICAL CEILING TILE  
AFF - ABOVE FINISHED FLOOR  
ALUM - ALUMINUM  
BATH - BATHROOM  
BLDG - BUILDING  
BSMT - BASEMENT  
BOT - BOTTOM  
CB - CATCH BASIN  
C/C - CENTER TO CENTER  
CCTV - CLOSED CIRCUIT TELEVISION  
CJ - CONTROL JOINT  
CL - CENTER LINE  
CLG - CEILING  
CLR - CLEAR  
CMU - CONCRETE MASONRY UNITS  
COL - COLUMN  
CONC - CONCRETE  
CONST - CONSTRUCTION  
CONT - CONTINUOUS  
CPP - CORRUGATED POLYETHYLENE PIPE  
CPT - CARPET  
CT - CERAMIC TILE  
DEMO - DEMOLISH, DEMOLITION  
DN - DOWN  
DS - DOWNSPOUT  
DTL - DETAIL  
DWG - DRAWING  
E.F. - EACH FACE  
E.W. - EACH WAY  
EA - EACH  
ELEC - ELECTRICAL  
ELEV - ELEVATION  
EMBED - EMBEDMENT  
EPS - EXPANDED POLYSTYRENE  
EQUIP - EQUIPMENT  
EW - EACH WAY  
EXP - EXPOSED  
EXP ANCHOR - EXPANSION ANCHOR  
EXT - EXTERIOR  
EX, EXIST - EXISTING  
FIN FLR - FINISHED FLOOR  
FND - FOUNDATION  
FRP - FIBER REINFORCED PLASTIC  
FT - FIRE TREATED  
FTG - FOOTING  
FV - FIELD VERIFY  
GA - GAUGE  
GALV - GALVANIZED  
GC - GENERAL CONTRACTOR  
GL BLK - GLASS BLOCK  
GWB - GYPSUM WALL BOARD  
GWT - GLAZED WALL TILE  
HBD - HARDBOARD  
HC - HANDICAP

ABBREVIATIONS (CONT.):

HM - HOLLOW METAL  
INSUL - INSULATION  
IGU - INSULATED GLASS UNIT  
INV - INVERT  
JT - JOINT  
LAM - LAMINATE  
MANUF - MANUFACTURER  
MAS - MASONRY  
MAX - MAXIMUM  
MIN - MINIMUM  
MR - MOISTURE RESISTANT  
MTL - METAL  
MO - MASONRY OPENING  
NIC - NOT IN CONTRACT  
NTS - NOT TO SCALE  
O/C - ON CENTER  
OD - OUTSIDE DIAMETER  
PL - PLATE  
PERF - PERFORATED  
PLAS - PLASTIC  
PLYWD - PLYWOOD  
PNT - PAINT  
PT - PRESSURE TREATED  
PPT - PRESSURE PRESERVATIVE TREATED  
PVMT - PAVEMENT  
QT - QUARRY TILE  
R - RISER  
RD - ROOF DRAIN  
RAD - RADIUS  
REQ'D - REQUIRED  
RO - ROUGH OPENING  
SC - SOLID CORE  
SAN - SANITARY  
SHT - SHEET  
SIM - SIMILAR  
SQ - SQUARE  
SS - STAINLESS STEEL  
STL - STEEL  
SUS - SUSPENDED  
SV - SHEET VINYL  
T - TREAD  
T/- TOP OF  
T&B - TOP AND BOTTOM  
TEMP - TEMPERED  
TYP - TYPICAL  
VCT - VINYL COMPOSITION TILE  
UG - UNDERGROUND  
VG - FIELD VERIFY  
GA - GAUGE  
GALV - GALVANIZED  
GC - GENERAL CONTRACTOR  
GL BLK - GLASS BLOCK  
GWB - GYPSUM WALL BOARD  
GWT - GLAZED WALL TILE  
HBD - HARDBOARD  
HC - HANDICAP


GENERAL NOTES:

- ALL DIMENSIONS TO, OF, AND IN EXISTING BUILDING SHALL BE VERIFIED IN FIELD BY CONTRACTOR.
- CONTRACTOR SHALL COORDINATE ALL WORK WITH ALL OTHER CONTRACTORS ON SITE. CONTRACTOR SHALL PROVIDE ALL MATERIALS AND LABOR FOR A COMPLETE INSTALLATION.
- ALL WORK SHALL COMPLY WITH NYS FIRE PREVENTION AND BUILDING CODE, LOCAL BUILDING CODES, AS WELL AS NATIONAL PLUMBING AND ELECTRICAL CODES.
- ALL WORK SHALL BE IN STRICT ACCORDANCE WITH MANUFACTURER'S WRITTEN INSTRUCTIONS FOR PREPARATIONS AND INSTALLATION OF MATERIALS.
- DO NOT CHANGE SIZE NOR SPACING OF STRUCTURAL ELEMENTS.
- DETAILS SHOWN ARE TYPICAL; SIMILAR DETAILS APPLY TO SIMILAR CONDITIONS UNLESS OTHERWISE INDICATED.
- THE CONTRACTOR AND/OR SUBCONTRACTORS ARE SOLELY RESPONSIBLE FOR EXECUTING THE WORK AND MAINTAINING THE WORK SITE IN ACCORDANCE WITH ALL APPLICABLE SAFETY CODES AND STANDARDS.
- CONTRACTOR SHALL PROVIDE PROTECTIVE BARRICADES, SIGNS AND LIGHTING TO PREVENT ANY UNAUTHORIZED PASSAGE INTO WORK AREA.
- PROTECT ALL EXISTING AND NEW BUILDING ELEMENTS INSTALLED BY OTHER CONTRACTS FROM DAMAGE. CONTRACTOR SHALL RESTORE ALL DAMAGED ELEMENTS TO ORIGINAL OR BETTER CONDITION.
- BRACE BUILDING UNTIL ALL STRUCTURAL ELEMENTS NEED FOR STABILITY ARE INSTALLED. THESE ELEMENTS ARE AS FOLLOWS: FLOOR DECK, ROOF DECK, BRACING MEMBERS, SHEAR WALLS.
- CONTRACTOR SHALL DETERMINE EXACT LOCATION OF EXISTING UTILITIES BEFORE COMMENCING WORK, HE AGREES TO BE FULLY RESPONSIBLE FOR ANY AND ALL DAMAGES WHICH MIGHT BE OCCASIONED BY HIS FAILURE TO EXACTLY LOCATE AND PRESERVE UNDERGROUND UTILITIES.
- CONTRACTOR SHALL NOTIFY THE ARCHITECT/ENGINEER IN WRITING OF ALL PROPOSED DEVIATIONS OR SUBSTITUTIONS FROM DIMENSIONS, MATERIALS, OR EQUIPMENT SHOWN ON THE DRAWINGS AND MAKE ONLY THOSE DEVIATIONS OR SUBSTITUTIONS ACCEPTABLE TO THE ARCHITECT/ENGINEER. NO CHANGES SHALL BE MADE WITH APPROVAL BY THE ARCHITECT/ENGINEER.
- CONTRACTOR SHALL VERIFY ALL DIMENSIONS PRIOR TO ORDER AND/OR INSTALLATION OF MATERIAL.
- DO NOT SCALE DRAWINGS. CONTRACTOR SHALL NOTIFY ARCHITECT/ENGINEER OF ANY DISCREPANCIES IN DIMENSIONS BETWEEN EXISTING CONDITIONS AND/OR ARCHITECTURAL DRAWINGS AND THE STRUCTURAL DRAWINGS.
- PROVIDE ALL DEMO REQUIRED FOR NEW INSTALLATIONS SHOWN, AND PATCH EXISTING MATERIALS BACK TO ORIGINAL CONDITION, OR TO A CONDITION TO RECEIVE NEW WORK AS APPLICABLE.
- EXAMINE ALL MECHANICAL, ELECTRICAL, PLUMBING & OTHER TRADE DRAWINGS FOR ADDITIONAL AND INCIDENTAL WORK RELATED TO OPENINGS, PENETRATIONS, EQUIPMENT PADS, EQUIPMENT ITEM OR TAG NUMBERS, AND OTHER ADDITIONAL WORK. COORDINATE WITH ALL OTHER TRADES & PROVIDE ALL LABOR & MATERIALS FOR A COMPLETE INSTALLATION.
- SUBMISSION AND COSTS ASSOCIATED WITH OBTAINING A BUILDING PERMIT ARE THE GENERAL CONTRACTORS RESPONSIBILITY.

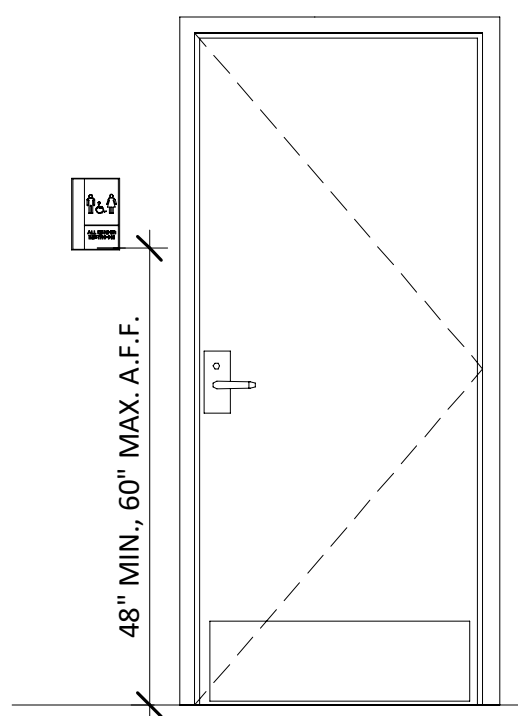

DOOR SIGN DETAIL


NOT TO SCALE

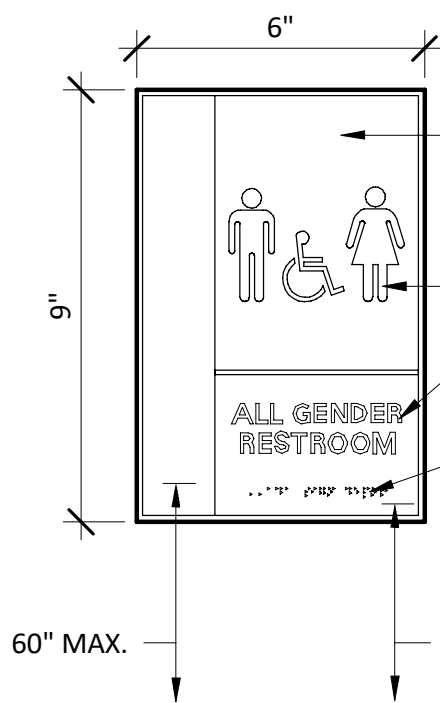

ADA SIGNAGE DETAIL


NOT TO SCALE

SEE FLOOR PLANS AND SPECIFICATIONS FOR ROOM NAMES AND NUMBERS FOR ROOM SIGNAGE  
LAYOUT, SIZE AND COLOR TO BE SELECTED BY OWNER  
RAISED SYMBOLS  
RAISED CHARACTERS - TO MATCH SPECIFIC ROOM NAMES  
BRAILLE  
PROVIDE (1) RESTROOM ADA COMPLIANT SIGN IN LOCATION SHOWN ON PLANS

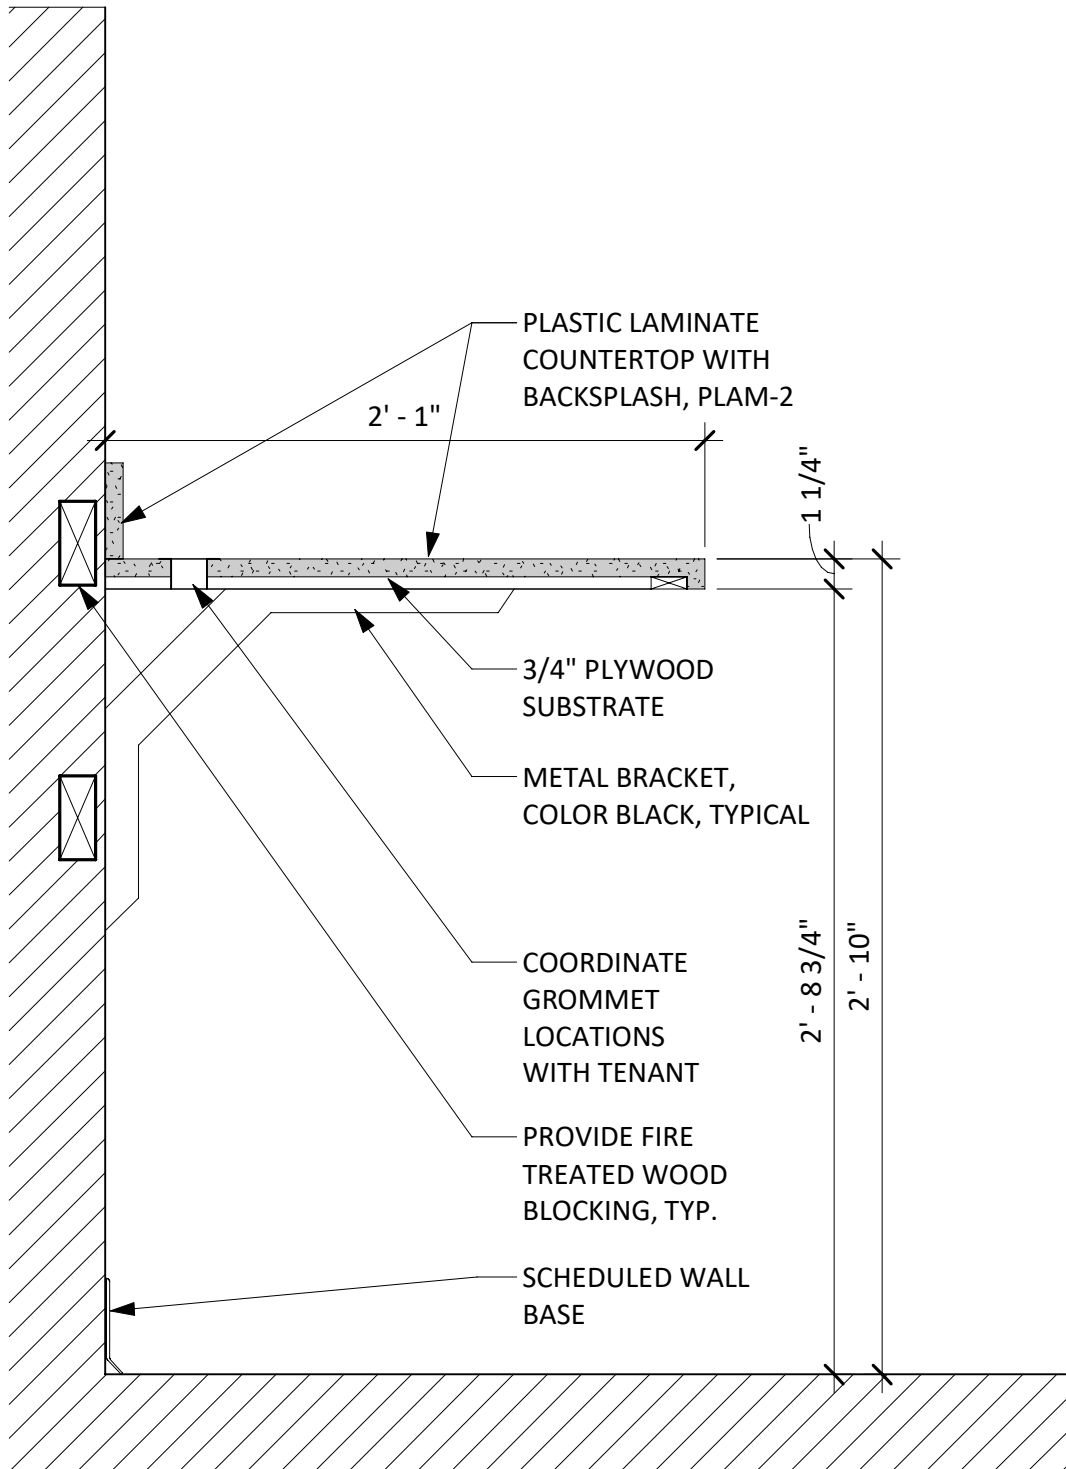

TYPICAL DESK DETAIL

SCALE: 1 1/2" = 1'-0"


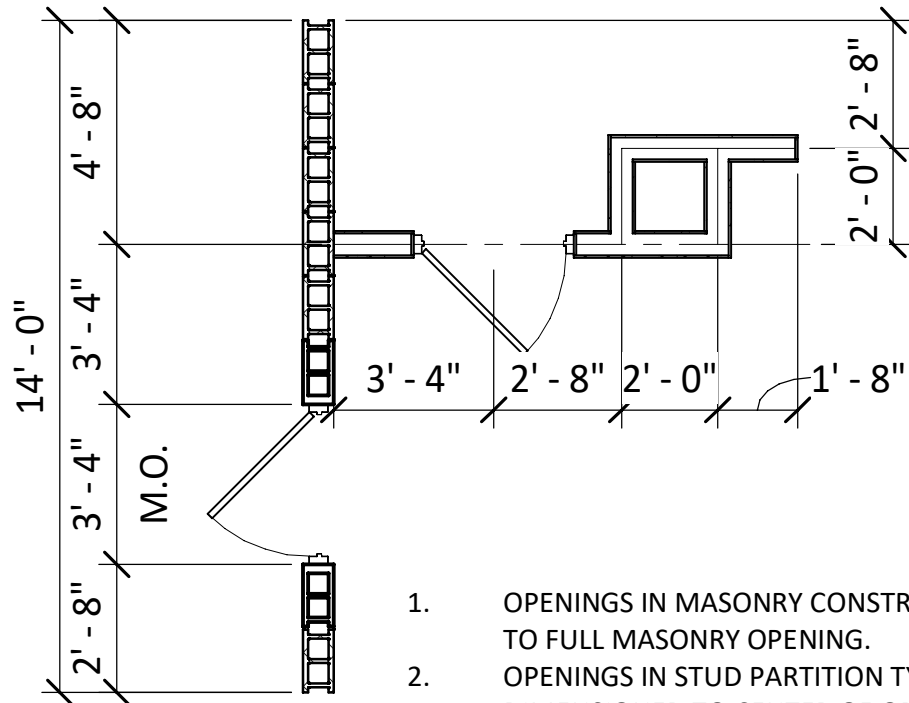


DIMENSIONING CONVENTIONS

NOT TO SCALE


TAG LEGEND

- DOOR TAG
- WINDOW TAG
- PARTITION TAG

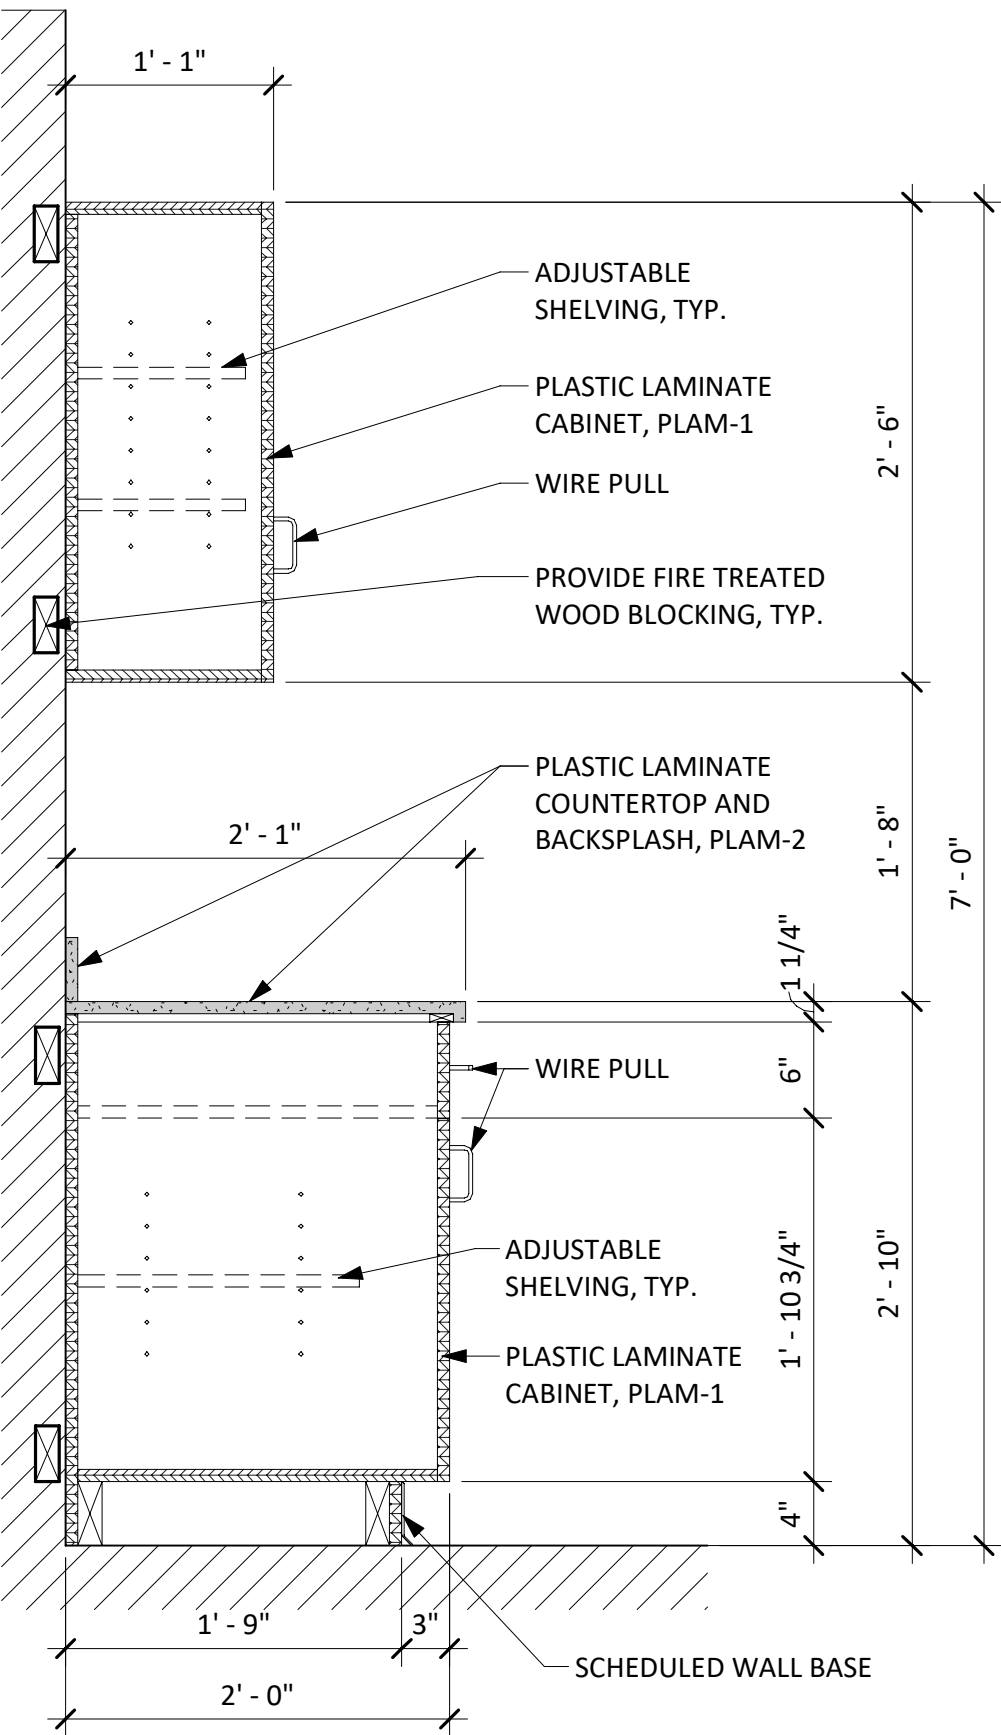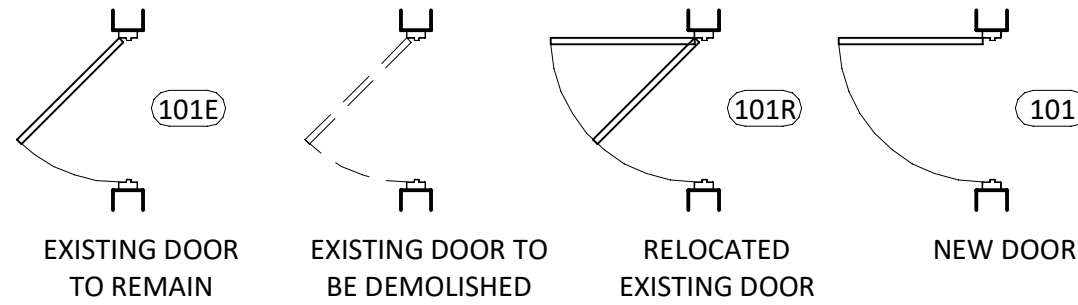


TYPICAL CABINETRY DETAIL

SCALE: 1" = 1'-0"

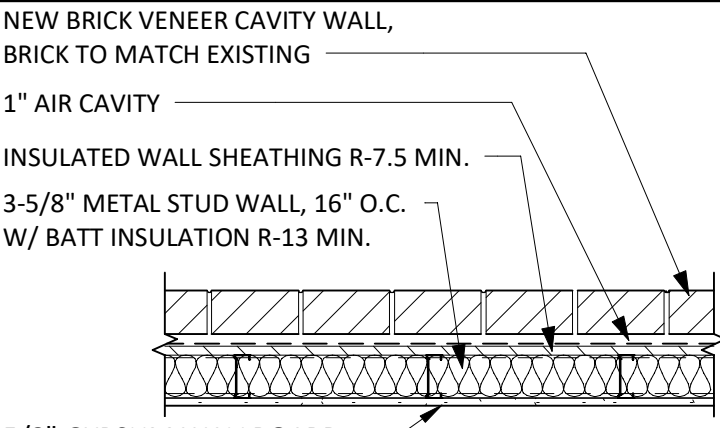


WALL TYPE

NEW BRICK VENEER CAVITY WALL,  
BRICK TO MATCH EXISTING  
1" AIR CAVITY  
INSULATED WALL SHEATHING R-7.5 MIN.  
3-5/8" METAL STUD WALL, 16" O.C.  
W/ BATT INSULATION R-13 MIN.

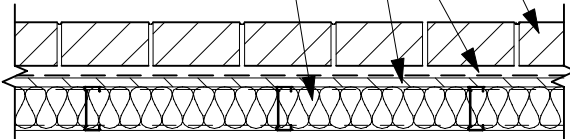


WALL TYPE

5/8" GYPSUM WALLBOARD  
3 5/8" METAL STUD WALL,  
STUDS SPACED AT 24" O.C.  
W/ BATT INSULATION R-13 MIN

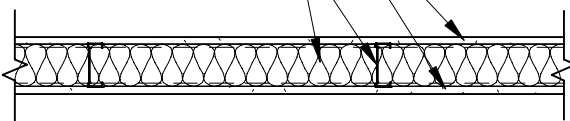


WALL TYPE

5/8" GYPSUM WALLBOARD  
3 5/8" METAL STUD WALL,  
STUDS SPACED AT 24" O.C.

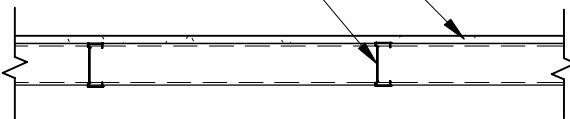


WALL TYPE

5/8" GYPSUM WALLBOARD  
5 1/2" METAL STUD WALL,  
STUDS SPACED AT 24" O.C.

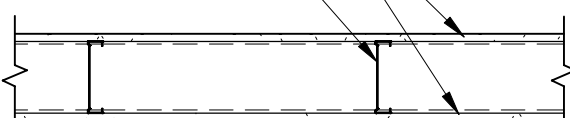


WALL TYPE

6" CMU

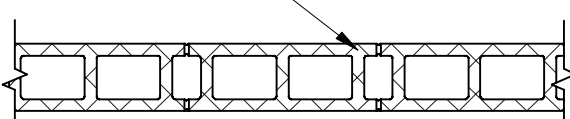


WALL TYPE

1" METAL LATHE & PLASTER FINISH  
6" CMU

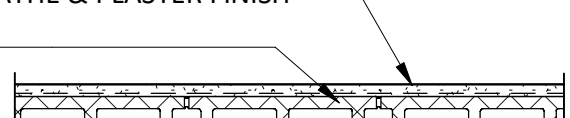


WALL TYPE

5/8" GYPSUM WALLBOARD  
3 5/8" METAL STUD WALL,  
STUDS SPACED AT 24" O.C.

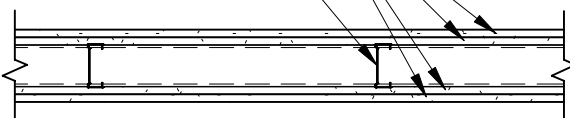


WALL TYPE

5/8" GYPSUM WALLBOARD  
5 1/2" METAL STUD WALL,  
STUDS SPACED AT 24" O.C.  
PROVIDE 5-1/2" BATT INSULATION IN WALLS ON THE EXTERIOR OF THE BUILDING

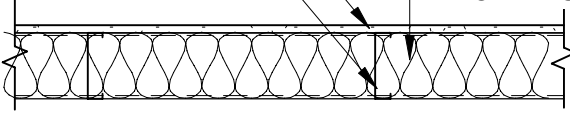

WALL TYPE

(2) LAYERS 5/8" GYPSUM WALLBOARD EACH SIDE  
3 5/8" METAL STUD WALL,  
STUDS SPACED AT 24" O.C. W/ SOUND ATTENUATION BATTS  
3 5/8" METAL STUD WALL,  
STUDS SPACED AT 24" O.C. W/ SOUND ATTENUATION BATTS

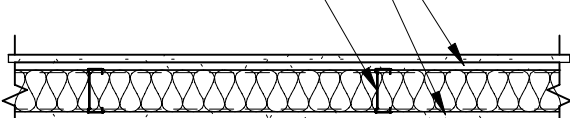

WALL TYPE

WALL TYPES

NOT TO SCALE

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REVISIONS

NO.	DESCRIPTION	DATE

CITY OF MIDDLETOWN  
NEW COURTHOUSE FACILITY  
ORANGE COUNTY, NEW YORK

LEGENDS, NOTES & TYPICAL DETAILS

CITY OF MIDDLETOWN

Barton & Loguidice  
443 Electronics Parkway  
Liverpool, NY 13088



NYS EXP.:

Date  
AUGUST, 2024

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AS SHOWN

Sheet Number

A001

Project Number  
1753.008.001



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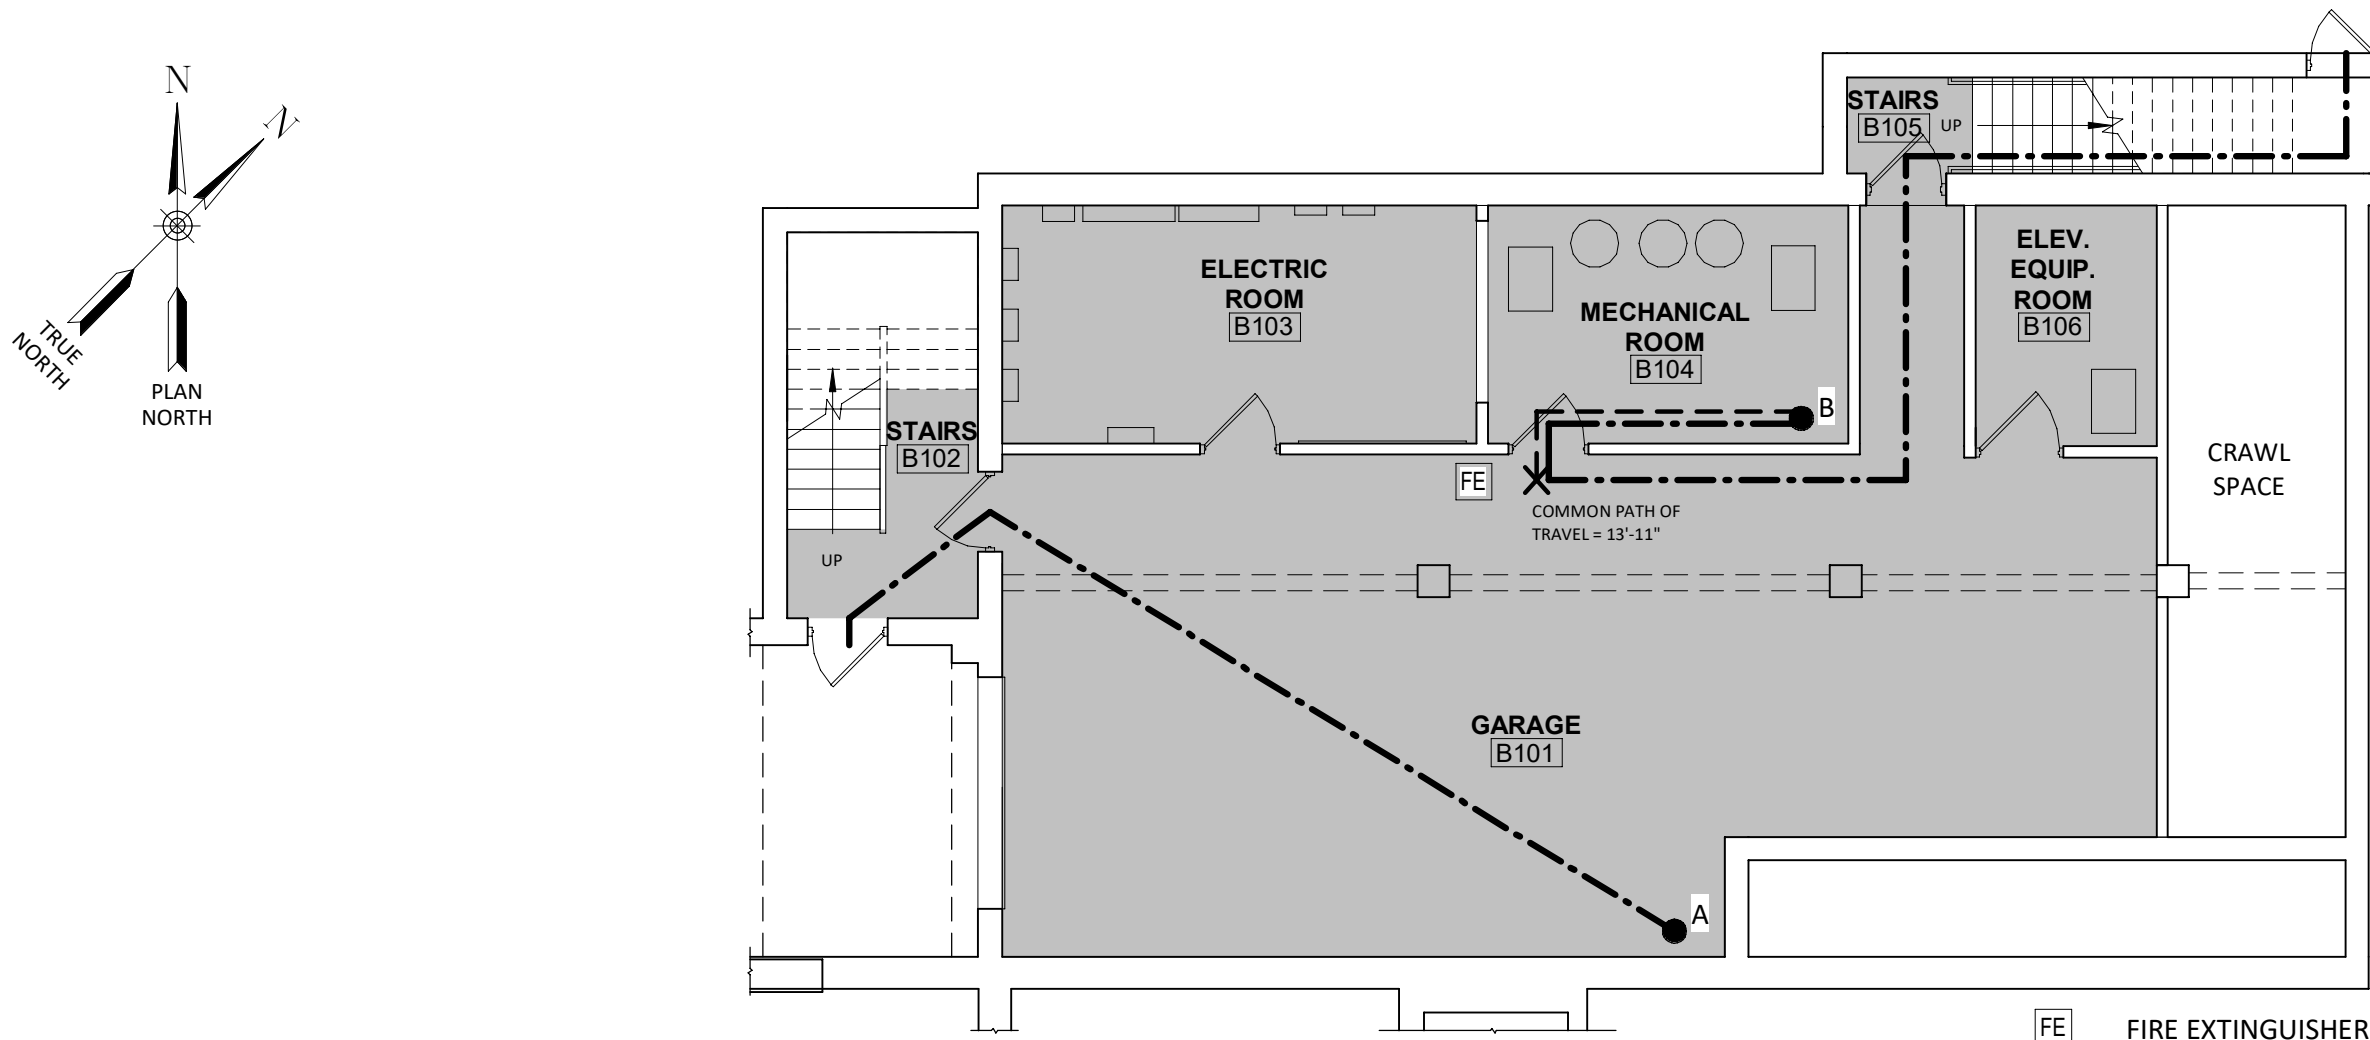
Checked by Checker

Drawn by ZDC

Designed by ZDC

TRB

In Charge of



**BASEMENT FLOOR PLAN**

SCALE: 1/8" = 1'-0"

**BASEMENT**  
**MAXIMUM EXIT TRAVEL DISTANCE (WITH SPRINKLER SYSTEM)**  
S-1 - WITH SPRINKLER SYSTEM - 250 FEET

**EXIT & TRAVEL DISTANCE DATA**

EXIT ROUTE	DISTANCE
A	33' - 0"
A	7' - 6"
A	1' - 0"
A:3	41' - 6"

**EXIT & TRAVEL DISTANCE DATA**

EXIT ROUTE	DISTANCE
B	10' - 6"
B	2' - 6"
B	15' - 0"
B	13' - 6"
B	18' - 6"
B	4' - 6"
B:6	64' - 6"

**FIRST FLOOR**  
**MAXIMUM EXIT TRAVEL DISTANCE (WITH SPRINKLER SYSTEM)**

A-3 - WITH SPRINKLER SYSTEM - 250 FEET  
B - WITH SPRINKLER SYSTEM - 300 FEET  
I-3 - WITH SPRINKLER SYSTEM - 200 FEET

**EXIT & TRAVEL DISTANCE DATA**

EXIT ROUTE	DISTANCE
A	12' - 6"
A	37' - 6"
A	31' - 6"
A:3	81' - 6"

**EXIT & TRAVEL DISTANCE DATA**

EXIT ROUTE	DISTANCE
B	23' - 6"
B	5' - 0"
B	21' - 6"
B:3	50' - 0"

**EXIT & TRAVEL DISTANCE DATA**

EXIT ROUTE	DISTANCE
C	14' - 3"
C	9' - 4"
C	18' - 6"
C	1' - 8"
C	19' - 4"
C	13' - 1"
C	3' - 4"
C:7	79' - 6"

**EXIT & TRAVEL DISTANCE DATA**

EXIT ROUTE	DISTANCE
D	10' - 4"
D	16' - 10"
D	19' - 9"
D	3' - 1"
D:4	50' - 0"

**EXIT & TRAVEL DISTANCE DATA**

EXIT ROUTE	DISTANCE
E	2' - 6"
E	9' - 8"
E	19' - 0"
E	15' - 4"
E	43' - 10"
E	41' - 0"
E	39' - 6"
E:7	170' - 10"

**EXIT & TRAVEL DISTANCE DATA**

EXIT ROUTE	DISTANCE
F	13' - 4"
F	27' - 0"
F	6' - 0"
F	50' - 2"
F:4	96' - 6"

**EXIT & TRAVEL DISTANCE DATA**

EXIT ROUTE	DISTANCE
G	4' - 0"
G	11' - 0"
G	12' - 0"
G	50' - 2"
G:4	77' - 2"

PROVIDE RECESSED FIRE CABINETS IN LOCATIONS SHOWN ON LIFE SAFETY DRAWINGS SEE SPECIFICATIONS FOR INFORMATION ON CABINET SELECTION AND FINISHES


To CABINET  
EL= 3'-6"

VERIFY W/ MANUF.

To FIN FLR  
EL= 0'-0"

**FIRE EXTINGUISHER CABINET DETAIL**

SCALE: 1 1/2" = 1'-0"

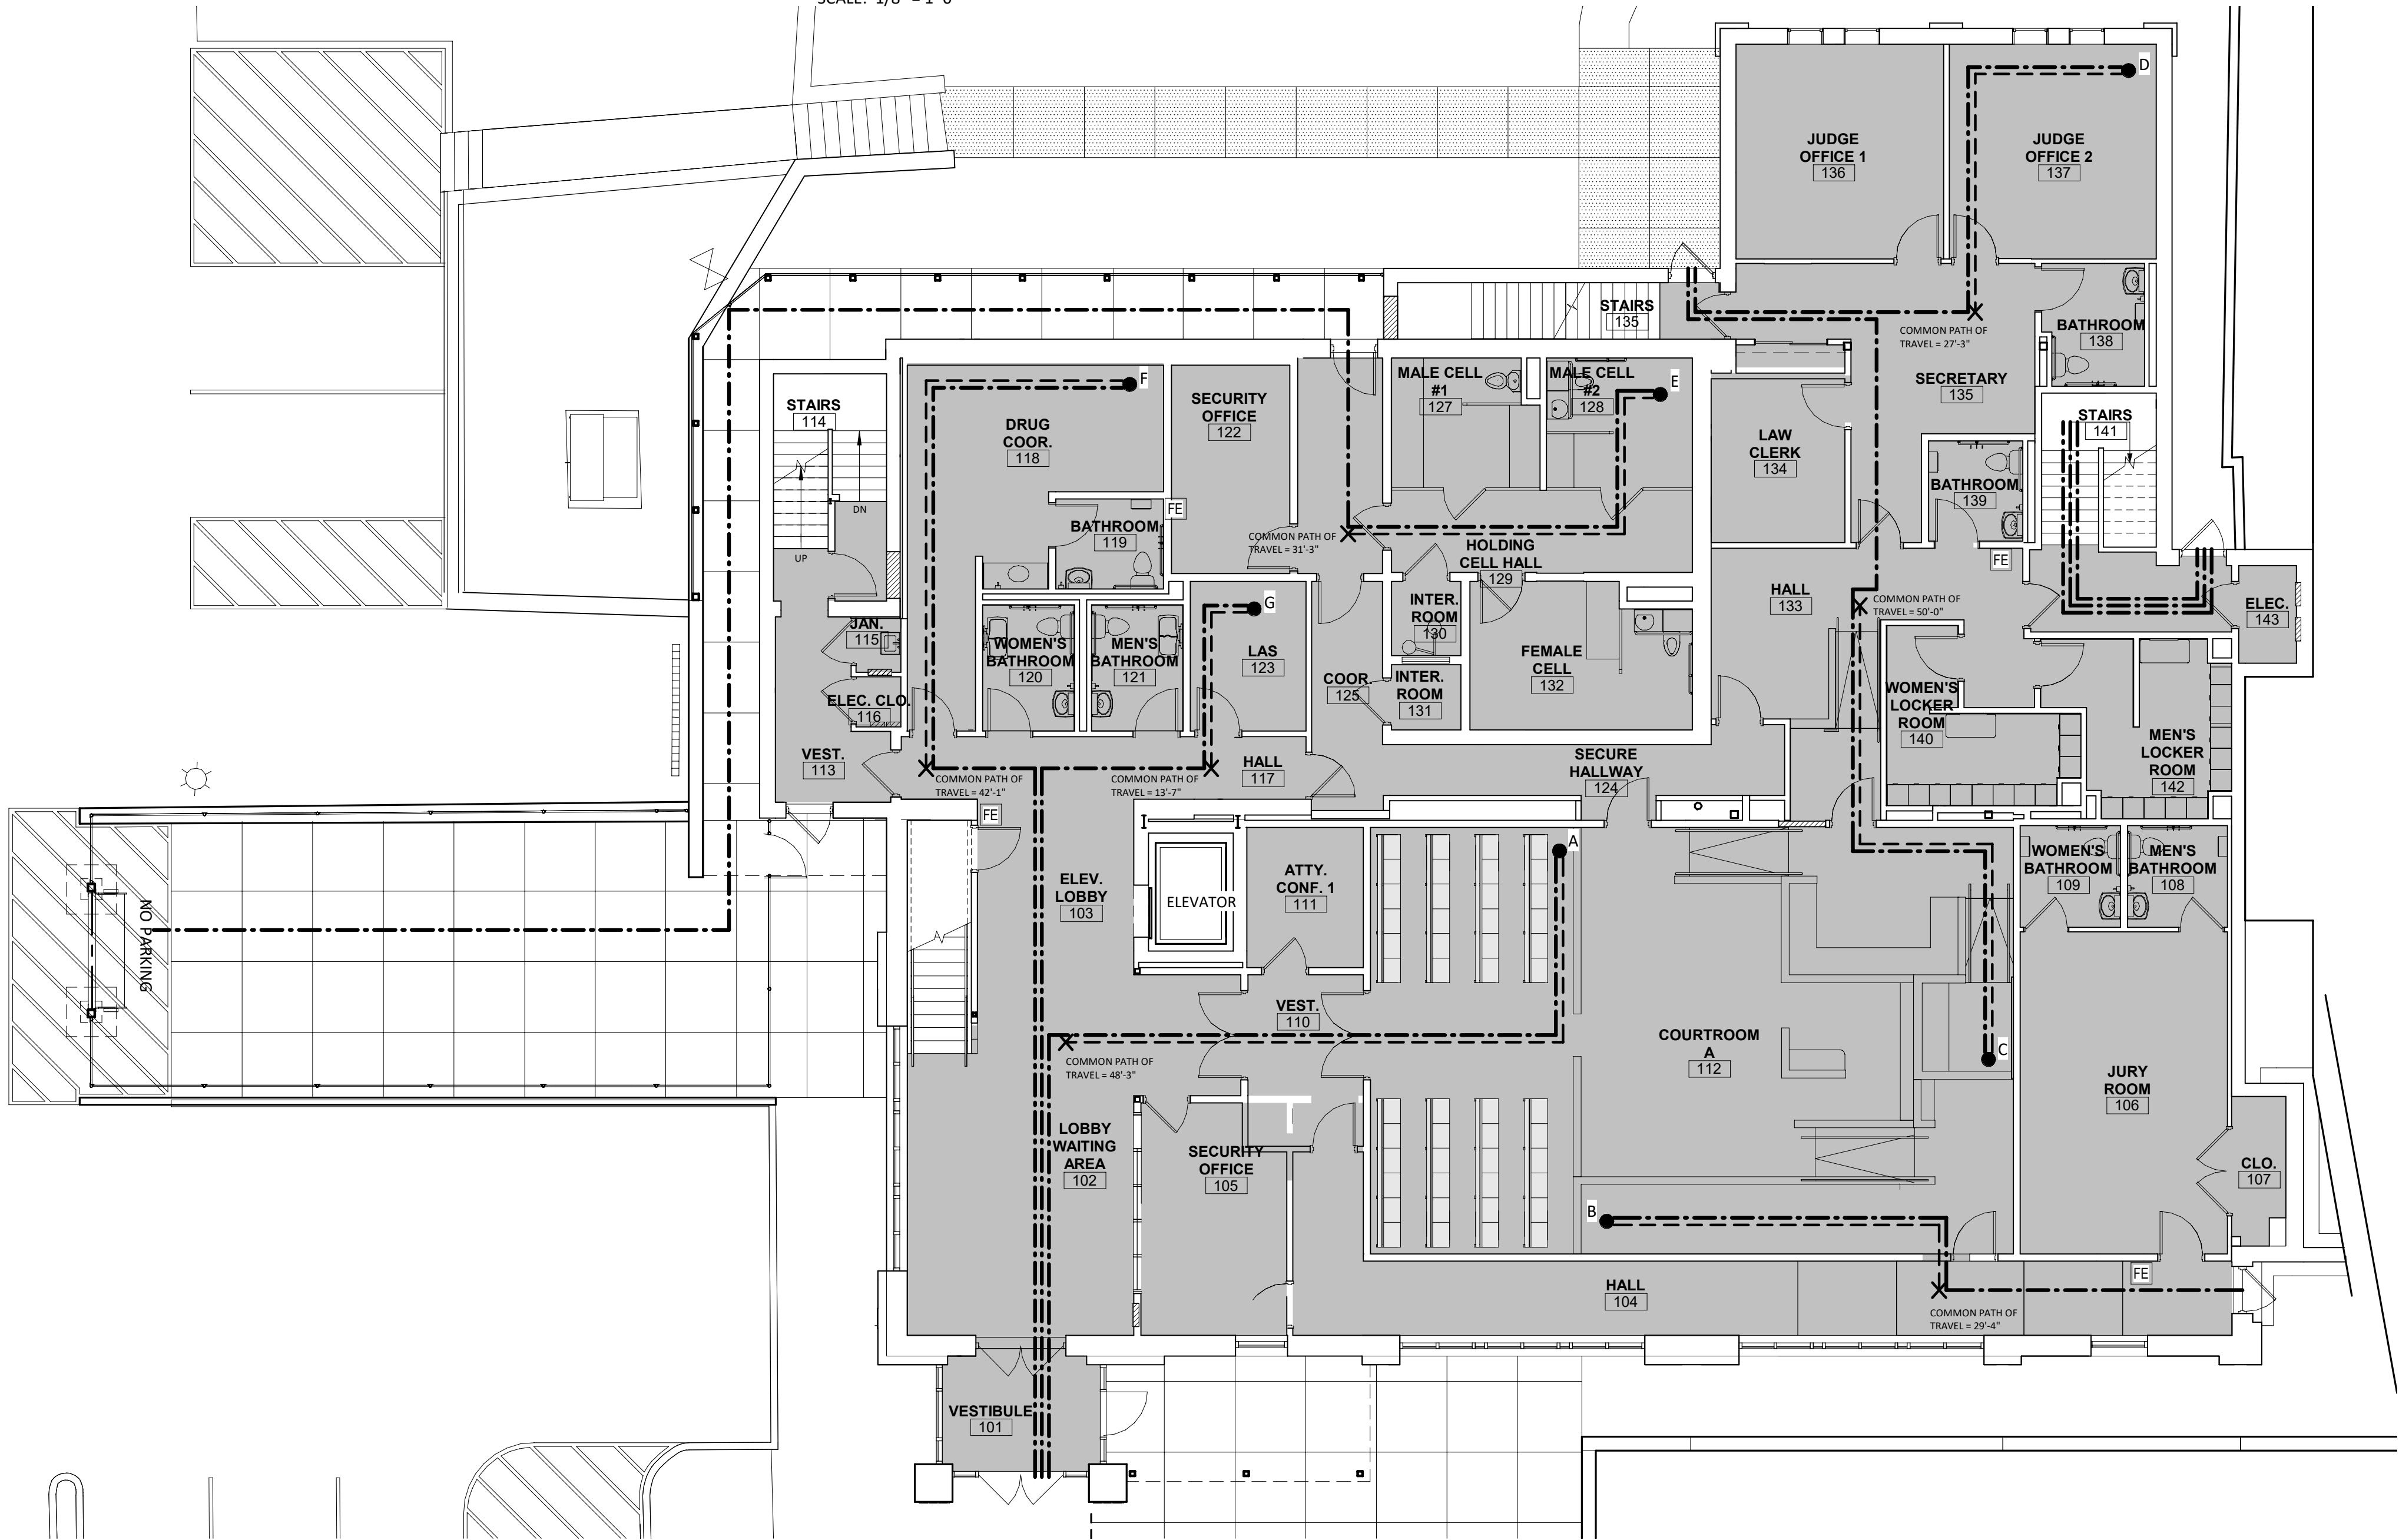

**FIRST FLOOR PLAN**

SCALE: 1/8" = 1'-0"

FE FIRE EXTINGUISHER

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**REVISIONS**

CITY OF MIDDLETOWN  
NEW COURTHOUSE FACILITY  
**BASEMENT & FIRST FLOOR EXITING PLANS**  
ORANGE COUNTY, NEW YORK

CITY OF MIDDLETOWN

CITY OF MIDDLETOWN

**Barton & Loguidice**  
443 Electronics Parkway  
Liverpool, NY 13088

**B&L**



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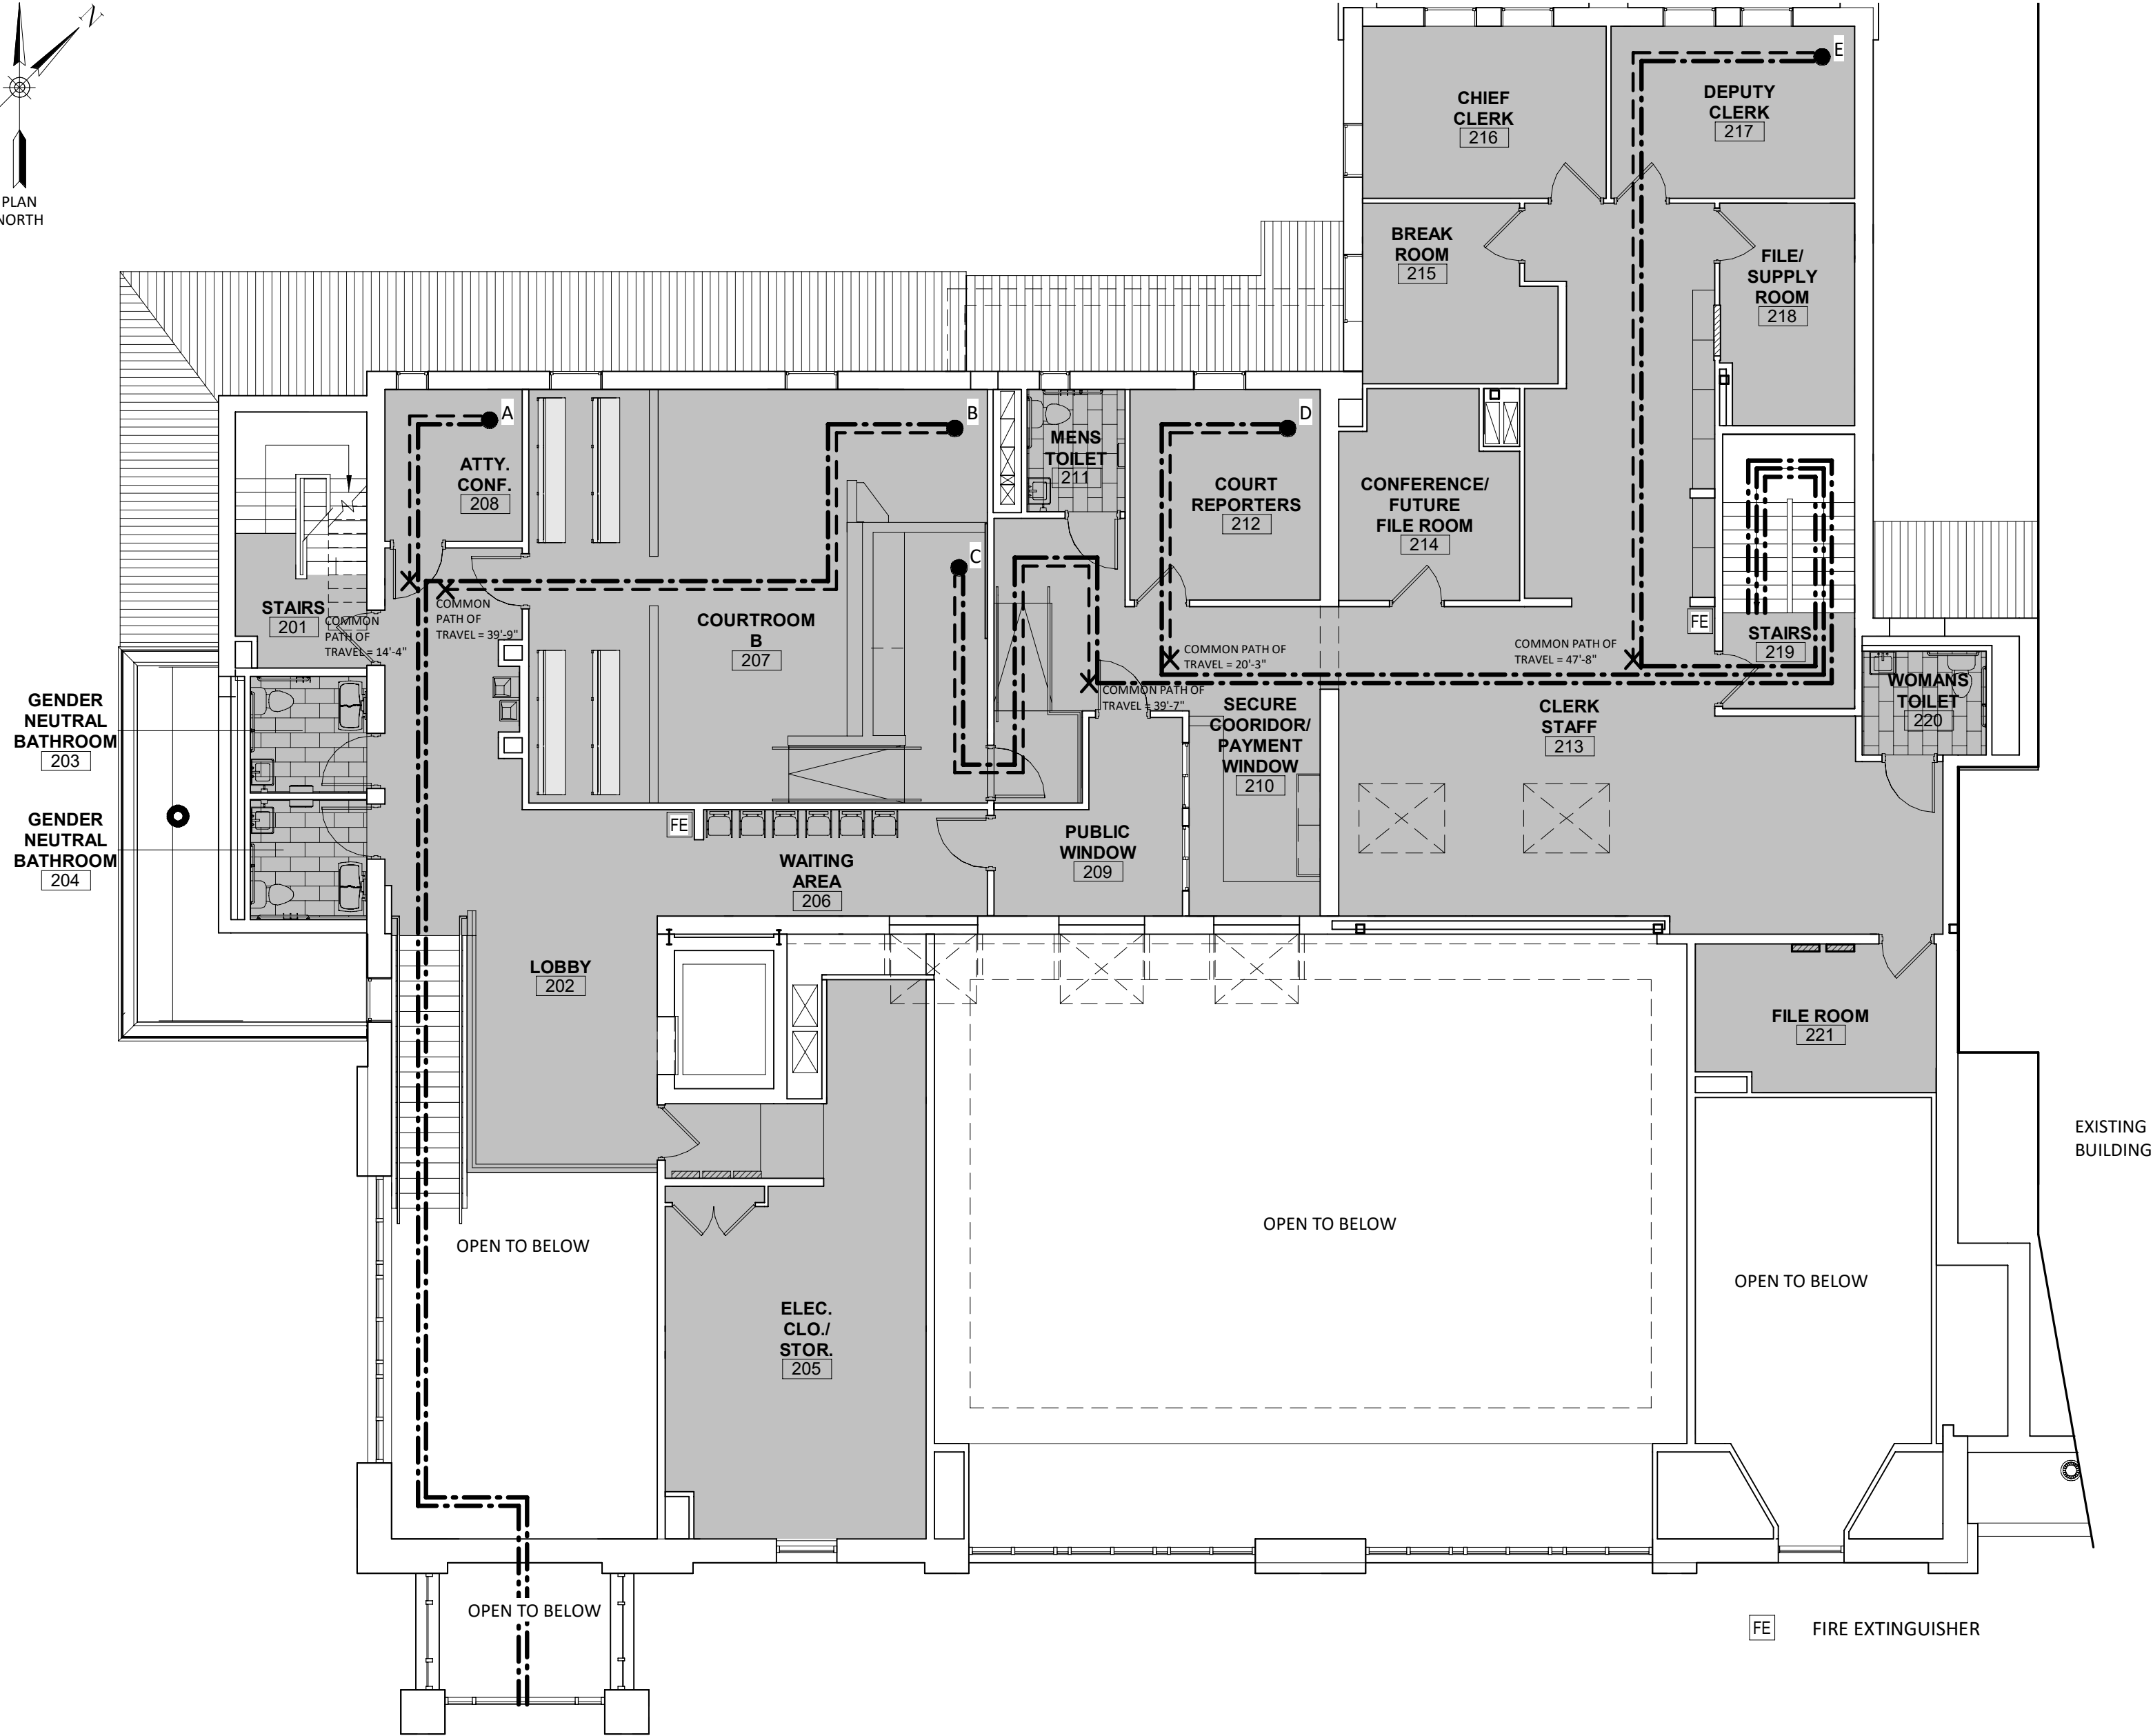
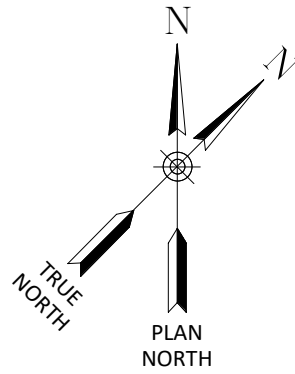
Date  
AUGUST, 2024

Scale  
AS SHOWN

Sheet Number  
**A002**

Project Number  
1753.008.001





**SECOND FLOOR PLAN**  
SCALE: 1/8" = 1'-0"

**SECOND FLOOR**  
**MAXIMUM EXIT TRAVEL DISTANCE (WITH**  
**SPRINKLER SYSTEM)**

A-3 - WITH SPRINKLER SYSTEM - 250 FEET  
B - WITH SPRINKLER SYSTEM - 300 FEET

EXIT & TRAVEL DISTANCE DATA	
EXIT ROUTE	DISTANCE
A	3' - 9"
A	65' - 1"
A	6' - 4"
A	12' - 4"
A:4	87' - 6"

EXIT & TRAVEL DISTANCE DATA	
EXIT ROUTE	DISTANCE
B	7' - 2"
B	9' - 6"
B	24' - 6"
B	55' - 4"
B	6' - 4"
B	12' - 4"
B:6	115' - 2"

EXIT & TRAVEL DISTANCE DATA	
EXIT ROUTE	DISTANCE
C	11' - 10"
C	4' - 1"
C	12' - 6"
C	4' - 0"
C	6' - 9"
C	44' - 8"
C	13' - 0"
C	4' - 6"
C	13' - 0"
C	9' - 6"
C	4' - 0"
C:11	127' - 10"

EXIT & TRAVEL DISTANCE DATA	
EXIT ROUTE	DISTANCE
D	7' - 2"
D	15' - 2"
D	40' - 0"
D	13' - 0"
D	4' - 6"
D	13' - 0"
D	9' - 6"
D	4' - 0"
D:8	106' - 4"

EXIT & TRAVEL DISTANCE DATA	
EXIT ROUTE	DISTANCE
E	10' - 4"
E	36' - 10"
E	10' - 10"
E	13' - 0"
E	4' - 6"
E	13' - 0"
E	9' - 6"
E	4' - 0"
E:8	102' - 0"


IT IS A VIOLATION OF THE NEW YORK STATE EDUCATION LAW, ARTICLE 145 §7209 SPECIAL PROVISIONS, FOR ANY PERSON, UNLESS THEY ARE ACTING UNDER THE DIRECTION OF A LICENSED PROFESSIONAL ENGINEER, ARCHITECT, LANDSCAPE ARCHITECT, OR LAND SURVEYOR, TO ALTER ANY ITEM IN ANY WAY IF AN ITEM BEARING THE STAMP OF A LICENSED PROFESSIONAL IS ALTERED, THE ALTERING PROFESSIONAL SHALL STAMP THE DOCUMENT AND INCLUDE THE NOTATION "ALTERED BY" FOLLOWED BY THEIR SIGNATURE, THE DATE OF SUCH ALTERATION, AND A SPECIFIC DESCRIPTION OF THE ALTERATION.

REVISIONS

CITY OF MIDDLETOWN  
NEW COURTHOUSE FACILITY  
**SECOND FLOOR EXITING PLAN**  
CITY OF MIDDLETOWN  
ORANGE COUNTY, NEW YORK

**Barton & Loguidice**  
443 Electronics Parkway  
Liverpool, NY 13088

NYS CERTIFICATE #  
0021642, 0020588, 0019903,  
0019905, 0020336

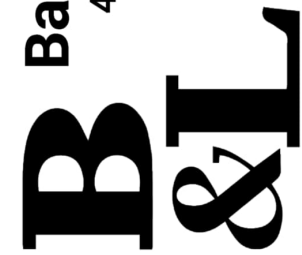

NYS EXP.:

Date  
AUGUST, 2024

Scale  
AS SHOWN

Sheet Number  
**A003**

Project Number  
1753.008.001







408.4.4 RELOCK CAPABILITY. DOORS REMOTELY UNLOCKED UNDER EMERGENCY CONDITIONS SHALL NOT AUTOMATICALLY RELOCK WHEN CLOSED UNLESS SPECIFIC ACTION IS TAKEN AT THE REMOTE LOCATION TO ENABLE DOORS TO RELOCK.

408.6 SMOKE BARRIER. OCCUPANCIES IN GROUP I-3 SHALL HAVE SMOKE BARRIERS COMPLYING WITH SECTIONS 408.6 AND 709 TO DIVIDE EVERY STORY OCCUPIED BY RESIDENTS FOR SLEEPING, OR ANY OTHER STORY HAVING AN OCCUPANT LOAD OF 50 OR MORE PERSONS, INTO NOT FEWER THAN TWO SMOKE COMPARTMENTS.

408.6.1 SMOKE COMPARTMENTS. THE NUMBER OF RESIDENTS IN ANY SMOKE COMPARTMENT SHALL BE NOT MORE THAN 200. THE DISTANCE OF TRAVEL TO A DOOR IN A SMOKE BARRIER FROM ANY ROOM DOOR REQUIRED AS EXIT ACCESS SHALL BE NOT GREATER THAN 150 FEET. THE DISTANCE OF TRAVEL TO A DOOR IN A SMOKE BARRIER FROM ANY POINT IN A ROOM SHALL BE NOT GREATER THAN 200 FEET.

408.6.2 REFUGE AREA. NOT LESS THAN 6 NET SQUARE FEET PER OCCUPANT SHALL BE PROVIDED ON EACH SIDE OF EACH SMOKE BARRIER FOR THE TOTAL NUMBER OF OCCUPANTS IN ADJOINING SMOKE COMPARTMENTS. THIS SPACE SHALL BE READILY AVAILABLE WHEREVER THE OCCUPANTS ARE MOVED ACROSS THE SMOKE BARRIER IN A FIRE EMERGENCY.

408.7 SECURITY GLAZING. IN OCCUPANCIES IN GROUP I-3, WINDOWS AND DOORS IN 1-HOUR FIRE BARRIERS CONSTRUCTED IN ACCORDANCE WITH SECTION 707, FIRE PARTITIONS CONSTRUCTED IN ACCORDANCE WITH SECTION 708 AND SMOKE BARRIERS CONSTRUCTED IN ACCORDANCE WITH SECTION 709 SHALL BE PERMITTED TO HAVE SECURITY GLAZING INSTALLED PROVIDED THAT THE FOLLOWING CONDITIONS ARE MET.

1. INDIVIDUAL PANELS OF GLAZING SHALL NOT EXCEED 1,296 SQUARE INCHES.
2. THE GLAZING SHALL BE PROTECTED ON BOTH SIDES BY AN AUTOMATIC SPRINKLER SYSTEM. THE SPRINKLER SYSTEM SHALL BE DESIGNED TO, WHEN ACTUATED, WET COMPLETELY THE ENTIRE SURFACE OF ANY GLAZING AFFECTED BY FIRE.
3. THE GLAZING SHALL BE IN A GASKETED FRAME AND INSTALLED IN SUCH A MANNER THAT THE FRAMING SYSTEM WILL DEFLECT WITHOUT BREAKING (LOADING) THE GLASS BEFORE THE SPRINKLER SYSTEM OPERATES.
4. OBSTRUCTIONS, SUCH AS CURTAIN RODS, DRAPERY TRAVERSE RODS, CURTAINS, DRAPES OR SIMILAR MATERIALS SHALL NOT BE INSTALLED BETWEEN THE AUTOMATIC SPRINKLERS AND THE GLAZING.

408.8.2 OCCUPANCY CONDITION 5. EACH SLEEPING AREA IN OCCUPANCY CONDITION 5 SHALL BE SEPARATED FROM ADJACENT SLEEPING AREAS, CORRIDORS AND COMMON SPACES BY A SMOKE-TIGHT PARTITION. ADDITIONALLY, COMMON SPACES SHALL BE SEPARATED FROM THE CORRIDOR BY A SMOKE-TIGHT PARTITION.

408.8.4 SMOKE-TIGHT DOORS. DOORS IN OPENINGS IN PARTITIONS REQUIRED TO BE SMOKE TIGHT BY SECTION 408.8 SHALL BE SUBSTANTIAL DOORS, OF CONSTRUCTION THAT WILL RESIST THE PASSAGE OF SMOKE. LATCHES AND DOOR CLOSURES ARE NOT REQUIRED ON CELL DOORS.

408.10 FIRE ALARM SYSTEM. A FIRE ALARM SYSTEM SHALL BE PROVIDED IN ACCORDANCE WITH SECTION 907.2.6.3.

408.11 AUTOMATIC SPRINKLER SYSTEM. GROUP I-3 OCCUPANCIES SHALL BE EQUIPPED THROUGHOUT WITH AN AUTOMATIC SPRINKLER SYSTEM IN ACCORDANCE WITH SECTION 903.2.6.

BC NYS CHAPTER 5 - GENERAL BUILDING HEIGHTS AND AREAS

504.2 MIXED OCCUPANCY. IN A BUILDING CONTAINING MIXED OCCUPANCIES IN ACCORDANCE WITH SECTION 508, NO INDIVIDUAL OCCUPANCY SHALL EXCEED THE HEIGHT AND NUMBER OF STORY LIMITS SPECIFIED IN THIS SECTION FOR THE APPLICABLE OCCUPANCIES.

504.3 HEIGHT IN FEET. THE MAXIMUM HEIGHT, IN FEET, OF A BUILDING SHALL NOT EXCEED THE LIMITS SPECIFIED IN TABLE 504.3.

TABLE 504.3 ALLOWABLE BUILDING HEIGHT IN FEET ABOVE GRADE PLANE

A & B - S - TYPE II B - 75 FEET  
I-3 - S - TYPE II B - 75 FEET

504.4 NUMBER OF STORIES. THE MAXIMUM NUMBER OF STORIES OF A BUILDING SHALL NOT EXCEED THE LIMITS SPECIFIED IN TABLE 504.4.

TABLE 504.4 ALLOWABLE NUMBER OF STORIES ABOVE GRADE PLANE

A-3 - S - TYPE II B - 3 STORIES  
B - S - TYPE II B - 4 STORIES  
I-3 - S - TYPE II B - 2 STORIES

506.2 ALLOWABLE AREA DETERMINATION. THE ALLOWABLE AREA OF A BUILDING SHALL BE DETERMINED IN ACCORDANCE WITH THE APPLICABLE PROVISIONS OF SECTION 506.2.1 THROUGH 506.2.4 AND SECTION 506.3.

TABLE 506.2 ALLOWABLE AREA FACTOR IN SQUARE FEET

A-3 - SM - TYPE II B - 28,500 SQUARE FEET  
B - SM - TYPE II B - 69,000 SQUARE FEET  
I-3 - SM - TYPE II B - 30,000 SQUARE FEET

506.2.4 MIXED-OCCUPANCY, MULTISTORY BUILDINGS. EACH STORY OF A MIXED-OCCUPANCY BUILDING WITH MORE THAN ONE STORY ABOVE GRADE PLANE SHALL INDIVIDUALLY COMPLY WITH THE APPLICABLE REQUIREMENTS OF SECTION 508.1. FOR BUILDINGS WITH MORE THAN THREE STORIES ABOVE GRADE PLANE, THE TOTAL BUILDING AREA SHALL BE SUCH THAT THE AGGREGATE SUM OF THE RATIOS OF THE ACTUAL AREA OF EACH STORY DIVIDED BY THE ALLOWABLE AREA OF SUCH STORIES, DETERMINED IN ACCORDANCE WITH EQUATION 5-3 BASED ON THE APPLICABLE PROVISIONS OF SECTION 508.1, SHALL NOT EXCEED THREE.

508.1 GENERAL. EACH PORTION OF A BUILDING SHALL BE INDIVIDUALLY CLASSIFIED IN ACCORDANCE WITH SECTION 302.1. WHERE A BUILDING CONTAINS MORE THAN ONE OCCUPANCY GROUP, THE BUILDING OR PORTION THEREOF SHALL COMPLY WITH THE APPLICABLE PROVISIONS OF SECTION 508.2, 508.3 OR 508.4, OR A COMBINATION OF THESE SECTIONS.

508.2 ACCESSORY OCCUPANCIES. ACCESSORY OCCUPANCIES ARE THOSE OCCUPANCIES THAT ARE ANCILLARY TO THE MAIN OCCUPANCY OF THE BUILDING OR PORTION THEREOF. ACCESSORY OCCUPANCIES SHALL COMPLY WITH THE PROVISIONS OF SECTION 508.2.1 THROUGH 508.2.4.

508.2.1 OCCUPANCY CLASSIFICATION. ACCESSORY OCCUPANCIES SHALL BE INDIVIDUALLY CLASSIFIED IN ACCORDANCE WITH SECTION 302.1. THE REQUIREMENTS OF THIS CODE SHALL APPLY TO EACH PORTION OF THE BUILDING BASED ON THE OCCUPANCY CLASSIFICATION OF THAT SPACE.

508.2.3 ALLOWABLE BUILDING AREA. THE ALLOWABLE AREA OF THE BUILDING SHALL BE BASED ON THE APPLICABLE PROVISIONS OF SECTION 506 FOR THE MAIN OCCUPANCY OF THE BUILDING. AGGREGATE ACCESSORY OCCUPANCIES SHALL NOT OCCUPY MORE THAN 10 PERCENT OF THE FLOOR AREA OF THE STORY IN WHICH THEY ARE LOCATED AND SHALL NOT EXCEED THE TABULAR VALUES FOR NONSPRINKLERED BUILDINGS IN TABLE 506.2 FOR EACH SUCH ACCESSORY OCCUPANCY.

508.2.4 SEPARATION OF OCCUPANCIES. NO SEPARATION IS REQUIRED BETWEEN ACCESSORY OCCUPANCIES AND THE MAIN OCCUPANCY.

508.4 SEPARATED OCCUPANCIES. BUILDINGS OR PORTIONS OF BUILDINGS THAT COMPLY WITH THE PROVISIONS OF THIS SECTION SHALL BE CONSIDERED AS SEPARATED OCCUPANCIES.

TABLE 508.4 REQUIRED SEPARATION OF OCCUPANCIES

A, B & I-3 - S - 1 HOUR REQUIRED SEPARATION

508.4.2 ALLOWABLE BUILDING AREA. IN EACH STORY, THE BUILDING AREA SHALL BE SUCH THAT THE SUM OF THE RATIOS OF THE ACTUAL BUILDING AREA OF EACH SEPARATE OCCUPANCY DIVIDED BY THE ALLOWABLE BUILDING AREA OF EACH SEPARATED OCCUPANCY SHALL NOT EXCEED 1.

FIRST FLOOR AREA= ((XXX/28,500)+(XXX/69,000)+(XXX/30,000)) =  
SECOND FLOOR AREA= ((XXX/28,500)+(XXX/69,000)) =

508.4.4.1 CONSTRUCTION. REQUIRED SEPARATIONS SHALL BE FIRE BARRIERS CONSTRUCTED IN ACCORDANCE WITH SECTION 707 OR HORIZONTAL ASSEMBLIES CONSTRUCTED IN ACCORDANCE WITH SECTION 711, OR BOTH, SO AS TO COMPLETELY SEPARATE ADJACENT OCCUPANCIES.

BC NYS CHAPTER 6 - TYPES OF CONSTRUCTION

601.1 SCOPE. THE PROVISIONS OF THIS CHAPTER SHALL CONTROL THE CLASSIFICATION OF BUILDINGS AS TO TYPE OF CONSTRUCTION.

TABLE 601 FIRE-RESISTANCE RATING REQUIREMENTS FOR BUILDING ELEMENTS

PRIMARY STRUCTURAL FRAME - TYPE II B - 0 HOURS  
BEARING WALLS - TYPE II B - 0 HOURS  
NONBEARING WALLS AND PARTITIONS - TYPE II B - 0 HOURS  
FLOOR CONSTRUCTION AND ASSOCIATED SECONDARY MEMBERS - TYPE II B - 0 HOURS  
ROOF CONSTRUCTION AND ASSOCIATED SECONDARY MEMBERS - TYPE II B - 0 HOURS

602.1 GENERAL. BUILDINGS AND STRUCTURES ERECTED OR TO BE ERECTED, ALTERED OR EXTENDED IN HEIGHT OR AREA SHALL BE CLASSIFIED IN ONE OF THE FIVE CONSTRUCTION TYPES DEFINED IN SECTIONS 602.2 THROUGH 602.5. THE BUILDING ELEMENTS SHALL HAVE A FIRE-RESISTANCE RATING NOT LESS THAN THAT SPECIFIED IN TABLE 601 AND EXTERIOR WALLS SHALL HAVE A FIRE-RESISTANCE RATING NOT LESS THAN THAT SPECIFIED IN TABLE 602. WHERE REQUIRED TO HAVE A FIRE-RESISTANCE RATING BY TABLE 601, BUILDING ELEMENTS SHALL COMPLY WITH THE APPLICABLE PROVISIONS OF SECTION 703.2. THE PROTECTION OF OPENINGS, DUCTS AND AIR TRANSFER OPENINGS IN BUILDING ELEMENTS SHALL NOT BE REQUIRED UNLESS REQUIRED BY OTHER PROVISIONS OF THIS CODE.

TABLE 602 FIRE-RESISTANCE RATING REQUIREMENTS FOR EXTERIOR WALLS BASED ON FIRE SEPARATION DISTANCE

DISTANCE GREATER THAN 10 FEET - TYPE II B - A, B, & I OCCUPANCIES - 0 HOURS

BC NYS CHAPTER 7 - FIRE AND SMOKE PROTECTION FEATURES

703.2 FIRE-RESISTANCE RATING. THE FIRE-RESISTANCE RATING OF BUILDING ELEMENTS, COMPONENTS OR ASSEMBLIES SHALL BE DETERMINED IN ACCORDANCE WITH THE TEST PROCEDURES SET FORTH IN ASTM E119 OR UL 263 OR IN ACCORDANCE WITH SECTION 703.3. THE FIRE-RESISTANCE RATING OF PENETRATIONS AND FIRE-RESISTANT JOINT SYSTEMS SHALL BE DETERMINED IN ACCORDANCE WITH SECTIONS 714 AND 715, RESPECTIVELY.

707.3.1 SHAFT ENCLOSURES. THE FIRE-RESISTANCE RATING OF THE FIRE BARRIER SEPARATING BUILDING AREAS FROM A SHAFT SHALL COMPLY WITH SECTION 713.4.

707.3.2 INTERIOR EXIT STAIRWAY AND RAMP CONSTRUCTION. THE FIRE-RESISTANCE RATING OF THE FIRE BARRIER SEPARATING BUILDING AREAS FROM AN INTERIOR EXIT STAIRWAY OR RAMP SHALL COMPLY WITH SECTION 1023.1.

707.3.3 ENCLOSURES FOR EXIT ACCESS STAIRWAYS. THE FIRE-RESISTANCE RATING OF THE FIRE BARRIER SEPARATING BUILDING AREAS FROM AN EXIT ACCESS STAIRWAY OR RAMP SHALL COMPLY WITH SECTION 713.4.

707.3.4 EXIT PASSAGEWAY. THE FIRE-RESISTANCE RATING OF THE FIRE BARRIER SEPARATING BUILDING AREAS FROM AN EXIT PASSAGEWAY SHALL COMPLY WITH SECTION 1024.3.

707.3.5 HORIZONTAL EXIT. THE FIRE-RESISTANCE RATING OF THE SEPARATION BETWEEN BUILDING AREAS CONNECTED BY A HORIZONTAL EXIT SHALL COMPLY WITH SECTION 1026.1.

707.3.6 ATRIUMS. THE FIRE-RESISTANCE RATING OF THE FIRE BARRIER SEPARATING ATRIUMS SHALL COMPLY WITH SECTION 404.6.

707.3.9 SEPARATED OCCUPANCIES. WHERE THE PROVISIONS OF SECTION 508.4 ARE APPLICABLE, THE FIRE BARRIER SEPARATING MIXED OCCUPANCIES SHALL HAVE A FIRE-RESISTANCE RATING OF NOT LESS THAN THAT INDICATED IN TABLE 508.4 BASED ON THE OCCUPANCIES BEING SEPARATED.

707.5 CONTINUITY. FIRE BARRIERS SHALL EXTEND FROM THE TOP OF THE FOUNDATION OR FLOOR/CEILING ASSEMBLY BELOW TO THE UNDERSIDE OF THE FLOOR OR ROOF SHEATHING, SLAB OR DECK ABOVE AND SHALL BE SECURELY ATTACHED THERETO. SUCH FIRE BARRIERS SHALL BE CONTINUOUS THROUGH CONCEALED SPACE, SUCH AS THE SPACE ABOVE A SUSPENDED CEILING. JOINTS AND VOIDS AT INTERSECTIONS SHALL COMPLY WITH SECTIONS 707.8 AND 707.9.

707.5.1 SUPPORTING CONSTRUCTION. THE SUPPORTING CONSTRUCTION FOR A FIRE BARRIER SHALL BE PROTECTED TO AFFORD THE REQUIRED FIRE-RESISTANCE RATING OF THE FIRE BARRIER SUPPORTED. HOLLOW VERTICAL SPACES WITHIN A FIRE BARRIER SHALL BE FIREBLOCKED IN ACCORDANCE WITH SECTION 718.2 AT EVERY FLOOR LEVEL.

707.6 OPENINGS. OPENINGS IN A FIRE BARRIER SHALL BE PROTECTED IN ACCORDANCE WITH SECTION 716. OPENINGS SHALL BE LIMITED TO A MAXIMUM AGGREGATE WIDTH OF 25 PERCENT OF THE LENGTH OF THE WALL, AND THE MAXIMUM AREA OF ANY SINGLE OPENING SHALL NOT EXCEED 156 SQUARE FEET. OPENINGS IN ENCLOSURES FOR EXIT ACCESS STAIRWAYS AND RAMPS, INTERIOR EXIT STAIRWAYS AND RAMPS AND EXIT PASSAGEWAYS SHALL ALSO COMPLY WITH SECTIONS 1019, 1023.4 AND 1024.5, RESPECTIVELY. EXCEPTIONS: 1. OPENINGS SHALL NOT BE LIMITED TO 156 SQUARE FEET WHERE ADJOINING FLOOR AREAS ARE EQUIPPED THROUGHOUT WITH AN AUTOMATIC SPRINKLER SYSTEM IN ACCORDANCE WITH SECTION 903.3.1.1.

707.7 PENETRATIONS. PENETRATIONS OF FIRE BARRIERS SHALL COMPLY WITH SECTION 714.

707.8 JOINTS. JOINTS MADE IN OR BETWEEN FIRE BARRIERS, AND JOINTS MADE AT THE INTERSECTION OF FIRE BARRIERS WITH UNDERSIDE OF A FIRE-RESISTANCE-RATED FLOOR OR ROOF SHEATHING, SLAB OR DECK ABOVE, AND THE EXTERIOR VERTICAL WALL INTERSECTION SHALL COMPLY WITH SECTION 715.

707.9 VOIDS AT INTERSECTIONS. THE VOIDS CREATED AT THE INTERSECTION OF A FIRE BARRIER AND A NONFIRE-RESISTANCE-RATED ROOF ASSEMBLY OR A NONFIRE-RESISTANCE-RATED EXTERIOR WALL ASSEMBLY SHALL BE FILLED. AN APPROVED MATERIAL OR SYSTEM SHALL BE USED TO FILL THE VOID, AND SHALL BE SECURELY INSTALLED IN OR ON THE INTERSECTION FOR ITS ENTIRE LENGTH SO AS NOT TO DISLODGE, LOOSEN OR OTHERWISE IMPAIR ITS ABILITY TO ACCOMMODATE EXPECTED BUILDING MOVEMENTS AND TO RETARD THE PASSAGE OF FIRE AND HOT GASES.

707.10 DUCTS AND AIR TRANSFER OPENINGS. PENETRATIONS IN A FIRE BARRIER BY DUCTS AND AIR TRANSFER OPENINGS SHALL COMPLY WITH SECTION 717.

708.3 FIRE-RESISTANCE RATING. FIRE PARTITIONS SHALL HAVE A FIRE-RESISTANCE RATING OF NOT LESS THAN 1 HOUR.

708.4 CONTINUITY. FIRE PARTITIONS SHALL EXTEND FROM THE TOP OF THE FOUNDATION OR FLOOR/CEILING ASSEMBLY BELOW AND BE SECURELY ATTACHED TO ONE OF THE FOLLOWING:

1. THE UNDERSIDE OF THE FLOOR OR ROOF SHEATHING, DECK OR SLAB ABOVE.
2. THE UNDERSIDE OF A FLOOR/CEILING OR ROOF/CEILING ASSEMBLY HAVING A FIRE-RESISTANCE RATING THAT IS NOT LESS THAN THE FIRE-RESISTANCE RATING OF THE FIRE PARTITION.

711.2.4.1 SEPARATING MIXED OCCUPANCIES. WHERE THE HORIZONTAL ASSEMBLY SEPARATES MIXED OCCUPANCIES, THE ASSEMBLY SHALL HAVE A FIRE-RESISTANCE RATING OF NOT LESS THAN THAT REQUIRED BY SECTION 508.4 BASED ON THE OCCUPANCIES BEING SEPARATED.

713.4 FIRE-RESISTANCE RATING. SHAFT ENCLOSURES SHALL HAVE A FIRE-RESISTANCE RATING OF NOT LESS THAN 2 HOURS WHERE CONNECTING FOUR STORIES OR MORE, AND NOT LESS THAN 1 HOUR WHERE CONNECTING LESS THAN FOUR STORIES. THE NUMBER OF STORIES CONNECTED BY THE SHAFT ENCLOSURE SHALL INCLUDE ANY BASEMENTS BUT NOT ANY MEZZANINES. SHAFT ENCLOSURES SHALL HAVE A FIRE-RESISTANCE RATING NOT LESS THAN THE FLOOR ASSEMBLY PENETRATED, BUT NEED NOT EXCEED 2 HOURS. SHAFT ENCLOSURES SHALL MEET THE REQUIREMENTS OF SECTION 703.2.1.

713.5 CONTINUITY. SHAFT ENCLOSURES SHALL BE CONSTRUCTED AS FIRE BARRIERS IN ACCORDANCE WITH SECTION 707 OR HORIZONTAL ASSEMBLIES CONSTRUCTED IN ACCORDANCE WITH SECTION 711, OR BOTH, AND SHALL HAVE CONTINUITY IN ACCORDANCE WITH SECTION 707.5 FOR FIRE BARRIERS OR SECTION 711.2.2 FOR HORIZONTAL ASSEMBLIES, AS APPLICABLE.

714.2 INSTALLATION. A LISTED PENETRATION FIRESTOP SYSTEM SHALL BE INSTALLED IN ACCORDANCE WITH THE MANUFACTURER'S INSTALLATION INSTRUCTIONS AND THE LISTING CRITERIA.

714.3 INSTALLATION DETAILS. WHERE SLEEVES ARE USED, THEY SHALL BE SECURELY FASTENED TO THE ASSEMBLY PENETRATED. THE SPACE BETWEEN THE ITEM CONTAINED IN THE SLEEVE AND THE SLEEVE ITSELF AND ANY SPACE BETWEEN THE SLEEVE AND THE ASSEMBLY PENETRATED SHALL BE PROTECTED IN ACCORDANCE WITH THIS SECTION. INSULATION AND COVERINGS ON OR IN THE PENETRATING ITEM SHALL NOT PENETRATE THE ASSEMBLY UNLESS THE SPECIFIC MATERIAL USED HAS BEEN TESTED AS PART OF THE ASSEMBLY IN ACCORDANCE WITH THIS SECTION.

714.4.1.1 FIRE-RESISTANCE-RATED ASSEMBLIES. THROUGH PENETRATIONS SHALL BE PROTECTED USING SYSTEMS INSTALLED AS TESTED IN THE APPROVED FIRE-RESISTANCE-RATED ASSEMBLY.

714.4.1.2 THROUGH-PENETRATION FIRESTOP SYSTEM. THROUGH PENETRATIONS SHALL BE PROTECTED BY AN APPROVED PENETRATION FIRESTOP SYSTEM INSTALLED AS TESTED IN ACCORDANCE WITH ASTM E814 OR UL 1479, WITH A MINIMUM POSITIVE PRESSURE DIFFERENTIAL OF 0.01 INCH OF WATER AND SHALL HAVE AN F RATING OF NOT LESS THAN THE REQUIRED FIRE-RESISTANCE RATING OF THE WALL PENETRATED.

714.4.3 DISSIMILAR MATERIALS. NONCOMBUSTIBLE PENETRATING ITEMS SHALL NOT CONNECT TO COMBUSTIBLE ITEMS BEYOND THE POINT OF FIRESTOPPING UNLESS IT CAN BE DEMONSTRATED THAT THE FIRE-RESISTANCE INTEGRITY OF THE WALL IS MAINTAINED.

714.5.1.1 FIRE-RESISTANCE-RATED ASSEMBLIES. THROUGH PENETRATIONS SHALL BE PROTECTED USING SYSTEMS INSTALLED AS TESTED IN THE APPROVED FIRE-RESISTANCE-RATED ASSEMBLY.

714.5.1.2 THROUGH-PENETRATION FIRESTOP SYSTEM. THROUGH PENETRATIONS SHALL BE PROTECTED BY AN APPROVED THROUGH-PENETRATION FIRESTOP SYSTEM INSTALLED AND TESTED IN ACCORDANCE WITH ASTM E814 OR UL 1479, WITH A MINIMUM POSITIVE PRESSURE DIFFERENTIAL OF 0.01 INCH OF WATER. THE SYSTEM SHALL HAVE AN F RATING/T RATING OF NOT LESS THAN 1 HOUR BUT NOT LESS THAN THE REQUIRED RATING OF THE FLOOR PENETRATED.

714.5.3 DISSIMILAR MATERIALS. NONCOMBUSTIBLE PENETRATING ITEMS SHALL NOT CONNECT TO COMBUSTIBLE MATERIALS BEYOND THE POINT OF FIRESTOPPING UNLESS IT CAN BE DEMONSTRATED THAT THE FIRE-RESISTANCE INTEGRITY OF THE HORIZONTAL ASSEMBLY IS MAINTAINED.

714.6.1 NONCOMBUSTIBLE PENETRATING ITEMS. NONCOMBUSTIBLE PENETRATING ITEMS THAT CONNECT NOT MORE THAN FIVE STORIES ARE PERMITTED, PROVIDED THAT THE ANNULAR SPACE IS FILLED TO RESIST THE FREE PASSAGE OF FLAME AND THE PRODUCTS OF COMBUSTION WITH AN APPROVED NONCOMBUSTIBLE MATERIAL OR WITH A FILL, VOID OR CAVITY MATERIAL THAT IS TESTED AND CLASSIFIED FOR USE IN THROUGH-PENETRATION FIRESTOP SYSTEMS.

714.6.2 PENETRATING ITEMS. PENETRATING ITEMS THAT CONNECT NOT MORE THAN TWO STORIES ARE PERMITTED, PROVIDED THAT THE ANNULAR SPACE IS FILLED WITH AN APPROVED MATERIAL TO RESIST THE FREE PASSAGE OF FLAME AND THE PRODUCTS OF COMBUSTION.

715.1 GENERAL. JOINTS INSTALLED IN OR BETWEEN FIRE-RESISTANCE-RATED WALLS, FLOOR OR FLOOR/CEILING ASSEMBLIES AND ROOFS OR ROOF/CEILING ASSEMBLIES SHALL BE PROTECTED BY AN APPROVED FIRE-RESISTANT JOINT SYSTEM DESIGNED TO RESIST THE PASSAGE OF FIRE FOR A TIME PERIOD NOT LESS THAN THE REQUIRED FIRE-RESISTANCE RATING OF THE WALL, FLOOR OR ROOF IN OR BETWEEN WHICH THE SYSTEM IS INSTALLED. FIRE-RESISTANT JOINT SYSTEMS SHALL BE TESTED IN ACCORDANCE WITH SECTION 715.3.

715.3 FIRE TEST CRITERIA. FIRE-RESISTANT JOINT SYSTEMS SHALL BE TESTED IN ACCORDANCE WITH THE REQUIREMENTS OF EITHER ASTM E1996 OR UL 2079. NONSYMMETRICAL WALL JOINT SYSTEMS SHALL BE TESTED WITH BOTH FACES EXPOSED TO THE FURNACE, AND THE ASSIGNED FIRE-RESISTANCE RATING SHALL BE THE SHORTEST DURATION OBTAINED FROM THE TWO TESTS. WHERE EVIDENCE IS FURNISHED TO SHOW THAT THE WALL WAS TESTED WITH THE LEAST FIRE-RESISTANT SIDE EXPOSED TO THE FURNACE, SUBJECT TO ACCEPTANCE OF THE BUILDING OFFICIAL, THE WALL NEED NOT BE SUBJECTED TO TESTS FROM THE OPPOSITE SIDE.

TABLE 716.1(2) OPENING FIRE PROTECTION ASSEMBLIES, RATINGS AND MARKINGS  
FIRE BARRIERS - 1 HOUR WALL ASSEMBLY - 1 HOUR FIRE DOOR W/ 100 SQ. IN. MAX VISION PANEL (D-H-60)

TABLE 716.1(3) FIRE WINDOW ASSEMBLY FIRE PROTECTION RATINGS  
ATRIUM SEPARATIONS - 1 HOUR WALL ASSEMBLY - 3/4 HOUR WINDOW ASSEMBLY W/ OH-45 OR W-60

716.2.6.1 DOOR CLOSING. FIRE DOORS SHALL BE LATCHING AND SELF OR AUTOMATIC CLOSING IN ACCORDANCE WITH THIS SECTION.

716.2.6.2 LATCH REQUIRED. UNLESS OTHERWISE SPECIFICALLY PERMITTED, SINGLE SIDE-HINGED SWINGING FIRE DOORS AND BOTH LEAVES OF PAIRS OF SIDE-HINGED SWINGING FIRE DOORS SHALL BE PROVIDED WITH AN ACTIVE LATCH BOLT THAT WILL SECURE THE DOOR WHEN IT IS CLOSED.

716.2.6.4 AUTOMATIC-CLOSING FIRE DOOR ASSEMBLIES. AUTOMATIC-CLOSING FIRE DOOR ASSEMBLIES SHALL BE SELF-CLOSING IN ACCORDANCE WITH NFPA 80.

716.2.6.5 DELAYED-ACTION CLOSERS. DOORS REQUIRED TO BE SELF-CLOSING AND NOT REQUIRED TO BE AUTOMATIC CLOSING SHALL BE PERMITTED TO BE EQUIPPED WITH DELAYED-ACTION CLOSERS.

716.2.9 LABELED PROTECTIVE ASSEMBLIES. FIRE DOOR ASSEMBLIES SHALL BE LABELED BY AN APPROVED AGENCY. THE LABEL SHALL COMPLY WITH NFPA 80, AND SHALL BE PERMANENTLY AFFIXED TO THE DOOR OR FRAME.

716.3.1 TESTING REQUIREMENTS. FIRE WINDOW ASSEMBLIES SHALL BE CONSTRUCTED OF ANY MATERIAL OR ASSEMBLY OF COMPONENT MATERIALS THAT CONFORMS TO THE TEST REQUIREMENTS OF SECTIONS 716.3.1.1 AND 716.1.2 AND THE FIRE PROTECTION RATING INDICATED IN TABLE 716.1(3).

716.3.2 PERFORMANCE REQUIREMENTS. FIRE WINDOW ASSEMBLIES SHALL BE INSTALLED IN THE ASSEMBLIES AND COMPLY WITH THE FIRE PROTECTION RATING SPECIFIED IN TABLE 716.1(3).

716.3.5 LABELED PROTECTIVE ASSEMBLIES. GLAZING IN FIRE WINDOW ASSEMBLIES SHALL BE LABELED BY AN APPROVED AGENCY. THE LABELS SHALL COMPLY WITH NFPA 80 AND SECTION 716.3.5.2.

716.3.5.2 LABELING REQUIREMENTS. FIRE-PROTECTION-RATED GLAZING SHALL BEAR A LABEL OR OTHER IDENTIFICATION SHOWING THE NAME OF THE MANUFACTURER, THE TEST STANDARD AND INFORMATION REQUIRED IN SECTION 716.1.2.2 AND TABLE 716.1(3) THAT SHALL BE ISSUED BY AN APPROVED AGENCY AND PERMANENTLY IDENTIFIED ON THE GLAZING.

717.5.2 FIRE BARRIERS. DUCTS AND AIR TRANSFER OPENINGS OF FIRE BARRIERS SHALL BE PROTECTED WITH LISTED FIRE DAMPERS INSTALLED IN ACCORDANCE WITH THEIR LISTING. DUCTS AND AIR TRANSFER OPENINGS SHALL NOT PENETRATE ENCLOSURES FOR INTERIOR EXIT STAIRWAYS AND RAMPS AND EXIT PASSAGEWAYS, EXCEPT AS PERMITTED BY SECTIONS 1023.5 AND 1024.6, RESPECTIVELY.

717.5.3 SHAFT ENCLOSURES. SHAFT ENCLOSURES THAT ARE PERMITTED TO BE PENETRATED BY DUCTS AND AIR TRANSFER OPENINGS SHALL BE PROTECTED WITH LISTED FIRE AND SMOKE DAMPERS INSTALLED IN ACCORDANCE WITH THEIR LISTING.

BC NYS CHAPTER 8 - INTERIOR FINISHES

TABLE 803.13 INTERIOR WALL AND CEILING FINISH REQUIREMENTS BY OCCUPANCY

A-3 - SPRINKLERED  
- INTERIOR EXIT STAIRWAYS - B  
- CORRIDORS AND ENCLOSURE FOR EXIT ACCESS STAIRWAYS - B  
- ROOMS AND ENCLOSED SPACES - C  
B - SPRINKLERED  
- INTERIOR EXIT STAIRWAYS - B  
- CORRIDORS AND ENCLOSURE FOR EXIT ACCESS STAIRWAYS - C  
- ROOMS AND ENCLOSED SPACES - C  
I-3 - SPRINKLERED  
- INTERIOR EXIT STAIRWAYS - A  
- CORRIDORS AND ENCLOSURE FOR EXIT ACCESS STAIRWAYS - A  
- ROOMS AND ENCLOSED SPACES - C

804.4.2 MINIMUM CRITICAL RADIANT FLUX. IN ALL OCCUPANCIES, INTERIOR FLOOR FINISH AND FLOOR COVERING MATERIALS IN ENCLOSURES FOR STAIRWAYS AND RAMPS, EXIT PASSAGEWAYS, CORRIDORS AND ROOMS OR SPACES NOT SEPARATED FROM CORRIDORS BY PARTITIONS EXTENDING FROM THE FLOOR TO THE UNDERSIDE OF THE CEILING SHALL WITHSTAND A MINIMUM CRITICAL RADIANT FLUX. THE MINIMUM CRITICAL RADIANT FLUX SHALL BE NOT LESS THAN CLASS I IN GROUPS I-1, I-2 AND I-3 AND NOT LESS THAN CLASS II IN GROUPS A, B, E, H, I-4, M, R-1, R-2 AND S. EXCEPTION: WHERE A BUILDING IS EQUIPPED THROUGHOUT WITH AN AUTOMATIC SPRINKLER SYSTEM IN ACCORDANCE WITH SECTION 903.3.1.1 OR 903.3.1.2, CLASS II MATERIALS ARE PERMITTED IN ANY AREA WHERE CLASS I MATERIALS ARE REQUIRED, AND MATERIALS COMPLYING WITH DOC FF-1 "PILL TEST" OR WITH ASTM D2859 ARE PERMITTED IN ANY AREA WHERE CLASS II MATERIALS ARE REQUIRED.

808.1.1 MATERIALS AND INSTALLATION. ACOUSTICAL MATERIALS COMPLYING WITH THE INTERIOR FINISH REQUIREMENTS OF SECTION 803 SHALL BE INSTALLED IN ACCORDANCE WITH THE MANUFACTURER'S RECOMMENDATIONS AND APPLICABLE PROVISIONS FOR APPLYING INTERIOR FINISH.

808.1.1.1 SUSPENDED ACOUSTICAL CEILINGS. SUSPENDED ACOUSTICAL CEILING SYSTEMS SHALL BE INSTALLED IN ACCORDANCE WITH THE PROVISIONS OF ASTM C635 AND ASTM C636.

808.1.1.2 FIRE-RESISTANCE-RATED CONSTRUCTION. ACOUSTICAL CEILING SYSTEMS THAT ARE PART OF FIRE-RESISTANCE-RATED CONSTRUCTION SHALL BE INSTALLED IN THE SAME MANNER USED IN THE ASSEMBLY TESTED AND SHALL COMPLY WITH THE PROVISIONS OF CHAPTER 7.

BC NYS CHAPTER 9 - FIRE PROTECTION AND LIFE SAFETY SYSTEMS

903.2.1.3 GROUP A-3. AN AUTOMATIC SPRINKLER SYSTEM SHALL BE PROVIDED THROUGHOUT STORIES CONTAINING GROUP A-3 OCCUPANCIES AND THROUGHOUT ALL STORIES FROM THE GROUP A-3 OCCUPANCY TO AND INCLUDING THE LEVELS OF EXIT DISCHARGE SERVING THAT OCCUPANCY WHERE ONE OF THE FOLLOWING CONDITIONS EXISTS:

1. THE FIRE AREA EXCEEDS 12,000 SQUARE FEET.
2. THE FIRE AREA HAS AN OCCUPANT LOAD OF 300 OR MORE.
3. THE FIRE AREA IS LOCATED ON A FLOOR OTHER THAN A LEVEL OF EXIT DISCHARGE SERVING SUCH OCCUPANCIES.

903.2.6 GROUP 1. AN AUTOMATIC SPRINKLER SYSTEM SHALL BE PROVIDED THROUGHOUT BUILDINGS WITH A GROUP I FIRE AREA.

903.3.1.1 NFPA 13 SPRINKLER SYSTEMS. WHERE THE PROVISIONS OF THIS CODE REQUIRE THAT A BUILDING OR PORTION THEREOF BE EQUIPPED THROUGHOUT WITH AN AUTOMATIC SPRINKLER SYSTEM IN ACCORDANCE WITH THIS SECTION, SPRINKLERS SHALL BE INSTALLED THROUGHOUT IN ACCORDANCE WITH NFPA 13 EXCEPT AS PROVIDED IN SECTIONS 903.3.1.1.1 AND 903.3.1.1.2.

906.1 WHERE REQUIRED. PORTABLE FIRE EXTINGUISHERS SHALL BE INSTALLED IN ALL OF THE FOLLOWING LOCATIONS:

1. IN GROUP A, B, E, F, H, I, M, R-1, R-2, R-4 AND S OCCUPANCIES.
2. ON EACH FLOOR OF STRUCTURES UNDER CONSTRUCTION, EXCEPT GROUP R-3 OCCUPANCIES, IN ACCORDANCE WITH SECTION 3315.1 OF THE FIRE CODE OF NEW YORK STATE.
5. WHERE REQUIRED BY THE FIRE CODE OF NEW YORK STATE SECTIONS INDICATED IN TABLE 906.1.

906.2 GENERAL REQUIREMENTS. PORTABLE FIRE EXTINGUISHERS SHALL BE SELECTED AND INSTALLED IN ACCORDANCE WITH THIS SECTION AND NFPA 10.

906.3 SIZE AND DISTRIBUTION. THE SIZE AND DISTRIBUTION OF PORTABLE FIRE EXTINGUISHERS SHALL BE IN ACCORDANCE WITH SECTIONS 906.3.1 THROUGH 906.3.4.

TABLE 906.3(1) FIRE EXTINGUISHERS FOR CLASS A FIRE HAZARDS (ORDINARY HAZARD OCCUPANCY)  
MINIMUM-RATED SINGLE EXTINGUISHER - 2-A  
MAXIMUM FLOOR AREA PER UNIT OF A - 1,500 SQUARE FEET  
MAXIMUM FLOOR AREA FOR EXTINGUISHER - 11,250 SQUARE FEET  
MAXIMUM DISTANCE OF TRAVEL TO EXTINGUISHER - 75 FEET

907.2 WHERE REQUIRED - NEW BUILDINGS AND STRUCTURES. AN APPROVED FIRE ALARM SYSTEM INSTALLED IN ACCORDANCE WITH THE PROVISIONS OF THIS CODE AND NFPA 72 SHALL BE PROVIDED IN NEW BUILDINGS AND STRUCTURES IN ACCORDANCE WITH SECTIONS 907.2.1 THROUGH 907.2.23 AND PROVIDE OCCUPANT NOTIFICATION IN ACCORDANCE WITH SECTION 907.5, UNLESS OTHER REQUIREMENTS ARE PROVIDED BY ANOTHER SECTION OF THIS CODE.

NOT FEWER THAN ONE MANUAL FIRE ALARM BOX SHALL BE PROVIDED IN AN APPROVED LOCATION TO INITIATE A FIRE ALARM SIGNAL FOR FIRE ALARM SYSTEMS EMPLOYING AUTOMATIC FIRE DETECTORS OR WATERFLOW DETECTION DEVICES. WHERE OTHER SECTIONS OF THIS CODE ALLOW ELIMINATION OF FIRE ALARM BOXES DUE TO SPRINKLERS, A SINGLE FIRE ALARM BOX SHALL BE INSTALLED.

907.2.1 GROUP A. A MANUAL FIRE ALARM SYSTEM THAT ACTIVATES THE OCCUPANT NOTIFICATION SYSTEM IN ACCORDANCE WITH SECTION 907.5 SHALL BE INSTALLED IN GROUP A OCCUPANCIES WHERE THE OCCUPANT LOAD DUE TO THE ASSEMBLY OCCUPANCY IS 300 OR MORE, OR WHERE THE GROUP A OCCUPANT LOAD IS MORE THAN 100 PERSONS ABOVE OR BELOW THE LOWEST LEVEL OF EXIT DISCHARGE. GROUP A OCCUPANCIES NOT SEPARATED FROM ONE ANOTHER IN ACCORDANCE WITH SECTION 707.3.10 SHALL BE CONSIDERED AS A SINGLE OCCUPANCY FOR THE PURPOSES OF APPLYING THIS SECTION. PORTIONS OF GROUP E OCCUPANCIES OCCUPIED FOR ASSEMBLY PURPOSES SHALL BE PROVIDED WITH A FIRE ALARM SYSTEM AS REQUIRED FOR THE GROUP E OCCUPANCY.

907.2.1.3 AUTOMATIC SMOKE DETECTION SYSTEM. A SMOKE DETECTION SYSTEM THAT ACTIVATES THE OCCUPANT NOTIFICATION SYSTEM WITH SECTION 907.5 SHALL BE INSTALLED IN GROUP A OCCUPANCIES UNLESS THE FIRE AREA IS PROTECTED WITH AN AUTOMATIC FIRE SPRINKLER SYSTEM, THAT ACTIVATES THE OCCUPANT NOTIFICATION SYSTEM, INSTALLED IN ACCORDANCE WITH SECTION 903.3.1.1.

907.2.6.3 GROUP I-3 OCCUPANCIES. GROUP I-3 OCCUPANCIES SHALL BE EQUIPPED WITH A MANUAL FIRE ALARM SYSTEM AND AUTOMATIC SMOKE DETECTION SYSTEM INSTALLED FOR ALERTING STAFF.

907.2.6.3.1 SYSTEM INITIATION. ACTUATION OF AN AUTOMATIC FIRE-EXTINGUISHING SYSTEM, AUTOMATIC SPRINKLER SYSTEM, A MANUAL FIRE ALARM BOX OR A FIRE DETECTOR SHALL INITIATE AN APPROVED FIRE ALARM SIGNAL THAT AUTOMATICALLY NOTIFIES STAFF.

907.2.6.3.2 MANUAL FIRE ALARM BOXES. MANUAL FIRE ALARM BOXES ARE NOT REQUIRED TO BE LOCATED IN ACCORDANCE WITH SECTION 907.4.2 WHERE THE FIRE ALARM BOXES ARE PROVIDED AT STAFF-ATTENDED LOCATIONS HAVING DIRECT SUPERVISION OVER AREAS WHERE MANUAL FIRE ALARM BOXES HAVE BEEN OMITTED.

907.2.6.3.2.1 MANUAL FIRE ALARM BOXES IN DETAINEE AREAS. MANUAL FIRE ALARM BOXES ARE ALLOWED TO BE LOCKED IN AREAS OCCUPIED BY DETAINEES, PROVIDED THAT STAFF MEMBERS ARE PRESENT WITHIN THE SUBJECT AREA AND HAVE KEYS READILY AVAILABLE TO OPERATE THE MANUAL FIRE ALARM BOXES.

IT IS A VIOLATION OF THE NEW YORK STATE EDUCATION LAW, ARTICLE 145 §7209 SPECIAL PROVISIONS, FOR ANY PERSON, UNLESS THEY ARE ACTING UNDER THE DIRECTION OF A LICENSED PROFESSIONAL ENGINEER, ARCHITECT,



**907.3 FIRE SAFETY FUNCTIONS.** AUTOMATIC FIRE DETECTORS UTILIZED FOR THE PURPOSE OF PERFORMING FIRE SAFETY FUNCTIONS SHALL BE CONNECTED TO THE BUILDING'S FIRE ALARM CONTROL UNIT WHERE A FIRE ALARM SYSTEM IS REQUIRED BY SECTION 907.2. DETECTORS SHALL, UPON ACTUATION, PERFORM THE INTENDED FUNCTION AND ACTIVATE THE ALARM NOTIFICATION APPLIANCES OR ACTIVATE A VISIBLE AND AUDIBLE SUPERVISORY SIGNAL AT A CONSTANTLY ATTENDED LOCATION. IN BUILDINGS NOT EQUIPPED WITH A FIRE ALARM SYSTEM, THE AUTOMATIC FIRE DETECTOR SHALL BE POWERED BY NORMAL ELECTRICAL SERVICE AND, UPON ACTUATION, PERFORM THE INTENDED FUNCTION. THE DETECTORS SHALL BE LOCATED IN ACCORDANCE WITH NFPA 72.

**907.3.1 DUCT SMOKE DETECTORS.** SMOKE DETECTORS INSTALLED IN DUCTS SHALL BE LISTED FOR THE AIR VELOCITY, TEMPERATURE AND HUMIDITY PRESENT IN THE DUCT. DUCT SMOKE DETECTORS SHALL BE CONNECTED TO THE BUILDING'S FIRE ALARM CONTROL UNIT WHERE A FIRE ALARM SYSTEM IS REQUIRED BY SECTION 907.2. ACTIVATION OF A DUCT SMOKE DETECTOR SHALL INITIATE A VISIBLE AND AUDIBLE SUPERVISORY SIGNAL AT A CONSTANTLY ATTENDED LOCATION AND SHALL PERFORM THE INTENDED FIRE SAFETY FUNCTION IN ACCORDANCE WITH THIS CODE AND THE MECHANICAL CODE OF NEW YORK STATE. IN FACILITIES THAT ARE REQUIRED TO BE MONITORED BY A SUPERVISING STATION, DUCT SMOKE DETECTORS SHALL REPORT ONLY AS A SUPERVISORY SIGNAL AND NOT AS A FIRE ALARM. THEY SHALL NOT BE USED AS A SUBSTITUTE FOR REQUIRED OPEN AREA DETECTION.

**907.3.2 SPECIAL LOCKING SYSTEMS.** WHERE SPECIAL LOCKING SYSTEMS ARE INSTALLED ON MEANS OF EGRESS DOORS IN ACCORDANCE WITH SECTIONS 1010.1.9.7 OR 1010.1.9.8, AN AUTOMATIC DETECTION SYSTEM SHALL BE INSTALLED AS REQUIRED BY THAT SECTION.

**907.3.3 ELEVATOR EMERGENCY OPERATION.** AUTOMATIC FIRE DETECTORS INSTALLED FOR ELEVATOR EMERGENCY OPERATION SHALL BE INSTALLED IN ACCORDANCE WITH THE PROVISIONS OF ASME A17.1/CSA B44 AND NFPA 72.

**907.3.4 WIRING.** THE WIRING TO THE AUXILIARY DEVICES AND EQUIPMENT USED TO ACCOMPLISH THE FIRE SAFETY FUNCTIONS SHALL BE MONITORED FOR INTEGRITY IN ACCORDANCE WITH NFPA 72.

**907.4.1 PROTECTION OF FIRE ALARM CONTROL UNIT.** IN AREAS THAT ARE NOT CONTINUOUSLY OCCUPIED, A SINGLE SMOKE DETECTOR SHALL BE PROVIDED AT THE LOCATION OF EACH FIRE ALARM CONTROL UNIT, NOTIFICATION APPLIANCE CIRCUIT POWER EXTENDERS, AND SUPERVISING STATION TRANSMITTING EQUIPMENT.

**907.4.2.1 LOCATION.** MANUAL FIRE ALARM BOXES SHALL BE LOCATED NOT MORE THAN 5 FEET FROM THE ENTRANCE TO EACH EXIT. IN BUILDINGS NOT PROTECTED BY AN AUTOMATIC SPRINKLER SYSTEM IN ACCORDANCE WITH SECTION 903.3.1.1 OR 903.3.1.2, ADDITIONAL MANUAL FIRE ALARM BOXES SHALL BE LOCATED SO THAT THE DISTANCE OF TRAVEL TO THE NEAREST BOX DOES NOT EXCEED 200 FEET.

**907.4.2.2 HEIGHT.** THE HEIGHT OF THE MANUAL FIRE ALARM BOXES SHALL BE NOT LESS THAN 42 INCHES AND NOT MORE THAN 48 INCHES MEASURED VERTICALLY, FROM THE FLOOR LEVEL TO THE ACTIVATING HANDLE OR LEVER OF THE BOX.

**907.4.3 AUTOMATIC SMOKE DETECTION.** WHERE AN AUTOMATIC SMOKE DETECTION SYSTEM IS REQUIRED IT SHALL UTILIZE SMOKE DETECTORS UNLESS AMBIENT CONDITIONS PROHIBIT SUCH AN INSTALLATION. IN SPACES WHERE SMOKE DETECTORS CANNOT BE UTILIZED DUE TO AMBIENT CONDITIONS, APPROVED AUTOMATIC HEAT DETECTORS SHALL BE PERMITTED.

**907.5 OCCUPANT NOTIFICATION SYSTEMS.** A FIRE ALARM SYSTEM SHALL ANNUNCIATE AT THE FIRE ALARM CONTROL UNIT AND SHALL INITIATE OCCUPANT NOTIFICATION UPON ACTIVATION, IN ACCORDANCE WITH SECTIONS 907.5.1 THROUGH 907.5.2.3.3. WHERE A FIRE ALARM SYSTEM IS REQUIRED BY ANOTHER SECTION OF THIS CODE, IT SHALL BE ACTIVATED BY:

1. AUTOMATIC FIRE DETECTORS.
2. AUTOMATIC SPRINKLER SYSTEM WATERFLOW DEVICES.
3. MANUAL FIRE ALARM BOXES.

**907.5.2.1 AUDIBLE ALARMS.** AUDIBLE ALARM NOTIFICATION APPLIANCES SHALL BE PROVIDED AND EMIT A DISTINCTIVE SOUND THAT IS NOT TO BE USED FOR ANY PURPOSE OTHER THAN THAT OF A FIRE ALARM.

**907.5.2.2 EMERGENCY VOICE/ALARM COMMUNICATION SYSTEMS.** EMERGENCY VOICE/ALARM COMMUNICATION SYSTEMS REQUIRED BY THIS CODE SHALL BE DESIGNED AND INSTALLED IN ACCORDANCE WITH NFPA 72. THE OPERATION OF ANY AUTOMATIC FIRE DETECTOR, SPRINKLER WATERFLOW DEVICE OR MANUAL FIRE ALARM BOX SHALL AUTOMATICALLY SOUND AN ALERT TONE FOLLOWED BY VOICE INSTRUCTIONS GIVING APPROVED INFORMATION AND DIRECTIONS FOR A GENERAL OR STAGED EVACUATION IN ACCORDANCE WITH THE BUILDING'S FIRE SAFETY AND EVACUATION PLANS REQUIRED BY SECTION 404 OF THE FIRE CODE OF NEW YORK STATE. IN HIGH-RISE BUILDINGS, THE SYSTEM SHALL OPERATE ON AT LEAST THE ALARMING FLOOR, THE FLOOR ABOVE AND THE FLOOR BELOW. SPEAKERS SHALL BE PROVIDED THROUGHOUT THE BUILDING BY PAGING ZONES. AT A MINIMUM, PAGING ZONES SHALL BE PROVIDED AS FOLLOWS:

1. ELEVATOR GROUPS.
2. INTERIOR EXIT STAIRWAYS.
3. EACH FLOOR.
4. AREAS OF REFUGE AS DEFINED IN CHAPTER 2.

**907.5.2.2.5 EMERGENCY POWER.** EMERGENCY VOICE/ALARM COMMUNICATIONS SYSTEMS SHALL BE PROVIDED WITH EMERGENCY POWER IN ACCORDANCE WITH SECTION 2702. THE SYSTEM SHALL BE CAPABLE OF POWERING THE REQUIRED LOAD FOR A DURATION OF NOT LESS THAN 24 HOURS, AS REQUIRED IN NFPA 72.

**907.5.2.3.1 PUBLIC USE AREAS AND COMMON USE AREAS.** VISIBLE ALARM NOTIFICATION APPLIANCES SHALL BE PROVIDED IN PUBLIC USE AREAS AND COMMON USE AREAS.

**907.6.1 WIRING.** WIRING SHALL COMPLY WITH THE REQUIREMENTS OF NFPA 70 AND NFPA 72. WIRELESS PROTECTION SYSTEMS UTILIZING RADIO-FREQUENCY TRANSMITTING DEVICES SHALL COMPLY WITH THE SPECIAL REQUIREMENTS FOR SUPERVISION OF LOW-POWER WIRELESS SYSTEMS IN NFPA 72.

**907.6.2 POWER SUPPLY.** THE PRIMARY AND SECONDARY POWER SUPPLY FOR THE FIRE ALARM SYSTEM SHALL BE PROVIDED IN ACCORDANCE WITH NFPA 72.

**907.6.3 INITIATING DEVICE IDENTIFICATION.** THE FIRE ALARM SYSTEM SHALL IDENTIFY THE SPECIFIC INITIATING DEVICE ADDRESS, LOCATION, DEVICE TYPE, FLOOR LEVEL WHERE APPLICABLE AND STATUS INCLUDING INDICATION OF NORMAL, ALARM, TROUBLE AND SUPERVISORY STATUS, AS APPROPRIATE.

**907.6.3.1 ANNUNCIATION.** THE INITIATING DEVICE STATUS SHALL BE ANNUNCIATED AT AN APPROVED ON-SITE LOCATION.

**907.6.4 ZONES.** EACH FLOOR SHALL BE ZONED SEPARATELY AND A ZONE SHALL NOT EXCEED 22,500 SQUARE FEET. THE LENGTH OF ANY ZONE SHALL NOT EXCEED 300 FEET IN ANY DIRECTION.

**907.6.4.1 ZONING INDICATOR PANEL.** A ZONING INDICATOR PANEL AND THE ASSOCIATED CONTROLS SHALL BE PROVIDED IN AN APPROVED LOCATION. THE VISUAL ZONE INDICATION SHALL LOCK IN UNTIL THE SYSTEM IS RESET AND SHALL NOT BE CANCELED BY THE OPERATION OF AN AUDIBLE-ALARM SILENCING SWITCH.

**907.6.5 ACCESS.** ACCESS SHALL BE PROVIDED TO EACH FIRE ALARM DEVICE AND NOTIFICATION APPLIANCE FOR PERIODIC INSPECTION, MAINTENANCE AND TESTING.

**907.6.6 MONITORING.** FIRE ALARM SYSTEMS REQUIRED BY THIS CHAPTER OR BY THE FIRE CODE OF NEW YORK STATE SHALL BE MONITORED BY AN APPROVED SUPERVISING STATION IN ACCORDANCE WITH NFPA 72.

**907.6.6.1 AUTOMATIC TELEPHONE-DIALING DEVICES.** AUTOMATIC TELEPHONE-DIALING DEVICES USED TO TRANSMIT AN EMERGENCY ALARM SHALL NOT BE CONNECTED TO ANY FIRE DEPARTMENT TELEPHONE NUMBER UNLESS APPROVED BY THE FIRE CHIEF.

**907.6.6.2 TERMINATION OF MONITORING SERVICE.** TERMINATION OF FIRE ALARM MONITORING SERVICES SHALL BE IN ACCORDANCE WITH SECTION 901.9 OF THE FIRE CODE OF NEW YORK STATE.

**907.7 ACCEPTANCE TESTS AND COMPLETION.** UPON COMPLETION OF THE INSTALLATION, THE FIRE ALARM SYSTEM AND ALL FIRE ALARM COMPONENTS SHALL BE TESTED IN ACCORDANCE WITH NFPA 72.

**907.8 INSPECTION, TESTING AND MAINTENANCE.** THE MAINTENANCE AND TESTING SCHEDULES AND PROCEDURES FOR FIRE ALARM AND FIRE DETECTION SYSTEMS SHALL BE IN ACCORDANCE WITH SECTION 907.8 OF THE FIRE CODE OF NEW YORK STATE AND NFPA 72.

**912.2 LOCATION.** WITH RESPECT TO HYDRANTS, DRIVEWAYS, BUILDINGS AND LANDSCAPING, FIRE DEPARTMENT CONNECTIONS SHALL BE SO LOCATED THAT FIRE APPARATUS AND HOSE CONNECTED TO SUPPLY THE SYSTEM WILL NOT OBSTRUCT ACCESS TO THE BUILDINGS FOR OTHER FIRE APPARATUS. THE LOCATION OF FIRE DEPARTMENT CONNECTIONS SHALL BE APPROVED BY THE FIRE CODE OFFICIAL.

**912.2.2 EXISTING BUILDINGS.** ON EXISTING BUILDINGS, WHEREVER THE FIRE DEPARTMENT CONNECTION IS NOT VISIBLE TO APPROACHING FIRE APPARATUS, THE FIRE DEPARTMENT CONNECTION SHALL BE INDICATED BY AN APPROVED SIGN MOUNTED ON THE STREET FRONT OR ON THE SIDE OF THE BUILDING. SUCH SIGN SHALL HAVE THE LETTERS "FDC" NOT LESS THAN 6 INCHES HIGH AND WORDS IN LETTERS NOT LESS THAN 2 INCHES HIGH OR AN ARROW TO INDICATE THE LOCATION. SUCH SIGNS SHALL BE SUBJECT TO THE APPROVAL OF THE FIRE CODE OFFICIAL.

**912.3 FIRE HOSE THREADS.** FIRE HOSE THREADS USED IN CONNECTION WITH STANDPIPE SYSTEMS SHALL BE APPROVED AND SHALL BE COMPATIBLE WITH FIRE DEPARTMENT HOSE THREADS.

**912.4 ACCESS.** IMMEDIATE ACCESS TO FIRE DEPARTMENT CONNECTIONS SHALL BE MAINTAINED AT ALL TIMES AND WITHOUT OBSTRUCTION BY FENCES, BUSHES, TREES, WALLS OR ANY OTHER FIXED OR MOVEABLE OBJECT. ACCESS TO FIRE DEPARTMENT CONNECTIONS SHALL BE APPROVED BY THE FIRE CODE OFFICIAL.

**912.5 SIGNS.** A METAL SIGN WITH RAISED LETTERS NOT LESS THAN 1 INCH IN SIZE SHALL BE MOUNTED ON ALL FIRE DEPARTMENT CONNECTIONS SERVING AUTOMATIC SPRINKLERS, STANDPIPES OR FIRE PUMP CONNECTIONS. SUCH SIGNS SHALL READ: AUTOMATIC SPRINKLERS OR STANDPIPES OR TEST CONNECTION OR A COMBINATION THEREOF AS APPLICABLE. WHERE THE FIRE DEPARTMENT CONNECTION DOES NOT SERVE THE ENTIRE BUILDING, A SIGN SHALL BE PROVIDED INDICATING THE PORTIONS OF THE BUILDING SERVED.

**912.6 BACKFLOW PROTECTION.** THE POTABLE WATER SUPPLY TO AUTOMATIC SPRINKLER AND STANDPIPE SYSTEMS SHALL BE PROTECTED AGAINST BACKFLOW AS REQUIRED BY THE PLUMBING CODE OF NEW YORK STATE.

**914.2 EQUIPMENT ROOM IDENTIFICATION.** FIRE PROTECTION EQUIPMENT SHALL BE IDENTIFIED IN AN APPROVED MANNER. ROOMS CONTAINING CONTROLS FOR AIR-CONDITIONING SYSTEMS, SPRINKLER RISERS AND VALVES OR OTHER FIRE DETECTION, SUPPRESSION OR CONTROL ELEMENTS SHALL BE IDENTIFIED FOR THE USE OF THE FIRE DEPARTMENT. APPROVED SIGNS REQUIRED TO IDENTIFY FIRE PROTECTION EQUIPMENT AND EQUIPMENT LOCATION SHALL BE CONSTRUCTED OF DURABLE MATERIALS, PERMANENTLY INSTALLED AND READILY VISIBLE.

**915.1 GENERAL.** CARBON MONOXIDE ALARMS AND CARBON MONOXIDE DETECTION SHALL BE INSTALLED IN NEW AND EXISTING BUILDINGS IN ACCORDANCE WITH SECTION 915 OF THE FIRE CODE OF NEW YORK STATE.

#### BC NYS CHAPTER 10 - MEANS OF EGRESS

**1003.2 CEILING HEIGHT.** THE MEANS OF EGRESS SHALL HAVE A CEILING HEIGHT OF NOT LESS THAN 7 FEET 6 INCHES ABOVE THE FINISHED FLOOR.

**1004.1 DESIGN OCCUPANT LOAD.** IN DETERMINING MEANS OF EGRESS REQUIREMENTS, THE NUMBER OF OCCUPANTS FOR WHOM MEANS OF EGRESS FACILITIES ARE PROVIDED SHALL BE DETERMINED IN ACCORDANCE WITH THIS SECTION.

#### OCCUPANT LOAD CALCULATIONS

<b>FIRST FLOOR</b>			
A-3 OCCUPANCY	= (800 NET SF/40 SF/OCCUPANT) + 56 OCCUPANTS (FIXED SEATING)	=	76 OCCUPANTS
B OCCUPANCY	= 5,390 GROSS SF/150 SF/OCCUPANT	=	36 OCCUPANTS
I-3 OCCUPANCY	= 20 SF/OCCUPANT IN HOLDING FACILITIES (MCKINNEY)	=	17 OCCUPANTS

<b>SECOND FLOOR</b>			
A-3 OCCUPANCY	= (372 NET SF/40 SF/OCCUPANT) + 27 OCCUPANTS (FIXED SEATING)	=	37 OCCUPANTS
B OCCUPANCY	= 4,116 GROSS SF/150 SF/OCCUPANT	=	28 OCCUPANTS

**TOTAL BUILDING OCCUPANCY** **=194 OCCUPANTS**

**1005.3.1 STAIRWAYS.** THE CAPACITY, IN INCHES, OF MEANS OF EGRESS STAIRWAYS SHALL BE CALCULATED BY MULTIPLYING THE OCCUPANT LOAD SERVED BY SUCH STAIRWAYS BY A MEANS OF EGRESS CAPACITY FACTOR OF 0.3 INCH PER OCCUPANT. WHERE STAIRWAYS SERVE MORE THAN ONE STORY, ONLY THE OCCUPANT LOAD OF EACH STORY CONSIDERED INDIVIDUALLY SHALL BE USED IN CALCULATING THE REQUIRED CAPACITY OF THE STAIRWAYS SERVING THAT STORY.

EXCEPTIONS:  
FOR OTHER THAN GROUP H AND I-2 OCCUPANCIES, THE CAPACITY, IN INCHES, OF MEANS OF EGRESS STAIRWAYS SHALL BE CALCULATED BY MULTIPLYING THE OCCUPANT LOAD SERVED BY SUCH STAIRWAYS BY A MEANS OF EGRESS CAPACITY FACTOR OF 0.2 INCH PER OCCUPANT IN BUILDINGS EQUIPPED THROUGHOUT WITH AN AUTOMATIC SPRINKLER SYSTEM INSTALLED IN ACCORDANCE WITH SECTION 903.3.1.1 OR 903.3.1.2 AND AN EMERGENCY VOICE/ALARM COMMUNICATION SYSTEM IN ACCORDANCE WITH SECTION 907.5.2.2.

**1005.3.2 OTHER EGRESS COMPONENTS.** THE CAPACITY, IN INCHES, OF MEANS OF EGRESS COMPONENTS OTHER THAN STAIRWAYS SHALL BE CALCULATED BY MULTIPLYING THE OCCUPANT LOAD SERVED BY SUCH COMPONENT BY A MEANS OF EGRESS CAPACITY FACTOR OF 0.2 INCH PER OCCUPANT.

EXCEPTIONS:  
FOR OTHER THAN GROUP H AND I-2 OCCUPANCIES, THE CAPACITY, IN INCHES, OF MEANS OF EGRESS COMPONENTS OTHER THAN STAIRWAYS SHALL BE CALCULATED BY MULTIPLYING THE OCCUPANT LOAD SERVED BY SUCH COMPONENT BY A MEANS OF EGRESS CAPACITY FACTOR OF 0.15 INCH PER OCCUPANT IN BUILDINGS EQUIPPED THROUGHOUT WITH AN AUTOMATIC SPRINKLER SYSTEM INSTALLED IN ACCORDANCE WITH SECTION 903.3.1.1 OR 903.3.1.2 AND AN EMERGENCY VOICE/ALARM COMMUNICATION SYSTEM IN ACCORDANCE WITH SECTION 907.5.2.2.

**TABLE 1006.2.1 SPACES WITH ONE EXIT OR EXIT ACCESS DOORWAY**  
A - MAX. OCCUPANT LOAD OF 49 - MAX. COMMON PATH OF EGRESS TRAVEL DISTANCE - 75 FEET  
B - MAX OCCUPANT LOAD OF 49 - MAX. COMMON PATH OF EGRESS TRAVEL DISTANCE - 100 FEET  
I-3 - MAX OCCUPANT LOAD OF 10 - MAX. COMMON PATH OF EGRESS TRAVEL DISTANCE - 100 FEET

**TABLE 1006.3.2 MINIMUM NUMBER OF EXITS OR ACCESS TO EXITS PER STORY**  
1-500 OCCUPANTS - 2 EXITS OR ACCESS TO EXITS FROM STORY

**1008.2 ILLUMINATION REQUIRED;** THE MEANS OF EGRESS SERVING A ROOM OR SPACE SHALL BE ILLUMINATED AT ALL TIMES THAT THE ROOM OR SPACE IS OCCUPIED.

**1008.3.1 GENERAL.** IN THE EVENT OF POWER SUPPLY FAILURE IN ROOMS AND SPACES THAT REQUIRE TWO OR MORE MEANS OF EGRESS, AN EMERGENCY ELECTRICAL SYSTEM SHALL AUTOMATICALLY ILLUMINATE ALL OF THE FOLLOWING AREAS:

1. AISLES.
2. CORRIDORS.
3. EXIT ACCESS STAIRWAYS AND RAMPS.

**1008.3.2 BUILDINGS.** IN THE EVENT OF POWER SUPPLY FAILURE IN BUILDINGS THAT REQUIRE TWO OR MORE MEANS OF EGRESS, AN EMERGENCY ELECTRICAL SYSTEM SHALL AUTOMATICALLY ILLUMINATE ALL OF THE FOLLOWING AREAS:

1. INTERIOR EXIT ACCESS STAIRWAYS AND RAMPS.
2. INTERIOR AND EXTERIOR EXIT STAIRWAYS AND RAMPS.
3. EXIT PASSAGeways.
4. VESTIBULES AND AREAS ON THE LEVEL OF DISCHARGE USED FOR EXIT DISCHARGE IN ACCORDANCE WITH SECTION 1028.1.
5. EXTERIOR LANDINGS AS REQUIRED BY SECTION 1010.1.6 FOR EXIT DOORWAYS THAT LEAD DIRECTLY TO THE EXIT DISCHARGE.

**1008.3.3 ROOMS AND SPACES.** IN THE EVENT OF POWER SUPPLY FAILURE, AN EMERGENCY ELECTRICAL SYSTEM SHALL AUTOMATICALLY ILLUMINATE ALL OF THE FOLLOWING AREAS:

1. ELECTRICAL EQUIPMENT ROOMS.
2. FIRE COMMAND CENTERS.
3. FIRE PUMP ROOMS.
4. GENERATOR ROOMS.
5. PUBLIC RESTROOMS WITH AN AREA GREATER THAN 300 SQUARE FEET.

**1008.3.5 ILLUMINATION LEVEL UNDER EMERGENCY POWER;** EMERGENCY LIGHTING FACILITIES SHALL BE ARRANGED TO PROVIDE INITIAL ILLUMINATION THAT IS NOT LESS THAN AN AVERAGE OF 1 FOOTCANDLE AND A MINIMUM AT ANY POINT OF 0.1 FOOTCANDLE MEASURED ALONG THE PATH OF EGRESS AT FLOOR LEVEL. ILLUMINATION LEVELS SHALL BE PERMITTED TO DECLINE TO 0.6 FOOTCANDLE AVERAGE AND A MINIMUM AT ANY POINT OF 0.06 FOOTCANDLE AT THE END OF THE EMERGENCY LIGHTING TIME DURATION. A MAXIMUM-TO-MINIMUM ILLUMINATION UNIFORMITY RATIO OF 40 TO 1 SHALL NOT BE EXCEEDED. IN GROUP I-2 OCCUPANCIES, FAILURE OF A SINGLE LAMP IN A LUMINAIRE SHALL NOT REDUCE THE ILLUMINATION LEVEL TO LESS THAN 0.2 FOOTCANDLE.

**1012.2 SLOPE.** RAMPS USED AS PART OF A MEANS OF EGRESS SHALL HAVE A RUNNING SLOPE NOT STEEPER THAN ONE UNIT VERTICAL IN 12 UNITS HORIZONTAL (8-PERCENT SLOPE). THE SLOPE OF OTHER PEDESTRIAN RAMPS SHALL NOT BE STEEPER THAN ONE UNIT VERTICAL IN EIGHT UNITS HORIZONTAL (12.5-PERCENT SLOPE).

**1012.5.1 WIDTH AND CAPACITY.** THE MINIMUM WIDTH AND REQUIRED CAPACITY OF A MEANS OF EGRESS RAMP SHALL BE NOT LESS THAN THAT REQUIRED FOR CORRIDORS BY SECTION 1020.2. THE CLEAR WIDTH OF A RAMP BETWEEN HANDRAILS, IF PROVIDED, OR OTHER PERMISSIBLE PROJECTIONS SHALL BE 36 INCHES MINIMUM.

**1012.6.2 WIDTH.** THE LANDING WIDTH SHALL BE NOT LESS THAN THE WIDTH OF THE WIDEST RAMP RUN ADJOINING THE LANDING.

**1012.6.3 LENGTH.** THE LANDING LENGTH SHALL BE 60 INCHES MINIMUM.

**1012.6.4 CHANGE IN DIRECTION.** WHERE CHANGES IN DIRECTION OF TRAVEL OCCUR AT LANDINGS PROVIDED BETWEEN RAMP RUNS, THE LANDING SHALL BE 60 INCHES BY 60 INCHES MINIMUM.

**1012.6.5 DOORWAYS.** WHERE DOORWAYS ARE LOCATED ADJACENT TO A RAMP LANDING, MANEUVERING CLEARANCES REQUIRED BY ICC A117.1 ARE PERMITTED TO OVERLAP THE REQUIRED LANDING AREA.

**1012.8 HANDRAILS.** RAMPS WITH A RISE GREATER THAN 6 INCHES (152 MM) SHALL HAVE HANDRAILS ON BOTH SIDES. HANDRAILS SHALL COMPLY WITH SECTION 1014.

**1013.1 WHERE REQUIRED;** EXITS AND EXIT ACCESS DOORS SHALL BE MARKED BY AN APPROVED EXIT SIGN READILY VISIBLE FROM ANY DIRECTION OF EGRESS TRAVEL. THE PATH OF EGRESS TRAVEL TO EXITS AND WITHIN EXITS SHALL BE MARKED BY READILY VISIBLE EXIT SIGNS TO CLEARLY INDICATE THE DIRECTION OF EGRESS TRAVEL IN CASES WHERE THE EXIT OR THE PATH OF EGRESS TRAVEL IS NOT IMMEDIATELY VISIBLE TO THE OCCUPANTS. INTERVENING MEANS OF EGRESS DOORS WITHIN EXITS SHALL BE MARKED BY EXIT SIGNS. EXIT SIGN PLACEMENT SHALL BE SUCH THAT ANY POINT IN AN EXIT ACCESS CORRIDOR OR EXIT PASSAGEWAY IS WITHIN 100 FEET OR THE LISTED VIEWING DISTANCE OF THE SIGN, WHICHEVER IS LESS, FROM THE NEAREST VISIBLE EXIT SIGN.

**1013.6.3 POWER SOURCE;** EXIT SIGNS SHALL BE ILLUMINATED AT ALL TIMES. TO ENSURE CONTINUED ILLUMINATION FOR A DURATION OF NOT LESS THAN 90 MINUTES IN CASE OF PRIMARY POWER LOSS, THE SIGN ILLUMINATION MEANS SHALL BE CONNECTED TO TO AN EMERGENCY POWER SYSTEM PROVIDED FROM STORAGE BATTERIES, UNIT EQUIPMENT OR AN ON-SITE GENERATOR. THE INSTALLATION OF THE EMERGENCY POWER SYSTEM SHALL BE IN ACCORDANCE WITH CHAPTER 27. GROUP I-2, CONDITION 2 EXIT SIGN ILLUMINATION SHALL NOT BE PROVIDED BY UNIT EQUIPMENT BATTERIES ONLY.

**1014.2 HEIGHT.** HANDRAIL HEIGHT, MEASURED ABOVE STAIR TREAD NOSINGS, OR FINISH SURFACE OF RAMP SLOPE, SHALL BE UNIFORM, NOT LESS THAN 34 INCHES AND NOT MORE THAN 38 INCHES. HANDRAIL HEIGHT OF ALTERNATING TREAD DEVICES AND SHIP'S LADDERS, MEASURED ABOVE TREAD NOSINGS, SHALL BE UNIFORM, NOT LESS THAN 30 INCHES AND NOT MORE THAN 34 INCHES.

**1014.6 HANDRAIL EXTENSIONS.** HANDRAILS SHALL RETURN TO A WALL, GUARD OR THE WALKING SURFACE OR SHALL BE CONTINUOUS TO THE HANDRAIL OF AN ADJACENT FLIGHT OF STAIRS OR RAMP RUN. WHERE HANDRAILS ARE NOT CONTINUOUS BETWEEN FLIGHTS, THE HANDRAILS SHALL EXTEND HORIZONTALLY NOT LESS THAN 12 INCHES BEYOND THE TOP RISER AND CONTINUE TO SLOPE FOR THE DEPTH OF ONE TREAD BEYOND THE BOTTOM RISER. AT RAMPS WHERE HANDRAILS ARE NOT CONTINUOUS BETWEEN RUNS, THE HANDRAILS SHALL EXTEND HORIZONTALLY ABOVE THE LANDING 12 INCHES MINIMUM BEYOND THE TOP AND BOTTOM OF RAMP RUNS. THE EXTENSIONS OF HANDRAILS SHALL BE IN THE SAME DIRECTION OF THE FLIGHTS OF STAIRS AT STAIRWAYS AND THE RAMP RUNS AT RAMPS.

#### TABLE 1017.2 EXIT ACCESS TRAVEL DISTANCE

- A - WITH SPRINKLER SYSTEM - 250 FEET
- B - WITH SPRINKLER SYSTEM - 300 FEET
- I-3 - WITH SPRINKLER SYSTEM - 200 FEET

#### BC NYS CHAPTER 11 - ACCESSIBILITY

**1108.2.2 WHEELCHAIR SPACES.** IN ROOMS AND SPACES USED FOR ASSEMBLY PURPOSES WITH FIXED SEATING, ACCESSIBLE WHEELCHAIR SPACES SHALL BE PROVIDED IN ACCORDANCE WITH SECTIONS 1108.2.2.1 THROUGH 1108.2.2.3.

#### TABLE 1108.2.2.1 ACCESSIBLE WHEELCHAIR SPACES

- 4 TO 25 CAPACITY OF SEATING - 1 WHEELCHAIR SPACE REQUIRED
- 26 TO 50 CAPACITY OF SEATING - 2 WHEELCHAIR SPACES REQUIRED

**1108.2.3 COMPANION SEATS.** AT LEAST ONE COMPANION SEAT SHALL BE PROVIDED FOR EACH WHEELCHAIR SPACE REQUIRED BY SECTIONS 1108.2.2.1 THROUGH 1108.2.2.3.

**1108.2.7.1 RECEIVERS.** THE NUMBER AND TYPE OF RECEIVERS SHALL BE PROVIDED FOR ASSISTIVE LISTENING SYSTEMS IN ACCORDANCE WITH TABLE 1108.2.7.1.

**TABLE 1108.2.7.1 RECEIVERS FOR ASSISTIVE LISTENING SYSTEMS**  
50 OR LESS CAPACITY OF SEATING - 2 RECEIVERS MIN - 2 RECEIVERS TO BE HEARING-AID COMPATIBLE MIN  
51 TO 200 CAPACITY OF SEATING - 3 RECEIVERS MIN - 2 RECEIVERS TO BE HEARING-AID COMPATIBLE MIN

**1108.4.1.1 JURY BOX.** A WHEELCHAIR SPACE SHALL BE PROVIDED WITHIN THE JURY BOX.

**1108.4.1.2 GALLERY SEATING.** WHEELCHAIR SPACES SHALL BE PROVIDED IN ACCORDANCE WITH TABLE 1108.2.2.1. DESIGNATED AISLE SEATS SHALL BE PROVIDED IN ACCORDANCE WITH SECTION 1108.2.5.

**1108.4.1.3 ASSISTIVE LISTENING SYSTEMS.** AN ASSISTIVE LISTENING SYSTEM MUST BE PROVIDED. RECEIVERS SHALL BE PROVIDED FOR THE ASSISTIVE LISTENING SYSTEM IN ACCORDANCE WITH SECTION 1108.2.7.1.

**1108.4.1.4 EMPLOYEE WORK STATIONS.** THE JUDGE'S BENCH, CLERK'S STATION, BAILIFF'S STATION, DEPUTY CLERK'S STATION AND COURT REPORTER'S STATION SHALL BE LOCATED ON AN ACCESSIBLE ROUTE. THE VERTICAL ACCESS TO ELEVATED EMPLOYEE WORK STATIONS IN A COURTROOM IS NOT REQUIRED AT THE TIME OF INITIAL CONSTRUCTION, PROVIDED A RAMP, LIFT OR ELEVATOR CAN BE INSTALLED WITHOUT REQUIRING RECONFIGURATION OR EXTENSION OF THE COURTROOM OR EXTENSION OF THE ELECTRICAL SYSTEM.

**1108.4.1.5 OTHER WORK STATIONS.** THE LITIGANT'S AND COUNSEL STATIONS, INCLUDING THE LECTERN, SHALL BE ACCESSIBLE.

**1108.4.2.1 CENTRAL HOLDING CELLS.** WHERE SEPARATE CENTRAL HOLDING CELLS ARE PROVIDED FOR ADULT MALES, JUVENILE MALES, ADULT FEMALES OR JUVENILE FEMALES, ONE OF EACH TYPE SHALL BE ACCESSIBLE. WHERE CENTRAL HOLDING CELLS ARE PROVIDED AND ARE NOT SEPARATED BY AGE OR SEX, AT LEAST ONE ACCESSIBLE CELL SHALL BE PROVIDED.

**1109.2 TOILET AND BATHING FACILITIES.** EACH TOILET ROOM AND BATHING ROOM SHALL BE ACCESSIBLE. WHERE A FLOOR LEVEL IS NOT REQUIRED TO BE CONNECTED BY AN ACCESSIBLE ROUTE, THE ONLY TOILET ROOMS OR BATHING ROOMS PROVIDED WITHIN THE FACILITY SHALL NOT BE LOCATED ON THE INACCESSIBLE FLOOR. EXCEPT AS PROVIDED FOR IN SECTIONS 1109.2.2 AND 1109.2.3, AT LEAST ONE OF EACH TYPE OF FIXTURE, ELEMENT, CONTROL OR DISPENSER IN EACH ACCESSIBLE TOILET ROOM AND BATHING ROOM SHALL BE ACCESSIBLE.

**1109.5.1 MINIMUM NUMBER.** NOT FEWER THAN TWO DRINKING FOUNTAINS SHALL BE PROVIDED. ONE DRINKING FOUNTAIN SHALL COMPLY WITH THE REQUIREMENTS FOR PEOPLE WHO USE A WHEELCHAIR AND ONE DRINKING FOUNTAIN SHALL COMPLY WITH THE REQUIREMENTS FOR STANDING PERSONS.

**1111.1 SIGNS.** REQUIRED ACCESSIBLE ELEMENTS SHALL BE IDENTIFIED BY THE INTERNATIONAL SYMBOL OF ACCESSIBILITY AT THE FOLLOWING LOCATIONS.

1. ACCESSIBLE PARKING SPACES REQUIRED BY SECTION 1106.1.
3. ACCESSIBLE PASSENGER LOADING ZONES.
5. ACCESSIBLE ENTRANCES WHERE NOT ALL ENTRANCES ARE ACCESSIBLE.

#### BC NYS CHAPTER 12 - INTERIOR ENVIRONMENT

**1202.1 GENERAL.** BUILDINGS SHALL BE PROVIDED WITH NATURAL VENTILATION IN ACCORDANCE WITH SECTION 1202.5 OR MECHANICAL VENTILATION IN ACCORDANCE WITH THE MECHANICAL CODE OF NEW YORK STATE.

**1203.1 EQUIPMENT AND SYSTEMS.** INTERIOR SPACES INTENDED FOR HUMAN OCCUPANCY SHALL BE PROVIDED WITH ACTIVE OR PASSIVE SPACE HEATING SYSTEMS CAPABLE OF MAINTAINING AN INDOOR TEMPERATURE OF NOT LESS THAN 68°F AT A POINT 3 FEET ABOVE THE FLOOR ON THE DESIGN HEATING DAY.

**1204.1 GENERAL.** EVERY SPACE INTENDED FOR HUMAN OCCUPANCY SHALL BE PROVIDED WITH NATURAL LIGHT BY MEANS OF EXTERIOR GLAZED OPENINGS IN ACCORDANCE WITH SECTION 1204.2 OR SHALL BE PROVIDED WITH ARTIFICIAL LIGHT IN ACCORDANCE WITH SECTION 1204.3. EXTERIOR GLAZED OPENINGS SHALL OPEN DIRECTLY ONTO A PUBLIC WAY OR ONTO A YARD OR COURT IN ACCORDANCE WITH SECTION 1205.

**1204.3 ARTIFICIAL LIGHT.** ARTIFICIAL LIGHT SHALL BE PROVIDED THAT IS ADEQUATE TO PROVIDE AN AVERAGE ILLUMINATION OF 10 FOOTCANDLES OVER THE AREA OF THE ROOM AT A HEIGHT OF 30 INCHES ABOVE THE FLOOR LEVEL.

**1204.4 STAIRWAY ILLUMINATION.** STAIRWAYS WITHIN DWELLING UNITS AND EXTERIOR STAIRWAYS SERVING A DWELLING UNIT SHALL HAVE AN ILLUMINATION LEVEL ON TREAD RUNS OF NOT LESS THAN 1 FOOTCANDLE. STAIRWAYS IN OTHER OCCUPANCIES SHALL BE GOVERNED BY CHAPTER 10.

**1204.4.1 CONTROLS.** THE CONTROL FOR ACTIVATION OF THE REQUIRED STAIRWAY LIGHTING SHALL BE IN ACCORDANCE WITH NFPA 70.

**1207.1 MINIMUM ROOM WIDTHS;** HABITABLE SPACES, OTHER THAN A KITCHEN, SHALL BE NOT LESS THAN 7 FEET IN ANY PLAN DIMENSION. KITCHENS SHALL HAVE A CLEAR PASSAGEWAY OF NOT LESS THAN 3 FEET BETWEEN COUNTER FRONTS AND APPLIANCES OR COUNTER FRONTS AND WALLS.

**1207.2 MINIMUM CEILING HEIGHTS;** OCCUPIED SPACES, HABITABLE SPACES AND CORRIDORS SHALL HAVE A CEILING HEIGHT OF NOT LESS THAN 7 FEET 6 INCHES ABOVE THE FINISHED FLOOR. BATHROOMS, TOILET ROOMS, KITCHENS, STORAGE ROOMS AND LAUNDRY ROOMS SHALL HAVE A CEILING HEIGHT OF NOT LESS THAN 7 FEET ABOVE THE FINISHED FLOOR.

**1207.3 ROOM AREA;** EVERY DWELLING UNIT SHALL HAVE NOT LESS THAN ONE ROOM THAT SHALL HAVE NOT LESS THAN 120 SQUARE FEET OF NET FLOOR AREA. OTHER HABITABLE ROOMS SHALL HAVE A NET FLOOR AREA OF NOT LESS THAN 70 SQUARE FEET.

**1209.2.1 FLOORS AND WALL BASES.** IN OTHER THAN DWELLING UNITS, TOILET, BATHING AND SHOWER ROOM FLOOR FINISH MATERIALS SHALL HAVE A SMOOTH, HARD, NONABSORBENT SURFACE. THE INTERSECTIONS OF SUCH FLOORS WITH WALLS SHALL HAVE A SMOOTH, HARD, NONABSORBENT VERTICAL BASE THAT EXTENDS UPWARD ONTO THE WALLS NOT LESS THAN 4 INCHES.

**1209.2.2 WALLS AND PARTITIONS.** WALLS AND PARTITIONS WITHIN 2 FEET OF SERVICE SINKS, URINALS AND WATER CLOSETS SHALL HAVE A SMOOTH, HARD, NONABSORBENT SURFACE, TO A HEIGHT OF NOT LESS THAN 4 FEET ABOVE THE FLOOR, AND EXCEPT FOR STRUCTURAL ELEMENTS, THE MATERIALS USED IN SUCH WALLS SHALL BE OF A TYPE THAT IS NOT ADVERSELY AFFECTED BY MOISTURE.

#### NYS ENERGY CONSERVATION CONSTRUCTION CODE (ECCC) REVIEW SUMMARY

##### 1. GENERAL REQUIREMENTS

**TABLE C301.1 NEW YORK STATE CLIMATE ZONES BY COUNTY**  
ZONE 5A - ORANGE COUNTY

**TABLE C303.1.3(1) DEFAULT GLAZED WINDOW, GLASS DOOR AND SKYLIGHT U-FACTORS**  
METAL FRAME TYPE WITH THERMAL BREAK - DOUBLE - 0.65  
NONMETAL OR METAL CLAD FRAME - DOUBLE - 0.55

**TABLE C303.1.3(2) DEFAULT OPAQUE DOOR U-FACTORS**  
INSULATED METAL (OTHER) DOOR - 0.60  
INSULATED, NONMETAL EDGE, MAX 45% GLAZING - 0.35

**TABLE C303.1.3(3) DEFAULT GLAZED FENESTRATION SHGC AND VT**  
SHGC - DOUBLE GLAZED - 0.7  
VT - DOUBLE GLAZED - 0.6

##### 2. COMMERCIAL ENERGY EFFICIENCY

**TABLE C402.1.3 OPAQUE THERMAL ENVELOPE INSULATION COMPONENT MINIMUM REQUIREMENTS, R-VALUE METHOD**  
ROOFS - INSULATION ENTIRELY ABOVE ROOF DECK - R-30.0 CI  
WALLS ABOVE GRADE - MASS - 11.4 CI  
WALLS ABOVE GRADE - METAL FRAMED - R-13 + R-7.5 CI  
FLOORS - MASS - R-10 CI  
SLAB ON GRADE FLOORS - UNHEATED SLABS - R-10.0 FOR 24" BELOW  
OPAQUE DOORS - NONSWINGING - R-4.75


**TABLE C402.1.4 OPAQUE THERMAL ENVELOPE ASSEMBLY MAXIMUM REQUIREMENTS, U-FACTOR METHOD**  
OPAQUE DOORS - SWINGING DOOR - U-0.37



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DEMOLITION NOTES:

- PATCHING: WHERE REMOVALS LEAVE HOLES AND DAMAGED SURFACES EXPOSED IN THE FINISHED WORK, PATCH AND REPAIR THESE HOLES AND DAMAGED SURFACES TO MATCH ADJACENT FINISHED SURFACES. WHERE NEW WORK IS TO BE APPLIED TO EXISTING SURFACES, PERFORM REMOVALS AND PATCHING IN A MANNER TO PRODUCE SURFACES SUITABLE FOR RECEIVING NEW WORK.
- DUST AND DEBRIS CONTROL: PROVIDE TEMPORARY INTERIOR ENCLOSURES, AS REQUIRED, TO PROTECT ALL OCCUPANTS AND TO PREVENT THE SPREAD OF DUST AND DEBRIS TO OCCUPIED PORTIONS OF THE BUILDING AND AVOID THE CREATION OF A NUISANCE OR HAZARD IN THE SURROUNDING AREA. CLEAN AND SWEEP THE WORK AREA DAILY.
- ALL MATERIALS AND EQUIPMENT REMOVED, AND NOT REUSED, SHALL BECOME THE PROPERTY OF THE CONTRACTOR AND SHALL BE REMOVED FROM THE OWNER'S PROPERTY.
- PROTECT ANY EXISTING UTILITIES, EQUIPMENT, WALLS, FLOOR FINISHES AND CEILINGS TO REMAIN FROM DAMAGE DUE TO DEMOLITION WORK. REPAIR ANY DAMAGE INCURRED WITH NEW OR LIKE MATERIALS BACK TO ORIGINAL CONDITION. THE CONTRACTOR IS RESPONSIBLE FOR ALL MEANS AND METHODS OF EXISTING AND NEW CONSTRUCTION TO PROVIDE A COMPLETED PROJECT IN ACCORDANCE WITH ALL APPLICABLE OSHA, FEDERAL, STATE AND LOCAL RULES AND REGULATIONS.
- THE CONTRACTOR IS RESPONSIBLE FOR SECURING THE ENTIRE STRUCTURE FROM WEATHER RELATED DAMAGE DURING CONSTRUCTION.
- ALL REMOVAL WORK SHOWN AND REQUIRED SHALL BE BY THIS CONTRACT. MAINTAIN ALL LEGAL EXITWAYS.
- PROVIDE ALL DEMO REQUIRED FOR NEW INSTALLATIONS SHOWN, AND PATCH EXISTING MATERIALS BACK TO ORIGINAL CONDITION, OR TO A CONDITION TO RECEIVE NEW WORK AS APPLICABLE AND THAT IS ACCEPTABLE TO THE ENGINEER.
- CONTRACTOR IS RESPONSIBLE FOR DISPOSAL OF ALL UNSUITABLE MATERIAL OFFSITE.
- CONTRACTOR IS RESPONSIBLE FOR COORDINATING STOCKPILE LOCATIONS FOR CONSTRUCTION MATERIALS.
- HAZARDOUS MATERIAL REMOVALS BY OWNER.

EXISTING ADJACENT BUILDING

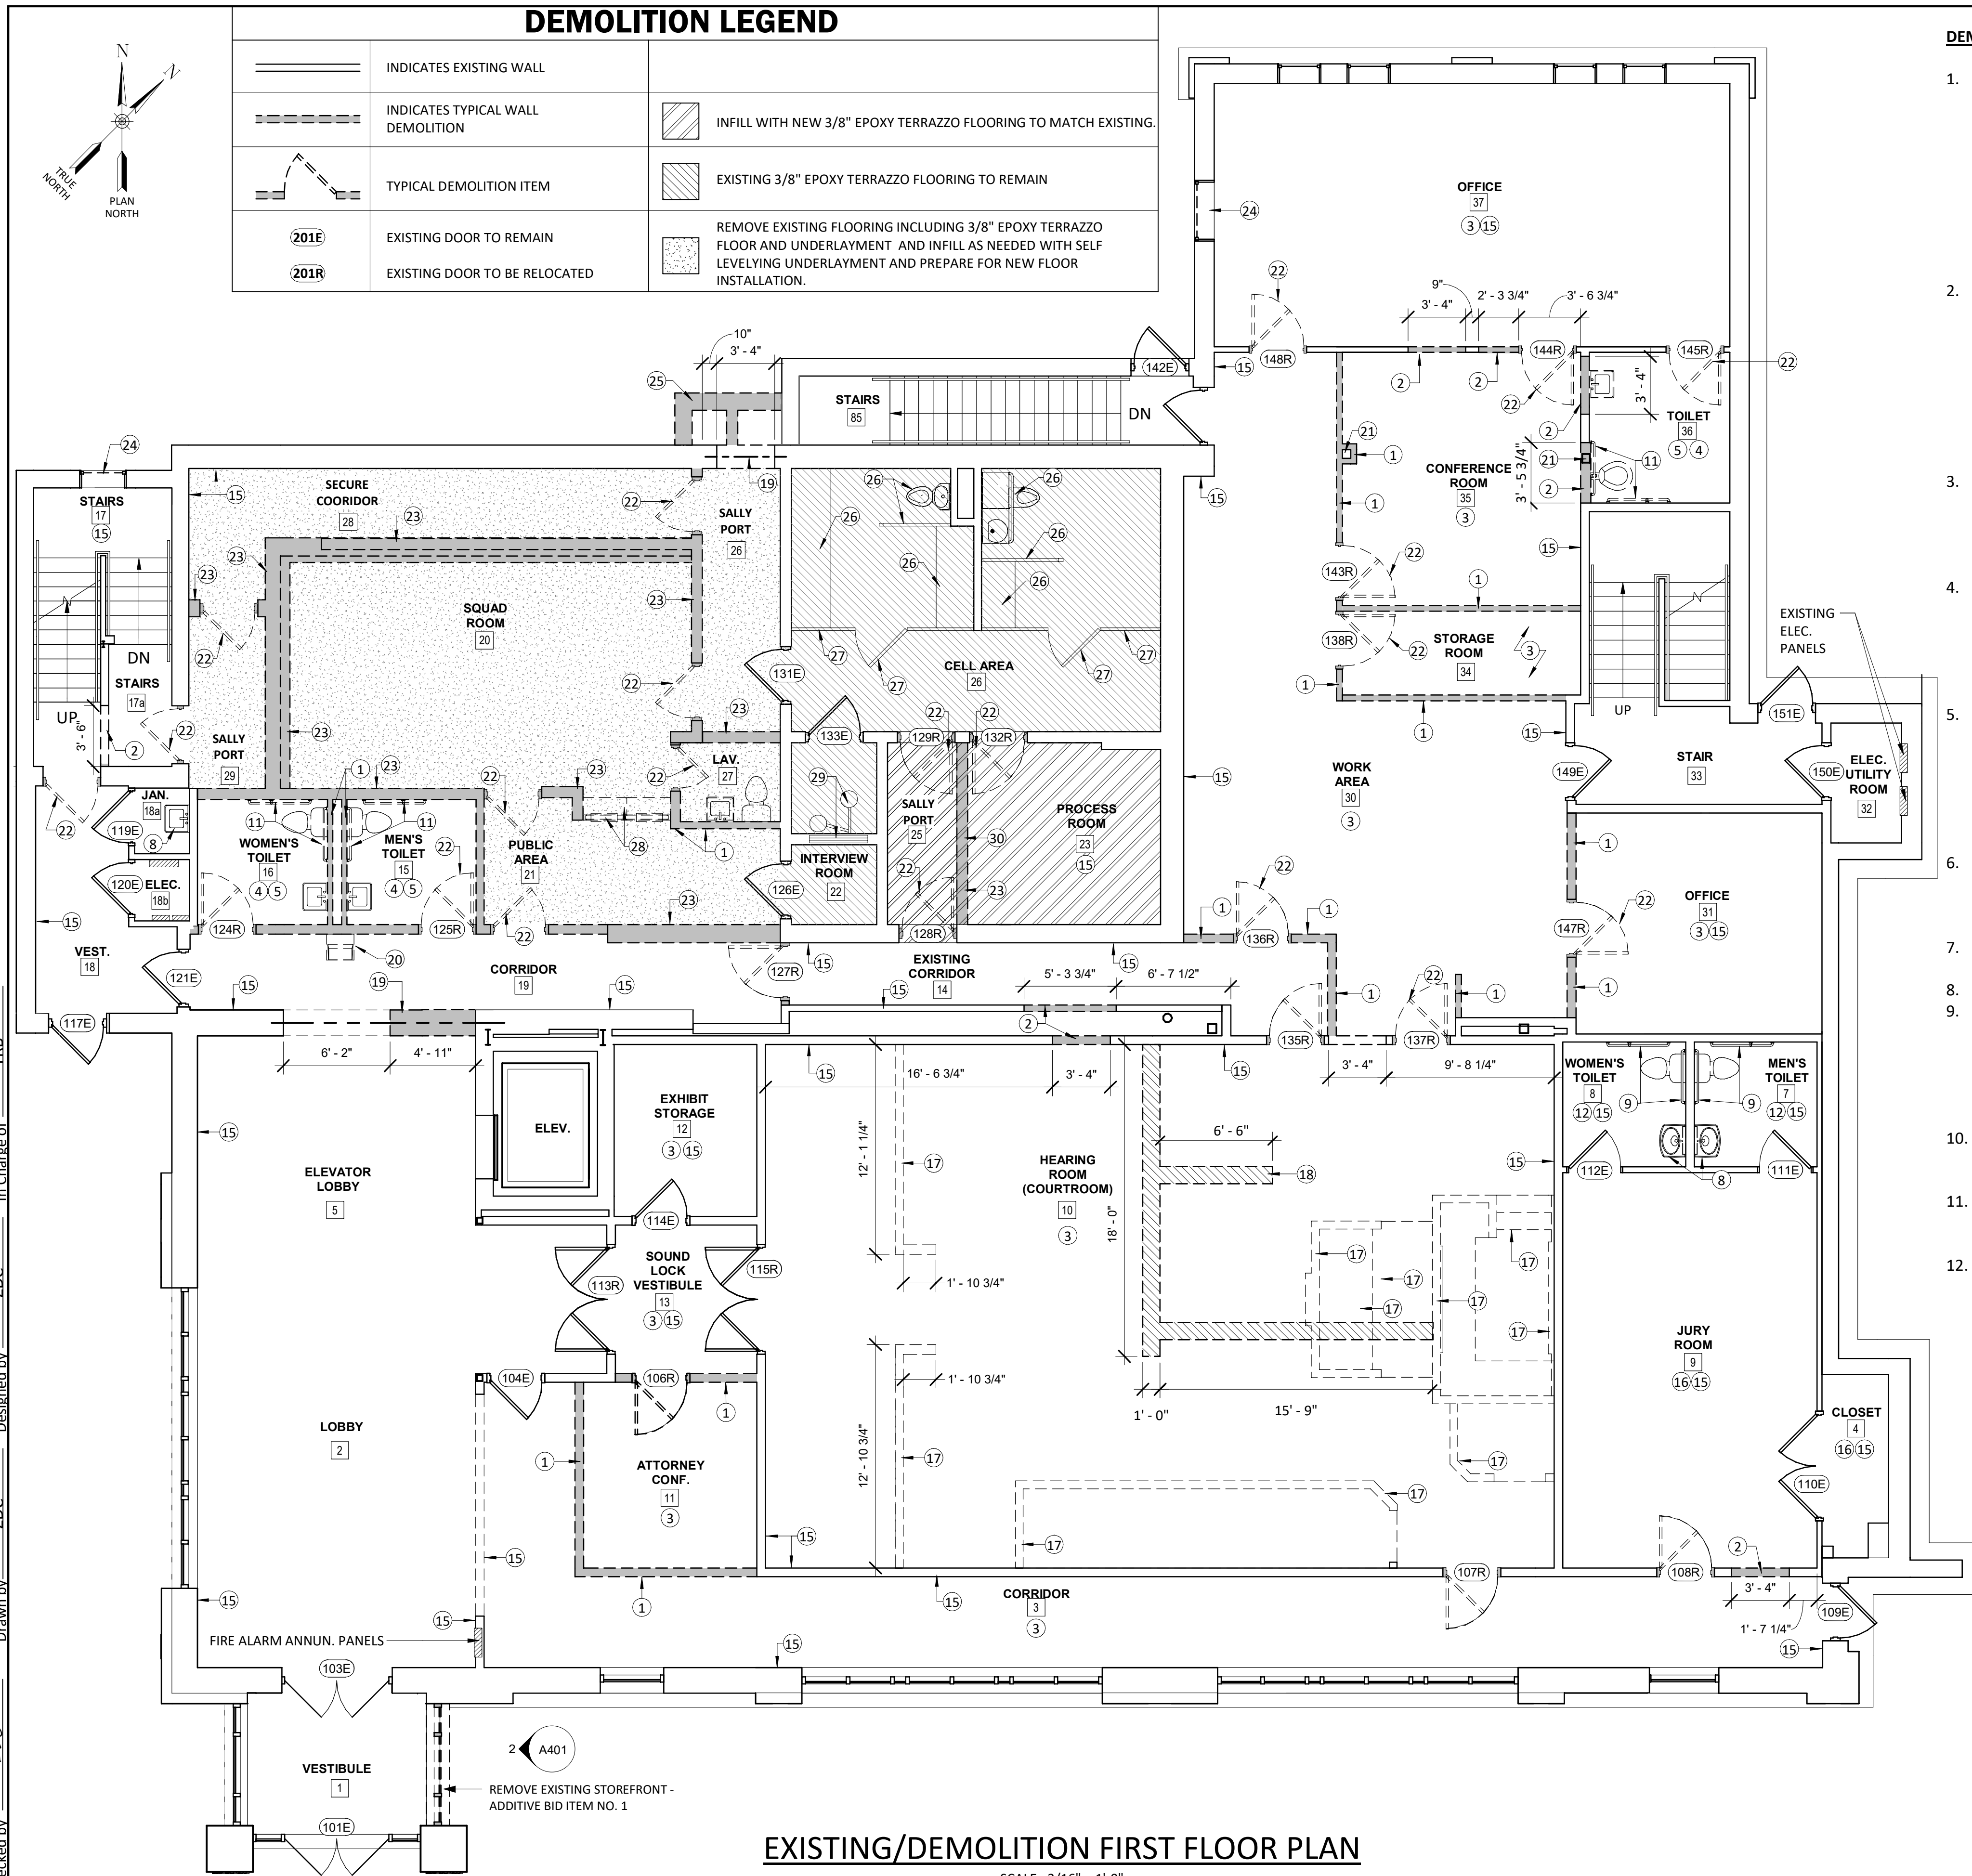DEMO KEY NOTES

- REMOVE EXISTING WALL PARTITION.
- REMOVE EXISTING WALL PARTITION TO CREATE NEW OPENINGS.
- REMOVE EXISTING FLOORING (CARPETING). PREPARE SURFACE AS REQD TO RECEIVE NEW FLOORING PER SCHEDULE.
- REMOVE EXISTING FLOORING (TILE). PREPARE SURFACE AS REQD TO RECEIVE NEW FLOORING PER SCHEDULE.
- REMOVE EXISTING TILE WAINSCOT & GWB THROUGHOUT BATHROOM DOWN TO STUDS.
- NOT USED
- REMOVE EXISTING BATHROOM FIXTURES IN THEIR ENTIRETY.
- EXISTING BATHROOM FIXTURES TO REMAIN PROTECT DURING CONSTRUCTION.
- EXISTING BATHROOM ACCESSORIES TO REMAIN PROTECT DURING CONSTRUCTION.
- EXISTING BATHROOM MIRROR TO BE REMOVED.
- REMOVE EXISTING BATHROOM FIXTURES.
- EXISTING FLOOR TILE TO REMAIN PROTECT DURING CONSTRUCTION.
- EXISTING WAINSCOT TILE TO REMAIN ON ALL FOUR WALLS PROTECT DURING CONSTRUCTION.
- EXISTING CABINTRY TO BE REMOVED
- PATCH AND REPAIR EXISTING WALLS TO A LEVEL 4 FINISH AND PREPARE WALLS TO BE PAINTED.
- EXISTING FLOORING TO REMAIN PROTECT DURING CONSTRUCTION.
- REMOVE EXISTING MILLWORK, CABINTRY, COUNTERTOPS & EQUIPMENT, WALL PANELS & PLATFORMS IN THEIR ENTIRETY
- CONCRETE SLAB DEMOLITION BY ELECTRICAL CONTRACTOR TO COMPLETE MODIFICATIONS AS SHOWN ON ELECTRICAL DRAWINGS. GENERAL CONTRACTOR IS RESPONSIBLE FOR SLAB INFILL.
- REMOVE EXISTING MASONRY WALL TO CREATE NEW OPENING. REFER TO LINTEL SCHEDULE ON STRUCTURAL DRAWINGS FOR REQUIREMENTS.
- REMOVE EXISTING DRINKING FOUNTAIN. CAP PLUMBING LINES & PATCH OPENINGS IN WALL.
- EXISTING COLUMN TO REMAIN.
- REMOVE EXISTING DOOR & FRAME.
- REMOVE EXISTING CMU BLOCK WALL PARTITIONS (INCL. GYPSUM AND STUDS) IN ITS ENTIRETY.
- REMOVE EXISTING WINDOW AND SILL IN ITS ENTIRETY.
- REMOVE EXISTING MASONRY CHIMNEY ENTIRELY INCLUDING FOUNDATIONS FULL HEIGHT. EXTERIOR BRICK SHOULD BE TOOTHED IN TO MATCH EXISTING COURSING TO BLEND IN WITH EXISTING CONDITIONS.
- EXISTING SINK/TOILET COMBINATIONS, BENCHES, ACCESSORIES AND DIVIDERS TO REMAIN
- EXISTING CELL BARS AND DOORS TO REMAIN.
- REMOVE EXISTING RECEPTION WINDOWS AND COUNTERTOPS.
- EXISTING INTERVIEW WINDOW SWIVEL STOOL TO REMAIN
- REMOVE EXISTING CMU BLOCK WALL PARTITIONS IN ITS ENTIRETY SALAVAGE CMY BLOCK FOR REUSE.
- NOT USED
- NOT USED
- NOT USED
- REMOVE EXISTING EYE WASH STATION AND INFILL MASONRY TO MATCH EXISTING.
- REMOVE EXISTING FLOOR DRAINS. CAP LINES AND PATCH FLOOR.

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REVISIONS

NO.	DESCRIPTION

CITY OF MIDDLETOWN  
NEW COURTHOUSE FACILITY  
CONTRACT 1A - GENERAL CONSTRUCTION

EXISTING/DEMOLITION FIRST FLOOR PLANS

CITY OF MIDDLETOWN  
ORANGE COUNTY, NEW YORK

Barton & Loguidice  
443 Electronics Parkway  
Liverpool, NY 13088

NYS CERTIFICATE #  
0021642, 0020588, 0019903,  
0019905, 0020336

**B&L**



NYS EXP.:

Date  
AUGUST, 2024

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Sheet Number  
AD101

Project Number  
1753.008.001



DEMOLITION NOTES:

1. PATCHING: WHERE REMOVALS LEAVE HOLES AND DAMAGED SURFACES EXPOSED IN THE FINISHED WORK, PATCH AND REPAIR THESE HOLES AND DAMAGED SURFACES TO MATCH ADJACENT FINISHED SURFACES. WHERE NEW WORK IS TO BE APPLIED TO EXISTING SURFACES, PERFORM REMOVALS AND PATCHING IN A MANNER TO PRODUCE SURFACES SUITABLE FOR RECEIVING NEW WORK.

2. DUST AND DEBRIS CONTROL: PROVIDE TEMPORARY INTERIOR ENCLOSURES, AS REQUIRED, TO PROTECT ALL OCCUPANTS AND TO PREVENT THE SPREAD OF DUST AND DEBRIS TO OCCUPIED PORTIONS OF THE BUILDING AND AVOID THE CREATION OF A NUISANCE OR HAZARD IN THE SURROUNDING AREA. CLEAN AND SWEEP THE WORK AREA DAILY.

3. ALL MATERIALS AND EQUIPMENT REMOVED, AND NOT REUSED, SHALL BECOME THE PROPERTY OF THE CONTRACTOR AND SHALL BE REMOVED FROM THE OWNER'S PROPERTY.

4. PROTECT ANY EXISTING UTILITIES, EQUIPMENT, WALLS, FLOOR FINISHES AND CEILINGS TO REMAIN FROM DAMAGE DUE TO DEMOLITION WORK. REPAIR ANY DAMAGE INCURRED WITH NEW OR LIKE MATERIALS BACK TO ORIGINAL CONDITION.

5. THE CONTRACTOR IS RESPONSIBLE FOR ALL MEANS AND METHODS OF EXISTING AND NEW CONSTRUCTION TO PROVIDE A COMPLETED PROJECT IN ACCORDANCE WITH ALL APPLICABLE OSHA, FEDERAL, STATE AND LOCAL RULES AND REGULATIONS.

6. THE CONTRACTOR IS RESPONSIBLE FOR SECURING THE ENTIRE STRUCTURE FROM WEATHER RELATED DAMAGE DURING CONSTRUCTION.

7. ALL REMOVAL WORK SHOWN AND REQUIRED SHALL BE BY THIS CONTRACT.



8. MAINTAIN ALL LEGAL EXITWAYS.

9. PROVIDE ALL DEMO REQUIRED FOR NEW INSTALLATIONS SHOWN, AND PATCH EXISTING MATERIALS BACK TO ORIGINAL CONDITION, OR TO A CONDITION TO RECEIVE NEW WORK AS APPLICABLE AND THAT IS ACCEPTABLE TO THE ENGINEER.

10. CONTRACTOR IS RESPONSIBLE FOR DISPOSAL OF ALL UNSUITABLE MATERIAL OFFSITE.

11. CONTRACTOR IS RESPONSIBLE FOR COORDINATING STOCKPILE LOCATIONS FOR CONSTRUCTION MATERIALS.

12. HAZARDOUS MATERIAL REMOVALS BY OWNER.

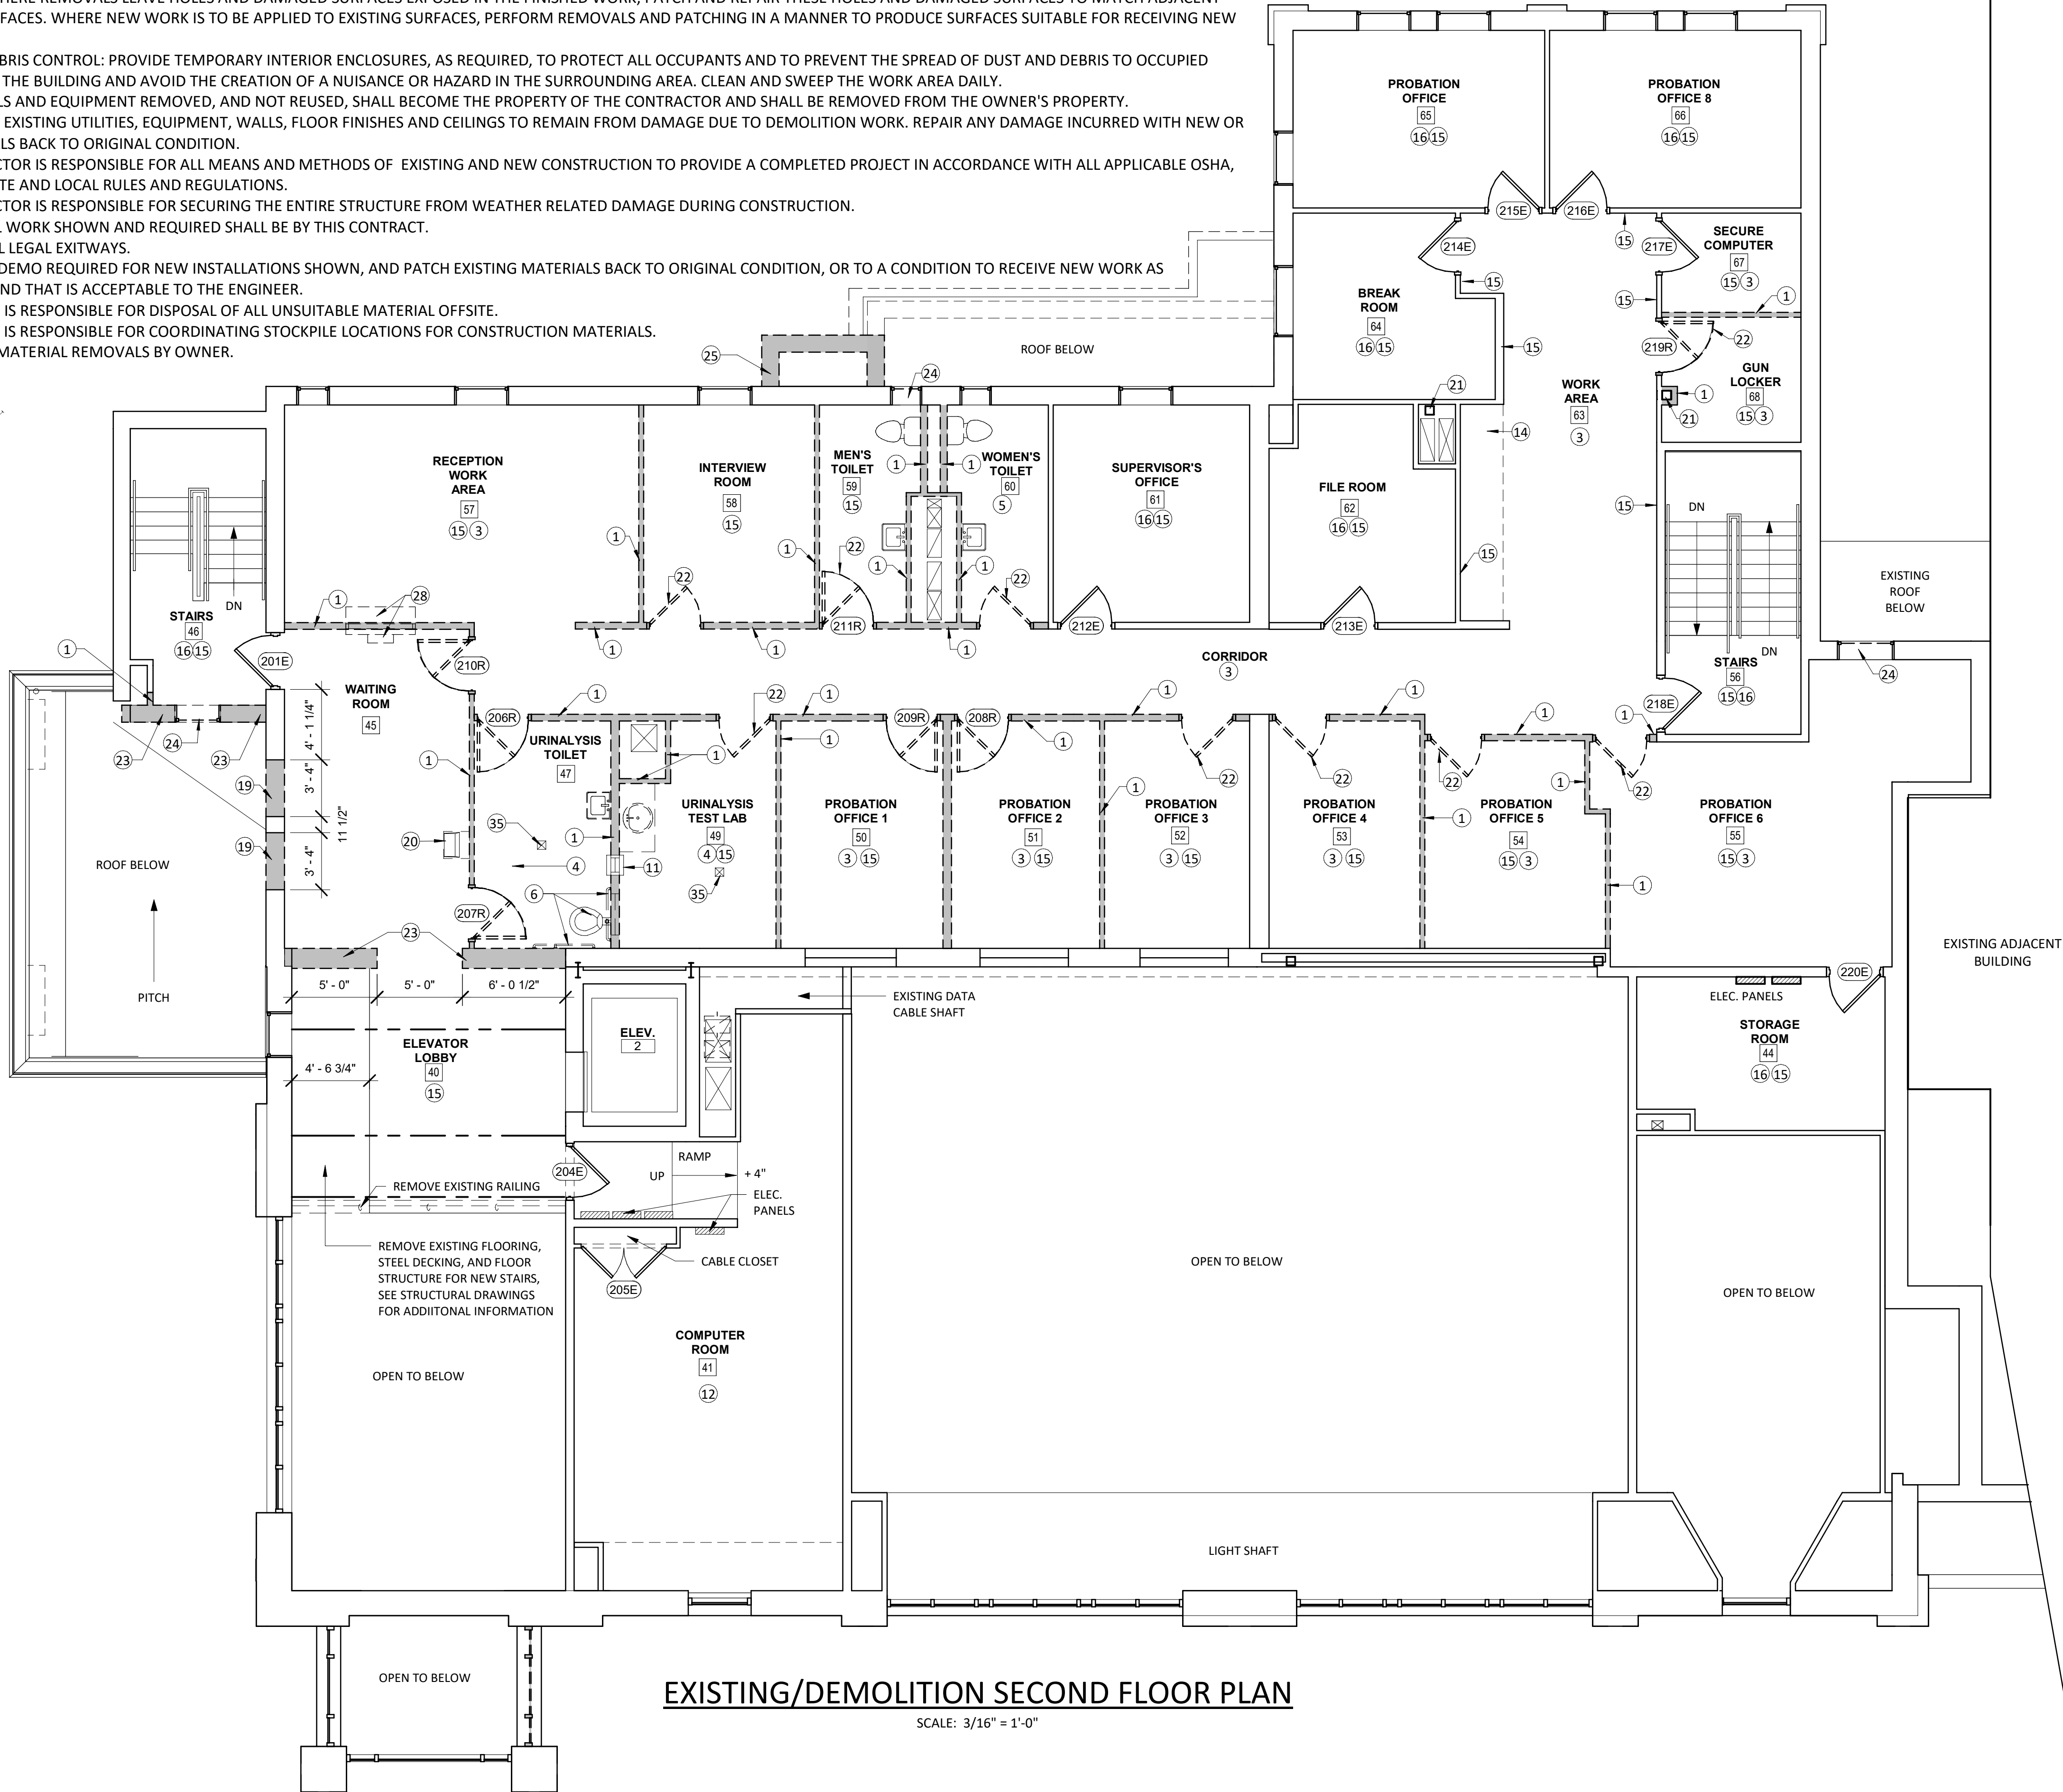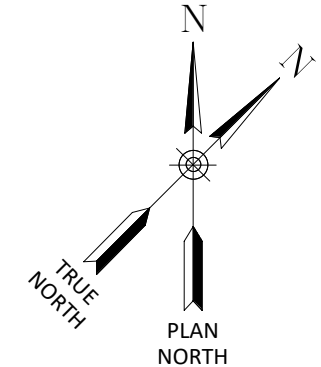

EXISTING/DEMOLITION SECOND FLOOR PLAN

SCALE: 3/16" = 1'-0"

DEMO KEY NOTES

- 1 REMOVE EXISTING WALL PARTITION.

2 REMOVE EXISTING WALL PARTITION TO CREATE NEW OPENINGS.

3 REMOVE EXISTING FLOORING (CARPETING). PREPARE SURFACE AS REQD TO RECEIVE NEW FLOORING PER SCHEDULE.

4 REMOVE EXISTING FLOORING (TILE). PREPARE SURFACE AS REQD TO RECEIVE NEW FLOORING PER SCHEDULE.

5 REMOVE EXISTING TILE WAINSCOT & GWB THROUGHOUT BATHROOM DOWN TO STUDS.

6 NOT USED

7 REMOVE EXISTING BATHROOM FIXTURES IN THEIR ENTIRETY.

8 EXISTING BATHROOM FIXTURES TO REMAIN PROTECT DURING CONSTRUCTION.

9 EXISTING BATHROOM ACCESSORIES TO REMAIN PROTECT DURING CONSTRUCTION.

10 EXISTING BATHROOM MIRROR TO BE REMOVED.

11 REMOVE EXISTING BATHROOM FIXTURES.

12 EXISTING FLOOR TILE TO REMAIN PROTECT DURING CONSTRUCTION.

13 EXISTING WAINSCOT TILE TO REMAIN ON ALL FOUR WALLS PROTECT DURING CONSTRUCTION.

14 EXISTING CABINERY TO BE REMOVED

15 PATCH AND REPAIR EXISTING WALLS TO A LEVEL 4 FINISH AND PREPARE WALLS TO BE PAINTED.

16 EXISTING FLOORING TO REMAIN PROTECT DURING CONSTRUCTION.

17 REMOVE EXISTING MILLWORK, CABINERY, COUNTERTOPS & EQUIPMENT, WALL PANELS & PLATFORMS IN THEIR ENTIRETY

18 CONCRETE SLAB DEMOLITION BY ELECTRICAL CONTRACTOR TO COMPLETE MODIFICATIONS AS SHOWN ON ELECTRICAL DRAWINGS. GENERAL CONTRACTOR IS RESPONSIBLE FOR SLAB INFILL.

19 REMOVE EXISTING MASONRY WALL TO CREATE NEW OPENING. REFER TO LINTEL SCHEDULE ON STRUCTURAL DRAWINGS FOR REQUIREMENTS.

20 REMOVE EXISTING DRINKING FOUNTAIN. CAP PLUMBING LINES & PATCH OPENINGS IN WALL.

21 EXISTING COLUMN TO REMAIN.

22 REMOVE EXISTING DOOR & FRAME.

23 REMOVE EXISTING CMU BLOCK WALL PARTITIONS (INCL. GYPSUM AND STUDS) IN ITS ENTIRETY.

24 REMOVE EXISTING WINDOW AND SILL IN ITS ENTIRETY.

25 REMOVE EXISTING MASONRY CHIMNEY ENTIRELY INCLUDING FOUNDATIONS FULL HEIGHT. EXTERIOR BRICK SHOULD BE TOOTHED IN TO MATCH EXISTING COURSING TO BLEND IN WITH EXISTING CONDITIONS.

26 EXISTING SINK/TOILET COMBINATIONS, BENCHES, ACCESSORIES AND DIVIDERS TO REMAIN

27 EXISTING CELL BARS AND DOORS TO REMAIN.

28 REMOVE EXISTING RECEPTION WINDOWS AND COUNTERTOPS.

29 EXISTING INTERVIEW WINDOW SWIVEL STOOL TO REMAIN

30 REMOVE EXISTING CMU BLOCK WALL PARTITIONS IN ITS ENTIRETY SALAVAGE CMY BLOCK FOR REUSE.

31 NOT USED


32 NOT USED

33 NOT USED

34 REMOVE EXISTING EYE WASH STATION AND INFILL MASONRY TO MATCH EXISTING.

35 REMOVE EXISTING FLOOR DRAINS. CAP LINES AND PATCH FLOOR.

DEMOLITION LEGEND

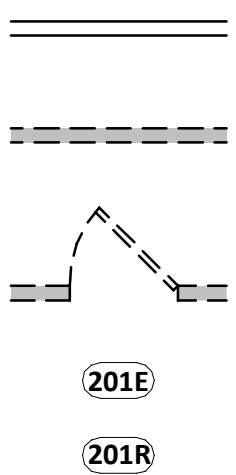

- INDICATES EXISTING WALL
- INDICATES TYPICAL WALL DEMOLITION
- TYPICAL DEMOLITION ITEM
- EXISTING DOOR TO REMAIN
- EXISTING DOOR TO BE RELOCATED

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REVISIONS


NO.	DESCRIPTION

CITY OF MIDDLETOWN  
NEW COURTHOUSE FACILITY

EXISTING/DEMOLITION SECOND FLOOR PLAN

CITY OF MIDDLETOWN  
ORANGE COUNTY, NEW YORK

Barton & Loguidice  
443 Electronics Parkway  
Liverpool, NY 13088

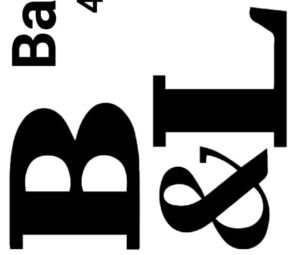


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Project Number 1753.008.001



- ROOF DEMOLITION KEYED PLAN NOTES**
- 1A REMOVE EXISTING EPDM MEMBRANE ROOFING, RIGID INSULATION, VAPOR BARRIER AND FULLY EXPOSE SLOPED ROOF METAL DECK AND PREPARE FOR REPLACEMENT
- 1B REMOVE EXISTING EPDM MEMBRANE ROOFING, TAPERED RIGID INSULATION SYSTEM, AND FULLY EXPOSE ROOF CONCRETE PLANK DECK AND PREPARE FOR REPLACEMENT
- 1C REMOVE EXISTING EPDM MEMBRANE ROOFING, RIGID INSULATION, VAPOR BARRIER AND FULLY EXPOSE POURED CONCRETE DECK OVER METAL DECK AND PREPARE FOR REPLACEMENT
- 2 REMOVE EXISTING METAL ROOF COPING SYSTEM AND PREPARE FOR REPLACEMENT
- 3 EXISTING HVAC EQUIPMENT TO BE REMOVED, CURBING TO REMAIN, REMOVE EXISTING MEMBRANE FLASHINGS AND PREPARE FOR REPLACEMENT
- 4 EXISTING ROOF VENT TO REMAIN, REMOVE EXISTING MEMBRANE FLASHINGS AND PREPARE FOR REPLACEMENT
- 5 EXISTING ELEVATOR PENTHOUSE HATCH TO REMAIN, REMOVE EXISTING MEMBRANE FLASHINGS AND PREPARE FOR REPLACEMENT
- 6 REMOVE EXISTING ROOF DRAIN STRAINER AND BOWL, PREPARE FOR NEW ROOFING, BOWL & STRAINER COVER.
- 7 EXISTING ROOF ACCESS HATCH TO REMAIN, REMOVE EXISTING MEMBRANE FLASHING AND PREPARE FOR REPLACEMENT
- 8 EXISTING SKYLIGHTS TO REMAIN, REMOVE EXISTING MEMBRANE FLASHING AND PREPARE FOR REPLACEMENT
- 9 EXISTING ROOF SCUPPERS TO REMAIN, REMOVE EXISTING MEMBRANE FLASHING AND PREPARE FOR REPLACEMENT
- 10 EXISTING CHIMNEY TO BE REMOVED FULL HEIGHT INCLUDING COPING, BRICK AND CMU BLOCK WALLS, FOUNDATIONS, CHIMNEY FLUE AND PREPARE FOR NEW WORK (BRICK TO BE SALVAGED FOR NEW MASONRY WORK INCLUDING BRICK INFILL AT CHIMNEY REMOVAL LOCATION)
- 11 EXISTING LIGHTS TO REMAIN
- 12 EXISTING PARAPET WALL REMOVE EXISTING EPDM WRAPPED OVER PARAPET AND PREPARED FOR PLACEMENT
- 13 EXISTING STANDING SEAM METAL ROOF TO BE MODIFIED (PANELS TO BE REMOVED AND RE-INSTALLED) TO ALLOW NEW CHIMNEY REMOVAL AND ROOF WORK FOR COVERED CANOPY
- 14 EXISTING ROOF VENT TO BE REMOVED, PROVIDE NEW ROOF INFILL AS NEEDED
- 15 EXISTING ROOF MECHANICAL EQUIPMENT & CURB TO BE REMOVED BY MECHANICAL CONTRACTOR AND EXISTING OPENING TO BE INFILLED BY GENERAL CONTRACTOR

**PLAN LEGEND**

- EXISTING CONCRETE PLANK ROOF DECK
- EXISTING SLOPED METAL ROOF DECK
- EXISTING POURED CONCRETE ON METAL ROOF DECK
- EXISTING METAL ROOF DECK

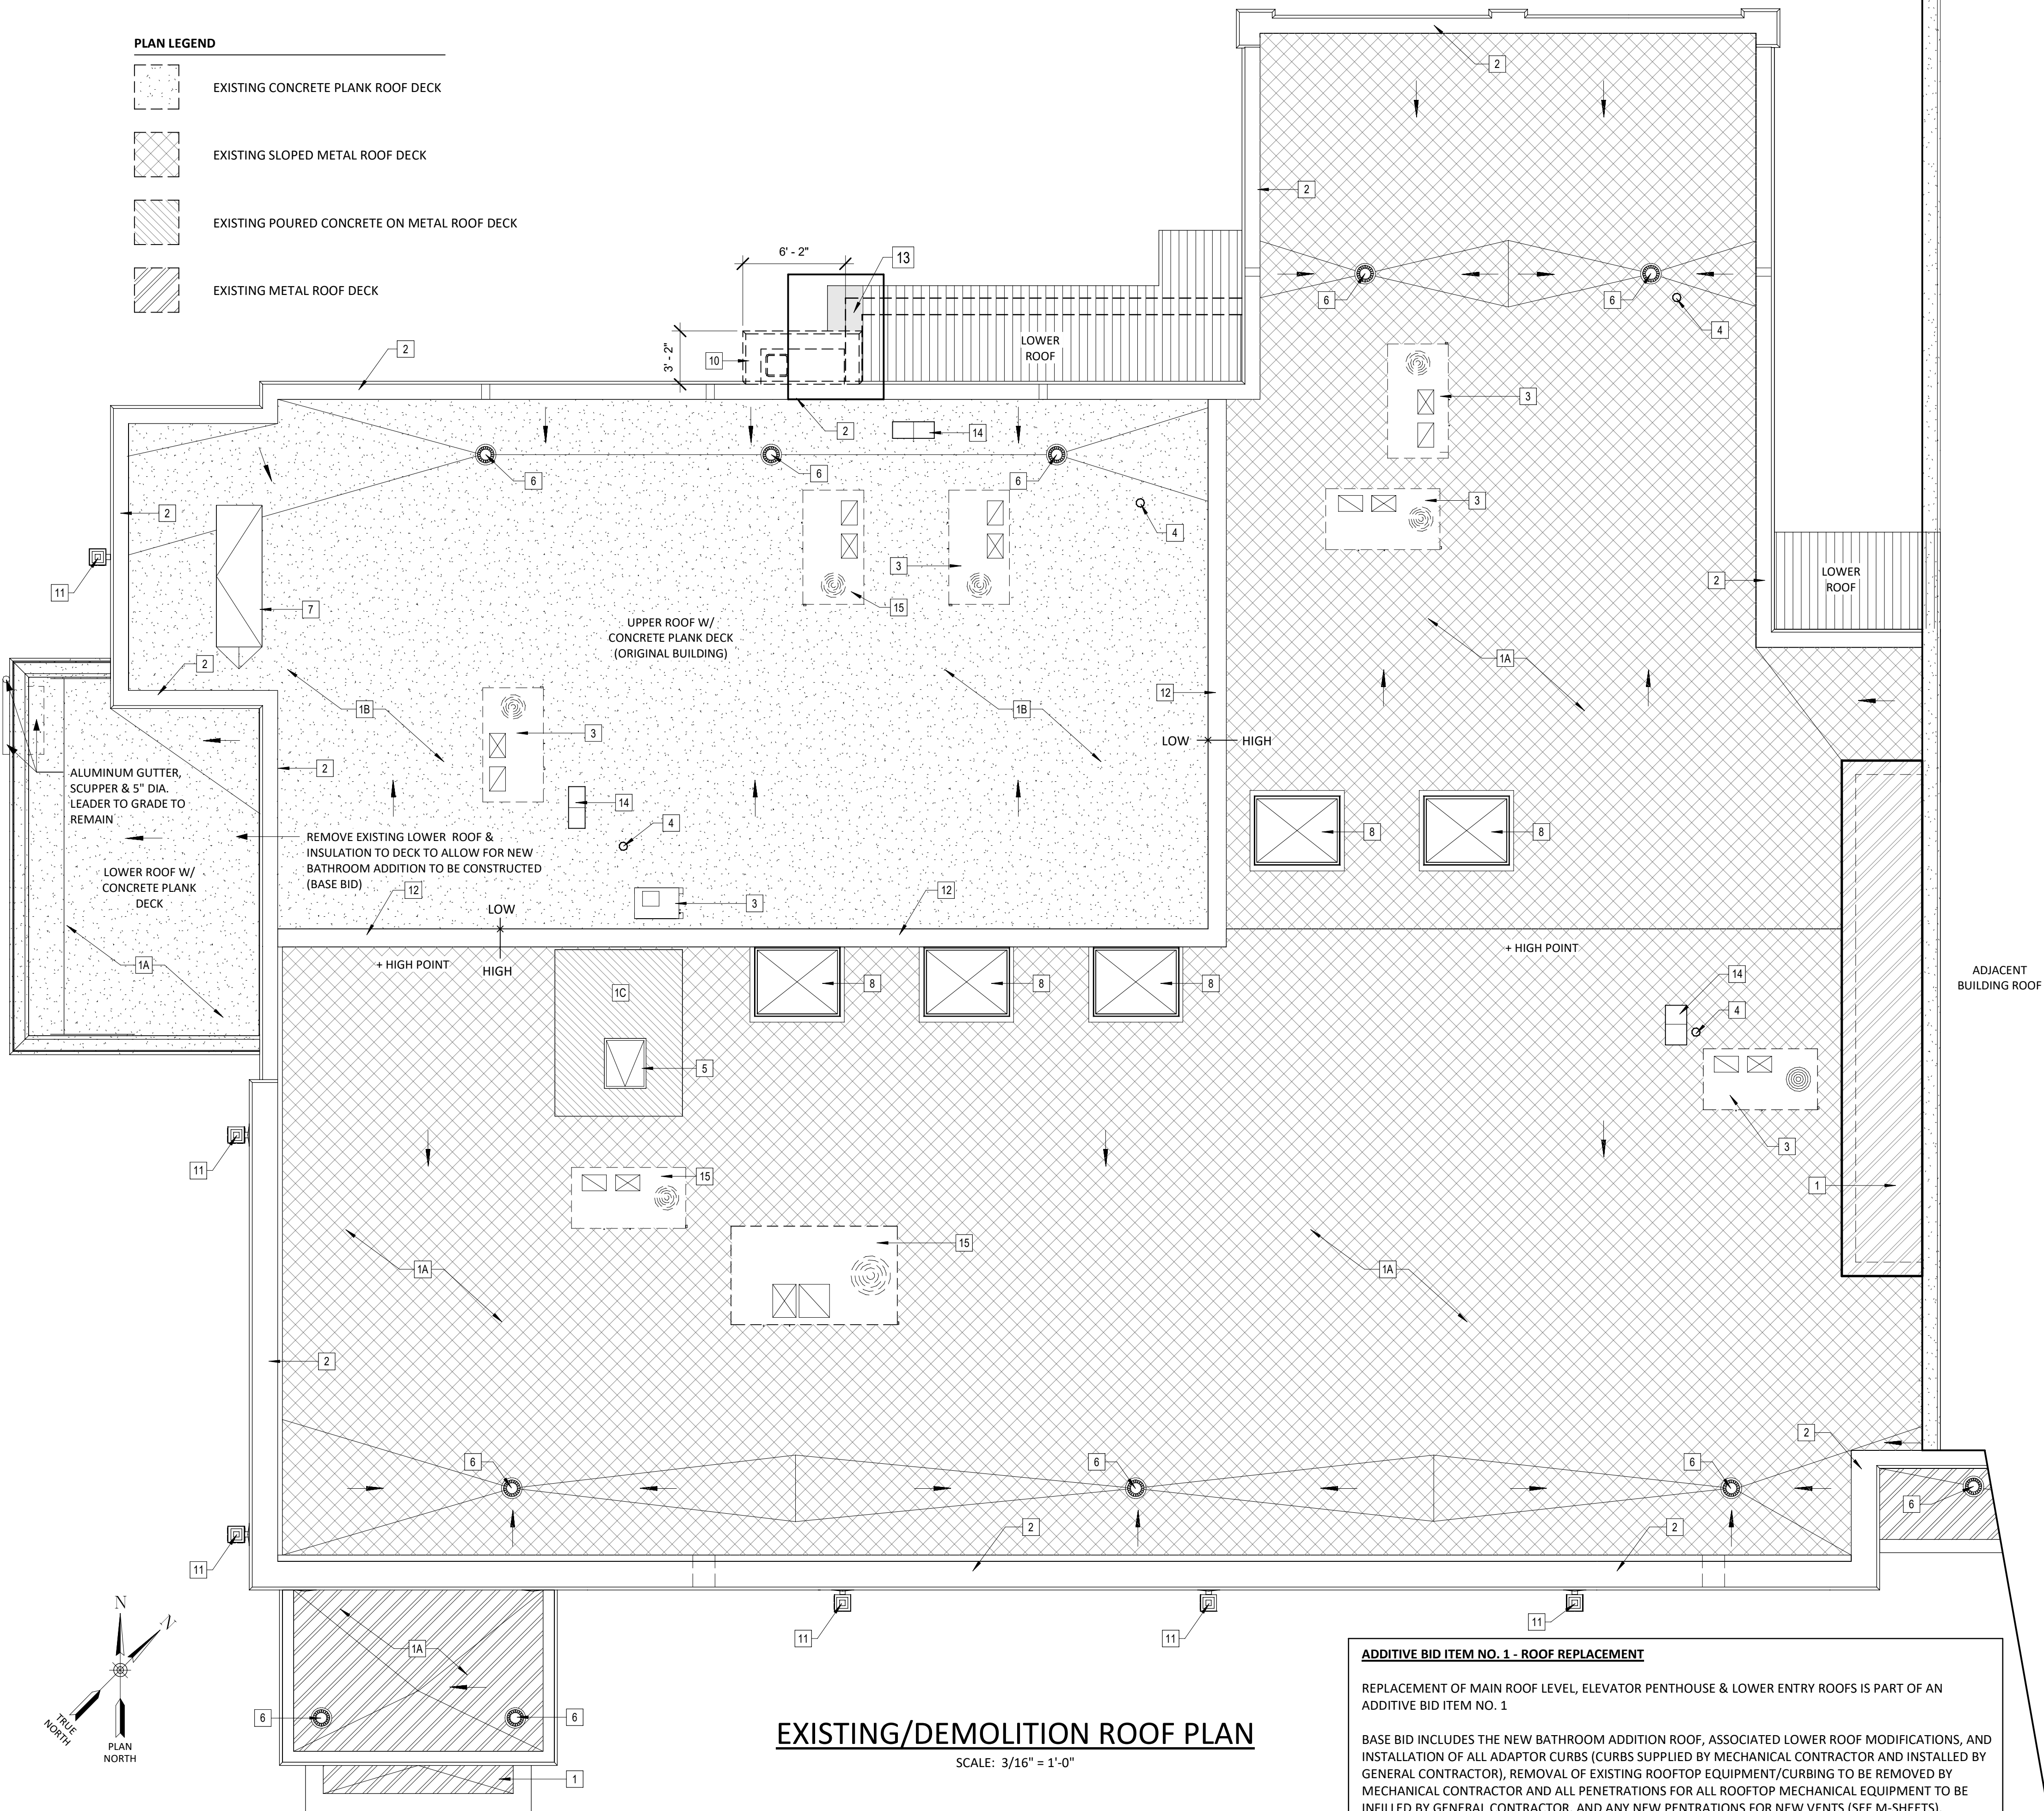

**EXISTING/DEMOLITION ROOF PLAN**

SCALE: 3/16" = 1'-0"

**ADDITIVE BID ITEM NO. 1 - ROOF REPLACEMENT**

REPLACEMENT OF MAIN ROOF LEVEL, ELEVATOR PENTHOUSE & LOWER ENTRY ROOFS IS PART OF AN ADDITIVE BID ITEM NO. 1

BASE BID INCLUDES THE NEW BATHROOM ADDITION ROOF, ASSOCIATED LOWER ROOF MODIFICATIONS, AND INSTALLATION OF ALL ADAPTOR CURBS (CURBS SUPPLIED BY MECHANICAL CONTRACTOR AND INSTALLED BY GENERAL CONTRACTOR), REMOVAL OF EXISTING ROOFTOP EQUIPMENT/CURBING TO BE REMOVED BY MECHANICAL CONTRACTOR AND ALL PENETRATIONS FOR ALL ROOFTOP MECHANICAL EQUIPMENT TO BE INFILLED BY GENERAL CONTRACTOR, AND ANY NEW PENETRATIONS FOR NEW VENTS (SEE M-SHEETS).

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**REVISIONS**

CITY OF MIDDLETOWN  
NEW COURTHOUSE FACILITY

**EXISTING/DEMOLITION ROOF PLAN (ADDITIVE BID  
ITEM NO. 1)**

CITY OF MIDDLETOWN

ORANGE COUNTY, NEW YORK

**Barton & Loguidice**  
443 Electronics Parkway  
Liverpool, NY 13088

NYS CERTIFICATE #  
0021642, 0020588, 0019903,  
0019905, 0020336



NYS EXP.:

Date  
AUGUST, 2024

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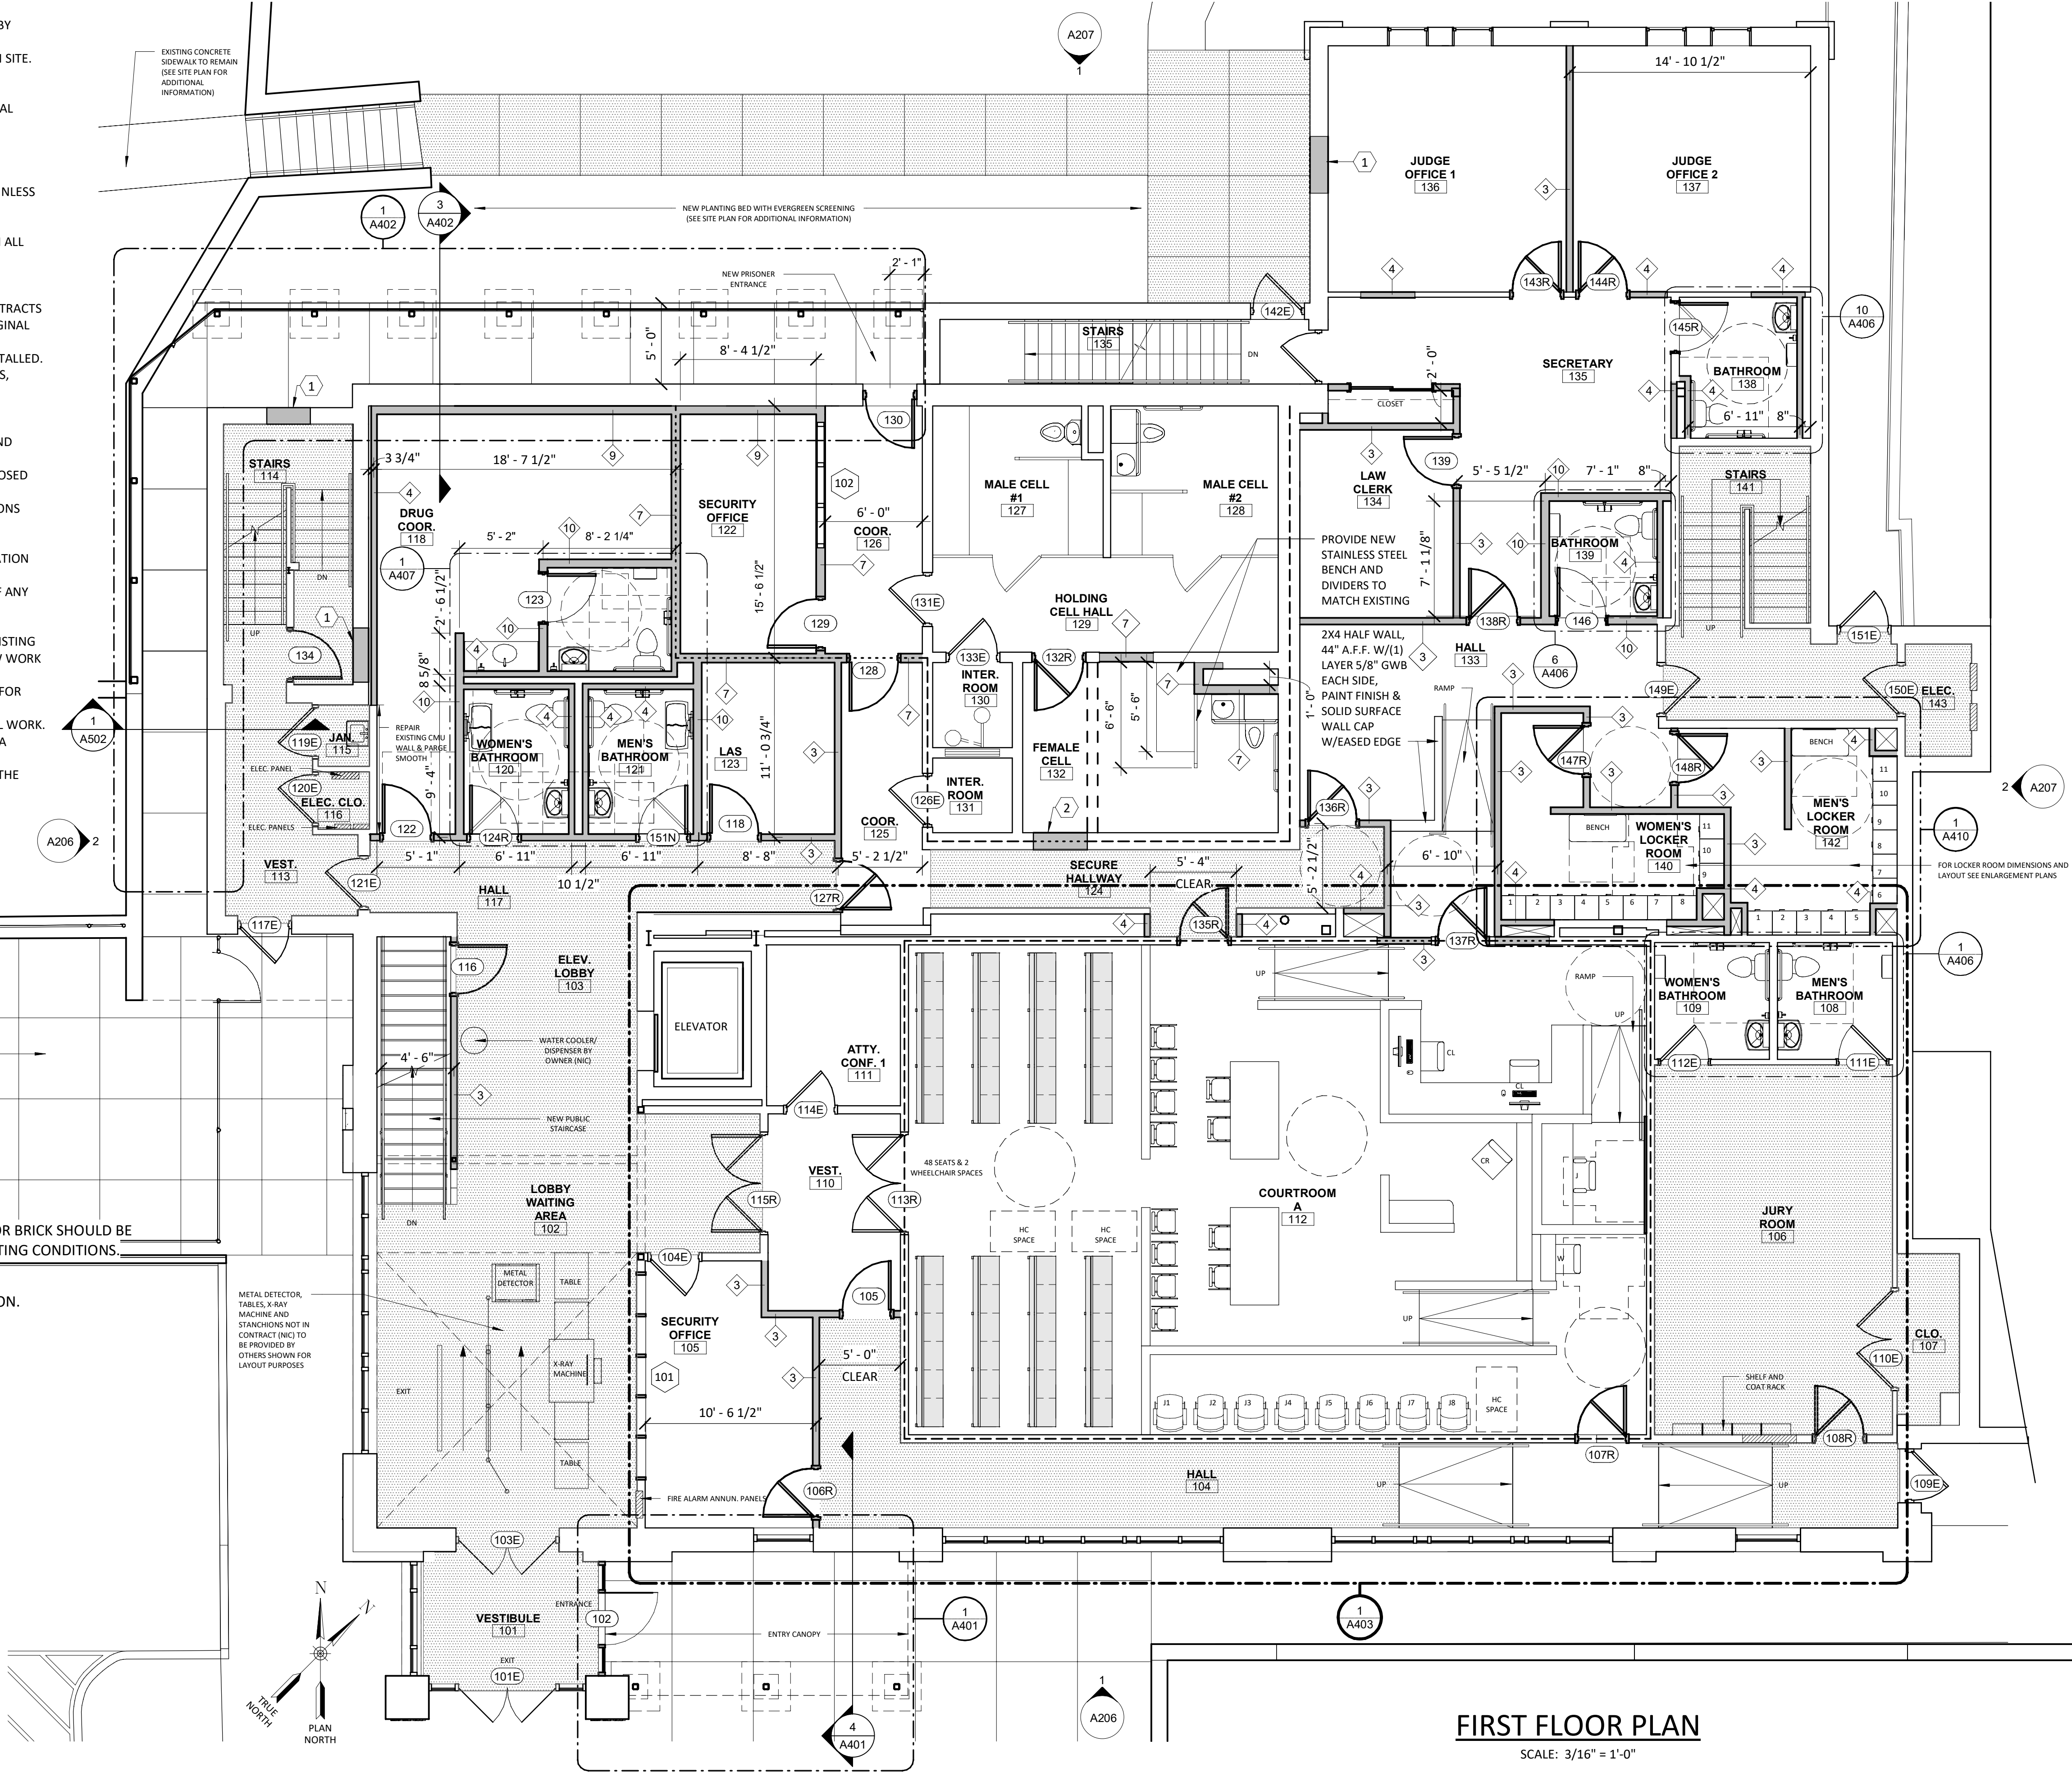
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- GENERAL NOTES:**
- ALL DIMENSIONS TO, OF, AND IN EXISTING BUILDING SHALL BE VERIFIED IN FIELD BY CONTRACTOR.
  - CONTRACTOR SHALL COORDINATE ALL WORK WITH ALL OTHER CONTRACTORS ON SITE.
  - CONTRACTOR SHALL PROVIDE ALL MATERIALS AND LABOR FOR A COMPLETE INSTALLATION.
  - ALL WORK SHALL COMPLY WITH NYS FIRE PREVENTION AND BUILDING CODE, LOCAL BUILDING CODES, AS WELL AS NATIONAL PLUMBING AND ELECTRICAL CODES.
  - ALL WORK SHALL BE IN STRICT ACCORDANCE WITH MANUFACTURER'S WRITTEN INSTRUCTIONS FOR PREPARATIONS AND INSTALLATION OF MATERIALS.
  - DO NOT CHANGE SIZE NOR SPACING OF STRUCTURAL ELEMENTS.
  - DETAILS SHOWN ARE TYPICAL; SIMILAR DETAILS APPLY TO SIMILAR CONDITIONS UNLESS OTHERWISE INDICATED.
  - THE CONTRACTOR AND/OR SUBCONTRACTORS ARE SOLELY RESPONSIBLE FOR EXECUTING THE WORK AND MAINTAINING THE WORK SITE IN ACCORDANCE WITH ALL APPLICABLE SAFETY CODES AND STANDARDS.
  - CONTRACTOR SHALL PROVIDE PROTECTIVE BARRICADES, SIGNS AND LIGHTING TO PREVENT ANY UNAUTHORIZED PASSAGE INTO WORK AREA.
  - PROTECT ALL EXISTING AND NEW BUILDING ELEMENTS INSTALLED BY OTHER CONTRACTS FROM DAMAGE. CONTRACTOR SHALL RESTORE ALL DAMAGED ELEMENTS TO ORIGINAL OR BETTER CONDITION.
  - BRACE BUILDING UNTIL ALL STRUCTURAL ELEMENTS NEED FOR STABILITY ARE INSTALLED. THESE ELEMENTS ARE AS FOLLOWS: FLOOR DECK, ROOF DECK, BRACING MEMBERS, SHEAR WALLS.
  - CONTRACTOR SHALL DETERMINE EXACT LOCATION OF EXISTING UTILITIES BEFORE COMMENCING WORK, HE AGREES TO BE FULLY RESPONSIBLE FOR ANY AND ALL DAMAGES WHICH MIGHT BE OCCASIONED BY HIS FAILURE TO EXACTLY LOCATE AND PRESERVE UNDERGROUND UTILITIES.
  - CONTRACTOR SHALL NOTIFY THE ARCHITECT/ENGINEER IN WRITING OF ALL PROPOSED DEVIATIONS OR SUBSTITUTIONS FROM DIMENSIONS, MATERIALS, OR EQUIPMENT SHOWN ON THE DRAWINGS AND MAKE ONLY THOSE DEVIATIONS OR SUBSTITUTIONS ACCEPTABLE TO THE ARCHITECT/ENGINEER. NO CHANGES SHALL BE MADE WITH APPROVAL BY THE ARCHITECT/ENGINEER.
  - CONTRACTOR SHALL VERIFY ALL DIMENSIONS PRIOR TO ORDER AND/OR INSTALLATION OF MATERIAL.
  - DO NOT SCALE DRAWINGS. CONTRACTOR SHALL NOTIFY ARCHITECT/ENGINEER OF ANY DISCREPANCIES IN DIMENSIONS BETWEEN EXISTING CONDITIONS AND/OR ARCHITECTURAL DRAWINGS AND THE STRUCTURAL DRAWINGS.
  - PROVIDE ALL DEMO REQUIRED FOR NEW INSTALLATIONS SHOWN, AND PATCH EXISTING MATERIALS BACK TO ORIGINAL CONDITION, OR TO A CONDITION TO RECEIVE NEW WORK AS APPLICABLE.
  - EXAMINE ALL MECHANICAL, ELECTRICAL, PLUMBING & OTHER TRADE DRAWINGS FOR ADDITIONAL AND INCIDENTAL WORK RELATED TO OPENINGS, PENETRATIONS, EQUIPMENT PADS, EQUIPMENT ITEM OR TAG NUMBERS, AND OTHER ADDITIONAL WORK. COORDINATE WITH ALL OTHER TRADES & PROVIDE ALL LABOR & MATERIALS FOR A COMPLETE INSTALLATION.
  - SUBMISSION AND COSTS ASSOCIATED WITH OBTAINING A BUILDING PERMIT ARE THE GENERAL CONTRACTORS RESPONSIBILITY.

- 1 INFILL OPENING TO MATCH EXISTING WALL CONSTRUCTION. EXTERIOR BRICK SHOULD BE TOOTHED IN TO MATCH EXISTING COURSING TO BLEND IN WITH EXISTING CONDITIONS.
- 2 INFILL CMU WALL OPENING TO MATCH EXISTING WALL CONSTRUCTION.

## NEW WORK LEGEND

---	EXISTING 1 HOUR RATED WALL
----	NEW 1 HOUR RATED WALL
	REFER TO BATHROOM ADDITION PLAN SHEET S101
	EXISTING FLOORING
==	INDICATES EXISTING WALL
---	INDICATES NEW WALL
201E	EXISTING DOOR TO REMAIN
201R	EXISTING DOOR TO BE RELOCATED



IT IS A VIOLATION OF THE NEW YORK STATE EDUCATION LAW, ARTICLE 145 §7209 SPECIAL PROVISIONS, FOR ANY PERSON, UNLESS THEY ARE ACTING UNDER THE DIRECTION OF A LICENSED PROFESSIONAL ENGINEER, ARCHITECT, LANDSCAPE ARCHITECT, OR LAND SURVEYOR, TO ALTER ANY ITEM IN ANY WAY IF AN ITEM BEARING THE STAMP OF A LICENSED PROFESSIONAL IS ALTERED, THE ALTERING PROFESSIONAL SHALL STAMP THE DOCUMENT AND INCLUDE THE NOTATION "ALTERED BY" FOLLOWED BY THEIR SIGNATURE, THE DATE OF SUCH ALTERATION, AND A SPECIFIC DESCRIPTION OF THE ALTERATION.

REVISIONS

1	01/31/23
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CITY OF MIDDLETOWN  
NEW COURTHOUSE FACILITY

**FIRST FLOOR NEW WORK PLAN**

ORANGE COUNTY, NEW YORK

**Barton & Loguidice**  
443 Electronics Parkway  
Liverpool, NY 13088

**B&L**



NYS EXP.:  
Date AUGUST, 2024  
Scale AS SHOWN  
Sheet Number **A201**  
Project Number 1753.008.001



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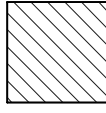
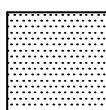
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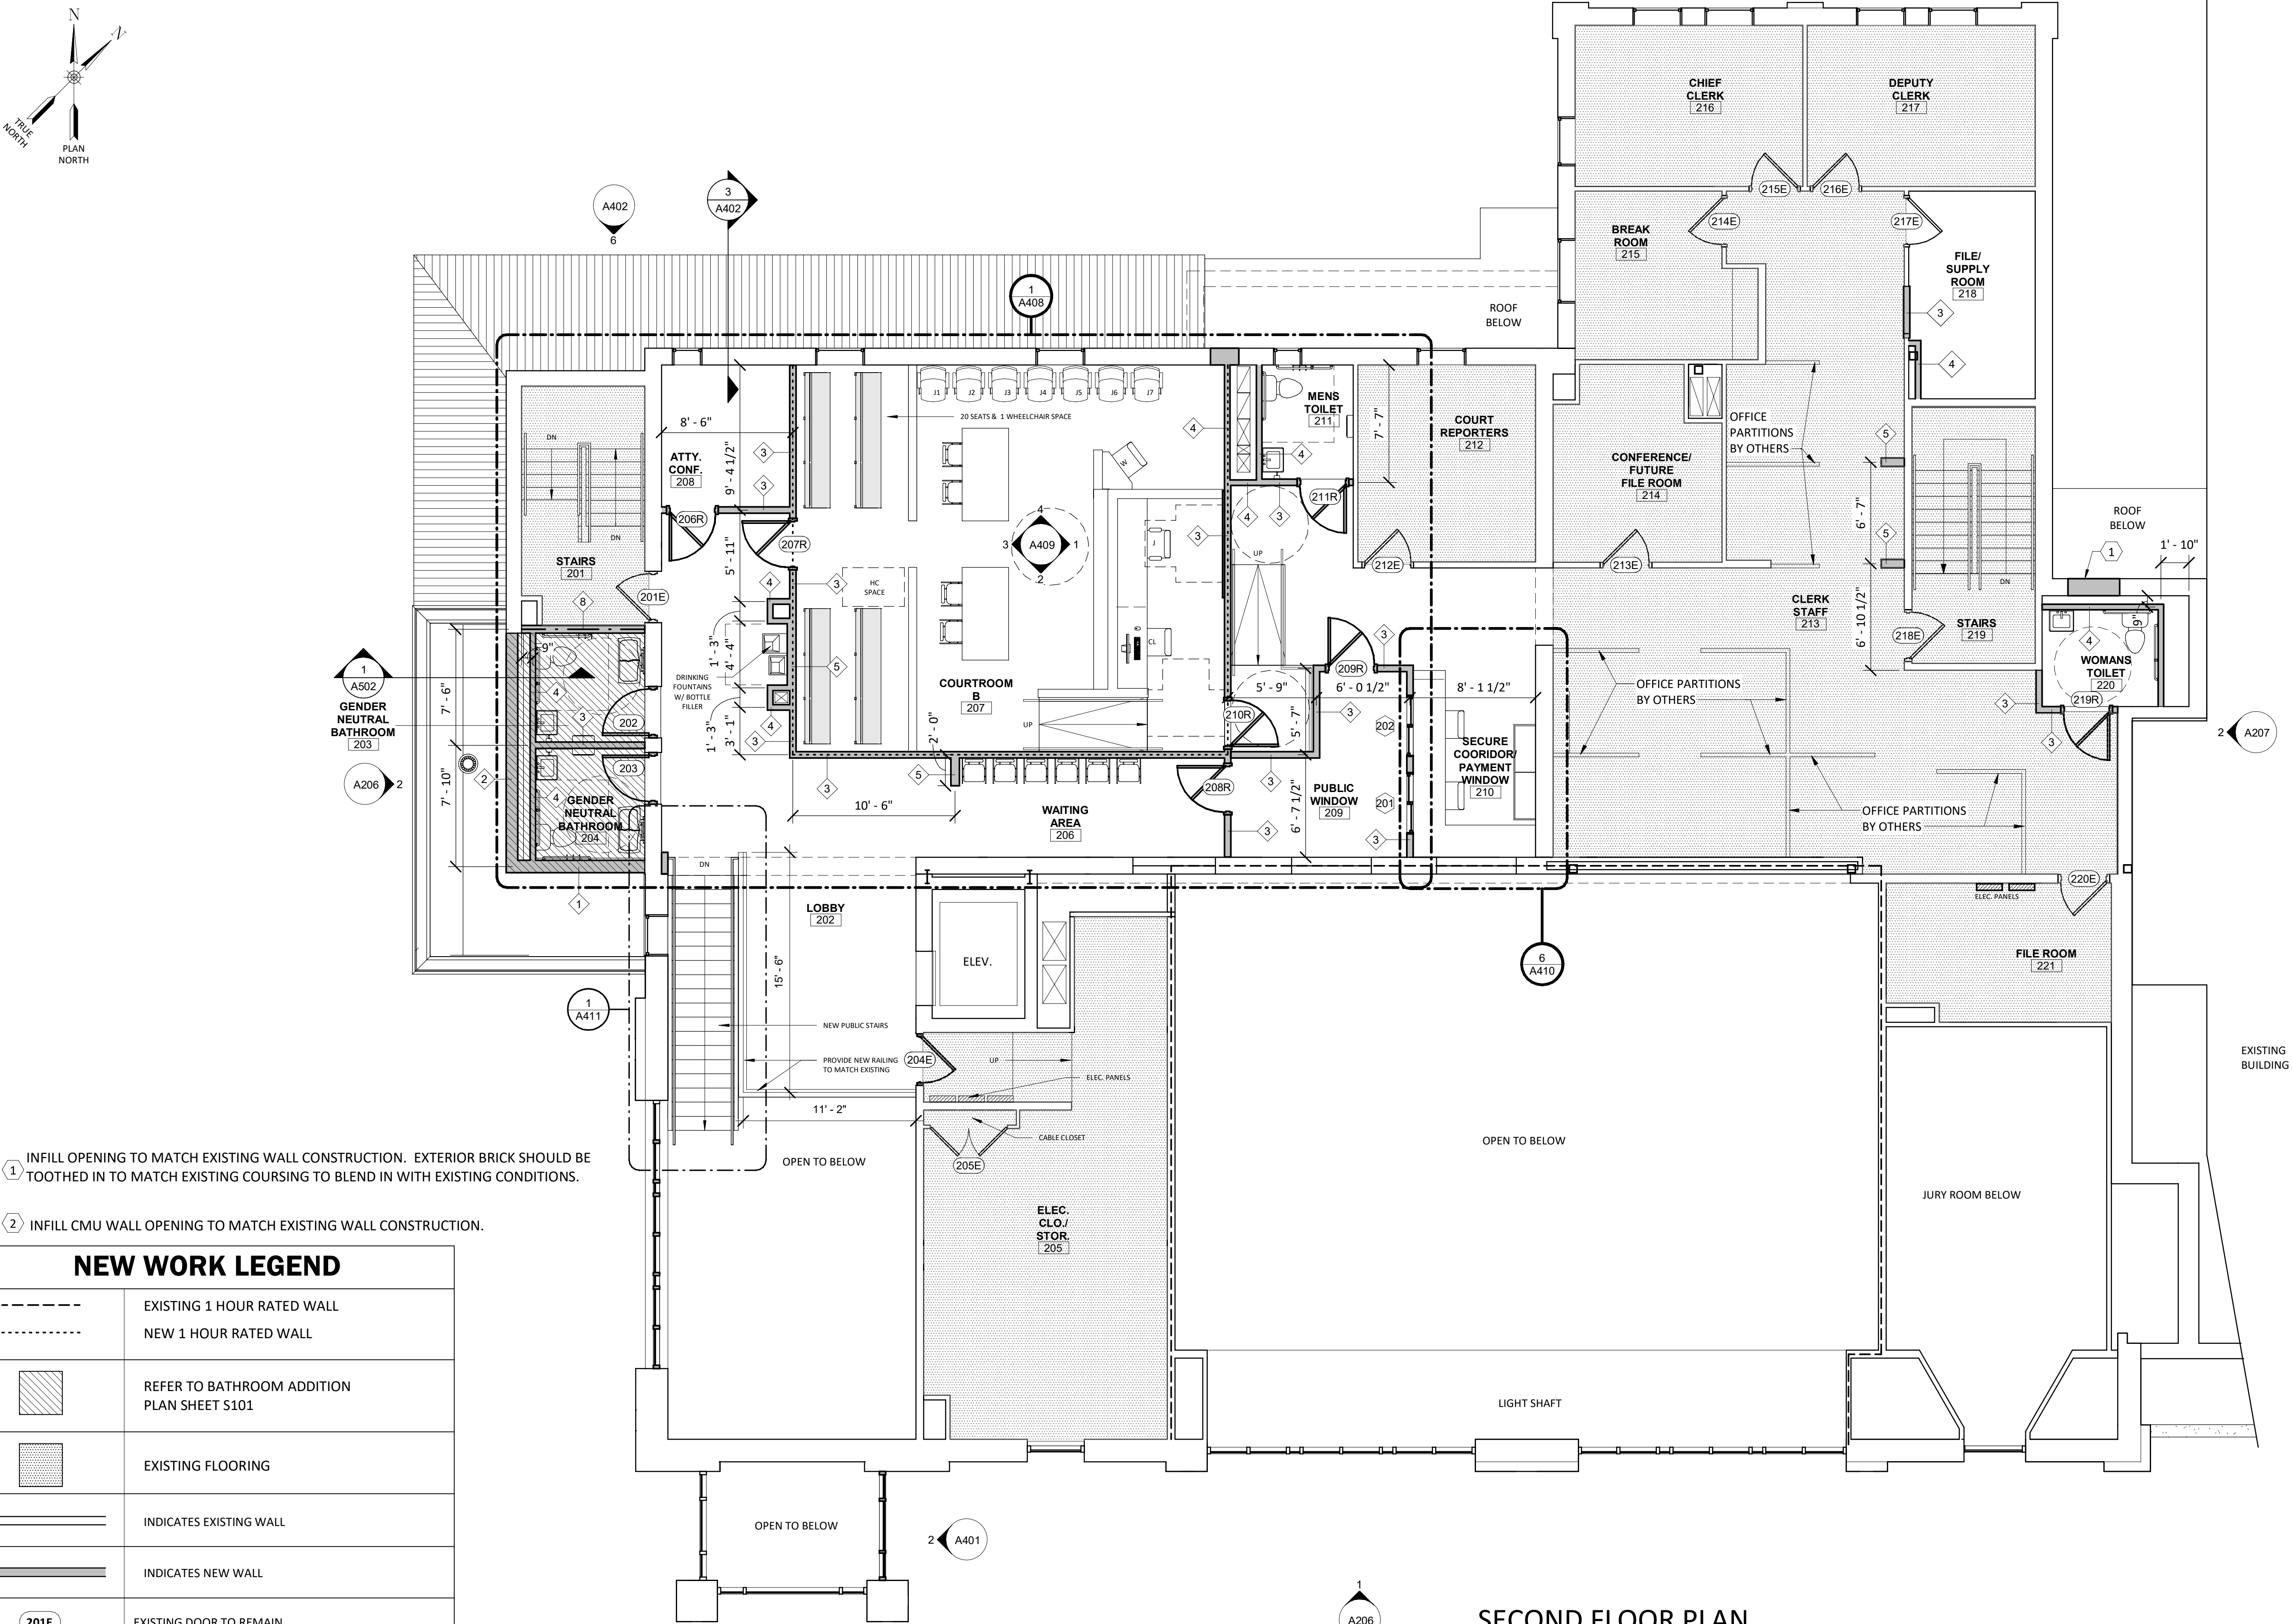
TRB

In Charge of

- 1 INFILL OPENING TO MATCH EXISTING WALL CONSTRUCTION. EXTERIOR BRICK SHOULD BE TOOTHED IN TO MATCH EXISTING COURSING TO BLEND IN WITH EXISTING CONDITIONS.
- 2 INFILL CMU WALL OPENING TO MATCH EXISTING WALL CONSTRUCTION.

### NEW WORK LEGEND

---	EXISTING 1 HOUR RATED WALL
.....	NEW 1 HOUR RATED WALL
	REFER TO BATHROOM ADDITION PLAN SHEET S101
	EXISTING FLOORING
=====	INDICATES EXISTING WALL
=====	INDICATES NEW WALL
201E	EXISTING DOOR TO REMAIN
201R	EXISTING DOOR TO BE RELOCATED



### SECOND FLOOR PLAN

SCALE: 3/16" = 1'-0"

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#### REVISIONS

CITY OF MIDDLETOWN  
NEW COURTHOUSE FACILITY

### SECOND FLOOR NEW WORK PLAN

CITY OF MIDDLETOWN

ORANGE COUNTY, NEW YORK

**Barton & Loguidice**  
443 Electronics Parkway  
Liverpool, NY 13088

NYS CERTIFICATE #  
0021642, 0020588, 0019903,  
0019905, 0020336



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Date  
AUGUST, 2024

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A202

Project Number  
1753.008.001



ROOF PLAN NOTES:

- 1 PRIMARY SCUPPER DRAIN (7" x 12") @ 5" ABOVE ROOF DECK, LEVEL WITH ROOF MINIMUM INSULATION.
- 2 SECONDARY SCUPPER DRAIN (7" x 12") @ 9" ABOVE ROOF DECK, ABOVE TAPERED INSULATION AT LOCATION.
- 3A EXISTING ROOF DRAIN WITH NEW BOWL AND COVER, PROVIDE INSULATION SUMP AROUND DRAINS.
- 3B NEW ROOF DRAIN WITH BOWL AND COVER, PROVIDE INSULATION SUMP AROUND DRAINS.
- 4 PROVIDE NEW INSULATION CANTS ON THE HIGH SIDE ALL EXISTING ROOF VENT HOODS AND EQUIPMENT TO PROVIDE POSITIVE DRAINAGE.
- 5 PROVIDE POLYISOCYANURATE (ISO) INSULATION (MIN. R-30CI) OVER ENTIRE BUILDING ROOF (PROVIDE THICKNESS NEEDED TO MEET R-30CI). PROVIDE VAPOR RETARDER & AIR BARRIER AS SPECIFIED AS PART OF INSULATION ENVELOPE INSTALLATION.
- 6 PROVIDE NEW TAPERED INSULATION PITCH 1/4" PER FOOT MIN. AS NEEDED TO PROVIDE POSITIVE DRAINAGE TO EXISTING AND NEW ROOF SCUPPER/DRAINS.
- 7 NEW 60 MIL. FULLY ADHERED (EPDM) ROOFING MEMBRANE SYSTEM AS AVAILABLE FROM FIRESTONE BUILDING PRODUCTS, OR APPROVED EQUAL.
- 8 PROVIDE NEW FLASHING MEMBRANE AT EXISTING VENT STACKS, EQUIPMENT HOODS
- 9 PROVIDE NEW EQUIPMENT CURBING (SUPPLIED BY MECHANICAL CONTRACTOR & INSTALLED BY GENERAL CONTRACTOR) AND FLASHING MEMBRANES AT EQUIPMENT CURBING.
- 10 EXISTING LIGHT FIXTURE TO REMAIN.
- 11 WRAP NEW EPDM UP EXISTING PARAPET WALL AND PROVIDE NEW METAL COPING SYSTEM.
- 12 EXISTING SMOKE HATCH PROVIDE NEW FLASHING MEMBRANE
- 13 NEW WATERDAM METAL COPING SYSTEM. PROVIDE ANCHORGARD EXTENDED CANTED FASCIA -12" (GALVANIZED WATERDAM VERSION) AS AVAILABLE FROM FIRESTONE BUILDING PRODUCTS, OR APPROVED EQUAL. COLOR TO BE SELECTED BY OWNER FROM MANUFACTURERS FULL RANGE OF COLOR OPTIONS.
- 14 WRAP EPDM UP ADJACENT BUILDING (MINIMUM 18" HIGH) AND PROVIDE TERMINATION BAR IN EXISTING BRICK WALL.
- 15 EXISTING ROOF SCUPPERS TO BE REMOVED, PROVIDE FLASHING MEMBRANE AND REINSTALL ROOF SCUPPER TO BE WEATHERTIGHT.
- 16 EXISTING ROOF SKYLIGHT PROVIDE NEW MEMBRANE FLASHINGS.
- 17 WRAP NEW EPDM OVER EXISTING PARAPET WALL/CURBING AND SPLICE INTO EPDM ROOF SYSTEMS ON EITHER SIDE.
- 18 WRAP NEW EPDM UP NEW PARAPET AND PROVIDE NEW METAL COPING SYSTEM. (ADDITIVE BID ITEM)
- 19 NEW ROOFTOP EQUIPMENT, SEE MECHANICAL PLANS FOR ADDITIONAL INFORMATION.
- 20 EXISTING ROOF ACCESS HATCH REMOVE, RAISE OPENING WITH P.T. WOOD BLOCKING, REINSTALL AND PROVIDE MEMBRANE FLASHING AT CURBING. (ADDITIVE BID ITEM)
- 21 EXISTING ROOFTOP EQUIPMENT TO REMAIN.
- 22 NEW ROOFTOP VENTS. SEE MECHANICAL SHEETS. INSTALL NEW CURBING PROVIDED BY MECHANICAL CONTRACTOR, PROVIDE FLASHING & PATCH/REPAIR ROOF AS REQUIRED.
- 23 INFILL EXISTING OPENING LEFT BY REMOVED ROOFTOP EQUIPMENT

GENERAL NOTES:

1. ALL DIMENSIONS TO, OF, AND IN EXISTING BUILDING SHALL BE VERIFIED IN FIELD BY CONTRACTOR.
2. CONTRACTOR SHALL COORDINATE ALL WORK WITH ALL OTHER CONTRACTORS ON SITE.
3. CONTRACTOR SHALL PROVIDE ALL MATERIALS AND LABOR FOR A COMPLETE INSTALLATION.
4. ALL WORK SHALL COMPLY WITH NYS FIRE PREVENTION AND BUILDING CODE, LOCAL BUILDING CODES, AS WELL AS NATIONAL PLUMBING AND ELECTRICAL CODES.
5. ALL WORK SHALL BE IN STRICT ACCORDANCE WITH MANUFACTURER'S WRITTEN INSTRUCTIONS FOR PREPARATIONS AND INSTALLATION OF MATERIALS.
6. DO NOT CHANGE SIZE NOR SPACING OF STRUCTURAL ELEMENTS.
7. DETAILS SHOWN ARE TYPICAL; SIMILAR DETAILS APPLY TO SIMILAR CONDITIONS UNLESS OTHERWISE INDICATED.
8. THE CONTRACTOR AND/OR SUBCONTRACTORS ARE SOLELY RESPONSIBLE FOR EXECUTING THE WORK AND MAINTAINING THE WORK SITE IN ACCORDANCE WITH ALL APPLICABLE SAFETY CODES AND STANDARDS.
9. CONTRACTOR SHALL PROVIDE PROTECTIVE BARRICADES, SIGNS AND LIGHTING TO PREVENT ANY UNAUTHORIZED PASSAGE INTO WORK AREA.
10. PROTECT ALL EXISTING AND NEW BUILDING ELEMENTS INSTALLED BY OTHER CONTRACTS FROM DAMAGE. CONTRACTOR SHALL RESTORE ALL DAMAGED ELEMENTS TO ORIGINAL OR BETTER CONDITION.
11. BRACE BUILDING UNTIL ALL STRUCTURAL ELEMENTS NEED FOR STABILITY ARE INSTALLED. THESE ELEMENTS ARE AS FOLLOWS: FLOOR DECK, ROOF DECK, BRACING MEMBERS, SHEAR WALLS.
12. CONTRACTOR SHALL DETERMINE EXACT LOCATION OF EXISTING UTILITIES BEFORE COMMENCING WORK, HE AGREES TO BE FULLY RESPONSIBLE FOR ANY AND ALL DAMAGES WHICH MIGHT BE OCCASIONED BY HIS FAILURE TO EXACTLY LOCATE AND PRESERVE UNDERGROUND UTILITIES.
13. CONTRACTOR SHALL NOTIFY THE ARCHITECT/ENGINEER IN WRITING OF ALL PROPOSED DEVIATIONS OR SUBSTITUTIONS FROM DIMENSIONS, MATERIALS, OR EQUIPMENT SHOWN ON THE DRAWINGS AND MAKE ONLY THOSE DEVIATIONS OR SUBSTITUTIONS ACCEPTABLE TO THE ARCHITECT/ENGINEER. NO CHANGES SHALL BE MADE WITH APPROVAL BY THE ARCHITECT/ENGINEER.
14. CONTRACTOR SHALL VERIFY ALL DIMENSIONS PRIOR TO ORDER AND/OR INSTALLATION OF MATERIAL.
15. DO NOT SCALE DRAWINGS. CONTRACTOR SHALL NOTIFY ARCHITECT/ENGINEER OF ANY DISCREPANCIES IN DIMENSIONS BETWEEN EXISTING CONDITIONS AND/OR ARCHITECTURAL DRAWINGS AND THE STRUCTURAL DRAWINGS.
16. PROVIDE ALL DEMO REQUIRED FOR NEW INSTALLATIONS SHOWN, AND PATCH EXISTING MATERIALS BACK TO ORIGINAL CONDITION, OR TO A CONDITION TO RECEIVE NEW WORK AS APPLICABLE.
17. EXAMINE ALL MECHANICAL, ELECTRICAL, PLUMBING & OTHER TRADE DRAWINGS FOR ADDITIONAL AND INCIDENTAL WORK RELATED TO OPENINGS, PENETRATIONS, EQUIPMENT PADS, EQUIPMENT ITEM OR TAG NUMBERS, AND OTHER ADDITIONAL WORK. COORDINATE WITH ALL OTHER TRADES & PROVIDE ALL LABOR & MATERIALS FOR A COMPLETE INSTALLATION.
18. SUBMISSION AND COSTS ASSOCIATED WITH OBTAINING A BUILDING PERMIT ARE THE GENERAL CONTRACTORS RESPONSIBILITY.

PLAN LEGEND


- NEW 60 MIL. FULLY ADHERED ETHYLENE PROPYLENE DIENE MONOMER (EPDM) MEMBRANE SYSTEM
- INDICATES ROOF SLOPE DIRECTION (PROVIDE 1/4" PER FOOT MINIMUM POSITIVE PITCH WITH TAPERED INSULATION TO DRAIN LOCATIONS ON PLANK DECK ROOF AND AT ROOF EDGES ON SLOPED METAL DECK TO PROVIDE POSITIVE PITCH TO ROOF DRAINS)
- WALL LINE

2020 ENERGY CONSERVATION CONSTRUCTION CODE OF NEW YORK STATE REQUIREMENTS:

CLIMATE ZONE: 5A (ORANGE COUNTY)

INSULATION ENTIRELY ABOVE ROOF DECK - R=30 CI (MIN.)

INSULATION ENTIRELY ABOVE ROOF DECK - U-0.032 (LESS THAN)

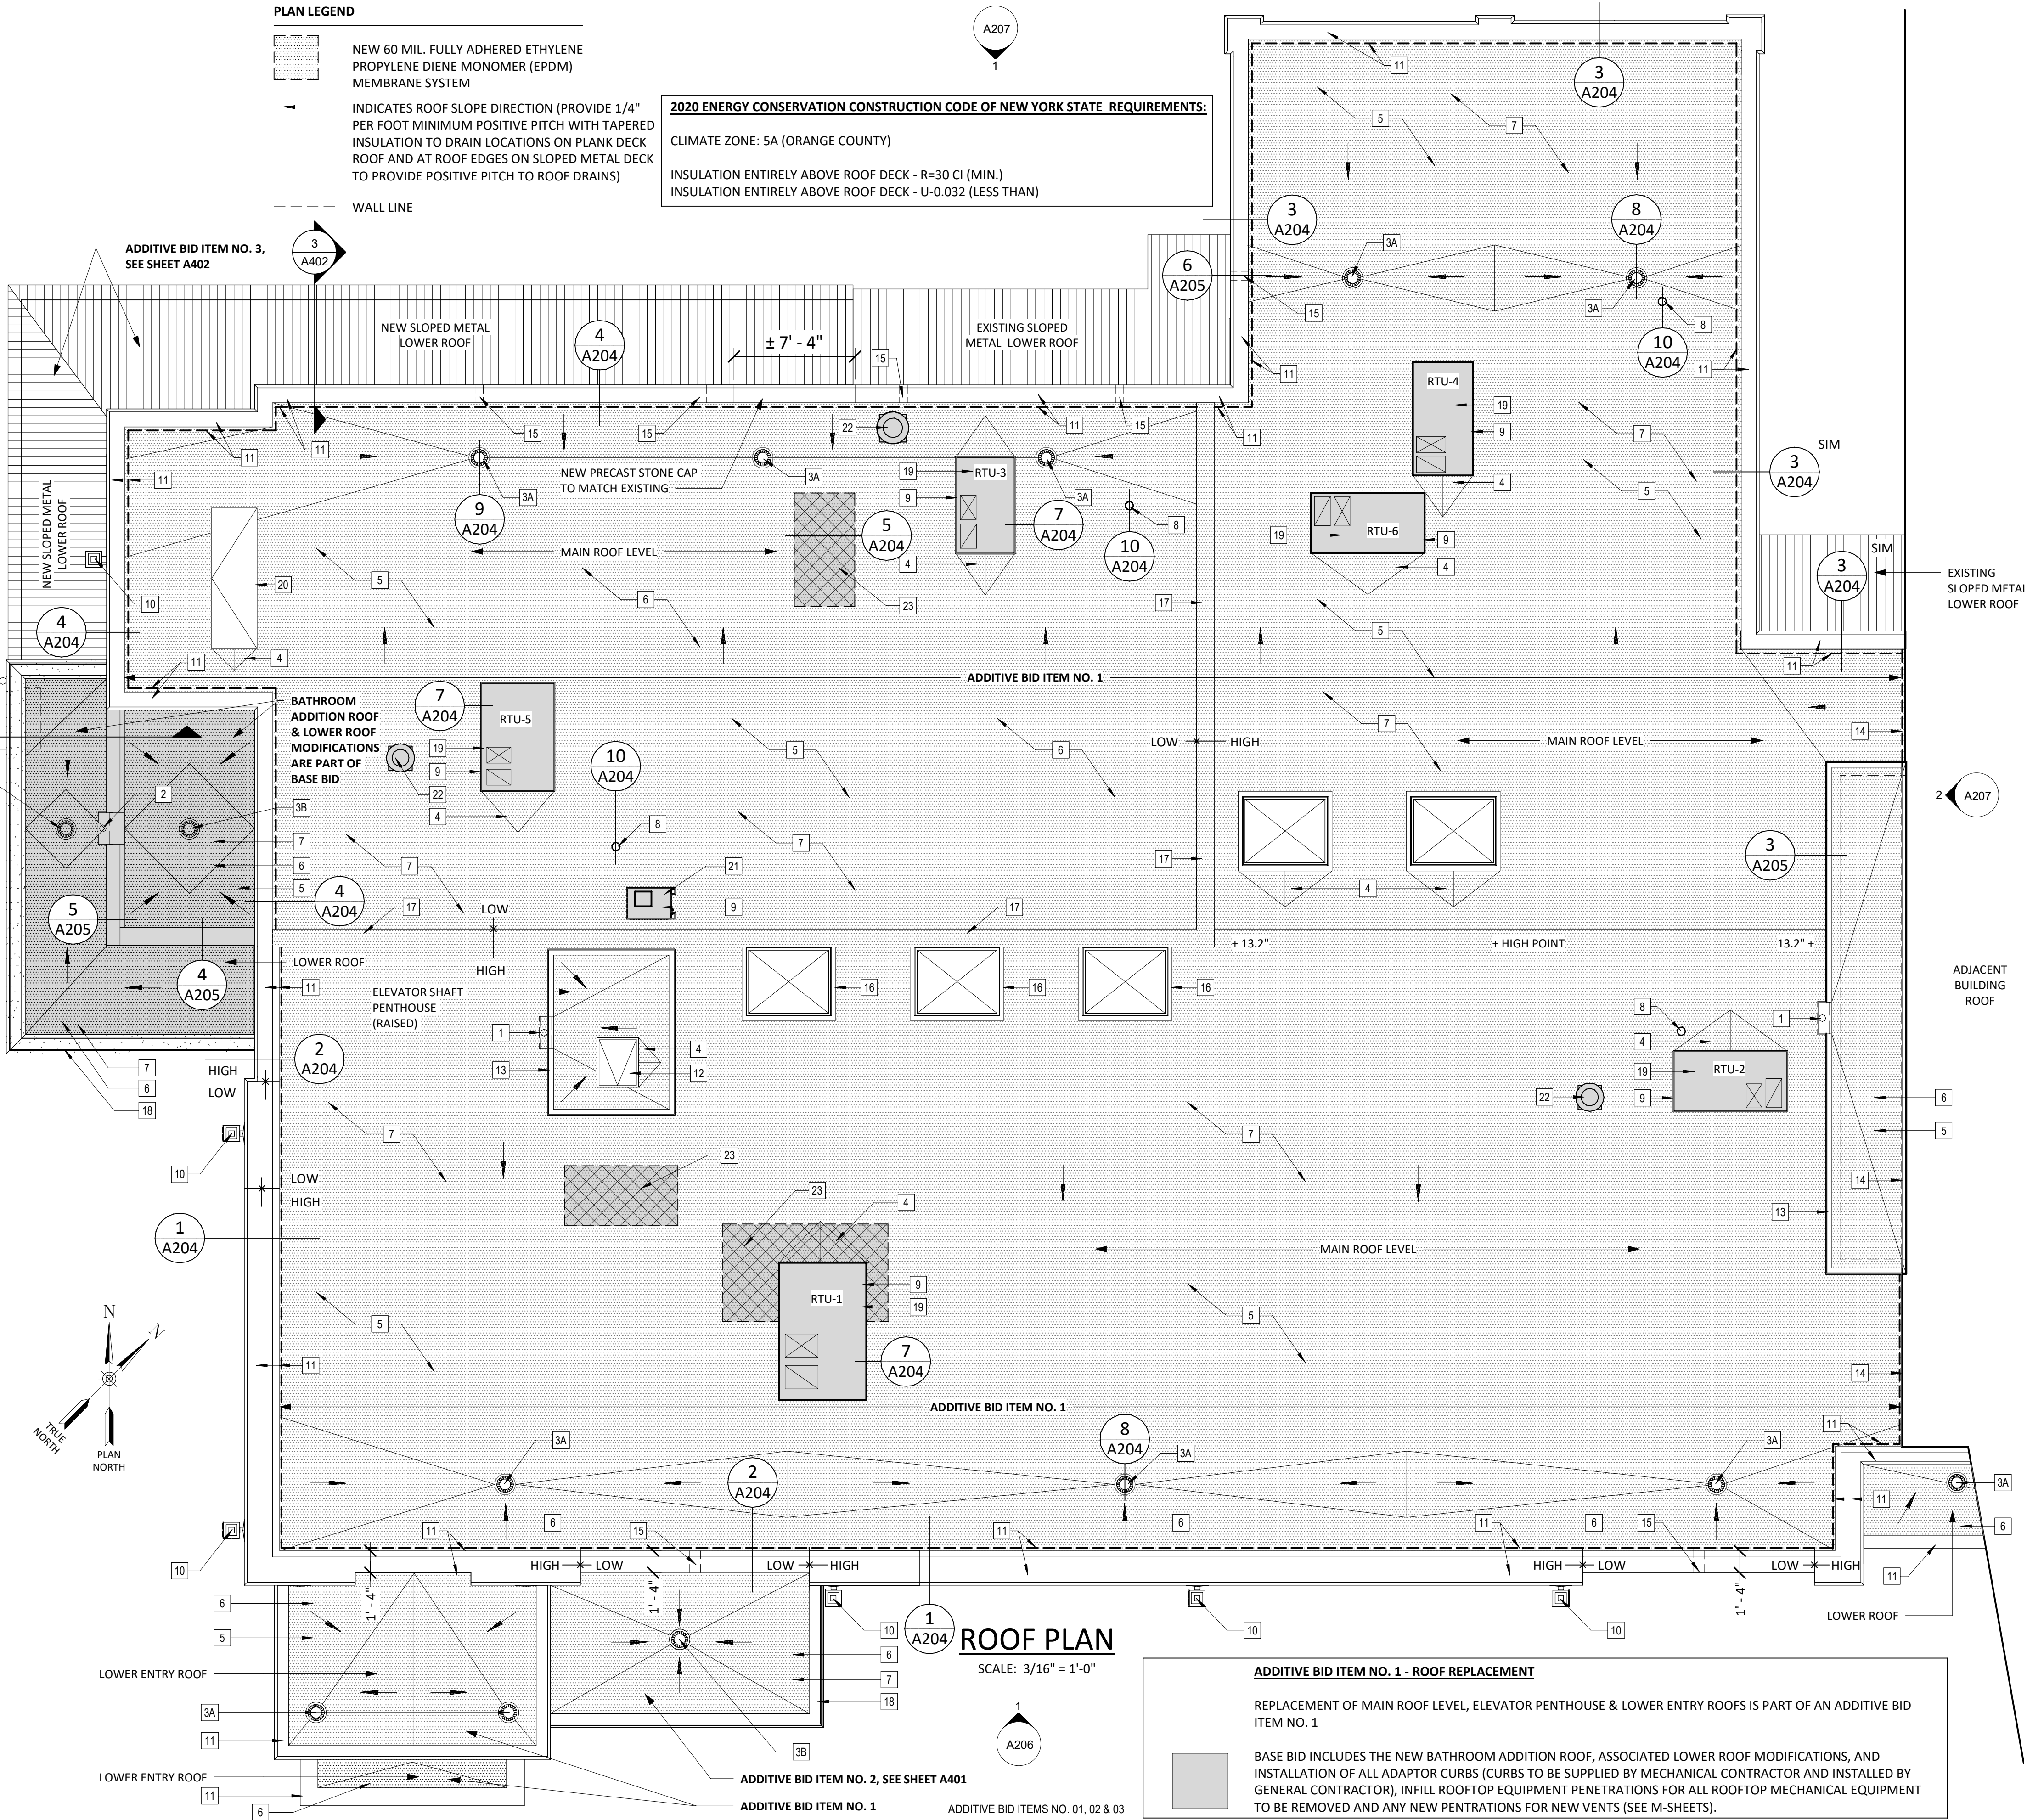

ROOF PLAN

SCALE: 3/16" = 1'-0"

ADDITIVE BID ITEM NO. 1 - ROOF REPLACEMENT

REPLACEMENT OF MAIN ROOF LEVEL, ELEVATOR PENTHOUSE & LOWER ENTRY ROOFS IS PART OF AN ADDITIVE BID ITEM NO. 1

BASE BID INCLUDES THE NEW BATHROOM ADDITION ROOF, ASSOCIATED LOWER ROOF MODIFICATIONS, AND INSTALLATION OF ALL ADAPTOR CURBS (CURBS TO BE SUPPLIED BY MECHANICAL CONTRACTOR AND INSTALLED BY GENERAL CONTRACTOR), INFILL ROOFTOP EQUIPMENT PENETRATIONS FOR ALL ROOFTOP MECHANICAL EQUIPMENT TO BE REMOVED AND ANY NEW PENETRATIONS FOR NEW VENTS (SEE M-SHEETS).

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REVISIONS

NO.	DESCRIPTION

CITY OF MIDDLETOWN  
NEW COURTHOUSE FACILITY

ROOF PLAN (ADDITIVE BID ITEM NO. 1)

CITY OF MIDDLETOWN

ORANGE COUNTY, NEW YORK

CITY OF MIDDLETOWN  
NEW COURTHOUSE FACILITY

CITY OF MIDDLETOWN  
NEW COURTHOUSE FACILITY

**Barton & Loguidice**  
443 Electronics Parkway  
Liverpool, NY 13088

NYS CERTIFICATE #  
0021642, 0020588, 0019903,  
0019905, 0020336

**B&L**



NYS EXP.:

Date

AUGUST, 2024

Scale

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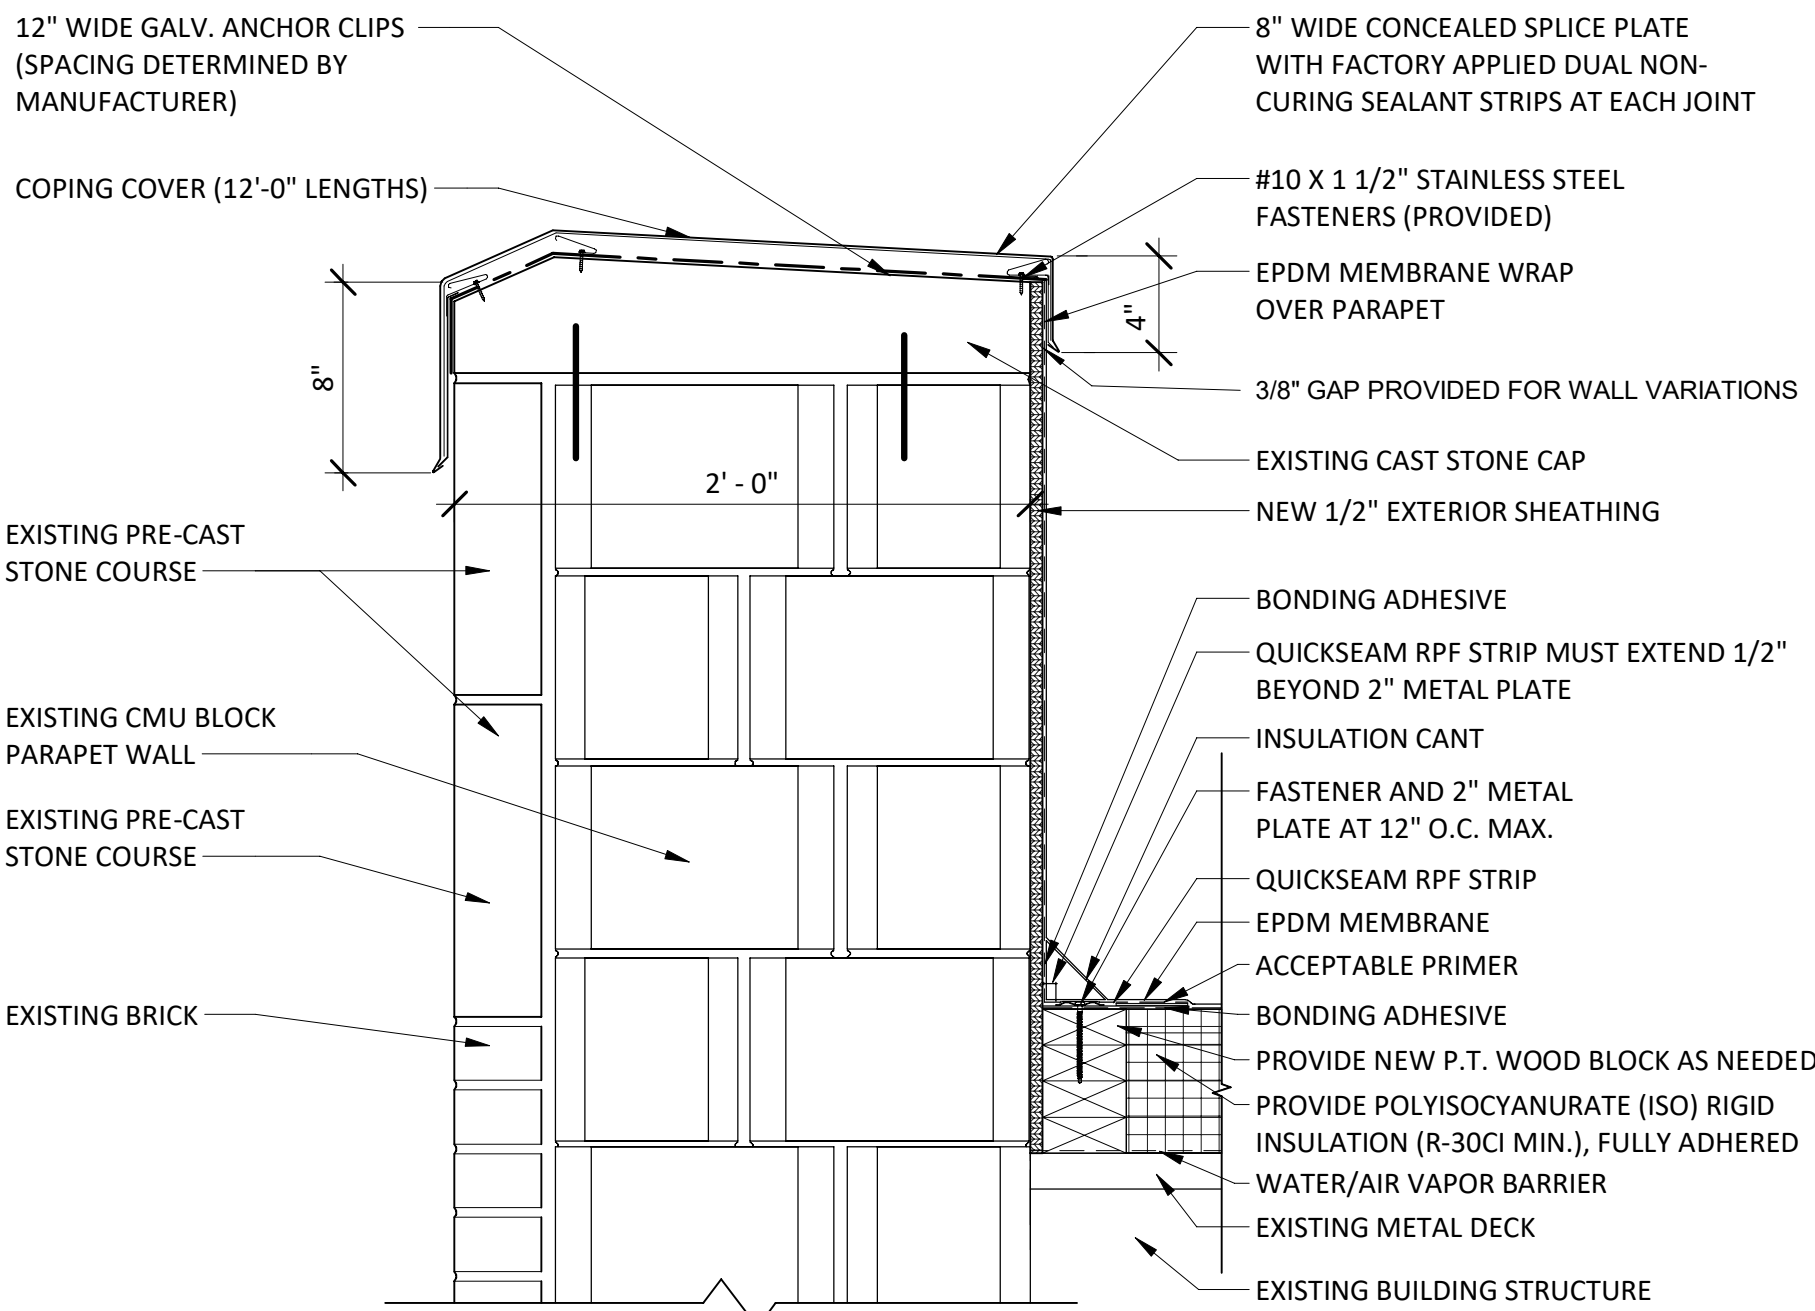
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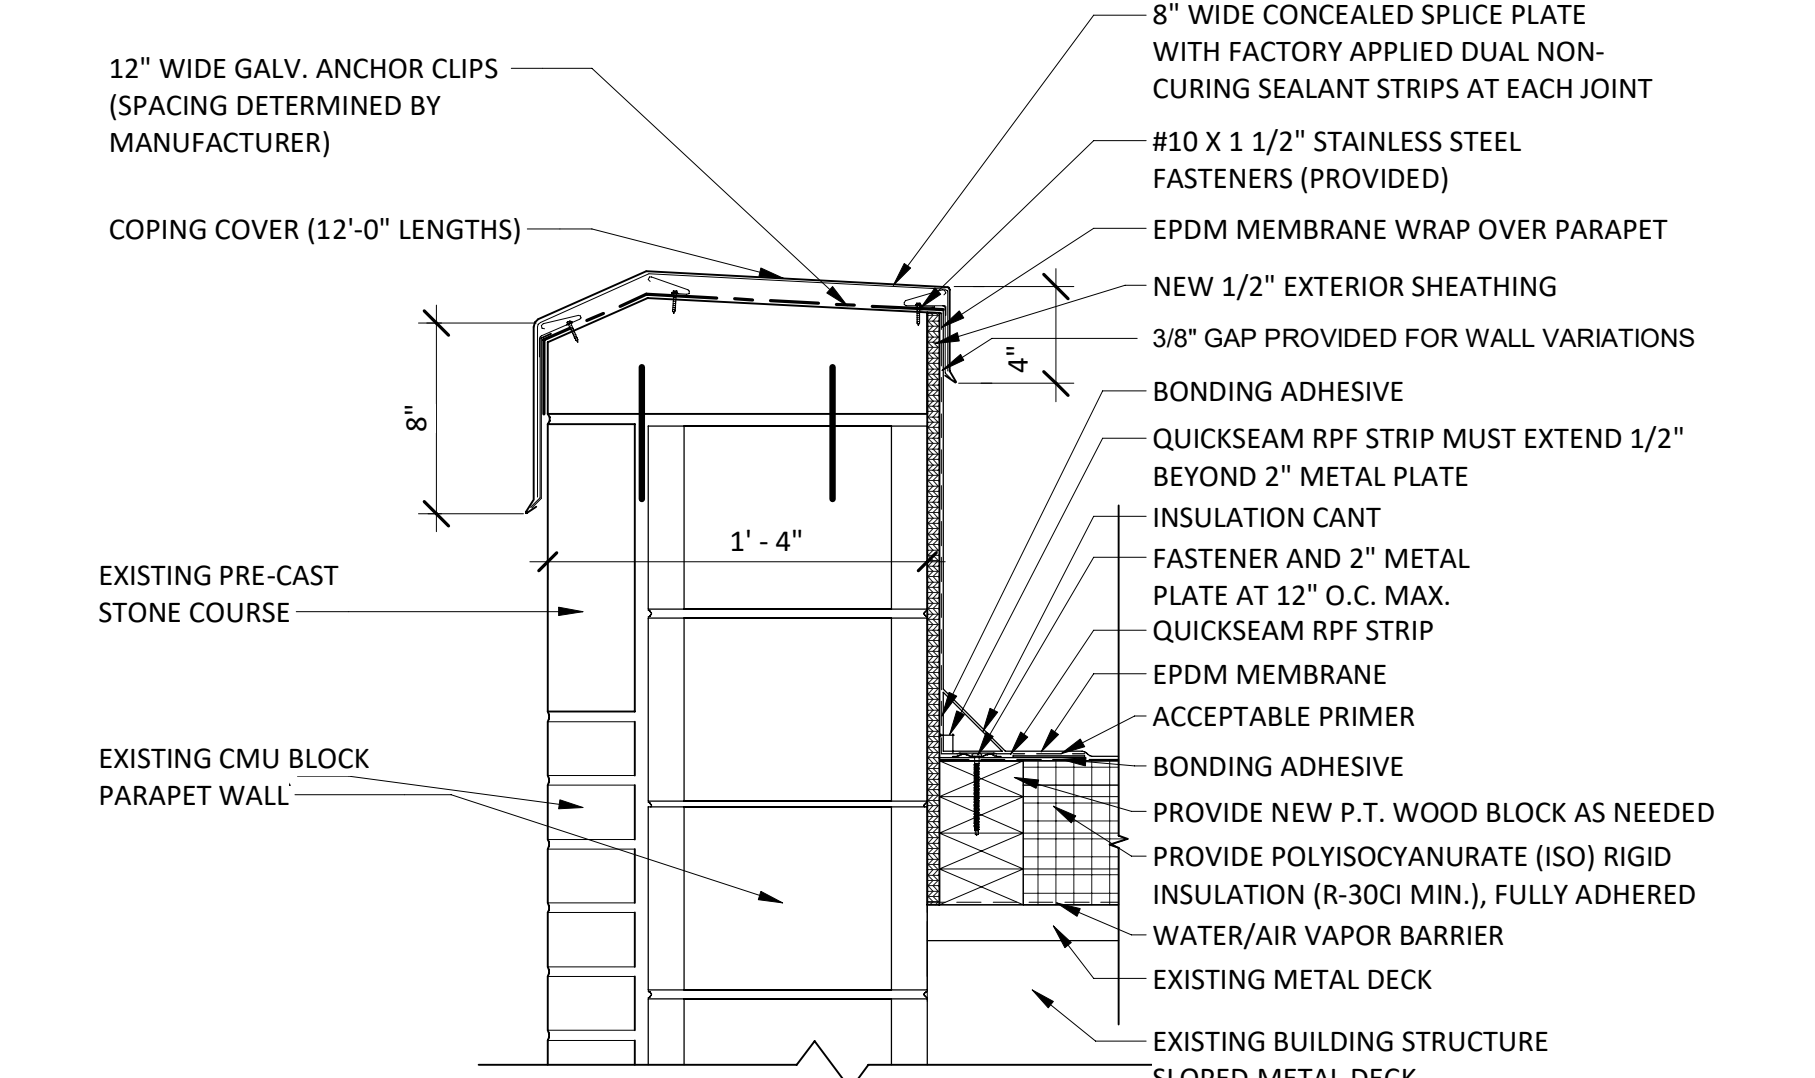
Project Number

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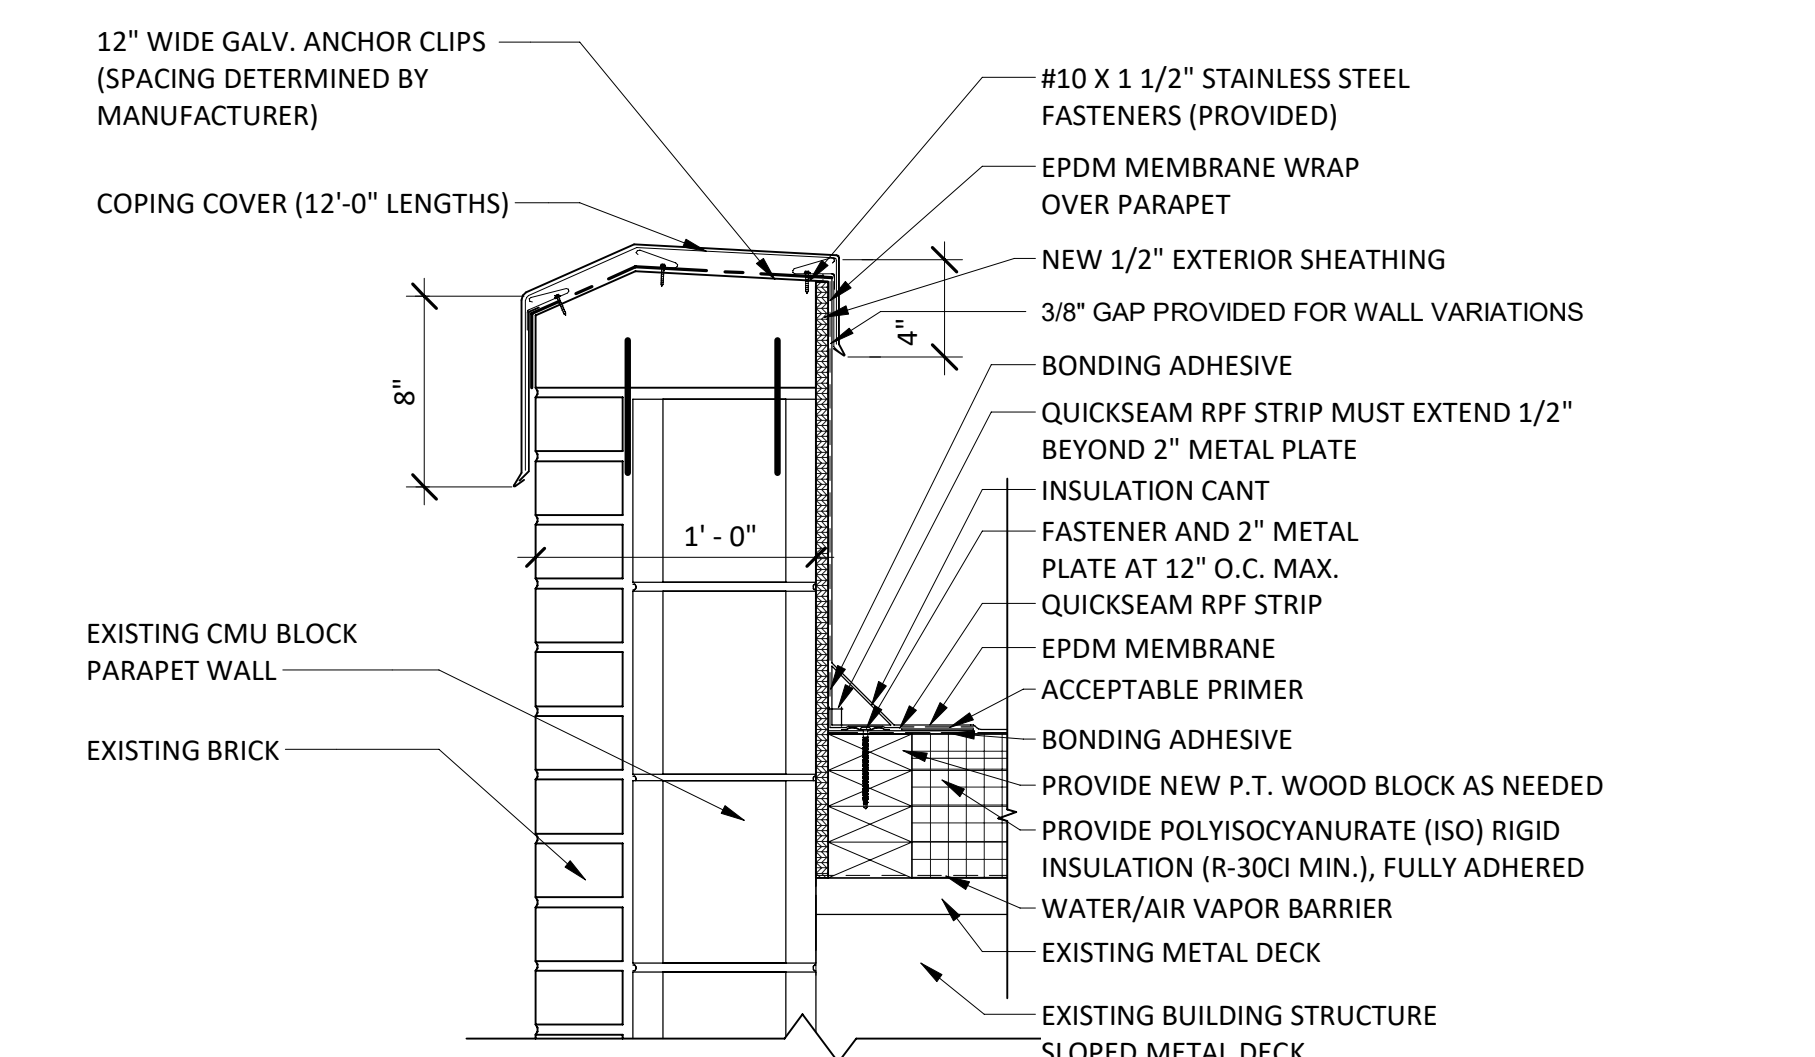





1 1 1/2" = 1'-0"




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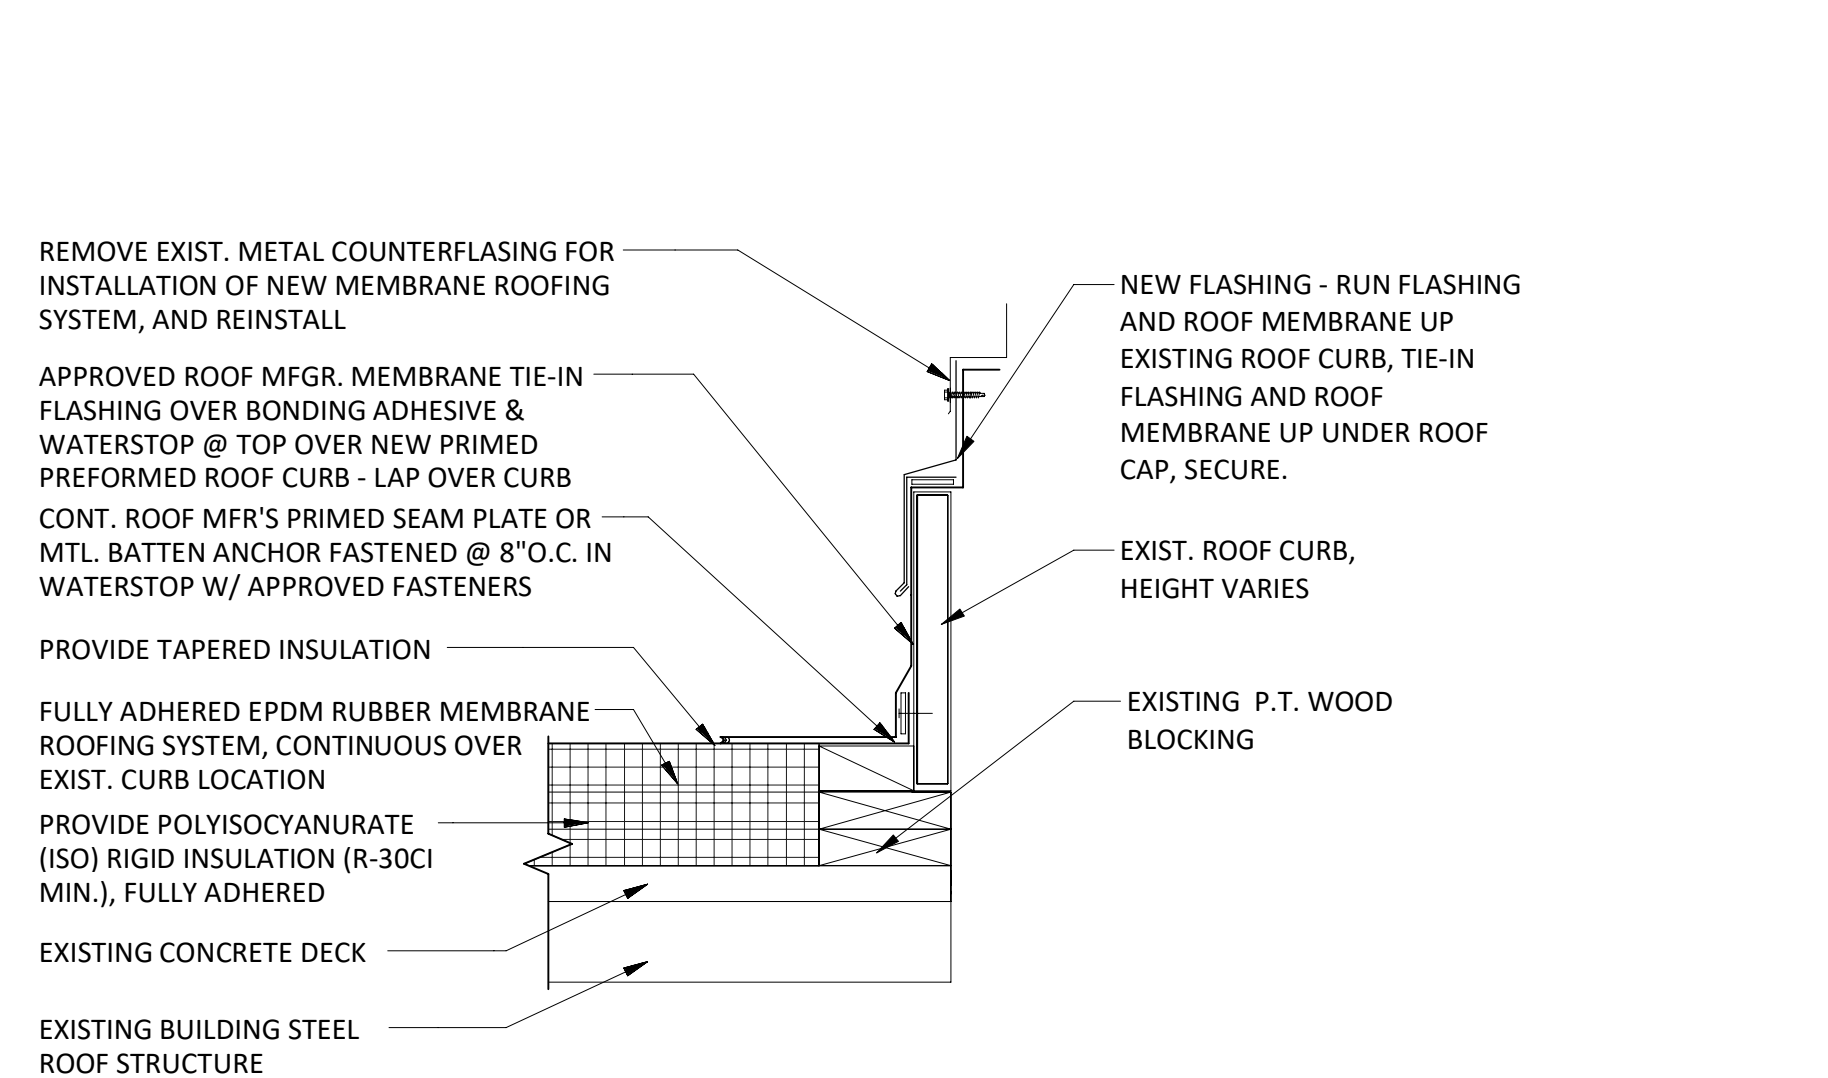
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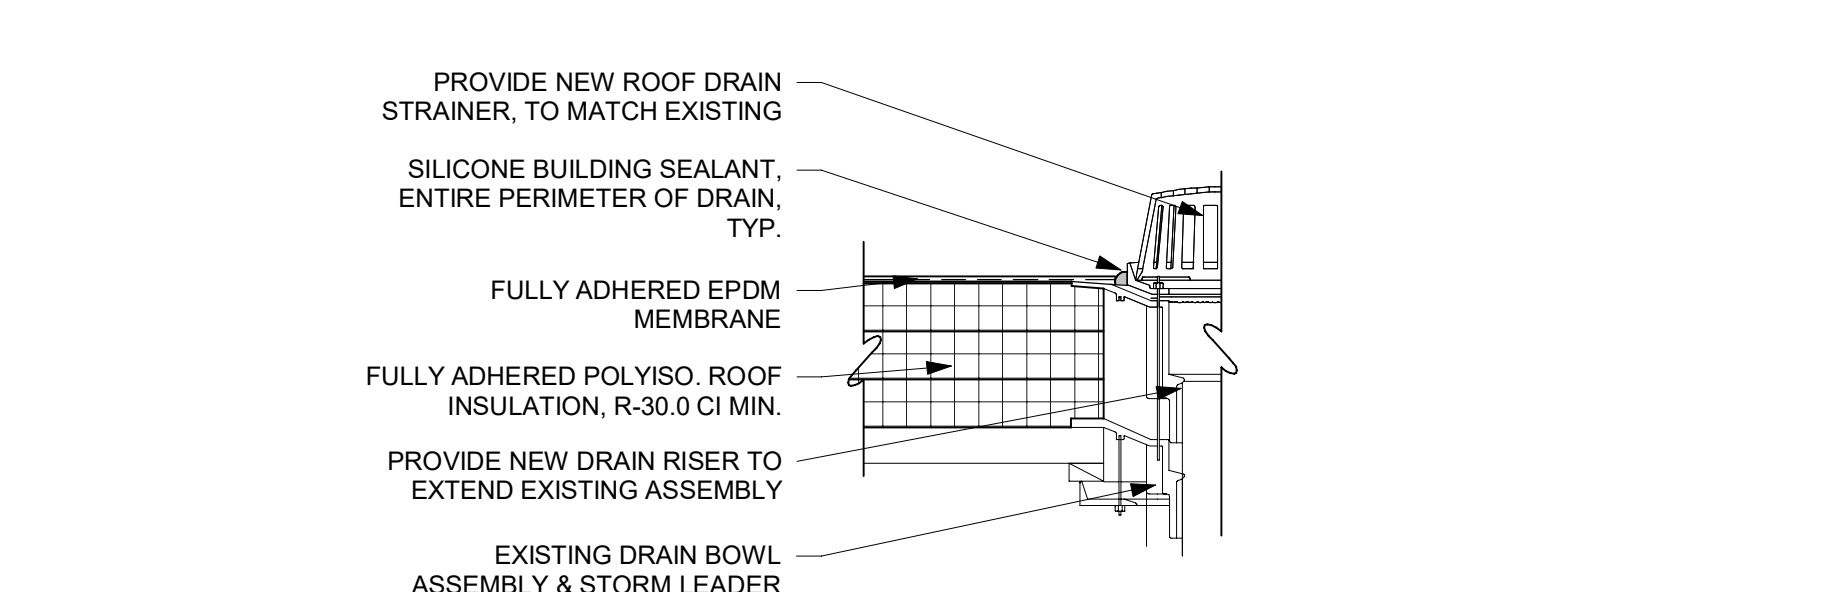
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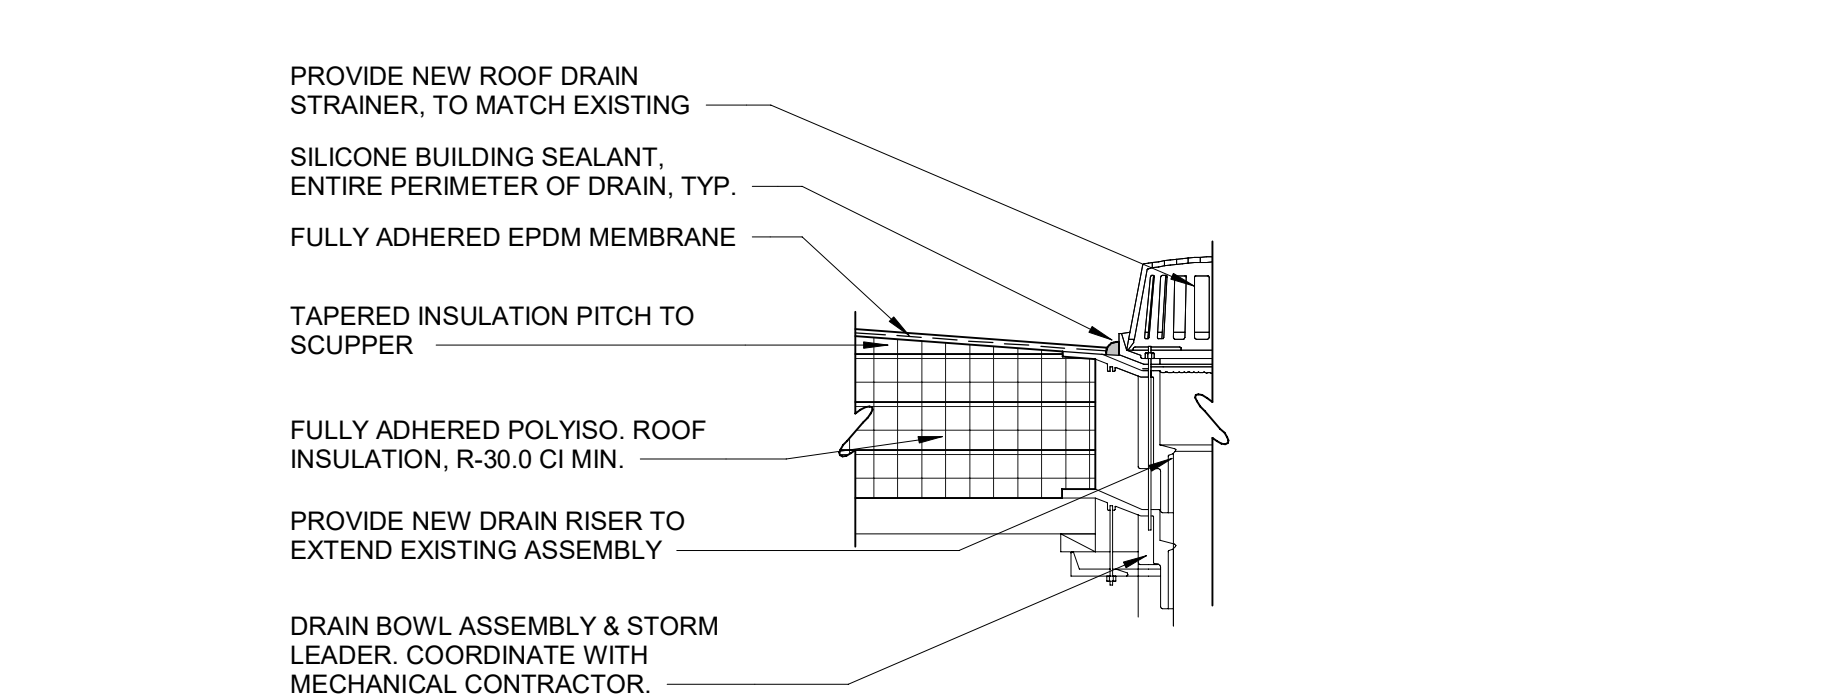
5 1 1/2" = 1'-0"




7 1 1/2" = 1'-0"

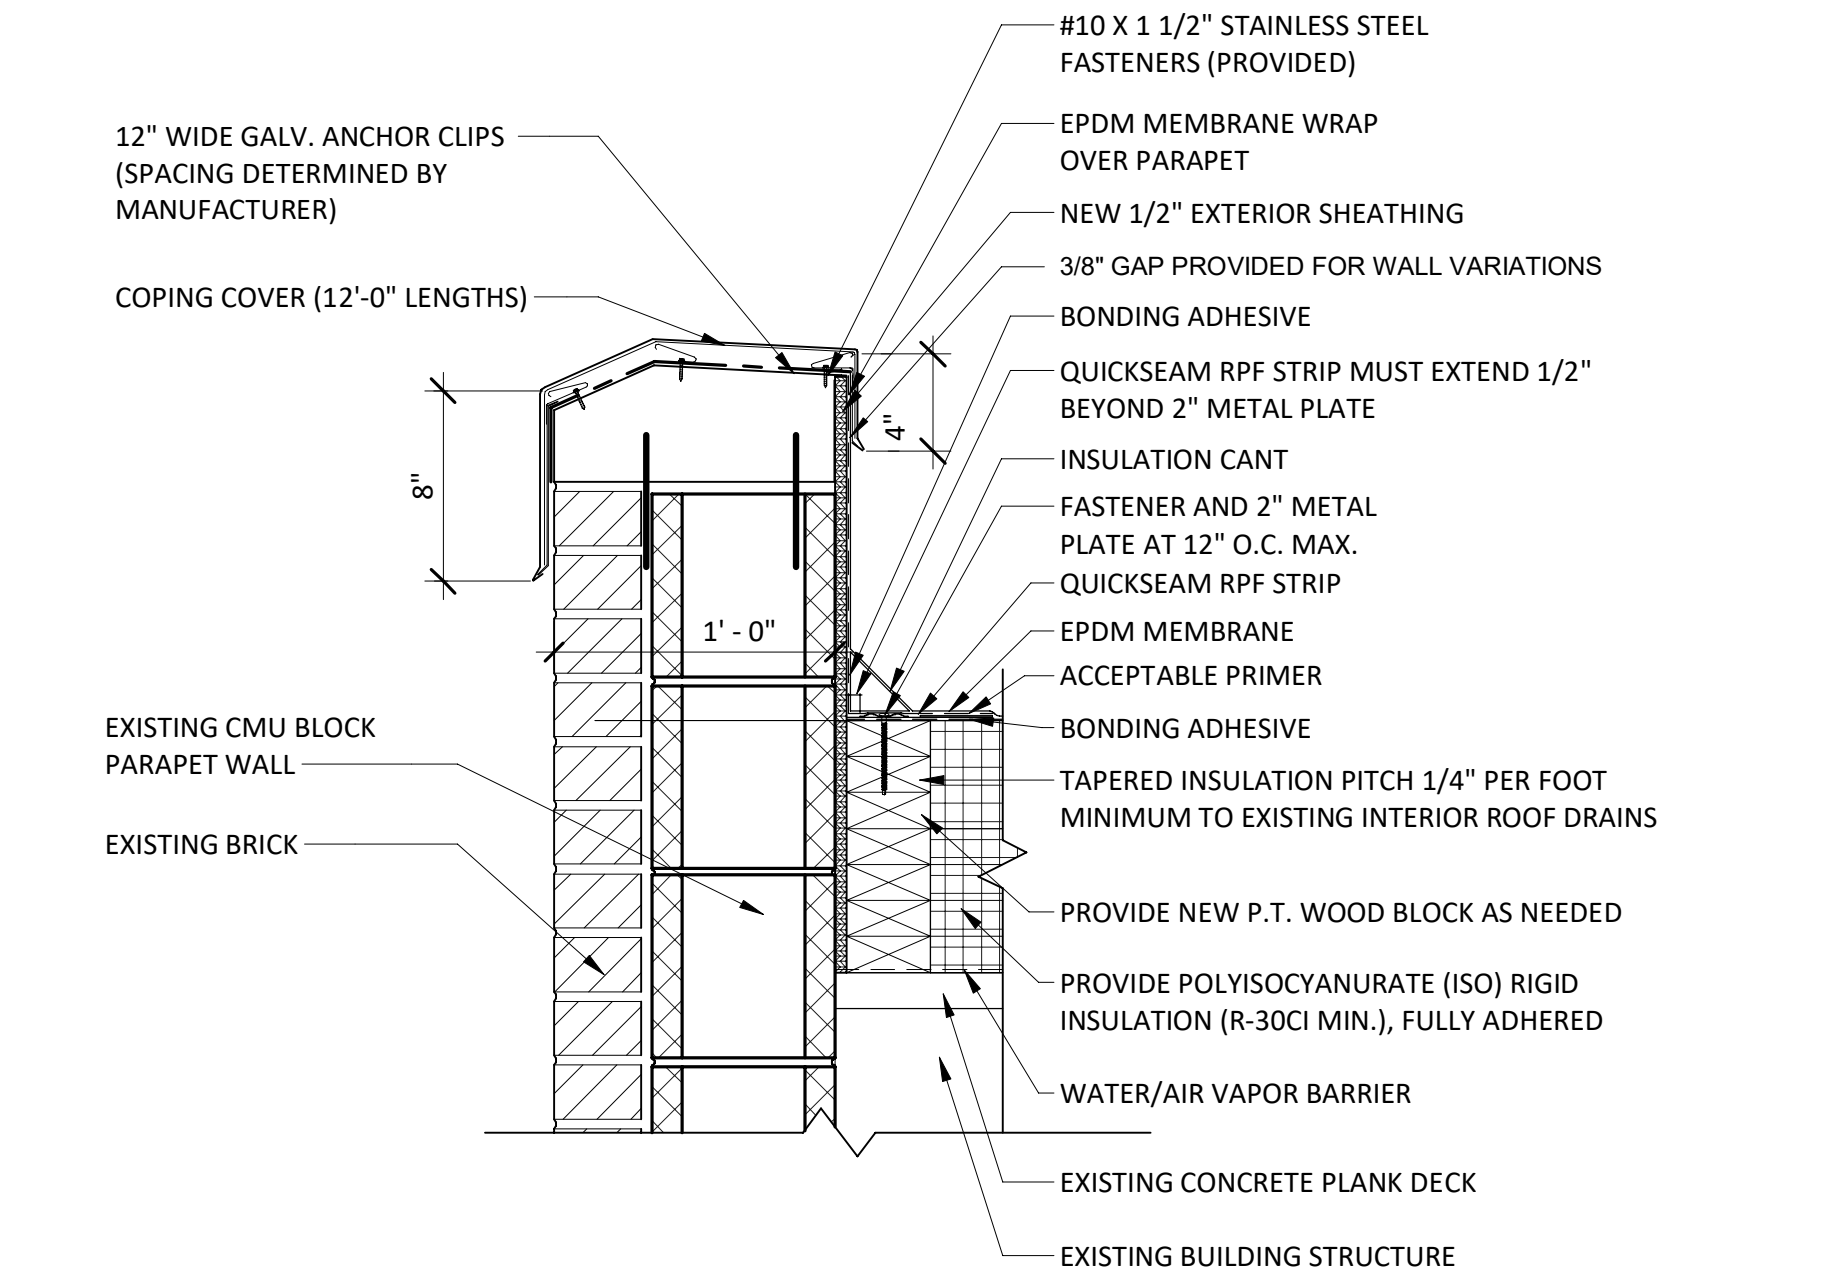


8 1 1/2" = 1'-0"

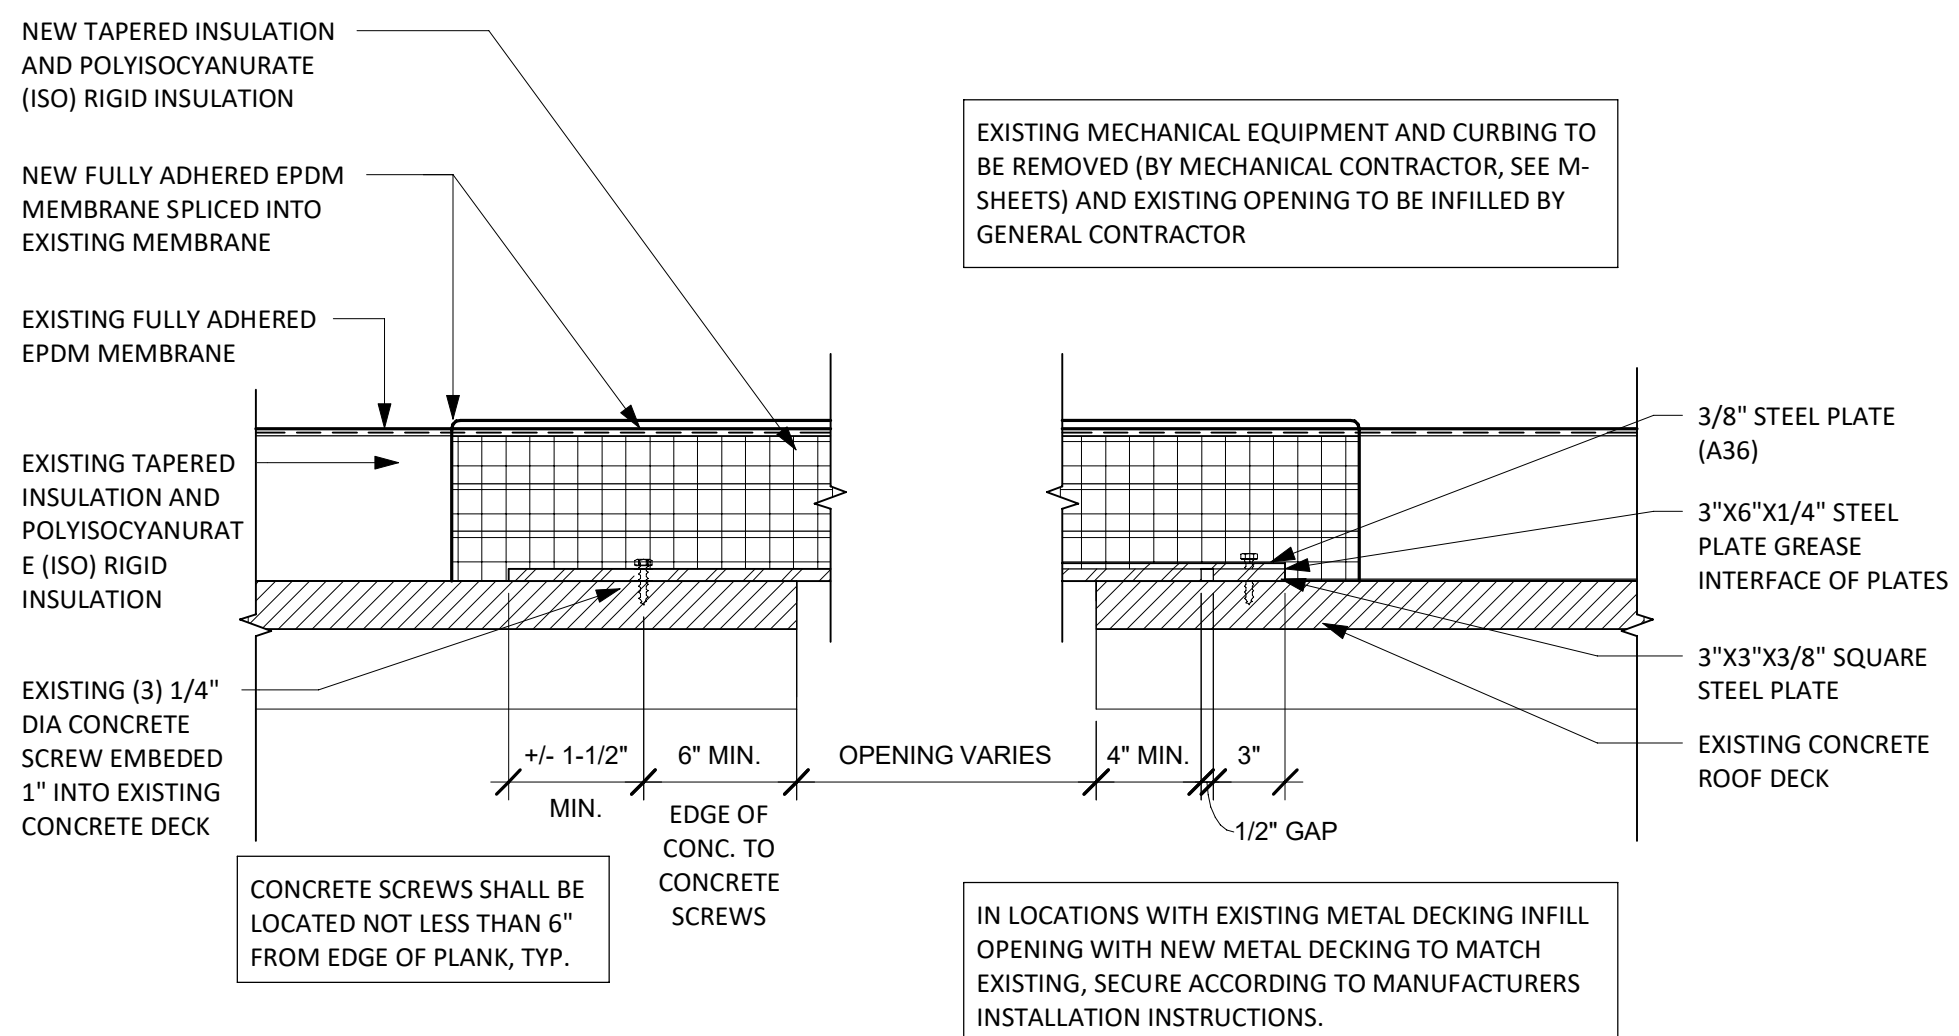

9 1 1/2" = 1'-0"

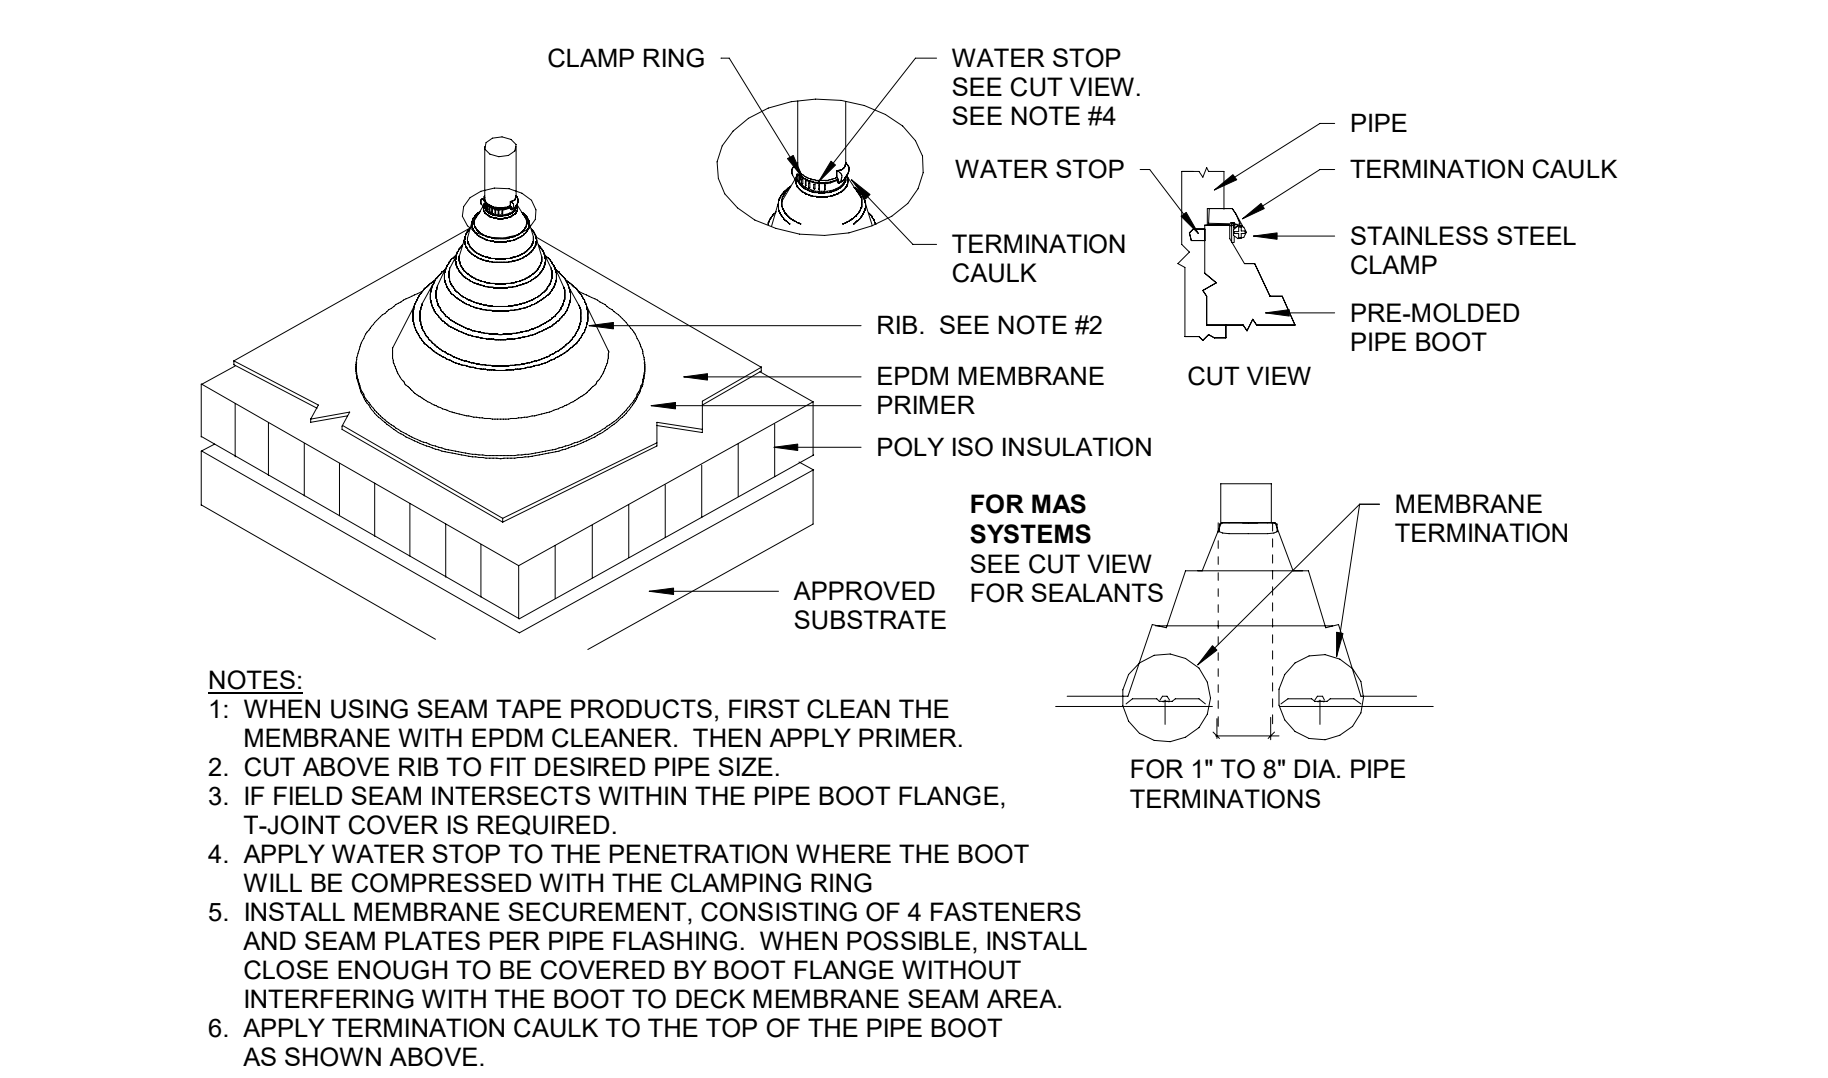

10 12" = 1'-0"

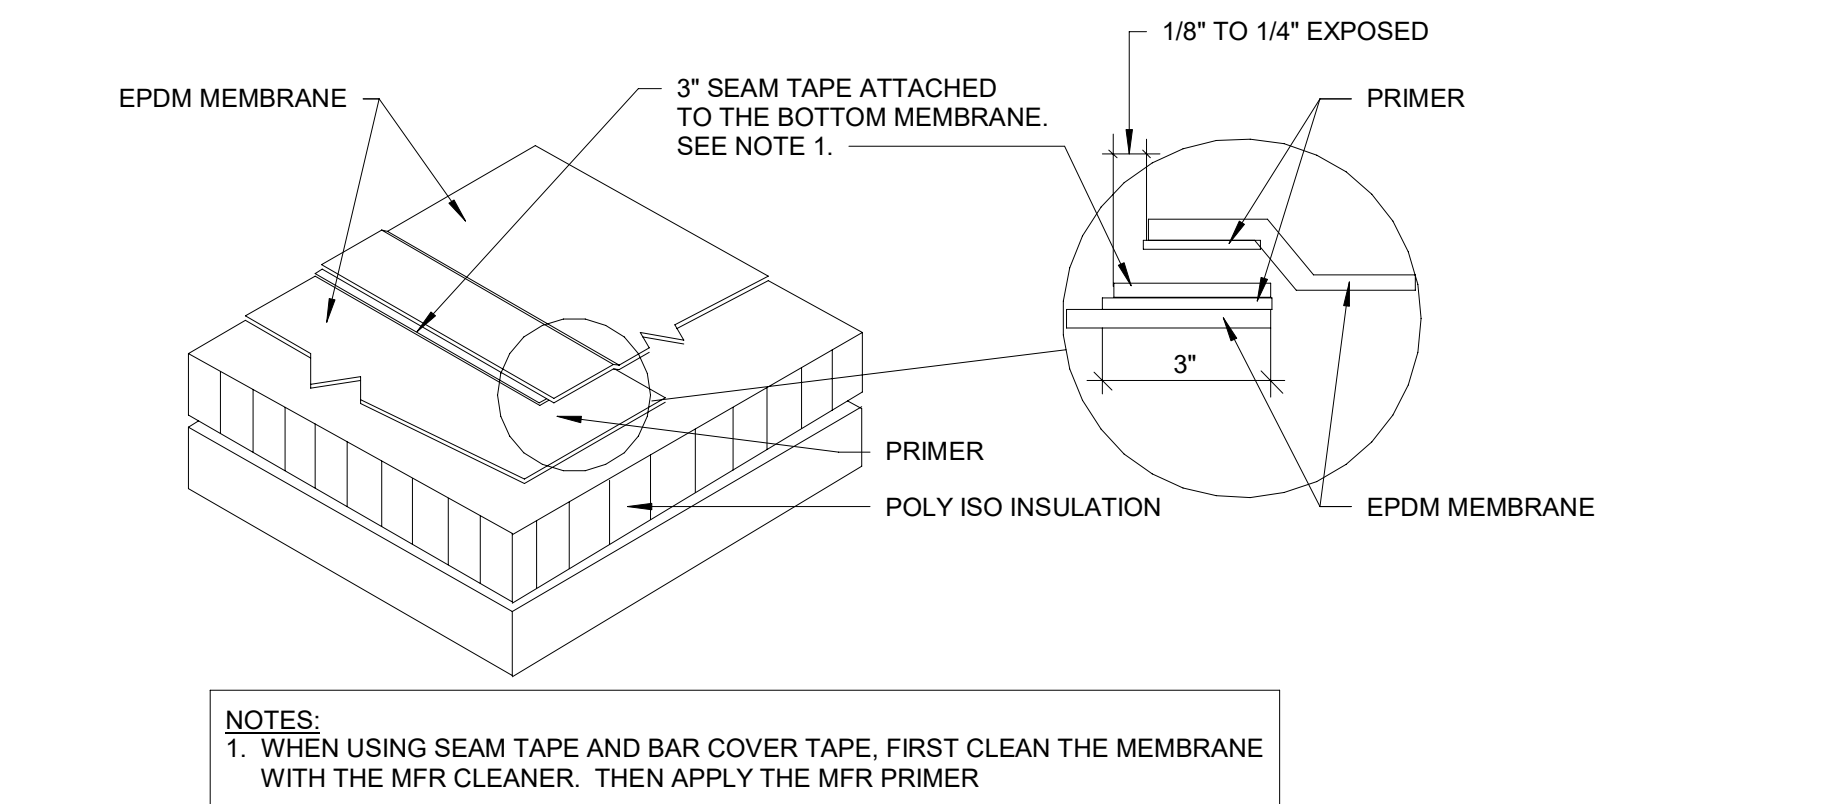

6 12" = 1'-0"

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REVISIONS	

CITY OF MIDDLETOWN  
NEW COURTHOUSE FACILITY  
ORANGE COUNTY, NEW YORK  
ROOF DETAILS  
CITY OF MIDDLETOWN

**Barton & Loguidice**  
443 Electronics Parkway  
Liverpool, NY 13088

**B&L**

NYS EXP.:

Date

AUGUST, 2024

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Sheet Number


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Project Number

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0019905, 0020336






- NOTES:
1. METAL COPING CAP, EXPANSION JOINT AND EDGE DETAILS ARE TYPICAL ONLY. ALL METAL WORK SHOULD BE INSTALLED TO SHEET METAL CODES (SMACNA). CLEAN ALL METAL PRIOR TO INSTALLATION OF ROOF MATERIALS.
  2. ALL WOOD NAILERS TO BE APPROVED MATERIAL. ATTACHMENT OF WOOD NAILER TO BE ACCOMPLISHED BY USING FASTENERS PROVIDED NO LESS THAN 125 LB OF PULLOUT RESISTANCE PER LINEAR FOOT, WITH FASTENER SPACING NO GREATER THAN 24" BETWEEN FASTENERS.
  3. ALL PARAPET WALLS AND ROOF CURBS MUST BE SUITABLE FOR FLASHING, I.E. CLEAN, TIGHT SMOOTH, NO CRACKS, ETC.
  4. WHEN FIELD MEMBRANE IN USED AS WALL OR CURB FLASHING, VERTICAL SEAMS MUST BE STRIPPED IN AT BASE OF ANGLE CHANGE WITH A 7" WIDE STRIP OF PEEL AND STICK FLASHING. SEE DETAIL 9/A504.

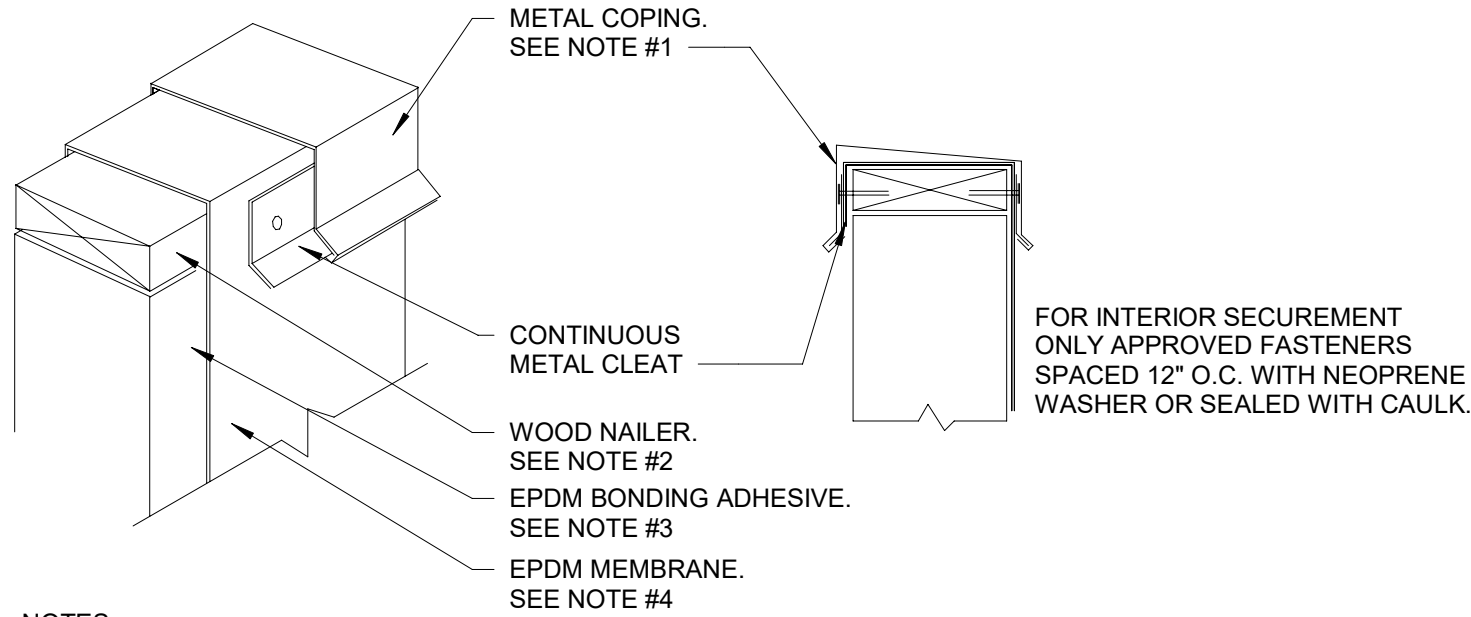
## 1 EPDM MEMBRANE COPING TERMINATION DETAIL

12" = 1'-0"

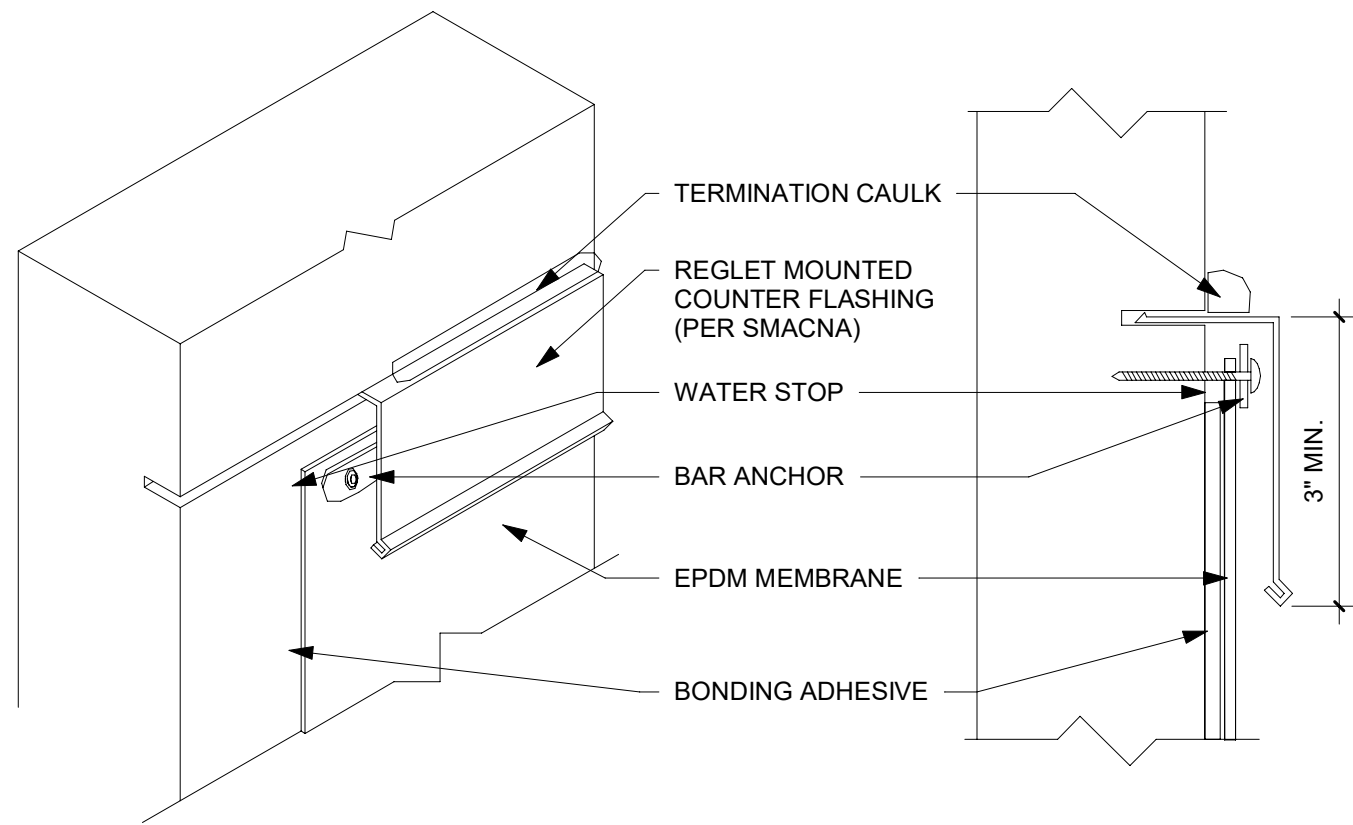

## 2 REGLET MOUNTED COUNTER FLASHING TERMINATION DETAIL


6" = 1'-0"

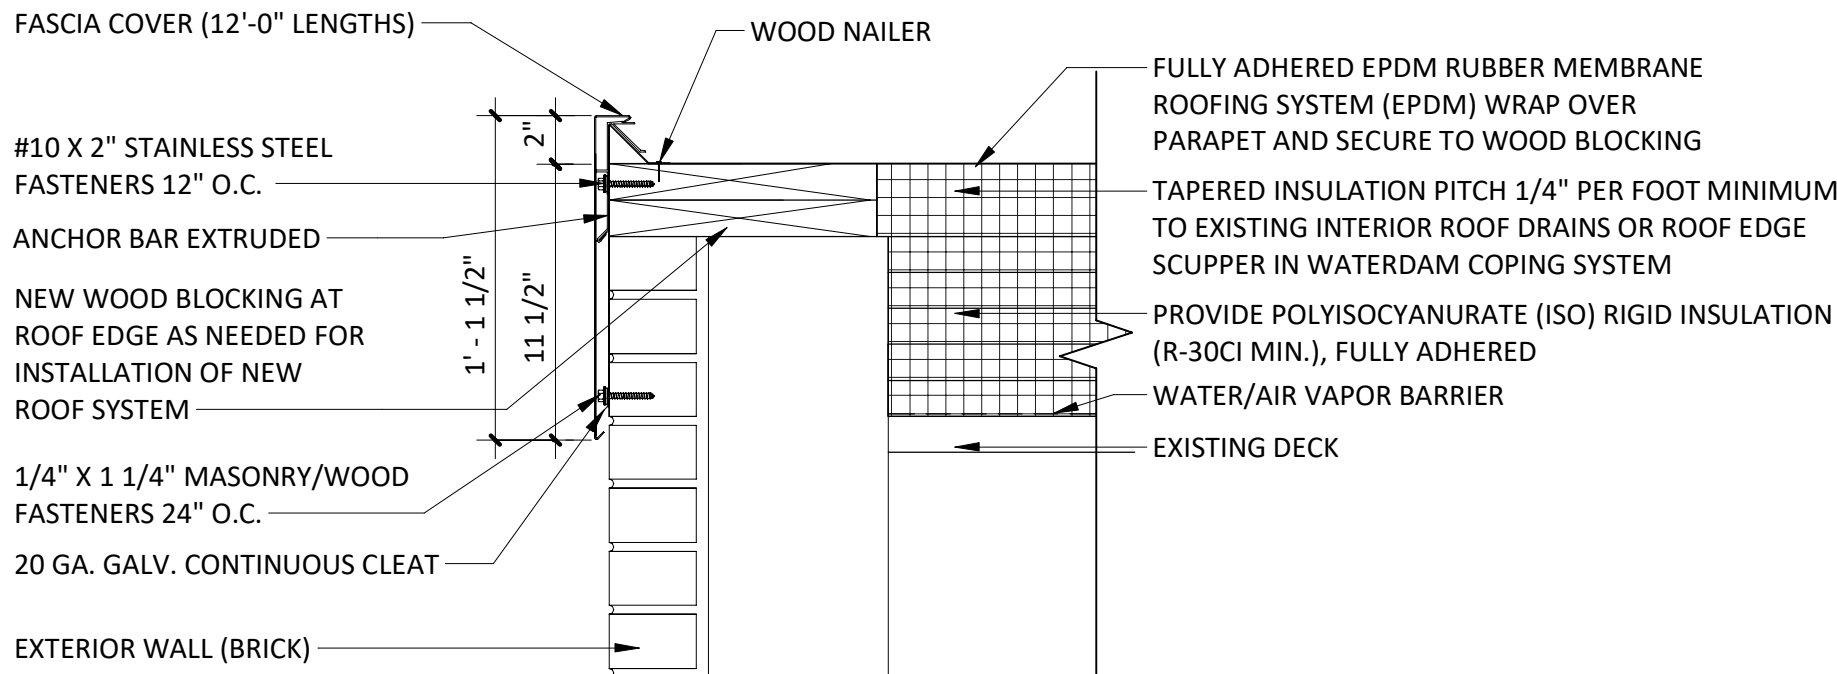

- NOTES:
1. PROVIDE ANCHORGARD EXTENDED CANTED FASCIA - 12" (GALVANIZED WATERDAM VERSION) AS AVAILABLE FROM FIRESTONE BUILDING PRODUCTS, OR APPROVED EQUAL, COLOR TO BE SELECTED BY OWNER FROM MANUFACTURERS FULL RANGE OF COLOR OPTIONS.
  2. PROVIDE DOWNSPOUT SCUPPER IN LOCATION SHOWN ON ROOF PLAN.
  3. INSTALL WATERDAM FASCIA COPINGS AND SCUPPERS PER MANUFACTURERS REQUIREMENTS.

## 3 ROOF METAL COPING DETAIL AT EXISTING ROOF


1 1/2" = 1'-0"

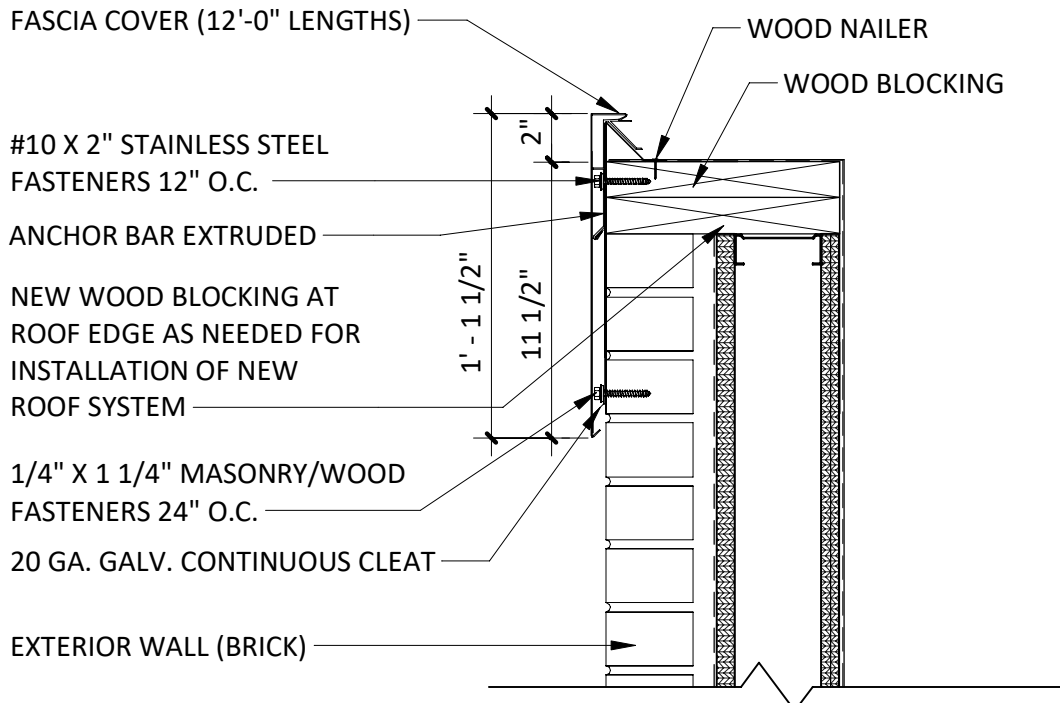

- NOTES:
1. PROVIDE ANCHORGARD EXTENDED CANTED FASCIA - 12" (GALVANIZED WATERDAM VERSION) AS AVAILABLE FROM FIRESTONE BUILDING PRODUCTS, OR APPROVED EQUAL, COLOR TO BE SELECTED BY OWNER FROM MANUFACTURERS FULL RANGE OF COLOR OPTIONS.
  2. PROVIDE DOWNSPOUT SCUPPER IN LOCATION SHOWN ON ROOF PLAN.
  3. INSTALL WATERDAM FASCIA COPINGS AND SCUPPERS PER MANUFACTURERS REQUIREMENTS.


## 4 NEW PARAPET METAL COPING DETAIL AT NEW ADDITION

1 1/2" = 1'-0"

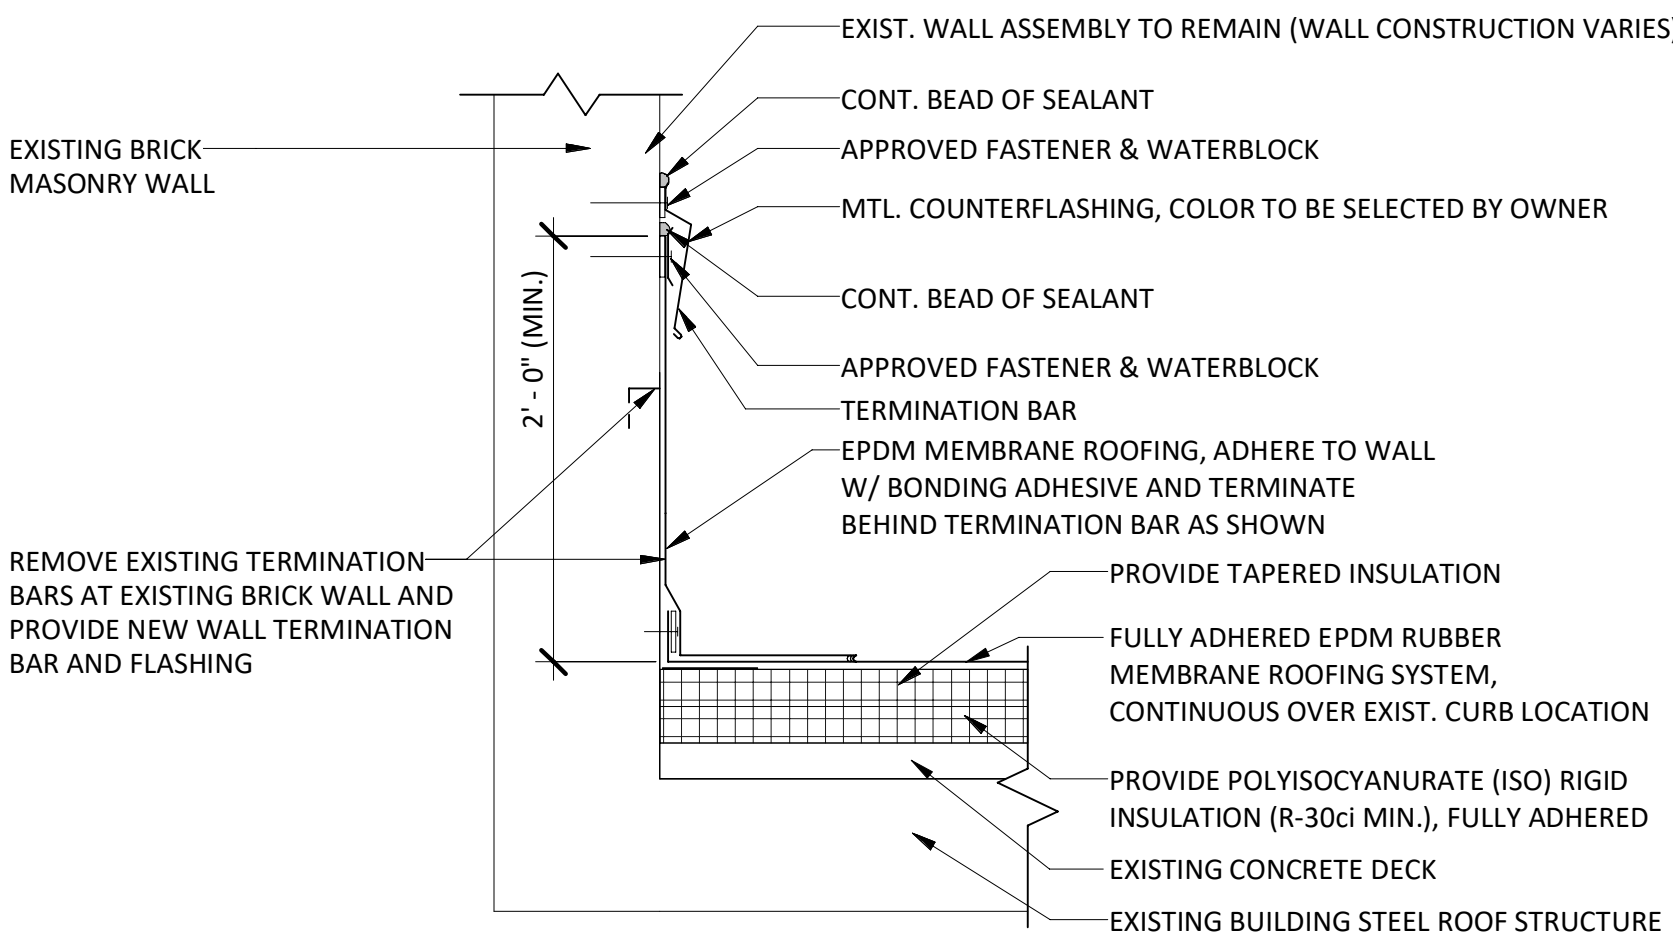

## 5 TYPICAL WALL TERMINATION DETAIL AT NEW ADDITION

1 1/2" = 1'-0"

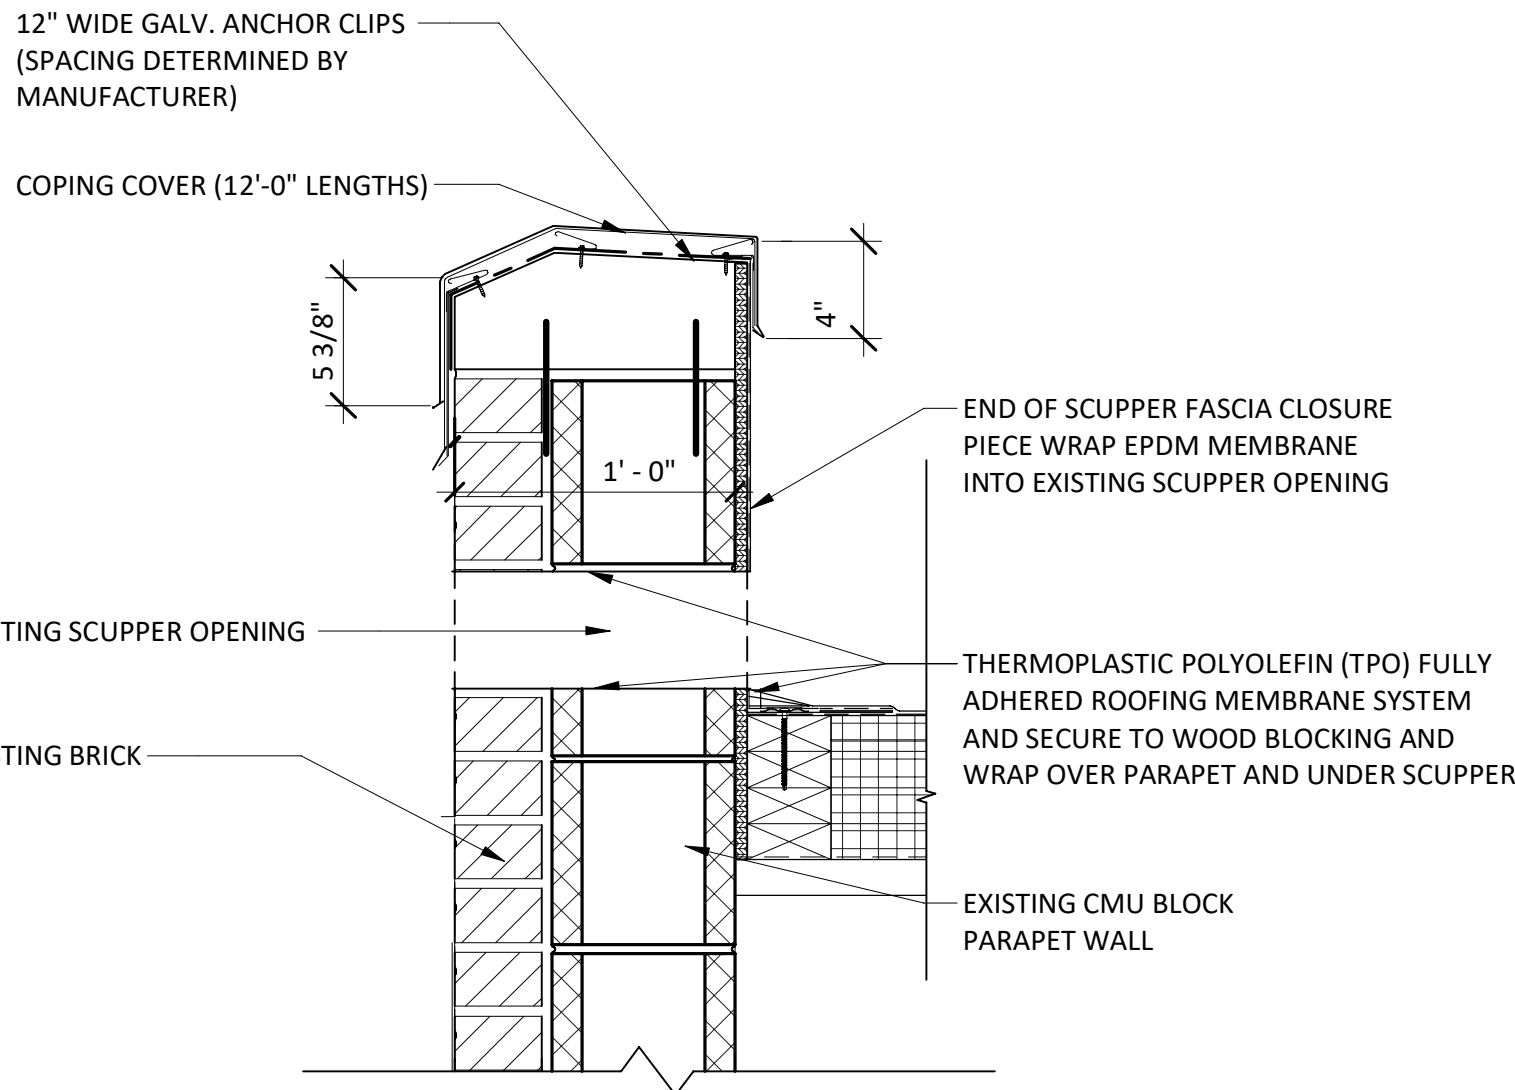

- NOTES:
1. PROVIDE ANCHORGARD EXTENDED CANTED FASCIA - 12" (GALVANIZED WATERDAM VERSION) AS AVAILABLE FROM FIRESTONE BUILDING PRODUCTS, OR APPROVED EQUAL, COLOR TO BE SELECTED BY OWNER FROM MANUFACTURERS FULL RANGE OF COLOR OPTIONS.
  2. INSTALL WATERDAM FASCIA COPINGS AND SCUPPERS PER MANUFACTURERS REQUIREMENTS.

## 6 ROOF METAL SCUPPER DETAIL

1 1/2" = 1'-0"

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### REVISIONS

NO.	DESCRIPTION

CITY OF MIDDLETOWN  
NEW COURTHOUSE FACILITY  
ORANGE COUNTY, NEW YORK

### ROOF DETAILS

CITY OF MIDDLETOWN

**Barton & Loguidice**  
443 Electronics Parkway  
Liverpool, NY 13088




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Project Number: 1753.008.001




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Checked by ZDC Drawn by ZDC Designed by ZDC In Charge of TRB

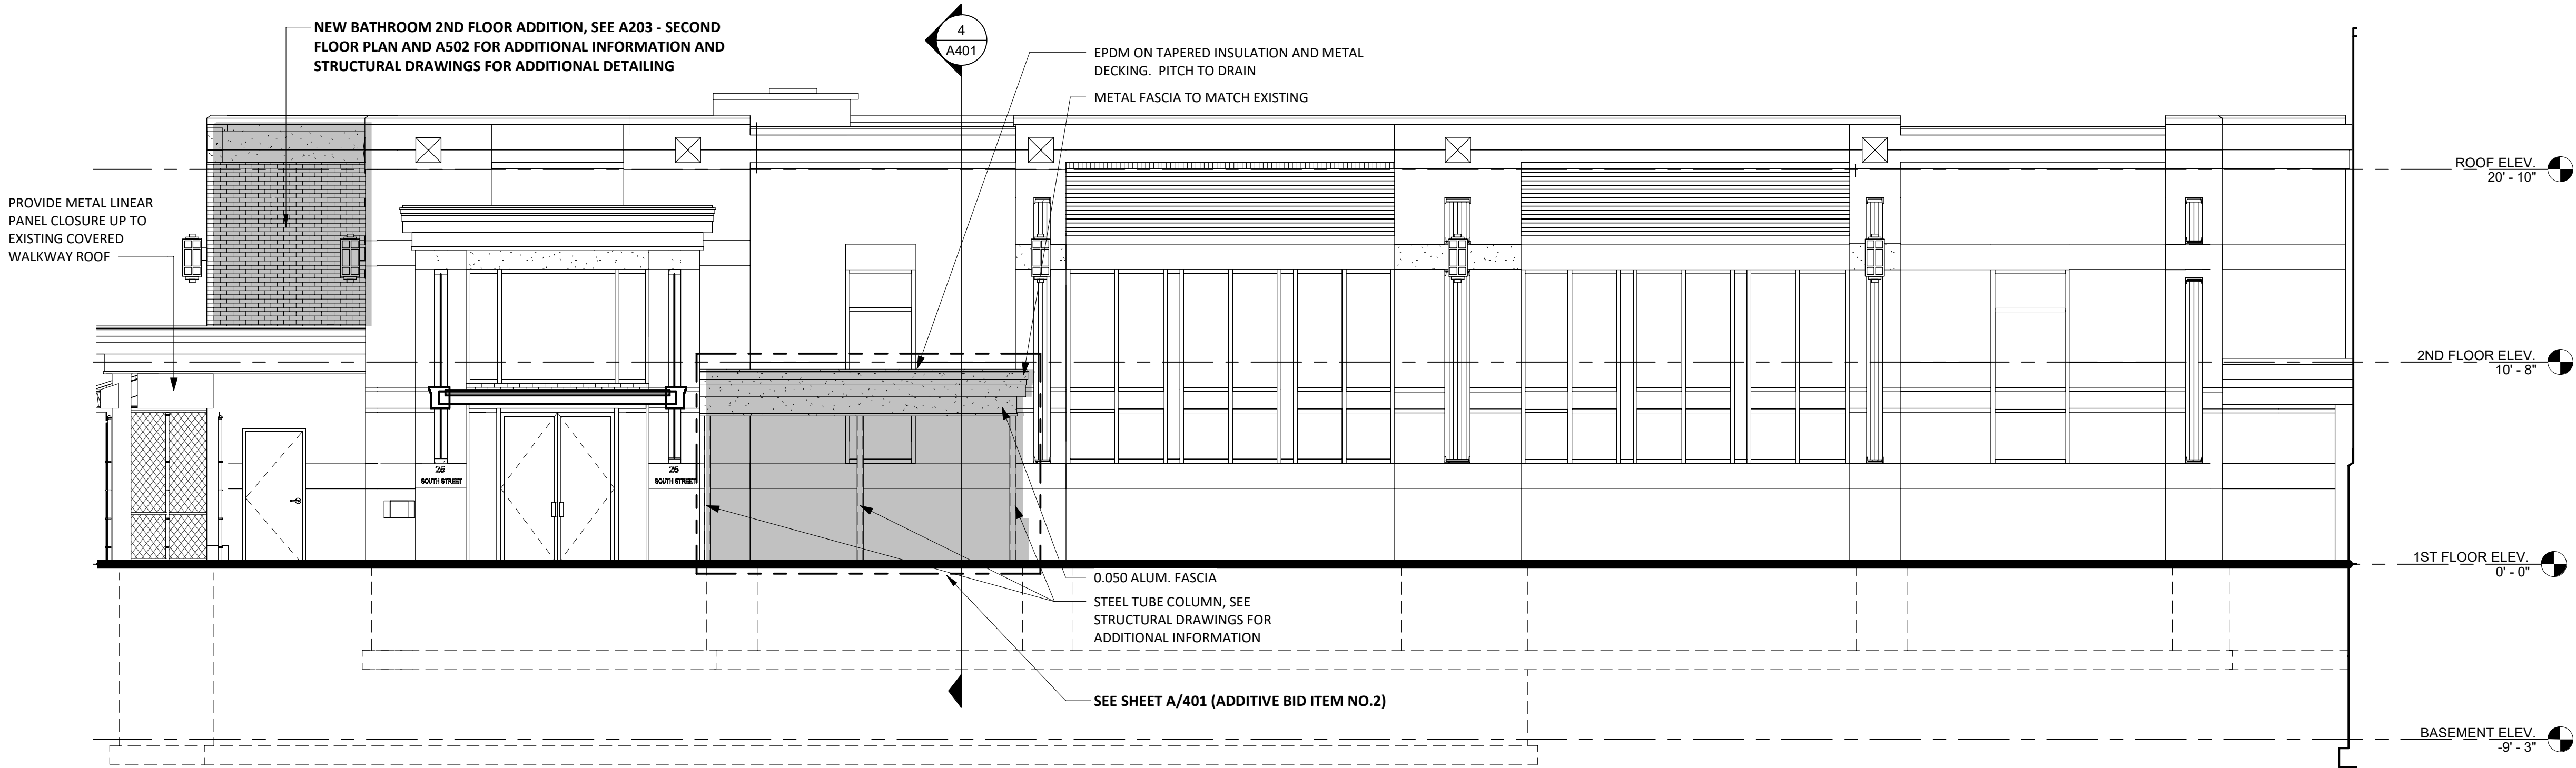

### SOUTH ELEVATION

SCALE: 3/16" = 1'-0"

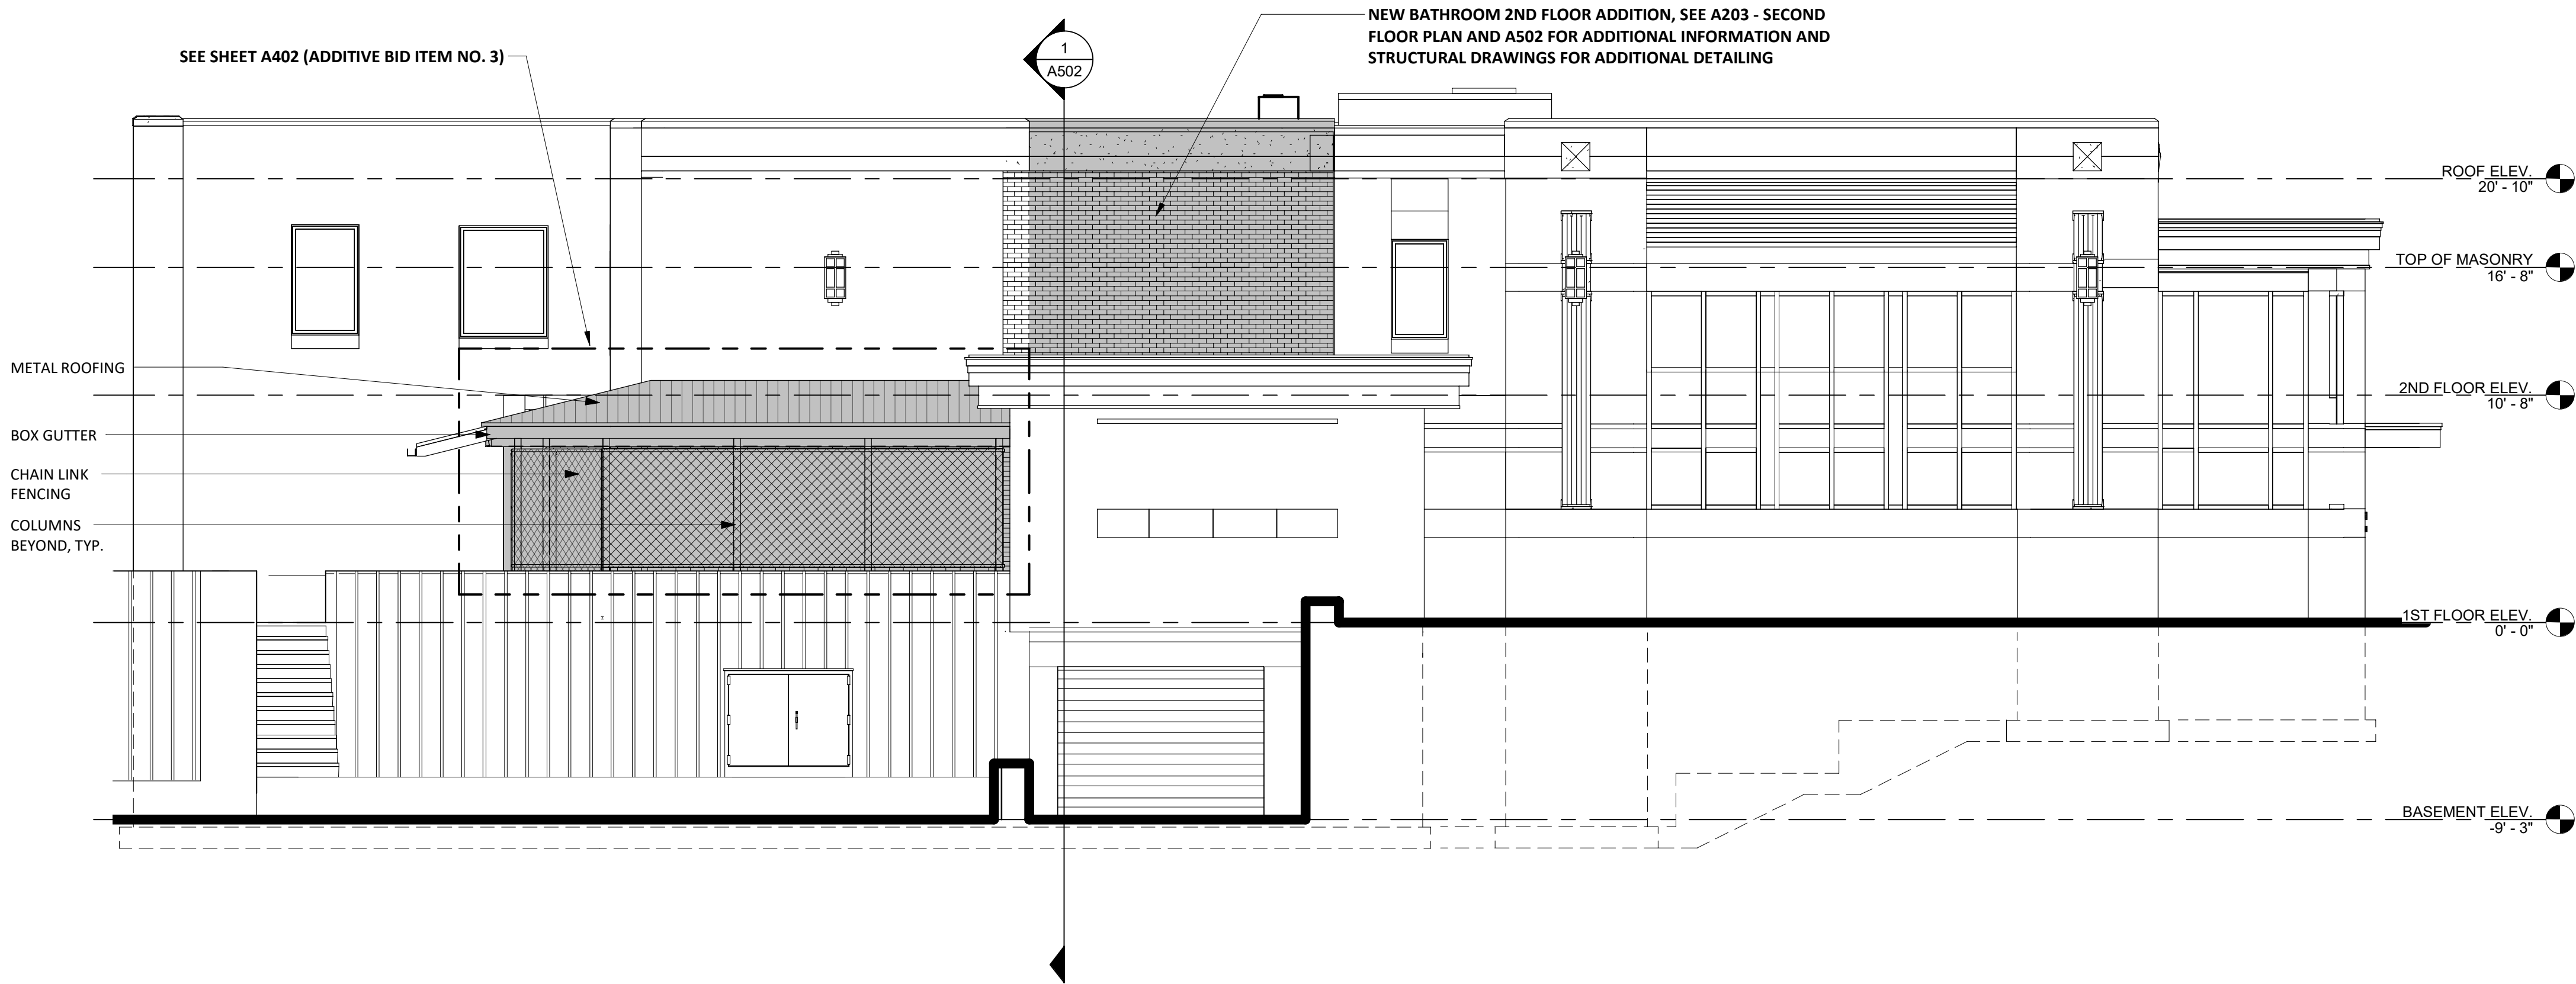

### WEST ELEVATION

SCALE: 3/16" = 1'-0"

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#### REVISIONS

CITY OF MIDDLETOWN  
NEW COURTHOUSE FACILITY

**BUILDING SOUTH AND WEST ELEVATIONS**

ORANGE COUNTY, NEW YORK

**Barton & Loguidice**  
443 Electronics Parkway  
Liverpool, NY 13088

NYS CERTIFICATE #  
0021642, 0020588, 0019903,  
0019905, 0020336

**B&L**



NYS EXP.:  
Date **AUGUST, 2024**

Scale  
**AS SHOWN**


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Project Number  
**1753.008.001**




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Checked by ZDC Drawn by ZDC Designed by ZDC In Charge of TRB



**NORTH ELEVATION**  
SCALE: 3/16" = 1'-0"

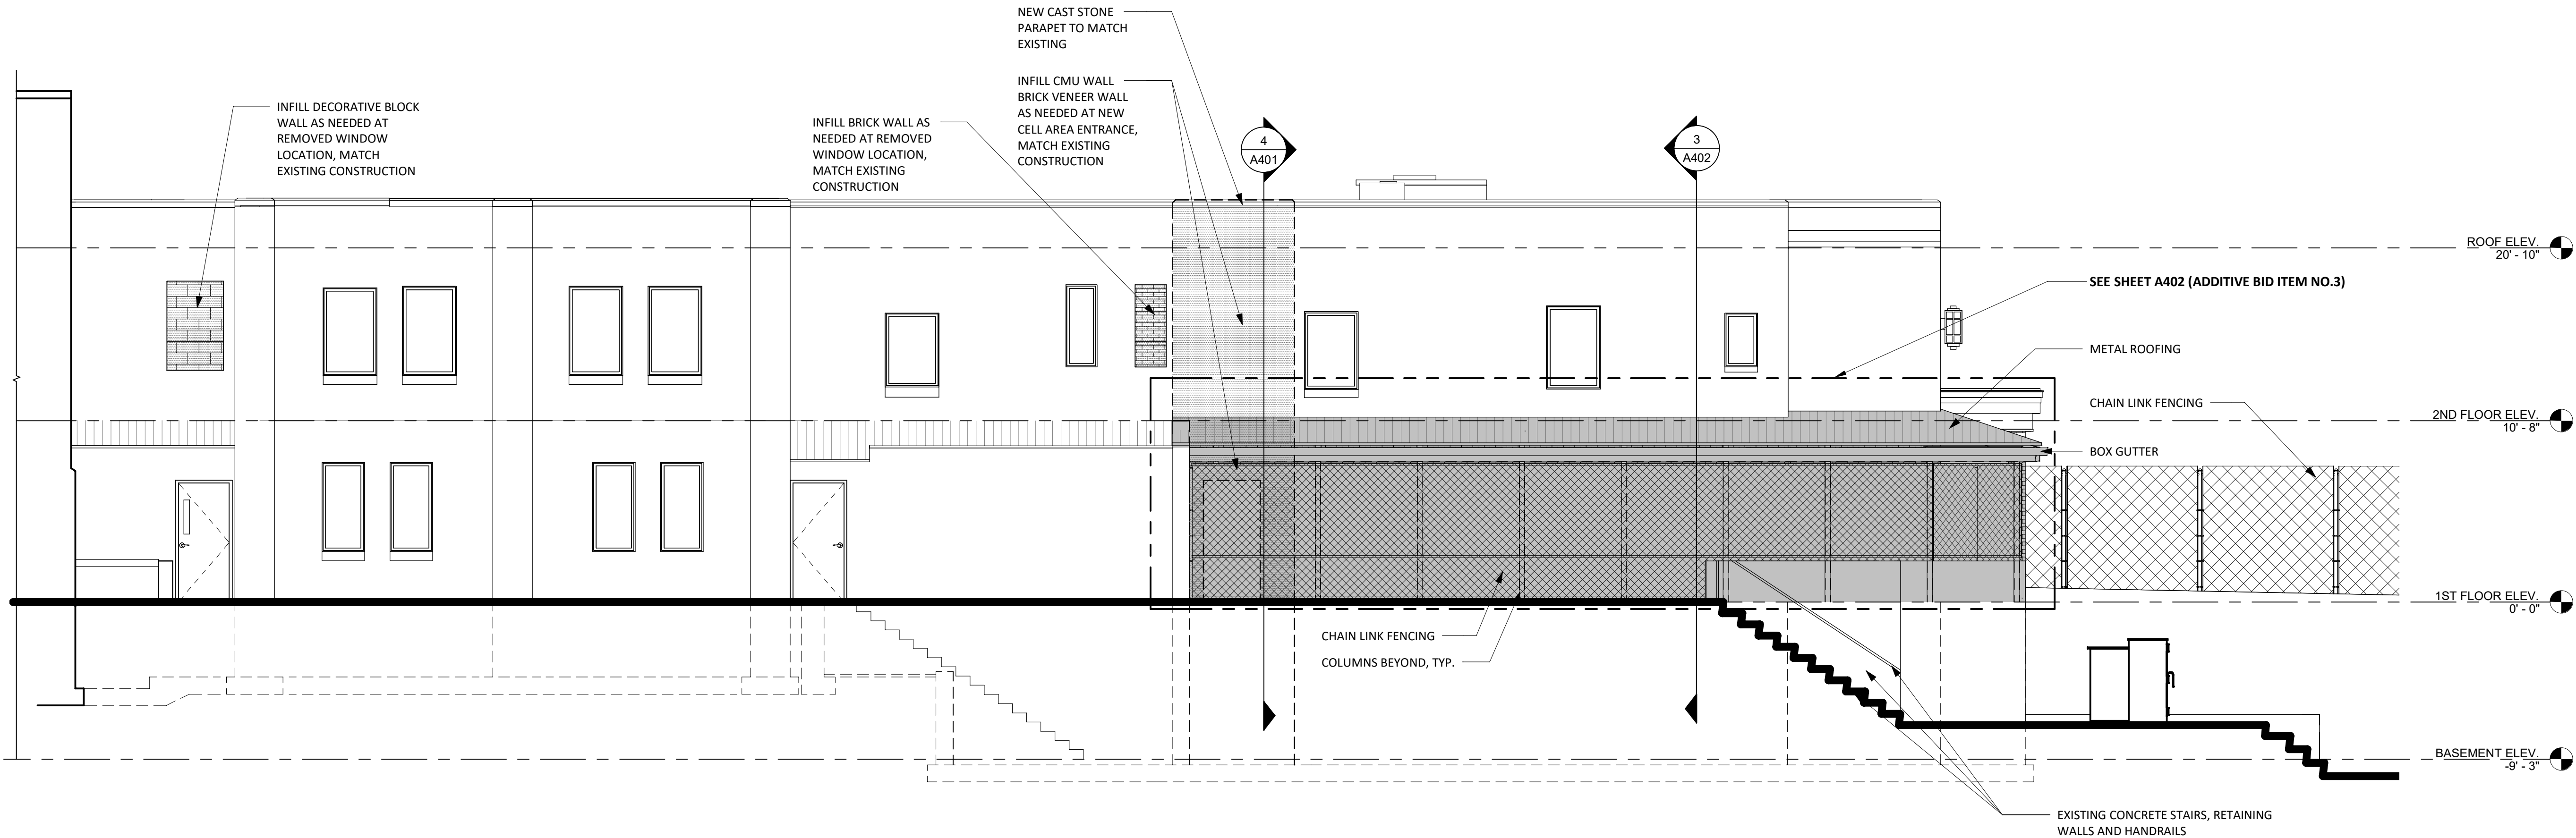

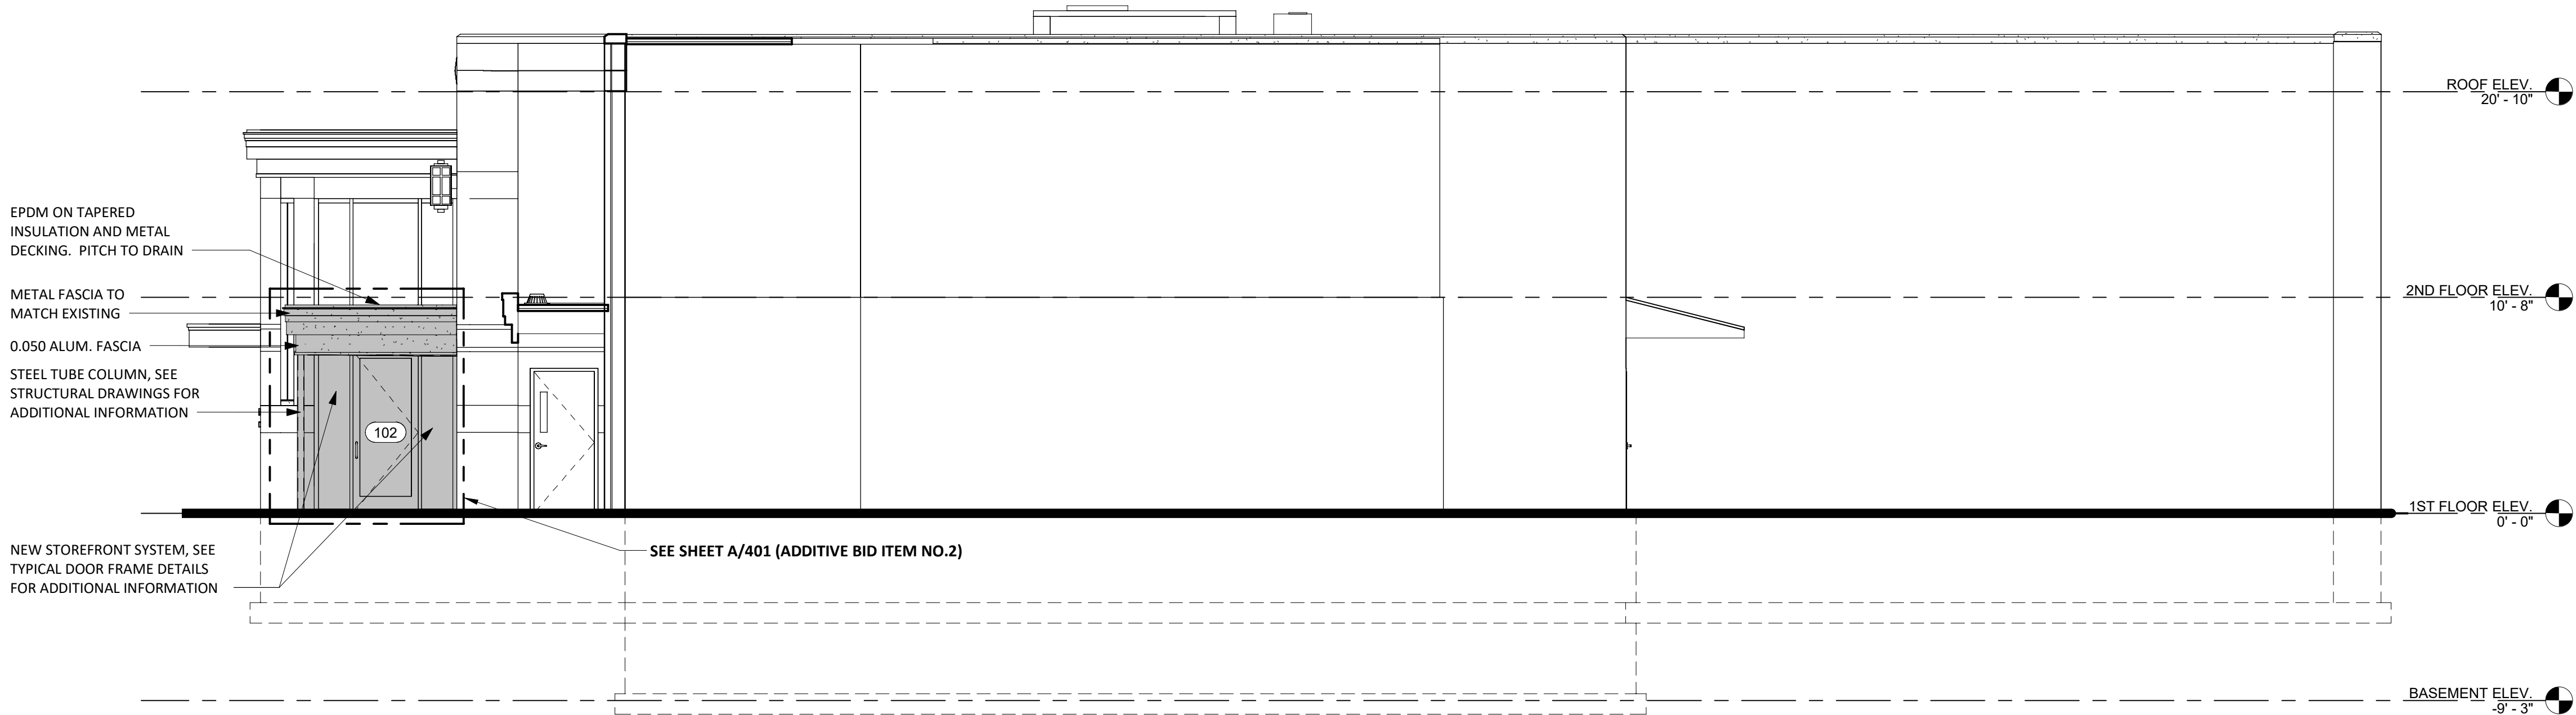**EAST ELEVATION**  
SCALE: 3/16" = 1'-0"

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REVISIONS

CITY OF MIDDLETOWN  
NEW COURTHOUSE FACILITY  
BUILDING NORTH AND EAST ELEVATIONS  
ORANGE COUNTY, NEW YORK  
CITY OF MIDDLETOWN

**Barton & Loguidice**  
443 Electronics Parkway  
Liverpool, NY 13088  
NYS CERTIFICATE #  
0021642, 0020588, 0019903,  
0019905, 0020336  
**B&L**



NYS EXP.:  
Date  
AUGUST, 2024

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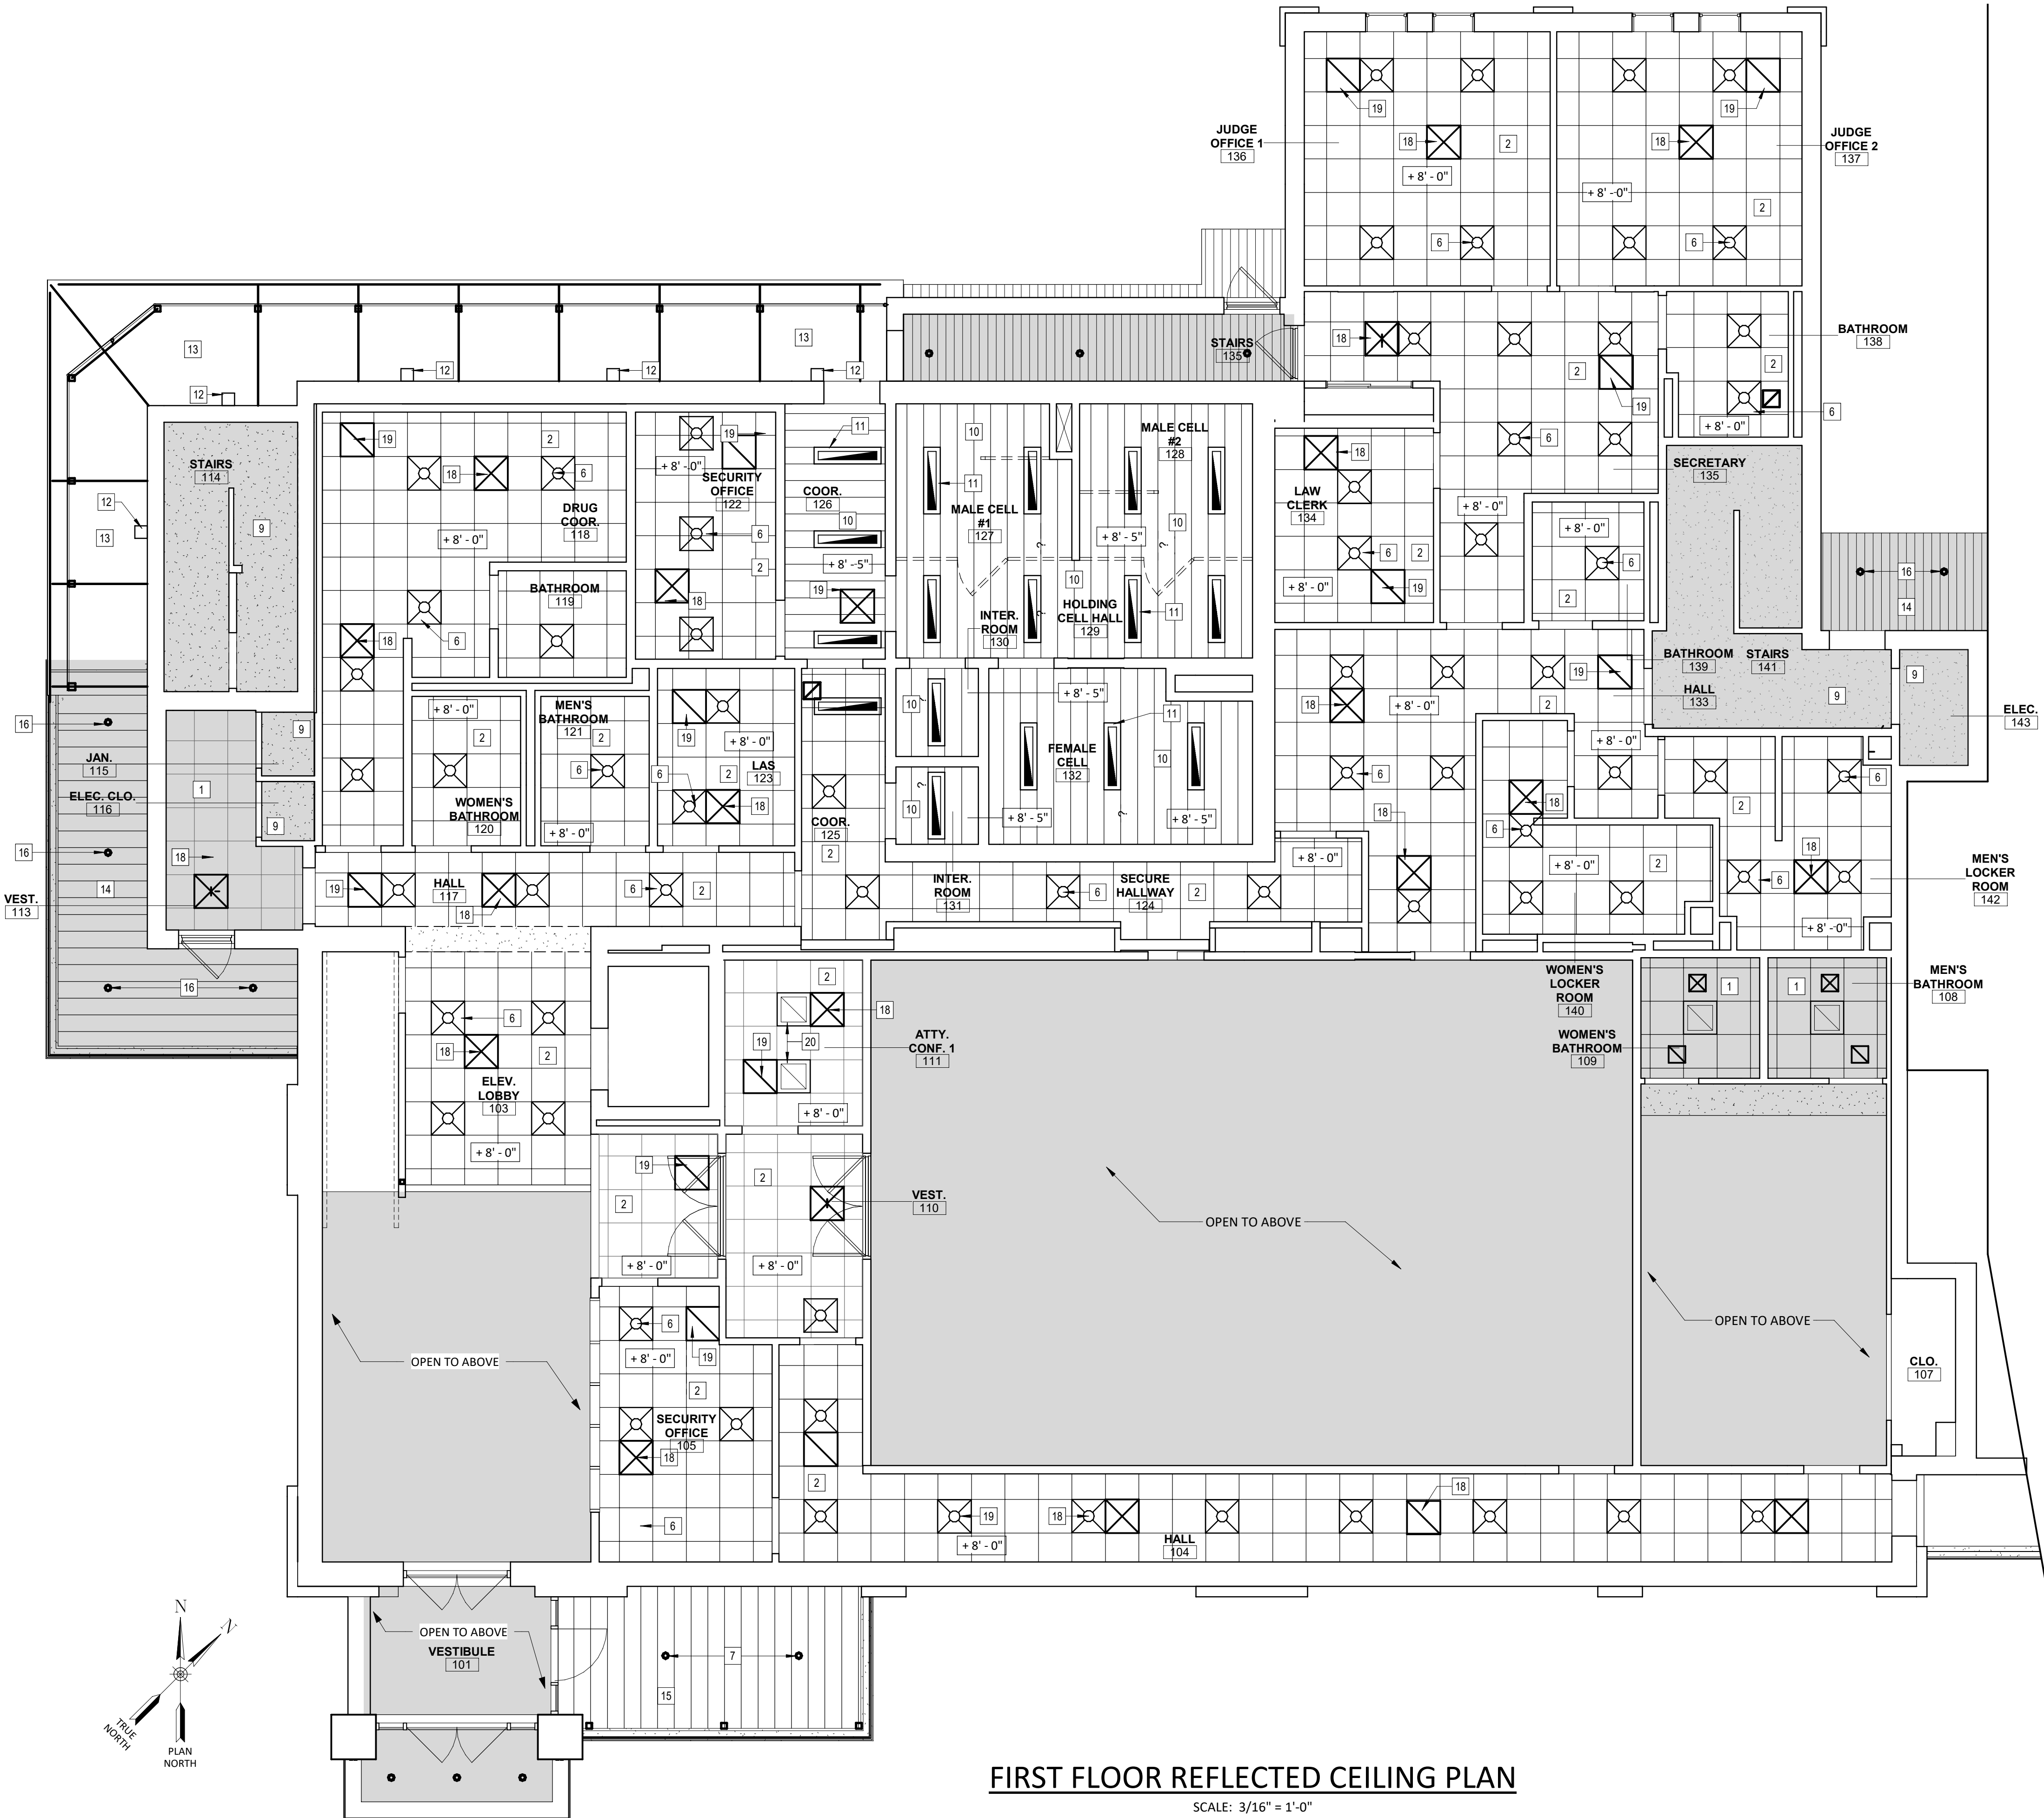
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Project Number  
1753.008.001



- KEYED REFLECTED CEILING NOTES
- EXISTING CEILING GRID, TILE & LIGHTS TO REMAIN
  - NEW 2 X 2 ACOUSTICAL CEILING TILE & GRID SYSTEM.
  - EXISTING SHEETROCKED SOFFIT TO REMAIN.
  - NEW SHEETROCKED DROPPED VALANCE.
  - NEW SHEETROCKED SOFFIT.
  - \*NEW 2X2 RECESSED LIGHT FIXTURE (TYP.)
  - \*NEW EXTERIOR 6" ROUND RECESSED CEILING POT LIGHT FIXTURE TO MATCH EXISTING
  - NEW HANGING GWB CEILING SYSTEM
  - EXISTING GWB CEILING & LIGHTS TO REMAIN
  - NEW HANGING 12" WIDE, 12 GA METALWORKS SECURE LOCK PLUS CEILING SYSTEM OR APPROVED EQUAL. COORDINATE LOCATIONS OF SUPPLY AND RETURN DIFFUSERS/REGISTERS AND PROVIDE PERFORATED PANELS AT THESE LOCATIONS (SEE MECHANICAL DWGS). MECHANICAL SUPPLY AND RETURNS WILL BE INSTALLED ABOVE THE CEILING SYSTEM.
  - \*NEW 12" X 48" RECESSED LIGHT FIXTURE
  - \* NEW 9" WALL PACK LIGHT FIXTURES
  - EXTERIOR WALKWAY CANOPY ROOF (STEEL DECK AND CANOPY STEEL STRUCTURE TO BE EXPOSED)
  - EXISTING LINEAR METAL CEILING SYSTEM TO REMAIN
  - NEW EXTERIOR LINEAR METAL CEILING SYSTEM TO MATCH EXISTING EXTERIOR 6" ROUND RECESSED POT LIGHT TO REMAIN
  - EXISTING INTERIOR 6" ROUND RECESSED POT LIGHTS TO REMAIN
  - \*NEW INTERIOR 6" ROUND RECESSED CEILING PIT LIGHT FIXTURE
  - \*\*NEW SUPPLY DIFFUSER (TYP.)
  - \*\* NEW RETURN GRILLE (TYP.)
  - NEW LIGHTS TO BE INSTALLED IN NEW ACOUSTICAL CEILING GRID SYSTEM. SEE ELECTRICAL DRAWINGS.
- \* SEE ELECTRICAL PLANS FOR LIGHT FIXTURE SELECTION
- \*\*SEE MECHANICAL PLANS FOR DIFFUSER AND GRILLE INFORMATION.

- EXISTING CEILINGS TO REMAIN REMOVE AND REPLACE ACOUSTICAL TILE AS NEEDED FOR MECHANICAL DUCT MODIFICATIONS
- EXISTING GWB CEILINGS TO REMAIN
- EXISTING METAL CEILING TO REMAIN



FIRST FLOOR REFLECTED CEILING PLAN

SCALE: 3/16" = 1'-0"

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REVISIONS

CITY OF MIDDLETOWN  
NEW COURTHOUSE FACILITY  
ORANGE COUNTY, NEW YORK

FIRST FLOOR REFLECTED CEILING PLAN

CITY OF MIDDLETOWN

**Barton & Loguidice**  
443 Electronics Parkway  
Liverpool, NY 13088

NYS CERTIFICATE #  
0021642, 0020588, 0019903,  
0019905, 0020336

**B&L**



NYS EXP.:

Date  
AUGUST, 2024

Scale  
AS SHOWN


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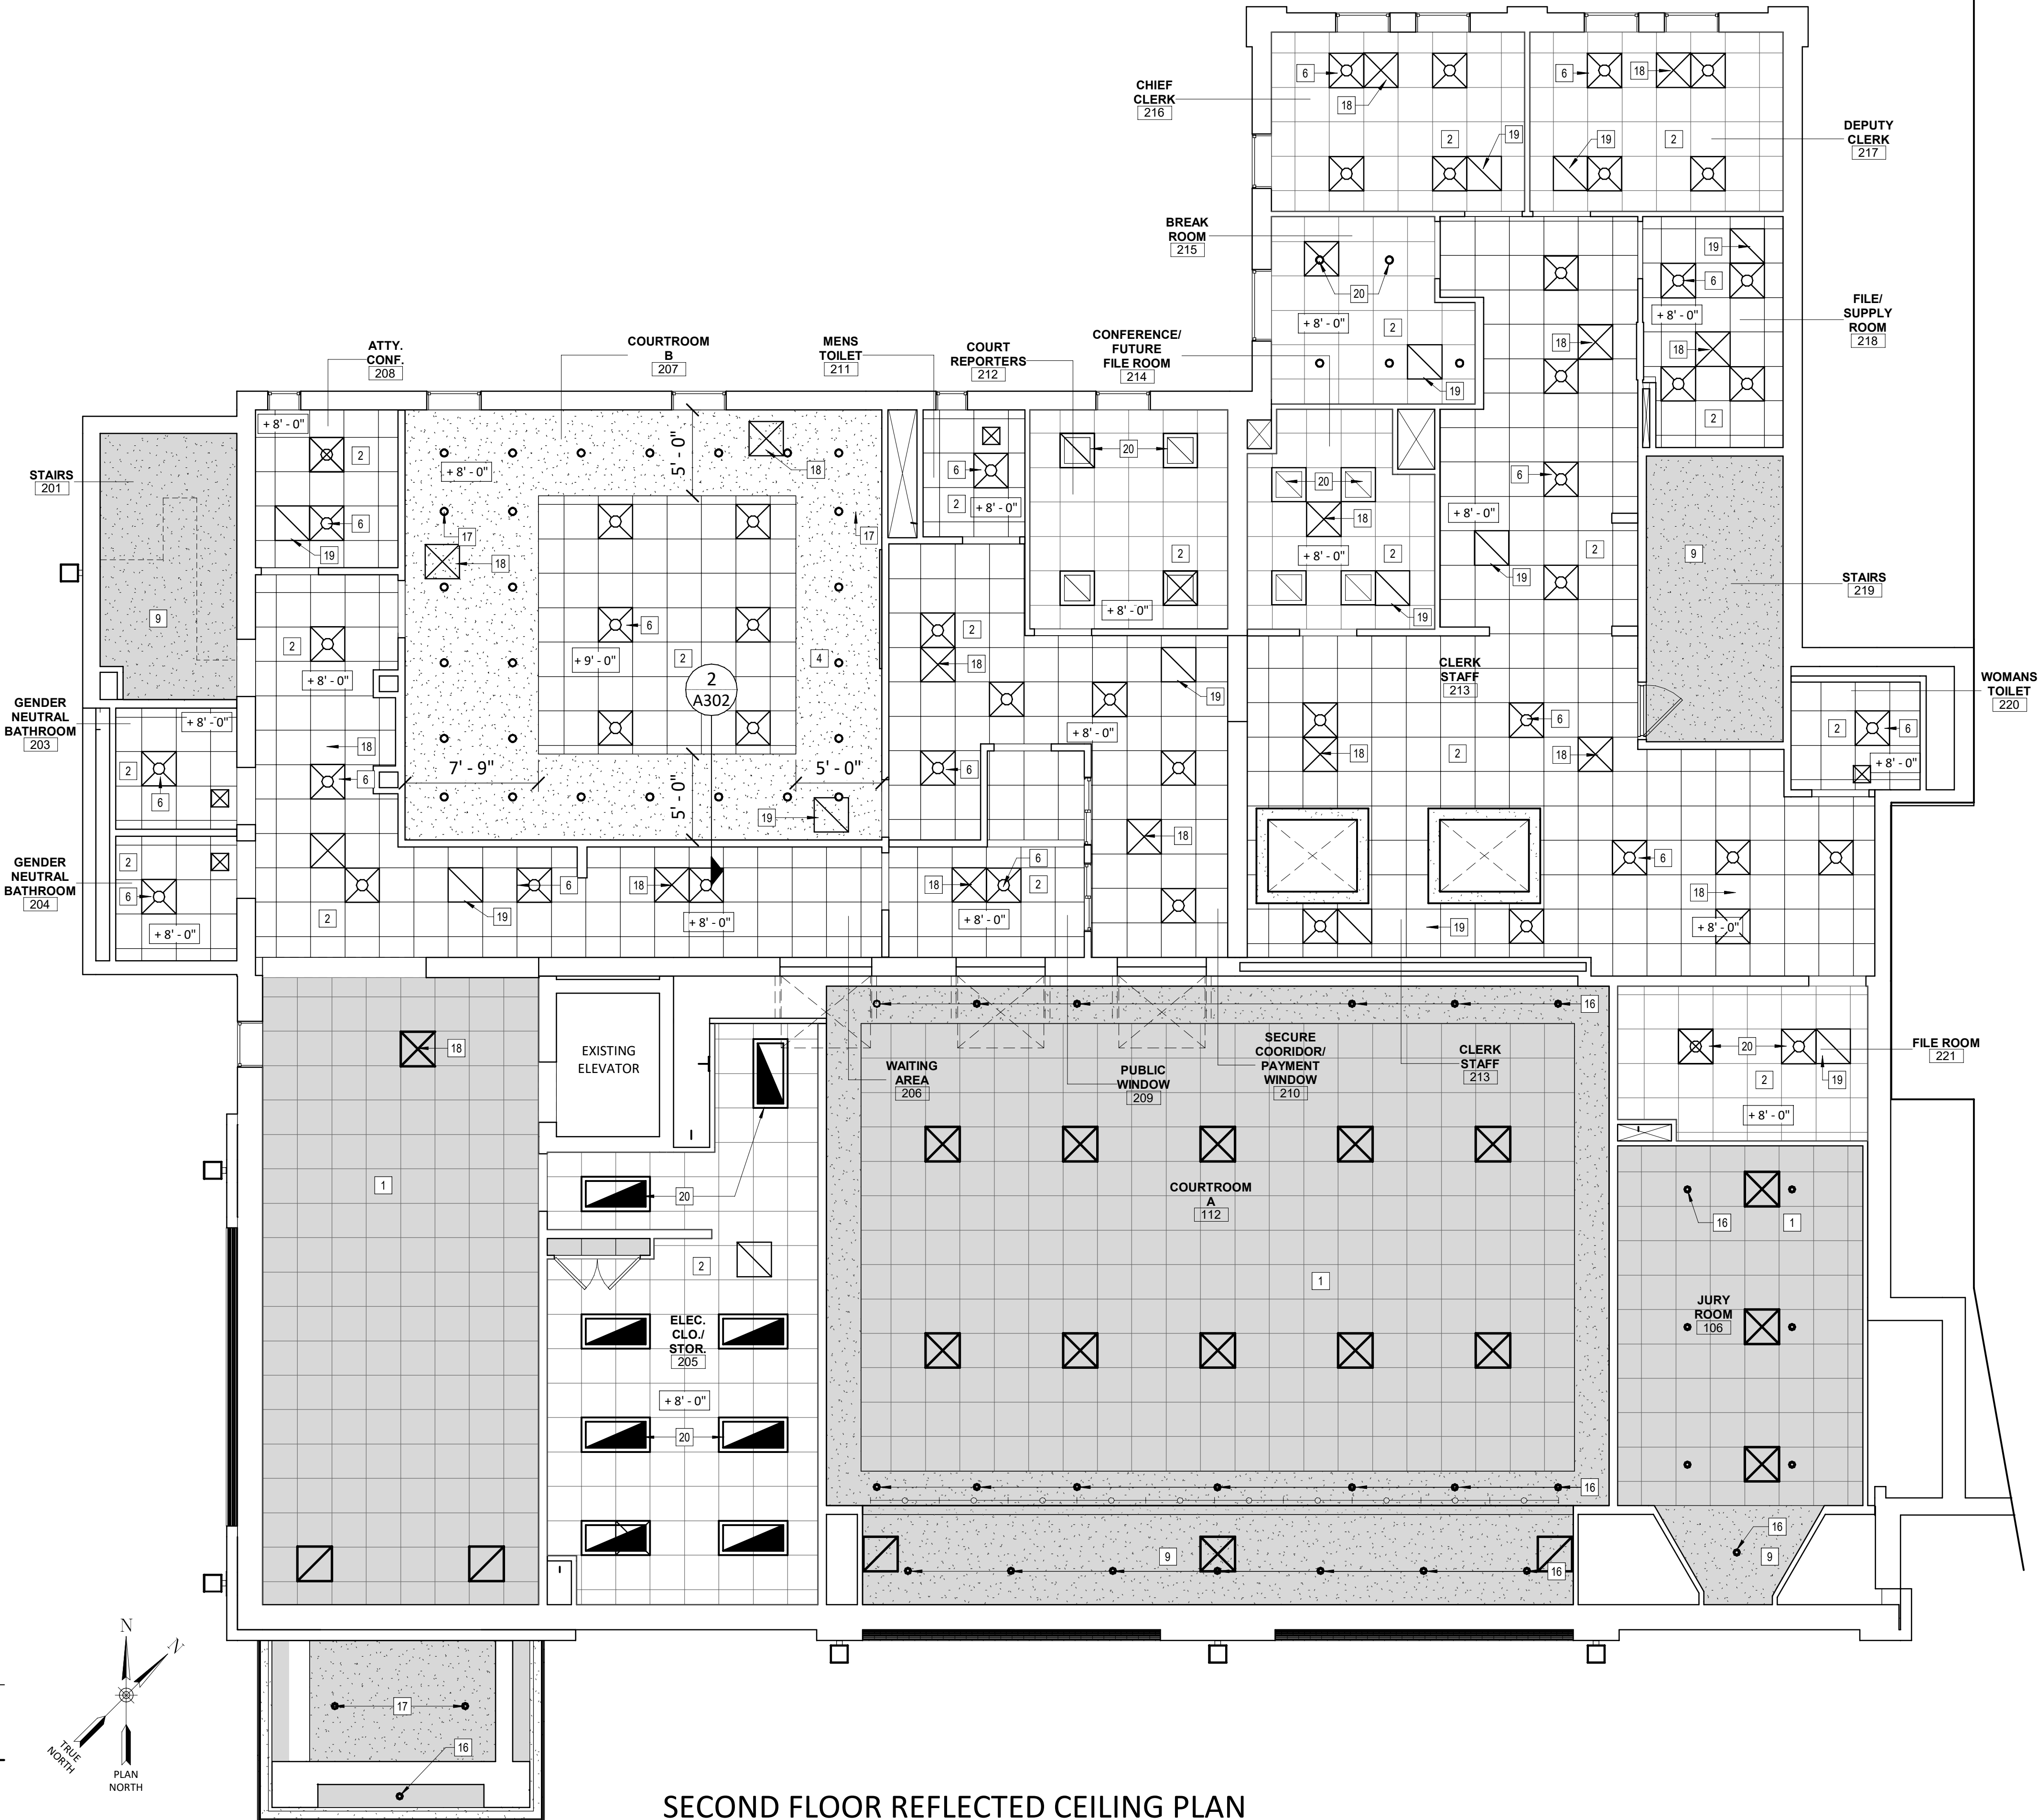
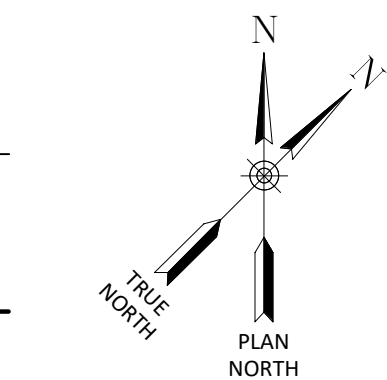
- KEYED REFLECTED CEILING NOTES
- EXISTING CEILING GRID, TILE & LIGHTS TO REMAIN
  - NEW 2 X 2 ACOUSTICAL CEILING TILE & GRID SYSTEM.
  - EXISTING SHEETROCKED SOFFIT TO REMAIN.
  - NEW SHEETROCKED DROPPED VALANCE.
  - NEW SHEETROCKED SOFFIT.
  - \*NEW 2X2 RECESSED LIGHT FIXTURE (TYP.)
  - \*NEW EXTERIOR 6" ROUND RECESSED CEILING POT LIGHT FIXTURE TO MATCH EXISTING
  - NEW HANGING GWB CEILING SYSTEM
  - EXISTING GWB CEILING & LIGHTS TO REMAIN
  - NEW HANGING 12" WIDE, 12 GA METALWORKS SECURE LOCK PLUS CEILING SYSTEM OR APPROVED EQUAL. COORDINATE LOCATIONS OF SUPPLY AND RETURN DIFFUSERS/REGISTERS AND PROVIDE PERFORATED PANELS AT THESE LOCATIONS (SEE MECHANICAL DWGS). MECHANICAL SUPPLY AND RETURNS WILL BE INSTALLED ABOVE THE CEILING SYSTEM.
  - \*NEW 12" X 48" RECESSED LIGHT FIXTURE
  - \*NEW 9" WALL PACK LIGHT FIXTURES
  - EXTERIOR WALKWAY CANOPY ROOF (STEEL DECK AND CANOPY STEEL STRUCTURE TO BE EXPOSED)
  - EXISTING LINEAR METAL CEILING SYSTEM TO REMAIN
  - NEW EXTERIOR LINEAR METAL CEILING SYSTEM TO MATCH EXISTING EXTERIOR 6" ROUND RECESSED POT LIGHT TO REMAIN
  - EXISTING INTERIOR 6" ROUND RECESSED POT LIGHTS TO REMAIN
  - \*NEW INTERIOR 6" ROUND RECESSED CEILING PIT LIGHT FIXTURE
  - \*\*NEW SUPPLY DIFFUSER (TYP.)
  - \*\* NEW RETURN GRILLE (TYP.)
  - NEW LIGHTS TO BE INSTALLED IN NEW ACOUSTICAL CEILING GRID SYSTEM. SEE ELECTRICAL DRAWINGS.
  - SEE ELECTRICAL PLANS FOR LIGHT FIXTURE SELECTION
  - SEE MECHANICAL PLANS FOR DIFFUSER AND GRILLE INFORMATION.

- EXISTING CEILINGS TO REMAIN REMOVE AND REPLACE ACOUSTICAL TILE AS NEEDED FOR MECHANICAL DUCT MODIFICATIONS
- EXISTING GWB CEILINGS TO REMAIN
- EXISTING METAL CEILING TO REMAIN



## 2 COURTROOM SOFFIT DETAIL

SCALE: 1" = 1'-0"

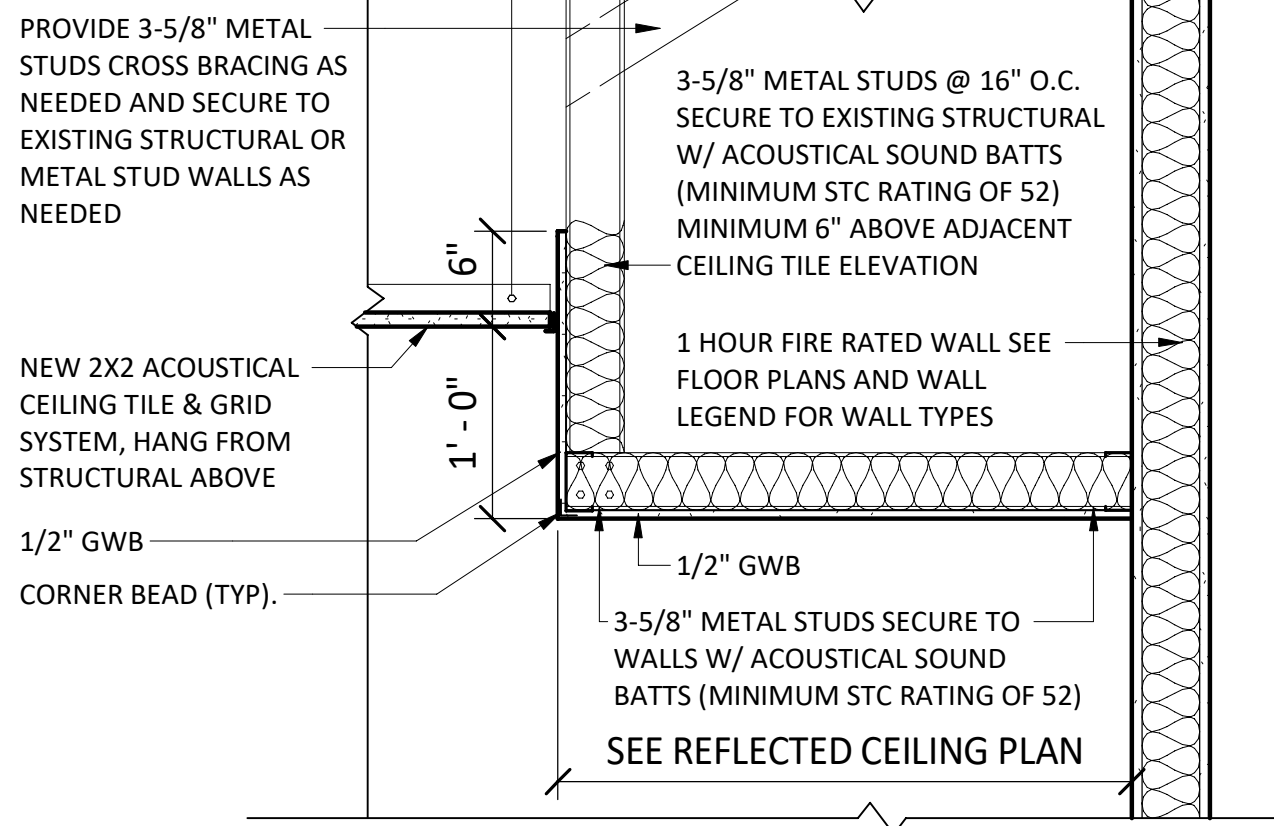

## SECOND FLOOR REFLECTED CEILING PLAN

SCALE: 3/16" = 1'-0"

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### REVISIONS

CITY OF MIDDLETOWN  
NEW COURTHOUSE FACILITY  
ORANGE COUNTY, NEW YORK

## SECOND FLOOR REFLECTED CEILING PLAN

CITY OF MIDDLETOWN

**Barton & Loguidice**  
443 Electronics Parkway  
Liverpool, NY 13088

NYS CERTIFICATE #  
0021642, 0020588, 0019903,  
0019905, 0020336



NYS EXP.:

Date  
AUGUST, 2024


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Project Number  
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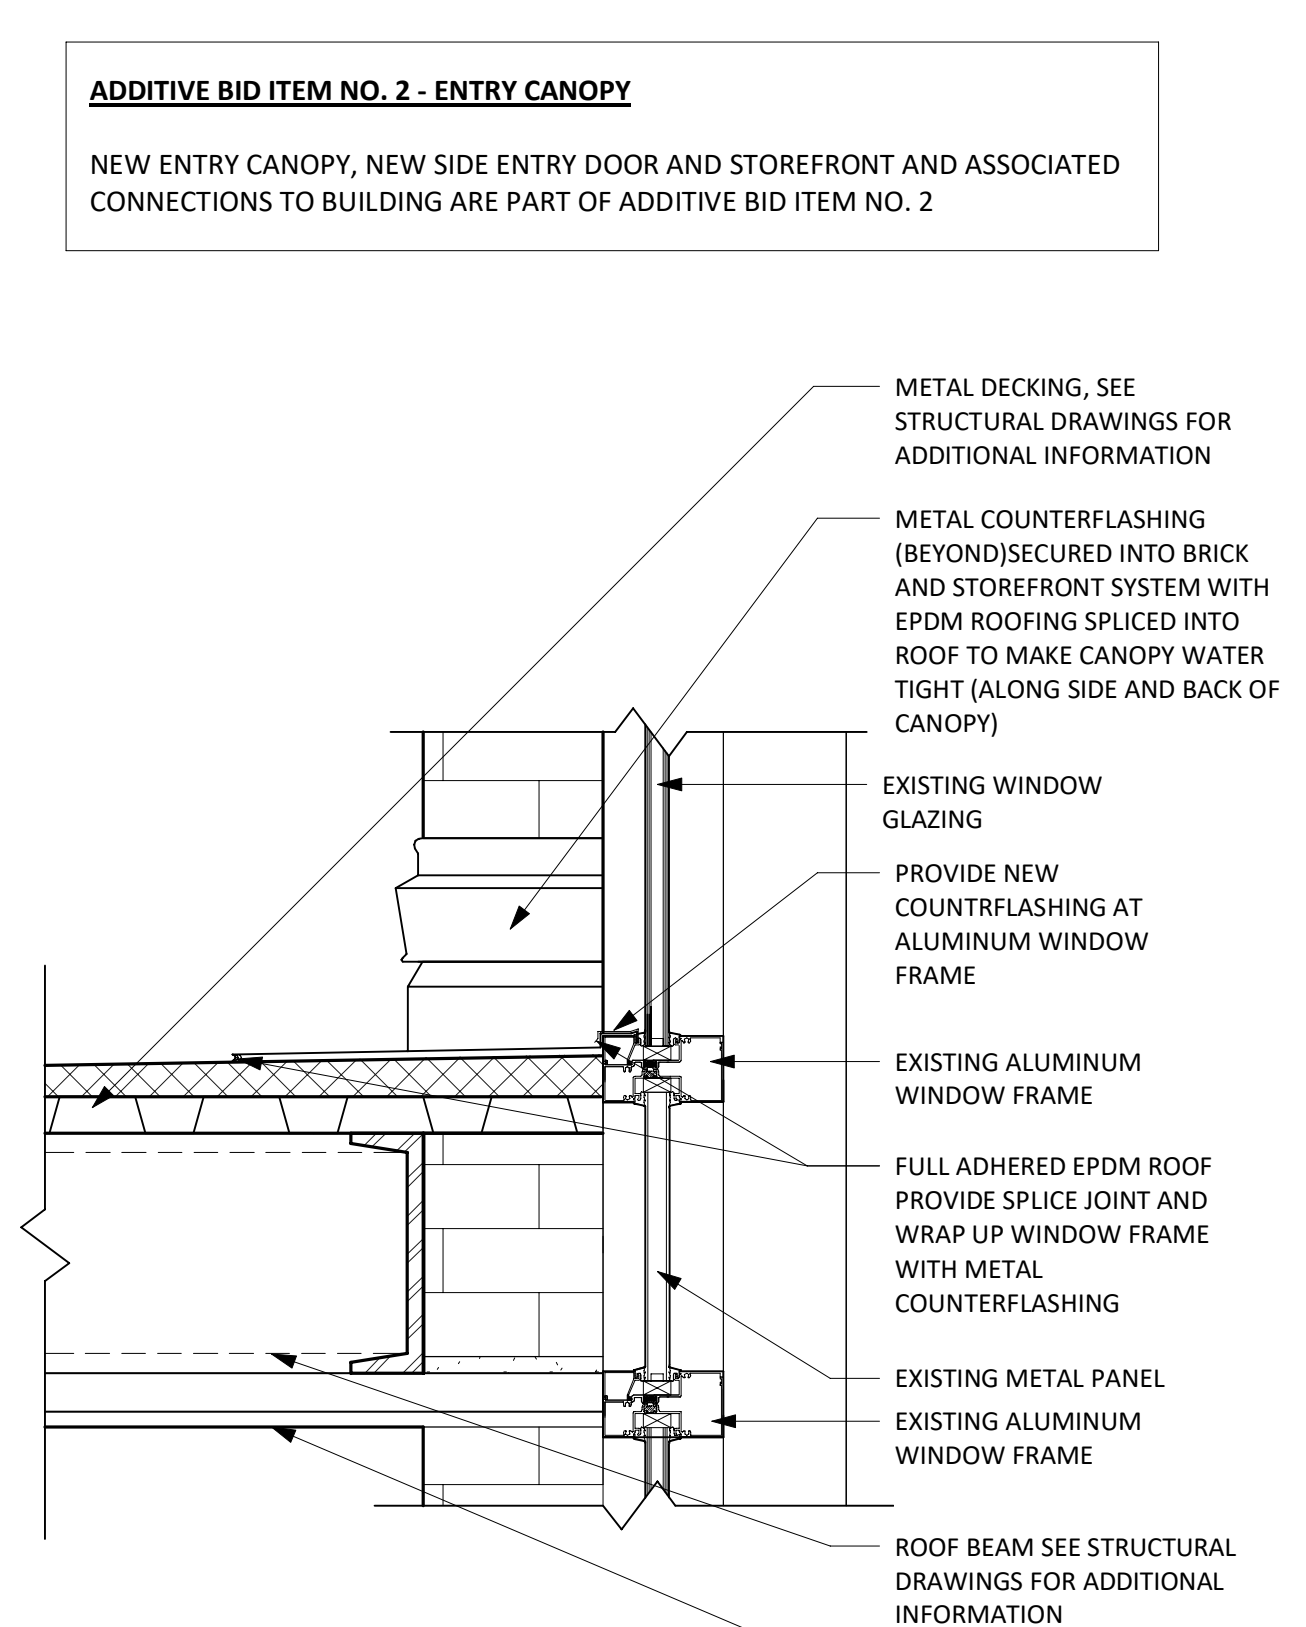


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Designed by ZDC  
In Charge of TRB




1 FRONT ENTRY CANOPY ENLARGEMENT PLAN  
A201 SCALE: 1/2" = 1'-0"

ADDITIVE BID ITEM NO. 02

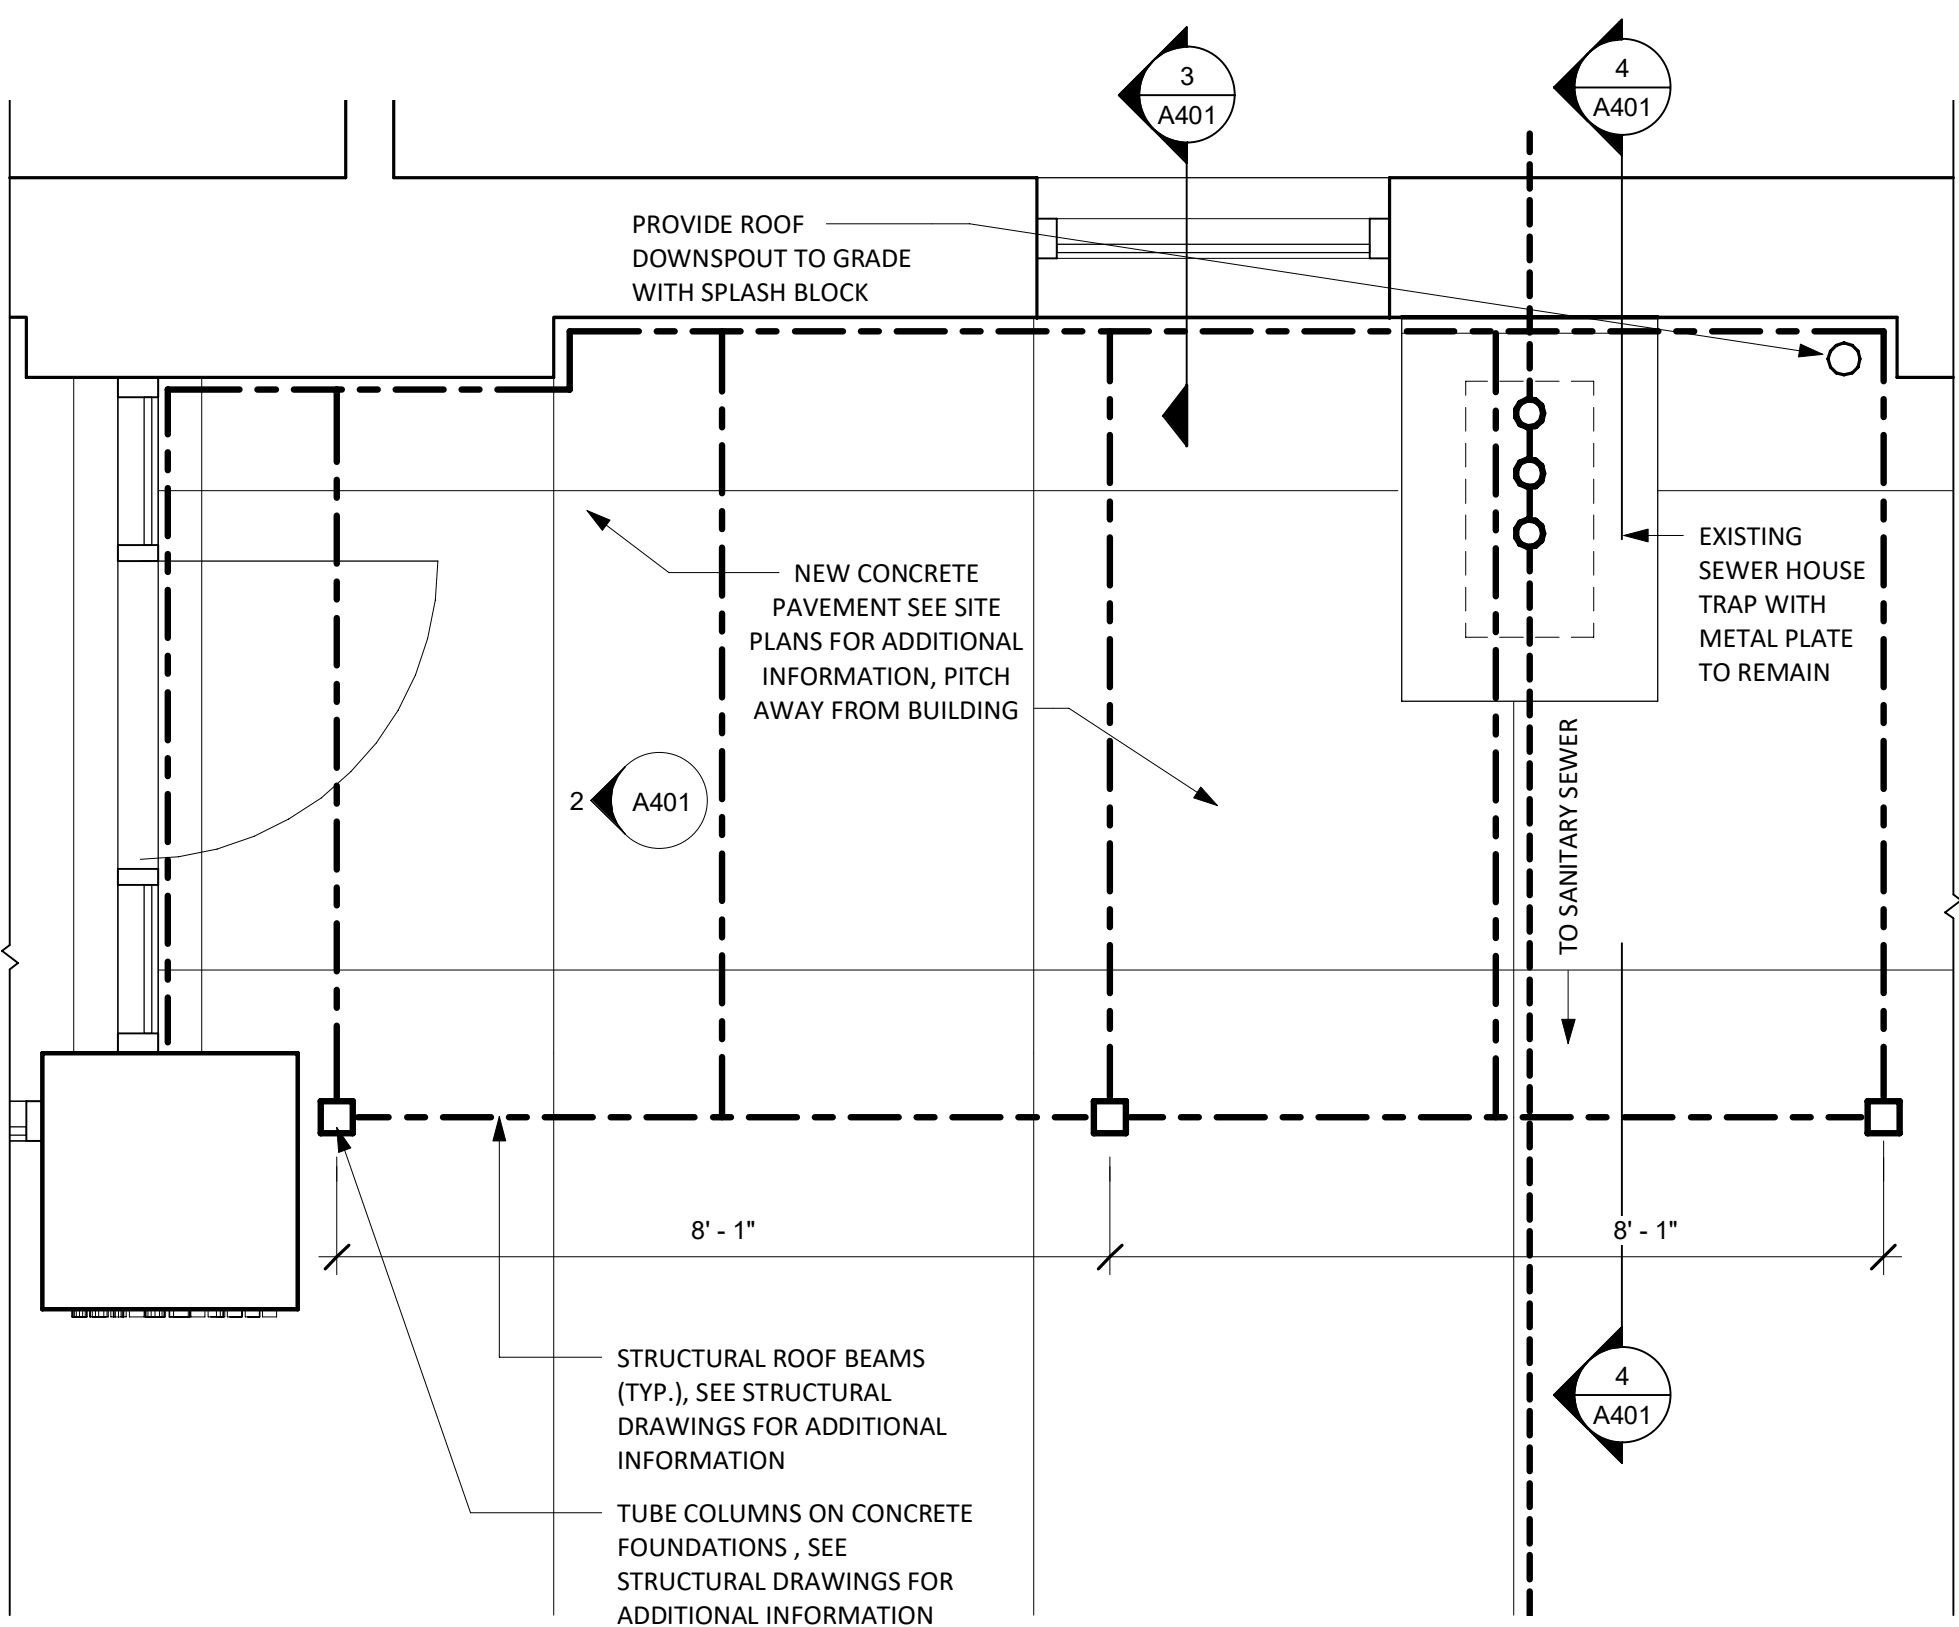


3 WINDOW FLASHING DETAIL  
A401 SCALE: 1 1/2" = 1'-0"

ADDITIVE BID ITEM NO. 02

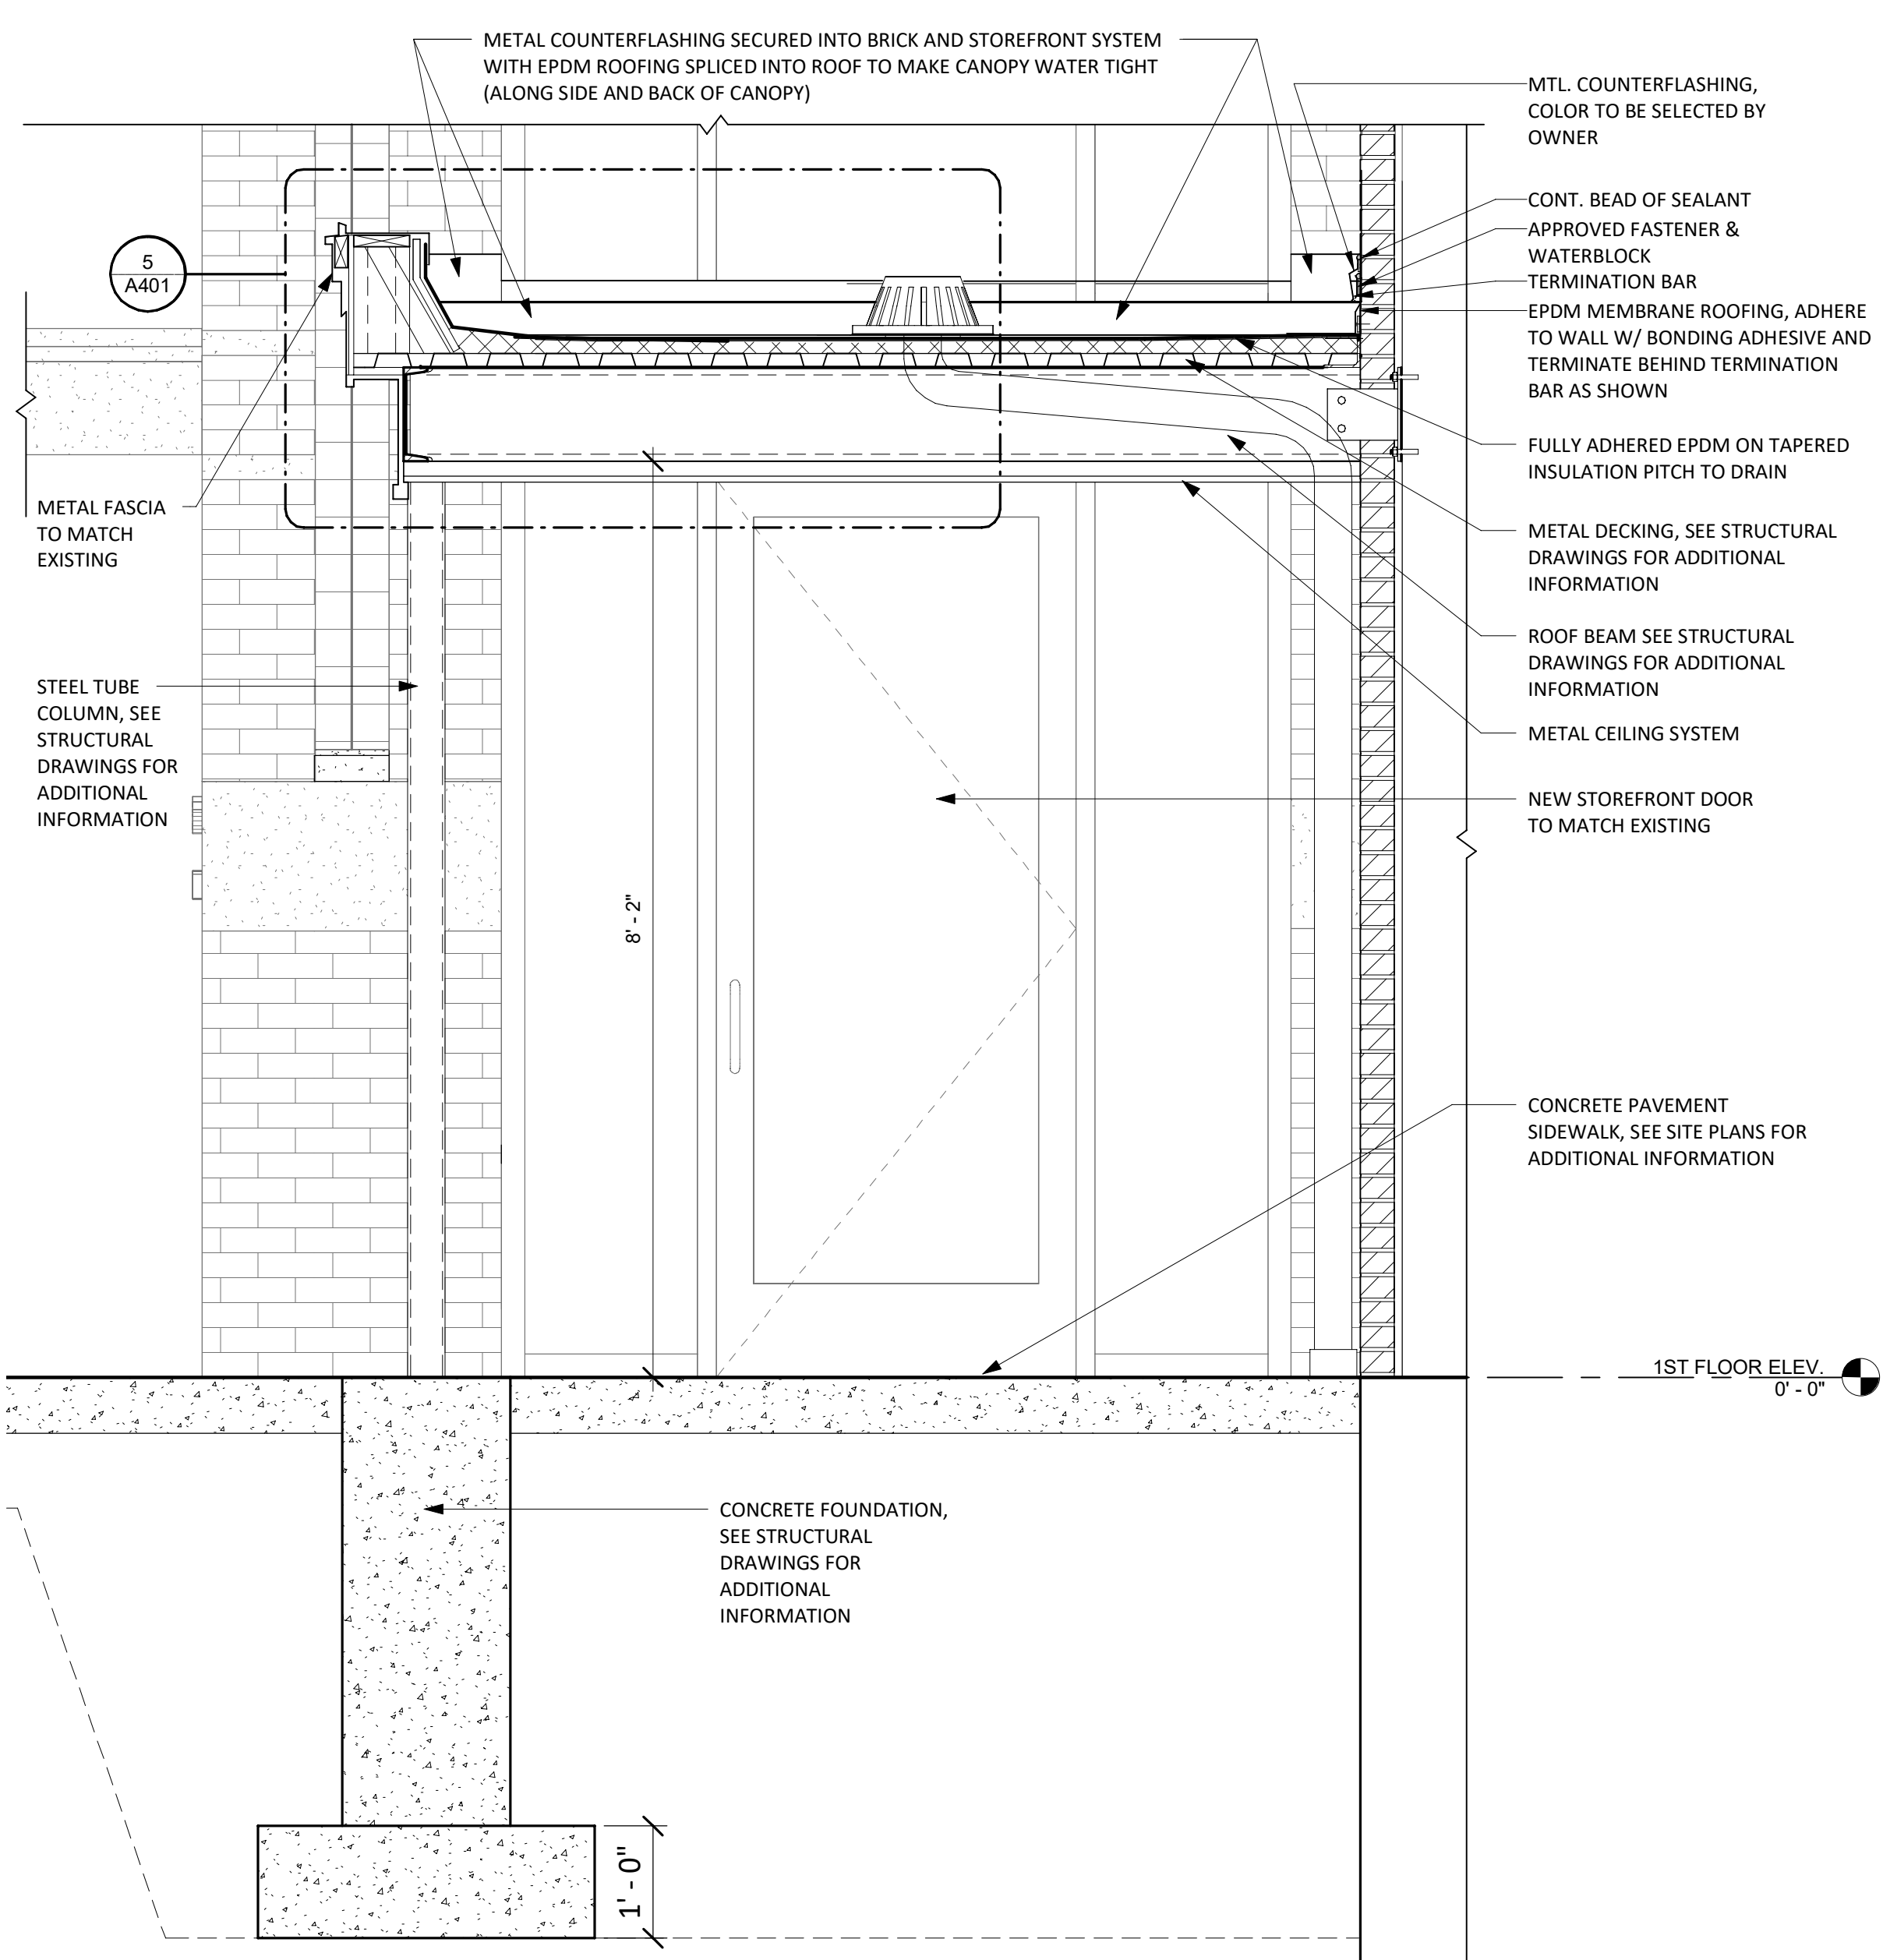


4 FRONT ENTRANCE CANOPY SECTION  
A201 SCALE: 3/4" = 1'-0"

ADDITIVE BID ITEM NO. 02

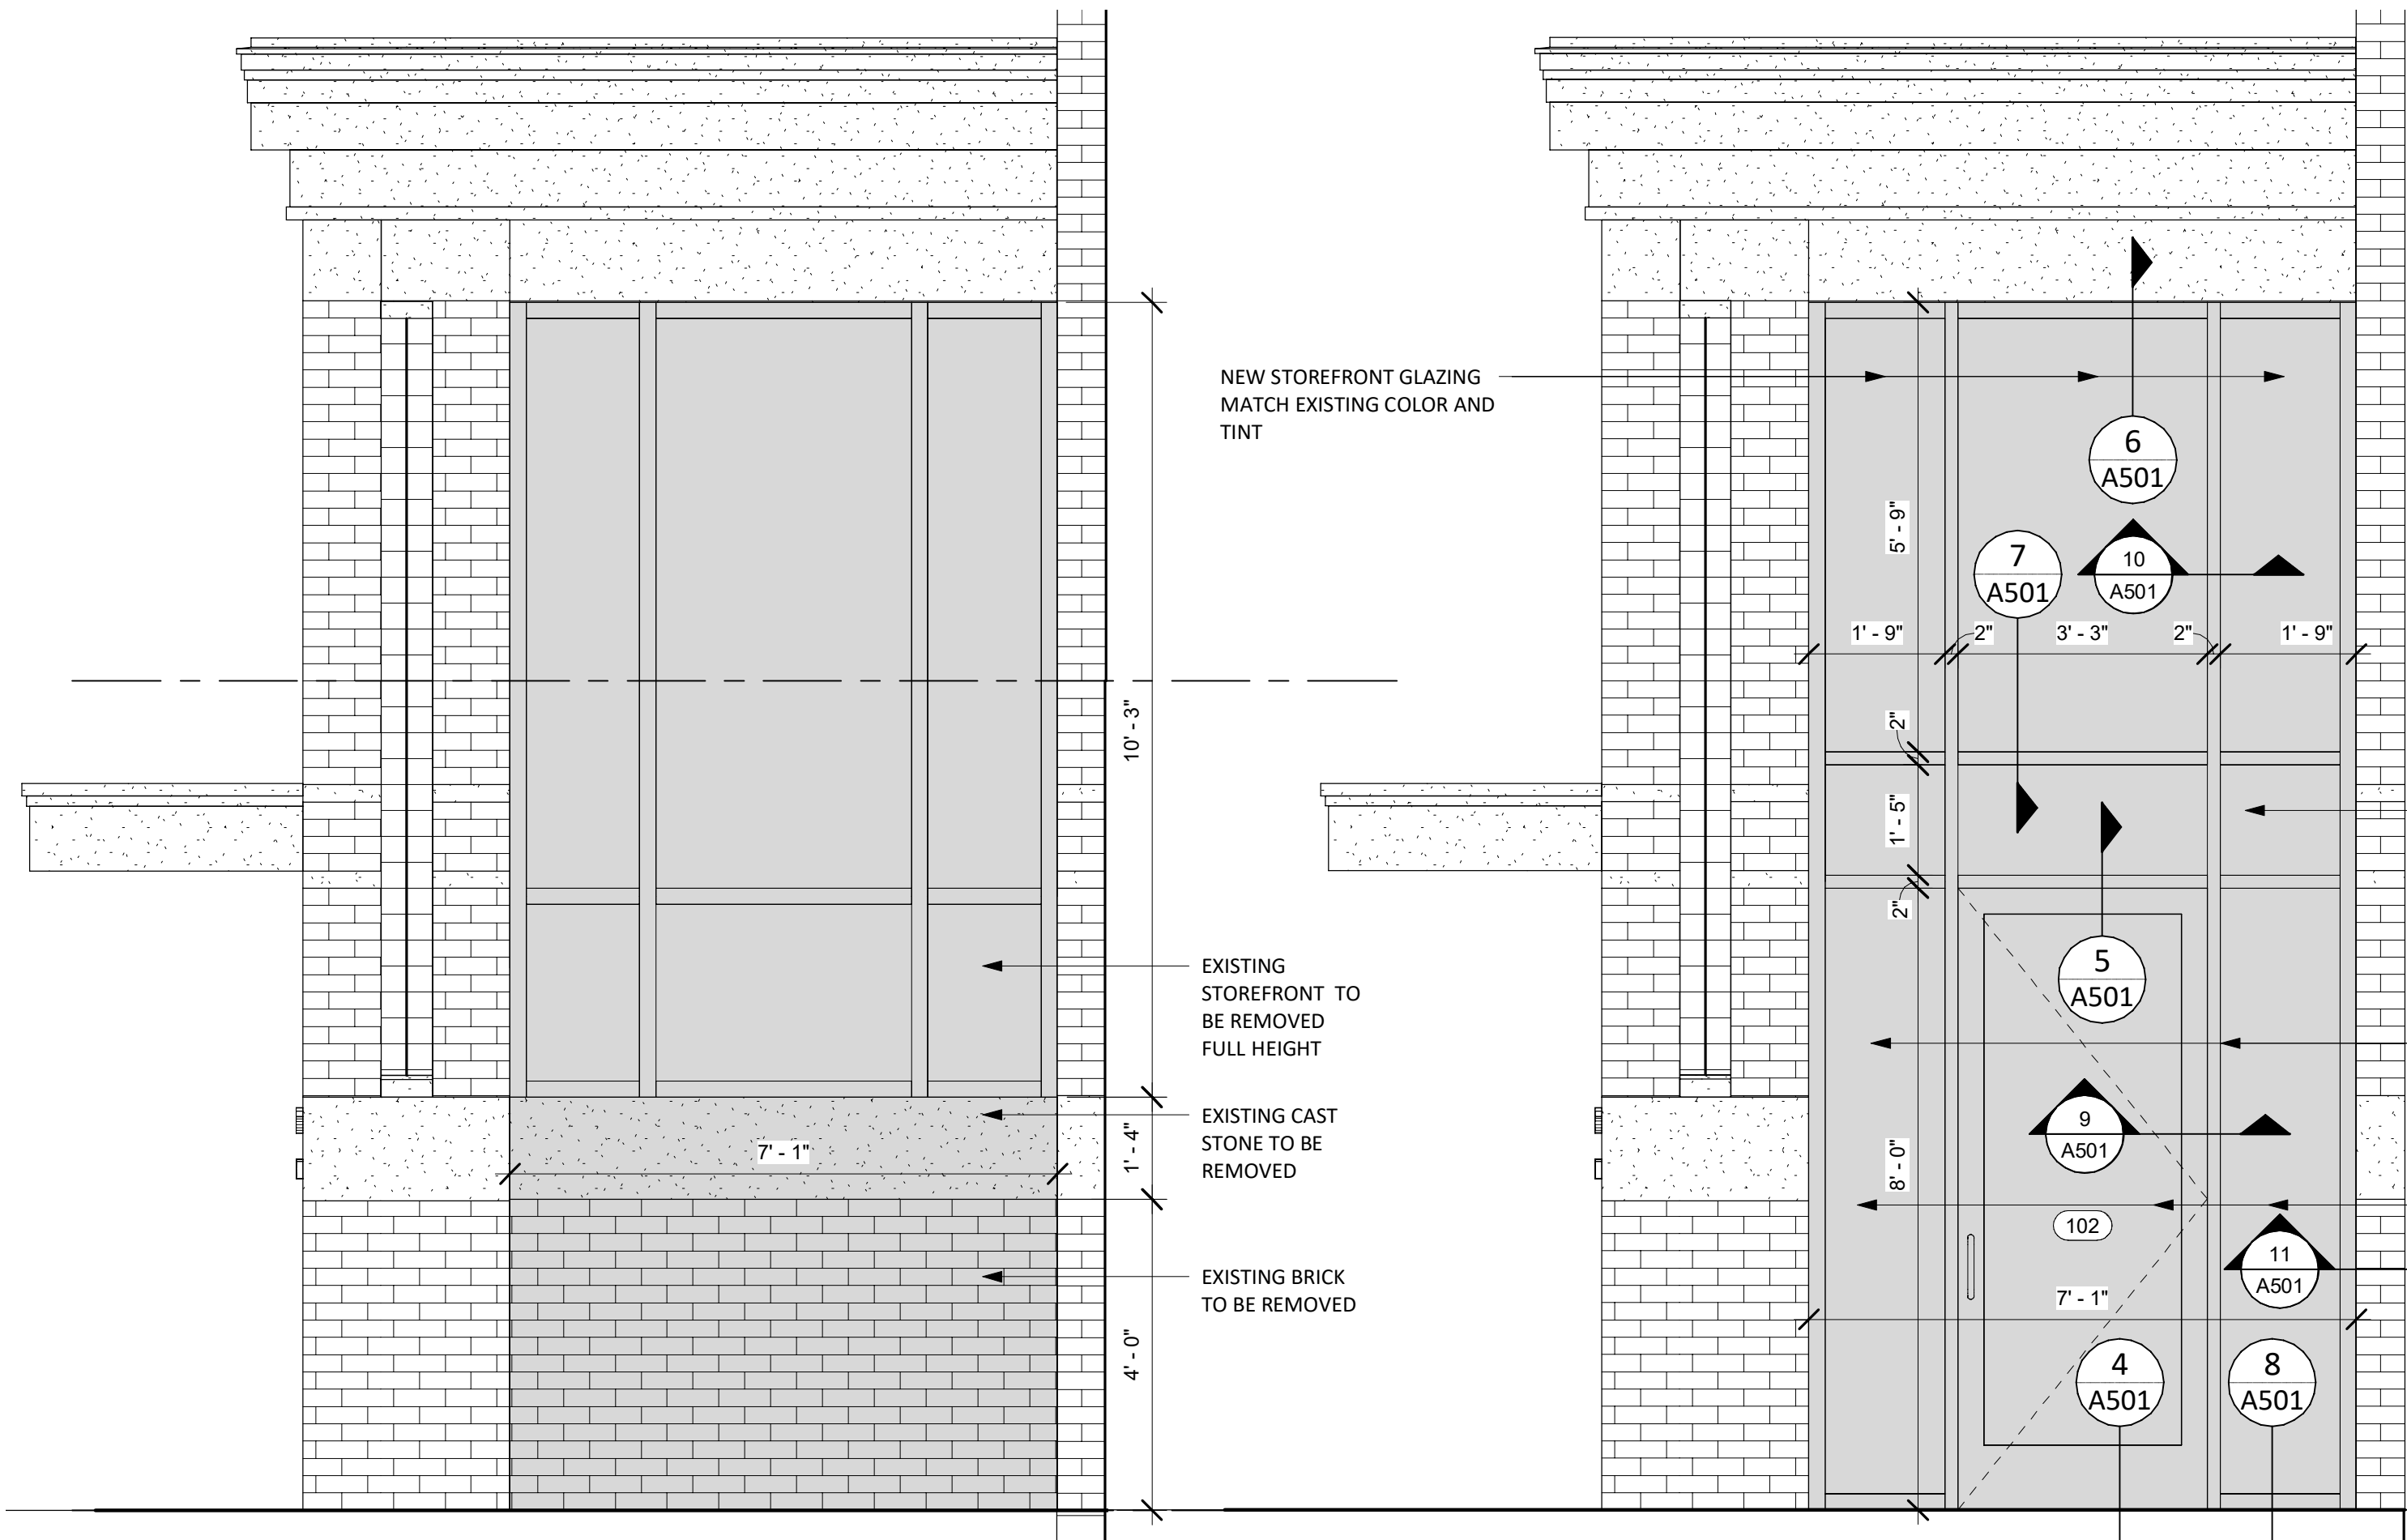

2 DEMOLITION AND NEW STOREFRONT ELEVATION  
A202 SCALE: 1/2" = 1'-0"

ADDITIVE BID ITEM NO. 02

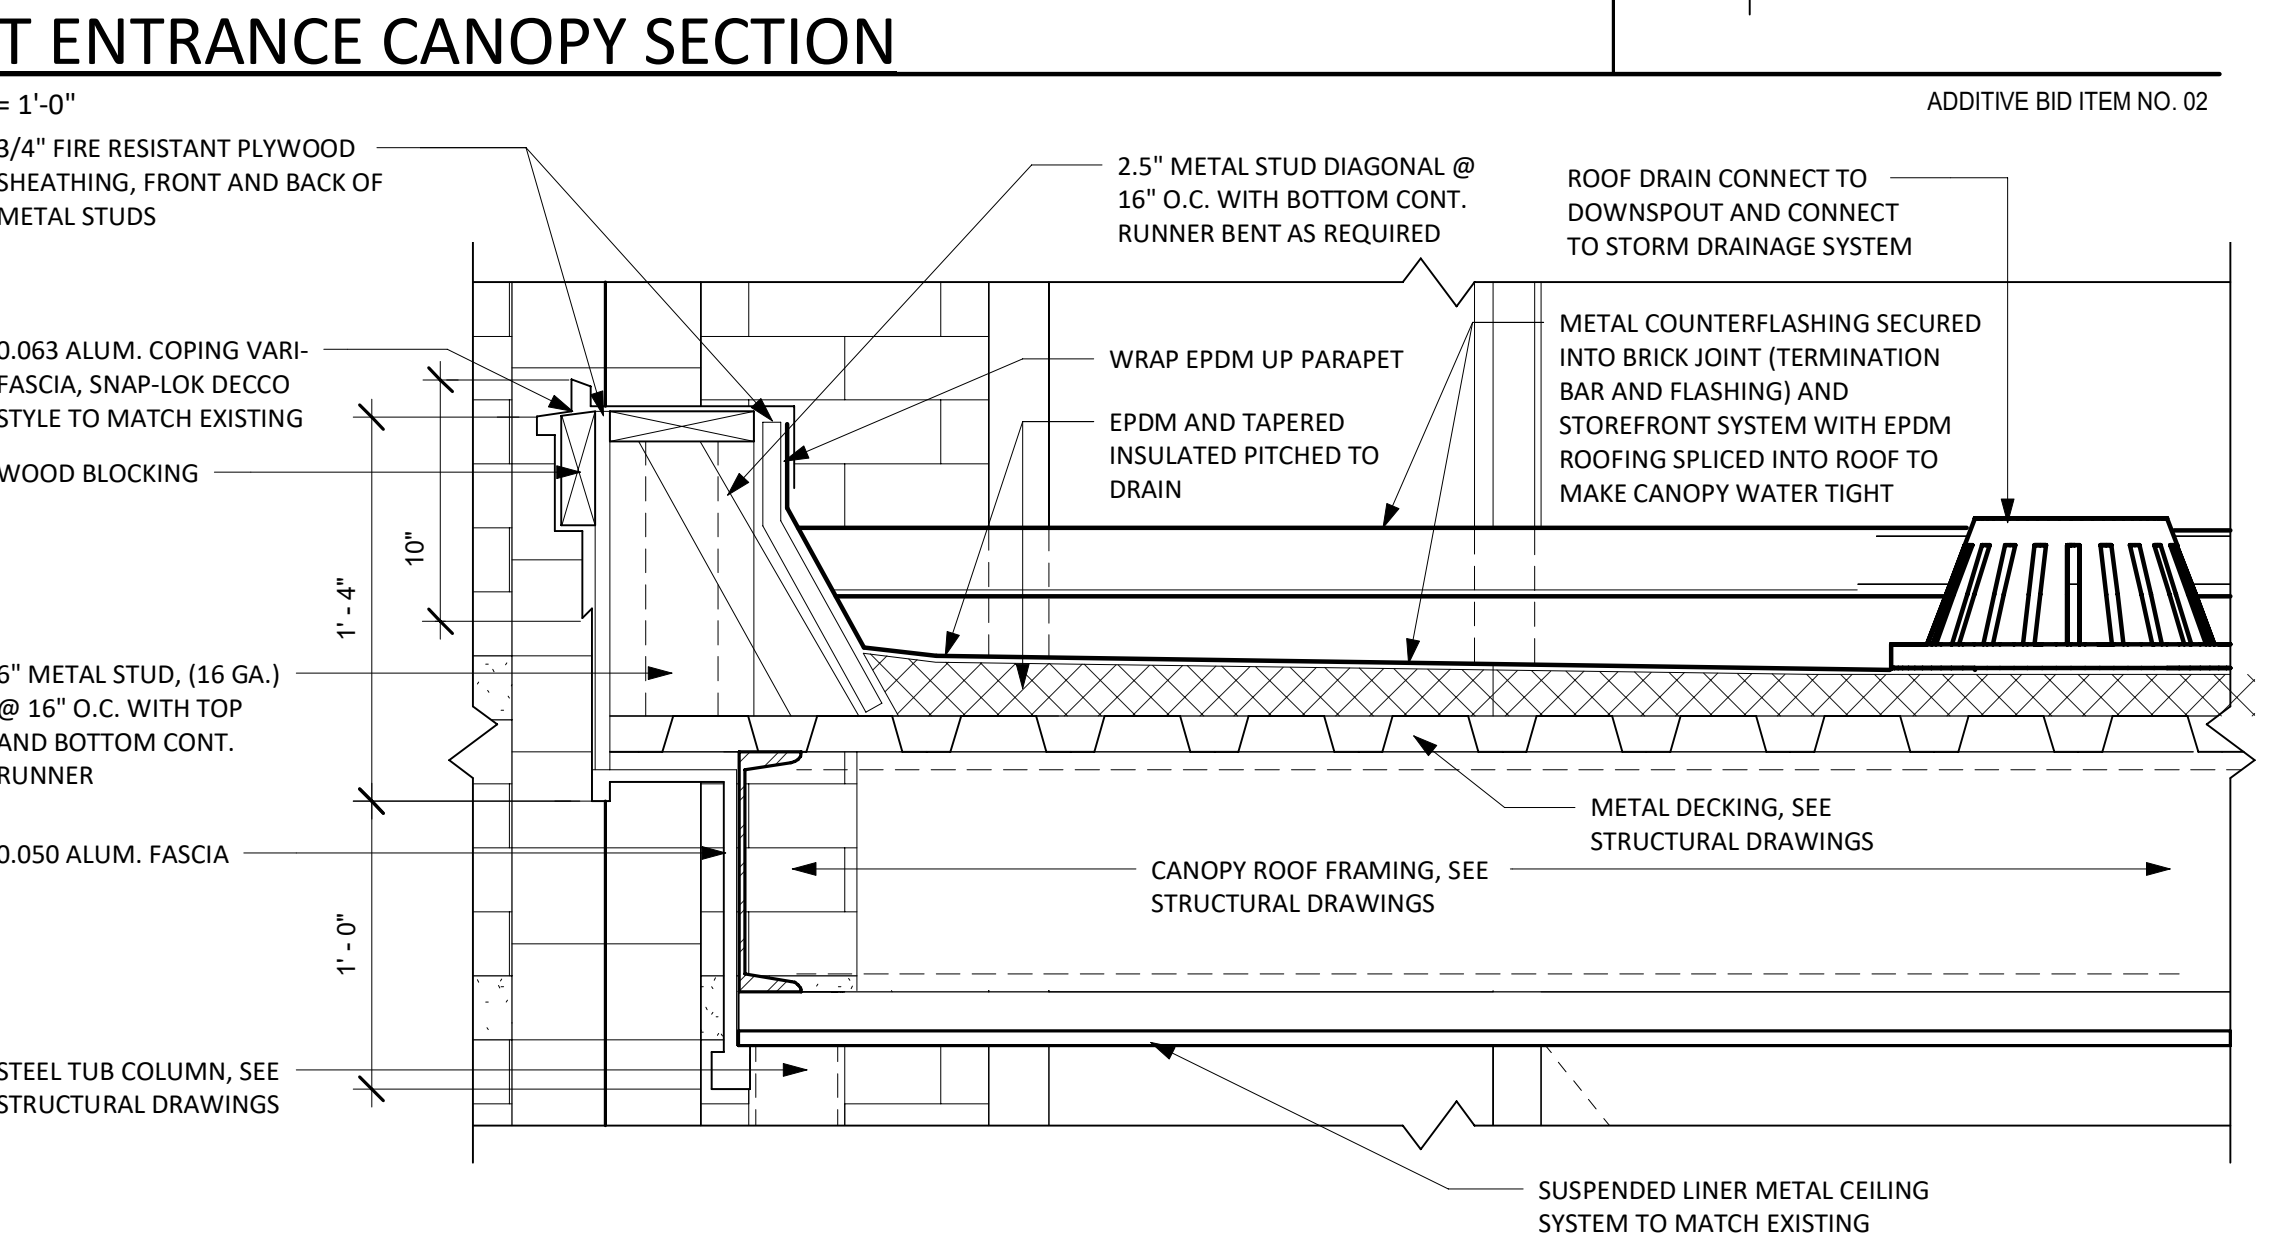

5 CANOPY ROOF FASCIA DETAIL  
A401 SCALE: 1 1/2" = 1'-0"

ADDITIVE BID ITEM NO. 02

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REVISIONS	

CITY OF MIDDLETOWN  
NEW COURTHOUSE FACILITY

**ENTRY CANOPY ENLARGEMENT PLAN, SECTIONS & DETAILS (ADDITIVE BID ITEM NO. 2)**

CITY OF MIDDLETOWN  
ORANGE COUNTY, NEW YORK

**Barton & Loguidice**  
443 Electronics Parkway  
Liverpool, NY 13088

NYS CERTIFICATE #  
0021642, 0020588, 0019903,  
0019905, 0020336

**B&L**

STATE OF NEW YORK  
SEAL OF THE STATE OF NEW YORK  
MAYNARD C. FULTON  
020743  
REGISTERED PROFESSIONAL ENGINEER


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Project Number  
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Designed by IDC  
In Charge of TRB

LEGEND

- 101 DOOR TAG  
11 PARTITION TAG

----- 1 HOUR RATED WALL CONSTRUCTION - FIRE BARRIER  
(SEE WALL LEGENDS FOR WALL CONSTRUCTION  
AND UL ASSEMBLY INFORMATION)

DIMENSIONS TO EXISTING WALLS IS TO FACE OF WALL, DIMENSIONS TO NEW WORK  
IS TO FACE OF STUD

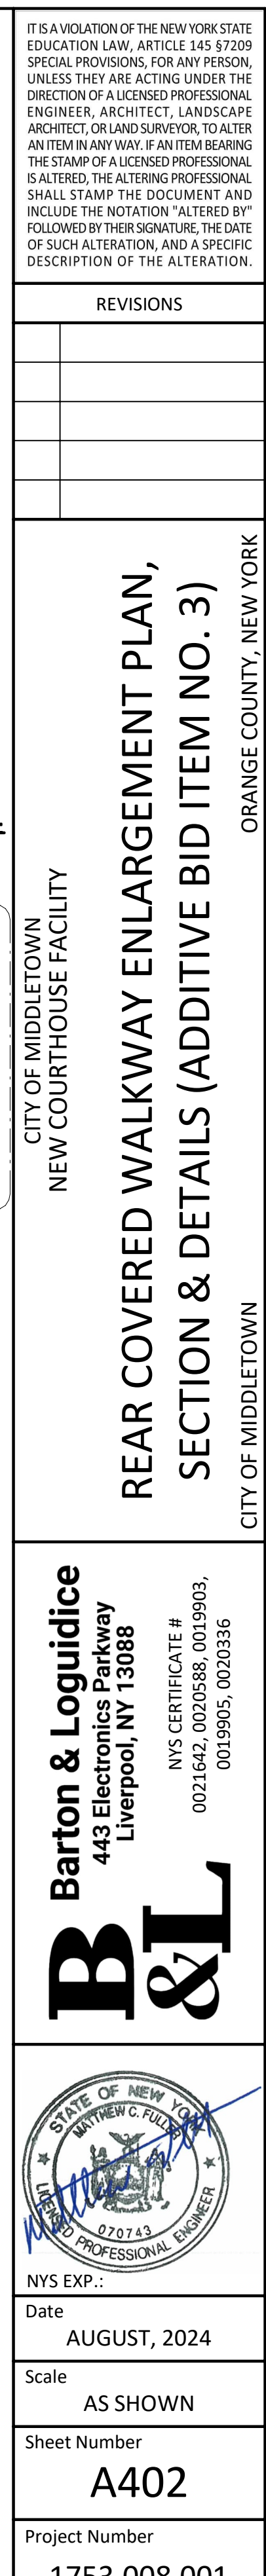
DIMENSIONS TO MILLWORK IF NOT NOTED IS TO FACE OF WALL, SEE MILLWORK  
ENLARGEMENT PLANS AND DETAILS FOR ADDITIONAL DETAILING AND TO LAYOUT  
MILLWORK AND MILLWORK SUPPORTS

DIMENSIONS TO FURNITURE IS TO EDGE OF TABLE, CHAIR, ETC.

FURNITURE UNLESS NOTED IS NOT IN CONTRACT.

1ST FLOOR ENLARGEMENT PLAN

SCALE: 3/8" = 1'-0"

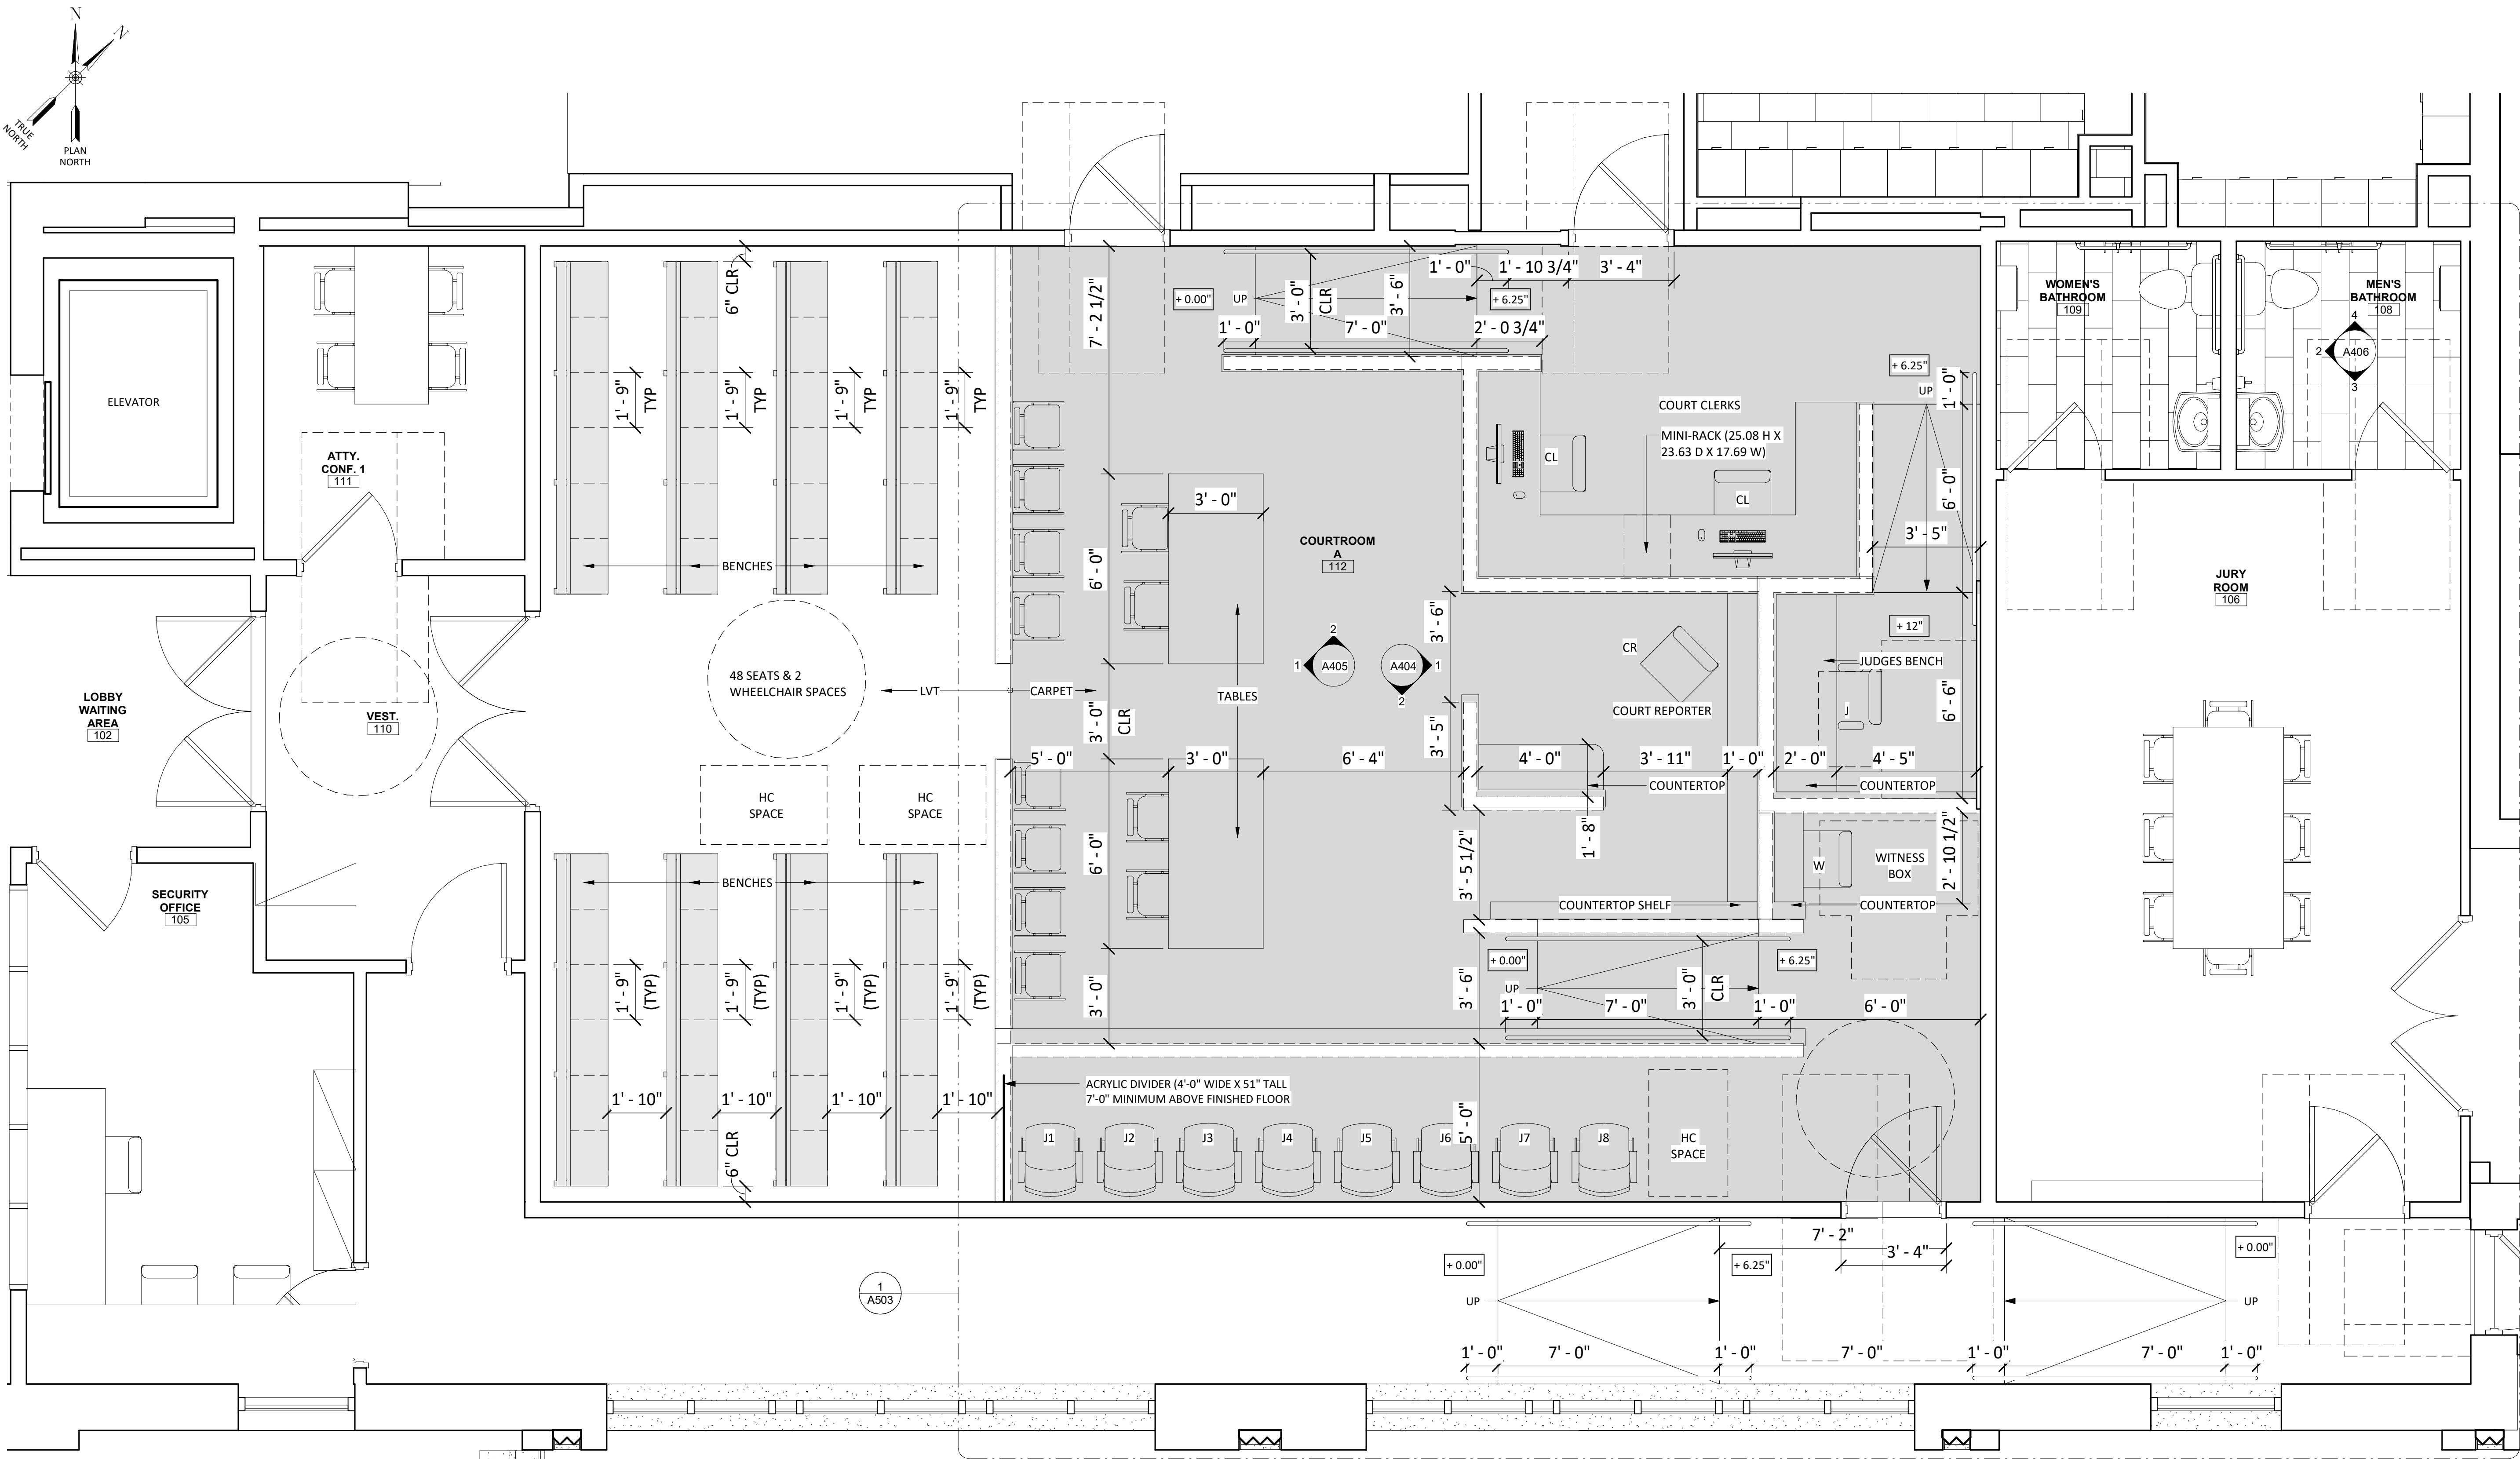

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EDUCATION LAW, ARTICLE 145 §7209  
SPECIAL PROVISIONS, FOR ANY PERSON,  
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DIRECTION OF A LICENSED PROFESSIONAL  
ENGINEER, ARCHITECT, LANDSCAPE  
ARCHITECT, OR LAND SURVEYOR, TO ALTER  
AN ITEM IN ANY WAY IF AN ITEM BEARING  
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IS ALTERED, THE ALTERING PROFESSIONAL  
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DESCRIPTION OF THE ALTERATION.

REVISIONS

CITY OF MIDDLETOWN  
NEW COURTHOUSE FACILITY

FIRST FLOOR COURTROOM ENLARGEMENT PLAN

CITY OF MIDDLETOWN

ORANGE COUNTY, NEW YORK

Barton & Loguidice  
443 Electronics Parkway  
Liverpool, NY 13088

NYS CERTIFICATE #  
0021642, 0020588, 0019903,  
0019905, 0020336



NYS EXP.:

Date  
AUGUST, 2024

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Sheet Number  
A403

Project Number  
1753.008.001



- COURTROOM ELEVATION KEYED NOTES
- 1

WOOD OR METAL DOOR WITH HOLLOW METAL FRAME, W/ OR W/O LITE (HALF) AND ADA COMPLIANT HARDWARE - 60 MINUTE RATED DOOR & FRAME, SEE DOOR SCHEDULE.
- 2

WALL MOUNTED FLAG POLES, BRACKETS AND FLAGS TO BE PROVIDED BY OWNER AND INSTALLED BY CONTRACTOR.
- 3

SOLID SURFACE CAPS/COUNTERTOPS.
- 4

4A. JUDGES BENCH, 4B. CLERKS AREA 4C. WITNESS BOX, 4D. JURY BOX, AND 4E. GALLERY SEPARATION WALLS WOOD VENEER.
- 5

SHEETROCKED SOFFIT OR HANGING SHEETROCKED CEILING.
- 6

ACOUSTICAL CEILING GRID SYSTEM.
- 7

WOOD PANELING BEHIND JUDGE AND WITNESS BOXES.
- 8

6" TALL - 3/4" WOOD TRIM BASE
- 9

NEW YORK STATE COURT SYSTEM SEAL (LIGHT WEIGHT) TO BE PROVIDED BY OWNER AND MOUNTED/INSTALLED WITH VELCRO OR PICTURE HOOKS ON WOOD PANELING BY CONTRACTOR, CENTER ON JUDGE'S BENCH.
- 10

TYPICAL 4" HIGH CAST BRONZE LETTERING (FINISH TO BE SELECTED BY OWNER) MOUNTED ON THE WOOD PANELING AT THE BACK OF THE JUDGE'S BENCH, CENTER ON JUDGES BENCH.
- 11

PAINTED GYPSUM WALL BOARD WALLS.
- 12

CARPET TILE/CARPETING FLOORING IN COURTROOM AREA, STEPS AND RAMPS. LUXURY VINYL TILE IN GALLERY AREA, ATTORNEY CONFERENCE ROOMS AND VESTIBULE.
- 13

ADA COMPLIANT ALUMINUM HANDRAIL.
- 14

JURY SWINGING GATE DOOR.
- 15

GALLERY WOOD BENCHES.
- 16

TABLES AND CHAIRS. (SOME ELEVATIONS CHAIRS AND TABLES HAVE BEEN REMOVED FOR DETAILING CLARITY).
- 17


ACOUSTICAL FABRIC WALL PANELS, PANELS BUTTED TOGETHER, PANEL SIZES AS SHOWN ON ELEVATIONS.
- 18

WOOD CHAIR RAIL.
- 19

WALL SCONCE LIGHT FIXTURE.
- 20

WOOD PANEL JOINTS/TRIM. PROVIDE EQUAL DISTANCE BETWEEN JOINTS ALONG LENGTHS OF WALLS. (SEE MILLWORK DETAILS FOR TYPICAL DETAILING AT CORNERS/ENDS OF MILLWORK).
- 21

6" VINYL WALL BASE

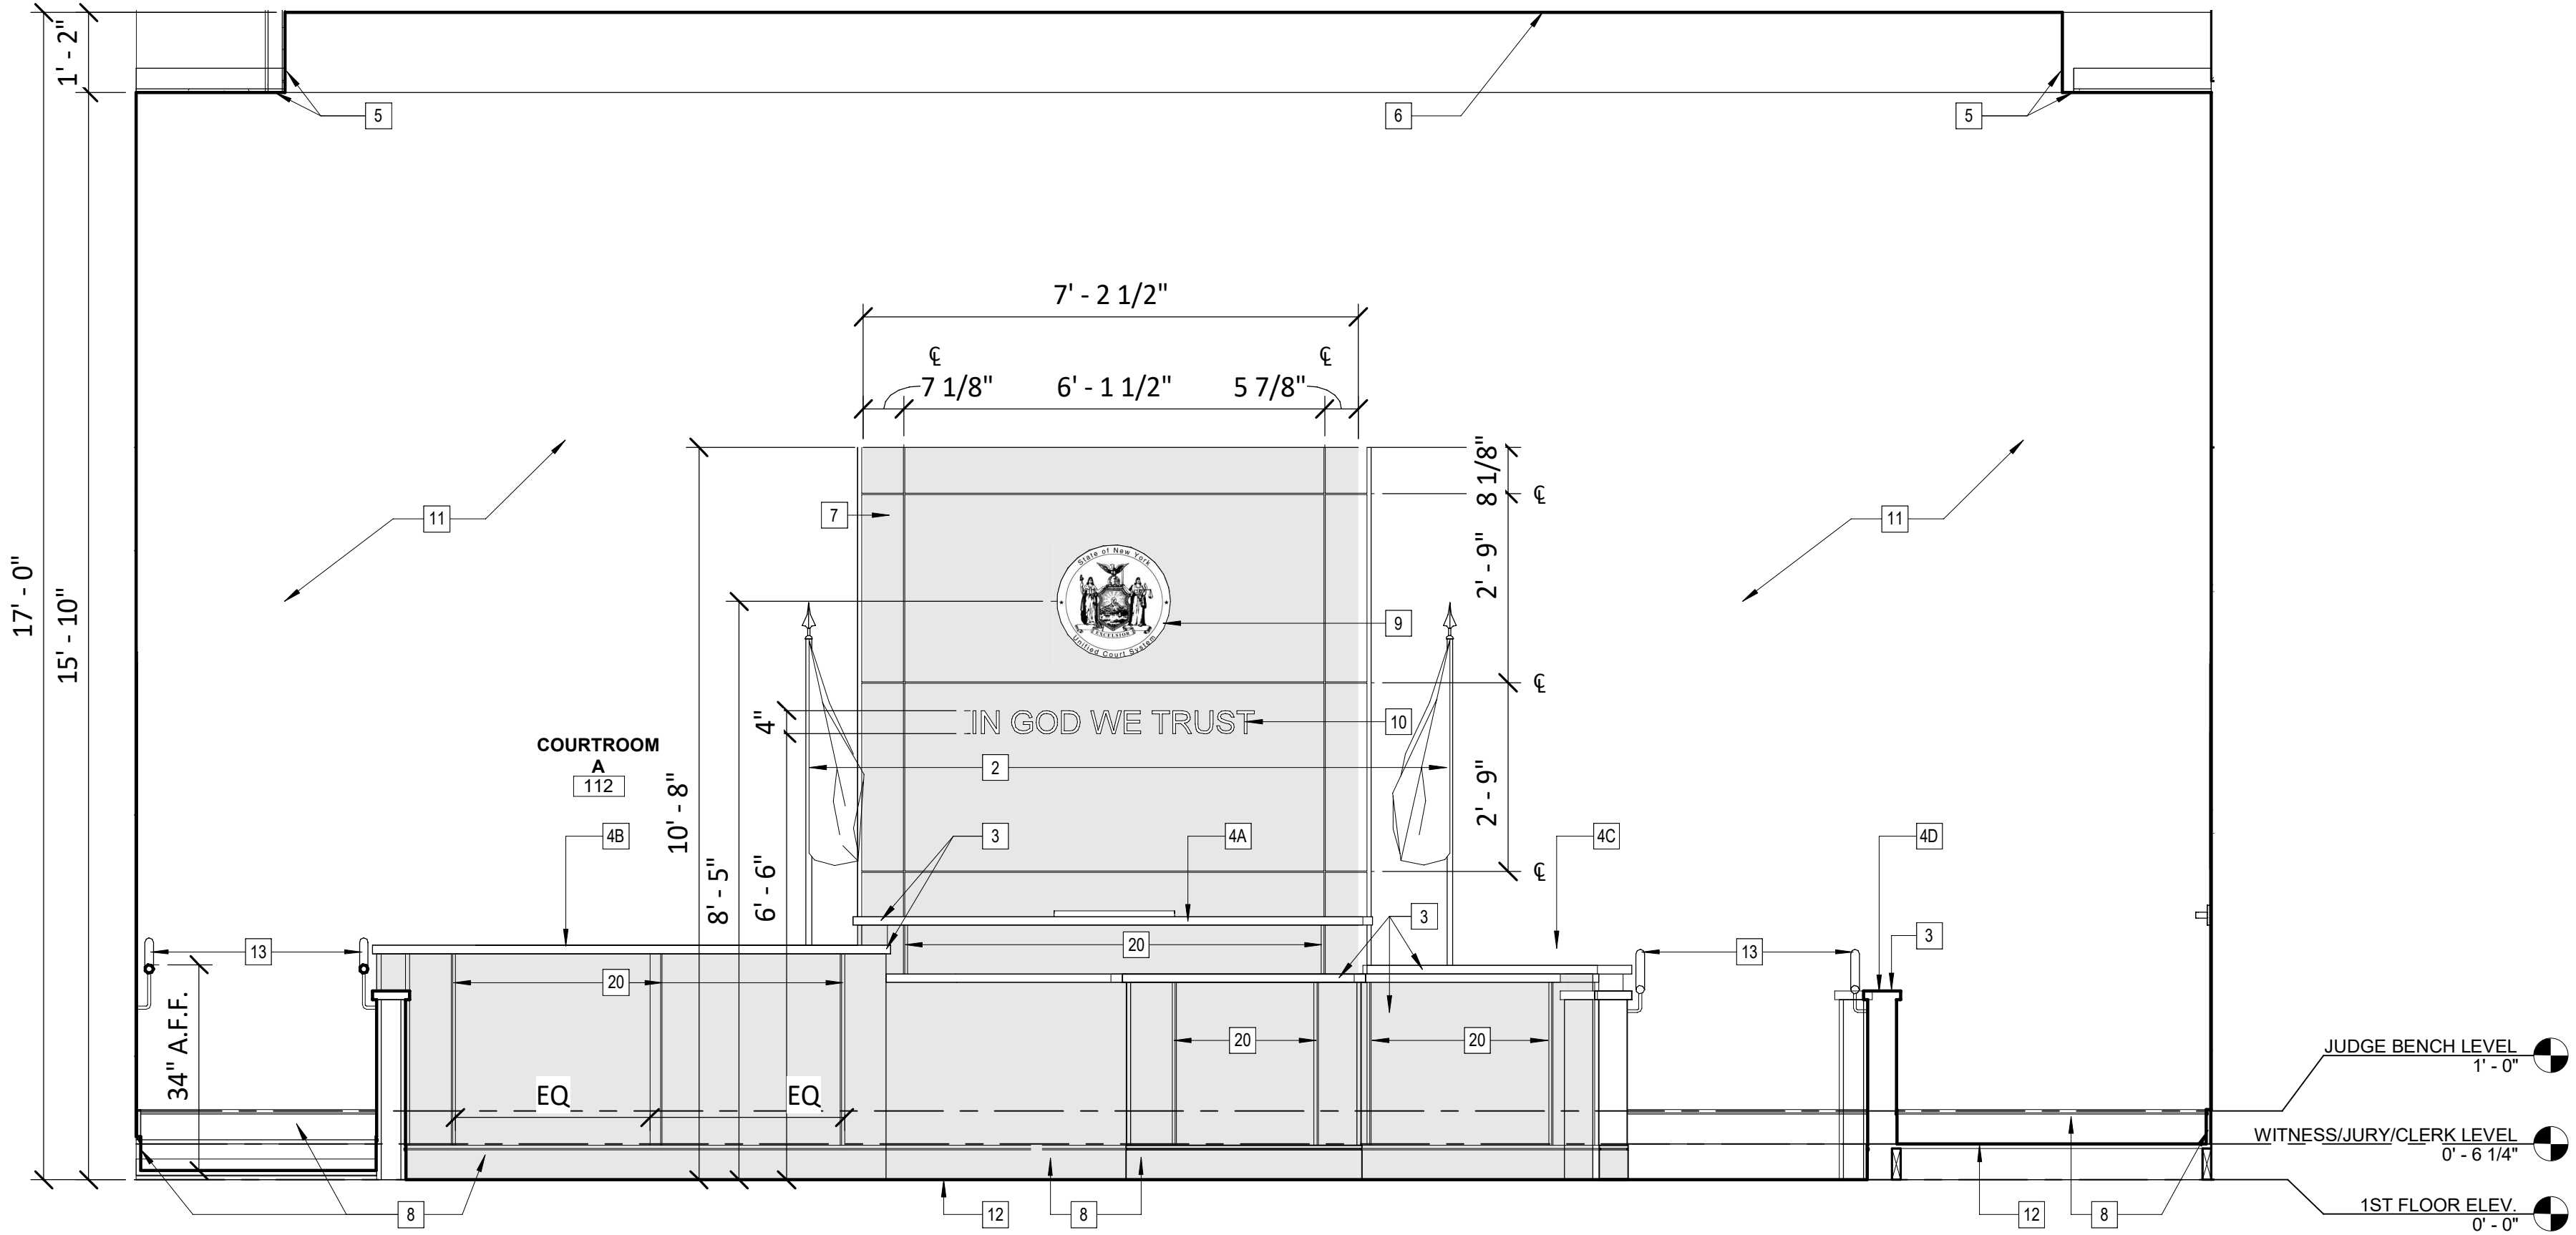


1

A403

COURTROOM A ELEVATION 1

SCALE: 1/2" = 1'-0"

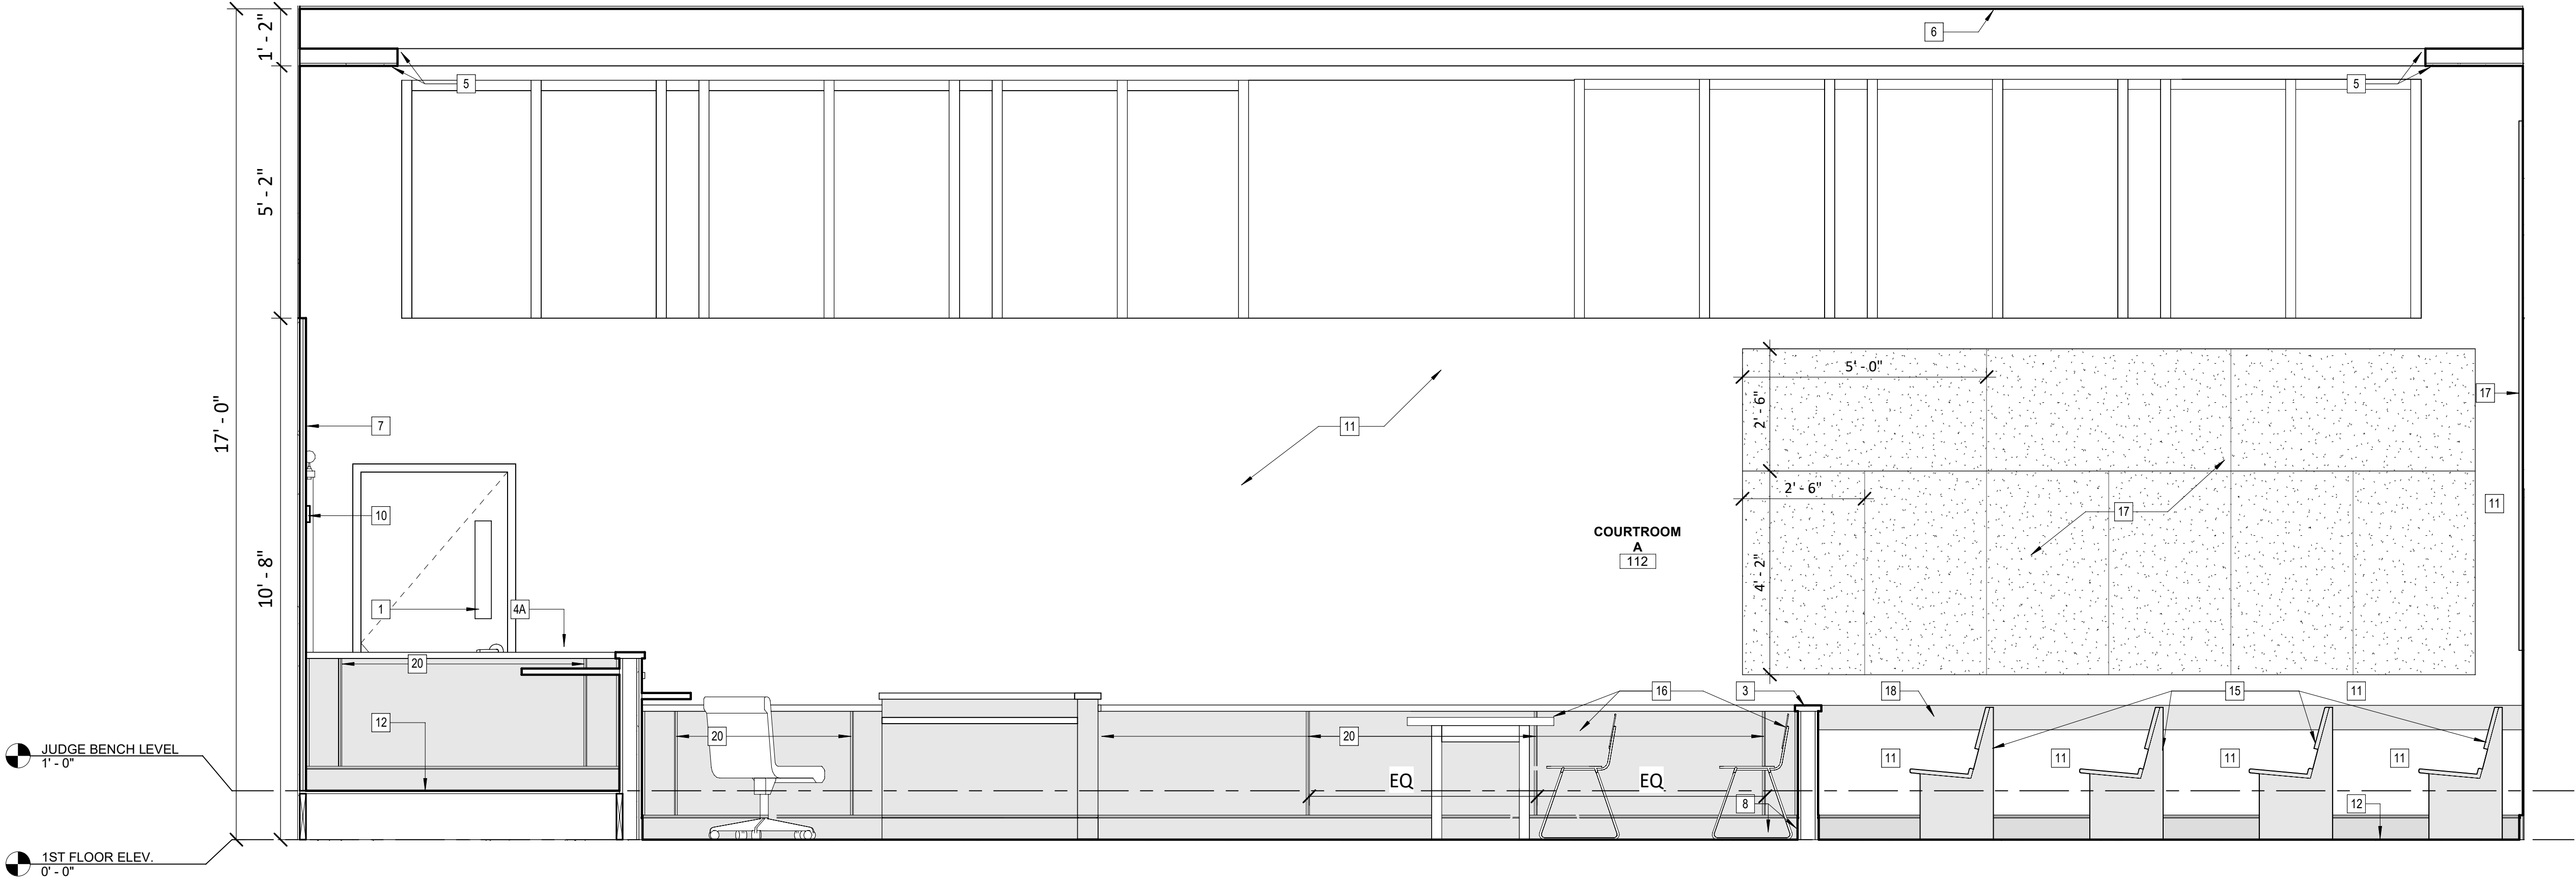

2

A403

COURTROOM A ELEVATION 2

SCALE: 1/2" = 1'-0"

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REVISIONS

CITY OF MIDDLETOWN  
NEW COURTHOUSE FACILITY

FIRST FLOOR COURTROOM INTERIOR ELEVATIONS

CITY OF MIDDLETOWN  
ORANGE COUNTY, NEW YORK

Barton & Loguidice

443 Electronics Parkway  
Liverpool, NY 13088

NYS CERTIFICATE #  
0021642, 0020288, 0019903,  
0019905, 0020336

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NYS EXP.:  
Date  
AUGUST, 2024

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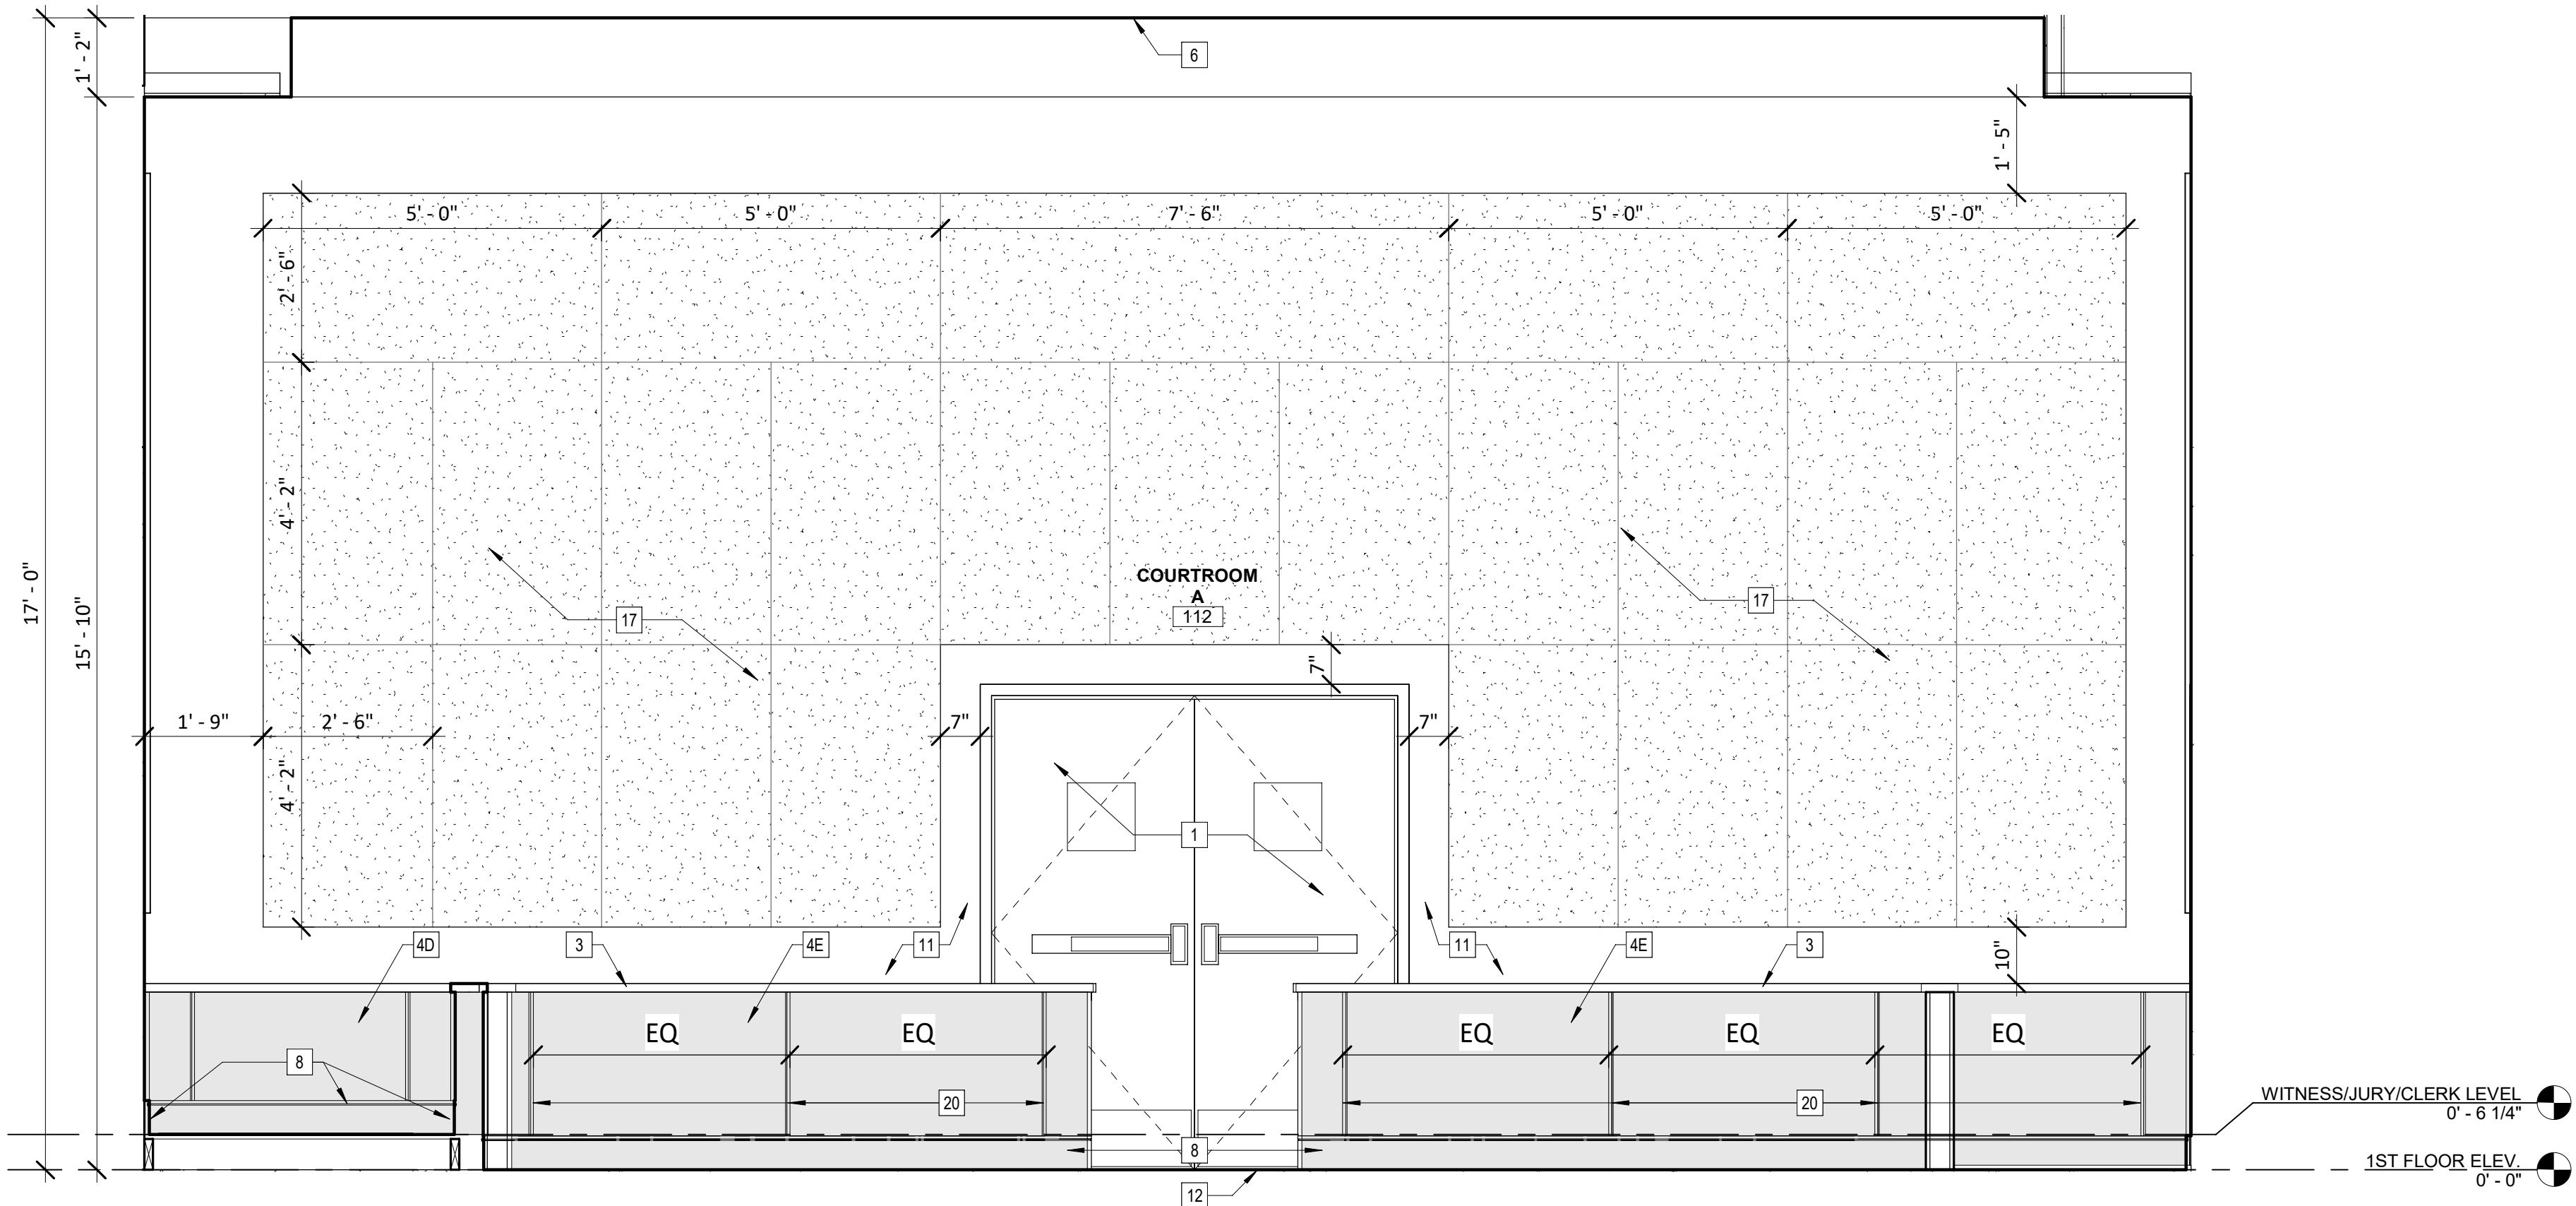
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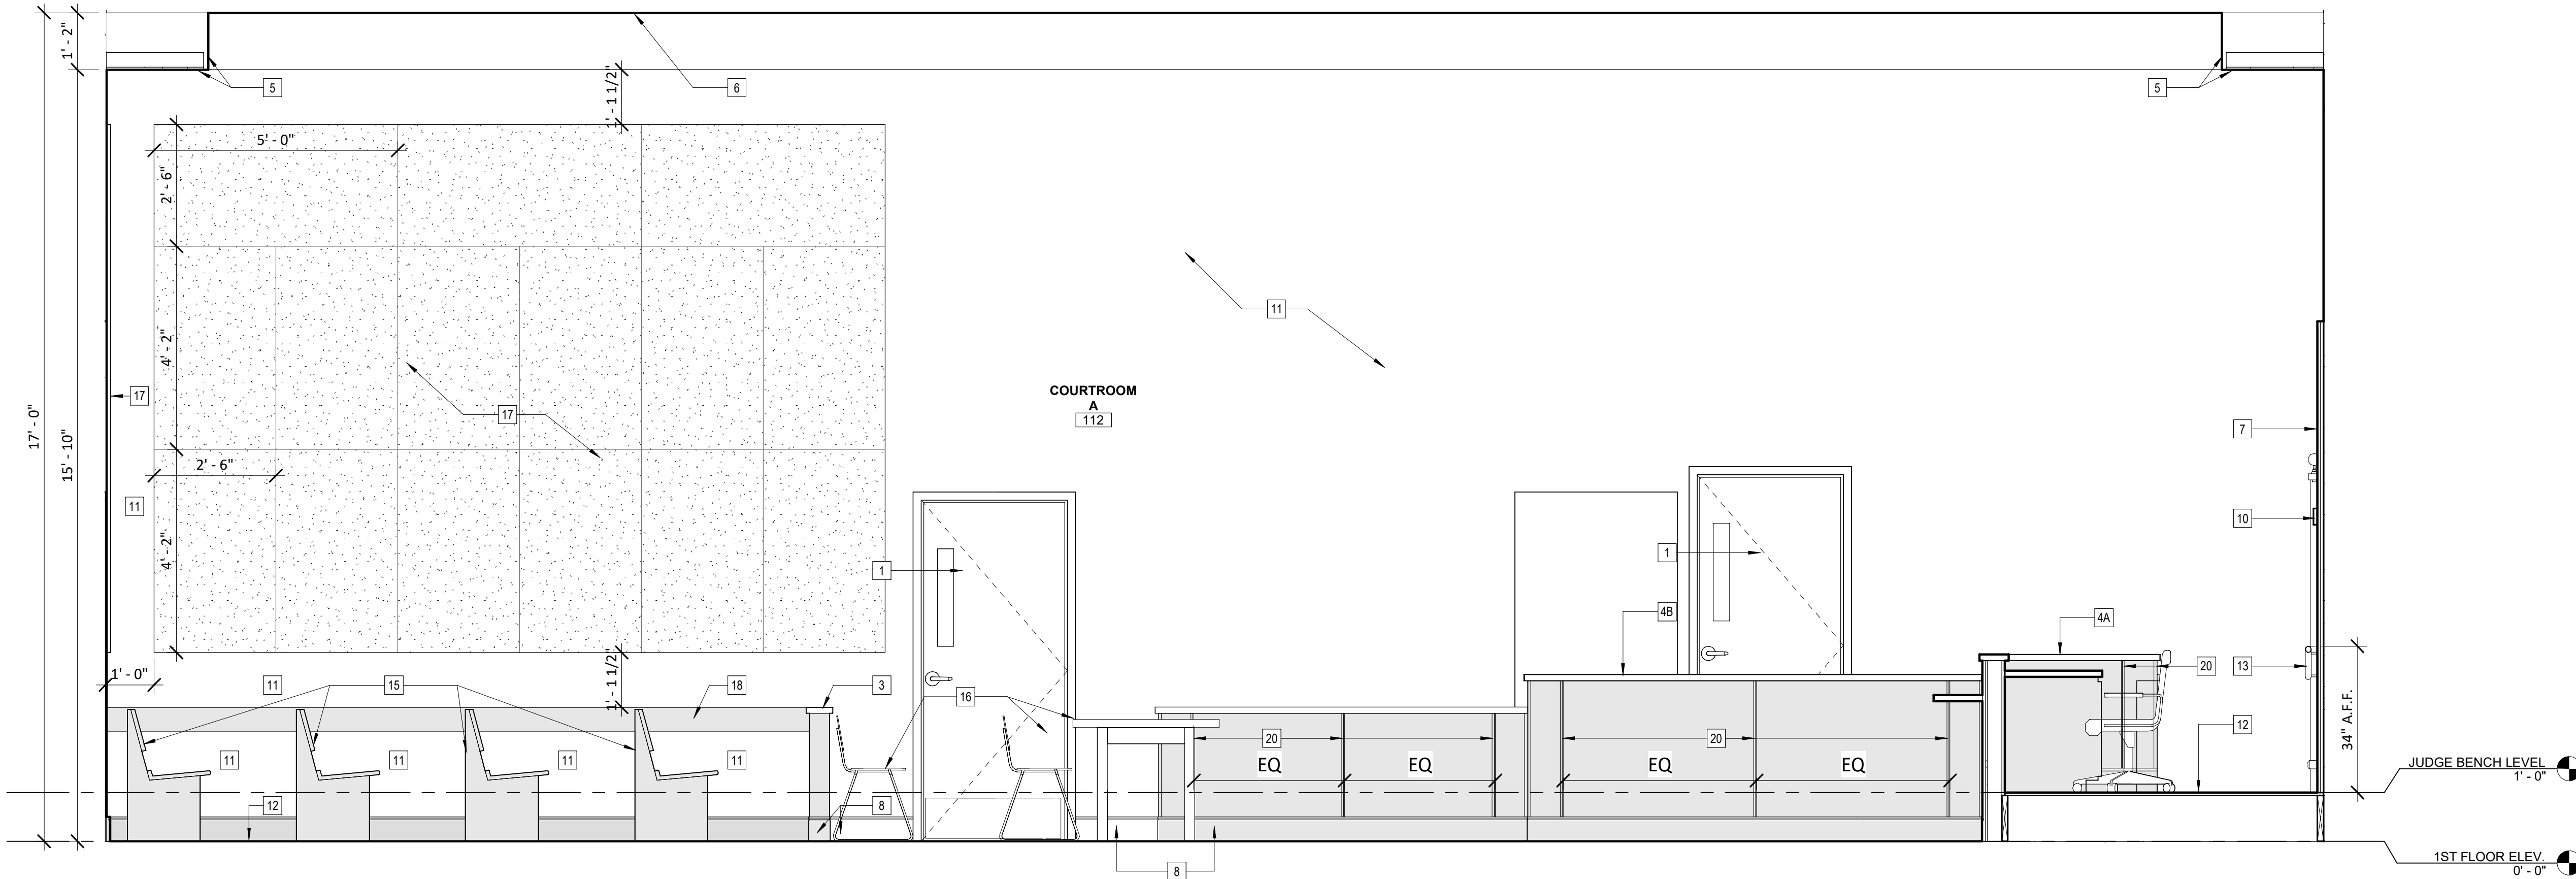


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- COURTROOM ELEVATION KEYED NOTES
- WOOD OR METAL DOOR WITH HOLLOW METAL FRAME, W/ OR W/O LITE (HALF) AND ADA COMPLIANT HARDWARE - 60 MINUTE RATED DOOR & FRAME, SEE DOOR SCHEDULE.
  - WALL MOUNTED FLAG POLES, BRACKETS AND FLAGS TO BE PROVIDED BY OWNER AND INSTALLED BY CONTRACTOR.
  - SOLID SURFACE CAPS/COUNTERTOPS.
  - 4A. JUDGES BENCH, 4B. CLERKS AREA 4C. WITNESS BOX, 4D. JURY BOX, AND 4E. GALLERY SEPARATION WALLS WOOD VENEER.
  - SHEETROCKED SOFFIT OR HANGING SHEETROCKED CEILING.
  - ACOUSTICAL CEILING GRID SYSTEM.
  - WOOD PANELING BEHIND JUDGE AND WITNESS BOXES.
  - 6" TALL - 3/4" WOOD TRIM BASE
  - NEW YORK STATE COURT SYSTEM SEAL (LIGHT WEIGHT) TO BE PROVIDED BY OWNER AND MOUNTED/INSTALLED WITH VELCRO OR PICTURE HOOKS ON WOOD PANELING BY CONTRACTOR, CENTER ON JUDGE'S BENCH.
  - TYPICAL 4" HIGH CAST BRONZE LETTERING (FINISH TO BE SELECTED BY OWNER) MOUNTED ON THE WOOD PANELING AT THE BACK OF THE JUDGE'S BENCH, CENTER ON JUDGES BENCH.
  - PAINTED GYPSUM WALL BOARD WALLS.
  - CARPET TILE/CARPETING FLOORING IN COURTROOM AREA, STEPS AND RAMPS. LUXURY VINYL TILE IN GALLERY AREA, ATTORNEY CONFERENCE ROOMS AND VESTIBULE.
  - ADA COMPLIANT ALUMINUM HANDRAIL.
  - JURY SWINGING GATE DOOR.
  - GALLERY WOOD BENCHES.
  - TABLES AND CHAIRS. (SOME ELEVATIONS CHAIRS AND TABLES HAVE BEEN REMOVED FOR DETAILING CLARITY).
  - ACOUSTICAL FABRIC WALL PANELS, PANELS BUTTED TOGETHER, PANEL SIZES AS SHOWN ON ELEVATIONS.
  - WOOD CHAIR RAIL.
  - WALL SCONCE LIGHT FIXTURE.
  - WOOD PANEL JOINTS/TRIM. PROVIDE EQUAL DISTANCE BETWEEN JOINTS ALONG LENGTHS OF WALLS. (SEE MILLWORK DETAILS FOR TYPICAL DETAILING AT CORNERS/ENDS OF MILLWORK).
  - 6" VINYL WALL BASE



**1 COURTROOM A ELEVATION 3**  
SCALE: 1/2" = 1'-0"



**2 COURTROOM A ELEVATION 4**  
SCALE: 1/2" = 1'-0"

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REVISIONS

NO.	DESCRIPTION

CITY OF MIDDLETOWN  
NEW COURTHOUSE FACILITY  
**FIRST FLOOR COURTROOM INTERIOR ELEVATIONS**  
CITY OF MIDDLETOWN  
ORANGE COUNTY, NEW YORK

**Barton & Loguidice**  
443 Electronics Parkway  
Liverpool, NY 13088  
NYS CERTIFICATE #  
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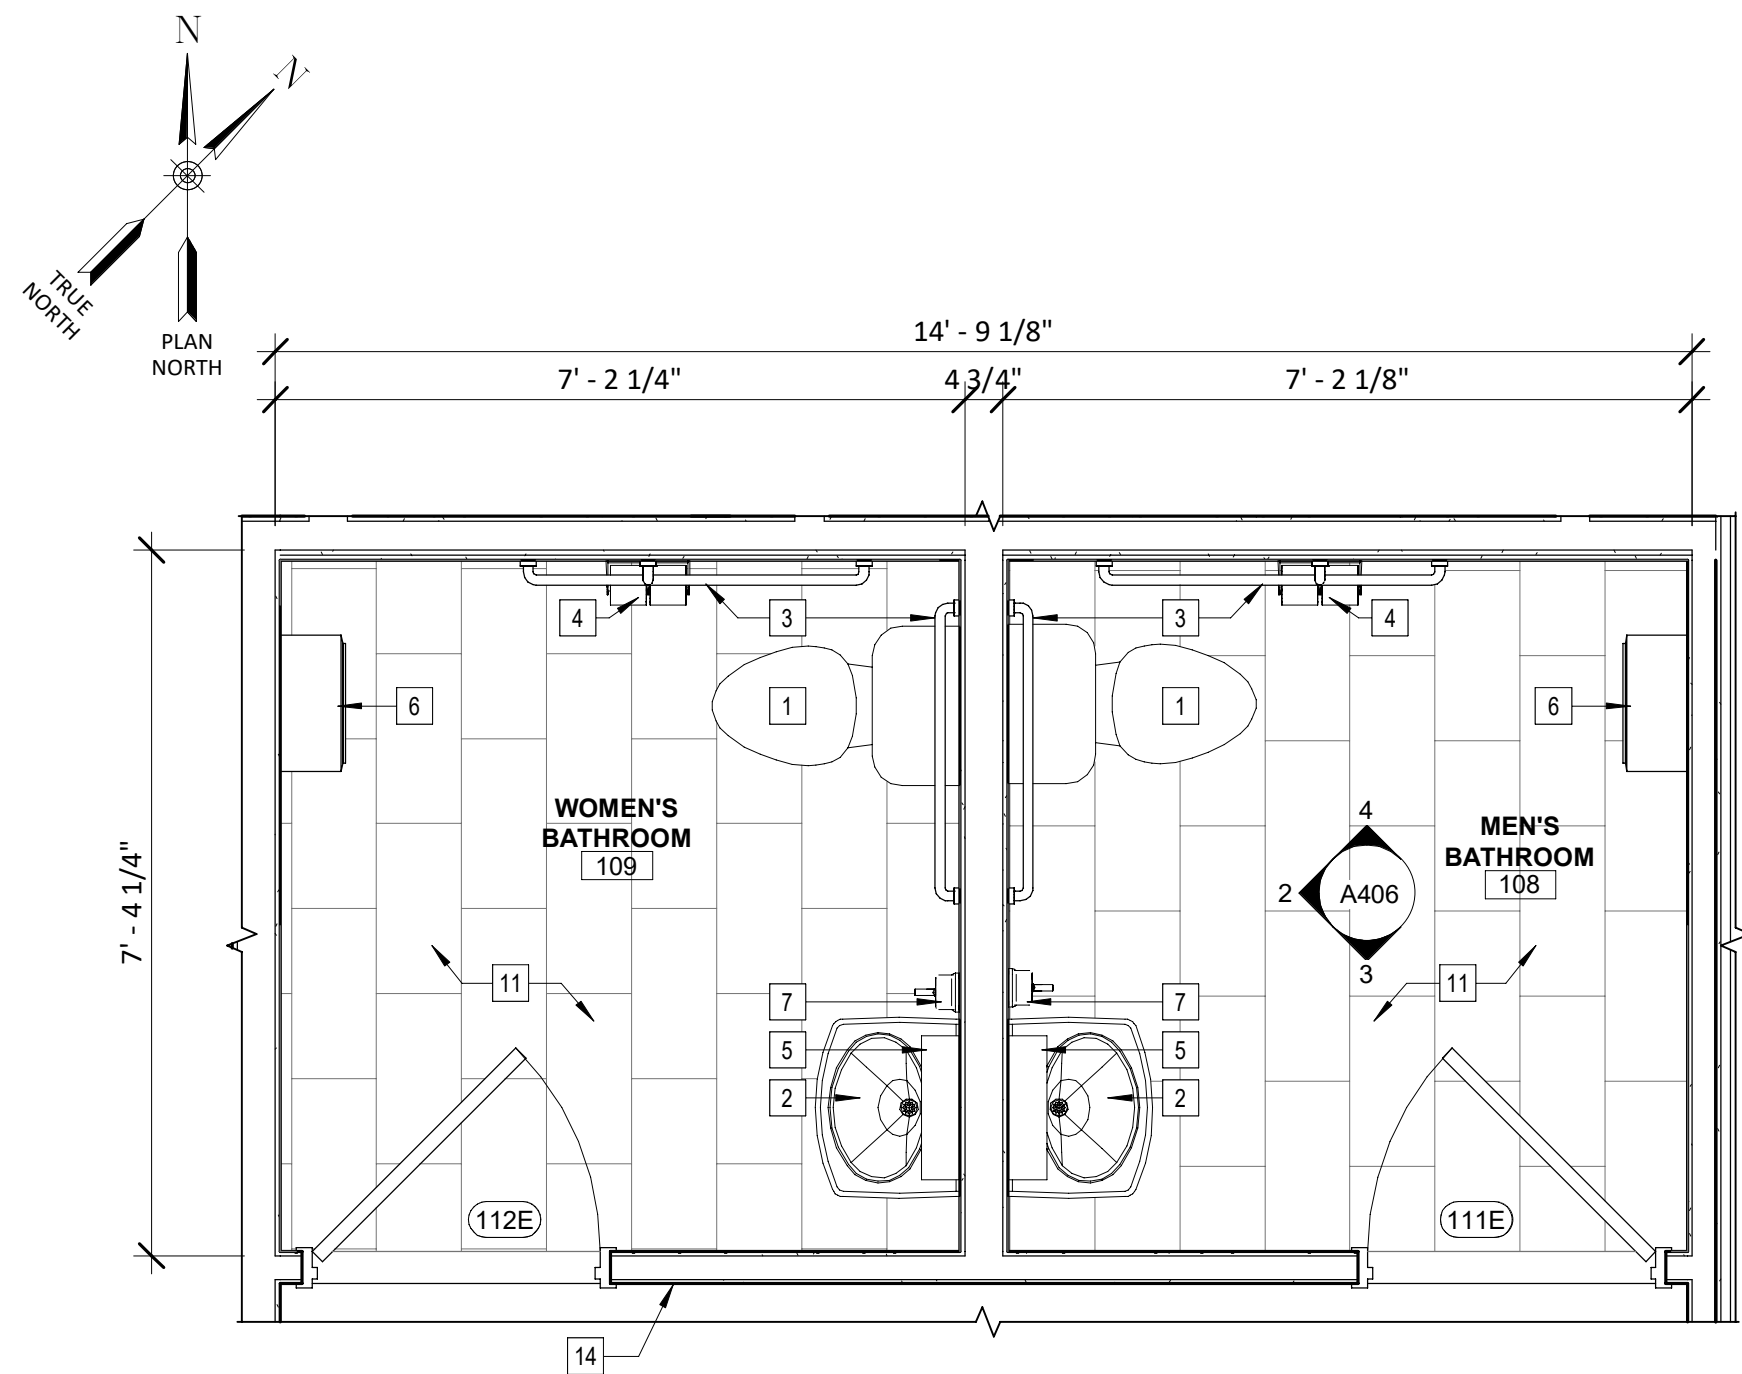
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**AUGUST, 2024**

Scale  
**AS SHOWN**


Sheet Number  
**A405**

Project Number  
**1753.008.001**







**1 ENLARGED BATHROOM 108 & 109 PLAN**  
A201 SCALE: 1/2" = 1'-0"

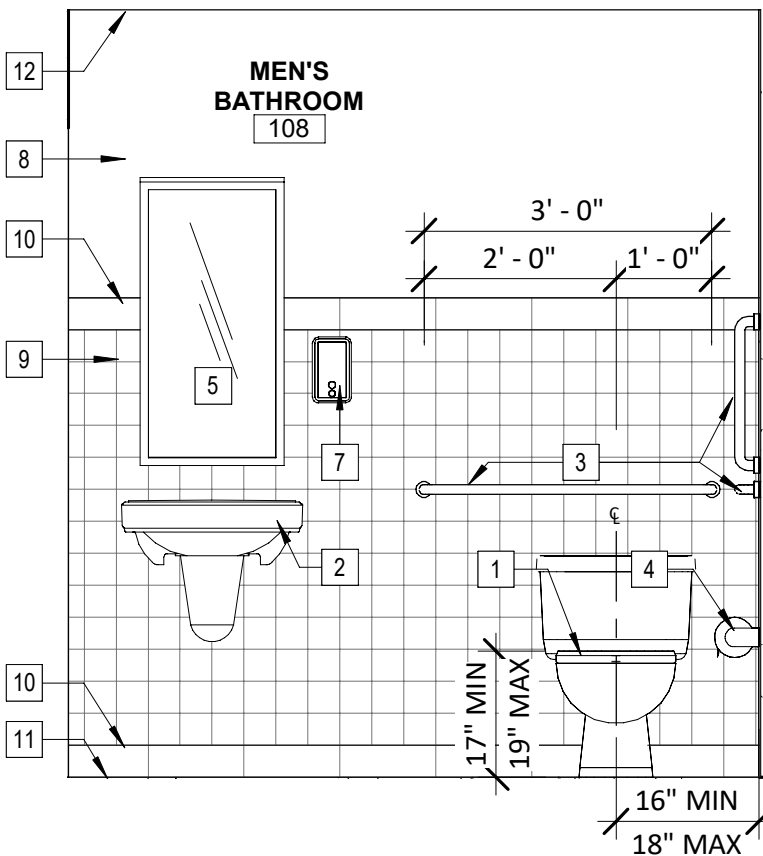


**2 BATH. 108 ELEVATION 1**  
A403 SCALE: 1/2" = 1'-0"

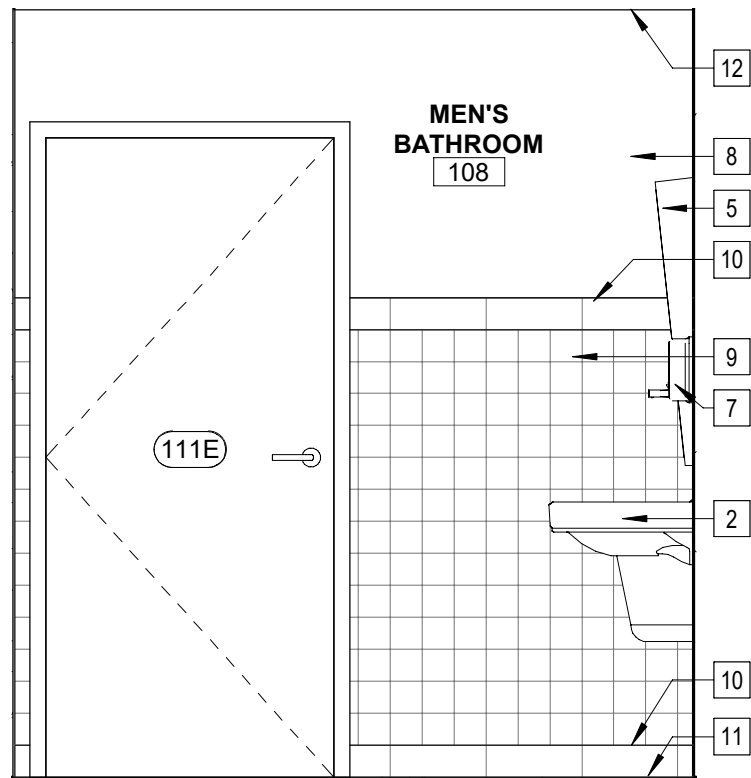


**3 BATH. 108 ELEVATION 2**  
A403 SCALE: 1/2" = 1'-0"

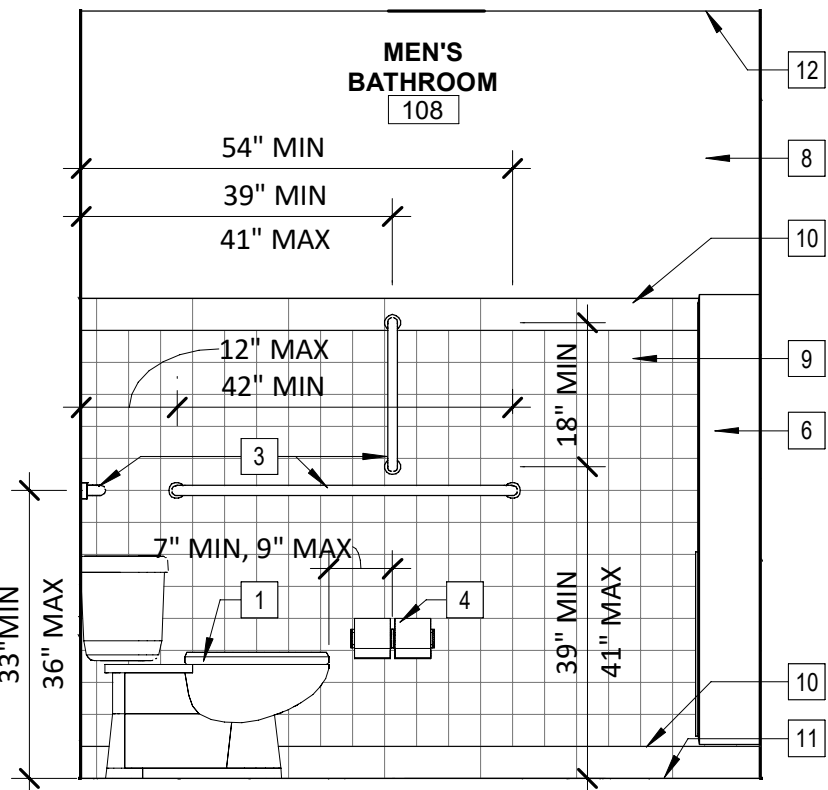


**4 BATH. 108 ELEVATION 3**  
A403 SCALE: 1/2" = 1'-0"

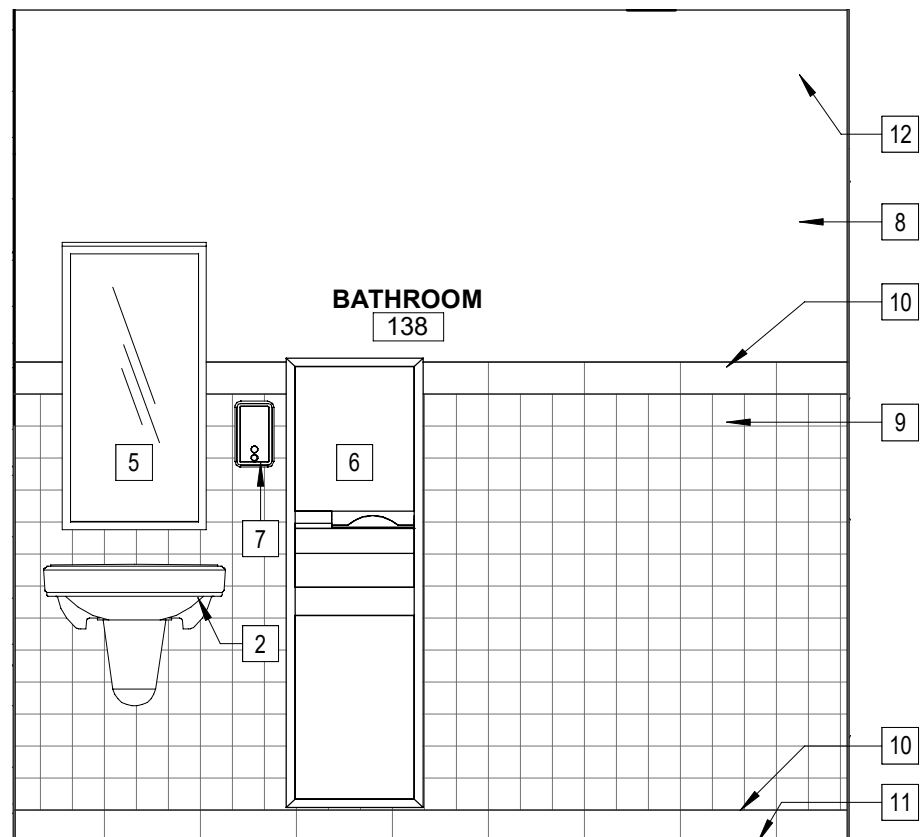


**5 BATHROOM 138 ELEVATION 2**  
A406 SCALE: 1/2" = 1'-0"

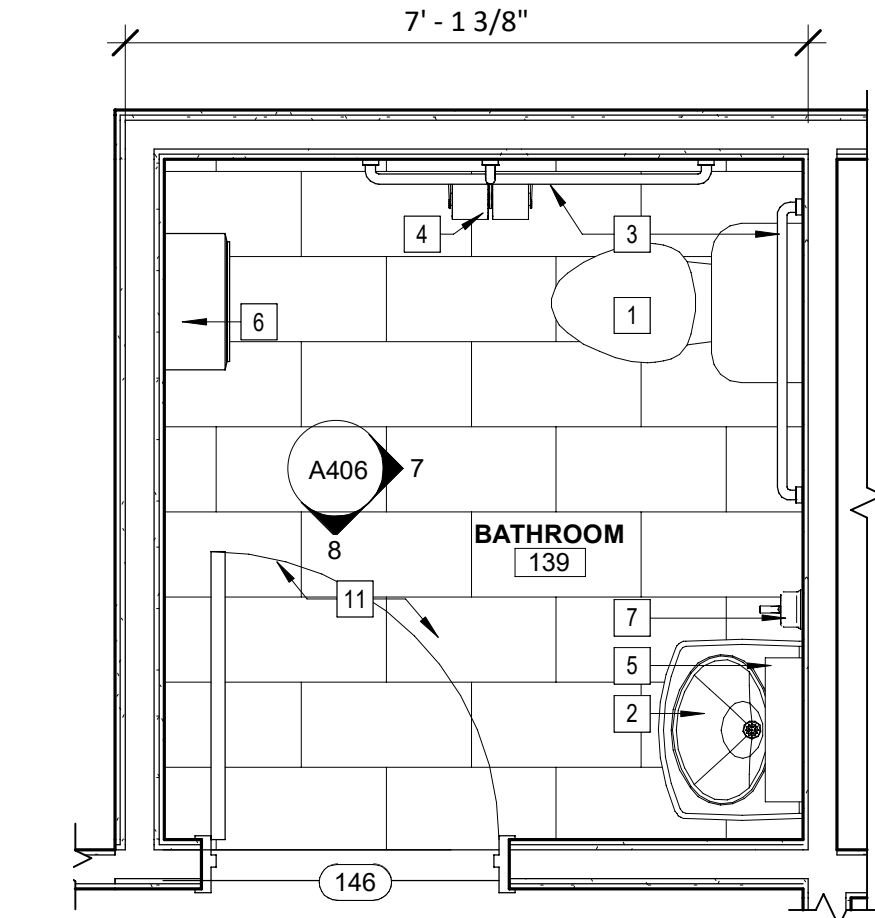


**6 ENLARGED BATHROOM 139 PLAN**  
A201 SCALE: 1/2" = 1'-0"

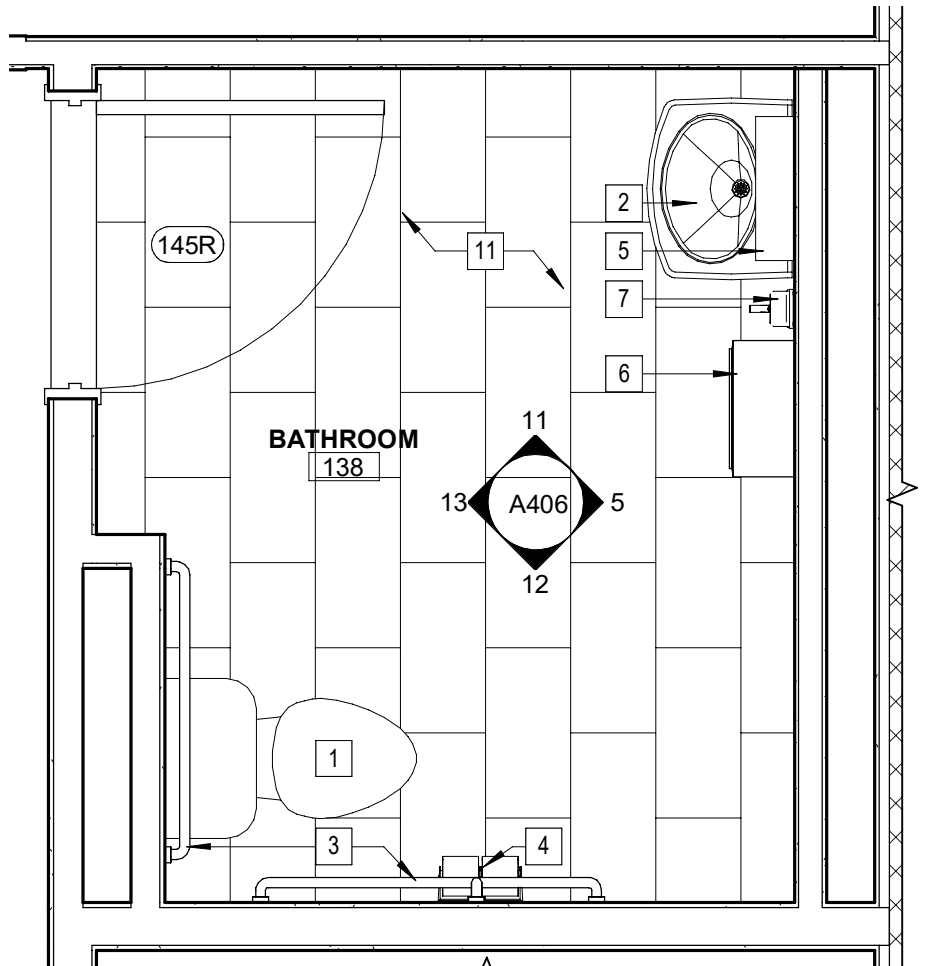


**10 ENLARGED BATHROOM 138 PLAN**  
A201 SCALE: 1/2" = 1'-0"

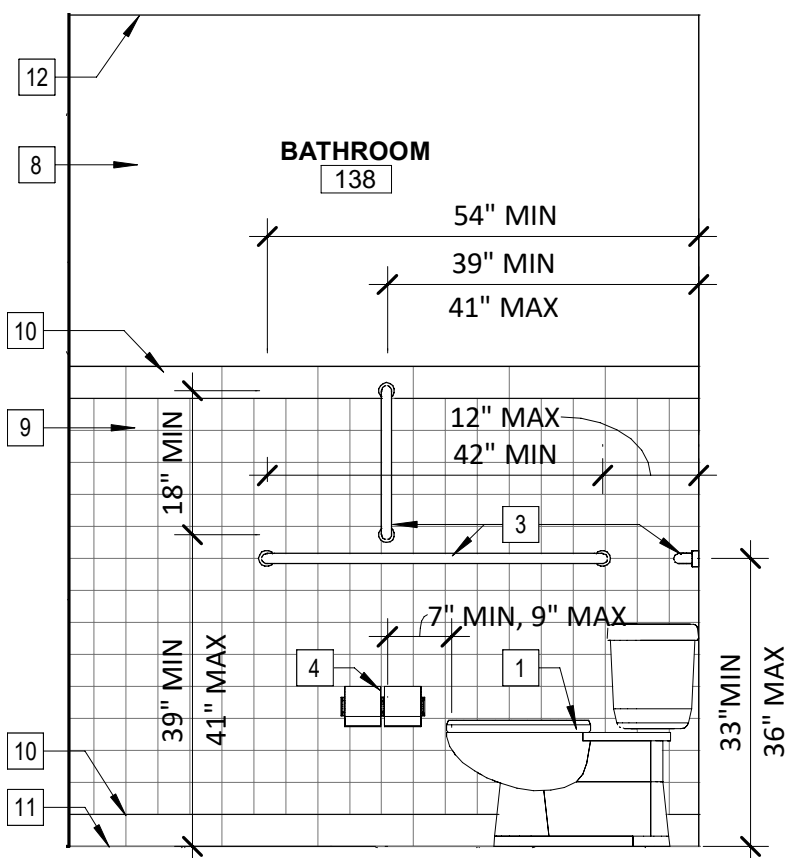


**12 BATHROOM 138 ELEVATION 3**  
A406 SCALE: 1/2" = 1'-0"

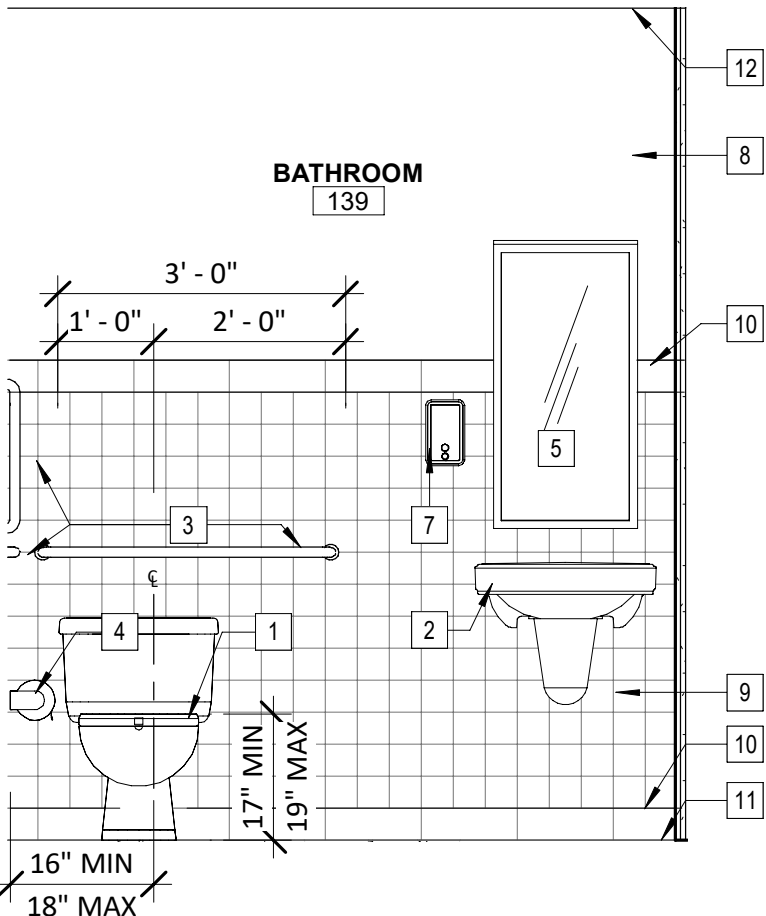


**7 BATH. 139 ELEVATION 1**  
A406 SCALE: 1/2" = 1'-0"

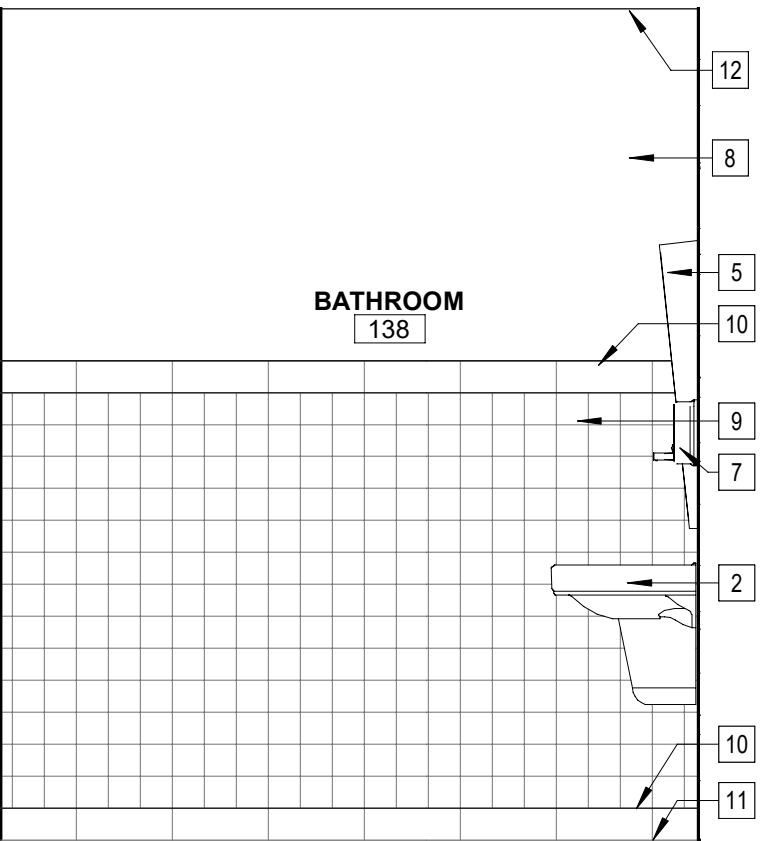

**11 BATHROOM 138 ELEVATION 1**  
A406 SCALE: 1/2" = 1'-0"

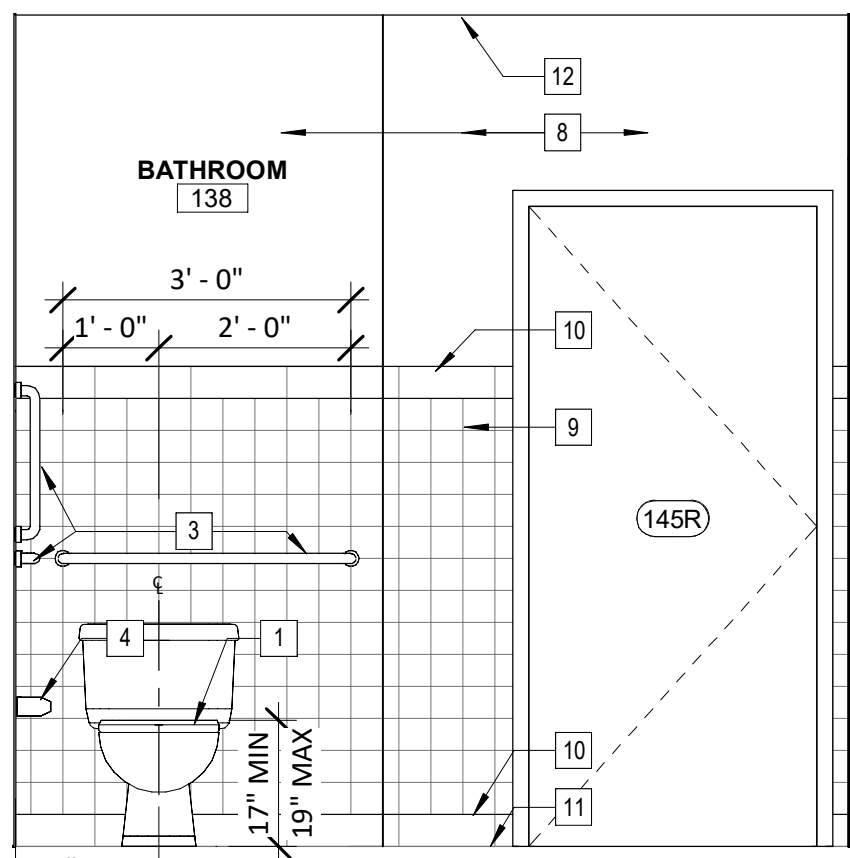

**13 BATHROOM 138 ELEVATION 4**  
A406 SCALE: 1/2" = 1'-0"

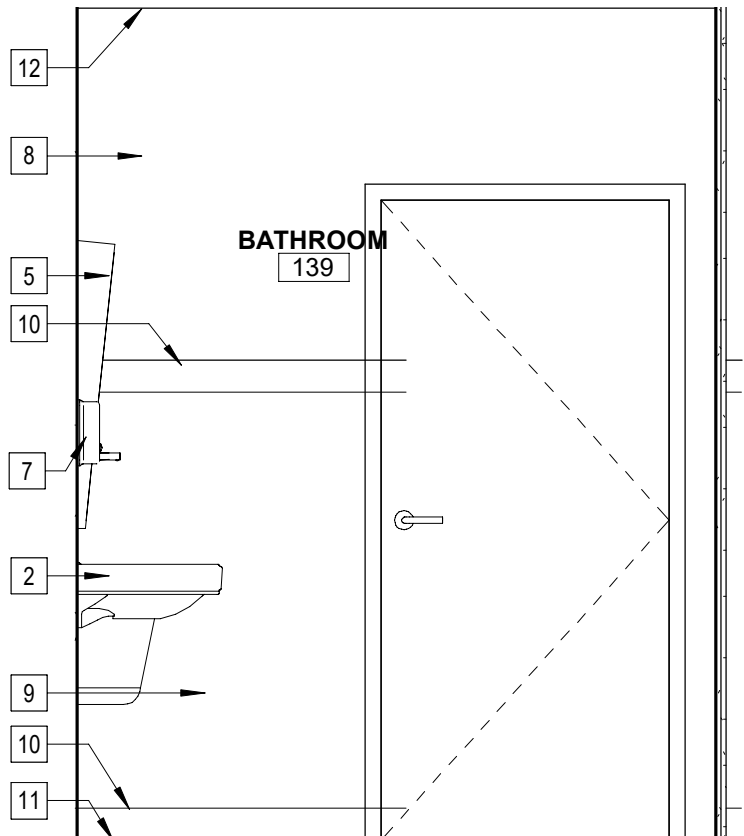

**8 BATH. 139 ELEVATION 2**  
A406 SCALE: 1/2" = 1'-0"

#### BATHROOM KEY NOTES

- SEE PLUMBING SHEETS FOR ADA COMPLIANT WATER CLOSET TOILET (SEAT 17 MIN. AND 19" MAX. OFF OF THE FLOOR) IN LOCATIONS SHOWN, SEE PLUMBING DRAWINGS FOR FIXTURE SELECTION, COLOR TO BE SELECTED BY OWNER.
- SEE PLUMBING SHEETS FOR ADA COMPLIANT WALL MOUNTED SINKS AND FAUCETS (THE FRONT OF THE SINK SHALL BE A MAXIMUM OF 34" ABOVE THE FLOOR) IN LOCATIONS SHOWN, SEE PLUMBING DRAWINGS FOR FIXTURE SELECTION, COLOR TO BE SELECTED BY OWNER. PROVIDE PIPE PROTECTION FOR WATER SUPPLY LINES AND DRAINPIPES UNDER THE SINKS. MAINTAIN PROPER ADA KNEE AND TOE CLEARANCE AT ALL FIXTURES.
- PROVIDE GRAB BARS IN LOCATIONS SHOWN AND AS FOLLOWS. FIXED SIDEWALL GRAB BAR 42" MINIMUM IN LENGTH, LOCATED 12" MAXIMUM FROM REAR WALL AND EXTENDING 54" MINIMUM FROM THE REAR WALL (33" MINIMUM AND 36" MAXIMUM TO TOP OF GRAB BAR OFF OF THE FLOOR). PROVIDE VERTICAL GRAB BAR 18" MINIMUM LENGTH AND SHALL BE MOUNTED WITH THE BOTTOM OF THE BAR LOCATED 39" MINIMUM AND 41" MAXIMUM OFF OF THE FLOOR AND 39" TO 41" TO THE CENTER OF THE BAR FROM THE BACK WALL. THE REAR GRAB BAR SHALL BE 36" MINIMUM IN LENGTH, AND EXTEND FROM THE CENTERLINE OF THE WATER CLOSET (TOILET) 12" MINIMUM ON THE SIDE CLOSEST TO THE WALL, AND 24" MINIMUM ON THE TRANSFER SIDE. PROVIDE ALL WOOD BLOCKING IN WALL AS NEEDED FOR THE INSTALLATION OF GRAB BARS.
- PROVIDE ADA COMPLIANT WALL MOUNTED JUMBO BATH TISSUE DOUBLE ROLL DISPENSER TO BE INSTALLED BY CONTRACTOR, 18" MINIMUM FROM THE FLOOR TO THE BOTTOM OF THE UNIT OR 48" MAXIMUM TO THE TOP OF THE UNIT FROM THE FLOOR AND 24" FROM THE BACK WALL TO THE BACK EDGE OF THE UNIT IN LOCATIONS SHOWN ON PLANS. COORDINATE LOCATION WITH GRAB BAR INSTALLATION.
- PROVIDE ADA COMPLIANT 24" W X 36" H MIRROR, WHICH SHALL BE MOUNTED WITH THE BOTTOM EDGE OF THE REFLECTING SURFACE NO HIGHER THAN 40" ABOVE THE FLOOR.
- PROVIDE ADA COMPLIANT WALL MOUNTED PAPER TOWEL DISPENSER AND WASTE DISPOSAL COMBINATION UNIT TO BE INSTALLED BY CONTRACTOR (MOUNT WITH THEIR 'OPERABLE PART' DISPENSING MECHANISM NO MORE THAN 48" ABOVE THE FLOOR) IN LOCATIONS SHOWN.
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- PRIME AND PAINTED GWB WALLS, COLOR TO BE SELECTED BY OWNER.
- 4" X 4" CERAMIC WALL TILE MAIN FIELD, COLOR TO BE SELECTED BY OWNER
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- 12" X 24" PORCELAIN TILE FLOOR, COLOR TO BE SELECTED BY OWNER.
- ACOUSTICAL CEILING TILES AND GRID SYSTEM.
- PROVIDE FIRE EXTINGUISHER CABINET, REFER TO DETAIL FOR MORE INFORMATION.
- PROVIDE ADA COMPLIANT TACTILE SIGNAGE (SYMBOL AT THE TOP, RAISED CHARACTERS AND BRAILLE AT THE BOTTOM) IN LOCATIONS SHOWN. BRAILLE SHALL BE 48 INCHES MINIMUM, AND 60 INCHES MAXIMUM ABOVE THE FLOOR, MEASURED TO THE BASELINE OF THE BRAILLE CELLS. SEE ADA COMPLIANT SIGNAGE DETAIL.
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#### REVISIONS

CITY OF MIDDLETOWN  
NEW COURTHOUSE FACILITY  
FIRST FLOOR ENLARGED BATHROOM PLANS AND  
INTERIOR ELEVATIONS  
ORANGE COUNTY, NEW YORK

**Barton & Loguidice**  
443 Electronics Parkway  
Liverpool, NY 13088



NYS EXP.:

Date  
AUGUST, 2024


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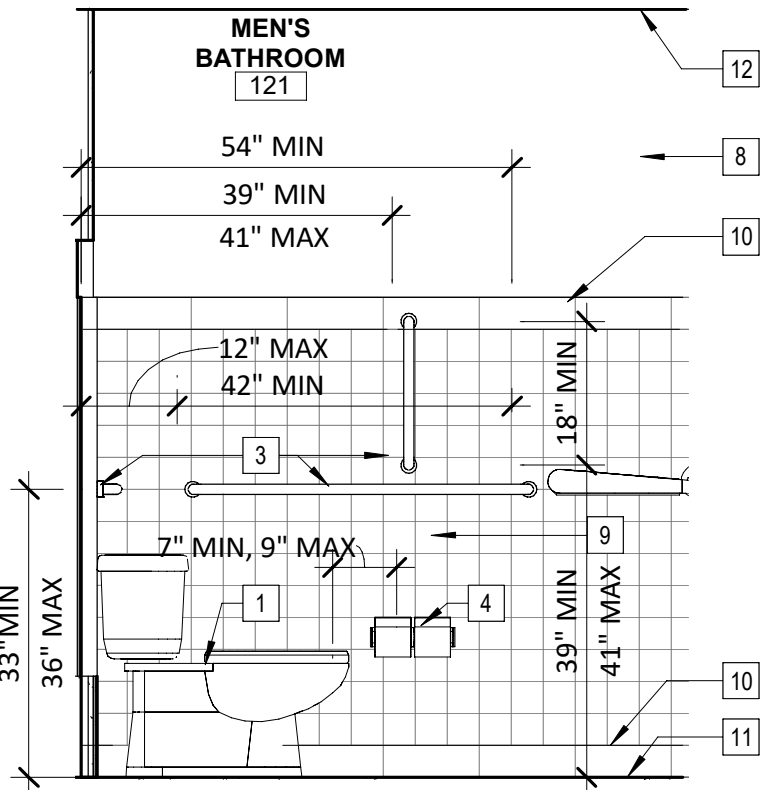
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Project Number  
1753.008.001







**1 ENLARGED DRUG COOR. BATHROOM PLANS**  
A201 SCALE: 1/2" = 1'-0"

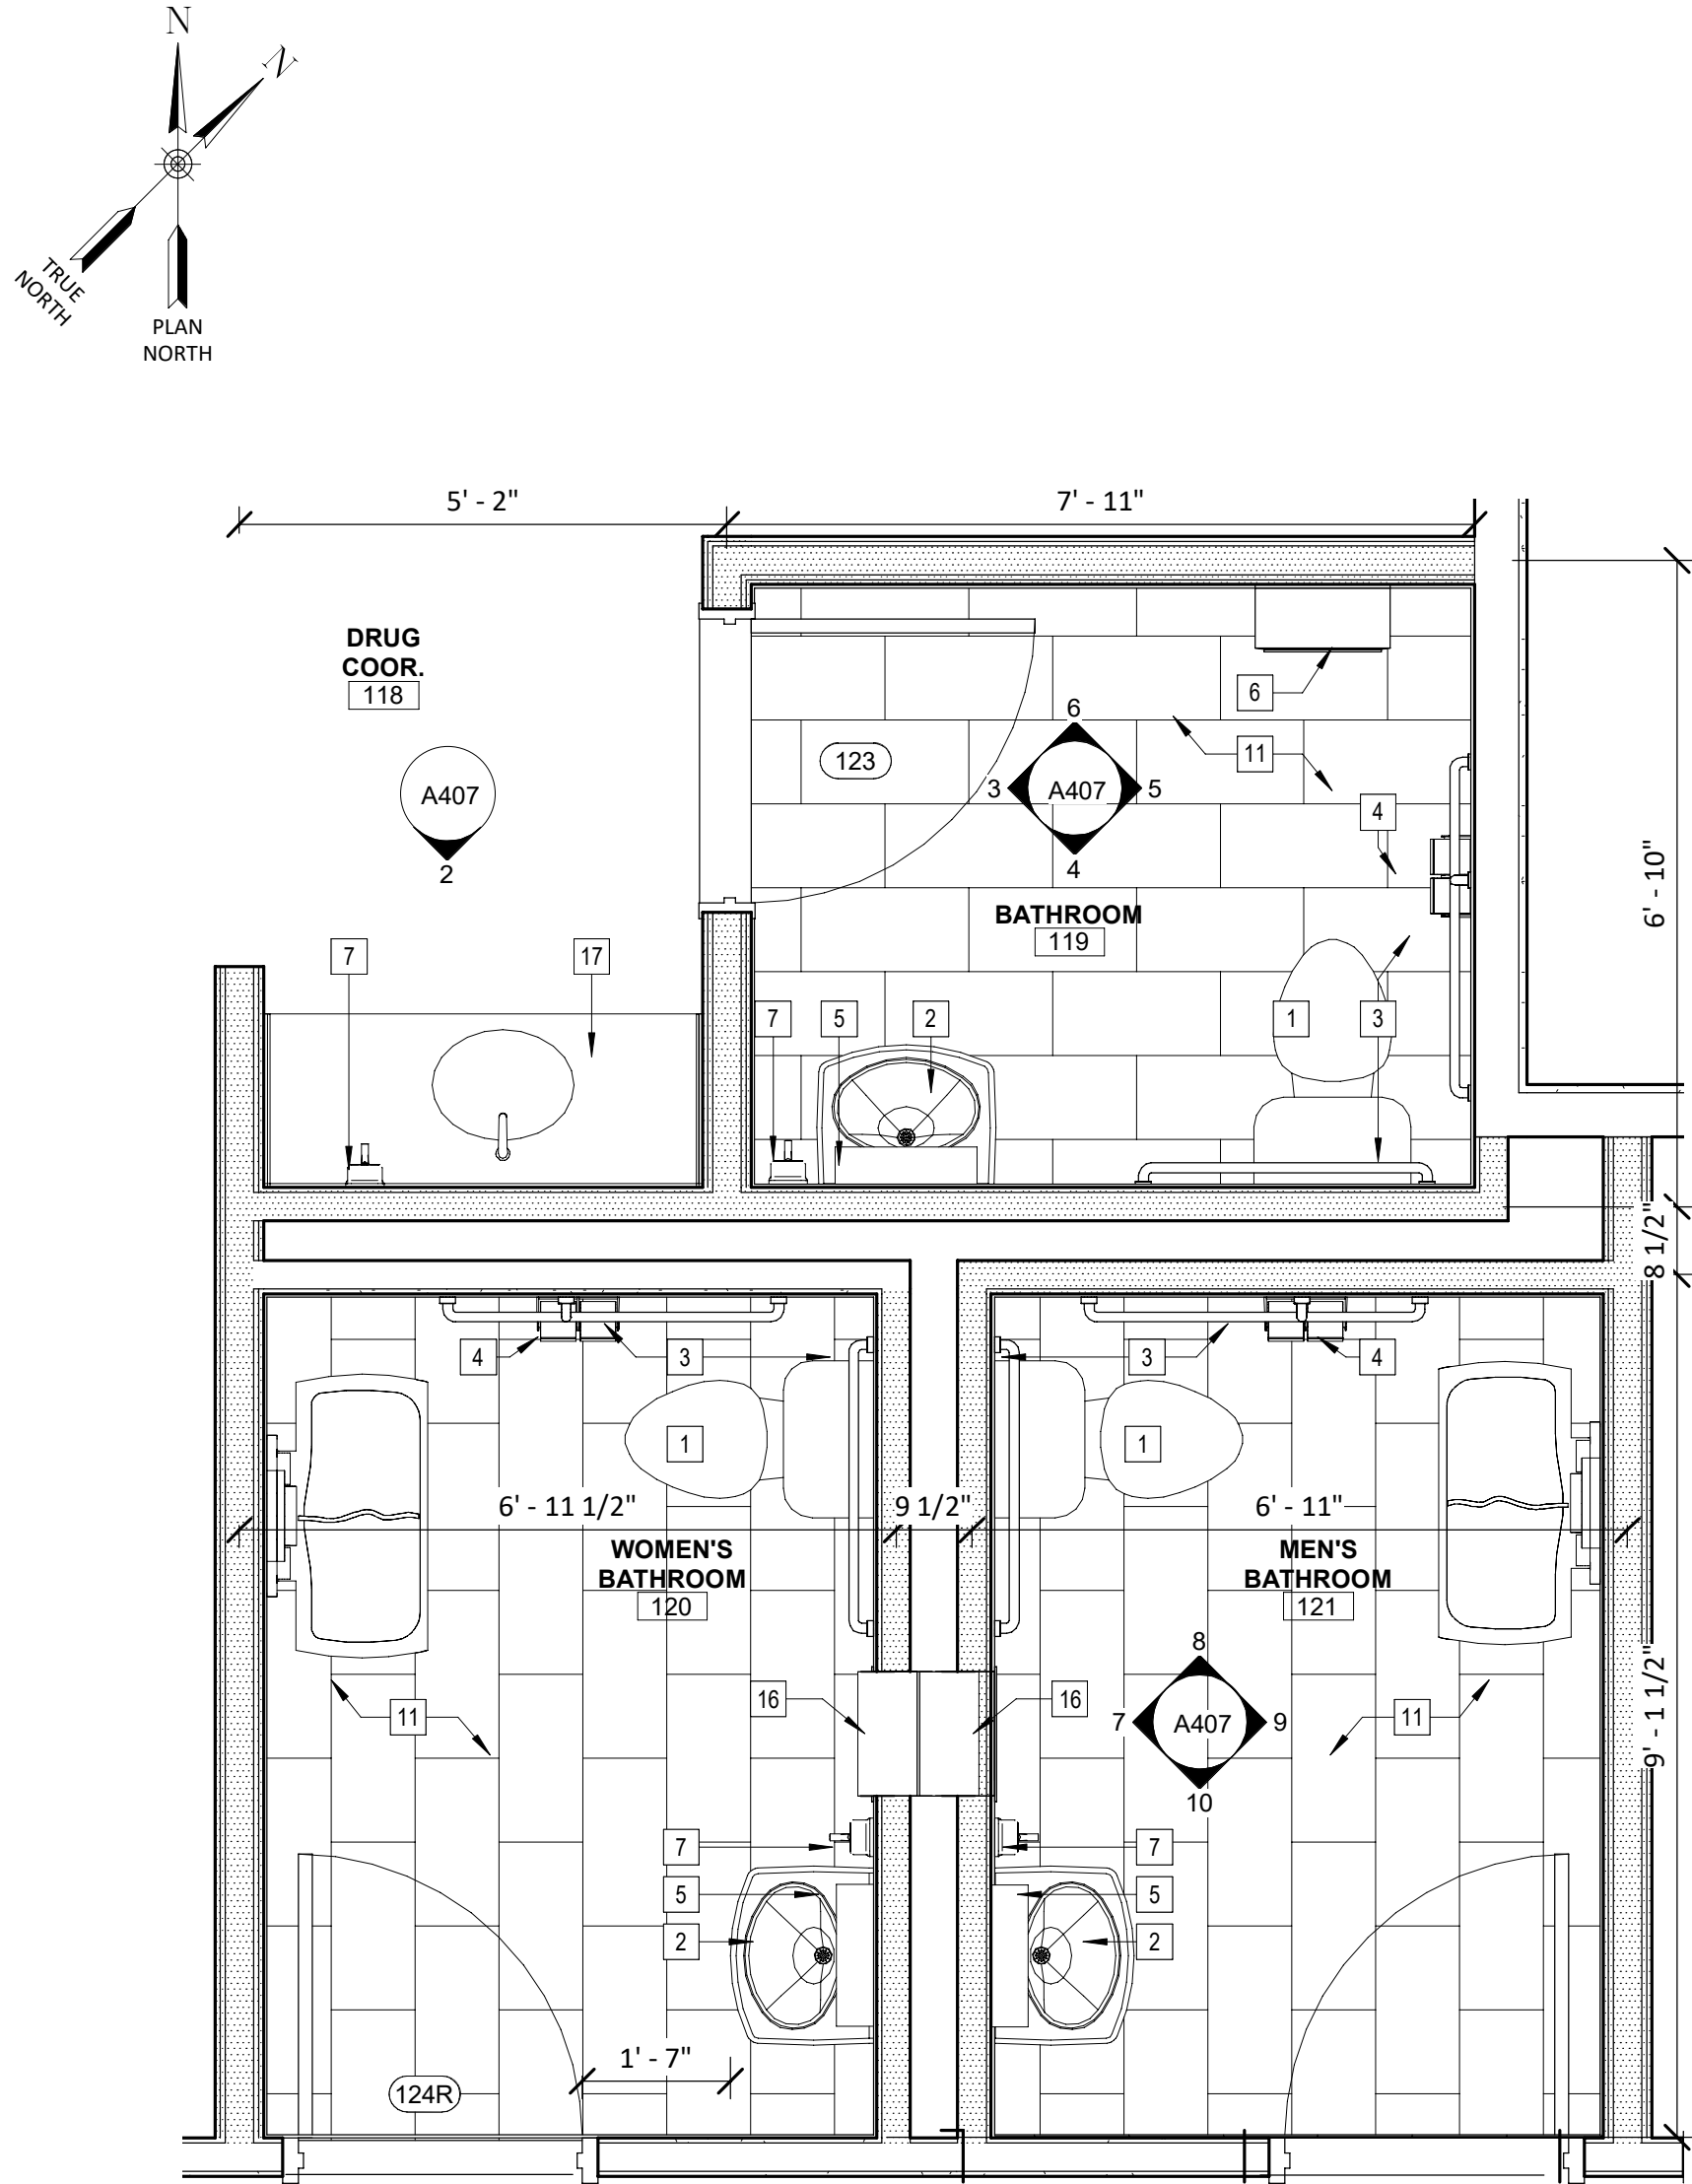


**8 BATH. 121 ELEVATION 2**  
A407 SCALE: 1/2" = 1'-0"

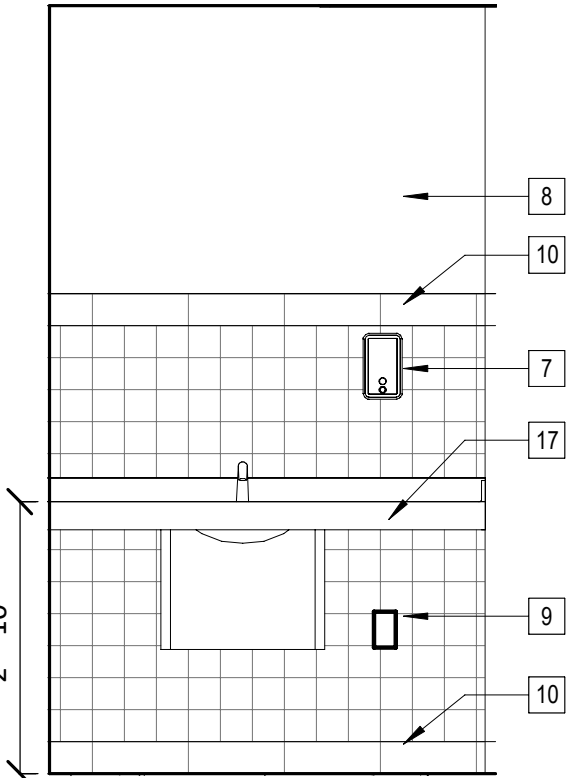


**2 DRUG COOR. ELEVATION**  
A407 SCALE: 1/2" = 1'-0"

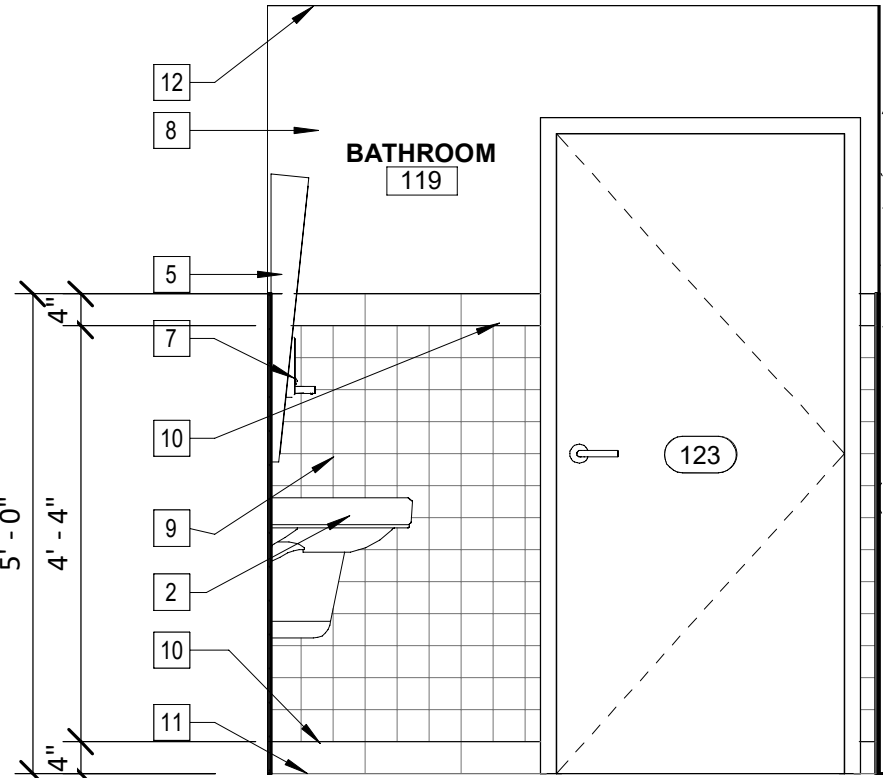


**3 BATH. 119 ELEVATION 1**  
A407 SCALE: 1/2" = 1'-0"

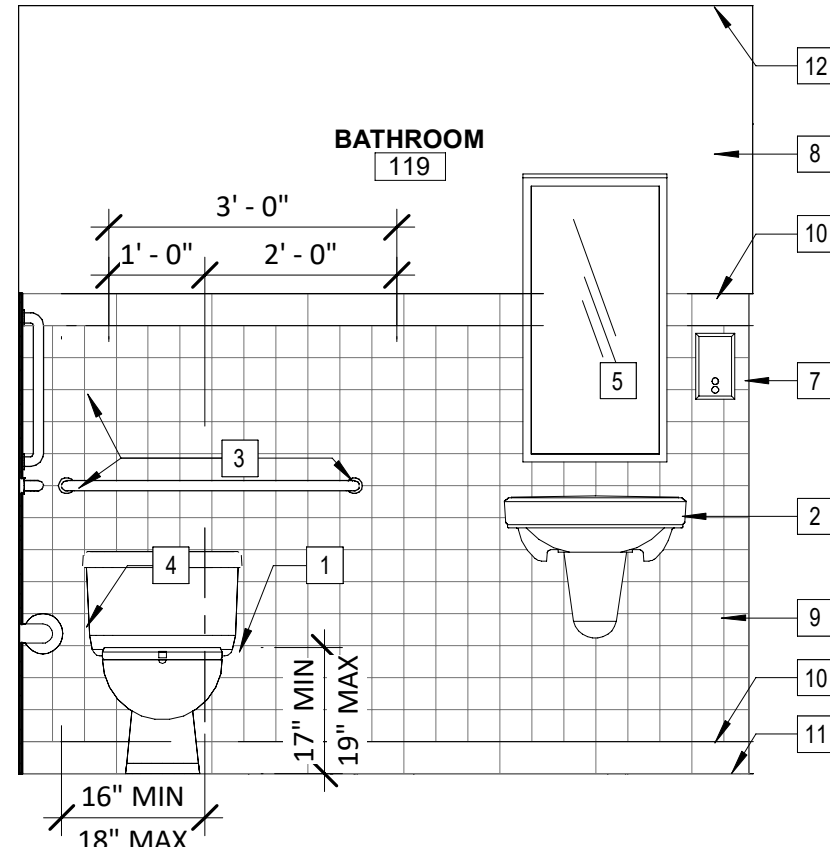


**4 BATH. 119 ELEVATION 2**  
A407 SCALE: 1/2" = 1'-0"

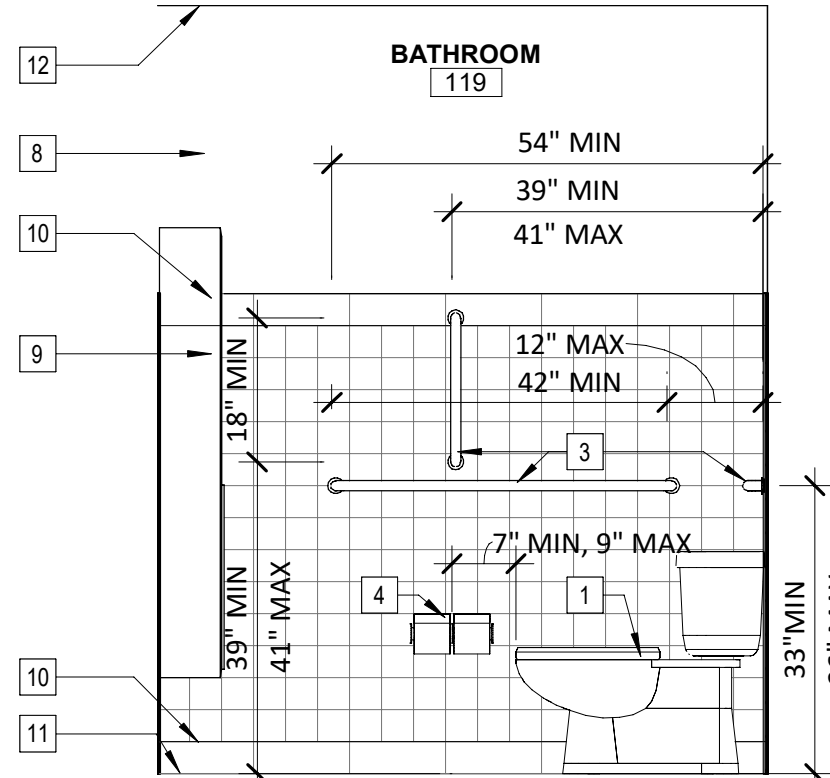


**5 BATH. 119 ELEVATION 3**  
A407 SCALE: 1/2" = 1'-0"

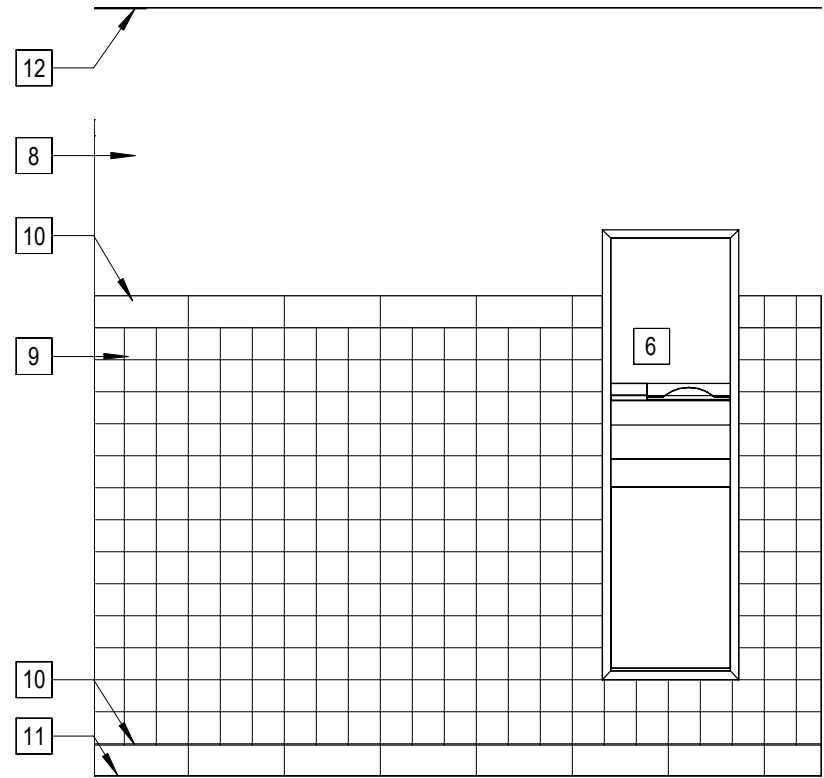


**6 BATH. 119 ELEVATION 4**  
A407 SCALE: 1/2" = 1'-0"

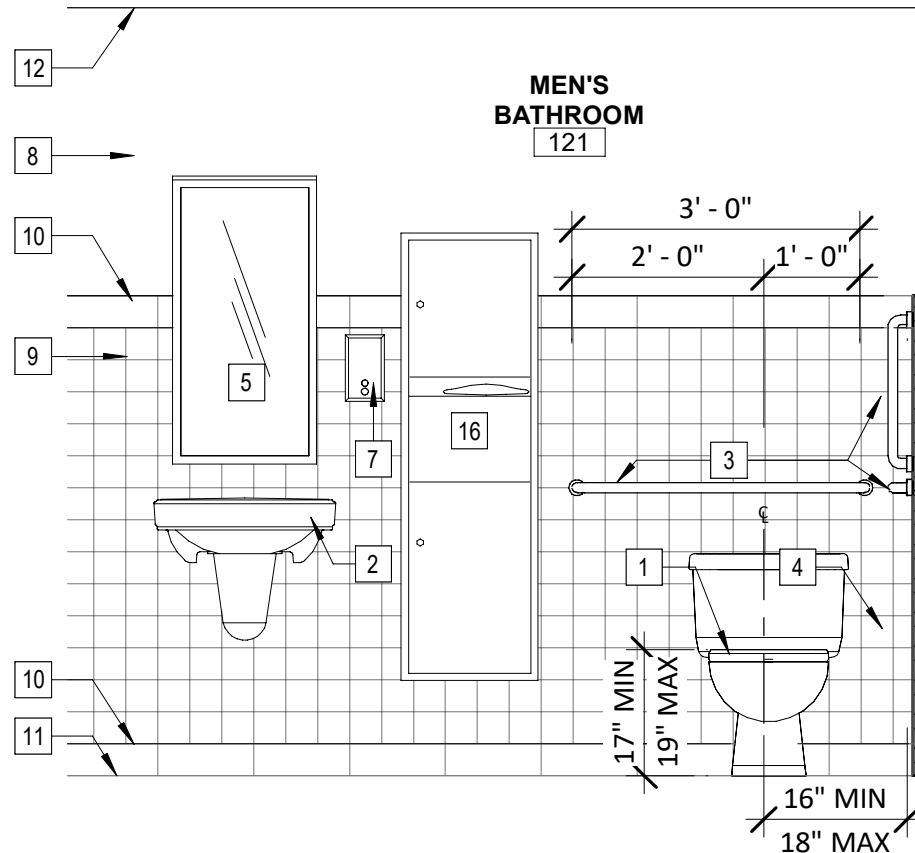

**7 BATH. 121 ELEVATION 1**  
A407 SCALE: 1/2" = 1'-0"

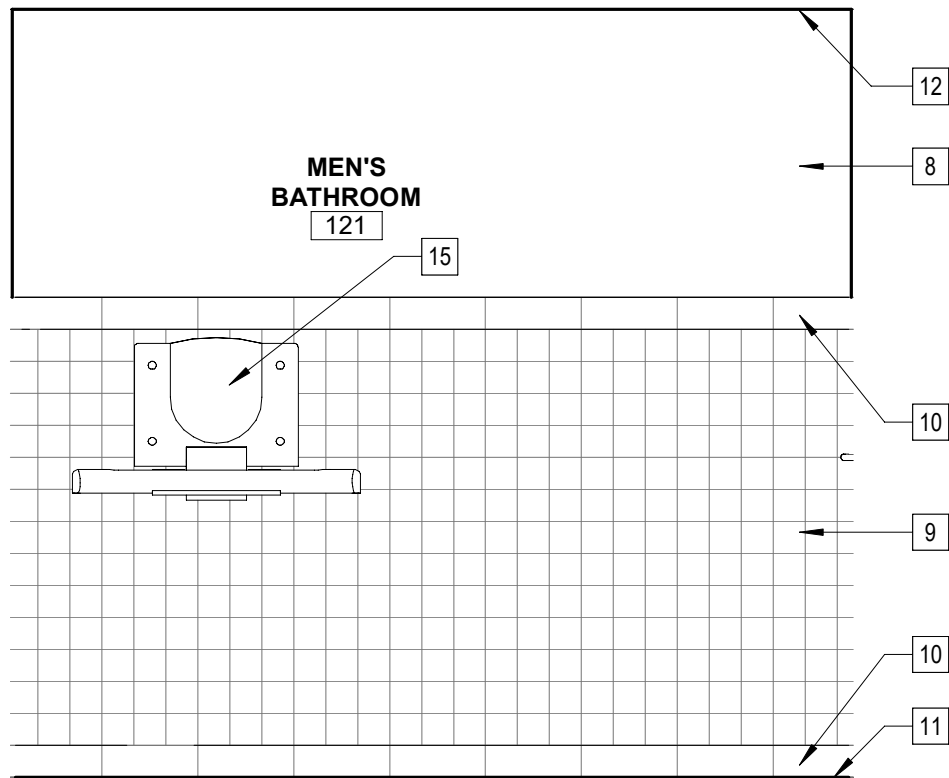

**9 BATH. 121 ELEVATION 3**  
A407 SCALE: 1/2" = 1'-0"

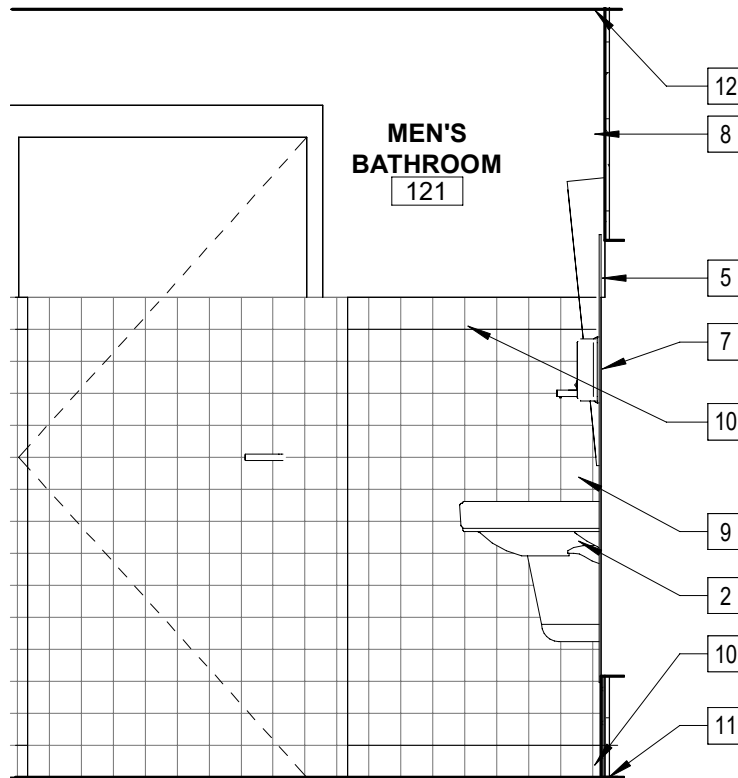

**10 BATH. 121 ELEVATION 4**  
A407 SCALE: 1/2" = 1'-0"

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FIRST FLOOR ENLARGED BATHROOM PLANS AND  
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**Barton & Loguidice**  
443 Electronics Parkway  
Liverpool, NY 13088

NYS CERTIFICATE #  
0021642, 0020588, 0019903,  
0019905, 0020336



NYS EXP.:

Date  
AUGUST, 2024

Scale  
AS SHOWN

Sheet Number  
A407

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- 8 12" X 24" PORCELAIN TILE FLOOR, COLOR TO BE SELECTED BY OWNER.

2ND FLOOR COURTROOM ENLARGEMENT PLAN

SCALE: 1/2" = 1'-0"

LEGEND

- 101 DOOR TAG
- 1 PARTITION TAG


1 HOUR RATED WALL CONSTRUCTION - FIRE BARRIER (SEE WALL LEGENDS FOR WALL CONSTRUCTION AND UL ASSEMBLY INFORMATION)

DIMENSIONS TO EXISTING WALLS IS TO FACE OF WALL, DIMENSIONS TO NEW WORK IS TO FACE OF STUD

DIMENSIONS TO MILLWORK IF NOT NOTED IS TO FACE OF WALL, SEE MILLWORK ENLARGEMENT PLANS AND DETAILS FOR ADDITIONAL DETAILING AND TO LAYOUT MILLWORK AND MILLWORK SUPPORTS

DIMENSIONS TO FURNITURE IS TO EDGE OF TABLE, CHAIR, ETC.

FURNITURE UNLESS NOTED IS NOT IN CONTRACT.

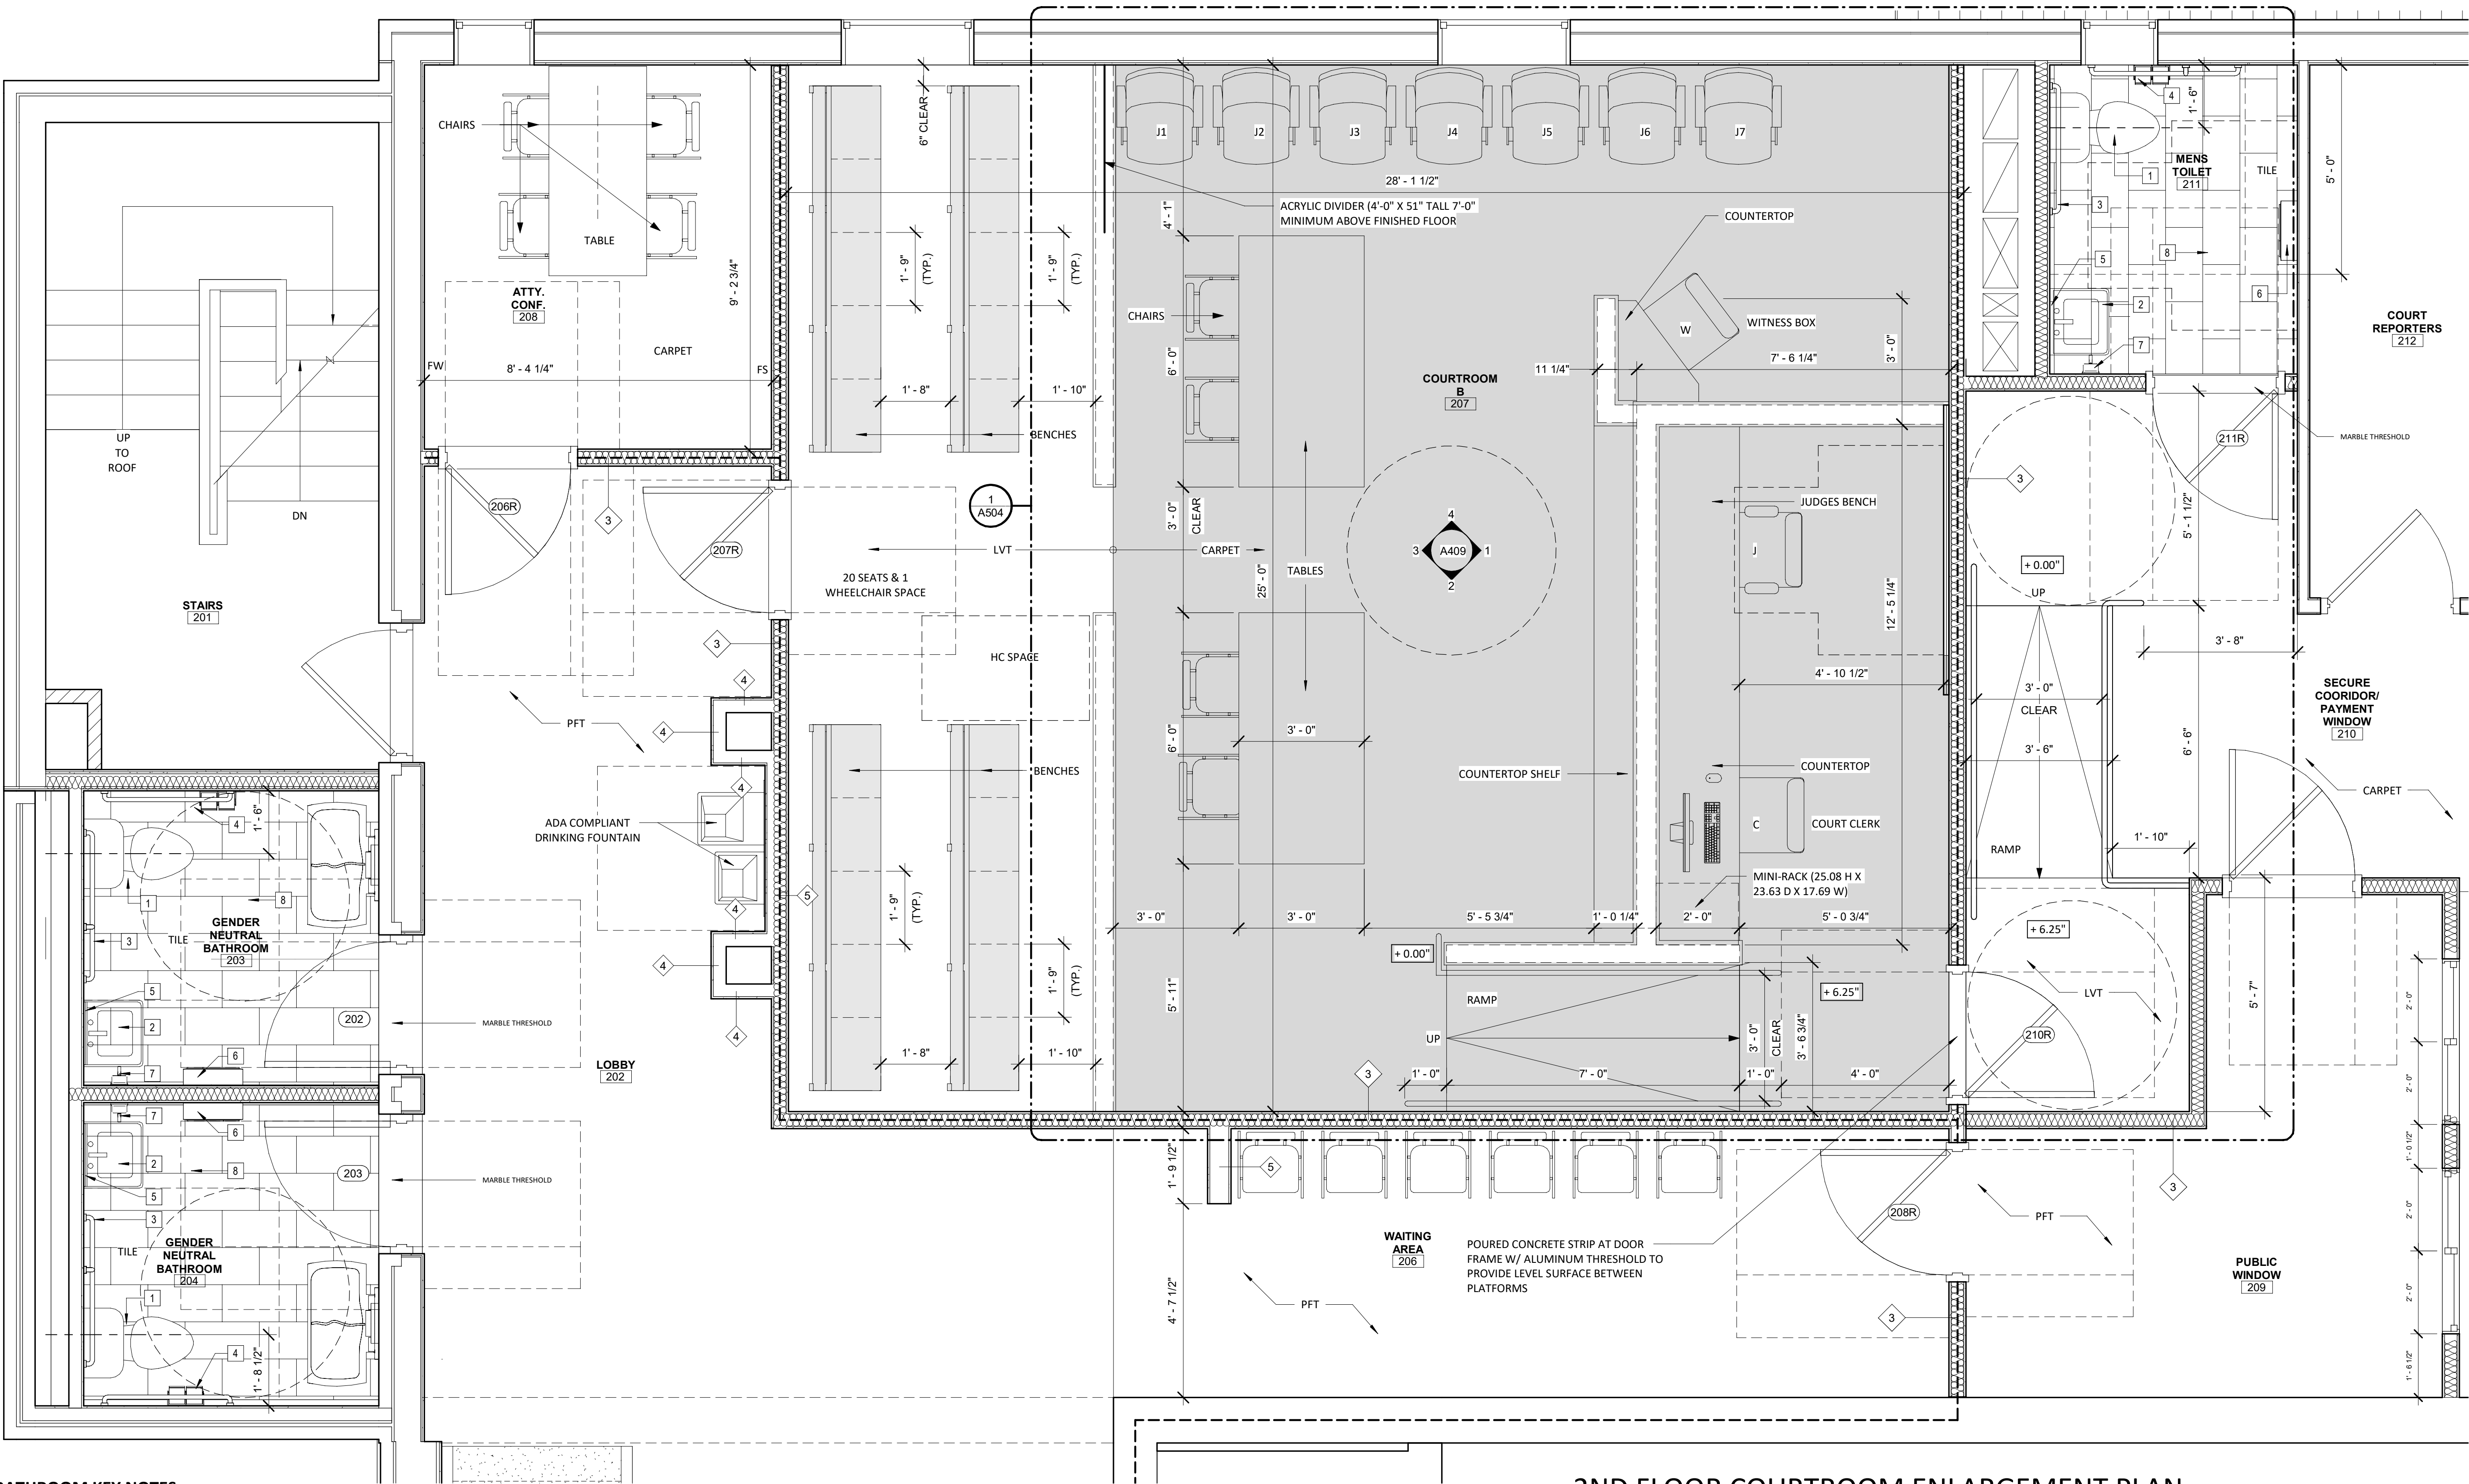

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REVISIONS

CITY OF MIDDLETOWN  
NEW COURTHOUSE FACILITY

**SECOND FLOOR COURTROOM ENLARGEMENT PLAN**

CITY OF MIDDLETOWN  
ORANGE COUNTY, NEW YORK

**Barton & Loguidice**  
443 Electronics Parkway  
Liverpool, NY 13088

NYS CERTIFICATE #  
0021642, 0020588, 0019903,  
0019905, 0020336



NYS EXP.:

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Scale  
AS SHOWN

Sheet Number  
A408


Project Number  
1753.008.001





- 1 WOOD OR METAL DOOR WITH HOLLOW METAL FRAME, W/ OR W/O LITE (HALF) AND ADA COMPLIANT HARDWARE - 60 MINUTE RATED DOOR & FRAME, SEE DOOR SCHEDULE.
- 2 WALL MOUNTED FLAG POLES, BRACKETS AND FLAGS TO BE PROVIDED BY OWNER AND INSTALLED BY CONTRACTOR.
- 3 SOLID SURFACE CAPS/COUNTERTOPS.
- 4 4A. JUDGES BENCH, 4B. CLERKS AREA 4C. WITNESS BOX, 4D. JURY BOX, AND 4E. GALLERY SEPARATION WALLS WOOD VENEER.
- 5 SHEETROCKED SOFFIT OR HANGING SHEETROCKED CEILING.
- 6 ACOUSTICAL CEILING GRID SYSTEM.
- 7 WOOD PANELING BEHIND JUDGE AND WITNESS BOXES.
- 8 6" TALL - 3/4" WOOD TRIM BASE
- 9 NEW YORK STATE COURT SYSTEM SEAL (LIGHT WEIGHT) TO BE PROVIDED BY OWNER AND MOUNTED/INSTALLED WITH VELCRO OR PICTURE HOOKS ON WOOD PANELING BY CONTRACTOR, CENTER ON JUDGE'S BENCH.
- 10 TYPICAL 4" HIGH CAST BRONZE LETTERING (FINISH TO BE SELECTED BY OWNER) MOUNTED ON THE WOOD PANELING AT THE BACK OF THE JUDGE'S BENCH, CENTER ON JUDGES BENCH.
- 11 PAINTED GYPSUM WALL BOARD WALLS.
- 12 CARPET TILE/CARPETING FLOORING IN COURTROOM AREA, STEPS AND RAMPS. LUXURY VINYL TILE IN GALLERY AREA, ATTORNEY CONFERENCE ROOMS AND VESTIBULE.
- 13 ADA COMPLIANT ALUMINUM HANDRAIL.
- 14 JURY SWINGING GATE DOOR.
- 15 GALLERY WOOD BENCHES.


- 16 TABLES AND CHAIRS. (SOME ELEVATIONS CHAIRS AND TABLES HAVE BEEN REMOVED FOR DETAILING CLARITY).
- 17 ACOUSTICAL FABRIC WALL PANELS, PANELS BUTTED TOGETHER, PANEL SIZES AS SHOWN ON ELEVATIONS.
- 18 WOOD CHAIR RAIL.
- 19 WALL SCENCE LIGHT FIXTURE.
- 20 WOOD PANEL JOINTS/TRIM. PROVIDE EQUAL DISTANCE BETWEEN JOINTS ALONG LENGTHS OF WALLS. (SEE MILLWORK DETAILS FOR TYPICAL DETAILING AT CORNERS/ENDS OF MILLWORK).
- 21 6" VINYL WALL BASE

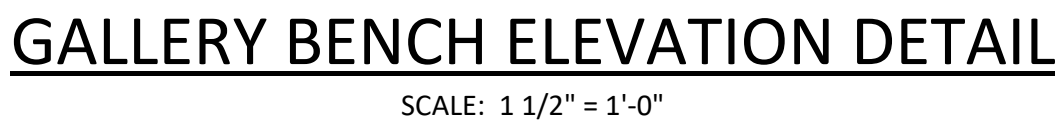

OFFICE OF THE COURT  
ADMINISTRATION (OCA) TO  
REVIEW AND APPROVE SHOP  
DRAWINGS PRIOR TO GALLERY  
BENCH PRODUCTION

PROVIDE FLAG POLE COMPONENTS AS AVAILABLE FROM EDER FLAG, OR APPROVED EQUAL, CONTRACTOR TO RECEIVE FINAL APPROVAL OF FLAG POLE COMPONENTS WITH OWNER

PROVIDE WOOD BLOCKING  
AS NEEDED TO SECURE  
FLAG MOUNTING  
BRACKETS INTO WALL


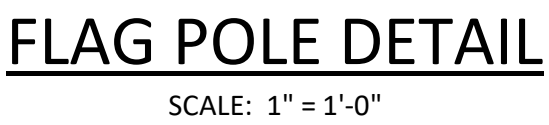


CITY OF MIDDLETOWN

Project Number  
1753 008 001



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In Charge of: TRB

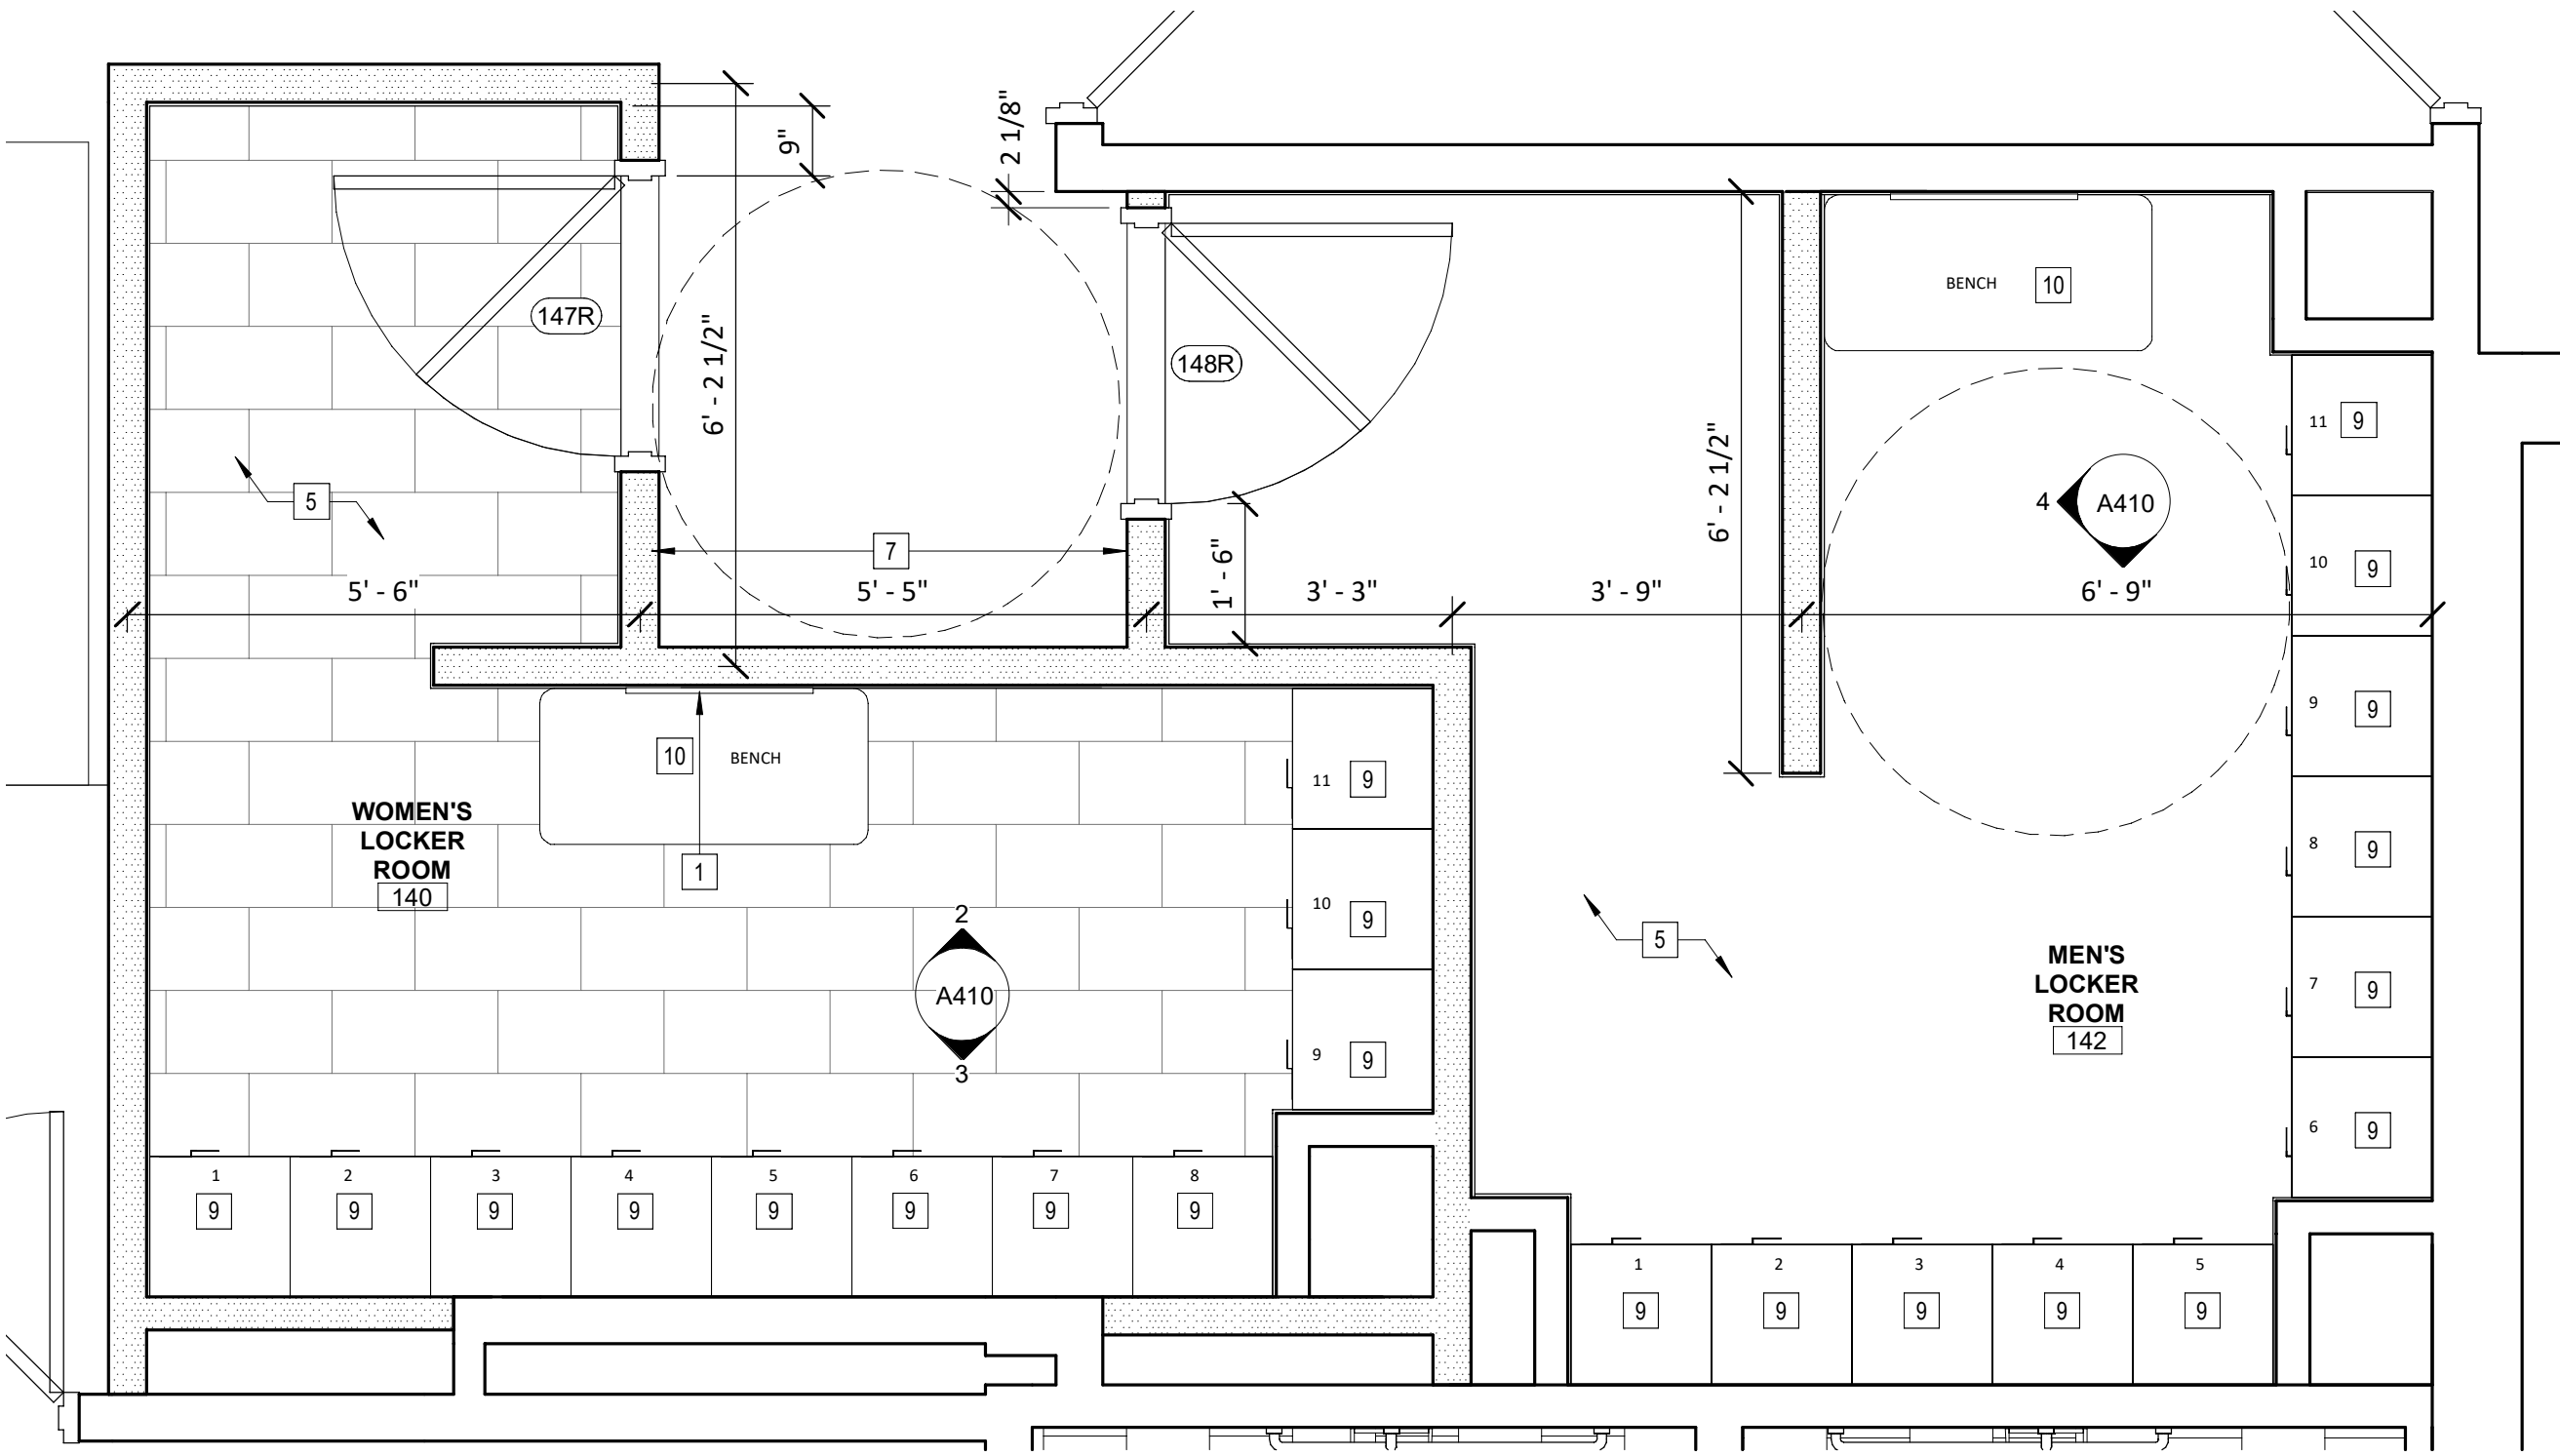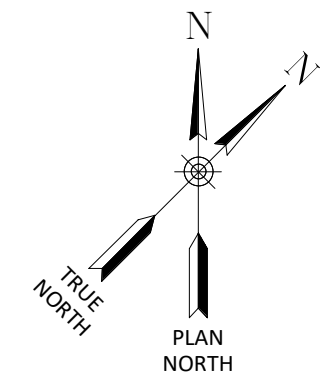


## LOCKER ROOM PLAN

SCALE: 1/2" = 1'-0"


### LOCKER ROOMS & PAYMENT WINDOW KEY NOTES

- 1 PROVIDE ADA COMPLIANT 24" W x 36" H MIRROR, WHICH SHALL BE MOUNTED WITH THE BOTTOM EDGE OF THE REFLECTING SURFACE NO HIGHER THAN 40" ABOVE THE FLOOR.
- 2 PRIME AND PAINTED GWB WALLS, COLOR TO BE SELECTED BY OWNER.
- 3 4" X 4" CERAMIC WALL TILE, COLOR TO BE SELECTED BY OWNER
- 4 4" X 12" CERAMIC WALL BULLNOSE & COVE BASE ON 2X4 P.T. WOOD PLATFORM W/ 1/2" PLYWOOD, COLOR TO BE SELECTED BY OWNER.
- 5 12" X 24" PORCELAIN TILE FLOOR, COLOR TO BE SELECTED BY OWNER.
- 6 24"X24" ACOUSTICAL CEILING TILES AND GRID SYSTEM.
- 7 PROVIDE ADA COMPLIANT TACTILE SIGNAGE (SYMBOL AT THE TOP, RAISED CHARACTERS AND BRAILLE AT THE BOTTOM) IN LOCATIONS SHOWN. BRAILLE SHALL BE 48 INCHES MINIMUM, AND 60 INCHES MAXIMUM ABOVE THE FLOOR, MEASURED TO THE BASELINE OF THE BRAILLE CELLS. SEE ADA COMPLIANT SIGNAGE DETAIL.
- 8 PROVIDE PLASTIC LAMINATE COUNTERTOP.
- 9 PROVIDE PERSONAL STORAGE LOCKER SYSTEM, SINGLE-DOOR LOCKERS 18"W X 21"D X 78" H W/ RECESSED HANDLES BY CORCRAFT PRODUCTS, OR APPROVED EQUAL. SEE SPECIFICATIONS FOR LOCKER SELECTION, COLOR TO BE SELECTED BY OWNER.
- 10 PROVIDE ADA COMPLIANT LOCKER BENCH. SEE PLAN FOR SIZES, COLOR TO BE SELECTED BY OWNER.
- 11 PROVIDE 36"W X 16"D X 28-1/2"H 2 DOOR & 2 DRAWER BASE CABINET (PLASTIC LAMINATE CASEWORK).
- 12 PROVIDE 24"W X 24"D X 28-1/2"H 2 DRAWER & 1 FILE DRAWER BASE CABINETS (PLASTIC LAMINATE CASEWORK).
- 13 PROVIDE 36"W X 12"D X 29"H MAILBOX (PLASTIC LAMINATE CASEWORK).
- 14 4" VINYL WALL BASE, COLOR TO BE SELECTED BY OWNER.
- 15 24" X 24" CARPET TILE FLOOR, COLOR TO BE SELECTED BY OWNER.

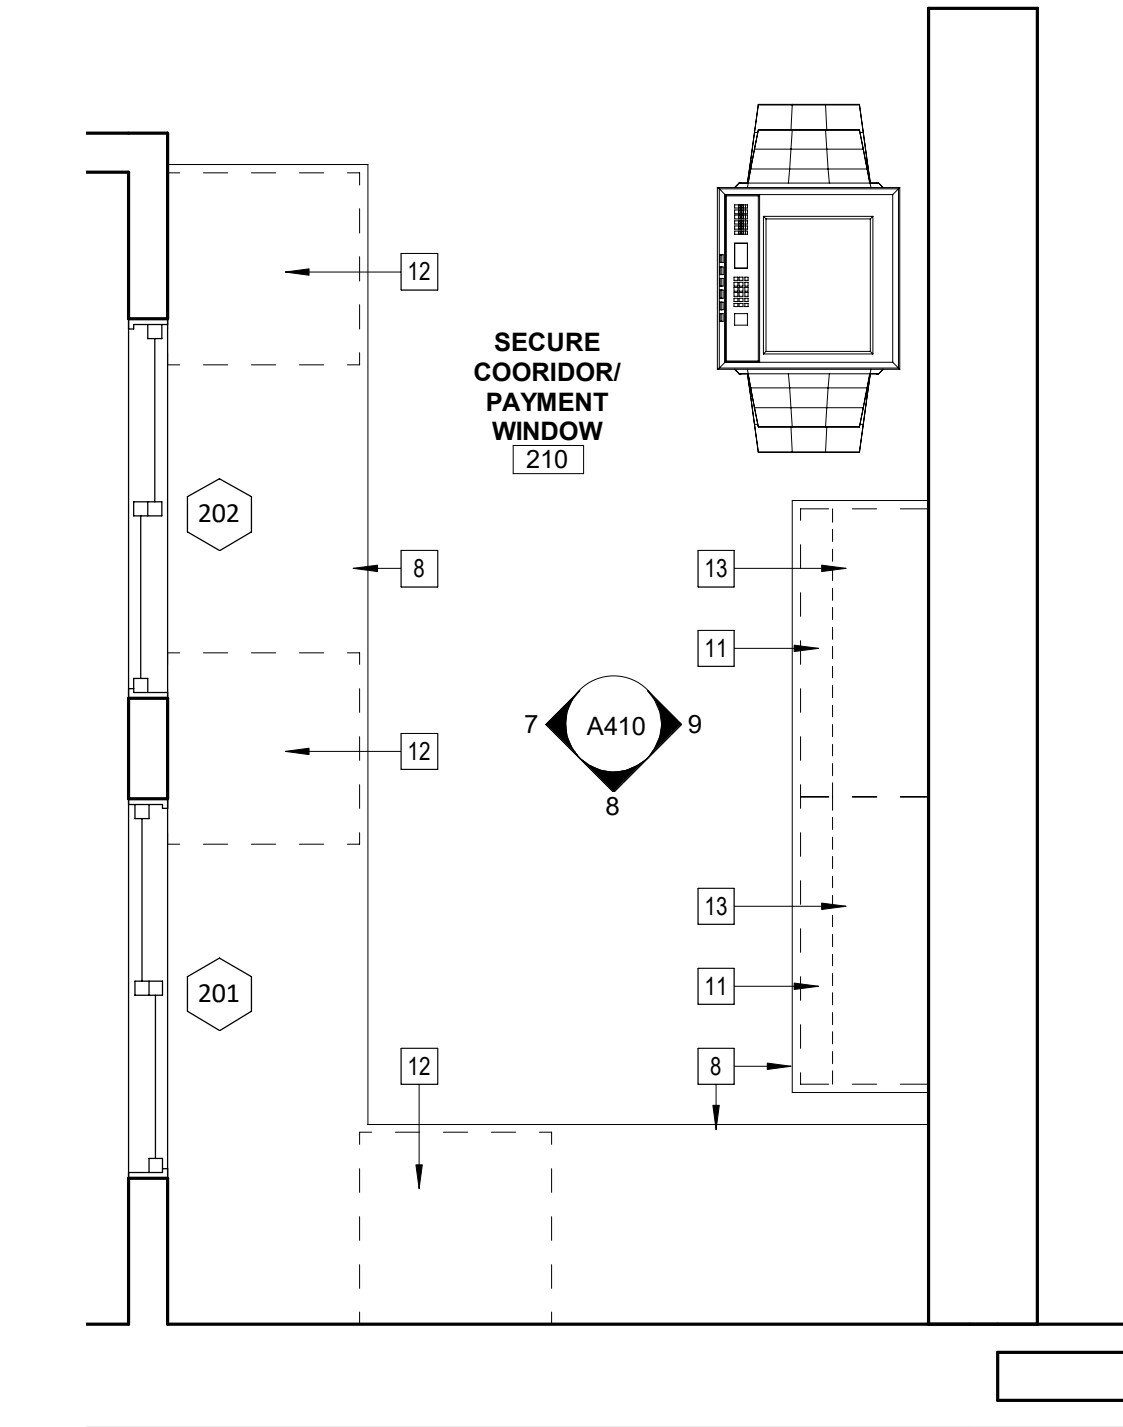


## 6 PAYMENT WINDOW ENLARGEMENT PLAN

A202 SCALE: 1/2" = 1'-0"

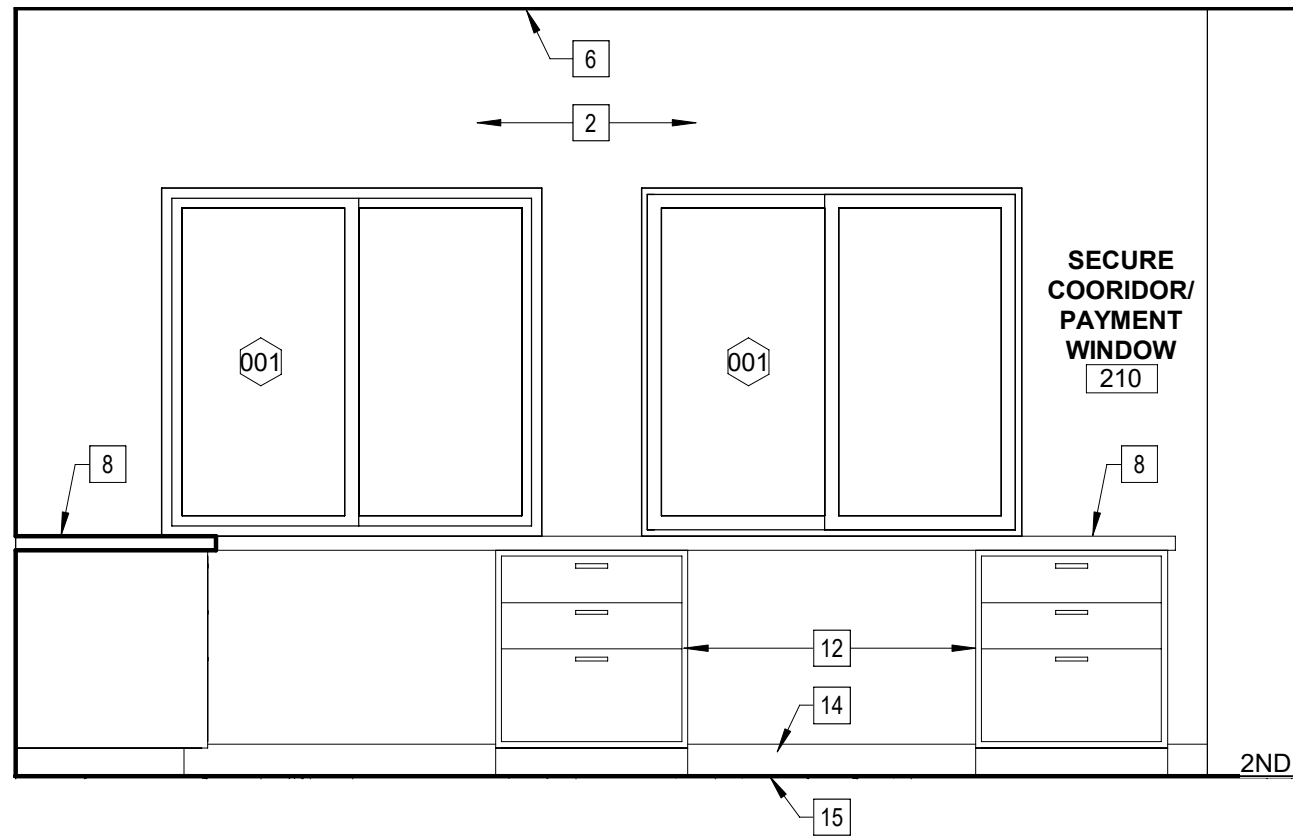


## 7 PAYMENT WINDOW ELEVATION 1

A403 SCALE: 1/2" = 1'-0"

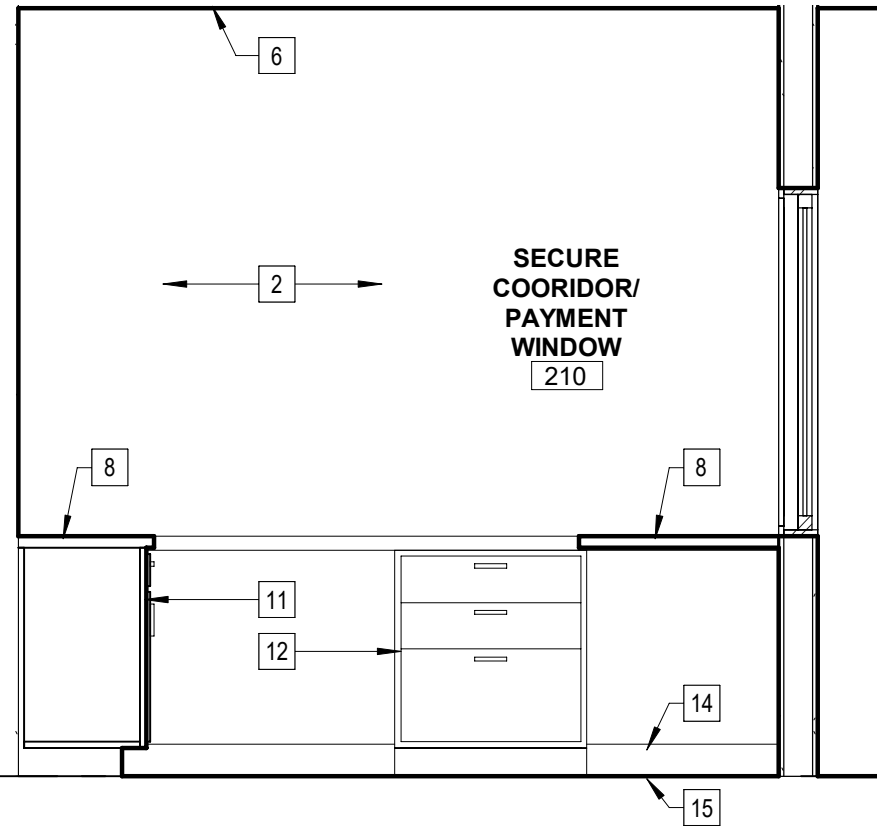


## 8 PAYMENT WINDOW ELEVATION 2

A408 SCALE: 1/2" = 1'-0"

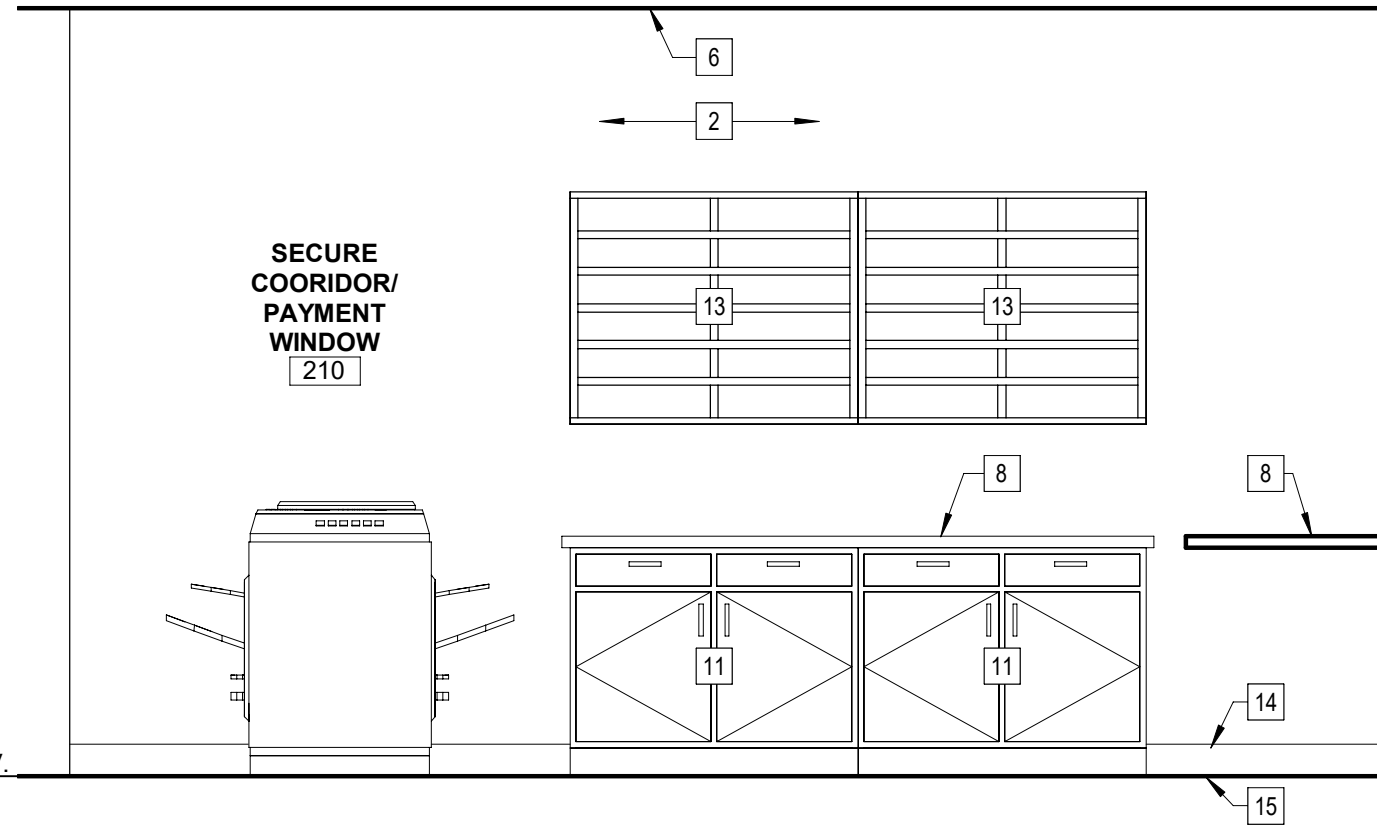


## 9 PAYMENT WINDOW ELEVATION 3

A403 SCALE: 1/2" = 1'-0"

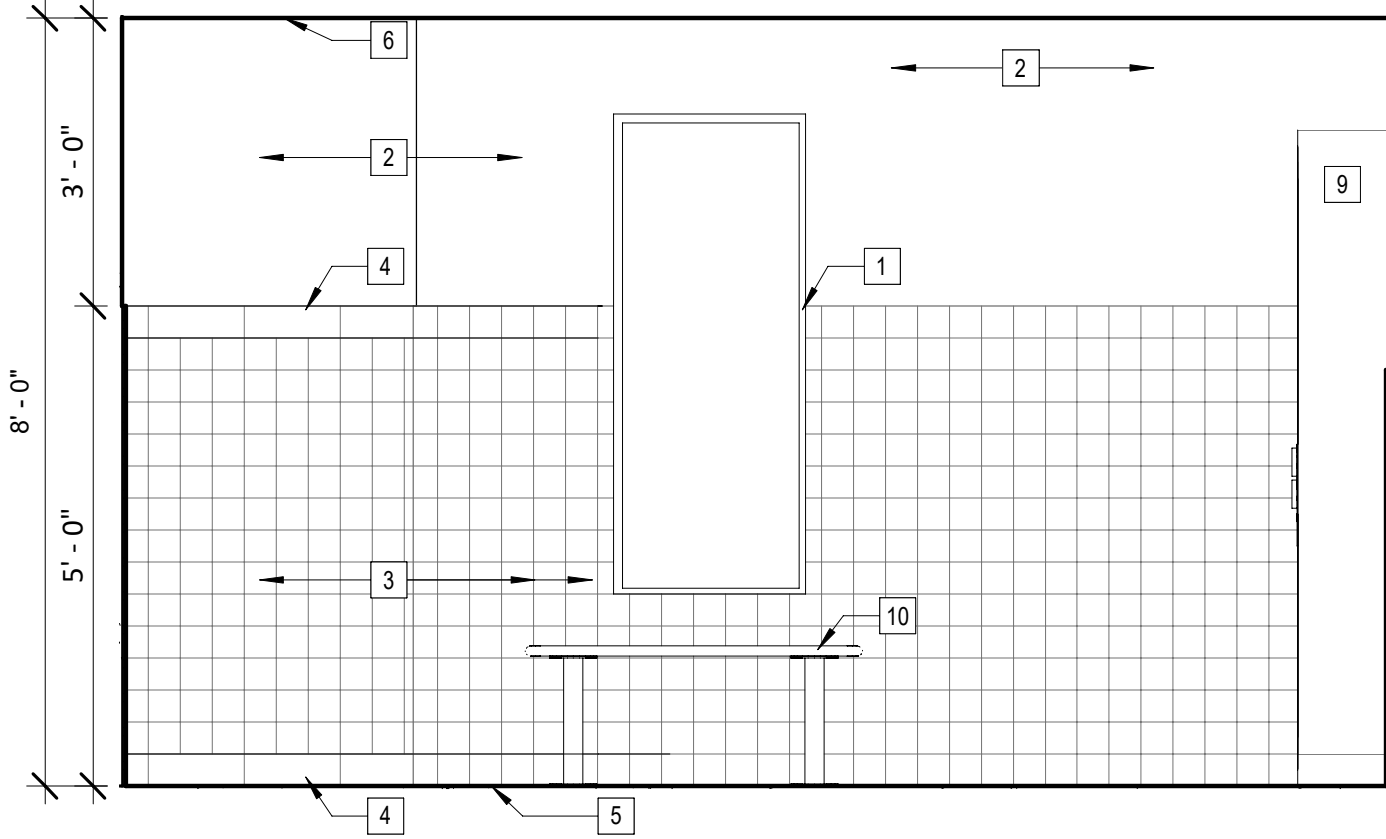


## 2 MEN'S LOCKER ROOM ELEVATION 1

A410 SCALE: 1/2" = 1'-0"

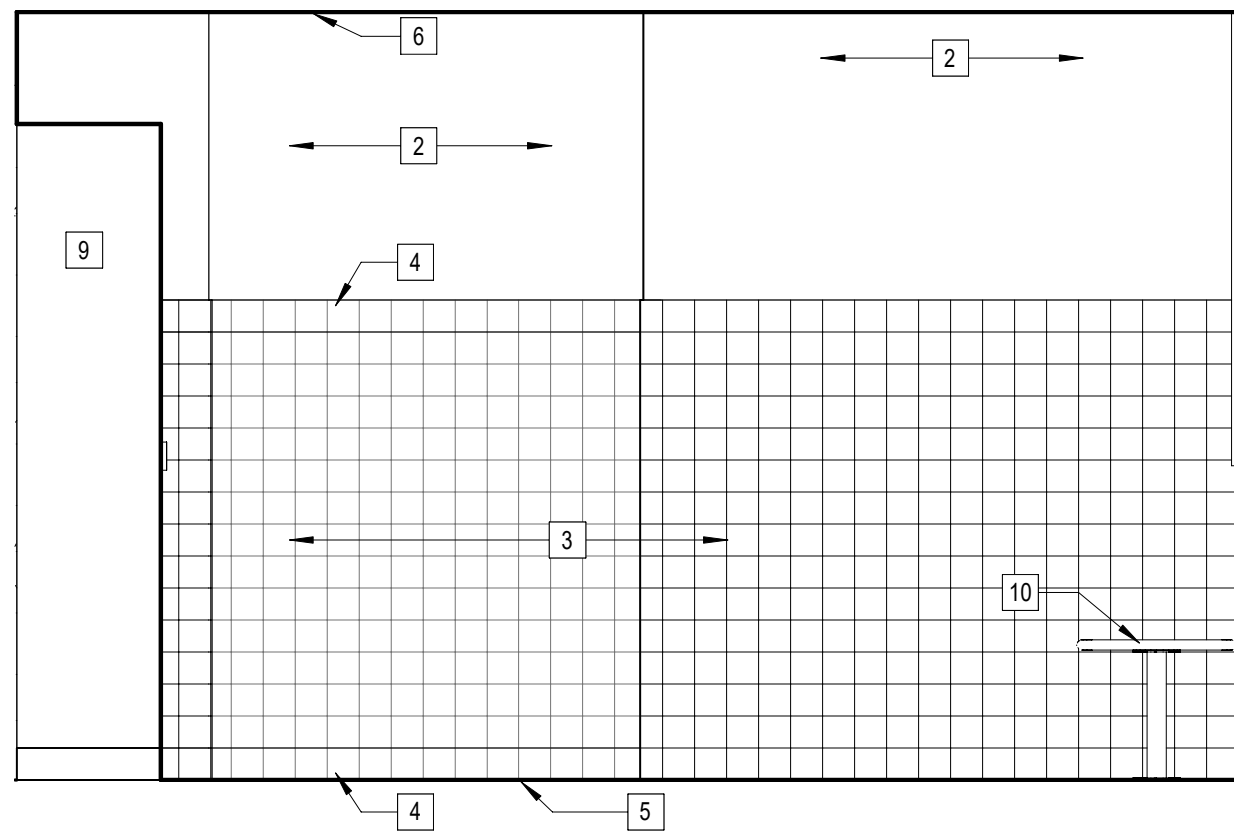


## 4 WOMEN'S LOCKER ROOM ELEVATION 1

A403 SCALE: 1/2" = 1'-0"

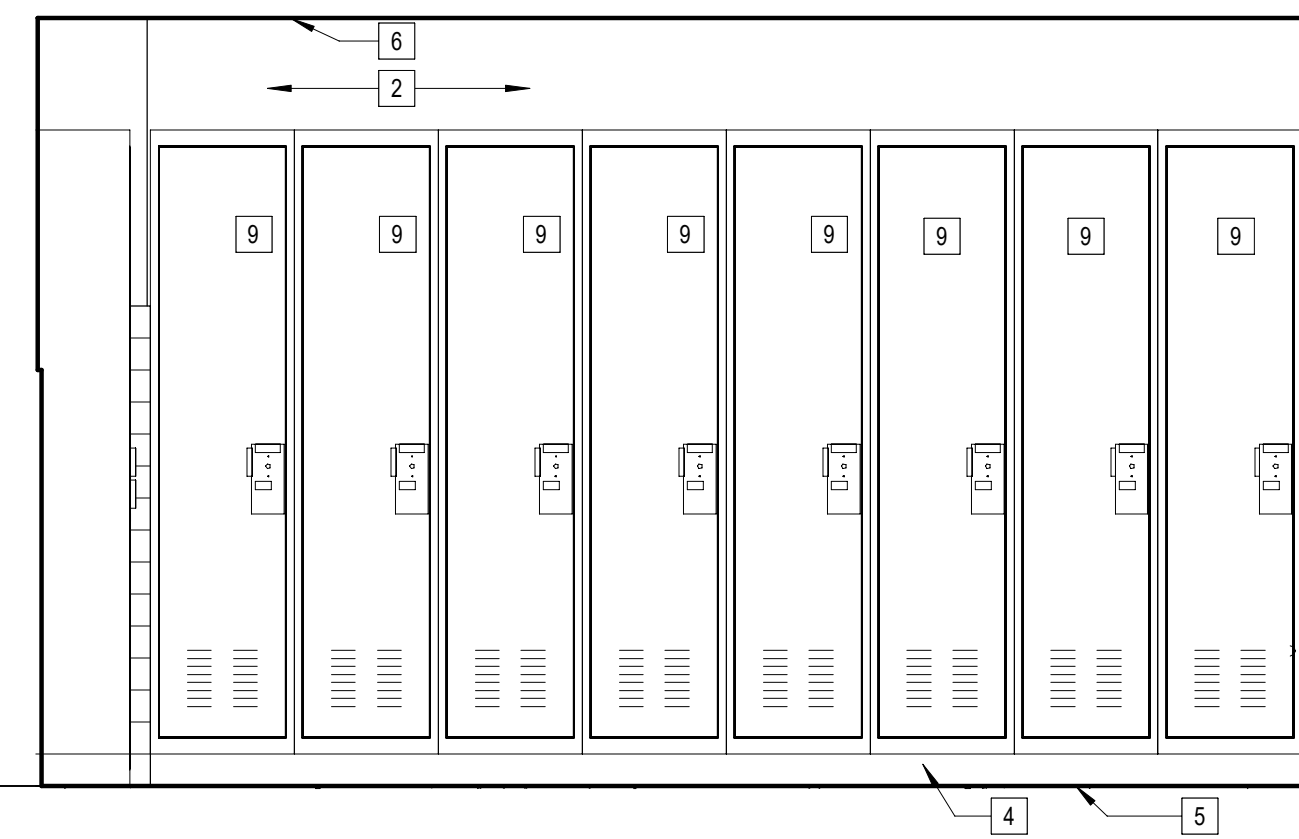

## 3 MEN'S LOCKER ROOM ELEVATION 2

A410 SCALE: 1/2" = 1'-0"

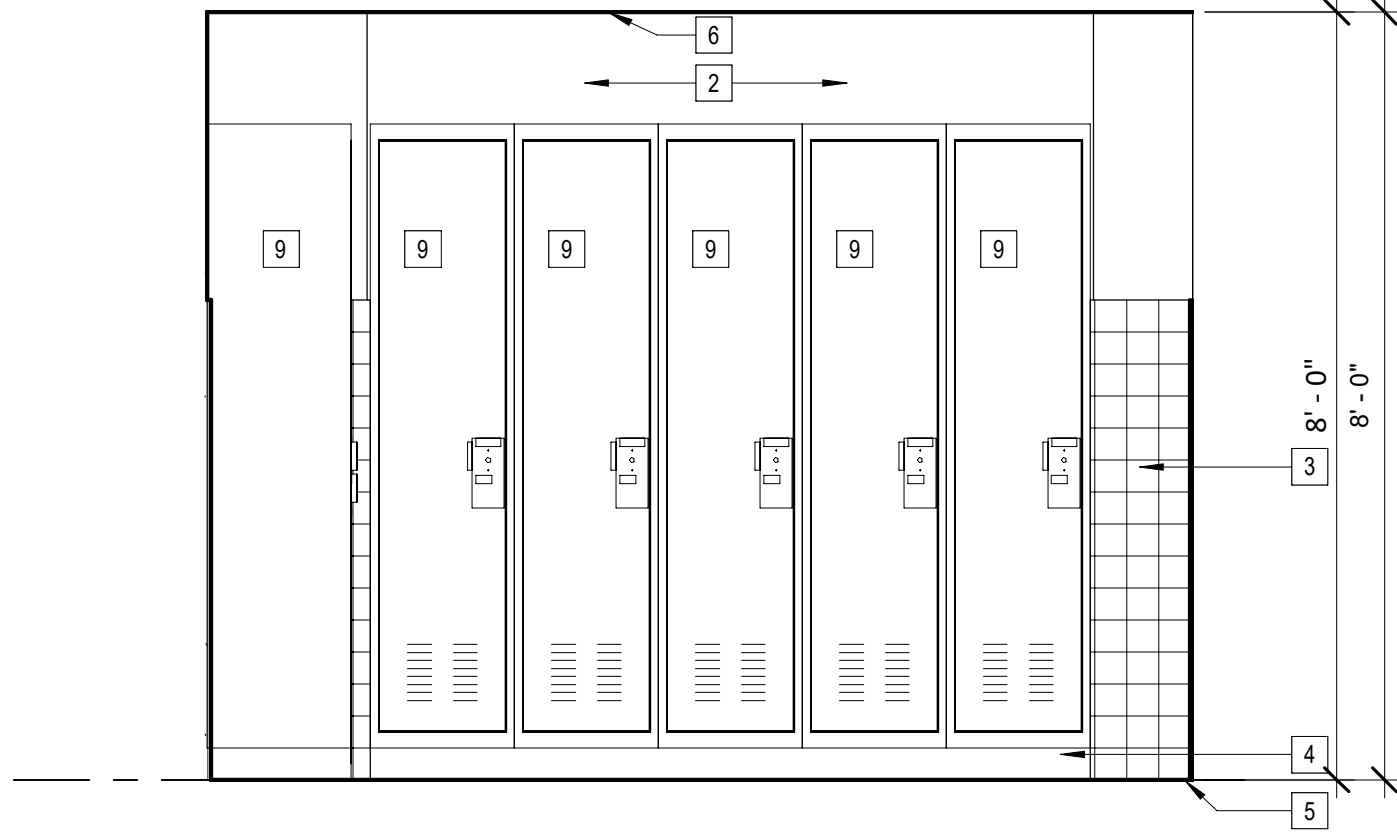

## 5 WOMEN'S LOCKER ROOM ELEVATION 2

A410 SCALE: 1/2" = 1'-0"

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### REVISIONS

CITY OF MIDDLETOWN  
NEW COURTHOUSE FACILITY  
ORANGE COUNTY, NEW YORK

## INTERIOR ELEVATIONS

CITY OF MIDDLETOWN  
NEW COURTHOUSE FACILITY

Barton & Loguidice  
443 Electronics Parkway  
Liverpool, NY 13088

NYS CERTIFICATE #  
0021642, 0020588, 0019903,  
0019905, 0020336

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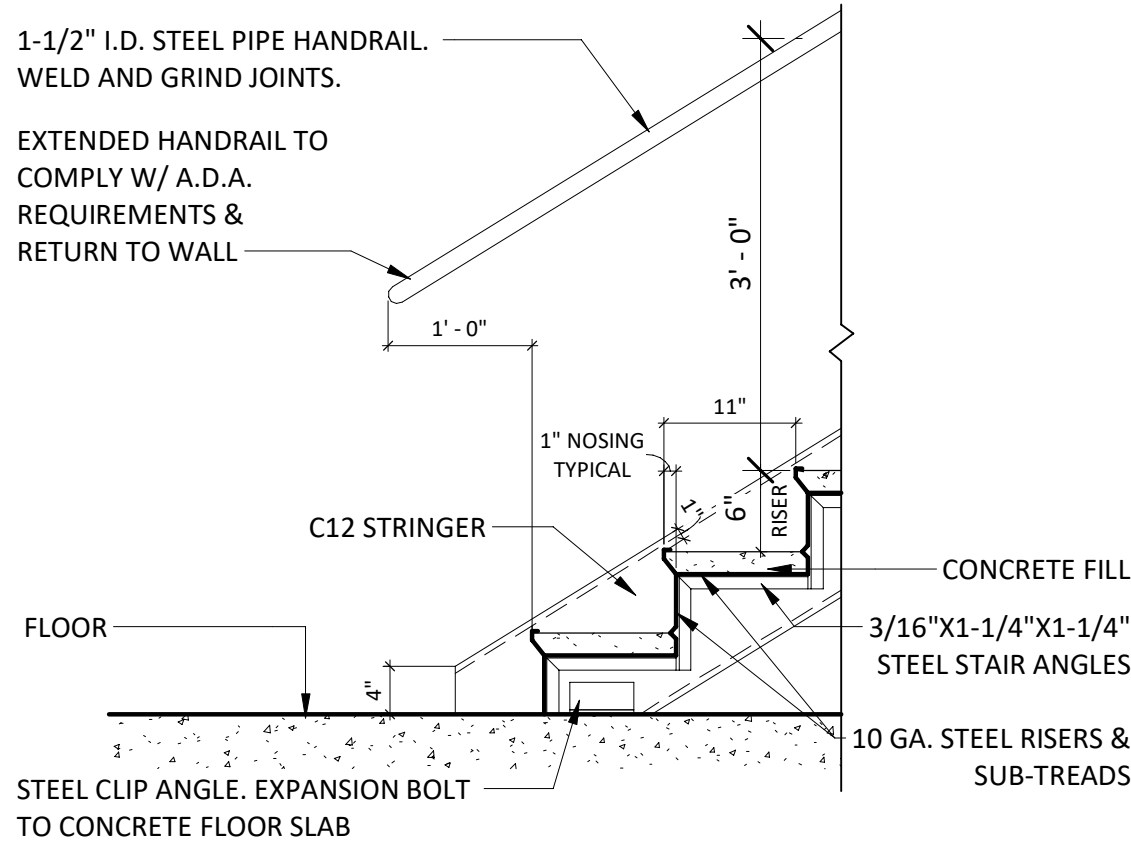
Project Number

1753.008.001




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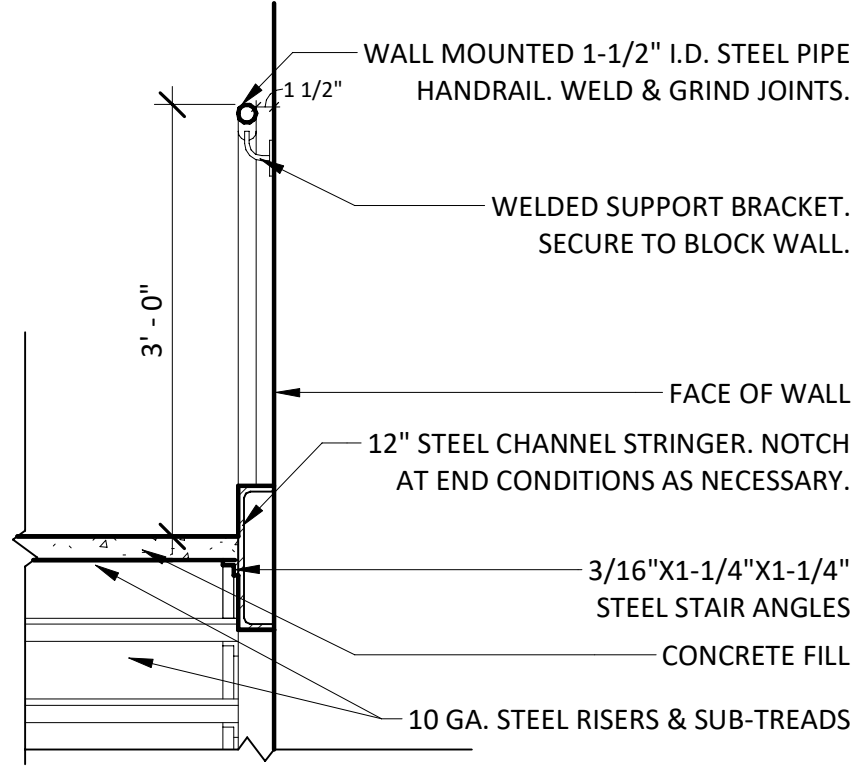
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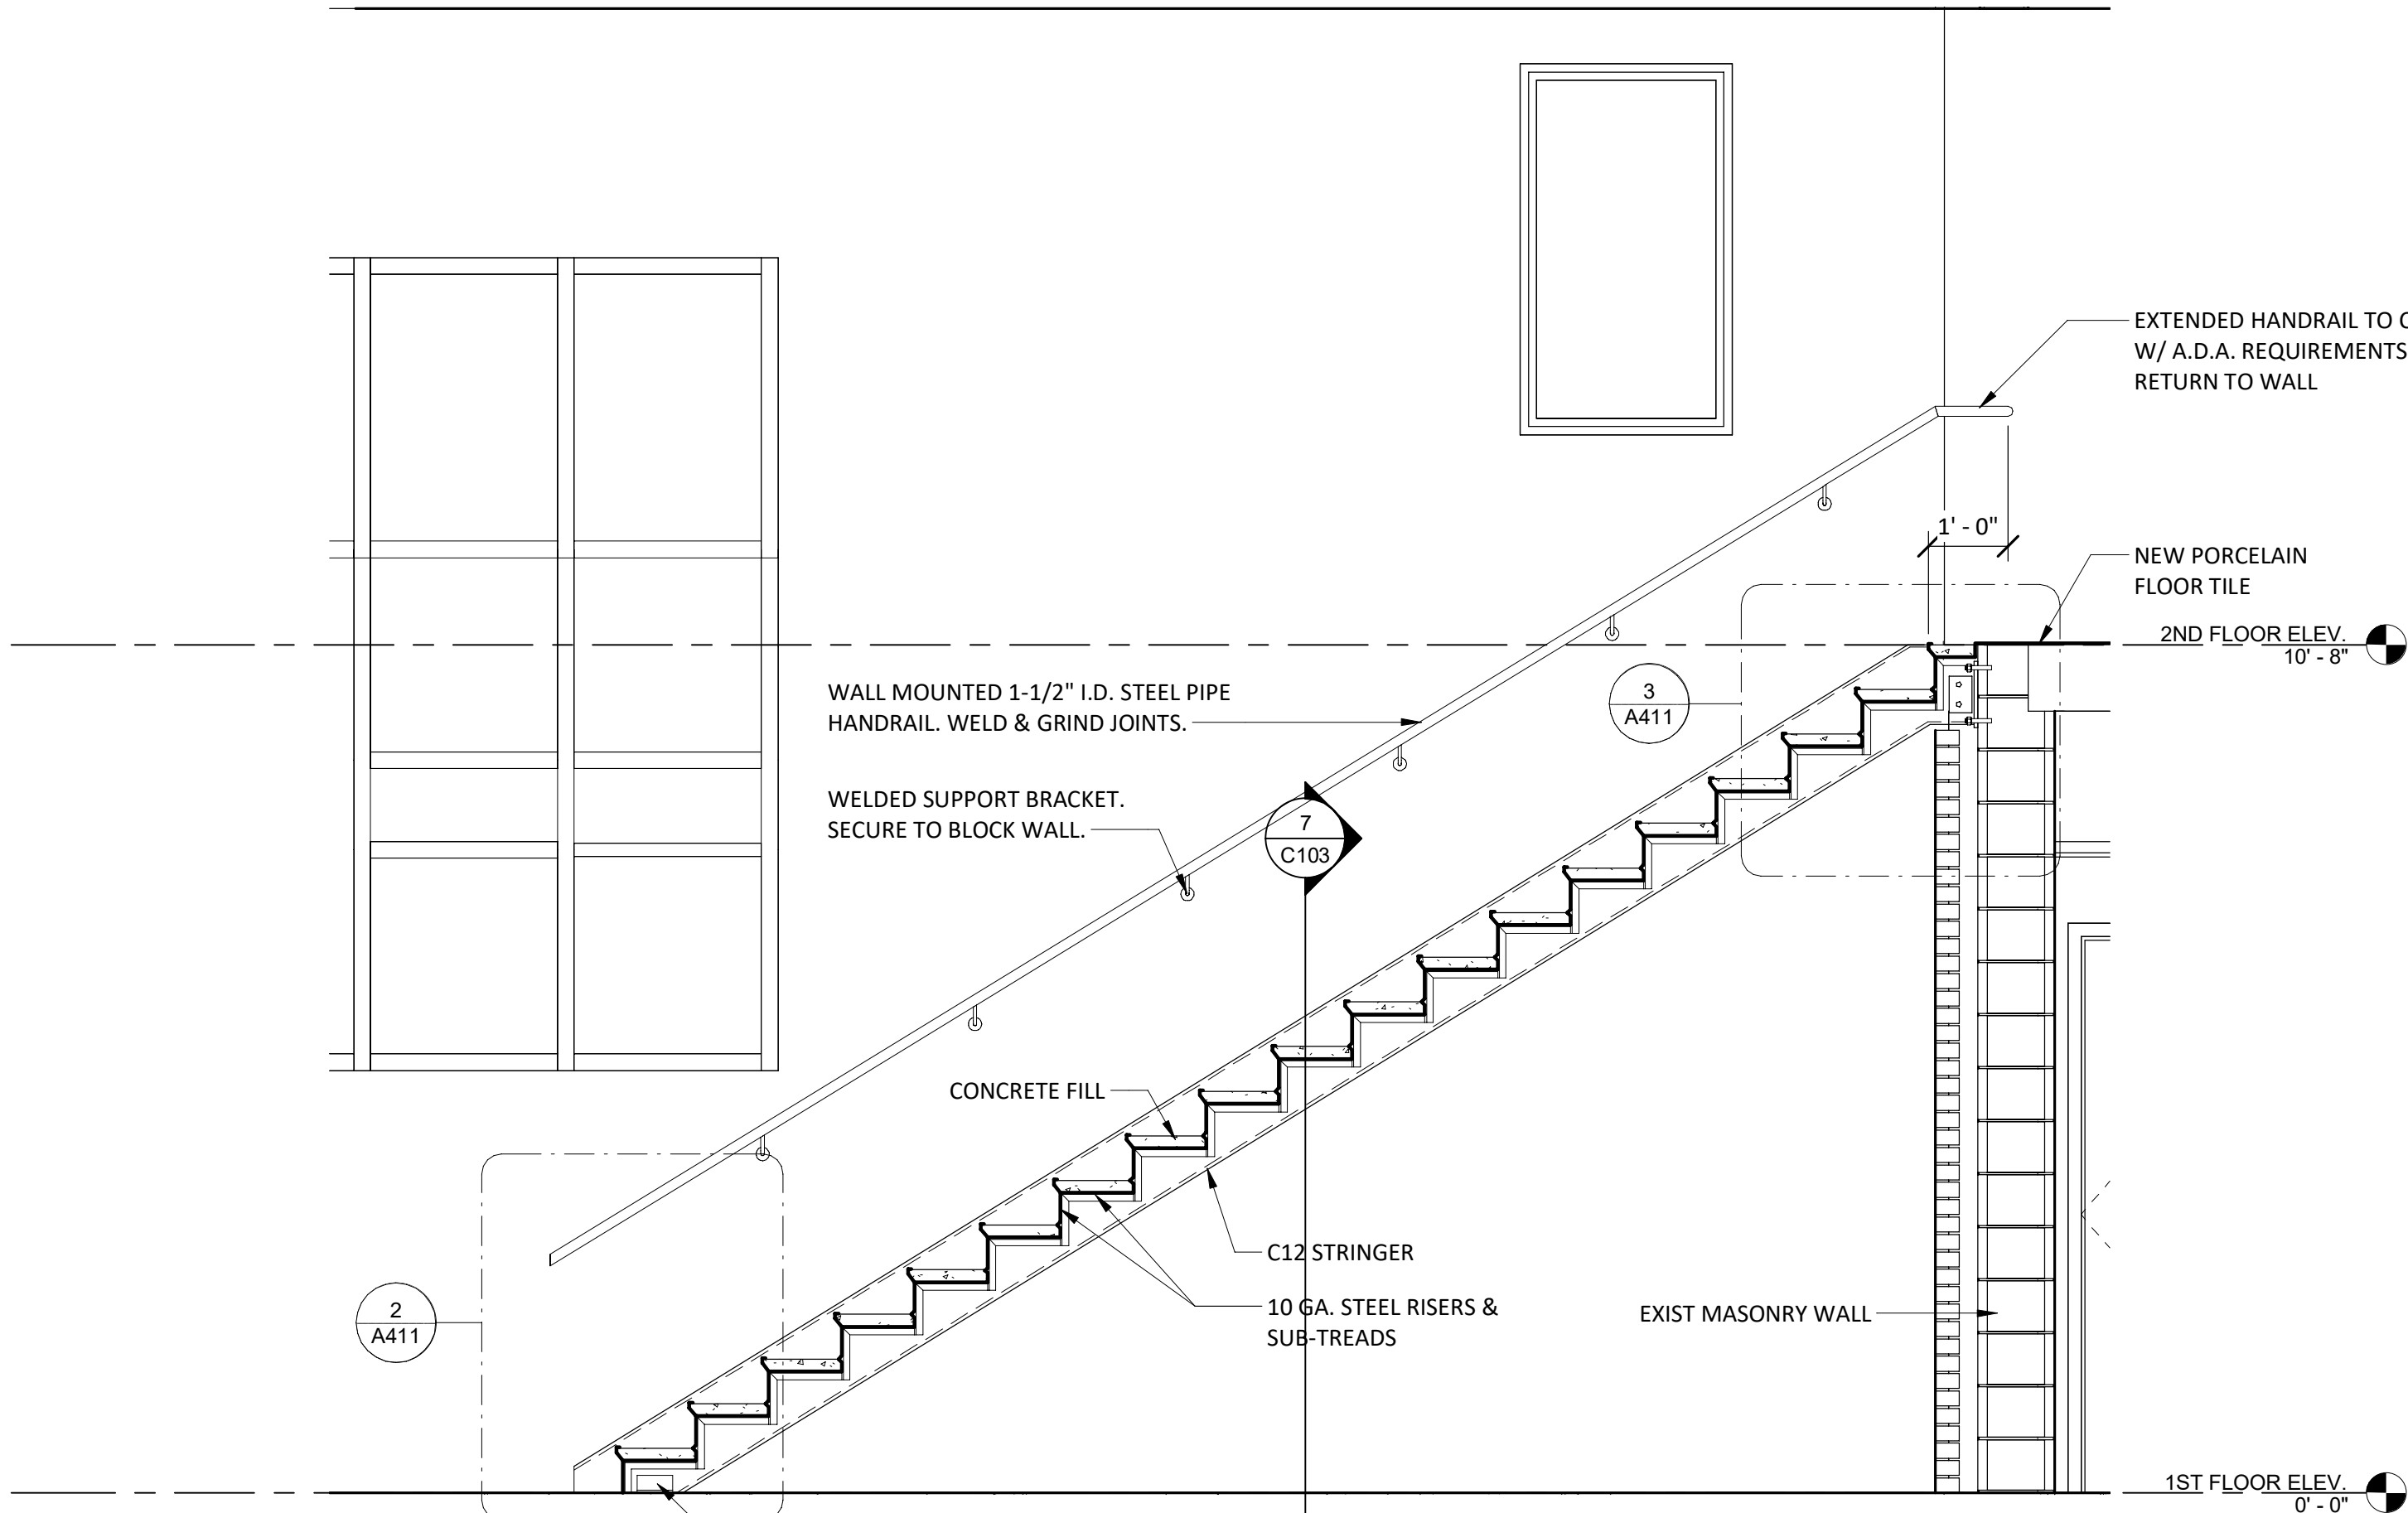
**2 CONCRETE PAN DETAIL AT FLOOR**  
SCALE: 3/4" = 1'-0"




**3 SECTION AT LANDING**  
SCALE: 3/4" = 1'-0"

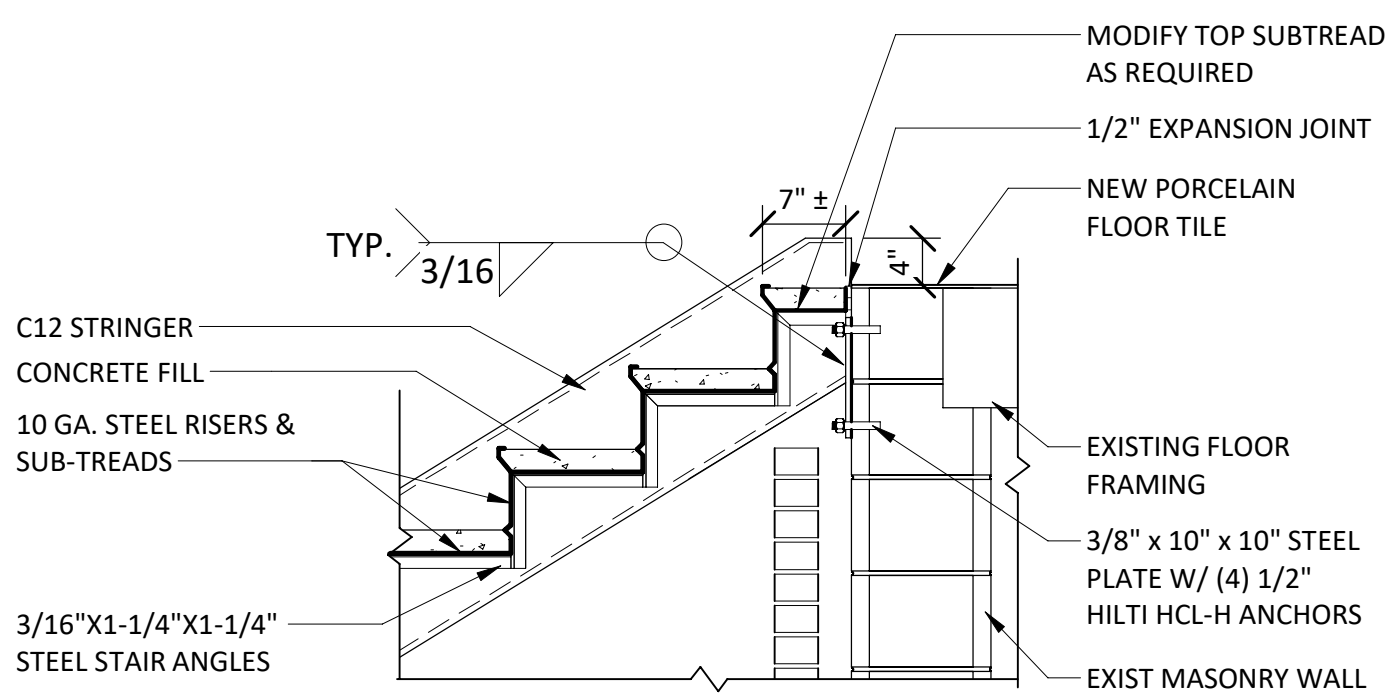

**4 STAIR CROSS SECTION**  
SCALE: 3/4" = 1'-0"



**5 STAIR SECTION**  
SCALE: 1/2" = 1'-0"

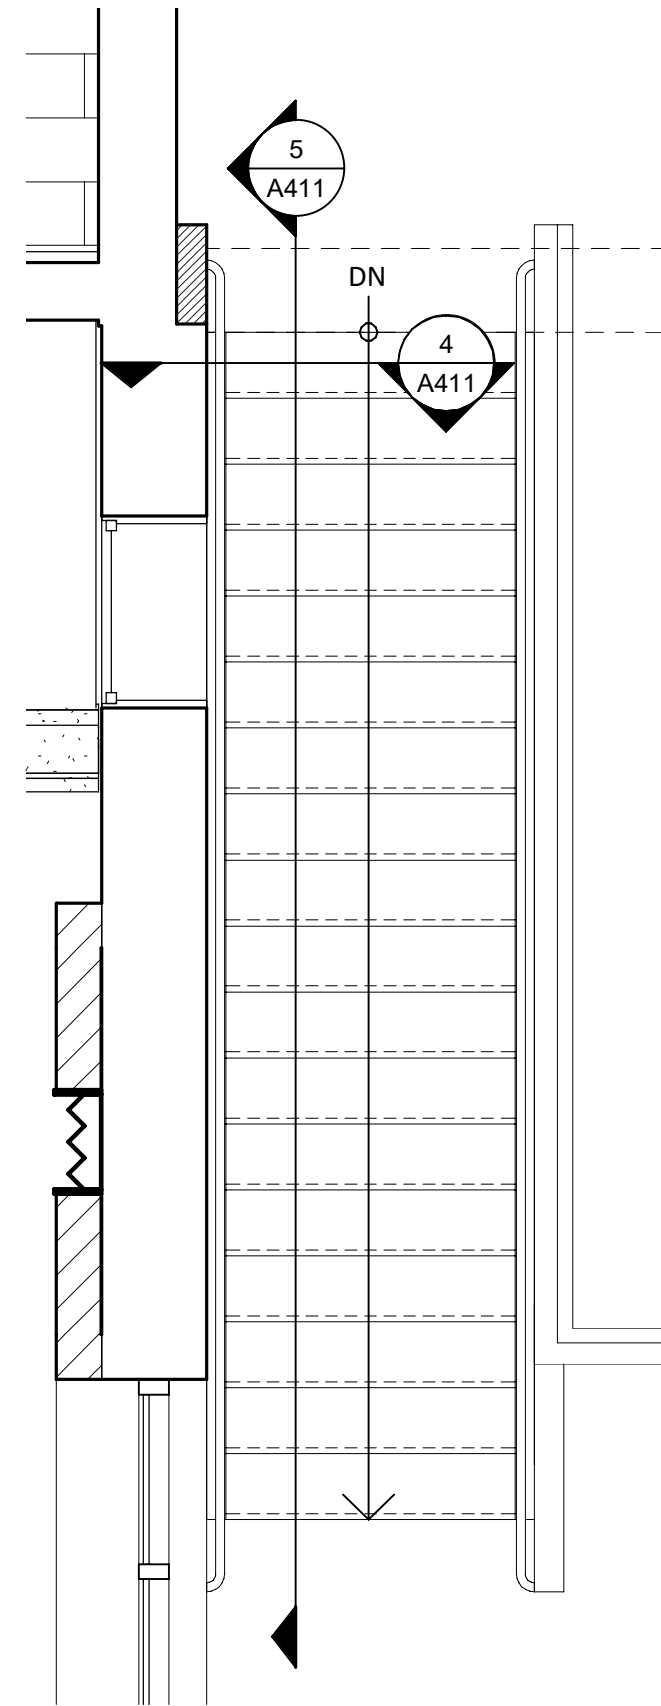

**1 STAIR PLAN**  
SCALE: 3/8" = 1'-0"

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REVISIONS

CITY OF MIDDLETOWN  
NEW COURTHOUSE FACILITY

**STAIR PLAN, SECTION AND DETAILS**

CITY OF MIDDLETOWN  
ORANGE COUNTY, NEW YORK

**Barton & Loguidice**  
443 Electronics Parkway  
Liverpool, NY 13088

NYS CERTIFICATE #  
0021642, 0020588, 0019903,  
0019905, 0020336

**B&L**



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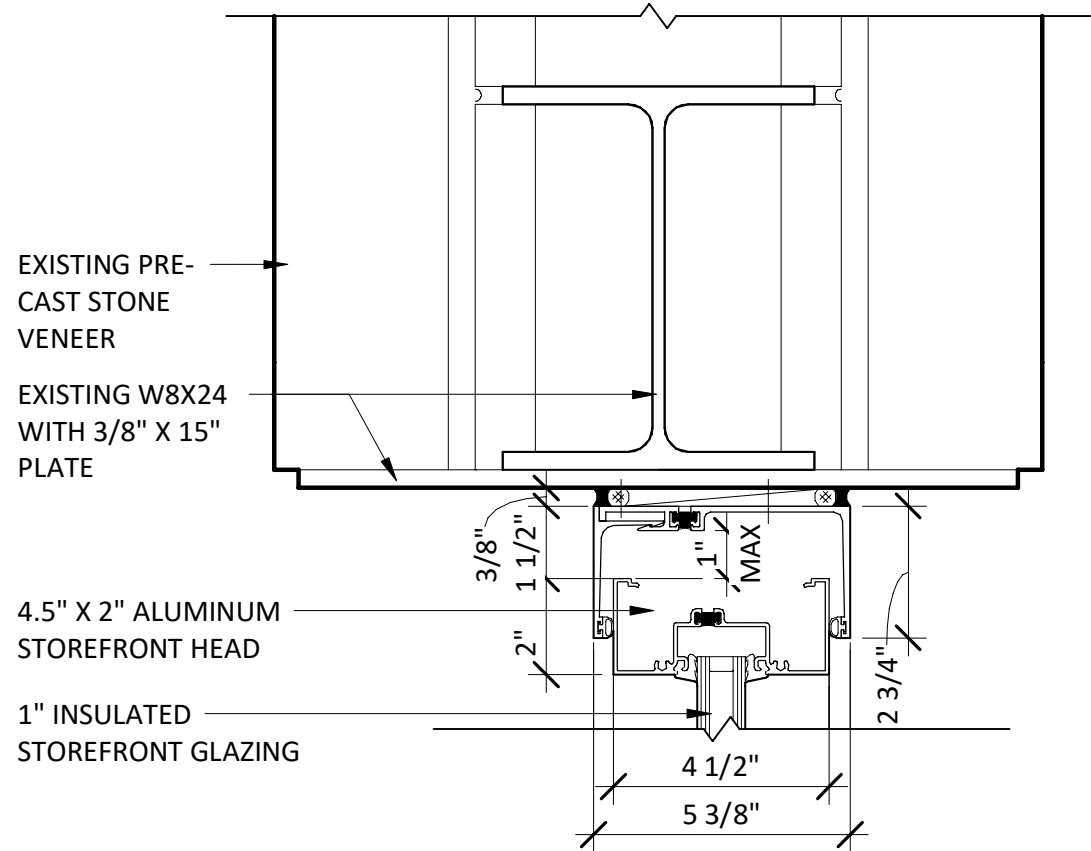
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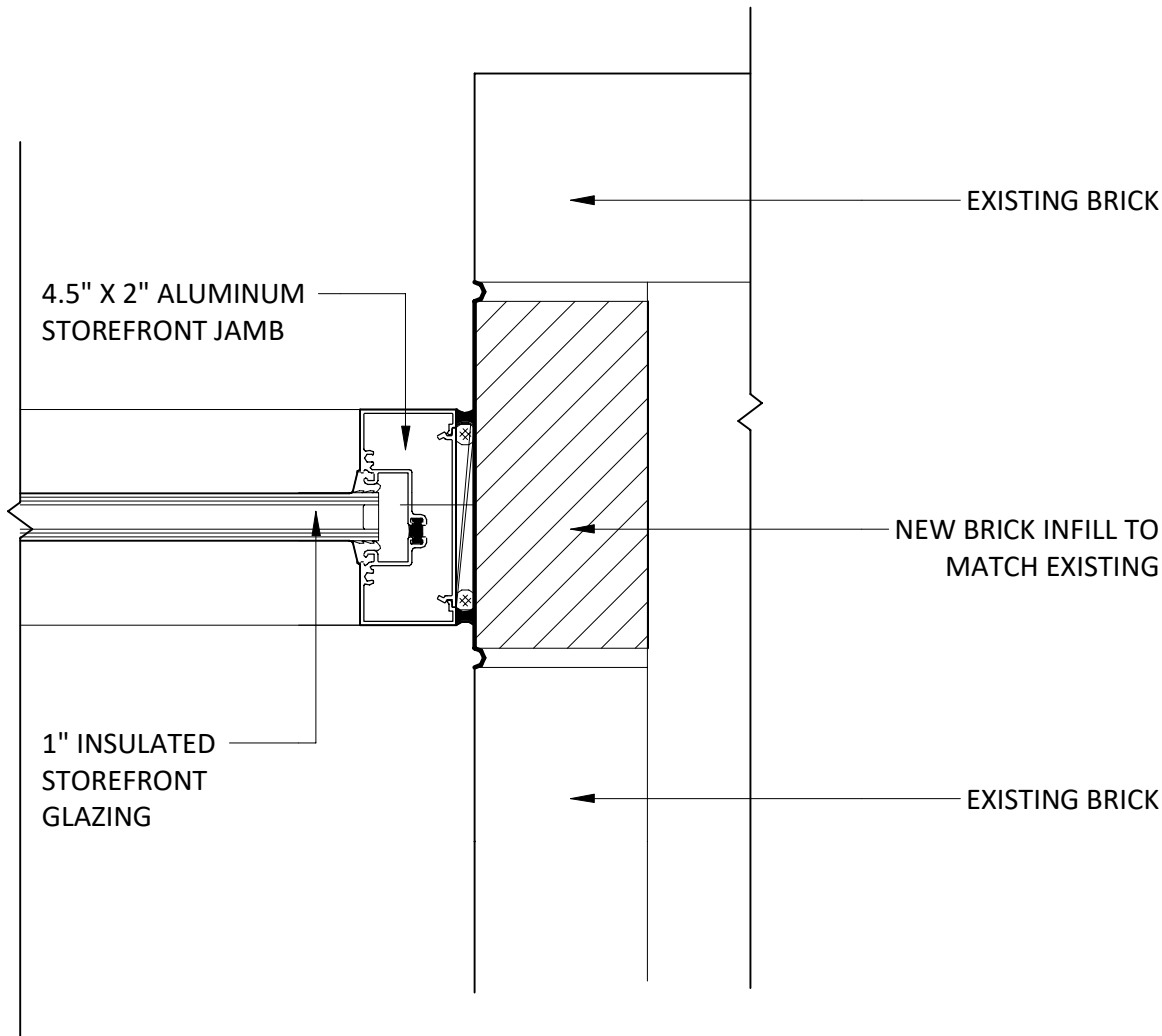
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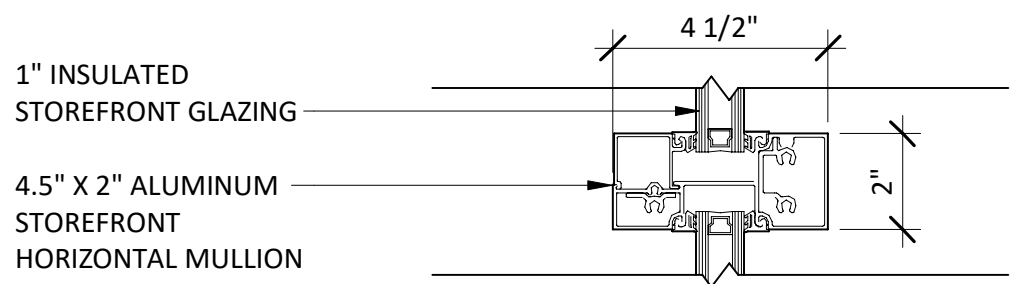
6 EXTERIOR STOREFRONT HEAD DETAIL  
A401 SCALE: 3" = 1'-0"

ADDITIVE BID ITEM NO. 02




11 EXTERIOR STOREFRONT JAMB DETAIL  
A401 SCALE: 3" = 1'-0"

ADDITIVE BID ITEM NO. 02




7 EXTERIOR STOREFRONT HORIZONTAL MULLION  
A401 SCALE: 3" = 1'-0"

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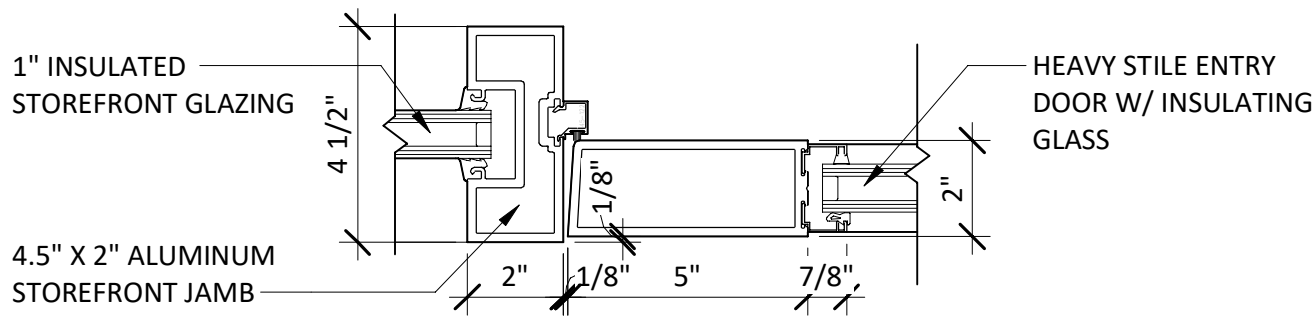
10 EXTERIOR STOREFRONT VERTICAL MULLION  
A401 SCALE: 3" = 1'-0"
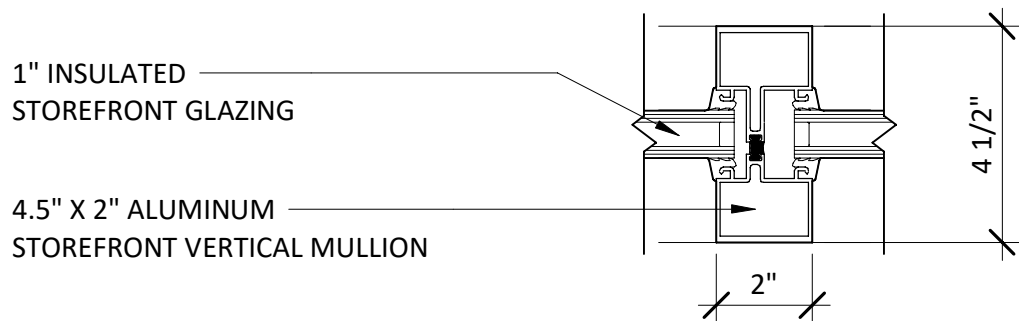
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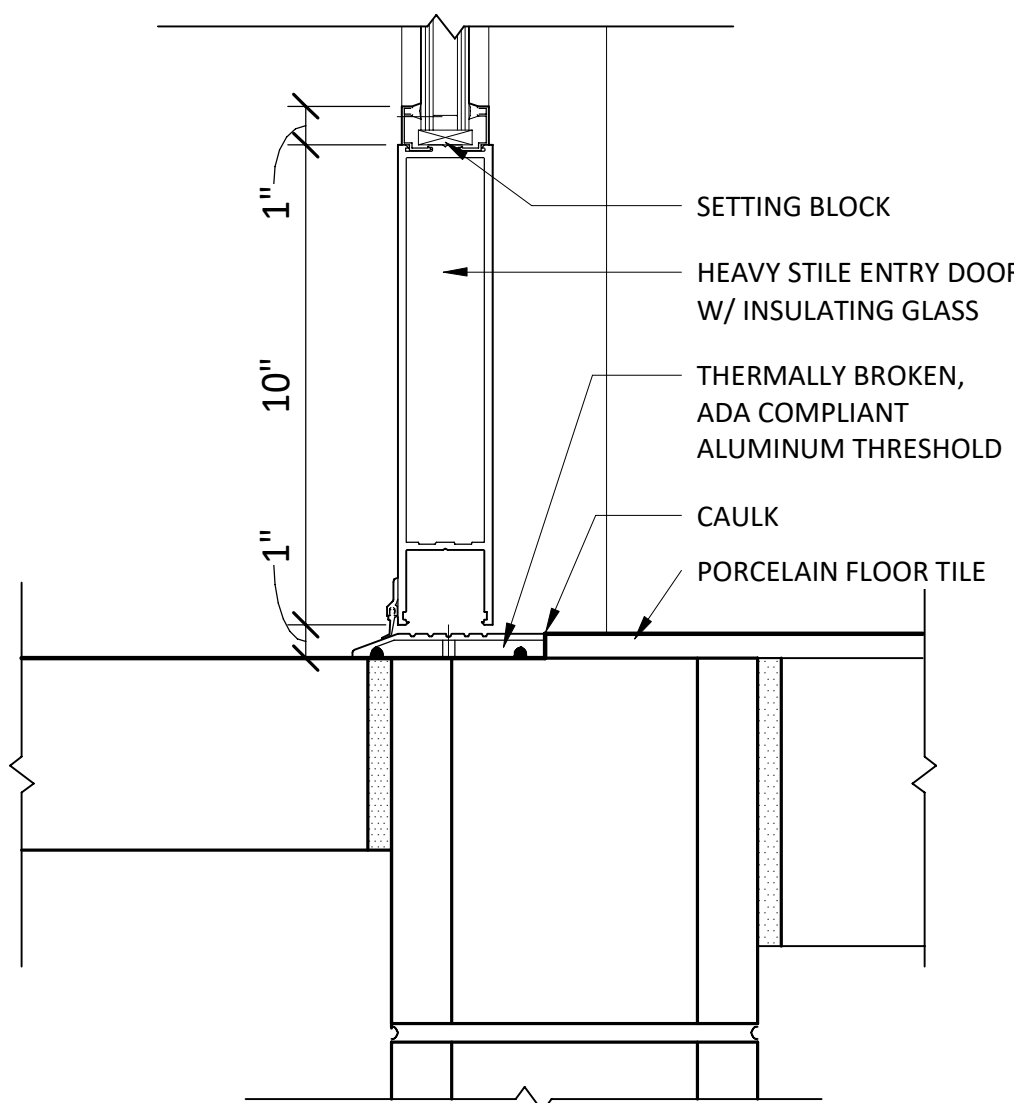
5 EXTERIOR STOREFRONT DOOR HEAD DETAIL  
A401 SCALE: 3" = 1'-0"

ADDITIVE BID ITEM NO. 02

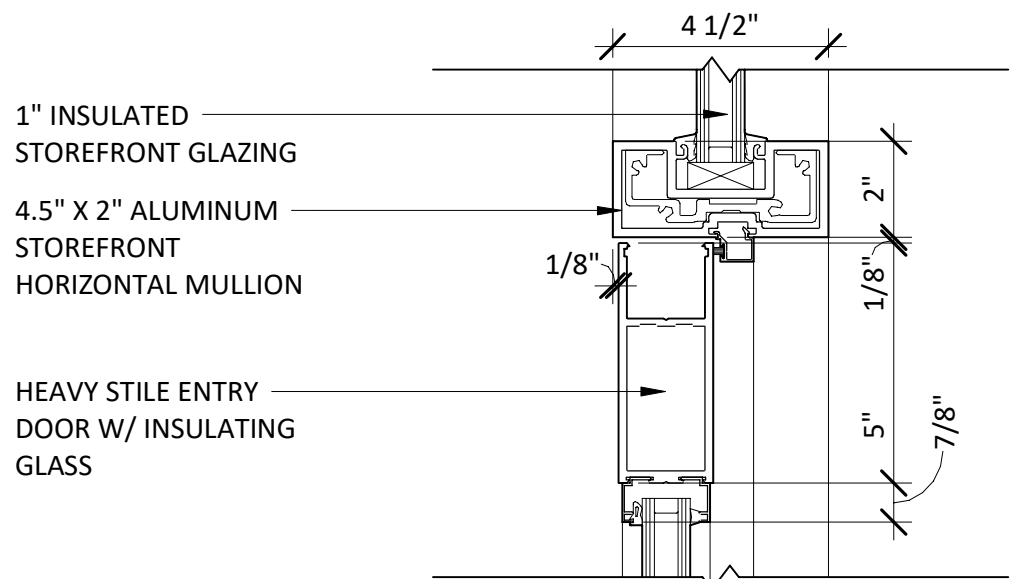


9 EXTERIOR STOREFRONT DOOR JAMB DETAIL  
A401 SCALE: 3" = 1'-0"

ADDITIVE BID ITEM NO. 02




4 EXTERIOR STOREFRONT THRESHOLD DETAIL  
A401 SCALE: 3" = 1'-0"

ADDITIVE BID ITEM NO. 02

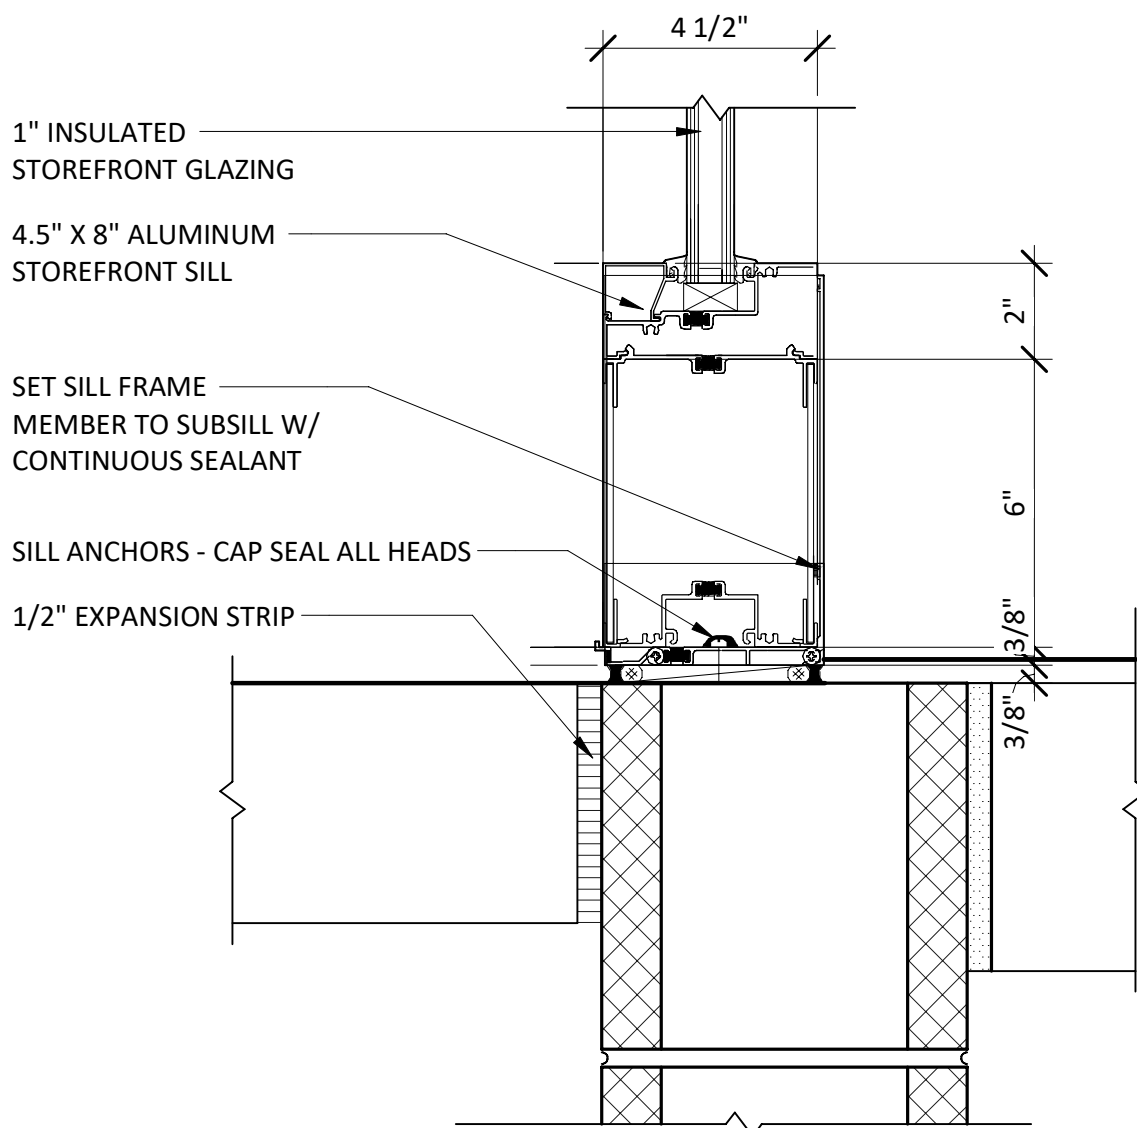


8 EXTERIOR STOREFRONT SILL DETAIL  
A401 SCALE: 3" = 1'-0"


ADDITIVE BID ITEM NO. 02

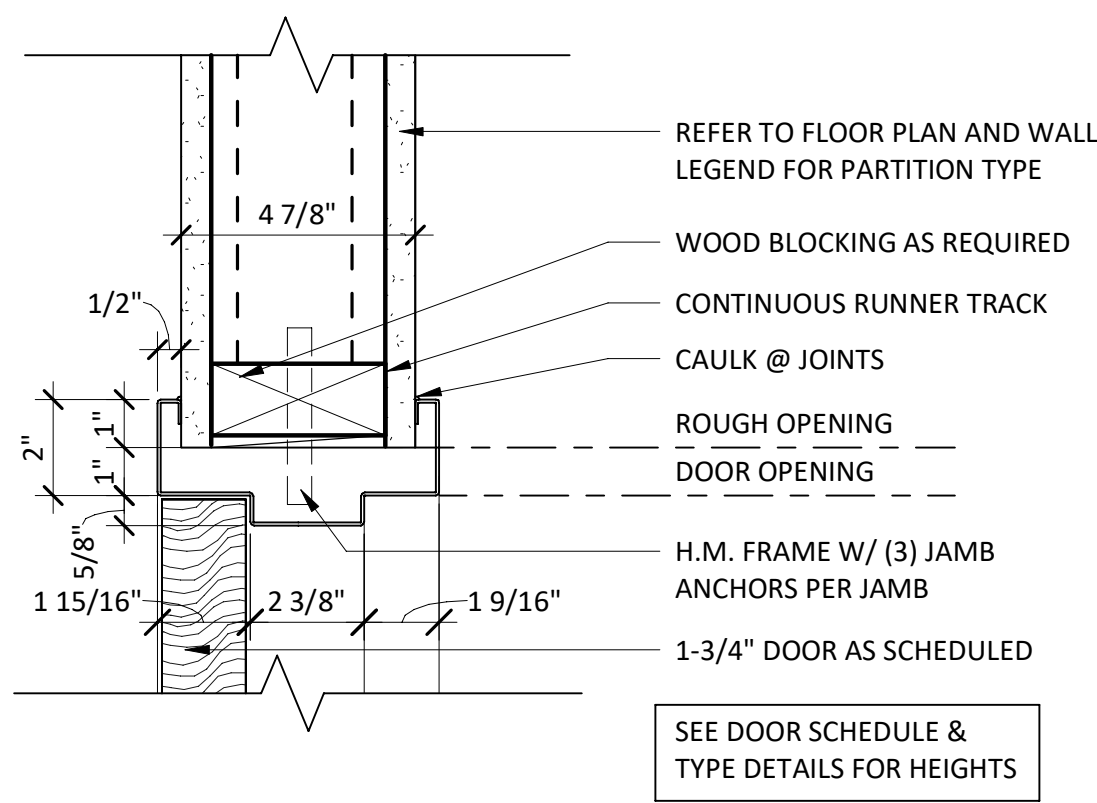


1 DOOR HEAD DETAIL 1  
SCALE: 3" = 1'-0"

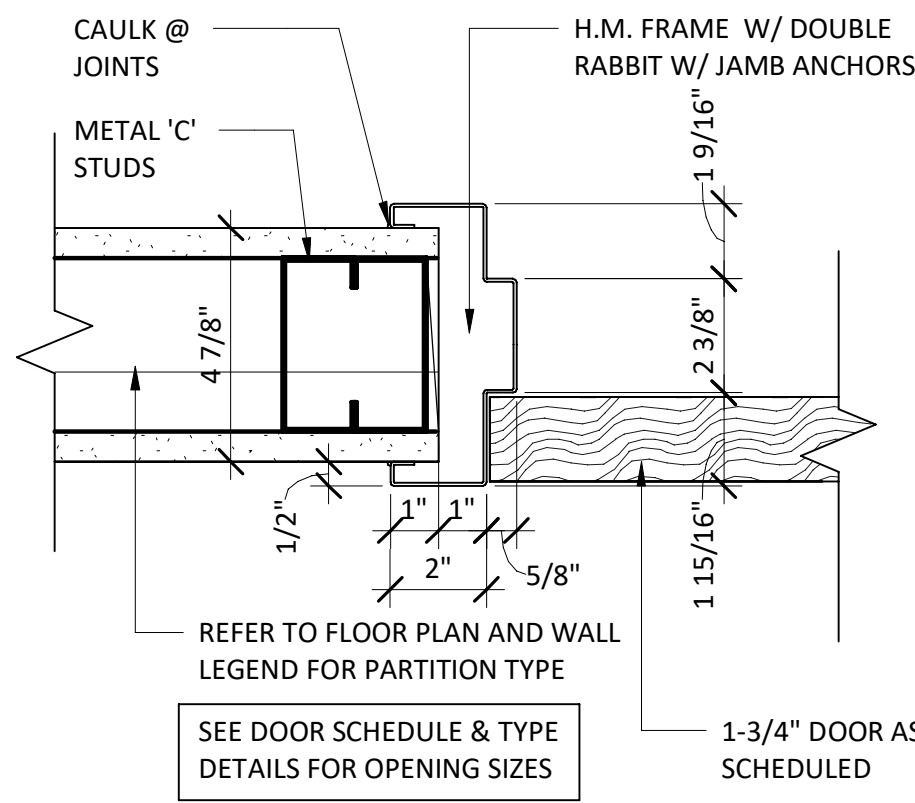


2 DOOR JAMB DETAIL 1  
SCALE: 3" = 1'-0"

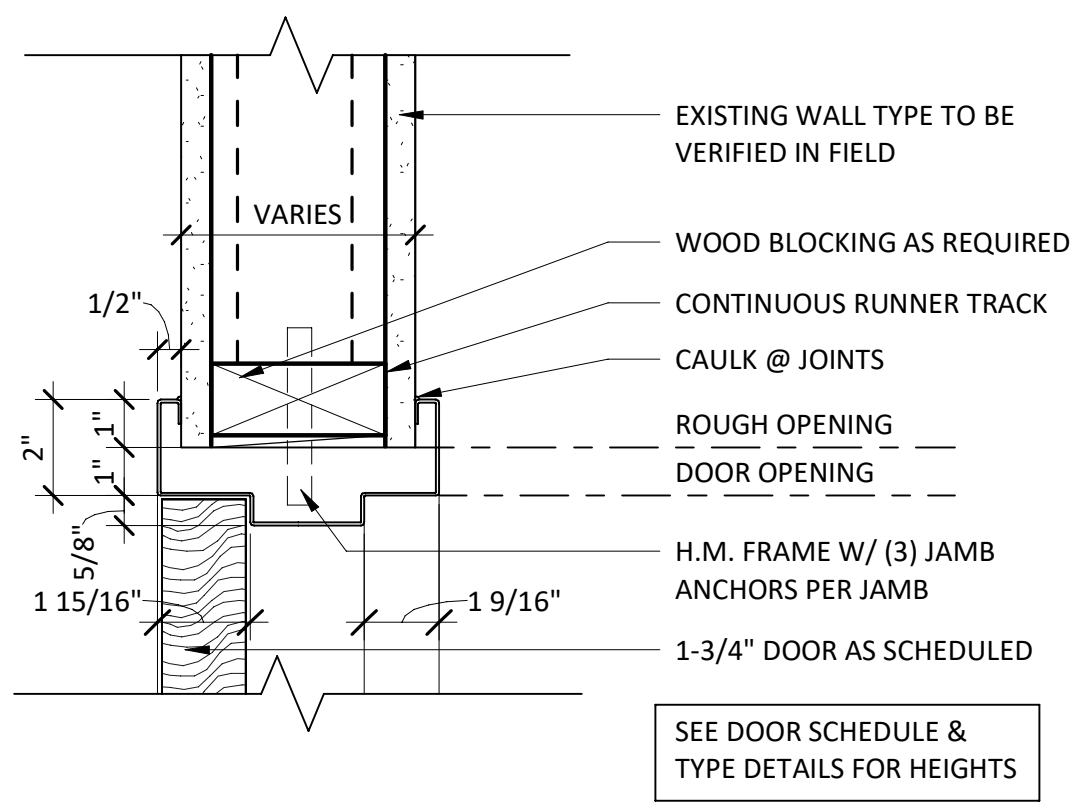


12 DOOR HEAD DETAIL 2  
SCALE: 3" = 1'-0"

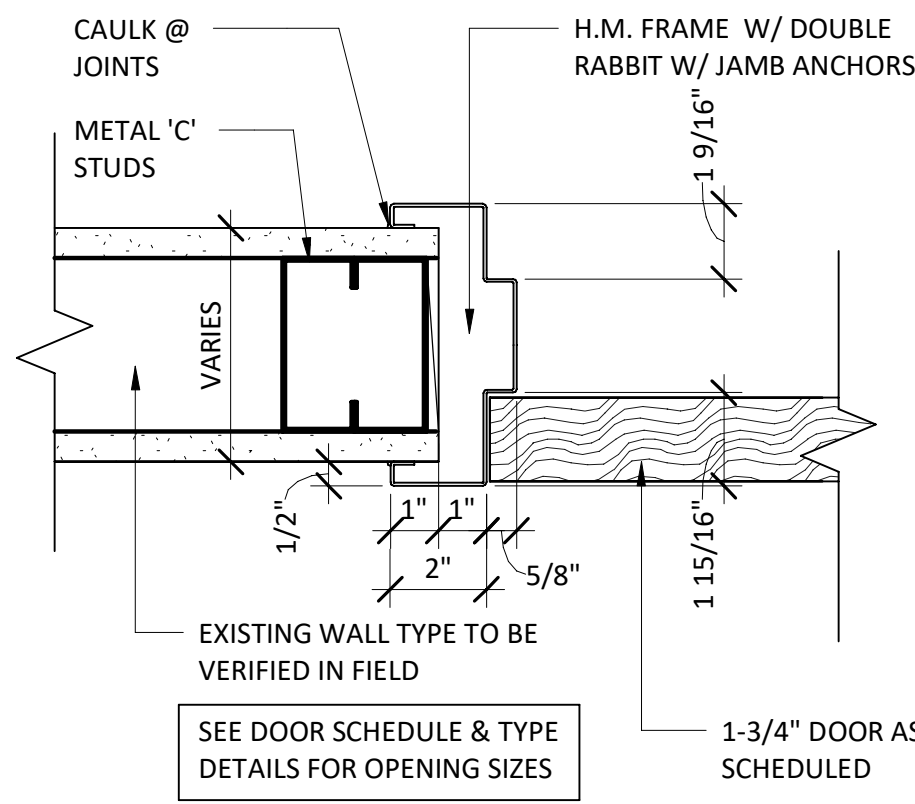

13 DOOR JAMB DETAIL 2  
SCALE: 3" = 1'-0"

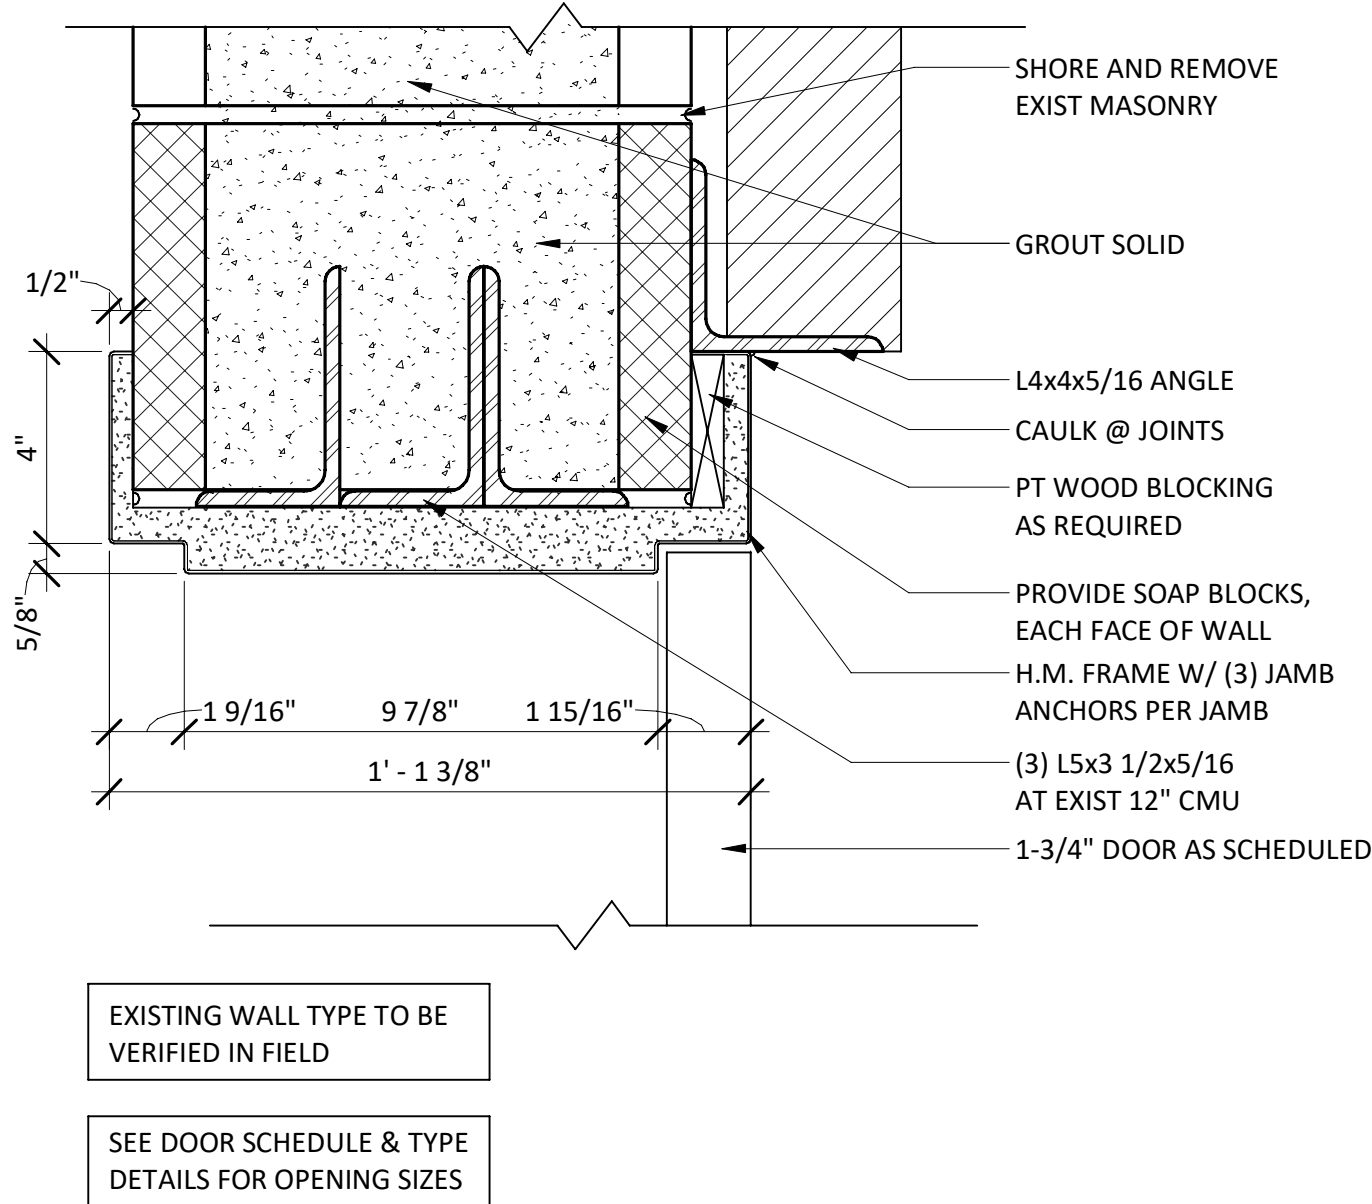

14 DOOR HEAD DETAIL 3  
SCALE: 3" = 1'-0"

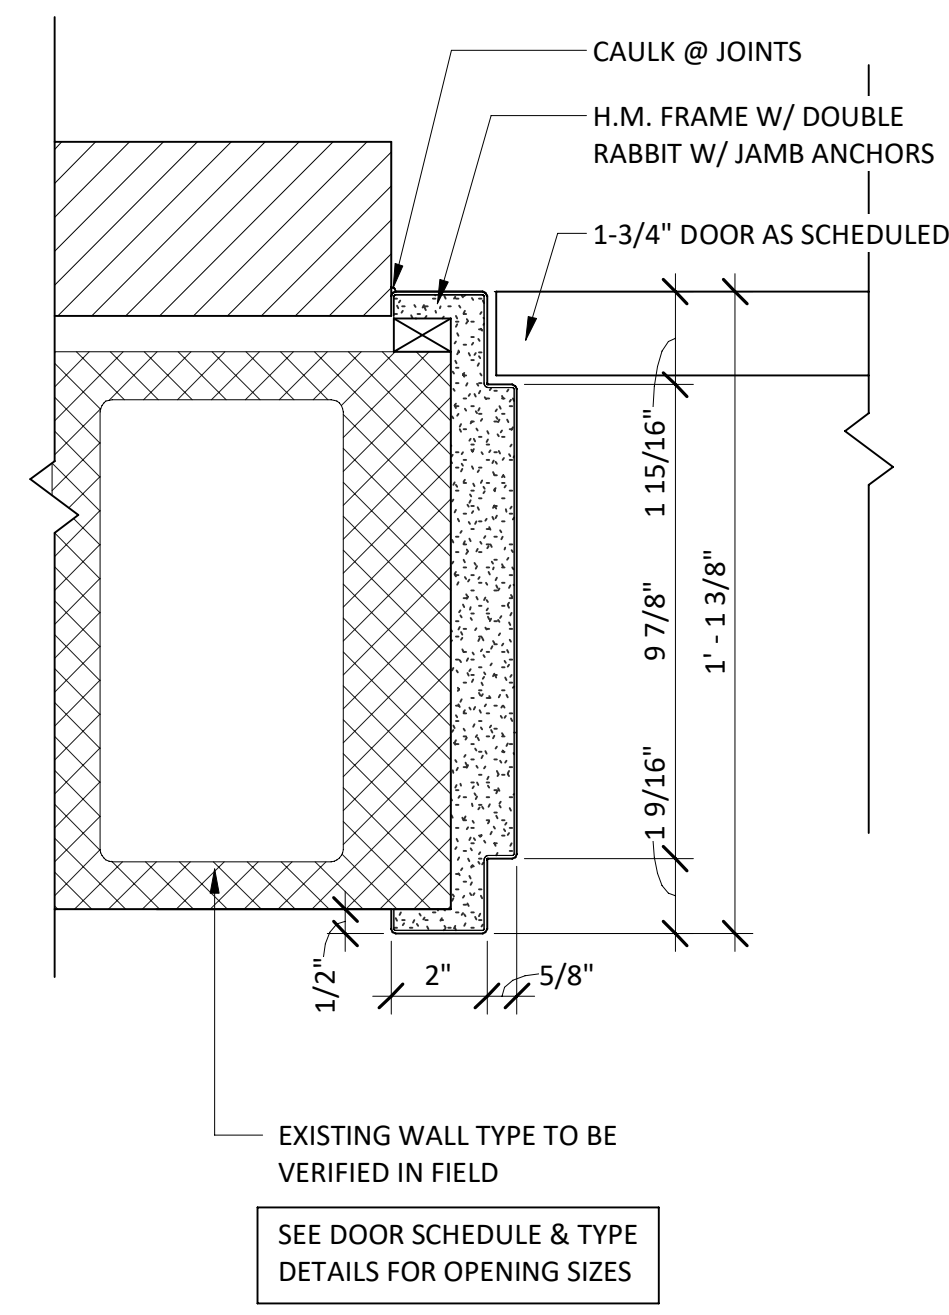

15 DOOR JAMB DETAIL 3  
SCALE: 3" = 1'-0"

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REVISIONS

CITY OF MIDDLETOWN  
NEW COURTHOUSE FACILITY

DOOR DETAILS

CITY OF MIDDLETOWN

ORANGE COUNTY, NEW YORK

Barton & Loguidice  
443 Electronics Parkway  
Liverpool, NY 13088



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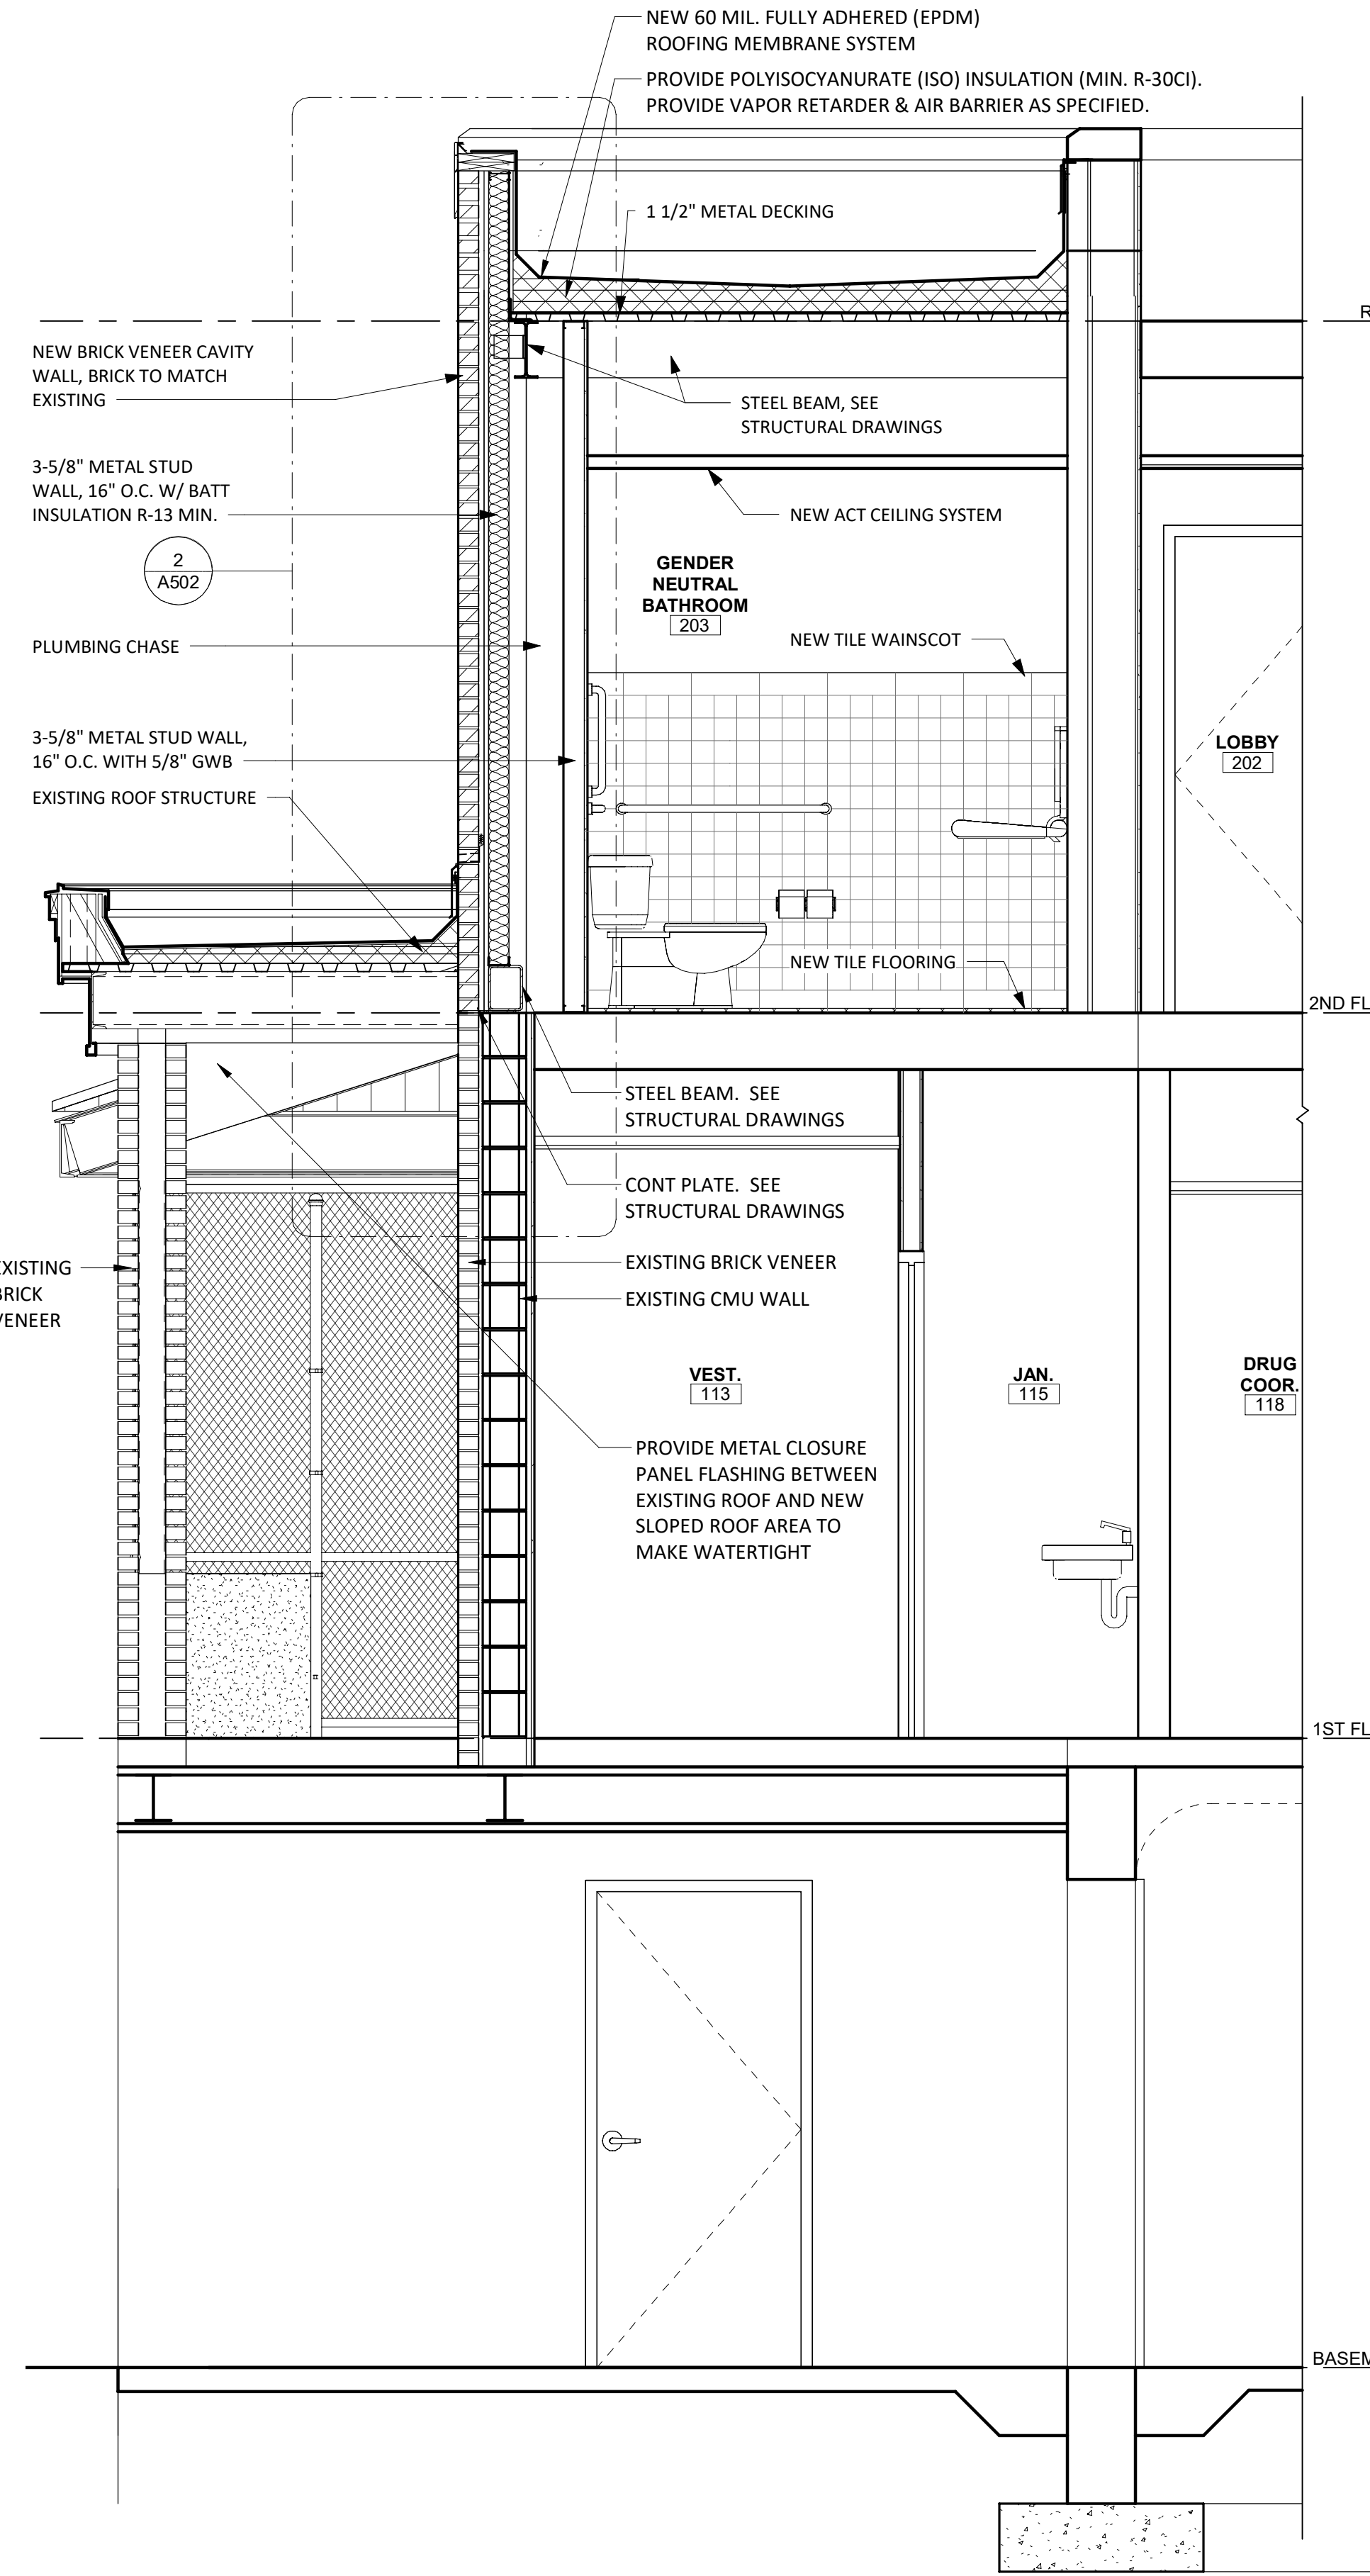
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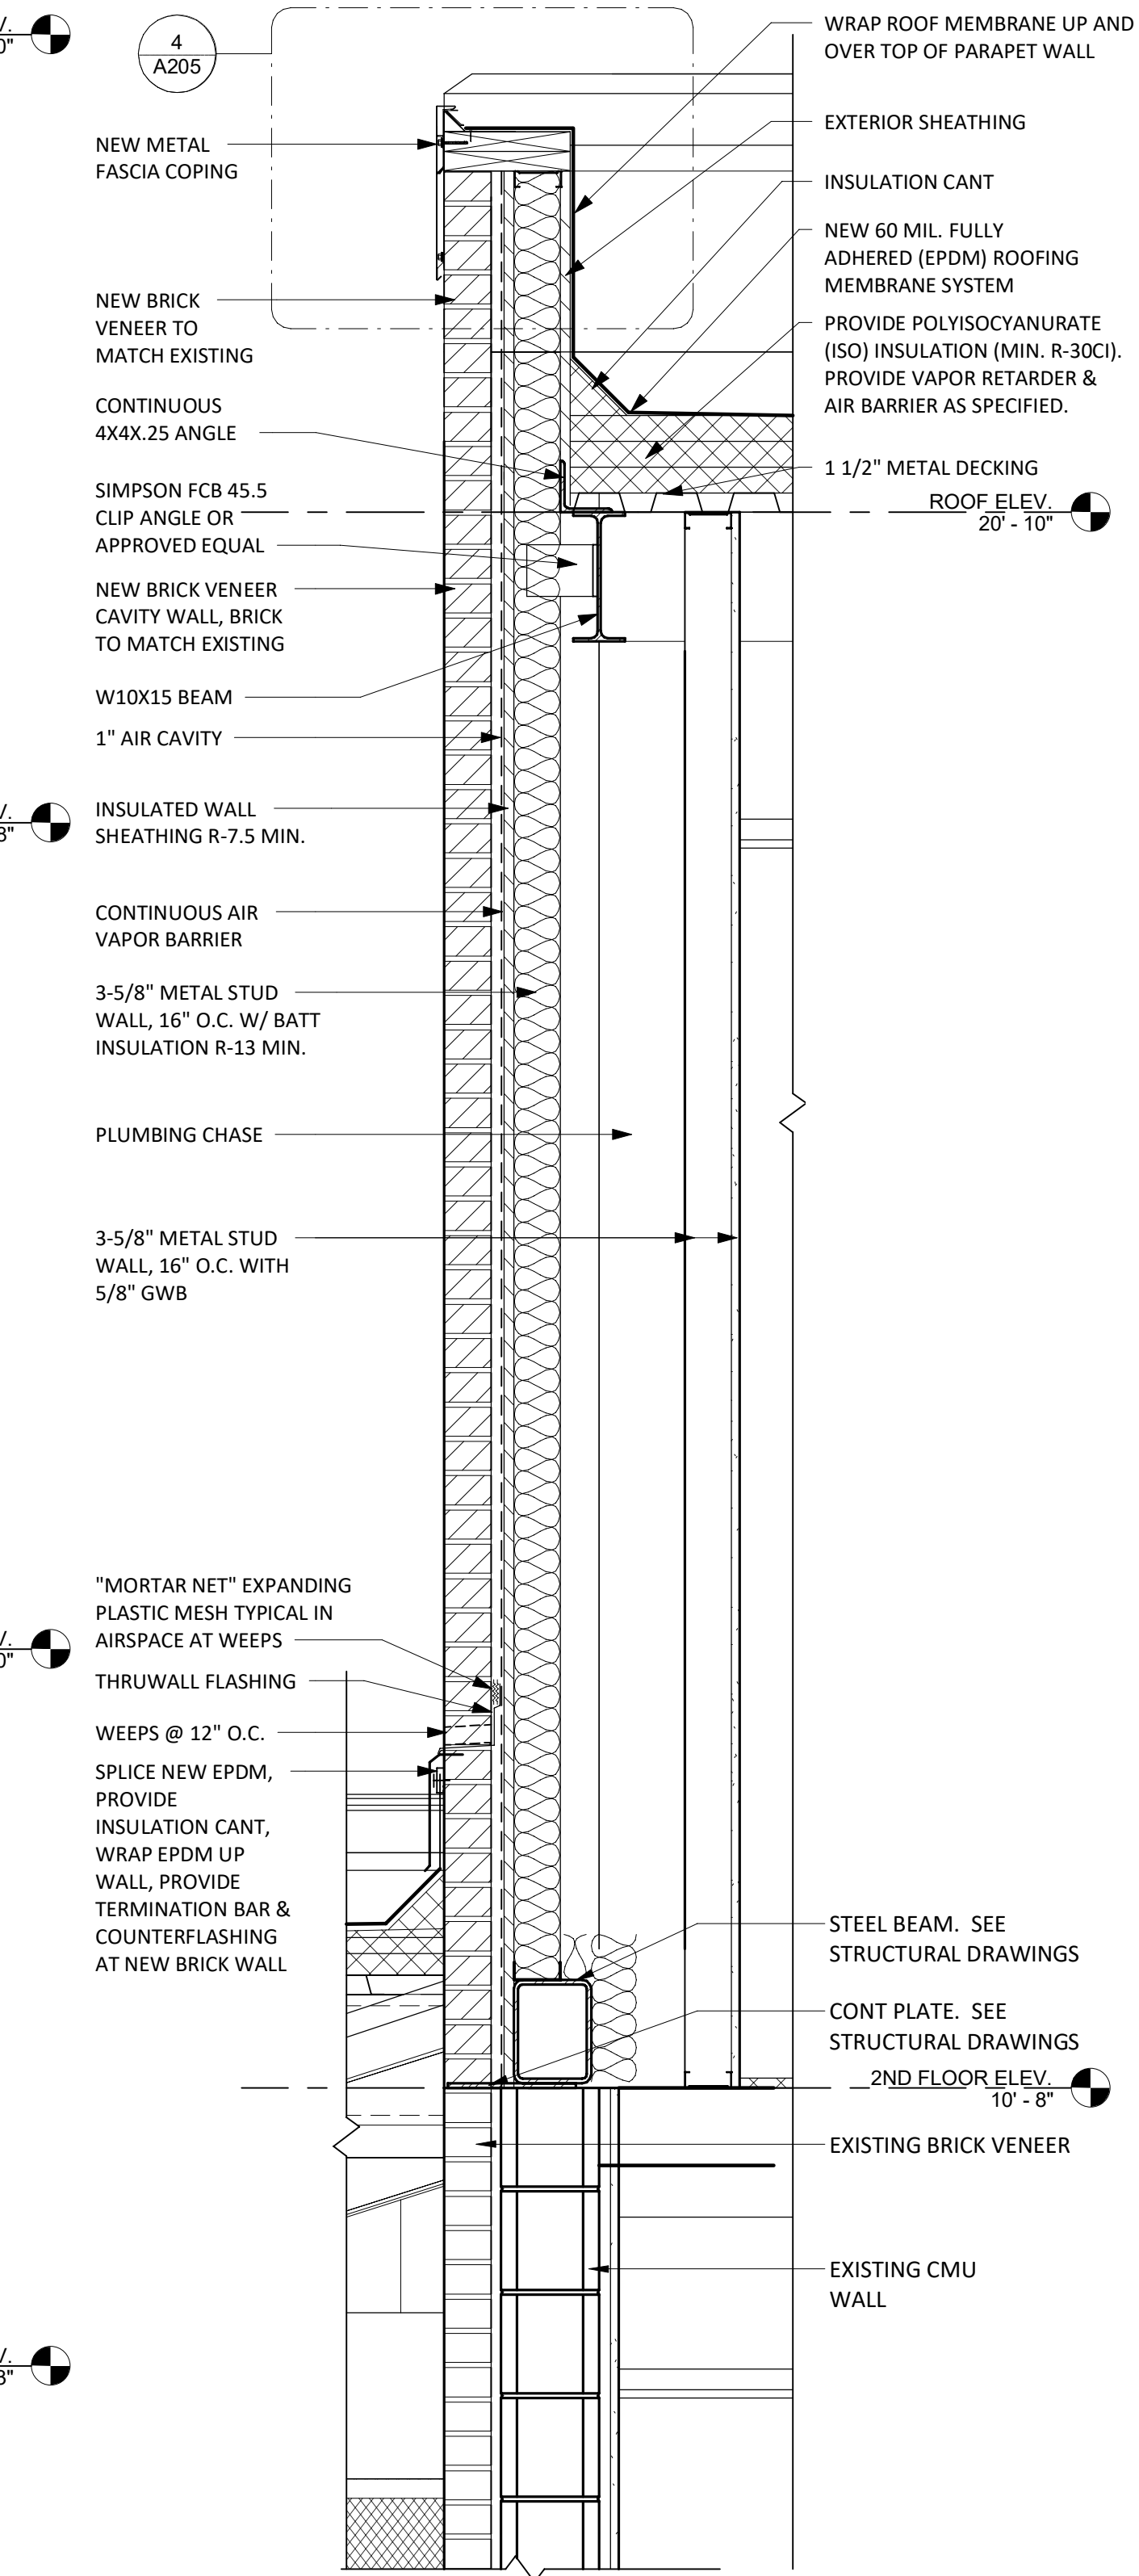
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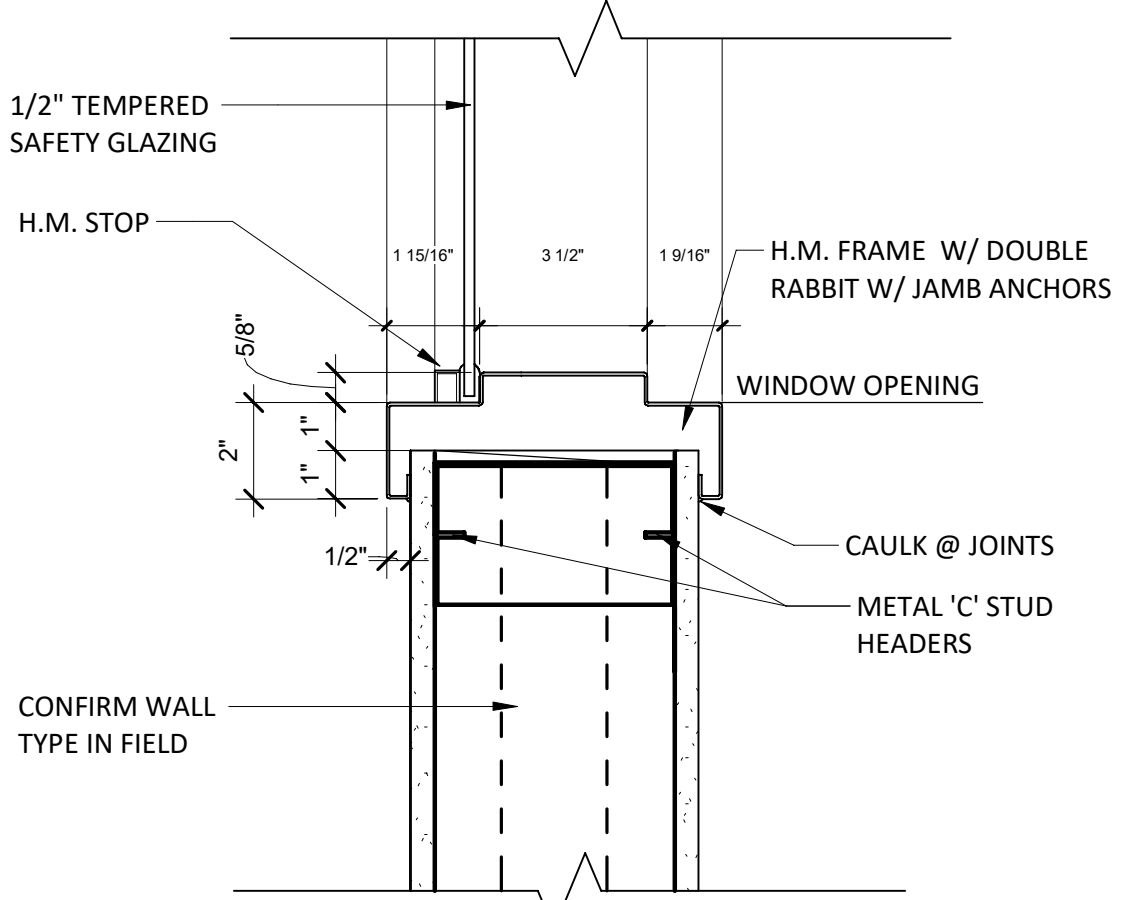
**1 BUILDING SECTION - SECOND FLOOR BATHROOM**  
A501 SCALE: 1/2" = 1'-0"




**2 SECOND FLOOR BATHROOM WALL SECTION**  
A502 SCALE: 1" = 1'-0"




**5 INTERIOR WINDOW SILL DETAIL**  
A601 SCALE: 3" = 1'-0"




**4 INTERIOR WINDOW HEAD DETAIL 1**  
A601 SCALE: 3" = 1'-0"

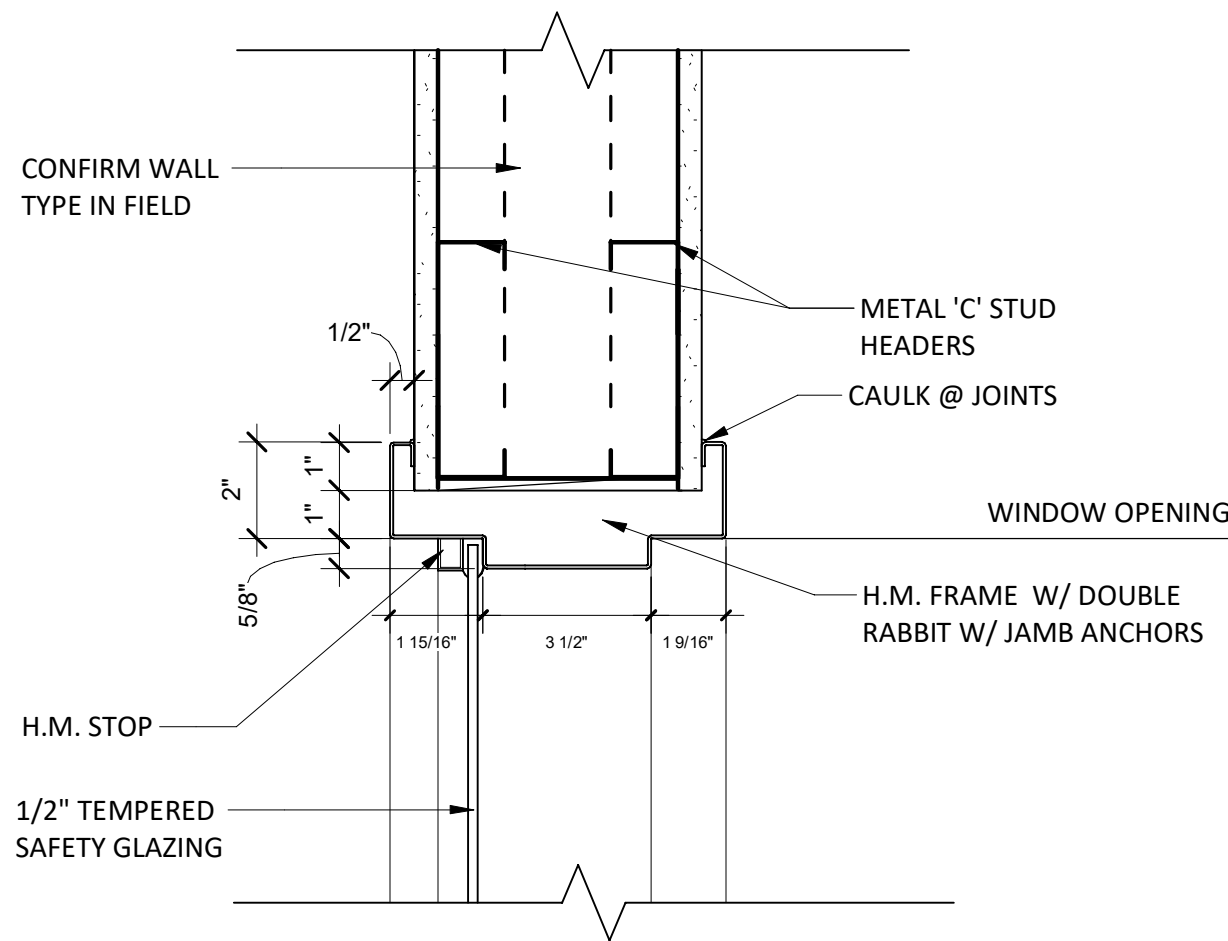

**3 INTERIOR WINDOW JAMB DETAIL 1**  
A601 SCALE: 3" = 1'-0"

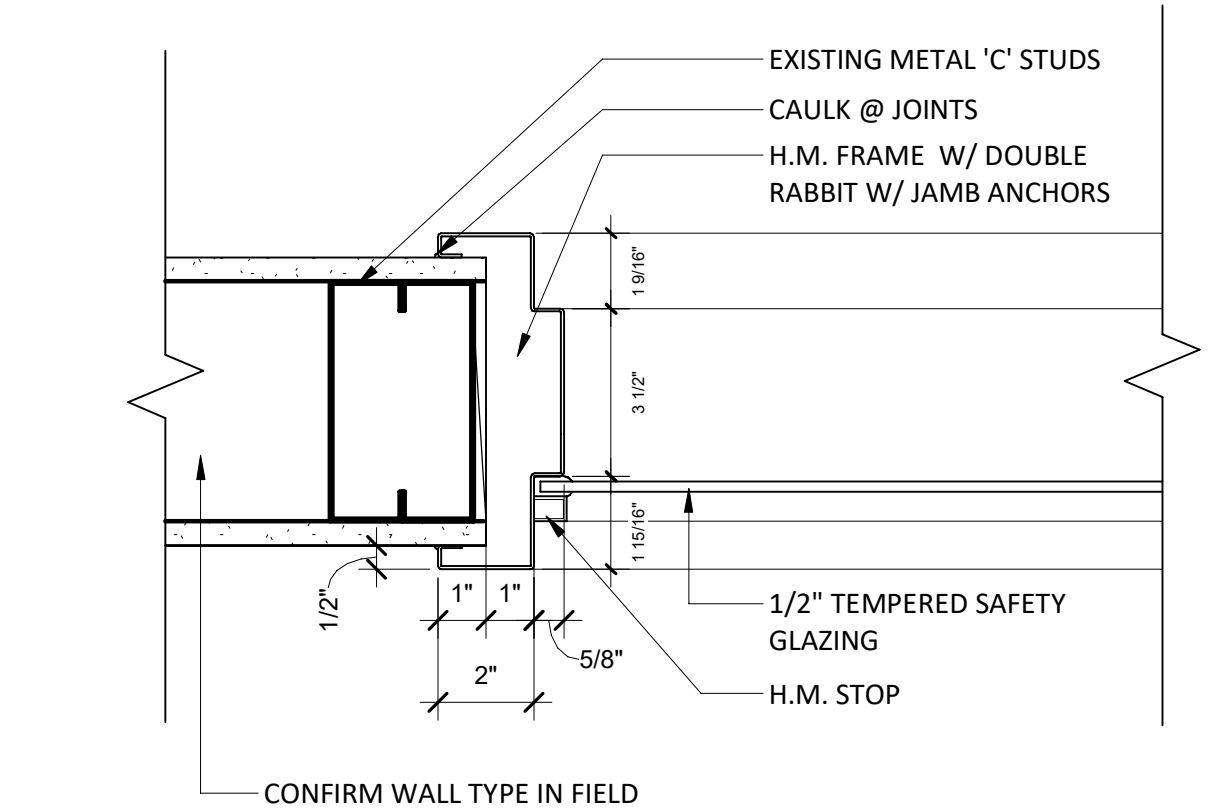


**6 SECURITY WINDOW DETAILS**  
A601 SCALE: 3" = 1'-0"

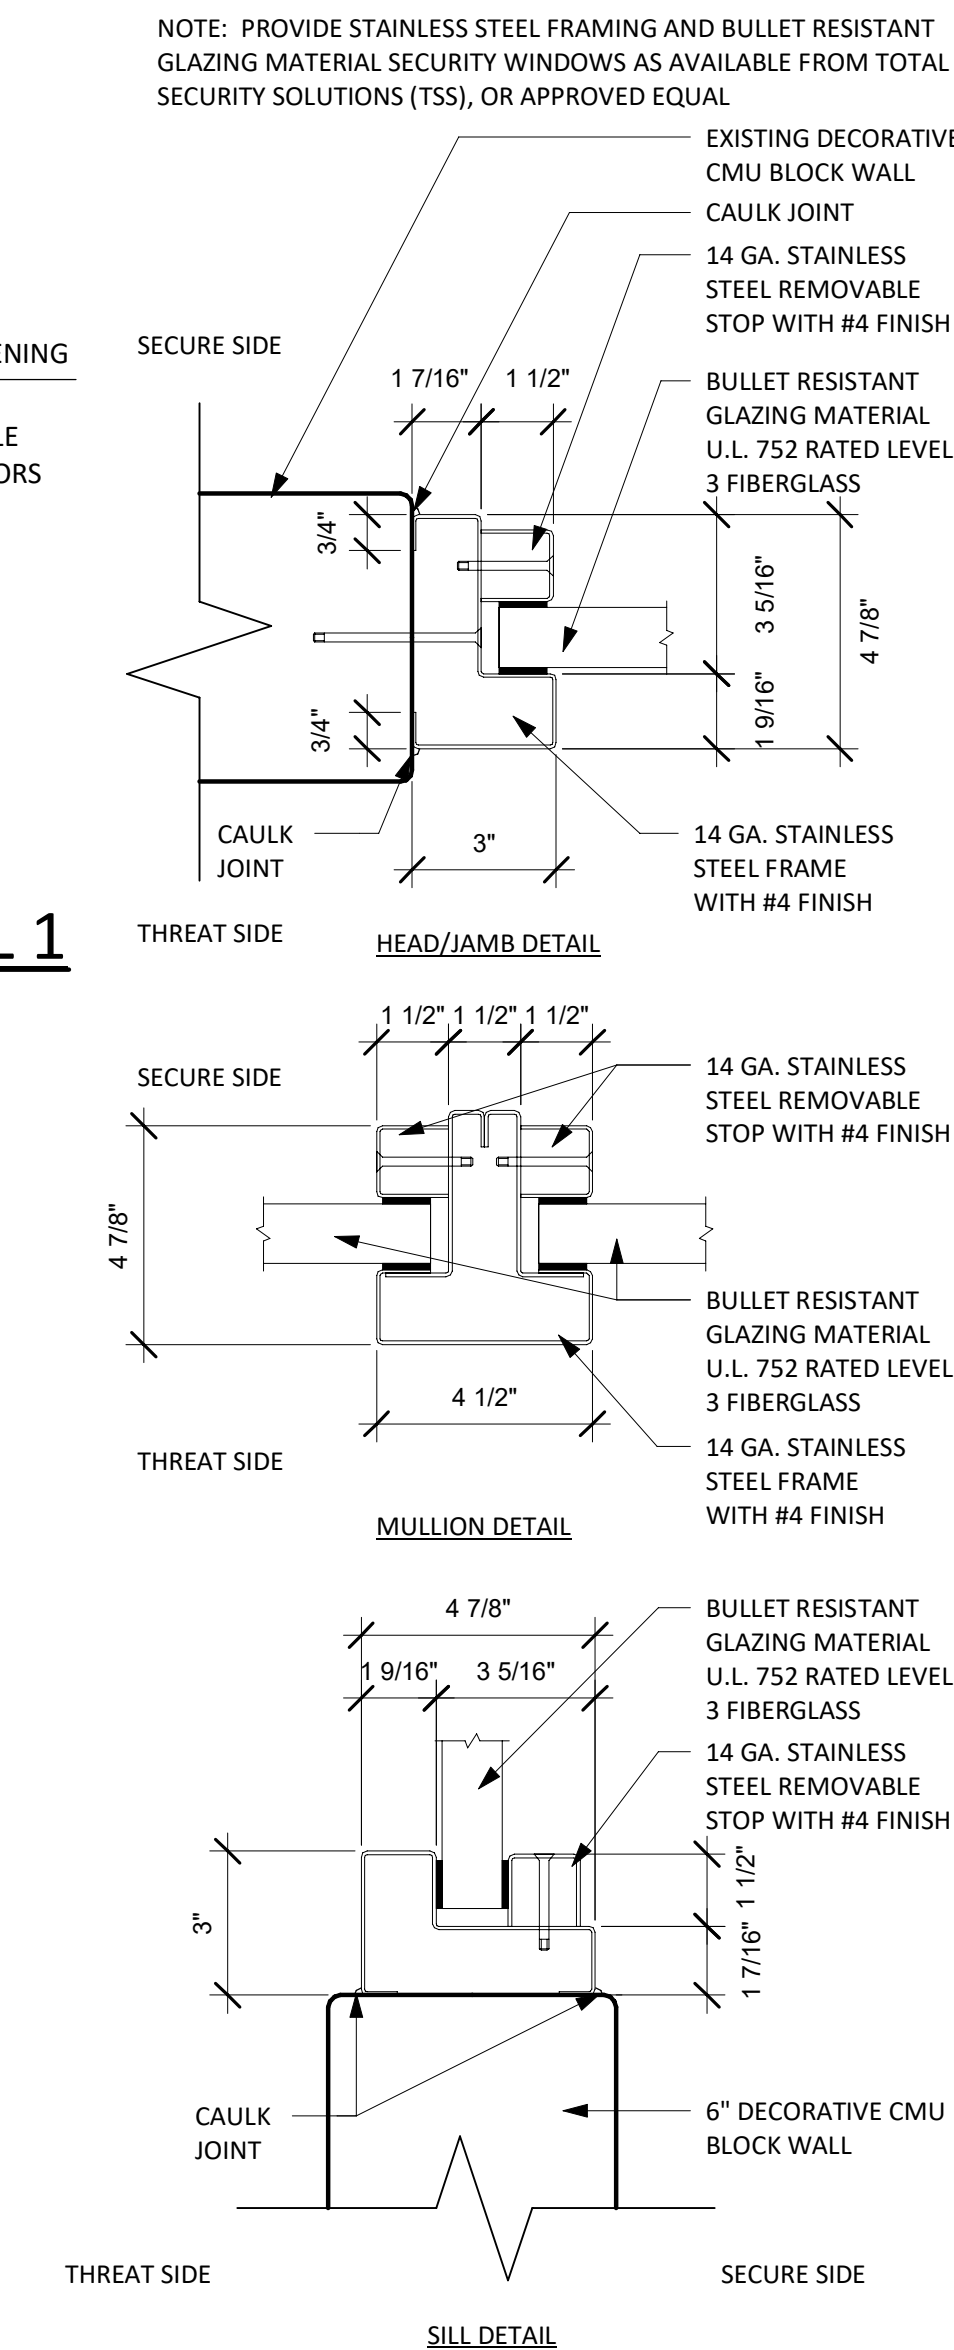









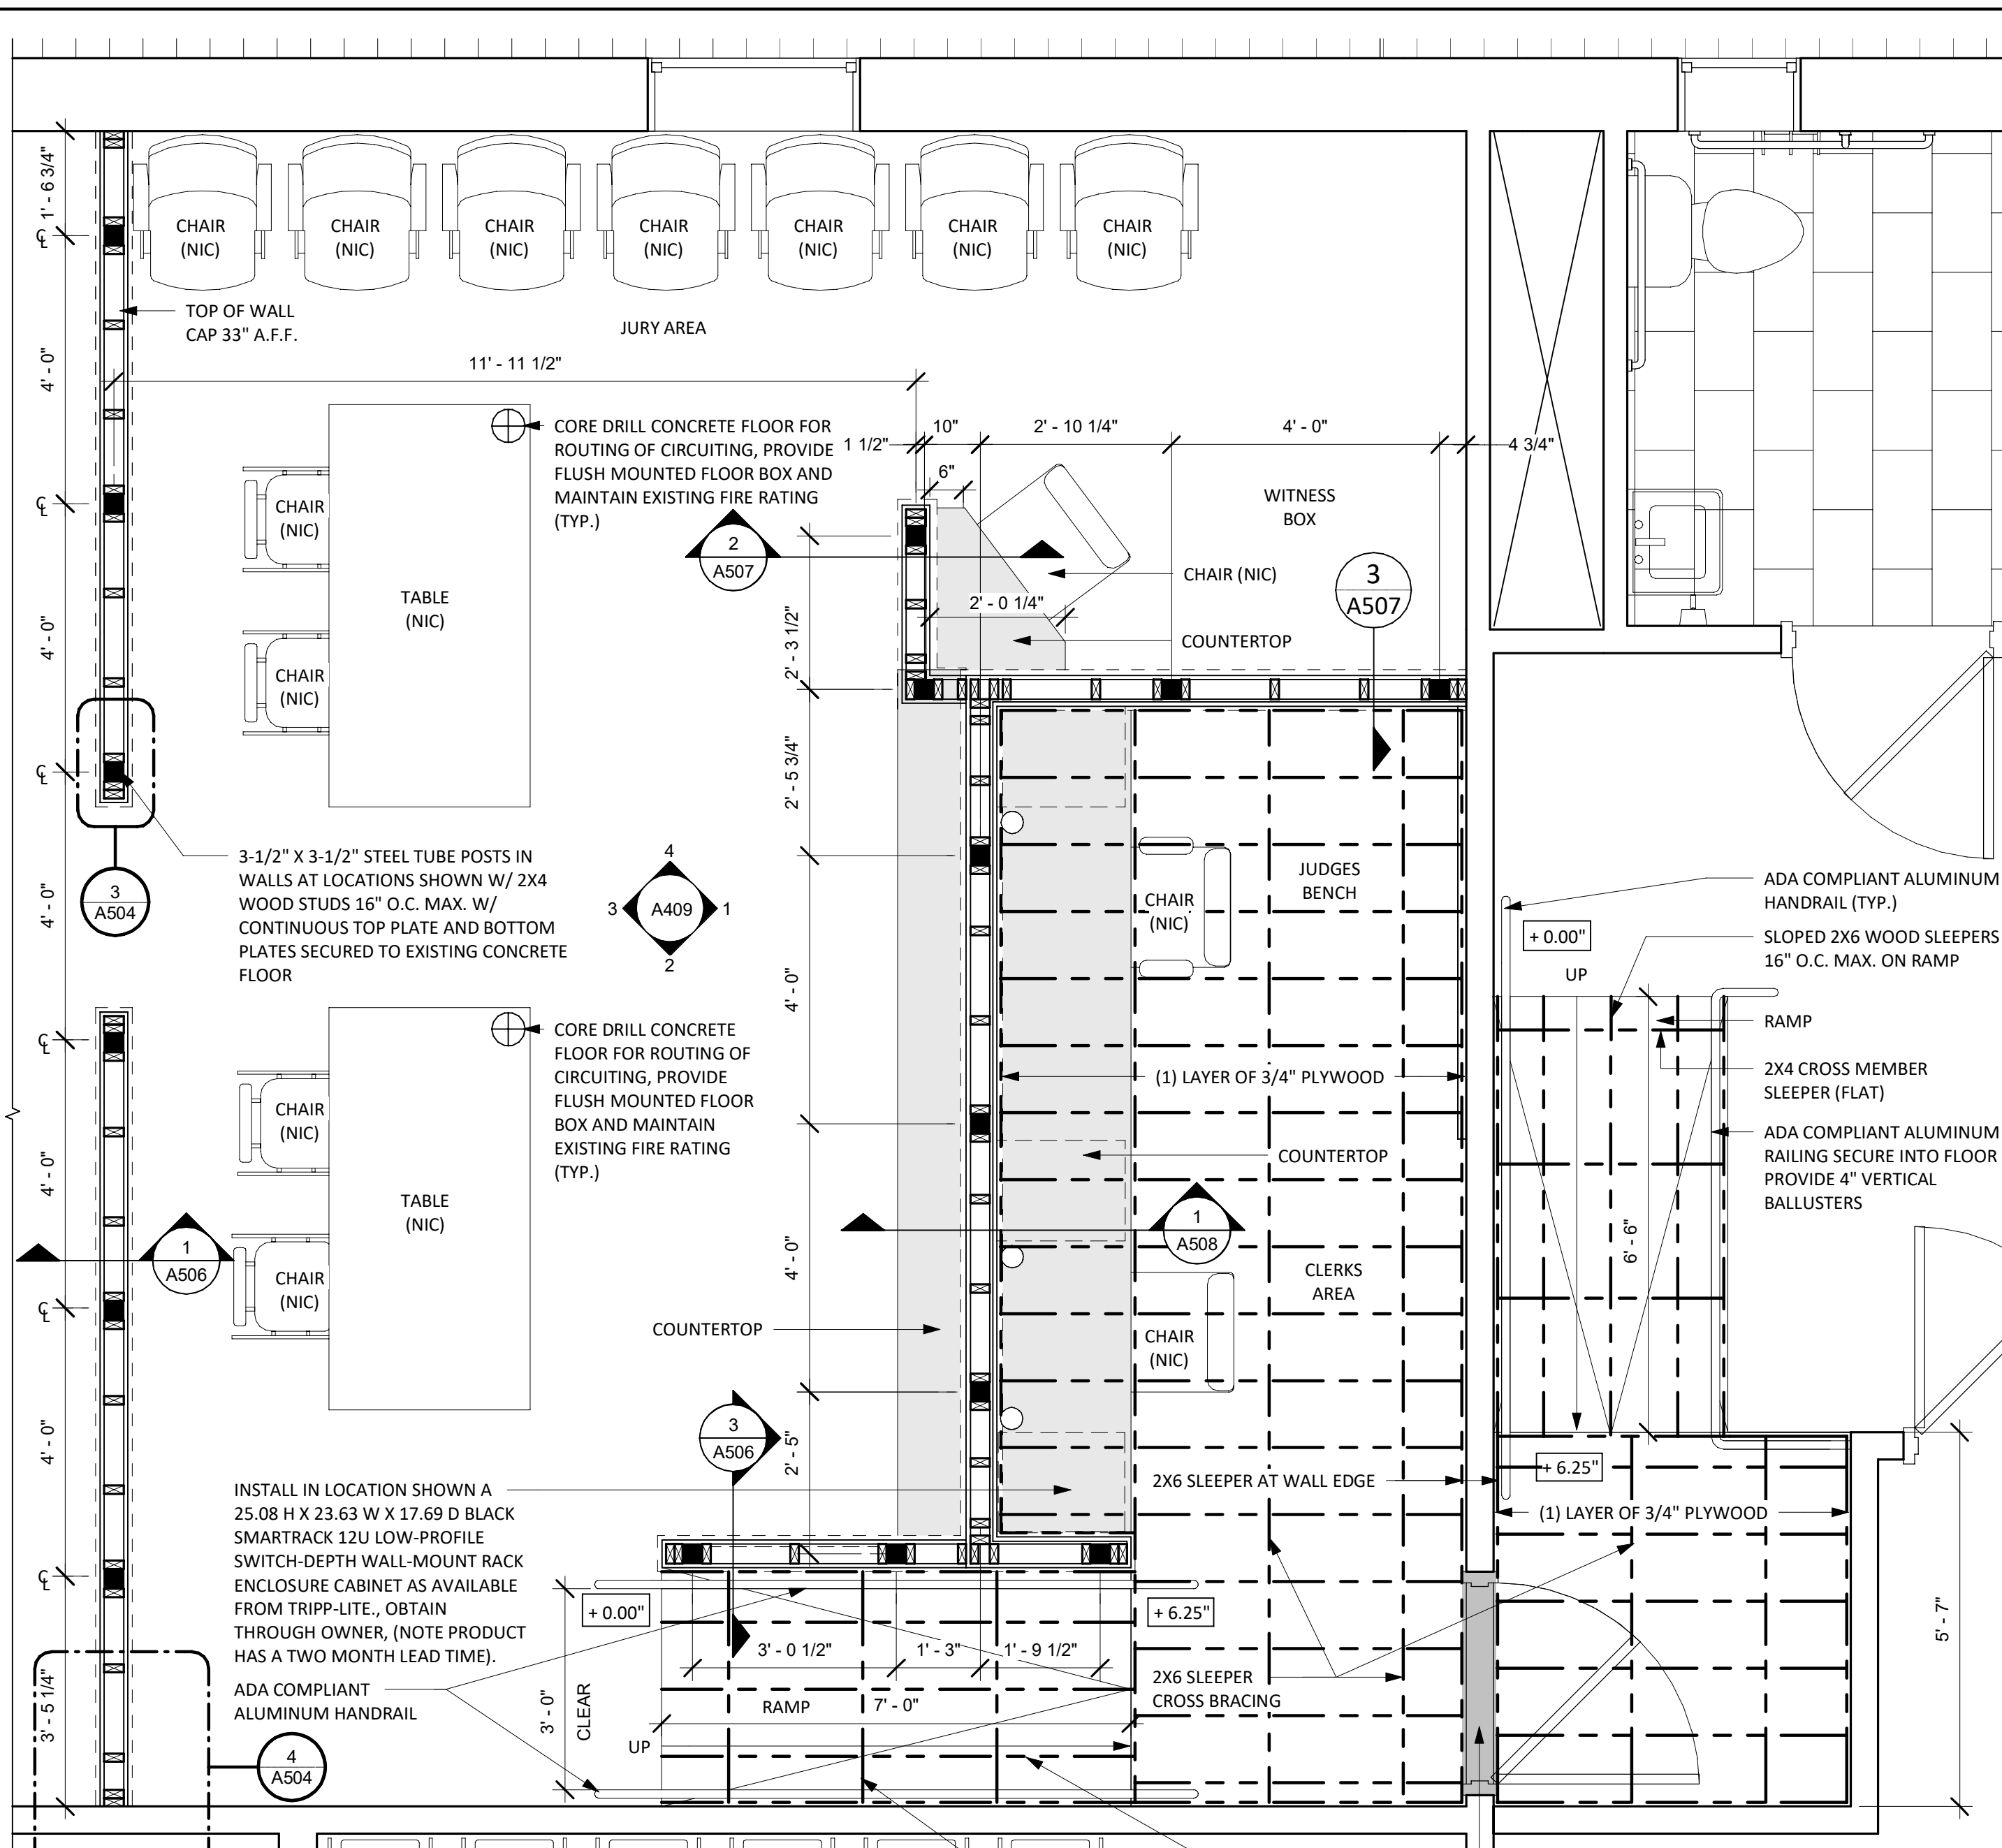


**1 COURTROOM B MILLWORK LAYOUT PLAN**  
A408 SCALE: 1/2" = 1'-0"

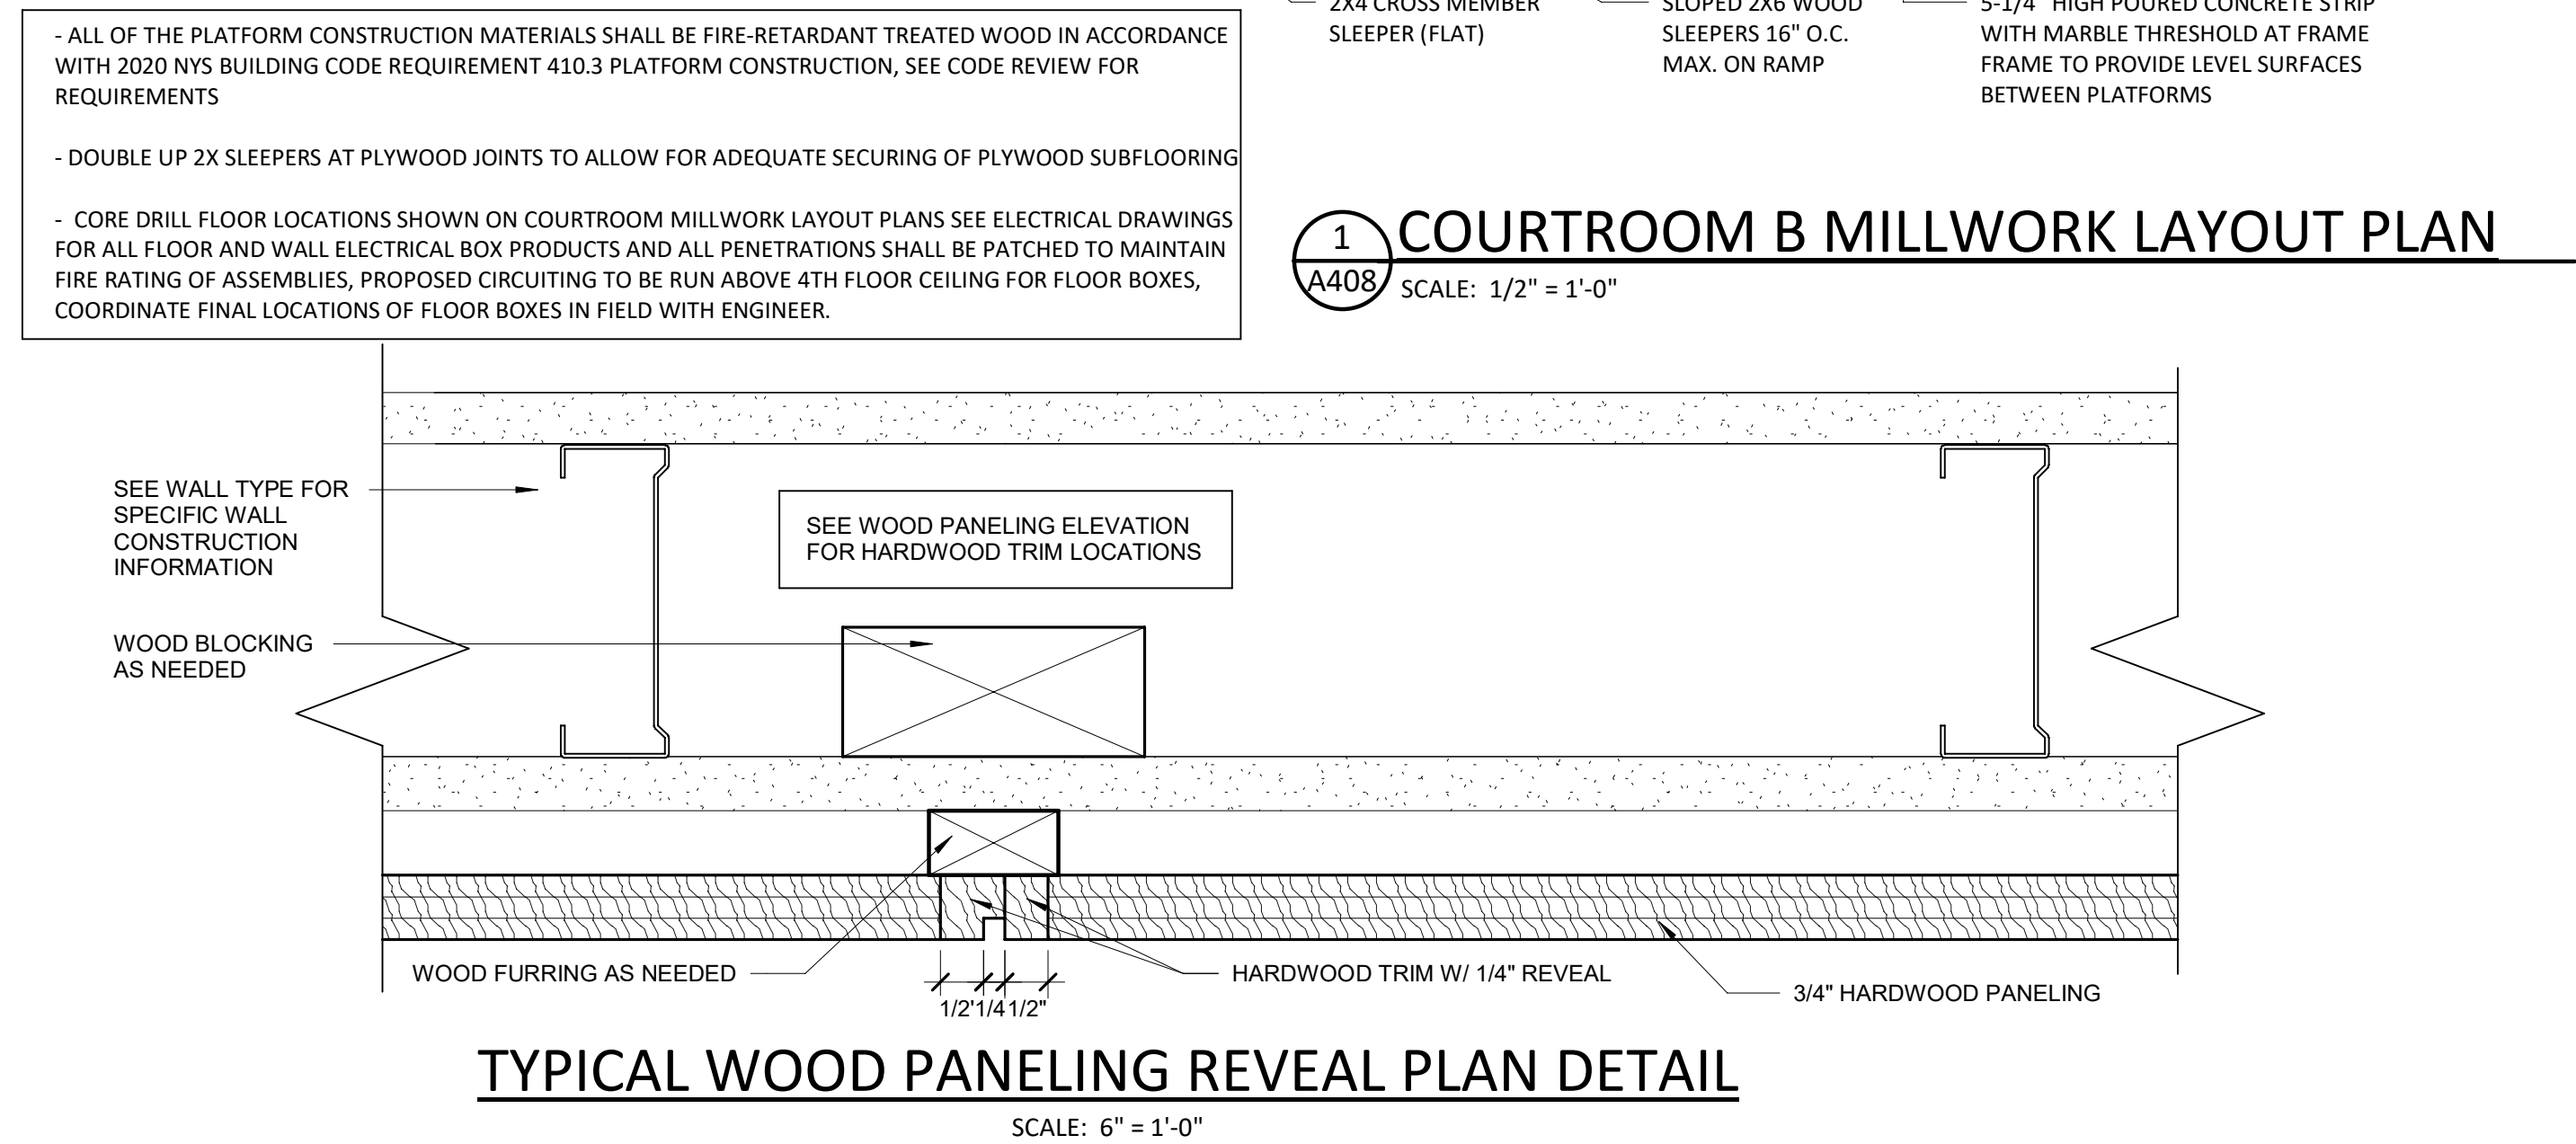



3 TYPICAL MILLWORK END WALL PLAN DETAIL  
A503 SCALE: 3" = 1'-0"

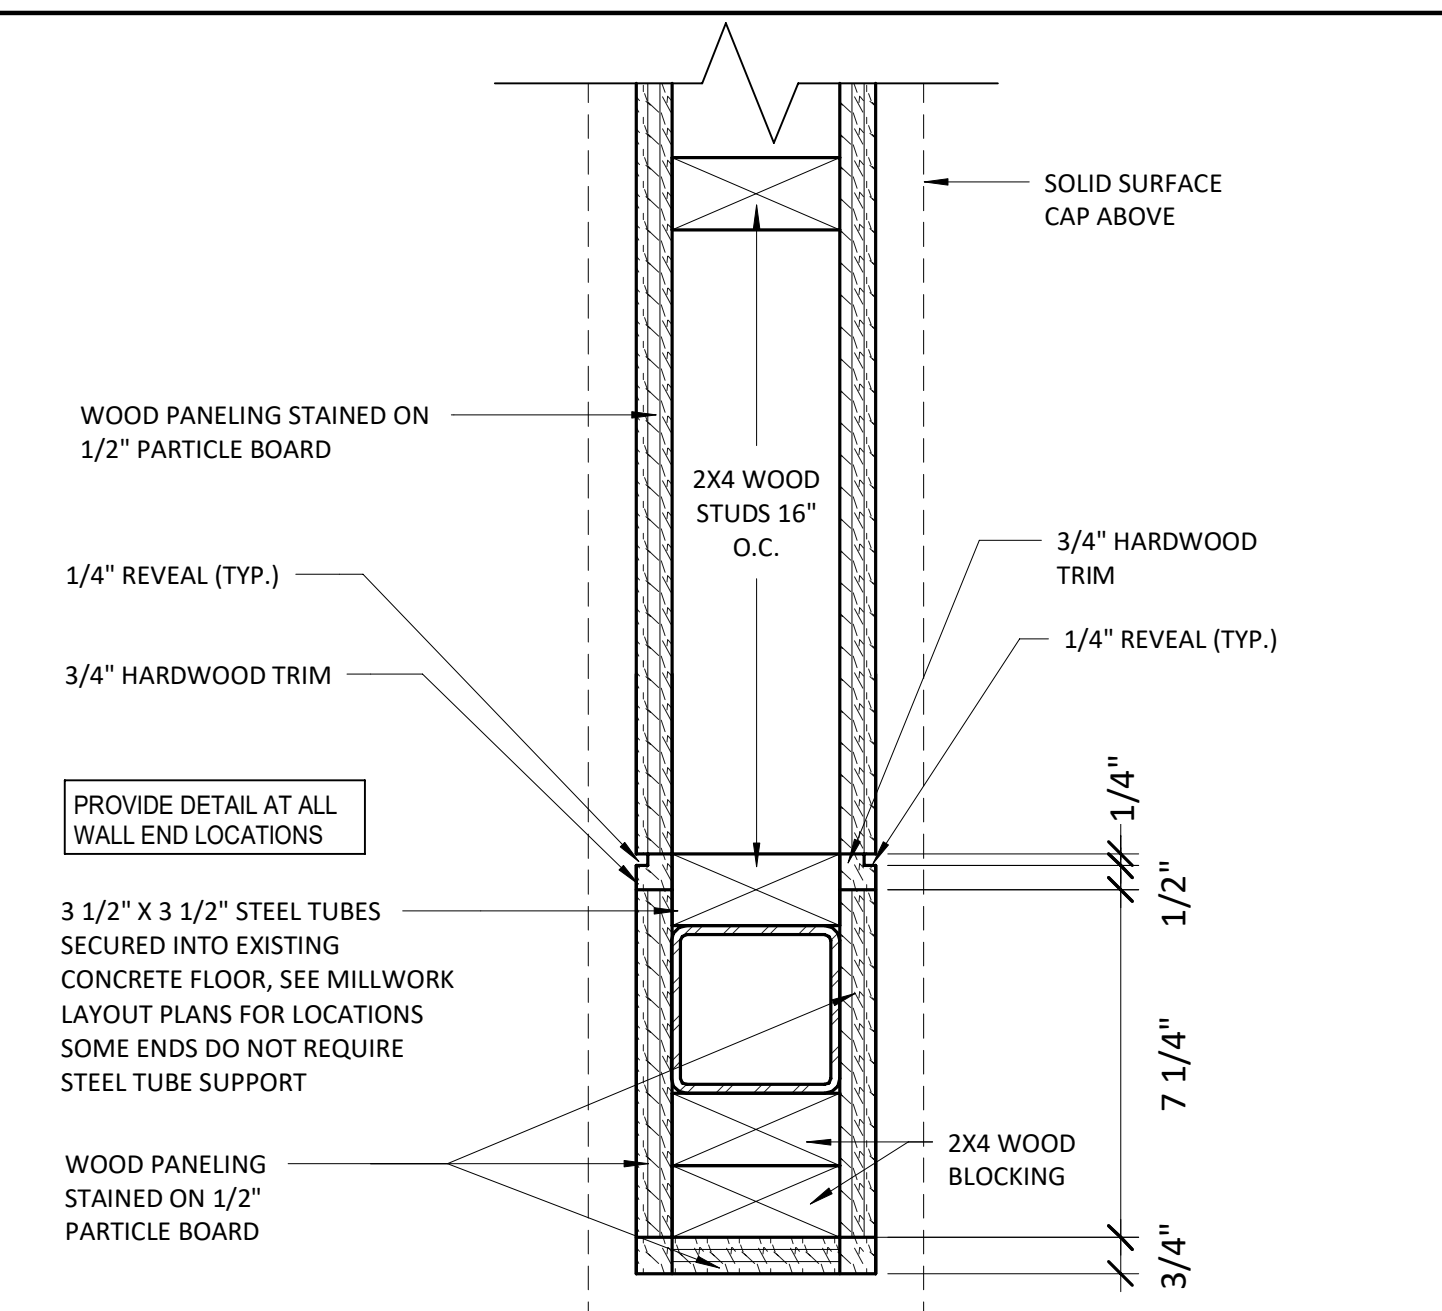

3 TYPICAL MILLWORK END WALL PLAN DETAIL  
A503 SCALE: 3" = 1'-0"

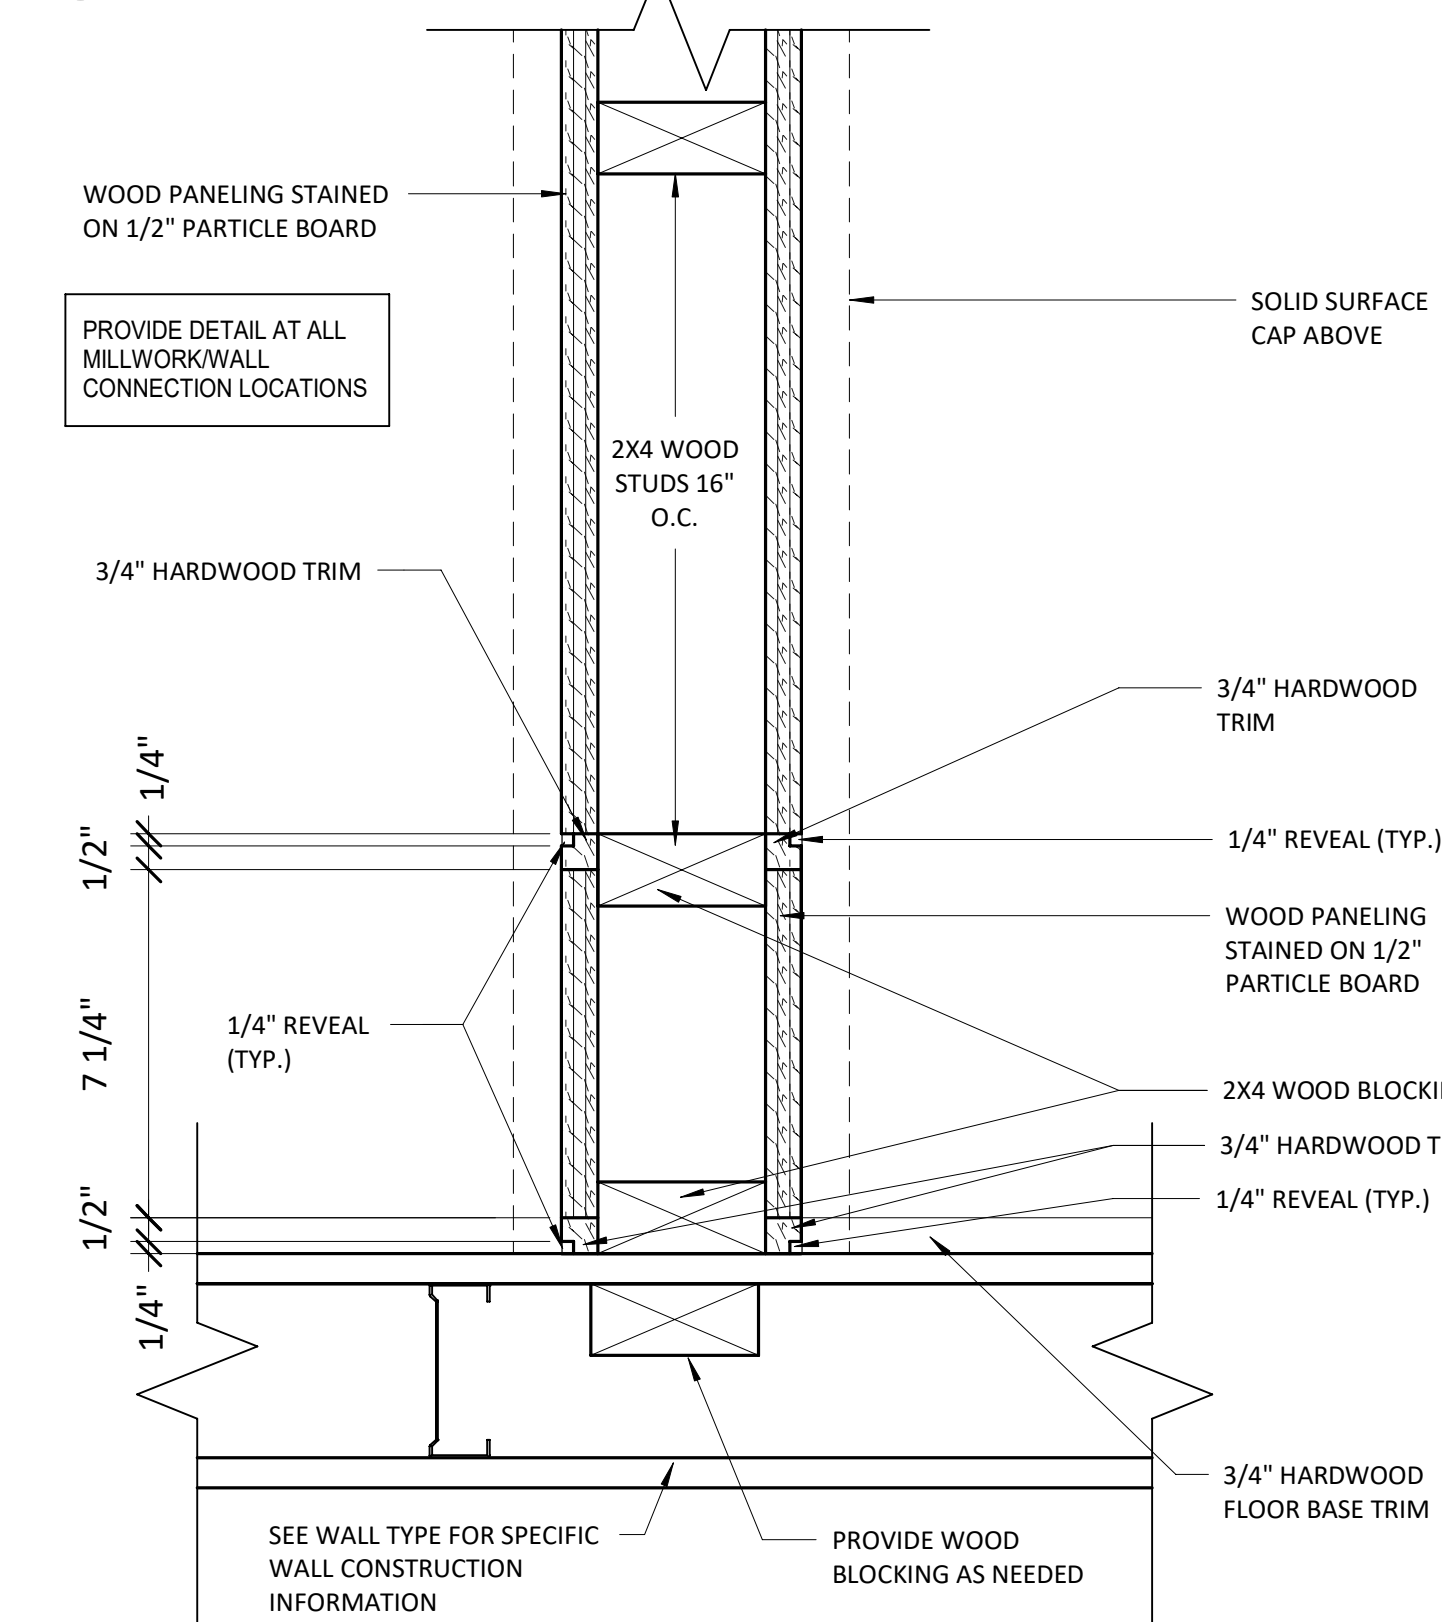


4 TYPICAL MILLWORK AT WALL PLAN DETAIL  
A503 SCALE: 3" = 1'-0"

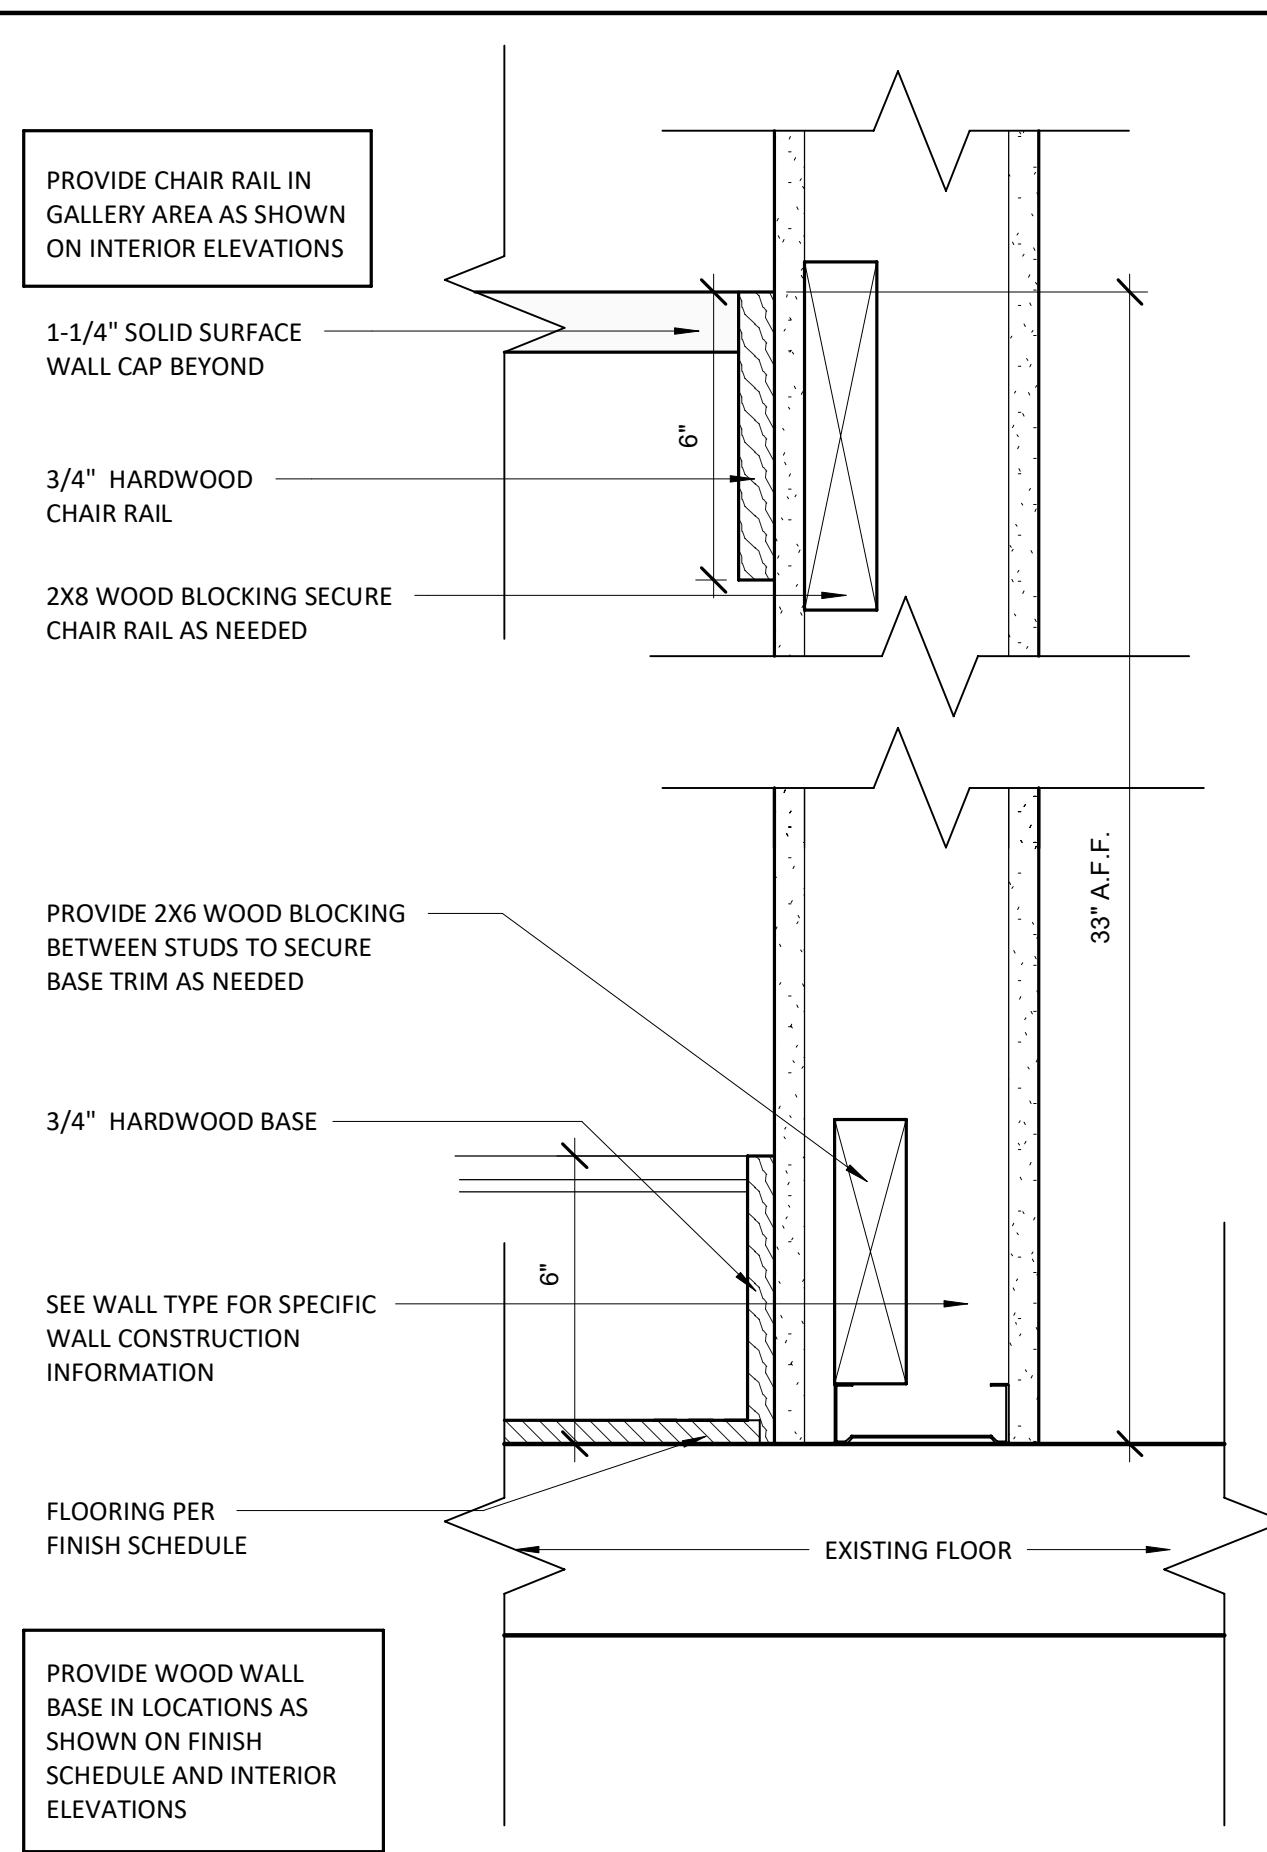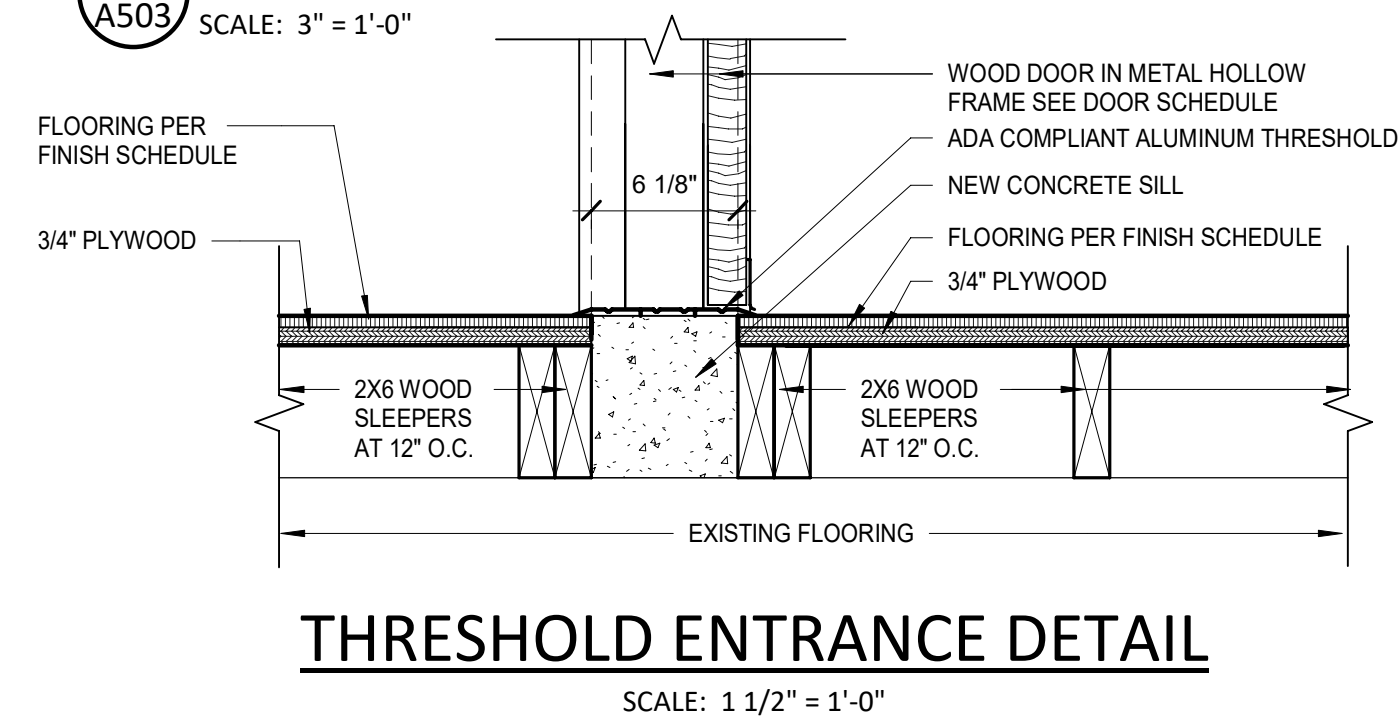

## WALL BASE & CHAIR RAIL DETAILS

SCALE: 3" = 1'-0"

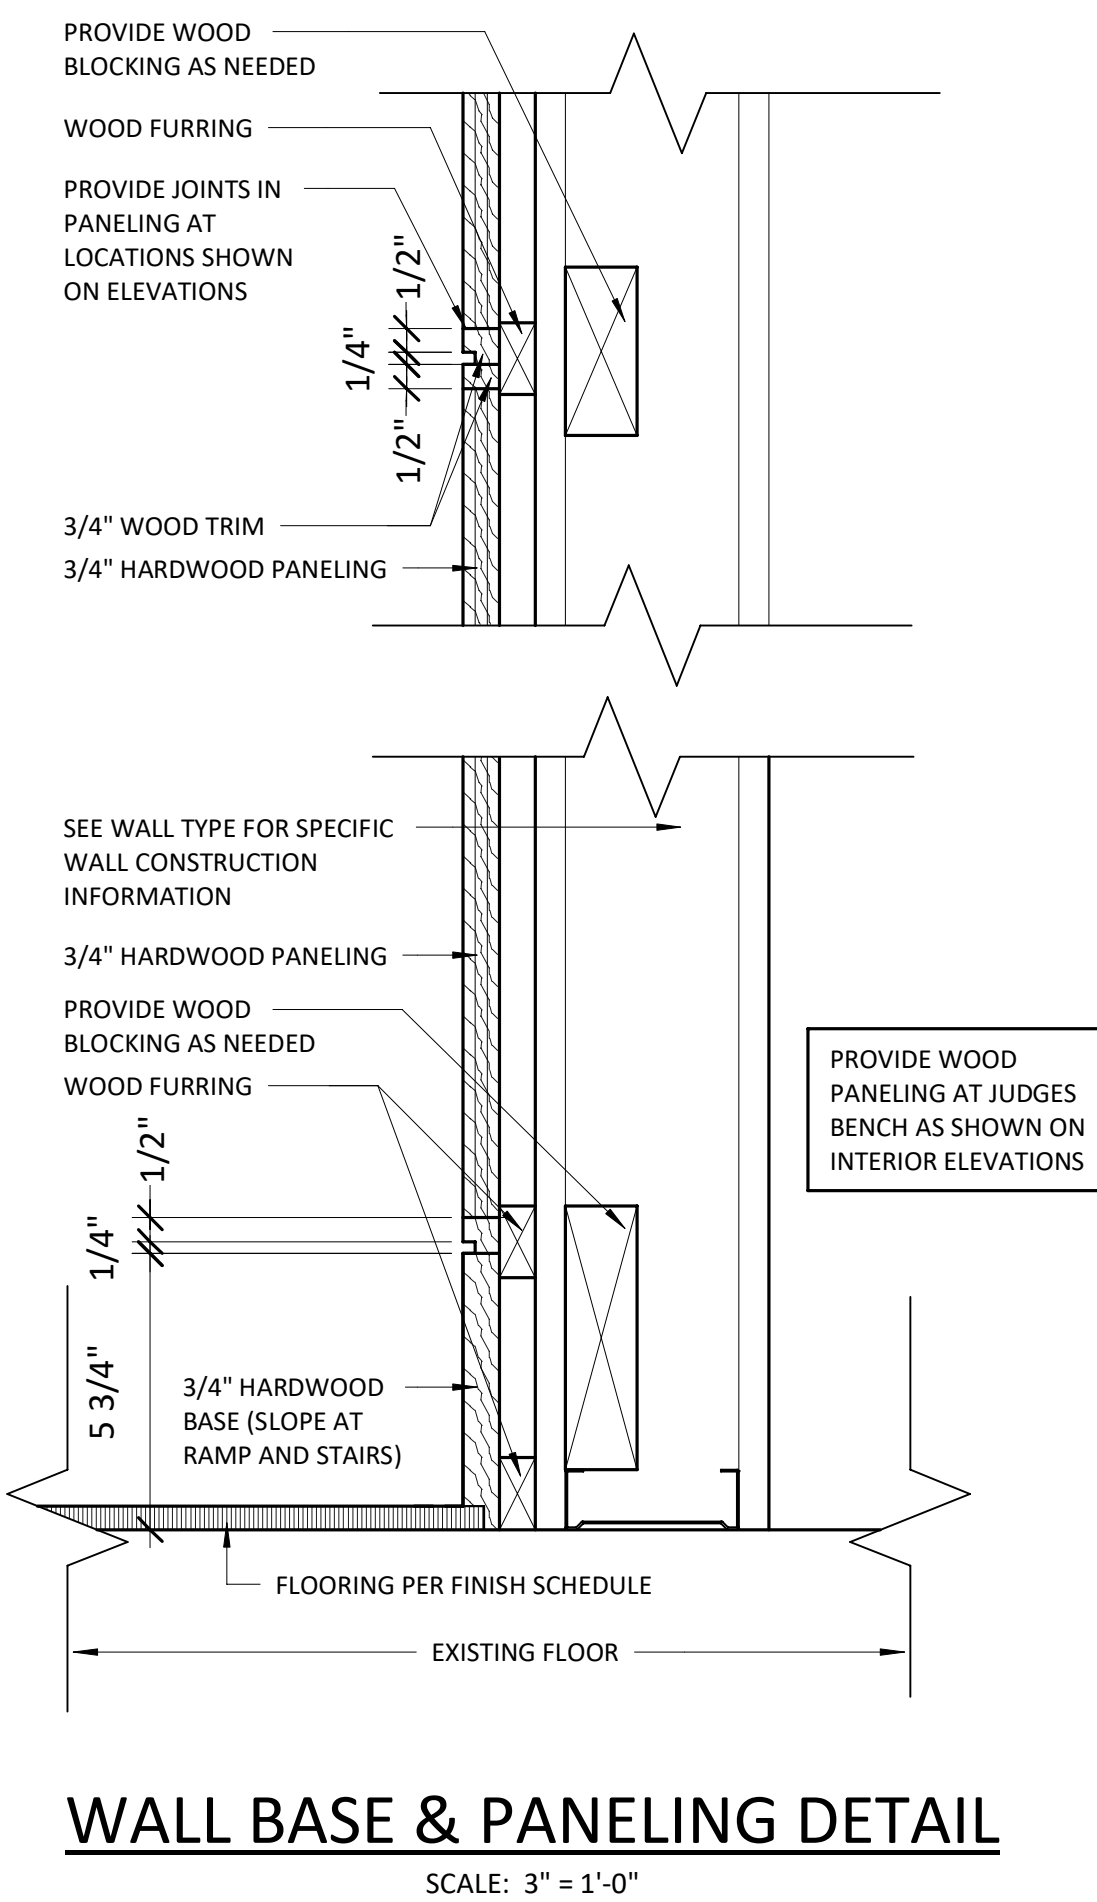

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REVISIONS	

CITY OF MIDDLETOWN  
NEW COURTHOUSE FACILITY

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COURTROOM B MILLWORK LAYOUT PLANS &  
DETAILS

CITY OF MIDDLETOWN

ORANGE COUNTY, NEW YORK

**B**  
**L**

**Barton & Loguidice**  
443 Electronics Parkway  
Liverpool, NY 13088

NYS CERTIFICATE #  
0021642, 0020588, 0019903,  
0019905, 0020336




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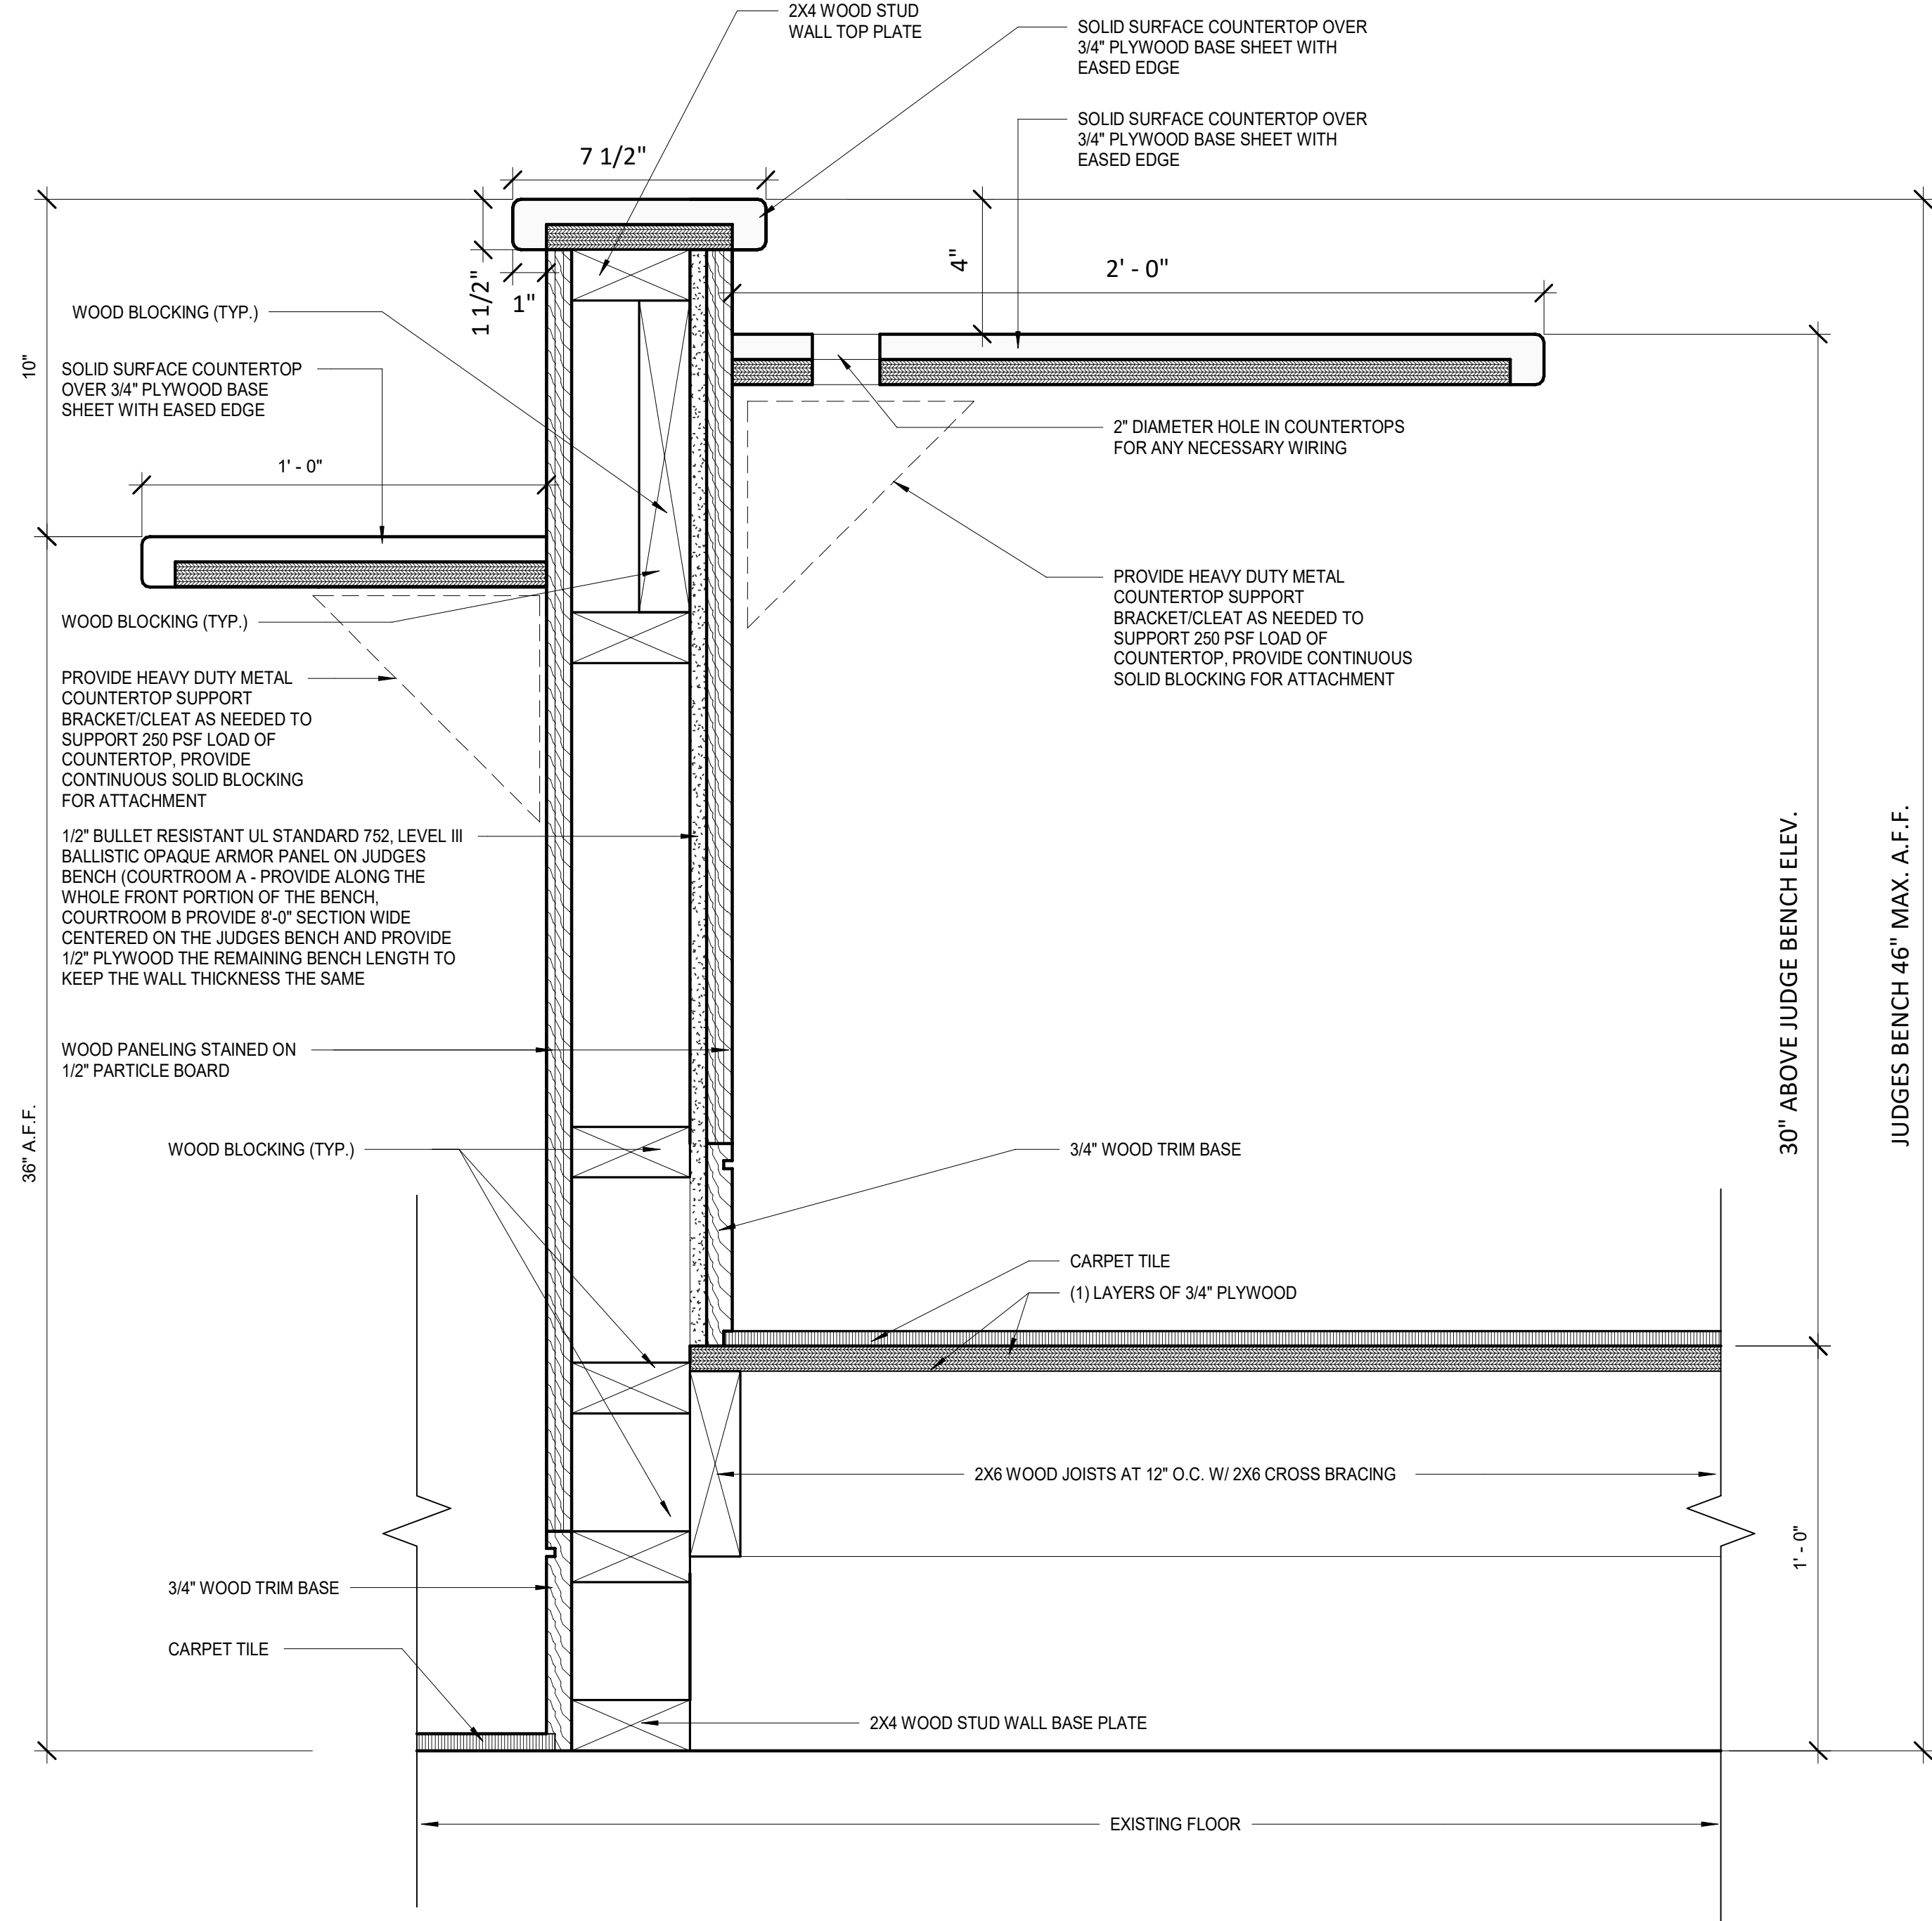
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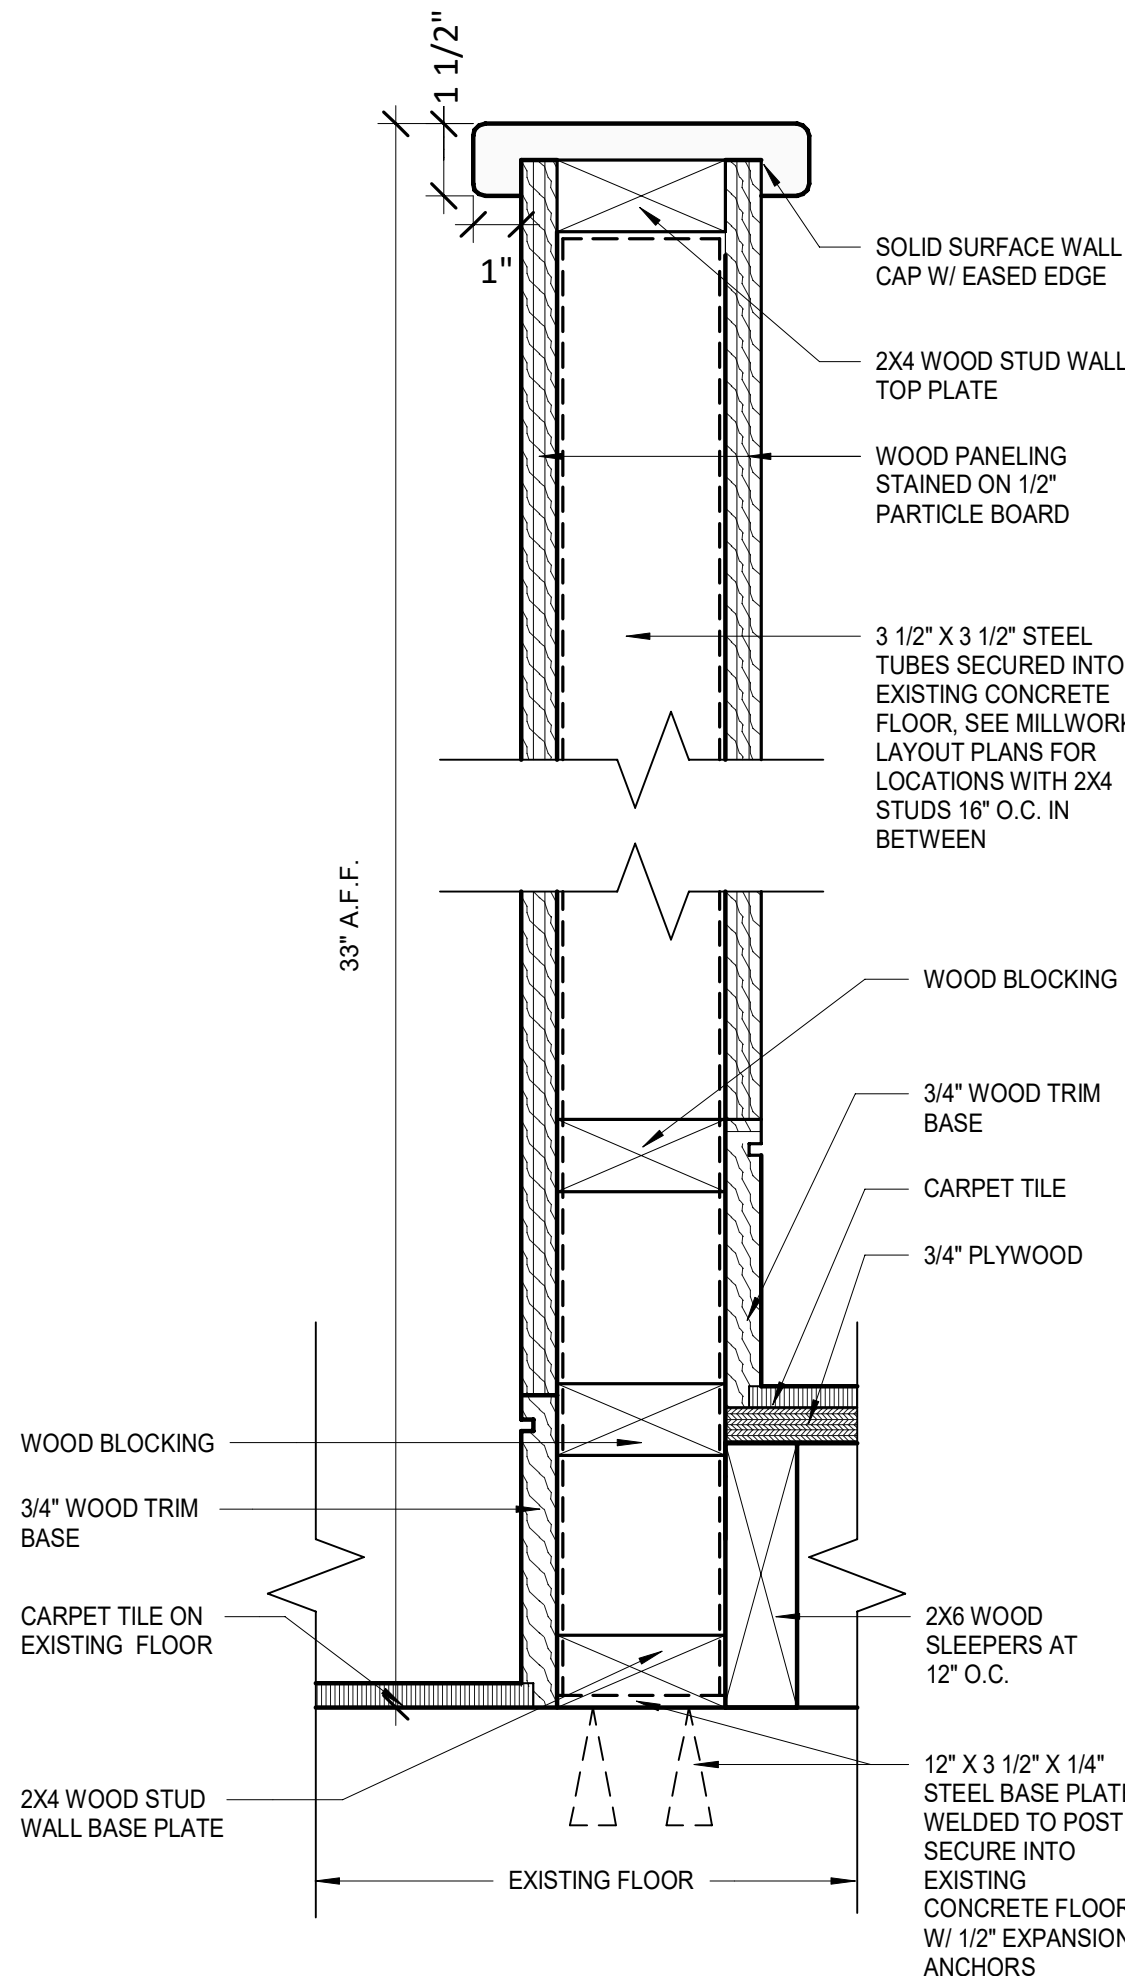
1 JUDGE BENCH WALL DETAIL 1  
A503 SCALE: 3" = 1'-0"



2 JUDGE BENCH WALL DETAIL 2  
A503 SCALE: 3" = 1'-0"



3 JURY BOX DETAIL  
A503 SCALE: 3" = 1'-0"

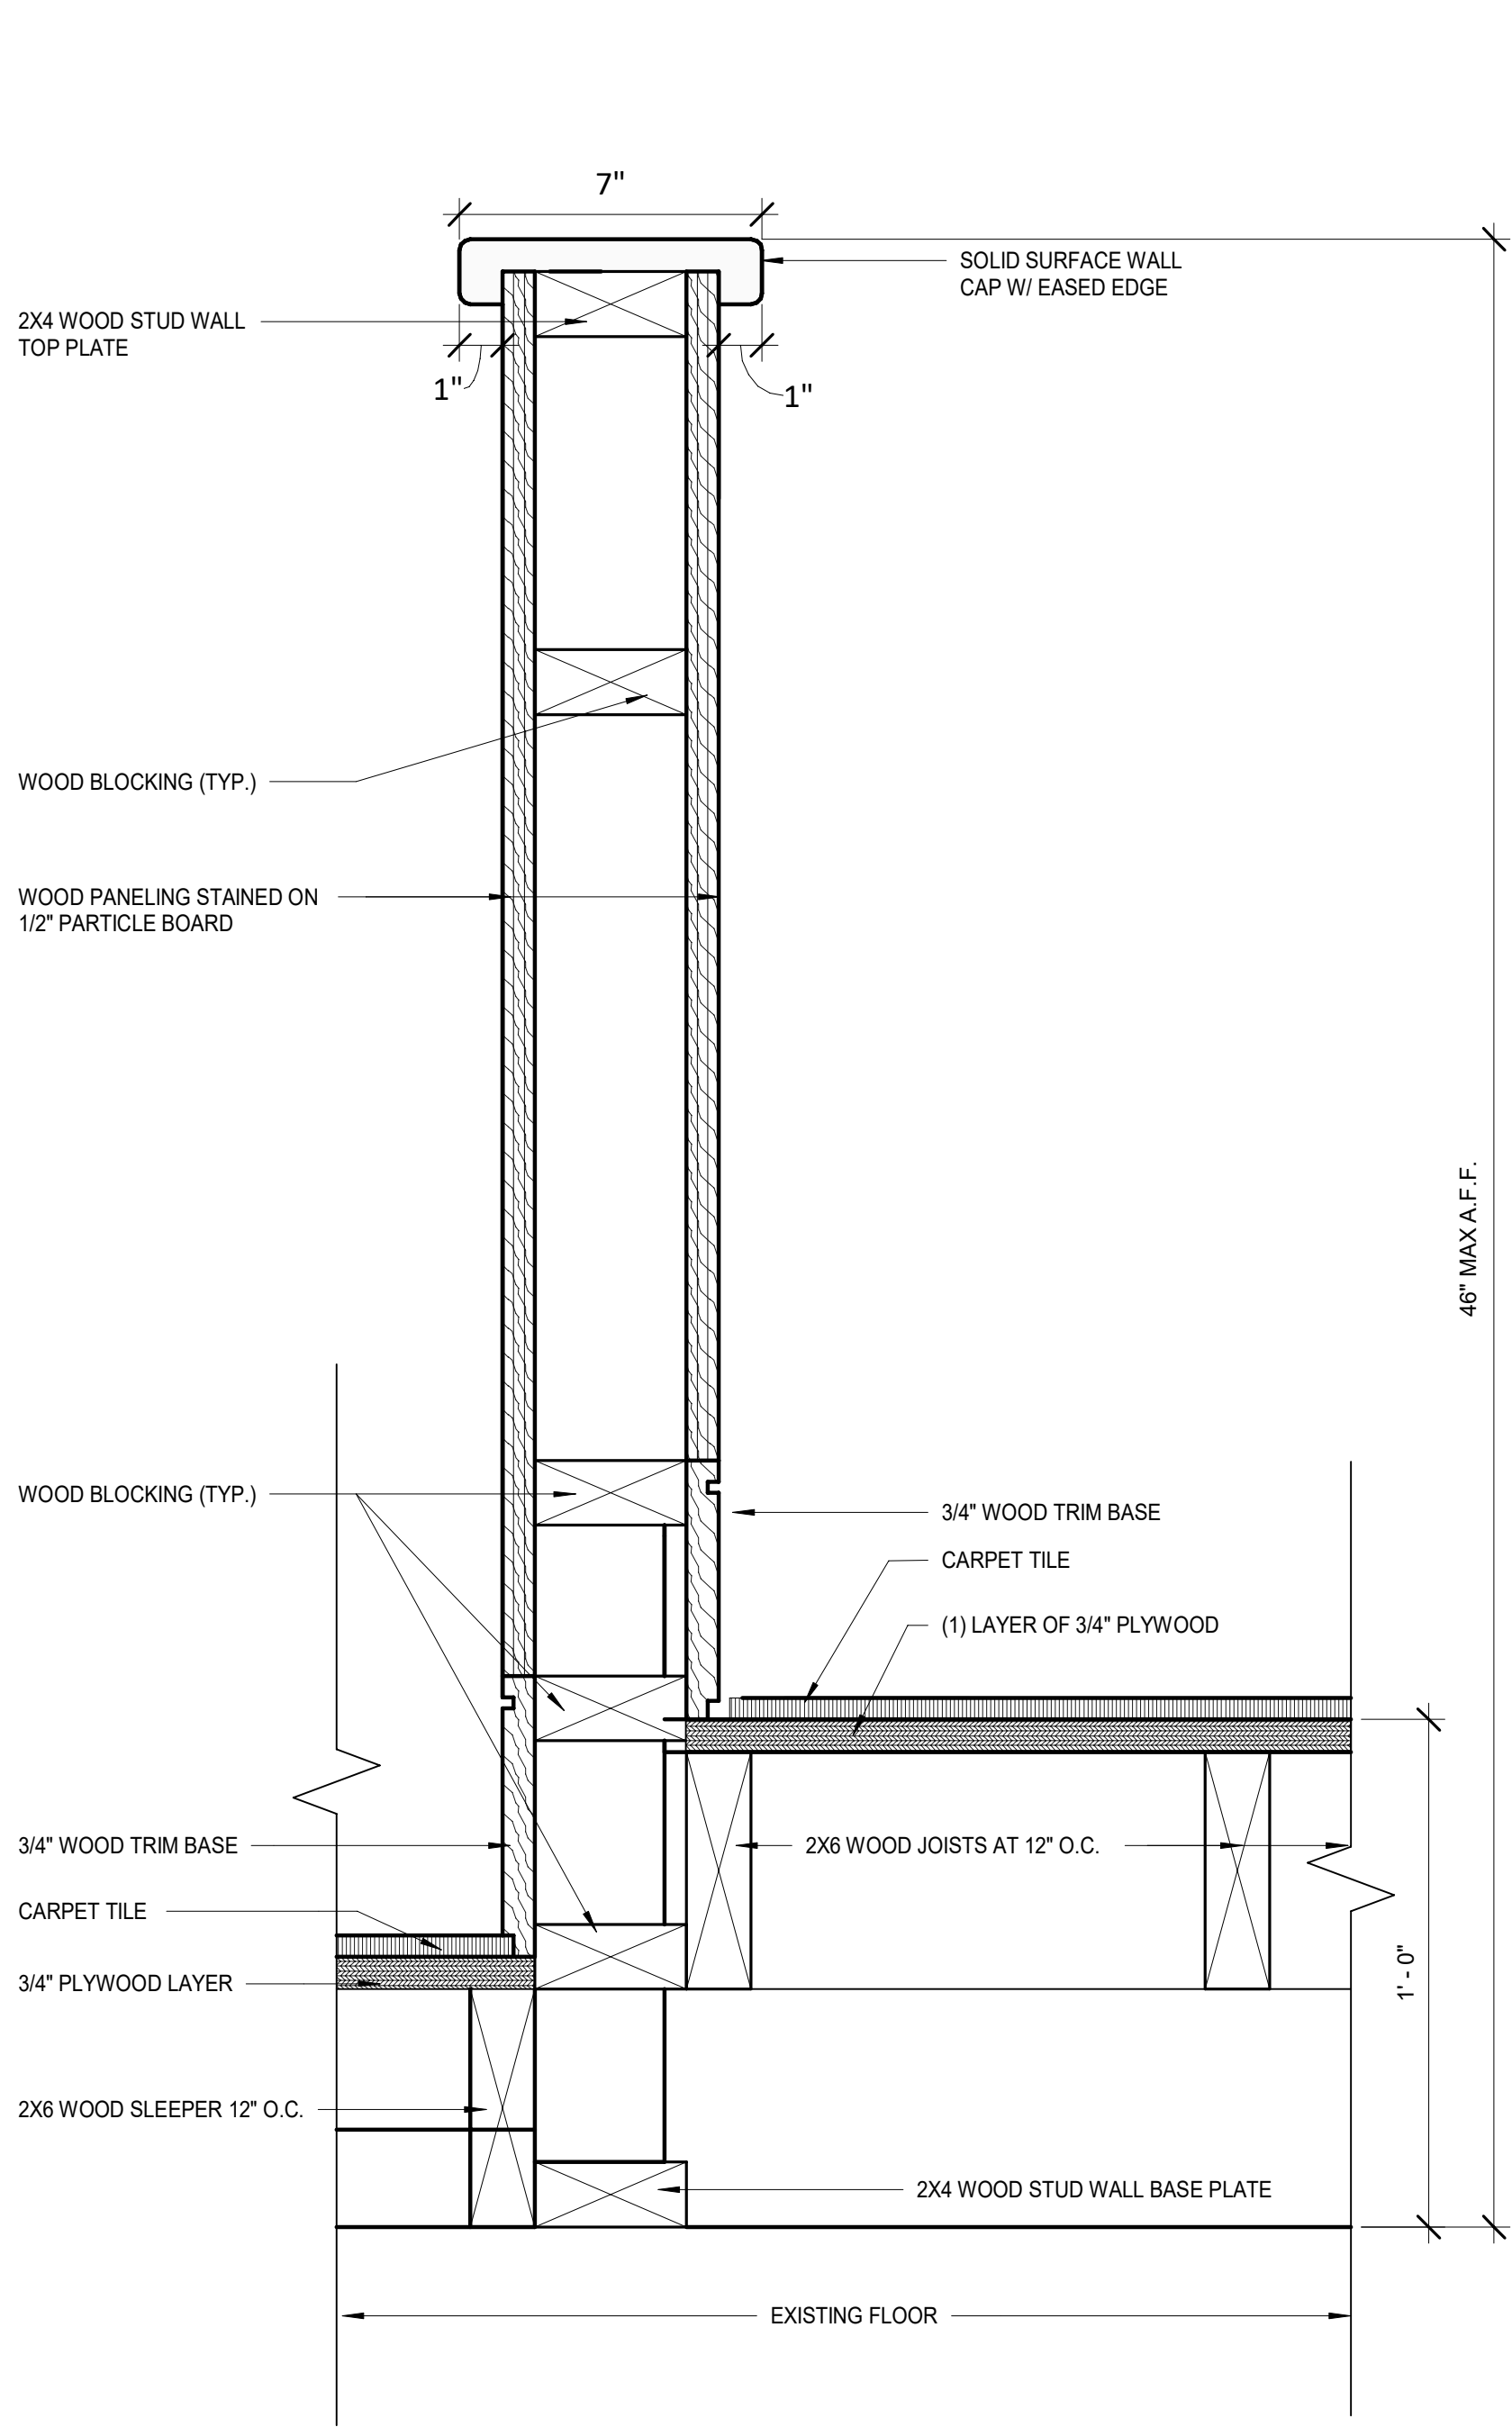

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REVISIONS	

CITY OF MIDDLETOWN  
NEW COURTHOUSE FACILITY  
COURTROOM MILLWORK DETAILS  
ORANGE COUNTY, NEW YORK  
CITY OF MIDDLETOWN

**Barton & Loguidice**  
443 Electronics Parkway  
Liverpool, NY 13088  
NYS CERTIFICATE #  
0021642, 0020588, 0019903,  
0019905, 0020336




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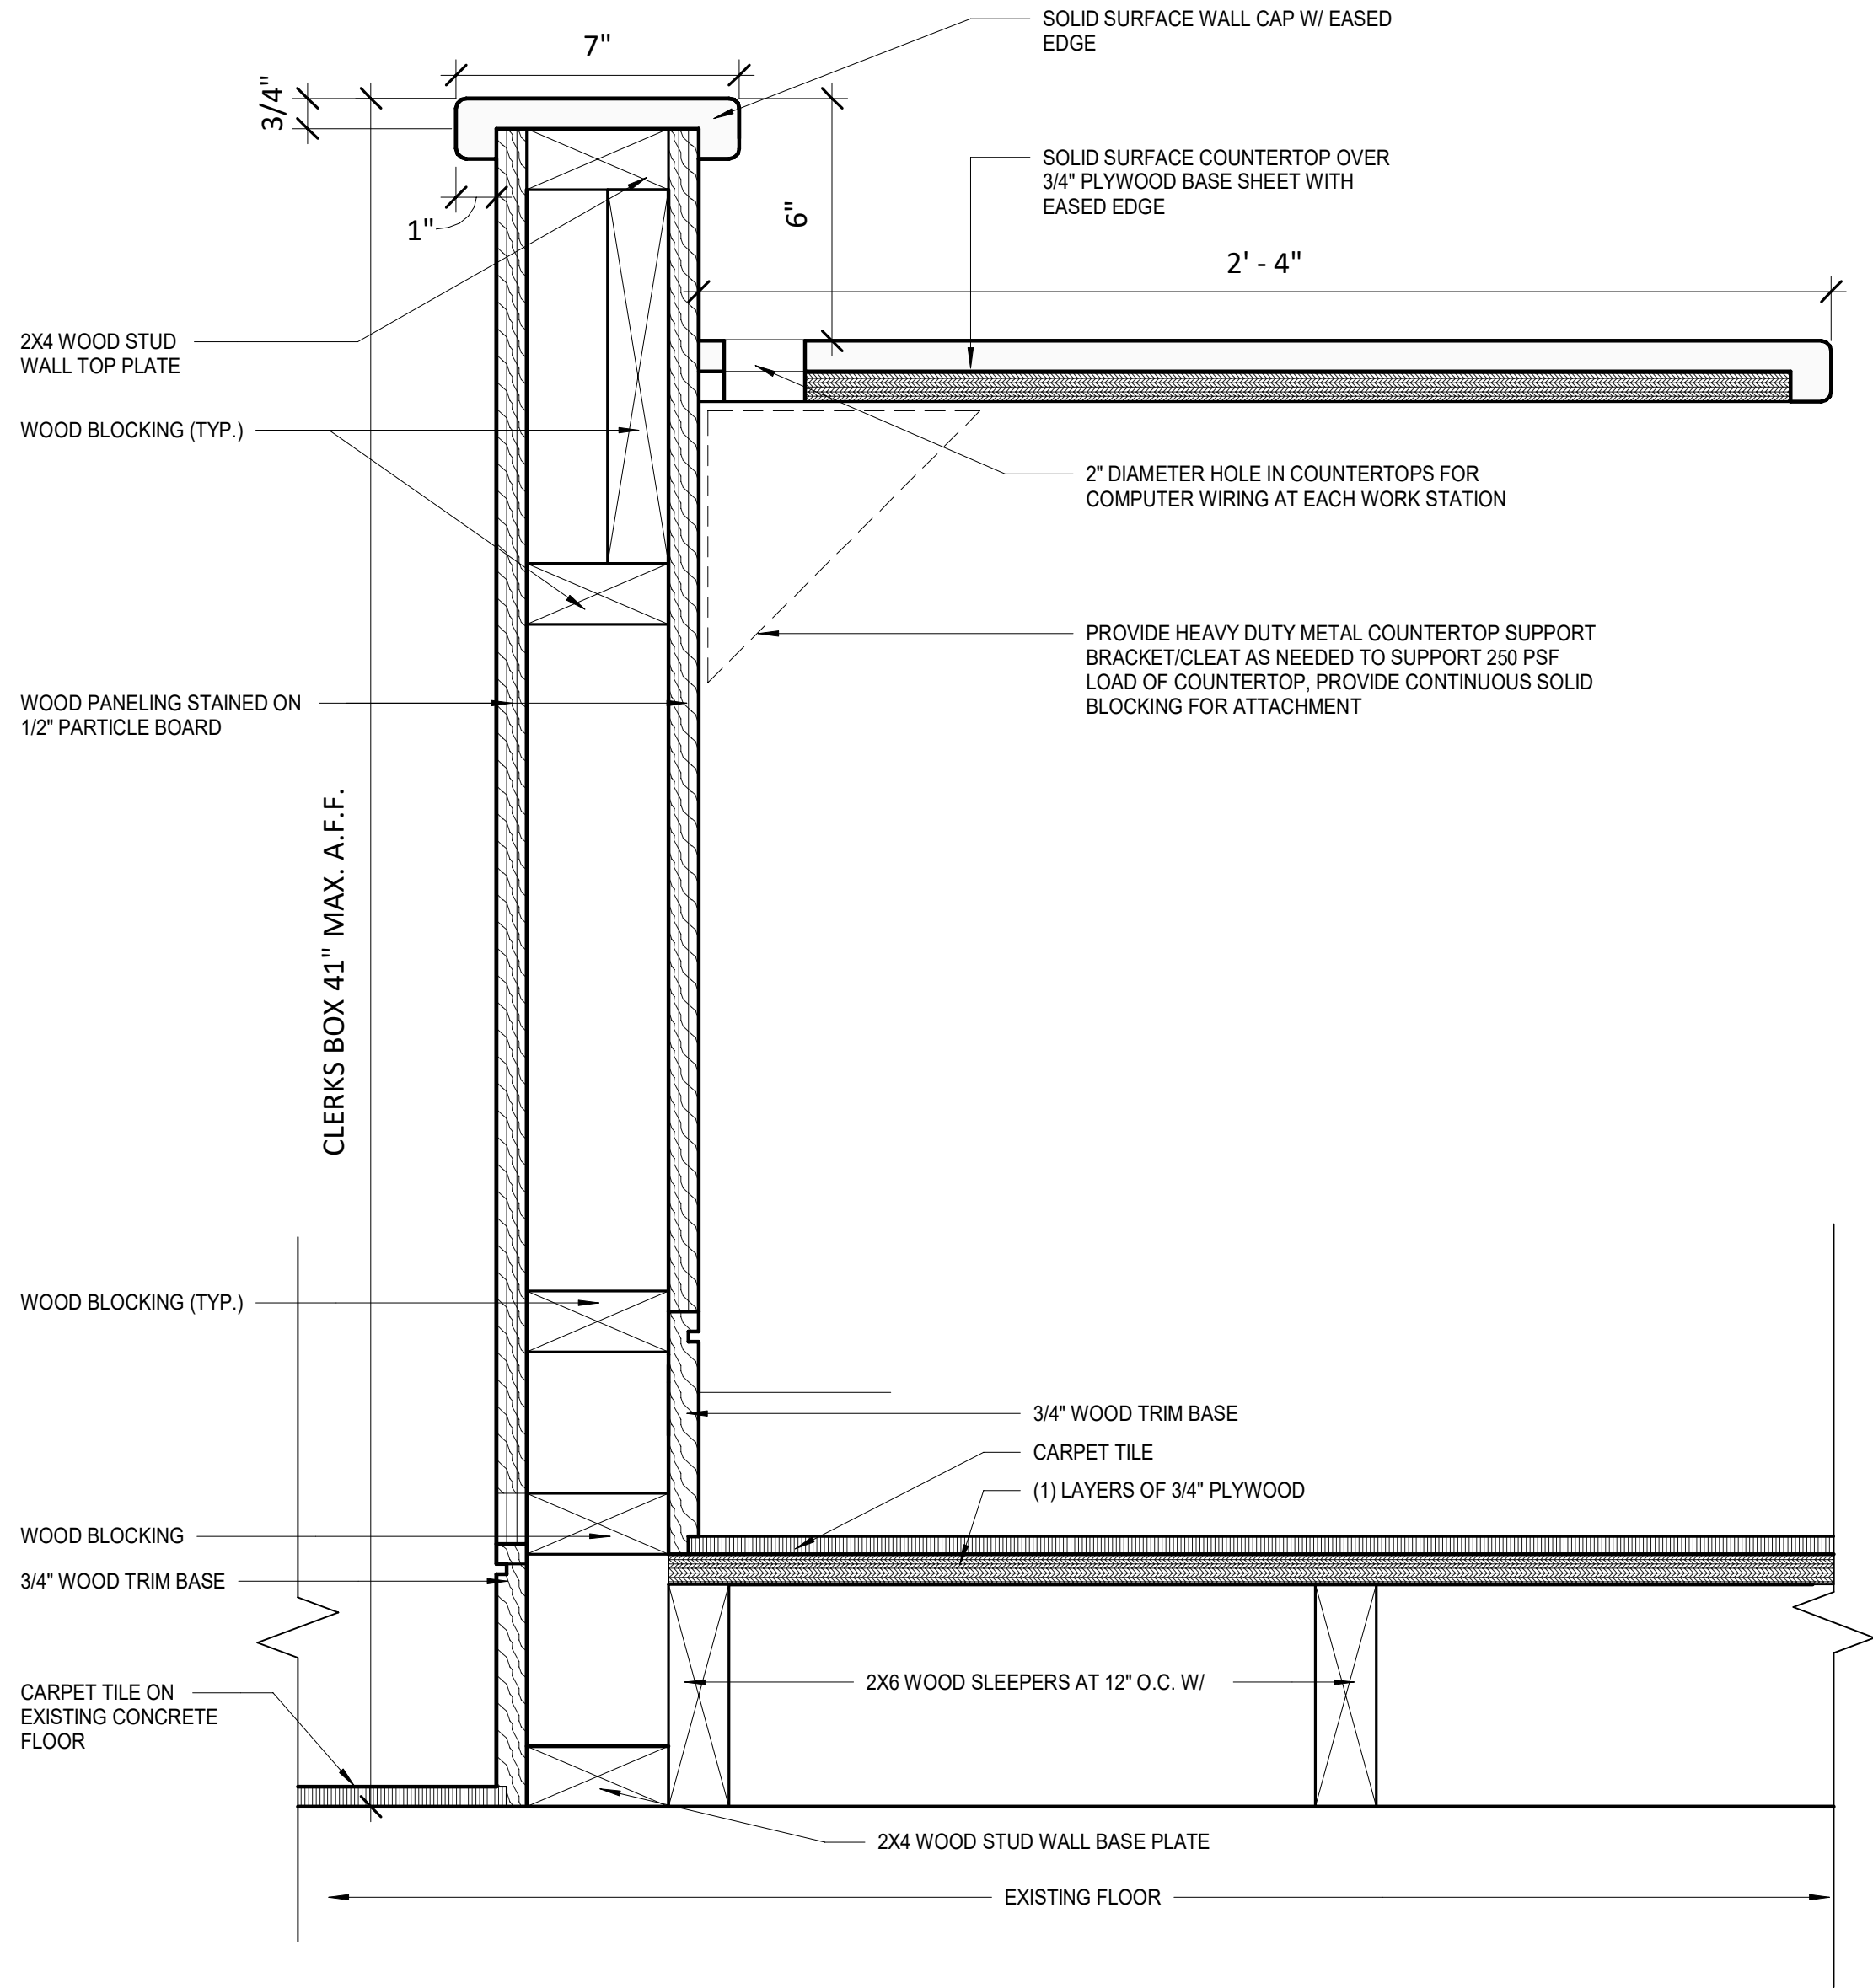


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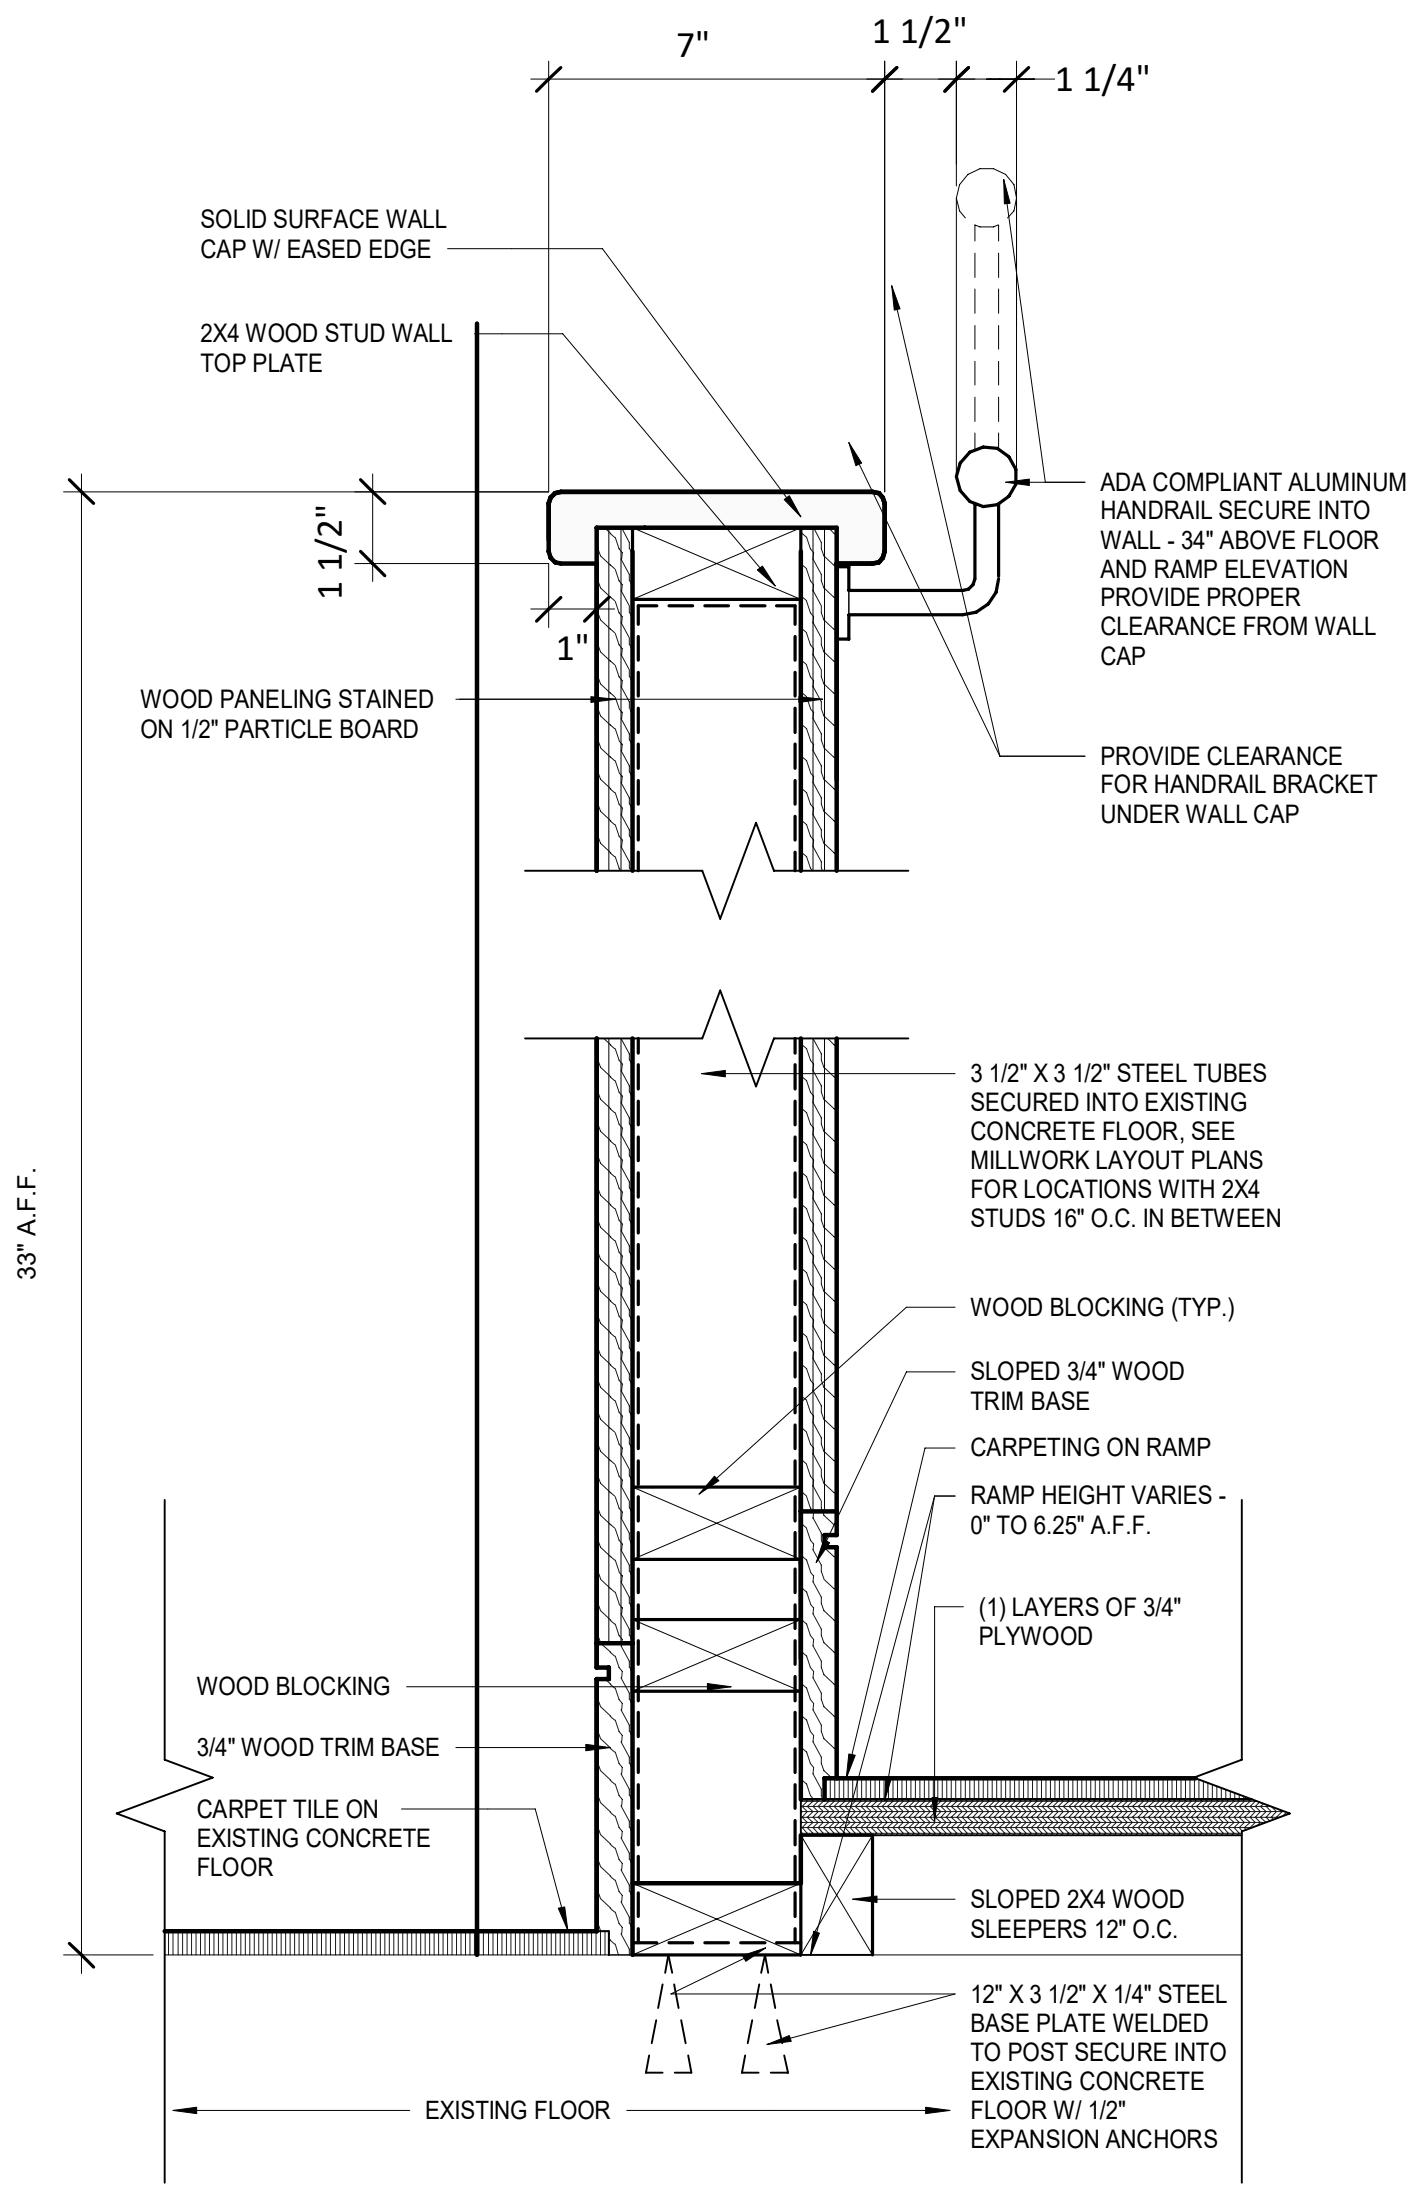
Checked by ZDC Drawn by ZDC Designed by ZDC In Charge of TRB



1 GALLERY WALL DETAIL  
A503 SCALE: 3" = 1'-0"

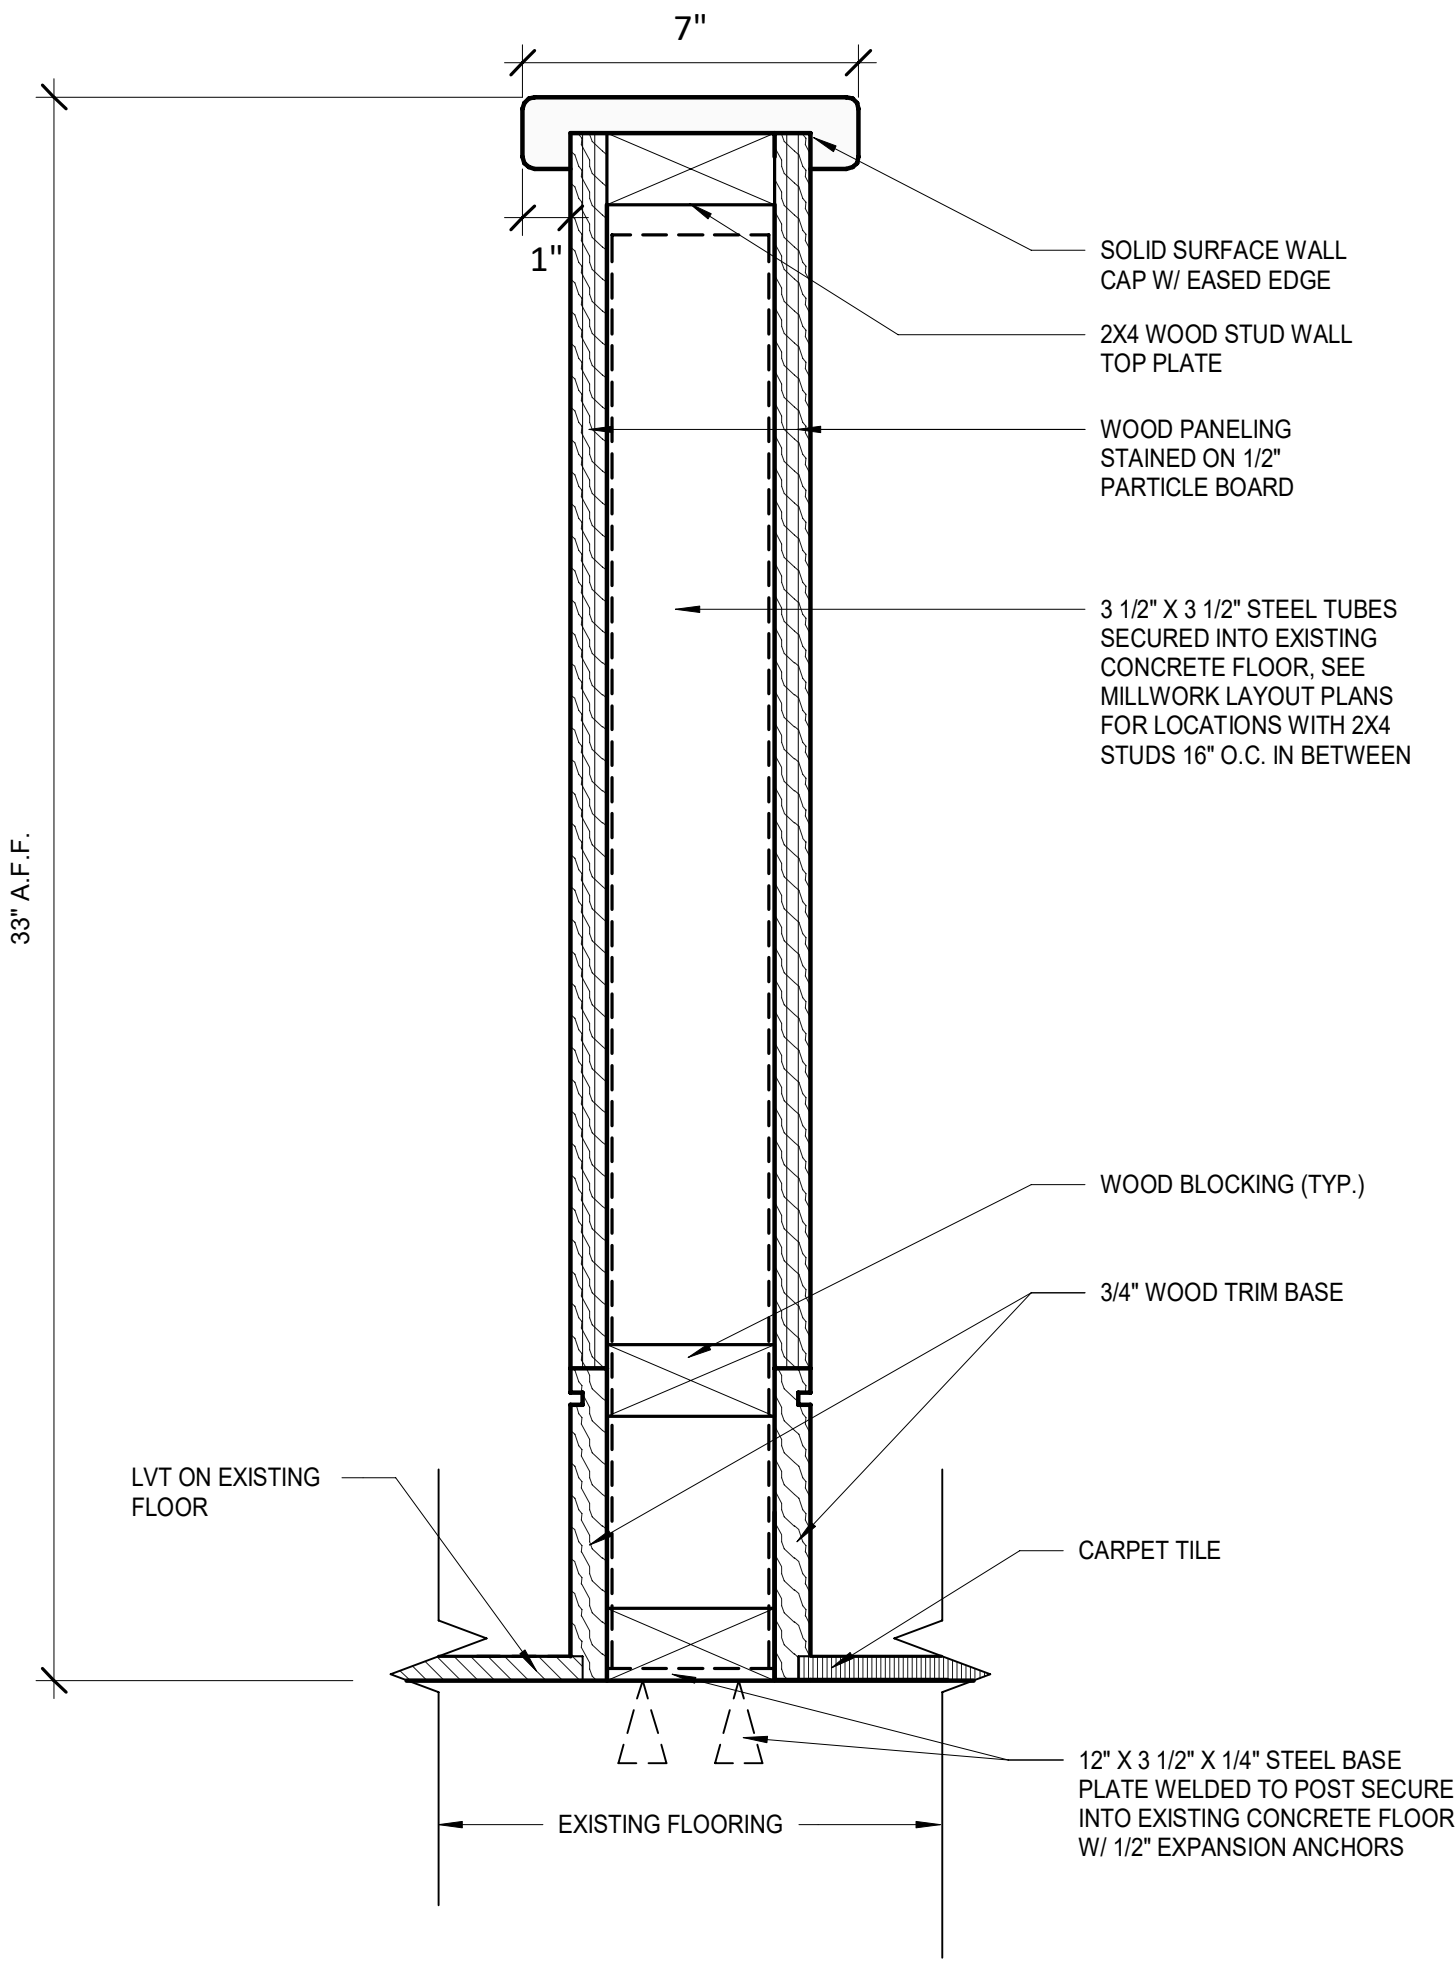

2 CLERKS AREA WALL DETAIL  
A503 SCALE: 3" = 1'-0"



3 RAMP DETAIL 1  
A503 SCALE: 3" = 1'-0"

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REVISIONS

CITY OF MIDDLETOWN  
NEW COURTHOUSE FACILITY  
ORANGE COUNTY, NEW YORK

COURTROOM MILLWORK DETAILS

CITY OF MIDDLETOWN  
NEW COURTHOUSE FACILITY

Barton & Loguidice  
443 Electronics Parkway  
Liverpool, NY 13088

NYS CERTIFICATE #  
0021642, 0020588, 0019903,  
0019905, 0020336

B&L



NYS EXP.:

Date  
AUGUST, 2024

Scale  
AS SHOWN

Sheet Number  
A506

Project Number  
1753.008.001



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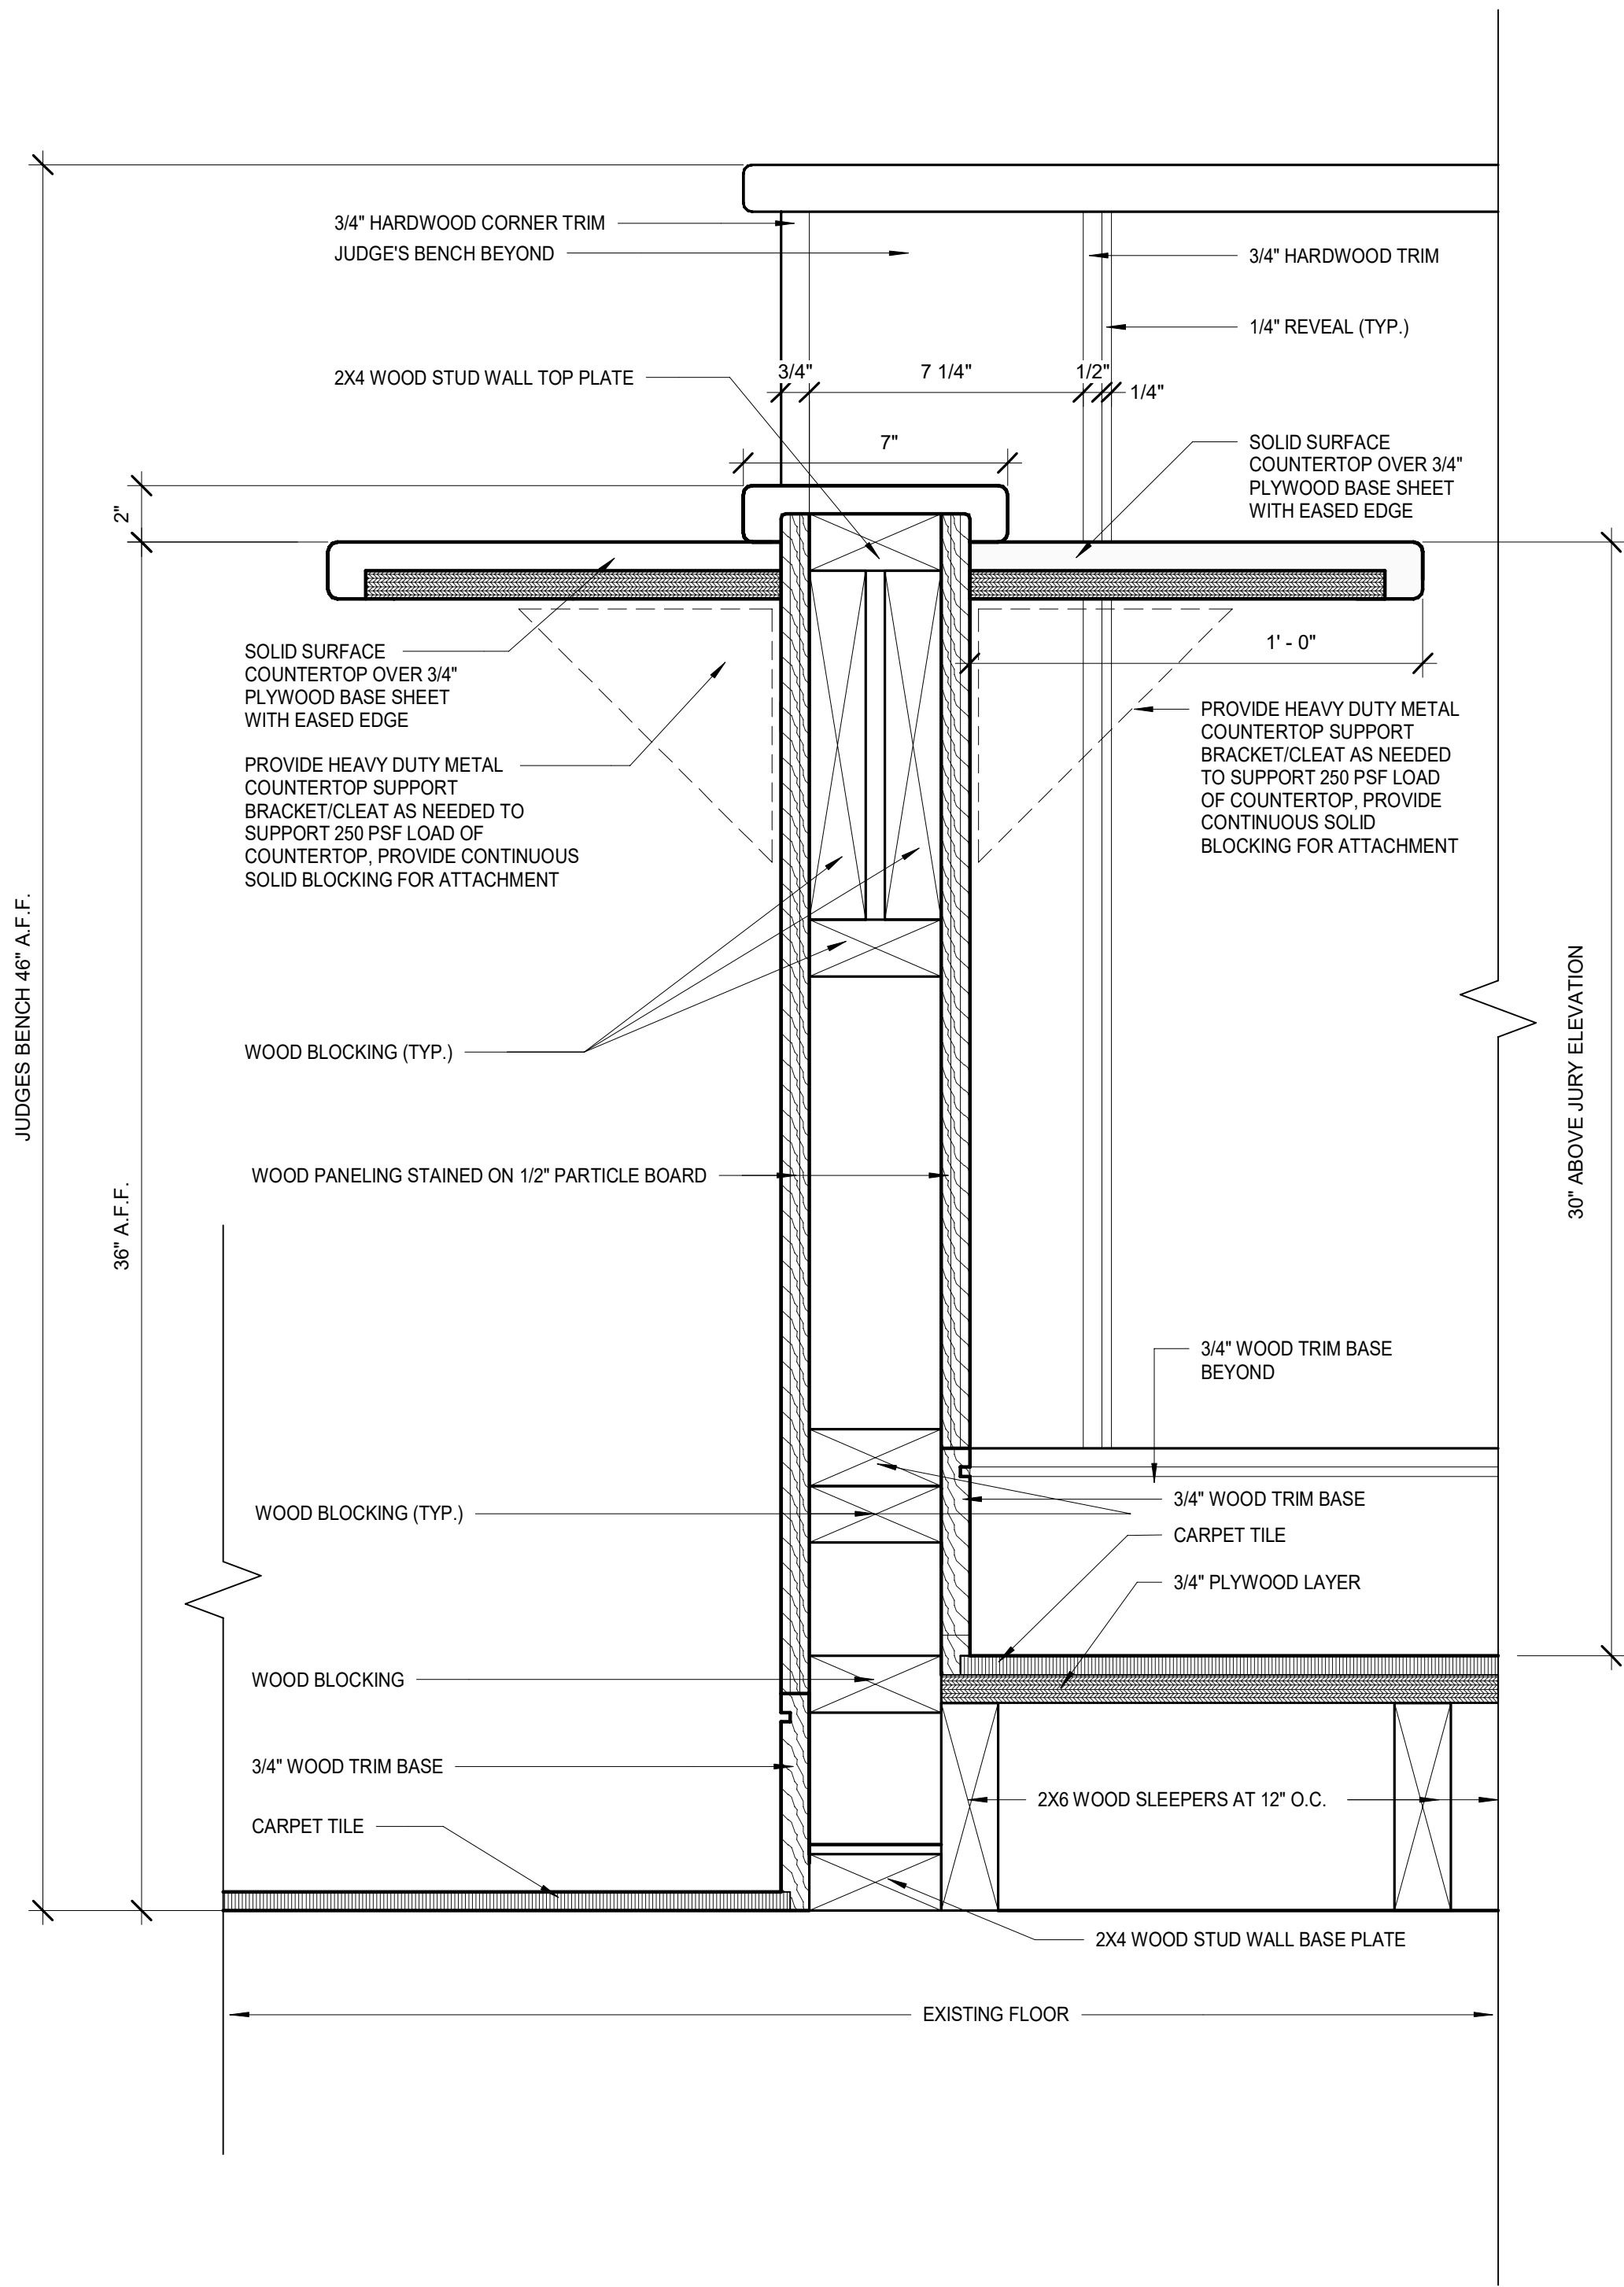
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TRB

In Charge of


1 WITNESS BOX WALL DETAIL 1

A503 SCALE: 3" = 1'-0"




2 WITNESS BOX WALL DETAIL 2

A504 SCALE: 3" = 1'-0"

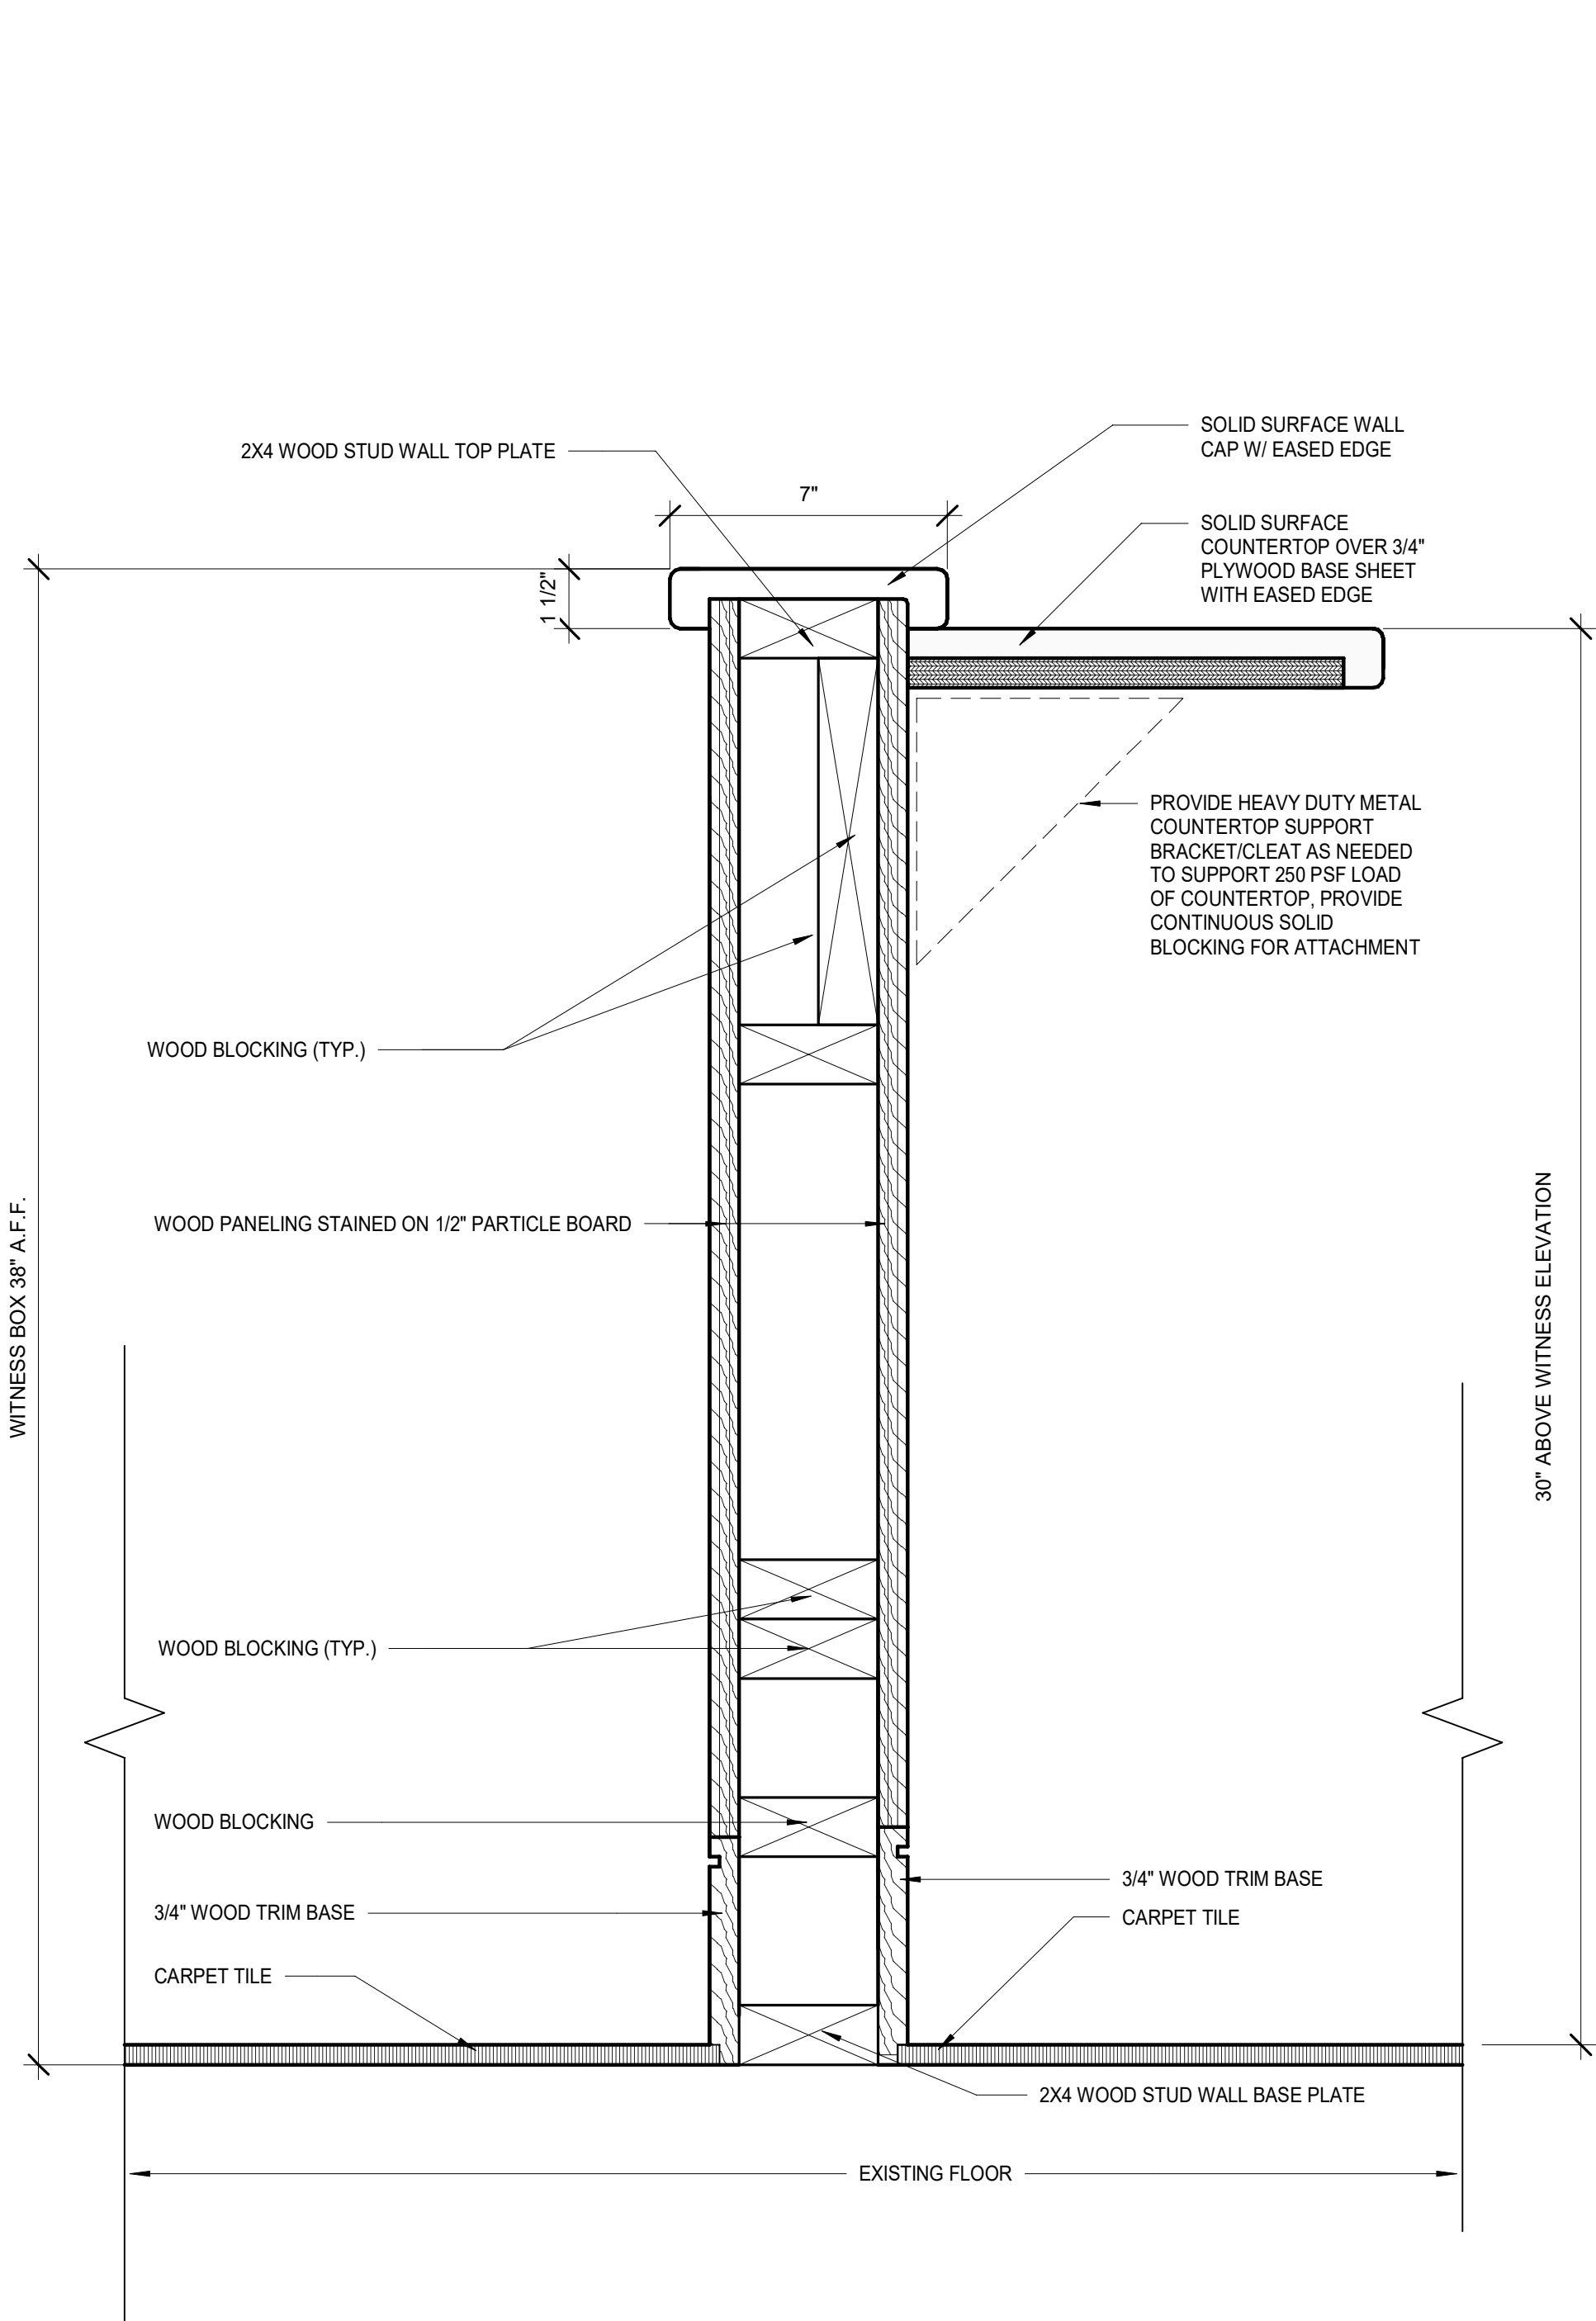

3 JUDGE BENCH WALL DETAIL 3

A504 SCALE: 3" = 1'-0"

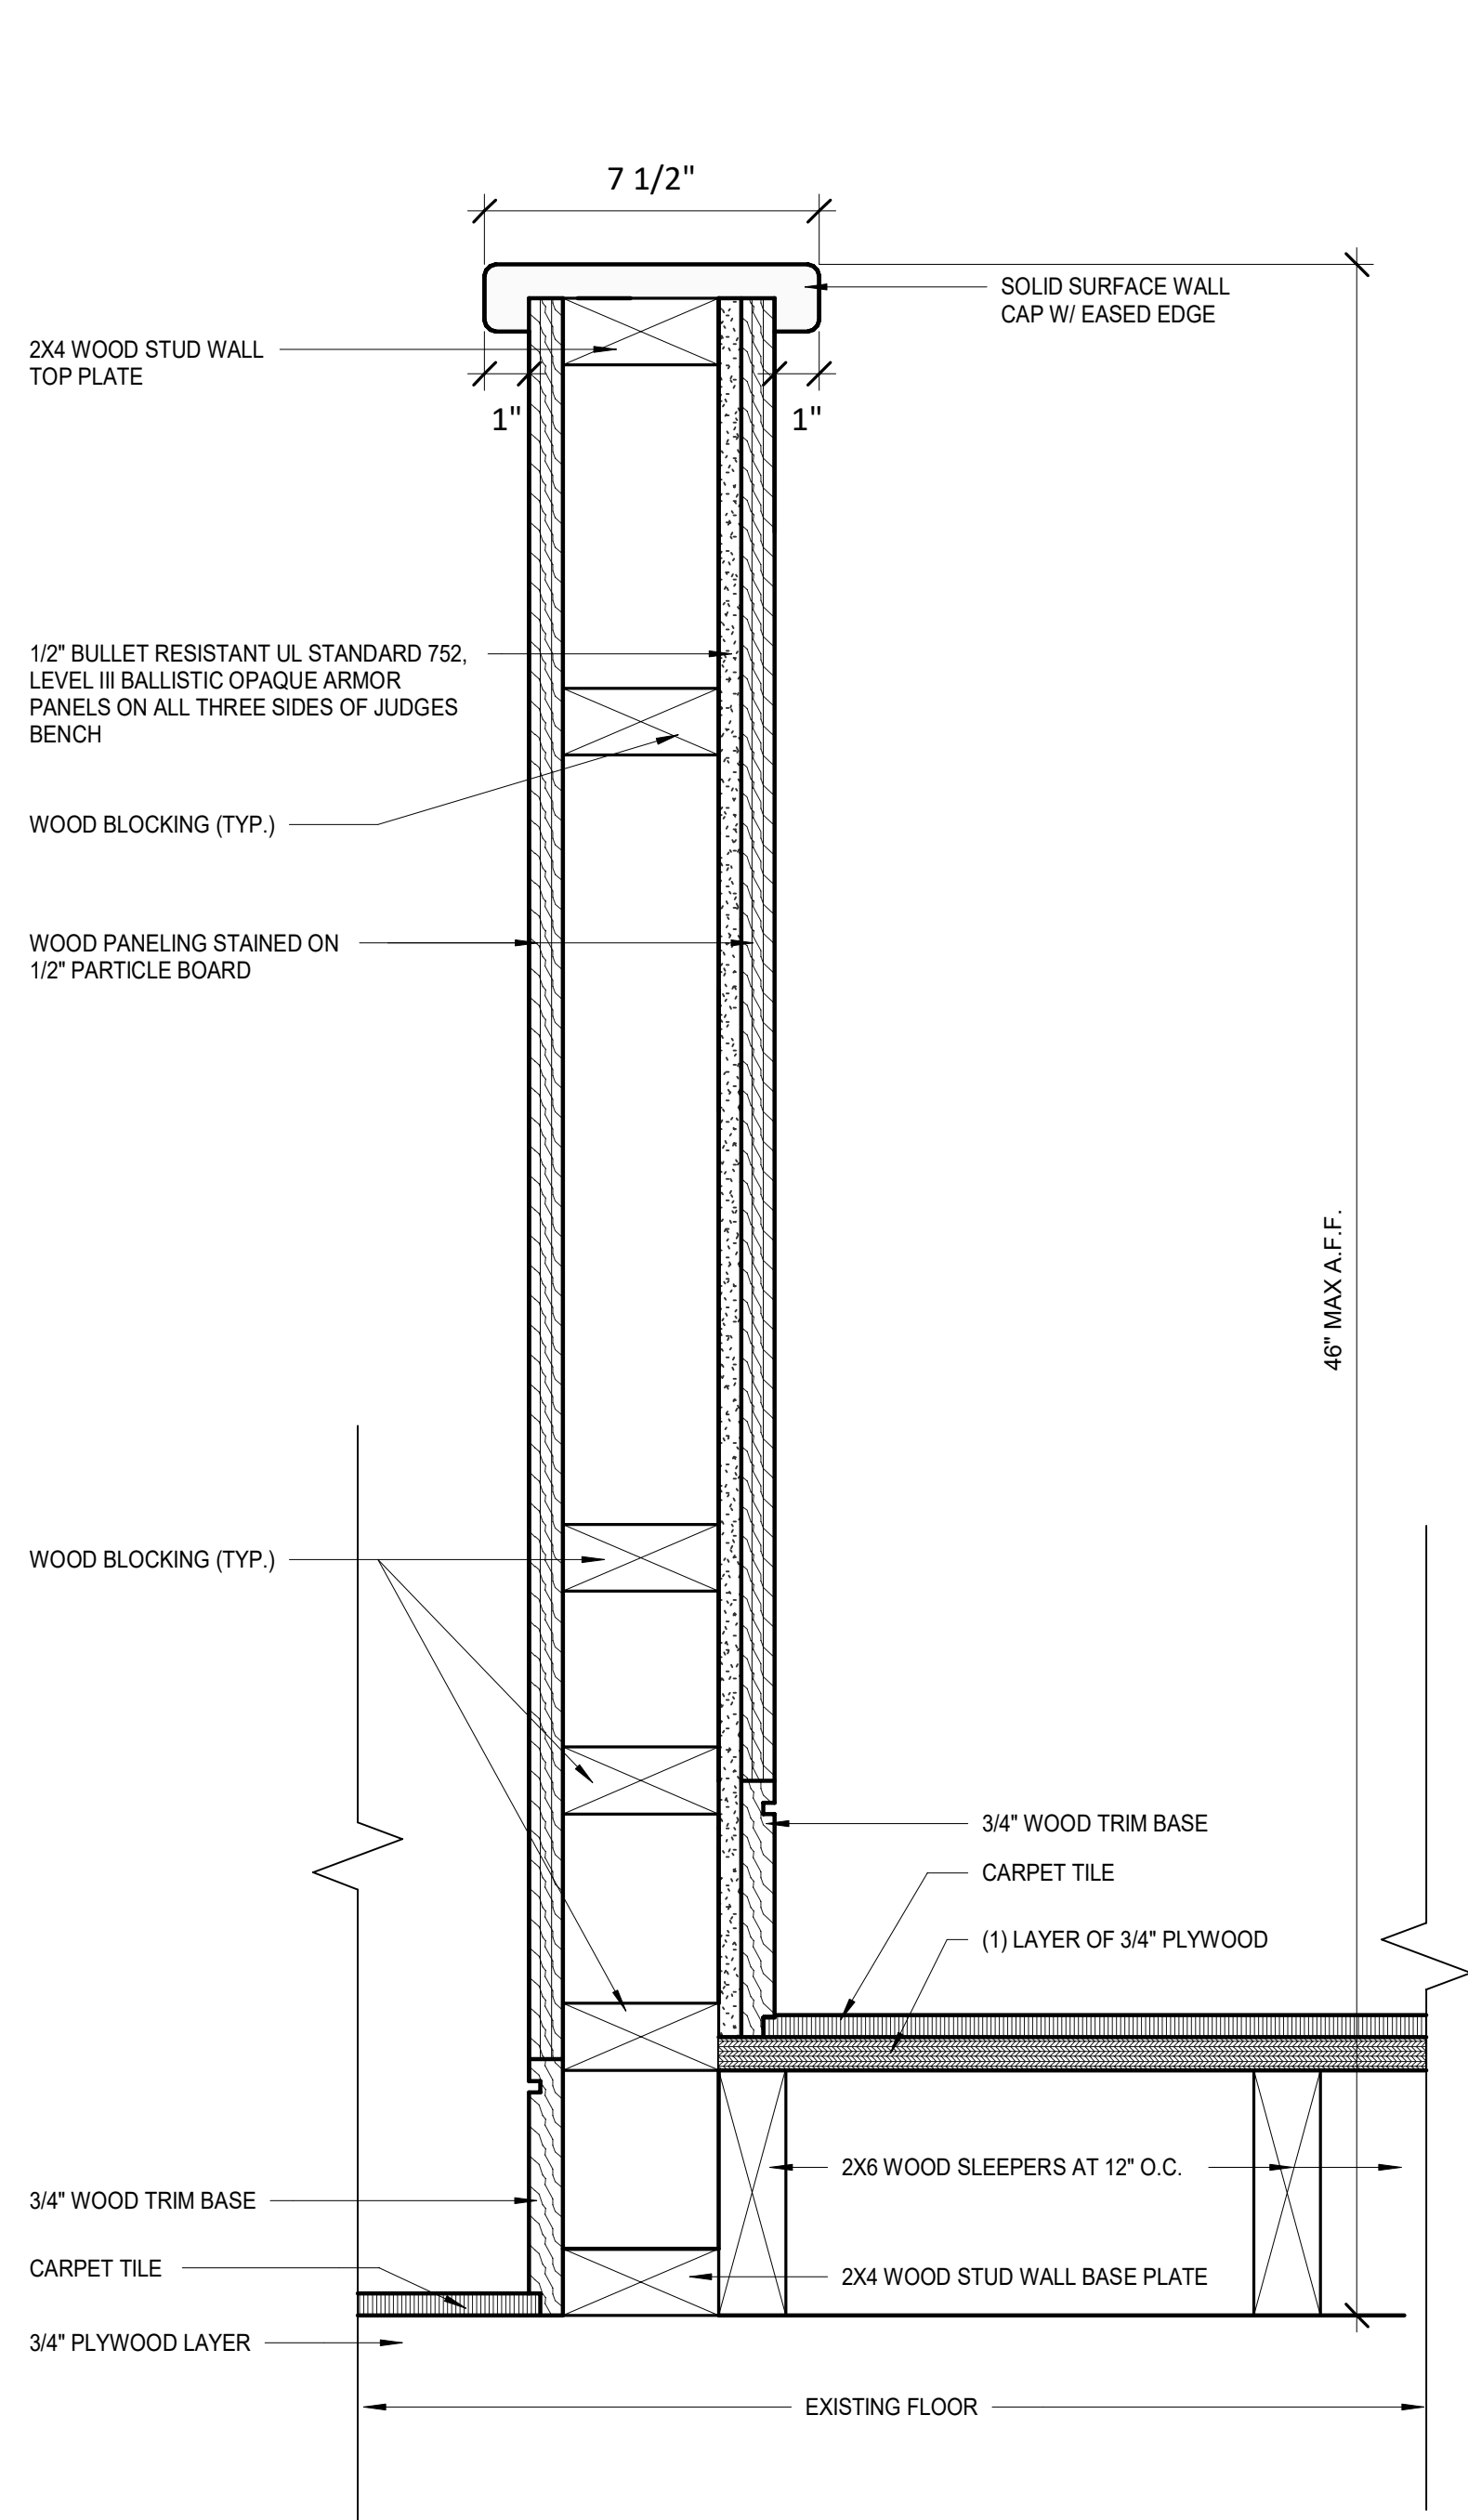

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REVISIONS	

CITY OF MIDDLETOWN  
NEW COURTHOUSE FACILITY  
COURTROOM MILLWORK DETAILS  
CITY OF MIDDLETOWN  
ORANGE COUNTY, NEW YORK

**Barton & Loguidice**  
443 Electronics Parkway  
Liverpool, NY 13088  
NYS CERTIFICATE #  
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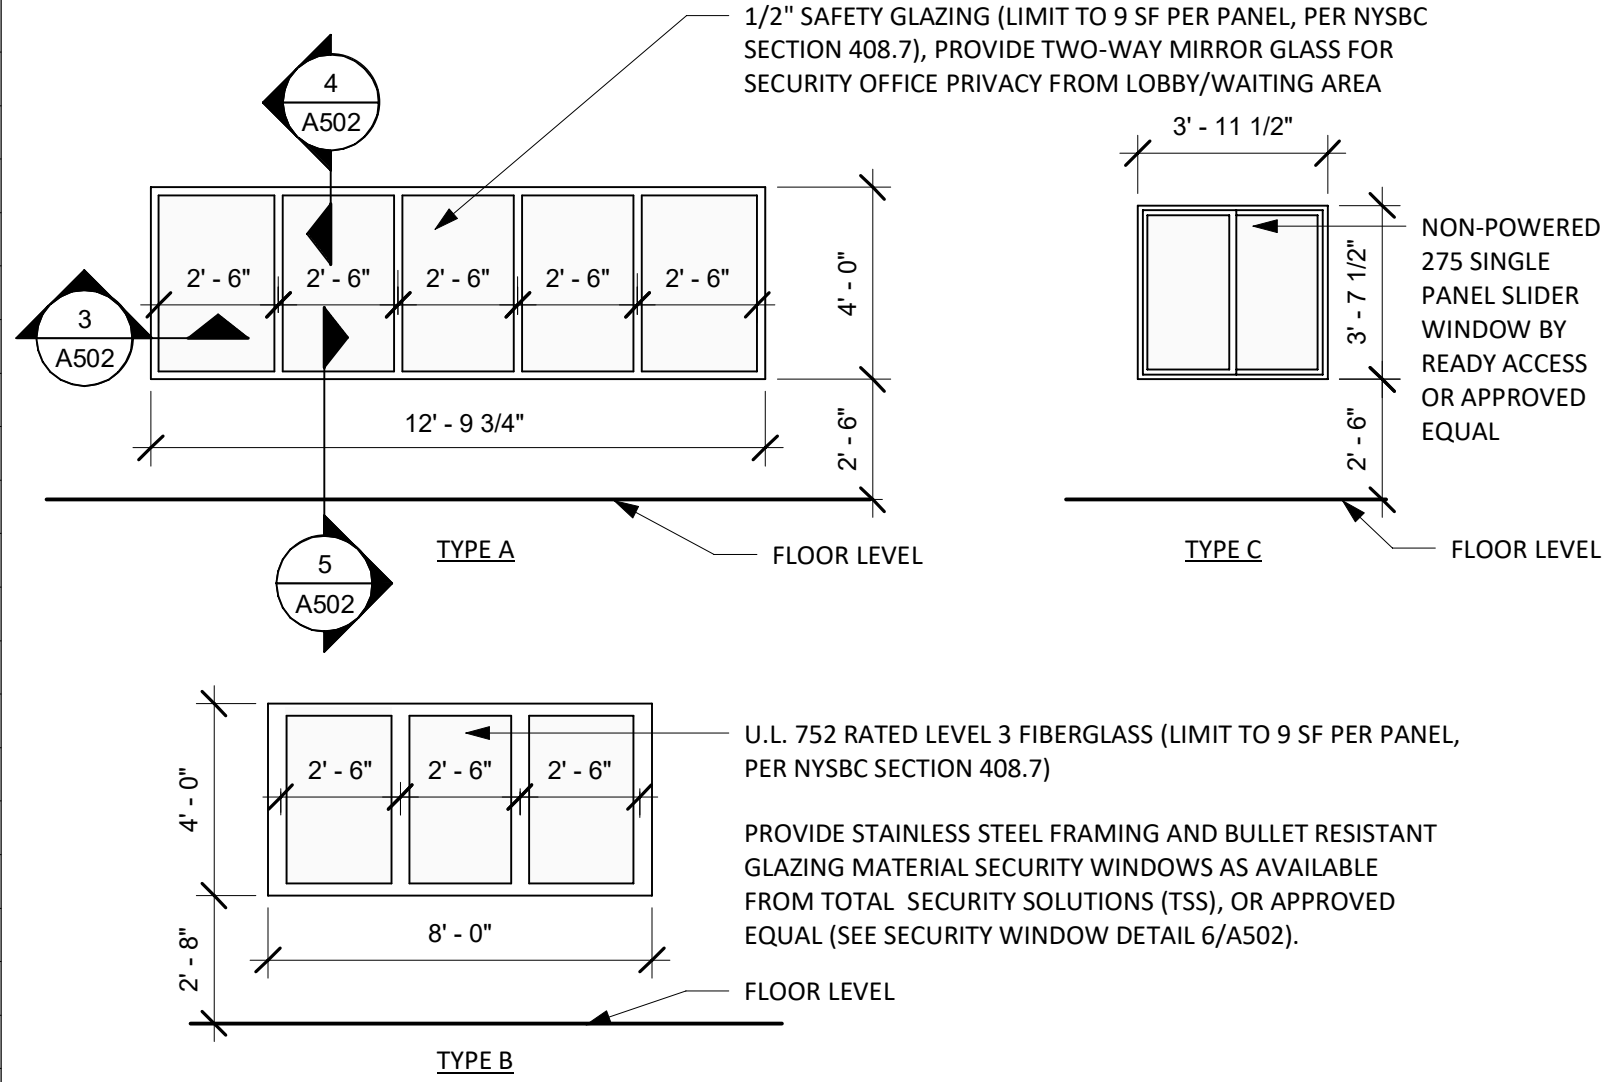






ROOM FINISH SCHEDULE										
ROOM NUMBER	ROOM NAME	FLOOR FINISH	BASE FINISH	WALL FINISH - NORTH	WALL FINISH - EAST	WALL FINISH - SOUTH	WALL FINISH - WEST	CEILING FINISH	CEILING HEIGHT	COMMENTS
101	VESTIBULE	EXIST	EXIST	EXIST	EXIST	EXIST	EXIST	EXIST		
102	LOBBY WAITING AREA	EXIST	EXIST	PNT	PNT	PNT	PNT	EXIST		
103	ELEV. LOBBY	EXIST	EXIST	PNT	PNT	PNT	PNT	ACT-1	8' - 0"	
104	HALL	EXIST/C/PFT	VB	PNT	PNT	PNT	PNT	ACT-1	8' - 0"	
105	SECURITY OFFICE	LVT	VB	PNT	PNT	PNT	PNT	ACT-1	8' - 0"	
106	JURY ROOM	EXIST	EXIST	PNT	PNT	PNT	PNT	EXIST		
107	CLO.	EXIST	EXIST	PNT	PNT	PNT	PNT	EXIST		
108	MEN'S BATHROOM	EXIST	EXIST	EXIST GWT/PNT	EXIST GWT/PNT	EXIST GWT/PNT	EXIST GWT/PNT	EXIST		
109	WOMEN'S BATHROOM	EXIST	EXIST	EXIST GWT/PNT	EXIST GWT/PNT	EXIST GWT/PNT	EXIST GWT/PNT	EXIST		
110	VEST.	LVT	VB	PNT	PNT	PNT	PNT	EXIST		
111	ATTY. CONF. 1	LVT	VB	PNT	PNT	PNT	PNT	EXIST		
112	COURTROOM A	C/LVT	WD	PNT/AWT	PNT	PNT/AWT	PNT/AWT	EXIST		
113	VEST.	EXIST	EXIST	PNT	PNT	PNT	PNT	EXIST		
114	STAIRS	EXIST	EXIST	PNT	PNT	PNT	PNT	EXIST		
115	JAN.	EXIST	EXIST	EXIST	EXIST	EXIST	EXIST	EXIST		
116	ELEC. CLO.	EXIST	EXIST	EXIST	EXIST	EXIST	EXIST	EXIST		
117	HALL	EXIST	VB	PNT	PNT	PNT	PNT	ACT-1	8' - 0"	
118	DRUG COOR.	C	VB	PNT	PNT	PNT	PNT	ACT-1	8' - 0"	PARGE EXIST CMU WALL SMOOTH
119	BATHROOM	PFT	GWT	GWT/PNT	GWT/PNT	GWT/PNT	GWT/PNT	ACT-1	8' - 0"	
120	WOMEN'S BATHROOM	PFT	GWT	GWT/PNT	GWT/PNT	GWT/PNT	GWT/PNT	ACT-1	8' - 0"	
121	MEN'S BATHROOM	PFT	GWT	GWT/PNT	GWT/PNT	GWT/PNT	GWT/PNT	ACT-1	8' - 0"	
122	SECURITY OFFICE	EXIST/T	-	D/CMU	D/CMU	D/CMU	D/CMU	ACT-1	8' - 0"	
123	LAS	C	VB	PNT	PNT	PNT	PNT	ACT-1	8' - 0"	
124	SECURE HALLWAY	EXIST	EXIST	PNT	PNT	PNT	PNT	ACT-1	8' - 0"	
125	COOR.	LVT	VB	PNT	PNT	PNT	PNT	ACT-1	8' - 0"	
126	COOR.	EXIST/T	-	D/CMU	D/CMU	PNT	PNT	LINEAR METAL	8' - 5"	
127	MALE CELL #1	EXIST/T	-	D/CMU	D/CMU	D/CMU	D.CMU	LINEAR METAL	8' - 5"	
128	MALE CELL #2	EXIST/T	-	D/CMU	D/CMU	D/CMU	D/CMU	LINEAR METAL	8' - 5"	
129	HOLDING CELL HALL	EXIST/T	-	D/CMU	D/CMU	D/CMU	D/CMU	LINEAR METAL	8' - 5"	
130	INTER. ROOM	EXIST/T	-	PNT	PNT	PNT	PNT	EXIST		
131	INTER. ROOM	EXIST/T	-	PNT	PNT	PNT	PNT	EXIST		
132	FEMALE CELL	EXIST/T	-	D/CMU	D/CMU	D/CMU	D/CMU	LINEAR METAL	8' - 5"	
133	HALL	LVT	VB	PNT	PNT	PNT	PNT	ACT-1	8' - 0"	
134	LAW CLERK	C	VB	PNT	PNT	PNT	PNT	ACT-1	8' - 0"	
135	SECRETARY	C	VB	PNT	PNT	PNT	PNT	ACT-1	8' - 0"	
135	STAIRS	EXIST	EXIST	PNT	PNT	PNT	PNT	EXIST		
136	JUDGE OFFICE 1	C	WB	PNT	PNT	PNT	PNT	ACT-1	8' - 0"	
137	JUDGE OFFICE 2	C	WB	PNT	PNT	PNT	PNT	ACT-1	8' - 0"	
138	BATHROOM	PFT	GWT	GWT/PNT	GWT/PNT	GWT/PNT	GWT/PNT	ACT-1	8' - 0"	
139	BATHROOM	PFT	GWT	GWT/PNT	GWT/PNT	GWT/PNT	GWT/PNT	ACT-1	8' - 0"	
140	WOMEN'S LOCKER ROOM	LVT	VB	PNT	PNT	PNT	PNT	ACT-1	8' - 0"	
141	STAIRS	EXIST	EXIST	PNT	PNT	PNT	PNT	EXIST		
142	MEN'S LOCKER ROOM	LVT	VB	PNT	PNT	PNT	PNT	ACT-1	8' - 0"	
143	ELEC.	EXIST	EXIST	EXIST	EXIST	EXIST	EXIST	EXIST		
201	STAIRS	EXIST	EXIST	PNT	PNT	PNT	PNT	EXIST		
202	LOBBY	PFT	VB	PNT	PNT	PNT	PNT	EXIST		
203	GENDER NEUTRAL BATHROOM	PFT	GWT	GWT/PNT	GWT/PNT	GWT/PNT	GWT/PNT	ACT-1	8' - 0"	
204	GENDER NEUTRAL BATHROOM	PFT	GWT	GWT/PNT	GWT/PNT	GWT/PNT	GWT/PNT	ACT-1	8' - 0"	
205	ELEC. CLO./ STOR.	EXIST	EXIST	EXIST	EXIST	EXIST	EXIST	EXIST		
206	WAITING AREA	PFT	VB	PNT	PNT	PNT	PNT	ACT-1	8' - 0"	
207	COURTROOM B	C/LVT	WB	PNT/AWT	PNT	PNT/AWT	PNT/AWT	ACT-2, GWB PT		
208	ATTY. CONF.	C	VB	PNT	PNT	PNT	PNT	ACT-1	8' - 0"	
209	PUBLIC WINDOW	PFT	VB	PNT	PNT	PNT	PNT	ACT-1	8' - 0"	
210	SECURE COORIDOR/ PAYMENT WINDOW	C	VB	PNT	PNT	PNT	PNT	ACT-1	8' - 0"	
211	MENS TOILET	PFT	GWT	GWT/PNT	GWT/PNT	GWT/PNT	GWT/PNT	ACT-1	8' - 0"	
212	COURT REPORTERS	EXIST	EXIST	PNT	PNT	PNT	PNT	EXIST		
213	CLERK STAFF	C	VB	PNT	PNT	PNT	PNT	ACT-1	8' - 0"	
214	CONFERENCE/ FUTURE FILE ROOM	EXIST	EXIST	PNT	PNT	PNT	PNT	EXIST		
215	BREAK ROOM	EXIST	EXIST	PNT	PNT	PNT	PNT	EXIST		
216	CHIEF CLERK	EXIST	EXIST	PNT	PNT	PNT	PNT	EXIST		
217	DEPUTY CLERK	EXIST	EXIST	PNT	PNT	PNT	PNT	EXIST		
218	FILE/ SUPPLY ROOM	C	VB	PNT	PNT	PNT	PNT	ACT-1	8' - 0"	
219	STAIRS	EXIST	EXIST	PNT	PNT	PNT	PNT	EXIST		
220	WOMANS TOILET	PFT	GWT	GWT/PNT	GWT/PNT	GWT/PNT	GWT/PNT	ACT-1	8' - 0"	
221	FILE ROOM	EXIST	EXIST	PNT	PNT	PNT	PNT	EXIST		

WINDOW SCHEDULE					
WINDOW NUMBER	TYPE	WIDTH	HEIGHT	MATERIAL	COMMENTS
101	A	12' - 9 3/4"	4' - 0"	HOLLOW METAL	TWO-WAY MIRROR GLASS
102	B	7' - 8 3/4"	4' - 2"	STAINLESS STEEL	SECURITY WINDOW AS AVAILABLE FROM TOTAL SECURITY SOLUTIONS OR APPROVED EQUAL
201	C	3' - 11 1/2"	3' - 7 1/2"	HOLLOW METAL	NON-POWERED 275 SINGLE PANEL SLIDER WINDOW BY READY ACCESS OR APPROVED EQUAL
202	C	3' - 11 1/2"	3' - 7 1/2"	HOLLOW METAL	NON-POWERED 275 SINGLE PANEL SLIDER WINDOW BY READY ACCESS OR APPROVED EQUAL



## INTERIOR WINDOW TYPES

SCALE: 1/4" = 1'-0"

### \*ROOM FINISH LEGEND

#### FLOOR FINISHES

**C** - PROVIDE CARPET TILE/CARPET AS AVAILABLE FROM SHAW INDUSTRIES OR APPROVED EQUAL, SIZE TO BE 24 X 24, COLOR TO BE SELECTED BY OWNER FROM MANUFACTURERS FULL RANGE OF COLORS.

**LVT** - PROVIDE LUXURY VINYL TILE AS AVAILABLE FROM ARMSTRONG FLOORING COMMERCIAL OR APPROVED EQUAL, SIZE TO BE 18X36 AND 18X18, COLOR TO BE SELECTED BY OWNER FROM MANUFACTURERS FULL RANGE OF COLORS.

**PFT** - PROVIDE PORCELAIN FLOOR TILE AS AVAILABLE FROM MARAZZI, OR APPROVED EQUAL, SIZE TO BE 12 x 24, COLOR TO BE SELECTED BY OWNER FROM MANUFACTURERS FULL RANGE OF COLORS.

**EXIST/T** - EXISTING TERRAZZO FLOORING, PROVIDE INFILL OF TERRAZZO FLOORING TO MATCH EXISTING

#### WALL BASE FINISH

**VB** - PROVIDE VINYL WALL BASE AS AVAILABLE FROM JOHNSONITE OR APPROVED EQUAL, SIZE TO BE 6", COLOR TO BE SELECTED BY OWNER FROM MANUFACTURERS FULL RANGE OF COLORS.

**WB** - WOOD WALL BASE, SEE DRAWINGS FOR SIZE, STAIN FINISH TO BE SELECTED BY OWNER FROM AVAILABLE OPTIONS.

#### WALL FINISHES

**PNT** - PROVIDE PAINT AS AVAILABLE FROM SHERWIN WILLIAMS OR APPROVED EQUAL, COLOR TO BE SELECTED BY OWNER FROM MANUFACTURERS FULL RANGE OF COLORS.

**GWT** - PROVIDE WAINSCOT GLAZED CERAMIC WALL TILE AS AVAILABLE FROM CROSSVILLE OR APPROVED EQUAL, SIZE TO BE 4X12, TILE COLOR TO BE SELECTED BY OWNER FROM MANUFACTURERS FULL RANGE OF COLORS.

**AWT** - PROVIDE ACOUSTICAL WALL TILE AS AVAILABLE FROM XOREL ARTFORM (SHAPE - PLANK - FABRIC WRAPPED ACOUSTICAL SUBSTRATE) OR APPROVED EQUAL, SIZE TO BE 10" H X 20" W X 1" D INSTALLED WITH MANUFACTURER'S RECOMMENDED ADHESIVE. WALL TILE COLOR AND FABRIC TO BE SELECTED BY OWNER FROM MANUFACTURERS FULL RANGE OF COLORS.

**D/CMU** - EXISTING DECORATIVE CONCRETE MASONRY UNIT BLOCK, PROVIDE INFILL OF CMU BLOCK TO MATCH EXISTING.

#### CEILING FINISHES

**ACT-1** - PROVIDE 5/8" 2 X 2 ACOUSTICAL CEILING GRID SYSTEM AS AVAILABLE FROM ARMSTRONG OR APPROVED EQUAL. SEE REFLECTED CEILING PLAN FOR LAYOUT.

**ACT-2** - PROVIDE 7/8" HIGH-NRC (.85/35) (MIN. STC RATING OF 52) 2 X 2 ACOUSTICAL CEILING GRID SYSTEM AS AVAILABLE FROM ARMSTRONG OR APPROVED EQUAL. SEE REFLECTED CEILING PLAN FOR LAYOUT.

**GWB PT** - PROVIDE PAINT (SOFFITS) AS AVAILABLE FROM SHERWIN WILLIAMS OR APPROVED EQUAL, COLOR TO BE SELECTED BY OWNER FROM MANUFACTURERS FULL RANGE OF COLORS.

**LINEAR METAL** - PROVIDE NEW HANGING 12" WIDE LINEAR METAL CEILING SYSTEM, METALWORKS SECURELOCK PLUS, AS AVAILABLE FROM ARMSTRONG OR APPROVED EQUAL. SEE REFLECTED CEILING PLAN FOR LAYOUT, COLOR TO BE SELECTED BY OWNER FROM MANUFACTURERS FULL RANGE OF COLORS.

\* RECEIVE LAYOUT PATTERN APPROVAL PRIOR TO THE INSTALLATION OF ROOM FINISH MATERIALS FROM OWNER.

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### REVISIONS

CITY OF MIDDLETOWN  
NEW COURTHOUSE FACILITY

CITY OF MIDDLETOWN

ROOM FINISH AND WINDOW SCHEDULES AND  
NOTES REVISION

ORANGE COUNTY, NEW YORK

**Barton & Loguidice**  
443 Electronics Parkway  
Liverpool, NY 13088  
NYS CERTIFICATE #  
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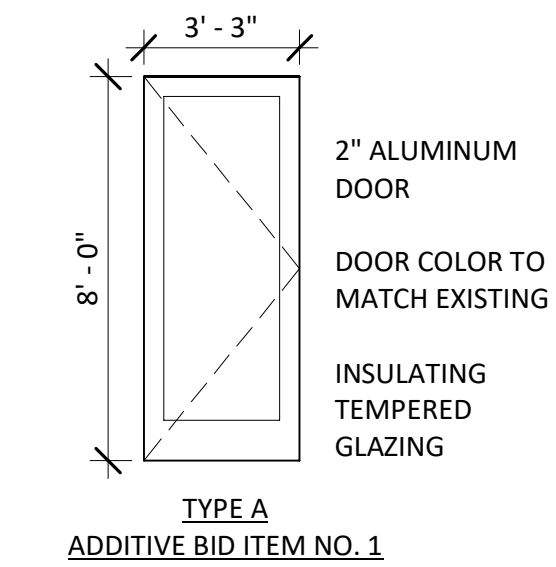
A601

Project Number


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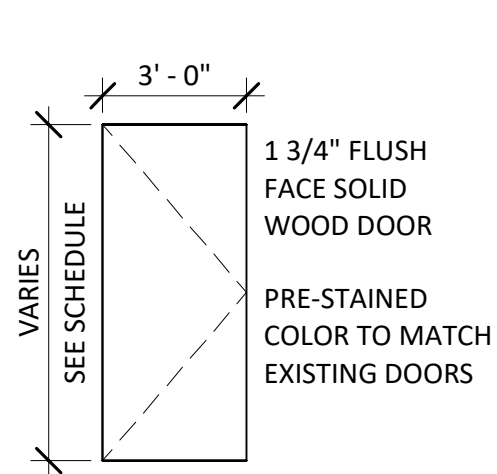
DOOR SCHEDULE															
DOOR NUMBER	DOOR						FIRE RATING	FRAME			HEAD DETAIL	JAMB DETAIL	HARDWARE	ELECTRIC STRIKE	COMMENTS
	TYPE	WIDTH	HEIGHT	THICKNESS	MATERIAL	FINISH		TYPE	MATERIAL	FINISH					
101E	EXIST	8' - 0"	8' - 0"	2"	EXIST	EXIST	-	EXIST	EXIST	EXIST	-	-	1	YES	
102	A	3' - 2 1/2"	8' - 0"	2"	ALUM	FACT	-	1	ALUM	FACT	5/A501	9/A501	2	YES	
103E	EXIST	6' - 0"	8' - 0"	2"	EXIST	EXIST	-	EXIST	EXIST	EXIST	-	-	-	-	
104E	EXIST	3' - 0"	7' - 0"	1 3/4"	EXIST	EXIST	45 MINUTE	EXIST	EXIST	EXIST	-	-	5	YES	
105	B	3' - 0"	7' - 0"	1 3/4"	WD	STAIN	-	2	HM	PNT	1/A501	2/A501	7	YES	
106R	RELOCATE	3' - 0"	7' - 0"	1 3/4"	EXIST	EXIST	-	2	HM	PNT	11/A501	2/A501	7	YES	
107R	RELOCATE	3' - 0"	7' - 0"	1 3/4"	EXIST	EXIST	45 MINUTE	2	HM	PNT	12/A501	13/A501	5	YES	INSTALL VISION PANEL
108R	RELOCATE	3' - 0"	7' - 0"	1 3/4"	EXIST	EXIST	45 MINUTE	2	HM	PNT	12/A501	13/A501	5	-	
109E	EXIST	3' - 0"	7' - 0"	1 3/4"	EXIST	PNT	90 MINUTE	EXIST	EXIST	PNT	-	-	3	YES	
110E	EXIST	6' - 0"	7' - 0"	1 3/4"	EXIST	EXIST	-	EXIST	EXIST	EXIST	-	-	9	-	
111E	EXIST	3' - 0"	7' - 0"	1 3/4"	EXIST	EXIST	-	EXIST	EXIST	EXIST	-	-	15	-	
112E	EXIST	3' - 0"	7' - 0"	1 3/4"	EXIST	EXIST	-	EXIST	EXIST	EXIST	-	-	15	-	
113R	RELOCATE	6' - 0"	7' - 0"	1 3/4"	EXIST	EXIST	45 MINUTE	4	HM	PNT	12/A501	13/A501	10	-	
114E	EXIST	3' - 0"	7' - 0"	1 3/4"	EXIST	EXIST	-	EXIST	EXIST	EXIST	-	-	5	-	
115R	RELOCATE	6' - 0"	7' - 0"	1 3/4"	EXIST	EXIST	-	4	HM	PNT	12/A501	13/A501	10	-	
116	C	3' - 0"	6' - 8"	1 3/4"	WD	STAIN	-	2	HM	PNT	1/A501	2/A501	6	-	
117E	EXIST	3' - 0"	6' - 8"	1 3/4"	EXIST	PNT	45 MINUTE	EXIST	EXIST	PNT	-	-	3	-	
118	B	3' - 0"	6' - 8"	1 3/4"	WD	STAIN	-	2	HM	PNT	12/A501	13/A501	6		
119E	EXIST	3' - 0"	6' - 8"	1 3/4"	EXIST	EXIST	45 MINUTE	EXIST	EXIST	EXIST	-	-	5	-	
120E	EXIST	3' - 0"	6' - 8"	1 3/4"	EXIST	EXIST	45 MINUTE	EXIST	EXIST	EXIST	-	-	5	-	
121E	EXIST	3' - 0"	7' - 0"	1 3/4"	EXIST	EXIST	90 MINUTE	EXIST	EXIST	EXIST	-	-	14	YES	
122	B	3' - 0"	6' - 8"	1 3/4"	WD	STAIN	-	2	HM	PNT	12/A501	13/A501	6		
123	C	3' - 0"	6' - 8"	1 3/4"	WD	STAIN	-	2	HM	PNT	1/A501	2/A501	11	-	
124R	RELOCATE	3' - 0"	6' - 8"	1 3/4"	EXIST	EXIST	45 MINUTE	2	HM	PNT	12/A501	13/A501	15	-	PROVIDE MARBLE THRESHOLD
126E	EXIST	3' - 0"	6' - 8"	1 3/4"	EXIST	EXIST	45 MINUTE	EXIST	EXIST	EXIST	-	-	5	YES	
127R	RELOCATE	3' - 0"	6' - 8"	1 3/4"	EXIST	EXIST	-	2	HM	PNT	1/A501	2/A501	5	YES	
128	F	3' - 0"	6' - 8"	1 3/4"	HM	PNT	45 MINUTE	5	HM	PNT	1/A501	2/A501	12	YES	
129	F	3' - 0"	6' - 8"	1 3/4"	HM	PNT	60 MINUTE	5	HM	PNT	12/A501	13/A501	12	YES	
130	D	3' - 0"	7' - 0"	1 3/4"	HM	PNT	60 MINUTE	3	HM	PNT	14/A501	15/A501	4	YES	INSULATED EXTERIOR DOOR
131E	EXIST	3' - 0"	6' - 8"	1 3/4"	EXIST	PNT	-	EXIST	EXIST	PNT	-	-	13	YES	
132R	RELOCATE	3' - 0"	6' - 8"	1 3/4"	EXIST	PNT	-	5	HM	PNT	12/A501	13/A501	16	YES	
133E	EXIST	3' - 0"	6' - 8"	1 3/4"	EXIST	PNT	-	EXIST	EXIST	PNT	-	-	16	YES	
134	D	3' - 0"	7' - 0"	1 3/4"	HM	PNT	-	3	HM	PNT	12/A501	13/A501	5	-	STAIRS 114 TO BE SECURE TO BASEMENT STAIRS
135R	RELOCATE	3' - 0"	7' - 0"	1 3/4"	EXIST	EXIST	60 MINUTE	2	HM	PNT	12/A501	13/A501	5	YES	INSTALL VISION PANEL
136R	RELOCATE	3' - 0"	7' - 0"	1 3/4"	EXIST	EXIST	45 MINUTE	2	HM	PNT	1/A501	2/A501	5	YES	
137R	RELOCATE	3' - 0"	7' - 0"	1 3/4"	EXIST	EXIST	45 MINUTE	2	HM	PNT	12/A501	13/A501	5	YES	INSTALL VISION PANEL
138R	RELOCATE	3' - 0"	7' - 0"	1 3/4"	EXIST	EXIST	45 MINUTE	2	HM	PNT	12/A501	13/A501	5	YES	INSTALL VISION PANEL
139	B	3' - 0"	7' - 0"	1 3/4"	WD	STAIN	-	2	HM	PNT	1/A501	2/A501	6	-	
140	E	5' - 0"	7' - 0"	1 3/8"	WD	STAIN		6	HM	PNT	-	-	8	-	
141E	EXIST	3' - 0"	7' - 0"	1 3/4"	EXIST	EXIST	-	EXIST	EXIST	PNT	-	-	14	YES	
142E	EXIST	3' - 0"	7' - 0"	1 3/4"	EXIST	PNT	45 MINUTE	EXIST	EXIST	PNT	-	-	3	-	
143R	RELOCATE	3' - 0"	7' - 0"	1 3/4"	EXIST	EXIST	45 MINUTE	2	HM	PNT	12/A501	13/A501	5	-	
144R	RELOCATE	3' - 0"	7' - 0"	1 3/4"	EXIST	EXIST	-	2	HM	PNT	12/A501	13/A501	5	-	
145R	RELOCATE	3' - 0"	7' - 0"	1 3/4"	EXIST	EXIST	-	2	HM	PNT	12/A501	13/A501	15	-	PROVIDE MARBLE THRESHOLD
146	C	3' - 0"	6' - 8"	1 3/4"	WD	PNT	-	2	HM	PNT	1/A501	2/A501	11	-	
147R	RELOCATE	3' - 0"	7' - 0"	1 3/4"	EXIST	EXIST	-	2	HM	PNT	1/A501	2/A501	5	-	
148R	RELOCATE	3' - 0"	7' - 0"	1 3/4"	EXIST	EXIST	-	2	HM	PNT	1/A501	2/A501	5	-	
149E	EXIST	3' - 0"	7' - 0"	1 3/4"	EXIST	EXIST	-	EXIST	EXIST	PNT	-	-	14	YES	
150E	EXIST	3' - 0"	7' - 0"	1 3/4"	EXIST	EXIST	60 MINUTE	EXIST	EXIST	PNT	-	-	5	-	
151E	EXIST	3' - 0"	7' - 0"	1 3/4"	EXIST	PNT	90 MINUTE	EXIST	EXIST	PNT	-	-	3	YES	
151N	RELOCATE	3' - 0"	6' - 8"	1 3/4"	EXIST	EXIST	90 MINUTE	2	HM	PNT	12/A501	13/A501	15	-	PROVIDE MARBLE THRESHOLD
201E	EXIST	3' - 0"	6' - 8"	1 3/4"	EXIST	EXIST	90 MINUTE	EXIST	EXIST	PNT	-	-	14	YES	
202	C	3' - 0"	7' - 0"	1 3/4"	WD	STAIN	-	3	HM	PNT	12/A501	13/A501	11	-	
203	C	3' - 0"	7' - 0"	1 3/4"	WD	STAIN	-	3	HM	PNT	12/A501	13/A501	11	-	
204E	EXIST	3' - 0"	6' - 8"	1 3/4"	EXIST	EXIST	45 MINUTE	EXIST	EXIST	PNT	-	-	5	-	
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206R	RELOCATE	3' - 0"	6' - 8"	1 3/4"	EXIST	EXIST	45 MINUTE	2	HM	PNT	1/A501	2/A501	5	-	
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212E	EXIST	3' - 0"	6' - 8"	1 3/4"	EXIST	EXIST	-	EXIST	EXIST	PNT	-	-	5	-	
213E	EXIST	3' - 0"	6' - 8"	1 3/4"	EXIST	EXIST	-	EXIST	EXIST	PNT	-	-	5	-	
214E	EXIST	3' - 0"	6' - 8"	1 3/4"	EXIST	EXIST	-	EXIST	EXIST	PNT	-	-	5	-	
215E	EXIST	3' - 0"	6' - 8"	1 3/4"	EXIST	EXIST	-	EXIST	EXIST	PNT	-	-	5	-	REPLACE VISION PANEL GLASS
216E	EXIST	3' - 0"	6' - 8"	1 3/4"	EXIST	EXIST	-	EXIST	EXIST	PNT	-	-	5	-	
217E	EXIST	3' - 0"	6' - 8"	1 3/4"	EXIST	EXIST	-	EXIST	EXIST	PNT	-	-	5	-	
218E	EXIST	3' - 0"	6' - 8"	1 3/4"	EXIST	EXIST	60 MINUTE	EXIST	EXIST	PNT	-	-	14	YES	
219R	RELOCATE	3' - 0"	6' - 8"	1 3/4"	EXIST	EXIST	90 MINUTE	2	HM	PNT	1/A501	2/A501	15	-	PROVIDE MARBLE THRESHOLD
220E	EXIST	3' - 0"	6' - 8"	1 3/4"	EXIST	EXIST	45 MINUTE	EXIST	EXIST	PNT	-	-	5	-	




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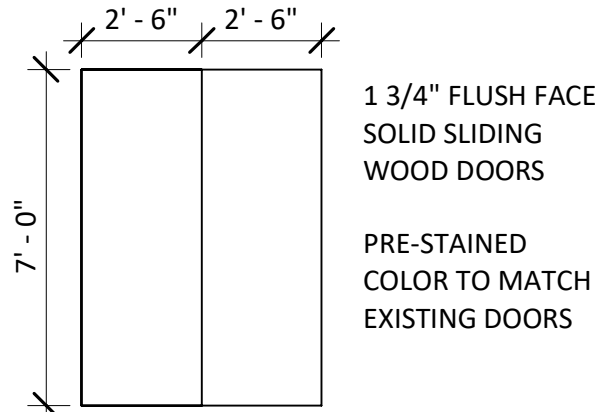
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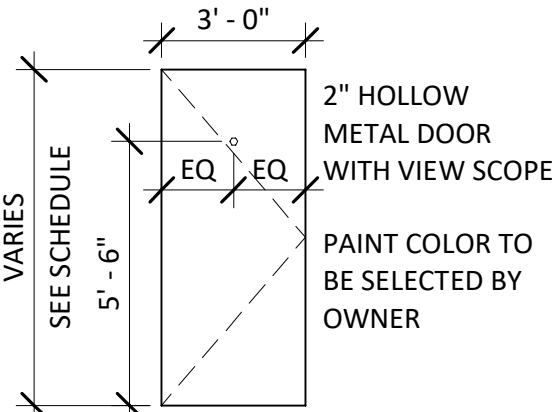
TYPE C



TYPE D

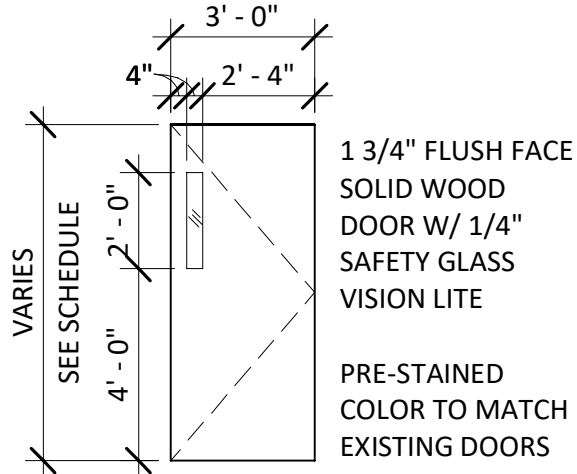


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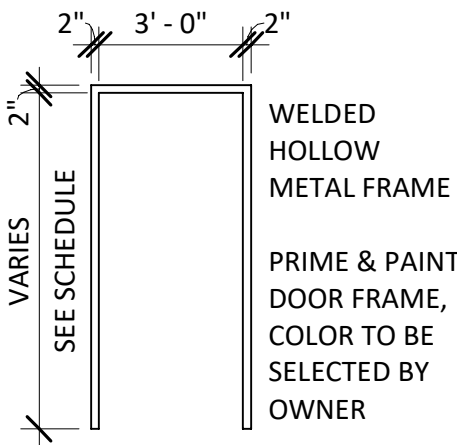
TYPE F
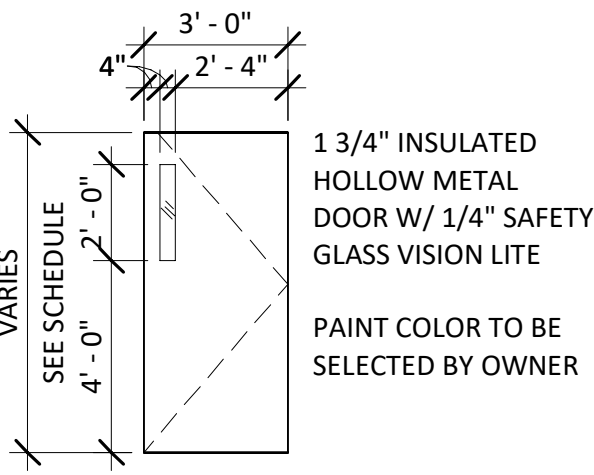
### DOOR TYPES


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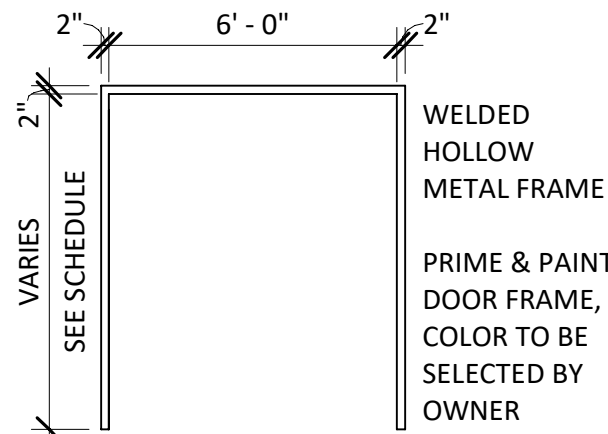
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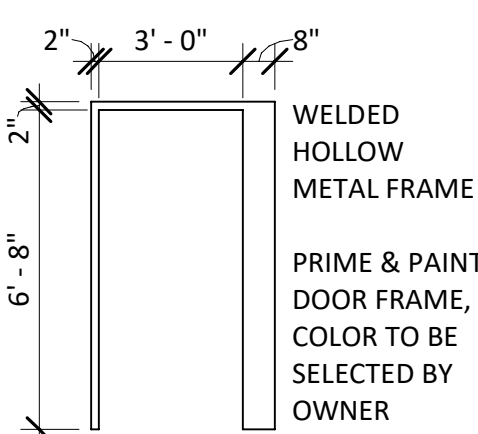
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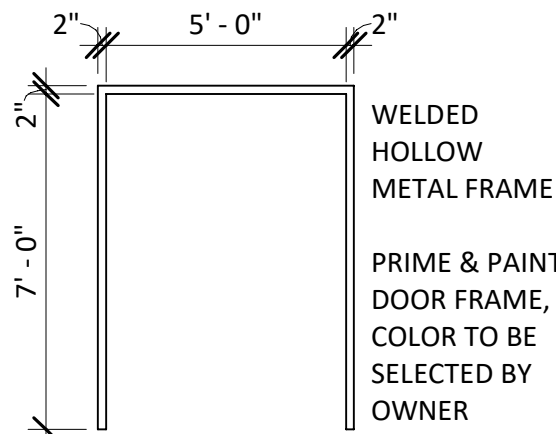
TYPE 3



TYPE 4

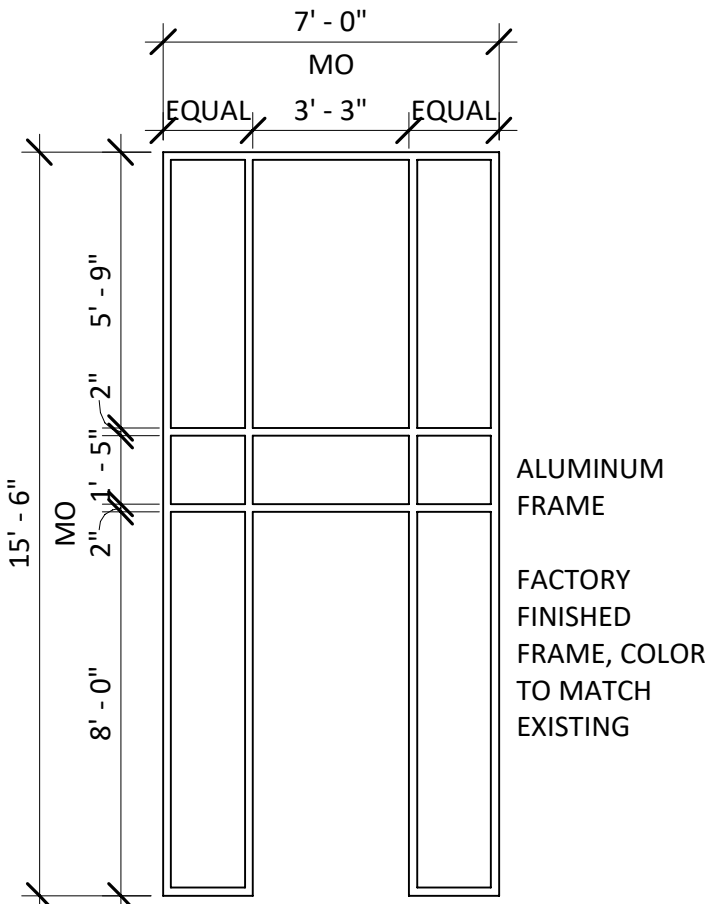

TYPE 5

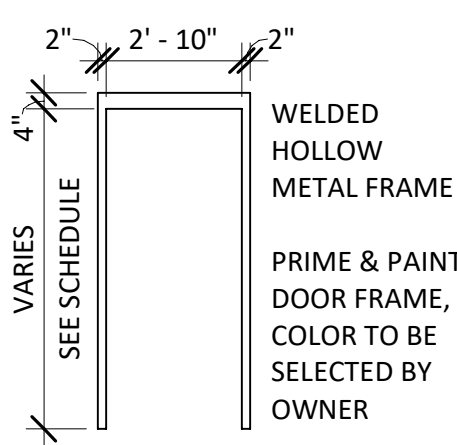

TYPE 6

### DOOR FRAMES TYPES

SCALE: 1/4" = 1'-0"

DOOR NUMBERS WITH "E" REFER TO EXISTING DOORS AND FRAMES REMAINING IN PLACE.

DOOR NUMBERS WITH "R" REFER TO EXISTING DOORS WHICH ARE RELOCATED. SEE EXISTING/DEMOLITION DRAWINGS FOR LOCATIONS OF RELOCATED DOORS. CERTAIN RELOCATED DOORS HAVE ELECTRIC STRIKES (SEE DOOR SCHEDULE) WHICH ARE TO BE RELOCATED. COORDINATE WITH ELECTRICAL CONTRACTORS.

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#### REVISIONS


CITY OF MIDDLETOWN  
NEW COURTHOUSE FACILITY

ORANGE COUNTY, NEW YORK

### DOOR SCHEDULE AND NOTES

**Barton & Loguidice**  
443 Electronics Parkway  
Liverpool, NY 13088

NYS CERTIFICATE #  
0021642, 0020588, 0019903,  
0019905, 0020336



NYS EXP.:


Date  
AUGUST, 2024

Scale  
AS SHOWN

Sheet Number  
A602

Project Number  
1753.008.001



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MODEL\_pstevens4FSVF.rvt  
Checked by:  Designer

Drawn by:  Author  
Designed by:  In Charge of

STRUCTURAL NOTES:

GENERAL:

1.

ALL STRUCTURES ARE DESIGNED IN ACCORDANCE WITH THE 2020 BUILDING CODE OF NEW YORK STATE.
2.

ALLOWABLE SOIL BEARING PRESSURE                      2,500 PSF
3.

DESIGN LOADS:  
DEAD LOADS:  
          ROOF DEAD LOAD                      18 PSF  
          FLOOR DEAD LOAD                  50 PSF  
  
LIVE LOADS:  
          ROOF LIVE LOAD                    20 PSF  
          FLOOR LIVE LOAD                  100 PSF  
  
SNOW LOAD:  
GROUND SNOW LOAD, Pg = 40 PSF  
SNOW EXPOSURE FACTOR, Ce = 1.0  
THERMAL FACTOR,            Ct = 1.0 (AT ADDITION)  
   Ct = 1.2 (AT CANOPY)  
SNOW LOAD IMPORTANCE FACTOR, Is = 1.1  
  
WIND LOAD:  
BASIC WIND SPEED (3-SECOND GUST) = 120 MPH  
WIND EXPOSURE B  
VELOCITY PRESSURE, Kz = 0.57  
TOPOGRAPHIC FACTOR, Kzt = 1.0  
WIND DIRECTIONALITY FACTOR, Kd = 0.85  
GROUND ELEVATION FACTOR, Ke = 1.0  
COMPONENTS AND CLADDING (CANOPY, NEGATIVE VALUE IS AWAY FROM SURFACE)  
          ZONE 2:     12.2 PSF / -27.4 PSF  
          ZONE 3:     12.2 PSF / -27.4 PSF  
  
SEISMIC CRITERIA:  
SEISMIC USE OCCUPANCY III  
SEISMIC IMPORTANCE FACTOR, Ie = 1.25  
SITE CLASS D  
BASIC SEISMIC-FORCE-RESISTING SYSTEM: N.A.  
DESIGN SPECTRAL RESPONSE ACCELERATION  
FOR SHORT PERIODS, Sds = 0.222  
AT 1-SECOND PERIOD, Sd1 = 0.087  
SEISMIC DESIGN CATEGORY B

4.

THE CONTRACTOR SHALL CHECK THE ARCHITECTURAL, PLUMBING, HVAC, AND ELECTRICAL DRAWINGS AND SPECIFICATIONS FOR ADDITIONAL INFORMATION NOT INDICATED ON THE STRUCTURAL DRAWINGS, SUCH INFORMATION INCLUDES, AS A MINIMUM, EMBEDDED SLEEVES AND INSERTS, MISCELLANEOUS DETAILS, SPECIAL FLOOR FINISHES, DOOR THRESHOLDS, SLOPES TO DRAINS, NAILERS, OPENINGS IN STRUCTURAL ELEMENTS, ETC.

EXCAVATION AND FILL:

1.

THE BOTTOM OF ALL CONCRETE FOUNDATIONS AND SLABS SHALL REST ON UNDISTURBED SOIL AND/OR APPROVED COMPACTED MATERIAL, AS DEFINED IN THE CONTRACT SPECIFICATIONS. ALL GRANULAR FILL MATERIALS BELOW SLABS SHALL BE OF THE THICKNESS SHOWN AND SHALL BE COMPACTED TO MINIMUM 95% MODIFIED PROCTOR DENSITY. SEE SPECIFICATIONS FOR COMPACTION AND FIELD TESTS.
2.

THE CONTRACTOR SHALL NOT COMMENCE FOUNDATION CONSTRUCTION WORK PRIOR TO INSPECTION AND APPROVAL OF THE BEARING SOIL BY AN INDEPENDENT TESTING LAB. SOILS TO BE TESTED BY SOIL PENTROMETER OR EQUAL TO VERIFY A MINIMUM BEARING PRESSURE OF 2,000 PSF.
3.

ALL EXCAVATIONS INTO UNDISTURBED SOILS SHALL BE COMPACTED TO MINIMUM 95% MODIFIED PROCTOR DENSITY.
4.

ALL EXCAVATIONS SHALL BE DEWATERED AS NECESSARY TO MAINTAIN GROUNDWATER AT LEAST 24" BELOW FOOTING BEFORE PLACING OF CONCRETE.

CONCRETE:

1.

DESIGN STRENGTH -  
STRUCTURAL CONCRETE AND SLAB ON GRADE - 4,000 PSI @ 28 DAYS
2.

STANDARDS -  
DESIGN ACI 318 - LATEST EDITION  
DETAILS ACI 315 - LATEST EDITION
3.

REINFORCING -  
MESH - ASTM A-185 (FLAT SHEETS)  
BARS - ASTM A-615 GRADE 60
4.

AIR CONTENT - ALL SLAB ON GRADE AND EXTERIOR CONCRETE SHALL BE AIR ENTRAINED IN ACCORDANCE WITH SPECIFICATION SECTION 03300.
5.

CONCRETE COVER OVER BARS:  
CONCRETE DEPOSITED ON GROUND - 3"  
FORMED CONCRETE EXPOSED TO GROUND, WEATHER OR WATER - 2"  
WALLS & SLABS NOT DIRECTLY EXPOSED TO GROUND, WATER OR WEATHER - 1"
6.

SPLICES IN REINFORCEMENT:  
UNLESS OTHERWISE NOTED, ALL SPLICES AND ANCHORAGES SHALL BE IN ACCORDANCE WITH ACI 318 CHAPTER 12. STAGGER SPLICES WHEREVER POSSIBLE AND LOCATE SO AS NOT TO IMPAIR STRENGTH OF MEMBERS.
7.

ALL EXPOSED EDGES OF CONCRETE SHALL HAVE A CHAMFER AS SHOWN ON DRAWINGS.
8.

THE CONTRACTOR SHALL NOT POUR ANY CONCRETE PRIOR TO INSPECTION OF THE REINFORCING STEEL AND AUTHORIZATION BY THE ENGINEER.

STRUCTURAL STEEL:

1.

STRUCTURAL STEEL:  
  
W: ASTM A992 (FY = 50 KSI)  
M, S, HP, C, MC, L, & PLATES: ASTM A36 (FY = 36 KSI)  
HSS: ASTM A500 GR. B (FY = 46 KSI)  
STEEL PIPE: ASTM A53 GR. B (FY = 35 KSI)  
HIGH STRENGTH BOLTS: ASTM A325-N, 3/4" Ø MIN.  
NUTS: ASTM A563  
WASHERS: ASTM F436  
DIRECT TENSION INDICATORS: ASTM F959  
THREADED ROD: ASTM A36  
ANCHOR RODS: ASTM F1554 GR. 36  
SHEAR STUD CONNECTORS: ASTM A108
2.

WELDING ELECTRODES SHALL BE AWS E-70XX. ALL SHOP CONNECTIONS SHALL BE WELDED UNLESS OTHERWISE SHOWN, ALL FIELD CONNECTIONS SHALL BE BOLTED.
3.

PROVIDE FRAMED OR SEATED BEAM CONNECTIONS IN ACCORDANCE WITH THE AISC MANUAL OF STEEL CONSTRUCTION. UNLESS OTHERWISE NOTED, BEAM CONNECTIONS SHALL BE DETAILED TO HAVE A CAPACITY OF NOT LESS THAN ONE-HALF THE TOTAL ALLOWABLE UNIFORM LOAD DETERMINED IN ACCORDANCE WITH AISC MANUAL OF STEEL CONSTRUCTION TABLE FOR "ALLOWABLE UNIFORM LOADS IN KIPS FOR BEAMS Laterally Supported", FOR BEAMS AND SPANS IN QUESTION. HOLES FOR SHOP AND FIELD CONNECTIONS SHALL BE DRILLED OR PUNCHED. NO BURNT HOLES WILL BE ALLOWED.
4.

CONTRACTOR SHALL SUPPLY AND USE ALL NECESSARY BRACING AND OTHER MEANS TO MAINTAIN STABILITY AND LOCATION OF STEEL FRAMING DURING CONSTRUCTION.

MASONRY NOTES:

1.

STANDARDS:  
  
- BUILDING CODE REQUIREMENTS FOR MASONRY STRUCTURES (ACI 530.1-02/ASCE 5-02/TMS 402-02)  
- SPECIFICATION FOR MASONRY STRUCTURES (ACI 530.1-02/ASCE 6-02/TMS 602-02)
2.

MINIMUM NET AREA COMPRESSIVE STRENGTH OF MASONRY (f'm) = 1,500 PSI.
3.

HOLLOW LOAD BEARING UNITS: ASTM C90, GRADE N-I OR N-II.
4.

HOLLOW NON-LOAD BEARING UNITS: ASTM C129, TYPE 1 OR II.
5.

SOLID LOAD BEARING UNITS: ASTM C145, GRADE S-I OR S-II.
6.

REINFORCEMENT: DEFORMED REINFORCING BARS THAT CONFORM TO ASTM A615 (FY= 60,000 PSI).
7.

JOINT REINFORCEMENT: HOT-DIP GALVANIZED MASONRY JOINT REINF. THAT CONFORMS TO ASTM A153, AND ASTM A951.
8.

PROVIDE MORTAR OF TYPE AND COLOR SPECIFIED THAT CONFORMS TO ASTM C270.
9.

GROUT SHALL BE PROPORTIONED AND MIXED IN ACCORDANCE WITH ASTM C476 AND SHALL ATTAIN A MINIMUM ULTIMATE COMPRESSIVE STRENGTH OF 3,000 PSI AT 28 DAYS IN ACCORDANCE WITH ASTM C1019. PROVIDE COARSE OR FINE GROUT IN ACCORDANCE WITH THE SPECIFICATIONS.
10.

GROUT SHALL BE PLACED IN A CONTINUOUS LIFT, WITH A MAXIMUM LIFT HEIGHT NOT EXCEED 5 FT. BETWEEN LIFTS, A HORIZONTAL CONSTRUCTION JOINT SHALL BE FORMED BY STOPPING GROUT 1 1/2" BELOW A HORIZONTAL MORTAR JOINT EXCEPT AT TOP OF WALLS.
11.

MAXIMUM GROUT PLACEMENT HEIGHT SHALL BE IN ACCORDANCE WITH ACI 530.1-02 SPECIFICATION FOR MASONRY STRUCTURES TABLE 7.
12.

CONSOLIDATE GROUT AT TIME OF PLACEMENT, CONSOLIDATE GROUT LIFTS 12" OR LESS IN HEIGHT BY MECHANICAL VIBRATION OR BY PUDDLING. CONSOLIDATE GROUT LIFTS MORE THAN 12" IN HEIGHT BY MECHANICAL VIBRATION AND RECONSOLIDATE BY MECHANICAL VIBRATION AFTER INITIAL WATER LOSS AND SETTLEMENT HAS OCCURRED.
13.

DO NOT USE GROUT OR MORTAR ADMIXTURES CONTAINING CALCIUM CHLORIDES, AIR-ENTRAINMENT OR ANTIFREEZE COMPOUNDS.
14.

REINFORCEMENT SHALL BE SECURELY PLACED USING APPROVED PREFABRICATED CORROSION RESISTANT METAL BAR POSITIONERS AND INSPECTED BY THE ENGINEER PRIOR TO GROUT PLACEMENT.
15.

VERTICAL REINFORCEMENT SHALL BE PROVIDED WITHIN 16" OF EACH SIDE OF OPENINGS, WITHIN 8" OF EACH SIDE OF MOVEMENT JOINTS, AND WITHIN 8" OF THE END OF WALLS.
16.

HORIZONTAL REINFORCEMENT SHALL BE PROVIDED AT THE BOTTOM AND TOP OF WALL OPENINGS AND SHALL EXTEND NOT LESS THAN 24" PAST OPENINGS, CONTINUOUSLY AT STRUCTURALLY CONNECTED ROOF AND FLOOR LEVELS, AND WITHIN 16" OF THE TOP OF WALLS.

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REVISIONS


CITY OF MIDDLETOWN  
NEW COURTHOUSE FACILITY

GENERAL STRUCTURAL NOTES

CITY OF MIDDLETOWN  
ORANGE COUNTY, NEW YORK



Barton & Loguidice

443 Electronics Parkway  
Liverpool, NY 13088



0021642, 0020388, 0019903, 0019905, 0020336

NYS CERTIFICATE #

NYS EXP.: May 31, 2026

Date

AUGUST, 2024

Scale

AS SHOWN


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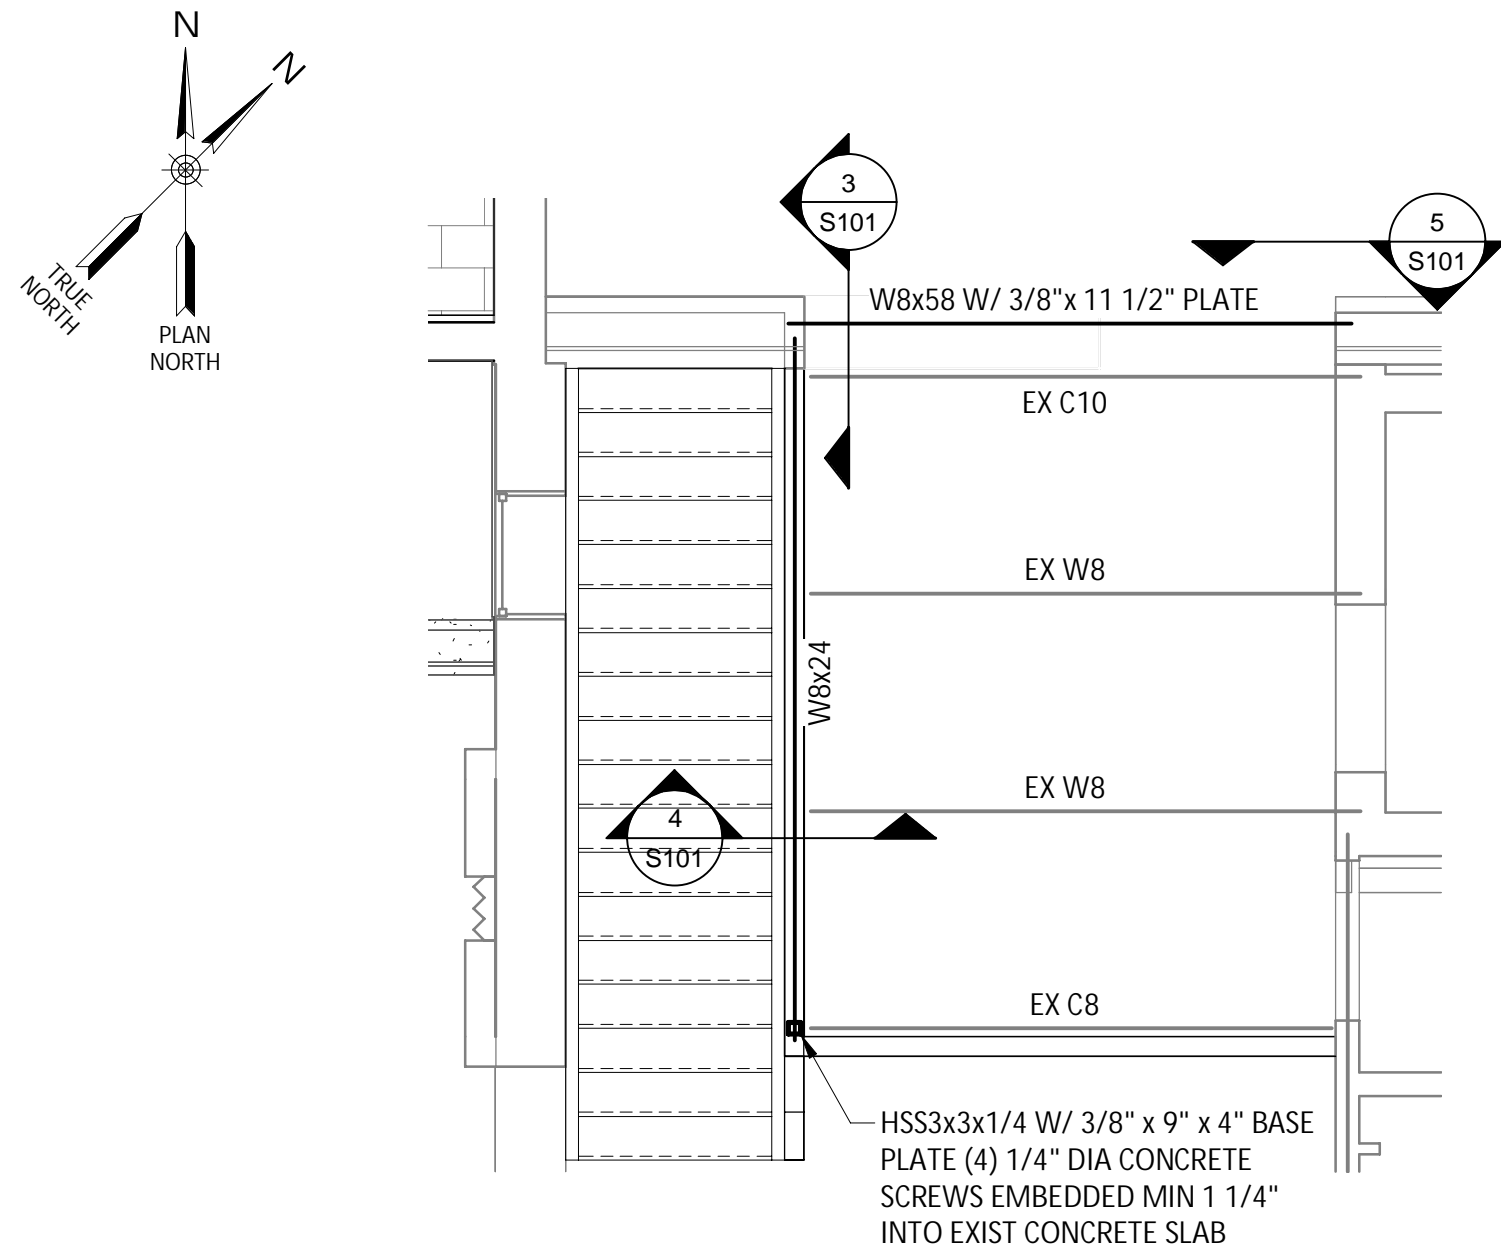
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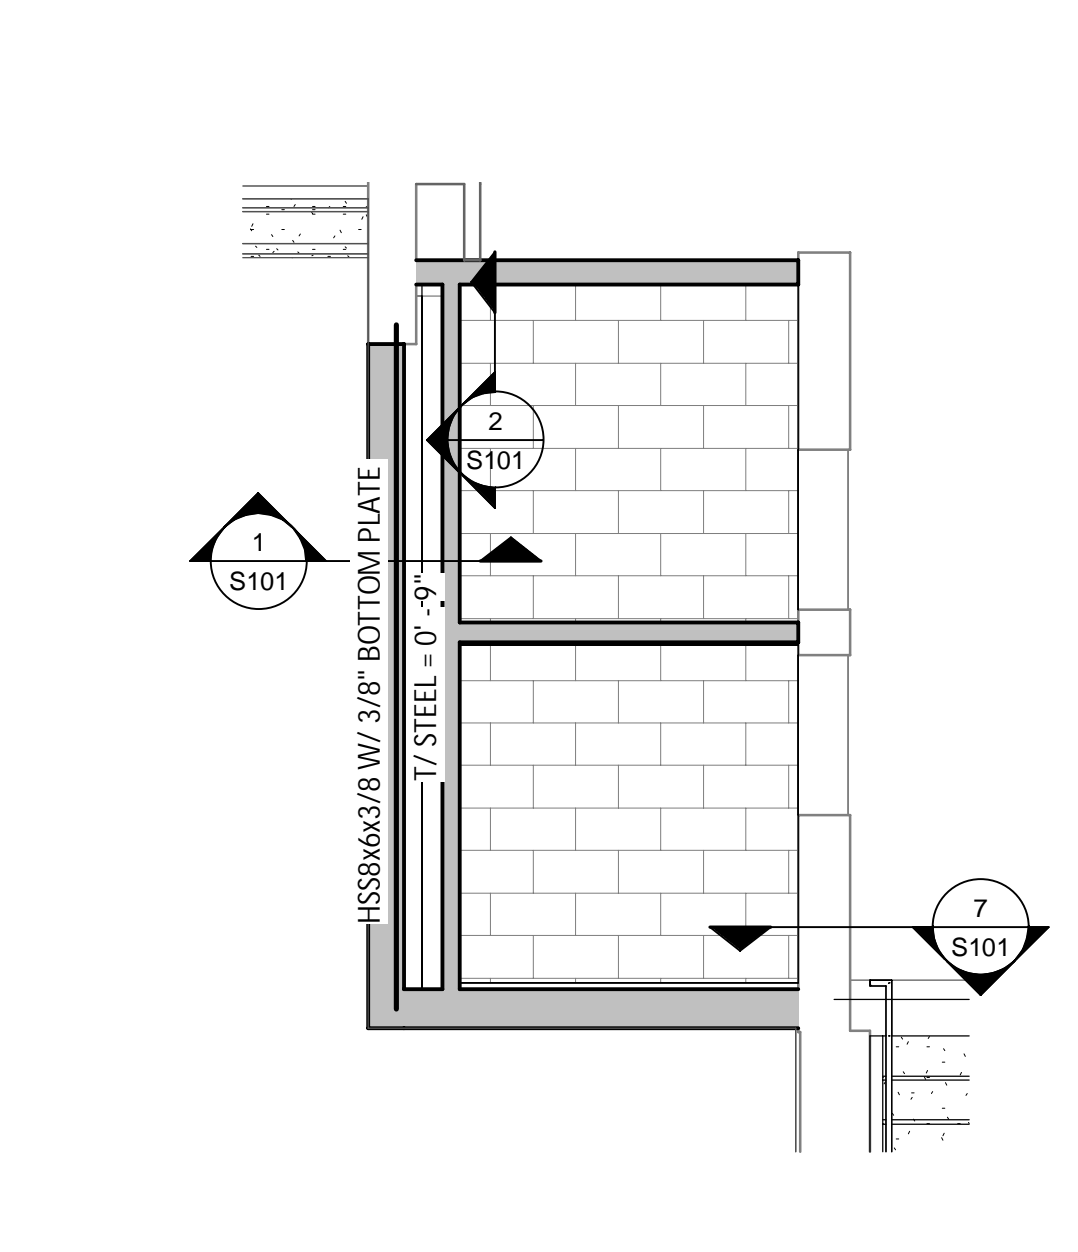
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Designed by:  PS  
In Charge of:  MCF




### STAIR FRAMING PLAN

SCALE: 1/4" = 1'-0"

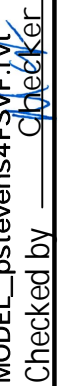


### BATHROOM ADDITION FLOOR PLAN

SCALE: 1/4" = 1'-0"

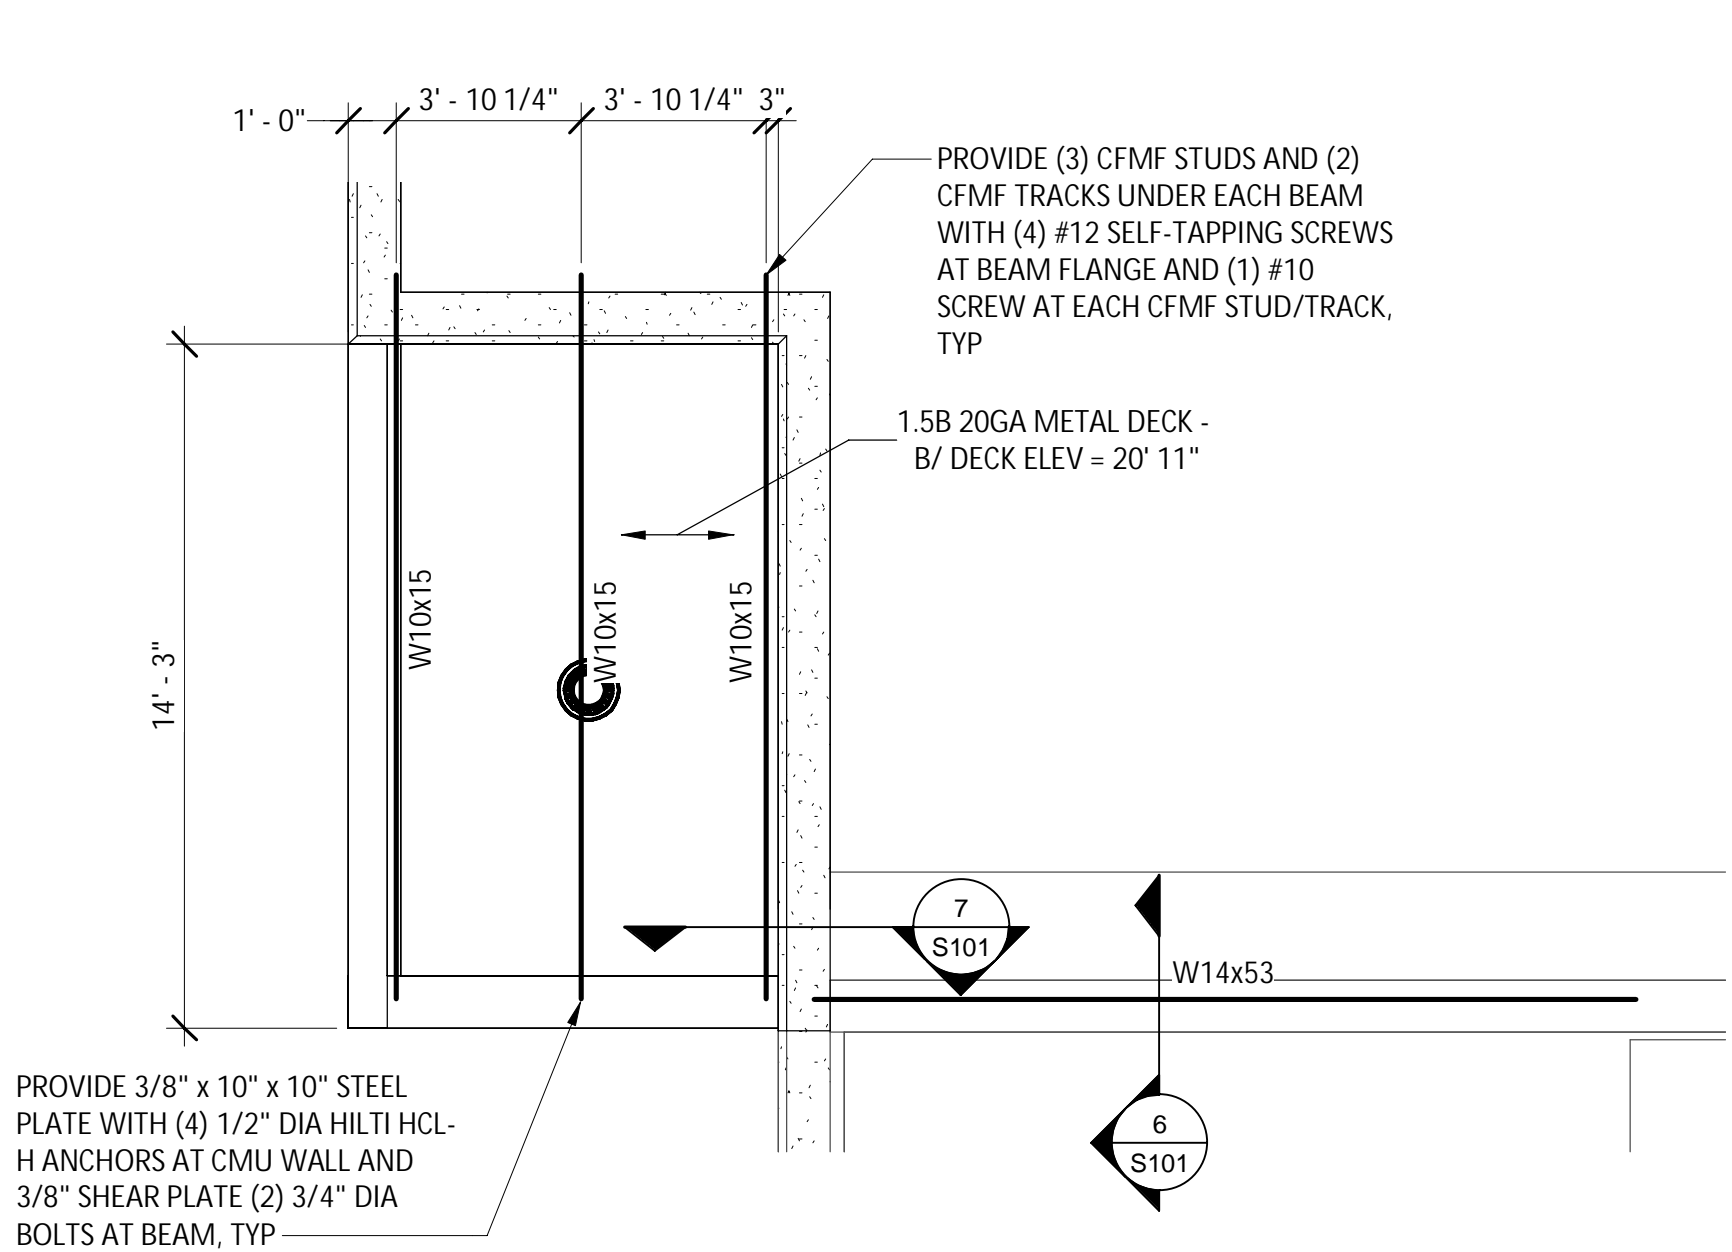


### PARTIAL ROOF FRAMING PLAN

SCALE: 1/4" = 1'-0"

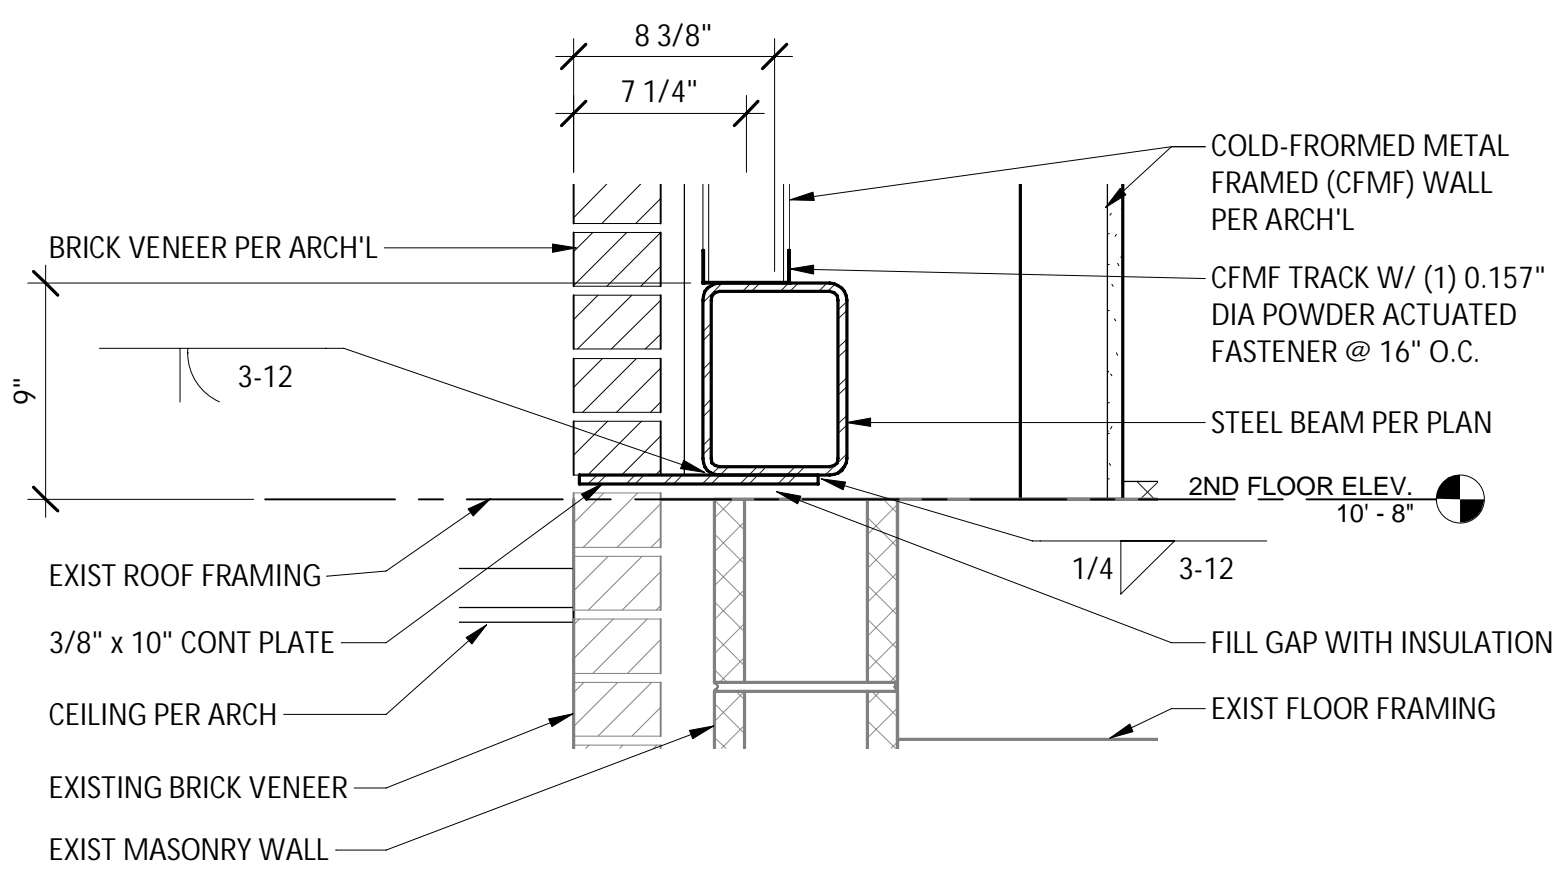


### 1 WALL SUPPORT BEAM

SCALE: 1 1/2" = 1'-0"

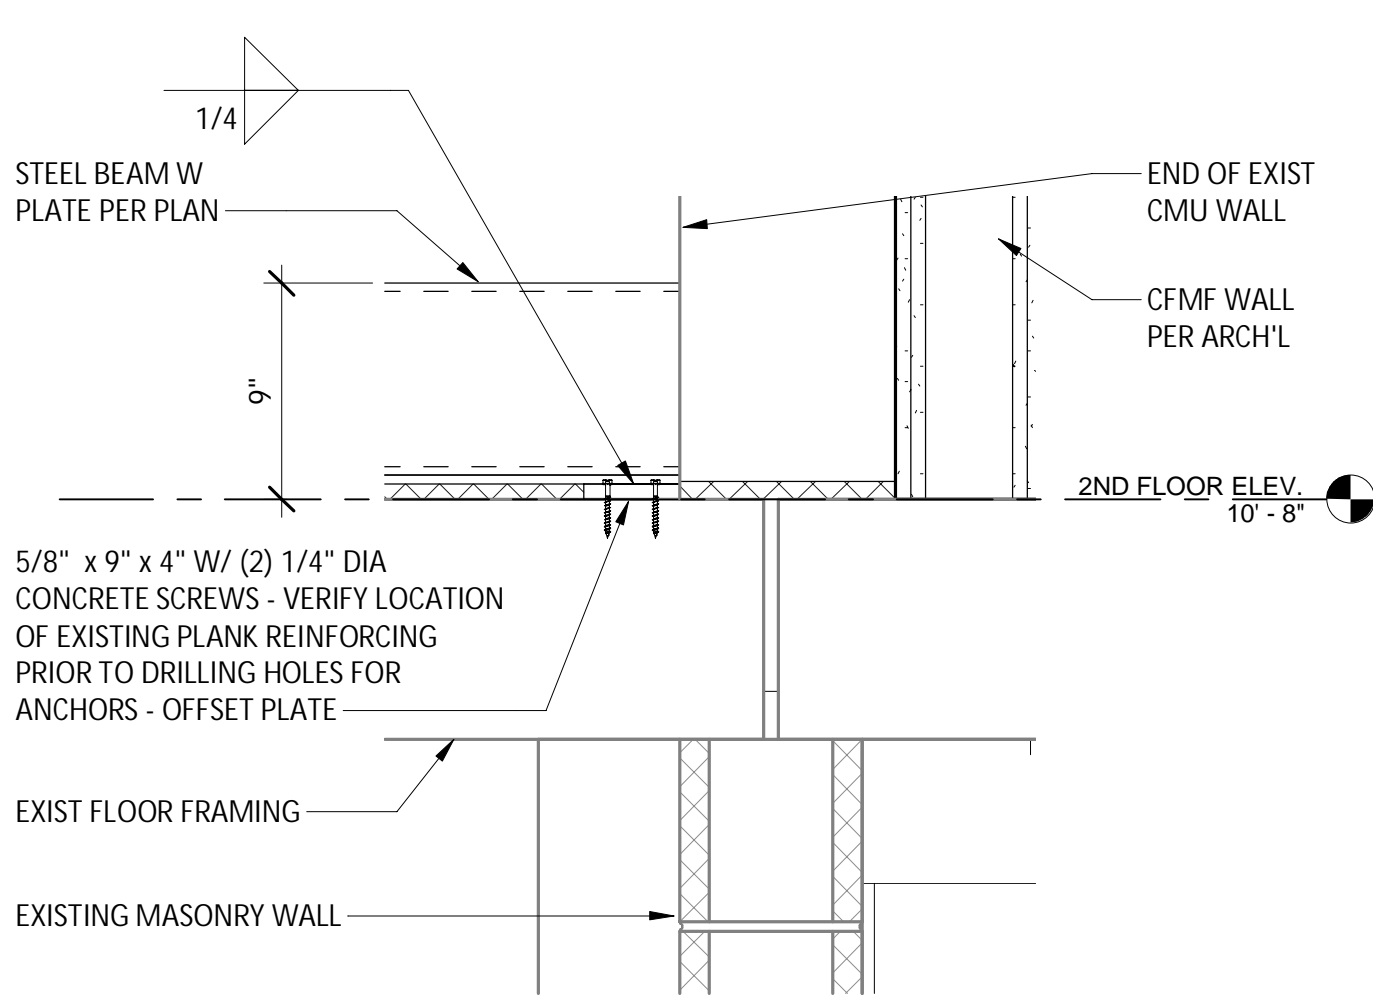


### 2 WALL SUPPORT BEAM CONNECTION

SCALE: 1 1/2" = 1'-0"

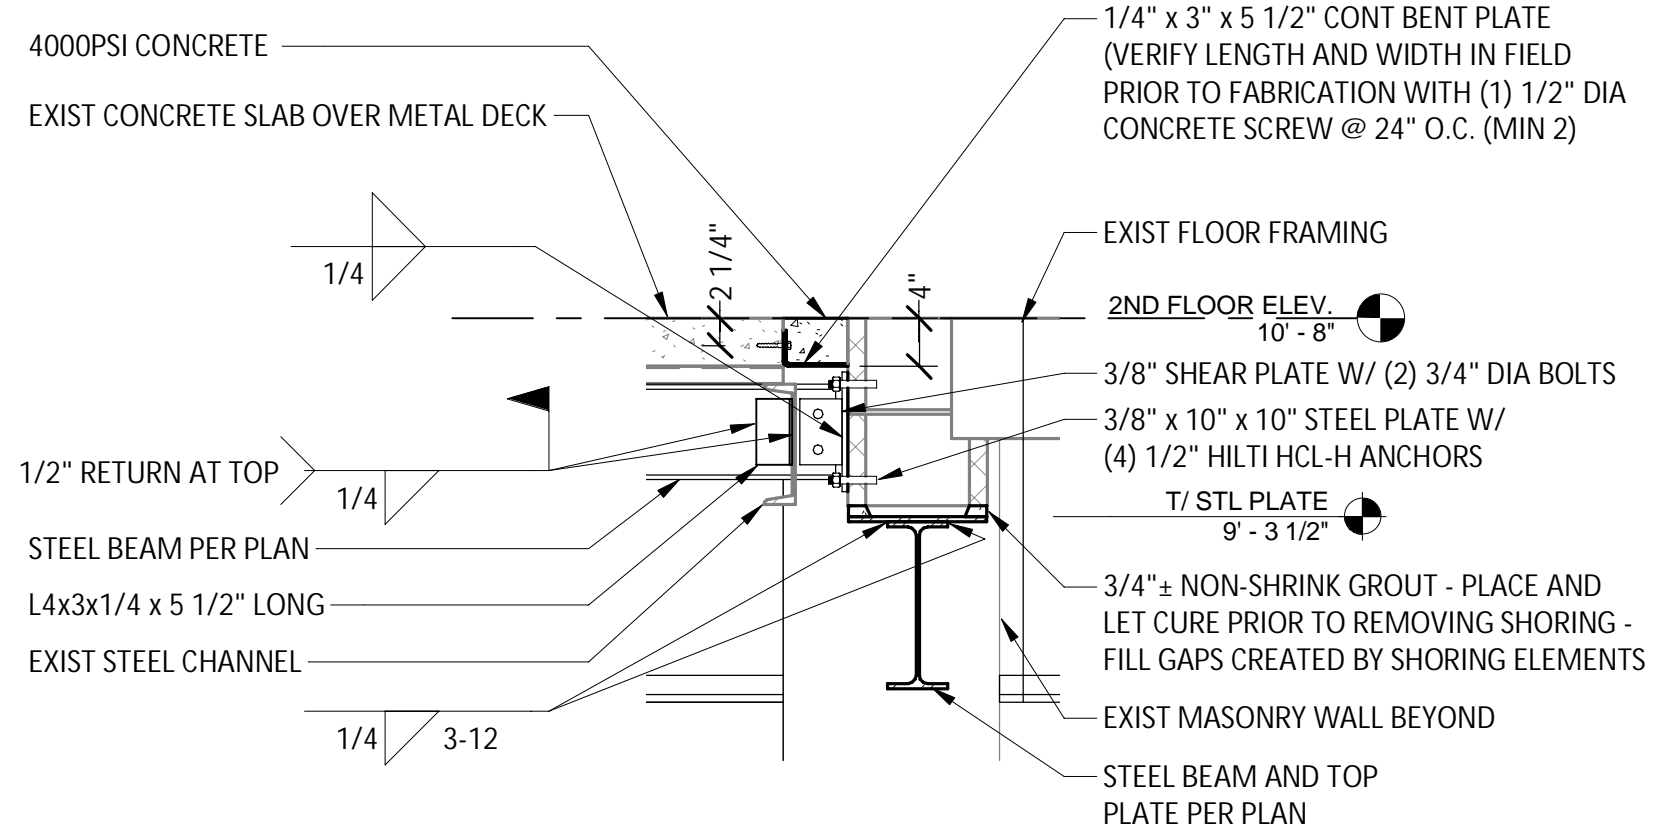


### 3 INTERIOR BEAM AT EXIST MASONRY WALL

SCALE: 3/4" = 1'-0"

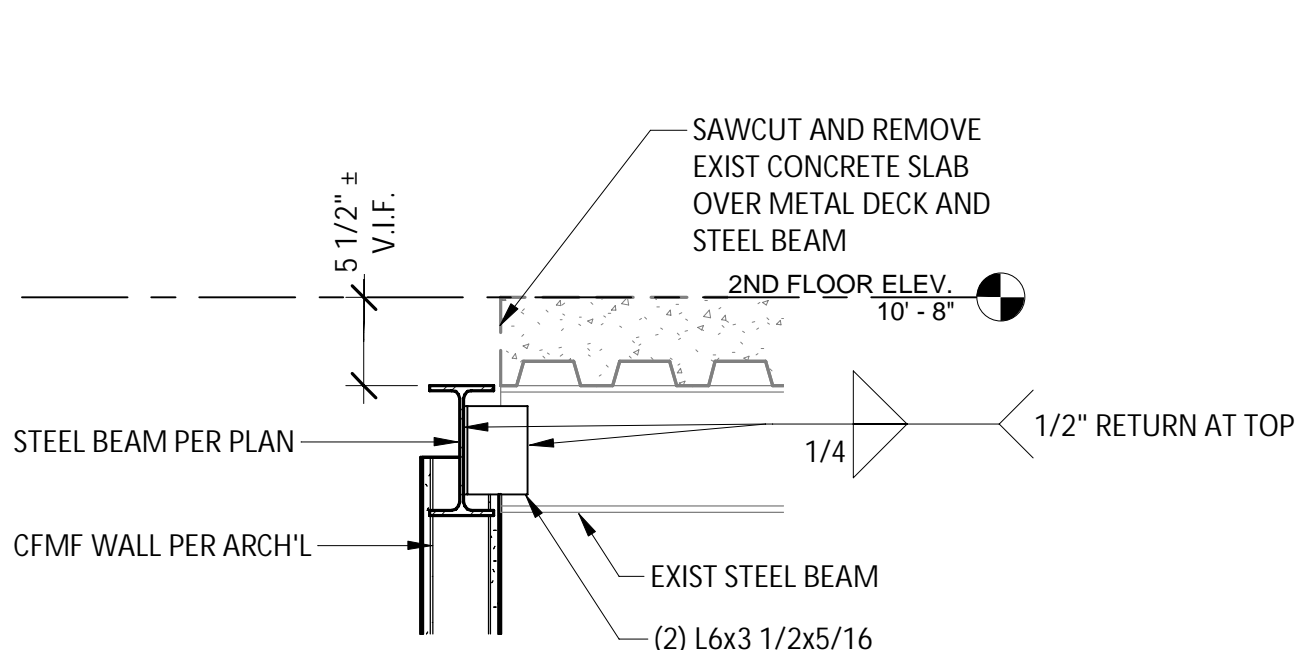


### 4 EXIST STEEL BEAM AT STEEL BEAM

SCALE: 1" = 1'-0"

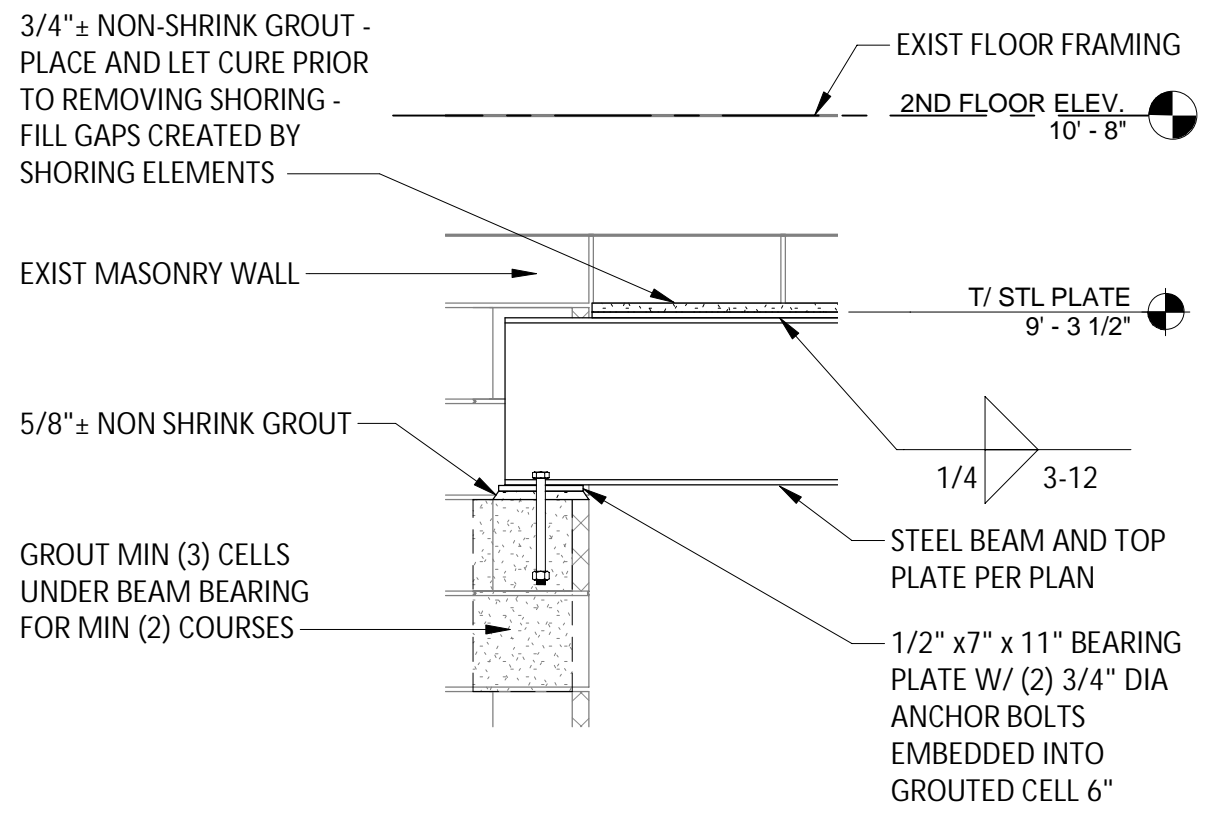


### 5 STEEL BEAM AT EXIST CMU WALL

SCALE: 3/4" = 1'-0"

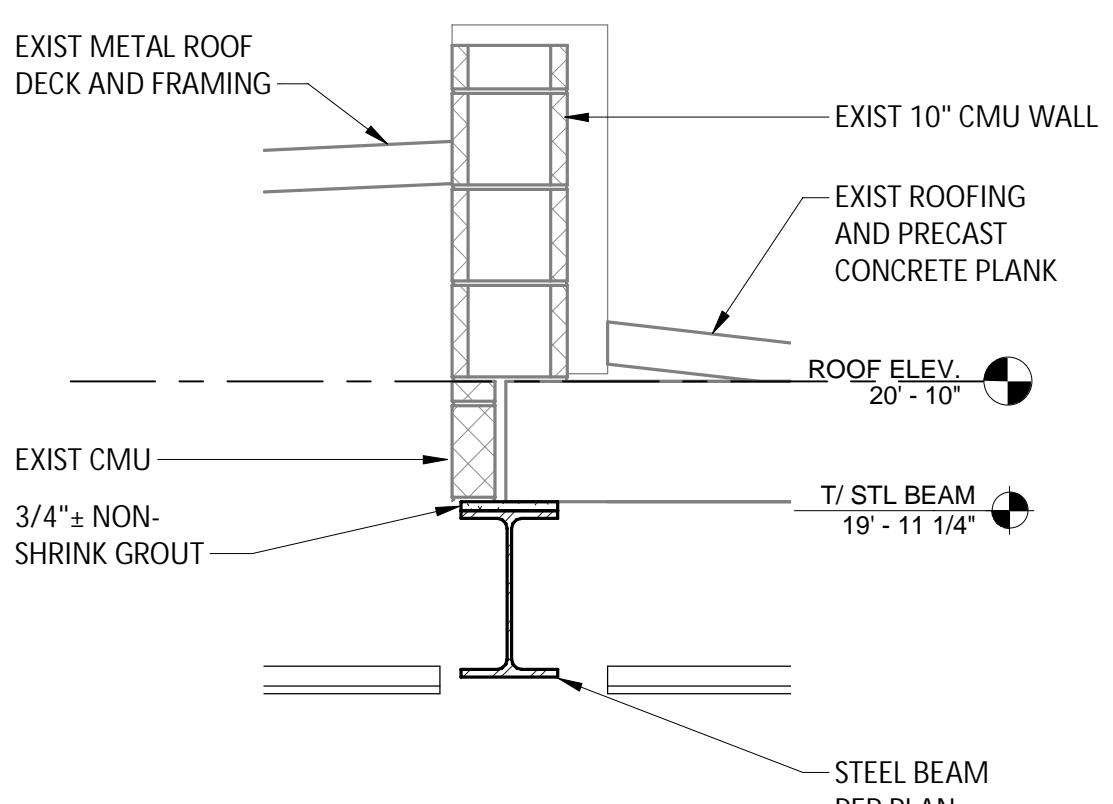

### 6 STEEL BEAM AT EXIST ROOF

SCALE: 3/4" = 1'-0"

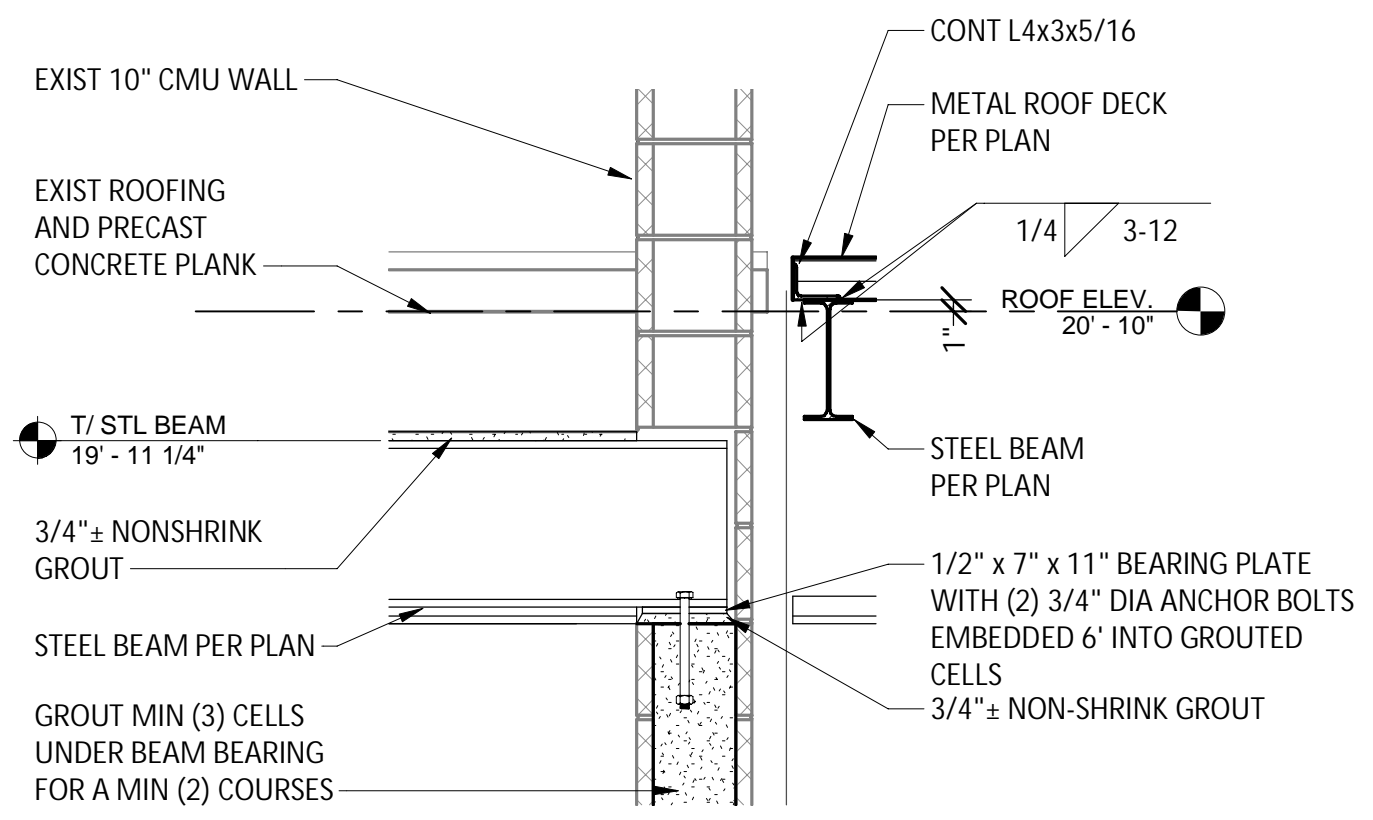

### 7 STEEL BEAM AT EXIST CMU WALL

SCALE: 3/4" = 1'-0"

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REVISIONS	

CITY OF MIDDLETOWN  
NEW COURTHOUSE FACILITY  
2ND FLOOR ADDITION AND STAIR FRAMING PLAN  
AND DETAILS  
CITY OF MIDDLETOWN  
ORANGE COUNTY, NEW YORK

**Barton & Loguidice**  
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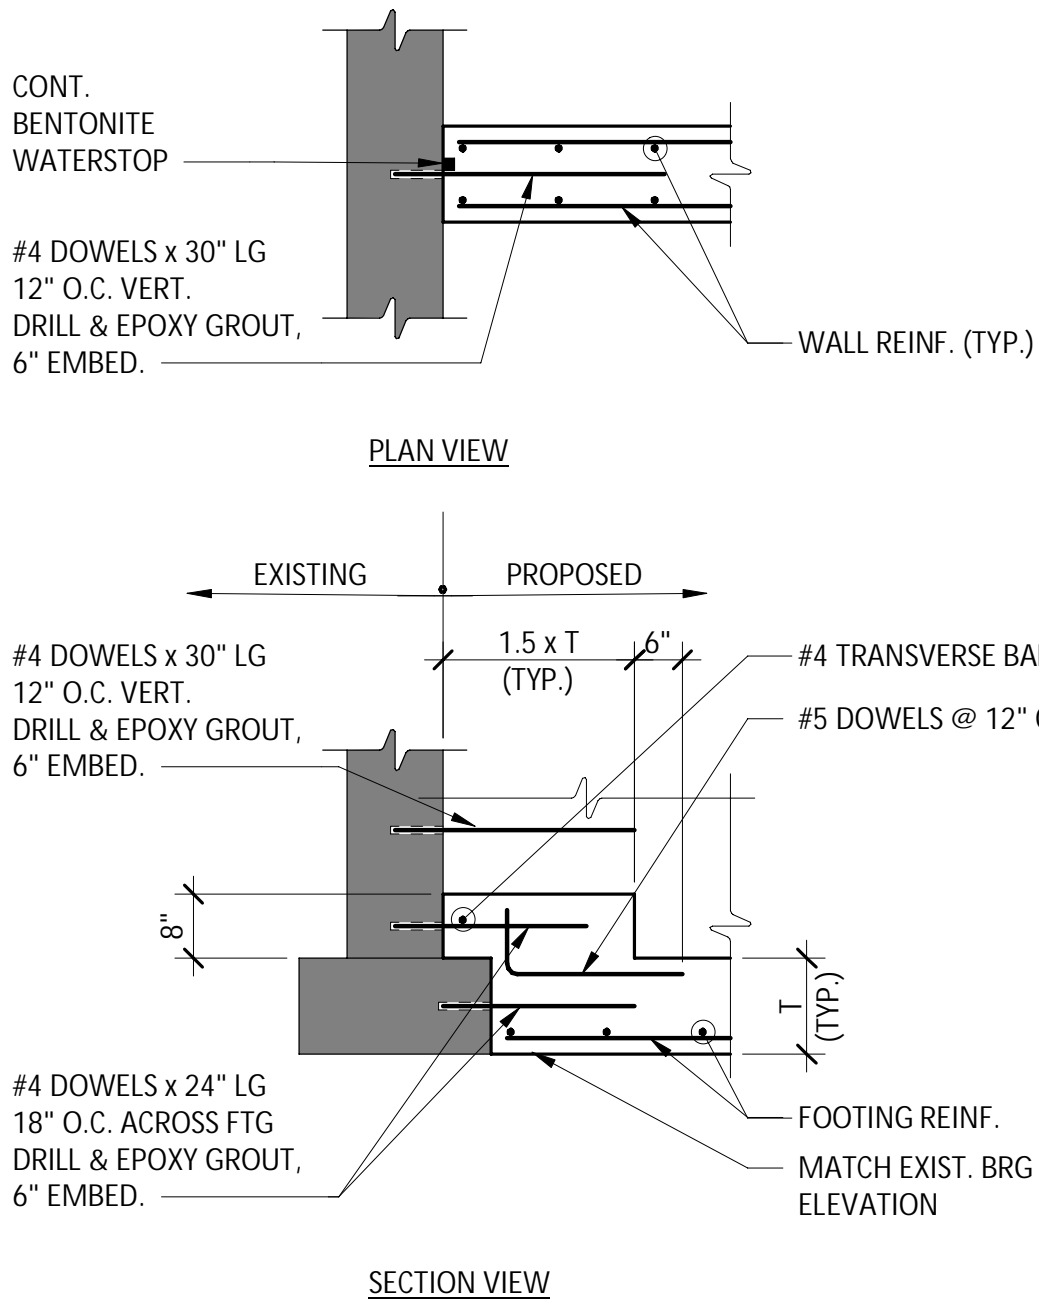


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Project Number  
1753.008.001











- NOTES:
- SEE PLANS FOR EXISTING AND PROPOSED WALL THICKNESS AND REINFORCING.
  - DETAIL SHALL BE USED UNLESS NOTED OTHERWISE ON DRAWINGS.

## NEW TO EXIST. FNDN WALL CONNECTION

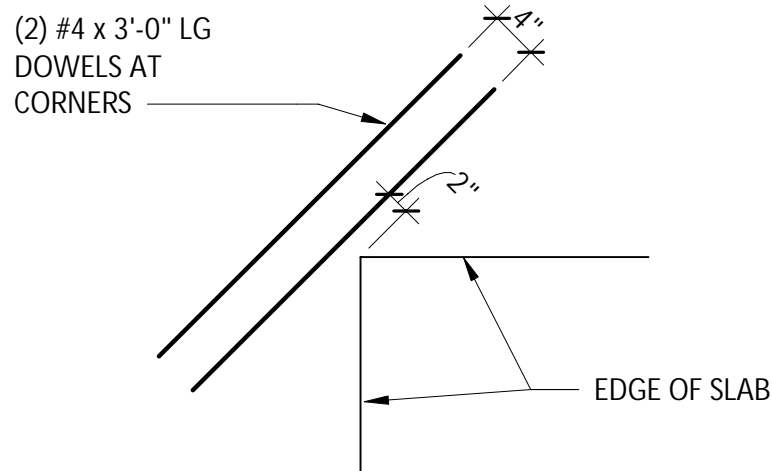


- DETAIL NOTES:
- THIS DETAIL SHALL OCCUR AT DOOR OPENINGS.
  - DOWELS SHALL BE LOCATED IN THE TOP OF THE SLAB, WHILE MAINTAINING PROPER COVER.

## S.O.G. REINF. AT RE-ENTRANT CORNERS

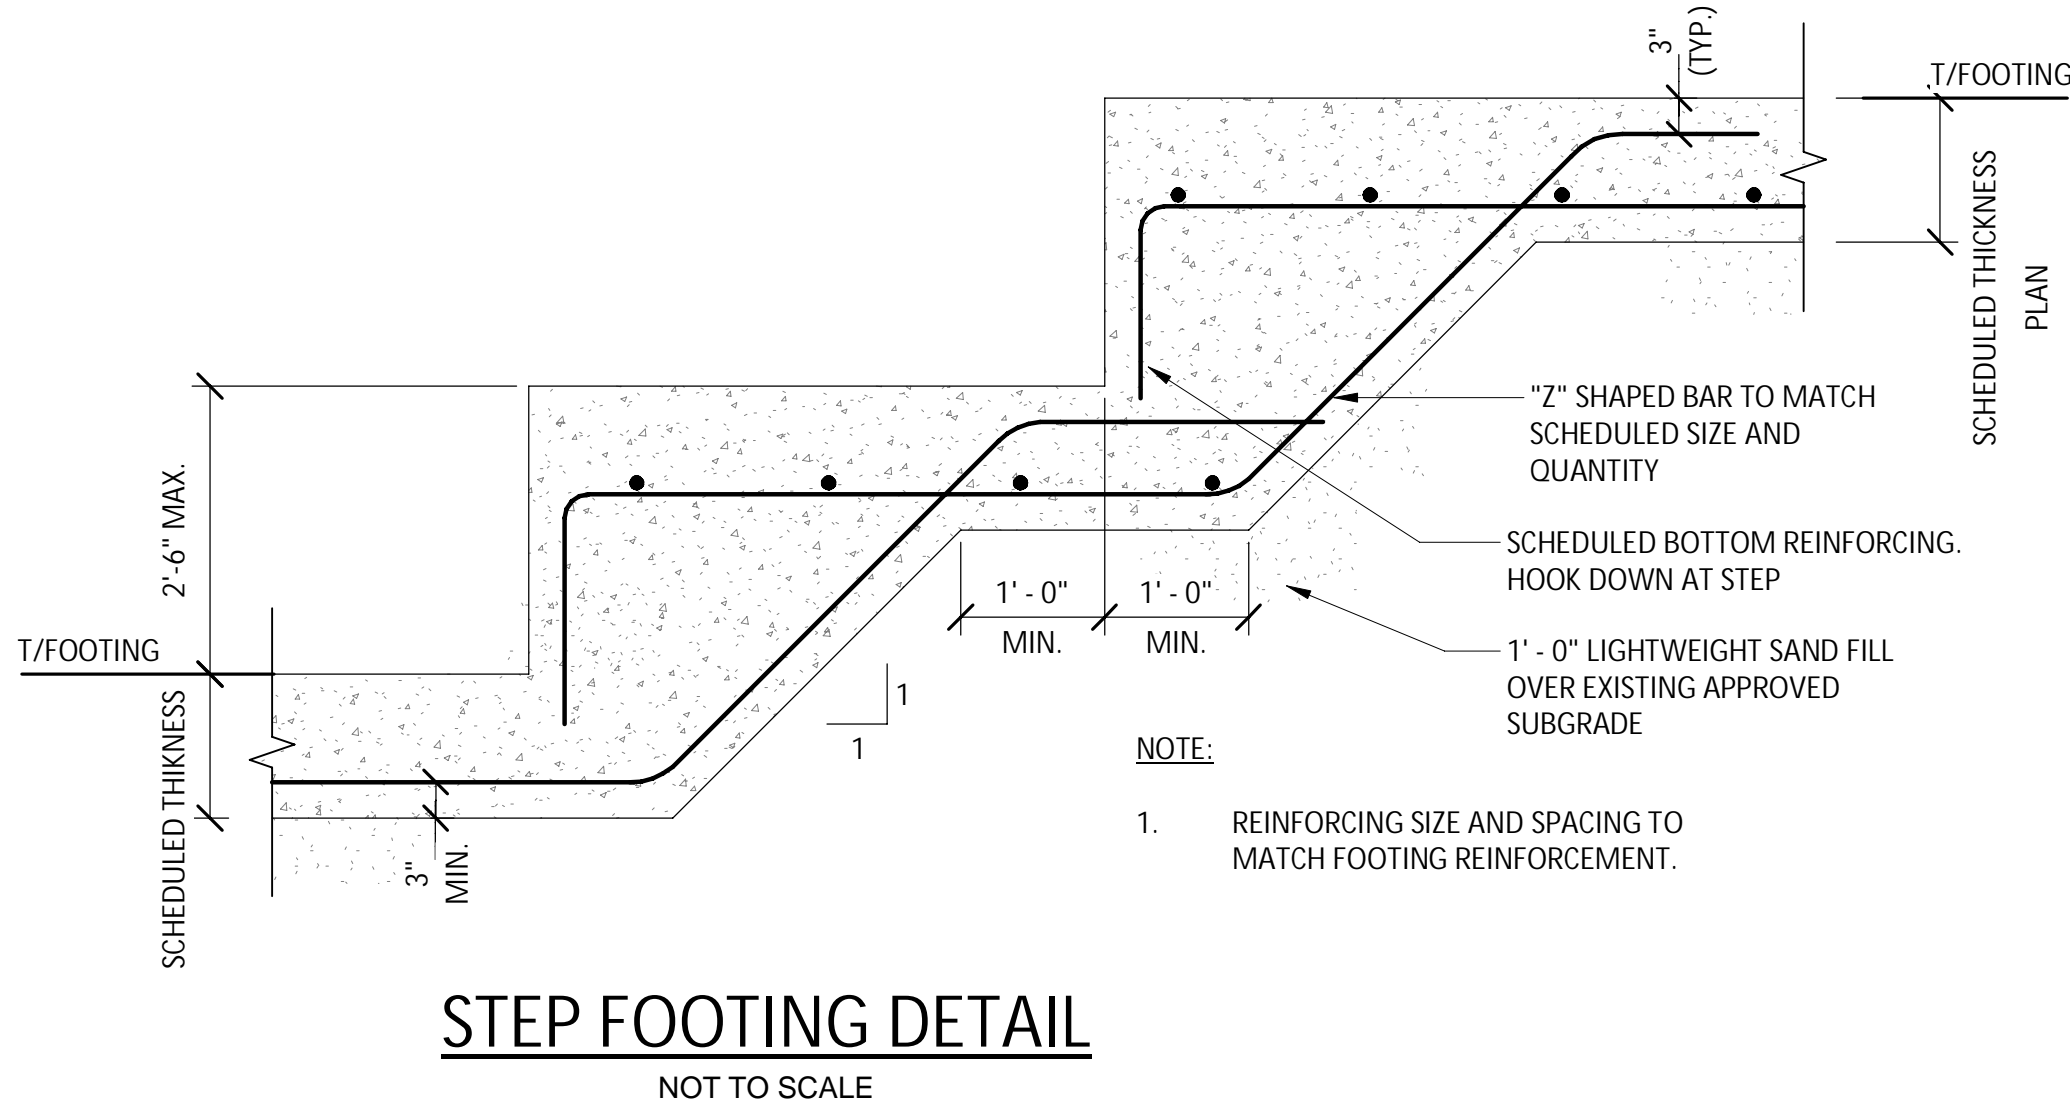


## STEP FOOTING DETAIL

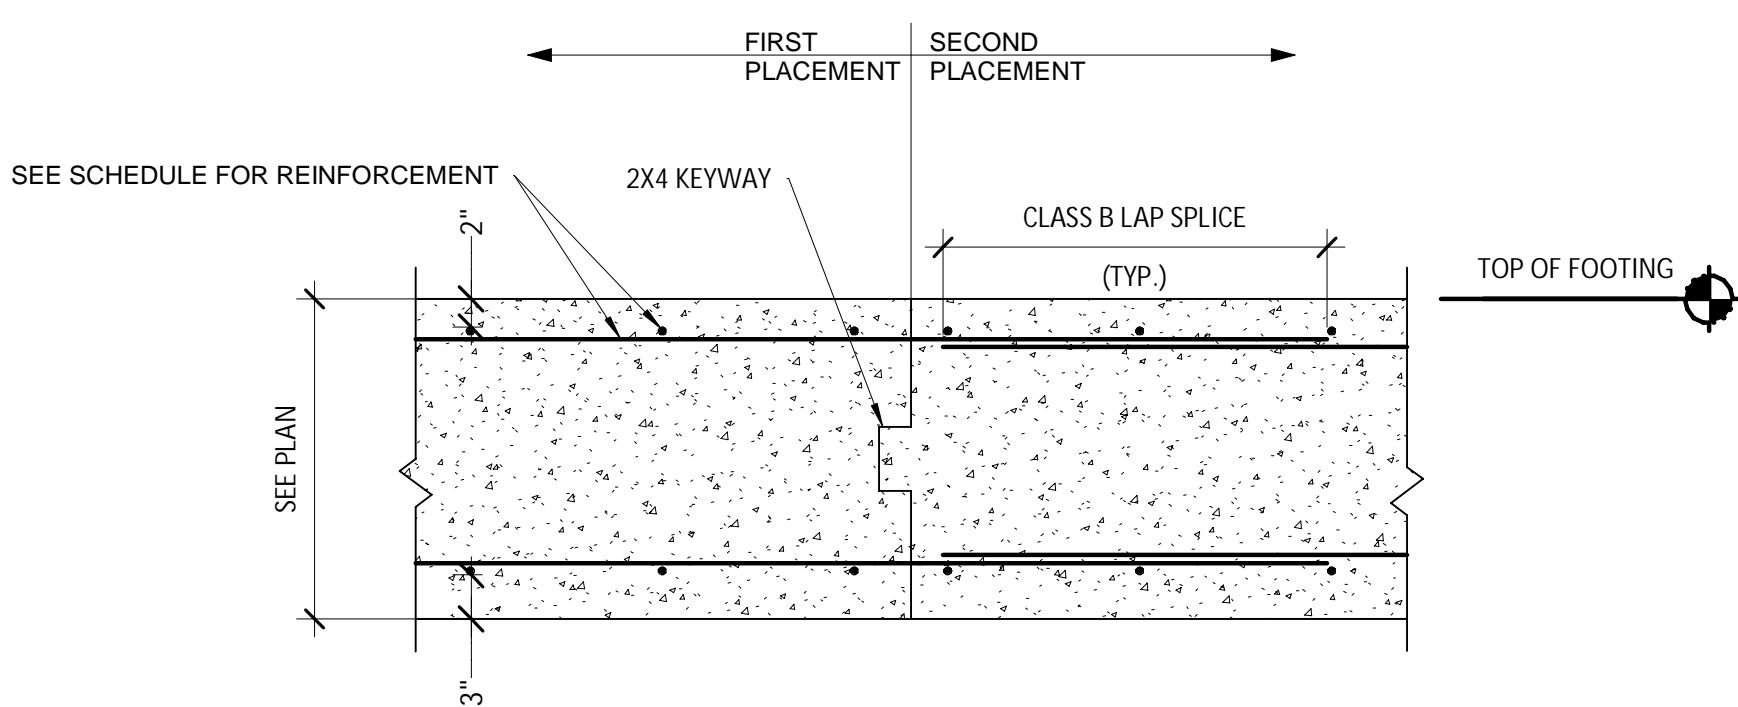

- NOTES:
- LOCATE CONSTRUCTION JOINT AT A CONTROL JOINT (CJ) LOCATION AND STOP EVERY OTHER TOP AND BOTTOM LONGITUDINAL BAR 2" CLR. FROM FACE OF JOINT.
  - LOCATIONS TO BE DETERMINED IN FIELD AT APPROXIMATELY 30' - 0" O.C. (MAX) SPACING.
  - PREPARE JOINT FACE PRIOR TO CONTINUING CONCRETE PLACEMENT IN ACCORDANCE WITH THE SPECIFICATIONS.
  - CONTRACTOR SHALL WAIT 48 HOURS BETWEEN PLACEMENT OF ADJACENT SECTIONS OF CONCRETE.


## TYP. FOOTING CONSTRUCTION JOINT

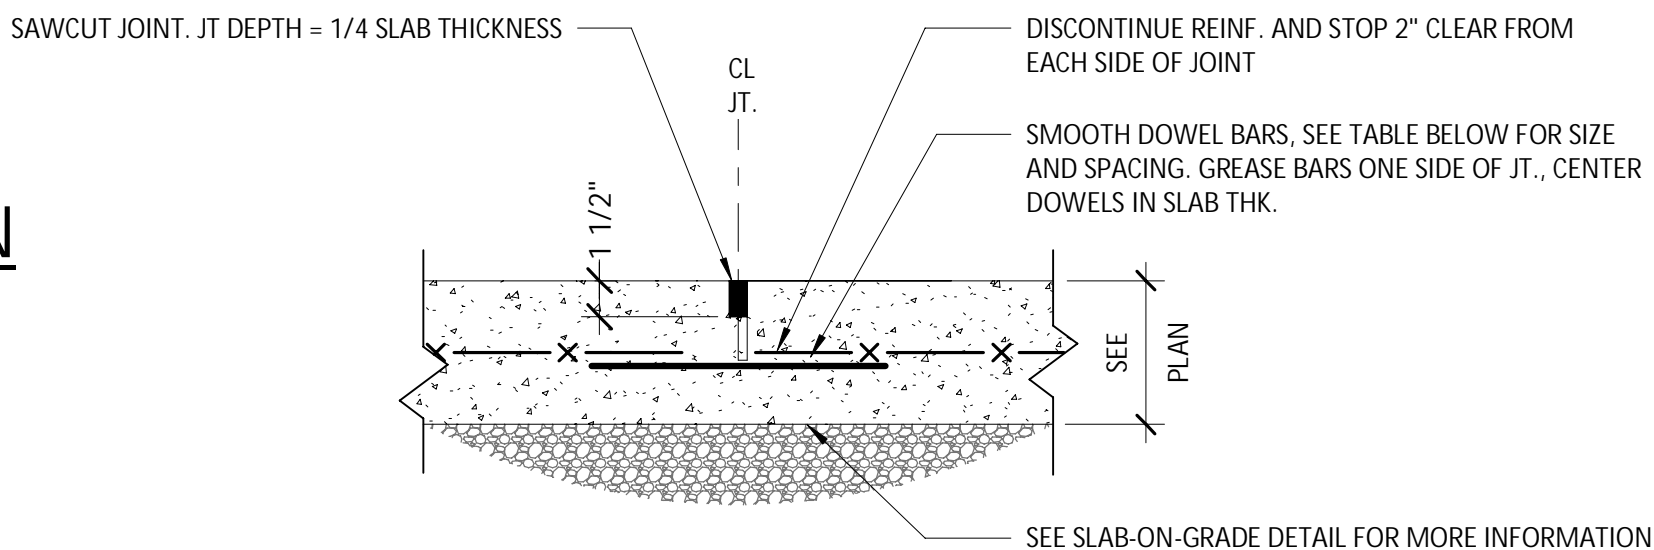


SLAB DEPTH	DOWEL DIMENSIONS			DOWEL SPACING CENTER TO CENTER		
	ROUND	SQUARE	RECTANGULAR	ROUND	SQUARE	RECTANGULAR
5" - 6"	3/4" x 14"	3/4" x 14"	3/8" x 2" x 12"	12"	14"	19"
7" - 8"	1" x 16"	1" x 16"	1/2" x 2-1/2" x 12"	12"	14"	18"
9" - 12"	1-1/4" x 18"	1-1/4" x 18"	3/4" x 2-1/2" x 12"	12"	12"	18"

- NOTES:
- TOLERANCE, +0" - 1/16" WITH CONCRETE SURFACE. ANY PROJECTION OF METAL ABOVE SURFACE MUST BE REMOVED BY GRINDING.
  - PROVIDE CONTROL JOINTS AT LOCATIONS AS SHOWN ON PLANS.
  - FILL JOINTS W/ JOINT SEALANT AND BACKER ROD, OR BOND BREAKER TAPE.
  - PROVIDE JOINT SIZE TO ACCOMMODATE INSTALLED SEALANT DIMENSIONS OF 2(W)-1(D) AND AN APPROPRIATELY SIZED (DIA) CLOSED CELL POLYETHYLENE FOAM BACKER ROD, OR BOND BREAKER TAPE.
  - JOINTS SHALL BE 1/4" WIDE (MIN.).
  - PROVIDE APPRD. MFG'D. DOWEL/BASKET ASSEMBLIES W/ DOWELS WELDED AT ALTERNATING ENDS (GREASE OPPOSITE ENDS).
  - SAWCUTTING SHALL BE COMPLETED WITHIN 18 HOURS OF CONCRETE POUR.

## TYP. SLAB ON GRADE CONTROL JOINT

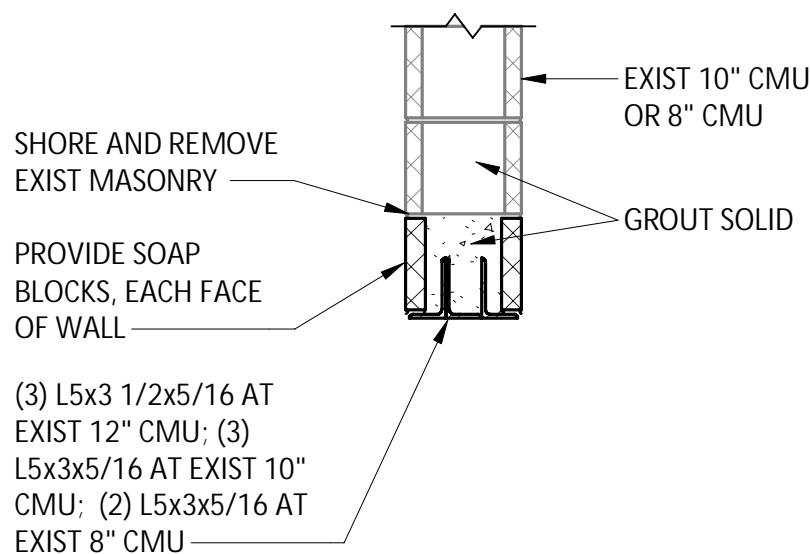


## LINTEL AT EXIST CMU WALL

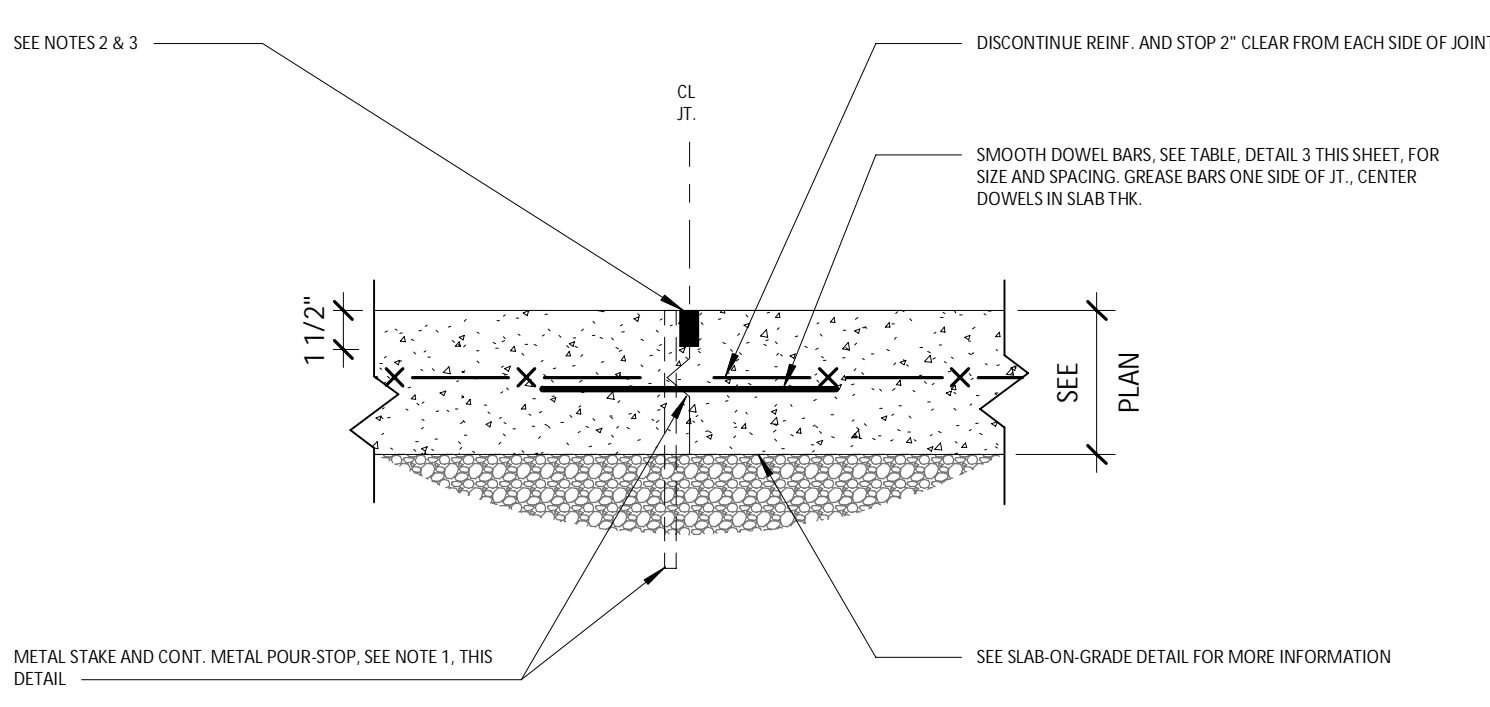


- NOTES:
- METAL CONSTRUCTION JOINT MUST BE CONTINUOUS FOR THE FULL WIDTH OF THE POUR. INDIVIDUAL SHORT SECTIONS ARE NOT PERMITTED. IN ORDER TO OBTAIN A CONTINUOUS STRIP, LAP AND FIELD WELD THE SECTIONS. METAL JOINT MATERIAL SHALL BE REMOVED PRIOR TO PLACING CONCRETE AT ADJACENT SLAB. TOP OF METAL STAKE SHALL BE LOCATED 1-INCH (MIN.) BELOW TOP OF FINAL CONC. SLAB ELEVATION.
  - PROVIDE JOINT SIZE AT TOP OF SLAB TO ACCOMMODATE INSTALLED SEALANT DIMENSIONS OF 2(W)-1(D) AND AN APPROPRIATELY SIZED (DIA) CLOSED CELL POLYETHYLENE FOAM BACKER ROD, OR BOND BREAKER TAPE.
  - FILL JOINTS W/ JOINT SEALANT AND BACKER ROD, OR BOND BREAKER TAPE.
  - PROVIDE APPRD. MFG'D. DOWEL/BASKET ASSEMBLIES W/ DOWELS WELDED AT ALTERNATING ENDS (GREASE OPPOSITE ENDS).
  - JOINTS TO BE LOCATED AT CONTROL JT. LOC'S. UNLESS NOTED OTHERWISE, OR DIRECTED BY THE ENGINEER. IF NOT LOCATED AT A SPECIFIED CONTROL JOINT LOCATION, NOTIFY ENGINEER FOR FURTHER DIRECTION.
  - SEE "TYP. SLAB-ON-GRADE CONTROL JOINT (CJ)" FOR DOWEL SIZE REQ'S.

## TYP. SLAB ON GRADE CONSTRUCTION JOINT

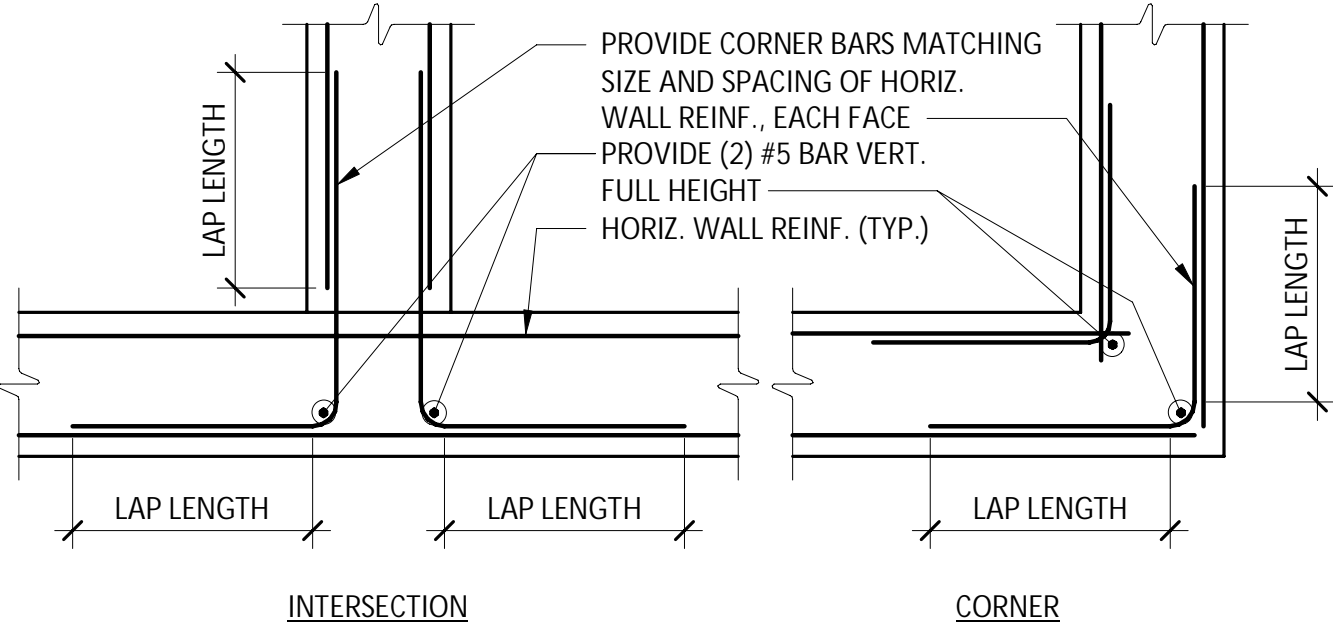

- DETAIL NOTES:
- VERTICAL WALL REINFORCING NOT SHOWN FOR CLARITY.
  - SEE "CONCRETE REINFORCING SPLICE AND EMBEDMENT" SCHEDULE FOR REQUIRED LAP LENGTHS.

## CONCRETE WALL INTERSECTION AND CORNER

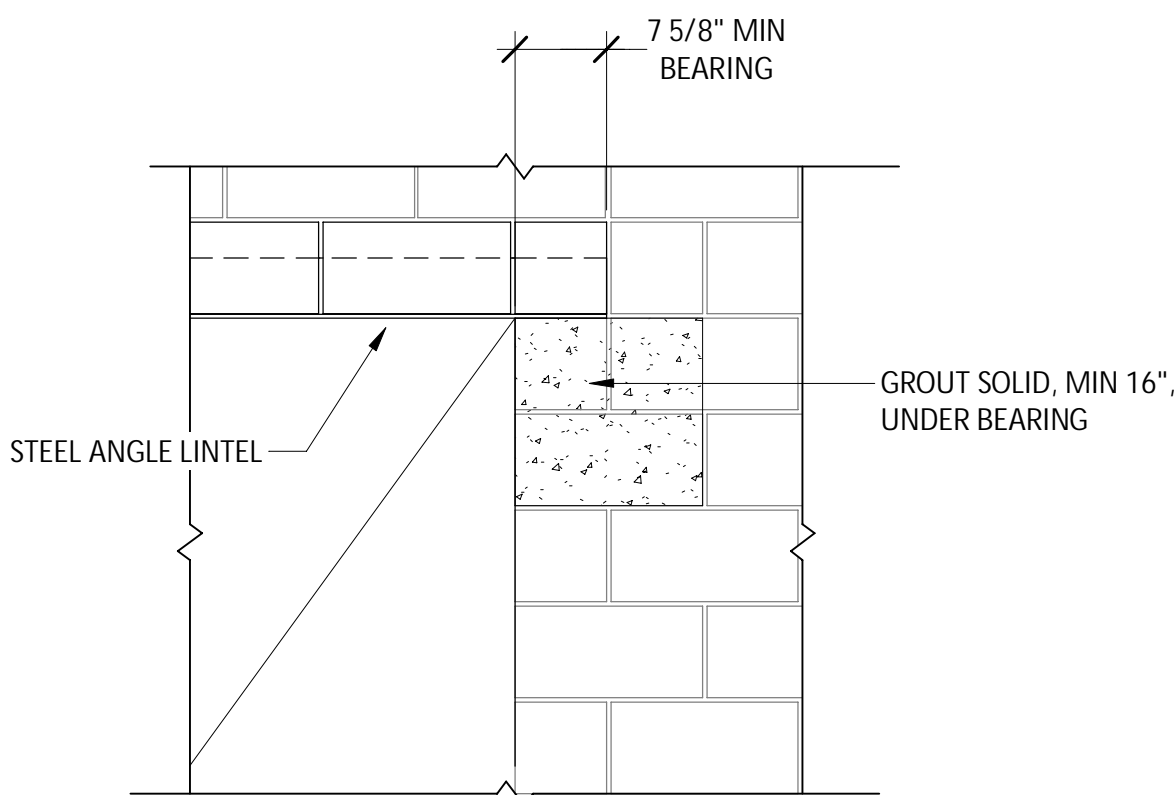

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### REVISIONS

NO.	DESCRIPTION

CITY OF MIDDLETOWN  
NEW COURTHOUSE FACILITY  
ORANGE COUNTY, NEW YORK

### TYPICAL DETAILS

CITY OF MIDDLETOWN

**Barton & Loguidice**  
443 Electronics Parkway  
Liverpool, NY 13088




NYS EXP.: May 31, 2026  
Date: AUGUST, 2024  
Scale: AS SHOWN  
Sheet Number: S501  
Project Number: 1753.008.001




ADDITIVE BID ITEM NO. 02 - FRONT ENTRY CANOPY, SEE ARCH DWGS  
ADDITIVE BID ITEM NO. 03 - REAR ENTRY CANOPY, SEE ARCH DWGS

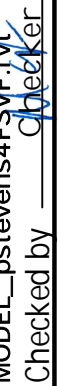


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Checked by: 

Designed by:  PS In Charge of:  MCF

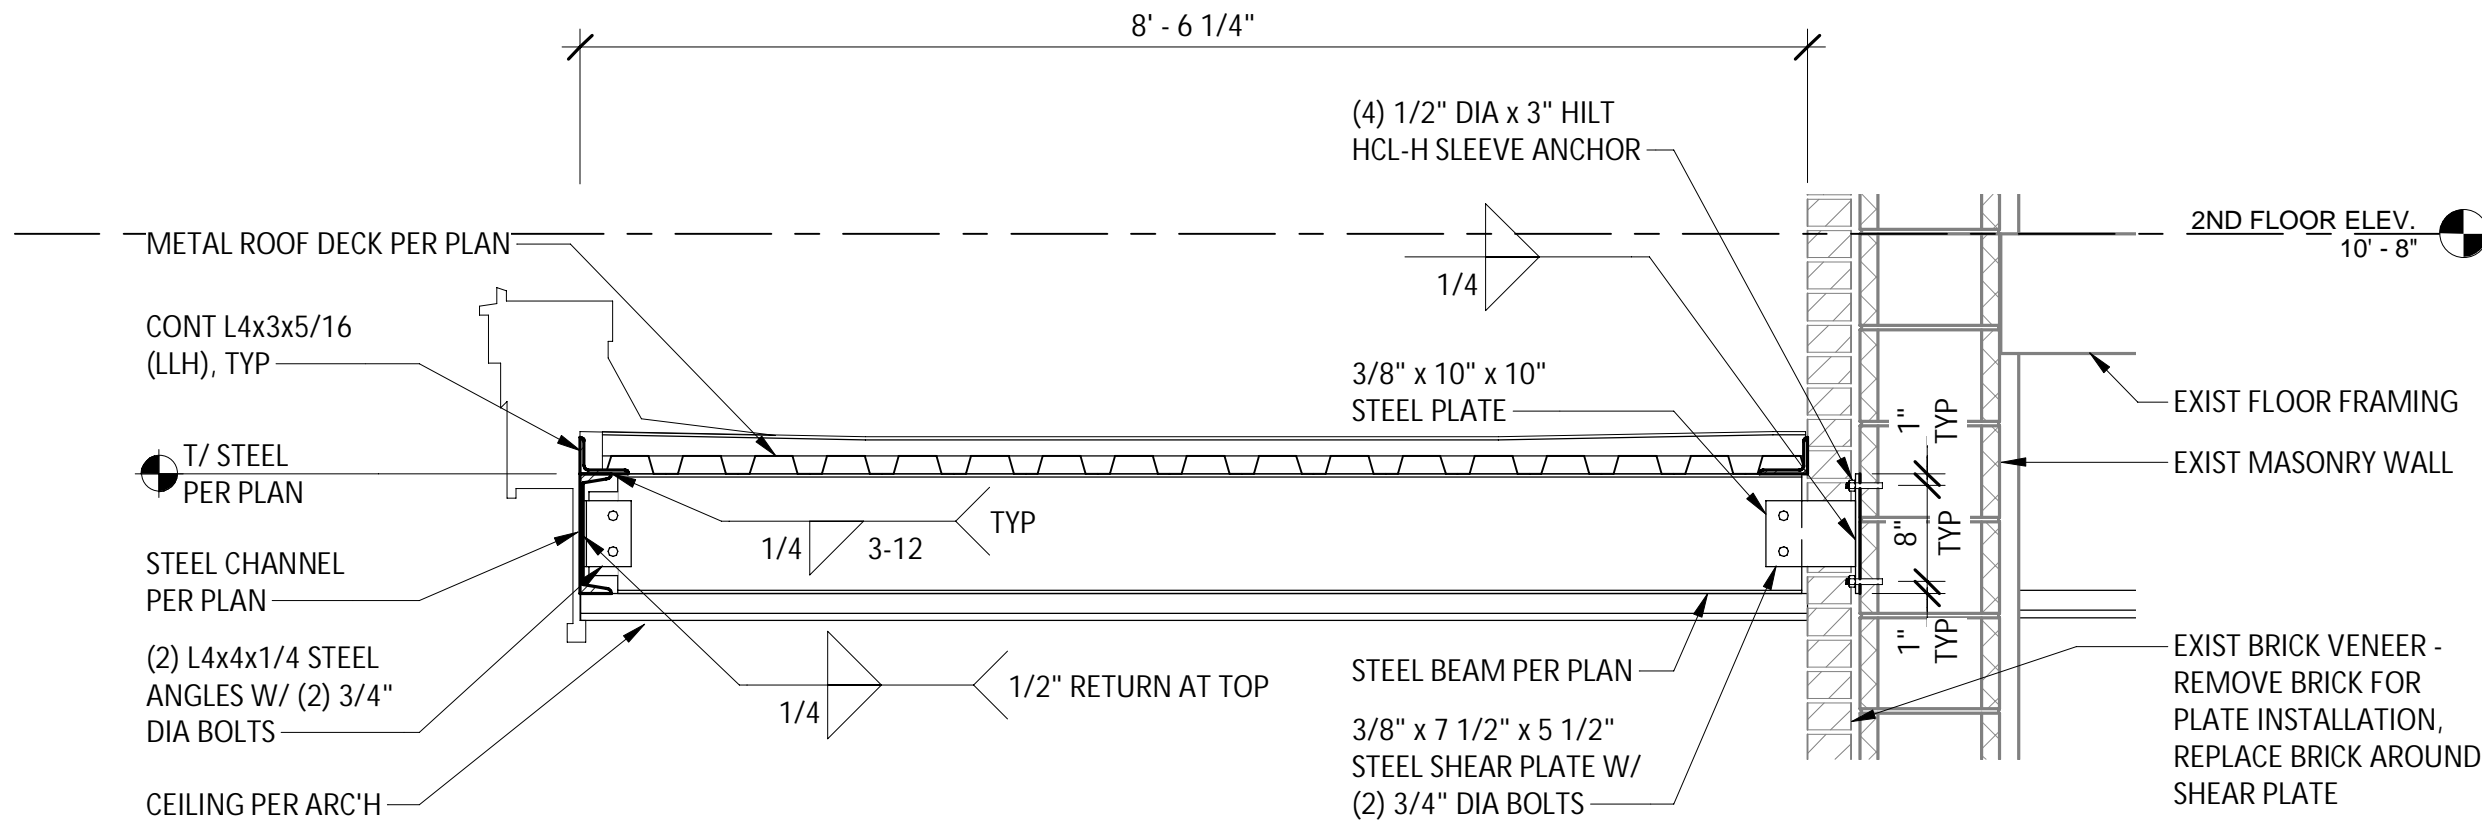

### 1 ENTRANCE CANOPY SECTION

S102 SCALE: 3/4" = 1'-0"

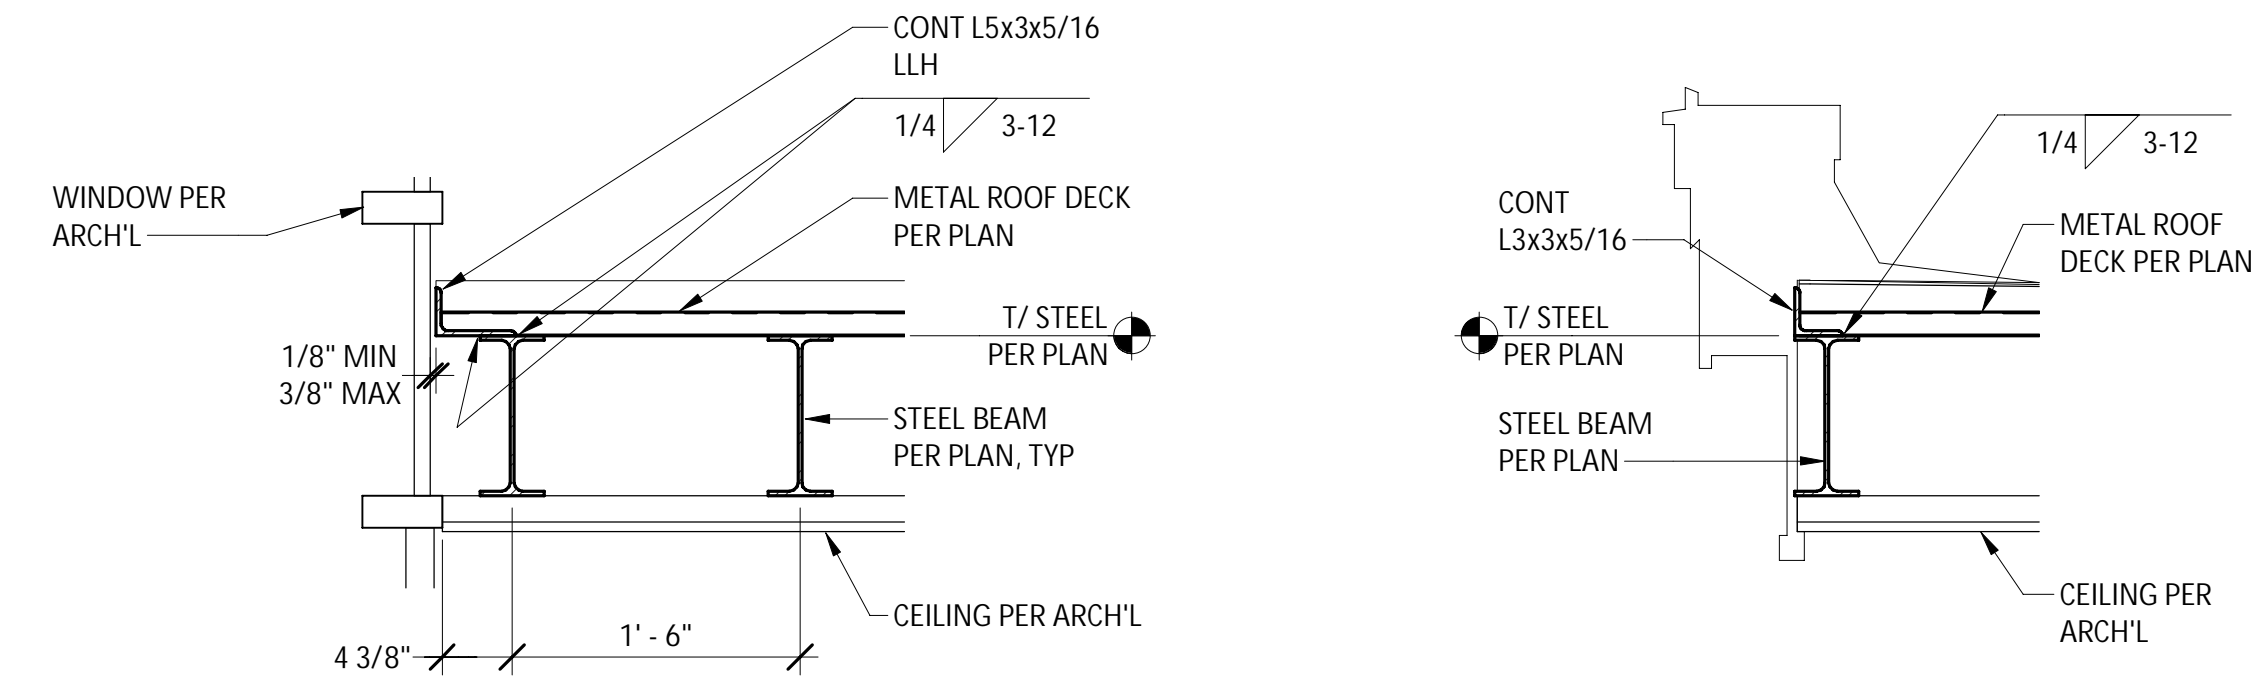


### 3 ENTRANCE CANOPY AT VESTIBULE

S102 SCALE: 1" = 1'-0"


### 4 METAL ROOF DECK AT STEEL BEAM

S102 SCALE: 1" = 1'-0"

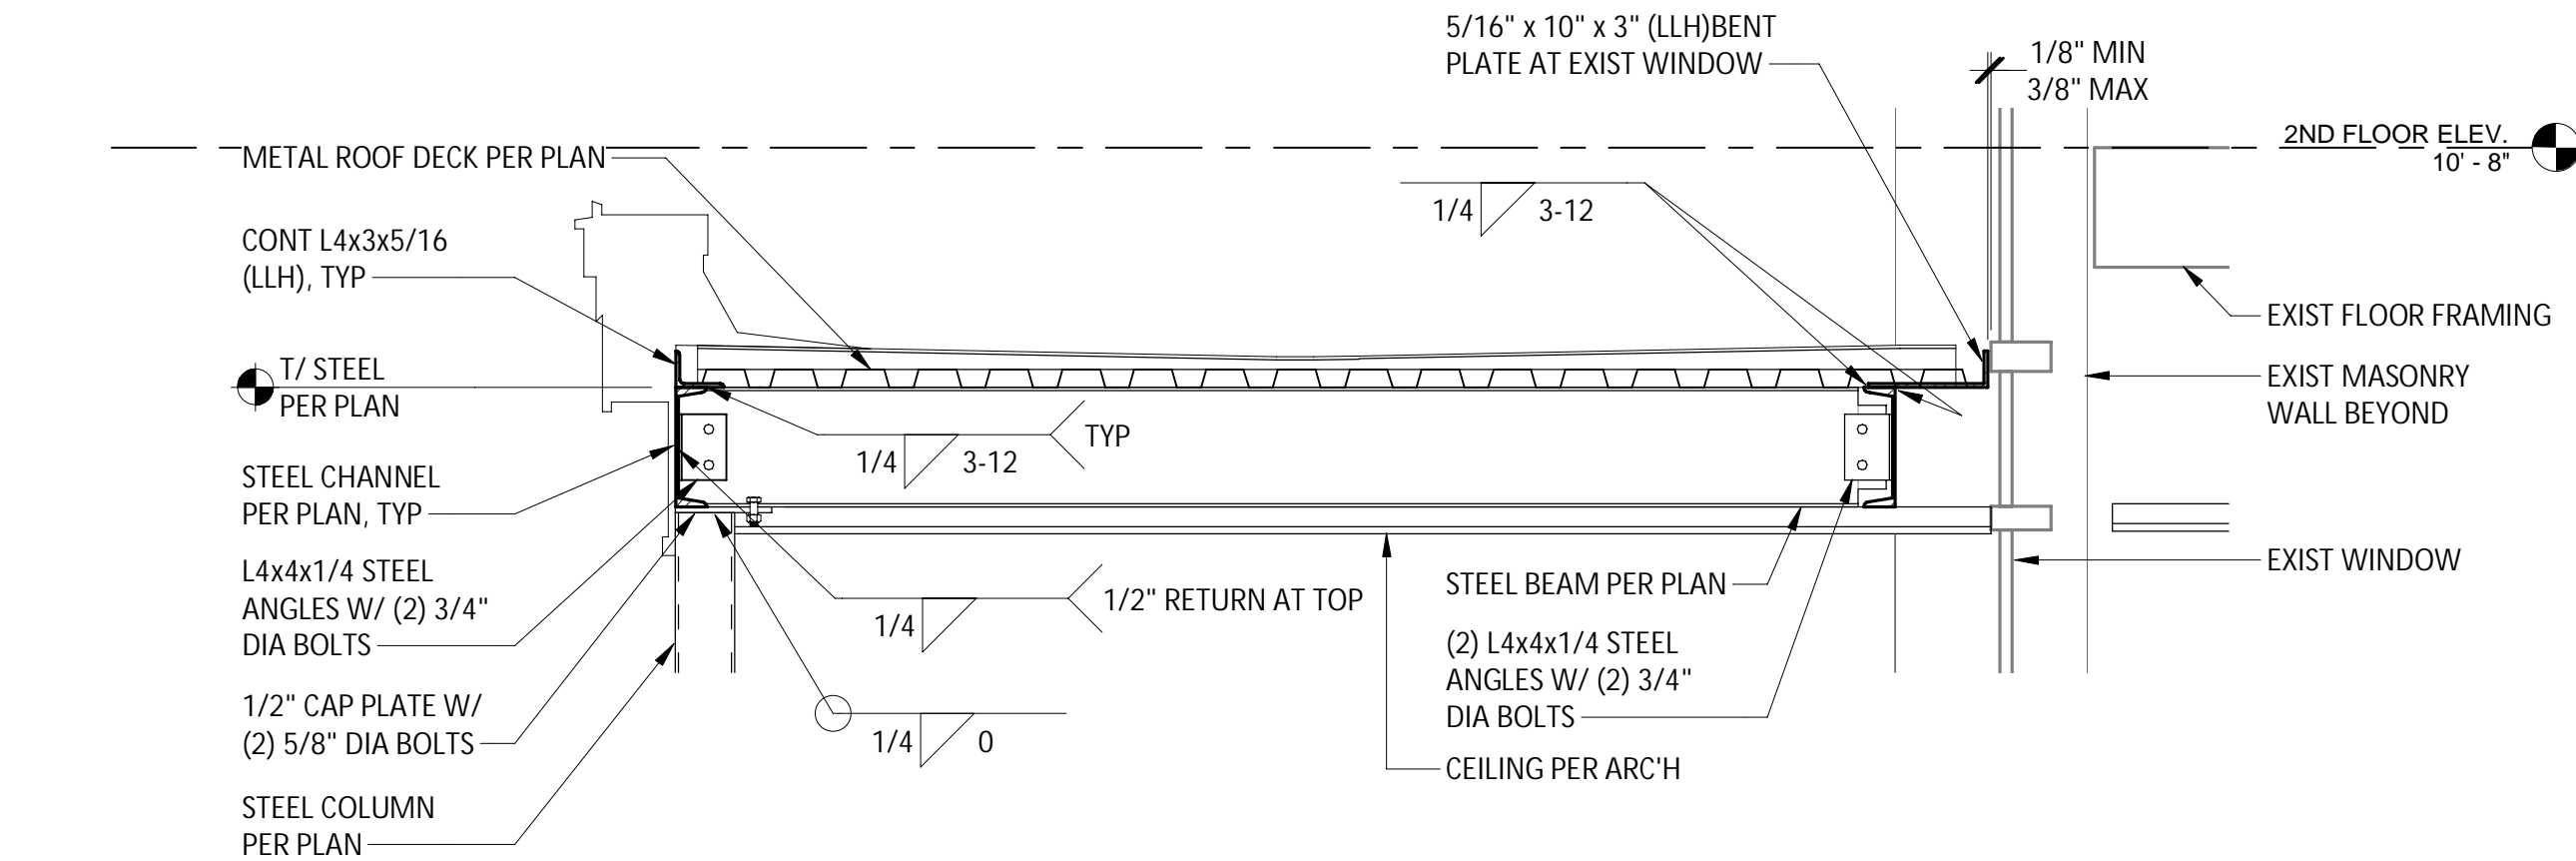


### 2 ENTRANCE CANOPY SECTION AT COLUMN

S102 SCALE: 3/4" = 1'-0"

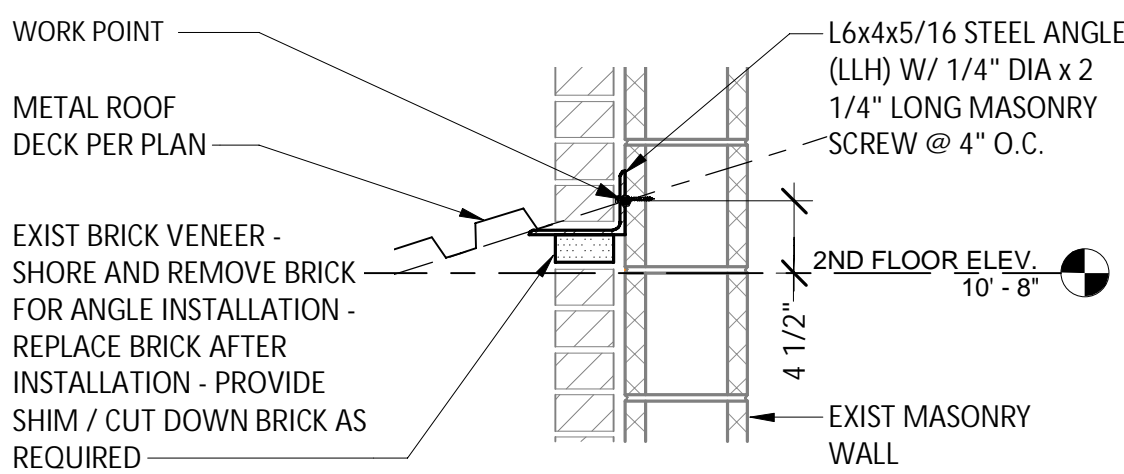


### 5 METAL ROOF DECK AT EXIST WALL

S102 SCALE: 1" = 1'-0"

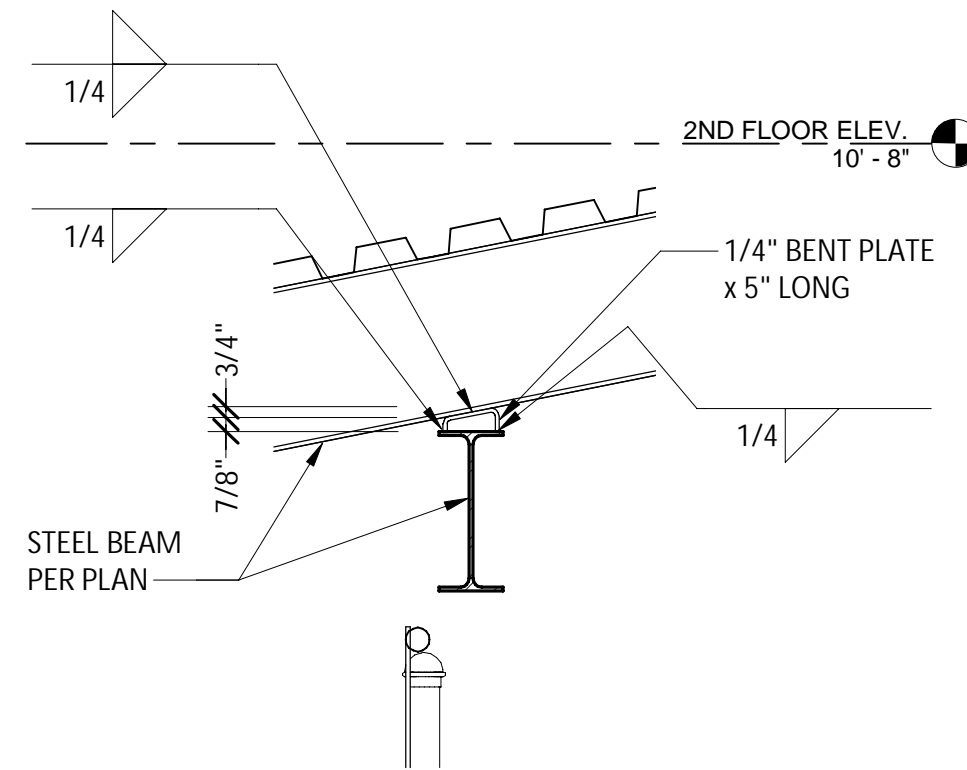


### 6 STEEL BEAM AT STEEL BEAM CONNECTION

S102 SCALE: 1" = 1'-0"

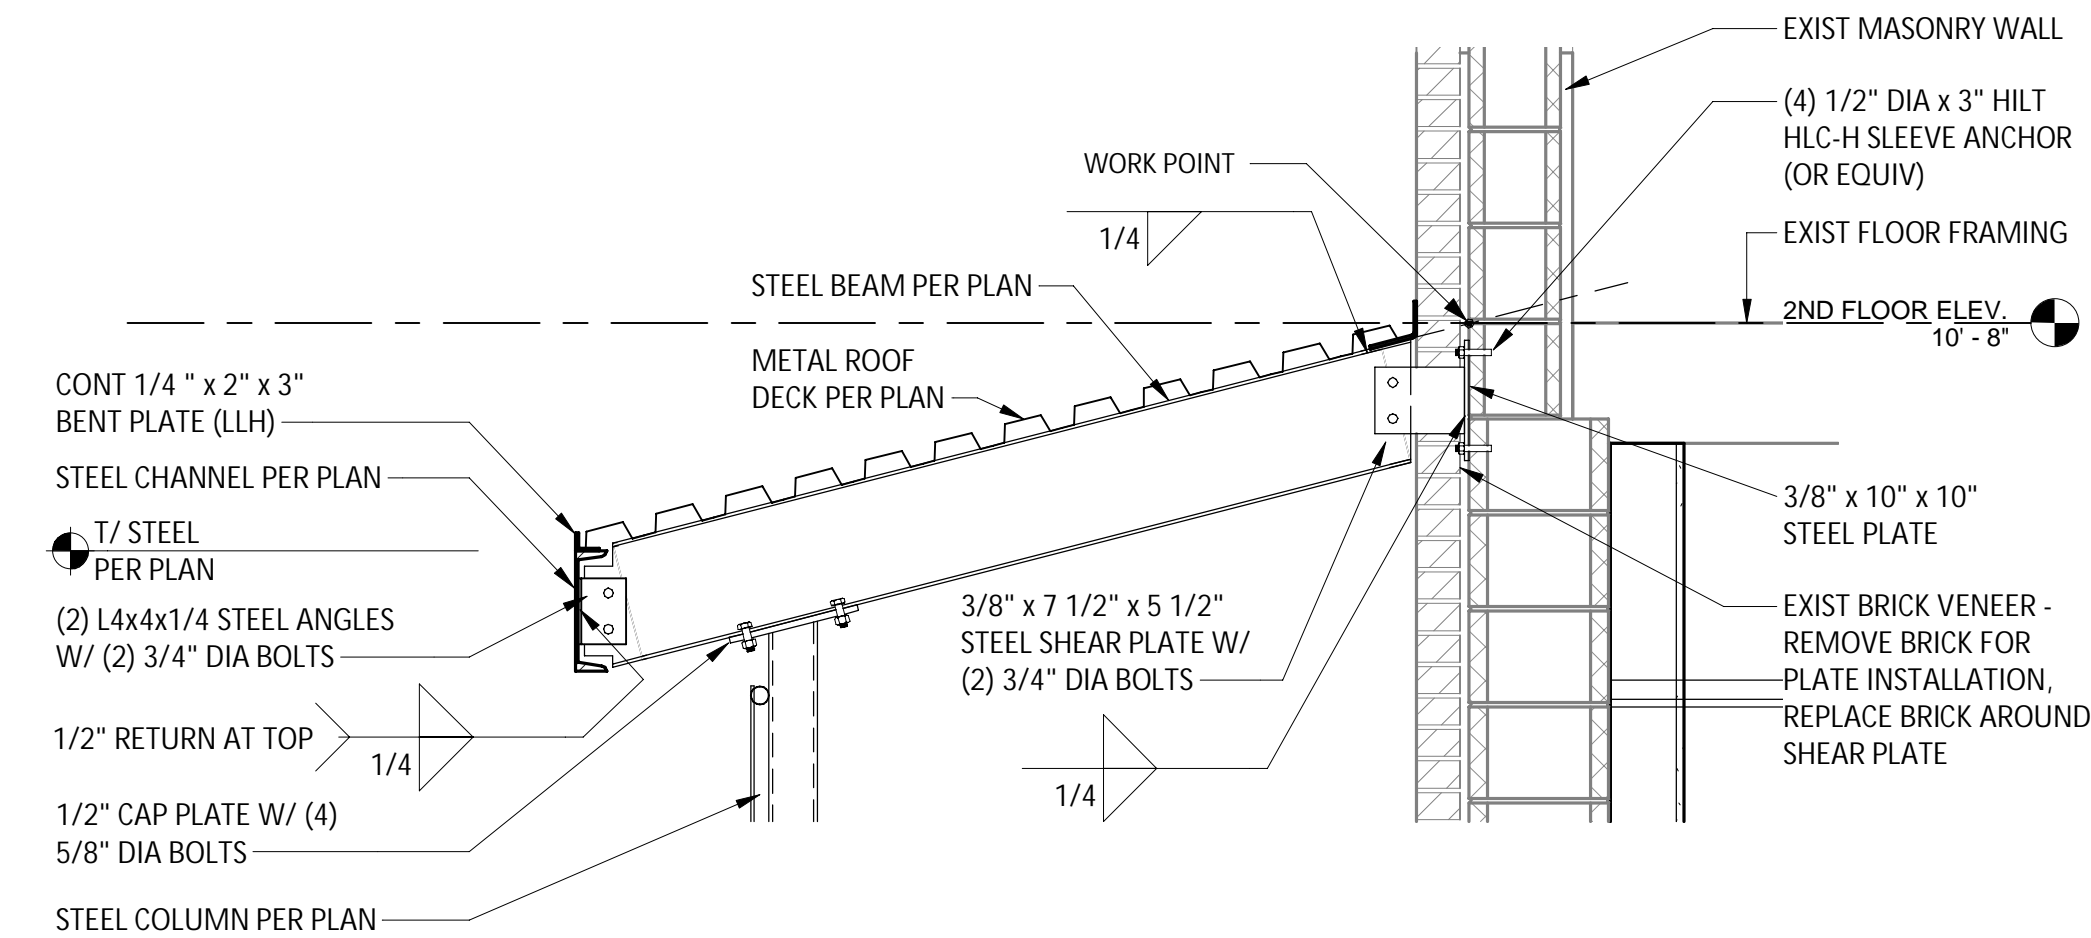


### 7 COVERED WALKWAY FRAMING SECTION

S102 SCALE: 3/4" = 1'-0"

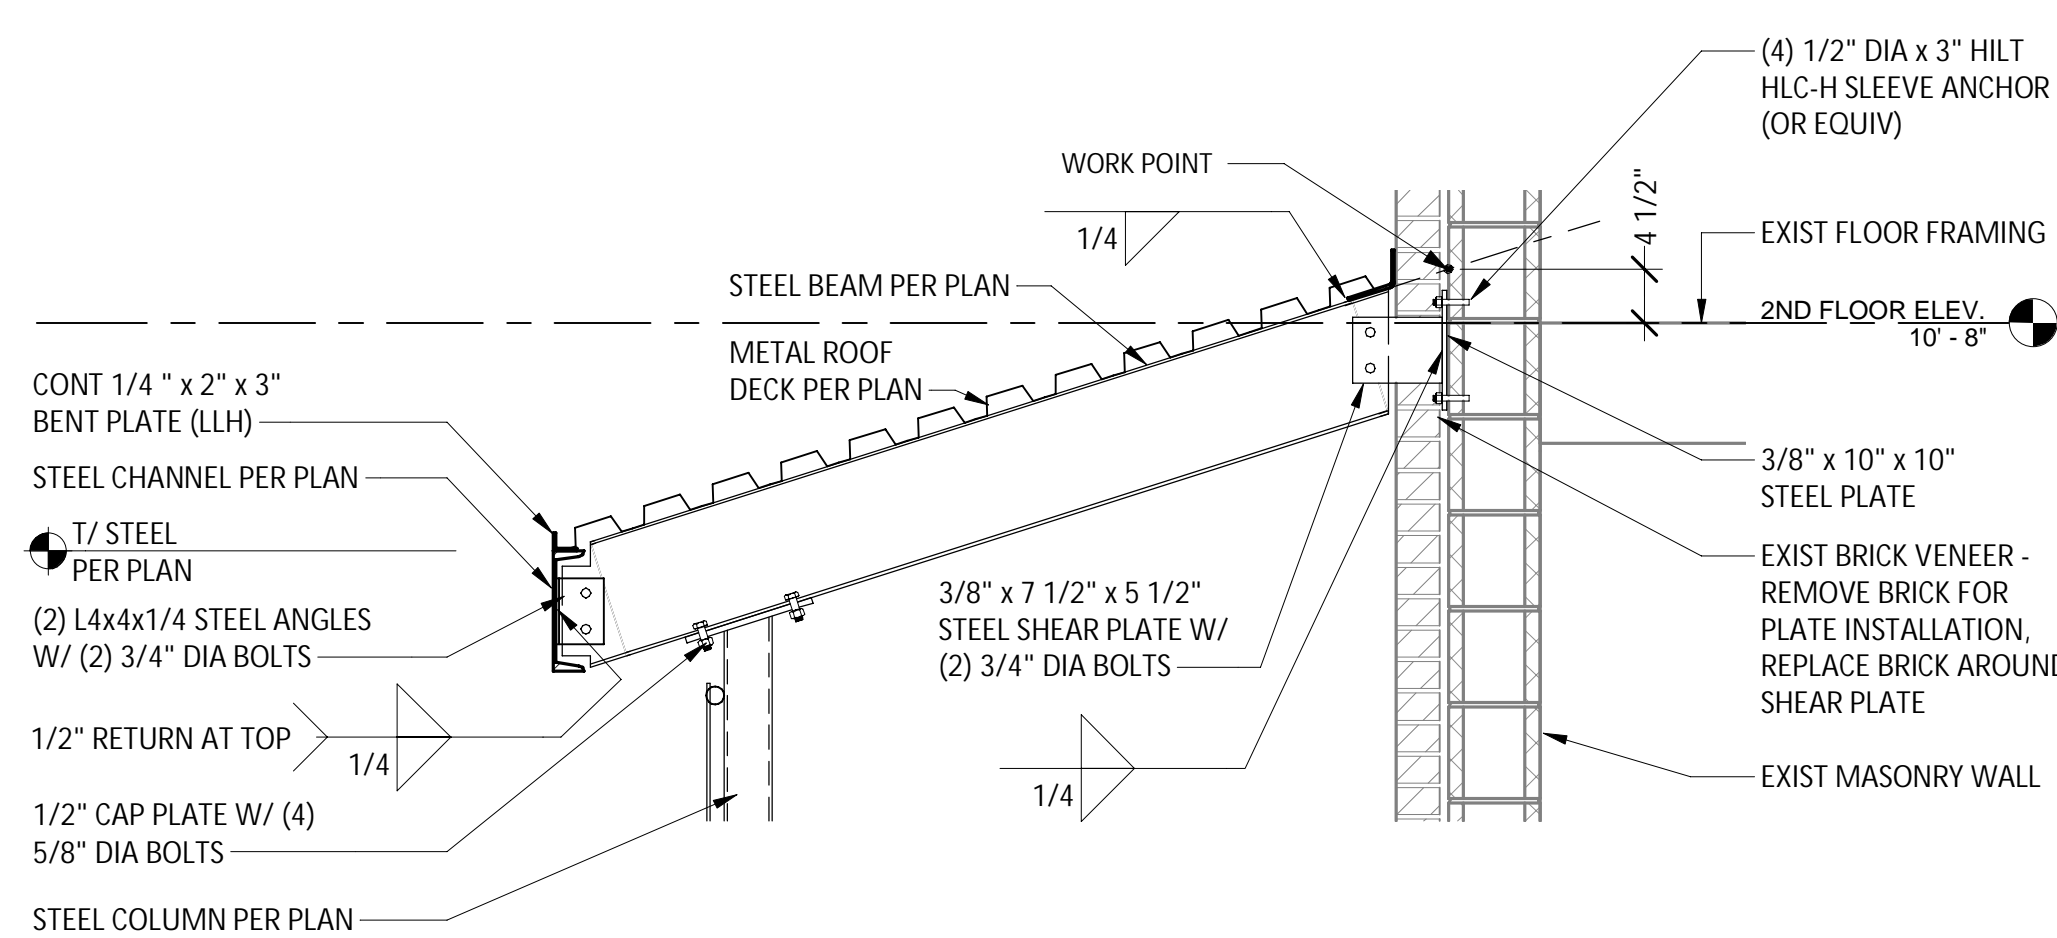

### 8 COVERED WALKWAY FRAMING SECTION

S102 SCALE: 3/4" = 1'-0"

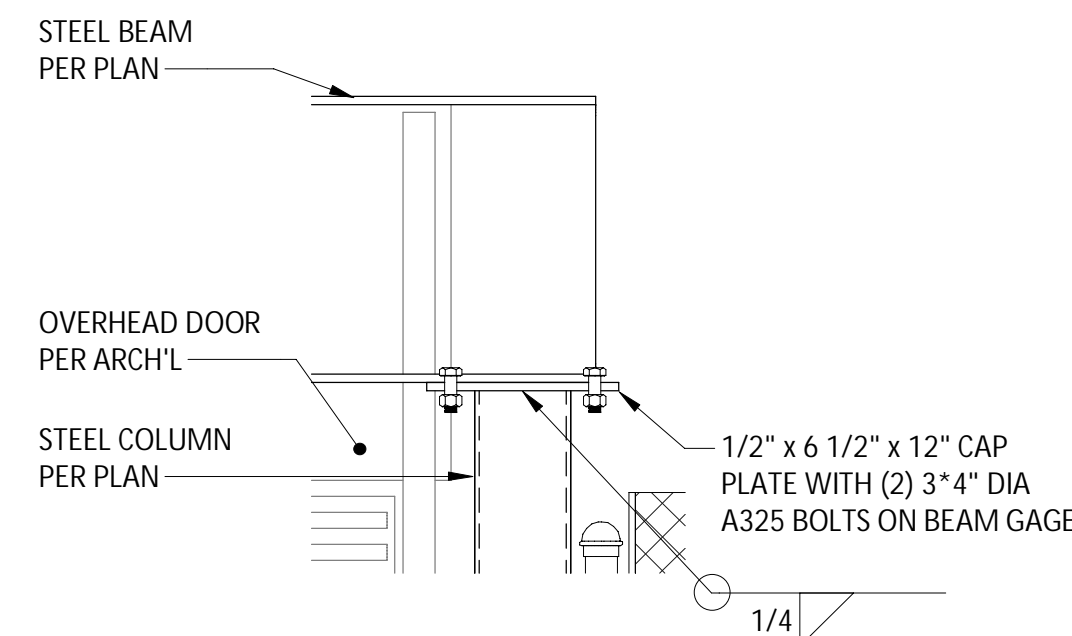

### 9 DROPOFF GATE BEAM AT COLUMN

S102 SCALE: 1" = 1'-0"

ADDITIVE BID ITEM NO. 02 - FRONT ENTRY CANOPY, SEE ARCH DWGS  
ADDITIVE BID ITEM NO. 03 - REAR ENTRY CANOPY, SEE ARCH DWGS

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#### REVISIONS

NO.	DESCRIPTION

CITY OF MIDDLETOWN  
NEW COURTHOUSE FACILITY  
FRONT ENTRANCE AND REAR COVERED WALKWAY  
FRAMING DETAILS  
CITY OF MIDDLETOWN  
ORANGE COUNTY, NEW YORK

**Barton & Loguidice**  
443 Electronics Parkway  
Liverpool, NY 13088  
**B&L**



NYS EXP.: May 31, 2026  
Date: AUGUST, 2024  
Scale: AS SHOWN  
Sheet Number: **S503**  
Project Number: 1753.008.001



- GENERAL NOTES:**
- DRAWINGS ARE DIAGRAMMATIC AND INDICATE GENERAL ARRANGEMENT OF SYSTEMS AND WORK INCLUDED IN THE CONTRACT. IT IS INTENDED THAT ALL COMPONENTS AND MATERIALS REQUIRED TO MAKE THE SYSTEMS COMPLETE, TESTED AND OPERATIONAL BE INSTALLED.
  - CONTRACTOR SHALL FIELD VERIFY ALL LOCATIONS, DIMENSIONS AND ELEVATIONS BEFORE DEMOLITION AND CONSTRUCTION.
  - ALL MATERIALS, EQUIPMENT, METHODS OF INSTALLATION, REMOVALS AND DISPOSAL SHALL BE IN ACCORDANCE WITH THE STANDARDS, REGULATIONS, CODES, ORDINANCES, AND LAWS OF AUTHORITIES THAT HAVE LAWFUL JURISDICTION.
  - COMPLETELY COORDINATE WORK OF THIS CONTRACT WITH WORK OF OTHER CONTRACTORS AND OWNERS WORK.
  - PROTECT ALL EXISTING BUILDING ELEMENTS AND SITE ELEMENTS TO REMAIN FROM ANY DAMAGE. CONTRACTOR SHALL RESTORE ALL EXISTING CONDITIONS AFFECTED BY DEMOLITION AND CONSTRUCTION TO ORIGINAL OR BETTER CONDITION.
  - WORK SHALL BE EXECUTED IN A WORKMANLIKE MANNER AND SHALL PRESENT NEAT, RECTILINEAR APPEARANCE WHEN COMPLETED. MAINTAIN MAXIMUM HEAD ROOM AT ALL TIMES.
  - MATERIALS AND EQUIPMENT SHALL BE NEW AND INSTALLED ACCORDING TO MANUFACTURER'S INSTRUCTIONS AND RECOMMENDATIONS. MAINTAIN MANUFACTURER'S EQUIPMENT CLEARANCES.
  - ALL EQUIPMENT PIPING, WIRING, INSULATION AND ANCILLARY MATERIALS INSTALLED IN HVAC AIR PLENUM SPACES SHALL MEET CODE REQUIREMENTS FOR SMOKE AND COMBUSTIBILITY.
  - DO NOT SUPPORT EQUIPMENT FROM SUSPENDED CEILINGS. ALL SUPPORT SHALL COME FROM BUILDING STRUCTURE. SUPPORTS SHALL BE SELECTED AND INSTALLED TO PROVIDE A VIBRATION FREE INSTALLATION.
  - DUCTWORK SHALL BE CONSTRUCTED AND INSTALLED IN ACCORDANCE WITH THE LATEST ISSUES OF SMACNA STANDARDS.
  - PROVIDE PROPER ACCESS TO MATERIALS AND EQUIPMENT THAT REQUIRE INSPECTION, REPLACEMENT, REPAIR OR SERVICE SUCH AS COILS, DAMPERS, HEATERS, VALVES, ETC. IF PROPER ACCESS CANNOT BE PROVIDED, CONFER WITH THE ENGINEER AS TO THE BEST METHOD OF APPROACH TO MINIMIZE THE EFFECT OF THE REDUCED ACCESS WHICH MAY RESULT.
  - RELOCATE EXISTING DUCTING, PIPING, CONDUIT AND OTHER INTERFERENCES TO INSTALL NEW EQUIPMENT AND MATERIALS. OFFSETS IN PIPING AND DUCTS, DIVIDED DUCTS AND TRANSITIONS AROUND OBSTRUCTIONS SHALL BE PROVIDED AT NO ADDITIONAL COST TO OWNER.
  - THOROUGHLY CLEAN ALL NEW DUCTWORK AFTER INSTALLATION.
  - NOTES, SYMBOLS LIST AND DETAILS ARE APPLICABLE TO ALL DRAWINGS IN THE CONTRACT.
  - ALL WORK SHOWN IS TO BE COMPLETED BY THIS CONTRACT UNLESS SPECIFICALLY INDICATED OTHERWISE.
  - FIRE STOP ALL NEW AND EXISTING SLEEVES THROUGH CONCRETE FLOORS AND FIRE RATED WALLS OR PARTITIONS WITH UL RATED ASSEMBLIES WITH EQUAL FIRE RATING. SEE ARCHITECTURAL PLANS FOR LOCATIONS OF FIRE RATED FLOOR AND WALL ASSEMBLIES.
  - CONTRACTOR IS RESPONSIBLE FOR ALL OWNER COORDINATION AND PROCEDURES RELATED TO ISOLATING, SHUTTING DOWN, DRAINING, FILLING AND RESTARTING SYSTEMS, INCLUDING THOSE REQUIRED FOR RELOCATIONS, TO ALLOW FOR COMPLETION OF ALL DEMOLITION AND NEW WORK. INTERRUPTIONS TO EXISTING SERVICES AND SYSTEMS SHALL BE AS SHORT AS POSSIBLE AND AT A TIME AND DURATION APPROVED BY THE OWNER. INCLUDE ALL PREMIUM TIME ASSOCIATED WITH INTERRUPTIONS. ALL SYSTEM INTERRUPTIONS SHALL BE SCHEDULED WITH OWNER AND COORDINATED WITH OTHER CONTRACTORS. CONTRACTOR SHALL FURNISH ALL FLUIDS REQUIRED, INCLUDING GLYCOL FOR FILLING NEW SYSTEMS AND REFILLING EXISTING SYSTEMS.

**ABBREVIATIONS:**


∠ - ANGLE  
AAD - AUTOMATIC AIR DAMPER  
ALUM - ALUMINUM  
BLDG - BUILDING  
BSMT - BASEMENT  
BOT - BOTTOM  
CFM - CUBIC FEET PER MINUTE  
CJ - CONTROL JOINT  
CL - CENTER LINE  
CLG - CEILING  
CLR - CLEAR  
CMU - CONCRETE MASONRY UNITS  
CONC - CONCRETE  
CONST - CONSTRUCTION  
DEMO - DEMOLISH, DEMOLITION  
DN - DOWN  
EA - EACH  
EC - ELECTRICAL CONTRACTOR  
ELEC - ELECTRICAL  
ELEV - ELEVATION  
EQUIP - EQUIPMENT  
E.S.P. - EXTERNAL STATIC PRESSURE  
EX, EXIST - EXISTING  
FIN FLR - FINISHED FLOOR  
FLA - FULL LOAD AMPS  
FPM - FEET PER MINUTE  
FTG - FOOTING  
GA - GAUGE  
GALV - GALVANIZED  
GC - GENERAL CONTRACTOR

**ABBREVIATIONS (CONT.):**


HP - HORSE POWER  
HZ - HERTZ  
INSUL - INSULATION  
INV - INVERT  
MANUF - MANUFACTURER  
MAX - MAXIMUM  
MC - MECHANICAL CONTRACTOR  
MIN - MINIMUM  
MTL - METAL  
NAT - NATURAL  
NTS - NOT TO SCALE  
OD - OUTSIDE DIAMETER  
PLAS - PLASTIC  
RD - ROOF DRAIN  
SAN - SANITARY  
SHT - SHEET  
SIM - SIMILAR  
SS - STAINLESS STEEL  
STL - STEEL  
T/ - TOP OF  
T&B - TOP AND BOTTOM  
TEMP - TEMPERED  
TYP - TYPICAL  
VIF - VERIFY IN FIELD  
W.G - WATER GAUGE

- LEGEND**
- S— SLOPE DN IN DIRECTION OF ARROW
  - /— BREAK
  - ##### PIPING/EQUIPMENT TO BE REMOVED
  - LIMIT OF REMOVAL
  - CONNECTION POINT TO EXISTING
  - TEE RISE
  - TEE DROP
  - PIPE RISE
  - PIPE DROP
  - DIRECTION OF FLOW
  - ⊥ CAP
  - ≡ UNION
  - ◁ CONCENTRIC REDUCER
  - ||— FLANGED CONNECTION
  - |||| FLEXIBLE CONNECTION
  - || BUTTERFLY VALVE
  - ||—○— PRESSURE GAUGE
  - ||—|| THERMOMETER
  - ||—/— MANUAL AIR VENT
  - ||—▲— AUTOMATIC AIR VENT
  - ||—/— STRAINER
  - ||—/— SWING CHECK VALVE
  - ||—/— BALL VALVE
  - ||—/— GATE VALVE


- LEGEND**
- ⊗ GLOBE VALVE
  - ⊗ TRIPLE DUTY VALVE
  - ⊗ BALANCE VALVE
  - ⊗ BALL VALVE W/ HOSE CONNECTION, CAP AND CHAIN
  - ⊗ PRESSURE REDUCING VALVE
  - ⊗ SAFETY RELIEF VALVE
  - ⊗ TEMPERATURE SENSOR
  - ⊗ PUMP
  - ⊗ CONTROL VALVE, 3-WAY, MODULATING
  - VOLUME DAMPER
  - ◆— FIRE DAMPER
  - ⊗ SUPPLY DUCT SECTION UP
  - ⊗ SUPPLY DUCT SECTION DOWN
  - ⊗ RET/EXH DUT SECTION UP
  - ⊗ RET/EXH DUT SECTION DOWN
  - ⊗ 45° BRANCH DUCT CONNECTION
  - ⊗ NEW SUPPLY DIFFUSER, REGISTER OR GRILLE (WITH CFM)
  - ⊗ NEW RETURN/EXHAUST REGISTER OR GRILLE (WITH CFM)
  - ⊗ THERMOSTAT (ARROW INDICATES DEVICE)
  - HWS— HOT WATER SUPPLY PIPING
  - HWR— HOT WATER RETURN PIPING

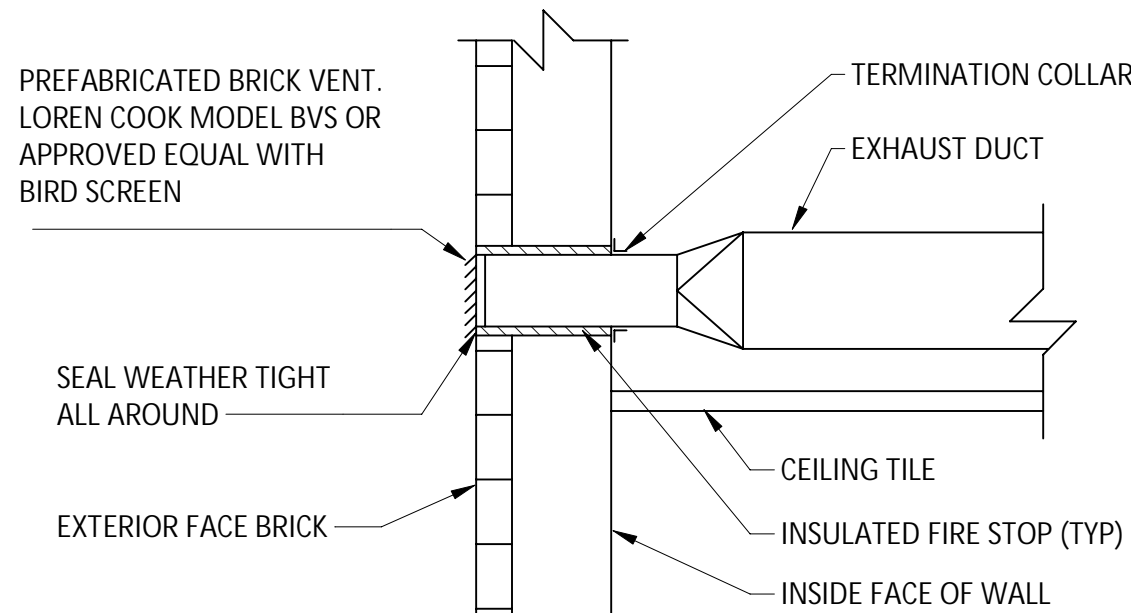


**③ BRICK VENT DETAIL**  
SCALE: NOT TO SCALE

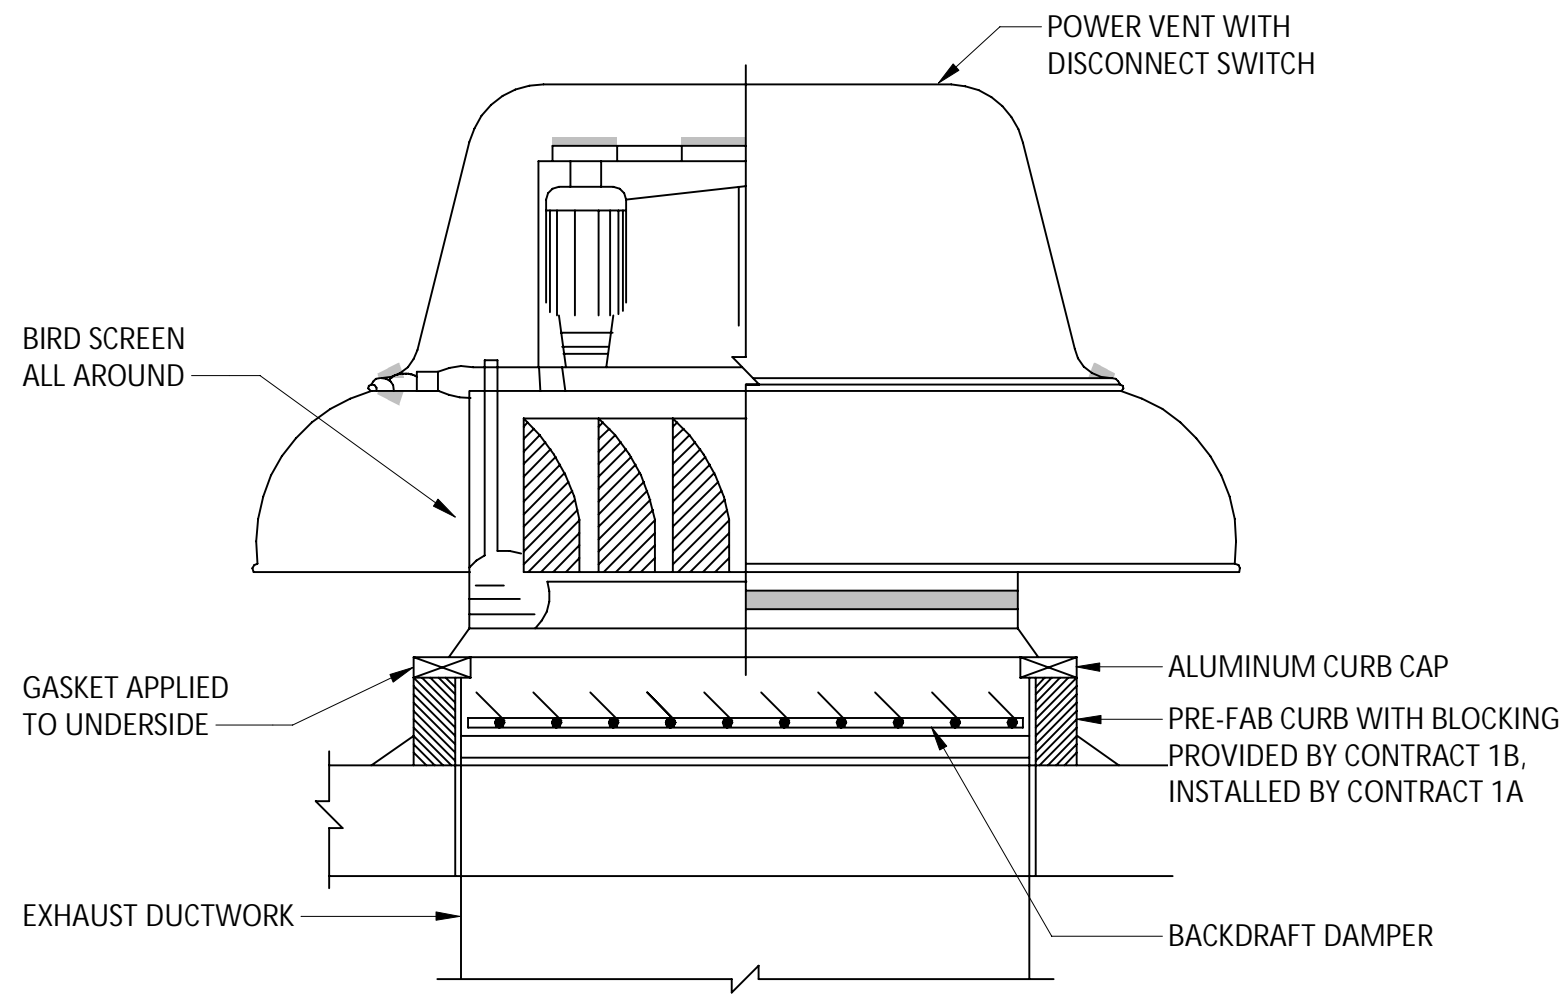


**⑤ EXHAUST FAN DETAIL**  
SCALE: NOT TO SCALE

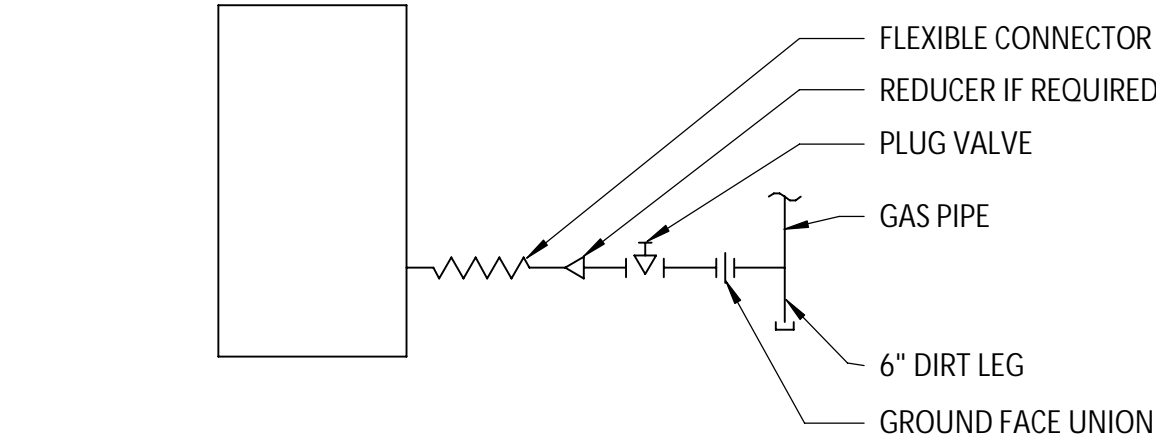

**① TYPICAL GAS FIRED APPLIANCE CONNECTION DETAIL**  
SCALE: NOT TO SCALE

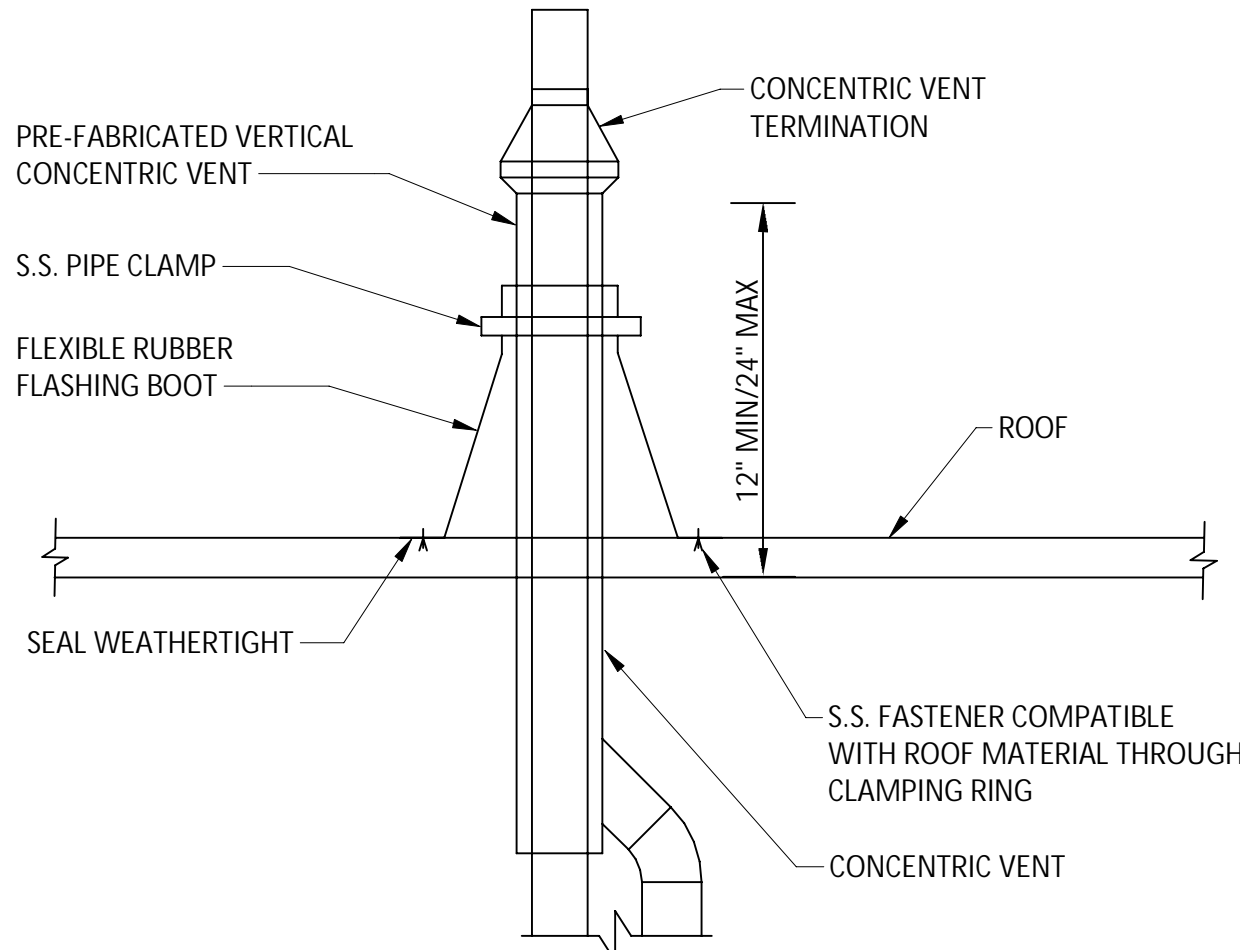


**② TYPICAL CONCENTRIC VENT DETAIL**  
SCALE: NOT TO SCALE

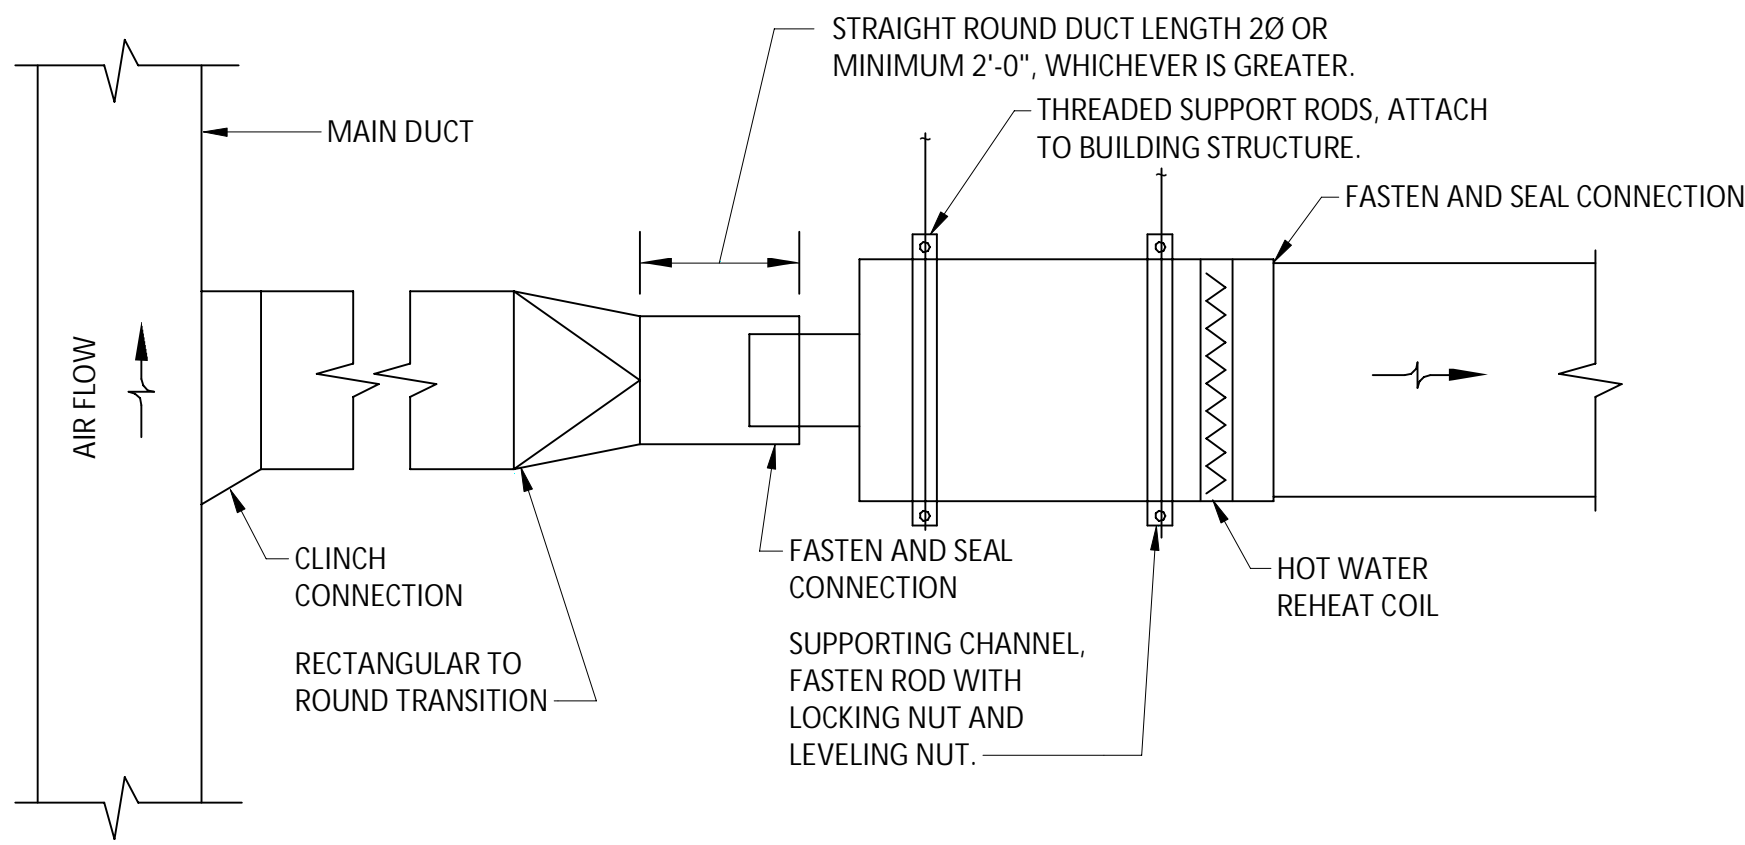

**NOTES:**

- THE OPERATION OF VARIABLE AIR VOLUME TERMINAL BOX ARE AFFECTED BY EXCESSIVE TURBULENCE ON THE ENTERING SIDE OF EACH TERMINAL BOX. THEREFORE, TERMINAL BOX MUST NOT BE INSTALLED TOO CLOSE TO MAIN DUCTS, ELBOWS AND FITTINGS.
- WHEN MINIMUM UPSTREAM STRAIGHT DUCT CONNECTION TO TERMINALS AS INDICATED ABOVE CANNOTBE MAINTAINED, PROVIDE ORIFICE PLATE, STRAIGHTENING VANES OR OTHER DEVICE AS RECOMMENDED BY TERMINAL BOX MANUFACTURER AND SUBMIT TO ENGINEER FOR REVIEW PRIOR TO INSTALLATION.
- DDC PANELS & MOTORS FOR NEW VAV TERMINAL BOXES SHALL BE PROVIDED BY CONTROLS MANUFACTURER AND SHALL BE DELIVERED TO VAV BOX MANUFACTURER. DDC PANEL SHALL CONTAIN STEP DOWN TRANSFORMER (120V AC TO 24V AC) TO POWER CONTROL & MOTOR. BOX MANUFACTURER SHALL FACTORY MOUNT DDC CONTROLLER & MOTOR ON LEFT OR RIGHT HAND SIDE OF VAV BOXES TO SUIT FIELD CONDITIONS. VAV BOX MANUFACTURER WILL PROVIDE ALL SENSORS & DAMPER WITH LINKAGES.
- ARRANGE ACCESS TO PERMIT EASY FIELD BALANCE AND MAINTENANCE OF TERMINAL UNIT.

**⑥ VAV BOX INSTALLATION DETAIL**  
SCALE: NOT TO SCALE

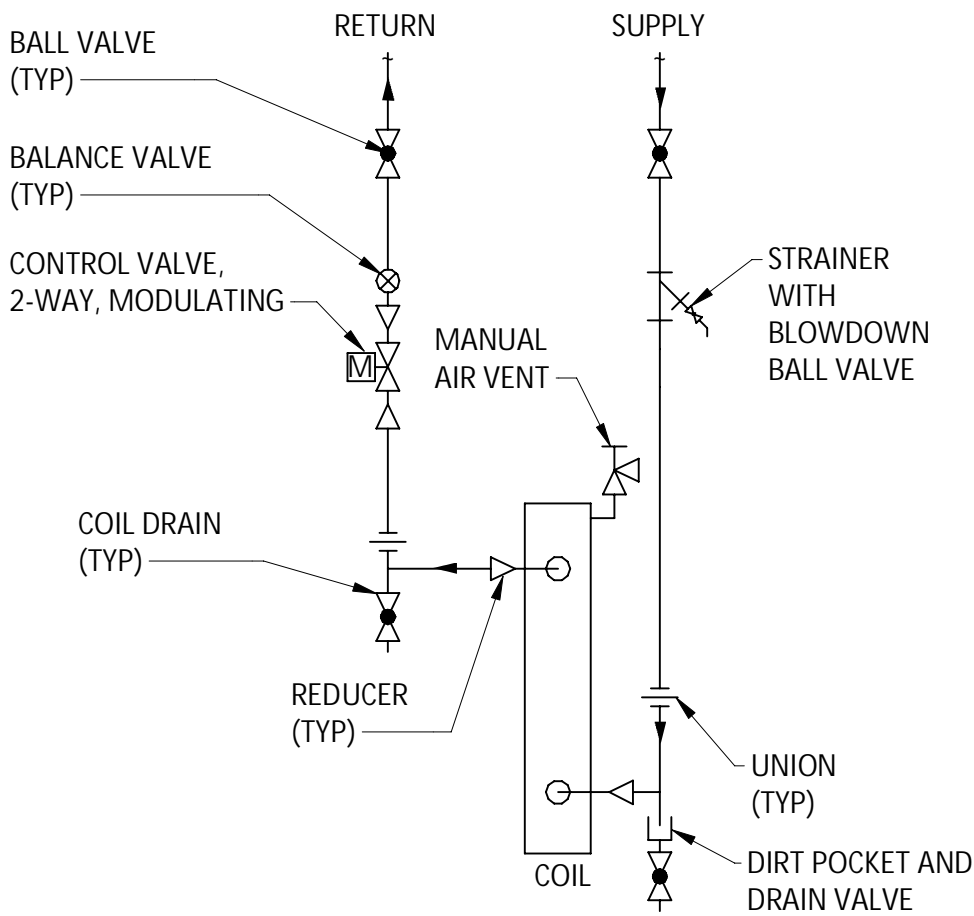

**NOTES:**

- REFER TO DRAWINGS FOR LINE SIZES.
- ALL ISOLATION VALVES AND ACCESSORIES SHALL BE LINE SIZE UNLESS OTHERWISE SHOWN.

**④ HOT WATER REHEAT COIL DETAIL**  
SCALE: NOT TO SCALE

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**REVISIONS**

NO.	DESCRIPTION	DATE

CITY OF MIDDLETOWN  
NEW COURTHOUSE FACILITY  
CONTRACT 1B - MECHANICAL CONSTRUCTION  
ORANGE COUNTY, NEW YORK  
CITY OF MIDDLETOWN

**SYMBOLS AND ABBREVIATIONS**

443 Electronics Parkway  
Liverpool, NY  
13088  
**Barton & Loguidice, D.P.C.**



NYS EXP.: 11/30/2025



Date  
**AUGUST, 2024**

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**AS SHOWN**

Sheet Number  
**M001**

Project Number  
**1753.008.001**



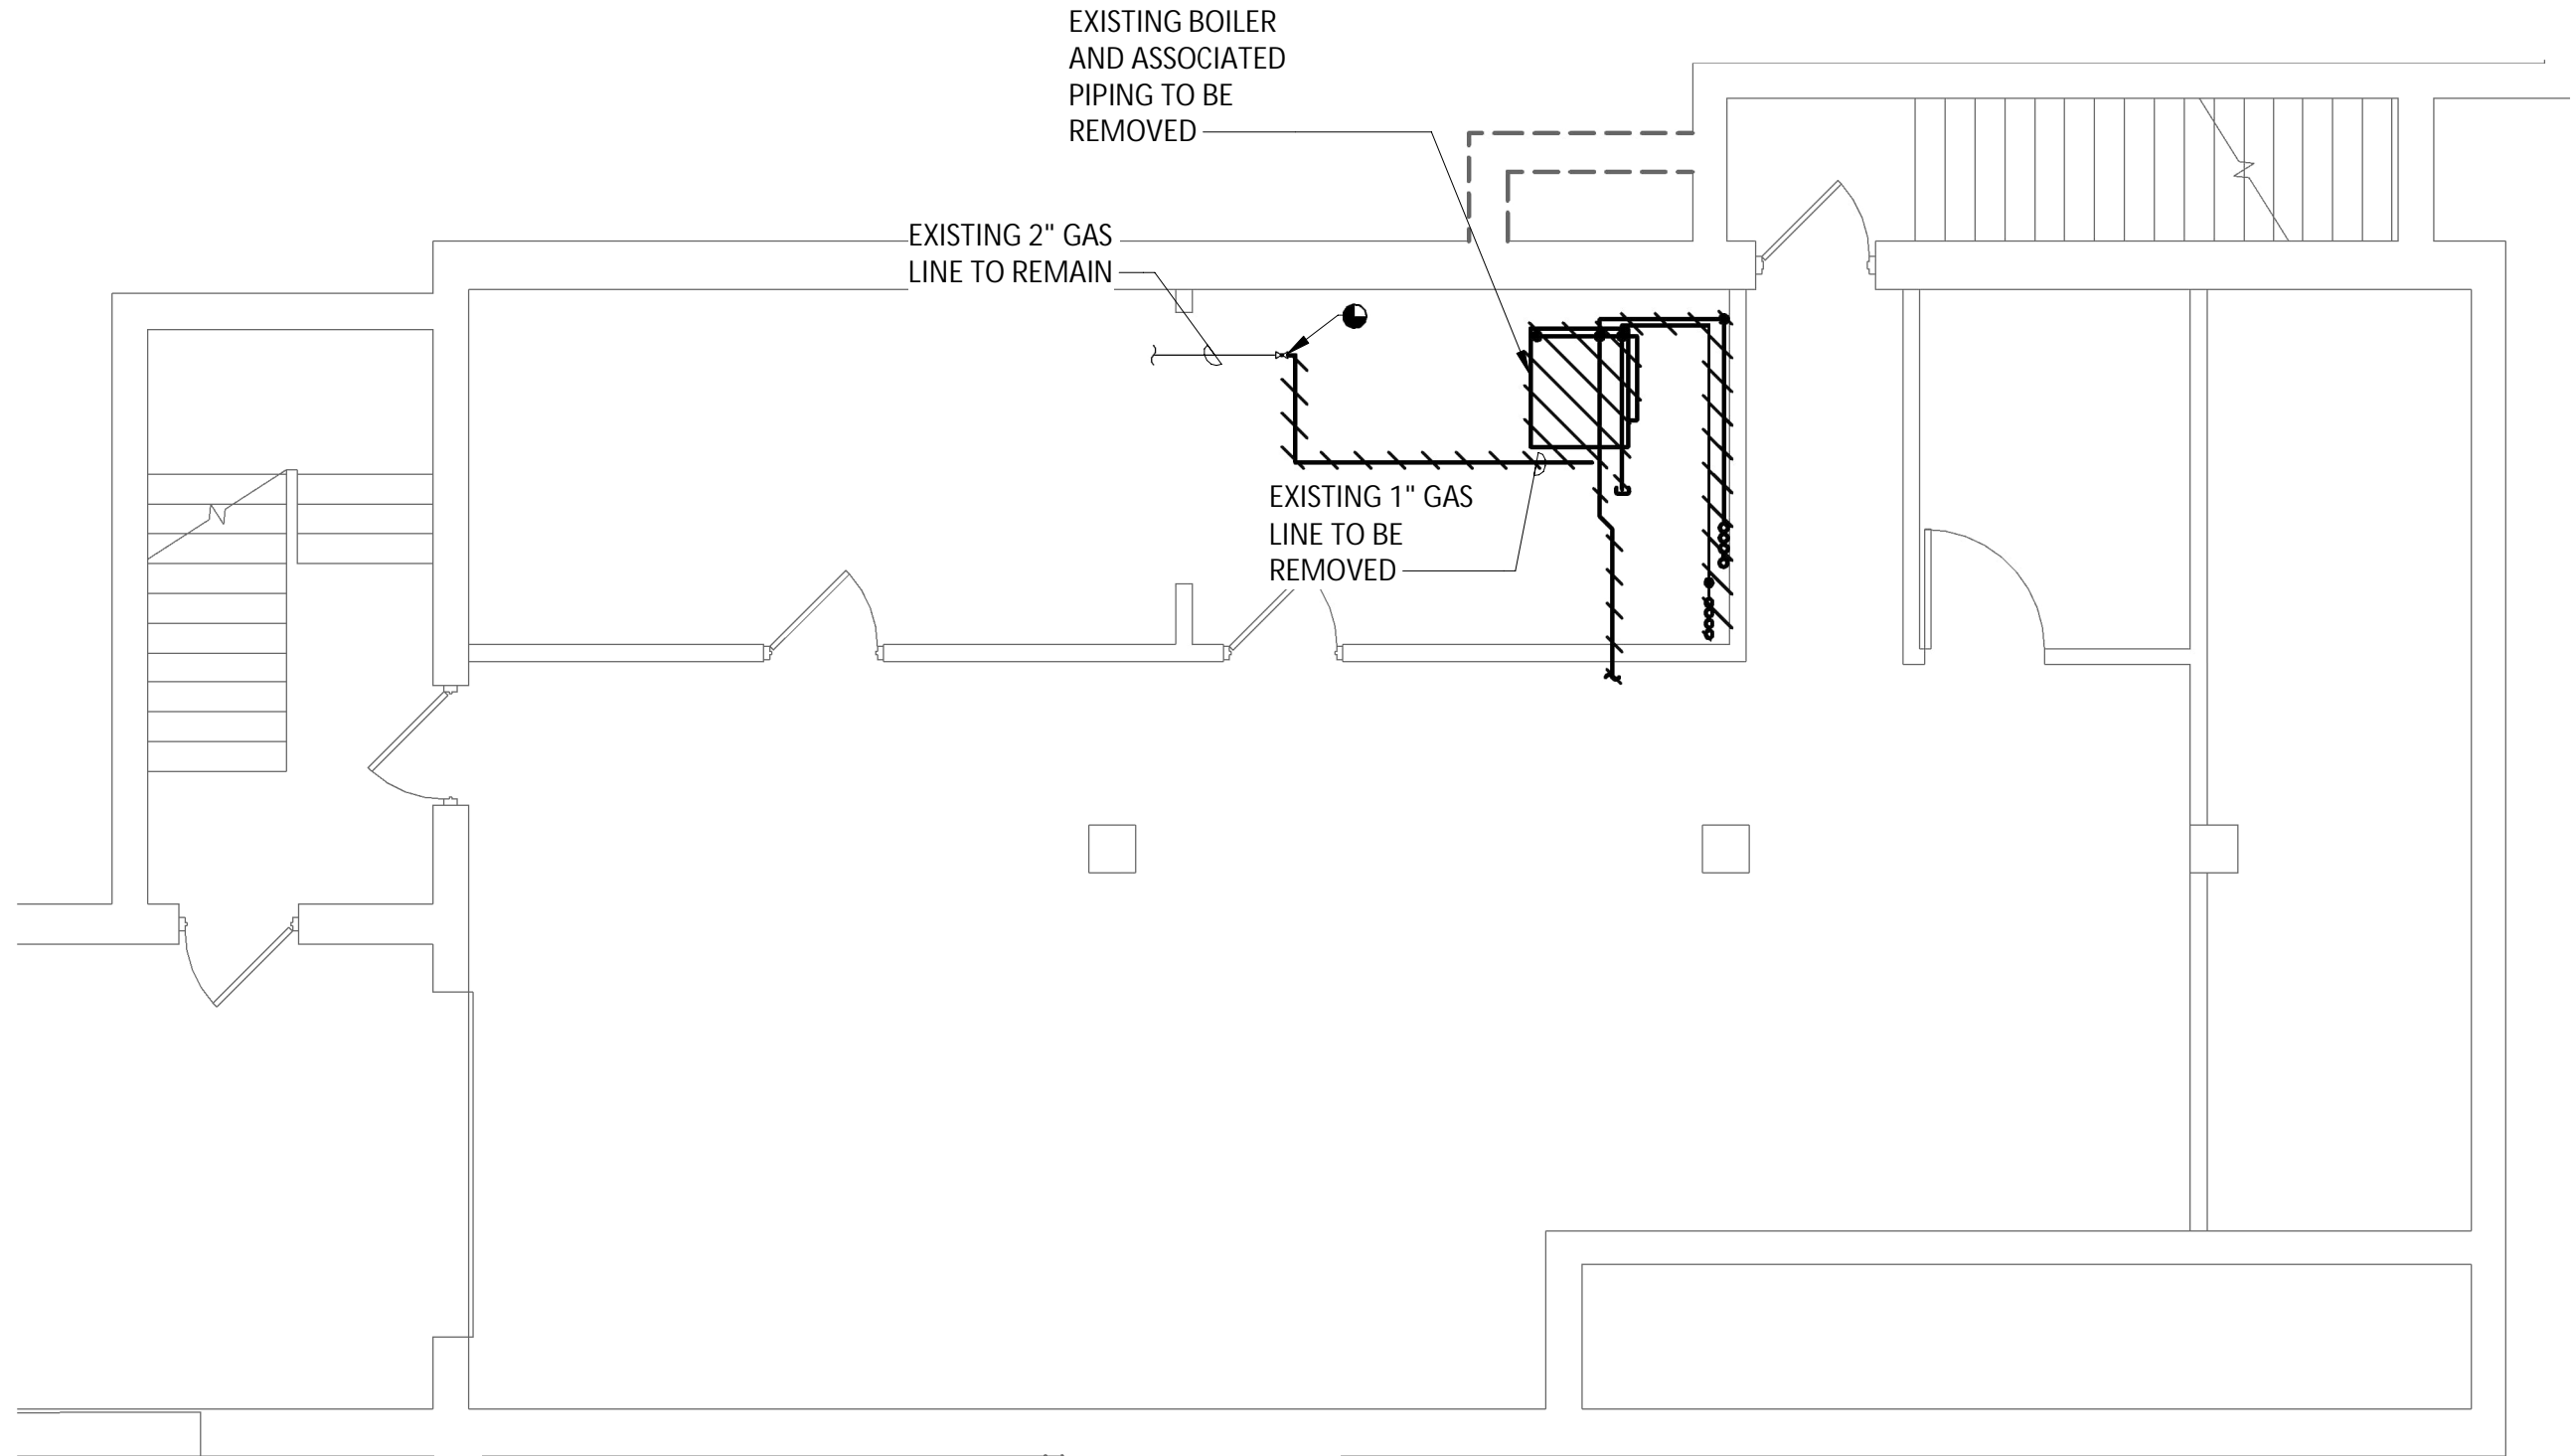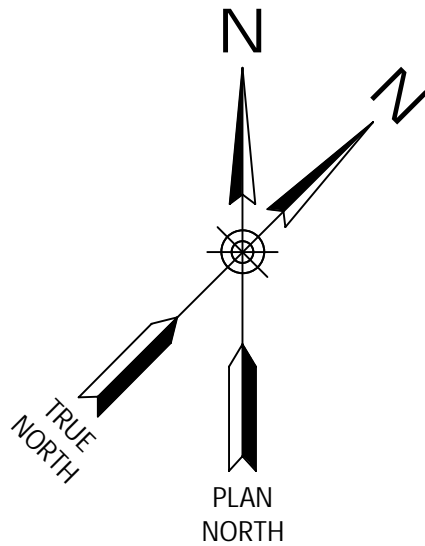

**BASEMENT HVAC PIPING DEMOLITION PLAN**  
SCALE: 3/16" = 1'-0"

- GENERAL NOTES:
1. REMOVE ALL EXISTING HOT WATER SUPPLY AND RETURN PIPING, VALVES AND INSULATION IN THE BASEMENT COMPLETE.
  2. REMOVE EXISTING BOILER VENTING COMPLETE. EXISTING CHIMNEY BEING REMOVED IN CONTRACT 1A.



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REVISIONS	

CITY OF MIDDLETOWN  
NEW COURTHOUSE FACILITY  
CONTRACT 1B - MECHANICAL CONSTRUCTION

CITY OF MIDDLETOWN

ORANGE COUNTY, NEW YORK

**BASEMENT HVAC DEMOLITION PLAN**

443 Electronics Parkway  
Liverpool, NY  
13088

**B**  
**&L**

**Barton & Loguidice, D.P.C.**

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Date  
AUGUST, 2024

Scale  
AS SHOWN

Sheet Number  
M100


Project Number  
1753.008.001





1. REMOVE ALL EXISTING HOT WATER SUPPLY AND RETURN PIPING, FIN TUBE, THERMOSTATS, VALVES AND INSULATION AT ALL LEVELS COMPLETE.
2. REMOVE EXISTING DUCTWORK AND DUCTWORK INSULATION BETWEEN FLOORS UNLESS SPECIFICALLY SHOWN TO REMAIN.

SCALE: 3/16" = 1'-0"

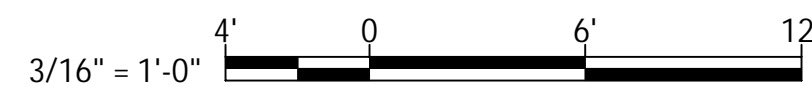

REVISIONS

SECTION  
ON PLAN


CITY OF MIDDLETOWN  
NEW COURTHOUSE FACILITY  
CONTRACT 1B - MECHANICAL CONSTRUCTION

# FIRST FLOOR HVAC DEMOLITION PLAN

CITY OF MIDDLETOWN

**B&L**  
4443 Electronics Parkway  
Liverpool, NY  
13088

**Barton & Loquidice, D.P.C.**

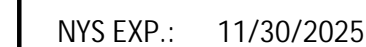

Date  
AUGUST, 2024

Scale  
AS SHOWN

Sheet Number  
M101



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Checked by \_\_\_\_\_ Drawn by \_\_\_\_\_ RAD \_\_\_\_\_ Designed by \_\_\_\_\_ RAD \_\_\_\_\_ In Charge of \_\_\_\_\_ E/H \_\_\_\_\_



**GENERAL NOTES:**

1. REMOVE ALL EXISTING HOT WATER SUPPLY AND RETURN PIPING, FIN TUBE, THERMOSTATS, VALVES AND INSULATION AT ALL LEVELS COMPLETE.
2. REMOVE EXISTING DUCTWORK AND DUCTWORK INSULATION BETWEEN FLOORS UNLESS SPECIFICALLY SHOWN TO REMAIN.

**KEYED NOTES:**

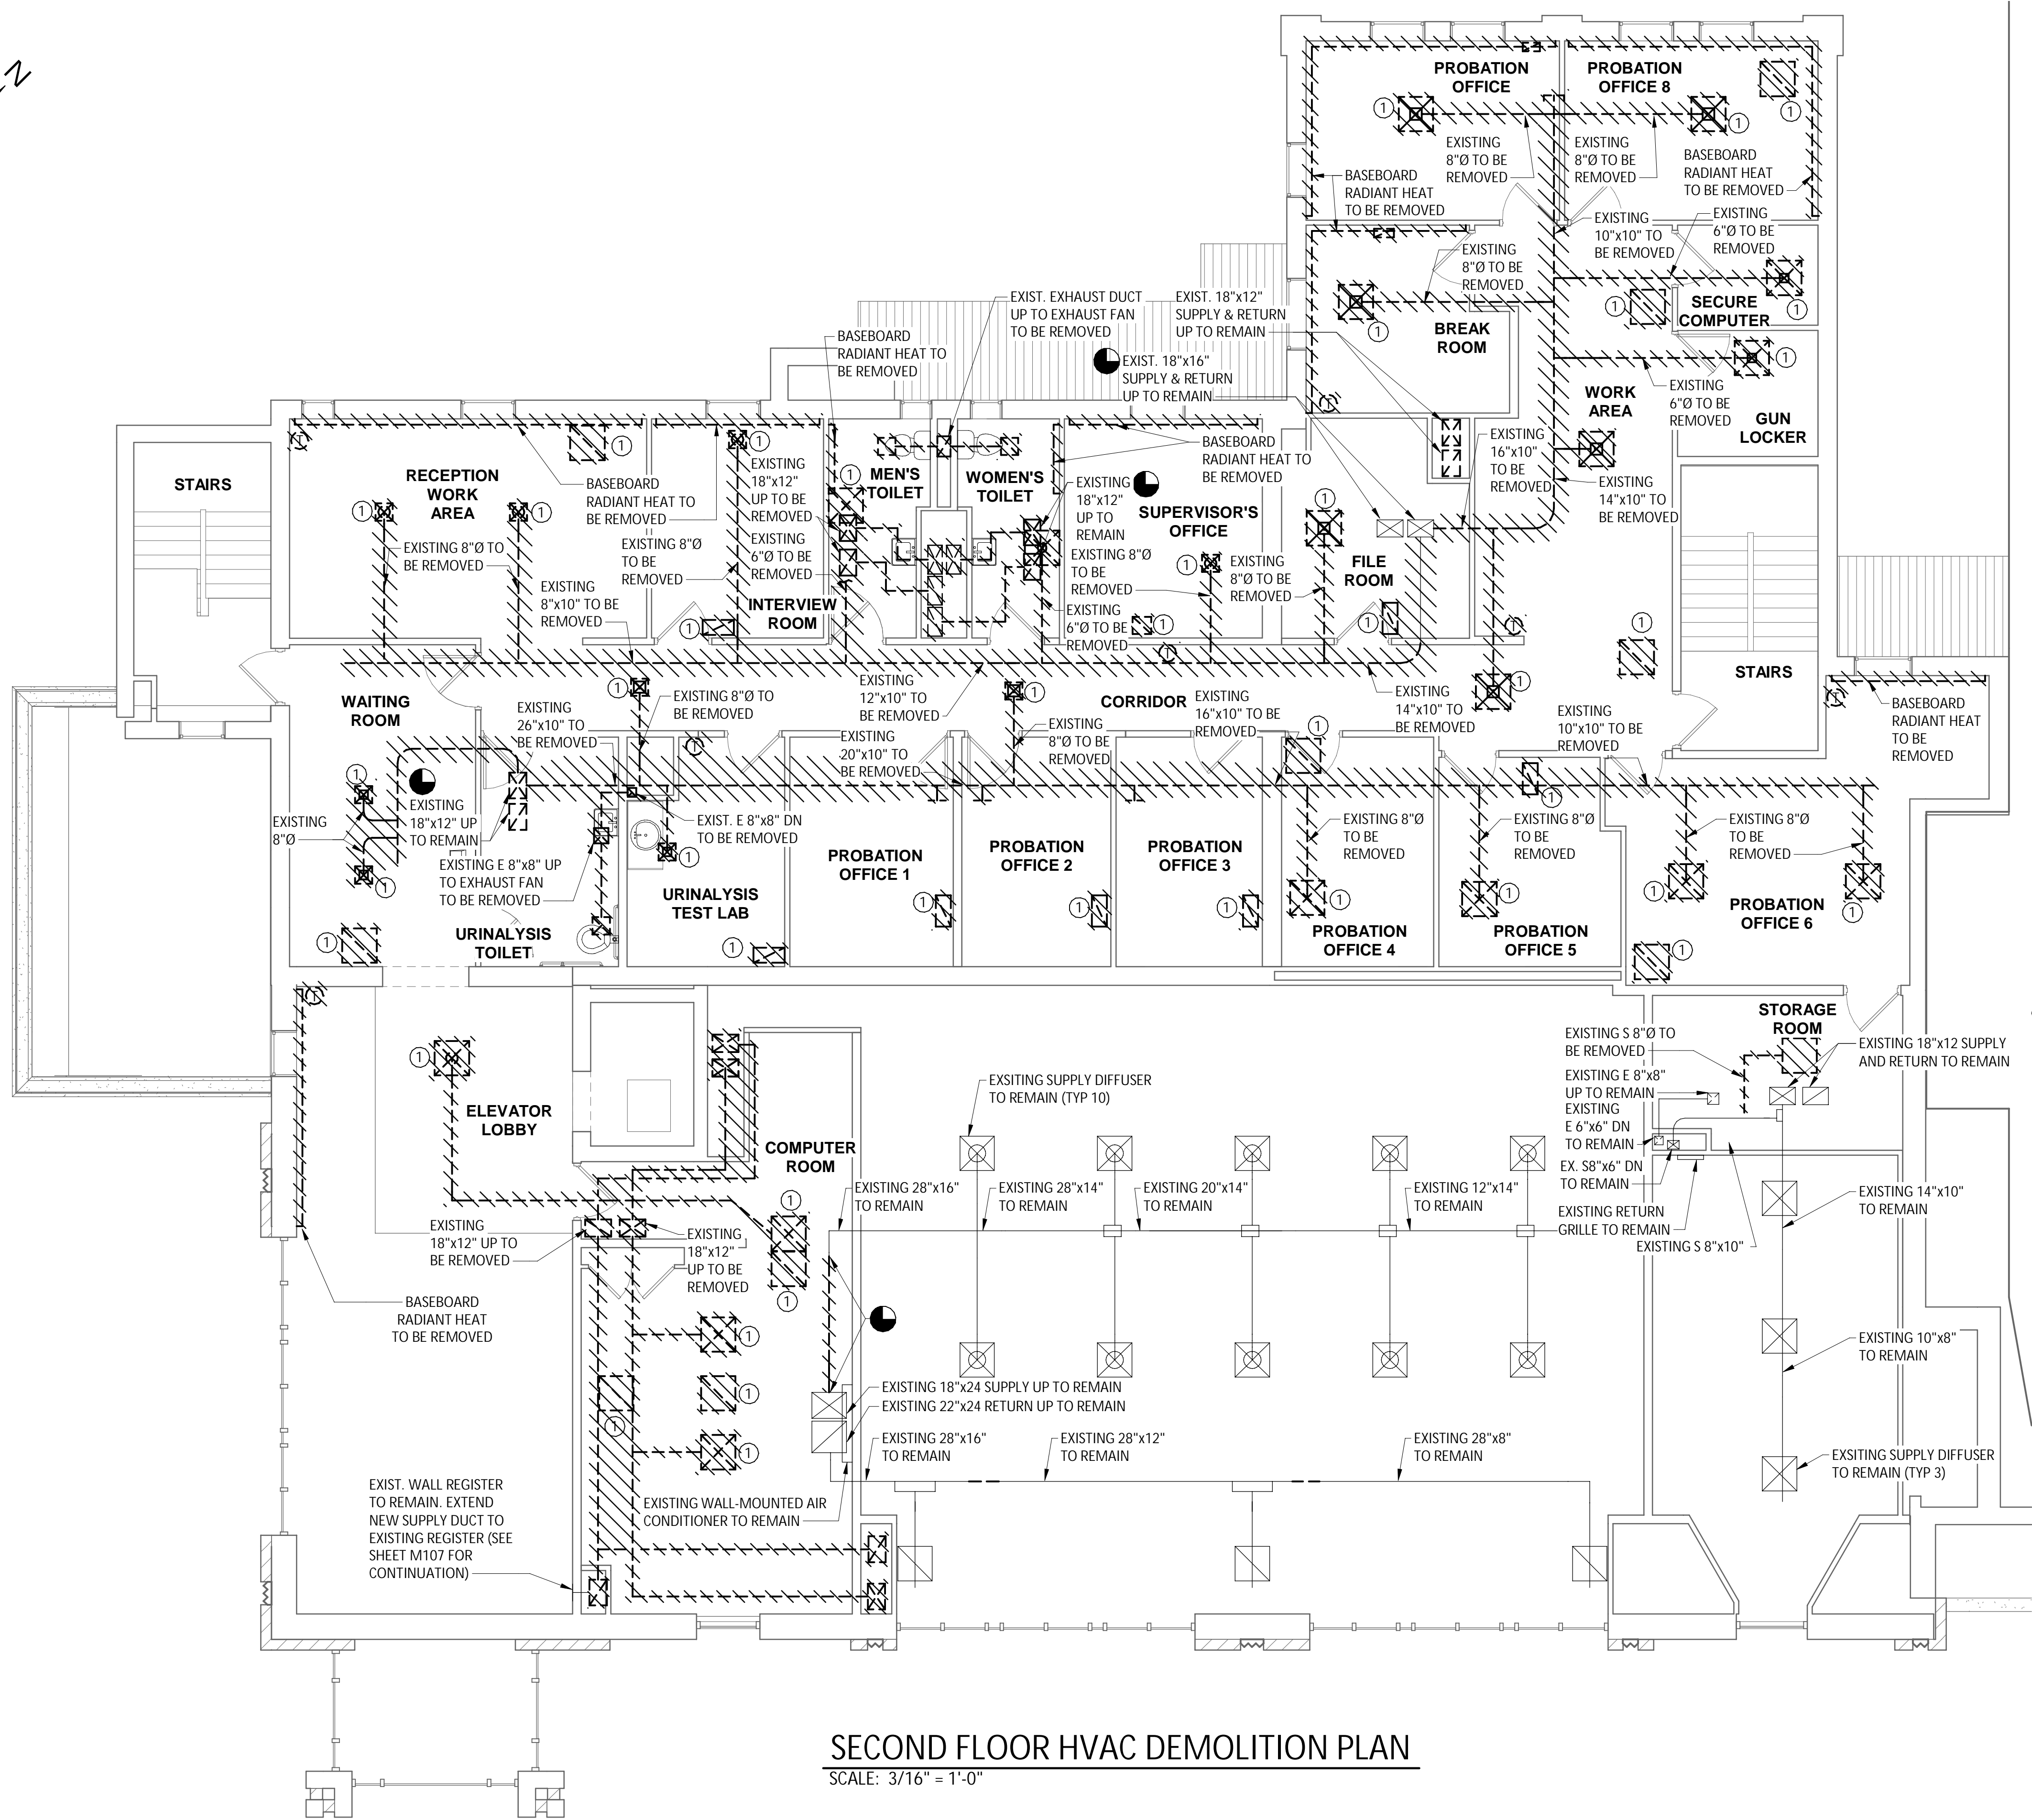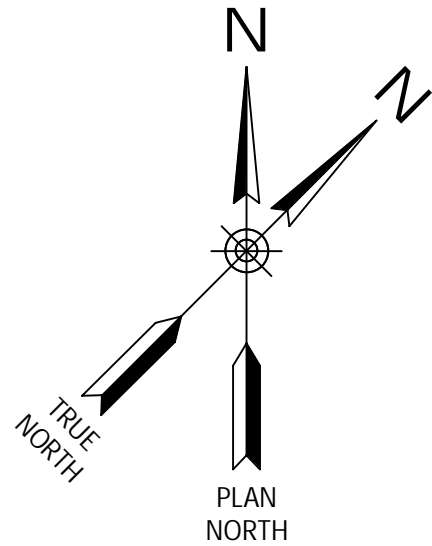- ① REMOVE SUPPLY DIFFUSER OR RETURN DIFFUSER IN ITS ENTIRETY.

**SECOND FLOOR HVAC DEMOLITION PLAN**

SCALE: 3/16" = 1'-0"

3/16" = 1'-0" 4' 0 6' 12'

IT IS A VIOLATION OF THE NEW YORK STATE EDUCATION LAW, ARTICLE 145 §7209 SPECIAL PROVISIONS, FOR ANY PERSON, UNLESS THEY ARE ACTING UNDER THE DIRECTION OF A LICENSED PROFESSIONAL ENGINEER, ARCHITECT, LANDSCAPE ARCHITECT, OR LAND SURVEYOR, TO ALTER ANY ITEM IN ANY WAY, IF AN ITEM BEARING THE STAMP OF A LICENSED PROFESSIONAL IS ALTERED, THE ALTERING PROFESSIONAL SHALL STAMP THE DOCUMENT AND INCLUDE THE NOTATION "ALTERED BY" FOLLOWED BY THEIR SIGNATURE, THE DATE OF SUCH ALTERATION, AND A SPECIFIC DESCRIPTION OF THE ALTERATION.

**REVISIONS**

NO.	DESCRIPTION
2	1/31/23 ADD. 2

CITY OF MIDDLETOWN  
NEW COURTHOUSE FACILITY  
CONTRACT 1B - MECHANICAL CONSTRUCTION  
**SECOND FLOOR HVAC DEMOLITION PLAN**  
CITY OF MIDDLETOWN  
ORANGE COUNTY, NEW YORK

443 Electronics Parkway  
Liverpool, NY  
13088  
**Barton & Loguidice, D.P.C.**



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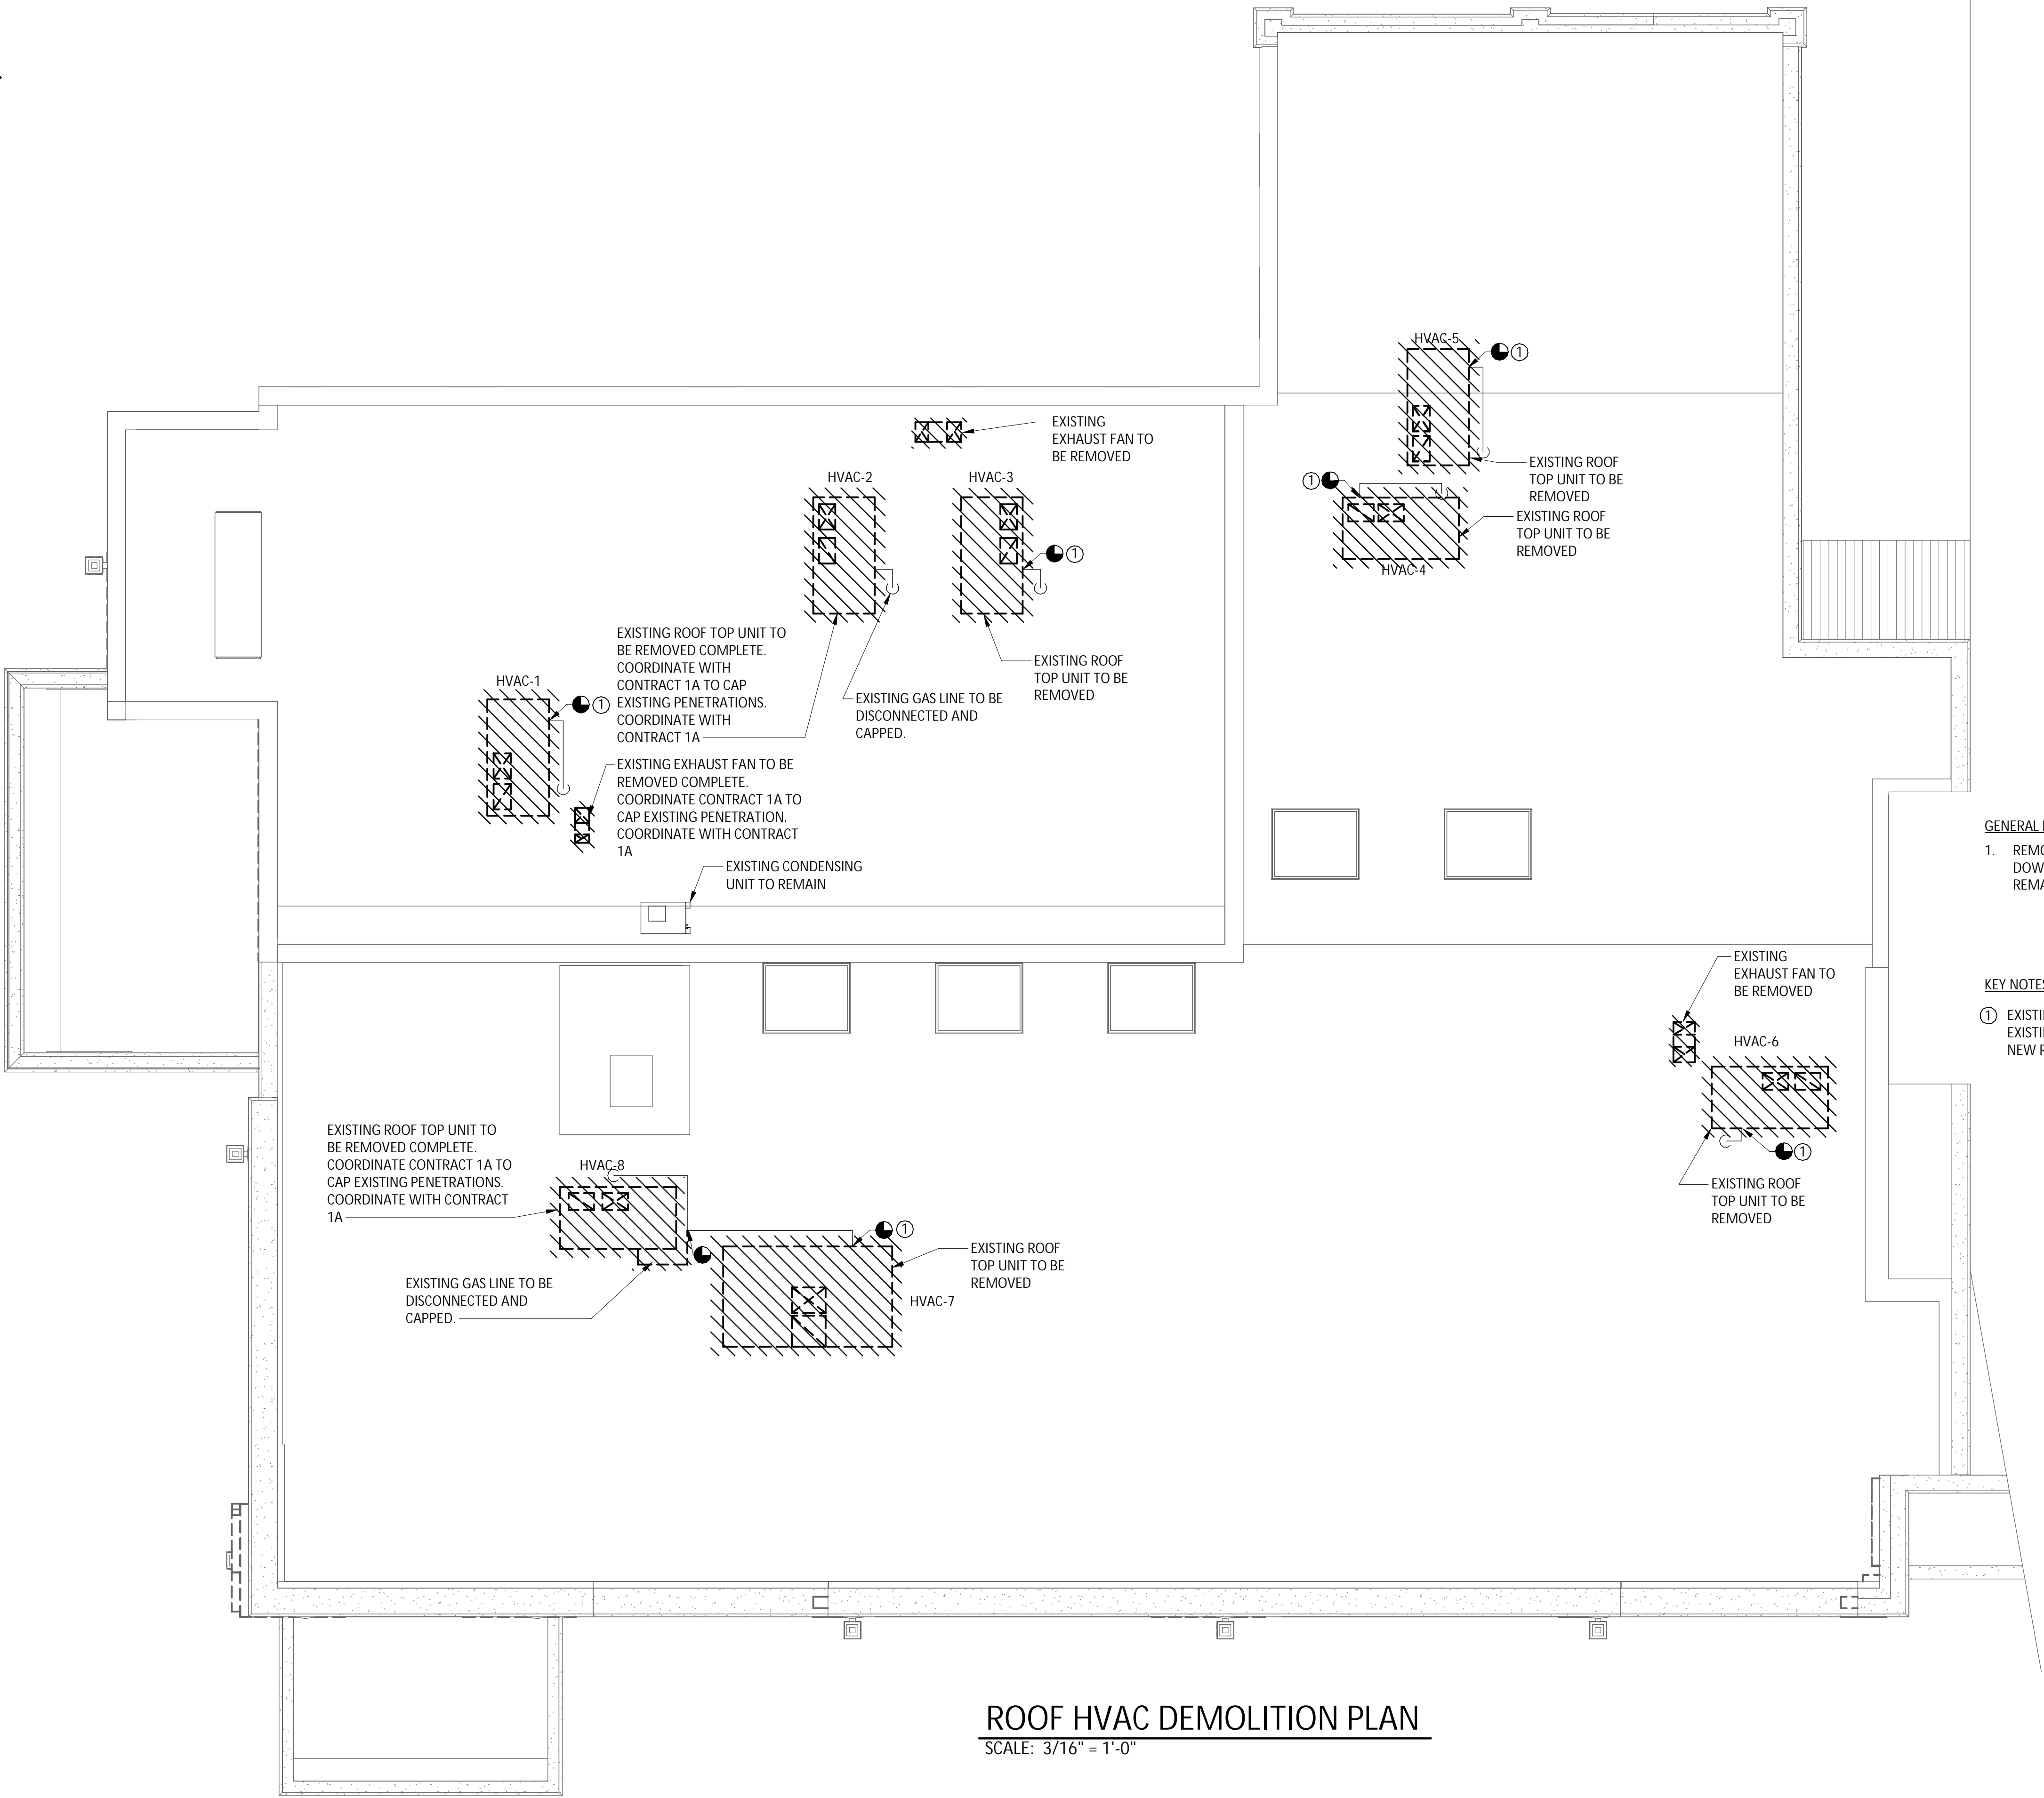
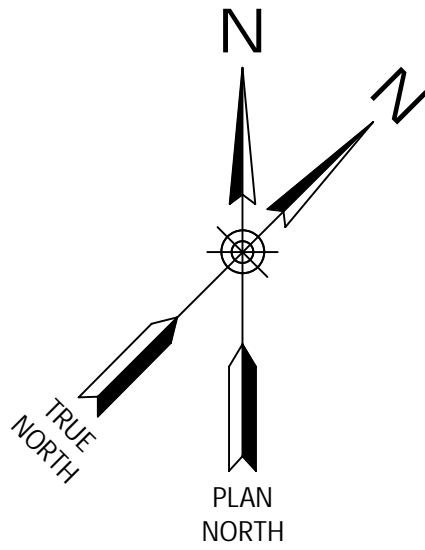
Date  
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M102

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1753.008.001





ROOF HVAC DEMOLITION PLAN  
SCALE: 3/16" = 1'-0"

- GENERAL NOTES:**
1. REMOVE EXISTING DUCTWORK AND DUCTWORK INSULATION DOWN THROUGH ROOF UNLESS SPECIFICALLY SHOWN TO REMAIN.
- KEY NOTES:**
- ① EXISTING GAS LINE TO BE DISCONNECTED FROM EXISTING ROOFTOP UNITS AND RECONNECTED TO NEW ROOFTOP UNITS.

IT IS A VIOLATION OF THE NEW YORK STATE EDUCATION LAW, ARTICLE 145 §7209 SPECIAL PROVISIONS, FOR ANY PERSON, UNLESS THEY ARE ACTING UNDER THE DIRECTION OF A LICENSED PROFESSIONAL ENGINEER, ARCHITECT, LANDSCAPE ARCHITECT, OR LAND SURVEYOR, TO ALTER ANY ITEM IN ANY WAY, IF AN ITEM BEARING THE STAMP OF A LICENSED PROFESSIONAL IS ALTERED, THE ALTERING PROFESSIONAL SHALL STAMP THE DOCUMENT AND INCLUDE THE NOTATION "ALTERED BY" FOLLOWED BY THEIR SIGNATURE, THE DATE OF SUCH ALTERATION, AND A SPECIFIC DESCRIPTION OF THE ALTERATION.

REVISIONS	



CITY OF MIDDLETOWN  
NEW COURTHOUSE FACILITY  
CONTRACT 1B - MECHANICAL CONSTRUCTION  
ROOF HVAC DEMOLITION PLAN  
ORANGE COUNTY, NEW YORK

443 Electronics Parkway  
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Date  
AUGUST, 2024  
Scale  
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Sheet Number  
M103  
Project Number  
1753.008.001






KEY NOTES:

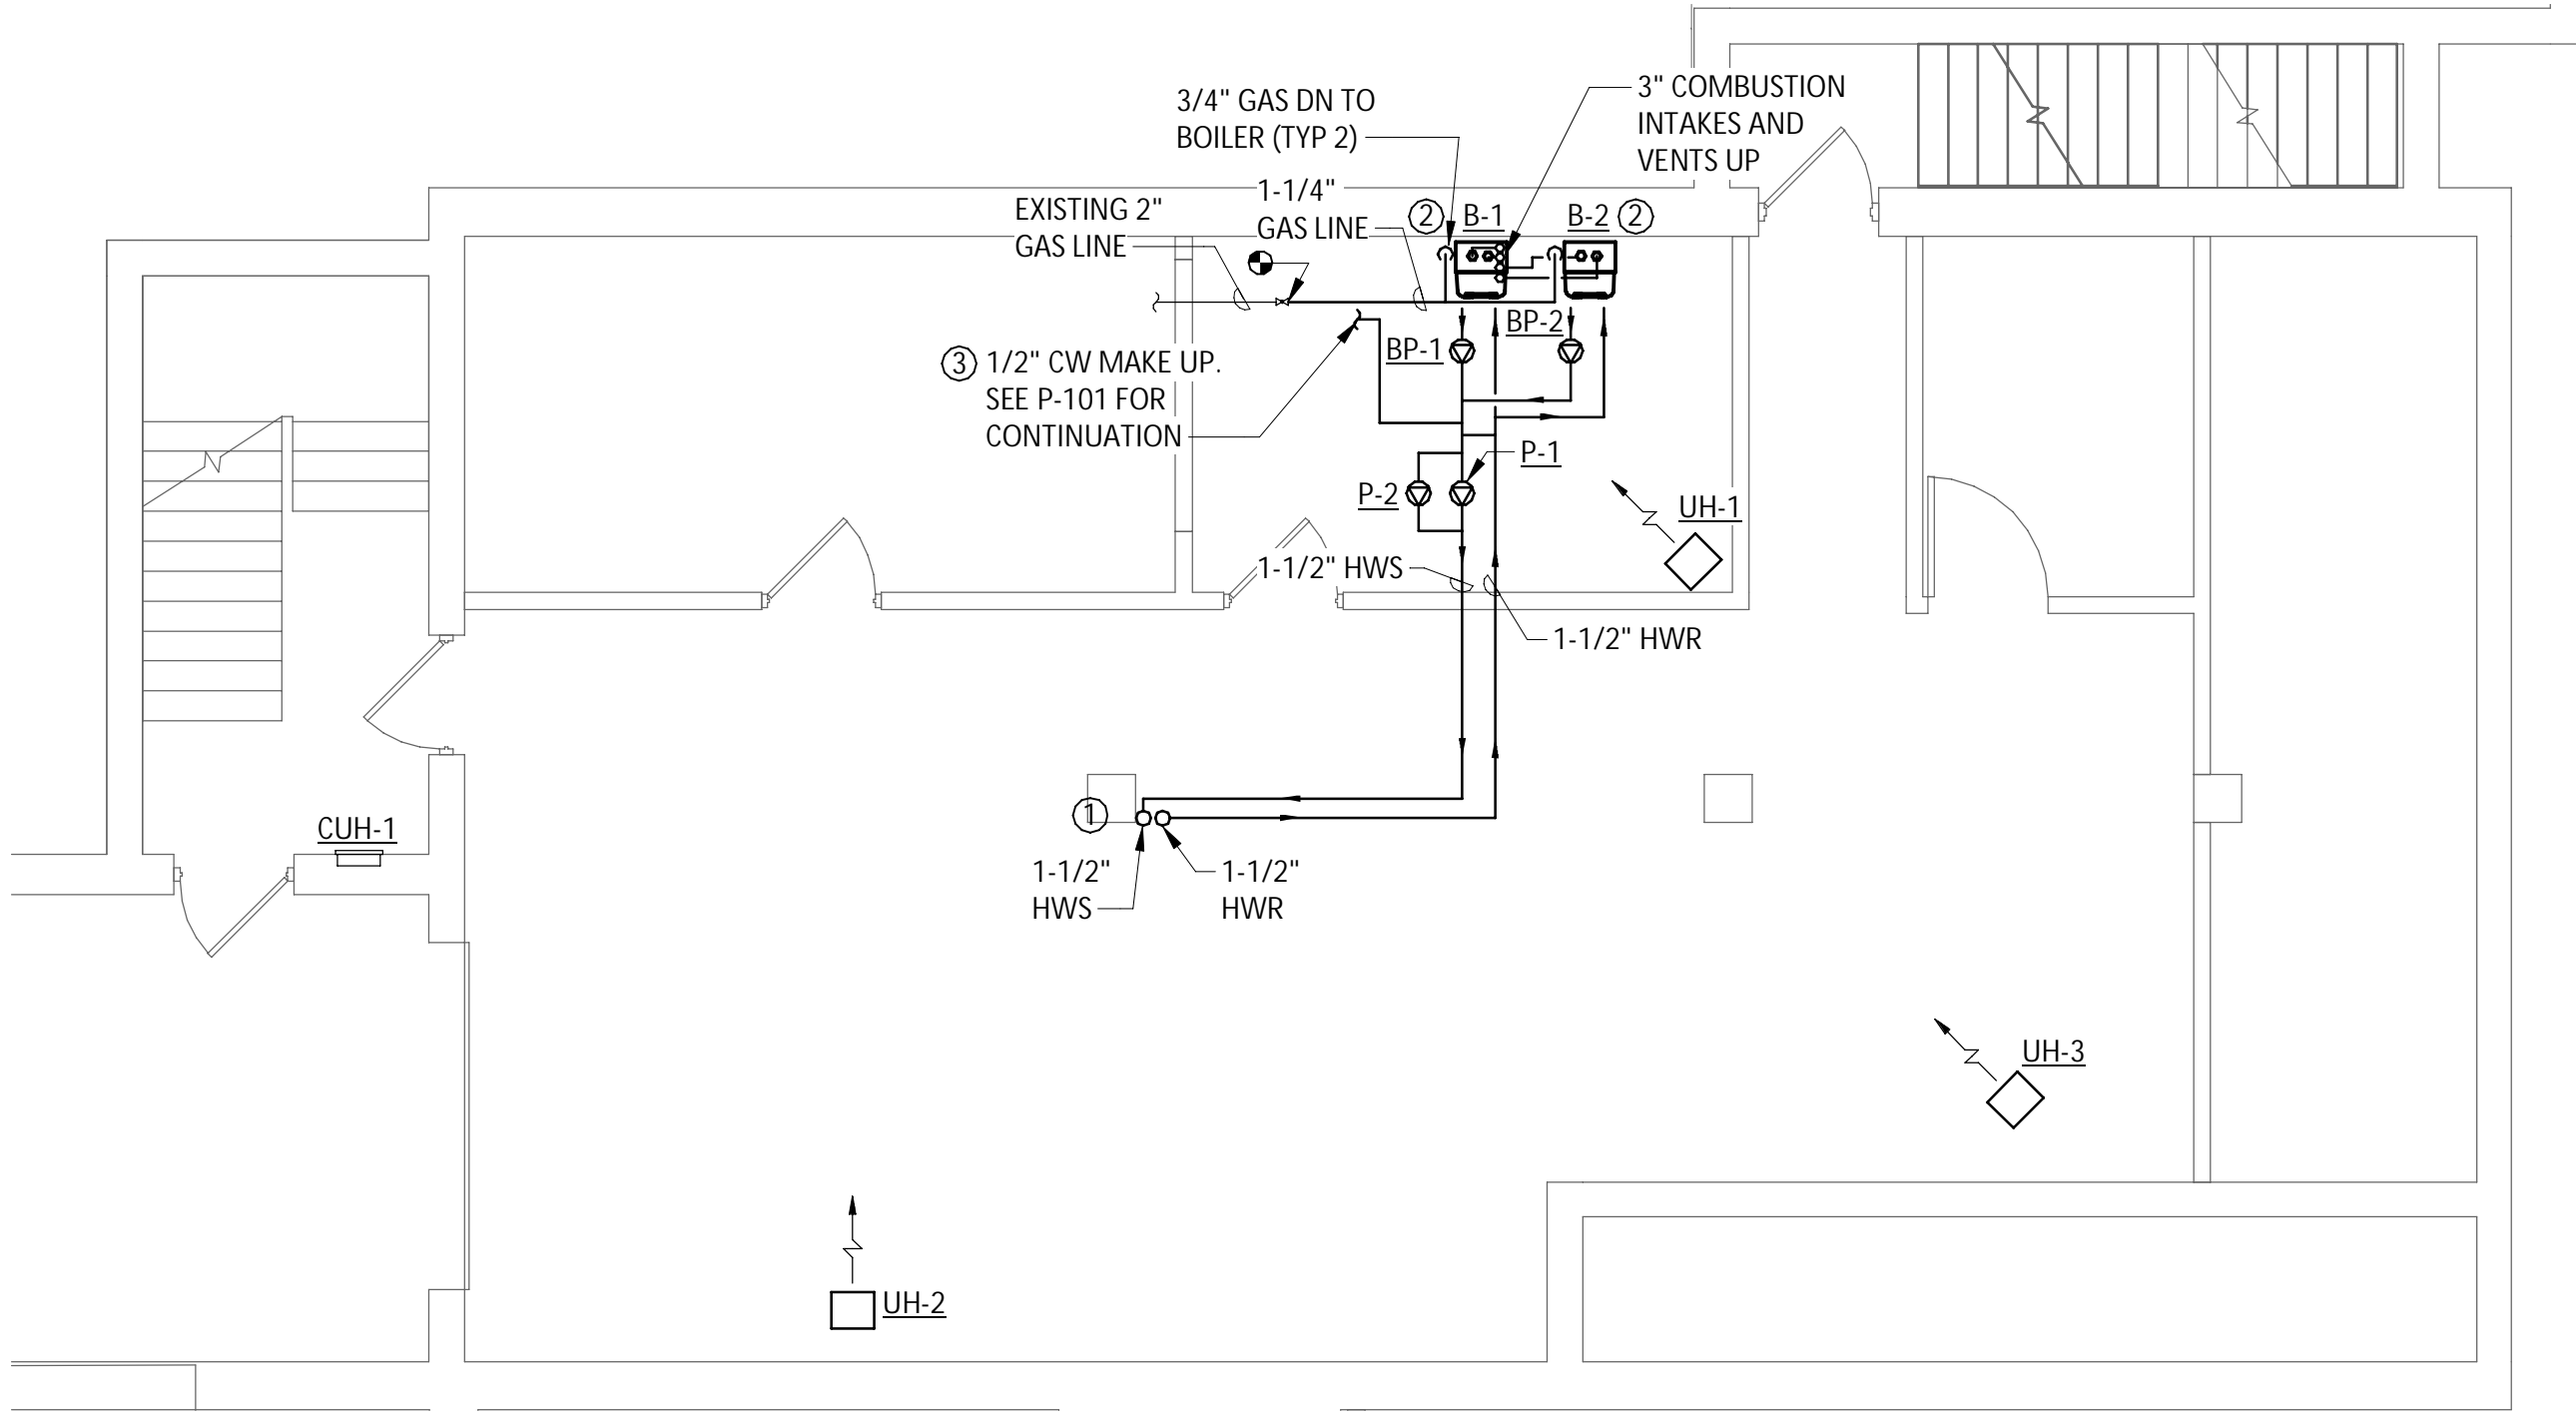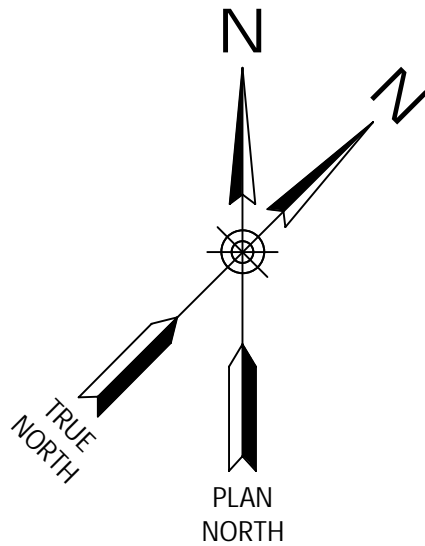- ① CORE DRILL THROUGH CEILING TO FLOOR ABOVE TO ACCOMODATE NEW PIPING. FIRE CAULK PENETRATIONS.
- ② NEW BOILERS ARE FLOOR MOUTNED. PROVIDE 6" CONCRETE EQUIPMENT PAD BELOW BOILERS.
- ③ COORDINATE NEW COLD WATER MAKE-UP CONNECTION FOR BOILER SYSTEM WITH CONTRACT 1C.

BASEMENT HVAC PIPING PLAN

SCALE: 3/16" = 1'-0"

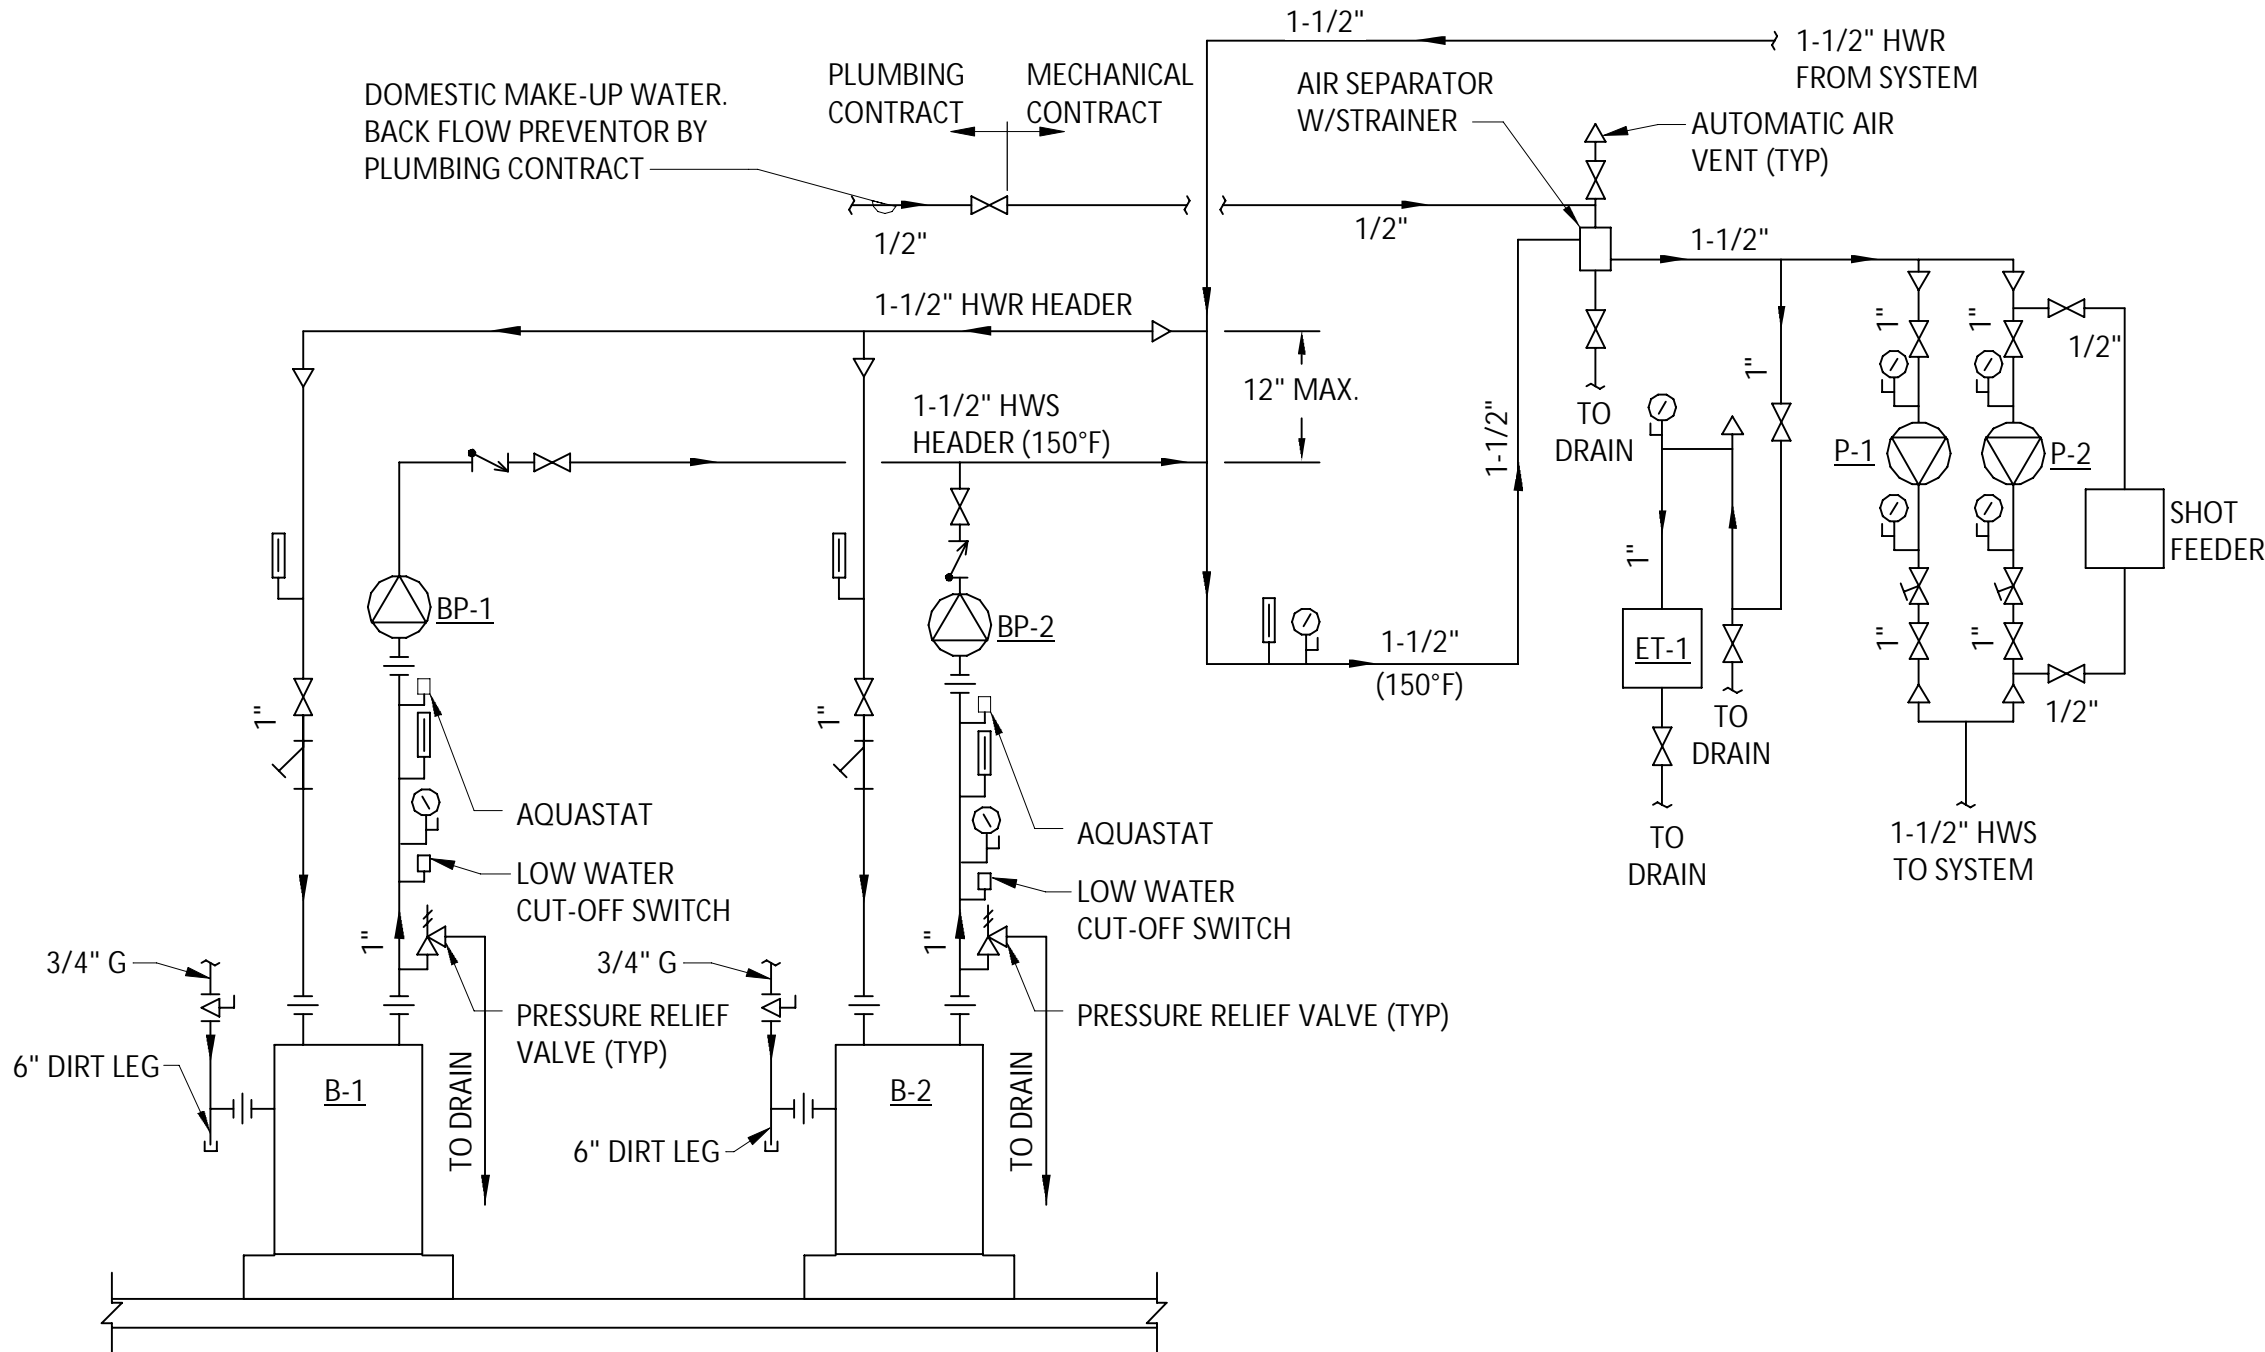

BOILER SYSTEM SCHEMATIC

NOT TO SCALE



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REVISIONS

CITY OF MIDDLETOWN  
NEW COURTHOUSE FACILITY  
CONTRACT 1B - MECHANICAL CONSTRUCTION  
BASEMENT HVAC PIPING PLAN  
CITY OF MIDDLETOWN  
ORANGE COUNTY, NEW YORK

443 Electronics Parkway  
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13088  
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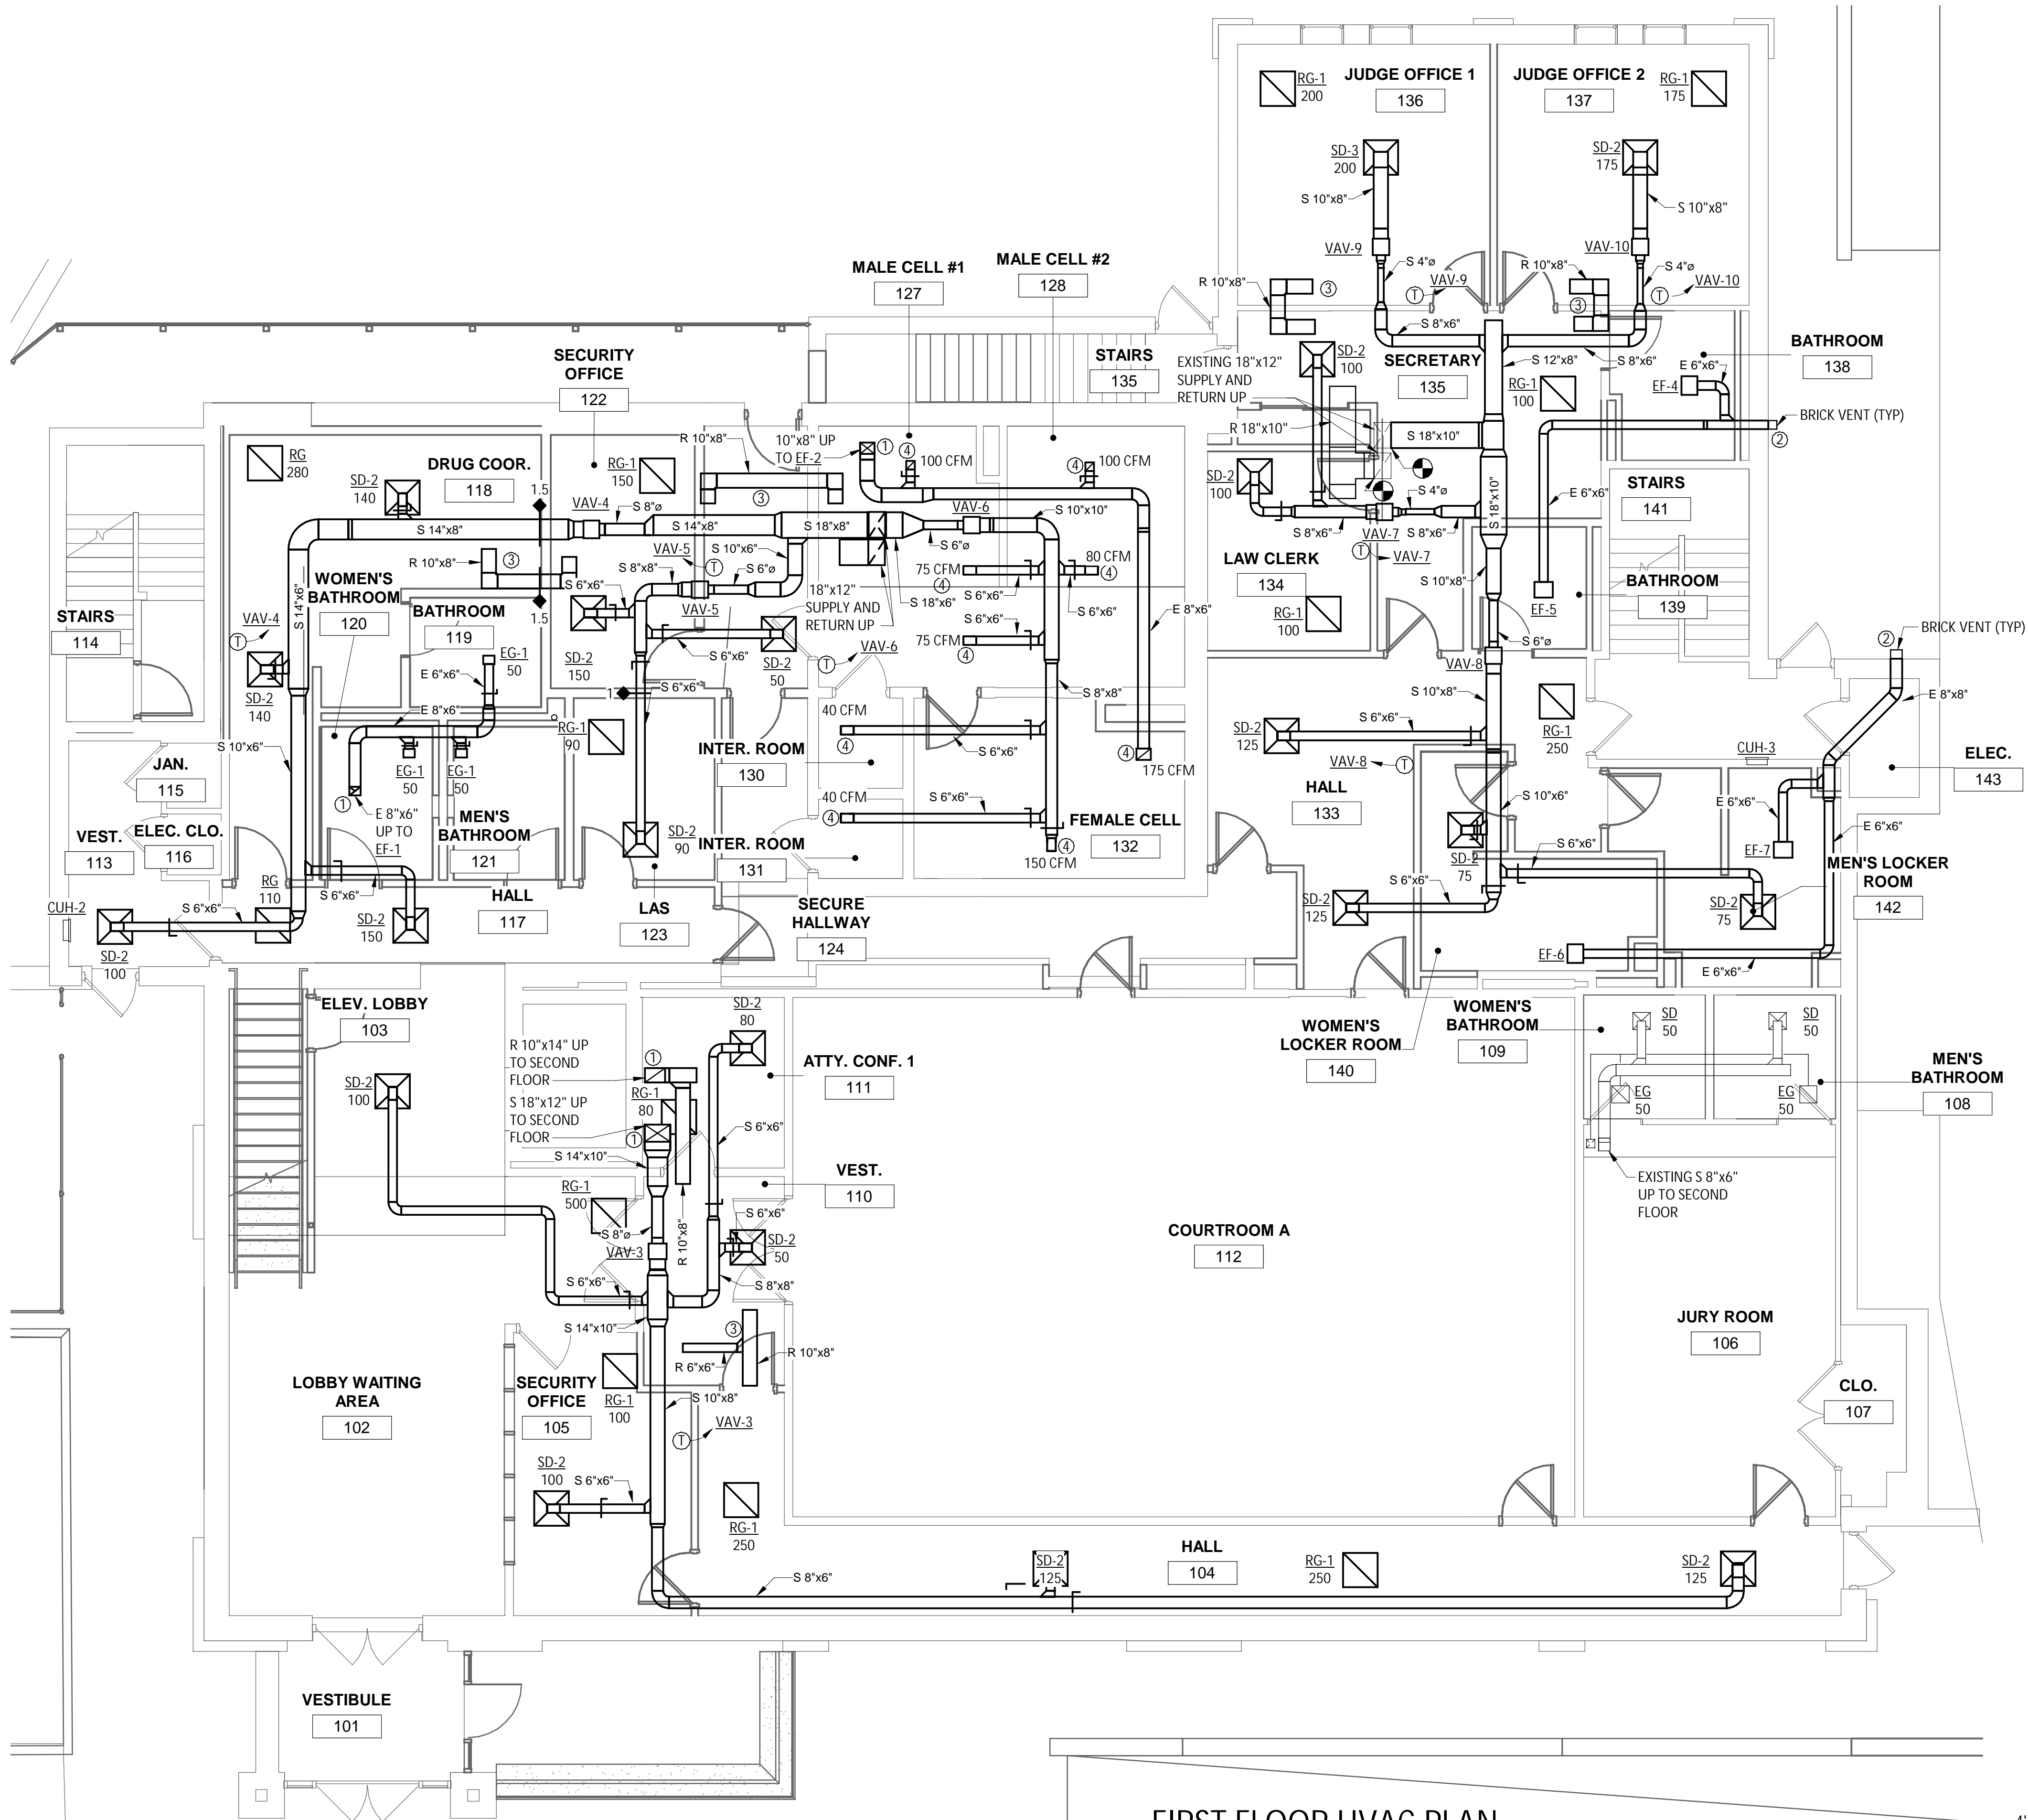
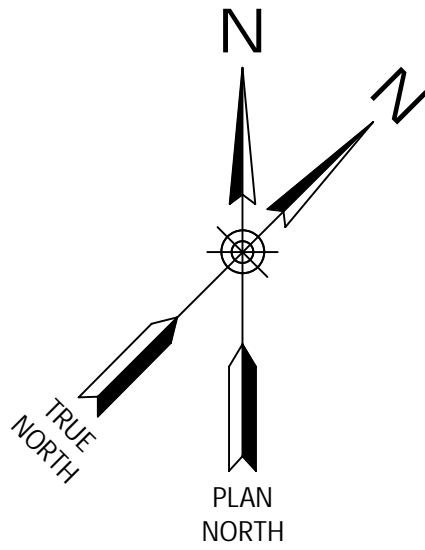
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AUGUST, 2024

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AS SHOWN

Sheet Number  
M104

Project Number  
1753.008.001





- KEY NOTES:
- ① SAW CUT THROUGH CEILING TO FLOOR ABOVE TO ACCOMMODATE NEW DUCT
  - ② COORDINATE NEW EXHAUST/BRICK VENT PENETRATIONS WITH CONTRACT 1A. SEE DETAIL ON SHEET M001.
  - ③ RETURN TRANSFER DUCT TO BE ACCOUSTICALLY LINED AND TERMINATED OPEN ENDED.
  - ④ TERMINATE DUCT WITH 45 DEGREE ELBOW DOWN OPEN ENDED ABOVE CEILING PANEL PERFORATION AREAS. COORDINATE EXACT LOCATIONS WITH CONTRACT 1A.

## FIRST FLOOR HVAC PLAN

SCALE: 3/16" = 1'-0"



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### REVISIONS

NO.	DESCRIPTION
2	1/31/23 ADD. 2

CITY OF MIDDLETOWN  
NEW COURTHOUSE FACILITY  
CONTRACT 1B - MECHANICAL CONSTRUCTION  
FIRST FLOOR HVAC PLAN

CITY OF MIDDLETOWN

ORANGE COUNTY, NEW YORK

443 Electronics Parkway  
Liverpool, NY  
13088

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**Barton & Loguidice, D.P.C.**



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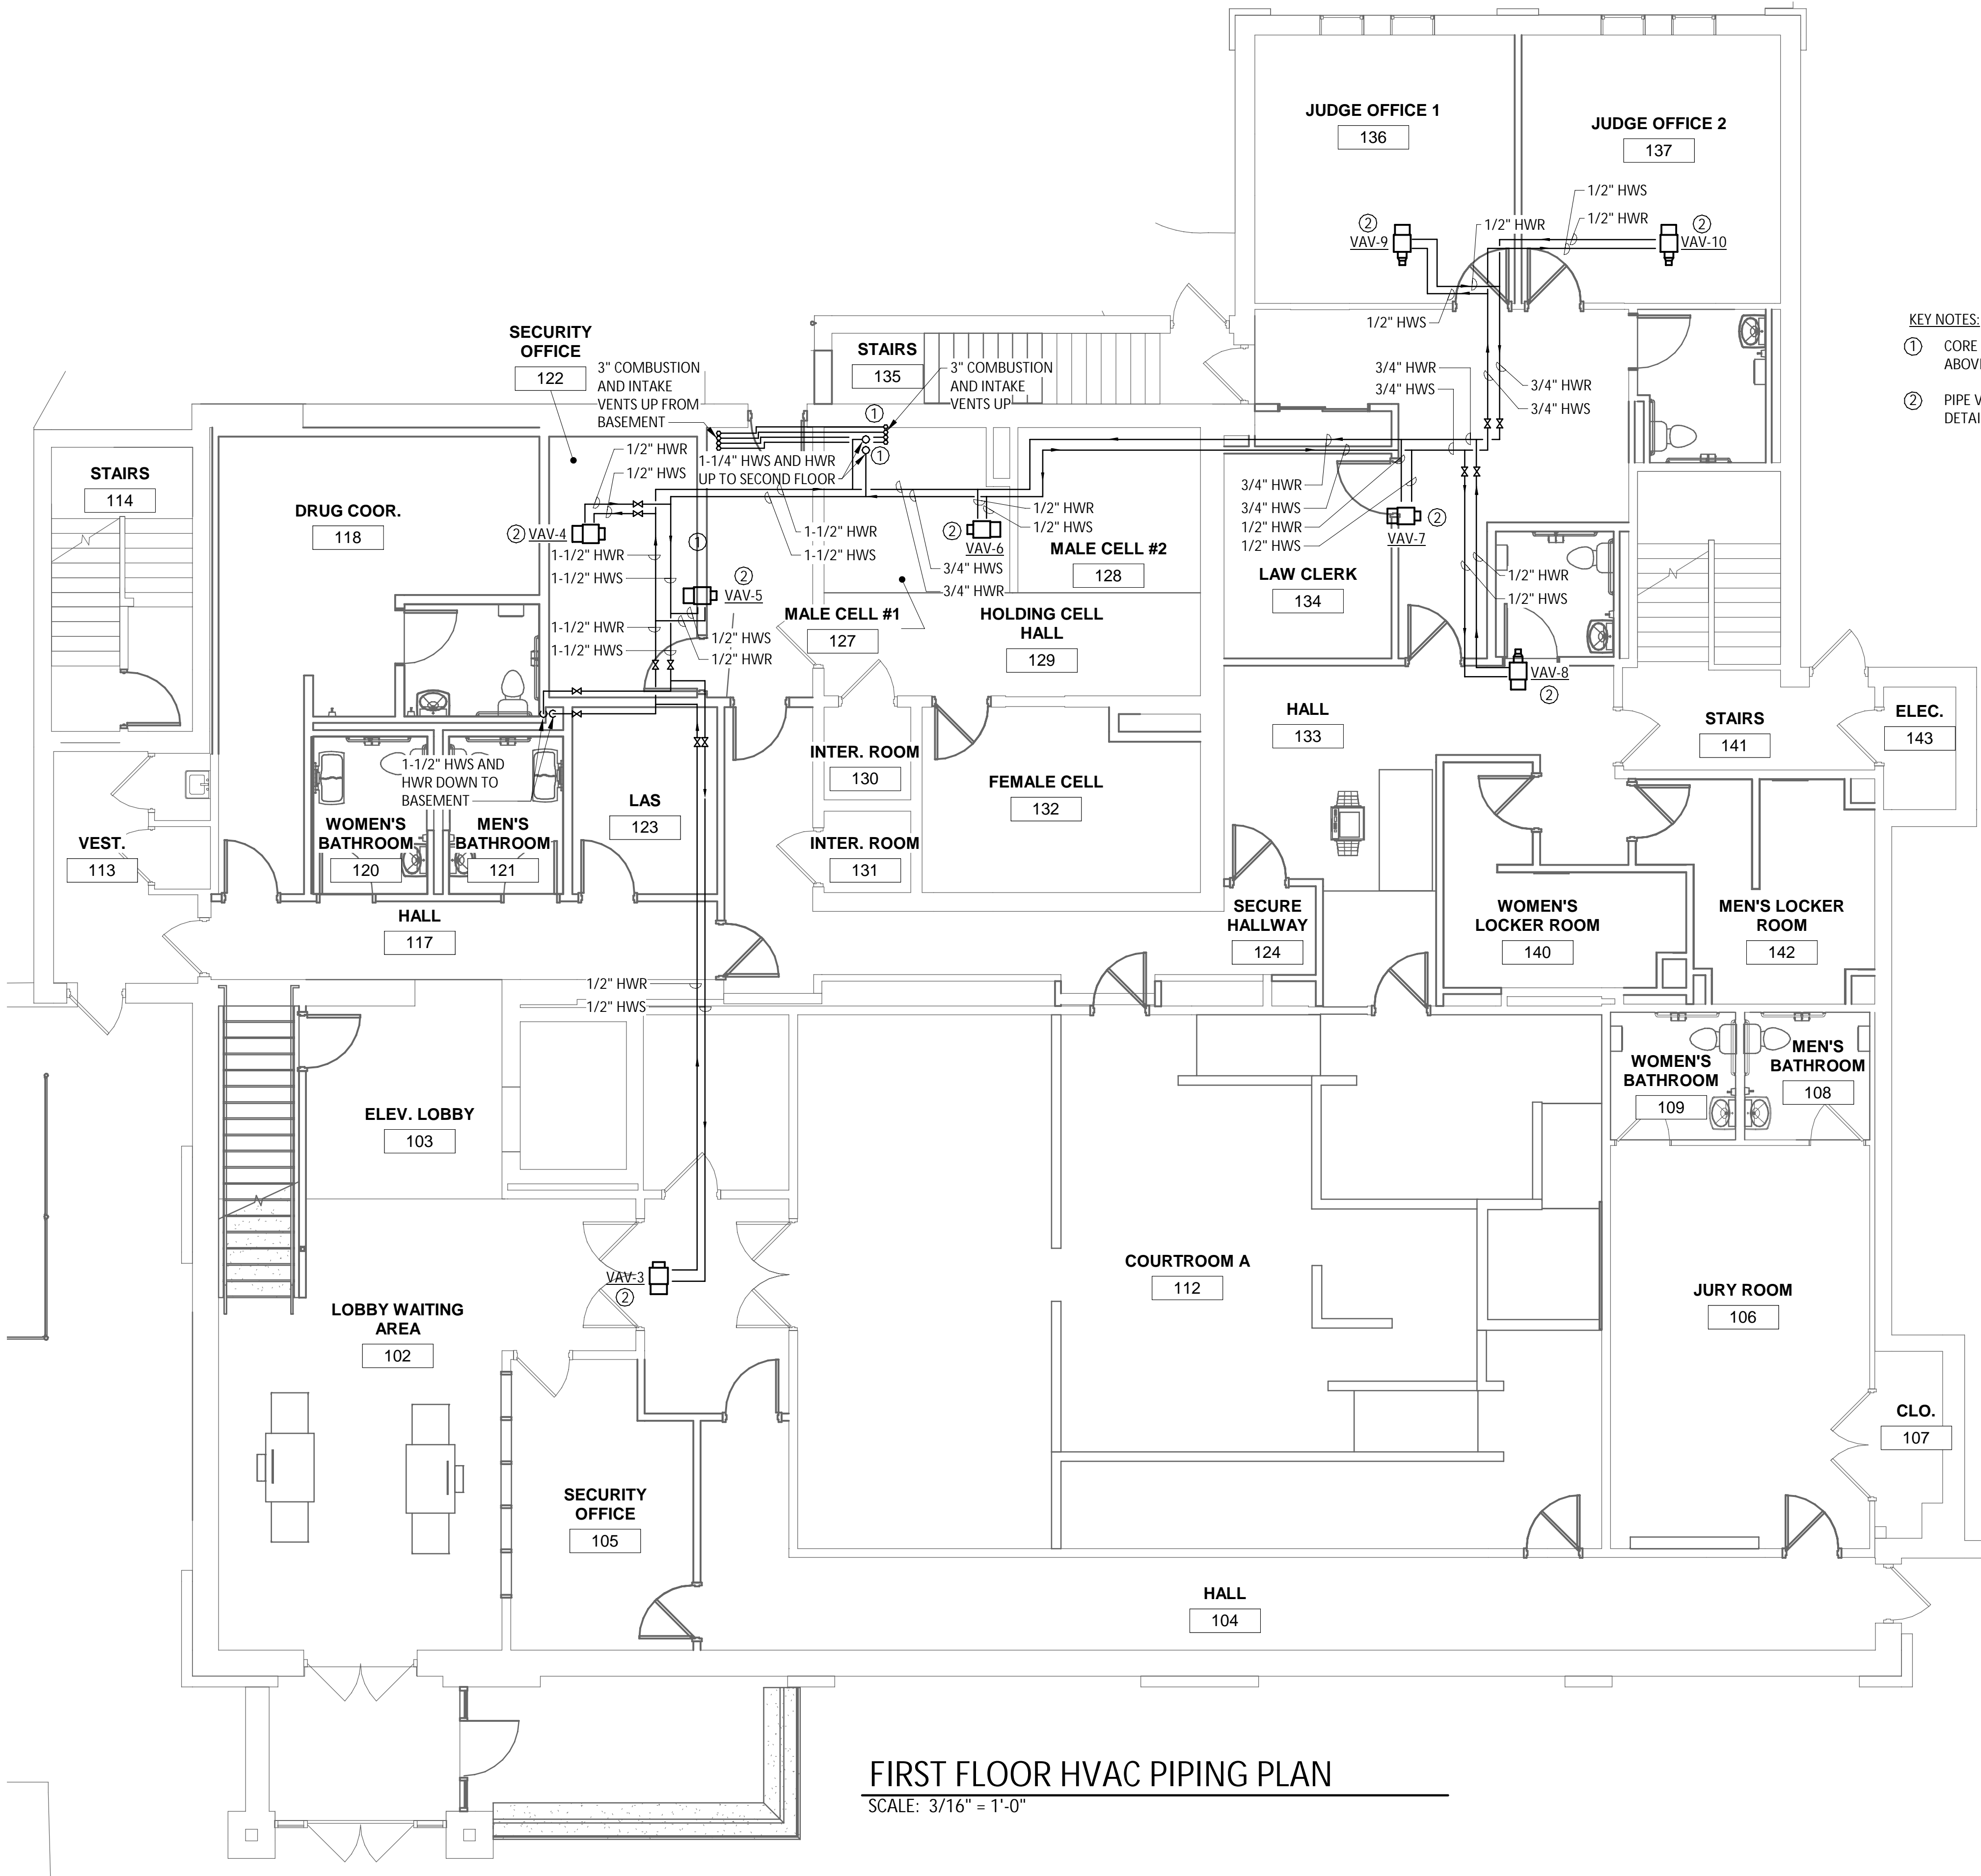
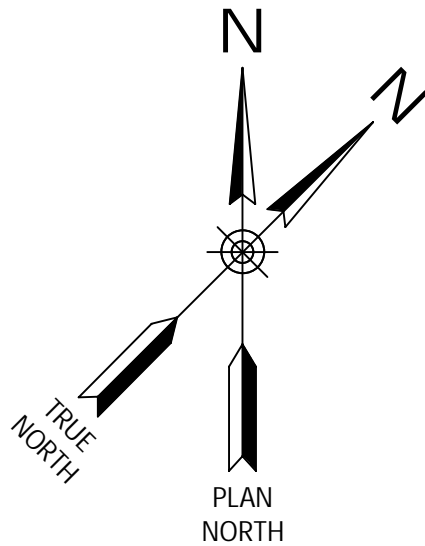
Date  
AUGUST, 2024

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Sheet Number  
M105

Project Number  
1753.008.001





KEY NOTES:

- ① CORE DRILL THROUGH CEILING TO FLOOR ABOVE TO ACCOMMODATE NEW PIPING.
- ② PIPE VAV'S PER HOT WATER REHEAT COIL DETAIL ON SHEET M001.

FIRST FLOOR HVAC PIPING PLAN

SCALE: 3/16" = 1'-0"

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REVISIONS	

CITY OF MIDDLETOWN  
NEW COURTHOUSE FACILITY  
CONTRACT 1B - MECHANICAL CONSTRUCTION  
FIRST FLOOR HVAC PIPING PLAN  
CITY OF MIDDLETOWN  
ORANGE COUNTY, NEW YORK

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AUGUST, 2024

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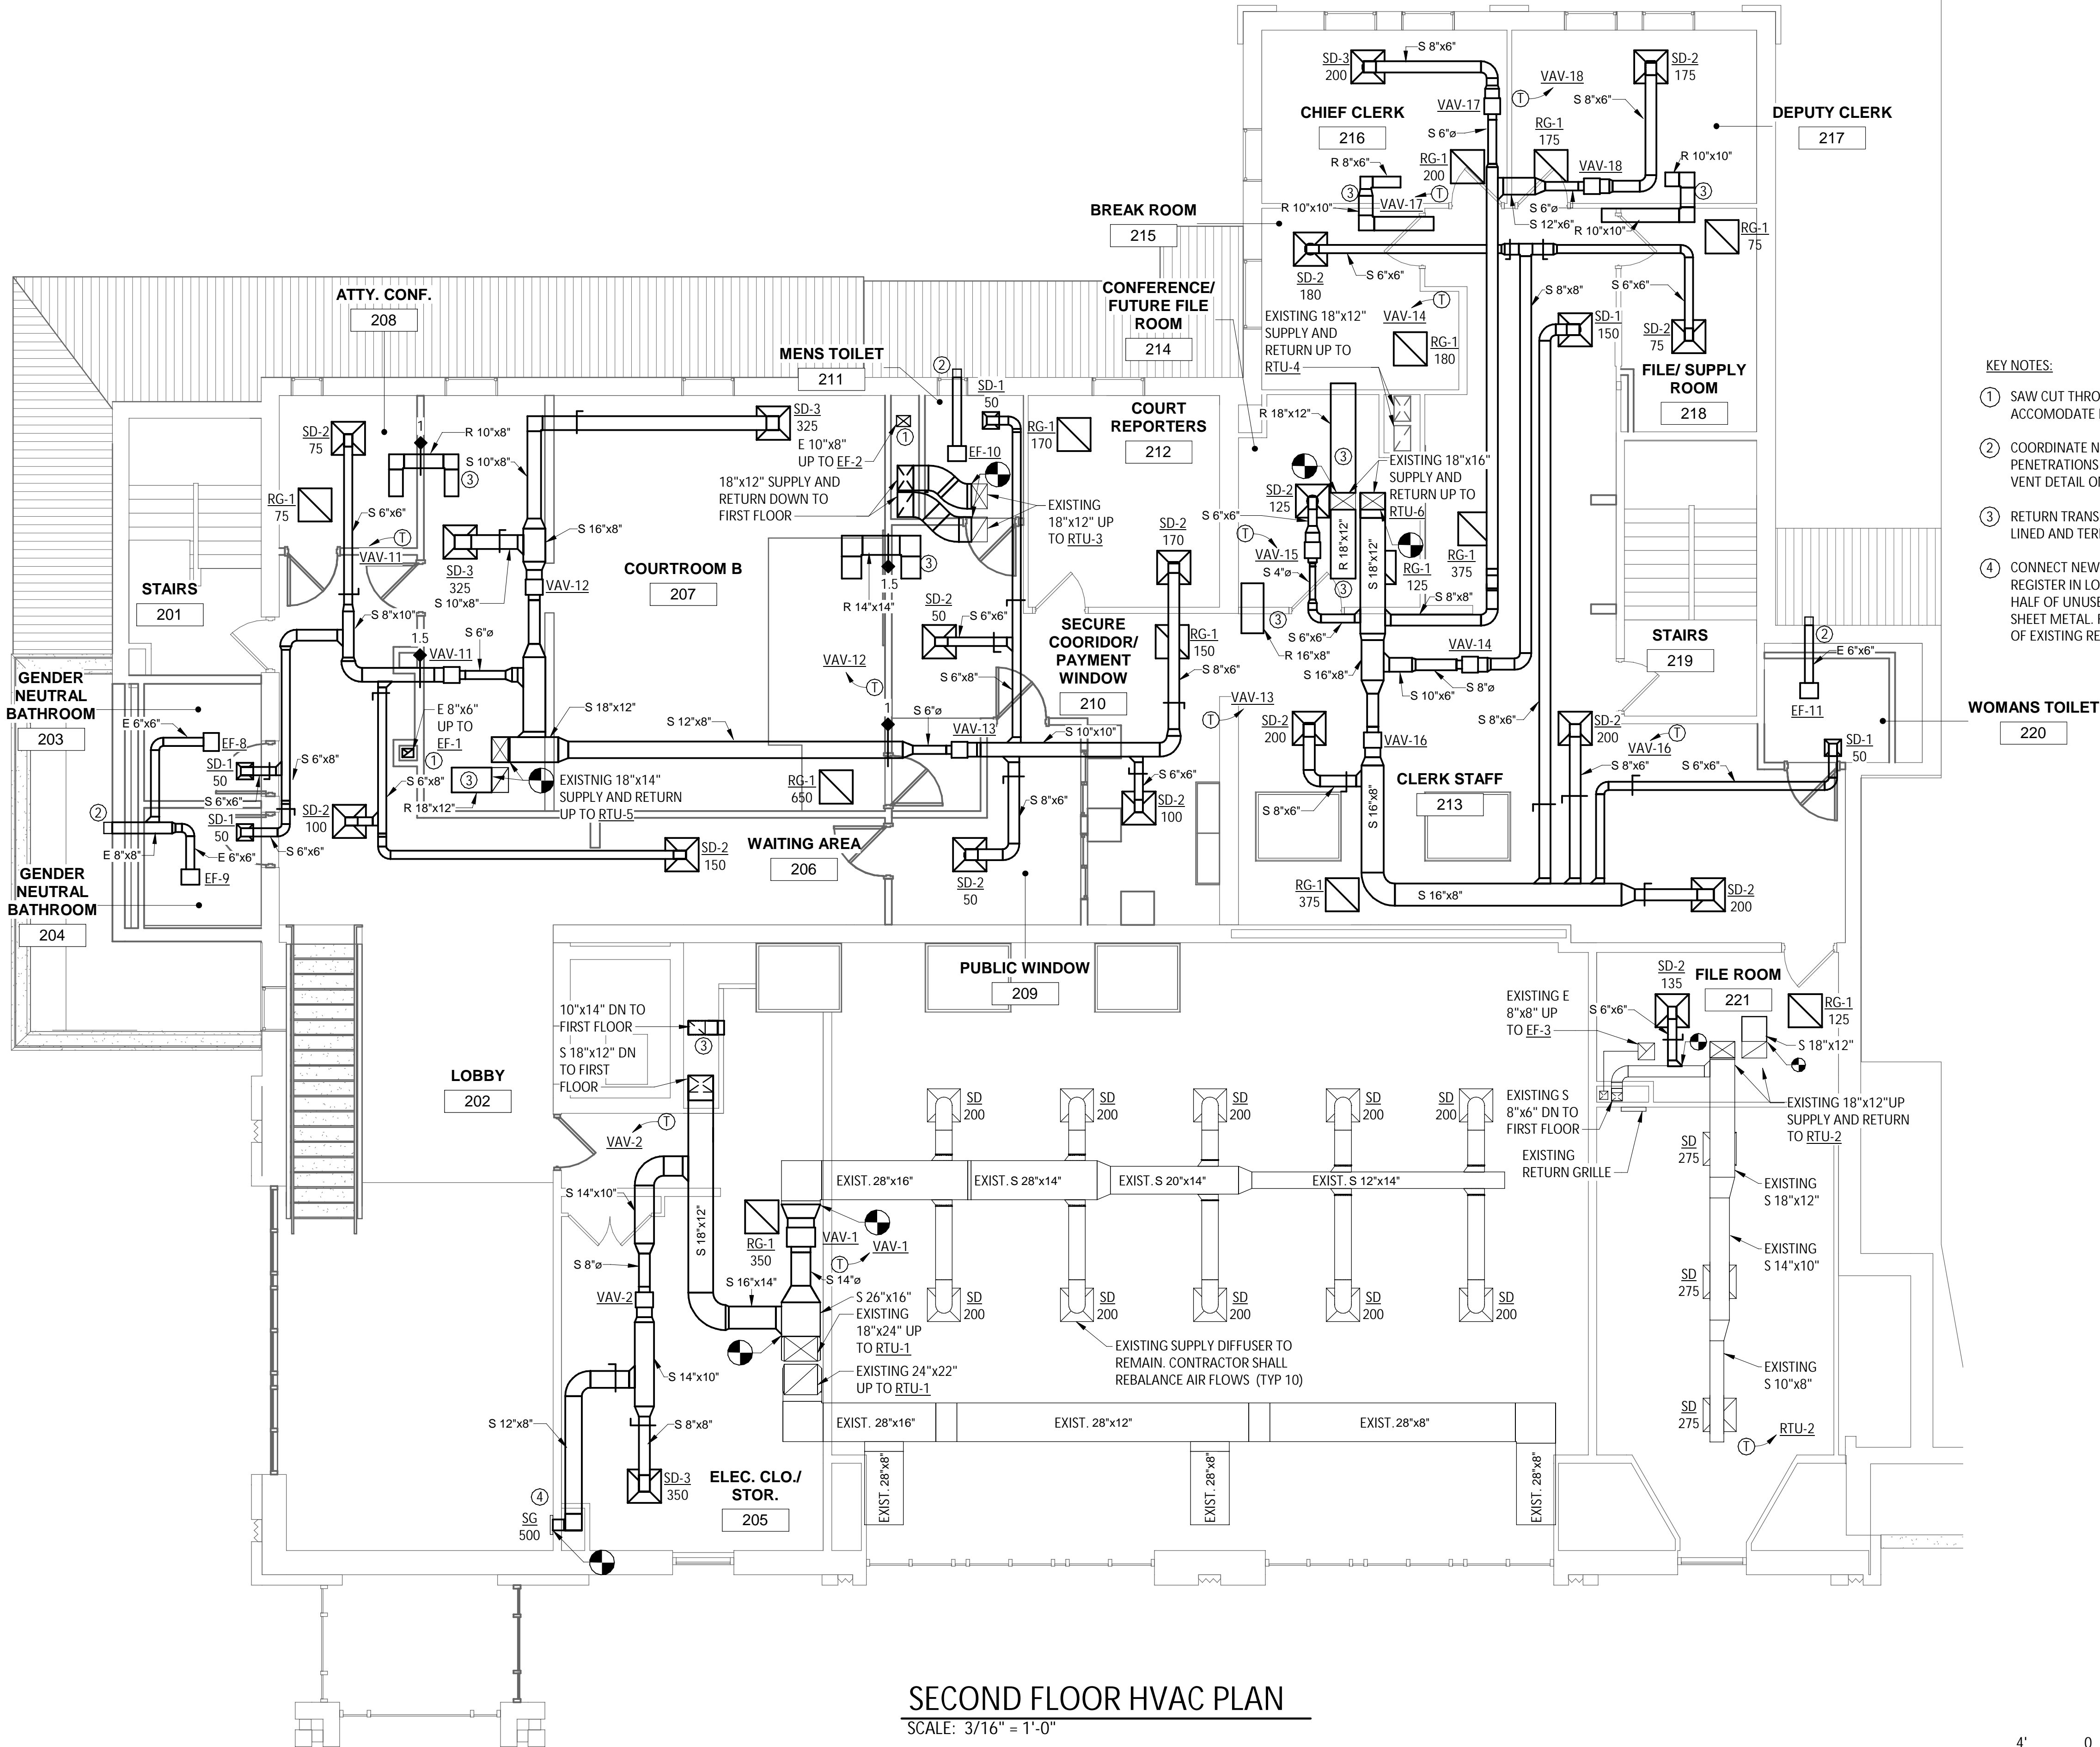
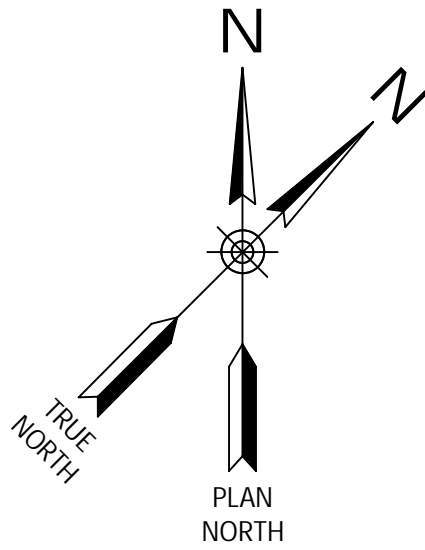
Sheet Number

M106

Project Number

1753.008.001





**KEY NOTES:**

- ① SAW CUT THROUGH CEILING TO FLOOR ABOVE TO ACCOMMODATE NEW DUCT.
- ② COORDINATE NEW EXHAUST/BRICK VENT PENETRATIONS WITH CONTRACT 1A. SEE BRICK VENT DETAIL ON SHEET M001
- ③ RETURN TRANSFER DUCT TO BE ACCOUSTICALLY LINED AND TERMINATED OPEN ENDED.
- ④ CONNECT NEW SUPPLY DUCT TO EXISTING REGISTER IN LOBBY WALL. BLOCK OFF BOTTOM HALF OF UNUSED REGISTER IN WALL CHASE USING SHEET METAL. FIELD VERIFY EXACT DIMENSIONS OF EXISTING REGISTER TO BE REUSED.

**SECOND FLOOR HVAC PLAN**

SCALE: 3/16" = 1'-0"

3/16" = 1'-0" 4' 0 6' 12'

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**REVISIONS**

2 1/31/23 ADD. 2

CITY OF MIDDLETOWN  
NEW COURTHOUSE FACILITY  
CONTRACT 1B - MECHANICAL CONSTRUCTION  
SECOND FLOOR HVAC PLAN

CITY OF MIDDLETOWN

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443 Electronics Parkway  
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Date  
AUGUST, 2024

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Sheet Number  
M107



Project Number  
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Checked by \_\_\_\_\_ Drawn by \_\_\_\_\_ RAD \_\_\_\_\_ Designed by \_\_\_\_\_ RAD \_\_\_\_\_ In Charge of \_\_\_\_\_ E/H \_\_\_\_\_



KEY NOTES:  
① PIPE VAV'S PER HOT WATER REHEAT COIL  
DETAIL ON SHEET M001.

SECOND FLOOR HVAC PIPING PLAN  
SCALE: 3/16" = 1'-0"

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REVISIONS

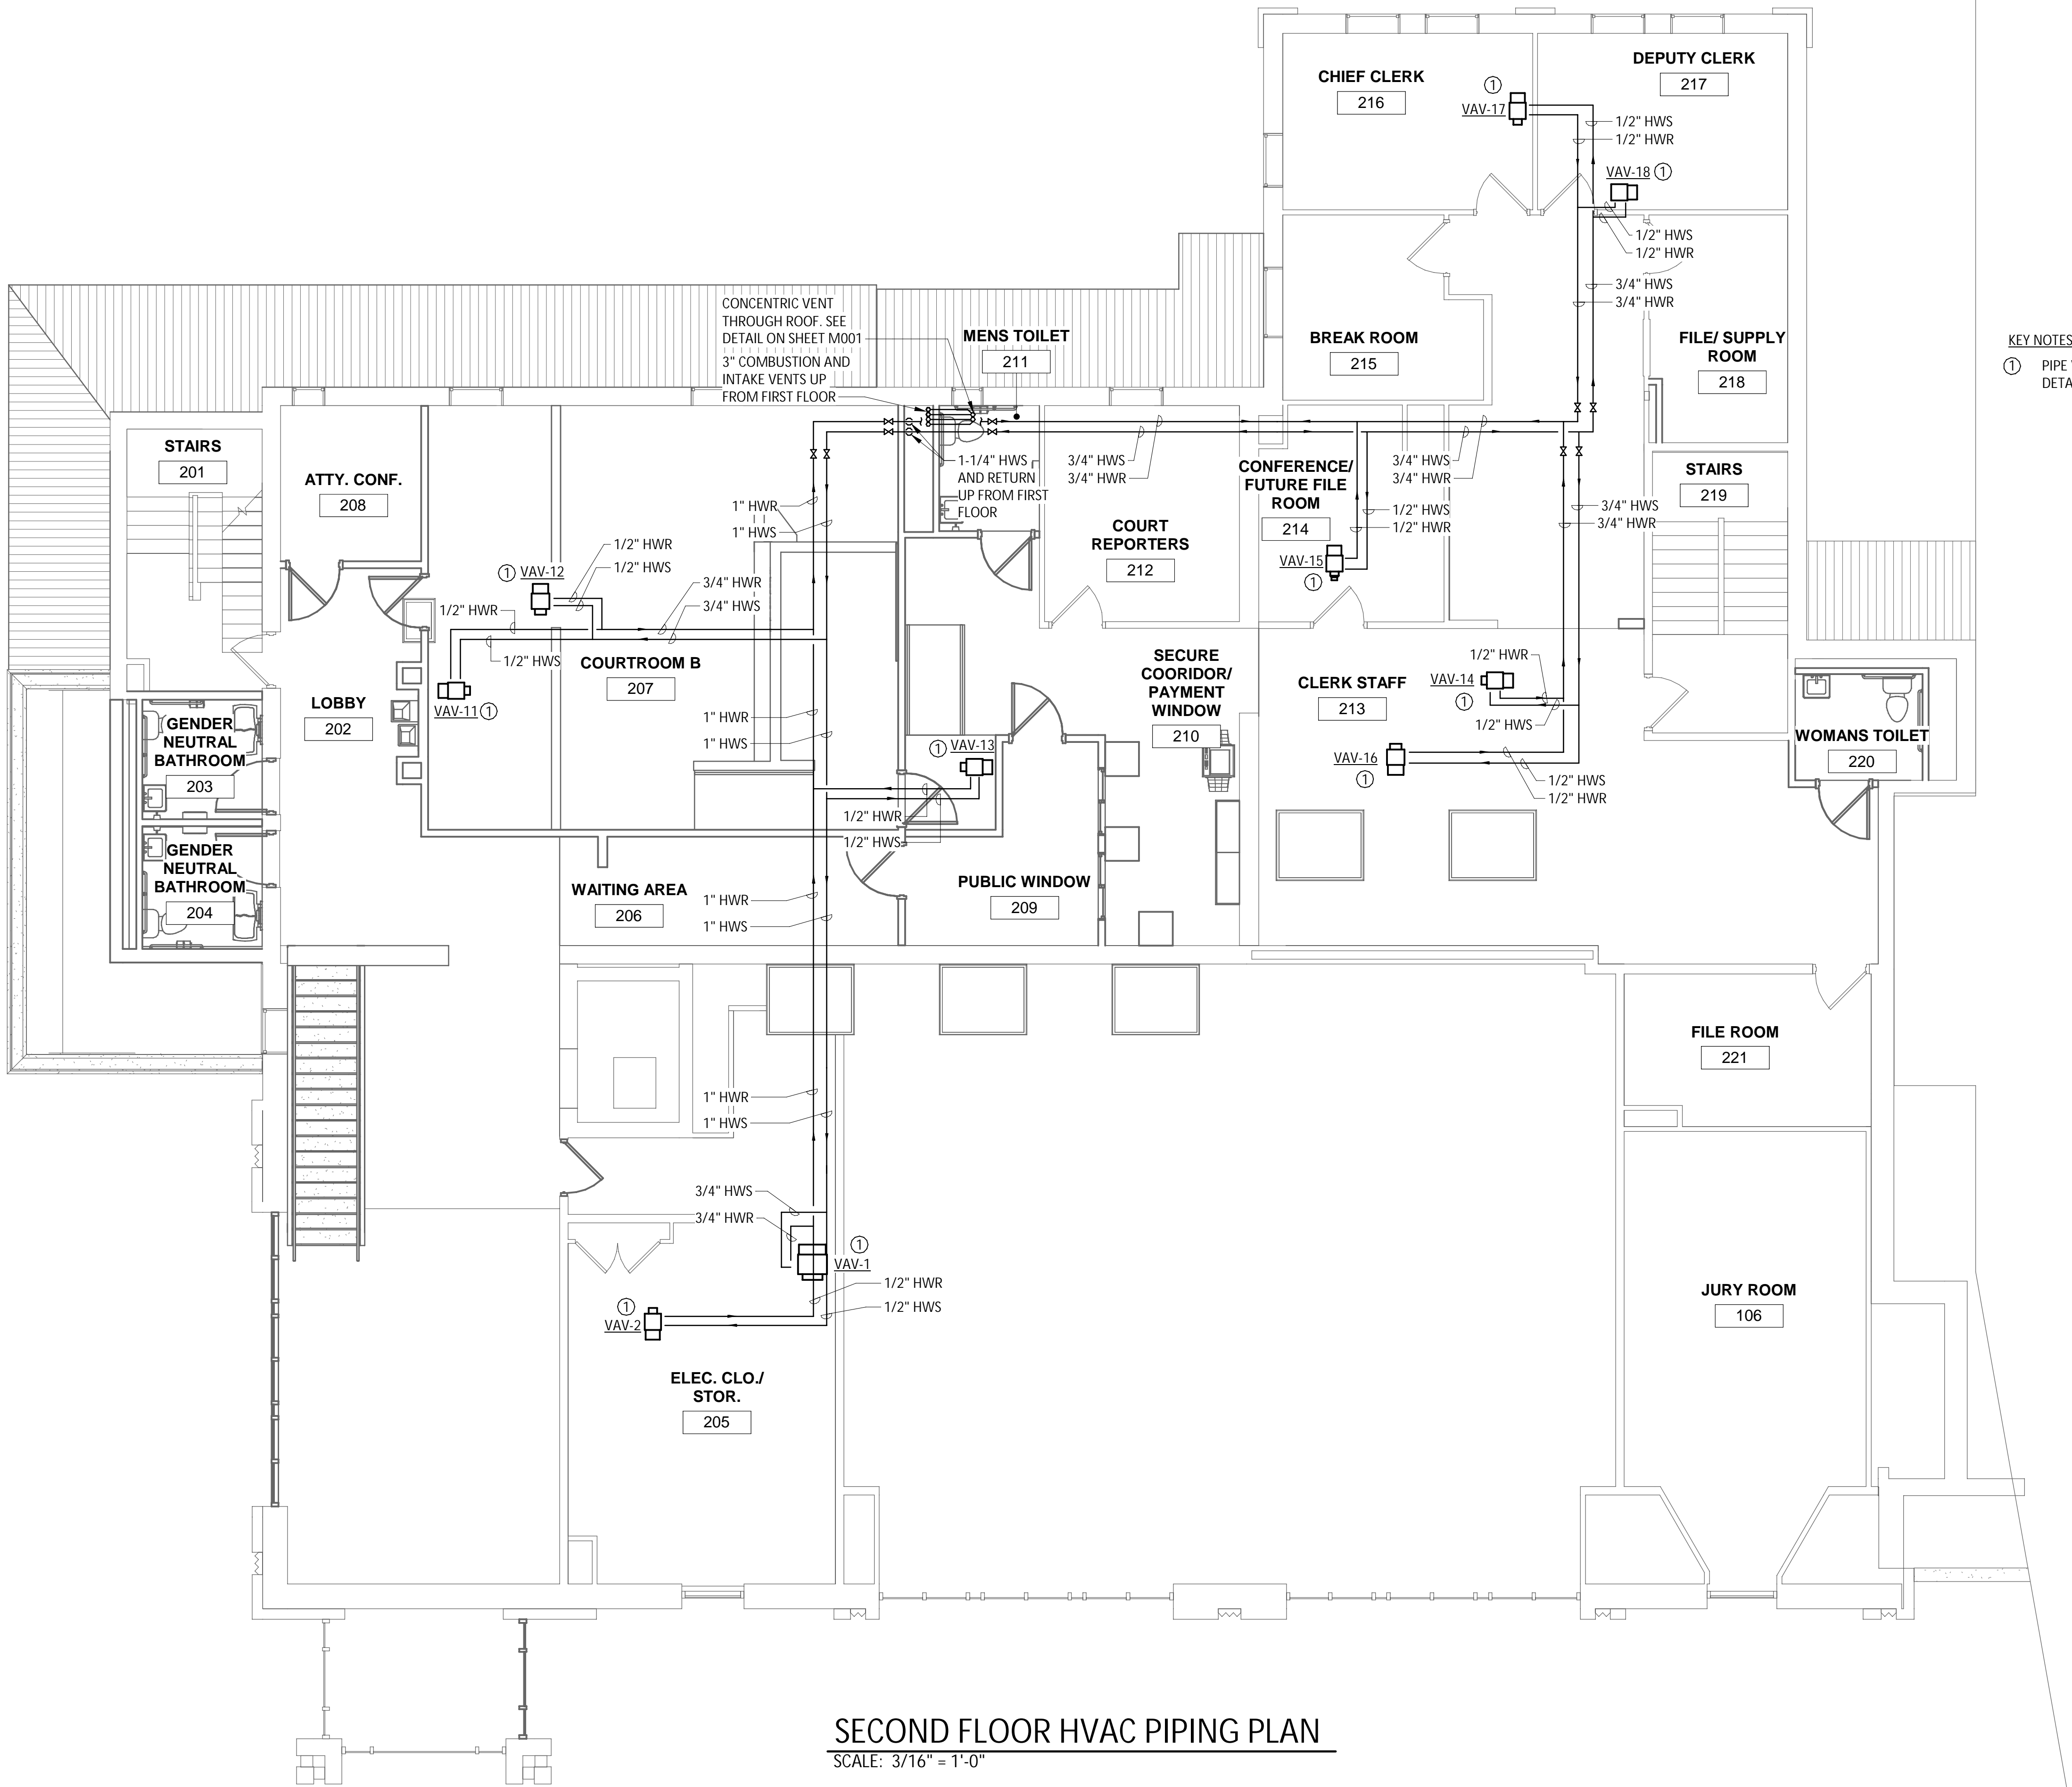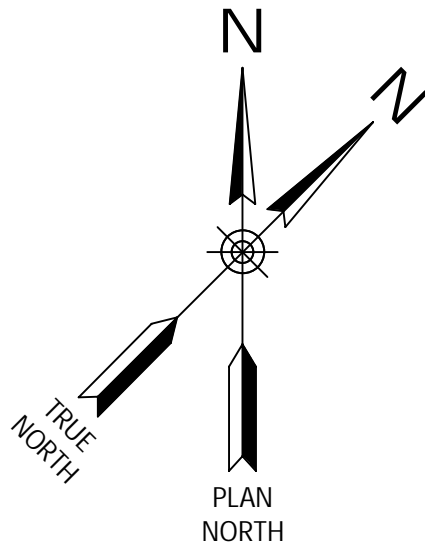CITY OF MIDDLETOWN  
NEW COURTHOUSE FACILITY  
CONTRACT 1B - MECHANICAL CONSTRUCTION  
SECOND FLOOR HVAC PIPING PLAN  
CITY OF MIDDLETOWN  
ORANGE COUNTY, NEW YORK

443 Electronics Parkway  
Liverpool, NY  
13088

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**Barton & Loguidice, D.P.C.**

STATE OF NEW YORK  
J. HORVAT  
No. 089099  
REGISTERED PROFESSIONAL ENGINEER

NYS EXP.: 11/30/2025



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M108

Project Number  
1753.008.001





- KEY NOTES:**
- ① EXTEND NEW DUCT CONNECTIONS BETWEEN NEW ROOFTOP UNIT AND EXISTING DUCT RISERS. FIELD VERIFY EXACT DIMENSIONS BEFORE DUCT FABRICATION AND INSTALLATION. FURNISH AND INSTALL ADAPTER CURBS FOR ALL NEW UNITS. SEE TYPICAL ROOF EQUIPMENT/CURB DETAIL ON SHEET A204. COORDINATE ROOFTOP INSTALLATION WITH CONTRACT 1A.
  - ② ADDITIVE BID ITEM NO. 1 – REMOVE THE EXISTING ROOFTOP UNITS WITH ASSOCIATED ROOFCURBS, AND FURNISH AND INSTALL NEW ROOFTOP UNITS. NEW ROOF CURBS SHALL BE PROVIDED BY CONTRACT 1B AND INSTALLED BY CONTRACT 1A.
  - ③ OPENINGS FOR EXISTING ROOFTOP UNITS REMOVED AND NOT REPLACED TO BE INFILLED AND REPAIRED BY CONTRACT 1A. CONTRACT 1B TO COORDINATE ASSOCIATED WORK WITH CONTRACT 1A.
  - ④ CONNECT EXISTING GAS LINE TO NEW ROOFTOP UNIT.
  - ⑤ REMOVE THE EXISTING ROOFTOP UNIT WITH ASSOCIATED ROOFCURB, AND FURNISH AND INSTALL NEW ROOFTOP UNITS. CONTRACT 1B SHALL PROVIDE NEW ROOF CURB WITH INSTALLATION BY CONTRACT 1A.

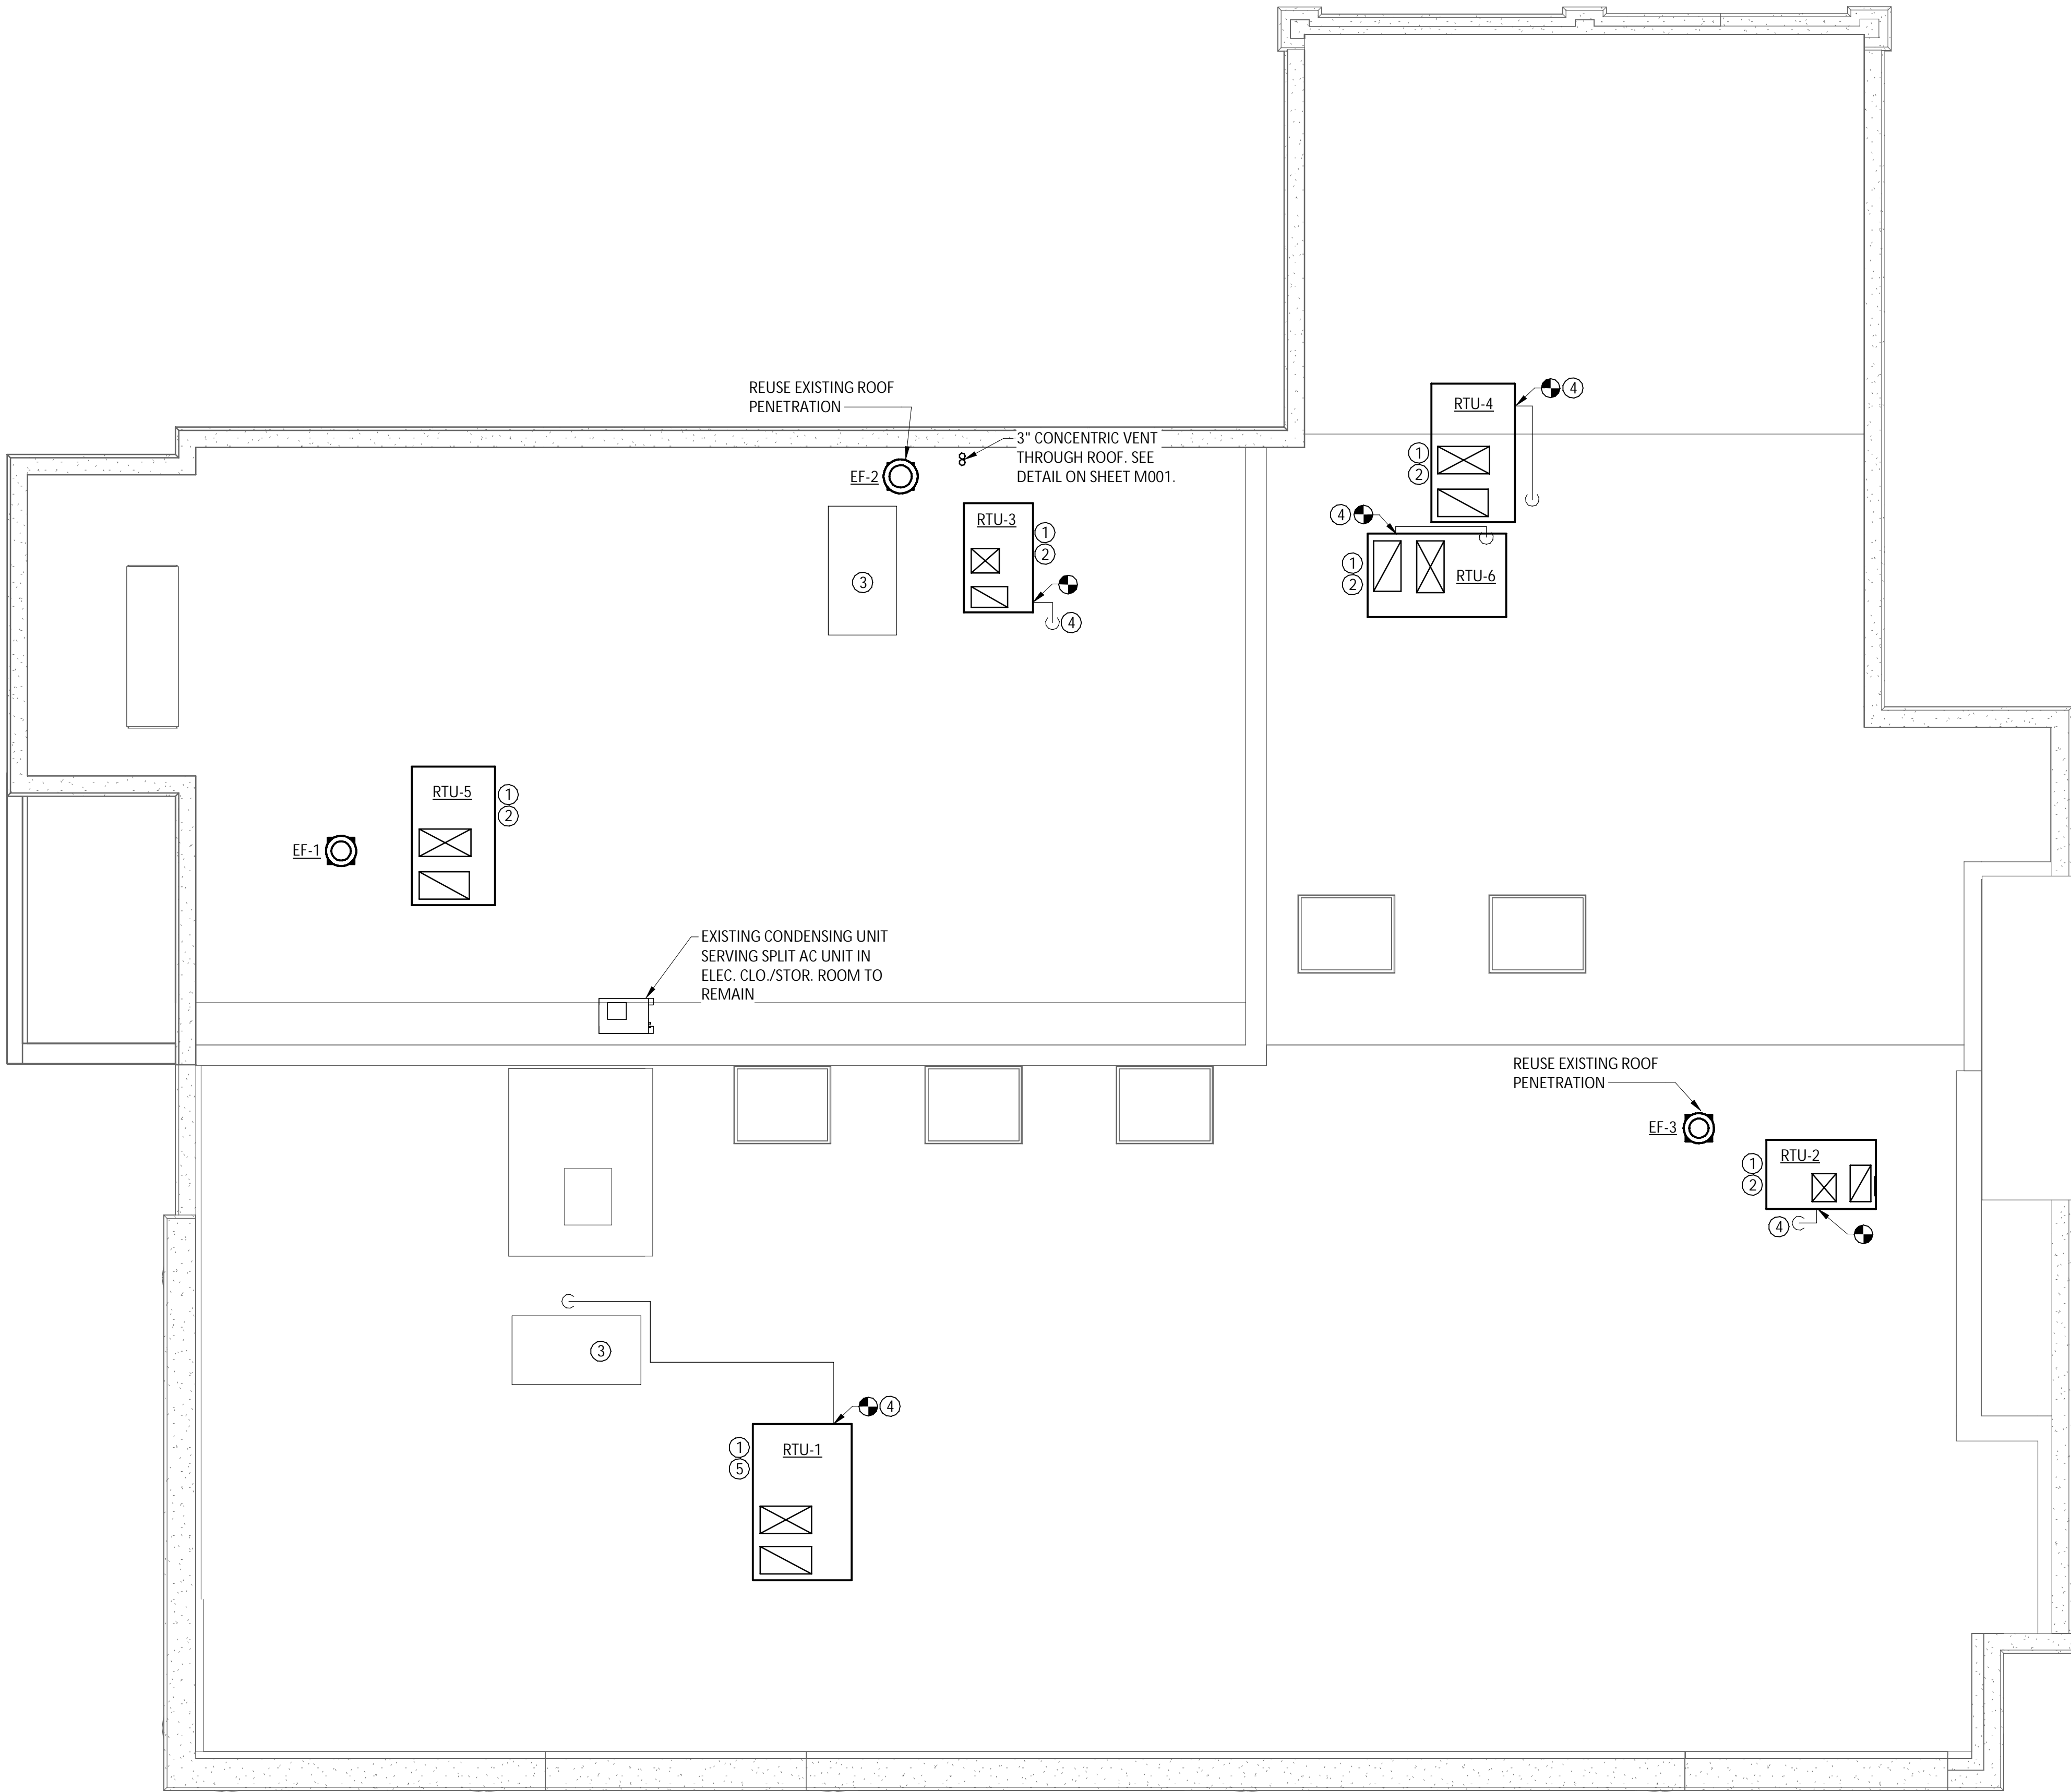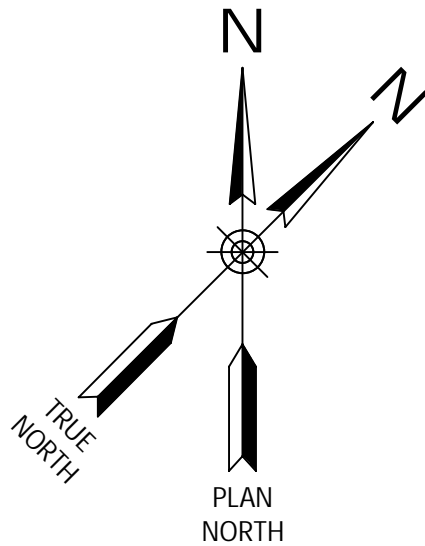**ROOF HVAC PLAN**  
SCALE: 3/16" = 1'-0"

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REVISIONS	

CITY OF MIDDLETOWN  
NEW COURTHOUSE FACILITY  
CONTRACT 1B - MECHANICAL CONSTRUCTION

ROOF HVAC PLAN

CITY OF MIDDLETOWN

ORANGE COUNTY, NEW YORK

443 Electronics Parkway  
Liverpool, NY  
13088

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Date: AUGUST, 2024

Scale: AS SHOWN

Sheet Number: **M109**

Project Number: 1753.008.001



DIFFUSER AND GRILLE SCHEDULE							
TYPE	DESCRIPTION	MAX SONES	BLOW PATTERN	FACE SIZE (IN)	NECK SIZE (IN)	AIR FLOW (CFM)	BASIS OF DESIGN
SD-1	SUPPLY DIFFUSER	-	4-WAY	12 x 12	4Ø	0-70	TITUS TMS
SD-2	SUPPLY DIFFUSER	19	4-WAY	24 x 24	6Ø	0-180	TITUS TMS
SG-1	SUPPLY GRILLE	22	4-WAY	14 x 14	12 x 12	0-500	TITUS 300RL
RG-1	EGGCRATE RETURN GRILLE	20	-	24 x 24	-	0-650	TITUS 50F
EG-1	EXHAUST GRILLE	19	-	10 x 8	8 x 6	0-175	TITUS 350R

- REMARKS:
- BALANCE ALL DUCT BRANCHES TO CFM VALUE SHOWN.
  - REFER TO PLANS FOR QUANTITIES, AIR FLOW. ALL BRANCH DUCT CONNECTING DIFFUSER TO MAIN SHALL BE THE SAME SIZE AS THE DIFFUSER NECK.
  - VERIFY MOUNTING FRAME. REFER TO REFLECTED CEILING PLAN FOR LOCATIONS AND CEILING TYPE. COORDINATE WITH OTHER CEILING MOUNTED EQUIPMENT.
  - PROVIDE WITH OPPOSED BLADE DAMPER, ADJUSTABLE WITHOUT DISASSEMBLY.
  - PROVIDE FACTORY SUPPLIED PLENUM FOR LINEAR DIFFUSER.

BOILER (B) SCHEDULE												
TAG	LOCATION	FUEL	MAXIMUM INPUT (MBH)	OUTPUT AT MAX. CAPACITY (MBH)	WATER			COMBUSTION EFFICIENCY	RELIEF VALVE SETTING (PSI)	VOLTS/ PHASE/ HZ	FULL LOAD AMPS	DESIGN EQUIPMENT
					FLOW RATE (GPM)	ENT./LVG. TEMP. (°F)	WATER CONTENT (GAL)					
B-1	BASEMENT	NG	110	101	7.5	120/150	2.5	95.1%	30	120/1	15	WEIL MCCLAIN EVG-110
B-2	BASEMENT	NG	110	101	7.5	120/150	2.5	95.1%	30	120/1	15	WEIL MCCLAIN EVG-110

- NOTES:
- PROVIDE COMPLETE WITH LOW-WATER CUTOFF, MANUAL RESET HIGH LIMIT AQUASTAT, PRESSURE/TEMPERATURE GAUGE AND DRAIN VALVE.
  - PROVIDE COMPLETE WITH ASME COMPLIANT PRESSURE RELIEF VALVE DESIGNED FOR THE BOILER OUTPUT CAPACITY.
  - PROVIDE DISCONNECT WITH THERMAL OVERLOAD PROTECTION.
  - HVAC CONTRACT SHALL FURNISH AND INSTALL UNIT AND ALL CONTROL EQUIPMENT, INCLUDING SENSORS, LOW VOLTAGE WIRING AND CONDUIT. LINE VOLTAGE WIRING (120V AND ABOVE) BY ELECTRICAL CONTRACT.

VARIABLE AIR VOLUME (VAV) SCHEDULE																
TAG	ASSOC. UNIT	AREA SERVED	ZONE	VAV BOX				HOT WATER REHEAT COIL							DESIGN BASIS	
				MAX CFM	MIN. CFM	NFCK SIZE (IN)	MAX AIR PD (IN WC)	LOAD (MBH)	EWLT (°F)	LWT (°F)	EAT (°F)	LAT (°F)	FLOW RATE (GPM)	MAX WATER PD (FT H2O)		COIL ROWS
VAV-1	RTU-1	112	1	2000	570	12	0.69	31.71	150	130	55	106.3	3.18	0.56	2	TRANE VCVWF12
VAV-2	RTU-1	102, 202, 205	2	850	150	8	0.66	8.86	150	130	55	108.38	0.87	0.07	2	TRANE VCVWF08
VAV-3	RTU-1	103, 104, 105, 110, 111	3	580	105	8	0.36	6.43	150	130	55	111.44	0.64	0.04	2	TRANE VCVWF08
VAV-4	RTU-3	113, 117, 118	4	530	105	8	0.31	6.43	150	130	55	111.44	0.64	0.04	2	TRANE VCVWF08
VAV-5	RTU-3	122, 123, 124, 126	5	290	75	5	0.19	5.38	150	130	55	121.14	0.54	0.20	2	TRANE VCVWF05
VAV-6	RTU-3	127, 128, 129, 130, 131, 132	6	460	150	6	0.53	9.22	150	130	55	111.69	0.92	0.52	2	TRANE VCVWF06
VAV-7	RTU-4	134, 135	7	200	50	4	0.10	3.98	150	134.06	55	128.39	0.50	0.18	2	TRANE VCVWF04
VAV-8	RTU-4	133, 140, 142	8	400	225	6	0.43	12.2	150	130	55	104.99	1.22	0.86	2	TRANE VCVWF06
VAV-9	RTU-4	136	9	200	50	4	0.10	3.98	150	134.06	55	128.39	0.50	0.18	2	TRANE VCVWF04
VAV-10	RTU-4	137	10	175	50	4	0.09	3.98	150	134.06	55	128.39	0.50	0.18	2	TRANE VCVWF04
VAV-11	RTU-5	203, 204, 206, 208	11	425	150	6	0.47	9.22	150	130	55	111.69	0.92	0.52	2	TRANE VCVWF06
VAV-12	RTU-5	207	12	650	275	8	0.43	13.67	150	130	55	100.85	1.37	0.16	2	TRANE VCVWF08
VAV-13	RTU-5	209, 210, 211, 212	13	420	75	6	0.46	5.38	150	130	55	121.14	0.54	0.20	2	TRANE VCVWF08
VAV-14	RTU-6	215, 218	14	255	50	5	0.16	3.98	150	134.06	55	128.39	0.50	0.18	2	TRANE VCVWF05
VAV-15	RTU-6	214	15	125	50	4	0.06	3.98	150	134.06	55	128.39	0.50	0.18	2	TRANE VCVWF04
VAV-16	RTU-6	213, 220	16	800	125	8	0.60	7.47	150	130	55	110.10	0.75	0.05	2	TRANE VCVWF08
VAV-17	RTU-6	216	17	200	50	4	0.10	3.98	150	134.06	55	128.39	0.50	0.18	2	TRANE VCVWF04
VAV-18	RTU-6	217	18	175	50	4	0.09	3.98	150	134.06	55	128.39	0.50	0.18	2	TRANE VCVWF04

- NOTES:
- PROVIDE INSULATED ACCESS DOOR WITHIN UNIT FOR INSPECTION AND SERVICE OF DAMPER
  - FURNISH AND INSTALL VAV UNIT, REHEAT COIL, PIPING, VALVES, ALL CONTROL EQUIPMENT (INCLUDING ACTUATOR, SENSORS & LOW VOLTAGE WIRING), AND SUPPORTS.
  - PROVIDED UNIT MOUNTED DISCONNECT

ROOFTOP UNIT SCHEDULE																
ITEM	SUPPLY AIR (CFM)	MIN. OUTSIDE AIR (CFM)	EXTERNAL STATIC (IN W.C.)	FAN DRIVE	FAN MOTOR HP	TOTAL COOLING CAP. (MBH)	SENSIBLE COOLING CAP. (MBH)	COOLING EAT (°F db/wb)	COOLING LAT (°F db/wb)	HEATING INPUT (MBH)	HEATING OUTPUT (MBH)	AIR TEMP RISE (°F db)	VOLTS	PHASE	MCA (AMPS)	DESIGN EQUIPMENT
RTU-1	3430	750	1.614	DIRECT	3.00	120	97.1	81.9/67.3	55.98/57.85	150	121.5	31.37	208	3	60.0	TRANE MODEL YHC120F
RTU-2	960	200	.75	DIRECT	0.75	36.58	27.30	82.5/67.6	56.16/55.14	60	48	46.5	208	3	24	TRANE MODEL YHC037E
RTU-3	1280	570	1.00	DIRECT	1.0	50.81	34.22	80.5/68.1	55.74/55.22	60	49	35.7	208	3	30	TRANE MODEL YHC047E
RTU-4	975	400	1.00	DIRECT	0.75	36.00	27.27	81.2/66.5	55.03/54.17	60	48	45.8	208	3	24	TRANE MODEL YHC037E
RTU-5	1495	450	1.00	DIRECT	1.0	54.06	39.37	83.4/68.8	59.02/57.39	80	64	43.5	208	3	30	TRANE MODEL YHC047E
RTU-6	1555	250	1.00	DIRECT	1.0	51.89	41.10	81.0/65.5	56.53/54.24	80	64	38.4	208	3	30	TRANE MODEL YHC047E

- NOTES:
- PROVIDE SMOKE DETECTOR AND CO<sub>2</sub> SENSOR IN RETURN DUCT MAIN, WITH ASSOCIATED WIRING AND CONTROLS.
  - PROVIDE ECONOMIZER FOR 100% OUTSIDE AIR MODE WITH DIFFERENTIAL ENTHALPY CONTROL AND TRANSMITTER, AND POWER EXHAUST.
  - PROVIDE WITH R410A TYPE REFRIGERANT, CRANKCASE HEATER AND LOW AMBIENT CONTROL.
  - PROVIDE MANUFACTURER SUPPLIED 24" ADAPTER CURB.

PUMP SCHEDULE										
TAG	SERVICE	MOTOR			PUMP RPM	FLUID	FLOW (GPM)	HEAD (FT WC)	TYPE	BASIS OF DESIGN
		HP	VOLTS	PHASE						
BP-1	BOILER B-1	1/8	115	1	3250	WATER	7.2	10	INLINE	TACO ECM OO15e
BP-2	BOILER B-2	1/8	115	1	3250	WATER	7.2	10	INLINE	TACO ECM OO15e
P-1	HOT WATER LOOP	1/2	115	1	1725	WATER	18	20	INLINE (CLOSE COUPLED)	BELL & GOSSETT e-90 1.25AAB
P-2	HOT WATER LOOP	1/2	115	1	1725	WATER	18	20	INLINE (CLOSE COUPLED)	BELL & GOSSETT e-90 1.25AAB

- NOTES:
- PROVIDE WITH COMBINATION MOTOR STARTER/DISCONNECT AND INTERLOCK OPERATION WITH ASSOCIATED BOILER.
  - RATED FOR 125PSI MAXIMUM WORKING PRESSURE AND 225°F MAXIMUM OPERATING TEMPERATURE.
  - FURNISH AND INSTALL UNIT AND ALL CONTROL EQUIPMENT, INCLUDING SENSORS , LOW VOLTAGE WIRING AND CONDUIT.

EXPANSION TANK (ET) SCHEDULE								
TAG	CONN. SIZE (IN)	SYSTEM	TANK TYPE	TANK VOLUME (GAL)	TANK ACCEPTANCE (GAL)	CHARGE PRESSURE (PSIG)	ORIENTATION	BASIS OF DESIGN
ET-1	3/4	HOT WATER	BLADDER	10	10	12	VERTICAL, FLOOR MOUNTED	BELL & GOSSETT B-35

- NOTES:
- TANK SHALL BE STEEL CONSTRUCTION WITH HEAVY DUTY BUTYL RUBBER DIAPHRAGM & FORGED STEEL CONNECTION FITTINGS.
  - EXPANSION TANK TO BE DESIGNED, CONSTRUCTED AND STAMPED PER ASME SECTION VIII, DIVISION 1.
  - TANK SHALL BE RATED FOR MAXIMUM WORKING PRESSURE OF 125 PSIG AND MAXIMUM WORKING TEMPERATURE OF 240°F.

EXHAUST FAN SCHEDULE											
TAG	AREA SERVED	LOCATION	CFM	E.S.P. (IN W.G.)	DRIVE	RPM	MOTOR			DESIGN EQUIPMENT	NOTES
							WATTS	VOLTS	PHASE		
EF-1	119, 120, 121	ROOF	150	.35	DIRECT	850	13	115	1	GREENHECK G-070-D	1,3,4
EF-2	127, 128, 129	ROOF	375	.35	DIRECT	850	13	115	1	GREENHECK G-095-VG	1,3,4
EF-3	108, 109	ROOF	100	.25	DIRECT	1,550	13	115	1	GREENHECK G-060-D	1,3,4
EF-4	138	CEILING	50	.25	DIRECT	850	13	115	1	GREENHECK SP-A70	1,2,4
EF-5	139	CEILING	90	.25	DIRECT	950	17	115	1	GREENHECK SP-A70	1,2,4
EF-6	140	CEILING	50	.25	DIRECT	850	13	115	1	GREENHECK SP-A70	1,2,4
EF-7	142	CEILING	50	.25	DIRECT	850	13	115	1	GREENHECK SP-A70	1,2,4
EF-8	203	CEILING	110	.25	DIRECT	1,100	21	115	1	GREENHECK SP-A70	1,2,4
EF-9	204	CEILING	170	.25	DIRECT	1,400	48	115	1	GREENHECK SP-A70	1,2,4
EF-10	211	CEILING	50	.25	DIRECT	850	13	115	1	GREENHECK SP-A70	1,2,4
EF-11	220	CEILING	50	.25	DIRECT	850	13	115	1	GREENHECK SP-A70	1,2,4

- NOTES:
- PROVIDE COMBINATION STARTER/DISCONNECT SWITCH WITH THERMAL OVERLOAD PROTECTION.
  - PROVIDE BACKDRAFT DAMPER, ALUMINUM BIRD SCREEN, WALL COLLAR, MOTORIZED SHUTTER AND SHUTTER GAURD.
  - PROVIDE BACKDRAFT DAMPER, ALUMINUM BIRD SCREEN AND MANUFACTURERS ROOF CURB.
  - FAN SHALL RUN CONTINUOUSLY WHILE BUILDING IS OCCUPIED.

ELECTRIC UNIT HEATER (UH) SCHEDULE								
TAG	LOCATION	MOUNTING TYPE	CAPACITY (KW)	VOLTS	PHASE	FULL LOAD AMPS	AIR FLOW (CFM)	DESIGN EQUIPMENT
UH-1	BASEMENT	CEILING	3	208	1	14.4	380	MODINE HER 30
UH-2	BASEMENT	CEILING	5	208	1	24.5	380	MODINE HER 50
UH-2	BASEMENT	CEILING	5	208	1	24.5	380	MODINE HER 50

- NOTES:
- FURNISH WITH FUSED DISCONNECT SWITCH.
  - PROVIDE MOUNTING BRACKETS AND SUPPORTS AS NECESSARY, FINISH TO MATCH UNIT HOUSING.
  - PROVIDE UNIT MOUNTED THERMOSTAT.

CABINET UNIT HEATER (CUH) SCHEDULE								
TAG	AIR FLOW (CFM)	CAP. (BTUH)	kW	TEMP. RISE (°F)	NO. OF FANS	ELEC.		BASIS OF DESIGN
						VOLTS	PHASE	
CUH-1	100	6,820	4.8	50	1	208	1	QMARK LFK488F
CUH-2	100	5,115	4.8	50	1	208	1	QMARK LFK488F
CUH-2	100	5,115	4.8	50	1	208	1	QMARK LFK488F

- NOTES:
- PROVIDE UNIT MOUNTED TAMPERPROOF THERMOSTAT AND DISCONNECT SWITCH.
  - PROVIDE WITH UNIT MOUNTED DAY/NIGHT RELAY AND SURFACE MOUNTING ADAPTER.

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REVISIONS	



- GENERAL NOTES:
- NOTES, SYMBOLS LIST AND DETAILS ARE APPLICABLE TO ALL DRAWINGS IN THIS CONTRACT.
  - ADDRESS QUESTIONS REGARDING DRAWINGS TO ENGINEER IN WRITING BEFORE COMMENCING WITH WORK. OTHERWISE, ENGINEER'S INTERPRETATION OF MEANING AND INTENT OF DRAWINGS SHALL BE FINAL.
  - DRAWINGS ARE DIAGRAMMATIC AND INDICATE GENERAL ARRANGEMENT OF SYSTEMS AND WORK INCLUDED IN THIS CONTRACT. IT IS INTENDED THAT ALL COMPONENTS AND MATERIALS REQUIRED TO MAKE THE SYSTEMS COMPLETE, TESTED AND OPERATIONAL BE INSTALLED.
  - CONTRACTOR SHALL FIELD VERIFY ALL LOCATIONS, DIMENSIONS AND ELEVATIONS BEFORE FABRICATION AND CONSTRUCTION.
  - ALL MATERIALS, EQUIPMENT AND METHODS OF INSTALLATION SHALL BE IN ACCORDANCE WITH THE STANDARDS, REGULATIONS, CODES, ORDINANCES, AND LAWS OF LOCAL, STATE, AND FEDERAL GOVERNMENTS, AND OTHER AUTHORITIES THAT HAVE LAWFUL JURISDICTION.
  - COMPLETELY COORDINATE WORK OF THIS CONTRACT WITH THE OPERATIONS AND THE WORK OF OTHER CONTRACTS.
  - WORK SHALL BE EXECUTED IN A WORKMANLIKE MANNER AND SHALL PRESENT NEAT, RECTILINEAR APPEARANCE WHEN COMPLETED. MAINTAIN MAXIMUM HEAD ROOM AT ALL TIMES.
  - MATERIALS AND EQUIPMENT SHALL BE NEW AND INSTALLED ACCORDING TO MANUFACTURER'S INSTRUCTIONS AND RECOMMENDATIONS. MAINTAIN MANUFACTURER'S EQUIPMENT CLEARANCES.
  - FIRE STOP ALL NEW AND EXISTING SLEEVES THROUGH CONCRETE FLOORS AND FIRE RATED WALLS OR PARTITIONS WITH UL RATED ASSEMBLIES WITH EQUAL FIRE RATING.
  - PROVIDE PROPER ACCESS TO EQUIPMENT THAT REQUIRES INSPECTION, REPLACEMENT OR REPAIR. ACCESS PANELS SHALL BE SIZED TO ALLOW THE REQUIRED ACCESS, BUT IN NO CASE LESS THAN 12"x12".
  - CONTRACTOR IS RESPONSIBLE FOR ALL OWNER COORDINATION AND PROCEDURES RELATED TO ISOLATING, SHUTTING DOWN, DRAINING, FILLING AND RESTARTING SYSTEMS, ALL SYSTEM INTERRUPTIONS SHALL BE SCHEDULED WITH OWNER AND COORDINATED WITH OTHER CONTRACTS.

LEGEND

- S SLOPE DN IN DIRECTION OF ARROW
- / — BREAK
- ○ — TEE RISE
- ⊕ — TEE DROP
- ○ — PIPE RISE
- ⊖ — PIPE DROP
- — — PIPE ABOVE SLAB OR GRADE
- — — — — PIPE BELOW SLAB OR GRADE
- DIRECTION OF FLOW
- ⌊ CAP
- ≡ UNION
- △ CONCENTRIC REDUCER
- ⊕ PRESSURE GAUGE
- ⊖ THERMOMETER
- ⌊ ⊕ STRAINER W/ BLOWDOWN VALVE
- ↗ SWING CHECK VALVE
- ⊕ BALL VALVE
- ⌊ ⊕ GATE VALVE
- ⌊ ⊕ TRIPLE DUTY VALVE
- ⊕ BALANCE VALVE
- ⌊ ⊕ BALL VALVE W/ HOSE CONNECTION, CAP AND CHAIN
- ⌊ ⊕ PRESSURE REDUCING VALVE
- ⌊ ⊕ SAFETY RELIEF VALVE
- ⌊ ⊕ TEMPERATURE SENSOR
- ⊕ PUMP
- ⌊ ⊕ LPG REGULATOR
- ⌊ ⊕ PLUG VALVE
- ⊕ FLOOR DRAIN
- ⌊ ⊕ NON-FREEZE WALL HYDRANT
- ⌊ ⊕ CLEANOUT
- ⊕ DECK PLATE CLEANOUT
- /// PIPING/EQUIPMENT TO BE REMOVED
- LIMIT OF REMOVAL
- CONNECTION POINT TO EXISTING

LEGEND - PIPING

- CW — DOMESTIC COLD WATER
- HW — DOMESTIC HOT WATER
- HWR — DOMESTIC HOT WATER RECIRCULATED
- D — DRAIN
- LPG — PROPANE
- SAN — SANITARY
- V — SANITARY VENT

ABBREVIATIONS

- ADA AMERICAN DISABILITIES ACT
- AFF ABOVE FINISHED FLOOR
- AHU AIR HANDLING UNIT
- BTU BRITISH THERMAL UNIT
- CI CAST IRON
- CO CLEANOUT
- CONC CONCRETE
- CW COLD WATER
- D DRAIN
- DCW DOMESTIC COLD WATER
- DHW DOMESTIC HOT WATER
- DIA DIAMETER
- DN DOWN
- DPCO DECK PLATE CLEANOUT
- DWV DRAIN, WASTE AND VENT
- EC ELECTRICAL CONTRACTOR
- ESP EXTERNAL STATIC PRESSURE
- ET EXPANSION TANK
- EX EXISTING
- FD FLOOR DRAIN
- FLR FLOOR
- FT WC FEET OF WATER COLUMN
- GA GAUGE
- GAL GALLON
- GALV GALVANIZED
- GC GENERAL CONTRACTOR
- GPF GALLONS PER FLUSH
- GPH GALLONS PER HOUR
- GPM GALLONS PER MINUTE
- HW HOT WATER
- HWR HOT WATER RECIRCULATED
- IN WC INCHES OF WATER COLUMN
- INV INVERT
- LAV LAVATORY
- MAX MAXIMUM
- MBH 1,000 BTU/HR
- MC MECHANICAL CONTRACTOR
- MIN MINIMUM
- SAN SANITARY
- SCH SCHEDULE
- SS STAINLESS STEEL
- T&B TOP & BOTTOM
- TYP TYPICAL
- V VENT
- VTR VENT THRU ROOF
- WC WATER CLOSET
- WH WALL HYDRANT
- WPCO WALL PLATE CLEANOUT

PLUMBING FIXTURE CONNECTION SCHEDULE					
FIXTURE NO.	FIXTURE TYPE	HW	CW	SAN	VENT
P-1	WATER CLOSET (FLOOR, ADA)	-	1/2"	3"	1-1/2"
P-2	LAVATORY (WALL, ADA)	1/2"	1/2"	1-1/4"	1-1/4"
P-3	COUNTERTOP SINK (MOLDED SINK TOP PROVIDED BY CONTRACT 1A)	1/2"	1/2"	1-1/4"	1-1/4"
P-4	DRINKING FOUNTAIN	-	1/2"	1-1/2"	1-1/4"
P-5	SECURITY COMBINATION WC/LAV.	1/2"	1"	3"	1-1/2"

- ADA - HANDICAP ACCESSABLE (ADA) FIXTURE
- FLOOR - FLOOR MOUNT
- WALL - WALL MOUNT (PROVIDE CARRIER BY JOSAM, OR EQUAL)

HOT WATER HEATER (HWH) SCHEDULE								
TAG	AREA SERVED	STORAGE (GAL)	FUEL	TEMP RISE (°F)	RECOVERY (GPH)	SUPPLY TEMP (°F)	ELECTRIC (VOLT/PH/HZ)	BASIS OF DESIGN
HWH-1	DHW SYSTEM	50	ELECTRIC	90	56	140	208/3/60	AO SMITH DVE-52-12.3


- NOTES:
- PROVIDE COMPLETE WITH ASME SAFETY RELIEF VALVE AND DRAIN VALVE.
  - INSTALL HOT WATER HEATER IN ACCORDANCE WITH THE MANUFACTURER'S INSTRUCTIONS AND RECOMMENDATIONS.
  - FURNISH AND INSTALL UNIT AND ALL CONTROL EQUIPMENT, INCLUDING SENSORS, CONTROL WIRING AND CONDUIT.

PUMP SCHEDULE								
TAG	EQUIPMENT SERVED	MOTOR			PUMP RPM	FLOW (GPM)	HEAD (FT WC)	TYPE
		WATTS	VOLTS	PHASE				
DWCP-1	HWH-1	4-60	115	1	2253	2	12	INLINE

- NOTES:
- FURNISH AND INSTALL DISCONNECT SWITCH WITH THERMAL OVERLOAD PROTECTION, TIMER AND AQUASTAT. UNIT SHALL BE FURNISHED WITH A PLUG-IN TYPE CORD AND BUILT-IN IMPEDIANCE PROTECTION.
  - UNIT SHALL BE BRONZE CONSTRUCTION SUTIABLE FOR POTABLE WATER.
  - FURNISH AND INSTALL UNIT AND ALL CONTROL EQUIPMENT, INCLUDING SENSORS, LOW VOLTAGE WIRING AND CONDUIT. LINE VOLTAGE POWER WIRING (120V AND ABOVE) SHALL BE BY THE ELECTRICAL CONTRACTOR.

EXPANSION TANK (ET) SCHEDULE							
TAG	CONN. SIZE (IN)	SYSTEM	TANK TYPE	TANK VOLUME (GAL)	TANK ACCEPTANCE (GAL)	ORIENTATION	BASIS OF DESIGN
ET-1	3/4	HW	BLADDER	5.0	3.3	VERTICAL, FLOOR MOUNTED	BELL & GOSSET PTA-12

- NOTES:
- TANK SHALL BE STEEL CONSTRUCTION WITH HEAVY DUTY BUTYL RUBBER DIAPHRAGM & FORGED STEEL CONNECTION FITTINGS.
  - EXPANSION TANK TO BE DESIGNED, CONSTRUCTED AND STAMPED PER ASME SECTION VII, DIVISION 1.
  - TANK SHALL BE RATED FOR MAXIMUM WORKING PRESSURE OF 125 PSIG AND MAXIMUM WORKING TEMPERATURE OF 240°F.

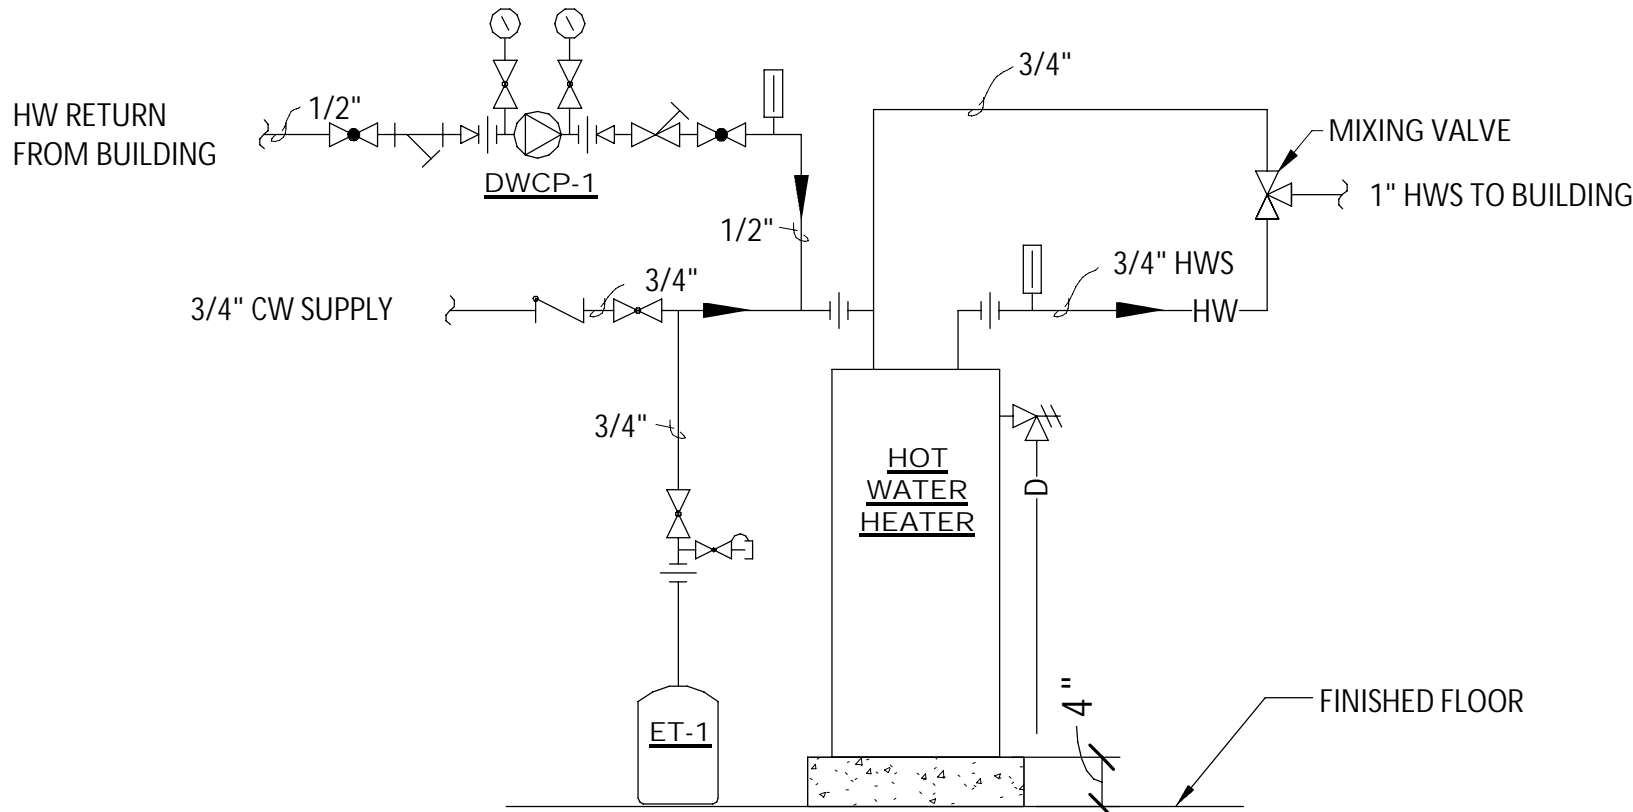

6 HOT WATER SYSTEM AND PIPING DIAGRAM

SCALE: NTS

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REVISIONS

NO.	DESCRIPTION

CITY OF MIDDLETOWN  
NEW COURTHOUSE FACILITY  
CONTRACT NO. 1C - PLUMBING CONSTRUCTION

**SYMBOLS AND ABBREVIATIONS**

ORANGE COUNTY, NEW YORK

CITY OF MIDDLETOWN

443 Electronics Parkway  
Liverpool, NY  
13088

**B&L**

**Barton & Loguidice, D.P.C.**



NYS EXP.: 11/30/2025

Date  
AUGUST, 2024

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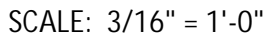
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Project Number  
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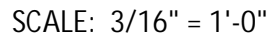


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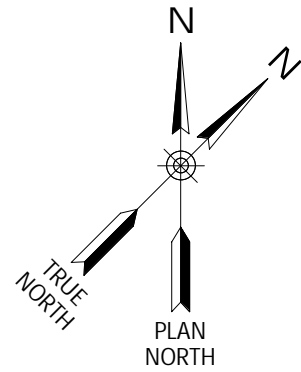
## 1. FIELD VERIFY LOCATIONS AND SIZES OF EX. WATER LINES



① CORE DRILL FLOOR SLAB ABOVE AS REQUIRED TO ACCOMMODATE NEW PIPE RISERS AND FIRE CAULK PENETRATIONS.


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KEY NOTE:

- ① REMOVE EXISTING PLUMBING FIXTURES WITH ASSOCIATED COLD AND HOT WATER SUPPLY PIPING, INSULATION, VALVES AND APPURTENANCES COMPLETE.
- ② DISCONNECT COLD AND HOT WATER PIPING FROM EXISTING FIXTURES TO REMAIN AT PONTS SHOWN.



FIRST FLOOR PLUMBING DEMOLITION PLAN

SCALE: 3/16" = 1'-0"
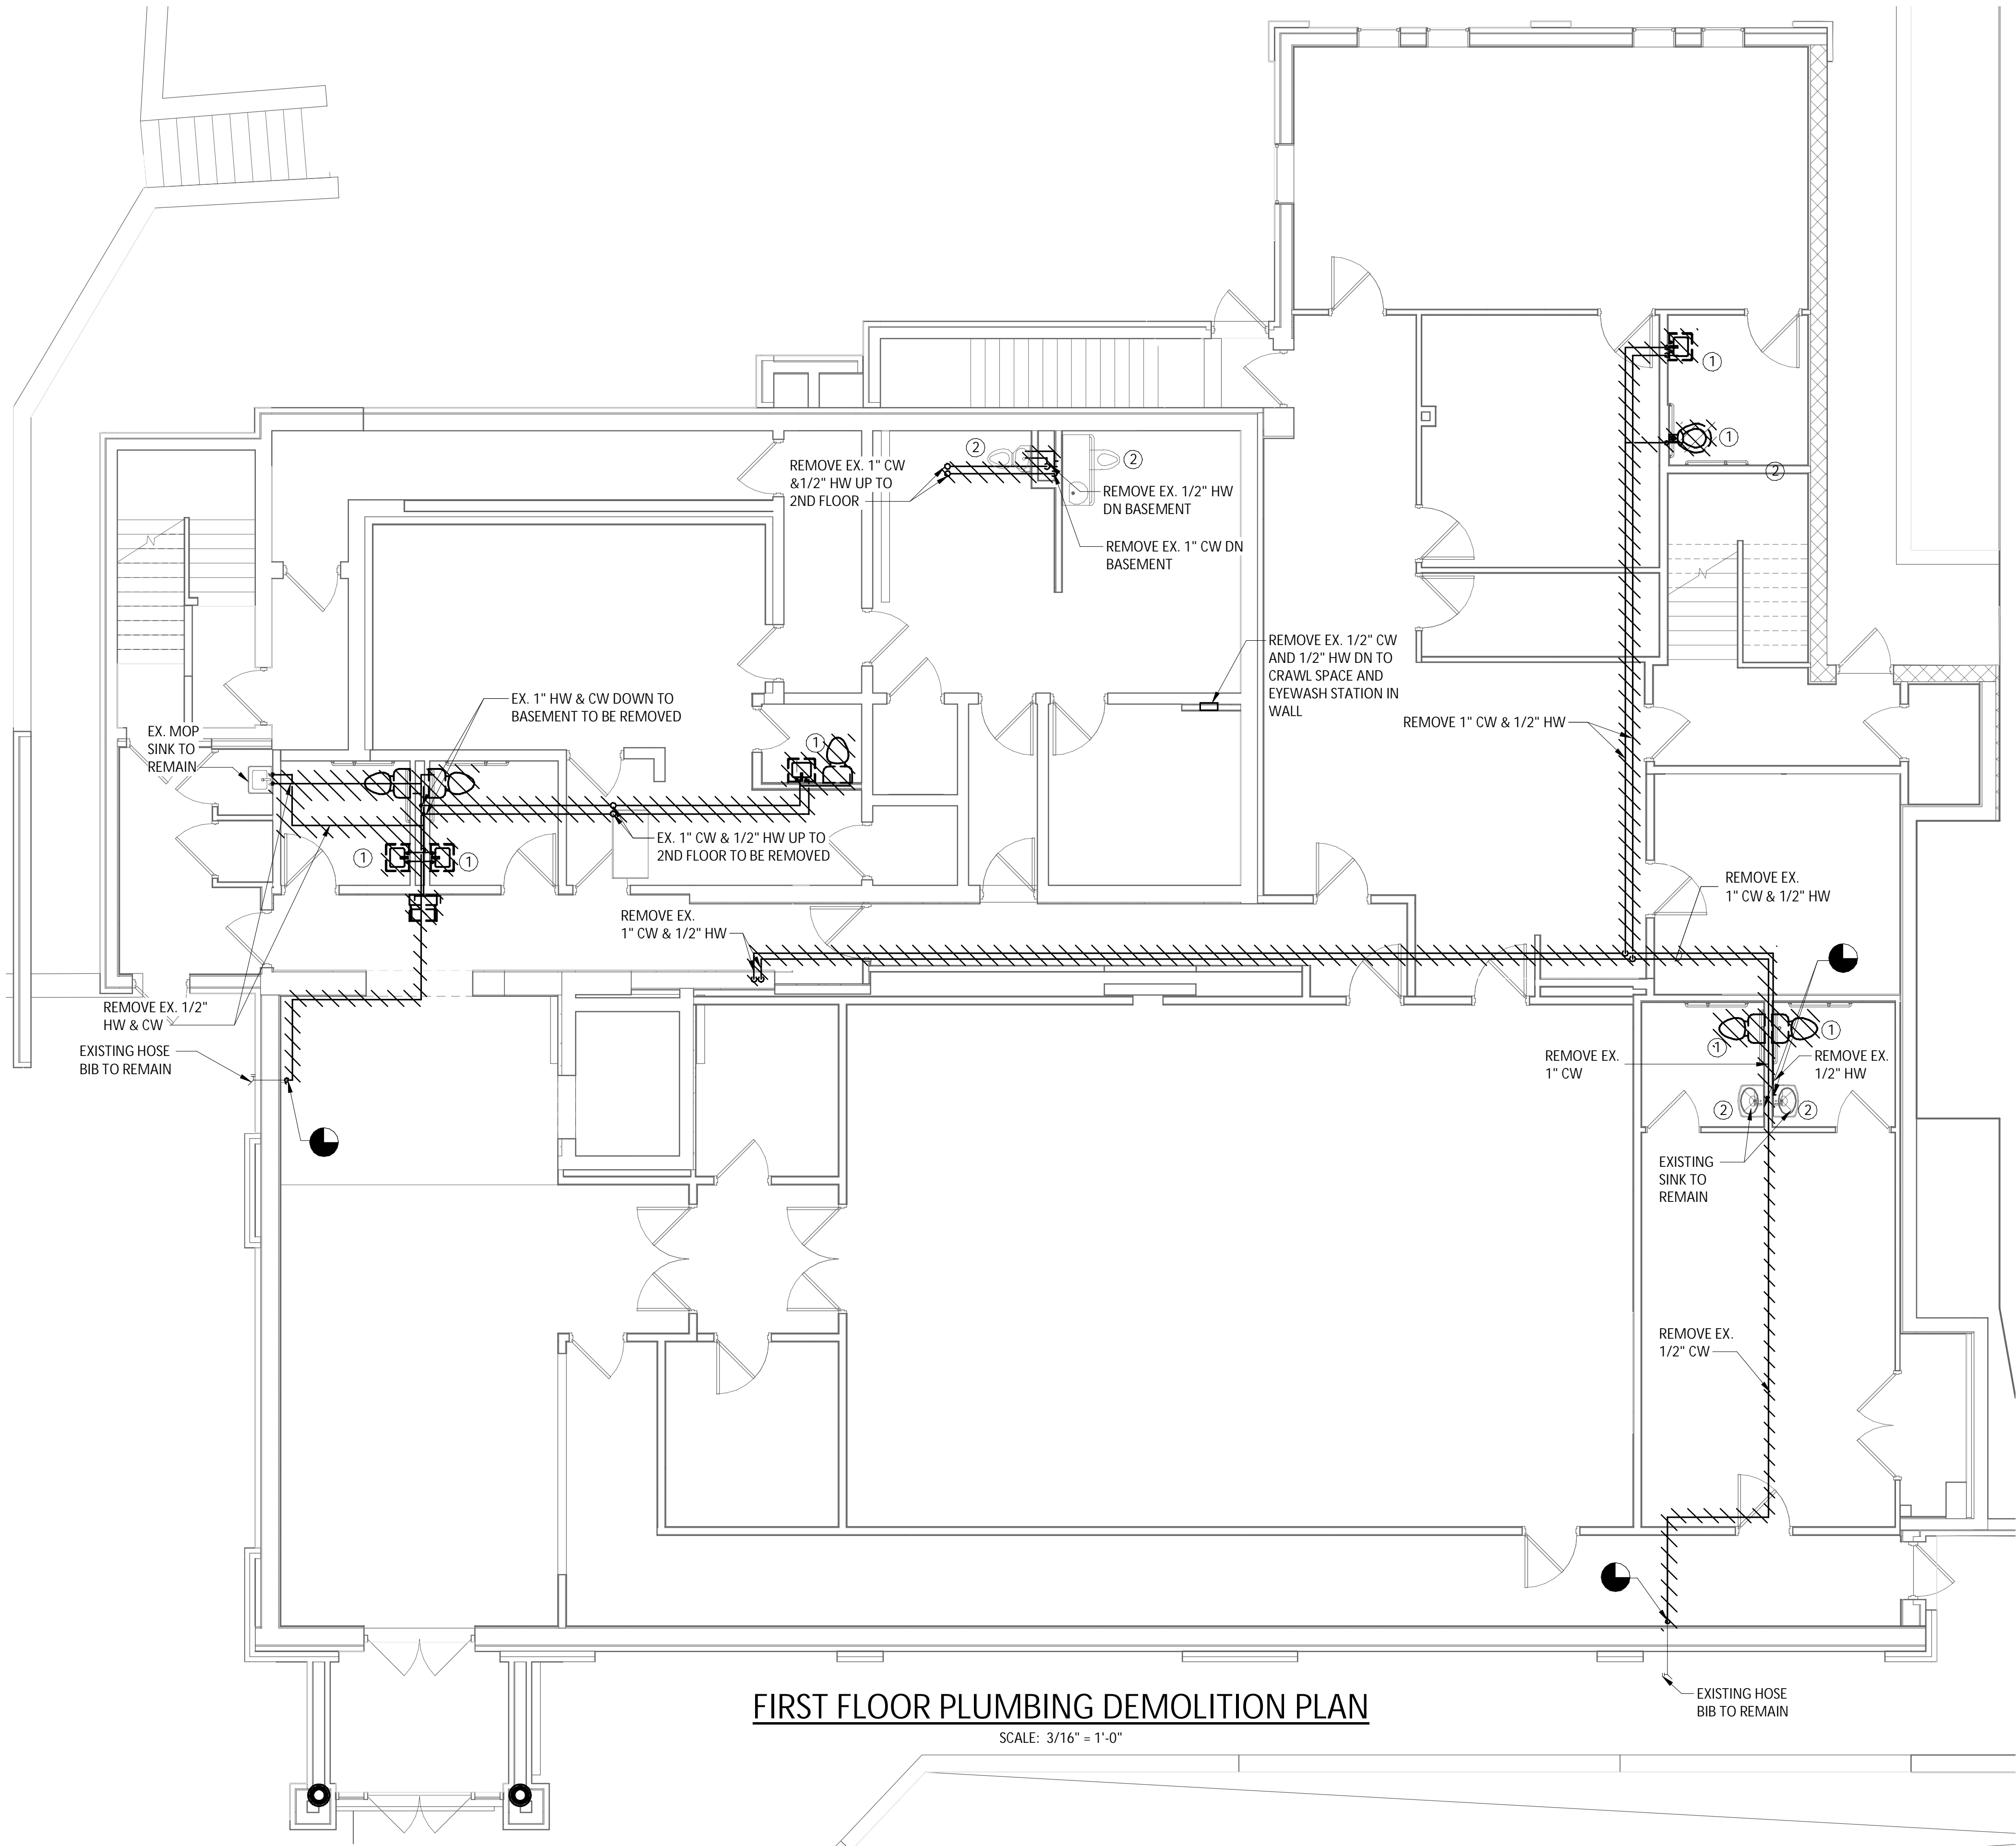
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REVISIONS

CITY OF MIDDLETOWN  
NEW COURTHOUSE FACILITY  
CONTRACT NO. 1C - PLUMBING CONSTRUCTION  
FIRST FLOOR PLUMBING DEMOLITION PLAN  
CITY OF MIDDLETOWN  
ORANGE COUNTY, NEW YORK

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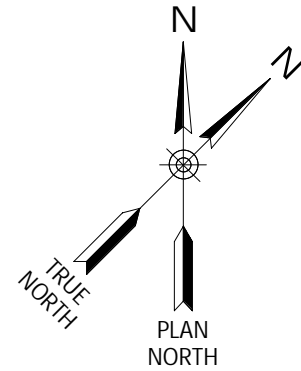
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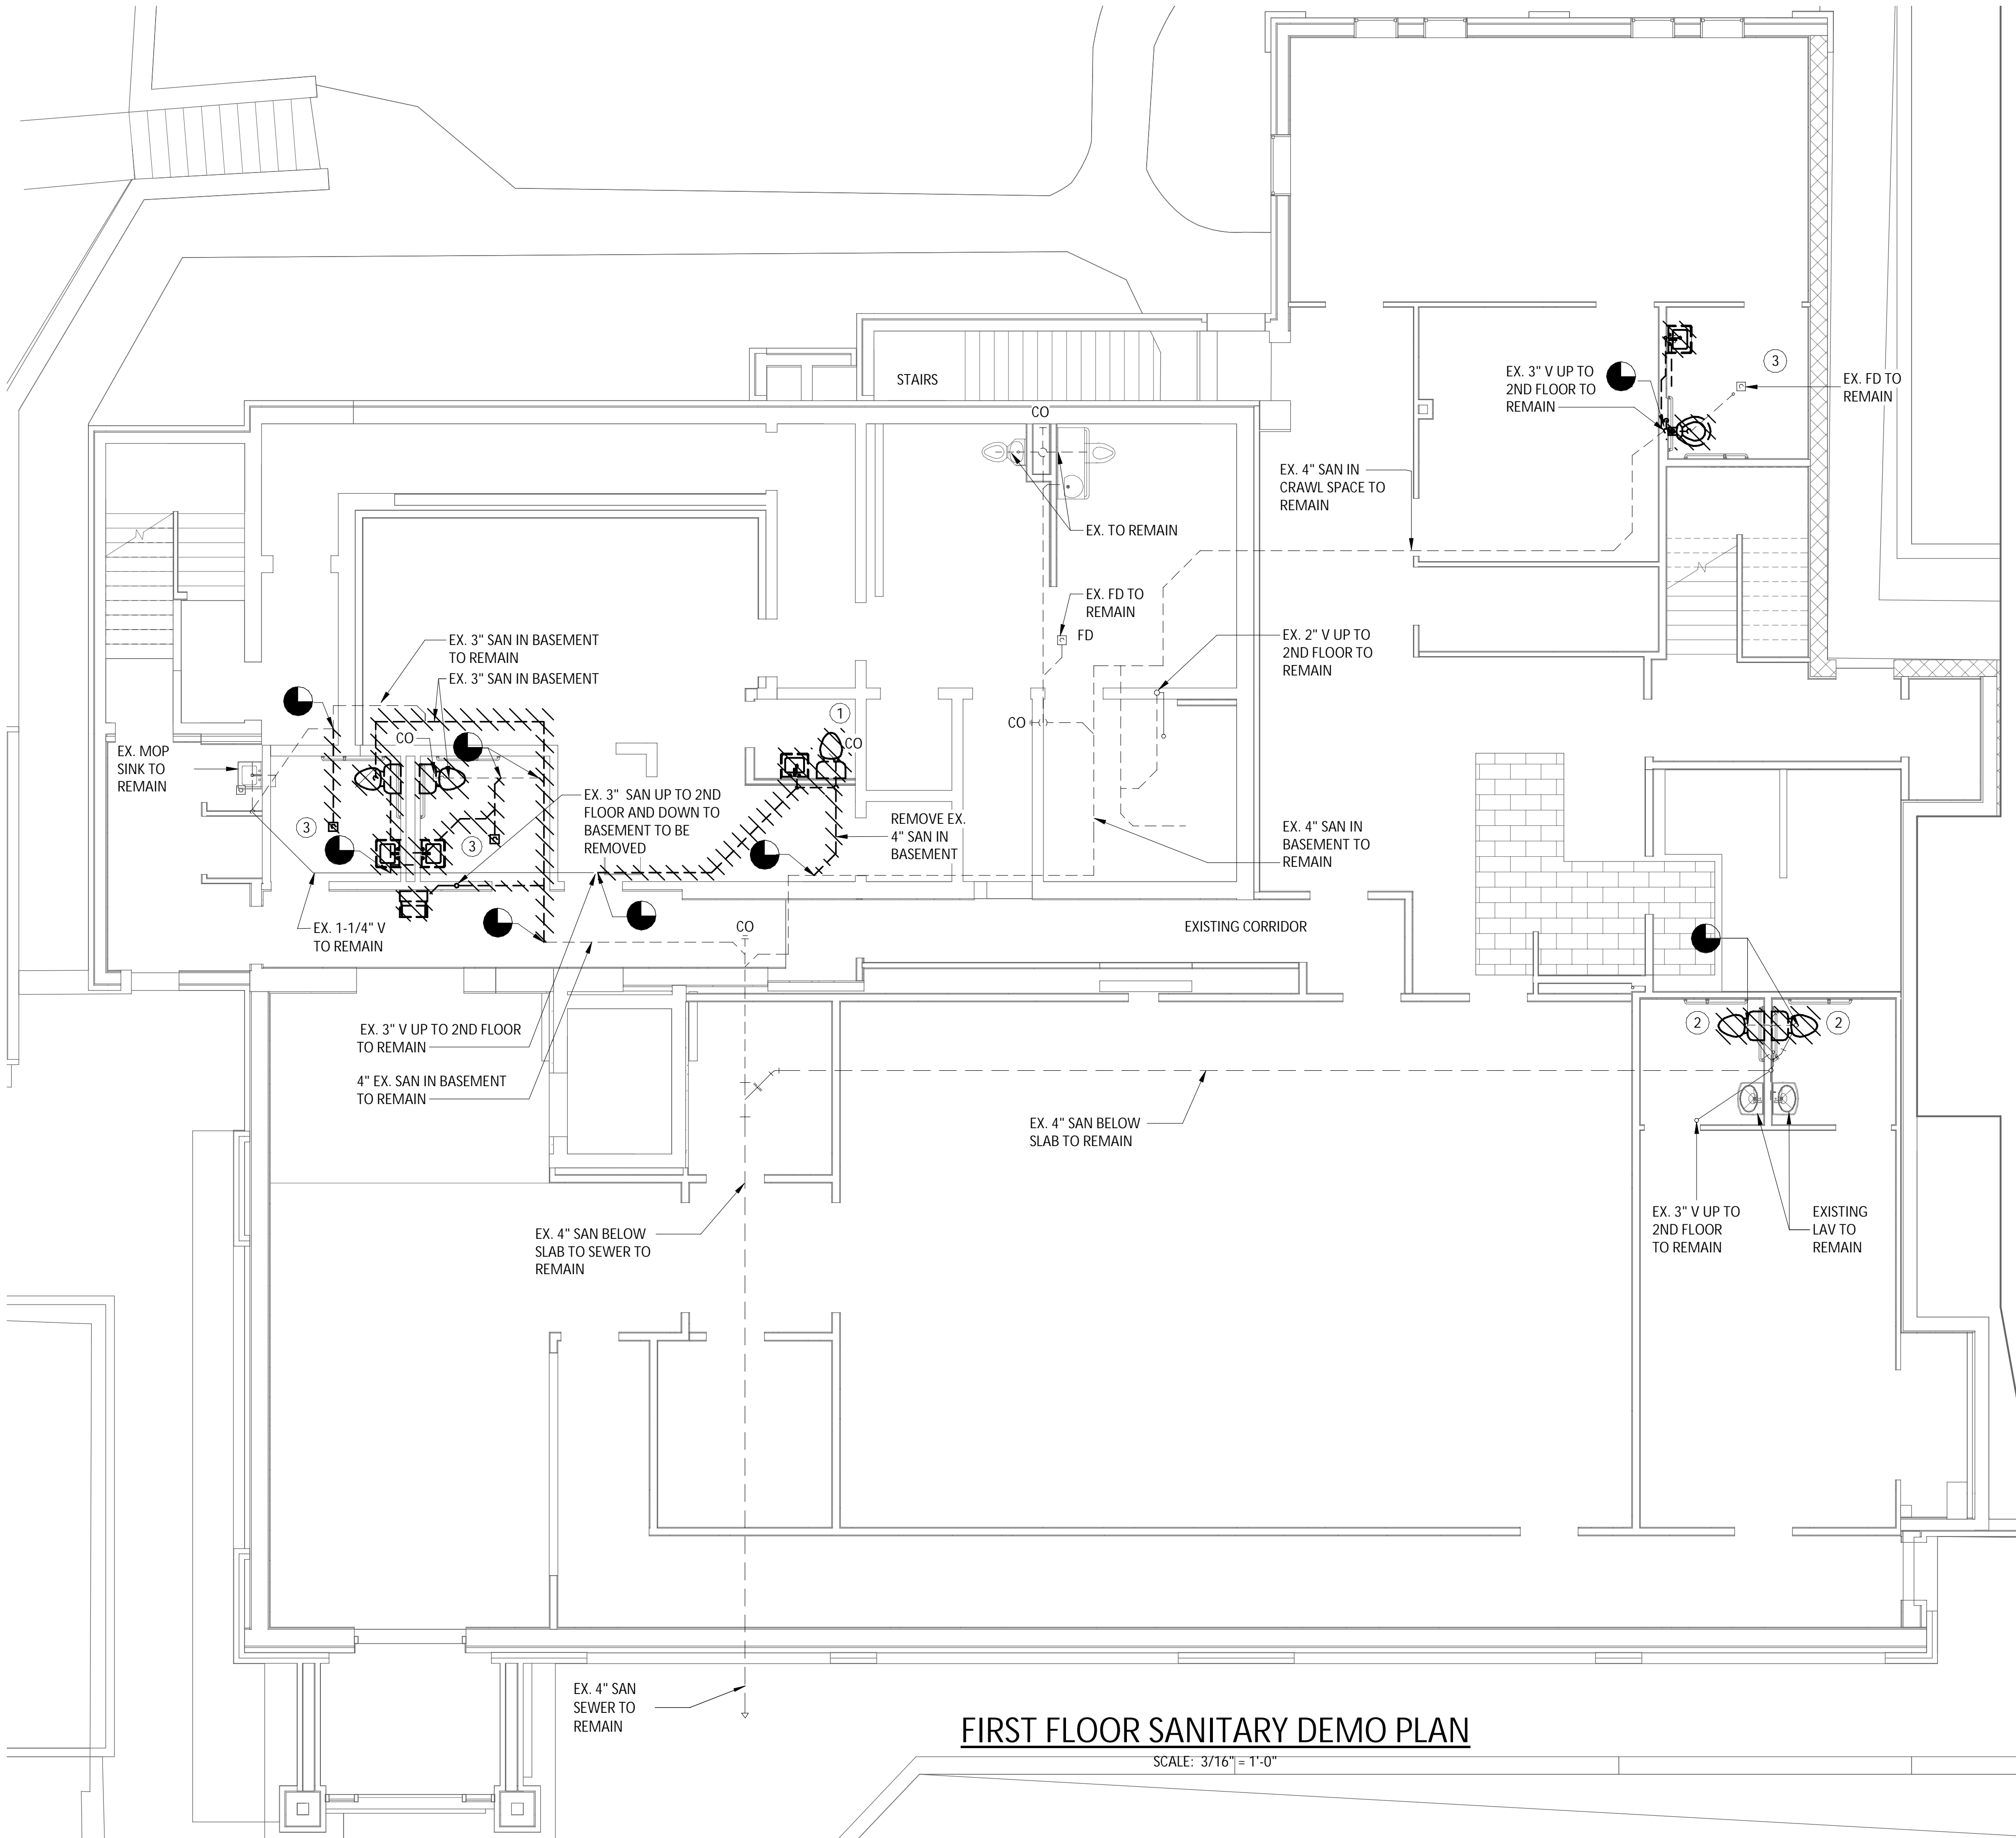
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KEY NOTES:

- 1 REMOVE EXISTING PLUMBING FIXTURES WITH ASSOCIATED SANITARY AND VENT CONNECTIONS. CAP BRANCH LINES AT MAINS.
- 2 DISCONNECT AND REMOVE EXISTING PLUMBING FIXTURES ONLY AS SHOWN.
- 3 REMOVE EXISTING PLUMBING FIXTURES WITH ASSOCIATED SANITARY AND VENT CONNECTIONS TO POINTS AS SHOWN.



FIRST FLOOR SANITARY DEMO PLAN

SCALE: 3/16" = 1'-0"

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REVISIONS

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NEW COURTHOUSE FACILITY  
CONTRACT NO. 1C - PLUMBING CONSTRUCTION  
FIRST FLOOR SANITARY DEMOLITION PLAN  
CITY OF MIDDLETOWN  
ORANGE COUNTY, NEW YORK

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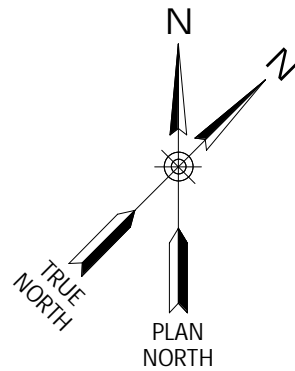
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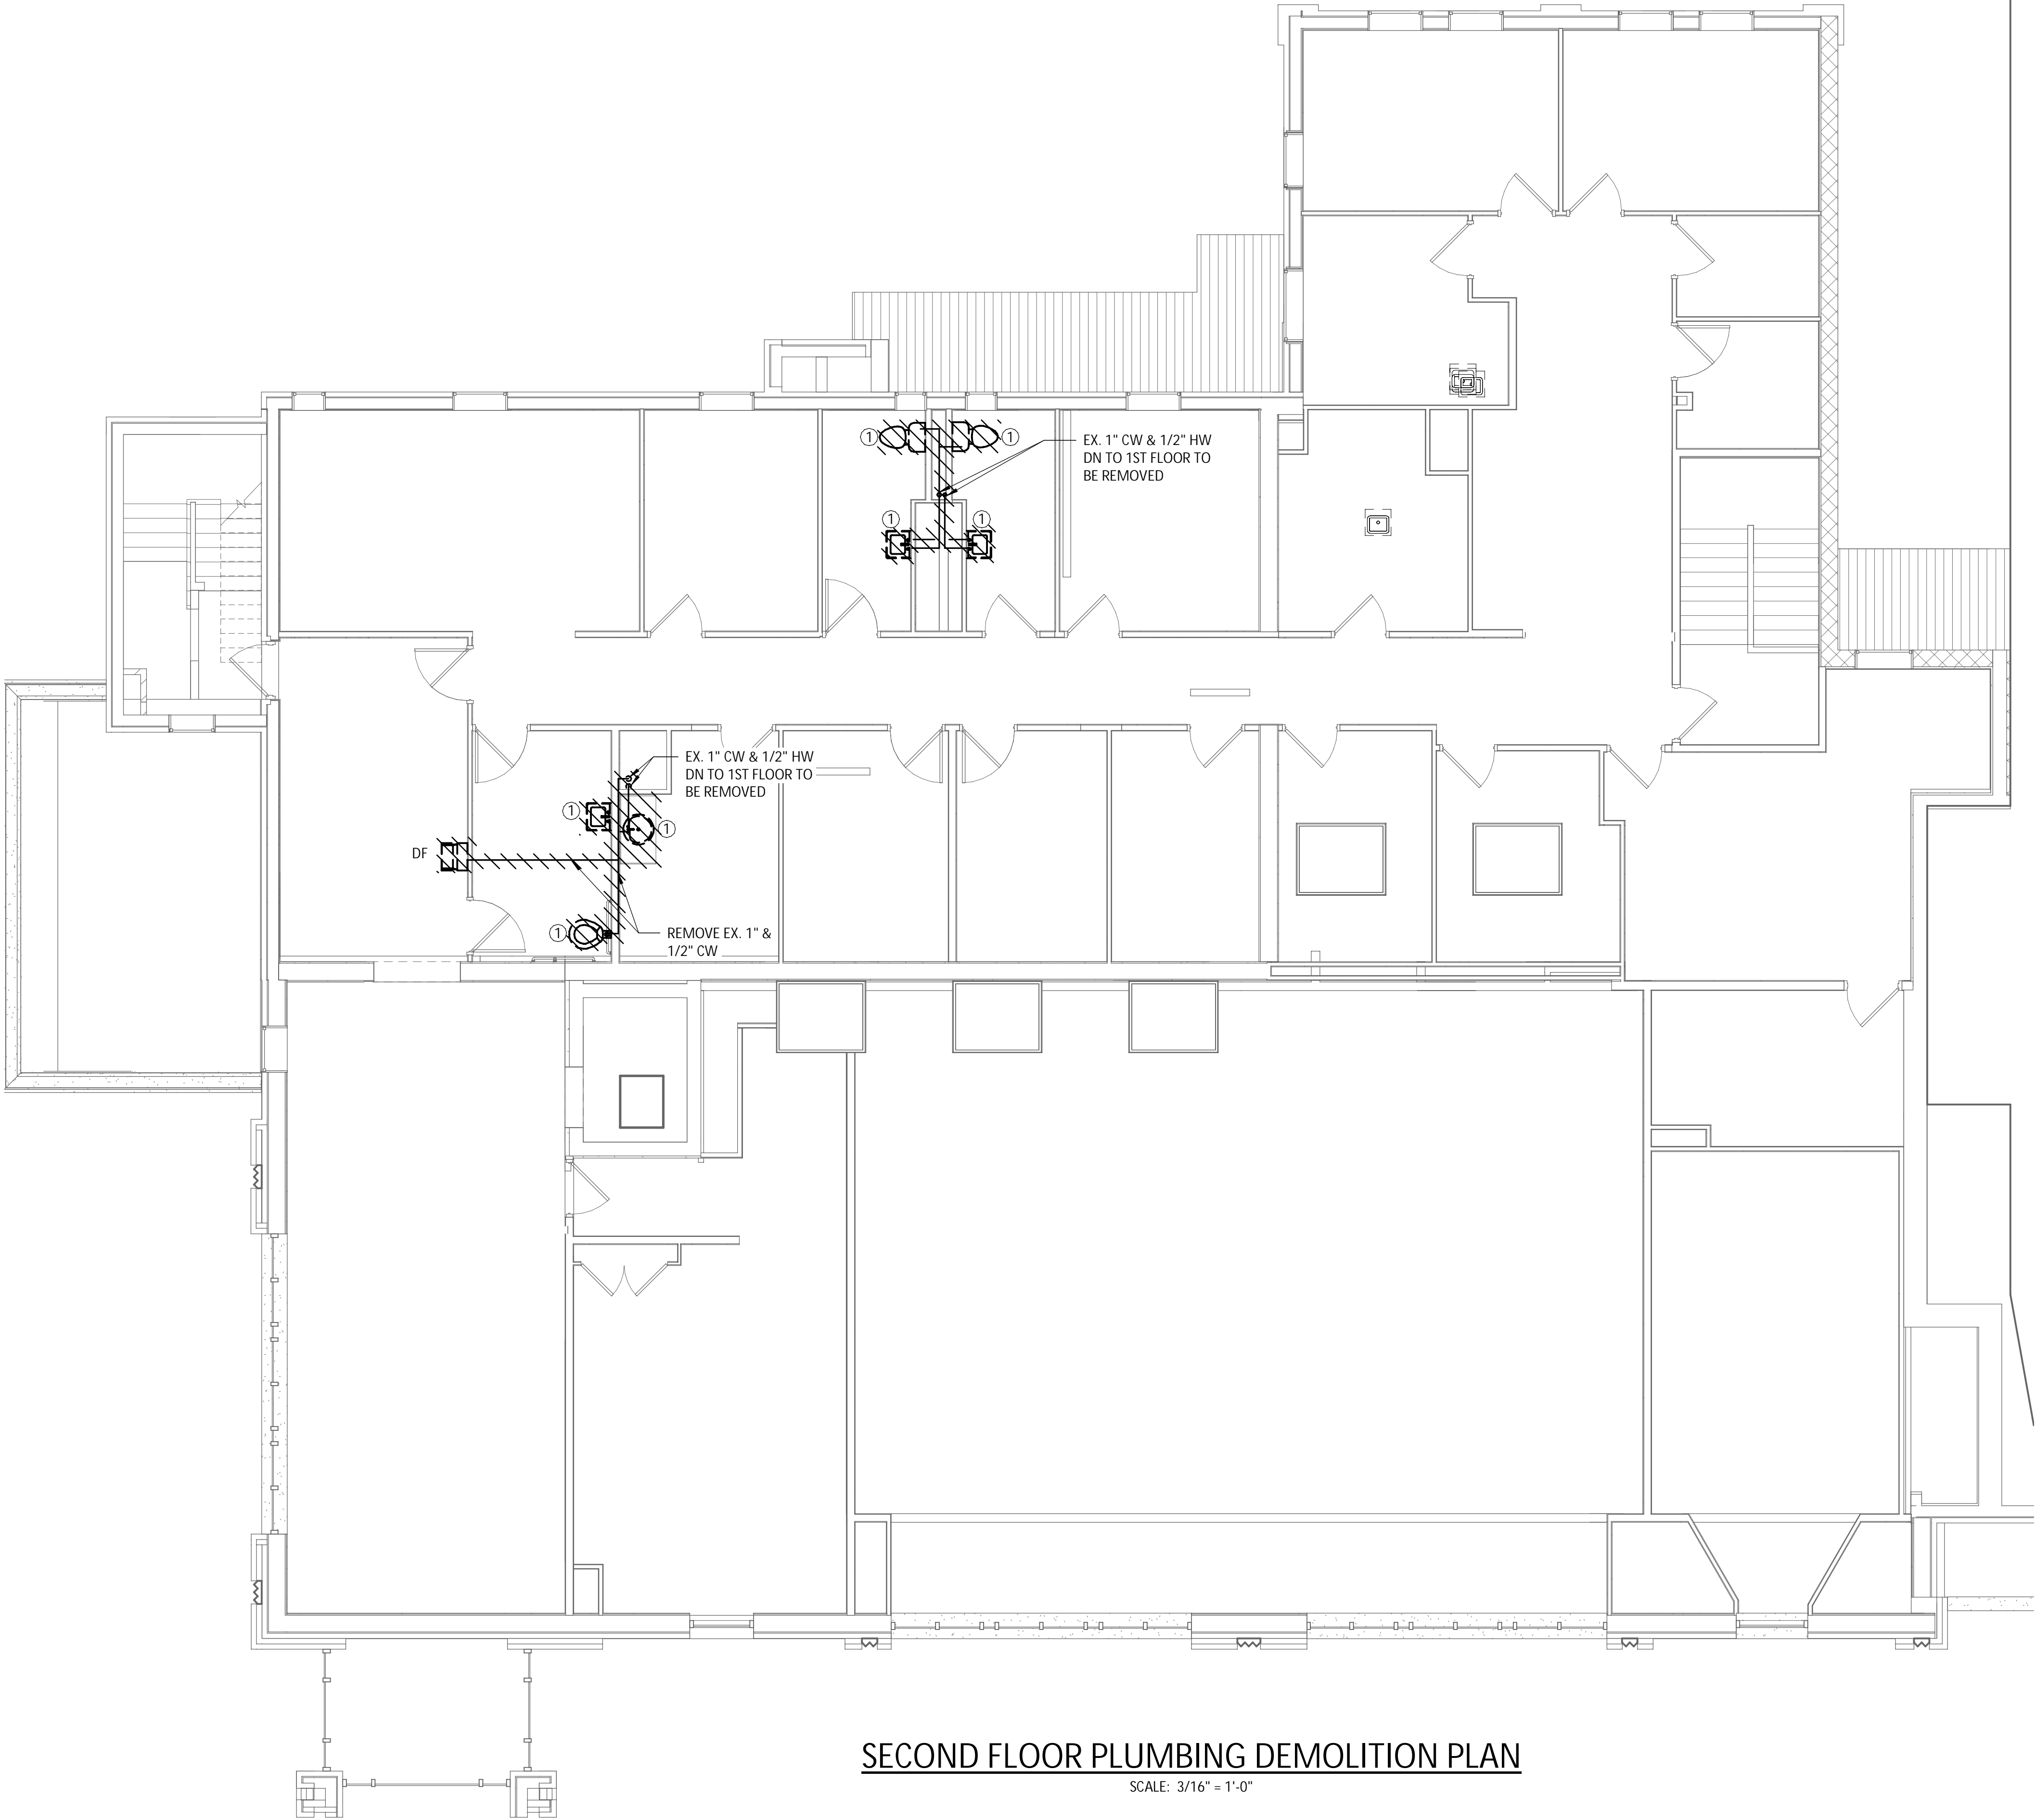
Project Number  
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KEY NOTES:

- ① REMOVE EXISTING PLUMBING FIXTURE AND ASSOCIATED HOT AND COLD WATER PIPING, INSULATION, VALVES AND APPURTENANCES.



SECOND FLOOR PLUMBING DEMOLITION PLAN

SCALE: 3/16" = 1'-0"

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REVISIONS	

CITY OF MIDDLETOWN  
NEW COURTHOUSE FACILITY  
CONTRACT NO. 1C - PLUMBING CONSTRUCTION  
SECOND FLOOR PLUMBING DEMOLITION PLAN  
CITY OF MIDDLETOWN  
ORANGE COUNTY, NEW YORK

443 Electronics Parkway  
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13088

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NYS EXP.: 11/30/2025

Date

AUGUST, 2024

Scale

AS SHOWN


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P104

Project Number


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**KEY NOTE:**

- ① REMOVE EXISTING PLUMBING FIXTURES WITH ASSOCIATED SANITARY AND VENT CONNECTIONS. CAP BRANCH LINES TO POINTS SHOWN.

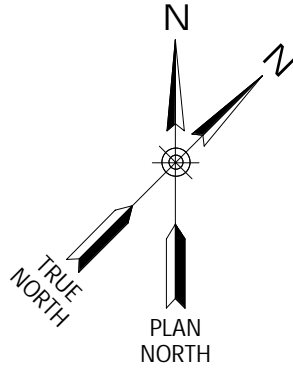

**SECOND FLOOR PLAN SANITARY DEMO PLAN**

SCALE: 3/16" = 1'-0"

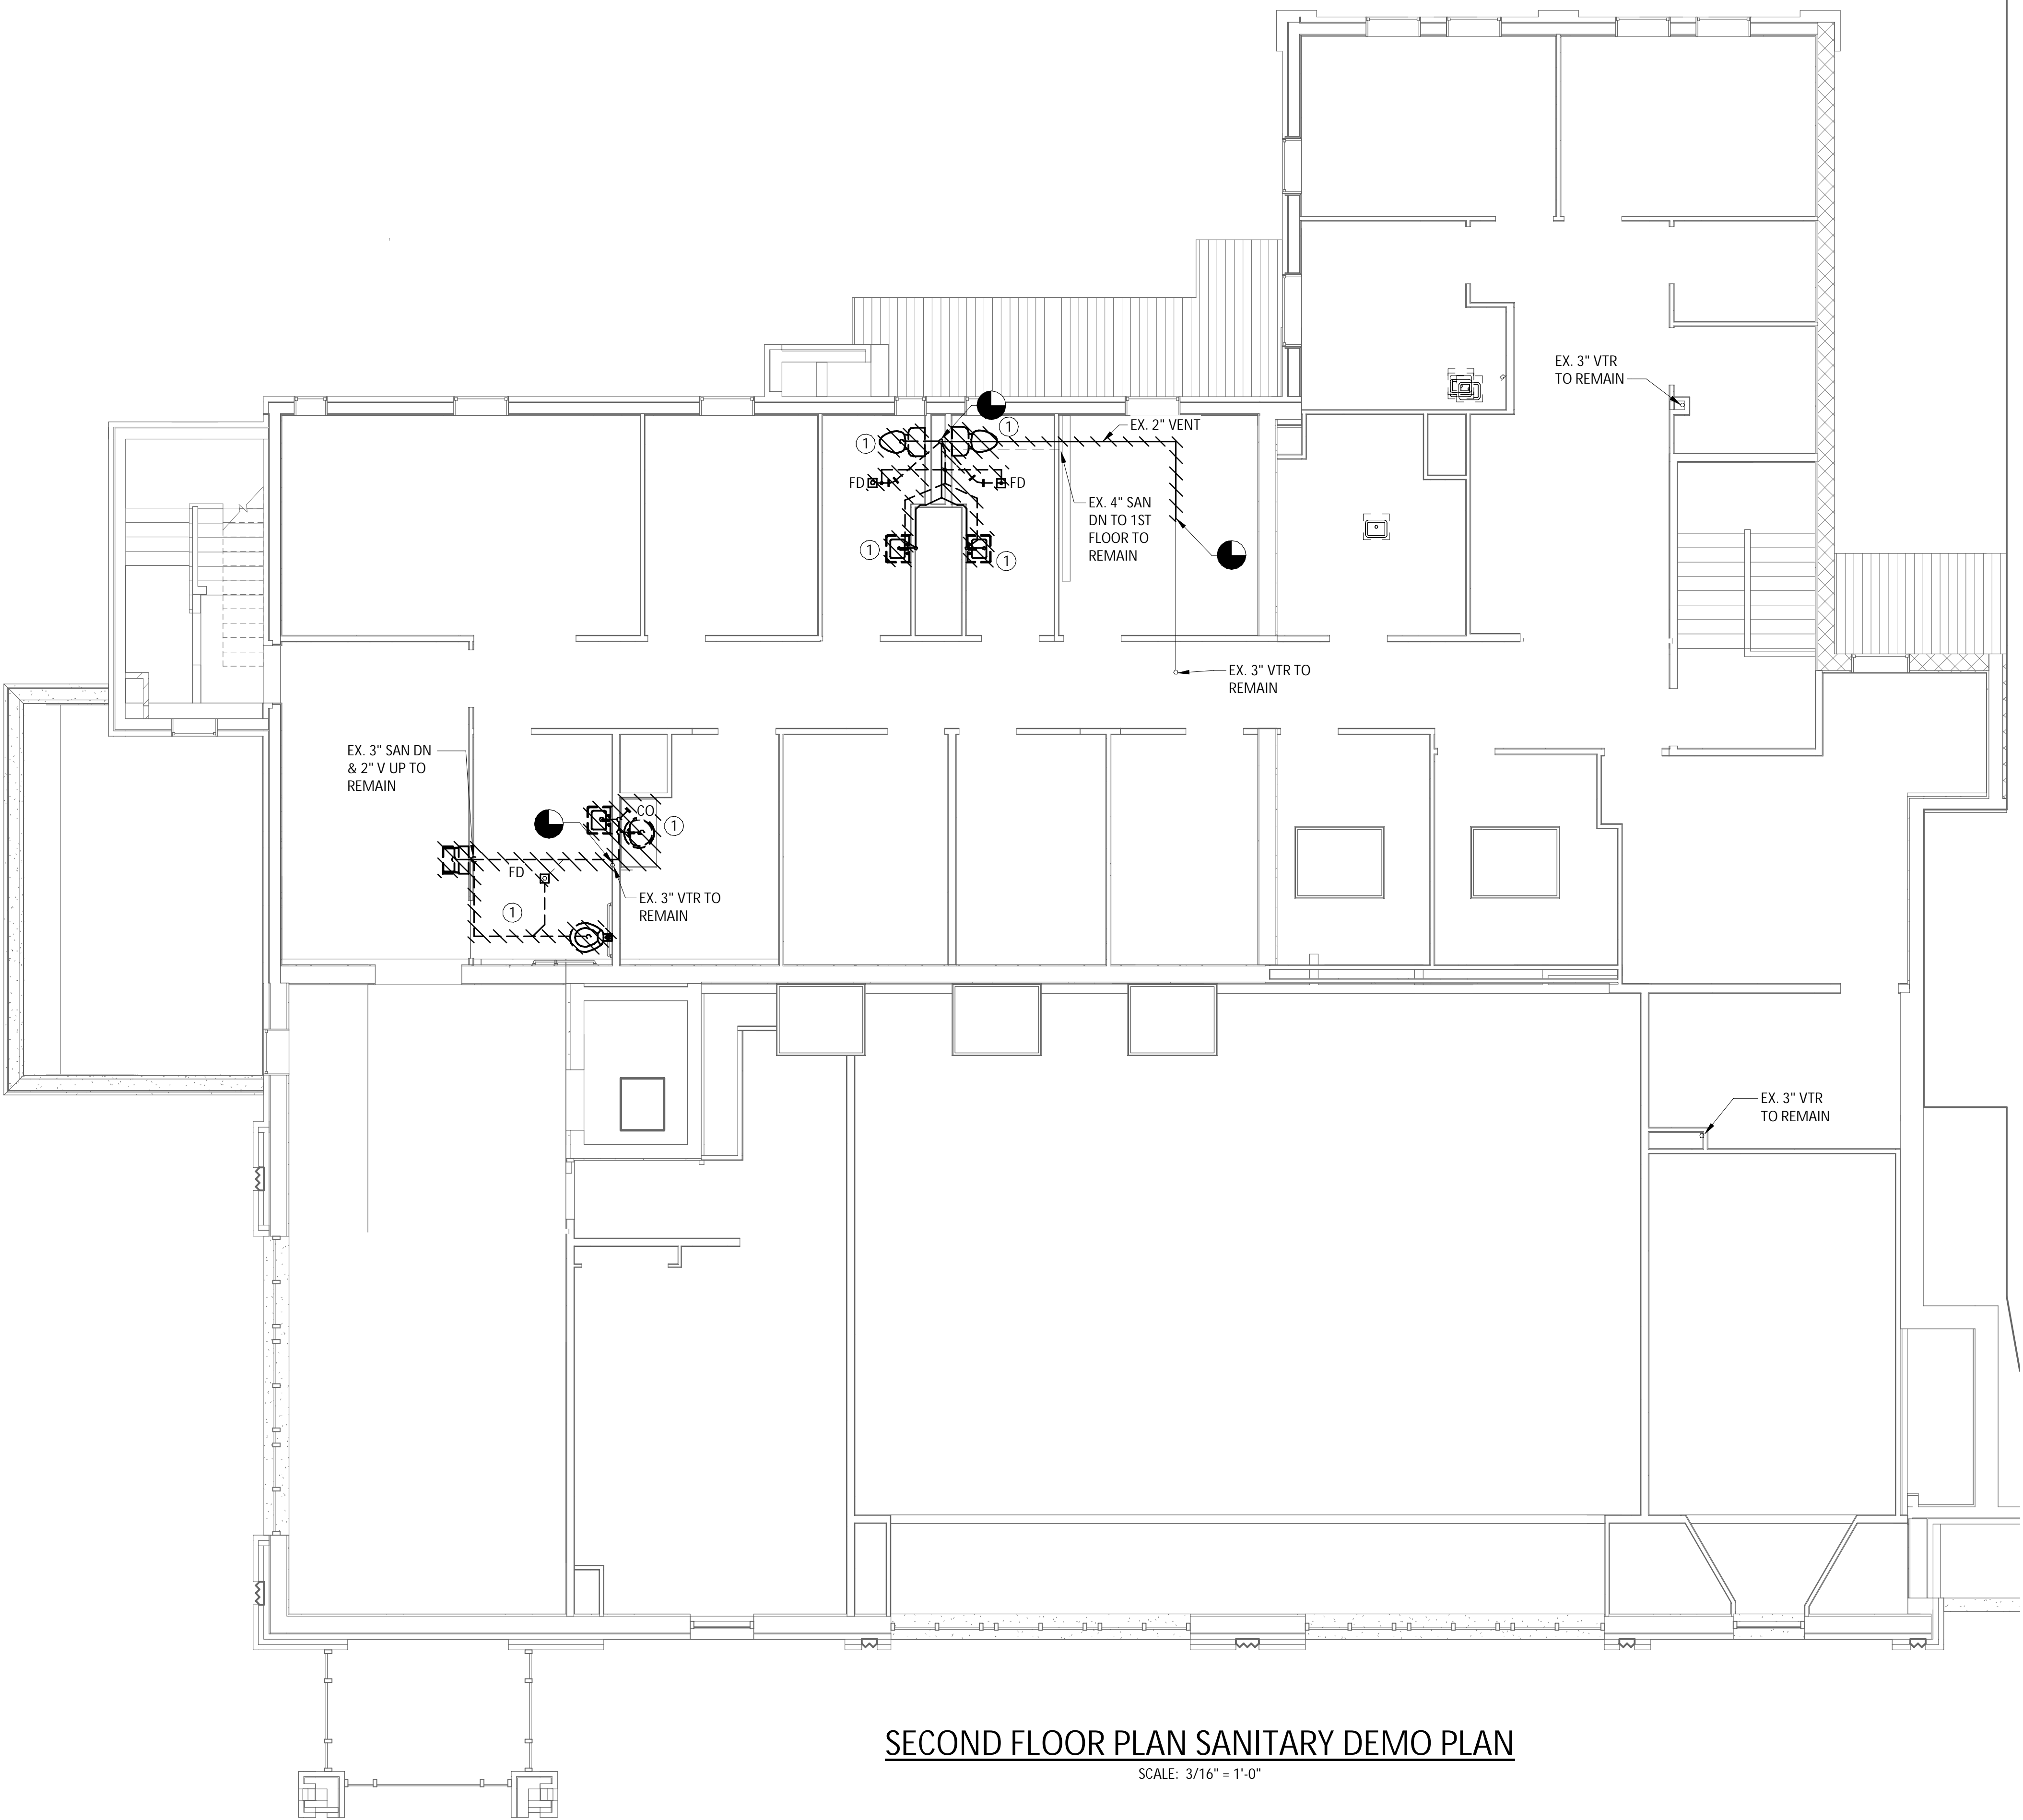IT IS A VIOLATION OF THE NEW YORK STATE EDUCATION LAW, ARTICLE 145 §7209 SPECIAL PROVISIONS, FOR ANY PERSON, UNLESS THEY ARE ACTING UNDER THE DIRECTION OF A LICENSED PROFESSIONAL ENGINEER, ARCHITECT, LANDSCAPE ARCHITECT, OR LAND SURVEYOR, TO ALTER ANY ITEM IN ANY WAY IF AN ITEM BEARING THE STAMP OF A LICENSED PROFESSIONAL IS ALTERED, THE ALTERING PROFESSIONAL SHALL STAMP THE DOCUMENT AND INCLUDE THE NOTATION "ALTERED BY" FOLLOWED BY THEIR SIGNATURE, THE DATE OF SUCH ALTERATION, AND A SPECIFIC DESCRIPTION OF THE ALTERATION.

**REVISIONS**

NO.	DESCRIPTION	DATE


CITY OF MIDDLETOWN  
NEW COURTHOUSE FACILITY  
CONTRACT NO. 1C - PLUMBING CONSTRUCTION  
**SECOND FLOOR SANITARY DEMOLITION PLAN**  
CITY OF MIDDLETOWN  
ORANGE COUNTY, NEW YORK

**B&L**  
443 Electronics Parkway  
Liverpool, NY  
13088  
**Barton & Loguidice, D.P.C.**




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Date  
AUGUST, 2024  
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Sheet Number  
P105  
Project Number  
1753.008.001



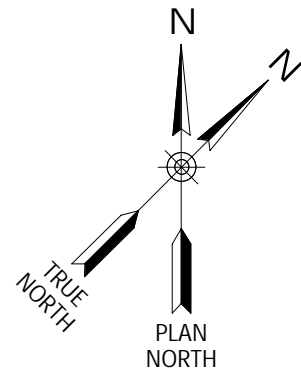

KEY NOTE:

- ① CONNECT NEW CW, HW, HWR TO EXISTING FIXTURE.  
② CORE DRILL AS REQUIRED TO ACCOMMODATE NEW PIPE RISERS. FIRE CAULK PENETRATIONS THROUGH THE FLOOR.

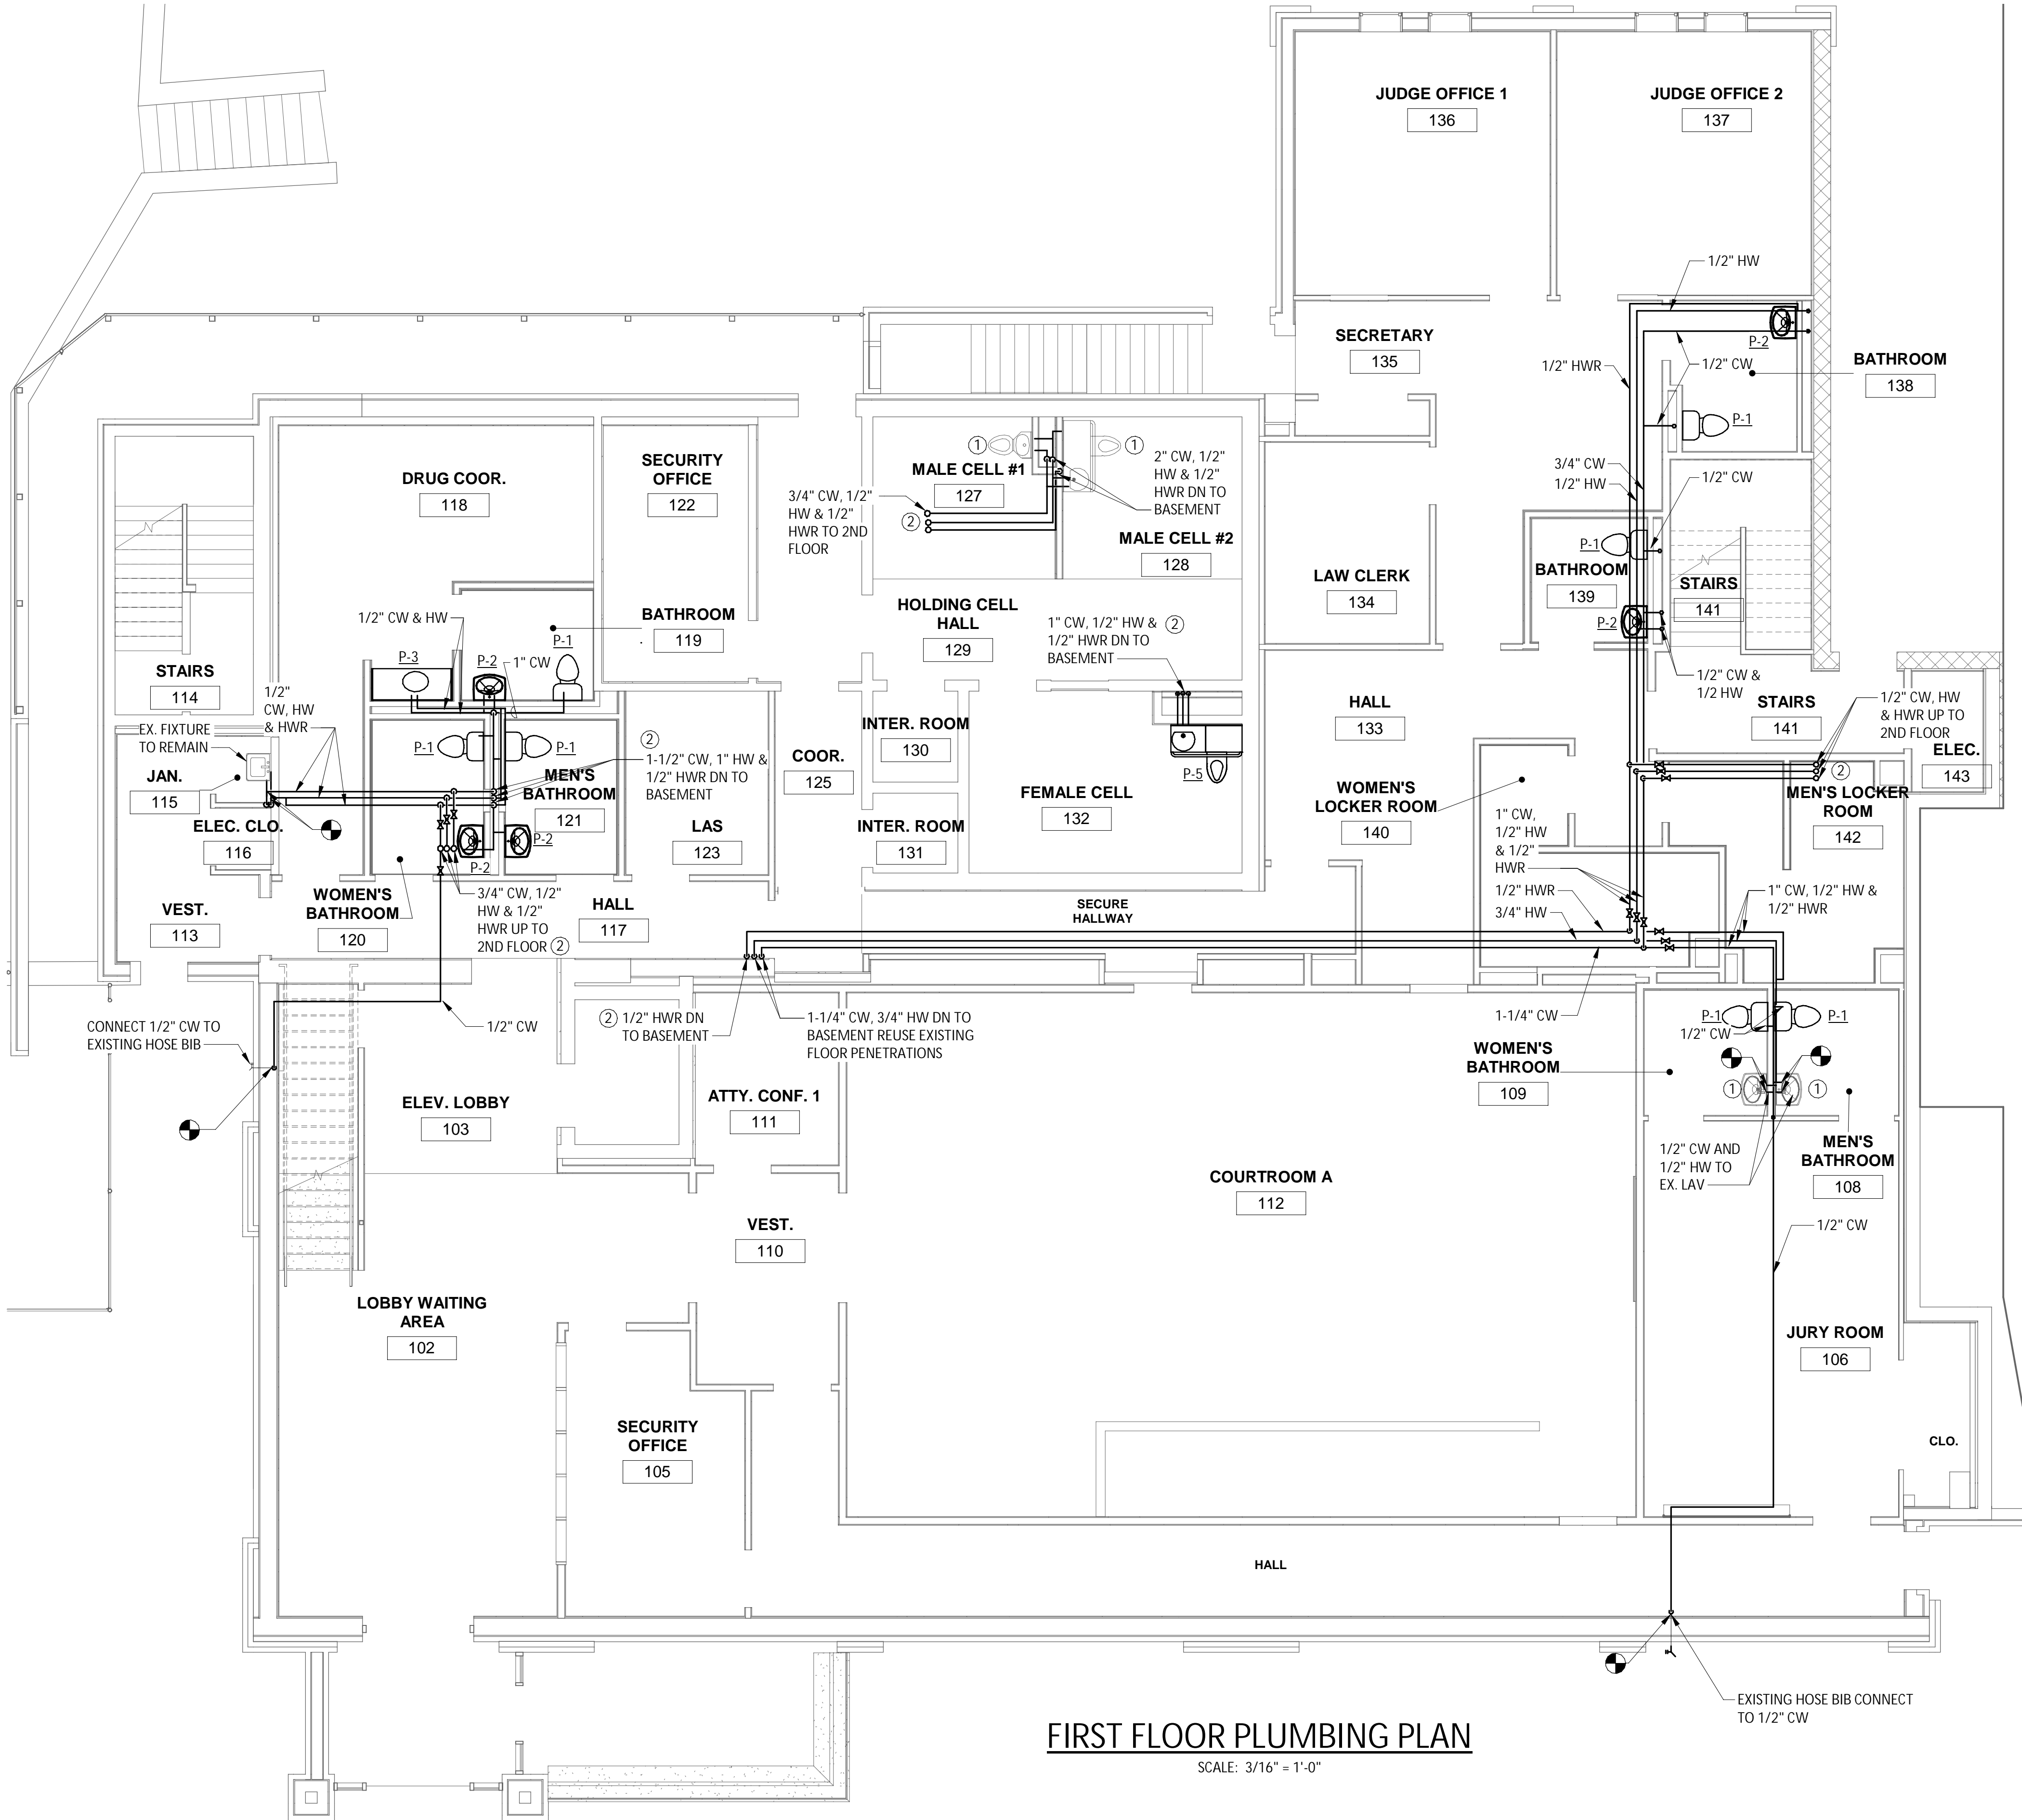

FIRST FLOOR PLUMBING PLAN

SCALE: 3/16" = 1'-0"

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REVISIONS

CITY OF MIDDLETOWN  
NEW COURTHOUSE FACILITY  
CONTRACT NO. 1C - PLUMBING CONSTRUCTION  
ORANGE COUNTY, NEW YORK

**B&L**  
443 Electronics Parkway  
Liverpool, NY  
13088  
**Barton & Loguidice, D.P.C.**



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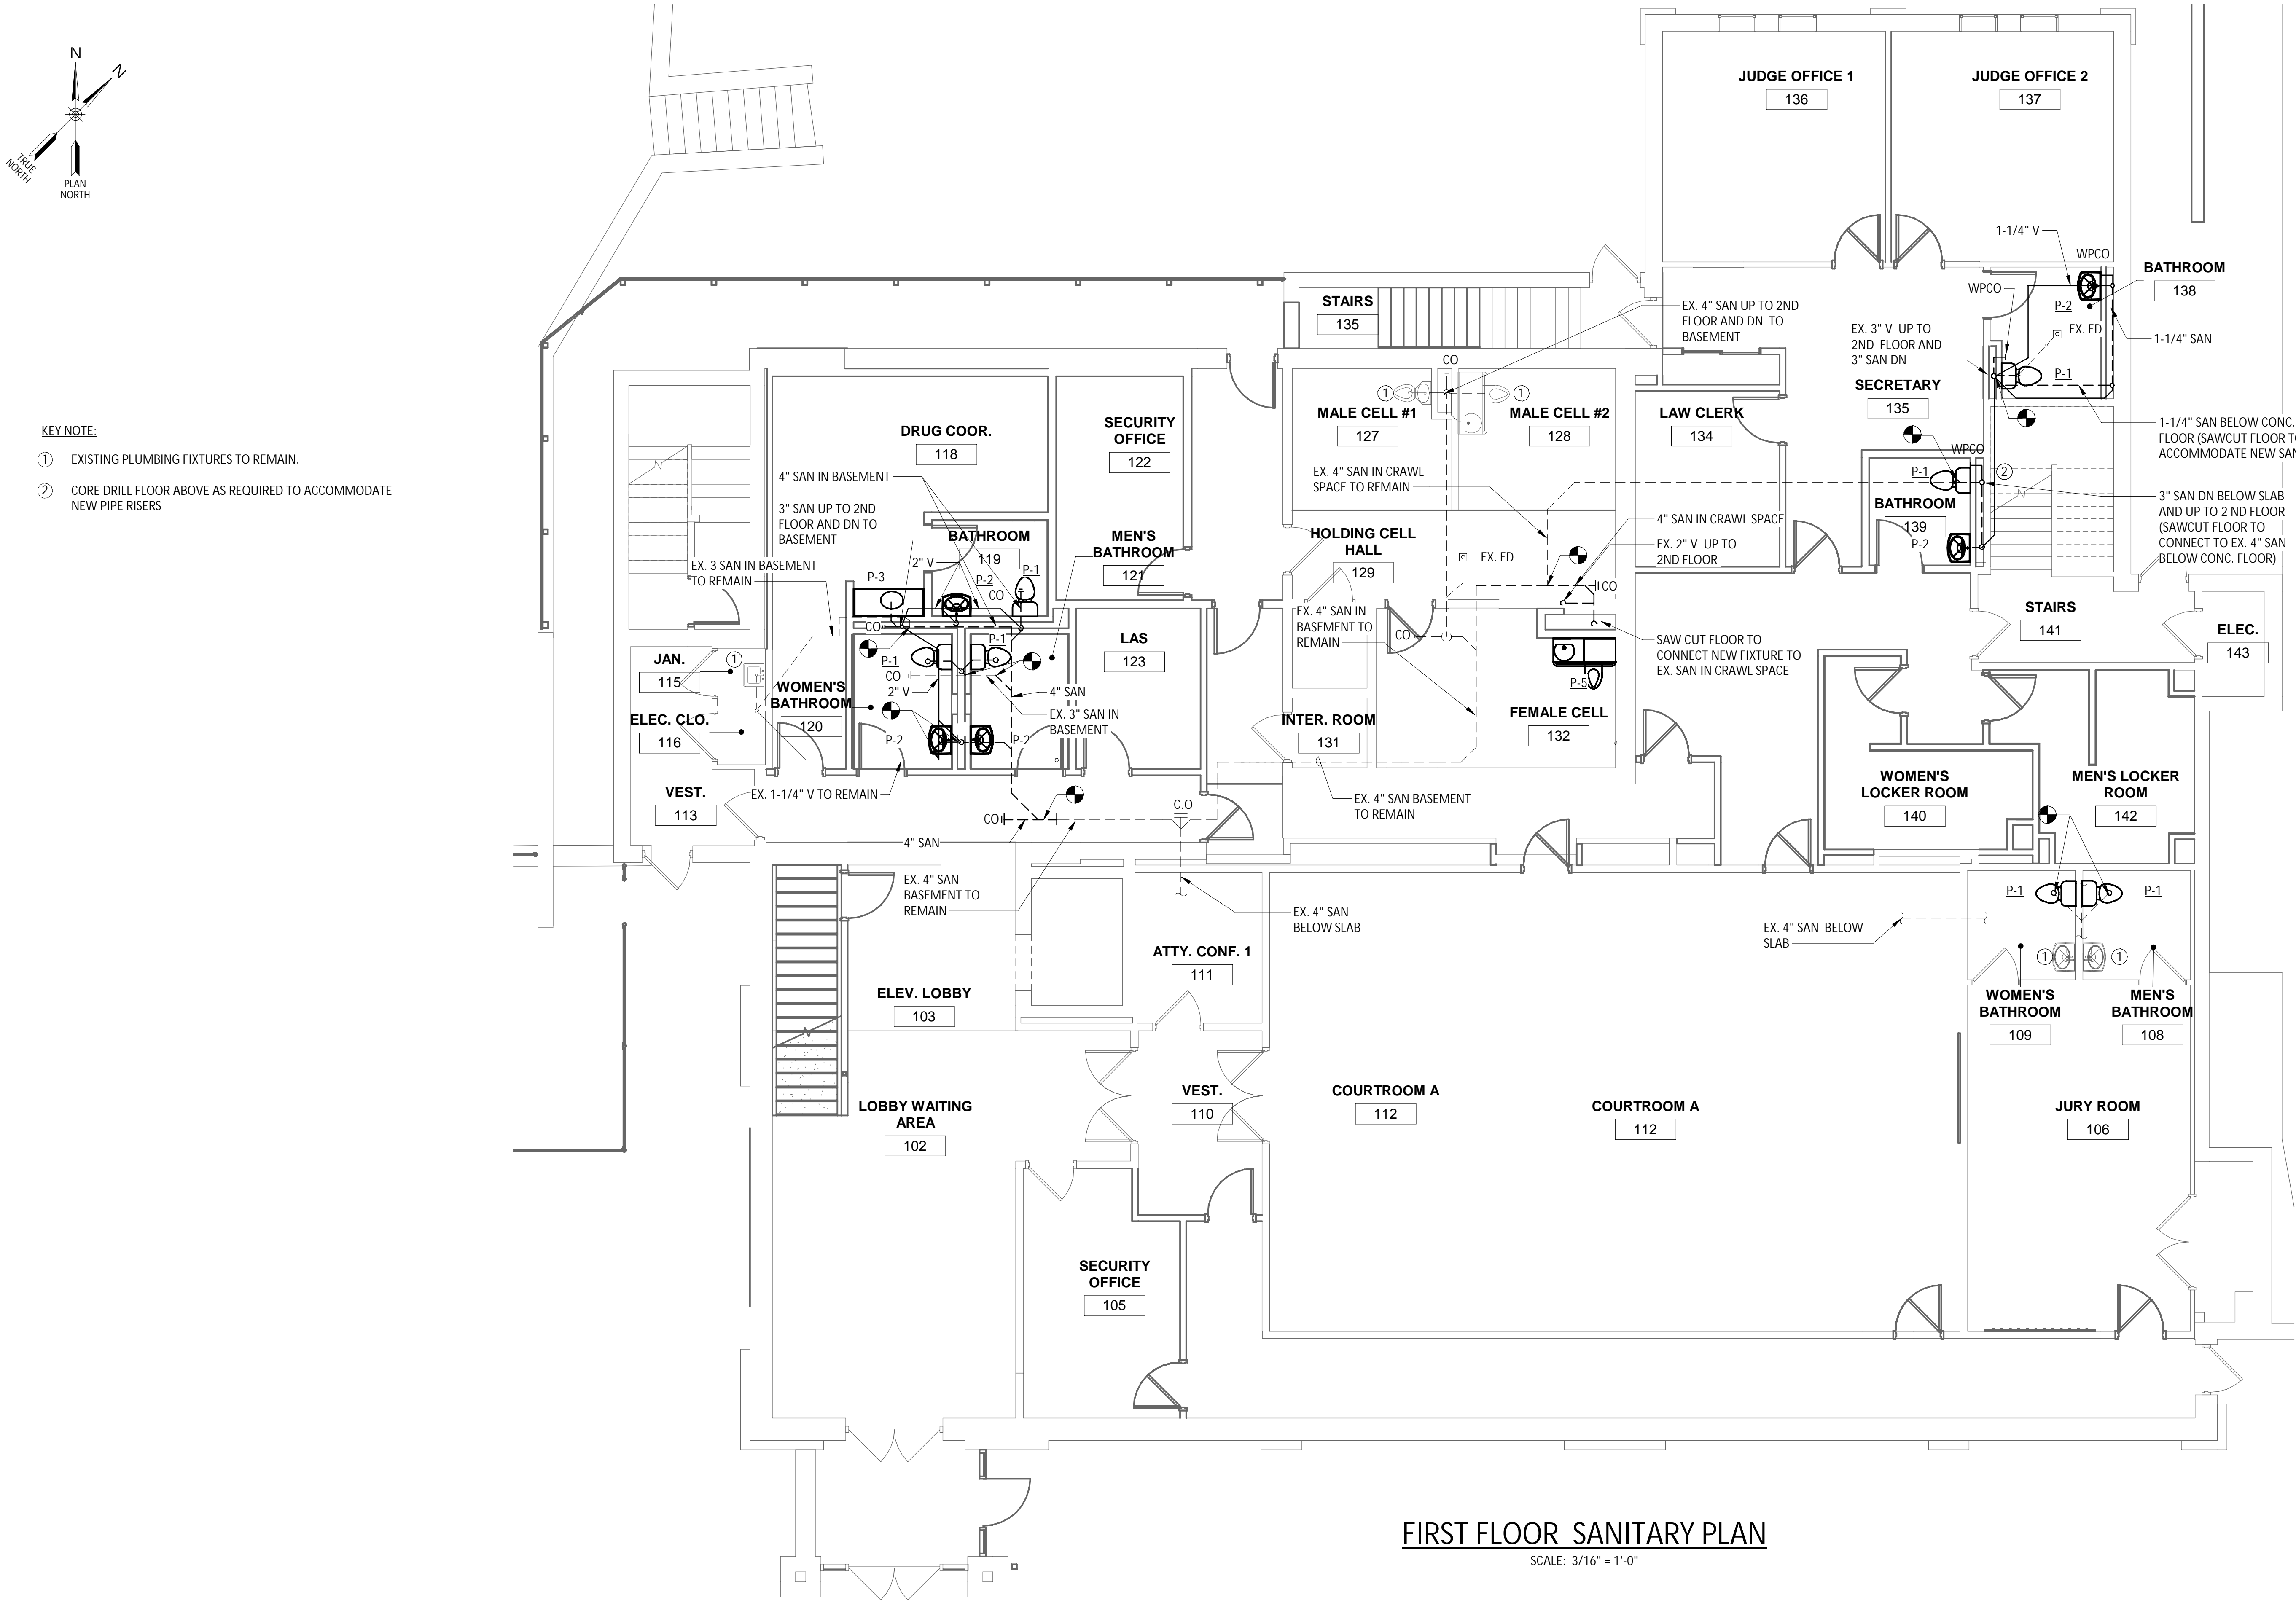
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AUGUST, 2024

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P106

Project Number  
1753.008.001





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REVISIONS

CITY OF MIDDLETOWN  
NEW COURTHOUSE FACILITY  
CONTRACT NO. 1C - PLUMBING CONSTRUCTION

ORANGE COUNTY, NEW YORK

443 Electronics Parkway  
Liverpool, NY  
13088

**B&L**

**Barton & Loguidice, D.P.C.**

STATE OF NEW YORK  
J. HORVATH  
No. 089099  
PLUMBING PROFESSIONAL ENGINEER

NYS EXP.: 11/30/2025


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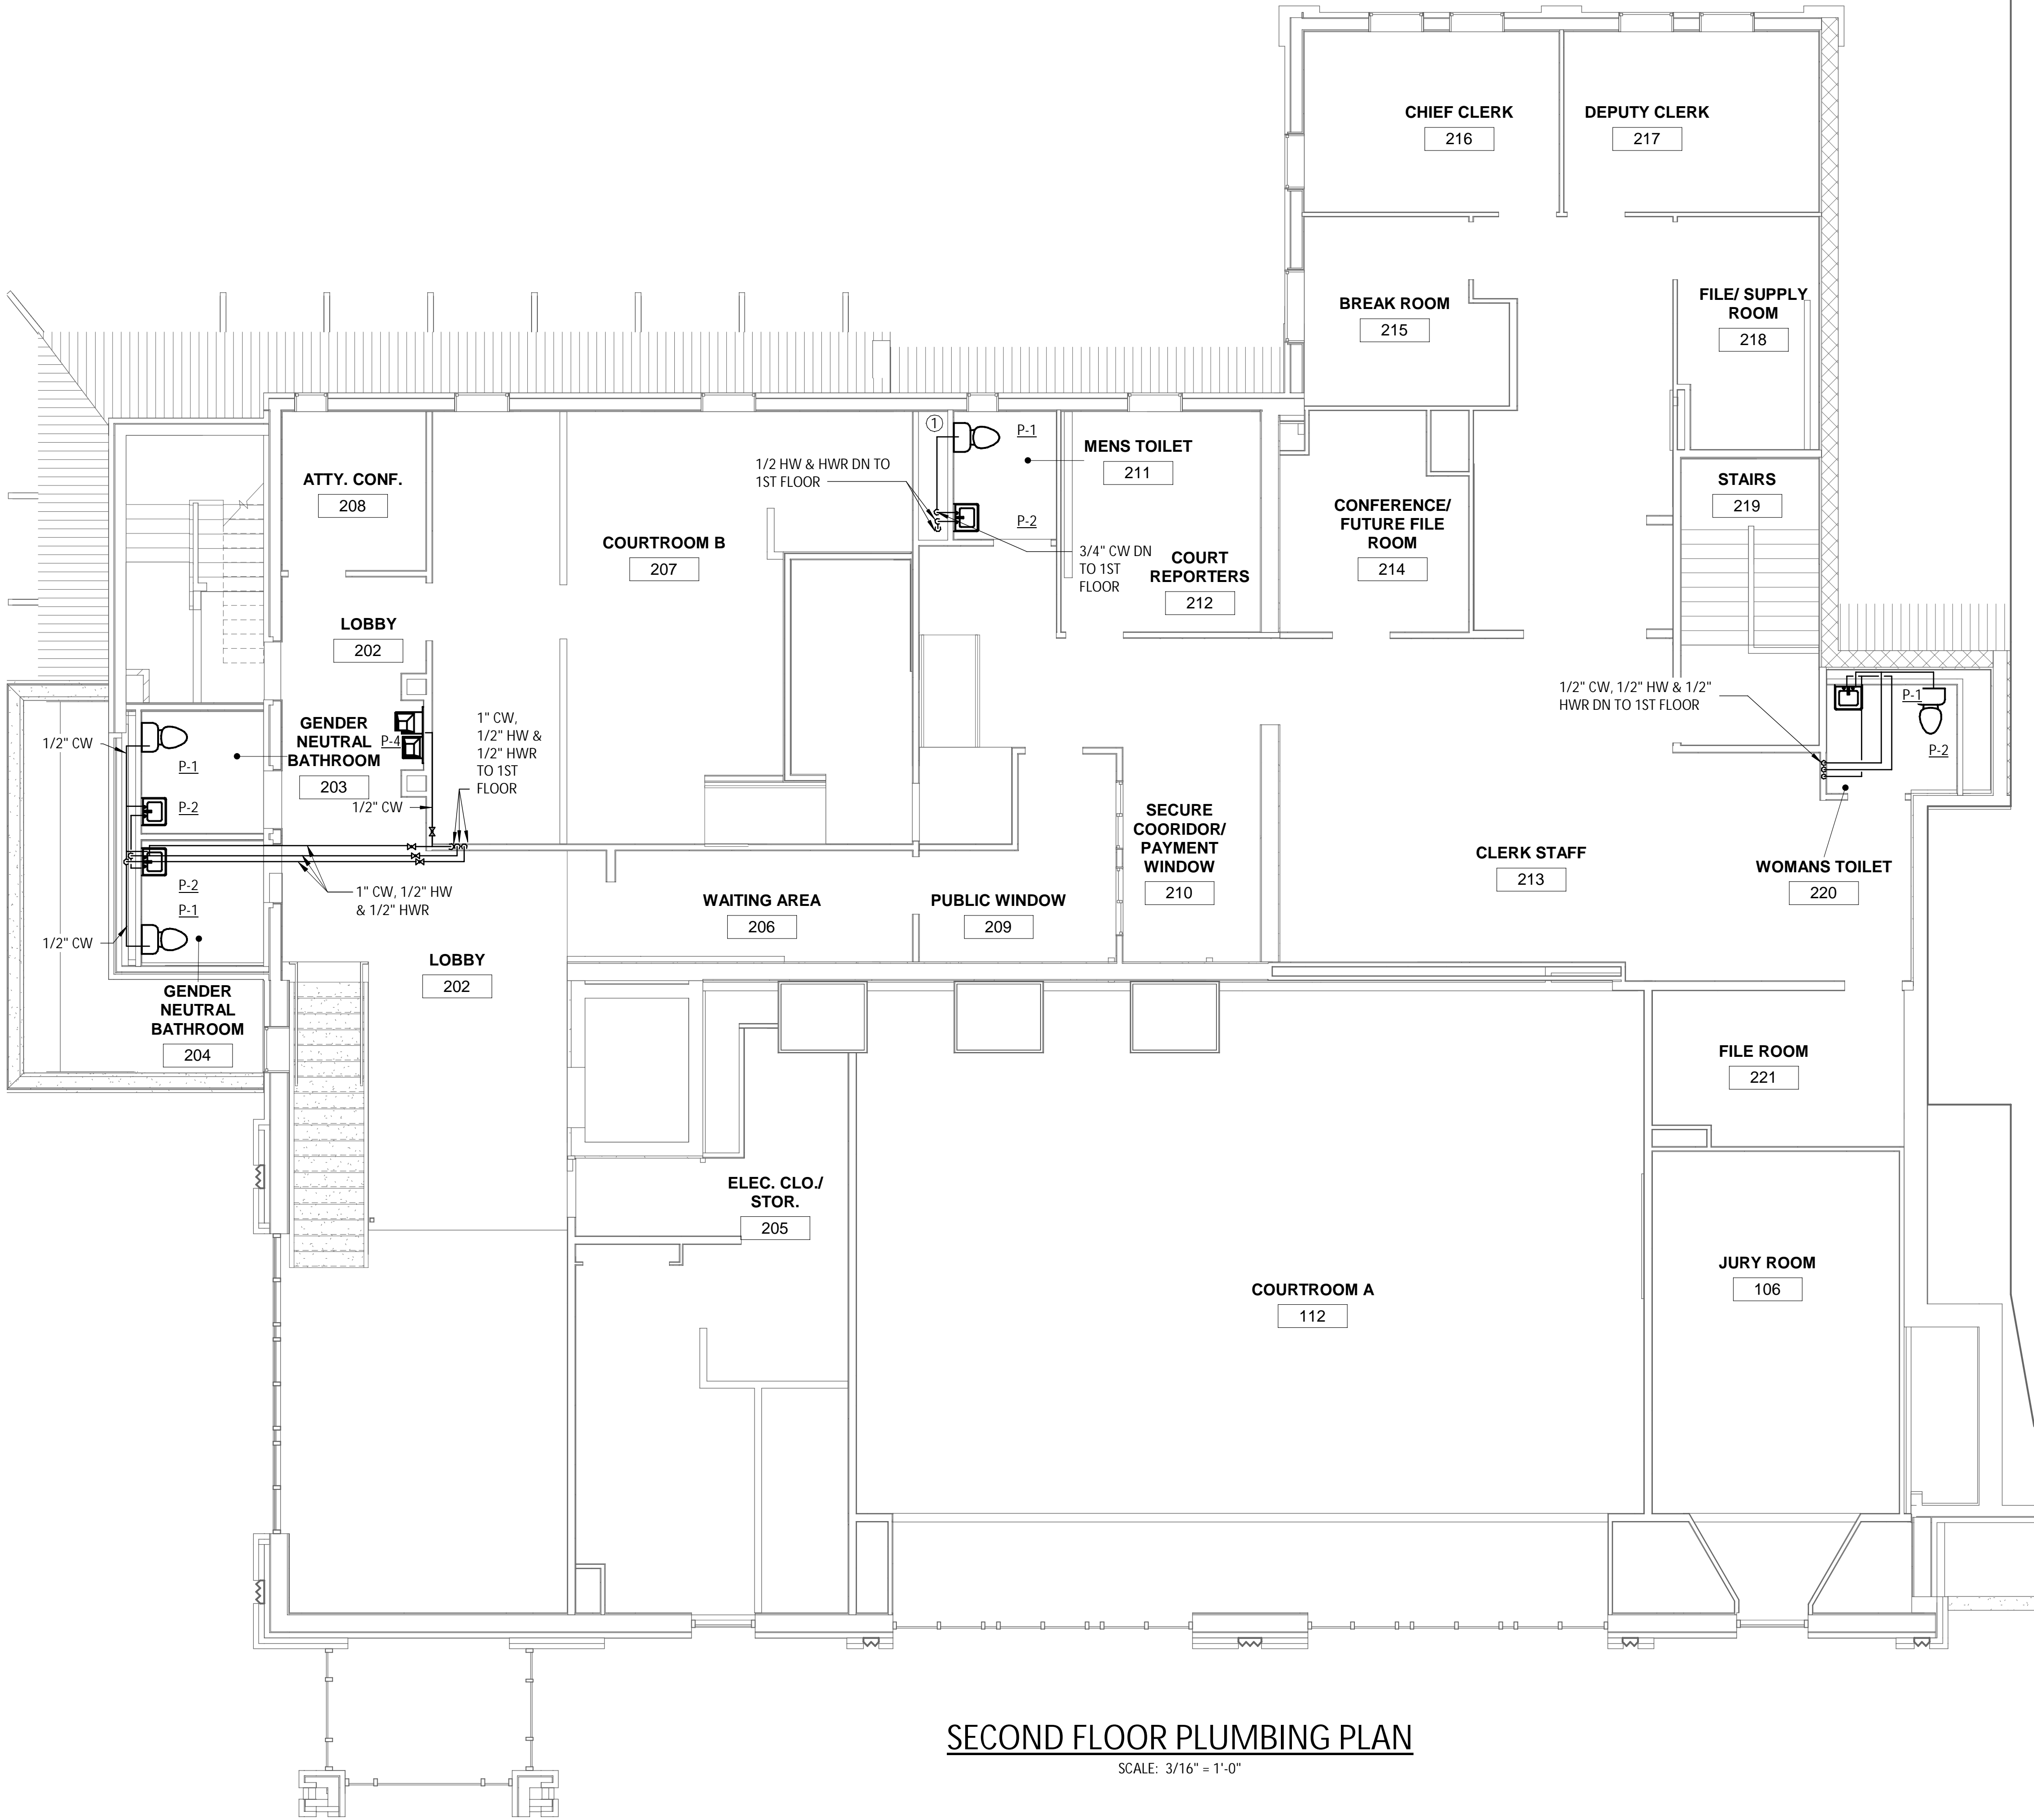
Sheet Number  
P107

Project Number  
1753.008.001





KEY NOTES:  
① COORDINATE PIPING IN CHASE WITH CONTRACT 1B TO ACCOMMODATE NEW DUCTWORK AND VENTING IN CHASE.

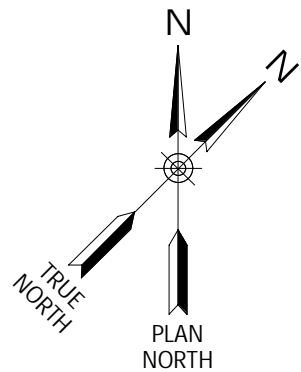

SECOND FLOOR PLUMBING PLAN  
SCALE: 3/16" = 1'-0"

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REVISIONS	


CITY OF MIDDLETOWN  
NEW COURTHOUSE FACILITY  
CONTRACT NO. 1C - PLUMBING CONSTRUCTION  
SECOND FLOOR PLUMBING PLAN  
CITY OF MIDDLETOWN  
ORANGE COUNTY, NEW YORK

443 Electronics Parkway  
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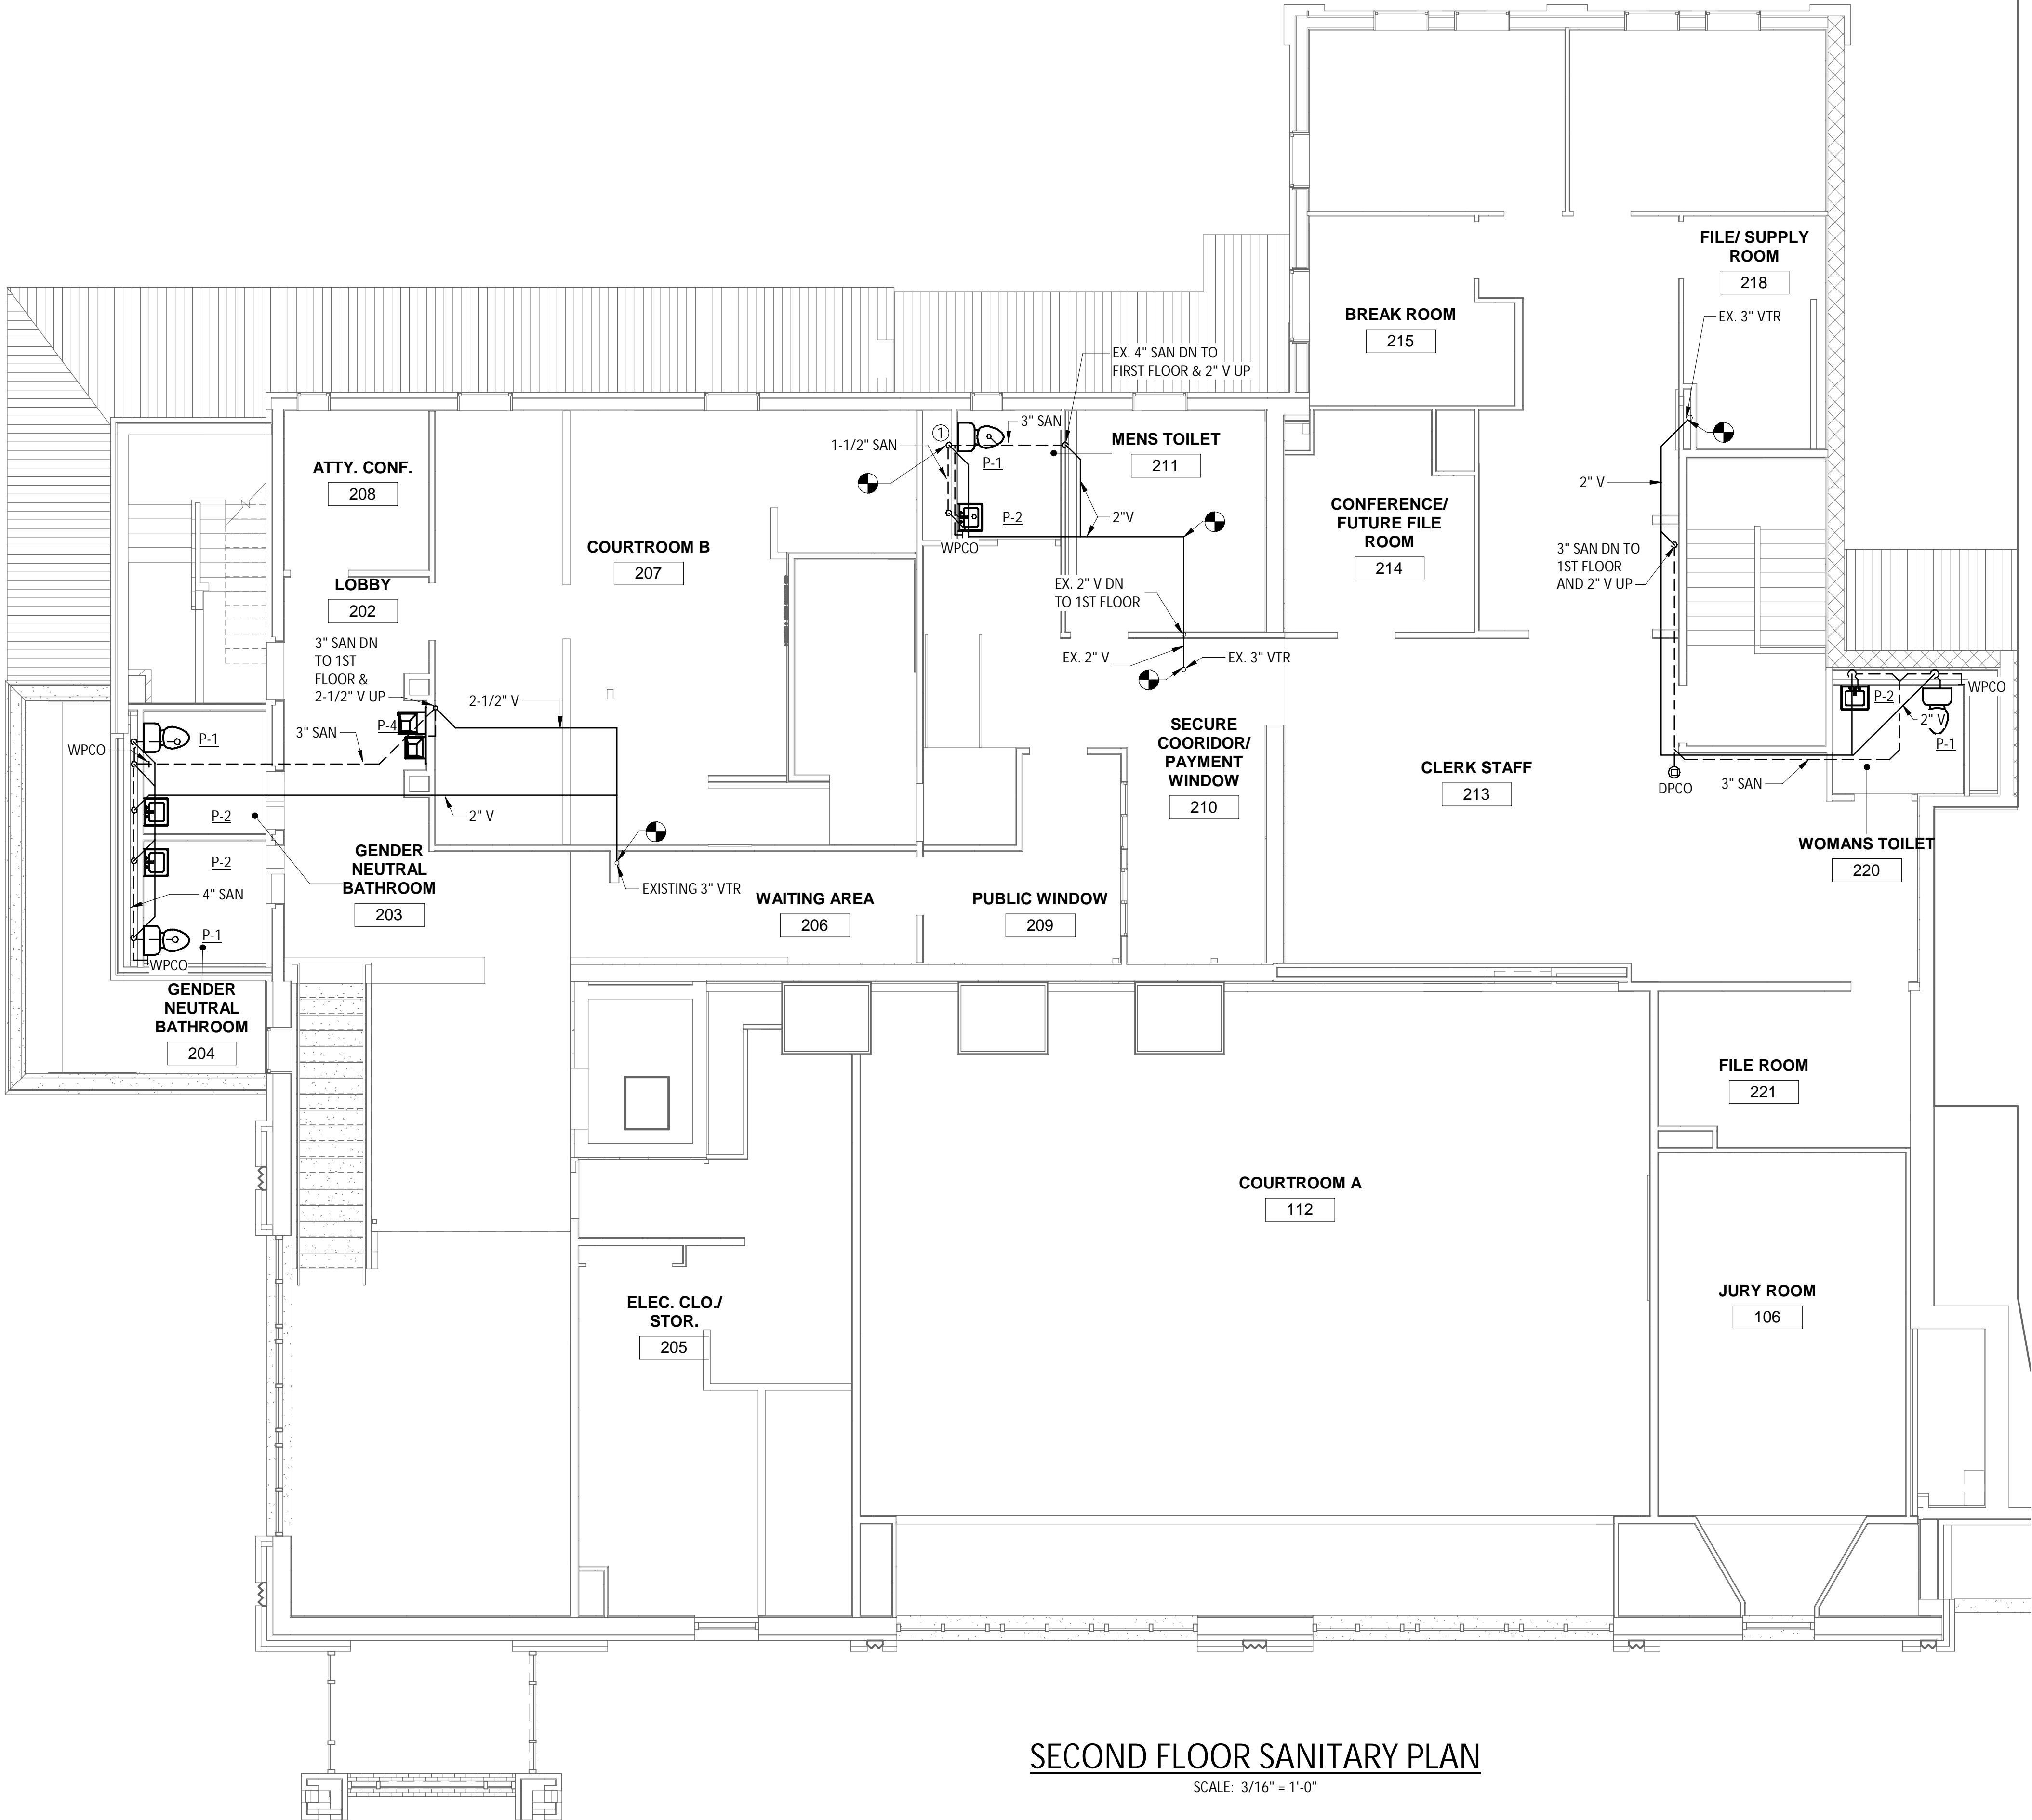


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AUGUST, 2024  
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Sheet Number  
P108  
Project Number  
1753.008.001



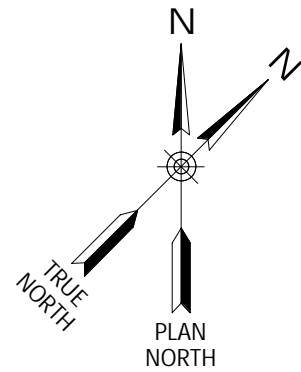

KEY NOTES:  
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SECOND FLOOR SANITARY PLAN  
SCALE: 3/16" = 1'-0"

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REVISIONS	

CITY OF MIDDLETOWN  
NEW COURTHOUSE FACILITY  
CONTRACT NO. 1C - PLUMBING CONSTRUCTION  
SECOND FLOOR SANITARY PLAN  
ORANGE COUNTY, NEW YORK  
CITY OF MIDDLETOWN

443 Electronics Parkway  
Liverpool, NY  
13088

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**Barton & Loguidice, D.P.C.**

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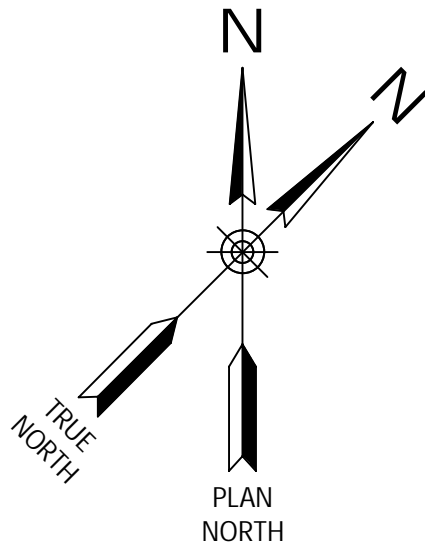
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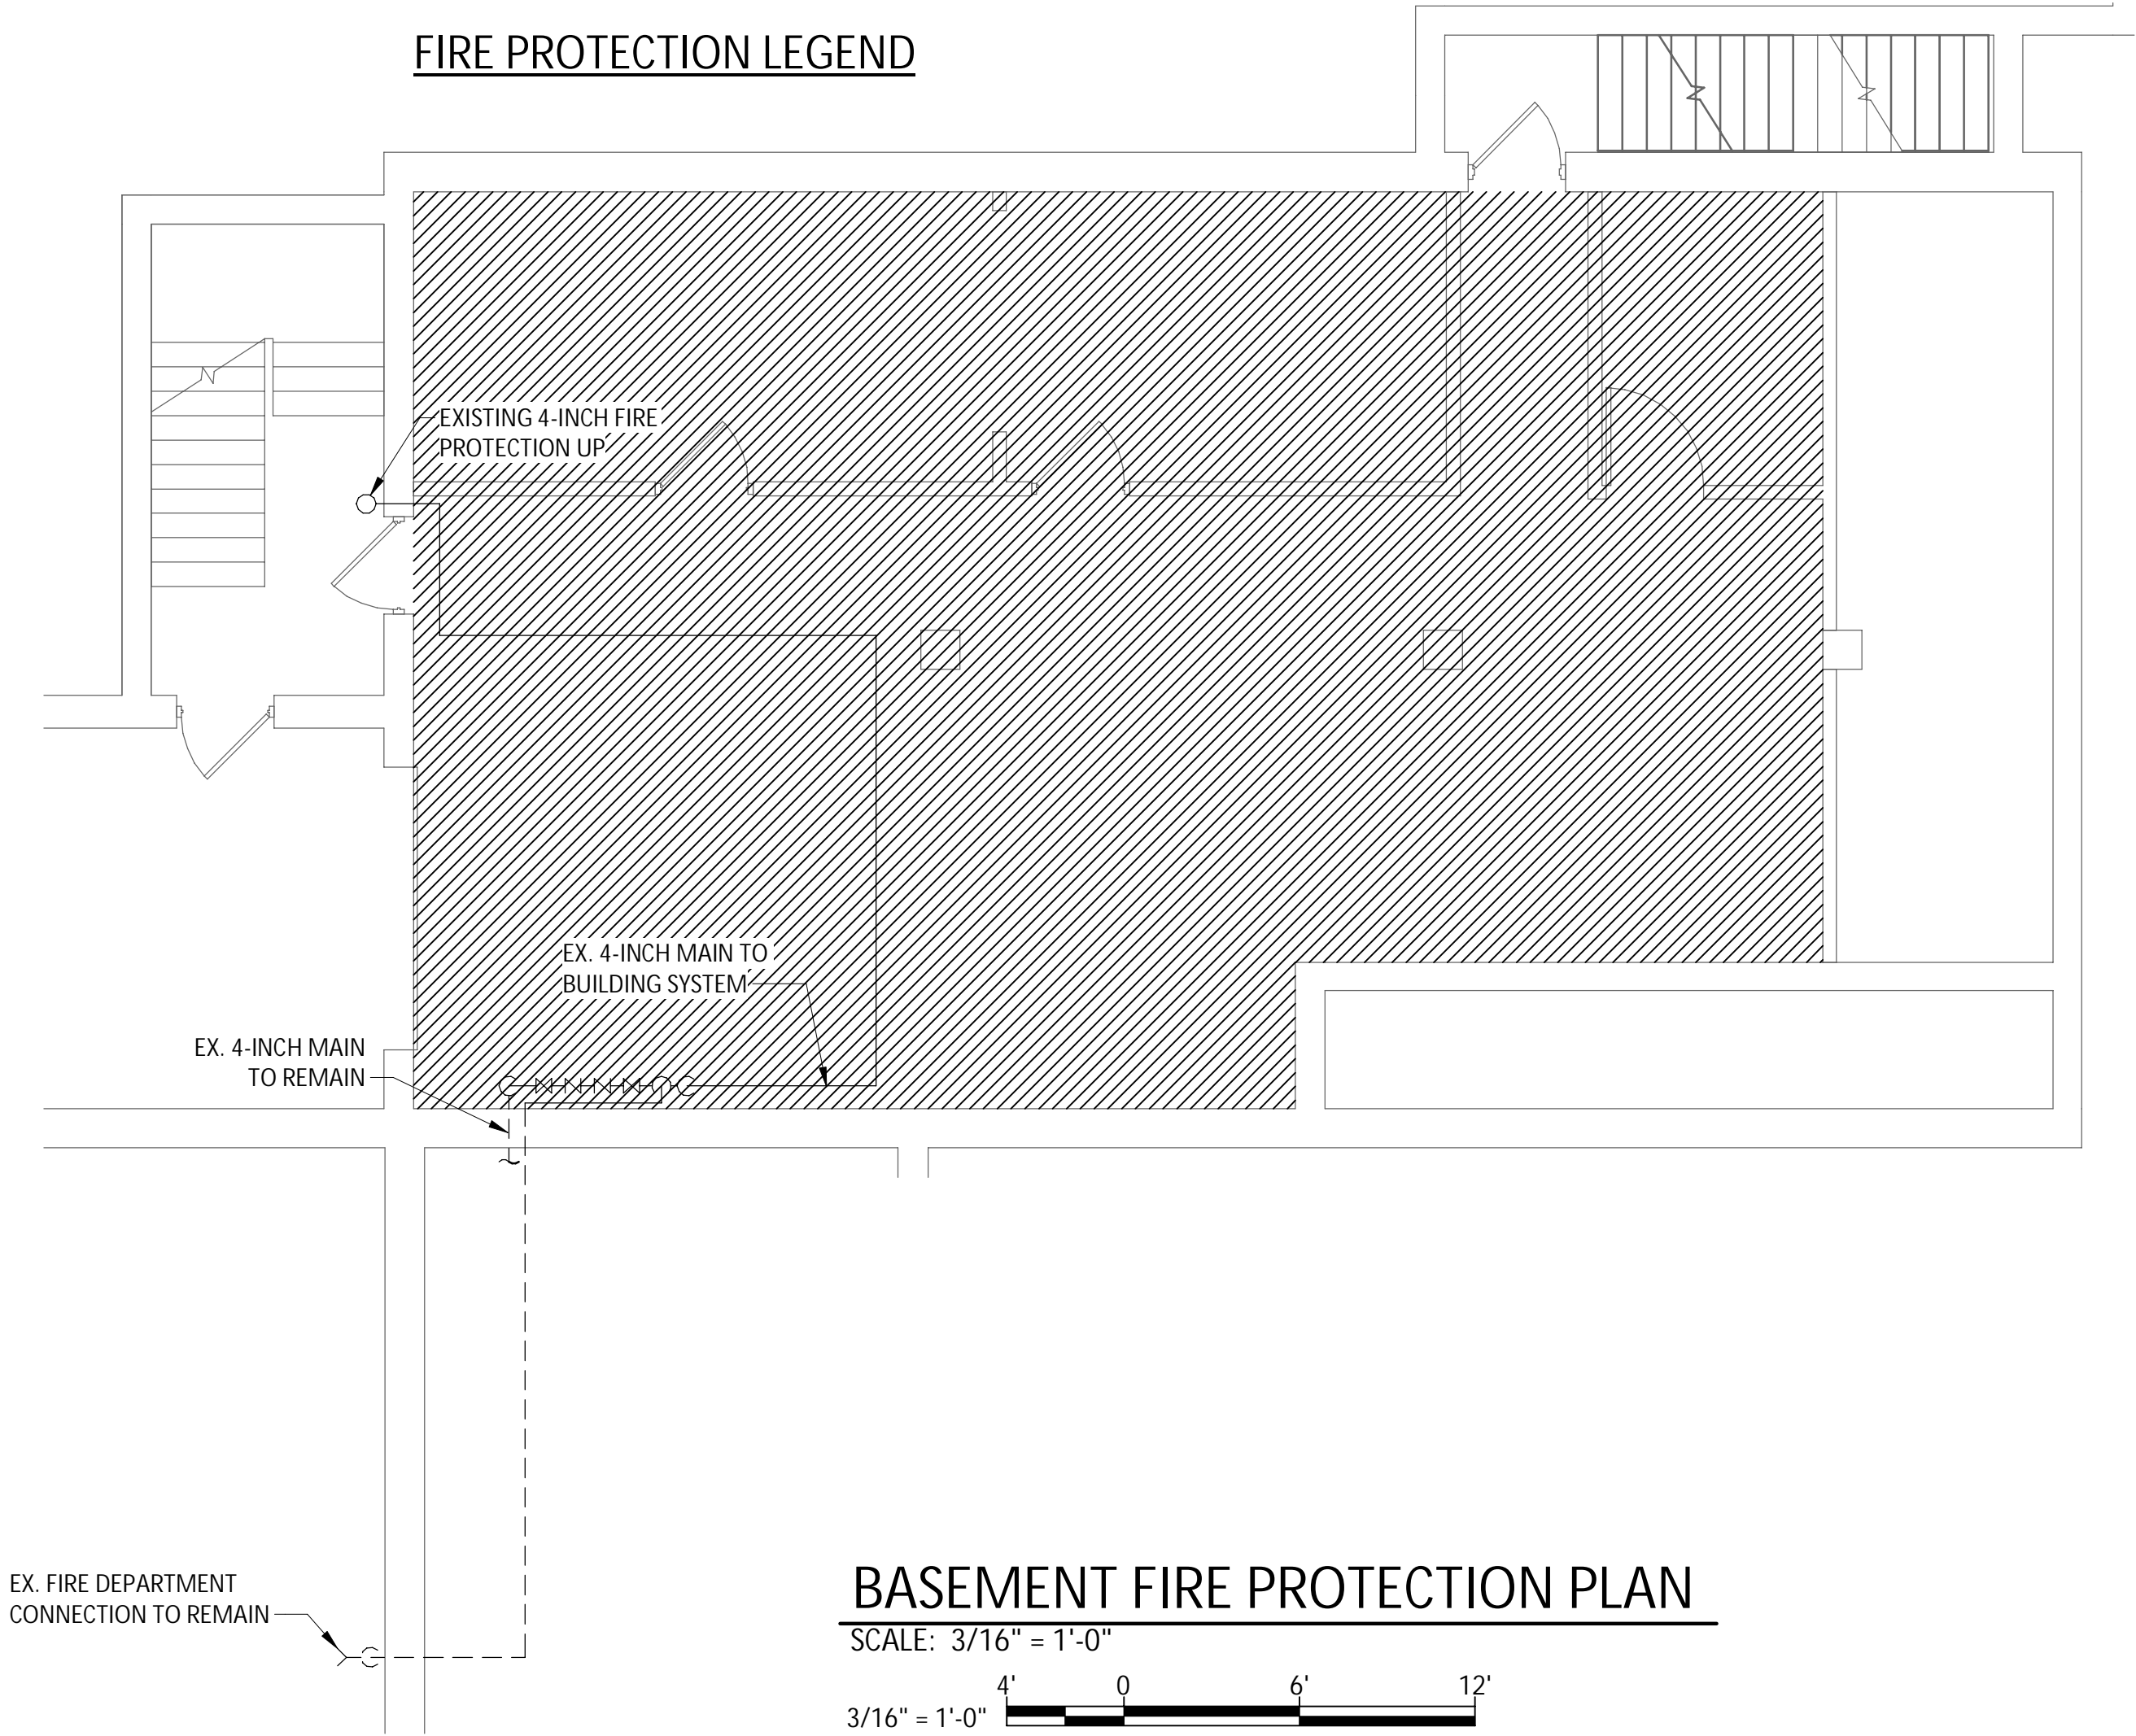
Project Number  
1753.008.001





PROVIDE ADDITIONAL HEAD(S) AND PIPING TO PROVIDE COVERAGE IN AREA AND EXTEND EXISTING SYSTEM.

FIRE PROTECTION LEGEND



BASEMENT FIRE PROTECTION PLAN

SCALE: 3/16" = 1'-0"



- GENERAL NOTES:**
- EXISTING FIRE PROTECTION SYSTEM TO REMAIN. CONTRACTOR SHALL COORDINATE WITH THE LOCAL UTILITY AND CONDUCT A FIRE FLOW TEST IN ACCORDANCE WITH NFPA 13 PRIOR TO PERFORMING ANY WORK. CONTRACTOR SHALL PAY FOR ANY/ALL FEES ASSOCIATED WITH THE TEST.
  - MODIFY EXISTING SPRINKLER HEAD LOCATIONS AND BRANCH PIPING AS REQUIRED TO PROVIDE SPRINKLER COVERAGE OF NEW OFFICE CONFIGURATIONS ON THE FIRST AND SECOND FLOORS IN ACCORDANCE WITH NFPA 13.
  - THESE DRAWINGS ARE DIAGRAMMATIC AND APPROXIMATE; IT IS THE RESPONSIBILITY OF THE INSTALLING CONTRACTOR FOR VERIFICATION OF ALL DIMENSIONS, MEASUREMENTS, AND LOCATIONS OF EXISTING FACILITIES, UTILITIES, EQUIPMENT, AND OTHER EXISTING CONDITIONS WHICH MAY AFFECT CONSTRUCTION PRIOR TO SHOP DRAWINGS AND INSTALLATION. HOWEVER, IN THE EVENT OF DISCREPANCIES BETWEEN THE DRAWINGS AND ACTUAL FIELD CONDITIONS, CONTACT THE CONTRACTING OFFICER IMMEDIATELY.
  - THE DESIGN AND INSTALLATION/MODIFICATION OF THE FIRE PROTECTION SYSTEMS SHALL BE IN STRICT ACCORDANCE WITH NFPA 13, 2016 EDITION; AND ANY APPLICABLE LOCAL, STATE, OR NATIONAL CODES AND STANDARDS.
  - THE ENTIRE FACILITY IS BEING PROTECTED BY AN AUTOMATIC WET PIPE SPRINKLER SYSTEM. COORDINATE SHUTDOWNS AND INTERRUPTIONS IN SPRINKLER PROTECTION WITH THE BUILDING OWNER AND THE AUTHORITY HAVING JURISDICTION.
  - THE SPRINKLER SYSTEM SHALL CONTINUE TO BE MONITORED BY THE FIRE ALARM SYSTEM.
  - THE INTENT OF THE FIRE PROTECTION WORK IS TO MODIFY THE EXISTING SYTEMS TO ACCOMMODATE THE NEW FLOOR PLAN.
  - ALL HANGERS SHALL BE PROVIDED AND INSTALLED IN ACCORDANCE WITH NFPA 13.
  - PROVIDE SLEEVES AND FIRESTOP SEALANTS WHERE PIPES PENETRATE FIRE RATED FLOORS AND WALLS. COMPLY WITH ASTM E-814 AND UL 1479. PROVIDE PIPE SLEEVES WITH FIRE STOP SEALANTS FOR ALL PIPING PENETRATING DRYWALL PARTITIONS, MASONRY PARTITIONS, AND FLOORS.
  - A MAXIMUM OF ONE SPRINKLER MAY BE SUPPLIED BY A SINGLE 1" OUTLET WITHOUT PROVIDING HYDRAULIC CALCULATIONS TO VALIDATE ADEQUACY. NEW MECHANICAL OUTLETS FOR NEW PENDENT HEADS SHOULD BE INSTALLED ON NEARBY BRANCHLINES.
  - FIRE PROTECTION PIPING IS TO BE LOCATED ABOVE THE CEILING UNLESS OTHERWISE NOTED.
  - COORDINATE WITH OTHERS THE FINAL LOCATIONS OF SPRINKLER HEADS, PIPING, AND ALL NEW WORK WITH EXISTING AND NEW LIGHT FIXTURES, DIFFUSERS, GRILLES, REGISTERS, SMOKE DETECTORS, SPEAKERS, AND OTHER CEILING MOUNTED DEVICES.
  - CENTER HEADS IN ALL CEILING TILES UNLESS ARCHITECT APPROVES ALTERNATE LOCATION. PROVIDE ADDITIONAL HEADS WHERE REQUIRED TO MEET COVERAGE REQUIREMENTS.
  - RELOCATE EXISTING SPRINKLER HEADS OR ADD NEW SPRINKLER HEADS AS SHOWN TO PROVIDE A CODE COMPLIANT SYSTEM WHILE ADHERING TO ALL OBSTUCTION RULES WITHIN NFPA 13.
  - LIGHT HAZARD OCCUPANCY, MAXIMUM OF 225FT² PER HEAD, MAXIMUM SPACING IS 15', MINIMUM SPACING IS 6', MINIMUM DISTANCE FROM WALL IS 4".
  - SEE ARCHITECTURAL PLANS FOR CEILING MATERIAL AND COORDINATE HEAD TYPE IN EACH LOCATION.
  - SEAL ALL PENETRATIONS IN ACCORDANCE WITH THE FIRE RATING OF WALLS, CEILINGS OR FLOORS. SEE ARCHITECTURAL PLANS FOR ADDITIONAL INFORMATION.
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- PIPING SHALL BE AS FOLLOWS:
- ALLIED SCHEDULE 40 WITH CAST IRON THREADED FITTINGS FOR BRANCH PIPING 1"-2" DIAMETER, OR APPROVED EQUAL.
  - ALLIED SCHEDULE 10 WITH GROOVED FITTINGS FOR SUPPLY AND MAIN PIPING 2-1/2" DIAMETER AND LARGER, U.O.N.
  - ALL HEADS SHALL BE FED USING 1-INCH DIAMETER PIPING MINIMUM SIZE.

DESIGN CRITERIA FOR WET PIPE SYSTEM:

- LIGHT HAZARD PER NFPA 13, MAXIMUM OF 225 FT² PER HEAD.
- QUICK RESPONSE CONCEALED, PENDANT OR UPRIGHT HEADS.
- DESIGN AREA = 1,500 SF
- DENSITY = 0.10 GPM/SF
- FLOW RATE (SPRINKLERS) 1,500 SF X .10 GPM/SF = 150 GPM
- FLOW RATE (HOSE STREAM) = 100 GPM
- FLOW RATE (MAX.) = 250 GPM
- DURATION OF SUPPLY = 30 MINUTES

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REVISIONS

CITY OF MIDDLETOWN  
NEW COURTHOUSE FACILITY  
CONTRACT 1B - MECHANICAL CONSTRUCTION  
FIRE PROTECTION GENERAL NOTES AND  
BASEMENT FIRE PROTECTION PLAN  
ORANGE COUNTY, NEW YORK  
CITY OF MIDDLETOWN

443 Electronics Parkway  
Liverpool, NY  
13088  
**Barton & Loguidice, D.P.C.**



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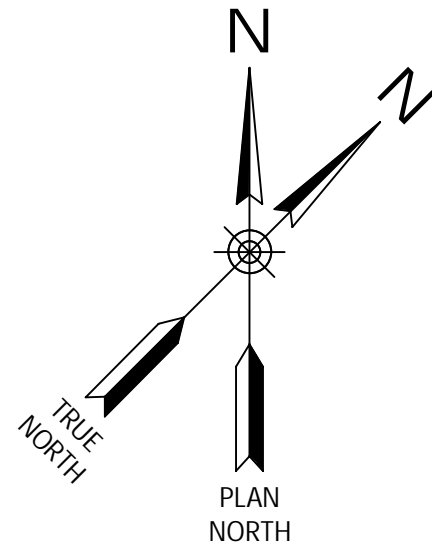
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
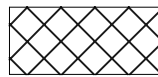
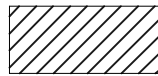
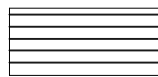
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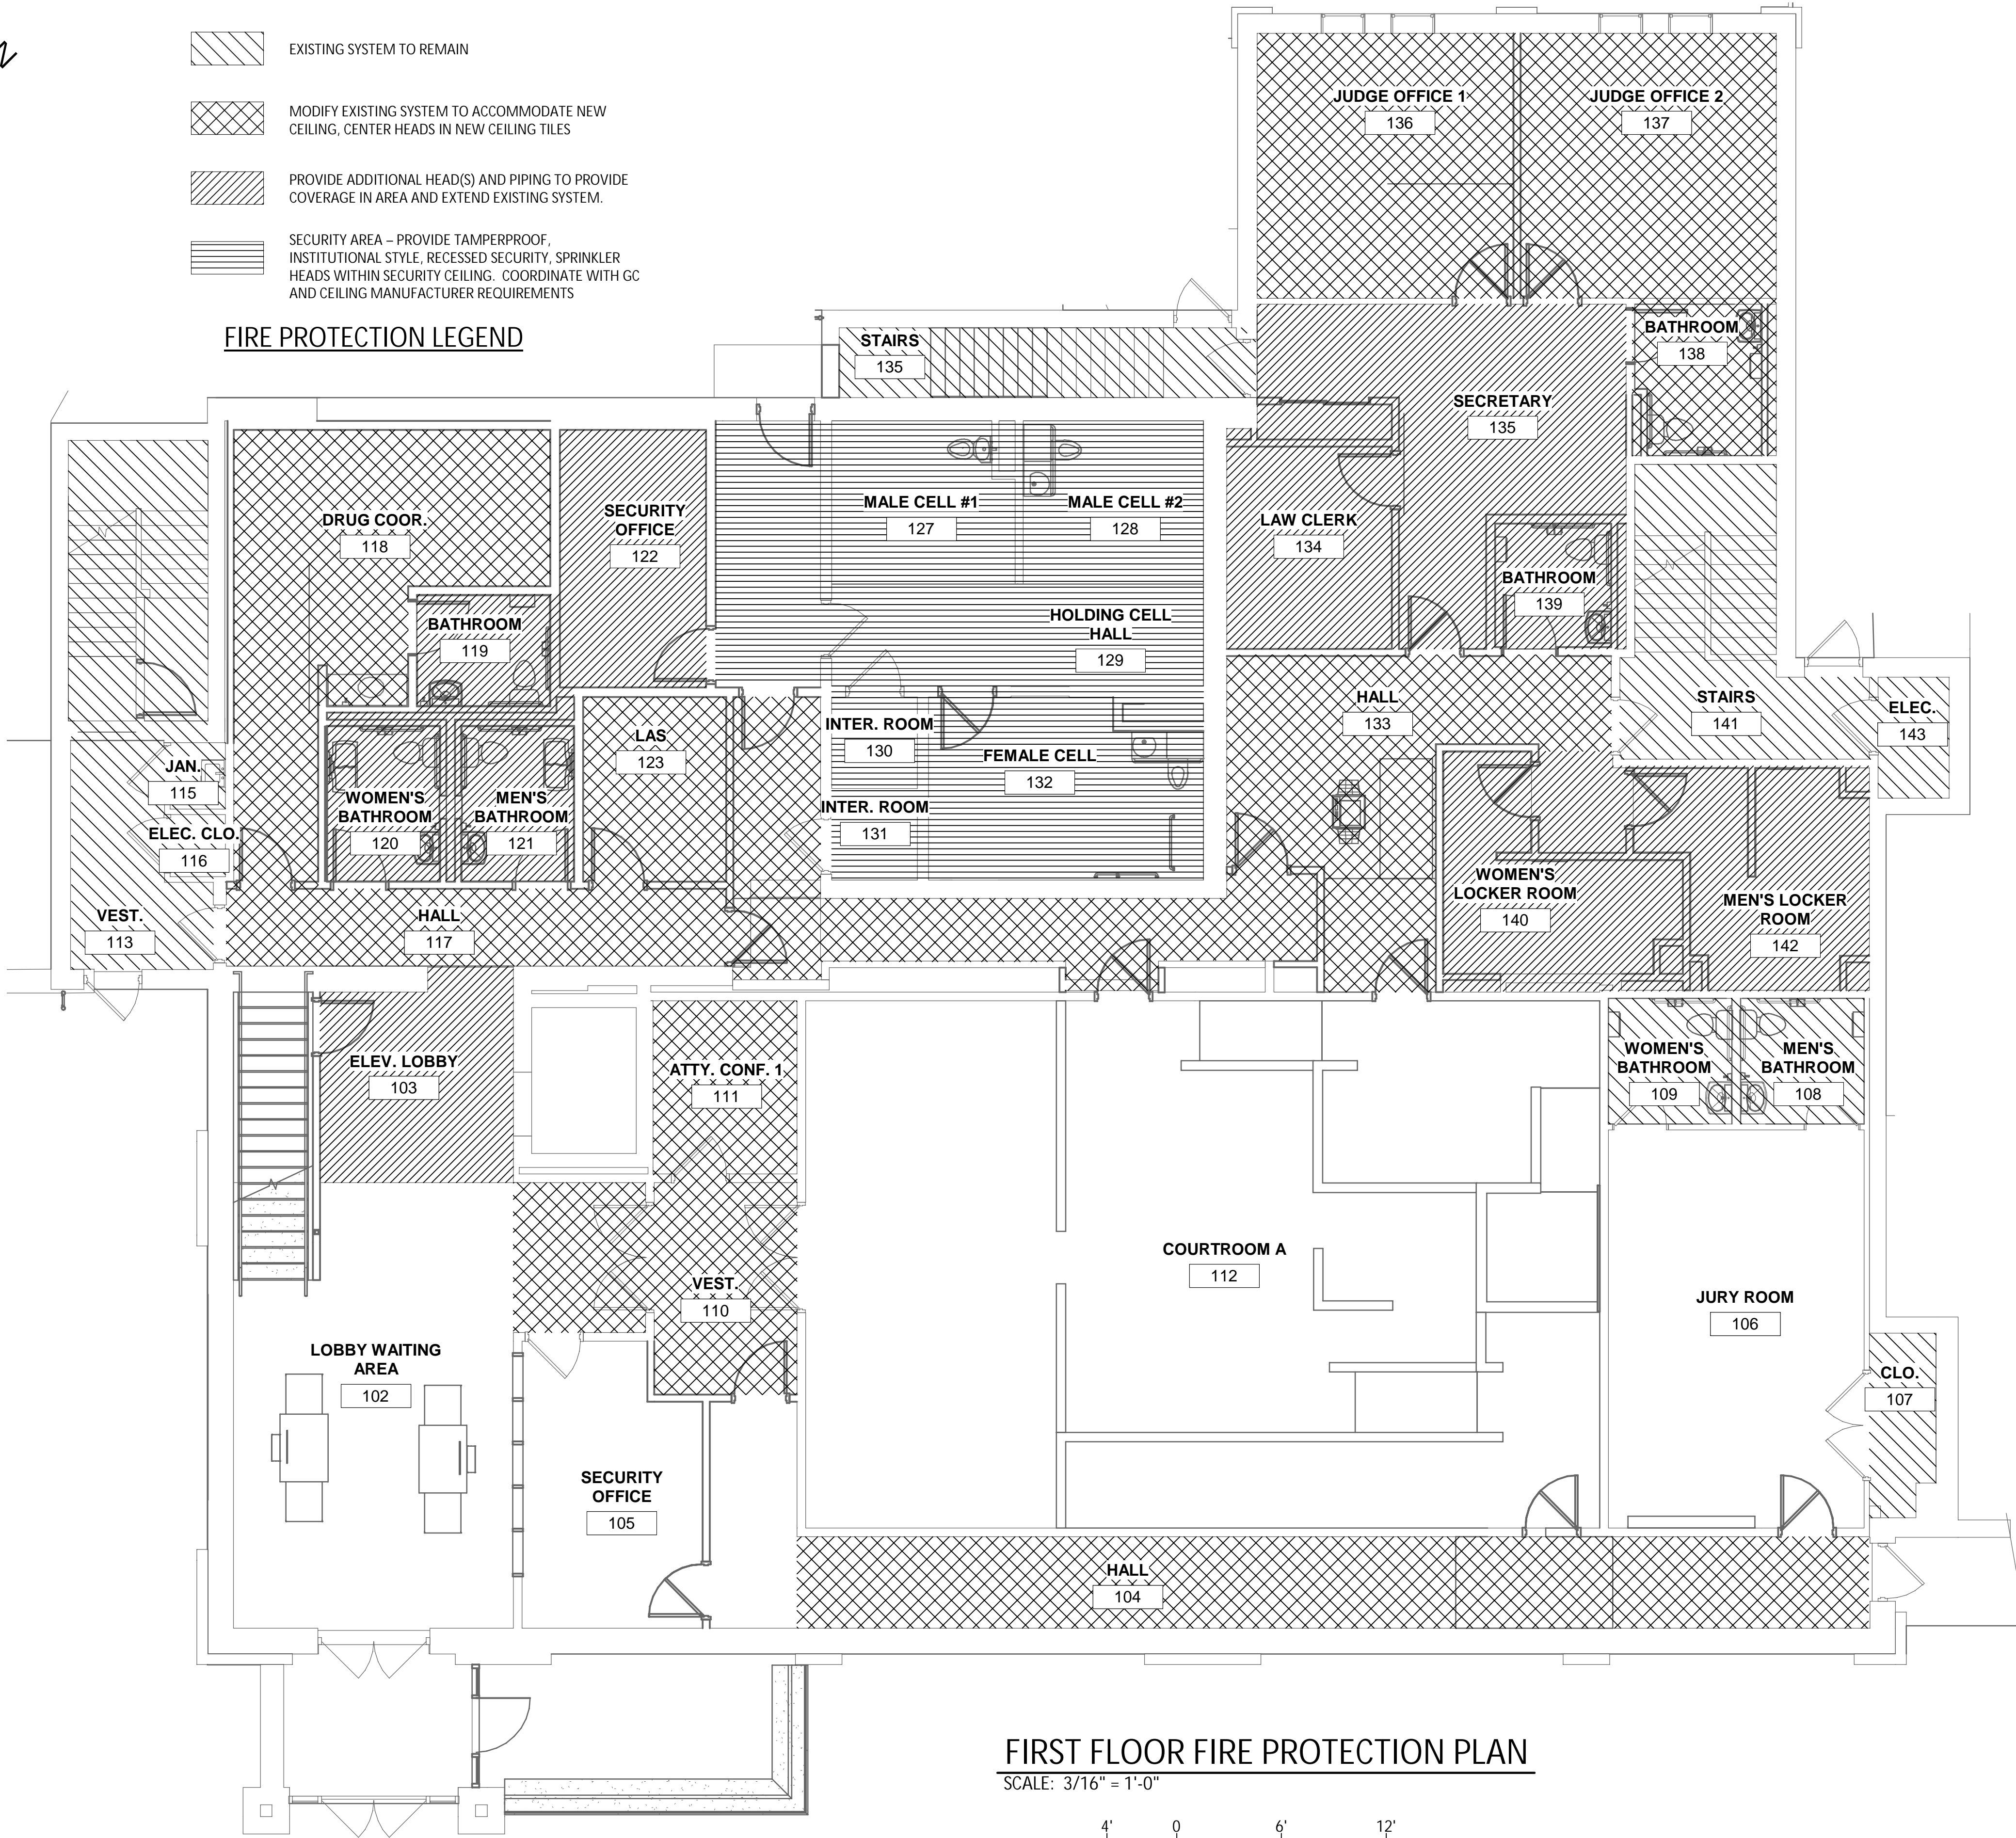
Project Number  
1753.008.001





-  EXISTING SYSTEM TO REMAIN
-  MODIFY EXISTING SYSTEM TO ACCOMMODATE NEW CEILING, CENTER HEADS IN NEW CEILING TILES
-  PROVIDE ADDITIONAL HEAD(S) AND PIPING TO PROVIDE COVERAGE IN AREA AND EXTEND EXISTING SYSTEM.
-  SECURITY AREA – PROVIDE TAMPERPROOF, INSTITUTIONAL STYLE, RECESSED SECURITY, SPRINKLER HEADS WITHIN SECURITY CEILING. COORDINATE WITH GC AND CEILING MANUFACTURER REQUIREMENTS

FIRE PROTECTION LEGEND



FIRST FLOOR FIRE PROTECTION PLAN

SCALE: 3/16" = 1'-0"



- GENERAL NOTES:**
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REVISIONS

CITY OF MIDDLETOWN  
NEW COURTHOUSE FACILITY  
CONTRACT 1B - MECHANICAL CONSTRUCTION  
ORANGE COUNTY, NEW YORK

FIRST FLOOR FIRE PROTECTION PLAN

443 Electronics Parkway  
Liverpool, NY  
13088  
**Barton & Loguidice, D.P.C.**



NYS EXP.: 11/30/2025


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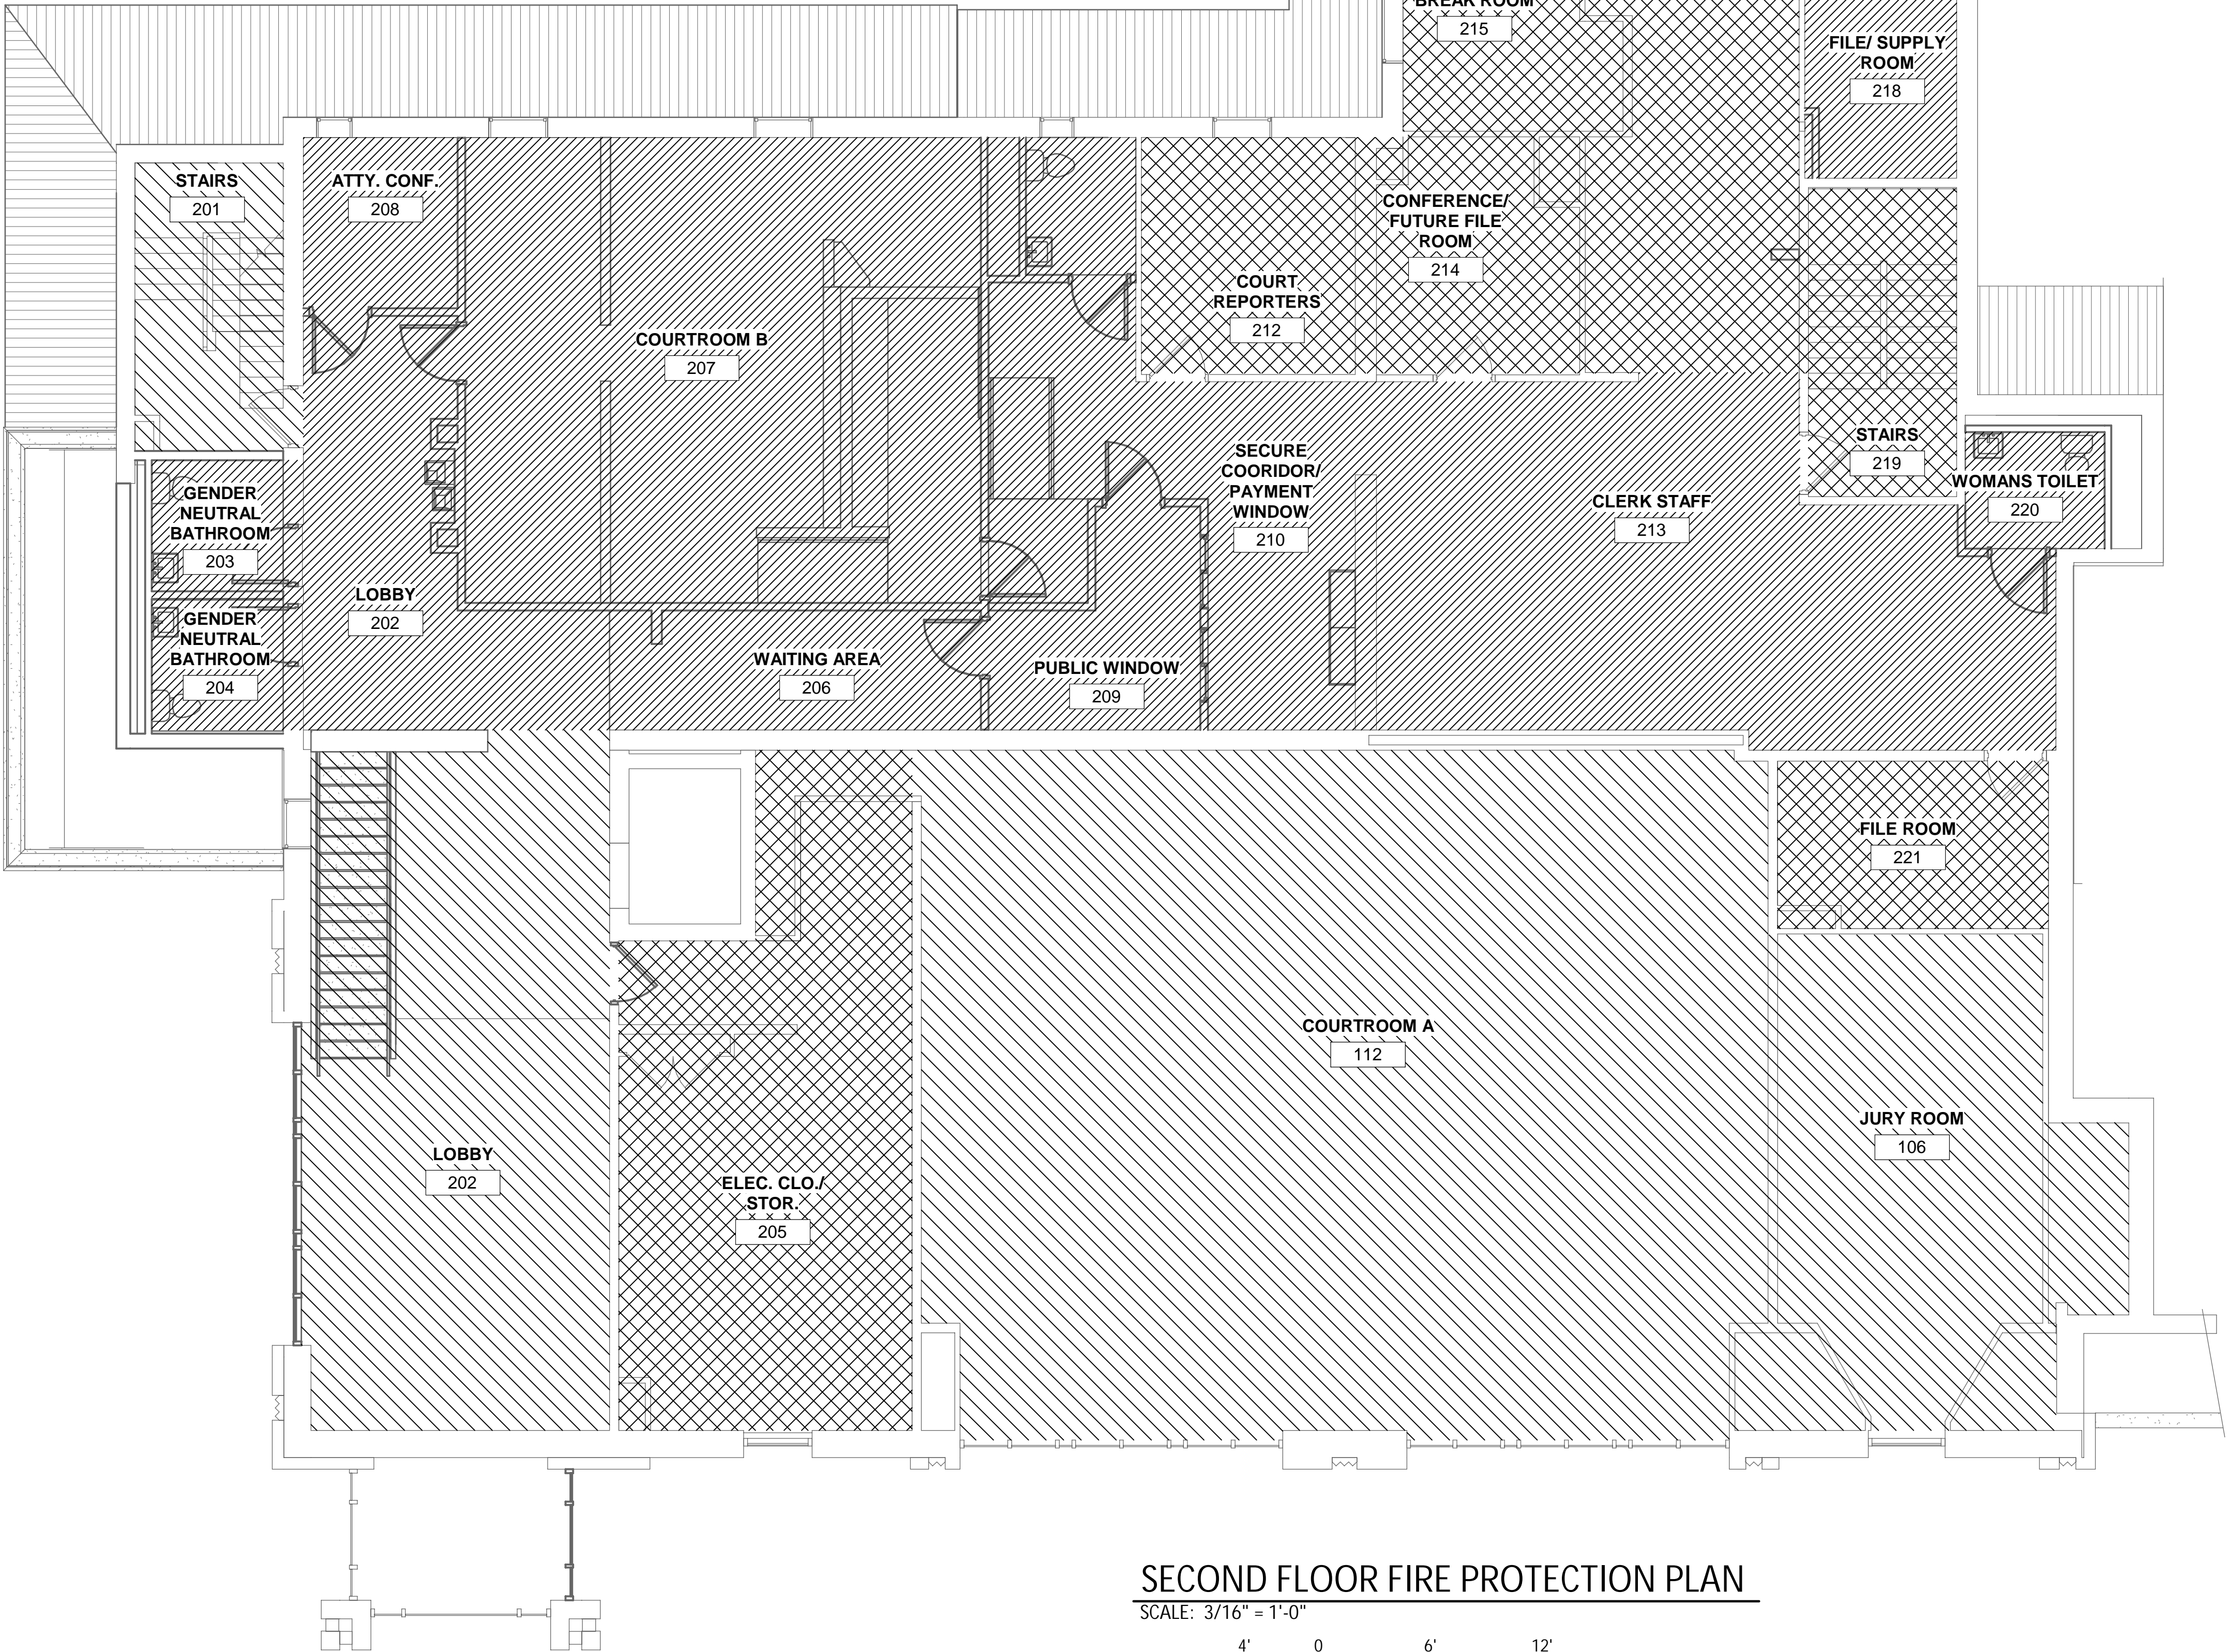
Project Number  
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- EXISTING SYSTEM TO REMAIN
- MODIFY EXISTING SYSTEM TO ACCOMMODATE NEW CEILING, CENTER HEADS IN NEW CEILING TILES
- PROVIDE ADDITIONAL HEAD(S) AND PIPING TO PROVIDE COVERAGE IN AREA AND EXTEND EXISTING SYSTEM.

FIRE PROTECTION LEGEND



SECOND FLOOR FIRE PROTECTION PLAN

SCALE: 3/16" = 1'-0"

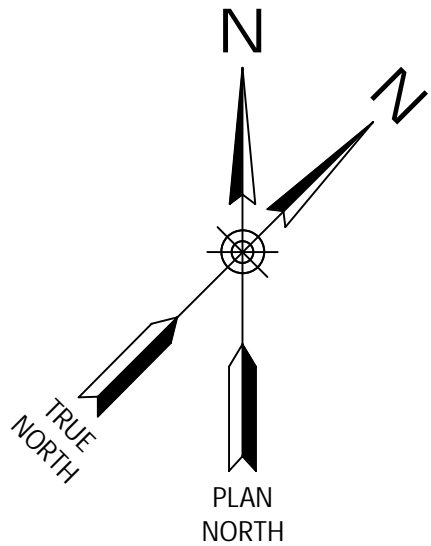

- GENERAL NOTES:**
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  - THESE DRAWINGS ARE DIAGRAMMATIC AND APPROXIMATE: IT IS THE RESPONSIBILITY OF THE INSTALLING CONTRACTOR FOR VERIFICATION OF ALL DIMENSIONS, MEASUREMENTS, AND LOCATIONS OF EXISTING FACILITIES, UTILITIES, EQUIPMENT, AND OTHER EXISTING CONDITIONS WHICH MAY AFFECT CONSTRUCTION PRIOR TO SHOP DRAWINGS AND INSTALLATION. HOWEVER, IN THE EVENT OF DISCREPANCIES BETWEEN THE DRAWINGS AND ACTUAL FIELD CONDITIONS, CONTACT THE CONTRACTING OFFICER IMMEDIATELY.
  - THE DESIGN AND INSTALLATION/MODIFICATION OF THE FIRE PROTECTION SYSTEMS SHALL BE IN STRICT ACCORDANCE WITH NFPA 13, 2016 EDITION: AND ANY APPLICABLE LOCAL, STATE, OR NATIONAL CODES AND STANDARDS.
  - THE ENTIRE FACILITY IS BEING PROTECTED BY AN AUTOMATIC WET PIPE SPRINKLER SYSTEM. COORDINATE SHUTDOWNS AND INTERRUPTIONS IN SPRINKLER PROTECTION WITH THE BUILDING OWNER AND THE AUTHORITY HAVING JURISDICTION.
  - THE SPRINKLER SYSTEM SHALL CONTINUE TO BE MONITORED BY THE FIRE ALARM SYSTEM.
  - THE INTENT OF THE FIRE PROTECTION WORK IS TO MODIFY THE EXISTING SYTEMS TO ACCOMMODATE THE NEW FLOOR PLAN.
  - ALL HANGERS SHALL BE PROVIDED AND INSTALLED IN ACCORDANCE WITH NFPA 13.
  - PROVIDE SLEEVES AND FIRESTOP SEALANTS WHERE PIPES PENETRATE FIRE RATED FLOORS AND WALLS. COMPLY WITH ASTM E-814 AND UL 1479. PROVIDE PIPE SLEEVES WITH FIRE STOP SEALANTS FOR ALL PIPING PENETRATING DRYWALL PARTITIONS, MASONRY PARTITIONS, AND FLOORS.
  - A MAXIMUM OF ONE SPRINKLER MAY BE SUPPLIED BY A SINGLE 1" OUTLET WITHOUT PROVIDING HYDRAULIC CALCULATIONS TO VALIDATE ADEQUACY. NEW MECHANICAL OUTLETS FOR NEW PENDENT HEADS SHOULD BE INSTALLED ON NEARBY BRANCHLINES.
  - FIRE PROTECTION PIPING IS TO BE LOCATED ABOVE THE CEILING UNLESS OTHERWISE NOTED.
  - COORDINATE WITH OTHERS THE FINAL LOCATIONS OF SPRINKLER HEADS, PIPING, AND ALL NEW WORK WITH EXISTING AND NEW LIGHT FIXTURES, DIFFUSERS, GRILLES, REGISTERS, SMOKE DETECTORS, SPEAKERS, AND OTHER CEILING MOUNTED DEVICES.
  - CENTER HEADS IN ALL CEILING TILES UNLESS ARCHITECT APPROVES ALTERNATE LOCATION. PROVIDE ADDITIONAL HEADS WHERE REQUIRED TO MEET COVERAGE REQUIREMENTS.
  - RELOCATE EXISTING SPRINKLER HEADS OR ADD NEW SPRINKLER HEADS AS SHOWN TO PROVIDE A CODE COMPLIANT SYSTEM WHILE ADHERING TO ALL OBSTUCTION RULES WITHIN NFPA 13.
  - LIGHT HAZARD OCCUPANCY, MAXIMUM OF 225FT<sup>2</sup> PER HEAD, MAXIMUM SPACING IS 15', MINIMUM SPACING IS 6', MINIMUM DISTANCE FROM WALL IS 4".
  - SEE ARCHITECTURAL PLANS FOR CEILING MATERIAL AND COORDINATE HEAD TYPE IN EACH LOCATION.
  - SEAL ALL PENETRATIONS IN ACCORDANCE WITH THE FIRE RATING OF WALLS, CEILINGS OR FLOORS. SEE ARCHITECTURAL PLANS FOR ADDITIONAL INFORMATION.
  - EACH CONTRACTOR SHALL BE RESPONSIBLE FOR ALL CUTTING AND PATCHING ASSOCIATED WITH THEIR WORK. WHERE EQUIPMENT IS COMPLETELY DEMOLISHED OR REMOVED AND REPLACED WITH NEW EQUIPMENT, ALL FINISHES, FLOORING, BASE AND WALL SHALL BE PATCHED TO MATCH SURROUNDING AREAS. FEATHER INTO EXISTING FINISHED CONDITIONS TO TRANSITION NEW PATCH WORK WITH EXISTING FINISHED CONDITIONS. ALL PATCHING AND PAINTING SHALL BE DONE IN A MANNER TO MATCH THE EXISTING SURFACE IN APPEARANCE AND FUNCTION. ALL PATCHING SHALL BE PERFORMED BY A CONTRACTOR SKILLED IN THE APPROPRIATE CRAFT AND FINAL PATCHING IS SUBJECT TO REVIEW AND APPROVAL BY THE ARCHITECT.
  - PIPING SHALL BE AS FOLLOWS:
    - ALLIED SCHEDULE 40 WITH CAST IRON THREADED FITTINGS FOR BRANCH PIPING 1"-2" DIAMETER, OR APPROVED EQUAL.
    - ALLIED SCHEDULE 10 WITH GROOVED FITTINGS FOR SUPPLY AND MAIN PIPING 2-1/2" DIAMETER AND LARGER, U.O.N.
    - ALL HEADS SHALL BE FED USING 1-INCH DIAMETER PIPING MINIMUM SIZE.

DESIGN CRITERIA FOR WET PIPE SYSTEM:

- LIGHT HAZARD PER NFPA 13, MAXIMUM OF 225 FT<sup>2</sup> PER HEAD.
- QUICK RESPONSE CONCEALED, PENDANT OR UPRIGHT HEADS.
- DESIGN AREA = 1,500 SF
- DENSITY = 0.10 GPM/SF
- FLOW RATE (SPRINKLERS) 1,500 SF X .10 GPM/SF = 150 GPM
- FLOW RATE (HOSE STREAM) = 100 GPM
- FLOW RATE (MAX.) = 250 GPM
- DURATION OF SUPPLY = 30 MINUTES

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REVISIONS

CITY OF MIDDLETOWN  
NEW COURTHOUSE FACILITY  
CONTRACT 1B - MECHANICAL CONSTRUCTION

SECOND FLOOR FIRE PROTECTION PLAN

CITY OF MIDDLETOWN

ORANGE COUNTY, NEW YORK

443 Electronics Parkway  
Liverpool, NY  
13088

**B&L**

**Barton & Loguidice, D.P.C.**



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GENERAL NOTES

CONTRACT DELINEATION

1. ALL ELECTRICAL WORK IS PERFORMED UNDER CONTRACT 1D - ELECTRICAL CONSTRUCTION.

SYMBOLS AND ABBREVIATIONS

1. THIS SHEET CONTAINS SYMBOLS AND ABBREVIATIONS TYPICALLY SHOWN ON ELECTRICAL DRAWINGS AND SCHEMATICS. THIS CONTRACT DRAWING SET MAY NOT CONTAIN ALL SYMBOLS AND ABBREVIATIONS SHOWN ON THIS SHEET.

PERMITS AND INSPECTIONS

1. THE CONTRACTOR SHALL OBTAIN ALL REQUIRED PERMITS AND ARRANGE FOR ALL REQUIRED INSPECTIONS IN ACCORDANCE WITH STATE AND LOCAL GOVERNING AUTHORITIES.  
2. ALL WORK SHALL BE DONE IN ACCORDANCE WITH NEC, AND STATE AND LOCAL GOVERNING REGULATIONS.

SCOPE

1. UNLESS OTHERWISE INDICATED, PROVIDE A COMPLETE AND OPERATIONAL ELECTRICAL SYSTEM INCLUDING ALL NECESSARY MATERIAL, LABOR, AND EQUIPMENT.  
2. ALL DISCONNECTS REQUIRED BY CODE MAY NOT BE SHOWN. CONTRACTOR SHALL PROVIDE ALL NECESSARY DISCONNECTS AND OVERCURRENT PROTECTIVE DEVICES.  
3. ALL EQUIPMENT AND MATERIAL SHALL BE LABELED AND LISTED, AND INSTALLED IN ACCORDANCE WITH THEIR LISTING.  
4. PROVIDE ELECTRICAL POWER WIRING TO ALL MECHANICAL EQUIPMENT.

COORDINATION OF WORK

1. THE CONTRACTOR SHALL COORDINATE AND VERIFY THAT WORKING AND DEDICATED EQUIPMENT SPACE REQUIREMENTS ARE MET PER NEC AND AHJ.  
2. FIELD LOCATE ALL CORE DRILL LOCATIONS.  
3. BEFORE CUTTING OR DRILLING INTO BUILDING ELEMENTS INSPECT AND LAYOUT WORK TO AVOID DAMAGING STRUCTURAL ELEMENTS AND BUILDING UTILITIES.  
4. BEFORE SELECTING MATERIAL AND EQUIPMENT, AND PROCEEDING WITH WORK, INSPECT AREAS WHERE MATERIAL AND EQUIPMENT ARE TO BE INSTALLED TO INSURE SUITABILITY, AND CHECK NEEDED SPACE FOR PLACEMENT, CLEARANCES AND INTERCONNECTIONS.  
5. COORDINATION OF POSSIBLE SYSTEM SHUT-DOWNS AND WORK AREAS NEED TO BE COORDINATED WITH THE OWNER.  
6. VERIFY RECEPTACLE, SWITCH, & COVER PLATE COLORS WITH OWNER.  
7. TURN OVER TO THE OWNER ALL MANUFACTURER'S WARRANTIES FOR EQUIPMENT AND MATERIALS PROVIDED.

DEFINITIONS

1. THE DEFINITION OF ELECTRICAL TERMS USED SHALL BE AS DEFINED IN THE EDITION OF THE NATIONAL ELECTRIC CODE (NEC) AS REFERENCED IN THE BUILDING CODE OF NEW YORK STATE.  
2. THE TERM "INDICATED" SHALL MEAN "AS SHOWN ON CONTRACT DOCUMENTS (SPECIFICATIONS, DRAWINGS, AND RELATED ATTACHMENTS)".  
3. THE TERM "PROVIDE" SHALL MEAN "TO FURNISH, INSTALL, AND CONNECT COMPLETELY".  
4. THE TERM "SIZE" SHALL MEAN ONE OR MORE OF THE FOLLOWING: "LENGTH, CURRENT AND VOLTAGE RATING, NUMBER OF POLES, NEMA SIZE, AND OTHER SIMILAR ELECTRICAL CHARACTERISTICS".

PLANS

1. ELECTRICAL PLANS, DETAILS, AND ONE LINE DIAGRAMS SHOW THE GENERAL LOCATION AND ARRANGEMENT OF THE ELECTRICAL SYSTEM. THEY ARE DIAGRAMMATIC AND DO NOT SHOW ALL CONDUIT BODIES, CONNECTORS, BENDS, FITTINGS, HANGERS, AND ADDITIONAL PULL BOXES WHICH THE CONTRACTOR MUST PROVIDE TO COMPLETE THE ELECTRICAL SYSTEM.  
2. ELECTRICAL PLANS AND DETAILS DO NOT SHOW ALL INTERFERENCES AND CONDITIONS, VISIBLE AND/OR HIDDEN, THAT MAY EXIST; THUS REQUIRING THE CONTRACTOR TO INSPECT AND SURVEY THE SPACE BEFORE PERFORMING THE WORK.

METHODS

1. ALL EXTERIOR CONDUITS TO HAVE DUCT SEAL INSTALLED AT ALL ENDS, BOXES, WEATHERHEADS, PENETRATIONS TO INTERIOR SPACES, ETC.  
2. DUCT BANKS SHALL NOT BE ROUTED DIRECTLY ABOVE OR BELOW EXISTING/PROPOSED UTILITIES EXCEPT WHEN CROSSING. WHERE CROSSING EXISTING OR PROPOSED UTILITIES DUCT BANKS SHALL CROSS AT 90 DEGREE ANGLES.  
3. ALL CONDUIT SYSTEMS EXPOSED TO TEMPERATURE DIFFERENTIALS, IN POTENTIAL CONDENSING ATMOSPHERES, EXTERIOR INSTALLED, OR INSTALLED UNDERGROUND SHALL HAVE PROVISIONS FOR DRAINING WATER OUT OF CONDUIT SYSTEMS.

UNDERGROUND UTILITIES

1. UNDERGROUND UTILITY LOCATIONS ARE NOT GUARANTEED, NOR IS THERE ANY GUARANTEE THAT ALL EXISTING UTILITIES WHETHER FUNCTIONAL OR ABANDONED WITHIN THE PROJECT AREA ARE SHOWN ON THESE DRAWINGS.  
2. THE CONTRACTOR SHALL DETERMINE THE EXACT LOCATION OF ALL UNDERGROUND UTILITIES BEFORE BEGINNING WORK & SHALL BE RESPONSIBLE FOR ALL DAMAGE RESULTING FROM HIS/HER WORK.  
3. THE CONTRACTOR SHALL NOTIFY "DIG SAFELY NEW YORK" 1-800-962-7962 PRIOR TO ANY EXCAVATION.

SYMBOLS

LINEWEIGHT AND LINETYPE DESIGNATIONS

EXISTING U.O.I.  
PROPOSED TO BE PROVIDED U.O.I.  
OVERHEAD ELECTRIC  
UNDERGROUND ELECTRIC

BASIC DRAWING SYMBOLS

UNDERGROUND DUCT BANK DESIGNATION  
DRAWING SPECIFIC NOTE  
FEEDER DESIGNATION  
REMOVALS  
BRANCH CONTINUATION CIRCUIT (2#12, 1#12G IN 3/4" C TO INDICATED PANEL, PROVIDE 20A, 1P BREAKER)  
DISTRIBUTION  
UTILITY POLE  
CIRCUIT BREAKER PANELBOARD, SURFACE MTD., 72" AFF (TO TOP)  
CIRCUIT BREAKER PANELBOARD, FLUSH MTD., 72" AFF (TO TOP)  
GENERATOR  
SELF CONTAINED METER  
METER CONNECTION WITH CURRENT TRANSFORMERS  
TRANSFORMER  
TRANSFORMER  
AUTOMATIC TRANSFER SWITCH

SWITCHES AND OVER CURRENT PROTECTION

FUSIBLE/SAFETY DISCONNECT  
CIRCUIT BREAKER  
FUSE  
DISCONNECT SWITCH  
FUSED DISCONNECT SWITCH  
SWITCH (OPEN)  
SWITCH (CLOSED)  
FUSE CUTOUT  
DRAW-OUT FRAME

GROUNDING

GROUND  
GROUND ROD

WIRING METHODS

GAS/WATER TIGHT PENETRATION  
INSULATED BUSHING OR CONDUIT STUB  
SEAL OFF  
PULL BOX, ITEM NUMBER  
JUNCTION BOX  
HAND HOLE, ITEM NUMBER

MOTORS AND MOTOR STARTERS

FAN/BLOWER  
MOTOR WITH HORSEPOWER  
VARIABLE FREQUENCY DRIVE (VFD)  
MANUAL MOTOR STARTER  
COMBINATION MAG. MOTOR STARTER W/FUSIBLE SWITCH,

FIRE PROTECTION

FIRE ALARM SYSTEM, SMOKE DETECTOR  
FIRE ALARM SYSTEM, PULLSTATION  
FIRE ALARM SYSTEM, FIRE ALARM CONTROL PANEL  
FIRE ALARM SYSTEM, HEAT DETECTOR  
FIRE ALARM SYSTEM, CARBON MONOXIDE DETECTOR  
FIRE ALARM SYSTEM, HORN/STROBE  
FIRE ALARM SYSTEM, HORN  
FIRE ALARM SYSTEM, STROBE  
SMOKE DETECTOR UNDER RAISED FLOOR

RECEPTACLES & DATA DEVICES

SINGLE RECEPTACLE  
DUPLEX RECEPTACLE, XXX-X INDICATES PANEL AND CIRCUIT NUMBER (2#12, 1#12G IN 3/4" C TO INDICATED PANEL, PROVIDE 20A, 1P BREAKER)  
DOUBLE DUPLEX RECEPTACLE  
QUADPLEX RECEPTACLE  
SPECIAL RECEPTACLE, 4" AFF, NEMA CONFIGURATION AS NOTED.  
SWITCHED DUPLEX RECEPTACLE OUTLET, SWITCH TOP HALF  
DUPLEX DATA RECEPTACLE (2 CAT6A CABLES PER SYMBOL)  
QUAD DATA RECEPTACLE (4 CAT6A CABLES PER SYMBOL)  
2 PORT TELEPHONE AND RJ-45 DATA OUTLET  
FLUSH MOUNT FLOOR BOX  
FLOORBOX WITH DATA RECEPTACLE, DUPLEX RECEPTACLE AND MIC RECEPTACLE  
FLOORBOX WITH DATA RECEPTACLE AND DUPLEX RECEPTACLE  
FLOORBOX WITH (2) DATA RECEPTACLE, DUPLEX RECEPTACLE AND MIC RECEPTACLE  
FLOORBOX WITH (2) DATA RECEPTACLE, DUPLEX RECEPTACLE AND MINI SPEAKER  
FLOORBOX WITH (4) DATA RECEPTACLE, QUAD RECEPTACLE AND MIC RECEPTACLE  
FLOORBOX WITH (4) DATA RECEPTACLE, QUAD RECEPTACLE, MIC RECEPTACLE AND MINI SPEAKER

LIGHTING (REFER TO LIGHTING FIXTURE SCHEDULE FOR FIXTURE TYPES)

WALL SWITCH  
DIMMER WALL SWITCH  
3-WAY WALL SWITCH  
CEILING MOUNTED OCCUPANCY/MOTION SENSOR  
2'X2' LED LIGHT FIXTURE, X INDICATES FIXTURE TYPE  
2'X4' LED LIGHT FIXTURE, X INDICATES FIXTURE TYPE  
WALL PACK, OUTDOOR LIGHTING FIXTURE, X INDICATES FIXTURE TYPE  
EXIT LIGHT FIXTURE, CEILING MOUNTED SHADING INDICATES FACE  
EXIT LIGHT FIXTURE, WALL MOUNTED, ARROWS AS INDICATED  
EMERGENCY LIGHTING UNIT, INTEGRAL BATTERY, X INDICATES FIXTURE TYPE  
SITE LIGHTING FIXTURE, TWIN POLE MOUNTED

CONTROL DEVICES

CONTACTOR (NO)  
CONTACTOR (NC)  
TEMPERATURE ACTUATED SWITCH (OPEN)  
TEMPERATURE ACTUATED SWITCH (CLOSED)  
PUSH BUTTON (OPEN)  
THERMOSTAT

SECURITY DEVICES

MASTER INTERCOM W/DOOR RELEASE  
MASTER INTERCOM W/DOOR RELEASE  
REMOTE INTERCOM  
INTERCOM WITH DURESS ALARM  
DURESS ALARM ACTIVATION DEVICE  
HEAT RISE DETECTOR  
MOTION DETECTOR  
DIGITAL KEYPAD  
CARD READER  
ALARM ANNUNCIATOR PANEL  
SECURITY CAMERA (CAMERAS PROVIDED BY OCA AND INSTALLED BY PROJECT COORDINATOR)  
TEL/DATA FLUSH MOUNTED FLOOR BOX  
WIRELESS ACCESS POINT  
AIPHONE  
KRONOS (2 CAT6A CABLES PER SYMBOL)  
OVERHEAD DOOR KEYPAD OPERATOR  
BALANCED MAGNETIC DOOR CONTACT  
MAGNETIC DOOR CONTACT  
IN CEILING SPEAKER  
DOOR CLOSER WITH DOOR POSITION SWITCH

ABBREVIATIONS

PHASE  
AMPERE  
AMP FRAME  
ABOVE FINISHED FLOOR  
AMERICAN NATIONAL STANDARDS INSTITUTE  
AMP TRIP  
AUTOMATIC TRANSFER SWITCH  
CONDUIT  
CIRCUIT BREAKER  
CIRCUIT  
COMBINATION STARTER  
COMMUNICATIONS  
CONCRETE  
CONSTRUCTION  
CONTROL PANEL  
CURRENT TRANSFORMER  
COPPER  
DISCONNECT  
DISTRIBUTION PANEL WITH ITEM NUMBER  
DRAWING  
ELECTRICAL CONTRACTOR  
EMERGENCY  
ELECTROMAGNETIC INTERFERENCE  
EMERGENCY POWER SUPPLY SYSTEM  
EQUIPMENT  
EXTERIOR  
FIRE ALARM  
FIRE ALARM ANNUNCIATION PANEL  
FIRE ALARM CONTROL PANEL  
FURNISHED BY  
FULL LOAD AMPACITY  
BOX COVER FUSTAT W/ SWITCH  
FAN SHUT-DOWN RELAY  
FEET  
FURNISHED  
GENERAL CONTRACTOR  
GROUND FAULT CIRCUIT INTERRUPTER  
GROUND  
HAND HOLE WITH ITEM NUMBER  
HIGH INTENSITY DISCHARGE  
HAND-OFF-AUTO SELECTOR SWITCH  
HORSEPOWER  
INCITES  
JUNCTION BOX  
1000 AMPERE INTERRUPTING CAPACITY  
1000 CIRCULAR MILS  
KILOWATT  
LIGHT EMITTING DIODE  
LOCATION  
LIGHTING PANEL WITH ITEM NUMBER  
LEVEL SENSOR  
LIGHTS  
MANUAL STARTER  
MAIN DISTRIBUTION PANEL WITH ITEM NUMBER

UNIT ABBREVIATIONS

AIR COOLED CONDENSING UNIT  
AIR HANDLING UNIT  
BOILER  
EXHAUST FAN  
UNIT HEATER  
ELECTRIC WATER COOLER  
FEED PUMP  
GREENSAND FILTER  
HOT WATER HEATER  
PUMP  
PACKAGED TERMINAL AIR CONDITIONING  
REMOTE THERMAL UNIT  
WELL PUMP  
VARIABLE FREQUENCY DRIVE

MAIN DISCONNECT WITH ITEM NUMBER  
MAIN CIRCUIT BREAKER  
MOTOR CONTROL CENTER  
MAIN CONTROL PANEL  
MANUFACTURER  
MINIMUM  
MOTOR STARTER  
MANUAL TRANSFER SWITCH  
NEUTRAL  
NORMALLY CLOSED  
NATIONAL ELECTRIC CODE  
NON-FUSED DISCONNECT  
NORMALLY OPEN  
POLE  
PULL BOX WITH ITEM NUMBER  
PROVIDED (FURNISHED AND INSTALLED)  
PHOTO CELL  
PHASE  
PANEL  
PRIMARY  
POUNDS PER SQUARE INCH  
PRESSURE TRANSDUCER  
POWER  
QUANTITY  
RECEPTACLE  
REQUIRED  
RIGID GALVANIZED STEEL  
SECONDARY  
SPECIFICATION  
SQUARE  
SWITCH  
SWITCHBOARD  
SYMMETRICAL  
TYPICAL  
UNDERGROUND ELECTRIC  
UNINTERRUPTIBLE POWER SUPPLY  
VOLTAGE  
VARIABLE FREQUENCY DRIVE  
WITH  
WEATHERPROOF  
TRANSFORMER

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REVISIONS





CITY OF MIDDLETOWN  
NEW COURTHOUSE FACILITY  
CONTRACT 1D - ELECTRICAL CONSTRUCTION  
ELECTRICAL GENERAL NOTES & LEGEND  
ORANGE COUNTY, NEW YORK  
CITY OF MIDDLETOWN

443 Electronics Parkway  
Liverpool, NY  
13088  
Barton & Loguidice, D.P.C.



NYS EXP.: 11/30/2025  
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BASEMENT POWER & SYSTEMS PLAN DEMO

SCALE: 3/16" = 1'-0"

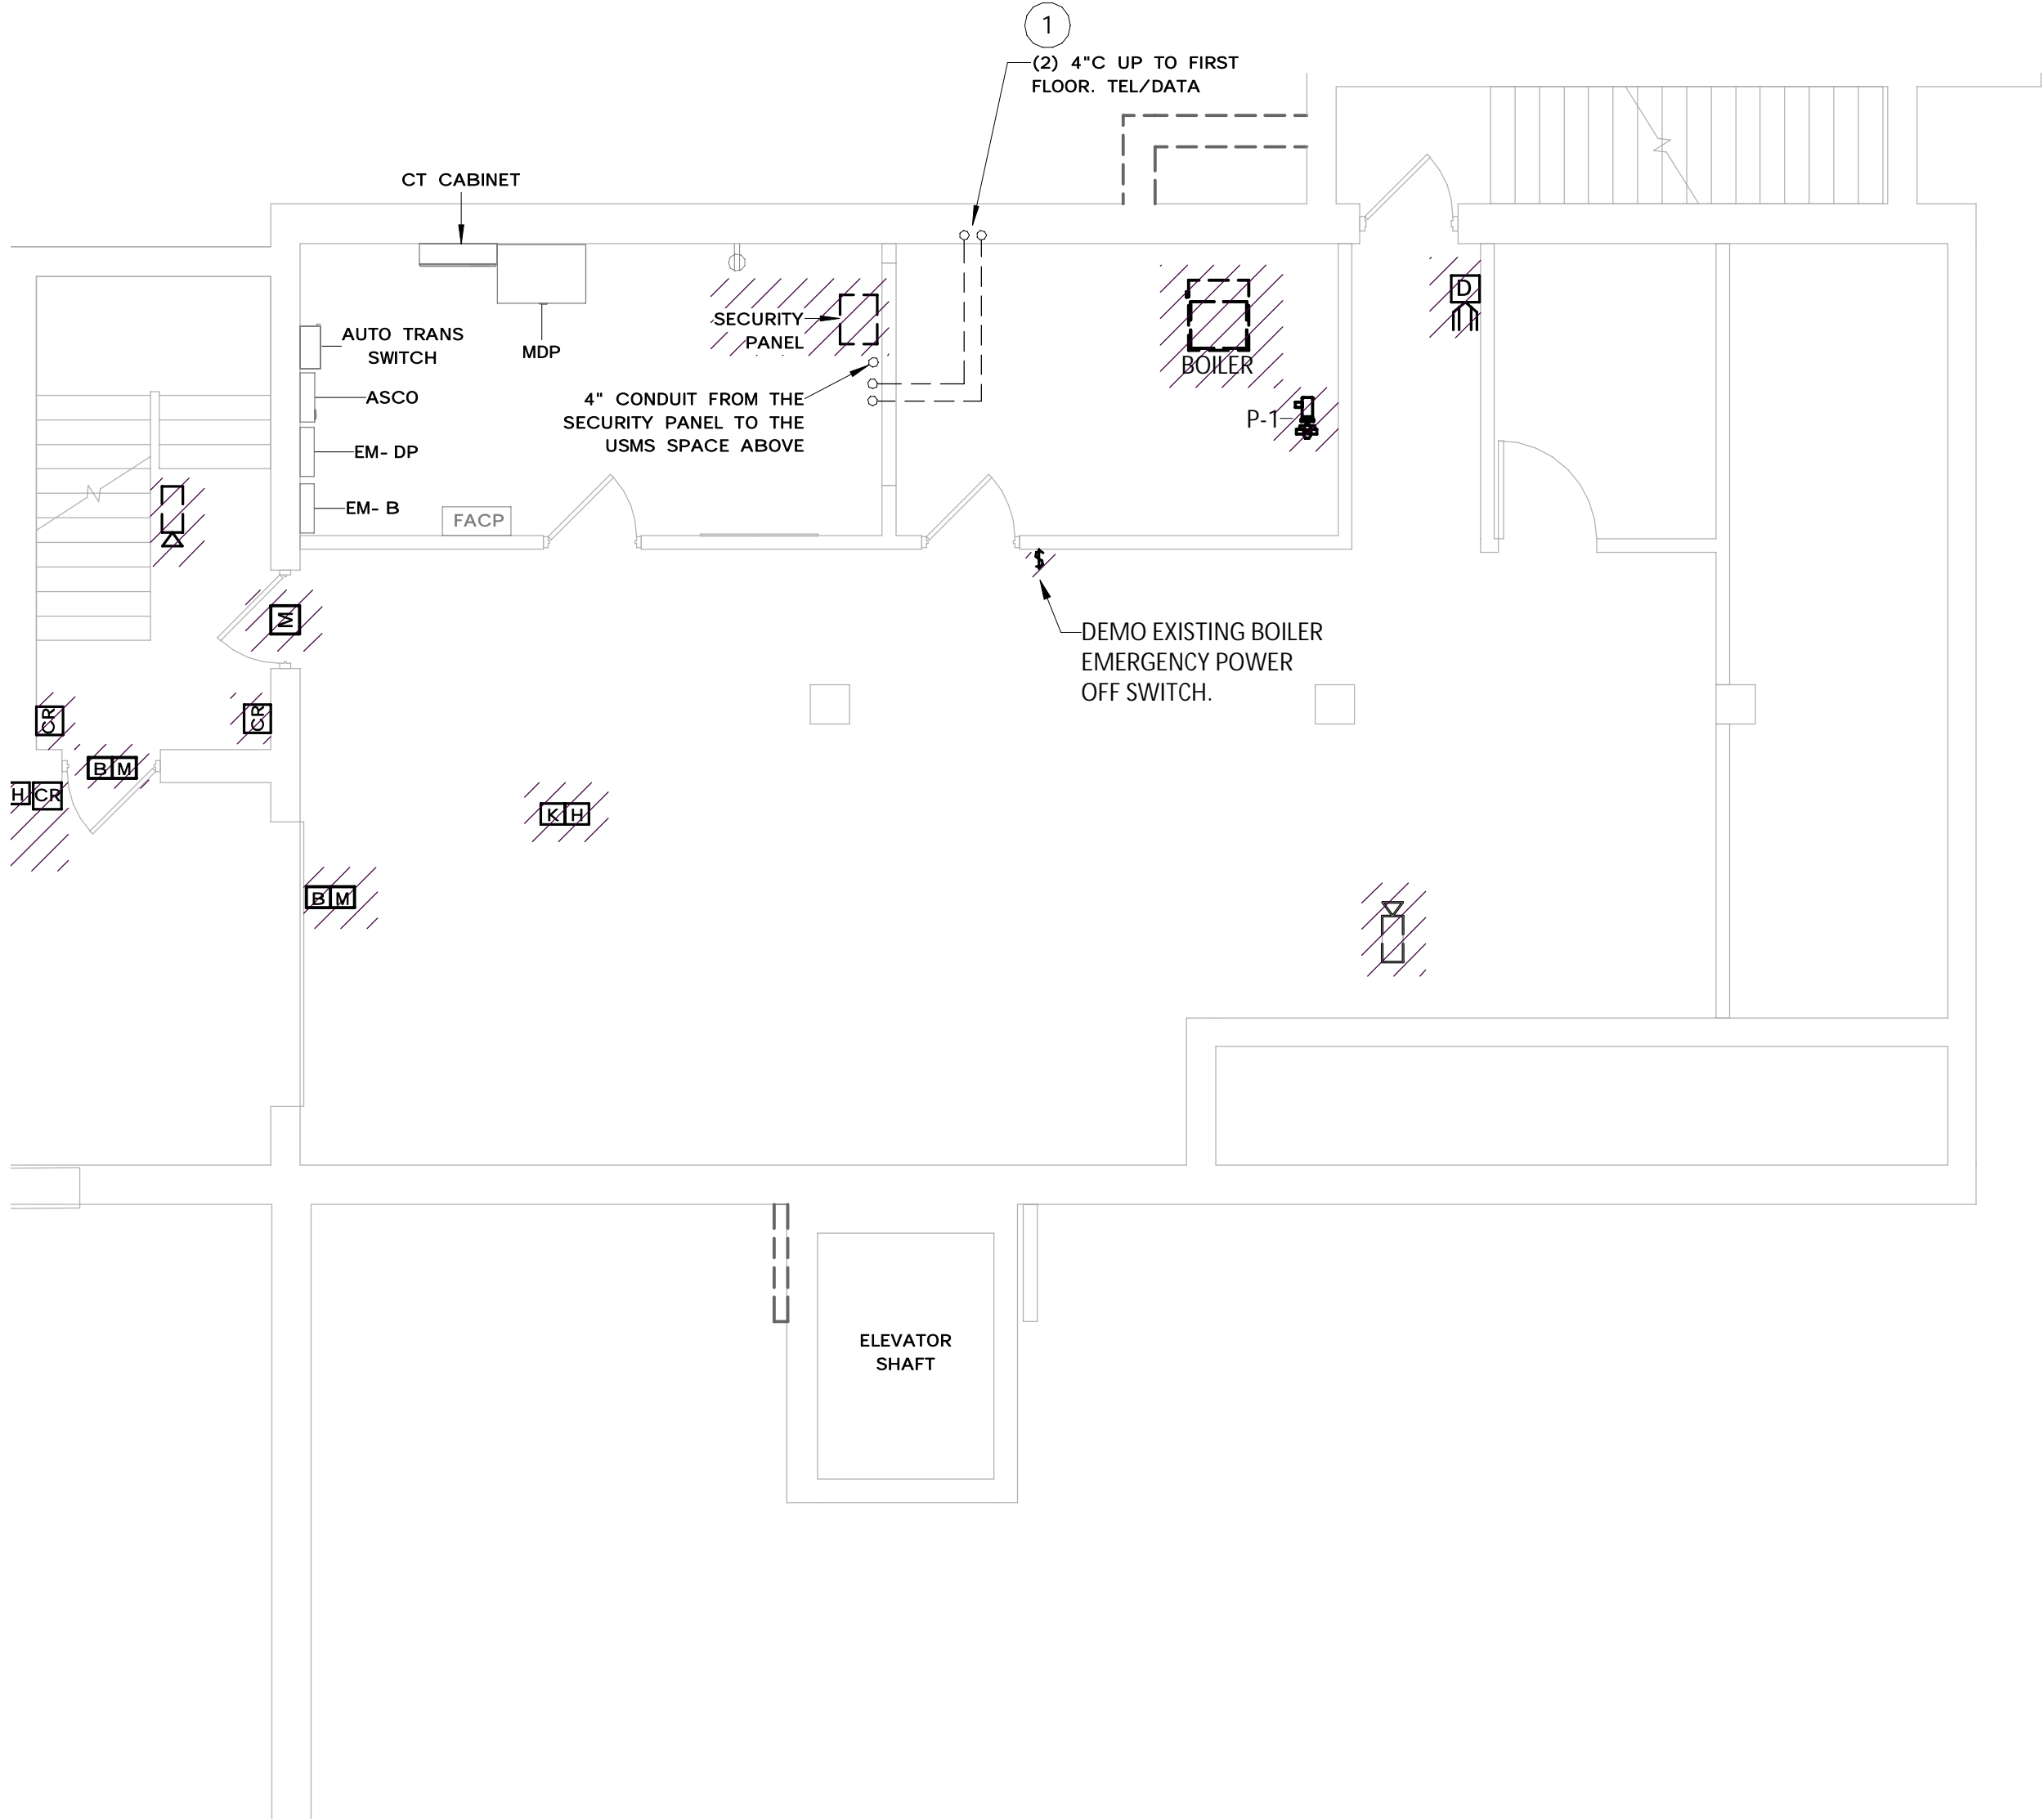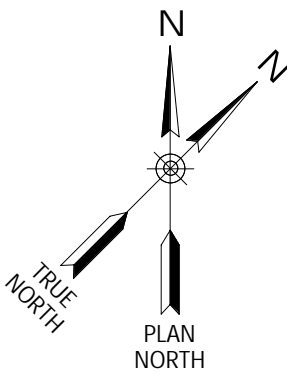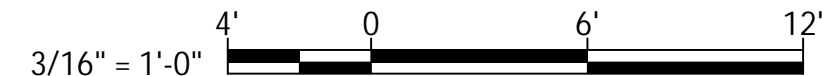GENERAL NOTES - BASEMENT POWER & SYSTEMS PLAN DEMO

- 1 - DEMO ALL EQUIPMENT SHOWN IN A HATCH PATTERN. DEMO ALL ASSOCIATED CONDUCTORS, RACEWAY, AND HARDWARE BACK TO ITS SOURCE.
- 2 - BASEMENT POWER & SYSTEMS PLAN DEMO DRAWING CREATED FROM DRAWINGS E-1 TITLED BASEMENT PLAN AND SE1 TITLED BASEMENT FLOOR SECURITY PLAN DIAGRAM DATED FEBRUARY 1, 2005, AND CURSORY FIELD OBSERVATIONS. CONTRACTOR TO FIELD VERIFY ALL EXISTING INFORMATION REQUIRED.
- 3 - MAINTAIN EXISTING CIRCUITS OTHER THAN THE ONES SHOWN TO BE DEMOED. UPDATE PANEL DIRECTORIES AS REQUIRED.
- 4 - CONTRACTOR SHALL VERIFY NO EQUIPMENT TO REMAIN IS CONNECTED TO CIRCUITS THAT ARE BEING REMOVED. MAINTAIN CIRCUIT CONTINUITY TO ALL EQUIPMENT TO REMAIN. PROVIDE ALL REQUIRED CIRCUIT MODIFICATIONS INCLUDING, BUT NOT LIMITED TO, CONDUIT, WIRE, JUNCTION BOXES, AND SPLICES.

KEYED NOTES - BASEMENT POWER & SYSTEMS PLAN DEMO

- 1 EXISTING CONDUITS AND PULLBOXES SHALL REMAIN AND BE REUSED.

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REVISIONS

CITY OF MIDDLETOWN  
NEW COURTHOUSE FACILITY  
CONTRACT 1D - ELECTRICAL CONSTRUCTION  
BASEMENT POWER & SYSTEMS PLAN DEMO  
CITY OF MIDDLETOWN  
ORANGE COUNTY, NEW YORK

443 Electronics Parkway  
Liverpool, NY  
13088

**B&L**

Barton & Loguidice, D.P.C.



Date  
AUGUST, 2024


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LEGEND	
	EQUIPMENT TO BE DEMOED
	PANELBOARD
	SECURITY CAMERA
	DATA RECEPTACLE
	DUPLEX RECEPTACLE
	CARD READER
	BOILER
	OVERHEAD DOOR KEYPAD OPERATOR
	BALANCED MAGNETIC DOOR CONTACT
	CARD READER
	MAGNETIC DOOR CONTACT





FIRST FLOOR POWER & SYSTEMS PLAN DEMO

SCALE: 3/16" = 1'-0"

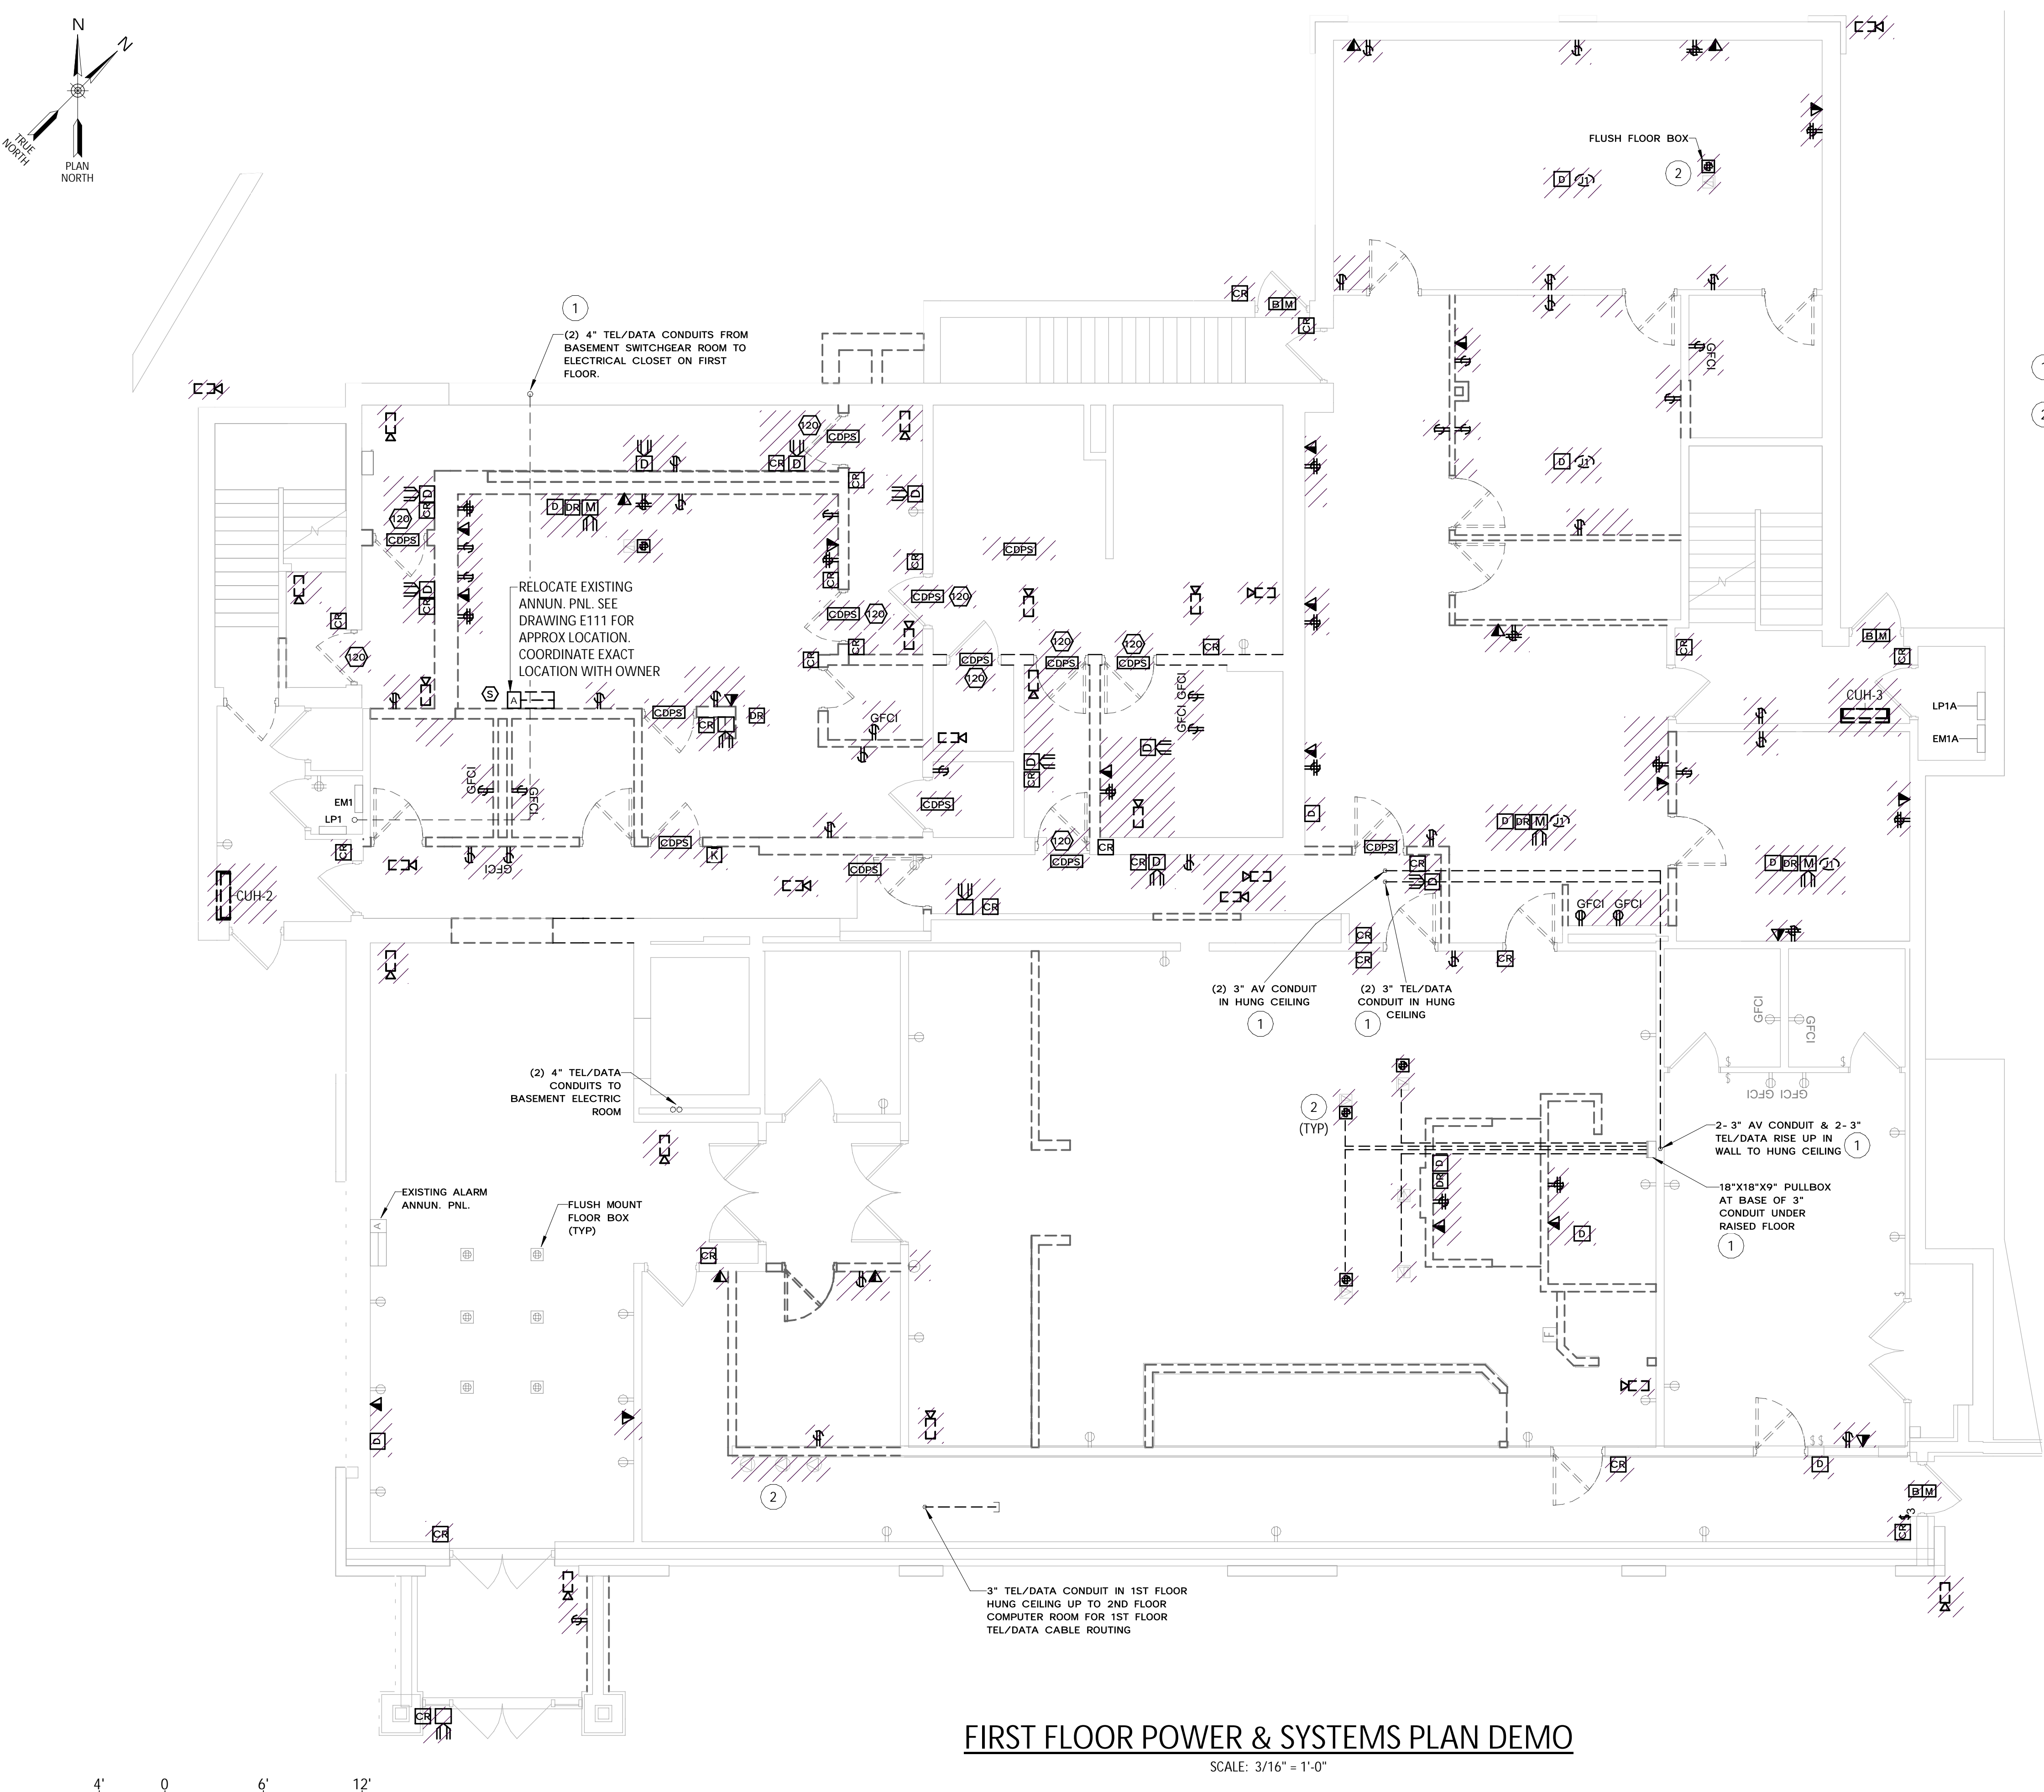GENERAL NOTES - FIRST FLOOR POWER & SYSTEMS PLAN DEMO

- 1 - DEMO ALL EQUIPMENT SHOWN IN HATCH PATTERN. DEMO ALL ASSOCIATED CONDUCTORS, RACEWAY AND HARDWARE BACK TO ITS SOURCE.
- 2 - FIRST FLOOR POWER & SYSTEMS PLAN DEMO DRAWING CREATED FROM DRAWINGS E-2P TITLED FIRST FLOOR PLAN POWER AND SE2 TITLED FIRST FLOOR SECURITY PLAN DIAGRAM DATED FEBRUARY 1, 2005 AND CURSORY FIELD OBSERVATIONS. CONTRACTOR TO FIELD VERIFY ALL EXISTING INFORMATION REQUIRED.
- 3 - MAINTAIN EXISTING CIRCUITS OTHER THAN THE ONES SHOWN TO BE DEMO'D. UPDATE PANEL DIRECTORIES AS REQUIRED.
- 4 - CONTRACTOR SHALL VERIFY NO EQUIPMENT TO REMAIN IS CONNECTED TO CIRCUITS THAT ARE BEING REMOVED. MAINTAIN CIRCUIT CONTINUITY TO ALL EQUIPMENT TO REMAIN. PROVIDE ALL REQUIRED CIRCUIT MODIFICATIONS INCLUDING, BUT NOT LIMITED TO, CONDUIT, WIRE, JUNCTION BOXES, AND SPLICES.

KEYED NOTES - FIRST FLOOR POWER & SYSTEMS PLAN DEMO

- 1 EXISTING CONDUITS AND PULLBOXES SHALL REMAIN AND BE REUSED.
- 2 AFTER REMOVING FLOOR BOXES PATCH AND REPAIR FLOOR TO ITS ORIGINAL STATE. WHEN REPAIRED ALL PATCHED FLOOR PENETRATIONS MUST BE 2 HOUR FIRE RATED.

LEGEND

	EQUIPMENT TO BE DEMOED
	PANELBOARD
	SECURITY CAMERA
	DATA RECEPTACLE
	DUPLEX RECEPTACLE
	CARD READER
	OVERHEAD DOOR KEYPAD OPERATOR
	BALANCED MAGNETIC DOOR CONTACT
	MAGNETIC DOOR CONTACT
	WALL MOUNTED HEATER
	INTERCOM WITH DURESS ALARM
	DURESS ALARM ACTIVATION DEVICE
	DOOR CLOSER WITH DOOR POSITION SWITCH
	MASTER INTERCOM W/DOOR RELEASE
	TEL/DATA FLUSH MOUNTED FLOOR BOX

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REVISIONS

CITY OF MIDDLETOWN  
NEW COURTHOUSE FACILITY  
CONTRACT 1D - ELECTRICAL CONSTRUCTION  
ORANGE COUNTY, NEW YORK

FIRST FLOOR POWER & SYSTEMS PLAN DEMO

443 Electronics Parkway  
Liverpool, NY  
13088  
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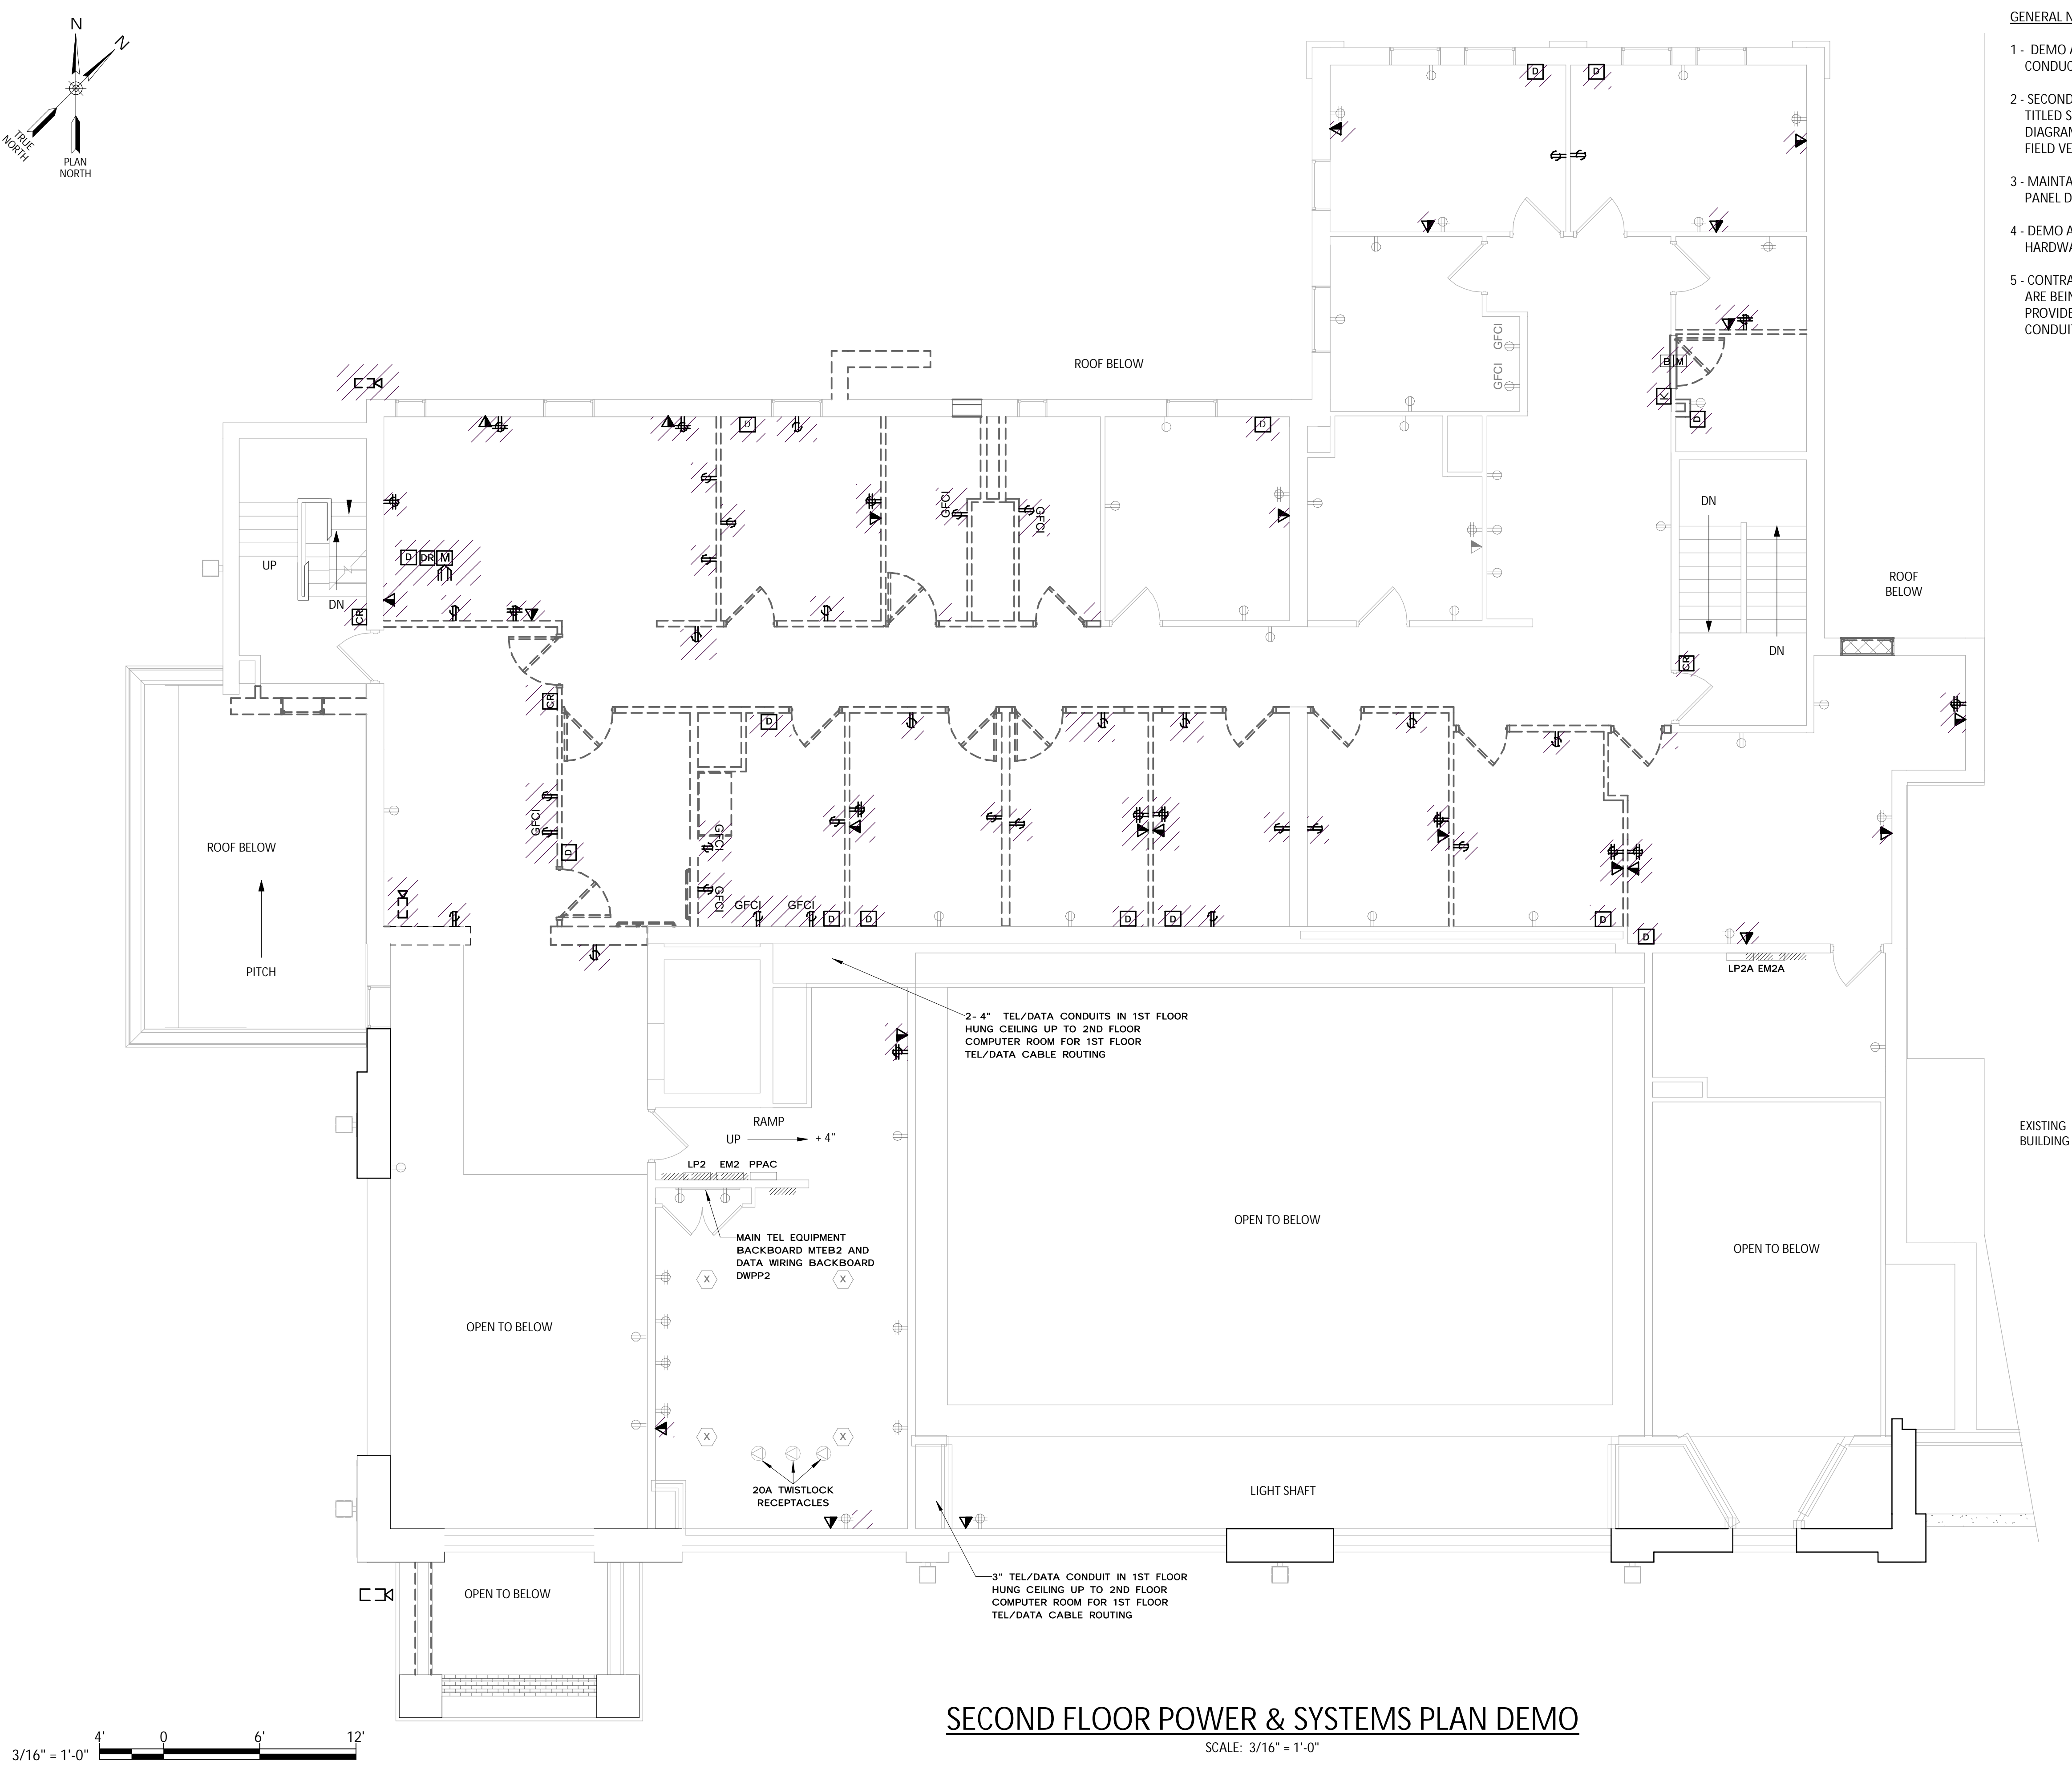
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1753.008.001





## SECOND FLOOR POWER & SYSTEMS PLAN DEMO

SCALE: 3/16" = 1'-0"

### GENERAL NOTES - SECOND FLOOR POWER & SYSTEMS PLAN DEMO

- 1 - DEMO ALL EQUIPMENT SHOWN IN A HATCH PATTERN. DEMO ALL ASSOCIATED CONDUCTORS, RACEWAY, AND HARDWARE BACK TO ITS SOURCE.
- 2 - SECOND FLOOR POWER & SYSTEMS PLAN DEMO DRAWING CREATED FROM DRAWINGS E-3P TITLED SECOND FLOOR PLAN POWER AND SE3 TITLED SECOND FLOOR SECURITY PLAN DIAGRAM DATED FEBRUARY 1, 2005 AND CURSORY FIELD OBSERVATIONS. CONTRACTOR TO FIELD VERIFY ALL EXISTING INFORMATION REQUIRED.
- 3 - MAINTAIN EXISTING CIRCUITS OTHER THAN THE ONES SHOWN TO BE DEMOED. UPDATE PANEL DIRECTORIES AS REQUIRED.
- 4 - DEMO ALL EQUIPMENT SHOWN HATCHED OUT. DEMO ALL CABLES, RACEWAY, AND HARDWARE ASSOCIATED. RETURN EQUIPMENT TO OWNER.
- 5 - CONTRACTOR SHALL VERIFY NO EQUIPMENT TO REMAIN IS CONNECTED TO CIRCUITS THAT ARE BEING REMOVED. MAINTAIN CIRCUIT CONTINUITY TO ALL EQUIPMENT TO REMAIN. PROVIDE ALL REQUIRED CIRCUIT MODIFICATIONS INCLUDING, BUT NOT LIMITED TO, CONDUIT, WIRE, JUNCTION BOXES, AND SPLICES.

LEGEND	
	EQUIPMENT TO BE DEMOED
	PANELBOARD
	SECURITY CAMERA
	DATA RECEPTACLE
	DUPLEX RECEPTACLE
	CARD READER
	MASTER INTERCOM W/DOOR RELEASE
	DURESS ALARM ACTIVATION DEVICE
	BALANCED MAGNETIC DOOR CONTACT
	DIGITAL KEYPAD

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REVISIONS	

CITY OF MIDDLETOWN  
NEW COURTHOUSE FACILITY  
CONTRACT 1D - ELECTRICAL CONSTRUCTION

SECOND FLOOR POWER & SYSTEMS PLAN DEMO

CITY OF MIDDLETOWN  
ORANGE COUNTY, NEW YORK

443 Electronics Parkway  
Liverpool, NY  
13088

**B&L**

**Barton & Loguidice, D.P.C.**


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E103

Project Number  
1753.008.001





## ROOF POWER PLAN DEMO

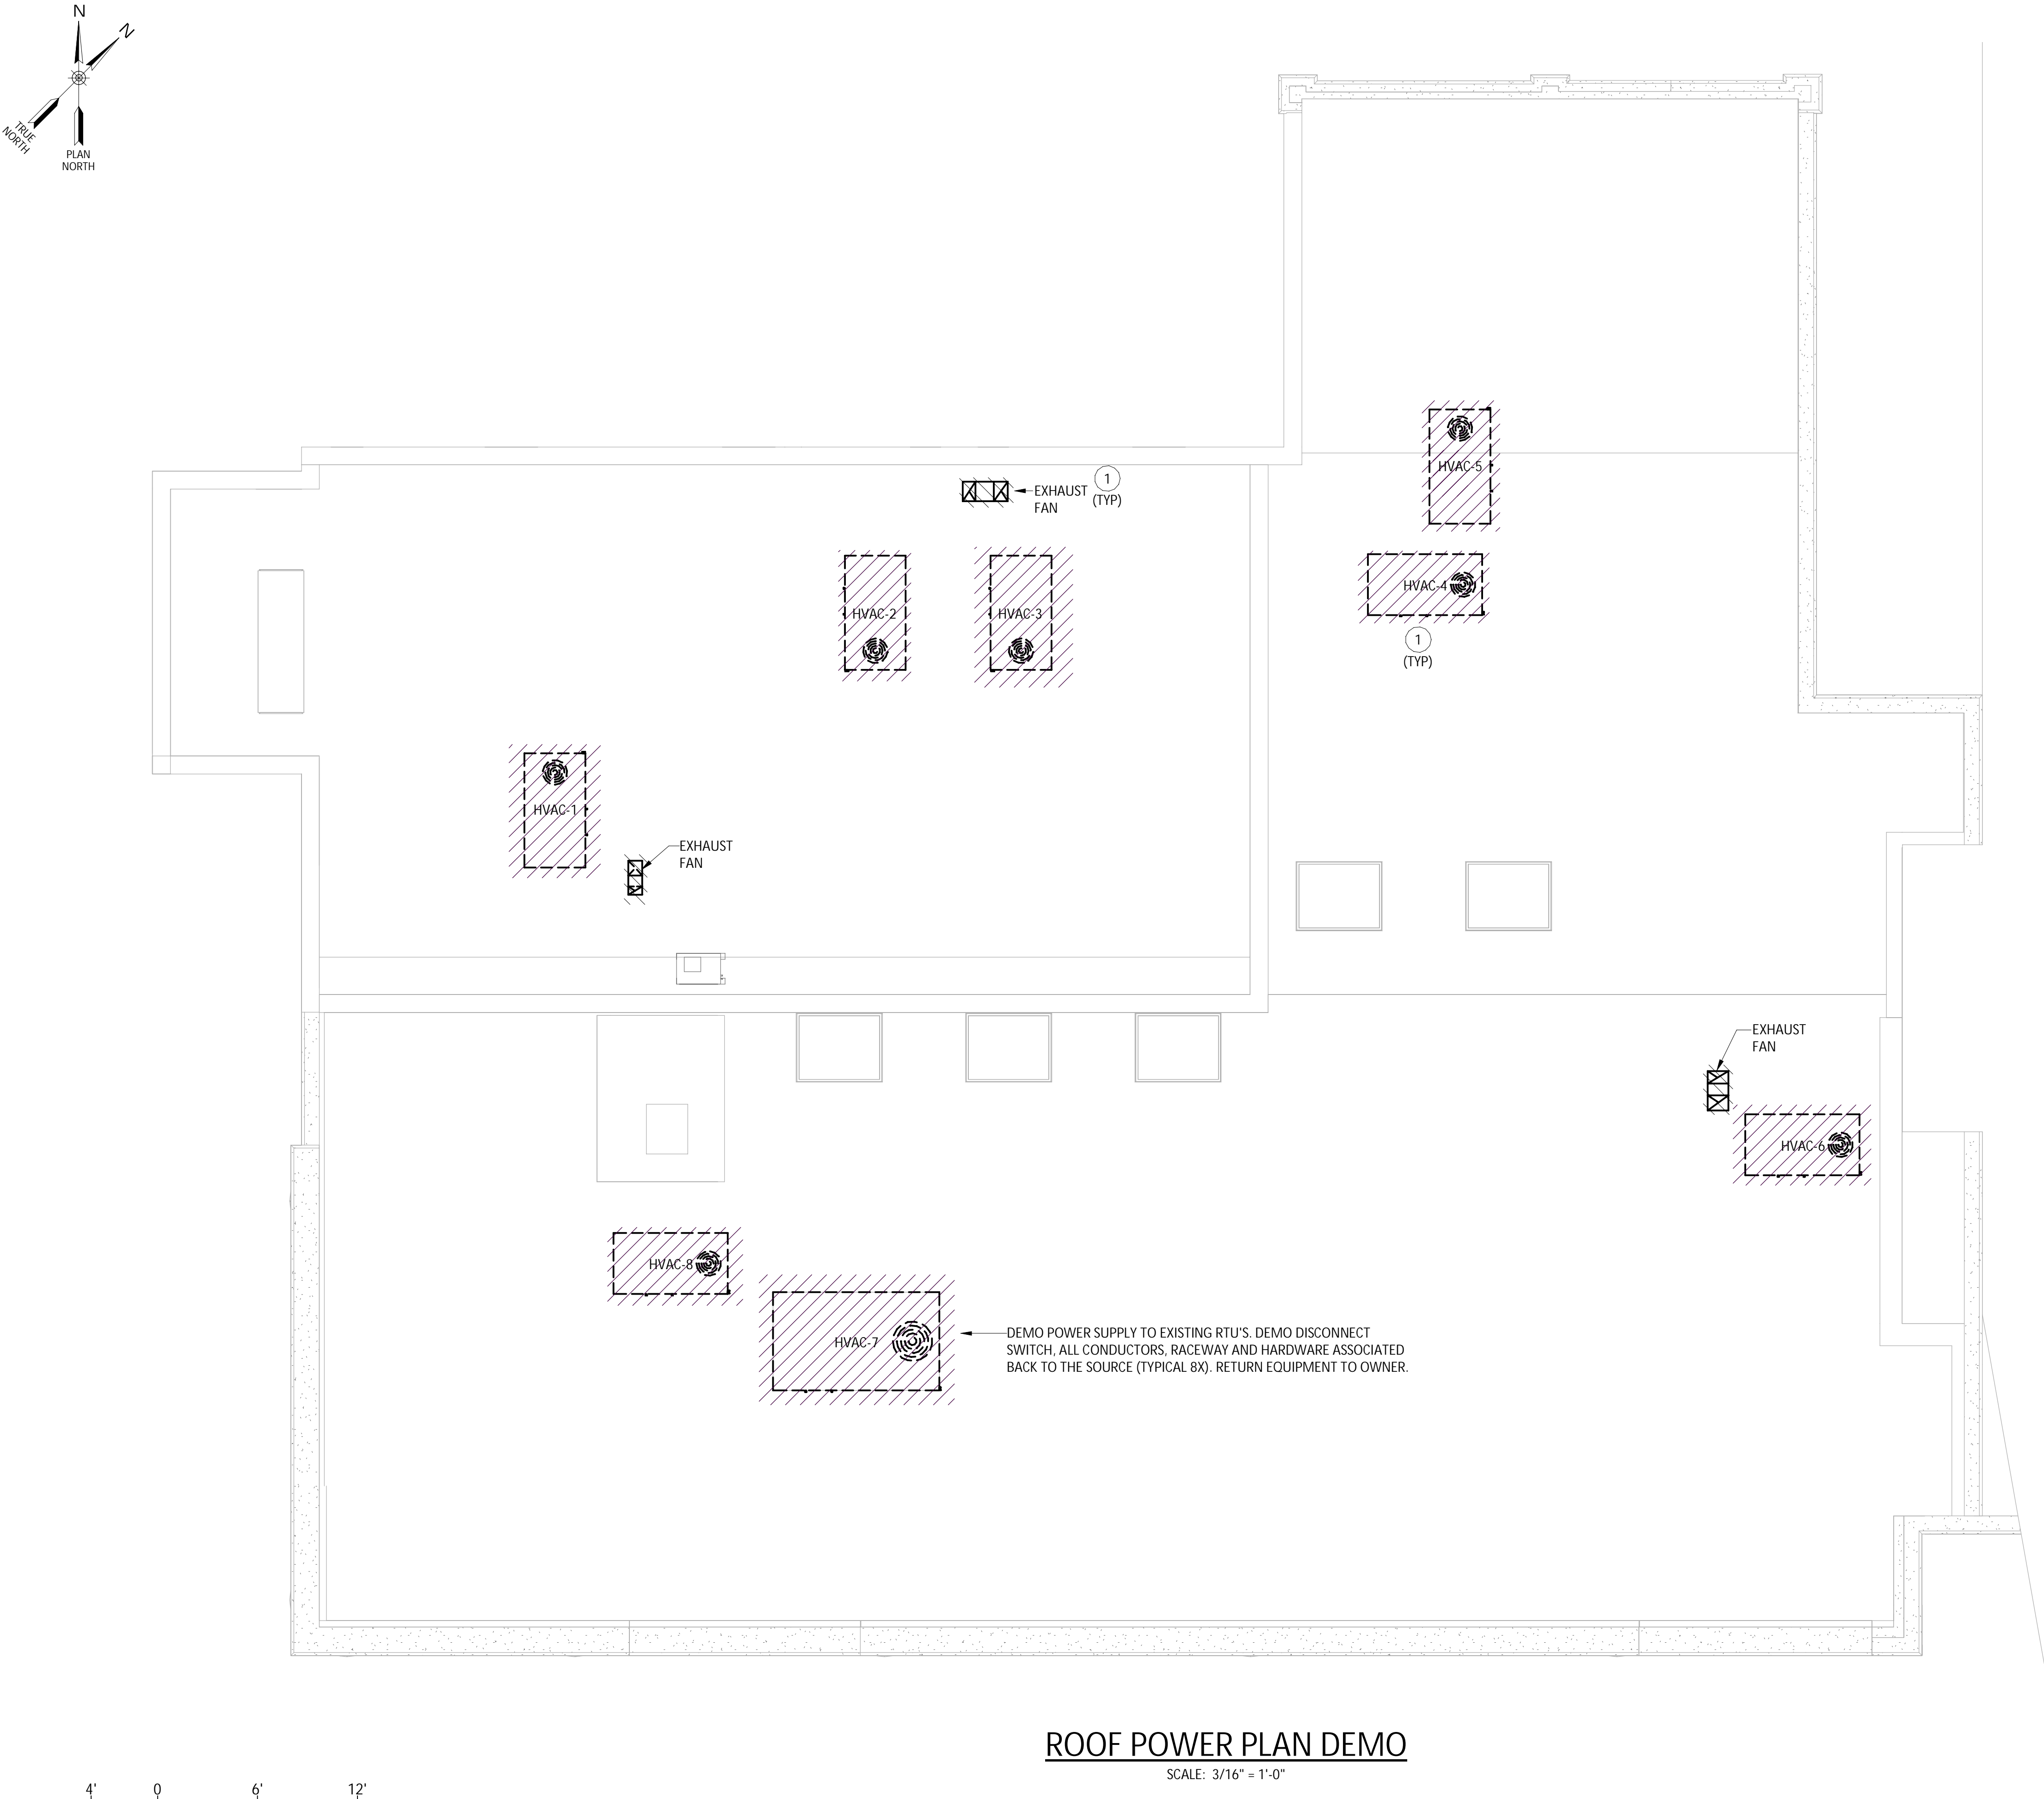SCALE: 3/16" = 1'-0"

### GENERAL NOTES - ROOF POWER PLAN DEMO

- 1 - DEMO ALL EQUIPMENT SHOWN IN A HATCH PATTERN. DEMO ALL ASSOCIATED CONDUCTORS, RACEWAY, AND HARDWARE BACK TO ITS SOURCE.
- 2 - ROOF POWER PLAN DEMO DRAWING CREATED FROM DRAWINGS E-4 TITLED ROOF PLAN POWER DATED JULY 30, 2004, AND CURSORY FIELD OBSERVATIONS. CONTRACTOR TO FIELD VERIFY ALL EXISTING INFORMATION REQUIRED.
- 3 - MAINTAIN EXISTING CIRCUITS OTHER THAN THE ONES SHOWN TO BE DEMOED. UPDATE PANEL DIRECTORIES AS REQUIRED.
- 4 - CONTRACTOR SHALL VERIFY NO EQUIPMENT TO REMAIN IS CONNECTED TO CIRCUITS THAT ARE BEING REMOVED. MAINTAIN CIRCUIT CONTINUITY TO ALL EQUIPMENT TO REMAIN. PROVIDE ALL REQUIRED CIRCUIT MODIFICATIONS INCLUDING, BUT NOT LIMITED TO, CONDUIT, WIRE, JUNCTION BOXES, AND SPLICES.

### KEYED NOTES - ROOF POWER PLAN DEMO

- 1 DEMO THE CONDUIT AND CONDUCTORS FROM THE EXISTING HVAC UNITS AND EXHAUST FANS BACK TO SOURCE PANEL. IN LOCATIONS WHERE THE CONDUIT PENETRATED THE ROOF, PATCH AND REPAIR ROOF TO ITS ORIGINAL CONDITION.

LEGEND	
	EQUIPMENT TO BE DEMOED

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REVISIONS	

CITY OF MIDDLETOWN  
NEW COURTHOUSE FACILITY  
CONTRACT 1D - ELECTRICAL CONSTRUCTION  
ROOF POWER PLAN DEMO  
ORANGE COUNTY, NEW YORK

CITY OF MIDDLETOWN

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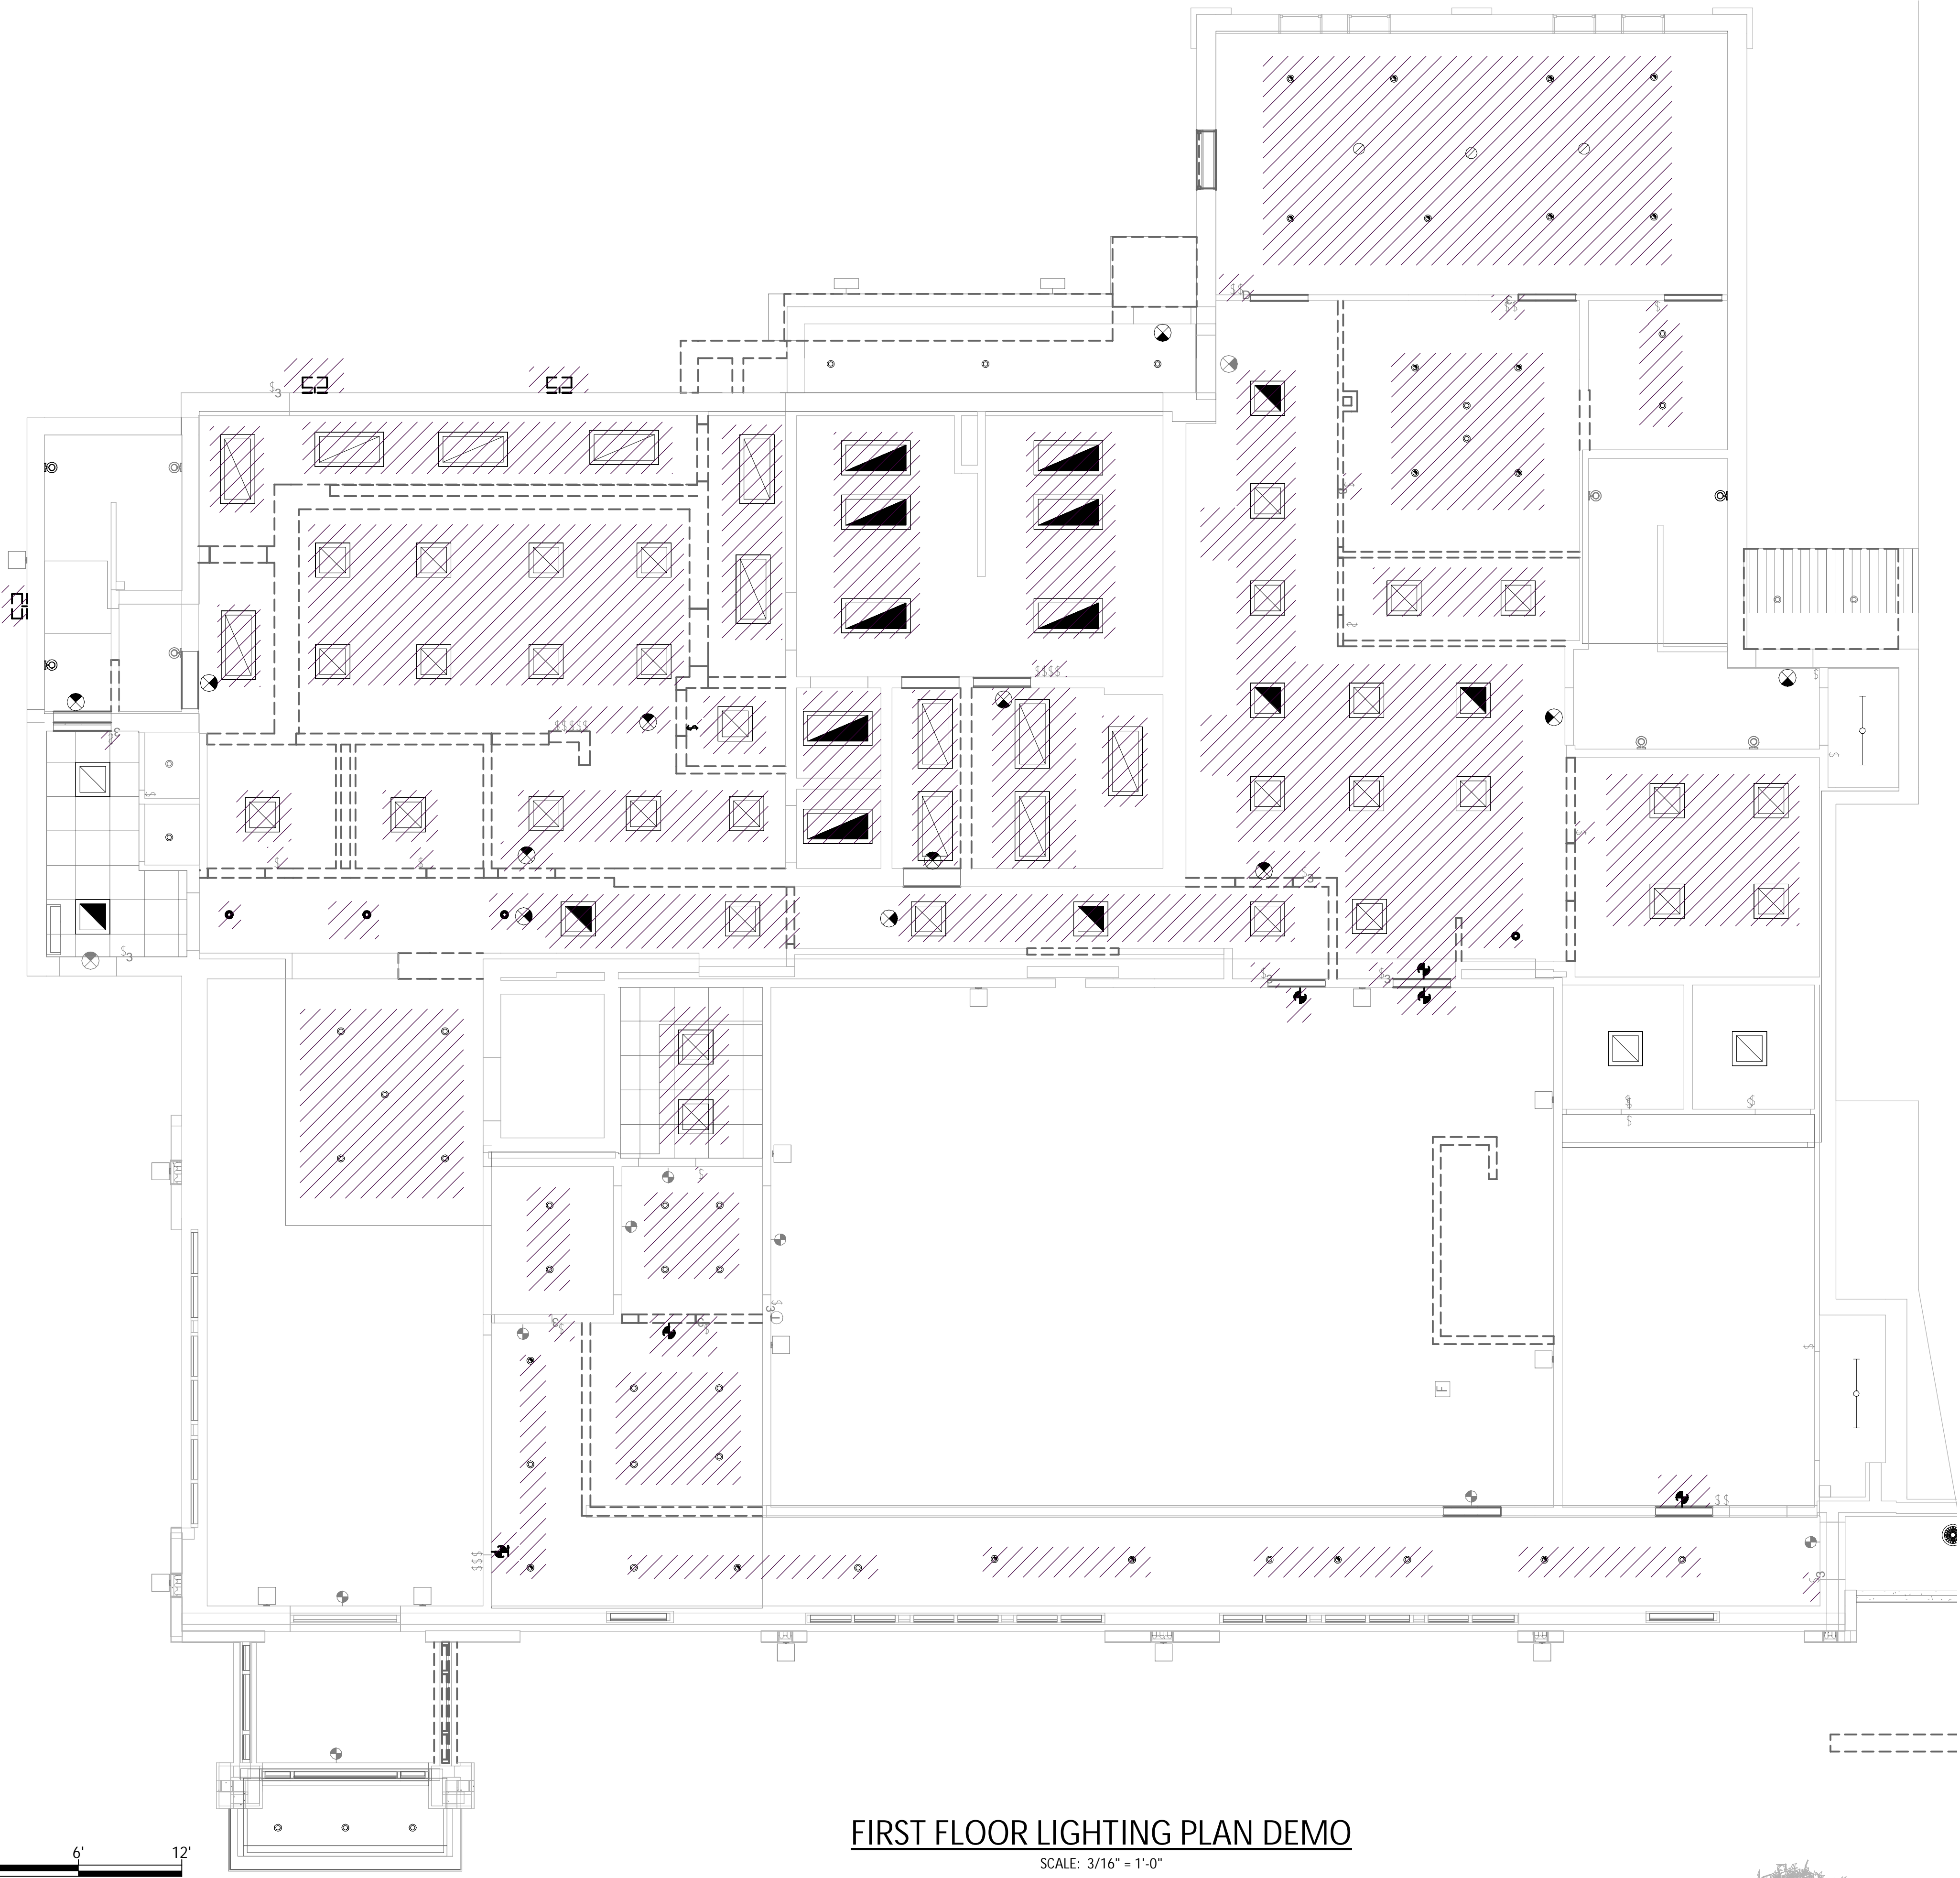
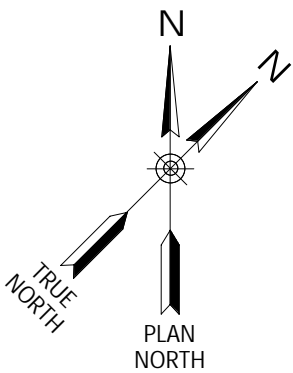
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FIRST FLOOR LIGHTING PLAN DEMO  
SCALE: 3/16" = 1'-0"

GENERAL NOTES - FIRST FLOOR LIGHTING PLAN DEMO

- 1 - DEMO ALL EQUIPMENT SHOWN IN A HATCH PATTERN. DEMO ALL ASSOCIATED CONDUCTORS, RACEWAY, AND HARDWARE BACK TO ITS SOURCE.
- 2 - FIRST FLOOR LIGHTING PLAN DEMO DRAWING CREATED FROM DRAWINGS E-2L TITLED FIRST FLOOR PLAN LIGHTING DATED JULY 30, 2004, AND CURSORY FIELD OBSERVATIONS. CONTRACTOR TO FIELD VERIFY ALL EXISTING INFORMATION REQUIRED.
- 3 - MAINTAIN EXISTING CIRCUITS OTHER THAN THE ONES SHOWN TO BE DEMOED. UPDATE PANEL DIRECTORIES AS REQUIRED.
- 4 - VERIFY REMOVALS DO NOT IMPACT EQUIPMENT AND DEVICES OTHER THAN THOSE THAT ARE TO BE REMOVED.
- 5 - EXTEND ALL CIRCUITING TO DEVICES AND EQUIPMENT TO REMAIN.
- 6 - ROOM NAMES NOT CALLED OUT FOR DRAWING CLARITY. FOR ROOM NAMES SEE DRAWING E102.
- 7 - CONTRACTOR SHALL VERIFY EQUIPMENT TO REMAIN IS CONNECTED TO CIRCUITS THAT ARE BEING REMOVED. MAINTAIN CIRCUIT CONTINUITY TO ALL EQUIPMENT TO REMAIN. PROVIDE ALL REQUIRED CIRCUIT MODIFICATIONS INCLUDING, BUT NOT LIMITED TO, CONDUIT, WIRE, JUNCTION BOXES, AND SPLICES.

LEGEND	
	EQUIPMENT TO BE DEMOED
	WALL SWITCH
	DIMMER WALL SWITCH
	3-WAY WALL SWITCH
	CEILING MOUNTED OCCUPANCY/MOTION SENSOR
	2'X2' LED LIGHT FIXTURE, X INDICATES FIXTURE TYPE
	2'X4' LED LIGHT FIXTURE, X INDICATES FIXTURE TYPE
	WALL PACK
	EXIT LIGHT FIXTURE, CEILING MOUNTED
	RECESSED LIGHT FIXTURE, CEILING MOUNTED

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REVISIONS	

CITY OF MIDDLETOWN  
NEW COURTHOUSE FACILITY  
CONTRACT 1D - ELECTRICAL CONSTRUCTION

FIRST FLOOR LIGHTING PLAN DEMO


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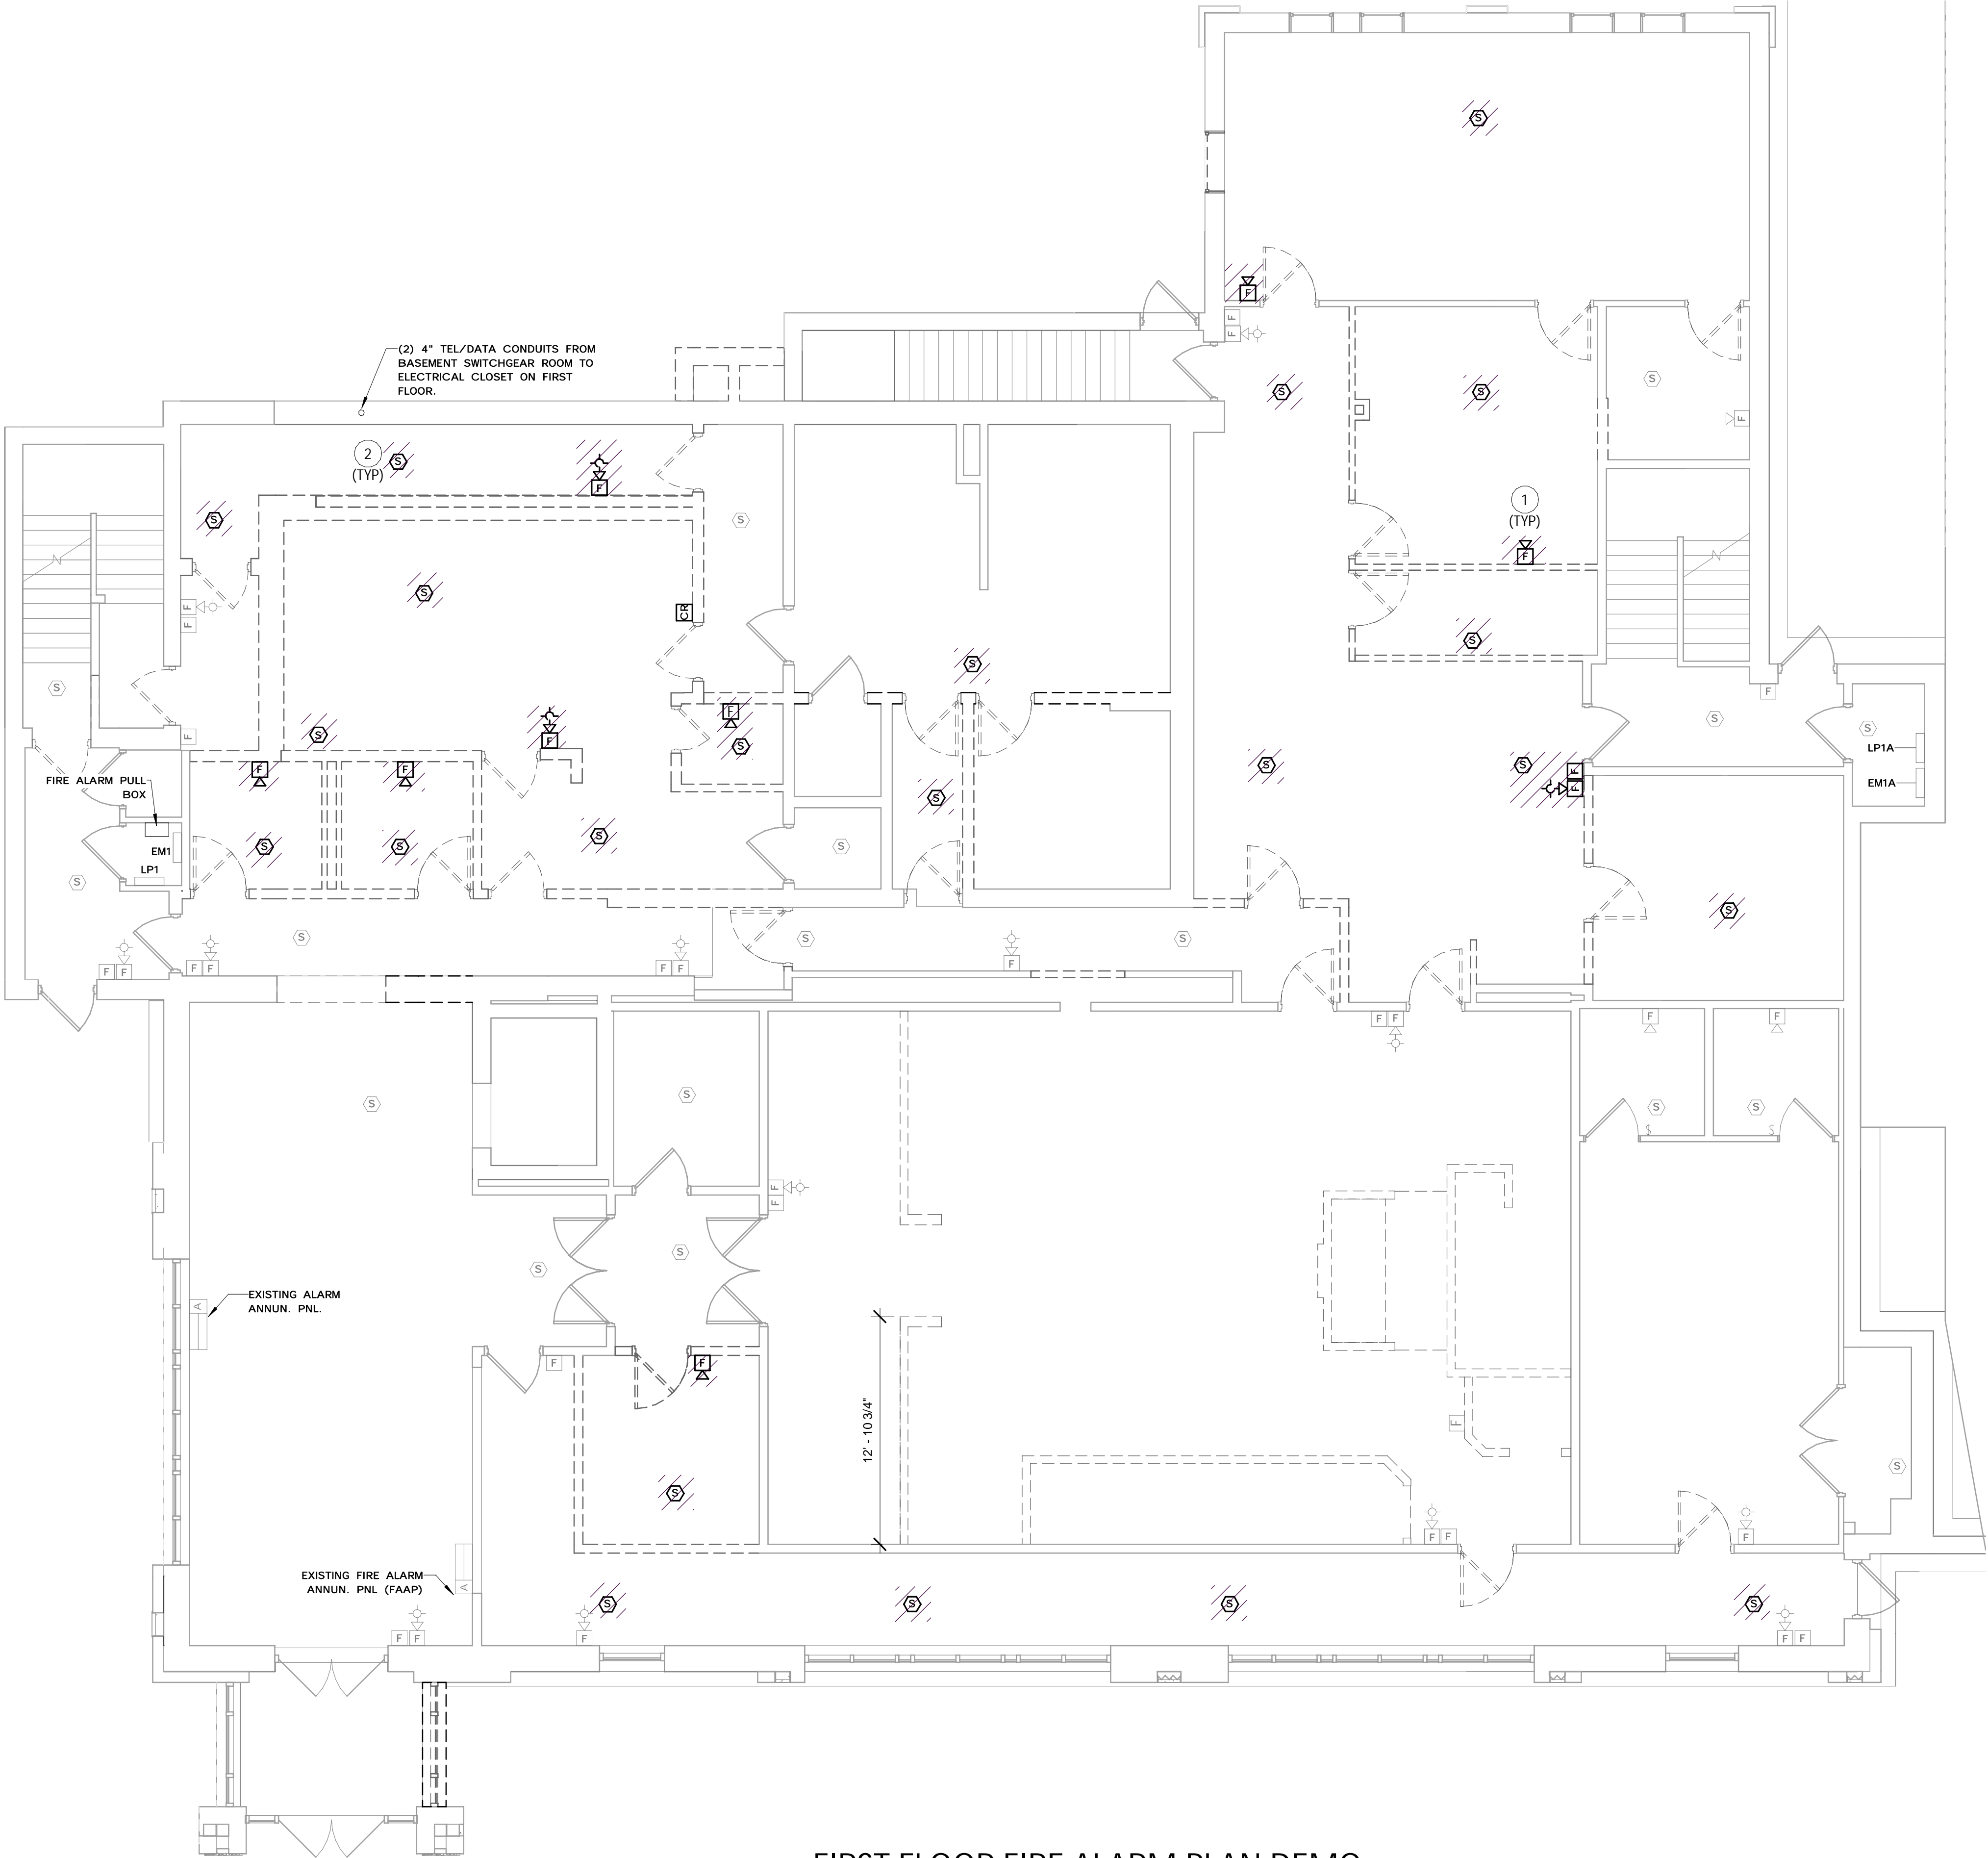
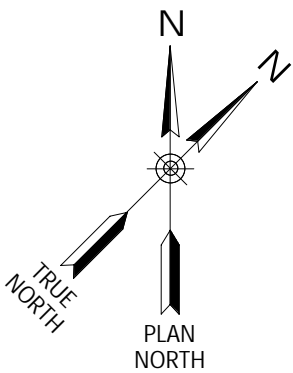




- 1 - DEMO ALL EQUIPMENT SHOWN IN A HATCH PATTERN. DEMO ALL ASSOCIATED CONDUCTORS, RACEWAY, AND HARDWARE BACK TO ITS SOURCE.
- 2 - SECOND FLOOR LIGHTING PLAN DEMO DRAWING CREATED FROM DRAWINGS E-3L TITLED SECOND FLOOR PLAN LIGHTING DATED JULY 30, 2004, AND CURSORY FIELD OBSERVATIONS. CONTRACTOR TO FIELD VERIFY ALL EXISTING INFORMATION REQUIRED.
- 3 - MAINTAIN EXISTING CIRCUITS OTHER THAN THE ONES SHOWN TO BE DEMOED. UPDATE PANEL DIRECTORIES AS REQUIRED.
- 4 - VERIFY REMOVALS DO NOT IMPACT EQUIPMENT AND DEVICES OTHER THAN THOSE THAT ARE TO BE REMOVED.
- 5 - EXTEND ALL CIRCUITING TO DEVICES AND EQUIPMENT TO REMAIN.
- 6 - FOR ALL EXISTING FIRE ALARM DEVICES NOT DEMO'D VERIFY THEY ARE PRESENT AND OPERATIONAL. (TYP OF ALL EXISTING POWER AND DATA OUTLETS AND FIRE ALARM DEVICES AS SHOWN).
- 7 - ROOM NAMES NOT CALLED OUT FOR DRAWING CLARITY. FOR ROOM NAMES SEE DRAWING ET03.
- 8 - CONTRACTOR SHALL VERIFY NO EQUIPMENT TO REMAIN IS CONNECTED TO CIRCUITS THAT ARE BEING REMOVED. MAINTAIN CIRCUIT CONTINUITY TO ALL EQUIPMENT TO REMAIN. PROVIDE ALL REQUIRED CIRCUIT MODIFICATIONS INCLUDING, BUT NOT LIMITED TO, CONDUIT, WIRE, JUNCTION BOXES, AND SPLICES.

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<p><b>Barton &amp; Loguidice, D.P.C.</b></p>		<p>CITY OF MIDDLETOWN</p>		<p>ORANGE COUNTY, NEW YORK</p>	
<p>Date AUGUST, 2024</p>		<p>Scale AS SHOWN</p>		<p>Sheet Number E106</p>	
<p>Project Number 1753.008.001</p>					



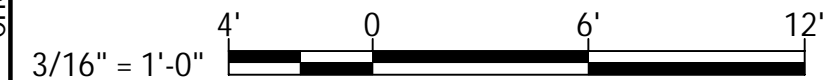

### FIRST FLOOR FIRE ALARM PLAN DEMO

SCALE: 3/16" = 1'-0"

#### GENERAL NOTES - FIRST FLOOR FIRE ALARM PLAN DEMO

- 1 - DEMO ALL EQUIPMENT SHOWN IN HATCH PATTERN. DEMO ALL ASSOCIATED CONDUCTORS, RACEWAY AND HARDWARE BACK TO ITS SOURCE.
- 2 - FIRST FLOOR FIRE ALARM PLAN DEMO DRAWING CREATED FROM DRAWING FA-2 TITLED FIRST FLOOR PLAN FIRE ALARM DATED FEBRUARY 1, 2005 AND CURSORY FIELD OBSERVATIONS. CONTRACTOR TO FIELD VERIFY ALL EXISTING INFORMATION REQUIRED.
- 3 - MAINTAIN EXISTING CIRCUITS OTHER THAN THE ONES SHOWN TO BE DEMO'D. UPDATE PANEL DIRECTORIES AS REQUIRED.
- 4 - CONTRACTOR SHALL VERIFY NO EQUIPMENT TO REMAIN IS CONNECTED TO CIRCUITS THAT ARE BEING REMOVED. MAINTAIN CIRCUIT CONTINUITY TO ALL EQUIPMENT TO REMAIN. PROVIDE ALL REQUIRED CIRCUIT MODIFICATIONS INCLUDING, BUT NOT LIMITED TO, CONDUIT, WIRE, JUNCTION BOXES, AND SPLICES.
- 5 - FOR ALL EXISTING FIRE ALARM DEVICES NOT DEMO'D VERIFY THEY ARE PRESENT AND OPERATIONAL.

#### KEYED NOTES - FIRST FLOOR FIRE ALARM PLAN DEMO

- 1 SEE DRAWING E605 FIRE ALARM RISER DIAGRAM DEMO FOR HORN/STROBE WIRING DETAILS.
- 2 SEE DRAWING E605 FIRE ALARM RISER DIAGRAM DEMO FOR SMOKE DETECTOR WIRING DETAILS.

LEGEND	
	EQUIPMENT TO BE DEMOED
	SMOKE DETECTOR
	HORN AND STROBE
	PULL STATION
	HORN
	PANELBOARD

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REVISIONS	


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NEW COURTHOUSE FACILITY  
CONTRACT 1D - ELECTRICAL CONSTRUCTION  
FIRST FLOOR FIRE ALARM PLAN DEMO  
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GENERAL NOTES - SECOND FLOOR FIRE ALARM PLAN DEMO

- 1 - DEMO ALL EQUIPMENT SHOWN IN HATCH PATTERN. DEMO ALL ASSOCIATED CONDUCTORS, RACEWAY AND HARDWARE BACK TO ITS SOURCE.
- 2 - SECOND FLOOR FIRE ALARM PLAN DEMO DRAWING CREATED FROM DRAWING FA-3 TITLED SECOND FLOOR PLAN FIRE ALARM DATED FEBRUARY 1, 2005 AND CURSORY FIELD OBSERVATIONS. CONTRACTOR TO FIELD VERIFY ALL EXISTING INFORMATION REQUIRED.
- 3 - MAINTAIN EXISTING CIRCUITS OTHER THAN THE ONES SHOWN TO BE DEMO'D. UPDATE PANEL DIRECTORIES AS REQUIRED.
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- 5 - FOR ALL EXISTING FIRE ALARM DEVICES NOT DEMO'D VERIFY THEY ARE PRESENT AND OPERATIONAL.

KEYED NOTES - SECOND FLOOR FIRE ALARM PLAN DEMO

- 1 SEE DRAWING E605 FIRE ALARM RISER DIAGRAM DEMO FOR HORN/STROBE WIRING DETAILS.
- 2 SEE DRAWING E605 FIRE ALARM RISER DIAGRAM DEMO FOR SMOKE DETECTOR WIRING DETAILS.

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REVISIONS

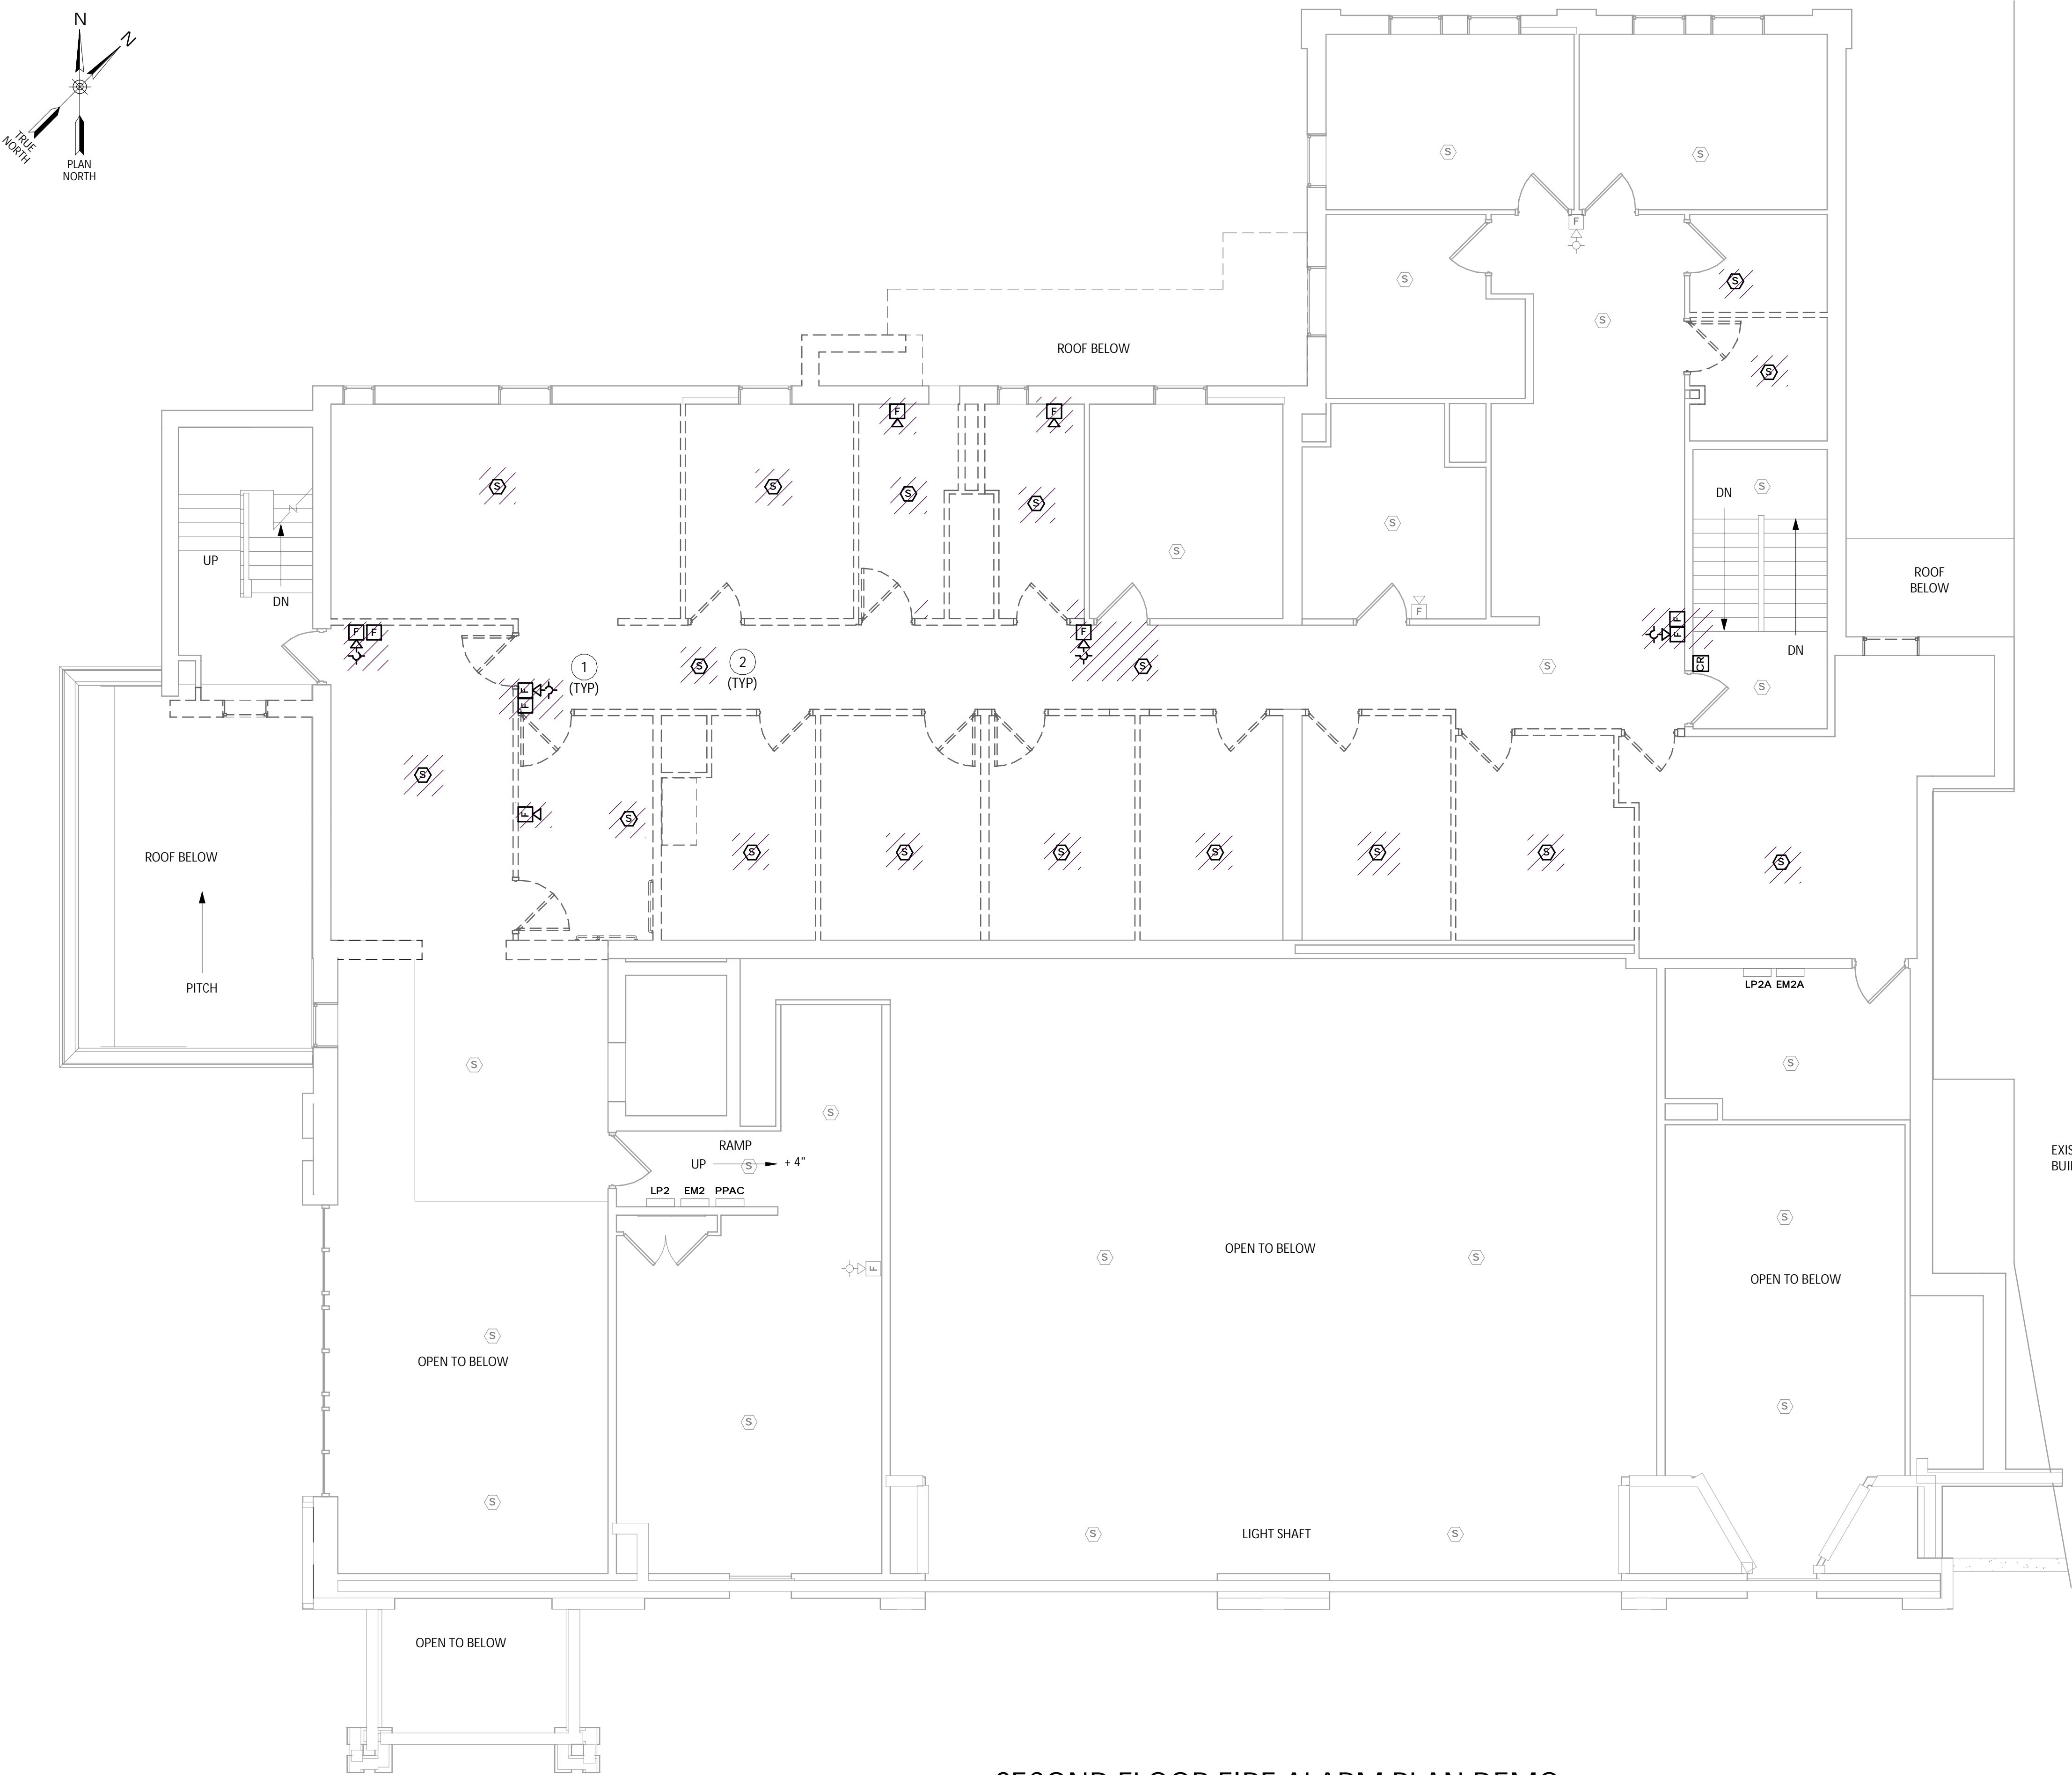CITY OF MIDDLETOWN  
NEW COURTHOUSE FACILITY  
CONTRACT 1D - ELECTRICAL CONSTRUCTION  
ORANGE COUNTY, NEW YORK

SECOND FLOOR FIRE ALARM PLAN DEMO

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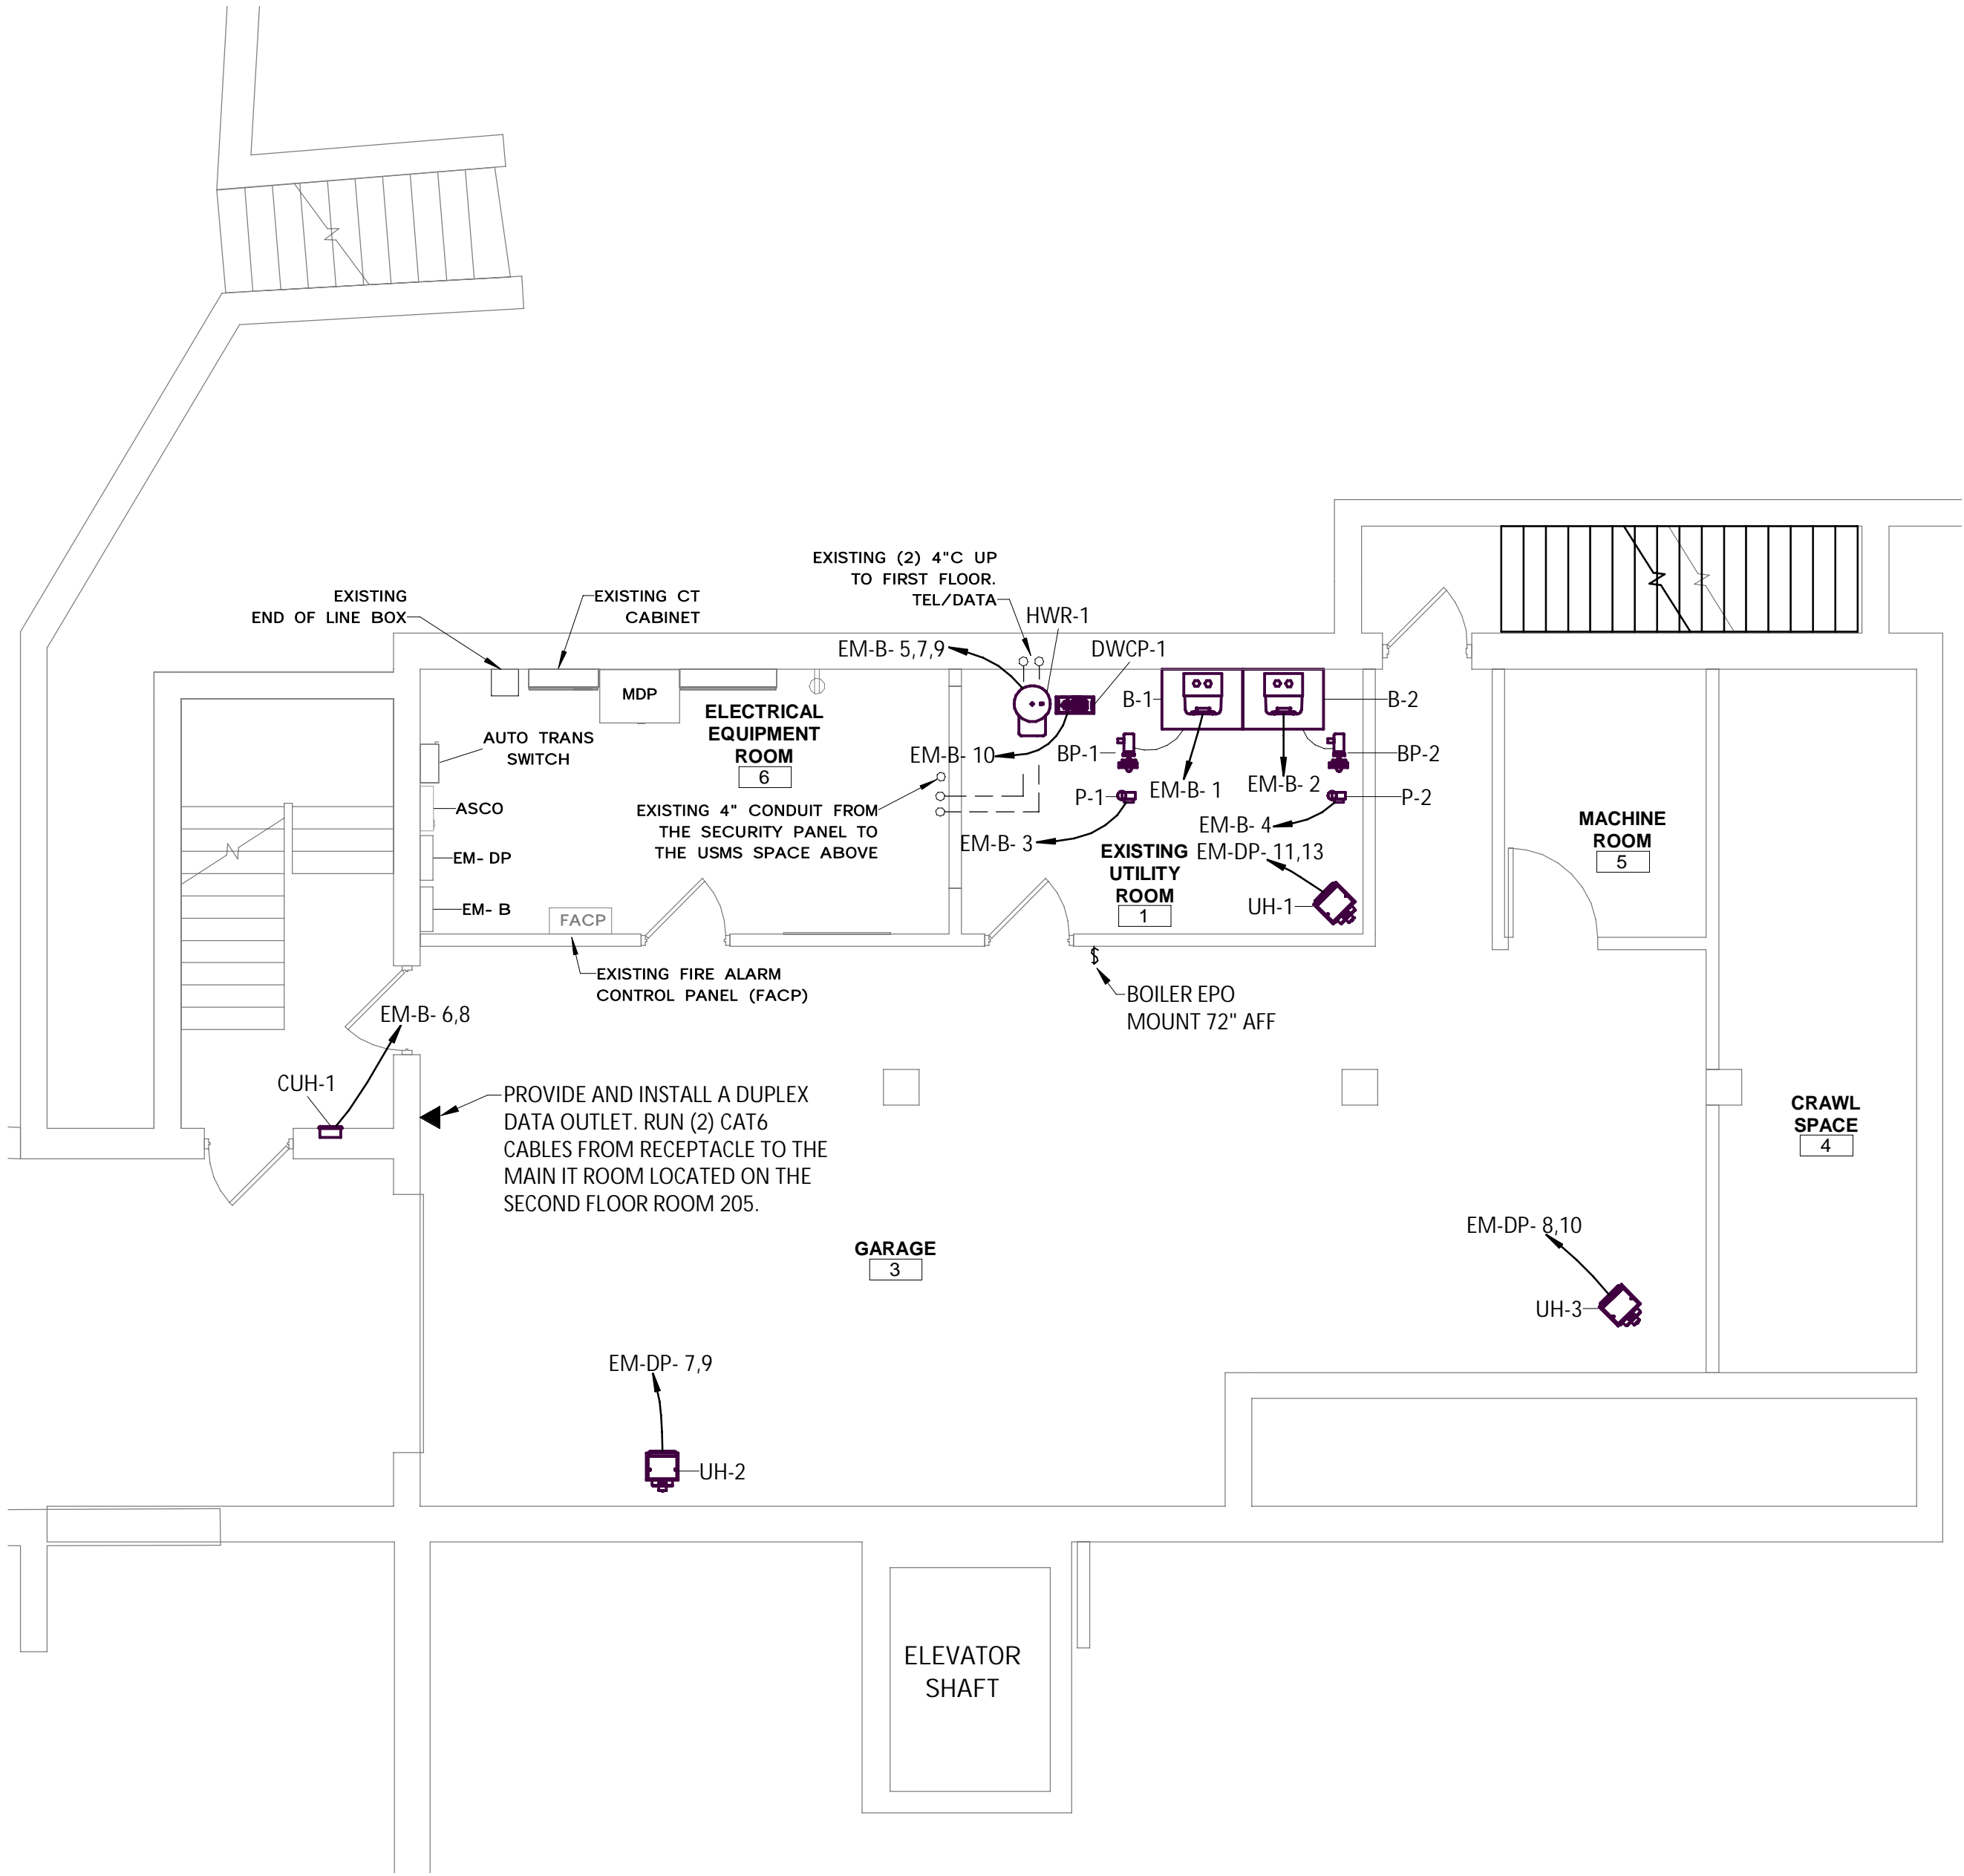
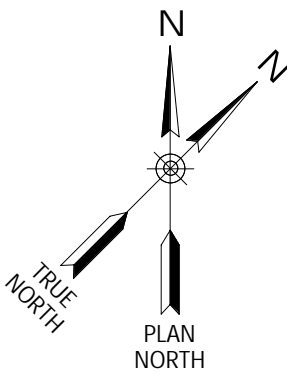
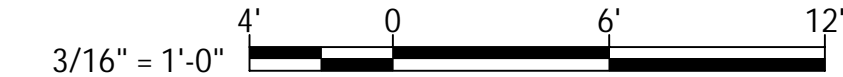


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LEGEND

- EQUIPMENT TO BE DEMOED
- SMOKE DETECTOR
- HORN AND STROBE
- PULL STATION
- HORN
- PANELBOARD





BASEMENT POWER & SYSTEMS PLAN INSTALL

SCALE: 3/16" = 1'-0"

GENERAL NOTES - BASEMENT POWER & SYSTEMS PLAN INSTALL

- 1 - ALL 120V RECEPTACLES SHALL BE TAMPER RESISTANT (TR).
- 2 - ALL CIRCUITING IS NOT SHOWN FOR CLARITY.
- 3 - HVAC AND MECHANICAL EQUIPMENT INSTALLED BY OTHERS. ELECTRICAL CONTRACTOR SHALL FURNISH AND INSTALL THE CONDUCTORS AND CONDUITS TO THE EQUIPMENT.
- 4 - ELECTRICAL SWITCH AND OUTLET BOXES SHALL BE SEALED USING A MOLDABLE PUTTY PAD AND A SEALANT (SUCH AS FD-150+ CAULK OR FB 1000 NS SEALANT, AS AVAILABLE FROM 3M, OR APPROVED EQUAL) AROUND THE PERIMETER OF THE BOX AT THE GYPSUM/BOX INTERFACE TO MINIMIZE THE TRANSMISSION OF SMOKE (AND SOUND).

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REVISIONS	

CITY OF MIDDLETOWN  
NEW COURTHOUSE FACILITY  
CONTRACT 1D - ELECTRICAL CONSTRUCTION  
**BASEMENT POWER & SYSTEMS PLAN INSTALL**  
CITY OF MIDDLETOWN  
ORANGE COUNTY, NEW YORK

443 Electronics Parkway  
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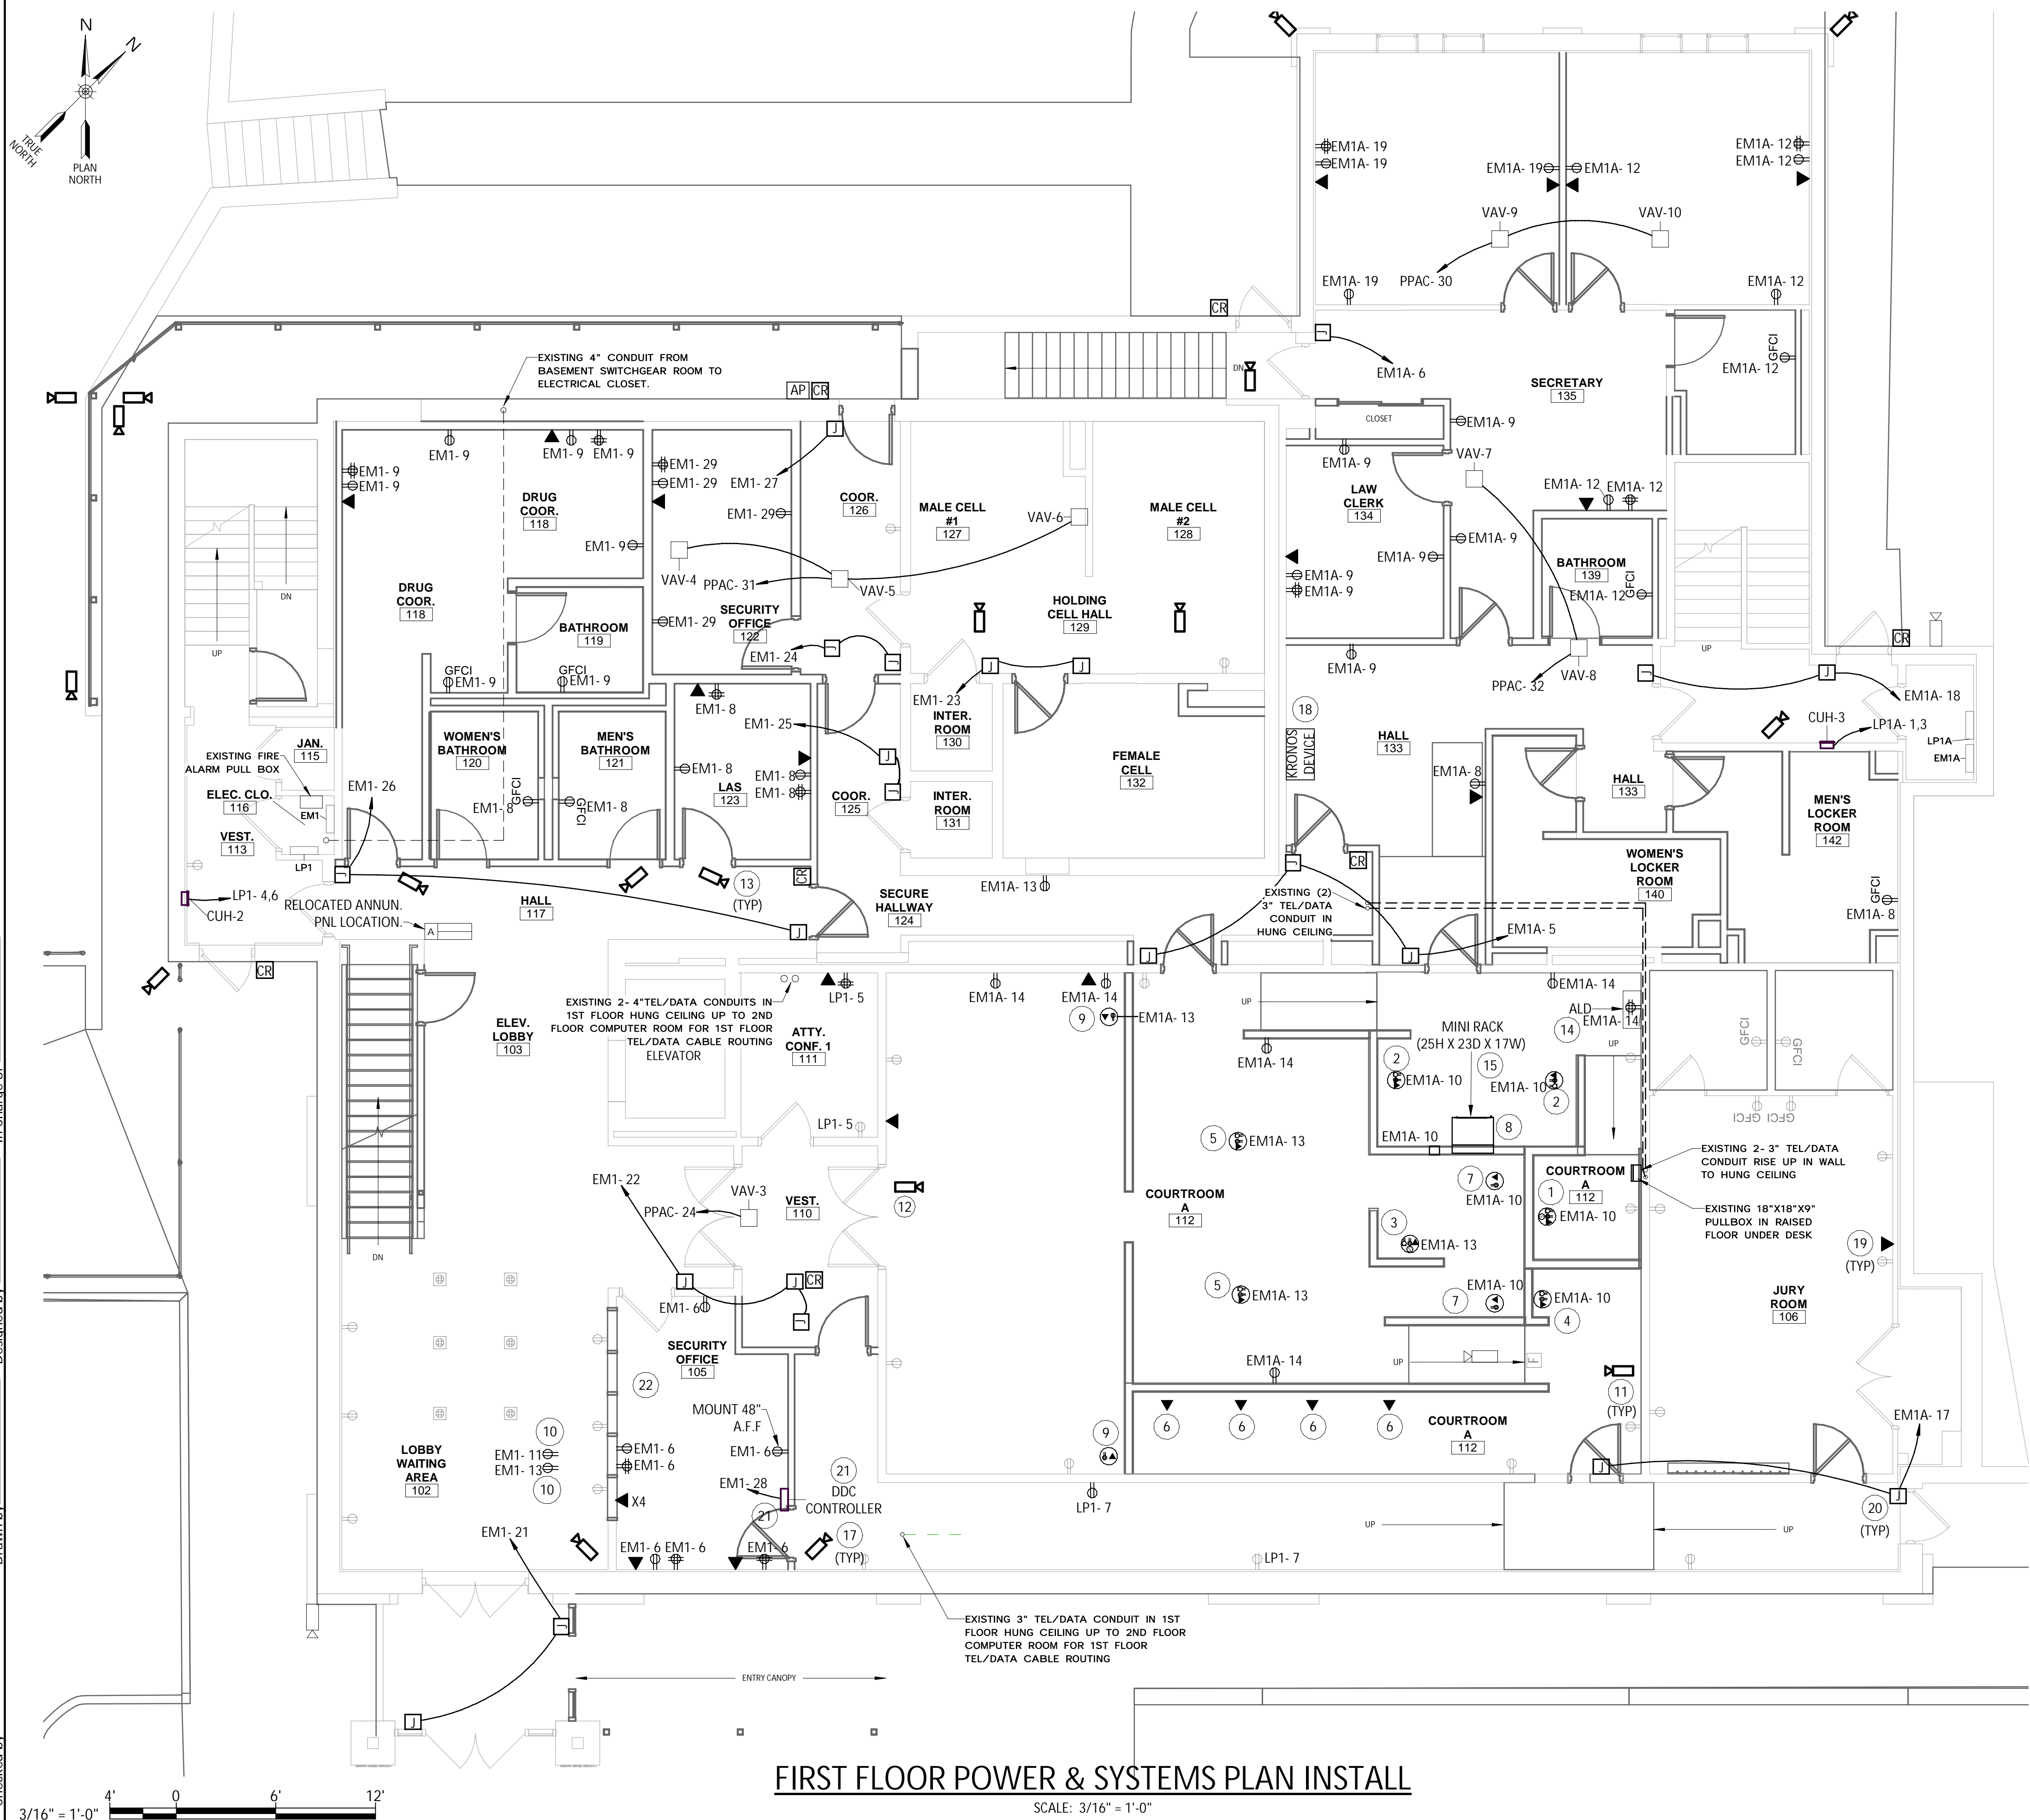
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FIRST FLOOR POWER & SYSTEMS PLAN INSTALL  
SCALE: 3/16" = 1'-0"

GENERAL NOTES - FIRST FLOOR POWER & SYSTEMS PLAN INSTALL

- 1 - ALL DATA LINES ARE TO BE RUN TO THE MAIN IT ROOM ON THE SECOND FLOOR UNLESS OTHERWISE NOTED.
- 2 - ALL 120V RECEPTACLES SHALL BE TAMPER RESISTANT (TR).
- 3 - ALL CIRCUITING IS NOT SHOWN FOR CLARITY.
- 4 - HVAC AND MECHANICAL EQUIPMENT INSTALLED BY OTHERS. ELECTRICAL CONTRACTOR SHALL FURNISH AND INSTALL THE CONDUCTORS AND CONDUITS TO THE EQUIPMENT.
- 5 - ELECTRICAL SWITCH AND OUTLET BOXES SHALL BE SEALED USING A MOLDABLE PUTTY PAD AND A SEALANT (SUCH AS FD-150+ CAULK OR FB 1000 NS SEALANT, AS AVAILABLE FROM 3M, OR APPROVED EQUAL) AROUND THE PERIMETER OF THE BOX AT THE GYPSUM/BOX INTERFACE TO MINIMIZE THE TRANSMISSION OF SMOKE (AND SOUND).
- 6 - ADJUST FLOOR BOX LOCATIONS AS NECESSARY TO COORDINATE WITH PROPOSED TABLES.
- 7 - PROVIDE COLOR-MATCHED, LOW-PROFILE, SURFACE WIREMOLD FOR ALL DEVICES LOCATED ON EXISTING BRICK WALLS. OWNER PERMISSION REQUIRED WHEN RUNNING ANY EXPOSED RACEWAY.
- 8 - ALL PENETRATIONS THROUGH FIRE-RATED WALLS ARE TO BE 2-HOUR FIRE-RATED. SEE ARCHITECTURAL DRAWINGS A201 FOR WALL RATINGS.
- 9 - ALL PENETRATIONS THROUGH THE FLOOR TO BE 2-HOUR FIRE RATED. SEE ARCHITECTURAL DRAWINGS A201 FOR FLOOR RATINGS.
- 10 - ALL RECEPTACLES AND DATA BOXES TO BE FLUSH INSTALLED IN NEW WALLS. BOXES SHALL NOT BE INSTALLED IN NEW MILLWORK WITHOUT PERMISSION FROM THE OWNER.

KEYED NOTES - FIRST FLOOR POWER & SYSTEMS PLAN INSTALL

- 1 FOR JUDGE - PROVIDE AND INSTALL (4) DATA RECEPTACLES, (1) MICROPHONE RECEPTACLE, (1) QUAD RECEPTACLE AND (1) MALE MICROPHONE CONNECTION IN FACEPLATE IN FLOOR LEGRAND WIREMOLD EVOLUTION SERIES 6" POKE THRU MODEL# 6ATC2PAVBX (CUSTOM CONFIG NEEDED PRIOR TO ORDERING).
- 2 FOR CLERK - PROVIDE AND INSTALL (4) DATA RECEPTACLES, (1) MICROPHONE RECEPTACLE AND (1) QUAD RECEPTACLE IN FLUSH FLOOR LEGRAND WIREMOLD EVOLUTION SERIES 6" POKE THRU MODEL# 6ATC2PAVBX (CUSTOM CONFIG NEEDED PRIOR TO ORDERING).
- 3 FOR REPORTER - PROVIDE AND INSTALL (2) DATA RECEPTACLE, (1) MICROPHONE RECEPTACLE AND (1) QUAD RECEPTACLE IN FLUSH FLOOR LEGRAND WIREMOLD EVOLUTION SERIES 6" POKE THRU MODEL# 6ATC2PAVBX (CUSTOM CONFIG NEEDED PRIOR TO ORDERING).
- 4 FOR WITNESS - PROVIDE AND INSTALL (2) DATA RECEPTACLE, (1) MICROPHONE RECEPTACLE AND (1) DUPLEX RECEPTACLE IN FLUSH FLOOR LEGRAND WIREMOLD EVOLUTION SERIES 6" POKE THRU MODEL# 6ATC2PAVBX (CUSTOM CONFIG NEEDED PRIOR TO ORDERING).
- 5 FOR COUNCIL - PROVIDE AND INSTALL (2) DATA RECEPTACLES, (1) MICROPHONE RECEPTACLES AND (1) DUPLEX RECEPTACLE IN FLUSH FLOOR LEGRAND WIREMOLD EVOLUTION SERIES 6" POKE THRU MODEL# 6ATC2PAVBX (CUSTOM CONFIG NEEDED PRIOR TO ORDERING).
- 6 FOR JURY BOX - PROVIDE AND INSTALL (2) DATA RECEPTACLES IN EACH FLUSH FLOOR LEGRAND WIREMOLD EVOLUTION SERIES 6" POKE THRU MODEL# 6ATC2PAVBX (CUSTOM CONFIG NEEDED PRIOR TO ORDERING). MOUNT FLOOR BOX AT THE CENTERLINE OF ALT SEATS (OCA PROVIDED MONITORS WILL BE P.O.E). (CUSTOM CONFIG NEEDED PRIOR TO ORDERING).
- 7 FOR FRONT OF BENCH - PROVIDE AND INSTALL (2) DATA RECEPTACLES AND (1) DUPLEX RECEPTACLE IN FLUSH FLOOR LEGRAND WIREMOLD EVOLUTION SERIES 6" POKE THRU MODEL# 6ATC2PAVBX (CUSTOM CONFIG NEEDED PRIOR TO ORDERING).
- 8 FOR MINI RACK - PROVIDE AND INSTALL (6) DATA RECEPTACLES AND (1) QUAD RECEPTACLE IN FLUSH FLOOR LEGRAND WIREMOLD EVOLUTION SERIES 6" POKE THRU MODEL# 6ATC2PAVBX (CUSTOM CONFIG NEEDED PRIOR TO ORDERING).
- 9 FOR FLAT SCREEN - PROVIDE AND INSTALL (2) DATA RECEPTACLES AND (1) DUPLEX RECEPTACLE MOUNTED AT 6'-6" TO BOTTOM OF FLAT SCREEN.
- 10 FLOOR BOX RECEPTACLES SHALL BE ON THEIR OWN DEDICATED CIRCUIT.
- 11 COURT ROOM CAMERAS INSTALLED BY OCA. PROVIDE AND INSTALL (3) DATA LINES BELDEN PART#5500FE (UPC#612825423867) IN A 4" X 4" JUNCTION BOX 7'-0" A.F.F. ALL CAMERA CABLES SHALL BE RAN TO THE ELEC CLO./STORAGE ROOM 205 ON THE SECOND FLOOR.
- 12 COURT ROOM CAMERAS INSTALLED BY OCA. PROVIDE AND INSTALL (4) DATA LINES BELDEN PART#5500FE (UPC#612825423867) IN A 4" X 4" JUNCTION BOX 7'-0" A.F.F. ALL CAMERA CABLES SHALL BE RAN TO THE ELEC CLO./STORAGE ROOM 205 ON THE SECOND FLOOR.
- 13 APPROXIMATE CAMERA LOCATION. COORDINATE EXACT LOCATION WITH OWNER. INSTALL OCS PROVIDED SECURITY CAMERA'S. PROVIDE CABLE GROMETS FOR PENETRATIONS. SEE DRAWING E123 FOR CAMERA BOX INSTALLATION DETAIL. ALL CAMERA CABLES SHALL BE RAN TO THE ELEC CLO./STORAGE ROOM 205 ON THE SECOND FLOOR.
- 14 PROVIDE AND INSTALL (2) MIC CABLES AND (1) #18 AWG DC POWER CABLE RUN BETWEEN THE EMITTER AND MINI RACK. DUPLEX RECEPTACLE FOR UNIT TO BE PROVIDED AND INSTALLED AT 7'-0" A.F.F.
- 15 LEAVE 10' OF EXTRA CABLE CORE FOR ALL SPEAKERS AND MICROPHONE CABLES AT THE MINI RACK FOR TERMINATION AND CABLE MANAGEMENT BY OCA.
- 16 DIRECT DIGITAL CONTROLLER (DDC) WILL BE PROVIDED BY THE CLIENT. ELECTRICAL CONTRACTOR SHALL PROVIDE 120V POWER. SEE ONE-LINE DIAGRAM EMERGENCY POWER INSTALL DRAWING E603.
- 17 PROVIDE AND INSTALL (2) CAT6A CABLES FROM EACH CAMERA TO THE ELEC CLO./STORAGE ROOM 205 ON THE SECOND FLOOR.
- 18 PROVIDE AND INSTALL (2) CAT6A CABLES FROM KRONOS DEVICE TO THE ELEC CLO./STORAGE ROOM 205 ON THE SECOND FLOOR.
- 19 PROVIDE AND INSTALL (2) CAT6A CABLE FROM EACH DATA RECEPTACLE TO THE ELEC CLO./STORAGE ROOM 205 ON THE SECOND FLOOR.
- 20 JUNCTION BOX FOR DOOR STRIKE POWER. SEE ELECTRICAL DETAIL DRAWING E119 FOR INSTALLATION DETAILS.

LEGEND			
	PANELBOARD		QUADPLEX RECEPTACLE
	SECURITY CAMERA		JUNCTION BOX
	DATA RECEPTACLE		FLOORBOX W/ELECTRICAL DEVICE
	DUPLEX RECEPTACLE		ALARM ANNUNCIATOR PANEL
	CARD READER		AIPHONE

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REVISIONS

NO.	DESCRIPTION


CITY OF MIDDLETOWN  
NEW COURTHOUSE FACILITY  
CONTRACT 1D - ELECTRICAL CONSTRUCTION  
ORANGE COUNTY, NEW YORK  
CITY OF MIDDLETOWN

443 Electronics Parkway  
Liverpool, NY  
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E110  
Project Number  
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## SECOND FLOOR POWER & SYSTEMS PLAN INSTALL

SCALE: 3/16" = 1'-0"

### GENERAL NOTES - SECOND FLOOR POWER & SYSTEMS PLAN INSTALL

- 1 - ALL DATA LINES ARE TO BE RUN TO THE MAIN IT ROOM ON THE SECOND FLOOR UNLESS OTHERWISE NOTED.
- 2 - ALL 120V RECEPTACLES SHALL BE TAMPER RESISTANT (TR).
- 3 - ALL CIRCUITING IS NOT SHOWN FOR CLARITY.
- 4 - HVAC AND MECHANICAL EQUIPMENT INSTALLED BY OTHERS. ELECTRICAL CONTRACTOR SHALL FURNISH AND INSTALL THE CONDUCTORS AND CONDUITS TO THE EQUIPMENT.
- 5 - ELECTRICAL SWITCH AND OUTLET BOXES SHALL BE SEALED USING A MOLDABLE PUTTY PAD AND A SEALANT (SUCH AS FD-150+ CAULK OR FB 1000 NS SEALANT, AS AVAILABLE FROM 3M, OR APPROVED EQUAL) AROUND THE PERIMETER OF THE BOX AT THE GYPSUM/BOX INTERFACE TO MINIMIZE THE TRANSMISSION OF SMOKE (AND SOUND).
- 6 - ADJUST FLOOR BOX LOCATIONS AS NECESSARY TO COORDINATE WITH PROPOSED TABLES.
- 7 - PROVIDE COLOR-MATCHED, LOW-PROFILE, SURFACE WIREMOLD FOR ALL DEVICES LOCATED ON EXISTING BRICK WALLS. OWNER PERMISSION REQUIRED WHEN RUNNING ANY EXPOSED RACEWAY.
- 8 - ALL PENETRATIONS THROUGH FIRE-RATED WALLS ARE TO BE 2-HOUR FIRE-RATED. SEE ARCHITECTURAL DRAWING A202 FOR WALL RATINGS.
- 9 - ALL PENETRATIONS THROUGH THE FLOOR TO BE 2-HOUR FIRE RATED. SEE ARCHITECTURAL DRAWING A202 FOR FLOOR RATINGS.
- 10 - ALL RECEPTACLES AND DATA BOXES TO BE FLUSH INSTALLED IN NEW WALLS. BOXES SHALL NOT BE INSTALLED IN NEW MILLWORK WITHOUT WRITTEN PERMISSION FROM THE OWNER.
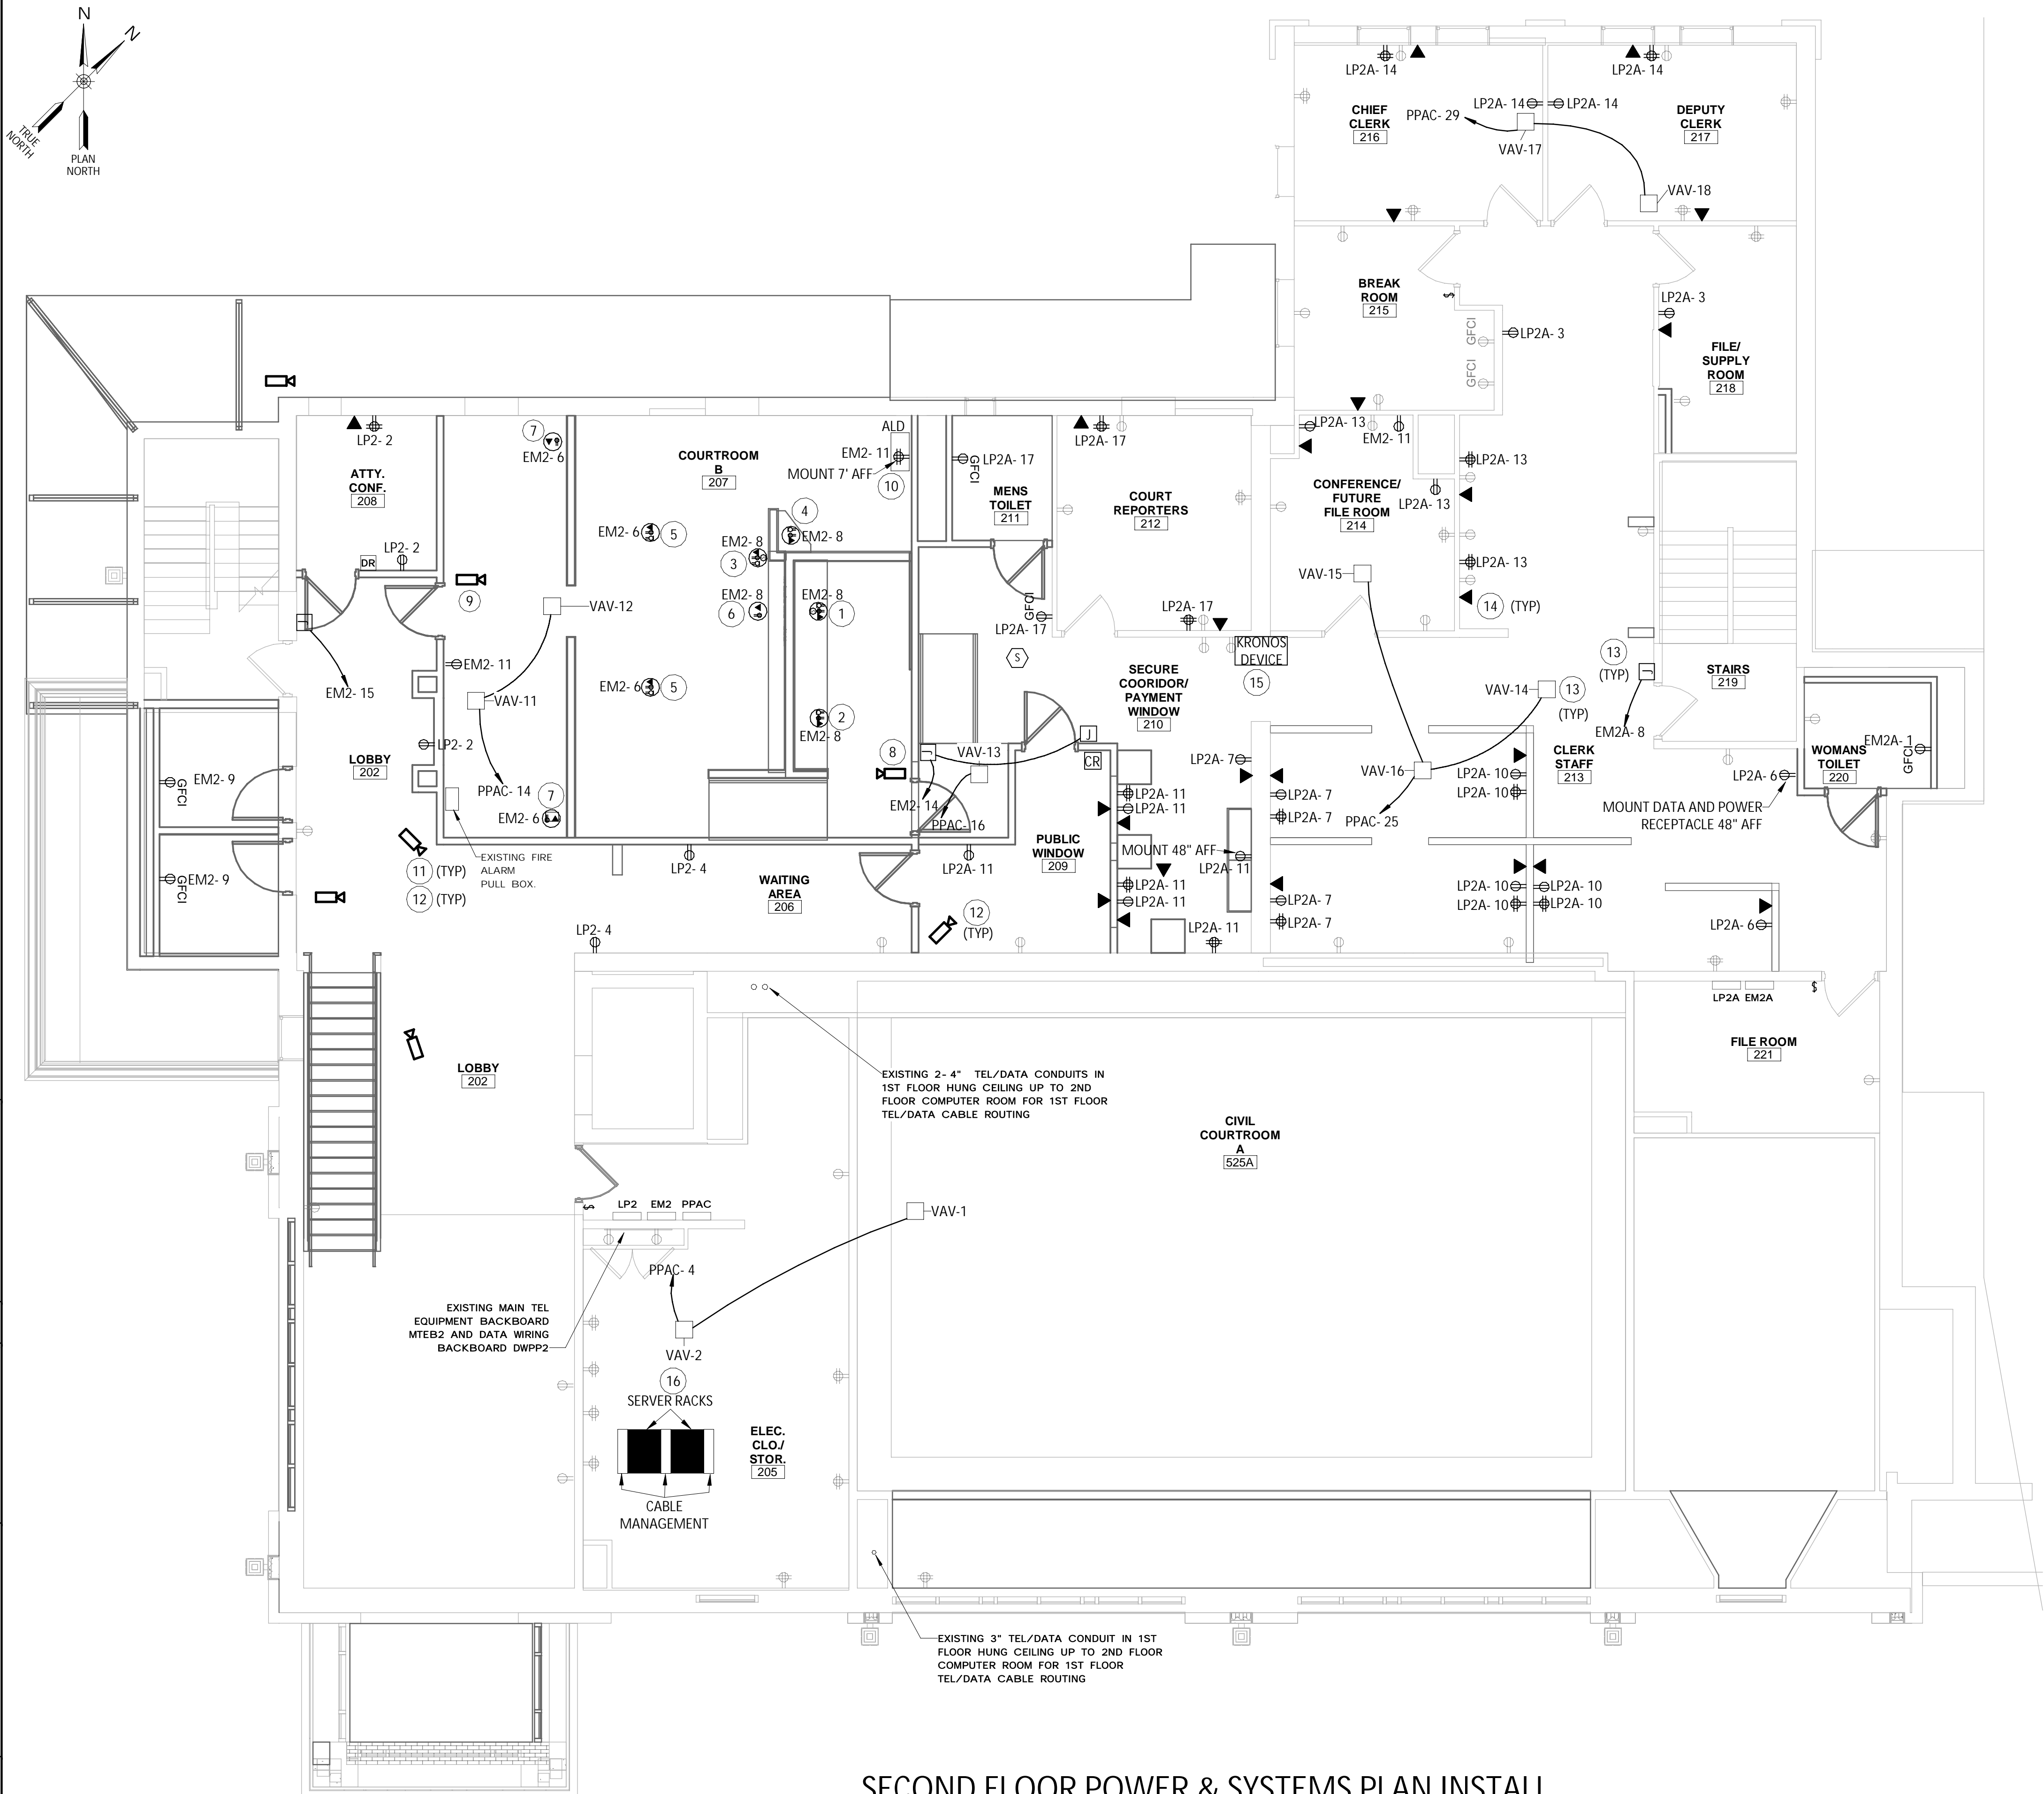
### KEYED NOTES - SECOND FLOOR POWER & SYSTEMS PLAN INSTALL

- 1 FOR JUDGE - PROVIDE AND INSTALL (4) DATA RECEPTACLES, (1) MICROPHONE RECEPTACLE, (1) QUAD RECEPTACLE AND (1) MALE MICROPHONE CONNEC TION IN FACEPLATE IN FLOOR LEGRAND WIREMOLD EVOLUTION SERIES 6" POKE THRU MODEL# 6ATC2PAVBX (CUSTOM CONFIG NEEDED PRIOR TO ORDERING).
- 2 FOR CLERK - PROVIDE AND INSTALL (4) DATA RECEPTACLES, (1) MICROPHONE RECEPTACLE AND (1) QUAD RECEPTACLE IN FLUSH FLOOR LEGRAND WIREMOLD EVOLUTION SERIES 6" POKE THRU MODEL# 6ATC2PAVBX (CUSTOM CONFIG NEEDED PRIOR TO ORDERING).
- 3 FOR REPORTER - PROVIDE AND INSTALL (2) DATA RECEPTACLE, (1) MICROPHONE RECEPTACLE AND (1) QUAD RECEPTACLE IN FLUSH FLOOR LEGRAND WIREMOLD EVOLUTION SERIES 6" POKE THRU MODEL# 6ATC2PAVBX (CUSTOM CONFIG NEEDED PRIOR TO ORDERING).
- 4 FOR WITNESS - PROVIDE AND INSTALL (2) DATA RECEPTACLE, (1) MICROPHONE RECEPTACLE AND (1) DUPLEX RECEPTACLE IN FLUSH FLOOR LEGRAND WIREMOLD EVOLUTION SERIES 6" POKE THRU MODEL# 6ATC2PAVBX (CUSTOM CONFIG NEEDED PRIOR TO ORDERING).
- 5 FOR COUNCIL - PROVIDE AND INSTALL (2) DATA RECEPTACLES, (2) MICROPHONE RECEPTACLES AND (1) DUPLEX RECEPTACLE IN FLUSH FLOOR LEGRAND WIREMOLD EVOLUTION SERIES 6" POKE THRU MODEL# 6ATC2PAVBX (CUSTOM CONFIG NEEDED PRIOR TO ORDERING).
- 6 FOR FRONT OF BENCH - PROVIDE AND INSTALL (2) DATA RECEPTACLES AND (1) DUPLEX RECEPTACLE IN FLUSH FLOOR LEGRAND WIREMOLD EVOLUTION SERIES 6" POKE THRU MODEL# 6ATC2PAVBX (CUSTOM CONFIG NEEDED PRIOR TO ORDERING).
- 7 FOR FLAT SCREEN - PROVIDE AND INSTALL (2) DATA RECEPTACLES AND (1) DUPLEX RECEPTACLE MOUNTED AT 6'-6" TO BOTTOM OF FLAT SCREEN.
- 8 COURT ROOM CAMERAS INSTALLED BY OCA. PROVIDE AND INSTALL (3) DATA LINES BELDEN PART#5500FE (UPC#612825423867) IN A 4" X 4" JUNCTION BOX 7'-0" A.F.F. ALL CAMERA CABLES SHALL BE RAN TO SECURITY OFFICE 105 LOCATED ON THE FIRST FLOOR.
- 9 COURT ROOM CAMERAS INSTALLED BY OCA. PROVIDE AND INSTALL (4) DATA LINES BELDEN PART#5500FE (UPC#612825423867) IN A 4" X 4" JUNCTION BOX 7'-0" A.F.F. ALL CAMERA CABLES SHALL BE RAN TO SECURITY OFFICE 105 LOCATED ON THE FIRST FLOOR.
- 10 PROVIDE AND INSTALL (2) MIC CABLES AND (1) #18 AWG DC POWER CABLE RUN BETWEEN THE EMITTER AND MINI RACK. MOUNT UNIT AT 7'-0" A.F.F.
- 11 APPROXIMATE CAMERA LOCATION. COORDINATE EXACT LOCATION WITH OWNER. INSTALL PROVIDED SECURITY CAMERA'S. RUN (2) CAT6A CABLES FROM EACH CAMERA TO SERVER RACKS IN SECURITY OFFICE 105. PROVIDE CABLE GROMETS FOR PENETRATIONS. ALL CAMERA CABLES SHALL BE RAN TO THE ELEC CLO./STORAGE ROOM 205.
- 12 PROVIDE AND INSTALL (2) CAT6A CABLES FROM EACH CAMERA TO THE ELEC CLO./STORAGE ROOM 205.
- 13 JUNCTION BOX FOR DOOR STRIKE POWER. SEE ELECTRICAL DETAIL DRAWING E119 FOR INSTALLATION DETAILS.
- 14 PROVIDE AND INSTALL (2) CAT6A CABLE FROM EACH DATA RECEPTACLE TO THE ELEC CLO./STORAGE ROOM 205.
- 15 PROVIDE AND INSTALL (2) CAT6A CABLES FROM EACH KRONOS DEVICE TO THE ELEC CLO./STORAGE ROOM 205.
- 16 ELECTRICAL CONTRACTOR SHALL PROVIDE (2) 19" 48U OPEN FRAME SERVER CABINETS AND PATCH PANELS FOR THE OCA PROVIDED SERVERS AND SWITCHES.

### LEGEND

	PANELBOARD		JUNCTION BOX
	SECURITY CAMERA		FLOORBOX W/ELECTRICAL DEVICE
	DATA RECEPTACLE		
	DUPLEX RECEPTACLE		
	QUADPLEX RECEPTACLE		
	CARD READER		

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### REVISIONS

NO.	DESCRIPTION

CITY OF MIDDLETOWN  
NEW COURTHOUSE FACILITY  
CONTRACT 1D - ELECTRICAL CONSTRUCTION  
**SECOND FLOOR POWER & SYSTEMS PLAN INSTALL**  
CITY OF MIDDLETOWN  
ORANGE COUNTY, NEW YORK

443 Electronics Parkway  
Liverpool, NY  
13088  
**Barton & Loguidice, D.P.C.**




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AUGUST, 2024

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**E111**

Project Number  
1753.008.001



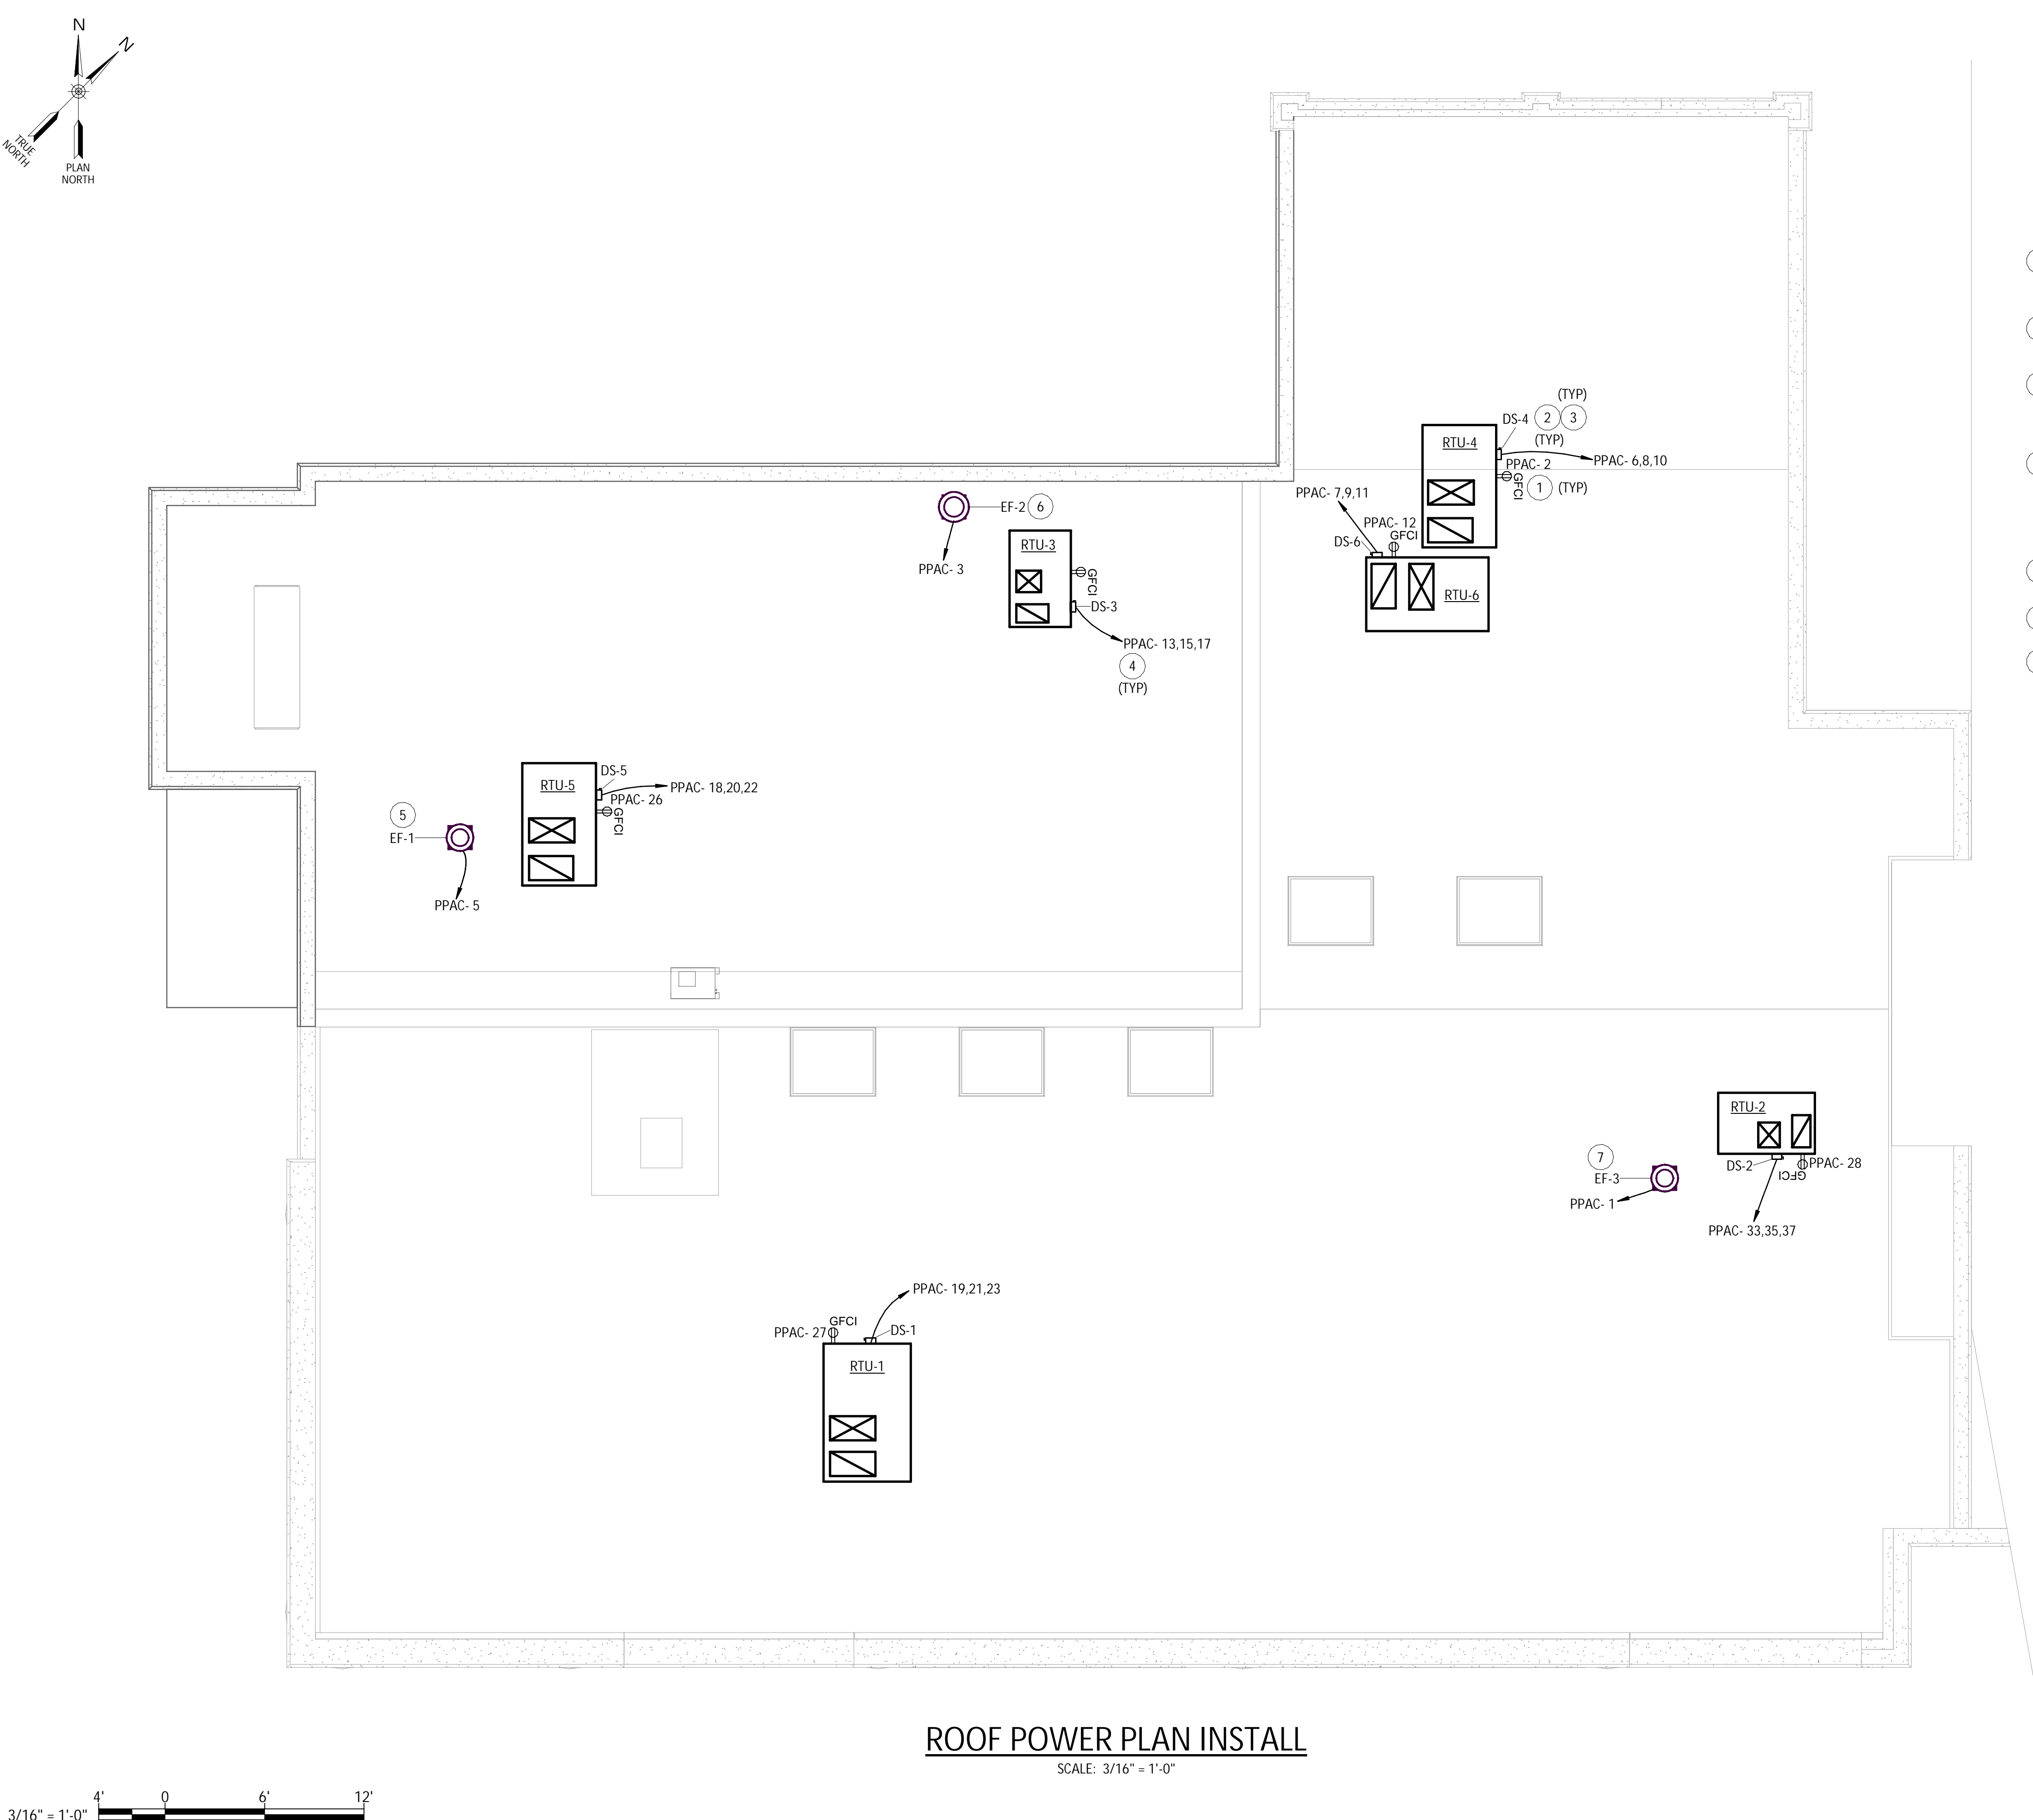

ROOF POWER PLAN INSTALL  
SCALE: 3/16" = 1'-0"

GENERAL NOTES - ROOF POWER PLAN INSTALL

- 1 - CONTRACTOR SHALL FIELD VERIFY ALL EXISTING CONDITIONS REQUIRED FOR INSTALLATION OF NEW ELECTRICAL SERVICE AND ELECTRICAL EQUIPMENT.
- 2 - ALL ELECTRICAL WORK SHALL CONFORM TO ALL STATE, LOCAL AND NATIONAL CODES.
- 3 - ELECTRICAL CONTRACTOR SHALL COORDINATE WITH OTHER CONTRACTORS DURING THE INSTALLATION OF ALL EQUIPMENT.
- 4 - PROVIDE GROUNDING PER NEC FOR ALL ELECTRICAL EQUIPMENT AND ASSOCIATED EQUIPMENT.

KEYED NOTES - ROOF POWER PLAN INSTALL

- 1 PROVIDE AND INSTALL LOCAL GFCI RECEPTACLE FOR RTU MAINTENANCE PURPOSES. SEE DRAWING E602 FOR CIRCUIT DETAILS. ROUTE CONDUCTOR AND CONDUITS TO PANEL PPAC LOCATED ON THE SECOND FLOOR SEE DRAWING E111 FOR LOCATION.
- 2 PROVIDE A DISCONNECT SWITCH FOR ALL RTU LOCATIONS. MOUNT DISCONNECT SWITCH TO UNIT AND RUN CONDUCTORS THRU THE ROOF TO PANEL PPAC ON THE SECOND FLOOR SEE DRAWING E111 FOR PANEL LOCATION. TYPICAL ALL RTU LOCATIONS.
- 3 CONTRACTOR SHALL MAKE ANY NECESSARY BUILDING PENETRATIONS TO ROUTE CABLE AND CONDUIT FROM THE EXTERIOR TO INTERIOR OF BUILDING. WHEN INSTALLATION IS COMPLETE MAKE PENETRATION WEATHER TIGHT IN ACCORDANCE WITH MANUFACTURER RECOMMENDATIONS.
- 4 CONTRACTOR TO PROVIDE 3/4" C WITH ROOF PENETRATION NEAR PENETRATION FOR POWER CIRCUIT. STUB AND AND CAP CONDUIT 10" BELOW AND 10" ABOVE ROOF FOR USE BY MECHANICAL CONTRACTOR FOR CONTROL CABLE. COORDINATE ALL WORK WITH MECHANICAL CONTRACT. ALL PENETRATIONS THROUGH ROOF TO BE MADE AS REQUIRED BY ROOF TYPE AND MANUFACTURER. ALL PENETRATIONS TO BE SEALED WATERTIGHT.
- 5 EXHAUST FAN #1 (EF-1) SHALL BE WIRED TO THE OCCUPANCY SENSORS IN ROOMS 119,120 AND 121. SEE FIRST FLOOR LIGHTING PLAN INSTALL E113 FOR SENSOR LOCATION.
- 6 EXHAUST FAN #2 (EF-2) SHALL BE WIRED TO THE BUILDING DDC SYSTEM AND CONTROLLED BY A SET SCHEDULE.
- 7 EXHAUST FAN #3 (EF-3) SHALL BE WIRED TO THE OCCUPANCY SENSORS IN ROOMS 108 AND 109. SEE FIRST FLOOR LIGHTING PLAN INSTALL E113 FOR SENSOR LOCATION.

LEGEND	
	DUPLEX RECEPTACLE
	EXHAUST FAN
	DISCONNECT SWITCH

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REVISIONS	

CITY OF MIDDLETOWN  
NEW COURTHOUSE FACILITY  
CONTRACT 1D - ELECTRICAL CONSTRUCTION  
ROOF POWER PLAN INSTALL  
ORANGE COUNTY, NEW YORK  
CITY OF MIDDLETOWN

443 Electronics Parkway  
Liverpool, NY  
13088

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**Barton & Loguidice, D.P.C.**

STATE OF NEW YORK  
J. HORVATH  
No. 089098  
ELECTRICAL ENGINEER



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FIRST FLOOR LIGHTING/SYSTEMS PLAN INSTALL

SCALE: 3/16" = 1'-0"

GENERAL NOTES - FIRST FLOOR LIGHTING/SYSTEMS PLAN INSTALL

- 1 - SEE DRAWING E118 ELECTRICAL SCHEDULES FOR LIGHT FIXTURE DETAILS.
- 2 - EMERGENCY LIGHT FIXTURES SHALL BE INSTALLED ON THE UNSWITCHED PORTION OF THE CIRCUIT.
- 3 - ELECTRICAL SWITCH AND OUTLET BOXES SHALL BE SEALED USING A MOLDABLE PUTTY PAD AND A SEALANT (SUCH AS FD-150+ CAULK OR FB 1000 NS SEALANT, AS AVAILABLE FROM 3M, OR APPROVED EQUAL) AROUND THE PERIMETER OF THE BOX AT THE GYPSUM/BOX INTERFACE TO MINIMIZE THE TRANSMISSION OF SMOKE (AND SOUND).
- 4 - CONNECT EMERGENCY EXIT LIGHTS SIGNS AND EMERGENCY EGRESS LIGHTING TO THE NEAREST UNSWITCHED LIGHTING CIRCUIT IN THE SAME ROOM OR AREA.
- 5 - ROOM NAMES NOT CALLED OUT FOR DRAWING CLARITY. FOR ROOM NAMES SEE DRAWING E110.

KEYED NOTES - FIRST FLOOR LIGHTING/SYSTEMS PLAN INSTALL

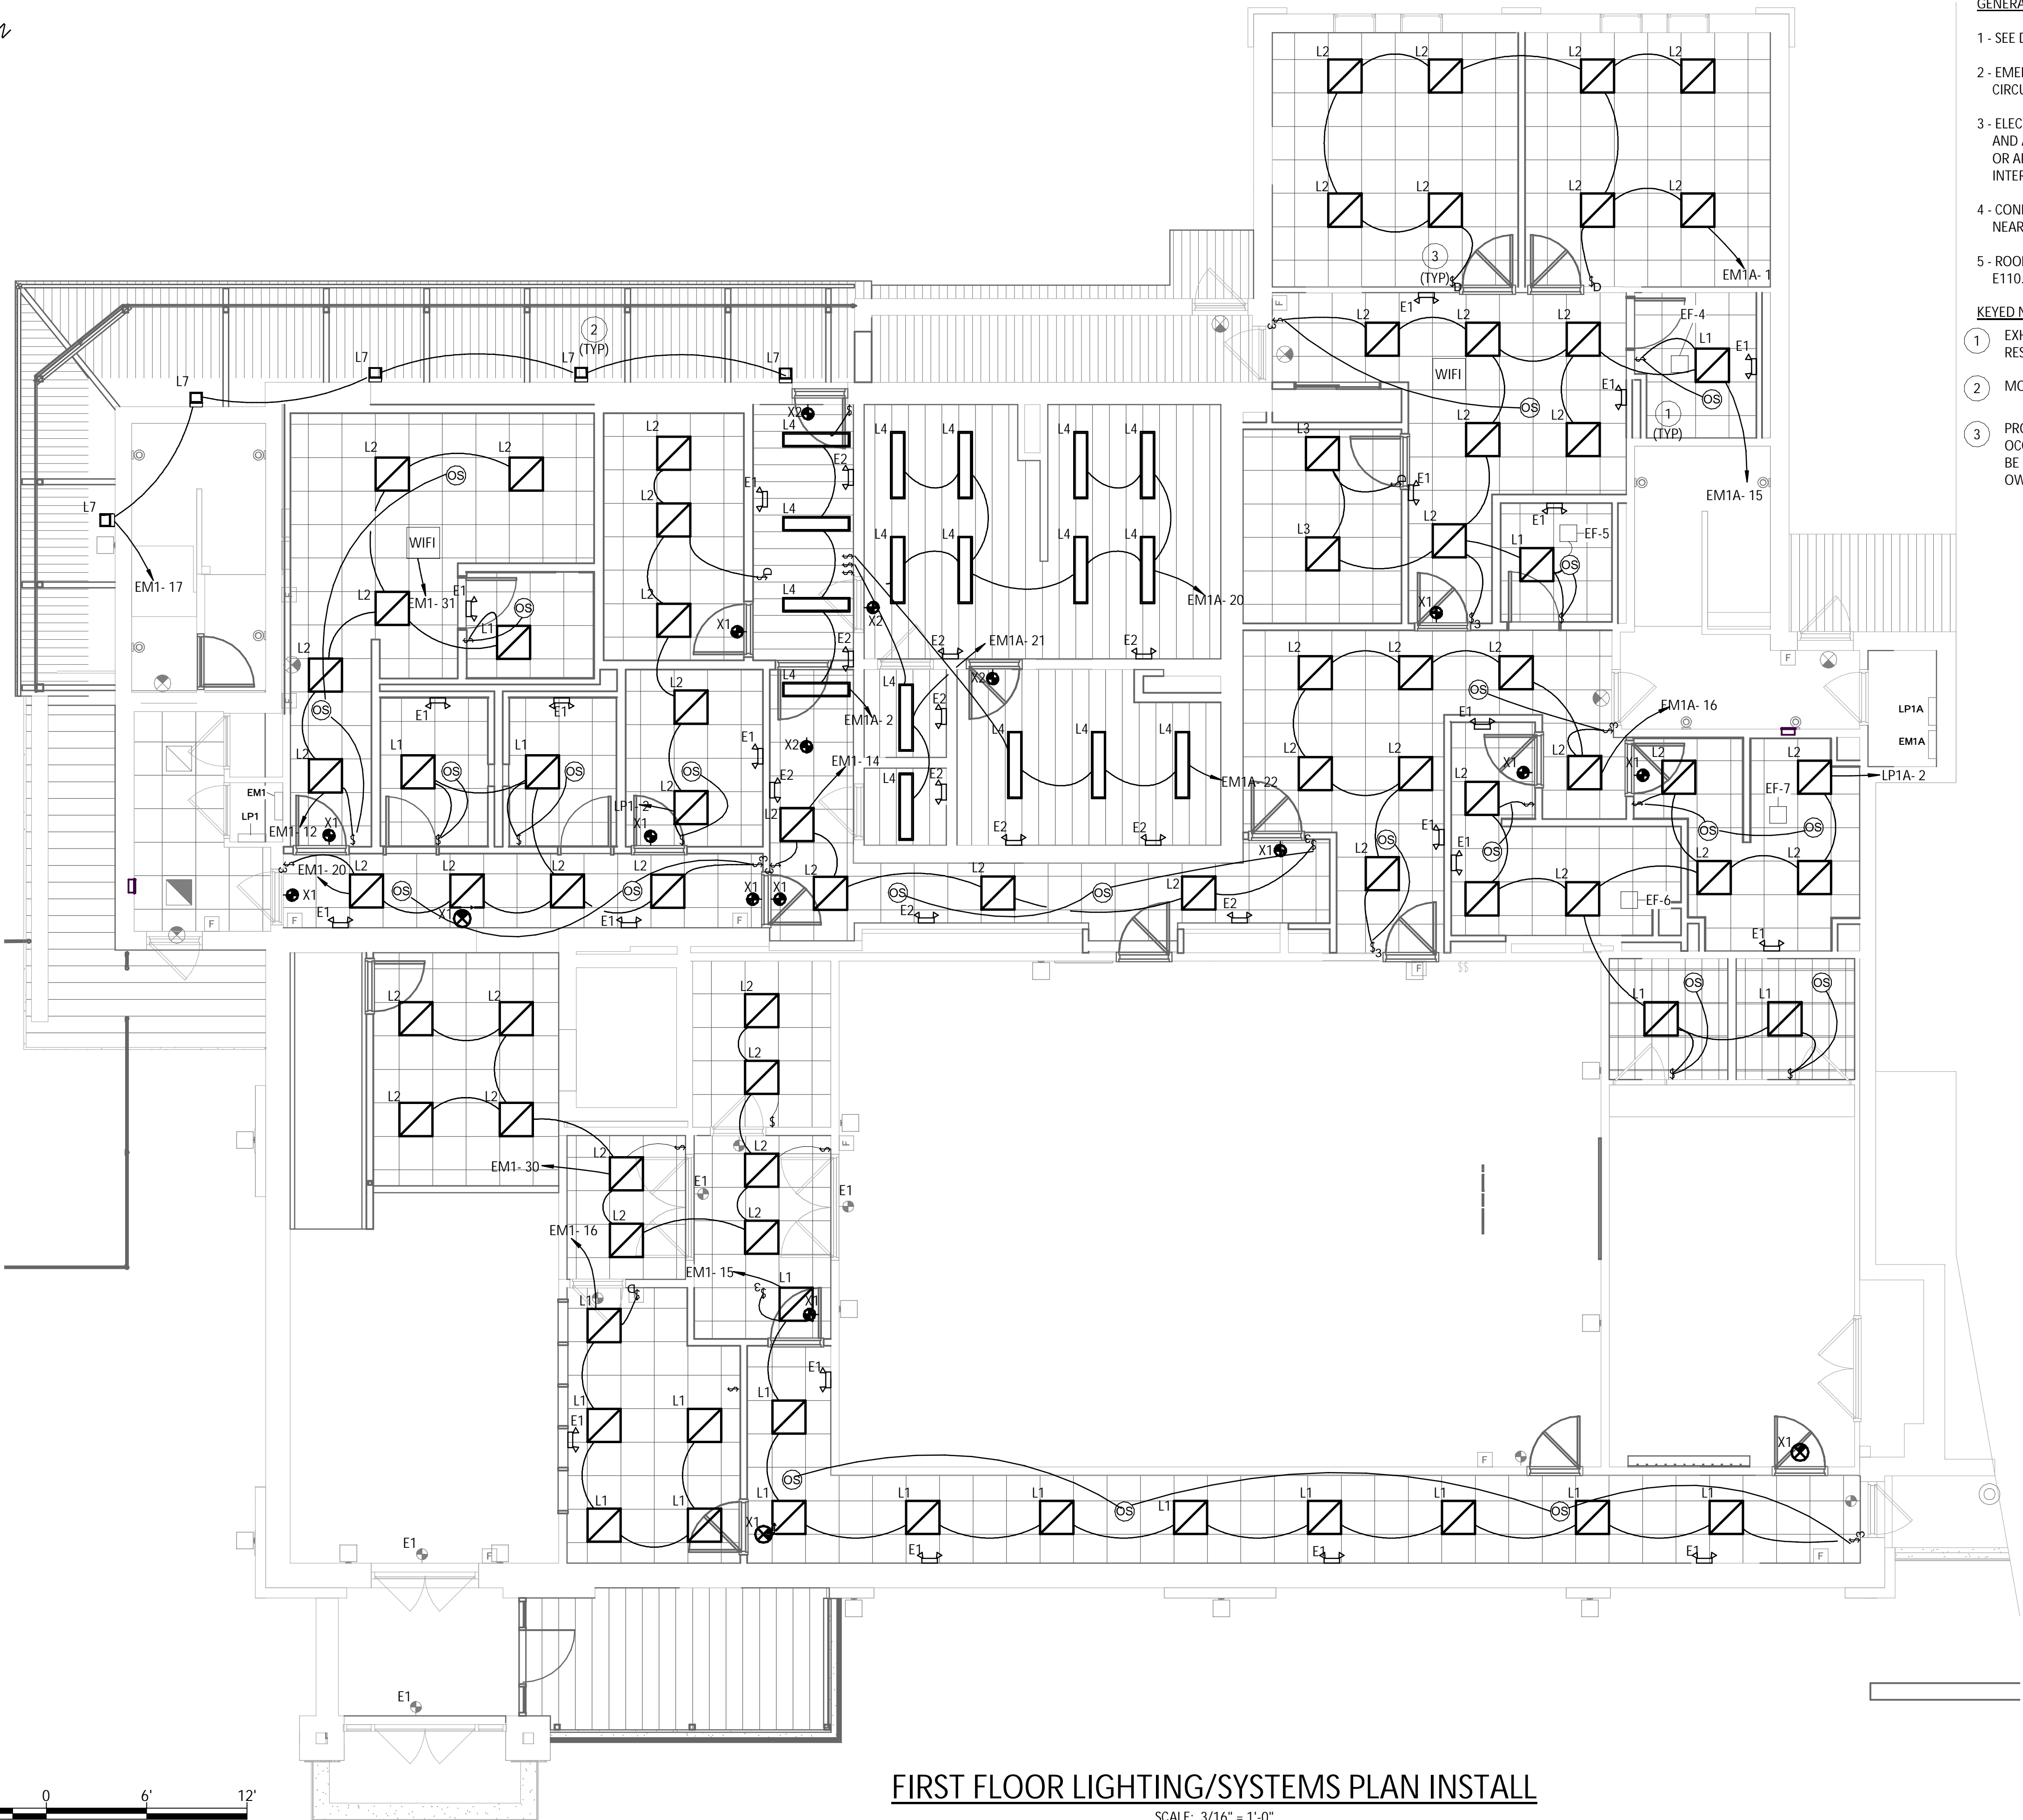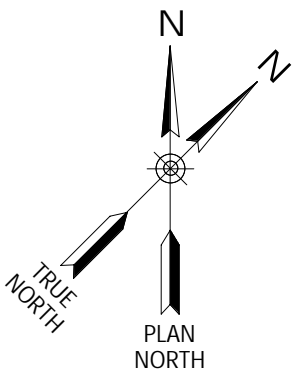- 1 EXHAUST FANS SHALL BE CONTROLLED BY THE OCCUPANCY SENSOR INSTALLED IN EACH RESPECTIVE BATHROOM. PROVIDE AND INSTALL 2#12 - 1#12GND IN 3/4" CONDUIT.
- 2 MOUNT E7 LIGHT FIXTURES 8'-0" ABOVE FINISH GRADE.
- 3 PROVIDE AND INSTALL LUTRON MAESTRO OR SIMILAR 0-10V DIMMER SINGLE POLE OCCUPANCY SENSOR SWITCHES OR EQUAL WHERE SHOWN. ALL NEW SWITCHES SHALL NOT BE INSTALLED ON THE FINISHED WOOD SURFACES. COORDINATE FINAL LOCATIONS WITH OWNER PRIOR TO INSTALLATION.

LEGEND	
\$	WALL SWITCH
\$D	DIMMER WALL SWITCH
\$3	3-WAY WALL SWITCH
OS	CEILING MOUNTED OCCUPANCY/MOTION SENSOR
□	2'X2' LED LIGHT FIXTURE, X INDICATES FIXTURE TYPE
□	2'X4' LED LIGHT FIXTURE, X INDICATES FIXTURE TYPE
⊗	EXIT LIGHT FIXTURE, CEILING MOUNTED
⊙	RECESSED LIGHT FIXTURE, CEILING MOUNTED
X	EMERGENCY LIGHTING UNIT
□	WALL PACK, OUTDOOR LIGHTING FIXTURE
□	CEILING RECESSED LIGHTING FIXTURE

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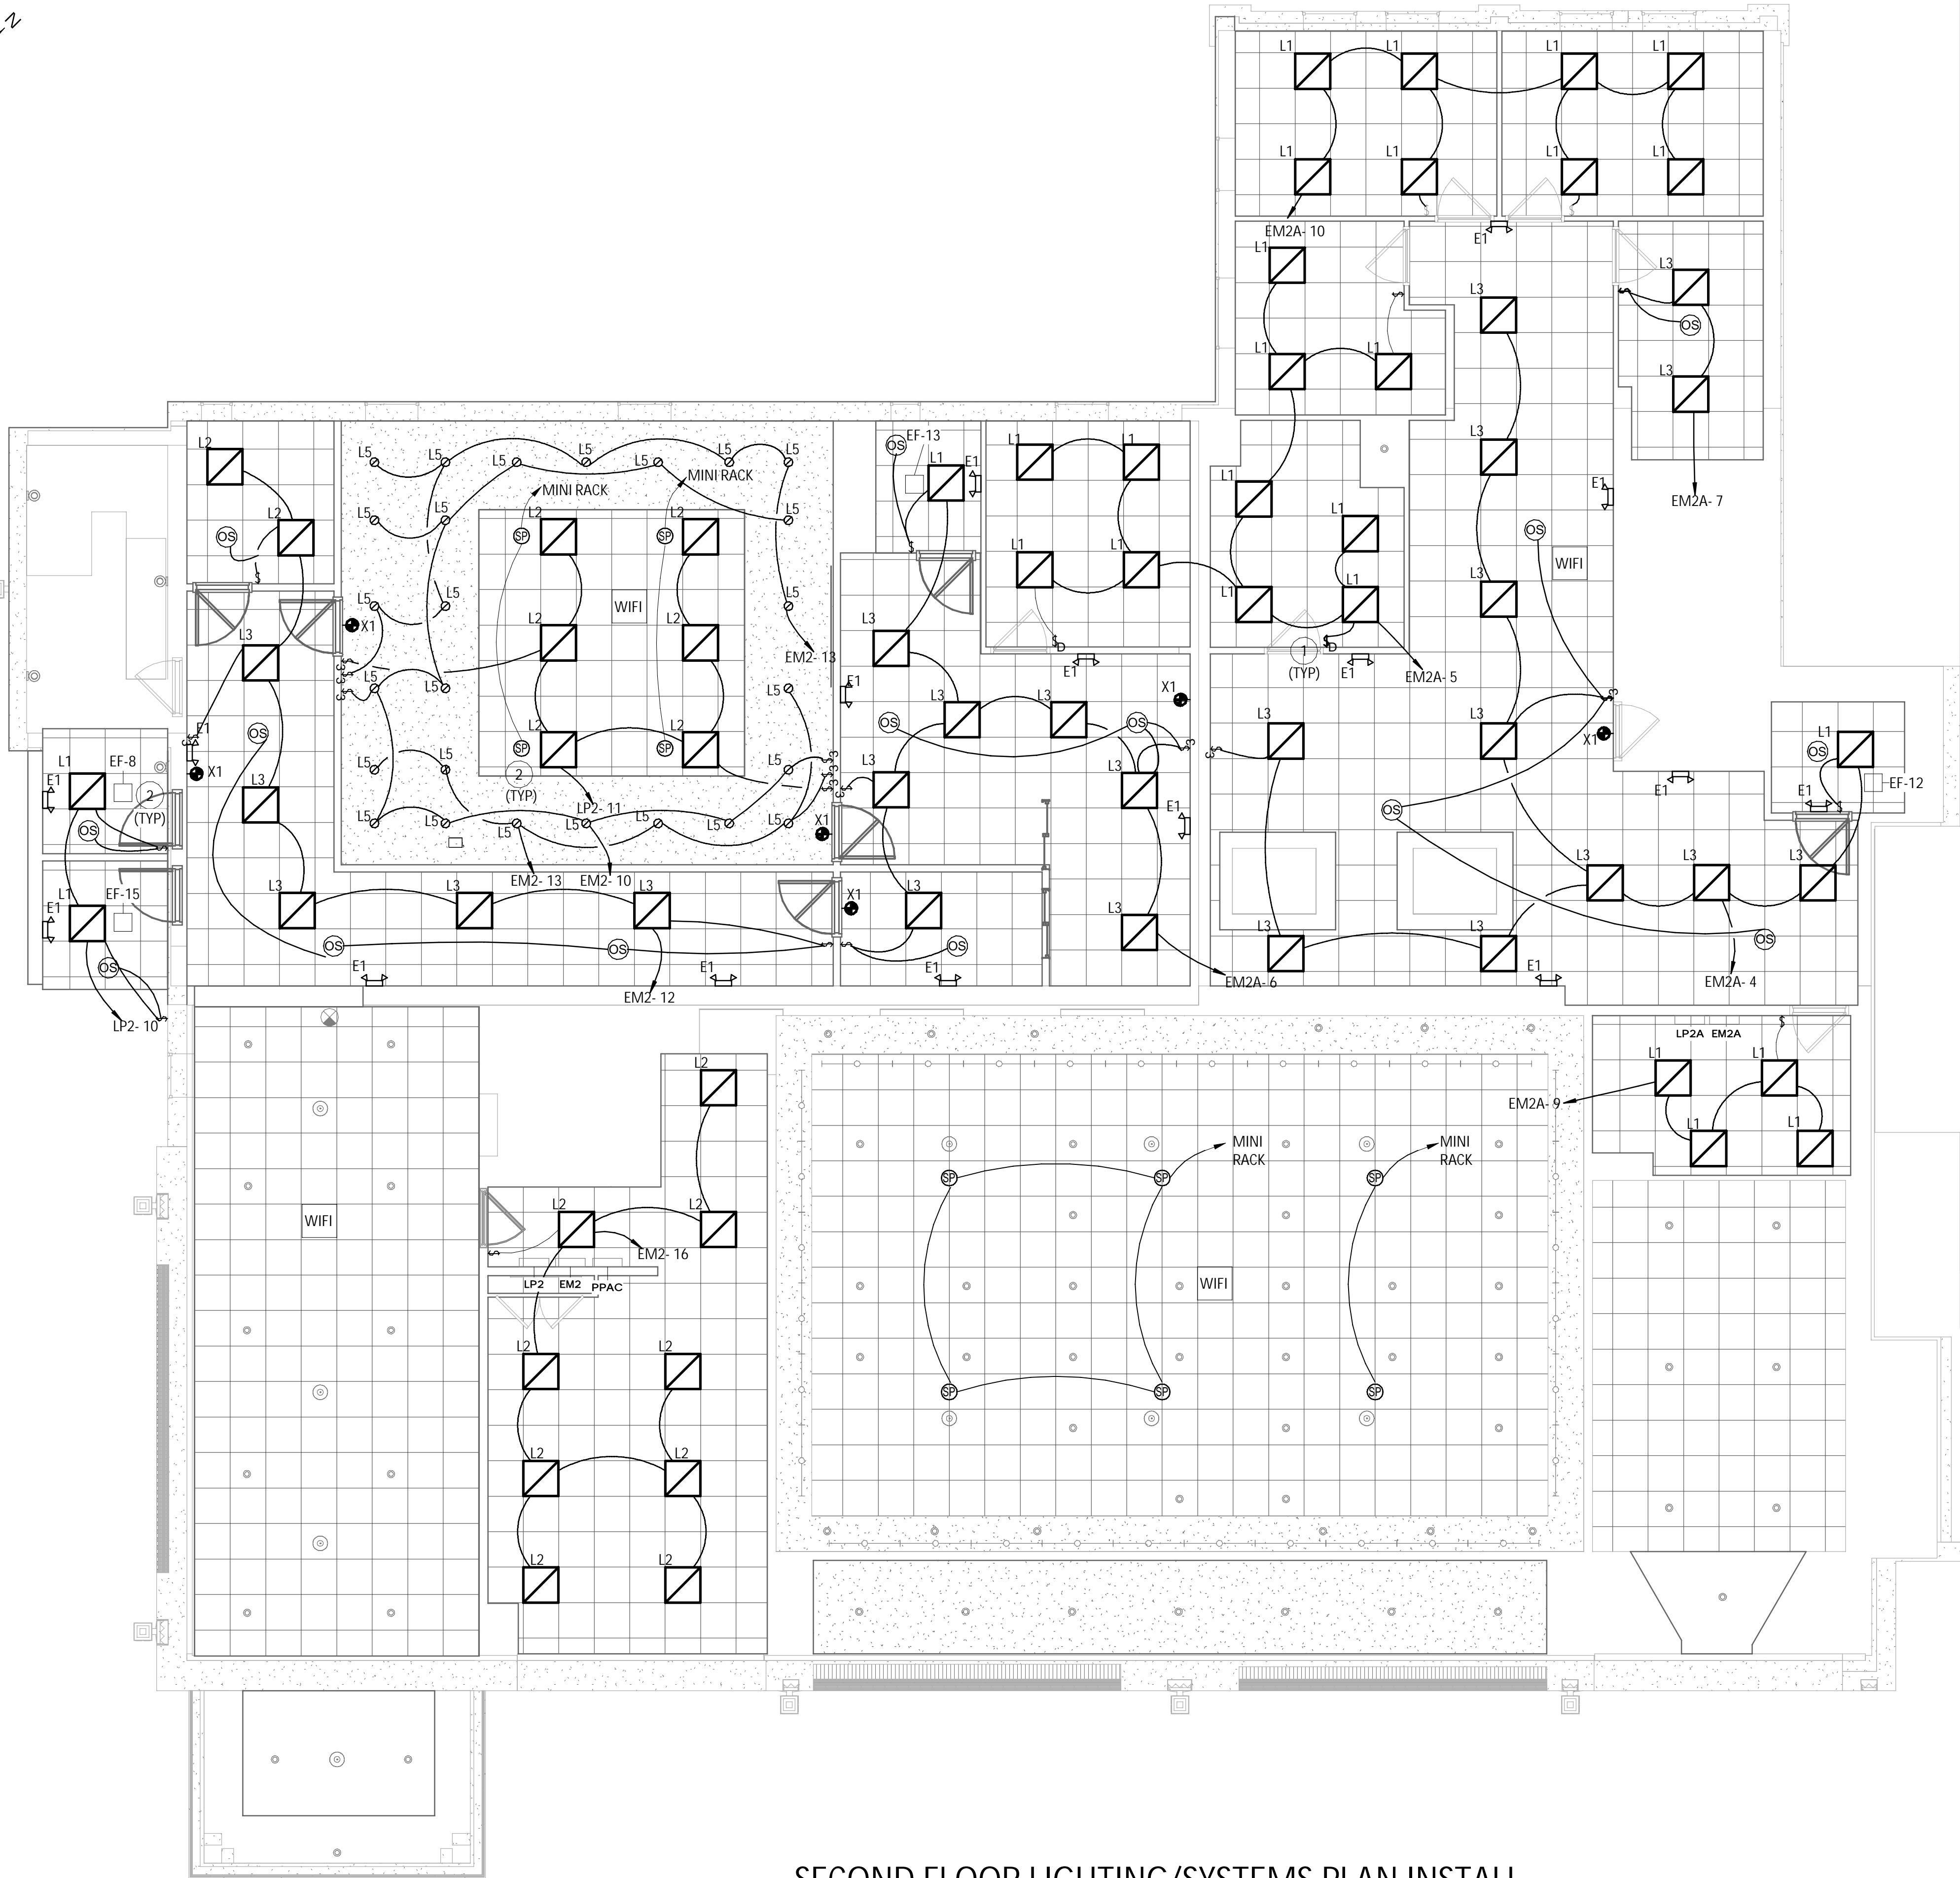
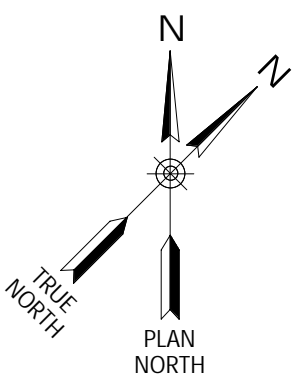
REVISIONS	

CITY OF MIDDLETOWN  
NEW COURTHOUSE FACILITY  
CONTRACT 1D - ELECTRICAL CONSTRUCTION  
FIRST FLOOR LIGHTING/SYSTEMS PLAN INSTALL  
CITY OF MIDDLETOWN  
ORANGE COUNTY, NEW YORK

443 Electronics Parkway  
Liverpool, NY  
13088  
**Barton & Loguidice, D.P.C.**

STATE OF NEW YORK  
J. HORVAT  
No. 089098  
ELECTRICIAN  
Date  
AUGUST, 2024  
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Sheet Number  
E113  
Project Number  
1753.008.001





GENERAL NOTES - SECOND FLOOR LIGHTING/SYSTEMS PLAN INSTALL

- 1 - SEE DRAWING E118 ELECTRICAL SCHEDULES FOR LIGHT FIXTURE DETAILS.
- 2 - EMERGENCY LIGHT FIXTURES SHOULD BE INSTALLED ON THE UNSWITCHED PORTION OF THE CIRCUIT.
- 3 - ELECTRICAL SWITCH AND OUTLET BOXES SHOULD BE SEALED USING A MOLDABLE PUTTY PAD AND A SEALANT (SUCH AS FD-150+ CAULK OR FB 1000 NS SEALANT, AS AVAILABLE FROM 3M, OR APPROVED EQUAL) AROUND THE PERIMETER OF THE BOX AT THE GYPSUM/BOX INTERFACE TO MINIMIZE THE TRANSMISSION OF SMOKE (AND SOUND).
- 4 - CONNECT EMERGENCY EXIT LIGHTS SIGNS AND EMERGENCY EGRESS LIGHTING TO THE NEAREST UNSWITCHED LIGHTING CIRCUIT IN THE SAME ROOM OR AREA.
- 5 - ROOM NAMES NOT CALLED OUT FOR DRAWING CLARITY. FOR ROOM NAMES SEE DRAWING E111.

SPEAKER NOTES - SECOND FLOOR LIGHTING/SYSTEMS PLAN INSTALL

- 1 - ALL SPEAKERS SHOULD BE SET TO 70 VOLTS, 15 WATTS.
- 2 - THE TWO SPEAKERS OVER THE JUDGES BENCH AREA SHOULD BE DAISY CHAINED (CONNECTED IN PARALLEL) WITH A SINGLE HOME RUN TO THE MIDI RACK. LEAVE 10' OF EXTRA CABLE CORE FOR ALL SPEAKER & MICROPHONE CABLES AT THE MIDI RACK FOR TERMINATION & CABLE MANAGEMENT BY OCA.
- 3 - THE REMAINING SPEAKERS IN THE ROOM CAN ALL BE DAISY CHAINED WITH ANOTHER HOME RUN TO THE MIDI RACK.

KEYED NOTES - SECOND FLOOR LIGHTING/SYSTEMS PLAN INSTALL

- 1 PROVIDE AND INSTALL LUTRON MAESTRO OR SIMILAR 0-10V DIMMER SINGLE POLE OCCUPANCY SENSOR SWITCHES OR EQUAL WHERE SHOWN. ALL NEW SWITCHES SHALL NOT BE INSTALLED ON THE FINISHED WOOD SURFACES. COORDINATE FINAL LOCATIONS WITH OWNER PRIOR TO INSTALLATION.
- 2 EXHAUST FANS SHALL BE CONTROLLED BY THE OCCUPANCY SENSOR INSTALLED IN EACH REPECTIVE BATHROOM. PROVIDE AND INSTALL 2#12 - 1#12GND IN 3/4" CONDUIT.

LEGEND

\$	WALL SWITCH
\$D	DIMMER WALL SWITCH
\$3	3-WAY WALL SWITCH
OS	CEILING MOUNTED OCCUPANCY/MOTION SENSOR
L1	2'X2' LED LIGHT FIXTURE, X INDICATES FIXTURE TYPE
SP	SPEAKER
⊗	EXIT LIGHT FIXTURE, CEILING MOUNTED
⊙	RECESSED LIGHT FIXTURE, CEILING MOUNTED
X	EMERGENCY LIGHTING UNIT
WIFI	WIRELESS ACCESS POINT

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REVISIONS

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NEW COURTHOUSE FACILITY  
CONTRACT 1D - ELECTRICAL CONSTRUCTION  
SECOND FLOOR LIGHTING/SYSTEMS PLAN INSTALL  
CITY OF MIDDLETOWN  
ORANGE COUNTY, NEW YORK

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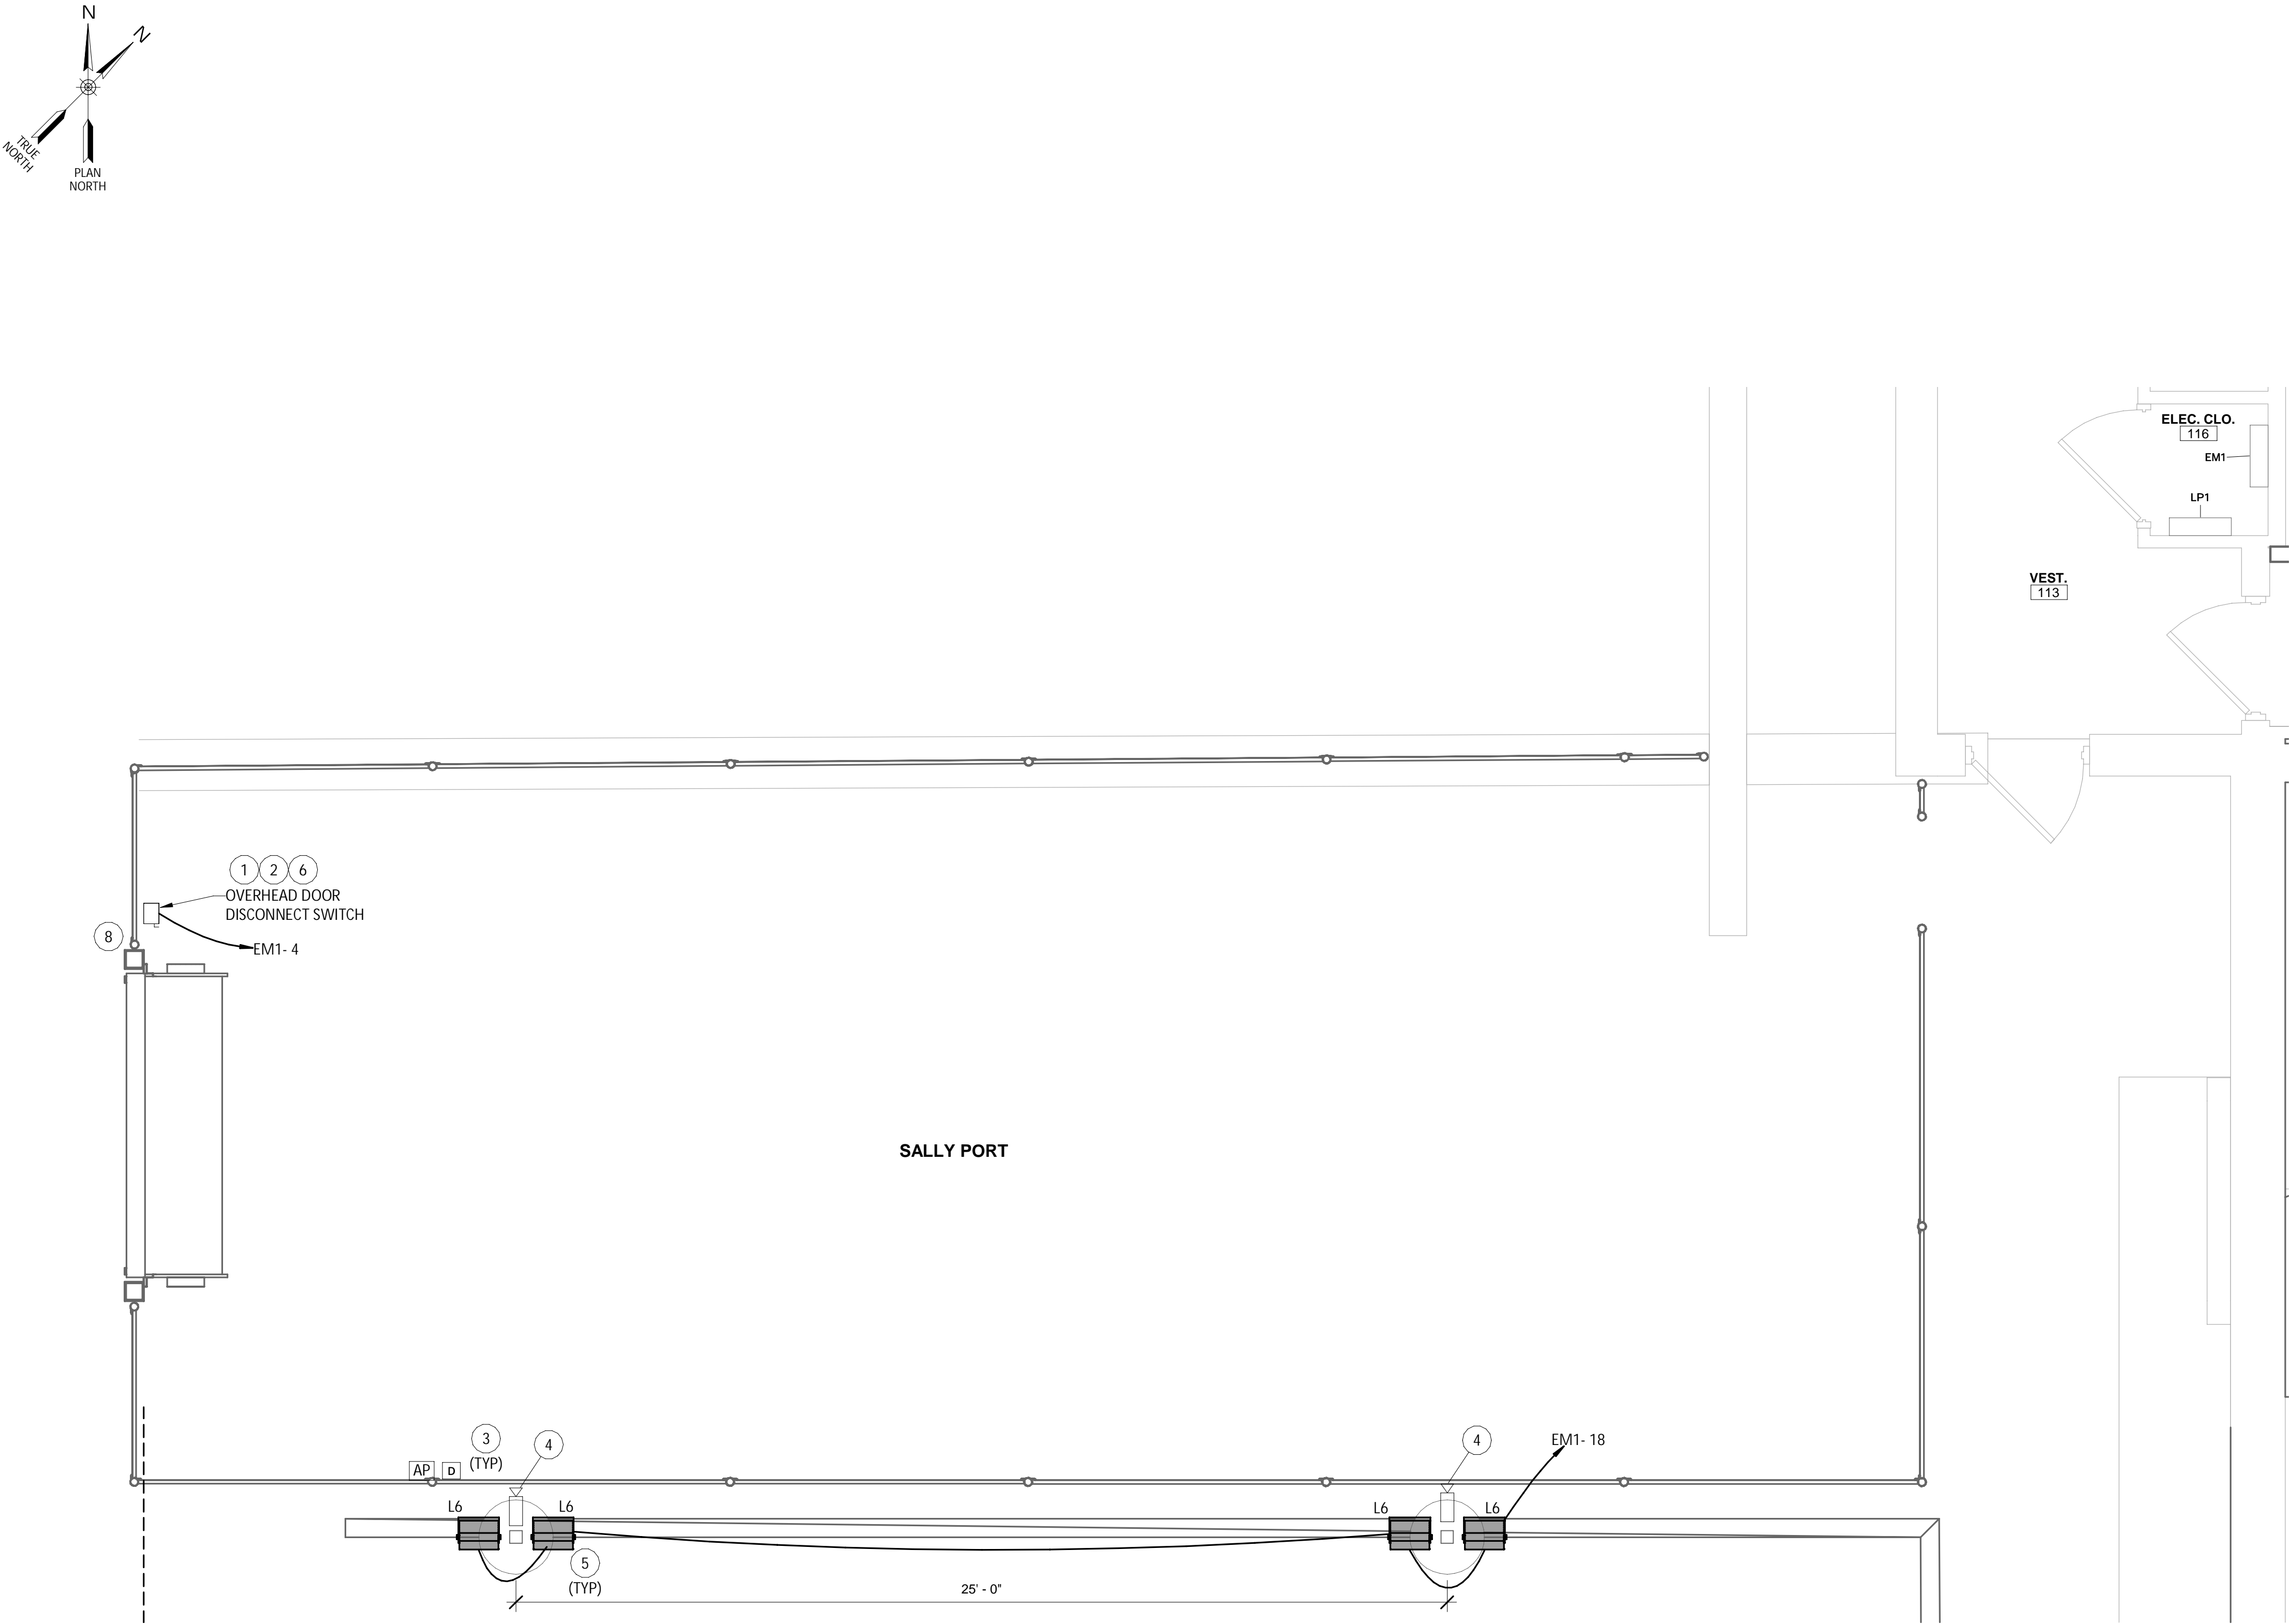
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SALLY PORT POWER, LIGHTING & SECURITY PLAN INSTALL

SCALE: 3/8" = 1'-0"

KEYED NOTES - SALLY PORT & SECURITY PLAN INSTALL

- 1 PROVIDE AND INSTALL 30A DISCONNECT SWITCH SQUARE-D H361 OR EQUAL. RUN 3# 10 - 1#10G IN 1" CONDUIT FROM NEW AUTO GARAGE DOOR OPENER TO PANEL EM1.
- 2 SEE DETAIL ON SHEET E118 FOR OVERHEAD DOOR WIRING DETAIL.
- 3 MOUNT PROVIDED WIRELESS AIPHONE AND DURESS BUTTON TO FENCE POLE. COORDINATE EXACT LOCATION WITH OWNER.
- 4 MOUNT PROVIDED SECURITY CAMERAS TO LIGHT POLES AT A HEIGHT OF 10' ABOVE FINISH GRADE. PROVIDE AND INSTALL (2) CAT6A CABLES FROM CAMERA TO THE ELEC CLO./STORAGE ROOM 205 ON THE SECOND FLOOR.
- 5 PROVIDE AND INSTALL 4" DIAMETER 15' ROUND STEEL POLES ACUITY PART NUMBER RSS-4B WITH BAND MOUNT BULLHORNS ACUITY PART NUMBER SMACBT-14/8T-RND-DBLXD OR EQUAL TO MOUNT SALLY PORT AREA LIGHT FIXTURES. TYPICAL 2X
- 6 CONTROLS FOR THE OVERHEAD DOOR WILL BE LOCATED IN THE SECURITY SUPERVISORS OFFICE 122 AND THE MAIN SECURITY OFFICE 105 LOCATED ON THE FIRST FLOOR . SEE DRAWING E110 FOR LOCATIONS.
- 7 INSTALL 12 #14AWG AND 2 #18 STP IN 1" CONDUIT TO THE MAIN SECURITY ROOM 105 ON THE FIRST FLOOR.
- 8 MOUNT PROVIDED SECURITY CAMERAS TO FENCE POLE AT A HEIGHT OF 6' ABOVE FINISH GRADE. PROVIDE AND INSTALL (2) CAT6A CABLES FROM CAMERA TO THE ELEC CLO./STORAGE ROOM 205 ON THE SECOND FLOOR.

LEGEND	
	PANELBOARD
	SECURITY CAMERA
	JUNCTION BOX
	AIPHONE
	DURESS ALARM ACTIVATION DEVICE
	DISCONNECT SWITCH
	POLE MOUNTED FLOOD LIGHT

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REVISIONS	

CITY OF MIDDLETOWN  
NEW COURTHOUSE FACILITY  
CONTRACT 1D - ELECTRICAL CONSTRUCTION

SALLY PORT POWER, LIGHTING & SECURITY PLAN  
INSTALL

CITY OF MIDDLETOWN  
ORANGE COUNTY, NEW YORK

443 Electronics Parkway  
Liverpool, NY  
13088

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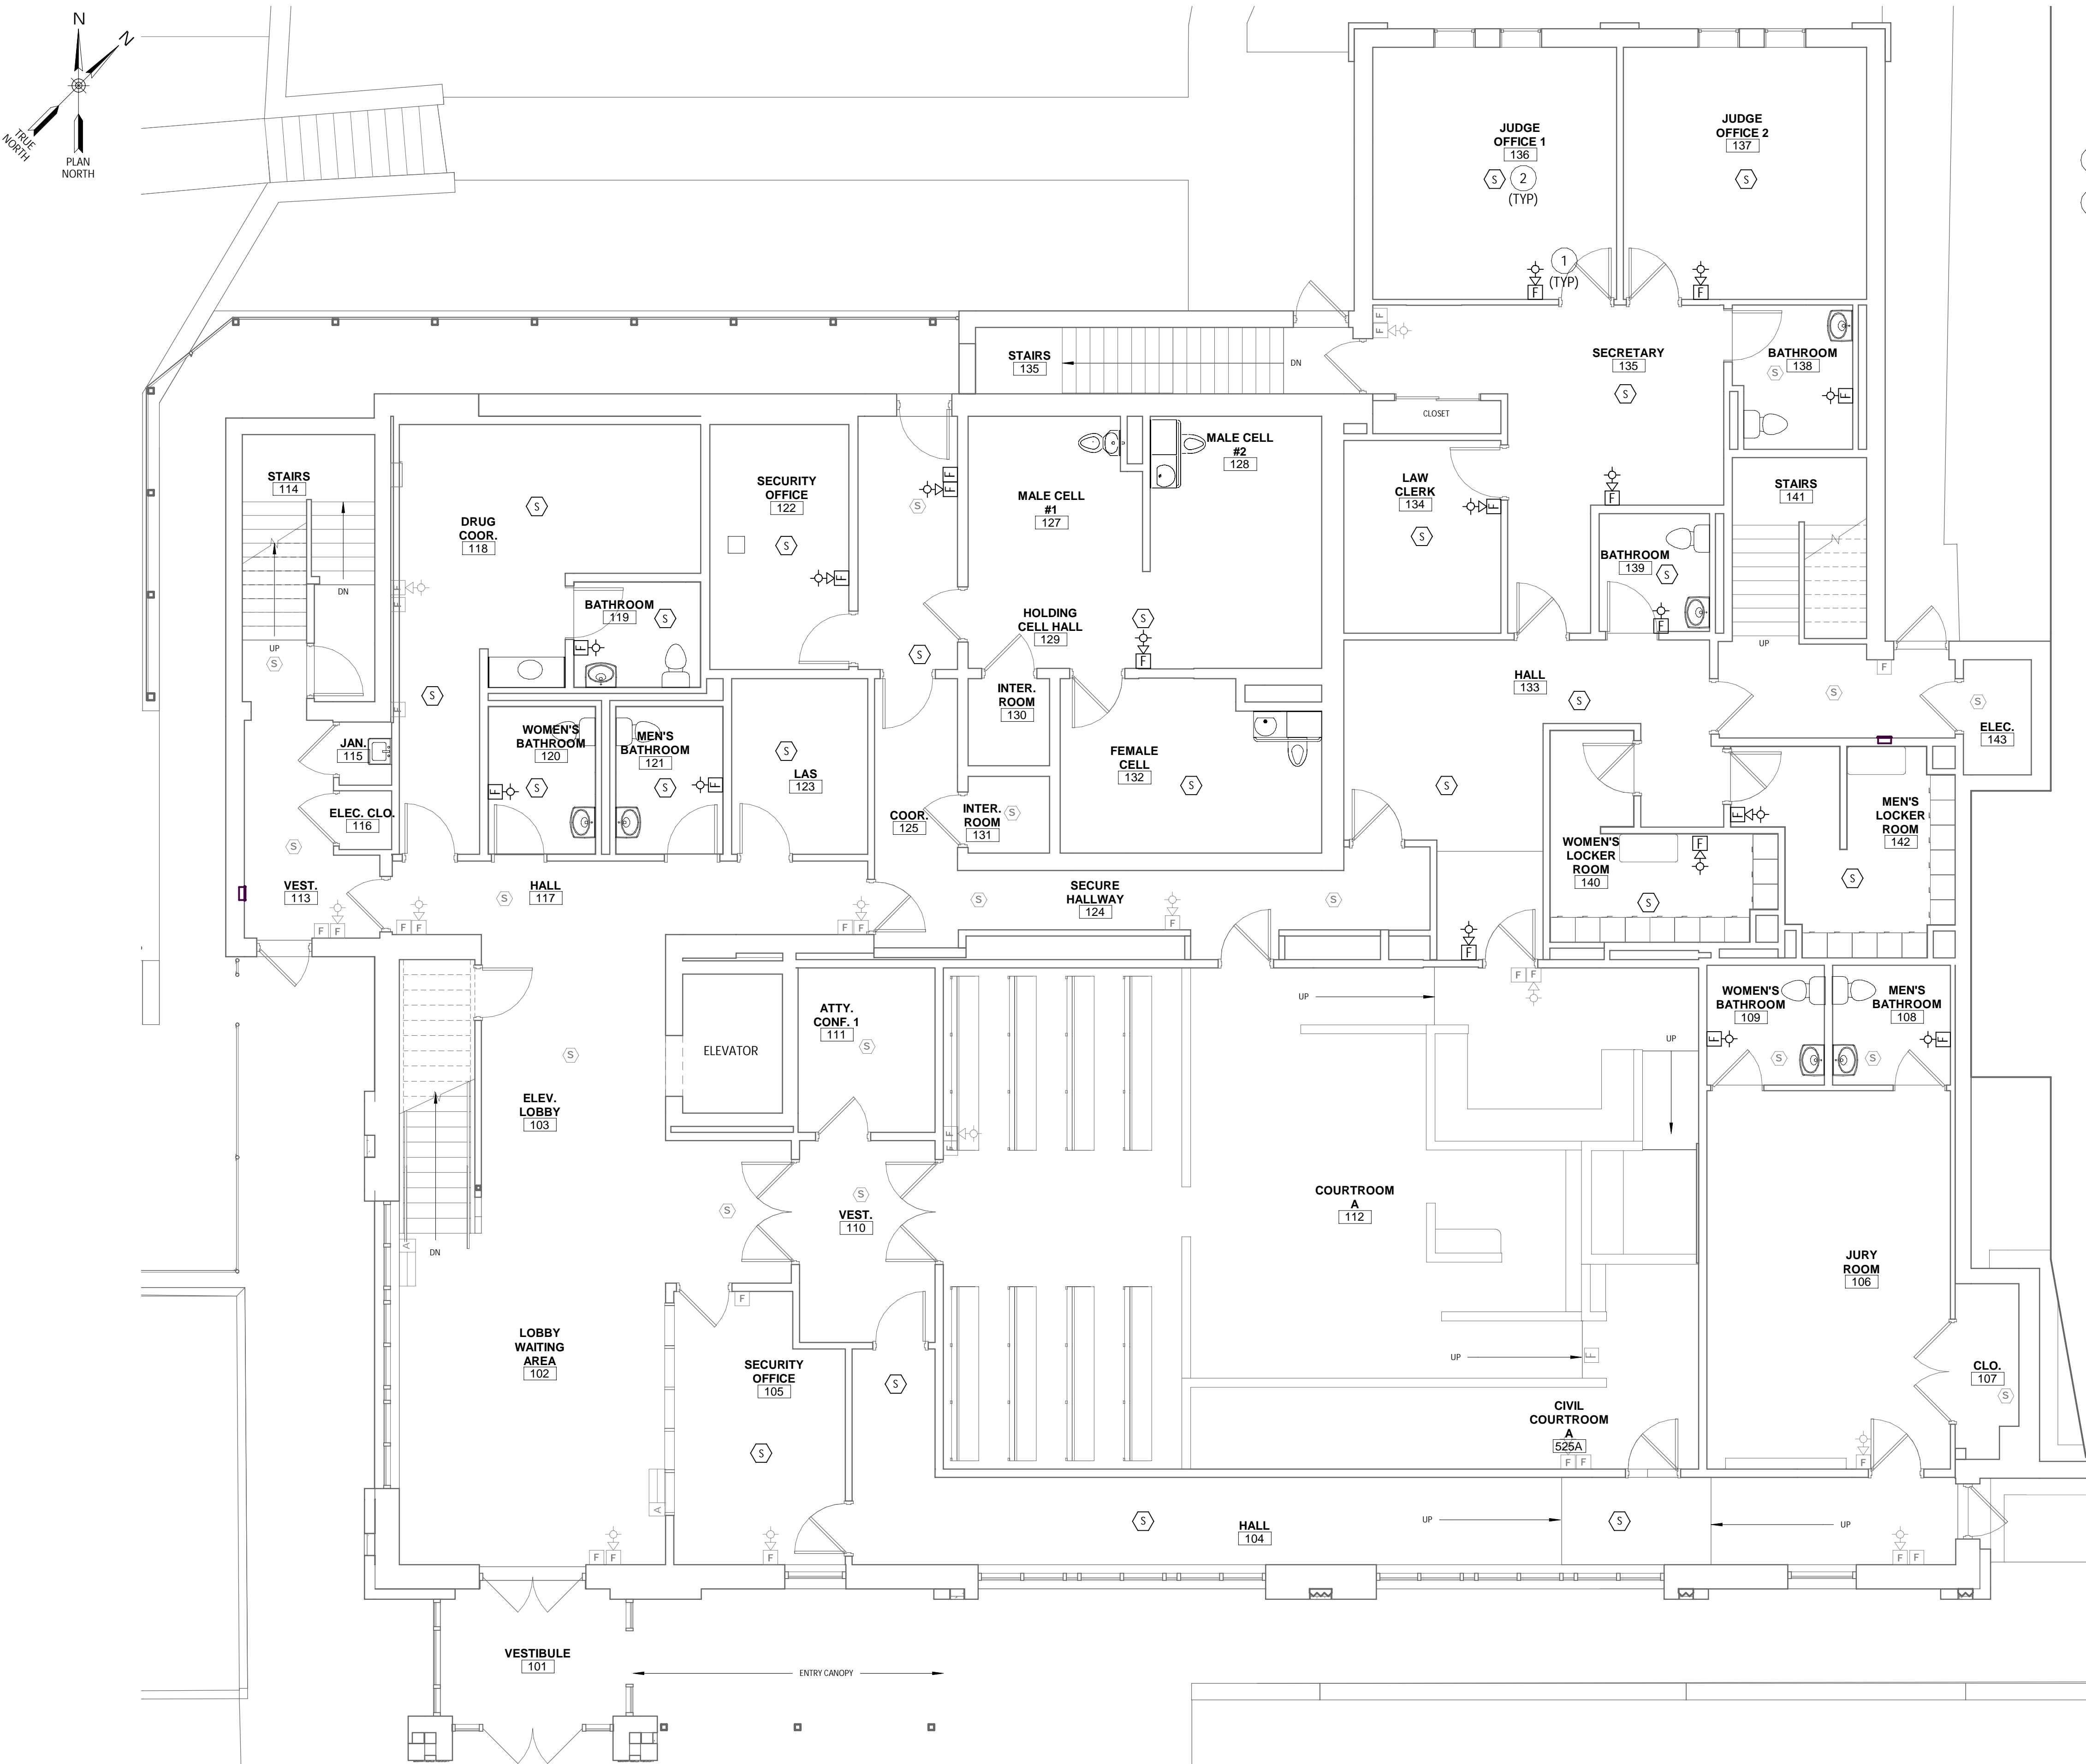


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Checked by TWMB Drawn by CJ Designed by CJ In Charge of TWMB

3/16" = 1'-0" 4' 0 6' 12'



## FIRST FLOOR FIRE ALARM PLAN INSTALL

SCALE: 3/16" = 1'-0"

### GENERAL NOTES - FIRST FLOOR FIRE ALARM PLAN INSTALL

1 - ALL FIRE ALARM DEVICES IN HALLS #124 & 126, MALE CELL #127,128,129, FEMALE CELL #132, INTERVIEW ROOM #130 & 131 SHALL HAVE TAMPER RESISTANT COVERS. ALL WIRING AND CONDUIT SHALL BE CONCEALED.

### KEYED NOTES - FIRST FLOOR FIRE ALARM PLAN INSTALL

- SEE DRAWING E605 FIRE ALARM RISER DIAGRAM INSTALL FOR HORN/STROBE WIRING DETAILS.
- SEE DRAWING E605 FIRE ALARM RISER DIAGRAM INSTALL FOR SMOKE DETECTOR WIRING DETAILS.

LEGEND	
	SMOKE DETECTOR
	HORN AND STROBE
	PULL STATION
	HORN
	PANELBOARD

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REVISIONS


CITY OF MIDDLETOWN  
NEW COURTHOUSE FACILITY  
CONTRACT 1D - ELECTRICAL CONSTRUCTION  
FIRST FLOOR FIRE ALARM PLAN INSTALL  
CITY OF MIDDLETOWN  
ORANGE COUNTY, NEW YORK

443 Electronics Parkway  
Liverpool, NY  
13088  
**B&L**  
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AUGUST, 2024  
Scale  
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Sheet Number  
E116  
Project Number  
1753.008.001





KEYED NOTES - SECOND FLOOR FIRE ALARM PLAN INSTALL

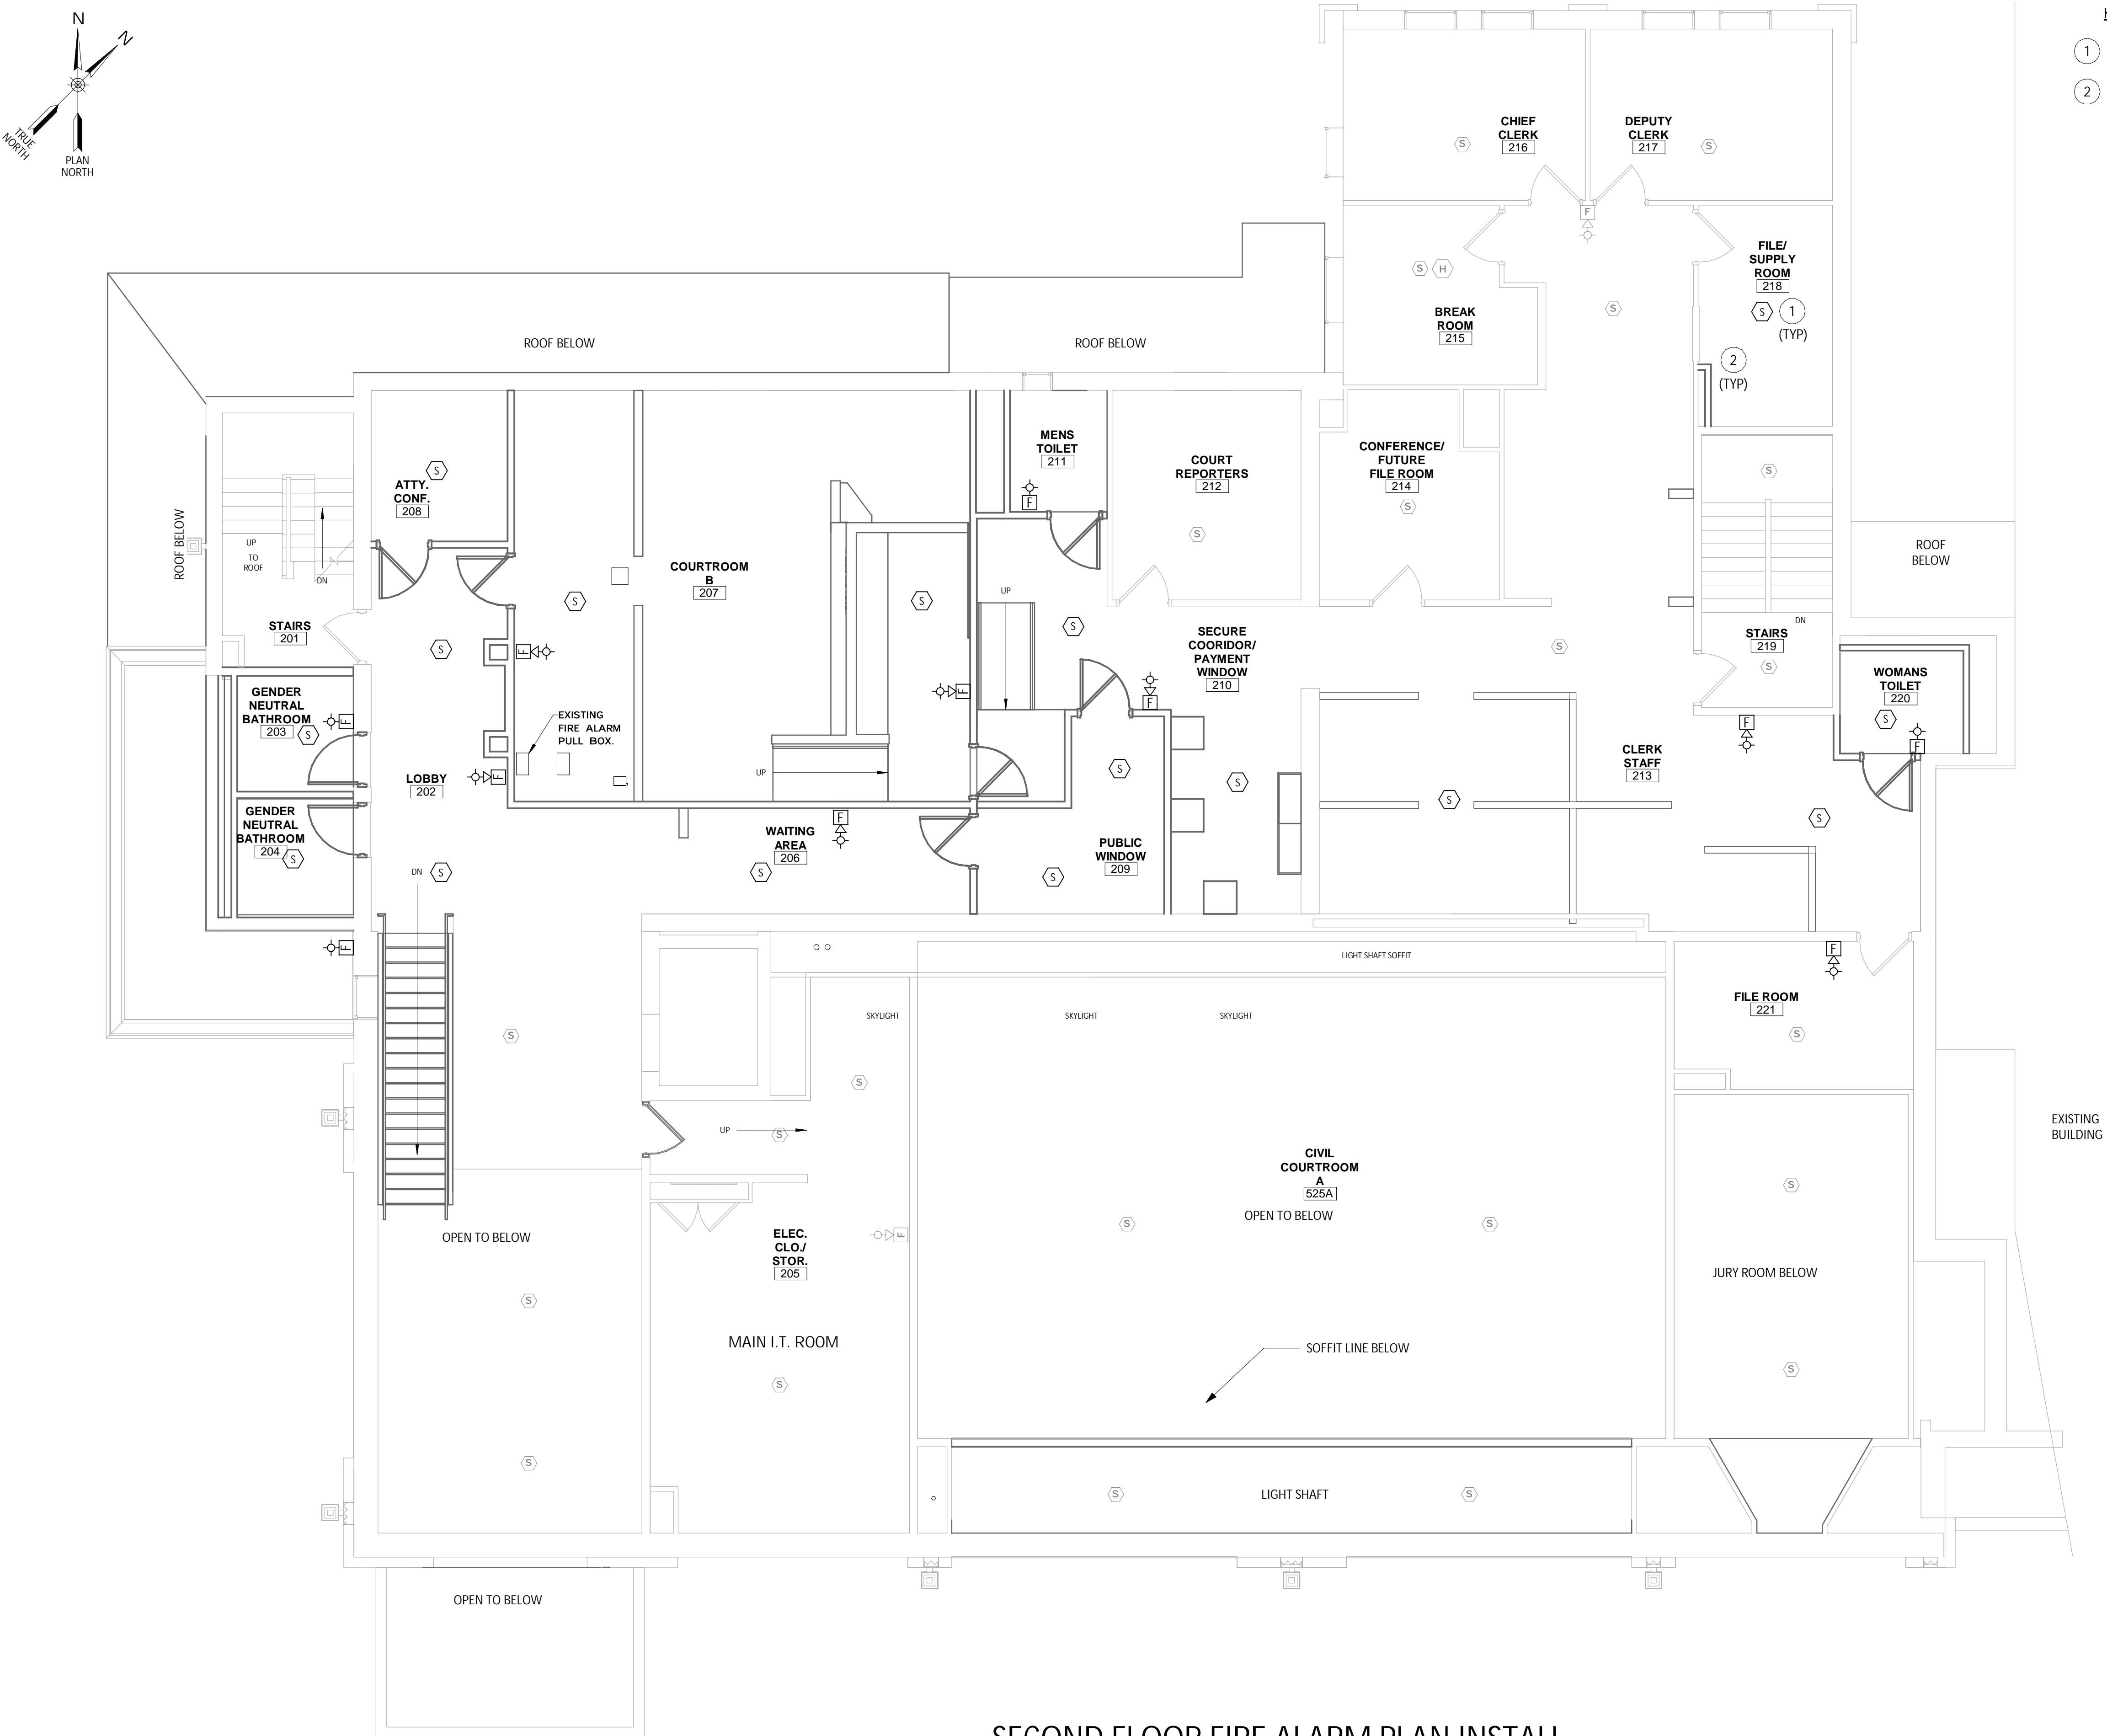- 1 SEE DRAWING E605 FIRE ALARM RISER DIAGRAM INSTALL FOR HORN/STROBE WIRING DETAILS.
- 2 SEE DRAWING E605 FIRE ALARM RISER DIAGRAM INSTALL FOR SMOKE DETECTOR WIRING DETAILS.

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REVISIONS	

CITY OF MIDDLETOWN  
NEW COURTHOUSE FACILITY  
CONTRACT 1D - ELECTRICAL CONSTRUCTION  
SECOND FLOOR FIRE ALARM PLAN INSTALL  
CITY OF MIDDLETOWN  
ORANGE COUNTY, NEW YORK

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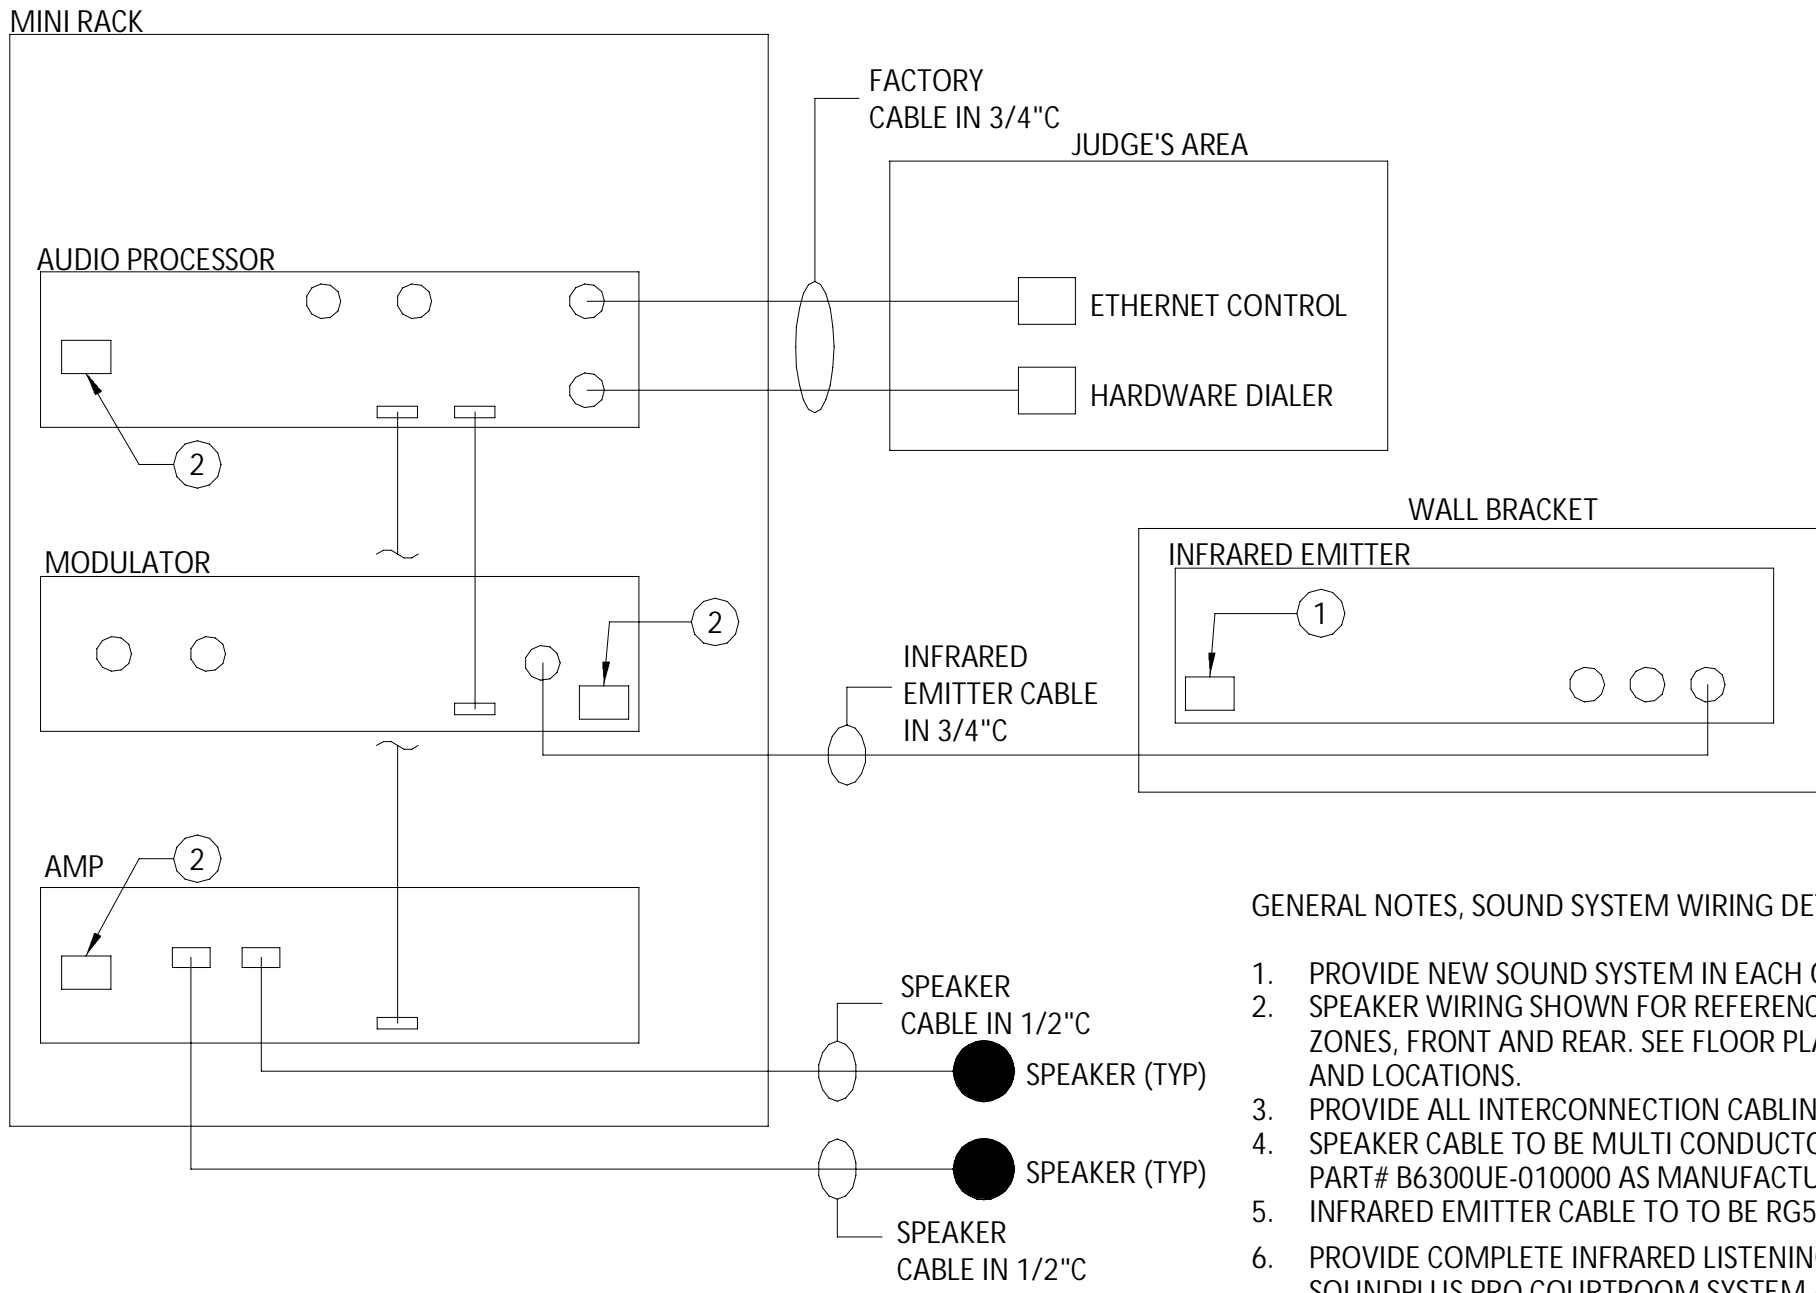
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E117  
Project Number  
1753.008.001

LEGEND	
	SMOKE DETECTOR
	HORN AND STROBE
	PULL STATION
	HORN
	PANELBOARD

SECOND FLOOR FIRE ALARM PLAN INSTALL

SCALE: 3/16" = 1'-0"





KEYED NOTES, SOUND SYSTEM DIAGRAM


1. PROVIDE DEDICATED 120V, 20A OUTLET FOR EMITTER AT EMITTER LOCATION. OUTLET TO BE PROVIDED IN RECESSED WALL BOX. CIRCUIT TO NEW PANELBOARD WITH 2#12, 1#12G IN 3/4" C. PROVIDE 20A, 1P CIRCUIT BREAKER.
2. UTILIZE 120V OUTLETS SHOWN ON FLOOR PLAN.

GENERAL NOTES, SOUND SYSTEM WIRING DETAIL

1. PROVIDE NEW SOUND SYSTEM IN EACH OF TWO (2) COURT ROOMS.
2. SPEAKER WIRING SHOWN FOR REFERENCE ONLY. WIRE SPEAKERS IN TWO ZONES, FRONT AND REAR. SEE FLOOR PLANS FOR SPEAKER QUANTITIES AND LOCATIONS.
3. PROVIDE ALL INTERCONNECTION CABLING/WIRING REQUIRED.
4. SPEAKER CABLE TO BE MULTI CONDUCTOR, 2 CONDUCTOR, 18AWG AS PART# B6300UE-010000 AS MANUFACTURED BY BELDEN.
5. INFRARED EMITTER CABLE TO TO BE RG58C, 50 OHM.
6. PROVIDE COMPLETE INFRARED LISTENING SYSTEM AS WIR SYS 1 SOUNDPLUS PRO COURTROOM SYSTEM AS MANUFACTURED BY WILLIAMS SOUND. SYSTEM TO INCLUDE:
  - (1) MOD 232 modulator
  - (1) WIR TX9 infrared emitter
  - (1) BKT 024 bracket
  - (4) RX22-4N infrared receivers
  - (4) HED 021 headphones
  - (2) NKL 001 neckloops
  - (1) RPK 005 rack panel kit
  - (1) IDP 008 ADA wall plaque
  - (8) BAT 001 AA alkaline batteries.

SOUND SYSTEM WIRING DETAIL

SCALE: NOT TO SCALE

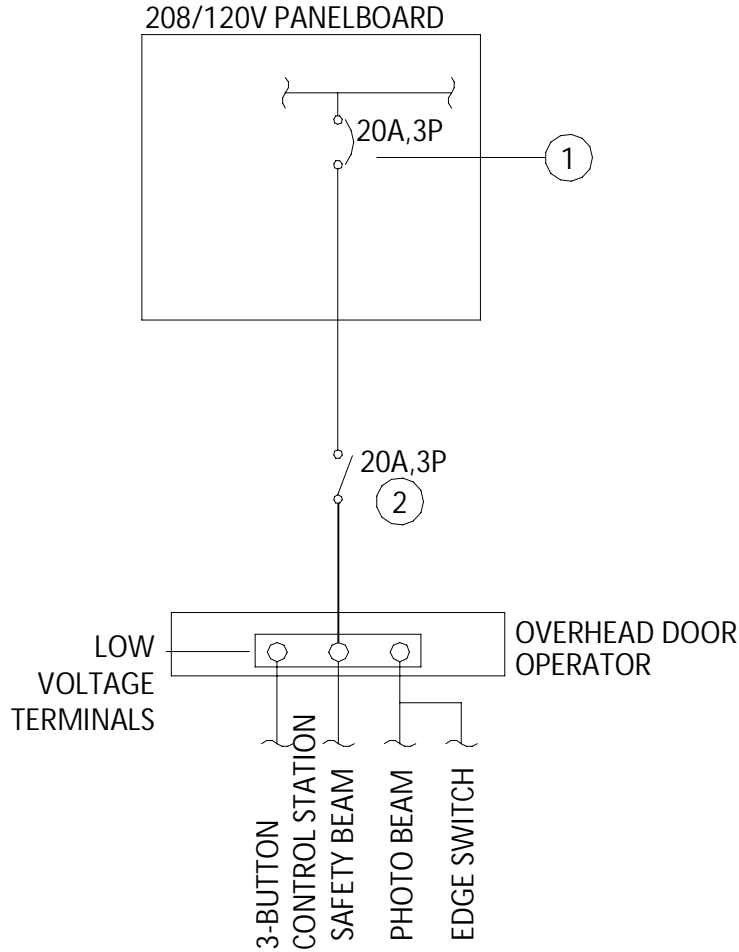

GENERAL NOTES, OVERHEAD DOOR - DIAGRAM


1. CIRCUITING, CIRCUIT BREAKER, DISCONNECT, AND LOW VOLTAGE WIRING SHOWN AS THE BASIS OF DESIGN. COORDINATE REQUIREMENTS WITH GENERAL CONTRACT PRIOR TO INSTALLATION.
2. ALL CIRCUITING SHALL BE IN CONDUIT.

KEYED NOTES, OVERHEAD DOOR - DIAGRAM

1. PROVIDE NEW CIRCUIT BREAKER IN EXISTING PANELBOARD. MATCH EXISTING KAIC RATINGS. (TYP)
2. SEE ONE-LINE DIAGRAM FOR CIRCUITING.

GARAGE DOOR WIRING DETAIL

SCALE: NOT TO SCALE

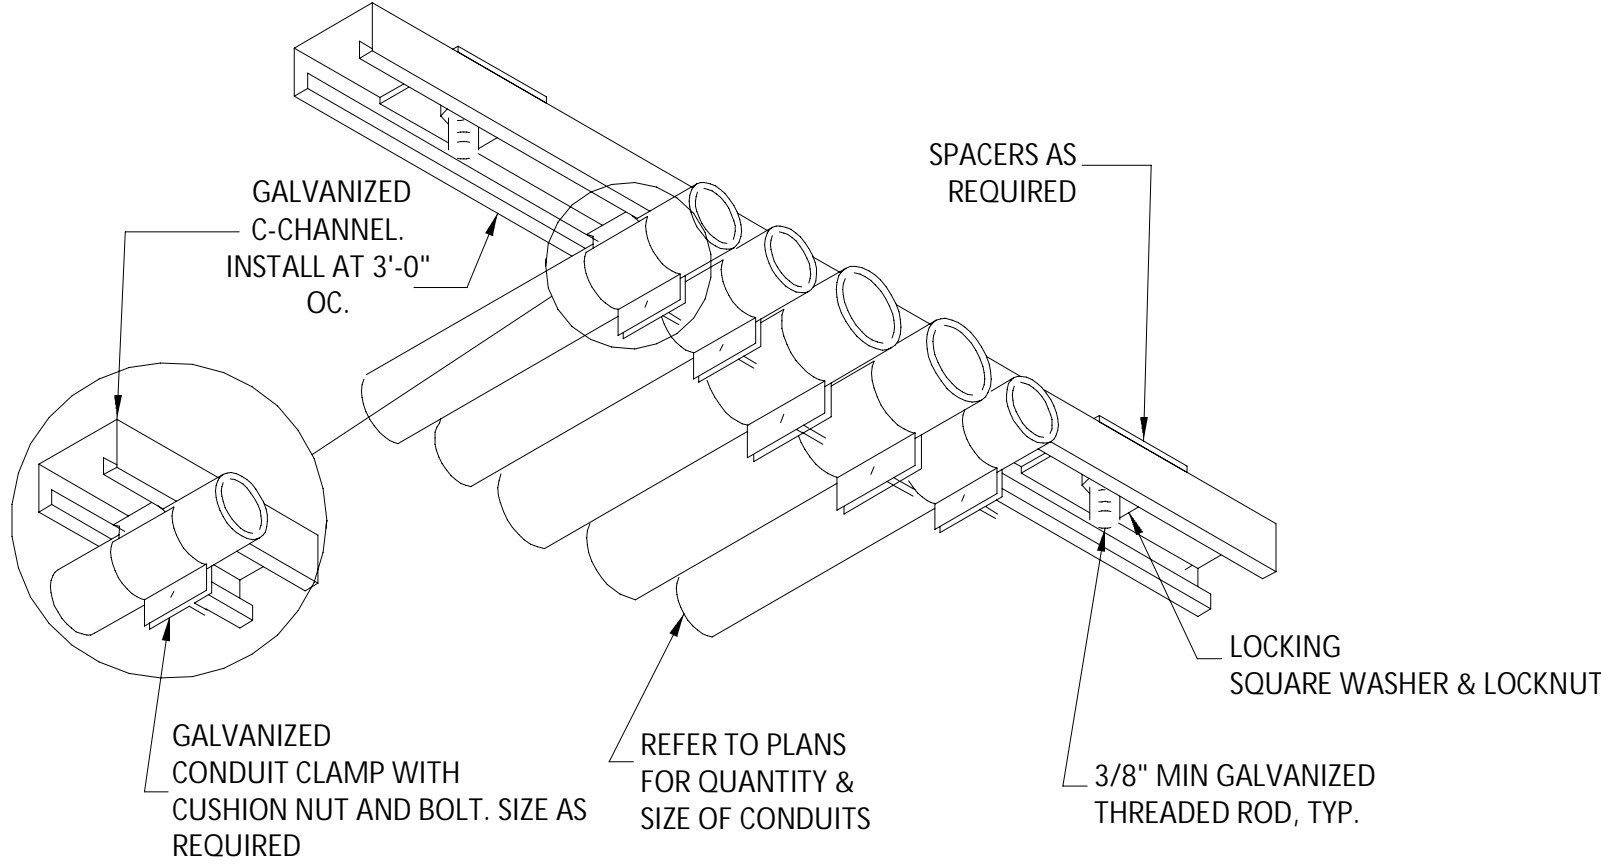

CONDUIT SUPPORT DETAIL

SCALE: NOT TO SCALE

LIGHT FIXTURE SCHEDULE										
DESIGNATION	TYPE	MANUFACTURER	CATALOG NUMBER	LUMENS	LIGHT COLOR	VOLTS	LIGHT DISTRIBUTION	INSTALLATION	FINISH / COLOR	REMARKS
L1	TROFFER	ACUITY	2BLT2 20L SDSM LP840	2000	4000K	120	N/A	CEILING/RECESSED	WHITE	
L2	TROFFER	ACUITY	2BLT2 33L SDSM LP840	3000	4000K	120	N/A	CEILING/RECESSED	WHITE	
L3	TROFFER	ACUITY	2BLT2 40L SDSM LP840	4000	4000K	120	N/A	CEILING/RECESSED	WHITE	
L4	TROFFER	KENALL	RMCA-4-TG-0-2-67L40K-IS-2-DV-0	5836	4000K	MULTI VOLT	N/A	CEILING RECESSED	WHITE	6
L5	RECESSED MOUNT	ACUITY	LDN6 40 15 L06 WR LSS MVOLT GZ10	1500	4000K	MULTI VOLT	N/A	CEILING	WHITE	
L6	FLOODLIGHT	ACUITY	RSXF1-P5-50K-AWFD-MVOLT-AAWSC-PE-DBLXD	N/A	5000K	MULTI VOLT	N/A	POLE MOUNT	BLACK	1
L7	WALL PACK	KENALL	FN9-2-7-MB-49L-40K8-120	N/A	5000K	MULTI VOLT	N/A	WALL MOUNT	BLACK	1,4
X1	EXIT LIGHT	ACUITY	LQM S W 3 R 120/277 M6	N/A	RED	120	N/A	SURFACE, WALL	WHITE	2,3
X2	TAMPER RESISTANT EXIT LIGHT	KENALL	MMEX-1-0-R-DT-1-EL	N/A	RED	120	N/A	SURFACE, WALL	WHITE	2,3,4
E1	EMERGENCY LIGHT	ACUITY	ELM4L	N/A	STANDARD	120	N/A	WALL	WHITE	2,3
E1	TAMPER REISITANT EMERGENCY LIGHT	KENALL	METELHC-24W-MW-2-6.5L-120	N/A	STANDARD	120	N/A	WALL	WHITE	2,3,4

GENERAL NOTES, LIGHT FIXTURE SCHEDULE

1. MODEL IS GIVEN FOR QUALITY ONLY. SUBSTITUTE LIGHT FIXTURES SHALL BE OF EQUAL OR GREATER QUALITY.
2. ALL FIXTURES TO BE PROVIDED WITH REQUIRED MOUNTING HARDWARE FOR INSTALLATION TYPE SHOWN.

REMARK, LIGHT FIXTURE SCHEDULE

1. PROVIDE FIXTURE WITH INTEGRATED PHOTOCCELL.
2. FIXTURE SHALL BE SELF DIAGNOSTIC.
3. PROVIDE WITH BATTERY PACK.
4. FIXTURE SHALL BE HIGH IMPACT AND VANDAL PROOF SUITABLE FOR HIGH SECURITY AREAS.

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REVISIONS

CITY OF MIDDLETOWN  
NEW COURTHOUSE FACILITY  
CONTRACT 1D - ELECTRICAL CONSTRUCTION  
ORANGE COUNTY, NEW YORK

ELECTRICAL SCHEDULES AND DETAILS

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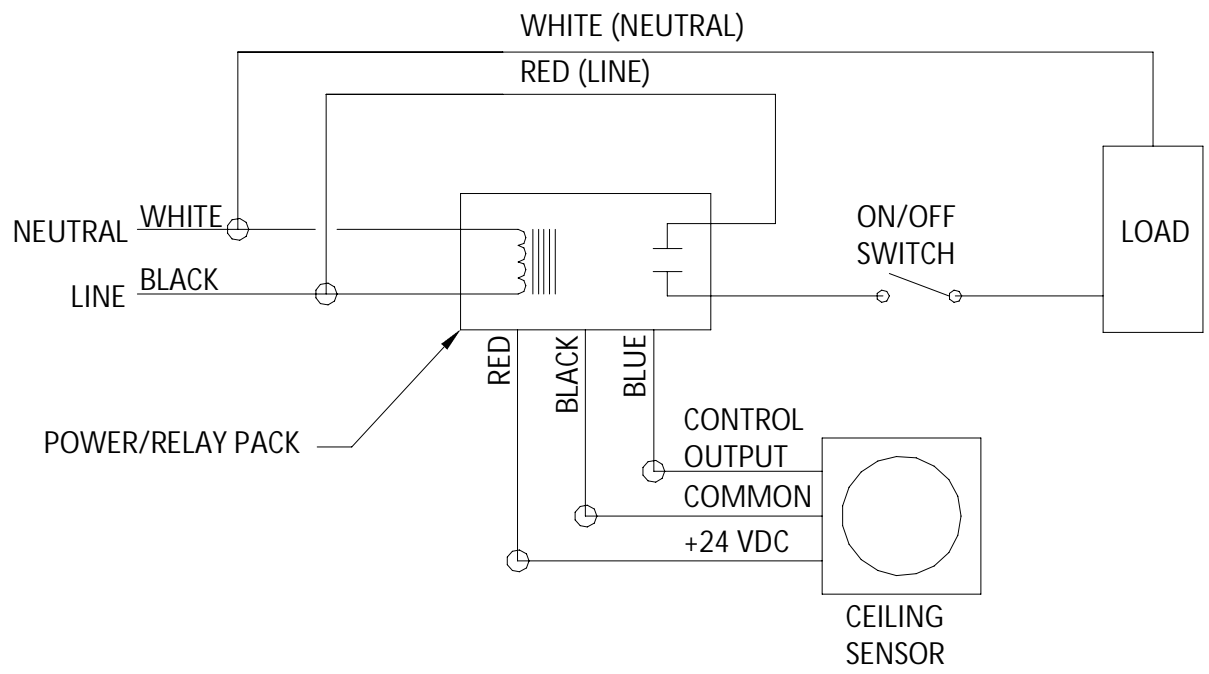
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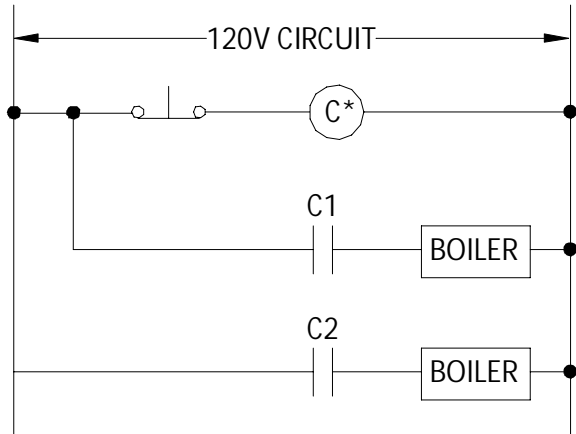


GENERAL NOTES, TYPICAL CEILING MOUNT OCCUPANCY SENSOR DETAIL - DIAGRAM

- 1 - CONTRACTOR TO PROVIDE A COMPLETE AND OPERATIONAL SYSTEM.
- 2 - PROVIDE ALL REQUIRED POWER/RELAY PACKS AND CIRCUITING.

TYPICAL CEILING MOUNT OCCUPANCY SENSOR DETAIL

SCALE: NOT TO SCALE




GENERAL NOTES, BOILER EMERGENCY SHUT OFF - DIAGRAM

- 1 - PROVIDE MUSHROOM HEAD EMERGENCY STOP PUSH BUTTON SWITCH AT LOCATION OF EACH BOILER ROOM EXIT DOOR.
- 2 - EMERGENCY STOP TO BE PUSH TO TRIP, PULL TO RESET. PROVIDE ALL REQUIRED CONTACTORS.
- 3 - PUSHING THE MUSHROOM HEAD EMERGENCY PUSH BUTTON SHALL BREAK POWER TO THE COIL AND THE CONTACTS SHALL OPEN.


BOILER EMERGENCY SHUT-OFF DETAIL

SCALE: NOT TO SCALE

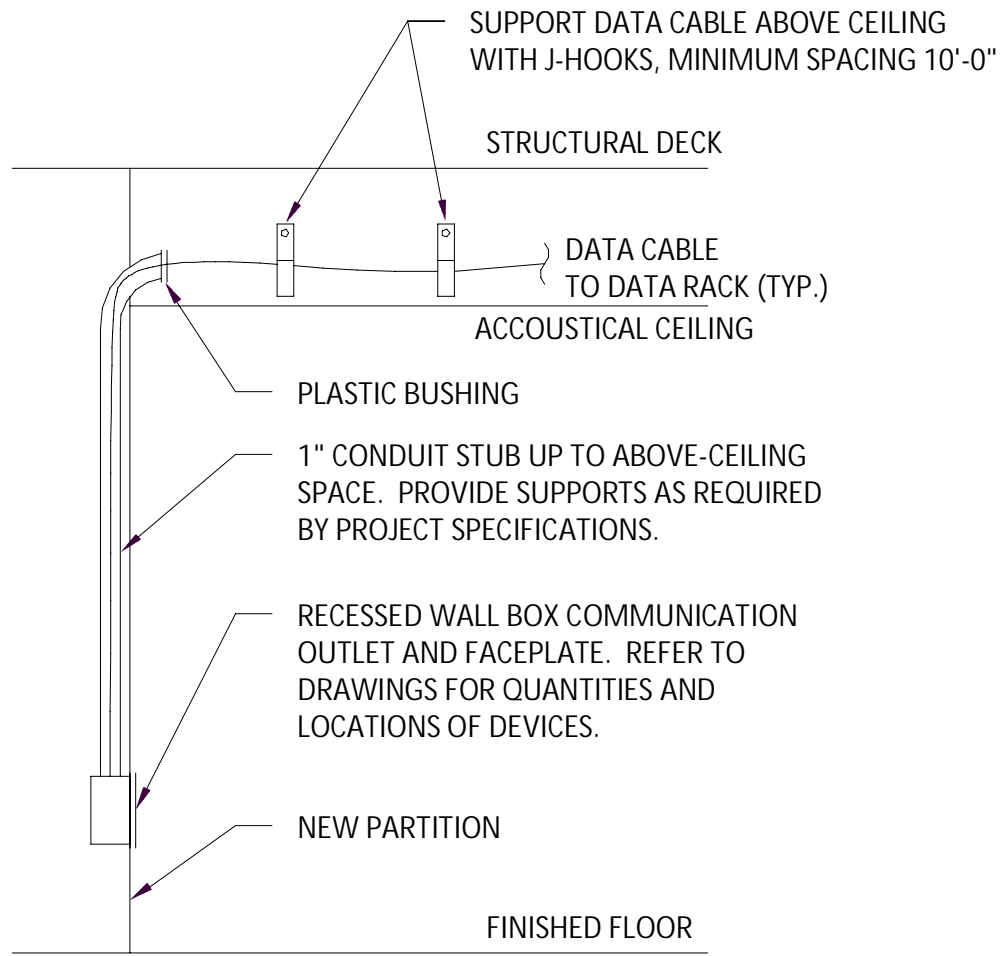

TYPICAL DATA CABLE ROUTING DETAIL

SCALE: NOT TO SCALE


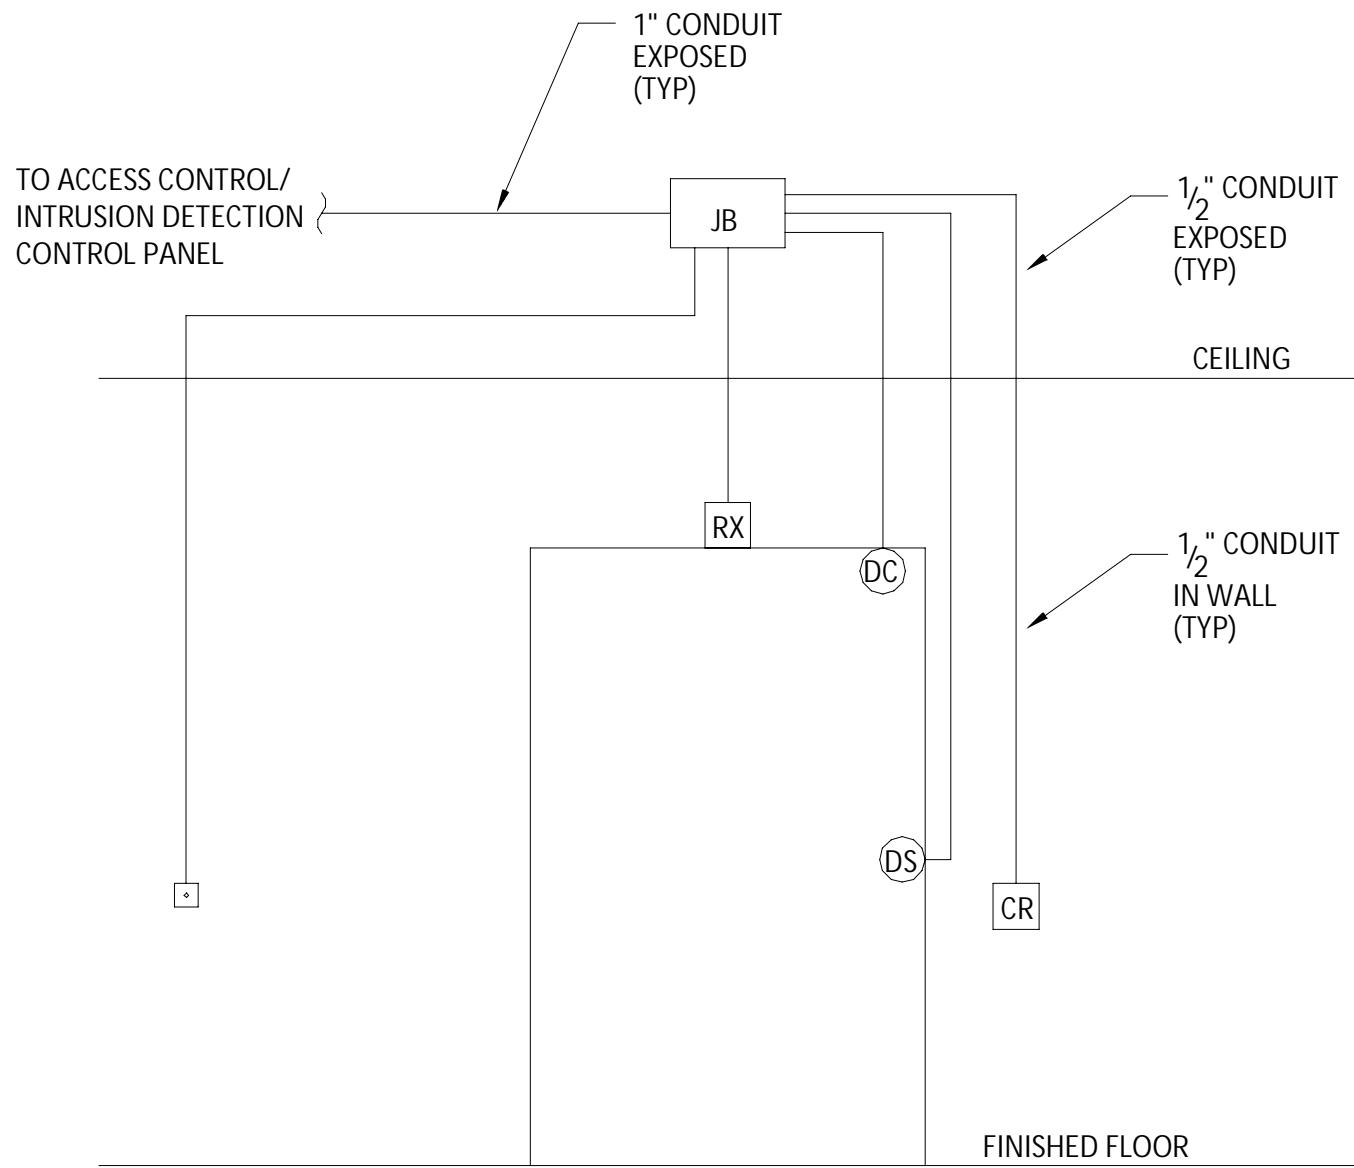


GENERAL NOTES, DOOR ACCESS CONTROL REQUIREMENTS - DIAGRAM

- 1 - REFER TO ONE-LINE DIAGRAM FOR POWER CIRCUITING TO DOOR STRIKES. DOOR STRIKES PROVIDED BY ARCHITECTURAL CONTRACT.
- 2 - COORDINATE INSTALLATION WITH ARCHITECTURAL CONTRACT AND OWNER.
- 3 - OWNER TO PROVIDE CONTROL CIRCUITING, CARD READER, DOOR CONTROLLERS, REQUEST TO EXIT, AND DOOR CONTACTS. EQUIPMENT SHOWN FOR REFERENCE. ELECTRICAL CONTRACT TO PROVIDE ALL REQUIRED JUNCTIONS BOXES AND RACEWAY FOR OWNER PROVIDED EQUIPMENT.

TYPICAL DOORWAY ACCESS CONTROL REQUIREMENTS

SCALE: NOT TO SCALE

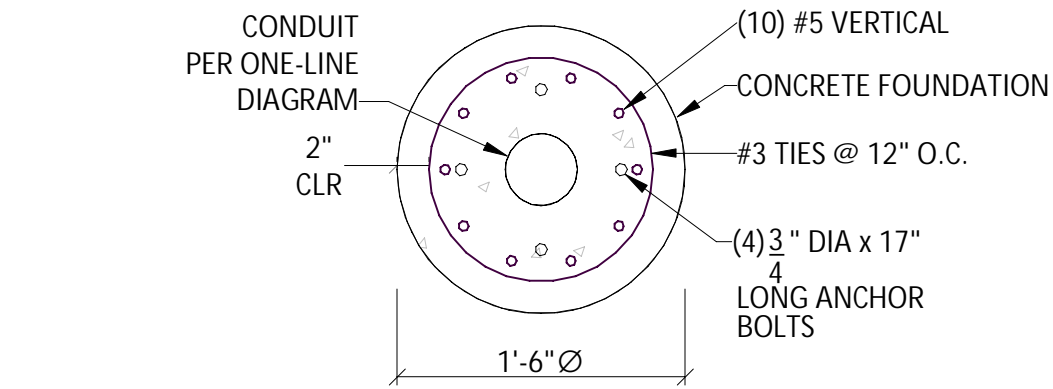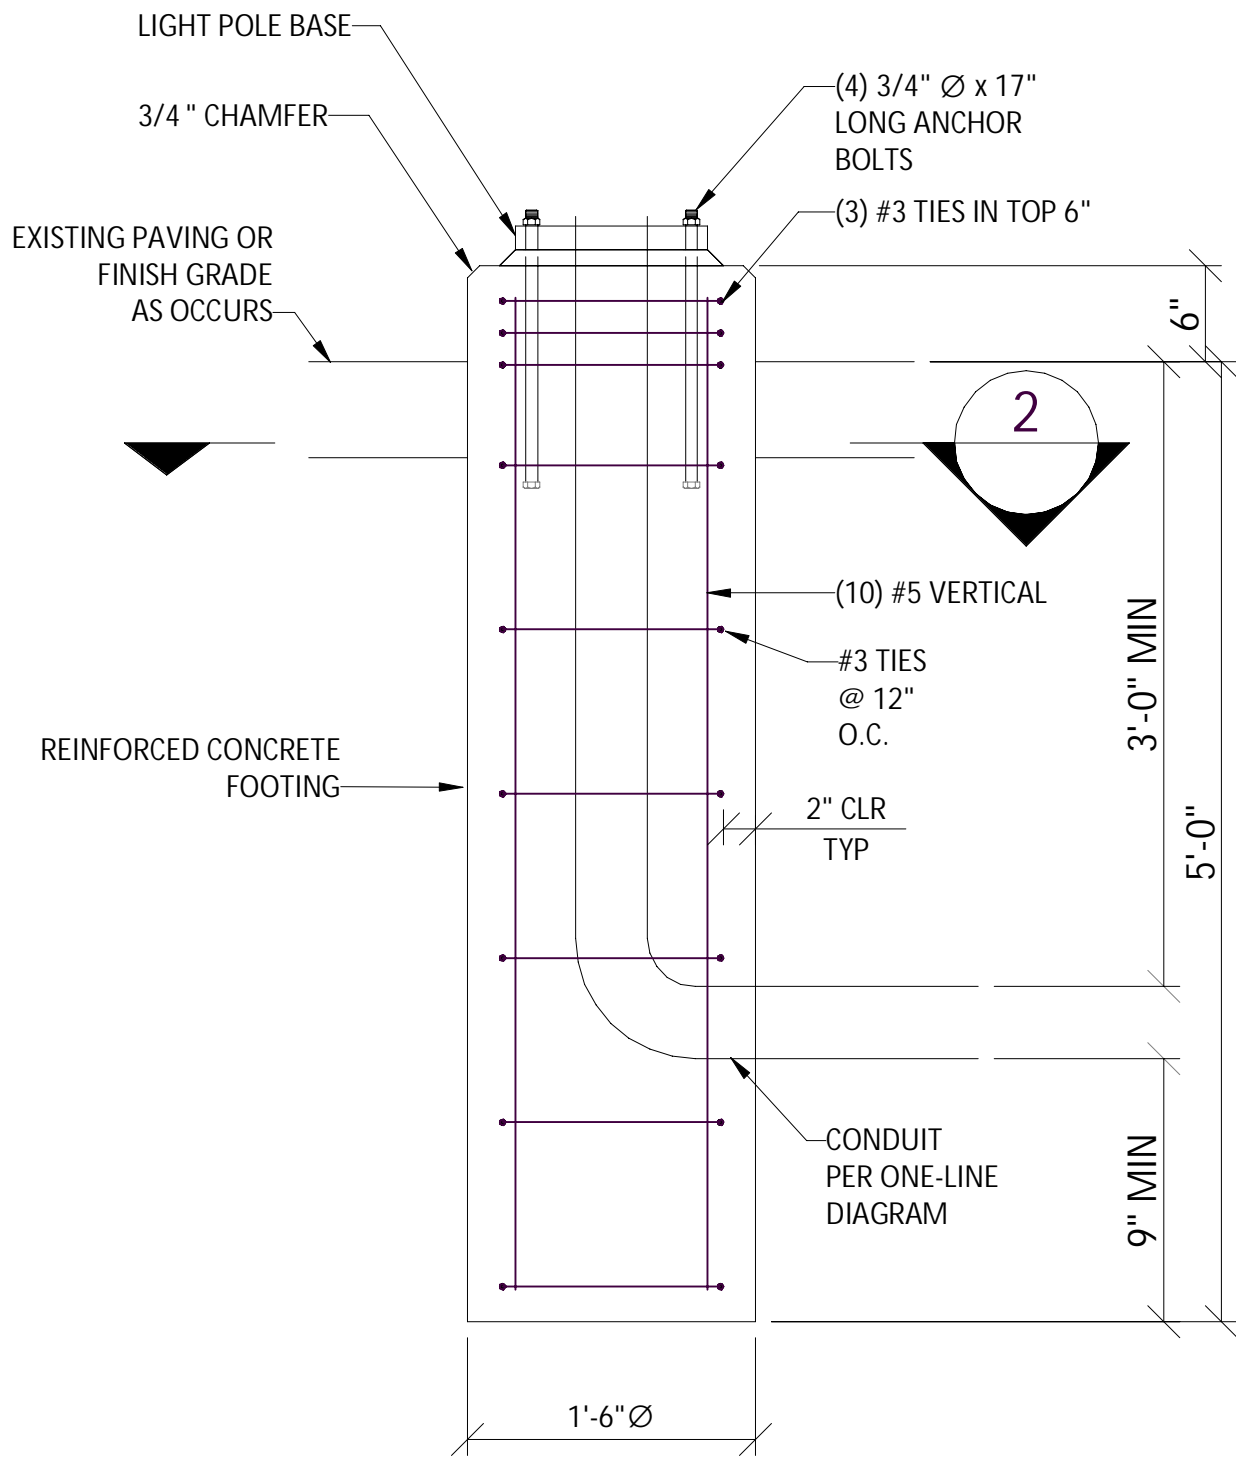

2 LIGHT POLE FOUNDATION SECTION

SCALE: NTS

LIGHT POLE FOUNDATION DETAIL

SCALE: NOT TO SCALE

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REVISIONS

CITY OF MIDDLETOWN  
NEW COURTHOUSE FACILITY  
CONTRACT 1D - ELECTRICAL CONSTRUCTION

ELECTRICAL DETAILS

CITY OF MIDDLETOWN

ORANGE COUNTY, NEW YORK

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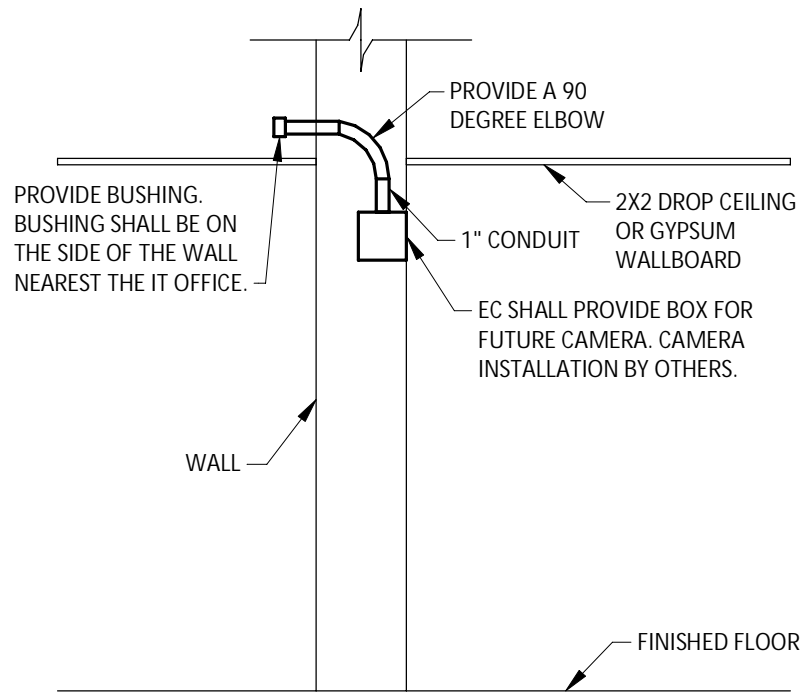
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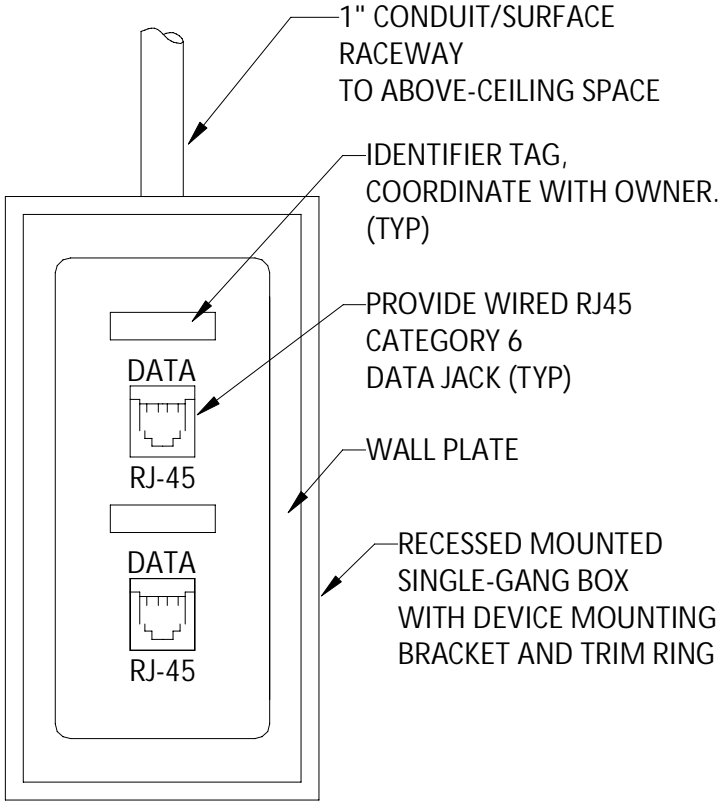
GENERAL NOTES, CAMERA BOX INSTALLATION DETAILS  
1 - THE EC SHALL PROVIDE BOXES IN THE WALLS. PROVIDE CONDUIT FROM THE BOX TO ABOVE THE DROP CEILING OR GYPSUM WALLBOARD.  
2 - CAMERAS, AND WIRING TO AND FROM BOXES BY OTHERS.

CAMERA BOX INSTALLATION DETAIL  
SCALE: NOT TO SCALE


CONDUIT SCHEDULE			
BUILDING OR AREA	AREA DESCRIPTION	CONDUIT TYPE	REMARKS
GENERAL (ALL AREAS)	INTERIOR - CONCEALED	EMT	1, 2
	INTERIOR - EXPOSED	WIREMOLD	1, 3
ELECTRICAL ROOMS	ALL	EMT	

GENERAL NOTES, CONDUIT SCHEDULE  
1 - CONDUIT TYPES ARE UNLESS OTHERWISE INDICATED OR REQUIRED BY EQUIPMENT OR CABLE MANUFACTURER. PROVIDE AS REQUIRED.  
  
REMARKS, CONDUIT SCHEDULE  
1 - EXPOSED SYSTEMS ONLY ACCEPTABLE WHERE DEVICES ARE INSTALLED ON EXISTING BLOCK WALL CONSTRUCTION.  
2- METAL CLAD, MC CABLE, ALLOWED FOR RECEPTACLE AND LIGHTING CIRCUITS.  
3 - WIREMOLD TO BE COLOR MATCHED TO ADJACENT SURFACES.


CONDUIT SCHEDULE  
SCALE: NOT TO SCALE



TYPICAL DATA PORT  
SCALE: NOT TO SCALE

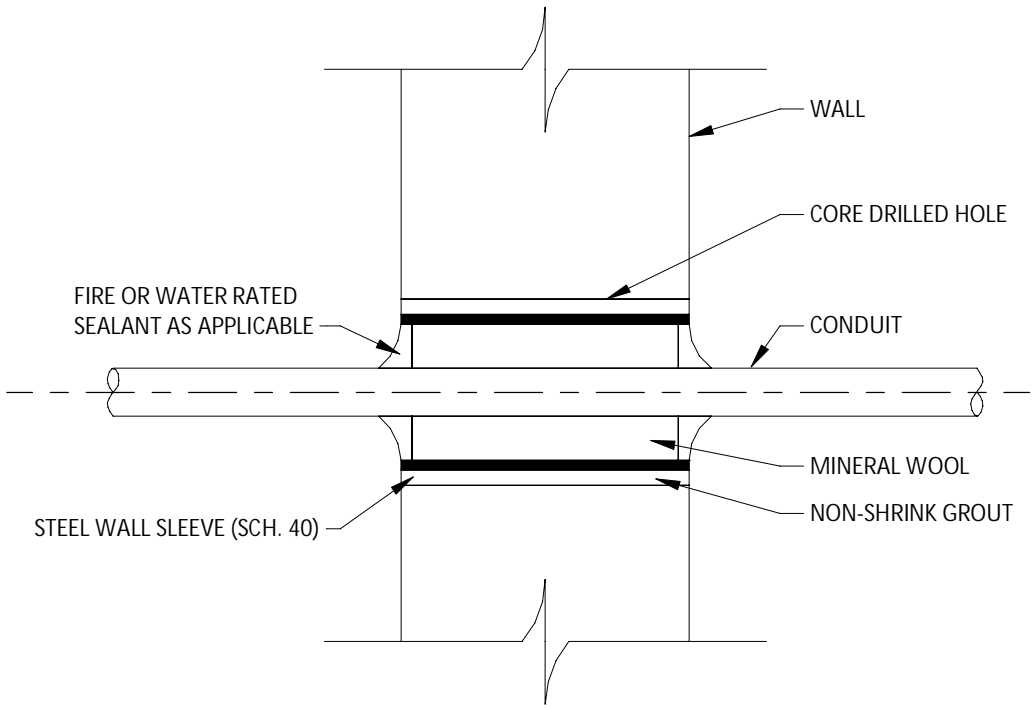

TYPICAL WALL/FLOOR CONDUIT PENETRATION DETAIL - FIRE RATED  
SCALE: NOT TO SCALE

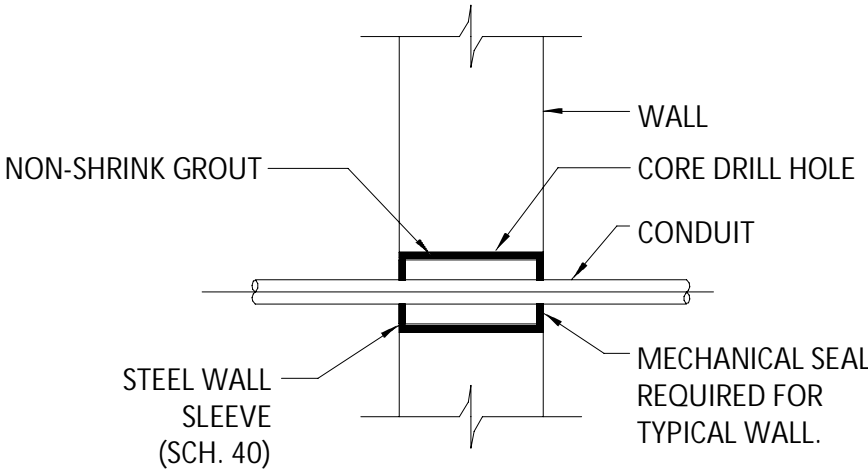

TYPICAL WALL/FLOOR CONDUIT PENETRATION DETAIL  
SCALE: NOT TO SCALE

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REVISIONS


CITY OF MIDDLETOWN  
NEW COURTHOUSE FACILITY  
CONTRACT 1D - ELECTRICAL CONSTRUCTION  
ELECTRICAL DETAILS

ORANGE COUNTY, NEW YORK

CITY OF MIDDLETOWN

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STATE OF NEW YORK  
ERIC J. HORVATH  
No. 089099  
ELECTRICAL PROFESSIONAL ENGINEER


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1753.008.001





## ONE LINE DIAGRAM DEMO

SCALE: NOT TO SCALE
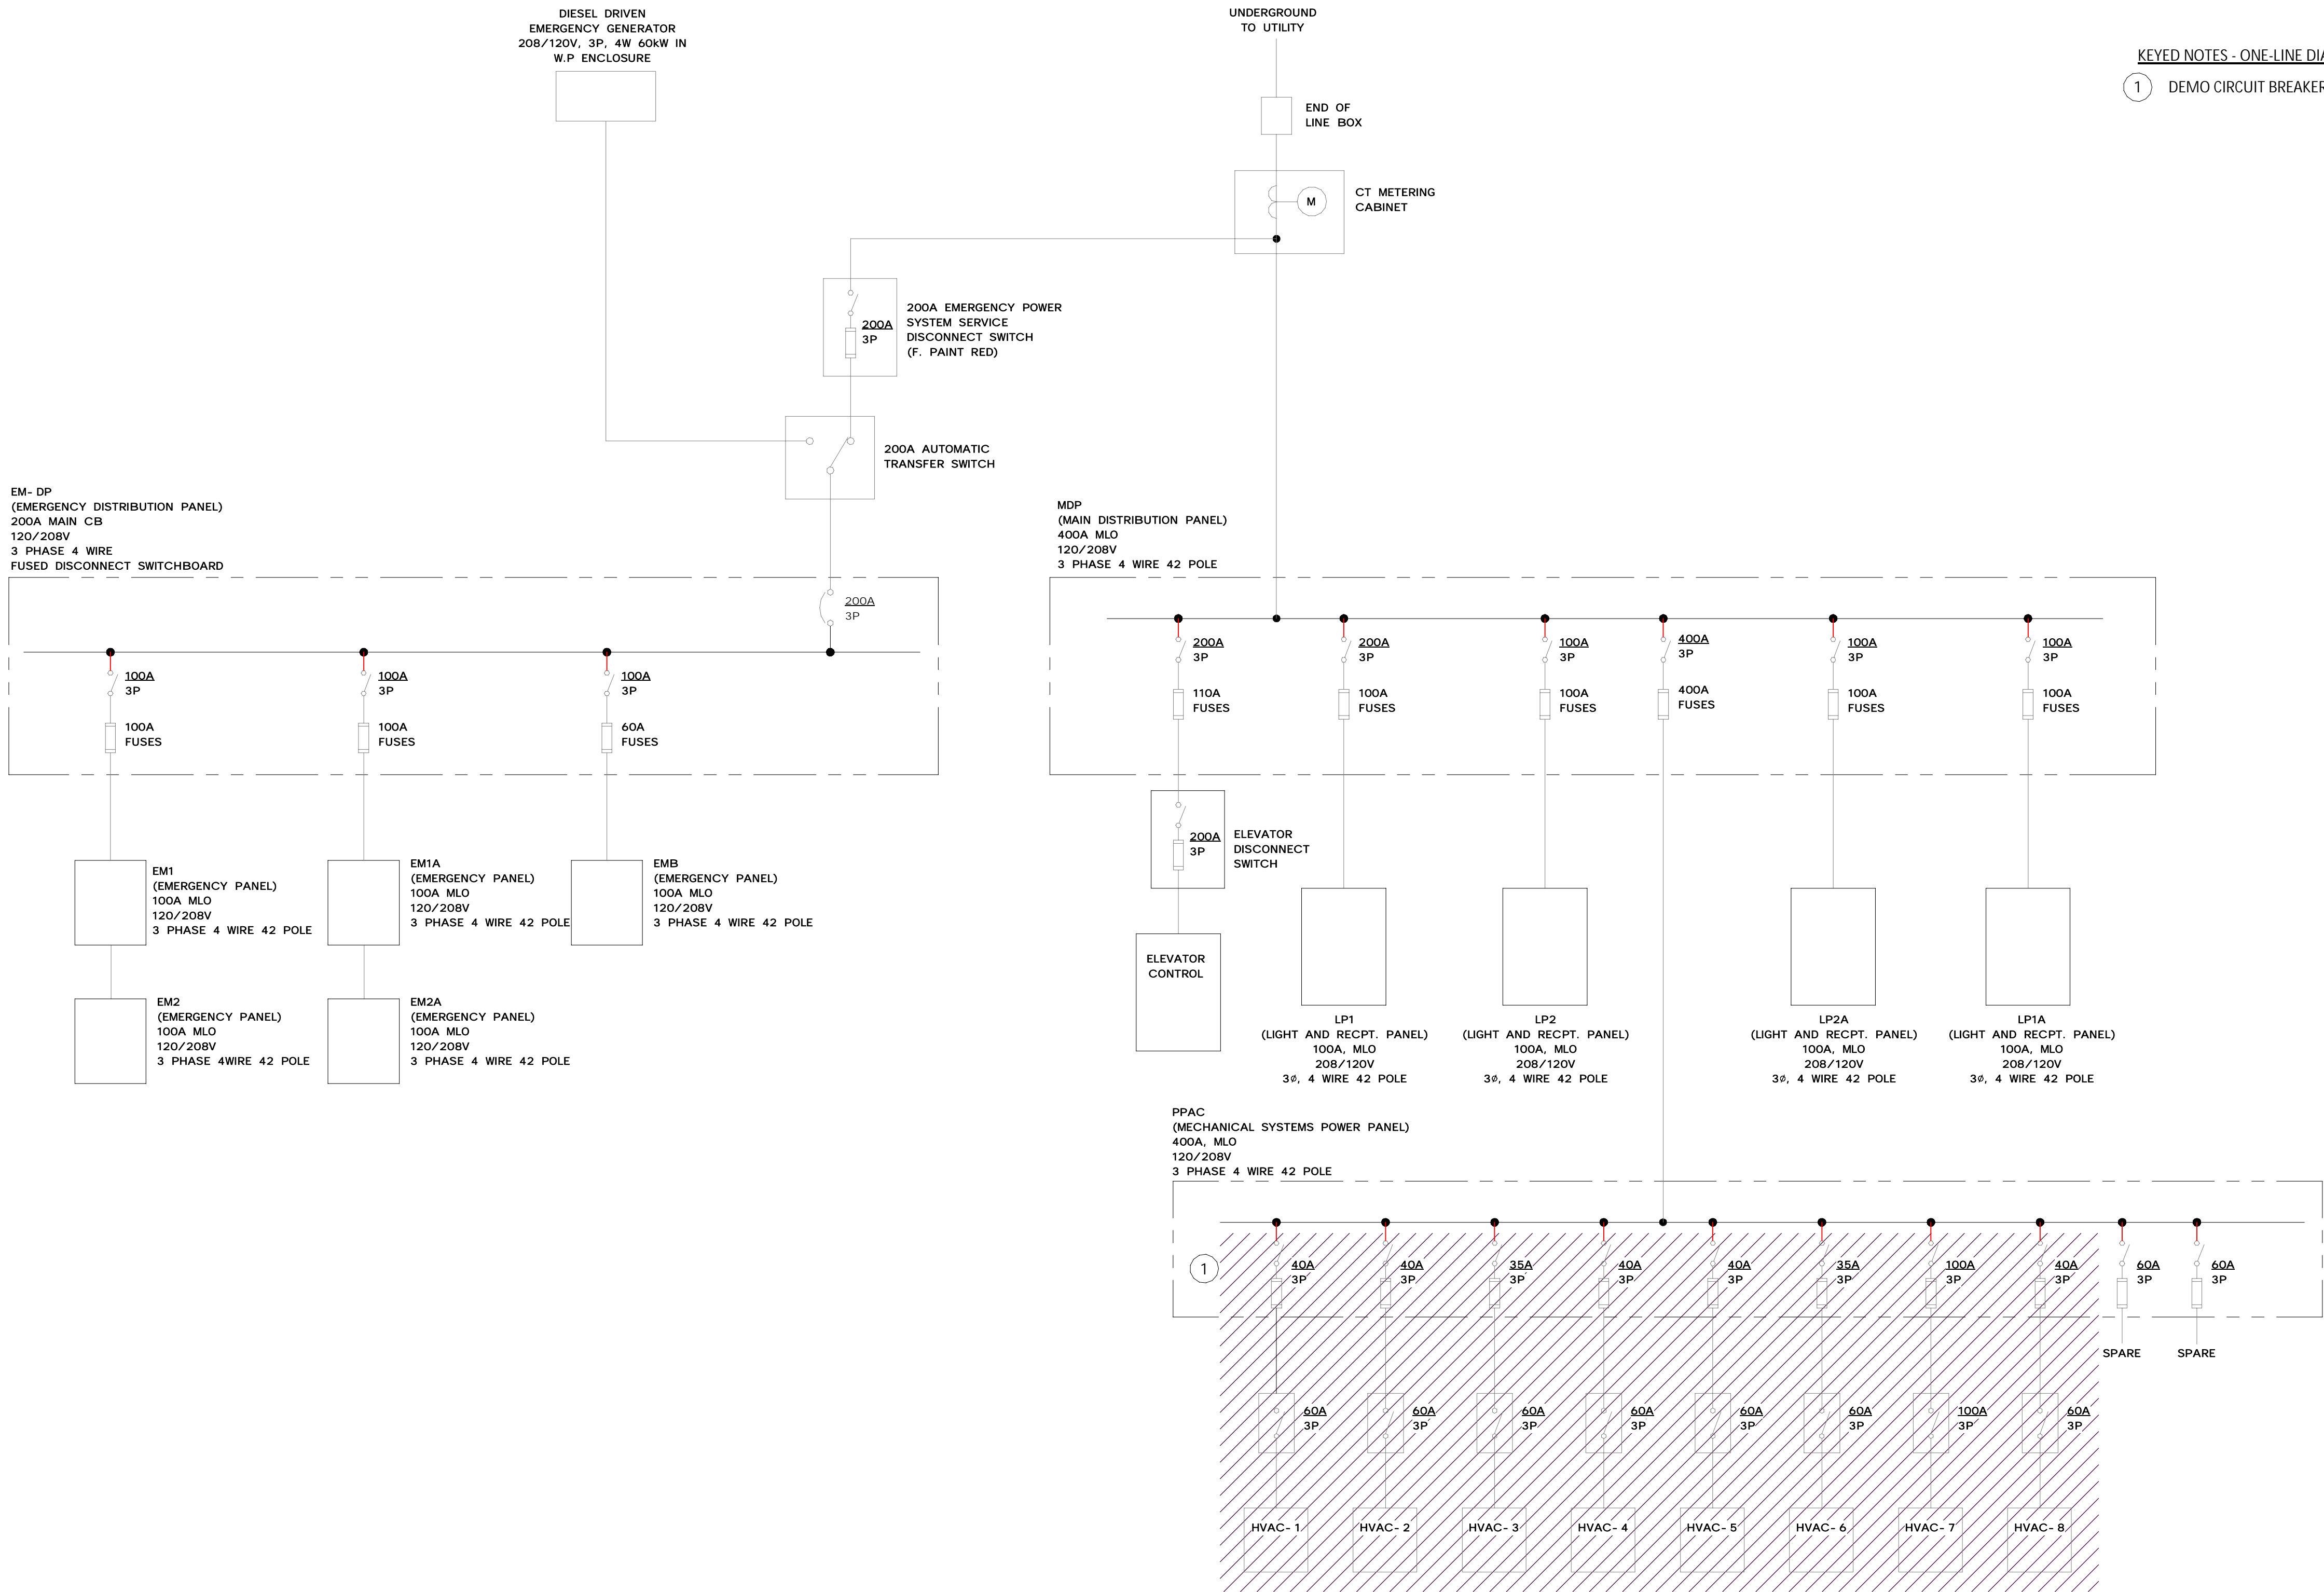
### GENERAL NOTES - ONE-LINE DIAGRAM DEMO

- 1 - ONE LINE DIAGRAM DEMO DRAWING CREATED FROM DRAWINGS E-5 TITLED ONE LINE RISER DIAGRAM DATED JULY 30, 2004 AND CURSORY FIELD OBSERVATIONS. CONTRACTOR TO FIELD VERIFY ALL EXISTING INFORMATION REQUIRED.
- 2 - MAINTAIN EXISTING CIRCUITS OTHER THAN THE ONES SHOWN TO BE DEMOED. UPDATE PANEL DIRECTORIES AS REQUIRED.

### KEYED NOTES - ONE-LINE DIAGRAM DEMO

- 1 DEMO CIRCUIT BREAKERS FOR ALL CIRCUITS BEING REMOVED.

LEGEND	
	EQUIPMENT TO BE DEMOED

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REVISIONS	

CITY OF MIDDLETOWN NEW COURTHOUSE FACILITY CONTRACT 1D - ELECTRICAL CONSTRUCTION <b>ONE LINE DIAGRAM DEMO</b>	ORANGE COUNTY, NEW YORK
CITY OF MIDDLETOWN	

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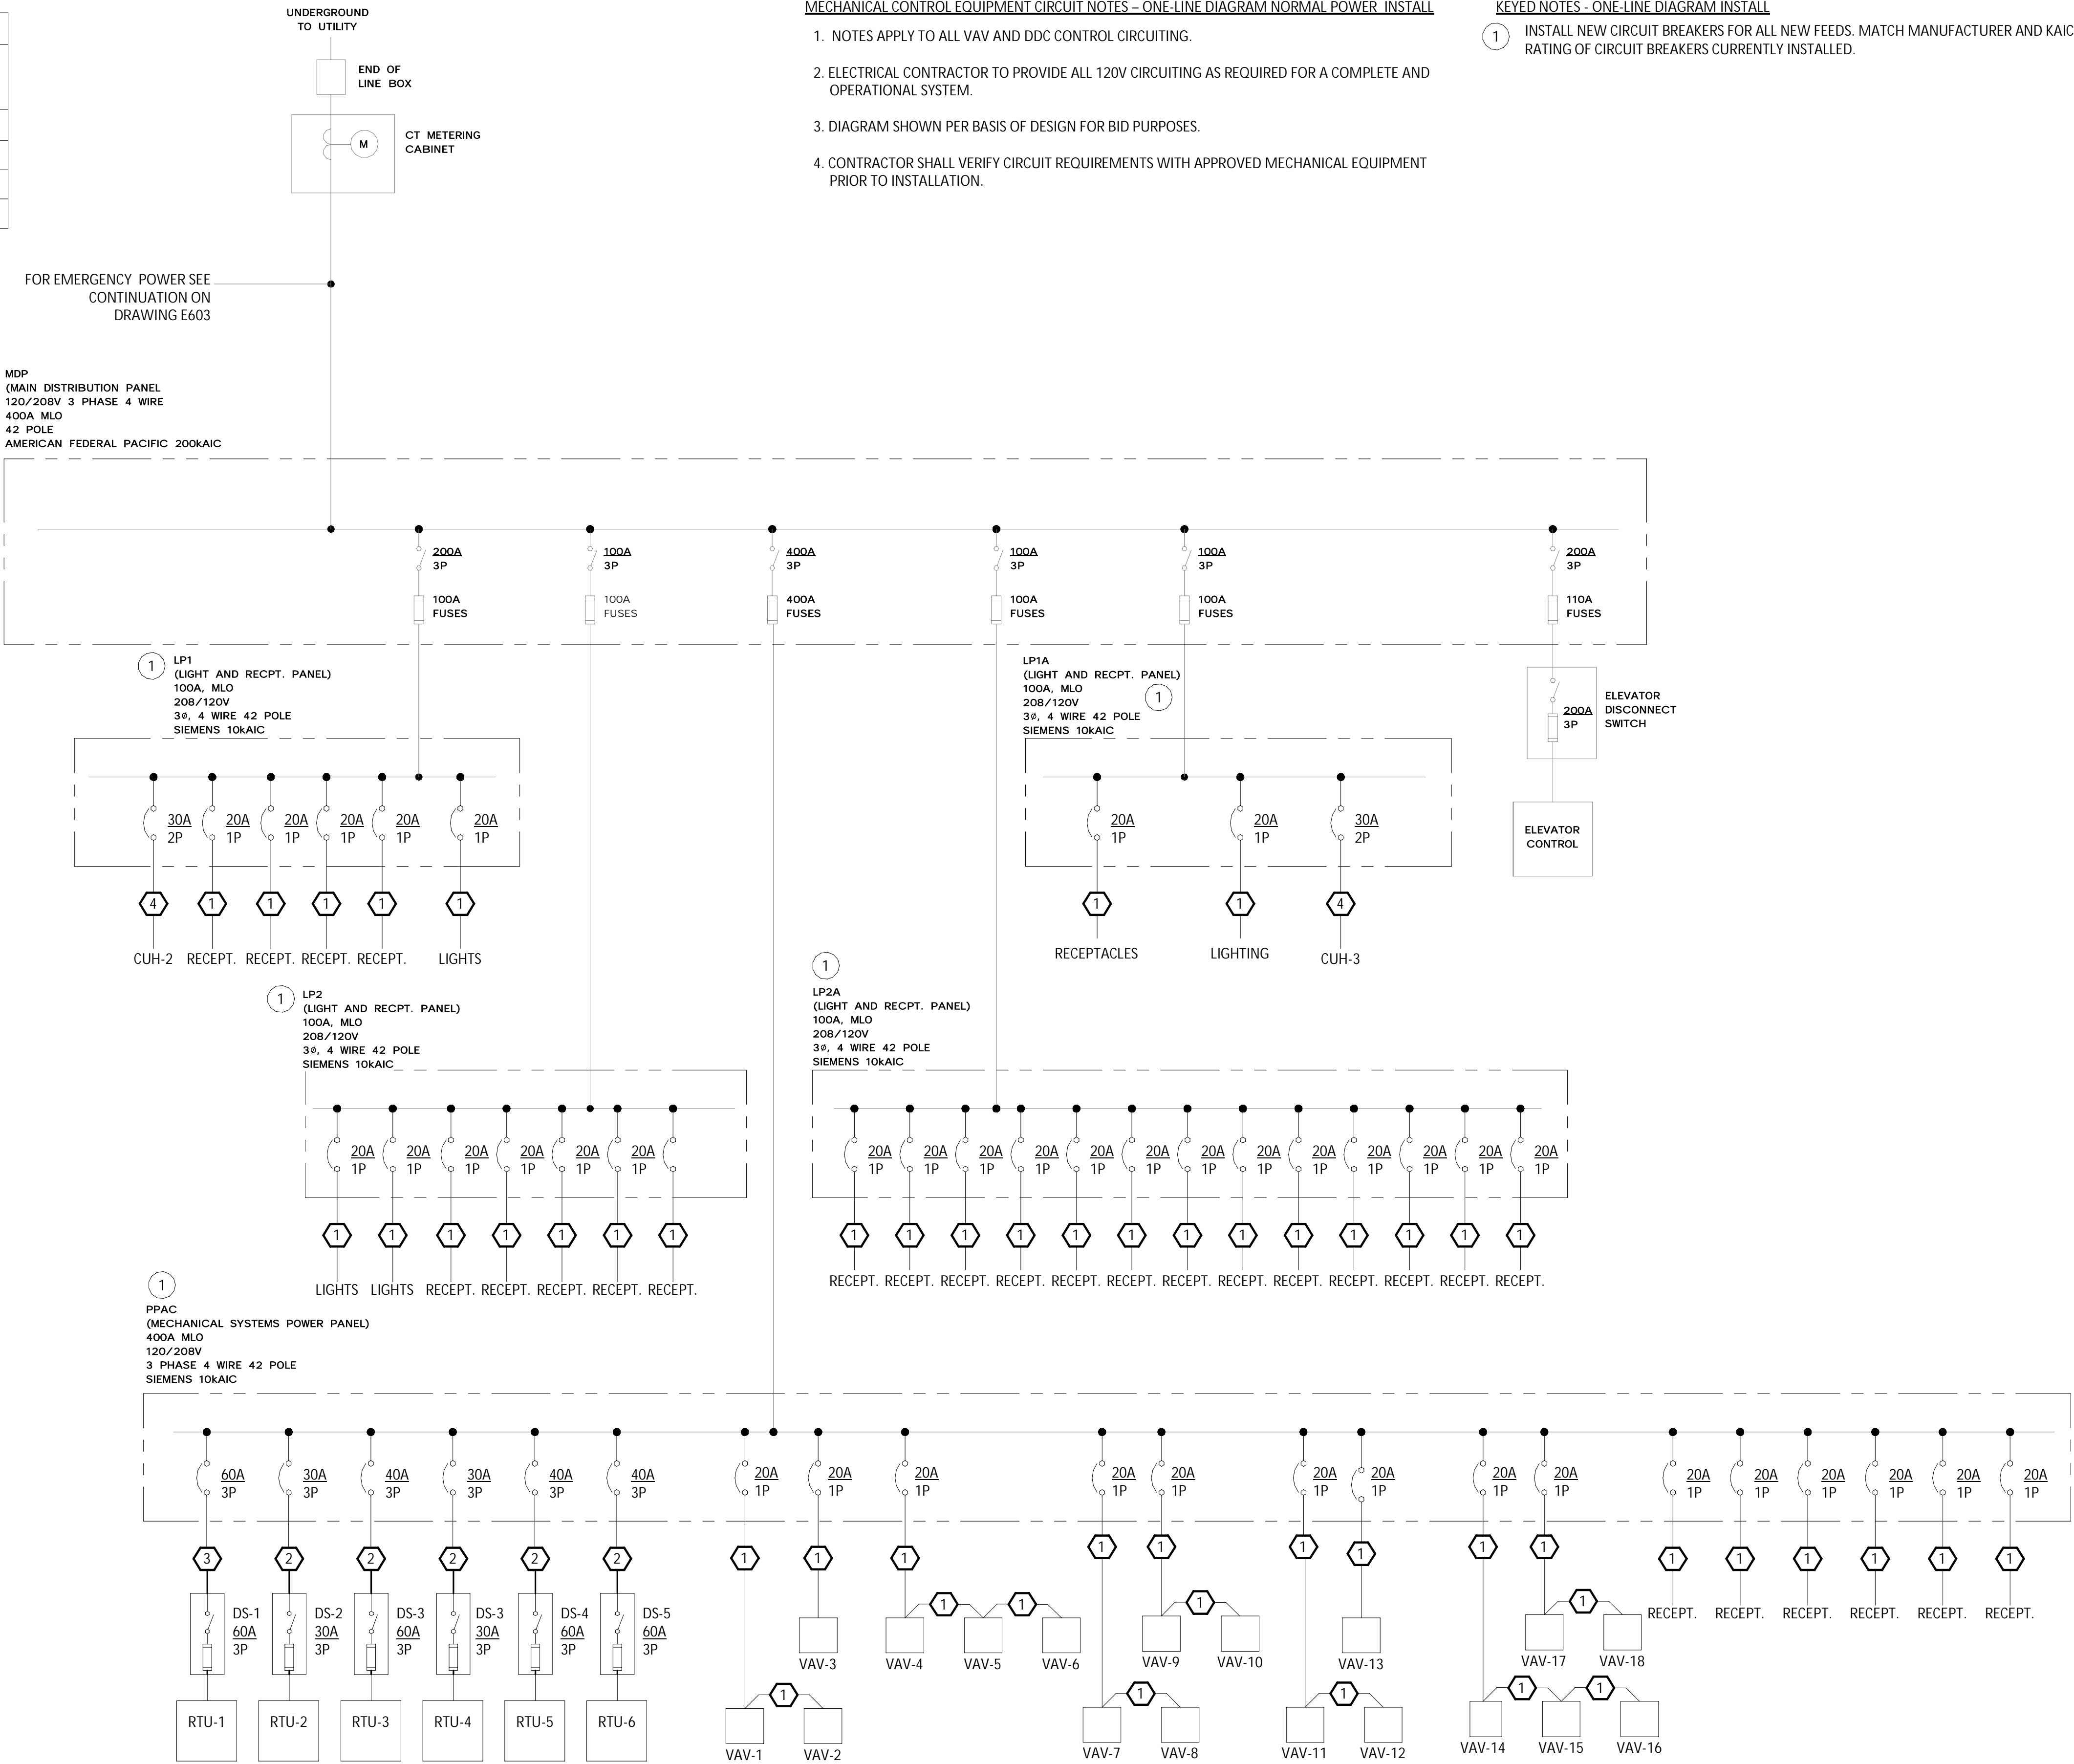


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CIRCUIT SCHEDULE			
DESIGNATION	CONDUCTORS	CONDUIT	REMARKS
1	2#12 - 1#12G	3/4"	
2	3#8 - 1#10G	1"	
3	3#4 - 1#10G	1.5"	
4	2#10 - 1#10G	1"	

GENERAL NOTES, CIRCUIT SCHEDULE  
1-VERIFY CIRCUIT REQUIREMENTS WITH APPLICABLE EQUIPMENT MANUFACTURERS PROVIDED WIRING AND CONDUIT REQUIRED.  
2-CONDUIT SIZE LISTED IS MIN. PROVIDE LARGER DIAMETER AS REQUIRED.



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REVISIONS	

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NEW COURTHOUSE FACILITY  
CONTRACT 1D - ELECTRICAL CONSTRUCTION


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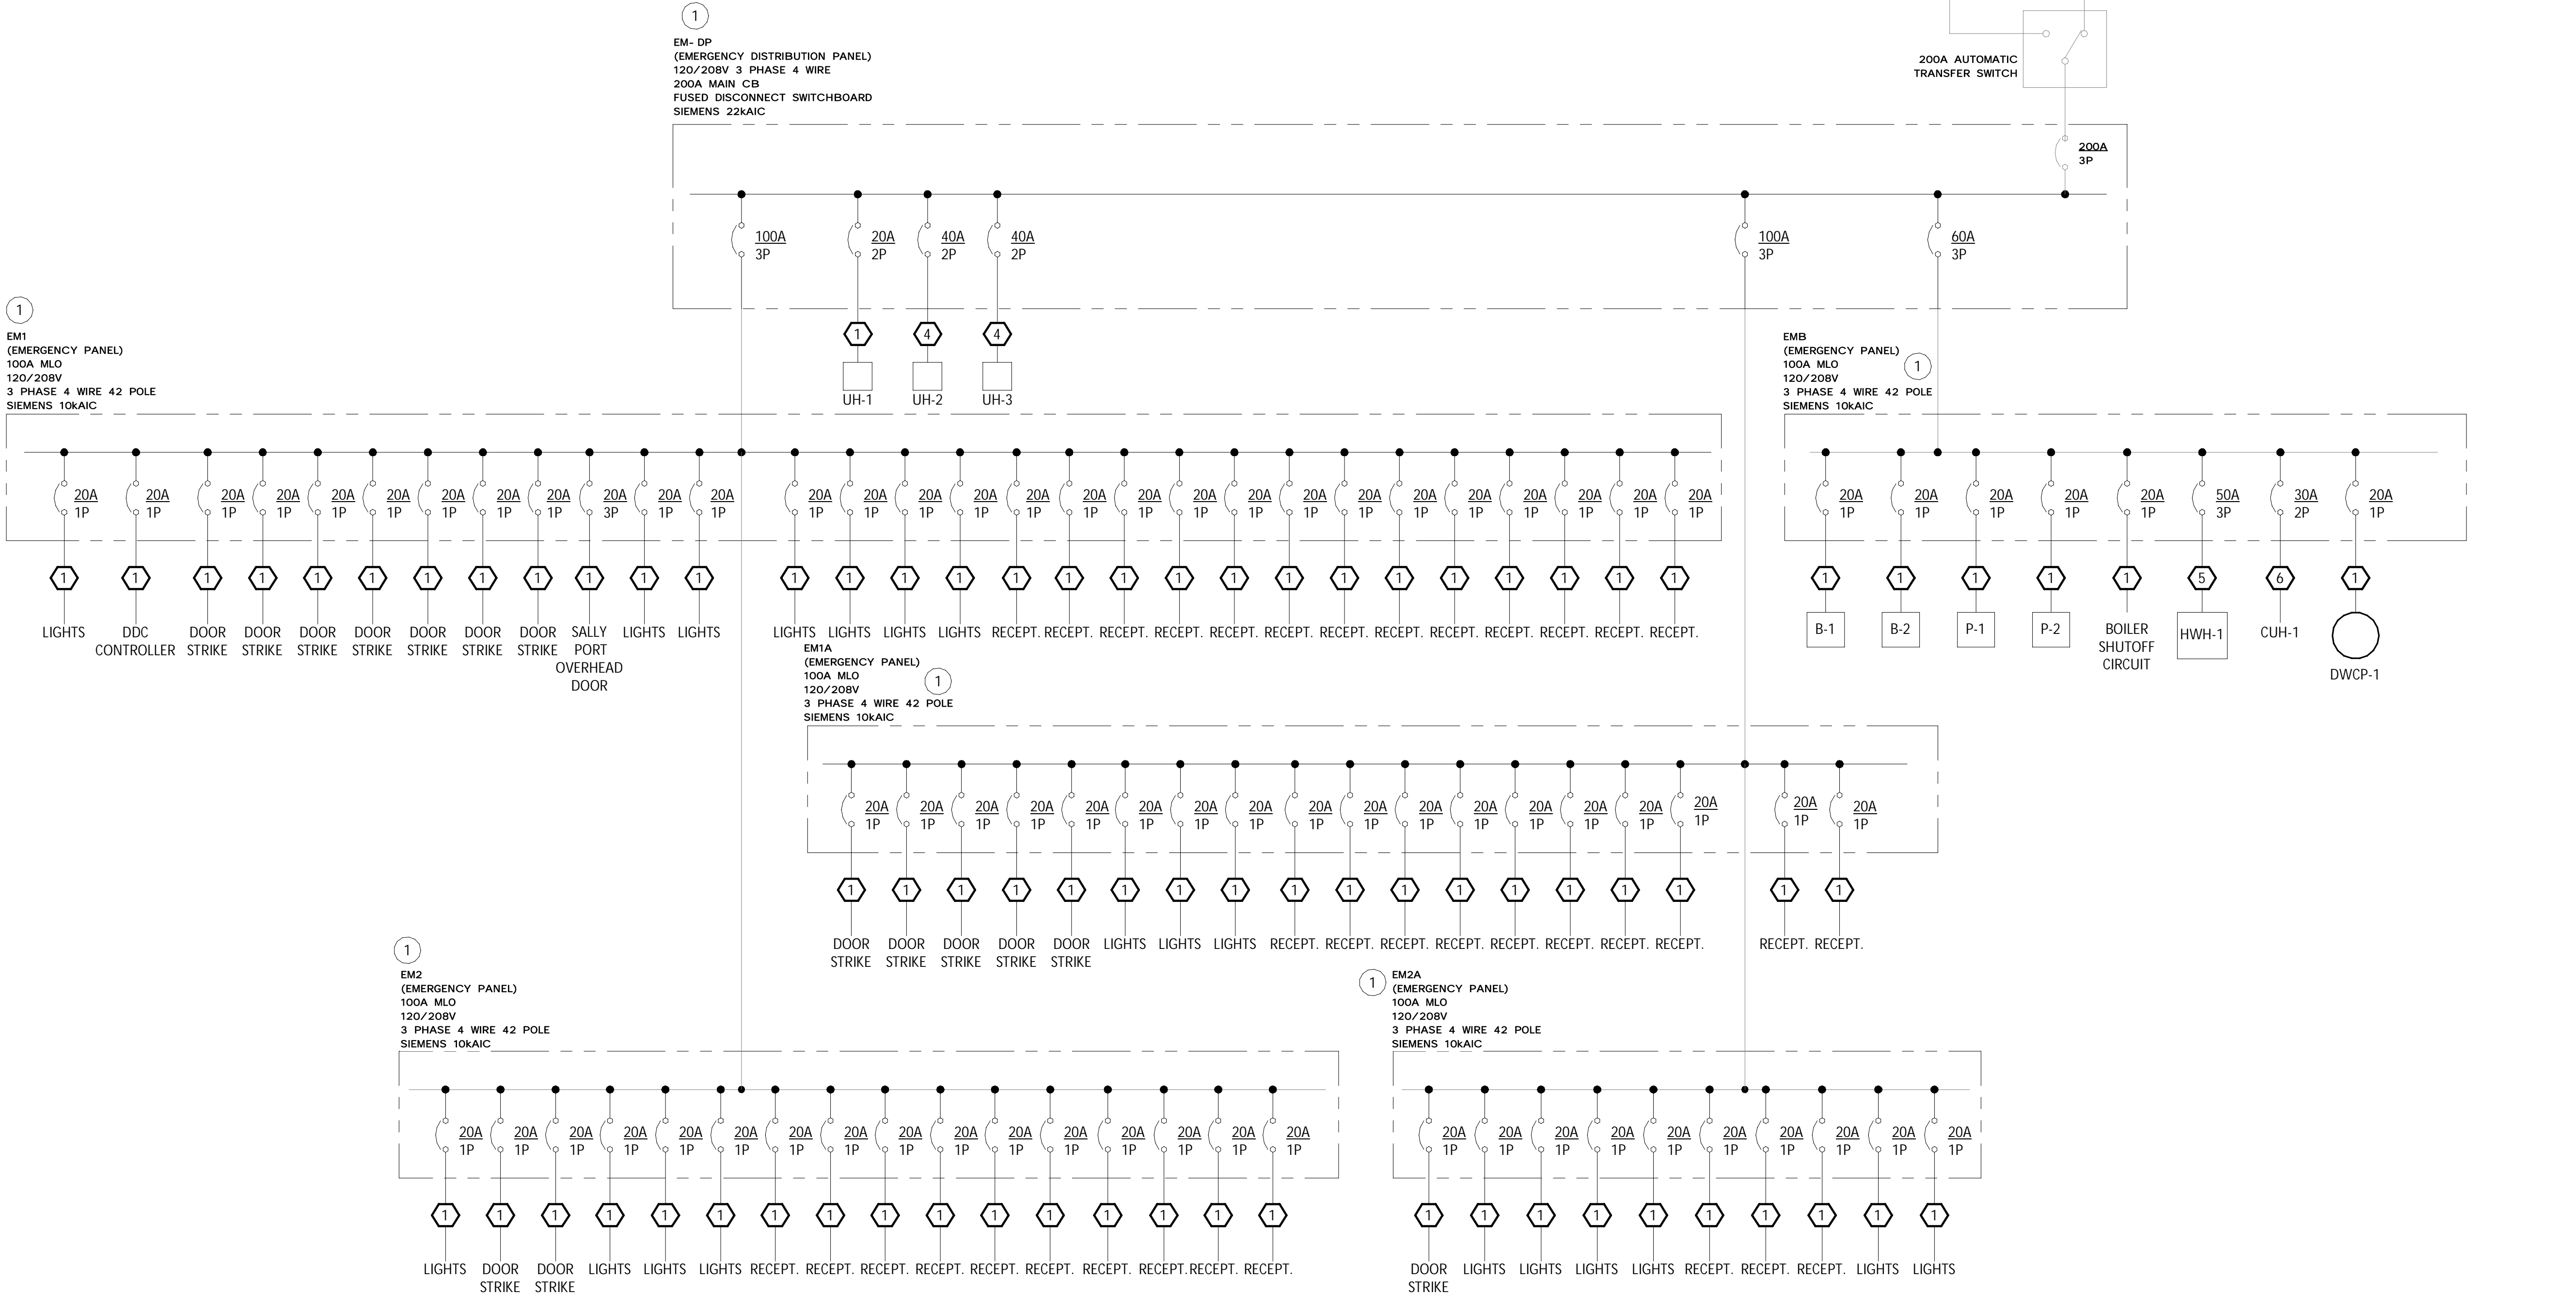
Sheet Number  
E602

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CIRCUIT SCHEDULE			
DESIGNATION	CONDUCTORS	CONDUIT	REMARKS
1	2#12 - 1#12G	3/4"	
2	3#8 - 1#10G	1"	
3	3#4 - 1#10G	1.5"	
4	2#8 - 1#10G	1"	
5	3#8 - 1#10G	1"	
6	2#10 - 1#10G	1"	

GENERAL NOTES: CIRCUIT SCHEDULE  
1-VERIFY CIRCUIT REQUIREMENTS WITH APPLICABLE EQUIPMENT MANUFACTURERS PROVIDED WIRING AND CONDUIT REQUIRED.  
2-CONDUIT SIZE LISTED IS MIN. PROVIDE LARGER DIAMETER AS REQUIRED.



ONE LINE DIAGRAM EMERGENCY POWER INSTALL

SCALE: NOT TO SCALE

MECHANICAL CONTROL EQUIPMENT CIRCUIT NOTES – ONE-LINE DIAGRAM NORMAL POWER INSTALL

- NOTES APPLY TO ALL VAV AND DDC CONTROL CIRCUITING.
- EC TO PROVIDE ALL 120V CIRCUITING AS REQUIRED FOR A COMPLETE AND OPERATIONAL SYSTEM.
- DIAGRAM SHOWN PER BASIS OF DESIGN FOR BID PURPOSES.
- CONTRACTOR SHALL VERIFY CIRCUIT REQUIREMENTS WITH APPROVED MECHANICAL EQUIPMENT PRIOR TO INSTALLATION.

KEYED NOTES - ONE-LINE DIAGRAM EMERGENCY POWER INSTALL

- INSTALL NEW CIRCUIT BREAKERS FOR ALL NEW FEEDS. MATCH MANUFACTURER AND KAIC RATING OF CIRCUIT BREAKERS CURRENTLY INSTALLED.

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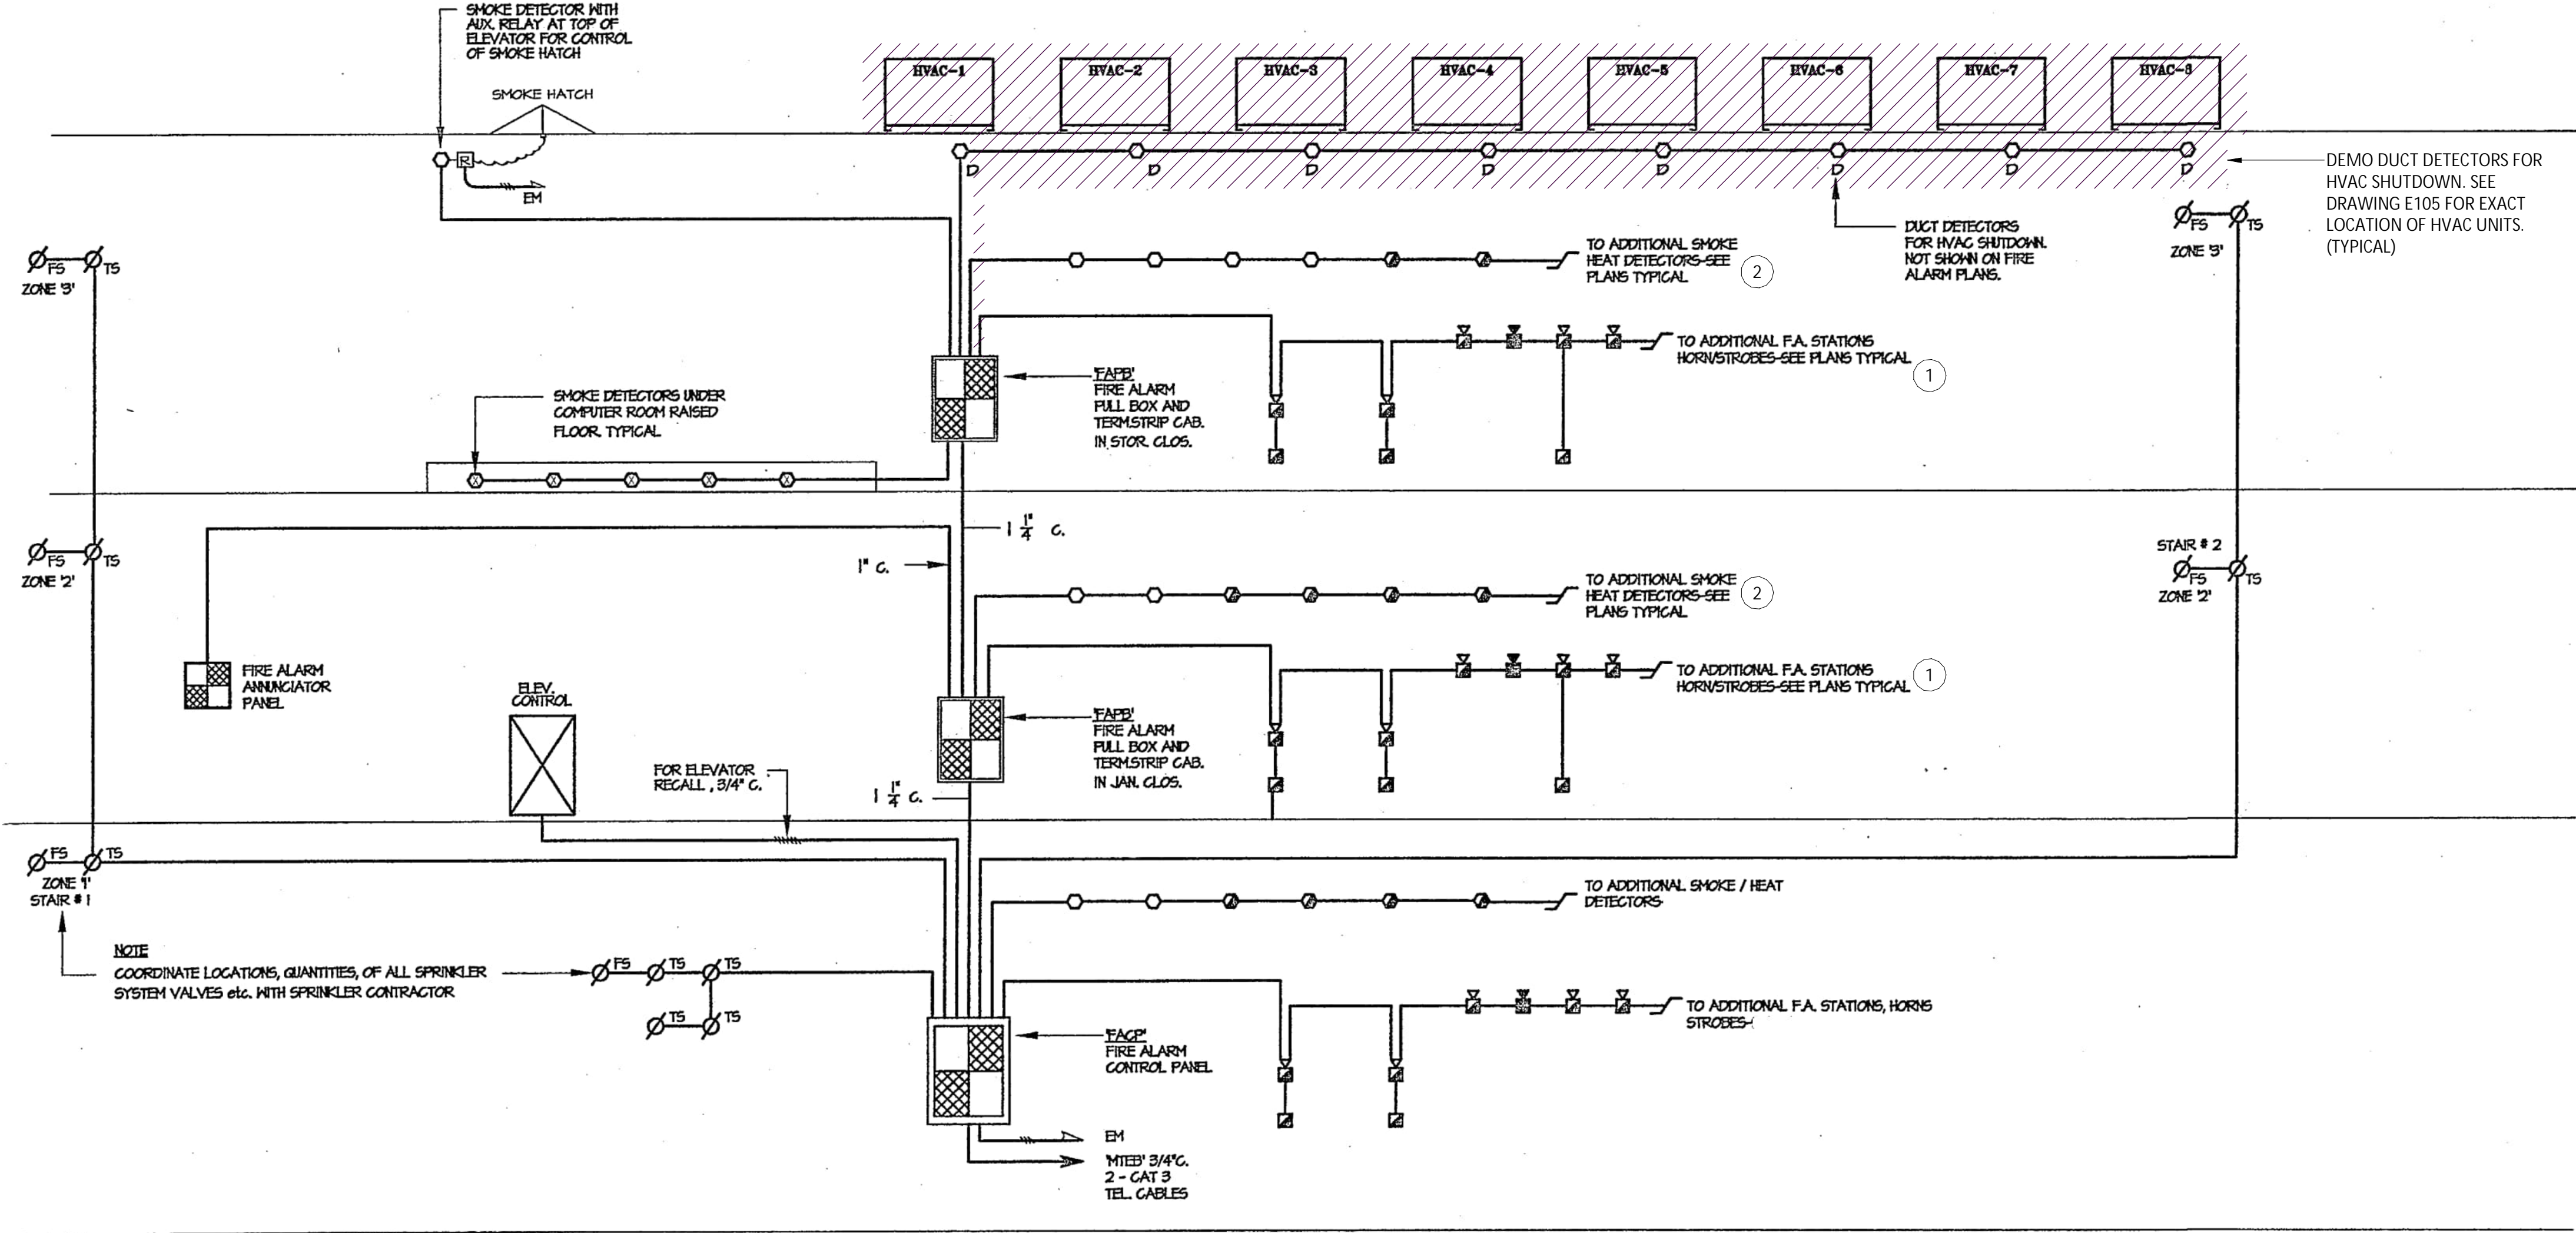
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ONE LINE DIAGRAM EMERGENCY POWER INSTALL  
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GENERAL NOTES - FIRE ALARM RISER DIAGRAM DEMO

1 - FIRE ALARM RISER DIAGRAM DEMO DRAWING CREATED FROM DRAWING FA-4 TITLED FIRE ALARM RISER DIAGRAM DATED JULY 30, 2004 AND CURSORY FIELD OBSERVATIONS. CONTRACTOR TO FIELD VERIFY ALL EXISTING INFORMATION REQUIRED.

KEYED NOTES - FIRE ALARM RISER DIAGRAM DEMO

- 1 DEMO FIRE ALARM HORN/STROBES PER DRAWINGS E107 AND E108. DEMO ALL CONDUCTORS, RACEY AND HARDWARE ASSOCIATED BACK TO SOURCE PANEL SHOWN ON THIS DRAWING.
- 2 DEMO FIRE ALARM SMOKE DETECTORS PER DRAWINGS E107 AND E108. DEMO ALL CONDUCTORS, RACEY AND HARDWARE ASSOCIATED BACK TO SOURCE PANEL SHOWN ON THIS DRAWING.

IT IS A VIOLATION OF THE NEW YORK STATE EDUCATION LAW, ARTICLE 145 §7209 SPECIAL PROVISIONS, FOR ANY PERSON, UNLESS THEY ARE ACTING UNDER THE DIRECTION OF A LICENSED PROFESSIONAL ENGINEER, ARCHITECT, LANDSCAPE ARCHITECT, OR LAND SURVEYOR, TO ALTER ANY ITEM IN ANY WAY IF AN ITEM BEARING THE STAMP OF A LICENSED PROFESSIONAL IS ALTERED, THE ALTERING PROFESSIONAL SHALL STAMP THE DOCUMENT AND INCLUDE THE NOTATION "ALTERED BY" FOLLOWED BY THEIR SIGNATURE, THE DATE OF SUCH ALTERATION, AND A SPECIFIC DESCRIPTION OF THE ALTERATION.

REVISIONS

CITY OF MIDDLETOWN  
NEW COURTHOUSE FACILITY  
CONTRACT 1D - ELECTRICAL CONSTRUCTION  
FIRE ALARM RISER DIAGRAM DEMO  
ORANGE COUNTY, NEW YORK

443 Electronics Parkway  
Liverpool, NY  
13088  
**Barton & Loguidice, D.P.C.**



Date  
AUGUST, 2024  
Scale  
AS SHOWN  
Sheet Number  
E604  
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1753.008.001

LEGEND

EQUIPMENT TO BE DEMOED

FIRE ALARM WIRING LEGEND


- 2 #16 THIN TWIST PAIR PER MANUAL STATION ZONE
- 2 #16 THIN TWIST PAIR PER SMOKE DETECTOR ZONE
- 2 #16 THIN TWIST PAIR PER HEAT DETECTOR ZONE
- 4 #12 THIN PER HORN/STROBE ZONE
- 2 #12 THIN PER STROBE ZONE
- 4 #16 THIN PER DUCT DETECTOR ZONE (S=SUPPLY, R=RETURN)
- 2 #14 THIN PER SPRINKLER SYSTEM TAMPER ZONE  
COORDINATE LOCATIONS WITH SPRINKLER DRAWINGS
- 2 #14 THIN PER SPRINKLER SYSTEM PRESSURE ZONE  
COORDINATE LOCATIONS WITH SPRINKLER DRAWINGS
- 2 #14 THIN PER SPRINKLER SYSTEM PRESSURE ZONE  
COORDINATE LOCATIONS WITH SPRINKLER DRAWINGS
- 2 #12 THIN PER MAGNETIC DOOR HOLDER ZONE

ALL WIRING SHALL BE TEFLON COATED FLEMING RATED CABLE, APPROVED FOR FIRE ALARM WIRING. WIRING SIZES INDICATED ARE MINIMUM SIZES REQUIRED. RUN WIRING IN MIN. 3/4" EMT, WHERE REQUIRED TO BE RUN EXPOSED. ALL WIRING SHALL BE IN ACCORDANCE WITH MANUFACTURER'S WIRING DIAGRAMS. SEE FLOOR PLANS FOR LOCATIONS AND QUANTITIES OF ALL DEVICES.

FIRE ALARM RISER DIAGRAM DEMO

SCALE: NOT TO SCALE



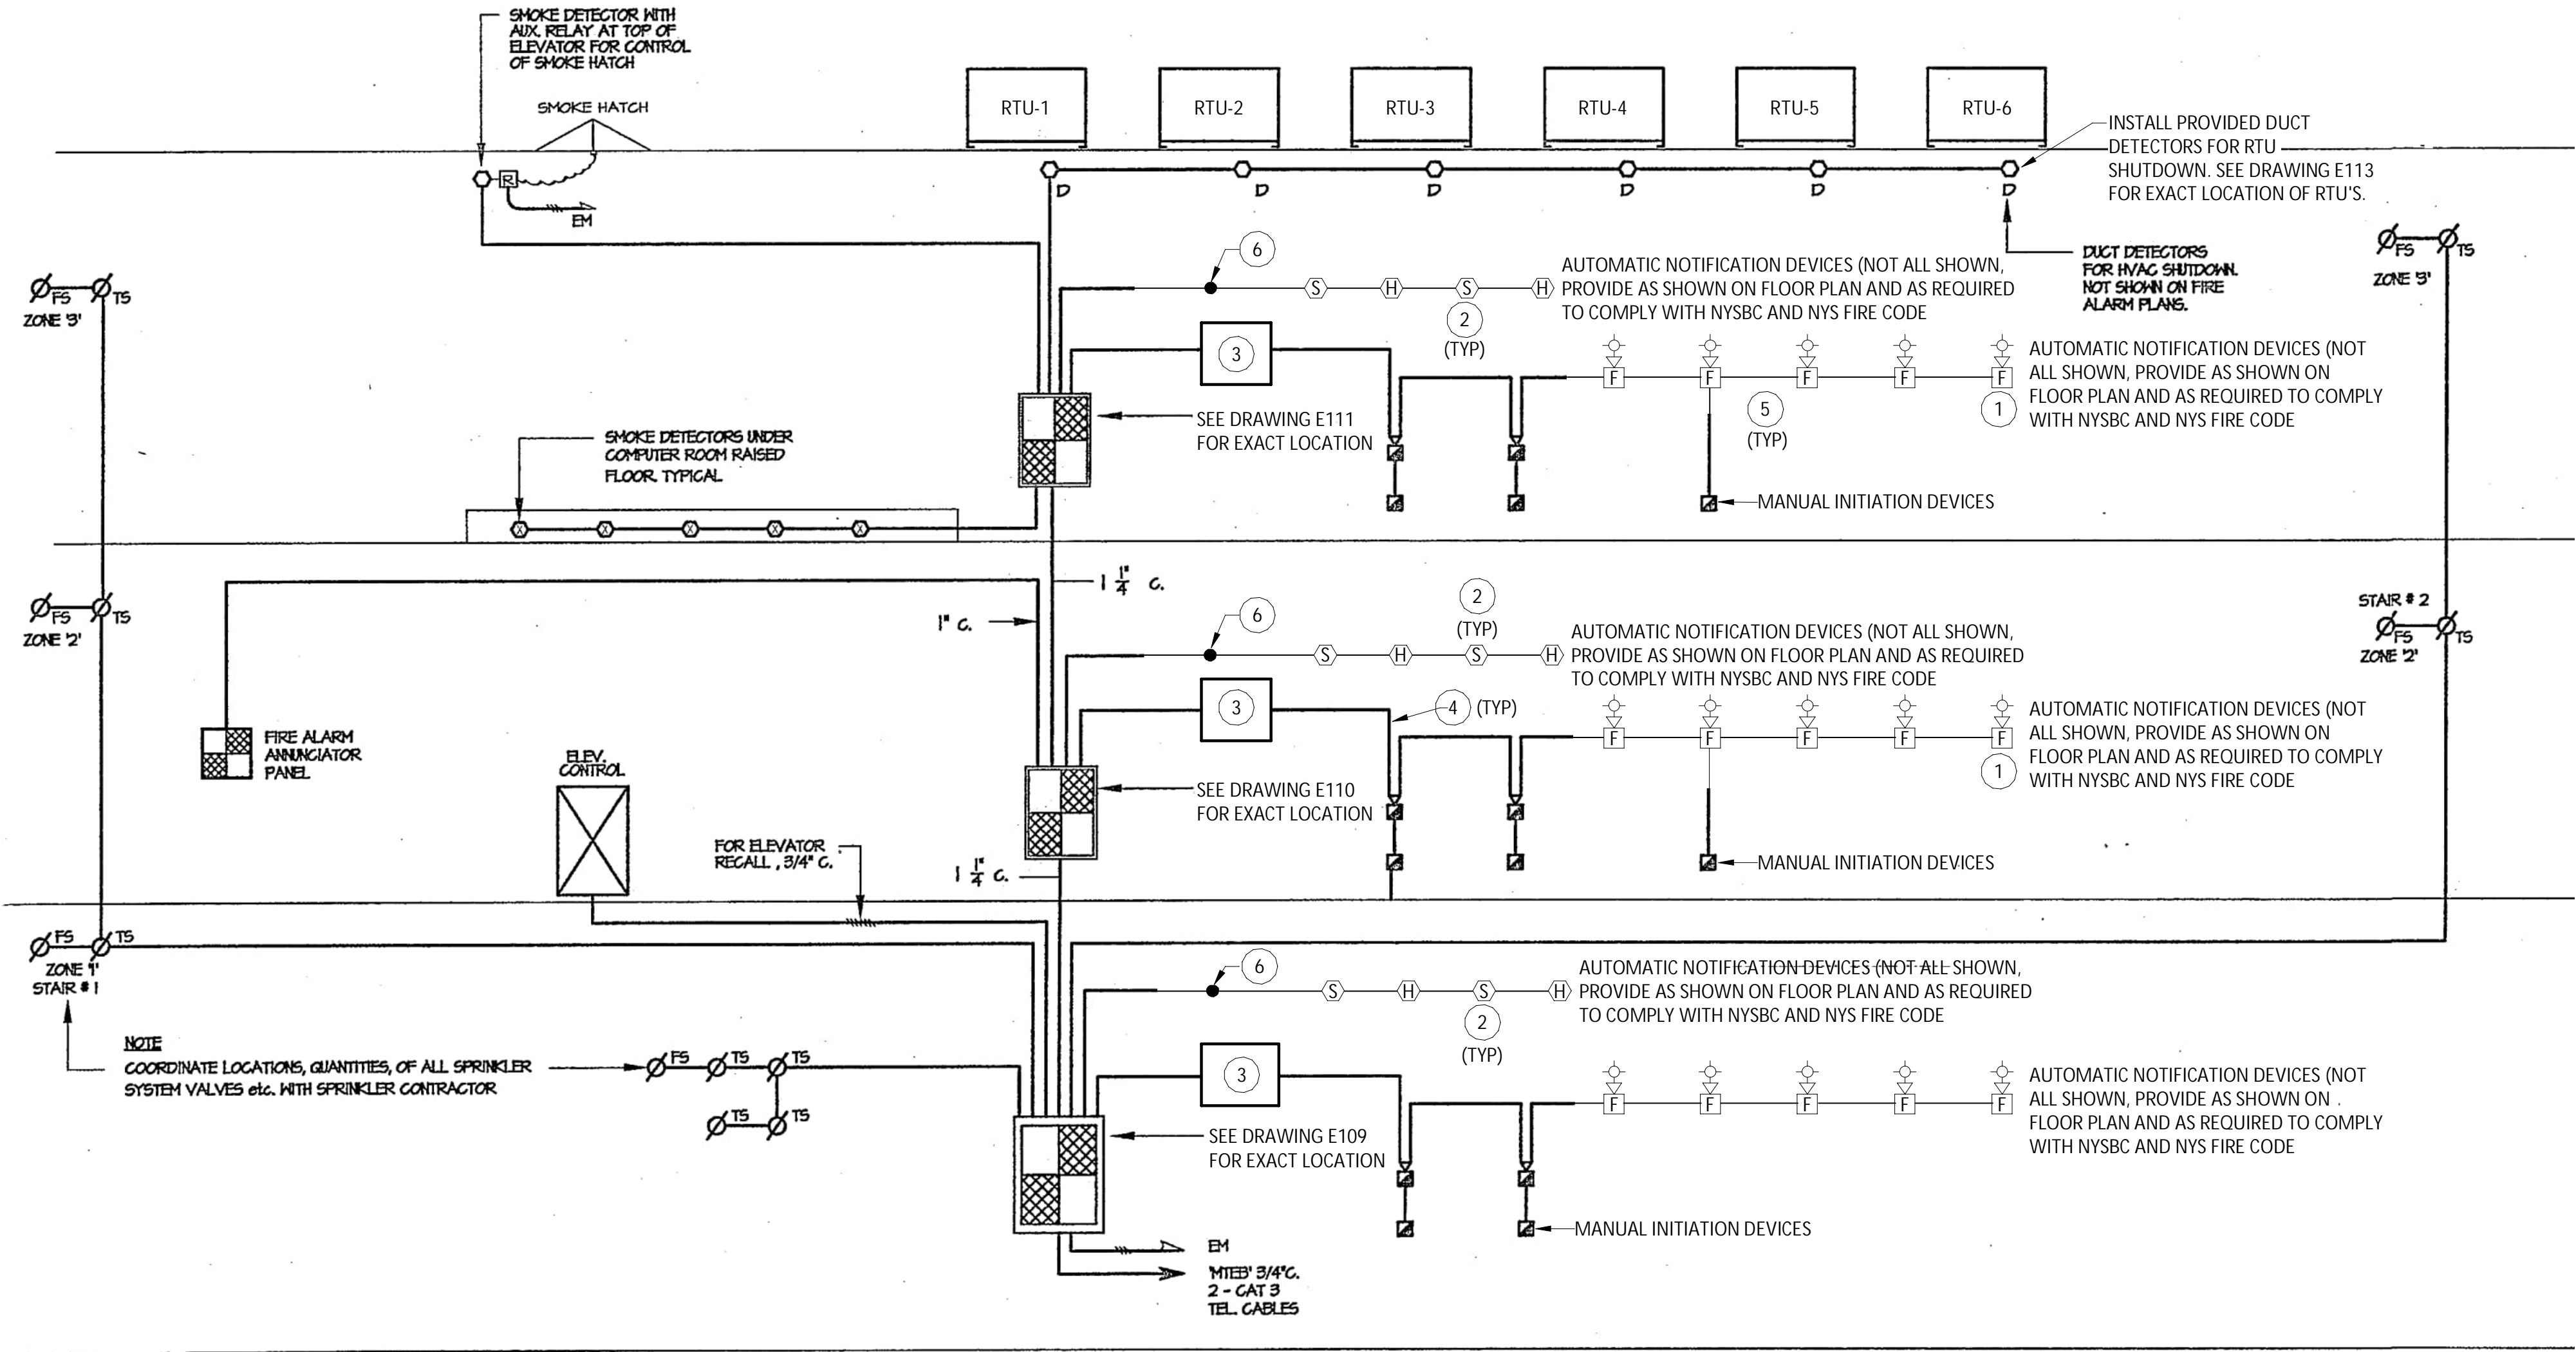

FIRE ALARM RISER DIAGRAM INSTALL

SCALE: NOT TO SCALE

GENERAL NOTES - FIRE ALARM RISER DIAGRAM INSTALL

- 1 - PROVIDE ALL FIRE ALARM DEVICES AND CIRCUITING TO COMPLY WITH REQUIREMENTS OF NFPA 72 FOR ALTERATION WORK.
- 2 - NO EXPOSED WIRE MOLD OR CONDUIT WILL BE ALLOWED EXCEPT WHERE INDICATED OR WITH PERMISSION OF THE OWNER.
- 3 - RISER DIAGRAM IS DIAGRAMMATIC ONLY AND INTENDED TO ILLUSTRATE SCOPE OF WORK.
- 4 - PROVIDE ALL ADDRESSABLE INTERFACE MODULES, RELAY EXPANSION MODULES, BOOSTER PANELS, AND HARDWARE TO ACCOMMODATE ALL DEVICES AS SHOWN.
- 5 - COORDINATE EXACT FIRE ALARM SYSTEM WIRING INCLUDING TYPES, QUANTITIES, AND ROUTING WITH FIRE ALARM MANUFACTURER AND SITE CONDITIONS.
- 6 - NOT ALL INTERCONNECTING WIRING IS INDICATED HERE. REFER TO SPECIFICATIONS FOR ADDITIONAL REQUIREMENTS.
- 7 - PROVIDE 2-HOUR FIRE-RATED CAULK AROUND CONDUITS WHERE THEY PENETRATE FLOORS AND RATED WALLS.
- 8 - ALL FIRE ALARM CIRCUITING TO BE IN CONDUIT.
- 9 - PROVIDE NYLON BUSHINGS ON BOTH ENDS OF ALL CONDUITS.
- 10 - PROVIDE 1/8" NYLON PULLROPE IN EACH CONDUIT.
- 11 - PROVIDE ALL WORK IN ACCORDANCE TO TIA/EIA 569.
- 12 - MINIMUM CONDUIT SIZE SHALL BE 1/2" ALL CONDUIT SHALL BE SIZED PER NEC REQUIREMENTS.
- 13 - ALL CONDUITS SHALL BE AS INDICATED ON CONDUIT SCHEDULE, PAINT ALL CONDUITS RED.
- 14 - PROVIDE ALL WIRING PER MANUFACTURER REQUIREMENTS. ALL WIRE SIZES SHALL BE SIZED PER NEC AT A MINIMUM, AND ACCOMMODATE VOLTAGE
- 15 - DROP DUE TO CIRCUIT LENGTHS. PROVIDE VENDOR VOLTAGE-DROP CALCULATIONS AND ASSOCIATED WIRE SIZING.
- 16 - PROVIDE POWER BOOSTER/EXTENDER PANELS WHEREVER REQUIRED FOR A COMPLETE AND OPERATIONAL SYSTEM.
- 17 - PROVIDE ALL WIRING, PROGRAMMING, CONTROL MODULES, MONITOR MODULES, AND OTHER SUCH DEVICES AS REQUIRED FOR A COMPLETE AND OPERATIONAL SYSTEM.

KEYED NOTES - FIRE ALARM RISER DIAGRAM INSTALL

- 1 PROVIDE AND INSTALL FIRE ALARM HORN/SROBES PER DRAWINGS E116 AND E117.
- 2 PROVIDE AND INSTALL FIRE ALARM SMOKE DETECTORS PER DRAWINGS E116 AND E117.
- 3 PROVIDE BOOSTER PANEL WITH CODE REQUIRED BATTERY POWER, POWER CIRCUITING, CIRCUIT BREAKER, AND ALL REQUIRED INTEGRATION TO EXISTING FIRE ALARM CONTROL PANEL.
- 4 PROVIDE QUANTITY OF NOTIFICATION CIRCUITS AS REQUIRED TO COMPLY WITH POWER OUTPUT AND VOLTAGE DROP REQUIREMENTS.
- 5 PROVIDE DEVICES WITH ONE-WAY COMMUNICATION SPEAKERS AS COORDINATED WITH OWNER AND REQUIRED.
- 6 CONNECT TO EXISTING SNC CIRCUITING. CONTRACTOR TO FILED VERIFY LOCATION AND PROVIDE ALL REQUIRED WORK FOR A COMPLETE AND FUNCTIONAL FIRE ALARM SYSTEM.

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