

FACILITIES MANAGEMENT

HON. EDWIN J. DAY COUNTY EXECUTIVE

ROBERT H. GRUFFI, P.E. LEED AP DIRECTOR, FACILITIES MANAGEMENT

CAPITAL PROJECT 1519
GOVERNMENT CENTER
BUILDING IMPROVEMENTS
COURTHOUSE COOLING TOWER
REPLACEMENT

1 SOUTH MAIN STREET NEW CITY, NY 10956

	DRAWING INDEX			
		ISSUES / REVISIONS		
# DMG	DRAWING TITLE	ISSUE FOR PERMIT	ISSUED FOR BID	
COVEF				
T0.1	COVER SHEET	Χ	X	
MECHA	NICAL			
M0.1	MECHANICAL ABBREVIATIONS, SYMBOLS, AND NOTES	Χ	X	
M1.1	MECHANICAL DEMOLITION PLANS	Χ	X	
M2.1	MECHANICAL NEW WORK PLANS	Χ	X	
M6.1	MECHANICAL SCHEDULES	Χ	X	
M7.1	MECHANICAL DETAILS	Χ	X	
ELECT	RICAL			
E0.1	ELECTRICAL ABBREVIATIONS, SYMBOLS AND NOTES	Χ	X	
E1.1	ELECTRICAL DEMOLITION PLANS	Χ	X	
E1.2	ELECTRICAL DEMOLITION SINGLE LINE DIAGRAMS AND PLAN	Χ	X	
E2.1	ELECTRICAL NEW WORK PLANS	Χ	X	
E2.2	ELECTRICAL NEW WORK SINGLE LINE DIAGRAMS AND PLAN	Χ	Х	
E7.1	ELECTRICAL DETAILS	Χ	X	

OLA Consulting Engineers
50 Broadway,
Hawthorne, NY 10532
914.747.2800

8 West 38th Street,
Suite 900
New York, NY 10017
646.849.4110

olace.com

Rockland County
Facilities Management

Robert H. Gruffi, P.E., LEED AP Director Facilities Management Rockland County Courthouse 1 South Main Street

New City, NY 10956

2 ISSUED FOR BID 09.09.2024
1 ISSUE FOR PERMIT 04.05.2024
NO. DESCRIPTION DATE

No use, reproduction or dissemination may be made of this drawing and the concepts set forth without the prior written consent of OLA Consulting Engineers, PC. Copyright © 201

CAPITAL PROJECT 1519
GOVERNMENT CENTER BUILDING
IMPROVEMENTS COURTHOSE
COOLING TOWER REPLACEMENT

1 SOUTH MAIN STREET NEW CITY, NY 10956

COVER SHEET

SCALE PROJECT NO. NRCK0018

DRAWN BY JC

CHECKED BY RS

DATE 2024.04.05

ABBRE	EVIATIONS		
BREVIATIO		ABBREVIATIO	
ABV AC	ABOVE AIR CONDITIONING UNIT	HVAC	HEATING, VENTILATING AND AIR CONDITIONING
ACCU	AIR COOLED CONDENSING UNIT	HWP	HEATING HOT WATER PUMP
AD	ACCESS DOOR	HWR	HEATING HOT WATER CURRY
ADA ADJ	AMERICAN DISABILITIES ACT ADJUSTABLE	HWS	HEATING HOT WATER SUPPLY HEAT EXCHANGER
AFF	ABOVE FINISHED FLOOR	HZ	HERTZ
AHC	ABOVE HUNG CEILING	ID	INSIDE DIAMETER
AHJ	AUTHORITIES HAVING JURISDICTION	IN	INCH, INCHES
AHU	AIR HANDLING UNIT	IN WG KW	INCHES WATER GAUGE KILOWATT
AP APPROX	ACCESS PANEL APPROXIMATE	KX	KITCHEN EXHAUST AIR
ARCH	ARCHITECTURAL	L	LOUVER
AUTO	AUTOMATIC	LAT	LEAVING AIR TEMPERATURE
В	BOILER	LB	POUND
BDD BEL	BACKDRAFT DAMPER BELOW	LF LPR	LINEAR FEET LOW PRESSURE STEAM RETURN
BHP	BRAKE HORSEPOWER	LPS	LOW PRESSURE STEAM SUPPLY
BTUH	BRITISH THERMAL UNITS PER HOUR	LVG	LEAVING
CA	COMPRESSED AIR	LWT	LEAVING WATER TEMPERATURE
CAV	CONSTANT AIR VOLUME	MAU MAX	MAKEUP AIR MAXIMUM
CD CFM	CEILING DIFFUSER CUBIC FEET PER MINUTE	MBH	1000 BRITISH THERMAL UNITS PER HOUR
CH	CHILLER	MCC	MOTOR CONTROL CENTER
CHWP	CHILLED WATER PUMP	MD	MOTORIZED DAMPER
CHWR	CHILLED WATER RETURN	MECH	MECHANICAL FOLUDIATION FOR THE PROPERTY OF THE
CHWS	CHILLED WATER SUPPLY	MER MIN	MECHANICAL EQUIPMENT ROOM MINIMUM
CNDS CO2	CONDENSATE CARBON DIOXIDE	MISC	MISCELLANEOUS
COD	CABLE OPERATED DAMPER	MPR	MEDIUM PRESSURE STEAM RETURN
CP	CONDENSATE PUMP	MPS	MEDIUM PRESSURE STEAM SUPPLY
СТ	COOLING TOWER	NC NC	NORMALLY CLOSED, NOISE CRITERIA
CWP	CONDENSER WATER PUMP	NO NTS	NORMALLY OPEN NOT TO SCALE
DB DDC	DRY BULB DIRECT DIGITAL CONTROL	OA	OUTSIDE AIR
DEM.	DEMOLISH	Р	PUMP
DET	DETAIL	PCWR	PRIMARY CONDENSER WATER RETURN
DIA, Ø	DIAMETER	PCWS PD	PRIMARY CONDENSER WATER SUPPLY PRESSURE DROP
DN DR	DOWN DIESEL RETURN	PD	PUMP DISCHARGE
DS	DIESEL SUPPLY	POC	POINT OF CONNECTION
DWG	DRAWING	POD	POINT OF DISCONNECTION
DX	DIRECT EXPANSION	POS	POSITIVE
EA EAT	EXHAUST AIR ENTERING AIR TEMPERATURE	PSI PSIA	POUNDS PER SQUARE INCH POUNDS PER SQUARE INCH ABSOLUTE
EER	ENERGY EFFICIENCY RATIO	PSIG	POUNDS PER SQUARE INCH GAUGE
EF	EXHAUST FAN	PTAC	PACKAGED TERMINAL AIR CONDITIONING UNIT
EL	ELEVATION	RA	RETURN AIR
ELEC	ELECTRICAL	REL REQD	REMOVE AND RELOCATE REQUIRED
ENT ER	ENTERING EXHAUST REGISTER	RF	RETURN FAN
ESP	EXTERNAL STATIC PRESSURE	RH	REHEAT COIL
ET	EXPANSION TANK	RL	REFRIGERANT LIQUID
EWT	ENTERING WATER TEMPERATURE	RLA	RATED LOAD AMPS
EX.	EXISTING	RPM RR	REVOLUTIONS PER MINUTE RETURN REGISTER
FCU FLEX	FAN COIL UNIT FLEXIBLE	RS	REFRIGERANT SUCTION
FLR	FLOOR	SA	SUPPLY AIR
FOR	FOIL OIL RETURN	SCWR	SECONDARY CONDENSER WATER SUPPLY
FOS	FUEL OIL VENT	SCWS SEER	SECONDARY CONDENSER WATER SUPPLY SEASONAL ENERGY EFFICIENCY RATIO
FOV FPM	FUEL OIL VENT FEET PER MINUTE	SEER	SHUT OFF VALVE
FS	FLOOR SINK	SP	STATIC PRESSURE
FSD	FIRE SMOKE DAMPER	SPECS	SPECIFICATIONS
FT	FLOOR, FEET	SR	SUPPLY REGISTER
FTR FV	FIN TUBE RADIATION FACE VELOCITY	SS STD	STAINLESS STEEL STANDARD
°F	DEGREES FAHRENHEIT	STRUCT	STRUCTURAL
GA	GAUGE	TA	TRANSFER AIR
GAL	GALLON	TD	TRANSFER DUCT
GALV	GALVANIZED	TDH TEFC	TOTAL DYNAMIC HEAD TOTALLY ENCLOSED FAN COOLED
GLR GLS	GLYCOL RETURN GLYCOL SUPPLY	TEMP	TEMPERATURE
GPM	GALLONS PER MINUTE	TSP	TOTAL STATIC PRESSURE
HG	REFRIGERANT HOT GAS	TX	TOILET EXHAUST AIR
HGT	HEIGHT	TYP.	TYPICAL
HORIZ	HORIZONTAL	UH	UNIT HEATER UNLESS OTHERWISE NOTED
HP HP	HORSEPOWER HEAT PUMP	UV	UNIT VENTILATOR
HPR	HIGH PRESSURE STEAM RETURN	VAV	VARIABLE AIR VOLUME
HPS	HIGH PRESSURE STEAM SUPPLY	VFD	VARIABLE FREQUENCY DRIVE
HR	HOUR	WB WG	WET BULB
HV	HEATING & VENTILATING UNIT	10163	INCHES OF WATER GAUGE

GENERAL SYMBOLS DESCRIPTION SYMBOL 1 VIEW TITLE SCALE: NTS PLAN TITLE NO. 1 TITLE MARK DETAIL VIEW NO. 1 M2.1 SCALE: NTS FOUND ON SHEET M-2.1 DETAIL REFERENCE DETAIL NO. 1 M7.1 FOUND ON SHEET M-7.1 SECTION MARK SECTION VIEW NO. 1 FOUND ON SHEET M-3.1 ENLARGED VIEW CALLOUT PLAN VIEW NO. 1 FOUND ON SHEET M4.1 REVISION CLOUD (DELTA 1) EXISTING TO REMAIN REMOVE AND RELOCATE **NEW WORK** EXISTING TO BE REMOVED _____ POINT OF CONNECTION POINT OF DISCONNECTION (#)

SHEET KEYNOTE

WATERSIDE SYMBOLS				
SYMBOL	DESCRIPTION			
	TEE DOWN			
C	ELBOW DOWN			
—	TEE UP			
O	ELBOW UP			
\triangleright	CONCENTRIC REDUCER			
	ECCENTRIC REDUCER			
◀	FLOW ARROW			
\$	3-WAY VALVE			
K	2-WAY VALVE			
₹	PLUG VALVE			
\mathcal{A}	LOCK SHIELD VALVE			
	GATE VALVE			
→	GLOBE VALVE			
本	OS&Y GATE VALVE			
6	BUTTERFLY VALVE			
101	BALANCING VALVE			
₹	SOLENOID VALVE			
Ŋ.	MOTORIZED VALVE			
oxdapsilon	ANGLE GLOBE VALVE			
₩	ANGLE GATE VALVE			
X	T&P RELIEF VALVE			
→	BALL VALVE			
₹	CHECK VALVE			
Å	PRESSURE REDUCING VALVE			
 _a -l	STRAINER			
\bigcup	BASKET STRAINER			
<u>↑</u>	MANUAL AIR VENT			
•	AUTOMATIC AIR VENT			
∅	PRESSURE GAUGE			
	THERMOMETER			
ι ι	UNION			
	PIPE GUIDE			
×	PIPE ANCHOR			
	FLEXIBLE CONNECTION			

GENERAL NOTES

- I. DUCT DIMENSIONS SHOWN ON MECHANICAL DRAWINGS REFER TO INSIDE CLEAR DUCT DIMENSIONS. WHERE DUCTWORK IS LINED THE CONTRACTOR SHALL INCREASE THE SIZE OF DUCT TO COMPENSATE
- 2. CONTRACTOR TO FIELD VERIFY ALL EXISTING CONDITIONS PRIOR TO THE BEGINNING OF WORK AND COORDINATE NEW WORK.
- 3. THIS CONTRACTOR SHALL SUBMIT FOR REVIEW A COMPOSITE SHOP DRAWING, FULLY COORDINATED WITH ALL OTHER TRADES. THE COORDINATED SHOP DRAWING SHALL INDICATE MECHANICAL EQUIPMENT, PIPING, POWER CONDUITS, AND STEEL DUNNAGE.
- I. CONTRACT DRAWINGS AS FAR AS THEY RELATE TO THE GENERAL ARRANGEMENT AND LOCATION OF EQUIPMENT, PIPING AND SHEETMETAL, SHALL BE UNDERSTOOD AS DIAGRAMMATIC. ANY CHANGES TO SHEETMETAL AND EQUIPMENT LOCATIONS NECESSARY TO AVOID INTERFERENCE WITH OTHER TRADES SHALL BE MADE AT NO EXTRA COST.

APPLICABLE CODES AND STANDARDS

THIS PROJECT SHALL COMPLY WITH, BUT NOT LIMITED TO THE FOLLOWING CODES AND STANDARDS:

- 2020 NEW YORK STATE BUILDING CODE
- 2020 NEW YORK STATE MECHANICAL CODE
- 2020 NEW YORK STATE ENERGY CODE
- 2020 NEW YORK STATE PLUMBING CODE
- 2020 NEW YORK STATE FIRE CODE
- 2017 NEW YORK STATE ELECTRICAL CODE
- ANY AND ALL LOCAL AMENDMENTS



ENGINEERS

CLIENT

OLA Consulting Engineers 50 Broadway,

Hawthorne, NY 10532 914.747.2800 8 West 38th Street,

Suite 900 New York, NY 10017 646.849.4110

olace.com

Rockland County

Facilities Management

Robert H. Gruffi, P.E., LEED AP

Director Facilities Management Rockland County Courthouse 1 South Main Street

New City, NY 10956

ISSUED FOR BID 09.09.2024 04.05.2024 **ISSUE FOR PERMIT** DATE DESCRIPTION


No use, reproduction or dissemination may be made of this drawing and the concepts set forth without the prior written consent of OLA Consulting Engineers, PC. Copyright © 2015


CAPITAL PROJECT 1519 GOVERNMENT CENTER BUILDING IMPROVEMENTS COURTHOSE COOLING TOWER REPLACEMENT

> 1 SOUTH MAIN STREET NEW CITY, NY 10956

MECHANICAL ABBREVIATIONS, SYMBOLS, AND NOTES

SEAL	SCALE 12" = 1'-0"	PROJECT NO. NRCK0018
	DRAWN BY JC	DRAWING NO.
	CHECKED BY RS	M0.1
	DATE 2024.04.05	

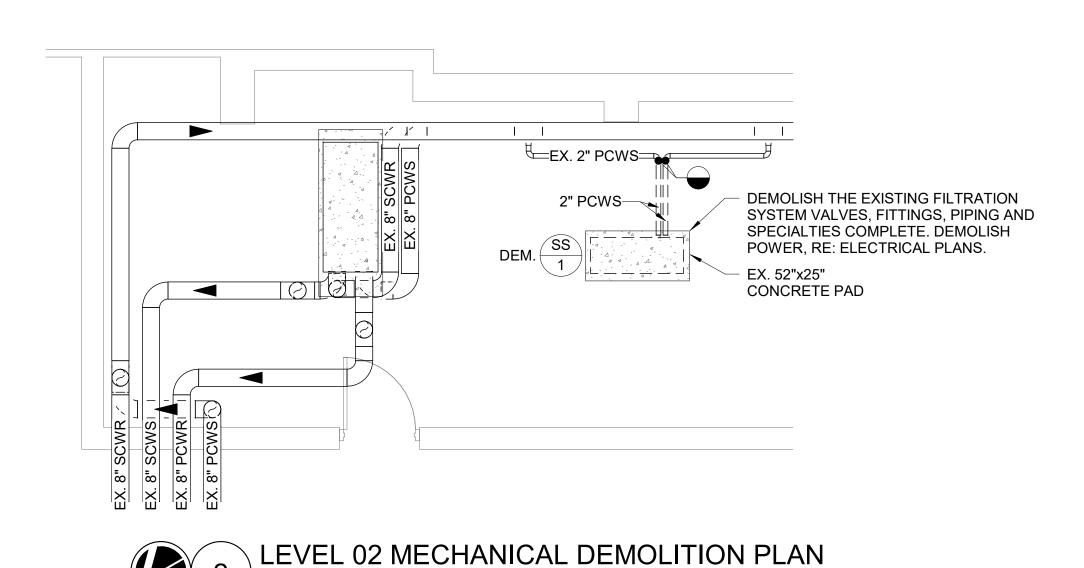

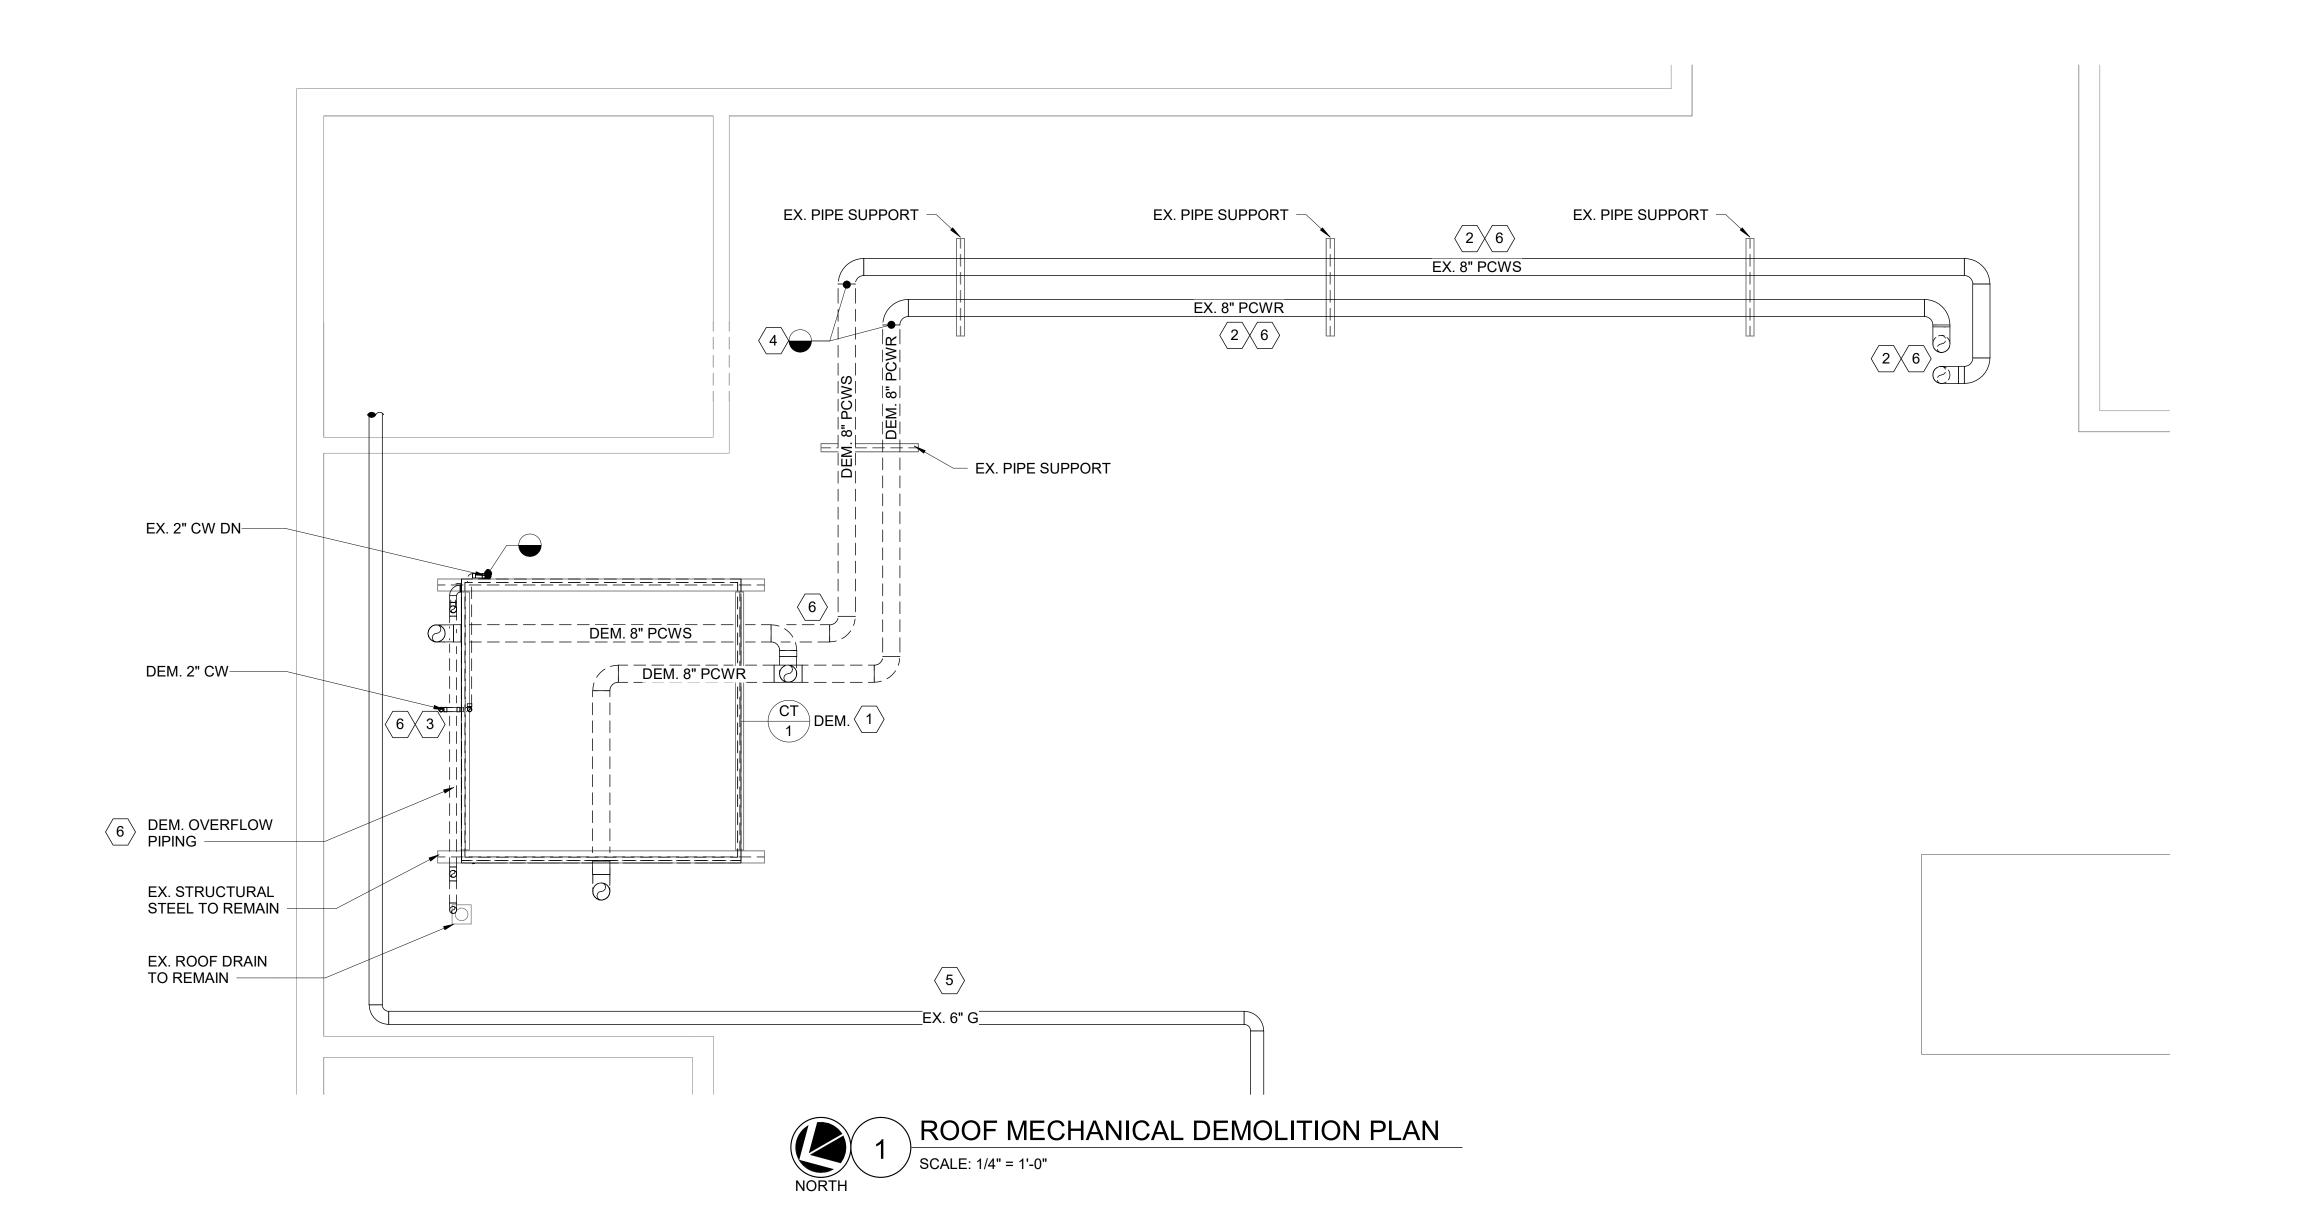

GENERAL NOTES

- 1. CONDITIONS MAY NOT BE EXACTLY AS INDICATED ON THIS DRAWING. HVAC CONTRACTOR SHALL VISIT THE SITE TO UNDERSTAND THE EXISTING FIELD CONDITIONS AND TO VERIFY SCOPE OF WORK PRIOR TO SUBMITTING BID. NO ALLOWANCE WILL BE MADE AFTER CONTRACT IS APPROVED.
- 2. ALL ABANDONED AND UNUSED EQUIPMENT SHALL BE REMOVED.
- 3. CONTRACTOR SHALL REPAIR ANY LEAKS IN THE CONDENSER WATER SYSTEM, INCLUDING PIPING NOT SPECIFICALLY SHOWN ON PLAN. SUBMIT REPORT TO ENGINEER.
- 4. COORDINATE ALL SHUTDOWNS WITH BUILDING FACILITIES, OWNER, AND TENANTS.



CLIENT

50 Broadway, Hawthorne, NY 10532

OLA Consulting Engineers

914.747.2800 8 West 38th Street, Suite 900 New York, NY 10017

olace.com


646.849.4110

Rockland County

Facilities Management

Robert H. Gruffi, P.E., LEED AP Director Facilities Management

Rockland County Courthouse 1 South Main Street New City, NY 10956

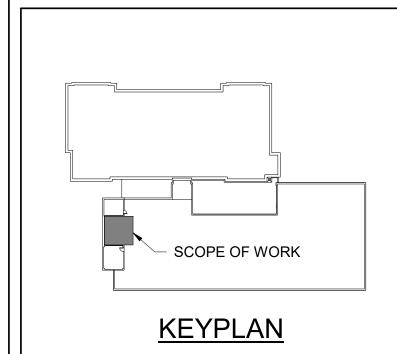

KEYNOTES

- 1 DEMOLISH COOLING TOWER AND ASSOCIATED PIPING AS SHOWN. REMOVE VIBRATION ISOLATORS AND DUNNAGE ON TOP OF THE STRUCTURAL STEEL FRAMING. STRUCTURAL STEEL FRAMING TO REMAIN.
- REMOVE INSULATION FOR ALL CONDENSER WATER PIPING ON THE ROOF. RE-FINISH ANY RUST-DAMAGED SEGMENTS OF THE CONDENSER WATER PIPING.
- DEMOLISH 2" CW BACK TO SHUT-OFF VALVE. CAP AND SEAL OPEN PIPING WHILE WORK IS NOT BEING PERFORMED.
- DISCONNECT CONDENSER WATER PIPING. CAP AND SEAL WHILE WORK IS NOT BEING PERFORMED.
- 5 NO WORK TO THE EXISTING GAS LINE. SHOWN FOR REFERENCE ONLY.
- 6 DEMOLISH HEAT TRACING ASSOCIATED ON THE EXISTING PCWS/R PIPING ABOVE THE ROOF.

2	ISSUED FOR BID	09.09.2024
1	ISSUE FOR PERMIT	04.05.2024
NO.	DESCRIPTION	DATE

No use, reproduction or dissemination may be made of this drawing and the concepts set forth without the prior written consent of OLA Consulting Engineers, PC. Copyright © 2015

CAPITAL PROJECT 1519
GOVERNMENT CENTER BUILDING
IMPROVEMENTS COURTHOSE
COOLING TOWER REPLACEMENT

1 SOUTH MAIN STREET NEW CITY, NY 10956


PLANS

MECHANICAL DEMOLITION

SCALE PROJECT NO.

SEAL	SCALE As indicated	PROJECT NO. NRCK0018
	DRAWN BY JC	DRAWING NO.
	CHECKED BY RS	M1.1
	DATE 2024.04.05	

16/2024 2:40:29 PM

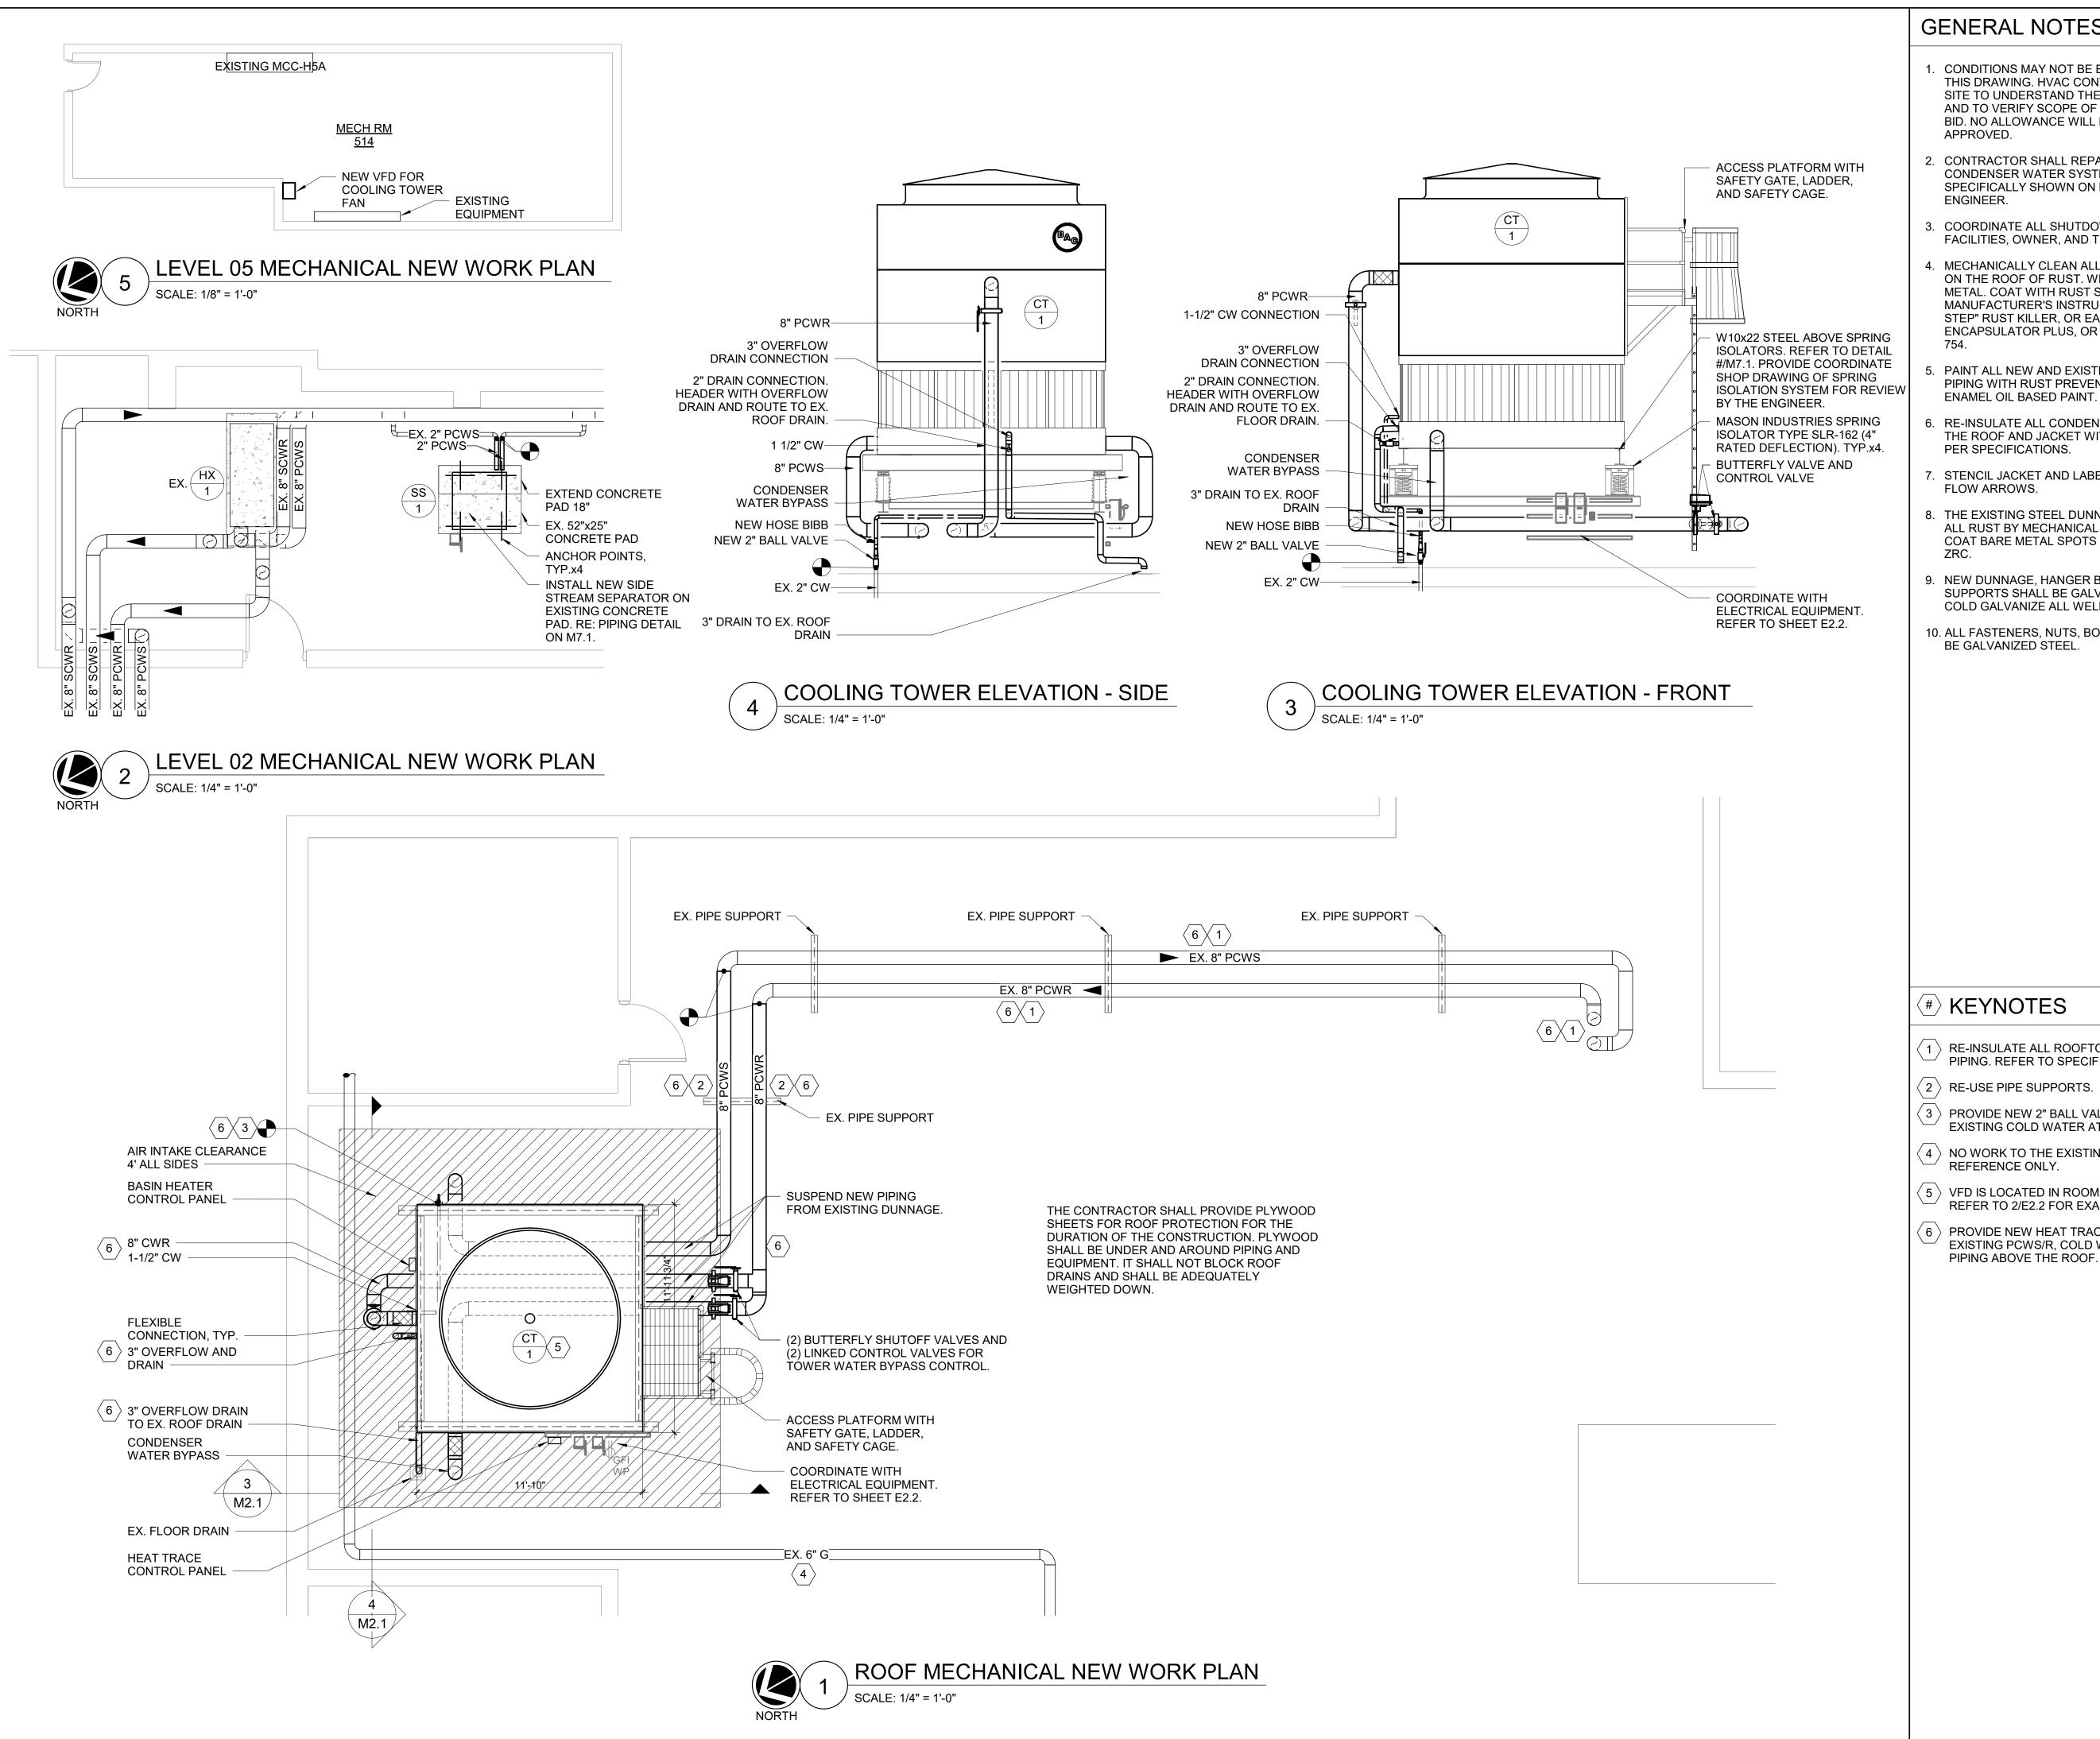

GENERAL NOTES

- CONDITIONS MAY NOT BE EXACTLY AS INDICATED ON THIS DRAWING. HVAC CONTRACTOR SHALL VISIT THE SITE TO UNDERSTAND THE EXISTING FIELD CONDITIONS AND TO VERIFY SCOPE OF WORK PRIOR TO SUBMITTING BID. NO ALLOWANCE WILL BE MADE AFTER CONTRACT IS APPROVED.
- CONTRACTOR SHALL REPAIR ANY LEAKS IN THE CONDENSER WATER SYSTEM, INCLUDING PIPING NOT SPECIFICALLY SHOWN ON PLAN. SUBMIT REPORT TO ENGINEER.
- . COORDINATE ALL SHUTDOWNS WITH BUILDING FACILITIES, OWNER, AND TENANTS.
- 4. MECHANICALLY CLEAN ALL THE EXISTING CWS&R PIPING ON THE ROOF OF RUST. WIRE WHEEL DOWN TO BASE METAL. COAT WITH RUST STOPPING AGENT AS PER MANUFACTURER'S INSTRUCTIONS . INTERSTATE "ONE STEP" RUST KILLER, OR EASTWOOD RUST ENCAPSULATOR PLUS, OR LOCKTITE RUST TREATMENT
- PAINT ALL NEW AND EXISTING CONDENSER WATER PIPING WITH RUST PREVENTATIVE PRIMER AND GRAY ENAMEL OIL BASED PAINT.
- RE-INSULATE ALL CONDENSER WATER PIPING ABOVE THE ROOF AND JACKET WITH WATERPROOF JACKET AS PER SPECIFICATIONS.
- STENCIL JACKET AND LABEL ALL PIPING INCLUDING FLOW ARROWS.
- 8. THE EXISTING STEEL DUNNAGE SHALL BE CLEANED OF ALL RUST BY MECHANICAL GRINDING OR WIRE WHEEL. COAT BARE METAL SPOTS WITH COLD GALVANIZED BY
- NEW DUNNAGE, HANGER BRACKETS, PIPE OR CONDUIT SUPPORTS SHALL BE GALVANIZED STEEL. CLEAN AND COLD GALVANIZE ALL WELDS IN THE FIELD WITH ZRC.
- 10. ALL FASTENERS, NUTS, BOLTS, WASHERS, ETC. SHALL BE GALVANIZED STEEL.



50 Broadway, Hawthorne, NY 10532

914.747.2800 8 West 38th Street, Suite 900

New York, NY 10017

olace.com

646.849.4110

CLIENT

CONSULTING


ENGINEERS

Rockland County

Facilities Management

Robert H. Gruffi, P.E., LEED AP **Director Facilities Management**

Rockland County Courthouse 1 South Main Street New City, NY 10956

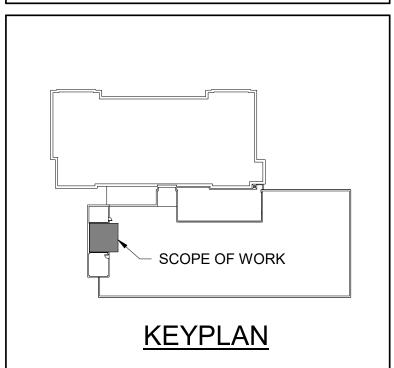

(#) KEYNOTES

- 1 RE-INSULATE ALL ROOFTOP CONDENSER WATER PIPING. REFER TO SPECIFICATIONS.
- \langle 2 angle RE-USE PIPE SUPPORTS.
- \langle 3 \rangle PROVIDE NEW 2" BALL VALVE AND CONNECT TO EXISTING COLD WATER AT ROOF PENETRATION.
- \langle 4 \rangle NO WORK TO THE EXISTING GAS LINE. SHOWN FOR REFERENCE ONLY.
- \langle 5 \rangle VFD IS LOCATED IN ROOM MECH RM 514 ON LEVEL 5. REFER TO 2/E2.2 FOR EXACT LOCATION.
- (6) PROVIDE NEW HEAT TRACING ON ALL NEW AND EXISTING PCWS/R, COLD WATER MAKEUP, AND DRAIN

2	ISSUED FOR BID	09.09.2024
1	ISSUE FOR PERMIT	04.05.2024
NO.	DESCRIPTION	DATE
No uso re	oproduction or dissomination may be made of	fthic

No use, reproduction or dissemination may be made of this drawing and the concepts set forth without the prior written consent of OLA Consulting Engineers, PC. Copyright © 2015

CAPITAL PROJECT 1519 **GOVERNMENT CENTER BUILDING** IMPROVEMENTS COURTHOSE COOLING TOWER REPLACEMENT

> 1 SOUTH MAIN STREET NEW CITY, NY 10956

MECHANICAL NEW WORK **PLANS**

SEAL	SCALE As indicated	PROJECT NO. NRCK0018
	DRAWN BY JC	DRAWING NO.
	CHECKED BY RS	M2.1
	DATE	

2024.04.05



OLA Consulting Engineers

50 Broadway, Hawthorne, NY 10532 914.747.2800

8 West 38th Street, Suite 900 New York, NY 10017 646.849.4110

Rockland County

Facilities Management

Robert H. Gruffi, P.E., LEED AP

Director Facilities Management

Rockland County Courthouse 1 South Main Street New City, NY 10956

COOLING TOWER SCHEDULE			
DESIGNATION	CT-1		
LOCATION	ROOF		
MANUFACTURER	BAC		
MODEL	PT2-1212A-2M1		
TYPE	INDUCED DRAFT COUNTERFLOW		
OPERATING WEIGHT (LBS)	12,440		
NOMINAL SIZE (TONS)	400		
DESIGN WET BULB TEMP. (°F)	78		
GPM (PER CELL)	1200		
WPD (FT H20)	12.2		
EWT / LWT (°F)	85/95		
FANS			
NO. OF FANS	1		
MOTOR HP (EACH)	20		
TOTAL FAN AIRFLOW (CFM)	90,356		
STARTER TYPE	VFD		
STARTER LOCATION	SEE PLANS		
DISCONNECT SWITCH	YES		
CONNECTION SIZES:			
INLET (IN.)	8		
OUTLET (IN.)	8		
COLD WATER MAKE UP (IN.)	1 1/2"		
DRAIN (IN.)	2		
OVERFLOW (IN.)	3		
ELECTRICAL DATA:			
VOLTAGE / PH / FREQ.	460/3/60		
NOTES: 1. PROVIDE UNITARY CONTROLLER E	BY AUTOMATIC TEMPERATURE CONTROLS		

MANUFACTURER. ALL CONTROLS SHALL BE TRANE TRACE SUMMIT COMPATIBLE WITH THE EXISTING BUILDING VERSION.

2. PROVIDE VIBRATION ISOLATION RAIL PACKAGE BY COOLING TOWER MANUFACTURER, TO BE INSTALLED BETWEEN THE TOWER & SUPPORTING STEEL. 3. PROVIDE WITH LOW SOUND FAN.

4. TOWER SHALL BE ALL 304 OR 316 STAINLESS STEEL CONSTRUCTION. 5. ALL MOTOR STARTERS, VARIABLE FREQUENCY DRIVES, AND DISCONNECT SWITCHES SHALL BE FURNISHED BY THE MECHANICAL CONTRACTOR & INSTALLED BY THE ELECTRICAL CONTRACTOR. 6. ALL MOTORS 1 HP OR GREATER SHALL BE PREMIUM EFFICIENCY.

7. ALL MOTORS FURNISHED WITH VARIABLE FREQUENCY DRIVES SHALL BE INVERTER DUTY RATED AND APPROVED FOR VARIABLE SPEED AND TORQUE APPLICATIONS. 8. PROVIDE WITH SERVICE PLATFORM WITH 42" HANDRAILS AROUND TOP OF

TOWER, SAFETY GATES AND ACCESS LADDER BY MANUFACTURER. ALL COMPONENTS SHALL BE GALVANIZED STEEL. 9. PROVIDE WITH ELECTRIC WATER LEVEL CONTROL PACKAGE.

10. PROVIDE WITH FACTORY-FURNISHED FULL FLOW BYPASS CONNECTION. 11. PROVIDE 12KW BASIN HEATER FOR EACH CELL WITH CONTROL PANEL, COMBINATION MOTOR STARTER AND DISCONNECT SWITCH. 460/3/60. 12. PROVIDE MECHANICAL VIBRATION CUTOUT SWITCH WITH SEPARATE 120V ELECTRICAL CONNECTION.

13. PROVIDE INLET SCREENS AND EXTENDED LUBRICATION LINES. 14. PROVIDE STEEL BRAIDED FLEXIBLE CONNECTION AT THE TOWER INLET AND

15. THE MECHANICAL CONTRACTOR SHALL FURNISH A VFD FOR THE COOLING TOWER FAN AS PER THE SPECIFICATIONS. THE VFD SHALL BE INSTALLED BY THE ELCTRICAL CONTRACTOR IN MER 514.

SIDE STREAM SEPARATOR SCHEDULE				
DESIGNATION	SS-1			
LOCATION	PUMP ROOM (LEVEL 02)			
MANUFACTURER	PEP			
MODEL	HMF-24			
MAX WORKING PRESSURE	150			
PUMP HORSEPOWER (HP)	2			
DIMENSIONS:				
LENGTH (IN.)	36			
WIDTH (IN.)	34			
HEIGHT (IN.)	55.25			
OPERATING WEIGHT (LBS.)	1,076			
CONNECTION SIZES:				
INLET (IN.)	1.5			
OUTLET (IN.)	1.5			
ELECTRICAL DATA:				
VOLTAGE / PH / FREQ.	460/3/60			
FLA (A)	2.7			

1. PROVIDE NEMA 4X CONTROL ENCLOSURE WITH DISCONNECT

2. PROVIDE A 1-1/2" AUTOMATIC BALL VALVE WITH ASSOCIATED WALL MOUNTED CONTROL PANEL. CONTROL PANEL AND VALVE SHALL BE 120V 3. PROVIDE INLET AND OUTLET VALVE KIT.

4. UNIT SHALL BE MANUFACTURED IN ACCORDANCE WITH ASME CODE.

EQUIPMENT NOTES

- 1. HEAT TRACING CABLE SHALL BE BASED ON NELSON TYPE CLT SELF-REGULATING HEATERS. HEATER CABLE PERFORMANCE FOR CONDENSER WATER PIPING SHALL BE 8 WATTS PER FOOT AT 120 VOLTS AND 15 AMPS. HEATER CABLE PERFORMANCE FOR MAKEUP COLD WATER AND DRAIN/OVERFLOW SHALL BE 5 WATTS PER FOOT AT 120 VOLTS AND 15 AMPS. SYSTEM SHALL BE COMPLETE WITH COMPATIBLE NELSON POWER CONNECTION KIT AND COMPATIBLE NELSON THERMOSTAT. SYSTEM SHALL BE UL LISTED AND APPROVED.
- 2. PIPE INSULATION (EXTERIOR): SHALL BE AEROFLEX AEROCELL WLP EPDM TUBE OR SHEET FOR PIPING WITH PREMOLDED PIPE FITTING INSULATION. INSTALL WITH AEROFLEX EPDM TAPE. PERMEABILITY SHALL BE 0.01 PER INCH. K +/- 0.245.
- 3. EXTERIOR PIPE JACKET: SHALL BE POLYGUARD-ALUMNAGUARD ALL WEATHER JACKET. COMPOSITE MEMBRANE CONSISTING OF MULTIPLE UV RESISTANT ALUMINUM FOIL POLYMER LAMINATE.

2	ISSUED FOR BID	09.09.202
1	ISSUE FOR PERMIT	04.05.202
NO.	DESCRIPTION	DATE

No use, reproduction or dissemination may be made of this drawing and the concepts set forth without the prior written consent of OLA Consulting Engineers, PC. Copyright © 2015


CAPITAL PROJECT 1519 GOVERNMENT CENTER BUILDING IMPROVEMENTS COURTHOSE COOLING TOWER REPLACEMENT


1 SOUTH MAIN STREET NEW CITY, NY 10956

MECHANICAL SCHEDULES

SEAL	SCALE	PROJECT NO. NRCK0018
	DRAWN BY JC	DRAWING NO.
	CHECKED BY RS	M6.1
	DATE	

2024.04.05

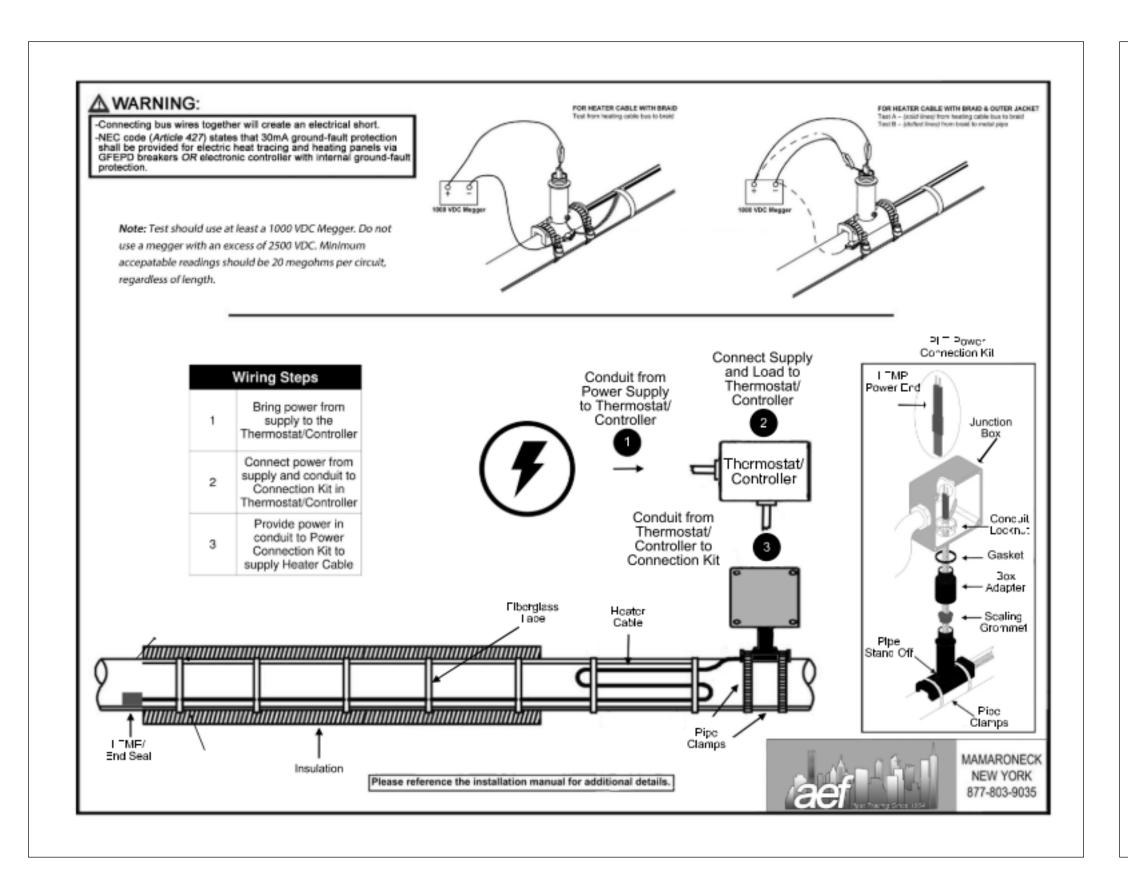

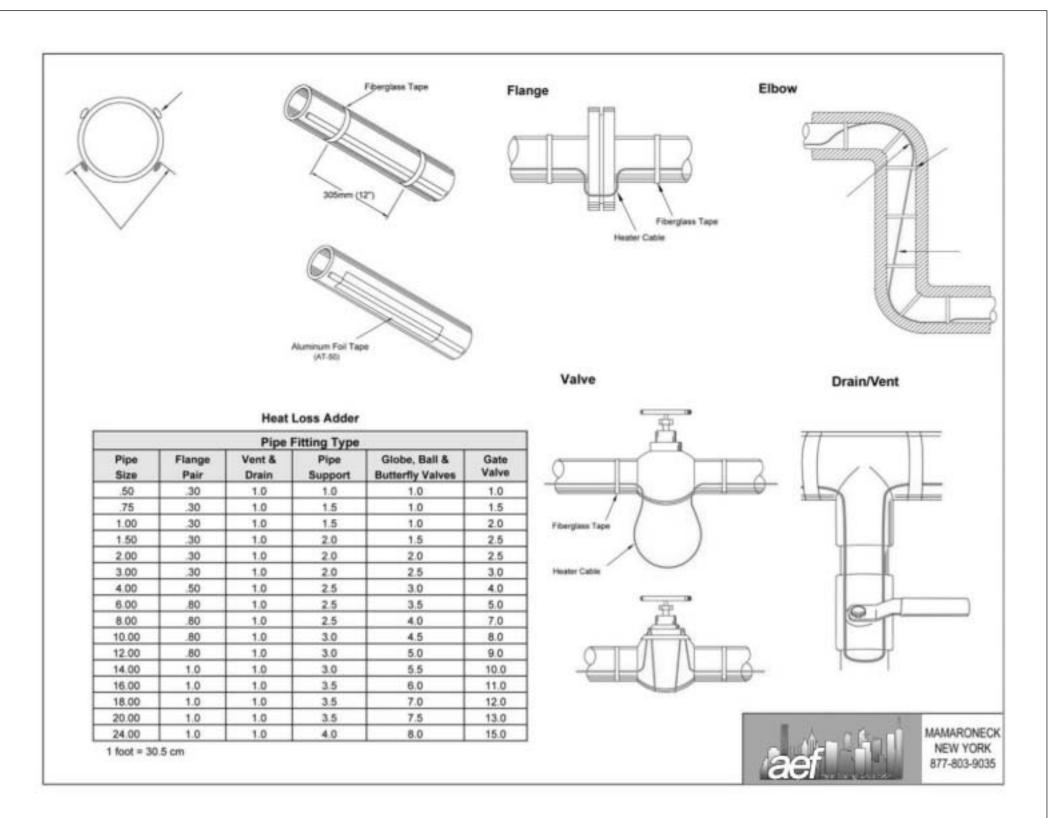

HEAT TRACE DETAILS

BMS NOTES: 1. HEAT TRACE SHALL OPERATE VIA CONTROL PANEL PROVIDED BY HEAT TRACE MANUFACTURER. THIS CONTRACTOR SHALL CONNECT TO COMMON ALARM DRY CONTACT FOR MONITORING AT THE BMS.

VIBRATION CUTOUT SWITCH BY MANUFACTURER

OVERFLOW DRAIN

DRAIN CONNECTION

MANUFACTURER

ELECTRIC WATER LEVEL


CONTROL PACKAGE BY

STEEL DUNNAGE WITH SPRING VIBRATION

ISOLATORS BY MASON


DESIGN.

CONNECTION

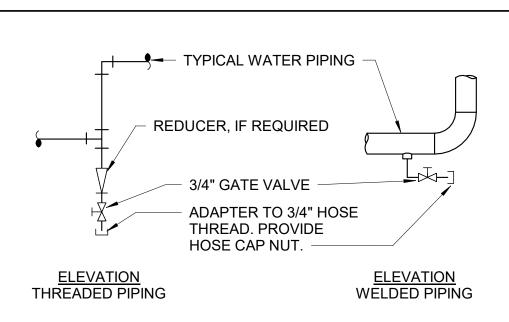

NOTES:
1. DRAIN ALL LOW POINTS AS INDICATED ABOVE. 2. WHERE SCALE POCKETS ARE SHOWN ON PIPE RISER DIAGRAMS AND/OR PLANS, LOCATE DRAIN AT BOTTOM OF SCALE POCKET.

DRAIN VALVE CONNECTION DETAIL **SCALE: NONE**

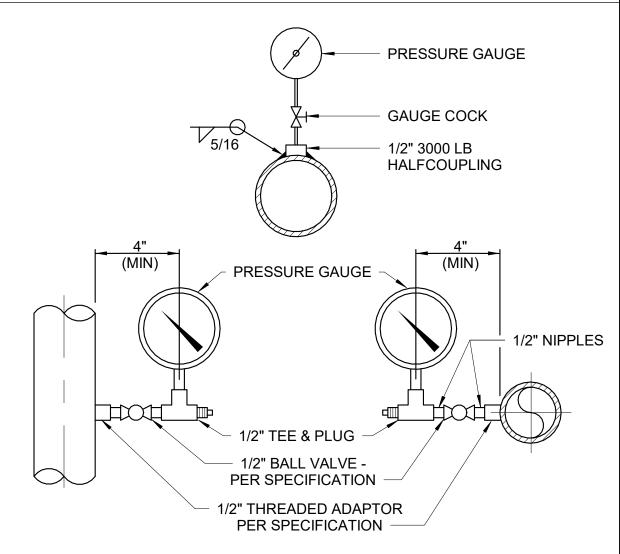

VERTICAL PROCESS LINE


HORIZONTAL PROCESS LINE

NOTE:
1. PROVIDE PETE'S PLUG IMMEDIATELY ADJACENT TO ALL GAUGE INSTALLATIONS FOR CALIBRATION.

PRESSURE GAUGE DETAIL

M7.1

M7.1

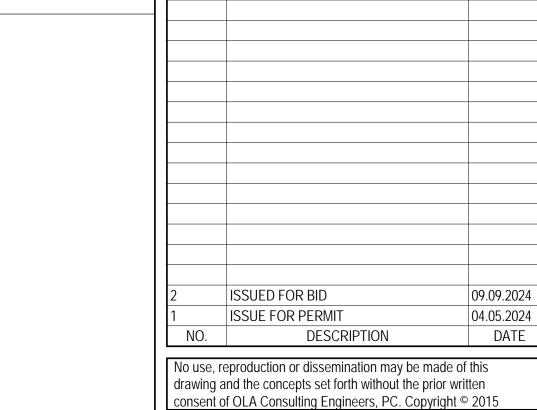

CAPITAL PROJECT 1519 **GOVERNMENT CENTER BUILDING** IMPROVEMENTS COURTHOSE **COOLING TOWER REPLACEMENT**

OLA Consulting Engineers

50 Broadway,

914.747.2800

646.849.4110

Rockland County

Facilities Management

Robert H. Gruffi, P.E., LEED AP **Director Facilities Management**

Rockland County Courthouse

1 South Main Street

New City, NY 10956

Suite 900

olace.com

CONSULTING

ENGINEERS

CLIENT

Hawthorne, NY 10532

8 West 38th Street,


New York, NY 10017


1 SOUTH MAIN STREET NEW CITY, NY 10956


MECHANICAL DETAILS

SEAL	SCALE	PROJECT NO.
	12" = 1'-0"	NRCK0018
	DRAWN BY JC	DRAWING NO.
	CHECKED BY RS	M7.1

DATE 2024.04.05

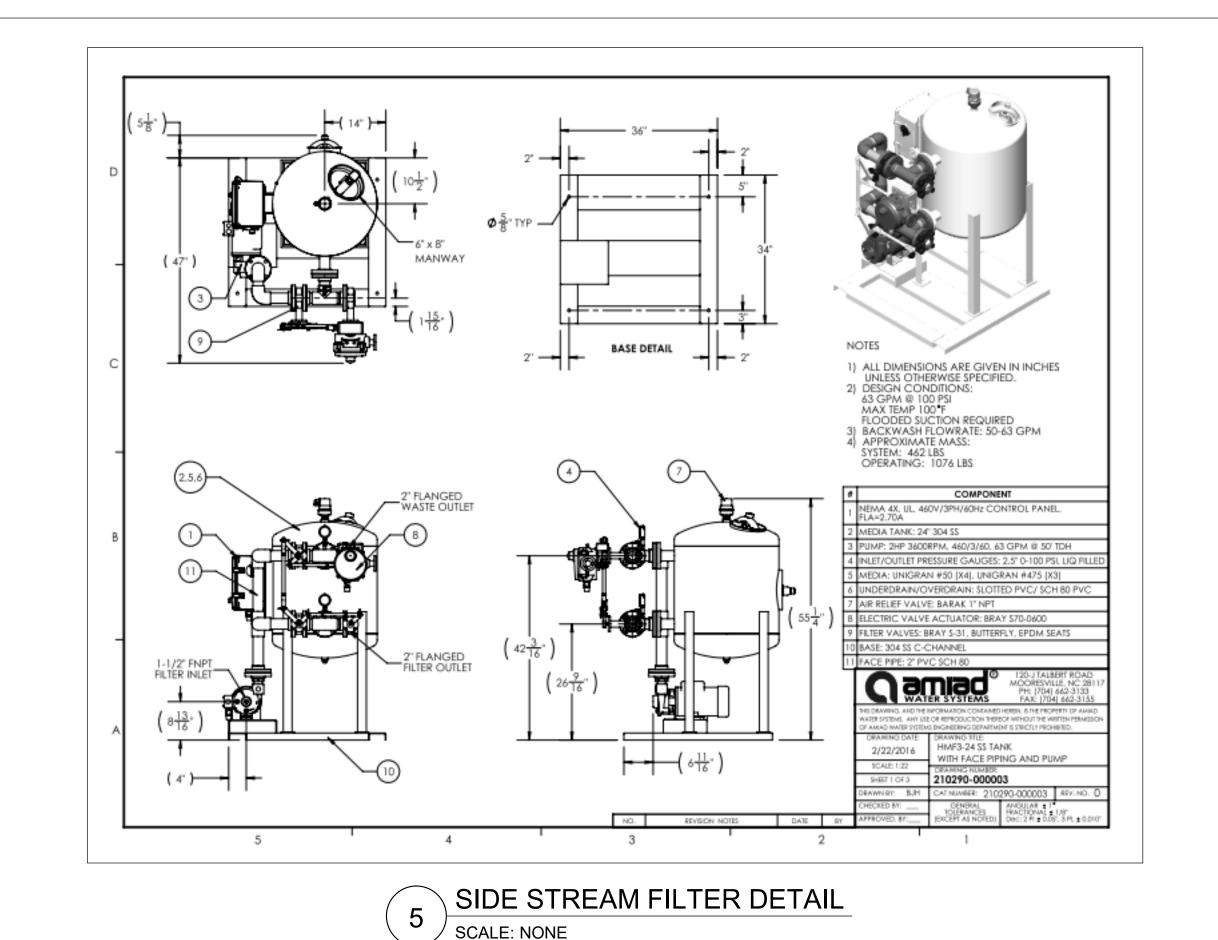

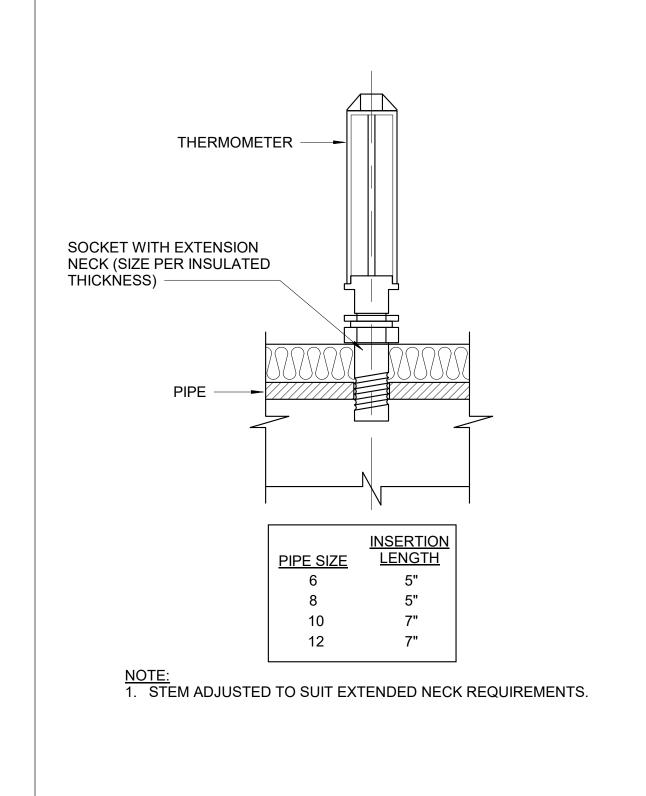

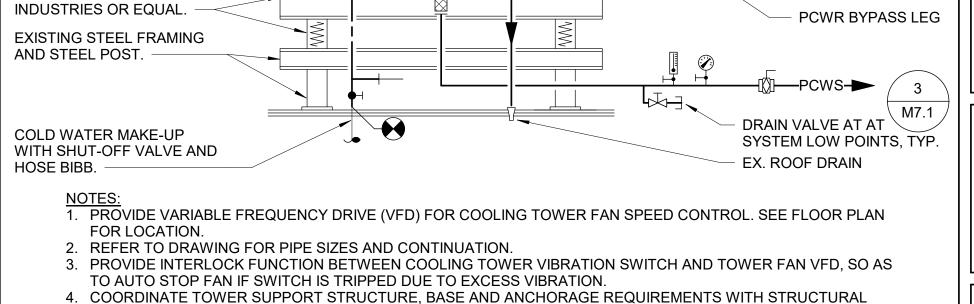


THERMOMETER INSTALLATION DETAIL SCALE: NONE

COOLING TOWER PIPING DETAIL SCALE: NONE

SYMBOL	ABBREVIATION	DESCRIPTION	SYMBOL	ABBREVIATION	DESCRIPTION	T
	-	CONDUIT AND WIRING		А	AMPERE(S)	
	-	CONDUIT & WIRING TO BE REMOVED UON		AC	AIR CONDITIONER	_
—UG	-	BURIED CONDUIT		ACC	AIR CONDITIONER CONDENSER	_
—ОН——	-	OVERHEAD CONDUCTORS		AFF	ABOVE FINISHED FLOOR	
	-	HOMERUN TO PANEL, ARROWS INDICATE # 1P		AF	AMPERAGE OF FUSE	
	-	MULTI-POLE HOMERUN		AGL	ABOVE GRADE LEVEL	<u>N</u>
	-	ELECTRICAL EQUIPMENT AS INDICATED		AHU	AIR HANDLING UNIT	1.
	-	ELECTRICAL EQUIPMENT TO BE REMOVED UON		AL	ALUMINIUM	2
M	-	ELECTRIC METER		ARC	ARC FAULT INTERRUPTER	
J	-	JUNCTION BOX		AS	AMPERAGE OF SWITCH	
	-	FUSED DISCONNECT SWITCH		AWG	AMERICAN WIRE GAUGE	
	-	UNFUSED DISCONNECT SWITCH		BCW	BARE COPPER WIRE	
	-	COMBINATION MOTOR STARTER/FUSED DISC.		BLDG	BUILDING	1
\boxtimes	-	MOTOR STARTER		BMS	BUILDING MANAGEMENT SYSTEM	
<i>/</i> /	-	MOTOR		С	CONDUIT	2
4	-	BATTERY PACK EMERGENCY LIGHT FIXTURE		СР	CONTROL PANEL	3
<u> </u>	-	EXIT LIGHT, FACES-SHADED, CHEVRON-ARROW		СКТ	CIRCUIT	
S _x	-	SINGLE POLE SWITCH		CLG	CEILING	
		(x - INDICATES FIXTURE BEING CONTROLLED)		COL	COLUMN	4
S_x^3	-	THREE WAY SWITCH		CU	COPPER	-
۸		(x - INDICATES FIXTURE BEING CONTROLLED)		CUH	CABINET UNIT HEATER	5
S_x^4	-	FOUR WAY SWITCH		DEM.	DEMOLISH AND REMOVE	
- x		(x - INDICATES FIXTURE BEING CONTROLLED)		DISC	DISCONNECT	
S _x ^{DIM}	-	DIMMER SWITCH		DIM	DIMMER	6
—x		(x - INDICATES FIXTURE BEING CONTROLLED)		DWG	DRAWING	7
S _M	-	MOTOR RATED TOGGLE SWITCH		EMT	ELECTRICAL METALLIC TUBING	, A
S_{K}	-	KEY OPERATED SINGLE POLE SWITCH		EM	EMERGENCY	
S_{V}	-	SPEED CONTROLLER (FB0)		EX.	EXISTING TO REMAIN	
S _V ⊕	-	DUPLEX RECEPTACLE		F	FLOOR	— В
	-	DOUBLE DUPLEX RECEPTACLE		FBO	FURNISHED BY OTHERS	
	_	SPECIAL RECEPTACLE		FC	FAN COIL UNIT	
MD	-	SECURITY MOTION DETECTOR		GEN	GENERATOR	c
KP	-	KEY PAD		GFI	GROUND FAULT INTERRUPTER	
PA	_	PANIC ALARM		HP	HORSEPOWER	
···	СВ	CIRCUIT BREAKER		HVAC	HEATING VENTILATION AIR CONDITIONING	
· ·	-	ENCLOSED CIRCUIT BREAKER		IMC	INTERMEDIATE METAL CONDUIT	
/ 200AS		FUSED SWITCH		KVA	KILO-VOLT-AMPERE	
OR_	GND	GROUND AS PER LOCAL CODE		KW	KILO-WATT	
= ///					MAXIMUM	1.
π	-	GROUND BAR		MAX	-	2.
OR ⊙	-	GROUND ROD		MCB	MAIN CIRCUIT BREAKER	
UW OR T	-	TRANSFER SWITCH		MIN	MINIMUM	3.
пп 🔲	XFMR	TRANSFORMER		MLO	MAIN LUG ONLY	
	СТ	CURRENT TRANSFORMER		NIC	NOT IN CONTRACT	4.
	-	UTILITY POLE		NL NTC	NIGHT LIGHT	
1 WM	WM	WATER MAIN		NTS	NOT TO SCALE	5.
B	- NC	BOILER BREAK GLASS STATION		OH	OVERHEAD	
		NORMALLY CLOSED CONTACTS		P	POLE	6.
	NO	NORMALLY OPEN CONTACTS		PBO	PROVIDED BY OTHERS	7.
M	CV	CONTROL VALVE		PNL	PANEL PANEL	
M	MD SD OP CESD	MOTORIZED DAMPER		PVC	POLY VINYL CHLORIDE	
	SD OR CFSD	SMOKE DAMPER		REL.	REMOVE AND RELOCATE	
UH UH	UH	UNIT HEATER		REM.	REMOVE AND REINSTALL.	8.
CL	CL	CLOCK		RTU	ROOF TOP UNIT	
•	A	AIR TERMINAL		SCH	SCHEDULE	9.
				SPD	SURGE PROTECTION DEVICE	
				SW	SWITCH(ES)	
				TELCO	TELEPHONE COMPANY	10
				TYP	TYPICAL	
				UG	UNDERGROUND	
				UON	UNLESS OTHERWISE NOTED	
				UV	UNIT VENTILATOR	
				VIF	VERIFY IN FIELD	1
				V	VOLT(S)	
				VSD	VARIABLE SPEED DRIVE	12
				WG	WIRE GUARD	1;
				WH	WATER HEATER	
				WP	WEATHERPROOF	
			NOTES:	ARREVIATIONS MAY	/ NOT BE APPLICABLE FOR THIS PROJECT.	
					LIGHT FIXTURE SYMBOLS.	11
						16
						17

AL BRANCH CIRCUIT WIRING LEGEND

- 2-#12 & 1-#12 GND (1-1P-20A OR 1-1P-15A CB)
- 3-#12 & 1-#12 GND (3P-20A OR 3P-15A CB) 2-#12 & 1-#12 GND (2P-20A OR 2P-15A CB)
- LIGHT FIXTURE TYPE SWITCH CONTROL

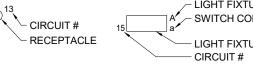

20V AND 277V CIRCUIT SHALL HAVE A DEDICATED NEUTRAL CONDUCTOR. D NEUTRAL HOMERUNS ARE NOT PERMITTED

ICTORS SHALL BE INCREASED FOR VOLTAGE DROP AND DERATING AS PER ABLE ELECTRICAL CODE. FOR CIRCUITS THAT ARE BETWEEN 100' AND 150' IN H, PHASE AND NEUTRAL CONDUCTORS SHALL BE #10 AWG. FOR CIRCUITS THAT TWEEN 150' AND 225' IN LENGTH, PHASE AND NEUTRAL CONDUCTORS SHALL BE 6. FOR LENGTHS GREATER THAN 225' IN LENGTH, VERIFY CONDUCTOR SIZES

NITION OF TERMS

- EVER IN THE CONTRACT DOCUMENTS THE WORD "CLIENT" IS USED, IT MUST DERSTOOD THAT "ROCKLAND COUNTY" IS INTENDED.
- EVER IN THE CONTRACT DOCUMENTS THE WORD "ENGINEER" IS USED, IT BE UNDERSTOOD THAT "OLA CONSULTING ENGINEERS" IS INTENDED.
- " MUST BE DEEMED TO CONSIST OF ALL LABOR AND OPERATIONS, PORTATION, HOISTING, MATERIALS, TOOLS, EQUIPMENT, SERVICES. CTIONS INVESTIGATIONS COORDINATION AND SUPERVISION REQUIRED AND / ASONABLY NECESSARY TO PRODUCE THE CONSTRUCTION REQUIRED BY THE
- SH" MEANS THE DESIGN, FABRICATION, PURCHASE AND DELIVERY TO THE
- LL OR INSTALLATION" MEANS THE ACT OF PHYSICALLY PLACING, APPLYING, IG, ERECTING, ANCHORING, SECURING, ETC., CONSTRUCTION MATERIALS, MENT, FURNISHINGS, APPLIANCES, AND SIMILAR ITEMS SPECIFIED AND SHED AT THE JOB SITE. INSTALLATION OF SPECIFIED ITEMS MUST BE ETE IN ALL RESPECTS.
- IDE" MEANS TO FURNISH AND INSTALL CONSTRUCTION MATERIAL, MENT, ETC, AS DEFINED ABOVE
- DLLOWING ARE DEFINITIONS OF SHOP DRAWING STAMP ACTIONS:
- CEPTIONS TAKEN" MEANS THAT THE SHOP DRAWING IS CORRECT AS TO RMANCE, CAPACITY, ETC. AND SUBSTANTIAL CONFORMANCE TO THE ACT DRAWINGS AND SPECIFICATIONS. FABRICATION AND/OR PURCHASE MAY
- CORRECTIONS NOTED" MEANS THAT THE SHOP DRAWING IS CORRECT AS TO RMANCE, CAPACITY, ETC. AND SUBSTANTIAL CONFORMANCE TO THE ACT DRAWINGS AND/OR SPECIFICATIONS, SUBJECT TO AND IN COMPLIANCE HE ANNOTATIONS AND/OR CORRECTIONS INDICATED ON THE SHOP NG. FABRICATION AND/OR PURCHASE MAY COMMENCE.
- D AND RESUBMIT" MEANS THAT THE COMMENTS AND/OR CORRECTION ARE FENSIVE AND IMPORTANT THAT THE REVIEWER WANTS TO SEE HOW THE ENTS AND/OR CORRECTIONS ARE RESOLVED PRIOR TO RELEASE FOR CATION AND/OR PURCHASE. FABRICATIONS AND/OR PURCHASE MAY NOT
- CTED" MEANS THAT THE SHOP DRAWING DOES NOT COMPLY OR CONFORM TO ONTRACT DRAWINGS AND/OR SPECIFICATIONS. FABRICATION AND/OR IASE MAY NOT COMMENCE.

RAL NOTES

- ORK SHOWN IS NEW UNLESS OTHERWISE NOTED (UON) EXISTING TO REMAIN
- AWINGS ARE TO BE CONSIDERED SCHEMATIC ONLY AND DO NOT NECESSARILY THE EXACT LOCATIONS AND DETAILS OF THE WORK TO BE INSTALLED.
- ACTOR TO FIELD VERIFY ALL EXISTING CONDITIONS PRIOR TO BEGINNING OF AND COORDINATE NEW WORK
- ECTRICAL CONTRACTOR SHALL BE RESPONSIBLE FOR OBTAINING ALL SARY PERMITS AND PAYING ALL FEES ASSOCIATED WITH THIS WORK ING FILING WITH THE UTILITY COMPANY (AS REQUIRED), AND WITH LOCAL RITY HAVING JURISDICTION.
- RICAL CONTRACTOR SHALL BE RESPONSIBLE TO HIRE A THIRD PARTY RICAL INSPECTION AGENCY TO PROVIDE UL INSPECTIONS AND SUBMIT A ICATE OF INSPECTION PRIOR TO FINAL REQUEST FOR PAYMENT.
- NDUCTORS SHALL BE COPPER UON "ON DRAWINGS".
- RONIC FILES OF THE MECHANICAL, ELECTRICAL, PLUMBING AND FIRE CTION DRAWINGS ARE AVAILABLE TO THE CONTRACTOR. THE ENGINEER MAY THE CONTRACTOR A LIMITED LICENSE TO MAKE A DERIVATIVE WORK OF THE ASE FOR THE PURPOSE OF SHOP DRAWINGS, SUBMITTALS AND AS-BUILT NGS. UPON REQUEST, THE ENGINEER SHALL PROVIDE A RELEASE FORM THAT E SIGNED AND RETURNED BY THE CONTRACTOR PRIOR TO RELEASE OF THE
- T NUMBERS ARE FOR INFORMATION PURPOSES ONLY. ACTUAL CIRCUIT RS SHALL BE DETERMINED IN THE FIELD.
- S OTHERWISE NOTED, DISCONNECT SWITCHES, STARTERS, HOAS AND MOTOR TOGGLE SWITCHES FOR MECHANICAL PUMPS, CABINET AND UNIT HEATERS, N FANS, ROOF FANS, VAV BOXES, COMPRESSORS, FAN COIL UNITS, AIR ERS AND CONDENSERS SHALL BEE FURNISHED BY THE MECHANICAL ACTOR AND INSTALLED BY THE ELECTRICAL CONTRACTOR. COORDINATE ALL WITH THE MECHANICAL CONTRACTOR.
- DRILLING OR TRENCHING THROUGH AN EXISTING FLOOR SLAB, WHEN RED. SHALL BE COORDINATED WITH THE OWNER. FLOOR SLABS SHALL BE SCANNED PRIOR TO CORE DRILLING OR TRENCHING. ALL WORK. INCLUDING PRILLING, RADAR SCAN, INSTALLATION OF FIRE STOPPING, & CONDUIT/CABLE LATION SHALL BE PERFORMED DURING NON-BUSINESS HOURS AND INCLUDED BID. USE EXTREME CAUTION DURING ANY CUTTING OPERATION TO AVOID E TO EXISTING EQUIPMENT/SYSTEMS. ANY ITEMS DAMAGED AS A RESULT OF DRILLING SHALL BE REPAIRED AT NO COST TO THE CLIENT. ALL CORES SHALL
- GFI RECEPTACLES ARE CIRCUITED WITH GENERAL CONVENIENCE TACLES, THE GFI RECEPTACLE SHALL BE THE LAST DEVICE ON THE CIRCUIT.
- L CONDUIT EXPANSION FITTINGS AT ALL LOCATIONS WHERE CONDUITS CROSS IG OR STRUCTURE EXPANSION JOINTS.
- ECTRICAL CONTRACTOR SHALL PROVIDE ALL CUTTING, PATCHING, PAINTING, NAL RESTORATION REQUIRED TO FACILITATE THE DEMOLITION AND LATION OF ALL ELECTRICAL EQUIPMENT. INCLUDING BUT NOT LIMITED TO BOARDS, CONDUITS, WIRING, DEVICES, FIXTURES, ETC. INCLUDING ABOVE SS. CONTRACTOR TO REMOVE AND REPLACE CEILINGS, AND OPEN AND PATCH AS REQUIRED TO EXECUTE THE ELECTRICAL WORK.
- NDUITS SHALL BE RECESSED IN NEW WALLS. SURFACE MOUNTED CONDUITS NLY BE ACCEPTED IN EXISTING AREAS WHERE ABSOLUTELY NECESSARY.
- ECTRICAL CONTRACTOR SHALL BE RESPONSIBLE FOR PROTECTING EXISTING GS IN AREAS OF WORK WHERE THE CEILINGS ARE DUE TO REMAIN. THE RICAL CONTRACTOR SHALL BE RESPONSIBLE FOR REPAIRING ANY DAMAGE TO IG TO REMAIN CEILINGS OR CEILING TILES CAUSE BY THE ELECTRICAL SCOPE
- OUPLEX AND QUAD RECEPTACLE SHALL BE LABELED WITH THE CIRCUIT NUMBER IT SERVES, ALPHANUMERICS TO BE 1/8" HIGH AND BLACK ON CLEAR ROUND. LABELS SHALL BE SELF ADHESIVE. IDENTIFY ASSOCIATED PANEL AND
- NDUCTORS INSTALLED BETWEEN VFDS AND ASSOCIATED MOTORS SHALL BE , 1000V IN RGS, IMC, EMT FMC OR LFMC.

DEMOLITION NOTES

. ALL EQUIPMENT SHALL BE DISCONNECTED AND REMOVED BACK TO POWER SOURCE ORIGINATION UNLESS OTHERWISE NOTED (UON) EXISTING TO REMAIN (EX.)

INDICATED SHALL BE FIELD VERIFIED PRIOR TO BID.

- CONTRACTOR SHALL VERIFY EXTENT OF DEMOLITION WORK IN THE FIELD PRIOR TO BID AND SHALL INCLUDE ALL LABOR AND MATERIALS IN BASE BID INCLUDING ALL TEMPORARY CONNECTIONS, CONDUIT AND WIRE IN ORDER TO ACCOMMODATE CONSTRUCTION AND PROVIDE CONTINUOUS SERVICE TO DEVICES AND SYSTEMS TO REMAIN, TEMPORARY AND PERMANENTLY. WORK REQUIRING THE SHUT-DOWN OF THE BUILDING POWER SHALL BE PERFORMED DURING OVERTIME AND SHALL BE INCLUDED
- CIRCUIT BREAKER, DISCONNECT SWITCHS, FUSES, CONDUIT AND CONDUCTOR SIZES
- ALL EXISTING ELECTRICAL EQUIPMENT NO LONGER IN USE. SUCH AS DISCONNECT SWITCHES, MOTOR CONTROLLERS, MOTOR STARTER PANELS, ETC. SHALL BE
- ALL DISCONNECTED & REMOVED EXISTING ELECTRICAL ITEMS THAT ARE NOT BEING REUSED SHALL BE RETURNED TO THE OWNER OR DISPOSED OF AS DIRECTED.
- THE CONTRACTOR SHALL INCLUDE IN THE BASE BID FOR ALL MATERIAL & LABOR REQUIRED FOR THE EXTENSIONS. REROUTING & RELOCATION OF EXISTING SYSTEM COMPONENTS, EQUIPMENT, WIRING, CONDUITS & CABLING SO AS TO MAINTAIN OPERATION OF ALL SYSTEMS THROUGHOUT THE BUILDING DURING DEMOLITION & CONSTRUCTION PHASES.

LIGHTNING PROTECTION SYSTEM NOTES:

1.) THE FOLLOWING IS A PERFORMANCE SPECIFICATION OF THE LIGHTNING PROTECTION SYSTEM. CONTRACTOR SHALL BE RESPONSIBLE TO HIRE AN ORGANIZATION THAT IS UL APPROVED (MASTER LABEL) TO MODIFY SUCH SYSTEMS. DESIGN SHALL BE FORWARDED TO THE ENGINEER AS A SHOP DRAWING FOR APPROVAL PRIOR TO CONSTRUCTION.

2.) A SYSTEM OF LIGHTNING PROTECTION SHALL BE PROVIDED AND INSTALLED IN COMPLIANCE WITH THE PROVISIONS OF THE LATEST "CODE OF PROTECTION AGAINST LIGHTNING" FOR BUILDINGS AS ADOPTED BY THE NATIONAL FIRE PROTECTION ASSOCIATION AND THE UNDERWRITERS' LABORATORIES, INC. FOR A MASTER LABEL

IF ANY DEPARTURES FROM THE CONTRACTOR DOCUMENTS ARE DEFMED NECESSARY BY THE CONTRACTOR, DETAILS OF SUCH DEPARTURES AND THE REASONS THEREFORE SHALL BE SUBMITTED AS SOON AS PRACTICABLE TO THE ENGINEER FOR APPROVAL. NO SUCH DEPARTURES SHALL BE MADE WITHOUT THE PRIOR WRITTEN APPROVAL OF THE OWNER AND THE ARCHITECT. ALSO, THE LIGHTNING PROTECTION SYSTEM SHALL BE INSTALLED BY A LIGHTNING PROTECTION CONTRACTOR WHO SPECIALIZES IN THIS FIELD.

THE LIGHTNING PROTECTION EQUIPMENT SPECIFICATION SHALL BE BASED ON EQUIPMENT MANUFACTURED BY HEARY BROS. LIGHTNING PROTECTION CO., INC. OF MOORE ROAD, SPRINVILLE, NEW YORK, 14141, OR EQUAL TO. ALL MATERIALS SHALL COMPLY IN WEIGHT, SIZE, AND COMPOSITION WITH THE REQUIREMENTS OF THE UNDERWRITERS' LABORATORIES, INC. AND THE NATIONAL FIRE PROTECTION ASSOCIATION CODE RELATING TO THIS TYPE OF STRUCTURE.

AIR TERMINALS SHALL BE 1/2" X 10" SOLID ALUMINUM AND SHALL EXTEND AT LEAST 18" ABOVE THE OBJECT TO BE PROTECTED. ALL AIR TERMINAL BASES SHALL BE CAST ALUMINUM WITH STAINLESS STEEL BOLT-PRESSURE CABLE CONNECTORS. THE AIR TERMINALS SHOULD BE SPACED SO AS NOT TO EXCEED 20 FEET APART AROUND THE OUTSIDE PERMITER OF THE ROOF OR THE RIDGE AND NOT OVER 50 FEET APART THROUGH THE CENTER OF FLAT ROOF AREAS. THE AIR TERMINALS IN THE CENTER ROOF AREA SHALL BE 1/2" X 24" SOLID ALUMINUM WITH A PROPER BRACE. ALL AIR TERMINAL BASES FOR FLAT ROOF AREAS SHALL BE OF THE ADHESIVE TYPE.

4) AIR TERMINALS

CONDUCTORS SHALL CONSIST OF U.L. LISTED 28 STRANDS OF 14 GAUGE ALUMINUM WIRE WEIGHING 114 LBS. PER 1000 FEET AND INSTALLED IN ACCORDANCE WITH THE U.L. CODE. A PERIMETER CABLE SHALL BE INSTALLED AROUND THE ENTIRE MAIN ROOF AND ALL HEAT REJECTION EQUIPMENT, EACH PERIMTER CABLE SHALL BE CONNECTED TO DOWN LEADS. PROVIDING A TWO-WAY PATH FROM GROUND TO FACH AIR TERMINAL ALL CENTER ROOF AIR TERMINALS SHALL BE INTERCONNECTED WITH CONDUCTORS TO THE OUTSIDE PERIMETER CABLE CONDUCTORS ON THE FLAT ROOF AREAS MAY BE RUN EXPOSED. GROUND CONNECTION SHALL BE MADE AROUND THE PERIMETER OF EACH ROOF AND TO THE MAIN DOWN CONDUCTOR AT THE MAXIMUM OF 100'-0" ON CENTERS.

ALL CONCEALED CONDUCTORS SHALL BE INSTALLED IN SCHEDULE 40, 1" PVC CONDUIT. CONDUIT TO BE FURNISHED AND INSTALLED BY THE ELECTRICAL CONTRACTOR. ALL DOWN CONDUCTORS SHALL RUN INSIDE WALLS OF THE BUILDING THROUGH THE 1" PVC CONDUIT.

CONDUCTOR FASTENERS SHALL BE AN APPROVED TYPE NON-CORROSIVE METAL, HAVE AMPLE STRENGTH TO SUPPORT CONDUCTORS, AND SHALL BE SPACED NOT TO EXCEED 3'-0" CENTERS, MASONRY TYPE CABLE FASTENERS SPACED EVERY 3'-0" ON MASONRY.

8) ROOF PENETRATION WHEREVER THE CONDUITS PENETRATES THE ROOF, COPPER PITCH PANS SHALL BE FURNISHED BY THE LIGHTNING PROTECTION CONTRACTOR AND INSTALLED BY THE ROOFING CONTRACTOR. WOOD NAILING BLOCKS SHALL BE FURNISHED AND INSTALLED BY THE ROOFING CONTRACTOR. ALL PATCHING AND MASONRY WORK SHALL BE FURNISHED AND INSTALLED BY THE ROOFING CONTRACTOR.

9.) DOWN CONDUCTORS BUILDINGS THAT ARE OF REINFORCED CONCRETE OR WALL BEARING STRUCTURES, THE CONCEALED DOWN CONDUCTORS SHALL BE INSTALLED IN SCHEDULE 40, 1" P.V.C. CONDUIT. EACH PERIMETER ROOF CABLE SHALL BE CONNECTED AT LEAST TWO (2) DOWN LEADS. THE AVERAGE DISTANCE BETWEEN DOWN LEADS SHALL NOT EXCEED 100 FEET IRREGULARLY SHAPED STRUCTURES MAY REQUIRE EXTRA DOWN CONDUCTORS TO PROVIDE A TWO-WAY PATH TO GROUND FROM EACH AIR TERMINAL.

10.) CABLE CONNECTORS ALL CABLE CONNECTORS SHALL BE CAST ALUMINUM WITH SCREW-PRESSURE TYPE STAINLESS STEEL BOLTS AND NUTS.

11) INTERCONNNECTION OF METALS ALL METAL BODIES WITHIN 6 FEET OF THE CONDUCTOR SHALL BE BONDED TO THE SYSTEM WITH APPROVED FITTINGS AND CONDUCTOR. CONNECTIONS BETWEEN DISSIMILAR METALS SHALL BE MADE WITH APPROVED BIMETALLIC CONNECTIONS.

12A.) BONDING OF ALL METALLIC OBJECTS AND SYSTEMS AT ROOF LEVELS AND ELSEWHERE ON THE STRUCTURE SHALL BE COMPLETE. PRIMARY BONDS FOR METAL BODIES OF CONDUCTANCE SHALL BE BONDED WITH APPROPRIATE FITTINGS AND FULL-SIZE CONDUCTOR; AND SHALL CONSIST OF, BUT NOT BE LIMITED TO, THE FOLLOWING: ROOF EXHAUST FANS, HVAC UNITS WITH RELATED PIPING DUCTWORK, EXHAUST VENTS AND ANY OTHER ROOF PIPING SYSTEMS, COOLING TOWERS, AND RAIL SYSTEMS, WINDOW WASHING TRACKS, ANTENNA MAST FOR T.V., RADIO OR MICROWAVE FLAG POLES, ROOF HANDRAILS AND/OR DECORATIVE SCREENS, ROOF LADDERS. SKYLIGHTS METAL PLUMBING STACKS, ETC. EXTERIOR ARCHITECTURAL METAL FASCIA AND/OR CURTAIN WALLS OR MULLIONS WHICH EXTEND THE FULL HEIGHT OF THE STRUCTURE SHALL ALSO BE BONDED, IF NOT INHERENTLY BONDED THRU THE BUILDING

12B.) METAL BODIES OF INDUCTANCE LOCATED WITHING 6 FEET OF A CONDUCTOR OR OBJECT WITH SECONDARY BONDS SHALL BE BONDED WITH SECONDARY CABLE AND FITTINGS. TYPICAL OF THESE ARE: ROOF FLASHINGS, PARAPET COPING CAPS, GRAVEL GUARDS, ISOLATED METAL BUILDING PANELS OR SIDING, ROOF DRAINS, DOWN SPOUTS, ROOF ISULATION VENTS, AND ANY OTHER SIZEABLE MISCELLANEOUS METALS, ETC.

GROUNDING TERMINATIONS SHALL BE MADE TO THE #4/0 AWG COPPER GROUND RING LOCATED AT THE BASE OF THE STRUCTURE. GROUND CONNECTIONS SHALL BE MADE AROUND THE PERIMETER OF THE STRUCTURE. AND IN NO CASE SHALL AVERAGE OVER 100'-0" APART GROUND TERMINALS SHALL BE 3/4" IN DIAMETER AND SHALL BE DRIVEN TO A MINIMUM DEPTH OF 10 FEFT AND MORE IF NECESSARY TO REACH PERMANENT MOISTURE. ONE GROUND SHALL HAVE CONNECTION TO THE WATER SYSTEM WHERE THE WATER SUPPLY ENTERS THE BUILDING - IN ADDITION TO ARTIFICIAL GROUND. IN CASE OF ROCK LEDGE OR OTHER CONDITIONS MAKING IT IMPOSSIBLE TO COMPLY WITH THE ABOVE, TRENCHING OR A COPPER GROUND PLATE WILL PERMITTED; PROVIDING IT WILL MEET THE UNDERWRITERS' LABORATORIES, INC. REQUIREMENTS.

4.) COMMON GROUNDING COMMON GROUNDS BETWEEN THE LIGHTNING PROTECTION SYSTEM AND THE ELECTRIC SERVICE ENTRANCE WIRES BE MADE BY THE ELECTRICAL CONTRACTOR, AS SHOWN IN THE DRAWINGS AND PER THE SPECIFICATIONS.

15.) UNDERWRITER'S LABORATORIES, INC MASTER LABEL SHALL BE FURNISHED AS EVIDENCE THAT THE INSTALLTION HAS MET WITH U.L. 96A CODE REQUIREMENTS. SHOP DRAWINGS IN DETAIL AND CATALOG CUTS SHALL BE SUBMITTED FOR APPROVAL BY THE ARCHITECT AND ENGINEER PRIOR TO INSTALLATION OF THE SYSTEM.

16.) THE LIGHTNING PROTECTION CONTRACTOR SHALL FURNISH OWNER AND ENGINEER WITH SYSTEM SHOP DRAWINGS FOR REVIEW. INCLUDE LAYOUT AND ALL COMPONENETS.

17.) THE ELECTRICAL CONTRACTOR SHALL INSTALL THE LIGHTNING PROTECTION SYSTEM PER THE LIGHTNING PROTECTION CONTRACTOR'S SHOP DRAWINGS, (APPROVED SET).



ENGINEERS

OLA Consulting Engineers 50 Broadway,

Hawthorne, NY 10532 914.747.2800 8 West 38th Street, Suite 900

646.849.4110

New York, NY 10017

CLIENT

Rockland County

olace.com

Facilities Management Robert H. Gruffi, P.E., LEED AP

Rockland County Courthouse 1 South Main Street **New City, NY 10956**

Director Facilities Management

ISSUED FOR BID 09.09.2024 ISSUE FOR PERMIT 04.05.2024 DATE DESCRIPTION NO.

No use, reproduction or dissemination may be made of this drawing and the concepts set forth without the prior written consent of OLA Consulting Engineers, PC. Copyright © 2015

CAPITAL PROJECT 1519 **GOVERNMENT CENTER BUILDING IMPROVEMENTS COURTHOSE** COOLING TOWER REPLACEMENT


> 1 SOUTH MAIN STREET NEW CITY, NY 10956

DRAWING TITLE **ELECTRICAL** ABBREVIATIONS, SYMBOLS

PROJECT NO. 1" = 1'-0" NRCK0018 DRAWN BY DRAWING NO. CHECKED BY

2024.04.05

AND NOTES

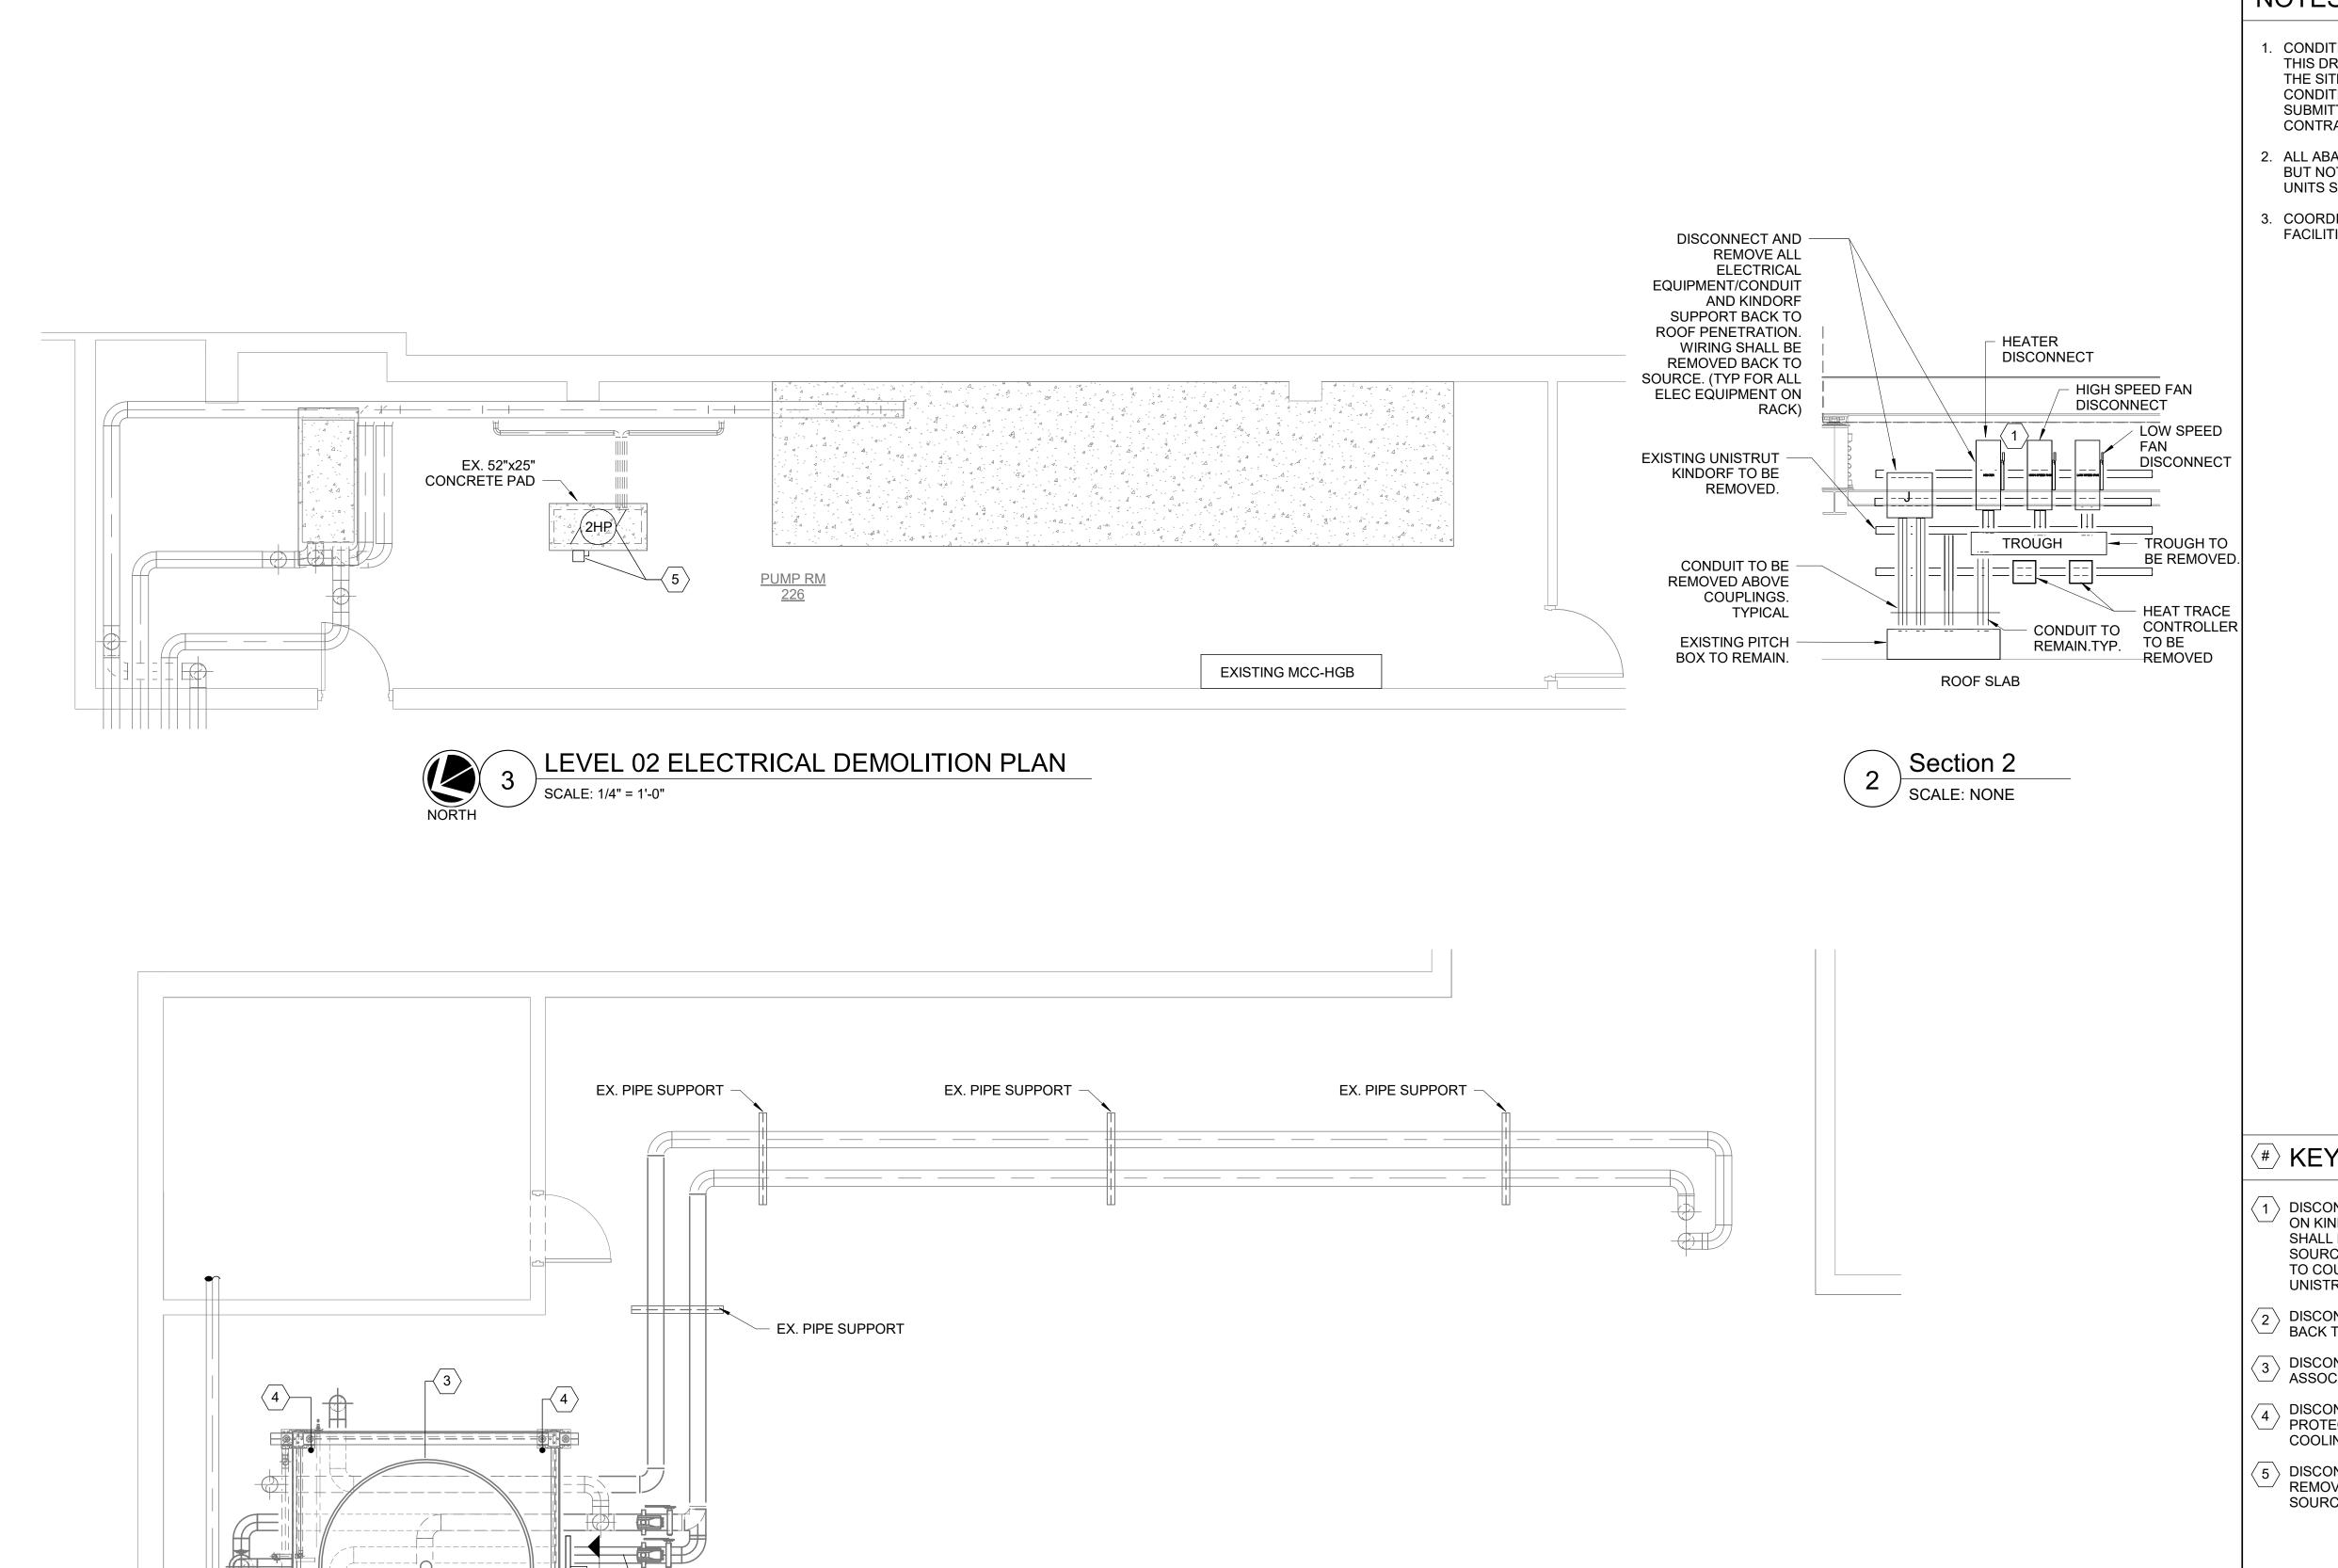

EXISTING ELECTRICAL

FOR COOLING TOWER

DISCONNECT SWITCHES (1)

ROOF ELECTRICAL DEMOLITION PLAN

NOTES

- . CONDITIONS MAY NOT BE EXACTLY AS INDICATED ON THIS DRAWING. ELECTRICAL CONTRACTOR SHALL VISIT THE SITE TO UNDERSTAND THE EXISTING FIELD CONDITIONS AND TO VERIFY SCOPE OF WORK PRIOR TO SUBMITTING BID. NO ALLOWANCE WILL BE MADE AFTER CONTRACT IS APPROVED.
- 2. ALL ABANDONED AND UNUSED EQUIPMENT, INCLUDING, BUT NOT LIMITED TO PIPING, DUCTWORK, AND TERMINAL UNITS SHALL BE REMOVED.
- 3. COORDINATE ALL SHUTDOWNS WITH BUILDING FACILITIES, OWNER, AND TENANTS.



CLIENT

Hawthorne, NY 10532 914.747.2800 8 West 38th Street,

50 Broadway,

Suite 900 New York, NY 10017 646.849.4110


Rockland County

olace.com

Facilities Management

Robert H. Gruffi, P.E., LEED AP **Director Facilities Management**

Rockland County Courthouse 1 South Main Street New City, NY 10956

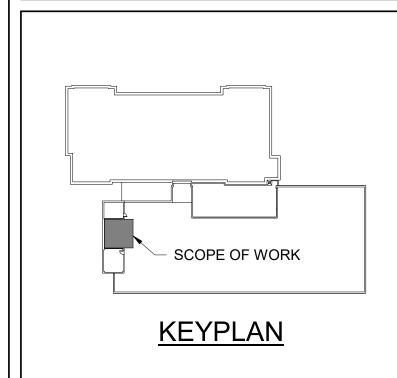

KEYNOTES

- 1 DISCONNECT AND REMOVE ALL DISCONNECT SWITCHES ON KINDORF UNISTRUT RACK. ALL ASSOCIATED WIRING SHALL BE DISCONNECTED AND REMOVED BACK TO SOURCE. EXISTING EXPOSED CONDUIT TO BE REMOVED TO COUPLINGS ABOVE PITCH BOX ON ROOF. KINDORF UNISTRUT TO BE REMOVED.
- DISCONNECT AND REMOVE ALL WIRING AND CONDUIT BACK TO SOURCE ASSOCIATED WITH HEAT TRACE
- DISCONNECT AND REMOVE ALL WIRING AND CONDUIT ASSOCIATED TO COOLING TOWER BACK TO SOURCE.
- DISCONNECT AND REMOVE ALL ASSOCIATED LIGHTNING PROTECTION AND GROUND WIRING ON EXISTING COOLING TOWER TO BE DEMOLISHED.
- \langle 5 \rangle DISCONNECT WATER FILTER SYSTEM PUMP WSF-1. REMOVE LOCAL DISCONNECT AND WIRING BACK TO SOURCE. CONDUIT TO REMAIN.

2	ISSUED FOR BID	09.09.2024
1	ISSUE FOR PERMIT	04.05.2024
NO.	DESCRIPTION	DATE
Nouse re	eproduction or dissemination may be made of	this
110 430,	production of dissorting the many so mand of	uns


drawing and the concepts set forth without the prior written consent of OLA Consulting Engineers, PC. Copyright © 2015

CAPITAL PROJECT 1519 GOVERNMENT CENTER BUILDING IMPROVEMENTS COURTHOSE COOLING TOWER REPLACEMENT

> 1 SOUTH MAIN STREET NEW CITY, NY 10956


ELECTRICAL DEMOLITION PLANS

SEAL	SCALE As indicated	PROJECT NO. NRCK0018
	DRAWN BY GD	DRAWING NO.
	CHECKED BY JF	E1.1
	DATE 2024.04.05	

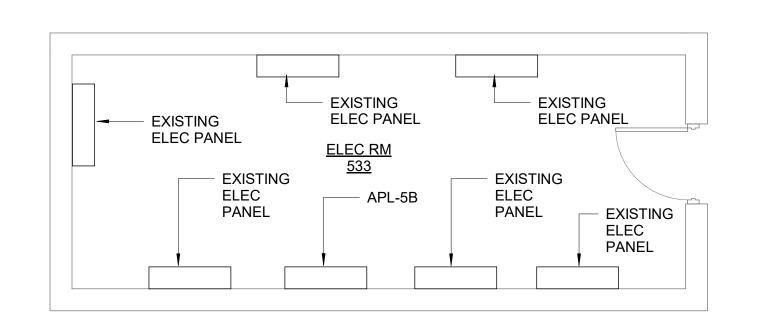



LEVEL 05 ELECTRICAL ROOM 533 DEMOLITION PLAN [/] SCALE: NONE

TO EXISTING

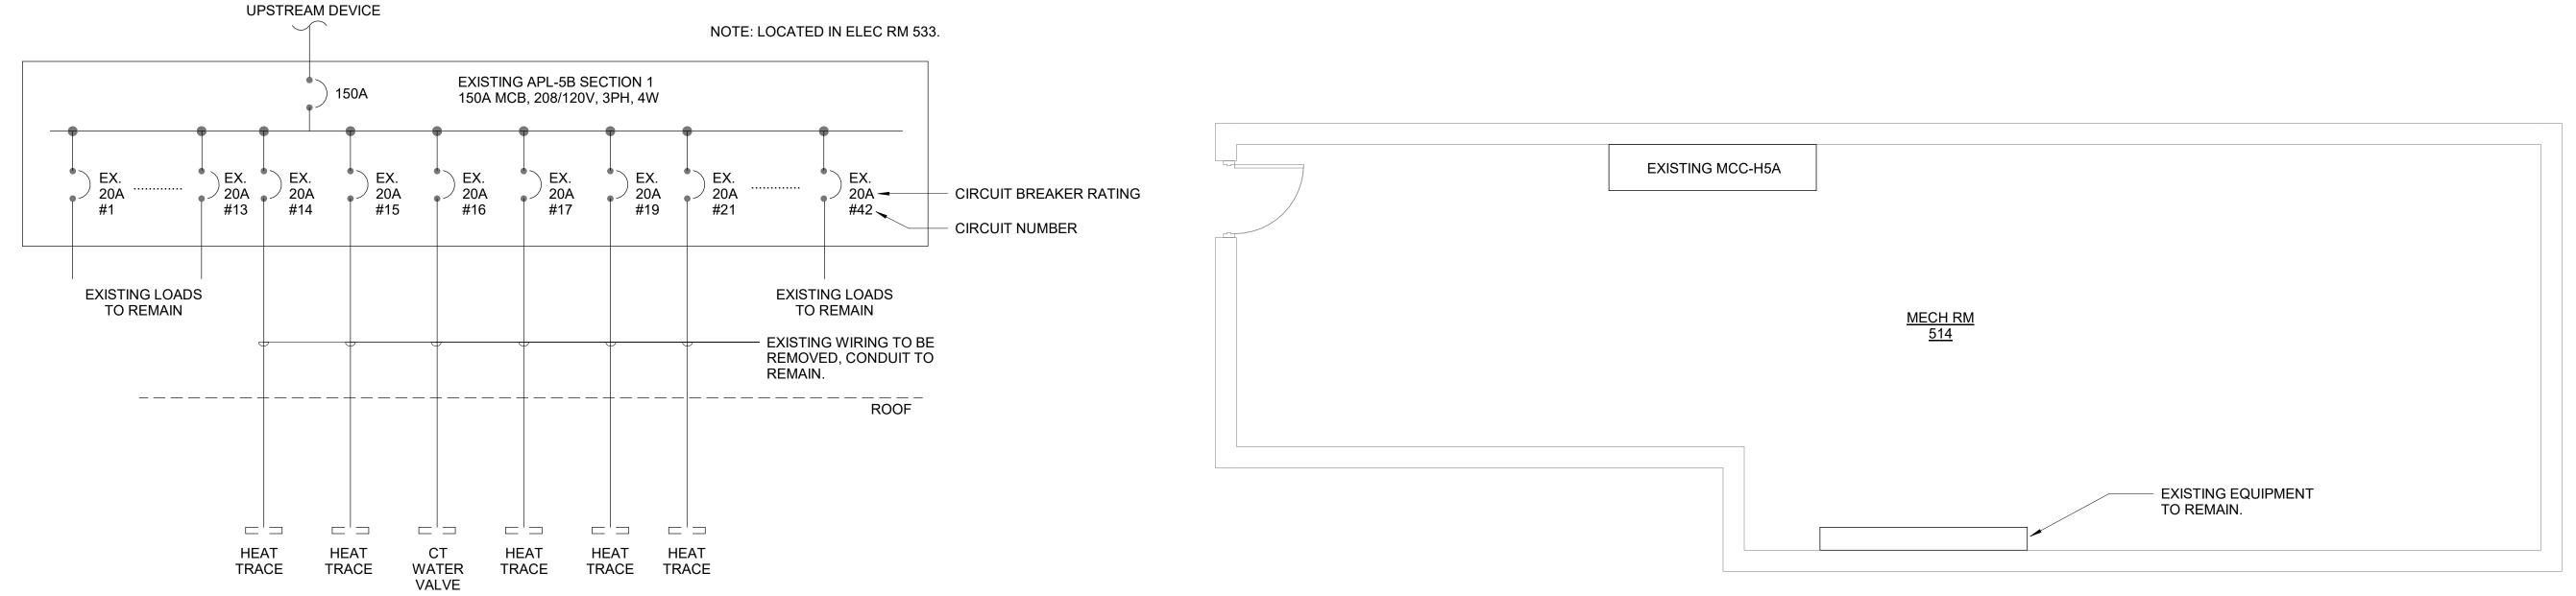

APL-5B SINGLE LINE DEMOLITION

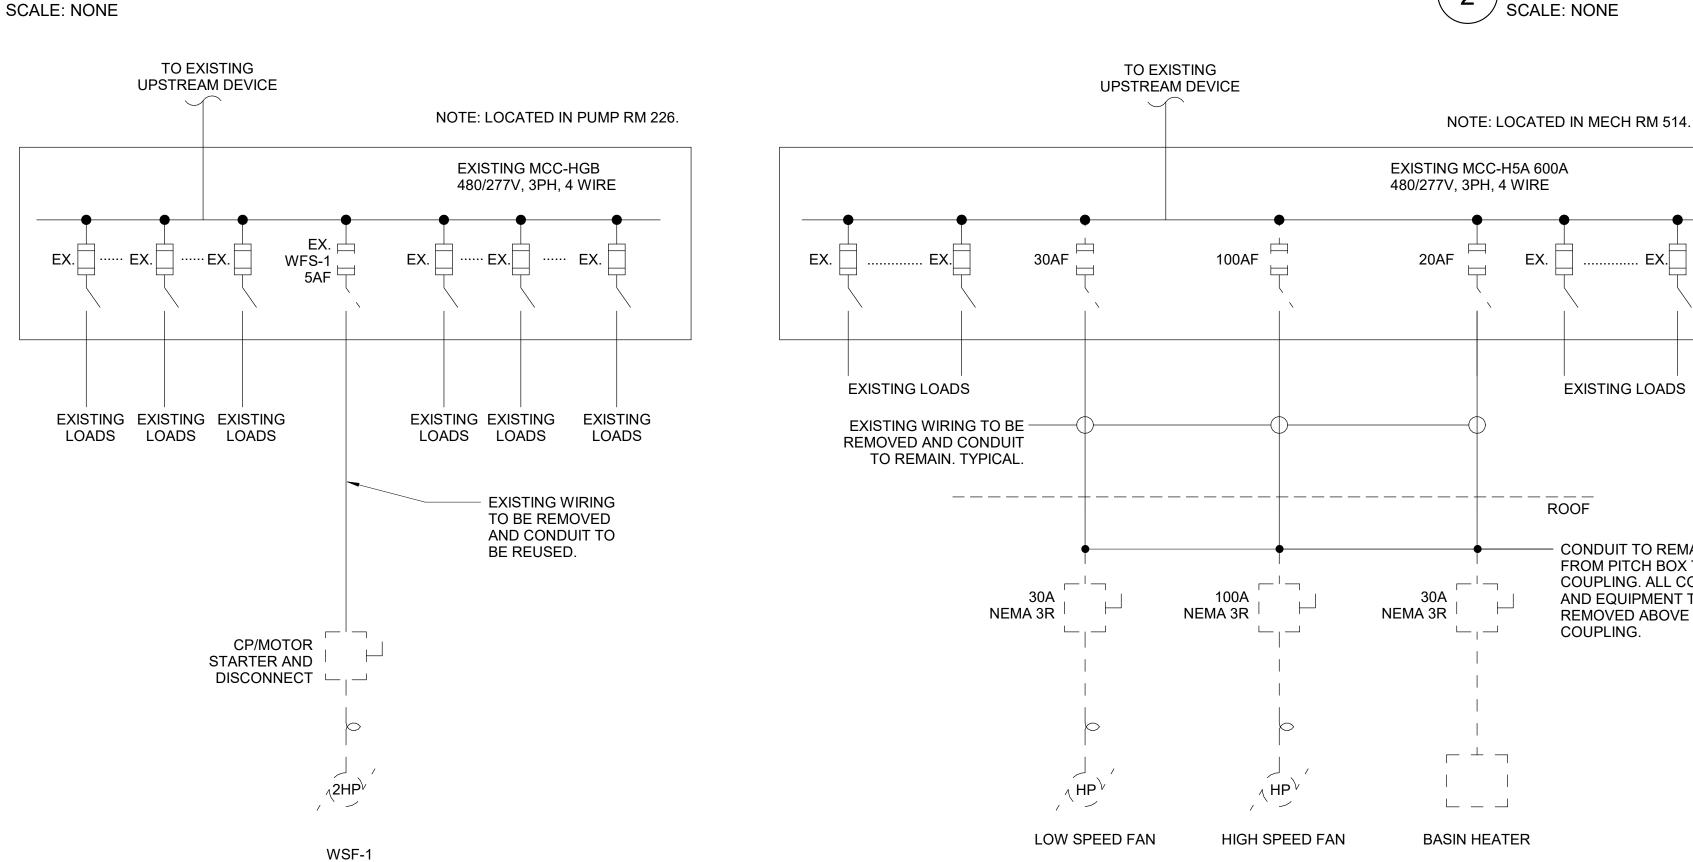

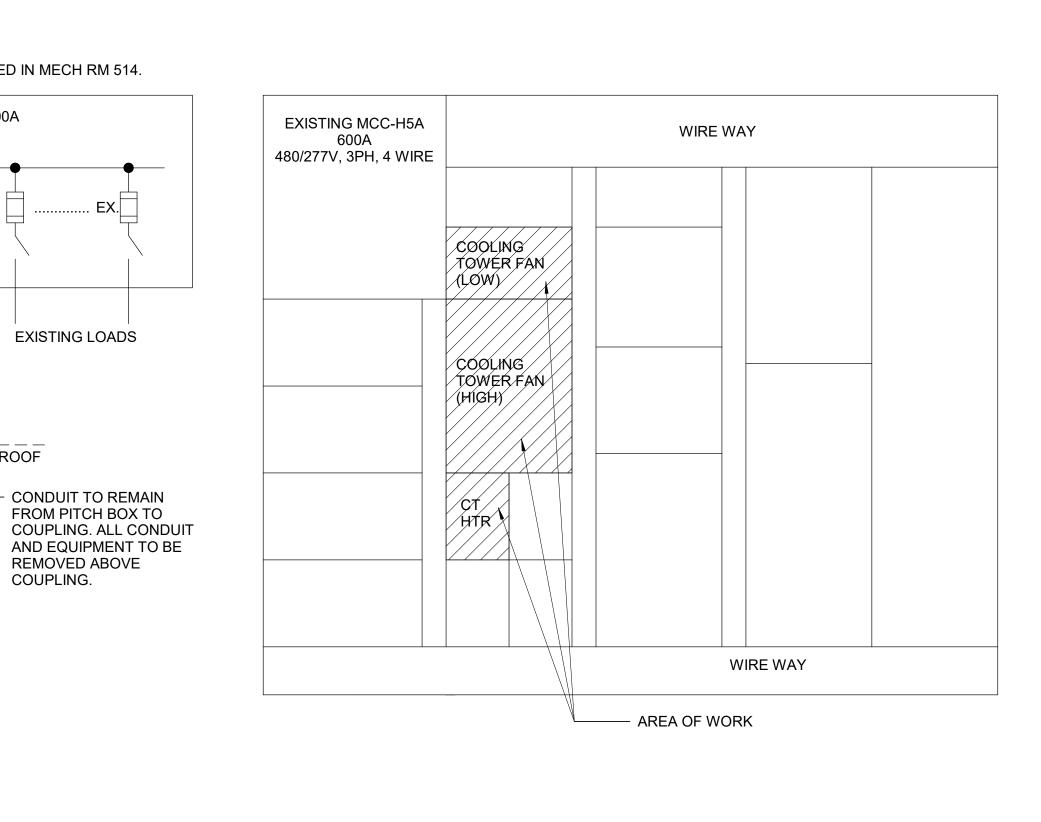

MCC-HGB SINGLE LINE DEMOLITION SCALE: NONE

MCC-5HA SINGLE LINE AND ELEVATION DEMOLITION SCALE: NONE

LEVEL 05 ELECTRICAL DEMOLITION PLAN

SCALE: NONE

EXISTING LOADS

CONDUIT TO REMAIN

FROM PITCH BOX TO

REMOVED ABOVE

COUPLING.

ROOF

NOTES

- 1. CONDITIONS MAY NOT BE EXACTLY AS INDICATED ON THIS DRAWING. ELECTRICAL CONTRACTOR SHALL VISIT THE SITE TO UNDERSTAND THE EXISTING FIELD CONDITIONS AND TO VERIFY SCOPE OF WORK PRIOR TO SUBMITTING BID. NO ALLOWANCE WILL BE MADE AFTER CONTRACT IS APPROVED.
- 2. ALL ABANDONED AND UNUSED EQUIPMENT, INCLUDING, BUT NOT LIMITED TO PIPING, DUCTWORK, AND TERMINAL UNITS SHALL BE REMOVED.
- 3. COORDINATE ALL SHUTDOWNS WITH BUILDING FACILITIES, OWNER, AND TENANTS.



ENGINEERS

CLIENT

50 Broadway, Hawthorne, NY 10532 914.747.2800

8 West 38th Street, Suite 900 New York, NY 10017 646.849.4110


olace.com


Rockland County

Facilities Management

Robert H. Gruffi, P.E., LEED AP **Director Facilities Management**

Rockland County Courthouse 1 South Main Street New City, NY 10956

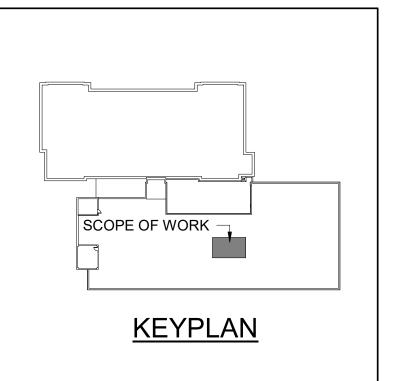

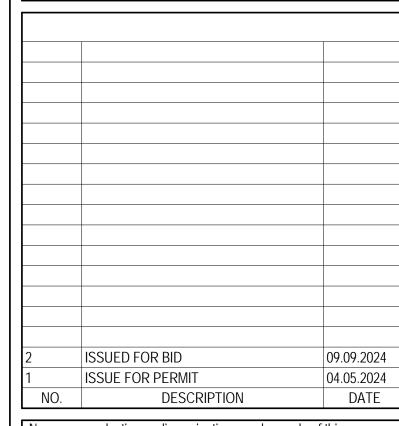


No use, reproduction or dissemination may be made of this drawing and the concepts set forth without the prior written consent of OLA Consulting Engineers, PC. Copyright © 2015

CAPITAL PROJECT 1519 GOVERNMENT CENTER BUILDING IMPROVEMENTS COURTHOSE COOLING TOWER REPLACEMENT


> 1 SOUTH MAIN STREET NEW CITY, NY 10956

ELECTRICAL DEMOLITION SINGLE LINE DIAGRAMS AND PLAN

PROJECT NO. NRCK0018 As indicated DRAWN BY DRAWING NO. CHECKED BY E1.2 2024.04.05

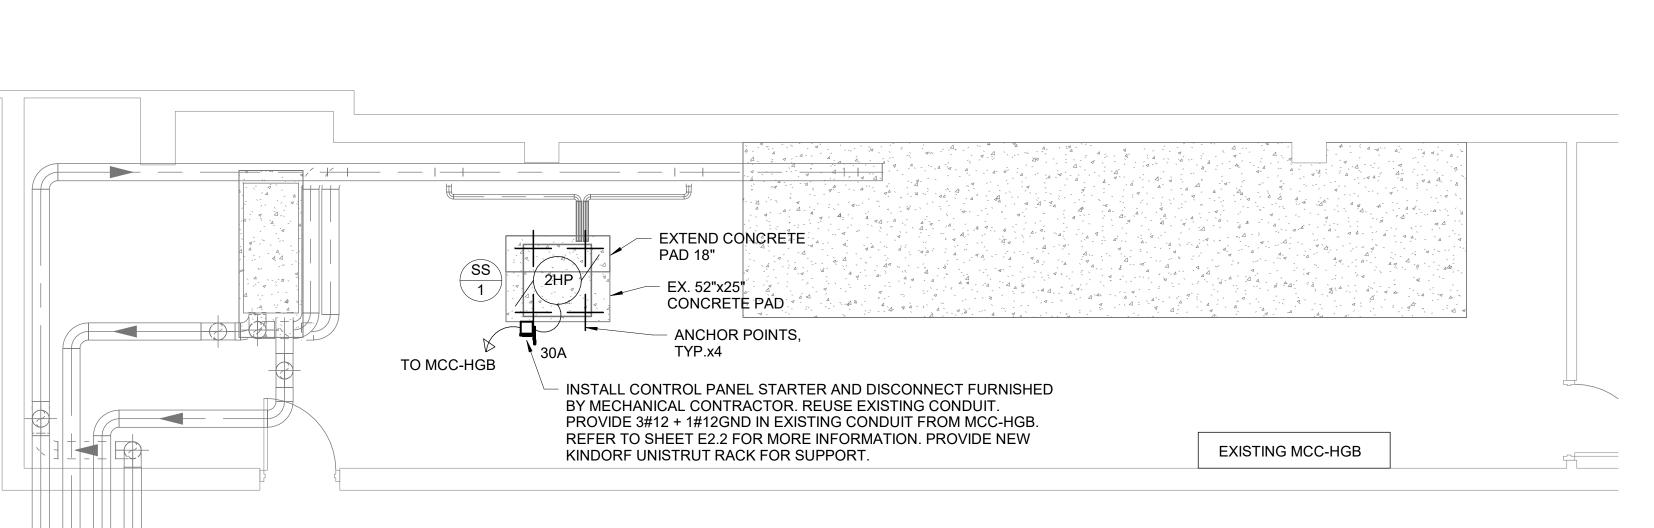


LEVEL 02 ELECTRICAL NEW WORK PLAN

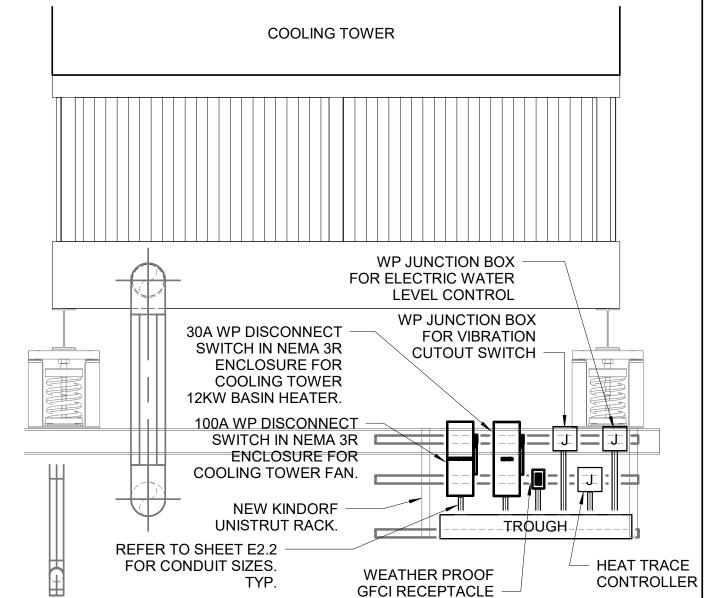

ELECTRICAL NEW WORK SCALE: 1/2" = 1'-0"

ROOF SLAB

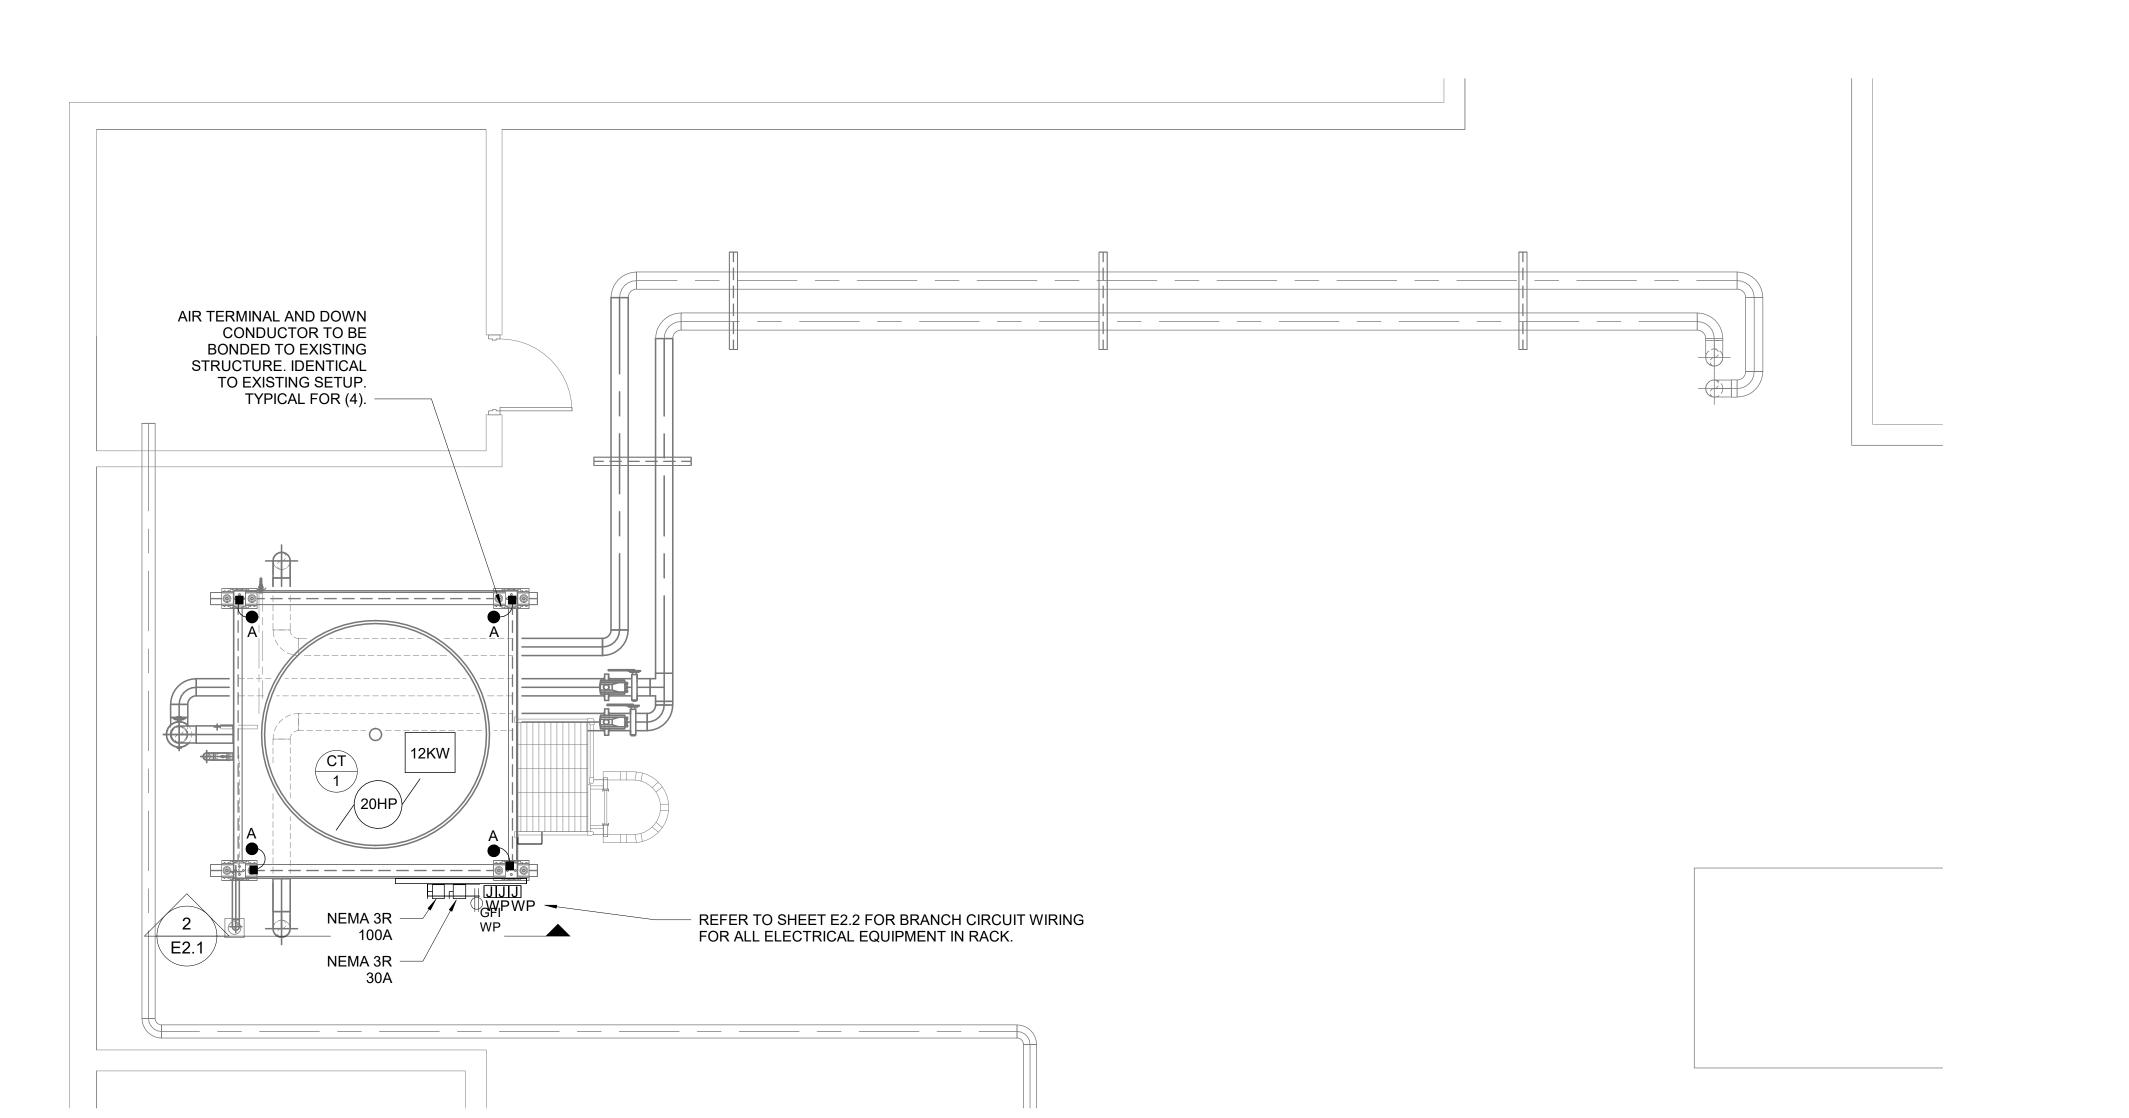

ROOF ELECTRICAL NEW WORK PLAN

NOTES

- 1. CONDITIONS MAY NOT BE EXACTLY AS INDICATED ON THIS DRAWING. ELECTRICAL CONTRACTOR SHALL VISIT THE SITE TO UNDERSTAND THE EXISTING FIELD CONDITIONS AND TO VERIFY SCOPE OF WORK PRIOR TO SUBMITTING BID. NO ALLOWANCE WILL BE MADE AFTER CONTRACT IS APPROVED.
- 2. ALL ABANDONED AND UNUSED EQUIPMENT, INCLUDING, BUT NOT LIMITED TO PIPING, DUCTWORK, AND TERMINAL UNITS SHALL BE REMOVED.
- 3. COORDINATE ALL SHUTDOWNS WITH BUILDING FACILITIES, OWNER, AND TENANTS.



50 Broadway, Hawthorne, NY 10532 914.747.2800 8 West 38th Street, Suite 900

OLA Consulting Engineers

New York, NY 10017 646.849.4110 olace.com


CLIENT


Rockland County

Facilities Management

Robert H. Gruffi, P.E., LEED AP **Director Facilities Management**

Rockland County Courthouse 1 South Main Street New City, NY 10956

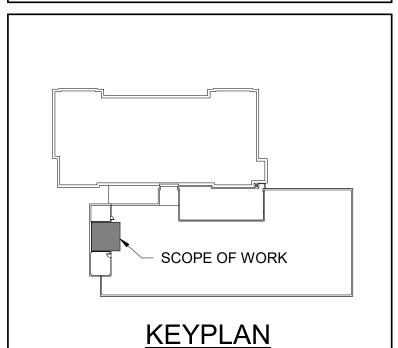

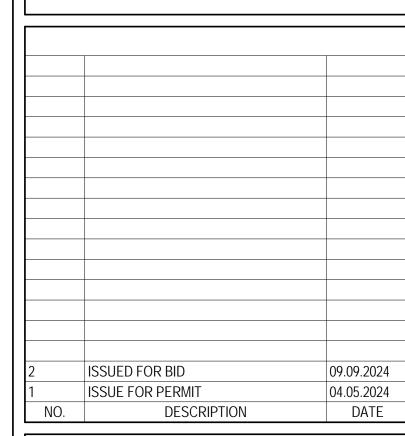


No use, reproduction or dissemination may be made of this drawing and the concepts set forth without the prior written consent of OLA Consulting Engineers, PC. Copyright © 2015

CAPITAL PROJECT 1519 GOVERNMENT CENTER BUILDING **IMPROVEMENTS COURTHOSE** COOLING TOWER REPLACEMENT

> 1 SOUTH MAIN STREET NEW CITY, NY 10956

ELECTRICAL NEW WORK PLANS

SEAL	SCALE As indicated	PROJECT NO. NRCK0018
	DRAWN BY GD	DRAWING NO.
	CHECKED BY JF	E2.1
	DATE 2024.04.05	

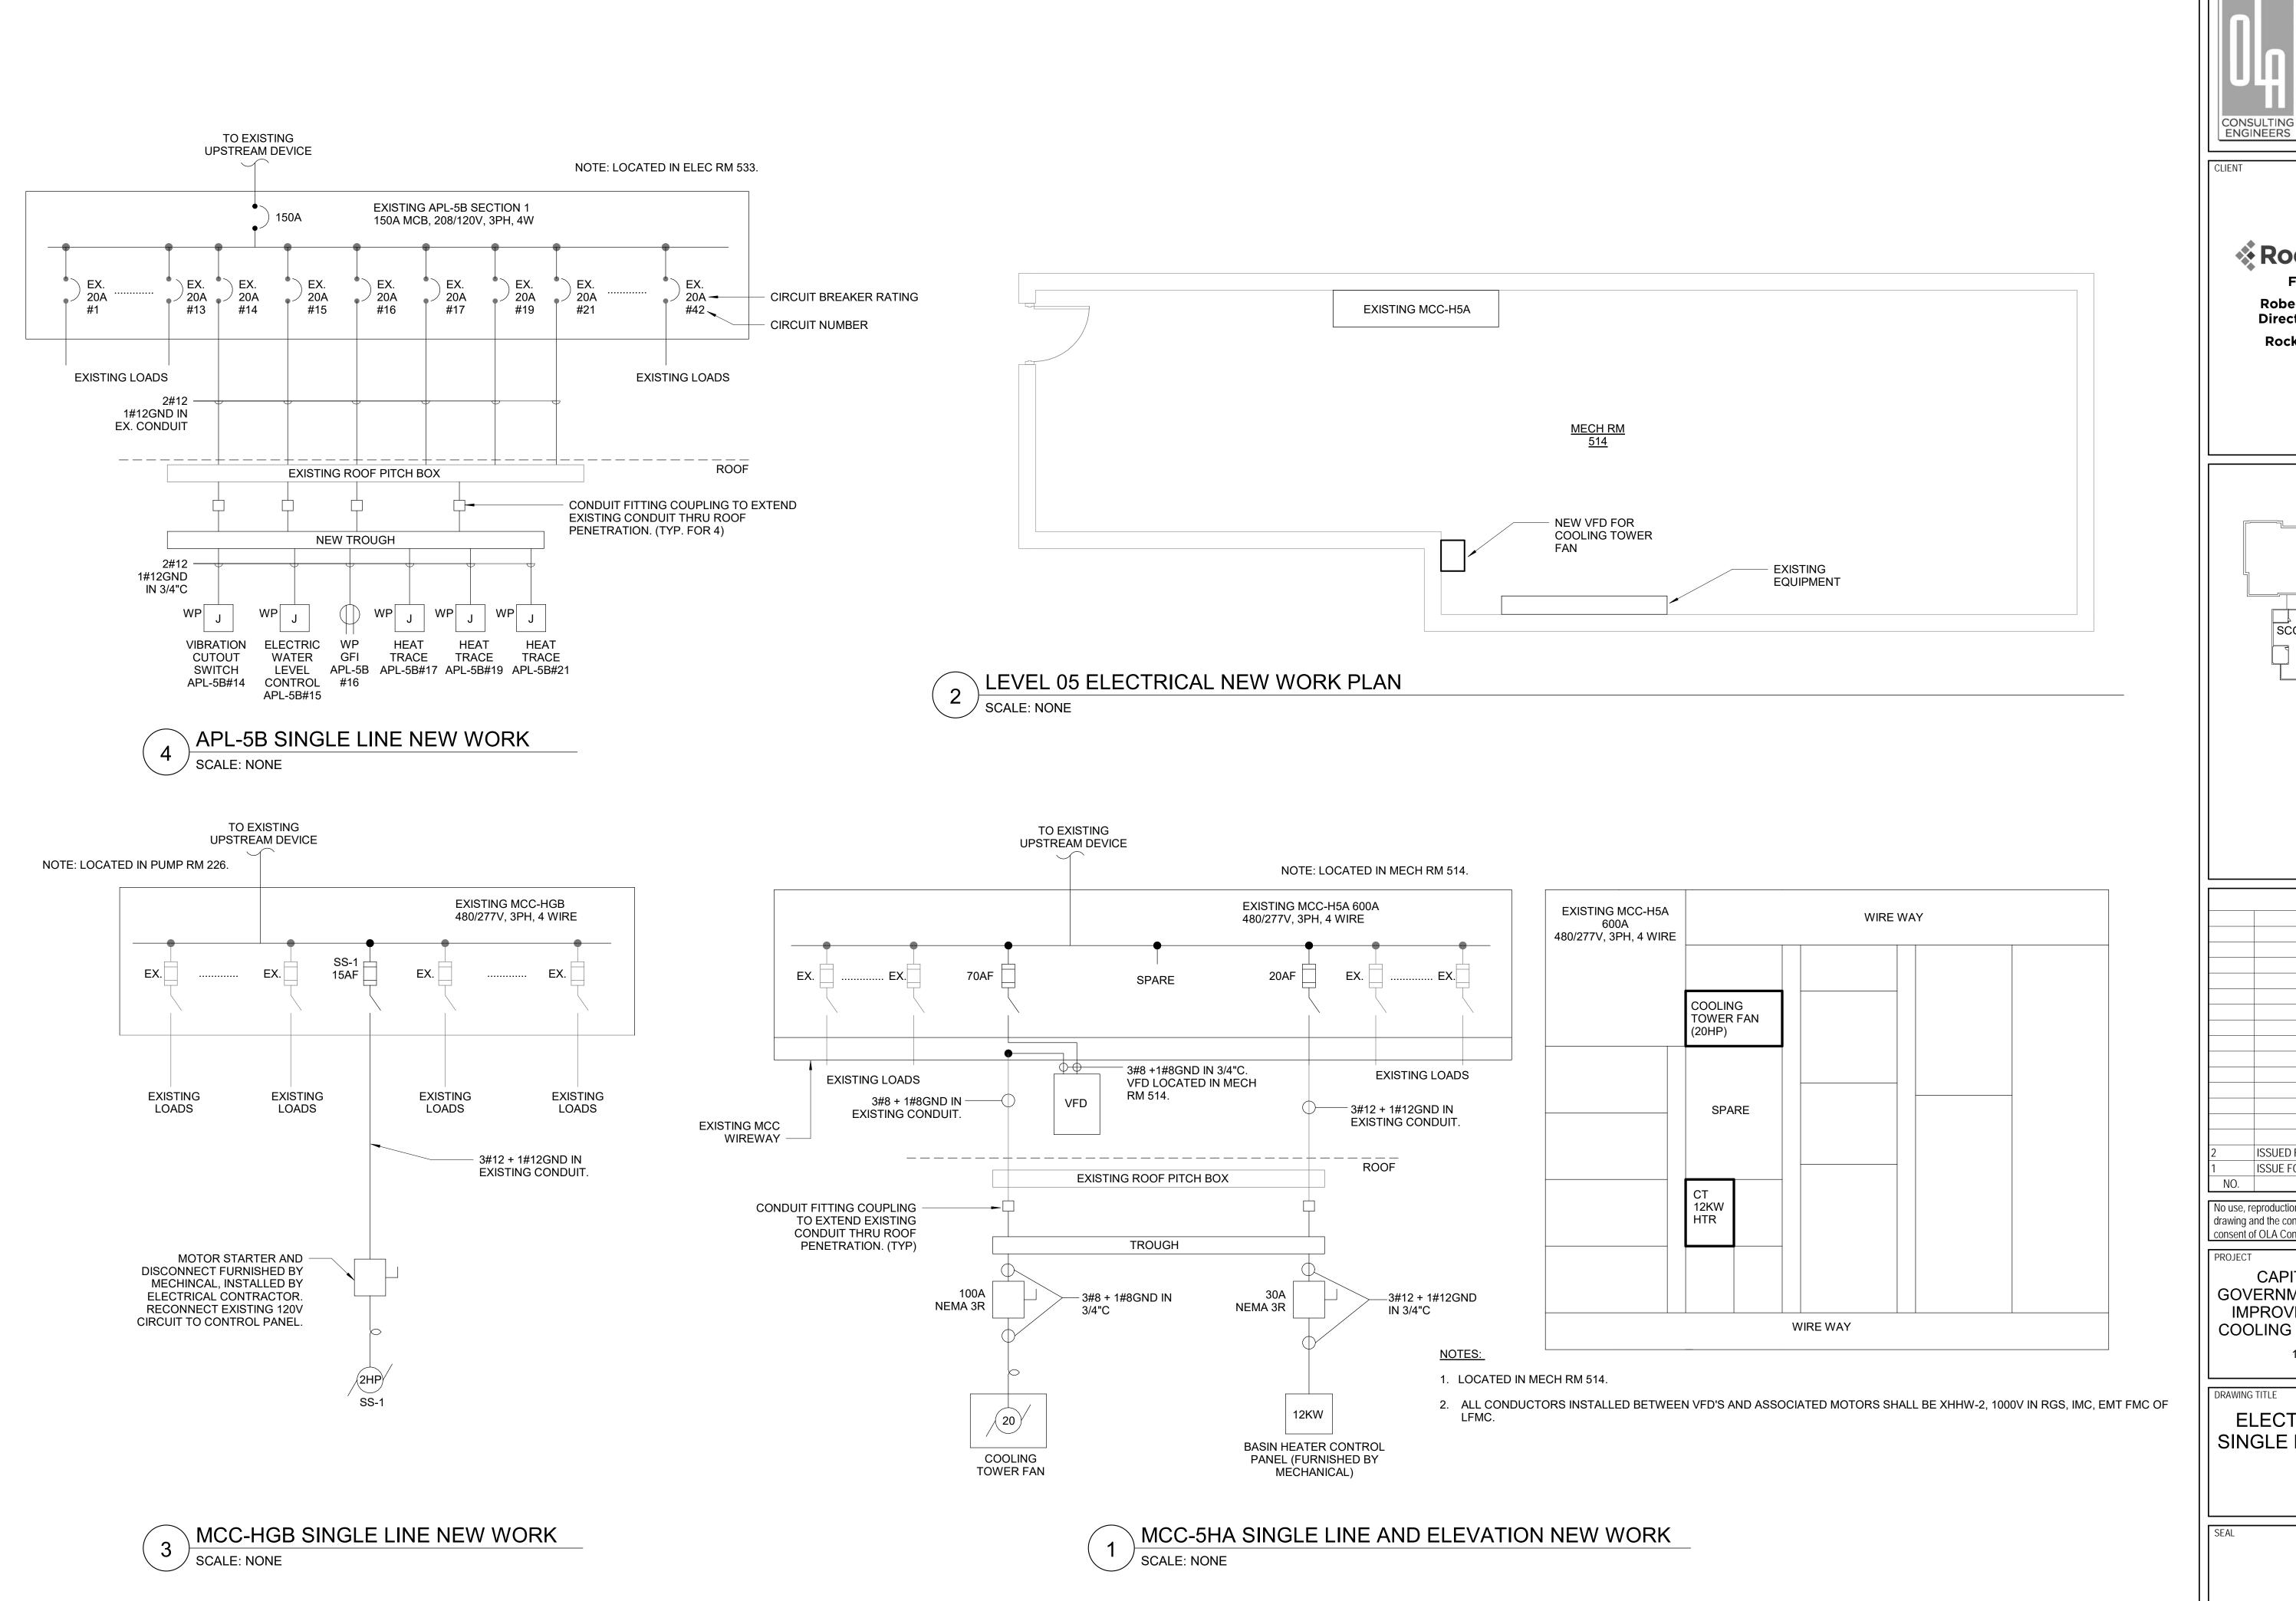

OLA Consulting Engineers 914.747.2800

50 Broadway, Hawthorne, NY 10532

8 West 38th Street, Suite 900 New York, NY 10017 646.849.4110


Rockland County


olace.com

Facilities Management

Robert H. Gruffi, P.E., LEED AP **Director Facilities Management**

Rockland County Courthouse 1 South Main Street New City, NY 10956

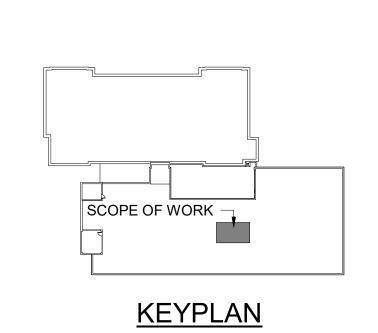

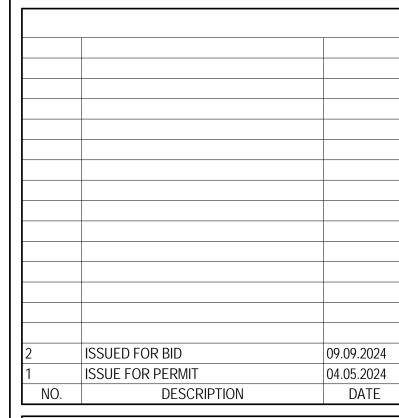


No use, reproduction or dissemination may be made of this drawing and the concepts set forth without the prior written consent of OLA Consulting Engineers, PC. Copyright © 2015

CAPITAL PROJECT 1519 **GOVERNMENT CENTER BUILDING IMPROVEMENTS COURTHOSE** COOLING TOWER REPLACEMENT

> 1 SOUTH MAIN STREET NEW CITY, NY 10956

ELECTRICAL NEW WORK SINGLE LINE DIAGRAMS AND PLAN

SEAL	SCALE As indicated	PROJECT NO.
	As indicated	NRCK0018
	DRAWN BY GD	DRAWING NO.
	CHECKED BY JF	E2.2
	DATE 2024.04.05	

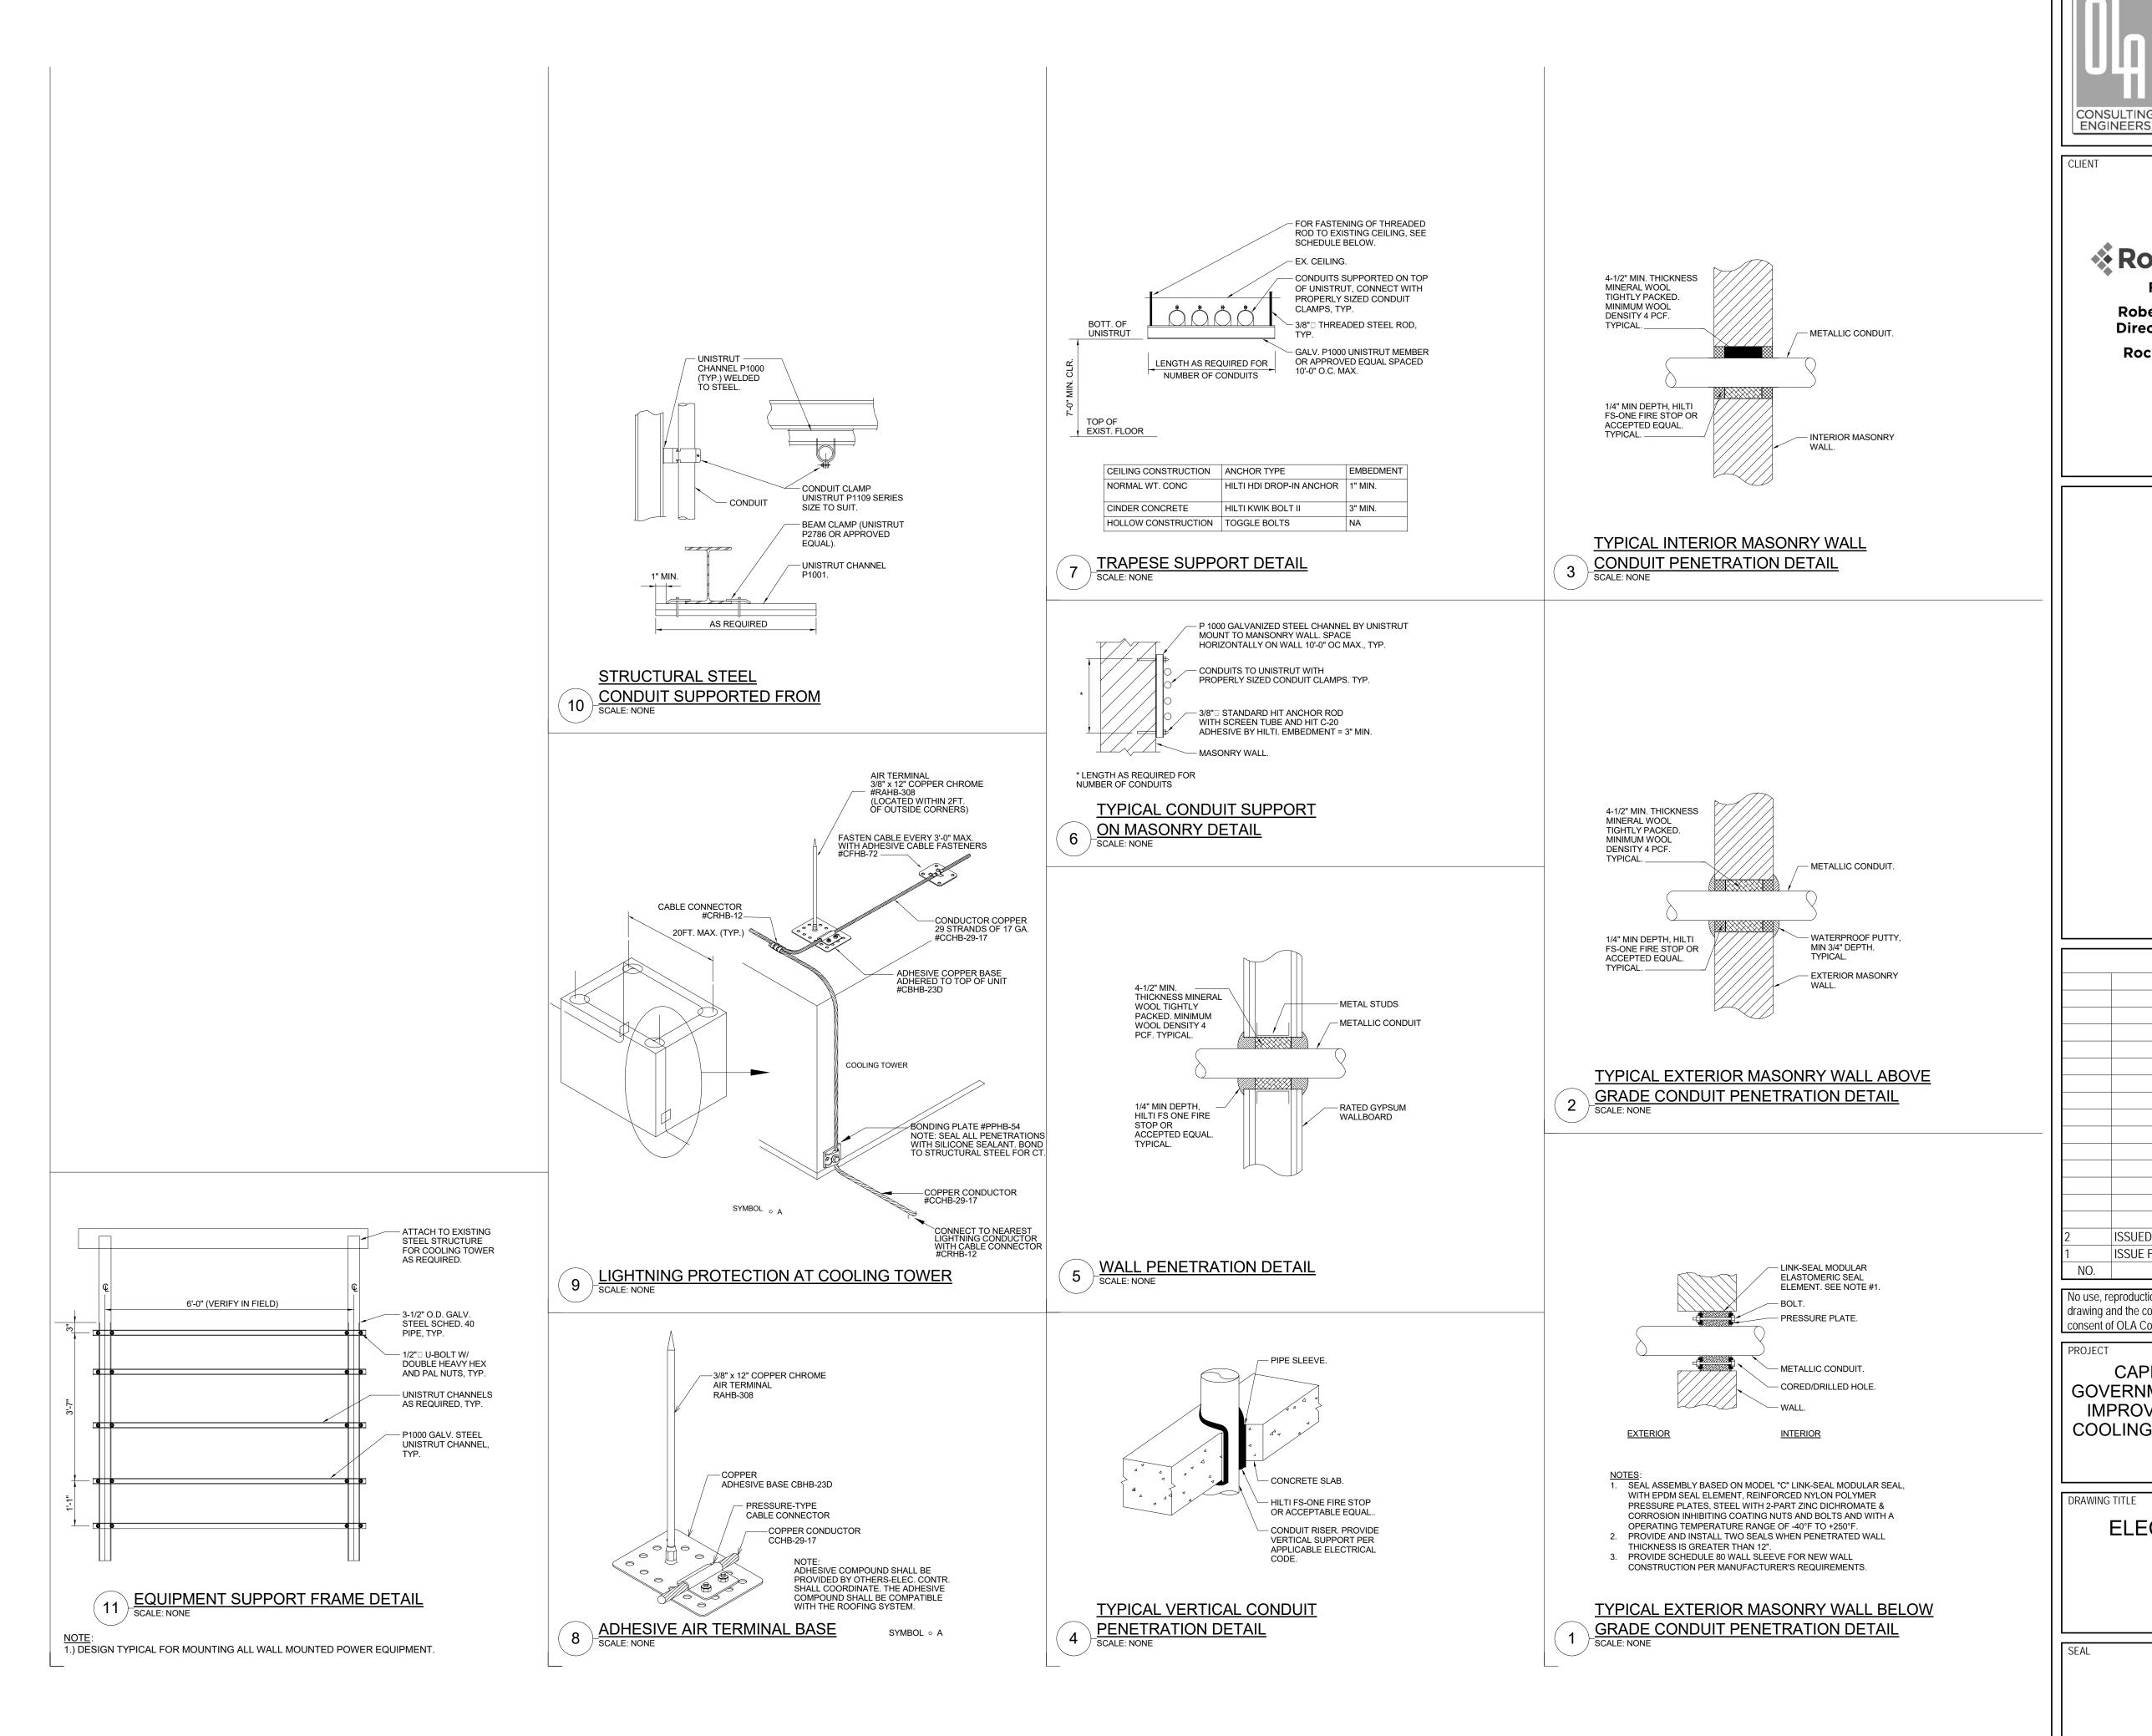

OLA Consulting Engineers

50 Broadway, Hawthorne, NY 10532 914.747.2800

8 West 38th Street, Suite 900 New York, NY 10017 646.849.4110

olace.com

Rockland County

Facilities Management

Robert H. Gruffi, P.E., LEED AP **Director Facilities Management**

Rockland County Courthouse 1 South Main Street New City, NY 10956

ISSUED FOR BID 09.09.2024 04.05.2024 **ISSUE FOR PERMIT** DATE DESCRIPTION

No use, reproduction or dissemination may be made of this drawing and the concepts set forth without the prior written consent of OLA Consulting Engineers, PC. Copyright © 2015

CAPITAL PROJECT 1519 **GOVERNMENT CENTER BUILDING** IMPROVEMENTS COURTHOSE COOLING TOWER REPLACEMENT

> 1 SOUTH MAIN STREET NEW CITY, NY 10956

ELECTRICAL DETAILS

SEAL	SCALE 1" = 1'-0"	PROJECT NO. NRCK0018
	DRAWN BY GD	DRAWING NO.
	CHECKED BY JF	E7.1
	DATE	1

2024.04.05