

Poughkeepsie, NY 1260



PROJECT INFORMATION

R22.14457.20

SOUTH ORANGETOWN CENTRAL **SCHOOL DISTRICT**

TAPPAN ZEE HIGH SCHOOL

PHASE 2: 2022 BOND

Building Address
15 DUTCH HILL ROAD, ORANGEBURG, NY


SED # 50-03-01-06-0-006-033

Registration Expiration Dates Lauren Tarsio 09/30/26 Anthony Marchetti 05/31/27 Dave Hart 02/28/25 Jennifer Wengender 06/30/27

PROJECT ISSUE & REVISION SCHEDULI


3 11/08/2024 BID ADDENDUM #3 5 11/19/2024 BID ADDENDUM #5

PROFESSIONAL STAMPS

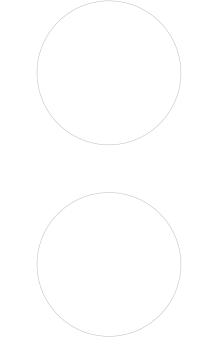

SHEET INFORMATION 10/25/2024 As indicated **BID DOCUMENTS**

TZHS

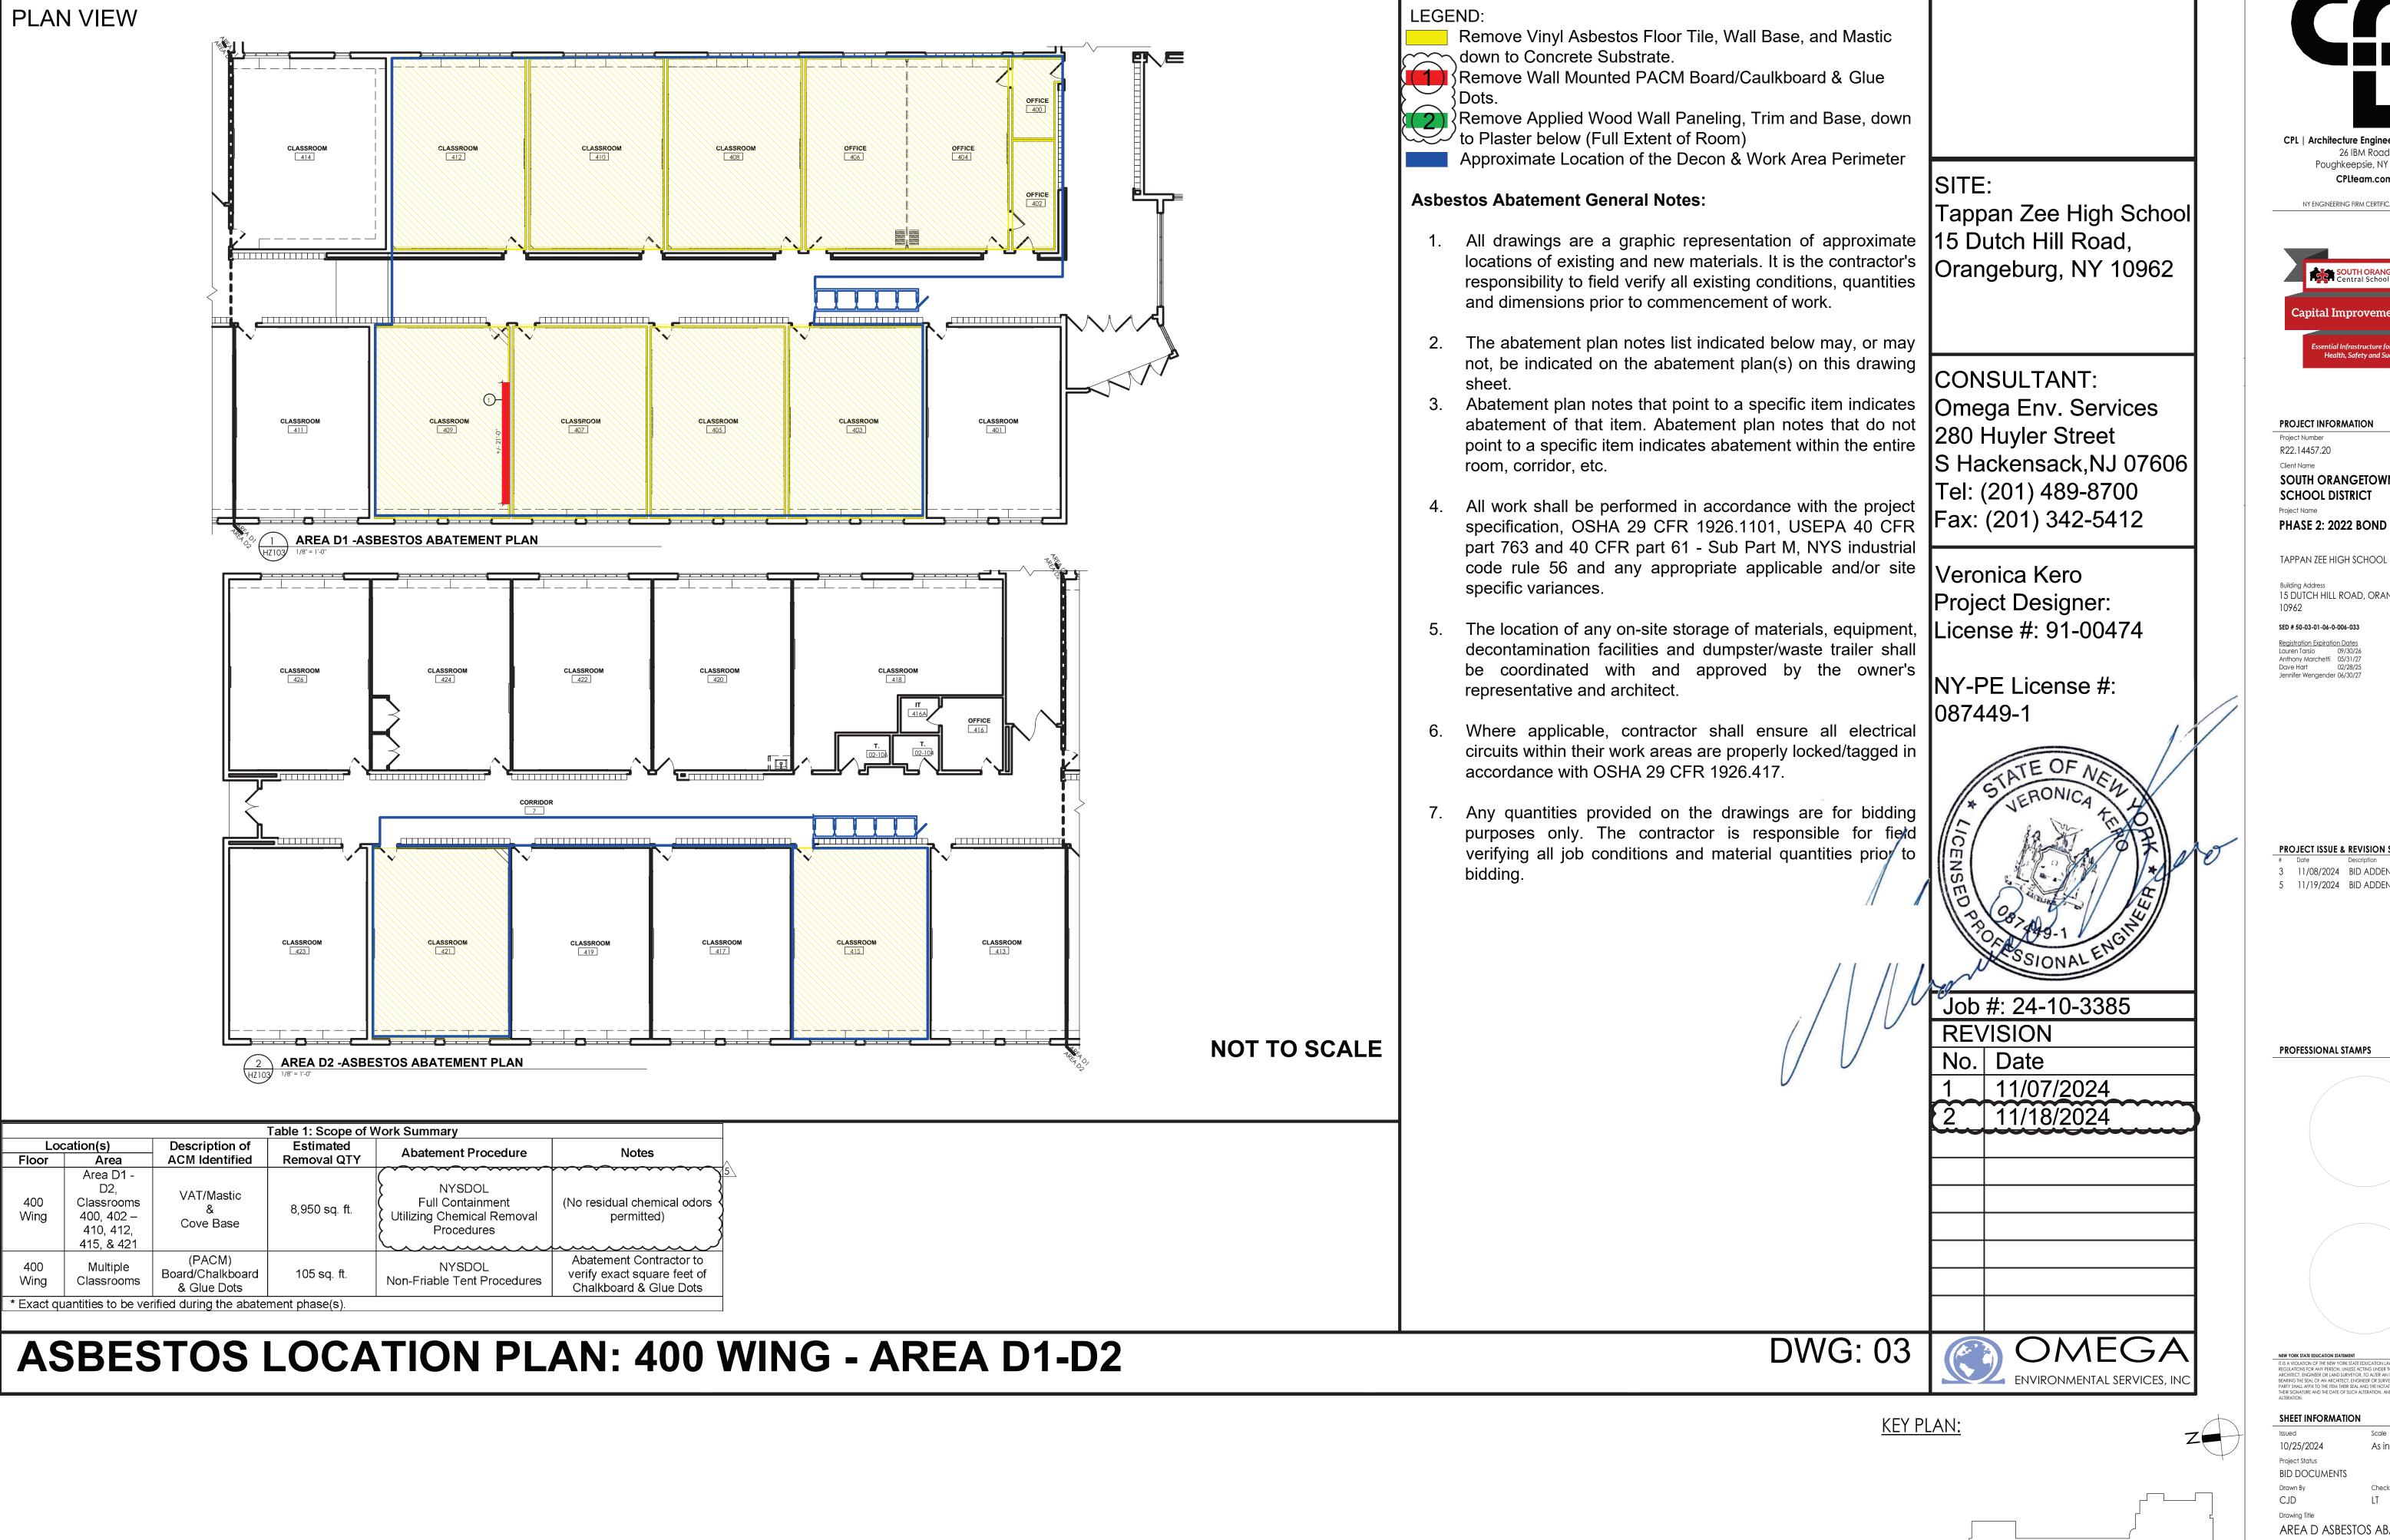

Poughkeepsie, NY 1260

PROJECT INFORMATION

R22.14457.20

SOUTH ORANGETOWN CENTRAL SCHOOL DISTRICT

TAPPAN ZEE HIGH SCHOOL


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3 11/08/2024 BID ADDENDUM #3 5 11/19/2024 BID ADDENDUM #5



SHEET INFORMATION

10/25/2024 As indicated **BID DOCUMENTS** CJD

TZHS

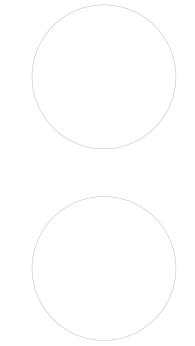

CPL | Architecture Engineering Planning 26 IBM Road Poughkeepsie, NY 12601 CPLteam.com

NY ENGINEERING FIRM CERTIFICATE #0021419



PROJECT INFORMATION

R22.14457.20

SOUTH ORANGETOWN CENTRAL SCHOOL DISTRICT
Project Name

PHASE 2: 2022 BOND

TAPPAN ZEE HIGH SCHOOL

15 DUTCH HILL ROAD, ORANGEBURG, NY 10962

1070Z SFD # 50-03-01-06-0-006-033

SED # 50-03-01-06-0-006-033


Registration Expiration Dates Lauren Tarsio 09/30/26 Anthony Marchetti 05/31/27 Dave Hart 02/28/25 Jennifer Wengender 06/30/27

PROJECT ISSUE & REVISION SCHEDUL

Date Description
1 11/01/2024 BID ADDENDUM #1

5 11/19/2024 BID ADDENDUM #5

PROFESSIONAL STAMPS

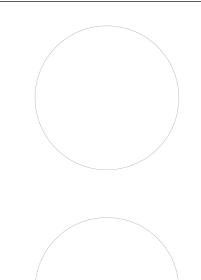

NEW YORK STATE EDUCATION STATEMENT
IT IS A VIOLATION OF THE NEW YORK STATE EDUCATION LAW AND THE COMMISSIONER
REGULATION FOR ANY PERSON, UNLESS ACTING UNDER THE DIRECTION OF A LICENSE
ARCHITECT, ENGINEER OR LAND SURVEYOR, TO ALTER AN ITEM IN ANY WAY. IF AN ITEM
BEARING THE SEAL OF AN ARCHITECT, ENGINEER OR SURVEYOR IS ALTERED, THE ALTERI
PARTY SHALL ARTH TO THE ITEM THEIR SEAL AND THE NOTATION TAITERED BY "FOOLITED".

SHEET INFORMATION

10/25/2024 As indicated
Project Status
BID DOCUMENTS
Drawn By Checked By
C.JD LT


CJD LT

Drawing Title

AREA C DEMOLITION FLOOR

TZHS

A103

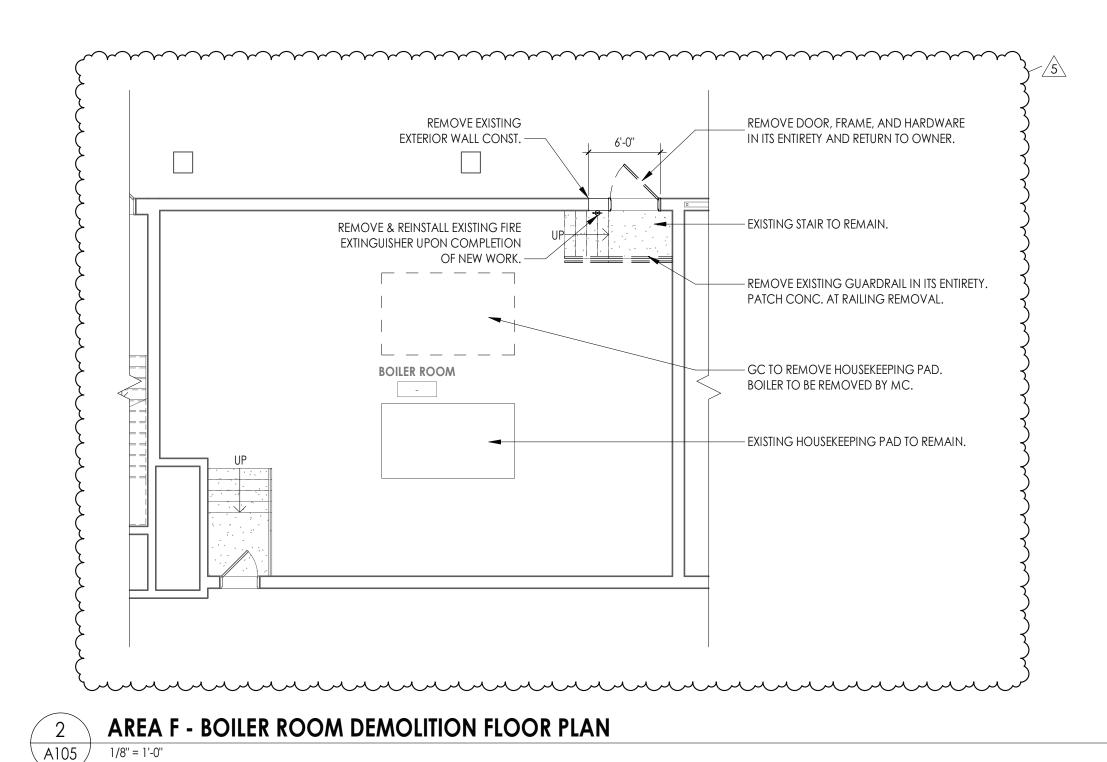

— DEMOLISH EXISTING FLOORING, WHERE INDICATED TO RECEIVE **NEW FINISHES** Cl TECH 124 126 Cl - SALVAGE WALL MTD. BOARDS **EACH SIDE &** RETURN TO OWNER OFFICE 124A (C1) CORRIDOR REMOVE AND SALVAGE (2) ROWS OF MATS PRIOR TO 428 START OF DEMOLITION -RETURN MATS TO OWNER

AREA E - GROUND FLOOR DEMOLITION PLAN - FITNESS ROOM

1/8" = 1'-0"

DEMOLITION GENERAL NOTES

- ALL DRAWINGS ARE GRAPHIC REPRESENTATION OF APPROXIMATE LOCATIONS OF MATERIALS TO BE REMOVED. IT IS THE CONTRACTORS RESPONSIBILITY TO FIELD VERIFY ALL EXISTING CONDITIONS & DIMENSIONS PRIOR TO COMMENCEMENT OF ALL DEMOLITION WORK.
- 2. REFER TO THE MECHANICAL, ELECTRICAL AND PLUMBING DRAWINGS FOR DEMOLITION OF EXISTING UTILITIES AND SERVICES.
- THE OWNER SHALL PROVIDE THE CONTRACTOR WITH A LIST OF ALL ITEMS TO BE SALVAGED PRIOR TO CONSTRUCTION.
 THE CONTRACTOR SHALL PROTECT ADJACENT SURFACES AND FINISHES NOT SCHEDULED FOR DEMOLITION WORK AND SHALL REPAIR ANY DAMAGED AREAS AS A
- RESULT OF CONTRACTED WORK AT NO ADDITIONAL COST TO THE OWNER.

 5. THE CONTRACTOR SHALL COORDINATE THE DEMOLITION WORK WITH THE OVERALL PROJECT PHASING.
- WORK AREAS SHALL BE MAINTAINED AND ALL WORK AREAS SHALL BE LEFT BROOM CLEANED AT END OF EACH DAY.
- THE CONTRACTOR SHALL MAINTAIN AND CONTINUE SAFE ACCESS TO ALL EXITS FOR THE BUILDING OCCUPANTS DURING CONSTRUCTION.
- 3. IN THE CASE THAT ANY SUSPICIOUS MATERIALS ARE UNCOVERED THAT APPEAR TO CONTAIN HAZARDOUS MATERIALS SUCH AS BUT NOT LIMITED TO MOLD, LEAD PAINT OR ASBESTOS, LEAVE THE PREMISES AND NOTIFY THE OWNER & ABATEMENT CONTRACTOR FOR REQUIRED TESTING AND/OR REMOVALS.
- P. REMOVE ALL MISCELLANEOUS WALL MOUNTED ITEMS ON WALLS SCHEDULED TO RECEIVE NEW FINISHES INCLUDING BUT NOT LIMITED TO TRIM, TACK STRIPS, FLAG HOLDERS, ETC.

DEMOLITION KEY NOTES

- (C1) REMOVE ACT CEILING SYSTEM IN ITS ENTIRETY
- (C2) REMOVE SPLINE CEILING SYSTEM IN ITS ENTIRETY
- (C3) REMOVE GYPSUM WALL BOARD SOFFIT IN ITS ENTIRETY
- REMOVE ACT CEILING SYSTEM IN ITS ENTIRETY. SALVAGE CEILING TILES TO BE REINSTALLED IN NEW GRID.
- (D1) REMOVE DOOR & HARDWARE. EXISTING FRAME TO REMAIN
- REMOVE DOOR, FRAME, AND HARDWARE IN ITS ENTIRETY AND RETURN TO
- REMOVE SLIDING DOOR, FRAME, AND HARDWARE IN ITS ENTIRETY. THRESHOLD TO REMAIN UNDISTRUBED AND TO BE REMOVED BY ABATEMENT CONTRACTOR.

 DAY REMOVE OPERABLE PARTITION IN ITS ENTIRETY, INCLUDING TRACK AND FRAMED WALL.
- VINYL ASBESTOS TILE FLOORING TO BE REMOVED BY ABATEMENT CONTRACTOR. REFER TO HZ DRAWINGS.
- (F2) REMOVE VCT FLOORING AND WALL BASE IN ITS ENTIRETY.
- (M1) REMOVE CASEWORK
- (M2) REMOVE WOOD TRIM FROM FRAMED OPENING, BOTH SIDES.
- (M3) REMOVE EXISTING UNIT VENTILATOR PLATFORM IN ITS ENTIRETY.
- M4) ABATEMENT CONTRACTOR TO REMOVE WALL MTD. BOARD IN ITS ENTIRETY

 (M5) NOT USED
- (M6) REMOVE CEILING FAN AND SALVAGE FOR REINSTALLATION.
- (M7) REMOVE EXISTING WALL MTD. FAN AND RETURN TO OWNER.
- REMOVE EXISTING WINDOW AC UNIT AND SURROUNDING PANEL.
 TURN AC UNIT OVER TO OWNER
- M9) EXISTING PTAC TO BE REMOVED BY M.C.
- (M10) EXISTING U.V. TO BE REMOVED BY M.C.
- (M1) EXISTING SSI TO BE REMOVED BY M.C.
- (M12) REMOVE & SALVAGE STOVE, RETURN TO OWNER
- (M13) REMOVE EXISTING TRACK AND WOOD TRIM IN ITS ENTIRETY.
- (P1) M.C. TO REMOVE EXISTING SINK. REFER TO PLUMBING DRAWINGS
 (P2) NOT USED


WILLIAM TO TO THE TOTAL TH

- (W1) REMOVE CMU WALL
- (W2) REMOVE STEEL STUD WALL
- (W3) REMOVE GYPSUM BOARD AND WOOD FRAMING IN ITS ENTIRETY
- ABATEMENT CONTRACTOR TO REMOVE WOOD WALL PANELING, BASE AND
 TRIM IN ITS ENTIRETY FROM WALLS, DOWN TO PLASTER BELOW. GC TO PREPARE
 SURFACE TO RECEIVE NEW GYPSUM BOARD

NOTE:

WALL MOUNTED BOARDS ARE TO REMAIN UNDISTURBED UNLESS OTHERWISE NOTED.

KEY PLAN:

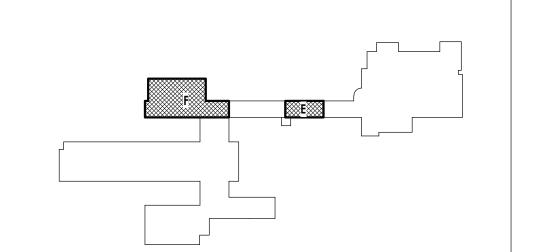



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NY ENGINEERING FIRM CERTIFICATE #0021419



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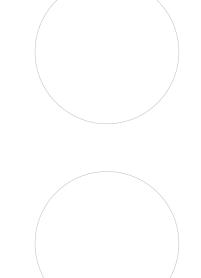
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5 11/19/2024 BID ADDENDUM #5

PROFESSIONAL STAMPS



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SHEET INFORMATION

Issued Scale

10/25/2024 As indicated

Project Status

BID DOCUMENTS

Drawn By Checked By

CJD LT

Drawing Title

AREA E & F DEMOLITION FLOOR

PLAN

TZHS A 105



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NY ENGINEERING FIRM CERTIFICATE #0021419

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R22.14457.20

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TAPPAN ZEE HIGH SCHOOL

15 DUTCH HILL ROAD, ORANGEBURG, NY


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2 11/06/2024 BID ADDENDUM #2

5 11/19/2024 BID ADDENDUM #5

PROFESSIONAL STAMPS




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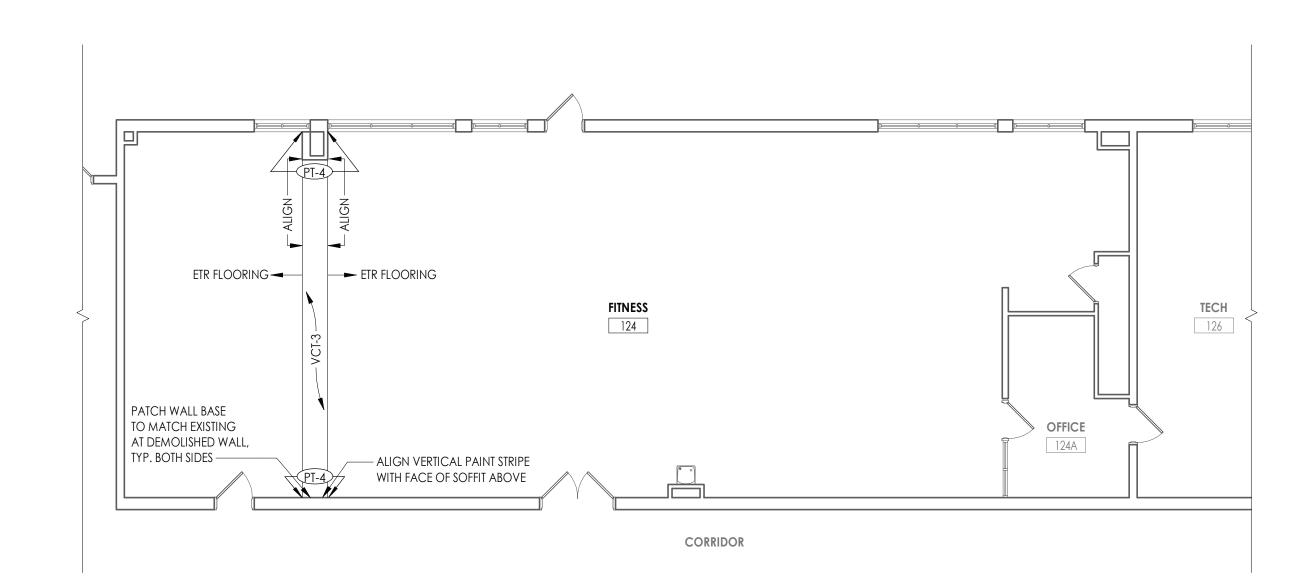
Drawing Title

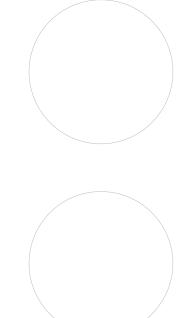AREA C NEW WORK PLAN

A203



AREA F - BOILER ROOM NEW WORK FLOOR PLAN A205 1/8" = 1'-0"

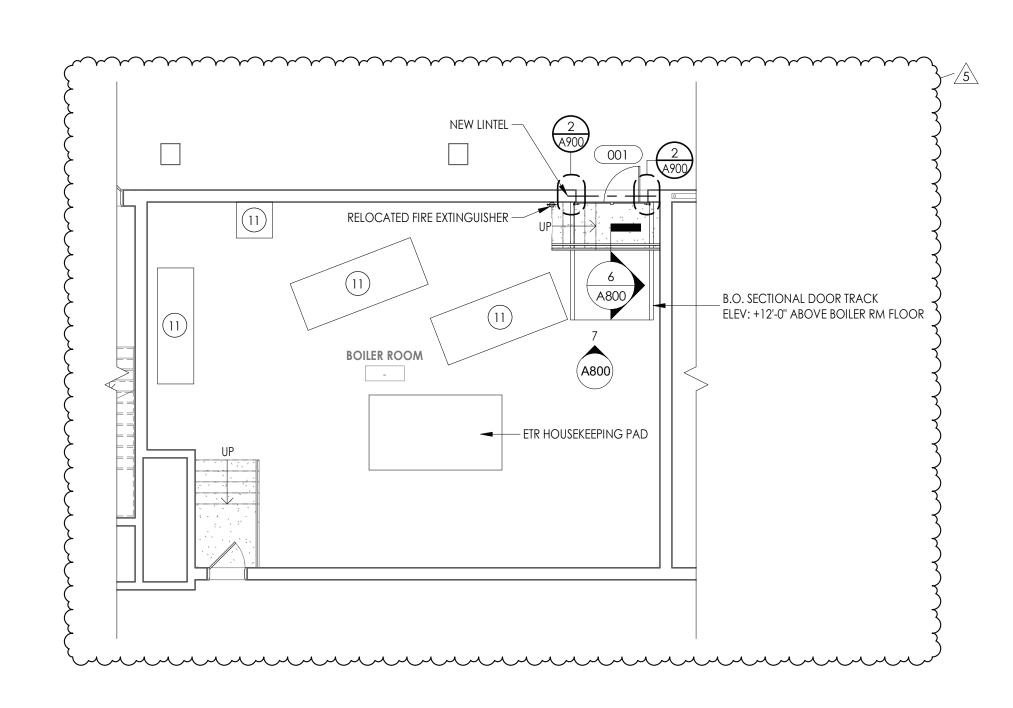


AREA E - GROUND FLOOR NEW WORK PLAN - FITNESS ROOM A205 1/8" = 1'-0"

FLOOR PLAN GENERAL NOTES

- ALL DRAWINGS ARE GRAPHIC REPRESENTATIONS OF APPROXIMATE LOCATIONS OF EXISTING AND NEW MATERIALS. FIELD VERIFY ALL EXISTING CONDITIONS PRIOR TO COMMENCEMENT OF WORK.
- THE CONTRACTOR IS RESPONSIBLE FOR DAMAGE TO ANY EXISTING FINISHES AND EQUIPMENT NOT REMOVED UNDER THE SCOPE OF WORK. ANY DAMAGE WILL BE REPAIRED TO THE OWNER/ARCHITECT'S SATISFACTION AT NO COST TO THE OWNER. WORK AREAS SHALL BE MAINTAINED AND ALL WORK AREAS SHALL BE LEFT BROOMED
- CLEAN AT END OF EACH DAY. THE CONTRACTOR SHALL PROVIDE DUST CONTROL BARRIERS AT ALL AREAS OF CONSTRUCTION.
- THE CONTRACTOR SHALL PATCH ALL SURFACES WHERE EXISTING MATERIALS HAVE BEEN DISTURBED TO MATCH AND BE FLUSH WITH ADJACENT CONSTRUCTION AT ALL FLOOR, WALL AND CEILING LOCATIONS.
- COORDINATE WITH OTHER TRADES FOR SEQUENCING OF WORK.

REFER TO I DRAWINGS FOR INTERIOR FINISHES

FLOOR PLAN LEGEND

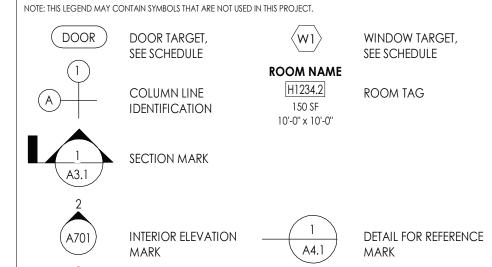

FLOOR PLAN KEY NOTES

EXTERIOR ELEVATION

- (1) PATCH PLASTER WALL AS REQ'D AT DEMOLISHED WALLS & CASEWORK
- 2 INFILL WALL OPENING WITH 8" CMU AND PLASTER BOTH SIDES TO MATCH EXISTING. PATCH WALL BASE TO MATCH EXISTING.
- 3 INFILL EXTERIOR MASONRY WALL AT DEMOLISHED UV LOCATIONS. REFER TO DETAIL 1/A800
- REPLACE WINDOW PANEL W/ GLAZING AT EXISTING AC REMOVAL. REFER TO A900
- 5 NEW CASEWORK. REFER TO INTERIOR ELEVATIONS AND A800 SERIES FOR DETAILS.
- (6) PATCH PLASTER WALL AT REMOVALS

KEY PLAN:

- (7) PATCH PLASTER WALL AT DEMOLISHED LIGHT FIXTURE
- (8) PATCH PLASTER WALL AS REQ'D AT DEMOLISHED TRACK
- 9 SMARTBOARD TO BE FURNISHED & INSTALLED BY OWNER. REFER TO T DRAWINGS FOR DATA CONNECTION LOCATIONS.
- LAMINATE GYPSUM WALL BOARD AS SPECIFIED. GYP TO EXTEND 6" MIN. ABOVE FINISHED CEILING. (11) NEW HOUSEKEEPING PAD BY GC. REFER TO DETAIL 8/A800 angle

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PROJECT INFORMATION

R22.14457.20 Client Name

DENOTES FINISH FLOOR

GRADE ELEVATION

SOUTH ORANGETOWN CENTRAL SCHOOL DISTRICT

TAPPAN ZEE HIGH SCHOOL

PHASE 2: 2022 BOND

Building Address 15 DUTCH HILL ROAD, ORANGEBURG, NY

10962


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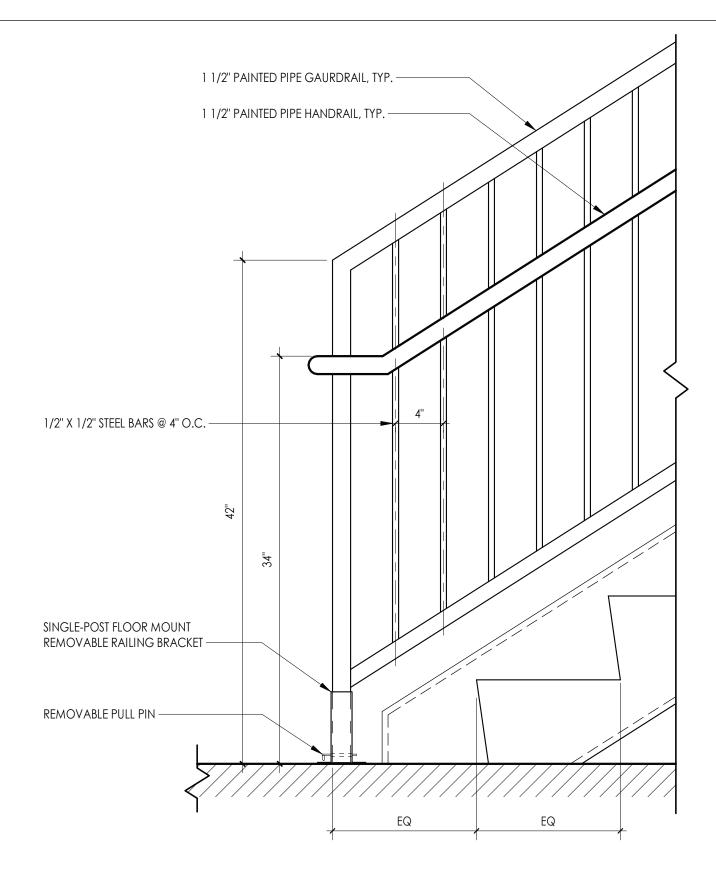
PROFESSIONAL STAMPS




SHEET INFORMATION

Issued 10/25/2024 As indicated Project Status BID DOCUMENTS Drawn By CJD Drawing Title


AREA E & F NEW WORK PLAN

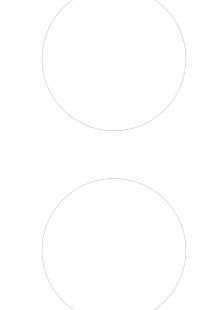


BOILER ROOM - ELEVATION OF STAIR END GUARDRAIL W/ HANDRAIL A800 1 1/2" = 1'-0"

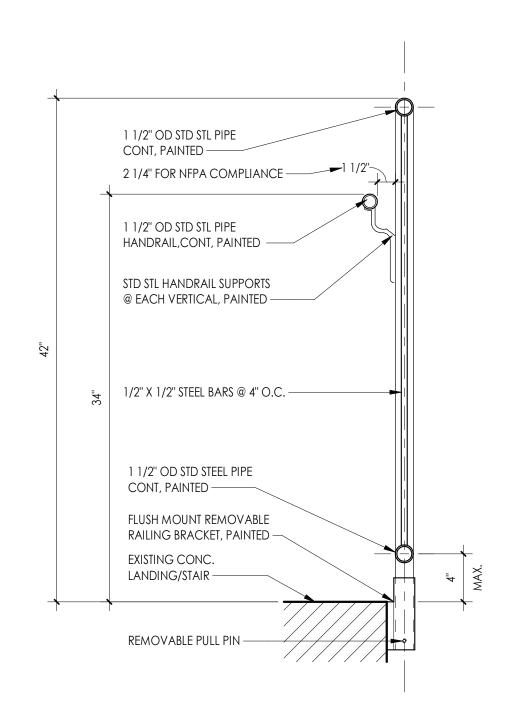


BOILER ROOM - SECTION THRU STAIR @ GUARDRAIL W/ HANDRAIL \ A800 / 1 1/2" = 1'-0"

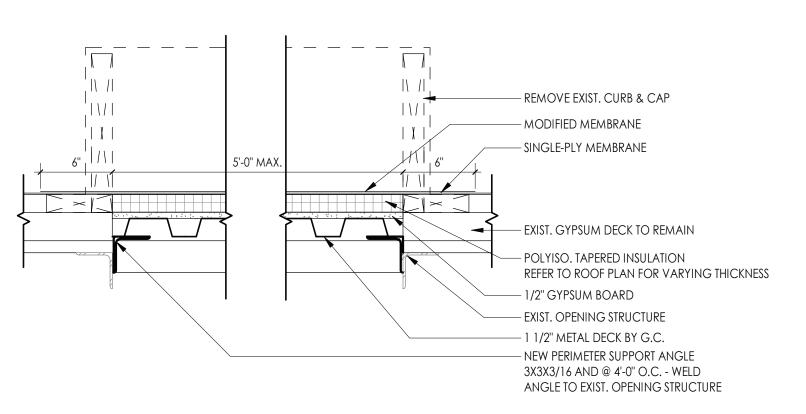


TYPICAL ROOF DECK INFILL DETAIL 1 1/2" = 1'-0" A800 /

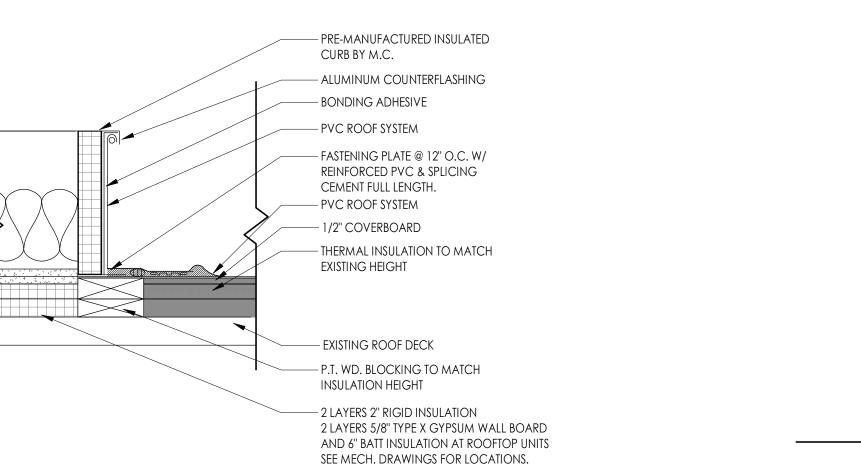


TYPICAL ROOF CURB DETAIL \ A800 \ \ 1 1/2" = 1'-0"

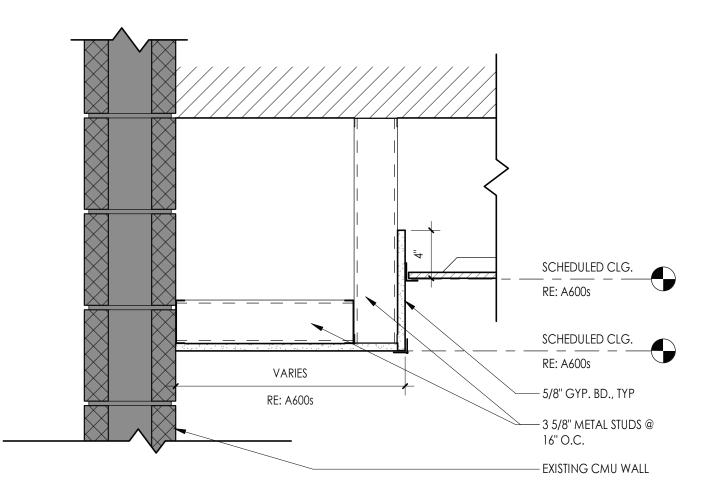

TYP. GWB SOFFIT DETAIL @ WALL ∖ A800 / 1 1/2" = 1'-0"

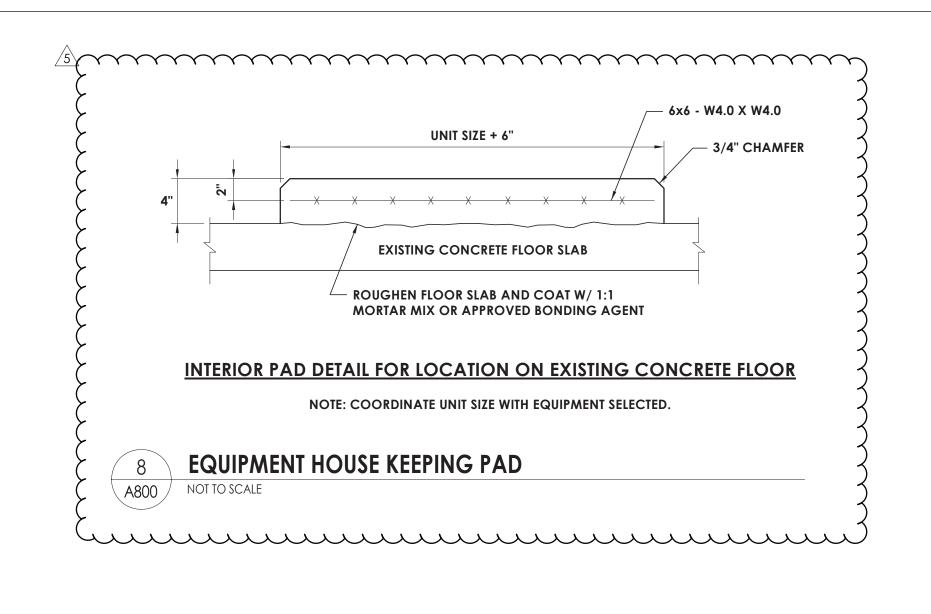

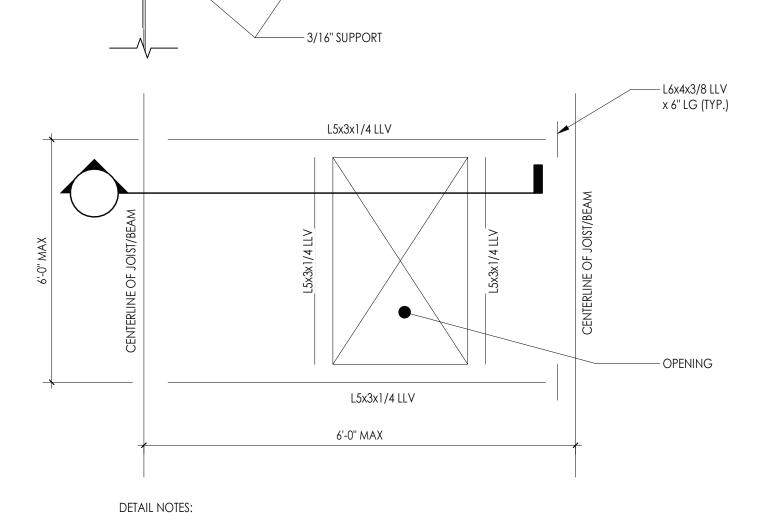


1. THE ABOVE STEEL SIZES SHALL BE USED UNLESS NOTED OTHERWISE ON THE PLANS.

CONTRACTOR AND FINAL APPROVED EQUIPMENT SUBMITTAL.

2. CONTRACTOR TO COORDINATE EQUIPMENT AND OPENING SUPPORTS WITH MECHANICAL

L6x4x3/8 LLV ----

x 6" LG

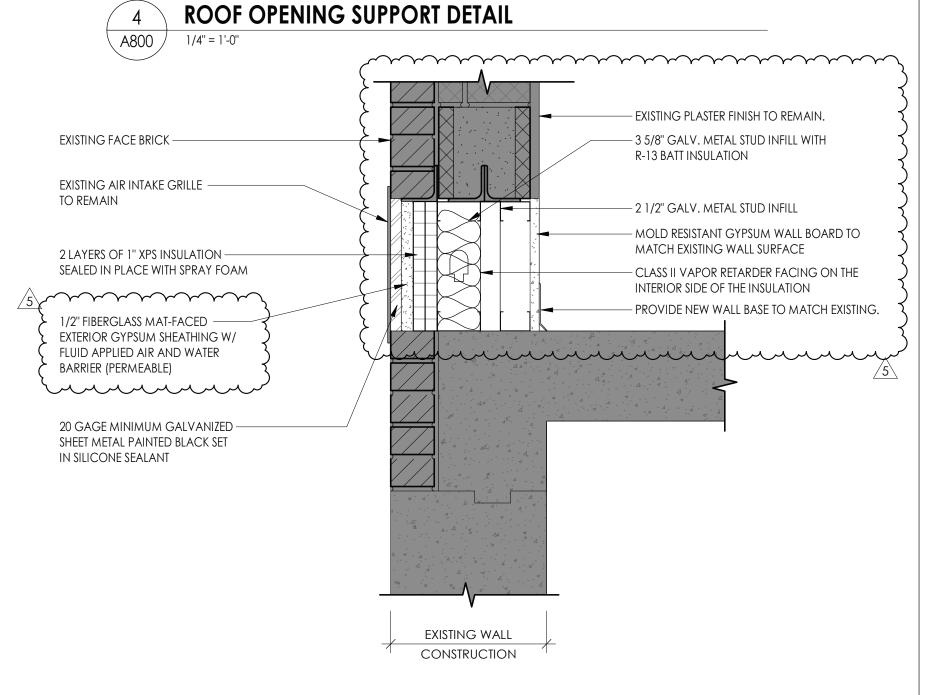





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NY ENGINEERING FIRM CERTIFICATE #0021419

PROJECT INFORMATION

R22.14457.20

— FLOOR/ROOF

DECK (TYP.)

Client Name SOUTH ORANGETOWN CENTRAL SCHOOL DISTRICT

PHASE 2: 2022 BOND

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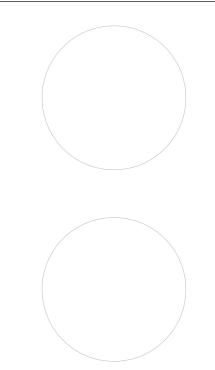
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5 11/19/2024 BID ADDENDUM #5

PROFESSIONAL STAMPS



SHEET INFORMATION

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Drawn By CPL CPL Drawing Title TYPICAL DETAILS

CASEWORK SCHEDULE												
TYPE MARK	C DESCRIPTION	DIMENSIONS	PRODUCT #	NOTES								
BASE CABIN	IET (BC)											
BC-1	2 DOORS, 1 ADJUSTABLE SHELF	VARIES; REF. A700 SERIES	TMI # B2052									
BC-2	2 EQUAL LATERAL FILE DRAWERS	VARIES; REF. A700 SERIES	TMI # D2804									
CUSTOM (C	·)											
C-1	2 DOORS, 1 ADJUSTABLE SHELF	VARIES; REF. A700 SERIES	TMI #B2052	REFERENCE TMI PRODUCT FOR DESIGN INTENT; CABINET TO BE CUSTOM 24" HIGH.								
C-2	2 EQUAL DRAWERS	VARIES; REF. A700 SERIES	TMI #D2001	REFERENCE TMI PRODUCT FOR DESIGN INTENT; CABINET TO BE CUSTOM 24" HIGH.								
METAL CABI	INET (MC)											
MC-1	OPEN SHELVING, 1 ADJUSTABLE SHELF	36"W x 29"H x 16"D	TRANE # SHL-B-B-1-03									
TALL CABINE	et (TC)											
TC-1	2 DOOR WARDROBE	VARIES; REF. A700 SERIES	TMI # T2586, TMI #2590	REFER TO ELEVATIONS FOR LEFT OR RIGHT WARDROBE PLACEMENT								
TC-2	NOT USED	NOT USED	NOT USED	NOT USED								
TC-3	ADJUSTABLE OPEN SHELVING	VARIES; REF. A700 SERIES	TMI # T1100									


CASEWORK GENERAL NOTES:

*NOTE:

RECEIVE LOCKS PER OWNER REQUEST. OWNER IS RESPONSIBLE FOR KEYING.

NOTE: CASEWORK BY OWNER (PROVIDE AND INSTALL), SHOWN FOR REFERENCE ONLY. ALL TRADES TO COORDINATE WITH CASEWORK CONTRACTOR AS REQUIRED.

**ALL WORK PERTAINS TO CASEWORK CONTRACTOR UNLESS NOTED OTHERWISE (GC=

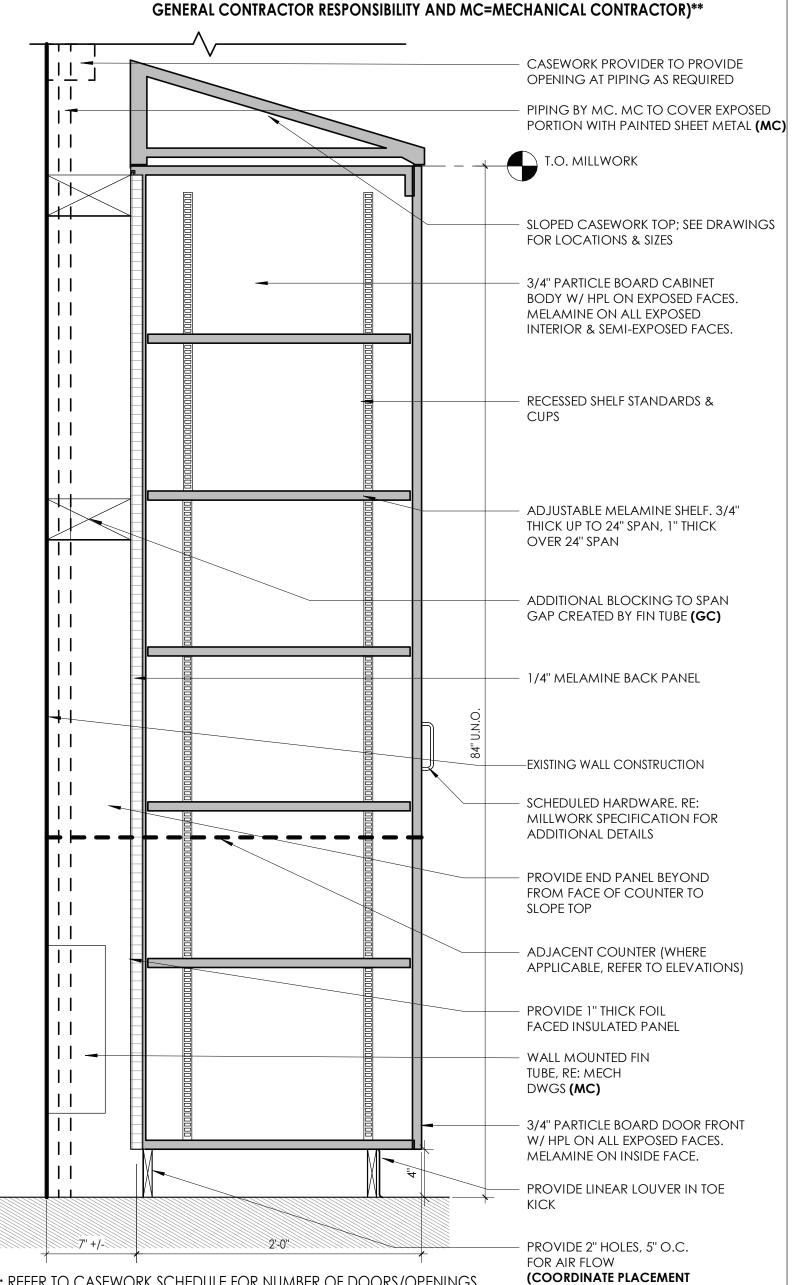

PROJECT INFORMATION

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CPL | Architecture Engineering Planning

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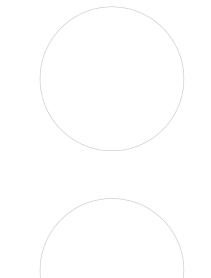
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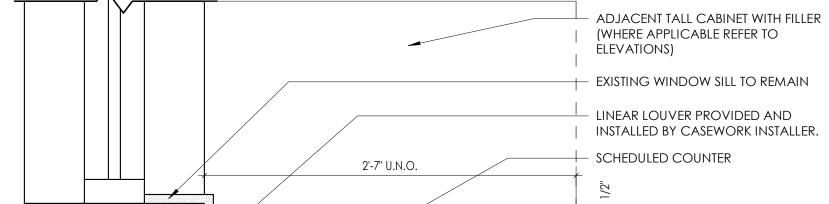
PROFESSIONAL STAMPS



SHEET INFORMATION

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Drawn By CPL Drawing Title MISC. DETAILS



ALL WORK PERTAINS TO CASEWORK CONTRACTOR UNLESS NOTED OTHERWISE (GC= GENERAL CONTRACTOR RESPONSIBILITY AND MC=MECHANICAL CONTRACTOR)

> PROVIDE 1" THICK FOIL FACED **INSULATED PANEL**

 WALL MOUNTED FIN TUBE, RE: MECH DWGS (MC)

PROVIDE LINEAR LOUVER IN TOE


PROVIDE 2" HOLES, 5" O.C. FOR AIR FLOW

(COORDINATE PLACEMENT

REQUIRED, VARIES. BASE CABINET W/ FIN TUBE VENTILATION

NOTE: REFER TO CASEWORK SCHEDULE FOR NUMBER OF DOORS/OPENINGS

11"+/-

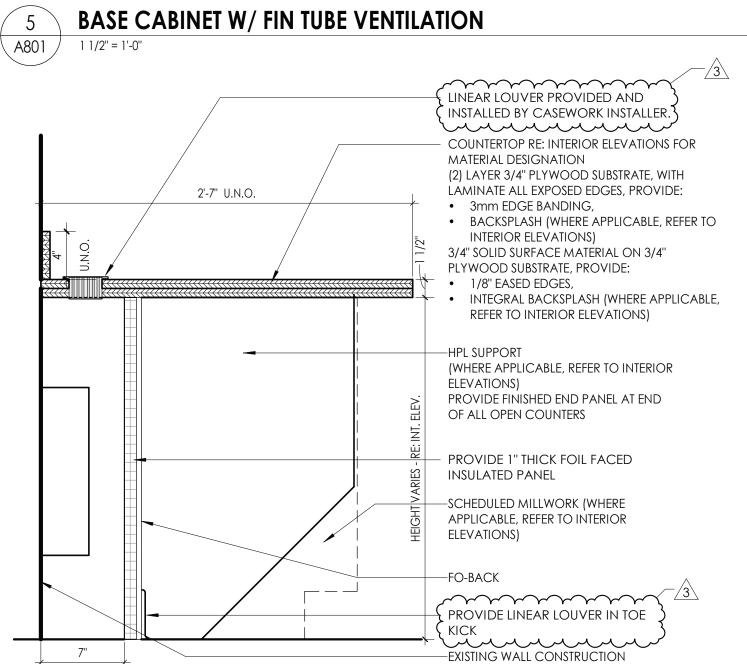

**ALL WORK PERTAINS TO CASEWORK CONTRACTOR UNLESS NOTED

OTHERWISE (GC= GENERAL CONTRACTOR RESPONSIBILITY)**

√A801 1 1/2" = 1'-0"

1. ALL CASEWORK WITH DOORS/ DRAWERS TO

 \cdot


TYPICAL LAMINATE WORKSURFACE SECTION

A801

REQUIRED, VARIES.

NOTE: REFER TO CASEWORK SCHEDULE FOR NUMBER OF DOORS/OPENINGS

TALL CABINET W/ FIN TUBE VENTILATION

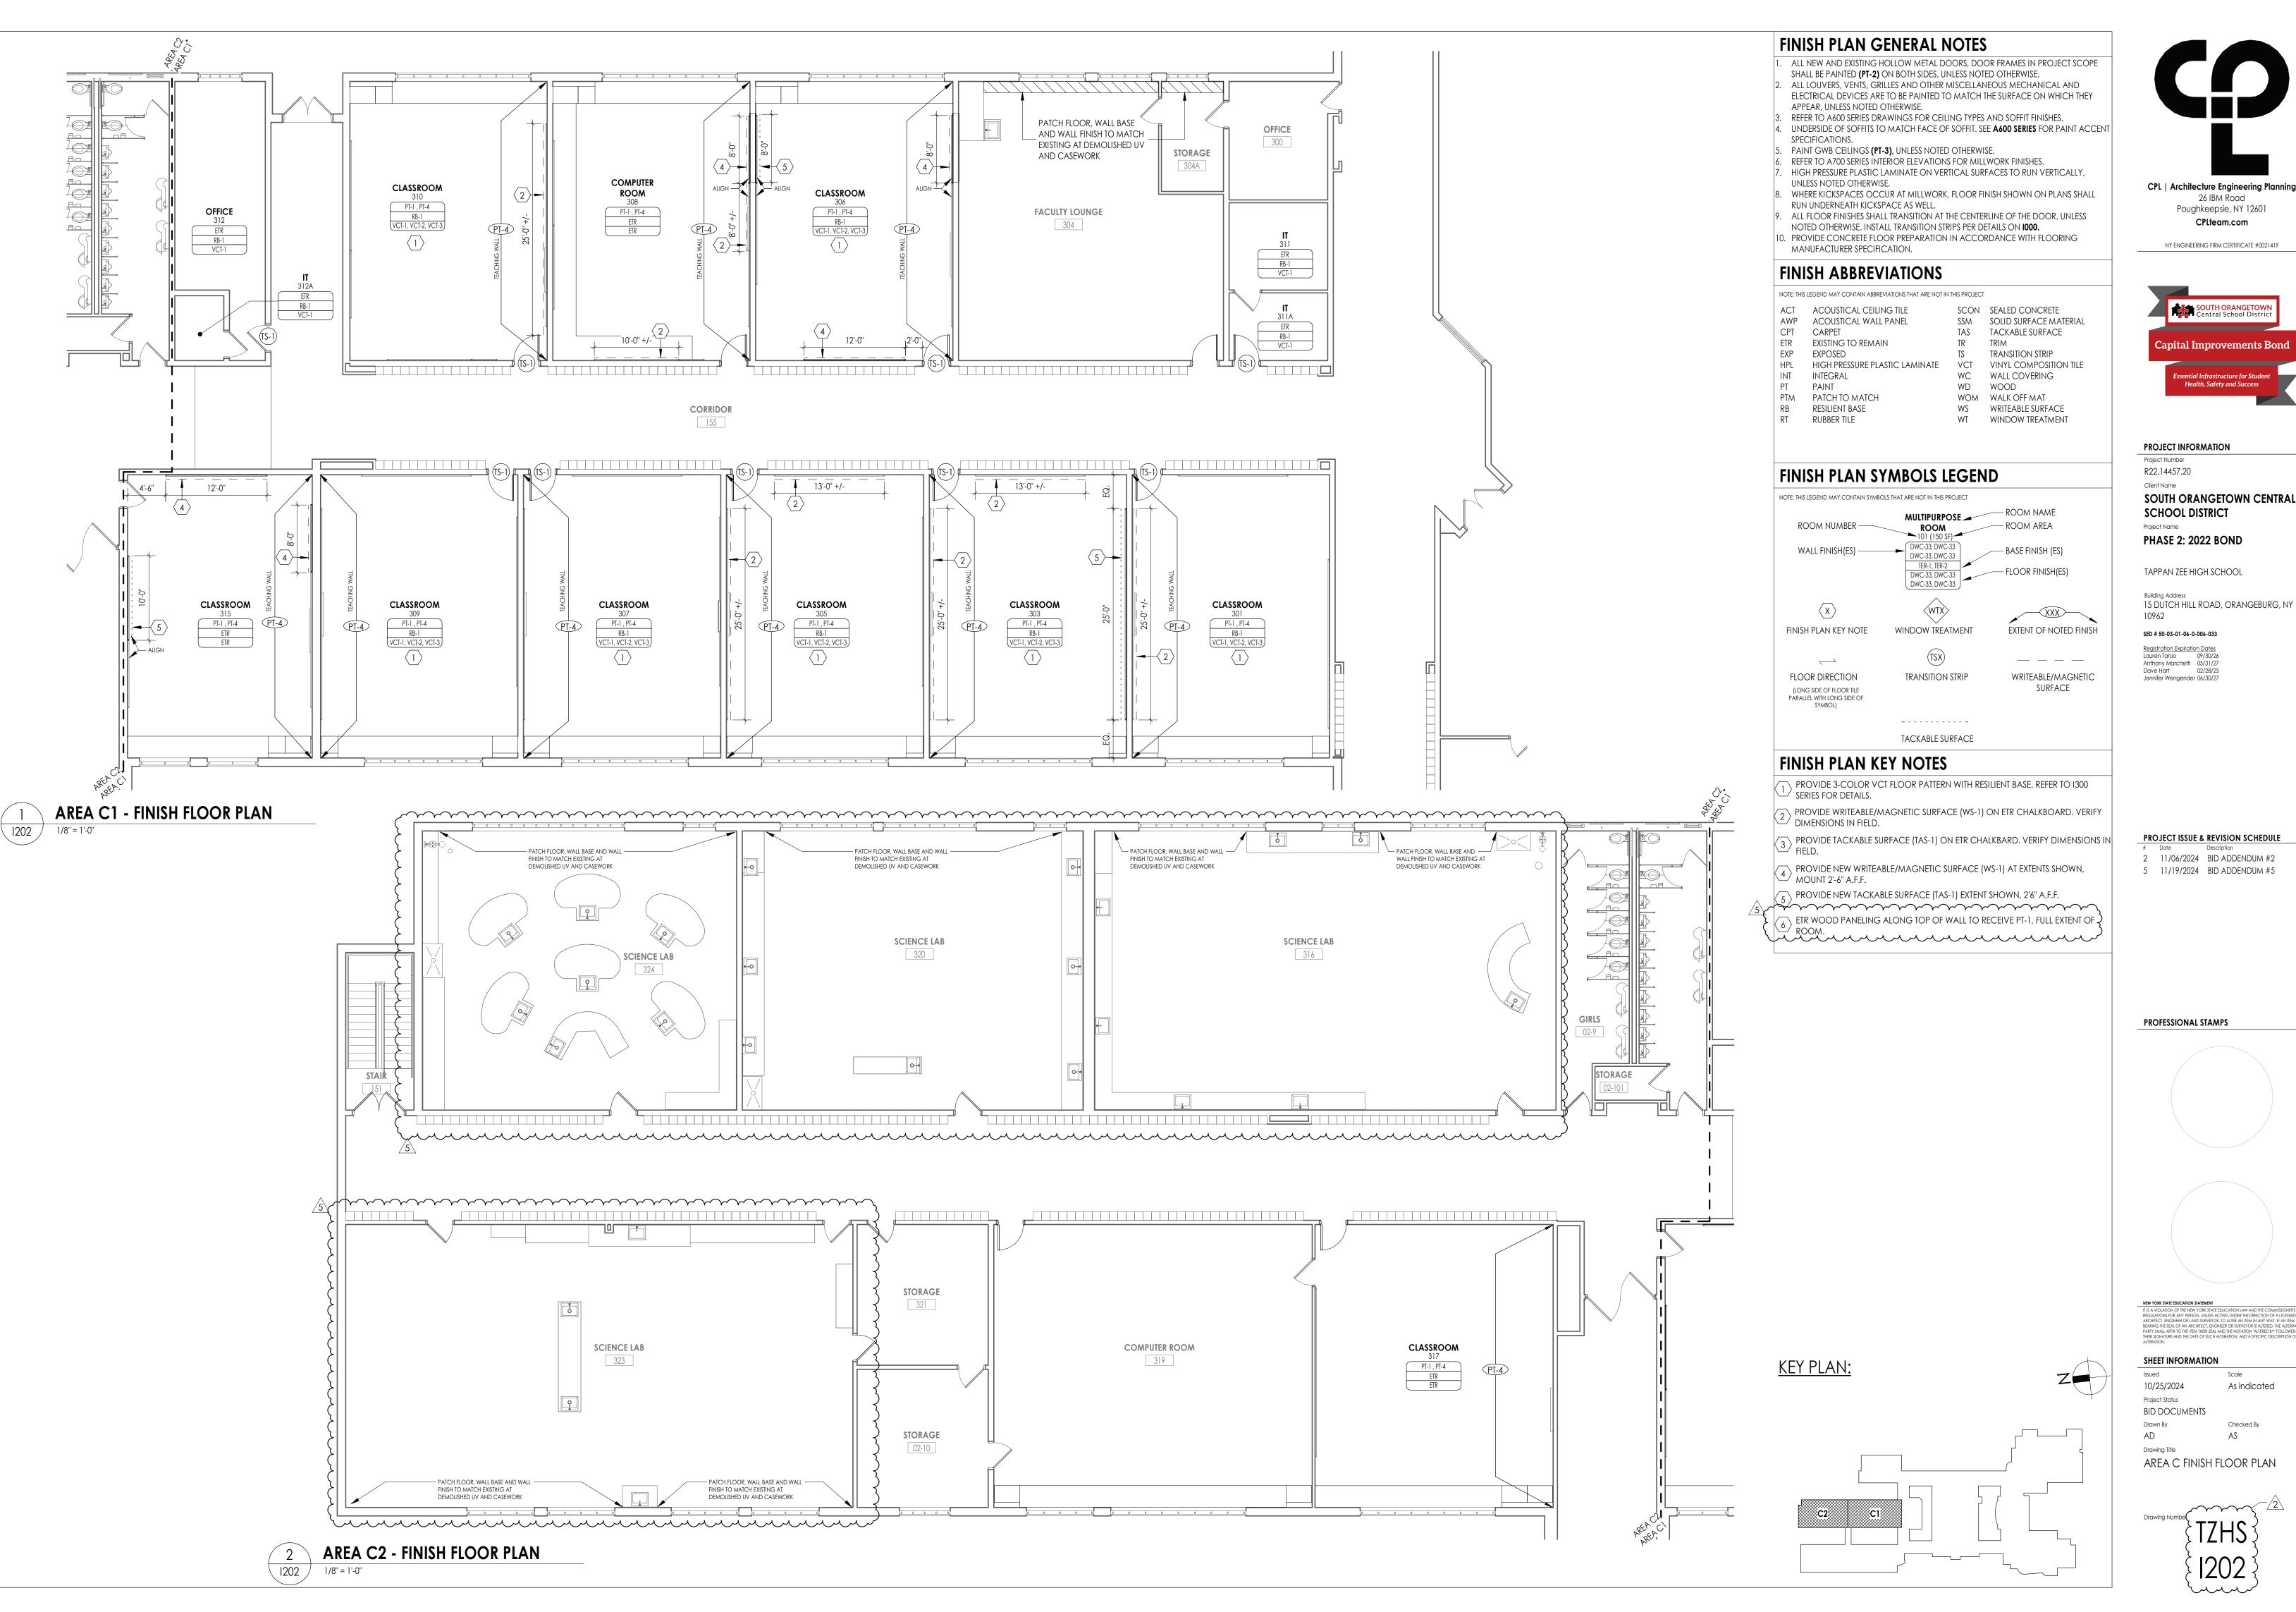

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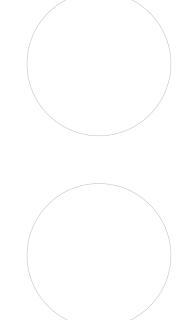
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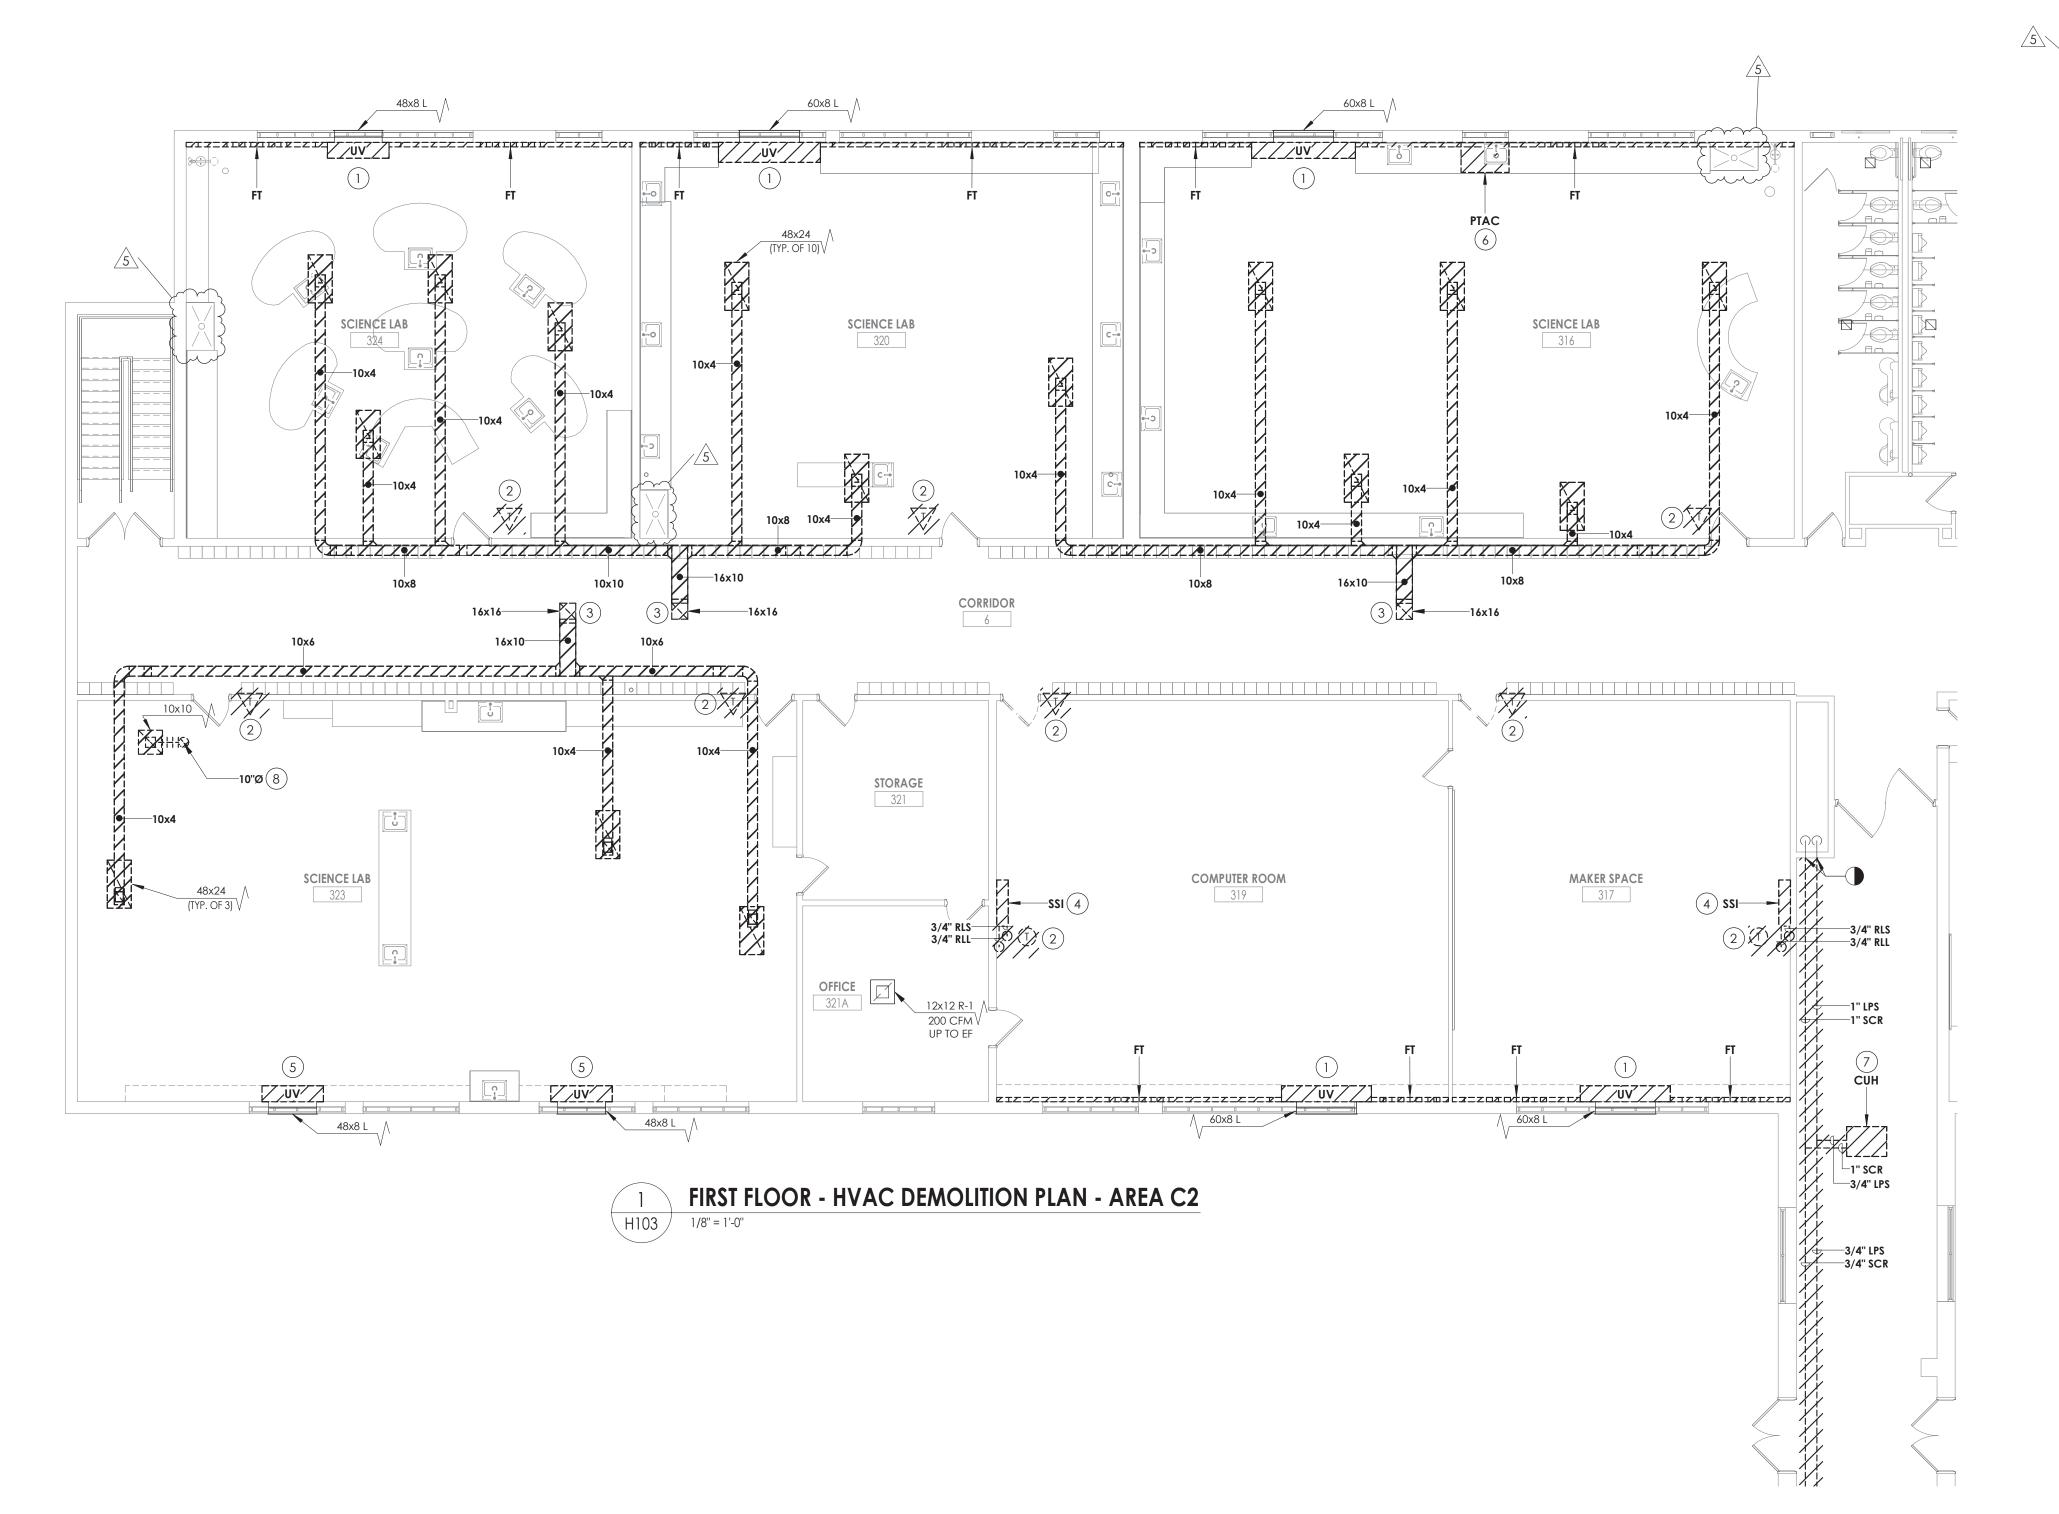
PROFESSIONAL STAMPS



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AREA C FINISH FLOOR PLAN



KEY NOTES

- 1 REMOVE EXISTING UNIT VENTILATOR AND FINTUBE. REMOVE PIPING TO LOWER LEVEL. LOUVER AND SLEEVE TO REMAIN. REFER TO ARCHITECTURAL PLANS.
- 2 REMOVE EXISTING TEMPERATURE SENSORS AND WIRING BACK TO CONTROL HEAD END. PREPARE FOR NEW WORK.
- NOT USED.
- 4) REMOVE EXISTING REFRIGERANT PIPING FROM CONDENSING UNIT ON ROOF TO UNIT IN THE CLASSROOM. PRIOR TO REMOVAL, DRAIN ALL PIPING AND DISPOSE OF ALL REFRIGERANT PER THE LATEST ADAPTED RULES AND REGULATION BY THE UNITED STATES ENVIRONMENTAL PROTECTION AGENCY (EPA). CONTRACTOR OR TECHNICIAN PERFORMING THE WORK SHALL BE AN EPA APPROVED AGENCY OR ORGANIZATION. REMOVE EXISTING INDOOR AND OUTDOOR SPLIT SYSTEMS. PATCH CURB WEATHER TIGHT.
- (5) REMOVE UNIT VENTILATOR AND ASSOCIATED PIPING. LOUVER AND SLEEVE TO REMAIN. REMOVE CASEWORK BACK TO FLOOR.
- (6) REMOVE PTAC UNIT IN WINDOW.
- 7) REMOVE CABINET UNIT HEATER AND REMOVE PIPING TO POINT INDICATED.
- 8 REMOVE EXISTING EXHAUST GRILLE AND ASSOCIATED DUCTWORK BACK TO EXHAUST FAN ON THE ROOF.

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NY ENGINEERING FIRM CERTIFICATE #0021419



PROJECT INFORMATION

14457.20

Client Name

SOUTH ORANGETOWN CENTRAL
SCHOOL DISTRICT

Project Name

TAPPAN ZEE HIGH SCHOOL

PHASE 2: 2022 BOND

Building Address 160 VAN WYCK RD., BLAUVELT, NY 10913


Reaistration Expiration Dates Lauren Tarsio 09/30/26 Anthony Marchetti 05/31/27 Dave Hart 02/28/25 Jennifer Wengender 06/30/27

SED # 50-03-01-06-0-006-033

PROJECT ISSUE & REVISION SCHEDULE

Date Description
5 11/19/24 BID ADDENDUM #5

PROFESSIONAL STAMPS

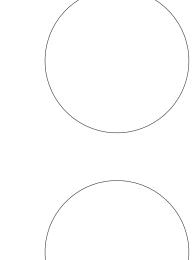

NEW YORK STATE EDUCATION STATEMENT

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REGULATIONS FOR ANY PERSON, UNLESS ACTING UNDER THE DIRECTION OF A LICENS
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PARTY SHALL AFRIX TO THE ITEM THER SEAL AND THE NOTATION "ALTERED BY" FOLLOW

SHEET INFORMATION

Issued Scale

10/25/2024 1/8" = 1'-0"

Project Status

BID DOCUMENTS

Drawn By Checked By

Drawn By Checked By
KCM JJM
Drawing Title

FIRST FLOOR DEMOLITION PLAN -AREA C2

> TZHS H103

KEY PLAN:





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NY ENGINEERING FIRM CERTIFICATE #0021419



PROJECT INFORMATION

Project Number 14457.20

Project Name

Client Name SOUTH ORANGETOWN CENTRAL SCHOOL DISTRICT

PHASE 2: 2022 BOND

TAPPAN ZEE HIGH SCHOOL

160 VAN WYCK RD., BLAUVELT, NY 10913


SED # 50-03-01-06-0-006-033


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PROJECT ISSUE & REVISION SCHEDULE

Date Description
5 11/19/24 BID ADDENDUM #5

PROFESSIONAL STAMPS



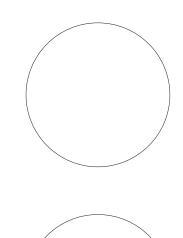

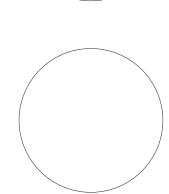
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BID DOCUMENTS Drawn By
KCM

ROOF DEMOLITION PLAN - AREA

TZHS H112

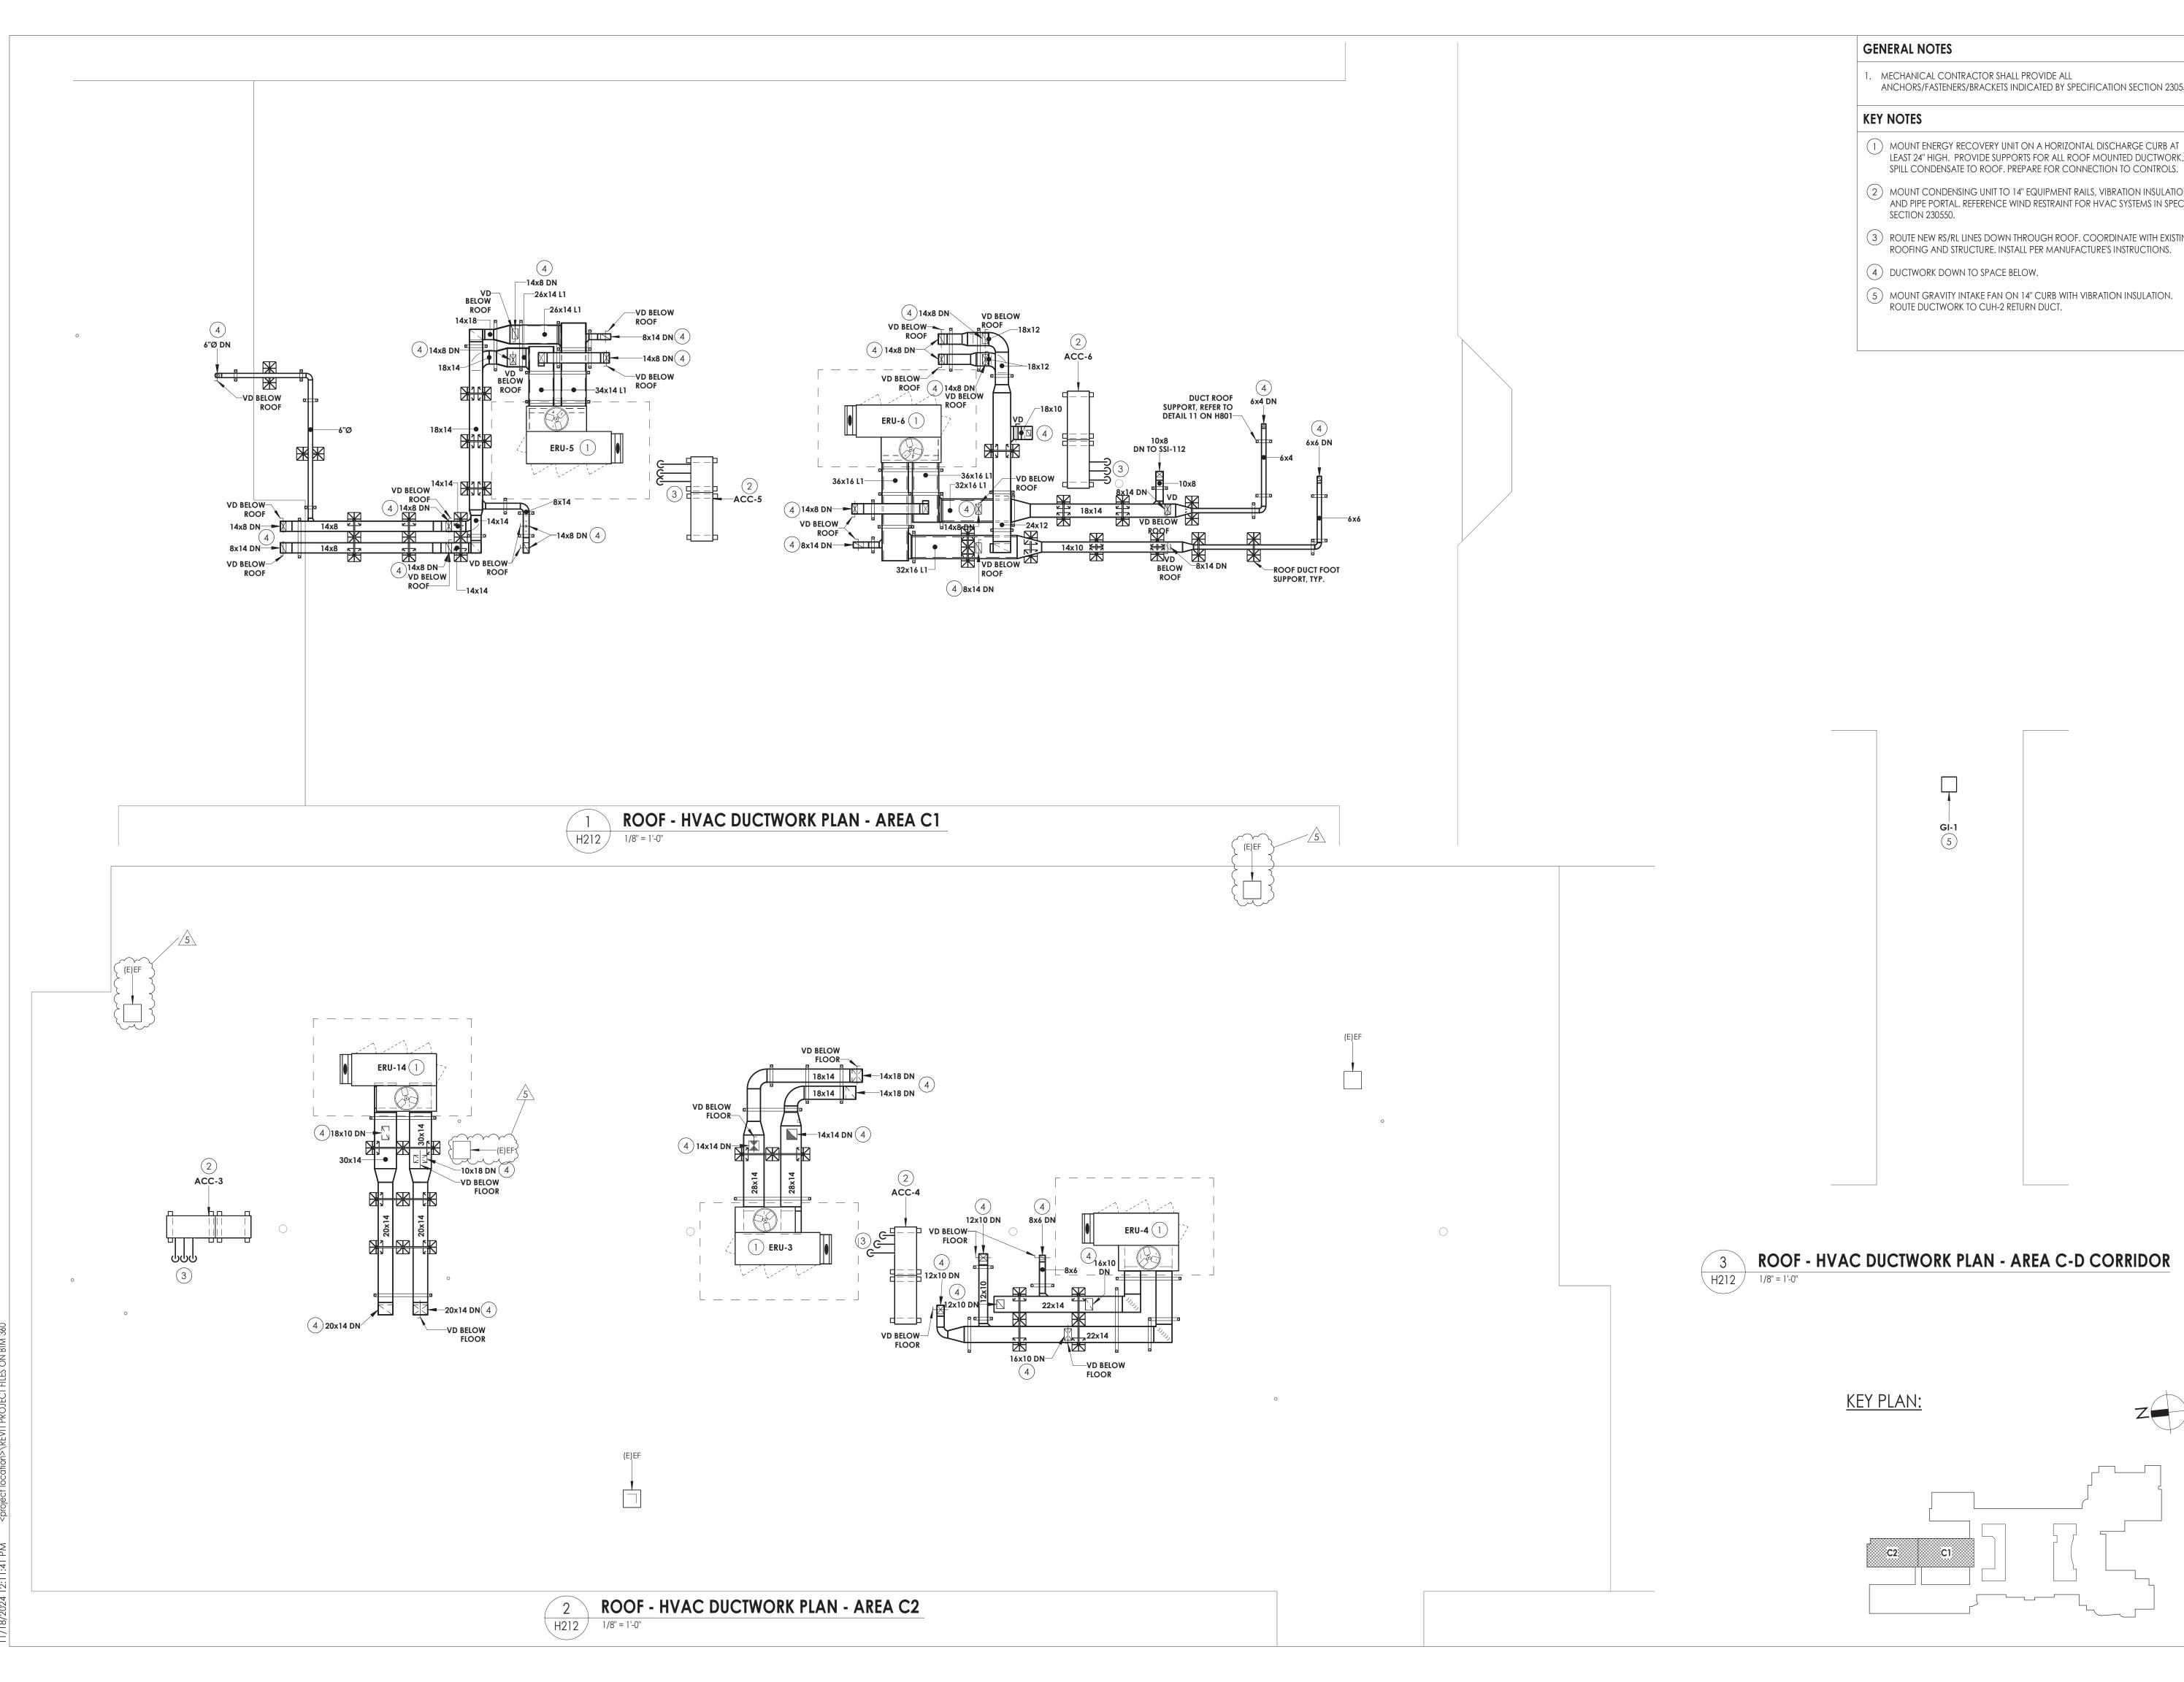

GENERAL NOTES

I. MECHANICAL CONTRACTOR SHALL PROVIDE ALL ANCHORS/FASTENERS/BRACKETS INDICATED BY SPECIFICATION SECTION 230550.

KEY NOTES

- (1) MOUNT ENERGY RECOVERY UNIT ON A HORIZONTAL DISCHARGE CURB AT LEAST 24" HIGH. PROVIDE SUPPORTS FOR ALL ROOF MOUNTED DUCTWORK. SPILL CONDENSATE TO ROOF. PREPARE FOR CONNECTION TO CONTROLS.
- (2) MOUNT CONDENSING UNIT TO 14" EQUIPMENT RAILS, VIBRATION INSULATION AND PIPE PORTAL. REFERENCE WIND RESTRAINT FOR HVAC SYSTEMS IN SPEC SECTION 230550.
- (3) ROUTE NEW RS/RL LINES DOWN THROUGH ROOF. COORDINATE WITH EXISTING ROOFING AND STRUCTURE. INSTALL PER MANUFACTURE'S INSTRUCTIONS.
- (4) DUCTWORK DOWN TO SPACE BELOW.

GI-1

(5) MOUNT GRAVITY INTAKE FAN ON 14" CURB WITH VIBRATION INSULATION. ROUTE DUCTWORK TO CUH-2 RETURN DUCT.

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PHASE 2: 2022 BOND

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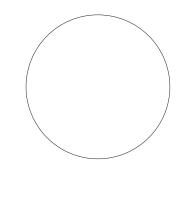
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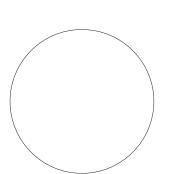
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PROJECT ISSUE & REVISION SCHEDULE

Date Description
3 11/08/24 BID ADDENDUM #3 4 11/15/24 BID ADDENDUM #4 5 11/19/24 BID ADDENDUM #5

PROFESSIONAL STAMPS






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ROOF DUCTWORK AND PIPING PLANS - AREAS C1 AND C2

H212



KEY NOTES

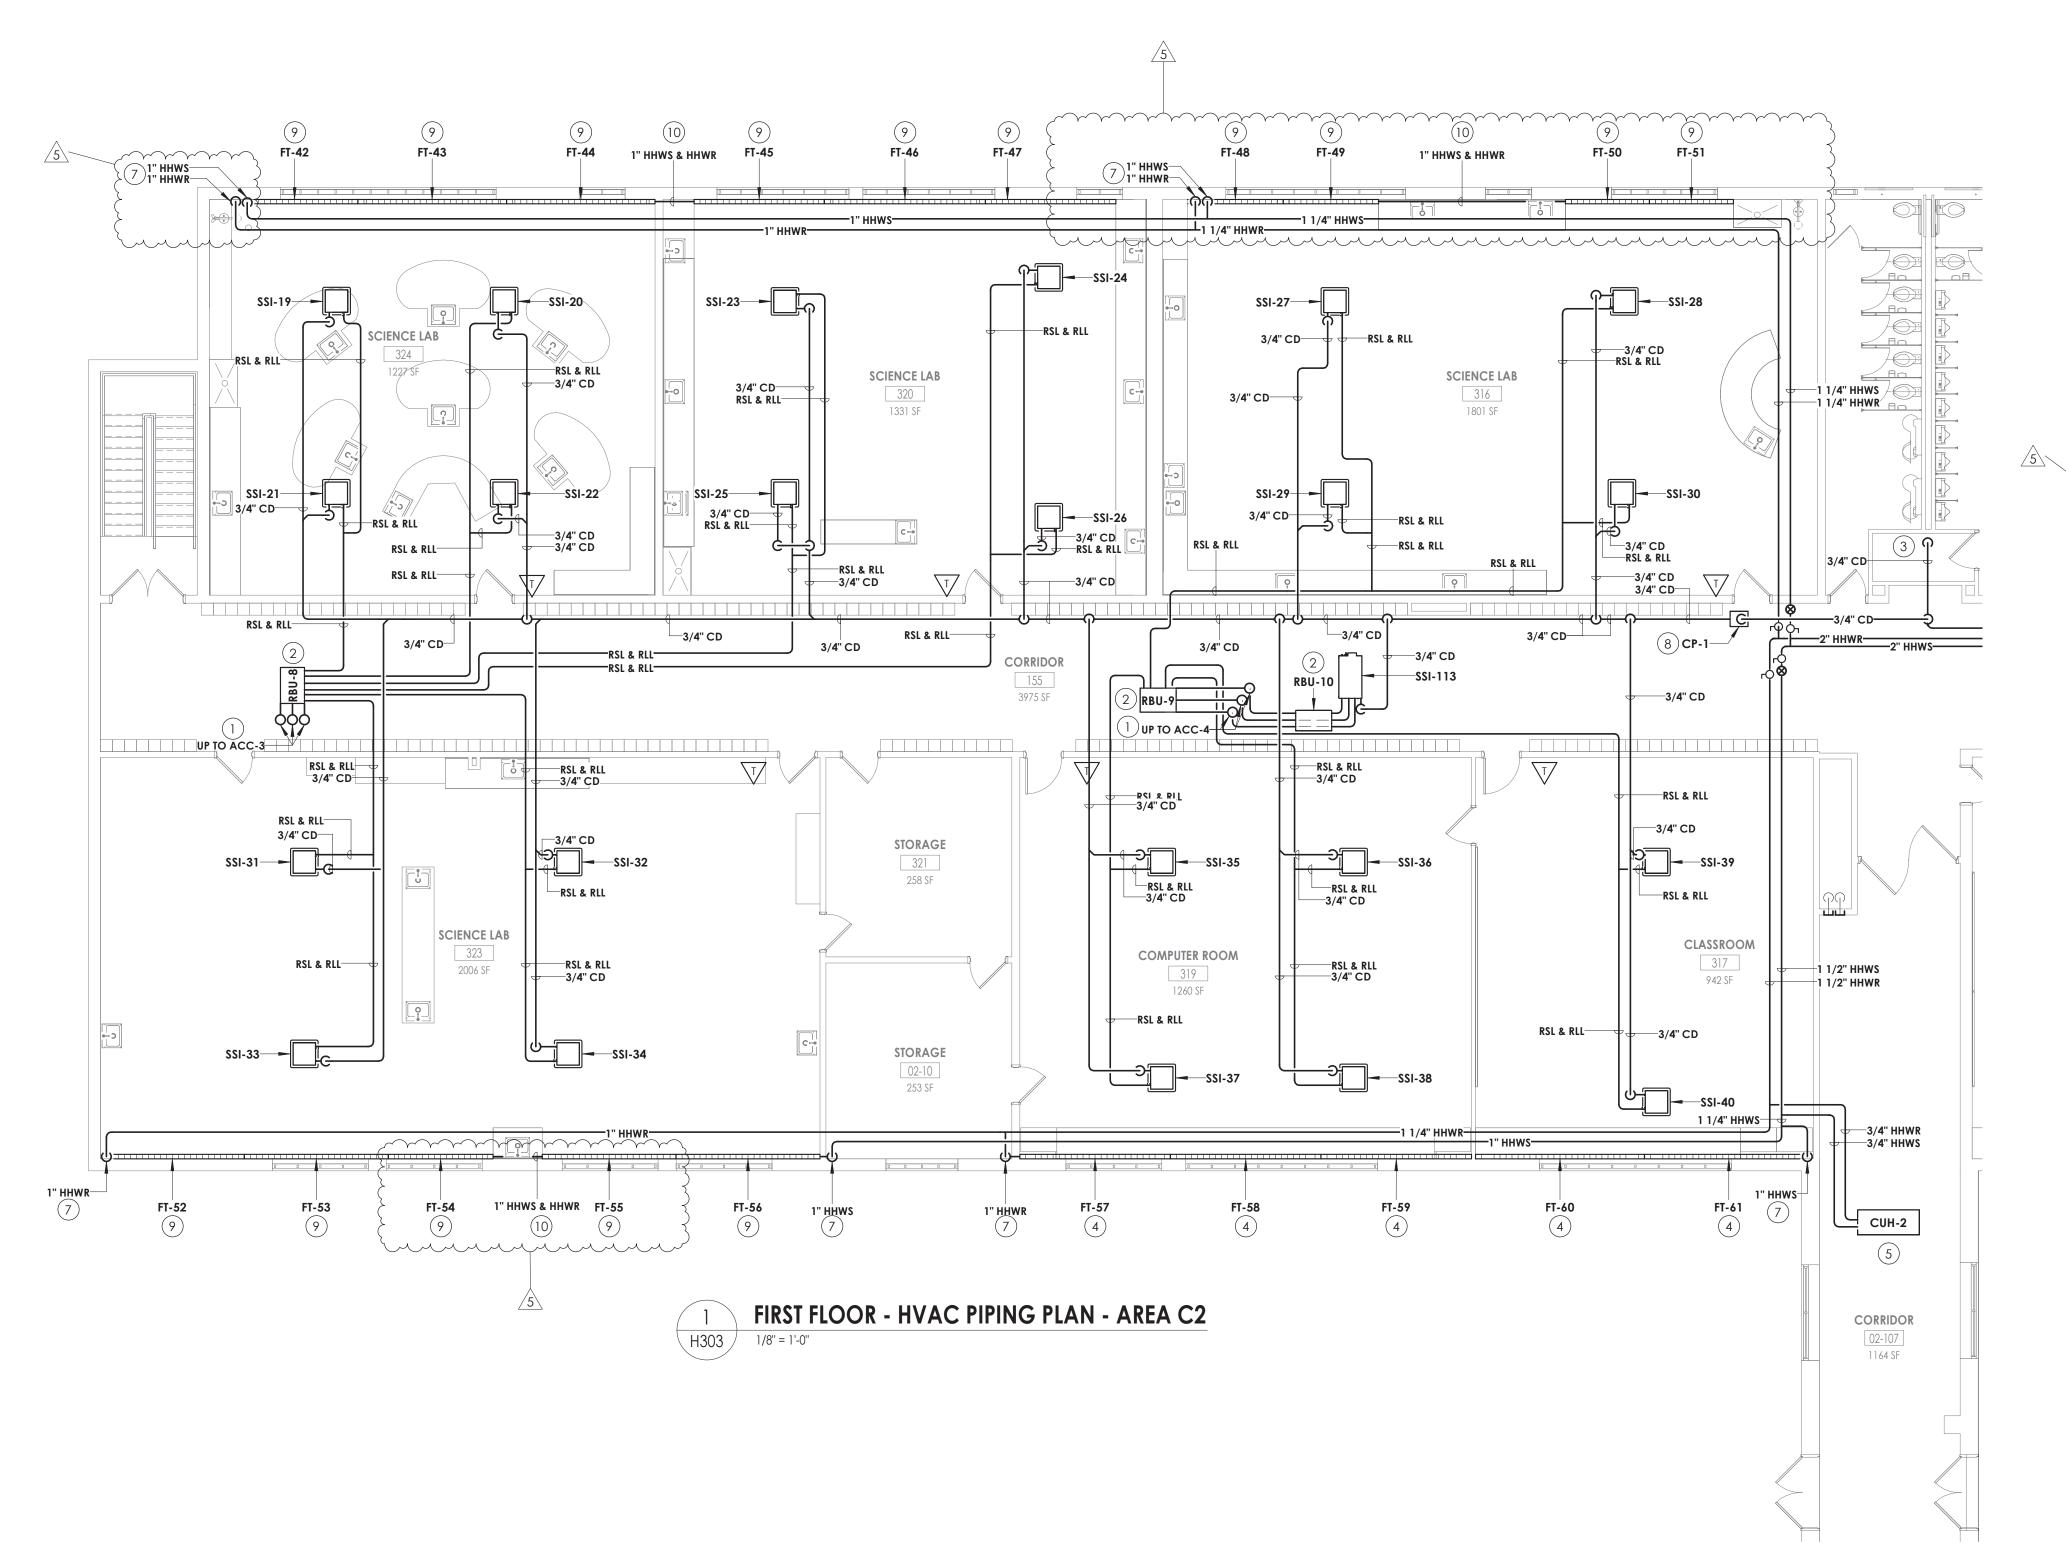- 1) RSL/RLL UP TO CONDENSING UNIT ON ROOF. REFER TO H600 FOR PIPE SIZES.
- PROVIDE BRANCH BOX. MOUNT UNIT AS HIGH AS POSSIBLE. COORDINATE PIPE ROUTING WITH DUCTWORK AND EXISTING STRUCTURE.
- 3 ROUTE CONDENSATE PIPING TO SANITARY. PROVIDE WITH AN INDIRECT CONNECTION.
- 4 PROVIDE FIN TUBE WITH DRAFTSTOP WHERE INDICATED.

MATCH THE CASEWORK.

- (5) INSTALL CABINET UNIT HEATER IN ACT CEILING GRID AND COORDINATE WITH ARCHITECTURAL, STRUCTURAL, AND LIGHTING. ROUTE PIPING ABOVE CEILING.
- 6 PROVIDE ENCLOSURE FOR FIN TUBE BETWEEN THE POINTS INDICATED.
 COORDINATE ENCLOSURE LENGTH WITH CASEWORK. ENCLOSURE PAINTED TO
- 7 FIN TUBE PIPING TO BE ROUTED ABOVE THE CEILING. PROVIDE 18 GAUGE GALVANIZED STEEL ENCLOSURE PAINTED TO MATCH THE WALL AROUND THE PIPING UP TO CEILING.
- 8 PROVIDE INLINE CONDENSATE PUMP. MOUNT ABOVE CEILING. ROUTE CONDENSATE PIPING AS HIGH AS POSSIBLE AND COORDINATE WITH
- (9) PROVIDE FIN TUBE WITH DRAFT STOP WHERE INDICATED. PROVIDE WITH ENCLOSER

(10) ROUTE HHWS & HHWR PIPING THROUGH EXISITNG CABINET. PROVIDE)
PENETRATION AND CORRDINATE WITH EXISTING DOMESTIC PIPING.

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Capital Improvements Bond

Essential Infrastructure for Student Health, Safety and Success

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PROJECT INFORMATION

14457.20

SOUTH ORANGETOWN CENTRAL SCHOOL DISTRICT
Project Name

TAPPAN ZEE HIGH SCHOOL

PHASE 2: 2022 BOND

Building Address 160 VAN WYCK RD., BLAUVELT, NY 10913

160 VAN WYCK RD., BLAUVELI, NY IL

SED # 50-03-01-06-0-006-033


Registration Expiration Dates

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PROJECT ISSUE & REVISION SCHEDULE

Date Description
2 11/06/24 BID ADDENDUM #2
3 11/08/24 BID ADDENDUM #3
5 11/19/24 BID ADDENDUM #5

PROFESSIONAL STAMPS

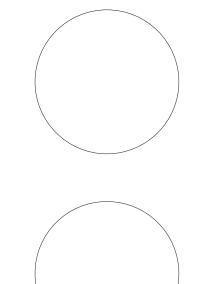

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PARTY SHALL AFTAT TO THE ITEM THEIR SEAL AND THE NOTATION "ALTERED BY FOLLOWED B

1/8" = 1'-0"

SHEET INFORMATION

Issued Scale

10/25/2024 1/8"

Project Status
BID DOCUMENTS


Drawn By Checke
KCM JJM

FIRST FLOOR PIPING PLAN - AREA

TZHS H303

KEY PLAN:

C2 C2

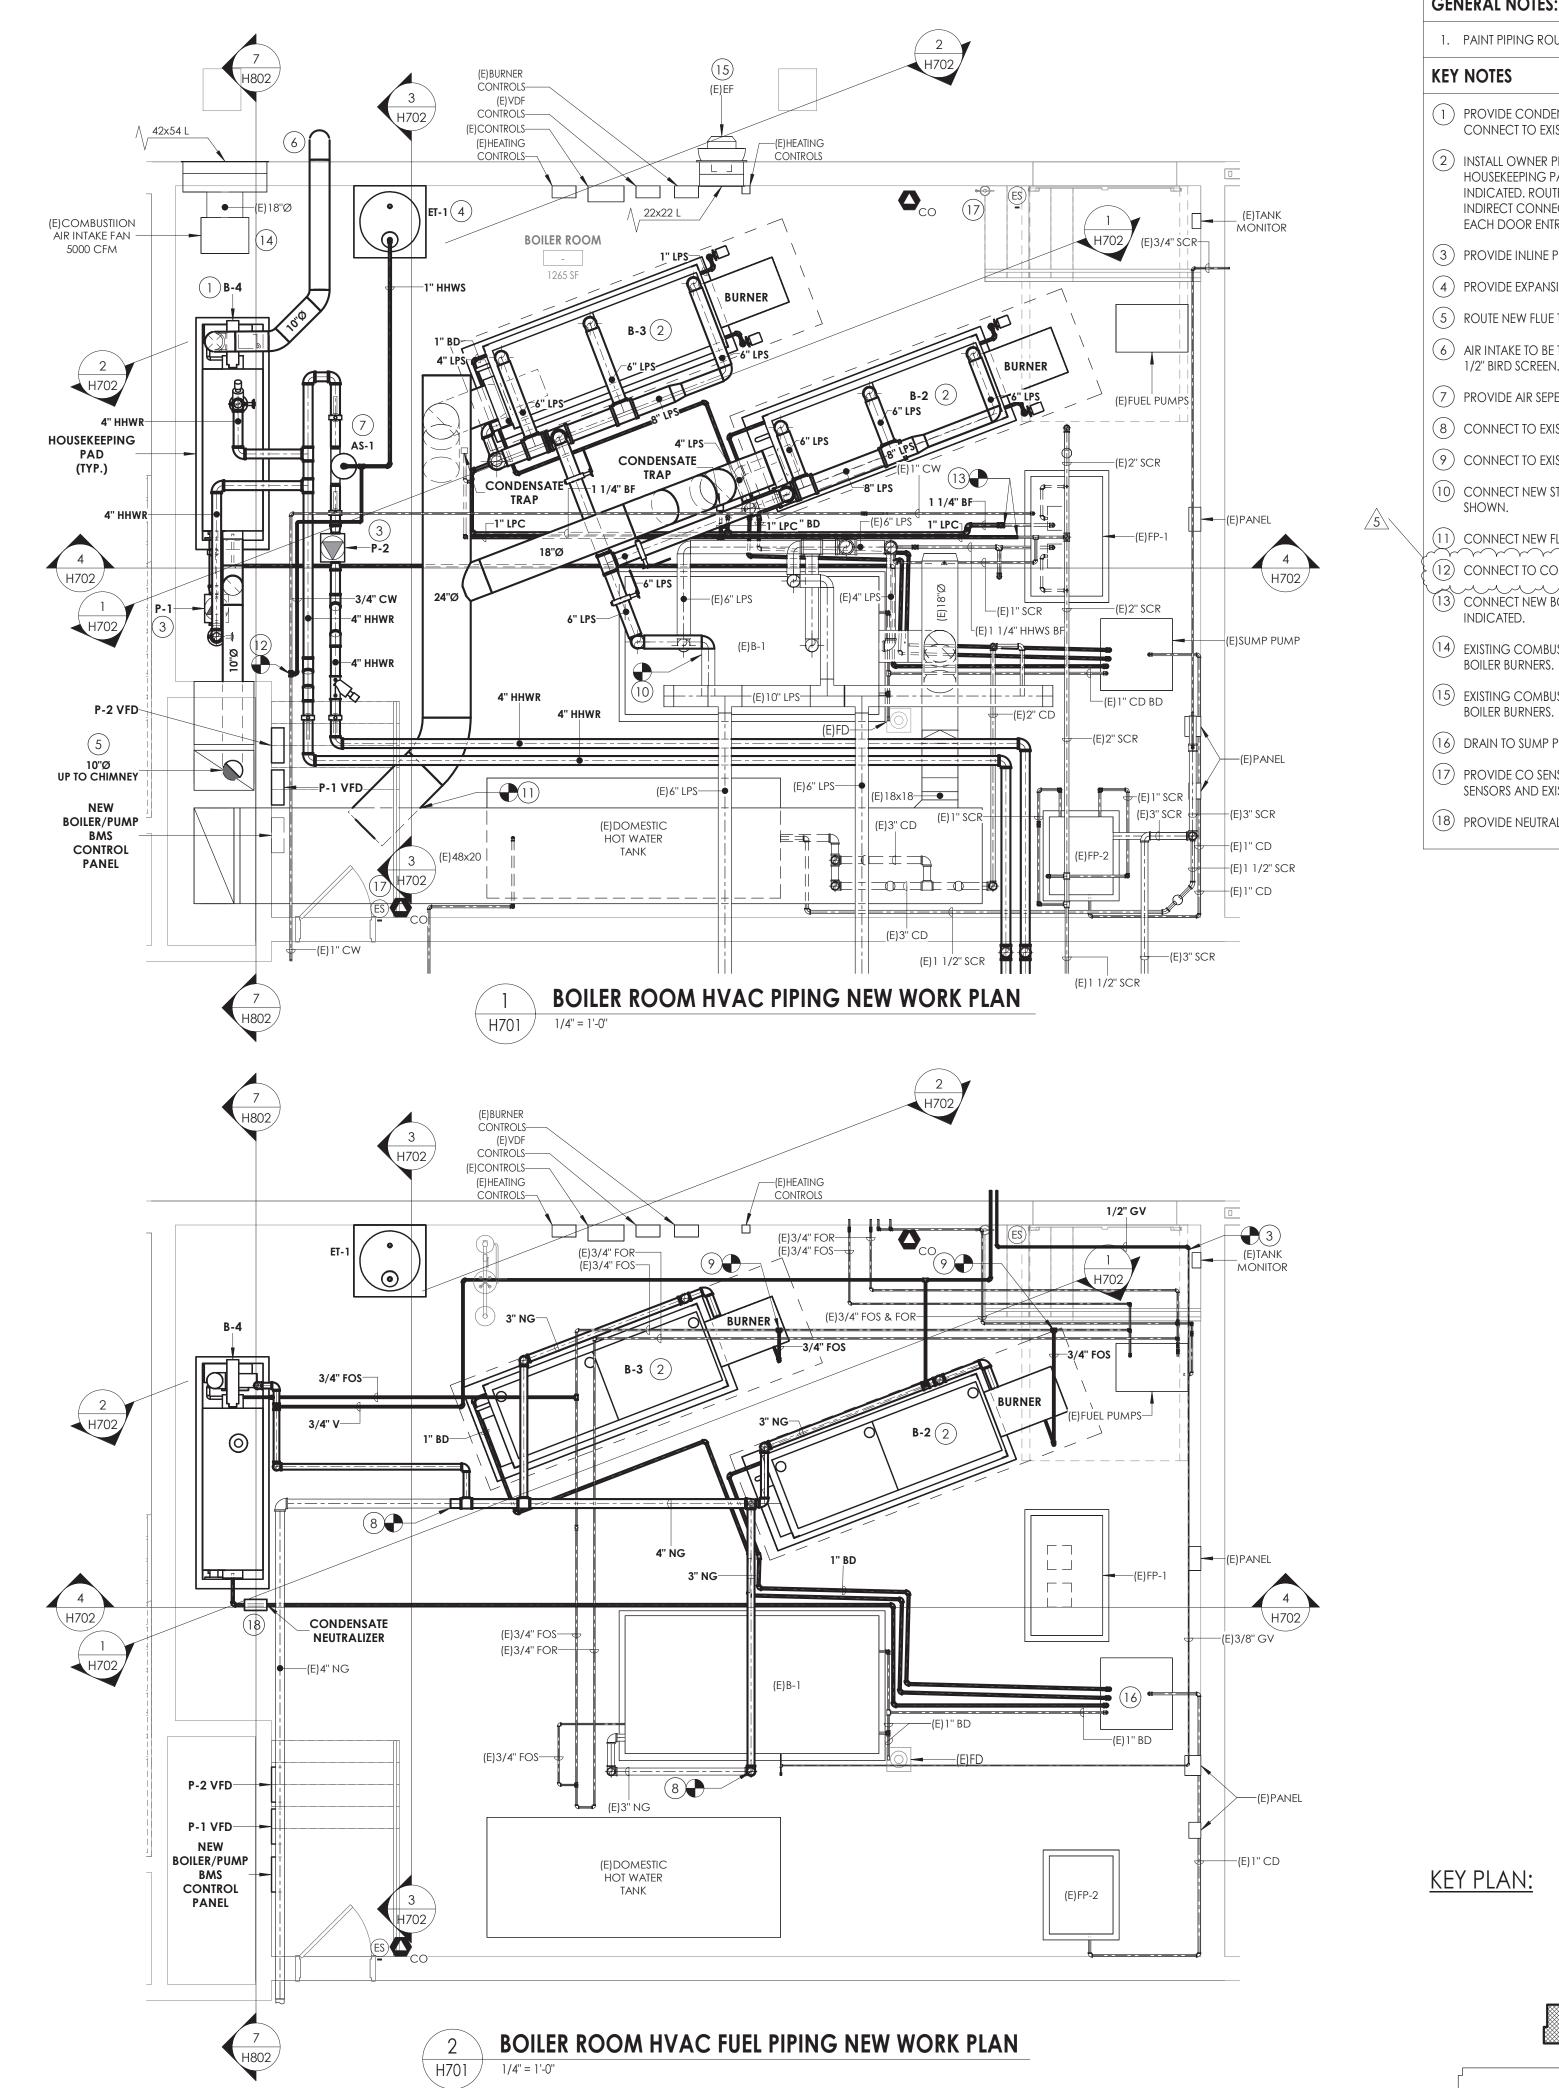

GENERAL NOTES:

1. PAINT PIPING ROUTED ON FLOOR YELLOW IN TRAP HAZARD PATHS.

KEY NOTES

- (1) PROVIDE CONDENSING BOILER AND INSTALL ON NEW HOUSEKEEPING PAD. CONNECT TO EXISTING EMERGENCY STOP BUTTON AT EACH DOOR ENTRY.
- (2) INSTALL OWNER PROVIDED STEAM BOILER AND TRIM BURNER ON NEW HOUSEKEEPING PAD. CONNECT TO STEAM PIPING AND FLUE AT POINTS INDICATED. ROUTE BLOW DOWN PIPING TO FLOOR DRAIN AND PROVIDE WITH INDIRECT CONNECTION. CONNECT TO EXISTING EMERGENCY STOP BUTTON AT EACH DOOR ENTRY.
- (3) PROVIDE INLINE PUMP.
- (4) PROVIDE EXPANSION TANK AND CONNECT TO HOT WATER SYSTEM.
- (5) ROUTE NEW FLUE THROUGH EXISTING CHIMNEY.
- (6) AIR INTAKE TO BE TERMINATED WITH DOWNWARDS 90° ELBOW AND WITH 1/2" x 1/2" BIRD SCREEN.
- (7) PROVIDE AIR SEPERATOR AND CONNECT TO HOT WATER RETURN PIPING.
- (8) CONNECT TO EXISTING NATURAL GAS PIPING AND ROUTE TO GAS TRAINS.
- (9) CONNECT TO EXISTING OIL SUPPLY/RETURN PIPING AND ROUTE TO BURNER.
- (10) CONNECT NEW STEAM PIPING TO EXISTING STEAM BRANCH IN LOCATION
- (11) CONNECT NEW FLUE TO EXISTING FLUE. MATCH/RE-INSULATE AS REQUIRED. 12) CONNECT TO COLD WATER MAKE UP. COORDINATE EXACT LOCATION. $rac{1}{3}$ (13) CONNECT NEW BOILER FEED PIPING TO EXISTING BOILER FEED PIPING AT POINT
- (14) EXISTING COMBUSTION AIR INTAKE FAN TO BE INTERCONNECTED TO STEAM
- (15) EXISTING COMBUSTION AIR RELIEF FAN TO BE INTERCONNECTED TO STEAM BOILER BURNERS.
- (16) DRAIN TO SUMP PUMP. PROVIDE AIR GAP.
- (17) PROVIDE CO SENSOR NEAR EACH EXIT. REFERENCED ON H502. CONNECT CO SENSORS AND EXISTING EMERGENCY SHUT-OFF CONTROLS TO ALL BOILERS.
- (18) PROVIDE NEUTRALIZATION TANK FOR CONDENSING BOILER.

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SOUTH ORANGETOWN CENTRAL SCHOOL DISTRICT PHASE 2: 2022 BOND

TAPPAN ZEE HIGH SCHOOL

160 VAN WYCK RD., BLAUVELT, NY 10913


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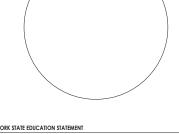
Reaistration Expiration Dates Lauren Tarsio 09/30/26 Anthony Marchetti 05/31/27 Dave Hart 02/28/25 Jennifer Wengender 06/30/27

PROJECT ISSUE & REVISION SCHEDULE

Date Description
2 11/06/24 BID ADDENDUM #2 5 11/19/24 BID ADDENDUM #5

PROFESSIONAL STAMPS



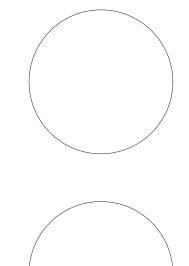

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BOILER ROOM ENLARGED NEW **WORK PLANS**

FIN TUBE SCHEDULE HOT WATER ENCLOSURE																	
TAG	LOCATION	TUBE SIZE	FIN SIZE H X W	EINI TVDE	TIEDS	BTUH/LF	ACTIVE LENGTH		OT WATE				MOUNT	OSURE APPROX	ENICL OSLIBE	TYPICAL UNIT MFG	NOTES:
IAG	LOCATION	(IN)	(IN)	FIIN ITFE	HEKS	DIUH/LF	(FT)	FLOW (GPM)	BTUH	AWT (°F)	H (IN.)	D (IN.)	HEIGHT (IN)	LENGTH (FT)	ENCLOSURE STYLE	& MODEL NO.	NOIES.
FT-1	208	1	3-5/8 X 4-1/4	Cu/AL	3-6 CL	1200	11	1.056	13200	140	30	5	21 3/8	12	BARE ELEMENT	STERLING JVB-B-C433	1,2
FT-2	208	1	3-5/8 X 4-1/4	Cu/AL	3-6 CL	1200	11	1.056	13200	140	30	5	21 3/8	12	BARE ELEMENT	STERLING JVB-B-C433	1,2
FT-3	206	1	3-5/8 X 4-1/4	Cu/AL	3-6 CL	1200	10.75	1.032	12900	140	30	5	21 3/8	12	BARE ELEMENT	STERLING JVB-B-C433	1,2
FT-4	206	1	3-5/8 X 4-1/4	Cu/AL	3-6 CL	1200	10.75	1.032	12900	140	30	5	21 3/8	12	BARE ELEMENT	STERLING JVB-B-C433	1,2
FT-5	204	1	3-5/8 X 4-1/4	Cu/AL	3-6 CL	1200	10.5	1.008	12600	140	30	5	21 3/8	11.5	BARE ELEMENT	STERLING JVB-B-C433	1,2
FT-6	204	1	3-5/8 X 4-1/4	Cu/AL	3-6 CL	1200	10.5	1.008	12600	140	30	5	21 3/8	11.5	BARE ELEMENT	STERLING JVB-B-C433	1,2
FT-7	202	1	3-5/8 X 4-1/4	Cu/AL	3-6 CL	1200	10.583	1.016	12700	140	30	5	21 3/8	12	BARE ELEMENT	STERLING JVB-B-C433	1,2
FT-8	202	1	3-5/8 X 4-1/4	Cu/AL	3-6 CL	1200	10.583	1.016	12700	140	30	5	21 3/8	12	BARE ELEMENT	STERLING JVB-B-C433	1,2
FT-9	200	1	3-5/8 X 4-1/4	Cu/AL	3-6 CL	1200	11	1.056	13200	140	30	5	21 3/8	12	BARE ELEMENT	STERLING JVB-B-C433 STERLING	1,2
FT-10	200	1	3-5/8 X 4-1/4	Cu/AL	3-6 CL	1200	11	1.056	13200	140	30	5	21 3/8	12	BARE ELEMENT	JVB-B-C433 STERLING	1,2
FT-11	211	1	3-5/8 X 4-1/4	Cu/AL	3-6 CL	1200	10.75	1.032	12900	140	30	5	21 3/8	11	BARE ELEMENT	JVB-B-C433 STERLING	1
FT-12	211	1	3-5/8 X 4-1/4	Cu/AL	3-6 CL	1200	10.75	1.032	12900	140	30	5	21 3/8	11	BARE ELEMENT	JVB-B-C433 STERLING	1
FT-13	209	1	3-5/8 X 4-1/4 3-5/8 X 4-1/4	Cu/AL	3-6 CL 3-6 CL	1200	10.75	1.032	12900	140	30	5	21 3/8	11.5	BARE ELEMENT BARE ELEMENT	JVB-B-C433 STERLING	1
FT-15	207	1	3-5/8 X 4-1/4	Cu/AL	3-6 CL	1200	10.75	1.032	12700	140	30	5	21 3/8	11.5	BARE ELEMENT	JVB-B-C433 STERLING	1
FT-16	207	1	3-5/8 X 4-1/4	Cu/AL	3-6 CL	1200	10.75	1.032	12900	140	30	5	21 3/8	11.5	BARE ELEMENT	JVB-B-C433 STERLING	1
FT-17	205	3/4	3-5/8 X 4-1/4	Cu/AL	3-6 CL	1320	9.75	1.0296	12870	140	30	5	21 3/8	10.25	BARE ELEMENT	JVB-B-C433 STERLING JVB-B-C3/4-433	1
FT-18	205	3/4	3-5/8 X 4-1/4	Cu/AL	3-6 CL	1320	9.75	1.0296	12870	140	30	5	21 3/8	10.25	BARE ELEMENT	STERLING	1
FT-19	205	3/4	3-5/8 X 4-1/4	Cu/AL	3-6 CL	1320	9.75	1.0296	12870	140	30	5	21 3/8	10.25	BARE ELEMENT	JVB-B-C3/4-433 STERLING JVB-B-C3/4-433	1
FT-20	201	3/4	3-5/8 X 4-1/4	Cu/AL	2-6 CL	780	6	0.3744	4680	140	24	5 5/16	28	7	TOP OUTLET	STERLING JVB-T-C3/4-435	3,4,5
FT-21	312	3/4	3-5/8 X 4-1/4	Cu/AL	2-6 CL	1120	9.667	0.86616	10827	140	24	5 5/16	28	11	TOP OUTLET	STERLING JVB-T-C3/4-434	2,3,4,5
FT-22	310	1	3-5/8 X 4-1/4	Cu/AL	3-6 CL	1280	11.167	1.14352	14294	140	30	5	21 3/8	12	BARE ELEMENT	STERLING JVB-B-C434	1,2
FT-23	310	1	3-5/8 X 4-1/4	Cu/AL	3-6 CL	1280	11.167	1.14352	14294	140	30	5	21 3/8	12	BARE ELEMENT	STERLING JVB-B-C434	1,2
FT-24	308	1	3-5/8 X 4-1/4	Cu/AL	3-6 CL	1280	11.167	1.14352	14294	140	30	5	21 3/8	12	BARE ELEMENT	STERLING JVB-B-C434	1,2
FT-25	308	1	3-5/8 X 4-1/4	Cu/AL	3-6 CL	1280	11.167	1.14352	14294	140	30	5	21 3/8	12	BARE ELEMENT	STERLING JVB-B-C434	1,2
FT-26	306	1	3-5/8 X 4-1/4	Cu/AL	3-6 CL	1280	11.167	1.14352	14294	140	30	5	21 3/8	12	BARE ELEMENT	STERLING JVB-B-C434	1,2
FT-27	306	1	3-5/8 X 4-1/4	Cu/AL	3-6 CL	1280	11.167	1.14352	14294	140	30	5	21 3/8	12	BARE ELEMENT	STERLING JVB-B-C434	1,2
FT-28	304	1	3-5/8 X 4-1/4	Cu/AL	3-6 CL	1380	11.583	1.2788	15985	140	30	5	21 3/8	8	TOP OUTLET	STERLING JVB-B-C435 STERLING	1,2
FT-29	304	1	3-5/8 X 4-1/4	Cu/AL	3-6 CL	1380	11.583	1.2788	15985	140	30	5	21 3/8	12	TOP OUTLET	JVB-B-C435 STERLING	1,2
FT-30	315	1	3-5/8 X 4-1/4	Cu/AL	3-6 CL	1280	10	1.024	12800	140	30	5	21 3/8	11	BARE ELEMENT	JVB-B-C434 STERLING	1,2
FT-31	315	1	3-5/8 X 4-1/4	Cu/AL	3-6 CL	1280	10	1.024	12800	140	30	5	21 3/8	11	BARE ELEMENT	JVB-B-C434 STERLING	1,2
FT-32 FT-33	309	1	3-5/8 X 4-1/4 3-5/8 X 4-1/4	Cu/AL	3-6 CL	1280	10.75	1.1008	13760	140	30	5	21 3/8	12	BARE ELEMENT	JVB-B-C434 STERLING	1,2
FT-34	307	1	3-5/8 X 4-1/4	Cu/AL	3-6 CL	1280	10.75	1.1264	14080	140	30	5	21 3/8	12	BARE ELEMENT	JVB-B-C434 STERLING	1,2
FT-35	307	1	3-5/8 X 4-1/4	CU/AL	3-6 CL	1280	11	1.1264	14080	140	30	5	21 3/8	12	BARE ELEMENT	JVB-B-C434 STERLING	1,2
FT-36	305	1	3-5/8 X 4-1/4	Cu/AL	3-6 CL	1280	11	1.1264	14080	140	30	5	21 3/8	12	BARE ELEMENT	JVB-B-C434 STERLING	1,2
FT-37	305	1	3-5/8 X 4-1/4	Cu/AL	3-6 CL	1280	11	1.1264	14080	140	30	5	21 3/8	12	BARE ELEMENT	JVB-B-C434 STERLING JVB-B-C434	1,2
FT-38	303	1	3-5/8 X 4-1/4	Cu/AL	3-6 CL	1280	11	1.1264	14080	140	30	5	21 3/8	12	BARE ELEMENT	STERLING JVB-B-C434	1,2
FT-39	303	1	3-5/8 X 4-1/4	Cu/AL	3-6 CL	1280	11	1.1264	14080	140	30	5	21 3/8	12	BARE ELEMENT	STERLING JVB-B-C434	1,2
FT-40	301	1	3-5/8 X 4-1/4	Cu/AL	3-6 CL	1280	11	1.1264	14080	140	30	5	21 3/8	12	BARE ELEMENT	STERLING JVB-B-C434	1,2
FT-41	301	1	3-5/8 X 4-1/4	Cu/AL	3-6 CL	1280	11	1.1264	14080	140	30	5	21 3/8	12	BARE ELEMENT	STERLING JVB-B-C434	1,2
FT-42	324	1	3-5/8 X 4-1/4	Cu/AL	3-6 CL	1230	10	0.984	12300	140	30	5	21 3/8	10.5	TOP OUTLET	STERLING JVB-B-C435	2,3,4
FT-43	324	1	3-5/8 X 4-1/4	Cu/AL	3-6 CL	1230	12	1.1808	14760	140	30	5	21.375	12.5	TOP OUTLET	STERLING JVB-B-C435	2,3,4
FT-44	324	1	3-5/8 X 4-1/4	Cu/AL	3-6 CL	1230	12	1.1808	14760	140	30	5	21.375	12.5	TOP OUTLET	STERLING JVB-B-C435	2,3,4
FT-45	320	1	3-5/8 X 4-1/4	Cu/AL	3-6 CL	1230	10	0.984	12300	140	30	5	21 3/8	10.9	TOP OUTLET	STERLING JVB-B-C435	2,3,4
FT-46	320	1	3-5/8 X 4-1/4	Cu/AL	3-6 CL	1230	12.5	1.23	15375	140	30	5	21.375	13.5	TOP OUTLET	STERLING JVB-B-C435	2,3,4
FT-47	320	1	3-5/8 X 4-1/4	Cu/AL	3-6 CL	1230	12.5	1.23	15375	140	30	5	21.375	13.5	TOP OUTLET	STERLING JVB-B-C435	2,3,4
FT-48	316	1	3-5/8 X 4-1/4	Cu/AL	3-6 CL		7.5	0.738	9225	140	30	5	21 3/8	8	TOP OUTLET	STERLING JVB-B-C435 STERLING	2,3,4
FT-49	316	1	3-5/8 X 4-1/4	Cu/AL	3-6 CL	1230	7.5	0.738	9225	140	30	5	21 3/8	8	TOP OUTLET	JVB-B-C435 STERLING	2,3,4
FT-50	316	1	3-5/8 X 4-1/4	Cu/AL	3-6 CL	1230	7	0.6888	8610	140	30	5	21 3/8	7	TOP OUTLET	JVB-B-C435 STERLING	2,3,4
FT-51	316	1	3-5/8 X 4-1/4	Cu/AL	3-6 CL	1230	6.5	0.6396	7995	140	30	5	21 3/8	7	TOP OUTLET	JVB-B-C435 STERLING	2,3,4
FT-52	323	1	3-5/8 X 4-1/4	Cu/AL	3-6 CL	1230	11	1.0824	13530	140	30	5	21 3/8	12	TOP OUTLET	JVB-B-C435 STERLING	2,3,4
FT-53	323	1	3-5/8 X 4-1/4 3-5/8 X 4-1/4		3-6 CL		11 8	1.0824 0.7872	13530 9840	140	30	5	21 3/8	8 3/4	TOP OUTLET	JVB-B-C435 STERLING	2,3,4
FT-55	323	1	3-5/8 X 4-1/4 3-5/8 X 4-1/4	Cu/AL	3-6 CL	•	10.5	1.0332	12915	140	30	5	21 3/8	8 3/4	TOP OUTLET	JVB-B-C435 STERLING	2,3,4
FT-56	323	1	3-5/8 X 4-1/4	-	3-6 CL		10.5	1.0332	13530	140	30	5	21 3/8	12	TOP OUTLET	JVB-B-C435 STERLING	2,3,4
FT-57	319	1	3-5/8 X 4-1/4		3-6 CL		10.75	1.1868	14835	140	30	5	21 3/8			SIEKLING	
FT-58	317	1	3-5/8 X 4-1/4	CU/AL	3-6 CL	1380	10.75	1.1868	14835	140	30	5	21 3/8	12.5	BARE ELEMENT	JVB-B-C435 STERLING	1,2
FT-59	319	1	3-5/8 X 4-1/4	Cu/AL	3-6 CL	1380	10.75	1.1868	14835	140	30	5	21 3/8	12.5	BARE ELEMENT	JVB-B-C435 STERLING JVB-B-C435	1,2
FT-60	317	1	3-5/8 X 4-1/4	Cu/AL	3-6 CL	1380	12	1.3248	16560	140	30	5	21 3/8	14	BARE ELEMENT	STERLING JVB-B-C435	1,2
FT-61	317	1	3-5/8 X 4-1/4	Cu/AL	3-6 CL	1380	12	1.3248	16560	140	30	5	21 3/8	14	BARE ELEMENT	STERLING JVB-B-C435	1,2
FT-62	414	1	3-5/8 X 4-1/4	Cu/AL	3-6 CL	1380	12	1.3248	16560	140	30	5	21 3/8	13.5	BARE ELEMENT	STERLING JVB-B-C435	1,2
FT-63	414	1	3-5/8 X 4-1/4	Cu/AL	3-6 CL	1380	12	1.3248	16560	140	30	5	21 3/8	13.5	BARE ELEMENT	STERLING JVB-B-C435	1,2
<u> </u>	I	I	I	1	1	ı		I	1	1	1			I	I	2 0-300	

						FII	N TUBE SC)						
		TUBE SIZE FIN SIZE ACTIVE ACTIVE HOT WATER ENCLOSURE ACTIVE ACTIVE HOT WATER MOUNT APPROX SHOLOSU											TYPICAL UNIT MFG				
TAG	LOCATION	(IN)	H X W (IN)	FIN TYPE	TIERS	BTUH/LF	LENGTH (FT)	FLOW (GPM)	BTUH	AWT (°F)	H (IN.)	D (IN.)	HEIGHT (IN)	LENGTH (FT)	ENCLOSURE STYLE	& MODEL NO.	NOTES
FT-64	412	1	3-5/8 X 4-1/4	Cu/AL	3-6 CL	1280	10.667	1.09232	13654	140	30	5	21 3/8	12	BARE ELEMENT	STERLING JVB-B-C434	1,2
FT-65	412	1	3-5/8 X 4-1/4	Cu/AL	3-6 CL	1280	10.667	1.09232	13654	140	30	5	21.375	12	BARE ELEMENT	STERLING JVB-B-C434	1,2
FT-66	410	1	3-5/8 X 4-1/4	Cu/AL	3-6 CL	1280	10.667	1.09232	13654	140	30	5	21 3/8	12	BARE ELEMENT	STERLING JVB-B-C434	1,2
FT-67	410	1	3-5/8 X 4-1/4	Cu/AL	3-6 CL	1280	10.667	1.09232	13654	140	30	5	21 3/8	12	BARE ELEMENT	STERLING JVB-B-C434	1,2
FT-68	408	1	3-5/8 X 4-1/4	Cu/AL	3-6 CL	1280	10.667	1.09232	13654	140	30	5	21 3/8	12	BARE ELEMENT	STERLING JVB-B-C434	1,2
FT-69	408	1	3-5/8 X 4-1/4	Cu/AL	3-6 CL	1280	10.667	1.09232	13654	140	30	5	21 3/8	12	BARE ELEMENT	STERLING JVB-B-C434	1,2
FT-70	406	1	4-1/4 SQ	Cu/AL	3-6 CL	1280	8.333	0.85328	10666	140	24	5 5/16	28	8.5	TOP OUTLET	STERLING JVB-T-C45	2,3,4,
FT-71	406	1	4-1/4 SQ	Cu/AL	3-6 CL	1280	8.333	0.85328	10666	140	24	5 5/16	28	8.5	TOP OUTLET	STERLING JVB-T-C45	2,3,4,
FT-72	404	1	4-1/4 SQ	Cu/AL	3-6 CL	1280	8.333	0.85328	10666	140	24	5 5/16	28	8.5	TOP OUTLET	STERLING	2,3,4,
FT-73	404	1	4-1/4 SQ	Cu/AL	3-6 CL	1280	8.333	0.85328	10666	140	24	5 5/16	28	8.5	TOP OUTLET	JVB-T-C45 STERLING	2,3,4,
FT-74	400	1	3-5/8 X 4-1/4	Cu/AL	2-6 CL	1010	4	0.3232	4040	140	20	5 5/16	24	5.25	TOP OUTLET	JVB-T-C45 STERLING	2,3,4,
FT-75	411	1	3-5/8 X 4-1/4	Cu/AL	3-6 CL	1280	10.833	1.10928	13866	140	30	5	21 3/8	12	BARE ELEMENT	JVB-T-C435 STERLING	1,2
																JVB-B-C434 STERLING	
FT-76	411	1	3-5/8 X 4-1/4	Cu/AL	3-6 CL	1280	10.833	1.10928	13866	140	30	5	21 3/8	12	BARE ELEMENT	JVB-B-C434 STERLING	1,2
FT-77	409	1	3-5/8 X 4-1/4	Cu/AL	3-6 CL	1280	10.833	1.10928	13866	140	30	5	21 3/8	12	BARE ELEMENT	JVB-B-C434 STERLING	1,2
FT-78	409	1	3-5/8 X 4-1/4	Cu/AL	3-6 CL	1280	10.833	1.10928	13866	140	30	5	21 3/8	12	BARE ELEMENT	JVB-B-C434	1,2
FT-79	407	1	3-5/8 X 4-1/4	Cu/AL	3-6 CL	1280	10.833	1.10928	13866	140	30	5	21 3/8	12	BARE ELEMENT	STERLING JVB-B-C434	1,2
FT-80	407	1	3-5/8 X 4-1/4	Cu/AL	3-6 CL	1280	10.833	1.10928	13866	140	30	5	21 3/8	12	BARE ELEMENT	STERLING JVB-B-C434	1,2
FT-81	405	1	3-5/8 X 4-1/4	Cu/AL	3-6 CL	1280	10.833	1.10928	13866	140	30	5	21 3/8	12	BARE ELEMENT	STERLING JVB-B-C434	1,2
FT-82	405	1	3-5/8 X 4-1/4	Cu/AL	3-6 CL	1280	10.833	1.10928	13866	140	30	5	21 3/8	12	BARE ELEMENT	STERLING JVB-B-C434	1,2
FT-83	403	1	3-5/8 X 4-1/4	Cu/AL	3-6 CL	1280	10.833	1.10928	13866	140	30	5	21 3/8	12	BARE ELEMENT	STERLING JVB-B-C434	1,2
FT-84	403	1	3-5/8 X 4-1/4	Cu/AL	3-6 CL	1280	10.833	1.10928	13866	140	30	5	21 3/8	12	BARE ELEMENT	STERLING JVB-B-C434	1,2
FT-85	401	1	3-5/8 X 4-1/4	Cu/AL	3-6 CL	1280	10.833	1.10928	13866	140	30	5	21 3/8	12	BARE ELEMENT	STERLING JVB-B-C434	1,2
FT-86	401	1	3-5/8 X 4-1/4	Cu/AL	3-6 CL	1280	10.833	1.10928	13866	140	30	5	21 3/8	12	BARE ELEMENT	STERLING JVB-B-C434	1,2
FT-87	426	1	3-5/8 X 4-1/4	Cu/AL	3-6 CL	1380	11	1.2144	15180	140	30	5	21 3/8	12	BARE ELEMENT	STERLING JVB-B-C435	1,2
FT-88	426	1	3-5/8 X 4-1/4	Cu/AL	3-6 CL	1380	11	1.2144	15180	140	30	5	21 3/8	12	BARE ELEMENT	STERLING JVB-B-C435	1,2
FT-89	424	1	3-5/8 X 4-1/4	Cu/AL	3-6 CL	1280	10.833	1.10928	13866	140	30	5	21 3/8	12	BARE ELEMENT	STERLING JVB-B-C434	1,2
FT-90	424	1	3-5/8 X 4-1/4	Cu/AL	3-6 CL	1280	10.833	1.10928	13866	140	30	5	21 3/8	12	BARE ELEMENT	STERLING	1,2
FT-91	422	1	3-5/8 X 4-1/4	Cu/AL	3-6 CL	1380	10.833	1.196	14950	140	30	5	21 3/8	12	BARE ELEMENT	JVB-B-C434 STERLING	1,2
FT-92	422	1	3-5/8 X 4-1/4	Cu/AL	3-6 CL	1380	10.833	1.196	14950	140	30	5	21 3/8	12	BARE ELEMENT	JVB-B-C435 STERLING	1,2
FT-93	420	1	3-5/8 X 4-1/4	Cu/AL	3-6 CL	1280	11	1.1264	14080	140	30	5	21 3/8	12	BARE ELEMENT	JVB-B-C435 STERLING	1,2
																JVB-B-C434 STERLING	
FT-94	420	1	3-5/8 X 4-1/4	Cu/AL	3-6 CL	1280	11	1.1264	14080	140	30	5	21 3/8	12	BARE ELEMENT	JVB-B-C434 STERLING	1,2
FT-95	418	1	3-5/8 X 4-1/4	Cu/AL	3-6 CL	1280	8.5	0.8704	10880	140	30	5	21 3/8	12	BARE ELEMENT	JVB-B-C434 STERLING	1,2
FT-96	418	1	3-5/8 X 4-1/4	Cu/AL	3-6 CL	1280	8.5	0.8704	10880	140	30	5	21 3/8	12	BARE ELEMENT	JVB-B-C434 STERLING	1,2
FT-97	418	1	3-5/8 X 4-1/4	Cu/AL	3-6 CL	1280	8.5	0.8704	10880	140	30	5	21 3/8	12	BARE ELEMENT	JVB-B-C434	1,2
FT-98	423	1	3-5/8 X 4-1/4	Cu/AL	3-6 CL	1380	10.75	1.1868	14835	140	30	5	21 3/8	12	BARE ELEMENT	STERLING JVB-B-C435	1,2
FT-99	423	1	3-5/8 X 4-1/4	Cu/AL	3-6 CL	1380	10.75	1.1868	14835	140	30	5	21 3/8	12	BARE ELEMENT	STERLING JVB-B-C435	1,2
FT-100	421	1	3-5/8 X 4-1/4	Cu/AL	3-6 CL	1280	10.75	1.1008	13760	140	30	5	21 3/8	12	BARE ELEMENT	STERLING JVB-B-C434	1,2
FT-101	421	1	3-5/8 X 4-1/4	Cu/AL	3-6 CL	1280	10.75	1.1008	13760	140	30	5	21 3/8	12	BARE ELEMENT	STERLING JVB-B-C434	1,2
FT-102	419	1	3-5/8 X 4-1/4	Cu/AL	3-6 CL	1280	11	1.1264	14080	140	30	5	21 3/8	12	BARE ELEMENT	STERLING JVB-B-C434	1,2
FT-103	419	1	3-5/8 X 4-1/4	Cu/AL	3-6 CL	1280	11	1.1264	14080	140	30	5	21 3/8	12	BARE ELEMENT	STERLING JVB-B-C434	1,2
FT-104	417	1	3-5/8 X 4-1/4	Cu/AL	3-6 CL	1280	11	1.1264	14080	140	30	5	21 3/8	12	BARE ELEMENT	STERLING JVB-B-C434	1,2
FT-105	417	1	3-5/8 X 4-1/4	Cu/AL	3-6 CL	1280	11	1.1264	14080	140	30	5	21 3/8	12	BARE ELEMENT	STERLING JVB-B-C434	1,2
FT-106	415	1	3-5/8 X 4-1/4	Cu/AL	3-6 CL	1280	10.75	1.1008	13760	140	30	5	21 3/8	12	BARE ELEMENT	STERLING JVB-B-C434	1,2
FT-107	415	1	3-5/8 X 4-1/4	Cu/AL	3-6 CL	1280	10.75	1.1008	13760	140	30	5	21 3/8	12	BARE ELEMENT	STERLING JVB-B-C434	1,2
FT-108	413	1	3-5/8 X 4-1/4	Cu/AL	3-6 CL	1280	10.75	1.1008	13760	140	30	5	21 3/8	12	BARE ELEMENT	STERLING JVB-B-C434	1,2
FT-109	413	1	3-5/8 X 4-1/4	Cu/AL	3-6 CL	1280	10.75	1.1008	13760	140	30	5	21 3/8	12	BARE ELEMENT	STERLING	1,2
IOTES:			LWORK, MILLWOR									_				JVB-B-C434	

2. CONTROL VALVES ABOVE THE CEILING.

3. COLOR BY ARCHITECT.


4. MC TO FIELD VERIFY ENCLOSURE LENGTH. ENCLOSURE TO BE FULL WIDTH WITHOUT GAPS.

5. COORDINATE HEIGHT WITH ELECTRICAL DEVICES.

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Poughkeepsie, NY 12601

NY ENGINEERING FIRM CERTIFICATE #0021419

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PROJECT INFORMATION

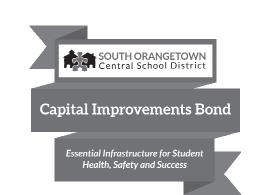Project Number 14457.20

Client Name
SOUTH ORANGETOWN CENTRAL
SCHOOL DISTRICT
Project Name
PHASE 2: 2022 BOND

TAPPAN ZEE HIGH SCHOOL

Building Address 160 VAN WYCK RD., BLAUVELT, NY 10913


SED # 50-03-01-06-0-006-033


Reaistration Expiration Dates Lauren Tarsio 09/30/26 Anthony Marchetti 05/31/27 Dave Hart 02/28/25 Jennifer Wengender 06/30/27

PROJECT ISSUE & REVISION SCHEDULE

Date Description
5 11/19/24 BID ADDENDUM #5

PROFESSIONAL STAMPS

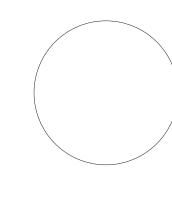

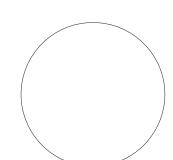

NEW YORK STATE EDUCATION STATEMENT

IT IS A VICILATION OF THE NEW YORK STATE EDUCATION LAW AND THE COMMISSIONER'S REGULATION FOR ANY PERSON, UNILESS ACTING UNDER THE DIRECTION OF A LICENSED ARCHITECT, ENGINEER OR LAND SURVEYOR, TO ALTER AN ITEM IN ANY WAY, IF AN ITEM BEARING THE SEAL OF AN ARCHITECT, ENGINEER OR SURVEYOR IS ALTERED, THE ALTERING PARTY SHALL AFRIX TO THE ITEM THEM SEAL AND THE NOTATION "LITERED BY" FOLLOWED BY THEIR SIGNATURE AND THE ONTATION" LAND A SPECIFIC DESCRIPTION OF THE

SHEET INFORMATION

| Issued | Scale | | 10/25/2024 | 12" = 1'-0" | | | Project Status | BID DOCUMENTS | | Checked By | | KCM | JJM | | Drawing Title | | HVAC SCHEDULES | | |

ving Number TZHS



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NY ENGINEERING FIRM CERTIFICATE #0021419

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PROJECT INFORMATION

14457.20

Client Name SOUTH ORANGETOWN CENTRAL SCHOOL DISTRICT

TAPPAN ZEE HIGH SCHOOL

160 VAN WYCK RD., BLAUVELT, NY 10913


SED # 50-03-01-06-0-006-033

Reaistration Expiration Dates Lauren Tarsio 09/30/26 Anthony Marchetti 05/31/27 Dave Hart 02/28/25 Jennifer Wengender 06/30/27

PROJECT ISSUE & REVISION SCHEDUL

5 11/19/24 BID ADDENDUM #5

PROFESSIONAL STAMPS

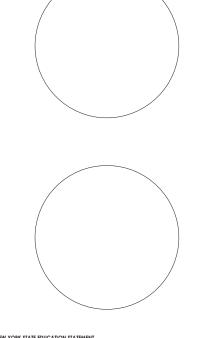

SHEET INFORMATION

Issued Scale 10/25/2024 **AS NOTED** Project Status BID DOCUMENTS Drawn By

FIRST FLOOR ELECTRICAL DEMOLITION PLAN - AREA C1 AND C2

E102



GENERAL NOTES

- A. UNLESS NOTED OTHERWISE, CONNECT NEW DEVICES SHOWN TO PANEL AND CIRCUIT BREAKER INDICATED ADJACENT TO DEVICE WITH (2) #12, (1) #12 GND IN 3/4" CONDUIT.
- B. ALL CIRCUITS OVER 100 FEET TO BE WIRED WITH #10 THHN.
- C. RECEPTACLES TO BE PLACED IN SURFACE RACEWAY, COORDINATE LOCATIONS WITH T-SERIES DRAWINGS.

KEY NOTES

- (1) ALL MECHANICAL EQUIPMENT POWER REQUIREMENTS ARE NOTED ON DRAWINGS E900, E901, E902. LABEL INDICATES EQUIPMENT TAG. REFER TO ELECTRICAL EQUIPMENT CONNECTION SCHEDULE ON SHEETS NOTED ABOVE.
- (2) CONNECT TO EXISTING 20A/1P CIRCUIT BREAKER AS NOTED. CIRCUITS ARE AVAILABLE FROM REMOVED UNIT VENTILATORS. CONFIRM AVAILABLE CIRCUITS IN FIELD ONCE UNIT VENTILATORS ARE REMOVED.
- (3) PROVIDE A 120/208V, 3-PHASE, 4-WIRE, 600-AMP, 54 CIRCUIT PANELBOARD AT LOCATION INDICATED. PROVIDE (2) SETS OF (4) #350 MCM, (1) #1 GND IN 4" CONDUIT FROM MDP IN BASEMENT TO NEW PANEL.
- (4) PROVIDE A 120/208V, 3-PHASE, 4-WIRE, 2,000-AMP, 54 CIRCUIT PANELBOARD AT LOCATION INDICATED. PROVIDE (5) SETS OF (4) #600 MCM, (1) #4/0 GND IN (5) 4" CONDUITS FROM MDP IN BASEMENT TO NEW PANEL.
- (5) PROVIDE 120-VOLT POWER TO FIRE/SMOKE DAMPERS AT LOCATIONS INDICATED. PROVIDE (2) #12, (1) #12GND IN 3/4" CONDUIT FROM PANEL/CIRCUIT INDICATED TO FIRE/SMOKE DAMPERS. PROVIDE A FIRE ALARM RELAY AT EACH FIRE/SMOKE DAMPER, AND WIRE TO FIRE ALARM CONTROL PANEL. COORDINATE ALL WORK WITH MECHANICAL CONTRACTOR.
- (6) CONNECT NEW EQUIPMENT TO TAGGED CIRCUITRY REWORK/EXTEND EXISTING CIRCUIT AS NECESSARY TO ACCOMMODATE NEW EQUIPMENT.
- (7) REINSTALL AND RECONNECT EXISTING POWER POLES TO TAGGED CIRCUITRY ONCE NEW CEILING IS IN PLACE.
- (8) REINSTALL AND RECONNECT EXISTING FLOOR BOXES TO TAGGED CIRCUITRY ONCE NEW FLOORING IS IN PLACE.

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NY ENGINEERING FIRM CERTIFICATE #0021419



PROJECT INFORMATION

14457.20 Client Name

SOUTH ORANGETOWN CENTRAL SCHOOL DISTRICT **PHASE 2: 2022 BOND**

TAPPAN ZEE HIGH SCHOOL

160 VAN WYCK RD., BLAUVELT, NY 10913


SED # 50-03-01-06-0-006-033

Registration Expiration Dates Lauren Tarsio 09/30/26 Anthony Marchetti 05/31/27 Dave Hart 02/28/25 Jennifer Wengender 06/30/27

PROJECT ISSUE & REVISION SCHEDULE

4 11/15/24 BID ADDENDUM #4 5 11/19/24 BID ADDENDUM #5

PROFESSIONAL STAMPS

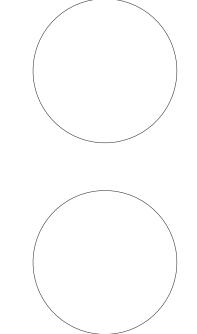

SHEET INFORMATION

Issued 10/25/2024 **AS NOTED** Project Status

BID DOCUMENTS Drawn By MAY

FIRST FLOOR ELECTRICAL NEW WORK PLAN - AREA C1 AND C2

E202



GENERAL NOTES

- A. FIXTURE TYPE MARK IS INDICATED ADJACENT TO ALL LIGHT FIXTURES. REFER TO LUMINAIRE SCHEDULE ON DRAWING E903 FOR FIXTURE DESCRIPTIONS, TYPES, NOTES, AND SPECIFICATIONS.
- B. ALL LIGHT FIXTURES SHOWN SHALL BE WIRED WITH (2) #12, (1) #12 GND IN 3/4" CONDUIT, WIRED TO PANEL AND CIRCUIT INDICATED. CIRCUITS EXCEEDING 100' SHALL BE WIRED WITH #10 CONDUCTORS.
- C. INSTALL SWITCHING AND LOW-VOLTAGE SENSORS AS SHOWN. PROVIDE ALL LOW-VOLTAGE WIRING BETWEEN SENSORS, CONTROLLERS, POWER PACKS, AND LUMINAIRES.
- D. ALL LOW VOLTAGE WIRING BETWEEN SENSORS, CONTROLLERS, POWER PACKS, AND LUMINAIRES SHALL BE IN 3/4" MC.
- E. PROVIDE ANY ADDITIONAL POWER SUPPLIES OR OTHER MISCELLANEOUS COMPONENTS REQUIRED FOR A COMPLETE, OPERATIONAL LIGHTING SYSTEM TO MEET THE DESIGN INTENT OF THE LIGHTING SEQUENCE OF OPERATIONS AS
- ALL FIXTURES INDICATED WITH "EM" DESIGNATION SHALL HAVE EMERGENCY BATTERY BACKUP AT EACH FIXTURE. BATTERY BACKUP PACK TO BE WIRED TO THE UNSWITCHED "HOT LEG" OF THE CIRCUITRY FEEDING THE SPACE.
- G. ALL FIXTURES INDICATED WITH "NL" DESIGNATION INDICATED A "CONSTANT ON" NIGHT LIGHT. FIXTURE TO BE WIRED TO THE UNSWITCHED "HOT LEG" OF THE CIRCUITRY FEEDING THE SPACE.

KEY NOTES

KEY PLAN:

- (1) CONNECT NEW FIXTURES TO EXISTING TAGGED CIRCUITRY. REWORK/EXTEND CIRCUITRY AS NECESSARY TO ACCOMMODATE NEW FIXTURE.
- (2) PROVIDE NEW SWITCHING, OCCUPANCY, AND DAYLIGHT SENSORS AS INDICATED. PROVIDE ALL NEW LOW-VOLTAGE WIRING TO FIXTURES AND DEVICES INDICATED. CONNECT NEW SWITCHES TO EXISTING TAGGED CIRCUITRY.
- (3) ALL EXISTING LIGHTING AND CEILING MOUNTED DEVICES TO BE REINSTALLED BACK IN PLACE IN NEW CEILING GRID. CONNECT TO EXISTING TAGGED
- (4) CONNECT NEW LIGHT FIXTURES TO EXISTING CIRCUITRY WITH (2) #12, (1) #12 GND IN MC.
- (5) PROVIDE NEW SMOKE DETECTORS AS SHOWN. PROVIDE NEW WIRING FROM SMOKE DETECTOR TO LOCAL SLC CIRCUIT WITHIN AREA.

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NY ENGINEERING FIRM CERTIFICATE #0021419



PROJECT INFORMATION

14457.20

Client Name SOUTH ORANGETOWN CENTRAL SCHOOL DISTRICT **PHASE 2: 2022 BOND**

TAPPAN ZEE HIGH SCHOOL


160 VAN WYCK RD., BLAUVELT, NY 10913

SED # 50-03-01-06-0-006-033

Reaistration Expiration Dates Lauren Tarsio 09/30/26 Anthony Marchetti 05/31/27 Dave Hart 02/28/25 Jennifer Wengender 06/30/27

PROJECT ISSUE & REVISION SCHEDULE # Date Description
5 11/19/24 BID ADDENDUM #5

PROFESSIONAL STAMPS

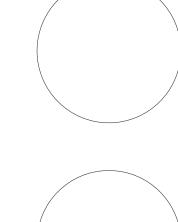


SHEET INFORMATION

10/25/2024 **AS NOTED** Project Status BID DOCUMENTS Drawn By

MAY

FIRST FLOOR LIGHTING PLAN AREA C1 AND C2

E302

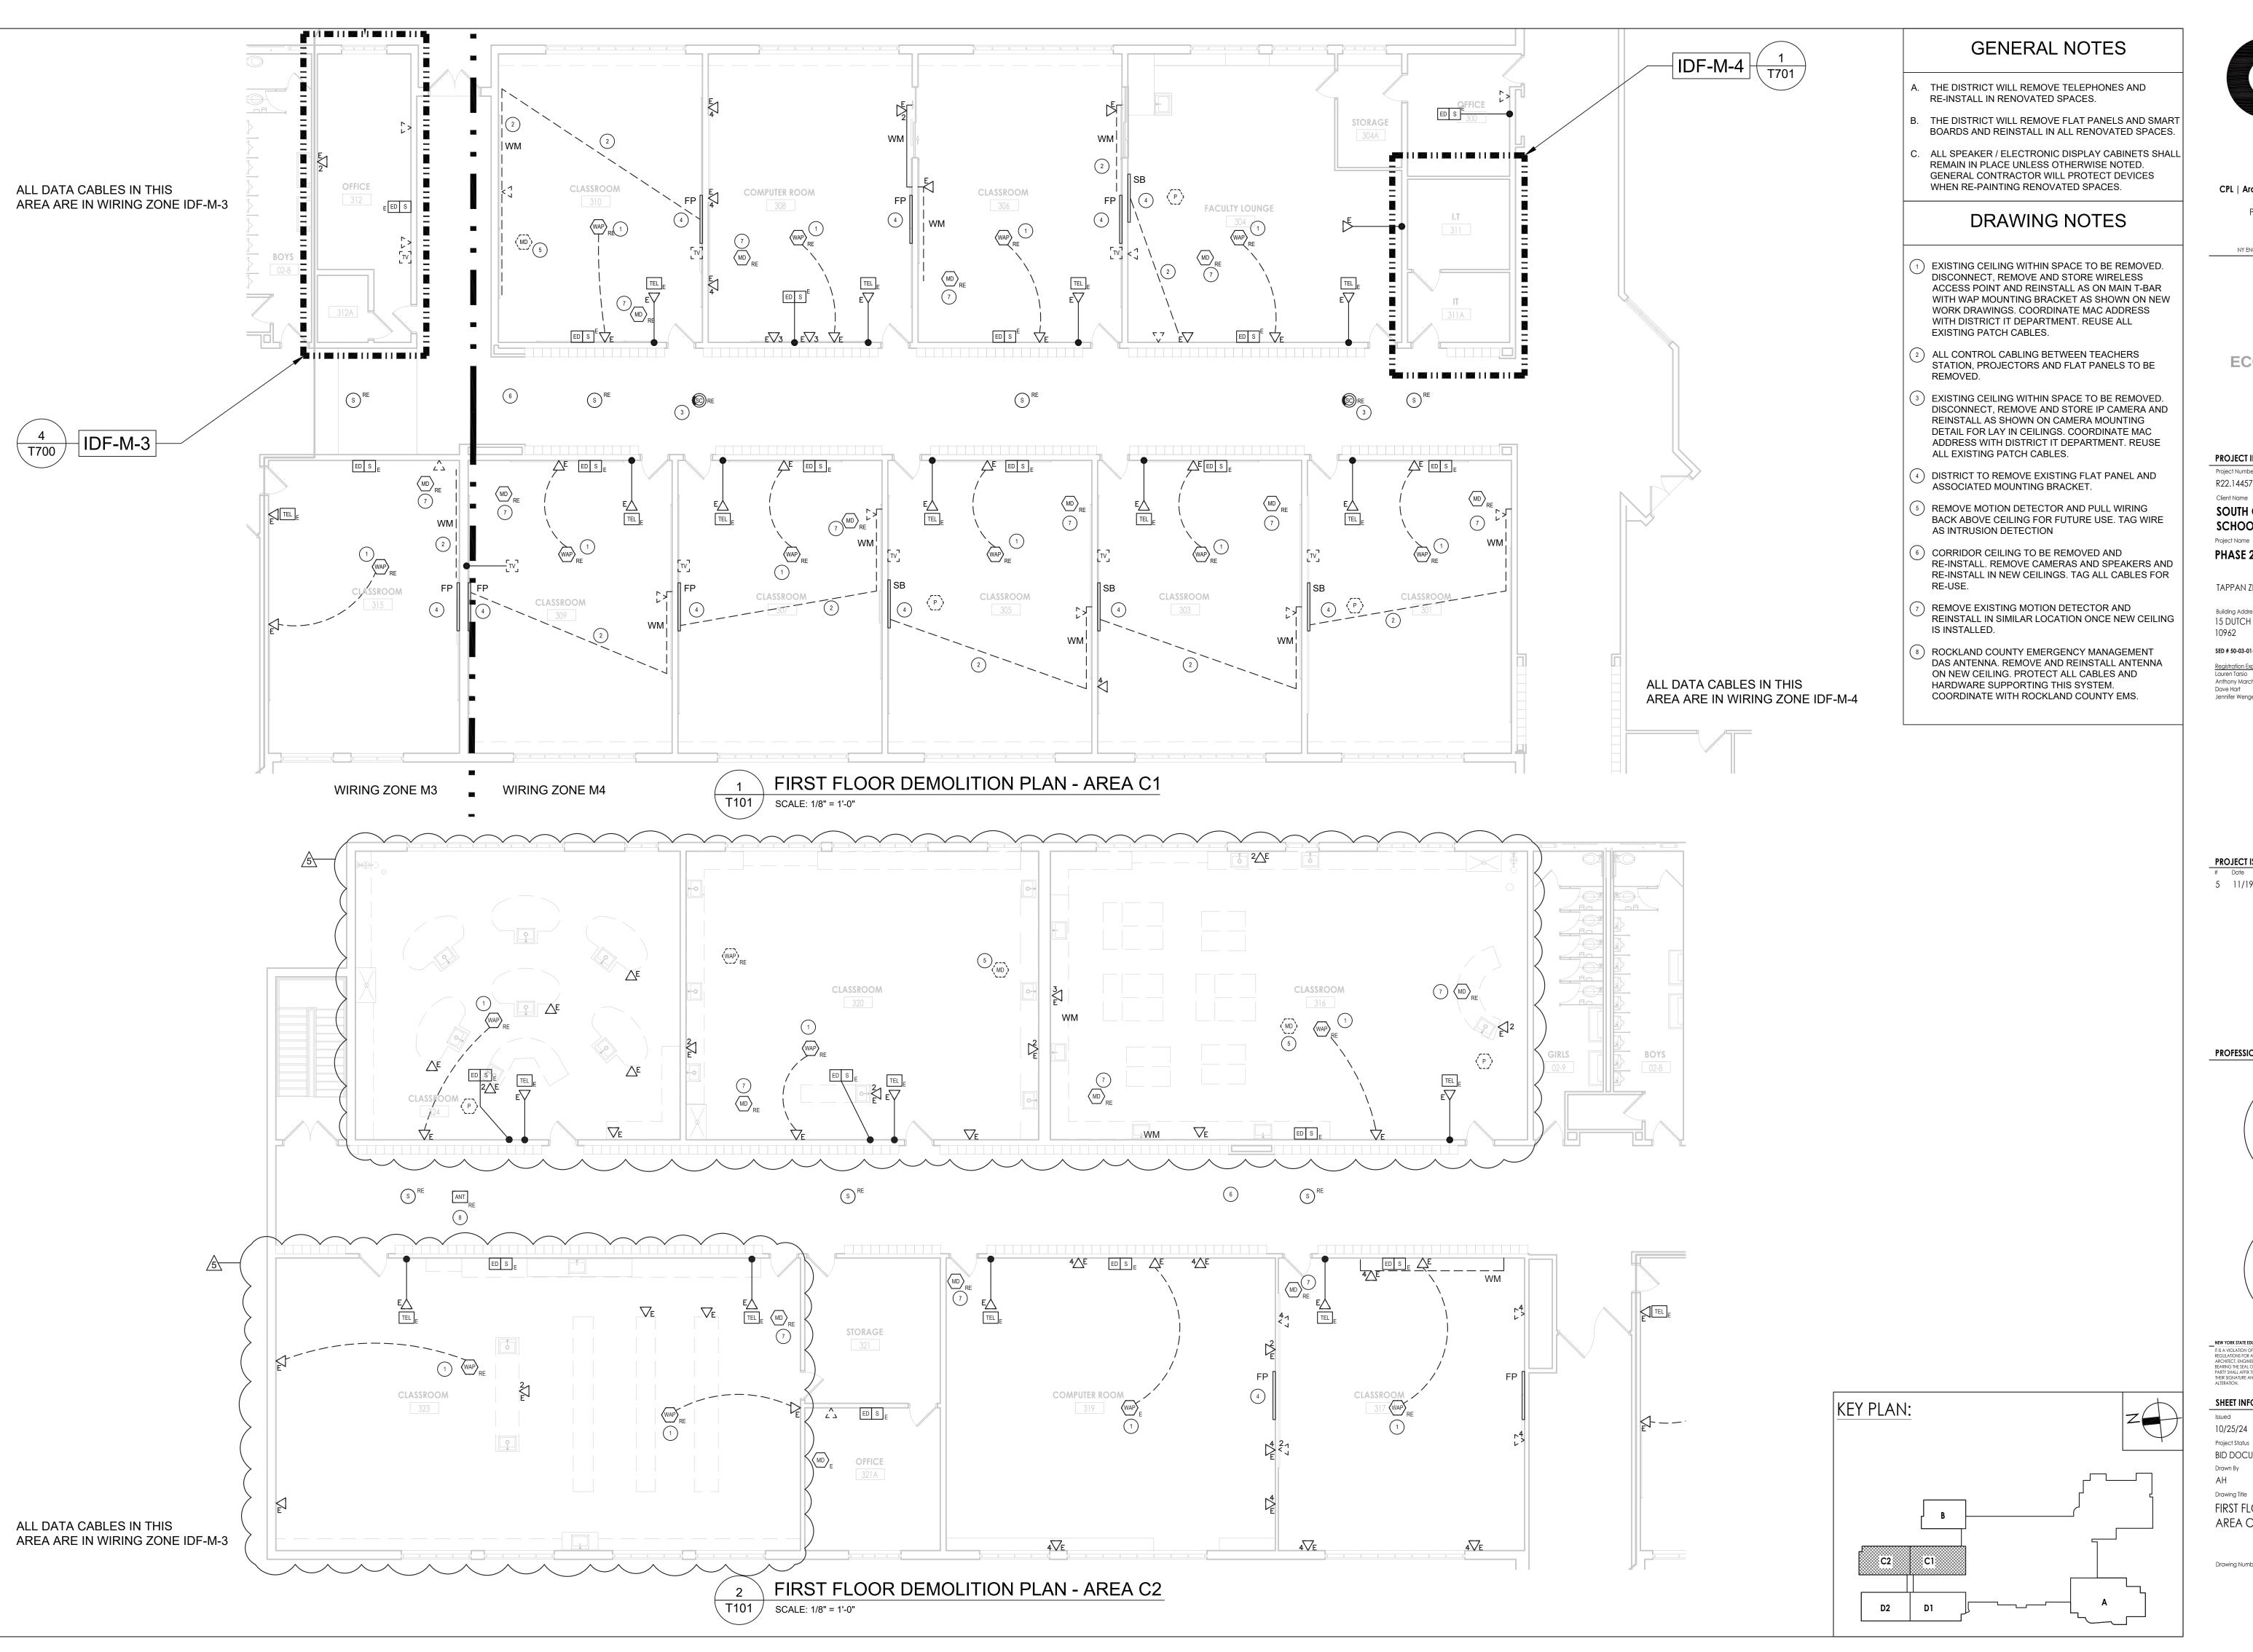

CPL | Architecture Engineering Planning

NY ENGINEERING FIRM CERTIFICATE #0021419

26 IBM Road

Poughkeepsie, NY 12601

CPLteam.com



PROJECT INFORMATION

R22.14457.20

SOUTH ORANGETOWN CENTRAL SCHOOL DISTRICT

PHASE 2: 2022 BOND

TAPPAN ZEE HIGH SCHOOL

15 DUTCH HILL ROAD, ORANGEBURG, NY


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Registration Expiration Dates Lauren Tarsio 09/30/26 Anthony Marchetti 05/31/27 Dave Hart 02/28/25 Jennifer Wengender 06/30/27

PROJECT ISSUE & REVISION SCHEDULE

5 11/19/2024 BID ADDENDUM #5


PROFESSIONAL STAMPS

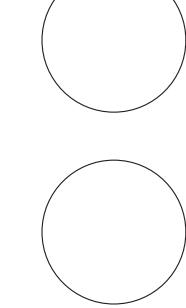

10/25/24 Project Status BID DOCUMENTS

FIRST FLOOR DEMOLITION PLAN -AREA C

T101

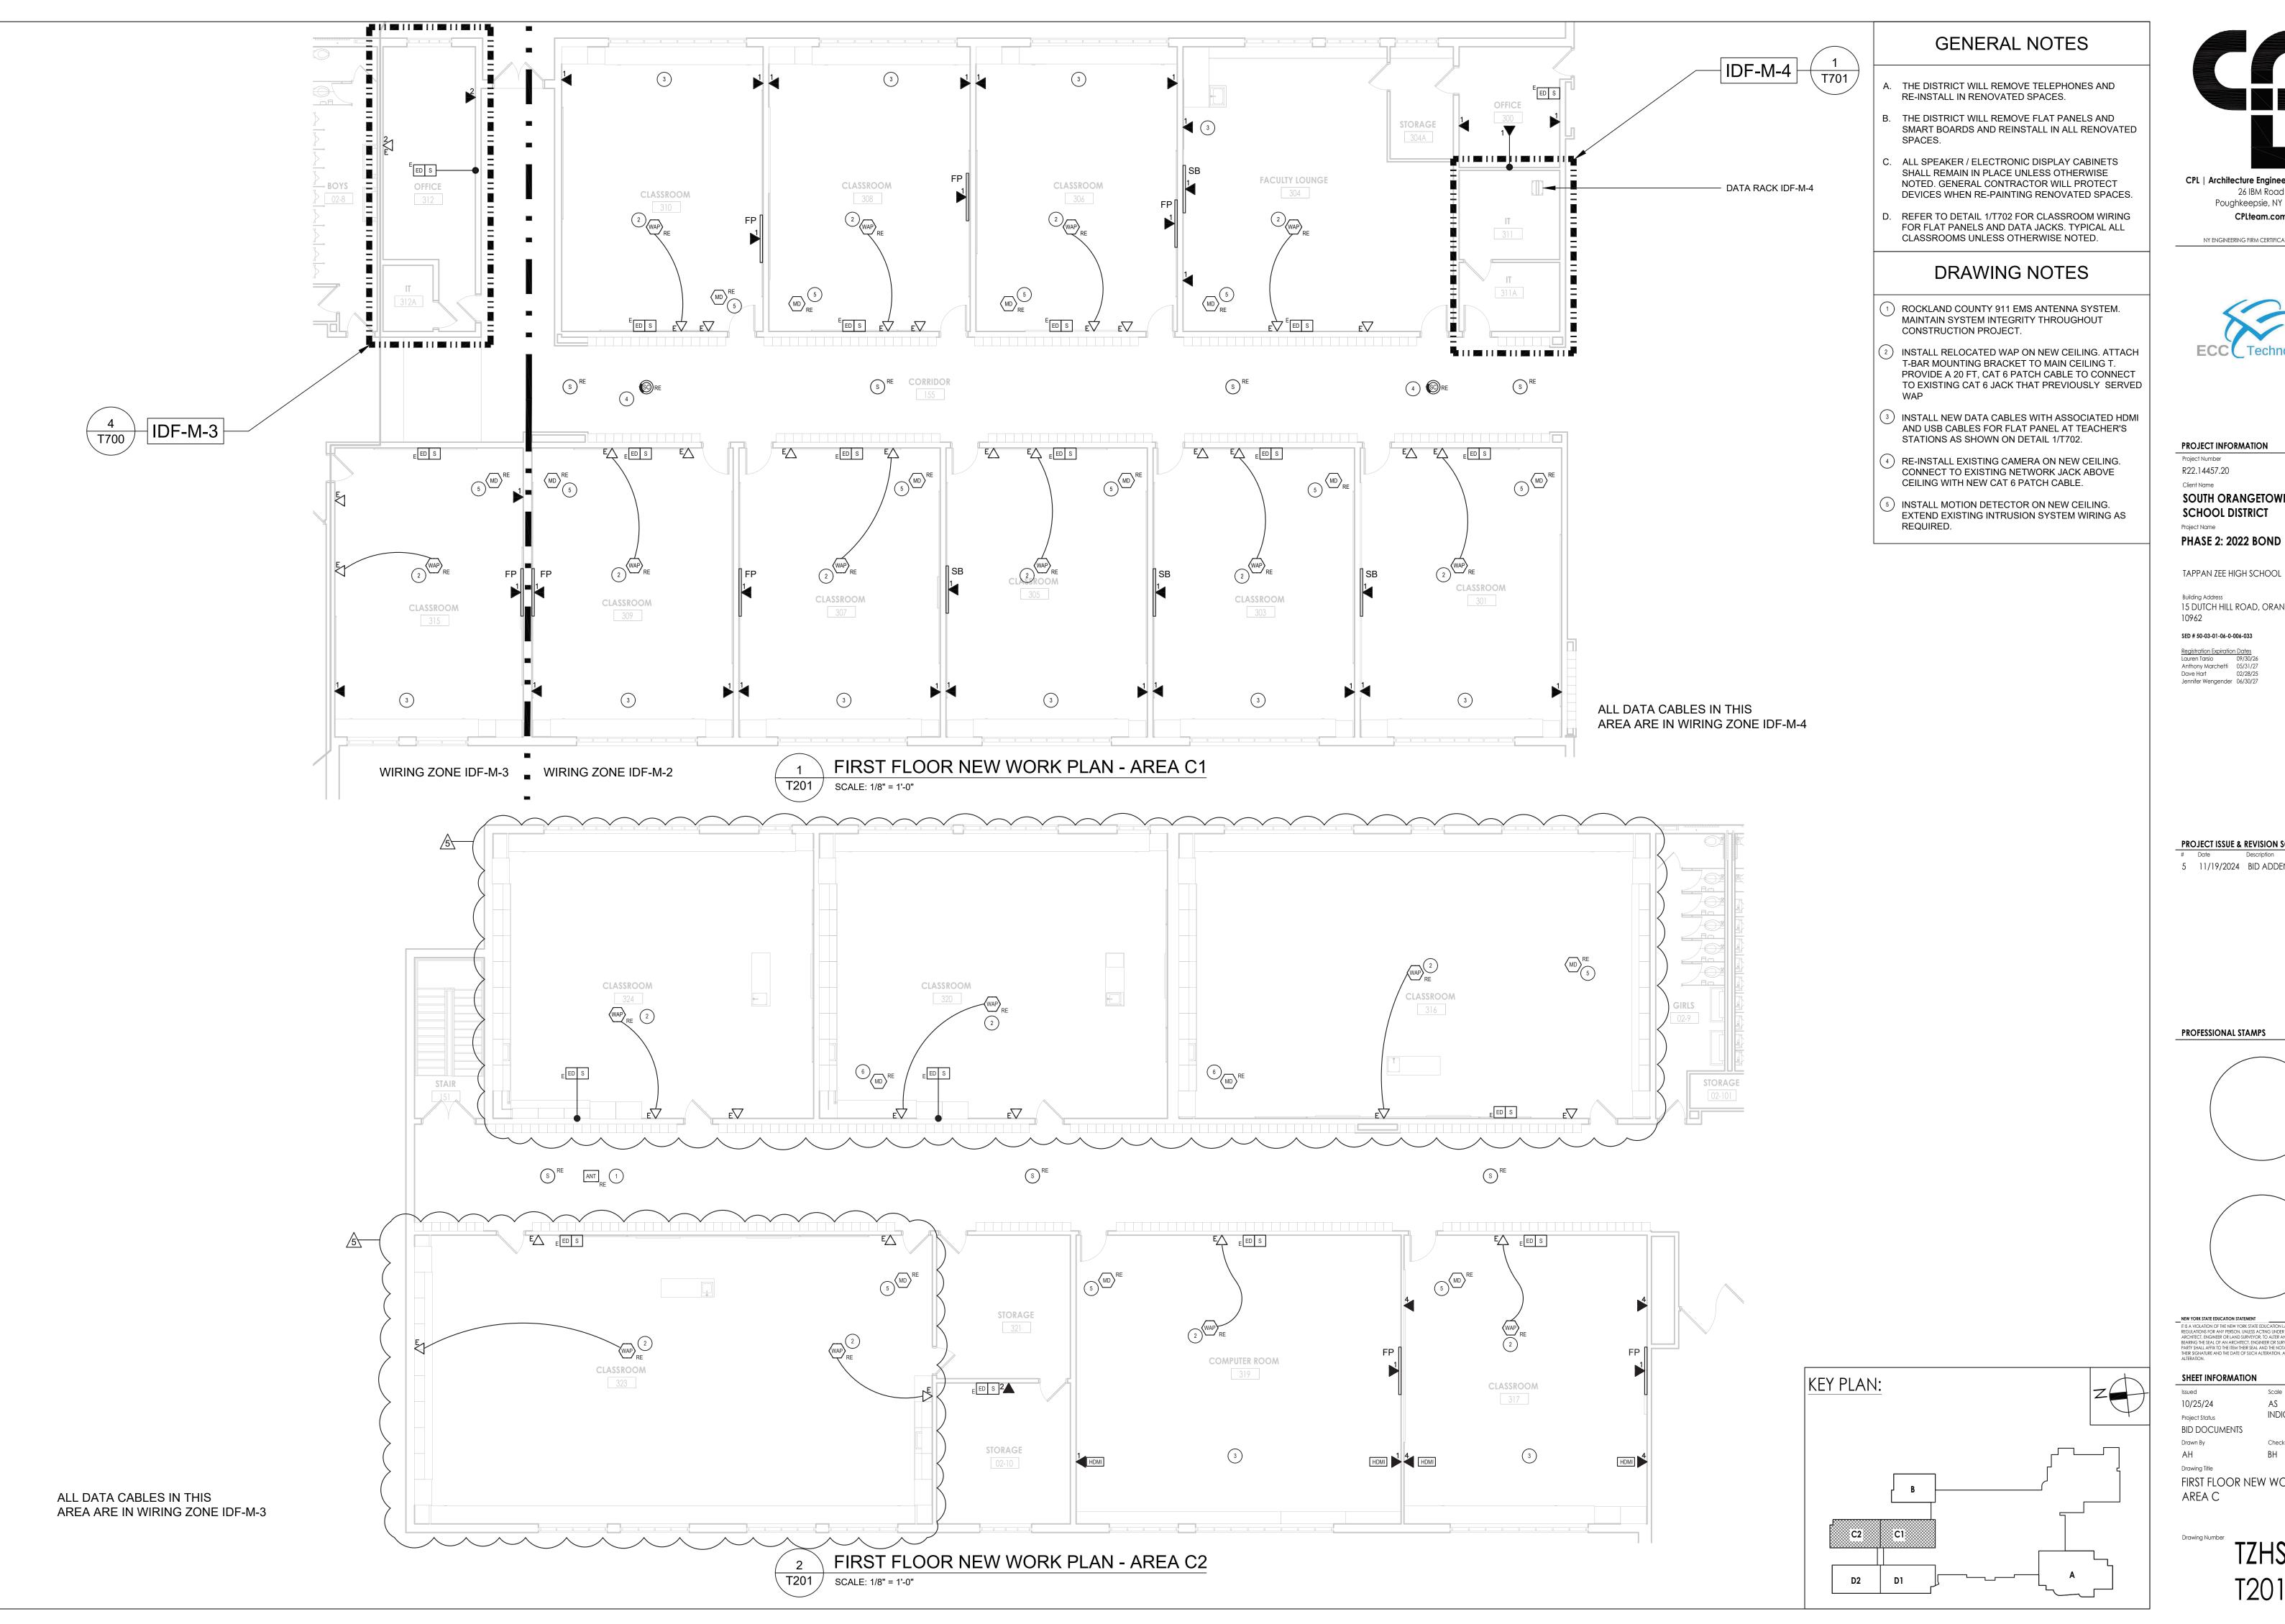

CPL | Architecture Engineering Planning 26 IBM Road Poughkeepsie, NY 12601 CPLteam.com

NY ENGINEERING FIRM CERTIFICATE #0021419



PROJECT INFORMATION

R22.14457.20

Client Name SOUTH ORANGETOWN CENTRAL SCHOOL DISTRICT

TAPPAN ZEE HIGH SCHOOL

15 DUTCH HILL ROAD, ORANGEBURG, NY 10962


SED # 50-03-01-06-0-006-033

Registration Expiration Dates
Lauren Tarsio 09/30/26
Anthony Marchetti 05/31/27
Dave Hart 02/28/25
Jennifer Wengender 06/30/27

PROJECT ISSUE & REVISION SCHEDULE

5 11/19/2024 BID ADDENDUM #5

PROFESSIONAL STAMPS

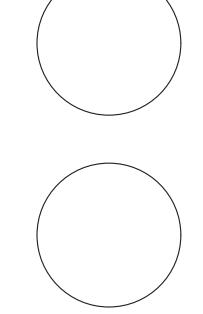

SHEET INFORMATION

10/25/24 Project Status BID DOCUMENTS Drawn By

INDICATED

Drawing Title FIRST FLOOR NEW WORK PLAN -AREA C

TZHS

T201