

#### **ADDENDUM NO.** 02

PROJECT: South Orangetown Central School District

PHASE 2: 2022 BOND

CPL PROJECT NO. 14457.20

DATE: November 6, 2024

Include this Addendum as part of the Contract Documents. It supplements portions of the original specifications and drawings, the extent of which shall remain, except as revised herein:

#### **CLARIFICATIONS**

- 1.1 All RFI's received prior to 11/01/24 have been responded to and are attached to this Addendum.
- On all drawing sheets in the H300 series change the fin tube cover note gauge from 20 to 18. "FIN TUBE PIPING TO BE ROUTED ABOVE THE CEILING. PROVIDE **18** GAUGE GALVANIZED STEEL ENCLOSURE PAINTED TO MATCH THE WALL AROUND THE PIPING UP TO CEILING."

#### **CHANGES TO THE SPECIFICATIONS**

- 2.1 Specification 230923 section 2.10.E.4 replace "Air Monitor Corp" with "Ebtron".
- 2.2 Specification 237416:

2.02.A.1 - Change "unit controls" to "Supervisory Refrigeration controls."

2.02.E.4 - Change "backdraft dampers" to "motorized dampers."

2.02.f.l.a - Change refrigerant to R454.


2.02.G.1 – Change refrigerant to R454.

2.02.H.1.b - Change refrigerant to R454.

2.20.L - Change to Aluminum Wheel.

#### **CHANGES TO THE DRAWINGS**

- 3.1 Drawing A203: Replace with attached revised A203.
- 3.2 Drawing A700: Replace with attached revised A700.
- 3.3 Drawing A701: Replace with attached revised A700.
- 3.4 Drawing A801: Replace with attached revised A801.
- 3.5 Drawing 1000: Replace with attached revised 1000.

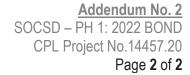



| 3.6  | Drawing I201: Replace with attached revised I201 |
|------|--|
| 3.7  | Drawing I202: Replace with attached revised I202 |
| 3.8  | Drawing I203: Replace with attached revised I203 |
| 3.9  | Drawing H100: Replace with attached revised H100 |
| 3.10 | Drawing H301: Replace with attached revised H301 |
| 3.11 | Drawing H302: Replace with attached revised H302 |
| 3.12 | Drawing H303: Replace with attached revised H303 |
| 3.13 | Drawing H304: Replace with attached revised H304 |
| 3.14 | Drawing H305: Replace with attached revised H305 |
| 3.15 | Drawing H701: Replace with attached revised H701 |
| 3.16 | Drawing P201: Replace with attached revised P201 |

END OF ADDENDUM NO. 02



RFI #: 01

Date: 10/29/2024

| Contractor Na | ame: UniMak, LLC   |        |            |
|---------------|--|--------|------------|
|               | Fasciglione Firm: CPL  |        |            |
|               | Oostinoski   |        |            |
| WE RI         | EQUEST YOUR ATTENTION (OR CONFIRMATION) REGARDING THE            | E FOLL | OWING:     |
| Subject:      | Anticipated Construction Schedule                                |        |            |
|               |  |        |            |
| Location:     | Tappan Zee High School, 15 Dutch Hill Road, Orangeburg, NY 10962 |        |            |
|               |  |        |            |
|               | Information is Requested By: UniMak, LLC                         |        |            |
| MESSAGE:      | Could you please inform us of the Anticipated Construction Sched | lule?  |            |
|               | - PLEASE REFER TO BID ADDENDUM #1, ISSUED 11/01/24 —             |        |            |
|               | L.FASCIGLIONE 11/06/24   |        |            |
|               |  |        |            |
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|               |  |        |            |
| Contractors N | Name: UniMak, LLC  |        |            |
| By: Ivo Dos   | stinoski   | Date:  | 10/29/2024 |



RFI #: 02

Date: 10/29/2024

| Contractor Name: UniMak, LLC  |
|---|
| o: Lisa Fasciglione Firm: CPL   |
| rom: Ivo Dostinoski   |
| WE REQUEST YOUR ATTENTION (OR CONFIRMATION) REGARDING THE FOLLOWING:                            |
| ubject: Verification of Notes on Teaching Wall for Sheets I203 and I202                         |
| ocation: Tappan Zee High School, 15 Dutch Hill Road, Orangeburg, NY 10962                       |
| Information is Requested By: UniMak, LLC  |
| MESSAGE: On sheet I203, rooms #421, #419, etc.—please confirm that there are no notes #2, #3,   |
| 4, or #5 on the teaching wall. The same applies to sheet I202 for rooms #317, #309, etc.        |
| TEACHING WALL BOARD SCOPE IS AS SHOWN ON THE BID DOCUMENTS  AND ADDENDA. L.FASCIGLIONE 11/06/24 |
|   |
|   |
|   |
|   |
|   |
| Contractors Name: UniMak, LLC   |
| By: Ivo Dostinoski Date: 10/29/2024   |



RFI #: 03

Date: 10/29/2024

| Contractor Na | ame: UniMak, LLC  |        |                  |
|---------------|---|--------|------------------|
|               | Fasciglione Firm: CPL  Oostinoski   |        |                  |
| WE RI         | EQUEST YOUR ATTENTION (OR CONFIRMATION) REGARDING THE   | E FOLI | OWING:           |
| Subject:      | Accessibility of Openings in Detail 1/A800 – Interior vs. Exterior Access   |        |                  |
| Location:     | Tappan Zee High School, 15 Dutch Hill Road, Orangeburg, NY 10962  |        |                  |
|               | Information is Requested By: UniMak, LLC  |        |                  |
|               | Regarding detail 1/A800, are the openings accessible from ground ble to complete all work from the interior?              | /grade | e level outside, |
|               | WORK SHOULD BE COMPLETED FROM THE INTERIOR, AS EXISTING GRILLES ARE TO REMAIN, PER DETAIL 1/A800.  L.FASCIGLIONE 11/06/24 |        |                  |
|               | <del>-</del>  |        |                  |
|               |   |        |                  |
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|               |   |        |                  |
|               |   |        |                  |
| Contractors N | Name: UniMak, LLC   |        |                  |
| By: Ivo Do    | stinoski  | Date:  | 10/29/2024       |



RFI #: 04

Date: 10/29/2024

| Contractor Na | Jame: UniMak, LLC  |                 |        |
|---------------|--|-----------------|--------|
|               | a Fasciglione Firm: CPL  |                 |        |
|               | Dostinoski   |                 |        |
| WE R          | REQUEST YOUR ATTENTION (OR CONFIRMATION) REGARDING TH  | HE FOLLOWING    | G:     |
| Subject:      | Dimensions and Length Confirmation for Openings in Detail 1/A800                                     |                 |        |
|               |  |                 |        |
| Location:     | Tappan Zee High School, 15 Dutch Hill Road, Orangeburg, NY 10962                                     |                 |        |
|               |  |                 |        |
|               | Information is Requested By: UniMak, LLC   |                 |        |
| MESSAGE:      | : For detail 1/A800, could you confirm the height of the opening a                                   | nd whether it e | xtends |
|               | yth of the openings labeled '3' on floor plans A202, A203, and A20                                   |                 |        |
|               |  |                 |        |
|               | <ul> <li>OPENINGS VARY - PLEASE ACCOUNT FOR 5 SF PER OPEN</li> <li>L.FASCIGLIONE 11/06/24</li> </ul> | ING —           |        |
|               | _ L.I AOOIGLIONE 11/00/24  |                 |        |
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|               |  |                 |        |
| Contractors 1 | Name: UniMak, LLC  |                 |        |
| By: Ivo Do    | ostinoski  | Date: 10/29/    | 2024   |



RFI #: 05

Date: 10/29/2024

| Contractor Na      | ame: UniMak, LLC   |
|--------------------|--|
| To: Lisa           | Fasciglione Firm: CPL  |
| From: <u>Ivo D</u> | Postinoski   |
| WE RI              | EQUEST YOUR ATTENTION (OR CONFIRMATION) REGARDING THE FOLLOWING:   |
| Subject:           | Requirements for Modified Ceilings in Room #312 – New Grid and Tile?   |
| Location:          | Tappan Zee High School, 15 Dutch Hill Road, Orangeburg, NY 10962   |
|                    | Information is Requested By: UniMak, LLC   |
|                    | For ceilings labeled as "modified," such as Room #312 on sheet A602, will these w grid and tile?   |
| "MODIFIE<br>SALVAG | REFER TO CEILING SYMBOL LEGEND FOR THE FOLLOWING LANGUAGE: ED ACT CEILING SYSTEM BY GC. PROVIDE NEW GRID & REINSTALL ED CEILING TILES" GLIONE 11/06/24 |
| Contractors N      | Name: UniMak, LLC  |
| By: Ivo Dos        | stinoski Date: 10/29/2024  |



RFI #: 06

Date: 10/29/2024

| Contractor 1  | Name: UniMak, LLC   |  |
|---|---|--|
| To: Lis   | isa Fasciglione Firm: CPL   |  |
| From: <u>Ivo</u>  | o Dostinoski  |  |
| WE I  | REQUEST YOUR ATTENTION (OR CONFIRMATION) REGARD   | ING THE FOLLOWING:   |
| Subject:  | Ceiling Tile Specification - Alternative to Armstrong #1820   |  |
| Location:   | Tappan Zee High School, 15 Dutch Hill Road, Orangeburg, NY  | 10962  |
|   | Information is Requested By: UniMak, LLC  |  |
| MESSAGE   | E: Sheet I000 specifies an Armstrong #1820 rated ceiling tile   | , but the grid system is not   |
| -   | uld we use an Armstrong #1717 or an equivalent non-rated til  | e with the same size   |
| and thickne   | ness?   |  |
| PER BU<br>FINISHE<br>GIVEN 1<br>REMAIN<br>ADDITIO<br>INCLUD<br>THE SC<br>STANDA | DINSE (ALS, 11/6):  JILDING CODE, A MINIMUM CLASS B RATING IS ES WITHIN AN E (EDUCATIONAL) OCCUPANCY THIS, THE CEILING SYSTEM OUTLINED ON THI N AS THE BASIS OF DESIGN. ONALLY, PER OUR PRODUCT REP, THE ENTIR DES THE GRID SYSTEMS IS CATAGORIZED AS CHOOL DISTRICT HAS ALSO MADE THIS CEILIN ARD THROUGHOUT ALL DISTRICT BUILDINGS NUE WITH THE STANDARD THROUGHOUT NEV | E BID DOCS IS TO E SYSTEM WHICH CLASS A. IG SYSTEM THEIR AND WOULD LIKE TO |
|   |   |  |
| Contractors   | rs Name: UniMak, LLC  |  |
| By: Ivo D   | Dostinoski  | Date: 10/29/2024   |



# FLOOR PLAN GENERAL NOTES

- ALL DRAWINGS ARE GRAPHIC REPRESENTATIONS OF APPROXIMATE LOCATIONS OF EXISTING AND NEW MATERIALS. FIELD VERIFY ALL EXISTING CONDITIONS PRIOR TO COMMENCEMENT OF WORK.
- THE CONTRACTOR IS RESPONSIBLE FOR DAMAGE TO ANY EXISTING FINISHES AND EQUIPMENT NOT REMOVED UNDER THE SCOPE OF WORK. ANY DAMAGE WILL BE REPAIRED TO THE OWNER/ARCHITECT'S SATISFACTION AT NO COST TO THE OWNER. WORK AREAS SHALL BE MAINTAINED AND ALL WORK AREAS SHALL BE LEFT BROOMED
- THE CONTRACTOR SHALL PROVIDE DUST CONTROL BARRIERS AT ALL AREAS OF
- THE CONTRACTOR SHALL PATCH ALL SURFACES WHERE EXISTING MATERIALS HAVE BEEN DISTURBED TO MATCH AND BE FLUSH WITH ADJACENT CONSTRUCTION AT ALL FLOOR, WALL AND CEILING LOCATIONS.
- COORDINATE WITH OTHER TRADES FOR SEQUENCING OF WORK.

DENOTES FINISH FLOOR **GRADE ELEVATION** 

# FLOOR PLAN LEGEND


NOTE: THIS LEGEND MAY CONTAIN SYMBOLS THAT ARE NOT USED IN THIS PROJECT.

DOOR TARGET, WINDOW TARGET, SEE SCHEDULE SEE SCHEDULE **ROOM NAME** H1234.2 COLUMN LINE **ROOM TAG** IDENTIFICATION 150 SF 10'-0" x 10'-0" SECTION MARK DETAIL FOR REFERENCE INTERIOR ELEVATION

# FLOOR PLAN KEY NOTES

- (1) PATCH PLASTER WALL AS REQ'D AT DEMOLISHED WALLS & CASEWORK
- 2 INFILL WALL OPENING WITH 8" CMU AND PLASTER BOTH SIDES TO MATCH EXISTING. PATCH WALL BASE TO MATCH EXISTING.
- 3 INFILL EXTERIOR MASONRY WALL AT DEMOLISHED UV LOCATIONS. REFER TO DETAIL 1/A800
- REPLACE WINDOW PANEL W/ GLAZING AT EXISTING AC REMOVAL. REFER TO A900
- NEW CASEWORK. REFER TO INTERIOR ELEVATIONS AND A800 SERIES FOR
- (6) PATCH PLASTER WALL AT REMOVALS
- (7) PATCH PLASTER WALL AT DEMOLISHED LIGHT FIXTURE
- (8) PATCH PLASTER WALL AS REQ'D AT DEMOLISHED TRACK
- 9 SMARTBOARD TO BE FURNISHED & INSTALLED BY OWNER. REFER TO T DRAWINGS FOR DATA CONNECTION LOCATIONS.
- LAMINATE GYPSUM WALL BOARD AS SPECIFIED. GYP TO EXTEND 6" MIN. ABOVE FINISHED CEILING.

PROFESSIONAL STAMPS

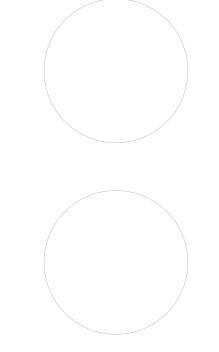

SHEET INFORMATION

10/25/2024 As indicated Project Status BID DOCUMENTS Drawn By

CJD Drawing Title AREA C NEW WORK PLAN

A203



CPLteam.com

NY ENGINEERING FIRM CERTIFICATE #0021419

PROJECT INFORMATION

SCHOOL DISTRICT

**PHASE 2: 2022 BOND** 

TAPPAN ZEE HIGH SCHOOL

SED # 50-03-01-06-0-006-033

Registration Expiration Dates Lauren Tarsio 09/30/26 Anthony Marchetti 05/31/27 Dave Hart 02/28/25 Jennifer Wengender 06/30/27

SOUTH ORANGETOWN CENTRAL


15 DUTCH HILL ROAD, ORANGEBURG, NY

PROJECT ISSUE & REVISION SCHEDULE

2 11/06/2024 BID ADDENDUM #2

R22.14457.20 Client Name

10962

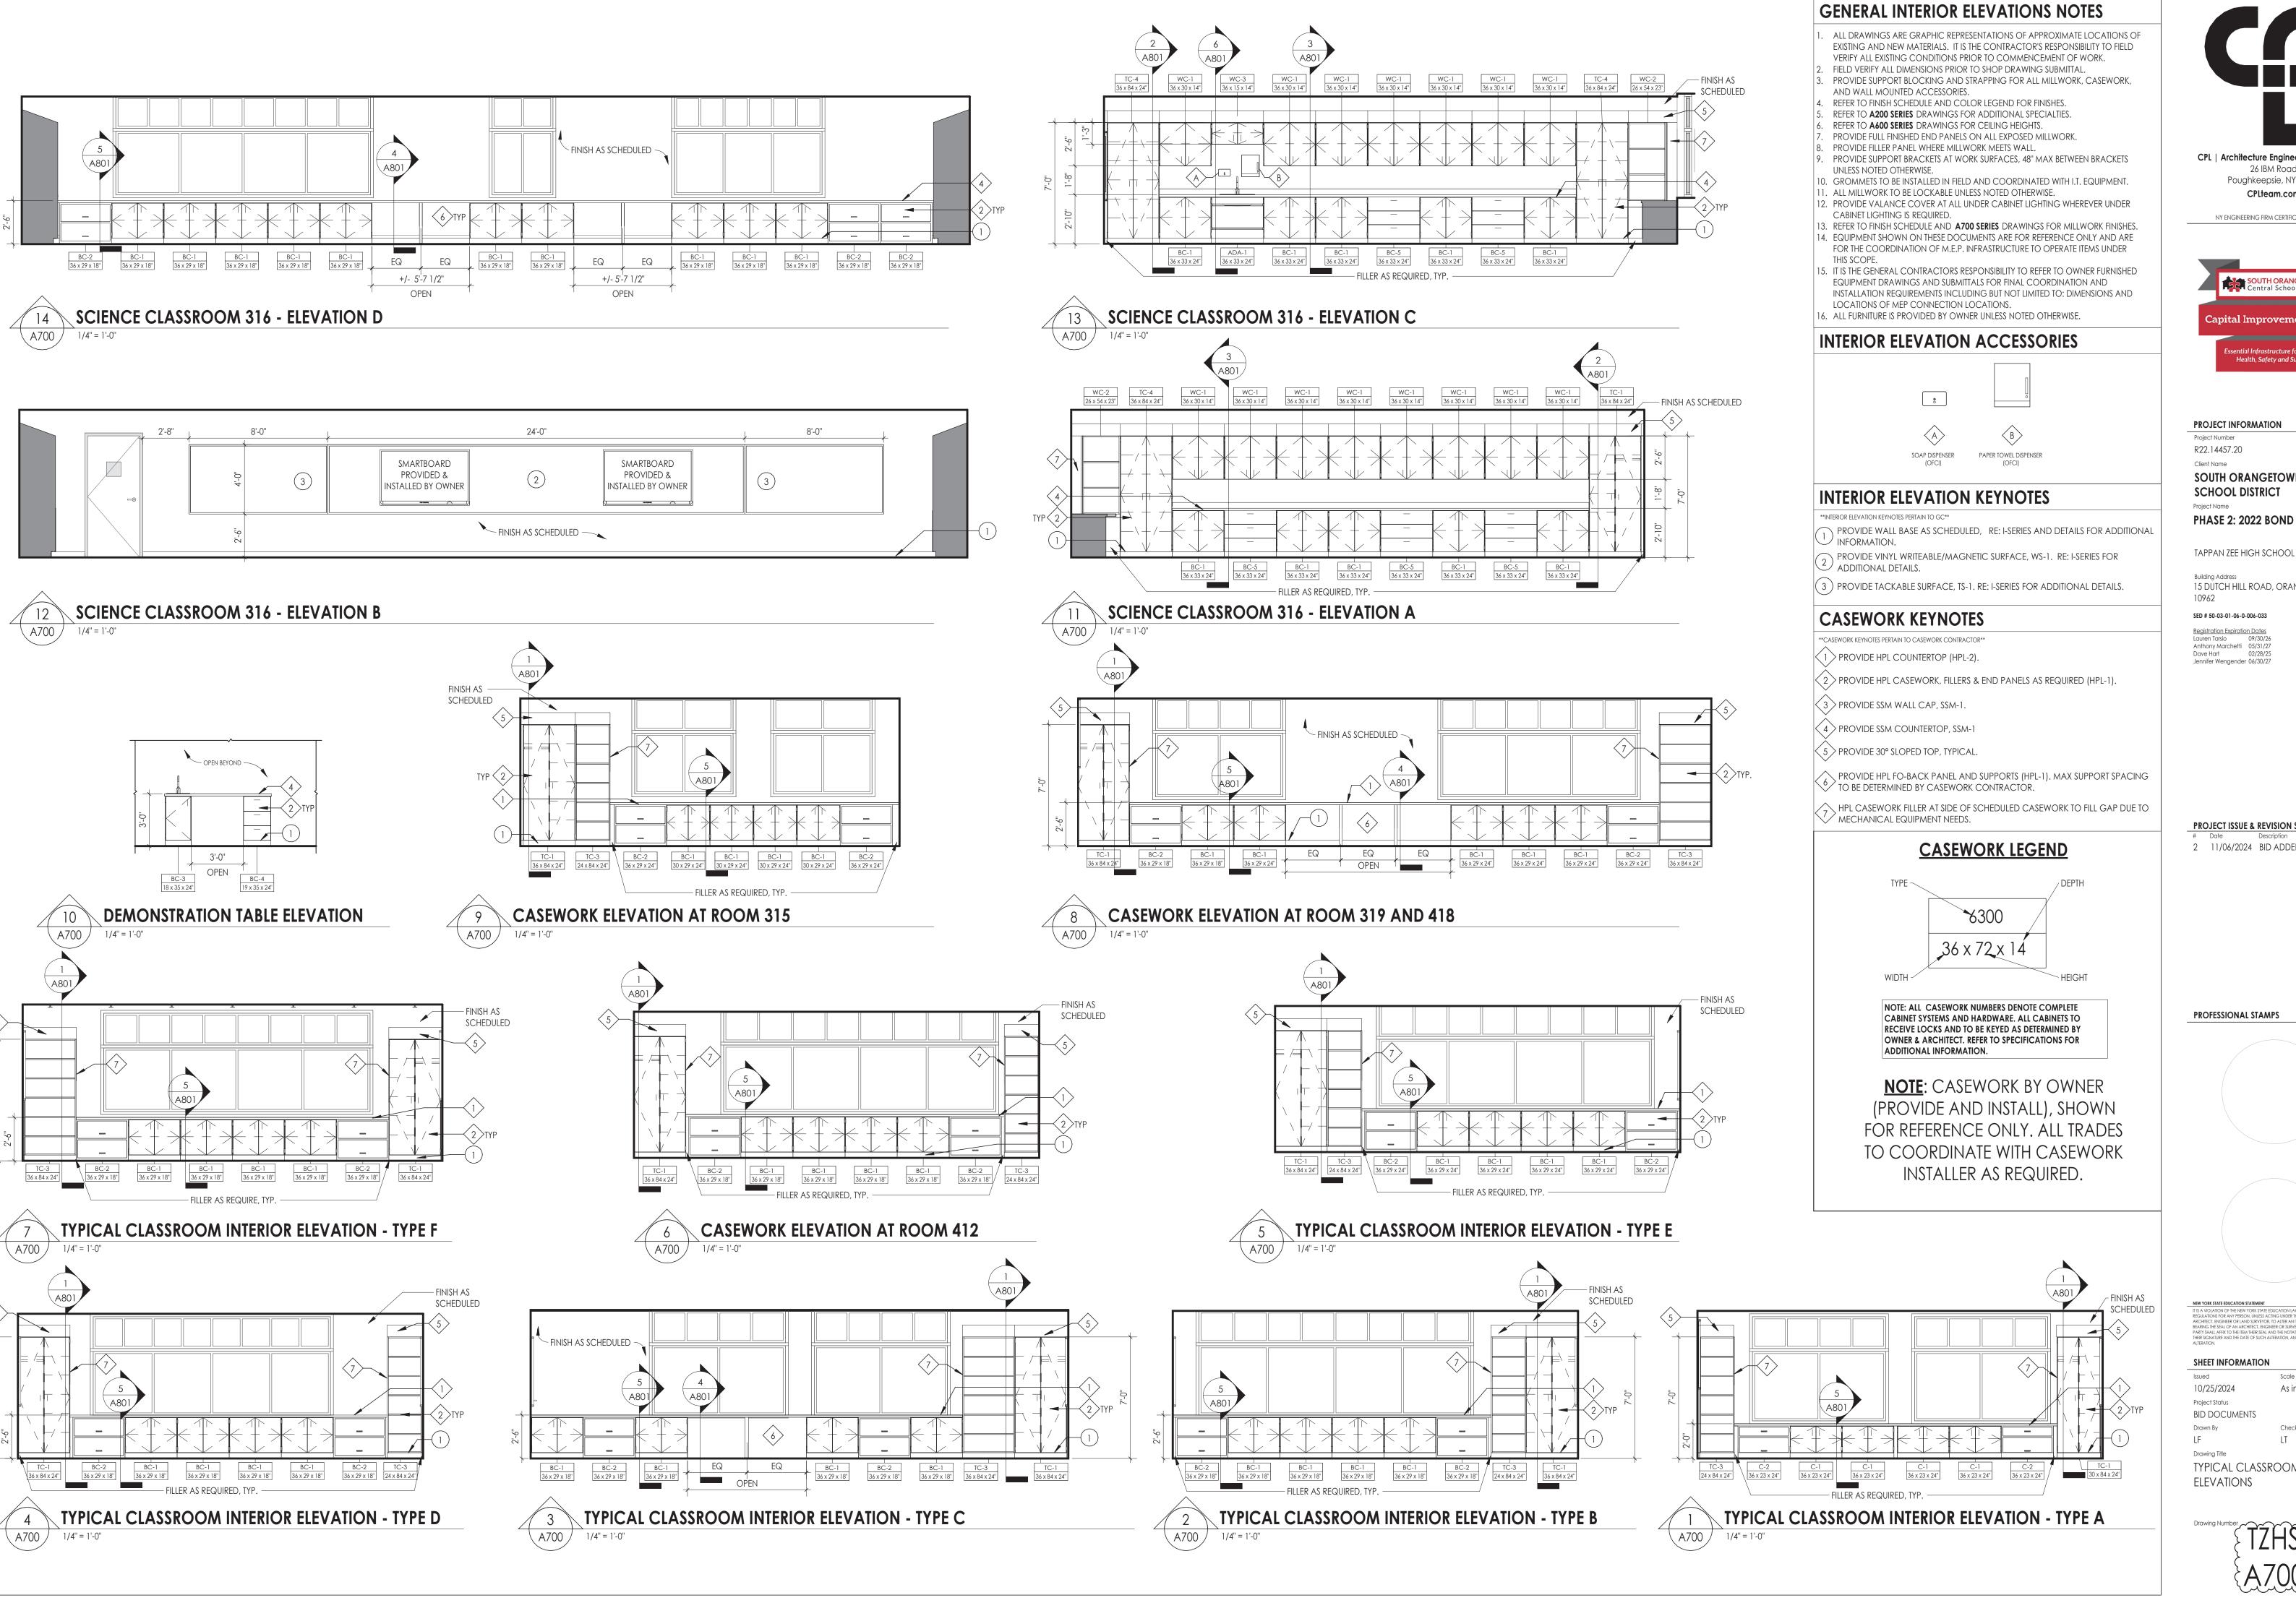

CPL | Architecture Engineering Planning 26 IBM Road Poughkeepsie, NY 12601 CPLteam.com

NY ENGINEERING FIRM CERTIFICATE #0021419



PROJECT INFORMATION

SOUTH ORANGETOWN CENTRAL SCHOOL DISTRICT

TAPPAN ZEE HIGH SCHOOL


15 DUTCH HILL ROAD, ORANGEBURG, NY

SED # 50-03-01-06-0-006-033

Lauren Tarsio 09/30/26 Anthony Marchetti 05/31/27 Jennifer Wengender 06/30/27


**PROJECT ISSUE & REVISION SCHEDULE** 

2 11/06/2024 BID ADDENDUM #2

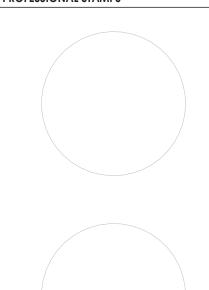

As indicated BID DOCUMENTS

TYPICAL CLASSROOM **ELEVATIONS** 

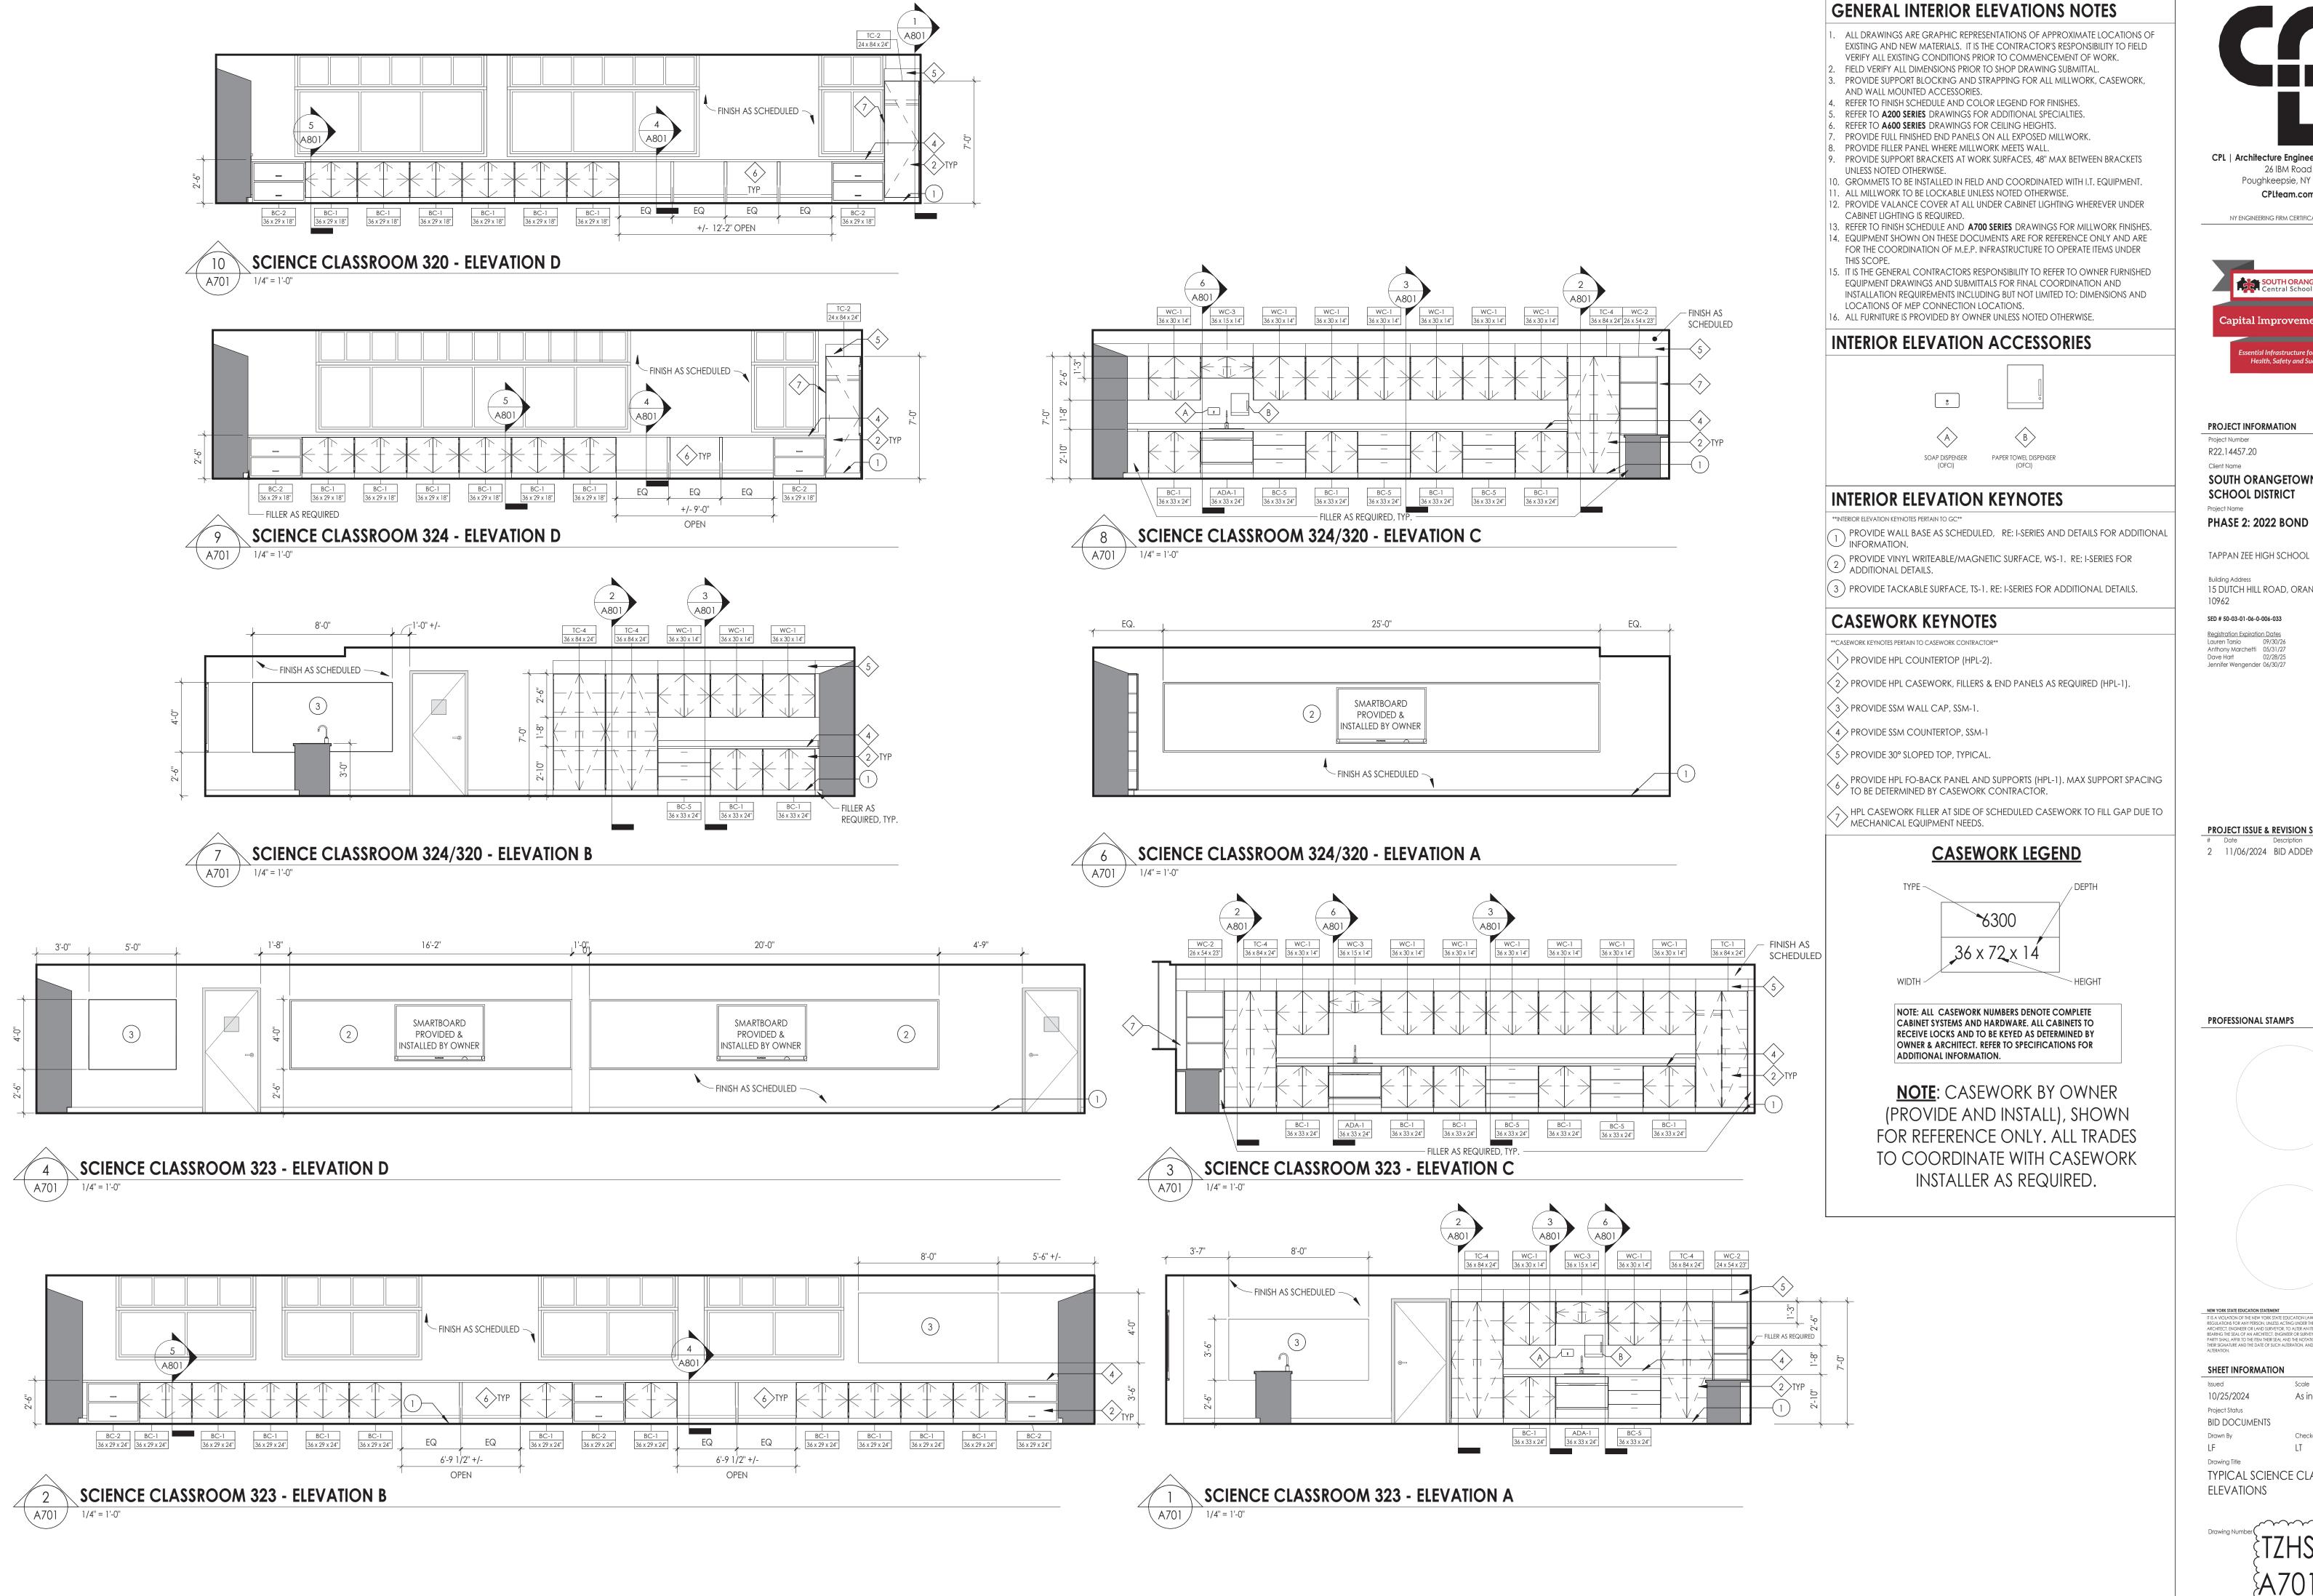

CPL | Architecture Engineering Planning 26 IBM Road Poughkeepsie, NY 12601

NY ENGINEERING FIRM CERTIFICATE #0021419

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PROJECT INFORMATION

R22.14457.20

SOUTH ORANGETOWN CENTRAL SCHOOL DISTRICT

15 DUTCH HILL ROAD, ORANGEBURG, NY 10962


SED # 50-03-01-06-0-006-033

Lauren Tarsio 09/30/26 Anthony Marchetti 05/31/27 Dave Hart 02/28/25 Jennifer Wengender 06/30/27

**PROJECT ISSUE & REVISION SCHEDULE** 

2 11/06/2024 BID ADDENDUM #2


PROFESSIONAL STAMPS

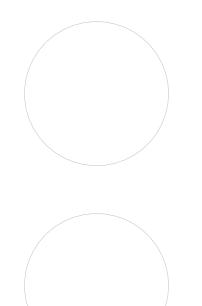

10/25/2024 As indicated Project Status BID DOCUMENTS

Drawn By Drawing Title

TYPICAL SCIENCE CLASSROOM **ELEVATIONS** 

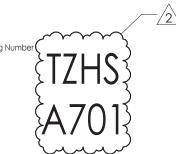

|                  |  | Cr                       | ASEWORK SCHEDULE         |   |
|------------------|--|--------------------------|--------------------------|---|
| TYPE MARK        | DESCRIPTION                                | DIMENSIONS               | PRODUCT #                | NOTES   |
| ADA SINK A       | PRON (ADA)                                 |                          |                          |   |
| ADA-1            | ADA COMPLIANT SINK APRON                   | 36" W X 34"H X 24"D      | TMI #B2545               |   |
| ASE CABIN        | FT (BC)                                    |                          |                          |   |
| BC-1             | 2 DOORS, 1 ADJUSTABLE SHELF                | VARIES; REF. A700 SERIES | TMI # B2052              |   |
| C-2              | 2 EQUAL LATERAL FILE DRAWERS               | VARIES; REF. A700 SERIES | TMI # D2804              |   |
| 3C-3             | 1 DOOR SINK CABINIET                       | 18"W x 36"H x 24"D       | TMI # B2500              | DEMONSTRATION TABLE   |
| 3C-4             | 1 FILE DRAWER/2 EQUAL DRAWERS              | 19"W x 36"H x 24"D       | TMI# 3862                | DEMONSTRATION TABLE   |
| 3C-5             | 3 EQUAL DRAWERS                            | VARIES; REF. A700 SERIES | TMI # D3001              |   |
| 3C-6             | 1 DOOR, 1 ADJUSTABLE SHELF                 | VARIES; REF. A700 SERIES | TMI # B2050, TMI # B2051 | REFER TO ELEVATIONS FOR LEFT OR RIGHT HINGE PLACEMENT                   |
| CUSTOM (C<br>C-1 | 2 DOORS, 1 ADJUSTABLE SHELF                | VARIES: REF. A700 SERIES | TMI #B2052               | REFERENCE TMI PRODUCT FOR DESIGN INTENT; CABINET TO BE CUSTOM 24" HIGH. |
| C-2              | 2 EQUAL DRAWERS                            | VARIES; REF. A700 SERIES | TMI #D2001               | REFERENCE TMI PRODUCT FOR DESIGN INTENT; CABINET TO BE CUSTOM 24" HIGH. |
| METAL CABI       | , ,  |                          |                          |   |
| MC-1             | OPEN SHELVING, 1 ADJUSTABLE SHELF          | 36"W x 29"H x 16"D       | TRANE # SHL-B-B-1-03     |   |
| ALL CABINI       | et (TC)                                    |                          |                          |   |
| C-1              | 2 DOOR WARDROBE                            | VARIES; REF. A700 SERIES | TMI # T2586, TMI #2590   | REFER TO ELEVATIONS FOR LEFT OR RIGHT WARDROBE PLACEMENT                |
| C-2              | 1 DOOR WARDROBE                            | VARIES; REF. A700 SERIES | TMI # T2570, # T2571     | REFER TO ELEVATIONS FOR LEFT OR RIGHT HINGE PLACEMENT                   |
| C-3              | ADJUSTABLE OPEN SHELVING                   | VARIES; REF. A700 SERIES | TMI # T1100              |   |
| C-4              | 2 DOORS, 1 FIXED SHELF, 4 ADJUSTABLE SHELF | VARIES; REF. A700 SERIES | TMI # T2102              |   |
| VALL CABIN       | NET (WC)                                   |                          |                          |   |
| NC-1             | 2 DOORS, 1 ADJUSTABLE SHELF                | VARIES; REF. A700 SERIES | TMI # W2052              |   |
| NC-2             | OPEN SHELVING, 2 ADJUSTABLE SHELVES        | VARIES; REF. A700 SERIES | TMI # H1050              |   |

# **CASEWORK GENERAL NOTES:**

# \*NOTE:

1. ALL CASEWORK WITH DOORS/ DRAWERS TO RECEIVE LOCKS PER OWNER REQUEST. OWNER IS RESPONSIBLE FOR KEYING.

\*\*ALL WORK PERTAINS TO CASEWORK CONTRACTOR UNLESS NOTED

OTHERWISE (GC= GENERAL CONTRACTOR RESPONSIBILITY)\*\*

PROVIDE WITH SLOPED TOP AS

SHOWN IN ELEVATIONS, UNLESS

3/4" PARTICLE BOARD CABINET

MELAMINE ON ALL ESPOSED

BODY W/ HPL ON EXPOSED FACES.

INTERIOR & SEMI-EXPOSED FACES.

RECESSED SHELF STANDARDS &

ADJUSTABE MELAMINE SHELF. 3/4"

THICK UP TO 24" SPAN, 1" THICK

1x NAILER -TYP. W/ 2x4 FRT WD

1/4" MELAMINE BACK PANEL

EXISTING WALL CONSTRUCTION

SCHEDULED HARDWARE. RE:

ADDITIONAL DETAILS

MILLWORK SPECIFICATION FOR

3/4" PARTICLE BOAR DOOR FRONT

W/ HPL ON ALL EXPOSED FACES.

SCHEDULED BASE (PROVIDED BY GC WEHERE

APPLICABLE)


MELAMINE ON INSIDE FACE.

BLOCKING BEYOND (GC) -

OVER 24" SPAN

NOTED OTHERWISE (U.N.O.)


**NOTE**: CASEWORK BY OWNER (PROVIDE AND INSTALL), SHOWN FOR REFERENCE ONLY. ALL TRADES TO COORDINATE WITH CASEWORK CONTRACTOR AS REQUIRED.

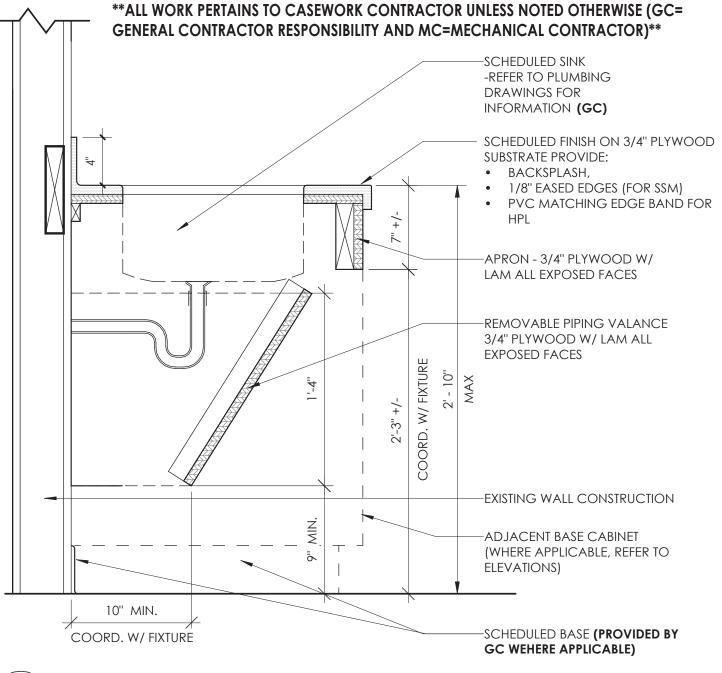


A801 1 1/2" = 1'-0"

# **ADA SINK**

## \*\*ALL WORK PERTAINS TO CASEWORK CONTRACTOR UNLESS NOTED OTHERWISE (GC= GENERAL CONTRACTOR RESPONSIBILITY AND MC=MECHANICAL CONTRACTOR)\*\*

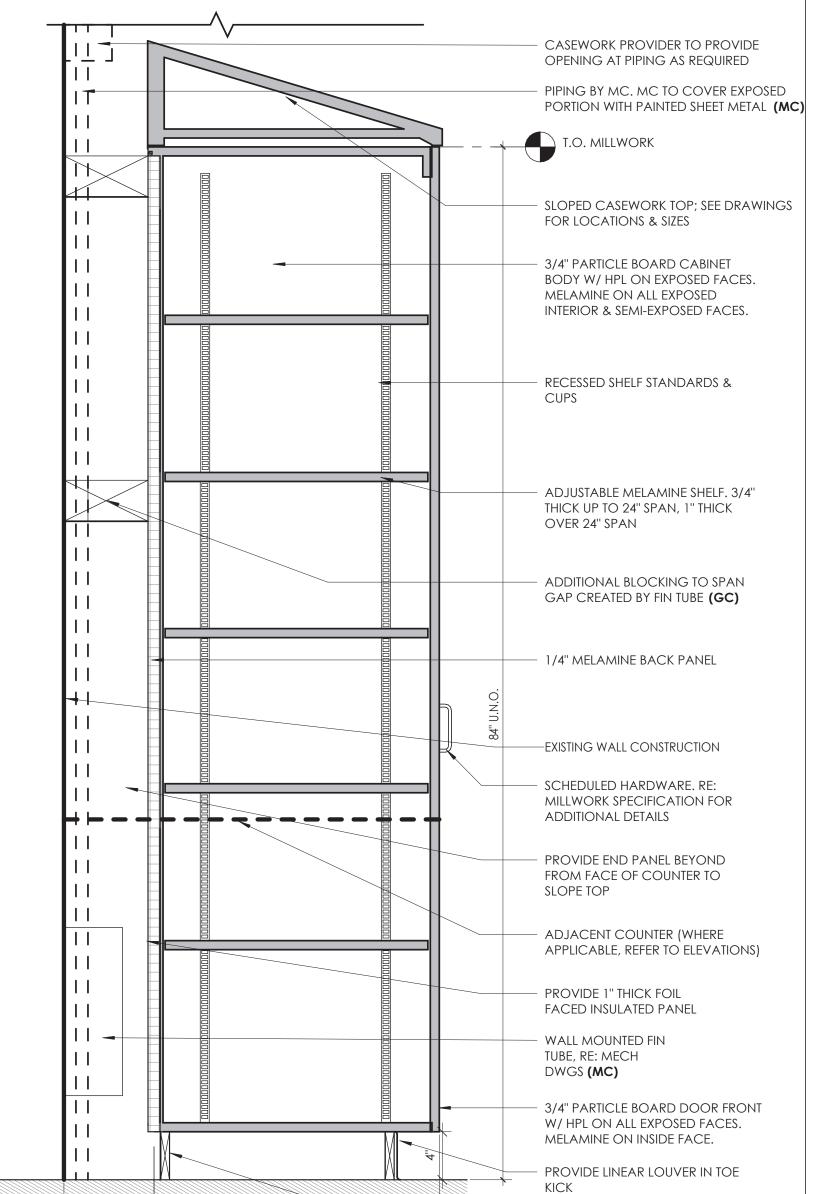


\*\*ALL WORK PERTAINS TO CASEWORK CONTRACTOR UNLESS NOTED OTHERWISE (GC= GENERAL CONTRACTOR RESPONSIBILITY AND MC=MECHANICAL CONTRACTOR)\*\*

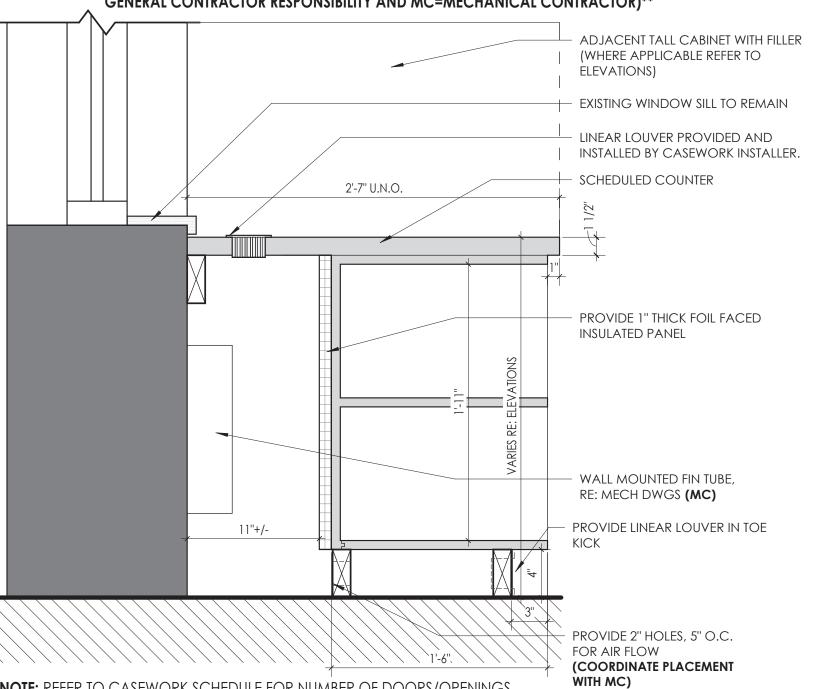

**NOTE:** REFER TO CASEWORK SCHEDULE FOR NUMBER OF DOORS/OPENINGS REQUIRED, VARIES. BASE CABINET W/ FIN TUBE VENTILATION

A801

1 1/2" = 1'-0"

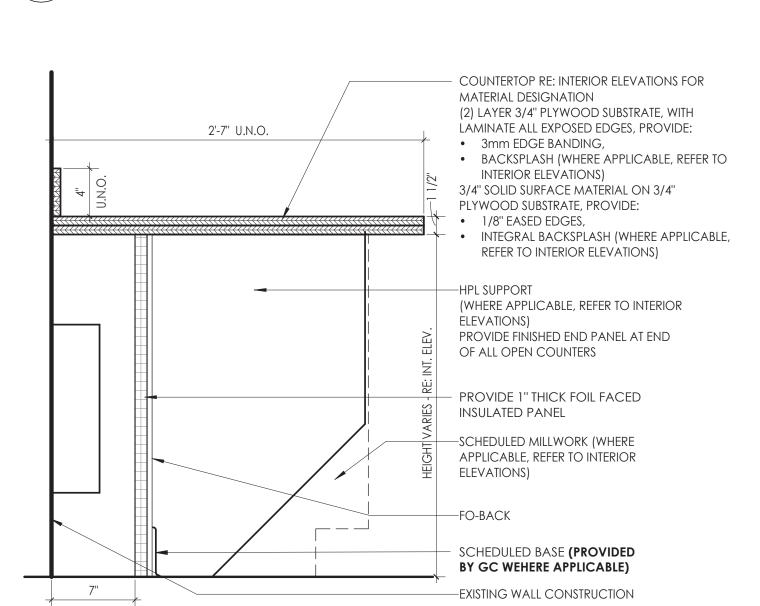

\*\*ALL WORK PERTAINS TO CASEWORK CONTRACTOR UNLESS NOTED OTHERWISE (GC= GENERAL CONTRACTOR RESPONSIBILITY)\*\*

TYPICAL LAMINATE WORKSURFACE SECTION \ A801 / 1 1/2" = 1'-0"

U.N.O. SCHEDULED MILLWORK (WHERE APPLICABLE, REFER TO INTERIOR ELEVATIONS) -EXISTING WALL CONSTRUCTION 2'-1" U.N.O. COUNTERTOP WITH BACKSPLASH **RE: INTERIOR ELEVATIONS** FOR MATERIAL DESIGNATION

1'-3"

\*\*ALL WORK PERTAINS TO CASEWORK CONTRACTOR UNLESS

NOTED OTHERWISE (GC= GENERAL CONTRACTOR

**RESPONSIBILITY**)\*\*

PROVIDE WITH SLOPED TOP AS

SHOWN IN ELEVATIONS, UNLESS NOTED OTHERWISE (U.N.O.) -

SCHEDULED MILLWORK (WHERE APPLICABLE, REFER TO INTERIOR ELEVATIONS) — SCHEDULED BASE (PROVIDED BY GC WEHERE APPLICABLE)

**NOTE:** REFER TO CASEWORK SCHEDULE FOR NUMBER OF DOORS/OPENINGS REQUIRED, VARIES.

TYPICAL BASE AND UPPER CABINETS @SCIENCE \ A801 ∫ 1 1/2" = 1'-0"

**NOTE:** REFER TO CASEWORK SCHEDULE FOR NUMBER OF DOORS/DRAWERS REQUIRED, VARIES.

TYPICAL TALL CABINET @ SCIENCE A801 1 1/2" = 1'-0"

REQUIRED, VARIES. TALL CABINET W/ FIN TUBE VENTILATION A801 1 1/2" = 1'-0"

**NOTE:** REFER TO CASEWORK SCHEDULE FOR NUMBER OF DOORS/OPENINGS

2'-0"

CPL | Architecture Engineering Planning

26 IBM Road Poughkeepsie, NY 12601

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NY ENGINEERING FIRM CERTIFICATE #0021419

PROJECT INFORMATION

R22.14457.20

SOUTH ORANGETOWN CENTRAL SCHOOL DISTRICT

TAPPAN ZEE HIGH SCHOOL

**PHASE 2: 2022 BOND** 

15 DUTCH HILL ROAD, ORANGEBURG, NY SED # 50-03-01-06-0-006-033


Registration Expiration Dates
Lauren Tarsio 09/30/26
Anthony Marchetti 05/31/27

Jennifer Wengender 06/30/27

**PROJECT ISSUE & REVISION SCHEDULE** 

2 11/06/2024 BID ADDENDUM #2

PROFESSIONAL STAMPS

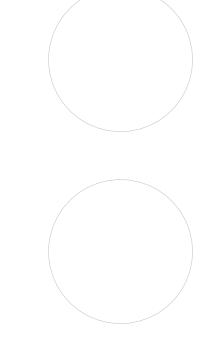

**SHEET INFORMATION** Issued 10/25/2024

As indicated Project Status BID DOCUMENTS Drawn By CPL

Drawing Title MISC. DETAILS

PROVIDE 2" HOLES, 5" O.C.

(COORDINATE PLACEMENT

FOR AIR FLOW

WITH MC)

|                                   |                                   |                              |   | INTERIOR FINISH SCHEDULE   |  |
|-----------------------------------|-----------------------------------|------------------------------|---|--|--|
| INISH CODE MANUFACTURER           | PATTERN/STYLE                     | COLOR                        | SIZE                                      | SPECIFICATIONS   | NOTES  |
| OUSTICAL CEILING TILE (ACT)       |                                   |                              |   |  |  |
| -1 ARMSTRONG OR EQUAL             | SCHOOL ZONE FINE FISSURED 1820    | WHITE                        | 24" X 24" X 3/4"                          | CLASS A FIRE PERFORMANCE; NRC .70; CAC 35; 85% LIGHT REFLECTANCE; BIOBLOCK, MILDEW & MOLD RESISTANT; WITH 15/16" PRELUDE XL SUSPENSION SYSTEM; WHITE   | TYPICAL 2'X2' ACT  |
| H PRESSURE PLASTIC LAMINATE (HPL) |                                   |                              |   |  |  |
| 1 WILSONART OR EQUAL              | AEON SCRATCH RESISTANT            | PHANTOM CHARCOAL 8214K-28    | N/A                                       | GLOSS LINE FINISH; CLASS B; VERTICAL SURFACE LAMINATE 335; GRAIN TO RUN VERTICALLY. FLAME SPREAD <= 45; STAIN RESISTANT; IMPACT RESISTANT; SURFACE WEAR RESISTANT; RADIANT HEAT RESIEDGE BANDING, MATCHING LAMINATE PATTERN. | STANT. PROVIDE WITH 3 WERTICAL; CASEWORK                 |
| -2 WILSONART OR EQUAL             | HORIZONTAL GRADE 350              | WHITE NEBULA 4621-60         | N/A                                       | MATTE FINISH; CLASS B; POSTFORMING HORIZONTAL SURFACE LAMINATE 350. FLAME SPREAD <= 60; STAIN RESISTANT; IMPACT RESISTANT; SURFACE WEAR RESISTANT; RADIANT HEAT RESISTANT. PROVID MATCHING LAMINATE PATTERN.                 | DE WITH 3mm EDGE BAN <b>BIDIRJ</b> ONTAL; COUNTERTOPS    |
| NT (PT)                           |                                   |                              |   |  |  |
| SHERWIN WILLIAMS OR EQUAL         | REFER TO SPECIFICATIONS           | ALPACA SW-7022               | N/A                                       | REFER TO SPECIFICATIONS  | FIELD, U.N.O.  |
| SHERWIN WILLIAMS OR EQUAL         | REFER TO SPECIFICATIONS           | CAVIAR SW-6990               | N/A                                       | REFER TO SPECIFICATIONS  | ACCENT COLOR; PAINT BOTH SIDES OF HM DOOR                |
| SHERWIN WILLIAMS OR EQUAL         | REFER TO SPECIFICATIONS           | CEILING BRIGHT WHITE SW-7007 | N/A                                       | REFER TO SPECIFICATIONS  | GYP CEILING; U.N.O.                                      |
| SHERWIN WILLIAMS OR EQUAL         | REFER TO SPECIFICATIONS           | STOP SW-6869                 | N/A                                       | REFER TO SPECIFICATIONS  | ACCENT COLOR   |
| IENT BASE (RB)                    |                                   |                              |   |  |  |
| TARKETT OR EQUAL                  | TRADITIONAL WALL BASE 1/8"        | BEDROCK TA6                  | 4" HIGH                                   | CLASS B <450 SMOKE DENSITY; CLASS 1 RADIANT PANEL; PROVIDE IN 120' ROLLS   | TYPICAL WALL BASE; U.N.O.                                |
| ITAKKETI OK EQOTE                 | THE BITTO IN THE BITTO IT         | BEBROOK I/10                 | 7 11011                                   | CL 60 D 400 SMOKE DETOIT, CL 60 TK/DI/MTT/MEE, TKO NDE IN 120 KOLLS  | THIOME WILL DIGE, C.N.O.                                 |
| D SURFACE MATERIAL (SSM-1)        |                                   |                              |   |  |  |
| 1 CORAIN                          | SOLID SURFACE MATERIAL            | EVEREST                      | N/A                                       | CLASS A; FLAME SPREAD INDEX <25, SMOKE DEVELOPMENT INDEX <25   | SCIENCE LAB COUNTERTOPS                                  |
|                                   |                                   |                              |   |  |  |
| (ABLE SURFACE (TAS)               |                                   |                              |   |  |  |
| 1 KOROSEAL OR EQUAL               | WALL TALKERS TAC-WALL             | QUARRY 92                    | 48" HIGH; LENGTH AS INDICATED ON DRAWINGS | CLASS B; BURLAP BACKING; SELF-HEALING LINOLEUM RESILIENT HOMOGENEOUS TACKABLE MATERIAL; COLOR EXTENDS FULL THICKNESS OF MATERIAL; PROVIDE IN 95 FOOT ROLLS; PROVIDE CLEAR, A LIMITED 5-YEAR WARRANTY                         | NODIZED TRIM AT ALL E <b>DYOPES;</b> AL TACKABLE SURFACE |
| nsition (ts)                      |                                   |                              |   |  |  |
| SCHLUTER SYSTEMS OR EQUAL         | VINPRO-U                          | ANODIZED ALUMINUM            | AS REQUIRED TO MEET MATERIAL THICKNESS    | SEE TRANSITION TYPE DETAILS; SLOPE MUST COMPLY WITH ADA REQUIREMENTS. REFER TO SPECIFICATIONS  | ETR TERRAZZO TO VCT/RT                                   |
| (L COMPOSITION TILE (VCT)         |                                   |                              |   |  |  |
| 1 ARMSTRONG FLOORING OR EQUA      | STANDARD EXCELON IMPERIAL TEXTURE | SILK 59234                   | 12" X 12" X 1/8"                          | CLASS 2 THROUGH PATTERN; TYPE II; CLASS 1 RADIANT PANEL; 2000 PSI; FAST START FACTORY FINISH; 5-YEAR LIMITED COMMERICAL WARRANTY, QUARTER TURN INSTALLATION.   | BASE BID - FIELD; U.N.O.                                 |
| ARMSTRONG FLOORING OR EQUA        |                                   | FIELD GRAY 51927             | 12" X 12" X 1/8"                          | CLASS 2 THROUGH PATTERN; TYPE II; CLASS 1 RADIANT PANEL; 2000 PSI; FAST START FACTORY FINISH; 5-YEAR LIMITED COMMERICAL WARRANTY, QUARTER TURN INSTALLATION.   | BASE BID - ACCENT COLOR                                  |
| ARMSTRONG FLOORING OR EQUA        | STANDARD EXCELON IMPERIAL TEXTURE | RUBY RED 57534               | 12" X 12" X 1/8"                          | CLASS 2 THROUGH PATTERN; TYPE II; CLASS 1 RADIANT PANEL; 2000 PSI; FAST START FACTORY FINISH; 5-YEAR LIMITED COMMERICAL WARRANTY, QUARTER TURN INSTALLATION.   | BASE BID - ACCENT COLOR                                  |
| ABLE SURFACE (WS)                 |                                   |                              |   |  |  |
| KOROSEAL OR EQUAL                 | WALL TALKERS MAG-RITE 59          | NATURAL WHITE M259-00        | 45" LENGTH AS RECHIRED PER DRAWIN         | NGS;CLASS A; TYPE II; WOVEN BACKING; MODERATE GLOSS FINISH; STRAIGHT MATCH PATTERN   | TYPICAL WRITEABLE SURFACE OVER ETR CHALKBOA              |
|                                   | MALL INLINUINAG-KIIL JA           | INATURAL WITHE MIZOT-UU      | REFER TO ELEVATIONS & FINISH SCHED        |  | THE ICAL WINILABLE SURFACE OVER LIK CHALKBOA             |

CONTRACTOR TO ENSURE THAT ALL MATERIALS ARE ORDERED MIN. 12 WEEKS PRIOR TO INSTALLATION DATE TO ACCOUNT FOR MATERIAL BACKORDERS. ADDITIONAL TIME MAY BE REQUIRED FOR SPECIALTY ITEMS; GC TO WORK WITH PRODUCT REP OR MANUFACTURER TO DETERMINE ADDITIONAL TIME MAY BE REQUIRED FOR SPECIALTY ITEMS; GC TO WORK WITH PRODUCT REP OR MANUFACTURER TO DETERMINE ADDITIONAL TIME MAY BE REQUIRED FOR SPECIALTY ITEMS; GC TO WORK WITH PRODUCT REP OR MANUFACTURER TO DETERMINE ADDITIONAL TIME MAY BE REQUIRED FOR SPECIALTY ITEMS; GC TO WORK WITH PRODUCT REP OR MANUFACTURER TO DETERMINE ADDITIONAL TIME MAY BE REQUIRED FOR SPECIALTY ITEMS; GC TO WORK WITH PRODUCT REP OR MANUFACTURER TO DETERMINE ADDITIONAL TIME MAY BE REQUIRED FOR SPECIALTY ITEMS; GC TO WORK WITH PRODUCT REP OR MANUFACTURER TO DETERMINE ADDITIONAL TIME MAY BE REQUIRED FOR SPECIALTY ITEMS; GC TO WORK WITH PRODUCT REP OR MANUFACTURER TO DETERMINE ADDITIONAL TIME MAY BE REQUIRED FOR SPECIALTY ITEMS; GC TO WORK WITH PRODUCT REP OR MANUFACTURER TO DETERMINE ADDITIONAL TIME MAY BE REQUIRED FOR SPECIALTY ITEMS; GC TO WORK WITH PRODUCT REP OR MANUFACTURER TO DETERMINE ADDITIONAL TIME MAY BE REQUIRED FOR SPECIALTY ITEMS.

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FINISH ABBREVIATIONS

NOTE: THIS LEGEND MAY CONTAIN ABBREVIATIONS THAT ARE NOT IN THIS PROJECT

ACT ACOUSTICAL CEILING TILE SCON SEALED CONCRETE AWP ACOUSTICAL WALL PANEL SSM SOLID SURFACE MATERIAL CPT CARPET TAS TACKABLE SURFACE

ETR EXISTING TO REMAIN EXP EXPOSED TS TRANSITION STRIP HPL HIGH PRESSURE PLASTIC LAMINATE VCT VINYL COMPOSITION TILE INT INTEGRAL

WC WALL COVERING PT PAINT WD WOOD PTM PATCH TO MATCH WOM WALK OFF MAT RB RESILIENT BASE WS WRITEABLE SURFACE RT RUBBER TILE WT WINDOW TREATMENT

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NY ENGINEERING FIRM CERTIFICATE #0021419



PROJECT INFORMATION

R22.14457.20

SOUTH ORANGETOWN CENTRAL SCHOOL DISTRICT Project Name

TAPPAN ZEE HIGH SCHOOL

**PHASE 2: 2022 BOND** 

15 DUTCH HILL ROAD, ORANGEBURG, NY


10962 SED # 50-03-01-06-0-006-033

Registration Expiration Dates Lauren Tarsio 09/30/26 Anthony Marchetti 05/31/27 Dave Hart 02/28/25 Jennifer Wengender 06/30/27

PROJECT ISSUE & REVISION SCHEDULE

2 11/06/2024 BID ADDENDUM #2

PROFESSIONAL STAMPS

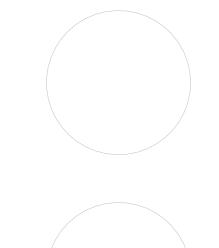


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INTERIORS GENERAL



\*\*FLOOR PATTERN ORIENTATION TO COORDINATE WITH TEACHING WALL, REFER TO 1200 SERIES FOR TEACHING WALL LOCATIONS\*\*



GENERAL FINISH MATERIAL NOTE:

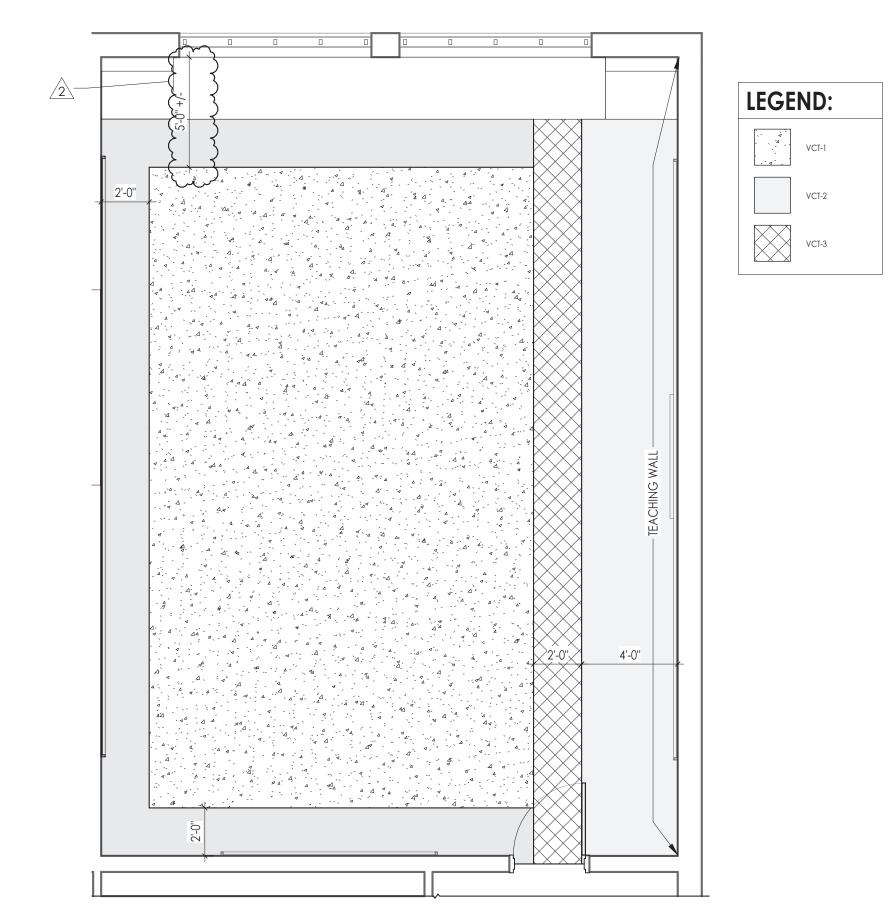CONTRACT IS TO INFORM CPL AS SOON AS POSSIBLE WITH ANY LEAD TIME OR AVAILABILITY ISSUES.

# FINISH PLAN GENERAL NOTES

- ALL NEW AND EXISTING HOLLOW METAL DOORS, DOOR FRAMES IN PROJECT SCOPE SHALL BE PAINTED (PT-2) ON BOTH SIDES, UNLESS NOTED OTHERWISE.
   ALL LOUVERS, VENTS, GRILLES AND OTHER MISCELLANEOUS MECHANICAL AND FLECTRICAL DEVICES ARE TO BE PAINTED TO MATCH THE SURFACE ON WHICH THEY
- ELECTRICAL DEVICES ARE TO BE PAINTED TO MATCH THE SURFACE ON WHICH THEY APPEAR, UNLESS NOTED OTHERWISE.

  3. REFER TO A600 SERIES DRAWINGS FOR CEILING TYPES AND SOFFIT FINISHES.

  4. UNDERSIDE OF SOFFITS TO MATCH FACE OF SOFFIT. SEE A600 SERIES FOR PAINT ACCENT
- SPECIFICATIONS.

  5. PAINT GWB CEILINGS (PT-3), UNLESS NOTED OTHERWISE.
- 6. REFER TO A700 SERIES INTERIOR ELEVATIONS FOR MILLWORK FINISHES.
  7. HIGH PRESSURE PLASTIC LAMINATE ON VERTICAL SURFACES TO RUN VERTICALLY, UNLESS NOTED OTHERWISE.
- WHERE KICKSPACES OCCUR AT MILLWORK, FLOOR FINISH SHOWN ON PLANS SHALL RUN UNDERNEATH KICKSPACE AS WELL.
   ALL FLOOR FINISHES SHALL TRANSITION AT THE CENTERLINE OF THE DOOR, UNLESS
- NOTED OTHERWISE. INSTALL TRANSITION STRIPS PER DETAILS ON **1000.**10. PROVIDE CONCRETE FLOOR PREPARATION IN ACCORDANCE WITH FLOORING MANUFACTURER SPECIFICATION.

# FINISH ABBREVIATIONS

NOTE: THIS LEGEND MAY CONTAIN ABBREVIATIONS THAT ARE NOT IN THIS PROJECT

ACT ACOUSTICAL CEILING TILE SCON SEALED CONCRETE

AWP ACOUSTICAL WALL PANEL SSM SOLID SURFACE MATERIAL

CPT CARPET TAS TACKABLE SURFACE

CPT CARPET TAS TACKABLE SURFACE
ETR EXISTING TO REMAIN TR TRIM
EXP EXPOSED TS TRANSITION STRIP
HPL HIGH PRESSURE PLASTIC LAMINATE VCT VINYL COMPOSITION TILE
INT INTEGRAL WC WALL COVERING

PT PAINT WD WOOD
PTM PATCH TO MATCH WOM WALK OFF MAT
RB RESILIENT BASE WS WRITEABLE SURFACE
RT RUBBER TILE WT WINDOW TREATMENT

# FINISH PLAN SYMBOLS LEGEND

NOTE: THIS LEGEND MAY CONTAIN SYMBOLS THAT ARE NOT IN THIS PROJECT MULTIPURPOSE ROOM NAME ROOM NUMBER ROOM
101 (150 SF) ROOM AREA DWC-33, DWC-33 WALL FINISH(ES) — BASE FINISH (ES) DWC-33, DWC-33 DWC-33, DWC-33 TER-1, TER-2 FLOOR FINISH(ES) DWC-33, DWC-33 WTX  $\langle \chi \rangle$  $\overline{\chi\chi\chi}$ EXTENT OF NOTED FINISH FINISH PLAN KEY NOTE WINDOW TREATMENT TSX FLOOR DIRECTION TRANSITION STRIP WRITEABLE/MAGNETIC (LONG SIDE OF FLOOR TILE PARALLEL WITH LONG SIDE OF SYMBOL) SURFACE -----TACKABLE SURFACE

# FINISH PLAN KEY NOTES

- PROVIDE 3-COLOR VCT FLOOR PATTERN WITH RESILIENT BASE. REFER TO I300 SERIES FOR DETAILS.
- PROVIDE WRITEABLE/MAGNETIC SURFACE (WS-1) ON ETR CHALKBOARD. VERIFY DIMENSIONS IN FIELD.
- PROVIDE TACKABLE SURFACE (TAS-1) ON ETR CHALKBARD. VERIFY DIMENSIONS IN FIELD.
- PROVIDE NEW WRITEABLE/MAGNETIC SURFACE (WS-1) AT EXTENTS SHOWN, MOUNT 2'-6" A.F.F.
- PROVIDE NEW TACKABLE SURFACE (TAS-1) EXTENT SHOWN, 2'6" A.F.F.
- 6 ETR WOOD PANELING ALONG TOP OF WALL TO RECEIVE PT-1, FULL EXTENT OF ROOM OTHER THAN TEACHING WALL TO RECIEVE PT-4 AT ETR WOOD PANELING

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NY ENGINEERING FIRM CERTIFICATE #0021419



PROJECT INFORMATION

Project Number R22.14457.20

SOUTH ORANGETOWN CENTRAL SCHOOL DISTRICT
Project Name

TAPPAN ZEE HIGH SCHOOL

**PHASE 2: 2022 BOND** 

Building Address 15 DUTCH HILL ROAD, ORANGEBURG, NY 10962

SED # 50-03-01-06-0-006-033

Reaistration Expiration Dates


Registration Expiration Dates Lauren Tarsio 09/30/26 Anthony Marchetti 05/31/27 Dave Hart 02/28/25

Jennifer Wengender 06/30/27

PROJECT ISSUE & REVISION SCHEDULE

# Date Description
2 11/06/2024 BID ADDENDUM #2

PROFESSIONAL STAMPS

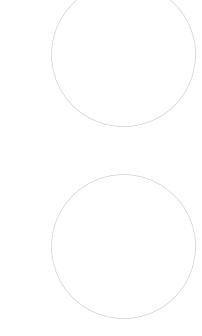

NEW YORK STATE EDUCATION STATEMENT

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SHEET INFORMATION

Issued Scale
10/25/2024 As indicated

Project Status
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Drawing Title
AREA B FINISH FLOOR PLAN

TZHS { 1201 }

KEY PLAN:

1 AREA B - FINISH FLOOR PLAN

1 AREA 1/8" = 1'-0"



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NY ENGINEERING FIRM CERTIFICATE #0021419



PROJECT INFORMATION

R22.14457.20

SOUTH ORANGETOWN CENTRAL SCHOOL DISTRICT

**PHASE 2: 2022 BOND** 

TAPPAN ZEE HIGH SCHOOL

15 DUTCH HILL ROAD, ORANGEBURG, NY 10962

SED # 50-03-01-06-0-006-033


Registration Expiration Dates
Lower Paris

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Issued Scale
10/25/2024 As indicated
Project Status

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Drawing Title
AREA C FINISH FLOOR PLAN

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NY ENGINEERING FIRM CERTIFICATE #0021419

26 IBM Road

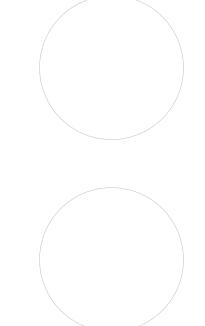Poughkeepsie, NY 12601

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PROJECT INFORMATION

R22.14457.20

SOUTH ORANGETOWN CENTRAL SCHOOL DISTRICT

**PHASE 2: 2022 BOND** 

TAPPAN ZEE HIGH SCHOOL


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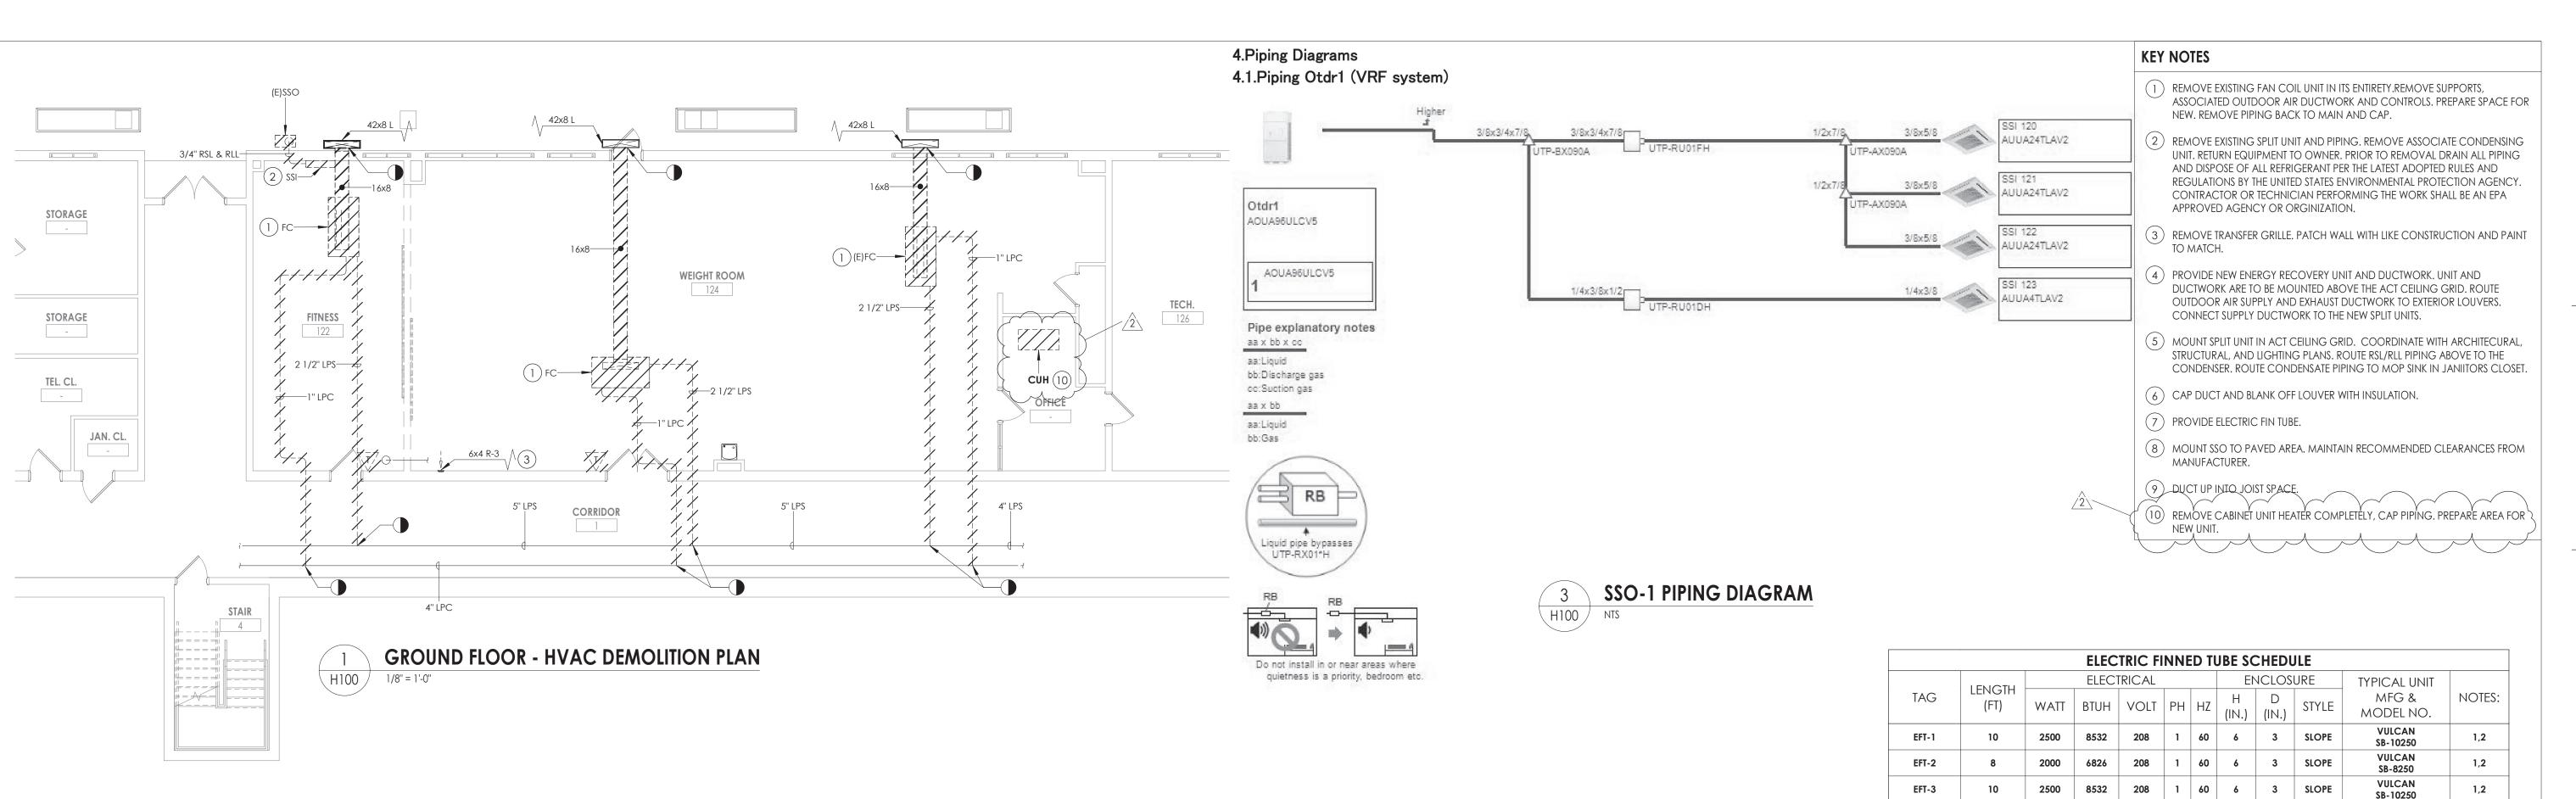
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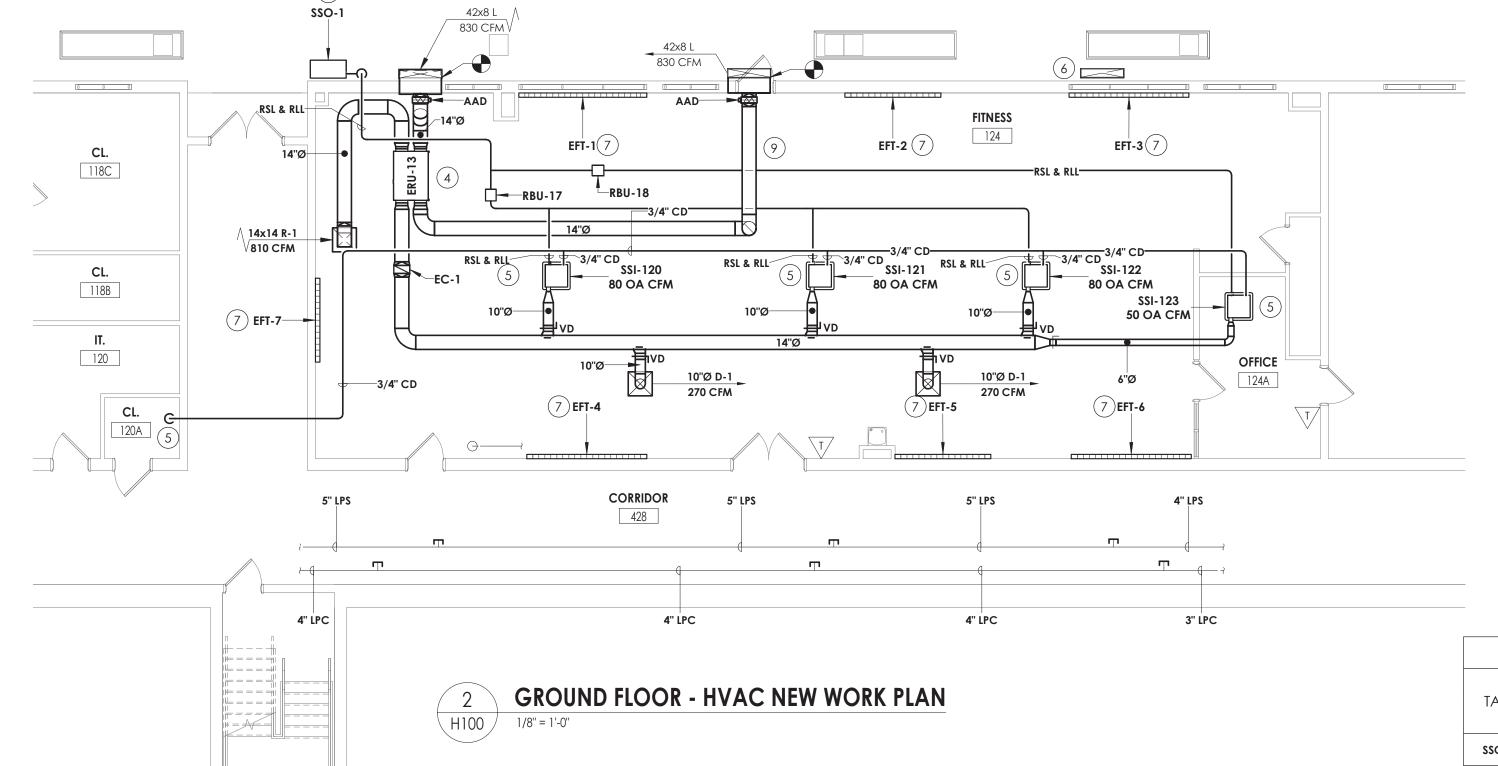
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|         | VRF INDOOR UNITS |                     |                             |                             |                                  |                                  |                              |                 |                   |      |      |                                    |           |  |  |
|---------|------------------|---------------------|-----------------------------|-----------------------------|----------------------------------|----------------------------------|------------------------------|-----------------|-------------------|------|------|------------------------------------|-----------|--|--|
| MARK    | ROOM<br>SERVED   | TYPE                | AIRFLOW<br>(H/M/L)<br>(CFM) | OUTDOOR<br>AIRFLOW<br>(CFM) | NOM.HEATING<br>CAPACITY<br>(MBH) | NOM.COOLING<br>CAPACITY<br>(MBH) | DIMENSIONS<br>(W" X H" X D") | WEIGHT<br>(LBS) | POWER<br>(Ø/V/Hz) | МОСР | FLA  | TYPICAL UNIT<br>MFG &<br>MODEL NO. | NOTES     |  |  |
| SSI-120 | 124              | CEILING<br>CASSETTE | 607/465/330                 | 80                          | 27                               | 24                               | 23 X 23 X 10                 | 44              | 208/1/60          | 0.78 | 0.62 | FUJITSU<br>AUUA24TLAV2             | 1,2,3,4,5 |  |  |
| SSI-121 | 124              | CEILING<br>CASSETTE | 607/465/330                 | 80                          | 27                               | 24                               | 23 X 23 X 10                 | 44              | 208/1/60          | 0.78 | 0.62 | FUJITSU<br>AUUA24TLAV2             | 1,2,3,4,5 |  |  |
| SSI-122 | 124              | CEILING<br>CASSETTE | 607/465/330                 | 80                          | 27                               | 24                               | 23 X 23 X 10                 | 44              | 208/1/60          | 0.78 | 0.62 | FUJITSU<br>AUUA24TLAV2             | 1,2,3,4,5 |  |  |
| SSI-123 | 124A             | CEILING<br>CASSETTE | 312/265/230                 | 50                          | 4.4                              | 4                                | 23 X 23 X 10                 | 40              | 208/1/60          | 0.29 | 0.23 | FUJITSU<br>AUUA4TLAV2              | 1,2,3,4,5 |  |  |

1. COLOR BY ARCHITECT.

2. COORDINATE HEIGHT WITH ELECTRICAL DEVICES.

208

**KEY PLAN:** 

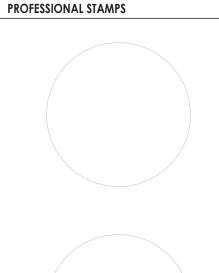1400 4774 208 1 60 6 3 SLOPE

EFT-4

EFT-5

EFT-6

2. BAC NET INTERGRATION TO BMS. 3. COLOR WHITE.

4. CONDENSATE PUMP.

5. OUTDOOR UNIT POWERS INDOOR UNITS.

|        |                                    |                               |                                |                                 | VRF BRANCH SELECTO                     | OR UNITS                                     |                           |                   |                  |                                    |
|--------|------------------------------------|-------------------------------|--------------------------------|---------------------------------|--|--|---------------------------|-------------------|------------------|------------------------------------|
| MARK   | NUMBER OF<br>BRANCHES<br>AVAILABLE | NUMBER OF<br>BRANCHES<br>USED | MAX TOTAL<br>CAPACITY<br>(MBH) | MAX BRANCH<br>CAPACITY<br>(MBH) | CONNECTED TOTAL HEATING CAPACITY (MBH) | CONNECTED TOTAL<br>COOLING CAPACITY<br>(MBH) | DIMENSIONS<br>(H × W × D) | POWER<br>(V/Ø/HZ) | POWER<br>(WATTS) | TYPICAL UNIT<br>MFG &<br>MODEL NO. |
| RBU-17 | 1                                  | 1                             | 96                             | 96                              | 85.4                                   | 76   | 11 X 33 X 15              | 208/1/60          | 41               | FUJITSU<br>UTP-RU01FH              |
| RBU-18 | 1                                  | 1                             | 96                             | 96                              | 85.4                                   | 76   | 11 X 33 X 15              | 208/1/60          | 41               | FUJITSU<br>UTP-RU01FH              |

|        | SPLIT SYSTEM OUTDOOR CONDENSING UNIT SCHEDULE |               |                 |                |                |                 |           |            |        |          |                           |      |      |                       |        |
|--------|---|---------------|-----------------|----------------|----------------|-----------------|-----------|------------|--------|----------|---------------------------|------|------|-----------------------|--------|
|        |   |               | NIONAINIAI      | AADII          | AADII          | ELECTRICAL DATA |           |            |        |          | DIATRICIONIC              | WT   |      | TYPICAL UNIT          |        |
| TAG    | LOCATION                                      | SERVES        | NOMINAL<br>TONS | MBH<br>COOLING | MBH<br>HEATING | FAN DATA        |           | COMPRESSOR | SYSTEM | POWER    | POWER (H X W X D)         |      | IEER |                       | NOTES: |
|        |   |               | 10143           | COOLING        | TILATINO       | MOTOR WATTS     | MOTOR FLA | RLA        | MCA    | (V/Ø/Hz) | (ITX VV X D)              | (LB) |      | MODEL NO.             |        |
| SSO-1  | EXTERIOR                                      | 124, 124A     | 8               | 96             | 108            | 375 X 2         | 1.4 + 0.9 | 27.5       | 39     | 208/3/60 | 69-9/16 X 42-1/4 X 23-5/8 | 511  | 23.1 | FUJITSU<br>AOU96RLAVL | 1,2    |
| NOTES: | 1. FACTORY MC                                 | DUNTED DISCO  | DNNECT          |                |                |                 |           |            |        |          |                           |      |      |                       |        |
|        | 2. LOW AMBIEN                                 | IT TEMPERATUR | RE KIT          |                |                |                 |           |            |        |          |                           |      |      |                       |        |

|      |              |     |         |      | ELECT      | RIC RE | HEAT C | OIL | SCHED | ULE    |              |      |             |        |
|------|--------------|-----|---------|------|------------|--------|--------|-----|-------|--------|--------------|------|-------------|--------|
|      | LOCATION     |     | AIR D   | DATA | ELECTRICAL |        |        | MFG | MFG   |        | TYPICAL UNIT |      |             |        |
| TAG  |              | CFM | TEMP °F |      | MAX APD    | KW     | VOLTS  | Ø   | AMPS  | SIZE H | SIZE L       | ROWS | MFG &       | NOTES: |
|      |              |     | ENT     | LVG  | (IN WC)    | N V V  | VOLI3  | 0   | AMIFS | (IN.)  | (IN.)        |      | MODEL NO.   |        |
| EC-1 | FITNESS ROOM | 830 | 40      | 72   | 0.08       | 28.68  | 208    | 3   | 138   | 12     | 12           | 4    | INDEECO QUZ | 1,2,3  |

2. CONNECT TO BMS.


3. FACTORY MOUNTED AND WIRED DISCONNECT.

|        | REGISTERS,           | GRILLES, ANI | D DIFFU | JSERS (F | ITNESS AREA)  |        |
|--------|----------------------|--------------|---------|----------|---------------|--------|
| TAG    | APPLICATION          | MATERIAL     | TYPE    | FINISH   | DESIGN EQUIP. | NOTES: |
| D-1    | SUPPLY               | STEEL        | LAY-IN  | WHITE    | PRICE SPD     | 1      |
| R-1    | RETURN/EA            | STEEL        | LAY-IN  | WHITE    | PRICE PDR     | 1      |
| NOTES: | 1 INCLUATED DACK DAN | 1            |         |          |               |        |

|        |                 |          |       |       |       |             |                    | <b>ENERG</b> | Y REG       | COVER       | Y UNITS (I         | NDOOR | S)        |                 |                            |          |     |              |                      |         |
|--------|-----------------|----------|-------|-------|-------|-------------|--------------------|--------------|-------------|-------------|--------------------|-------|-----------|-----------------|----------------------------|----------|-----|--------------|----------------------|---------|
| TA C   | LOCATION        | AREA     | SA    | EA    | RA    | SUPPLY FAN  |                    |              | EXHAUST FAN |             |                    |       | OPERATING | EILTEDS         | ELECTRICAL<br>REQUIREMENTS |          |     | TYPICAL UNIT | NOTEC.               |         |
| TAG    | LOCATION        | SERVED   | (CFM) | (CFM) | (CFM) | FAN<br>TYPE | E.S.P.<br>(IN. WC) | WATTS        | HP          | FAN<br>TYPE | E.S.P.<br>(IN. WC) | WATTS | HP        | WEIGHT<br>(LBS) | FILTERS                    | V/Ø/HZ   | FLA | МСА          | MFG &<br>MODEL NO.   | NOTES:  |
| ERU-13 | 124             | 124, 125 | 830   | 830   | 830   | DIRECT      | 0.5                | 1270         | 0.75        | DIRECT      | 0.5                | 1270  | 0.75      | 275             | MERV 13                    | 208/1/60 | 4.5 | 10.1         | RENEWAIRE<br>HE1XINH | 1,2,3,4 |
| NOTES: | 1. FACTORY MOUN |          |       | NECT. |       |             |                    |              |             |             |                    |       |           |                 |                            |          |     |              |                      |         |

2. FRESH AIR AND EXHAUST DAMPERS. 3. TERMINAL STRIP FOR BMS CONTROL OF FAN AND DAMPERS.

4. DIRTY FILTER SENSORS.

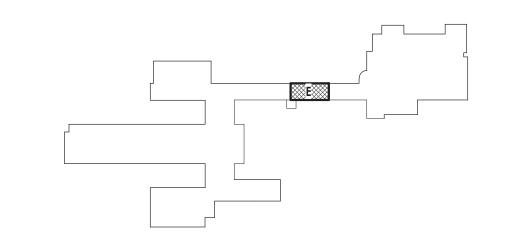

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Poughkeepsie, NY 12601 CPLteam.com

NY ENGINEERING FIRM CERTIFICATE #0021419

Capital Improvements Bon

PROJECT INFORMATION

14457.20 Client Name

SOUTH ORANGETOWN CENTRAL SCHOOL DISTRICT

**PHASE 2: 2022 BOND** 

TAPPAN ZEE HIGH SCHOOL

160 VAN WYCK RD., BLAUVELT, NY 10913

SED # 50-03-01-06-0-006-033

Reaistration Expiration Dates Lauren Tarsio 09/30/26 Anthony Marchetti 05/31/27 Dave Hart 02/28/25 Jennifer Wengender 06/30/27

1,2

1,2

1,2

1,2

SB-10250 VULCAN

SB-8250 VULCAN


SB-10250 VULCAN

SB-7200

PROJECT ISSUE & REVISION SCHEDULE

2 11/06/24 BID ADDENDUM #2

PROFESSIONAL STAMPS

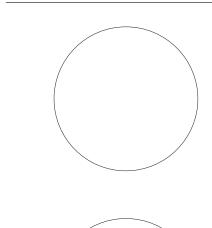




SHEET INFORMATION

Issued 10/25/2024 As indicated Project Status BID DOCUMENTS

Drawn By KCM

GROUND FLOOR DEMOLITION & NEW WORK PLAN - AREA E

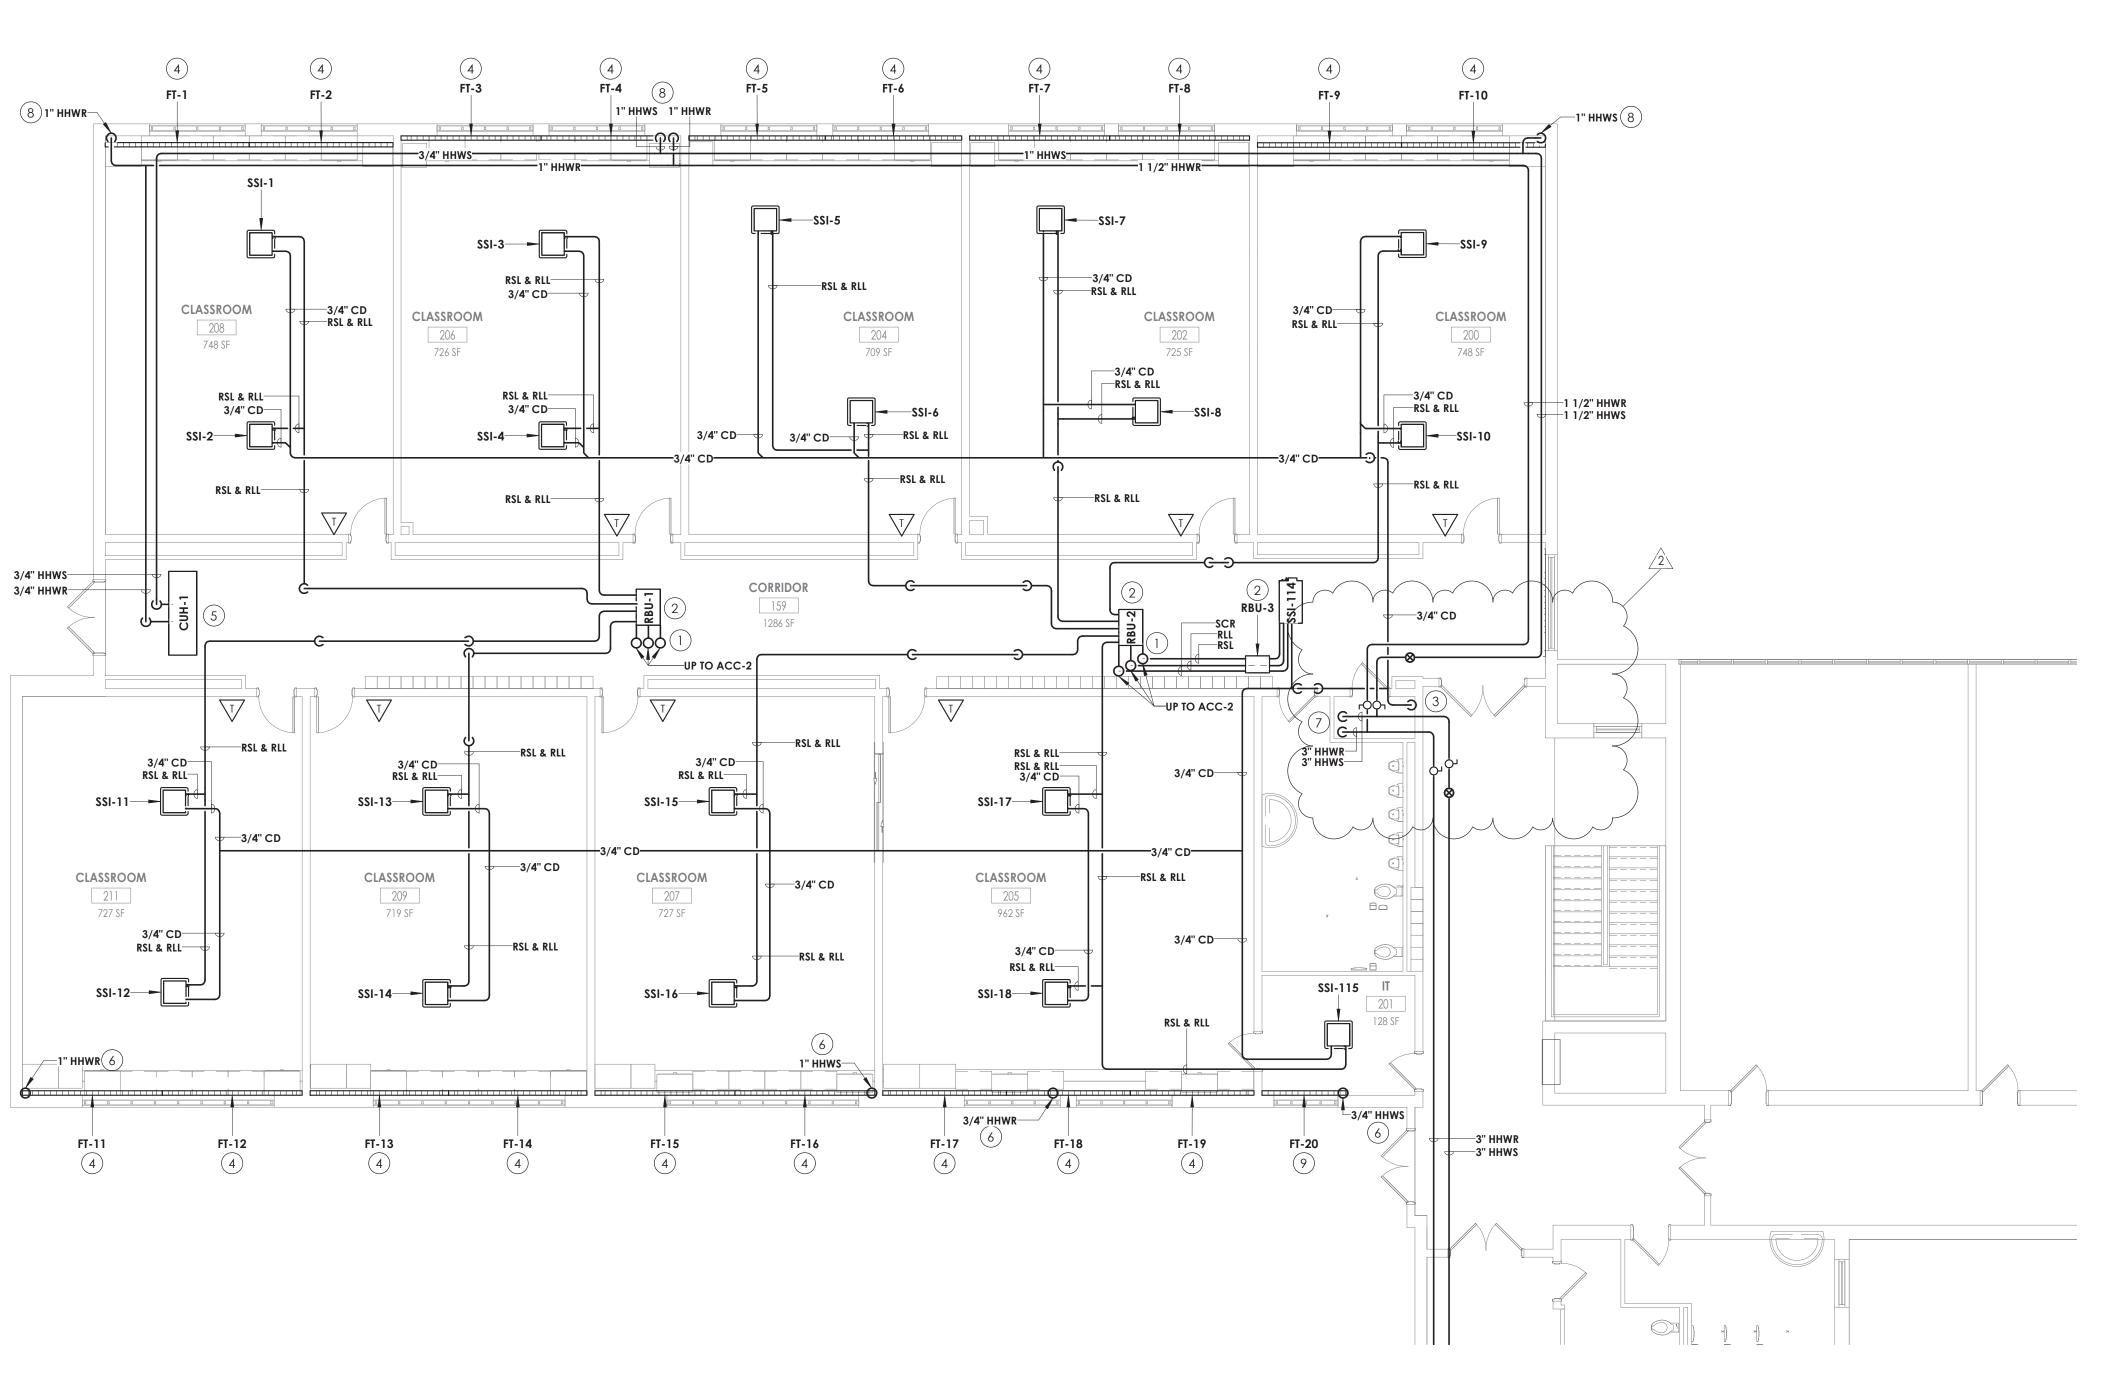

FIRST FLOOR - HVAC PIPING PLAN - AREA B

# KEY NOTES

- 1) RSL/RLL UP TO CONDENSING UNIT ON ROOF. REFER TO H600 FOR PIPE SIZES.
- 2 PROVIDE BRANCH BOX. MOUNT UNIT AS HIGH AS POSSIBLE. COORDINATE PIPE ROUTING WITH DUCTWORK AND EXISTING STRUCTURE.
- (3) ROUTE CONDENSATE TO EXISTING SINK. PROVIDE WITH AN INDIRECT CONNECTION.
- (4) PROVIDE FIN TUBE WITH DRAFTSTOP WHERE INDICATED.
- (5) INSTALL CABINET UNIT HEATER IN ACT CEILING GRID AND COORDINATE WITH ARCHITECTURAL, STRUCTURAL, AND LIGHTING. ROUTE PIPING ABOVE CEILING.
- (6) FIN TUBE PIPING TO BE ROUTED TO THE LOWER LEVEL.
- (7) MOUNT PIPING TO WALL AND ROUTE DOWN TO LOWER LEVEL. FIELD VERIFY EXACT DROP LOCATION.
- (8) FIN TUBE PIPING TO BE ROUTED ABOVE THE CEILING. PROVIDE 20 GAUGE GALVANIZED STEEL ENCLOSURE PAINTED TO MATCH THE WALL AROUND THE PIPING UP TO CEILING.
- 9 PROVIDE FIN TUBE WITH ENCLOSURE.



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#### PROJECT INFORMATION

14457.20

SOUTH ORANGETOWN CENTRAL SCHOOL DISTRICT

TAPPAN ZEE HIGH SCHOOL

**PHASE 2: 2022 BOND** 


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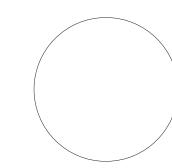
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PROJECT ISSUE & REVISION SCHEDULE # Date Description
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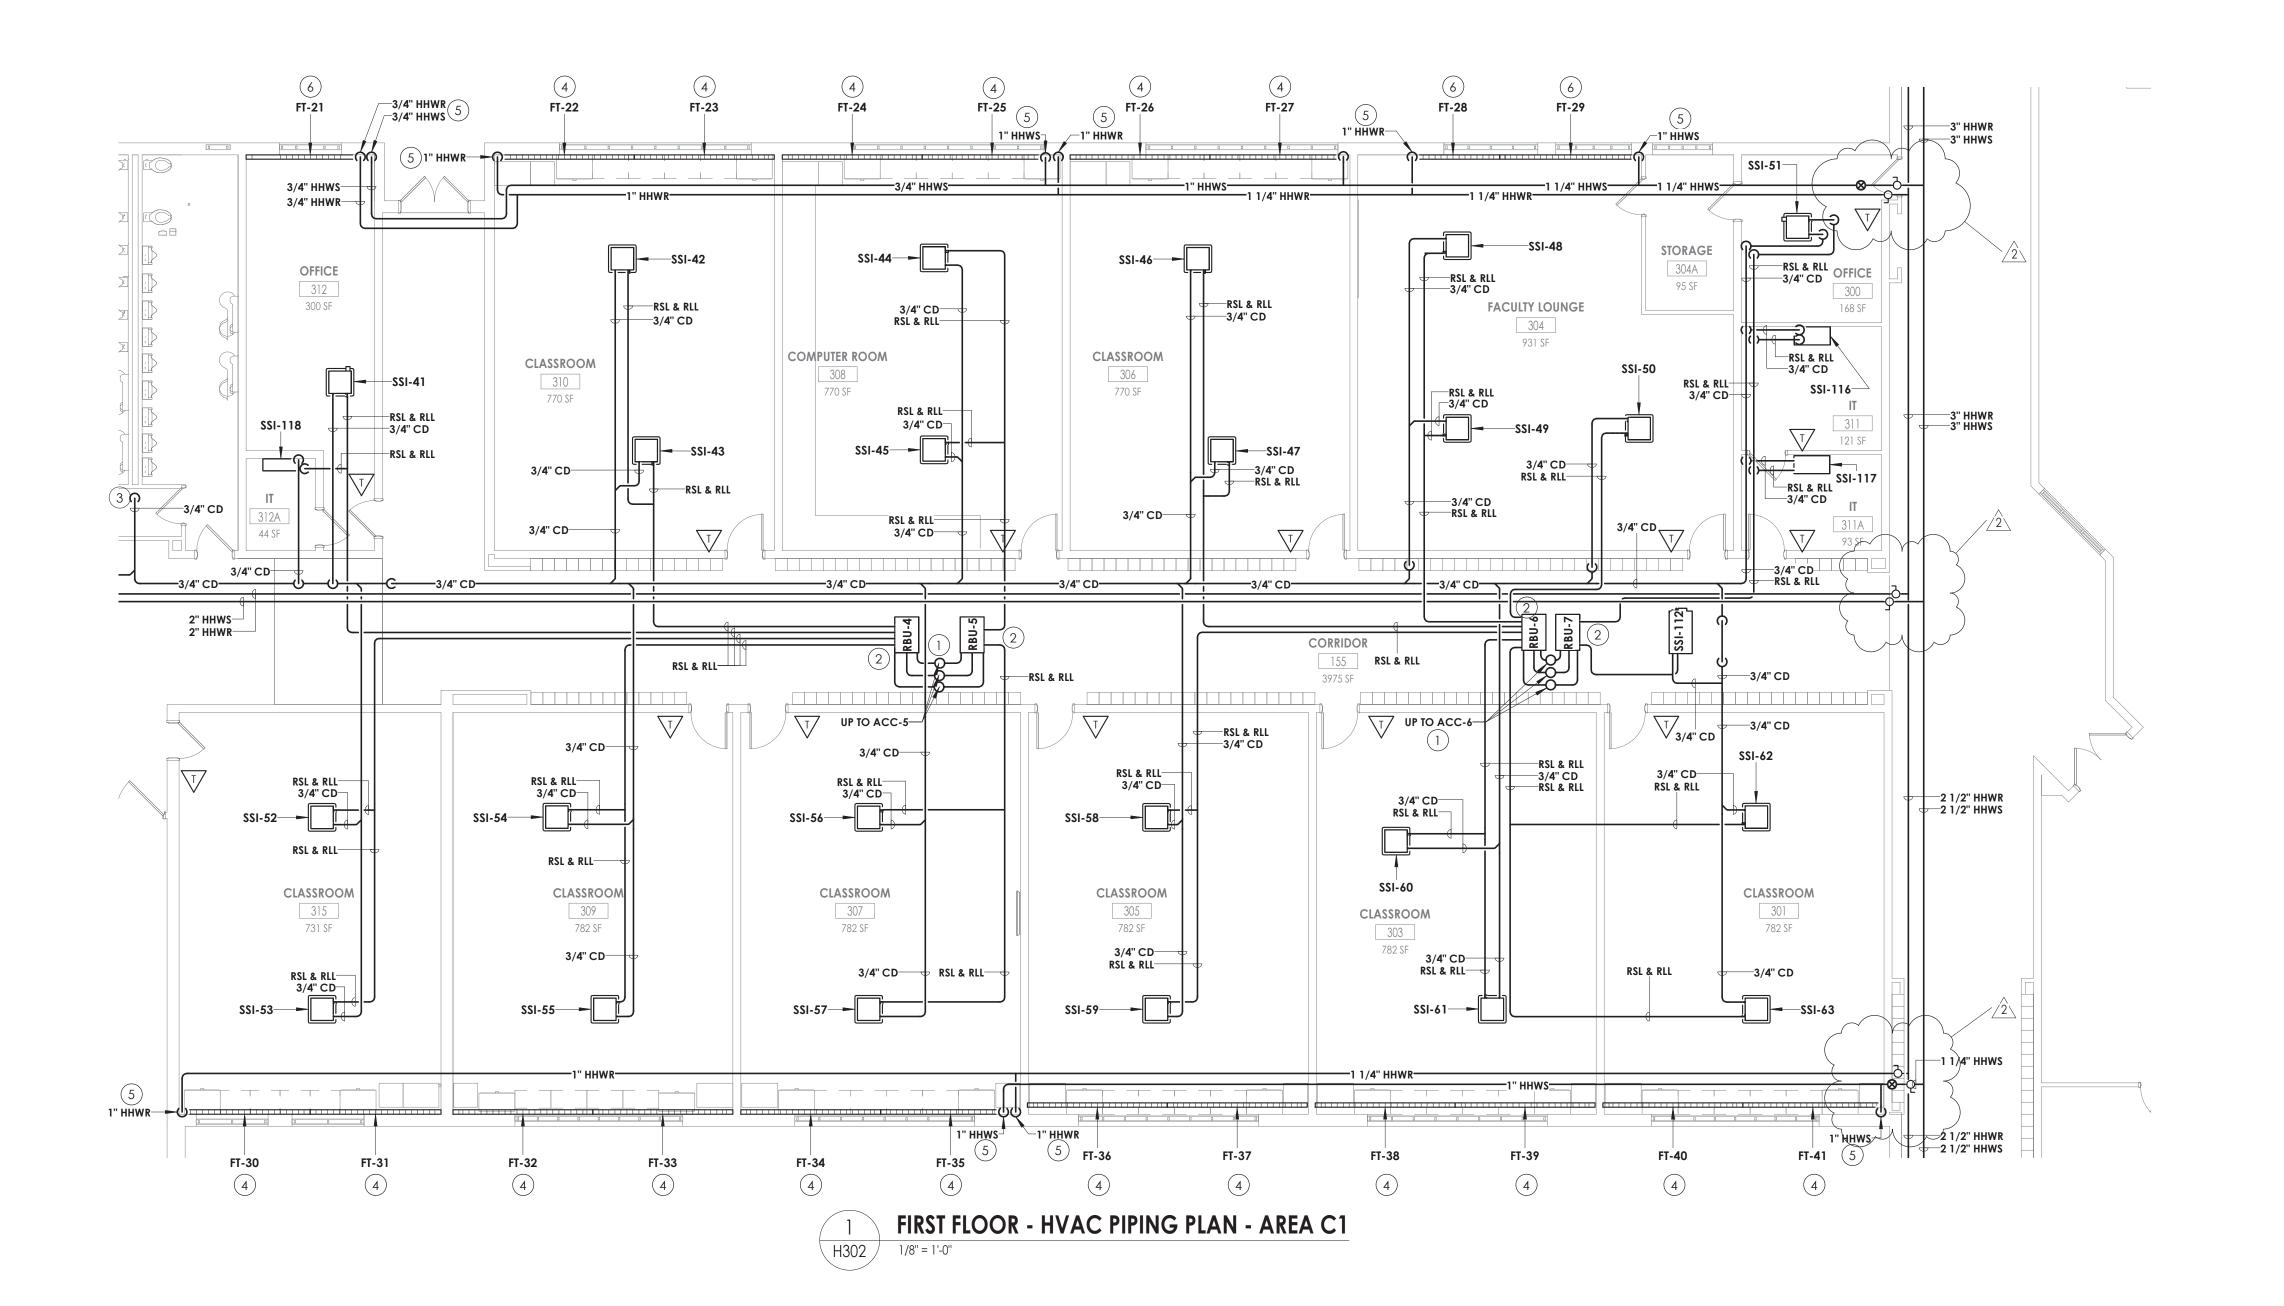
PROFESSIONAL STAMPS





SHEET INFORMATION Issued Scale 10/25/2024 1/8" = 1'-0" Project Status BID DOCUMENTS

Drawn By KCM FIRST FLOOR PIPING PLAN - AREA

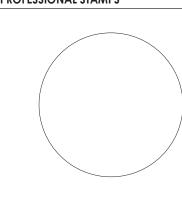

### **KEY NOTES**

- 1) RSL/RLL UP TO CONDENSING UNIT ON ROOF. REFER TO H600 FOR PIPE SIZES.
- PROVIDE BRANCH BOX. MOUNT UNIT AS HIGH AS POSSIBLE. COORDINATE PIPE ROUTING WITH DUCTWORK AND EXISTING STRUCTURE.
- ROUTE CONDENSATE PIPING TO SANITARY. PROVIDE WITH AN INDIRECT CONNECTION.
- 4 PROVIDE FIN TUBE WITH DRAFT STOP WHERE INDICATED.
- (5) FIN TUBE TO BE ROUTE PIPING ABOVE THE CEILING. PROVIDE 20 GAUGE GALVANIZED STEEL ENCLOSURE PAINTED TO MATCH THE WALL AROUND THE PIPING UP TO CEILING.
- 6 PROVIDE FIN TUBE WITH ENCLOSURE PAINT TO MATCH THE WALL AROUND ENCLOSURE.



NY ENGINEERING FIRM CERTIFICATE #0021419



PROJECT INFORMATION

14457.20 Client Name

SOUTH ORANGETOWN CENTRAL SCHOOL DISTRICT
Project Name

TAPPAN ZEE HIGH SCHOOL

**PHASE 2: 2022 BOND** 

Building Address

160 VAN WYCK RD., BLAUVELT, NY 10913

SED # 50-03-01-06-0-006-033


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PROJECT ISSUE & REVISION SCHEDULE

2 11/06/24 BID ADDENDUM #2

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BEARING, HE SEAL OF AN ARCHHELT, ENGINEER OR SURVEYOR AS HE PARTY SHALL AFFAT TO THE IRISH HER SEAL AND THE NOTATION "ALTERE THEIR SIGNATURE AND THE DATE OF SUCH ALTERATION, AND A SPECIFIC ALTERATION.

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10/25/2024 1/8" = 1'-0"

Project Status
BID DOCUMENTS

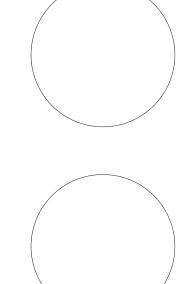
Drawn By Checked By
KCM JJM

FIRST FLOOR PIPING PLAN - AREA

TZHS H302

KEY PLAN:

C1

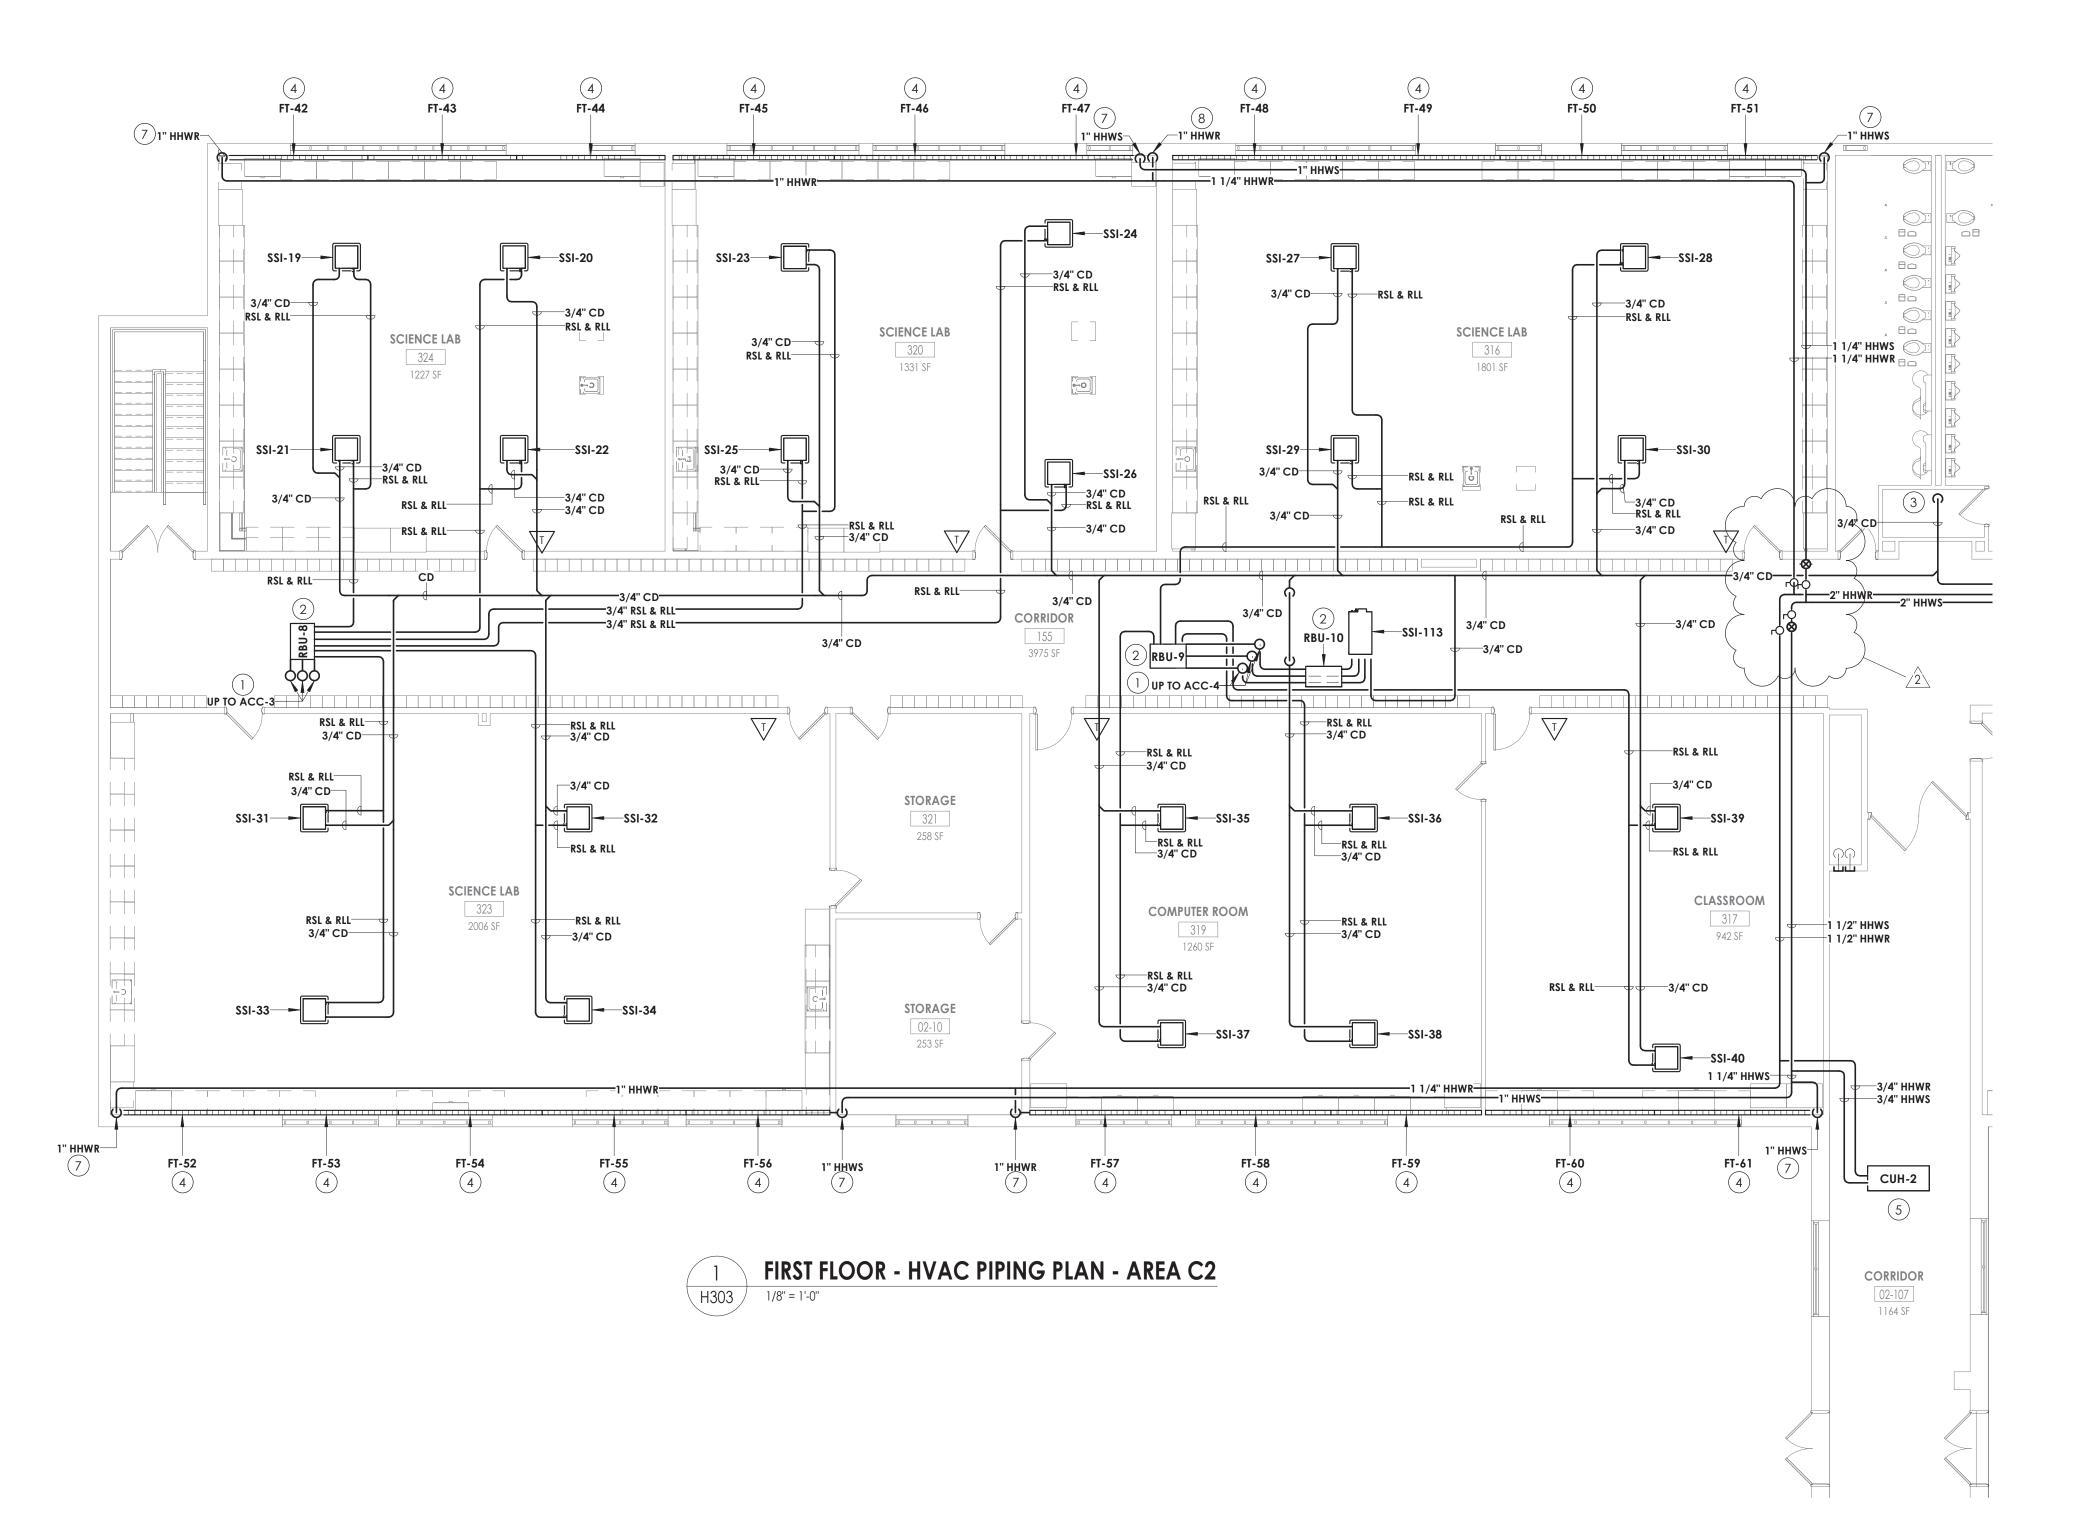

### KEY NOTES

- (1) RSL/RLL UP TO CONDENSING UNIT ON ROOF. REFER TO H600 FOR PIPE SIZES.
- (2) PROVIDE BRANCH BOX. MOUNT UNIT AS HIGH AS POSSIBLE. COORDINATE PIPE ROUTING WITH DUCTWORK AND EXISTING STRUCTURE.
- (3) ROUTE CONDENSATE PIPING TO SANITARY. PROVIDE WITH AN INDIRECT CONNECTION.
- (4) PROVIDE FIN TUBE WITH DRAFTSTOP WHERE INDICATED.
- INSTALL CABINET UNIT HEATER IN ACT CEILING GRID AND COORDINATE WITH ARCHITECTURAL, STRUCTURAL, AND LIGHTING. ROUTE PIPING ABOVE CEILING.
- PROVIDE ENCLOSURE FOR FIN TUBE BETWEEN THE POINTS INDICATED.
- COORDINATE ENCLOSURE LENGTH WITH CASEWORK. ENCLOSURE PAINTED TO (6) MATCH THE CASEWORK.
- (7) FIN TUBE PIPING TO BE ROUTED ABOVE THE CEILING. PROVIDE 20 GAUGE GALVANIZED STEEL ENCLOSURE PAINTED TO MATCH THE WALL AROUND THE PIPING UP TO CEILING.



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PROJECT INFORMATION

14457.20

Client Name SOUTH ORANGETOWN CENTRAL SCHOOL DISTRICT

TAPPAN ZEE HIGH SCHOOL

PHASE 2: 2022 BOND


**Building Address** 160 VAN WYCK RD., BLAUVELT, NY 10913

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SED # 50-03-01-06-0-006-033

PROJECT ISSUE & REVISION SCHEDULE # Date Description
2 11/06/24 BID ADDENDUM #2

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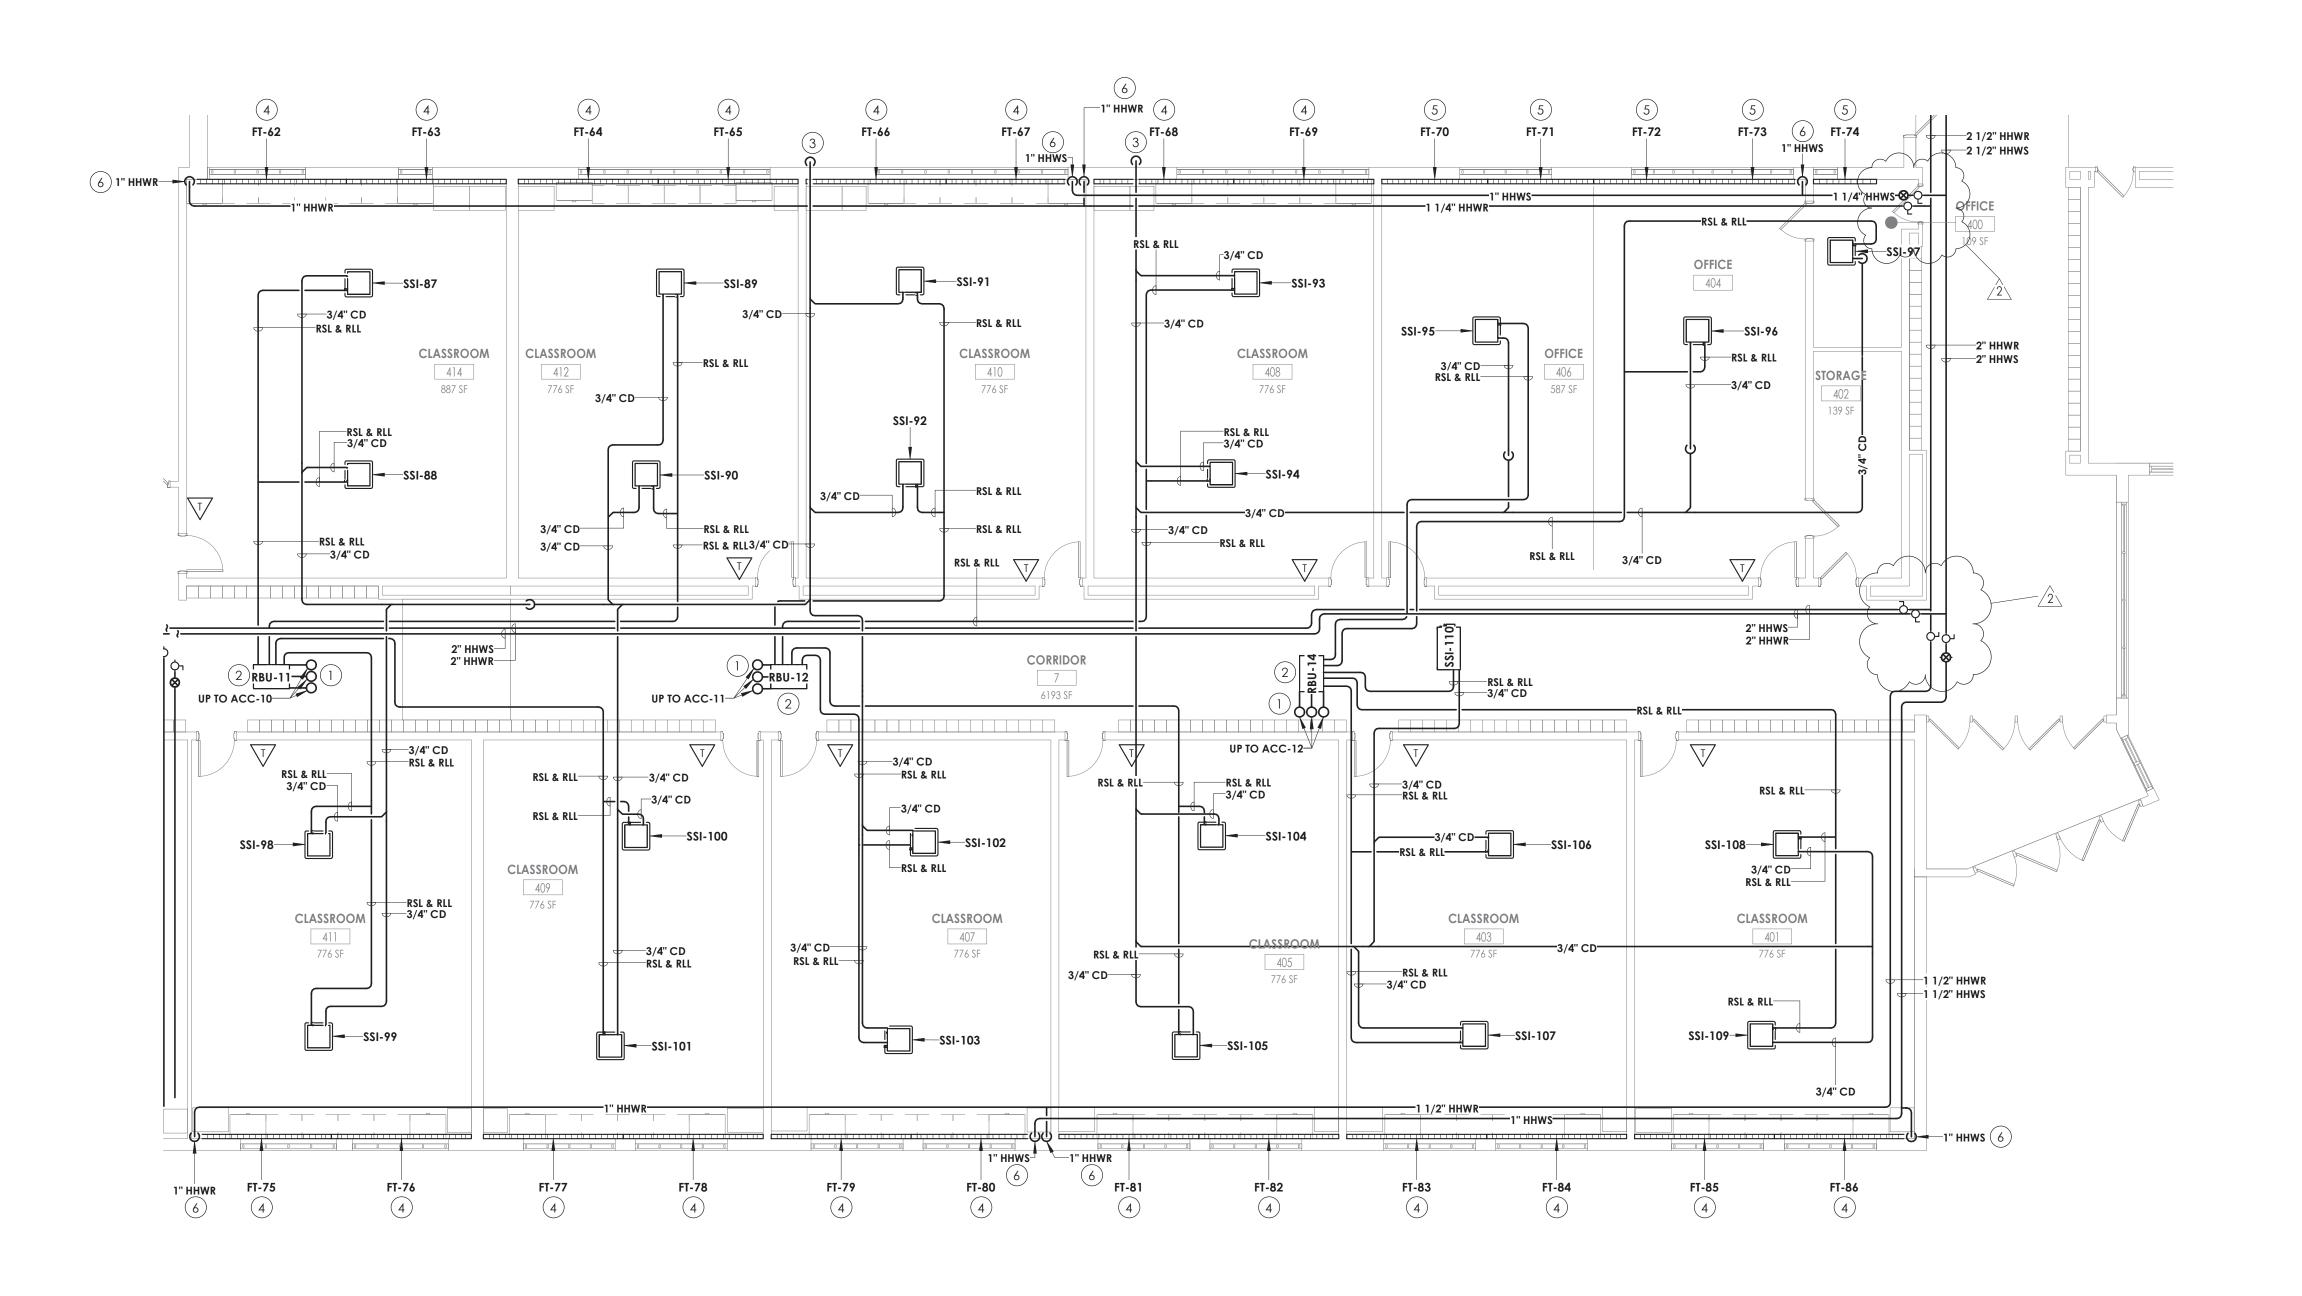


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Issued 10/25/2024 1/8" = 1'-0" Project Status

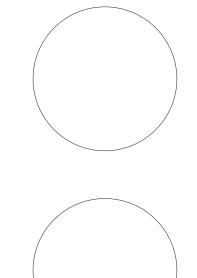BID DOCUMENTS Drawn By KCM

FIRST FLOOR PIPING PLAN - AREA



1 FIRST FLOOR - HVAC PIPING PLAN - AREA D1
H304 1/8" = 1'-0"

# KEY NOTES

- 1) RSL/RLL UP TO CONDENSING UNIT ON ROOF. REFER TO H601 FOR PIPE SIZES
- PROVIDE BRANCH BOX. MOUNT UNIT AS HIGH AS POSSIBLE. COORDINATE PIPE ROUTING WITH DUCTWORK AND EXISTING STRUCTURE.
- 3 ROUTE CONDENSATE PIPING TO EXTERIOR FOR DISCHARGE. PROVIDE WITH AN INDIRECT CONNECTION.
- 4) PROVIDE FIN TUBE WITH DRAFTSTOP WHERE INDICATED.
- 5) PROVIDE FIN TUBE WITH ENCLOSURE.
- 6 FIN TUBE PIPING TO BE ROUTED ABOVE THE CEILING. PROVIDE 20 GAUGE GALVANIZED STEEL ENCLOSURE PAINTED TO MATCH THE WALL AROUND THE PIPING UP TO CEILING.



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#### PROJECT INFORMATION

14457.20

SOUTH ORANGETOWN CENTRAL SCHOOL DISTRICT

PHASE 2: 2022 BOND

TAPPAN ZEE HIGH SCHOOL

Building Address 160 VAN WYCK RD., BLAUVELT, NY 10913


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PROJECT ISSUE & REVISION SCHEDULE

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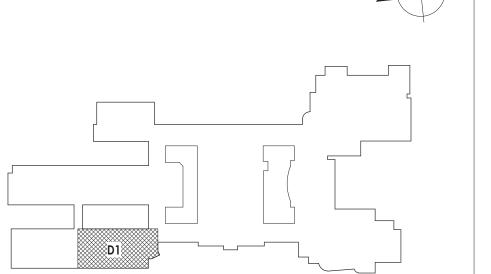
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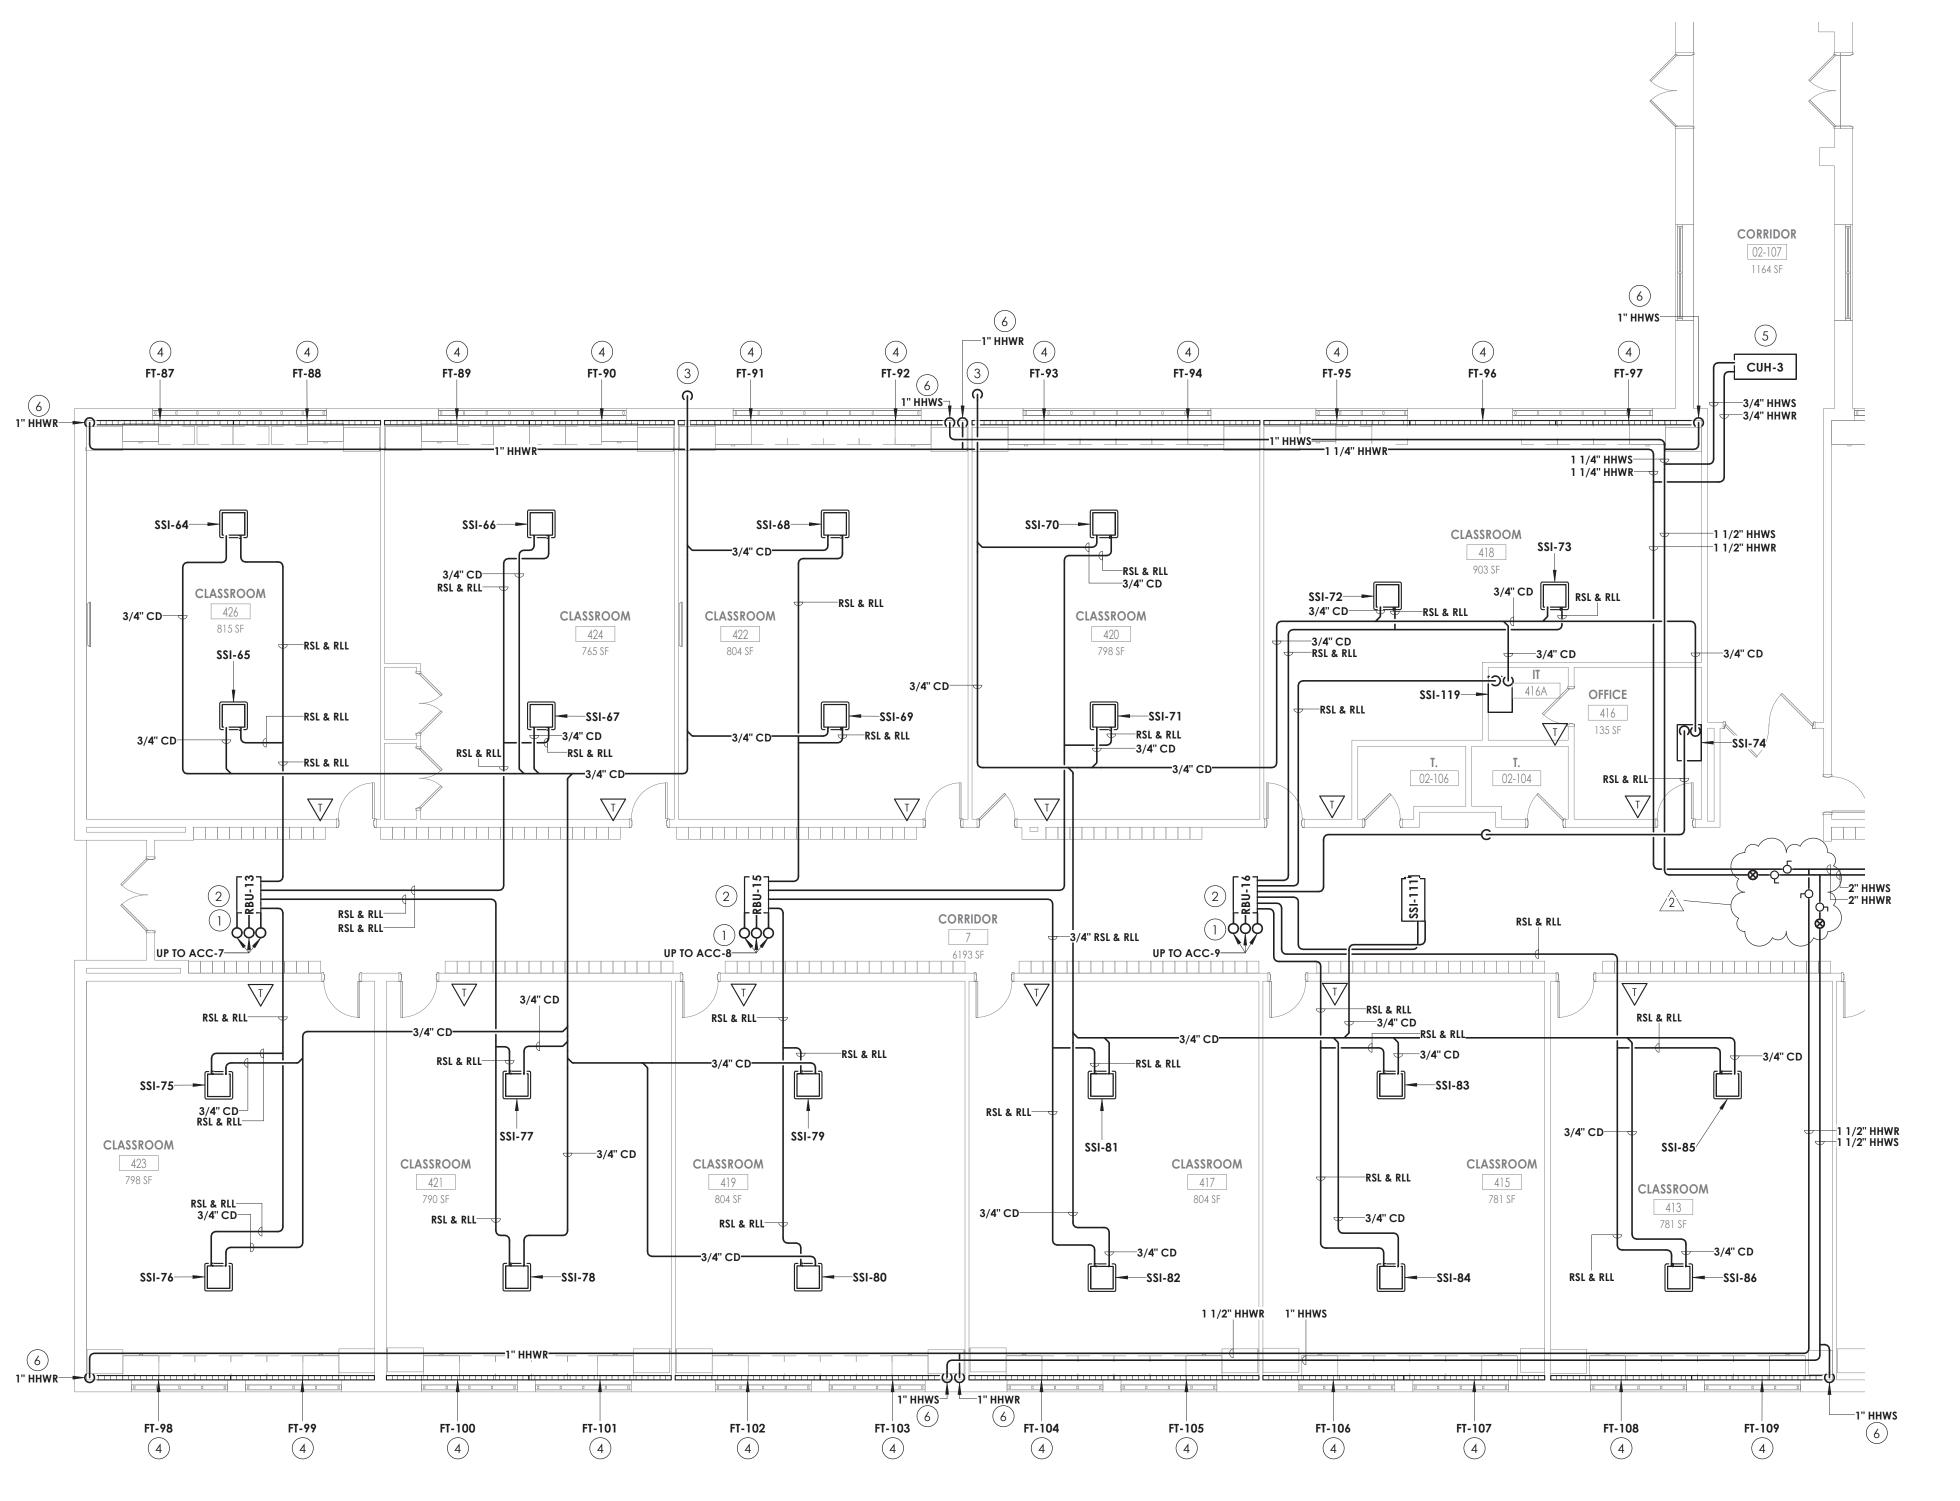
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Project Status
BID DOCUMENTS
Drawn By Checke
KCM JJM

Prawing Title
FIRST FLOOR PIPING PLAN - AREA
D1

TZHS H304



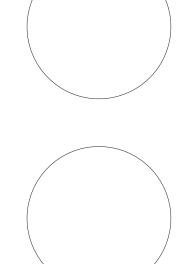

FIRST FLOOR - HVAC PIPING PLAN - AREA D2

# KEY NOTES

- 1) RSL/RLL UP TO CONDENSING UNIT ON ROOF. REFER TO H601 FOR PIPE SIZES
- 2 PROVIDE BRANCH BOX. MOUNT UNIT AS HIGH AS POSSIBLE. COORDINATE PIPE ROUTING WITH DUCTWORK AND EXISTING STRUCTURE.
- (3) ROUTE CONDENSATE PIPING TO EXTERIOR FOR DISCHARGE. PROVIDE WITH AN INDIRECT CONNECTION.
- (4) PROVIDE FIN TUBE WITH DRAFTSTOP WHERE INDICATED.
- (5) INSTALL CABINET UNIT HEATER IN ACT CEILING GRID AND COORDINATE WITH ARCHITECTURAL, STRUCTURAL, AND LIGHTING. ROUTE PIPING ABOVE CEILING.
- (6) FIN TUBE PIPING TO BE ROUTED ABOVE THE CEILING. PROVIDE 20 GAUGE GALVANIZED STEEL ENCLOSURE PAINTED TO MATCH THE WALL AROUND THE PIPING UP TO CEILING.





PROJECT INFORMATION

14457.20

SOUTH ORANGETOWN CENTRAL SCHOOL DISTRICT

TAPPAN ZEE HIGH SCHOOL

PHASE 2: 2022 BOND


160 VAN WYCK RD., BLAUVELT, NY 10913

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PROJECT ISSUE & REVISION SCHEDULE # Date Description
2 11/06/24 BID ADDENDUM #2

PROFESSIONAL STAMPS




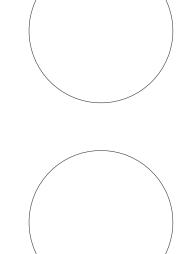

SHEET INFORMATION Issued 10/25/2024 1/8" = 1'-0" Project Status

BID DOCUMENTS Drawn By KCM

FIRST FLOOR PIPING PLAN - AREA

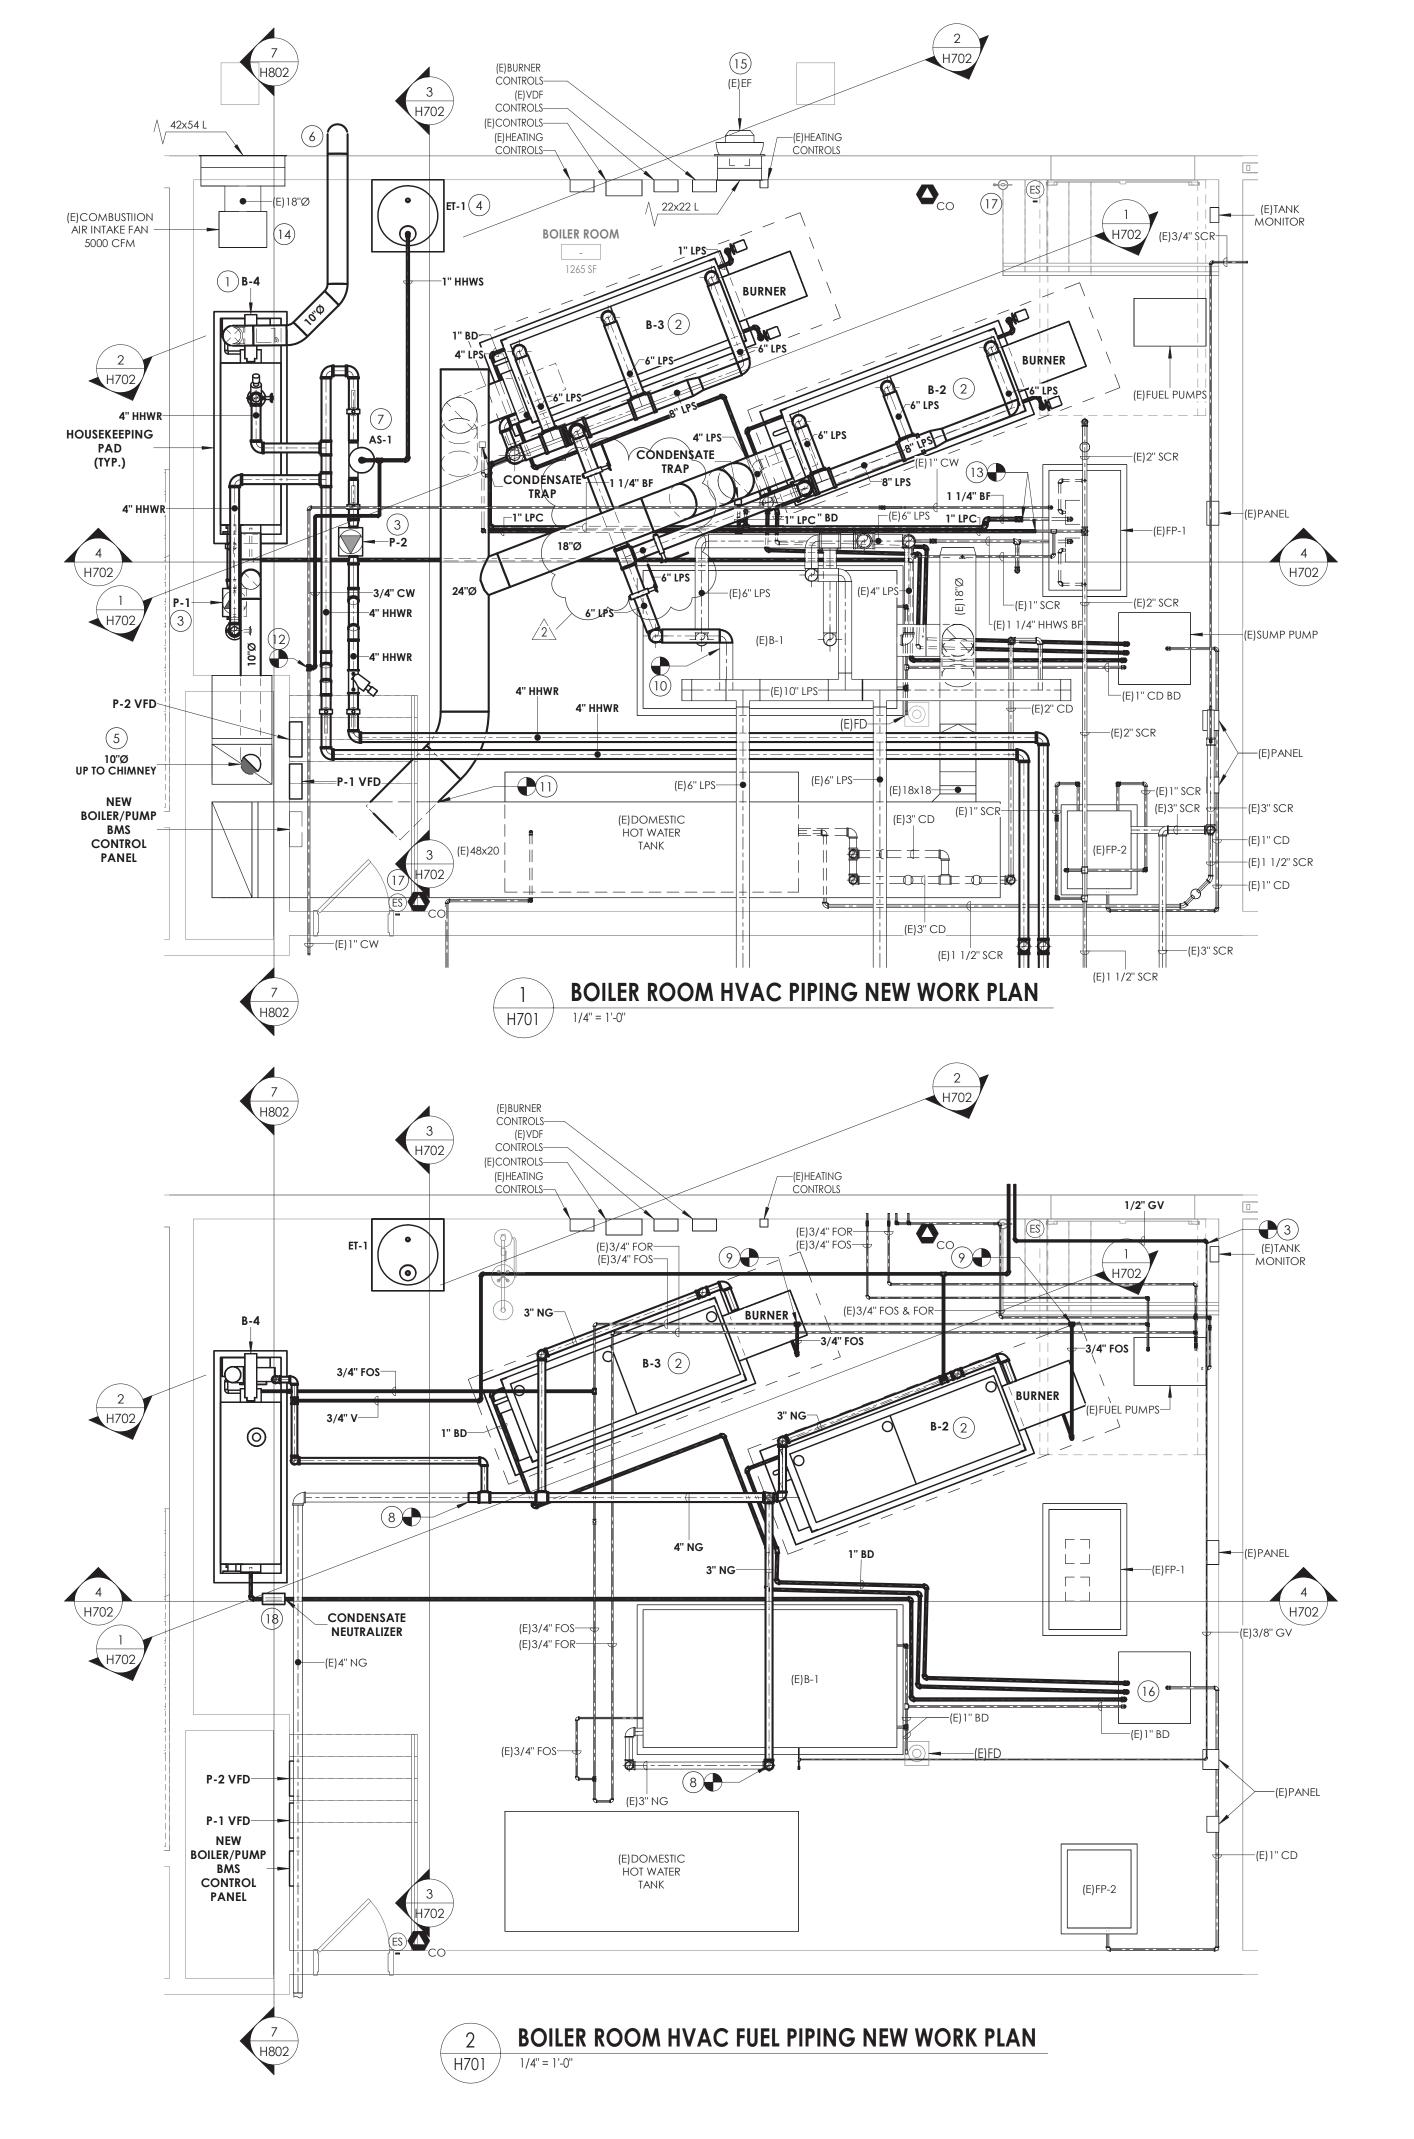

#### GENERAL NOTES:

1. PAINT PIPING ROUTED ON FLOOR YELLOW IN TRAP HAZARD PATHS.

## KEY NOTES

- 1 PROVIDE CONDENSING BOILER AND INSTALL ON NEW HOUSEKEEPING PAD. CONNECT TO EXISTING EMERGENCY STOP BUTTON AT EACH DOOR ENTRY.
- (2) INSTALL OWNER PROVIDED STEAM BOILER AND TRIM BURNER ON NEW HOUSEKEEPING PAD. CONNECT TO STEAM PIPING AND FLUE AT POINTS INDICATED. ROUTE BLOW DOWN PIPING TO FLOOR DRAIN AND PROVIDE WITH INDIRECT CONNECTION. CONNECT TO EXISTING EMERGENCY STOP BUTTON AT EACH DOOR ENTRY.
- (3) PROVIDE INLINE PUMP.
- 4) PROVIDE EXPANSION TANK AND CONNECT TO HOT WATER SYSTEM.
- 5) ROUTE NEW FLUE THROUGH EXISTING CHIMNEY.
- (6) AIR INTAKE TO BE TERMINATED WITH DOWNWARDS 90° ELBOW AND WITH 1/2" x 1/2" BIRD SCREEN.
- 7 PROVIDE AIR SEPERATOR AND CONNECT TO HOT WATER RETURN PIPING.
- (8) CONNECT TO EXISTING NATURAL GAS PIPING AND ROUTE TO GAS TRAINS.
- (9) CONNECT TO EXISTING OIL SUPPLY/RETURN PIPING AND ROUTE TO BURNER.
- (10) CONNECT NEW STEAM PIPING TO EXISTING STEAM BRANCH IN LOCATION SHOWN.
- (11) CONNECT NEW FLUE TO EXISTING FLUE. MATCH/RE-INSULATE AS REQUIRED.
- (12) CONNECT TO COLD WATER MAKE UP, PROVIDED BY PLUMBER IN THIS AREA. COORDINATE EXACT LOCATION.
- (13) CONNECT NEW BOILER FEED PIPING TO EXISTING BOILER FEED PIPING AT POINT INDICATED
- (14) EXISTING COMBUSTION AIR INTAKE FAN TO BE INTERCONNECTED TO STEAM
- EXISTING COMBUSTION AIR RELIEF FAN TO BE INTERCONNECTED TO STEAM BOILER BURNERS.
- (16) DRAIN TO SUMP PUMP. PROVIDE AIR GAP.

BOILER BURNERS.

**KEY PLAN:** 

- PROVIDE CO SENSOR NEAR EACH EXIT. REFERENCED ON H502. CONNECT CO SENSORS AND EXISTING EMERGENCY SHUT-OFF CONTROLS TO ALL BOILERS.
- 18) PROVIDE NEUTRALIZATION TANK FOR CONDENSING BOILER.



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#### PROJECT INFORMATION

14457.20

SOUTH ORANGETOWN CENTRAL SCHOOL DISTRICT
Project Name
PHASE 2: 2022 BOND

TAPPAN ZEE HIGH SCHOOL

Building Address 160 VAN WYCK RD., BLAUVELT, NY 10913


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SHEET INFORMATION


Issued Scale
10/25/2024 1/4" = 1'-0"
Project Status
BID DOCUMENTS
Drawn By Checked By
KCM JJM


Drawing Title
BOILER ROOM ENLARGED NEW
WORK PLANS


TZHS H701

# **KEY NOTES:**

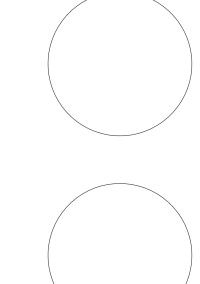- PROVIDE SINK, SUPPORTS, DOMESTIC WATER SUPPLY LINES, SUPPLY SHUT OFF VAVLES, P-TRAP WITH ACID NEUTRALIZTION KIT, SANITARY PIPING, & AIR ADMITTANCE VALVE FOR VENTING.
- PROVIDE 1" DOMESTIC COLD WATER AND 1" DOMESTIC HOT WATER TO MIXING VAVLE MV-1. PROVIDE 1-1/4" TEMPERED WATER SUPPLY TO EMERGENCY EYEWASH STATION, EMS-1.
- 3 PROVIDE EMERGENCY SHOWER/EYEWASH STATION EMS-1, GUARDIAN MODEL# G1996. CONNECT TO 1-1/4" TEMPERED WATER SUPPLY FROM MIXING VALVE MV-1.

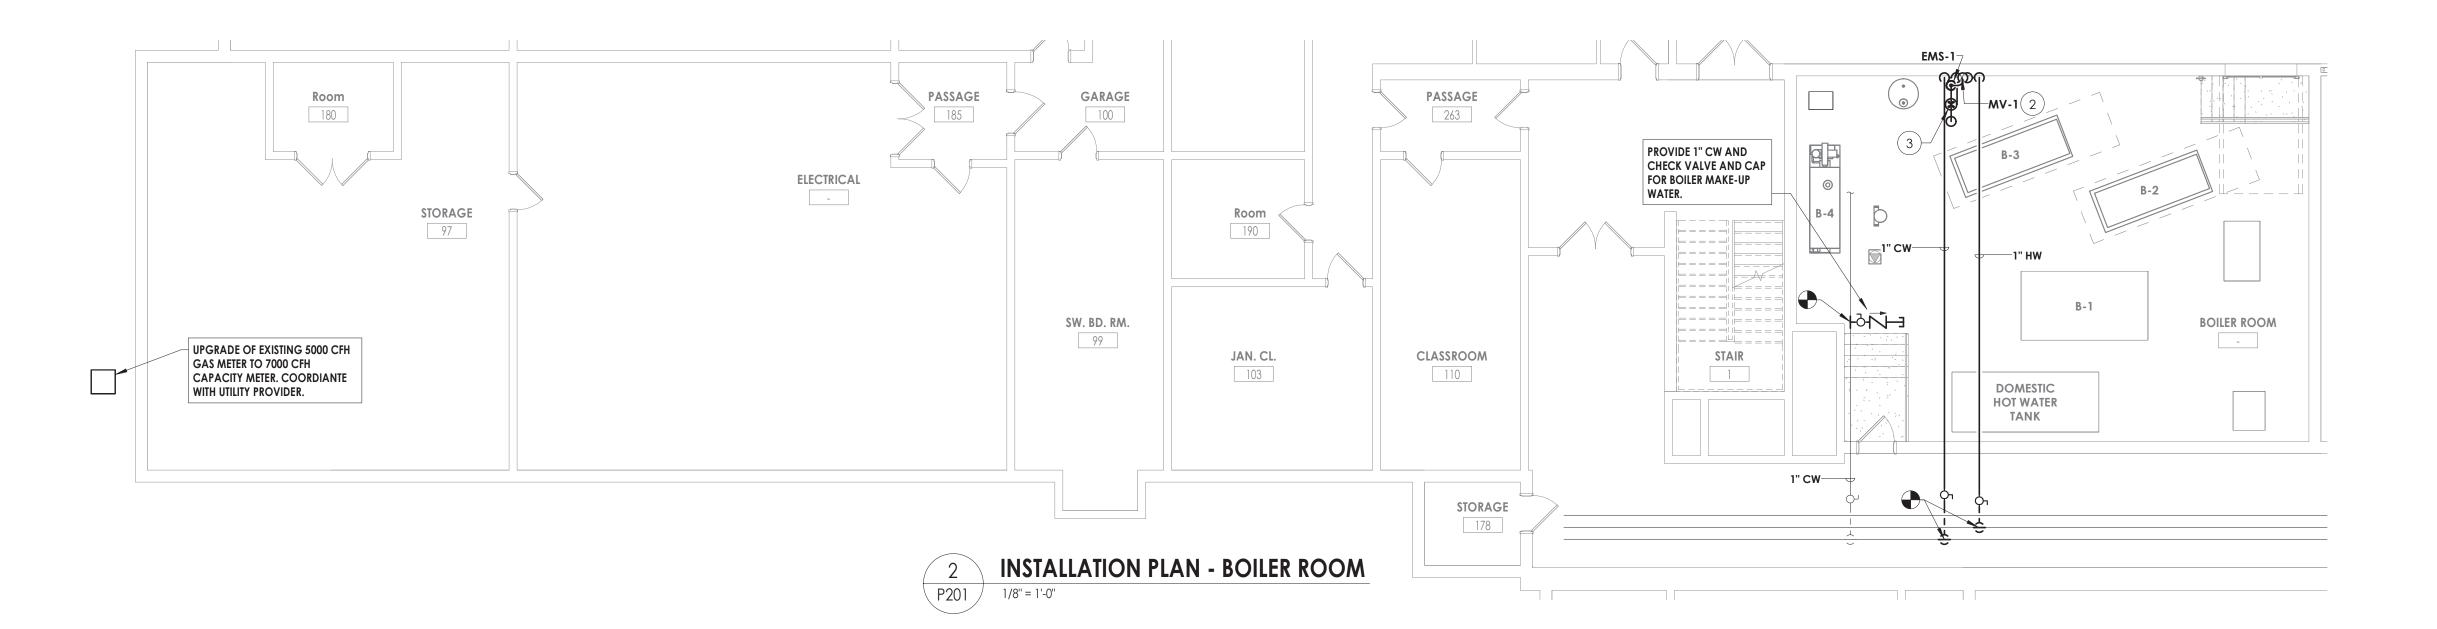

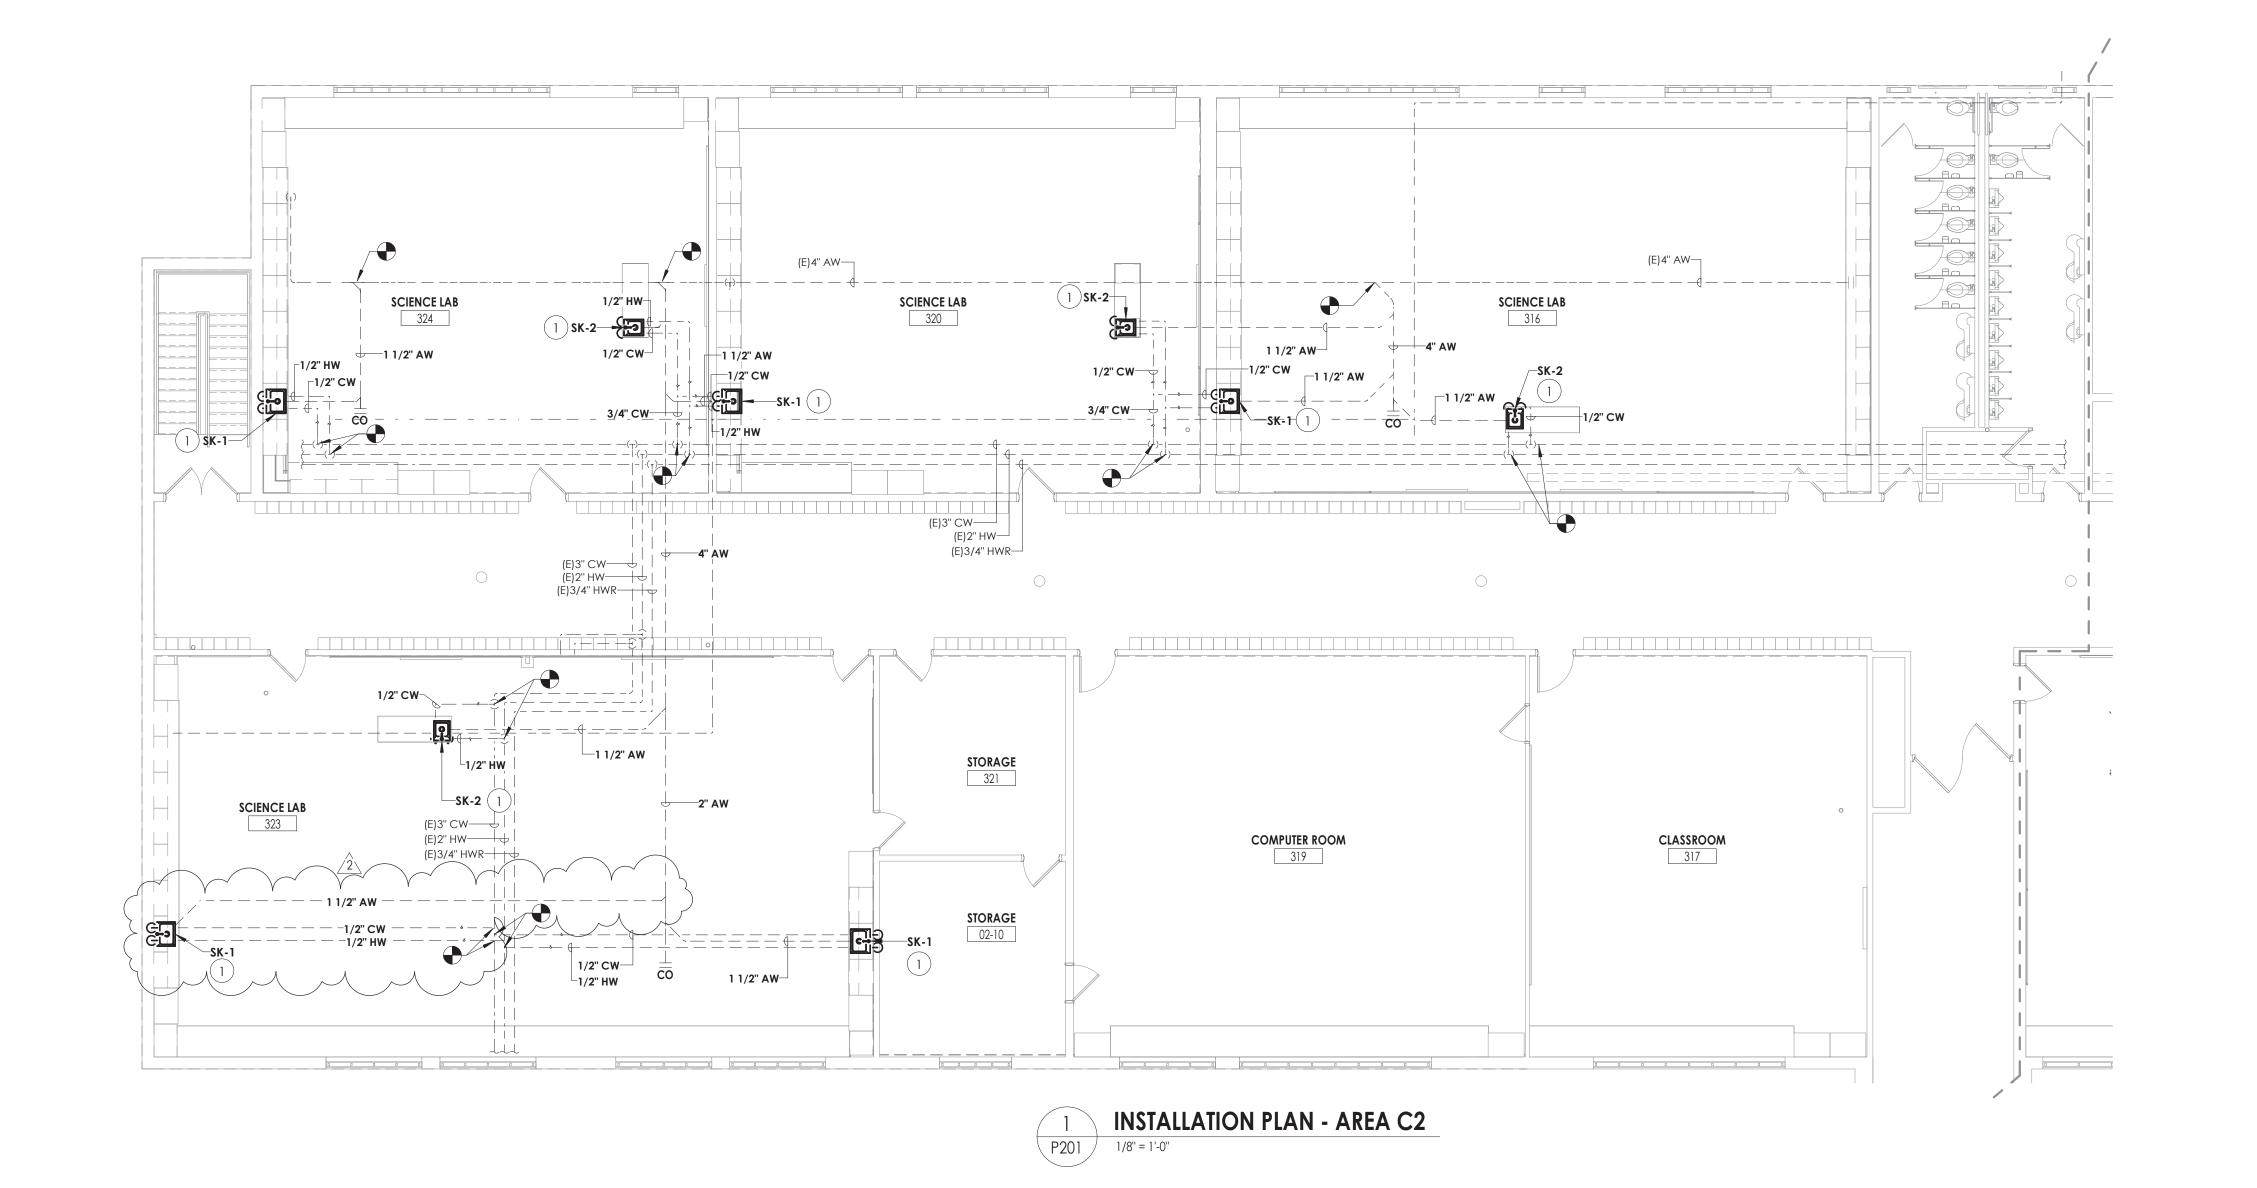

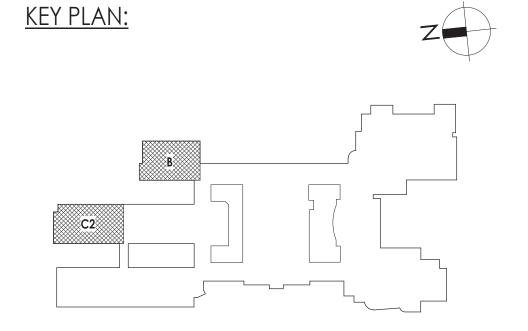

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SOUTH ORANGETOWN

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Capital Improvements Bond

Essential Infrastructure for Student
Health, Safety and Success

PROJECT INFORMATION
Project Number

14457.20 Client Name

SOUTH ORANGETOWN CENTRAL SCHOOL DISTRICT
Project Name

TAPPAN ZEE HIGH SCHOOL

**PHASE 2: 2022 BOND** 

Building Address 160 VAN WYCK RD., BLAUVELT, NY 10913


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BEARING THE SEAL OF AN ARCHITECT, ENGINEER OR SURVEYOR:
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SHEET INFORMATION

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Drawn By Checked By

MLS JJW

Drawing Title

INSTALL PLAN - AREA C2 & F

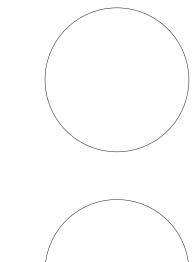TZHS