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	ABBREVIATIONS
AB	ABOVE
AD	ACCESS DOOR
AFF	ABOVE FINISHED FLOOR
BEL	BELOW
BHP	BRAKE HORSEPOWER
B.R.	BOTTOM REGISTER
CLG	CEILING
CONN	CONNECT, CONNECTIONS
DB	DRY BULB
DIA	DIAMETER
DN	DOWN
DWG	DRAWING
EA	EACH
EFF	EFFICIENCY
EL	ELEVATION
ENT	ENTERING
FF	FINISHED FLOOR
FL	FLOOR
FPM	FEET PER MINUTE
FPS	FEET PER SECOND
HP	HORSEPOWER
HZ	HERTZ (CYCLES PER SECOND)
IOM	INSTALLATION AND OPERATION MANUAL
KW	KILOWATTS
LVG	LEAVING
MBH	THOUSANDS OF BTU PER HOUR
MFR	MANUFACTURER
NO.	NUMBER
OAI	OUTSIDE AIR INTAKE
PH	PHASE
PSIG	POUNDS PER SQUARE INCH GAUGE
RPM	ROTATIONS PER MINUTE
Д	SQUARE FEET
SP	STATIC PRESSURE
∆T	TEMPERATURE DIFFERENCE IN °F.
TYP	TYPICAL
T.R.	TOP REGISTER
V	VOLTS
WB	WET BULB

	EQUIPMENT TAGS										
TAG/NO DESCRIPTION											
EAV/1 EXHAUST AIR VALVE No.1											
EF/1	EXHAUST FAN No.1										
HC/1	DUCT MOUNTED HEATING COIL No.1										
VAV/1	VARIABLE AIR VOLUME BOX No.1										

NOTE: THE LETTER "X" BEFORE A TAG DENOTES EXISTING EQUIPMENT.

	DU	CTWORK LEGEND
SYMBOL	ABBREV	DESCRIPTION
	N	NECK SIZE
	VD	VOLUME DAMPER
	MD	MOTORIZED DAMPER
	AM	AIRFLOW MEASURING STATION
	FC	FLEXIBLE CONNECTION
~ ↓ □ ↓		RISE OR DROP IN THE DIRECTION OF AIR FLOW
		CEILING SUPPLY AIR DEVICE
		CEILING RETURN OR EXHAUST AIR DEVICE
	AL	ACOUSTICAL LINING
		SIDE CONNECTED SUPPLY, RETURN OR EXHAUST AIR DEVICE
	DD	DUCT DETECTOR
 	FD FSD	FIRE DAMPER FIRE SMOKE DAMPER
HTT		
	BS TS	BOTTOM SPLIT SIZE TOP SPLIT SIZE
	EQS	EQUAL SPLIT
	TV	TURNING VANES
	OAI SA	OUTSIDE AIR INTAKE SUPPLY AIR
(// /<u>}</u> – {/ //}	TGFD	BACK-TO-BACK TOP GRILLES WITH FIRE DAMPER
		LOUVERED DOOR
- U -		UNDER-CUT DOOR
Ū		THERMOSTAT
00		OCCUPANCY SENSOR
(CO2)		CARBON DIOXIDE SENSOR
	AD(#-LxW)	ACCESS DOOR(# OF A.D LENGTH (IN) x WIDTH (IN))
	WMS	WIRE MESH SCREEN
	CFM	CUBIC FEET PER MINUTE
		FUTURE EXTENSION OF CAPPED DUCTWORK

	PIPE SYSTEM LEGEND
SYMBOL	DESCRIPTION
—— CHWR ——	CHILLED WATER RETURN
—— CHWS ——	CHILLED WATER SUPPLY
—— DR ——	DRAIN LINE
—— HHGR ——	HEATING HOT GLYCOL RETURN
—— HHGS ——	HEATING HOT GLYCOL SUPPLY
—— HHWR ——	HEATING HOT WATER RETURN
—— HHWS ——	HEATING HOT WATER SUPPLY
—— HTWR ——	HIGH TEMPERATURE WATER RETURN
—— HTWS ——	HIGH TEMPERATURE WATER SUPPLY
—— RHWR ——	REHEAT WATER RETURN
	REHEAT WATER SUPPLY

		DIDING LEGEND						
0/4/20/	ADDD=::	PIPING LEGEND						
SYMBOL	ABBREV	DESCRIPTION						
	GA GL	GATE VALVE GLOBE VALVE						
fi fi								
	BF	BUTTERFLY VALVE						
	ВА	BALL VALVE						
	CV	2-WAY CONTROL VALVE						
<u> </u>	PV	PLUG VALVE						
	СН	CHECK VALVE						
	PSR	PRESSURE SAFTEY RELIEF VALVE						
	TP	TEMPERATURE PROBE						
	STR	STRAINER WITH BLOW-OFF VALVE AND CAP						
	TH	THERMOMETER						
	PG	PRESSURE GAUGE						
	FPC	FLEXIBLE PIPE CONNECTION						
		CAP						
—— ——	U	UNION						
<u> </u>	СО	CLEAN-OUT						
	RED	CONCENTRIC REDUCER						
T	НВ	HOSE BID						
-		FLOW ARROW						
\longrightarrow		BREAK						
\longrightarrow		DROP						
—)		45° DROP						
		BOTTOM TAKE-OFF						
		VALVE DROP						
		PLUG VALVE IN DROP						
	FM	FLOW METER						
<u></u>		AIR VENT VALVE						
		THERMOWELL						
X		ANCHOR						
		GUIDE						
-53-	CBV	CIRCUIT BALANCING VALVE						
	BFP	BACKFLOW PREVENTOR						
H		BRAIDED EXPANSION LOOP						
\dashv I		BLIND FLANGE						
T .		IT DROP						

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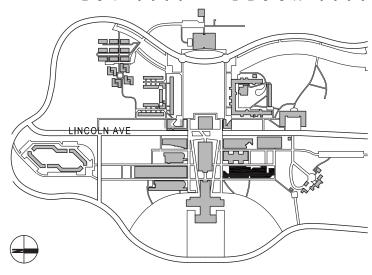
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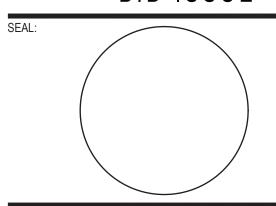


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BUILDING DEPARTMENT NOTE:

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BID ISSUE



02 02.20.2024 ISSUED FOR BID 12.04.2023 ISSUED FOR CLIENT APPROVAL

DESCRIPTION

SCALE: AS NOTED PROJECT NO: 10967 DATE:

DRAWING TITLE:

MECHANICAL LEGENDS, NOTES & ABBREVIATIONS (SHEET 1 OF 2)

DRAWING NUMBER

DRAWING 1 OF 13

M-001.00

			AIR DEVICE SCHEDU	JLE	
TYPE	SYMBOL	FACE SIZE	DESCRIPTION	CFM RANGE	NECK SIZE
A	A(CFM)	24x24	FOUR WAY BLOW CEILING DIFFUSER	0-100 101-200 201-315 316-425 426-600 601-740	6"Ø 8"Ø 10"Ø 12Ø 14Ø 15Ø
Α	A(CFM)	24x24	THREE WAY BLOW CEILING DIFFUSER	0-140 141-220 221-315	8"Ø 10"Ø 12Ø
A	A(CFM)	24x24	TWO WAY BLOW CEILING DIFFUSER	0-80 81-140 141-220 221-315	8"Ø 10"Ø 12Ø 14Ø
В	B(CFM)	12x12 24x12 24x24	RETURN OR EXHAUST REGISTER	0-400 401-1,100 1,101-1,880	10x10 22x10 22x22
С	C(CFM)	SEE DRAWINGS	RETURN REGISTER SIDEWALL	SEE DRAWINGS	SEE DRAWINGS
D	D(CFM)	13.5" Ø 18" Ø 22.5" Ø	ROUND FOUR WAY BLOW CEILING DIFFUSER	0-150 151-275 276-436	6" Ø 8" Ø 10" Ø
Е	E(CFM)	SEE DRAWINGS	RETURN OR EXHAUST REGISTER	SEE DRAWINGS	SEE DRAWINGS

- TYPE 'A' TITUS MODEL OMNI FULL FACE (MODULE SIZE 24x24) STEEL AIR DEVICE WITH ROUND NECK, (LAY-IN TYPE), PROVIDE EQUALIZING GRID. AG-75 OPPOSED BLADE DAMPER. MOLDED INSULATION BLANKET AND DIRECTIONAL BLOW CLIPS AS REQUIRED. (ANEMOSTAT AS EQUAL)
- TYPE 'B' TITUS MODEL 350RL STEEL AIR DEVICE, WITH FIXED 3/4" SPACED BLADES, 35° DEFLECTION BORDER TYPE 3 FOR LAY-IN APPLICATION OR BORDER TYPE 1 FOR 10x10 NK., SURFACE MOUNT APPLICATION, MODEL AG-15 OPPOSED BLADE DAMPER. (ANEMOSTAT AS EQUAL)
- TYPE 'C' TITUS MODEL 350RS-SS RETURN AIR REGISTER WITH 3/4" FIXED SPACED 35 DEGREE DEFLECTION HORIZONTAL LOVERS AND OPPOSED BLADE DAMPER (NAILOR, ANEMOSTAT).
- TYPE 'D' TITUS MODEL R-OMNI FACE (SIZE 18" Ø) STEEL AIR DEVICE WITH FINISHED IN #84 BLACK ROUND NECK, PROVIDE EQUALIZING GRID, AG-75 OPPOSED BLADE DAMPER, MOLDED INSULATION BLANKET. (ANEMOSTAT AS EQUAL)
- TYPE 'E' TITUS MODEL SSBG STAINLESS STEEL LINEAR BAR GRILLE, 1/8" BARS SPACED 3/8" & Ø DEFLECTION, 1" FLANGE FRAME. (ANEMOSTAT AS EQUAL)

NOTES:

- PROVIDE EQUALIZING GRID AT ALL ROUND NECK TAKEOFFS FROM BRANCH RECTANGULAR DUCTWORK.
- PROVIDE SHOP DRAWINGS INCLUDING THROW DATA, NC VALUES, ETC.
- EXACT COLOR & FINISH FOR ALL AIR DEVICES SHALL BE SELECTED AND APPROVED BY ARCHITECT.
- COORDINATE AIR DEVICES/BORDER TYPE WITH ARCHITECTS CEILING GRID PRIOR TO RELEASE OF ORDER.
- 5. EXACT LOCATION OF ALL AIR DEVICES TO BE AS PER ARCHITECTS REFLECTED CEILING PLAN.
- CONTRACTOR SHALL APPLY FLAT BLACK PAINT TO INTERIOR PORTIONS OF DUCT AND/OR GRILLES WHERE VISIBLE FROM FLOOR LEVEL.
- 7. NC VALUE NOT TO EXCEED NC 25.

	DUCTWORK CL	<u>ASS</u>	
<u>SYSTEM</u>	DUCT PRESSURE CLASS	DUCT SEAL CLASS	DUCT LEAK CLASS CFM/100SF
RECTANGULAR SUPPLY UPSTREAM VAV / DOWNSTREAM VAV	+4" W.G. / +2" W.G.	А	6
RECTANGULAR RETURN	-2" W.G.	А	6
RECTANGULAR EXHAUST	-2" W.G.	А	6
ROUND SUPPLY UPSTREAM VAV / DOWNSTREAM VAV	+4" W.G / +2" W.G.	А	3
ROUND RETURN	-2" W.G.	А	3
ROUND EXHAUST	-2" W.G.	A	3

GENERAL NOTES:

- ALL WORK SHALL BE PERFORMED BY PROFESSIONALS IN THE FIELD AND COMPLY WITH THE APPLICABLE REGULATIONS OF NYS BUILDING CODES (MECHANICAL CODE, ENERGY CONSERVATION CONSTRUCTION CODE, ETC.), OSHA AND CAMPUS WORK RULES.
- ALL NOTES PROVIDED IN THESE DOCUMENTS ARE PART OF THE CONTRACT AND CARRY EQUAL VALUE.
- 3. CONTRACTOR SHALL BE RESPONSIBLE FOR ALL PERMITS AND BE RESPONSIBLE TO ARRANGE AND SECURE ALL NECESSARY INSPECTIONS...
- ALL WORK PERFORMED BY THE CONTRACTOR/SUB-CONTRACTORS SHALL CONFORM TO THE REQUIREMENTS OF MUNICIPAL, LOCAL OR FEDERAL AND STATE LAWS, AS WELL AS ANY OTHER GOVERNING REQUIREMENTS, WHETHER OR NOT SPECIFIED ON THE DRAWINGS.
- CONTRACTOR SHALL SOLELY BE RESPONSIBLE FOR JOBSITE SAFETY AND SHALL ARRANGE WORK IN SUCH A MANNER TO PROVIDE FOR SAFE ACCESS FOR COLLEGE'S INSPECTION OF ALL WORK.
- 6. THE TERMS "PROVIDE" OR "FURNISH AND INSTALL" SHALL INCLUDE ALL LABOR, MATERIALS, DEVICES, WIRING, RIGGING, SUPPORTS, DELIVERY ETC. THAT WOULD BE NECESSARY TO PROVIDE FOR A FULLY FUNCTIONAL DEVICE AS INDICATED.
- ALL MATERIAL SHALL BE NEW. REBUILT OR REFURBISHED MATERIALS SHALL BE REJECTED.
- 8. ALL WORK SHALL BE PERFORMED WITH MINIMAL INTERRUPTION TO THE COLLEGE. ANY WORK REQUIRING UTILITY SHUTDOWN. OR OTHER DISRUPTION SHALL NOT BE DONE WITHOUT COLLEGE'S
- THE CONTRACTOR SHALL FURNISH ALL EQUIPMENT, MATERIALS, SHOP DRAWINGS, AND PERFORMANCE INFORMATION ON ALL PRODUCTS FOR APPROVAL. ALL PRODUCTS INSTALLED WITHOUT APPROVAL SHALL BE AT RISK. APPROVAL SHALL BE LIMITED TO THAT THE PRODUCT COMPLIES WITH THE SPECIFICATIONS OR EXPECTED PERFORMANCE; ACTUAL PERFORMANCE TO THE LIMITS DEFINED SHALL BE THE RESPONSIBILITY OF THE CONTRACTOR.
- 10. CONTRACTOR SHALL PROVIDE INSTRUCTION TO THE OWNER FOR ALL EQUIPMENT SUPPLIED AND INSTALLED UNDER THIS CONTRACT, INCLUDING ANY WORK PERFORMED BY SUBCONTRACTORS.
- 11. THE CONTRACTOR IS RESPONSIBLE TO CONFIRM AND COORDINATE JOBSITE DIMENSIONS THAT AFFECT THE ERECTION OR OPERATION OF SYSTEMS, AS INTENDED BY THESE CONTRACT DOCUMENTS. THE CONTRACTOR SHALL ENSURE INSTALLED EQUIPMENT MAINTAINS ADEQUATE CLEARANCES FOR OPERATIONAL ACCESS AND SERVICE, AND SHALL MAINTAIN ANY CLEARANCES REQUIRED BY ALL APPLICABLE CODES.
- 12. THE CONTRACTOR SHALL MAKE ALL REQUIRED ARRANGEMENTS FOR DELIVERY OF EQUIPMENT AND/OR MATERIALS. IT SHALL BE THE RESPONSIBILITY OF THE CONTRACTOR TO CHECK THE RULES AND REGULATIONS GOVERNING WORK ON THE PREMISES.
- 13. CONTRACTOR SHALL BE RESPONSIBLE TO REMOVE ALL RUBBISH AND WASTE MATERIALS. AT THE END OF EACH WORK DAY THE PROJECT SITE SHALL BE LEFT IN A SAFE AND BROOM CLEANED CONDITION.
- 14. CONTRACTOR SHALL PROPERLY PROTECT THE BUILDING AND ANY ADJOINING PROPERTY OR WORK AND ANY DAMAGE TO THE SAME CAUSED BY HIS WORK OR WORKMEN MUST BE MADE GOOD WITHOUT DELAY. PATCHING AND REPLACING OF DAMAGED WORK.
- 15. ALL ACCEPTANCE TESTING SHALL BE WITNESSED BY THE COLLEGE OR THE COLLEGE'S REPRESENTATIVE.
- 16. THE CONTRACTOR SHALL MAINTAIN THE WORK AREA IN A STATE FREE FROM HAZARDS AND A NEAT AND CLEAN CONDITION AT THE END OF EACH WORKDAY. THE CONTRACTOR SHALL TAKE ALL NECESSARY PRECAUTIONS, FOLLOW SAFE WORKING PRACTICES, AND MAINTAIN THE SITE AND ADJACENT AREAS SAFE FOR WORKERS AND FACILITY EMPLOYEES.
- 17. ALL MATERIALS, TOOLS, TRUCKS ETC. SHALL BE STORED IN AREAS DESIGNATED BY THE COLLEGE. CONTRACTOR SHALL BE RESPONSIBLE FOR PRODUCT STORAGE CONDITIONS AND SECURITY. THE OWNER SHALL NOT BE RESPONSIBLE FOR ANY OF THE CONTRACTOR'S SHIPPING, DELIVERY OR OFFLOADING.
- 18. IT IS A VIOLATION OF STATE LAW TO FOR ANY PERSON OR PERSONS TO ALTER THESE PLANS. ANY MODIFICATIONS SHALL BE UNDER THE DIRECTION OF A NYS LICENSED ENGINEER.

DRAWING NOTES:

- CONTRACTOR SHALL COMPLY WITH THE LATEST EPA REFRIGERANT EVACUATION RECLAMATION REQUIREMENTS (SECTION 608) PRIOR TO REMOVAL OF AIR CONDITIONING UNITS.
- CONTRACTOR TO DEMOLISH ALL EXISTING MECHANICAL EQUIPMENT AND APPURTENANCES INCLUDING AIR CONDITIONING UNITS. HEATING AND VENTILATION UNITS. TERMINAL BOXES, AND ALL ASSOCIATED DAMPERS, CONTROLS, DUCTWORK AND PIPING.
- PROVIDE MANUFACTURER'S RECOMMENDED CLEARANCES FOR ALL EQUIPMENT
- ALL DUCTWORK SHOWN IS SCHEMATIC AND INTENDED FOR DESIGN PURPOSES ONLY, CONTRACTOR SHALL OFFSET ALL NEW DUCTS AS REQUIRED TO AVOID CONFLICTS WITH MINIMUM ADDITION TO DUCT EQUIVALENT LENGTH. SHOP DRAWINGS SHALL BE SUBMITTED FOR APPROVAL.
- ALL DUCTWORK SHALL BE SUPPORTED AT DISTANCES NOT EXCEEDING THE SPACING IN NYS MECHANICAL CODE MC TABLE 305.4.
- PROVIDE ACCESS DUCT DOOR 2" SMALLER THAN DUCT WIDTH AND A MAXIMUM OF 24" IN LENGTH AND WIDTH AT ALL CONTROL DAMPERS, FIRE DAMPER, FIRE SMOKE DAMPER AND SMOKE DAMPER

	HVAC LEGEND										
SYMBOL	DESCRIPTION										
	EXISTING DUCTWORK/PIPING/EQUIPMENT TO REMAIN										
++++++	EXISTING DUCTWORK/PIPING/EQUIPMENT TO BE REMOVED										
	NEW DUCTWORK/PIPING										
•	POINT OF NEW WORK CONNECTED TO EXISTING WORK										
•	POINT OF DISCONNECT FROM EXISTING WORK										

DEMOLITION NOTES:

- 1. PROVIDE ALL LABOR, MATERIAL, EQUIPMENT, STORAGE FACILITIES, SERVICES AND SUPERVISION NECESSARY FOR THE DEMOLITION WORK AS INDICATED ON DRAWINGS AND
- 2. ALL EXISTING EQUIPMENT, MATERIALS AND WORK SHALL BE PROTECTED FROM DAMAGE DURING DEMOLITION. CONTRACTOR SHALL BE HELD RESPONSIBLE FOR ALL DAMAGE OCCURRING FROM HIS WORK
- 3. ALL WORK SHALL BE EXECUTED IN AN ORDERLY AND CAREFUL MANNER WITH DUE CONSIDERATION FOR PUBLIC SAFETY AND IN CONFORMANCE WITH OSHA REGULATIONS.
- 4. CONTRACTOR SHALL PROVIDE BARRIERS TO PREVENT DUST, ODORS, DIRT AND DEBRIS FROM MIGRATING TO AREAS NOT AFFECTED BY THIS WORK.
- 5. REMOVAL OF ANY MATERIAL AND EQUIPMENT SHALL INCLUDE ALL ASSOCIATED ITEMS SUCH AS FASTENERS, SUPPORTS, CONDUIT, FLASHING, ADHESIVE, ETC.
- EXISTING EQUIPMENT OR MATERIALS NOT SHOWN TO BE RE-USED BY OWNER. OR NOT SHOWN ON THE DRAWINGS TO BE RETAINED BY THE OWNER SHALL BECOME THE PROPERTY OF THE CONTRACTOR AND SHALL BE REMOVED FROM THE PREMISES.
- 7. ALL CHARGES ASSOCIATED WITH TESTING, FILING, DISPOSAL, PREPARATION AND SUBMISSION OF ALL REQUIRED DOCUMENTATION SHALL BE INCLUDED IN THE CONTRACTOR'S BID. ALL REQUIRED FORMS, RECORDS, TEST, DISPOSAL AND TRANSPORTATION COSTS AND THE LIKE SHALL BE INCLUDED IN THE CONTRACTOR'S PROPOSAL. NO ADDITIONAL COSTS SHALL BE PAID TO THE CONTRACTOR BECAUSE OF THE CONTRACTOR'S FAILURE TO COMPLY WITH THE ABOVE.
- 8. ALL DUCTWORK IS SHOWN DIAGRAMMATICALLY, CONTRACTOR TO FIELD VERIFY.

DUCTWORK NOTES

- THE MATERIALS, THICKNESS AND CONSTRUCTION OF SHEET METAL DUCTS SHALL PROVIDE STRUCTURAL STRENGTH AND DURABILITY, DUCTS SHALL BE CONSTRUCTED, BRACED AND REINFORCED IN ACCORDANCE WITH LOW PRESSURE AND HIGH PRESSURE DUCT STANDARDS OF THE SHEET METAL AND AIR CONDITIONING CONTRACTORS NATIONAL ASSOCIATION (SMACNA), LATEST EDITION IN PRINT OR IN ACCORDANCE WITH THE FUNDAMENTALS VOLUME BOOK OF THE AMERICAN SOCIETY OF HEATING, REFRIGERATION AND AIR CONDITIONING ENGINEERS (ASHRAE), LATEST EDITION IN PRINT.
- DUCTS SHALL BE SUBSTANTIALLY SUPPORTED. HANGERS AND BRACKETS FOR SUPPORTING DUCTS SHALL BE OF METAL HANGERS SHALL HAVE SUFFICIENT STRENGTH AND DURABILITY AND SUFFICIENT RESISTANCE TO THE CORROSIVE EFFECTS OF THE ATMOSPHERE TO WHICH THEY WILL BE EXPOSED, TO PROPERLY AND SAFELY SUPPORT THE DUCTWORK. HANGERS SHALL NOT BE USED IN DIRECT CONTACT WITH A DISSIMILAR METAL THAT WOULD CAUSE GALVANIC ACTION IN THE HANGER, DUCT, FASTENINGS OR STRUCTURE.
- HANGERS SHALL CONFORM TO THE FOLLOWING MINIMUM REQUIREMENTS:
 - a. HANGERS SHALL BE FASTENED TO THE SIDES OF DUCT. FOR DUCTS OVER 48 INCHES WIDE, HANGERS SHALL TURN UNDER DUCT AT LEAST TWO INCHES AND SHALL BE FASTENED TO THE BOTTOM AS WELL AS TO THE SIDES.
 - b. FOR DUCTS WITH A CROSS-SECTIONAL AREA OF TWO SQUARE FEET OR LESS, HANGERS SHALL BE CONSTRUCTED OF AT LEAST ONE INCH BY 1/16 INCH STEEL STRAP.
 - c. FOR DUCTS WITH A CROSS SECTIONAL AREA OVER TWO SQUARE FEET, HANGERS SHALL BE CONSTRUCTED OF THREADED STEEL ROD (MINIMUM 1/2"-DIAMETER) WITH STEEL SINGLE TRAPEZE SUPPORTS.
- DUCTS AND ALL PARTS OF THE DUCT SYSTEM SHALL BE SUBSTANTIALLY SUPPORTED AND SECURELY FASTENED TO THE STRUCTURAL MEMBERS OF THE BUILDING WITH APPROVED DEVICES OF NONCOMBUSTIBLE MATERIAL DESIGNED TO CARRY THE REQUIRED LOADS. THE USE OF EXPANSION BOLTS IN CINDER CONCRETE IS PROHIBITED. CONNECTIONS SHALL NOT IMPAIR THE EFFECTIVENESS OF THE FIRE PROTECTION OF STRUCTURAL MEMBERS.
- 5. DUCTS SHALL NOT BE HUNG FROM OR SUPPORTED BY SUSPENDED CEILINGS.

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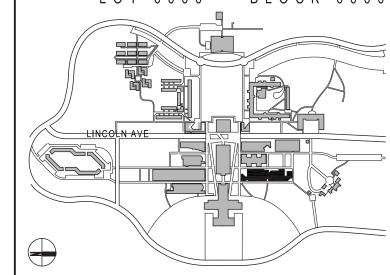
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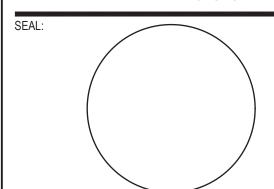


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BID ISSUE



02.20.2024 ISSUED FOR BID 12.04.2023 ISSUED FOR CLIENT APPROVAL

NO DATE DESCRIPTION

SCALE: AS NOTED PROJECT NO: 10967 DATE:

DRAWING TITLE:

MECHANICAL LEGENDS, NOTES & ABBREVIATIONS (SHEET 2 OF 2)

DRAWING NUMBER

DRAWING 2 OF 13

M-002.00

1 .																						
				(SINGLE	E DUCT	VARIAB	LE AIR	VOLUM	E OR C	ONSTA	NT AIR	VOLU	IME BO	OX SC	HEDUL	E					
П				1441/		INLET	OUTLET	SOUND PO	WER DATA					HOT WA	ATER HEA	TING COIL						
	TAG	LOCATION	ASSOCIATED UNIT	MAX CFM	MIN CFM	DUCT	DUCT		IC)	HEATING	EWT °F	LWT °F	GPM	EAT °F	LAT °F	MBH	WPD FT	APD IN W.G.	DOME	FPI	MANUFACTURER AND MODEL	REMARK
Ш	17.0		ONT	01 141	OI W	SIZE, IN	SIZE, IN.	RAD.	DISCH.	CFM	EVVI F	LVVIF	GPIVI	EAT F	LAIF	IVIDIT	WPDFI	APD IN W.G.	ROWS	I FFI	WOBEL	
	VAV/1-0-14	DARK ROOM	XAHU/1	500	250	8	12x10	19	27	500	180	131	0.70	55	85	16.3	0.12	0.17	2	10	TITUS DESV	1-5
	VAV/1-0-16	CLASSROOM	XAHU/1	960	480	12	16x15	19	23	960	180	122.5	0.16	55	85	31.1	0.16	0.16	2	10	TITUS DESV	1-5
	VAV/1-0-17	WORK ROOM, FILM DEVELOP	XAHU/1	1,320	660	14	20x17.5	18	19	1,320	180	119.1	0.15	55	85	42.768	0.13	0.15	2	10	TITUS DESV	1-5

REMARKS:

- 1. PROVIDE SHOP DRAWINGS INCLUDING SOUND DATA, BOX PERFORMANCE, AND CONTROLS.
- 2. ALL PERFORMANCE TESTS BASED ON TESTS CONDUCTED IN ACCORDANCE WITH ASHRAE 130-2016 AND AHRI 880-2017.
- 3. CONTROLLER TO BE PROVIDED BY CONTROLS VENDOR AND MOUNTED BY FACTORY.
- 4. PROVIDE INTEGRAL 120V-24V TRANSFORMER AND DISCONNECT SWITCH.
- 5. PROVIDE INTEGRAL COIL AND ACCESS DOOR FOR ALL UNITS SHOWN TO HAVE A COIL ABOVE.

	EXHAUST AIR VALVE SCHEDULE													
TAG	LOCATION	ASSOCIATED UNIT	ASSOCIATED VAV	MAX AIRFLOW (CFM)	MIN AIRFLOW (CFM)	BOX SIZE	MANUFACTURER AND MODEL	REMARKS						
EAV/1-0-10	WORK ROOM	XEF/1	XVAV-1-0-17	1,700	-	12	ACCUTROL AVC4212-17-F	1-3						

REMARKS:

- 1. ALL PERFORMANCE TESTS BASED ON TESTS CONDUCTED IN ACCORDANCE WITH ASHRAE 130-2016 AND AHRI 880-2017.
- 2. CONTROLLER TO BE PROVIDED BY CONTROLS VENDOR AND MOUNTED BY FACTORY.
- 3. PROVIDE SHOP DRAWINGS INCLUDING SOUND DATA, BOX PERFORMANCE, AND CONTROLS.

	EXISTING - RELOCATED SINGLE DUCT VARIABLE AIR VOLUME OR CONSTANT AIR VOLUME BOX NEW PERFORMANCE SCHEDULE																				
TAG	LOCATION	ASSOCIATED UNIT	MAX CFM	MIN CFM	INLET DUCT SIZE, IN	OUTLET DUCT SIZE, IN.	1	SOUND POWER DATA (NC) HE		EWT °F	LWT °F	GPM	HOT WA		TING COIL MBH	WPD FT	APD IN W.G.	ROWS	FPI	MANUFACTURER AND MODEL	REMARKS
XVAV/1-0-15	TECH ROOM, FILM UNLOAD 022C & 022D	XAHU/1	175	88	6	12x8	13	20	175	180	160	0.6	55	85	5.7	0.12	0.03	1	10	TITUS DESV	1
XVAV/1-0-25	CORRIDORS	XAHU/1	590	590	8	12x10	19	27	590	180	160	1.9	55	85	19.1	0.68	0.23	2	10	TITUS DESV	1

REMARKS:

1. NEW CONTROLLER TO BE PROVIDED BY CONTROLS VENDOR AND MOUNTED BY FACTORY.

EXISTING - RELOCATED EXHAUST AIR VALVE SCHEDULE									
TAG	LOCATION	ASSOCIATED UNIT	ASSOCIATED VAV	MAX AIRFLOW (CFM)	MIN AIRFLOW (CFM)	BOX SIZE	ACTUATOR	MANUFACTURER AND MODEL	REMARKS
XEAV/1-0-4	DARK ROOM	XEF/1	XVAV-1-0-14	630	-	10	SSA FLP 2-10V	ACCUTROL AVC4210-17-F	
XEAV/1-0-5	DARK ROOM	XEF/1	XVAV-1-0-14	630	-	10	SSA FLP 2-10V	ACCUTROL AVC4210-17-F	1
XEAV/1-0-6	WORK ROOM, W.I.C. & FILM DEVELOP	XEF/1	XVAV-1-0-17	495	-	8	SSA FLP 2-10V	ACCUTROL AVC4210-17-F	

EMARKS:

1. NEW CONTROLLER TO BE PROVIDED BY CONTROLS VENDOR AND MOUNTED BY FACTORY.

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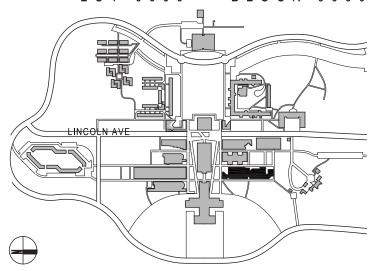
244 FIFTH AVENUE, SUITE B265, NEW YORK, NY 10001 T. 212-787-4558

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PLAN LOT 0000 BLOCK 0000




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BID ISSUE



 02
 02.20.2024
 ISSUED FOR BID

 01
 12.04.2023
 ISSUED FOR CLIENT APPROVAL

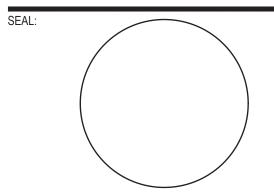NO DATE DESCRIPTION

ISSUES

SCALE: AS NOTED PROJECT NO: 10967 DATE:


DRAWING TITLE:

MECHANICAL SCHEDULES

DRAWING NUMBER

DRAWING 3 OF 13

M-003.00

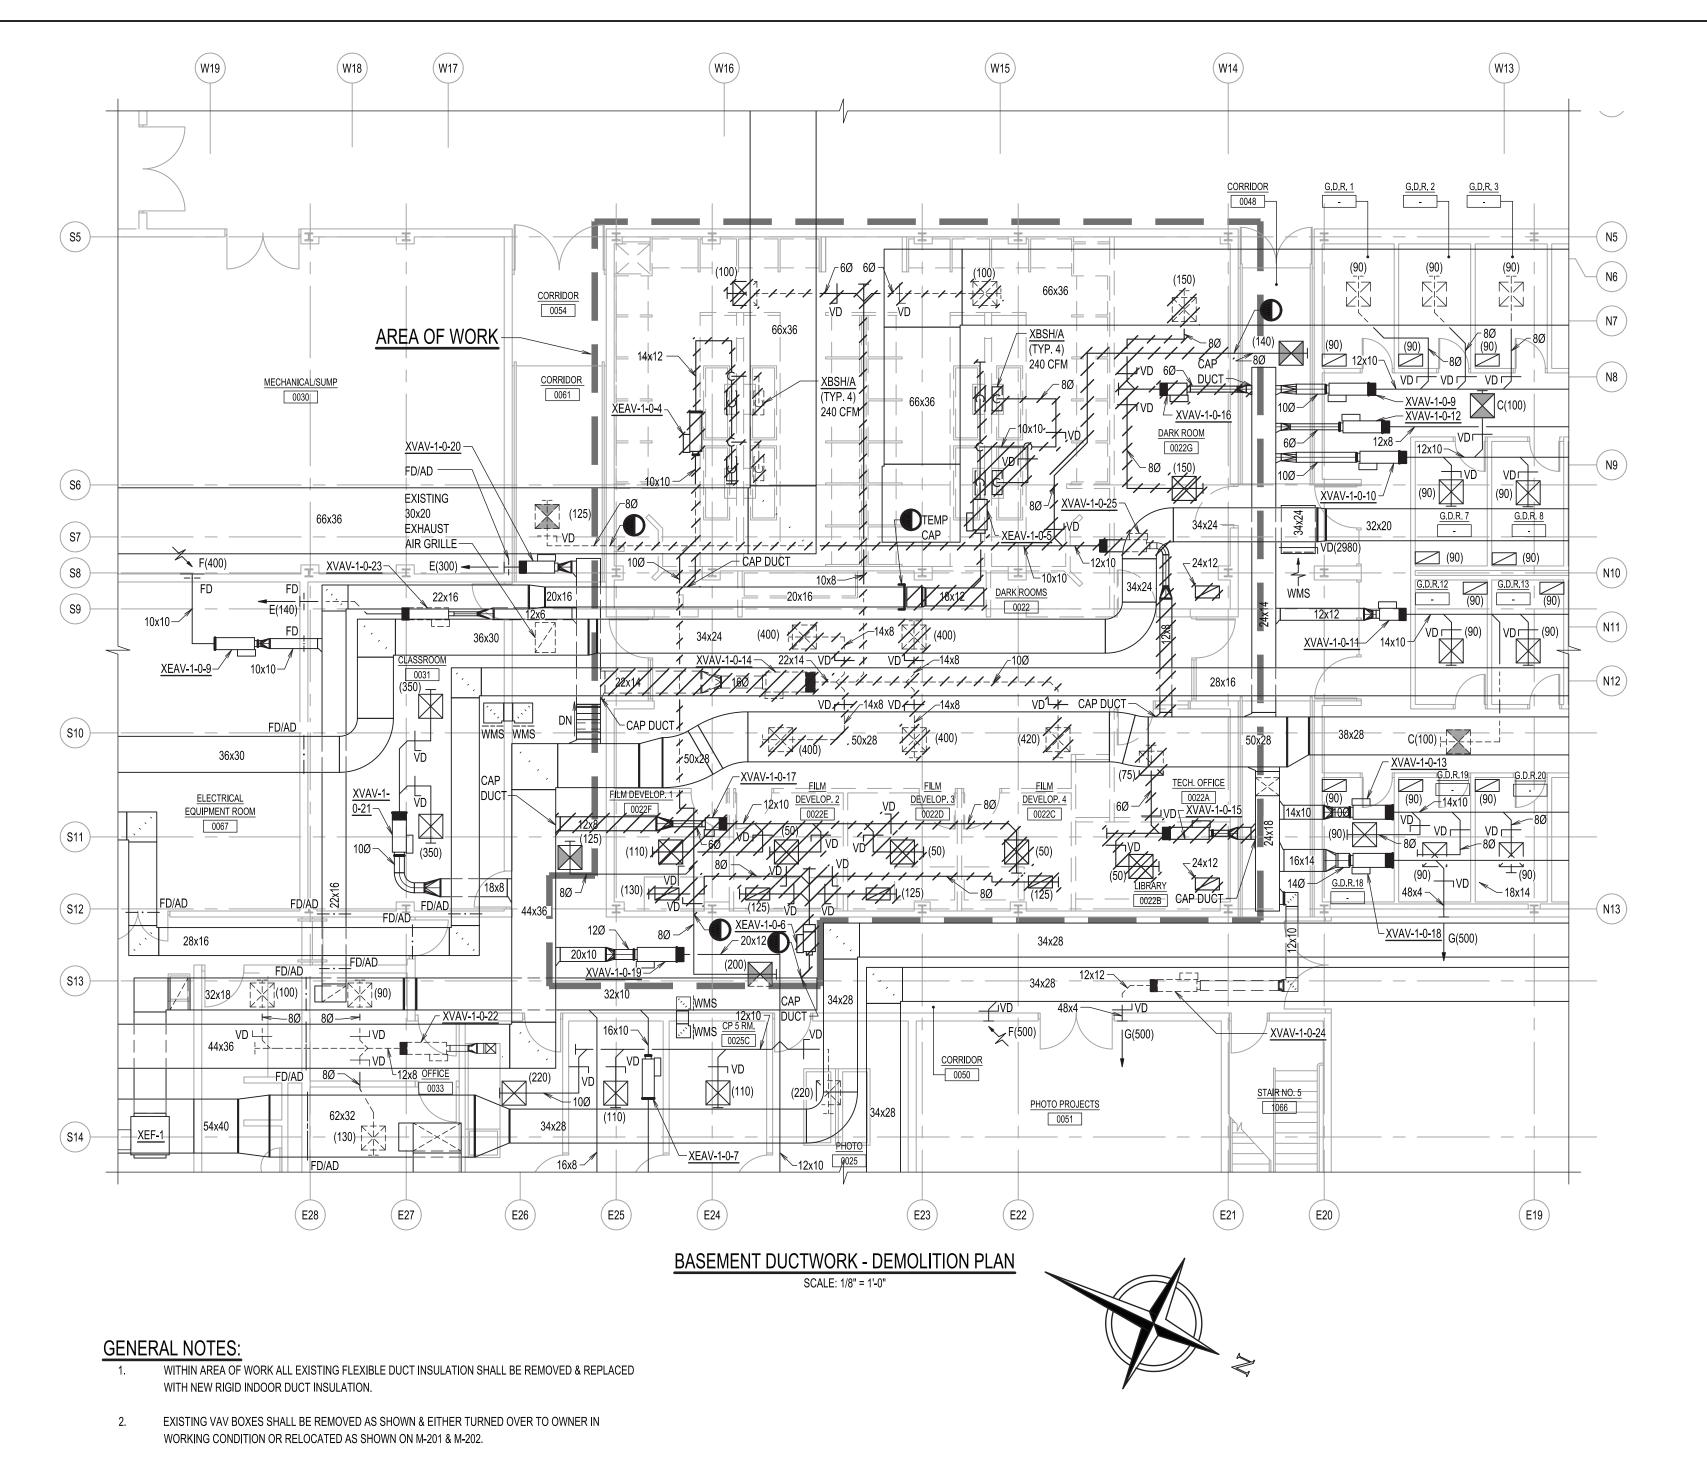

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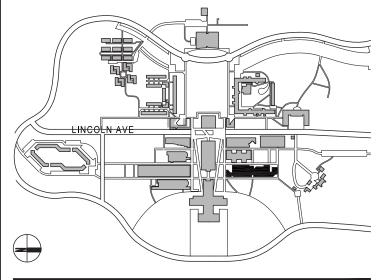
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KEYPLAN LOT 0000 BLOCK 0000




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NO DATE DESCRIPTION

1550E5

SCALE: AS NOTED PROJECT NO: 10967 DATE:

DRAWING TITI

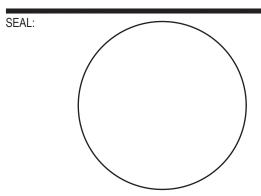MECHANICAL BASEMENT
DUCTWORK - DEMOLITION PLAN

DRAWING NUMBER

DRAWING 4 OF 13

M-101.00

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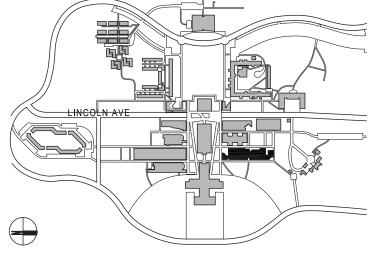
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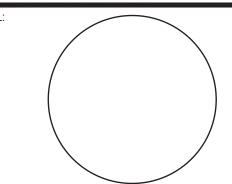
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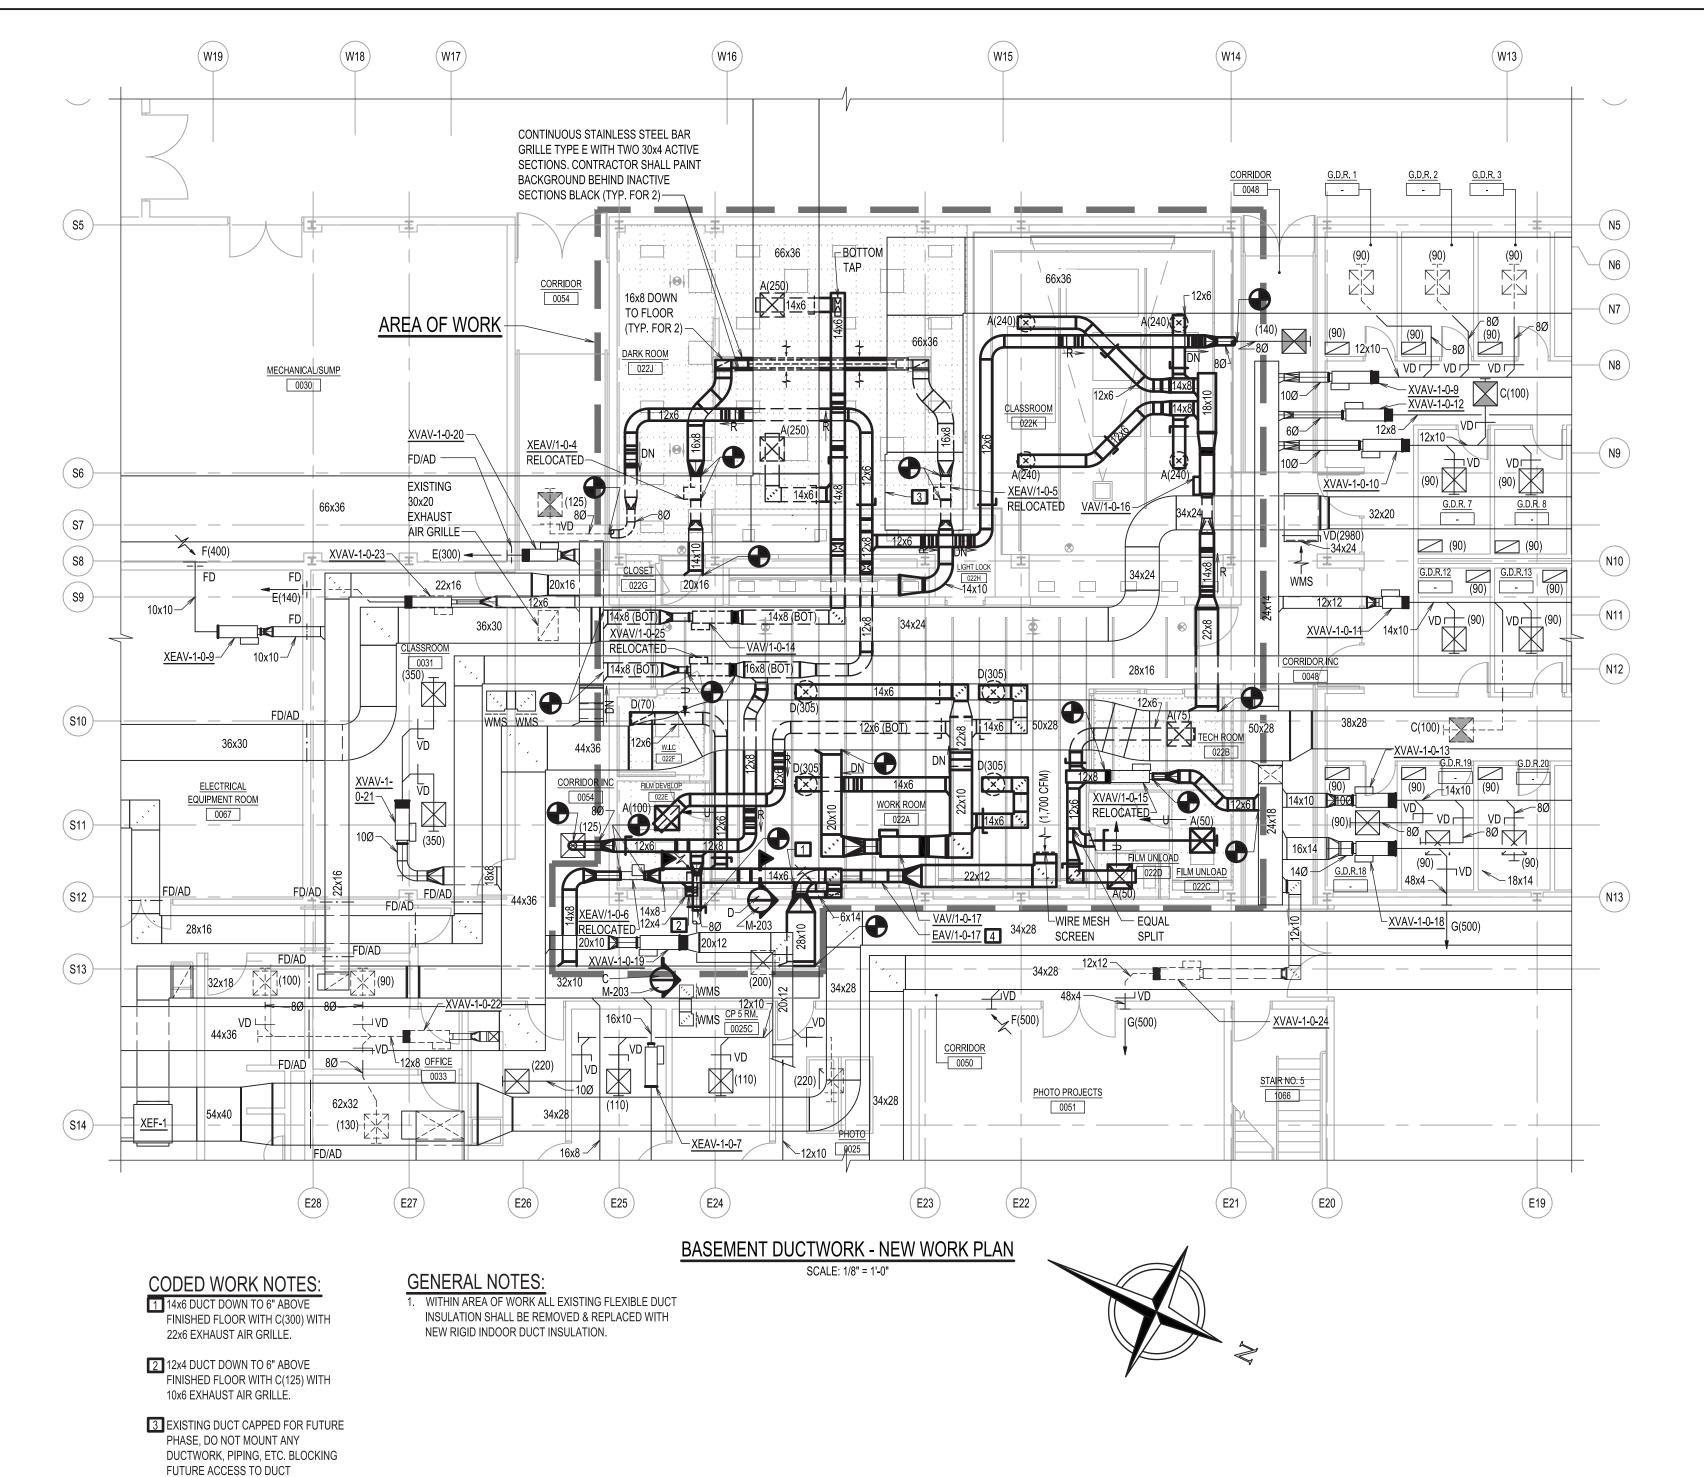
PROJECT NO: 10967 DATE:

MECHANICAL BASEMENT PIPING -

DRAWING 5 OF 13

M-102.00

4 MOUNT BOX WITH CONTROL PANEL ON BOTTOM OF BOX FOR ACCESS.



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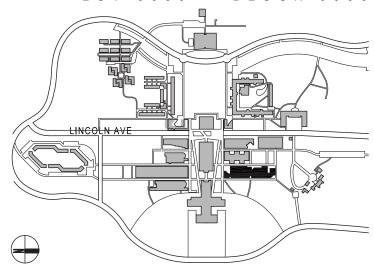
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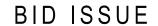
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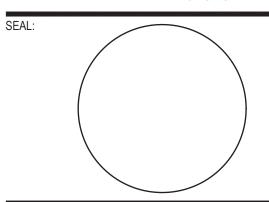


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DESCRIPTION NO DATE

SCALE: AS NOTED PROJECT NO: 10967 DATE:

DRAWING TITLE:

MECHANICAL BASEMENT **DUCTWORK - NEW WORK PLAN**

DRAWING NUMBER

DRAWING 6 OF 13

M-201.00

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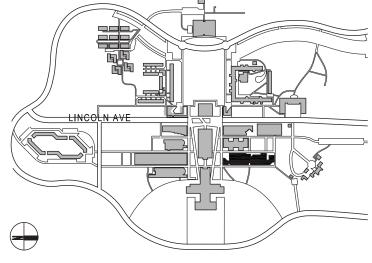
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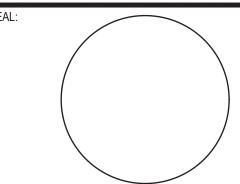


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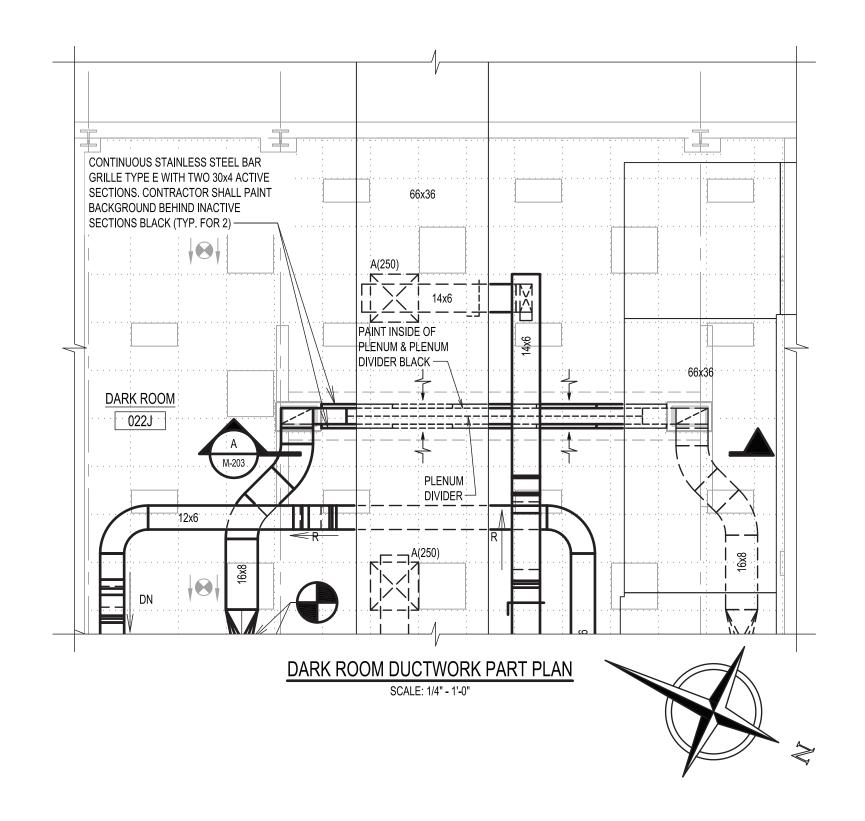
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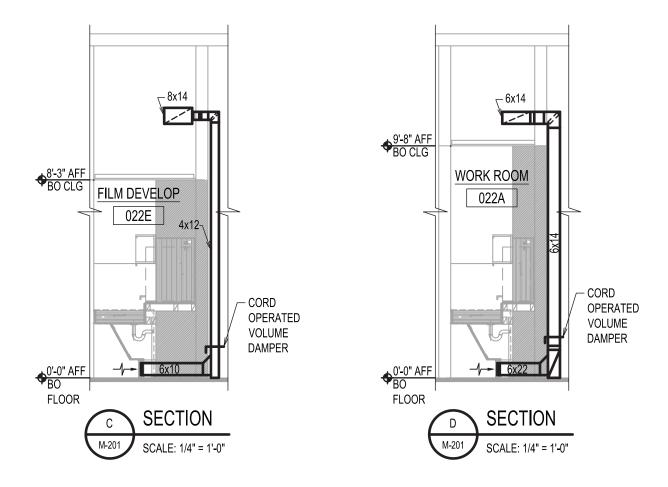
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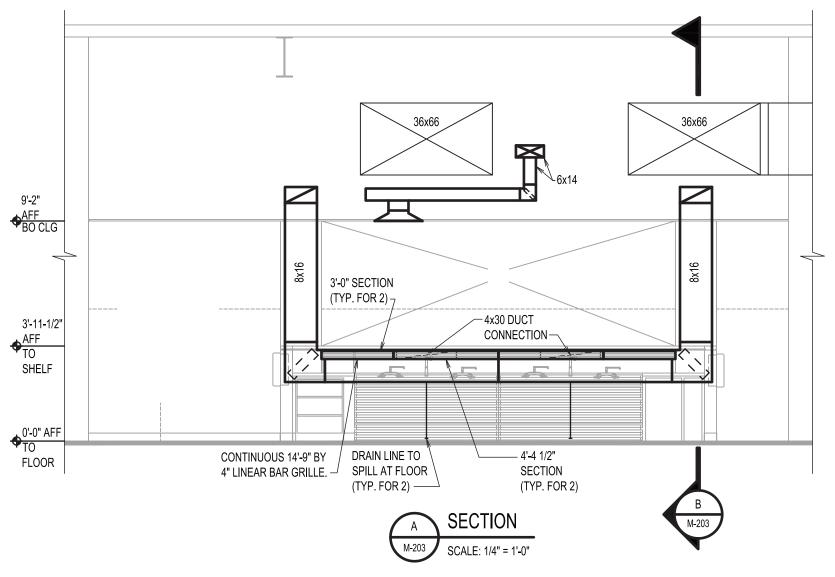
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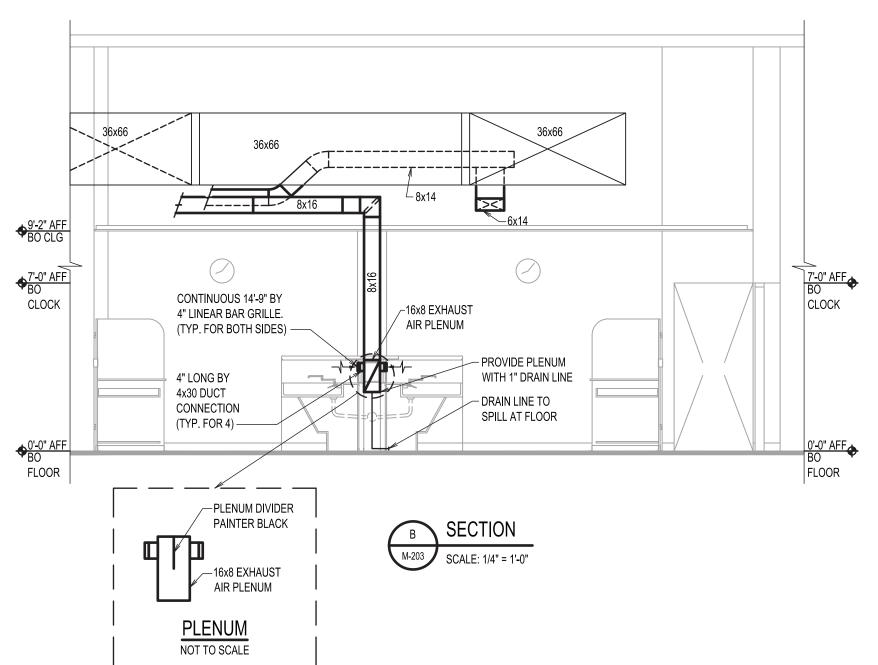
DRAWING 7 OF 13

M-202.00









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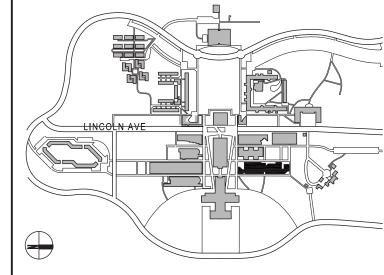
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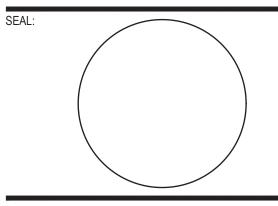


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01	12.04.2023	ISSUED FOR CLIENT APPROVAL

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PROJECT NO: 10967 DATE: SCALE: AS NOTED


DRAWING TITLE:

MECHANICAL PART PLANS & SECTIONS

DRAWING NUMBER

DRAWING 8 OF 13

M-203.00

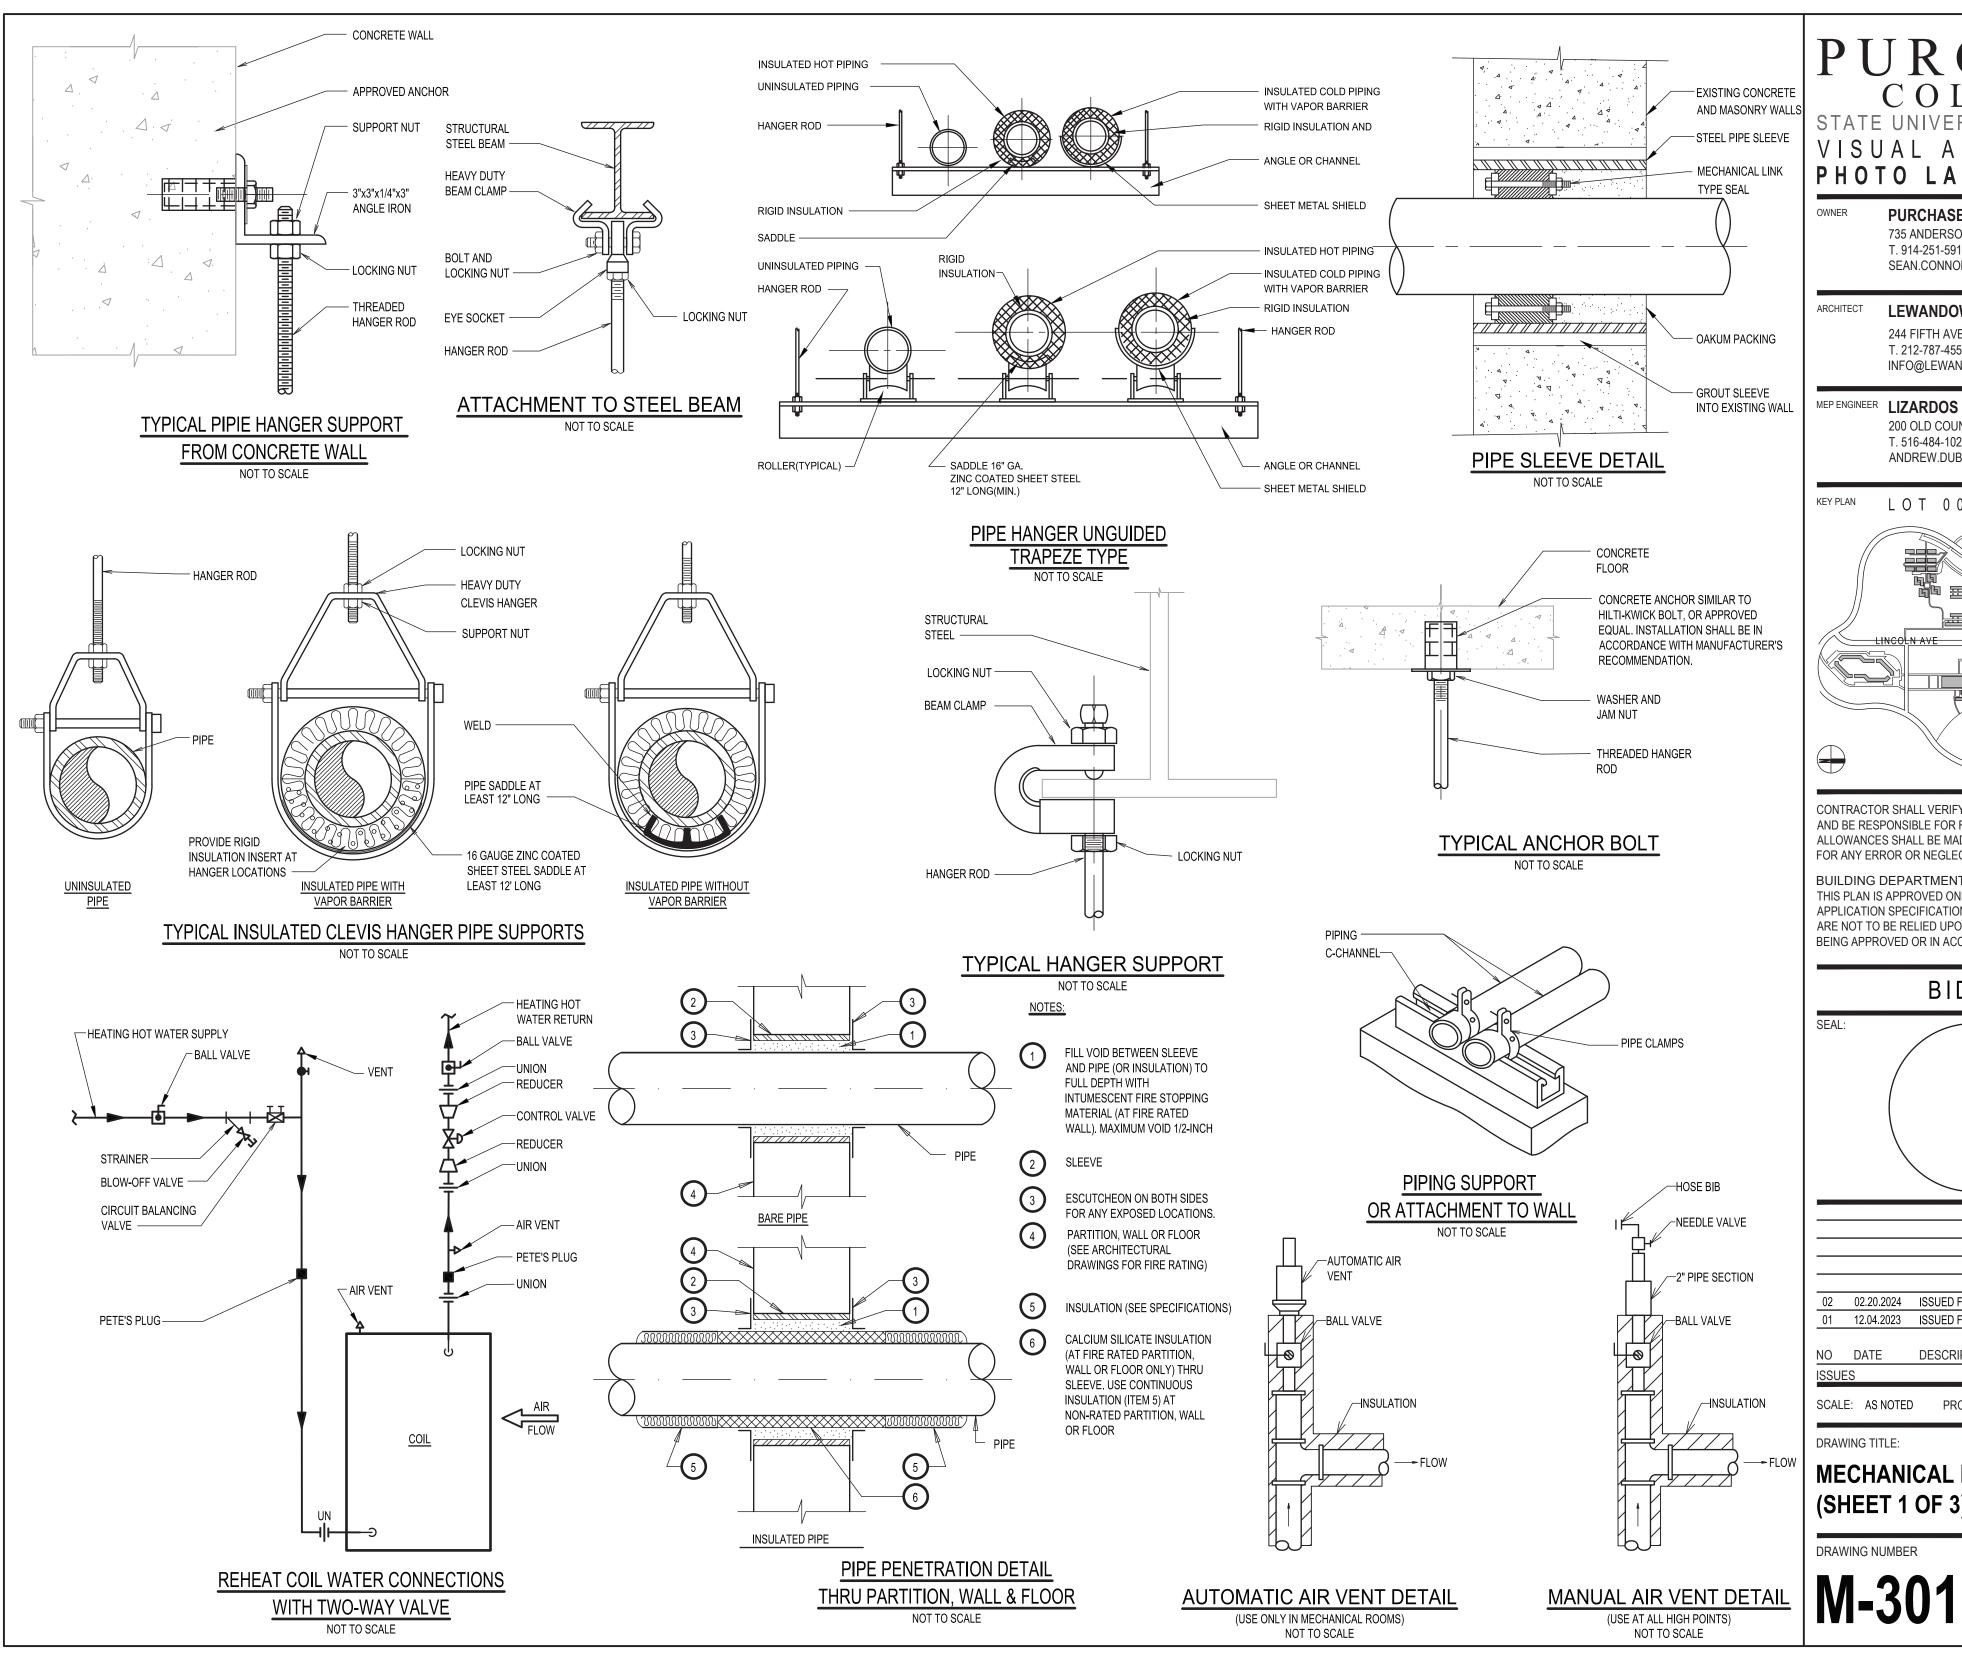

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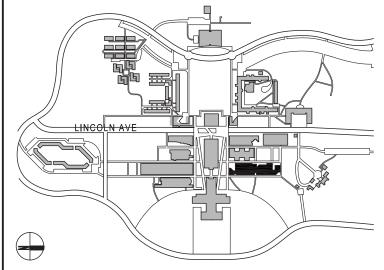
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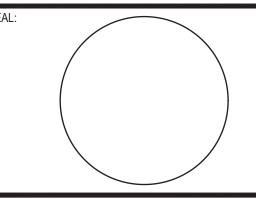


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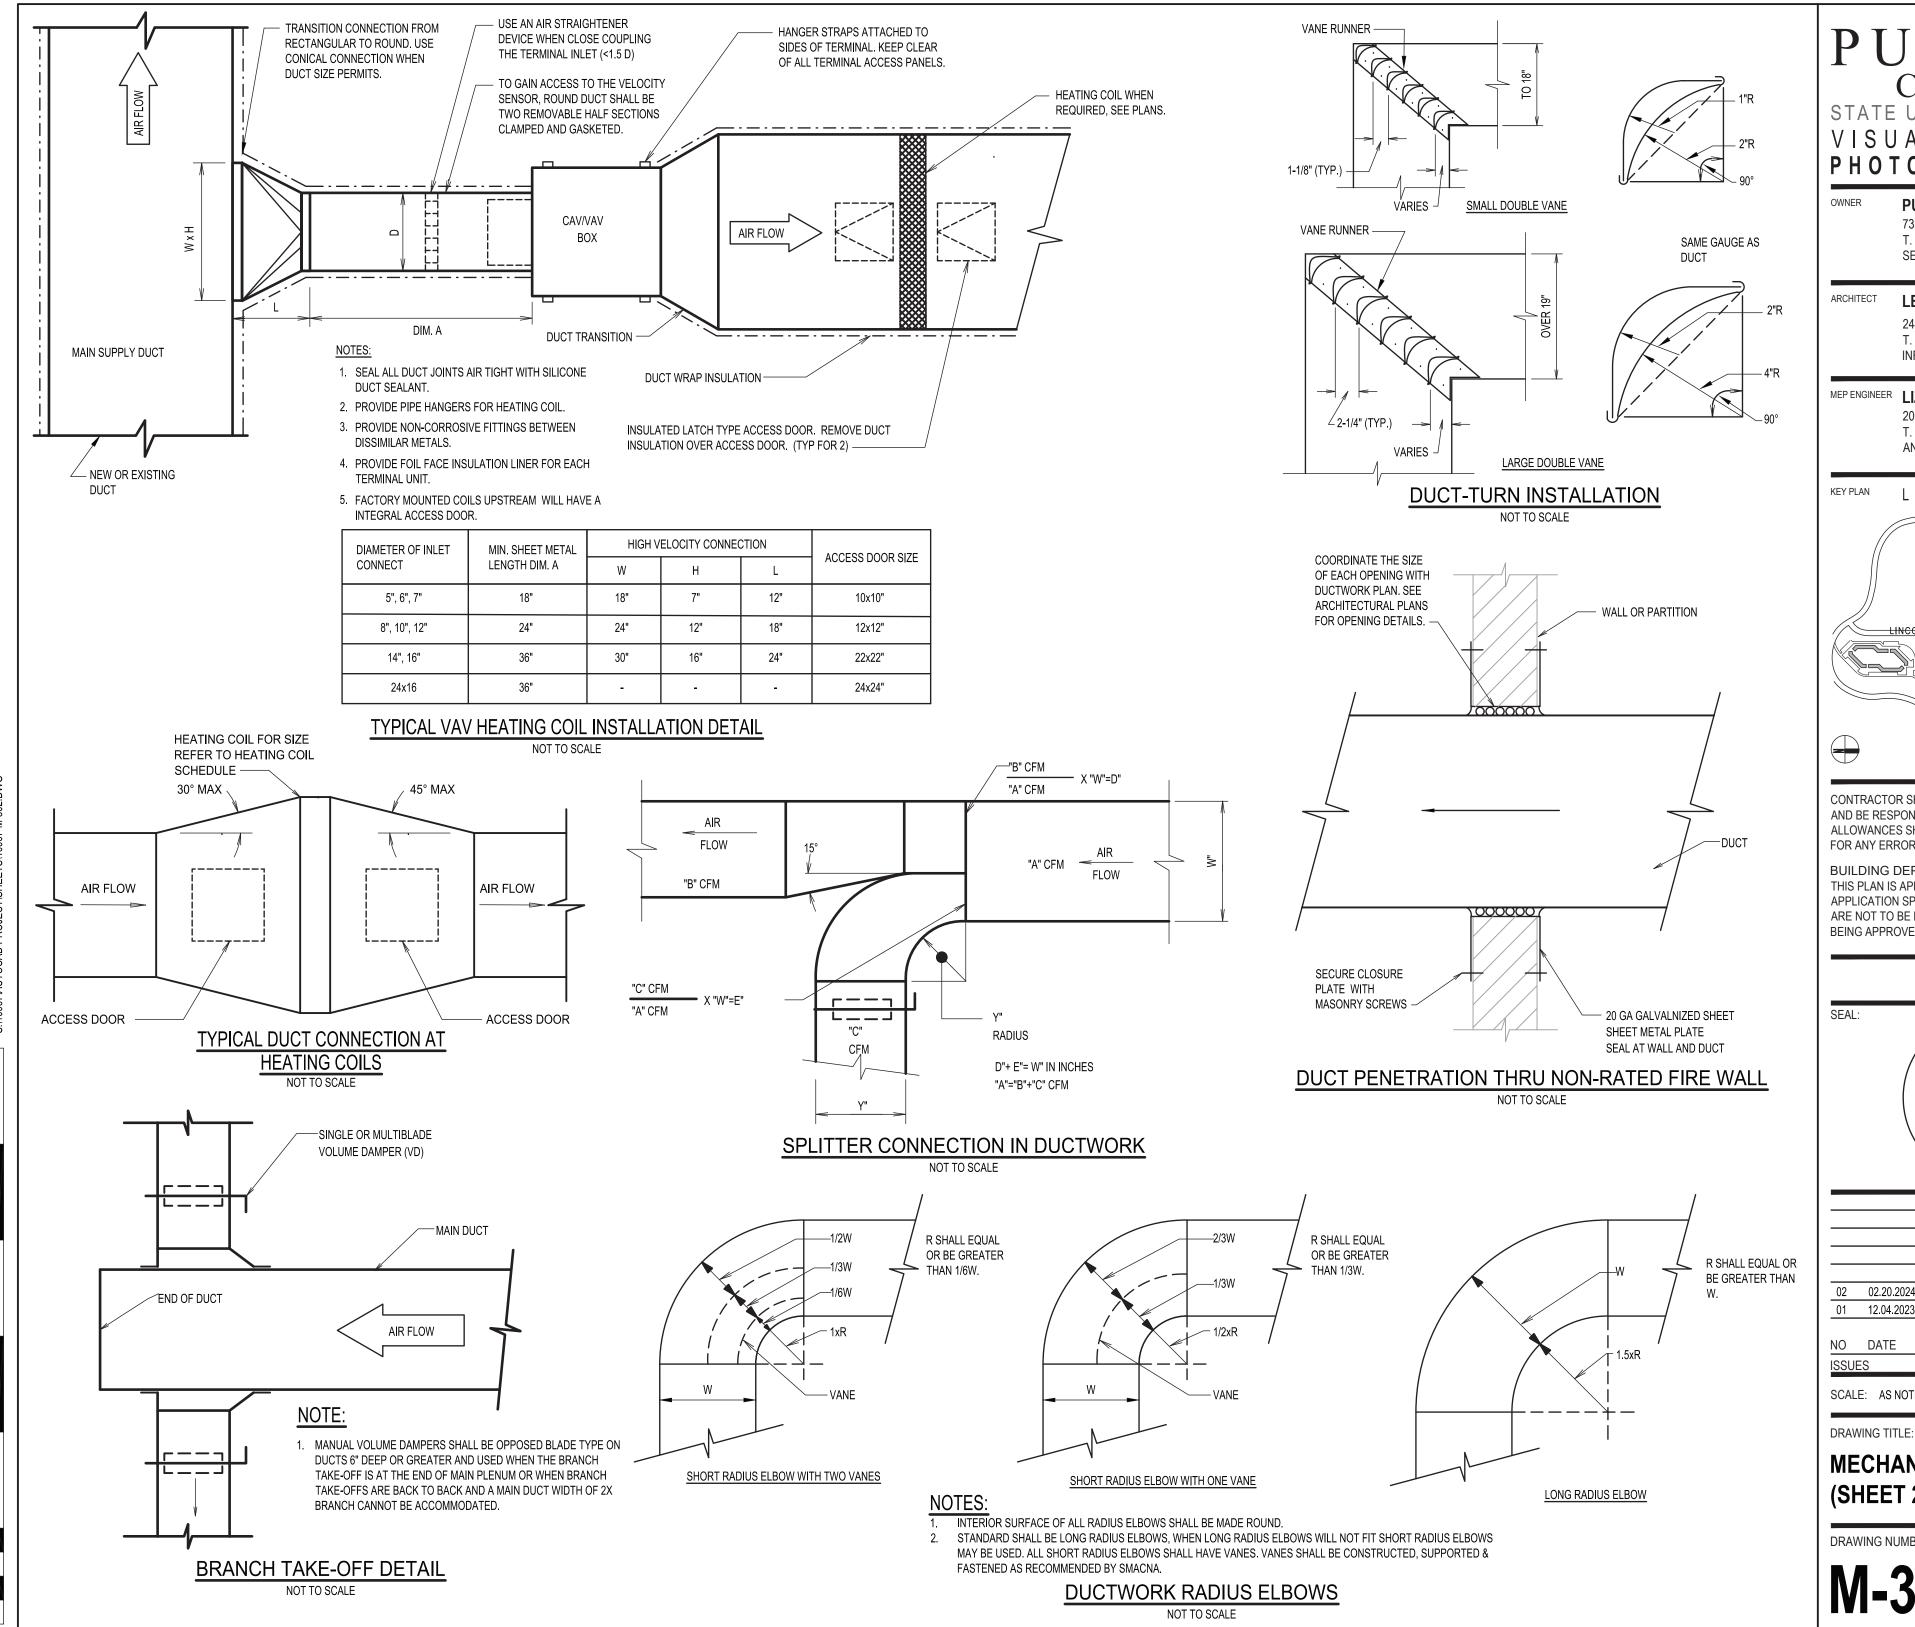
DESCRIPTION

PROJECT NO: 10967 DATE:

MECHANICAL DETAILS (SHEET 1 OF 3)

DRAWING 9 OF 13

M-301.00



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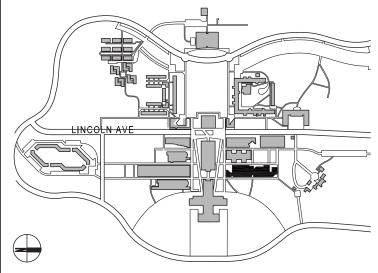
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LOT 0000 BLOCK 0000




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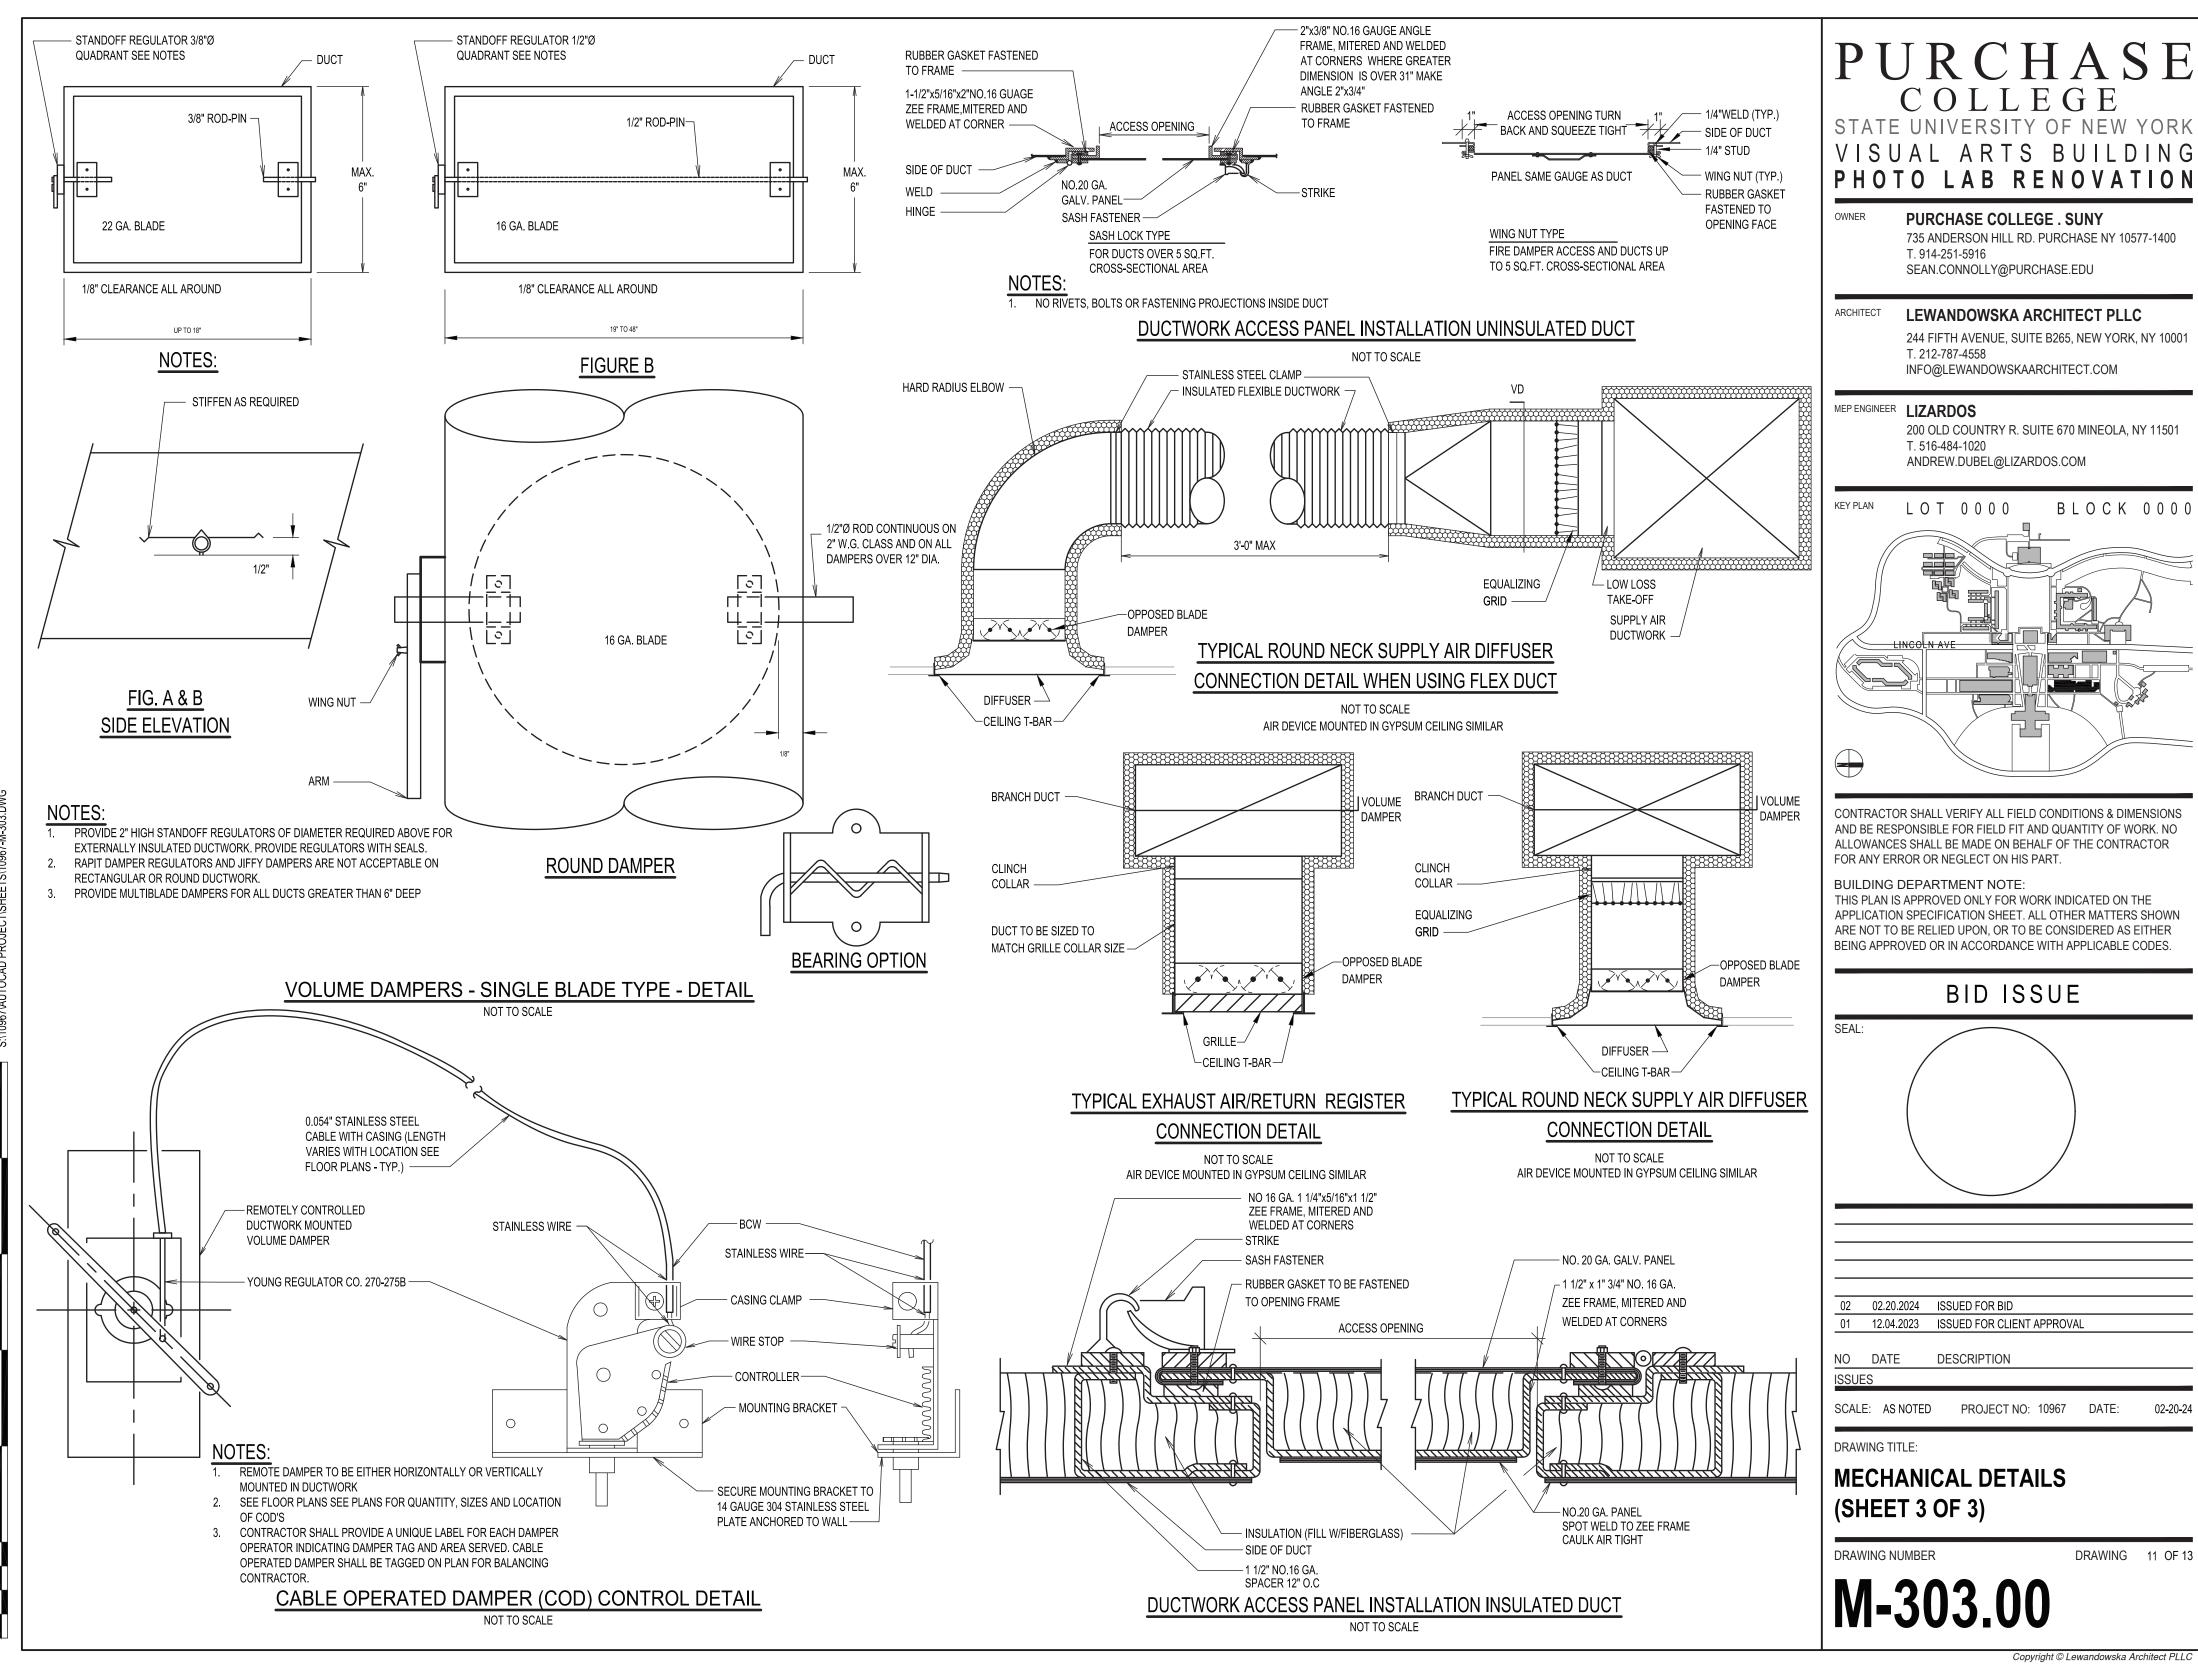
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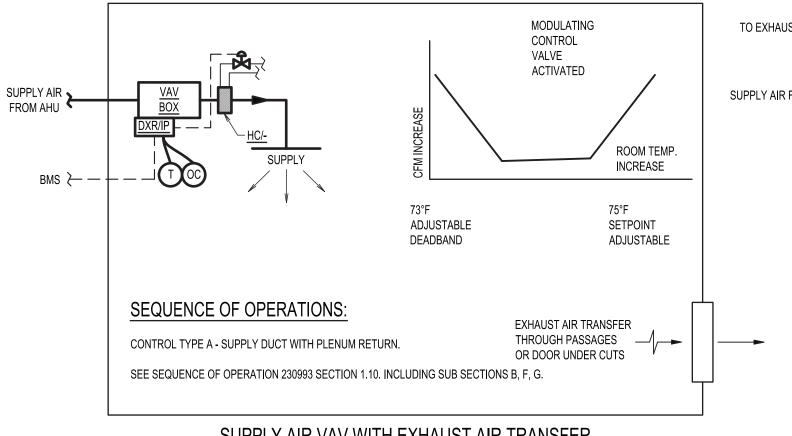
MECHANICAL DETAILS

(SHEET 2 OF 3)

DRAWING NUMBER DRAWING 10 OF 13

M-302.00

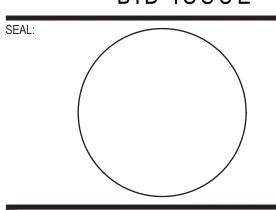





SUPPLY AIR VAV WITH EXHAUST AIR TRANSFER

ROOM DIAGRAM - TYPE A

NOT TO SCALE

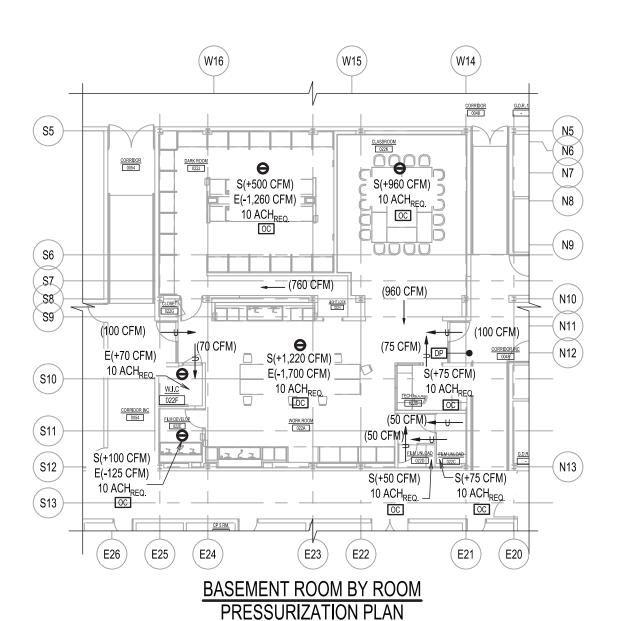

SCALE:1/16"=1'-0"

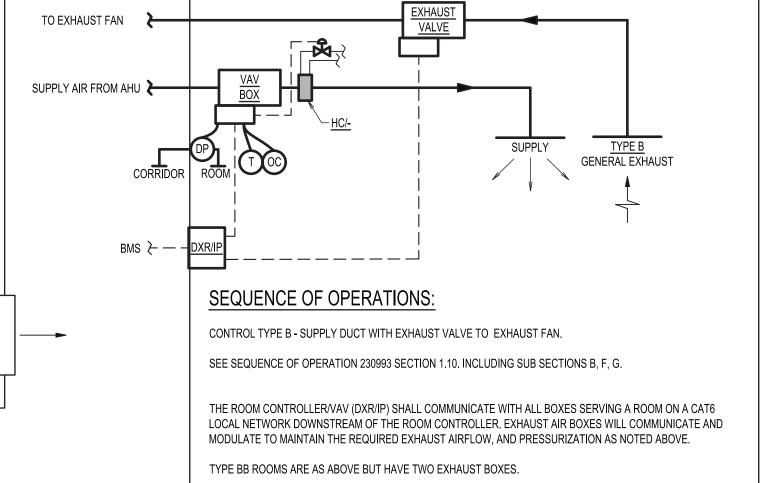

SUPPLY AIR VAV WITH EXHAUST ROOM DIAGRAM - TYPE B & BB

NOT TO SCALE



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ISSUES

SCALE: AS NOTED PROJECT NO: 10967 DATE:


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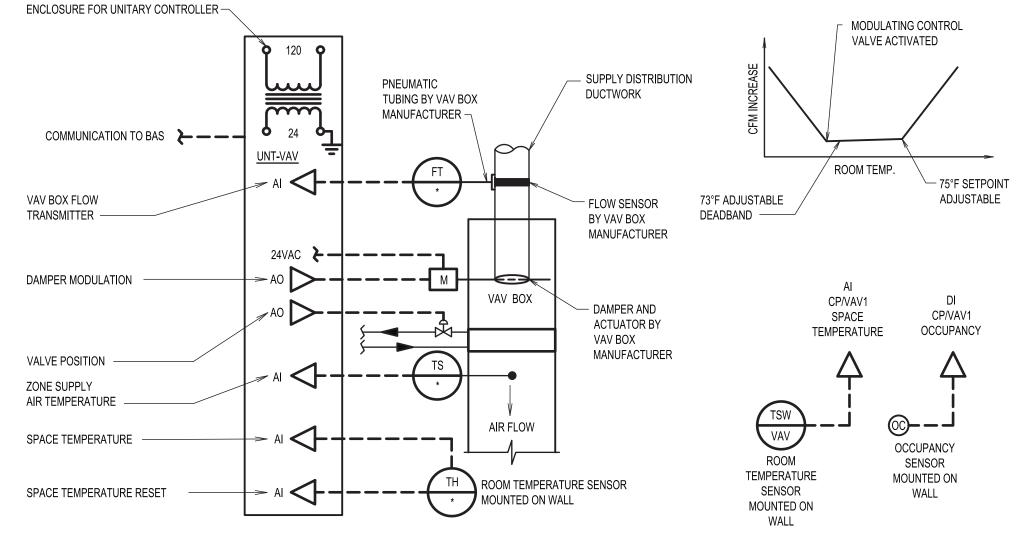
MECHANICAL CONTROLS (SHEET 1 OF 2)

DRAWING NUMBER


DRAWING 12 OF 13

M-401.00



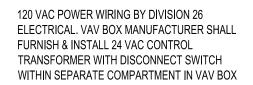

TYPICAL CONTROL DIAGRAM FOR SUPPLY VAV BOX WITH REHEAT HOT WATER (RHW) COIL

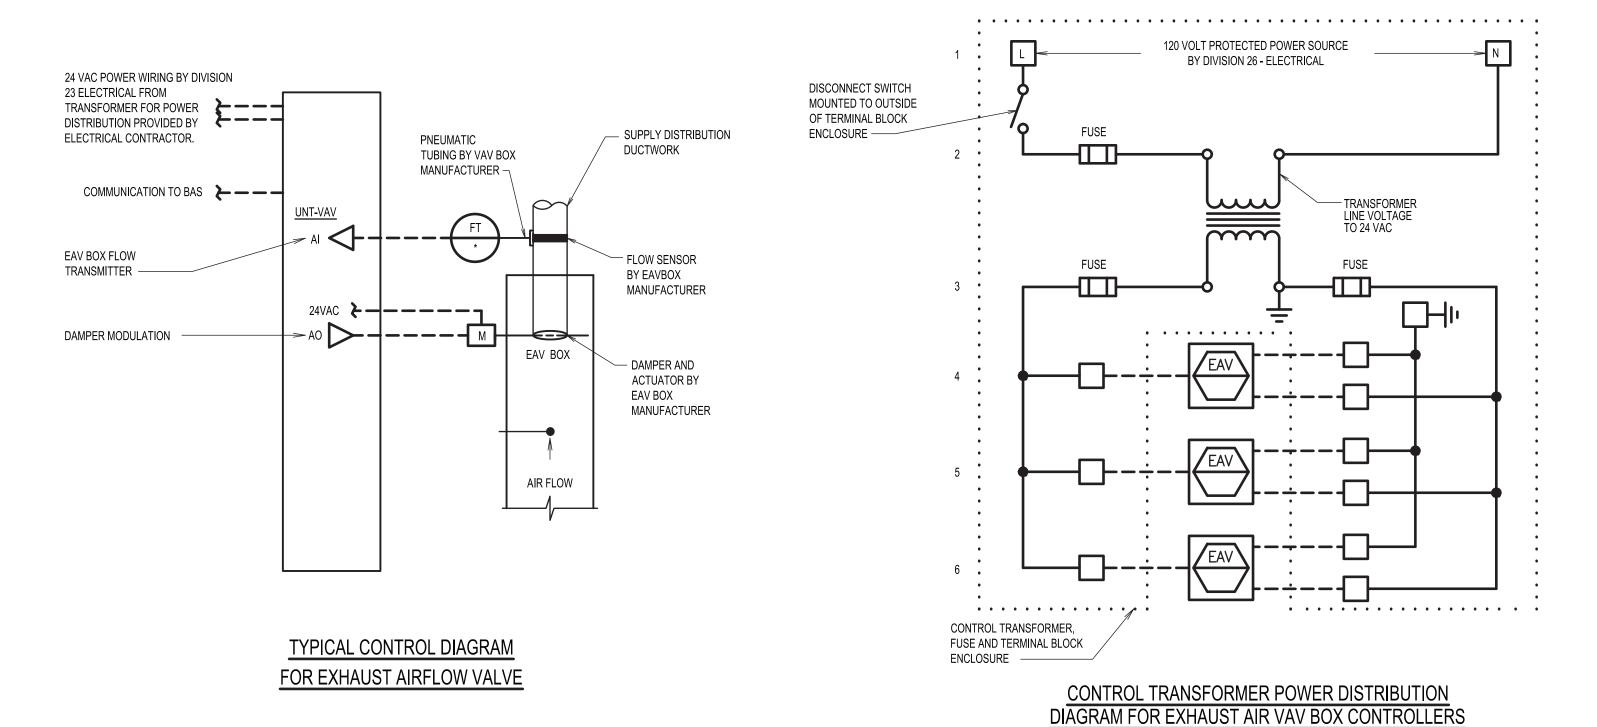

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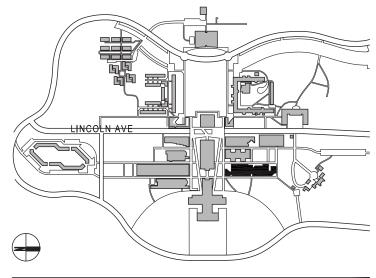
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KEYPLAN LOT 0000 BLOCK 0000




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NO DATE DESCRIPTION

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(TYPICAL FOR ALL EXHAUST AIR VAV CONTROLLERS

SCALE: AS NOTED PROJECT NO: 10967 DATE: 02-2

DRAWING TITLE:

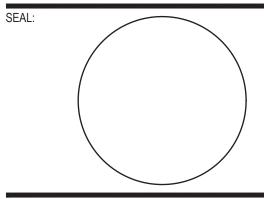MECHANICAL CONTROLS (SHEET 2 OF 2)

DRAWING NUMBER

DRAWING 13 OF 13

M-402.00

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