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PLUMBING DEMOLITION AND ALTERATION WORK NOTES:

1. EXISTING PIPING SERVING BASEMENT LEVEL TO REMAIN IN PLACE, TO BE RELOCATED AT CONSTRUCTION PHASE. TAKE CARE TO KEEP PIPING INTACT DURING DEMOLITION.
2. EACH BIDDER ARE ENCOURAGED TO VISIT THE SITE AND BECOME INFORMED AS TO THE CONDITION OF THE PREMISES AND EXTENT AND CHARACTER OF WORK REQUIRED. NO ADDITIONAL COMPENSATION WILL BE APPROVED DUE TO FIELD CONDITIONS.
3. PROVIDE DEMOLITION FOR WORK AS SHOWN ON DRAWINGS OR DESCRIBED HEREIN. IF ASBESTOS INSULATION IS PRESENT, INFORM THE OWNER IN WRITING SO THAT SUCH REMOVAL CAN BE CARRIED OUT BY QUALIFIED PERSONNEL HIRED BY THE OWNER. DO NOT COMMENCE DEMOLITION UNTIL SUCH WORK HAS BEEN COMPLETED.
4. REFER TO ARCHITECTURAL DRAWINGS FOR IDENTIFICATION OF FIXTURES AND EQUIPMENT TO BE REMOVED.
5. ALL PIPING FROM FIXTURES AND EQUIPMENT TO BE REMOVED SHALL BE CAPPED BACK AT STACK AND RISERS. IN NO CASE SHALL DEAD ENDS REMAIN ON SANITARY PIPING. DEAD ENDS SHALL NOT EXCEED A MAXIMUM OF 2'-0".
6. EXACT SIZES AND LOCATIONS OF ALL EXISTING PIPING SHALL BE VERIFIED ON THE JOB.
7. NO REMOVED EXISTING PIPING SHALL BE REUSED UNLESS OTHERWISE INDICATED.
8. THE CONTRACTOR SHALL NOT INTERRUPT ANY OF THE SERVICES OF THE EXISTING BUILDING NOR INTERFERE WITH THE SERVICES IN ANY WAY WITHOUT THE EXPRESSED PERMISSION OF THE OWNER. SUCH INTERRUPTIONS AND INTERFERENCES SHALL BE MADE AS BRIEF AS POSSIBLE AND ONLY AT THE TIME SUITED BY THE OWNER.
9. WHERE THE WORK MAKES TEMPORARY SHUTDOWNS OF SERVICES UNAVOIDABLE, THEY SHALL BE MADE AT NIGHT OR AT TIMES AS WILL CAUSE THE LEAST INTERFERENCE WITH THE ESTABLISHED OPERATING ROUTINE OF THE BUILDING.
10. THE CONTRACTOR SHALL ARRANGE THE WORK CONTINUOUSLY AND TO ASSURE THAT SERVICES WILL BE SHUTDOWN AND CUT-INS DONE ONLY DURING THE TIME ACTUALLY REQUIRED TO MAKE THE NECESSARY CONNECTIONS TO EXISTING WORK.
11. THE CONTRACTOR SHALL COORDINATE/CONFIRM WITH THE CAMPUS ON HOW FAR IN ADVANCE THAT A WRITTEN NOTICE MUST BE SUBMITTED FOR ANY REQUESTED SHUTDOWNS.
12. ANY AND ALL REQUIRED DEMOLITION WORK TO BE PERFORMED ABOVE EXISTING SUSPENDED CEILINGS AND FURRED OUT WALLS SHALL BE DONE AT A TIME WHEN THE EXISTING CEILINGS AND FURRED OUT WALLS ARE REMOVED.
13. TO INSURE CONTINUOUS OPERATION, MAKE ALL NECESSARY TEMPORARY CONNECTIONS BETWEEN NEW AND EXISTING WORK. ALL COSTS RESULTING FROM TEMPORARY SHUTDOWNS SHALL BE BORNE BY THE CONTRACTOR.
14. ALL EXISTING SYSTEMS SHALL BE LEFT IN PERFECT WORKING ORDER UPON COMPLETION OF ALL NEW WORK.
15. REFER TO SPECIFICATIONS FOR ADDITIONAL REQUIREMENTS.

GENERAL PLUMBING NOTES:

1. CONTRACTOR SHALL VERIFY EXISTING CONDITIONS IN FIELD PRIOR TO COMMENCEMENT OF WORK.
2. EXISTING PIPING ARRANGEMENTS ARE APPROXIMATE AND ARE SHOWN FOR ESTIMATING PURPOSES ONLY. CONTRACTOR MUST VERIFY EXACT LOCATIONS AND ROUTING PRIOR TO INSTALLATION OF NEW WORK.
3. CONTRACTOR SHALL COORDINATE WORK WITH ALL OTHER TRADES AND EXISTING CONDITIONS ON THE JOB SITE AND MAINTAIN REQUIRED CEILING HEIGHTS AND CONDITIONS.
4. CONTRACTOR SHALL PROVIDE ALL MATERIALS, EQUIPMENT, SERVICES, LABOR AND TESTS NECESSARY FOR COMPLETE EXECUTION OF ALL WORK.
5. MATERIALS, EQUIPMENT AND SYSTEMS INSTALLED SHALL MEET ALL PERTINENT REQUIREMENTS OF NEW YORK CITY BUILDING CODES, NATIONAL FIRE PROTECTION ASSOCIATION, FEDERAL REGULATIONS, OCCUPATIONAL SAFETY AND HEALTH ACT (OSHA) AND ANY NATIONALLY RECOGNIZED APPROVAL AGENCIES AS WELL AS APPLICABLE LOCAL CODES AND REGULATIONS.
6. CONTRACTOR SHALL BE RESPONSIBLE TO REPAIR AND REPLACE ANY EXISTING SUSPENDED CEILINGS AND/OR FINISHES DAMAGED BY INSTALLATION OF PIPING UNDER CONTRACT.
7. ALL WORK IN THE SUB-BASEMENT HUNG CEILINGS SHALL BE PERFORMED AFTER HOURS OR ON PREMIUM TIME AS SCHEDULED BY THE CONTRACTOR WITH HOSPITAL. THE CONTRACTOR SHALL COORDINATE THE EXACT WORK SCHEDULE WITH PRIOR TO STARTING WORK. IF NECESSARY THE WORK SHALL BE PHASED IN ORDER TO KEEP THE SUB-BASEMENT CORRIDORS REMAIN ACTIVE AT ALL TIMES.

DRAWINGS LIST

DRAWINGS LIST	
P-001.00	PLUMBING LEGENDS, NOTES, ABBREVIATIONS AND SCHEDULES
P-101.00	PLUMBING BASEMENT LEVEL PART PLAN - DEMOLITION
P-201.00	PLUMBING BASEMENT LEVEL PART PLAN - DEMOLITION
P-301.00	PLUMBING RISER DIAGRAMS
P-401.00	PLUMBING DETAILS

PLUMBING INSULATION SCHEDULE

INSULATE THE FOLLOWING:

1. HOT WATER PIPING
2. COLD WATER PIPING
3. LAVATORY TRAP AND WATER SUPPLIES

INSULATION PRODUCTS AND INSTALLATION SHALL COMPLY WITH ENERGY CONSERVATION CONSTRUCTION CODE OF NEW YORK STATE.

HOT WATER PIPING INSULATION SHALL BE PREFORMED, SNAP-ON FIBERGLASS INSULATION WITH PAINTABLE WHITE KRAFT OR ALUMINUM FOIL JACKET.

DOMESTIC COLD WATER PIPING INSULATION SHALL BE SIMILAR TO HOT WATER WITH VAPOR BARRIER.

INSULATION THICKNESS SCHEDULE












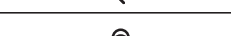
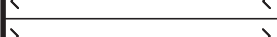
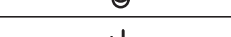
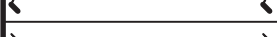
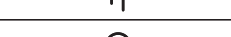




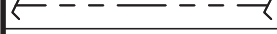
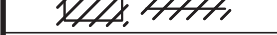


SERVICE	INSULATION THICKNESS FOR PIPE SIZES*		
	1" AND LESS **	1-1/4" TO 2"	3" TO 4"
DOMESTIC COLD WATER (CW)	1"	1"	1"
DOMESTIC HOT WATER (HW)	1"	1"	1"

\* BASIS RN4

\*\* RUNOUTS AS DEFINED BY ENERGY CONSERVATION CONSTRUCTION CODE OF NEW YORK STATE CAN BE 1/2" THICK UP TO 140° F. 3/4" OVER 140° F.

\*\*\* INSULATION HAVING A CONDUCTIVITY NOT EXCEEDING 0.27 BTU PER IN/H SFx°F

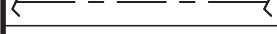PLUMBING LEGEND

SYMBOL	ABBREV.	DESCRIPTION	SYMBOL	ABBREV.	DESCRIPTION
	AW	ACID SOIL, WASTE PIPING			FLOW ARROW
	AW	ACID SOIL, WASTE PIPING UNDERSLAB			DROP
	AV	ACID VENT PIPING			SHUT-OFF VALVE
	CW	COLD WATER PIPING			STOP VALVE
	HW	HOT WATER PIPING			BREAK
	EX-AW	EXISTING ACID SOIL, WASTE PIPING			RISER
	EX-AW	EXISTING AW SOIL, WASTE PIPING UNDERSLAB		CO	CLEANOUT
	EX-AV	EXISTING ACID VENT PIPING		CODP	CLEANOUT DECK PLATE
	CW	EXISTING COLD WATER PIPING			BOTTOM TAKE-OFF
	HW	EXISTING HOT WATER PIPING			AIR RELIEF VALVE
		FIXTURE/PIPING TO BE REMOVED		ETR	EXISTING TO REMAIN
		NEW CONNECTION TO EXISTING		VIF	VERIFY IN FIELD
		CAP			
		POINT OF DISCONNECTION			

FIXTURE CONNECTION SCHEDULE

TAG	ABBREV	DESCRIPTION	SOIL	VENT	COLD WTR	HOT WTR
P-1	SK	SINK	2"	2"	1/2"	1/2"
-	EW	EYEWASH/DRENCH	-	-	1/2"	1/2"

PLUMBING FIXTURE SCHEDULE

DESIGNATION	FIXTURE	MODEL NUMBER	FAUCET	GPM	TRAP SIZE	CHAIR CARRIER SUPPORT	REMARKS
P-1	SINK	ARKAY SINK PAN MODEL #ES-30 x 72 x 6", 20 GUAGE, 316 STAINLESS STEEL, STAND MOUNTED	CHICAGO MANUAL FAUCET MODEL #445-DJ13-317XKABCP, WALL MOUNTED, AERATOR, WRISTBLADE HANDLES	2.2 GPM 10 GPM	1-1/2"x1-1/2"C.P. CAST BRASS "P" TRAP	STAND MOUNTED	PROVIDE HAWS EYE/FACE WASH MODEL #6710 DECK MOUNT, WITH TMV MODEL #9201EW, LAMINAR FLOW, TEMPERATURE SET @ 86 °F


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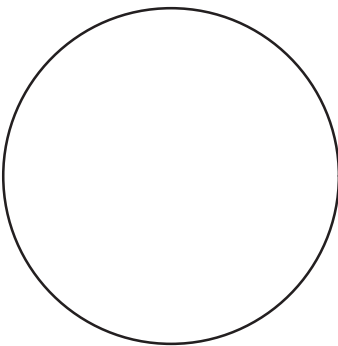


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BID ISSUE

SEAL:



02	02.02.2024	ISSUED FOR BID
1	12.04.2023	ISSUED FOR CLIENT APPROVAL

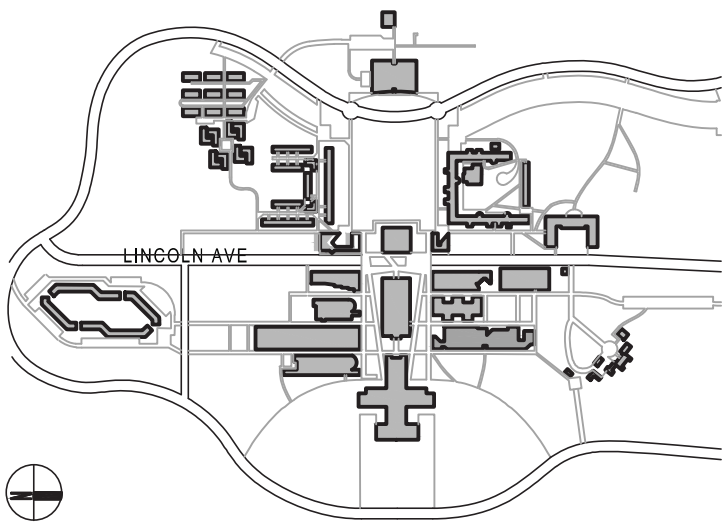NO	DATE	DESCRIPTION
ISSUES		

SCALE: AS NOTED PROJECT NO: 10967 DATE: 09-20-23


DRAWING TITLE:

PLUMBING LEGENDS, NOTES AND ABBREVIATIONS

DRAWING NUMBER DRAWING 1 OF 5

P-001.00

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PLUMBING BASEMENT PART PLAN - DEMOLITION  
SCALE: 1/4" = 1'-0"

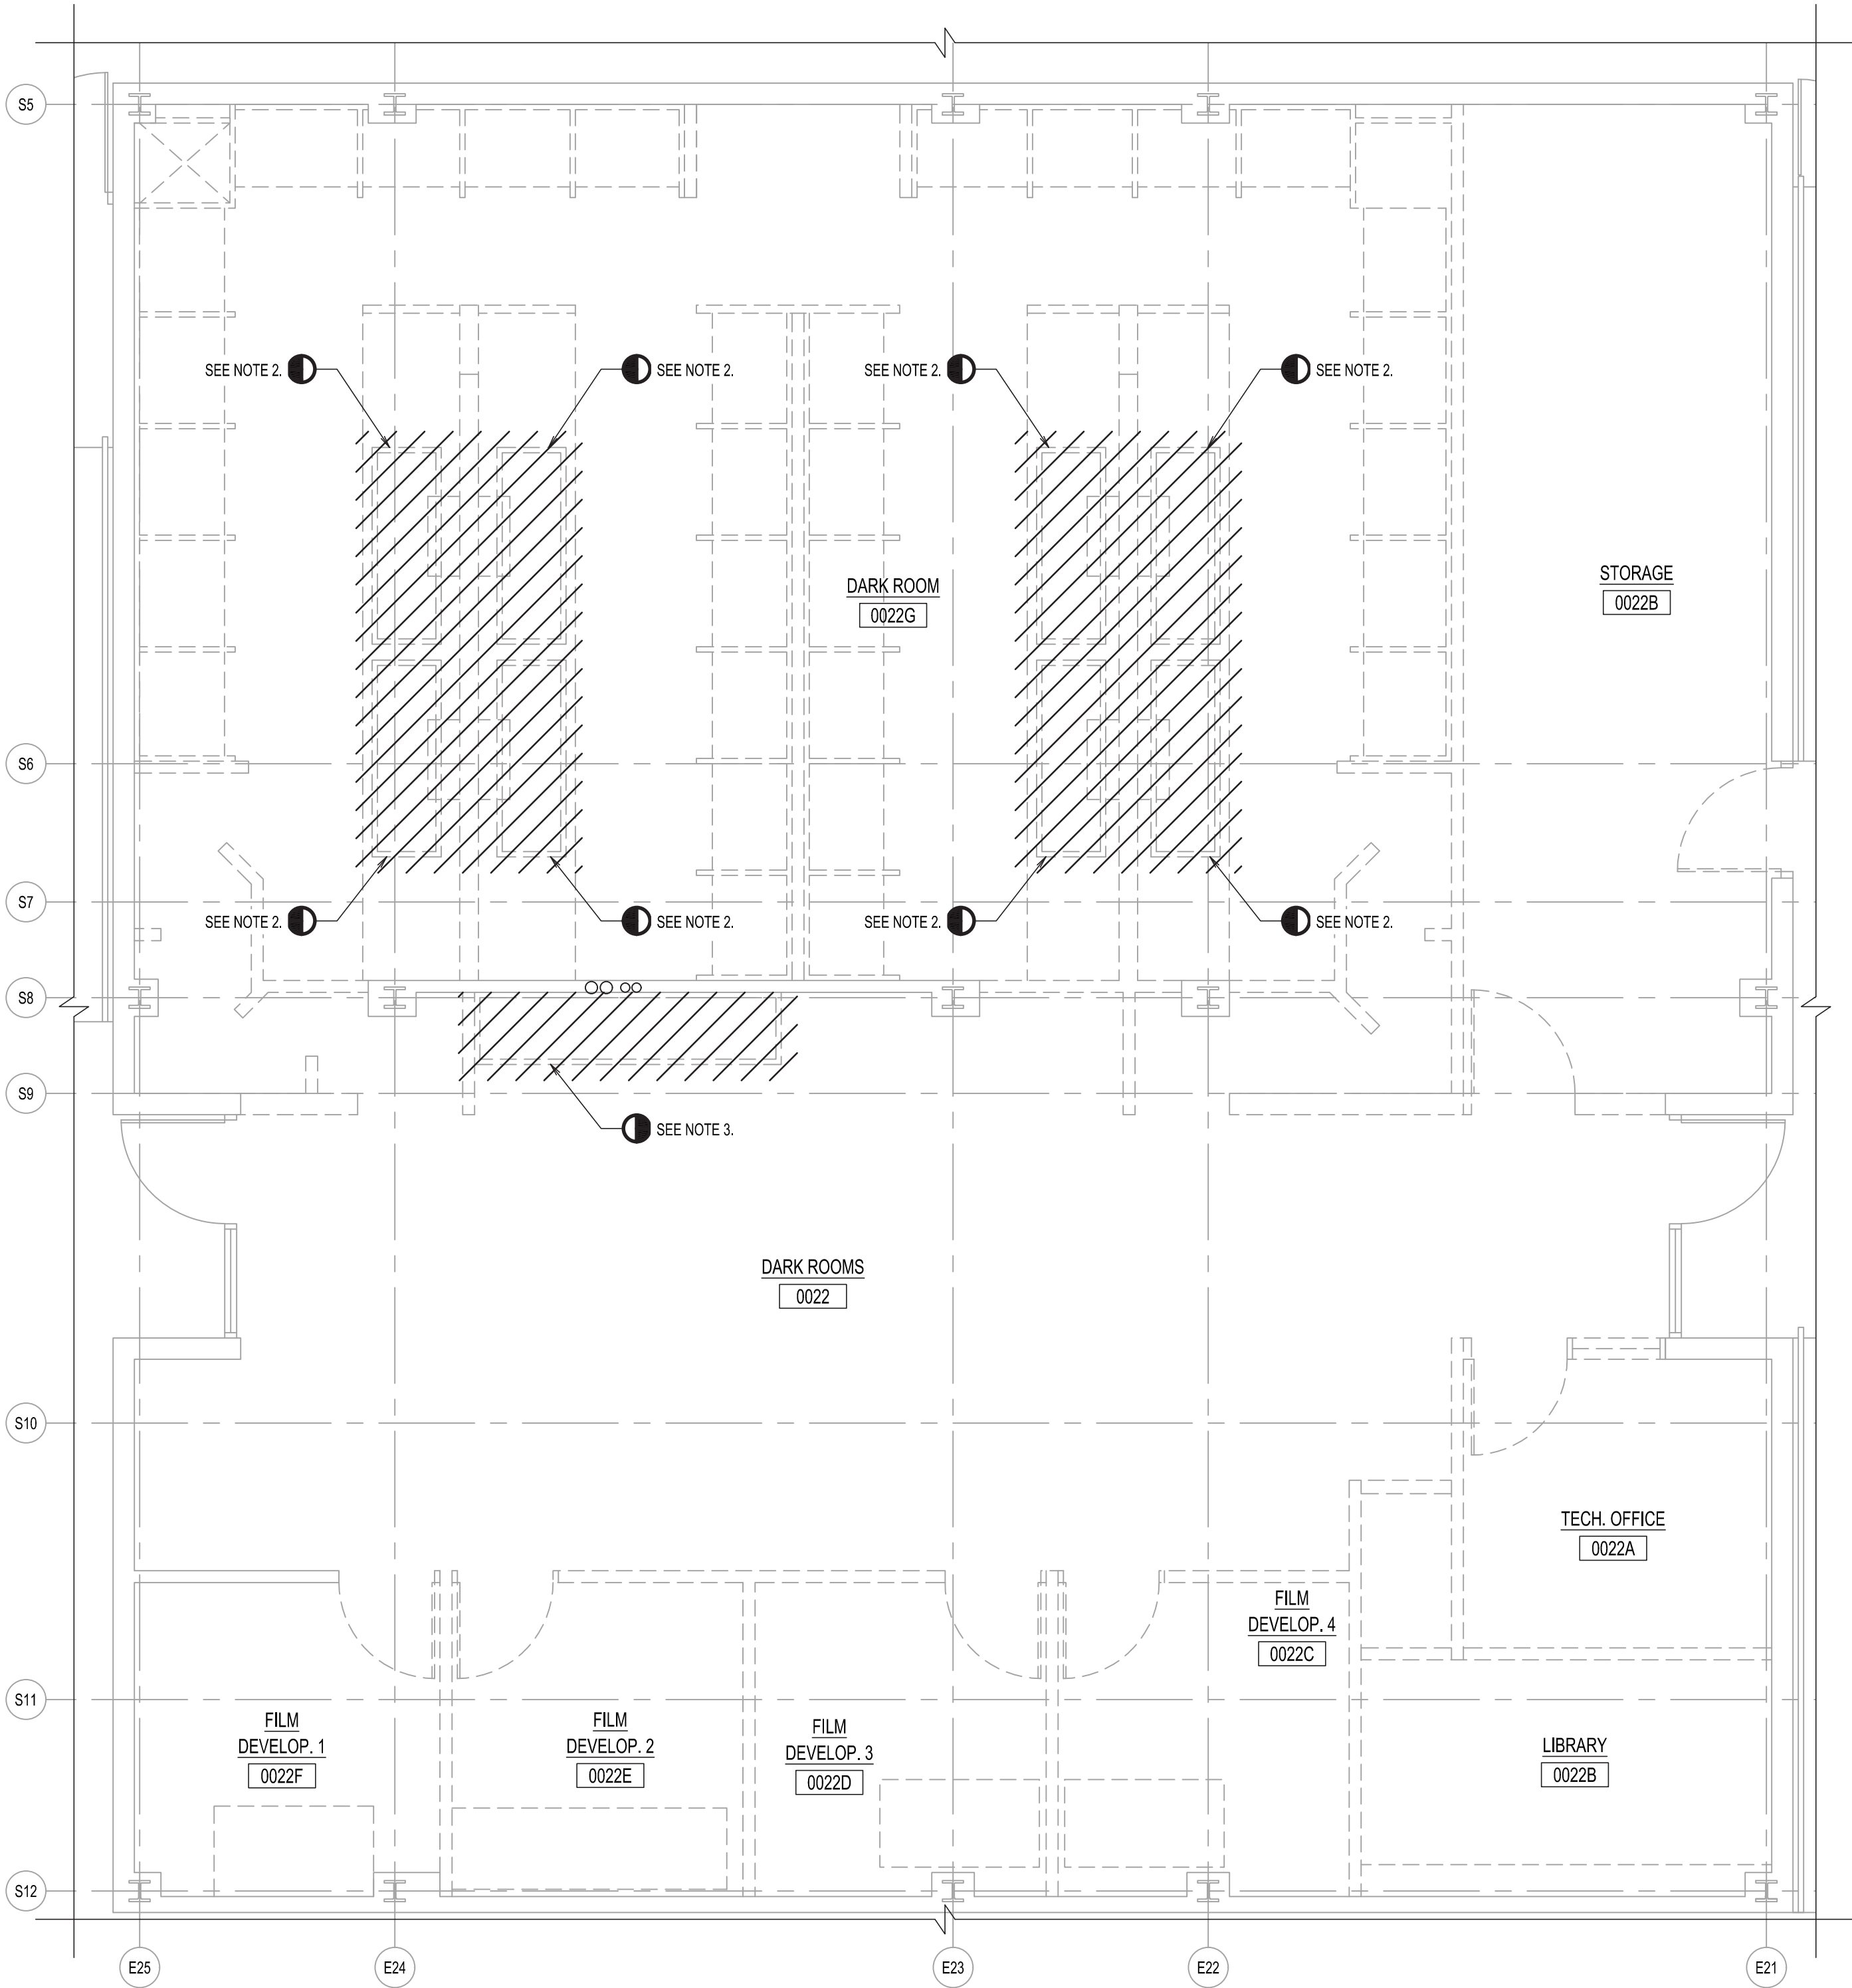NOTES:

1. NEW PLUMBING LEGENDS, NOTES ABBREVIATIONS AND SCHEDULES SEE DRAWING P-001.
2. DISCONNECT AND REMOVE EXISTING DARK ROOM FLOOR MOUNTED SINKS, 2" W., 2" V., 1/2" HW AND 1/2" CW PIPING, CUT AND CAP EXISTING 3" W. AT CEILING OF FLOOR BELOW, 2" V., AND 3/4" H&CW PIPING IN THE CEILING. PREP EXISTING PIPING NEW CONNECTIONS. FOR ADDITIONAL INFORMATION SEE CONTRACT DRAWING P-201.
3. DISCONNECT AND REMOVE EXISTING DARK ROOM FLOOR MOUNTED SINK, 2" W., 2" V., 1/2" HW AND 1/2" CW PIPING, CUT AND CAP EXISTING 3" W., 2" V. AND 3/4" H&CW PIPING BEHIND FINISHED WALL. PREP EXISTING PIPING CAPPED OUTLETS FOR NEW CONNECTIONS. FOR ADDITIONAL INFORMATION SEE CONTRACT DRAWING P-201.


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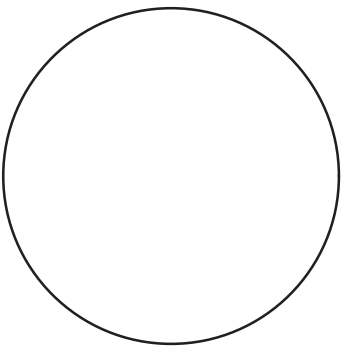


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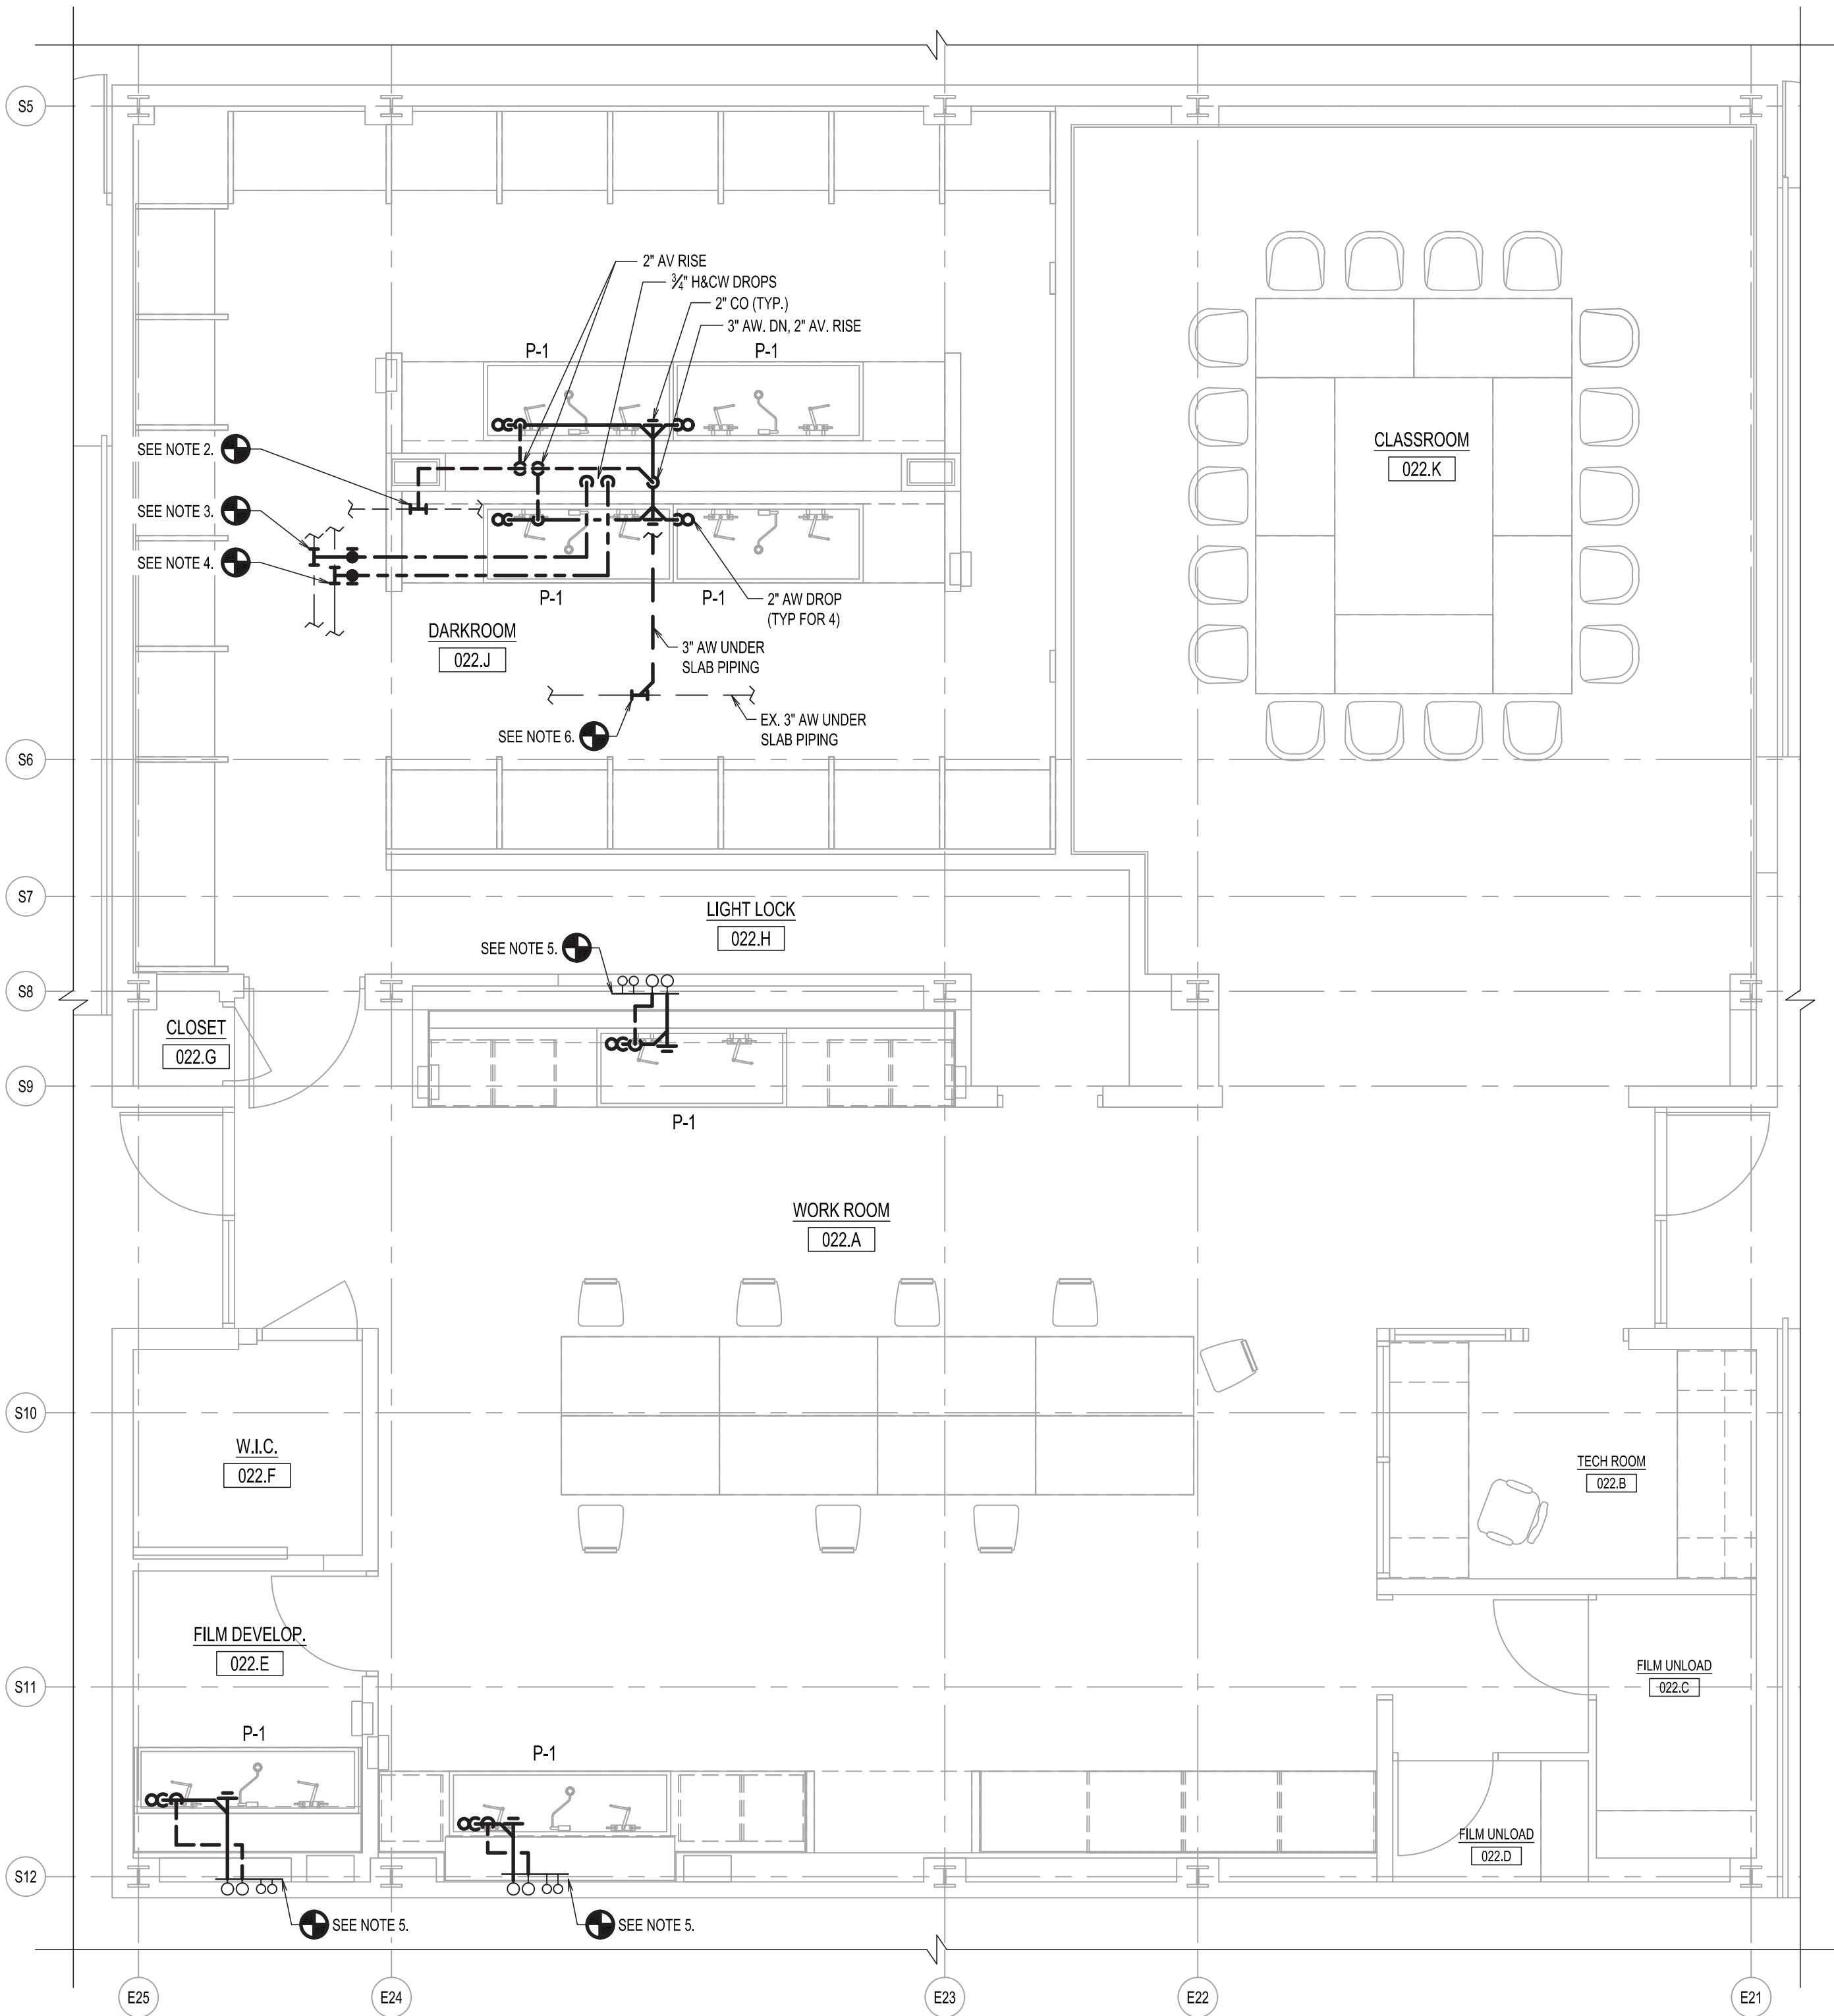
PLUMBING BASEMENT PART PLAN  
- DEMOLITION

DRAWING NUMBER DRAWING 2 OF 5

P-101.00

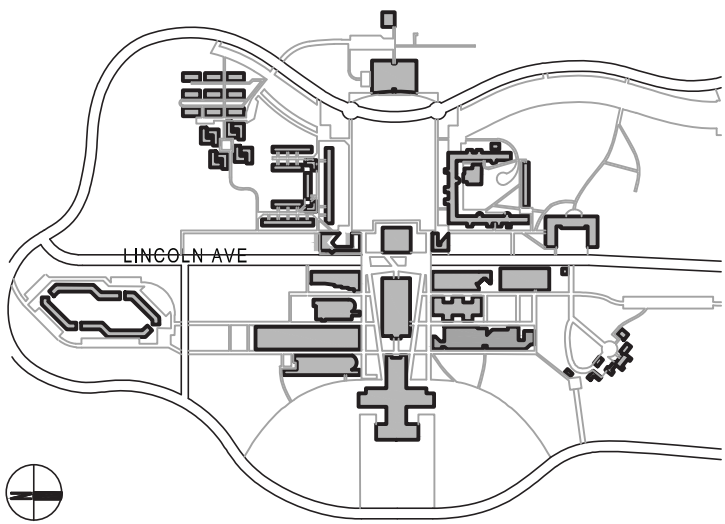

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PLUMBING BASEMENT PART PLAN - DEMOLITION  
SCALE: 1/4" = 1'-0"

NOTES:

1. NEW PLUMBING LEGENDS, NOTES ABBREVIATIONS AND SCHEDULES SEE DRAWING P-001.
2. CONNECT NEW 2" AV. PIPING TO EXISTING 2" AV. PIPING IN CEILING.
3. CONNECT NEW 3/4" CW TO EXISTING 3/4" CW PIPING IN CEILING.
4. CONNECT NEW 3/4" HW TO EXISTING 3/4" HW PIPING IN CEILING.
5. CONNECT NEW 2" AW, 2" AV, 3/2" H&CW PIPING TO THE EXISTING 2" AW, 2" AV, 3/4" H&CW PIPING LOCATED BEHIND THE FINISHED WALL.
6. CONNECT NEW 3" AW UNDER SLAB TO EXISTING 3" ACID WASTE UNDER SLAB PIPING. PIPING MATERIALS SHALL MATCH EXISTING. NO DEAD PIPING ALLOWED.


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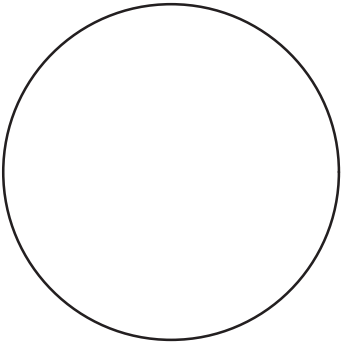


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DRAWING TITLE:

PLUMBING BASEMENT PART PLAN  
- NEW WORK

DRAWING NUMBER DRAWING 3 OF 5

P-201.00

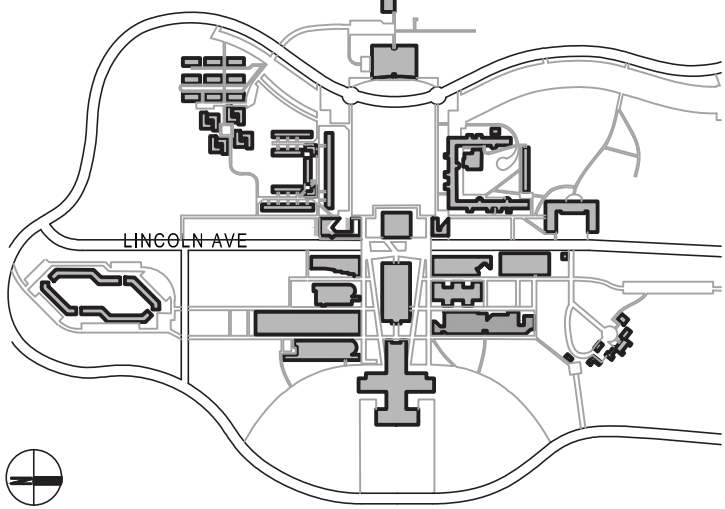
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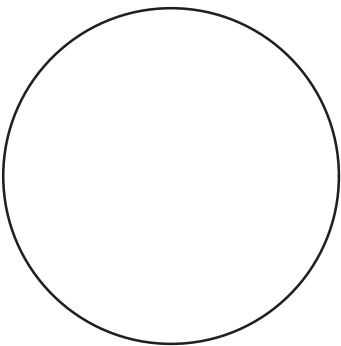


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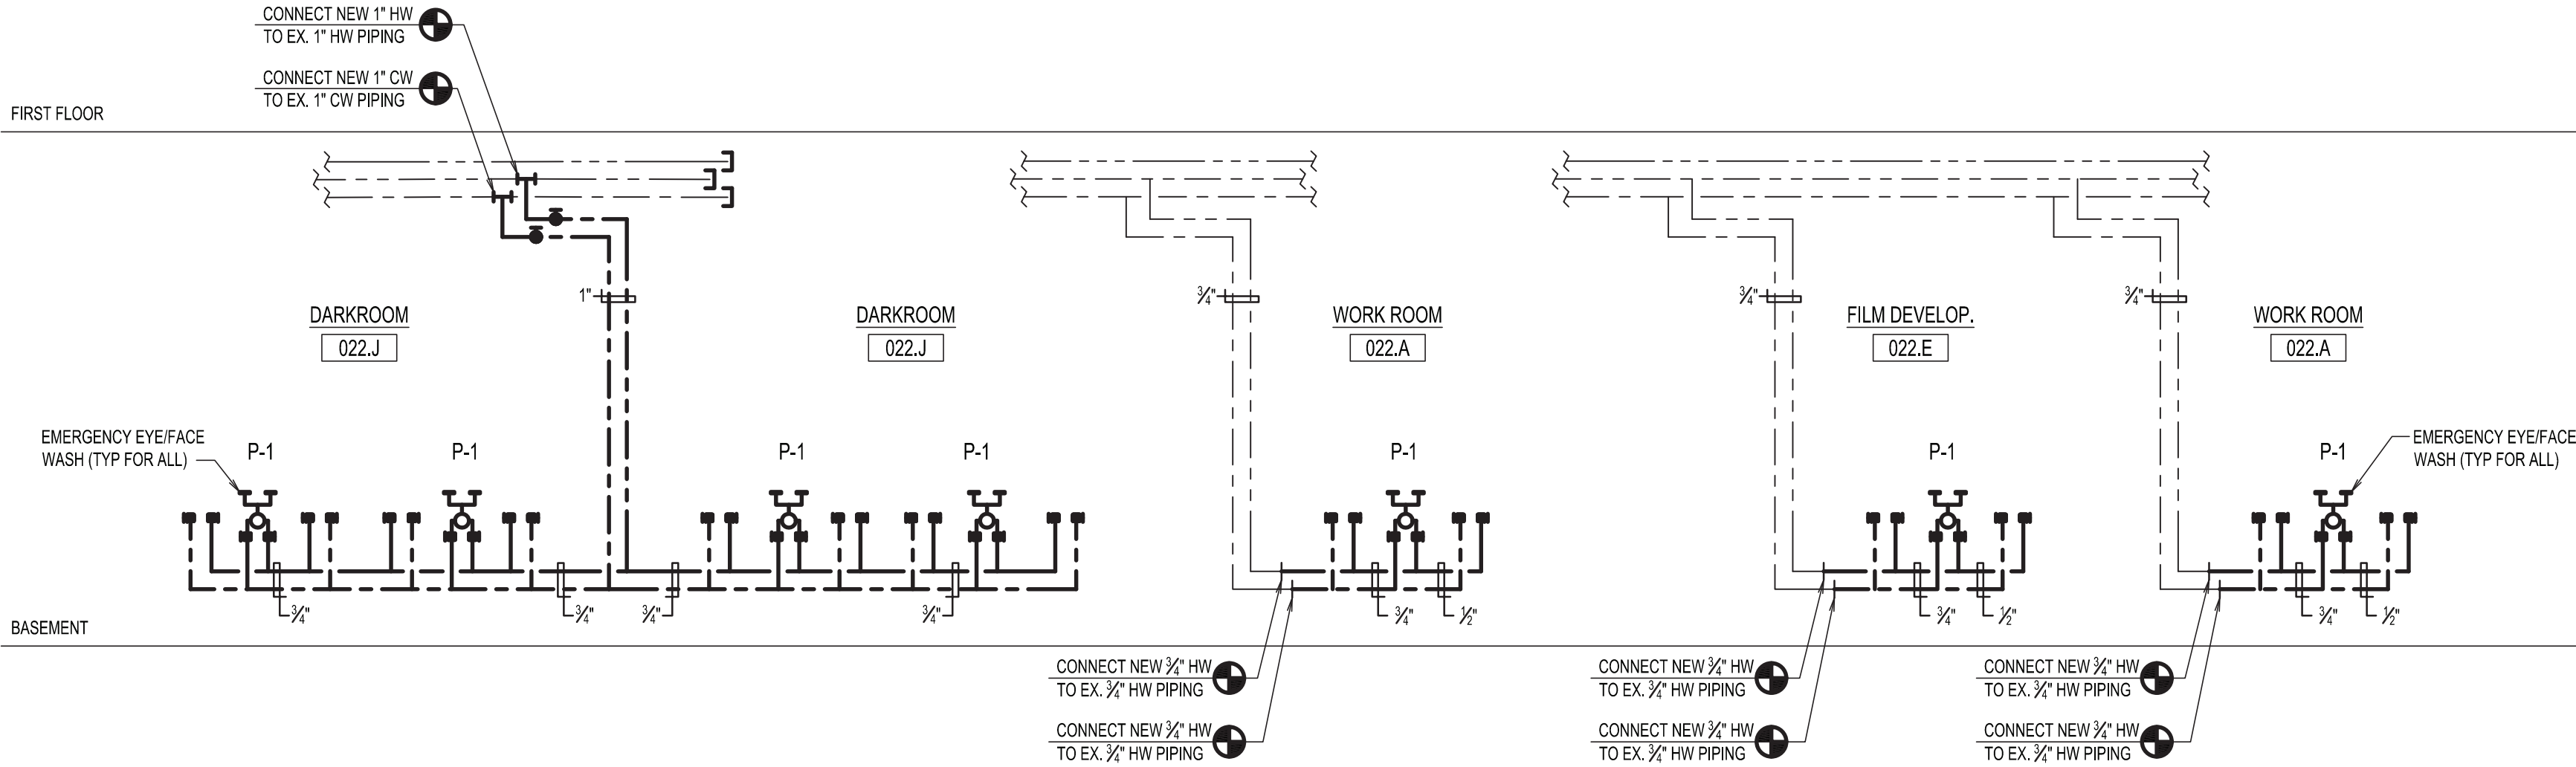
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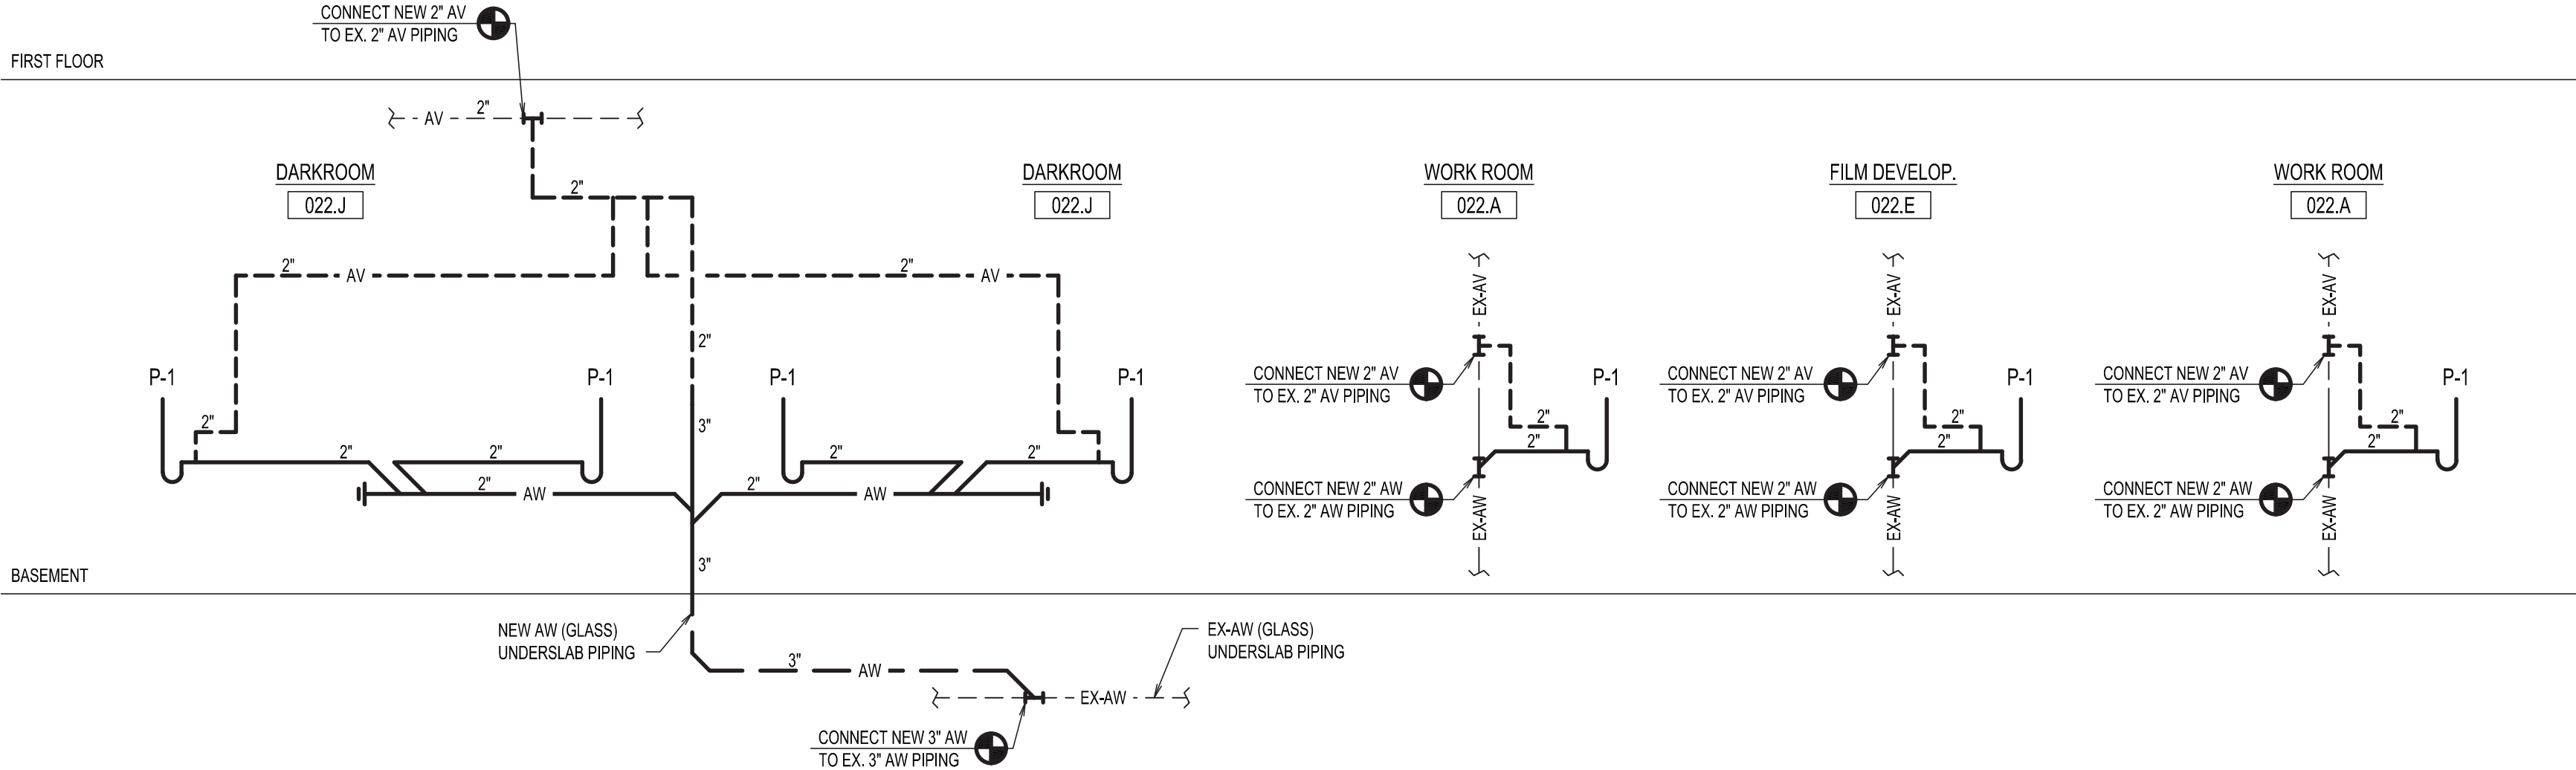
PLUMBING RISER DIAGRAMS

DRAWING NUMBER DRAWING 4 OF 5

P-301.00

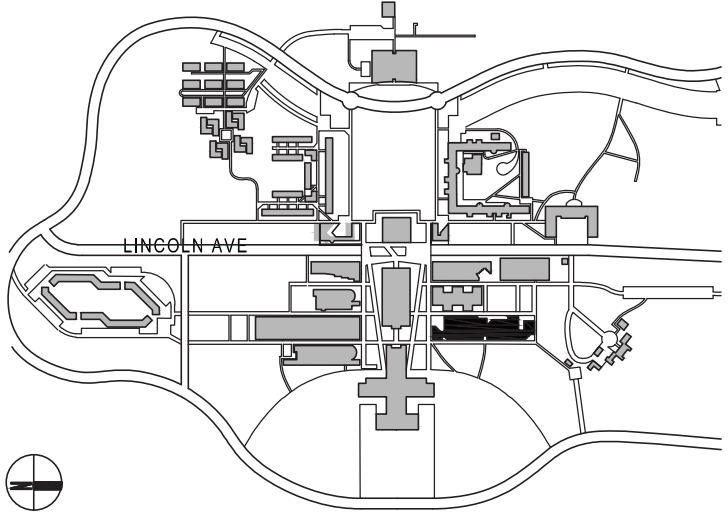

DOMESTIC WATER RISER DIAGRAM  
NOT TO SCALE




SANITARY RISER DIAGRAM  
NOT TO SCALE

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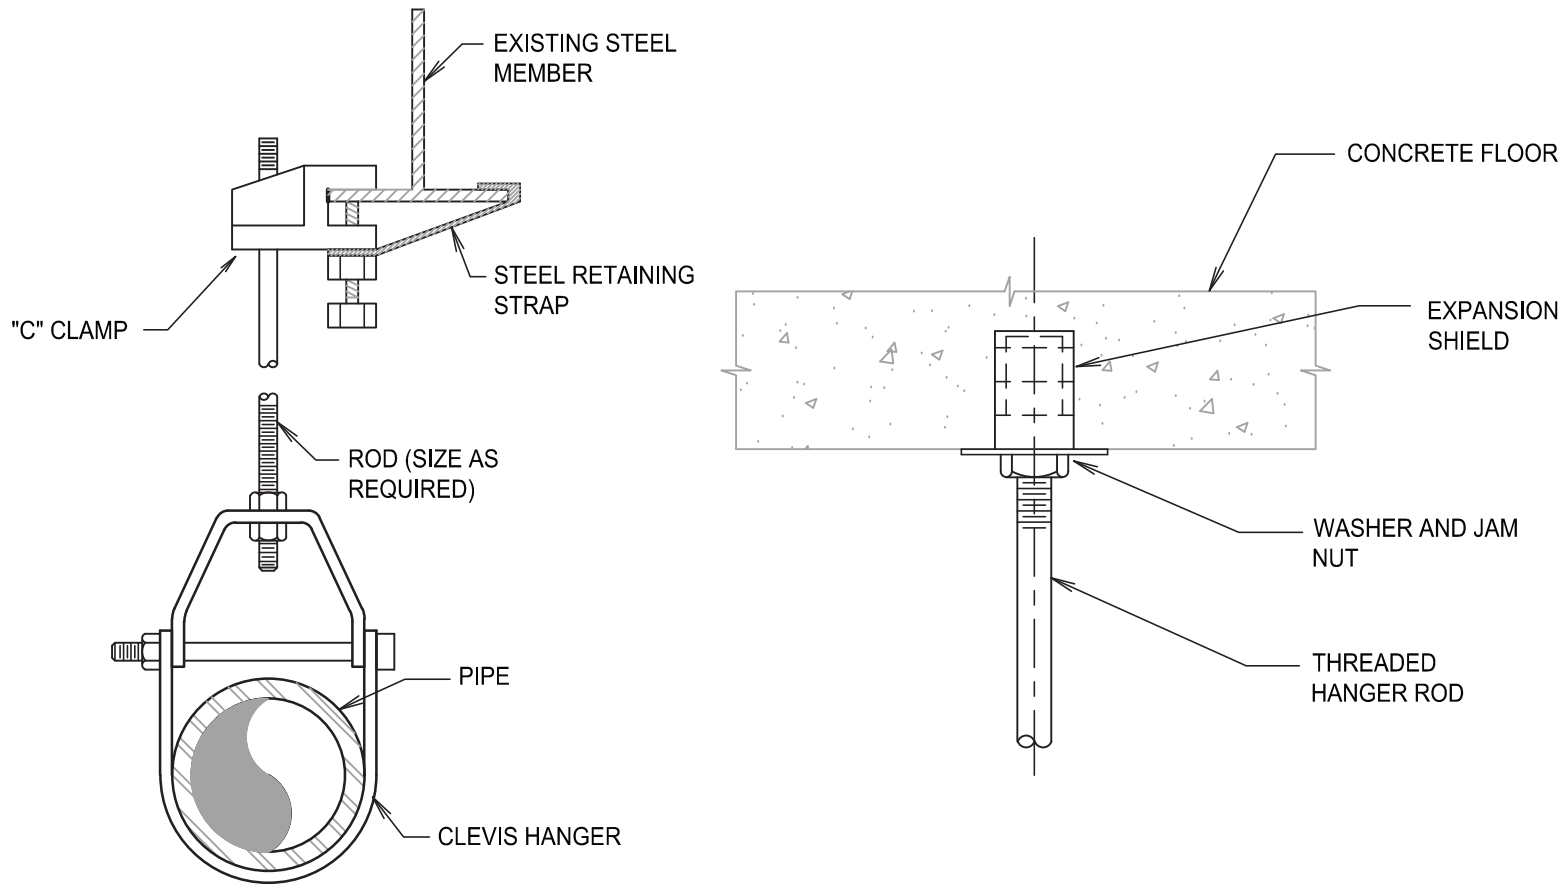


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TYPICAL CLEVIS HANGER PIPE SUPPORT DETAIL

NOT TO SCALE

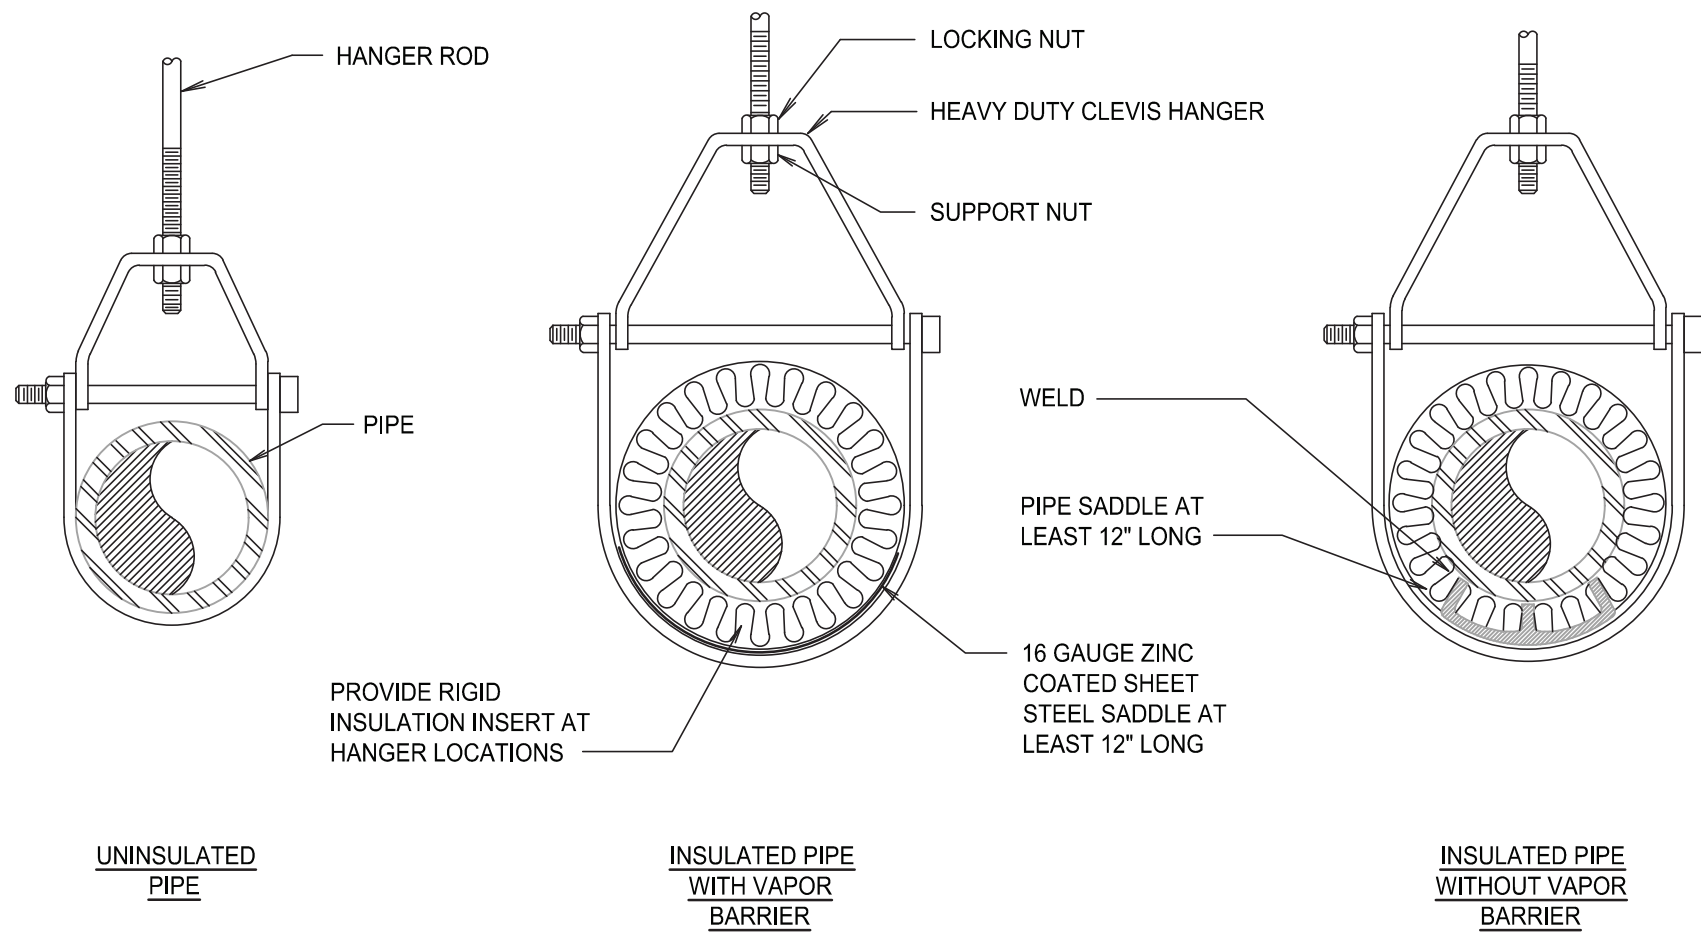


TYPICAL HANGER DETAIL

NOT TO SCALE


TYPICAL EXPANSION DETAIL

NOT TO SCALE

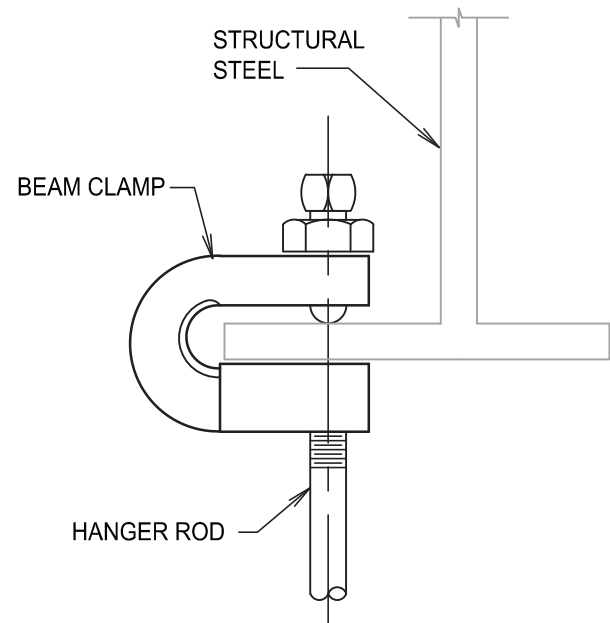


TYPICAL EXPANSION DETAIL

NOT TO SCALE

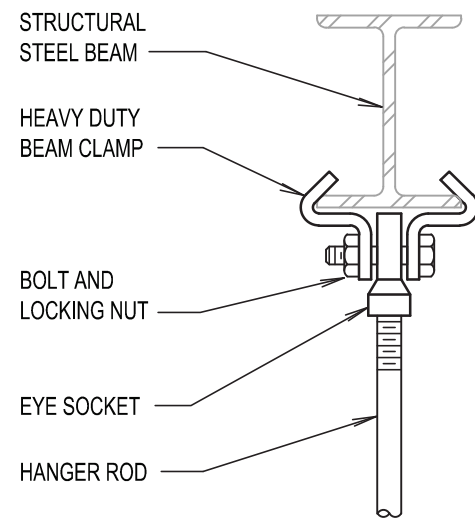

ATTACHMENT TO STEEL BEAM


NOT TO SCALE

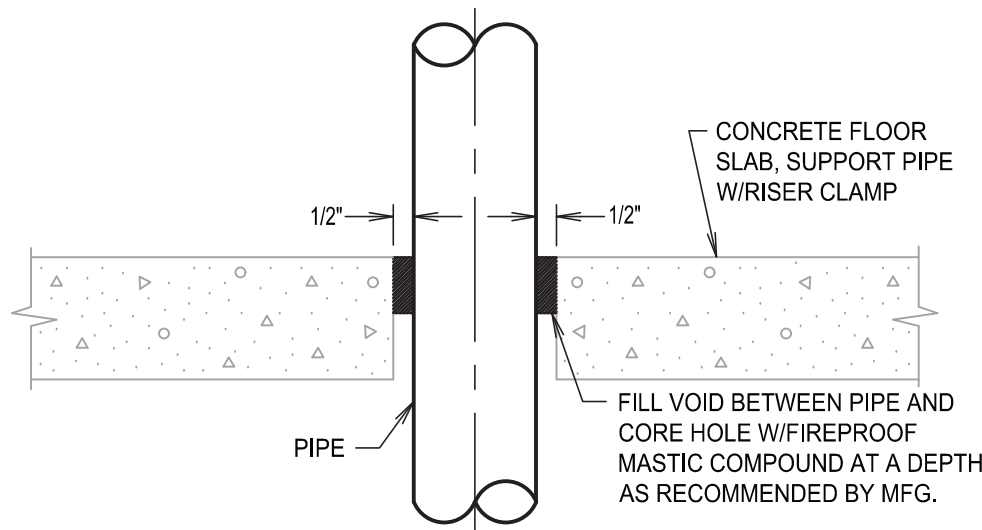

NOTE:  
COORDINATE ALL CORE HOLE  
PENETRATIONS W/STRUCTURAL ENGINEER.


PIPE CORE HOLE DETAIL

NOT TO SCALE

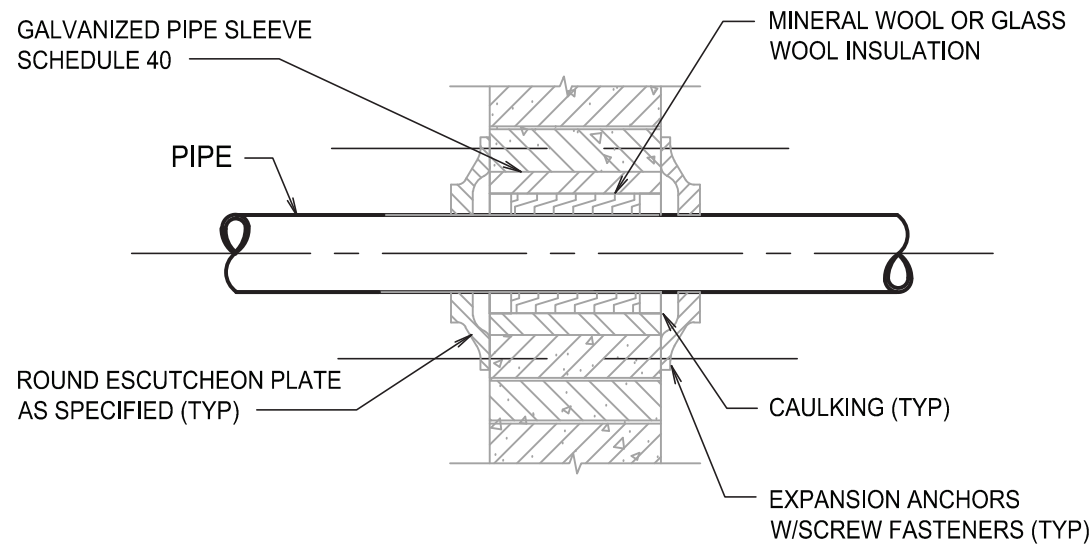

PIPE PENETRATION IN INTERIOR PARTITION DETAIL

NOT TO SCALE

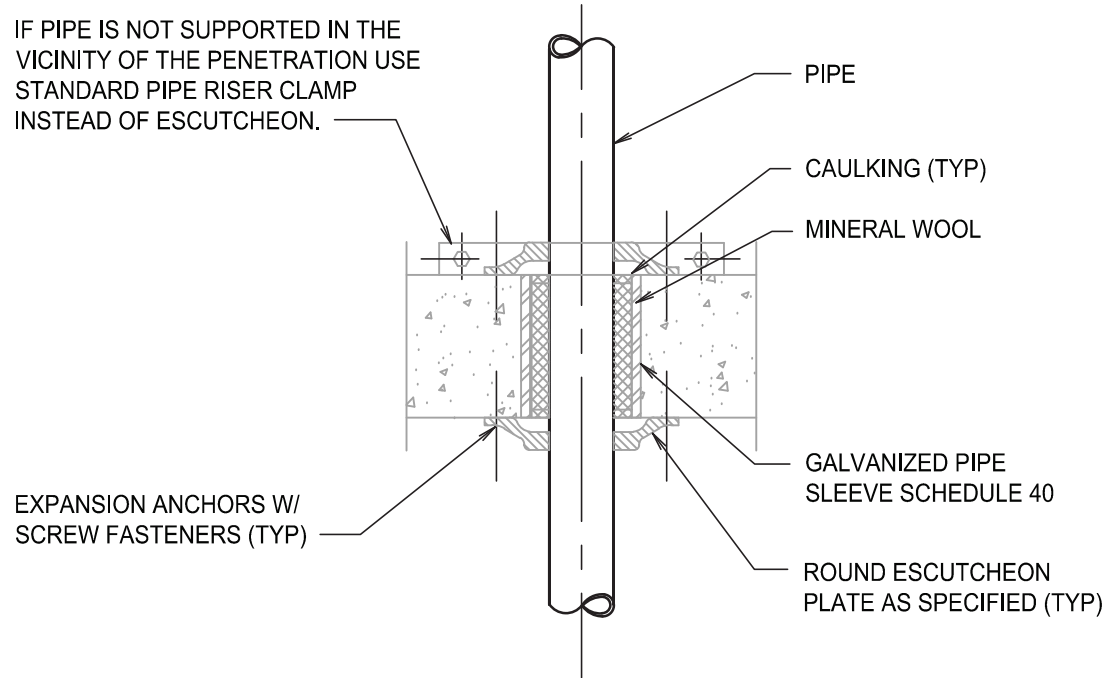

PIPE PENETRATION IN FLOOR SLAB DETAIL

NOT TO SCALE

# PURCHASE COLLEGE


## STATE UNIVERSITY OF NEW YORK VISUAL ARTS BUILDING PHOTO LAB RENOVATION

OWNER  
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MEP ENGINEER  
**LIZARDOS**  
200 OLD COUNTRY R. SUITE 670 MINEOLA, NY 11501  
T. 516-484-1020  
ANDREW.DUBEL@LIZARDOS.COM


KEY PLAN LOT 0000 BLOCK 0000



CONTRACTOR SHALL VERIFY ALL FIELD CONDITIONS & DIMENSIONS AND BE RESPONSIBLE FOR FIELD FIT AND QUANTITY OF WORK. NO ALLOWANCES SHALL BE MADE ON BEHALF OF THE CONTRACTOR FOR ANY ERROR OR NEGLECT ON HIS PART.

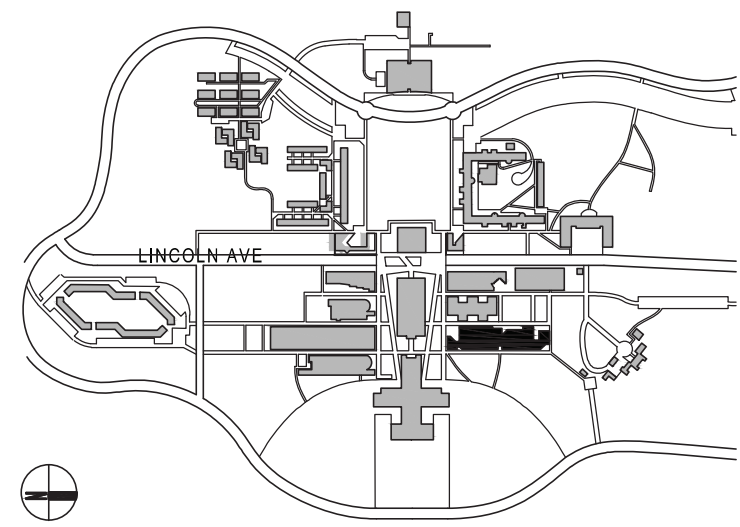BUILDING DEPARTMENT NOTE:  
THIS PLAN IS APPROVED ONLY FOR WORK INDICATED ON THE APPLICATION SPECIFICATION SHEET. ALL OTHER MATTERS SHOWN ARE NOT TO BE RELIED UPON, OR TO BE CONSIDERED AS EITHER BEING APPROVED OR IN ACCORDANCE WITH APPLICABLE CODES.

## BID ISSUE

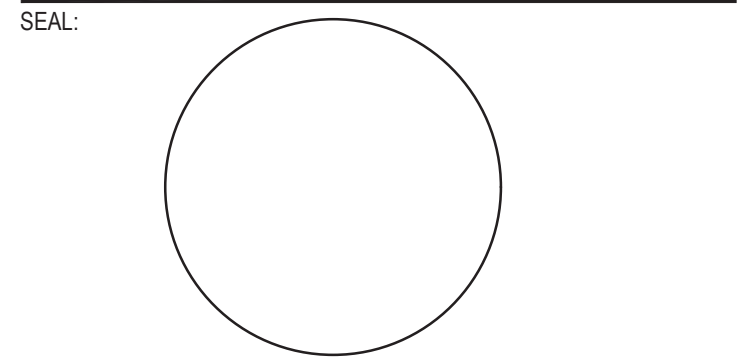

02	02.02.2024	ISSUED FOR BID
1	12.04.2023	ISSUED FOR CLIENT APPROVAL

NO	DATE	DESCRIPTION
ISSUES		

SCALE: AS NOTED PROJECT NO: 10967 DATE: 00-00-00

DRAWING TITLE:

## PLUMBING DETAILS

DRAWING NUMBER DRAWING 5 OF 5

# P-401.00