GENERAL FIRE PROTECTION NOTES:


- 1. CONTRACTOR SHALL VERIFY EXISTING ELEVATIONS IN FIELD PRIOR TO COMMENCEMENT OF WORK.
- 2. PIPING ARRANGEMENTS ARE APPROXIMATE. CONTRACTOR MUST VERIFY EXACT LOCATION AND ROUTING PRIOR TO INSTALLATION.
- 3. CONTRACTOR SHALL COORDINATE WORK WITH ALL OTHER TRADES AND EXISTING CONDITIONS ON THE JOB SITE AND MAINTAIN REQUIRED CEILING HEIGHTS AND CONDITIONS.
- 4. CONTRACTOR SHALL PROVIDE ALL MATERIALS, EQUIPMENT, SERVICES, LABOR AND TESTS NECESSARY FOR COMPLETE EXECUTION OF ALL PLUMBING WORK.
- 5. MATERIALS, EQUIPMENT AND SYSTEMS INSTALLED SHALL MEET ALL PERTINENT REQUIREMENTS OF NEW YORK STATE BUILDING CODES, NATIONAL FIRE PROTECTION ASSOCIATION, FEDERAL REGULATIONS, OCCUPATIONAL SAFETY AND HEALTH ACT (OSHA) AND ANY NATIONALLY RECOGNIZED APPROVAL AGENCIES AS WELL AS APPLICABLE LOCAL CODES AND REGULATIONS.
- 6. SPRINKLER CONTRACTOR SHALL BE RESPONSIBLE FOR REPAIR AND REPLACEMENT OF ANY EXISTING SUSPENDED CEILINGS AND/OR FINISHES DAMAGED BY INSTALLATION OF PIPING UNDER SPRINKLER CONTRACT.
- 7. PIPE SIZING AND PIPE LAYOUT SHOWN ARE BASED ON DESIGN PIPING LAYOUT ONLY. ACTUAL PIPE SIZES AND PIPING CONFIGURATION SHALL BE DETERMINED BY THE CONTRACTORS HYDRAULIC CALCULATIONS AND COORDINATION WITH THE OTHER TRADES BASED ON THEIR INSTALLATION DRAWINGS. THE CONTRACTOR SHALL ALLOW FOR THIS AND INCLUDE THIS IN THEIR CONTRACT PRICE.
- 8. BE ADVISED THAT IT IS THE SPRINKLER CONTRACTORS RESPONSIBLE FOR OBTAINING ANY AND ALL FINAL APPROVALS FOR THEIR INSTALLED SYSTEM BASED ON THESE COORDINATED SHOP DRAWING(S) AND HYDRAULIC CALCULATIONS. THE INSTALLATION SHALL BE CERTIFIED BY THE SPRINKLER CONTRACTOR AND THESE SPRINKLER PLAN(S) AND HYDRAULIC CALCULATIONS SHALL BE SIGNED AND SEALED BY YOUR ENGINEER AND BE SUBMITTED TO THE NYC DOB TO REPLACE LIZARDOS AS THE ENGINEER OF RECORD.
- 9. THE CONTRACTOR SHALL PHASE THE INSTALLATION OF THE NEW SPRINKLER SYSTEM PER THE PROGRAM AS INDICATED ON THE ARCHITECTURAL DRAWINGS. THE EXISTING SPRINKLER SYSTEM WITHIN THE PHASED AREA OF WORK SHALL BE CAPPED AND REMOVED AS REQUIRED HOWEVER, THE EXISTING SYSTEM OUTSIDE OF THE CURRENT PHASE OF THE WORK SHALL REMAIN IN SERVICE. MAKE TEMPORARY PIPING CONNECTIONS AS REQUIRED TO ASSURE THE EXISTING SYSTEM IS KEPT IN SERVICE.

SPRINKLER LEGEND		
•	NEW CONCEALED PENDENT TYPE SPRINKLER HEAD	
× _R	EXISTING SPRINKLER HEAD TO BE RELOCATED	
× _D	EXISTING SPRINKLER HEAD TO BE REMOVED	
	NEW SPRINKLER PIPING	
	EXISTING SPRINKLER/FIRE STANDPIPE PIPING	
	NEW CONNECTION TO EXISTING	
	POINT OF DISCONNECTION	
EXIST	EXISTING	
SPKR	SPRINKLER	
CONN	CONNECTION	
DN	DOWN	
RCV	RISER CONTROL VALVE WITH TAMPER SWITCH	
FCV	FLOOR CONTROL VALVE	

DRAWINGS LIST		
SP-001.00	SPRINKLER LEGENDS, NOTES, ABBREVIATIONS AND DETAILS	
SP-201.00	SPRINKLER BASEMENT PART PLAN - NEW WORK	
SP-301.00	SPRINKLER RISER DIAGRAM	


SPRINKLER SCOPE OF WORK

- 1. DISCONNECT AND REMOVE EXISTING CONCEALED PENDENT TYPE SPRINKLER HEAD AND ASSOCIATED PIPING.
- 2. FURNISH AND INSTALL NEW SPRINKLER HEADS LOCATED PER REVISED ARCHITECTURAL AND LIGHTING PLAN.
- 3. CONNECT NEW 1" SPRINKLER PIPE TO EXISTING SPRINKLER BRANCH PIPING AND NEW SPRINKLER HEAD.

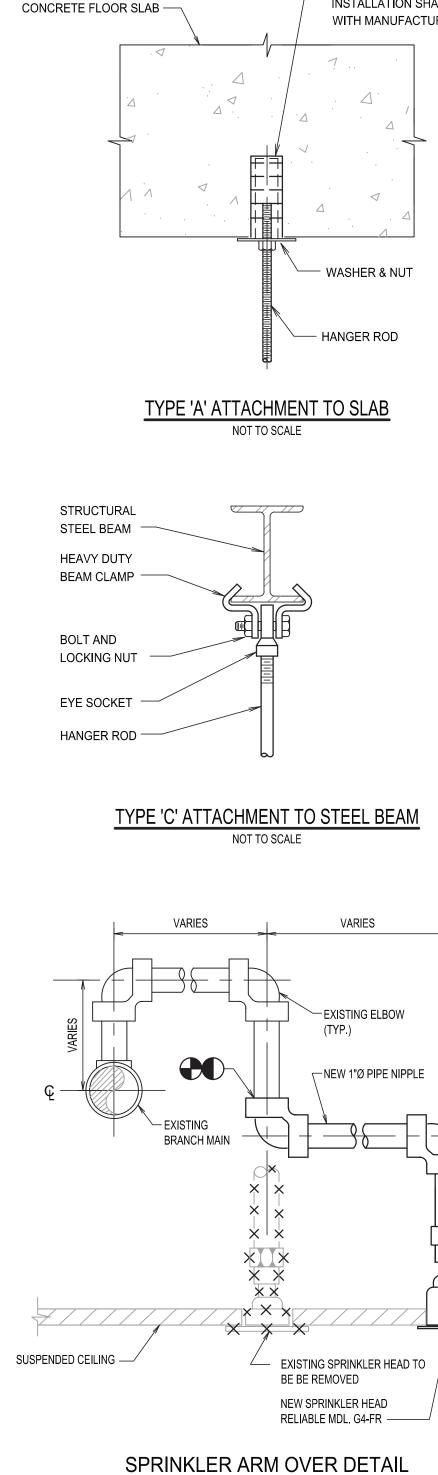

NOT TO SCALE

CONCRETE ANCHOR HILTI-KWICK BOLT, SERIES HDI, OR APPROVED EQUAL. INSTALLATION SHALL BE IN ACCORDANCE WITH MANUFACTURER'S RECOMMENDATION.

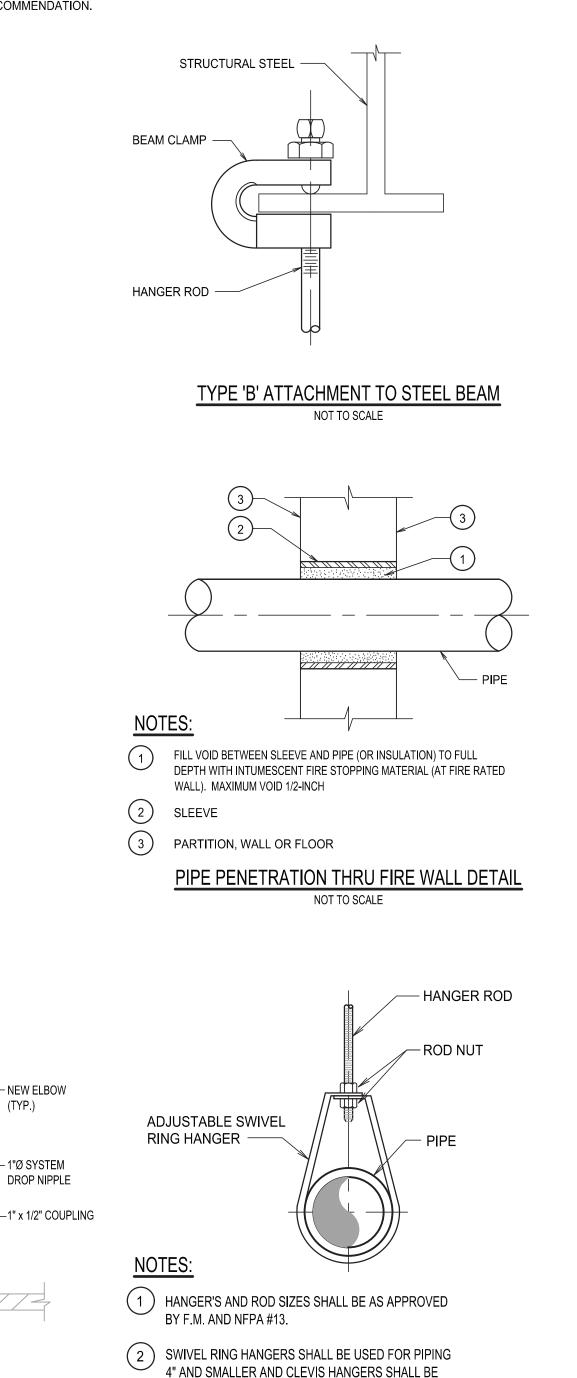


PURCHASE COLLEGE STATE UNIVERSITY OF NEW YORK VISUAL ARTS BUILDING PHOTO LAB RENOVATION OWNER **PURCHASE COLLEGE . SUNY** 735 ANDERSON HILL RD. PURCHASE NY 10577-1400 T. 914-251-5916 SEAN.CONNOLLY@PURCHASE.EDU ARCHITECT LEWANDOWSKA ARCHITECT PLLC 244 FIFTH AVENUE, SUITE B265, NEW YORK, NY 10001 T. 212-787-4558 INFO@LEWANDOWSKAARCHITECT.COM MEP ENGINEER LIZARDOS 200 OLD COUNTRY R. SUITE 670 MINEOLA, NY 11501 T. 516-484-1020 ANDREW.DUBEL@LIZARDOS.COM KEY PLAN LOT 0000 BLOCK 0000 \bigcirc CONTRACTOR SHALL VERIFY ALL FIELD CONDITIONS & DIMENSIONS AND BE RESPONSIBLE FOR FIELD FIT AND QUANTITY OF WORK. NO ALLOWANCES SHALL BE MADE ON BEHALF OF THE CONTRACTOR FOR ANY ERROR OR NEGLECT ON HIS PART. BUILDING DEPARTMENT NOTE: THIS PLAN IS APPROVED ONLY FOR WORK INDICATED ON THE APPLICATION SPECIFICATION SHEET. ALL OTHER MATTERS SHOWN ARE NOT TO BE RELIED UPON, OR TO BE CONSIDERED AS EITHER BEING APPROVED OR IN ACCORDANCE WITH APPLICABLE CODES. **BID ISSUE** SEAL: 02.02.2024 ISSUED FOR BID 02 12.04.2023 ISSUED FOR CLIENT APPROVAL NO DATE DESCRIPTION ISSUES SCALE: AS NOTED PROJECT NO: 10967 DATE: 02-09-24 DRAWING TITLE: SPRINKLER LEGENDS, NOTES, ABBREVIATIONS AND DETAILS DRAWING NUMBER DRAWING 1 OF 3 **SP-001.00**

SPRINKLER PIPE HANGER SUPPORT DETAIL

NOT TO SCALE

USED FOR PIPING LARGER THAN 4 INCHES.

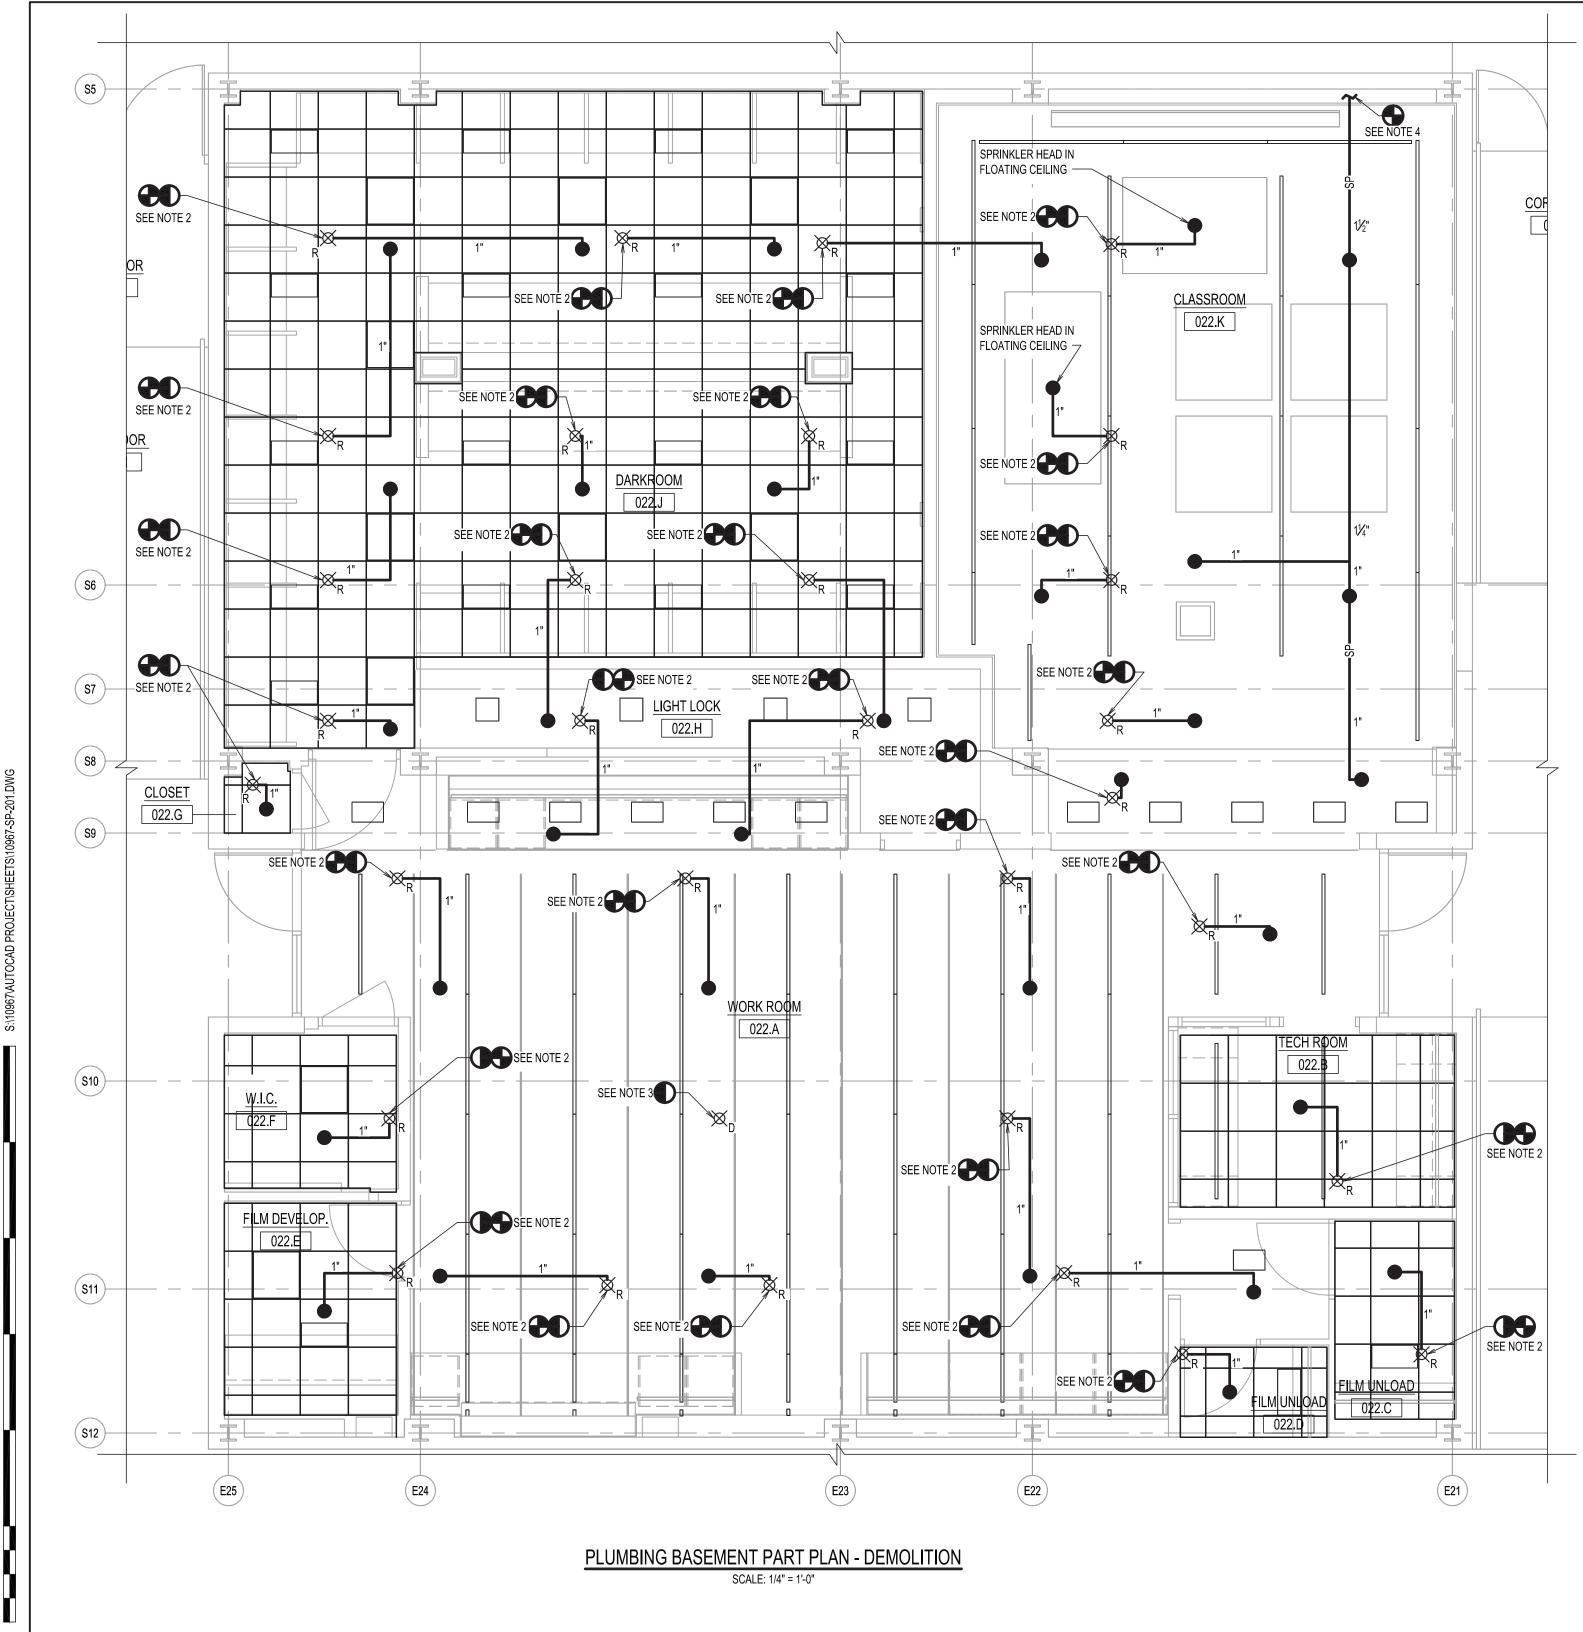




NOTES:

- 1. NEW SPRINKLER LEGENDS, NOTES ABBREVIATIONS AND SCHEDULES SEE DRAWING SP-001.
- 2. DISCONNECT AND REMOVE EXISTING CONCEALED PENDENT TYPE SPRINKLER HEAD. CONNECT NEW 1" SPRINKLER PIPE TO EXISTING PIPING, FURNISH AND INSTALL NEW CONCEALED PENDENT TYPE SPRINKLER HEAD. FOR ADDITIONAL INFORMATION SEE SPRINKLER ARMOVER DETAIL.
- 3. DISCONNECT AND REMOVE EXISTING CONCEALED PENDENT TYPE SPRINKLER HEAD. CAP SPRINKLER PIPE ABOVE FINISHED CEILING.
- CONNECT NEW 1½" SPRINKLER PIPE TO THE EXISTING 4" SPRINKLER MAIN. EXACT POINT OF CONNECTION SHALL BE FIELD VERIFIED.
- 5. FURNISH AND INSTALL NEW CONCEALED PENDENT TYPE SPRINKLER HEAD IN FLOATING CEILING.

PURCHASE COLLEGE STATE UNIVERSITY OF NEW YORK VISUAL ARTS BUILDING PHOTO LAB RENOVATION OWNER PURCHASE COLLEGE . SUNY 735 ANDERSON HILL RD. PURCHASE NY 10577-1400 T. 914-251-5916 SEAN.CONNOLLY@PURCHASE.EDU ARCHITECT LEWANDOWSKA ARCHITECT PLLC 244 FIFTH AVENUE, SUITE B265, NEW YORK, NY 10001 T. 212-787-4558 INFO@LEWANDOWSKAARCHITECT.COM MEP ENGINEER LIZARDOS 200 OLD COUNTRY R. SUITE 670 MINEOLA, NY 11501 T. 516-484-1020 ANDREW.DUBEL@LIZARDOS.COM KEY PLAN LOT 0000 BLOCK 0000 \bigcirc CONTRACTOR SHALL VERIFY ALL FIELD CONDITIONS & DIMENSIONS AND BE RESPONSIBLE FOR FIELD FIT AND QUANTITY OF WORK. NO ALLOWANCES SHALL BE MADE ON BEHALF OF THE CONTRACTOR FOR ANY ERROR OR NEGLECT ON HIS PART. BUILDING DEPARTMENT NOTE: THIS PLAN IS APPROVED ONLY FOR WORK INDICATED ON THE APPLICATION SPECIFICATION SHEET. ALL OTHER MATTERS SHOWN ARE NOT TO BE RELIED UPON, OR TO BE CONSIDERED AS EITHER BEING APPROVED OR IN ACCORDANCE WITH APPLICABLE CODES. BID ISSUE SEAL: 02 02.02.2024 ISSUED FOR BID 12.04.2023 ISSUED FOR CLIENT APPROVAL DESCRIPTION NO DATE ISSUES SCALE: AS NOTED PROJECT NO: 10967 DATE: 02-09-24 DRAWING TITLE: SPRINKLER BASEMENT PART PLAN - NEW WORK DRAWING NUMBER DRAWING 2 OF 3 **SP-201.00**

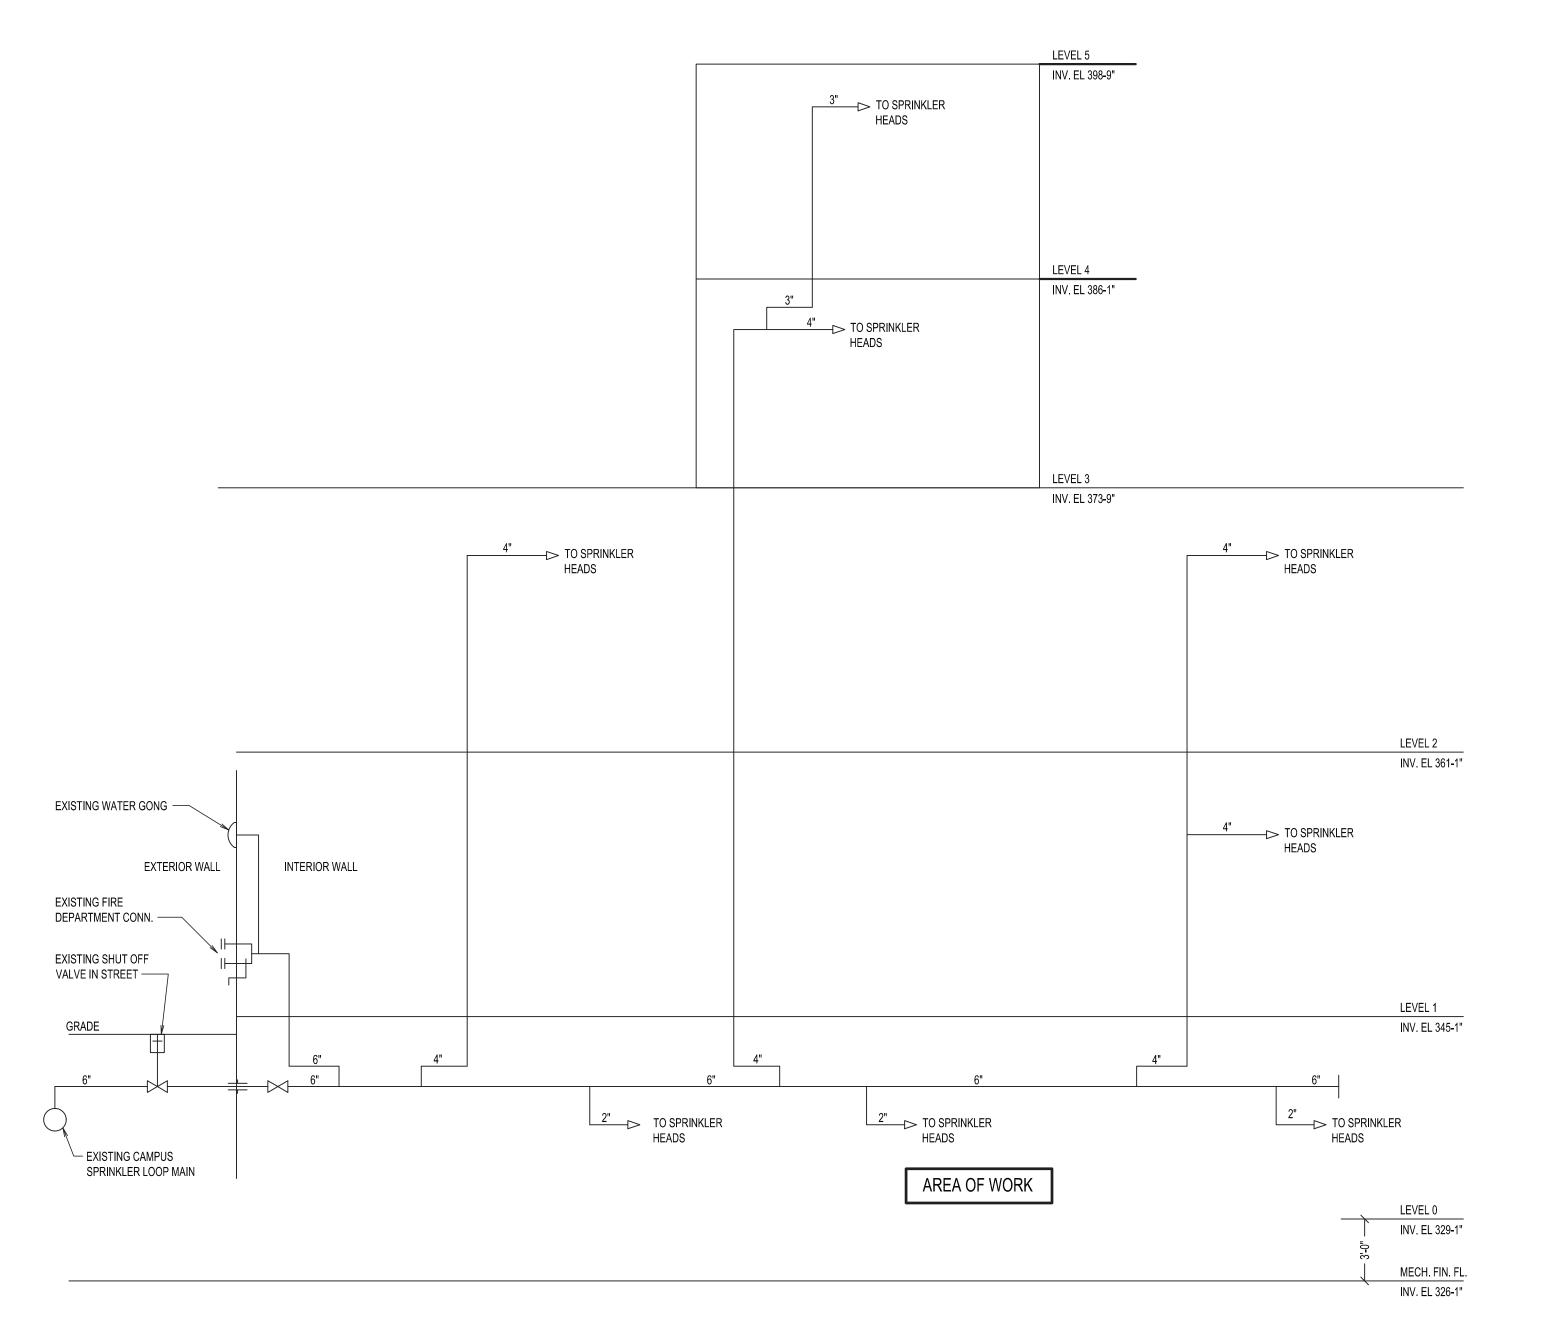

SPRINKLER HEAD COUNT		
31	EXISTING SPRINKLER HEADS IN AREA OF WORK	
30	SPRINKLER HEADS RELOCATED	
1	SPRINKLER HEADS DELETED	
30	TOTAL SPRINKLER HEADS IN AREA OF WORK	

SPRINKLER RISER DIAGRAM

NOT TO SCALE



