SOUTH ORANGETOWN CENTRAL SCHOOL DISTRICT 2024 CAPITAL IMPROVEMENTS PROJECT

SOUTH ORANGETOWN MIDDLE SCHOOL

BID DOCUMENTS

SED#:50-03-01-06-0-013-031

160 VAN WYCK RD, BLAUVELT, NY 10913

DRAWING LIST G000 COVER LIFE SAFETY CODE PLAN LOWER LEVEL HAZMAT ASBESTOS ABATEMENT PLAN NURSE'S OFFICE DEMOLITION FLOOR PLAN & ROOF PLAN A100 NURSE'S OFFICE NEW WORK FLOOR PLAN, ROOF PLAN & REFLECTED CEILING PLAN INTERIOR ELEVATIONS TYPICAL DETAILS CASEWORK DETAILS DOOR PANELS, FRAME TYPES & SCHEDULES INTERIOR FINISH PLAN, SCHEDULE & DETAILS HVAC SYMBOLS LEGEND AND CONTRACTOR NOTES FIRST FLOOR AND ROOF MECHANICAL DEMOLITION AND NEW WORK PLAN MECHANICAL SCHEDULES NURSE'S OFFICE DEMOLITION AND NEW WORK PLANS ELECTRICAL SYMBOLS LEGEND, NOTES & SYSTEM DIAGRAMS FIRST FLOOR DEMOLITION PLAN FIRST FLOOR ELECTRICAL NEW WORK PLAN

GENERAL NOTES

THE DESIGN OF THIS PROJECT CONFORMS TO ALL APPLICABLE PROVISIONS OF NEW YORK STATE UNIFORM FIRE PREVENTION AND BUILDING CODE, THE NEW YORK STATE ENERGY CONSERVATION CODE, AND THE MANUAL OF PLANNING STANDARDS OF THE NEW YORK STATE EDUCATION DEPARTMENT.

ARCHITECT CERTIFICATION

TO THE BEST OF MY KNOWLEDGE, INFORMATION AND BELIEF, THE PLANS AND SPECIFICATIONS ARE IN ACCORDANCE WITH APPLICABLE REQUIREMENTS OF THE BUILDING CODE OF NEW YORK STATE, THE ENERGY CONSERVATION CONSTRUCTION CODE OF NEW YORK STATE, NYSDOL INDUSTRIAL CODE RULE 56 AND THE CONSTRUCTION STANDARD OF THE NEW YORK STATE EDUCATION DEPARTMENT. NO ASBESTOS CONTAINING MATERIALS ARE SPECIFIED FOR USE IN NEW CONSTRUCTION.

LAUREN TARSIO Registered Architect Registration

N.Y.S. Registration No. Expiration Date

PROJECT ABBREVIATIONS

AFF ABOVE FINISHED FLOOR AP ACCESS PANEL CONTR CONTRACTOR COUSTICAL CEILING TILE ACOUSTICAL CEILING TILE AWP ACOUSTICAL WALL PANEL DP DAMP PROOFING FIN FINISH FF FINISH FLOOR JAN JANITOR JS JANITOR SINK OPNG OPENING OD OUTSIDE DIAMETER SS STC STC STC FF FINISH FLOOR FF FINISH FLOOR FF FINISH FLOOR FF FINISH FLOOR FF FINISH FLOOR FF FINISH FLOOR FF FINISH FLOOR FF FINISH FLOOR FF FINISH FLOOR STC OD OUTSIDE DIAMETER SS STC OPNG OPENING OD OUTSIDE DIAMETER STD STC ON CENTER SPEC STC OPNG OPENING OD OUTSIDE DIAMETER SS STD	SOUND TRANSMISSION COEFFICIT SPECIFICATION SQUARE STAINLESS STEEL STANDARD STEEL STORAGE STRUCTURAL GLAZED FACING TILL
ACOUS ACOUSTICAL ACOUSTICAL CEILING TILE ACOUSTICAL WALL PANEL CJ CONTROL JOINT FEC FIRE EXTINGUISHER CABINET FH FIRE HOSE FL,FLR FLOOR FL,FLR FLOOR FEC FIRE EXTINGUISHER CABINET FLOOR FIRE EXTINGUISHER CABINET JS JANITOR SINK OPNG OPENING OD OUTSIDE DIAMETER OH OVERHEAD OH OVERHEAD	SQUARE STAINLESS STEEL STANDARD STEEL STORAGE
ACT ACOUSTICAL CEILING TILE AWP ACOUSTICAL WALL PANEL DP DAMP PROOFING FI,FLR FLOOR JT JOINT OD OUTSIDE DIAMETER SS STD	STAINLESS STEEL STANDARD STEEL STORAGE
WP ACOUSTICAL WALL PANEL DP DAMP PROOFING FL,FLR FLOOR OH OVERHEAD STD	STANDARD STEEL STORAGE
	STEEL STORAGE
	STORAGE
dj adjacent	
/C AIR CONDITIONING DEPT DEPARTMENT FTG FOOTING PT PAINT(ED) STOR	STRUCTURAL GLAZED EACING TILL
LT ALTERNATE DET,DTL DETAIL FND FOUNDATION LBL LABEL PR PAIR SGFT	SIKUCTUKAL OLAZLOTACINO IIL
LUM ALUMINUM DIA DIAMETER FS FULL SIZE LABORATORY PTR PAPER TOWEL RECEPTOR ST STL	STRUCTURAL STEEL
B ANCHOR BOLT DIM DIMENSION FUT FUTURE LAM LAMINATE(D) PKG PARKING STRUCT	STRUCTURE, STRUCTURAL
NOD ANODIZED DISP DISPENSER LAV LAVATORY PART BD PARTICLE BOARD SUSP	SUSPENDED
PPROX APPROXIMATE DSP DISPOSAL GALVANIZED LYR LAYER PARTITION SAT	SUSPENDED ACOUSTICAL TILE
RCH ARCHITECT, ARCHITECTURAL DO DITTO, REPEAT, SAME G GAS LDR LEADER PVMT PAVEMENT	
D AREA DRAIN DR DOOR GA GAUGE LH LEFT HAND PL PLATE TEL	TELEPHONE
CM ASBESTOS CONTAINING MATERIAL DBL DOUBLE GEN GENERAL LIB LIBRARY PLBG PLUMBING TEMP	TEMPERATURE
AT DN DOWN GC GENERAL CONTRACTOR LT LIGHT PLYWO PLYWOOD THK	THICKNESS
UTO AUTOMATIC DS DOWNSPOUT GL GLASS, GLAZING LW LIGHT WEIGHT PVC POLYVINYL CHLORIDE TPD	TOILET PAPER DISPENSER
DT DRAIN TILE GB GRAB BAR PC CONC PRECAST CONCRETE TOS	TOP OF SLAB/STEEL
BEARING PLATE DWR DRAWER GR GRADE, GRADING MACH MACHINE PRE FAB PREFABRICATED TOW	TOP OF WALL
BENCH MARK DWG DRAWING GSF GROSS SQUARE FOOT MH MAN HOLE PT PRESSURE TREATED TYP	TYPICAL
TUM BITUMINOUS DF DRINKING FOUNTAIN GYP GYPSUM MHC MAN HOLE COVER PL PROPERTY LINE	
K BLOCK GYP BD GYPSUM BD MFR MANUFACTURE UNFIN	UNFINISHED
KG BLOCKING EA EACH GWB GYPSUM WALL BOARD MFRR MANUFACTURER QTY QUANTITY UNO	UNLESS NOTED OTHERWISE
D BOARD EF EACH FACE MAS MASONRY U	URINAL
OT BOTTOM EW EACH WAY HARDWARE MO MASONRY OPENING RAD RADIUS	
rk brick e east hdwd hardwood mat materials recp receptacle ven	VENEER
DG BUILDING ELEC ELECTRICAL HVAC HEATING, VENTILATING & AIR MAX MAXIMUM RE: REFER TO VIF	VERIFY IN FIELD
N BULLNOSE ELEV ELEVATION CONDITIONING MECH MECHANICAL REF REFERENCE VEST	VESTIBULE
EL ELEVATOR HT, HGT HEIGHT METAL REFR REFRIGERATOR VOL	VOLUME
AB CABINET EMER EMERGENCY HEX HEXAGONAL MTL METAL REINFORCED(ING)	
CAST IRON ENCL ENCLOSURE HWY HIGHWAY M METER REQ'D REQUIRED WC	WATER CLOSET
B CATCH BASIN OR CHALK BOARD ENTR ENTRANCE HM HOLLOW METAL MEZZ MEZZANINE REV REVISED WT	WEIGHT
LG CEILING EQ EQUAL HORIZONTAL MIN MINIMUM RH RIGHT HAND WWF	WELDED WIRE FABRIC
LG HT CEILING HEIGHT EQUIP EQUIPMENT HB HOSE BIBB MISC MISCELLANEOUS R RISER WWM	WELDED WIRE MESH
L CENTER LINE EST ESTIMATE(D) HW HOT WATER MR MOISTURE RESISTANT RD ROOF DRAIN W	WEST
ER CERAMIC EXHST EXHAUST HR HOUR MTD MOUNTED RM ROOM WIND	WINDOW
IRC CIRCUMFERENCE EXIST EXISTING W/	WITH
O CLEAN OUT ETR EXISTING TO REMAIN IN INCH NATURAL W/O	WITHOUT
LR CLEAR EXP EXPANSION INCL INCLUDING NRC NOISE REDUCTION COEFFICIENT SAN SANITARY WD	WOOD
OL COLUMN EJ EXPANSION JOINT ID INSIDE DIAMETER NOM NOMINAL SCHED SCHEDULE	
	YARD
MU CONCRETE MASONRY UNIT FAB FABRICATE INT INTERIOR NIC NOT IN CONTRACT SECT SECTION	
ONST CONSTRUCTION FT FEET INTERMEDIATE NTS NOT TO SCALE SIM SIMILAR	
TIT CONSTRUCTION JOINT FIG FIGURE INV INVERT NO, # NUMBER SSM SOLID SURFACE MATERIAL	

OWNER



SOUTH ORANGETOWN CENTRAL SCHOOL DISTRICT 160 VAN WYCK RD.

ARCHITECT/ENGINEER



CPL | Architecture Engineering Planning









PROJECT INFORMATION

R23.01124.00

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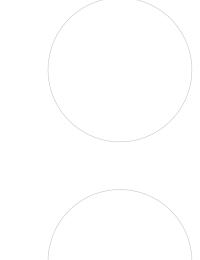
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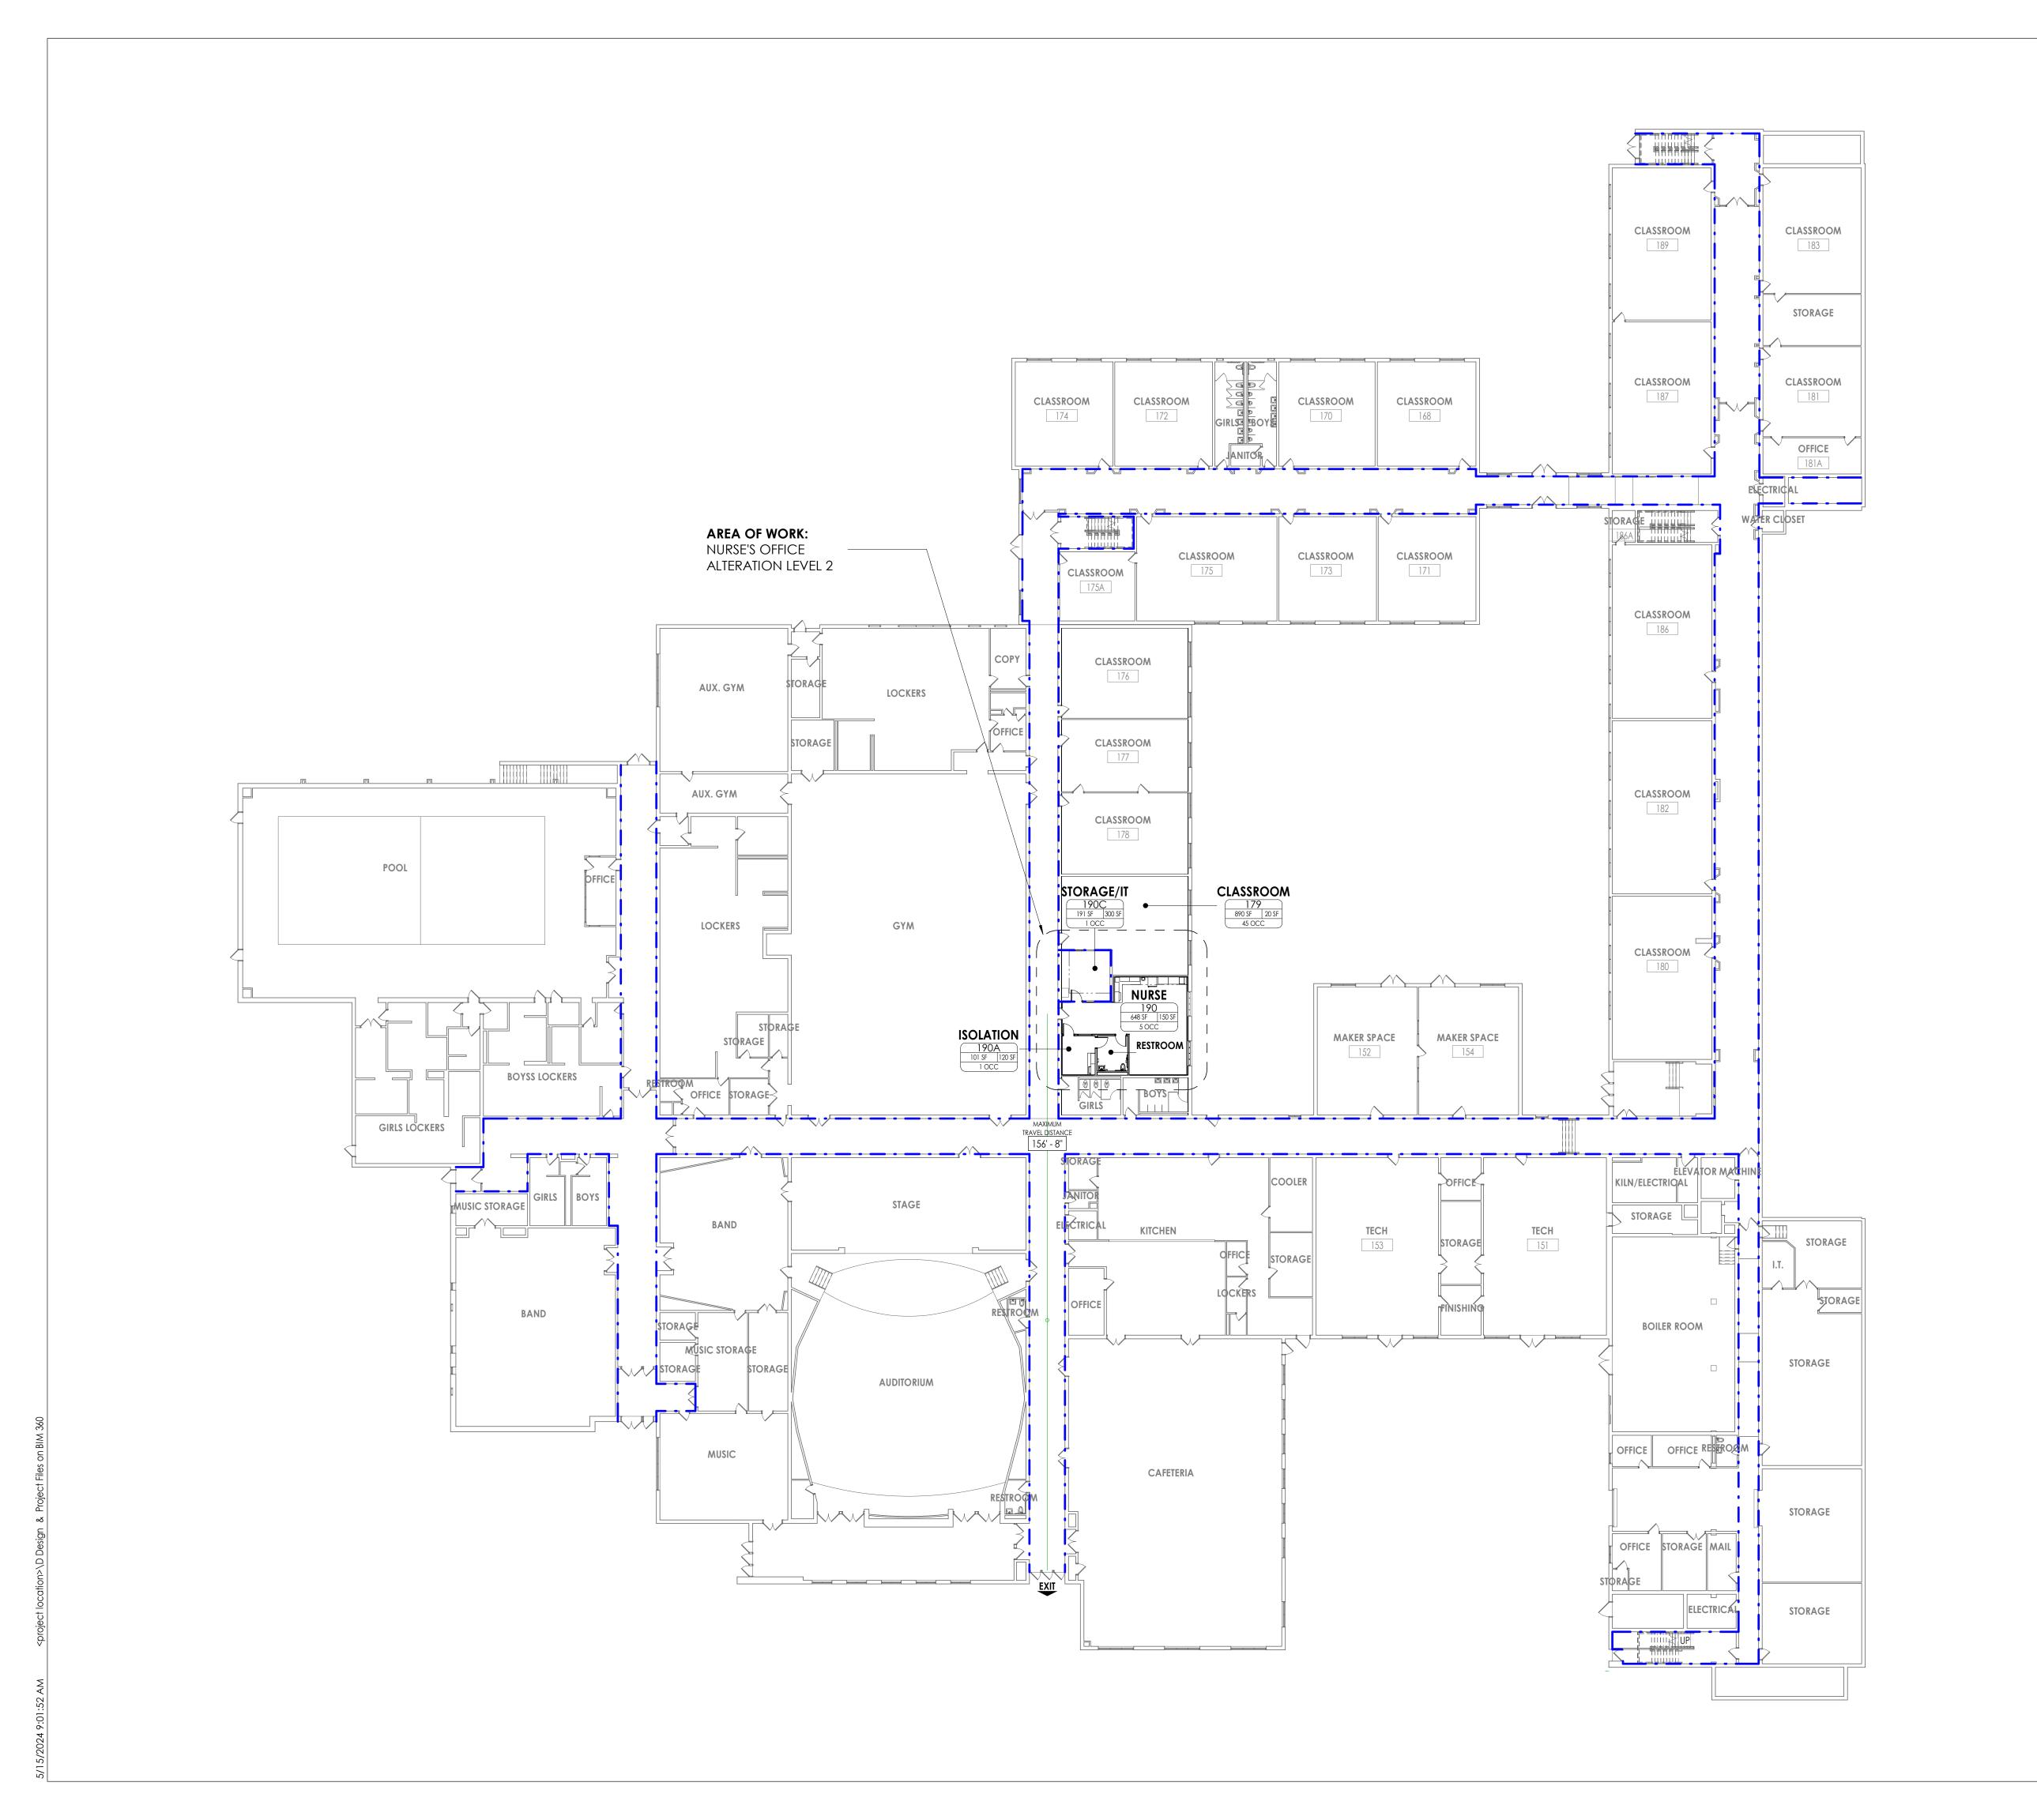




SHEET INFORMATION Issued

05/15/24 Project Status BID DOCUMENTS CPL Drawing Title

COVER



LIFE SAFETY SYMBOL LEGEND EXIT ROOM NAME **ROOM NAME** ROOM NUMBER ROOM AREA OCCUPANT LOAD FACTOR OCCUPANT LOAD TRAVEL DISTANCE MAXIMUM TRAVEL DISTANCE TO EXIT 1 HOUR RATED FIRE BARRIER

LIFE SAFETY CODE SUMMARY

BUILDING OCCUPANCY: E, EDUCATIONAL

CONSTRUCTION CLASSIFICATION: TYPE IIB

BUILDING HEIGHT & AREA LIMITATIONS:

NO CHANGE TO BUILDING AREA

DESIGN CRITERIA NOTES

GENERAL BUILDING CODE

THE CONSTRUCTION DOCUMENTS ARE BASED ON THE REQUIREMENTS OF THE 2020 BUILDING CODE OF NEW YORK STATE.

RISK CATEGORY OF BUILDING AND OTHER STRUCTURES

THE BUILDING HAS BEEN ASSIGNED AN RISK CATEGORY IN ACCORDANCE WITH PREVIOUSLY MENTIONED BUILDING CODE WITH THE FOLLOWING CRITERIA: A. RISK CATEGORY: III, GROUP E OCCUPANCY

DEAD AND LIVE LOADS

A. THE DEAD LOADS ARE THE SELF WEIGHT OF MATERIALS OF CONSTRUCTIONIN CORPORATED INTO AND ON THE BUILDING.

B. THE UNIFORMLY DISTRIBUTED AND/OR CONCENTRATED LIVE LOADS USED IN THE DESIGN OF THE BUILDING ARE BASED ON THE FOLLOWING INTENDED USE OR OCCUPANCIES:

a. CORRIDORS: 100 POUNDS PER SQUARE FOOT (PSF)

b. CORRIDORS ABOVE FIRST FLOOR: 80 PSF

c. STAIRS AND EXITS: 100 PSF / 300 LB ON TREADS, 4 SQUARE INCH AREA

d. LOBBIES: 100 PSF

e. CLASSROOM: 40 PSF

f. OFFICE: 50 PSF g. ROOFS: 20 PSF / 300 LB ON MAINTENANCE SURFACE

ROOF SNOW LOAD DATA SNOW LOADS ARE BASED ON CHAPTER 7 OF THE AMERICAN SOCIETY OF CIVIL ENGINEERS, MINIMUM DESIGN LOADS FOR BUILDINGS AND OTHER STRUCTURES,

ASCE 7 AND THE FOLLOWING CRITERIA:

A. GROUND SNOW LOAD (Pg): 30 PSF B. FLAT-ROOF SNOW LOAD (Pf): 23.1 PSF

C. SNOW EXPOSURE FACTOR (Ce): 1.0

D. SNOW LOAD IMPORTANCE FACTOR (Is): 1.10 THERMAL FACTOR (Ct): 1.0

DRIFT SURCHARGE LOADS (Pd): N/A

G. WIDTH OF SNOW DRIFTS (w): N/A

WIND DESIGN DATA

WIND PRESSURES ARE BASED ON CHAPTER 26 OF THE AMERICAN SOCIETY OF CIVIL ENGINEERS, MINIMUM DESIGN LOADS FOR BUILDINGS AND OTHER STRUCTURES, ASCE 7 AND THE FOLLOWING CRITERIA:

ULTIMATE DESIGN WIND SPEED (Vult): 123 MPH (3 SECOND GUST)

NOMINAL DESIGN WIND SPEED (Vasd): 96 MPH

RISK CATEGORY: III WIND EXPOSURE CATEGORY: B

INTERNAL PRESSURE COEFFICIENT (GCPI): +0.18/-0.18

F. COMPONENTS AND CLADDING: +24 / -32 PSF SEISMIC DESIGN DATA

ACCORDANCE WITH THE PREVIOUSLY MENTIONED BUILDING CODE WITH THE

THE STRUCTURE AND COMPONENTS OF THE BUILDING HAVE BEEN DESIGNED IN

FOLLOWING CRITERIA:

A. RISK CATEGORY: III

SEISMIC IMPORTANCE FACTOR, le: 1.25 0.2 SEC. MAPPED SPECTRAL ACCELERATION (Ss): 0.299G

D. 1 SEC. MAPPED SPECTRAL ACCELERATION (S1): 0.062G SITE CLASS: D

0.2 SEC SPECTRAL RESPONSE COEFF. (SDS): 0.311G

G. 1 SEC SPECTRAL RESPONSE COEFF. (SD1): 0.098G

H. SEISMIC DESIGN CATEGORY: B

I. BASIC SEISMIC-FORCE RESISTING SYSTEM: MASONRY BEARING WALLS

DESIGN SEISMIC BASE SHEAR (KIPS): N/A K. SEISMIC RESPONSE COEFFICIENT, Cs: 0.0171X

L. RESPONSE MODIFICATION FACTOR, R: 2.0 M. ANALYTICAL PROCEDURE: EQUIVALENT LATERAL FORCE PROCEDURE (ELFP)

SEISMIC DEMANDS ON NONSTRUCTURAL COMPONENTS

SEISMIC DEMAND ON NONSTRUCTURAL COMPONENTS AND CONNECTIONS OF THOSE COMPONENTS TO THE PRIMARY STRUCTURE SHALL BE DESIGNED IN ACCORDANCE WITH THE PREVIOUSLY MENTIONED BUILDING CODE, THE GENERAL SEISMIC CRITERIA LISTED ABOVE, AND THE REQUIREMENTS OF ASCE 7, CHAPTER 13

AS APPROPRIATE. GEOTECHNICAL INFORMATION

THE STRUCTURE HAS BEEN DESIGNED BASED ON THE ASSUMED FOLLOWING CRITERIA:

A. ALLOWABLE BEARING: 2,000 PSF B. SUBGRADE MODULUS: 100 PCI


FLOOD DESIGN CRITERIA

THE BUILDING IS NOT LOCATED IN WHOLE OR IN PART WITHIN A FLOOD HAZARD AREA AS ESTABLISHED PER THE PREVIOUSLY MENTIONED BUILDING CODE.

O. ROOF RAIN LOAD DATA

RAIN INTENSITY: 2.75 IN/HR ROOF TOP EQUIPMENT ANCHORAGE

ALL ROOF TOP EQUIPMENT CURBS, MECHANICAL EQUIPMENT, TIE DOWNS, AND CONNECTIONS OF ALL EQUIPMENT TO BUILDING STRUCTURE FOR WIND AND SEISMIC LOADING ARE TO BE DESIGNED BY A REGISTERED PROFESSIONAL ENGINEER

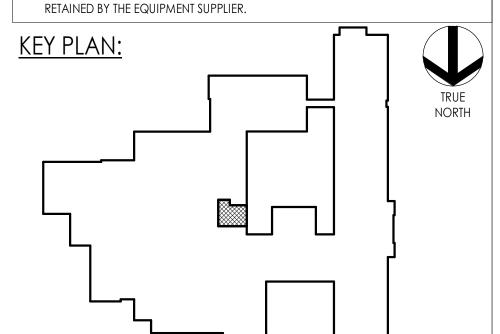





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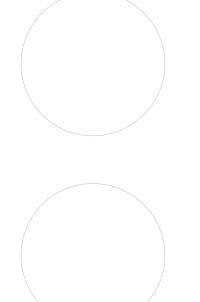
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CPL CPL Drawing Title

LIFE SAFETY CODE PLAN LOWER LEVEL

ASBESTOS ABATEMENT GENERAL NOTES

- . ALL DRAWINGS ARE A GRAPHIC REPRESENTATION OF APPROXIMATE LOCATIONS OF EXISTING AND NEW MATERIALS TO BE ABATED. IF THERE ARE ANY DISCREPANCIES WITH WHAT EXISTS TO WHAT IS INDICATED IN THE CONTRACT DOCUMENTS THE CONTRACTOR SHALL REPORT THE DISCREPANCY TO THE ARCHITECT. IT IS THE CONTRACTOR'S RESPONSIBILITY TO FIELD VERIFY ALL EXISTING CONDITIONS, QUANTITIES AND DIMENSIONS PRIOR TO COMMENCEMENT OF WORK.
- 2. ABATEMENT PLAN NOTES THAT POINT TO A SPECIFIC ITEM INDICATES ABATEMENT OF THAT ITEM. ABATEMENT PLAN NOTES THAT DO NOT POINT TO A SPECIFIC ITEM INDICATES ABATEMENT WITHIN THE ENTIRE ROOM, CORRIDOR, ETC.
- 3. ALL WORK SHALL BE PERFORMED IN ACCORDANCE WITH THE PROJECT SPECIFICATION, OSHA 29 CFR 1926.1101, USEPA 40 CFR PART 763 AND 40 CFR PART 61 - SUB PART M, NYS INDUSTRIAL CODE RULE 56 AND ANY APPROPRIATE APPLICABLE AND/OR SITE SPECIFIC VARIANCES.
- 4. THE LOCATION OF ANY ON-SITE STORAGE OF MATERIALS, EQUIPMENT, DECONTAMINATION FACILITIES AND DUMPSTER/WASTE TRAILER SHALL BE COORDINATED WITH AND APPROVED BY THE OWNER'S REPRESENTATIVE AND ARCHITECT.
- 5. WHERE APPLICABLE, CONTRACTOR SHALL ENSURE ALL ELECTRICAL CIRCUITS WITHIN THEIR WORK AREAS ARE PROPERLY LOCKED/TAGGED IN ACCORDANCE WITH OSHA 29 CFR 1926.417.
- 6. ANY QUANTITIES PROVIDED ON THE DRAWINGS ARE FOR BIDDING PURPOSES ONLY. THE CONTRACTOR IS RESPONSIBLE FOR FIELD VERIFYING ALL JOB CONDITIONS AND MATERIAL QUANTITIES PRIOR TO BIDDING.

ASBESTOS ABATEMENT KEY NOTES

- REMOVE BY ABATEMENT, ASBESTOS CONTAINING PIPE FITTING PER QUANTITY SHOWN
- REMOVE BY ABATEMENT, ASBESTOS CONTAINING PIPE INSULATION WITHIN GYP. SOFFIT PER QUANTITY SHOWN
- (A3) REMOVE BY ABATEMENT, TACK BOARD AND MASTIC

KEY PLAN:

PROJECT INFORMATION R23.01124.00 SOUTH ORANGETOWN CENTRAL SCHOOL DISTRICT

CPL | Architecture Engineering Planning

26 IBM Road Poughkeepsie, NY 12601

CPLteam.com

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2024 CAPITAL IMPROVEMENTS


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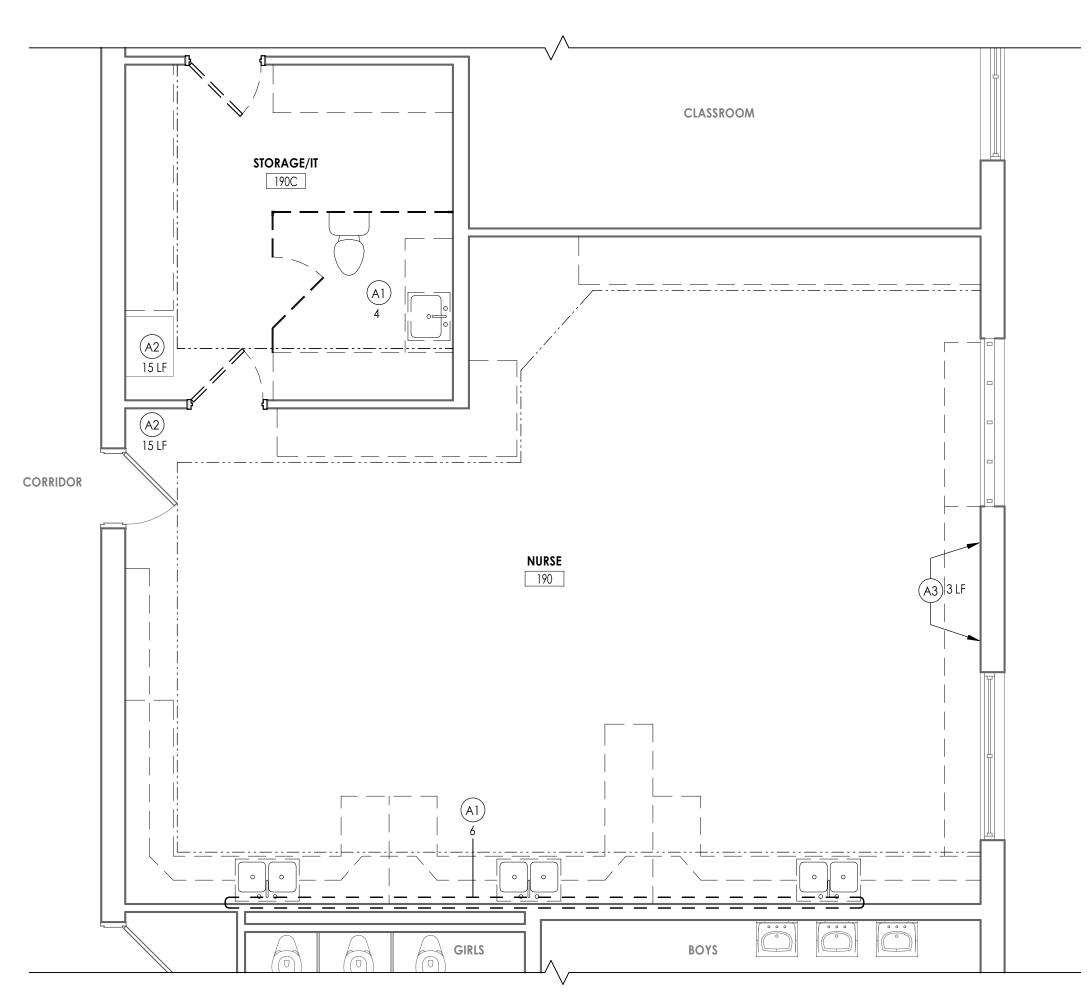


SHEET INFORMATION

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ASBESTOS ABATEMENT PLAN

HZ100

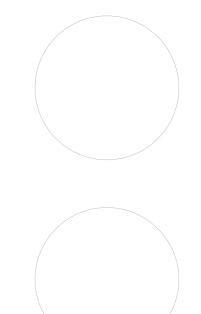

NURSE'S OFFICE ASBESTOS ABATEMENT PLAN

DEMOLITION ROOF PLAN GENERAL NOTES

- I. IT IS THE CONTRACTOR'S RESPONSIBILITY TO FAMILIARIZE THEMSELVES WITH ALL EXISTING CONDITIONS AND DETAILS INVOLVED IN THE DEMOLITION WORK. 2. THE OWNER SHALL PROVIDE THE CONTRACTOR WITH A LIST OF ALL ITEMS TO BE SALVAGED PRIOR TO CONSTRUCTION.
- 3. THE CONTRACTOR SHALL PROTECT ADJACENT SURFACES AND FINISHES NOT SCHEDULED FOR DEMOLITION WORK AND SHALL REPAIR ANY DAMAGED AREAS AS A RESULT OF CONTRACTED WORK AT NO ADDITIONAL COST TO THE OWNER.
- 4. THE CONTRACTOR SHALL COORDINATE THE DEMOLITION WORK WITH THE OVERALL PROJECT PHASING.
- THE CONTRACTOR SHALL MAINTAIN AND CONTINUE SAFE ACCESS TO ALL EXITS FOR THE BUILDING OCCUPANTS DURING CONSTRUCTION.

DEMOLITION ROOF PLAN KEY NOTES



REMOVE ROOF SYSTEM DOWN TO ROOF DECK

MC TO CUT AND REMOVE ROOF DECK TO FACILITATE (2) MECHANICAL WORK. GC TO PROVIDE STRUCTURAL SUPPORT PER ROOF OPENING SUPPORT DETAIL. COORDINATE WITH MC FOR EXACT SIZE

AND LOCATION.

DEMOLITION GENERAL NOTES

- ALL DRAWINGS ARE GRAPHIC REPRESENTATION OF APPROXIMATE LOCATIONS OF MATERIALS TO BE REMOVED. IT IS THE CONTRACTORS RESPONSIBILITY TO FIELD VERIFY ALL EXISTING CONDITIONS & DIMENSIONS PRIOR TO COMMENCEMENT OF ALL DEMOLITION WORK.
- REFER TO THE MECHANICAL, ELECTRICAL AND PLUMBING DRAWINGS FOR DEMOLITION OF EXISTING UTILITIES AND SERVICES.
- THE OWNER SHALL PROVIDE THE CONTRACTOR WITH A LIST OF ALL ITEMS TO BE SALVAGED PRIOR TO CONSTRUCTION. THE CONTRACTOR SHALL PROTECT ADJACENT SURFACES AND FINISHES NOT SCHEDULED FOR DEMOLITION WORK AND SHALL REPAIR ANY DAMAGED AREAS AS A RESULT OF CONTRACTED WORK AT NO ADDITIONAL COST TO THE OWNER.
- THE CONTRACTOR SHALL COORDINATE THE DEMOLITION WORK WITH THE OVERALL PROJECT PHASING. WORK AREAS SHALL BE MAINTAINED AND ALL WORK AREAS SHALL BE LEFT BROOM
- CLEANED AT END OF EACH DAY. THE CONTRACTOR SHALL MAINTAIN AND CONTINUE SAFE ACCESS TO ALL EXITS FOR
- THE BUILDING OCCUPANTS DURING CONSTRUCTION. IN THE CASE THAT ANY SUSPICIOUS MATERIALS ARE UNCOVERED THAT APPEAR TO CONTAIN HAZARDOUS MATERIALS SUCH AS BUT NOT LIMITED TO MOLD, LEAD PAINT OR ASBESTOS, LEAVE THE PREMISES AND NOTIFY THE OWNER & ABATEMENT CONTRACTOR FOR REQUIRED TESTING AND/OR REMOVALS.



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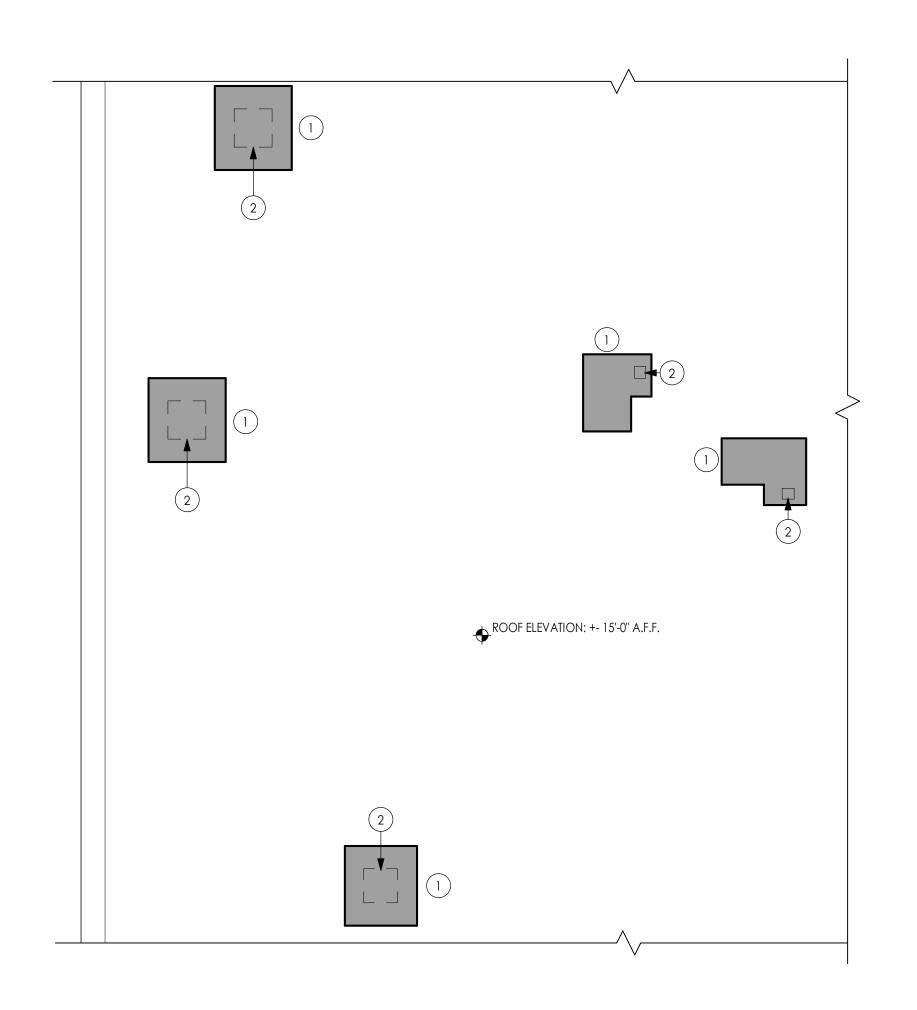
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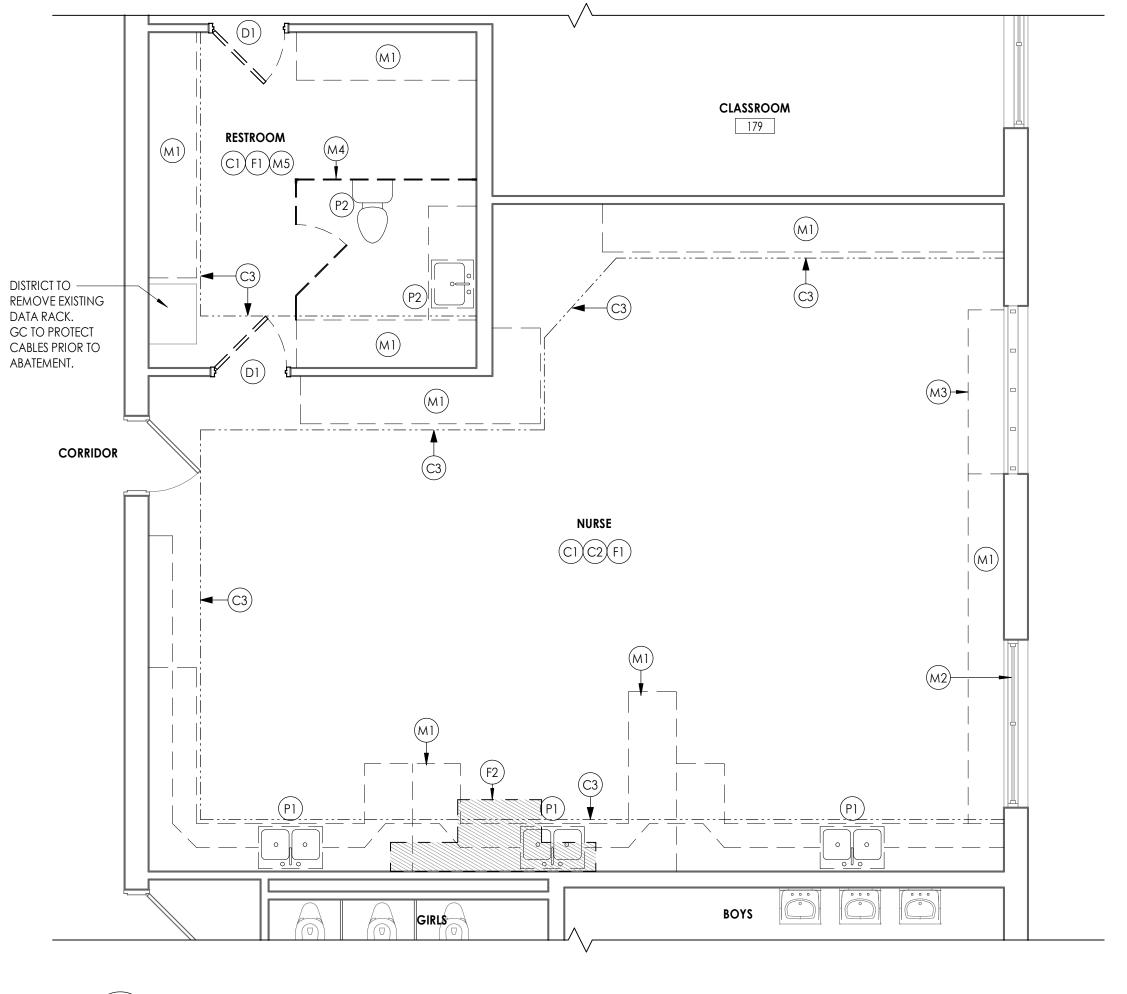
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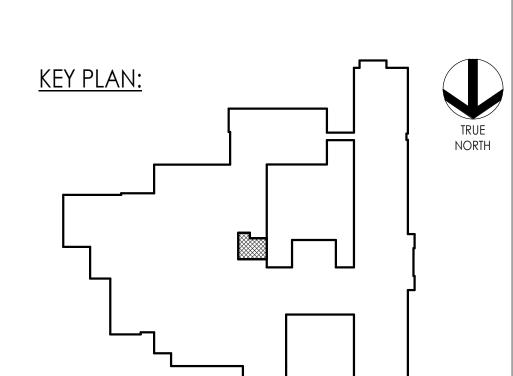
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DEMOLITION KEY NOTES

- (C1) REMOVE EXISTING PLASTER CEILING IN ITS ENTIRETY.
- (C2) REMOVE CEILING MTD CURTAIN TRACK
- (C3) REMOVE LATH & PLASTER SOFFIT IN ITS ENTIRETY.
- (D1) REMOVE DOOR, FRAME AND HARDWARE IN ITS ENTIRETY.
- (F1) REMOVE VCT FLOORING AND WALL BASE IN ITS ENTIRETY.
- SAWCUT & REMOVE SLAB TO FACILITATE UNDERGROUND PLUMBING WORK. COORDINATE W/ PC FOR FINAL LOCATION
- (M1) REMOVE CASEWORK
- (M2) REMOVE EXISTING AC UNIT AND RETURN TO OWNER.
- (M3) EXISTING U.V. REMOVED BY M.C.
- (M4) REMOVE TOILET PARTITIONS
- (M5) REMOVE AND SALVAGE TOILET ACCESSORIES FOR RE-INSTALLATION
- (P1) P.C. TO REMOVE EXISTING SINKS. REFER TO PLUMBING DRAWINGS.
- (P2) P.C. TO REMOVE RESTROOM FIXTURES. REFER TO PLUMBING DRAWINGS.








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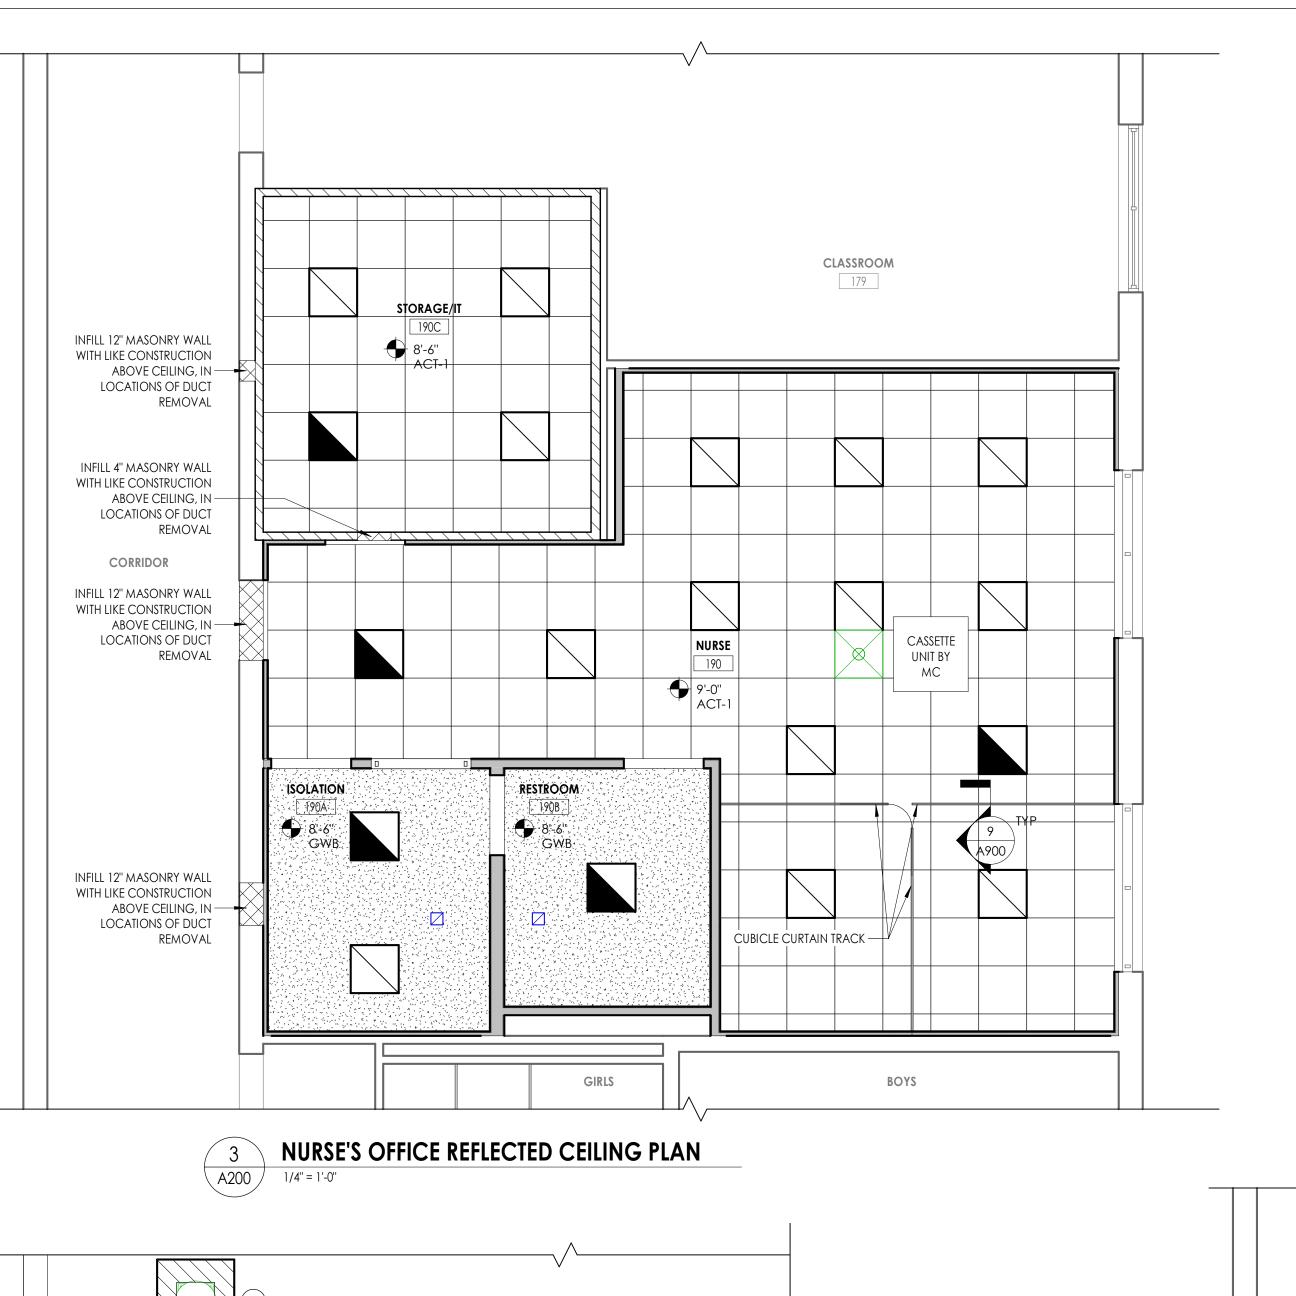
CPL NURSE'S OFFICE DEMOLITION


FLOOR PLAN & ROOF PLAN

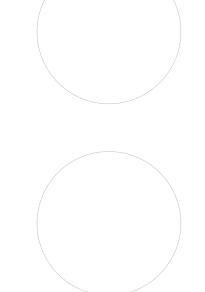A100

PARTIAL DEMOLITION ROOF PLAN - NURSE'S OFFICE AREA A100) 1/4" = 1'-0"

NURSE'S OFFICE DEMOLITION PLAN A100 1/4" = 1'-0"



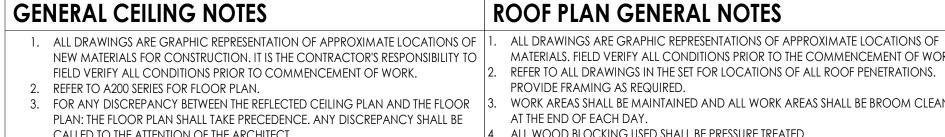

CALLED TO THE ATTENTION OF THE ARCHITECT.

4. THROUGH-PENETRATION FIRESTOPPING FOR THE WORK OF EACH CONTRACT SHALL BE PROVIDED BY EACH CONTRACT FOR ITS OWN WORK.

5. COORDINATE CEILING INSTALLATIONS WITH MECHANICAL, ELECTRICAL AND PLUMBING DRAWINGS.

6. REFER TO "H" SERIES DRAWINGS FOR DIFFUSERS AND GRILLE LOCATIONS.

7. REFER TO "E" SERIES DRAWINGS FOR LIGHTING TYPES AND CONTROLS. 8. WORK AREAS SHALL BE MAINTAINED AND ALL WORK AREAS SHALL BE LEFT BROOMED CLEAN AT THE END OF EACH DAY

9. CENTER CEILING GRID (EACH WAY) IN ROOMS SCHEDULED TO RECEIVE ACOUSTICAL CEILING SYSTEMS UNLESS OTHERWISE NOTED 10. VERIFY WITH ARCHITECT THE INSTALLATION OF ANY CEILING TILES LESS THAN 4" IN

11. PROVIDE MOISTURE RESISTANT GYP. BD. AT ALL TOILET ROOM, JANITOR'S CLOSET AND OTHER WET LOCATION CEILING ASSEMBLIES. 12. ALL GYP. BD. CEILINGS SHALL BE PRIMED AND PAINTED SCHEDULED COLOR.

SUPPLY AIR DIFFUSERS

NEW ACOUSTICAL TILE

CEILING

PROVIDE 1-HR RATED SHAFT WALL ASSEMBLY PER DETAIL 1/A400

13. WHERE APPLICABLE ALL FIXTURES AND DEVICES SHALL BE CENTERED ON A CEILING 14. INSTALL CONTROL JOINTS IN GYP. CEILINGS PER ASTM C 840.

CEILING SYMBOL LEGEND

NEW GYPSUM WALL

ACT-1 CEILING TYPE AND CEILING HEIGHT ABOVE FINISHED FLOOR

BOARD CEILING

CEILING PLAN LEGEND

NURSE'S OFFICE NEW WORK FLOOR PLAN

A200

1/4" = 1'-0"

ROOF PLAN GENERAL NOTES

ROOF PLAN LEGEND

ROOF PLAN KEY NOTES

TO MATCH EXISTING AS REQ'D.

EXISTING ROOFING

MATERIALS. FIELD VERIFY ALL CONDITIONS PRIOR TO THE COMMENCEMENT OF WORK REFER TO ALL DRAWINGS IN THE SET FOR LOCATIONS OF ALL ROOF PENETRATIONS.

PROVIDE FRAMING AS REQUIRED. WORK AREAS SHALL BE MAINTAINED AND ALL WORK AREAS SHALL BE BROOM CLEAN

AT THE END OF EACH DAY ALL WOOD BLOCKING USED SHALL BE PRESSURE TREATED.

THE ROOF ELEVATIONS SHOWN ON THE PLAN ARE SHOWN TO ESTABLISH RELATIVE HEIGHTS OF THE INDIVIDUAL ROOFS. NO WEEP HOLES SHALL BE COVERED OR PLUGGED AS A RESULT OF THE ROOFING

WORK, UNLESS OTHERWISE DIRECTED. MAINTAIN WATER TIGHTNESS AND PROVIDE PROTECTION AT ANY/ALL OPENINGS IN THE ROOF LEFT AT THE END OF EACH DAY.

PROVIDE CRICKETS FOR WATER DIVERSION AT ALL CURBS, RAILS, ETC. WHICH RUN PERPENDICULAR TO THE SLOPE OF THE INSULATION/SLOPED STRUCTURE. ALL ROOF TOP UNITS SHALL BE MOUNTED ON 16" MIN. INSULATED METAL CURBS. PROVIDE TAPERED INSULATION CRICKETS AS REQUIRED TO SHED WATER. WOOD BLOCKING SHALL BE PROVIDED SO CURBS ARE 12" ABOVE FINISHED ROOF SURFACE. 10. ALL SADDLES AND CRICKETS ARE TO HAVE A MIN. 1/4" PER FOOT SLOPE AS INDICATED. PROVIDE CRICKETS FOR DIVERSION OF WATER AT ALL CURBS, RAILS, ETC. WHICH RUN

PERPENDICULAR TO SLOPE OF INSULATION. . AT ALL MECHANICAL EQUIPMENT, PROVIDE SLOPED INSULATION AS REQUIRED TO DRAIN ROOF WATER AWAY FROM HIGH SIDE OF CURBS. 12. ALL CURBS FOR MECHANICAL EQUIPMENT SHALL BE PROVIDED BY THE MECHANICAL CONTRACTOR AND INSTALLED BY THE GENERAL CONTRACTOR. ASSOCIATED

ROOF/FLASHING BY GENERAL CONTRACTOR. 13. THE INSTALLED ROOFING SYSTEM SHALL MEET ALL REQUIREMENTS FOR CLASSIFICATION AS A UL CLASS "A" ROOF ASSEMBLY.

PROVIDE NEW ROOFING SYSTEM TO MATCH EXISTING

MECHANICAL EQUIPMENT SUPPORT RAIL OR ROOF CURB PROVIDED &

PENETRATION CURB PROVIDED & INSTALLED BY MC. GC TO FLASH INTO

OF WORK.

FLOOR PLAN GENERAL NOTES

ALL DRAWINGS ARE GRAPHIC REPRESENTATIONS OF APPROXIMATE LOCATIONS OF NEW MATERIALS. FIELD VERIFY ALL EXISTING CONDITIONS PRIOR TO COMMENCEMENT

ALL WALL DIMENSIONS INDICATED ON FLOOR PLANS ARE FROM FACE OF STUD TO

FACE OF STUD UNLESS OTHERWISE NOTED.

SEE SHEET A400 FOR INTERIOR PARTITION TYPES. SEE A900s FOR INTERIOR AND EXTERIOR DOORS AND WINDOWS.

WORK AREAS SHALL BE MAINTAINED AND ALL WORK AREAS SHALL BE LEFT BROOMED CLEAN AT END OF EACH DAY. COORDINATE WITH OTHER TRADES FOR SEQUENCING OF WORK.

REFER TO A701 FOR TYPICAL FIXTURE MOUNTING HEIGHTS AND ACCESSORIES LEGEND. REFER TO A701 FOR FURNISH AND INSTALL SCOPE OF EQUIPMENT AND ACCESSORIES. EQUIPMENT SHOWN ON THESE DOCUMENTS ARE FOR REFERENCE ONLY AND ARE FOR COORDINATION OF M,E,P INFRASTRUCTURE TO OPERATE ITEMS INCLUDED UNDER THE SCOPE.

REFER TO OWNER FURNISHED EQUIPMENT DRAWINGS AND SUBMITTALS FOR FINAL COORDINATION AND INSTALLATION REQUIREMENTS INCLUDING BUT NOT LIMITED TO:

DIMENSIONS, LOCATIONS & MEP CONNECTION LOCATION. ALL FURNITURE IS PROVIDED BY OWNER UNLESS NOTED OTHERWISE.

. PATCH AND FINISH ALL EXISTING WALLS TO REMAIN WITHIN THE PROJECT LIMIT AREA TO RECEIVE SPECIFIED FINISHES. . ALL EXISTING EXPANSION JOINT COVERS OR ASSEMBLIES ARE TO BE PROTECTED AND

MAINTAINED DURING THE COURSE OF CONSTRUCTION UNLESS OTHERWISE NOTED. . PROVIDE CONCRETE FLOOR PATCH AND FLOOR LEVELING AT EXISTING CONCRETE FLOORS FOR NEW FINISHES.

FLOOR PLAN LEGEND

NOTE: THIS LEGEND MAY CONTAIN SYMBOLS THAT ARE NOT USED IN THIS PROJECT.

(DOOR) DOOR TARGET, WINDOW TARGET, SEE SCHEDULE SEE SCHEDULE **ROOM NAME** H1234.2 COLUMN LINE **ROOM TAG** 150 SF IDENTIFICATION 10'-0" x 10'-0" XXX WALL TYPE SEE A/400 SECTION MARK) INSTALLED BY M.C. G.C. TO FLASH INTO EXISTING ROOFING & PATCH ROOFING DETAIL FOR REFERENCE EXTERIOR ELEVATION DENOTES FINISH FLOOR GRADE ELEVATION

FLOOR PLAN KEY NOTES

INFILL EXTERIOR MASONRY WALL AT DEMOLISHED U.V. LOCATIONS. REFER TO DETAIL 1/A800

INSTALL OWNER SUPPLIED GLAZING AT OPENING WITH NEW STOPS. REFER TO

NEW CASEWORK BY OTHERS. GC TO PROVIDE BLOCKING AND WALL BASE. REFER TO INTERIOR ELEVATIONS AND A800 SERIES FOR DETAILS

(4) PROVIDE SLAB INFLL PER DETAIL 8/P201 & 4/A800

INFILL EXISTING 4" CMU WALL WITH 1 HR RATED ASSEMBLY: 2.5" MTL. STUDS & GYPSUM BOARD. NEW GYP TO BE FLUSH ON CLASSROOM SIDE

(6) EXISTING DATA RACK TO BE REINSTALLED BY DISTRICT

PATCH WALL BASE TO MATCH EXISTING AT NEW WALL. PAINT WALL CORNER TO


PROVIDE AND INSTALL MEDICUS HEALTH DOUBLE DOOR DOUBLE LOCK) NARCOTICS CABINET ITEM #2976M1, OR EQUAL. VERIFY LOCATION WITH ARCHITECT PRIOR TO INSTALLATION

(9) ROOM SIGN - REFER TO 10/A900

10) REFRIGERATOR AND WATER COOLER PROVIDED AND INSTALLED BY DISTRICT.

(11) REFER TO RCP & A400 SHEET FOR SHAFT WALL DETAIL AND EXTENTS

(12) INFILL MASONRY WALL AT DUCT REMOVAL ABOVE CEILING. REFER TO RCP.

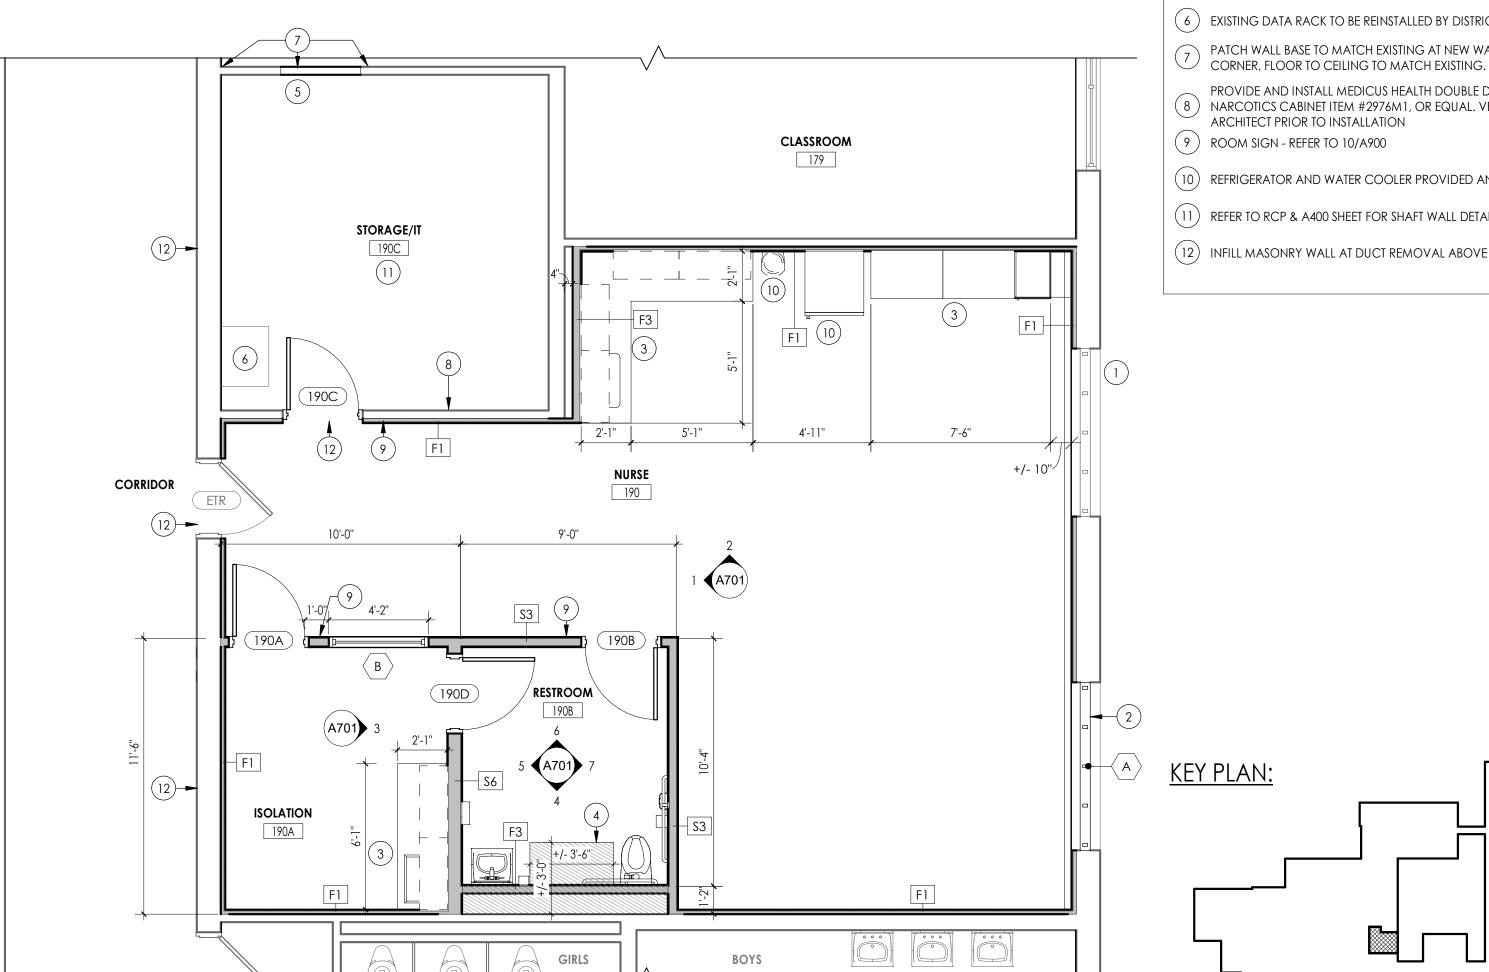





PROJECT INFORMATION

R23.01124.00

SOUTH ORANGETOWN CENTRAL SCHOOL DISTRICT

2024 CAPITAL IMPROVEMENTS **PROJECT**

SOUTH ORANGETOWN MIDDLE SCHOOL


160 VAN WYCK ROAD, BLAUVELT, NY 10913

SED # 50-03-01-06-0-013-031

Registration Expiration Dates Lauren Tarsio 09/30/26 Anthony Marchetti 05/31/24 Dave Hart 02/28/25 Jennifer Wengender 06/30/24

PROJECT ISSUE & REVISION SCHEDULI

PROFESSIONAL STAMPS

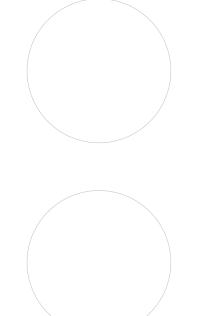

SHEET INFORMATION

TRUE


NORTH


05/15/24 As indicated Project Status BID DOCUMENTS

Drawn By CPL CPL

NURSE'S OFFICE NEW WORK FLOOR PLAN, ROOF PLAN & REFLECTED CEILING PLAN

A200

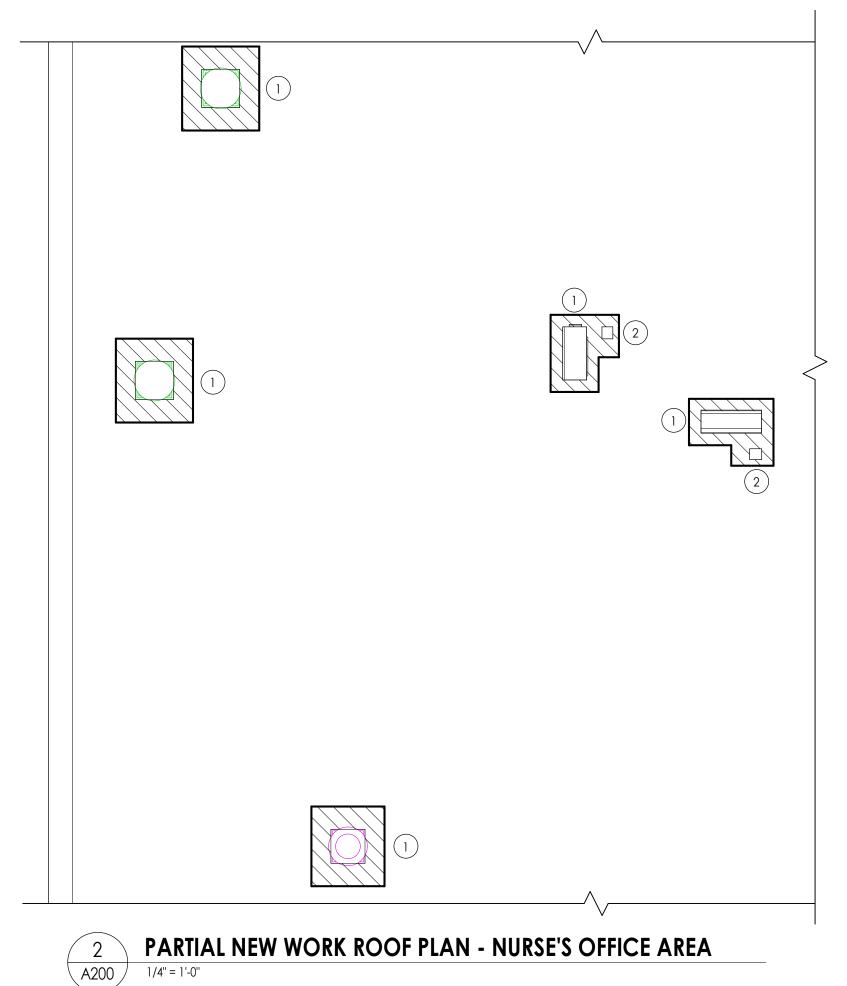


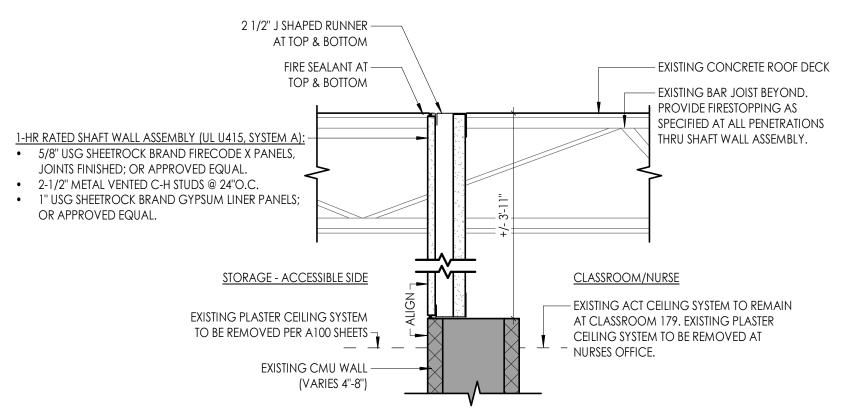


NOTE: REFER TO RCP 3/A200 FOR LOCATIONS


STORAGE ROOM SHAFT WALL √ A400 / 1 1/2" = 1'-0"

MIN. PLUMBING CHASE DIMENSIONAL REQUIREMENTS PARTITION GENERAL NOTES ///4" CMU/// STUD WALL CHASE CHASE EXISTING WALL 3. SINGLE FIXTURE W/ STUD WALL AND EXISTING WALL. 1. BACK TO BACK FIXTURES W/ 4" MASONRY WALLS STUD WALL CHASE STUD WALL 4. BACK TO BACK CHASE FIXTURES W/ STUD WALL EXISTING WALL 2.. SINGLE FIXTURE W/ 4" MASONRY 6" STUD WALL WALLS AND EXISTING WALL. 5. SINK CARRIER WALL

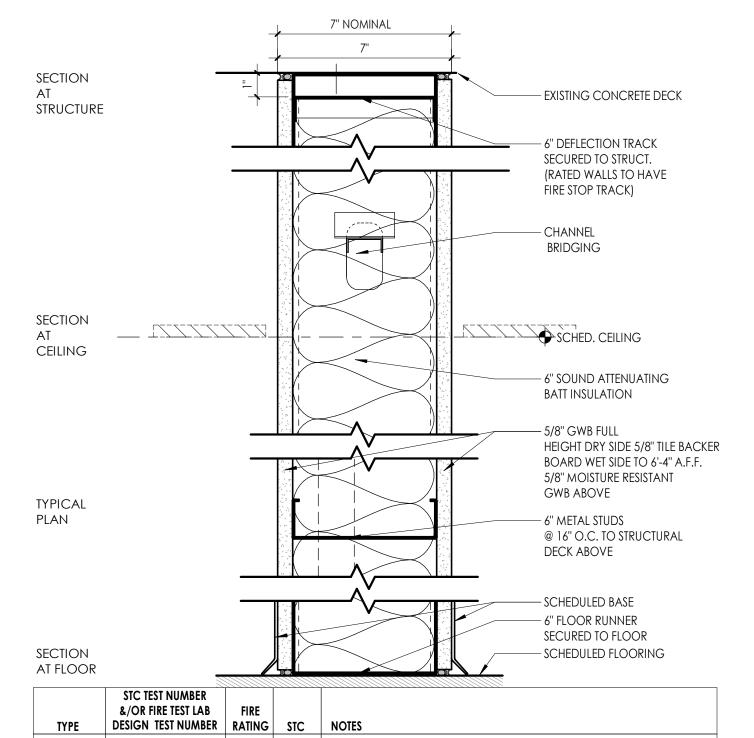


SMOKE/ACOUSTICAL SEALANT AT TOP AND BOTTOM

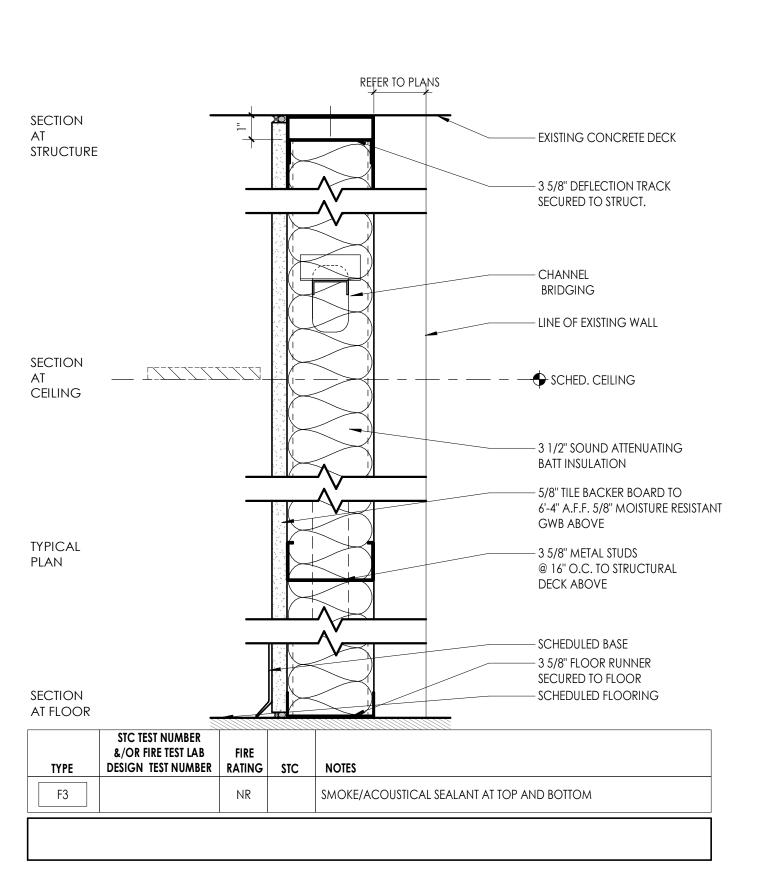

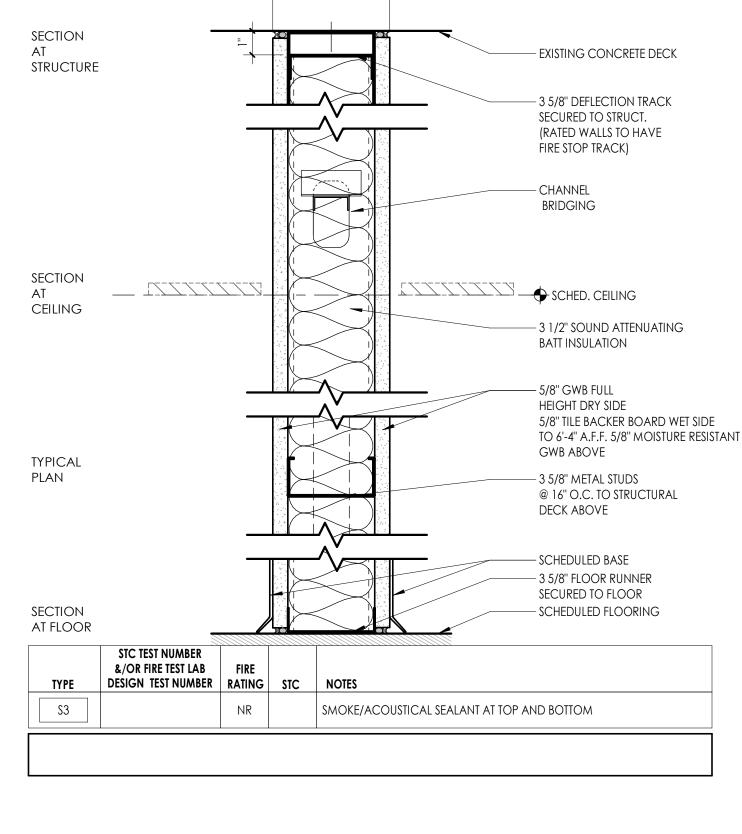


5" NOMINAL

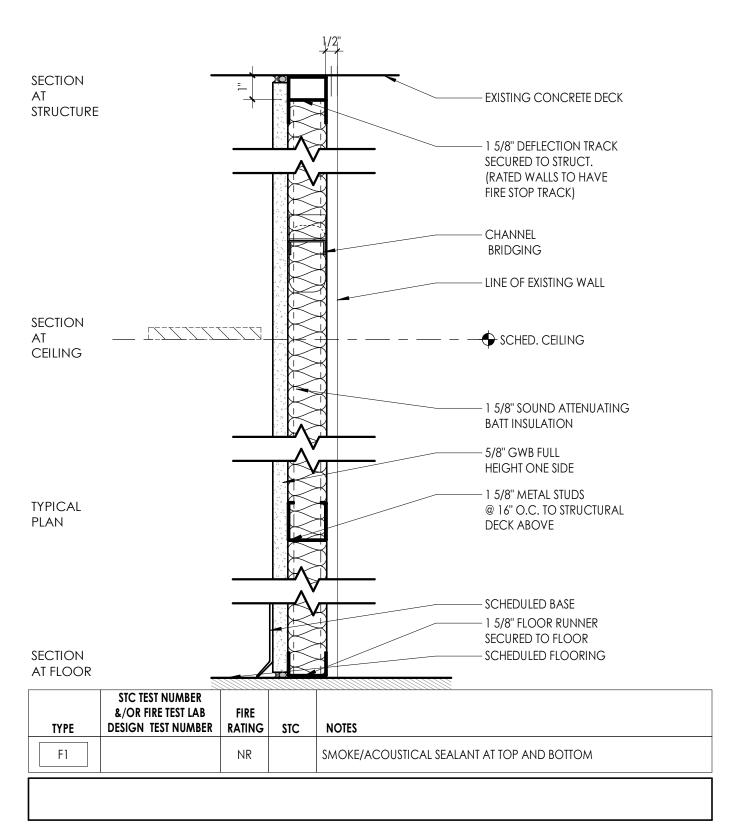


- . ALL WALL TYPES MAY NOT BE USED ON THIS PROJECT.
- UNLESS NOTED OTHERWISE ALL PARTITIONS ARE FULL HEIGHT, EXTEND & SECURE TO UNDERSIDE OF CONCRETE DECK
 - PROVIDE UL APPROVED JOINT AT ALL TOP OF WALL AND WALL TO WALL CONDITIONS AT ALL RATED WALLS.
- 4. PROVIDE DEFLECTION TRACKS AT METAL STUD PARTITIONS THAT TERMINATE AT THE UNDERSIDE OF STRUCTURE AND
- 5. ALL PENETRATIONS IN FIRE RATED PARTITIONS TO BE FIRE STOPPED AND SEALED. REFER TO SPEC DIVISION 7.
- 6. REFER TO STRUCTURAL DRAWINGS FOR MASONRY WALL REINFORCEMENT.
- 7. ALL PARTITIONS SHALL BE SEALED TO PREVENT PASSAGE FOR SMOKE. 8. CONTRACTOR TO REFER TO CODE/LIFE SAFETY DRAWINGS FOR RATED PARTITIONS AND UL ASSEMBLIES.
- P. REFER TO INTERIOR DRAWINGS FOR LOCATIONS OF WALL TILE, AND OTHER SPECIALTY WALL FINISHES. 10. REFER TO SPECIFICATIONS FOR METAL STUD GAUGE REQUIREMENTS.
- CONTRACTOR IS RESPONSIBLE TO COORDINATE ALL PARTITION ACCESSORIES (APPLIED FINISHES, RESILIENT CHANNEL, ADDITIONAL LAYERS OF SHEATHING, SHIELDING, ETC.) ITEMS SHOWN IN TYPICAL WALL CONSTRUCTION DETAILS MAY HAVE TO BE ARRANGED ON DIFFERENT SIDES OF WALL ASSEMBLY TO ACHIEVE FLUSH CONTINUOUS WALL SURFACES. ANY CONFLICTS SHOULD BE BROUGHT TO THE ATTENTION OF THE ARCHITECT.

PARTITION TYPE TAG LEGEND

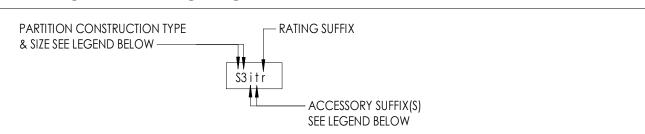

PARTITION CONSTRUCTION TYPE & SIZE LEGEND

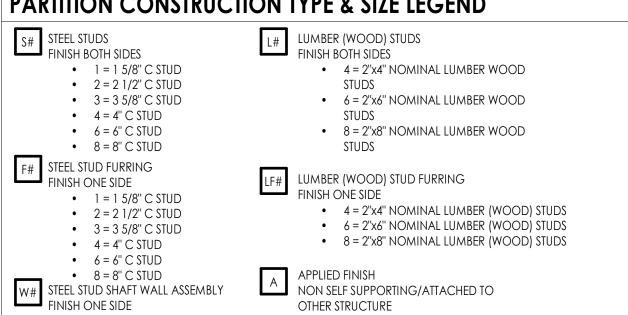

- 2 = 2 1/2" CH SHAFT WALL
- C# RESILIENT CHANNEL
 NON SELF SUPPORTING/ATTACHED TO 4 = 4" CH SHAFTWALL STUD 6 = 6" CH SHAFTWALL STUD OTHER STRUCTURE 1 = 1/2" RC-1 RESILIENT CHANNEL B# CONSTRUCTION BARRIER/TEMP WALL • 2 = 1/2" RC-2 RESILIENT CHANNEL
 - 1 = 1 5/8" C STUD • 2 = 2 1/2" C STUD H# HAT CHANNEL NON SELF SUPPORTING/ATTACHED TO OTHER • 3 = 3 5/8" C STUD 4 = 4" C STUD STRUCTURE 6 = 6" C STUD
- 1 = 7/8" HAT CHANNEL 8 = 8" C STUD • 2 = 1 1/2" HAT CHANNEL Z# ZEE-FURRING NON SELF SUPPORTING/ATTACHED TO OTHER CONCRETE MASONRY UNIT 4 = 4" NOMINAL CMU 6 = 6" NOMINAL CMU STRUCTURE
- 8 = 8" NOMINAL CMU 1 = 1" ZEE FURRING • 10 = 10" NOMINAL CMU • 1.5 = 1 1/2" ZEE FURRING • 12 = 12" NOMINAL CMU 2 = 2" ZEE FURRING • 2.5 = 2 1/2" ZEE FURRING

PARTITION TYPE SUFFIX

ACCESSORIES SUFFIX:

- i Sound attenuating batt insulation (fiberglass) friction fit between Studs to fill cavity
- w SOUND ATTENUATING FIRE BATT INSULATION (ROCK WOOL) FRICTION FIT BETWEEN STUDS TO FILL CAVITY

• 3 = 3" ZEE FURRING

- t CERAMIC WALL TILE (1) SIDE W/ THINSET MORTAR BED, 5/8" CEMENT BACKER BOARD IN LIEU OF 5/8" GYP. AT TILE LOCATIONS - SEE INTERIOR ELEVATIONS FOR TILE EXTENTS
- th CERAMIC WALL TILE (2) SIDES W/ THINSET MORTAR BED, 5/8" CEMENT BACKER BOARD IN LIEU OF 5/8" GYP. AT TILE LOCATIONS - SEE INTERIOR ELEVATIONS FOR TILE EXTENTS
- b INTERIOR VENEER MASONRY/STONE APPLIED FINISH, REFER TO DETAILS FOR CONSTRUCTION, AND INTERIOR ELEVATIONS FOR EXTENTS


g - CMU WALL GROUT CORES SOLID

- s ADD 1/2" RC1 RESILIENT SOUND CHANNEL BEHIND SPECIFIED SHEATHING
- k ADD ADDITIONAL (1) LAYER OF 5/8" GYP BOARD, TO ONE SIDE OF WALL
- kk ADD ADDITIONAL (2) LAYERS OF 5/8" GYP BOARD, (1) EA. SIDE OF WALL
- e ADD ADDITIONAL (1) LAYER OF 5/8" FRT PLYWOOD BOLTED TO WALL FOR MOUNTING OF ELECTRICAL PANELS/ EQUIPMENT WHERE NOTED ON ELEC. DWGS.
- v SUBSTITUE (1) LAYER OF 5/8" SOUNDBLOCK GYP. W/ INTEGRAL VISCOELASTIC POLYMER CORE FOR (1) LAYER OF
- SPECIFIED 5/8" TYPE X GYP. vv - SUBSTITUE 5/8" SOUNDBLOCK GYP. W/ INTEGRAL VISCOELASTIC POLYMER CORE FOR ALL LAYER OF SPECIFIED 5/8"
- p LEAD SHIELDING REFER TO PHYSICIST REPORT FOR REQUIREMENTS
- x COPPER MAGNETIC/RF SHIELDING REFER TO PHYSICIST REPORT FOR REQUIREMENTS
- C WALL FINISH TO TERMINATE 6" ABV. HIGHEST ADJACENT CEILING STUDS TO RUN TO UNDERSIDE OF DECK ABOVE.
- y WALL STRUCTURE TERMINATES 12" ABV. HIGHEST ADJACENT CEILING, PROVIDE STRUCTURAL BRACING AT TOP OF WALL AS REQUIRED.
- n KNEE WALL, REFER TO INTERIOR ELEVATIONS FOR HEIGHT & SILL CONDITION, REFER TO STRUCTURAL DETAILS FOR REQUIRED SUPPLEMENTAL STEEL AND ANCHORING REQUIREMENTS

RATING SUFFIX:

- r 1 HR RATED ASSEMBLY REFER TO UL DETAILS FOR RATED CONSTRUCTION REQUIREMENTS
- d 2 HR RATED ASSEMBLY REFER TO UL DETAILS FOR RATED CONSTRUCTION REQUIREMENTS
- rd 3 HR RATED ASSEMBLY REFER TO UL DETAILS FOR RATED CONSTRUCTION REQUIREMENTS
- dd 4 HR RATED ASSEMBLY REFER TO UL DETAILS FOR RATED CONSTRUCTION REQUIREMENTS



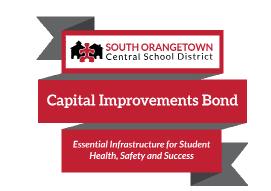

PROJECT INFORMATION

R23.01124.00

SOUTH ORANGETOWN CENTRAL SCHOOL DISTRICT

2024 CAPITAL IMPROVEMENTS

PROJECT SOUTH ORANGETOWN MIDDLE SCHOOL


160 VAN WYCK ROAD, BLAUVELT, NY 10913

SED # 50-03-01-06-0-013-031

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PROFESSIONAL STAMPS



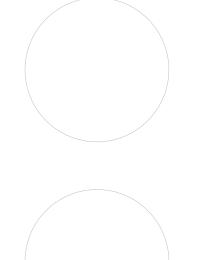


SHEET INFORMATION

Issued 05/15/24 As indicated Project Status BID DOCUMENTS Drawn By


CPL

Drawing Title WALL TYPES

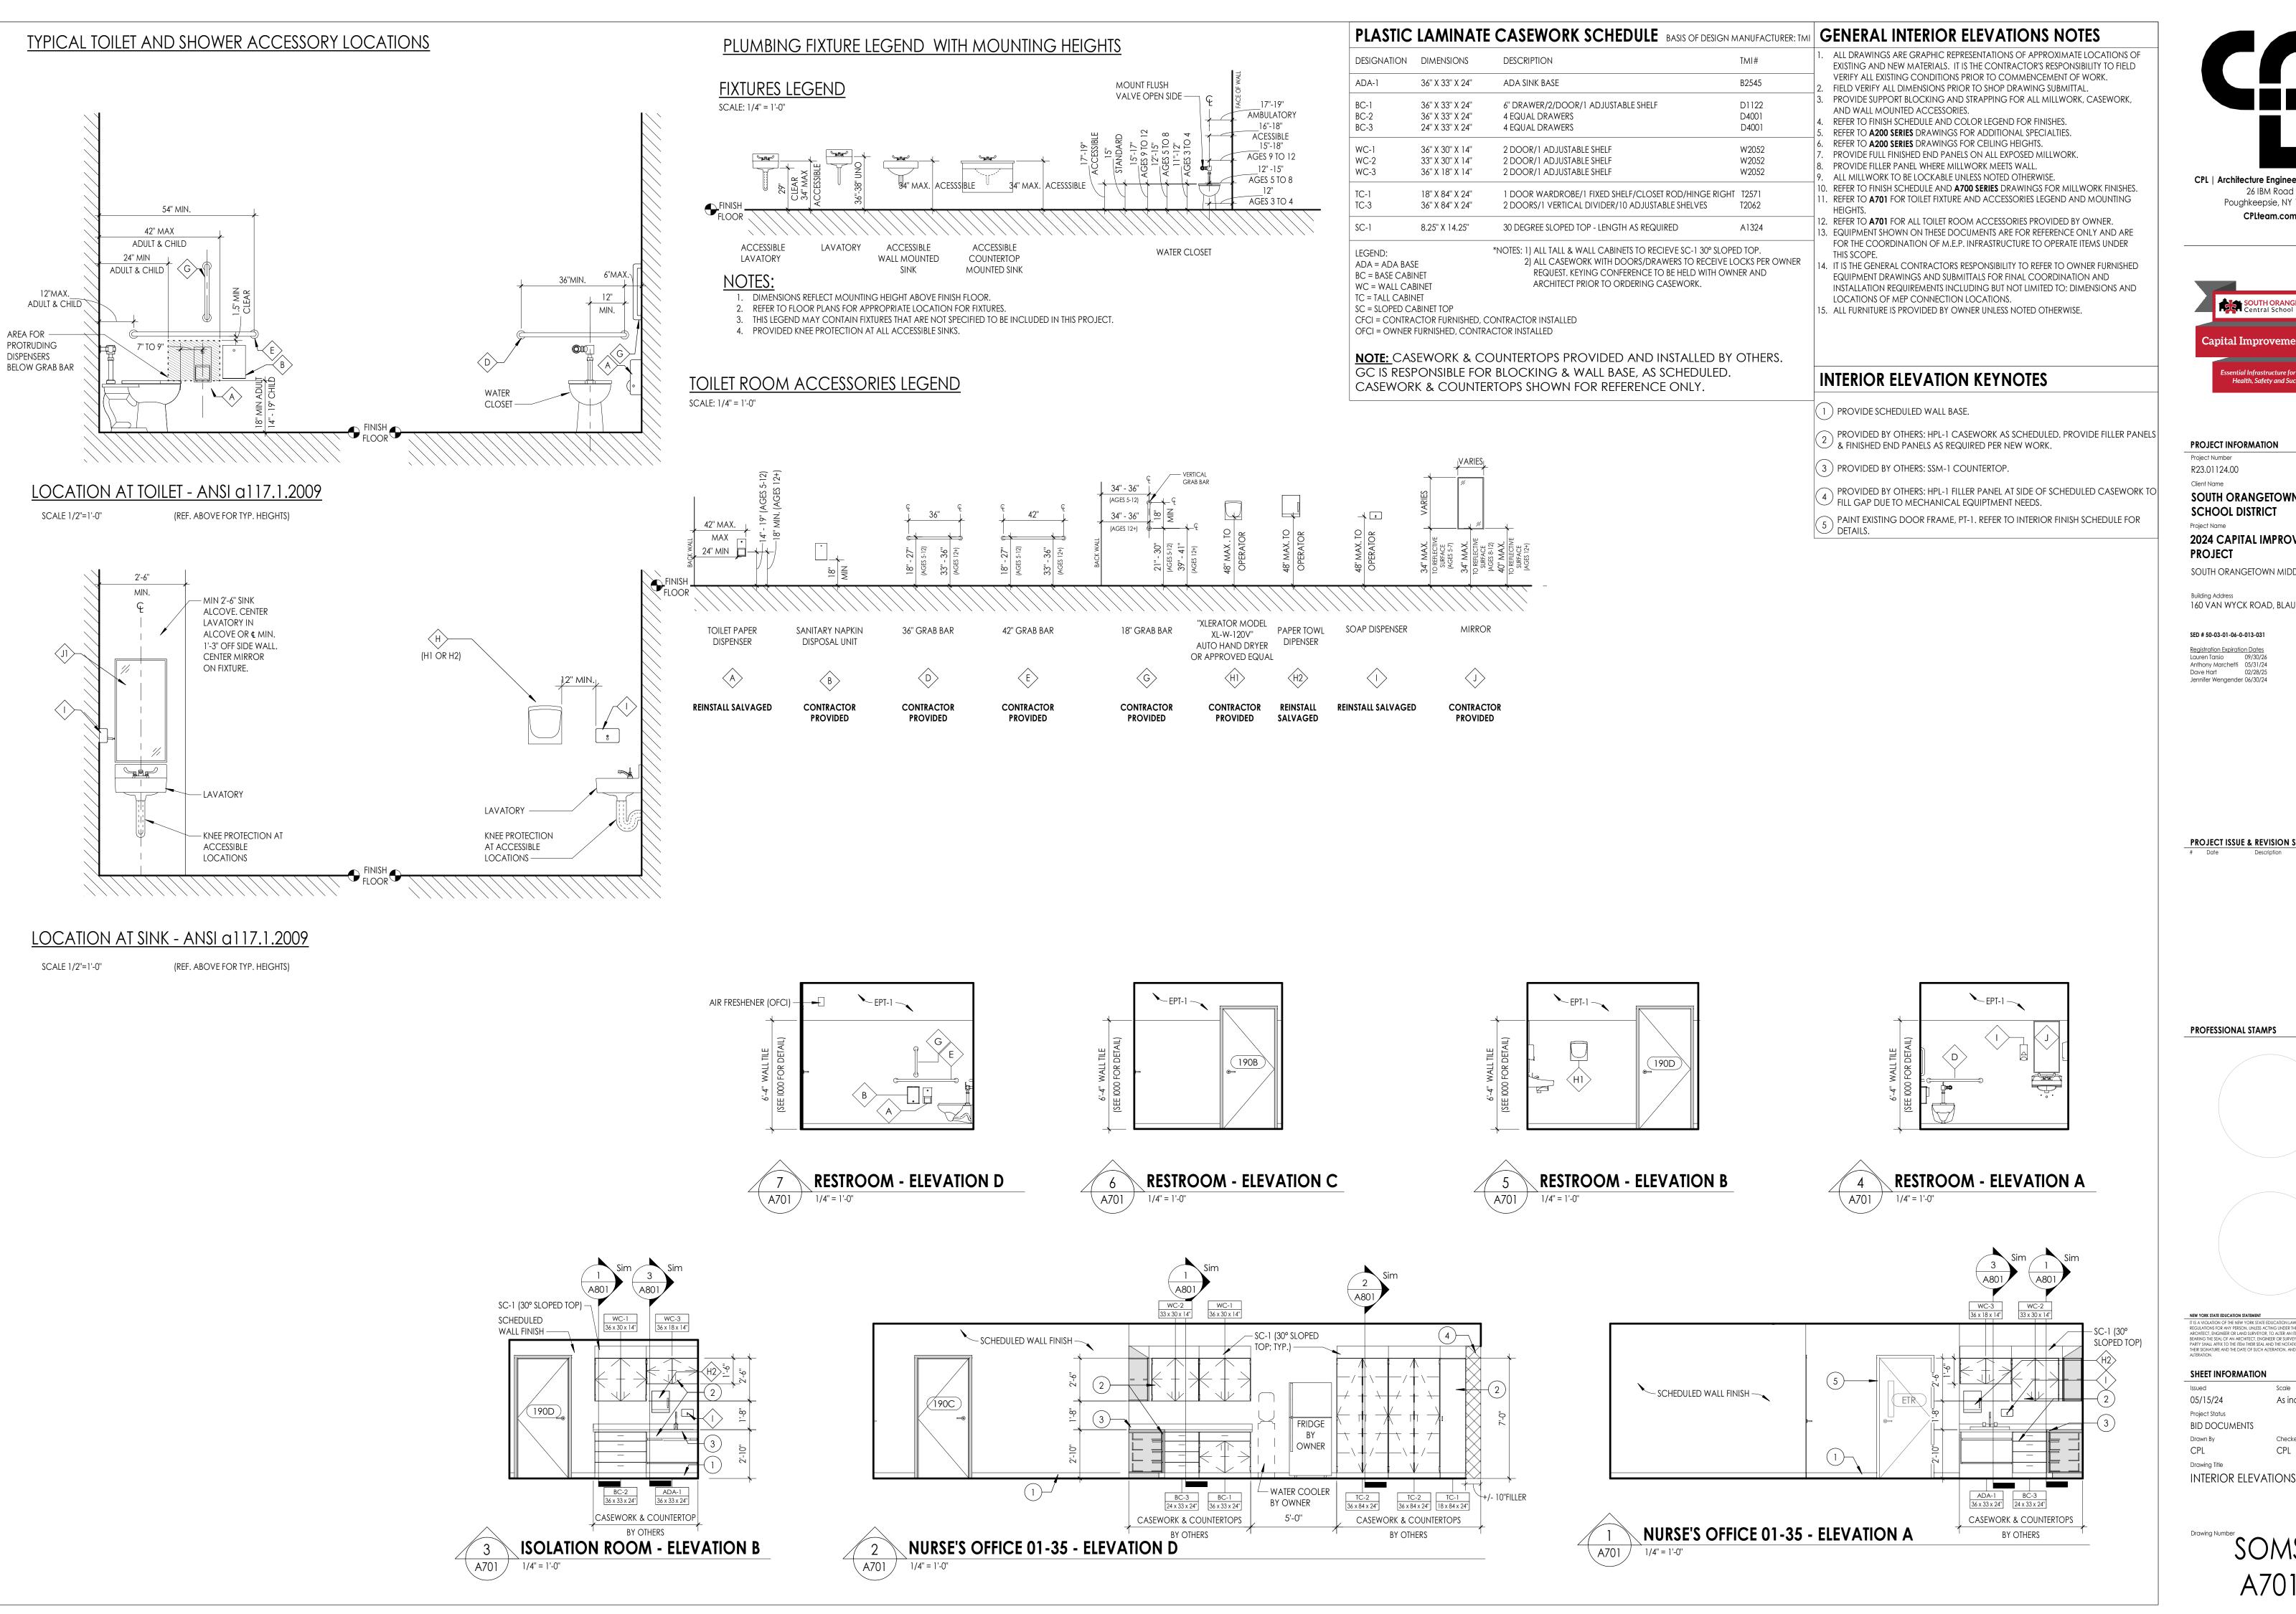

CPL | Architecture Engineering Planning 26 IBM Road Poughkeepsie, NY 12601

CPLteam.com

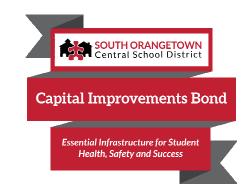

PROJECT INFORMATION

R23.01124.00

SOUTH ORANGETOWN CENTRAL SCHOOL DISTRICT

2024 CAPITAL IMPROVEMENTS **PROJECT**

SOUTH ORANGETOWN MIDDLE SCHOOL


160 VAN WYCK ROAD, BLAUVELT, NY 10913


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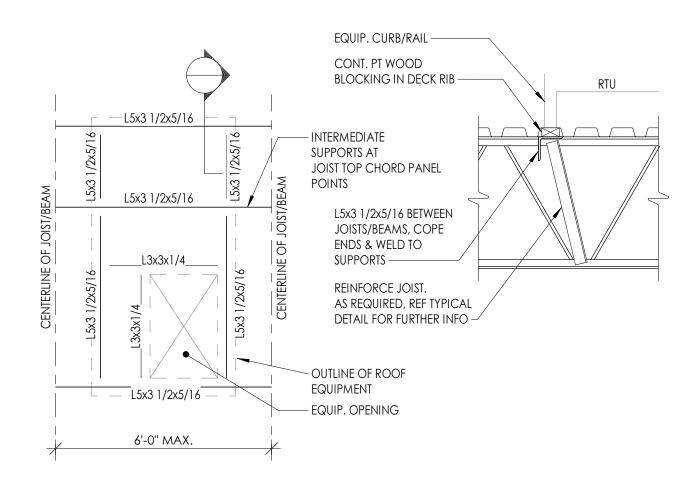
A701

DETAIL NOTES:

1. REFER TO MECHANICAL AND PLUMBING DRAWINGS FOR UTILITY LOCATIONS.

8 NEW_DEMO UTILITIES AT EXISTING SLAB ON GRADE

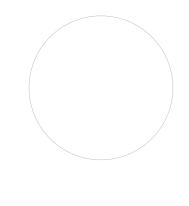A800 3/4" = 1'-0"

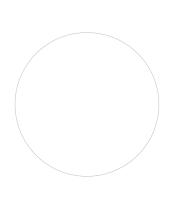


DETAIL NOTES:

- THE ABOVE STEEL SIZES SHALL BE USED UNLESS NOTED OTHERWISE ON THE PLANS.
 CONTRACTOR TO COORDINATE EQUIPMENT AND OPENING SUPPORTS WITH MECHANICAL CONTRACTOR AND FINAL APPROVED FOLLOWERS SUBMITTAL
- CONTRACTOR AND FINAL APPROVED EQUIPMENT SUBMITTAL.

 3. L4x4x5/16 MEMBERS CAN BE REPLACED WITH L3x3x1/4 MEMBERS FOR EQUIPMENT LESS THAN 1,000 LB IN TOTAL WEIGHT (INCLUDES OPERATING WEIGHT).




ROOF EQUIPMENT SUPPORT DETAIL

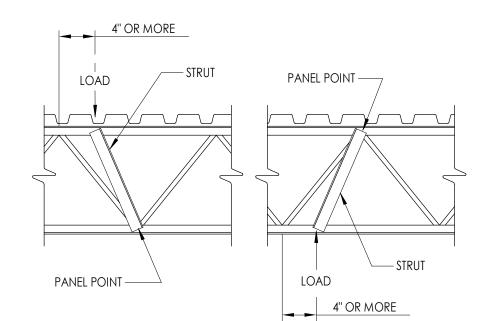


NOTE:
WHEN A CONCENTRATED LOAD EQUAL TO OR GREATER THAN 200LBS. OCCURS 4" OR MORE FROM A PANEL POINT, A FIELD WELDED STRUT COMPOSED OF (2) L2x2x3/16 SHALL BE ADDED FROM THE POINT OF THE CONCENTRATED LOAD TO THE PANEL POINT ON THE OPPOSITE CHORD.



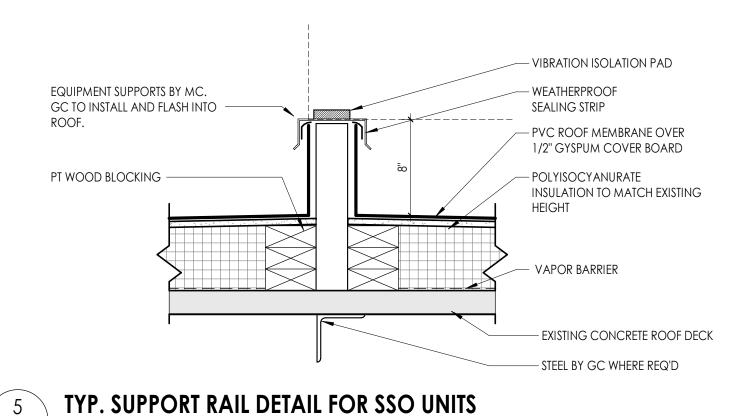




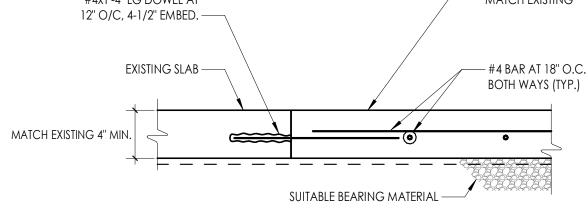




A800

1 1/2" = 1'-0"

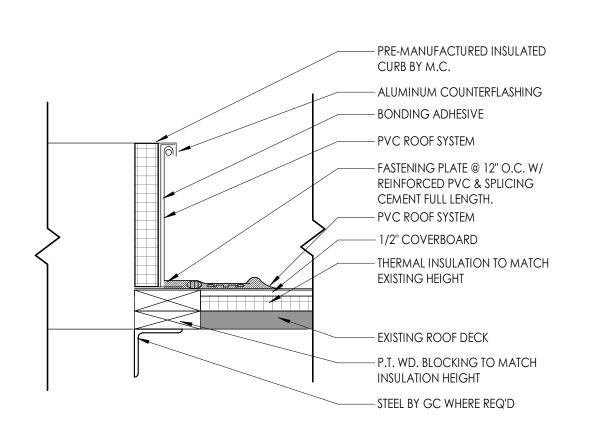



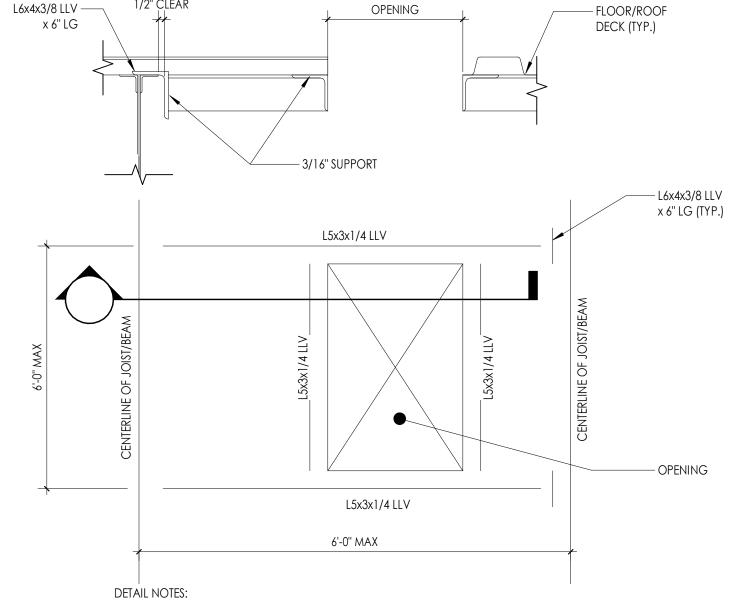

1. THE ABOVE STEEL SIZES SHALL BE USED UNLESS NOTED OTHERWISE ON THE PLANS.

2. CONTRACTOR TO COORDINATE EQUIPMENT AND OPENING SUPPORTS WITH MECHANICAL CONTRACTOR AND FINAL APPROVED EQUIPMENT SUBMITTAL.

2 ROOF A800 1/4" = 1'-0"

ROOF OPENING SUPPORT DETAIL

EXISTING FACE BRICK

3 5/8" METAL STUD INFILL WITH BATT INSULATION

EXISTING AIR INTAKE GRILLE

TO REMAIN

2 LAYERS OF 1" XPS INSULATION

SEALED IN PLACE WITH SPRAY FOAM

PLYWOOD SUBSTRATE

20 GAGE MINIMUM GALVANIZED

SHEET METAL PAINTED BLACK SET IN SILICONE SEALANT

EXISTING WALL

CONSTRUCTION



CPL | Architecture Engineering Planning
26 IBM Road
Poughkeepsie, NY 12601

CPLteam.com

Capital Improvements Bond

Essential Infrastructure for Student Health, Safety and Success

PROJECT INFORMATION
Project Number

R23.01124.00

SOUTH ORANGETOWN CENTRAL SCHOOL DISTRICT

2024 CAPITAL IMPROVEMENTS PROJECT

SOUTH ORANGETOWN MIDDLE SCHOOL


Building Address 160 VAN WYCK ROAD, BLAUVELT, NY 10913

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Date Description

PROFESSIONAL STAMPS



NEW YORK STATE EDUCATION STATEMENT

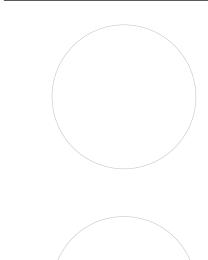IT IS A VIOLATION OF THE NEW YORK STATE EDUCATION LAW AND THE COMMISSIONER'S
REGULATIONS FOR ANY PERSON, UNLESS ACTING UNDER THE DIRECTION OF A LICENSED
ARCHITECT, ENGINEER OR LAND SURVEYOR. TO ALTER AN ITEM, IN ANY WAY, IF AN ITEM
BEARING THE SEAL OF AN ARCHITECT, ENGINEER OR SURVEYOR IS ALTERED, THE ALTERING
PARTY SHALL AFFIX TO THE ITEM THEIR SEAL AND THE NOTATION "ALTERED BY" FOLLOWED B

ARCHITECT, ENGINEER OR LAND SURVEYOR, TO ALTER AN ITEM IN ANY WAY, IF AL BEARING THE SEAL OF AN ARCHITECT, ENGINEER OR SURVEYOR SO, STREED, THE A PARTY SHALL AFFIX TO THE ITEM THEIR SEAL AND THE NOTATION "ALTERED BY" FOLI THEIR SIGNATURE AND THE DATE OF SUCH ALTERATION, AND A SPECIFIC DESCRIPT ALTERATION.

Issued Scale
05/15/24 As indicated
Project Status

Project Status
BID DOCUMENTS
Drawn By Checked By
CPL CPL
Drawing Title
TYPICAL DETAILS

SOMS AROO

NOTE: CASEWORK & COUNTERTOPS PROVIDED & INSTALLED BY OTHERS. GC IS RESPONSIBLE FOR BLOCKING & WALL BASE AS SCHEDULED. CASEWORK & COUNTERTOPS SHOWN FOR REFERENCE ONLY.

> - 3/4" PARTICLE BOARD CABINET BODY W/ LAM ON EXPOSED FACE MELAMINE ON ALL EXPOSED INTERIOR AND SEMI-EXPOSED

- 3/4" PARTICLE BOARD DOOR FRONT W/

- RECESSED SHELF STANDARDS & CLIPS

FOR ADDITIONAL INFORMATION

W/ 2x4 FRT WD BLOCKING BEYOND

- SCHEDULED WORK SURFACE

- SIDE SPLASH AT PERPENDICULAR WALL(S)

RE: INTERIOR ELEVATIONS FOR MATERIAL DESIGNATION

- 3/4" PARTICLE BOARD DRAWER W/ LAM ALL EXPOSED

PROVIDE 1/4" MELAMINE DRAWER BOTTOM AND FULL

FACES, MELAMINE ON SEMI-EXPOSED FACES.

- 3/4" PARTICLE BOARD DOOR FRONT W/ LAM ALL EXPOSED FACES, MELAMINE ON INSIDE FACE

- 3/4" PARTICLE BOARD CABINET BODY W/ LAM ON EXPOSED FACE, MELAMINE ON ALL EXPOSED

EXTENSION DRAWER GUIDES U.N.O.

- 1'-8" DEEP MELAMINE ADJ. SHELF, TYP OF (2) U.N.O. 3/4" THICK UP TO 24" SPAN, 1" THICK OVER 24" SPAN

INTERIOR AND SEMI-EXPOSED FACES

- SCHEDULED BASE

- 3/4" TOE KICK - TYP

- 1/4" MELAMINE BACK PANEL

1x NAILER -TYP.

- 1/4" MELAMINE BACK PANEL

LAM ALL EXPOSED FACES, MELAMINE ON INSIDE

— 1'-1" DEEP MELAMINE ADJ. SHELF, TYP OF (2) U.N.O.

- SCHEDULED HARDWARE, RE: SPECIFICATION

- 3/4" PARTICLE BOARD FASCIA AND NAILER W/ LAM ALL EXPOSED FACES (SEE INTERIOR ELEV.)

HEIGHT VARIES, COORD. WITH LIGHT FIXTURE

3/4" THICK UP TO 24" SPAN, 1" THICK OVER 24" SPAN

SLOPED CASERWORK TOP; SEE DRAWINGS

FOR LOCATIONS & SIZES

2'-1" U.N.O.

1'-9" U.N.O.

NOTE: REFER TO CASEWORK SCHEDULE FOR NUMBER OF DOORS/DRAWERS REQUIRED, VARIES.





PROJECT INFORMATION

R23.01124.00

SOUTH ORANGETOWN CENTRAL SCHOOL DISTRICT

2024 CAPITAL IMPROVEMENTS PROJECT

SOUTH ORANGETOWN MIDDLE SCHOOL


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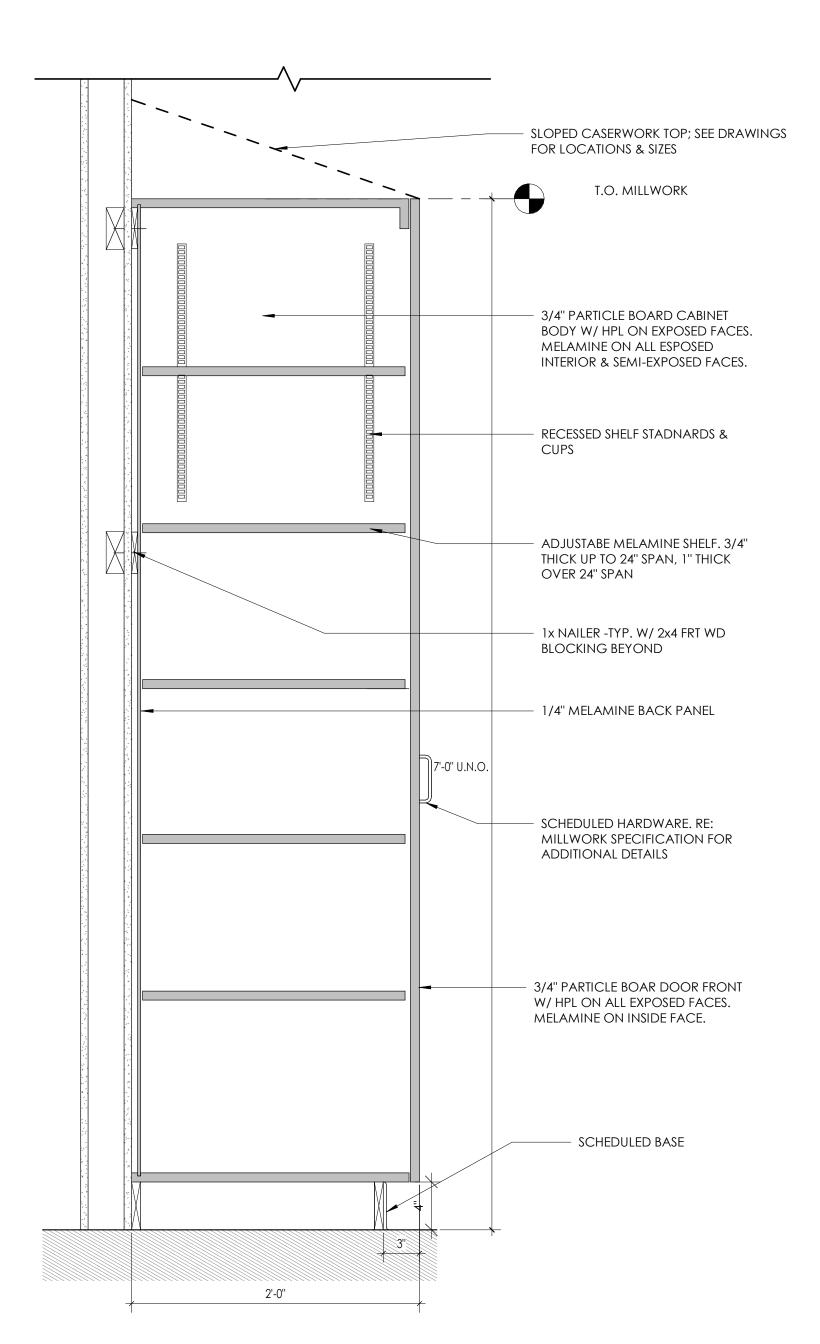
PROFESSIONAL STAMPS



SHEET INFORMATION Issued 05/15/24 Project Status

1 1/2" = 1'-0" BID DOCUMENTS Drawn By


CPL Drawing Title CASEWORK DETAILS

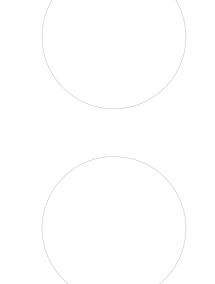

NOTE: REFER TO CASEWORK SCHEDULE FOR NUMBER OF DOORS/OPENINGS REQUIRED, VARIES.







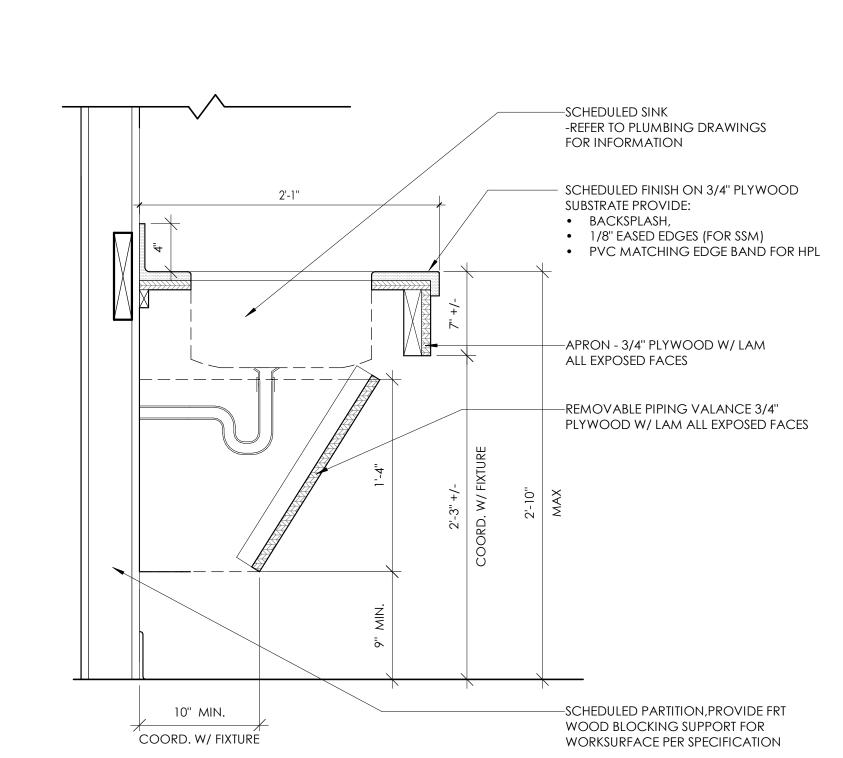




				DOOR	SCHE	DULE- NEV	٧		
D	OOR			DOOR PAI	NELS			DOOR FRAME	
DOOR	FIRE RATING	PANEL TYPE	TOTAL	PANEL DIME	NSIONS	PANEL FINISH	FRAME TYPE	FRAME WIDTH	FRAME HEIGHT
NUMBER	(MIN)	PANEL 1	WIDTH	HEIGHT	THICKNESS	PANEL FINISH	FRAMETIFE	FRAME WIDIN	FRAME HEIGHT
190A		PNL-F-WD	3'-0"	7'-0"	0'-1 3/4"	WOOD	FRM-00HM1	3'-4"	7'-2"
190B		PNL-F-WD	3'-0"	7'-0"	0'-1 3/4"	WOOD	FRM-00HM1	3'-4"	7'-2"
190C	45	PNL-F-WD	3'-0"	7'-0"	0'-1 3/4"	WOOD	FRM-00HM1	3'-4"	7'-2"
190D		PNL-F-WD	3'-0"	7'-0"	0'-1 3/4"	WOOD	FRM-00HM1	3'-4"	7'-2"

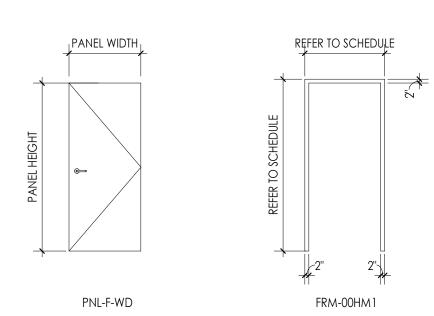


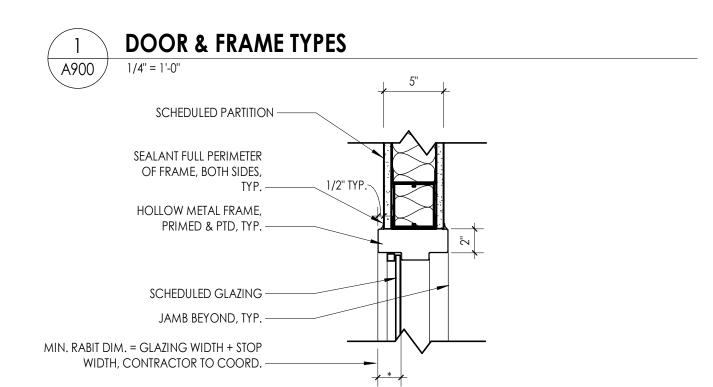




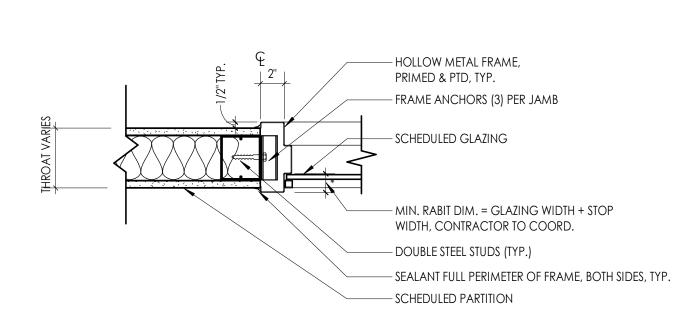




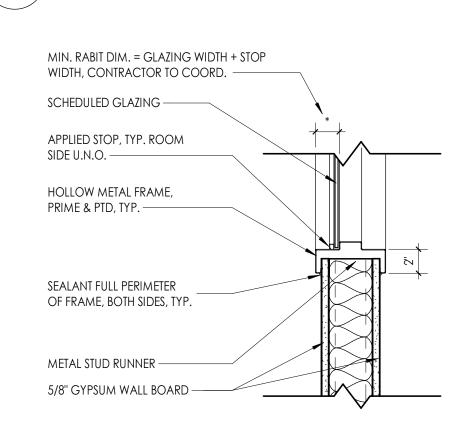




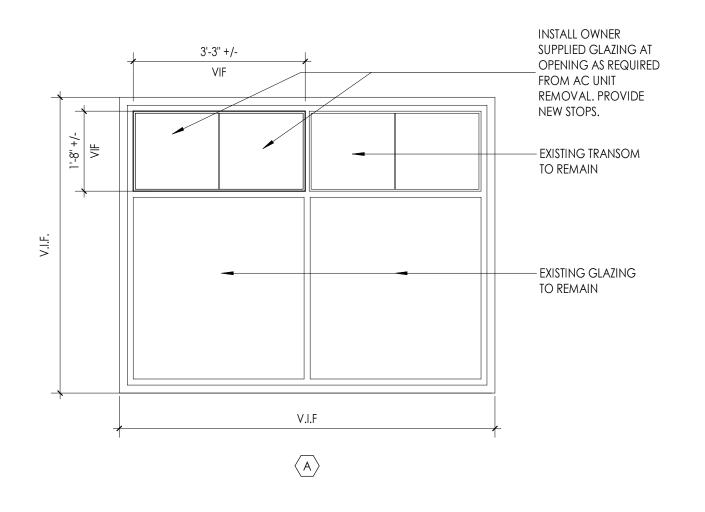


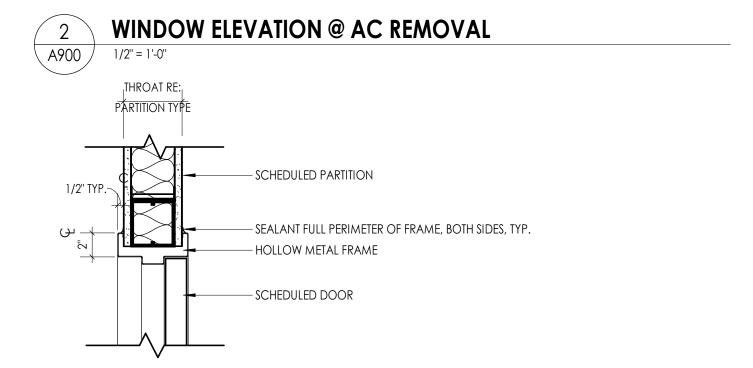




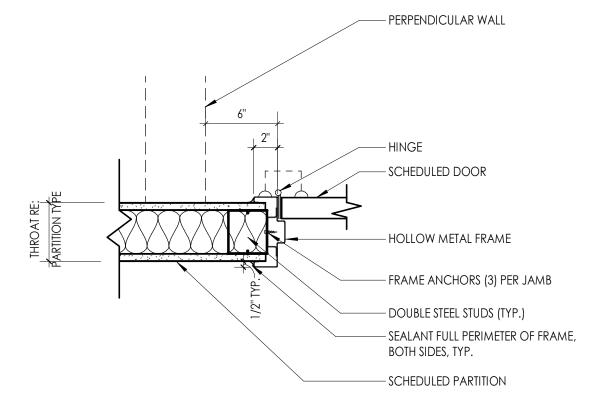




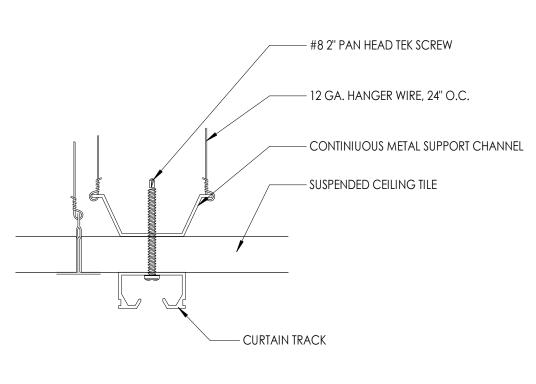



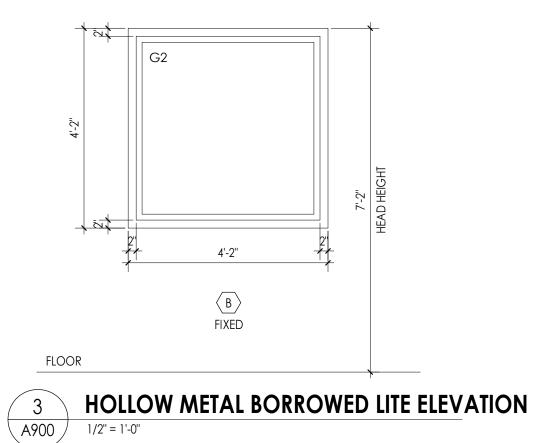

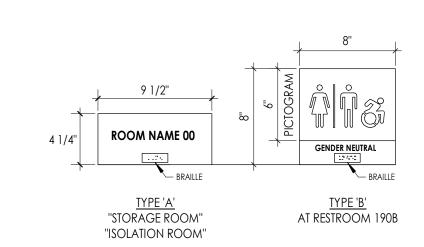



DOOR AND FRAME NOTES

- 1. REFER TO A900S FOR DOOR & FRAME SCHEDULE
- 2. ALL FRAMES ARE TO RECEIVE FULL PERIMETER SEALANT. INTERIOR AND EXTERIOR 3. ALL DOOR AND WINDOW OPENING DIMENSIONS ARE TO BE VERIFIED IN FIELD
- AND COORDINATED WITH APPROVED SHOP DRAWINGS PRIOR TO FABRICATION. 4. SEE SCHEDULE FOR DOOR & FRAME MATERIAL

DOOR AND FRAME SCHEDULE LEGEND

NOTE: THIS LEGEND MAY CONTAIN SYMBOLS THAT ARE NOT USED IN THIS PROJECT. DOOR OR FRAME MATERIAL DOOR OR FRAME FINISH

ACR ACROVYN DOOR PTD PAINT

ACR-L ACROVYN LEAD LINED DOOR **WOOD STAIN**

ALUM ALUMINUM DB DARK BRONZE(ANODIZED) ETR EXISTING TO REMAING SS STAINLESS STEEL

HM HOLLOW METAL BE BAKED ENAMEL HM-L HOLLOW METAL LEAD LINED

IHM INSULATED HOLLOW METAL WD WOOD

WD-L WOOD LEAD LINED

G2

GLAZING DESCRIPTION

1" THICK INSULATED GLASS (CLEAR, TEMPERED, LOW-E) 1/4" THICK SAFETY FLOAT GLASS (CLEAR, TEMPERED)

PROJECT INFORMATION

R23.01124.00

Client Name SOUTH ORANGETOWN CENTRAL SCHOOL DISTRICT

CPL | Architecture Engineering Planning

26 IBM Road

Poughkeepsie, NY 12601

CPLteam.com

2024 CAPITAL IMPROVEMENTS **PROJECT**

SOUTH ORANGETOWN MIDDLE SCHOOL


Building Address 160 VAN WYCK ROAD, BLAUVELT, NY 10913


SED # 50-03-01-06-0-013-031

Registration Expiration Dates Lauren Tarsio 09/30/26 Anthony Marchetti 05/31/24 Dave Hart 02/28/25 Jennifer Wengender 06/30/24

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PROFESSIONAL STAMPS



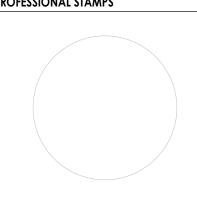

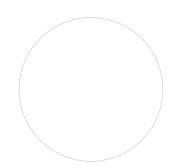SHEET INFORMATION


Issued 05/15/24 As indicated Project Status BID DOCUMENTS


Drawn By CPL CPL Drawing Title

DOOR PANELS, FRAME TYPES & SCHEDULES

				IN.	NTERIOR FINISH SCHEDULE	
INISH CODE	MANUFACTURER	PATTERN/STYLE	COLOR	SIZE	SPECIFICATIONS	NOTES
	CEILING TILE (ACT)					
CT-1	ARMSTRONG CEILINGS OR EQUAL	SCHOOL ZONE FINE FISSURED 1820	WHITE	24" X 24" X 3/4"	CLASS A FIRE PERFORMANCE; NRC .70; CAC 35; 82% LIGHT REFLECTANCE; BIOBLOCK, MILDEW & MOLD RESISTANT; WITH 15/16" PRELUDE XL SUSPENSION SYSTEM; WHITE	TYPICAL 2'X2' ACT
IBICLE CURT	TAIN (CC)					
C-1	INPRO OR EQUAL	SHIELD BY PANAZ FABRIC. PATTERN TBD	TBD	54" MIN. FABRIC WIDTH; SEAM AS DETERMINED BY SELECTED pattern	PASSES NFPA 701 FIRE TESTING; 53.52% FLAME RETARDANT POLYESTER, 46.48% POST-CONSUMER RECYCLED POLYESTER; RAILROADED INSTALLATION. PROVIDE WITH CLICKEZE CUBICLE CURTAIN TRACK, COLOR: WHITE	E. TYPICAL CUBICLE CURTAIN
				SELECTED PUTTERN		
OXY PAINT (V /					
T-1	SHERWIN WILLIAMS OR EQUAL	PRO-INDUSTRIAL WATER BASED CATALYZED EPOX	Y WESTHIGHLAND WHITE SW-7566	N/A	REFER TO SPECIFICATIONS	TOILET ROOM
ROUT (GRT)						
	LATICRETE OR EQUAL	SPECTRLOCK PRO	BRIGHT WHITE 44	JOINT SIZE DETERMINED BY MANUFACTURER	HIGH PERFORMANCE EPOXY GROUT WITH MICROBAN ANTIMICROBIAL PROTECTION	WALL TILE GROUT
SRT-2	LATICRETE OR EQUAL	SPECTRLOCK PRO	NATURAL GREY 24	JOINT SIZE DETERMINED BY MANUFACTURER	HIGH PERFORMANCE EPOXY GROUT WITH MICROBAN ANTIMICROBIAL PROTECTION	FLOOR TILE GROUT
GH PRESSURI	RE PLASTIC LAMINATE (HPL)					
	WILSONART OR EQUAL	AEON SCRATCH RESISTANT	PHANTOM CHARCOAL 8214K-28	N/A	GRAIN TO RUN VERTICALLY	VERTICAL; CASEWORK
						'
AINT (PT)	CHEDWIN WILLIAMS OF FOUR	DDO 144D 000	CAVIAR CW 1000	N/A	DEFED TO SDECIFICATIONS	UNA EDAL (EC. 0. D.O.O.C.)
	SHERWIN WILLIAMS OR EQUAL SHERWIN WILLIAMS OR EQUAL	PRO MAR 200 PRO MAR 200	CAVIAR SW-6990 CEILING BRIGHT WHITE SW-7007	N/A N/A	REFER TO SPECIFICATIONS REFER TO SPECIFICATIONS	HM FRAMES & DOORS CEILINGS
	SHERWIN WILLIAMS OR EQUAL	PRO MAR 200	ALPACA SW-7022	N/A	REFER TO SPECIFICATIONS	FIELD, U.N.O.
	SHERWIN WILLIAMS OR EQUAL	PRO MAR 200	DELFT SW-9134	N/A	REFER TO SPECIFICATIONS	ACCENT
	1					
HEET VINYL (S V-1	SV) TARKETT OR EQUAL	ARIA 3.0	DIORITE 0672	6.5' X 75.5' ROLL X 0.080 THK	CLASS 1 FIRE RESISTANCE, HOMOGENOUS VINYL CONSTRUCTION; 2MM WEAR LAYER; 2MM TOTAL THICKNESS; DIRECT GLUE-DOWN INSTALLATION; LIMITED 10-YEAR WARRANTY; INSTALL WITH 4" INTEGRAL BASE;	TYPICAL FLOORING
	TANKETT ON EGOAL	71177 (0.0	DIONITE GOVE	0.0 X 7 0.0 KGLE X 0.000 H K	HEAT-WELD SEAMS TO MATCH.	TTTTOALTEGORIATO
OUD SUDEAC	SE AAATEDIAI (SSAA)					
	CE MATERIAL (SSM) CORIAN OR EQUAL	N/A	EVEREST	3/4" THICK	REFER TO SPECIFICATIONS	TYPICAL COUNTERTOP
	OSKINIK SK EQONE	147.	L / L / L / L / L / L / L / L / L / L /	o, i mon	KEI EN 10 OF EGILLO, MIGHA	THE OCCUPANCE
LE - BASE (TB)						
B-1	CROSSVILLE OR EQUAL	COLOR BY NUMBERS - COVE BASE	TEA FOR TWO GLOSS WT02	4" X 8" X 1/4"	C650 CHEMICAL RESISTANT; MOHS 7; INSTALL WITH 1/16" GROUT JOINT	TOILET ROOM
LE - FLOOR (T	TF)					
	DALTILE OR EQUAL	KEYSTONES	UPSTOWN TAUPE SPECKLE D202	2" X 2" MOSAIC (12" X 24" DOT-MOUNTED SHEET)	C650 CHEMICAL RESISTANT; CVOF > 0.42; INSTALL WITH 1/8" GROUT JOINT	TOILET ROOM
LE - WALL (TV	T. Control of the con	OOL OD DV AULUDEDS	TEA FOR TWO OLOGO WITOO	#IV 0II V 17 #I	OVER CHEMICAL PERMITANT, MODINE, A INSTALL WITH A REPORT TO ME	TOURT DOOL SIELD THE
	CROSSVILLE OR EQUAL	COLOR BY NUMBERS	TEA FOR TWO GLOSS WT02	4" X 8" X 1/4"	C650 CHEMICAL RESISTANT; MOHS 7; INSTALL WITH 1/16" GROUT JOINT C650 CHEMICAL RESISTANT; MOHS 7; INSTALL WITH 1/16" GROUT JOINT	TOILET ROOM; FIELD TILE
V-2	CROSSVILLE OR EQUAL	COLOR BY NUMBERS	CARBON 14 WT14	4" X 8" X 1/4"	C650 CHEMICAL RESISTANT, MOHS 7; INSTALL WITH 1/16 GROUT JOINT	TOILET ROOM; ACCENT TILE
RANSITION (TS	S)					
	DALTILE OR EQUAL	MARBLE THRESHOLD	TBD	1/2" THICK	TRANSITION MUST BE ADA COMPLAINT	SV TO TILE
5-2	SCHLUTER SYSTEMS OR EQUAL	SCHIENE	SATIN ANODIZED ALUMINUM (AE)	AS REQUIRED	TRANSITION MUST BE ADA COMPLAINT	SV TO ETR TERRAZZO
RIM (TR)						
	SCHLUTER SYSTEMS OR EQUAL	JOLLY	SATIN ANODIZED ALUMINUM (AE)	AS REQUIRED TO MEET TILE THICKNESS	INSTALL AT ALL EXPOSED EDGES & OUTSIDE CORNERS OF TILE INSTALLATION	TOILET ROOM
			1			1
VINDOW TREA		E COPENI, OF OREVES	WILLIE II N. IS. 1. 7503	FILL BANGE WIDTH VARIES OF TO VITATION	DUUTSULADE AAANUMA QUITSULWITH WASSIADE FASSIA AAANDDITED AAANADITED AAANADIT	TVDIOALUMIDOUS
	BLUESHADE BY DRAPERY INDUSTRIES OR EQUAL BLUESHADE BY DRAPERY INDUSTRIES OR EQUAL		WHITE/LINEN 7501		BLUESHADE MANUAL CLUTCH WITH 4" SQUARE FASCIA; ANODIZED ALUMINUM.	TYPICAL WINDOW TREATM
	INDUENHALIE KY DRAPERY INDUNIRIEN (DR ECHIAL	ILIOCKE - 0% OLENNE??	CHARTREUX 000608	IFULL KANGE; WIDTH VAKIES; G.C. TO VERIFY IN FIELD	BLUESHADE MANUAL CLUTCH WITH 4" SQUARE FASCIA; ANODIZED ALUMINUM.	BLACKOUT SHADE AT

NOTE: CONTRACTOR TO ENSURE ALL MATERIALS ARE ORDERED MIN. 12 WEEKS PRIOR TO SCHEDULED INSTALLATION DATE TO ACCOUNT FOR MATERIAL BACKORDERS. ADDITIONAL LEAD TIMES. IT IS THE CONTRACTORS RESPONSIBILITY TO ENSURE ALL MATERIALS ARE IN STOCK AND AVAILABLE WITHIN THE CONSTRUCTION WINDOW. CONTRACTOR SHALL INFORMA CPL AS SOON AS POSSIBLE OF ANY LEAD TIME OR AVAILABILITY ISSUES.

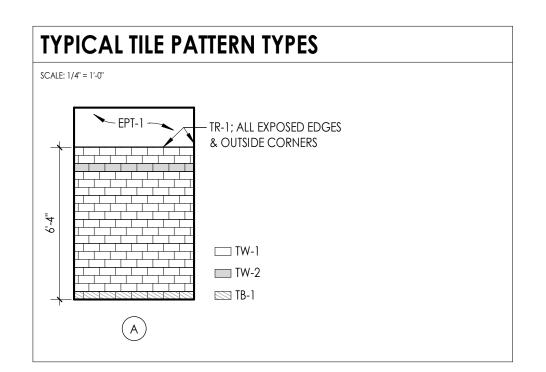

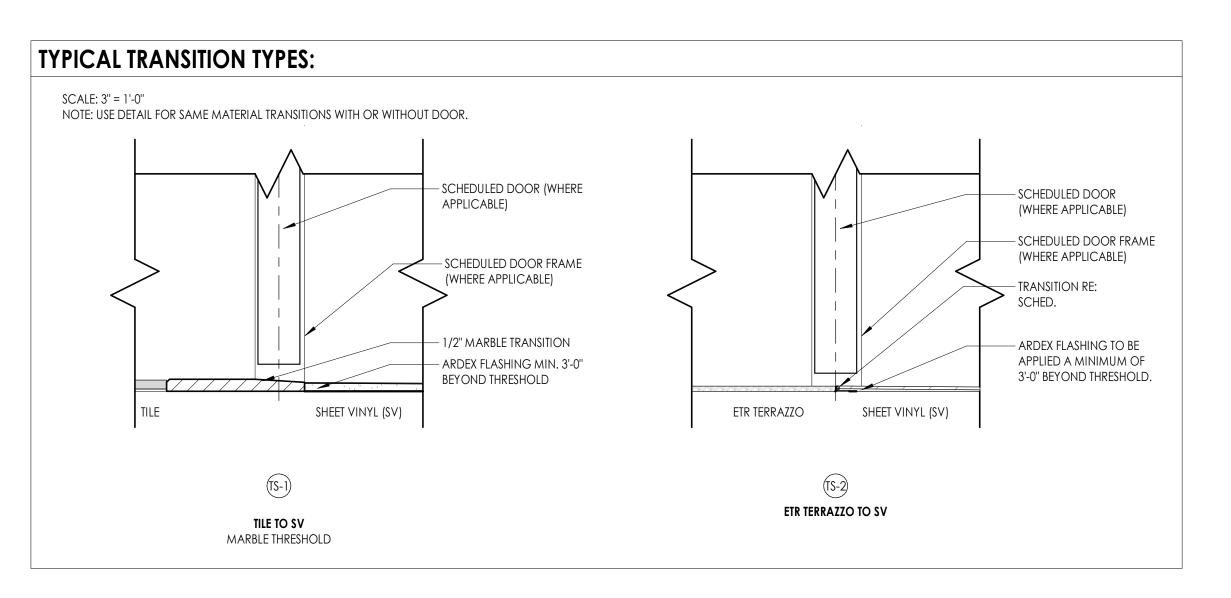




FINISH PLAN GENERAL NOTES

- ALL NEW AND EXISTING HOLLOW METAL DOORS, DOOR FRAMES AND WINDOW FRAMES IN PROJECT SCOPE SHALL BE PAINTED (PT-1), UNLESS NOTED OTHERWISE. ALL LOUVERS, VENTS, GRILLES AND OTHER MISCELLANEOUS MECHANICAL AND
- ELECTRICAL DEVICES ARE TO BE PAINTED TO MATCH THE SURFACE ON WHICH THEY APPEAR, UNLESS NOTED OTHERWISE.
- REFER TO A600 SERIES DRAWINGS FOR CEILING TYPES AND SOFFIT FINISHES. UNDERSIDE OF SOFFITS TO MATCH FACE OF SOFFIT. SEE **A600 SERIES** FOR PAINT ACCENT SPECIFICATIONS.
- PAINT GWB CEILINGS (PT-2), UNLESS NOTED OTHERWISE.
- REFER TO A700 SERIES INTERIOR ELEVATIONS FOR MILLWORK FINISHES. ALL WINDOW SILLS SHALL BE **SSM-2**, UNLESS OTHERWISE NOTED. HIGH PRESSURE PLASTIC LAMINATE ON VERTICAL SURFACES TO RUN VERTICALLY,
- UNLESS NOTED OTHERWISE. WHERE KICKSPACES OCCUR AT MILLWORK, FLOOR FINISH SHOWN ON PLANS SHALL
- RUN UNDERNEATH KICKSPACE AS WELL. 10. ALL FLOOR FINISHES SHALL TRANSITION AT THE CENTERLINE OF THE DOOR, UNLESS
- NOTED OTHERWISE. INSTALL TRANSITION STRIPS PER DETAILS ON **1000**. 1. PROVIDE CONCRETE FLOOR PREPARATION IN ACCORDANCE WITH FLOORING MANUFACTURER SPECIFICATION.
- 12. ALL NON-EPOXY GROUT TO BE SEALED A MINIMUM OF TWO TIMES PRIOR TO COMPLETION.

FINISH ABBREVIATIONS


11141311	ADDICTALICIA?		
NOTE: THIS LEGENI	D MAY CONTAIN ABBREVIATIONS THAT ARE NOT IN TH	IIS PROJECT	
ACT	ACOUSTICAL CEILING TILE	RB	RESILIENT BASE
AGL	ART GLASS	RP	RESIN PANEL
AWP	ACOUSTICAL WALL PANEL	RS	RESILIENT SHEET
CC	CUBICLE CURTAIN	RST	RESILIENT STAIR TREAD
CG	CORNER GUARD	RT	RESILIENT TILE
CHR	CHAIR RAIL	SC	SPECIALTY CEILING
CPT	CARPET	SCON	SEALED CONCRETE
CR		SN	
DG		SSM	SOLID SURFACE MATERIAL
DS	DIVIDER STRIP	ST	STONE VENEER
DWC	DIGITAL WALL COVERING	SV	SHEET VINYL
DWP	DIGITAL WALL PANEL	SWP	SHEET WALL PROTECTION
EPT	EPOXY PAINT	TB	TILE BASE
ERF	EPOXY RESIN FLOOR	TER	TERRAZZO
ETR	EXISTING TO REMAIN	TF	TILE FLOOR
EXP	EXPOSED	TR	TRIM
FILM		TS	
FRP	FIBER REINFORCED PANEL	TW	TILE WALL
GRT			UPHOLSTERY
HPL	HIGH PRESSURE PLASTIC LAMINATE	VCT	VINYL COMPOSITION TILE
HR	HAND RAIL	VET	VINYL ENHANCED TILE
INT		VQT	VINYL QUARTZ TILE
LVT	LUXURY VINYL TILE	WC	WALL COVERING
PT	PAINT	WD	WOOD
PTM		WG	WALL GUARD
QB	QUARRY TILE BASE	WOM	WALK OFF MAT
QT	QUARRY TILE	WS	WRITEABLE SURFACE
QTZ	QUARTZ	WT	WINDOW TREATMENT


FINISH PLAN SYMBOLS LEGEND

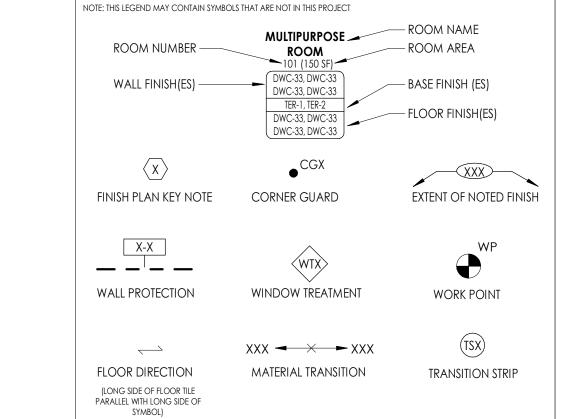

FINISH PLAN KEY NOTES

- oxed EPOXY PAINT (EPT-1) ABOVE. REFER TO TYPICAL TILE PATTERN "A" ON 1000 FOR
- PROVIDE SCHEDULED SHEET VINYL (SV-1) WITH 4" INTEGRAL BASE FULL PERIMETER OF ROOM.

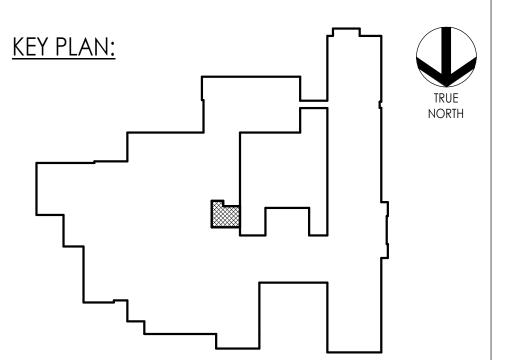

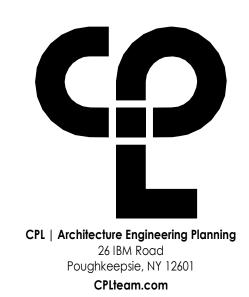



PROJECT INFORMATION

R23.01124.00

Client Name SOUTH ORANGETOWN CENTRAL SCHOOL DISTRICT

2024 CAPITAL IMPROVEMENTS **PROJECT**

SOUTH ORANGETOWN MIDDLE SCHOOL


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SED # 50-03-01-06-0-013-031

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PROFESSIONAL STAMPS



SHEET INFORMATION

05/15/24 As indicated Project Status BID DOCUMENTS AD/SG ALS

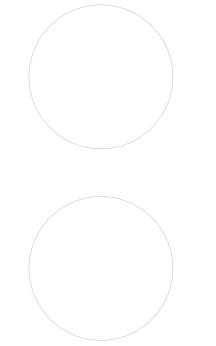INTERIOR FINISH PLAN, SCHEDULE & DETAILS

		T			HVAC SYMBOLS LIST	T				
MBOL	DESCRIPTION	SYMBOL	DESCRIPTION	SYMBOL	DESCRIPTION		SYMBOL	DESCRIPTION		S
AAD	AUTOMATIC AIR DAMPER	<u> </u>	CONNECTION - TOP	(DBL)	DOUBLE WALL LINED DUCT		24X12		— 1-1/2 TIMES BRANCH SIZE	
ACC	AIR-COOLED CONDENSING UNIT	 	CONNECTION - BOTTOM	20/10	DUCT SECTION - SUPPLY		12X10	SUPPLY / RETURN /	2 T-1/2 TIMES BRANCH SIZE	
A D	ACCESS DOOR ABOVE FINISHED FLOOR	-	DIRECTION OF FLOW	20/10	DUCT SECTION - RETURN/EXHAUST		VD VD	EXHAUST AIR TAKEOFFS	12X10	
A F F A H U	AIR HANDLING UNIT	D	REDUCER	S A"	DUCT SECTION - ROUND DUCT IN INCHES				VD VD	
BBD	BOILER BLOW DOWN		CAPORPLUG	AXB FO	DUCT SECTION - FLAT OVAL DUCT IN INCHES		<u> </u>			
B D	BACKDRAFT DAMPER	С+	ELBOW DOWN	4 7	A C O U STIC THERM A L LIN IN G		24X12 8"Ø	SUPPLY / RETURN /	1-1/2 TIMES BRANCH SIZE	
C A	COMPRESSED AIR		ELBOW UP				V.D.	EXHAUST AIR TAKEOFFS	8"Ø	
CD	COOLING COIL CONDENSATE DRAIN	101			TELNIBLE BUCHWORK		, v b		VD VD	
CFM	CUBIC FEET PER MINUTE		TEE OUTLET - UP		FLEXIBLE CONNECTION		<u> </u>		\sim	
H W R	CHILLED WATER RETURN	131	TEE OUTLET - DOWN	FC I			14"Ø — 10"Ø		— CONICAL TEE	
HW S	CHILLED WATER SUPPLY	<u> </u>	UNION		FIRE DAMPER			SUPPLY AIR TAKEOFFS	10.0 d	
C R	CONDENSER WATER RETURN		GATE VALVE	•			V D		VD VD	
C W	CONDENSER WATER SUPPLY DOMESTIC COLD WATER	δ	BALL VALVE		SMOKE DAMPER		<u>ہ</u>		<u> </u>	
D	DRAIN		BALANCING VALVE	•		<u>\$</u>	14"Ø		LATERAL	
(E)	EXISTING	<u> </u>	STRAINER				10"Ø	SUPPLY AIR	§ 1010	
EA	EXHAUST AIR			<u> </u>	COMBINATION FIRE AND SMOKE DAMPER	<u>\$</u>	VD)	TAKEOFFS	4 ND 10.0	
EC	ELECTRIC AL CONTRACTOR	The state of the s	STRAINER WITH BLOW-DOWN	•		•	<u></u>		b	
EF	EX H A U ST F A N		BUTTERFLY VALVE		VOLUME DAMPER		1 2412		T-1	
RHC	ELECTRIC REHEAT COIL		BUTTERFLY CONTROL VALVE,		DAMPER CONTROL, PARALLEL BLADE		24X12		18X12	
ETR	EXISTING TO REMAIN		PNEUMATIC 2-WAY BUTTERFLY CONTROL VALVE,		DAMPER CONTROL, OPPOSED BLADE	}	18X12	SUPPLY AIR TAKEOFFS	18X12 12X10 6X12	
EUH	ELECTRIC UNIT HEATER	-	ELECTRIC ACTUATOR		DAMILE CONIROL, OFFOSED BLADE	<u>→</u>	20X12		20X12	
F&T	FLOAT AND THERMOSTATIC TRAP	— ⋈—	GLOBE VALVE		AUTOMATIC AIR DAMPER					-
PM	FAN-COIL UNIT FEET PER MINUTE	<u> </u>	CHECK VALVE				24X12 —12X10	SUPPLY/RETURN		
FT	FIN-TUBE		TRIPLE DUTY VALVE	AAD		AAD	TIZATU TIZATU	EXHAUST AIR TAKEOFFS W /	24X12	
G C	GENERAL CONTRACTOR	<u> </u>	GAS COCK, PLUG VALVE		DACK DRAFT DAMPED		V D	REGISTER/GRILLE/	VD VD	
G R	GLYCOL RETURN		UNDERCUT DOOR 1"	BDD	BACK DRAFT DAMPER	BDD	لــــــــــــــــــــــــــــــــــــ	DIFFUSER		
G S	GLYCOL SUPPLY	—ф	LOUVERED DOOR W/SQ. FT. OF FREE AREA				∑ VD		VD	[
нс	HVAC CONTRACTOR	^ M	AIR VENT - MANUAL	BG	BLAST GATE	 		SUPPLY/RETURN EXHAUST AIR		
H W R	HEATING HOT WATER RETURN	↑ A	AIR VENT - AUTOMATIC			BG	lvp.	END OF MAIN		
HW S	HEATING HOT WATER SUPPLY		FLANGE	20/10		12X10		BRANCH TAKEOFFS	VD '	
H P	HEAT PUMP			12X10	AIR DUCT (FIRST FIGURE IS DUCT WIDTH/TOP,	12X10	``			
IPC .	HIGH PRESSURE CONDENSATE		CONTROL/SOLENOIND VALVE, ELECTRIC 2-WAY		SECOND FIGURE IS DUCT DEPTH)		¥V D	SUPPLY/RETURN	T VD	
HPS	HIGH PRESSURE STEAM		CONTROL VALVE, ELECTRIC 3-WAY	10/20 -	_	10/20		EXHAUST AIR	K.	
LF	LINEAR FOOTAGE OF FIN-TUBE RADIATION		CONTROL VALVE, PNEUMATIC 2-WAY	10/20 7	<u> </u>		₩V D	END OF MAIN BRANCH TAKEOFFS	VD VD	
LPC	LOW PRESSURE CONDENSATE	<u> </u>	CONTROL VALVE, PNEUMATIC 3-WAY	**	MULTI-BLADE AIR EXTRACTOR		<u></u>			
LPG LPS	LIQUEFIED PROPANE GAS LOW PRESSURE STEAM				TURNING VANES				↑ ↑	
M B H	1,000 BTU/HR		RELIEF / SAFETY VALVE		EXISTING WORK TO BE REMOVED (HATCHED)		, ()	LONG RADIUS 90° ELBOW	W R	
M C	MECHANICAL CONTRACTOR		PRESSURE REDUCING VALVE	•	POINT OF CONNECTION			R/W = 1.5		
MPC	MEDIUM PRESSURE CONDENSATE		VACUUM BREAKER		POINT OF DISCONNECTION					
M P S	MEDIUM PRESSURE STEAM		FLEXIBLE PIPE CONNECTOR		AIR FLOW SENSOR					
M R D	MONOFLO FITTING DOWN - HHWR							LONG RADIUS	W R	
M S D	MONOFLO FITTING DOWN - HHWS		EXPANSION COMPENSATOR W/GUIDES		FILTER			45° ELBOW		
A U W	MAKE-UP WATER		EXPANSION JOINT		TRANSITION SQUARE TO ROUND			R/W = 1.5		
N C	NORMALLY CLOSED	X	PIPE ANCHOR	4						_
N G	NATURAL GAS	=	PIPE GUIDE		HUMIDIFIER DISPERSION TUBE				L-T	
N O	NORMALLY OPEN		THERM OSTATIC TRAP	K			γ	90° ELBOW With Turning		
N TS O A	NOT TO SCALE OUTSIDE AIR	- FT -	FLOAT & THERMOSTATIC TRAP	RISE	DICE IN DUCT			VANES	7 3	
PC	PLUMBING CONTRACTOR	BT	BUCKETTRAP		RISE IN DUCT					
PD	PUMP DISCHARGE	TD	THERMODYNAMIC TRAP	DROP			<u>√</u>		1 - √ T	
H W R	PRIMARY HEATING HOT WATER RETURN		THERM O M ETER	D	DROP IN DUCT	1	8X16 — 18X8	90 VERTICAL	18X8	
H W S	PRIMARY HEATING HOT WATER SUPPLY		WELL		SQUARE CEILING DIFFUSER (4 WAY)			SPLIT OFF (PLAN VIEW)	18X16 18X8	
RA	RETURN AIR						18X8 — ´	,		
R D	REFRIGERANT DISCHARGE		PRESSURE GAUGE		ROUND CEILING DIFFUSER		20X10 20X10			
RHC	HOT WATER REHEAT COIL		STEAM PRESSURE GAUGE		SQUARE OR RECTANGULAR CEILING GRILLE		20X10 20X10	DUCT TURNING	20X10	
RLL	REFRIGERANT LIQUID PIPE		WITH 1/4" NEEDLE VALVE		SUPPLY REGISTER, RETURN OR EXHAUST GRILLE			UP OR DOWN		
RSL	REFRIGERANT SUCTION PIPE		PRESSURE GAUGE		CHARLY DIFFHARE A WAY 2 WAY 2 WAY		U MAX	AIR TERMINAL UNIT-DU U - UNIT TYPE		
RTU	ROOFTOP UNIT		WITH 1/4" NEEDLE VALVE	1-WAY 2-WAY 3-WAY	SUPPLY DIFFUSER, 1-WAY, 2-WAY, 3-WAY		MIN	MAX = MAXIMUM CFM MIN = MINIMUM CFM		
R V	ROOF VENT		PNEUMATIC (CONTROL) TUBING	8"Ø D.3	CEILING DIFFUSER		G PM	AIR TERMINAL UNIT-DU	CTWORK	
S A H W R	SUPPLY AIR SECONDARY HEATING HOT WATER RETURN		BUTTERFLY VALVE WITH PNEUMATIC AND MANUAL OPERATORS	8"Ø, D-3 300 CFM	WITH NECK SIZE, TYPE, & CFM		U G PM M A X	GPM = GALLONS PER N MAX = MAXIMUM GPN		
H W K H W S	SECONDARY HEATING HOT WATER SUPPLY	xx	PIPING		CELLING BETHEN OR FYHARES CRIVE			FAN POWERED AIR		\dashv
SSI	SPLIT SYSTEM INDOOR SECTION (EVAPORATOR SECTION)	xx	PIPING BELOW GRADE	10"x10", G-3	CEILING RETURN OR EXHAUST GRILLE WITH SIZE, TYPE, & CFM		M A X U M IN FA N	TERMINAL UNIT U - UNIT TYPE		
SSO	SPLIT SYSTEM OUTDOOR SECTION (CONDENSING UNIT)			300 CFM			FAN	MAX = PRIMARY MAX		
TC	TEMPERATURE CONTROLS CONTRACTOR		BASE MOUNTED PUMP	10"x8", R-2 300 CFM	SUPPLY REGISTER WITH SIZE, TYPE, & CFM			FAN = FAN CFM		4
UH	UNIT HEATER		IN-LINE PUM P	,			TYPE	TYPE = VALANCE TYPE		
UV	UNIT VENTILATOR		AIR TERMINAL UNIT WITH REHEAT COIL AND SOUND	10"x8", G-2	RETURN OR EXHAUST GRILLE		C O IL SIZE CLNG GPM	COIL SIZE = COIL LENG CLNG GPM = COOLING	GPM	
٧	VENT		ATTENUATOR	300 C FM V	WITH SIZE, TYPE, & CFM		HTNG GPM	HTNG GPM = HEATING	G P M	_ [
AHP	WATER-TO-AIR HEAT PUMP		AIR TERMINAL UNIT WITH		AIR FLOW		X	X = DIFFUSER OR GRIL		
WHP	WATER-TO-WATER HEAT PUMP		SOUND ATTENUATOR	L1	ACOUSTIC/THERMAL DUCTWORK LINING - 1 INCH THICK		XXX	XX = AIR FLOW VALUE		
			AIR TERMINAL UNIT WITH REHEAT COIL	L2	ACOUSTIC/THERMAL DUCTWORK LINING -			1		
			AIR TERMINAL UNIT		2 INCH THICK ACOUSTIC/THERMAL DUCTWORK PLENUM					
				PL1	LINING - 1 INCH THICK ACOUSTIC/THERMAL DUCTWORK PLENUM					
		W/W ENCL	WALL TO WALL FIN TUBE ENCLOSURE	PI 2		•				

ACOUSTIC/THERMAL DUCTWORK PLENUM LINING - 2 INCH THICK

WALL TO WALL FIN TUBE ENCLOSURE

SYMBOLS GENERAL NOTES:

DESCRIPTION

CURRENT TRANSDUCER

OPEN/CLOSED

EN A BLE/DISA BLE

FLOW TRANSMITTER

PRESSURE TRANSMITTER

DUCT SMOKE DETECTOR

SPACE TEMPERATURE SENSOR

SPACE CARBON DIOXIDE SENSOR

SPACE CARBON MONOXIDE SENSOR

VARIABLE SPEED / FREQUENCY DRIVE

DIFFERENTIAL STATIC PRESSURE SWITCH

DIGITAL INPUT (TO BUILDING MANAGEMENT SYSTEM)

DIGITAL OUTPUT (FROM BUILDING MANAGEMENT SYSTEM)

ANALOG OUTPUT (FROM BUILDING MANAGEMENT SYSTEM)

ANALOG INPUT (TO BUILDING MANAGEMENT SYSTEM)

SPACE NATURAL GAS SENSOR

SPACE SENSOR WITH GUARD

SPACE HUMIDISTAT

WATER FLOW SENSOR

ELECTRIC ACTUATOR

COOLING COIL

HEATING COIL

GASFURNACE

FLOW SWITCH

PRESSURE GAUGE

ELECTRICAL INTERFACE

SPEED FEED BACK

POSITION FEEDBACK

FREEZE STAT SENSOR

TRAVERSE AVERAGING SENSOR

END SWITCH

FREEZE-STAT

HUMIDIFIER

ALARM

STATUS

RELAY

PNEUMATIC ACTUATOR

SPACE THERM OSTAT

START/STOP

ELECTRIC/PNEUMATIC SWITCH OR RELAY

PNEUMATIC/ELECTRIC SWITCH OR RELAY

TEMPERATURE SENSOR (DUCT OR PIPE MOUNTED)

HUMIDITY SENSOR (DUCT MOUNTED)

DIFFERENTIAL PRESSURE TRANSMITTER


ELECTRIC/PNEUMATIC TRANSDUCER

ELECTRIC/ELECTRONIC TRANSDUCER

VALVE AND DAMPER ACTUATOR TYPES (ELECTRIC OR PNEUMATIC) WHICH ARE INDICATED IN HVAC TEMPERATURE CONTROL DRAWINGS SHALL SUPERSEDE TYPE INDICATED ON ALL OTHER HVAC DRAWINGS.

HVAC CONTRACTOR GENERAL NOTES:

- A. IT IS THE RESPONSIBILITY OF THE CONTRACTOR TO FIELD VERIFY EXISTING CONDITIONS WITHIN THE BUILDING PRIOR TO COMMENCEMENT OF ALL DEMOLITION AND NEW WORK.
- IT IS THE RESPONSIBILITY OF THE CONTRACTOR TO REMOVE AND REPLACE EXISTING CEILINGS, UNLESS OTHERWISE NOTED ON THE ARCHITECTURAL DRAWINGS, FOR PERFORMING DEMOLITION OR NEW WORK WITHIN THE BUILDING. THE EXISTING CEILINGS SHALL BE REMOVED IN A MANNER TO AVOID DAMAGE TO THE CEILING SYSTEMS. STORAGE OF CEILING SYSTEM COMPONENTS FOR REINSTALLATION IS THE RESPONSIBILITY OF THE CONTRACTOR. THE STORAGE OF ALL MATERIAL SHALL BE IN AREAS OR LOCATIONS APPROVED BY THE OWNER. THE OWNER WILL NOT COMPENSATE FOR ANY DAMAGED OR LOST MATERIAL WHILE IN STORAGE. AFTER COMPLETION OF ALL DEMOLITION OR NEW WORK, THE CONTRACTOR SHALL REINSTALL THE CEILING SYSTEMS TO MATCH THE ORIGINAL INSTALLATION.
- DEMOLITION DRAWINGS SHOW MAJOR EQUIPMENT, PIPING, AND DUCTWORK REMOVALS. THE INTENT IS NOT TO IDENTIFY ALL MISCELLANEOUS PIPING, PIPING ACCESSORIES, DUCTWORK, DUCTWORK ACCESSORIES, SUPPORTS, CONTROLS, CONTROL ACCESSORIES, CONTROL WIRING, CONDUIT, AND PNEUMATIC CONTROL TUBING TO BE DISCONNECTED AND REMOVED, BUT IS THE REQUIREMENT UNDER THIS CONTRACT. NO EQUIPMENT, PIPING, OR DUCTWORK SHALL BE ABANDONED IN PLACE, UNLESS OTHERWISE NOTED ON THE DRAWINGS.
- ALL EQUIPMENT INDICATED TO BE TURNED OVER TO THE OWNER SHALL BE DISCONNECTED AND REMOVED FROM THE EXISTING SYSTEMS AND DELIVERED (INCLUDING LOADING AND UNLOADING) TO A STORAGE AREA WITHIN THE BUILDING AS SELECTED BY THE OWNER. IT WILL BE THE RESPONSIBILITY OF THE CONTRACTOR TO REPAIR ANY EQUIPMENT DAMAGED DURING REMOVAL AND DELIVERY. ANY DAMAGE TO EQUIPMENT PRIOR TO DISCONNECTING SHOULD BE REPORTED TO THE OWNER'S REPRESENTATIVE. IF NOT REPORTED, THE CONTRACTOR TAKES FULL RESPONSIBILITY FOR REPAIRS TO THE EQUIPMENT.
- BEFORE DISCONNECTING, REMOVING, OR SERVICING ANY AIR CONDITIONING EQUIPMENT OR SYSTEMS CONTAINING REFRIGERANTS, THE EQUIPMENT OR SYSTEMS SHALL BE EVACUATED OF ALL REFRIGERANT PER THE LATEST ADOPTED RULES AND REGULATIONS BY THE UNITED STATES ENVIRONMENTAL PROTECTION AGENCY (EPA). THE CONTRACTOR OR TECHNICIAN PERFORMING THE WORK SHALL BE CERTIFIED BY AN EPA APPROVED CERTIFYING AGENCY OR ORGANIZATION.
- ALL DUCTWORK, PIPING, AND CONDUIT PENETRATIONS THROUGH RATED WALLS OR FLOORS SHALL BE PROVIDED WITH FIRE/SMOKE STOPPINGS PER SPECIFICATION. REFER TO CODE ANALYSIS DRAWING FOR ALL RATED WALL LOCATIONS. ALL FLOORS SHALL BE CONSIDERED RATED.
- UNLESS SHOWN ON THE ARCHITECTURAL DRAWINGS, IT IS THE RESPONSIBILITY OF THIS CONTRACT TO PATCH AND FINISH ALL EXISTING DUCTWORK OR PIPE PENETRATIONS THROUGH FLOORS, ROOFS, INTERIOR WALLS, AND EXTERIOR WALLS AFTER DEMOLITION WORK. IN ADDITION, ALL NEW PENETRATIONS SHALL BE PROVIDED FOR INSTALLATION OF MECHANICAL SYSTEMS INCLUDING, BUT NOT LIMITED TO, EQUIPMENT, CURBING, DUCTWORK, PIPING, CONTROLS, ETC. PATCHING AND FINISHING SHALL MATCH EXISTING CONSTRUCTION INCLUDING FIRE RATINGS. PROVIDE LINTELS PER LINTEL SCHEDULE.
- IT IS NOT THE INTENT OF THE DRAWINGS TO SHOW ALL AIR VENTS AND DRAINS IN THE PIPING SYSTEMS. IT IS THE RESPONSIBILITY OF THE CONTRACTOR TO PROVIDE AIR VENTS AT ALL SYSTEM HIGH POINTS AND AT AREAS WITHIN THE PIPING SYSTEMS THAT COULD ACCUMULATE OR TRAP AIR WHICH WOULD PREVENT PROPER VENTING OR OPERATION OF THE SYSTEMS. DRAINS SHALL BE PROVIDED AT ALL LOW POINTS WITHIN THE PIPING SYSTEM TO FACILITATE COMPLETE DRAINING OF THE SYSTEM.
- PROVIDE THERMAL EXPANSION COMPENSATORS AND THERMAL EXPANSION LOOPS IN PIPING SYSTEM PER INDUSTRY STANDARDS.

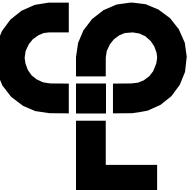

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PRO JECT IN FORM ATION

R23.01124.00

SOUTH ORANGETOWN CENTRAL SCHOOL DISTRICT

PROJECT SOUTH ORANGETOWN MIDDLE SCHOOL

2024 CAPITAL IMPROVEMENTS


160 VAN WYCK ROAD, BLAUVELT, NY 10913

SED # 50-03-01-06-0-013-031

Reaistration Expiration Dates
Lauren Tarsio 09/30/23
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PRO FESSIONAL STAMPS




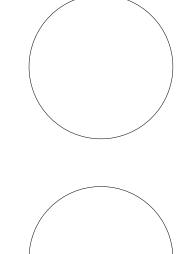

SHEET IN FORMATION

Issue d NOTTO SCALE 05/15/2024 Project Status BID DOCUMENTS Drawn By

BKM AJS HVAC SYMBOLS LEGEND AND CONTRACTOR NOTES

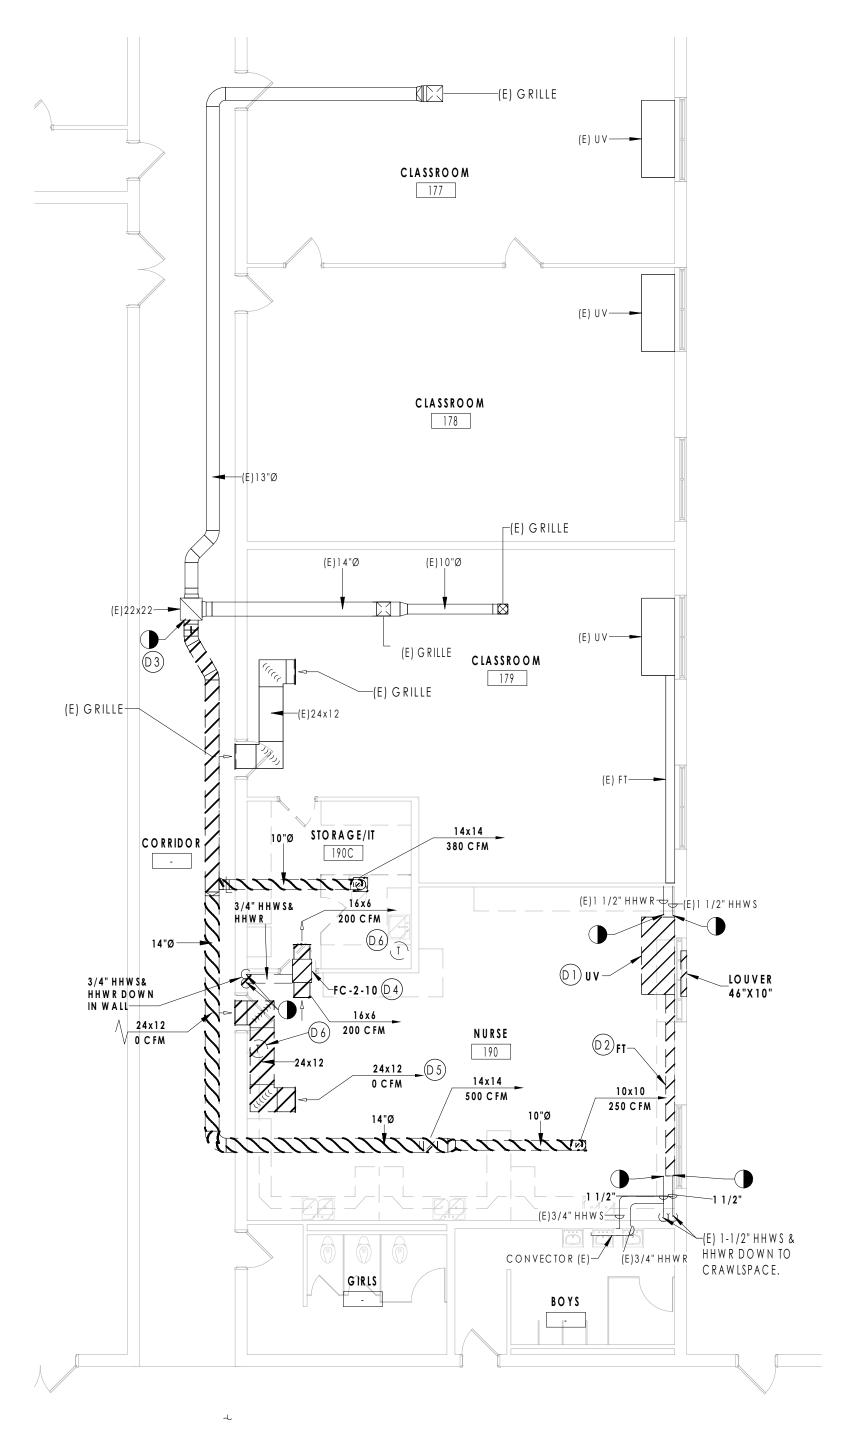


FIRST FLOOR MECHANICAL DEMOLITION PLAN

1/8" = 1'-0"


FIRST FLOO

1/8" = 1'-0"

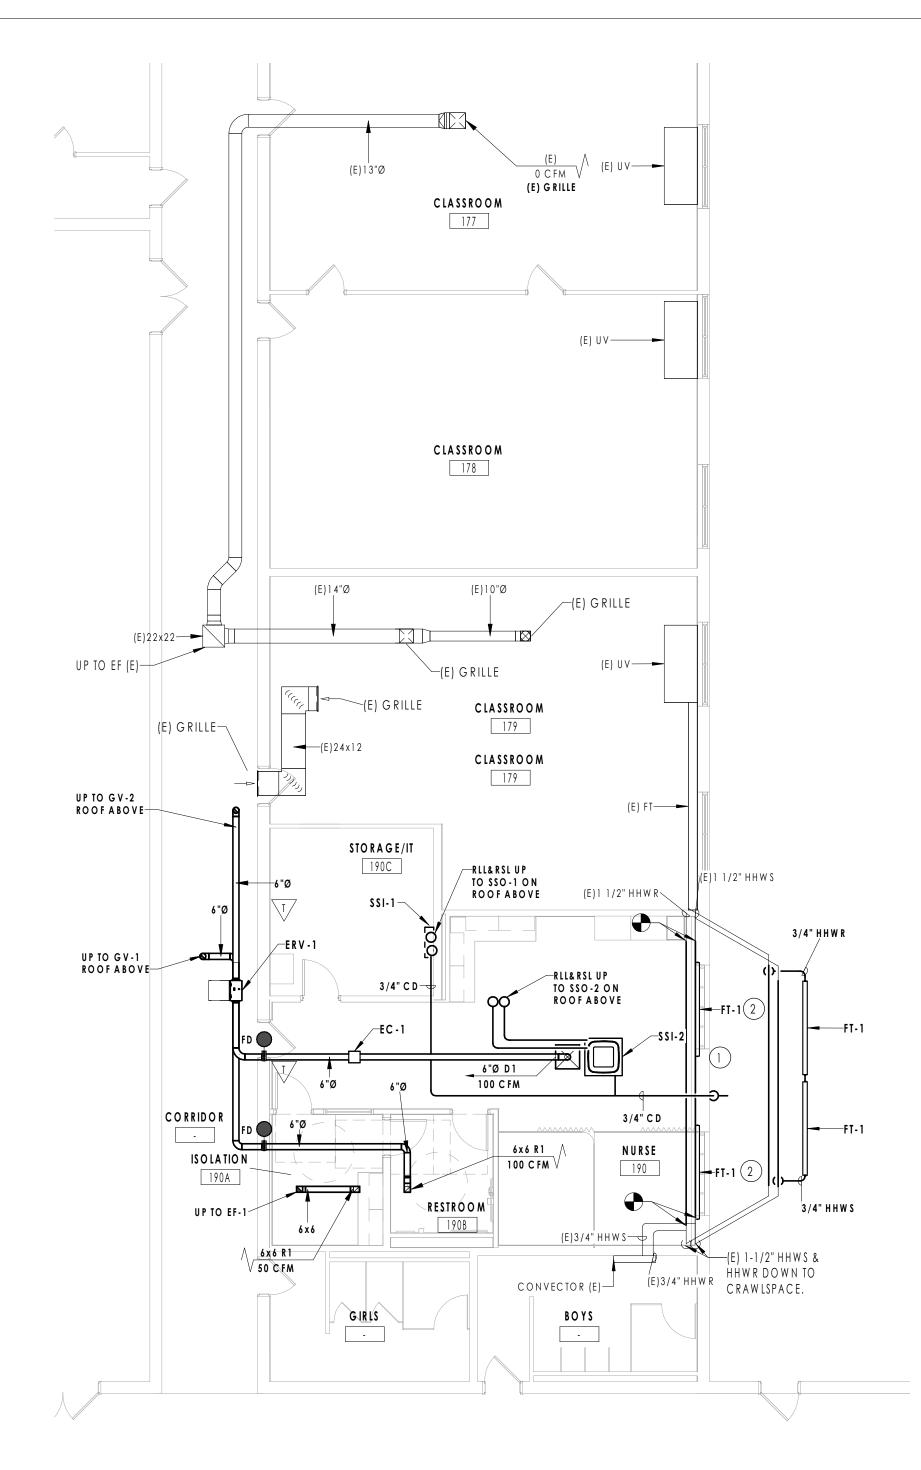


FIRST FLOOR MECHANICAL NEW WORK PLAN

1/8" = 1'-0"

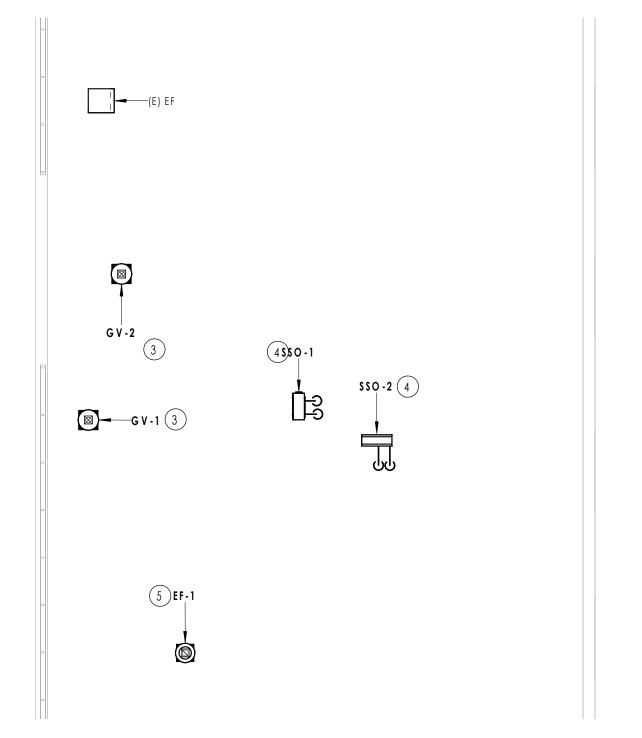

3 ROOF MECHANICAL NEW WORK PLAN
1/8" = 1'-0"

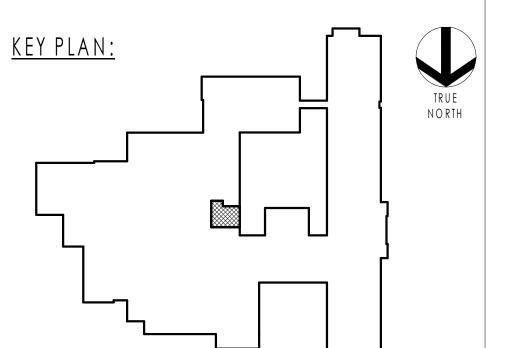

GENERAL NOTES

1. SIZE ALL REFRIGERANT PIPING PER MANUFACTURER'S RECOMMENDATIONS.

2. ALL NEW EQUIPMENT TO BE PROVIDED WITH STANDALONE CONTROLS, AND BACNET CAPABILITY FOR FUTURE CONNECTION TO BMS SYSTEM.

3. PROVIDE PIPE FORTRESS COVERS FOR ALL EXPOSED REFRIGERANT AND CONDENSATE DRAIN PIPING.

DEMOLITION KEY NOTES

- REMOVE EXISTING UNIT VENTILATOR IN ITS ENTIRETY INCLUDING PIPNG BACK TO POINTS INDICATED, CONTROLS, LOUVER AND SLEEVE. COORIDINATE REMOVAL OF LOUVER WITH G.C.
- REMOVE EXISTING FIN TUBE IN ITS ENTIRETY INCLUDING ENCLOSURE AND PIPING BACK TO POINTS INDICATED. PREPARE FOR NEW WORK.
- REMOVE EXISTING EXHAUST GRILLES AND DUCTWORK BACK TO POINT INDICATED. PATCH AND SEAL DUCTWORK AIRTIGHT.
- REMOVE EXISTING FAN COIL IN ITS ENTIRETY INCLUDING ALL DUCTWORK, GRILLES, CONTROLS, AND HEATING HOT WATER SUPPLY AND RETURN PIPING TO DROP IN WALL, CAP AND ABANDON PIPING.
- (D5) REMOVE EXISTING TRANFER DUCT AND GRILLES IN ITS ENTIRETY. COORDINATE WITH G.C.
- (D6) REMOVE EXISTING WALL MOUNTED THERMOSTAT AND ALL CONTROL WIRING. PREPARE FOR NEW WORK.

KEY NOTES

- PROVIDE CONDENSATE DRAIN PIPING OUT TO COURTYARD AND DOWN THE SIDE OF THE BUILDING. TERMINANTE AWAY FROM BUILDING. TERMINATE WITH INSECT SCREEN ON OUTLET.
- PROVIDE 6' FIN TUBE UNDER EXISTING WINDOWS. FIN TUBE ENCLOSURE TO BE EXTENDED FROM WALL TO NEW CASEWORK. PROVIDE 1-1/2" HHWS & HHWR PIPING TO CONNECT EXISTING HOT WATER LOOP AND MAINTAIN FLOW. EXPLODED FIN TUBE CONNECTION VIEW SHOWN FOR REFERENCE. COORDINATE WITH G.C.
- FURNISH AND INSTALL GRAVITY VENTILATOR ON WIND RATED CURB AND CONNECT TO ERV DUCTWORK BELOW. MAINTAIN ANY EXISTING ROOF WARRANTIES
- 4 FURNISH AND INSTALL SPLIT SYSTEM HEAT PUMP NEW 12" EQUIPMENT RAILS. RUN REFRIGERANT PIPNG DOWN TO INDOOR UNITS BELOW WITH PIPE PORTAL.
- 5 FURNISH AND INSTALL EXHAUST FAN ON WIND RATED CURB AND CONNECT FAN TO NEW DUCTWORK BELOW. MAINTAIN ANY EXISTING ROOF WARRANTIES.

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R23.01124.00

PROJECT

SOUTH ORANGETOWN CENTRAL SCHOOL DISTRICT
Project Name
2024 CAPITAL IMPROVEMENTS

SOUTH ORANGETOWN MIDDLE SCHOOL


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SED # 50-03-01-06-0-013-031

Reaistration Expiration Dates Lauren Tarsio 09/30/23 Anthony Marchetti 05/31/24 Dave Hart 02/28/25 Jennifer Wengender 06/30/24

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NEW YORK STATE EDUCATION STATEMENT


IT IS A VIOLATION OF THE NEW YORK STATE EDUCATION LAW AND THE COMMISSIONER REGULATION STORM BY PERSON, UNLESS ACTING UNDER THE DIRECTION OF A LICENSS ARCHITECT, ENGINEER OR LAND SURVEYOR, TO ALLER AN ITEM IN ANY WAY. IF AN INTERPRETABLE OF THE ALTER BEARING THE SEAL OF AN ARCHITECT, ENGINEER OR SURVEYOR IS ALTERED, THE ALTER PARTY SHALL AFER TO THE IEM THEIR SEAL AND THE NOTATION "ALTERED, THE ALTER PARTY SHALL AFER TO THE IEM THEIR SEAL AND THE NOTATION" ALTERED SY FOLOWER


BEAKING THE SEAL OF AN ACKHINE I, ENGINEER OF SURVEYED AS ALTERED BY PARTY SHALL AFFIX TO THE HIEM THEIRS SEAL AND THE NOTATION "ALTERED BY THEIR SIGNATURE AND THE DATE OF SUCH ALTERATION, AND A SPECIFIC DE ALTERATION.

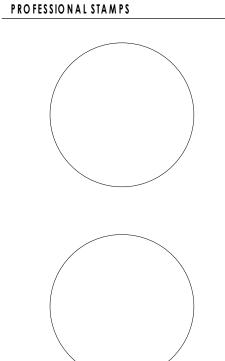Project Status
BID DOCUMENTS
Drawn By Checked
BKM BKM

FIRST FLOOR AND ROOF
MECHANICAL DEMOLITION AND
NEW WORK PLAN


SOMS H201

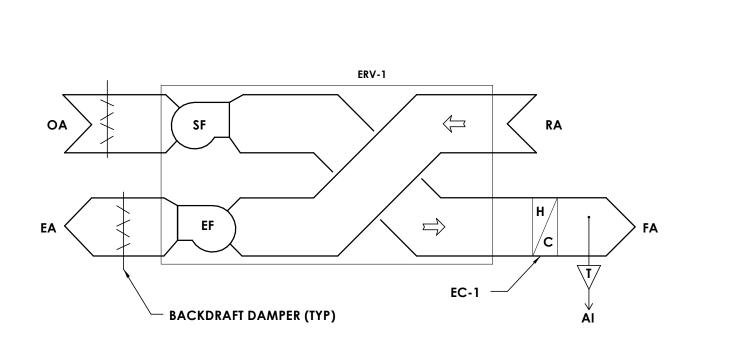


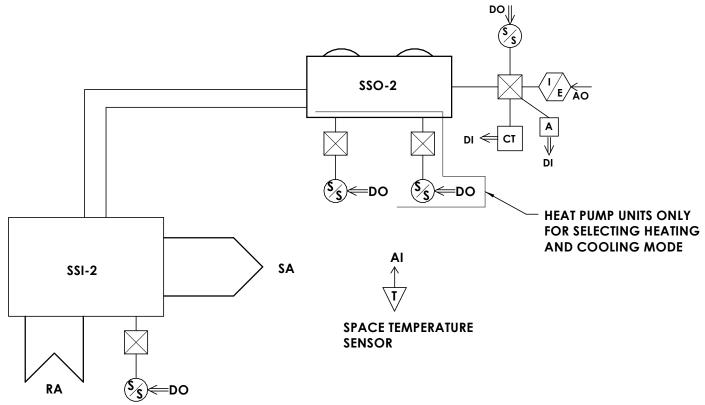

VRF MANUFACTURER TO PROVIDE CONTROL OF SPACE TEMPERATURE SET POINTS, OCCUPIED/UNOCCUPIED MODES, HEATING, COOLING MODES AND LOAD DEMAND.


ERV AND NURSES OFFICE SPLIT SYSTEM CONTROLS DIAGRAM

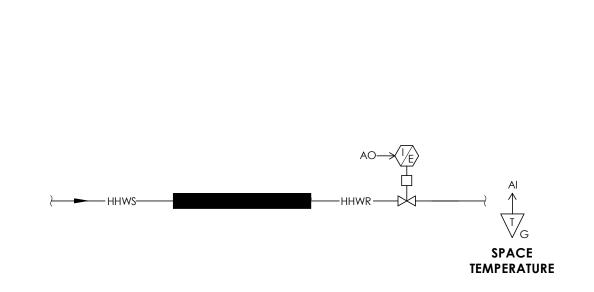

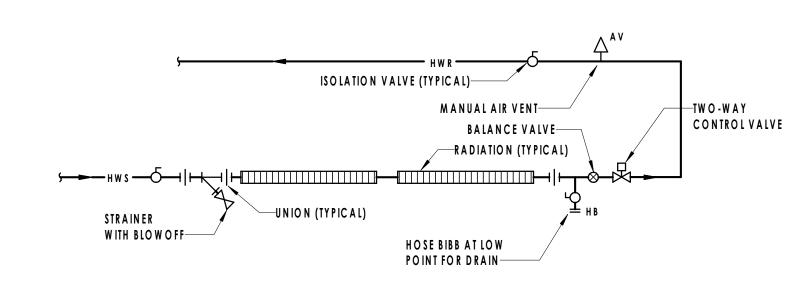


FIN RADIATION PIPING SCHEMATIC NOTTO SCALE

FIN TUBE CONTROLS DIAGRAM H800 12" = 1'-0"

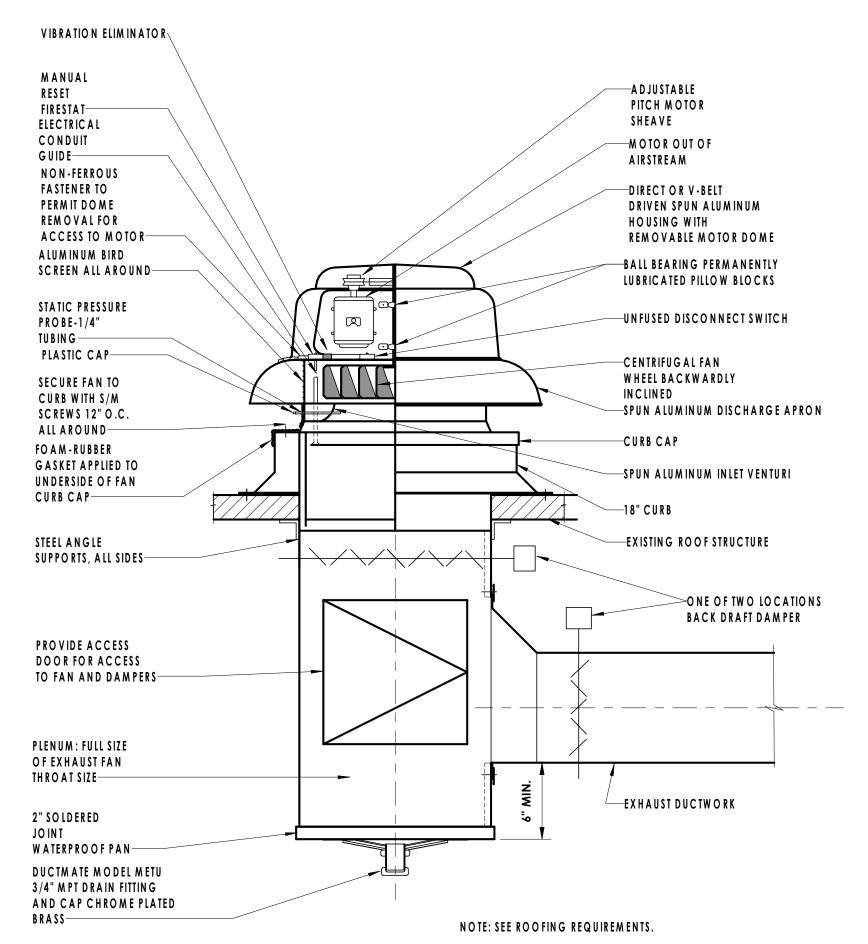



ROOF EXHAUST FAN DETAIL

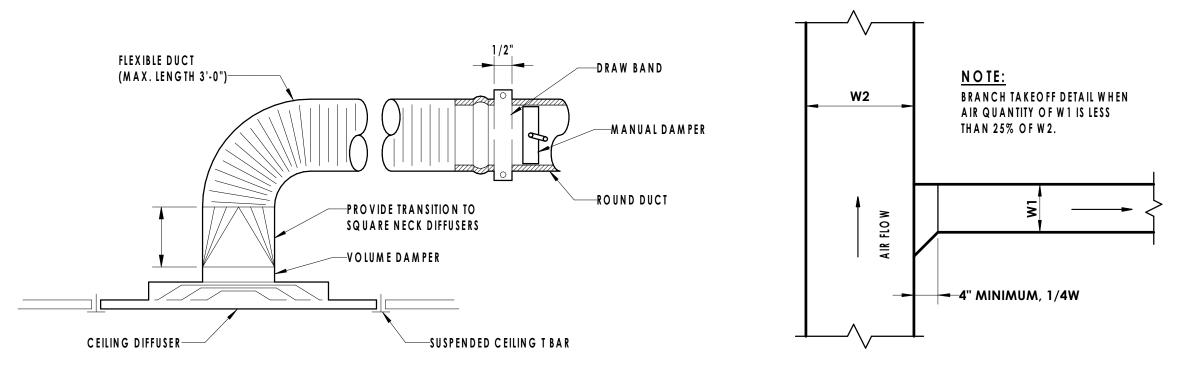

DIFFUSER DETAIL

BRANCH TAKE-OFF NOTTO SCALE

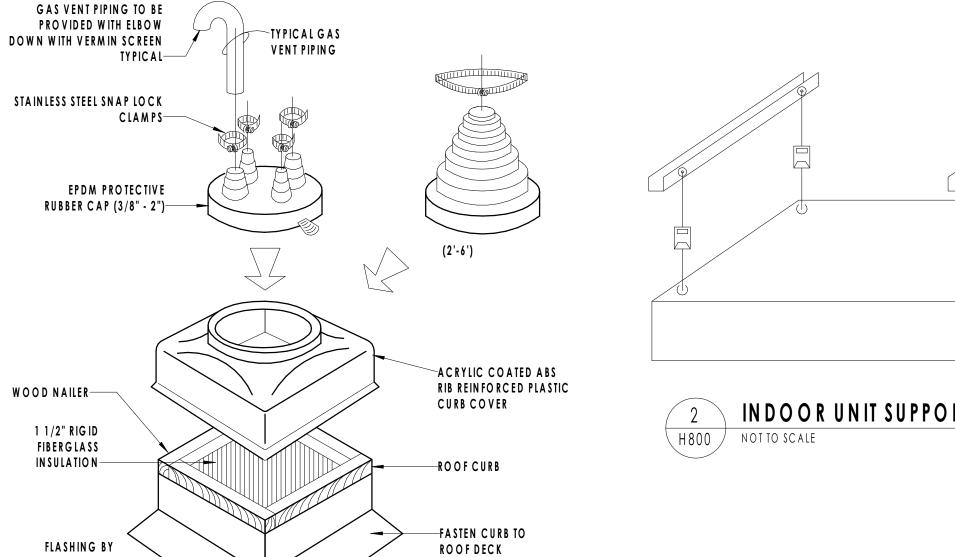

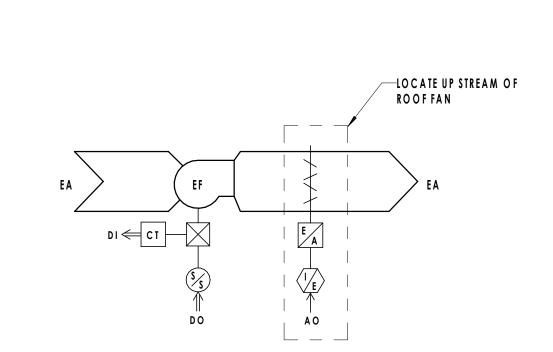


PIPE PORTAL DETAIL


NOT TO SCALE

GENERAL CONRACTOR-

EXHAUST FAN CONTROLS DIAGRAM H800 NOTTO SCALE

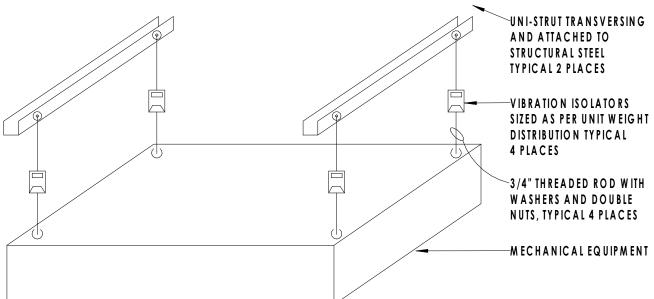

INDOOR UNIT SUPPORT INSTALLATION DETAIL

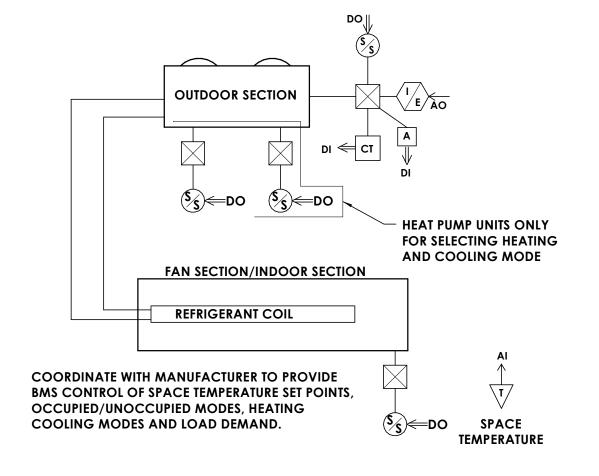

IT CLOSET SPLIT SYSTEM CONTROLS DIAGRAM H800 12" = 1'-0"

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PRO JECT IN FORM ATION

Project Number R23.01124.00

SOUTH ORANGETOWN CENTRAL SCHOOL DISTRICT

2024 CAPITAL IMPROVEMENTS PROJECT SOUTH ORANGETOWN MIDDLE SCHOOL


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PRO FESSIONAL STAMPS



SHEET IN FORMATION

Issue d 04/12/2024 As indicated Project Status BID DOCUMENTS Drawn By Checked By

BKM AJS Drawing Title DETAILS AND CONTROLS DIAGRAM

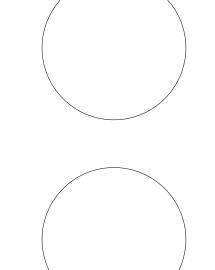											ENE	RGY RECO	VERY SCHEE	DULE									
	Sl	UPPLY FAN		EXH	HAUST FAN				WINTER	CONDITIONS					SUMMER	CONDITIONS		Е	ELECTRICAL				
TA C						ENTERING C	ONDITIONS	LEAVING	CONDITIONS			ENTERING (CONDITIONS	LEAVING C	Onditions						VA/EICHT /I DCV	TYPICAL UNIT MFG	NOTES
TAG CFM E.S.P. (IN WC) CFM	СҒМ	E.S.P. (IN WC)	ОА	RA	SUP	PPLY AIR	SENSIBLE EFFECTIVENESS %	TOTAL EFFECTIVENESS %	OA	RA	SUPPL	Y AIR	SENSIBLE EFFECTIVENESS %	TOTAL EFFECTIVENESS %	VOLTS/HZ/Ø	FLA (PER FAN		WEIGHT (LBS)	& MODEL NO.	NOTES			
						DB/WB (°F)	DB/WB (°F)	DB (°F)	WB (°F)			DB/WB (°F)	DB/WB (°F)	DB (°F)	WB (°F)								
ERV-1	100	0.5		100	0.5	2/.4	70/55	53	42	75	69	92/74	75/63	79.25	67	75	55	120/60/1	1.22	10	36	RENEWAIRE EV PREMIUM MH	1,2

1. PROVIDE FACTORY MOUNTED DISCONNECT SWITCH.

NOTES: 2. TWO EC MOTORS.

3. PROVIDE WITH DIGITAL TIME CLOCK CONTROLLER AND FUTURE CONNECTION TO BMS.

3. PROVIDE MANUFACTURER'S STANDARD ROOF CURB.

								FIN TU	BE SCI	HEDULE								
TAC	TAG FIN SIZE (W X H)	EINIC DED ET	EINI TVDE	TUDE CI7E	TIEDS	LENGTH (ET)			HOT WA	TER				ENCL	OSURE		TYPICAL UNIT MFG	NOTES:
IAG	FIIN SIZE (W X II)	FIINS FER FI.	FIIN ITFE	IODE SIZE	IIEKS			BTU/H/FT	BTU/H	EWT (F°)	LWT (F°)	AWT (F°)	HEIGHT (IN.)	DEPTH (IN.)	HEIGHT AFF (IN.)	& MODEL NO		NOTES.
FT-1	4-1/4" X 3-5/8"	32	CU/AL	3/4"	1	7	0.65	930	6510	180	160	170	24	5 5/16	4	SLOPE TOP	STERLING JVB-ARS	1, 2, 3

1. PROVIDE ACCESS DOOR IN ENCLOSURE AS NECESSARY FOR ACCESS TO SHUTOFF VALVE, CONTROL VALVE, AND ACCESSORIES.

NOTES: 2. ENCLOSURE COLOR TO BE SELECTED BY ARCHITECT.

3. PROVIDE WITH 16 GAUGE ENCLOSURE.

							HEAT PUMP SCHEDULE							
TAG	LOCATION	SERVICE	MANUFACTURER	MODEL	NOMINAL CAP. (TONS)	REF. TYPE	RATED COOLING CAPACITY (MBH)	RATED HEATING CAPACITY (MBH)	EER	МСА	МОР	VOLT/Ø	OPERATING WEIGHT (LBS.)	NOTES
SSO-1	ROOF	SSI-1	DAIKIN	RXL09WMVJU9	0.75	410A	9,000	10,900	11.5	8.7	15	208/1	63	1,2,3
SSO-2	ROOF	SSI-2	DAIKIN	RZQ24TAVJUA	2	410A	24,000	27,000	12	16.5	20	208/1	172	1,2,3

1. FACTORY MOUNTED AND WIRED DISCONNECT.

NOTES: 2. MOUNT ON 12" EQUIPMENT RAILS.

3. PROVIDE DRAIN PAN HEATER.

	DUCT MOUNTED HEATING COIL SCHEDULE (ELECTRIC)														
TAC		SEB//ICE	MANUFACTURER	MODEL	CEVV	ΕΔΤ (°Ε)	Ι ΔΤ (°Ε)	ΚW	H (IN.) x L (IN.)	STEPS	ELE	CTRI	CAL	WEIGHT (LBS)	NOTES
TAG I	LOCATION	SERVICE	MANOIACIONEN	MODEL	CIM			INVV	11 (IIN.) A L (IIN.)	SILIS	V	PH	HZ	WEIGHT (EBS)	NOILS
EC-1	NURSE 190	ERV-1	RENEWAIRE	RH SERIES	100	53	84.5	1	8 X 11-1/2	4	120	1	60	10	1,2
NOTES:	1. PROVIDE DUC	CT MOUNTED	TEMPERATURE SENSOR.												
	2. PROVIDE SCR	CONTROLS,	and electronic step c	ONTROLLER											

					SPLIT SYSTE	M INDOOR U	JNITS SCH	HEDULE					
TA C	TAG LOCATION	CEDVEC	A A A A A A A A A A A A A A A A A A A	MODEL	TVDE	CEAA (11 (AA (1)	RATED C	AP. (BTUH)	MEIGHT (LDC)	NAC A	MOD		NOTES
IAG		SERVES	MANUFACTURER	MODEL	TYPE	CFM (H/M/L)	HEATING	COOLING	, ,	MCA	MOP	POWER (VOLTS/Ø)	NOTES
SSI-1	STORAGE/IT	STORAGE/IT	DAIKIN	FTX09WMVJU 9	WALL MOUNTED	417/297/244	10,900	9,000	18	8.7	15	208/1	1,2,3,4
SSI-2	NURSE	NURSE	DAIKIN	FCQ24TAVJU	CEILING CASSETTE	777/618/477	27,000	24,000	63	0.7	15	208/1	1,2,3,4

MINIMUM HEATING AMBIENT TEMPERATURE OF -4 F
 DRAIN PAIN LEVEL SENSORS.

OTES:

3. PROVIDE BACNET INTERFACE.

4. PROVIDE MANUFACTURER'S CONDENSATE PUMP.

	FAN SCHEDULE															
TAG	LOCATION	SERVICE	MANUFACTURER	MODEL	TYPE	CFM	ESP (IN.WG.)	DRIVE	MOTOR HP	MOTOR RPM	V	PH	HZ	SONES	WEIGHT (LBS)	NOTES
EF-1	ROOF	ISOLATION ROOM	GREENHECK	G-60-VG	DOWNBLAST	50	0.13	DIRECT	0.07	972	115	1	60	1.2	19	1,2,3
	1. PROVIDE WITI	H BACKDRAFT DAM	PER.													
NOTES:	OTES: 2. PROVIDE WITH ECM MOTOR.															

			G	RAVITY VENTILATO	R SCHEDULE			
TAG	LOCATION	SERVICE	THROAT AREA (SQ. FT.)	ROOF OPENING (IN)	AIR FLOW (CFM)	SP (IN. W.G.)	TYPICAL UNIT MFG & MODEL NO.	NOTES
GV-1	ROOF	ERV-1 INTAKE	0.35	10.5X10.5	100	0.013	GREENHECK GRSI-8	1,2.3
GV-2	ROOF	ERV-1 RELIEF	0.35	10.5X10.5	100	0.008	GREENHECK GRSR-8	1,2,3

1. WIRE MESH BIRD SCREEN.

NOTES: 2. BACKDRAFT DAMPER

3. PROVIDE WIND RATED ROOF CURB 14" HIGH.

					SOUTH ORANGETOWN MIDDL	E SCHOOL NURSES OUT	SIDE AIR CALCS				
SPACE	OCCUPANC'	y classification	TOTAL SQ. FT.	OCCUPANT DENSITY #/1000 SQ. FT.	TOTAL OCCUPANCY FOR VENTILATION	O.A. PER PERSON (CFM)	O.A. PER SQ. FT. (CFM)	Vbz (CFM)	AIR DISTRIBUTION EFFECTIVENESS	Voz=Vot (CFM)	TOTAL EXHAUST REQUIRED (CFM)
NURSE 190	OFFICE SPACE		670.0	5	4	5	0.06	60	0.8	75	0
SOLATION 190	A ISOLATION ROOM	l	107.0	0	0	0	0	0	0.8	0	50
RESTROOM 190	DB TOILET		85.0	0	0	0	0	0	0.8	0	100
T/STORAGE 190C	IT SPACE		192.0	0	0	0	0	0	0.8	0	0

REGISTERS, GRILLES, AND DIFFUSERS									
TAG	APPLICATION	MATERIAL	TYPE	FINISH	DESIGN EQUIP.	NOTES:			
D1	SUPPLY	STEEL	LAY-IN	WHITE	PRICE SCD	1			
R1	RETURN/EA	STEEL	LAY-IN	WHITE	PRICE 535	1			
NOTES.	1. 24X24 FACE SIZE.								
NOTES:	2. SEE PLANS FOR SIZE.								

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C PLte a m . c o m

NY ENGINEERING FIRM CERTIFICATE #018330

50 Front Street Suite 202, Newburgh, NY 12550



PRO JECT IN FORM ATION

R23.01124.00

Client Name
SOUTH ORANGETOWN CENTRAL
SCHOOL DISTRICT
Project Name
2024 CAPITAL IMPROVEMENTS

PROJECT
SOUTH ORANGETOWN MIDDLE SCHOOL

Building Address
160 VAN WYCK ROAD, BLAUVELT, NY 10913


SED # 50-03-01-06-0-013-031


Realstration Expiration Dates
Lauren Tarsio 09/30/23
Anthony Marchetti 05/31/24
Dave Hart 02/28/25
Jennifer Wengender 06/30/24

PROJECT ISSUE & REVISION SCHEDULE

Date Description

PRO FESSIONAL STAMPS

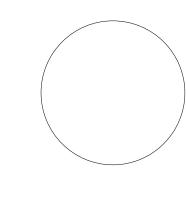

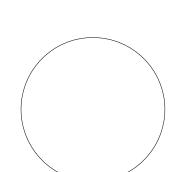

NEW YORK STATE EDUCATION STATEMENT

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PARTY SHALL AFFIX TO THE IGHT HEIR SEAL AND THE NOTATION "ALTERED BY" FOLLOWE
THEIR SIGNATURE AND THE DATE OF SUCH ALTERATION, AND A SPECIFIC DESCRIPTION

Issued Scale
04/12/2024
Project Status
BID DOCUMENTS
Drawn By Checked By
BKM AJS
Drawing Title
MECHANICAL SCHEDULES

SOMS HODO

PLUMBING EQUIPMENT & FIXTURE SCHEDULE									
MARK	FIXTURE	CW	HW	SAN	V	DESCRIPTION	MANUFACTURER	MODEL	REMARKS
LAV-1	LAVATORY	1/2"	1/2"	1 1/4"	1 1/2"	LUCERNE WALL HUNG LAVATORY, VITREOUS CHINA, ADA COMPLIANT, BATTERY POWERED SENSOR OPERATED FAUCET.	AMERICAN STANDARD	0356.041	FAUCET: SLOAN EFT-85, 0.5 GPM
SK-1	SINK (DROPIN)	1/2"	1/2"	1 1/2"	1 1/2"	ADA SINGLE BASIN, 22"x19-1/2"x5-1/2" DROP-IN SINK, STAINLESS STEEL. SINGLE-HANDLE GOOSENECK FAUCET.	JUST MANUFACTURING	SLADA1921A55-J	FAUCET: AMERICAN STANDARD 7100.271H, 1.5 GPM
WC-1	ADA WATER CLOSET (WALL)	1"		4''	2"	AFWALL MILLENIUM WALL MOUNTED WATER CLOSET, VITREOUS CHINA, ADA COMPLIANT, BATTERY POWERED SENSOR OPERATED FLUSH VALVE, 1,28 GPF	AMERICAN STANDARD	2257.101	FLUSH VALVE: SLOAN REGAL 111 SFSM, 1.28 GPF

KEY NOTES:

- 1) DISCONNECT & REMOVE EXISTING WATER CLOSET, TRIM, AND
- RELATED WATER/DRAIN/VENT PIPING. (2) DISCONNECT & REMOVE EXISTING LAVATORY, SUPPORTS, TRIM,
- AND RELATED WATER/DRAIN/VENT PIPING.
- (3) DISCONNECT & REMOVE EXISTING SINK, SUPPORTS, TRIM, AND RELATED WATER/DRAIN/VENT PIPING. REMOVE PIPING BACK MAIN AND CAP.
- (4) PROVIDE LAVATORY AT ADA MOUNTING HEIGHT. PROVIDE
- CARRIER, DOMESTIC WATER SUPPLY LINES, SUPPLY SHUT OFF VALVES, P-TRAP, SANITARY PIPING, & VENT PIPING.
- (5) PROVIDE WALL HUNG WATER CLOSET AND CARRIER, COLD WATER SUPPLY LINE, SUPPLY SHUT OFF VAVLE, SANITARY PIPING, & VENT PIPING.
- (6) PROVIDE SINK, SUPPORTS, DOMESTIC WATER SUPPLY LINES, $\stackrel{\smile}{\sim}$ Supply shut off vavles, P-trap, Sanitary Piping, & Vent
- (7) RETAIN EXISTING ROUGH-IN DOMESTIC COLD, DOMESTIC HOT, SANITARY, AND VENT PIPING CONNECTIONS FROM DEMOLISHED SINK AND PREPARE FOR RECONNECTION OF NEW SINK IN ADJACENT ROOM.
- (8) CONNECT SINK TO EXISTING DOMESTIC COLD, DOMESTIC HOT. SANITARY, AND VENT PIPING ROUGH-IN CONNECTIONS.
- (9)REMOVE PIPING BACK TO MAIN AND CAP. (10) PLUMBING CONTRACTOR TO OPEN WALL TO PROVIDE ACCESS
- FOR NEW VENT CONNECTION. (11) PLUMBING CONTRACTOR TO PATCH 1 HOUR RATED MASONRY

1 1 1 1

1 1 1 1

PIPING LOCATED IN

BELOW SLAB TUNNELS


(E) 1 1/4" HW

CLOSET

E) 1/2" HWR-----

-|--|- (E)1" CW ---+--

WALL TO CLOSE VENT CONNECTION ACCESS.

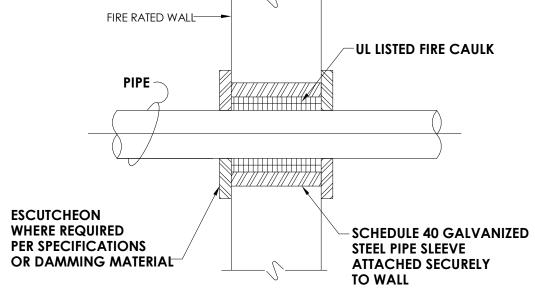

SCALE: N.T.S

CUT UNDERGROUND ABANDONED BENEATH

(D)LAVATORY

(D)SINK (3)

└_(E)4" SAN- —


NURSE SUITE DEMOLITION PLAN

PIPING LOCATED IN


BELOW SLAB TUNNELS

(D)SINK (3)



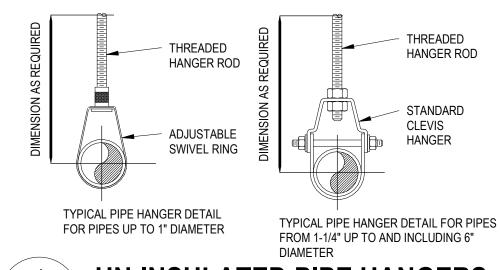



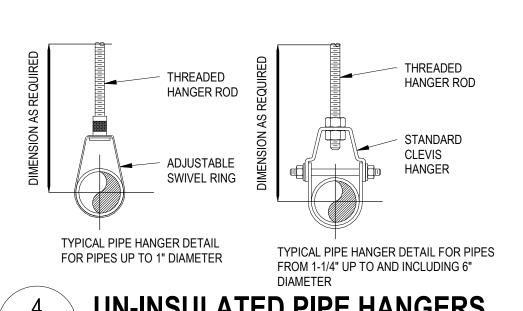




SLOPE TO DRAIN -

NEOPRENE

GASKET

CONCRETE

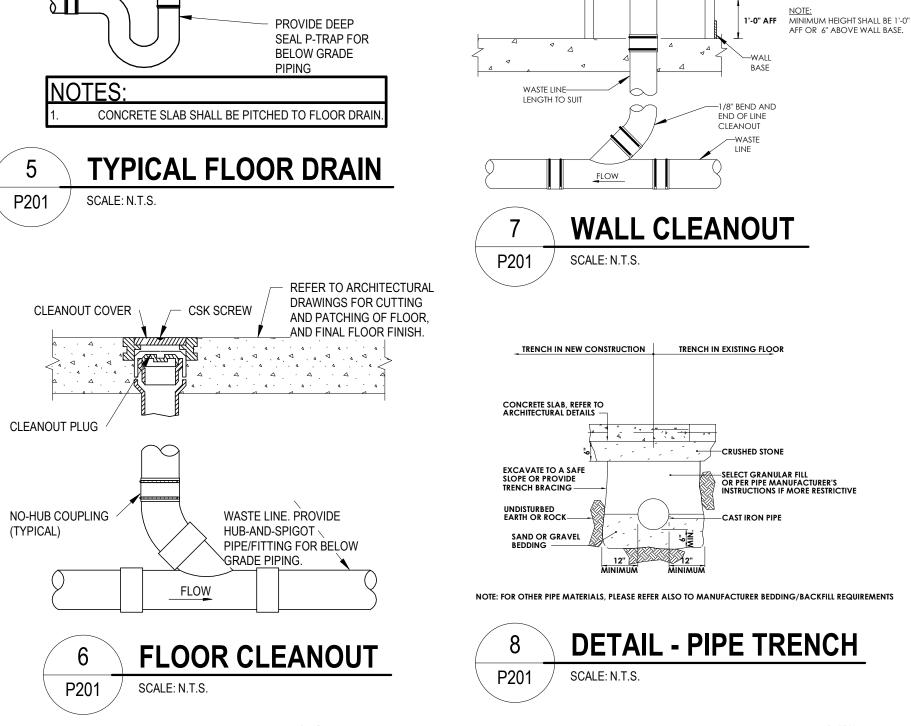

WASTE OR VENT

FOR WALL CONSTRUCTION

DRAWINGS.

FLOOR DRAIN STRAINER


PROVIDE

TRAP SEAL


FINISHED FLOOR

REFER TO ARCHITECTURAL

DRAWINGS FOR FLOOR CONSTRUCTION

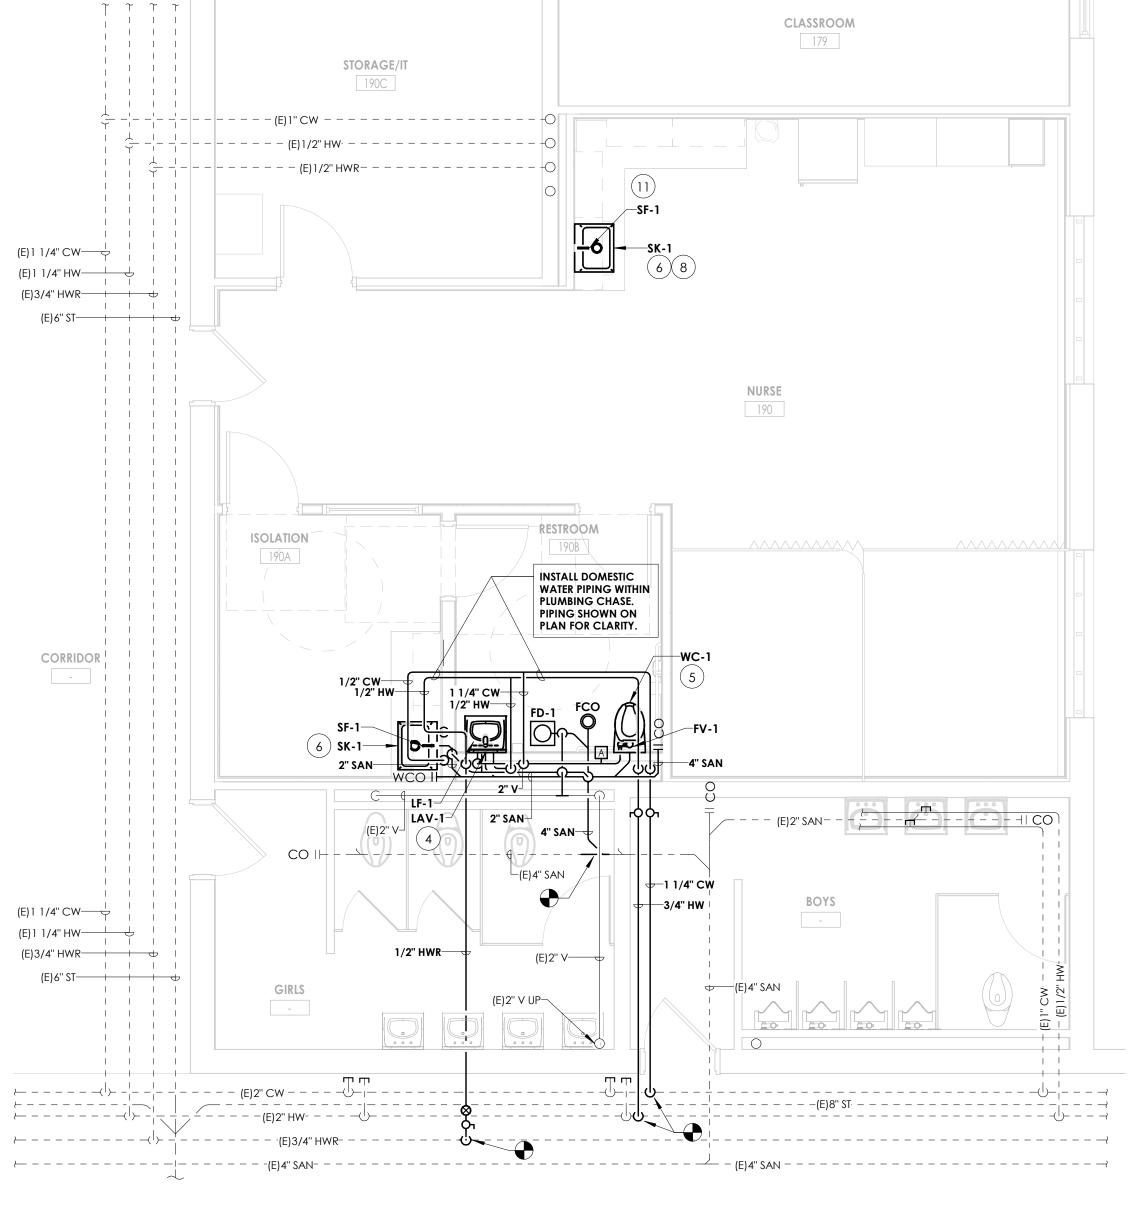



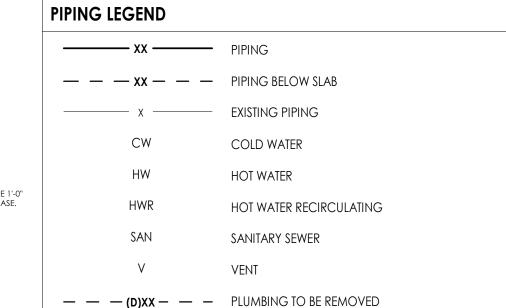

FIXTURES & FITTINGS LEGEND

TEE OUTLET - UP

TEE OUTLET - DOWN

—γ—— CONNECTION TOP

C ELBOW - TURNED UP

CONNECTION - BOTTOM

ELBOW - TURNED DOWN

BALL VALVE

BALANCING VALVE

CHECK VALVE

co II CLEAN OUT

FLOOR CLEAN OUT

WCO I WALL CLEAN OUT

HOSE BIBB

FLOOR DRAIN

POINT OF CONNECTION

POINT OF REMOVAL

BUTTERFLY VALVE

-18 GAUGE ROUND

STEEL COVER



NY ENGINEERING FIRM CERTIFICATE #018330

50 Front Street Suite 202,

Newburgh, NY 12550

CPLteam.com



PROJECT INFORMATION

R23.01124.00

Client Name SOUTH ORANGETOWN CENTRAL SCHOOL DISTRICT

2024 CAPITAL IMPROVEMENTS **PROJECT**

SOUTH ORANGETOWN MIDDLE SCHOOL

160 VAN WYCK ROAD, BLAUVELT, NY 10913

SED # 50-03-01-06-0-013-031

Registration Expiration Dates Lauren Tarsio 09/30/23 Anthony Marchetti 05/31/24 Jennifer Wengender 06/30/24

A. ALL WORK SHALL COMPLY WITH STATE AND LOCAL CODES.

GENERAL NOTES

B. DOMESTIC WATER LINES SHALL BE TYPE L COPPER, LEAD FREE JOINTS. INSULATE ALL PIPING WITH 1" THICK PREFORMED FIBERGLASS PIPE INSULATION WITH ASJ COVER. ALL FITTINGS AND VALVES TO BE COVERED WITH PREFORMED PVC FITTING COVERS. ALL EXPOSED VERTICAL FIXTURE SUPPLY LINES TO BE COVERED WITH PVC JACKET TO 7' ABOVE FINISHED FLOOR.

C. UNDERGROUND SANITARY AND VENT PIPING SHALL BE SERVICE WEIGHT CAST IRON, HUB AND SPIGOT WITH RUBBER GASKET PUSH JOINTS. ABOVE GROUND SANITARY AND VENT PIPING SHALL BE DWV COPPER WITH DWV COPPER FITTINGS OR NO-HUB CAST IRON.


D. IT IS THE RESPONSIBILITY OF THE PLUMBING CONTRACTOR TO FIELD VERIFY EXISTING CONDITIONS WITHIN THE BUILDING PRIOR TO COMMENCEMENT OF ALL DEMOLITION AND NEW WORK.

E. IT IS THE RESPONSIBILITY OF THE PLUMBING CONTRACTOR TO REMOVE AND REPLACE EXISTING CEILINGS UNLESS OTHERWISE NOTED ON THE ARCHITECTURAL DRAWINGS, FOR PERFORMING DEMOLITION OR NEW WORK WITHIN THE BUILDING. THE CONTRACTOR SHALL REINSTALL THE CEILING SYSTEMS TO MATCH THE ORIGINAL INSTALLATION. ANY CEILING SYSTEM COMPONENT DAMAGED DURING DEMOLITION, STORAGE, OR RE-INSTALLATION SHALL BE REPLACED WITH A NEW AT NO EXPENSE TO THE OWNER.

ALL PIPING AND CONDUIT PENETRATIONS THRU RATED WALLS OR FLOORS SHALL BE PROVIDED WITH FIRE/SMOKE STOPPING.


G. UNLESS SHOWN ON THE ARCHITECTURAL DRAWINGS, IT IS THE RESPONSIBILITY OF THE PLUMBING CONTRACTOR TO PATCH AND FINISH ALL EXISTING PIPE PENETRATIONS AND TRENCHING THRU FLOOR AND WALLS AFTER DEMOLITION. IN ADDITION, ALL NEW PENETRATIONS AND TRENCHING SHALL BE PROVIDED FOR INSTALLATION OF PLUMBING SYSTEMS INCLUDING, BUT NOT LIMITED TO, EQUIPMENT, PIPING, ETC.


H. TRENCHING AND BACKFILL IS THE RESPONSIBILITY OF THE PC.

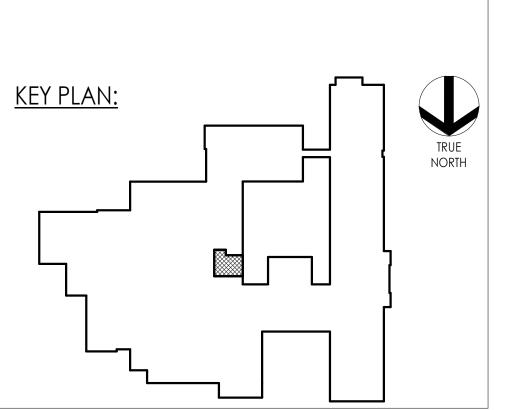

PROJECT ISSUE & REVISION SCHEDULE

PROFESSIONAL STAMPS

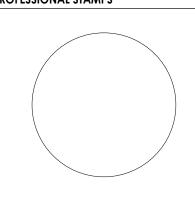

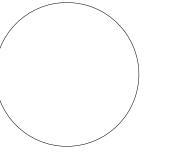

SHEET INFORMATION

05/15/2024 As indicated Project Status BID DOCUMENTS Drawn By


MLS NURSE'S OFFICE DEMOLITION AND NEW WORK PLANS

(NONE) SINGLE POLE TOGGLE SWITCH 2 TWO POLE TOGGLE SWITCH 3 THREE WAY TOGGLE SWITCH 4 FOUR WAY TOGGLE SWITCH WP SINGLE POLE WEATHER PROOF SWITCH K SINGLE POLE KEYED SWITCH P SINGLE POLE SWITCH WITH PILOT LIGHT TM SINGLE POLE SWITCH WITH ONE HOUR TIMER THERMAL SWITCH TP THERMAL SWITCH WITH PILOT LIGHT M MOMENTARY CONTACT SWITCH LV LOW VOLTAGE SWITCH D DIMMER SWITCH OCCUPANCY SENSOR SWITCH V VACANCY SENSOR SWITCH ROMAN NUMERAL DESIGNATES NUMBER OF SWITCHES LOWER CASE LETTER DESIGNATES SWITCH LEG SINGLE RECEPTACLE DUPLEX RECEPTACLE QUADRAPLEX RECEPTACLE SPECIAL RECEPTACLE GFI GROUND FAULT CIRCUIT INTERRUPTER WP WEATHER PROOF IN-USE COVER SS SURGE SUPPRESSION C COUNTER HEIGHT TR TAMPER RESISTANT, UL LISTED IG ISOLATED GROUND RT RAIN TITE E EMERGENCY X TYPE X (SEE RECEPTACLE SCHEDULE) **POWER POLE** \Box RECESSED FLOOR MOUNTED DUPLEX RECEPTACLE SURFACE MOUNTED FLOOR RECEPTACLE CEILING MOUNTED DUPLEX RECEPTACLE --- C --- CONDUIT —— W —— EXPOSED LOW VOLTAGE WIRING HORIZONTAL NON-METALLIC WIREWAY WITH DATA JACK OUTLETS AND ISOLATED GROUND TYPE DUPLEX RECEPTACLES VERTICAL NON-METALLIC WIREWAY WITH DATA JACK OUTLETS AND ISOLATED GROUND TYPE DUPLEX RECEPTACLES ---- WM ---- WIRE MOLD JUNCTION BOX F FIRE SYSTEM s SECURITY SYSTEM DISCONNECT SWITCH DISCONNECT SWITCH - WEATHER PROOF (NEMA 3R) FUSED DISCONNECT SWITCH COMBINATION FUSED DISCONNECT/ MAGNETIC STARTER SWITCH HOA HAND/OFF/AUTO SS START/STOP MANUAL STARTER COMBINATION VARIABLE FREQUENCY DRIVE AND DISCONNECT VARIABLE FREQUENCY DRIVE PUSHBUTTON - START, STOP ST/SP/PL PUSHBUTTON - START, STOP, WITH PILOT LIGHT □□□ UP/DN/SP PUSHBUTTON - UP, DOWN, STOP EF-1 / MOTOR WITH DESIGNATOR DOOR POWER OPERATOR TIME CLOCK HAND DRYER, HARD WIRED BRANCH CIRCUIT HOME RUN WITH PANEL NAME AND CIRCUIT NUMBER, QUANTITY OF ARROWHEADS DENOTES QUANTITY OF BRANCH CIRCUITS GFI TYPE BREAKER A.F. BKR. ARC FAULT BREAKER BRANCH CIRCUIT WIRING, PROVIDE QUANTITIES OF CONDUCTORS REQUIRED FOR CIRCUITING AND SWITCHING AS INDICATED POWER LEG ONLY (NO SWITCH LEG BETWEEN ROOMS) HARDWIRE CONNECTION O+----- CONDUIT RISER UP —— CONDUIT RISER DOWN TRANSFORMER TYPE "K" TRANSFORMER MUSHROOM HEAD PUSH BUTTON (EMERGENCY STOP)

EMERGENCY BREAK GLASS STATION

GROUNDING ROD

SINGLE LINE DIAGRAM LEGEND:

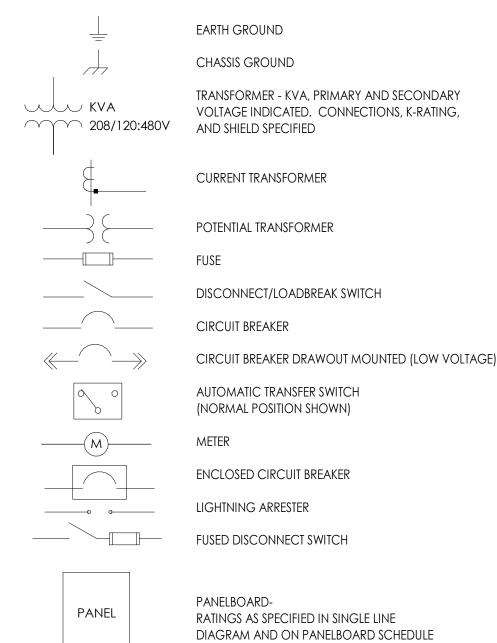

COMMUNICATIONS LEGEND:

▼ *	TELEPHONE DROP

(NONE) STANDARD MODULAR JACK FOR TELEPHONE WALL MOUNTED TELEPHONE MODULAR JACK PUBLIC TELEPHONE MODULAR JACK C COUNTER HEIGHT MODULAR JACK

TELEPHONE FLOOR DROP

DATA DROP

COMBINATION TELEPHONE/DATA DROP

WIRELESS ACCESS POINT

WIRELESS TRANSMITTER

DATA RACK

COAX CABLE DROP

CEILING MOUNT LCD PROJECTOR

SPEAKER (PUBLIC ADDRESS) (NONE) CEILING MOUNTED

SPEAKER (LOCAL SOUND SYSTEM)

W WALL MOUNTED

SPEAKER HORN

MICROPHONE JACK

SPEAKER JACK

VOLUME CONTROL

CLOCK

DOUBLE FACE CLOCK

COMBINATION CLOCK AND SPEAKER

INTERCOM STATION

REMOTE PRE-AMPLIFIER AND PAGING MICROPHONE

CONSOLE JACK

HOUSE LIGHT CONTROL STATION

WALL BOX AS SPECIFIED

FB FLOOR BOX

SYMBOLS SHOWN ON THIS ELECTRICAL SYMBOLS LIST ARE FOR REFERENCE PURPOSES ONLY. ALL OF THESE SYMBOLS MAY NOT BE USED FOR THIS PROJECT.

FIRE/LIFE SAFETY LEGEND:

FIRE ALARM PULL STATION

FIRE ALARM BELL

HFIRE ALARM HORN

FIRE ALARM HORN AND STROBE COMBINATION

FIRE ALARM HORN AND STROBE COMBINATION, WEATHER PROOF

S FIRE ALARM SPEAKER

FIRE ALARM SPEAKER - CEILING MOUNTED

FIRE ALARM SPEAKER AND STROBE COMBINATION

FIRE ALARM STROBE

FIRE ALARM STROBE - CEILING MOUNTED

SMOKE DETECTOR

SMOKE DETECTOR WITH GUARD

CARBON MONOXIDE DETECTOR

NATURAL GAS SENSOR

HEAT DETECTOR

COMBINATION SMOKE/HEAT DETECTOR

HEAT DETECTOR - 190° FIXED TEMPERATURE

HEAT DETECTOR - EXPLOSION PROOF

BEAM SMOKE DETECTOR TRANSMITTER

BEAM SMOKE DETECTOR RECEIVER

DUCT DETECTOR

SA INDICATES INSTALLATION IN SUPPLY AIR RA INDICATES INSTALLATION IN RETURN AIR

REMOTE TEST STATION FOR DUCT DETECTOR

FIRE ALARM SHUT DOWN RELAY

FIRE DOOR HOLD OPEN

TAMPER SWITCH

FLOW SWITCH

FIRE SUPRESSION ANSUL SYSTEM CONNECTION

(FR)* SMOKE DAMPER RELAY CONNECTION SD/FD SMOKE DAMPER AND FIRE DAMPER SD SMOKE DAMPER

CONTROL MODULE, ADDRESSABLE

AREA OF RESCUE CALL STATION

AREA OF RESCUE MASTER TELEPHONE STATION

SECURITY LEGEND:

SECURITY KEY PAD

 \mathbb{C} VIDEO CAMERA

CCTV VIDEO MONITOR

PASSIVE INFRARED MOTION DETECTOR

PROXIMITY CARD READER

CALL SWITCH

DOOR CONTACT

WINDOW CONTACT

ELECTRIC STRIKE DOOR RELEASE

MAGNETIC DOOR RELEASE

NURSE CALL LEGEND:

NURSE CALL BUTTON

NURSE CALL PATIENT BED STATION

CODE CALL BUTTON

NURSE CALL STAFF ASSIST STATION

NURSE CALL STAFF STATION

NURSE CALL DUTY/STAFF STATION

NURSE CALL DUTY STATION

NURSE CALL LIGHT

NURSE CALL CODE LIGHT

NURSE CALL ZONE LIGHT

NURSE CALL EMERGENCY PULL STATION

NURSE CALL MASTER STATION

NURSE CALL INFRARED SENSOR

LIGHT FIXTURE LEGEND:

 \bigcirc \bigcirc \bigcirc

LIGHTING FIXTURE (SEE LIGHTING FIXTURE SCHEDULE FOR LETTER DESIGNATION AND DESCRIPTION OF FIXTURES)

EMERGENCY AND/OR NIGHT LIGHTING FIXTURE

EXIT LIGHTING FIXTURE UNIVERSAL MOUNT, SINGLE/DOUBLE FACE (WHERE USED, ARROW INDICATES CHEVRON DIRECTION)

BATTERY POWERED EMERGENCY LIGHT

EMERGENCY LIGHT REMOTE HEAD

TRACK LIGHTING

POLE MOUNTED LIGHTING (QUANTITY AND ORIENTATION OF HEADS AS SHOWN)

OS OCCUPANCY SENSOR - CEILING MOUNTED

(OSW) OCCUPANCY SENSOR - WALL MOUNTED LIGHTING CONTACTOR

PHOTOCELL

PANEL LEGEND:

EXISTING ELECTRICAL PANEL

NEW ELECTRICAL PANEL

MDP MAIN DISTRIBUTION PANEL LOW VOLTAGE PANEL HIGH VOLTAGE PANEL

LIGHTING CONTROL PANEL ISOLATED GROUND PANEL

MSB MAIN SWITCH BOARD

MCC MOTOR CONTROL CENTER TVSS TRANSIENT VOLTAGE SURGE SUPPRESSION

AUTOMATIC TRANSFER SWITCH

ELECTRICAL SYSTEMS PANEL \boxtimes

SACP SECURITY ALARM CONTROL PANEL

FACP FIRE ALARM CONTROL PANEL PA PUBLIC ADDRESS CONTROL PANEL

FAAP FIRE ALARM ANNUNCIATOR PANEL

ELECTRICAL PANELBOARD LABELING PLACARD

LINE 1 - PANELBOARD NAME: PP1 (EXAMPLE)

LINE 2 - VOLTAGE AND PHASE: 480/277V-3PH-4W (EXAMPLE) LINE 3 - WHERE PANELBOARD IS FED FROM: FF MSB BREAKER #14 (EXAMPLE

GENERAL ELECTRICAL NOTES:

1) HATCHED AREAS ///// DESIGNATE EXISTING EQUIPMENT TO BE REMOVED, UNLESS OTHERWISE NOTED.

2) ALL WORK TO BE DONE IN ACCORDANCE WITH THE LATEST ADOPTED EDITION OF THE NATIONAL ELECTRIC CODE (NFPA 70).

3) CONTRACTOR SHALL FIELD VERIFY ALL CONDITIONS AND COORDINATE WITH EXISTING EQUIPMENT PRIOR TO BIDDING.

BUILDING:

4) INSTALL DATA JACKS FOR CEILING MOUNTED WIRELESS TRANSMITTERS ABOVE CEILING IN ALL AREAS WHERE THERE IS AN ACCESSIBLE CEILING, UNLESS OTHERWISE NOTED. PROVIDE FLUSH MOUNTED JACKS IN ALL HARD CEILINGS.

5) ALL CONDUIT AND WIRING TO BE CONCEALED IN WALLS, FLOOR, OR ABOVE CEILINGS UNLESS OTHERWISE NOTED OR APPROVED BY THE ARCHITECT/ENGINEER. ALL DEVICE OUTLET BOXES SHALL BE RECESSED UNLESS OTHERWISE NOTED OR APPROVED BY THE ARCHITECT/ENGINEER. WHERE APPROVED OR NOTED, SURFACE METAL RACEWAY AND DEVICE BOXES SHALL BE USED IN-LIEU

6) ALL CONDUIT ROUTES SHOWN ARE APPROXIMATE ONLY. CONTRACTOR SHALL FIELD VERIFY FINAL ROUTE.

OF CONDUIT AND CONCEALED BOXES AT NO EXTRA COST TO THE OWNER.

7) CONDUIT RUNS SHOWN ARE SCHEMATICAL AND DO NOT INDICATE THE NECESSARY FITTINGS AND JUNCTION BOXES THAT ARE INCLUDED IN THE SCOPE OF THE WORK.

GROUNDING:

8) ALL METAL RACEWAYS, INCLUDING CONDUIT, WIRE TROUGHS, WIREMOLD, ETC., SHALL BE GROUNDED. ALL CONNECTIONS IN METAL RACEWAYS SHALL BE COMPLETED IN SUCH A MANNER AS TO MAINTAIN A CONTINUOUS PATH TO GROUND THROUGHOUT THE ENTIRE LENGTH OF THE RACEWAY.

WIRING:

9) UNLESS NOTED OTHERWISE ON THE DRAWINGS OR ON THE EQUIPMENT WIRING SCHEDULE, EACH BRANCH CIRCUIT SHALL BE THREE (3) #12 AWG THHN/THWN (1 HOT, 1 NEUTRAL & 1 EQUIPMENT GROUND) IN 3/4" EMT CONDUIT. PROTECT EACH CIRCUIT WITH A 20 AMPERE, 1-POLE OVERCURRENT DEVICE UNLESS OTHERWISE NOTED. PROVIDE #10 AWG FOR 120V BRANCH CIRCUITS LONGER THAN 100 FEET. COMBINED NEUTRALS ARE NOT PERMITTED.

INSTALLATION HEIGHTS:

HEIGHT TO CENTER OF EQUIPMENT ABOVE FINISHED FLOOR UNLESS OTHERWISE NOTED TO BE THE FOLLOWING:

 RECEPTACLE = 18" SWITCH = 44"


MODULAR JACK FOR WALL MOUNTED TELEPHONE = 52"

 MODULAR TELEPHONE JACK = 18" AUDIO/VISUAL FIRE ALARM INDICATORS = 88"

 FIRE ALARM PULL STATIONS = 48" TELEVISION OUTLET = 7'-0" COMPUTER OUTLET = 18"

 CALL SWITCH = 44" REMOTE TEST STATION FOR DUCT DETECTOR = 52"

C = ABOVE COUNTER BACKSPLASH, COORDINATE WITH ARCHITECTURAL ELEVATIONS.

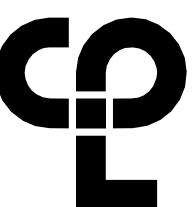

CPL | Architecture Engineering Planning 50 Front Street Suite 202, Newburgh, NY 12550 CPLteam.com

NY ENGINEERING FIRM CERTIFICATE #018330



PROJECT INFORMATION

R23.01124.00 Client Name

SOUTH ORANGETOWN CENTRAL SCHOOL DISTRICT

PROJECT SOUTH ORANGETOWN MIDDLE SCHOOL

2024 CAPITAL IMPROVEMENTS

160 VAN WYCK ROAD, BLAUVELT, NY 10913

SED # 50-03-01-06-0-013-031

Registration Expiration Dates Lauren Tarsio 09/30/23 Anthony Marchetti 05/31/24 Dave Hart 02/28/25 Jennifer Wengender 06/30/24

PROJECT ISSUE & REVISION SCHEDULE

PROFESSIONAL STAMPS

NEW YORK STATE EDUCATION STATEMENT


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REGULATIONS FOR ANY PERSON, UNLESS ACTING UNDER THE DIRECTION OF A LICENSED
ARCHITECT, ENGINEER OR LAND SURVEYOR, TO ALTER AN ITEM IN ANY WAY. IF AN ITEM
BEARING THE SEAL OF AN ARCHITECT, ENGINEER OR SURVEYOR IS ALTERED, THE ALTERING
PARTY SHALL AFFIX TO THE TIEM THEIR SEAL AND THE NOTATION "ALTERED BY" FOLLOWED E
THEIR SIGNATURE AND THE DATE OF SUCH ALTERATION, AND A SPECIFIC DESCRIPTION OF
ALTERATION.

Issued 05/15/24 AS NOTED Project Status BID DOCUMENTS

SHEET INFORMATION

Drawn By MAY

ELECTRICAL SYMBOLS LEGEND, NOTES & SYSTEM DIAGRAMS

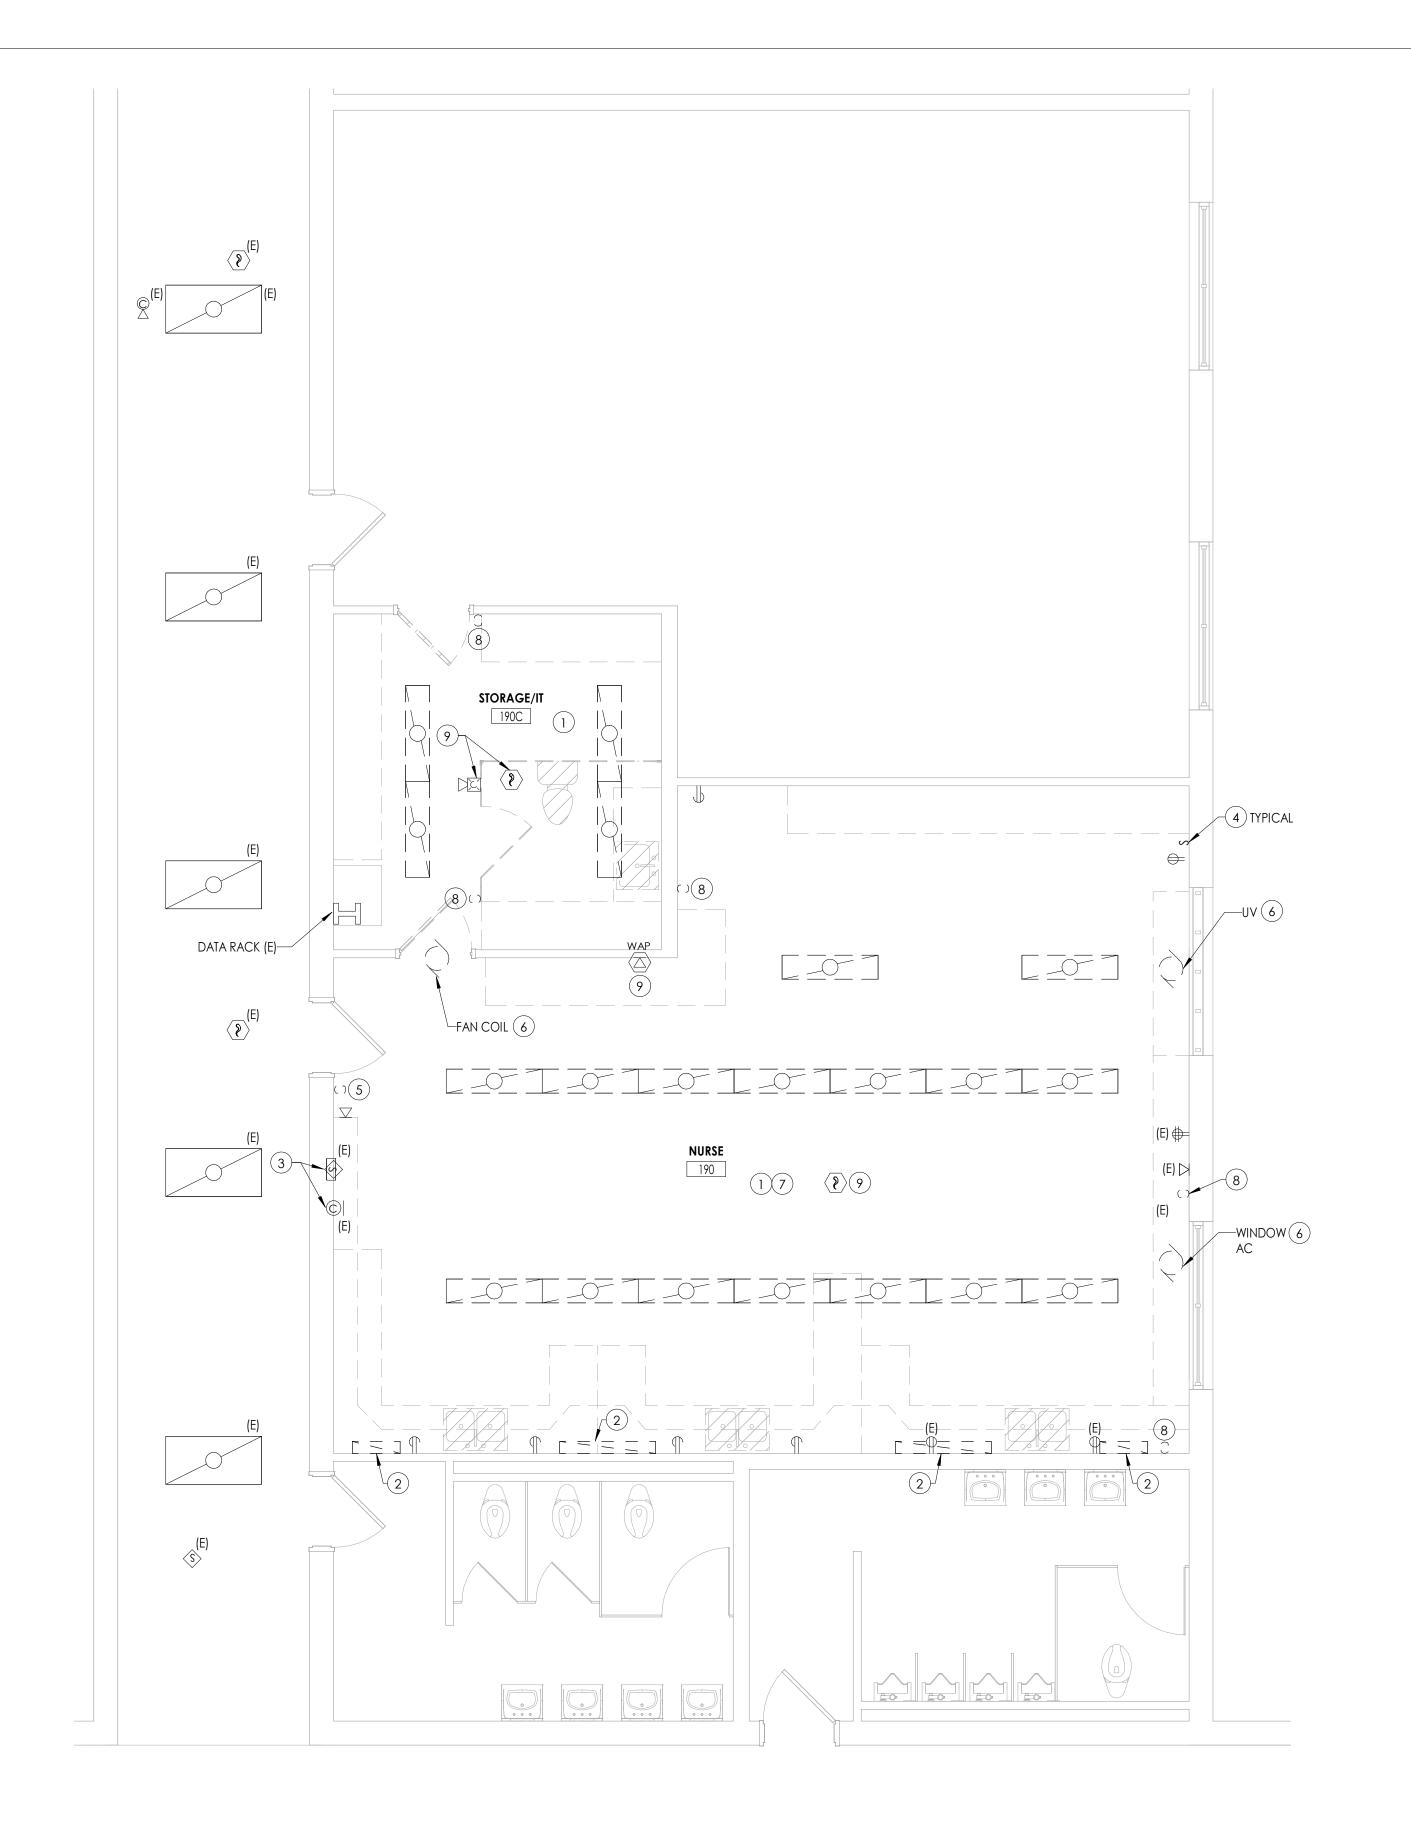

1 FIRST FLOOR ELECTRICAL DEMOLITION PLAN E100 1/4" = 1'-0"

GENERAL NOTES

- A. ALL ITEMS SHOWN ARE TO BE REMOVED UNLESS LABELED AS (E) EXISTING.
 REMOVAL OF DEVICE INCLUDES ITS ASSOCIATED CABLING/BRANCH CIRCUIT
 WIRING, AND RACEWAY.
- B. ANY EXISTING DEVICE TO REMAIN, LABELED AS (E) SHALL REMAIN IN PLACE AS WELL AS ITS' ASSOCIATED CIRCUITING AND CONDUIT, UNLESS OTHERWISE NOTED.
- C. THE CONTRACTOR SHALL REMOVE THE EXISTING ELECTRIC IN AREAS OF NEW RENOVATIONS TO ACCOMMODATE NEW CONSTRUCTION. REROUTING OF EXISTING MAY BE REQUIRED AT NEW OPENINGS IN EXISTING CONSTRUCTION OR INTERFERENCE WITH OTHER NEW WORK AS NOTED IN THE FOLLOWING NOTES.
- D. DRAWINGS INDICATE SPECIFIC ITEMS TO BE REMOVED AND/OR RELOCATED IN ORDER TO INDICATE GENERAL SCOPE. ADDITIONAL ITEMS NOT INDICATED, BUT NECESSARY FOR PROJECT RENOVATIONS, SHALL BE REMOVED, RELOCATED AND/OR REROUTED. THE CONTRACTOR SHALL ASSUME WITHIN THE BASE BID A NOMINAL AMOUNT OF BRANCH CIRCUITS, FIXTURES, DEVICES, AND SYSTEMS WIRING WITHIN WALLS OR OPENINGS BEING REMOVED OR RELOCATED AS REQUIRED TO ACCOMMODATE THE NEW CONSTRUCTION.
- E. WHERE DEVICES, FIXTURES, ETC. ARE INDICATED TO BE REMOVED, THEY AND THEIR RELATED WIRING/CONDUIT SHALL BE REMOVED BACK TO THE SOURCE PANELBOARD UNLESS OTHERWISE NOTED. ON CIRCUITS WHERE OTHER DEVICES, FIXTURES, ETC. ARE FOUND THAT MUST REMAIN, MAINTAIN CIRCUIT CONTINUITY BY PROVIDING ADDITIONAL WIRING, TO FEED THROUGH TO THESE REMAINING ITEMS. RELOCATE ANY CIRCUITS THAT REMAIN, TO AVOID CONFLICT WITH NEW CONSTRUCTION AS REQUIRED. PROPERLY TERMINATE ALL WIRING.
- F. COORDINATE DEMOLITION OF EQUIPMENT, DEVICES, ETC. WITH OTHER DISCIPLINES AS APPLICABLE. REFER TO ARCHITECTURAL DEMOLITION DRAWINGS AND NOTES FOR COORDINATION.
- G. DRAWINGS ARE GRAPHICAL REPRESENTATIONS OF APPROXIMATE EQUIPMENT AND DEVICE LOCATIONS. CONTRACTOR SHALL VISIT THE SITE TO DETERMINE THE EXACT EXTENT OF ELECTRICAL WORK REQUIRED TO COMPLETE THE PROJECT. EXISTING CONDITIONS ARE TAKEN FROM FIELD OBSERVATION AND EXISTING BUILDING DOCUMENTS. OTHER ELECTRICAL ITEMS MAY EXIST FOR WHICH THE CONTRACTOR IS RESPONSIBLE.
- H. CONTRACTOR SHALL PROPERLY DISPOSE OF ALL ITEMS, EQUIPMENT, PANELS, LIGHT FIXTURES, ETC. BEING REMOVED AS PART OF THIS PROJECT. THE OWNER SHALL HAVE THE RIGHT OF RETAINING ANY ITEMS BEING REMOVED.
- I. CONTRACTOR SHALL PROVIDE NEW COVERPLATES ON ALL BOXES OF UNUSED AND/OR REMOVED FLUSH MOUNT DEVICES UPON COMPLETION OF PROJECT.
- J. FIREPROOFING AND/OR FIRE STOP MATERIALS REMOVED FROM FIRE RATED WALLS AND CEILINGS AS A RESULT OF DEMOLITION SHALL BE RE-INSTALLED USING AN APPROVED METHOD AS DESCRIBED IN ASSOCIATED PROJECT SPECIFICATIONS.

KEY NOTES

- DISCONNECT AND REMOVE EXISTING LIGHT FIXTURES. TAG CIRCUITRY FOR RE-USE.
- 2 DISCONNECT AND AND REMOVE LIGHT FIXTURE IN THEIR ENTIRETY. REMOVE CONDUIT/WIRING BACK TO SOURCE.
- 3 DISCONNECT AND STORE CLOCK AND SPEAKER FOR RE-USE. TAG WIRING FOR RE-USE.
- (4) DISCONNECT AND REMOVE ALL LIGHT SWITCHES AND WIRING IN THEIR ENTIRETY.
- 5 DISCONNECT AND REMOVE EXISTING SWITCH AND CIRUCITRY. BACK BOX AND CONDUIT TO REMAIN.
- (6) DISCONNECT AND REMOVE EXISTING CONDUIT AND WIRING TO EQUIPMENT IN ITS ENTIRETY.
- WALLS IN THIS ROOM ARE TO BE FURRED OUT TO ACCOMMODATE NEW DEVICES. EXISTING DEVICES LOCATED ON WALLS ARE TO BE DISCONNECT, REMOVED, AND TAGGED FOR RE-USE.
- 8 DISCONNECT AND REMOVE EXISTING SWITCHES, CIRCUITRY, CONDUIT AND BACKBOXES. REMOVE WIRING BACK TO SOURCE.
- 9 DISCONNECT EXISTING DEVICES SHOWN FOR RE-LOCATION. STORE DEVICES AND TAG ALL CIRCUITRY FOR RE-USE.

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NY ENGINEERING FIRM CERTIFICATE #018330



PROJECT INFORMATION

R23.01124.00

SOUTH ORANGETOWN CENTRAL SCHOOL DISTRICT

2024 CAPITAL IMPROVEMENTS PROJECT

Building Address 160 VAN WYCK ROAD, BLAUVELT, NY 10913


SOUTH ORANGETOWN MIDDLE SCHOOL

SED # 50-03-01-06-0-013-031

Reaistration Expiration Dates Lauren Tarsio 09/30/23 Anthony Marchetti 05/31/24 Dave Hart 02/28/25 Jennifer Wengender 06/30/24

Date Pescription

PROFESSIONAL STAMPS

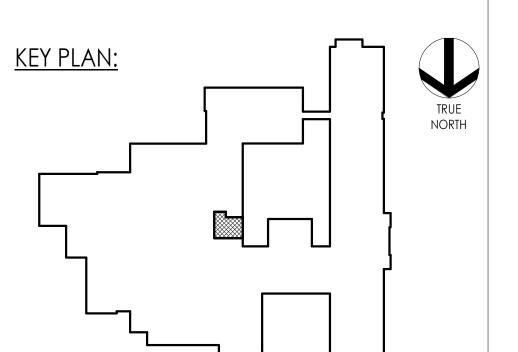

NEW YORK STATE EDUCATION STATEMENT

IT IS A VIOLATION OF THE NEW YORK STATE EDUCATION LAW AND THE COMMISSIONER'S
REGULATIONS FOR ANY PERSON, UNLESS ACTING UNDER THE DIRECTION OF A LICENSED
ARCHITECT, ENGINEER OR LAND SURVEYOR, TO ALTER AN ITEM IN ANY WAY, IF AN ITEM
BEARING THE SEAL OF AN ARCHITECT, ENGINEER OR SURVEYOR IS ALTERED, THE ALTERING
PARTY SHALL AFFIX TO THE ITEM THEIR SEAL AND THE NOTATION "ALTERED BY" FOLLOWED BY
THEIR SIGNATURE AND THE DATE OF SUCH ALTERATION, AND A SPECIFIC DESCRIPTION OF TH
ALTERATION.

SHEET INFORMATION

O5/15/24 As indicated


Project Status
BID DOCUMENTS

Drawn By Checked By
MAY JBT

Drawing Title

FIRST FLOOR DEMOLITION PLAN

SOMS E100

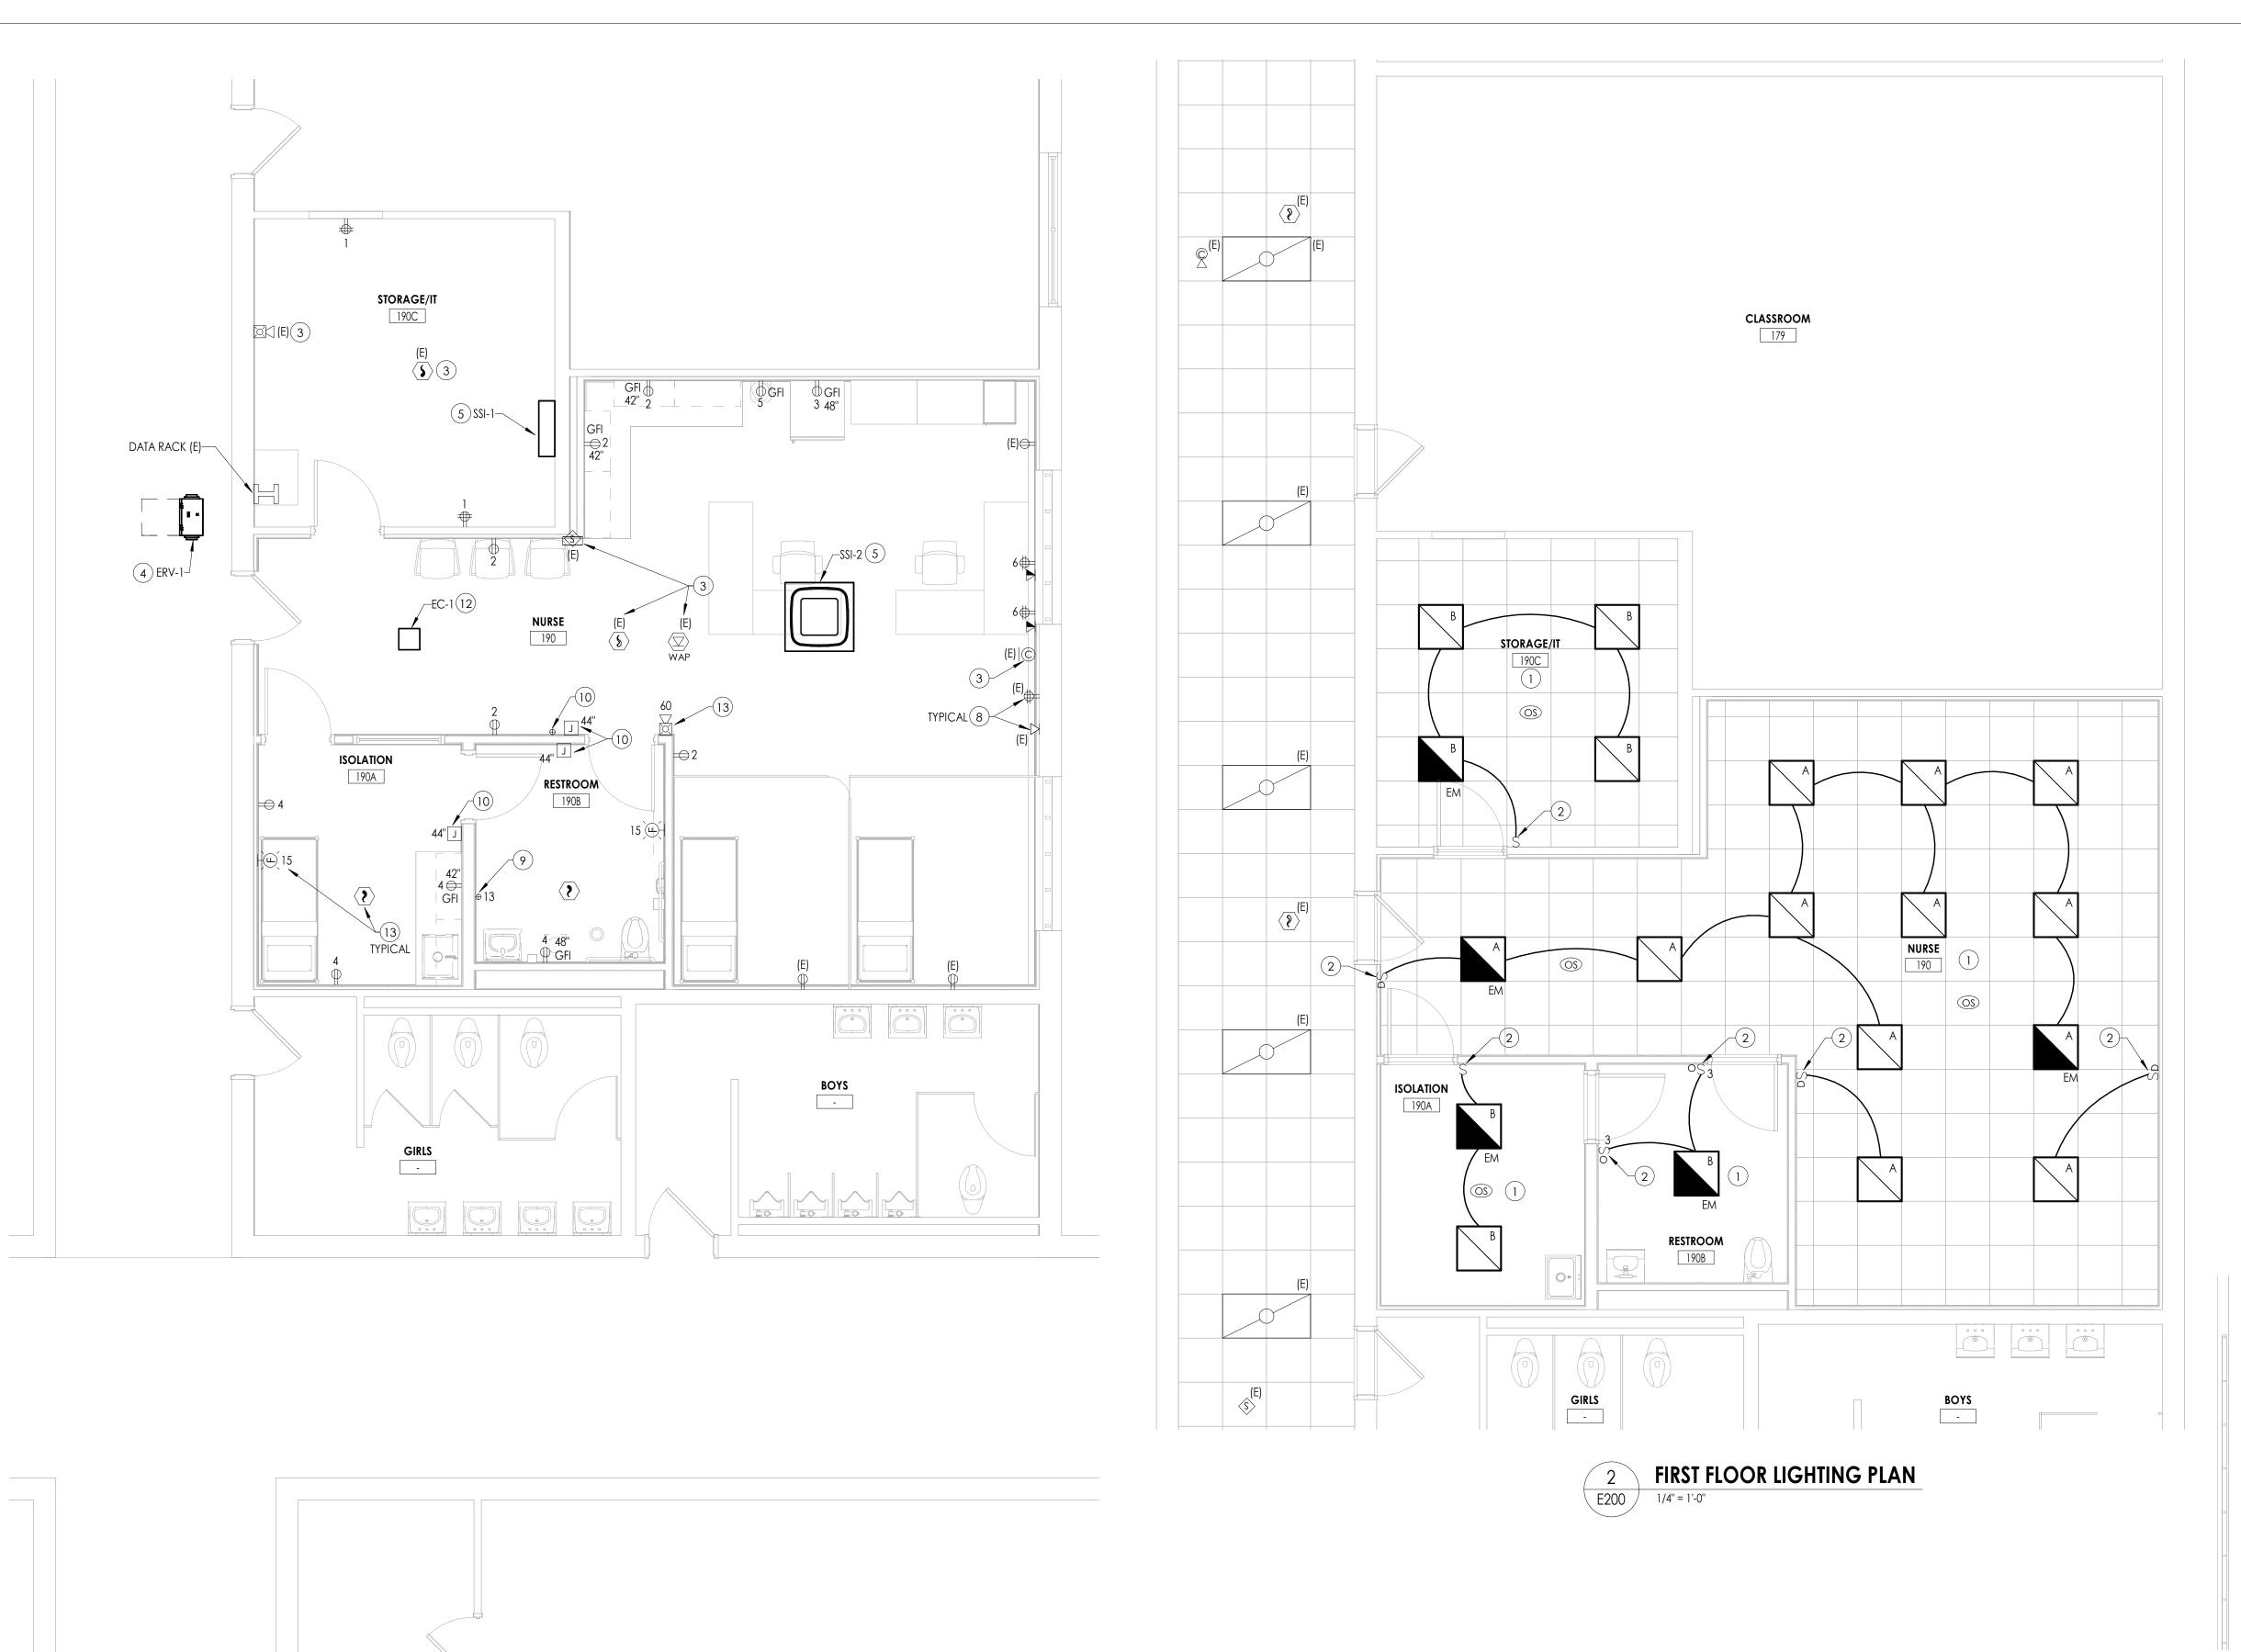

LUMINAIRE SCHEDULE DESCRIPTION **DESIGN MAKE** MODEL NUMBER VOLTS REMARKS: WATTS TEMPERATURE 2X2 RECESSED LED TROFFER SIGNIFY LIGHTING 42-22-D1-ST-L-935-40-Q-1-UNV-E UNV 3500K 2X2 RECESSED LED TROFFER WITH EMERGENCY BATTERY BACKUP SIGNIFY LIGHTING 42-22-D1-ST-L-935-40-Q-B-UNV-E UNV 3500K 2,3 2X2 RECESSED LED FLAT PANEL SIGNIFY LIGHTING 2FPZ-38B-835-2-DS-UNV-DIM-FMA22 UNV 29 3500K 2FPZ-38B-835-2-DS-UNV-DIM-BSL6SLT-FMA23 B/EM 2X2 RECESSED LED FLAT PANEL EMERGENCY BATTERY BACKUP SIGNIFY LIGHTING UNV 1,2,3 3500K

1. FIXTURES ARE TO BE PROVIDED WITH GYP CEILING MOUNTING FLANGE KIT, PART NO. FMA22

PANEL LVP2

E200 /

FIRST FLOOR ELECTRICAL NEW WORK PLAN


2. ALL FIXTURES SHOWN WITH AN "EM" DESIGNATION INDICATES AND EMERGENCY FIXTURE. PROVIDE EMERGENGY BATTERY BACKUP FOR EACH FIXTURE INDICATED. 3. ALL "EM" BATTERY BACKUPS WITHIN FIXTURE SHALL BE WIRED TO THE UNSWITCHED HOT LEG OF THE CIRCUIT FEEDING IT.

GENERAL NOTES

- A. FOR ALL 120V DEVICES SHOWN, WIRE WITH (2)#12, #12G IN 3/4"C AND CONNECT TO EXISTING SPARE 20A/1P CIRCUIT BREAKER IN PANEL LVP2 INDICATED BY CIRCUIT NUMBER ADJACENT TO DEVICE.
- B. ALL CIRCUITS OVER 100 FEET TO BE WIRED WITH #10 THHN.
- C. FIXTURE TYPE MARK IS INDICATED ADJACENT TO ALL LIGHT FIXTURES. REFER TO LUMINAIRE SCHEDULE ON THIS DRAWING FOR FIXTURE DESCRIPTIONS, TYPES, NOTES, AND SPECIFICATIONS.
- D. ALL LIGHT FIXTURES SHOWN SHALL BE WIRED WITH (2) #12, (1) #12GND IN 3/4" CONDUIT, WIRED TO PANEL AND CIRCUIT INDICATED. CIRCUITS EXCEEDINIG 100' SHALL BE WIRED WITH #10 CONDUCTORS.
- PROVIDE ANY ADDITIONAL POWER SUPPLIES OR OTHER MISCELLANEOUS COMPONENTS REQUIRED FOR A COMPLETE, OPERATIONAL LIGHTING SYSTEM TO MEET THE DESIGN INTENT OF THE LIGHTING SEQUENCE OF OPERATIONS AS
- G. FOR ALL DATA/VOICE DEVICES SHOWN, PROVIDE A FLUSH MOUNTED 2-GANG BOX WITH SINGLE GANG DEVICE RING. PROVIDE (2) CATEGORY 6 UTP CABLE IN 1-1/4" CONDUIT TO DEVICE LOCATIONS. CABLING TO RUN TO DATA RACK IN STORAGE/IT 190C. PROVIDE 2-PORT FACEPLATE, BRACKETS, (2) RJ-45 JACKS, ETC, AT EACH LOCATION.


KEY NOTES

- (1) CONNECT NEW LIGHT FIXTURES AND SWITCHES TO EXISTING TAGGED CIRCUITRY.
- (2) PROVIDE NEW SWITCHES AS INDICATED. PROVIDE ALL LOW VOLTAGE WIRING, POWER PACKS, AND DEVICES AS NECESSARY TO PROVIDE A COMPLETE LIGHTING SYSTEM.
- (3) NEW LOCATION OF EXISTING DEVICES. CONNECT TO EXISTING TAGGED WIRING. REWORK/EXTEND WIRING AS NECESSARY TO ACCOMMODATE NEW DEVICE LOCATIONS.
- (4) PROVIDE (2) #12, (1) #12 GND IN 3/4" CONDUIT FROM PANEL LVP2, CIRCUIT 7 TO ERV-1. UTILIZE EXISTING 20-AMP, 1-POLE CIRCUIT BREAKER.
- (5) PROVIDE (2) #12, (1) #12 GND IN 3/4" CONDUIT FROM PANEL LVP2, CIRCUIT 8,10 TO SSI-1 AND SSI-2. PROVIDE A 20-AMP, 2-POLE CIRCUIT BREAKER IN SPACES INDICATED. PROVIDE (2) #12, (1) #12 GND IN 3/4" CONDUIT FROM PANE LVP2, CIRCUIT 16 TO CONDENSATE PUMPS FOR SSI-1 AND SSI-2. PROVIDE A 20-AMP, 1-POLE CIRCUIT BREAKER IN SPACE INDICATED.
- (6) PROVIDE (2) #10, (1) #12 GND IN 3/4" CONDUIT FROM PANEL LVP2, CIRCUIT 9,11 TO SSO-1. PROVIDE A 20-AMP, 2-POLE CIRCUIT BREAKER IN SPACES
- (7) PROVIDE (2) #10, (1) #12 GND IN 3/4" CONDUIT FROM PANEL LVP2, CIRCUIT 12,14 TO SSO-2. PROVIDE A 20-AMP, 2-POLE CIRCUIT BREAKER IN SPACES
- (8) EXISTING WALL MOUNTED DEVICES TO BE PLACED IN NEW FURRED OUT WALLS AT LOCATIONS INDICATED.
- (9) PROVIDE (2) #12, (1) #12GND IN 3/4" CONDUIT FROM PANEL LVP2, CIRCUIT 13 TO NEW HAND DRYER. UTILIZE EXISTING 20-AMP, 1-POLE CIRCUIT BREAKER.
- (10) PROVIDE JUNCTION BOXES AT LOCATIONS INDICATED FOR COMMUNICATING BATHROOM PACKAGE. PROVIDE 3/4" CONDUITS FROM EACH BOX AND EACH POWER TRANSFER HINGE TO ABOVE CEILING DOOR POWER SUPPLY. PROVIDE (2) #12, (1) #12GND IN 3/4" CONDUIT FROM PANEL LVP2, CIRCUIT 15, TO DOOR POWER SUPPLY. UTILIZE EXISTING 20-AMP, 1-POLE CIRCUIT BREAKER. ALL CONTROL WIRING DONE BY DOOR HARDWARE INSTALLER. COORDINATE ALL WORK AND LOCATIONS WITH DOOR HARDWARE INSTALLER PRIOR TO INSTALLATION.
- (11) PROVIDE (2) #10, (1) #12 GND IN 3/4" CONDUIT FROM PANEL LVP2, CIRCUIT 16 TO EF-1. PROVIDE A 20-AMP, 1-POLE CIRCUIT BREAKER IN SPACE INDICATED.
- (12) PROVIDE (2) #12, (1) #12 GND IN 3/4" CONDUIT FROM PANEL LVP2, CIRCUIT 18 TO EC-1. PROVIDE A 20-AMP, 1-POLE CIRCUIT BREAKER IN SPACE INDICATED.
- (13) PROVIDE NEW FIRE ALARM DEVICES AT LOCATIONS INDICATED. DEVICES TO MATCH EXISTING EST FIRE ALARM PANEL DEVICES. PROVIDE ALL WIRING FROM DEVICES TO LOCAL SLC LOOP. PROVIDE TESTING OF ALL DEVICES TO ENSURE SYSTEM IS IN WORKING ORDER. COORDINATE TESTING WITH OPEN SYSTEMS, THE SCHOOLS FIRE ALARM VENDOR.

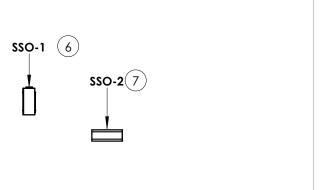





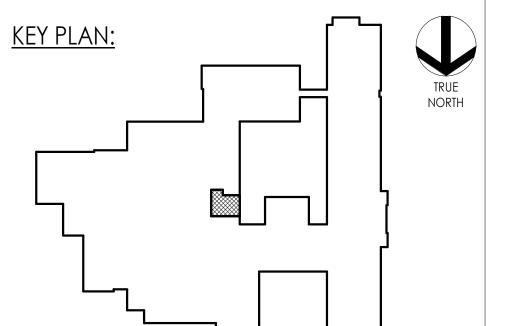

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PROJECT ISSUE & REVISION SCHEDULE

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05/15/24 As indicated Project Status BID DOCUMENTS Drawn By MAY

FIRST FLOOR ELECTRICAL NEW **WORK PLAN**