VALLEY CENTRAL SCHOOL DISTRICT MONTGOMERY ELEMENTARY SCHOOL 2023 CAPITAL PROJECT - PHASE 1

ISSUED FOR BID: 10/18/24

CSARCH - ARCHITECTS

BLAKE ENGINEERING, PLLC - M.E.P. ENGINEERS

PASSERO ASSOCIATES - SITE/CIVIL AND STRUCTURAL ENGINEERS


AECC ENVIRONMENTAL CONSULTING - HAZARDOUS MATERIALS DESIGNERS

STATE EDUCATION DEPARTMENT PROJECT CONTROL NUMBER:

2023 CAPITAL PROJECT - PHASE 1 44-13-01-06-0-004-015

THE DESIGN OF THIS PROJECT CONFORMS TO APPLICABLE PROVISIONS OF THE NEW YORK STATE UNIFORM FIRE PREVENTION AND BUILDING CODE, THE NEW YORK STATE ENERGY CONSERVATION CONSTRUCTION CODE, AND THE MANUAL OF PLANNING STANDARDS OF THE NEW YORK STATE EDUCATION DEPARTMENT.

CSArch PROJECT NO. 187-2302.01

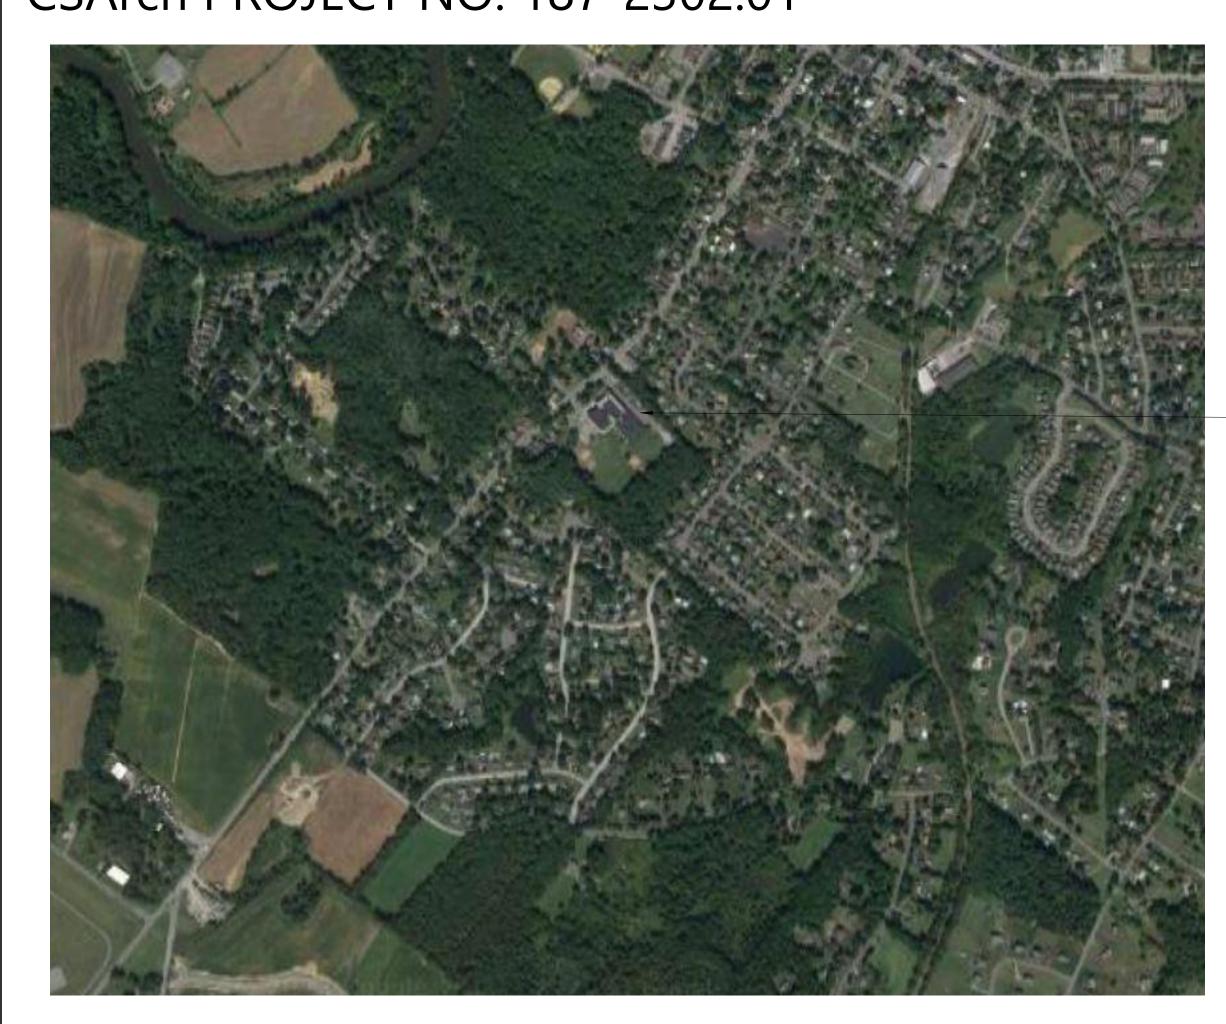

– Montgomery Elementary School 141 Union St Montgomery, NY 12549

VICINITY MAP NTS



DRAWING LIST

GENERAL DRAWINGS

MES G000 COVER & SHEET INDEX

MES G001 SYMBOLS, ABBREVIATIONS, MISC, AND PARTITION TYPES

MES G111 OVERALL FLOOR PLAN - FIRST FLOOR

LIFE SAFETY DRAWINGS

MES LS111 FIRST FLOOR LIFE SAFETY PLAN

MES LS112 SMOKE ZONE PLANS

ARCHITECTURAL DEMOLITION DRAWINGS

MES AD111 ENLARGED REMOVAL PLAN - FIRST FLOOR - AREA C

ARCHITECTURAL DRAWINGS MES A111 ENLARGED NEW WORK PLAN - FIRST FLOOR - AREA C

MES A201 EXTERIOR ELEVATIONS

MES A202 EXTERIOR ELEVATIONS

MES A811 REFLECTED CEILING PLAN - FIRST FLOOR - AREA C MES A901 DOOR, WINDOW, & STOREFRONT DETAILS

ARCHITECTURAL FINISH DRAWINGS

MES AF111 MATERIAL SCHEDULE & FLOOR FINISHES PLAN - AREA C

PLUMBING GENERAL DRAWINGS

MES P001 PLUMBING NOTES, SCHEDULE, LEGEND & DETAILS

PLUMBING DRAWINGS

MES P111 PLUMBING PLANS

MECHANICAL GENERAL DRAWINGS MES M001 MECHANICAL NOTES, LEGENDS, SCHEDULES & DETAILS

MECHANICAL DEMOLITION DRAWINGS

MES MD111 MECHANICAL DEMOLITION PLAN

MECHANICAL DRAWINGS
MES M111 MECHANICAL PLAN

ELECTRICAL GENERAL DRAWINGS


MES E001 ELECTRICAL NOTES, LEGENDS, SCHEDULES & DETAILS

| ELECTRICAL DEMOLITION DRAWINGS | MES ED111 | ELECTRICAL DEMOLITION PLAN


MES EDITI ELECTRICAL DEMOLITION PLAT

ELECTRICAL DRAWINGS

MES E111 ELECTRICAL PLAN

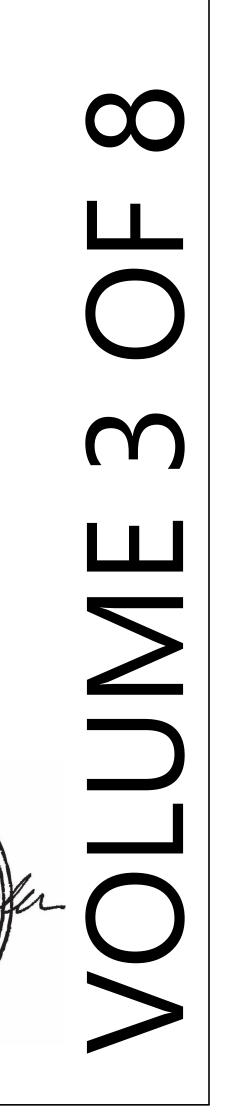

EXPIRATION DATE: 02/28/2025

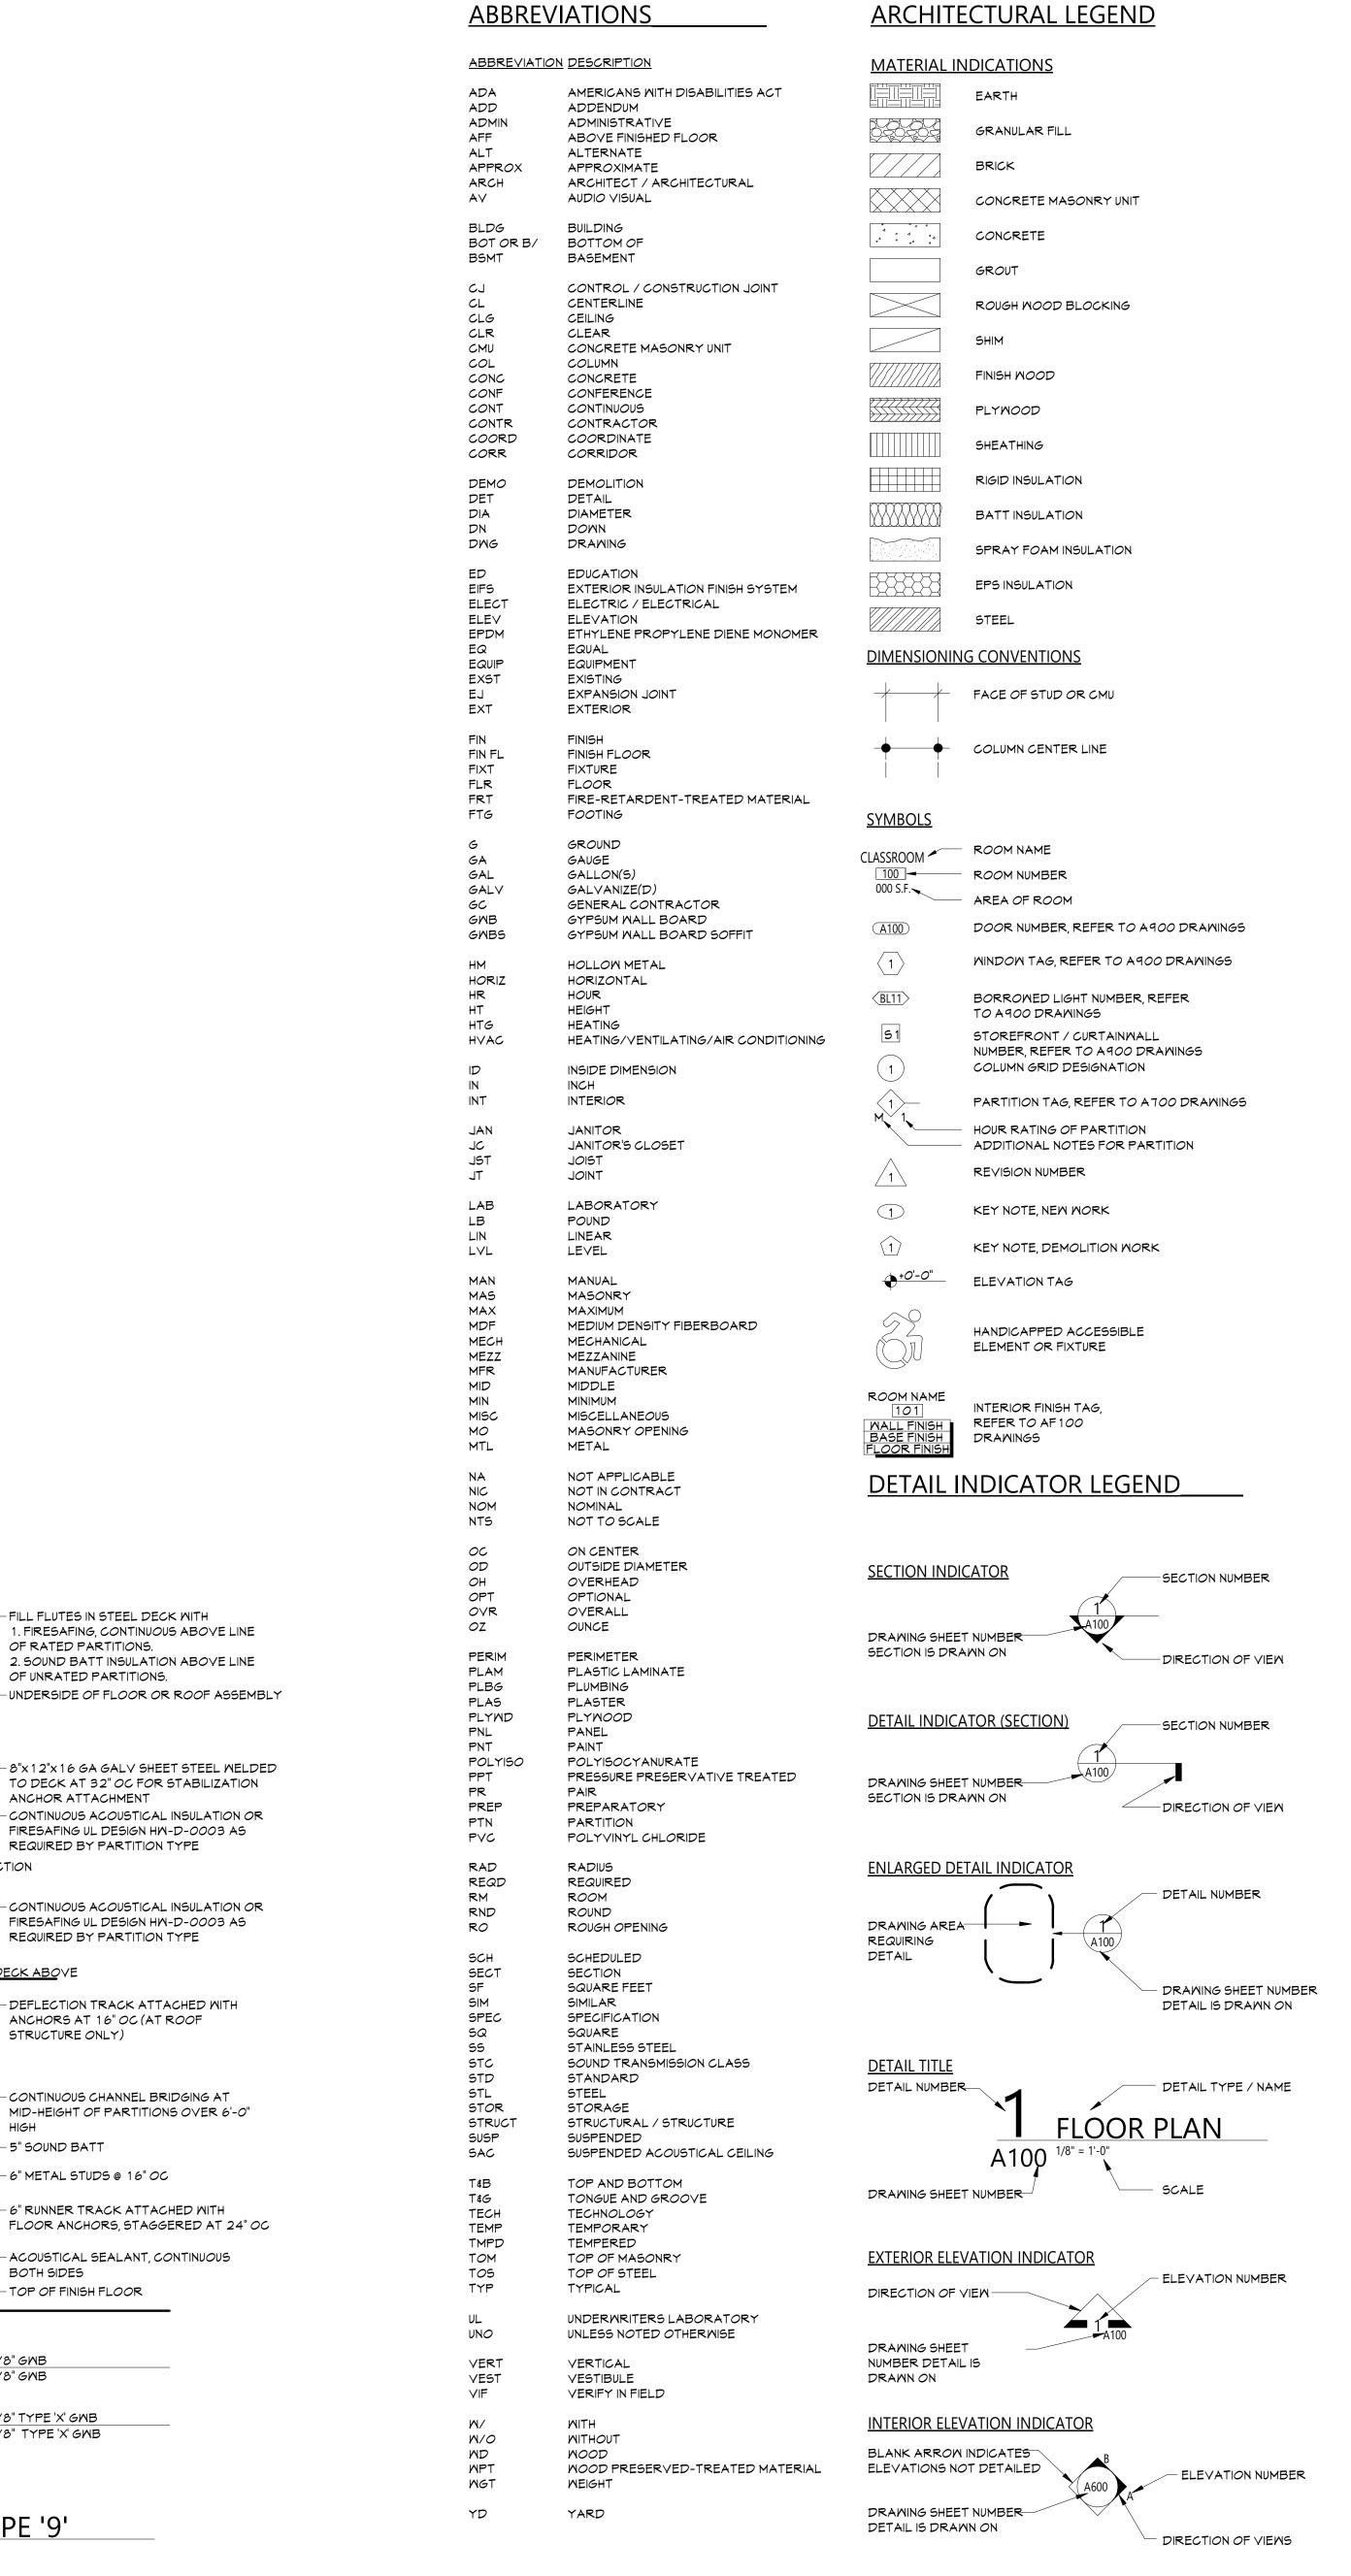

OF RATED PARTITIONS.

ANCHOR ATTACHMENT

STRUCTURE ONLY)

- 5" SOUND BATT

BOTH SIDES

2 - 5/8" GMB UL U419 5/8" GMB

52 | 1 HOUR | 5/8" TYPE 'X' GMB

UL U465 5/8" TYPE 'X' GMB


- TOP OF FINISH FLOOR

-6" METAL STUDS @ 16" OC

OPPOSITE FLUTE DIRECTION

BOTTOM PLANE OF DECK ABOVE

OF UNRATED PARTITIONS.

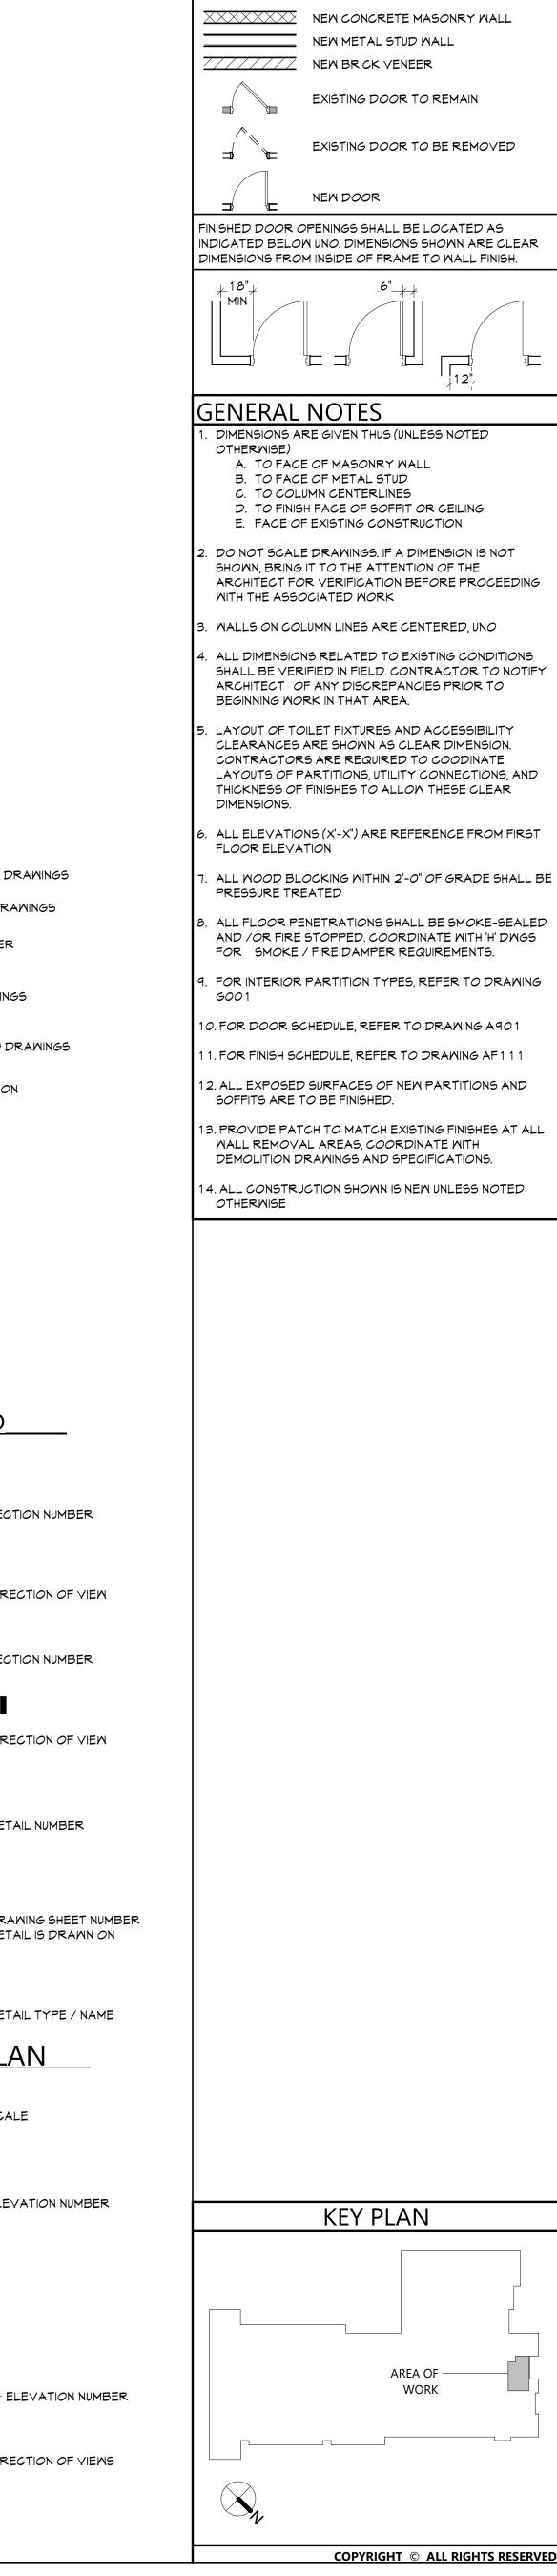

PLAN GRAPHICS LEGEND

---- TO BE REMOVED

---- EXISTING CONSTRUCTION

EXISTING CONSTRUCTION TO REMAIN

EXPIRATION DATE: 02/28/2025

DATE DESCRIPTION **Proj. #:** 44-13-01-06-0-004-015 CSArch Proj. #:

Issued for Bid:

SYMBOLS, **ABBREVIATIONS** MISC AND **PARTITION**

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CONSTRUCTION DOCUMENTS

 Drawn By:
 Author

 Checked By:
 Checker

 Proj. #:
 44-13-01-06-0-004-015

 CSArch Proj. #:
 187-2302.01

 Issued for Bid:
 10/18/24

OVERALL FLOOR PLAN -FIRST FLOOR


G111

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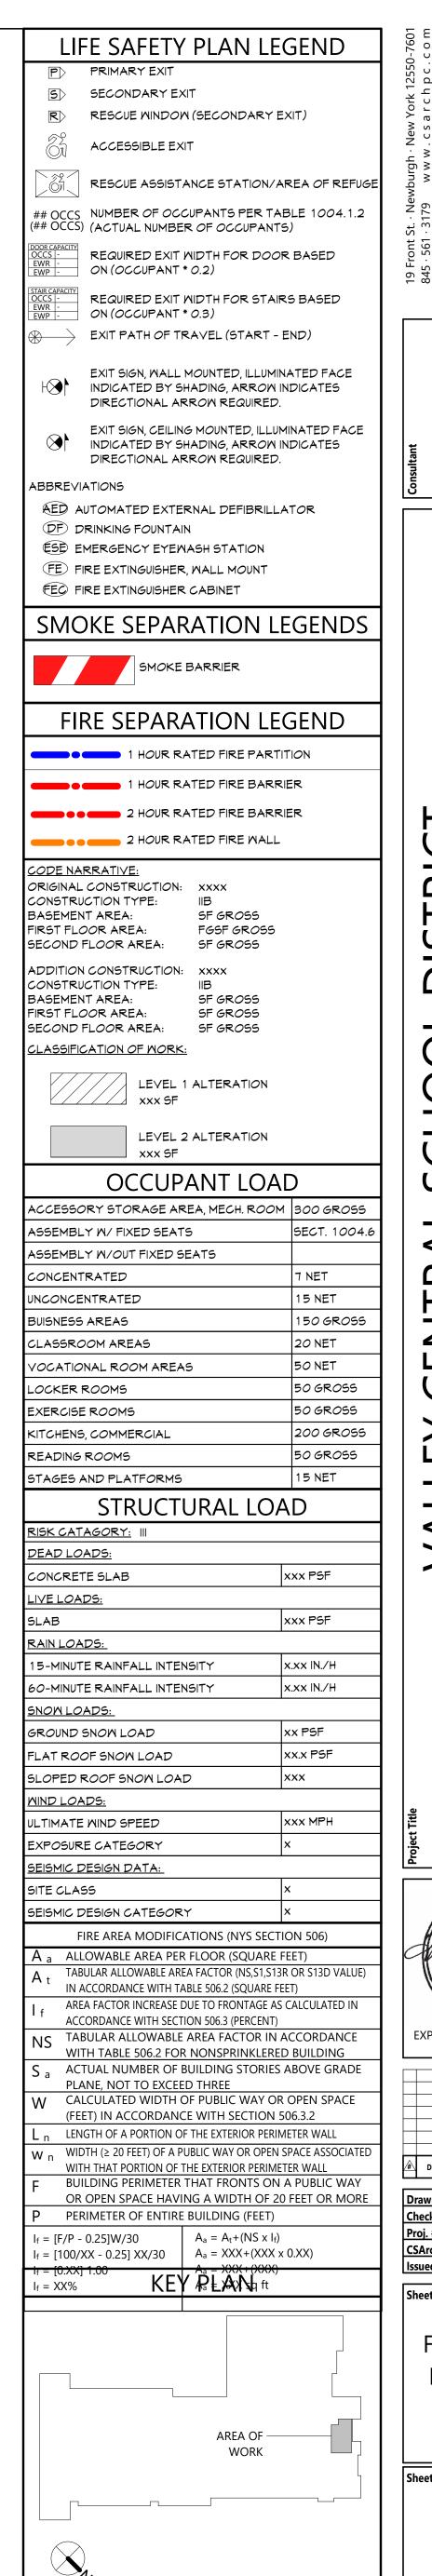
CONSTRUCTION DOCUMENTS

GENERAL DESIGN LOAD REQUIREMENTS **BUILDING CODE SECTION** OCCUPANCY/USE/LOCATION REQUIRED **LOADING TYPE** 2020 BUILDING CODE OF NEW SCHOOLS - CLASSROOMS 40 PSI MINIMUM UNIFORM **DISTRIBUTED LIVE LOADS** YORK STATE TABLE 1607.1 SCHOOLS - FIRST FLOOR CORRIDORS 100 PSI SCHOOLS - CORRIDORS ABOVE FIRST FLOOR 80 PSI OFFICE BUILDINGS - OFFICES 50 PSI ROOFS - ORDINARY/FLAT (NON-OCCUPIABLE) 40 PSI GROUND SNOW LOADS 2020 BUILDING CODE OF NEW 40 PSI ORANGE COUNTY YORK STATE FIGURE 1608.2 MONTGOMERY, NY **FLAT ROOF SNOW LOADS** 2020 BUILDING CODE OF NEW ORANGE COUNTY 28 PSI YORK STATE FIGURE 1608.2 MONTGOMERY, NY **DESIGN WIND SPEEDS** 2020 BUILDING CODE OF NEW RISK CATEGORY III 130 VMPH YORK STATE FIGURE 1609.3 MONTGOMERY, NY



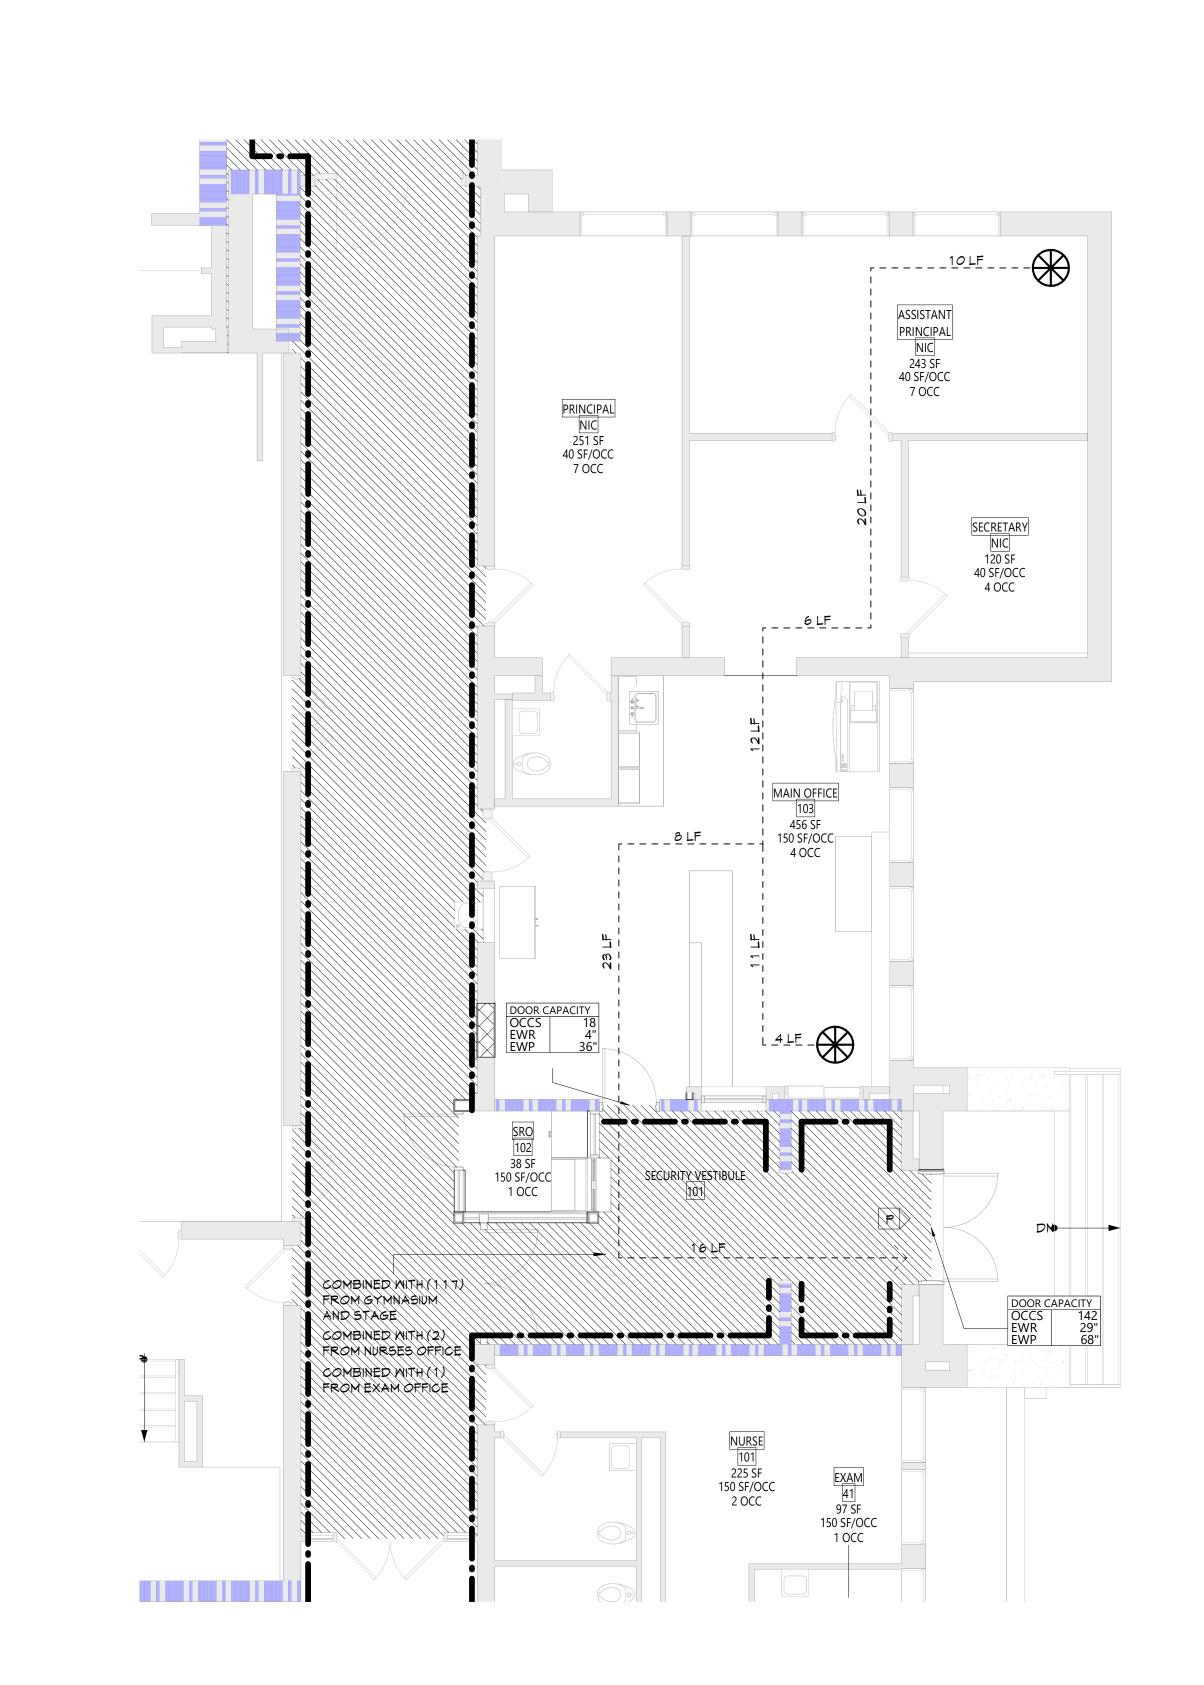

LIFE SAFETY PLAN - VESTIBULE



EXPIRATION DATE: 02/28/2025

DESCRIPTION Proj. #: 44-13-01-06-0-004-015
CSArch Proj. #: 187-2302.01

FIRST FLOOR LIFE SAFETY PLAN

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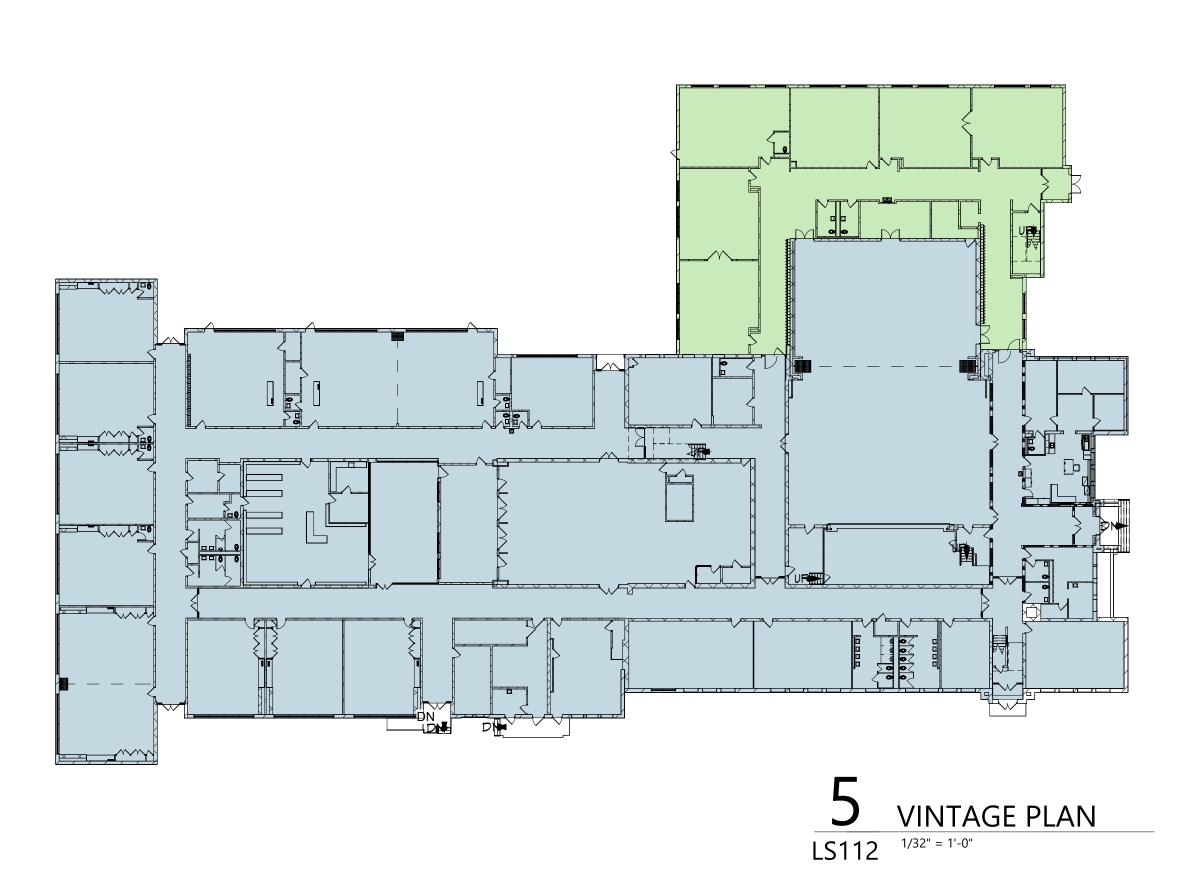
CONSTRUCTION DOCUMENTS


SMOKE ZONE PLANS


Sheet No. MES CONSTRUCTION DOCUMENTS


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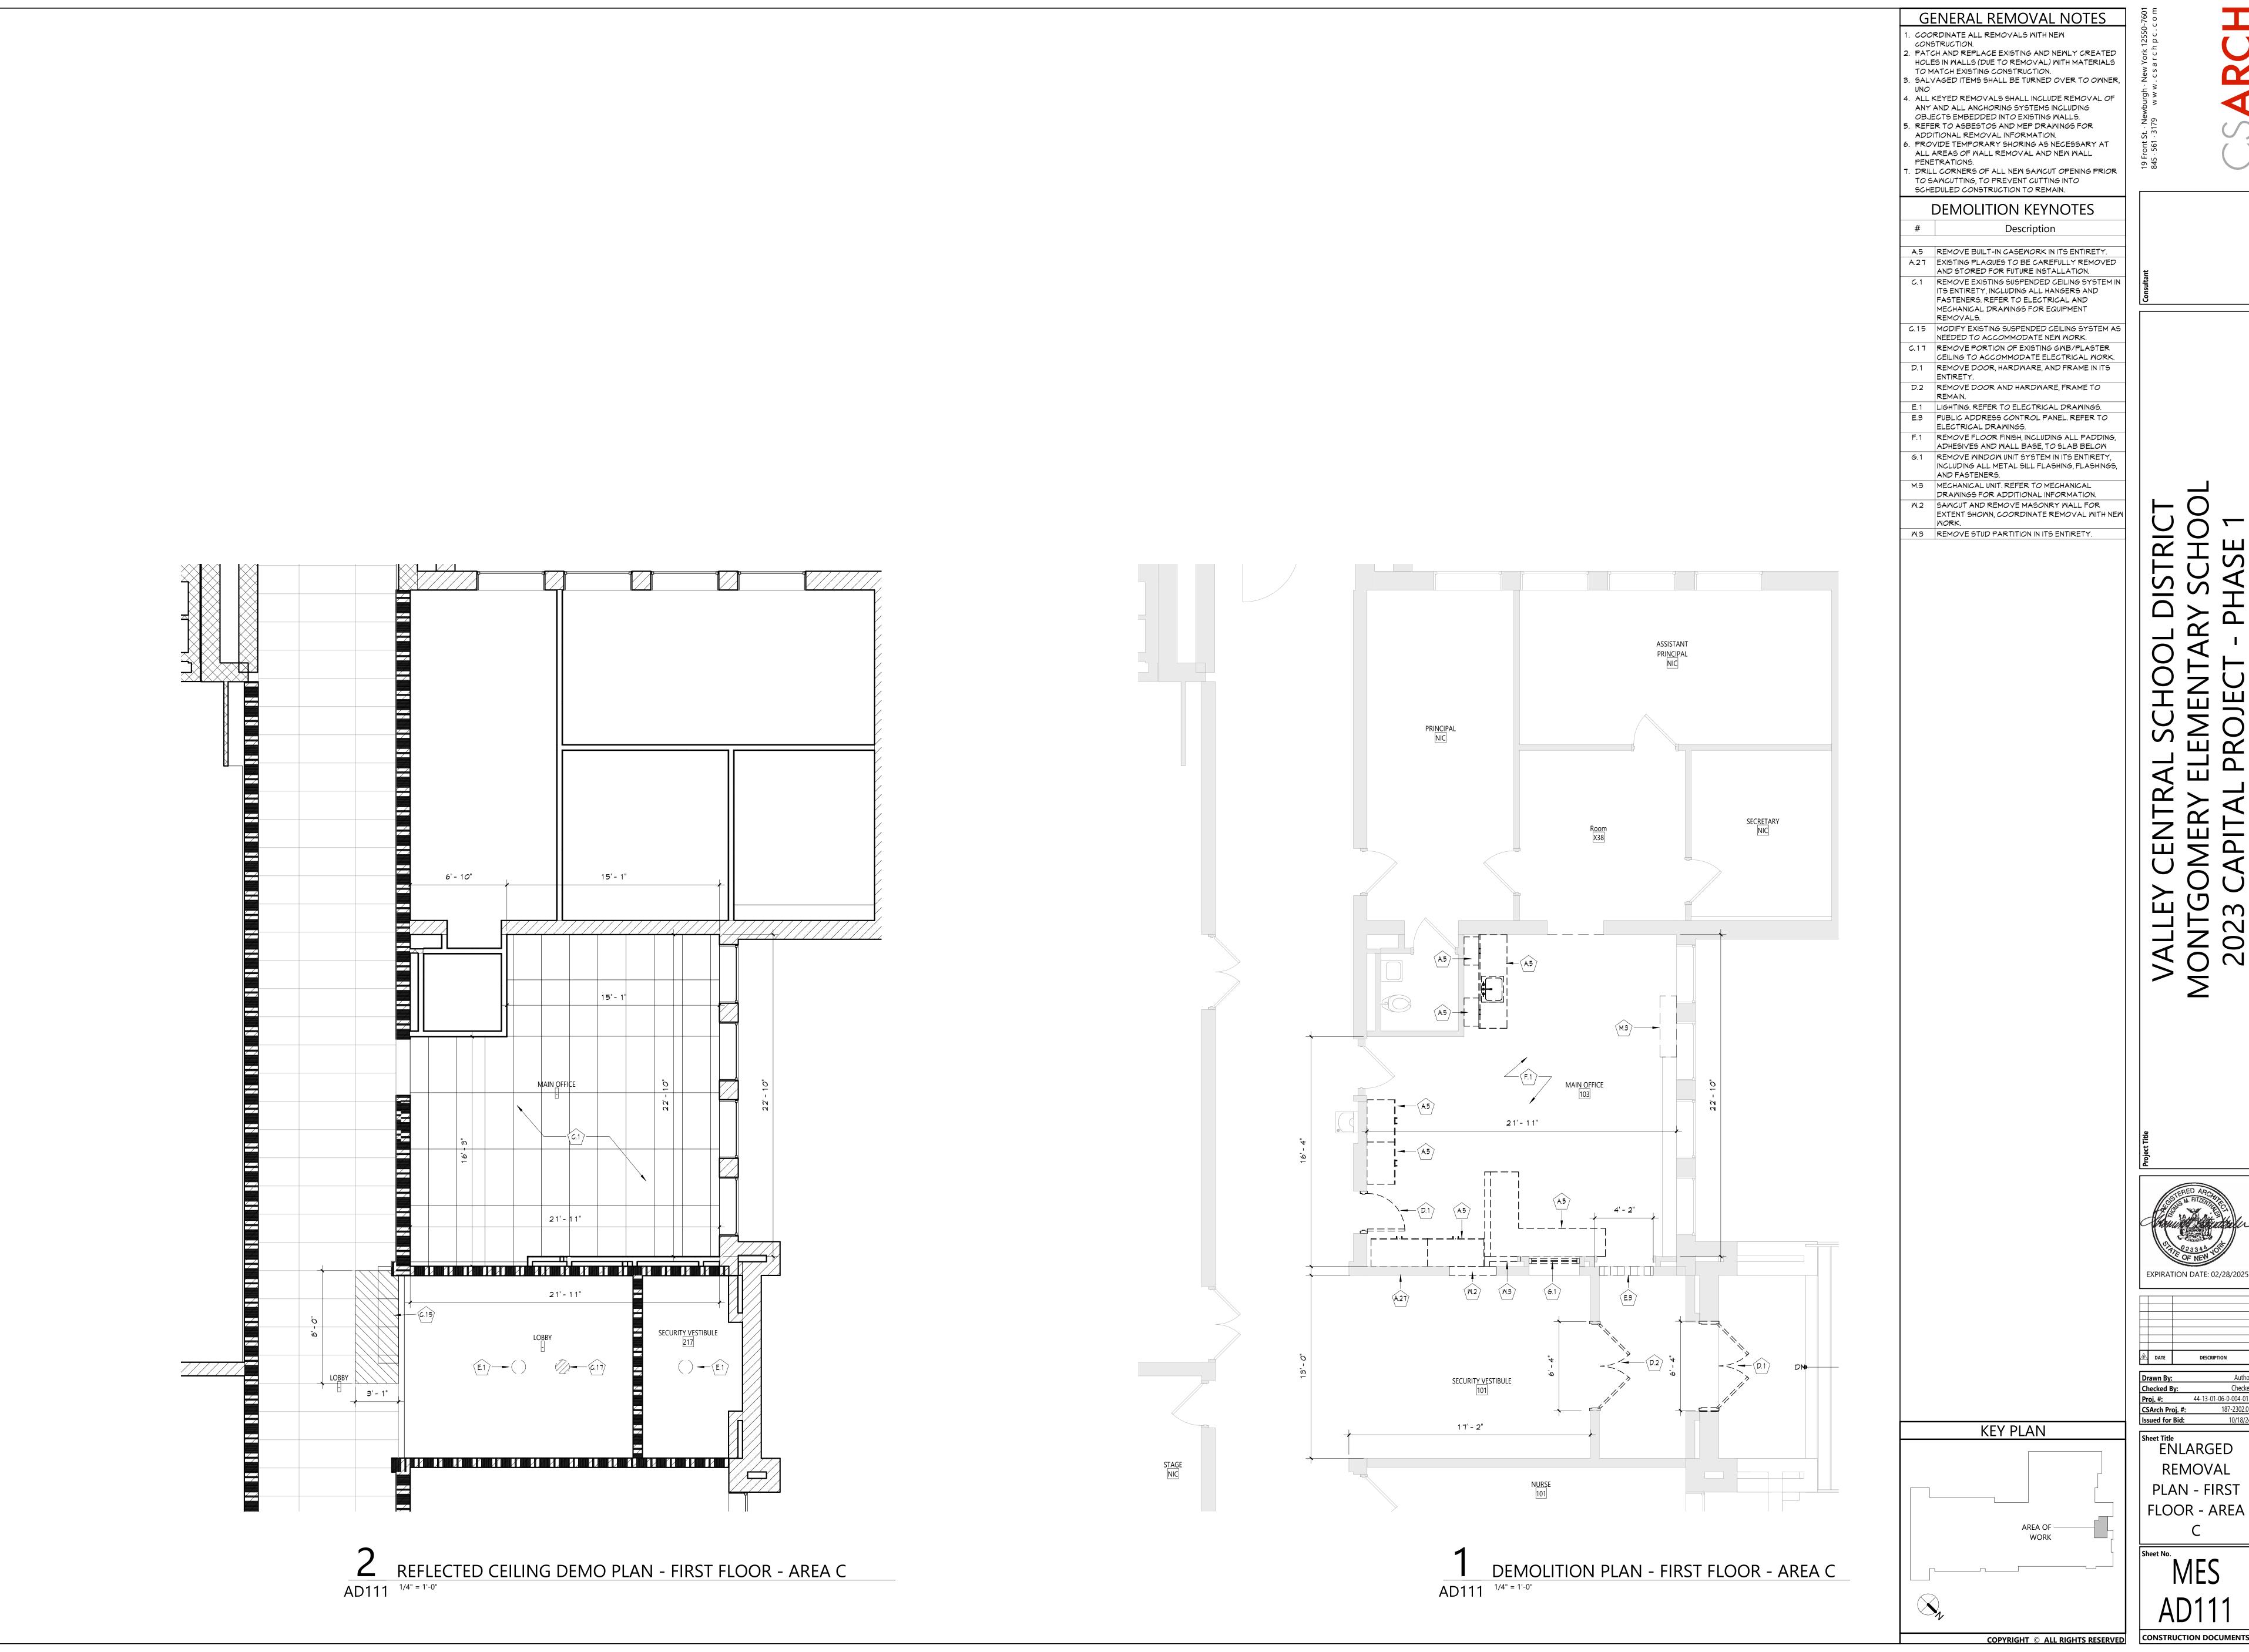







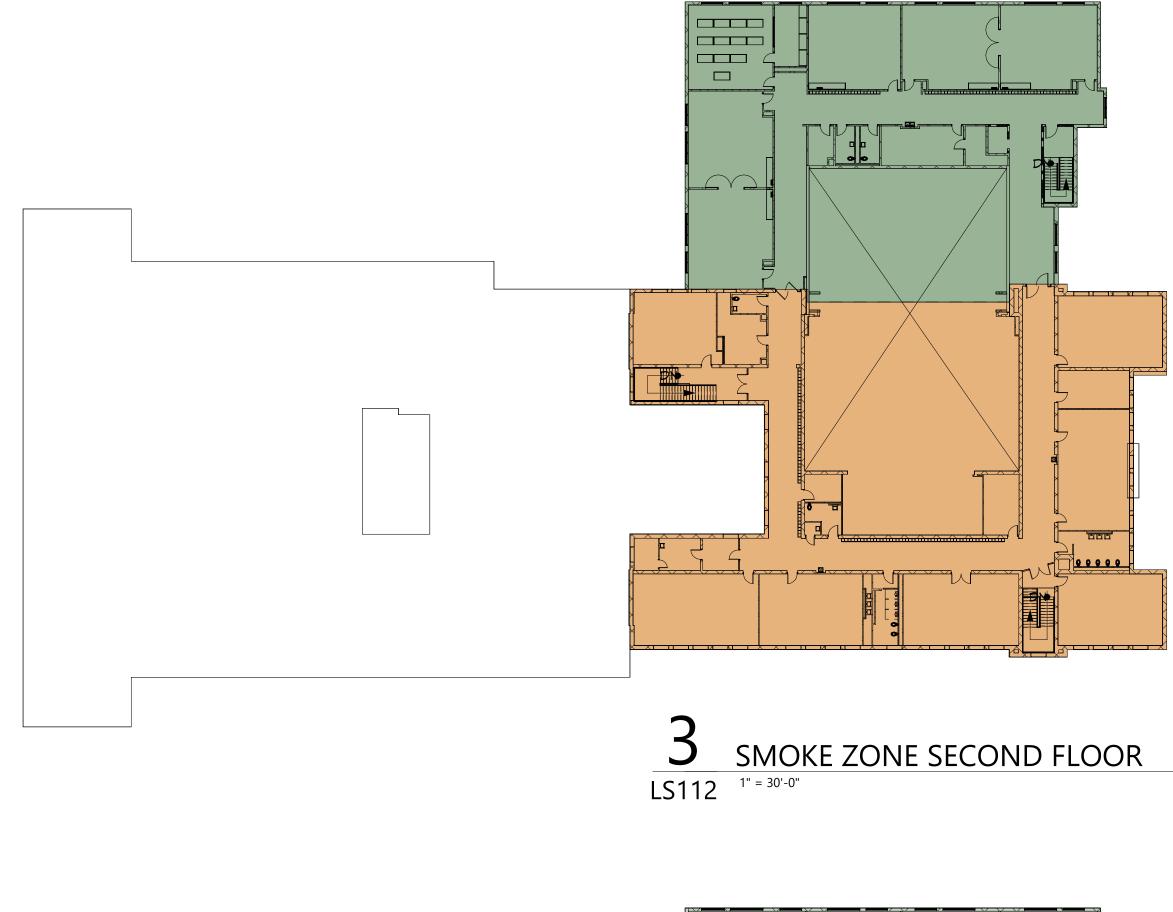

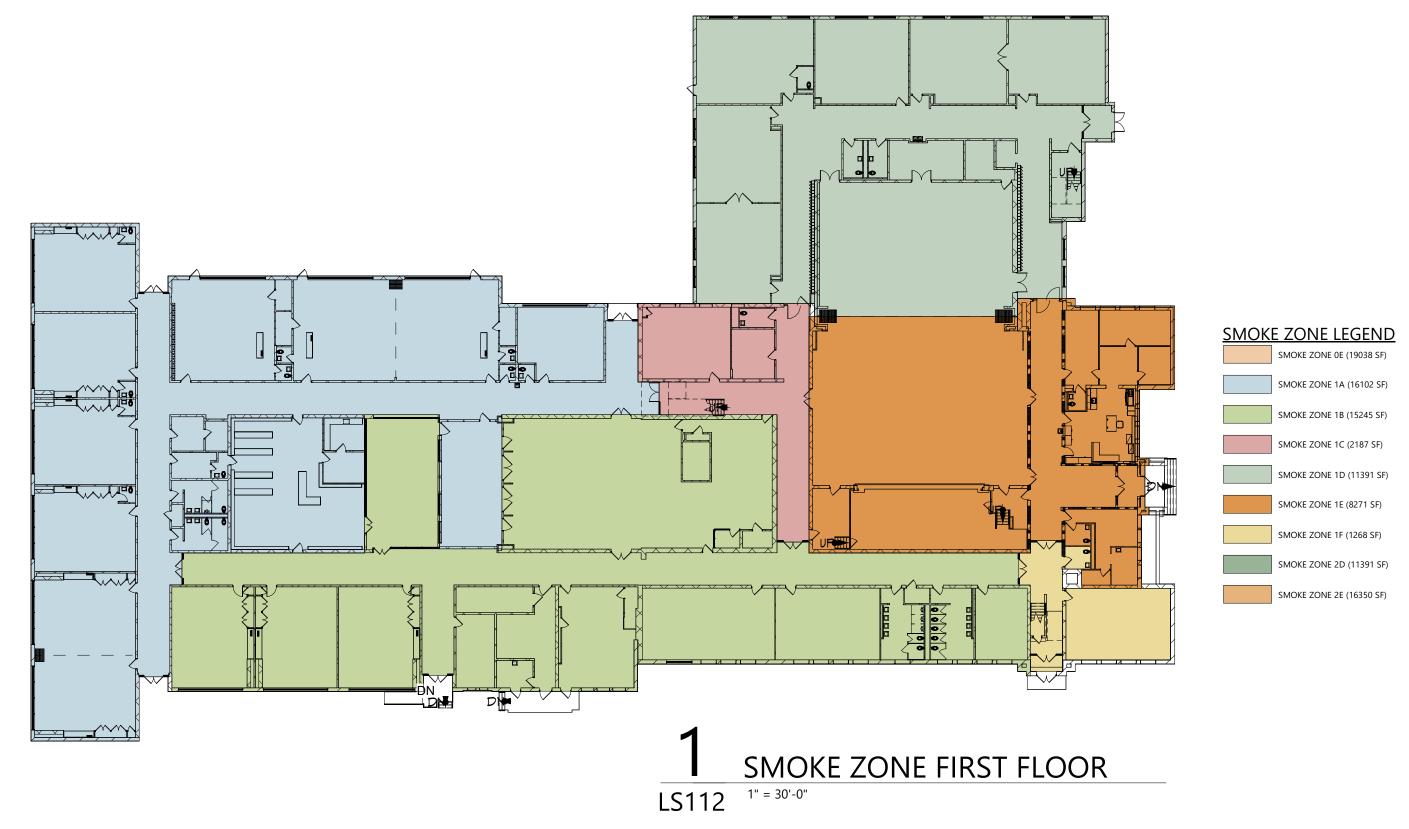2 SMOKE ZONE BASEMENT
LS112 1" = 30'-0"

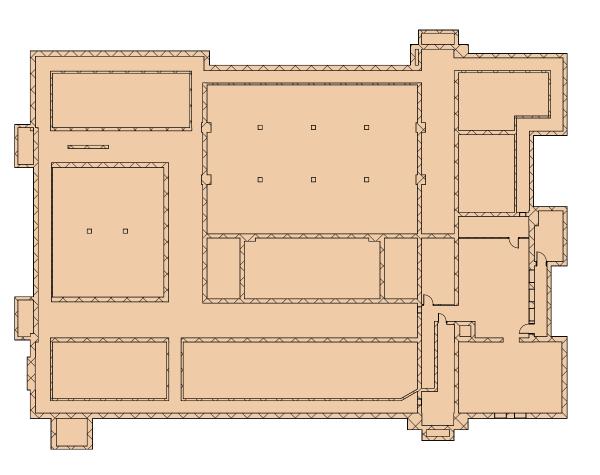

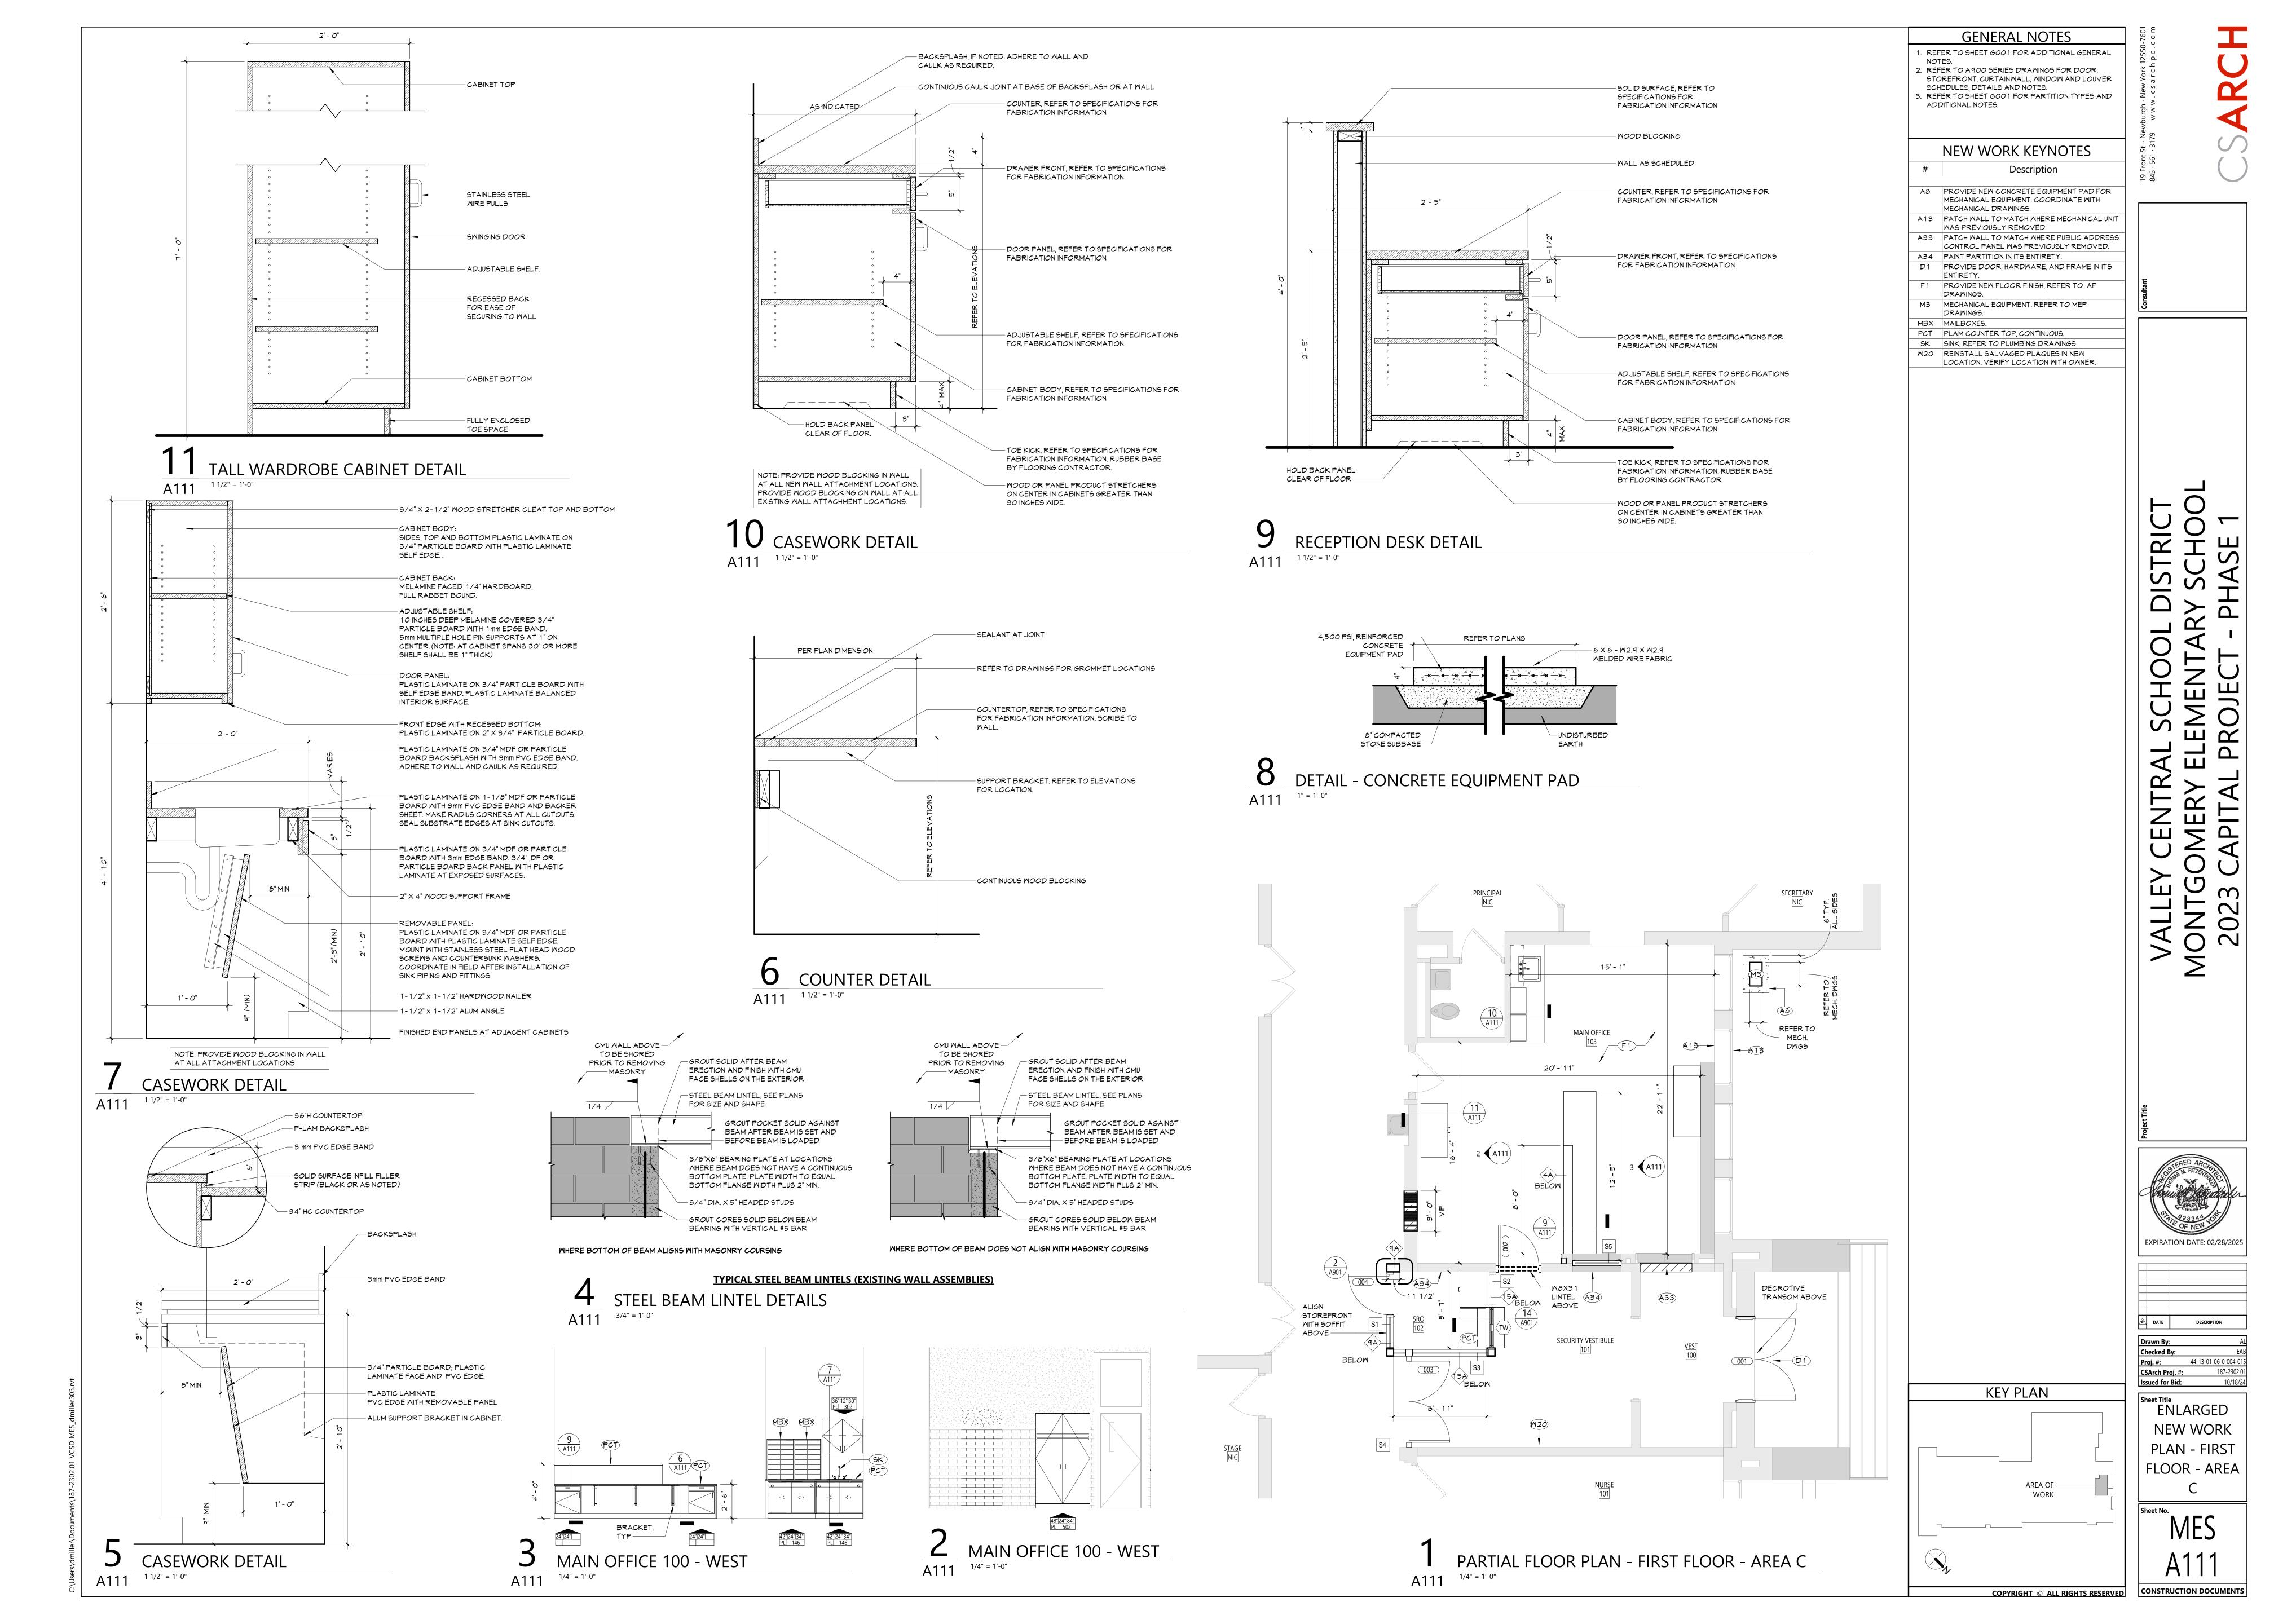

	Ε	XPIRA	TION DATE: 02/28/
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	#	DATE	DESCRIPTION
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Drawn By:
Checked By:
Proj. #: 44-13-01-06-0CSArch Proj. #: 187Issued for Bid: 1

Sheet Title

EXTERIOR ELEVATIONS

Sheet No.

MES

A201

REVOKAND SPLACE BUT NO
CALLARS OF MORE COMME

WEST - EXT ELEVATION

A 201 1/8" = 1'-0"

REMOVE AND REPLACE EXISTING CAULKING AT VERTICAL EXPANSION JOINT (APPROX. 32 LF)	REMOVE AND REPLACE EXISTING I GAULKING AT VERTICAL EXPANSION	REMOVE AND REPLACE EXISTING CAULKING AT INSIDE CORNER JOINT (APPROX. 16 LF)	REMOVE AND REPLACE EXISTING CAULKING AT INSIDE CORNER JOINT (APPROX. 16 LF) REMOVE AND REPLACE EXISTING CAULKING AT INSIDE CORNER REMOVE AND REPLACE EXISTING REMOVE AND REPLACE EXISTING CAULKING AT INSIDE CORNER REMOVE AND REPLACE EXISTING CAULKING AT INSIDE CORNER CAULKING AT	/E AND REPLACE EXISTING ULKING AT INSIDE CORNER JOINT (APPROX. 16 LF)	REMOVE AND REPLACE EXISTING CAULKING AT INSIDE CORNER JOINT (APPROX. 16 LF)
REMOVE AND REPLACE EXISTING GAULKING AT VERTICAL EXPANSION JOINT (APPROX. 32 LF)	JOINT (APPROX 32 LF)			CLEAN MASONRY AT BASE OF WALL (APPROX. 300 SF)	

EAST - EXT ELEVATION
A201 1/8" = 1'-0"

	OF NEW 100 TO TO TO THE TOTAL THE TOTAL TO T
# DATE	DESCRIPTION
Drawn By:	Au
Checked B	y: Che
Proi. #:	44-13-01-06-0-004

CSArch Proj. #:


EXTERIOR ELEVATIONS

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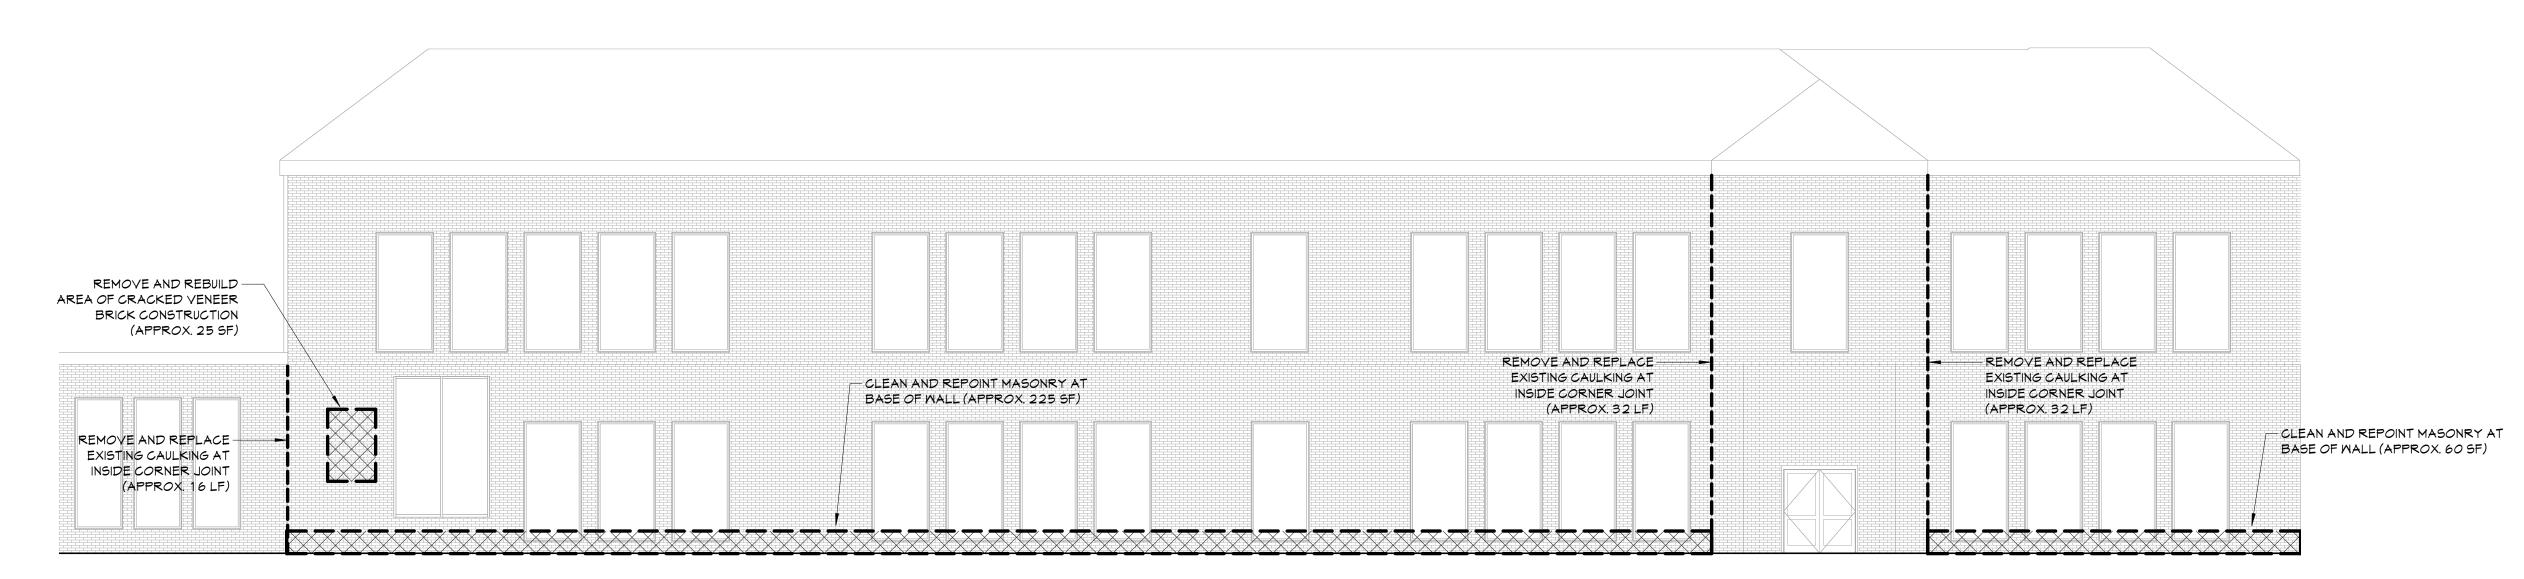
CONSTRUCTION DOCUMENTS

REMOVE AND REPLACE EXISTING CAULKING AT INSIDE CORNER JOINT (APPROX. 32 LF) REMOVE AND REPLACE
EXISTING CAULKING AT
INSIDE CORNER JOINT
(APPROX. 16 LF) REMOVE AND REPLACE
EXISTING CAULKING AT
INSIDE CORNER JOINT
(APPROX. 16 LF)


4 SOUTH - EXT ELEVATION 2

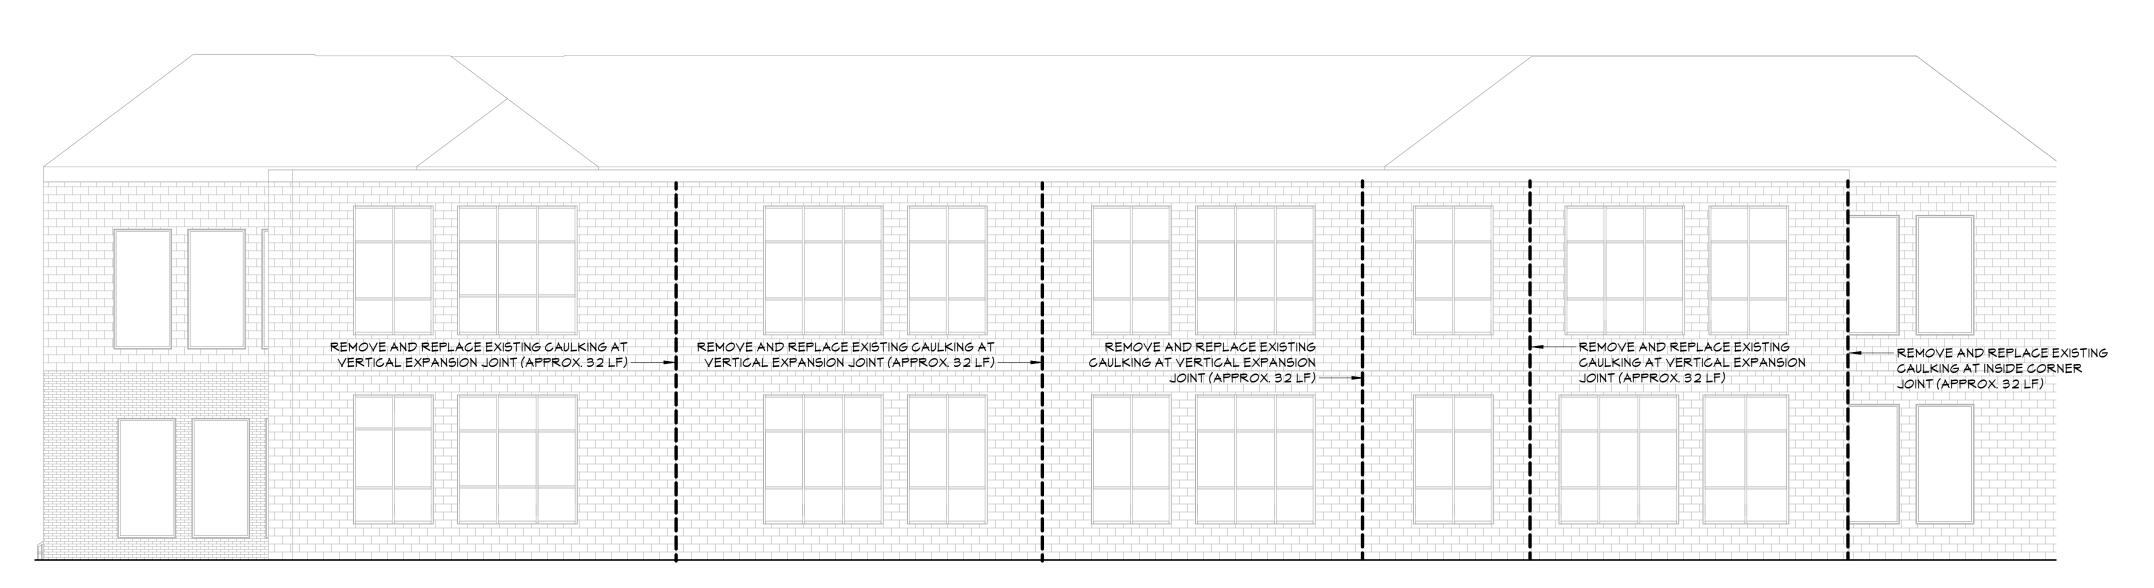



SOUTH - EXT ELEVATION 1 1/8" = 1'-0"



NORTH - EXT ELEVATION 2 1/8" = 1'-0"

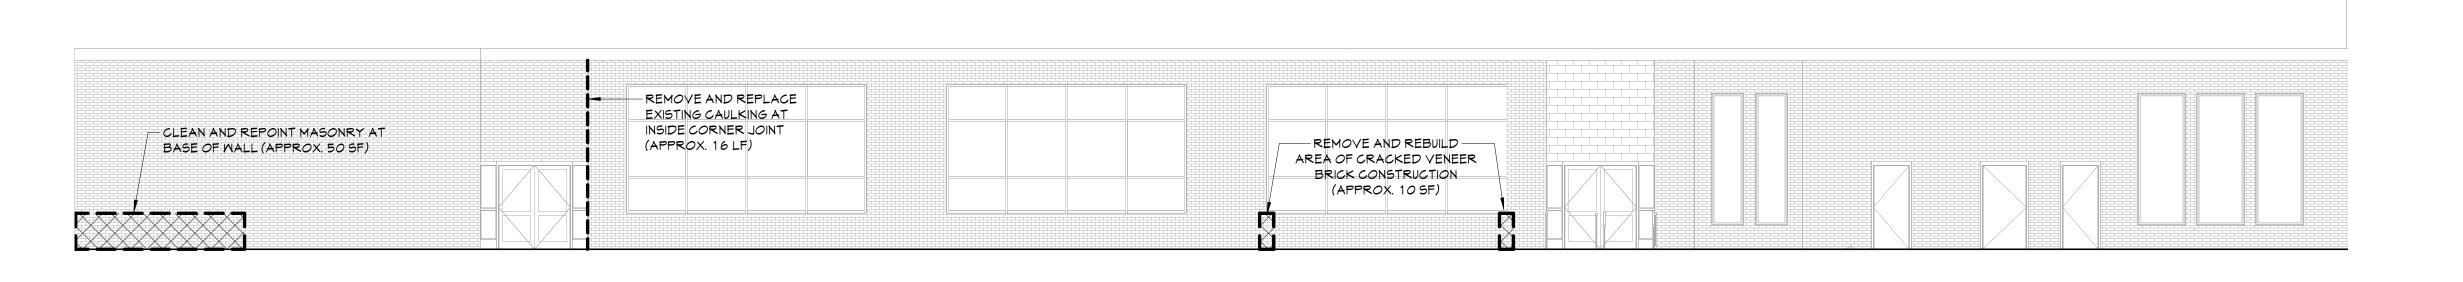


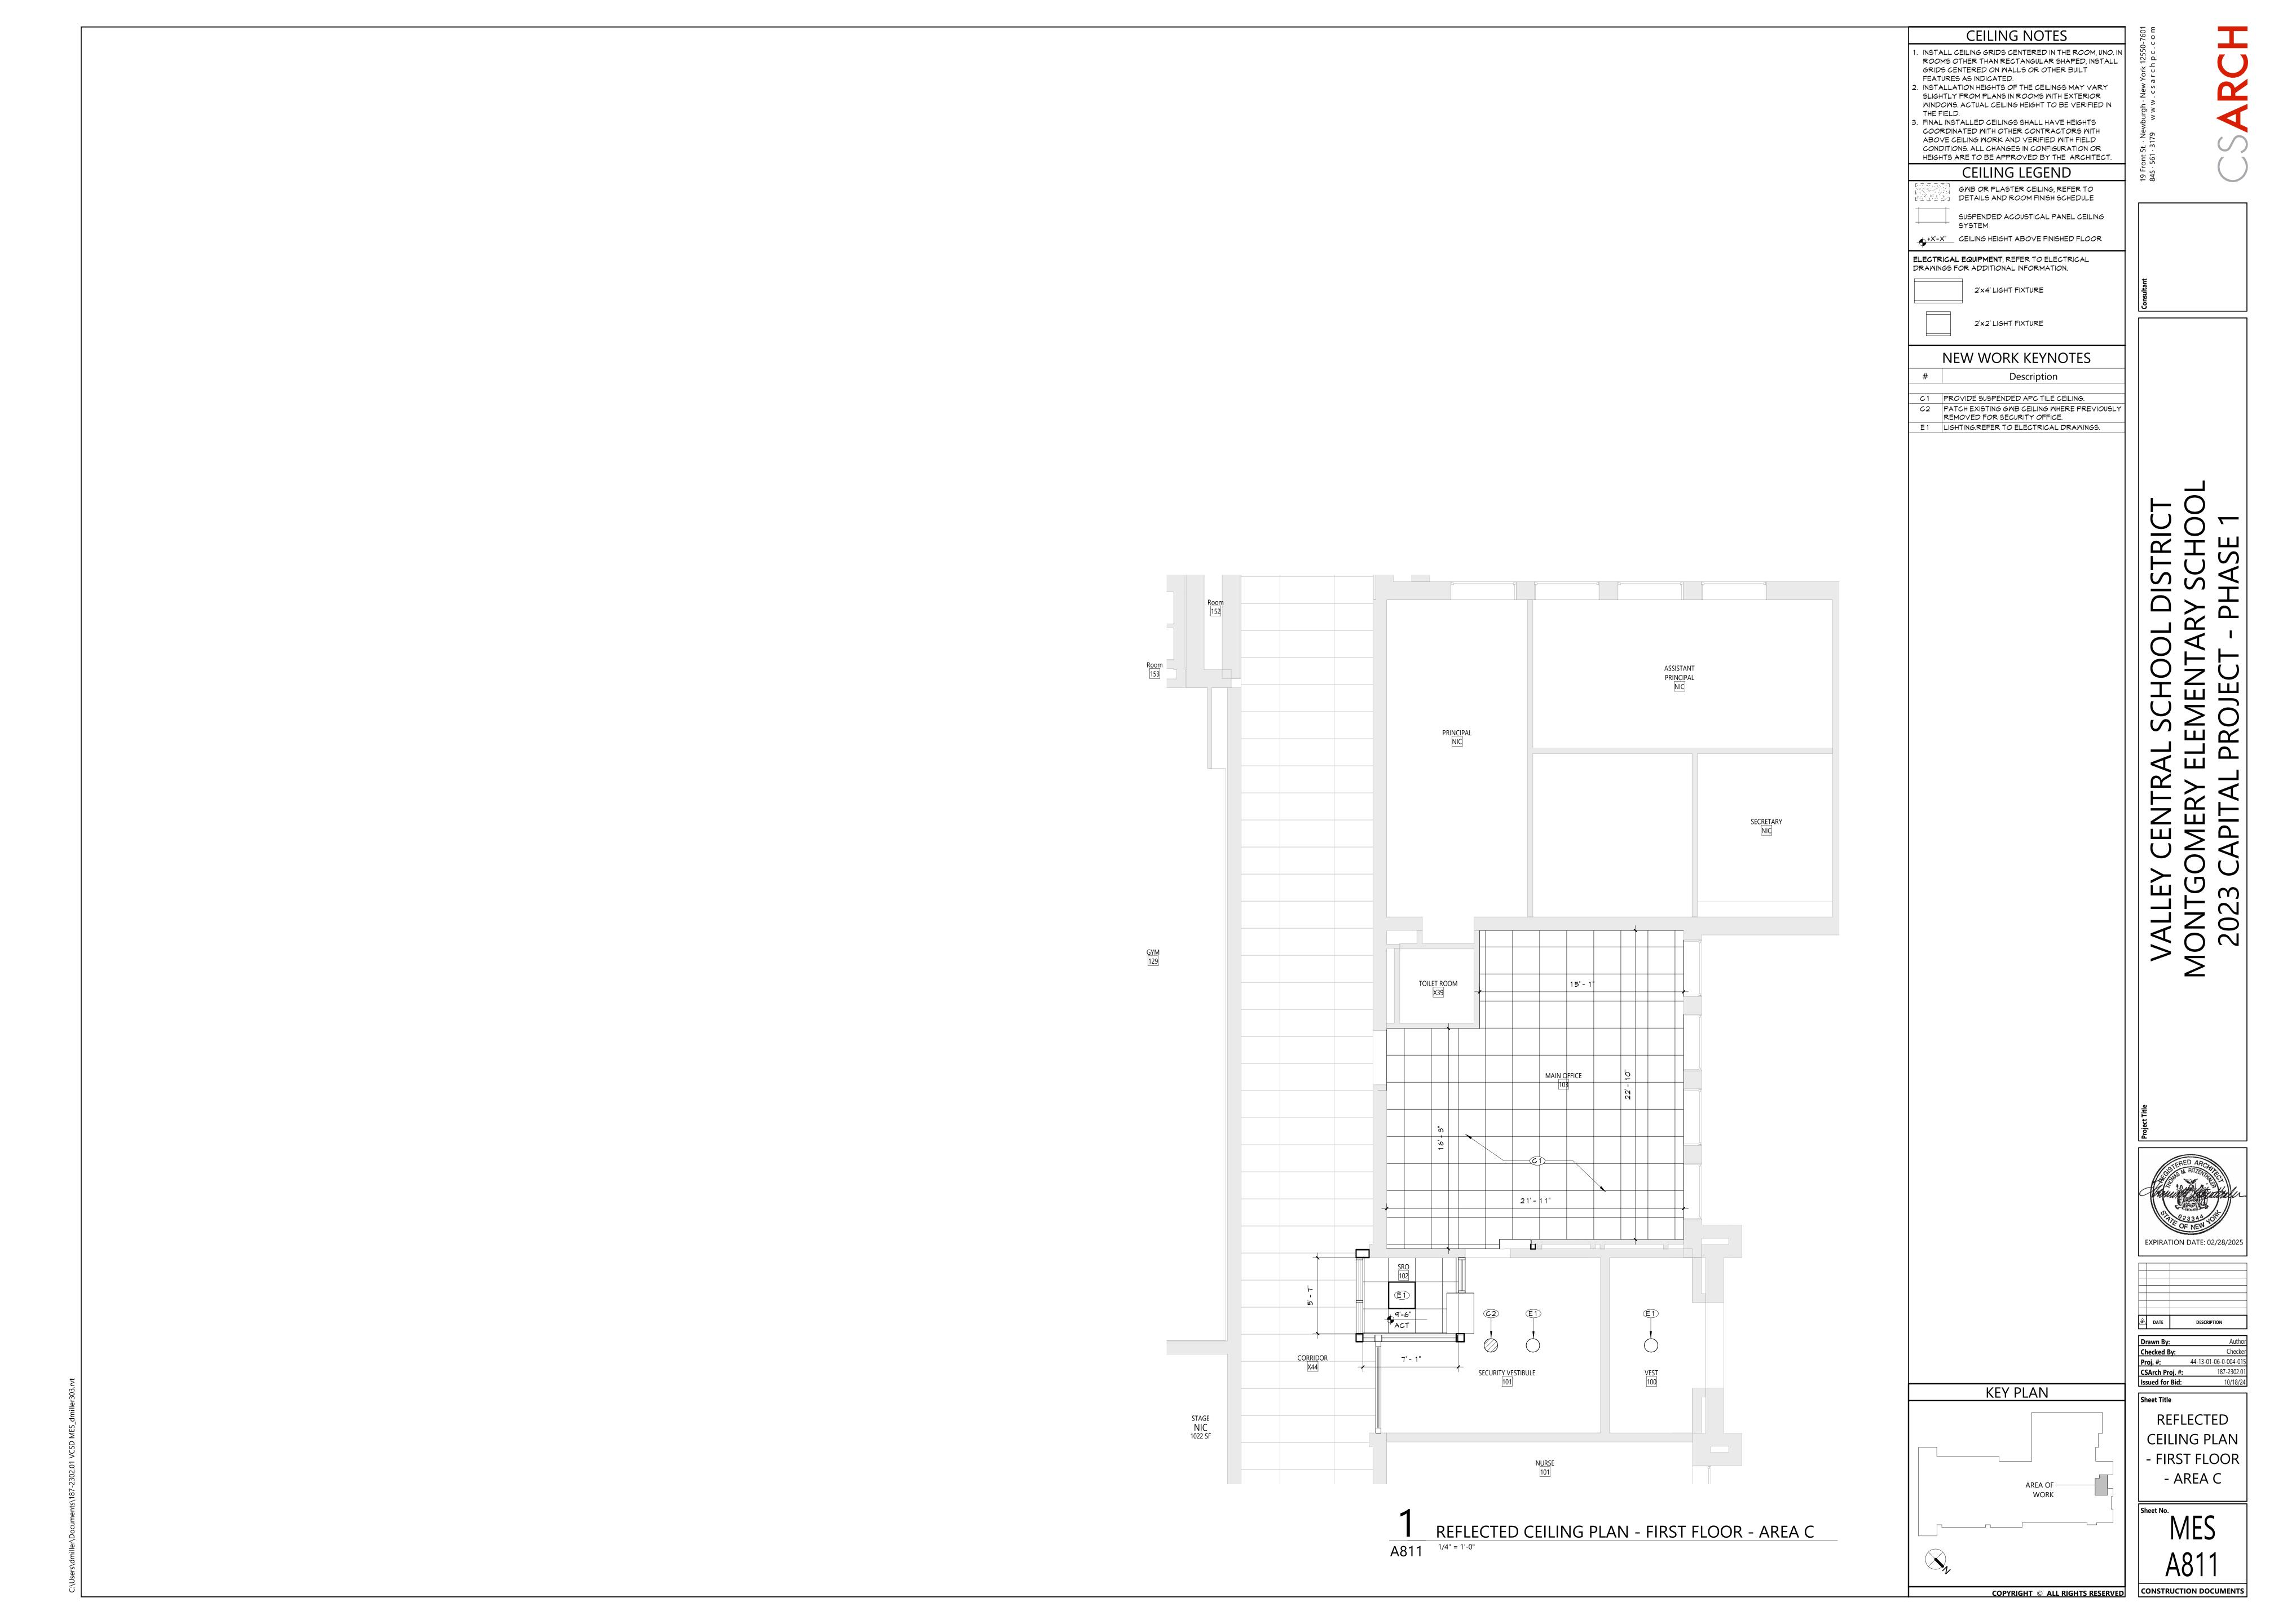

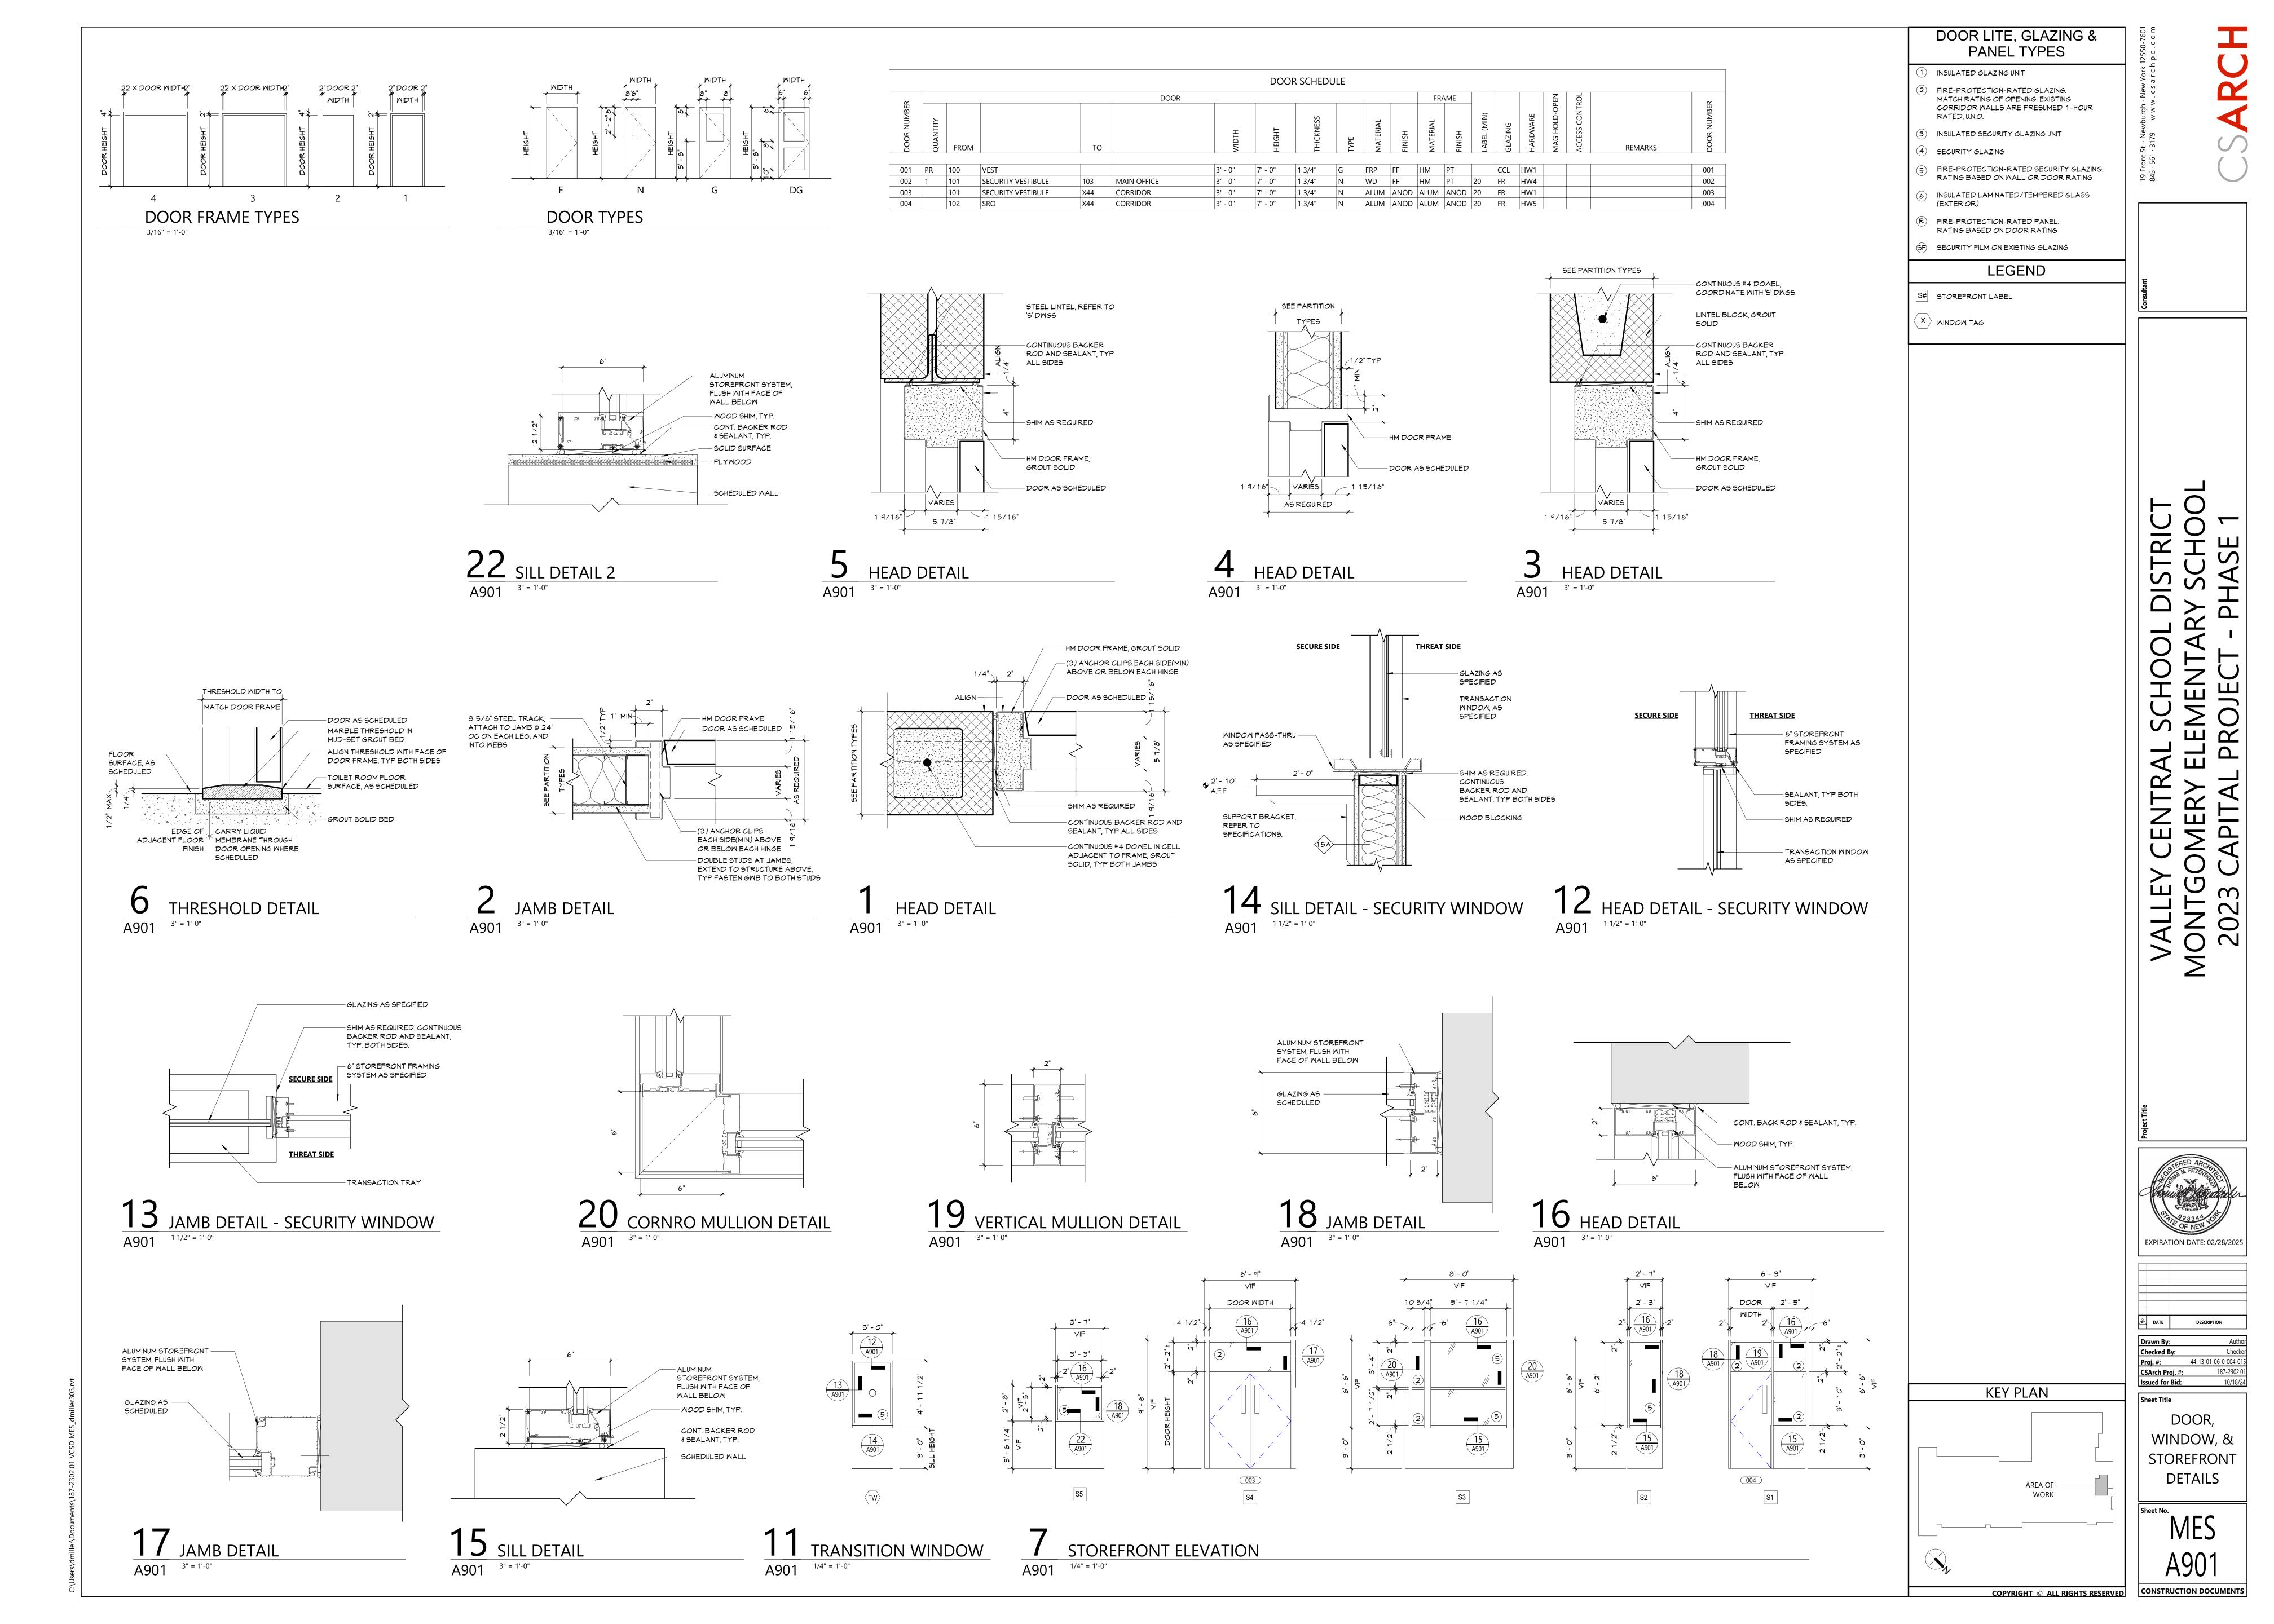

ROOM FINISH SCHEDULE												
ROOM		FLOC)R									
NUMBER	ROOM NAME	FINISH	BASE	Wall Finish	Accent_Wall	CEILING	Comments					
103	MAIN OFFICE	VCT-1	RB-1	PNT-1								
X38	Room	VCT-1	RB-1	PNT-1								

	MATERIALS LEGND												
MATERIAL	MANUFACTURER	MODEL	COLOR #/NAME	Material: URL	SIZE	NOTE							
PAINT													
PNT-1	SHERMIN MILLIAMS	EGG-SHELL				GENERAL WALL PAINT							
PNT-2	SHERMIN MILLIAMS	SEMI-GLOSS				HM DOOR PAINT							
PLASTIC LAI PLAM-1	MINATE MILSONART					CASEMORK							
PLAM-1	MILSONART					CASEMORK							
	MILSONART		MATCH EXISTING		6"	CASEWORK TYP. BASE							
PLAM-1 RUBBER BA RB-1	MILSONART SE		MATCH EXISTING		6"								

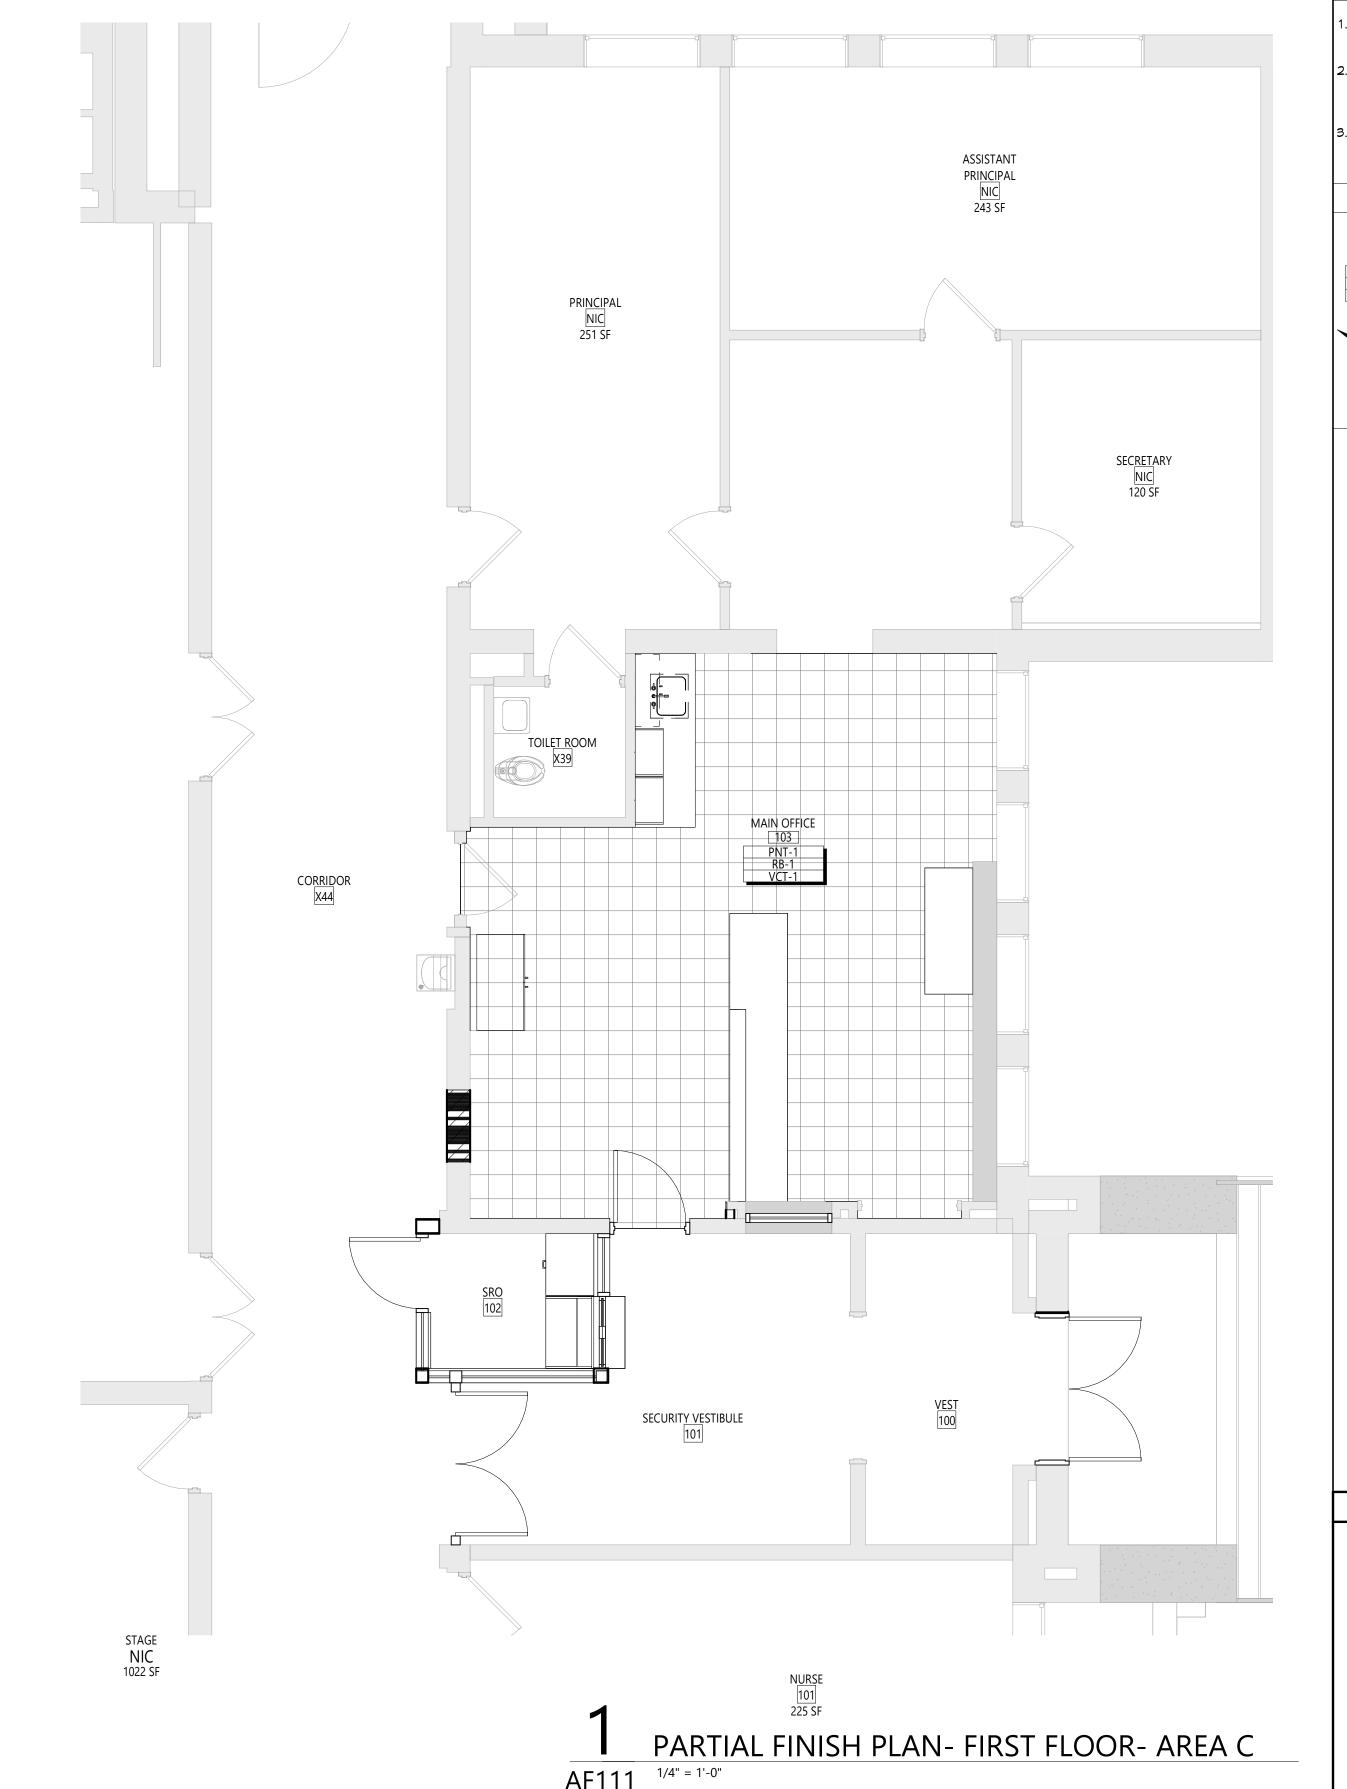

DISCLAIMER NOTE MANUFACTURER'S NAMES AND FINISH INFORMATION ARE INDICATED AS REFERENCED TO THE ARCHITECT'S BASIS-OF-DESIGN SELECTIONS AND HAVE BEEN DETERMINED PRIOR TO BID. THE CONTRACTOR AND OWNER ARE HEREBY NOTIFIED THAT FINISHES INSTALLED IN THE WORK ARE SUBJECT TO CHANGE IN RESPONSE TO SUBMITTALS, CONFIRMED SELECTIONS, PRODUCT AVAILABILITY AND THE SUBSEQUENT COORDINATION OF FINISHES BY ARCHITECT AND MAY DIFFER FROM PRODUCTS LISTED **ABBREVIATIONS** ARCHITECTURAL CONCRETE MASONRY UNIT ACOUSTICAL CEILING TILE APC BBT BRK CFMUNC CPT CTB CTT ETX ACOUSTICAL PANEL CEILING BIO-BASED TILE CERAMIC FLOOR TILE CONCRETE MASONRY UNIT CONCRETE CARPET CERAMIC TILE BASE CERAMIC WALL TILE EXISTING TO REMAIN EXPOSED EXISTING FAC/FF FACTORY FINISH GYPSUM WALL BOARD LINEAR METAL CEILING MUSIC STORAGE SYSTEM METAL WALL PANEL POLISHED CONCRETE PLAM PLASTIC LAMINATE PLAS PNT RAF PLASTER RESILIENT ATHLETIC FLOORING RB RF RUBBER BASE RESINOUS FLOORING RUBBER STAIR TREAD / LANDING RUBBER TILE FLOORING SCONC SEALED CONCRETE STAINLESS STEEL SYNTHETIC TURF FLOORING TERR TERRAZZO TOILET PARTITIONS TYPICAL VINYL COMPOSITION TILE VINYL COMPOSITION TILE ANTI-STATIC VINYL WALLCOVERING MOOD ATHLETIC FLOORING MOOD MALK-OFF MAT GENERAL FINISH NOTES . ALL EXPOSED SURFACES OF NEW PARTITIONS ARE TO BE PAINTED. 2. WHEN ANY WORK IS PERFORMED ON ANY EXISTING WALL, THE ENTIRE WALL SURFACE IS TO BE PAINTED CORNER TO CORNER, UNLESS NOTED OTHERWISE. 3. ALL EXPOSED GROUND FACE CMU LOCATIONS TO RECEIVE GRAFFITI COATING, TYPICAL FOR INTERIOR LOCATIONS. FINISH KEYS PNT-# ACCENT PAINT LOCATION = VCT-1 KEY PLAN Sheet Title MATERIAL SCHEDULE & FLOOR FINISHES PLAN - AREA C

CONSTRUCTION DOCUMENTS

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r\Documents\187-2302.01 VCSD MES_dmiller303.rvt

	Plumbing Fixture Schedule													
FIXTURE	DESCRIPTION		PIPING	CONNECT	ION	WATER SUPPLY	DRAINAGE FIXTURE	ADA	ELECTRONIC CONTROL	MANUFACTURER/MODEL	REMARKS			
MARK	DESCRIPTION	H.W.	C.W.	WASTE	VENT	FIXTURE UNITS	UNITS	(Y/N)	(Y/N)	(OR ACCEPTABLE EQUAL)	NEWANNO			
1	SINGLE BOWL SINK 1/2 1/2 2 1-1/2 1.4 2 N N STEEL, 6-1/2" DEPTH; FURNISH W/ DRAIN & STRAINER MODEL #LKPD1 AND REQUIREMENTS													


HEAVY DUTY CLEVIS HANGER (FOR 1/2" UP TO & INCL. 3" PIPE)		ADJUSTABLE HANGER WITH ROLLER (FOR 4" TO 6" PIPE) LOCKING NUT
SUPPORT NUT		INSULATION — PIPE
GALVANIZED INSULATION SHIELD 12"LONG.		
MIN.9 lb/cft DENSITY RIGID INSULATION AT SHIELD		PIPE COVERING PROTECTION 16 GA SADDLE
NOTES:	·	

1. PIPE 8" AND LARGER SHALL HAVE ROLLER SUPPORTED WITH DUAL RODS. 2. FOR CHW SERVICE OVER 3" REPLACE SADDLE WITH 12" LONG 14 GA SHIELD WITH RIGID INSULATION BETWEEN PIPE AND SHIELD.


PIPE Ø (IN.)	SPACING BETWE ANGERS (FT.)	EN	MIN. ROD SIZE					
	STEEL PIPE	COPPER PIPE	CPVC	(IN.)				
1/2 THRU 1	7	5	3/8					
1-1/2 THRU 2	9	9 8 6 11 9 7.5						
2-1/2	11							
3	12	10	7.5	1/2				
4	14	12	8.5	5/8				
6	17	14	9	3/4				
8	19	16	10	7/8				
10	22	18	7/8					

Pipe Hanger Support

\P001 / N.T.S.

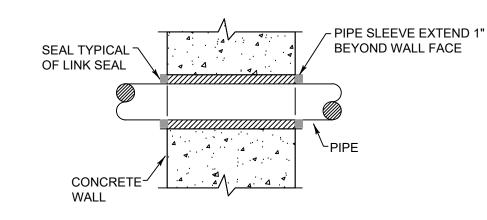

Exterior Wall Pipe Penetrations P001 N.T.S.

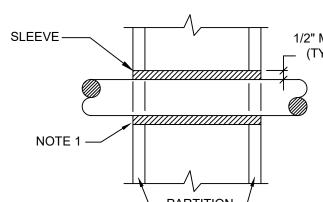



Plumbing Legend:

DOMESTIC COLD WATER SUPPLY HOT WATER RETURN SANITARY SEWER, ABOVE GRADE SANITARY SEWER, BELOW GRADE GREASE WASTE, BELOW GRADE PLUMBING VENT STORM WATER, ABOVE GRADE

STORM WATER, BELOW GRADE NATURAL GAS PIPING

CONCENTRIC REDUCER OR INCREASER ECCENTRIC REDUCER TOP CONNECTION, 45° OR 90° BOTTOM CONNECTION, 45° OR 90°

1/2" MAX _ (TYP)

1. AT FIRE RATED PARTITIONS, ADD ADDITIONAL LAYER OF FIRE SAFING INSULATION AROUND PENETRATION SO AS TO FILL CAVITY.

CEILING ARE TO BE FIRE STOPPED AROUND THE PENETRATION.

110 °F DOMESTIC HOT WATER SUPPLY 140 °F DOMESTIC HOT WATER SUPPLY

DIRECTION OF PIPE SLOPE (DOWN)

CAPPED OUTLET

SOLENOID VALVE

GATE VALVE

GLOBE VALVE

CHECK VALVE

BUTTERFLY VALVE

PRESSURE GAUGE

DRAIN VALVE

CLEANOUT

WALL CLEANOUT

FLOOR CLEANOUT

CLEANOUT TO GRADE

DOUBLE CLEANOUT TO GRADE

PLUMBING FIXTURE MARK

FLEXIBLE PIPING CONNECTION

C.O.

W.C.O.

F.C.O.

C.O.T.G.

D.C.O.T.G.

(P-X)

FULL PORT BALL VALVE

PRESSURE REDUCING VALVE (PRV)

SIDE CONNECTION

RISE OR DROP IN PIPE PIPE UP

> PIPE DOWN POINT OF CONNECTION BETWEEN NEW AND EXISTING WORK HOSE BIB

- PARTITION -

2. DUCT AND PIPE PENETRATIONS THRU CORRIDOR WALLS ABOVE THE

Plumbing Notes: 1. ALL MATERIALS AND EQUIPMENT ARE TO BE NEW, UNUSED, AND FREE FROM DEFECTS OF ANY KIND. THE BASIS OF QUALITY SHALL BE THE LATEST REVISION OF ASTM, ANSI, OR OTHER ACCEPTABLE STANDARDS.

2. THESE DRAWINGS ARE DIAGRAMMATIC, AND INDICATE GENERAL ARRANGEMENT OF WORK. THE CONTRACTOR SHALL BE RESPONSIBLE TO HAVE REVIEWED THE SITE FOR HIS WORK PRIOR TO HAVING SUBMITTED HIS PROPOSAL. NO ADDITIONAL COMPENSATION WILL BE ALLOWED FOR CONDITIONS FOUND DURING THE COURSE OF THE CONTRACT.

3. THE CONTRACTOR SHALL COORDINATE HIS WORK WITH THAT OF ALL OTHER TRADES.

4. ALL CUTTING, PATCHING, FIRE-STOPPING, AND SURFACE RESTORATION IN

REQUIRED IN CONNECTION WITH WORK UNDER THIS CONTRACT.

CONNECTION WITH THIS TRADE SHALL BE COMPLETED BY THIS CONTRACTOR. 5. THIS CONTRACTOR SHALL PAY ALL FEES, GIVE ALL NOTICES, FILE ALL NECESSARY DRAWINGS, AND OBTAIN ALL PERMITS, INSPECTIONS AND CERTIFICATES OF APPROVAL

6. ALL WORK IN ASSOCIATION WITH THIS CONTRACT SHALL BE COMPLETED IN STRICT COMPLIANCE WITH THE 2020 BUILDING CODE OF NEW YORK STATE, 2020 PLUMBING CODE OF NEW YORK STATE, 2020 FUEL GAS CODE OF NEW YORK STATE & 2020 ENERGY CONSERVATION CONSTRUCTION CODE OF NEW YORK STATE.

WHERE THE PROJECT INVOLVES A GAS SERVICE, THIS CONTRACTOR SHALL BE RESPONSIBLE FOR ALL COORDINATION, APPLICATIONS AND FEES OF ALL WORK ASSOCIATED WITH THE LOCAL GAS UTILITY COMPANY. ALL WORK INVOLVING THE GAS UTILITY COMPANY SHALL BE COMPLETED IN ACCORDANCE WITH THEIR REGULATIONS AND GUIDELINES.

8. ALL DOMESTIC COLD AND HOT WATER PIPING AND FITTINGS ARE TO BE INSULATED WITH 1" THICK RIGID ONE-PIECE MOLDED SECTIONAL FIBERGLASS PIPE COVERING WITH UNIVERSAL JACKET. ALL JOINTS ARE TO BE COMPLETELY SEALED A MINIMUM OF 6" BEYOND JOINT ENDS.

9. ALL PIPING SHALL BE PROPERLY SUPPORTED AND ROUTED PARALLEL OR PERPENDICULAR TO BUILDING WALLS. THE CONTRACTOR SHALL FURNISH AND INSTALL ALL SUPPORT HANGERS AND MISCELLANEOUS METALS REQUIRED FOR PROPER INSTALLATION OF WORK.

10. ALL EXPOSED PIPING, FITTINGS, TRAPS, ESCUTCHEONS, VALVES, ETC. SHALL BE CHROME PLATED.

11. SLOPE SANITARY DRAINAGE PIPING 2" DIAMETER AND SMALLER NOT LESS THAN 1/4" PER FOOT. SLOPE SANITARY DRAINAGE PIPING OVER 2" DIAMETER NOT LESS THAN 1/8" PER FOOT.

12. INSTALL A CLEANOUT AT THE BASE OF EACH SOIL STACK, AT EACH CHANGE IN DIRECTION, AT INTERVALS NOT OVER 50 FEET AND ELSEWHERE AS SHOWN ON DRAWINGS OR REQUIRED BY CODE.

13. PROVIDE EXPOSED PIPING WITH CHROME PLATED CAST BRASS ESCUTCHEON WITH SET SCREW WHERE PENETRATING FLOORS, CEILINGS, WALLS OR PARTITIONS.

14. TEST PIPING AND PROVE TIGHT FOR AT LEAST TWO HOURS IN ACCORDANCE WITH REQUIREMENTS OF AUTHORITIES HAVING JURISDICTION AND/OR AS SPECIFIED. TEST SHALL BE PERFORMED IN THE PRESENCE OF THE ENGINEER AND LOCAL INSPECTOR. TEST SHALL BE REPEATED IF NECESSARY UNTIL FINAL APPROVAL OF SYSTEM IS OBTAINED.

14.1. WATER & GAS PIPING TO BE AIR-PRESSURE TESTED TO 1-1/2 TIMES MAXIMUM WORKING PRESSURE.

14.2. DRAINAGE, WASTE & VENT PIPING TO BE TESTED BY FILLING THE SYSTEM WITH WATER TO 10-FEET ABOVE HIGHEST POINT.

15. SUPPORT HORIZONTAL PIPING UTILIZING A SPACING PER PIPING MANUFACTURER'S REQUIREMENTS.

16. INSTALL VALVES ON THE ENTIRE DISTRIBUTION SYSTEM. SO LOCATED AS TO GIVE COMPLETE CONTROL TO ALL FIXTURES AND EQUIPMENT.

17. INSTALL DRAIN VALVES AT BASE OF ALL RISERS AND AT LOW POINTS OF PIPING

18. THE CONTRACTOR IS RESPONSIBLE TO TEST ALL EQUIPMENT, PIPING, FIXTURES, AND SYSTEMS INSTALLED UNDER THIS CONTRACT TO ENSURE PROPER OPERATION PRIOR TO FINAL ACCEPTANCE BY THE OWNER AND ENGINEER.

19. THE CONTRACTOR IS RESPONSIBLE TO DETERMINE WHETHER SPECIAL LICENSING IS REQUIRED IN ORDER TO PERFORM THE REQUIRED WORK IN THE MUNICIPALITY WHERE THE PROJECT IS LOCATED. IF THE CONTRACTOR CANNOT OBTAIN THE REQUIRED LICENSING TO COMPLETE THE WORK WITHIN THE PROJECT SCHEDULE, THEN THE

20. CONTRACTOR IS RESPONSIBLE TO CREATE AND SUBMIT RED-LINE "AS-BUILT" PLANS TO THE ENGINEER AT THE END OF THE PROJECT. AS-BUILT PLANS SHALL ACCURATELY REPRESENT THE SYSTEMS AS THEY WERE INSTALLED.


CONTRACTOR SHALL NOT BE PERMITTED TO BID ON THIS PROJECT.



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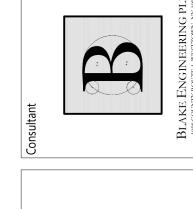



Drawn By: 44-13-01-06-0-004-015 Proj. #: CSArch Proj. #:

PLUMBING NOTES, SCHEDULE,

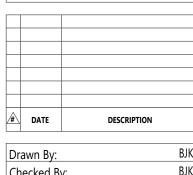LEGEND &

DETAILS



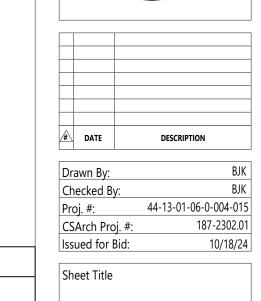



KEY PLAN

AREA OF ——— WORK

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PLUMBING **PLANS**



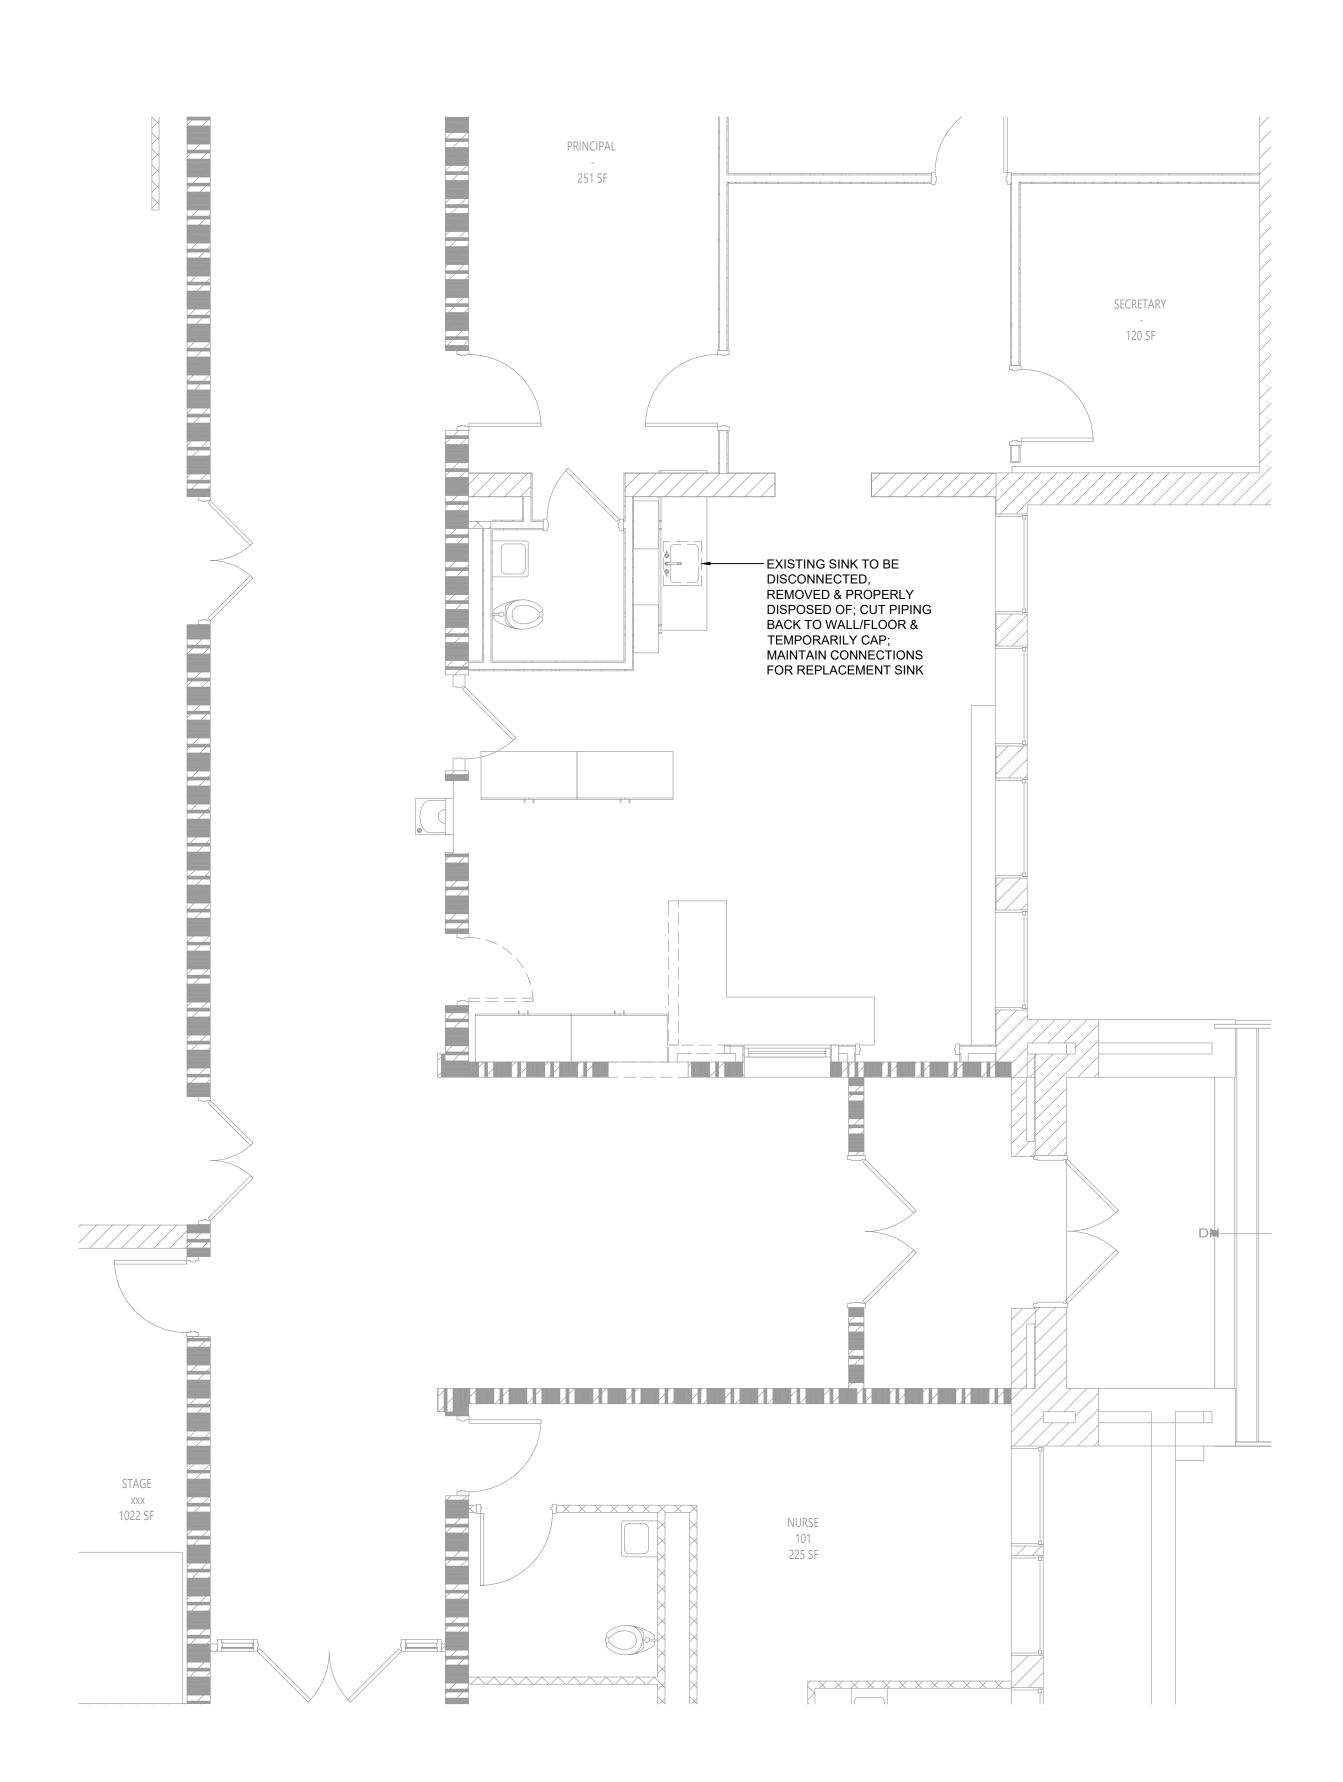

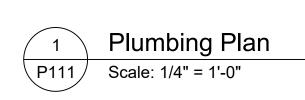PRINCIPAL 251 SF

2" DRAIN; CONNECT TO EXISTING DRAIN & VENT PIPING

- 1/2" CWS & HWS; CONNECT TO EXISTING WATER LINES

SECRETARY

PD111 Plumbing Demolition Plan
Scale: 1/4" = 1'-0"

Mechanical Notes:

OR OTHER ACCEPTABLE STANDARDS.

AND ARE REFLECTED ON HIS SUBMITTALS.

NEW YORK STATE.

REQUIREMENTS.

ACCEPTANCE.

PROPER INSTALLATION OF WORK.

THROUGH MANUAL AIR VENTS.

FINAL APPROVAL OF SYSTEM IS OBTAINED.

AND AT HIGH POINTS OF THE PIPING SYSTEM.

ENGINEER'S ATTENTION PRIOR TO PROCEEDING.

AUTHORITIES HAVING JURISDICTION.

COMPLETE CONTROL TO ALL FIXTURES AND EQUIPMENT.

1. ALL MATERIALS AND EQUIPMENT ARE TO BE NEW, UNUSED, AND FREE FROM DEFECTS

2. THESE DRAWINGS ARE DIAGRAMMATIC, AND INDICATE GENERAL ARRANGEMENT OF

CONNECTION WITH THIS TRADE SHALL BE COMPLETED BY THIS CONTRACTOR.

7. THIS CONTRACTOR SHALL PAY ALL FEES, GIVE ALL NOTICES, FILE ALL NECESSARY

8. ALL WORK IN ASSOCIATION WITH THIS CONTRACT SHALL BE COMPLETED IN STRICT

9. ALL PIPING SHALL BE PROPERLY SUPPORTED AND ROUTED PARALLEL OR

10. ALL PIPING SHALL BE PITCHED SUCH THAT AIR IN THE SYSTEM CAN BE VENTED

11. TEST PIPING AND PROVE TIGHT FOR AT LEAST TWO HOURS TO TWICE THE SYSTEM

12. SUPPORT HORIZONTAL PIPING UTILIZING A SPACING PER PIPING MANUFACTURER'S

13. INSTALL VALVES ON THE ENTIRE DISTRIBUTION SYSTEM, SO LOCATED AS TO GIVE

14. INSTALL DRAIN VALVES AT BASE OF ALL RISERS AND AT LOW POINTS OF PIPING

15. INSTALL ALL HYDRONIC PIPING AS HIGH AS POSSIBLE PROVIDING RISERS, DROPS AND

16. THE ENTIRE HYDRONIC SYSTEM IS TO BE BALANCED TO WITHIN 10% OF THE

17. ALL DUCTWORK IS TO BE CONSTRUCTED OF GALVANIZED SHEET STEEL (EXCEPT

18. PROVIDE MANUAL DAMPERS AT EACH SPLIT OR TAP CONNECTION TO TRUNK DUCTS

INACCESSIBLE CEILINGS SHALL BE INSTALLED WITH REMOTE GEAR OPERATORS.

19. FURNISH & INSTALL FUSIBLE LINK FIRE DAMPERS AT ALL LOCATIONS WHERE DUCT PENETRATES FIRE-RATED FLOOR OR CEILING ASSEMBLY WHETHER OR NOT

20. INSTALL TURNING VANES ON ALL RECTANGULAR TURNS. TURNING VANES SHALL BE

DOUBLE THICKNESS TYPE CONSTRUCTED IN ACCORDANCE WITH SMACNA MANUAL.

21. ROUND SHEET STEEL ELBOWS ARE TO BE INSTALLED AT THE DUCT CONNECTION TO ALL SUPPLY AIR DIFFUSERS. SHEET STEEL PLENUM BOXES ARE TO BE INSTALLED AT

22. INSTALL ALL DUCTWORK AS HIGH AS POSSIBLE PROVIDING RISERS, DROPS AND

23. THE ENTIRE AIR DISTRIBUTION SYSTEM IS TO BE BALANCED TO WITHIN 10% OF THE

24. THE CONTRACTOR IS RESPONSIBLE TO TEST ALL EQUIPMENT, PIPING, FIXTURES, AND

25. THE CONTRACTOR IS RESPONSIBLE TO DETERMINE WHETHER SPECIAL LICENSING IS REQUIRED IN ORDER TO PERFORM THE REQUIRED WORK IN THE MUNICIPALITY

26. CONTRACTOR IS RESPONSIBLE TO CREATE AND SUBMIT RED-LINE "AS-BUILT" PLANS TO THE ENGINEER AT THE END OF THE PROJECT. AS-BUILT PLANS SHALL

THERMOSTAT PROVIDED BY OWNER, INSTALLED BY CONTRACTOR;

THEN THE CONTRACTOR SHALL NOT BE PERMITTED TO BID ON THIS PROJECT.

ACCURATELY REPRESENT THE SYSTEMS AS THEY WERE INSTALLED.

MOUNT 5'-0" A.F.F. IN LOCATIONS SHOWN ON PLANS

SYSTEMS INSTALLED UNDER THIS CONTRACT TO ENSURE PROPER OPERATION PRIOR

WHERE THE PROJECT IS LOCATED. IF THE CONTRACTOR CANNOT OBTAIN THE

REQUIRED LICENSING TO COMPLETE THE WORK WITHIN THE PROJECT SCHEDULE,

THE DUCT CONNECTION TO ALL RETURN AND EXHAUST AIR GRILLES. THE CONTRACTOR IS TO PAINT THE INSIDE OF THE SHEET STEEL PLENUM BOXES FLAT

OFFSETS TO CLEAR STRUCTURAL MEMBERS, LIGHT FIXTURES, OTHER PIPING, AND

OTHER OBSTRUCTIONS. WHERE CONFLICTS ARISE, IT SHALL BE BROUGHT TO THE

BE A MINIMUM OF 20 GA. DOUBLE PANEL INSULATED TYPE.

ENGINEER'S ATTENTION PRIOR TO PROCEEDING.

TO FINAL ACCEPTANCE BY THE OWNER AND ENGINEER.

SPECIFIED AIRFLOW REQUIREMENTS.

Mechanical Equipment

SYSTEM. INSTALL MANUAL AIR VENT VALVE FACILITIES AT THE TOP OF ALL RISERS

OFFSETS TO CLEAR STRUCTURAL MEMBERS, LIGHT FIXTURES, OTHER PIPING, AND OTHER OBSTRUCTIONS. WHERE CONFLICTS ARISE, IT SHALL BE BROUGHT TO THE

SPECIFIED WATER FLOWRATE REQUIREMENTS. A CERTIFIED BALANCING REPORT

AND VERIFICATION IS TO BE SUBMITTED TO THE ENGINEER PRIOR TO FINAL

WHERE OTHERWISE SPECIFIED) WITH GAUGES, BRACING AND CONSTRUCTION IN

ACCORDANCE WITH THE LATEST SMACNA DUCT MANUAL STANDARDS AND ALL OTHER

FOR BALANCING PURPOSES WHETHER OR NOT SPECIFICALLY SHOWN ON DRAWINGS.

EACH DAMPER SHALL BE OF THE OPPOSED BLADE DAMPER TYPE INSTALLED WITH AN

OPERATOR AND LOCKING DEVICE. ALL DAMPERS LOCATED ABOVE HARD OR

SPECIFICALLY SHOWN. INSTALL DUCTWORK CASING ACCESS DOORS AND FRAMES AHEAD OF EACH FIRE DAMPER FOR INSPECTION AND MAINTENANCE. DOORS SHALL

WORKING PRESSURE. TEST SHALL BE PERFORMED IN THE PRESENCE OF THE

ENGINEER AND LOCAL INSPECTOR. TEST SHALL BE REPEATED IF NECESSARY UNTIL

PERPENDICULAR TO BUILDING WALLS. THE CONTRACTOR SHALL FURNISH AND

INSTALL ALL SUPPORT HANGERS AND MISCELLANEOUS METALS REQUIRED FOR

APPROVAL REQUIRED IN CONNECTION WITH WORK UNDER THIS CONTRACT.

DRAWINGS, AND OBTAIN ALL PERMITS, INSPECTIONS AND CERTIFICATES OF

COMPLIANCE WITH THE 2020 BUILDING CODE OF NEW YORK STATE, 2020 MECHANICAL CODE OF NEW YORK STATE & 2020 ENERGY CONSERVATION CONSTRUCTION CODE OF

OF ANY KIND. THE BASIS OF QUALITY SHALL BE THE LATEST REVISION OF ASTM, ANSI,

WORK. THE CONTRACTOR SHALL BE RESPONSIBLE TO HAVE REVIEWED THE SITE FOR

HIS WORK PRIOR TO HAVING SUBMITTED HIS PROPOSAL. NO ADDITIONAL

COMPENSATION WILL BE ALLOWED FOR CONDITIONS FOUND DURING THE COURSE OF


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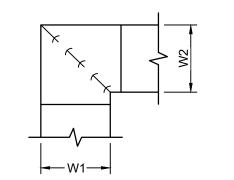
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44-13-01-06-0-004-015 Proj. #: 187-2302.01 CSArch Proj. #: Issued for Bid:


Sheet Title NOTES, LEGENDS,

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- 1. ALL VANED ELBOWS SHALL BE CONSTRUCTED AND INSTALLED AS DETAILED BY
- 2. WHEN W1 IS NOT EQUAL TO W2, VANE SHALL BE SINGLE VANE TYPE REGARDLESS OF W DIMENSION.
- 3. ALL SINGLE VANES SHALL HAVE A 2" RADIUS, 1-1/2" MAXIMUM SPACE BETWEEN VANES AND A 3/4" TRAILING EDGE.
- 4. WHEN W EQUALS W2 AND W1 IS GREATER THAN 20" VANES SHALL BE DOUBLE



1" MIN. ON TOP

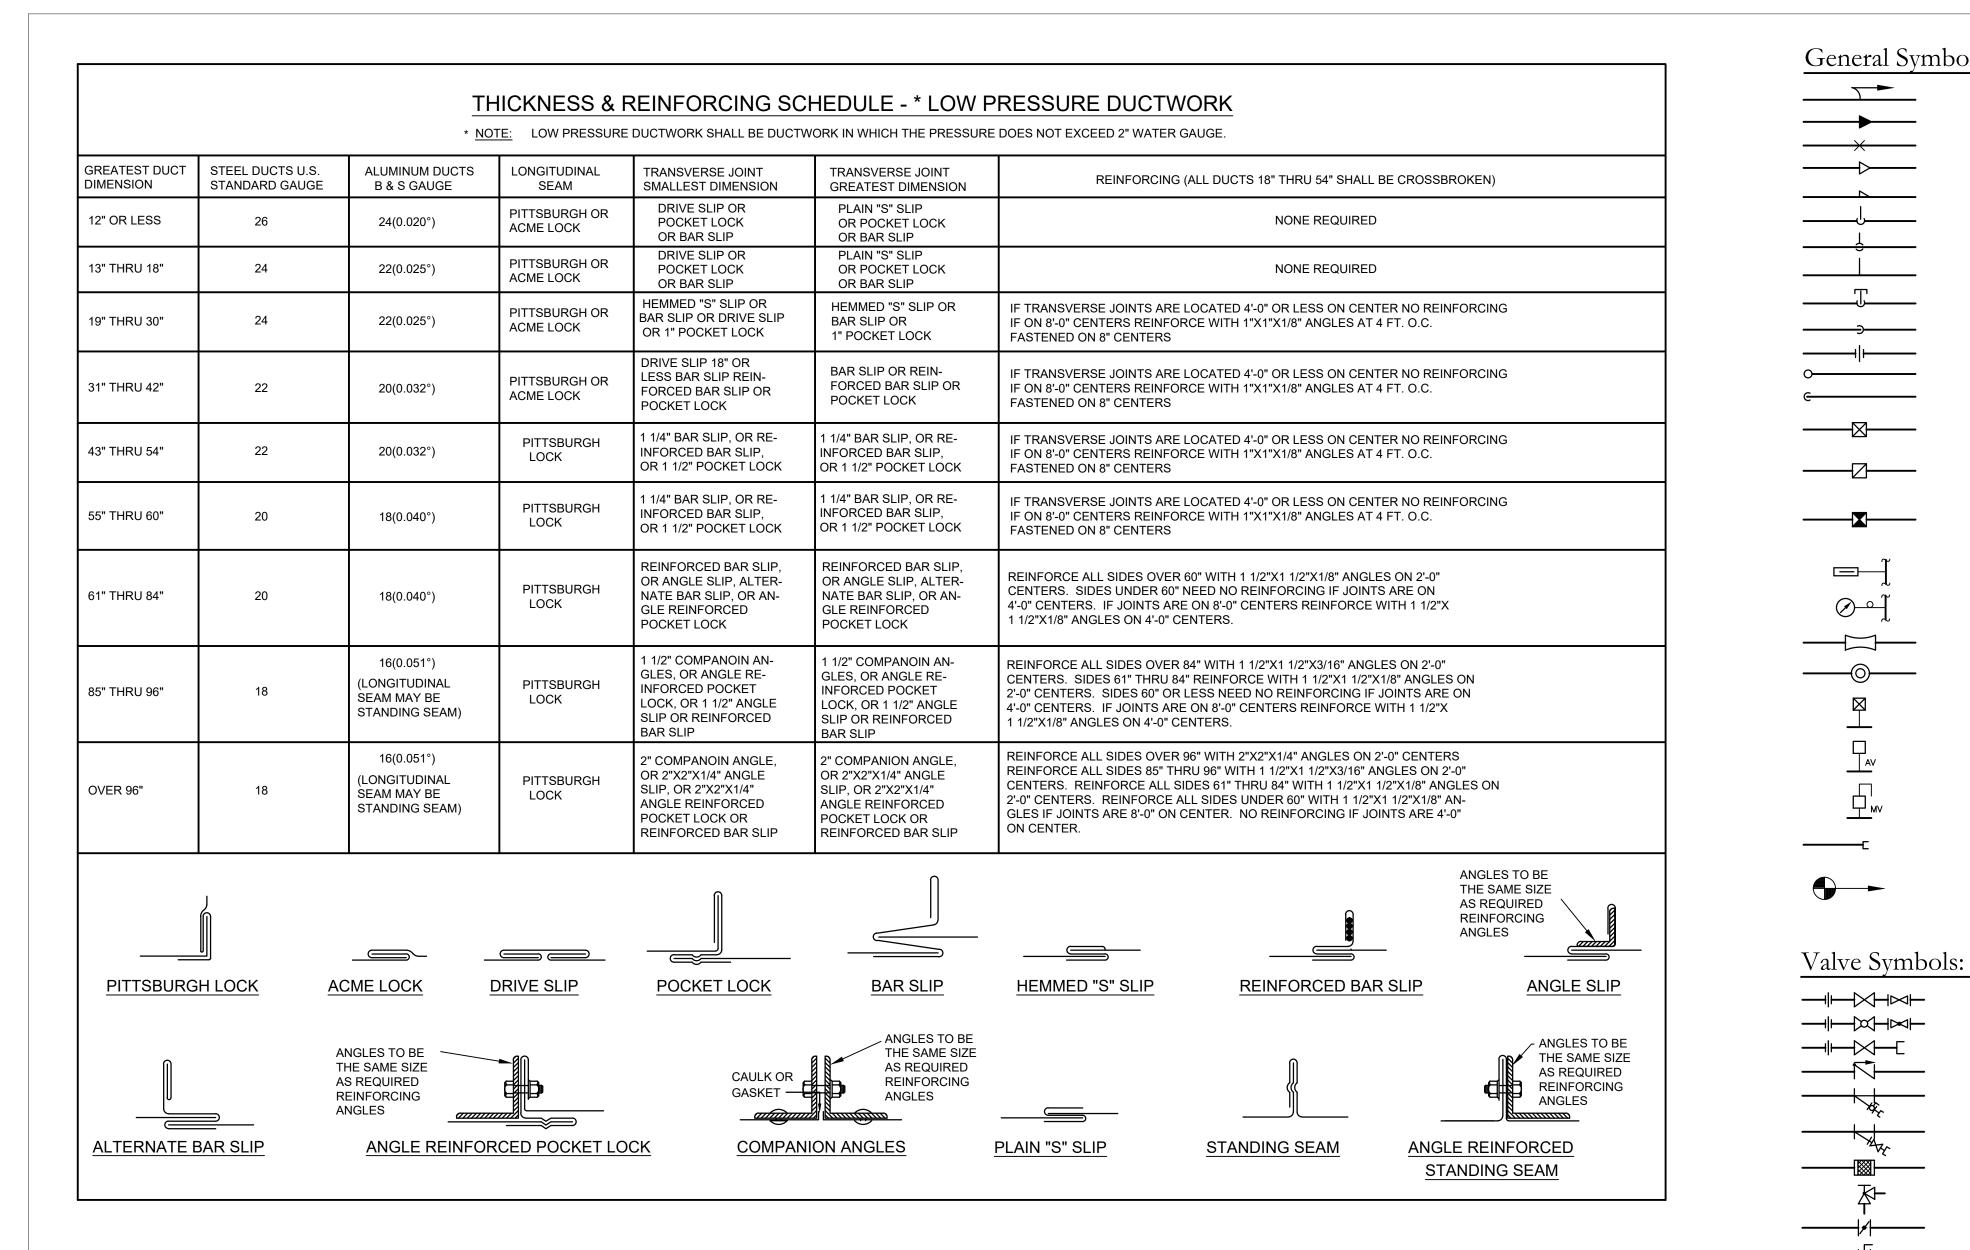
AND BOTTOM

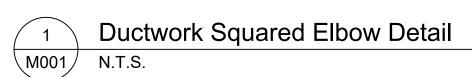MAIN DUCT -

SUPPLY

AIRFLOW

SEAL ALL -

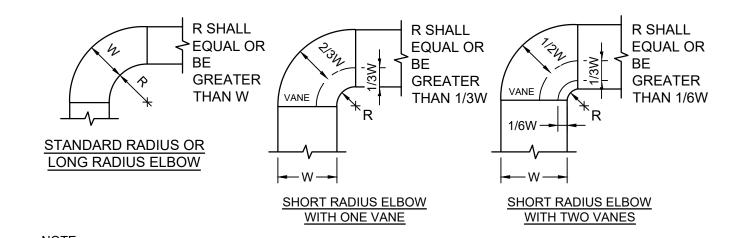

- 1. THE INTERIOR SURFACE OF ALL RADIUS ELBOWS SHALL BE MADE ROUND.
- 2. ALL STANDARD RADIUS ELBOWS CAN BE SUBSTITUTED WITH SHORT RADIUS ELBOWS. ALL SHORT RADIUS ELBOWS SHALL HAVE VANES. VANES SHALL BE CONSTRUCTED, SUPPORTED AND FASTENED AS RECOMMENDED BY SMACNA.



- 1" MIN. ON TOP

AND BOTTOM


■ EQUAL TO REQ'D

BRANCH DUCT


DIMENSIONS


1/4 BRANCH DUCT

WIDTH, BUT MIN. 4"

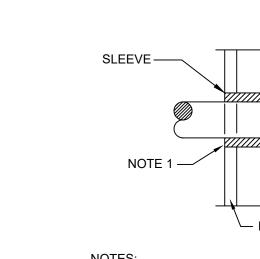

1. AT FIRE RATED PARTITIONS, ADD ADDITIONAL LAYER OF FIRE SAFING INSULATION AROUND PENETRATION SO AS TO FILL CAVITY. 2. DUCT AND PIPE PENETRATIONS THRU CORRIDOR WALLS ABOVE THE CEILING ARE TO BE FIRE STOPPED AROUND THE PENETRATION.

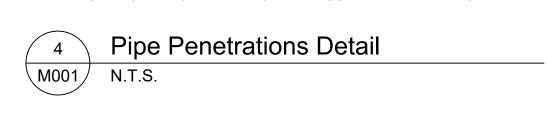

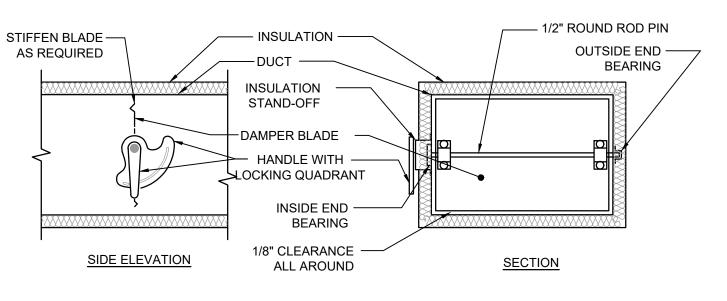

SEAL ALL—

AROUND


- ADJUSTABLE

ELBOW RINGS

Typical Branch Take-Off Fitting Detail

1. DELETE INSULATION STAND-OFF ON DUCTWORK WITHOUT EXTERIOR INSULATION. 2. DETAIL SHOWS SINGLE-BLADE DAMPER. DAMPER INSTALLATION SHALL BE SIMILAR FOR MULTI-BLADE DAMPERS & ROUND DAMPERS.



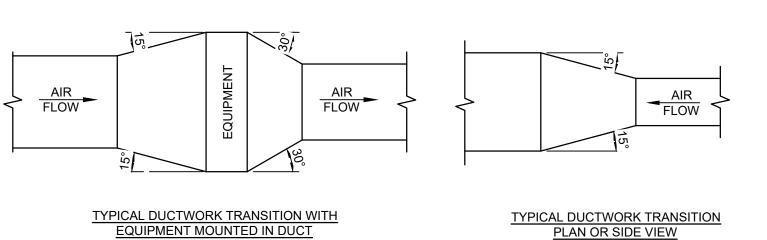


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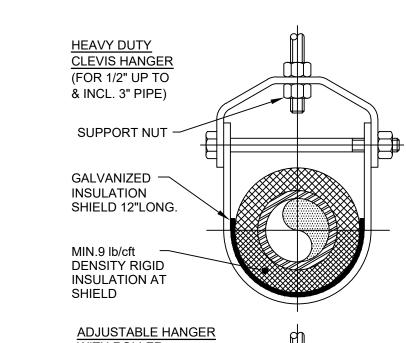
PLAN OR SIDE VIEW


TYPICAL DUCTWORK TRANSITION
PLAN OR SIDE VIEW

NOTE: UNLESS OTHERWISE INDICATED ON PLANS, MAXIMUM ANGLES SHOWN SHALL APPLY.

Ductwork Transition Detail



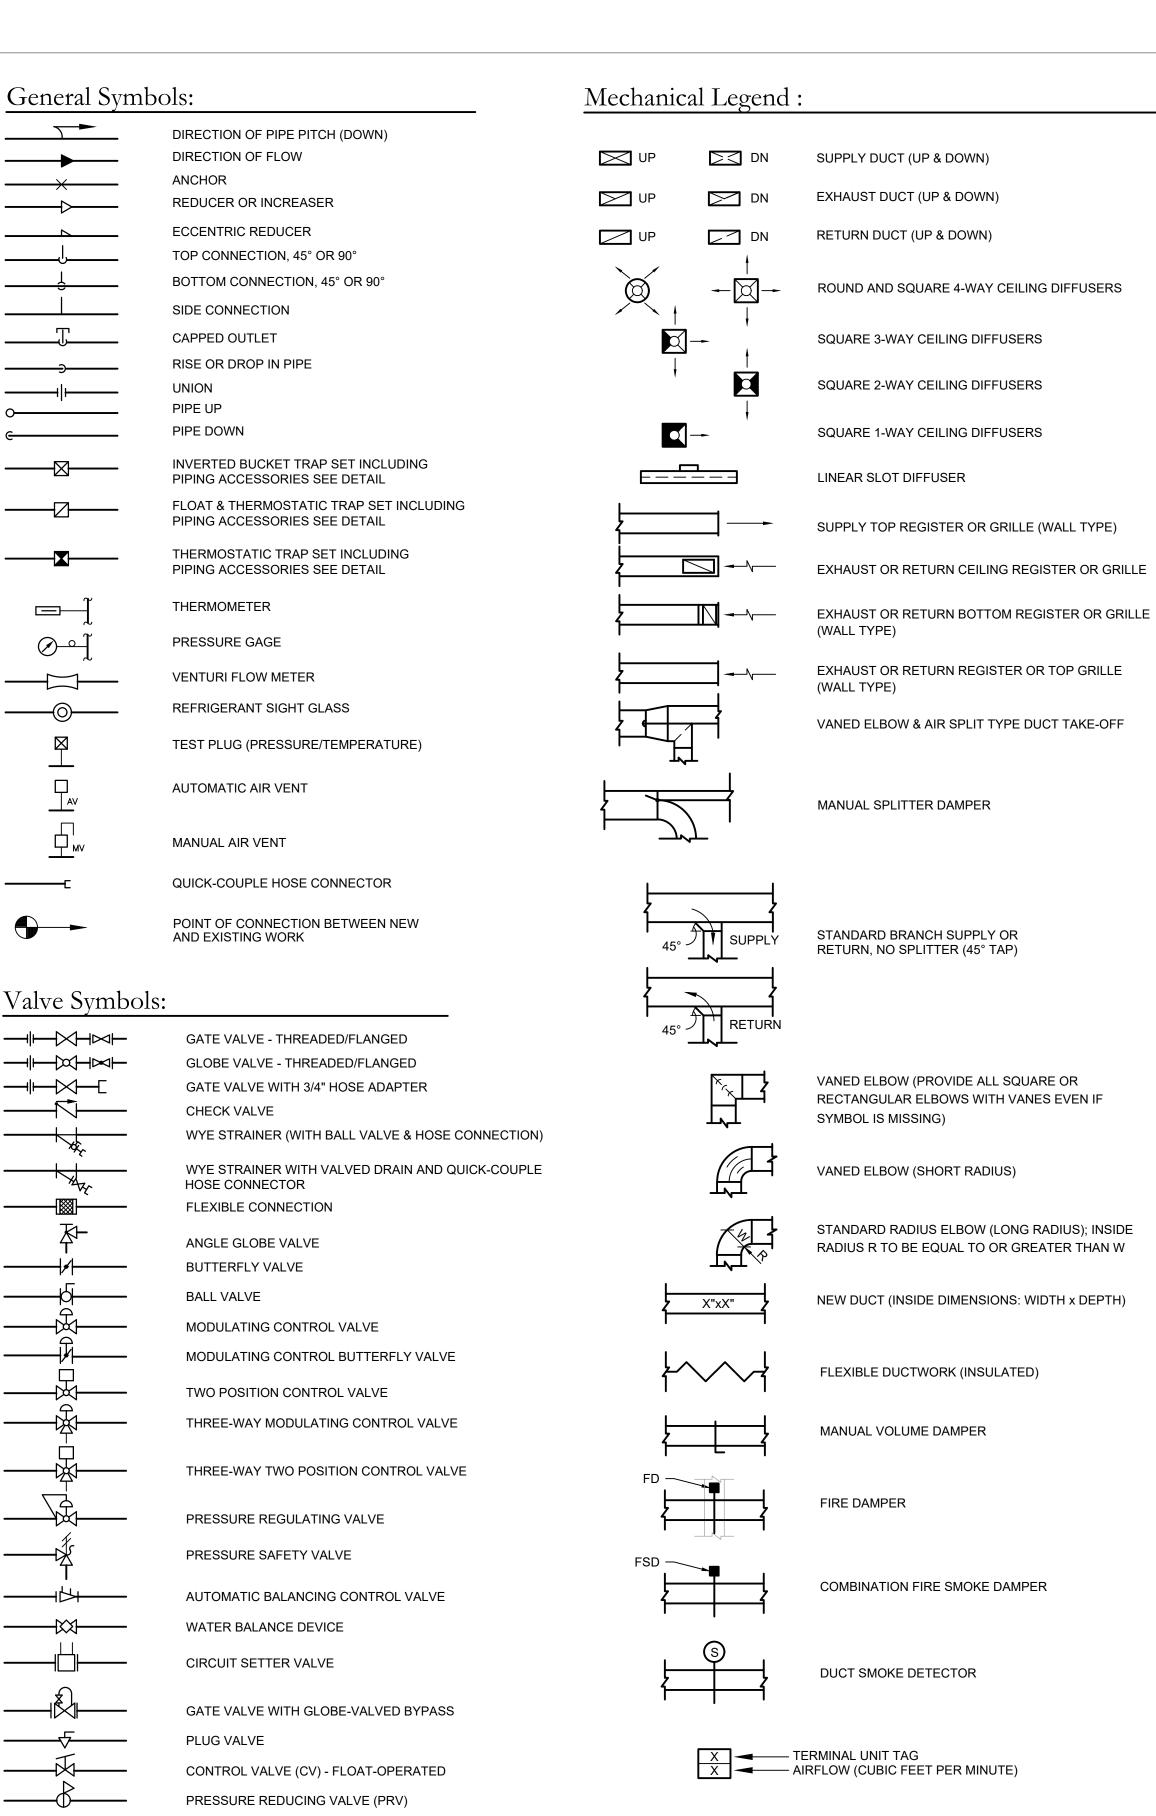

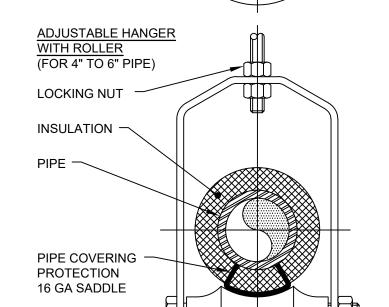


1. PIPE 8" AND LARGER SHALL HAVE ROLLER SUPPORTED WITH DUAL RODS. 2. FOR CHW SERVICE OVER 3" REPLACE SADDLE WITH 12" LONG 14 GA SHIELD

WITH RIGID INSULAT	FION BETWEEN	I PIPE AND SHIE	LD.	
PIPE Ø (IN.)		SPACING BETWE ANGERS (FT.)	EN	MIN. ROD SIZE
	STEEL PIPE	COPPER PIPE	CPVC	(IN.)
1/2 THRU 1	7	5	5	3/8
1-1/2 THRU 2	9	8	6	3/8
2-1/2	11	9	7.5	1/2
3	12	10	7.5	1/2
4	14	12	8.5	5/8
6	17	14	9	3/4
8	19	16	10	7/8
10	22	18	10.5	7/8


Pipe Hanger Support

$\MO01$ N.T.S.

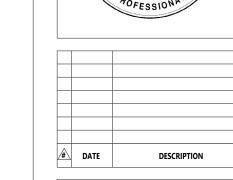

MECHANICAL SCHEDULES & DETAILS

CONSTRUCTION DOCUMENTS

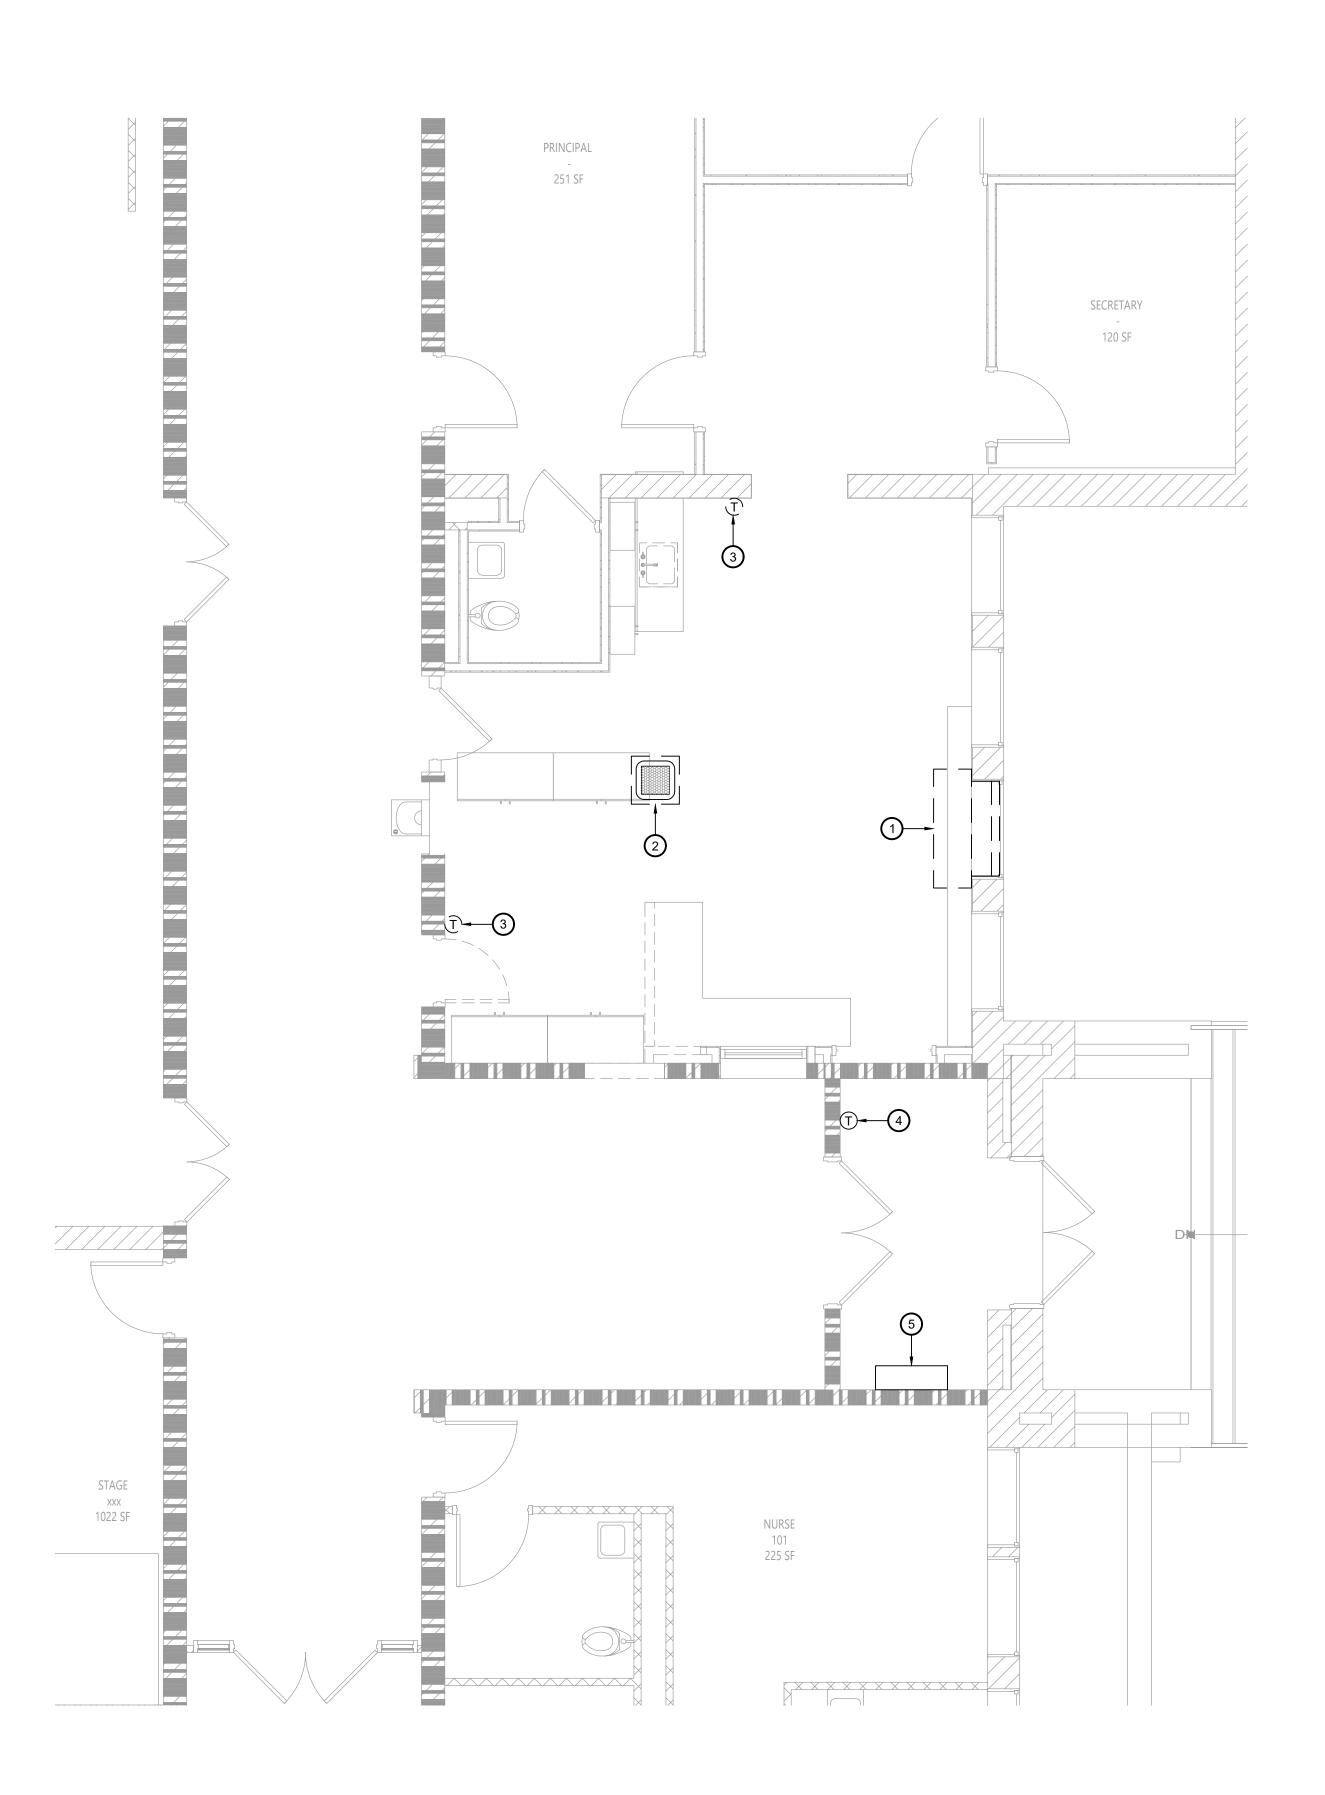



Mechanical Demolition Plan MD111 Scale: 1/4" = 1'-0"

Key Notes:


- EXISTING UNIT VENTILATOR TO BE DISCONNECTED, REMOVED & PROPERLY DISPOSED OF INCLUDING ANY PIPING, CONTROLS, LOUVERS, HANGERS, SUPPORTS, ACCESSORIES, ETC.; REMOVE PIPING BACK TO MAINS & CAP; SEAL EXTERIOR LOUVER WEATHER TIGHT W/ RIGID INSULATION ON INSIDE FACE
- EXISTING CEILING CASSETTE & ASSOCIATED CONDENSING UNIT TO BE DISCONNECTED, REMOVED & PROPERLY DISPOSED OF INCLUDING ANY REFRIGERANT PIPING, CONDENSATE PIPING, CONTROLS, HANGERS, SUPPORTS, ACCESSORIES, ETC.; RECOVER & DISPOSE OF REFRIGERANT PER EPA & DEC GUIDELINES
- EXISTING THERMOSTAT TO BE DISCONNECTED, REMOVED & PROPERLY DISPOSED OF INCLUDING ANY ASSOCIATED WIRING,
- TUBING, CONDUIT, ACCESSORIES, ETC.;

EXISTING THERMOSTAT TO REMAIN EXISTING CONVECTOR TO REMAIN

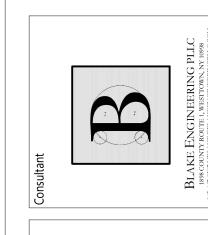

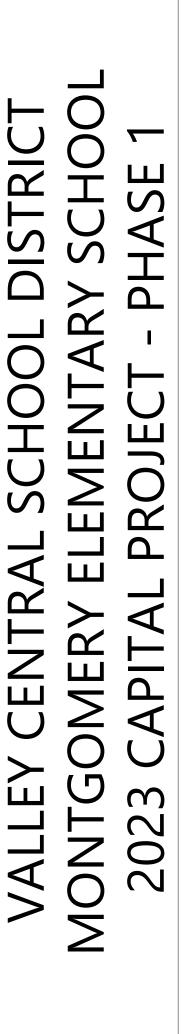



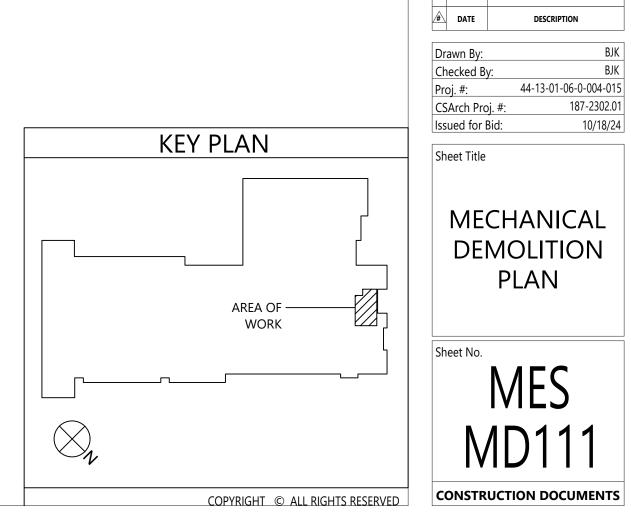

VRF System Notes:

CONTRACTOR.

SERIES OR EQUAL

LINES AT EVERY FAN COIL UNIT.

WIRING BY THE MECHANICAL CONTRACTOR.

WIRED 7 DAY PROGRAMMABLE THERMOSTAT SHALL BE FURNISHED BY MECHANICAL CONTRACTOR FOR EACH INDOOR UNIT. THERMOSTATS SHIP LOOSE FOR FIELD INSTALLATION AND

MECHANICAL CONTRACTOR TO PROVIDE CENTRAL CONTROLLER FOR LOCAL SET POINT CONTROL AND SYSTEM VIEWING. CONTROLLER TO BE INSTALLED AND WIRING BY MECHANICAL CONTRACTOR. 24V POWER BY ELECTRICAL CONTRACTOR.

DISCONNECT SWITCHES FOR CONDENSING UNITS AND INDOOR

AND INSTALLED BY THE ELECTRICAL CONTRACTOR.

UNITS SHALL BE FURNISHED BY THE MECHANICAL CONTRACTOR

. EXTERNAL SUPPORTS FOR INDOOR AND CONDENSING UNITS

SHALL BE FURNISHED AND INSTALLED BY THE MECHANICAL


FILTER RACK AND 2" PLEATED MERV-13 FILTERS FOR DUCTED UNITS SHALL FURNISHED AND INSTALLED BY THE MECHANICAL CONTRACTOR. FILTER RACK SHALL BE GALVANIZED STEEL, FULLY INSULATED & FACTORY ASSEMBLED. TYPICAL OF FLT-H

CONDENSATE PUMPS SHIP FOR FIELD INSTALLATION BY

MECHANICAL CONTRACTOR FOR WALL MOUNTED UNITS. DUCTED UNITS FURNISHED WITH FACTORY MOUNTED CONDENSATE PUMP. MECHANICAL CONTRACTOR TO PROVIDE

CONDENSATE PIPING FROM ALL UNITS TO SANITARY DRAIN. FIELD VERIFY EXACT ROUTING AND TERMINATION POINT IN

7. PROVIDE REFRIGERANT ISOLATION VALVES ON LIQUID AND GAS

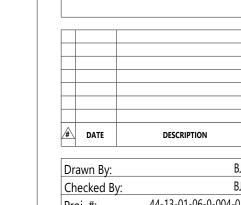

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MECHANICAL PLAN

KEY PLAN

AREA OF ——— WORK

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ASSISTANT PRINCIPAL SECRETARY 120 SF REFRIGERANT & CONDENSATE PIPING DN. ALONG WALL IN LINESET COVER; SPILL CONDENSATE TO SPLASHBLOCK @ GRADE - INSTALL UNIT ON 12" HIGH STAND ON TOP OF 6" THICK CONCRETE PAD; MOUNT W/ VIBRATION ISOLATORS ☐ BALÂNCE OUTSIDE -AIR TO 65 CFM PROVIDE FAN COIL UNITS W/ FILTER RACKS AND 2" MERV-13 FILTERS; LAYOUT UNITS, PIPING & DUCTWORK TO MAINTAIN FULL ACCESS TO THE EQUIPMENT FOR MAINTENANCE AND FILTER CHANGES SECURITY VESTIBULE

Mechanical Plan M111 Scale: 1/4" = 1'-0"

	INDOOR MINI-SPLIT UNIT SCHEDULE																		
EQUIPMENT TAG	EQUIPMENT (OR ACCEPT MODEL MINI-SPLIT UNIT RINI DING AIRFLOW AIRFLOW OUTDOOR							EXTERNAL STATIC		ELEC PC REQUII	TRICAL WER REMENT	TS	WEIGHT (LB)	NOTES					
FCU-1	MITSUBISHI	PEAD-A18AA8	DUCTED MEDIUM STATIC	MAIN OFFICE	600	18.0	80.0	67.0	21.6	70.0	60.0	HP-1	0.50	208	1	60	121	60	HYPER HEATING UNIT; SEE VRF SYSTEM NOTES

	AIR-COOLED HEAT PUMP SCHEDULE																			
EQUIPMENT TAG								REFRIGERANT	SOUND PRESSURE LEVEL COOLING/ HEATING (dBA)	VOLT.	REQ	ECTRICA POWER UIREME Hz.	NTS	MOCP	WEIGHT (LB)	NOTES				
HP-1	MITSUBISHI	SUZ-KA18NAHZ	FCU-1	INVERTER SCROLL HERMETIC	18.0	21.6	0 TO 115	-13 TO 75	12.8	18.9	3.3	R410A	52/53	208	1	60	17	30	131	HYPER HEATING UNIT; FURNISH W/ REQUIRED PIPING ACCESSORIES

	AIR GRILLE/DIFFUSER SCHEDULE													
EQUIPMENT	MODEL	PANEL/FRAME SIZE	_	MAX	DAMPER	FINISH	NOTES							
TAG	(OR ACCEPT. EQUAL)	MODEL	AIR DEVICE TYPE	MIN.	MAX.	DROP (IN. W.C.)	MOUNTING	(IN.)	(IN.)	NC	DAIVIPER	THINIOTT	NOTES	
D-1	KRUEGER	PLQ-6-F23-24x24-PR10-IB-44	SQUARE PLAQUE FACE DIFFUSER	50	175	0.10	LAY-IN	24"x24"	6"Ø	20	OBD	WHITE	PROVIDE W/ INSULATED BLANKET ON BACKPAN	
D-2	KRUEGER	PLQ-8-F23-24x24-PR10-IB-44	SQUARE PLAQUE FACE DIFFUSER	176	300	0.10	LAY-IN	24"x24"	8"Ø	20	OBD	WHITE	PROVIDE W/ INSULATED BLANKET ON BACKPAN	
R-1	KRUEGER	S80P-20x20-F23-24x24-00-00-00-44	PERFORATED FACE RETURN GRILLE	0	1,600	0.10	LAY-IN	24"x24"	20"x20"	25	-	WHITE	FURNISH & INSTALL FULL-SIZE SHEET METAL PLENUM BOX ON REAR OF GRILLE, PAINT INSIDE FLAT BLACK	

LOUVER SCHEDULE														
EQUIPMENT	QTY.	MANUFACTURER (OR ACCEPT.	MODEL	AIR DEVICE TYPE	LOUVER SIZE			FREE AREA	AIRFLOW		MOUNTING	SCREEN	FINISH	NOTES
TAG	QII.	EQUAL)	MODEL	AIR DEVICE TYPE	WIDE	HIGH	DEPTH	(SQ. FT.)	(CFM)	(FT./MIN.)	MOONTING	SCREEN	FINION	NOTES
L-1	1	RUSKIN	ELF6375DX	STATIONARY LOUVER	18"	12"	6"	0.63	65	103.2	EXTERIOR WALL	YES	TBD	1, 2 & 3

FURNISH WITH INSECT-SCREEN OPTION.
 FURNISH W/ PROPER MOUNTING HARDWARE.

SPLIT SYSTEMS WITH DUCT FAN COIL & HEAT PUMP FURNISHED BY ——

OWNER, INSTALLED BY CONTRACTOR; CONTRACTOR IS RESPONSIBLE

TO RECEIVE THE EQUIPMENT DELIVERY AT THE PROJECT SITE, MOVE

EQUIPMENT FROM TRUCK(S) TO A DESIGNATED STORAGE LOCATION ON THE SITE & RIG THE UNIT INTO THE FINAL INSTALLATION LOCATION;

CONTRACTOR IS TO PROVIDE ALL ASSOCIATED COMPONENTS, I.E.,

OTHERWISE NOTED IN THE PROJECT DOCUMENTS; REFER TO FRONT

DUCTWORK, PIPING, CONTROLS, ACCESSORIES, ETC. UNLESS

END DOCUMENTS FOR ADDITIONAL INFORMATION

LIGHTING FIXTURE SCHEDULE										
TAG	SYMBOL	MANUFACTURER & MODEL	TYPE	VOLTAGE	# OF LAMPS	LAMP WATTS	FIXTURE WATTS	MOUNTING	SIZE	NOTES
А	lacksquare	HE WILLIAMS RECESSED DIRECT/INDIRECT DIG-S22-L32/840-AD-DIM-UNV	LED	120	1	25.8	25.8	RECESSED	2'x2'	4000K COLOR TEMPERATURE
B-EM	В-ЕМ	HE WILLIAMS VOLTAIRE ARCHITECTURAL WALL PACK VWPH-L30/740-T3-DBZ-SDGL-EM/10WC-DIM-UNV	LED	120	1	36	36	SURFACE WALL MOUNT	12"x12"	VANDAL RESISTANT; 4000K COLOR TEMPERATURE; W/ LED EMERGENCY 90 MINUTE LOW TEMPERATURE BATTERY BACKUP; UL 924 LISTED FIXTURE
С	\bigcirc_{c}	LIGHTSMITH / JEFFERSON LIGHTING CALCUTTA PENDANT LED PD-6209-HNA-ABB-DIM	LED	120	1	52	52	RECESSED	20"x19"	-
-	\bigoplus	HE WILLIAMS LED EMERGENCY LIGHT EMER/LED-WHT-SDT-D	LED	120	2	1.0	2.0	UNIVERSAL	-	UL 924 LISTED FIXTURE; 90-MINUTE BATTERY BACKUP
-	\$ ⊗	HE WILLIAMS LED EXIT & EMERGENCY LIGHT EXIT/EM/LED-R-WHT-RC-SDT-D	LED	120	2	1.5	3.4	UNIVERSAL	-	UL 924 LISTED FIXTURE; 90-MINUTE BATTERY BACKUP; PROVIDE W/ REMOTE HEAD MODEL WETRHL-T-WHT-HL-MV
-	⊗	HE WILLIAMS LED EXIT LIGHT EXIT-R-EM-WHT-SDT-D	LED	120	1	3.8	3.8	UNIVERSAL	-	90-MINUTE BATTERY BACKUP

FIRE ALARM LEGEND:

HORN/STROBE DEVICE, ONE ASSEMBLY; MTD. 80" A.F.F. UNLESS OTHERWISE NOTED; 15 CANDELA UNLESS OTHERWISE NOTED

STROBE DEVICE; MTD. 80" A.F.F. UNLESS OTHERWISE NOTED; 15

CANDELA UNLESS OTHERWISE NOTED

MANUAL PULL STATION; MTD. 48" A.F.F.

WATER FLOW SWITCH

VALVE TAMPER SWITCH

DETECTOR; LETTER INDICATES AS FOLLOWS: BLANK = SMOKE DETECTOR P = PHOTOELECTRIC SMOKE

M = MULTIPLE STATION SMOKE ALARM D = PHOTOELECTRIC DUCT SMOKE DETECTOR FSD = DUCT SMOKE DETECTOR FOR FIRE SMOKE DAMPER

RATE OF RISE HEAT DETECTOR, 135°F

CARBON MONOXIDE DETECTOR; MTD. 60" A.F.F.

ADDRESSABLE FIRE ALARM CONTROL PANEL

FIRE ALARM ANNUNCIATOR PANEL

REMOTE TEST SWITCH & LED FOR DUCT SMOKE DETECTORS

FIRE ALARM RELAY

SECURITY LEGEND:

PANIC BUTTON - 18/4 SHIELDED

INTERCOM

DOOR RELEASE BUTTON - 16/2 SHIELDED

WORKSTATION FOR CARD ACCESS & VIDEO SYSTEM

CARD READER - 22/6 SHIELDED

REQUEST TO EXIT - 18/4 SHIELDED

MAGNETIC DOOR CONTACT - 16/2 SHIELDED

ELECTRIC LOCK - 16/2 SHIELDED

ELECTRICAL LEGEND:

MOTOR

EARTH GROUND

JUNCTION BOX EMERGENCY POWER OFF BUTTON

MOLDED CASE CIRCUIT BREAKER

FUSE WITH RATING

DISCONNECT SWITCH, FUSED

DISCONNECT SWITCH, UNFUSED

STARTER, COMBINATION WITH DISCONNECT SWITCH STARTER OR MOTOR CONTROLLER

M

20A 120V DUPLEX CEILING MOUNTED RECEPTACLE

20A 120V DUPLEX WALL MOUNTED RECEPTACLE; 18" A.F.F. UNLESS OTHERWISE NOTED

20A 120V DUPLEX WALL MOUNTED RECEPTACLE WITH GROUND FAULT CIRCUIT INTERRUPTER

20A 120V QUADRAPLEX RECEPTACLE

WALL MOUNTED SPECIAL PURPOSE RECEPTACLE

⇒ USB 20A 120V WALL MOUNTED USB CHARGER RECEPTACLE TYPICAL OF HUBBELL USB20X OR ACCEPTABLE EQUAL

FLOOR MOUNTED BOX W/ DUPLEX RECEPTACLE; FLUSH MOUNTED

FLOOR MOUNTED BOX W/ DUPLEX RECEPTACLE & 2 PORT ETHERNET OUTLET; FLUSH MOUNTED

FLOOR MOUNTED BOX W/ QUAD RECEPTACLE & 2 PORT ETHERNET OUTLET; FLUSH MOUNTED

WALL PHONE OUTLET MTD. 48" A.F.F.; 3/4" EMT CDT. IN WALL TO ABOVE CEILING; PROVIDE 1 PORT ETHERNET WALL PLATE; PROVIDE (1) CAT 6E CABLES FROM WALL PLATE TO NEAREST IT CLOSET

WALL BOX FOR TELEVISION CONNECTION; 1-1/4" EMT CDT. IN WALL TO ABOVE CEILING W/ PULL CORD TELEPHONE/DATA COMMUNICATION BOX W/ (2) 3/4" EMT CDT. IN

PROVIDE (2) CAT 6E CABLES FROM WALL PLATE TO NEAREST IT BRANCH CIRCUIT HOMERUN; LINES INDICATE NUMBER OF CIRCUITS,

NEUTRAL, AND SWITCH LEG CONDUCTORS; ONE SEPARATE

GROUNDING CONDUCTOR SHALL BE PROVIDED FOR EACH

WALL TO ABOVE CEILING; PROVIDE 2 PORT ETHERNET WALL PLATE;

OC= OCCUPANCY SENSOR

HOMERUN; NOT SHOWN 2 = DOUBLE POLE BLANK = SINGLE POLE 3 = THREE-WAY 4 = FOUR-WAY D = DIMMER K = KEY OPERATED P = WITH PILOT LIGHT PB= PUSH BUTTON T = TIMER OPERATED WP= WEATHER PROOF

DUAL TECHNOLOGY OCCUPANCY SENSOR

DAYLIGHT SENSOR

X = EXPLOSION PROOF

MULTIMEDIA BOX. PROVIDE DEVICE BOX AT 60" ABOVE FINISHED FLOOR WITH DUPLEX RECEPTACLE & (2) CAT6E PORTS. PROVIDE FACEPLATES AND (2) 1-1/4" CONDUITS STUBBED ABOVE CEILING. (1) W/ CAT6E CABLES RUN TO NEAREST IT CLOSET & (1) W/ PULL CORD FOR FUTURE HDMI. RECESS MOUNT BOX TYPICAL OF WIREMOLD EVOLUTION SERIES WITH CONCEALED CONDUITS IN EXISTING FRAMED WALLS AND ALL NEW WALLS. PROVIDE SURFACE MOUNT BOXES WITH DUAL CHANNEL SURFACE MOUNT RACEWAY (LEGRAND WIREMOLD 5400 SERIES) WHERE INSTALLED ON EXISTING MASONRY

ELECTRICAL NOTES:

- 1. ALL MATERIALS AND EQUIPMENT ARE TO BE NEW, UNUSED, AND FREE FROM DEFECTS OF ANY KIND. THE BASIS OF QUALITY SHALL BE THE LATEST REVISION OF ASTM, ANSI, OR OTHER ACCEPTABLE STANDARDS.
- 2. THESE DRAWINGS ARE DIAGRAMMATIC, AND INDICATE GENERAL ARRANGEMENT OF WORK. THE CONTRACTOR SHALL BE RESPONSIBLE TO HAVE REVIEWED THE SITE FOR HIS WORK PRIOR TO HAVING SUBMITTED HIS PROPOSAL. NO ADDITIONAL COMPENSATION WILL BE ALLOWED FOR CONDITIONS FOUND DURING THE COURSE OF THE CONTRACT.
- 3. THE CONTRACTOR SHALL COORDINATE HIS WORK WITH THAT OF ALL OTHER
- 4. ALL WORK INCLUDING LABOR AND MATERIALS SHALL BE FULLY GUARANTEED FOR ONE (1) YEAR FROM THE DATE OF PAYMENT AND FINAL ACCEPTANCE BY THE OWNER AND ENGINEER.
- 5. ALL CUTTING, PATCHING, FIRE-STOPPING, AND SURFACE RESTORATION IN CONNECTION WITH THIS TRADE SHALL BE COMPLETED BY THIS CONTRACTOR.
- 6. A MINIMUM OF FOUR (4) COPIES OF SHOP DRAWINGS SHALL BE SUBMITTED TO THE ARCHITECT FOR APPROVAL PRIOR TO ORDERING AND INSTALLATION OF THE EQUIPMENT AND/OR MATERIALS. BY SUBMITTING SHOP DRAWINGS, THE CONTRACTOR REPRESENTS THAT ACTUAL FIELD CONDITIONS ARE VERIFIED BY HIM AND ARE REFLECTED ON HIS SUBMITTALS.
- 7. THIS CONTRACTOR SHALL PAY ALL FEES, GIVE ALL NOTICES, FILE ALL NECESSARY DRAWINGS, AND OBTAIN ALL PERMITS, INSPECTIONS AND CERTIFICATES OF APPROVAL REQUIRED IN CONNECTION WITH WORK UNDER THIS CONTRACT.
- 8. EQUIPMENT AND MATERIALS FOR WHICH UNDERWRITERS LABORATORIES INC. (UL) PROVIDES PRODUCT LISTING SERVICE SHALL BE LISTED AND BEAR THE LISTING MARK.
- ALL WORK IN ASSOCIATION WITH THIS CONTRACT SHALL BE COMPLETED IN STRICT COMPLIANCE WITH THE 2017 NATIONAL ELECTRIC CODE, 2020 BUILDING CODE OF NEW YORK STATE, 2020 FIRE CODE OF NEW YORK STATE & 2020 ENERGY CONSERVATION CONSTRUCTION CODE OF NEW YORK STATE.
- 10. ALL NEW LIGHTING FIXTURES SHALL BE INSTALLED FULLY LAMPED AND OPERABLE. THE CONTRACTOR SHALL TURN OVER TO THE OWNER SPARE LAMPS OF EVERY TYPE ON THE PROJECT IN AN AMOUNT NOT LESS THAN 20% OF THE TOTAL NUMBER OF EACH TYPE (MINIMUM 1 PER TYPE).
- 11. THIS CONTRACTOR SHALL BE RESPONSIBLE FOR ALL COORDINATION, APPLICATIONS AND FEES OF ALL WORK ASSOCIATED WITH THE LOCAL UTILITY COMPANY AND/OR THE TELEPHONE COMPANY. ALL WORK INVOLVING THE UTILITY COMPANY SHALL BE COMPLETED IN ACCORDANCE WITH THEIR REGULATIONS AND GUIDELINES.
- 12. ALL CONDUCTORS SHALL BE COPPER, SHALL NOT BE LESS THAN #12 AWG, AND SHALL NOT EXCEED 70 FEET FROM PANEL BOARD TO FURTHEST CONNECTION UNLESS OTHERWISE NOTED ON PLANS.
- 13. LIGHTING LOADS SHALL NOT BE COMBINED ON THE SAME CIRCUIT AS ANY OTHER ELECTRICAL LOADS.
- 14. CONTRACTOR SHALL BE RESPONSIBLE TO FURNISH & INSTALL ALL SMALL DETAILS AND INCIDENTAL WORK NOT SHOWN OR SPECIFIED, BUT WHICH CAN BE REASONABLY INFERRED AS REQUIRED FOR A COMPLETE AND OPERATING SYSTEM OF HIGH QUALITY MEETING ALL APPLICABLE CODES AND REGULATIONS.
- 15. FOR EACH NEW OR MODIFIED ELECTRICAL PANEL, THE CONTRACTOR SHALL PROVIDE A TYPE WRITTEN DIRECTORY CARD TO REFLECT ALL CIRCUITING. ADDITIONALLY, THE CONTRACTOR SHALL LABEL (WITH A PERMANENT MARKER OR LABEL) EACH RECEPTACLE ON THE INSIDE OF EACH FACE PLATE WITH PANEL AND CIRCUIT NUMBER DESIGNATION.
- 16. MINIMUM REQUIREMENT FOR EQUIPMENT GROUNDING SHALL BE GOVERNED BY THE NEC. ALL GROUNDS, BONDING, ETC. SHALL MEET THESE REQUIREMENTS. THE CONTRACTOR SHALL FURNISH AND INSTALL ANY AND ALL ITEMS NECESSARY TO MEET THESE REQUIREMENTS AT NO EXTRA COST, EVEN IF SUCH ITEMS ARE NOT DETAILED ON THE DRAWINGS.
- 17. ALL CONDUIT AND CABLE SHALL BE PROPERLY SUPPORTED AND ROUTED PARALLEL OR PERPENDICULAR TO BUILDING WALLS. THE CONTRACTOR SHALL FURNISH AND INSTALL ALL SUPPORT HANGERS AND MISCELLANEOUS METALS REQUIRED FOR PROPER INSTALLATION OF WORK.
- 18. THE CONTRACTOR IS RESPONSIBLE TO TEST ALL EQUIPMENT, WIRING, DEVICES, AND SYSTEMS INSTALLED UNDER THIS CONTRACT TO ENSURE PROPER OPERATION PRIOR TO FINAL ACCEPTANCE BY THE OWNER AND ENGINEER.
- 19. THE CONTRACTOR IS RESPONSIBLE TO DETERMINE WHETHER SPECIAL LICENSING IS REQUIRED IN ORDER TO PERFORM THE REQUIRED WORK IN THE MUNICIPALITY WHERE THE PROJECT IS LOCATED. IF THE CONTRACTOR CANNOT OBTAIN THE REQUIRED LICENSING TO COMPLETE THE WORK WITHIN THE PROJECT SCHEDULE, THEN THE CONTRACTOR SHALL NOT BE PERMITTED TO BID ON THIS PROJECT.

	WIRE COLOR CODING TABLE							
PHASE	WIRES	VOLTAGE	L1	L2	L3	NEUTRAL	GROUND	
1	2 (1)	120	BLACK	-	-	WHITE	-	
1	2 (1)	208	BLACK	RED	-	-	-	
1	3	120	BLACK	-	-	WHITE	GREEN (2)	
1	3	208	BLACK	RED	-	ı	GREEN (2)	
3	4	208	BLACK	RED	BLUE	-	GREEN (2)	
3	5	208	BLACK	RED	BLUE	WHITE	GREEN (2)	
1	3	277	BROWN	-	-	GRAY	GREEN (2)	
1	3	480	BROWN	ORANGE	-	-	GREEN (2)	
3	4	480	BROWN	ORANGE	YELLOW	-	GREEN (2)	
3	5	480	BROWN	ORANGE	YELLOW	GRAY	GREEN (2)	

FOR DOUBLE INSULATED EQUIPMENT ONLY.

CONDUCTORS.

FIRE ALARM AUDIO/VISUAL DEVICES

EMERGENCY LIGHTS (WALL MOUNTED)

EXIT LIGHTS (WALL MOUNTED)

TV & A/V OUTLETS

GREEN/YELLOW MAY BE USED: - GREEN/YELLOW SHALL BE GREEN WITH ONE OR MORE YELLOW STRIPES. - GREEN = 50 TO 70%, YELLOW = 50 TO 30%. - GREEN/YELLOW IS THE ONLY COLOR INTERNATIONALLY ACCEPTED FOR USE AS AN EQUIPMENT GROUNDING CONDUCTOR.

- GREEN OR GREEN/YELLOW MUST ONLY BE USED FOR GROUNDING

DEVICE MOUNTING	G HEIGHTS			
POWER RECEPTACLES (INTERIOR)	18" A.F.F.			
POWER RECEPTACLES (EXTERIOR)	36" A.F.G.			
POWER RECEPTACLES (@ COUNTER)	44" A.F.F.			
LIGHT SWITCHES	44" A.F.F. TO TOP OF DEVICE			
DISCONNECT SWITCHES	SEE NEC 404.8(A)			
TELEPHONE/DATA RECEPTACLES	18" A.F.F.			
TELEPHONE/DATA RECEPTACLES (@ COUNTER)	44" A.F.F.			
WALL TELEPHONE RECEPTACLES	48" A.F.F. TO TOP OF DEVICE			
FIRE ALARM PULL STATIONS	42" A.F.F. MIN./44" A.F.F. MAX.			

NOTE: ALL DIMENSIONS ARE TO CENTER OF DEVICE UNLESS OTHERWISE NOTED

#\ DATE DESCRIPTION 80" A.F.F. MIN./96" A.F.F. MAX. 12" ABOVE DOOR Drawn By: 44-13-01-06-0-004-015 Proj. #:


CSArch Proj. #: Issued for Bid:

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ELECTRICAL NOTES, LEGENDS, SCHEDULES & **DETAILS**

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1 Electrical Demolition Plan
ED111 Scale: 1/4" = 1'-0"

Key Notes:

- EXISTING UNIT VENTILATOR TO BE REMOVED; DISCONNECT, REMOVE & PROPERLY DISPOSE OF ALL ASSOCIATED CONDUITS, WIRING, DISCONNECTS, ETC.; REMOVE ALL CONDUITS AND WIRING BACK TO SOURCE
- DISCONNECT, REMOVE & PROPERLY DISPOSE OF LIGHT FIXTURE & ASSOCIATED WIRING & CONDUIT; MAINTAIN EXISTING CIRCUIT AS NEEDED FOR ANY ADJACENT LIGHTING THAT REMAINS IN PLACE, OTHERWISE TERMINATE AT SOURCE
- EXISTING CEILING CASSETTE & CONDENSING UNIT TO BE REMOVED; DISCONNECT, REMOVE & PROPERLY DISPOSE OF ALL ASSOCIATED CONDUITS, WIRING, DISCONNECTS, ETC.; REMOVE ALL CONDUITS AND WIRING BACK TO SOURCE
- EXISTING WIRELESS ACCESS POINT TO BE DISCONNECTED, REMOVED & STORED; TEMPORARILY SUPPORT DATA CABLING UNTIL REINSTALLATION IN NEW CEILING
- DISCONNECT, REMOVE & PROPERLY DISPOSE OF FIRE ALARM
 DEVICE & ASSOCIATED WIRING & CONDUIT; REMOVE ALL CONDUITS
 AND WIRING BACK TO SOURCE; MAINTAIN CONTINUITY OF EXISTING
 FIRE ALARM CIRCUITS
- EXISTING FIRE ALARM ANNUNCIATOR PANEL TO REMAIN; TEMPORARILY REMOVE, PROTECT & STORE DURING CONSTRUCTION; REINSTALL AFTER COMPLETION OF VESTIBULE
- EXISTING INTERCOM & CARD ACCESS CONTROL TO REMAIN;
- TEMPORARILY REMOVE, PROTECT & STORE DURING CONSTRUCTION; REINSTALL AFTER COMPLETION OF VESTIBULE
- DISCONNECT, REMOVE & PROPERLY DISPOSE OF RECEPTACLE & ASSOCIATED WIRING & CONDUIT; REMOVE ALL CONDUITS AND WIRING BACK TO SOURCE

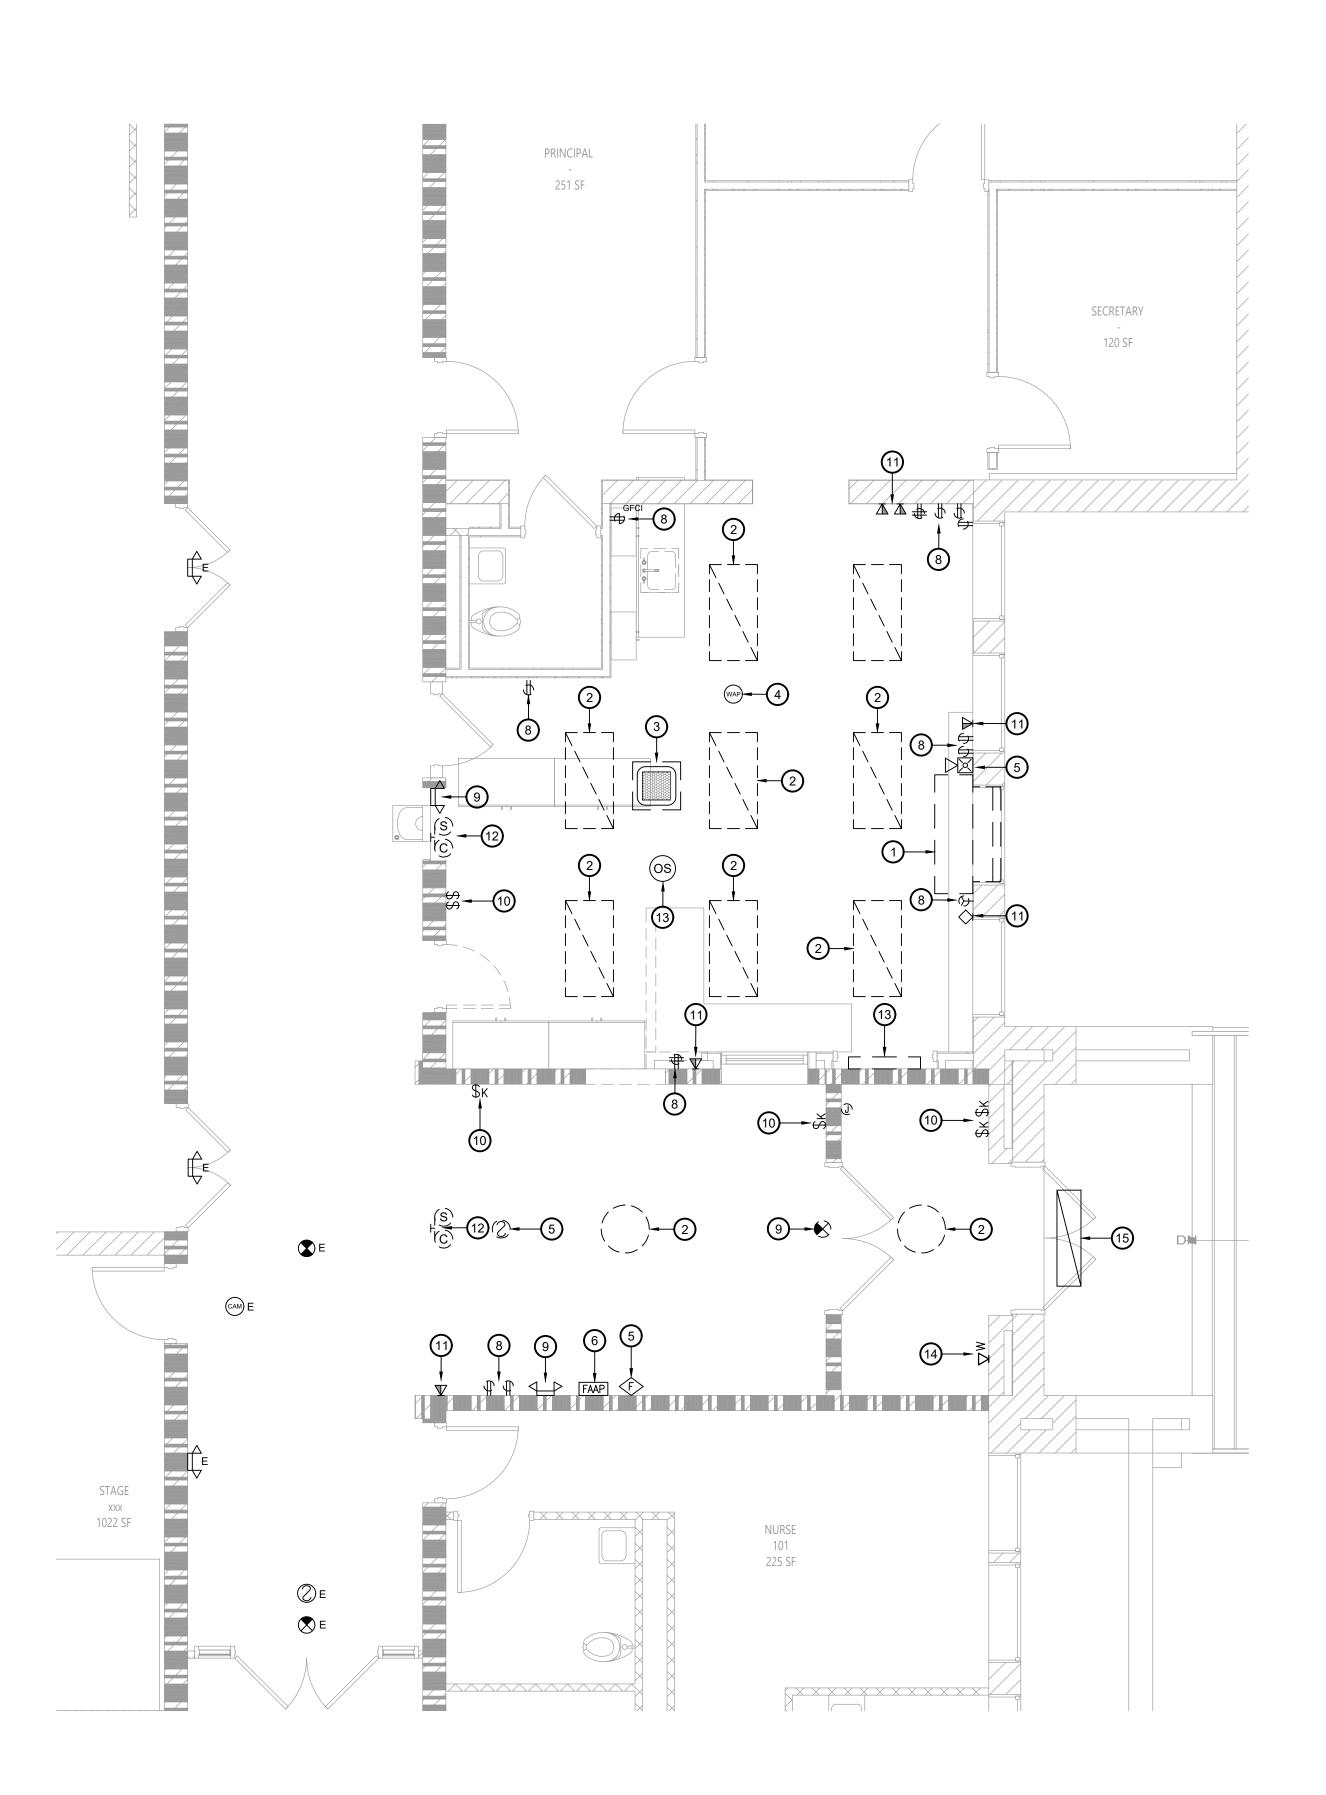 DISCONNECT, REMOVE & PROPERLY DISPOSE OF EXIT/
- EMERGENCY LIGHT & ASSOCIATED WIRING & CONDUIT; MAINTAIN EXISTING CIRCUIT AS NEEDED FOR ANY ADJACENT LIGHTING THAT REMAINS IN PLACE, OTHERWISE TERMINATE AT SOURCE
- DISCONNECT, REMOVE & PROPERLY DISPOSE OF LIGHT SWITCHES
 & ASSOCIATED WIRING & CONDUIT; REMOVE ALL CONDUITS AND
 WIRING BACK TO SOURCE

 DISCONNECT, REMOVE & PROPERLY DISPOSE OF DATA OUTLET &
- ASSOCIATED WIRING & CONDUIT; REMOVE ALL CONDUITS AND WIRING BACK TO SOURCE

 DISCONNECT, REMOVE & PROPERLY DISPOSE OF WALL MOUNTED
- (12) CLOCK/SPEAKER & ASSOCIATED WIRING & CONDUIT; REMOVE ALL CONDUITS AND WIRING BACK TO SOURCE


 DISCONNECT, REMOVE & PROPERLY DISPOSE OF ABANDONED
- DUKANE PA/CLOCK SYSTEM & ASSOCIATED WIRING & CONDUIT;
 REMOVE ALL CONDUITS AND WIRING BACK TO SOURCE

 DISCONNECT, REMOVE & PROPERLY DISPOSE OF ABANDONED PAY
- DISCONNECT, REMOVE & PROPERLY DISPOSE OF ABANDONED PAY
 PHONE & ASSOCIATED WIRING & CONDUIT; REMOVE ALL CONDUITS
 AND WIRING BACK TO SOURCE
- EXISTING LIGHT FIXTURE TO REMAIN



VALLEY CENTRAL SCHOOL DISTRICT MONTGOMERY ELEMENTARY SCHOOL 2023 CAPITAL PROJECT - PHASE 1



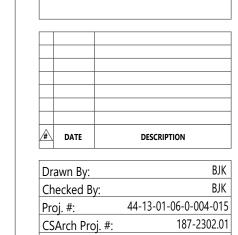

Drawn By:
Checked By:
Proj. #: 44-13-01-06-0-00
CSArch Proj. #: 187-23
Issued for Bid: 10/
Sheet Title

ELECTRICAL

DEMOLITION PLAN


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AREA OF ——— WORK


KEY PLAN





Electrical Plan E111 Scale: 1/4" = 1'-0"

Key Notes:

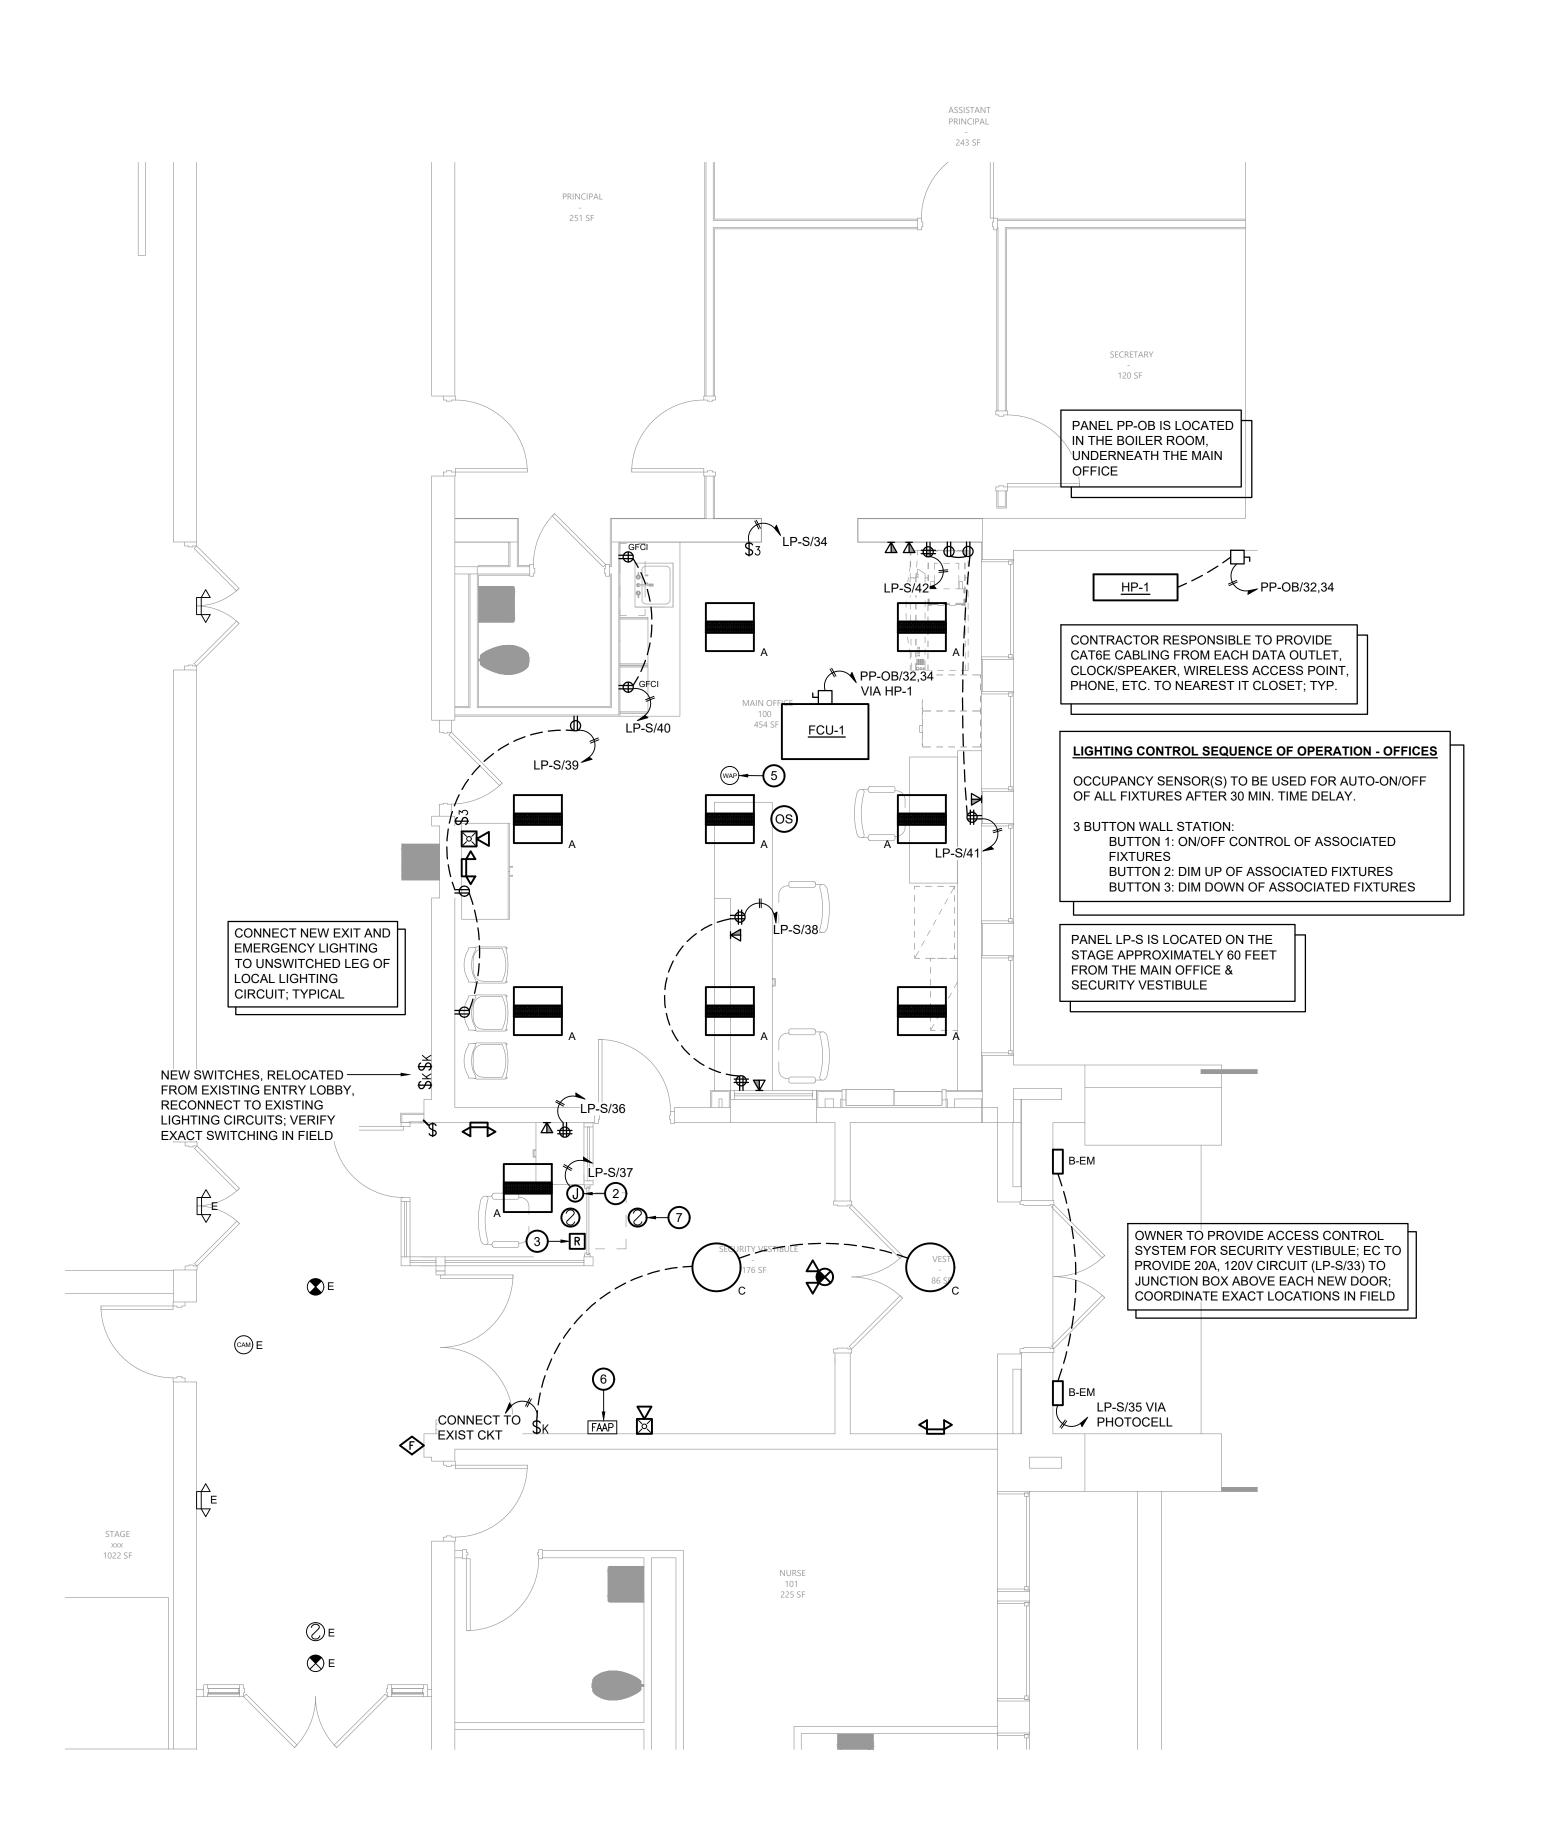- EXISTING LIGHT FIXTURE TO REMAIN
- PROVIDE NEW 120V ELECTRICAL CONNECTION FOR FIRE SHUTTER
- FIRE ALARM RELAY; FIRE SHUTTER TO CLOSE UPON ACTIVATION OF FIRE ALARM
- RELOCATE EXISTING LIGHT FIXTURE TO AVOID CONFLICT W/ NEW SECURITY OFFICE; CENTER FIXTURE IN VESTIBULE; EXTEND WIRING & CONDUIT FROM EXISTING CIRCUIT AS NECESSARY
- REINSTALL EXISTING WIRELESS ACCESS POINT; CONNECT TO EXISTING DATA CABLING
- EXISTING FIRE ALARM ANNUNCIATOR PANEL TO REMAIN; TEMPORARILY REMOVE, PROTECT & STORE DURING CONSTRUCTION; REINSTALL AFTER COMPLETION OF VESTIBULE
- PROVIDE SMOKE DETECTORS ON BOTH SIDES OF THE AUTOMATIC FIRE SHUTTER AT THE TRANSACTION WINDOW; CONNECT TO THE EXISTING BUILDING FIRE ALARM SYSTEM

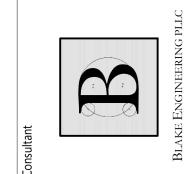

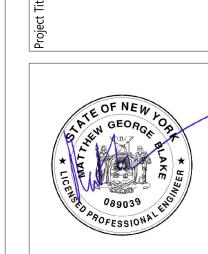

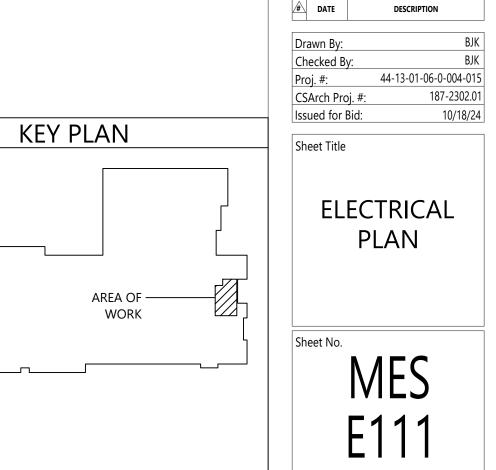

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