### COUNTY OF WESTCHESTER NEW YORK

### DEPARTMENT OF PUBLIC WORKS AND TRANSPORTATION DIVISION OF ENGINEERING

### **ADDENDUM NO. 2**

### **CONTRACT NO. 22-510**

### **FOR**

### JACKSON AVENUE PUMPING STATION REHABILITATION BRONX VALLEY SANITARY SEWER DISTRICT TOWN OF GREENBURGH, NEW YORK

The attention of the bidders is directed to the following changes, additions, and/or substitutions affecting the above-referenced contract(s).

### A. RE: GENERAL CONTRACT INFORMATION:

**Item 1:** Bidders Questions and Responses

Attached hereto.

### **B.** RE: THE SPECIFICATIONS:

Item 1: Specification 01540 Paragraph 1.03.G.2

Delete "384" and Replace with "156"

Item 2: Specification 01640

<u>Delete</u> table "Schedule Of Equipment Testing And Manufacture's Services" and <u>Replace</u> with Attachment 2 in Addendum No. 2.

Item 3: Specification 08710 Section 3.06

**Delete** Paragraph 3.06 "Hardware Sets"

Item 4: Specification 15060, Paragraph 2.13

**Delete** Paragraph 2.13 "Insulation"

### Item 5: Specification 16900

Add the following as paragraph 2.14

"2.14 HEAT DETECTORS

Edwards Signaling, Rate Compensation Heat Detectors (302 series), sensor rated 194°F, suitable for use in Class 1, Div. 1 Group D hazardous areas, or equal."

Item 6: Specification 33213

In paragraph 3.02.B <u>Delete</u> "One full 8-hour day" and <u>Replace</u> with "<u>12-hours</u>"

### C. <u>RE: THE DRAWINGS:</u>

**Item 1:** Drawing E-006

In the upper Level Floor Plan Revise the callout "TELEMETRY PANEL AND PANEL MOUNTED RECEPTACLE" to the following,

"TELEMETRY PANEL AND PANEL MOUNTED RECEPTACLE INSTALLED ON 1" PLYWOOD TELECOM BACKBOARD, PAINTED BLACK"

Item 2: Drawing E-010

In note 2 of the Typical Ventilation Elementary, <u>Delete</u> "See spec section XXXXXX" <u>Replace</u> with "See specification section 15831"

**Item 3:** Drawing E-011

**<u>Delete</u>** Drawing E-011 **<u>Replace</u>** with Attachment 3 in Addendum No. 2.

**Item 4:** Drawing E-013

Add the following note to the Level Float Mounting Detail

"Note: Provide two (2) stainless steel mounting brackets, one at each side of the divided wet well. Coordinate location in field with Owner and Engineer."

ALL PROVISIONS OF THE CONTRACT NOT AFFECTED BY THE FOREGOING SHALL REMAIN IN FULL FORCE AND EFFECT.

COUNTY OF WESTCHESTER
DEPARTMENT OF PUBLIC WORKS

By: Hugh J. Greechan, Jr., P.E. Commissioner

Dated: March 20, 2024 White Plains, New York

## Bidders Questions and Response

### **BIDDER'S QUESTIONS AND RESPONSES**

### CONTRACT NO. 22-510 JACKSON AVENUE PUMPING STATION REHABILITATION BRONX VALLEY SANITARY SEWER DISTRICT TOWN OF GREENBURGH, NEW YORK

### To All Contractors:

Contractors submitting proposals for the above-named project shall take note of the following changes, additions, deletions, clarifications, etc., in the Contract Documents, which shall become a part of and have precedence over anything contrarily shown or described in the Contract Documents, and all such shall be taken into consideration and be included in the Contractor's bid proposal.

Below are the *Questions* that have been submitted with **Responses**:

<u>Question 1:</u> Please provide geotechnical information regarding the presence of rock, water and/or hazardous/contaminated materials. If there is no information available, how will the contractor be compensated for handling these unknown conditions, if encountered?

**Response:** Geotechnical information is not available. The contract documents include provisions for unforeseen conditions.

**Question 2:** Section 1.03.G of specification 01540-Temporary Bypass Pumping indicates the following elevations:

- Forcemain Discharge Manhole Elevation 241.5
- Ground elevation at pump station 384

The contract drawings show approximate ground elevation at the pump station of  $156\pm$ . Please confirm if the elevation listed in the specification is an error.

**Response:** This Specification has been modified in Addendum No. 2.

*Question 3:* Please provide as-built drawings of the existing superstructure.

**Response:** Available "Record Plans" can be found in Attachment 1 in Addendum No. 2.

**Question 4**: Please provide the size and depth of the bypass pumping manhole shown on drawing G-008.

**Response:** Additional information about the manhole is available in the "Record Plans" drawings in Attachment 1 in Addendum No. 2.

<u>Question 5:</u> Specification 41220-Hoists and Cranes, section 3.04 refers to specification 01640 for manufacturer's representative's services, then indicates other services required by the representative. Specification 01640 does not list any manufacturer's service requirements for the hoists and cranes. Please confirm the contract requirements.

**Response:** This Specification has been modified in Addendum No. 2.

<u>Question 6:</u> The manufacturer's representative's services in specification 11291-Sluice Gates, section 3.03.B, do not match the services shown on the schedule in specification 01640 page 13. Please confirm the requirements.

**Response:** Refer to response to question 5.

<u>Question 7:</u> Specification 33213-Water Supply Well, sections 3.02 and 3.03 refer to specification 01640 for manufacturer's representative's services, then indicates other services required by the representative. Specification 01640 does not list any manufacturer's service requirements for the well pump system. Please confirm the contract requirements.

**Response:** Refer to response to question 5.

<u>Question 8:</u> Please provide additional information related to the Bypass Manhole shown on drawing G-008. Does this manhole include both a connection for the bypass discharge hookup and a valve on the existing forcemain to prevent the backflow of sewage into the pump station?

**Response:** Additional information is available in the "Record Plans" drawings in Attachment 1.

<u>Question 9:</u> There is a leader note on drawing G-007 "Provide extended valve operators to 6" below cover onto existing valves inside manhole." Additional details are needed in order to determine the exact scope of work required.

**Response:** Additional information is available in the "Record Plans" drawings in Attachment 1.

<u>Question 10:</u> Please advise if reinforcement is required for the concrete encased ductbanks shown on drawing E-003, and provide details if required.

**Response:** reinforcement is not required for concrete encased ductbanks shown on E-003.

**Question 11:** Could you please provide us borings for the project? How deep is the water table at this "location"? Is there any rock?

**Response:** Refer to response to Question 1. Groundwater fluctuates throughout the season and can be as high as 1 foot below grade.

<u>Question 12:</u> General Note #31 on drawing H-001 reads: "All ductwork open to the drywell shall be stainless steel 316. All ductwork open to the wetwell shall be fiberglass." There is no ductwork in the wetwell, but there is ductwork in the levels above the wetwell as shown on drawing H-005. Please provide clarification on the drawings as to which ductwork, if any, is scheduled to be fiberglass.

**Response:** Duct work located on the wet well side of the building will be open to the wet well.

<u>Question 13:</u> Find this RFI requesting clarification on door hardware schedule. They do not match between the drawings & specifications. Please advise what to use.

**Response:** The hardware schedule on the drawings is to be used. This Specification has been modified in Addendum No. 2.

<u>Question 14:</u> Division 15, Section 15060, Paragraph 2.13 states that piping shall be insulated in accordance with section 15260, Piping Insulation. However, Section 15260 does not exist in project specifications. Please clarify.

**Response:** This Specification has been modified in Addendum No. 2.


<u>Question 15:</u> Upon review, it was noted the specs contained the following language regarding the OCP: d) Owners Protective Liability Policy naming the County as insured, with a minimum limit of liability per occurrence of \$3,000,000 (where applicable, or as determined by the Director, Risk Management) Please confirm that an OCP policy is required for this project?


**Response:** Refer to the contract documents for insurance requirements.


<u>Question 16:</u> Regarding the MSA MultiGard 5000 Gas Detection System specified in 17650, please confirm that the contract requires this system, which is capable of monitoring up to 32 sample ports, even though there is only one sample port required in the contract.


**Response:** Bid as specified.




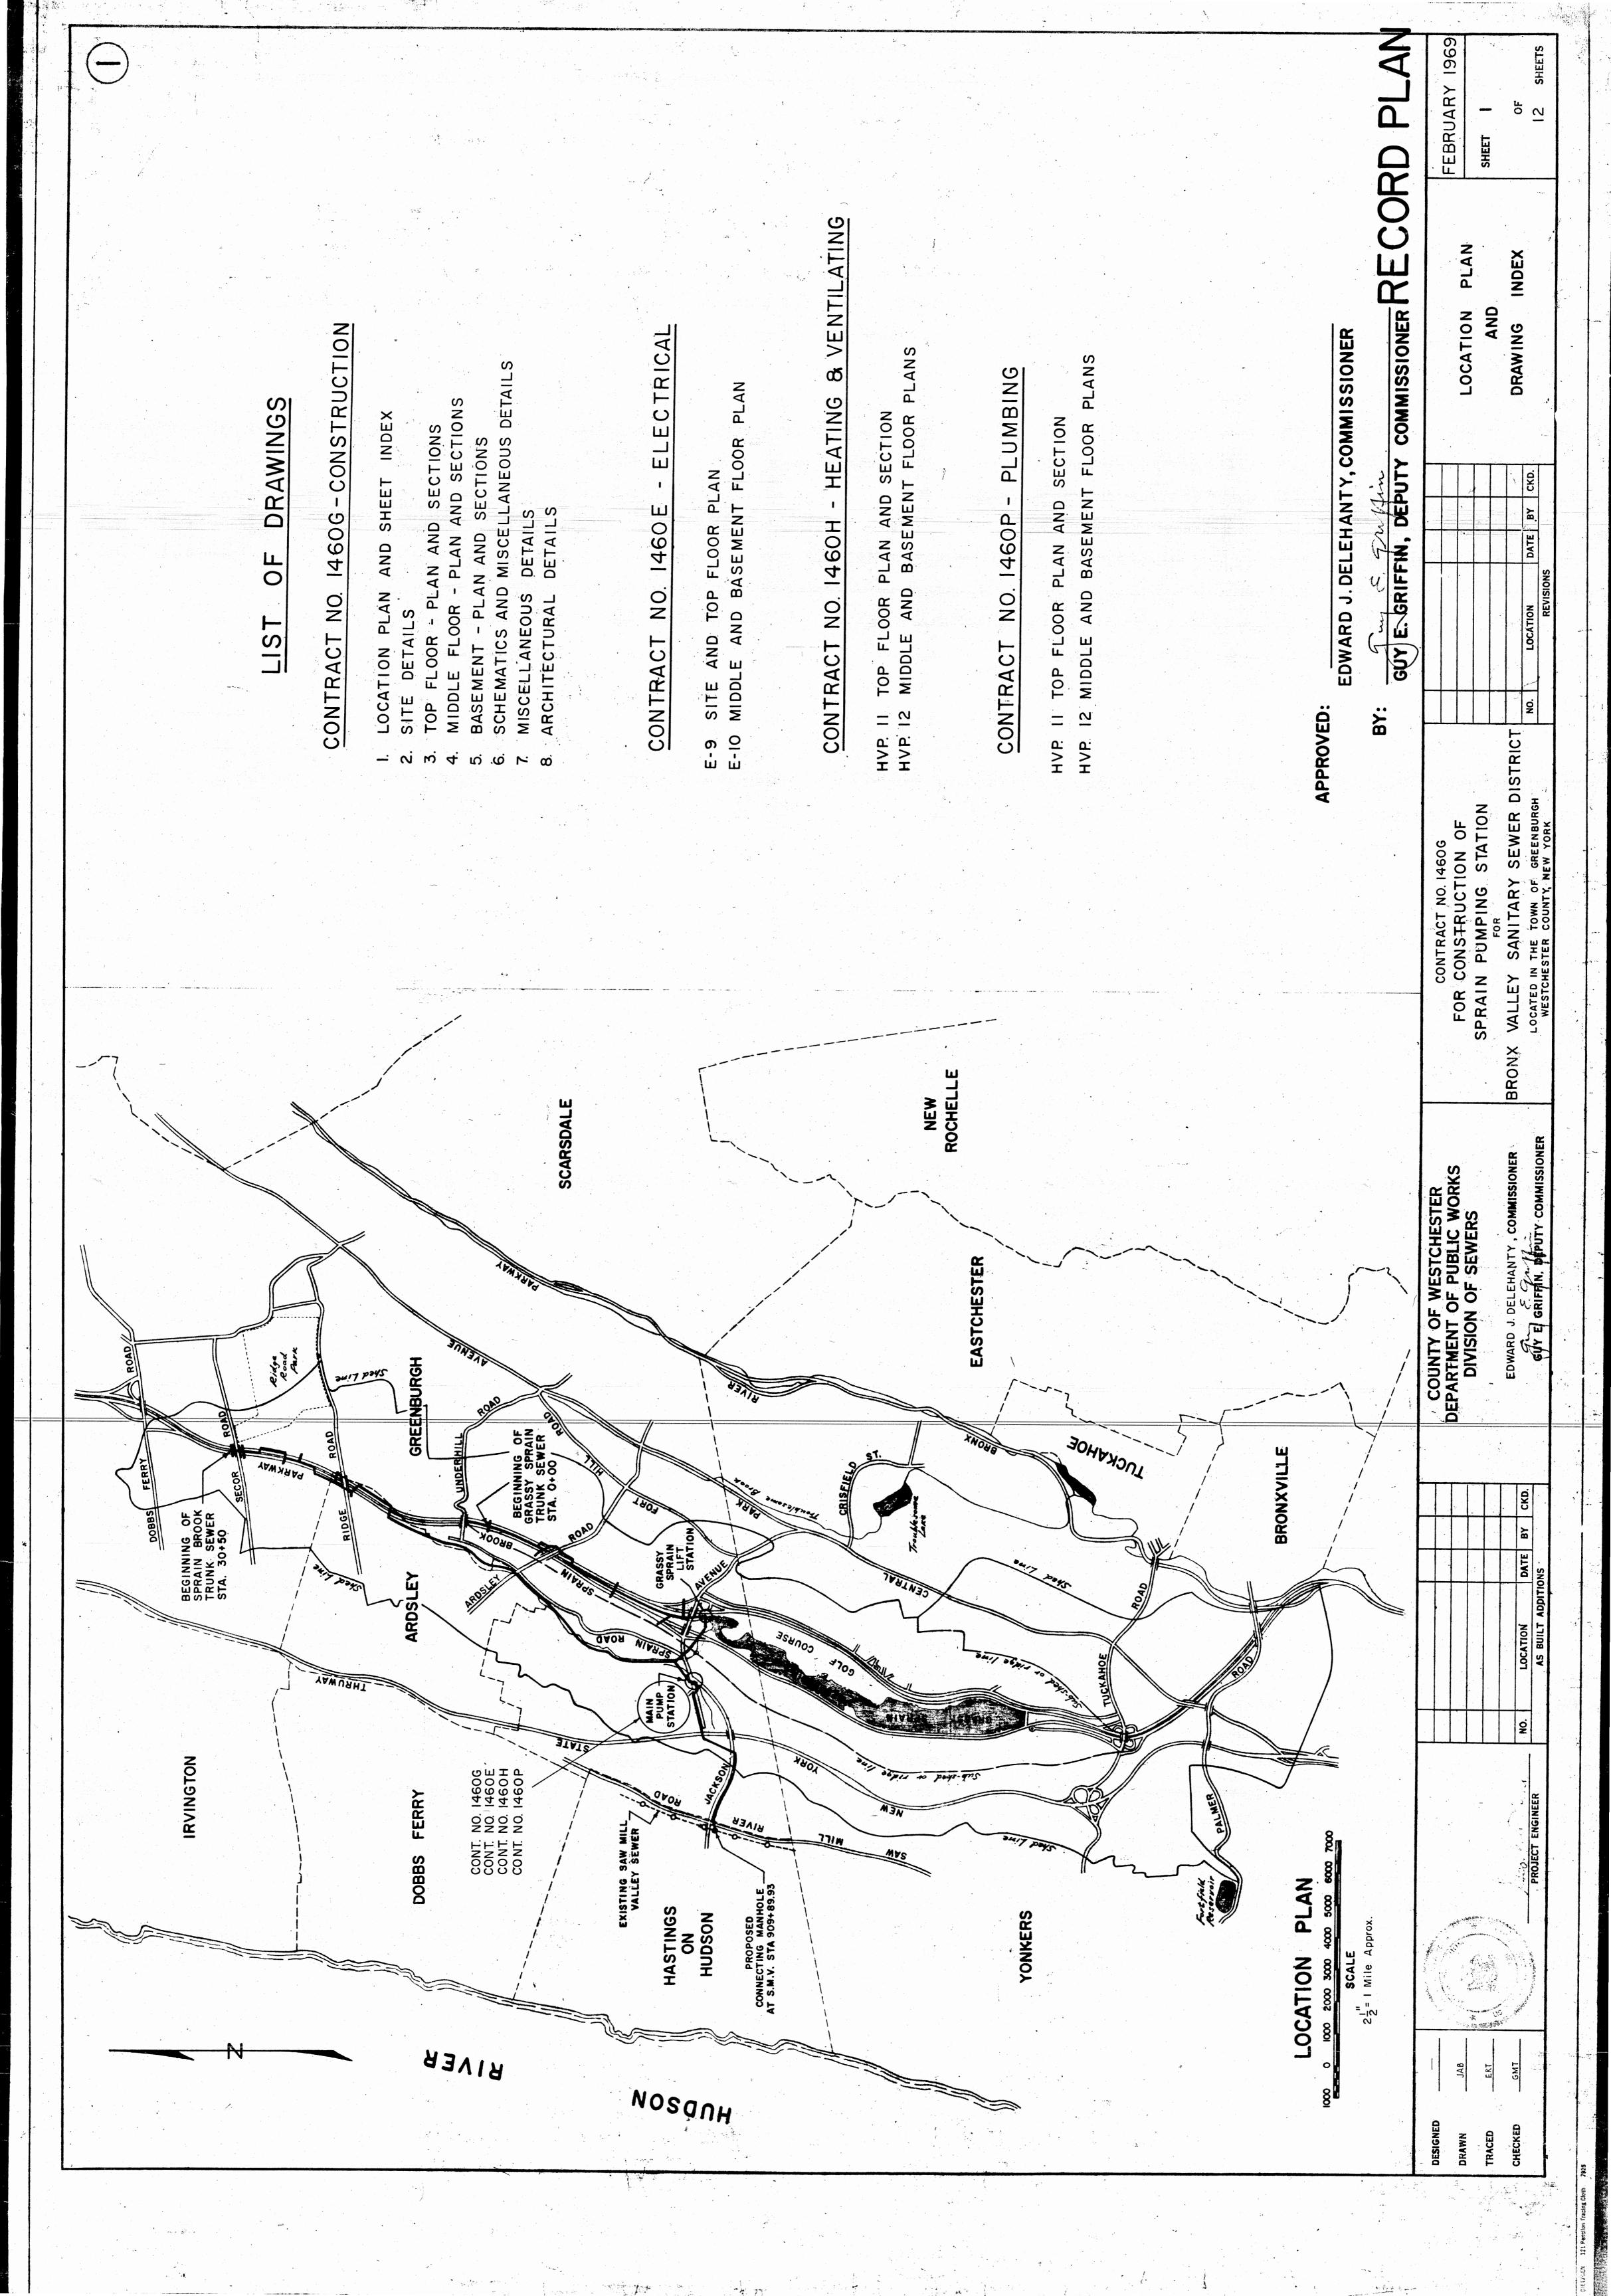


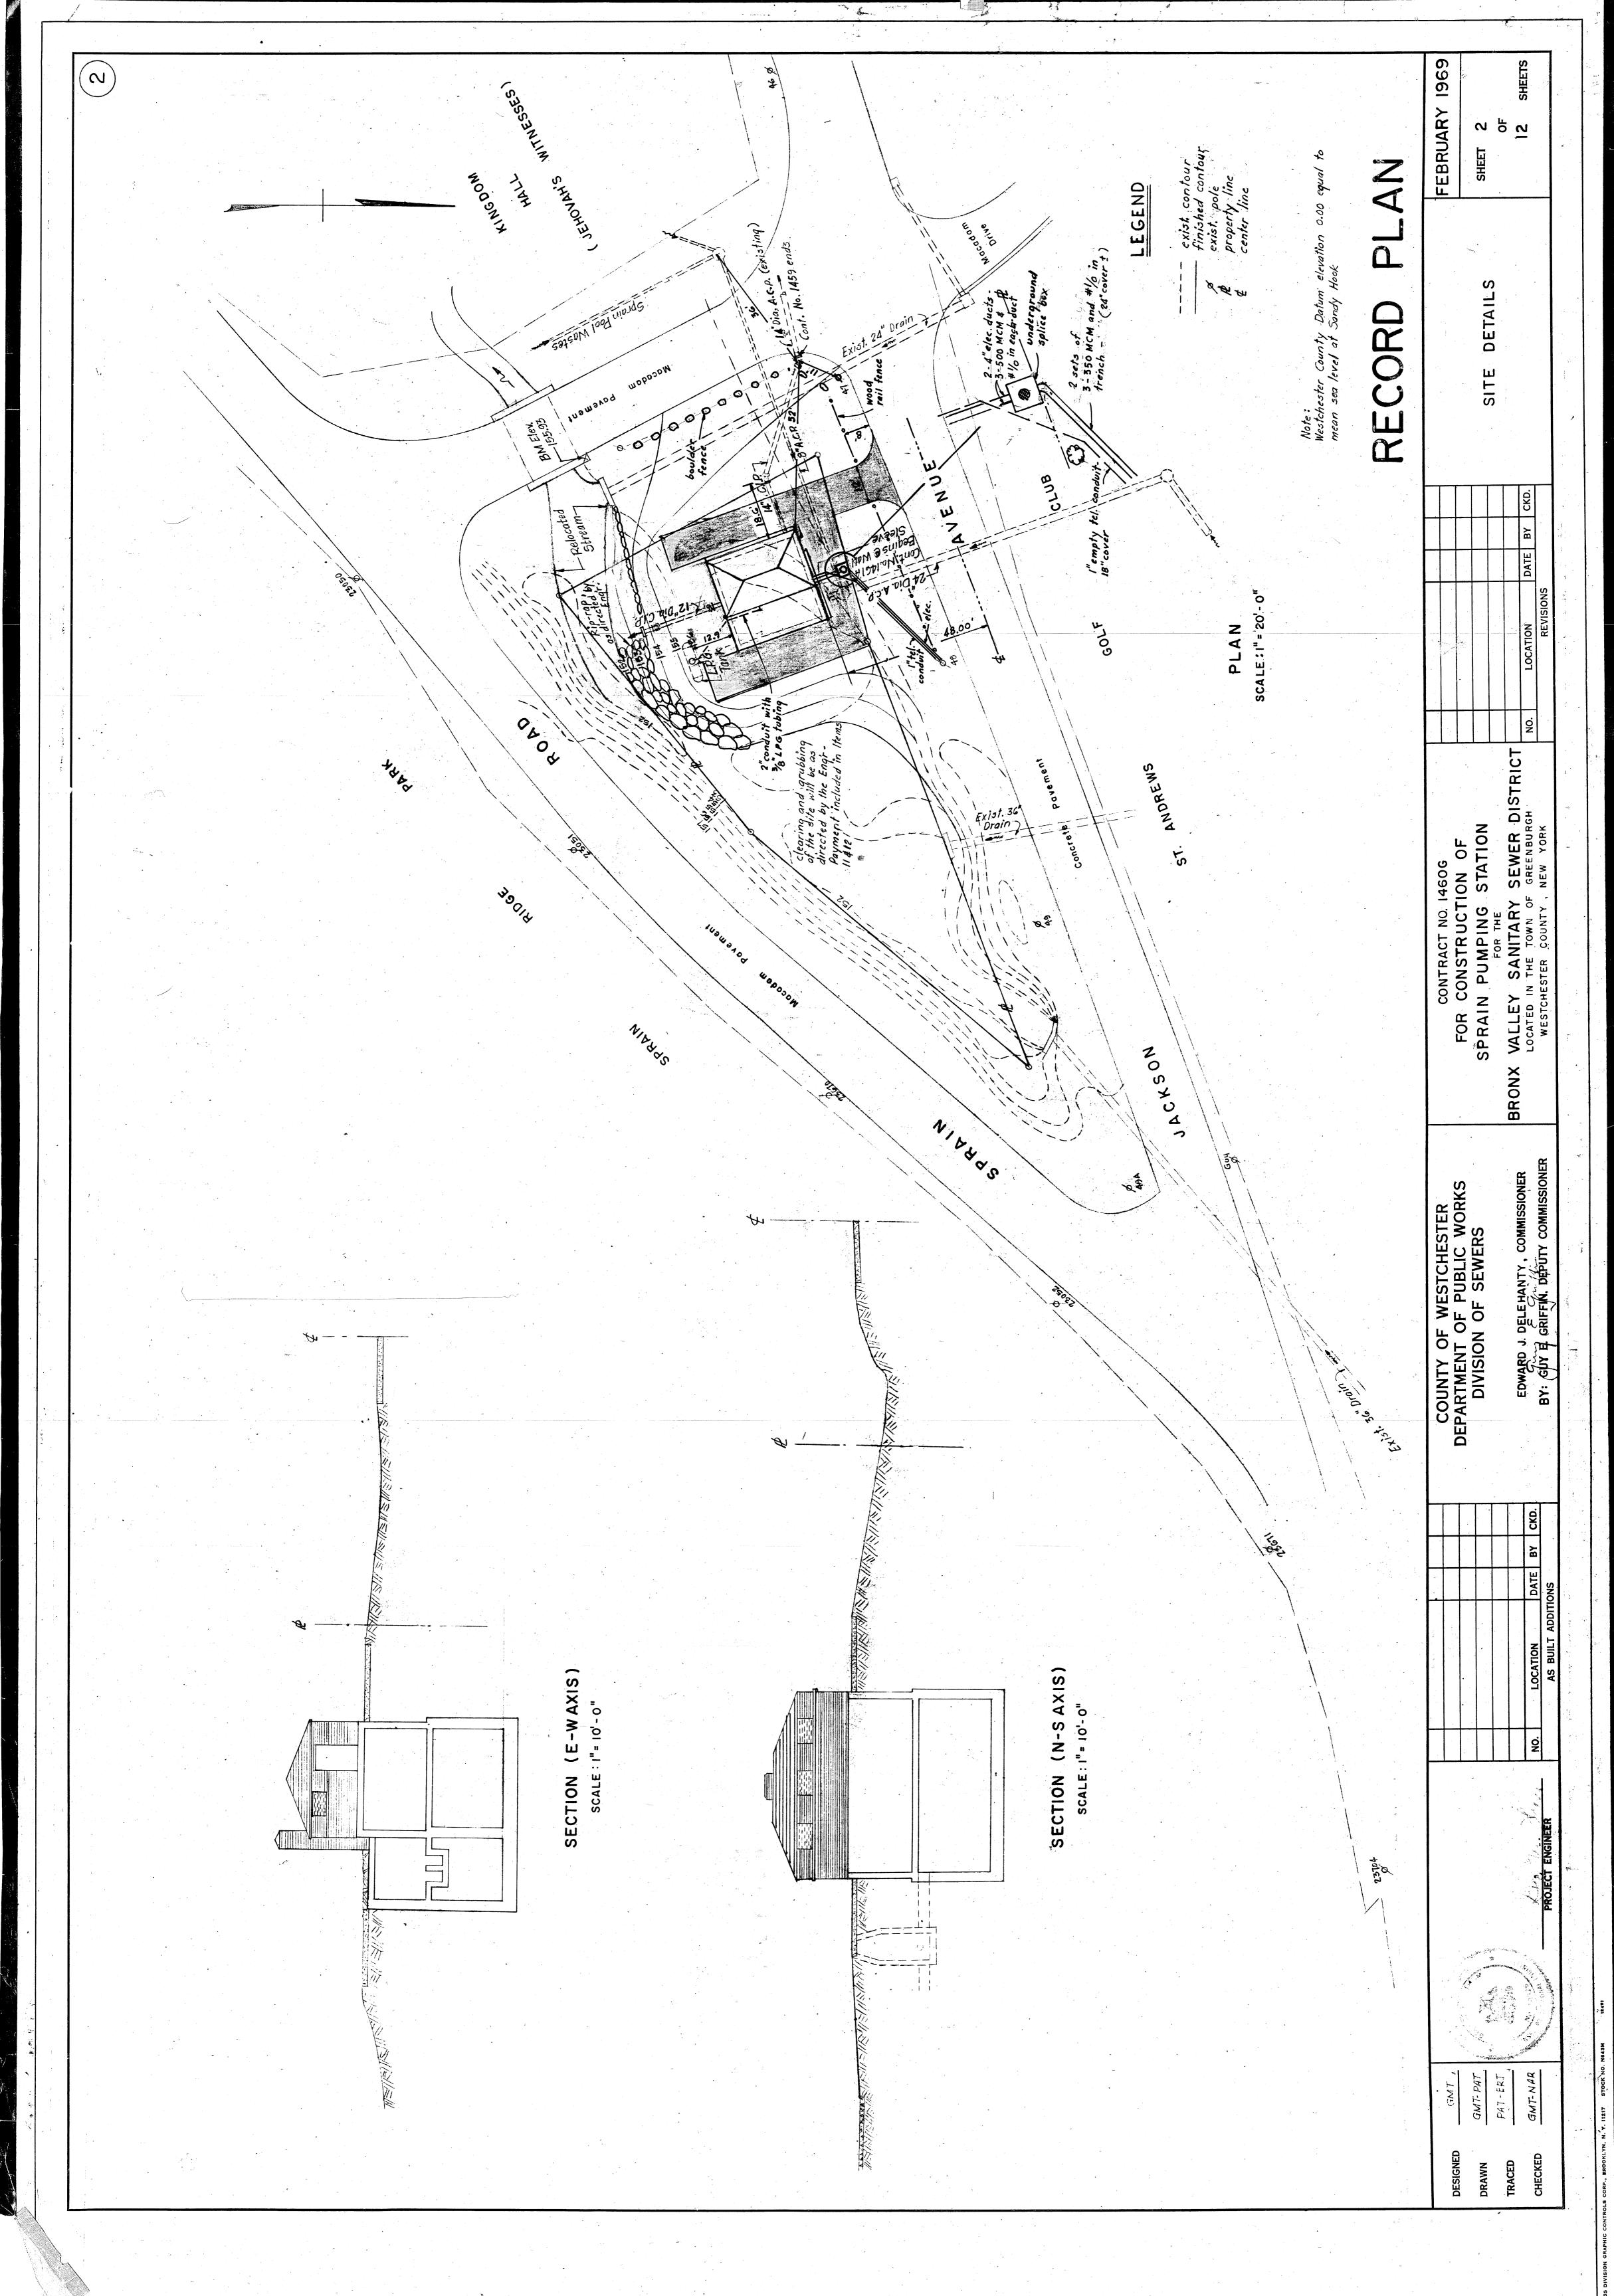


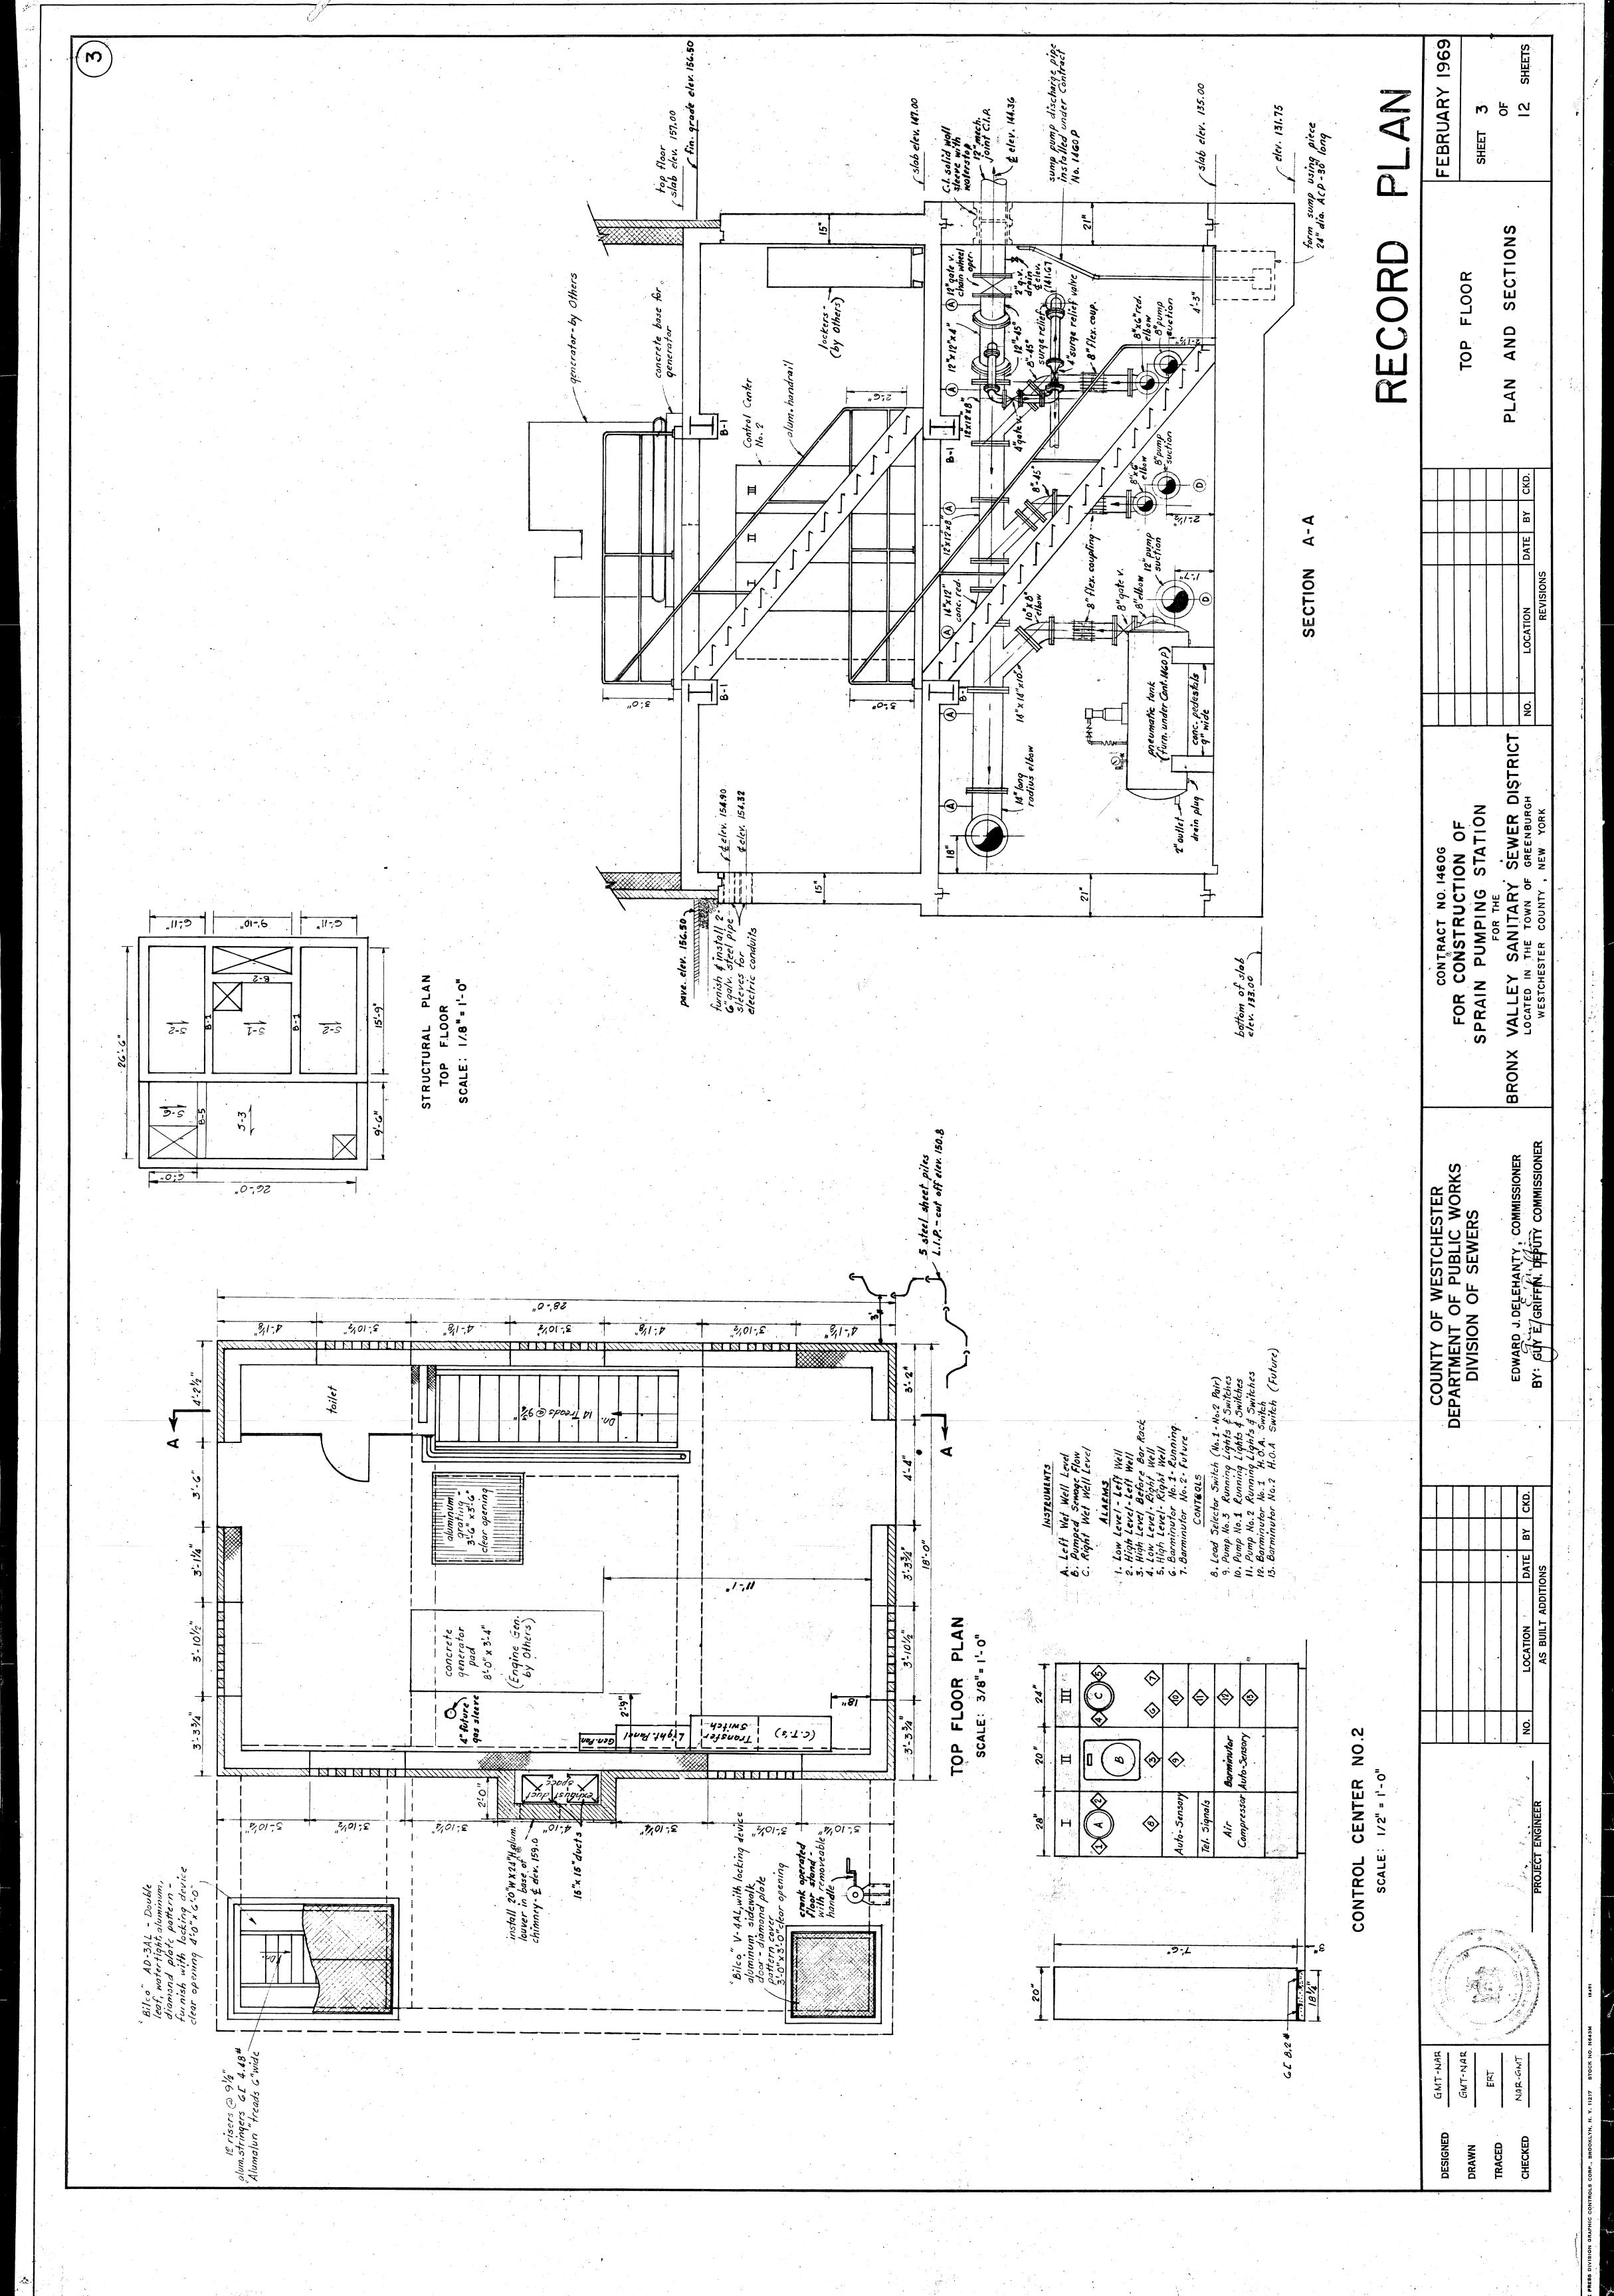


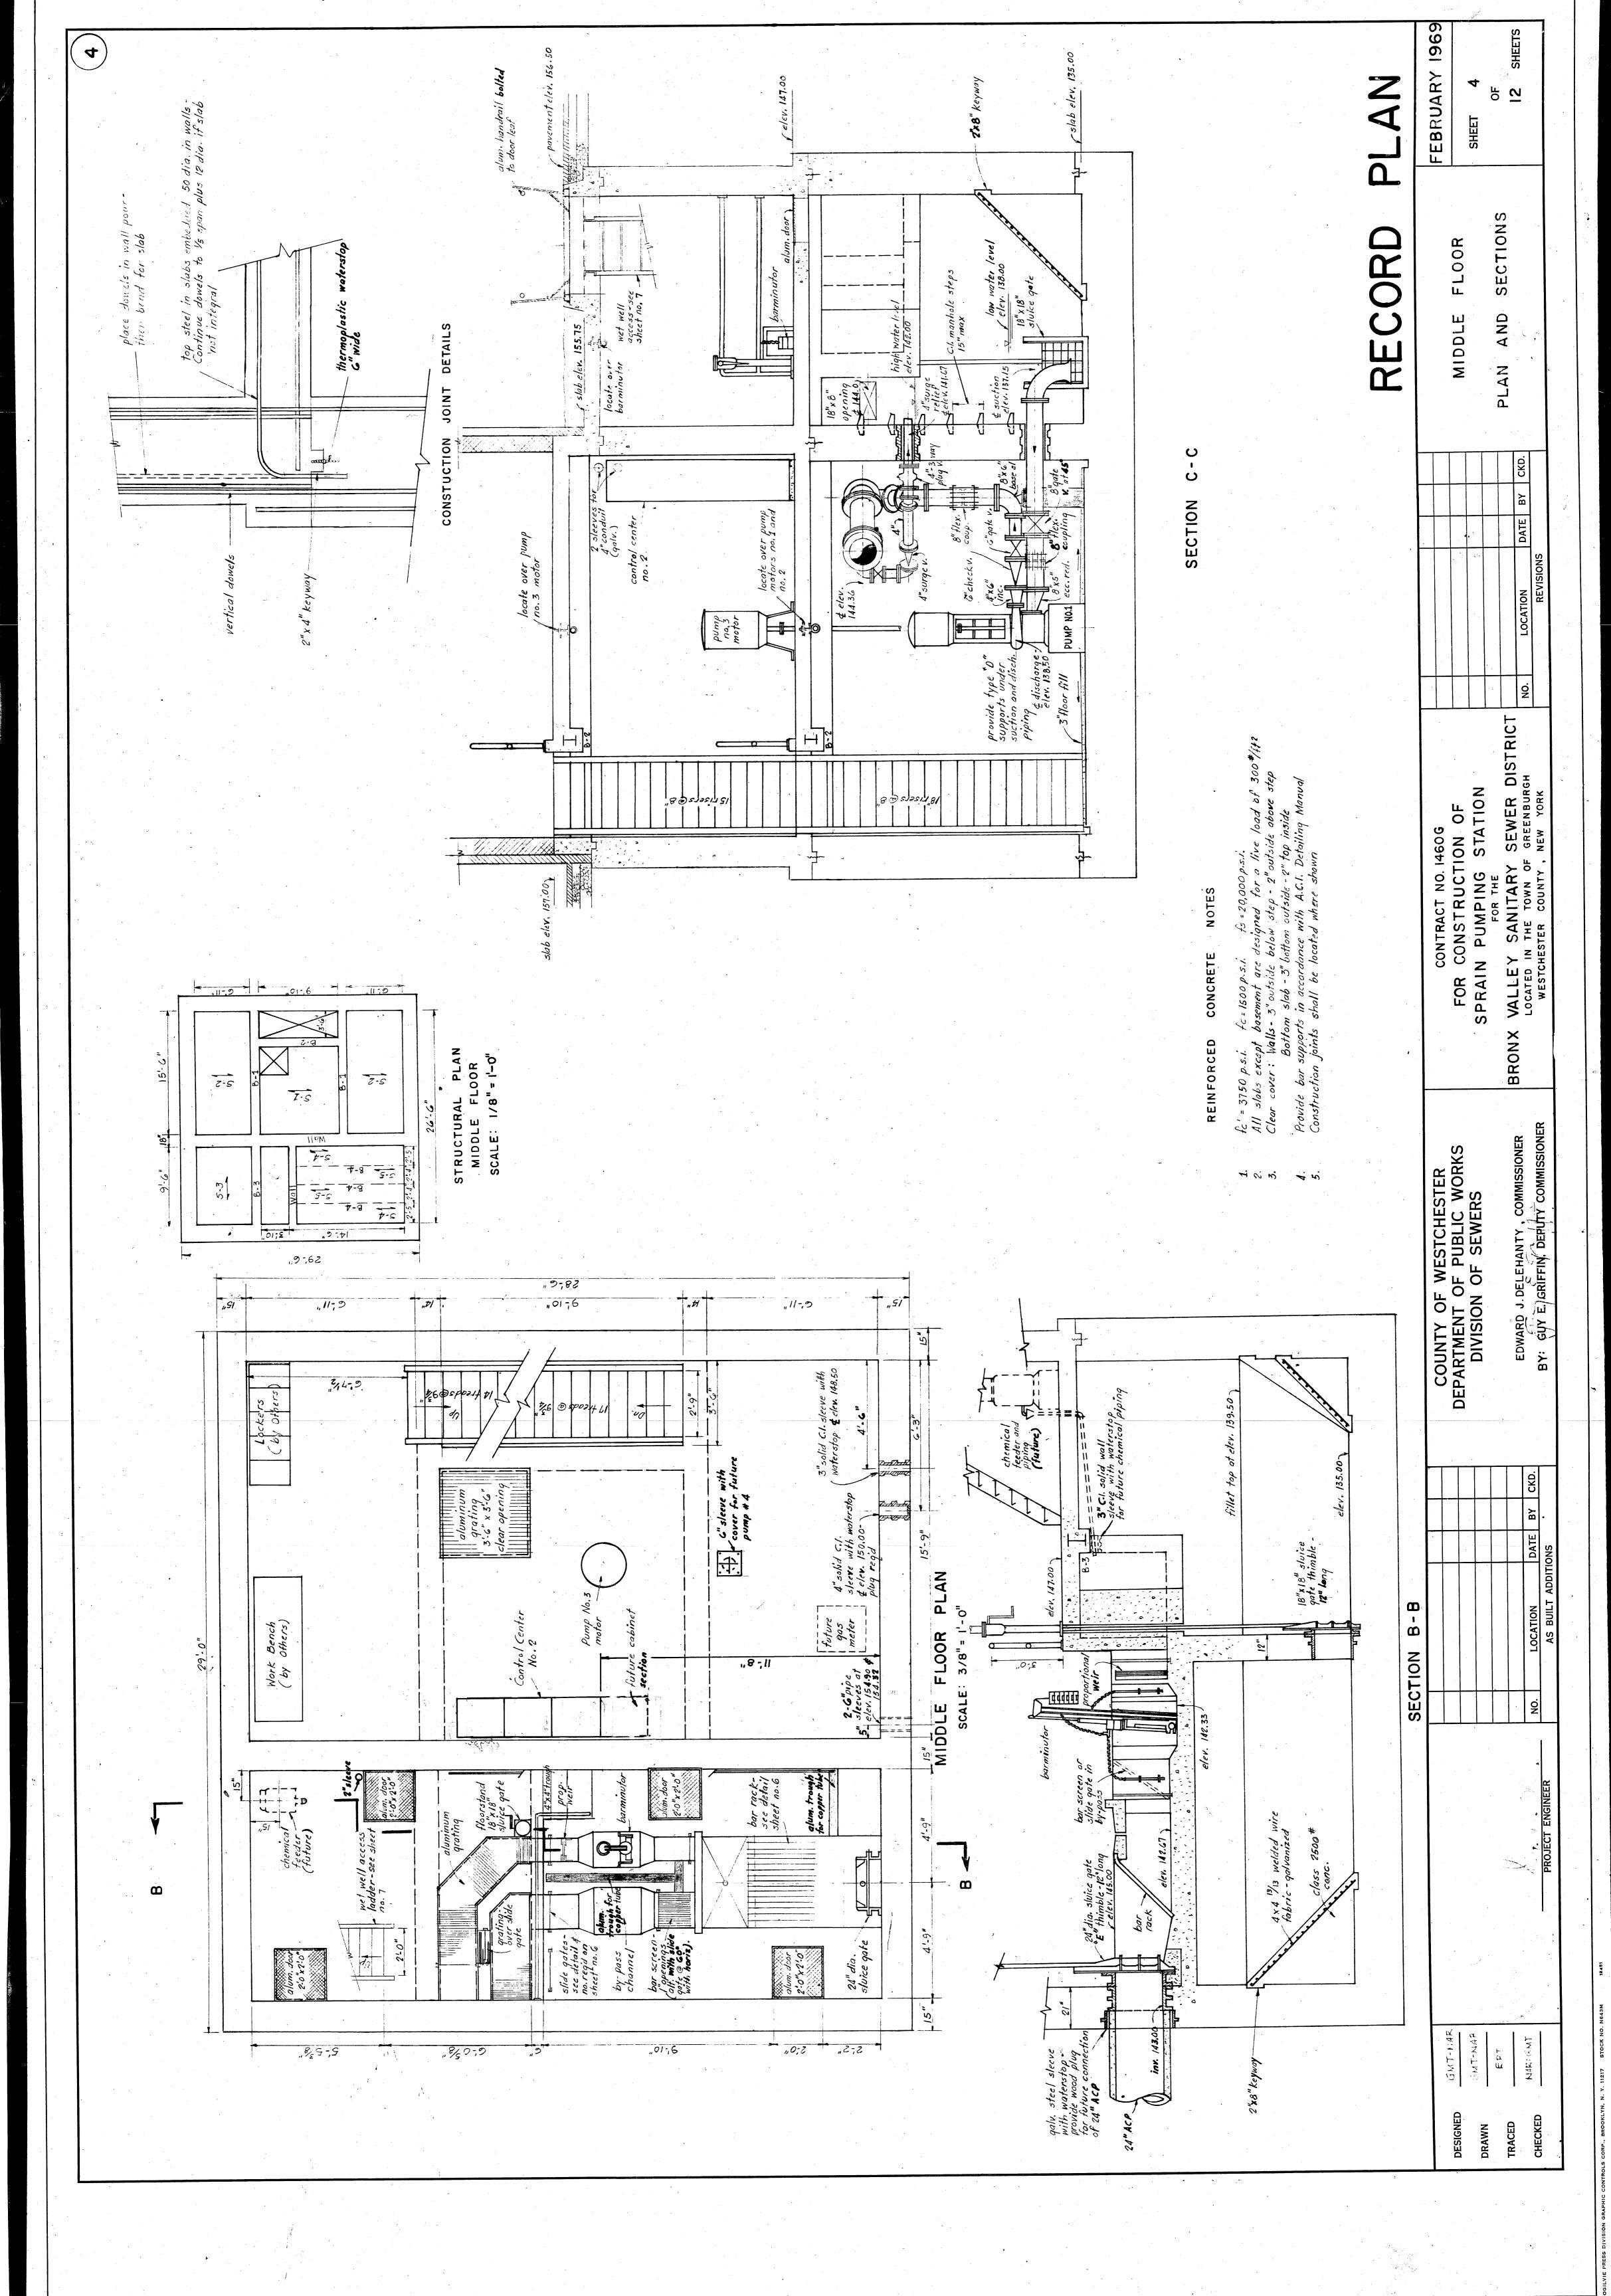


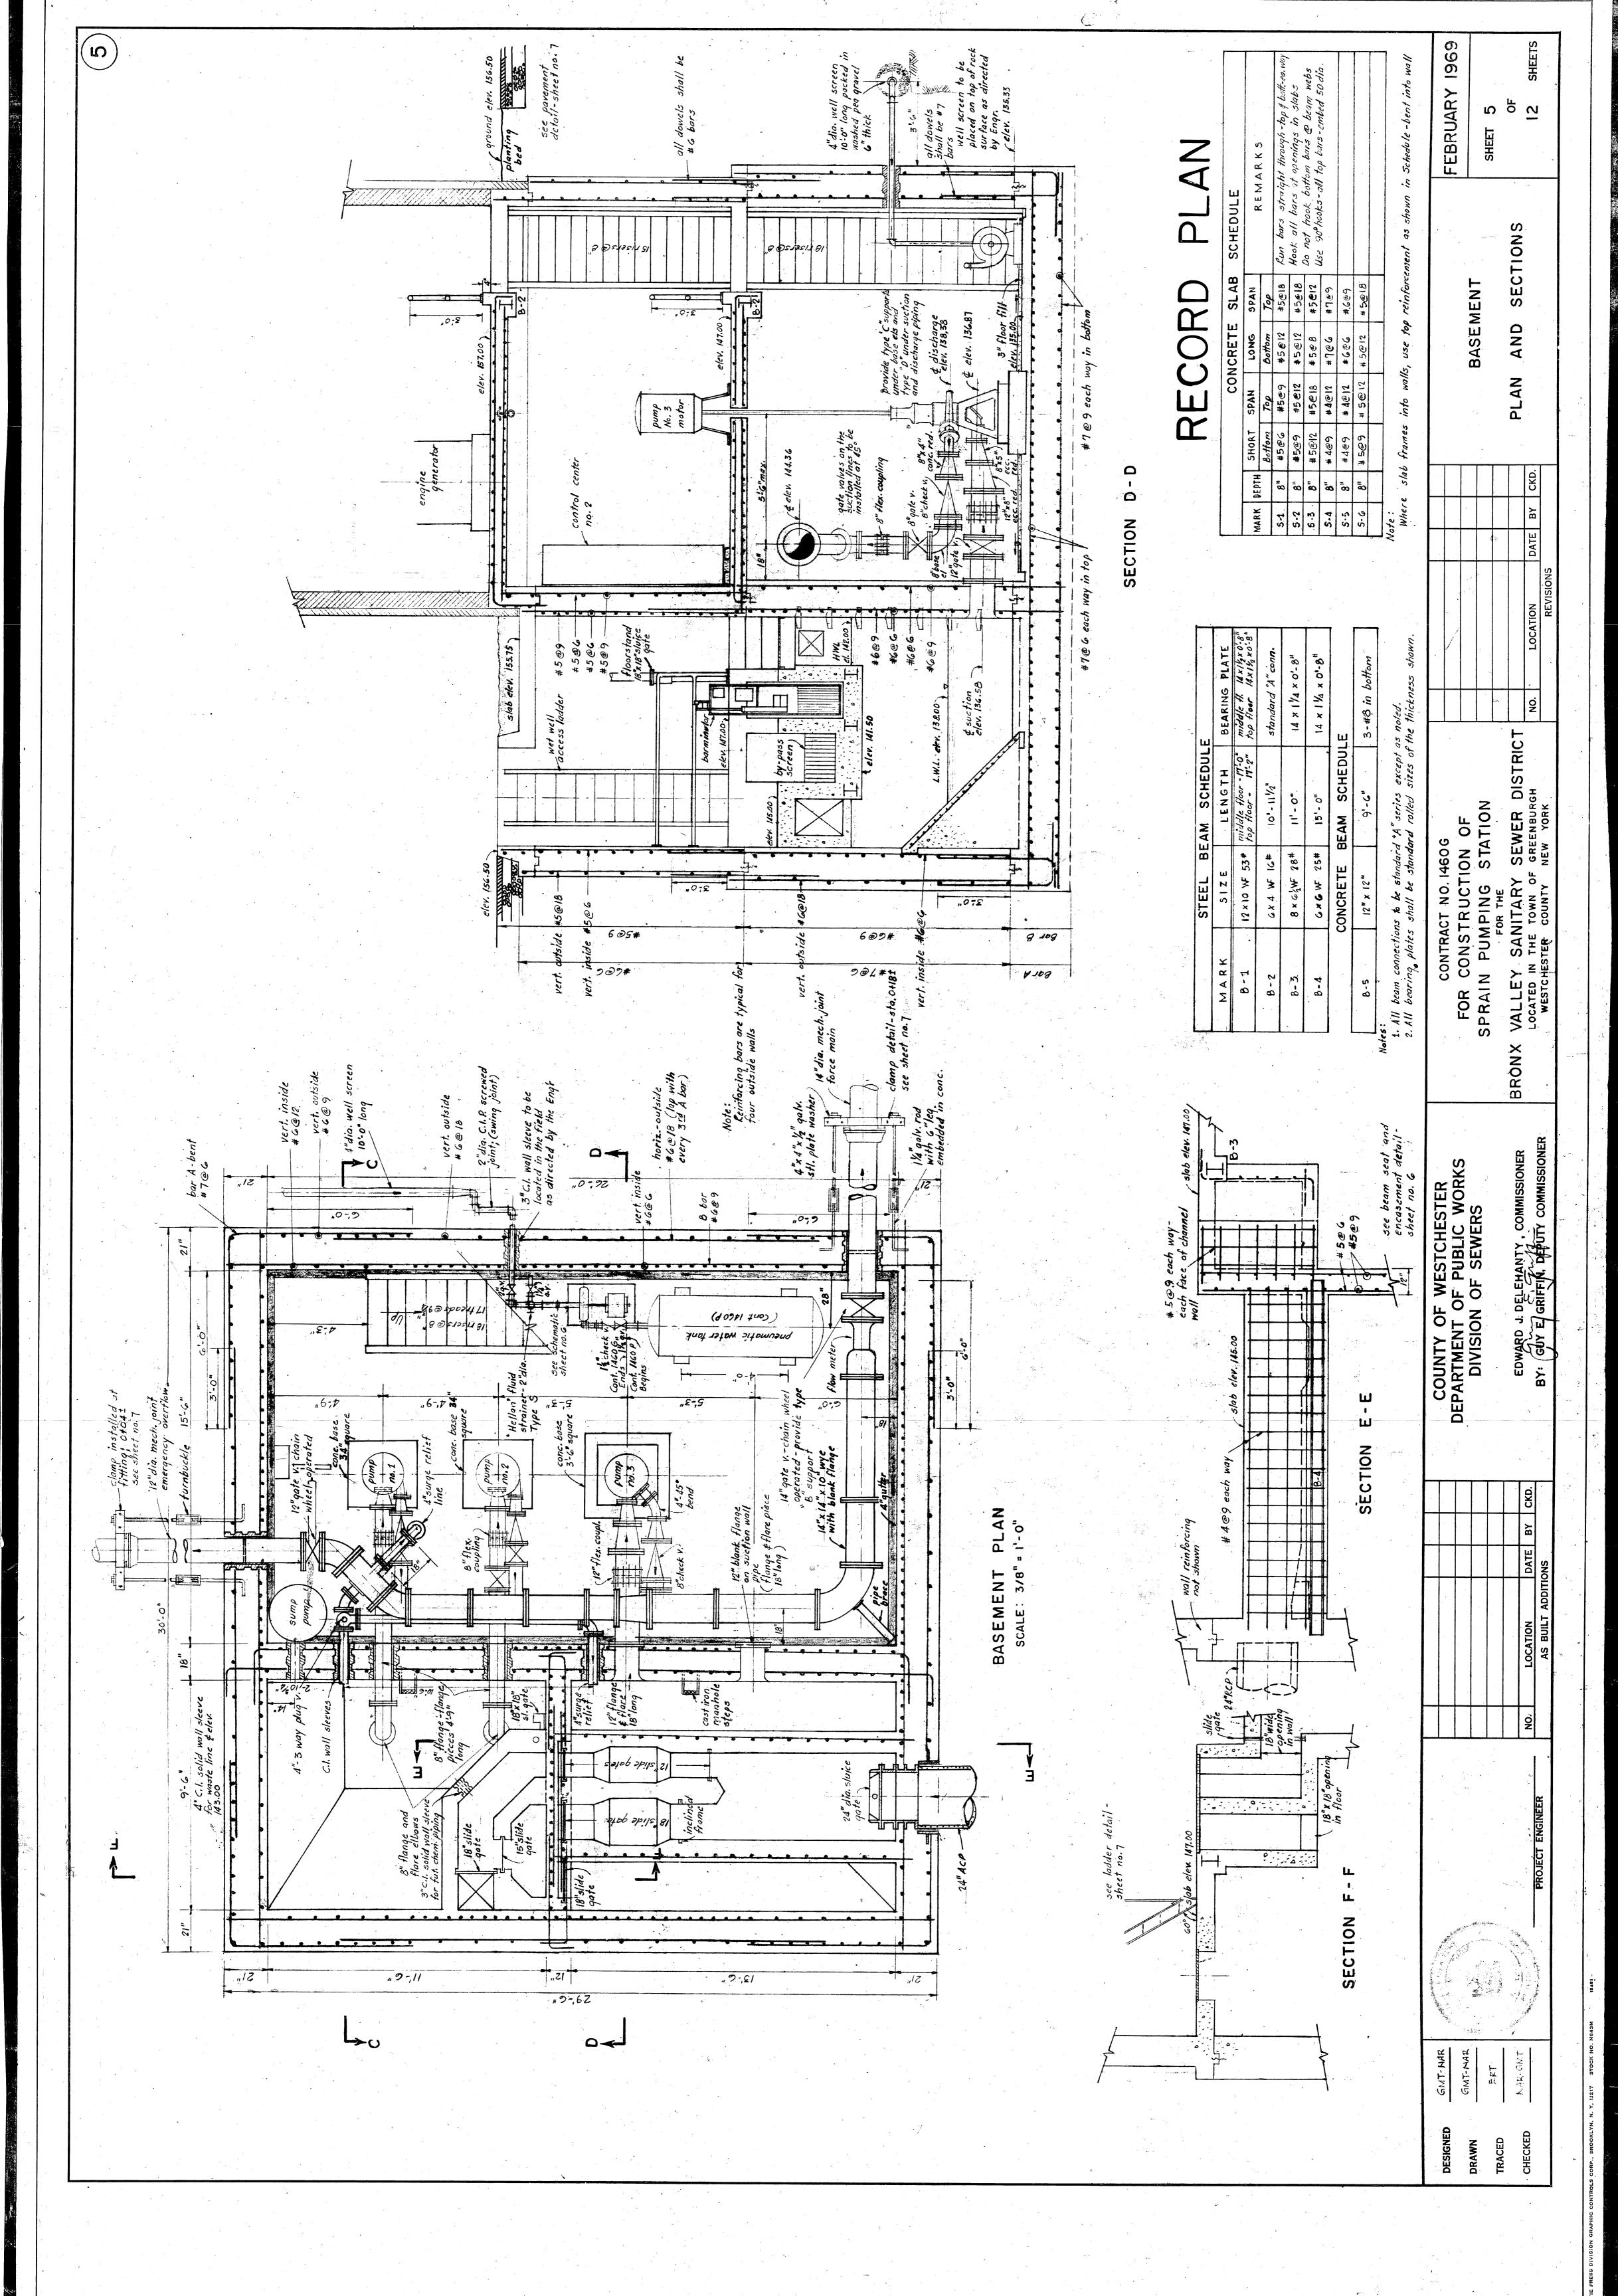


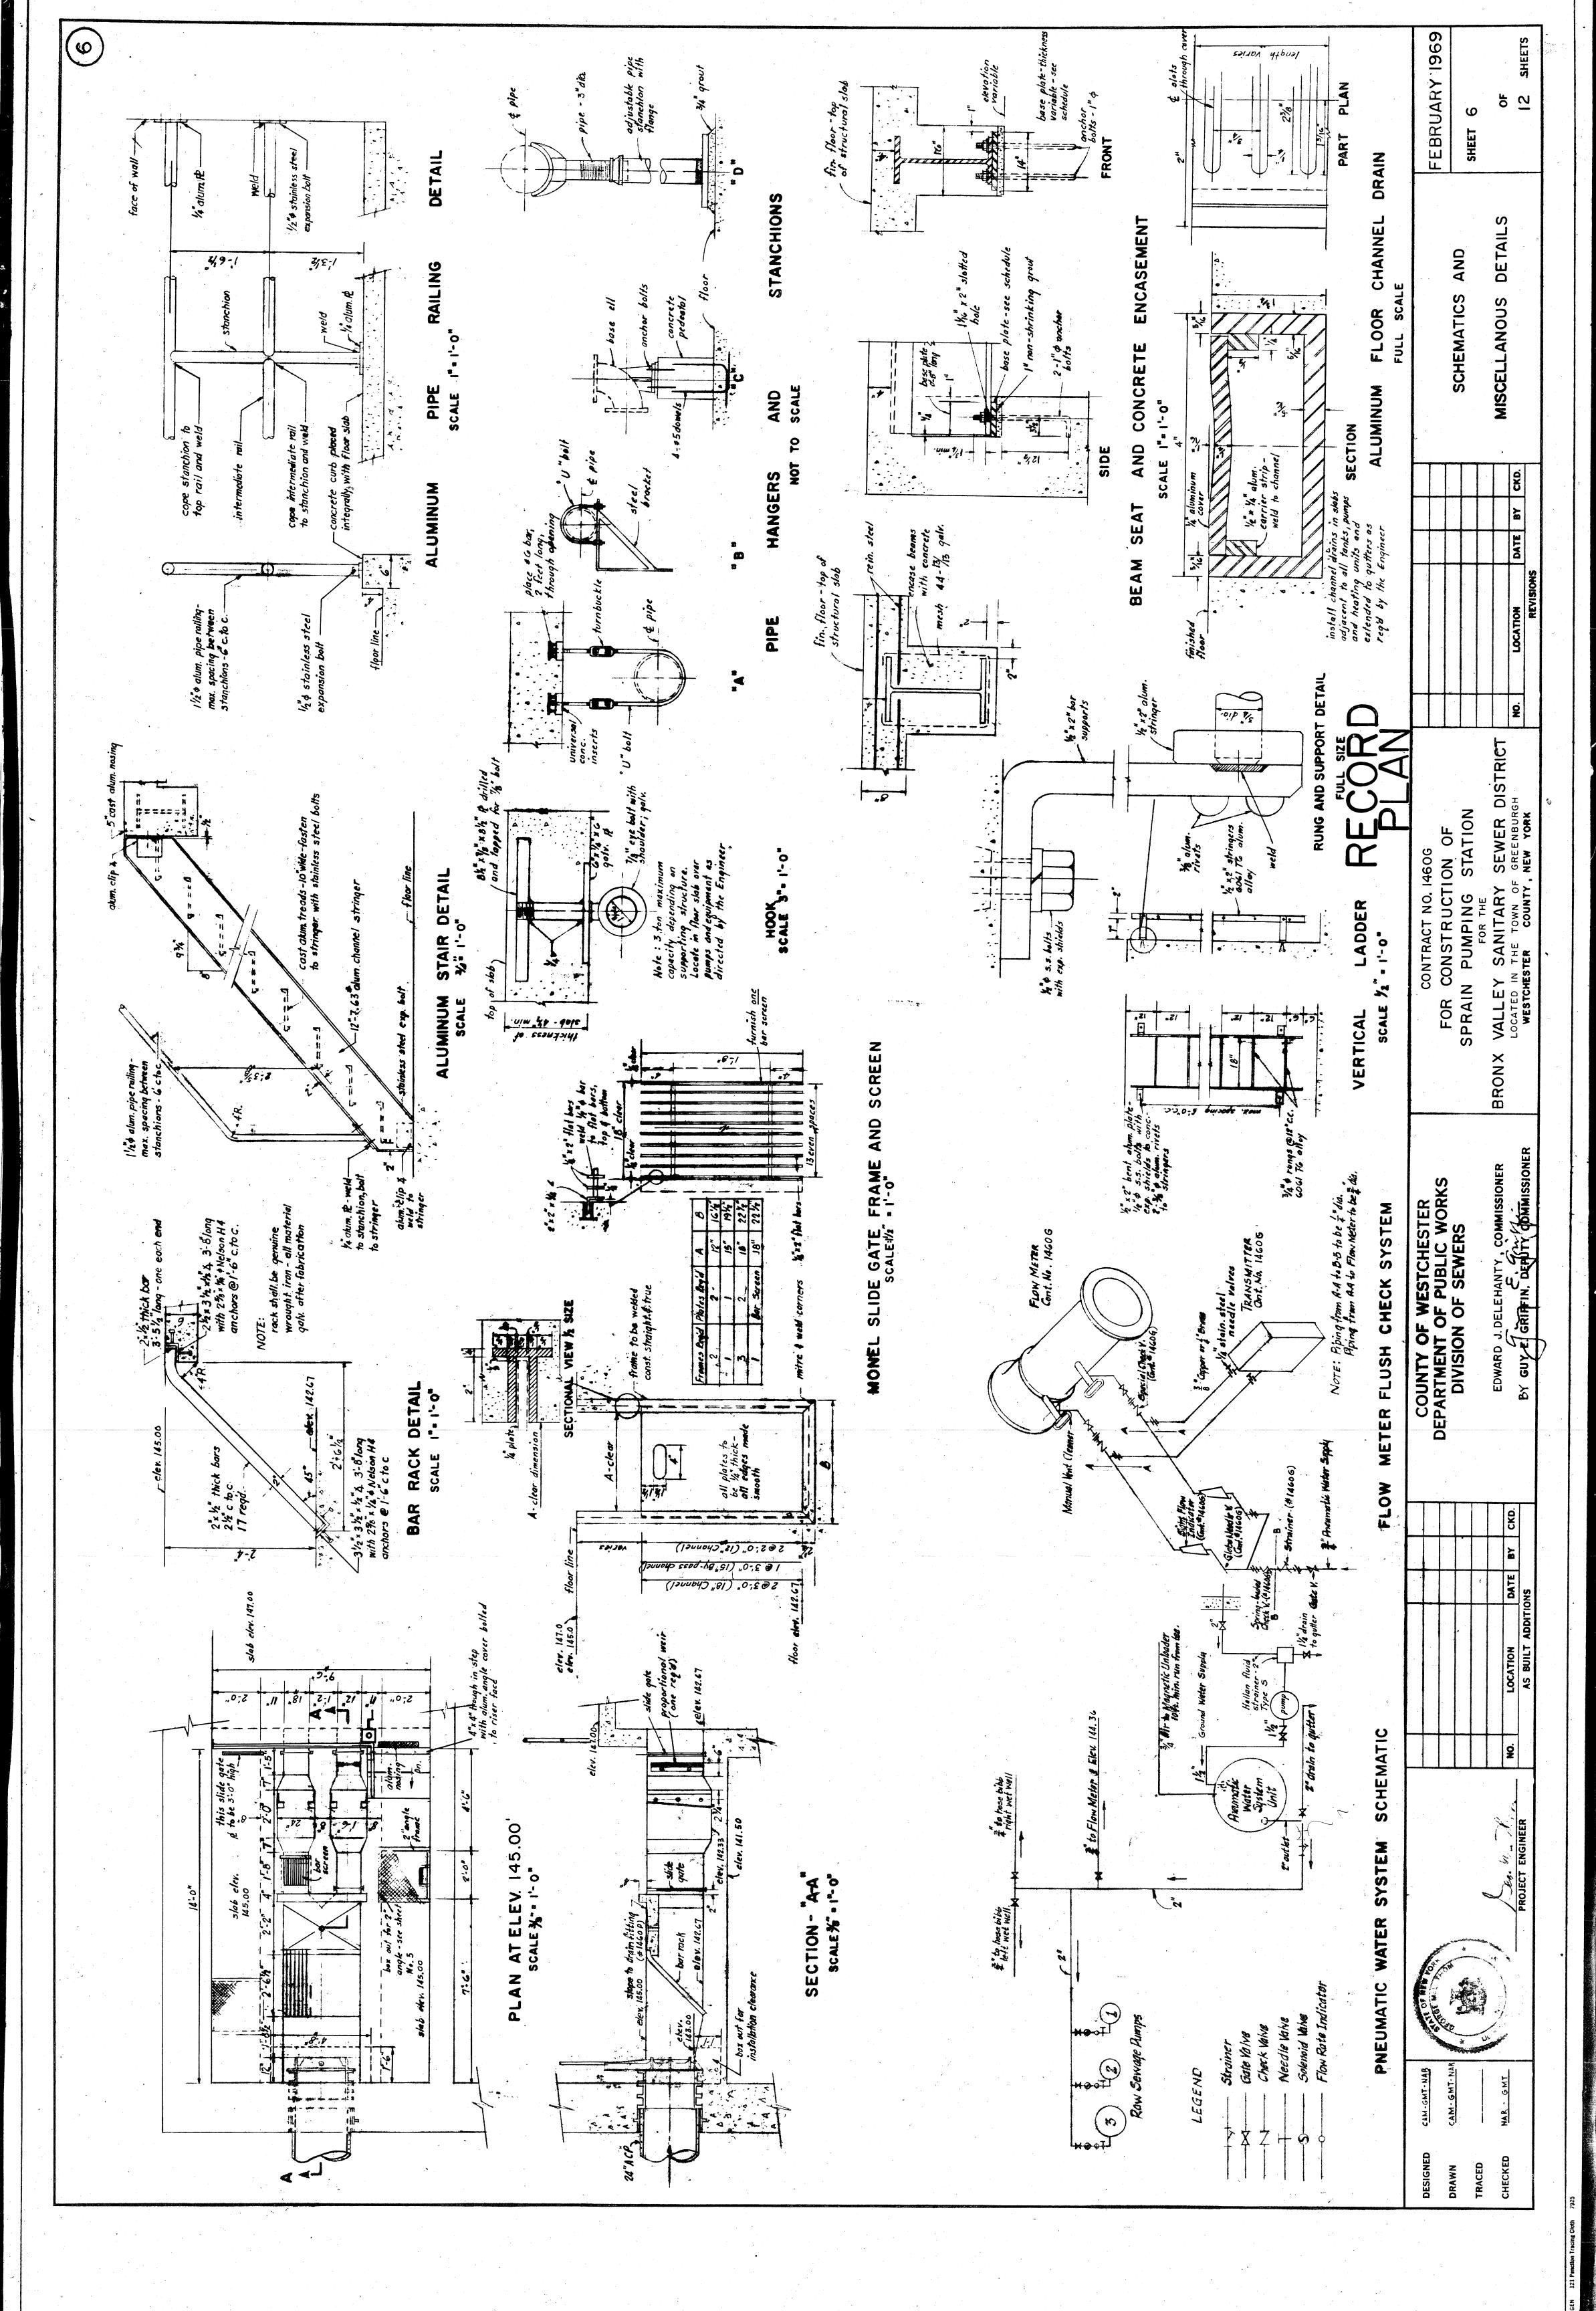


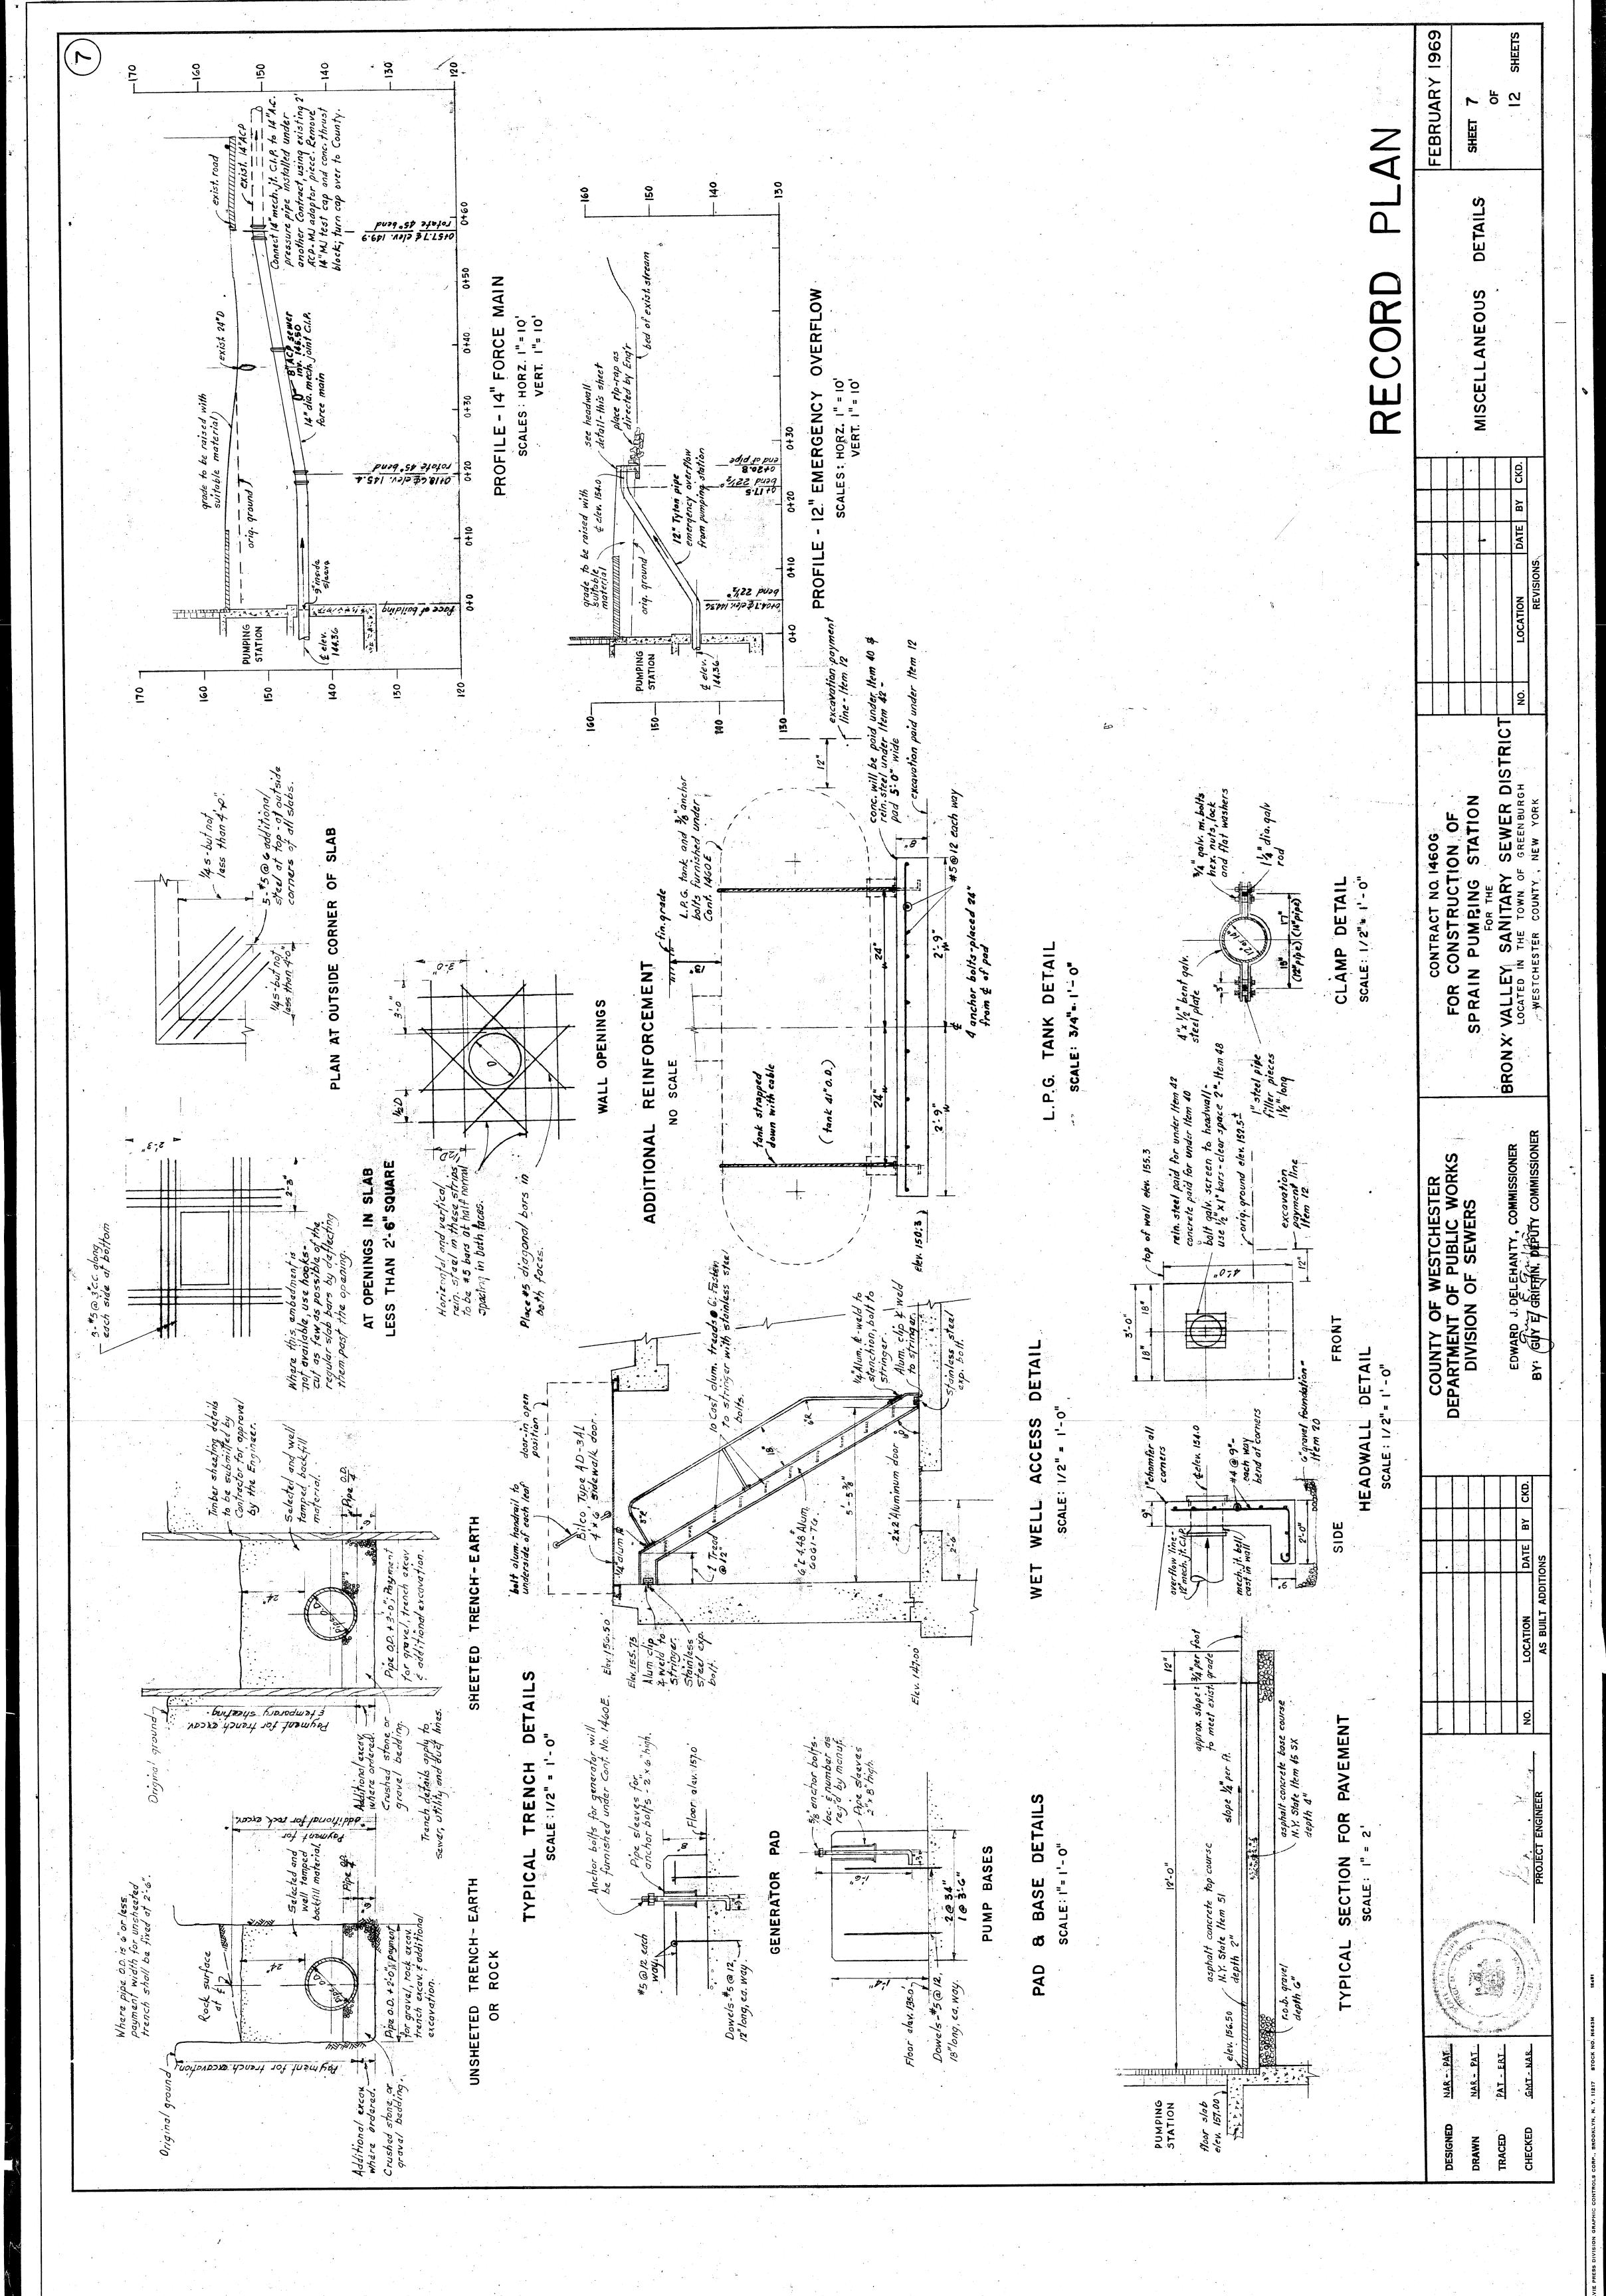


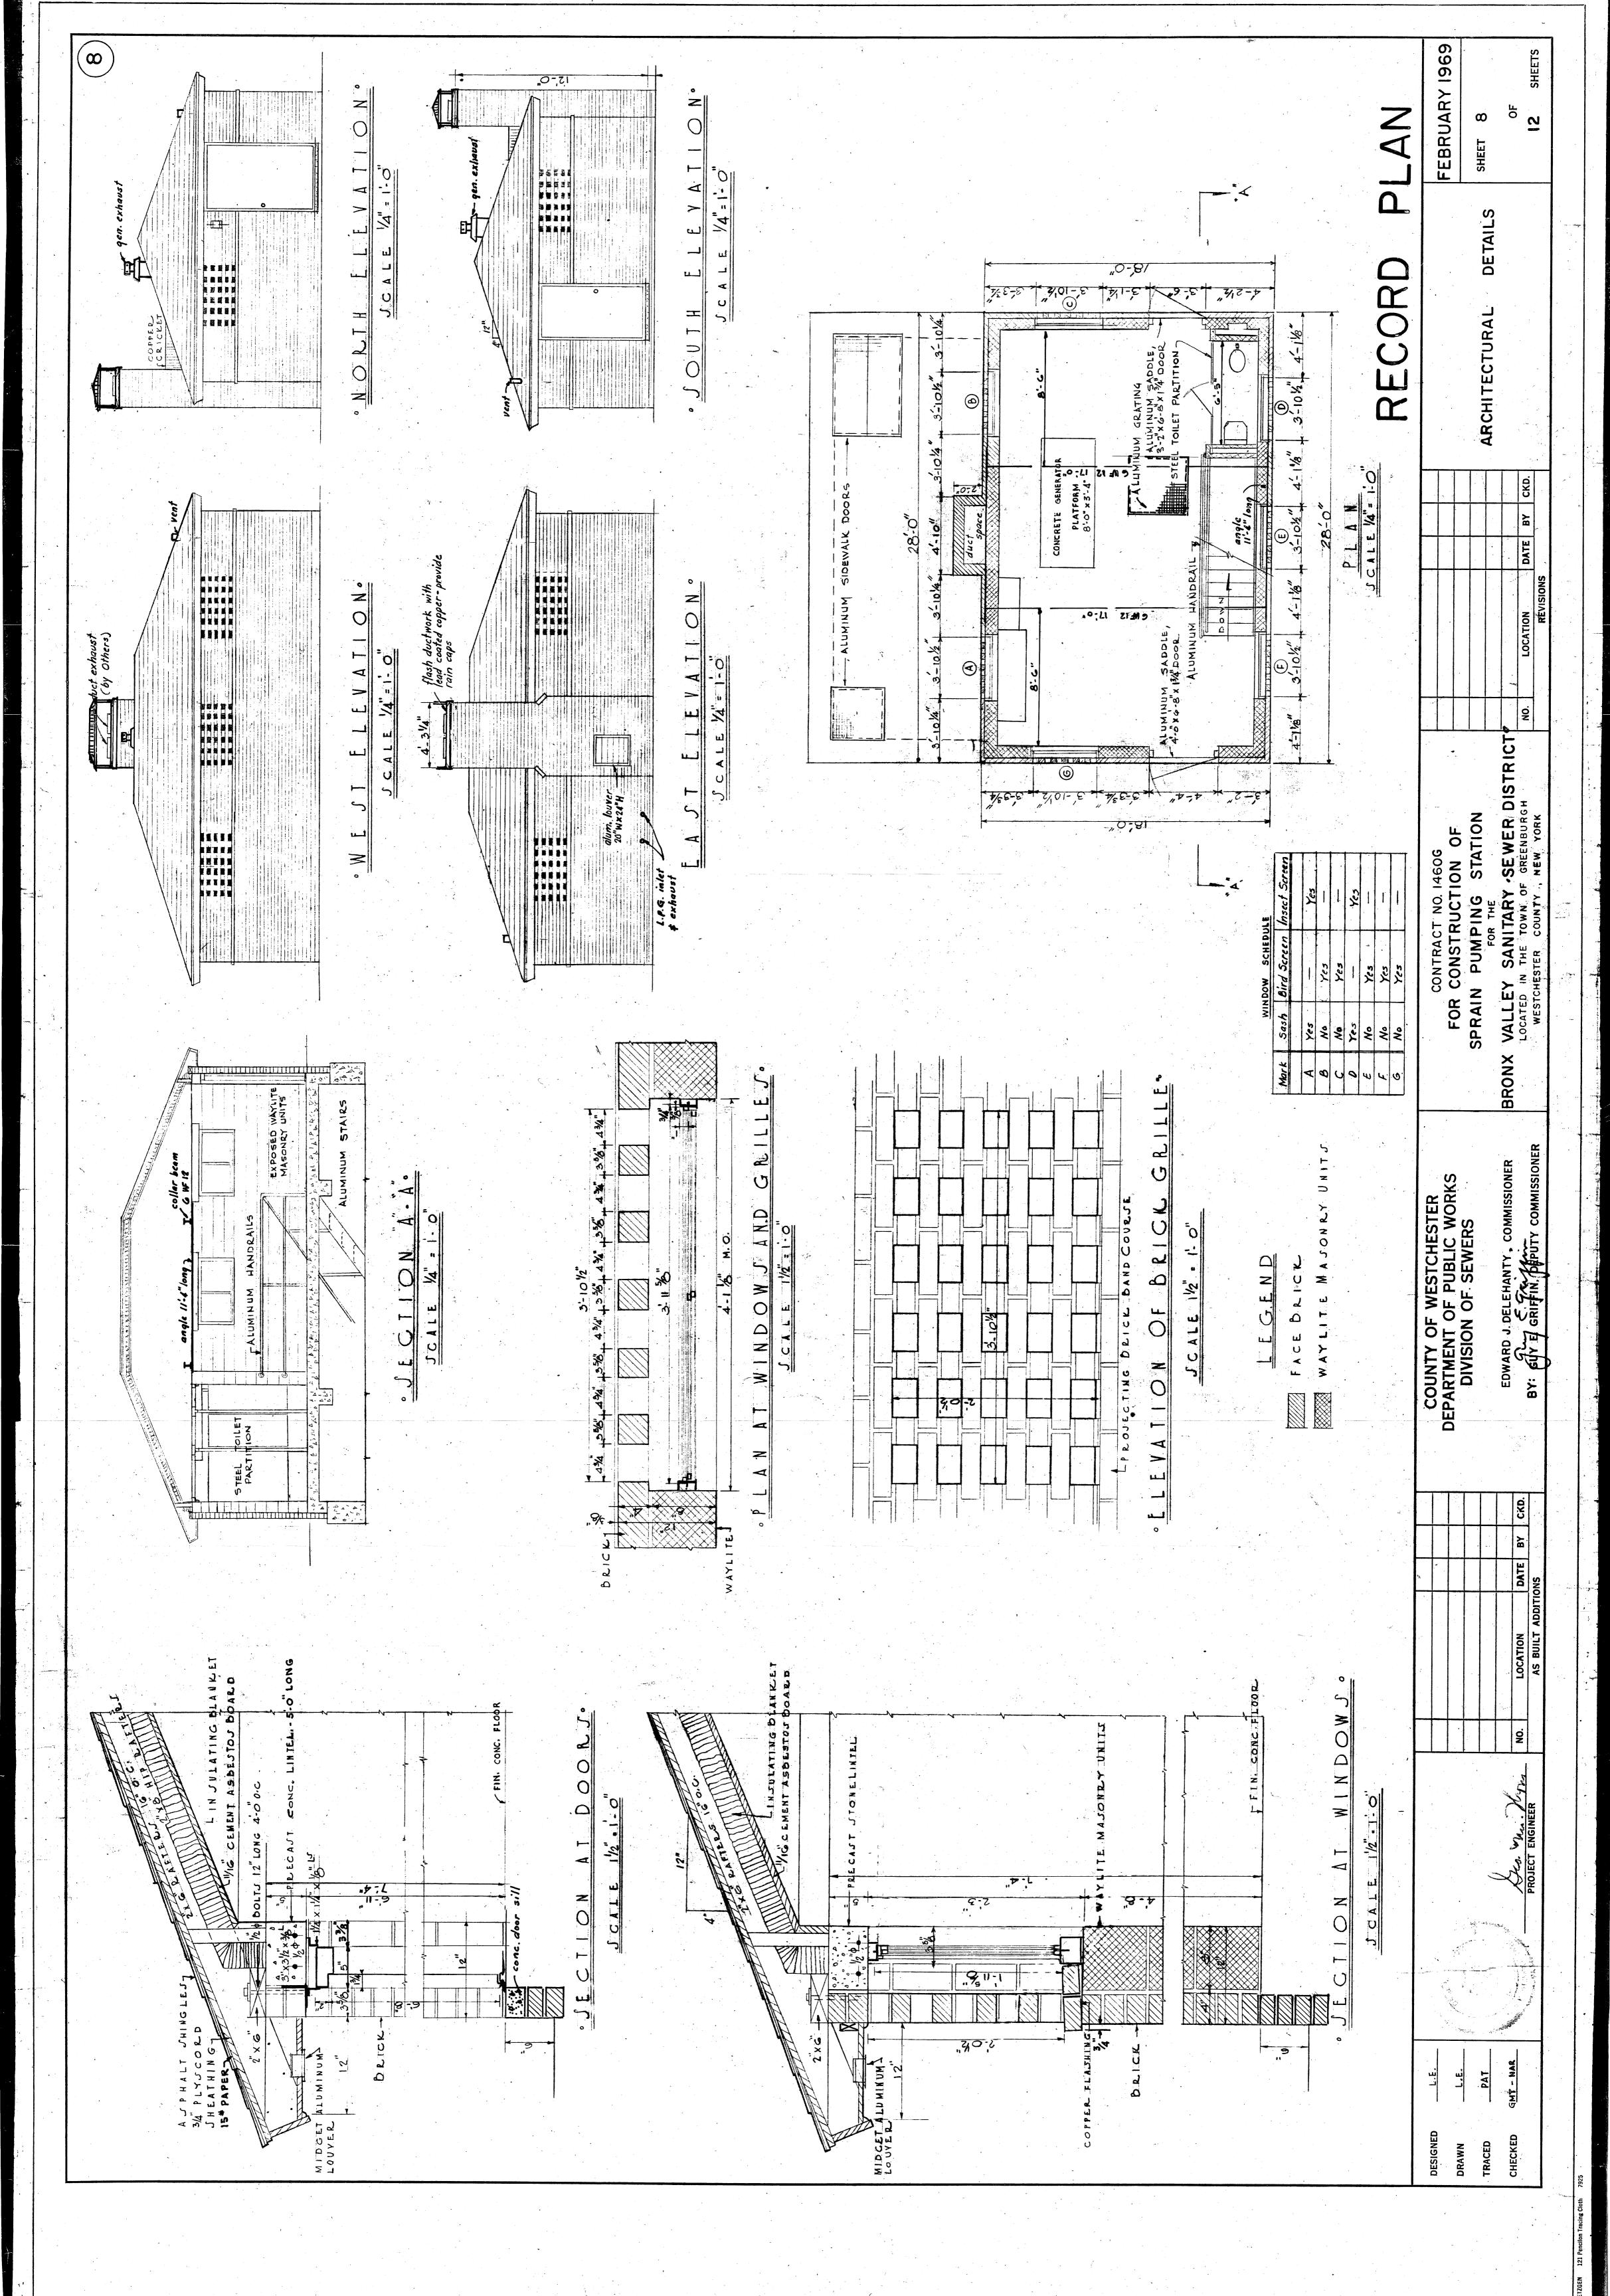

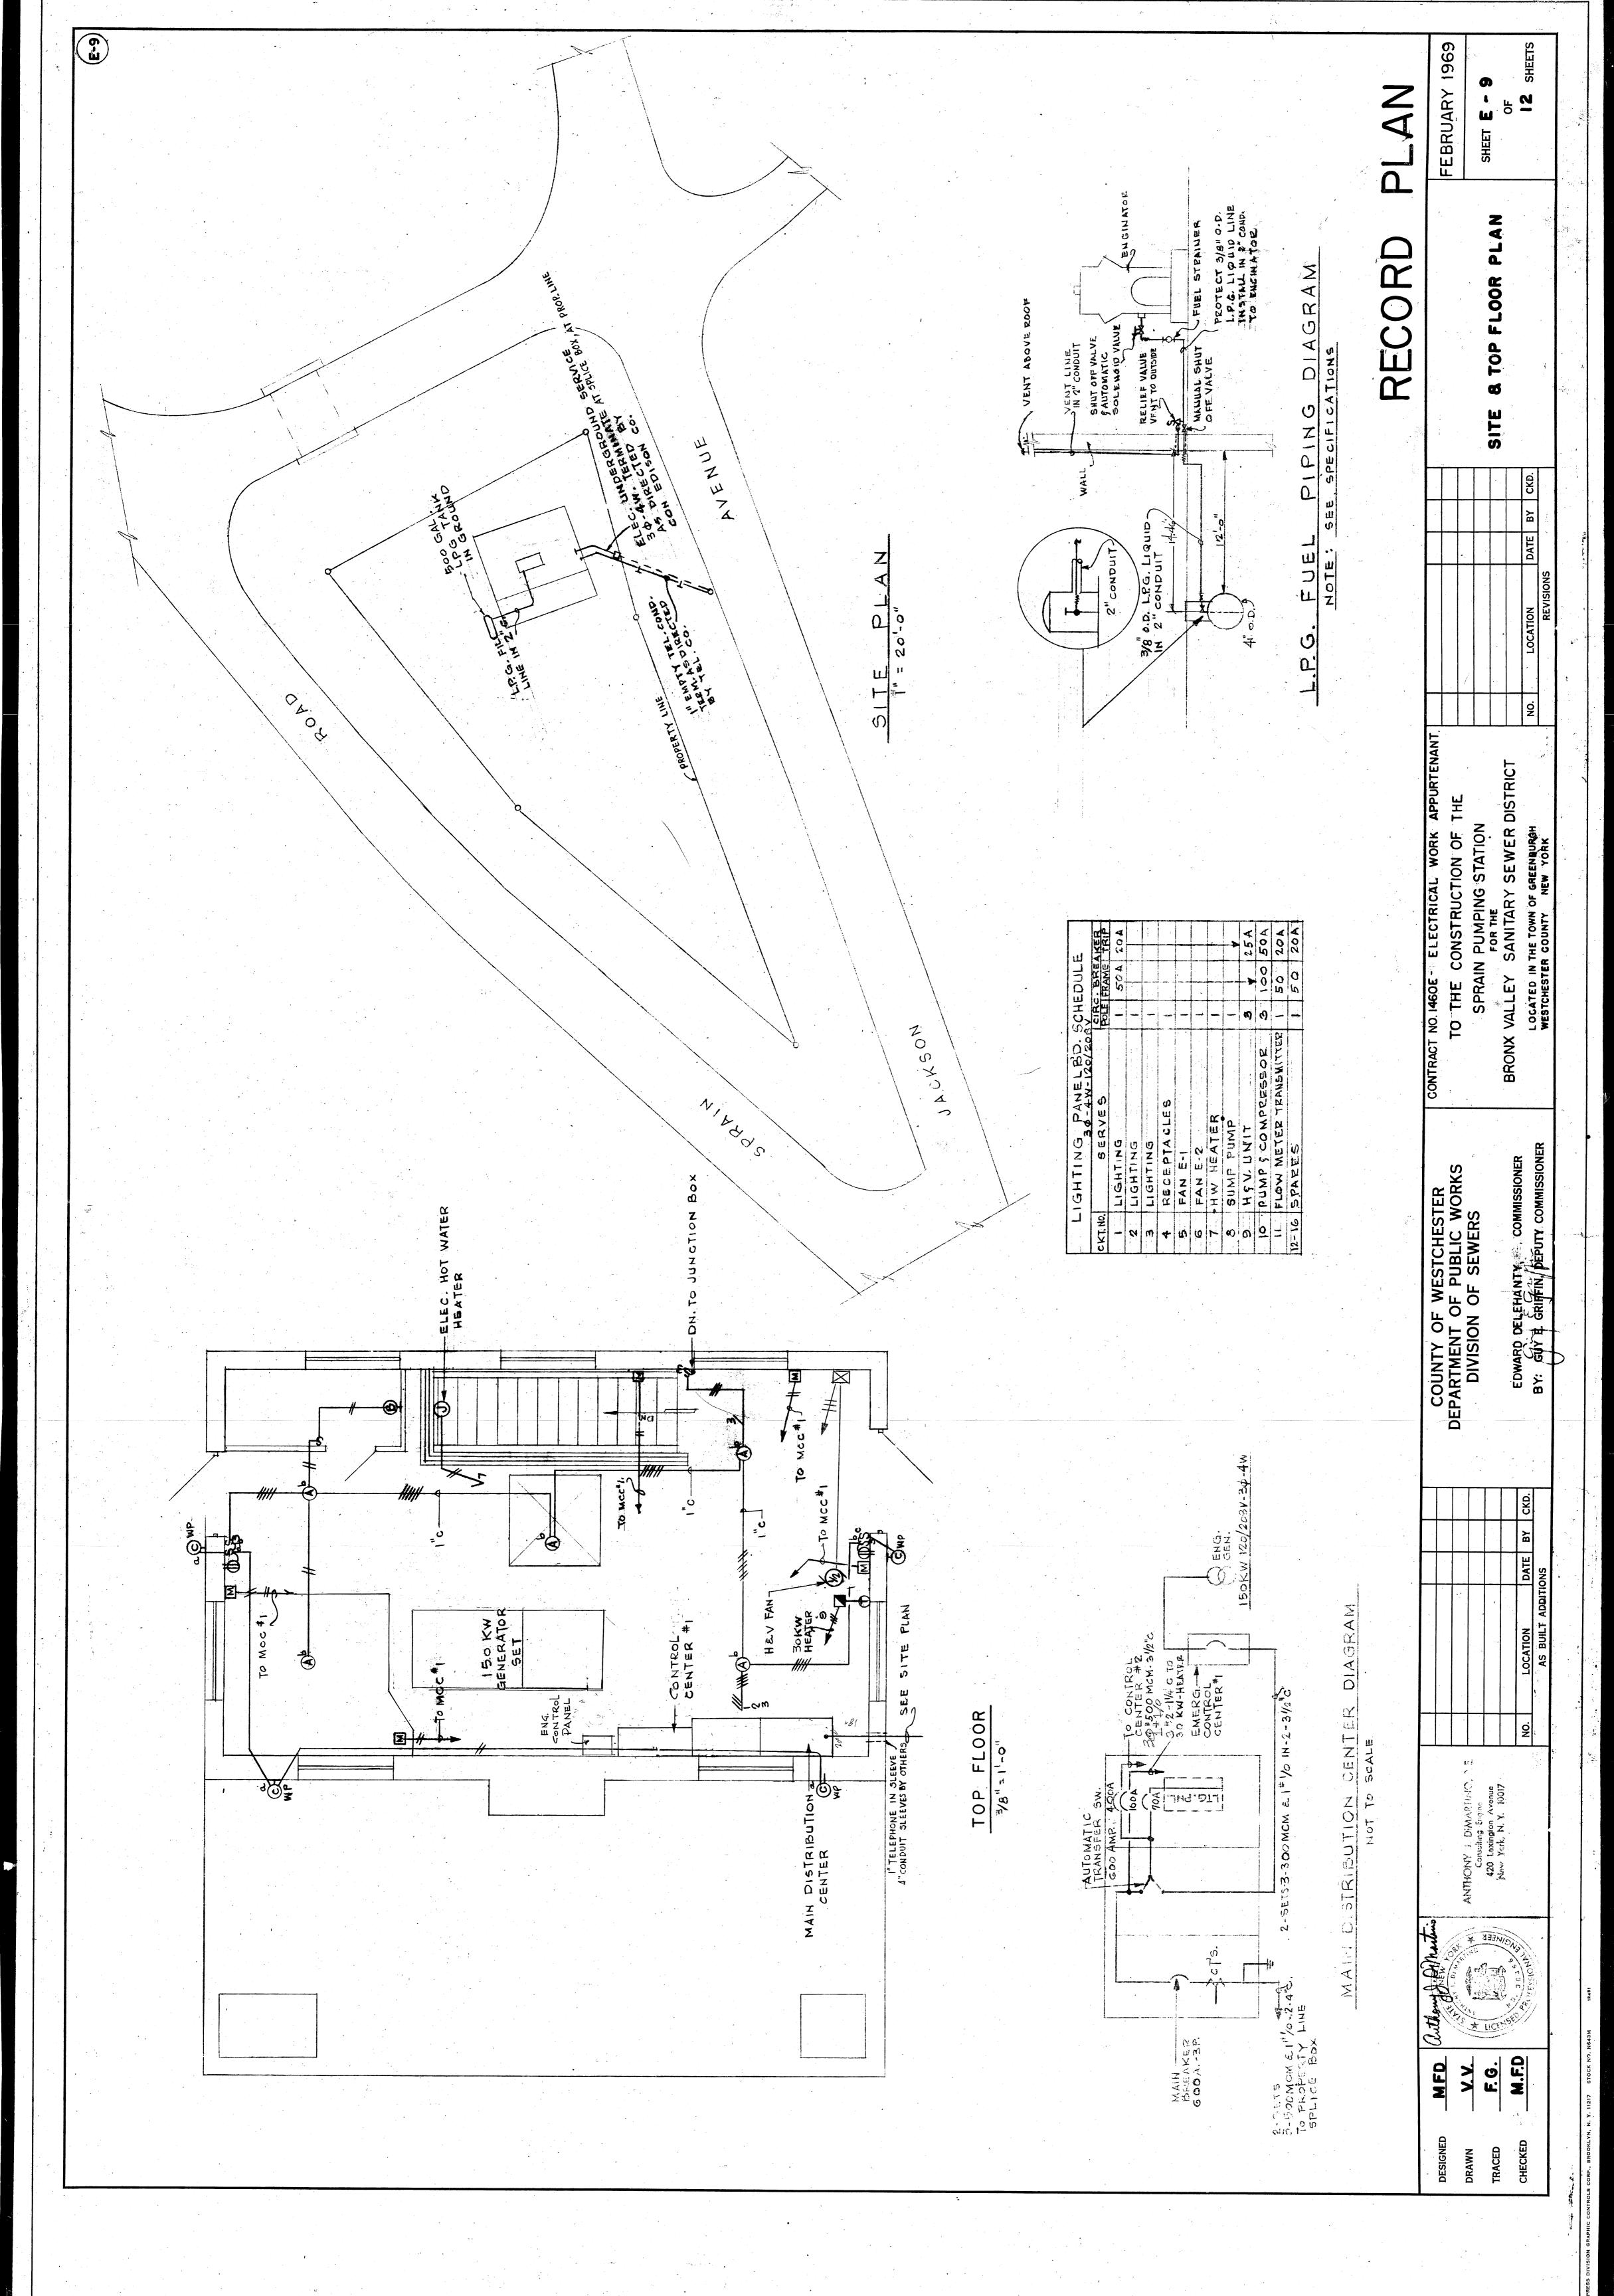

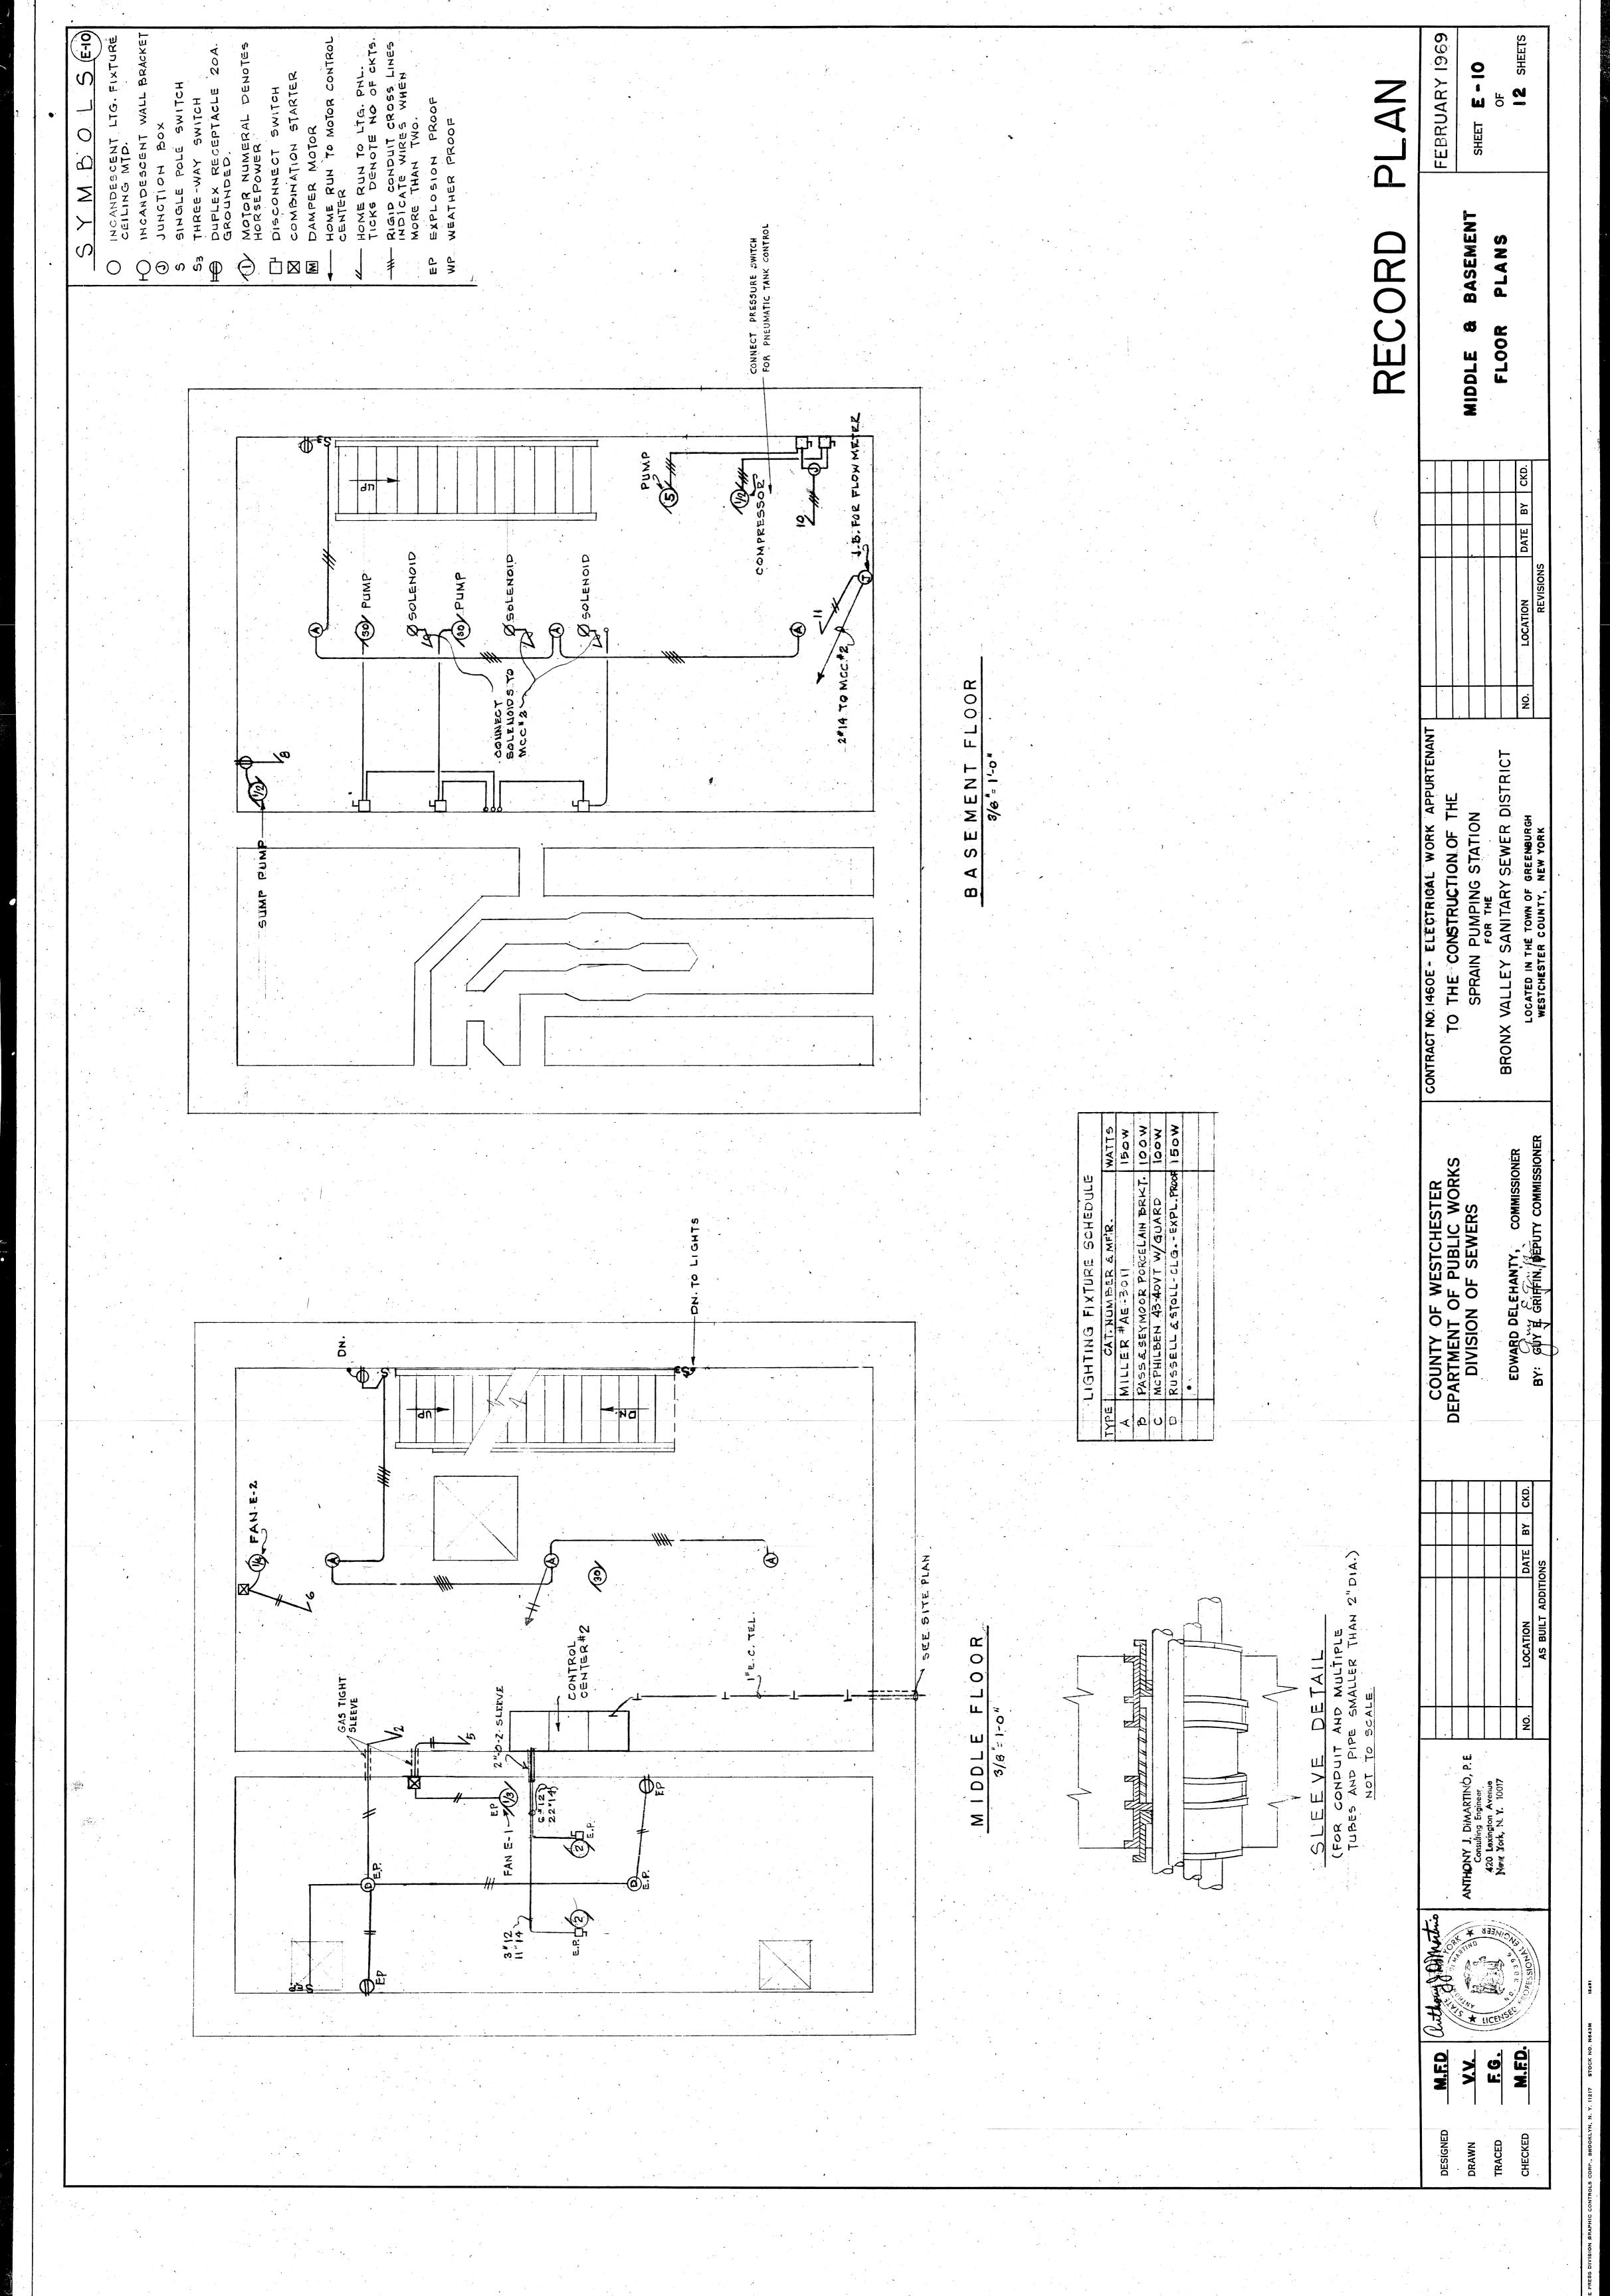


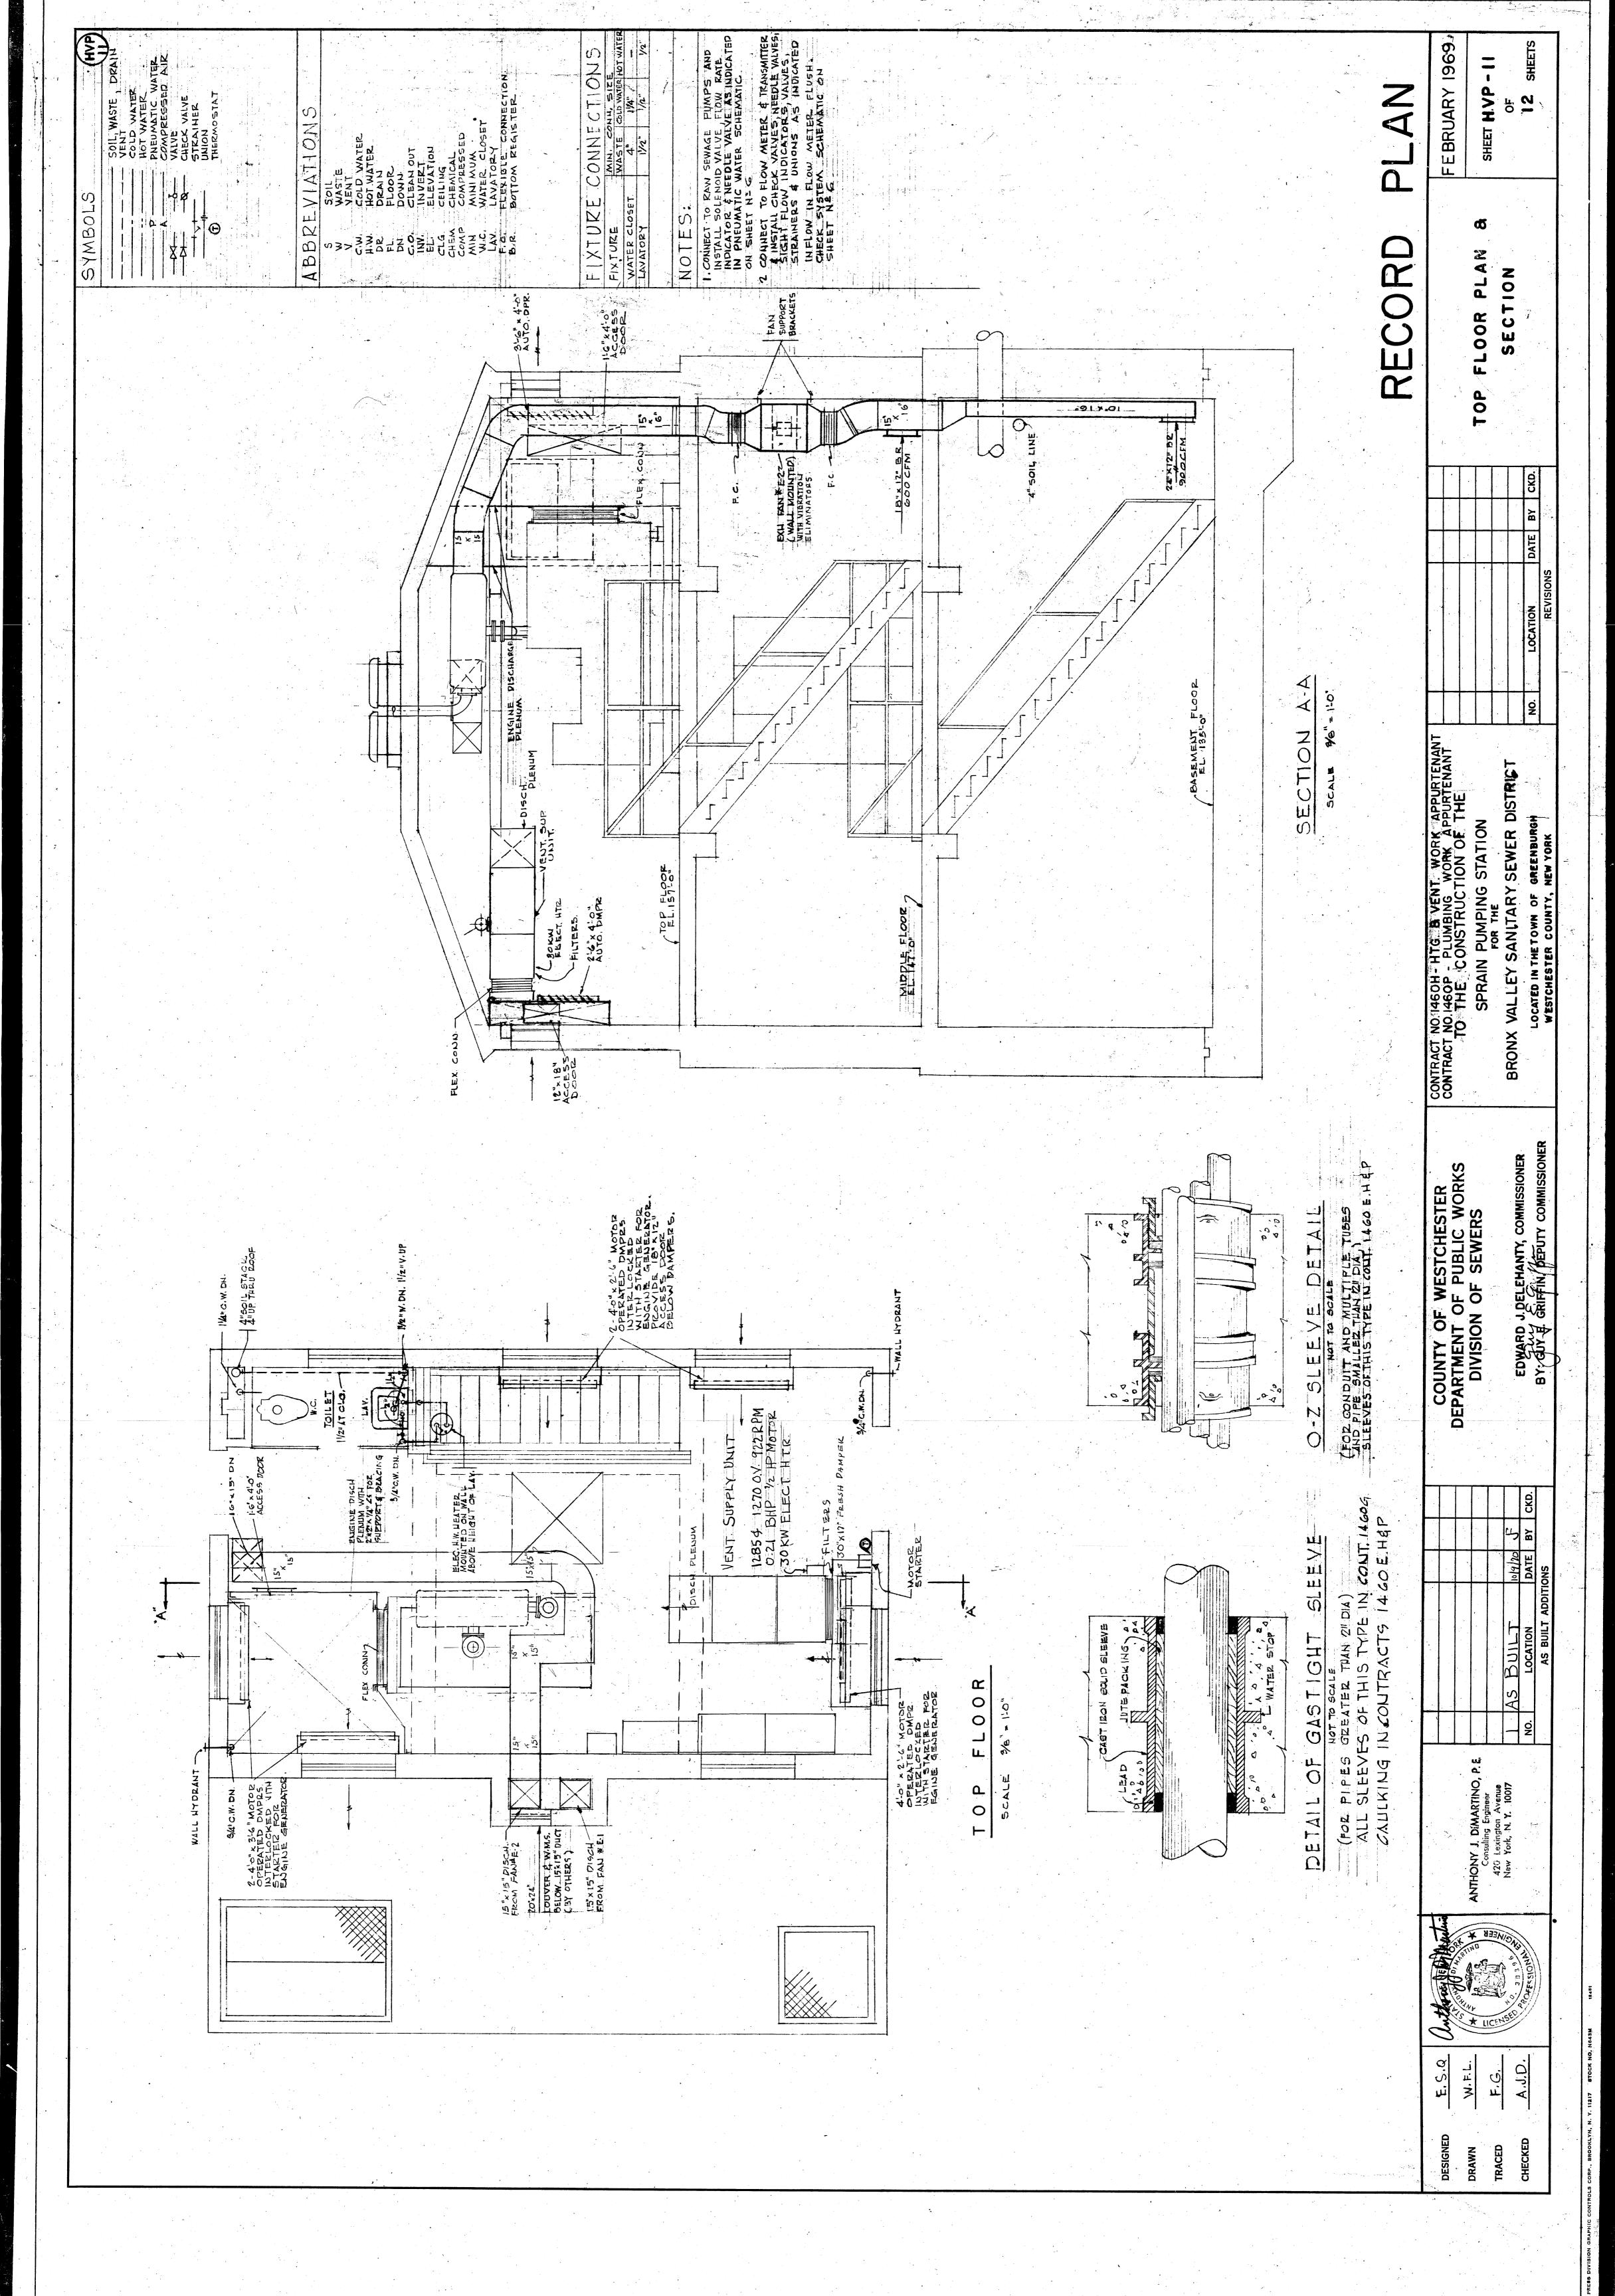

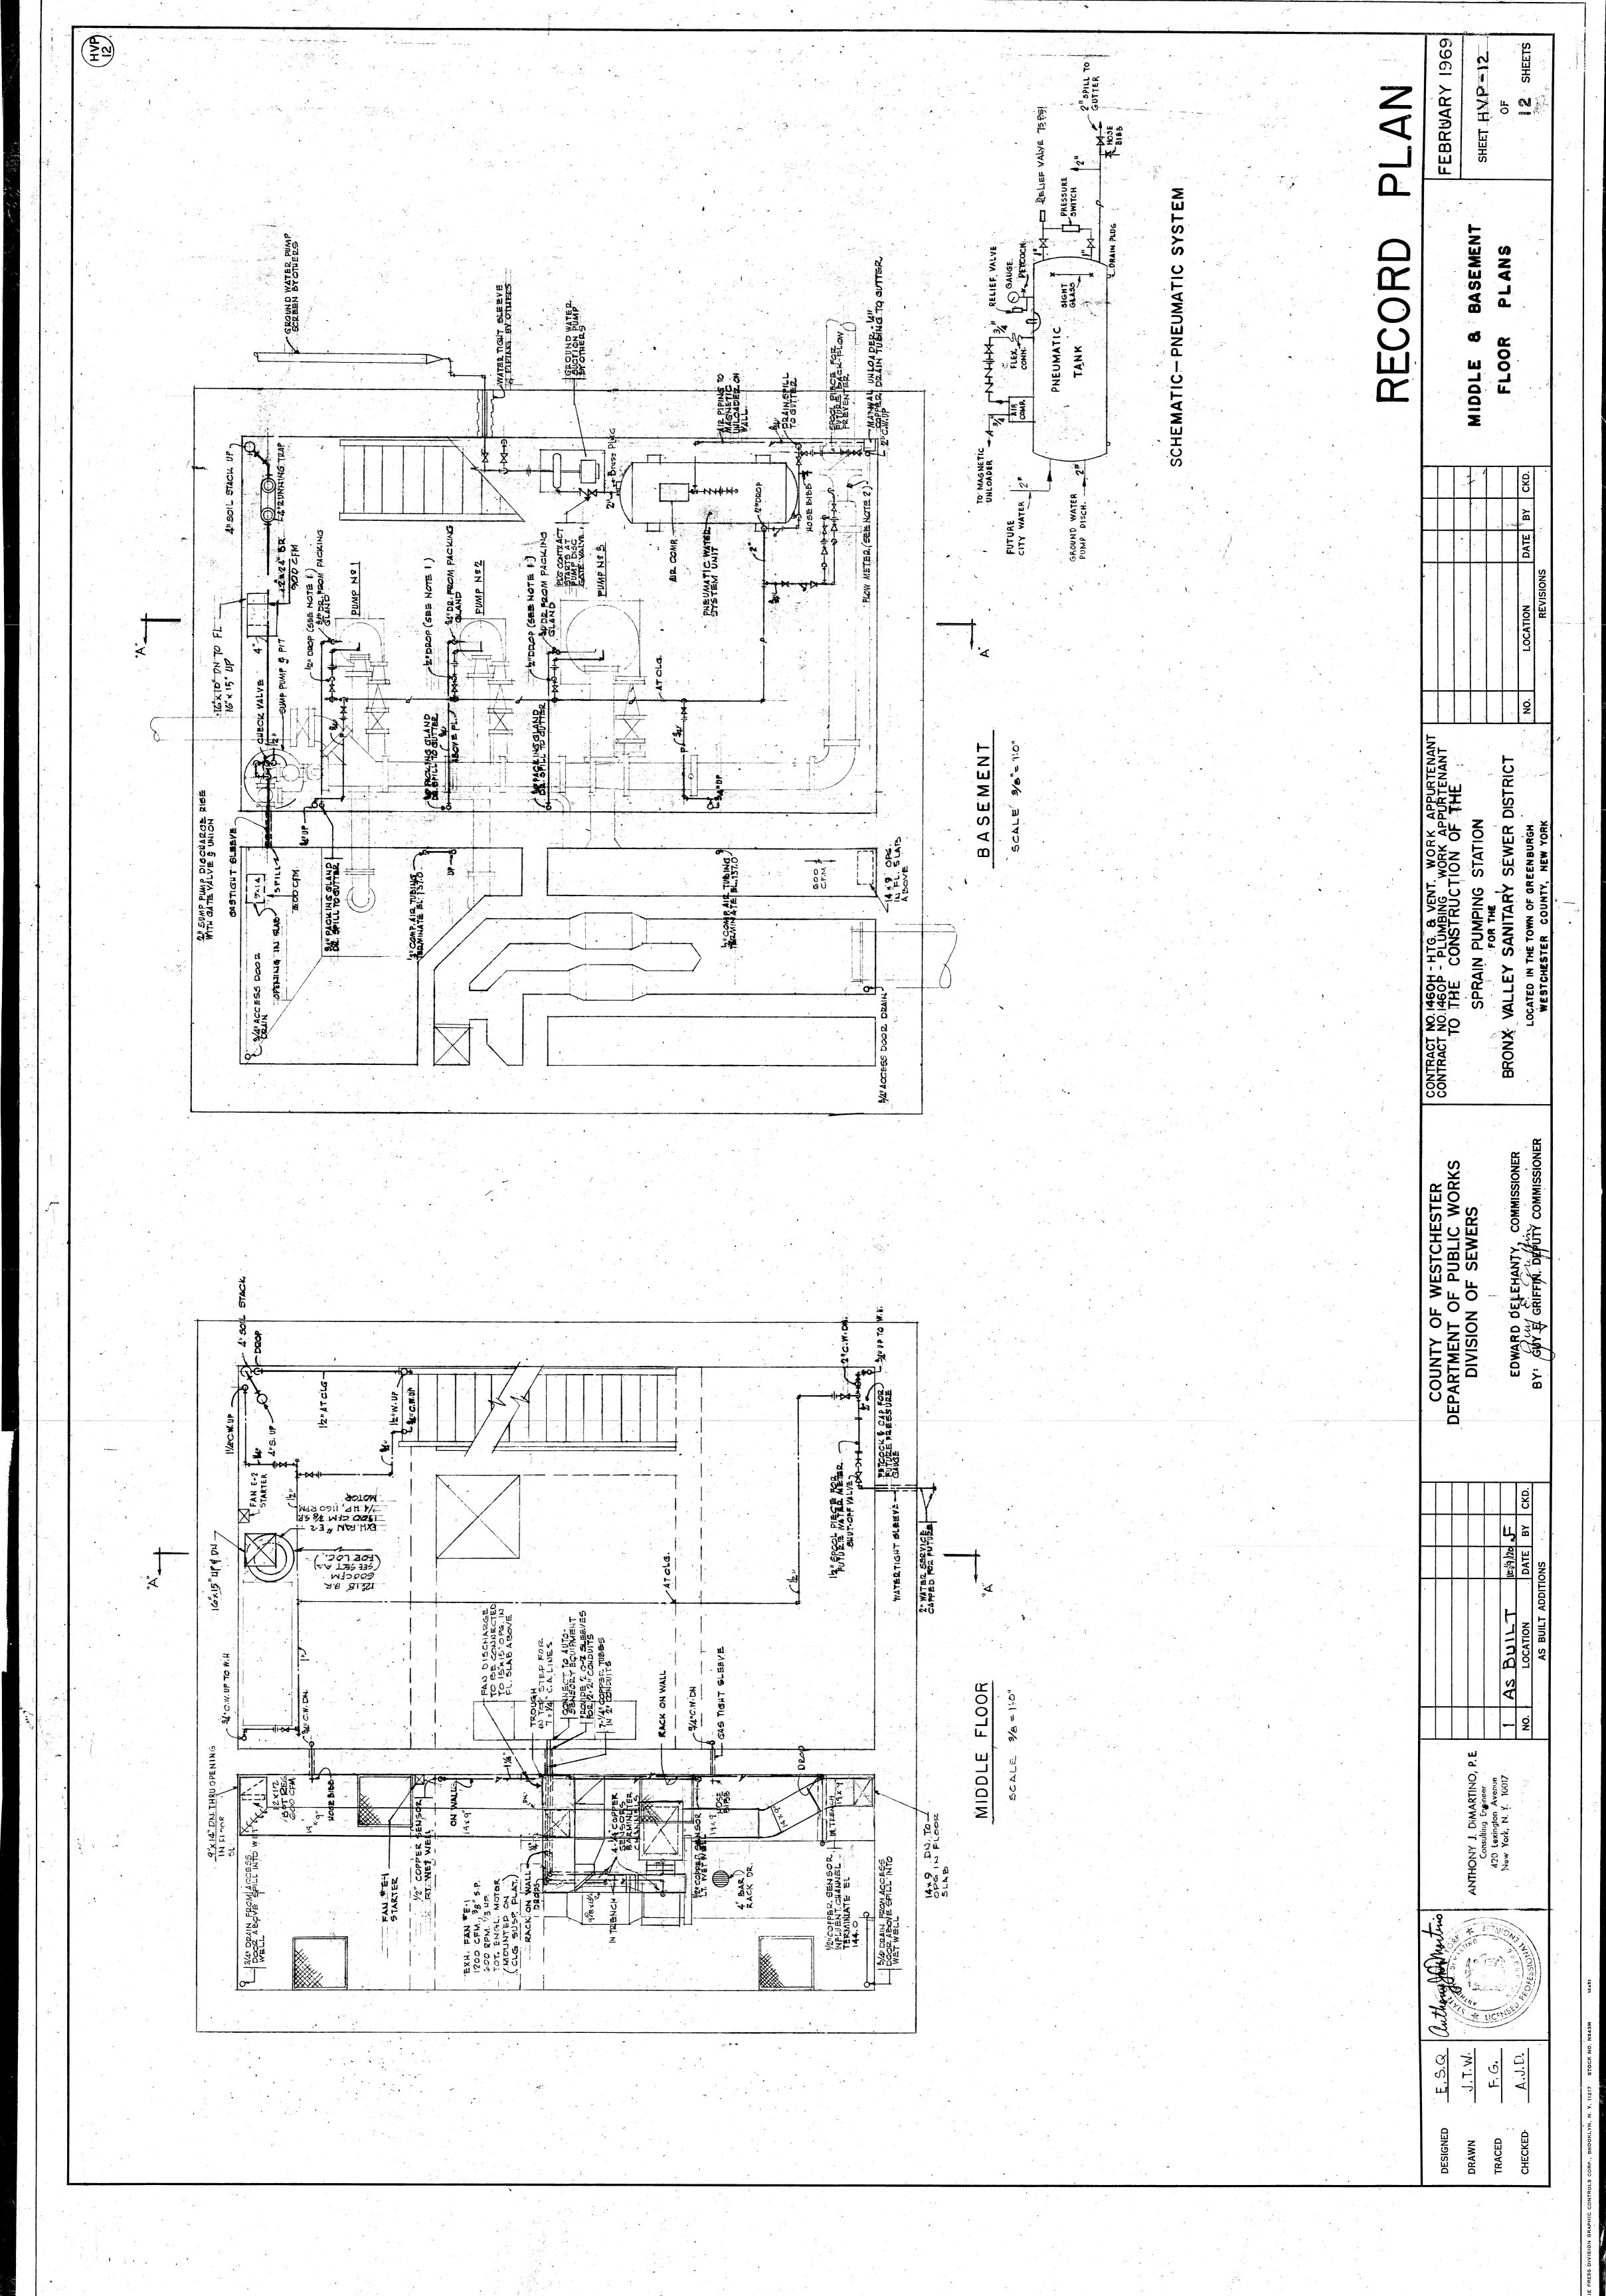

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202-0?-T-1 202-0?-G-2 202-0?-G-3 202-0?-G-3

202-02-G-5 202-02-G-6 202-02-G-7 202-02-G-8 202-02-G-9

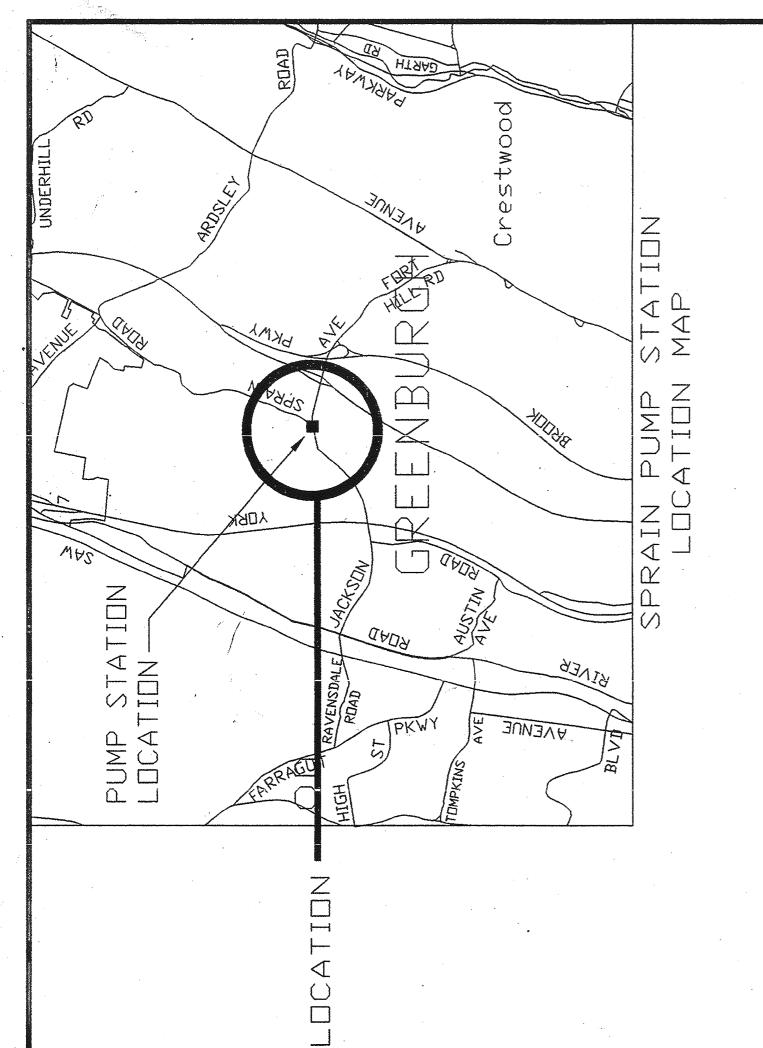CONTRACT ND. 96-572-GC
SPRAIN PUMP STATION
T-1 TITLE SHEET
A-1 FLOOR PLANS, ELEVATIONS AND DETAILS
M-1 SITE PLAN AND LEGEND
M-2 PART SITE PLAN - TEMPORARY PIPING PLAN
M-3 BASEMENT & MIDDLE FLOOR PLAN - DEMOLITION
M-4 SECTIONS - DEMOLITION
M-5 BASEMENT & MIDDLE FLOOR PLAN
M-5 BASEMENT & MIDDLE FLOOR PLAN
M-5 SECTIONS
M-7 SECTIONS
M-8 MANHOLE DETAILS AND BUBBLER DETAIL

CONTRACT NO. 96-572-HV

SPRAIN PUMP STATION

H-1 BASEMENT & MIDDLE FLOOR PLAN - DEMOLITION

H-2 TOP FLOOR PLAN - DEMOLITION

H-3 SECTIONS - DEMOLITION

H-4 BASEMENT & MIDDLE FLOOR PLAN TOP FLOOR PLAN SECTION AND SCHEDULES 202-02-HV-15

- DEMOLITION AND PHASING SCHEDULE CONTRACT NO. 96-572-E
SPRAIN PUMP STATION
E-1 SITE PLAN, LEGEND AND ELEVATION
E-2 BASEMENT AND MIDDLE FLOOR PLANS E-3 MAIN FLOOR PLAN - DEMOLITION
E-4 BASEMENT AND MIDDLE FLOOR PLANS E-5 MAIN FLOOR PLAN - POWER 202-02-E-17 202-02-E-18 202-02-E-19 202-02-E-20 202-02-E-21

202-02-E-23 202-02-E-24 202-02-E-25

BASEMENT AND MIDDLE FLOOR PLANS - LIGHTING, FIXTURE SCHEDULE AND LIGHTING MAIN FLOOR PLAN - LIGHTING AND DETAIL POWER SINGLE LINE DIAGRAM AND PANEL SCHEDULE SINGLE LINE DIAGRAMS AND DETAIL

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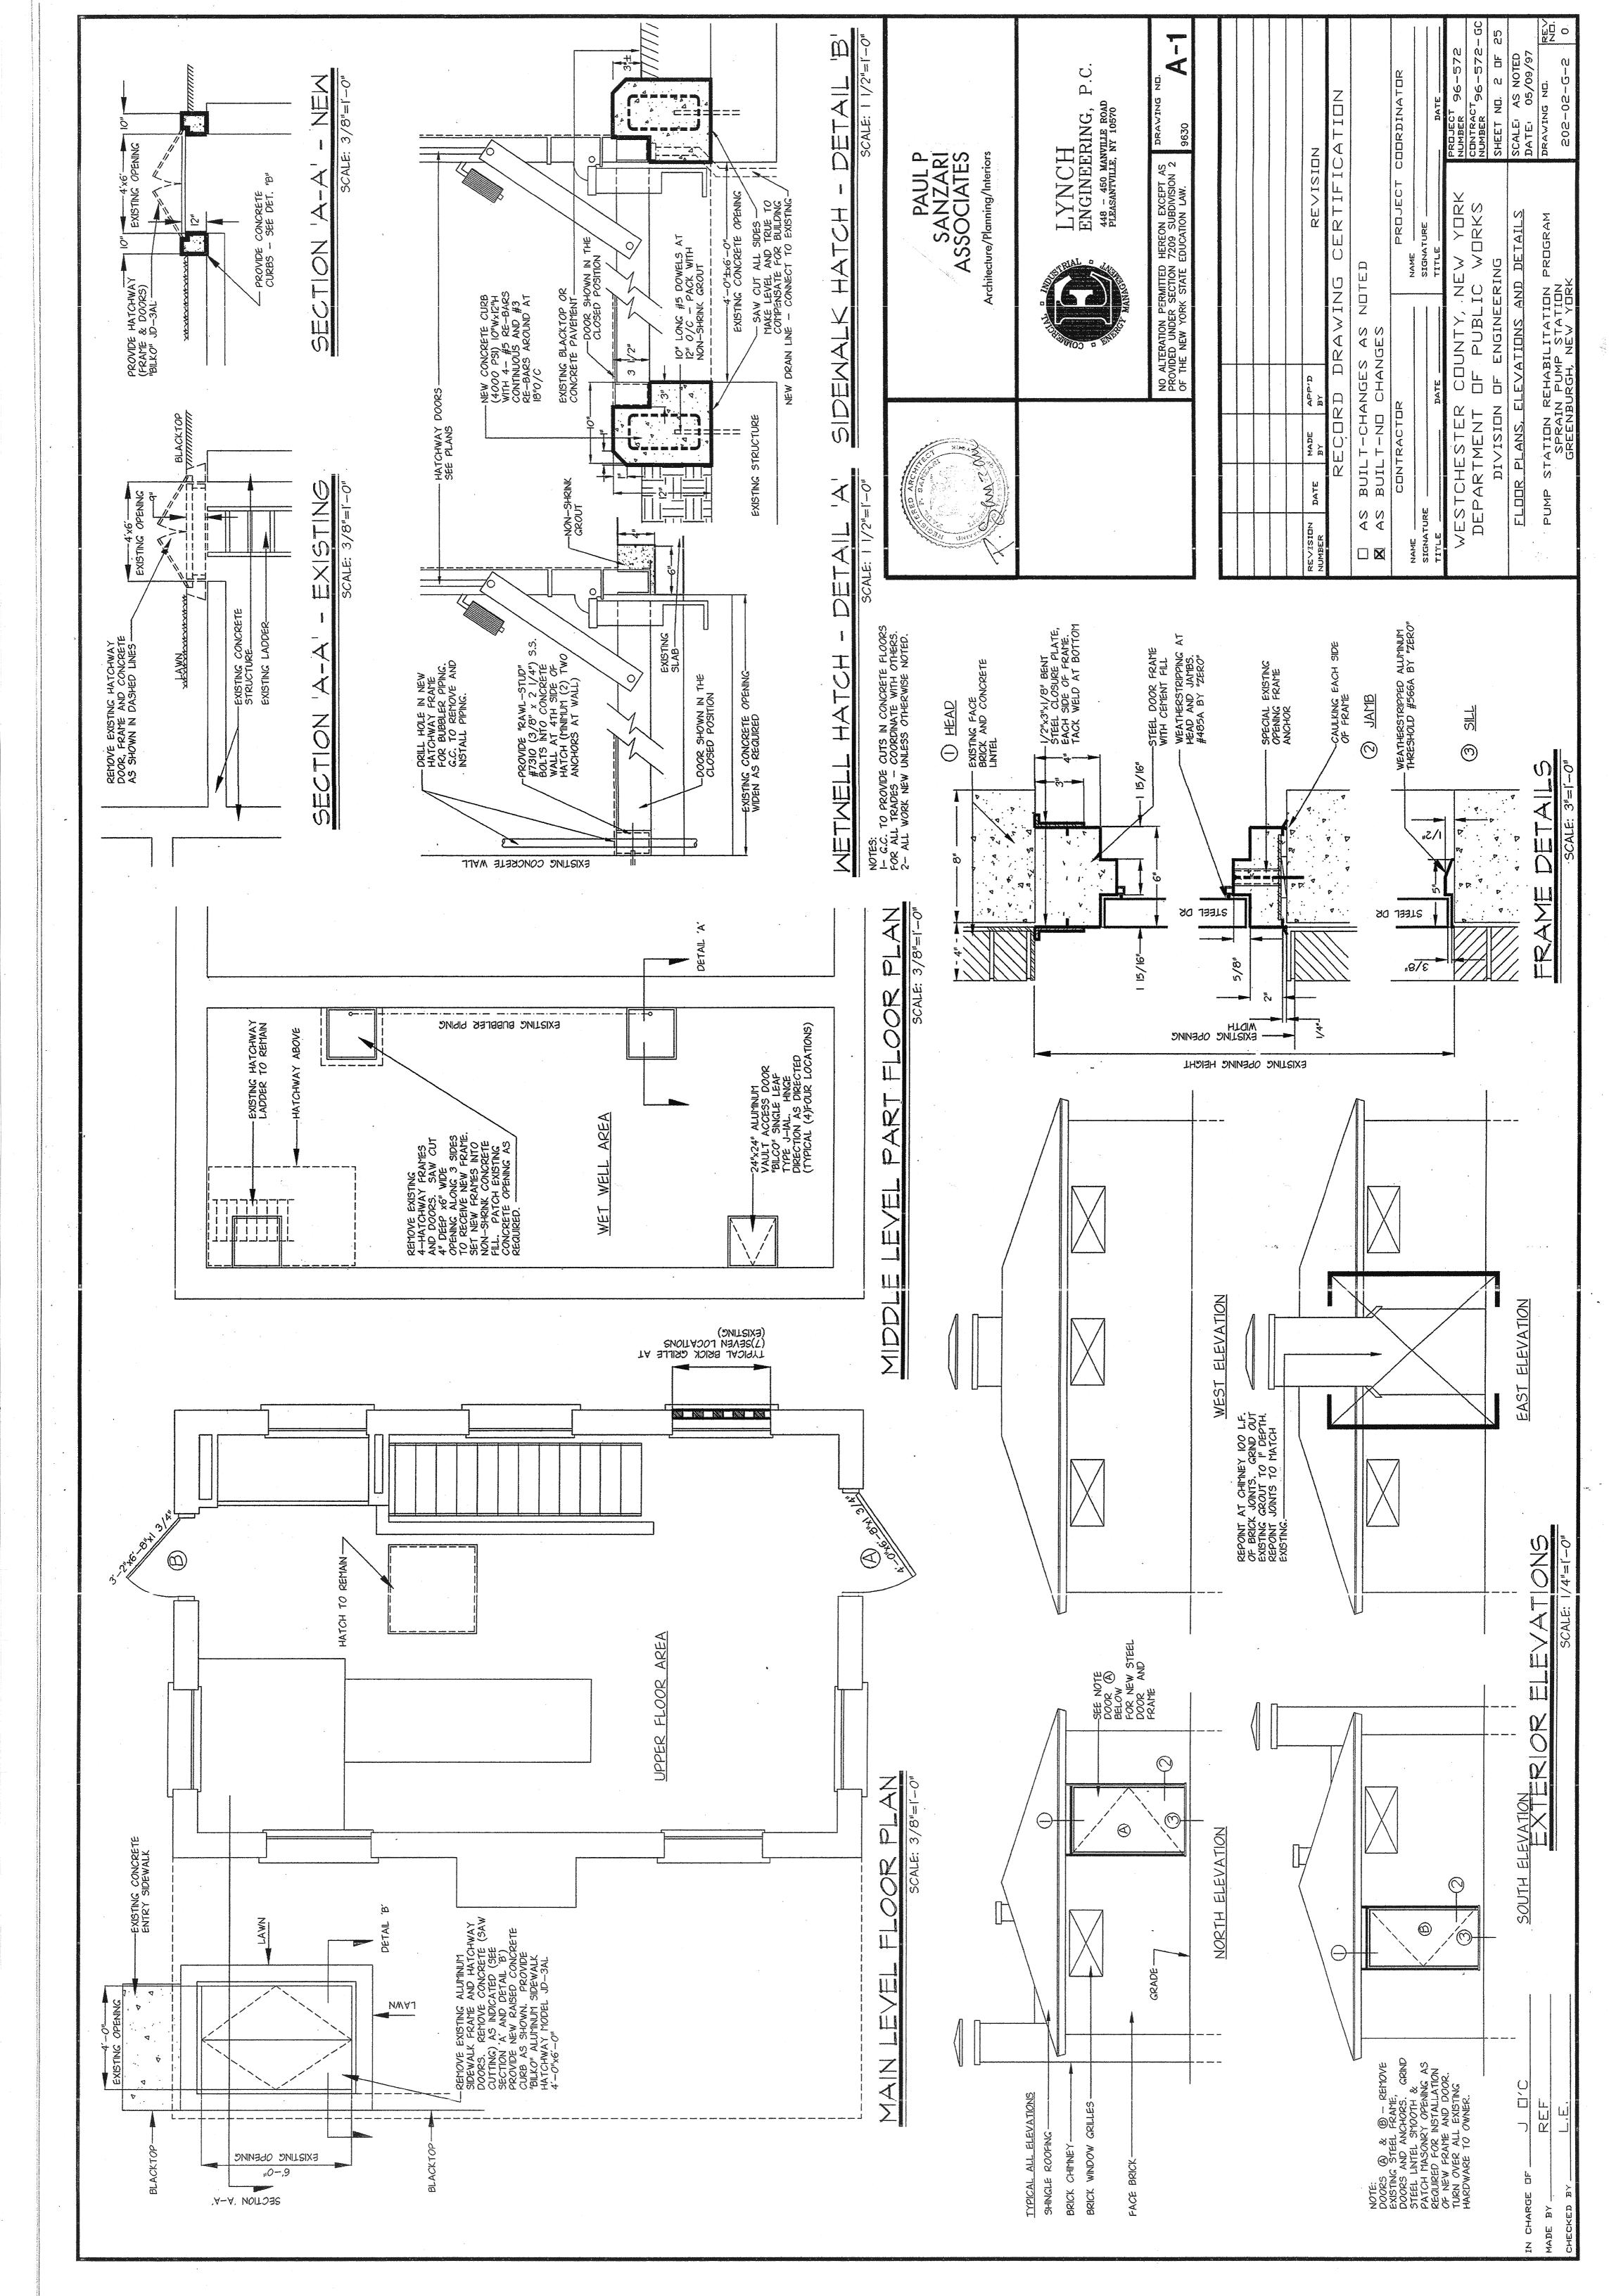
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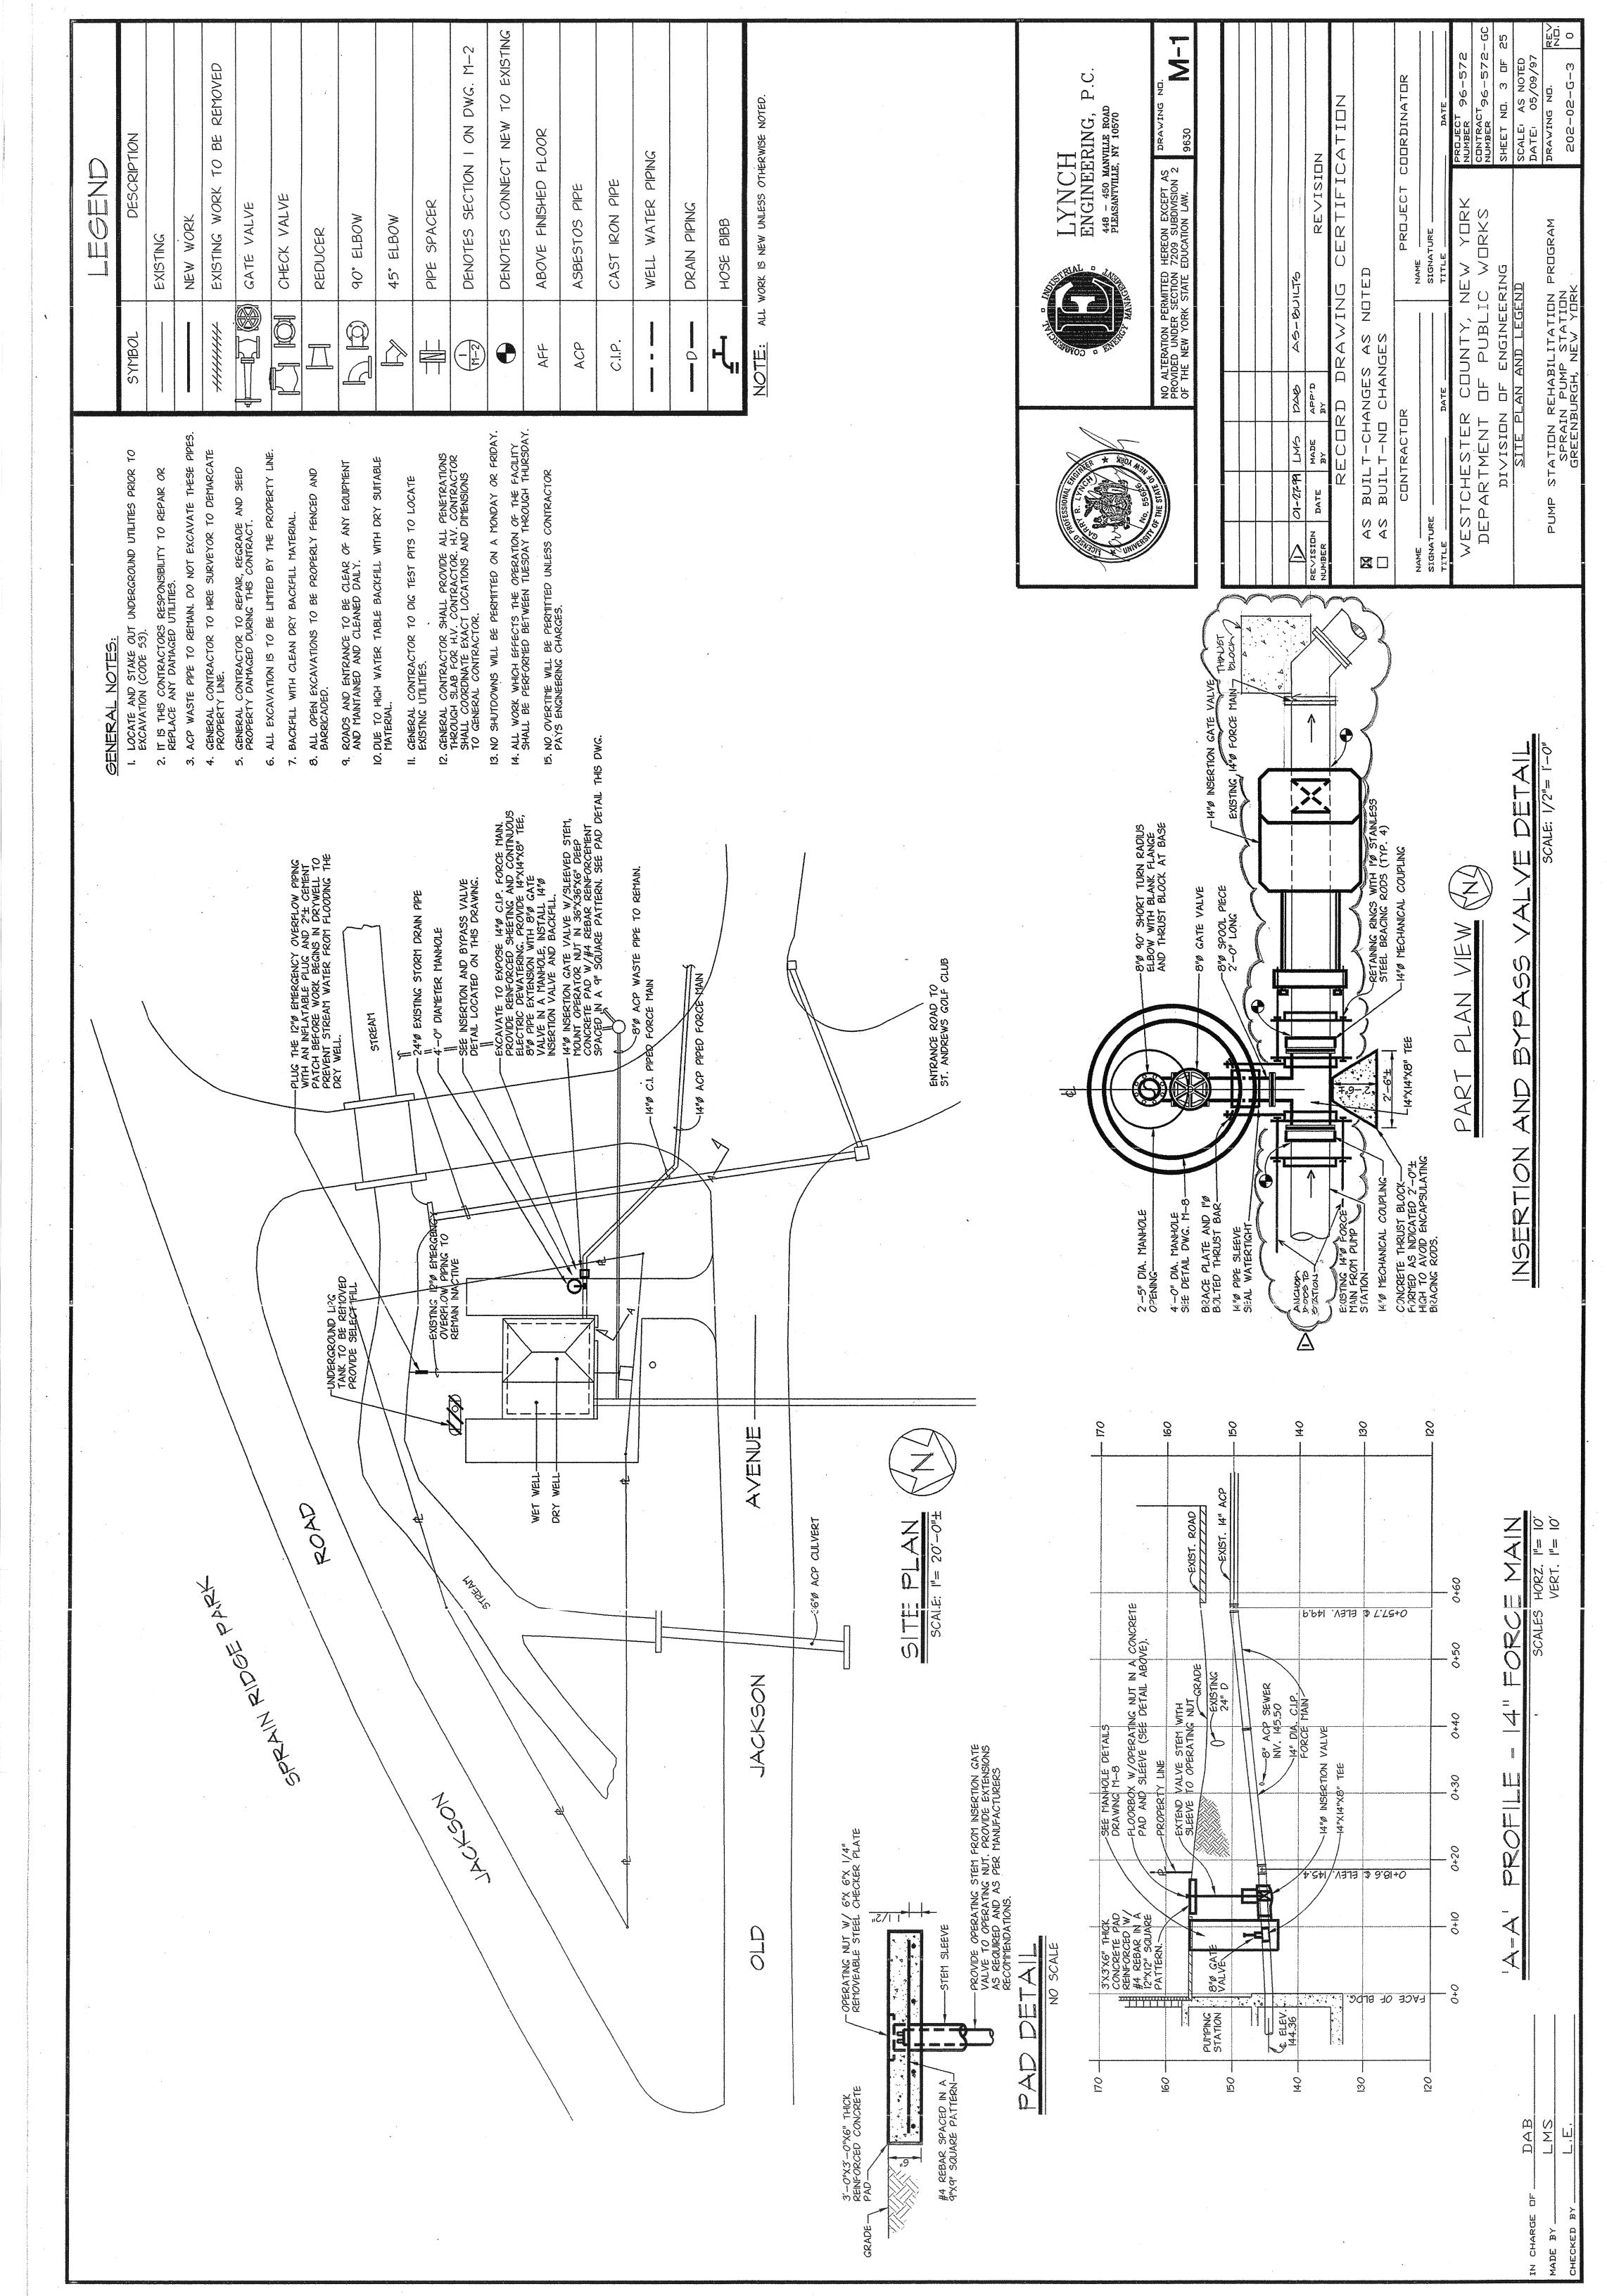
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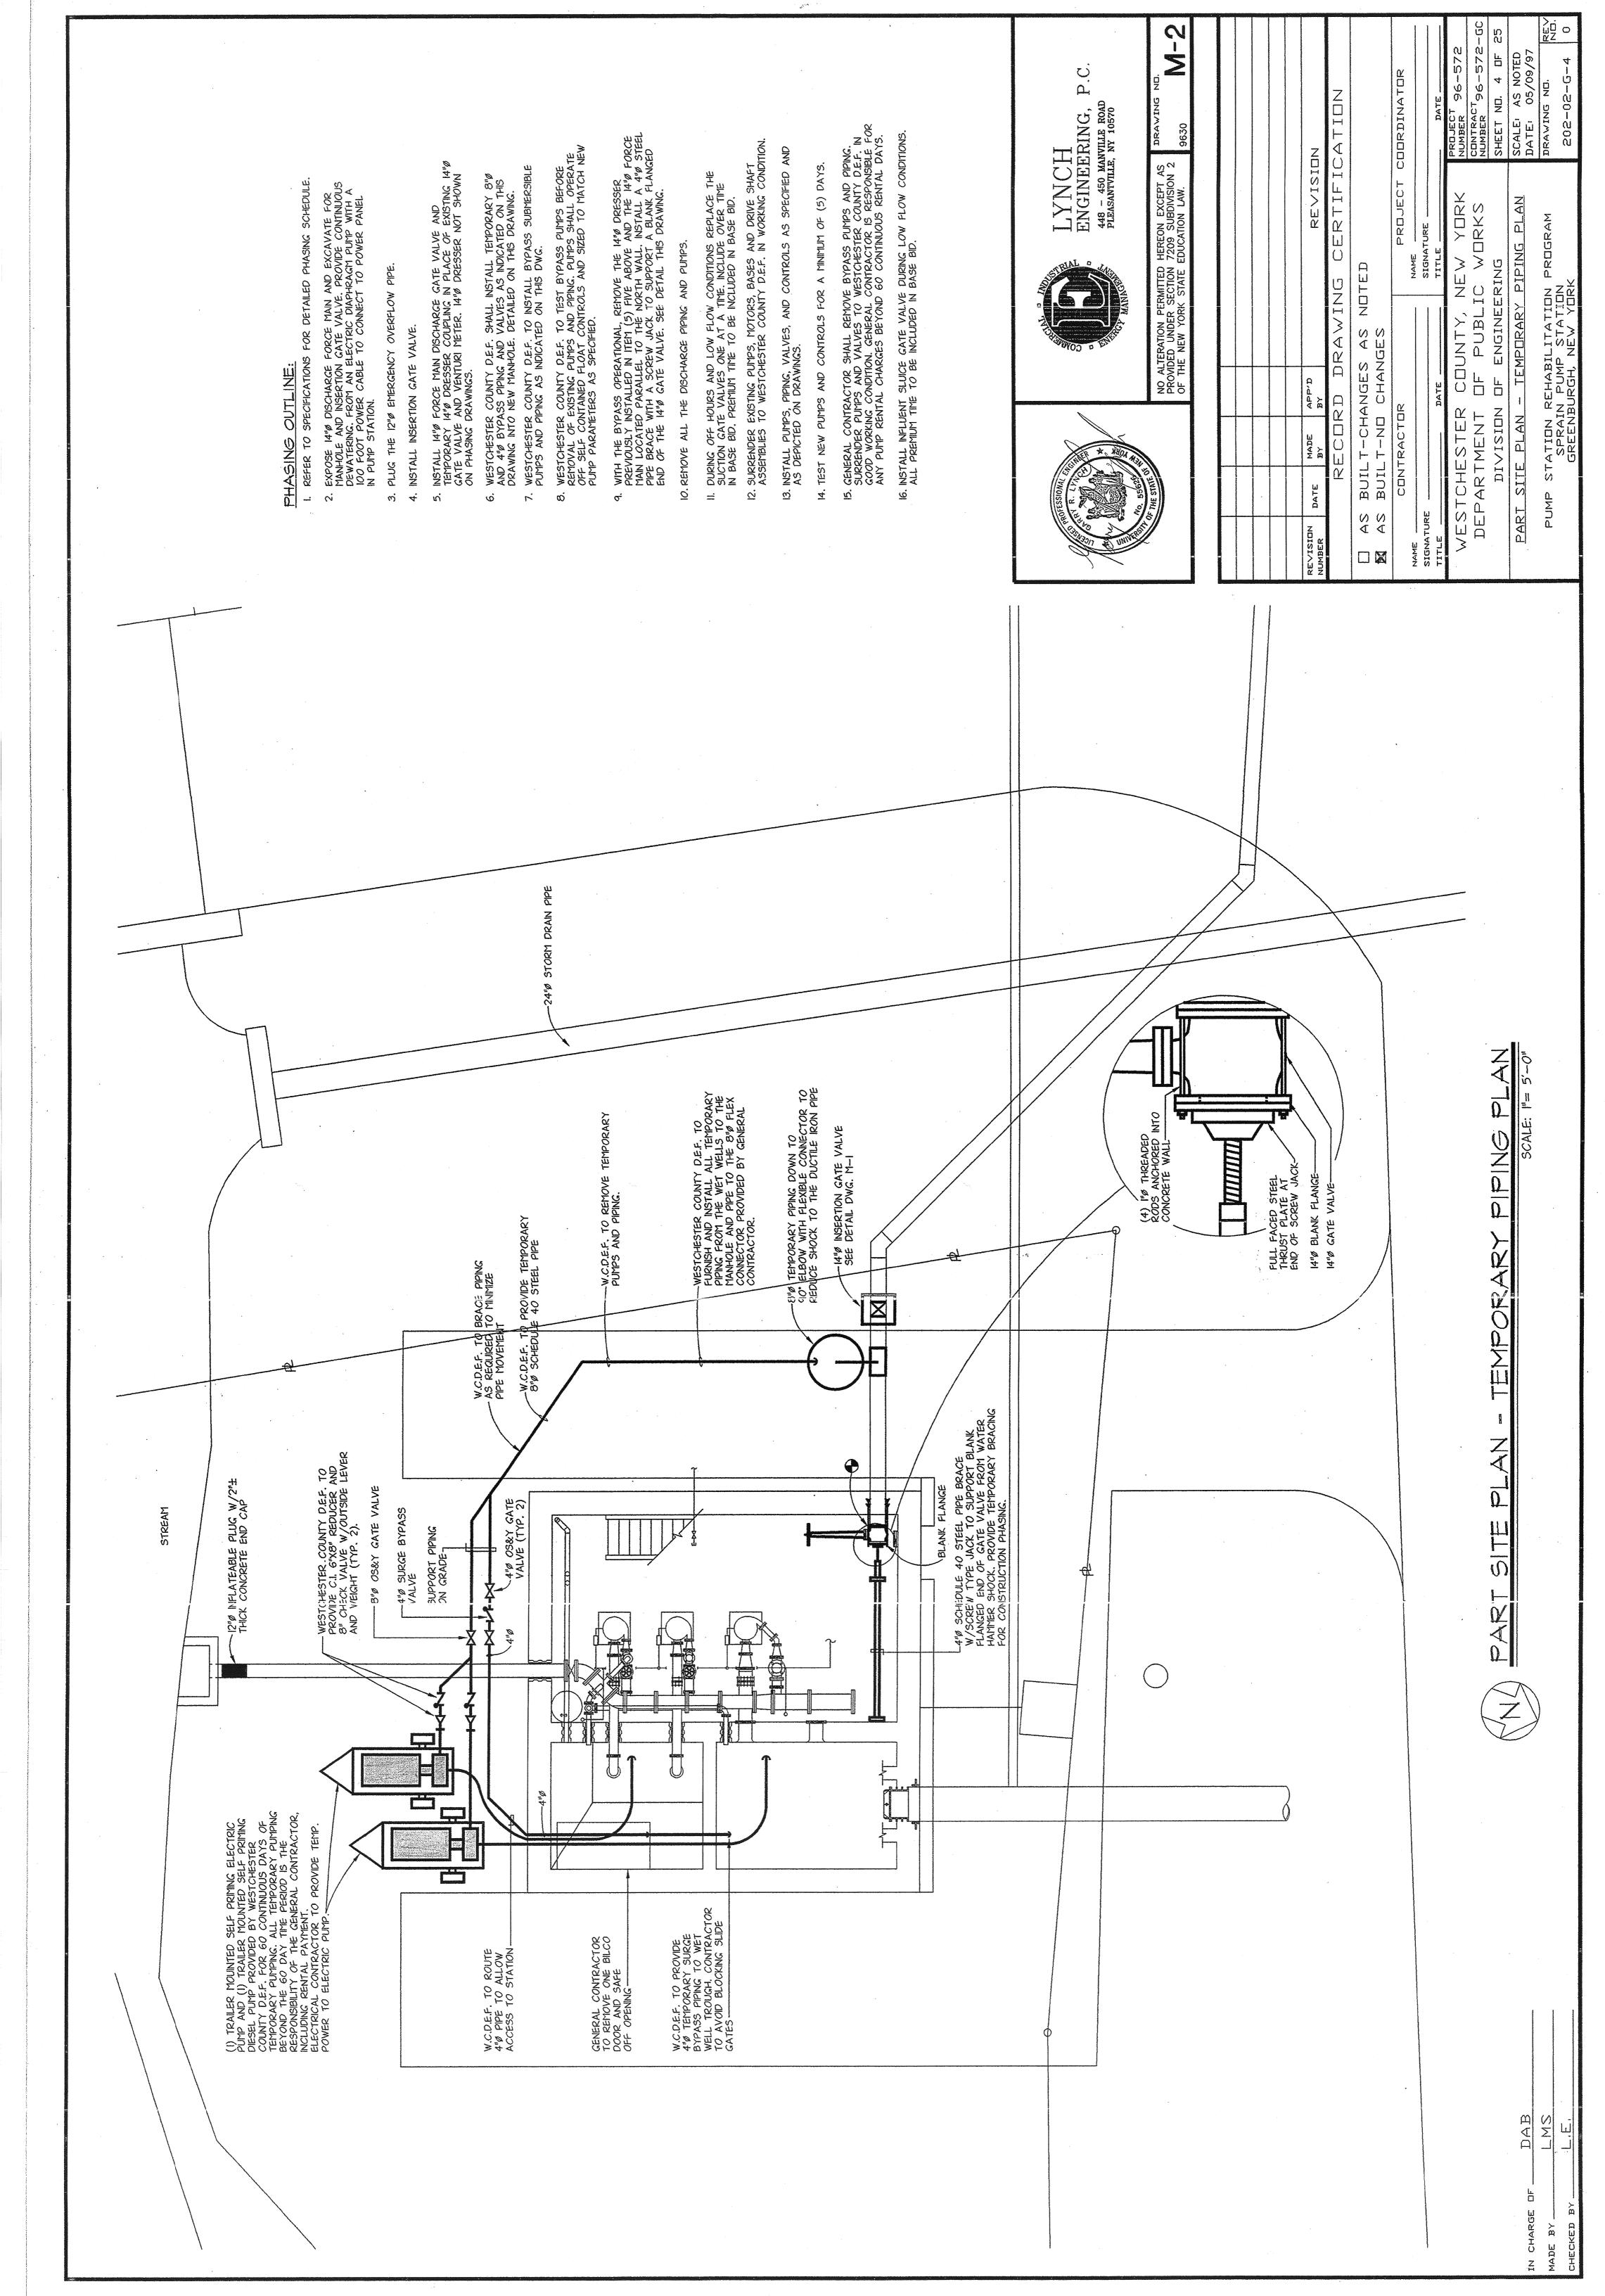
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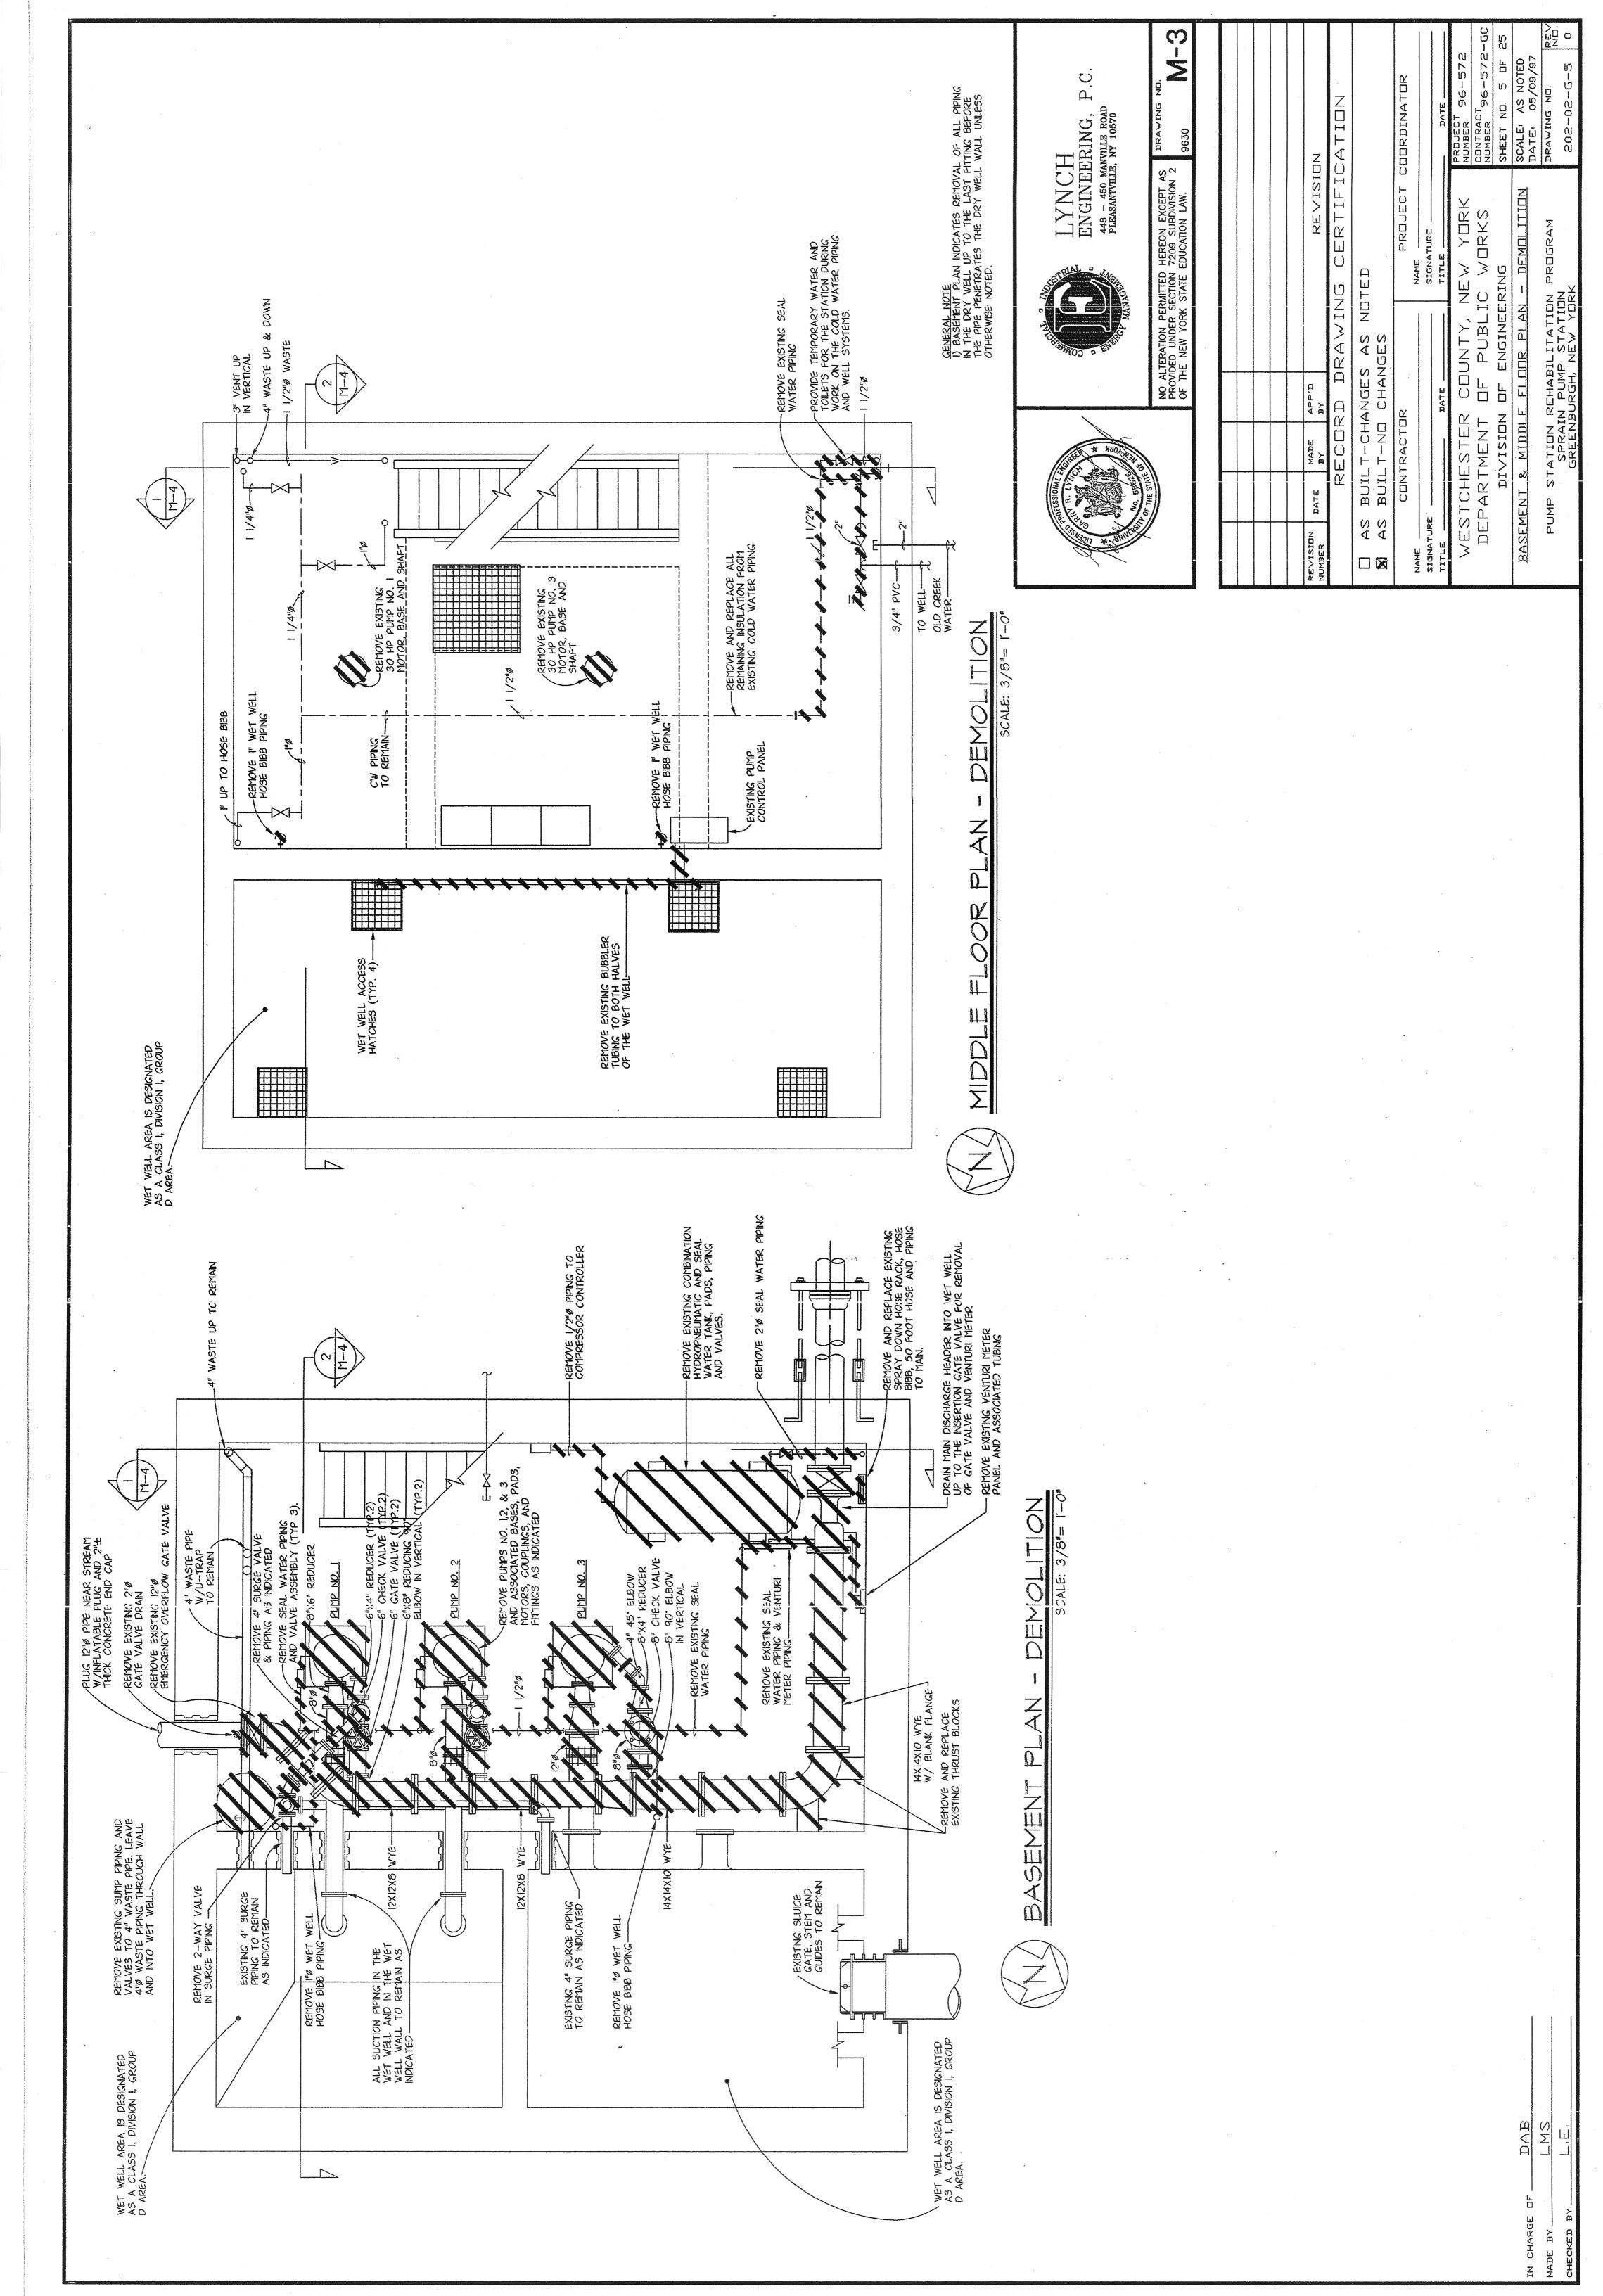
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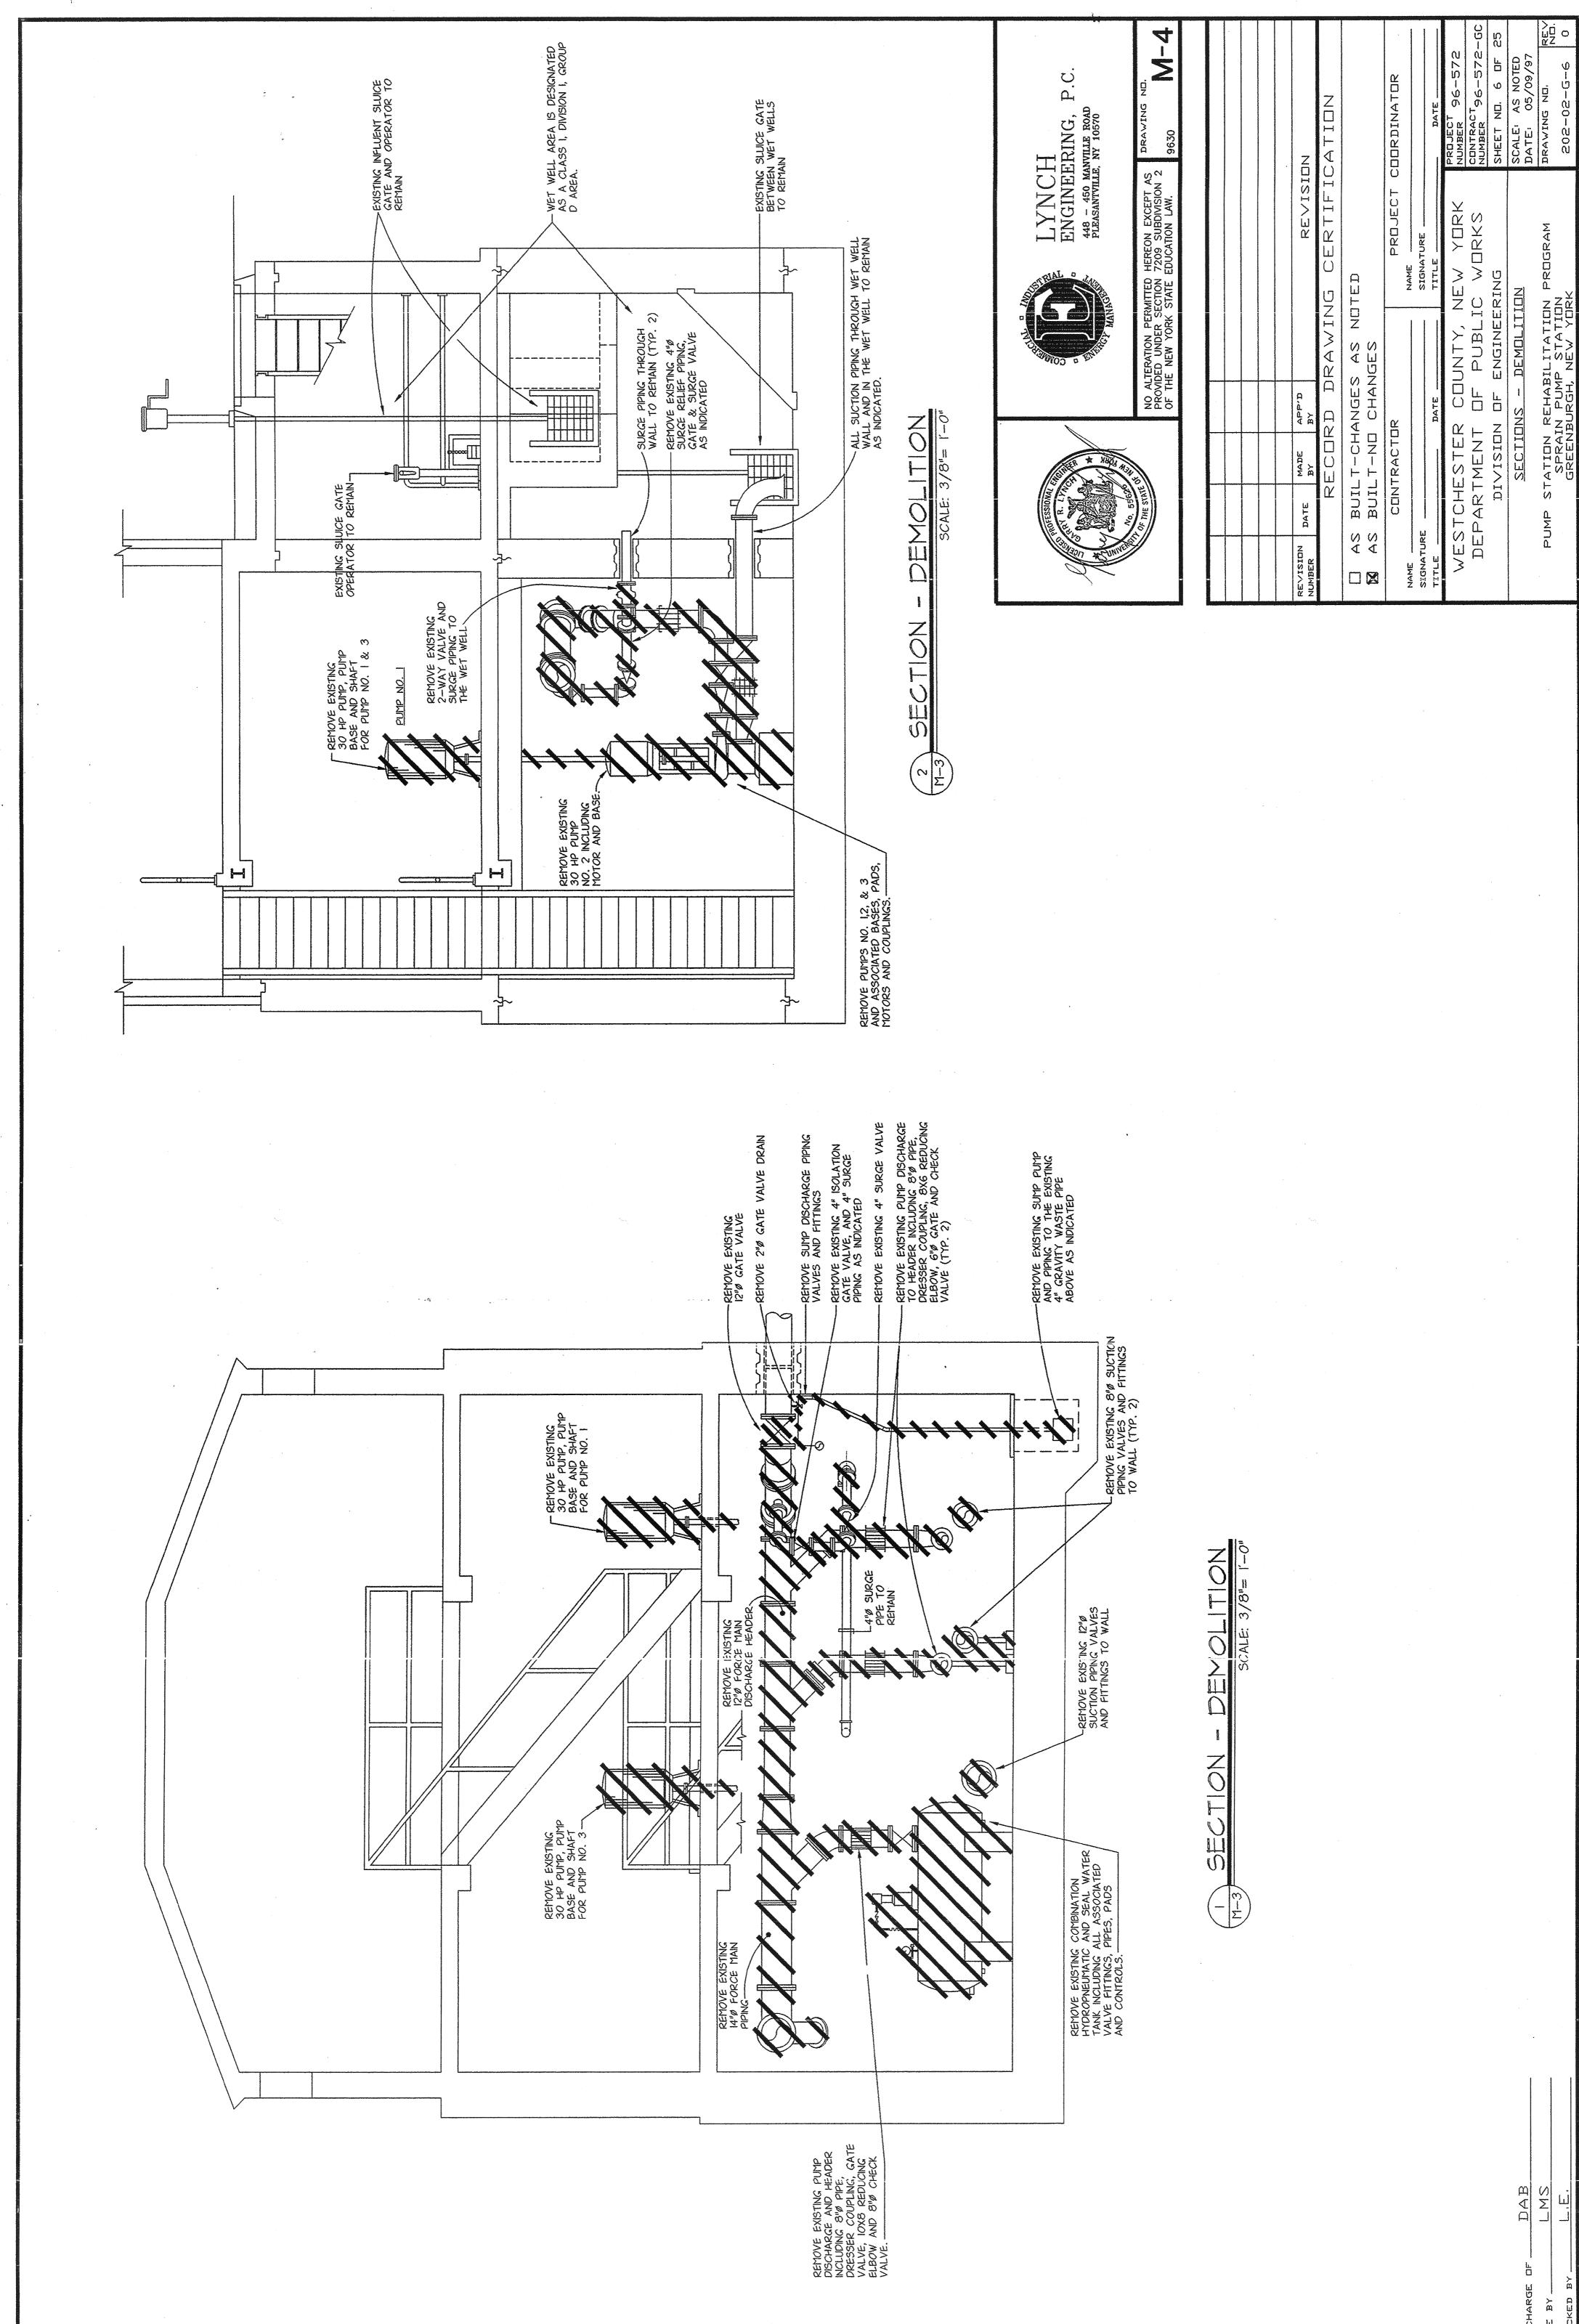
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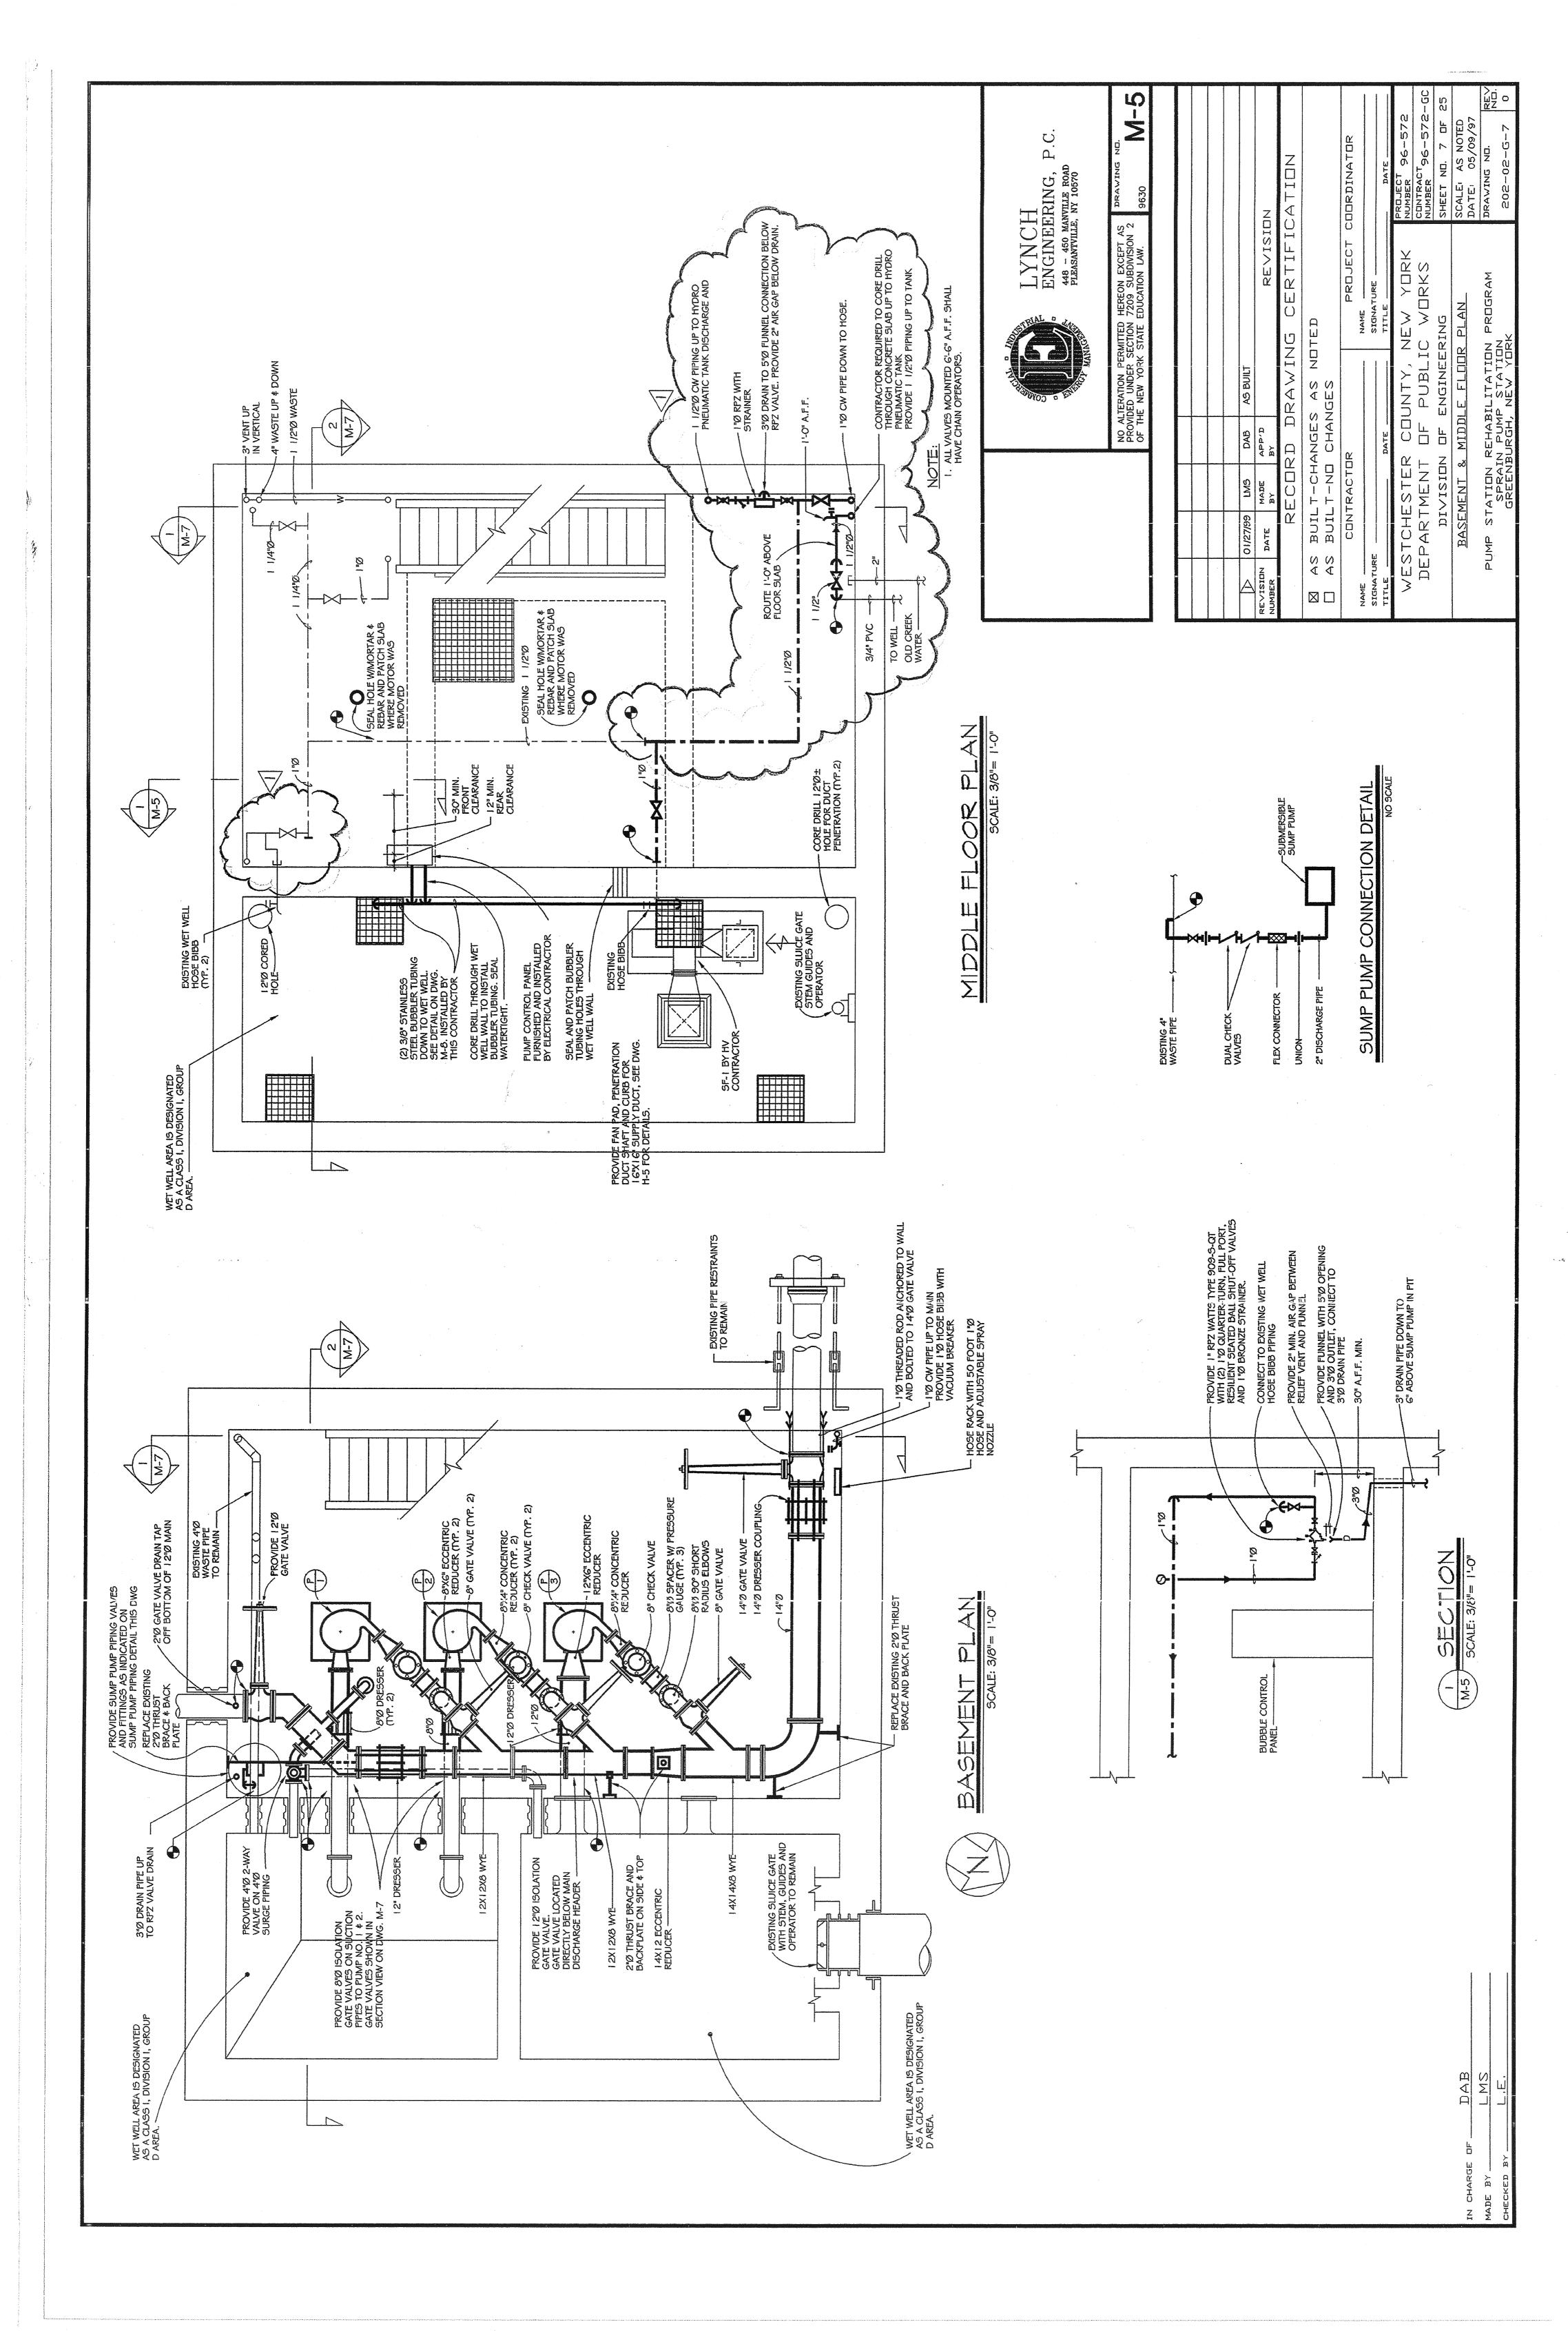











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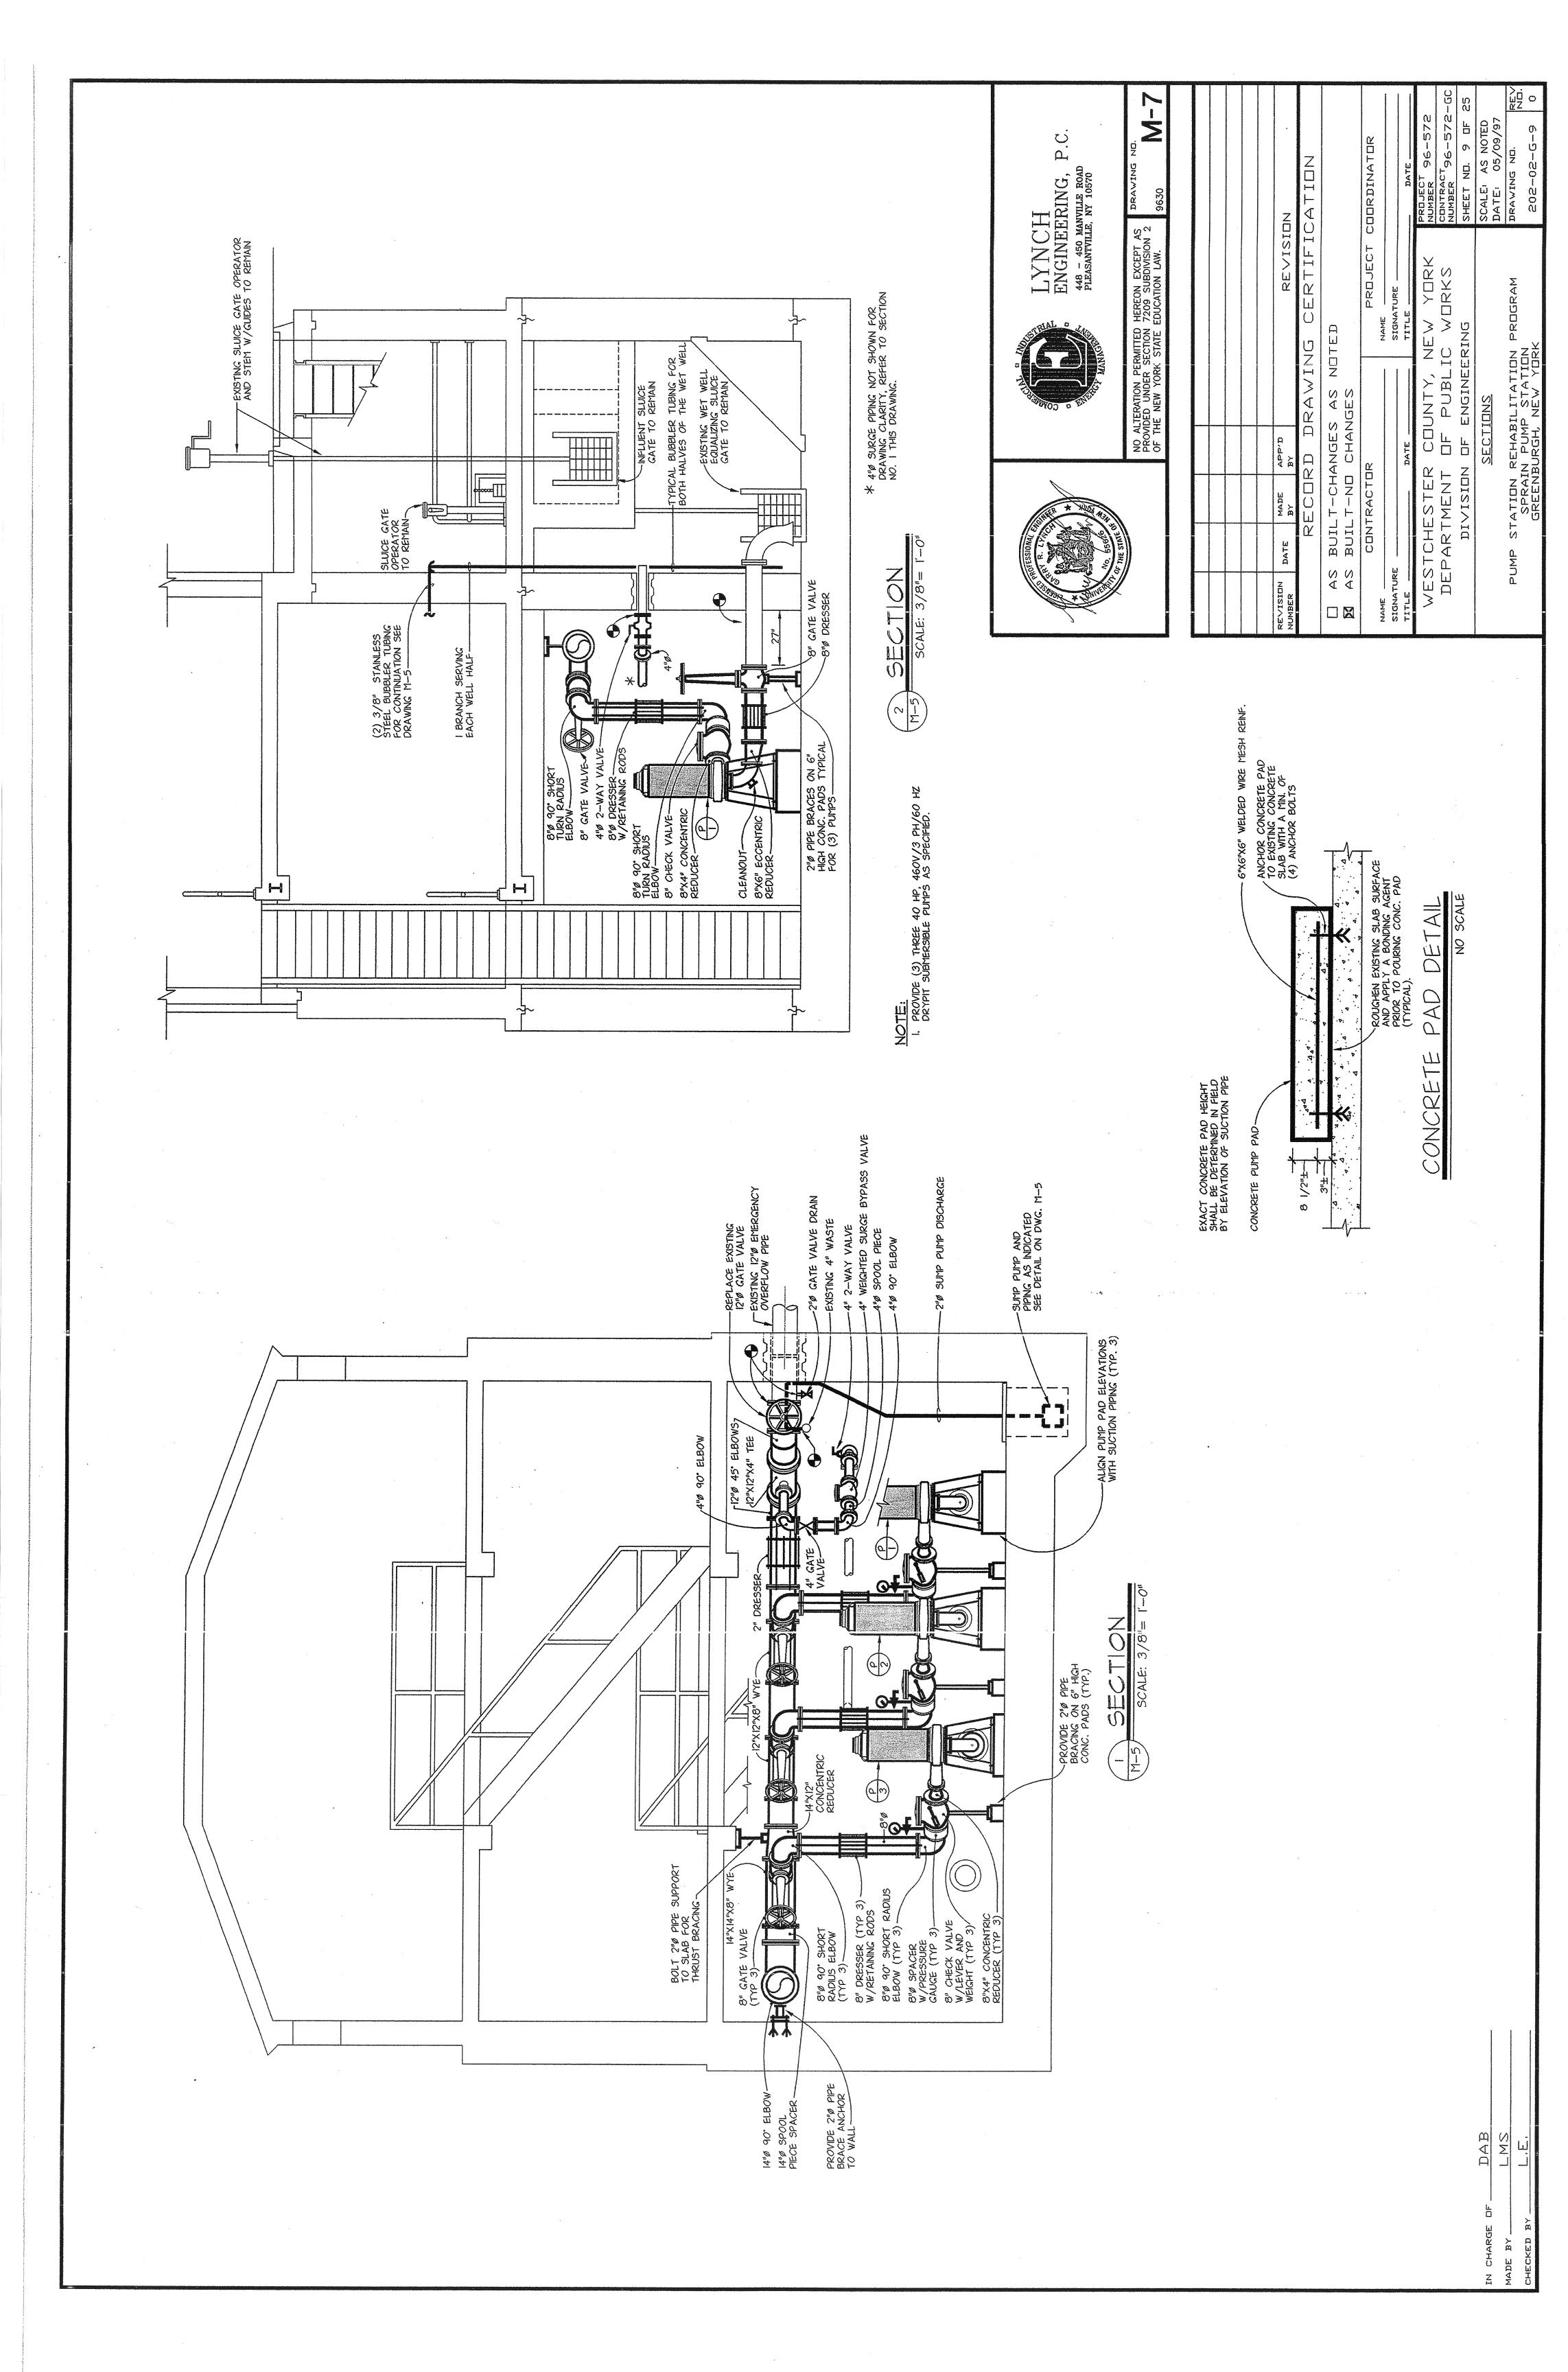



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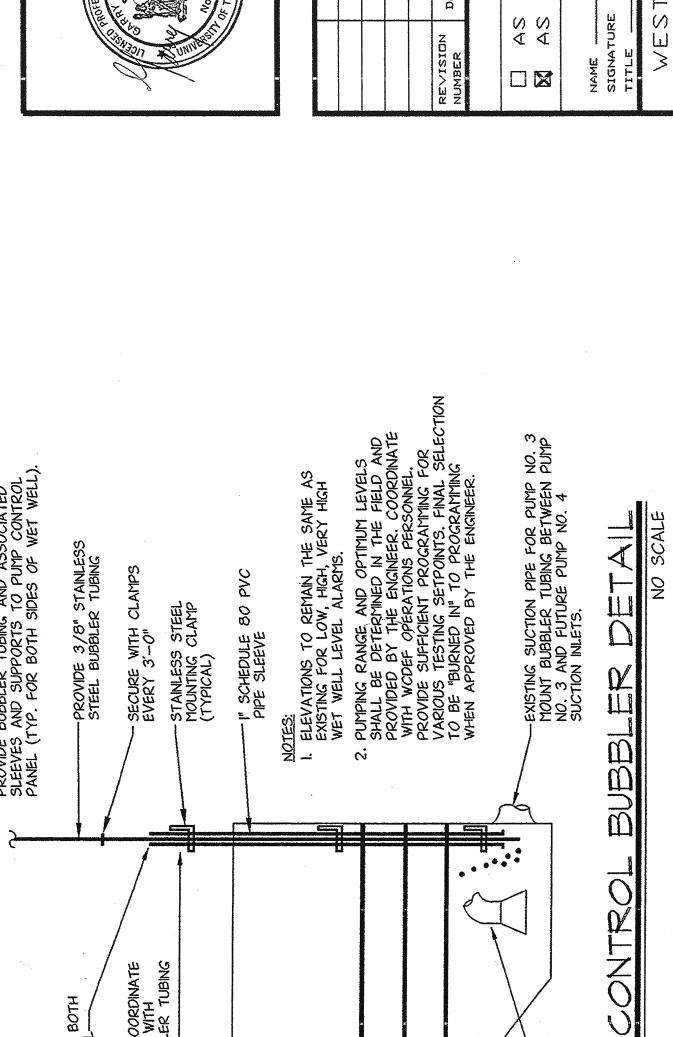
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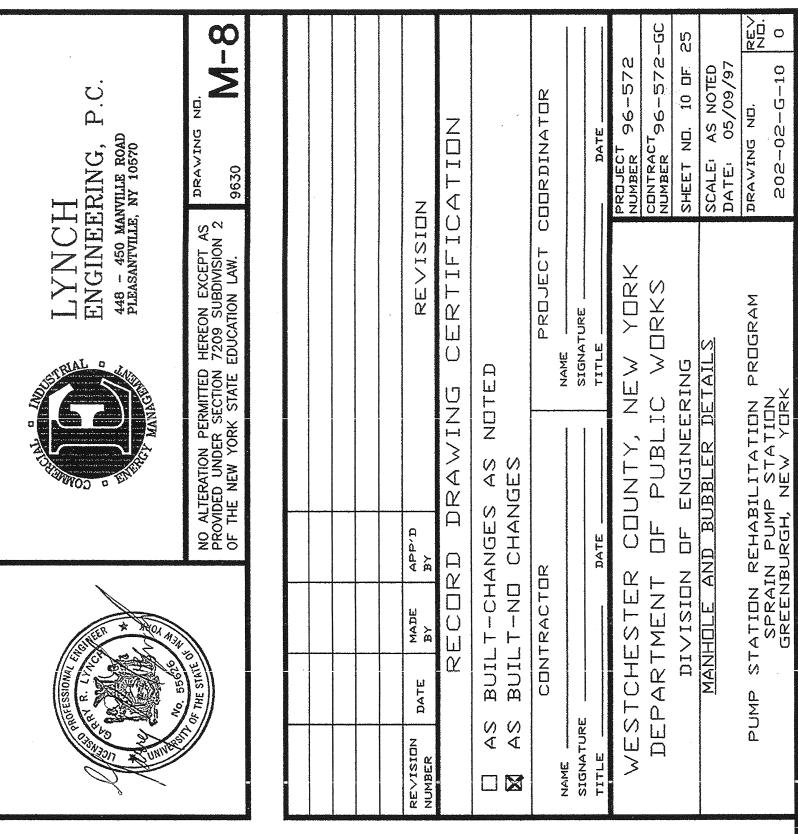
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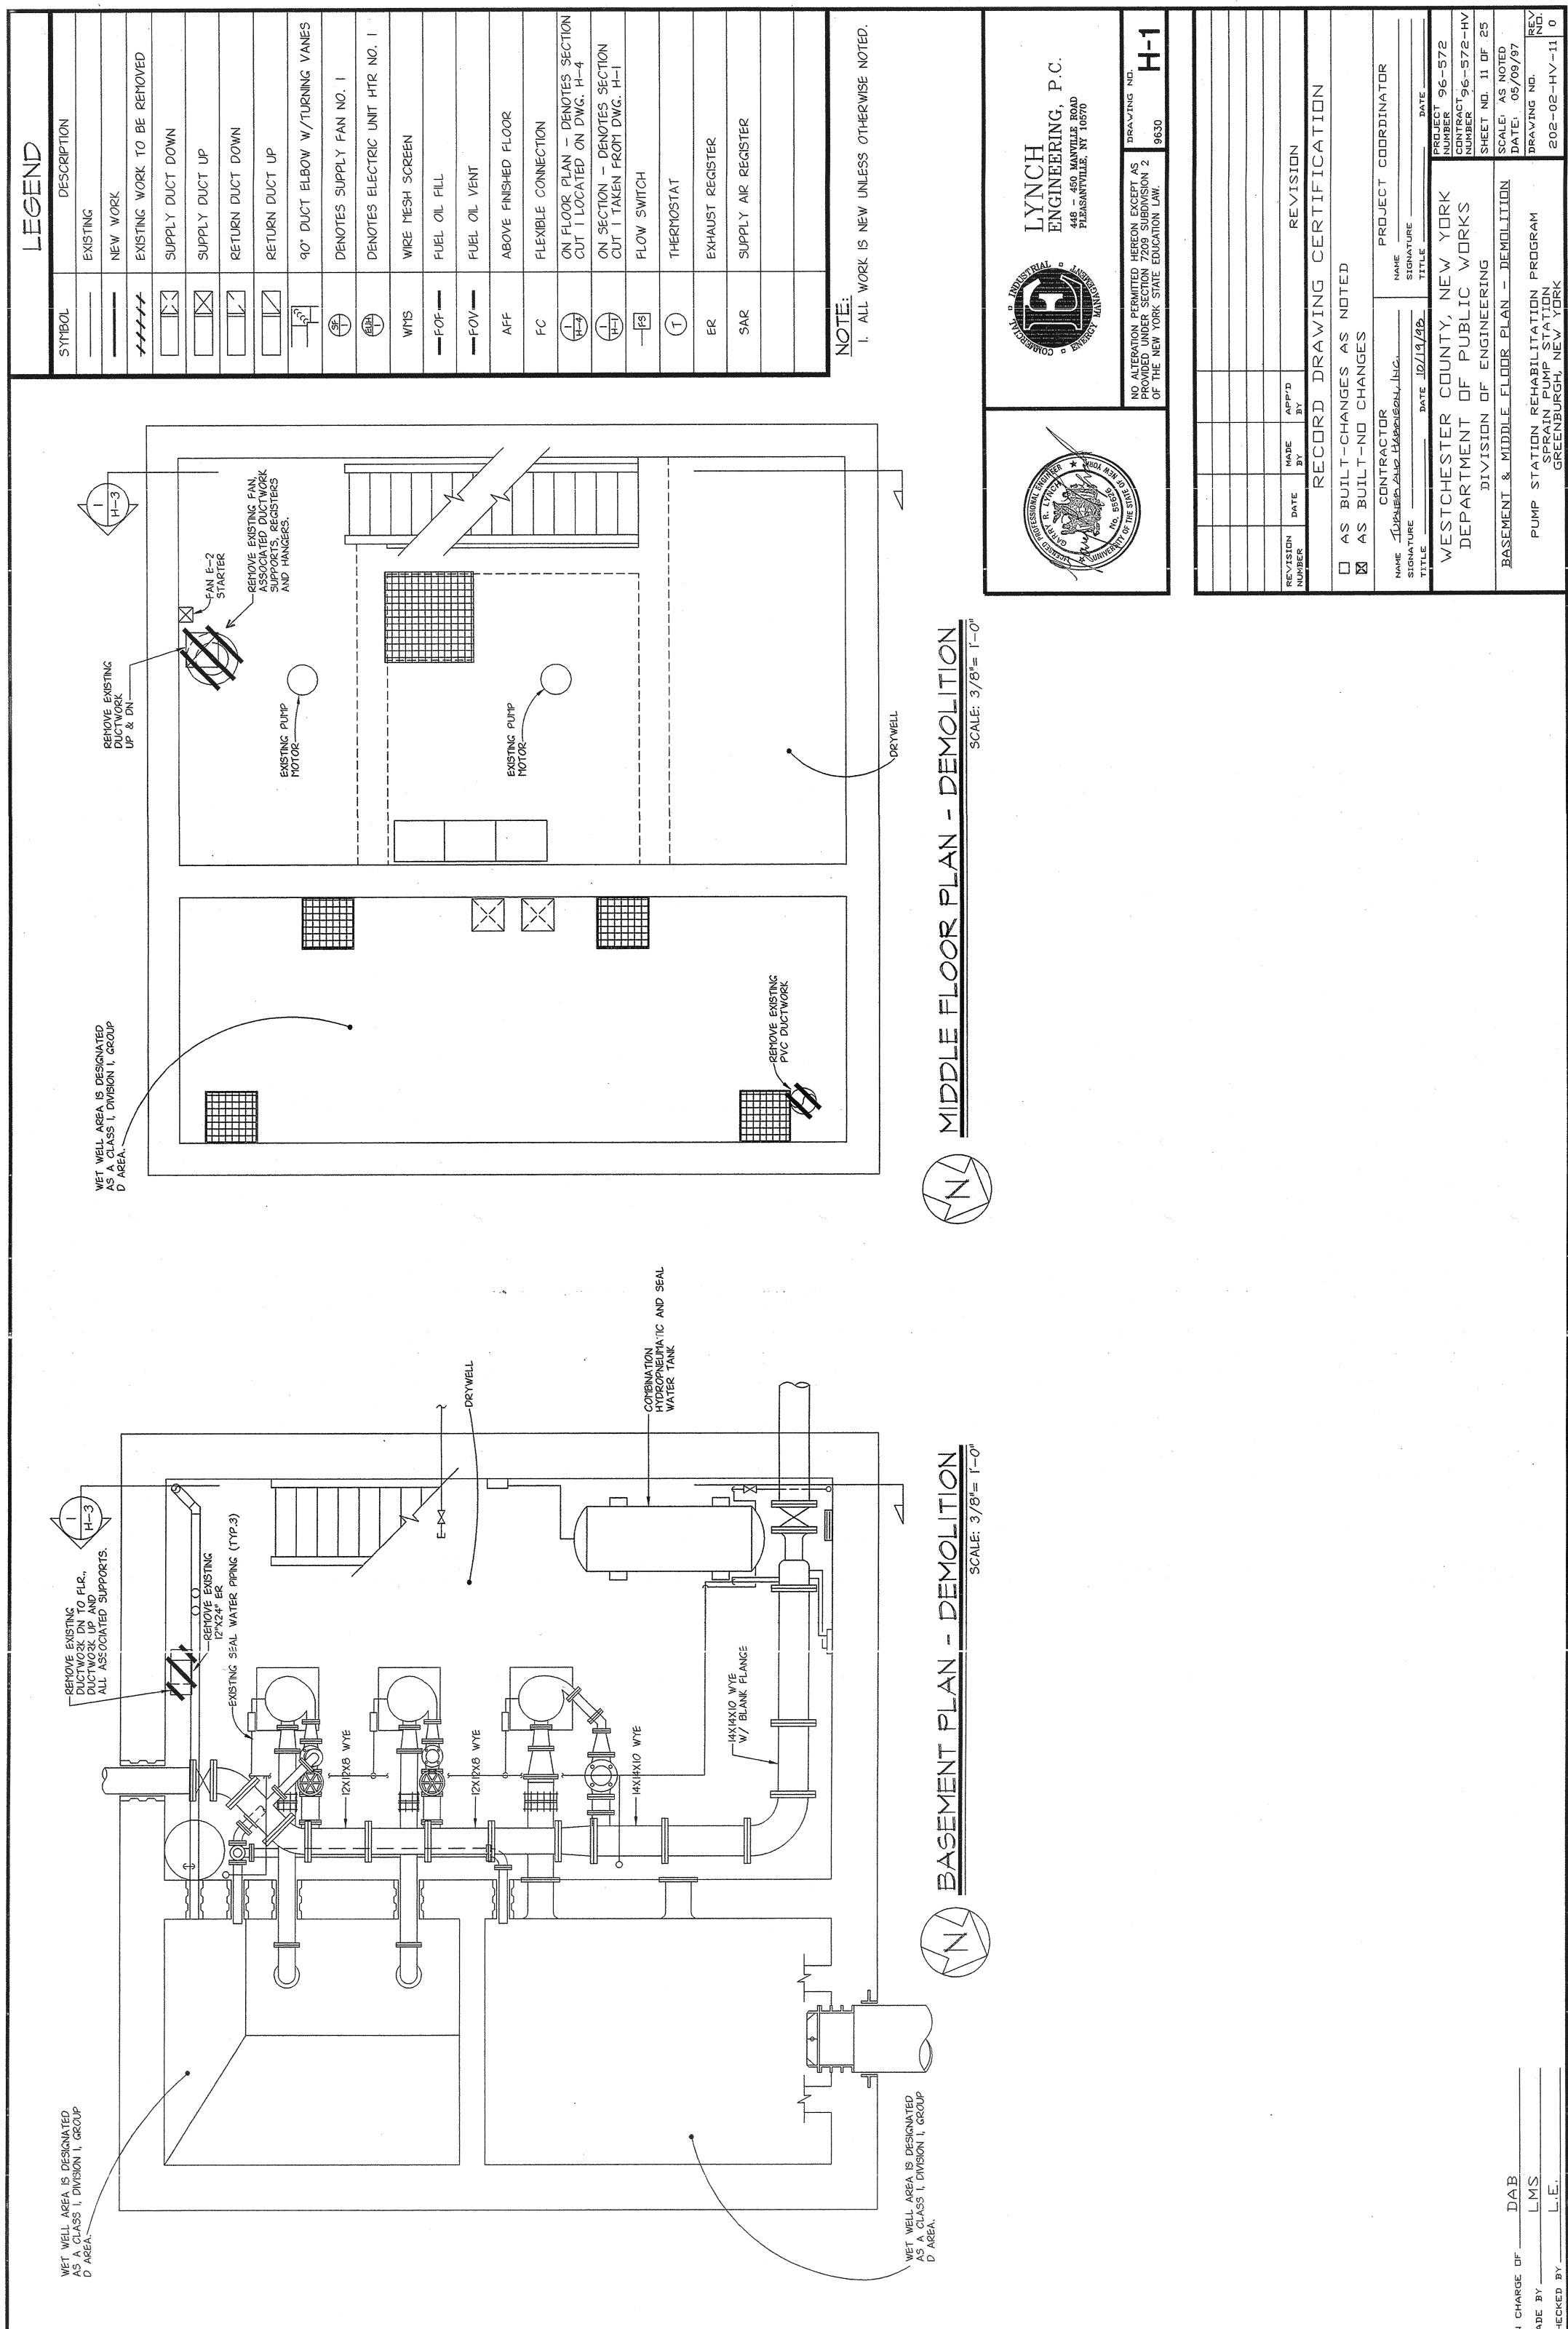
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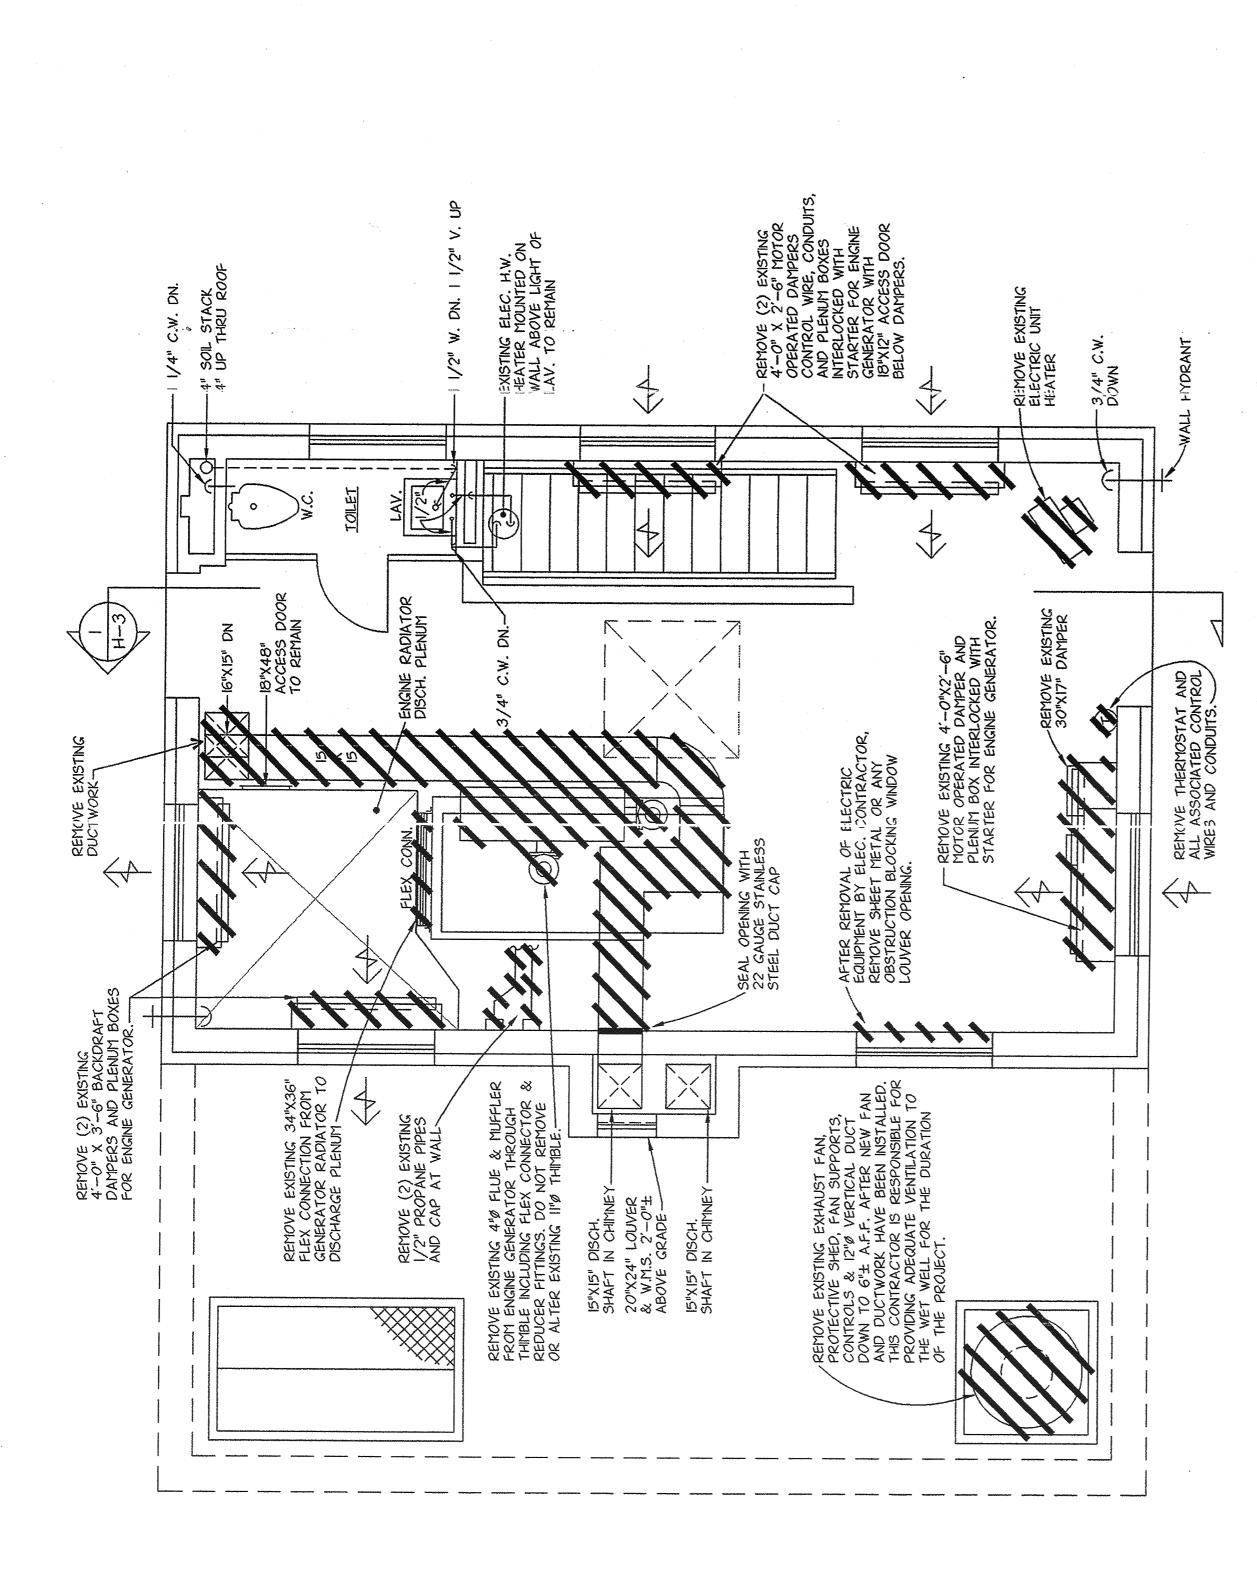
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DEPARTMENT OF PUBLIC WORKS

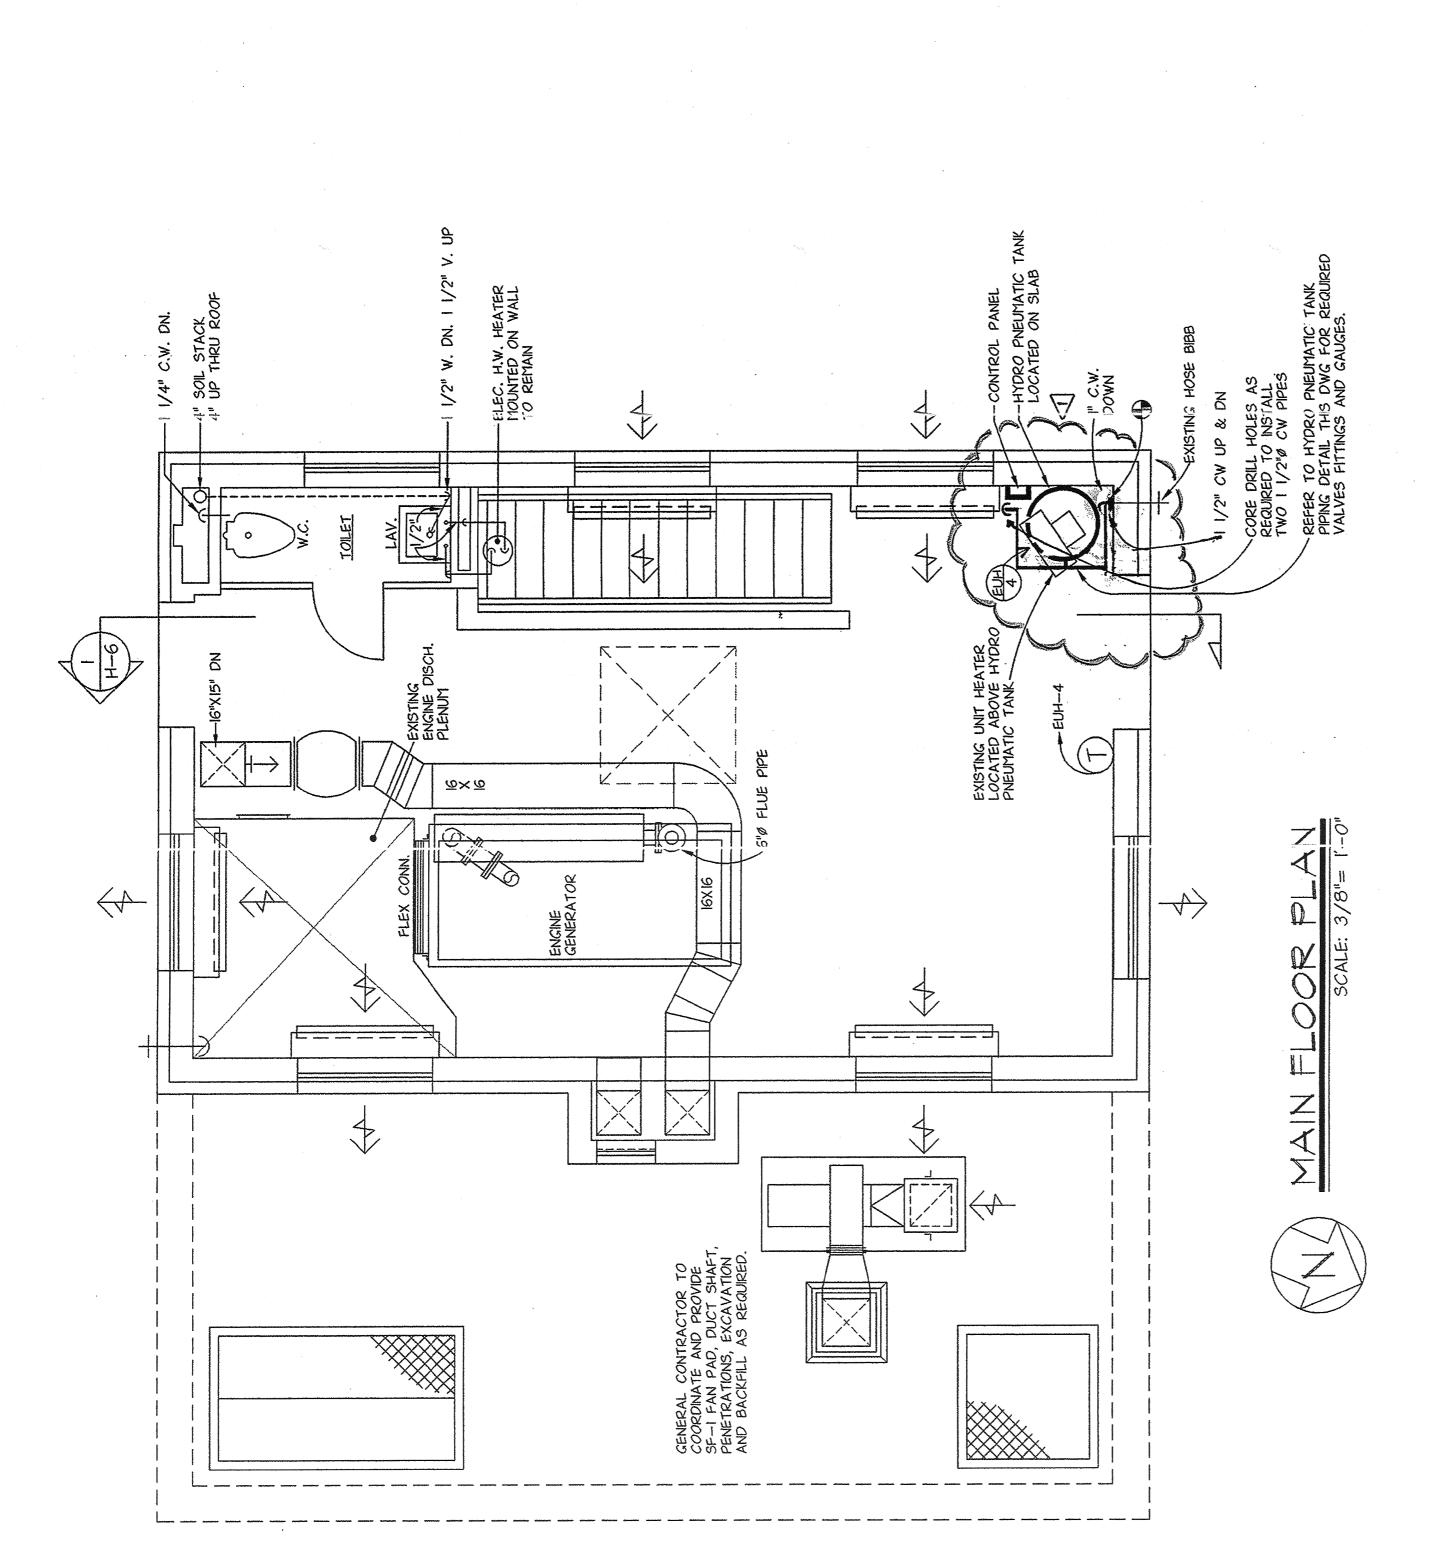DIVISION OF ENGINEERING
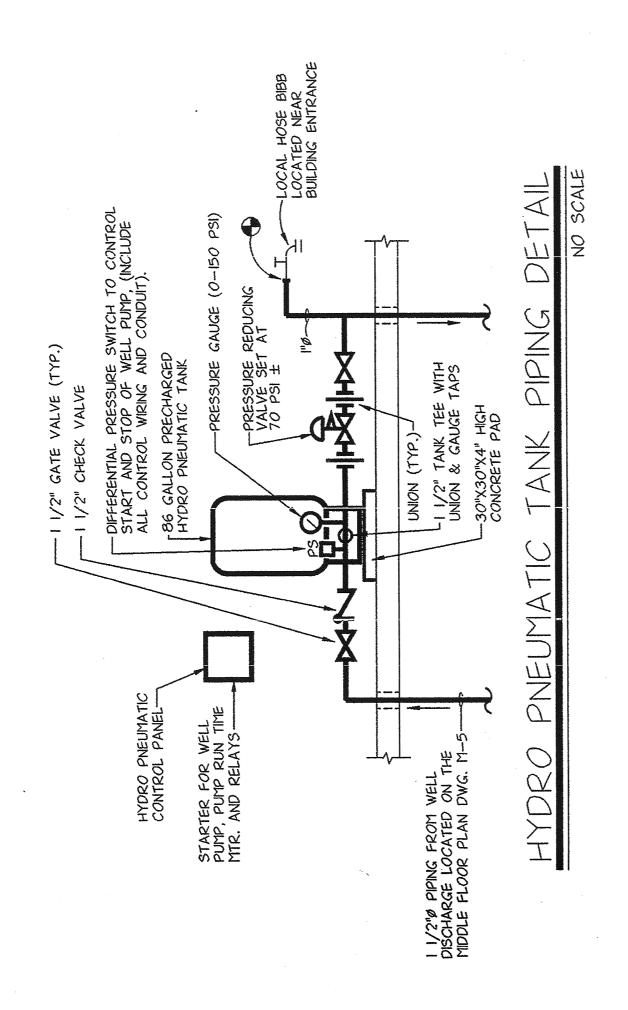
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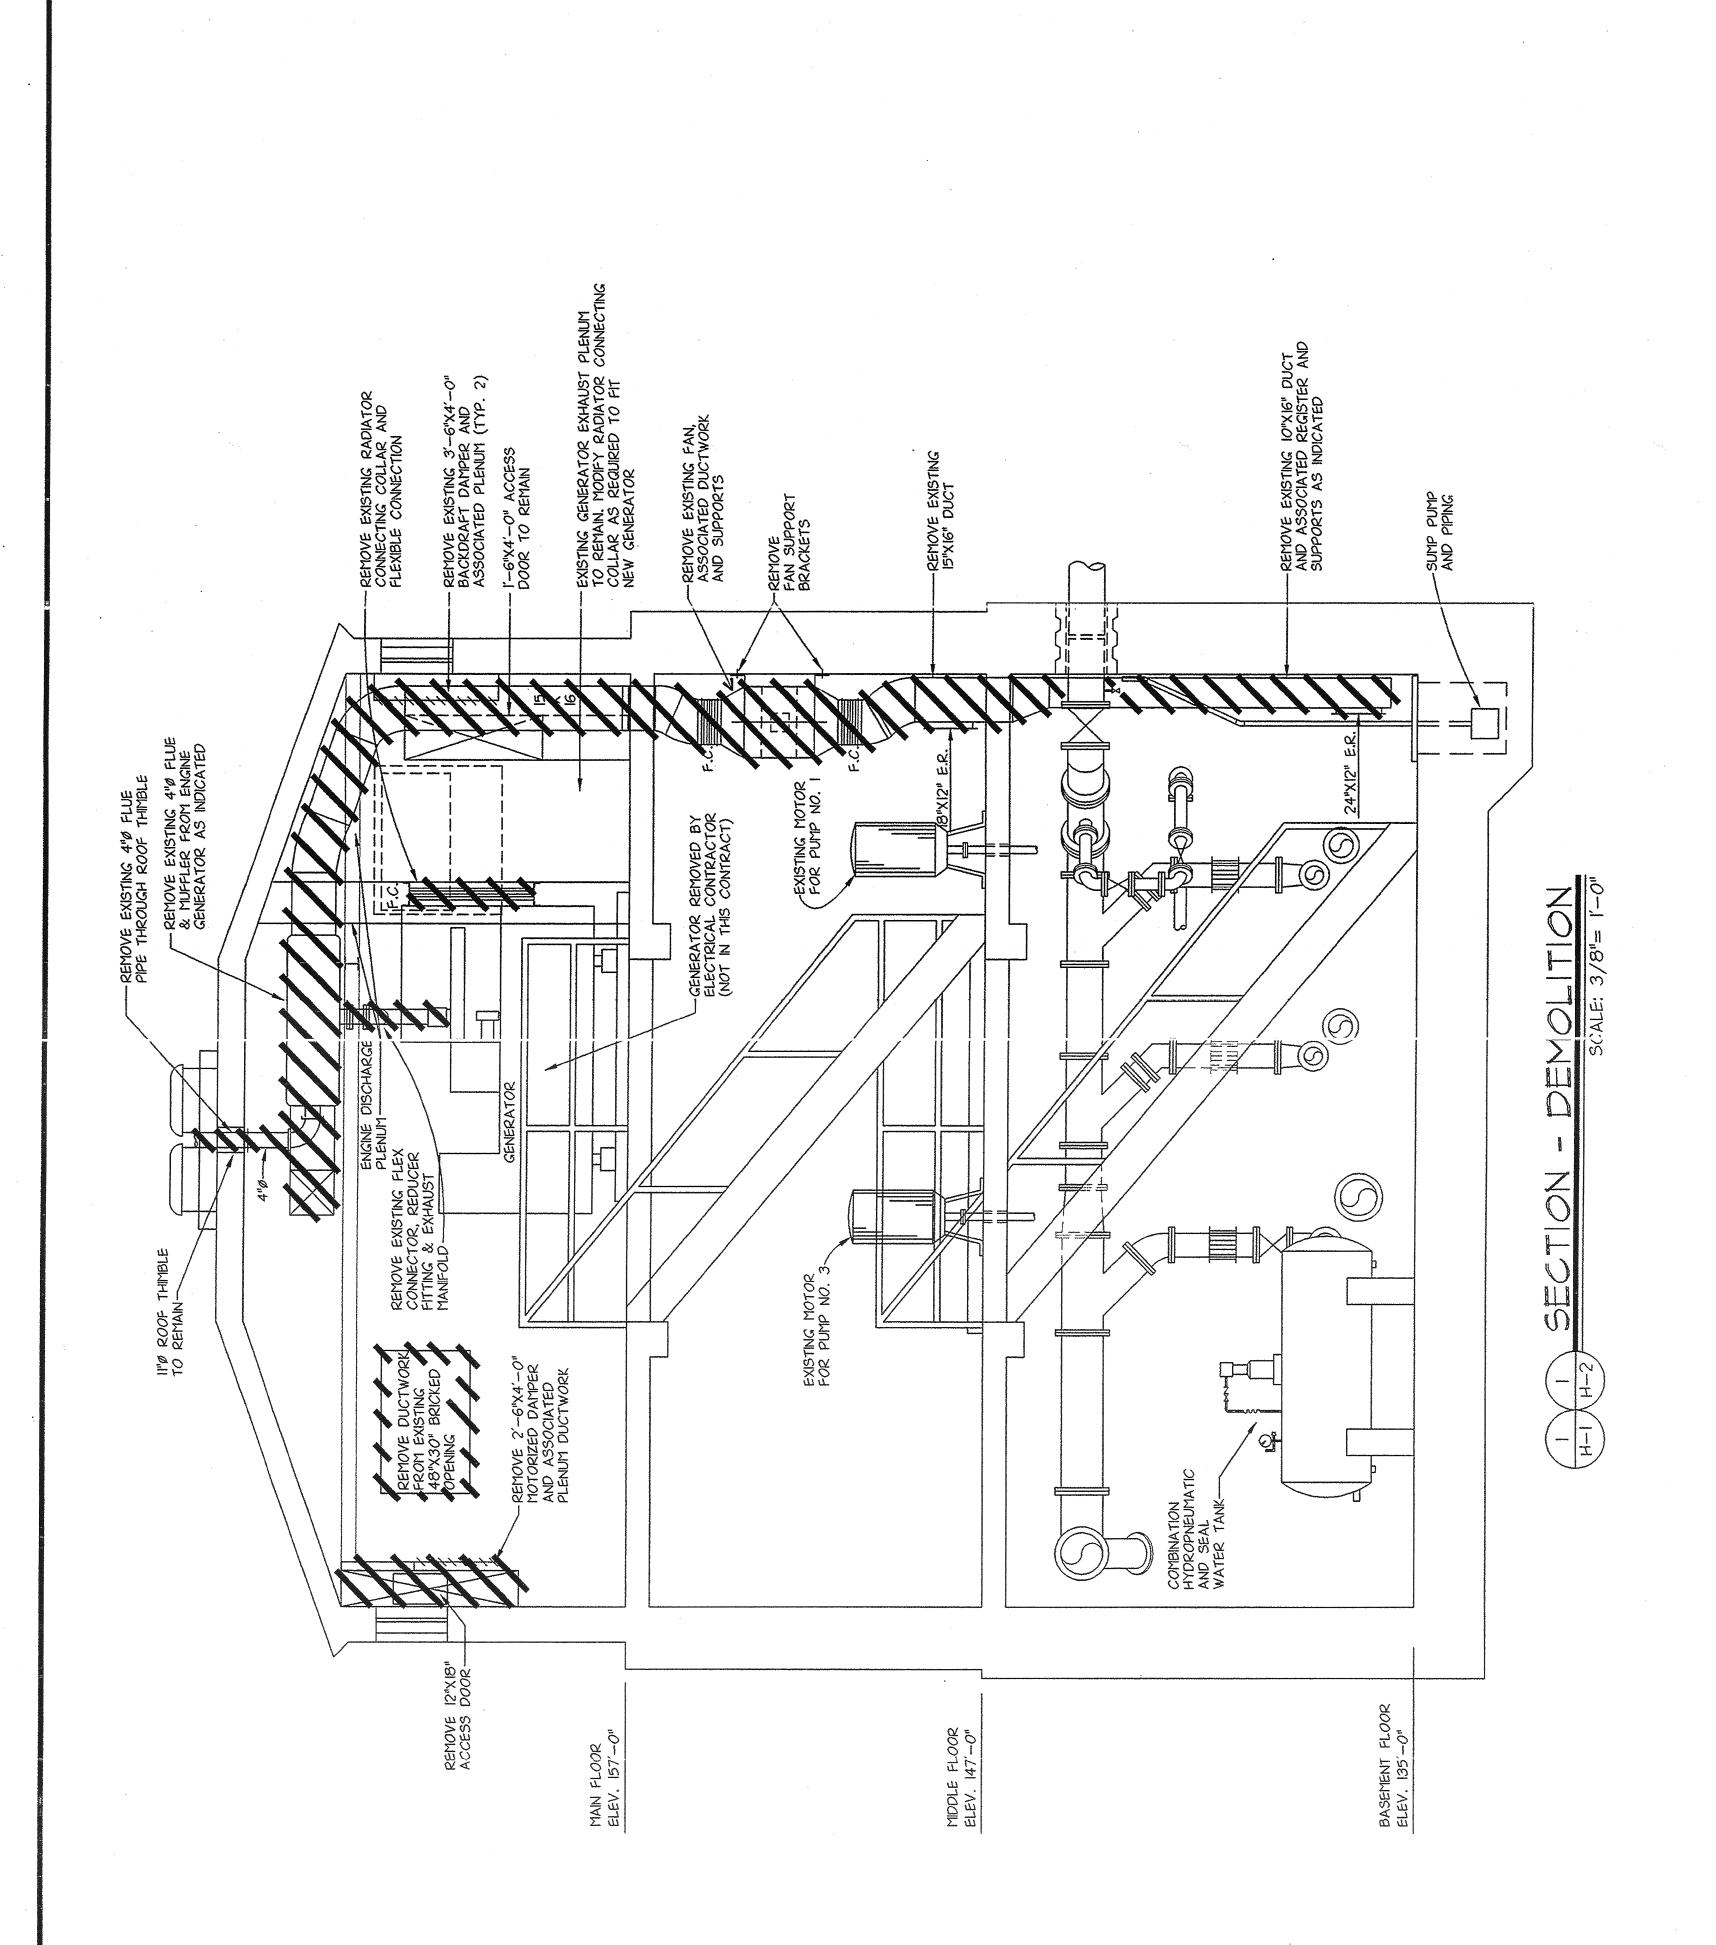
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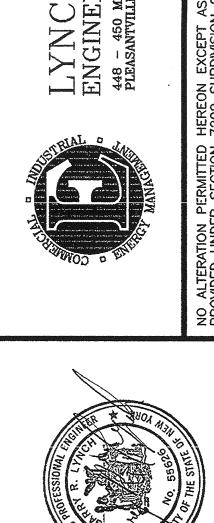
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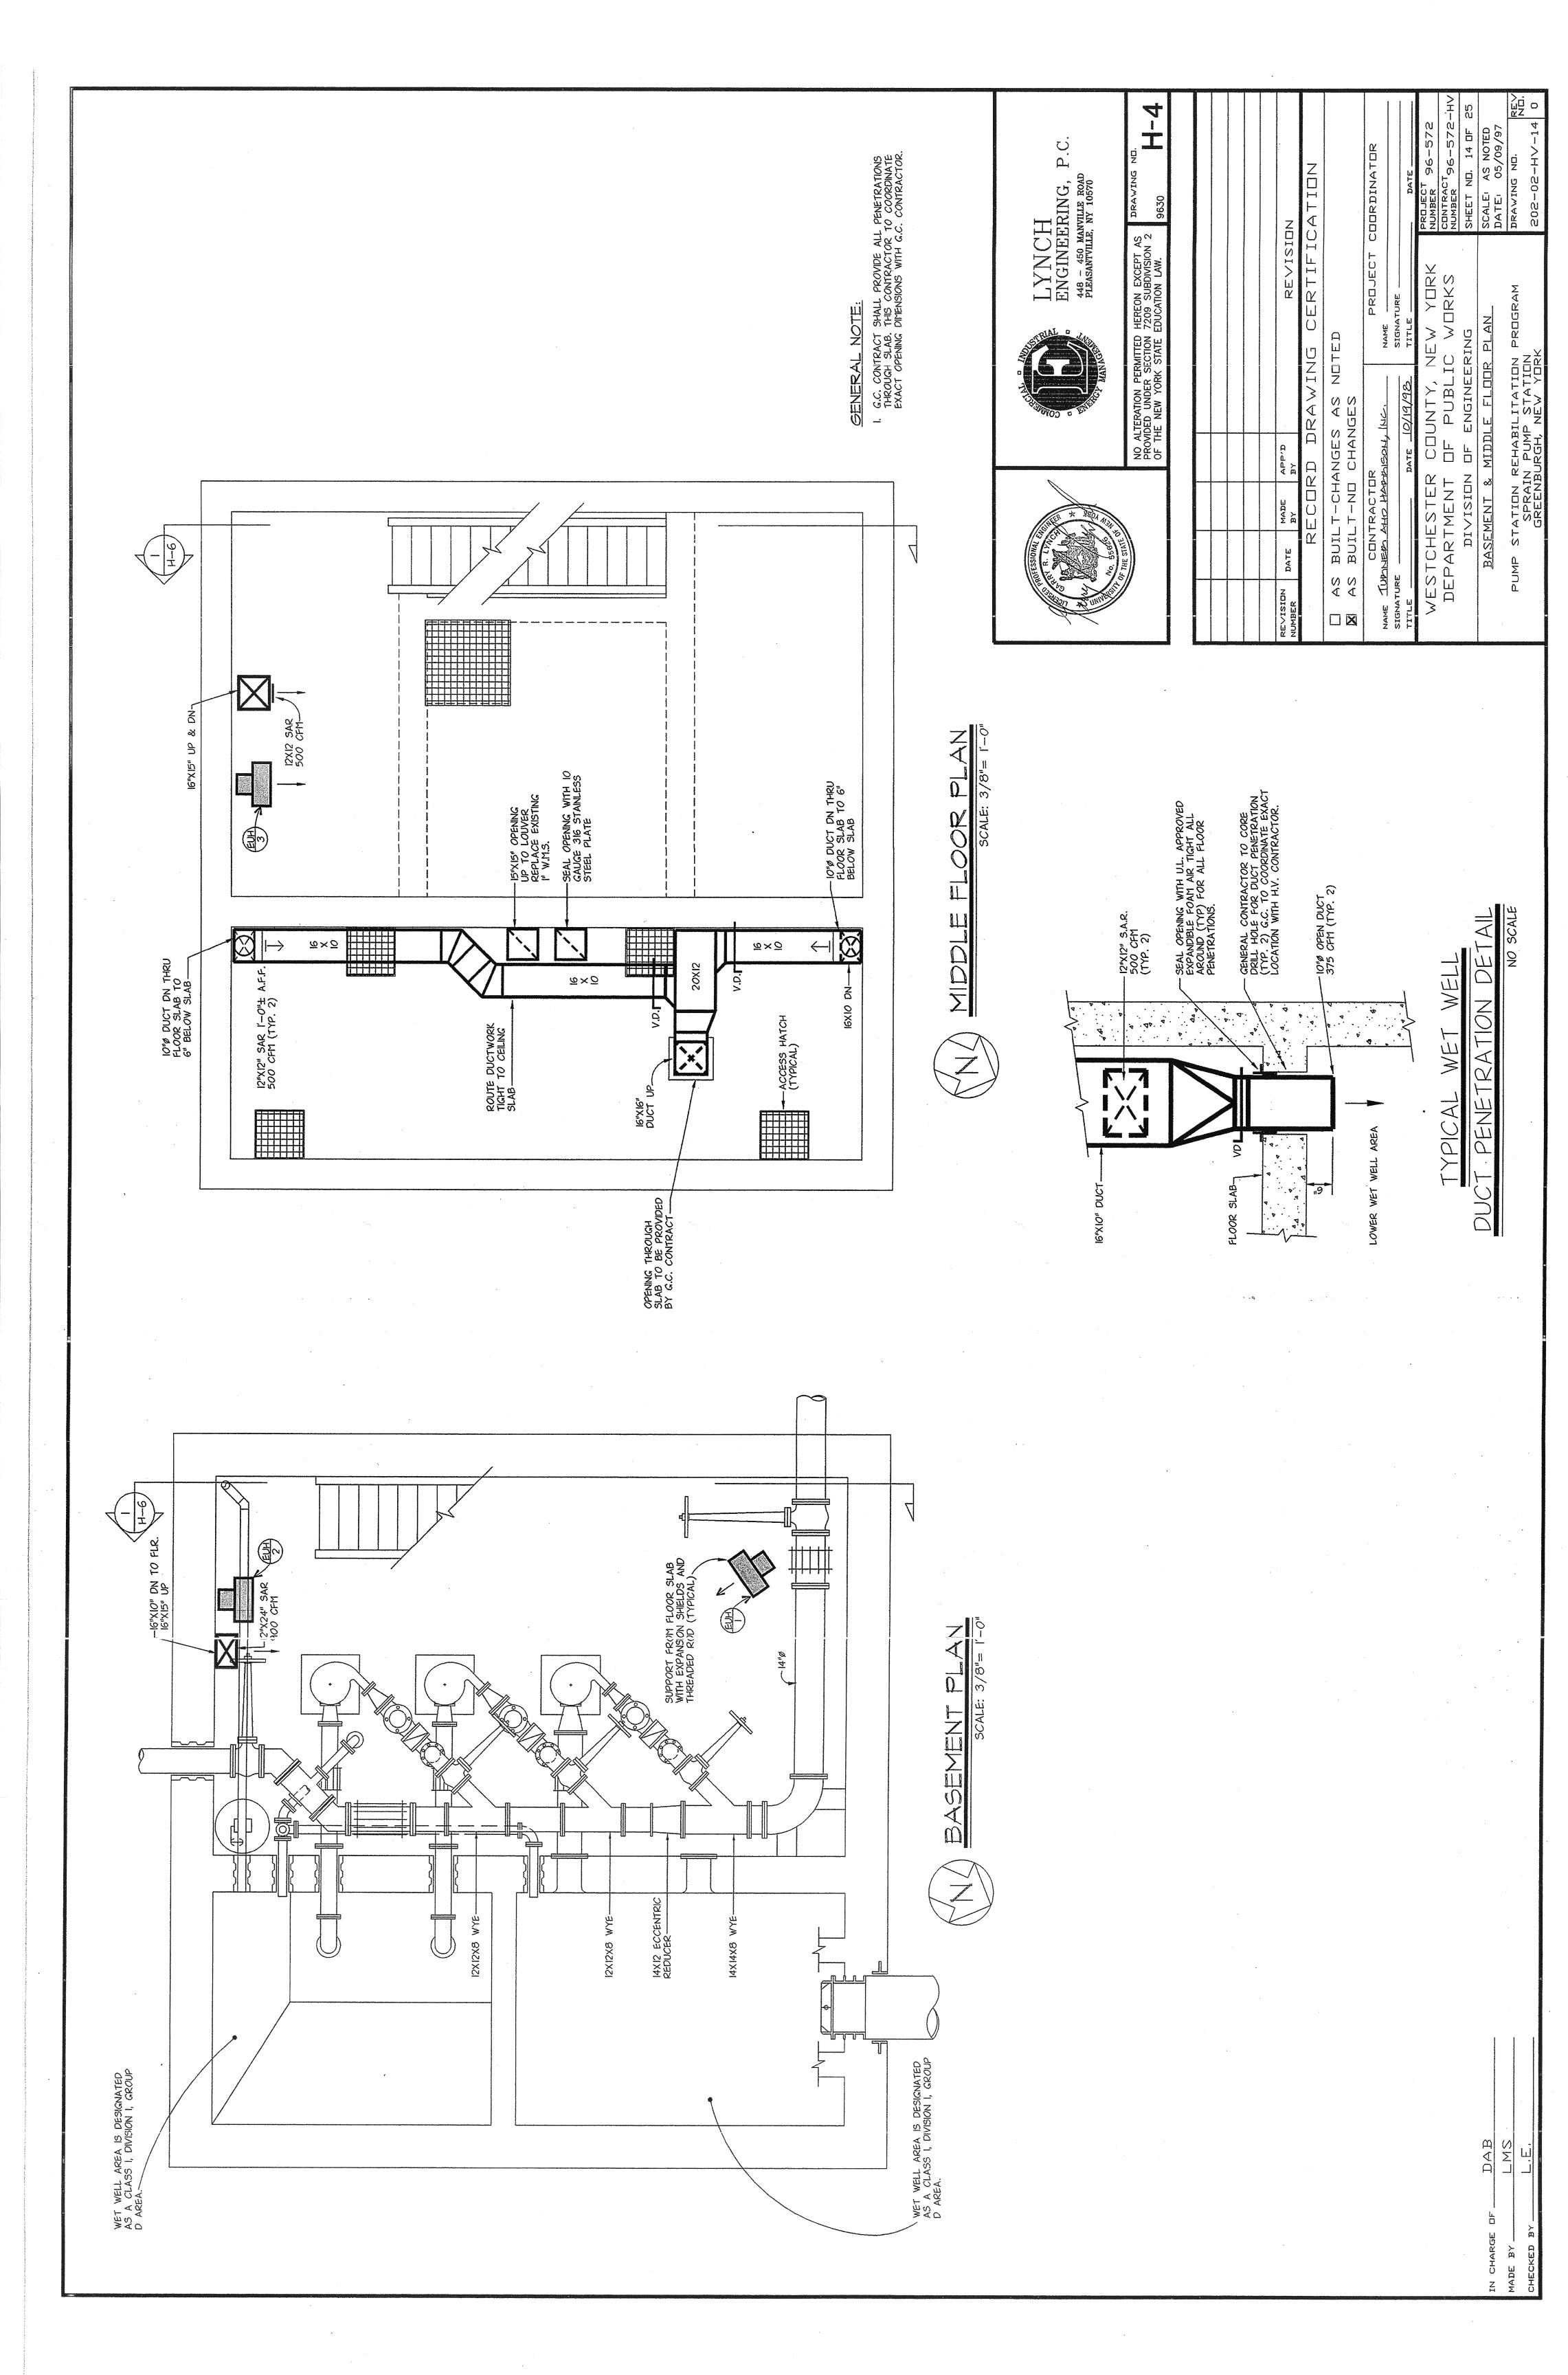
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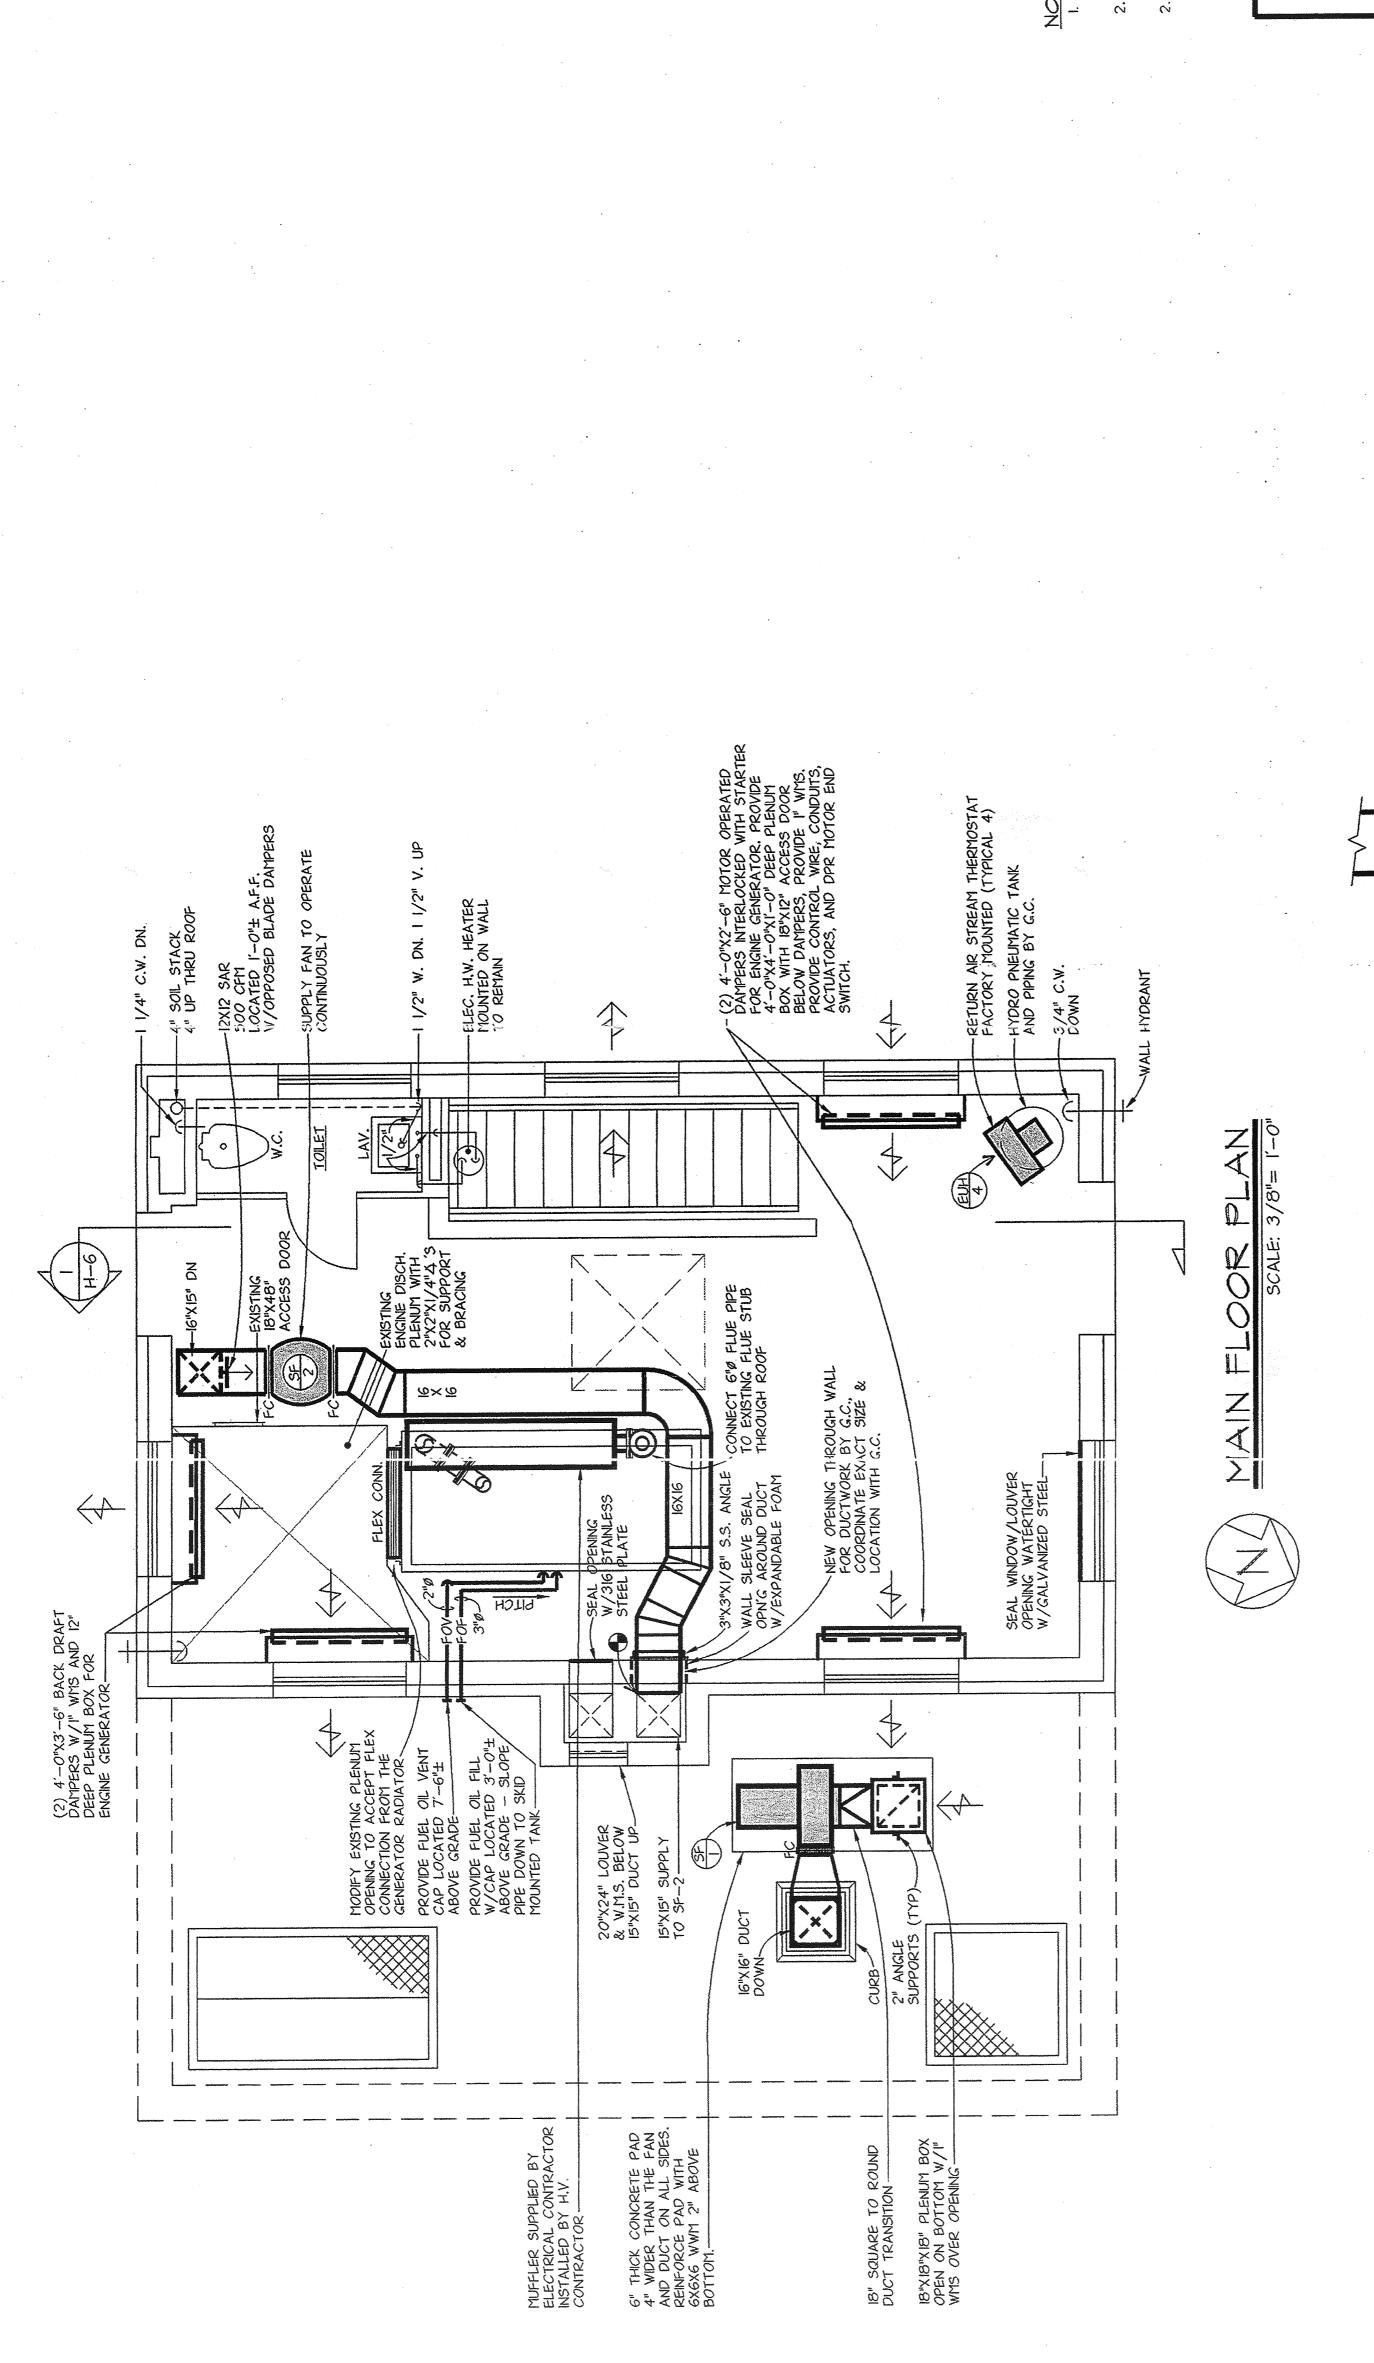
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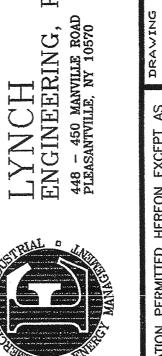
NOTE:
I. ALL PLENUM BOXES AND DUCTWORK SHALL BE 316 STAINLESS STEEL.

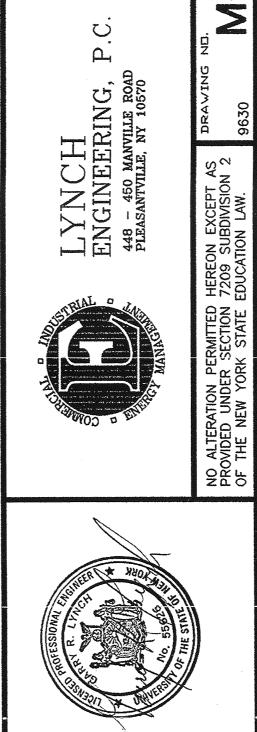2. ALL FANS AND DAMPERS TO BE ALUMINUM AS SPECIFIED.

2. PROVIDE FLUE FOR GENERATOR FOR A FULLY FUNCTIONING SYSTEM INCLUDING ALL FITTINGS, FLEX CONNECTORS, ADAPTORS, FLUE CAPS, COLLARS, HANGERS, ETC.

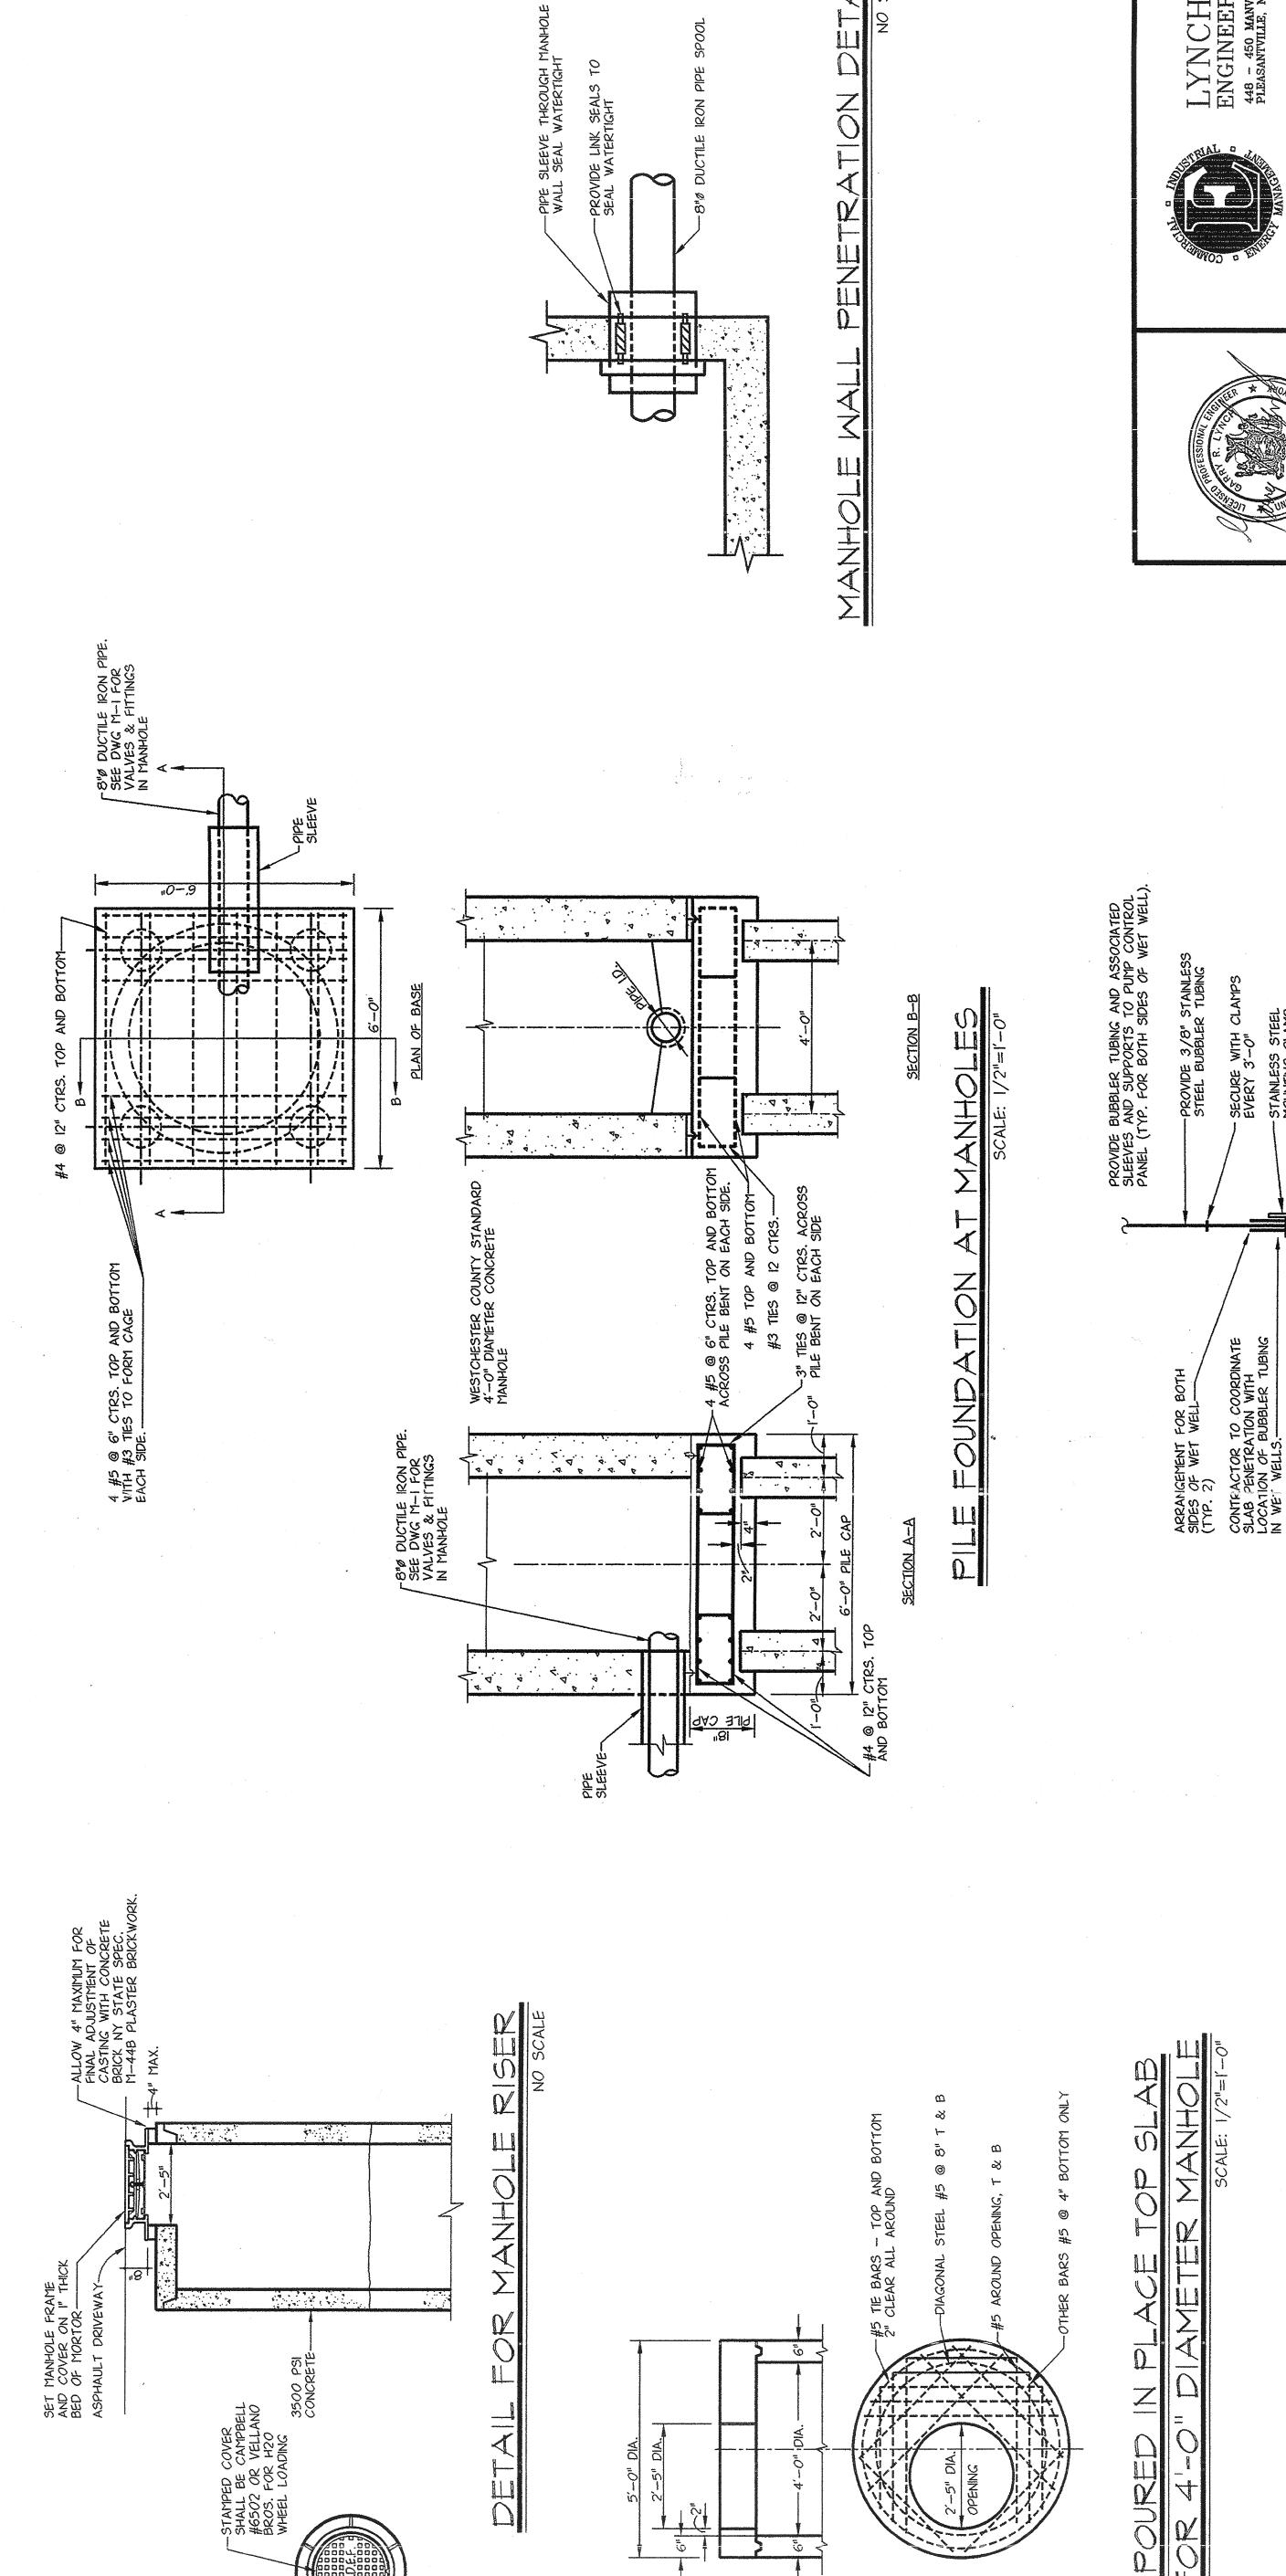





NO ALTERATION PERMITTED HEREON EXCEPT AS PROVIDED UNDER SECTION 7209 SUBDIVISION 2 OF THE NEW YORK STATE EDUCATION LAW.

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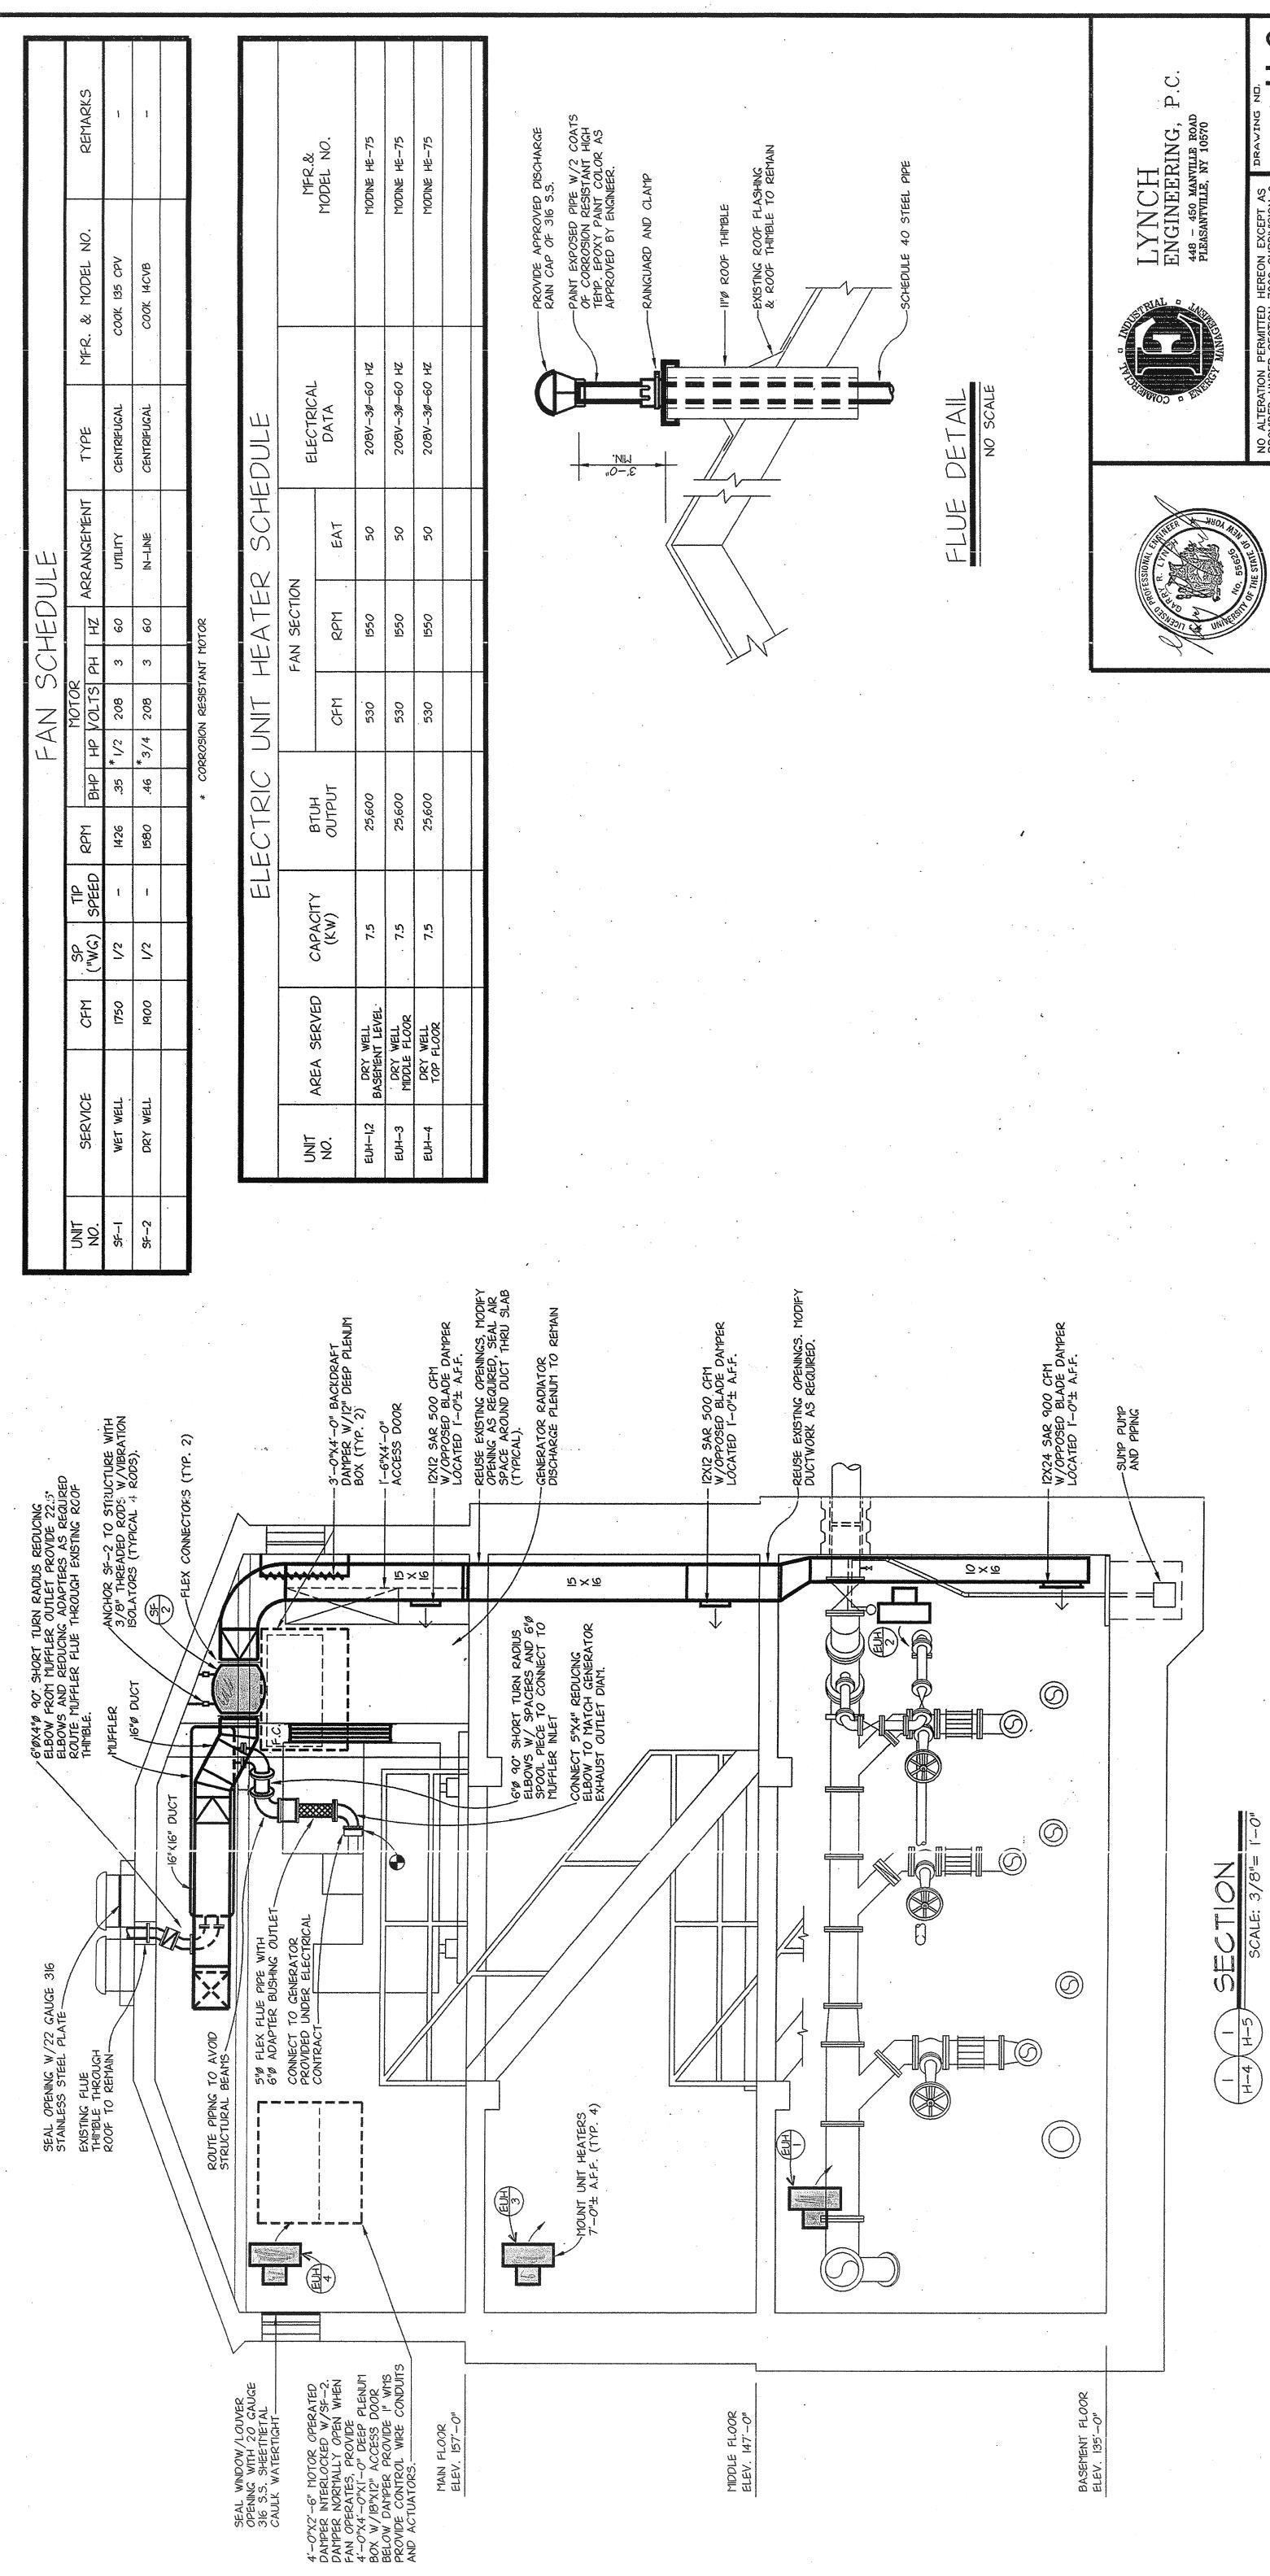
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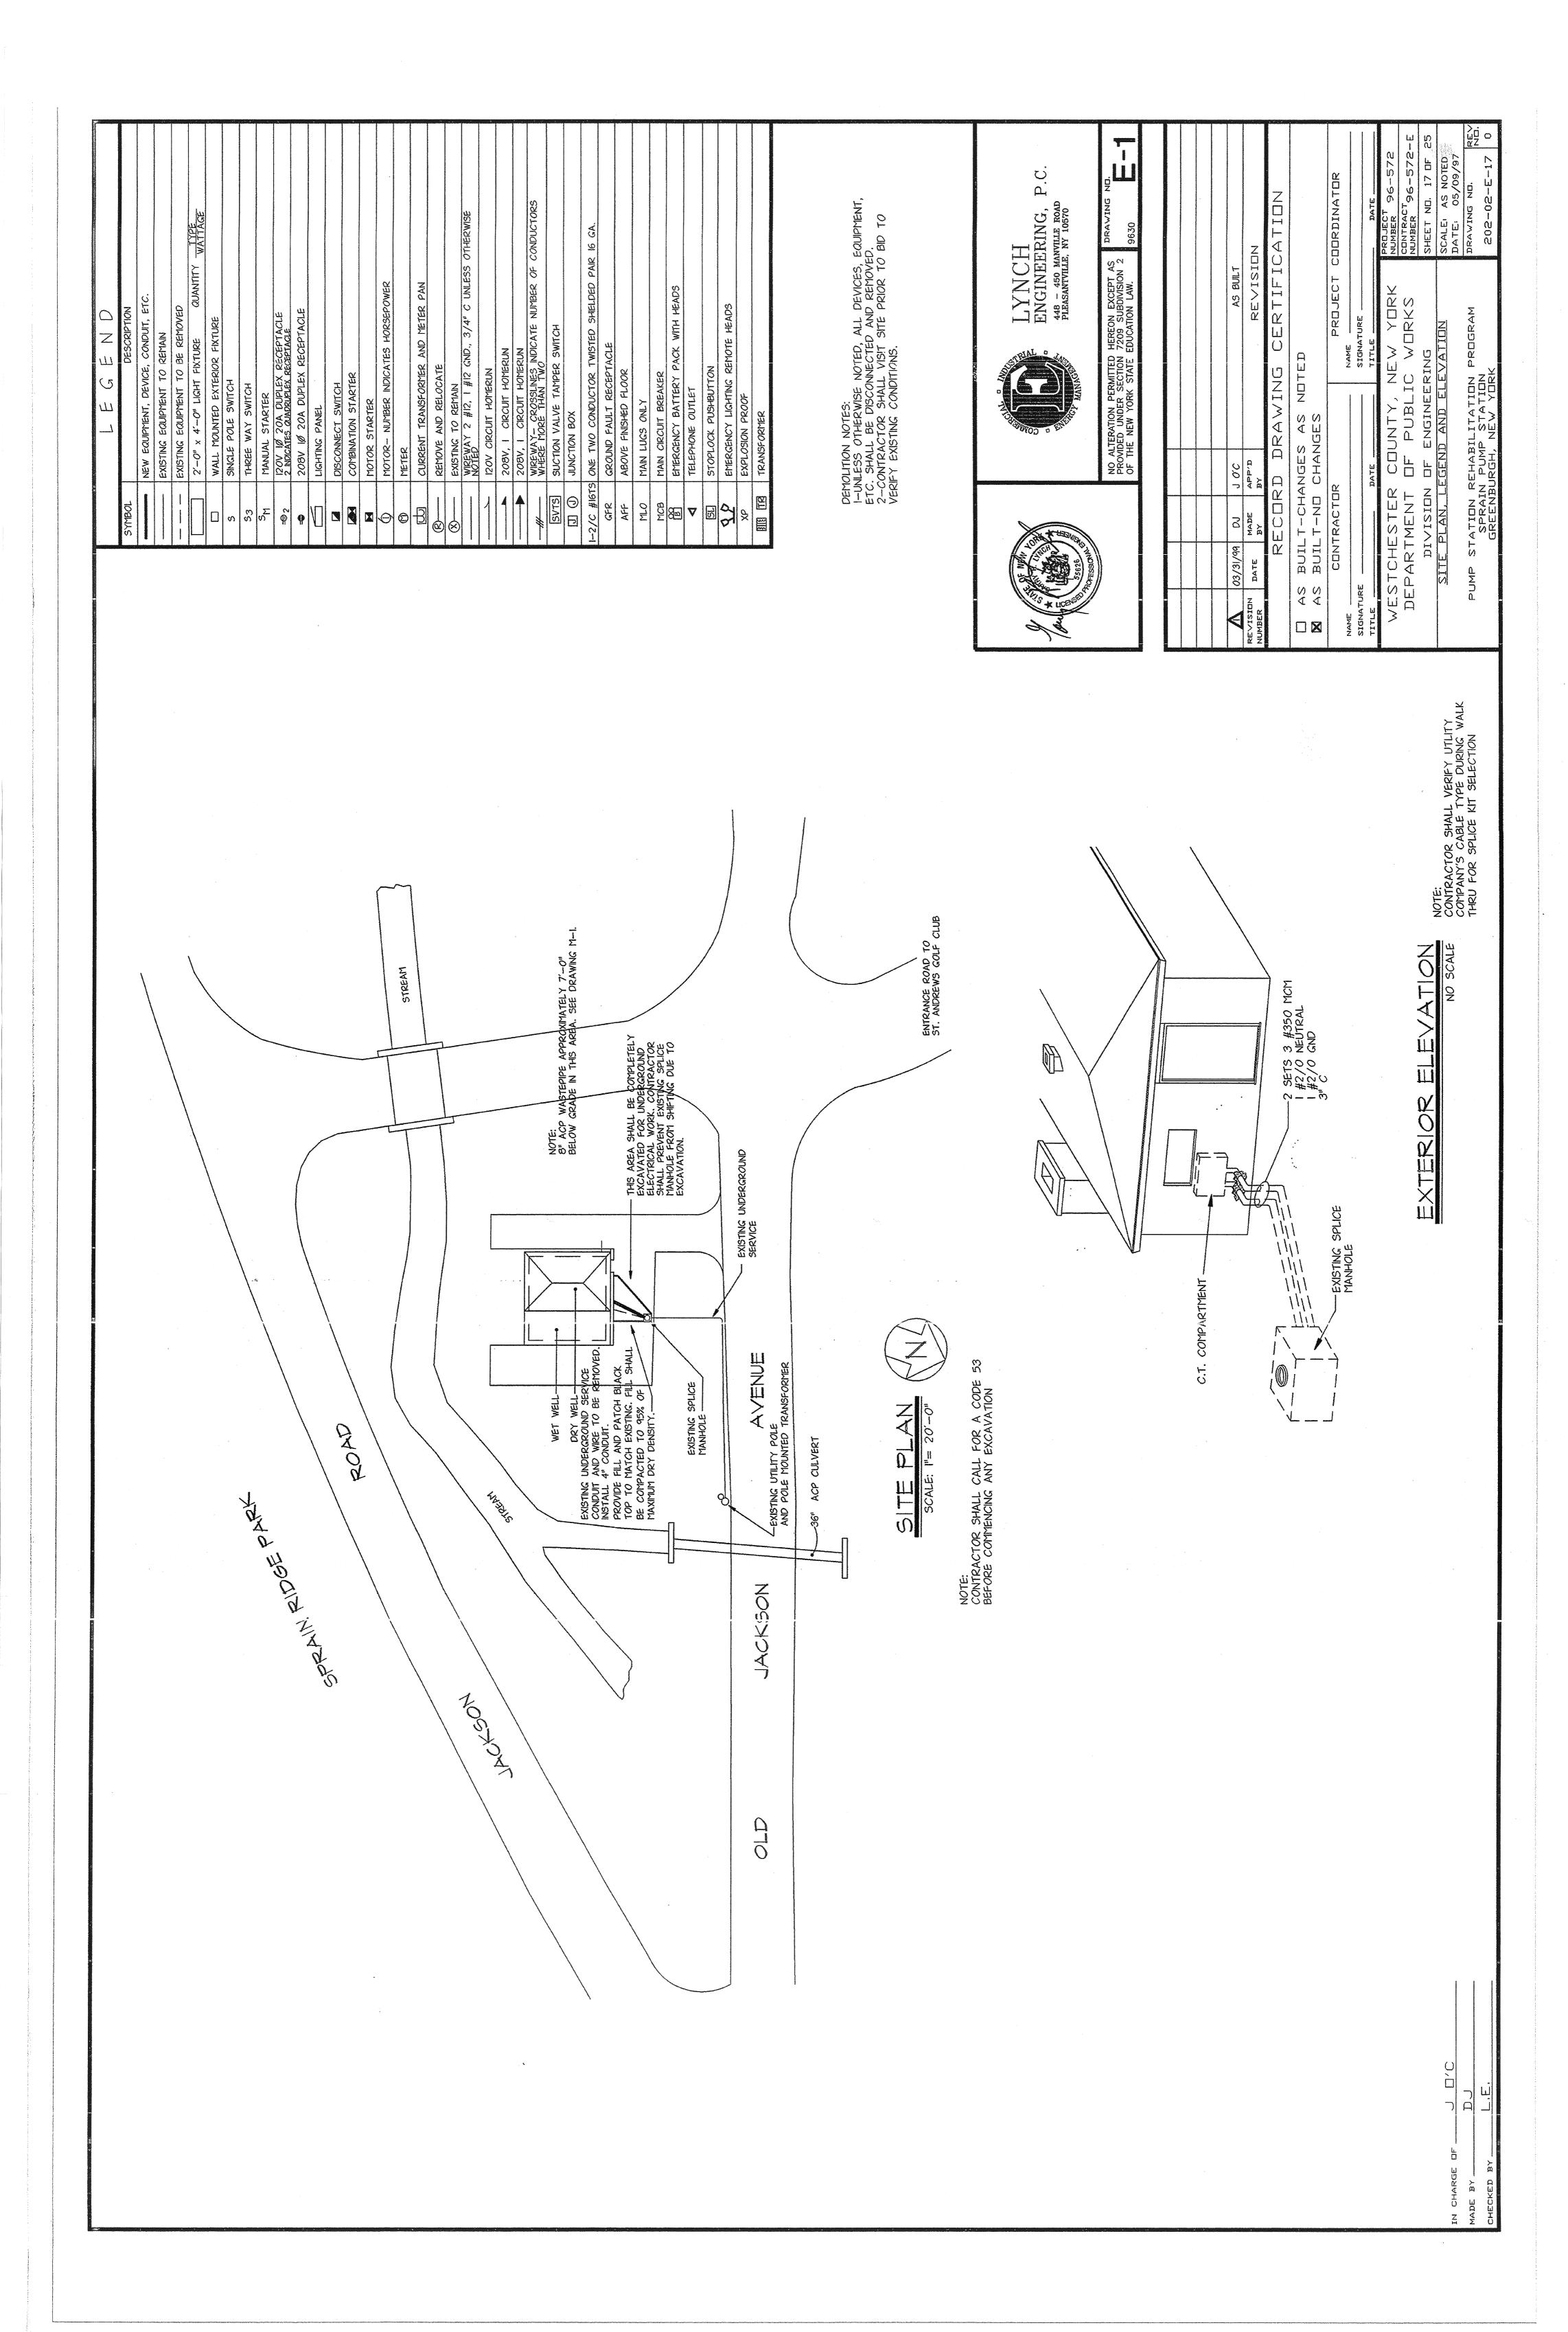



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PUMP STATION REHABILITATION	EHABI	LITATION PROGRAM	RAM	DRAWING NO. REV


202-02-HV-16

STATION REHABILITATION PROGRAM SPRAIN PUMP STATION GREENBURGH, NEW YORK

DAB IN CHARGE



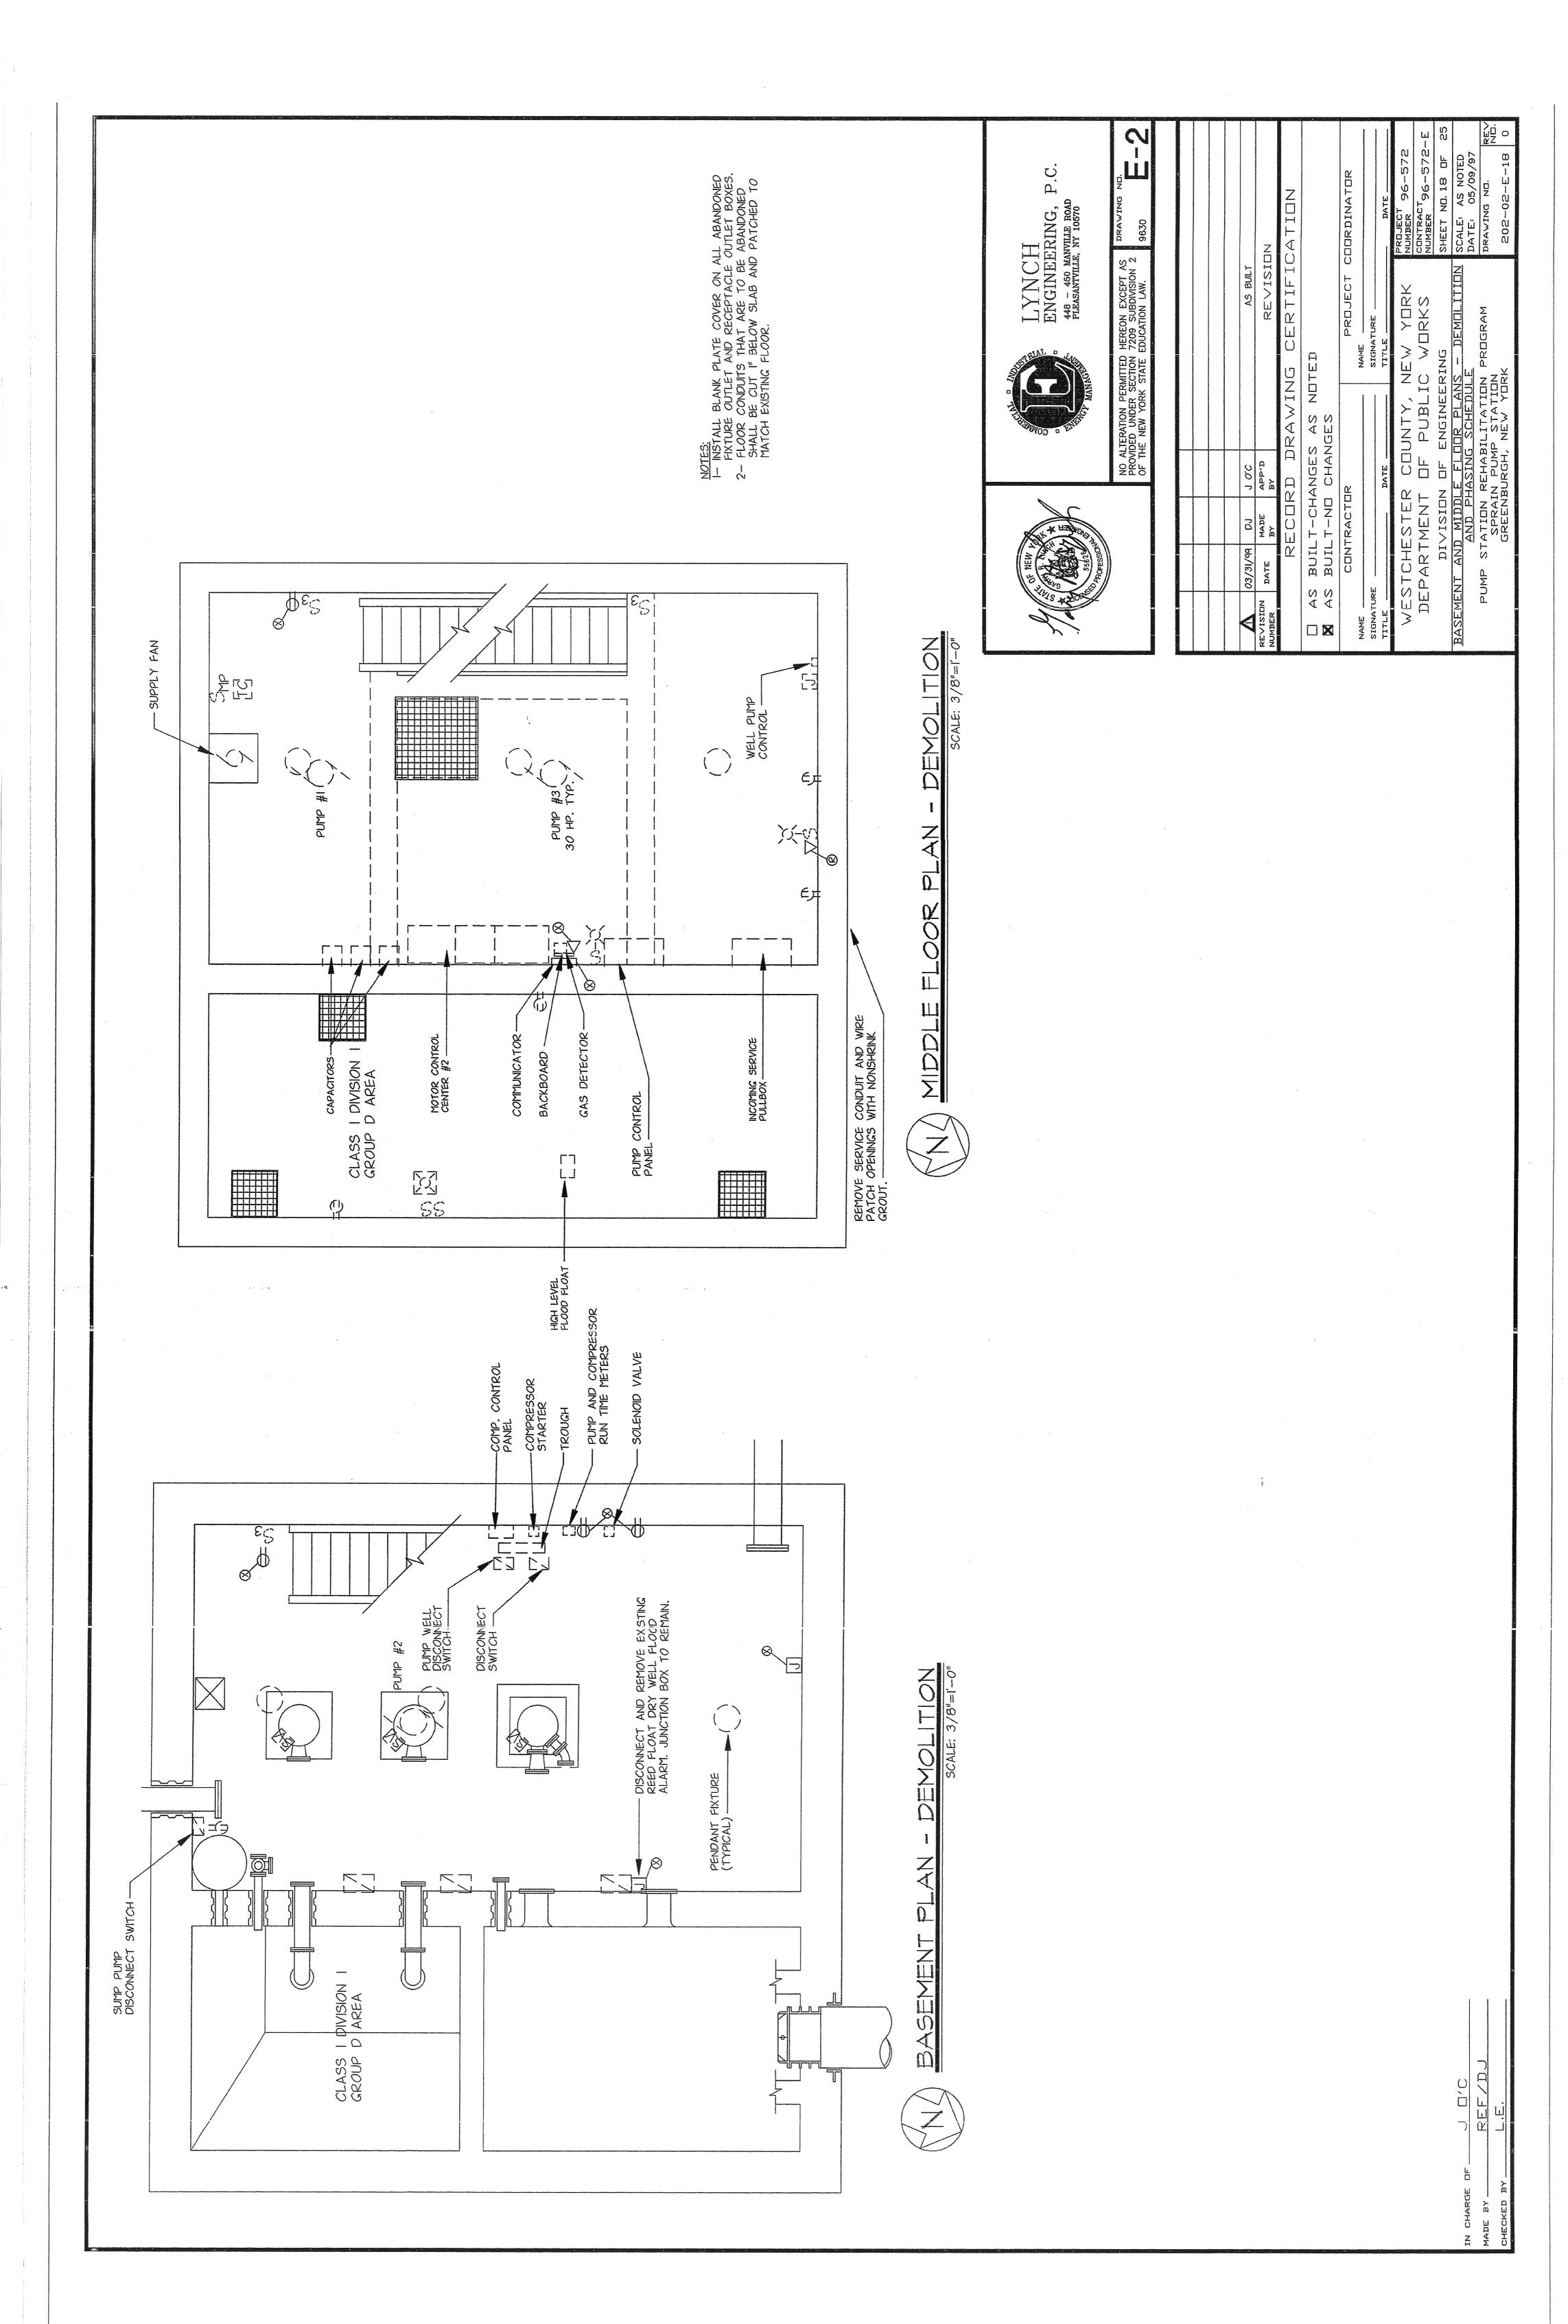

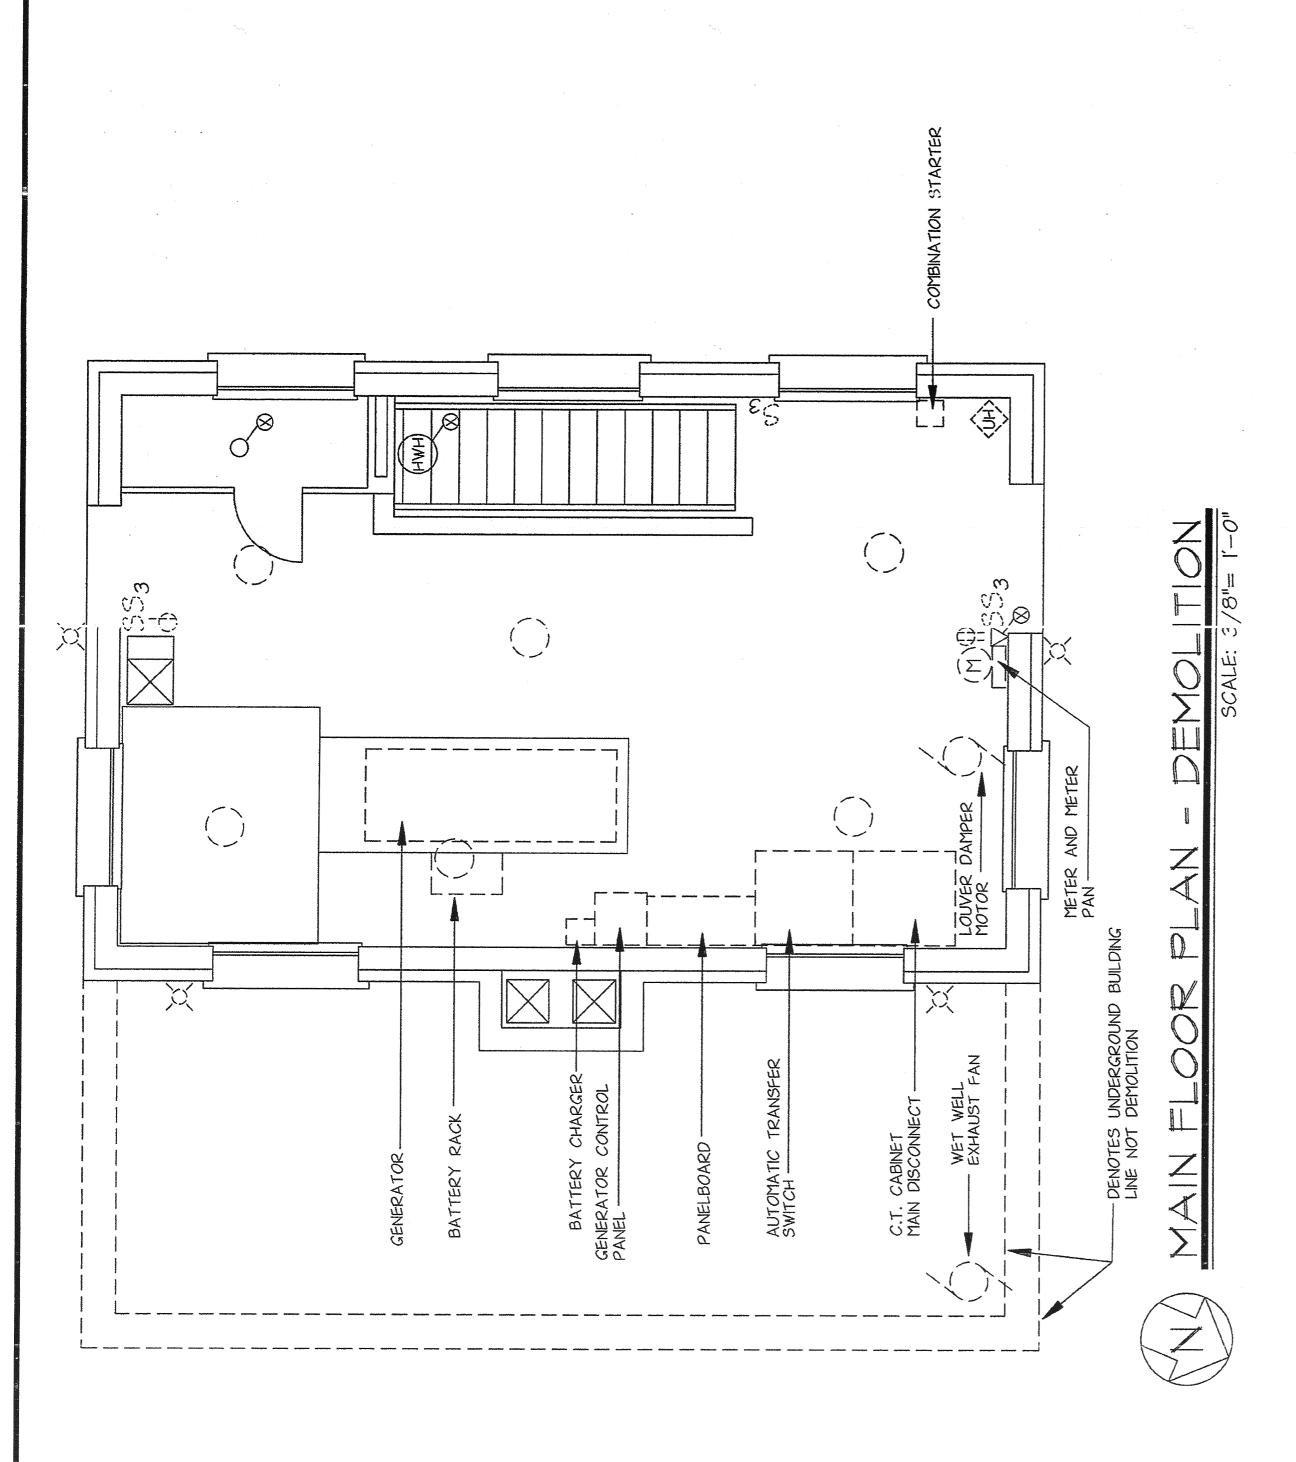

HE FOLLOWING EQUIPMENT SHALL BE TURNED WER TO THE OWNER IN WORKING CONDITION

1) GENERATOR AND ALL ACCESSORIES

2) BATTERIES AND RACK

3) BATTERY CHARGER

4) GENERATOR CONTROL PANEL

5) AUTOMATIC TRANSFER SWITCH

ENGINEERING, P.C.

ENGINEERING, P.C.

448 - 450 MANVILLE ROAD

PLEASANTVILLE, NY 10570

AND ALTERATION PERMITTED HEREON EXCEPT AS
PROVIDED UNDER SECTION 7209 SUBDIVISION 2

OF THE NEW YORK STATE EDUCATION LAW.

9630

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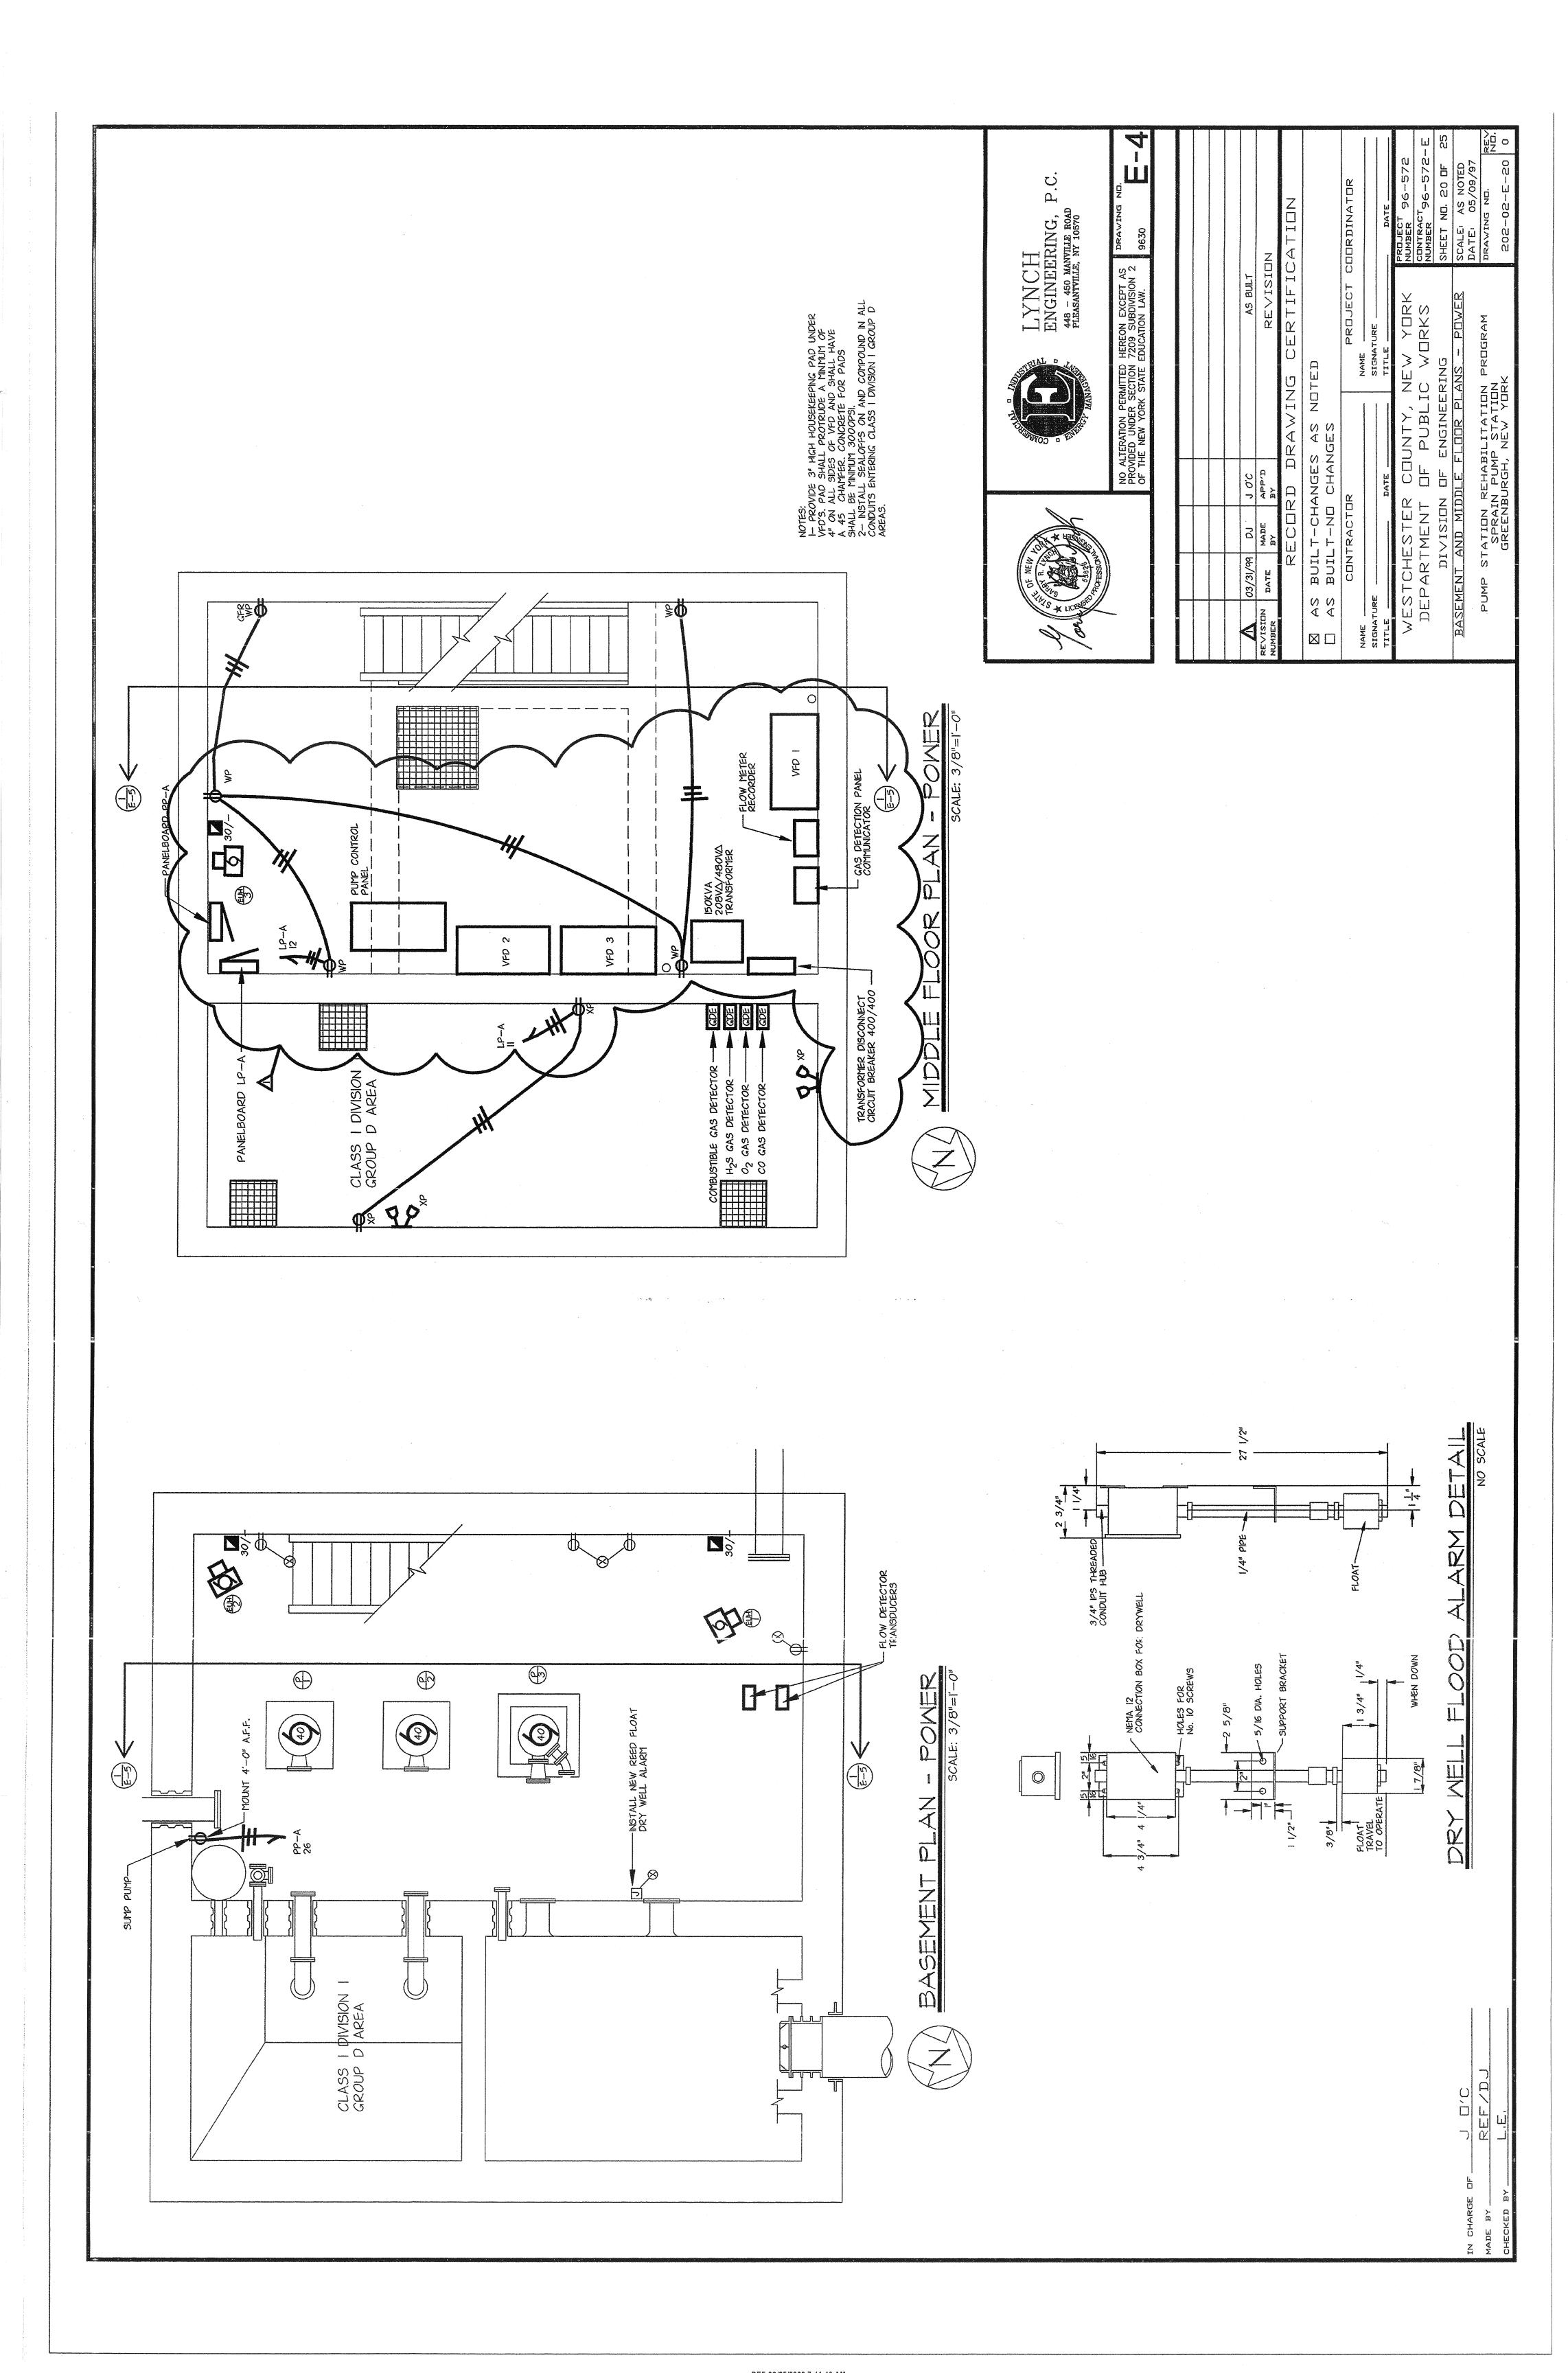
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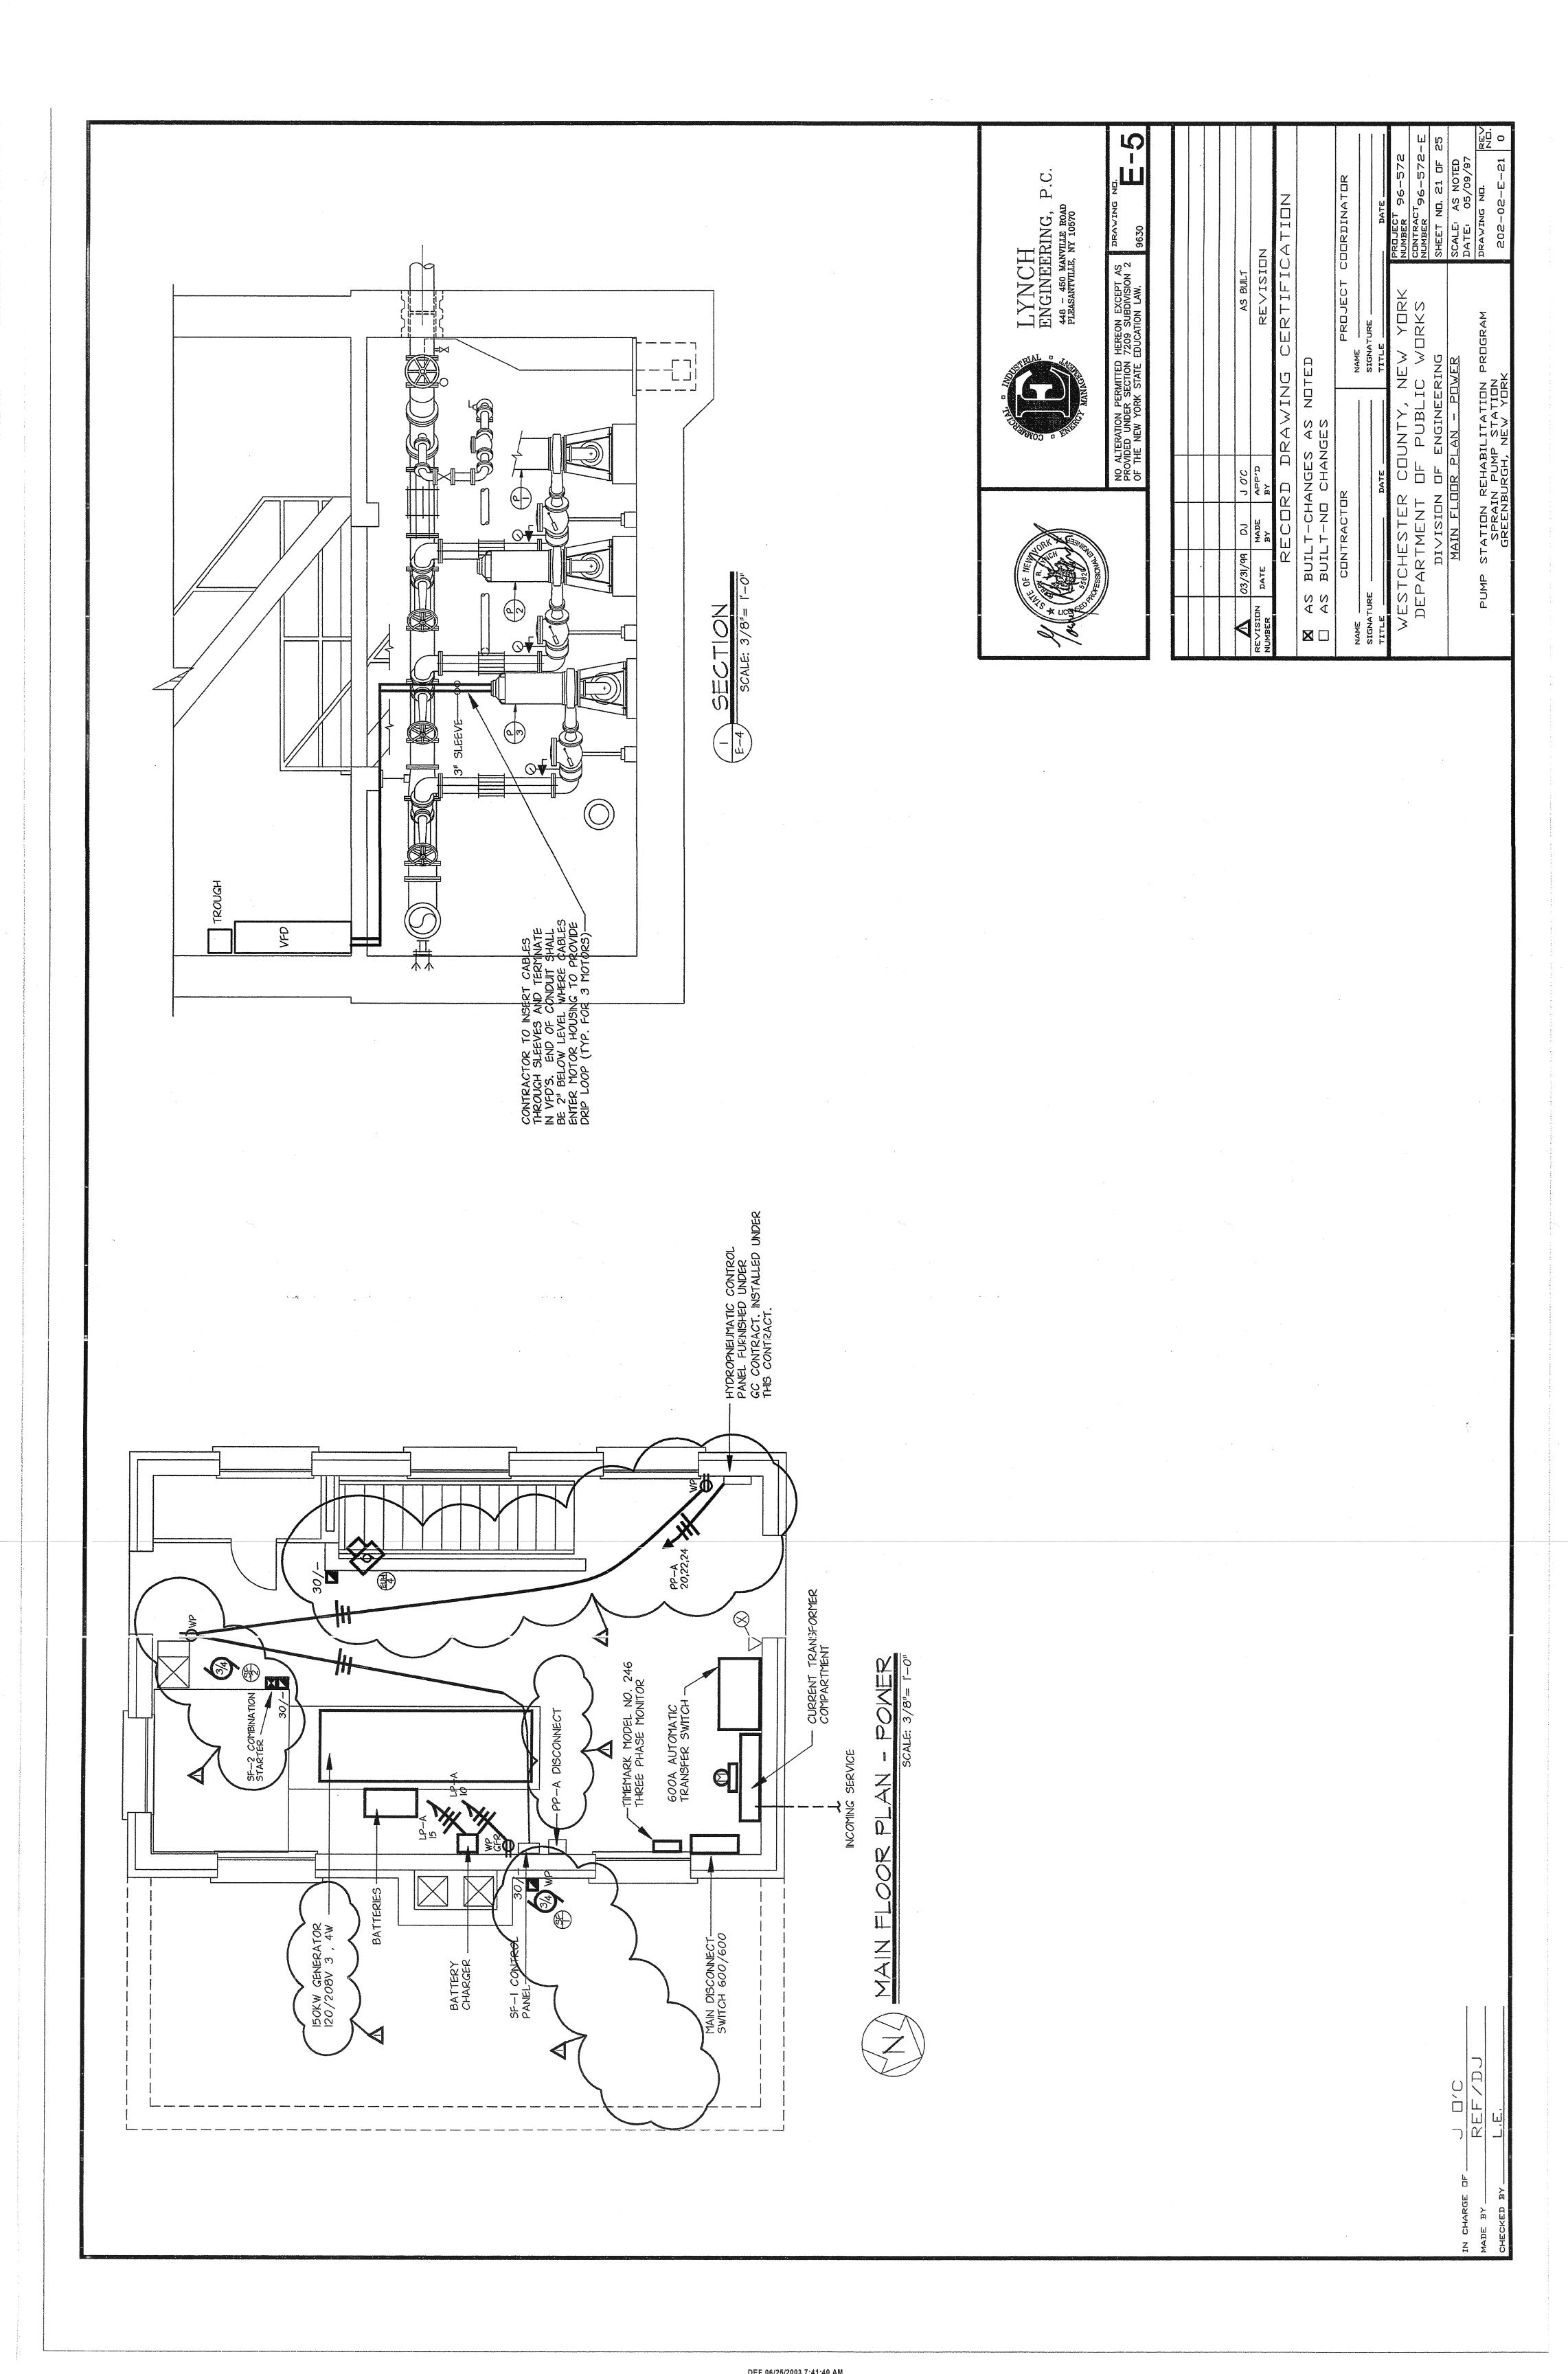
PROGRAM


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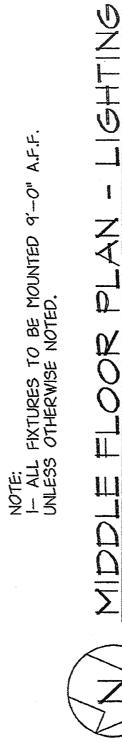






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DRAWING NO.		9630	
	COVIDED UNDER SECTION /209 SUBDIVISION 2		

WITH GUARD, 30% REFLECTOR, HIGH POWER FACTOR BALLAST (MINIMUM 90%)
VANDAL PROOF SHIELD, HARDWARE WITH PHOTOCELL /FIXTURE
T-8 LAMPS, ELECTRONIC BALLAST, HIGH IMPACT ACRIVIC DIFFUSER

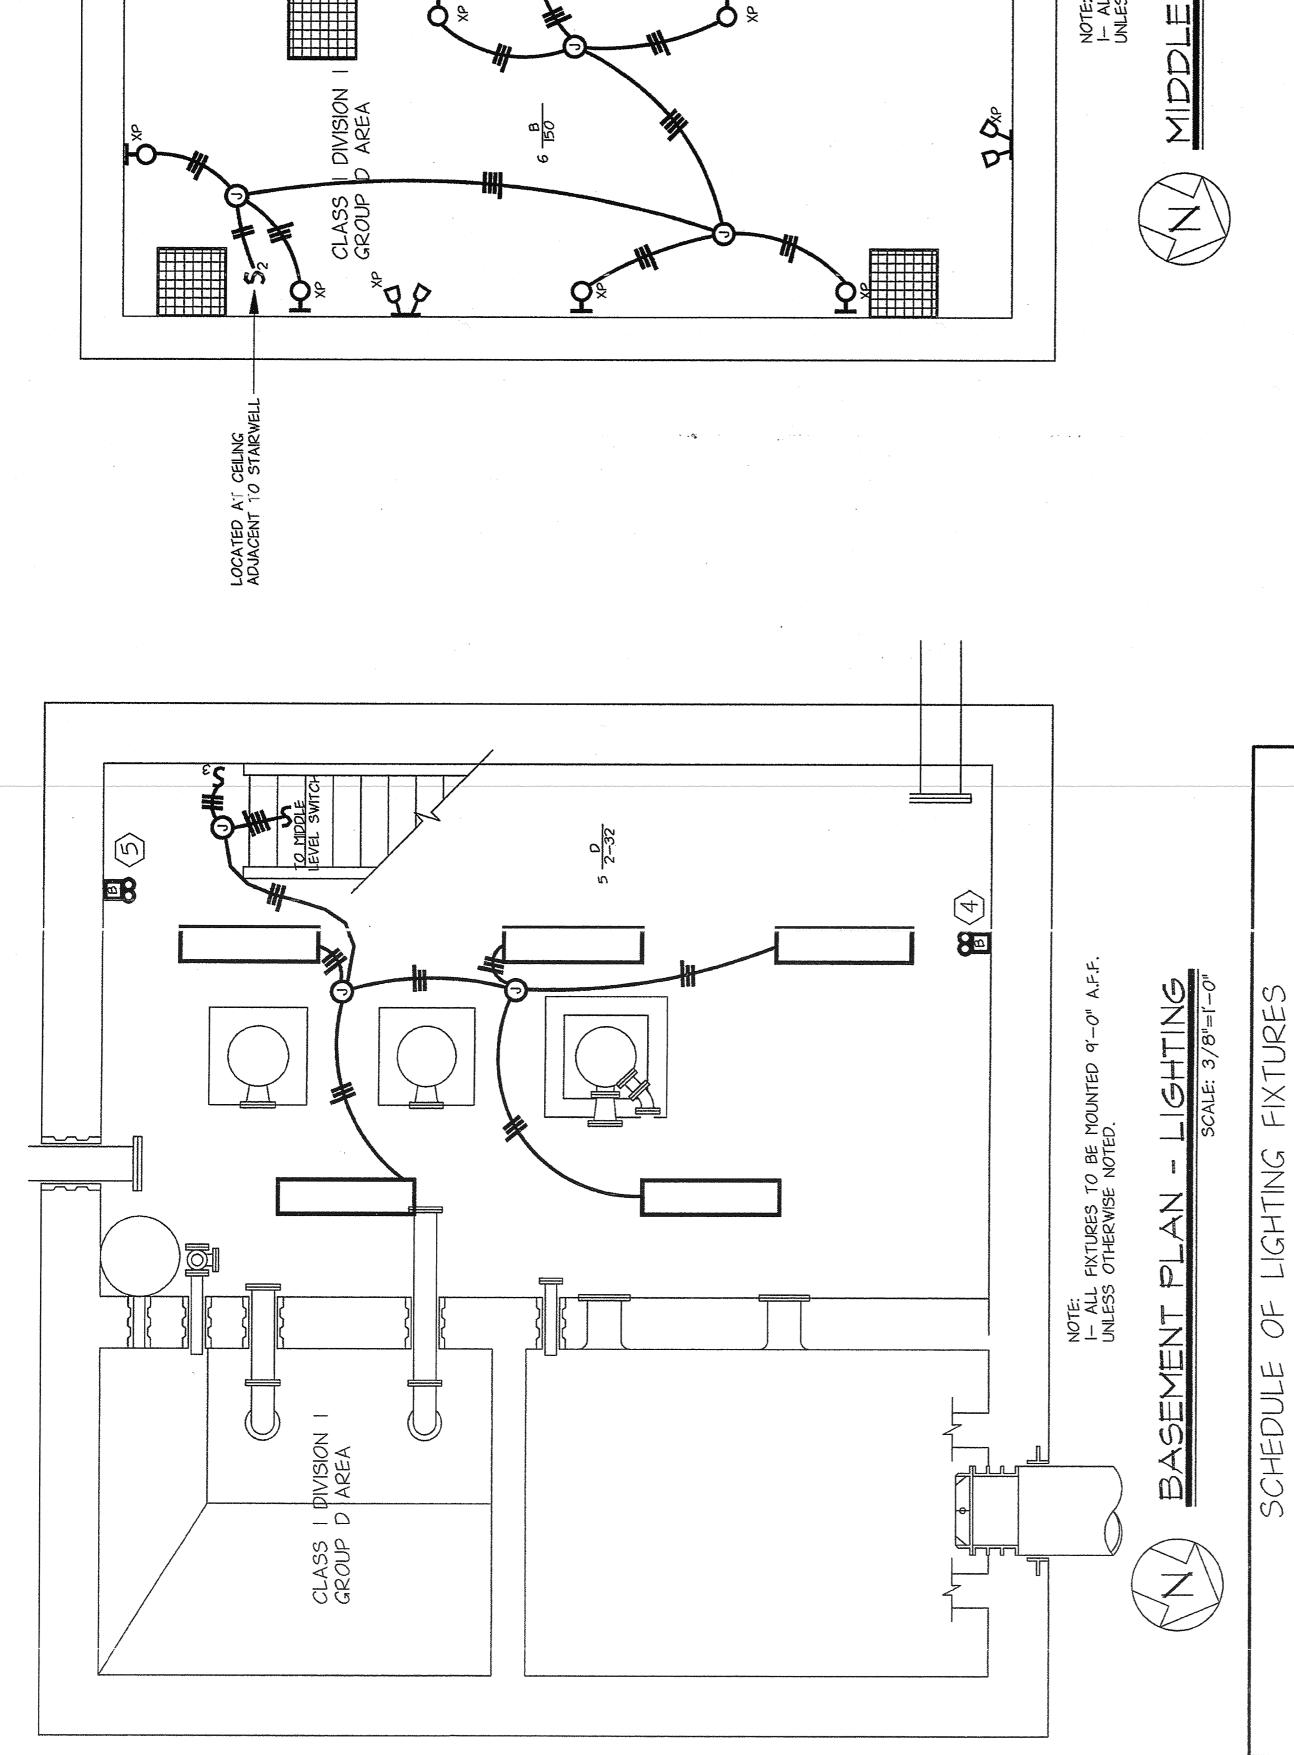CROUSE HINDS HAZARD GUARD EVMBX42151

120V

WALL

150W HPS

 $\omega$ 

MOLDCAST PARACYL

120V

WALL

SOW HPS

O

LITHONIA DM

120V

CEILING/ PENDENT

2-32 FL

 $\bigcirc$ 

12V/I2W HALOGEN LAMPS, AMMETER, VOLTMETER, LOAD DISCONNECT SWITCH

CROUSE HINDS ELPS SERIES I2VDC, TUNGSTEN HALOGEN LAMP

SERIES

LITHONIA NEMA

800

RENIARKS
T-8 LAMPS, ELECTRONIC BALLAST,
VANDAL SHIELDS

FIXTURE MANUFACTURER AND CATALOG NUMBER

VOLTAGE

MOUNTING

LAMPS WATTS

TYPE

LITHONIA VDC

120V

WALL

2-32 FL

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DRAWING NO. REV	BIME STATION BEHABILITATION PROGRAM	DEHARI	ATTO.	LV QMI	٥
DATE: 05/09/97	ING SINGLE LINE DIAGRAM	ND LIGHT	OULE A	SCHEI	FIXTURE
SCALE: AS NOTED	BASEMENT AND MIDDLE FLOOR PLANS - LIGHTING	DLE FLC	ND MII	1ENT A	BASEN
SHEET NO. 22 OF 25	ISION OF ENGINEERING	N OF E	VISI	DIV	
CONTRACT 96-572-E	DEPARTMENT OF PUBLIC WORKS		MEN.	PART	DE
PROJECT 96-572	WESTCHESTER COUNTY, NEW YORK	R COU	STE	STCHE	WE
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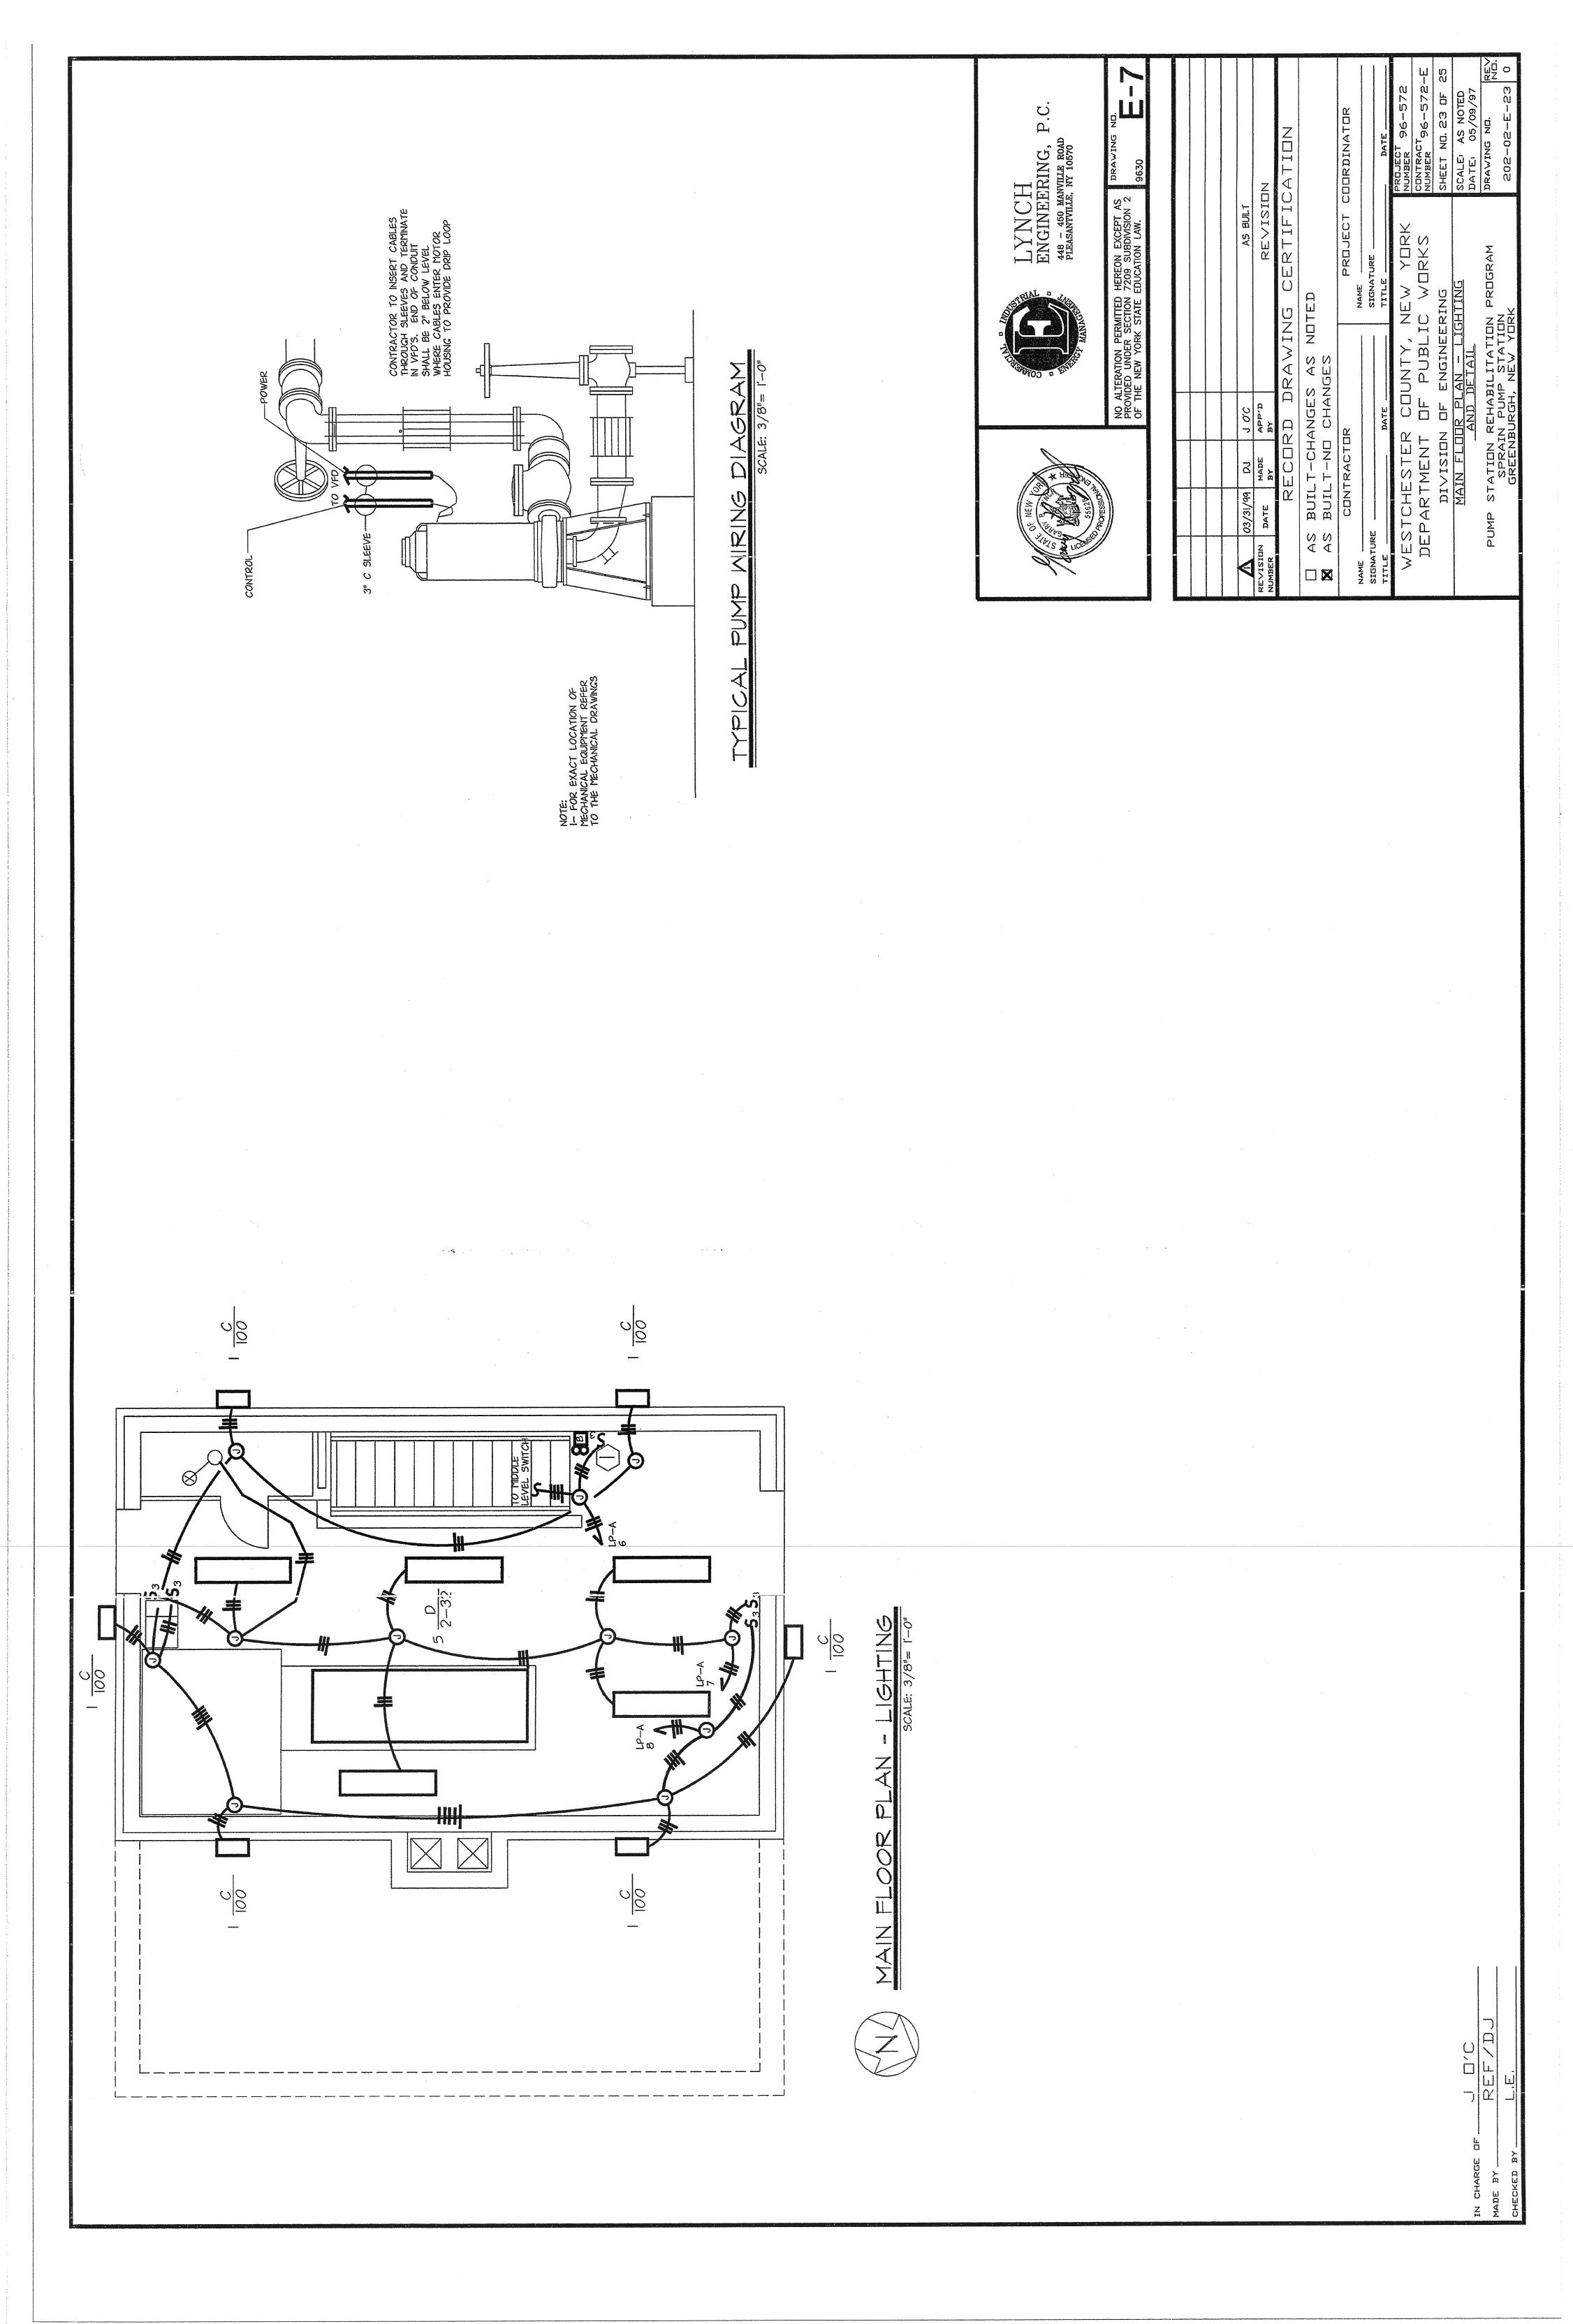
EMERGENCY BATTERY PACK SINGLE LINE DIAGRAM


NOTE: I— ALL FIXTURES TO BE MOUNTED 9'-O" A.F.F. UNLESS OTHERWISE NOTED.

NOTE: I- ALL FIXTUR


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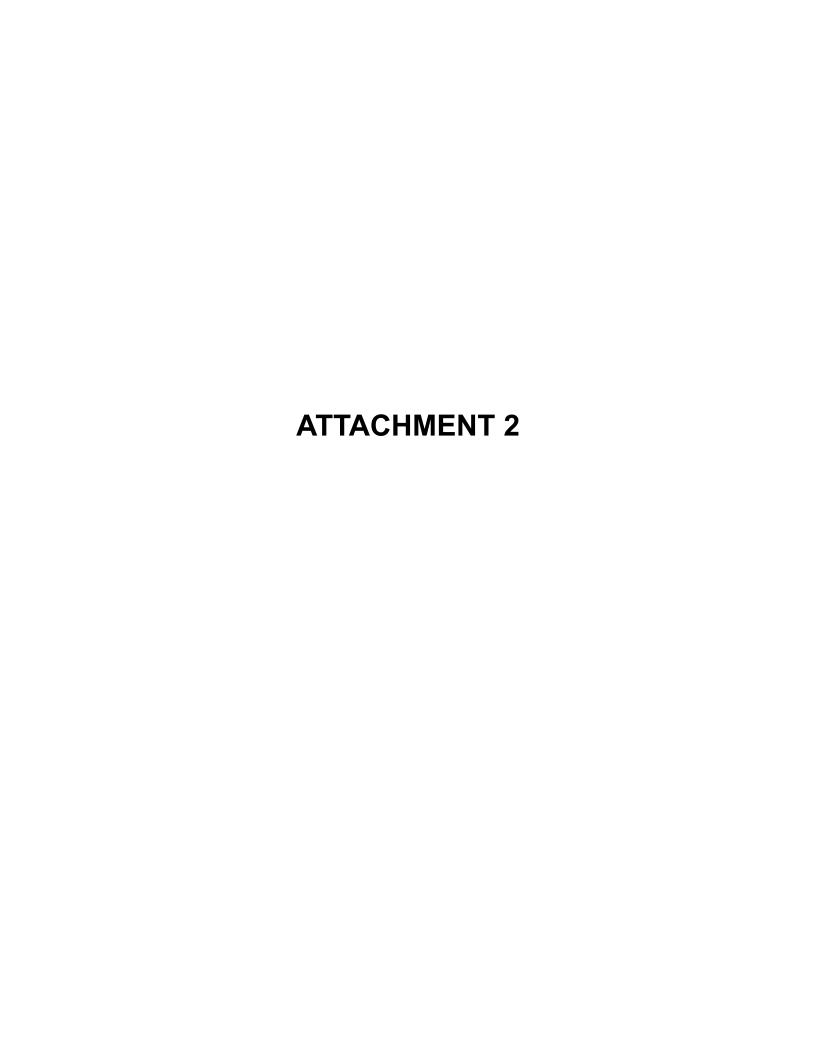
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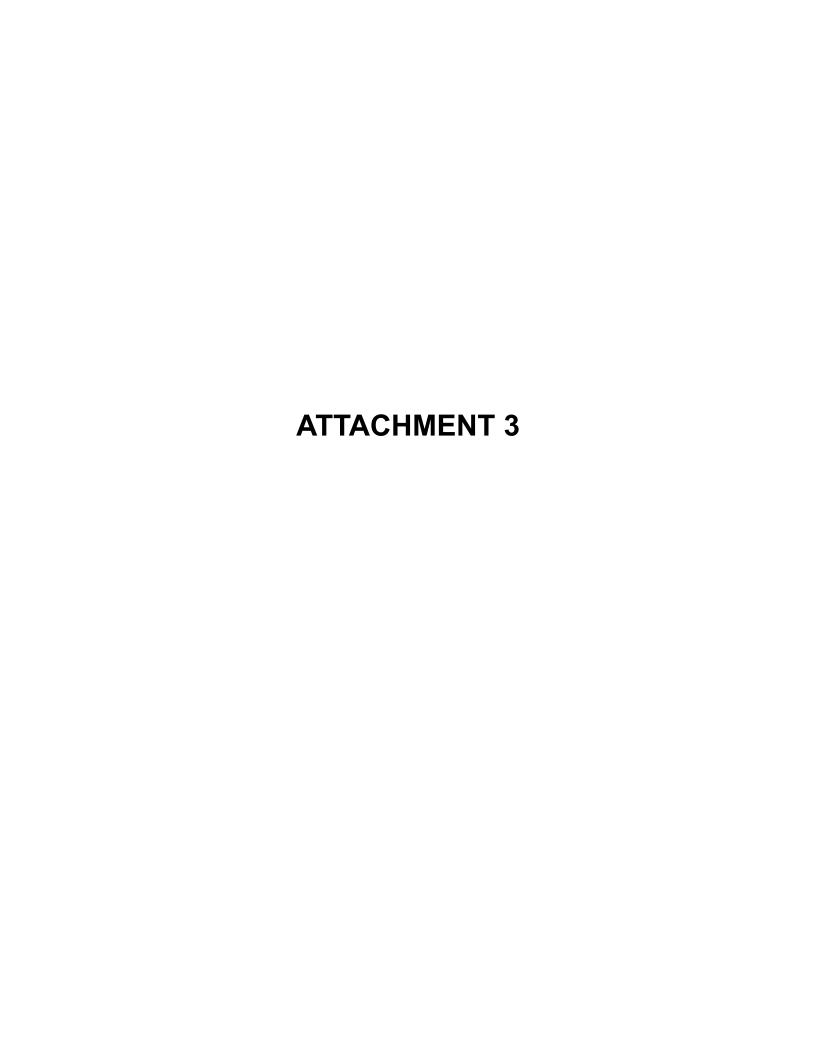
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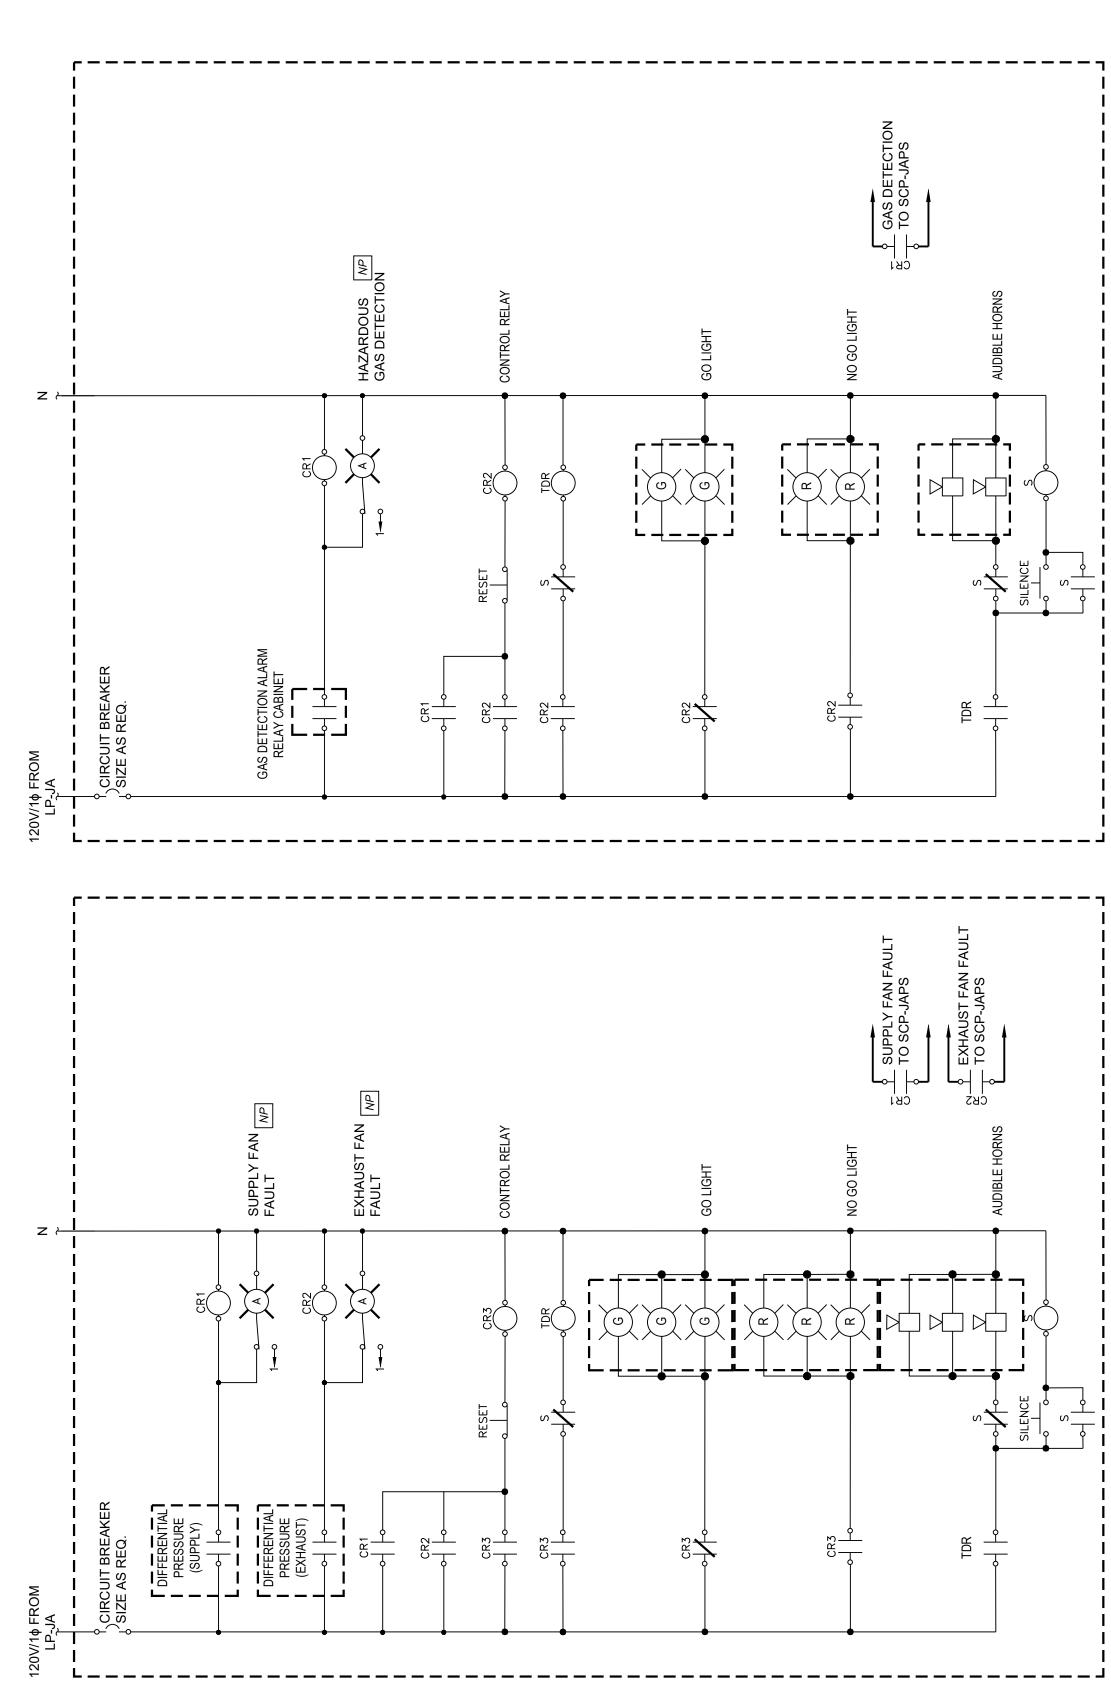




## SCHEDULE OF EQUIPMENT TESTING AND MANUFACTURER'S SERVICES

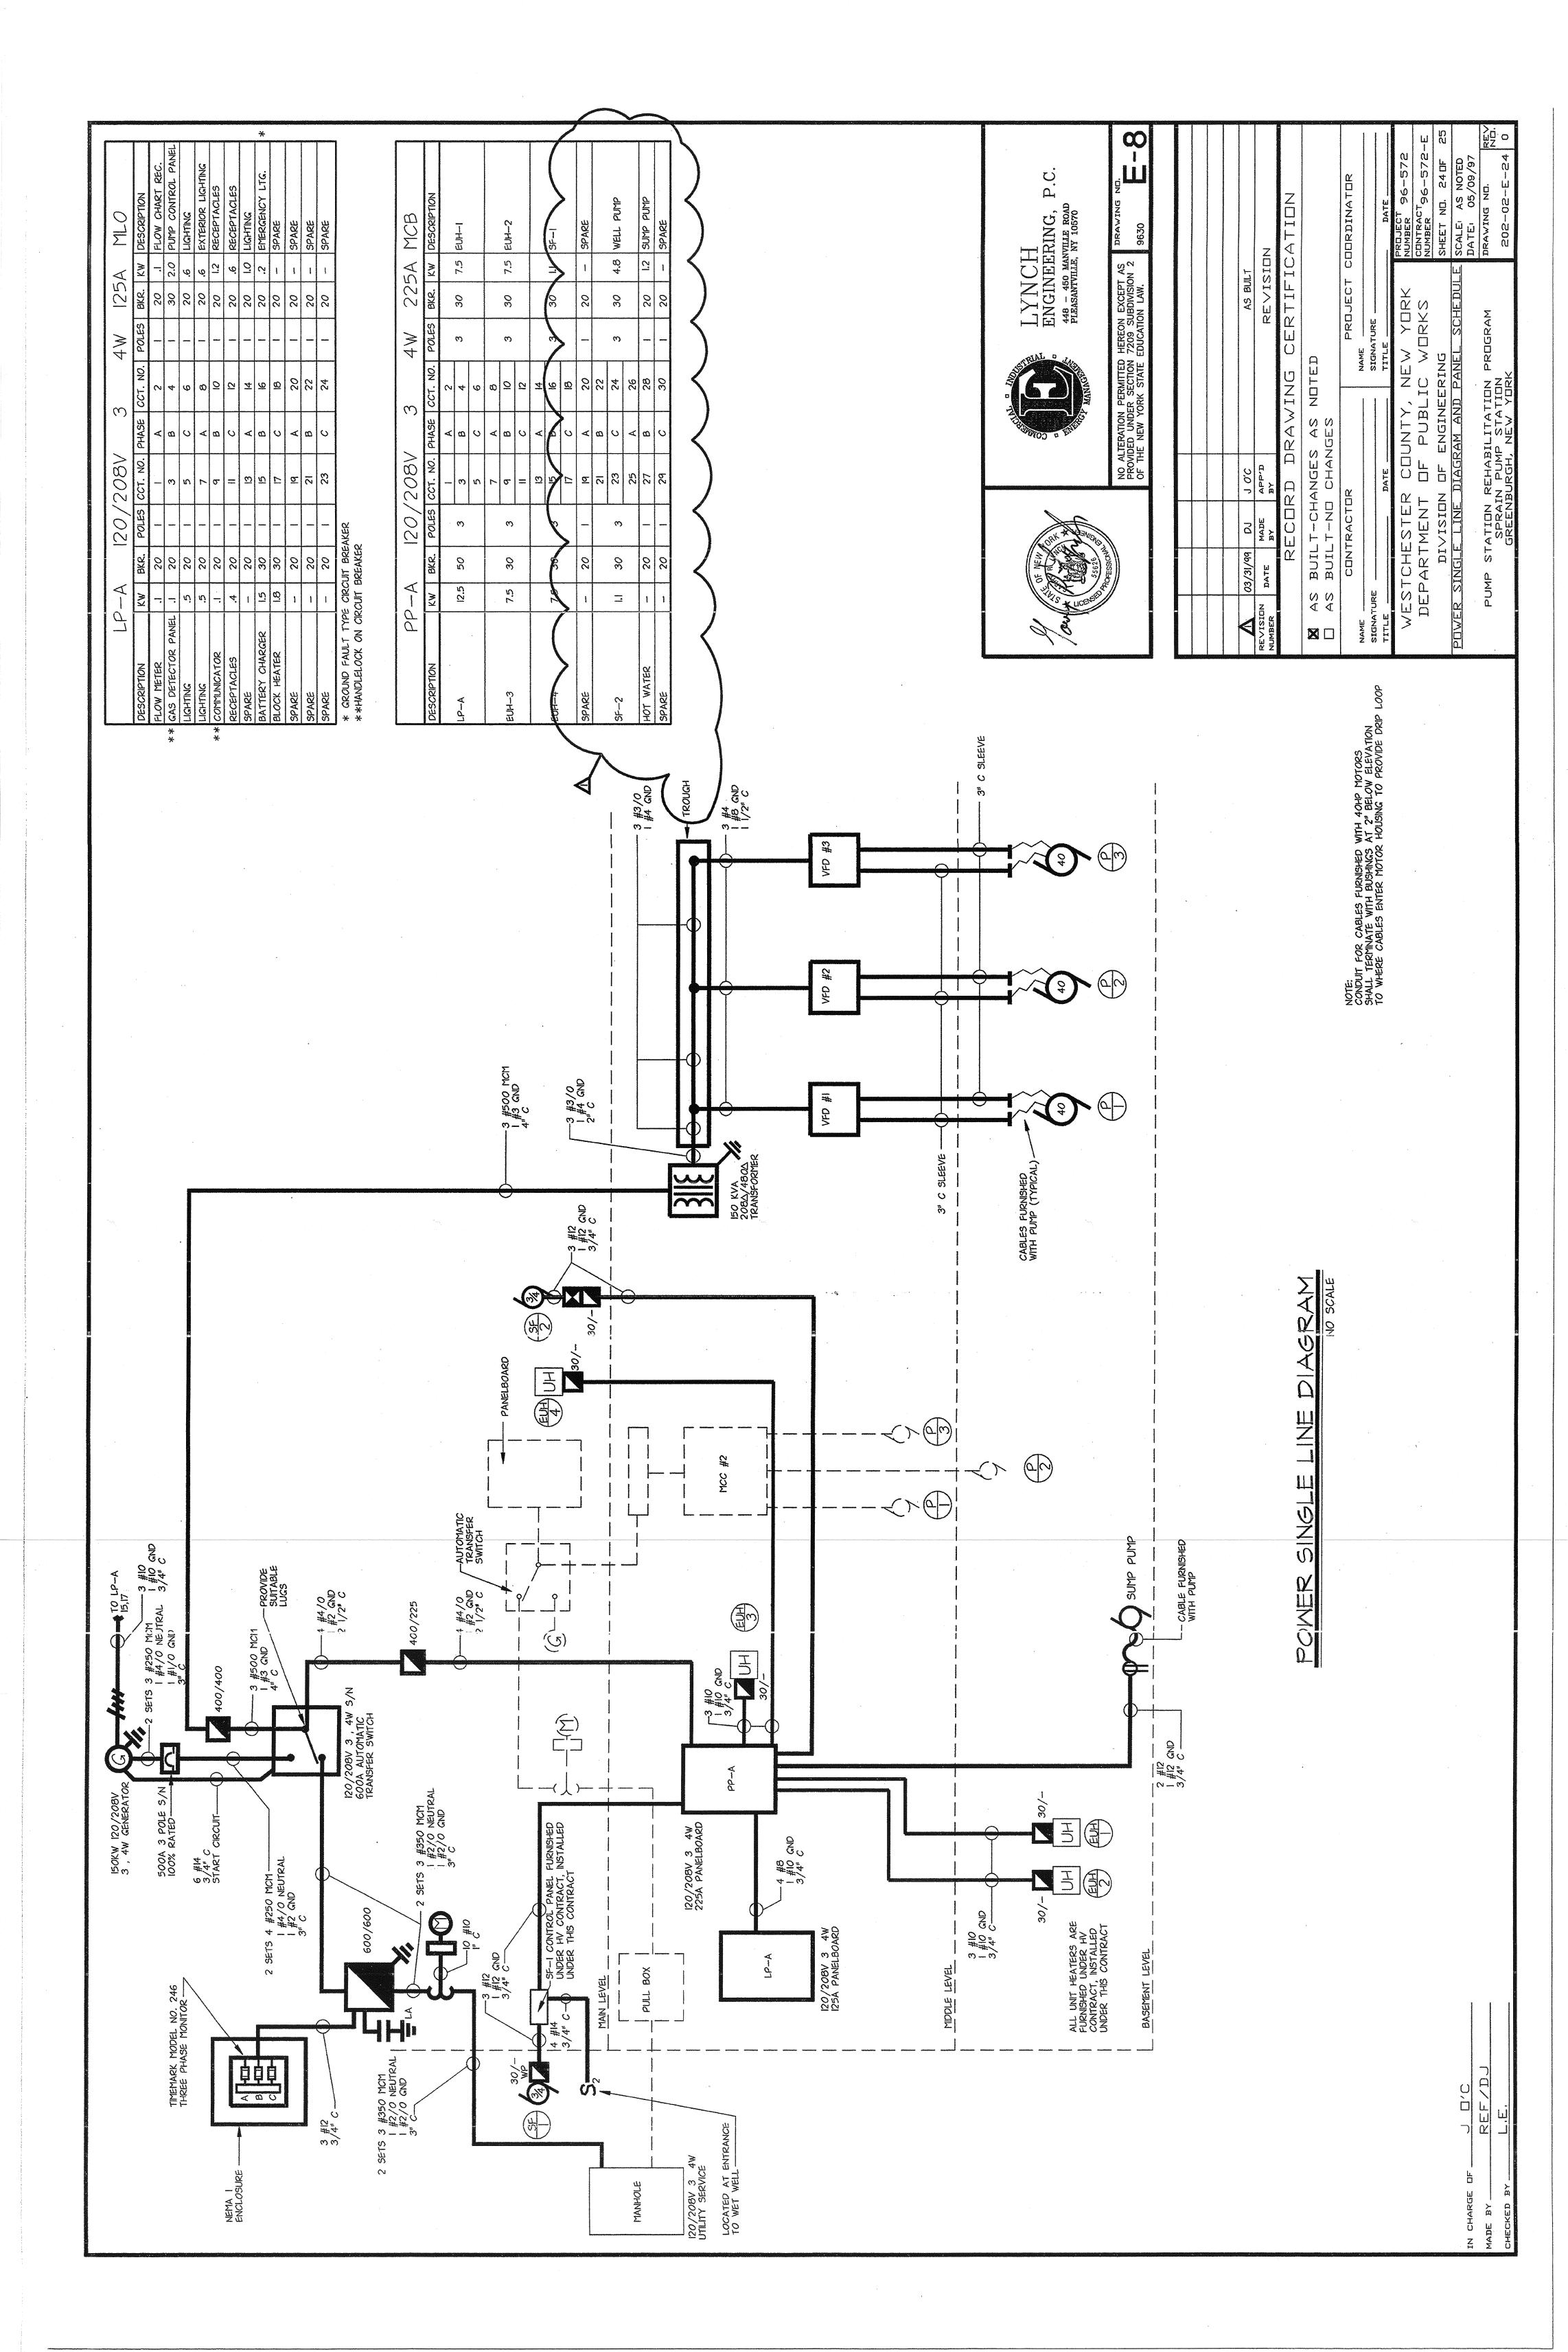						Service	Services of Manufacturer's Representative	urer's	
Equipment Item	Spec. Section	Performance Affidavit	Shop Tests	Field Tests	Instal- lation Cert.	Installation Days	Final Acceptance Days	Instruction Days	Operation & Maintenance Manual
Sluice Gates	11291	Yes	Yes	Yes	Yes	1/2	1/2	1/2	Yes
Dry Pit Submersible Pumps	11303	Yes	Yes	Yes	Yes	1	1	1	Yes
Programmable Logic Controllers (PLCs)	17095	No	Yes	Yes	Yes	2	1	1	Yes
Bubbler Level Sensing Equipment	17095	oN	Yes	Yes	Yes	I	1/2	1/2	Yes
Level Measurement (Suspended Pressure Transducer Type)	17095	oN	$ m N_{O}$	Yes	Yes	I	1/2	1/2	Yes
Flow Meters (Magnetic Type)	17095	No	No	Yes	Yes	1/2	1/2	1/2	Yes
Pressure Transmitters and Associated Flow Measuring Equipment	17095	No	No	Yes	Yes	1/2	1/2	1/2	Yes
Circular Chart Recorders	17095	oN	No	Yes	Yes	1/2	1/2	1/2	Yes
Gas Detection System	17650	oN	No	Yes	Yes	1	1/2	1/2	Yes
Water Supply Well	33213	oN	No	Yes	Yes	1/2	1	1/2	Yes
Hoists and Cranes	41220	No	No	Yes	Yes	1/2	1/2	1/2	Yes



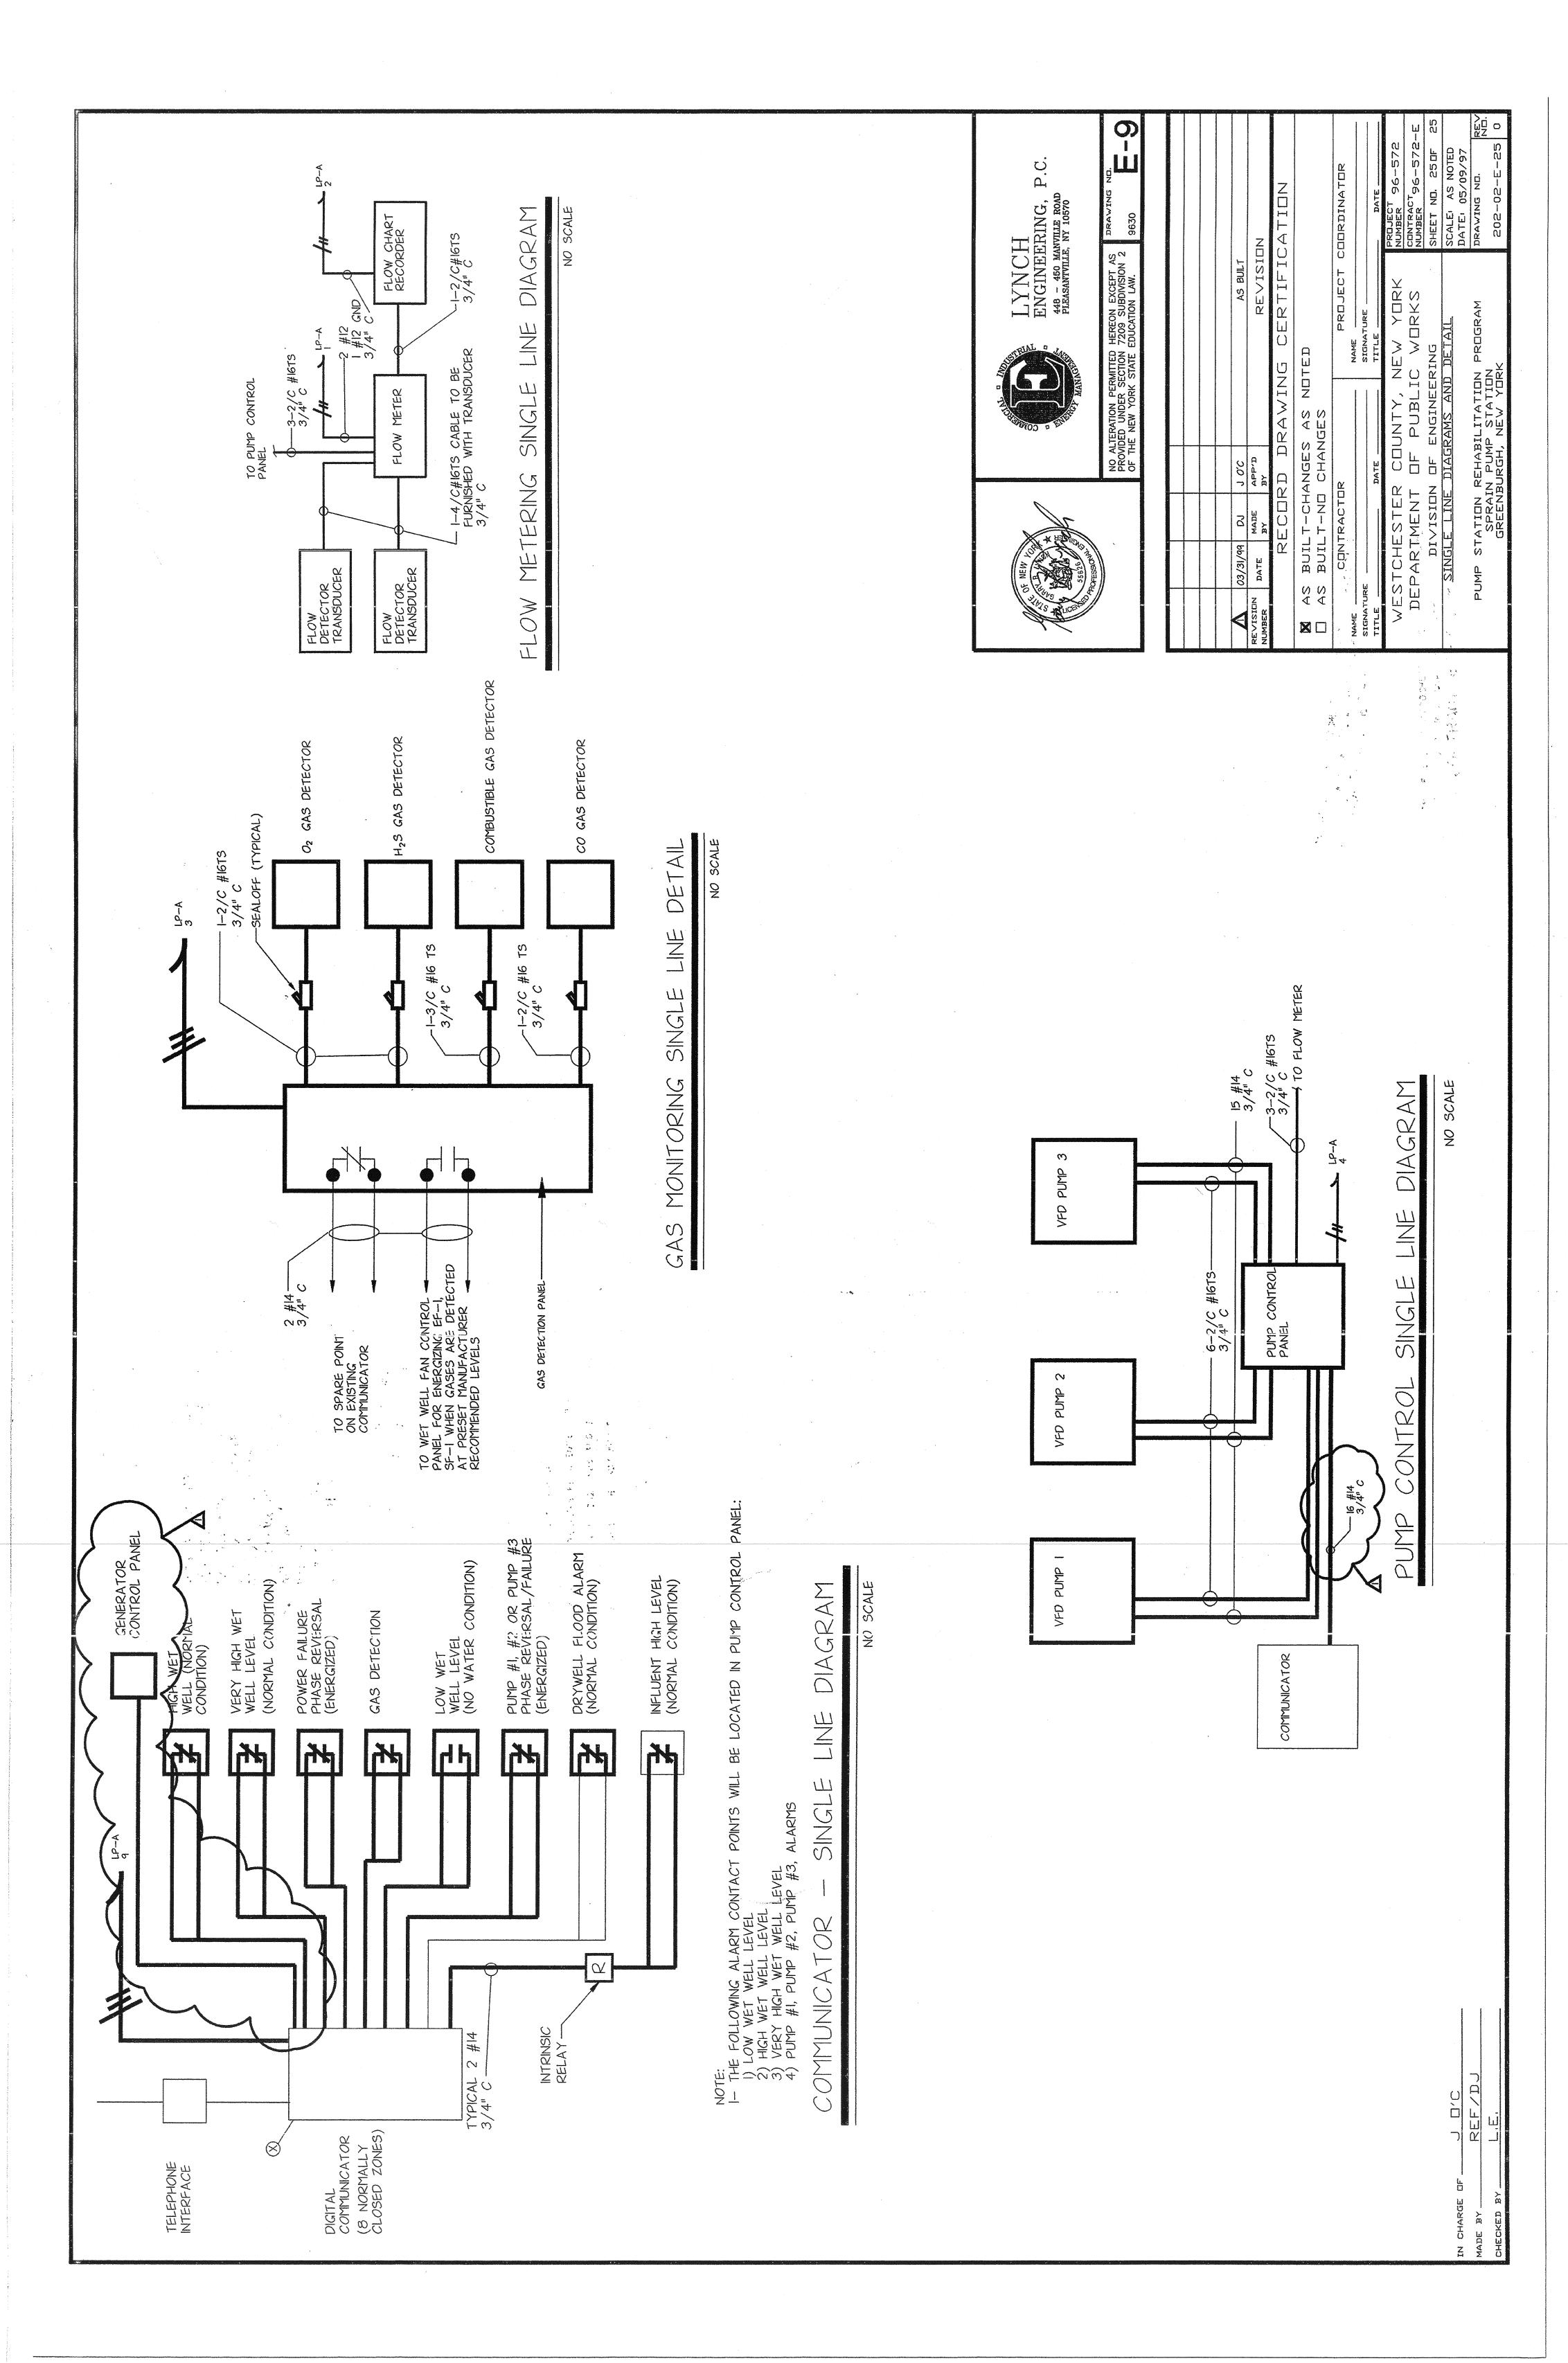

GAS DETECTION ALARM RELAY **WET WELL** 

A

**VENTILATION ALARM REI** 

DRY WELL

CABINET ELEMENTARY

NO SCALE

NOTES:


1. REFER TO FLOOR PLANS FOR ALARM RELAY CABINET LOCATION, GO/NO GO LIGHT AND AUDIBLE HORN QUANTITY, AND THE DIFFERENTIAL PRESSURE SWITCHES LOCATION AND QUANTITY.

CABINET ELEMENTARY

NO SCALE

NOTES:

1. REFER TO FLOOR PLANS FOR ALARM RELAY CABINET LOCATION, GO/NO GO LIGHT AND AUDIBLE HORN QUANTITY, AND THE AIT LOCATION AND QUANTITY.

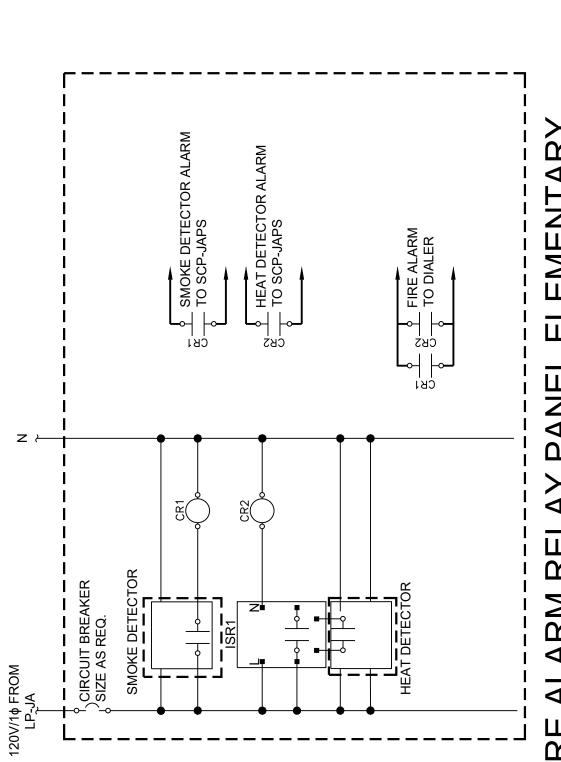

AY PANEL ELEMENTARY FIRE ALARM REL

Landscape Architecture, Engineering & Environmental Services, D.P.C. 217 Montgomery Street, Suite 1100 Syracuse, New York 13202

P. 315.471.0688 Design & Research, **Environmental** REVISION environment better MADE BY Q DATE

RECORD DRAWING CERTIFICATION AS

PROJECT - CHANGES AS NOTED - NO CHANGES CONTRACTOR BUILT

COORDINATOR

DATE CONTRACT NUMBER

22-510 E-011

SHEET NO. 43 OF 55

SCALE: AS SHOWN

DATE: 10/05/2023

DPW FILE NO. REV.
202-02-E-68-0 0 WESTCHESTER COUNTY, NEW YORK

DEPARTMENT OF PUBLIC WORKS AND TRANSPORTATION

DIVISION OF ENGINEERING

JACKSON AVENUE PUMPING STATION REHABILITATION

BRONX VALLEY SANITARY SEWER DISTRICT

TOWN OF GREENBURGH, NEW YORK

ELEMENTARY DIAGRAMS II NAME SIGNATURE TITLE NAME SIGNATURE TITLE

MODIFICATION IS A VIOLATION OF CHAPTER 16, TITLE VIII, ARTICLE 145 § 7209.2 NYS EDUCATION LAW, UNLESS ACTING UNDER THE DIRECTION OF A LICENSED PROFESSIONAL ENGINEER. IF A DOCUMENT BEARING THE SEAL OF AN ENGINEER IS ALTERED, THE ALTERING ENGINEER SHALL AFFIX TO THE DOCUMENT THEIR SEAL AND THE NOTATION "ALTERED BY" FOLLOWED BY THEIR SIGNATURE AND THE DATE OF SUCH ALTERATION, AND A SPECIFIC DESCRIPTION OF THE ALTERATION.

IN CHARGE OF CHECKED BY MADE BY