


UNDERGROUND CONDUITS ENTERING EXISTING BUILDING WALL SCALE: NOT TO SCALE

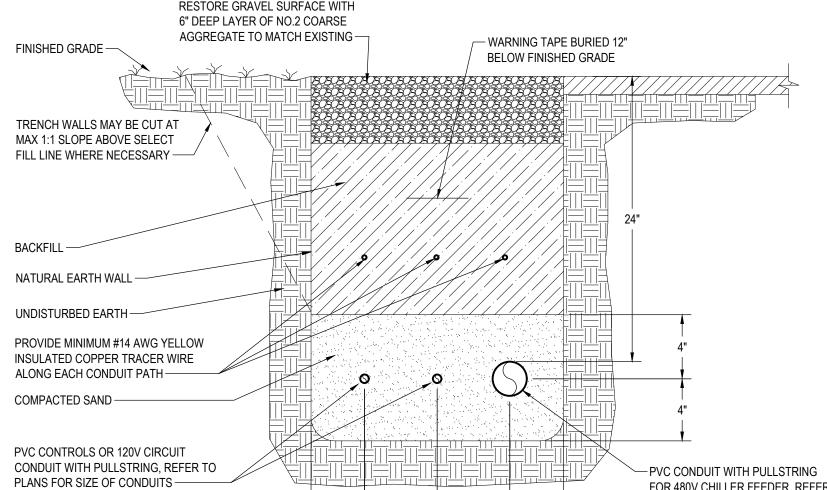

SCALE: NOT TO SCALE

TYPICAL CONDUIT TRENCH DETAIL

-MASONRY OR CONCRETE PARTITION **EXISTING** - CUT EXISTING CONDUIT CONCRETE FLUSH WITH FLOOR AND FLOOR ----GRIND SMOOTH TO EXISTING FLOOR. - EXISTING IN-SLAB PORTION FILL END OF CONDUIT WITH OF CONDUIT SHALL REMAIN CONCRETE, TROWEL SMOOTH FINISH FLUSH PROVIDE WADDING

208/120 3Ø 4W, SURFACE MOUNTED, 10KAIC EXISTING PANEL 'RP1-B' SCHEDULE 100A MAIN LUGS, 1-30 POS SECTION EXISTING SQUARE D TYPE NQOD (E) 20/1 AF-AC-1 2 (E) 20/1 BOILER ROOM ROOF OUTLETS 3 (E) 20/1 AF-HV-1 4 (E) 20/1 EF-10 5 (E) 20/1 AF-AC-5 6 (E) 20/1 EF-11 ' | (E) | 20/1 | UNIT HEATER 8 (E) 20/1 EF-18 9 | (E) | 20/1 | LIGHTING PLENUM & HV-1 & AC-1 10 (E) 20/1 EF-25 11 | (1) | 20/1 | SPARE 12 (E) 20/1 OUTLETS ROOF 13 (E) 20/1 AF-HV-3 14 (E) 20/1 EF-24 (RECEPT) 16 (1) 20/1 SPARE 30/2 PANEL RP1-B2 18 (E) 20/1 EF-24 19 (E) 20/1 GLYCOL PUMP 20 (E) 20/1 UNIT HEATER 22 (E) 20/1 DAMPER MOTORS 21 | (E) | 25/1 | PARKING LOT BLOCK HEATER 23 (E) 25/1 PARKING LOT BLOCK HEATER 24 (E) 25/1 EF STARTERS CONTROL CIRCUIT 25 | (E) | 25/1 | PARKING LOT BLOCK HEATER 26 (E) 25/1 PARKING LOT BLOCK HEATER 7 (E) 25/1 PARKING LOT BLOCK HEATER 28 (E) 25/1 PARKING LOT BLOCK HEATER 29 (E) 25/1 PARKING LOT BLOCK HEATER 30 (E) 25/1 PARKING LOT BLOCK HEATER (E) 60/3 MAIN CIRCUIT BREAKER (E) EXISTING CIRCUIT BREAKER AND LOAD SHALL REMAIN (1) EXISTING CIRCUIT BREAKER LABELED "CONTROL CIRCUIT CHILLER" SHALL REMAIN, REMOVE EXISTING BRANCH CIRCUITRY


> EXISTING PANEL RP1-B SCHEDULE SCALE: NOT TO SCALE

(2) EXISTING 20A CIRCUIT BREAKERS LABELED "CONTROL CIRCUIT CHILLER" SHALL BE REMOVED AND REPLACED WITH


BREAKER SHOWN, REMOVE AND REPLACE BRANCH CIRCUITRY AND REVISE PANEL SCHEDULE LABEL AS SHOWN. EXTEND

AND REVISE PANEL SCHEDULE LABEL TO INDICATE SPARE AS SHOWN.

BRANCH CIRCUITRY TO PANELBOARD SHOWN.

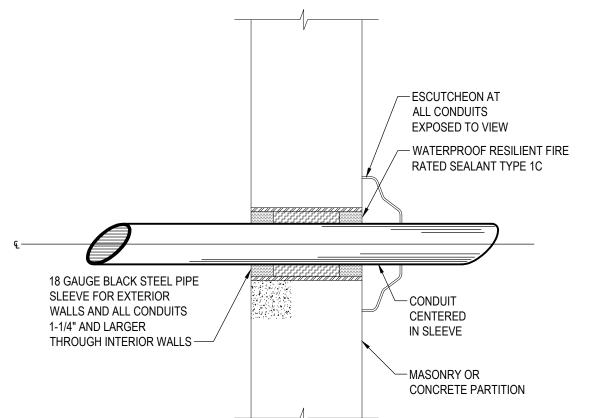


CONDUIT THROUGH EXTERIOR WALLS ABOVE GRADE SCALE: NOT TO SCALE

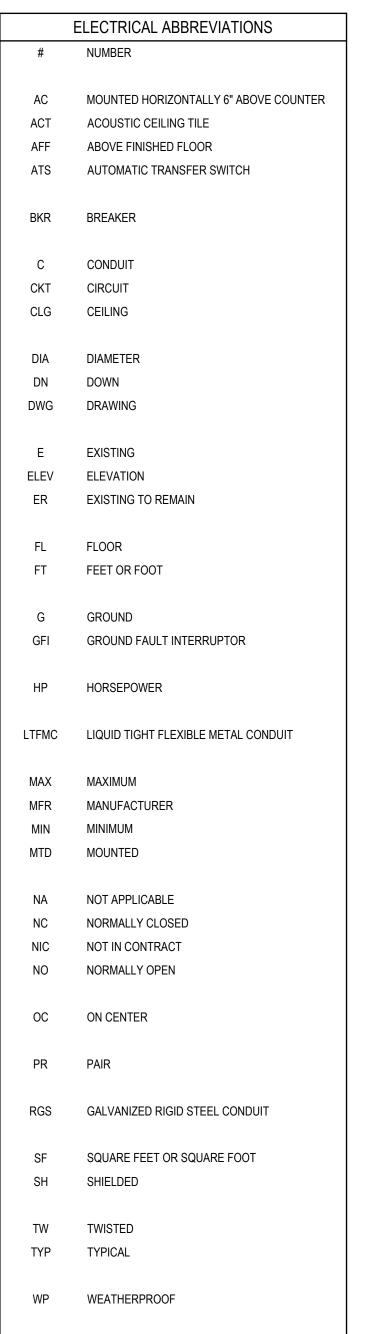


XFMR

TRANSFORMER

SYMBOL	DESCRIPTION
0202	WIRING
	_
	CIRCUIT WIRING TYPE ① UNLESS OTHERWISE NOTED HOMERUN (20/2) CIRCUIT BREAKER, (20/1) UNLESS OTHERWISE NOTED
PANEL	BOARDS (PLAN VIEW)
	(120/208) VOLT PANELBOARD
	(277/480) VOLT PANELBOARD
	, , , , , , , , , , , , , , , , , , , ,
	OUTLETS
φ	1'-6" MOUNTING HEIGHT
Ф 48"	SPECIAL MOUNTING HEIGHT
Фс	CEILING MOUNTED OUTLET
#	QUAD OUTLET, 1'-6" MOUNTING HEIGHT
	LINOTION DOVES
	UNCTION BOXES
<u>(j)</u>	POWER JUNCTION BOX
<u> </u>	DATA JUNCTION BOX
	EQUIPMENT
M	MOTOR
SWITCH SIZE FUSE SIZE	DISCONNECT SWITCH
	MOTOR STARTER
SWITCH SIZE FUSE SIZE	COMBINATION MOTOR STARTER
0	PUSHBUTTON

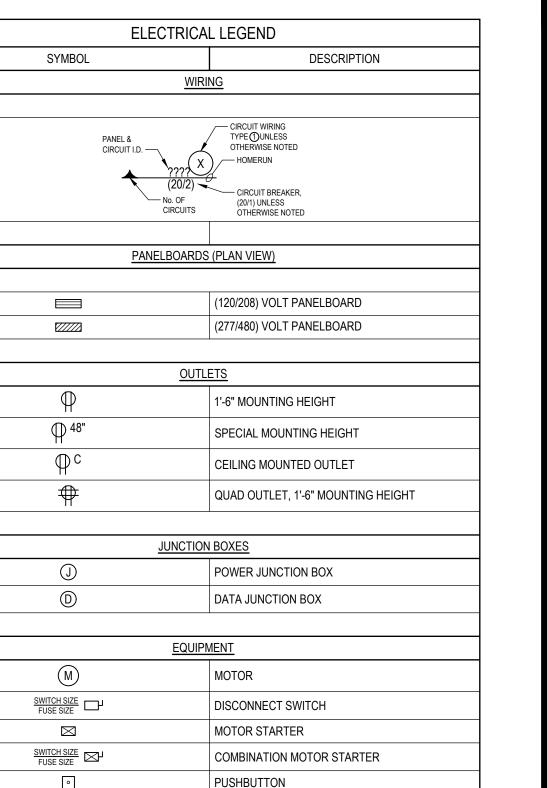

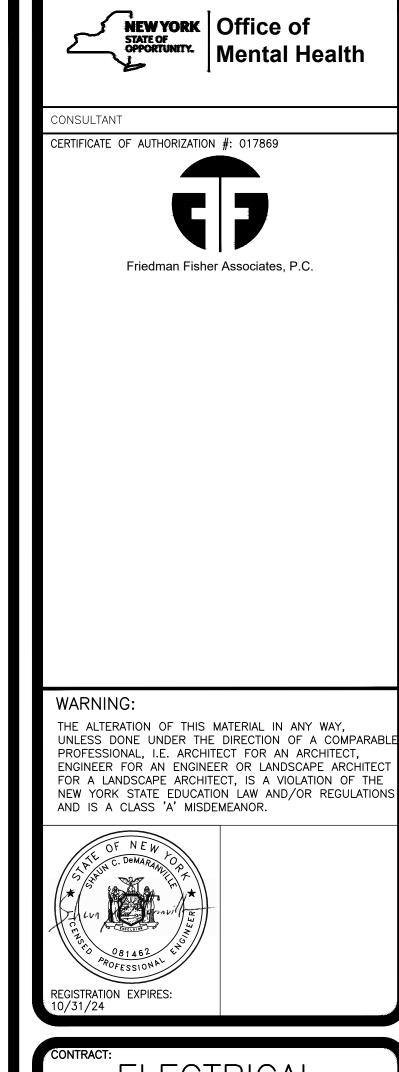

REPLACE BUILDING CHILLERS, BUILDING 144 COOK CHILL PRODUCTION CENTER 145 OLD ORANGEBURG ROAD ORANGEBURG, NY

> OFFICE OF MENTAL HEALTH

CLIENT:

12/6/2023 BID DOCUMENTS DATE DESCRIPTION **-** F NUMBER: DESIGNED BY: DRAWN BY: FIELD CHECK: APPROVED: SHEET TITLE:

SYMBOLS LEGEND, **ABBREVIATIONS** AND DETAILS

DRAWING NUMBER:

E - 00115 of 18

RESTORE GRAVEL SURFACE WITH FOR 480V CHILLER FEEDER, REFER 4" **----** 7.5" **-----** 4" **---**TO PLANS FOR SIZE OF CONDUITS

> TYPICAL EXISTING CONDUIT CONCRETE CAPPING DETAIL SCALE: NOT TO SCALE

MATERIAL WITHIN EXISTING

CONDUIT TO SUPPORT

CONCRETE CAPPING

WITH EXISTING FLOOR -