



4 Third Floor Key Plan - Vintage

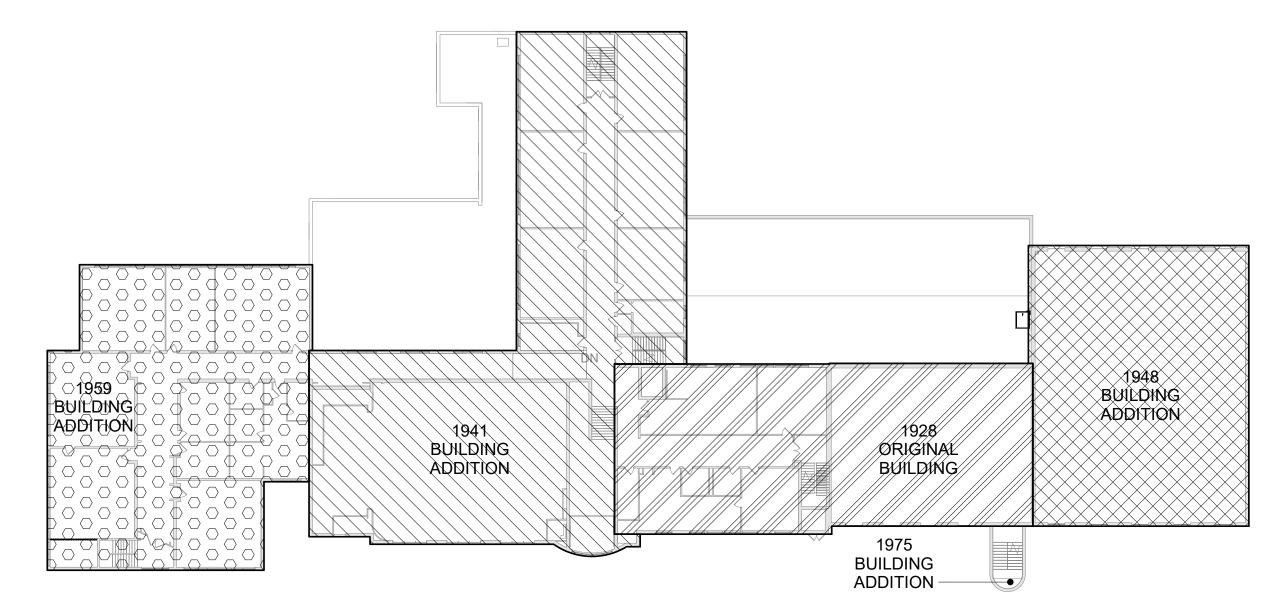


3 Second Floor Key Plan - Vintage

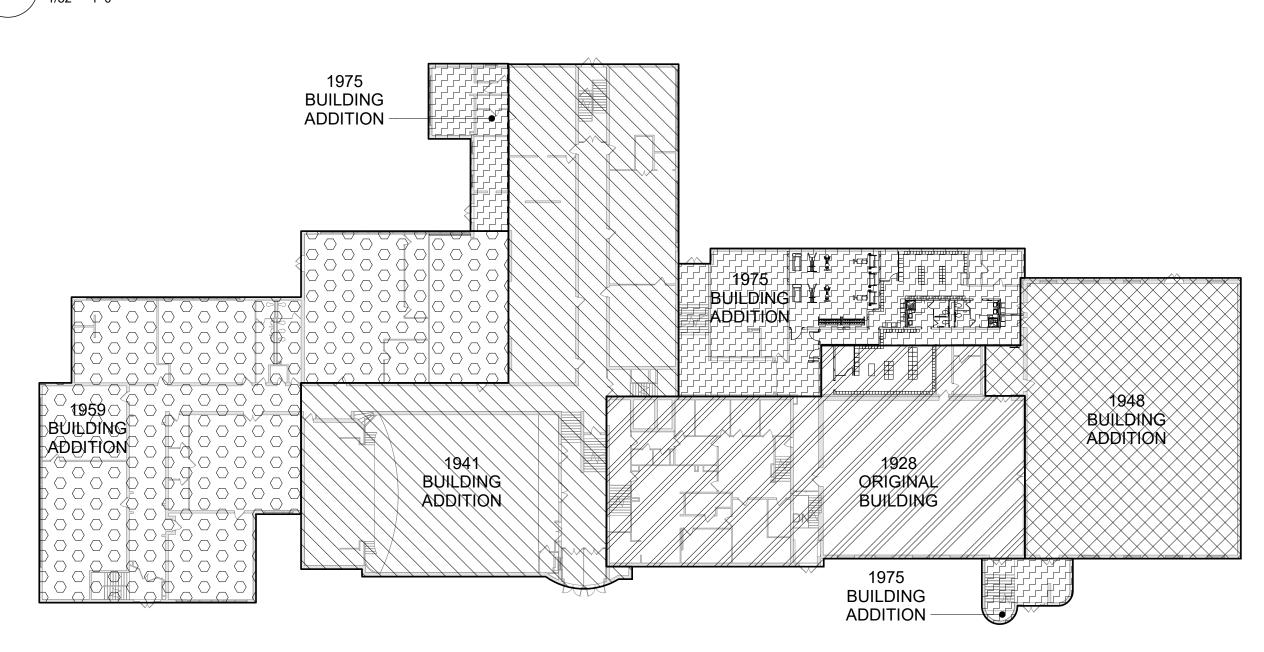

First Floor Key Plan - Vintage

1/32" = 1'-0"

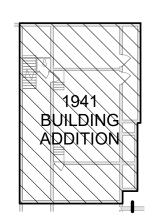

Code Compliance Review

<u>PROJECT LOCATION:</u> 109 BONA VENTURA AVE, WALLKILL, NY 12589 BOUNDED BY BONA VENTURA AVENUE TO THE SOUTH, LAVOLETTA STREET TO THE NORTH, AND 3RD STREET TO THE WEST.

PROJECT DESCRIPTION:
THIS PROJECT INCLUDES RENOVATION OF THE BOYS AND GIRLS LOCKER ROOMS WITH A NEW WEIGHT ROOM, AND CEILINGS REPLACEMENTS ON THE FIRST AND SECOND FLOORS. RENOVATION INCLUDED MECHANICAL, ELECTRICAL AND PLUMBING TO SUPPORT RENOVATED SPACES.

WORK GENERALLY CONSISTS OF THE FOLLOWING:

ALTERATIONS - LEVEL 1 CEILING REPLACEMENTS

ALTERATIONS - LEVEL 2 RENOVATION OF BOYS' AND GIRLS' LOCKER ROOMS

APPLICABLE CODES AND STANDARDS:

BASED ON THE NEW YORK STATE UNIFORM FIRE PREVENTION AND BUILDING CODE, 2020 BCNYS, 2020 EBCNYS AND 2020 ECCNYS, ICC A117.1-09 STANDARD FOR ACCESSIBLE AND USABLE BUILDINGS AND FACILITIES AND COMMISSIONER OF EDUCATIONS 155 REGULATIONS (SED MPS-22).

BUILDING DATA:

BUILDING: JOHN G BORDEN MIDDLE SCHOOL 109 BONA VENTURA AVE WALLKILL, NY 12589

DESCRIPTION: THREE STORY MASONRY AND REINFORCED CONCRETE BUILDING WITH BASEMENT.

YEAR BUILT: 1928 ADDITIONS: 1941, 1948, 1959, 1975

BUILDING AREA: BASEMENT 1ST FLOOR

2,437 SQFT 46,147 SQFT 2ND FLOOR 19,801 SQFT 3RD FLOOR 19,090 SQFT

TOTAL GROSS AREA= 87,475 SQFT

CODE DATA SUMMARY: USE GROUP: E : EDUCATION

CONSTRUCTION TYPE -EXISTING:

NEW: SPRINKLERED:

LOCATION AREA WORK AREA: % OF TOTAL

1ST FLOOR 3332 SQFT 7.2%

PATH OF CODE COMPLIANCE:

2020 EXISTING BUILDING CODE of NYS 301.3.2 WORK AREA COMPLIANCE METHOD

CHAPTER 6 - CLASSIFICATION OF WORK 602 ALTERATION - LEVEL 1 (CHAPTER 7) 603 ALTERATION - LEVEL 2 (CHAPTER 8)

NEW CONSTRUCTION WILL COMPLY WITH REQUIREMENTS OF THE 2020 BCNYS, 2020 EBCNYS AND 2020 ECCNYS, ICC A117.1-09 STANDARD FOR ACCESSIBLE AND USABLE BUILDINGS AND FACILITIES AND COMMISSIONER OF EDUCATIONS 155 REGULATIONS (SED MPS-22).

EXIT TRAVEL DISTANCE (PER TABLE 1017.2): FOR EXIT TRAVEL DISTANCE - SEE BG351.

CORRIDOR ENCLOSURES (PER TABLE 1020.1): FOR CORRIDOR FIRE RESISTANCE - SEE ENLARGED PLANS, PARTITION TYPES AND DOOR SCHEDULE. ALL CROSS CORRIDOR PARTITIONS ARE SMOKE PARTITIONS AND EXTEND FROM FINISH FLOOR TO

UL DESIGN NUMBERS:

1 HR. STUD PARTITIONS

1. RATING PROVIDED BY 4" SOLID CONCRETE MASONRY UNITS - DETERMINATION OF EQUIVALENT THICKNESS OF CMU REQUIRED IS BASED ON SECTION 721 PRESCRIPTIVE FIRE RESISTANCE, TABLE 721.1 (2) RATED FIRE RESISTANCE PERIODS FOR VARIOUS WALLS AND PARTITIONS, ITEM NUMBER 3-1.2

2. ALL CMU CONSTRUCTION SHALL MEET FIRE RESISTANCE REQUIREMENTS INDICATED IN CHART OF SAME NAME ABOVE, BLOCK TYPE AS REQUIRED TO COMPLY WITH UL DESIGN NUMBERS AND AS REQUIRED TO COMPLY WITH RATED WALLS INDICATED ON CODE COMPLIANCE DRAWINGS. PROVIDE MINIMUM 4" SOLID CMU AT SUCH LOCATIONS REGARDLESS IF NOTED AS

Occupancy Total Water Closets Water Closets Lavatories

Number (Urinals) (Urinals) Required of Required

Ocupants Male Female Male Female Male Female Male Female

1329 14 14 19 19 14 14 14 14

PLUMBING FIXTURE COUNT PER TABLE 2902.1


INTERIOR FINISH REQUIREMENTS:


ALL FINISHES IN CORRIDORS AND ASSEMBLY SPACES SHALL HAVE A FIRE HAZARD CLASSIFICATION PER MANUAL OF PLANNING STANDARDS SECTION S202-2, a. THROUGH e.

RESCUE LABEL / SIGNAGE NOTES:

1. REFER TO PLANS FOR RESCUE WINDOW LOCATIONS.

REFER TO SPECIFICATION SECTION 10 14 00 AND SIGNAGE DRAWINGS FOR TYPES AND LOCATIONS.

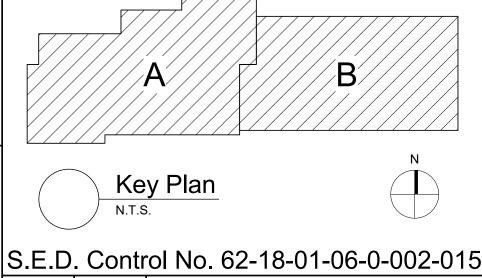

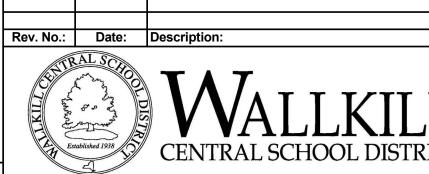



General Code Notes

COORDINATE WITH FLOOR PLANS, WALL SECTIONS AND

ALL WALLS, INCLUDING AT CORRIDORS, SHALL EXTEND

AT AREAS OF PROJECT WORK, COMPLETELY SEAL ALL

NEW OR EXISTING, TYPICAL UNLESS NOTED OTHERWISE.

ALL WALLS, INCLUDING CORRIDOR WALLS, EXTEND TO THE ROOF DECK

— — — — — COMMON EGRESS PATH

NUMBER OF OCCUPANTS IN EACH SPACE, UNO

OR FLOOR DECK ABOVE UNLESS NOTED OTHERWISE.

RESCUE WINDOW

1928 ORIGINAL BUILDING

1941 BUILDING ADDITION

1948 BUILDING ADDITION

1959 BUILDING ADDITION

1975 BUILDING ADDITION

DISCREPANCIES BETWEEN DRAWINGS.

PARTITION TYPES FOR RATED WALL TYPES AND LOCATIONS. IMMEDIATELY NOTIFY ARCHITECT OF ANY WALL RATING

COMPLETELY TO THE UNDERSIDE OF DECKING, SUPPORTING STRUCTURE OR ROOF ABOVE, TYPICAL UNLESS NOTED

PENETRATIONS REQUIRED TO COMPLY WITH FIRE RESISTANCE

RATINGS IDENTIFIED ON THE DRAWINGS, REGARDLESS IF WALL IS

Tetra Tech Engineers, Architects & Landscape Architects, P.C.



Wallkill Central School District Wallkill, New York

Reconstruction to: John G. Borden Middle School

Code Compliance Review and Vintage

06/30/2023 Project No.: 17597-22002

BG350

Drawing Number: