	LIGHTING FIXTURE SCHEDULE									
TAG	SYMBOL	MANUFACTURER & MODEL	TYPE	VOLTAGE	# OF LAMPS	LAMP WATTS	FIXTURE WATTS	MOUNTING	SIZE	NOTES
А	⊟ _c	HE WILLIAMS FIELD SELECT TROFFER FT-22-LS/8CS-AF-DIM-UNV	LED	120	1	23.8	23.8	RECESSED	2'x2'	SET FIXTURE TO 3400 LUMEN SETTING AND 4000K COLOR TEMPERATURE SETTING
-	\Box	HE WILLIAMS LED EMERGENCY LIGHT EMER/LED-WHT-SDT-D	LED	120	2	1.0	2.0	UNIVERSAL	-	UL 924 LISTED FIXTURE; 90-MINUTE BATTERY BACKUP

120/208V 3Ø 4W+G				BUS	RATIN	G: 800A				М
CONNECTED LOAD	CONDUCTORS	CKT. BREAKER AMPACITY	POSITION	L1 KVA	L2 KVA	L3 KVA	POSITION	CKT. BREAKER AMPACITY	CONDUCTORS	CONNECTED LOAD
			1	·/.			2			
DOAS-1	(3) #2 CU & (1) #6 GND.	110	3		·/.		4	125	(3) #1 CU & (1) #6 GND.	DOAS-2
			5			·/_	6			
			7	·/.			8			
DOAS-3	(3) #2 CU & (1) #6 GND.	110	9		·/.		10	125	(3) #1 CU & (1) #6 GND.	DOAS-4
			11			·/.	12			
DOAS-1 FS DAMPERS	(2) #12 CU & (1) #12 GND.	20	13	·/.			14	20	(2) #12 CU & (1) #12 GND.	DOAS-2 FS DAMPERS
DOAS-3 FS DAMPERS	(2) #12 CU & (1) #12 GND.	20	15		·/.		16	20	(2) #12 CU & (1) #12 GND.	DOAS-4 FS DAMPERS
			17			·/.	18			
EXISTING LOAD RELOCATED FROM MDP	(3) #4 CU & (1) #10 GND.	20	19	·/.			20	20	(3) #4 CU & (1) #10 GND.	EXISTING LOAD RELOCATED FROM MDF
		20	21		-/-		22	20		
SPARE	-	20	23			-/-	24	20	-	SPARE
SPARE	-	20	25	·/.			26	20	-	SPARE
SPARE	-	20	27		·/.		28	20	-	SPARE
SPARE	_	20	29			-/	30	20	-	SPARE

∖ E001 / Scale: None

ELECTRICAL LEGEND:

MOTOR

EARTH GROUND

JUNCTION BOX

- FUSE WITH RATING

MOLDED CASE CIRCUIT BREAKER

DISCONNECT SWITCH, FUSED

DISCONNECT SWITCH, UNFUSED

STARTER, COMBINATION WITH DISCONNECT SWITCH

STARTER OR MOTOR CONTROLLER

METER

20A 120V DUPLEX CEILING MOUNTED RECEPTACLE

OTHERWISE NOTED 20A 120V DUPLEX WALL MOUNTED RECEPTACLE WITH GROUND

20A 120V DUPLEX WALL MOUNTED RECEPTACLE; 18" A.F.F. UNLESS

FAULT CIRCUIT INTERRUPTER 20A 120V QUADRAPLEX RECEPTACLE

WALL MOUNTED SPECIAL PURPOSE RECEPTACLE

⇒ USB 20A 120V WALL MOUNTED USB CHARGER RECEPTACLE TYPICAL OF HUBBELL USB20X OR ACCEPTABLE EQUAL

FLOOR BOX WITH STAINLESS COVER TYPICAL OF LEW EECTRIC #OB-1-SP OR ACCEPTABLE EQUAL; PUSH BUTTON OPEN; FULLY IP66 RATED WATER PROOF (WHEN IN CLOSED POSITION); W/ 20A 125V

E60120 GFCI RECEPTACLE (UNLESS OTHERWISE NOTED) WALL PHONE OUTLET MTD. 48" A.F.F.; 3/4" EMT CDT. IN WALL TO

WALL BOX FOR TELEVISION CONNECTION; 1-1/4" EMT CDT. IN WALL TO ABOVE CEILING W/ PULL CORD

ABOVE CEILING W/ PULL CORD

TELEPHONE/DATA COMMUNICATION BOX W/ (2) 3/4" EMT CDT. IN WALL TO ABOVE CEILING W/ PULL CORD; NO FACE PLATE

BRANCH CIRCUIT HOMERUN; LINES INDICATE NUMBER OF CIRCUITS, NEUTRAL, AND SWITCH LEG CONDUCTORS; ONE SEPARATE GROUNDING CONDUCTOR SHALL BE PROVIDED FOR EACH HOMERUN; NOT SHOWN

BLANK = SINGLE POLE 2 = DOUBLE POLE 4 = FOUR-WAY 3 = THREE-WAYD = DIMMER K = KEY OPERATED P = WITH PILOT LIGHT PB= PUSH BUTTON T = TIMER OPERATED WP= WEATHER PROOF X = EXPLOSION PROOF OC= OCCUPANCY SENSOR

DUAL TECHNOLOGY OCCUPANCY SENSOR

DAYLIGHT SENSOR

HORN/STROBE DEVICE, ONE ASSEMBLY; MTD. 80" A.F.F. UNLESS OTHERWISE NOTED; 15 CANDELA UNLESS OTHERWISE NOTED

STROBE DEVICE; MTD. 80" A.F.F. UNLESS OTHERWISE NOTED; 15 CANDELA UNLESS OTHERWISE NOTED

MANUAL PULL STATION; MTD. 48" A.F.F.

WATER FLOW SWITCH

VALVE TAMPER SWITCH

DETECTOR; LETTER INDICATES AS FOLLOWS: BLANK = SMOKE DETECTOR P = PHOTOELECTRIC SMOKE M = MULTIPLE STATION SMOKE ALARM D = PHOTOELECTRIC DUCT SMOKE DETECTOR FSD = DUCT SMOKE DETECTOR FOR FIRE SMOKE DAMPER

RATE OF RISE HEAT DETECTOR, 135°F

CARBON MONOXIDE DETECTOR; MTD. 60" A.F.F.

FIRE ALARM ANNUNCIATOR PANEL

ADDRESSABLE FIRE ALARM CONTROL PANEL

REMOTE TEST SWITCH & LED FOR DUCT SMOKE DETECTORS

FIRE ALARM RELAY

ELECTRICAL NOTES:

- 1. ALL MATERIALS AND EQUIPMENT ARE TO BE NEW, UNUSED, AND FREE FROM DEFECTS OF ANY KIND. THE BASIS OF QUALITY SHALL BE THE LATEST REVISION OF ASTM, ANSI, OR OTHER ACCEPTABLE STANDARDS.
- 2. THESE DRAWINGS ARE DIAGRAMMATIC, AND INDICATE GENERAL ARRANGEMENT OF WORK. THE CONTRACTOR SHALL BE RESPONSIBLE TO HAVE REVIEWED THE SITE FOR HIS WORK PRIOR TO HAVING SUBMITTED HIS PROPOSAL. NO ADDITIONAL COMPENSATION WILL BE ALLOWED FOR CONDITIONS FOUND DURING THE COURSE OF THE CONTRACT.
- 3. THE CONTRACTOR SHALL COORDINATE HIS WORK WITH THAT OF ALL OTHER
- 4. ALL WORK INCLUDING LABOR AND MATERIALS SHALL BE FULLY GUARANTEED FOR ONE (1) YEAR FROM THE DATE OF PAYMENT AND FINAL ACCEPTANCE BY THE OWNER AND ENGINEER.
- 5. ALL CUTTING, PATCHING, FIRE-STOPPING, AND SURFACE RESTORATION IN CONNECTION WITH THIS TRADE SHALL BE COMPLETED BY THIS CONTRACTOR.
- 6. A MINIMUM OF FOUR (4) COPIES OF SHOP DRAWINGS SHALL BE SUBMITTED TO THE ARCHITECT FOR APPROVAL PRIOR TO ORDERING AND INSTALLATION OF THE EQUIPMENT AND/OR MATERIALS. BY SUBMITTING SHOP DRAWINGS, THE CONTRACTOR REPRESENTS THAT ACTUAL FIELD CONDITIONS ARE VERIFIED BY HIM AND ARE REFLECTED ON HIS SUBMITTALS.
- 7. THIS CONTRACTOR SHALL PAY ALL FEES, GIVE ALL NOTICES, FILE ALL NECESSARY DRAWINGS, AND OBTAIN ALL PERMITS, INSPECTIONS AND CERTIFICATES OF APPROVAL REQUIRED IN CONNECTION WITH WORK UNDER THIS CONTRACT.
- 8. EQUIPMENT AND MATERIALS FOR WHICH UNDERWRITERS LABORATORIES INC. (UL) PROVIDES PRODUCT LISTING SERVICE SHALL BE LISTED AND BEAR THE LISTING MARK.
- 9. ALL WORK IN ASSOCIATION WITH THIS CONTRACT SHALL BE COMPLETED IN STRICT COMPLIANCE WITH THE 2017 NATIONAL ELECTRIC CODE, 2020 BUILDING CODE OF NEW YORK STATE, 2020 FIRE CODE OF NEW YORK STATE & 2020 ENERGY CONSERVATION CONSTRUCTION CODE OF NEW YORK STATE.
- 10. ALL NEW LIGHTING FIXTURES SHALL BE INSTALLED FULLY LAMPED AND OPERABLE. THE CONTRACTOR SHALL TURN OVER TO THE OWNER SPARE LAMPS OF EVERY TYPE ON THE PROJECT IN AN AMOUNT NOT LESS THAN 20% OF THE TOTAL NUMBER OF EACH TYPE (MINIMUM 1 PER TYPE).
- 11. THIS CONTRACTOR SHALL BE RESPONSIBLE FOR ALL COORDINATION, APPLICATIONS AND FEES OF ALL WORK ASSOCIATED WITH THE LOCAL UTILITY COMPANY AND/OR THE TELEPHONE COMPANY. ALL WORK INVOLVING THE UTILITY COMPANY SHALL BE COMPLETED IN ACCORDANCE WITH THEIR REGULATIONS AND GUIDELINES.
- 12. ALL CONDUCTORS SHALL BE COPPER, SHALL NOT BE LESS THAN #12 AWG, AND SHALL NOT EXCEED 70 FEET FROM PANEL BOARD TO FURTHEST CONNECTION UNLESS OTHERWISE NOTED ON PLANS.
- 13. LIGHTING LOADS SHALL NOT BE COMBINED ON THE SAME CIRCUIT AS ANY OTHER ELECTRICAL LOADS.
- 14. CONTRACTOR SHALL BE RESPONSIBLE TO FURNISH & INSTALL ALL SMALL DETAILS AND INCIDENTAL WORK NOT SHOWN OR SPECIFIED, BUT WHICH CAN BE REASONABLY INFERRED AS REQUIRED FOR A COMPLETE AND OPERATING SYSTEM OF HIGH QUALITY MEETING ALL APPLICABLE CODES AND REGULATIONS.
- 15. FOR EACH NEW OR MODIFIED ELECTRICAL PANEL, THE CONTRACTOR SHALL PROVIDE A TYPE WRITTEN DIRECTORY CARD TO REFLECT ALL CIRCUITING. ADDITIONALLY, THE CONTRACTOR SHALL LABEL (WITH A PERMANENT MARKER OR LABEL) EACH RECEPTACLE ON THE INSIDE OF EACH FACE PLATE WITH PANEL AND CIRCUIT NUMBER DESIGNATION.
- 16. MINIMUM REQUIREMENT FOR EQUIPMENT GROUNDING SHALL BE GOVERNED BY THE NEC. ALL GROUNDS, BONDING, ETC. SHALL MEET THESE REQUIREMENTS. THE CONTRACTOR SHALL FURNISH AND INSTALL ANY AND ALL ITEMS NECESSARY TO MEET THESE REQUIREMENTS AT NO EXTRA COST, EVEN IF SUCH ITEMS ARE NOT DETAILED ON THE DRAWINGS.
- PARALLEL OR PERPENDICULAR TO BUILDING WALLS. THE CONTRACTOR SHALL FURNISH AND INSTALL ALL SUPPORT HANGERS AND MISCELLANEOUS METALS REQUIRED FOR PROPER INSTALLATION OF WORK. 18. THE CONTRACTOR IS RESPONSIBLE TO TEST ALL EQUIPMENT, WIRING, DEVICES,

17. ALL CONDUIT AND CABLE SHALL BE PROPERLY SUPPORTED AND ROUTED

19. THE CONTRACTOR IS RESPONSIBLE TO DETERMINE WHETHER SPECIAL LICENSING IS REQUIRED IN ORDER TO PERFORM THE REQUIRED WORK IN THE MUNICIPALITY WHERE THE PROJECT IS LOCATED. IF THE CONTRACTOR CANNOT OBTAIN THE REQUIRED LICENSING TO COMPLETE THE WORK WITHIN THE PROJECT SCHEDULE, THEN THE CONTRACTOR SHALL NOT BE PERMITTED TO BID ON THIS PROJECT.

AND SYSTEMS INSTALLED UNDER THIS CONTRACT TO ENSURE PROPER OPERATION PRIOR TO FINAL ACCEPTANCE BY THE OWNER AND ENGINEER.

	WIF	RE CO	LOR	COD	ING '	TABL]	E
PHASE	WIRES	VOLTAGE	L1	L2	L3	NEUTRAL	GROUND
1	2 (1)	120	BLACK	-	-	WHITE	-
1	2 (1)	208	BLACK	RED	-	-	-
1	3	120	BLACK	-	-	WHITE	GREEN (2
1	3	208	BLACK	RED	-	-	GREEN (2
3	4	208	BLACK	RED	BLUE	-	GREEN (2
3	5	208	BLACK	RED	BLUE	WHITE	GREEN (2
1	3	277	BROWN	-	-	GRAY	GREEN (2
1	3	480	BROWN	ORANGE	-	_	GREEN (2
3	4	480	BROWN	ORANGE	YELLOW	_	GREEN (2
3	5	480	BROWN	ORANGE	YELLOW	GRAY	GREEN (2

FOR DOUBLE INSULATED EQUIPMENT ONLY.

GREEN/YELLOW MAY BE USED: - GREEN/YELLOW SHALL BE GREEN WITH ONE OR MORE YELLOW STRIPES. - GREEN = 50 TO 70%, YELLOW = 50 TO 30%. - GREEN/YELLOW IS THE ONLY COLOR INTERNATIONALLY ACCEPTED FOR USE AS AN EQUIPMENT GROUNDING CONDUCTOR. - GREEN OR GREEN/YELLOW <u>MUST</u> ONLY BE USED FOR GROUNDING


DEVICE MOUNTING HEIGHTS							
POWER RECEPTACLES (INTERIOR)	18" A.F.F.						
POWER RECEPTACLES (EXTERIOR)	36" A.F.G.						
POWER RECEPTACLES (@ COUNTER)	44" A.F.F.						
LIGHT SWITCHES	44" A.F.F. TO TOP OF DEVICE						
DISCONNECT SWITCHES	SEE NEC 404.8(A)						
TELEPHONE/DATA RECEPTACLES	18" A.F.F.						
TELEPHONE/DATA RECEPTACLES (@ COUNTER)	44" A.F.F.						
WALL TELEPHONE RECEPTACLES	48" A.F.F. TO TOP OF DEVICE						
FIRE ALARM PULL STATIONS	42" A.F.F. MIN./44" A.F.F. MAX.						
FIRE ALARM AUDIO/VISUAL DEVICES	80" A.F.F. MIN./96" A.F.F. MAX.						
EXIT LIGHTS (WALL MOUNTED)	12" ABOVE DOOR						
EMERGENCY LIGHTS (WALL MOUNTED)	90" A.F.F.						
TV & A/V OUTLETS	18" A.F.F.						
NOTE: ALL DIMENSIONS ARE TO CENTER OF DEVI	NOTE: ALL DIMENSIONS ARE TO CENTER OF DEVICE UNLESS OTHERWISE NOTED						




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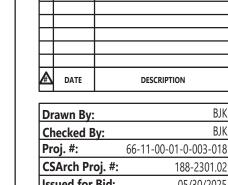
ELECTRICAL NOTES, LEGEND **DETAILS &**

SCHEDULES



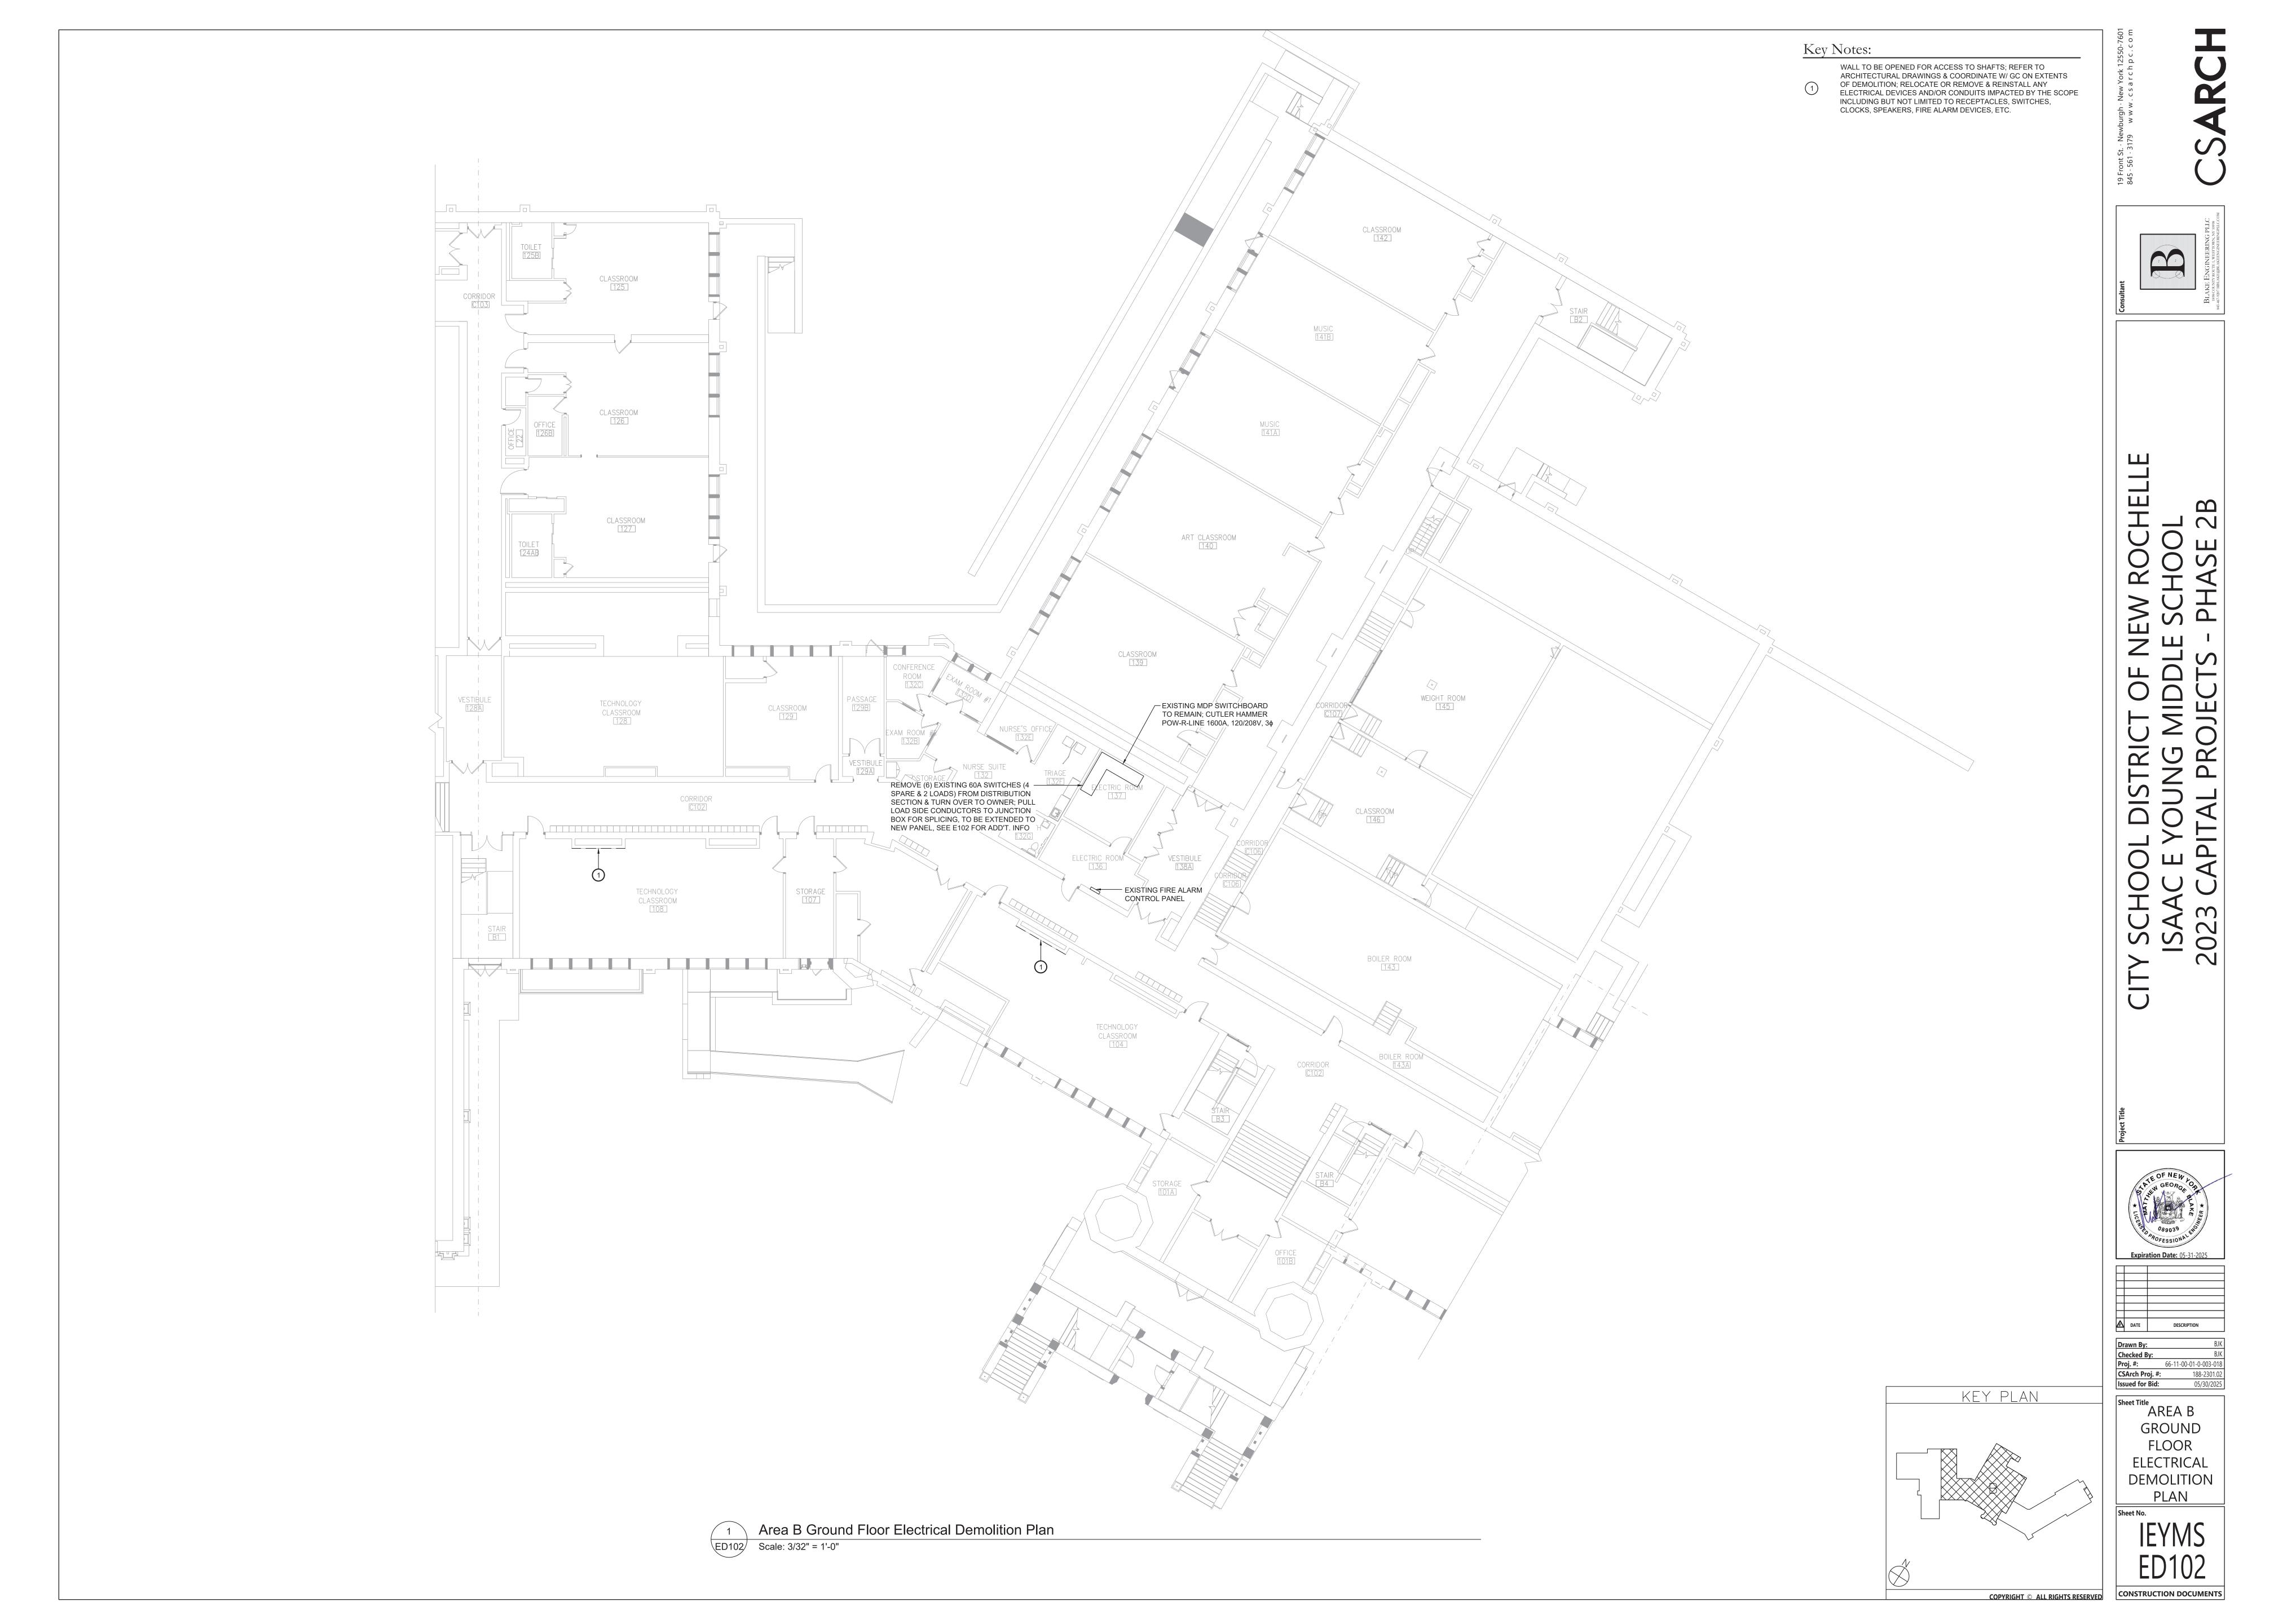

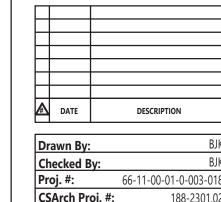DEMOLITION



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 BJK

 Checked By:
 BJK


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 66-11-00-01-0-003-018

 CSArch Proj. #:
 188-2301.02

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 05/30/2025

AREA C 1ST FLOOR ELECTRICAL DEMOLITION PLAN

IEYMS ED122

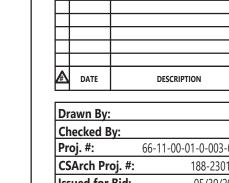

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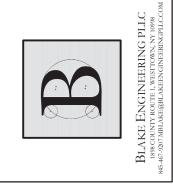
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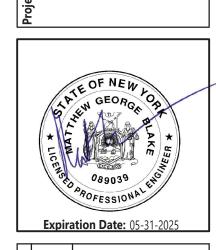
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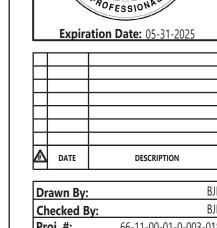
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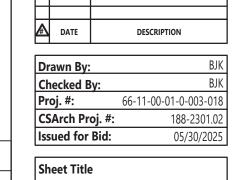
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AREA C 2ND FLOOR ELECTRICAL DEMOLITION PLAN











AREA B ROOF ELECTRICAL DEMOLITION PLAN


IEYMS ED132



CITY SCHOOL DISTRICT OF ISAAC E YOUNG MIDDI 2023 CAPITAL PROJECTS

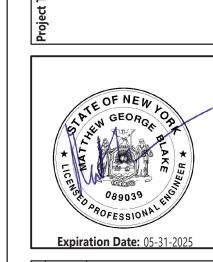

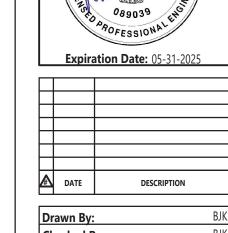


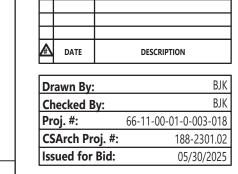



AREA C ROOF ELECTRICAL DEMOLITION PLAN



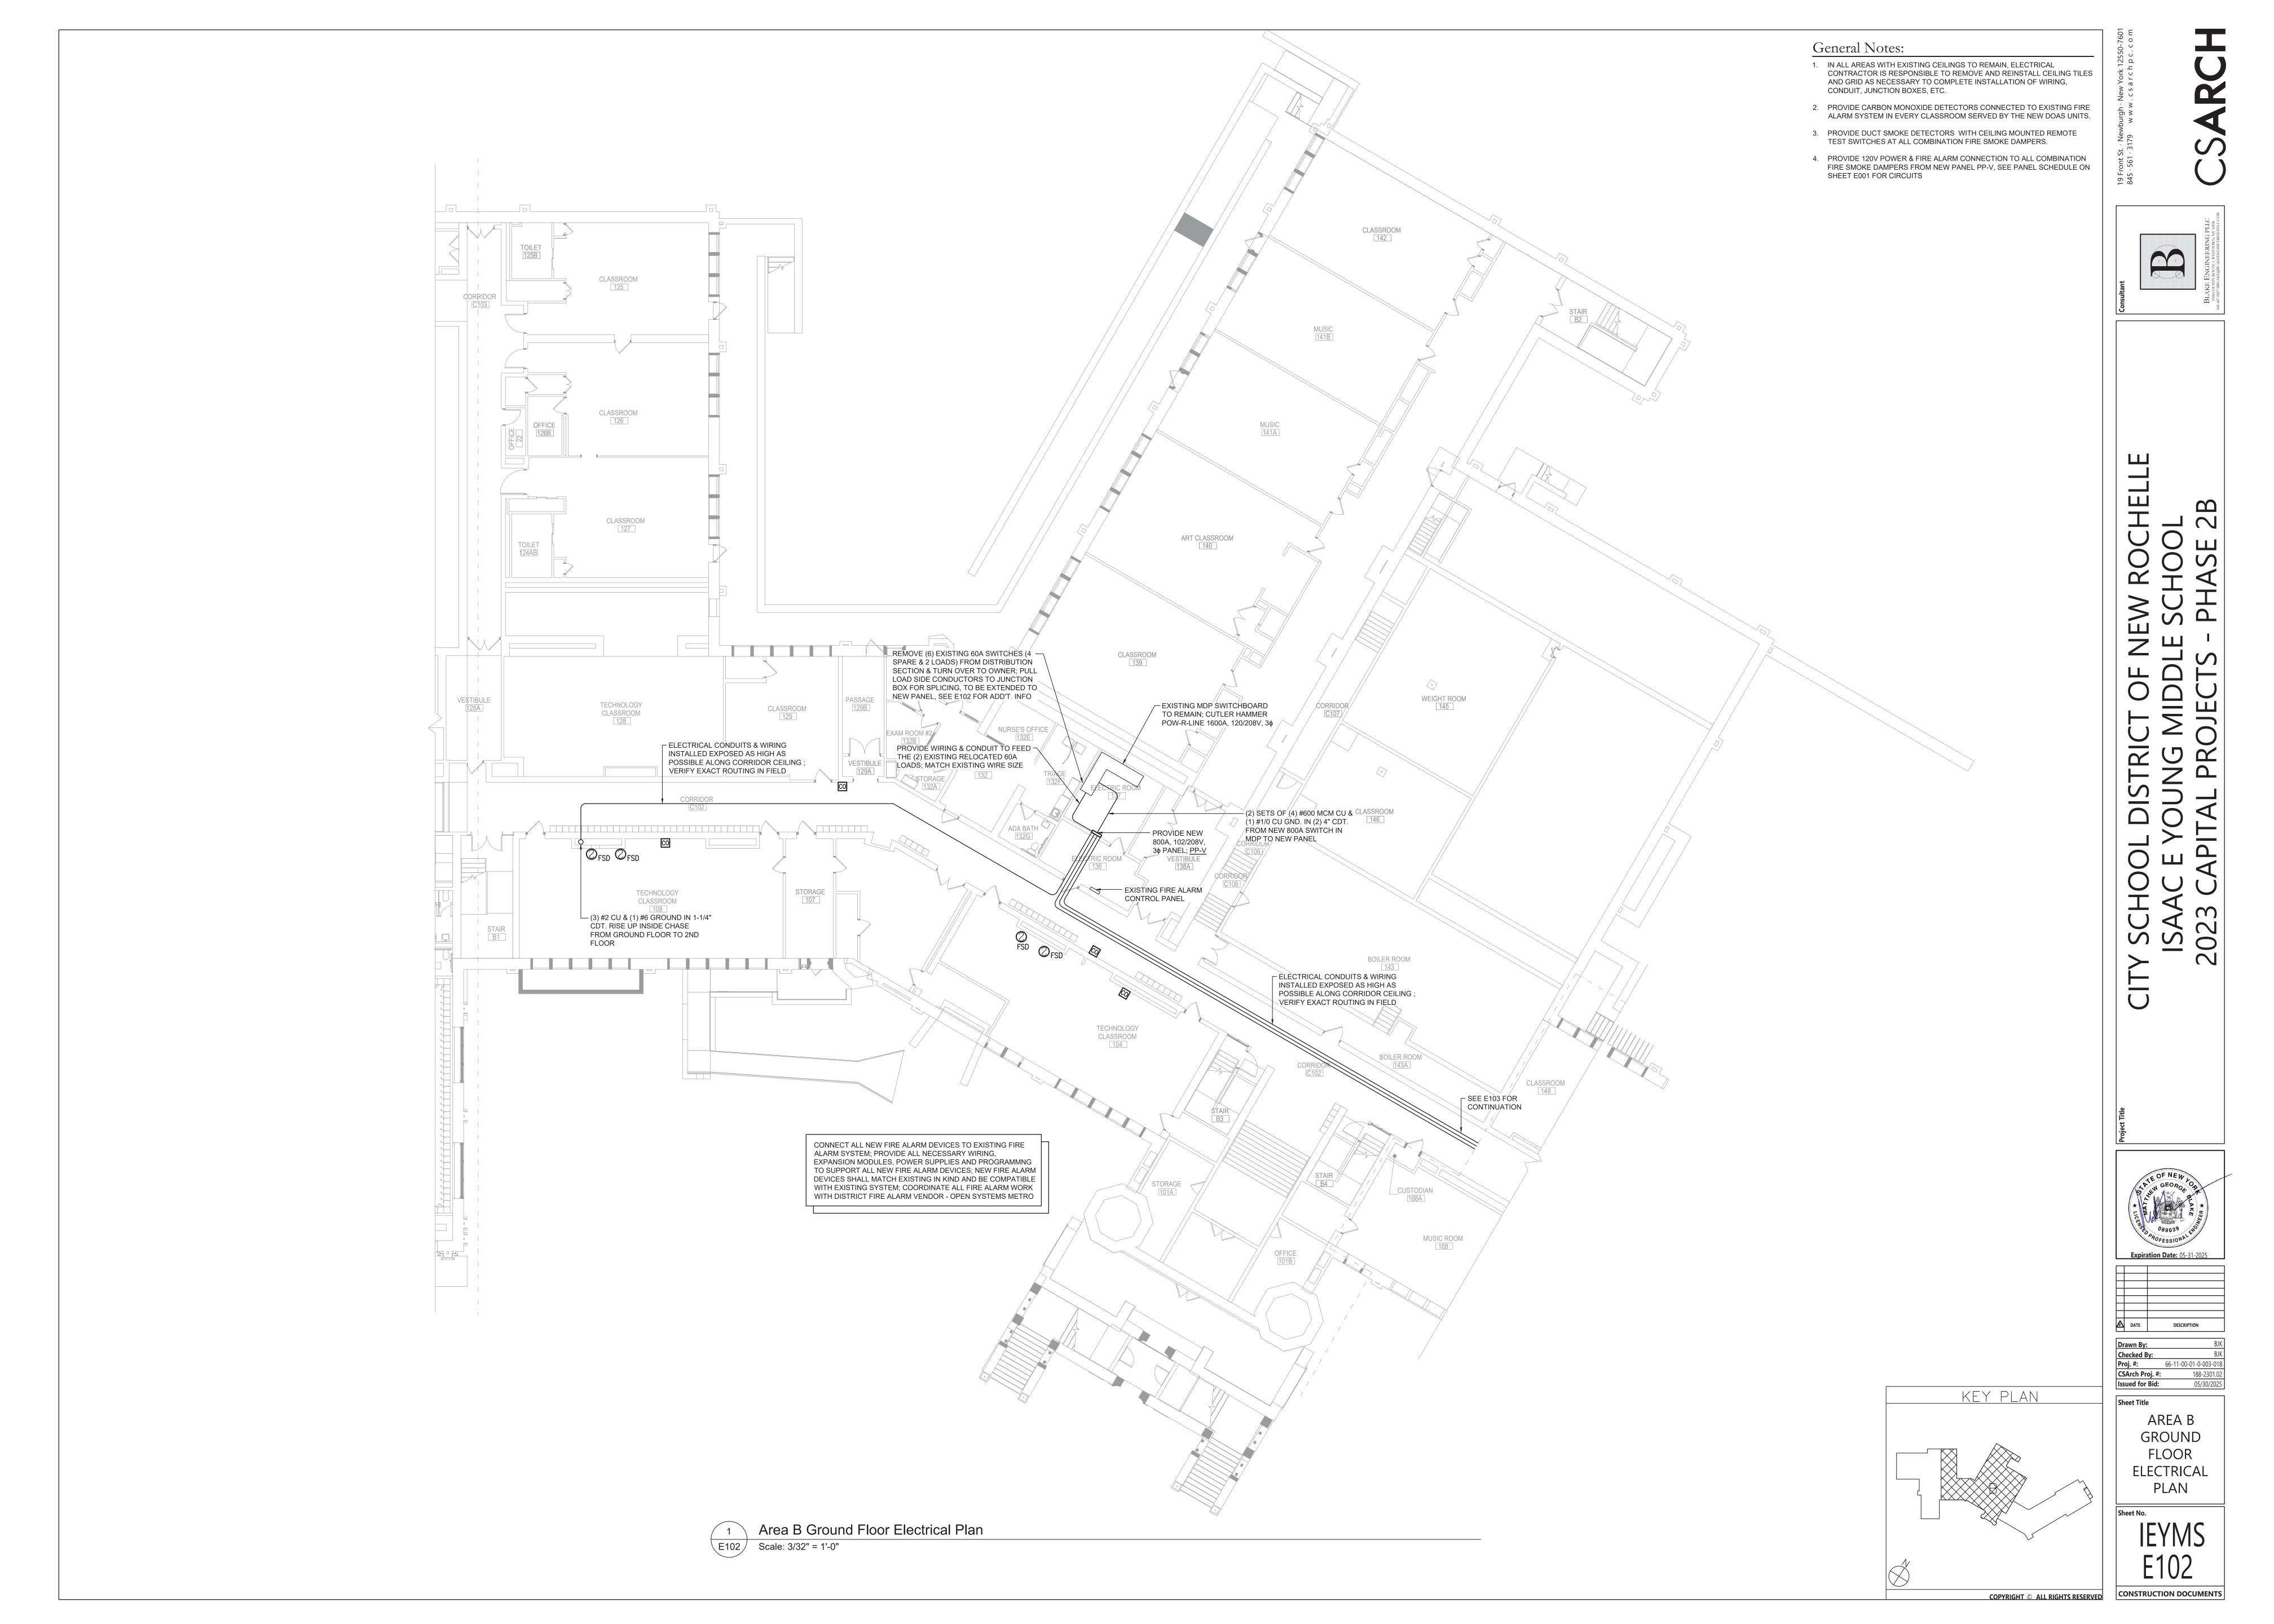

- IN ALL AREAS WITH EXISTING CEILINGS TO REMAIN, ELECTRICAL CONTRACTOR IS RESPONSIBLE TO REMOVE AND REINSTALL CEILING TILES AND GRID AS NECESSARY TO COMPLETE INSTALLATION OF WIRING, CONDUIT, JUNCTION BOXES, ETC.
- PROVIDE CARBON MONOXIDE DETECTORS CONNECTED TO EXISTING FIRE ALARM SYSTEM IN EVERY CLASSROOM SERVED BY THE NEW DOAS UNITS.
- 3. PROVIDE DUCT SMOKE DETECTORS WITH CEILING MOUNTED REMOTE TEST SWITCHES AT ALL COMBINATION FIRE SMOKE DAMPERS.
- 4. PROVIDE 120V POWER & FIRE ALARM CONNECTION TO ALL COMBINATION FIRE SMOKE DAMPERS FROM NEW PANEL PP-V, SEE PANEL SCHEDULE ON SHEET E001 FOR CIRCUITS

Consultant

BLAKE ENGINEERING PLLC
1898 COUNTY ROUTE, I, WIESTTOWN, NY 16998
845-467-9207 MBLAKE@BLAKERNGINEBRINGPLL.C.COM

CITY SCHOOL DISTRICT OF NEW ROCHELLE ISAAC E YOUNG MIDDLE SCHOOL 2023 CAPITAL PROJECTS - PHASE 2B

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 BJK

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Sheet Title

AREA C


GROUND


FLOOR

ELECTRICAL


Sheet No.

IEYMS
E103

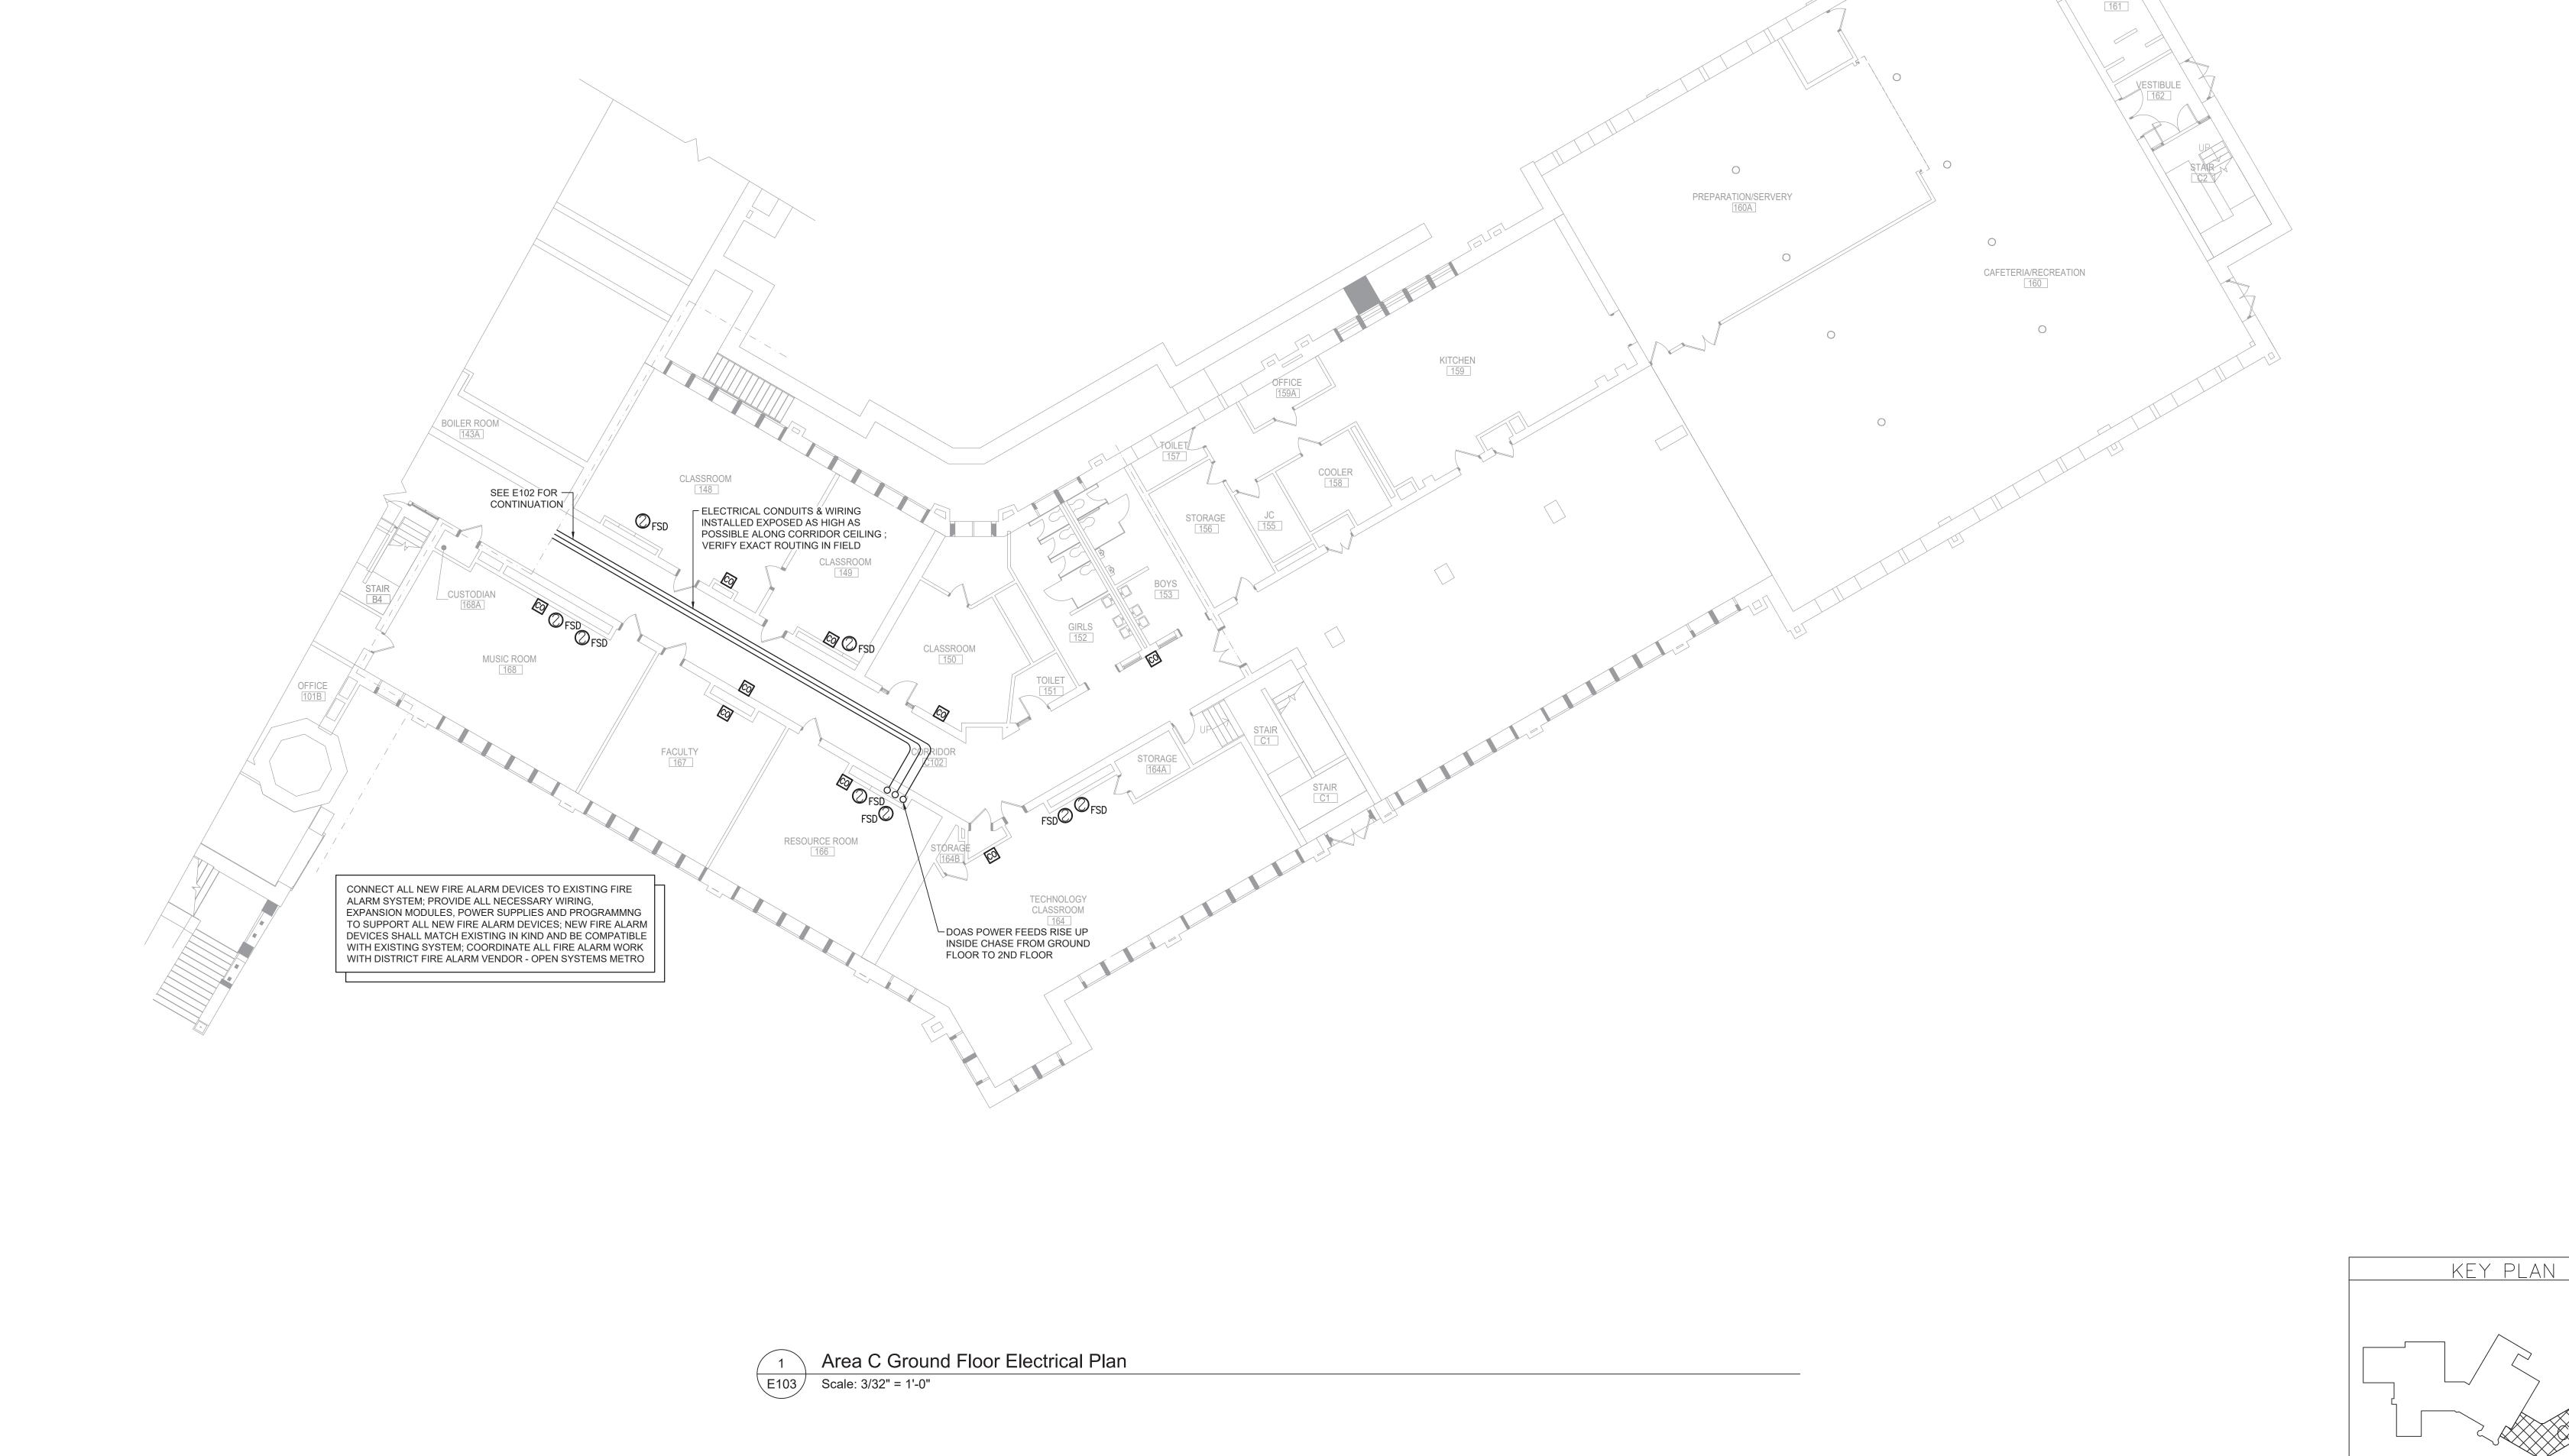

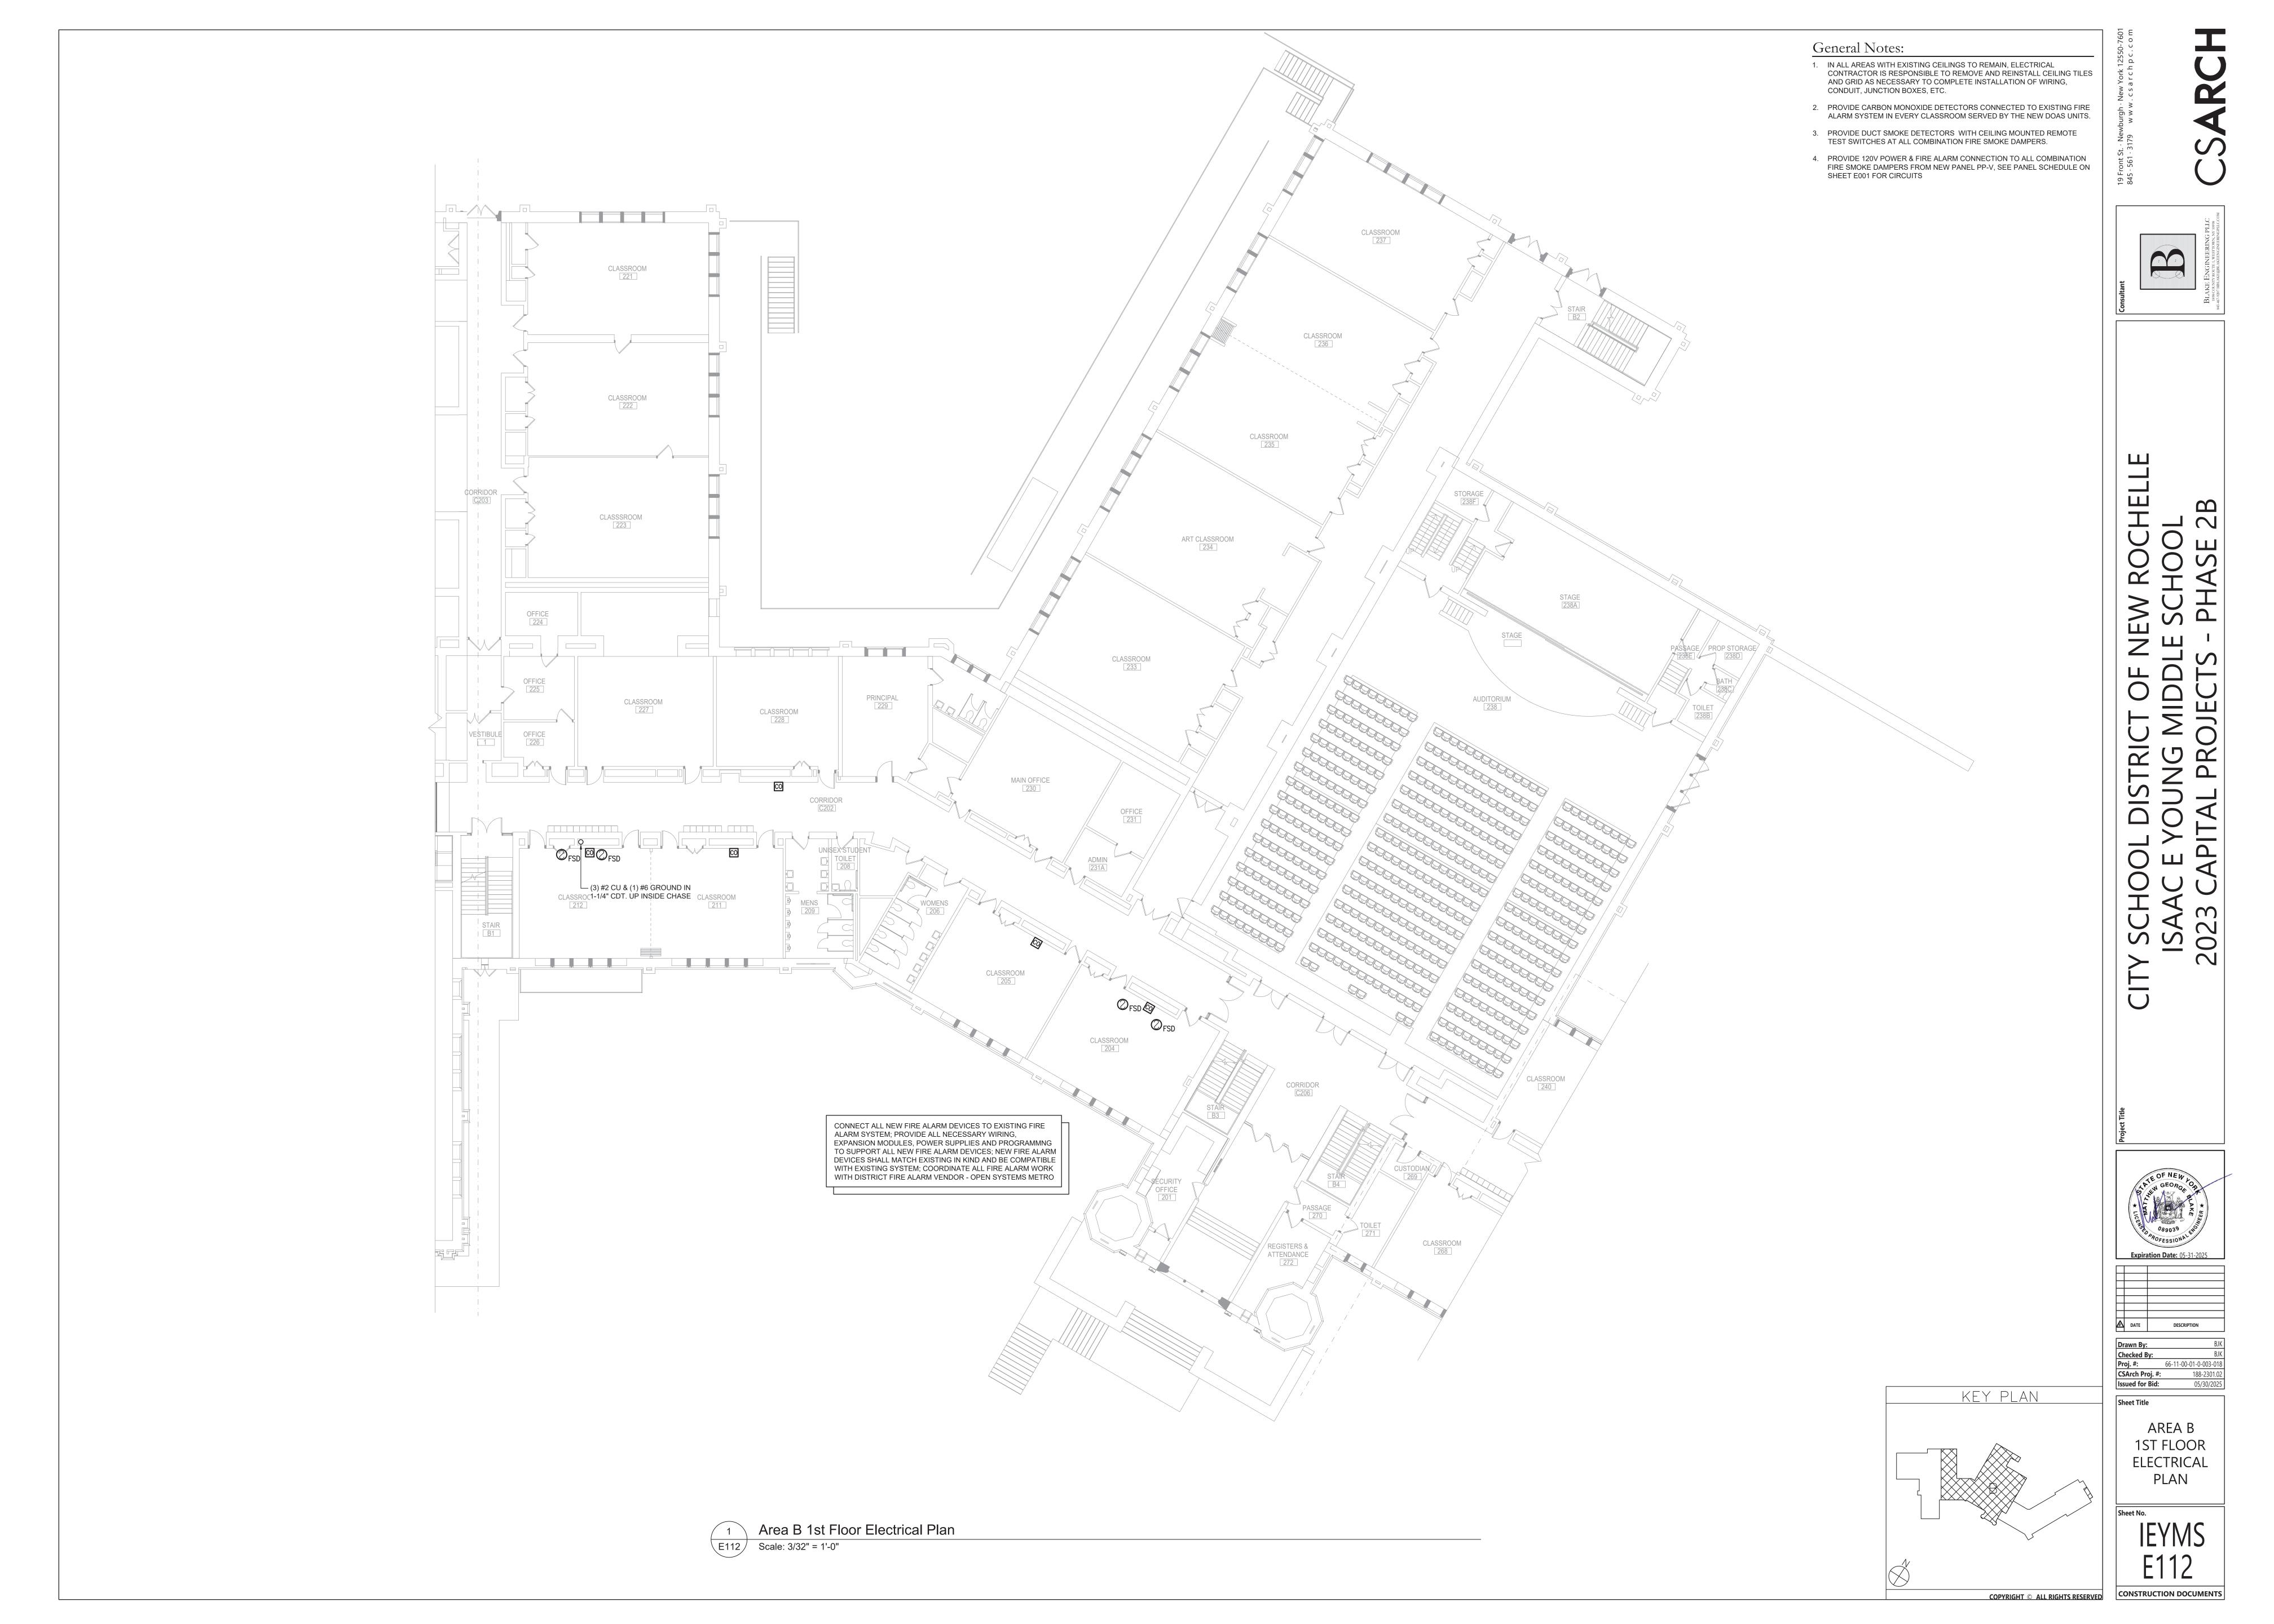

- 1. IN ALL AREAS WITH EXISTING CEILINGS TO REMAIN, ELECTRICAL CONTRACTOR IS RESPONSIBLE TO REMOVE AND REINSTALL CEILING TILES AND GRID AS NECESSARY TO COMPLETE INSTALLATION OF WIRING, CONDUIT, JUNCTION BOXES, ETC.
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AREA C

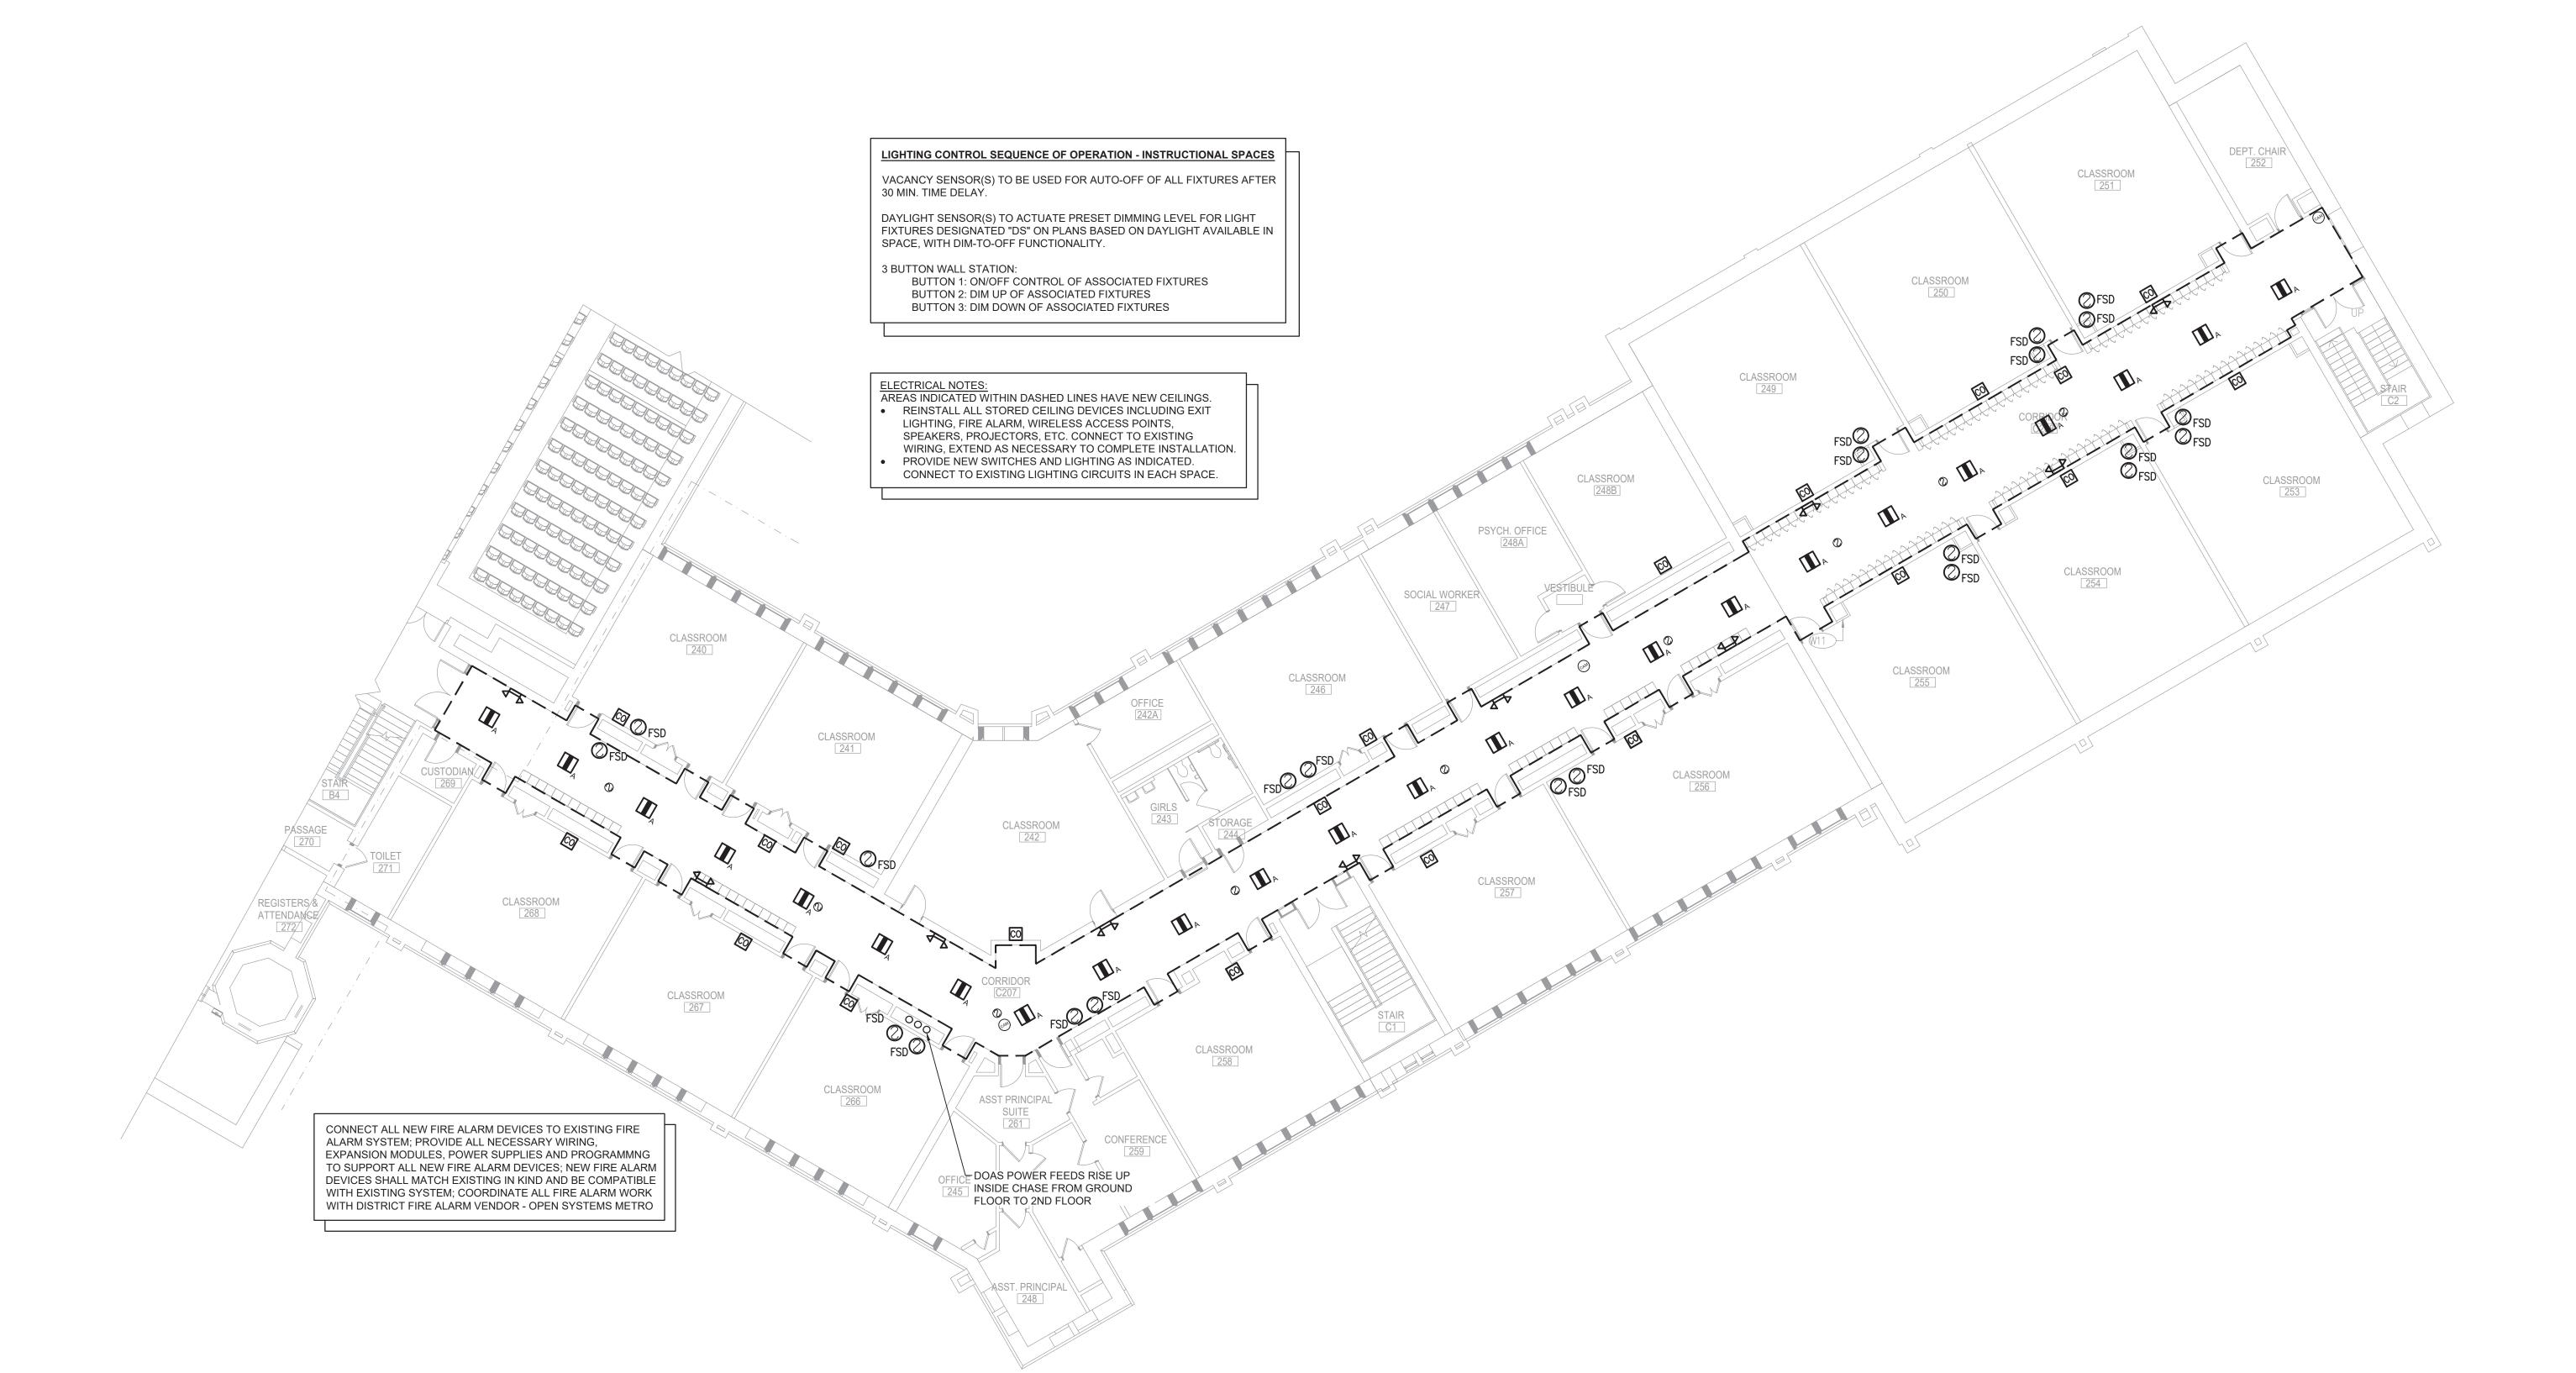KEY PLAN


1ST FLOOR ELECTRICAL PLAN

CONSTRUCTION DOCUMENTS

1 Area C 1st Floor Electrical Plan
E113 Scale: 3/32" = 1'-0"

General Notes:

1. IN ALL AREAS WITH EXISTING CEILINGS TO REMAIN, ELECTRICAL

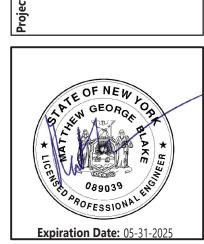



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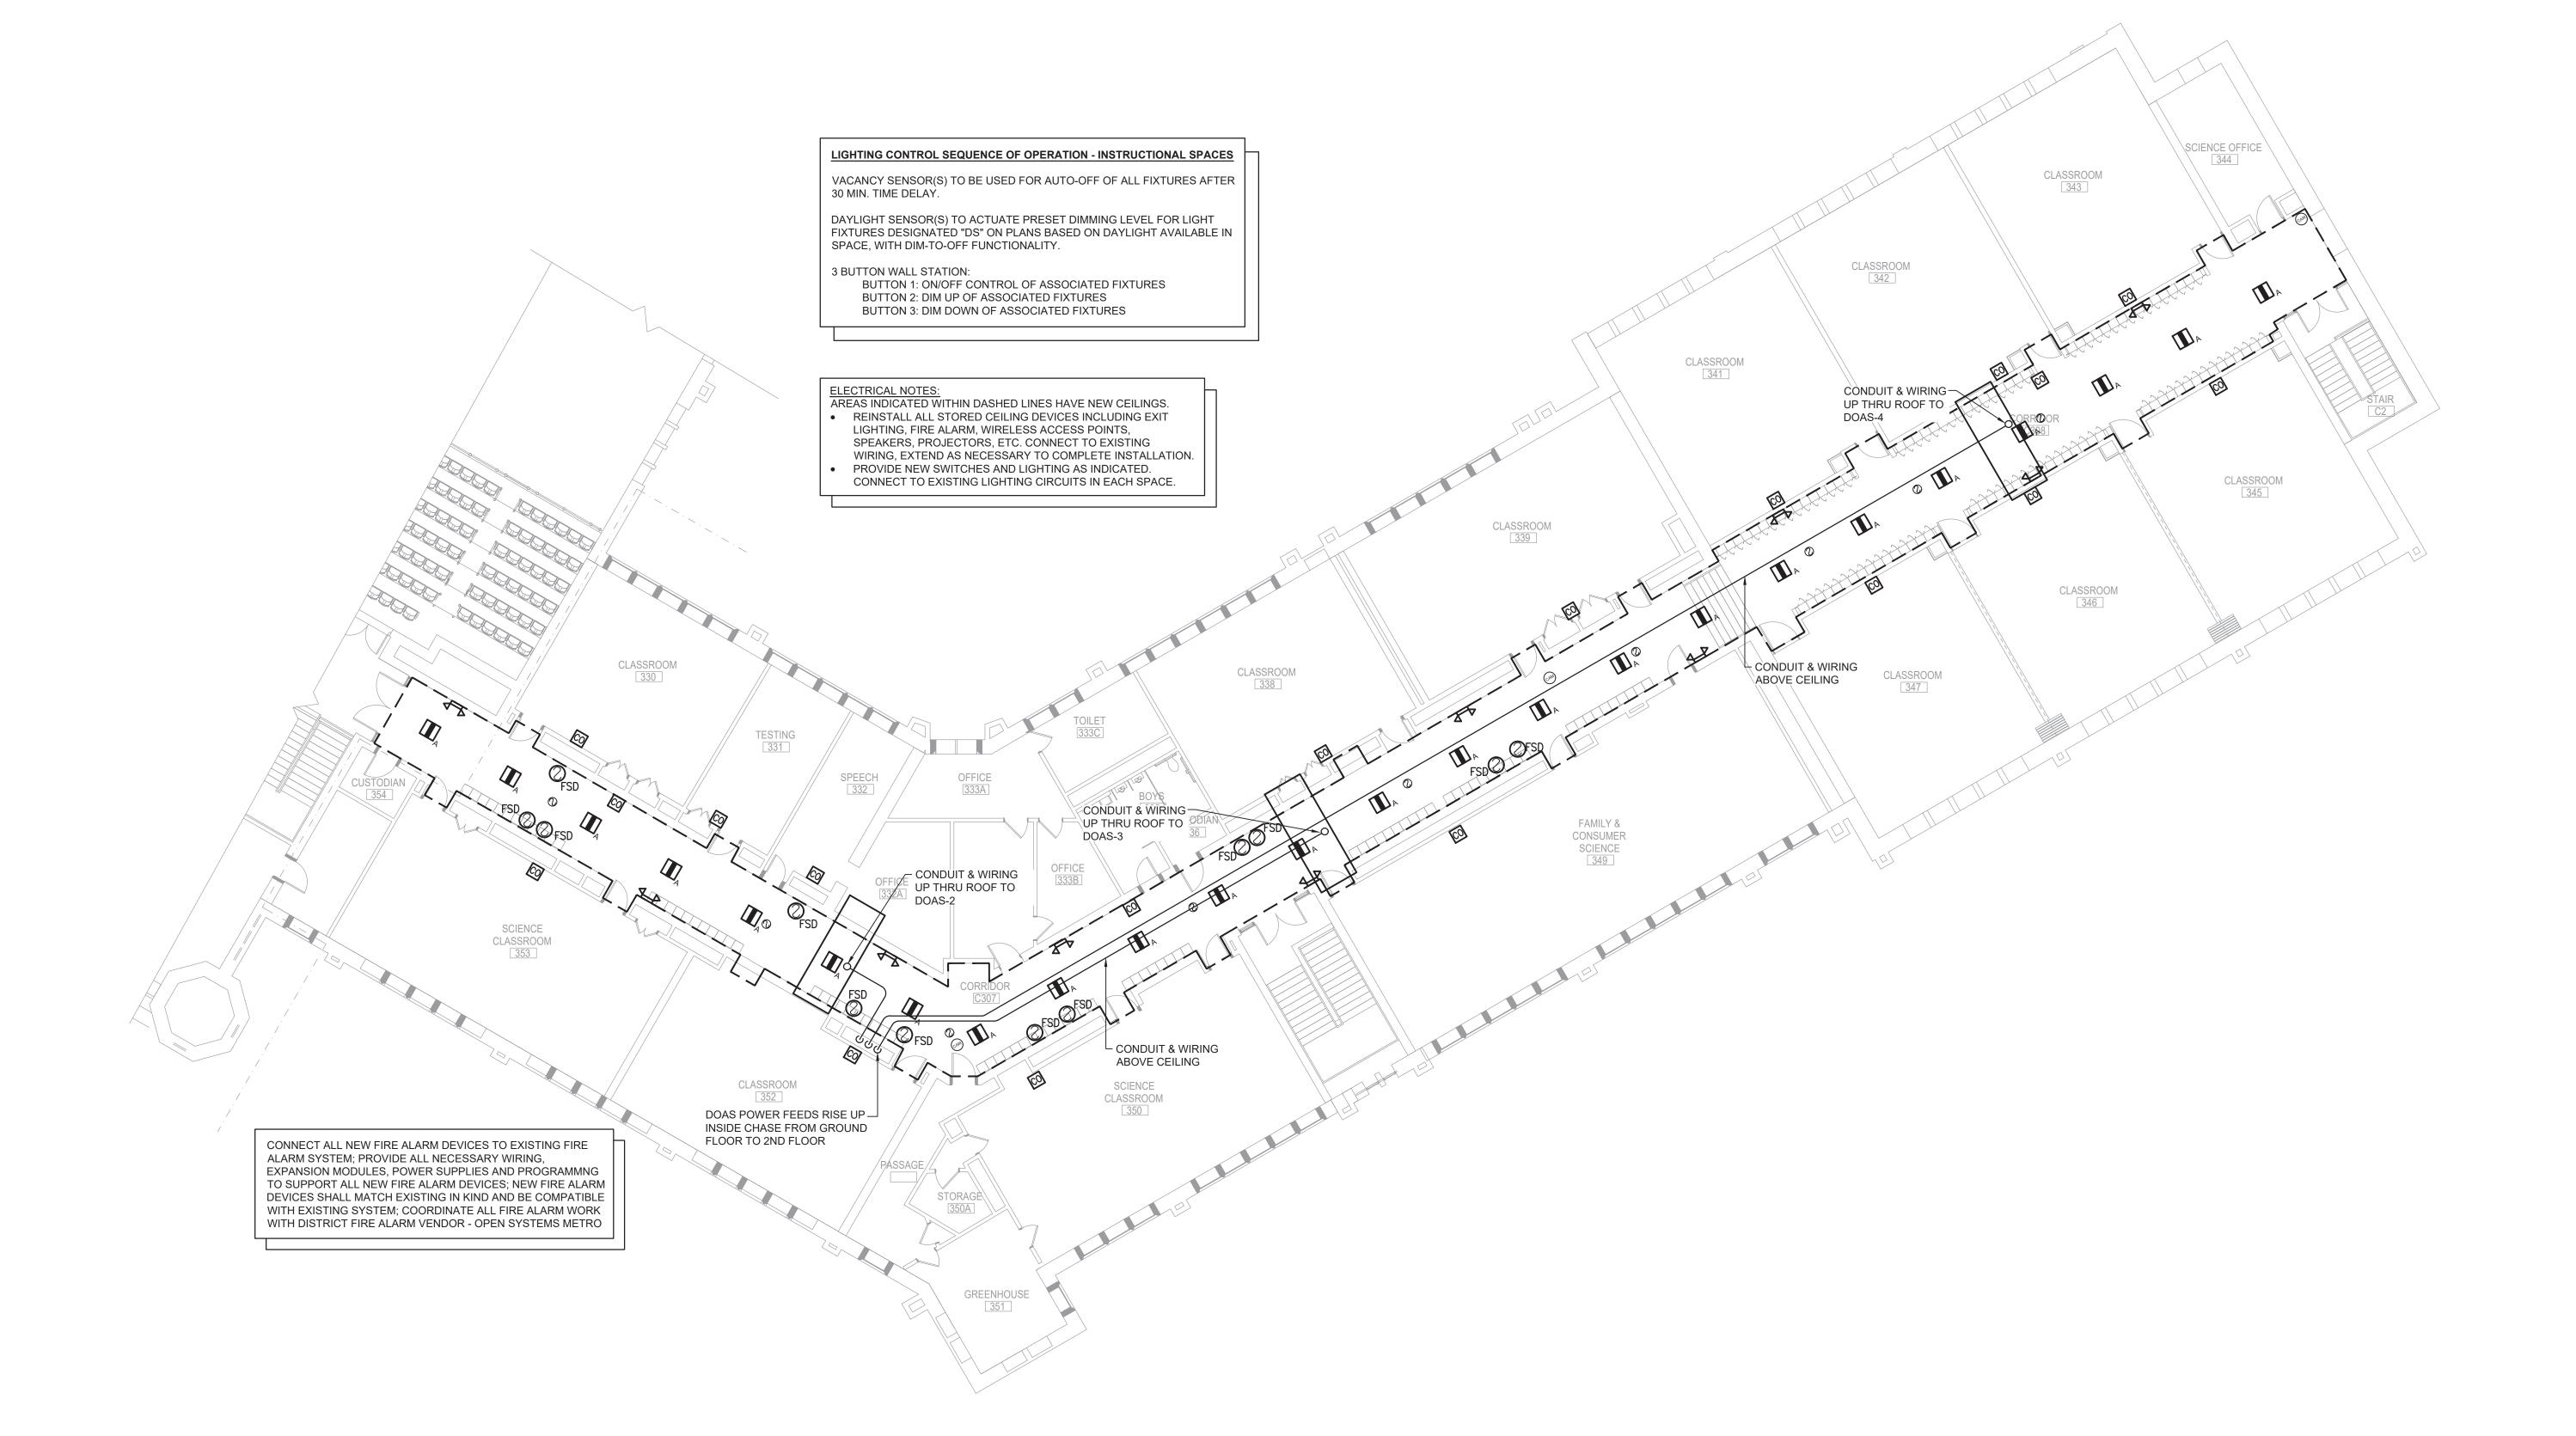
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Expiration Date: 05-31-2025

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AREA C
2ND FLOOR
ELECTRICAL

KEY PLAN

Sheet No.

IEYMS
E123

CONSTRUCTION DOCUMENTS

PLAN

Area C 2nd Floor Electrical Plan

E123 Scale: 3/32" = 1'-0"



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AREA C

ROOF ELECTRICAL PLAN