

CLF

ABBREVIATIONS ADDRESSABLE RELAY ANALYSIS ELEMENT AEM ASSEMBLIES ELECTRONIC MONITOR (MONITORS LVTU'S) AFG ABOVE FINISHED GRADE AHU AIR HANDLING UNIT AMPERE INTERRUPTING CAPACITY AIC AIT ANALYSIS INDICATING TRANSMITTER ANSI AMERICAN NATIONAL STANDARDS INSTITUTE **ASCE** AMERICAN SOCIETY OF CIVIL ENGINEERS **ASME** AMERICAN SOCIETY OF MECHANICAL ENGINEERS AMPERE FRAME ΑT AMPERE TRIP ATS AUTOMATIC TRANSFER SWITCH BC BYPASS CONTACTOR BIM BREAKER INTERFACE MODULE BKR BREAKER

CBMM CIRCUIT BREAKER METERING MODULE (FOR FEEDER BREAKERS CED CENTRAL ENERGY DISPLAY (MONITORS CBMM'S)

CMU CENTRAL MONITORING UNIT (MONITORS MMS') CPT CONTROL POWER TRANSFORMER CT **CURRENT TRANSFORMER** DB DUCTBANK

CURRENT LIMITING FUSE

DSW DISCONNECT SWITCH EHH ELECTRIC HAND HOLE EMH ELECTRIC MANHOLE EO ELECTRICALLY OPERATED

ETM ELAPSED TIME METER FAAP FIRE ALARM ANNUNCIATOR PANEL **FACP** FIRE ALARM CONTROL PANEL FS FLOW SWITCH FSL FLOW SWITCH LOW

FVNR FULL VOLTAGE NON-REVERSING FVR FULL VOLTAGE REVERSING **GFCI** GROUND FAULT CIRCUIT INTERRUPTER **GFCT** GROUND FAULT CURRENT TRANSFORMER

GNG GO-NO GO GND GROUND HOA HAND-OFF-AUTO HPU HYDRAULIC POWER UNIT INPUT CONTACTOR

IEEE INSTITUTE OF ELECTRICAL AND ELECTRONICS ENGINEERS ISO INTERNATIONAL ORGANIZATION FOR STANDARDIZATION JUNCTION BOX

LCP LOCAL CONTROL PANEL LCS LOCAL CONTROL STATION LIGHTING PANEL LS LEVEL SWITCH LEVEL SWITCH LOW LEVEL SWITCH LOW-LOW

LEVEL SWITCH HIGH LEVEL SWITCH HIGH-HIGH LEVEL TRANSMITTER LVTU LOW VOLTAGE TRIP UNIT METERING AND PROTECTION MOTOR CONTROL CENTER

MCC MULTI-FUNCTION RELAY MANHOLE

MMP METER MONITOR & PROTECTION MICROPROCESSOR MOTOR STARTER MMS

MOD MOTOR OPERATED DAMPER MOG MOTOR OPERATED GATE

T IS A VIOLATION OF SECTION 7209.2 OF THE NEW YORK STATE EDUCATION LAW FOR ANY ERSON. UNLESS ACTING UNDER THE DIRECTION OF A LICENSED PROFESSIONAL NGINEER, TO ALTER IN ANY WAY PLANS, SPECIFICATIONS, PLATS OR REPORTS TO WHICH THE SEAL OF A PROFESSIONAL ENGINEER HAS BEEN APPLIED. IF AN ITEM BEARING THE SEAL OF A PROFESSIONAL ENGINEER IS ALTERED, THE ALTERING ENGINEER SHALL AFFIX O THE ITEM HIS SEAL AND THE NOTATION "ALTERED BY" FOLLOWED BY HIS SIGNATURE, HE DATE, AND A SPECIFIC DESCRIPTION OF THE ALTERATION.

THE DATE,	AND A SPECIFIC DESCRIPTION OF THE ALTERATION	N.			
				PROJECT ENGINEER:	R. FROST
				DESIGNED BY:	Y. ABDALLA
				DRAWN BY:	Y. ABDALLA
				CHECKED BY:	G. MARKOU
				IF THIS BAR DOES NOT MEASURE 1" THEN DRAWING	0 1/2" 1"
REV	ISSUED FOR	DATE	BY	IS NOT TO FULL SCALE	

ABBREVIATIONS, CONT.

MOTOR OPERATED LOUVER MOV MOTOR OPERATED VALVE MOTOR PROTECTION RELAY

MPR MTD MOUNTED

MTS MANUAL TRANSFER SWITCH **MWTS** MOTOR WINDING TEMPERATURE SWITCH

NORMALLY CLOSED NEC NATIONAL ELECTRICAL CODE

NEMA NATIONAL ELECTRICAL MANUFACTURERS ASSN NFPA NATIONAL FIRE PROTECTION ASSOCIATION

NO NORMALLY OPEN NTS NOT TO SCALE NWP **NETWORK PROTECTOR OUTPUT CONTACTOR** OVERLOAD

PULLBOX

PHOTOCELL PIT PRESSURE INDICATING TRANSMITTER PROGRAMMABLE LOGIC CONTROLLER PLC

POWER PANEL PHASE SHIFTING TRANSFORMER POTENTIAL TRANSFORMER PUSH TO TEST

PHOTOVOLTAIC END-OF-LINE RESISTOR RCS REMOTE CONTROL STATION RECP RECEPTACLE

REMOTE I/O

RIO

RMROOM RTD RESISTANCE THERMAL DEVICE **RVAT** REDUCED VOLTAGE AUTO TRANSFORMER

RVSS REDUCED VOLTAGE SOLID STATE S.E. SERVICE ENTRANCE SMM SUB METER MODULE SP. C. SPARE CONDUIT

SURGE PROTECTIVE DEVICE SPD SST STAINLESS STEEL **SWGR** SWITCHGEAR TB TEST BLOCK TIMED CLOSE TO TIMED OPEN

TSH TWISTED SHIELDED TYP **TYPICAL** UNINTERRUPTIBLE POWER SUPPLY

VENDOR CONTROL PANEL VCP VARIABLE FREQUENCY DRIVE

VIF VERIFY IN FIELD WEATHER PROOF CORROSION RESISTANT

WT WEIGHT XFMR TRANSFORMER

NOTES:

- 1. THE INSTALLATION OF ALL CONCRETE ENCASED ELECTRICAL CONDUITS SHALL COMPLY WITH ACI 318, SECTION 20.7. CONTRACTOR SHALL SUPPLY EXPANSION JOINT FITTINGS AS REQUIRED FOR THERMAL EXPANSION AND DEFLECTION.
- 2. BOND ALL NEW CONCRETE ENCASED GROUND CONDUCTORS TO EXISTING GROUND CONDUCTORS IN ALL MANHOLES, PULL BOXES, CABLE TRAYS, AND SIMILAR LOCATIONS WHERE APPLICABLE.
- 3. UNLESS OTHERWISE SPECIFIED OR NOTED, ALL WALL MOUNTED ELECTRICAL PANELS, ENCLOSURES, AND SIMILAR EQUIPMENT SHALL BE MOUNTED 6'-6" (MAX) FROM THE TOP OF THE PANEL TO FINISHED FLOOR OR GRADE.
- 4. UNLESS OTHERWISE NOTED, ALL LIGHTING SWITCHES, CONTROL SWITCHES, AND SIMILAR EQUIPMENT SHALL BE MOUNTED WITH THEIR CENTERLINE APPROXIMATELY 4'-0" ABOVE FINISHED FLOOR, SLAB, OR GRADE.
- 5. A SEPARATE EQUIPMENT GROUNDING CONDUCTOR SHALL BE PROVIDED FOR EACH CIRCUIT (SEPARATE CONDUCTOR IN THE CONDUIT). THE CONDUCTOR SHALL BE TERMINATED AT THE PROPER DEVICE, TERMINAL, OR LUG AT THE POWER SOURCE (MCC GROUND BUS, PANELBOARD GROUND BUS, ETC.). GROUND CONDUCTOR SIZE SHALL BE PER THE LATEST EDITION OF THE NEC.
- 6. LIGHTNING PROTECTION SYSTEMS SHALL BE PROVIDED FOR THE STRUCTURES INDICATED ON THE DRAWINGS AND IN ACCORDANCE WITH SECTION 26 41 13.
- 7. FIRE ALARM SYSTEMS SHALL BE PROVIDED FOR THE STRUCTURES INDICATED ON THE DRAWINGS AND IN ACCORDANCE WITH SECTION 28 46 20.
- 8. REFERENCE SECTION 01 73 12 FOR CONSTRUCTION SEQUENCING REQUIREMENTS.
- 9. CONDUIT HOMERUNS ARE NOT SHOWN ON THE DRAWINGS. CONTRACTOR SHALL REFER TO CONDUIT AND WIRE SCHEDULES, RISER DIAGRAMS, SINGLE LINE DIAGRAMS, AND OTHER DRAWINGS FOR CONDUIT AND WIRE REQUIREMENTS.
- 10. ALL POWER CONDUITS ARE SHOWN DIAGRAMMATICALLY. EXACT ROUTING SHALL BE DETERMINED BY THE CONTRACTOR IN THE FIELD, EXCEPT WHERE SPECIFICALLY DIMENSIONED ON PLANS.
- 11. EXACT CONDUIT STUB-UP LOCATIONS SHALL BE DETERMINED BY THE CONTRACTOR BASED ON THE CERTIFIED MANUFACTURER'S DRAWINGS OF THE RESPECTIVE EQUIPMENT. CONDUITS SHALL BE INSTALLED COMMENSURATE WITH THE EQUIPMENT FURNISHED.
- 12. ALL ELECTRICAL NON-STRUCTURAL COMPONENTS ARE SUBJECT TO SEISMIC DESIGN CATEGORY 'B' AND ARE THEREFORE EXEMPT FROM SEISMIC ANCHORAGE AND BRACING AS STIPULATED IN SECTION 01 73 23 - SEISMIC ANCHORAGE AND BRACING.
- 13. ALL ELECTRICAL WORK MUST BE DONE IN ACCORDANCE WITH NFPA 70E.



Hazen HAZEN AND SAWYER 498 SEVENTH AVENUE, 11th FLOOR **NEW YORK, NEW YORK 10018**

WESTCHESTER JOINT WATER WORKS MAMARONECK, NY

RYE LAKE WATER FILTRATION PLANT HARRISON, NY


ELECTRICAL **GENERAL NOTES & ABBREVIATIONS**


DATE:	FEB 2025
HAZEN NO.:	90388-000
CONTRACT NO.:	A1364-A
DRAWING NUMBER:	


307 of 392


E-002


BID SET

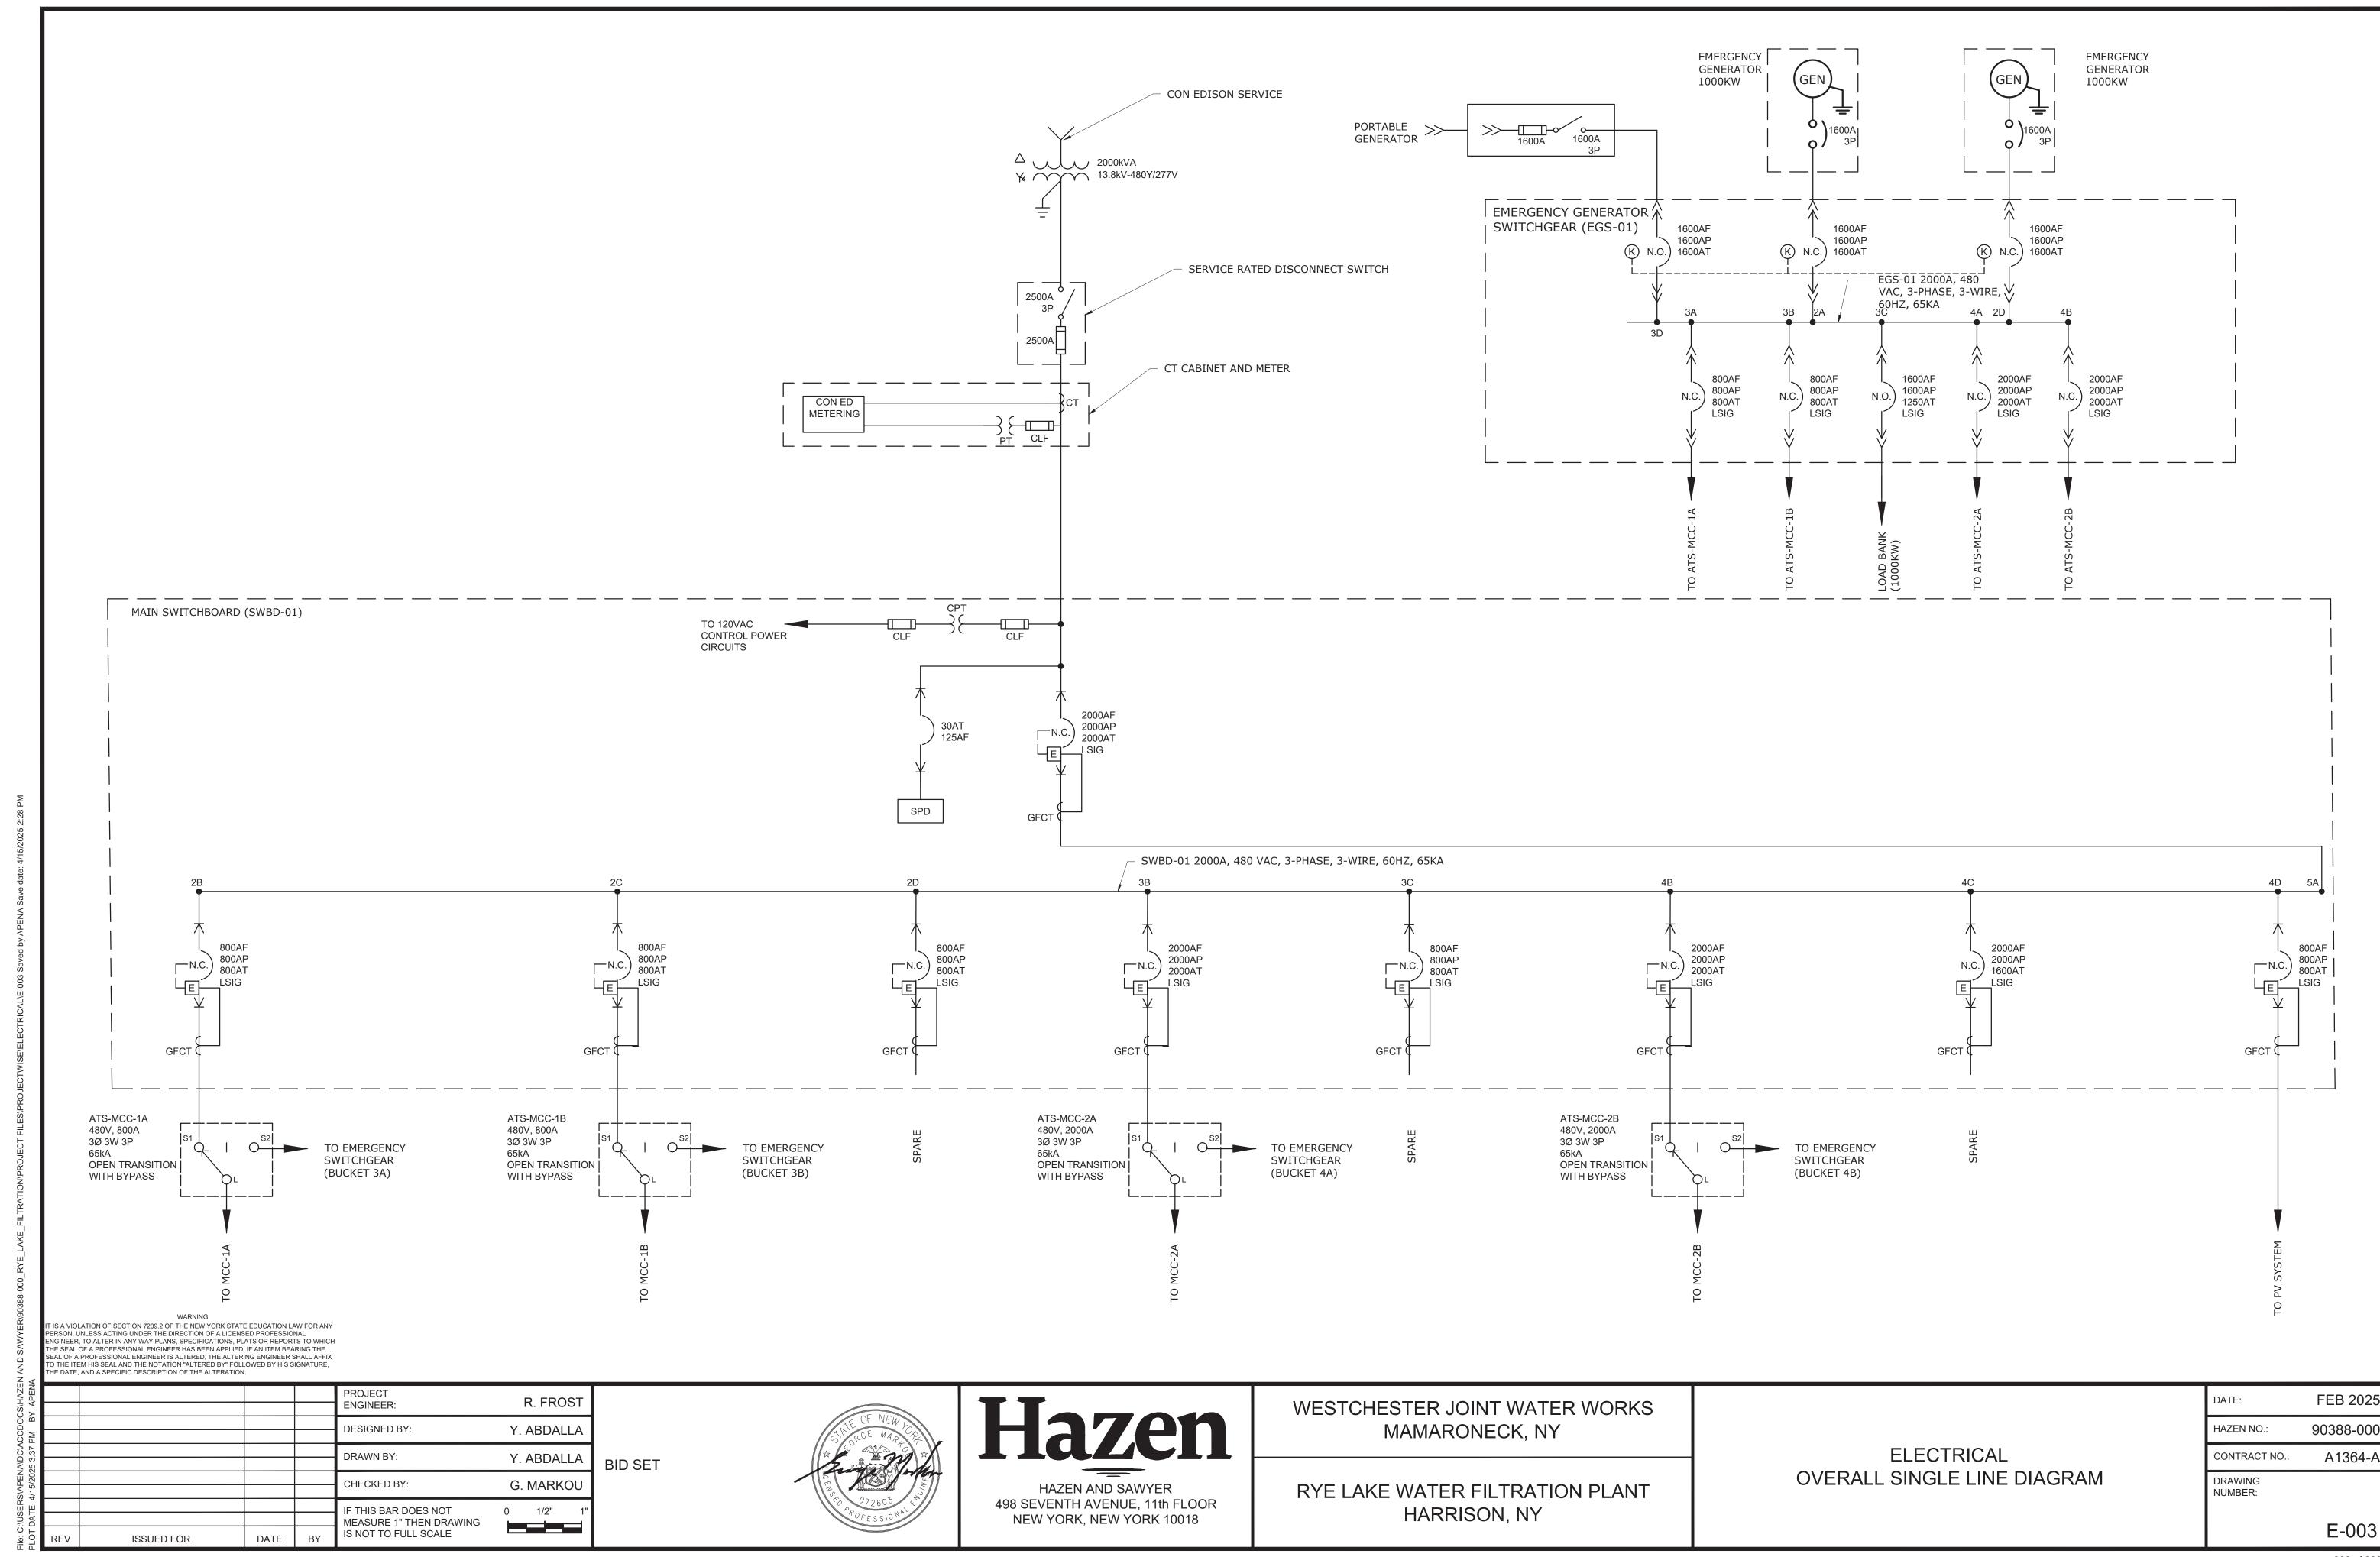

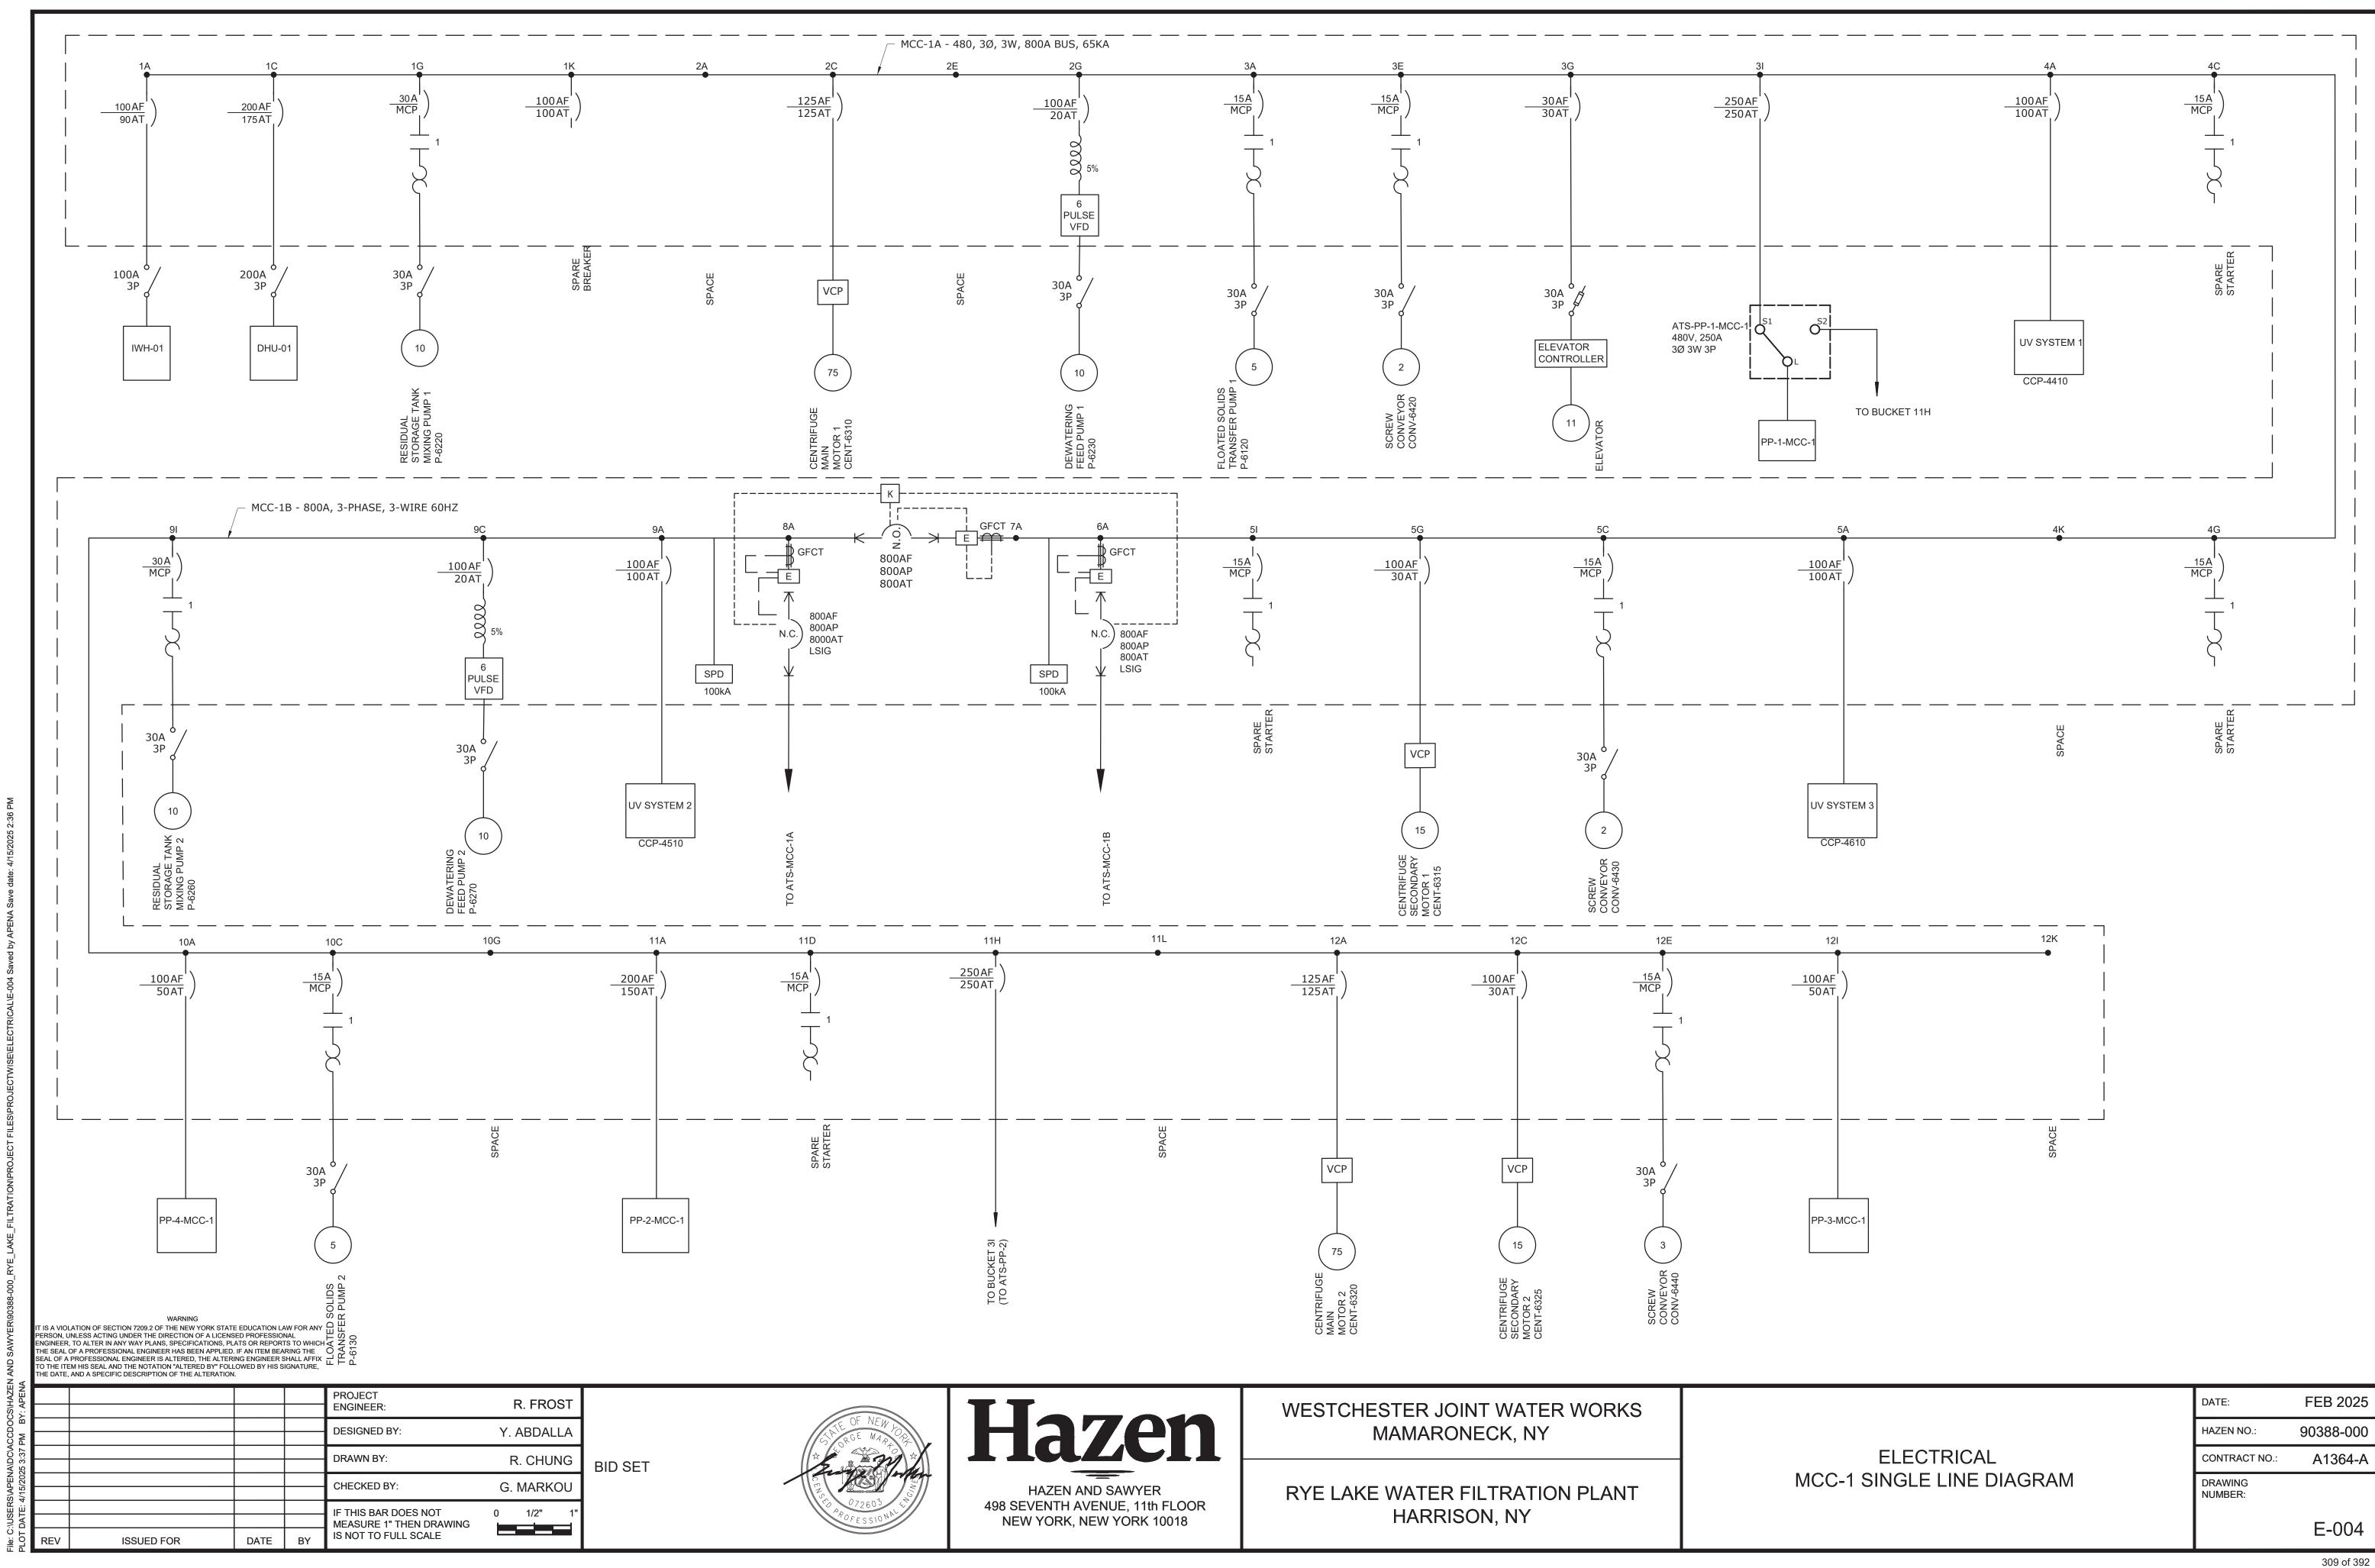

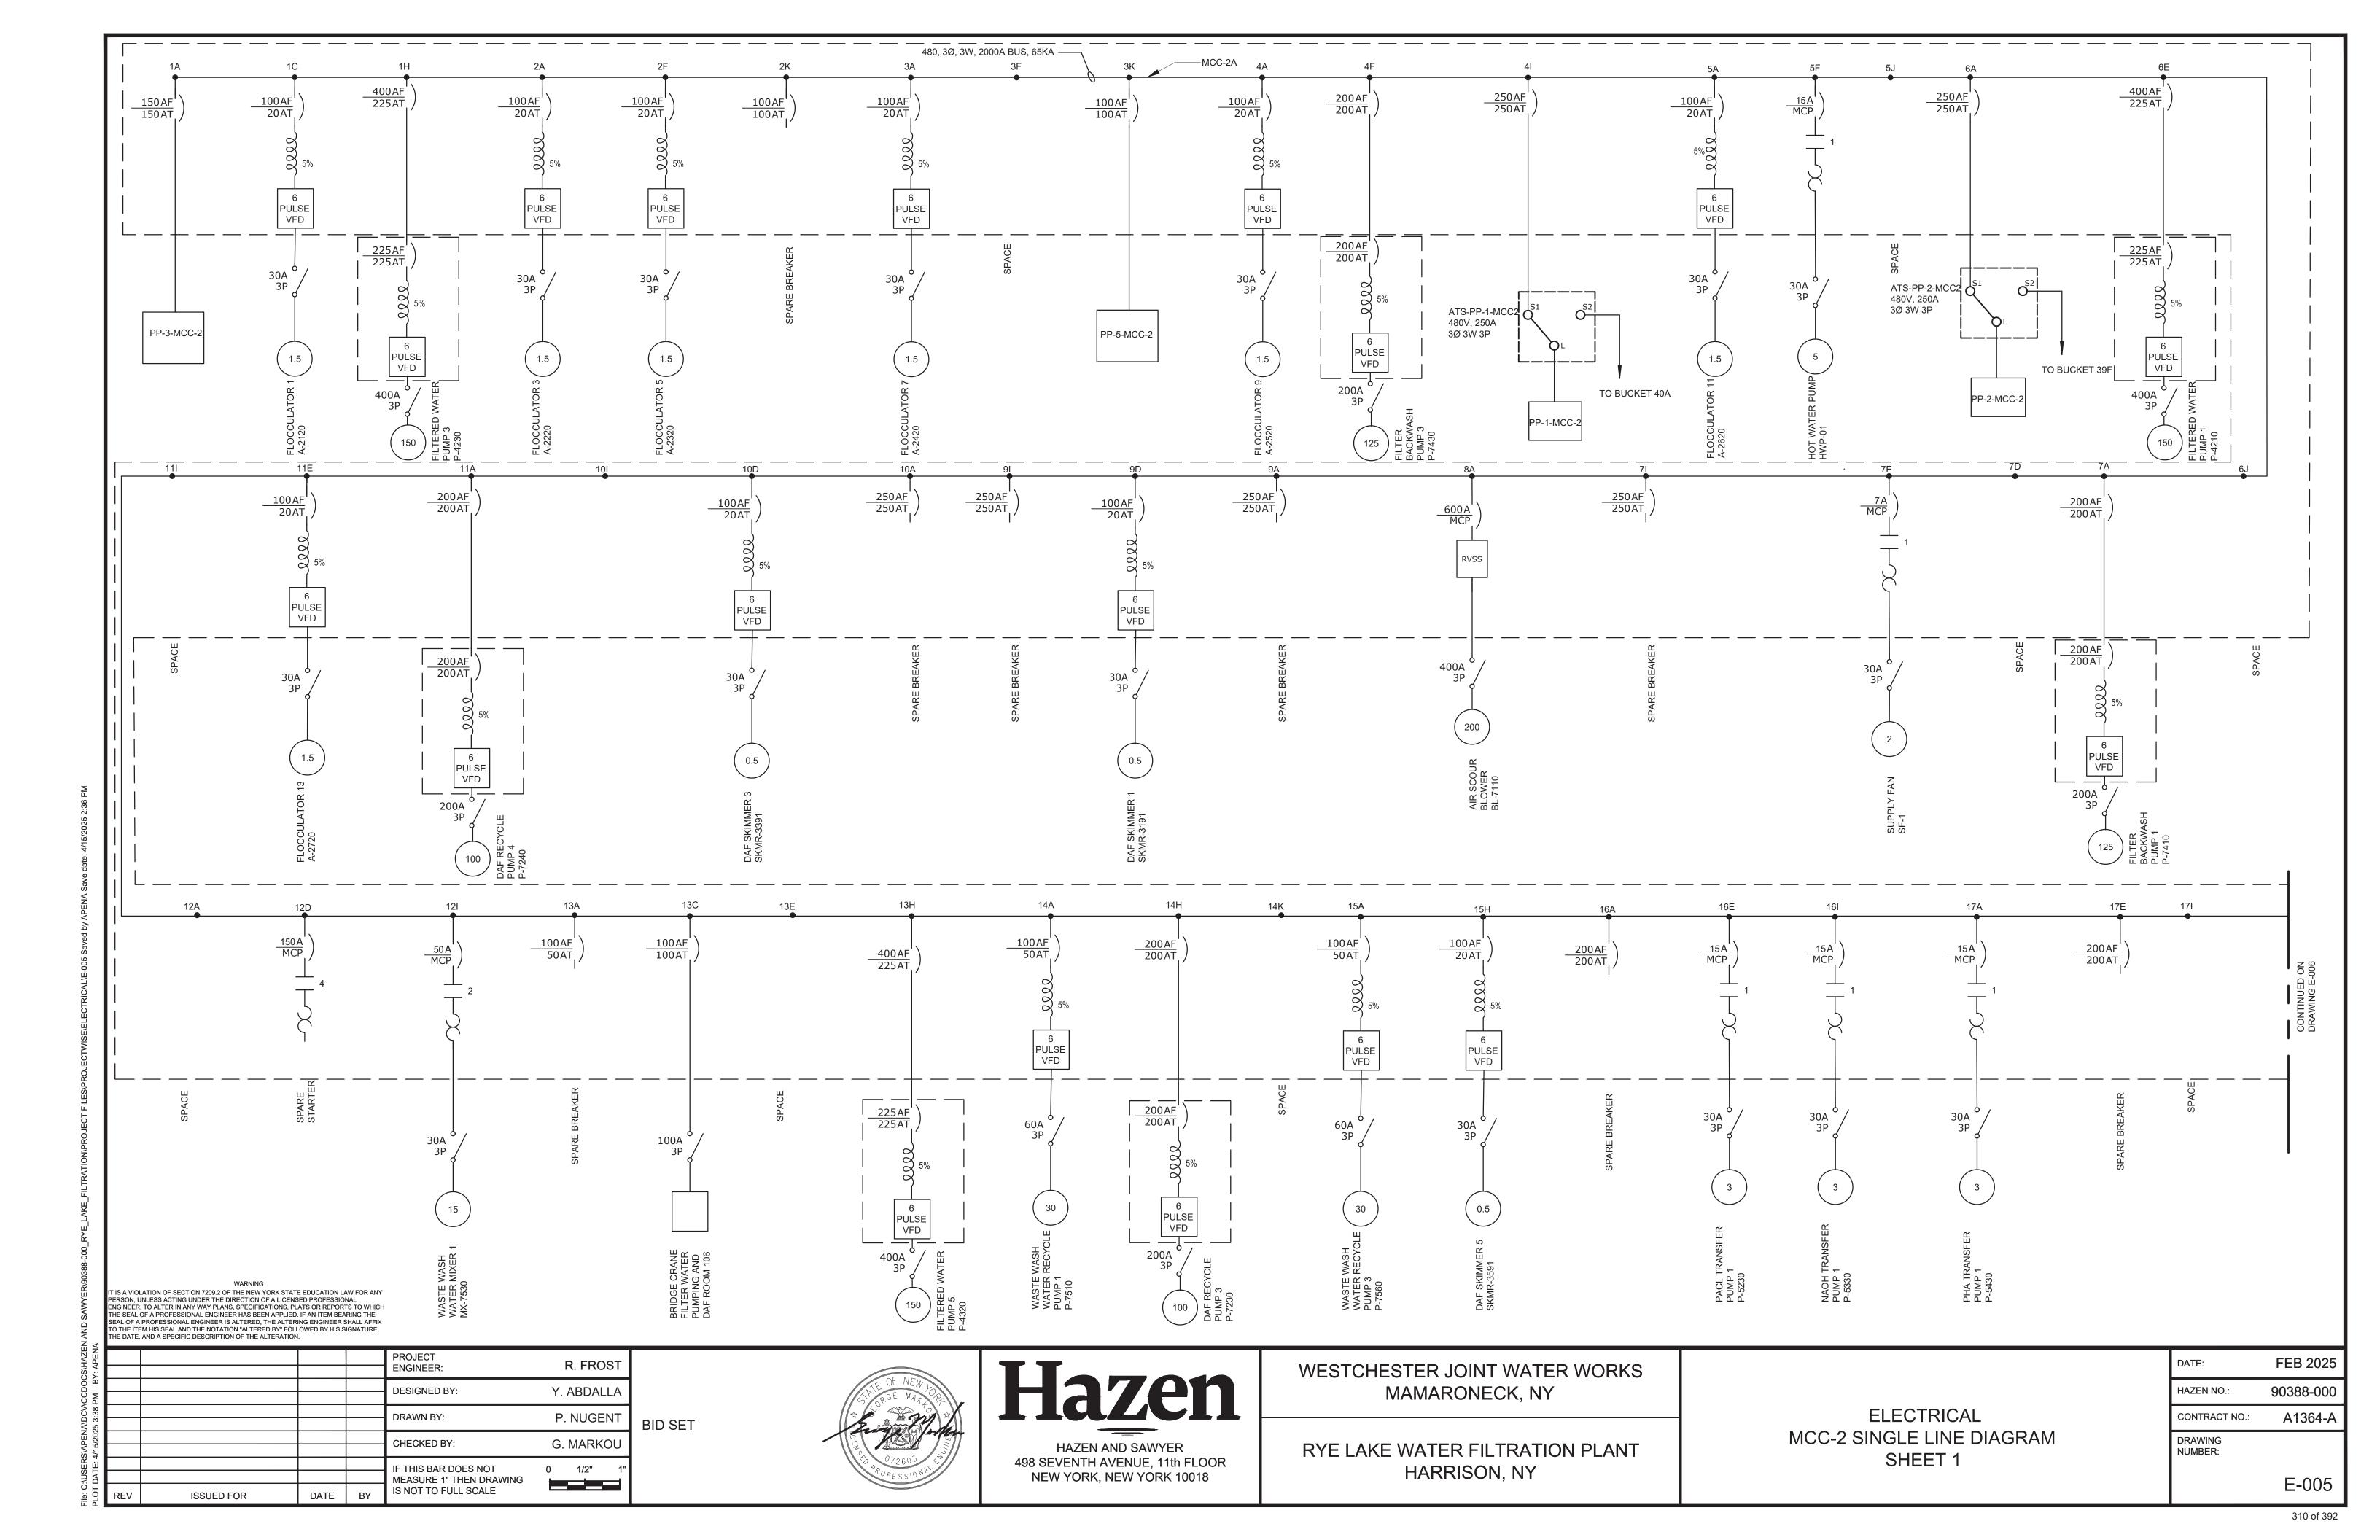

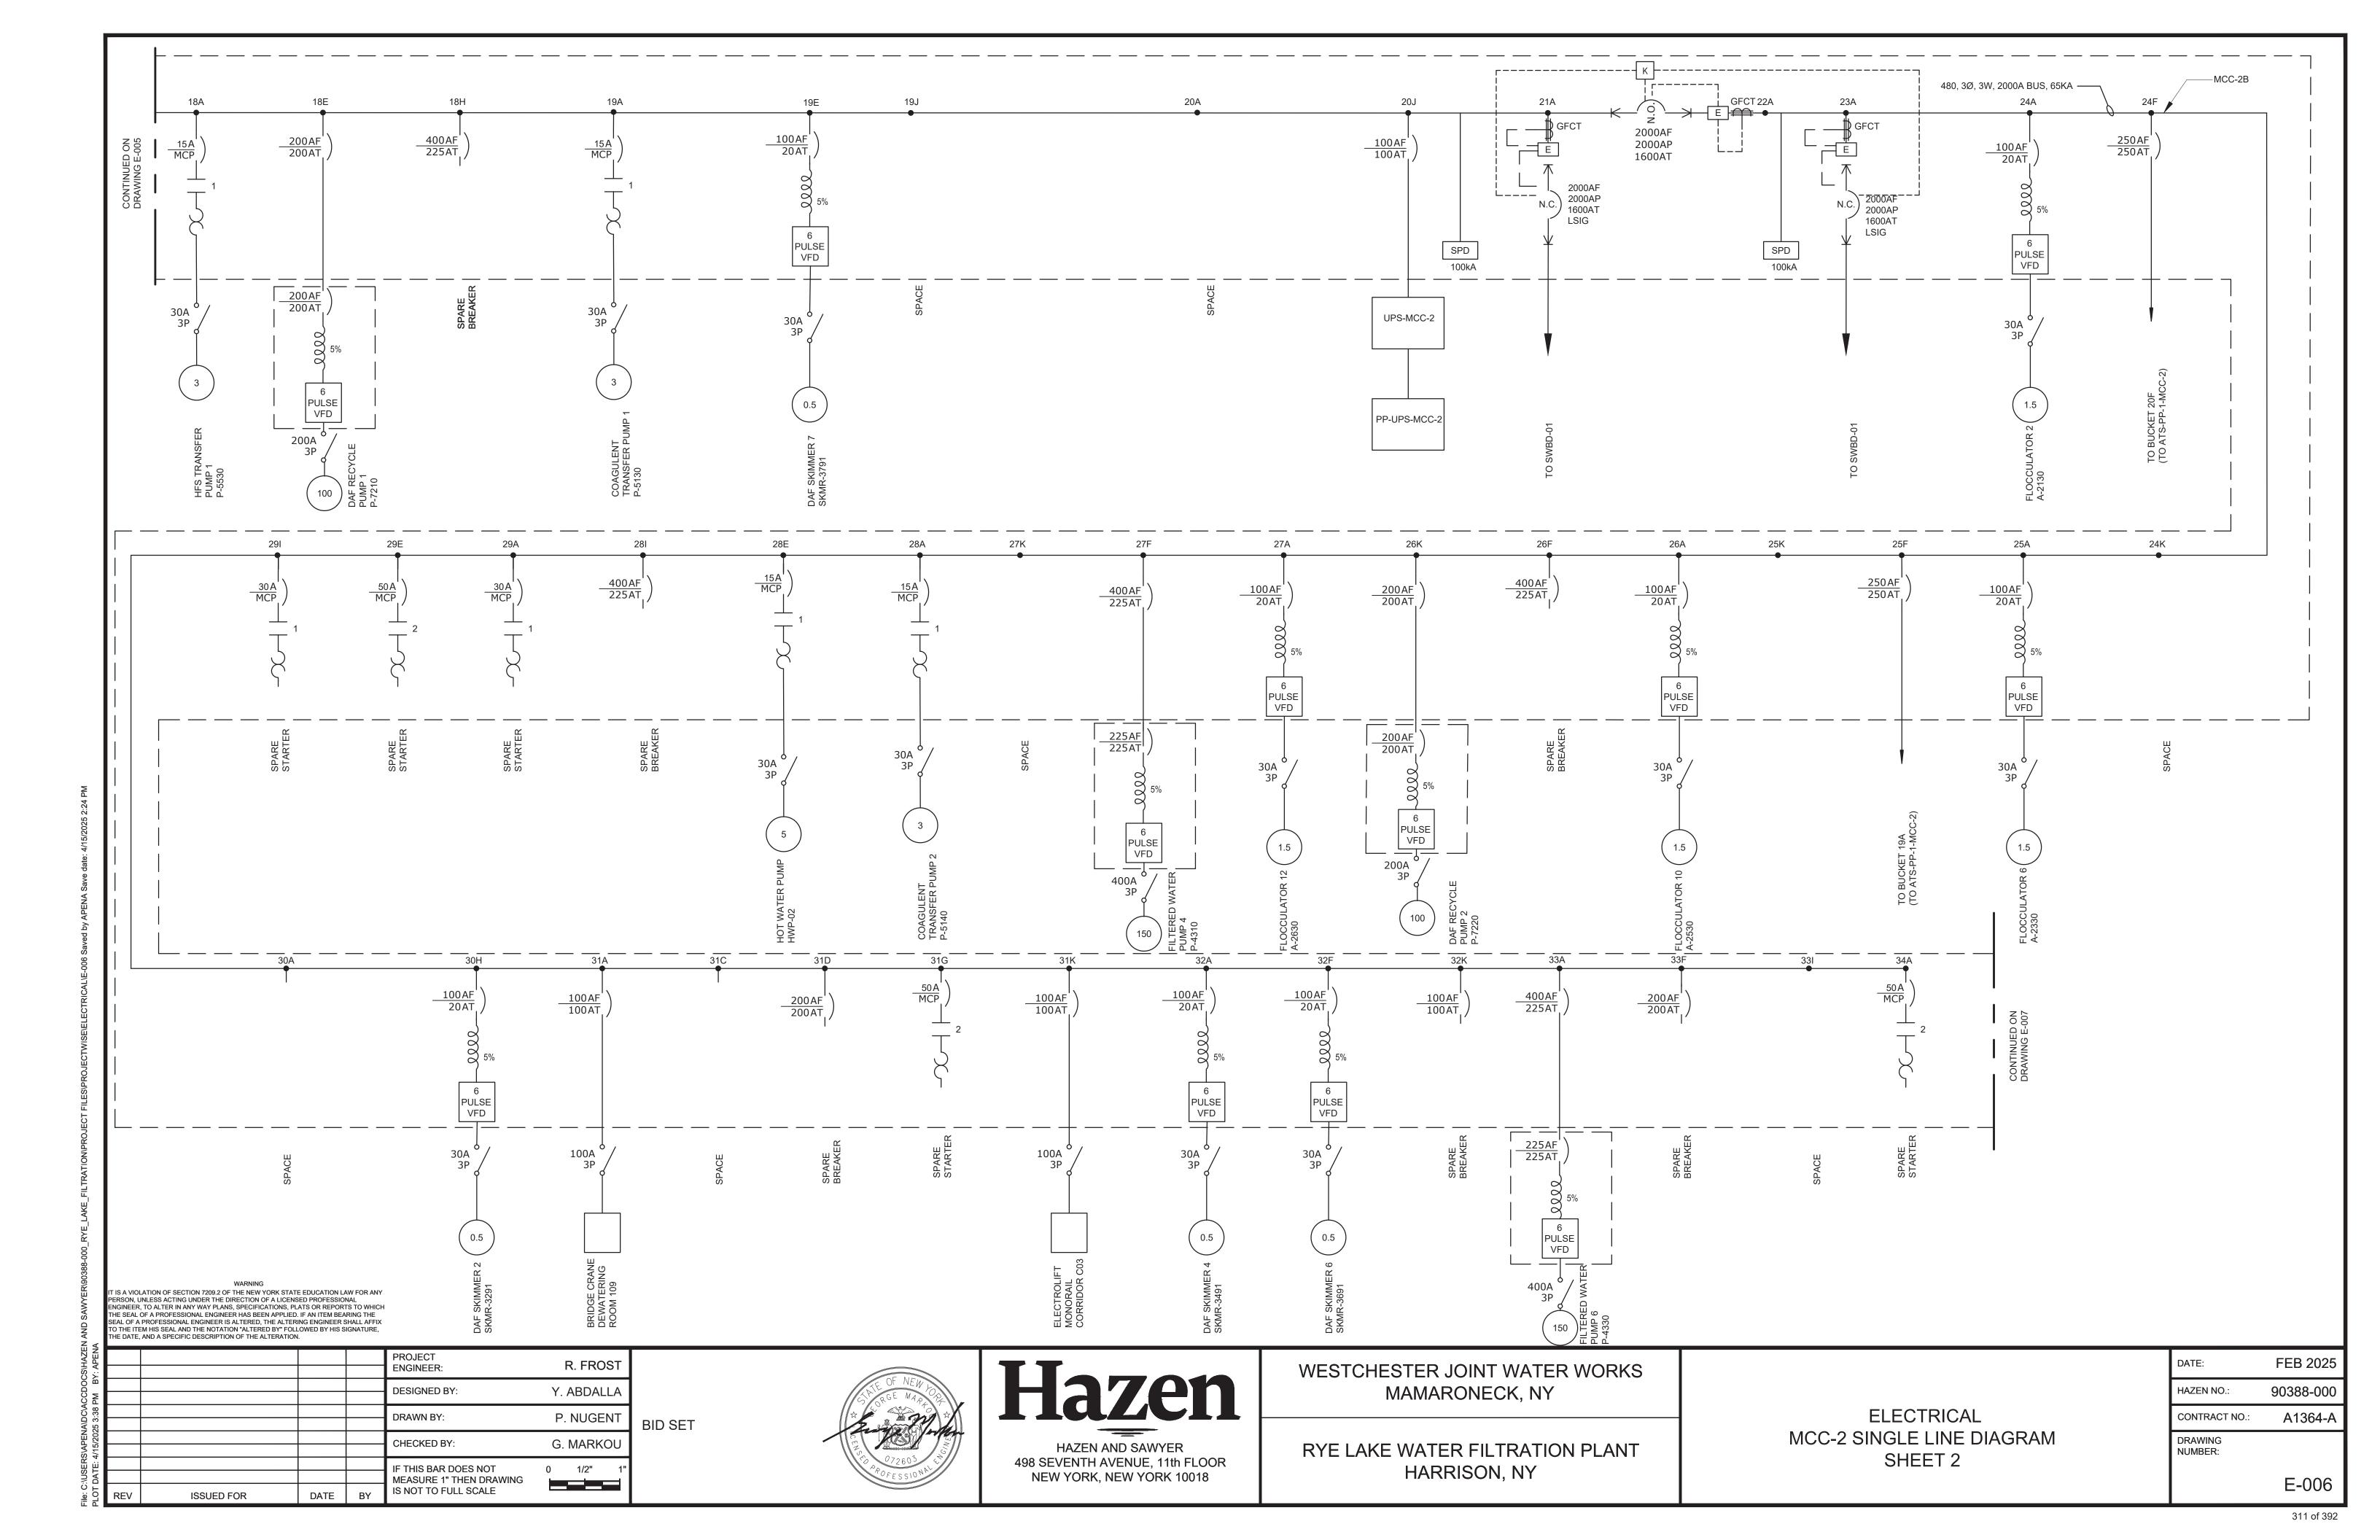

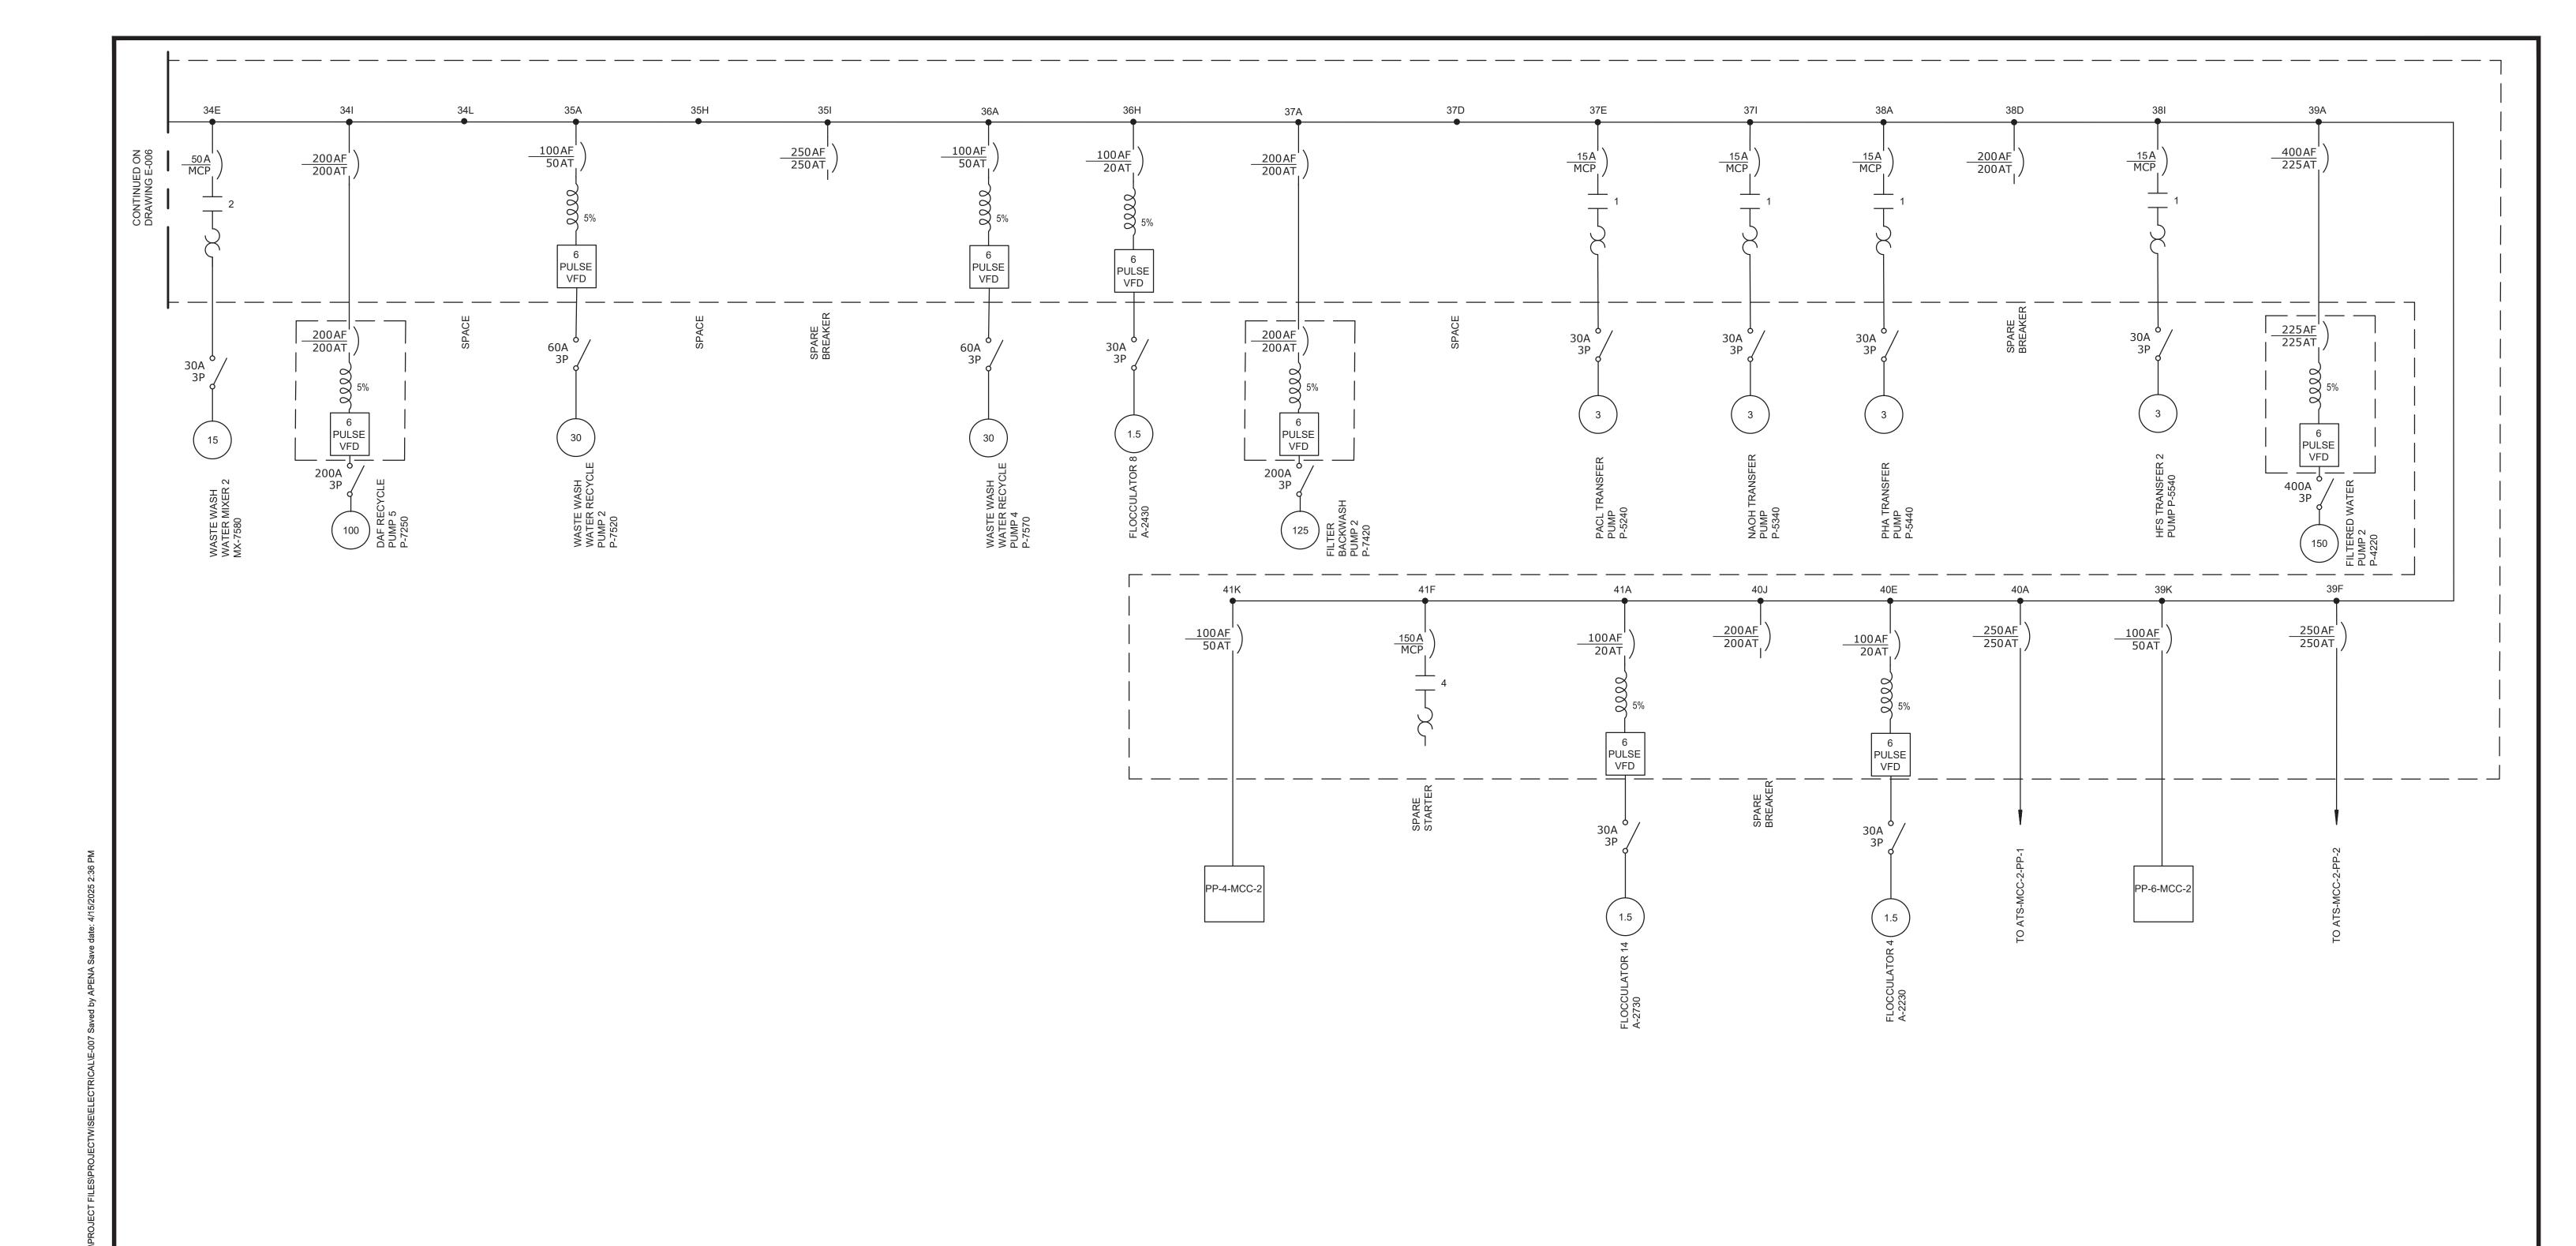

WARNING
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Y: APEN					PROJECT ENGINEER:	R. FROST
PM BY					DESIGNED BY:	Y. ABDALLA
3:38					DRAWN BY:	P. NUGENT
4/15/2025					CHECKED BY:	G. MARKOU
DATE: 4					IF THIS BAR DOES NOT MEASURE 1" THEN DRAWING	0 1/2" 1"
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BID SET

HAZEN AND SAWYER
498 SEVENTH AVENUE, 11th FLOOR

NEW YORK, NEW YORK 10018

WESTCHESTER JOINT WATER WORKS
MAMARONECK, NY

RYE LAKE WATER FILTRATION PLANT HARRISON, NY ELECTRICAL MCC-2 SINGLE LINE DIAGRAM SHEET 3 DATE: FEB 2025


HAZEN NO.: 90388-000

CONTRACT NO.: A1364-A

DRAWING NUMBER:

E-007

312 of 392

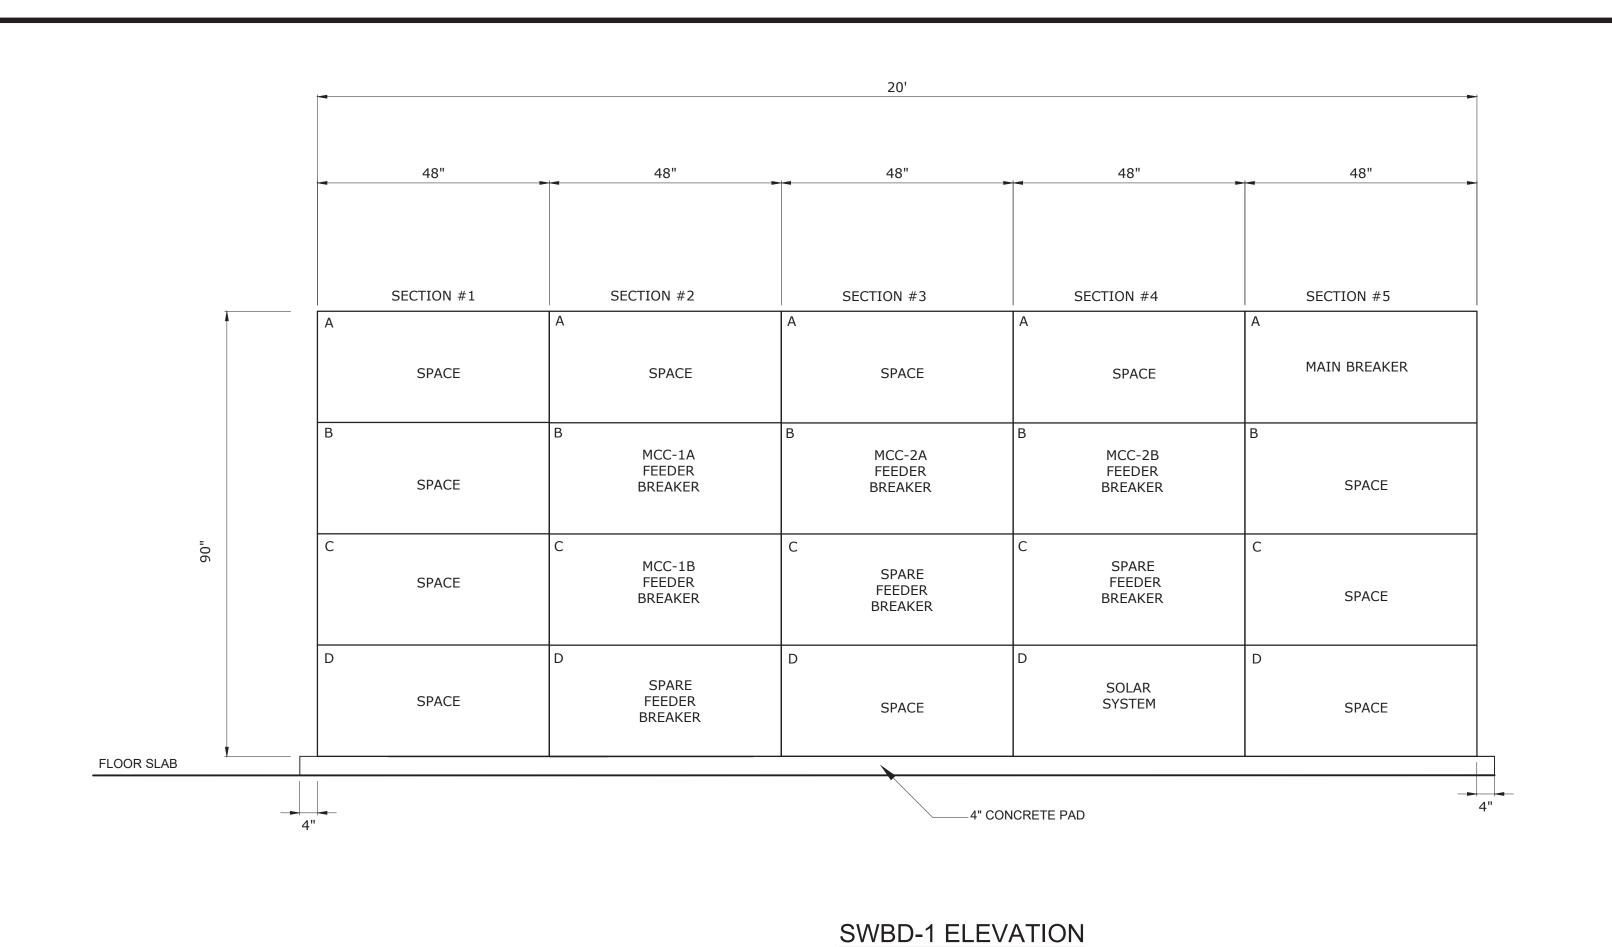

SWBD-1 SIDE VIEW)

(NOT TO SCALE)

(NOT TO SCALE) 102" 22" 22" SECTION #1 SECTION #2 SECTION #3 SECTION #4 ATS-MCC-1A ATS-MCC-2A **GENEREATOR 1** BREAKER ATS-MCC-1B ATS-MCC-2B GENERATOR CONTROLS MASTER CONTROLS SPACE LOAD BANK GENEREATOR 2 BREAKER PORTABLE SPACE GENERATOR FLOOR SLAB _4" CONCRETE PAD


SWITCHGEAR (FRONT)

REAR ACCESSIBLE DOOR (TYP)

FLOOR SLAB

4" CONCRETE PAD

LEGS-1 SIDE VIEW
(NOT TO SCALE)

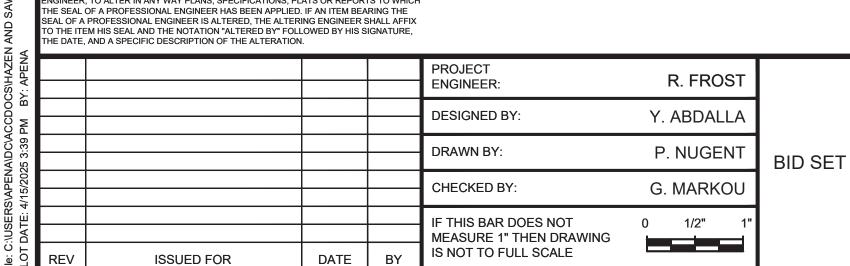

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OF NEW LONG TO THE OF NEW LONG TO THE OF NEW LONG TO THE OFFICE OF THE O

EGS-1 ELEVATION

(NOT TO SCALE)

HAZEN AND SAWYER
498 SEVENTH AVENUE, 11th FLOOR
NEW YORK, NEW YORK 10018

WESTCHESTER JOINT WATER WORKS
MAMARONECK, NY

RYE LAKE WATER FILTRATION PLANT HARRISON, NY ELECTRICAL SWITCHBOARD AND GENERATOR SWITCHGEAR ELEVATIONS DATE: FEB 2025

HAZEN NO.: 90388-000


CONTRACT NO.: A1364-A


DRAWING NUMBER:

E-008

REAR OF SWITCHBOARD

- 4" CONCRETE PAD

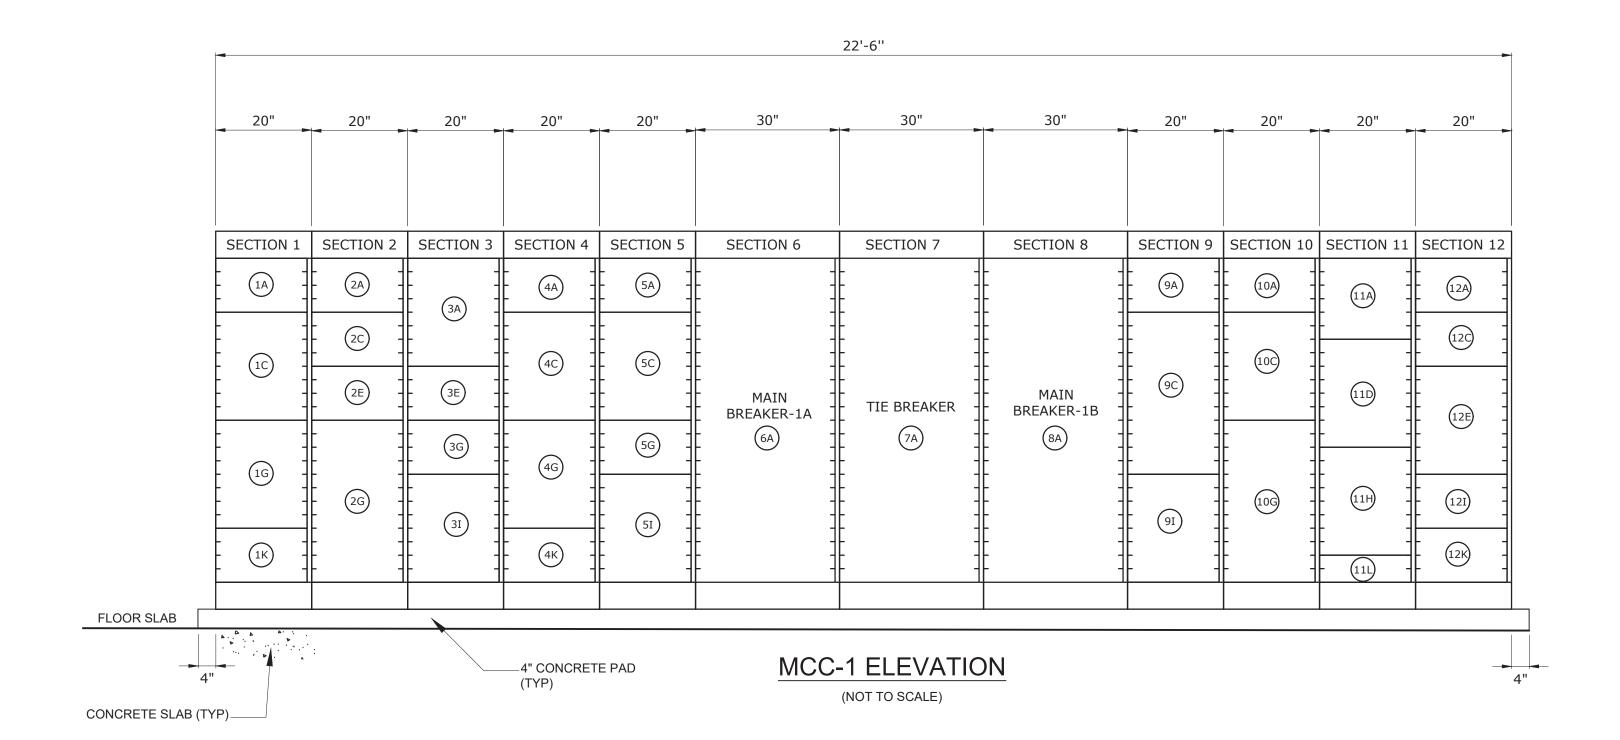

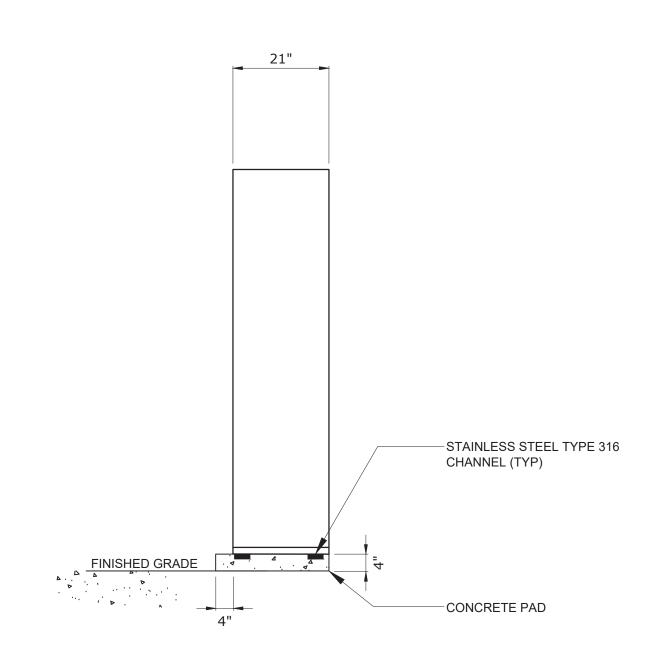

MOTOR CONTROL CENTER DETAIL (SIDE VIEW)

(NOT TO SCALE)

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THE DATE, AND A SPECIFIC DESCRIPTION OF THE ALTERATION.

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Y: APENA					PROJECT ENGINEER:	R. FROST	
PM BY					DESIGNED BY:	Y. ABDALLA	
3:39					DRAWN BY:	P. NUGENT	BID SET
4/15/2025					CHECKED BY:	G. MARKOU	
DATE: 4					IF THIS BAR DOES NOT MEASURE 1" THEN DRAWING	0 1/2" 1"	
10	REV	ISSUED FOR	DATE	BY	IS NOT TO FULL SCALE		


Hazen HAZEN AND SAWYER 498 SEVENTH AVENUE, 11th FLOOR NEW YORK, NEW YORK 10018


WESTCHESTER JOINT WATER WORKS MAMARONECK, NY

RYE LAKE WATER FILTRATION PLANT HARRISON, NY

ELECTRICAL MCC-1 ELEVATION

DATE:	FEB 2025
HAZEN NO.	90388-000
CONTRACT	NO.: A1364-A
DRAWING NUMBER:	
	F-009

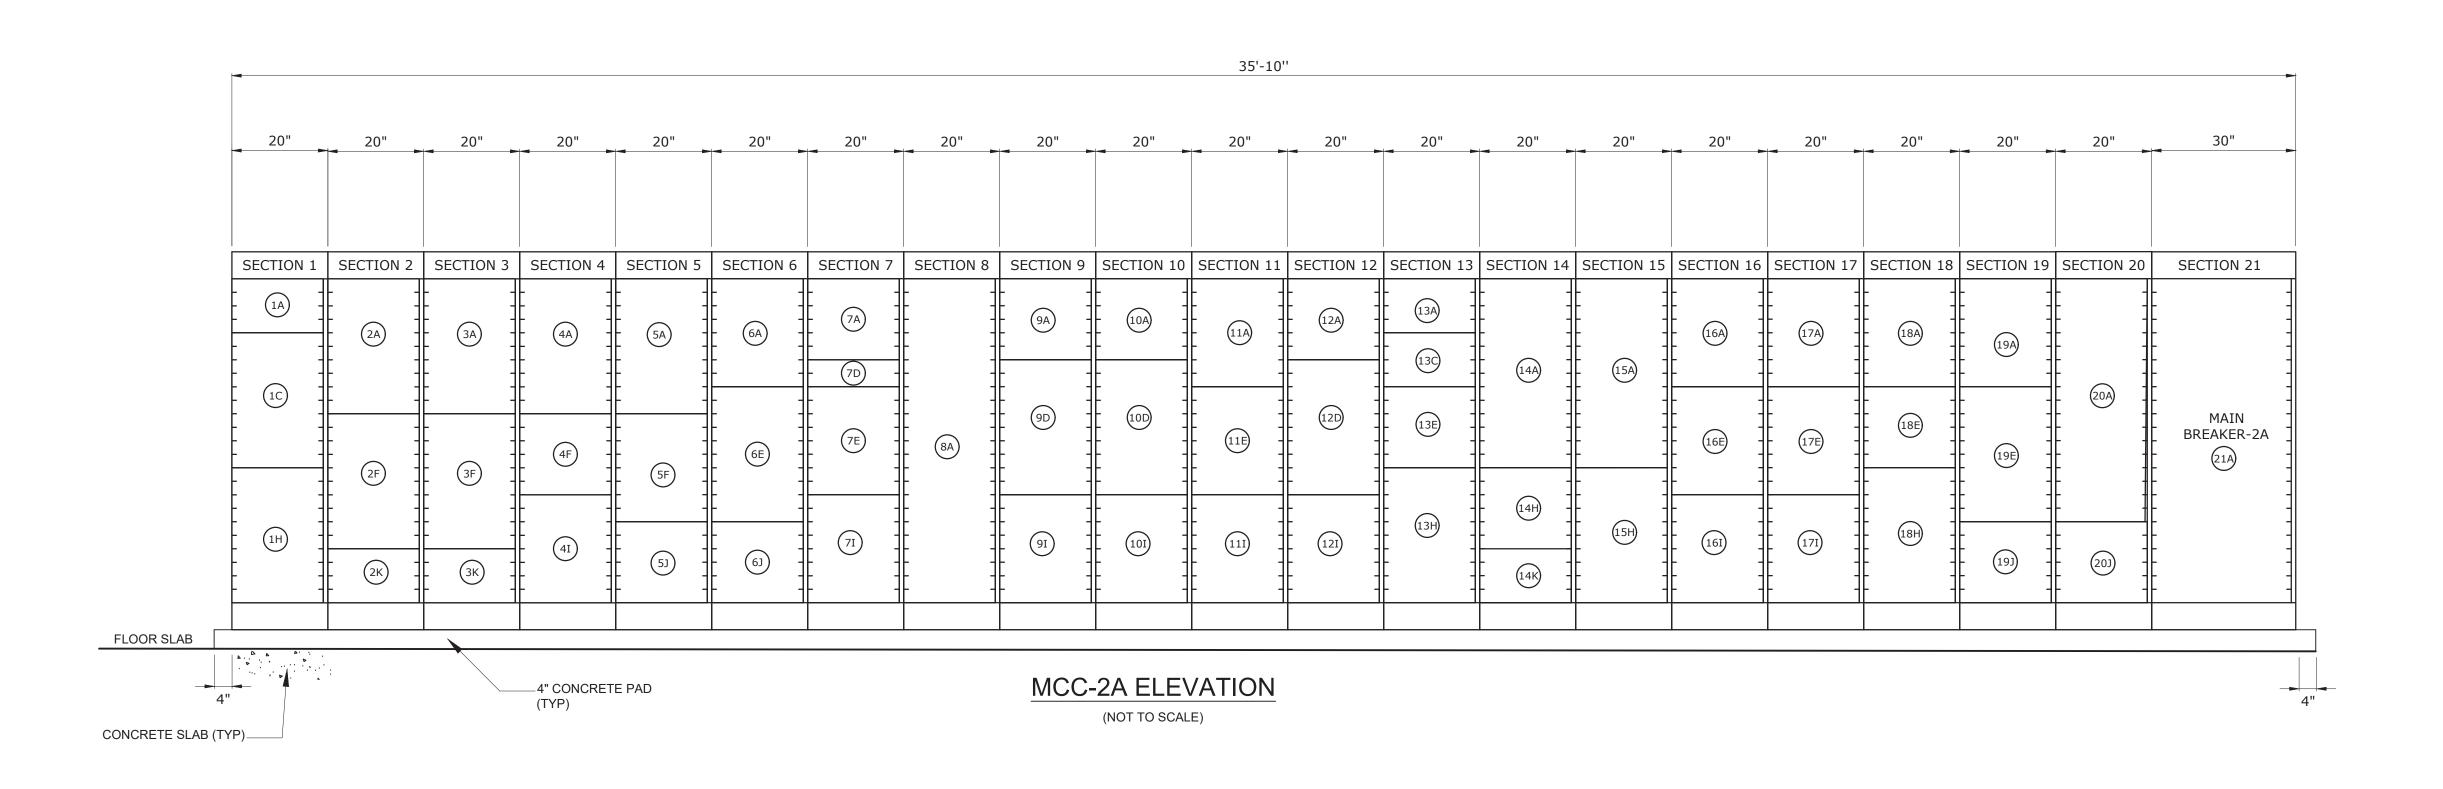

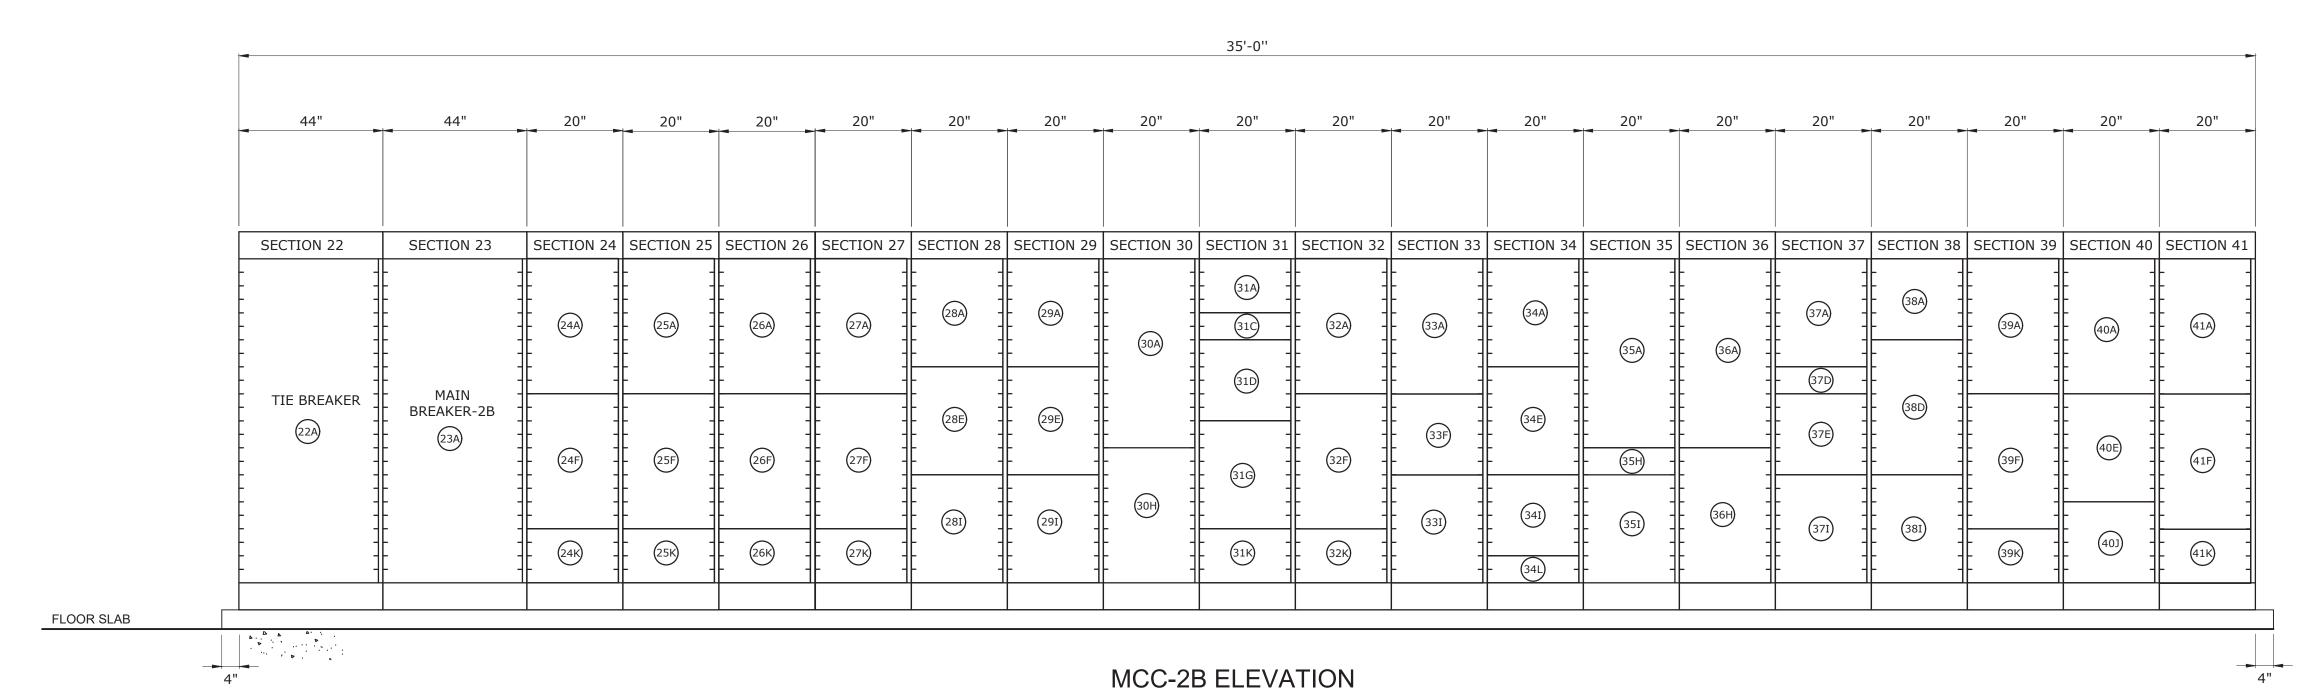

(NOT TO SCALE)

STAINLESS STEEL TYPE 316
CHANNEL (TYP)

CONCRETE PAD (TYP)

MOTOR CONTROL CENTER DETAIL
(SIDE VIEW)

(NOT TO SCALE)

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⋖						
BY: APENA					PROJECT ENGINEER:	R. FROST
PM B					- DESIGNED BY:	Y. ABDALLA
3:39					- DRAWN BY:	P. NUGENT
4/15/2025					- CHECKED BY:	G. MARKOU
DATE: 4					IF THIS BAR DOES NOT MEASURE 1" THEN DRAWING	0 1/2" 1"
.OT	REV	ISSUED FOR	DATE	BY	IS NOT TO FULL SCALE	

RGE MARTORY

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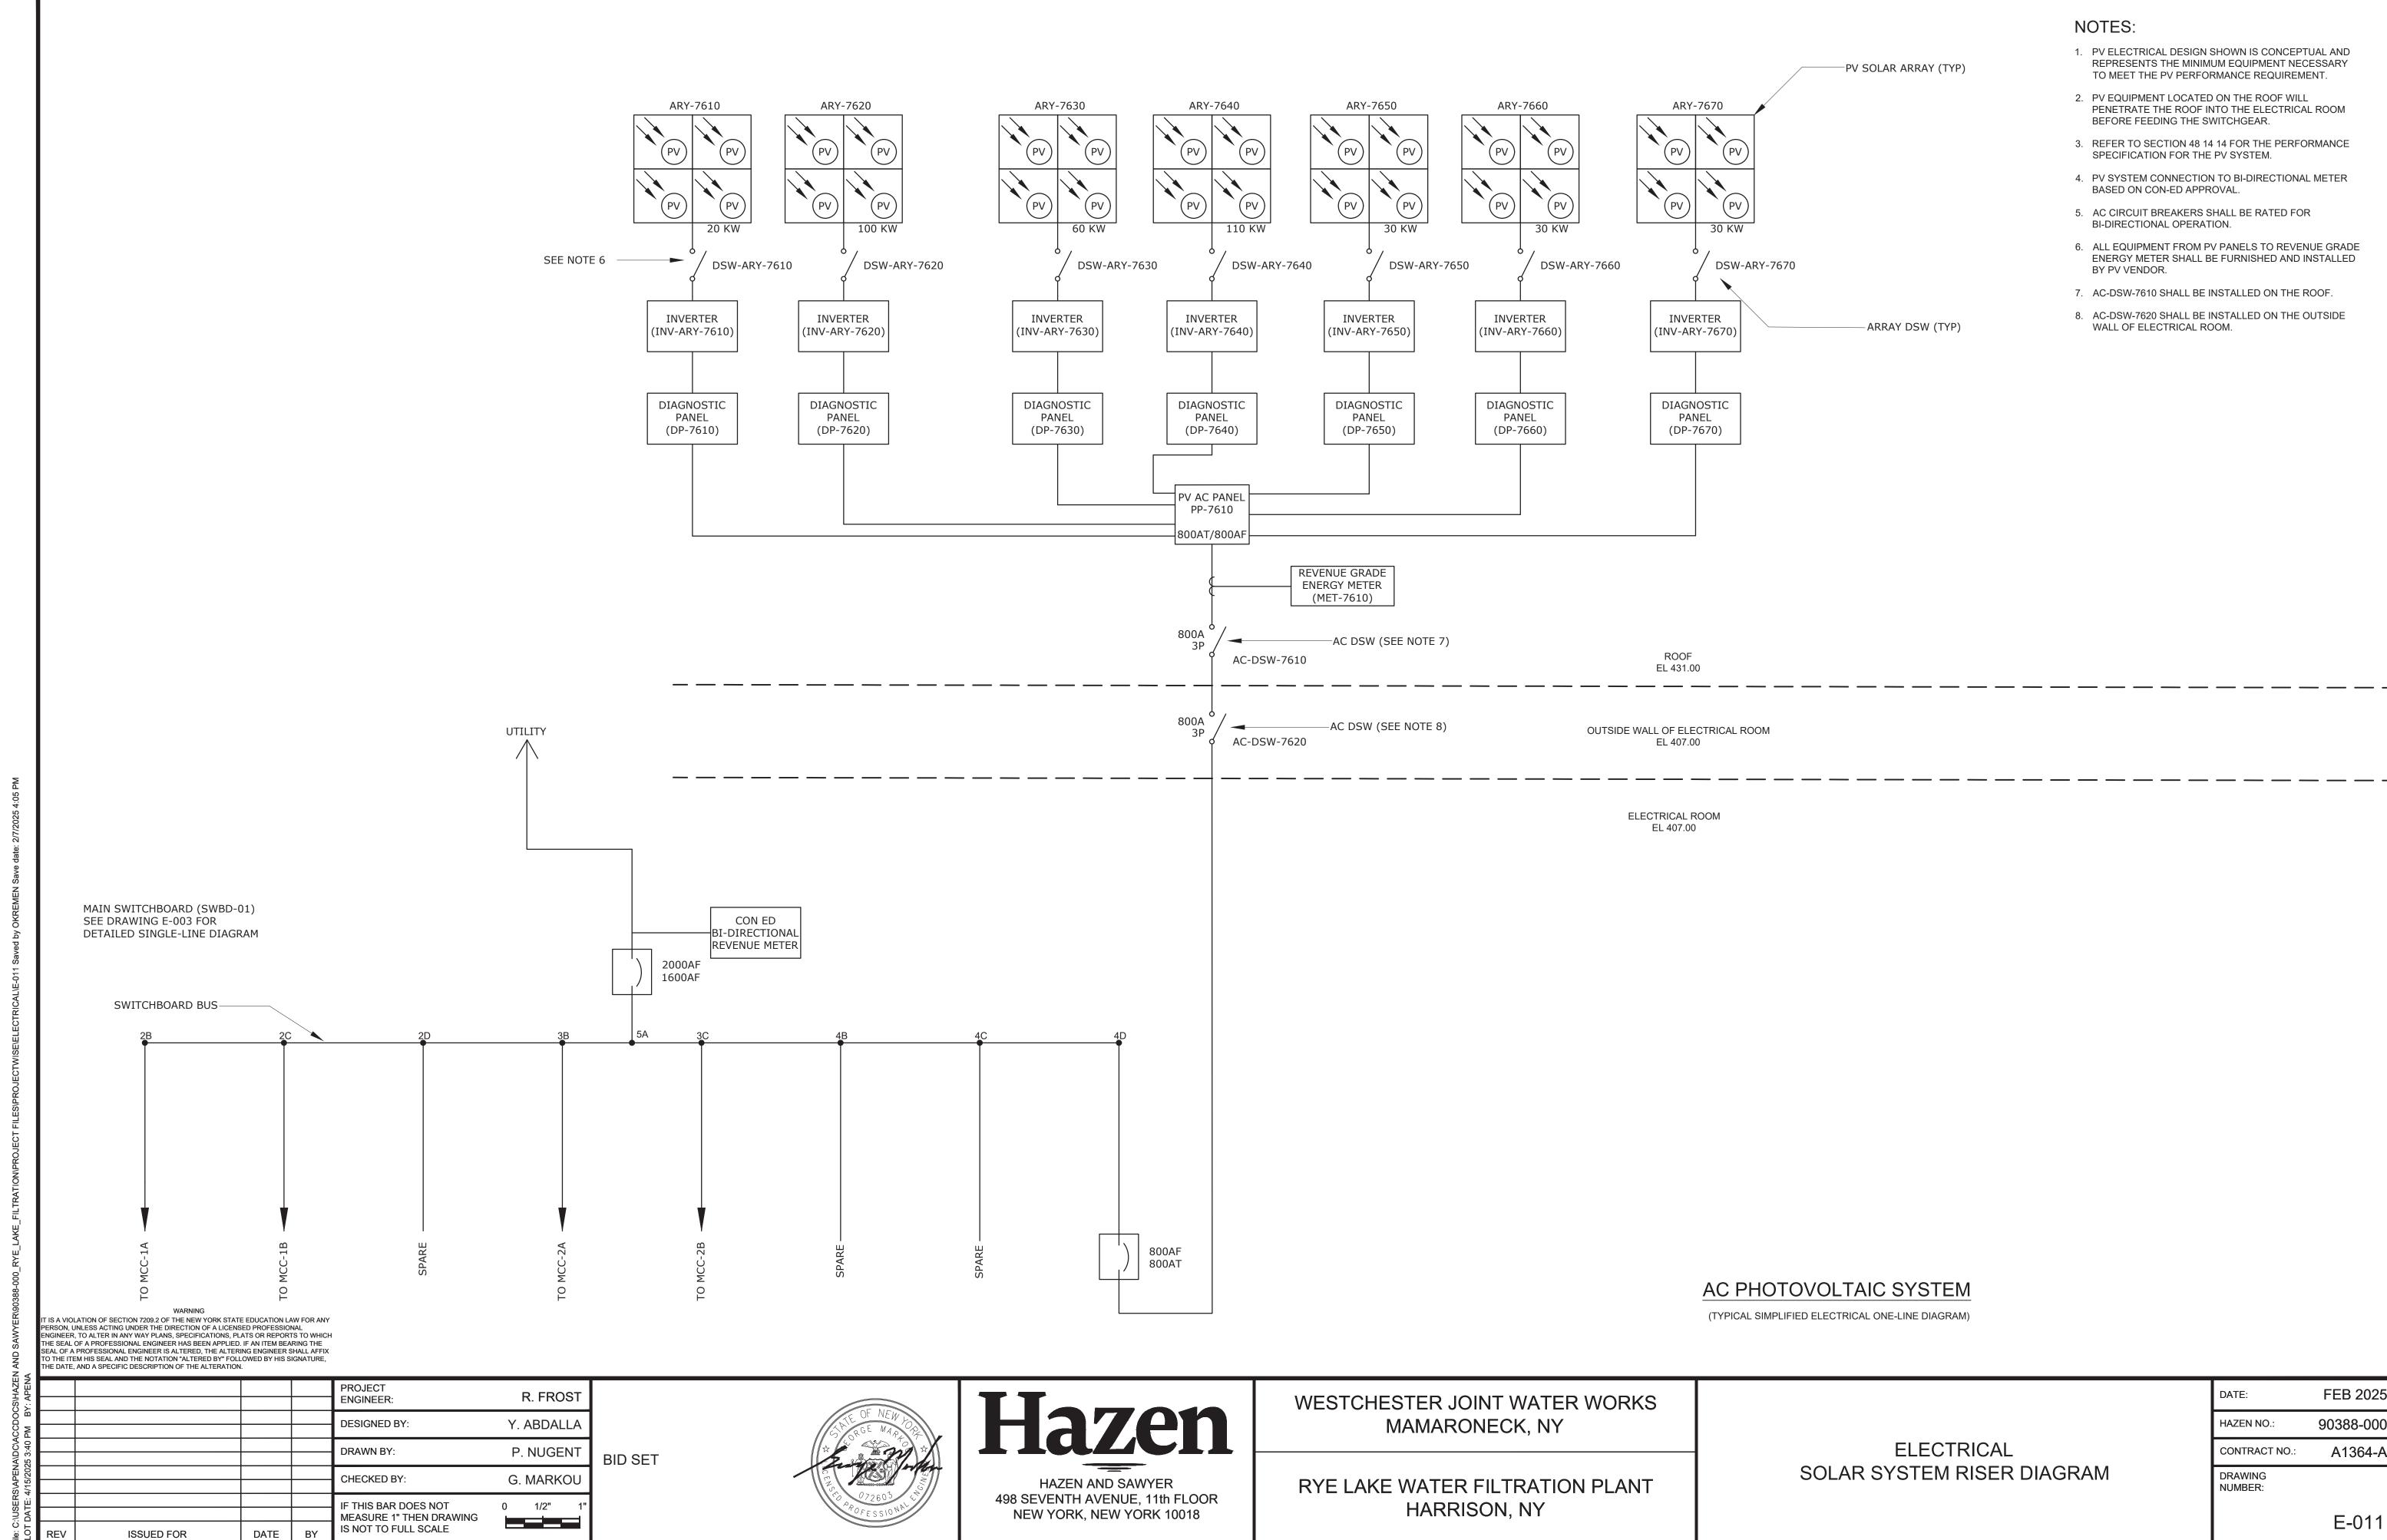
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498 SEVENTH AVENUE, 11th FLOOR
NEW YORK, NEW YORK 10018

WESTCHESTER JOINT WATER WORKS MAMARONECK, NY

RYE LAKE WATER FILTRATION PLANT HARRISON, NY

ELECTRICAL MCC-2 ELEVATION

DATE:	FEB 2025
HAZEN NO.:	90388-000
CONTRACT NO.:	A1364-A
DRAWING NUMBER:	
	E-010



480 VOLTS					P	OWER PAN	EL PP-3-MC0	C-1				TYPE:	NEMA 4X	
3 PHASE, 3 WIRE					MAIN BREAKER							OUNT:	SURFACE	
					100A 3P							ATION:	PIPE GALLERY (PLATFORM)	
DESCRIPTION	TRIP	POLE	СКТ	KILO-	VOLT-AMF	PERES	KILO-	KILO-VOLT-AMPERES			DOLE	TRIP	DESCRIPTION	
DESCRIPTION	TRIP	POLE	No.	Α	В	С	А	В	С	No.	POLE	IKIP	DESCRIPTION	
			1	0.20			0.20			2				
MOV-3160	20	3	3		0.20			0.20		4	3	20	MOV-3180	
			5			0.20			0.20	6				
			7	0.20			0.30			8				
MOV-3260	20	3	9		0.20			0.30		10	3	20	MOV-3280	
			11			0.20			0.30	12				
			13	0.20			0.30			14	1			
MOV-3360	20	3	15		0.20			0.30		16	3	20	MOV-3380	
			17			0.20			0.30	18				
			19	0.20			0.20			20	1			
MOV-3150	20	3	21		0.20			0.20			20	MOV-3170		
			23			0.20			0.20	24				
			25	0.20			0.20			26	1			
MOV-3250	20	3	27		0.20			0.20		28	3	20	MOV-3270	
			29			0.20			0.20	30				
			31	0.20			-			32	1			
MOV-3350	20	3	33		0.20			-		34	3	20	SPARE	
			35			0.20			-	36	_			
			37	-			-			38				
SPARE	20	3	39		-			-		40	3	20	SPARE	
			41			-			-	42				
			<u> </u>							T	1			
			TOTAL	1	1	1	1	1	1	TOTAL]		NOTES:	
					HASE TOT		101	AL LOAD (KVA)	-			65kAIC	
	2 2 2						7 TOTAL LOAD (A)			100kA SPD				
							10		(A)	-				
								9						

480 VOLTS						POWER PA	NEL PP-2-M	ICC-1				TYPE:	NEMA 4X			
3 PHASE, 3 WIRE				MAIN BREAKER								MOUNT: SURFACE				
					150	A 3P		LOCATION: DEWATERING ROOM								
DECODIDATION	TDID	DOL E	CKT	KILO-VOLT-AMPERES			KILO-	VOLT-AMF	PERES	СКТ	DOL 5	TDID	DECODIDATION			
DESCRIPTION	TRIP	POLE	No.	А	В	С	АВ		С	No.	POLE	IRIP	DESCRIPTION			
25.0040			1	7.00			10.00	10.00		2			V=1.5 / 50 1.00 /			
CP-6010	40	3	<u>3</u> 5		7.00	7.00		10.00	10.00	6	3	50	XFMR-LP2-MCC1			
			7	0.33		7.00	0.33		10.00	8						
SLG-6450	20	3	9		0.33			0.33		10	3	20	ROLL-UP DOOR (109-2)			
			11			0.33			0.33	12						
0.000	20	١	13	0.33	0.00	\vdash	0.33	0.00		14 16	,	20	CL C 4250			
SLG-6460	20	3	15 17		0.33	0.33		0.33	0.33	18	3	20	SLG-4250			
	\neg		19	0.33		0.00	5.00		0.00	20						
SLG-6470	20	3	21		0.33			5.00		22	3	25	LCP-7700			
			23			0.33			5.00	24						
PARE	20	3	25 27	-			0.33	0.33		26 28	3	20	ROLL-UP DOOR (109-1)			
PFARE	20	3	29		-	 		0.33	0.33	30	3	20	ROLL-OF BOOK (109-1)			
			31	-			-		0.00	32						
PARE	20	3	33		-			-		34	3	20	SPARE			
			35			-			-	36						
PARE	20	3	37 39	-	_		-	_		38 40	3	20	SPARE			
N AIL	20		41						-	42	ľ	20	SI AIL			
	•		<u> </u>			<u> </u>	•				•					
			TOTAL	8	8	8	16	16	16	TOTAL]		NOTES:			
		,		Pl	HASE TOT	AL	ТОТ	AL LOAD (KVA)		•		65kAIC			
				24	24	24		72		1			100kA SPD			
							ТО	TAL LOAD	(A)	1						
								87		1						

480 VOLTS						POWER PA	NEL PP-4-N	1CC-1		TYPE: NEMA 1					
3 PHASE, 3 WIRE				MAIN BREAKER							MOUNT: SURFACE				
						50 <i>A</i>	A 3P				LOC	ATION:	ELECTRICAL ROOM 119		
DECODIDATION	ON TRIP POLE CKT KILO-VOLT-AMPERES							VOLT-AMF	PERES	СКТ	DOLE	TDID	DESCRIPTION		
DESCRIPTION	IRIP	POLE	No.	А	В	С	А	В	С	No.	POLE	TRIP	DESCRIPTION		
			1	1.00			1.00			2					
MOV-1901	20	3	3		1.00			1.00		4	3	20	MOV-1902		
			5			1.00			1.00	6					
			7	-			-			8					
SPARE	20	3	9		-			-		10	3	20	SPARE		
			11			-			-	12					
			13	-			-			14					
SPARE	20	3	15		-	-		-		16	3	20	SPARE		
			17			-			-	18					
					_										
			TOTAL	1	1	1	1	1	1	TOTAL			NOTES:		
				P	HASE TOT	AL	TOT	AL LOAD (KVA)				65kAIC		
				2	2	2		6					100kA SPD		
			·				ТО	TAL LOAD	(A)						
								7]					

480 VOLTS						POWER	PAN	EL PP-1-MCC-2					TYPE:	NEMA 1		
3 PHASE, 3 WIRE						M	AIN E	BREAKER		MOUNT: SURFACE						
				250A 3P								LOCATION: ELECTRICAL ROOM 203				
DESCRIPTION	TDID	POLE	CKT	KILO-	VOLT-AMF	PERES		KILO-VOL	T-AMPERES	3	СКТ	POLE	TDID	DESCRIPTION		
DESCRIPTION	IRIP	POLE	No.	Α	В	С		А	В	С	No.	POLE	IRIP	DESCRIPTION		
			1	2.00				10.00			2					
AHU-02	20	3	3		2.00				10.00		4	3	50	XFMR-LP5-MCC-2		
			5			2.00				10.00	6					
			7	6.00				3.00			8					
AHU-03	30	3	9		6.00				3.00		10	3	60	AHU-08		
			11			6.00				3.00	12					
			13	8.00				0.80			14					
AHU-04	40	3	15		8.00				0.80		16	3	20	AHU-09		
			17			8.00				0.80	18					
			19	2.00				10.00			20					
AHU-05	20	3	21		2.00				10.00		22	3	50	XFMR-LP1-MCC-2		
			23			2.00				10.00	24					
			25	1.00				10.00			26					
MOV-3770	20	3	27		1.00				10.00		28	3	50	XFMR-LP3-MCC-2		
			29			1.00				10.00	30					
			31	2.10				-			32					
EF-07	20	3	33		2.10				-		34	3	20	SPARE		
			35			2.10				-	36					
			37	-				-			38					
SPARE	20	3	39		-				-		40	3	20	SPARE		
			41			-				-	42					
					_		_		_		_	_				
			TOTAL	21	21	21	L		34		TOTAL]		NOTES:		
				Pl	HASE TOT	AL		TOTAL I	OAD (KVA)					65kAIC		
				55	55	55	L		165		1			100kA SPD		
							L	TOTAL	LOAD (A)		1					
									198							

WARNING
IT IS A VIOLATION OF SECTION 7209.2 OF THE NEW YORK STATE EDUCATION LAW FOR ANY PERSON, UNLESS ACTING UNDER THE DIRECTION OF A LICENSED PROFESSIONAL ENGINEER, TO ALTER IN ANY WAY PLANS, SPECIFICATIONS, PLATS OR REPORTS TO WHICH THE SEAL OF A PROFESSIONAL ENGINEER HAS BEEN APPLIED. IF AN ITEM BEARING THE SEAL OF A PROFESSIONAL ENGINEER IS ALTERED, THE ALTERING ENGINEER SHALL AFFIX TO THE ITEM HIS SEAL AND THE NOTATION "ALTERED BY" FOLLOWED BY HIS SIGNATURE, THE DATE, AND A SPECIFIC DESCRIPTION OF THE ALTERATION.

Y: APEN				PROJECT ENGINEER:	I	R. FRO	ST
M BY				DESIGNED BY:	Υ.	ABDAL	LA
3:41				DRAWN BY:	P.	NUGE	NT
4/15/2025				CHECKED BY:	G.	MARK	OU
LOT DATE: V	ISSUED FOR	DATE	BY	IF THIS BAR DOES NOT MEASURE 1" THEN DRAWING IS NOT TO FULL SCALE	0	1/2"	1" =



BID SET

HAZEN AND SAWYER
498 SEVENTH AVENUE, 11th FLOOR

NEW YORK, NEW YORK 10018

WESTCHESTER JOINT WATER WORKS MAMARONECK, NY

RYE LAKE WATER FILTRATION PLANT HARRISON, NY ELECTRICAL
PANEL BOARD SCHEDULES - SHEET 1

DATE: FEB 2025

HAZEN NO.: 90388-000

CONTRACT NO.: A1364-A

DRAWING NUMBER:

E-012

480 VOLTS						POWER PA	NEL PP-4-N	ICC-2				TYPE:	NEMA 4X
3 PHASE, 3 WIRE						MAIN BF	REAKER				M	OUNT:	SURFACE
						50A	3P				LOC	ATION:	PIPE GALLERY PLATFORM
DESCRIPTION	TRIP	POLE	CKT	KILO-	VOLT-AMF	PERES	KILO-	VOLT-AMF	PERES	СКТ	DOLE	TRIP	DESCRIPTION
DESCRIPTION	IRIP	POLE	No.	Α	В	С	Α	В	С	No.	POLE	IRIP	DESCRIPTION
			1	0.20			0.20			2			
MOV-3460	20	3	3		0.20			0.20		4	3	20	MOV-3450
		\vdash	5 7	0.20		0.20	0.20		0.20	6 8			
MOV-3560	20	3	9	0.20	0.20	 	0.20	0.20		10	3	20	MOV-3550
MOV 0000	-		11		0.20	0.20		0.20	0.20	12	1	-	We v 6666
			13	0.20			0.20			14			
MOV-3760	20	3	15		0.20			0.20	0.00	16	3	20	MOV-3650
		\vdash	17 19	0.20		0.20	0.20		0.20	18 20			
MOV-3860	20	3	21	0.20	0.20	 	0.20	0.20		22	3	20	MOV-3750
WO V 0000	20		23		0.20	0.20		0.20	0.20	24	1 ~	= "	W V - 07 00
			25	0.20			0.20			26			
MOV-3480	20	3	27		0.20			0.20		28	3	20	MOV-7450
	_		29 31	0.20		0.20	+		0.20	30	-	<u> </u>	
MOV-3580	20	3	33	0.20	0.20	\vdash	-	-		32 34	3	20	SPARE
WO V-0000	20		35		0.20	0.20			-	36	1 ~	~	OF AIRE
			37	-			-			38			
SPARE	20	3	39		-			-		40	3	20	SPARE
			41			-			-	42			<u> </u>
		1	тоты Т	1				1 4		ITOTAL	1		NOTES:
			TOTAL	<u>'</u>	1	1	1	1	1	TOTAL	J		NOTES:
			Į	Pl	HASE TOT	AL	ТОТ	AL LOAD (KVA)]			65kAIC
			[2	2	2		7					100kA SPD
							ТО	TAL LOAD	(A)	1			
								8		1			

480 VOLTS						POWER PA	NEL PP-6-N	ACC-2				TYPE:	NEMA 4X
3 PHASE, 3 WIRE						MAIN BF	REAKER				М	OUNT:	SURFACE
						50A	3P				LOC	ATION:	PIPE GALLERY PLATFORM
DESCRIPTION	TDID	POLE	CKT	KILO-	VOLT-AMF	PERES	KILO-	VOLT-AMF	PERES	СКТ	POLE	TRIP	DESCRIPTION
DESCRIPTION	IRIP	POLE	No.	Α	В	С	Α	В	С	No.	POLE	IKIP	DESCRIPTION
MOV-4240	20	3	3	0.20	0.20		0.20	0.20		2	3	20	MOV-7440
VIO V -4240	20		5		0.20	0.20		0.20	0.20	6	<u> </u>	20	1000-7-4-40
MOV-4340	20	3	7 9	0.20	0.20		0.30	0.30	-	8 10	3	20	ROLL-UP DOOR (129-2)
			11		0.20	0.20		0.00	0.30	12	<u> </u>	20	
SPARE	20	3	13 15	-	_		<u> </u>	-	-	14 16	3	20	SPARE
			17			-			-	18	<u> </u>		5 · 7 · 1 · 1
SPARE	20	3	19 21	-	-		-	-		20	3	20	SPARE
			23			-			-	24	1		
SPARE	20	3	25 27	-	-		-	-		26 28	3	20	SPARE
	_	_	29 31	-			_		-	30 32	-		
SPARE	20	3	33		-			-		34	3	20	SPARE
			35 37				_		-	36 38	-		
SPARE	20	3	39		-			-		40	3	20	SPARE
			41			-			-	42			
			TOTAL	0	0	0	1	1	1 1	TOTAL	1		NOTES:
		l			HASE TOT			AL LOAD (KVA)	1	J		65kAIC
				1	1	1		3	· · · · · · · · · · · · · · · · · · ·	1			100kA SPD
							TC	TAL LOAD	(A)	1			
								3	` /	1			

BID SET

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BY: APE					PROJECT ENGINEER:	R. FROST
PM B					DESIGNED BY:	Y. ABDALLA
AUC 4					DRAWN BY:	P. NUGENT
4/15/2025					CHECKED BY:	G. MARKOU
./USERS DATE: 4/					IF THIS BAR DOES NOT MEASURE 1" THEN DRAWING	0 1/2" 1"
9 O.	RFV	ISSUED FOR	DATE	BY	IS NOT TO FULL SCALE	

Hazen HAZEN AND SAWYER 498 SEVENTH AVENUE, 11th FLOOR NEW YORK, NEW YORK 10018

WESTCHESTER JOINT WATER WORKS MAMARONECK, NY

RYE LAKE WATER FILTRATION PLANT HARRISON, NY

ELECTRICAL PANEL BOARD SCHEDULES - SHEET 2

100kA SPD

FEB 2025 90388-000 HAZEN NO.: A1364-A CONTRACT NO.: DRAWING NUMBER: E-013

480 VOLTS						POWER P	ANEL PP-3-	MCC-2				TYPF:	NEMA 4X
3 PHASE, 3 WIRE							BREAKER						SURFACE
0 1 1 <i>i</i> 1 (0 2 , 0 7)							OA 3P						FILTERED WATER PUMP ROOM
	T		OLIT	KII O	VOLT-AMP			-VOLT-AMF	DEDES	OLIT	LOGA	THOIN.	TIETERED WATERT OWN ROOM
DESCRIPTION	TRIP	POLE	CKT No.	A A	B B	C	A	B	C	CKT No.	POLE	TRIP	DESCRIPTION
	+		1	13.00			3.70	 	 	2			
COMP 7240	60	,		13.00	13.00		3.70	3.70	-		3	20	L CD 7040
COMP-7310	60	3	3		13.00	40.00		3.70	0.70	4	3	20	LCP-7610
	+		5			13.00	0.00	-	3.70	6			
	1		7	-			2.00			8			
COMP-7320	60	3	9		-			2.00		10	3	20	TWH-01
			11			-			2.00	12			
			13	10.00			0.30			14			
XFMR-LP4-MCC-2	50	3	15		10.00			0.30		16	3	20	ROLL-UP DOOR (106-2)
			17			10.00			0.30	18			
			19	-			-			20			
SPARE	20	3	21		-			-		22	3	20	SPARE
			23			-			-	24			
	+		25	_			_	†	<u> </u>	26			
SPARE	20	3	27		-			 -		28	3	20	SPARE
OI AIL	20	ľ						 		30		20	OI AILE
	+		29			-		 	-				
			31	-			-	 		32			
SPARE	20	3	33		-			 -		34	3	20	SPARE
			35			-			-	36			
			37	-			-			38			
SPARE	50	3	39		-			-		40	3	20	SPARE
			41			-			-	42			
	•						· ·	•	•				
		1	TOTAL	23	23	23	6	6	6	TOTAL			NOTES:
					HASE TOTA		<u> </u>	ΓAL LOAD (\vdash	ı		65kAIC
				29	29	29		87	,	1			100 kA SPD
			l	20	20	20	T(OTAL LOAD	(Δ)	1			100 10 (01)
								105	(71)	1			
								105					
480 VOLTS						POWER F	PANEL PP-5	-MCC-2				TYPE:	NEMA 4X
3 PHASE, 3 WIRE							BREAKER				M		SURFACE
							0A 3P						PIPE GALLERY PLATFORM
		1	0.7	KII O	-VOLT-AMI			D-VOLT-AMI	DEDES	1 01/7	T	T	THE GALLERAT EATH GIAW
DESCRIPTION	TRIP	POLE	CKT No.		B	1	┥ ├──	_		CKT No.	POLE	TRIP	DESCRIPTION
	+		1	A 0.20	В	С	0.20	В	С	2	-	├─	
MOV-2110	20	3	3	0.20	0.20		0.20	0.20		4	3	20	MOV-2510
	+		5 7	0.20	-	0.20	0.20		0.20	6 8	-	-	
MOV-2210	20	3	9	0.20	0.20		0.20	0.20		10	3	20	MOV-2610
	+		11 13	0.20		0.20	0.20		0.20	12 14	-	-	
MOV-2310	20	3	15	0.20	0.20		0.20	0.20		16	3	20	MOV-2710
	+-		17 19	0.20		0.20			0.20	18 20			
MOV-2410	20	3	21	0.20	0.20		 -	-		22	3	20	SPARE
			23			0.20	1		-	24	<u> </u>		
SPARE	20	3	25 27	-	-	+	┤┝╌	-	1	26 28	3	20	SPARE
			29			-			-	30	1		
SPARE	20	3	31 33	-	-		 -	-		32 34	3	20	SPARE
	_	1	35			-			-	36	1—		
SPARE	20	3	37 39	-	-	+	┨┝	-	+	38 40	3	20	SPARE
			41			-			_	42	1		
							,				,		
			TOTAL	1	1	1	1	1	1	TOTAL]		NOTES:
				Р	HASE TOT	AL	TC	TAL LOAD	(KVA)				65kAIC
I					1		1			7			

480 VOLTS						POWER PA	NEL PP-	UPS-MO	CC-2				TYPE:	NEMA 1
3 PHASE, 3 WIRE						MAIN B	REAKER					М	OUNT:	SURFACE
						100	A 3P					LOC	ATION:	ELECTRICAL ROOM 203
DESCRIPTION	TDID	POLE	СКТ	KILO-	VOLT-AMF	PERES	KII	O-VOL	T-AMF	PERES	СКТ	DOLE	TDID	DECODIDATION
DESCRIPTION	TRIP	POLE	No.	А	В	С	А		В	С	No.	POLE	TRIP	DESCRIPTION
			1	0.20			0.20				2			
MOV-7352	20	3	3		0.20			0).20		4	3	20	MOV-7362
			5			0.20				0.20	6			
			7	5.00			5.00				8			
XFMR-IP-1-MCC-2	40	3	9		5.00			5	5.00		10	3	40	XFMR-IP-2-MCC-2
			11			5.00				5.00	12			
			13	-			-				14			
SPARE	20	3	15		-				-		16	3	20	SPARE
			17			-				-	18			
			19	-			-				20			
SPARE	20	3	21		-				-		22	3	20	SPARE
			23			-				-	24			
			25	-							26			
SPARE	20	3	27		-				-		28	3	20	SPARE
			29			-				-	30			
			TOTAL	5	5	5	5		5	5	TOTAL]		NOTES:
				P	HASE TOT	AL	Т	OTAL L	OAD (KVA)				65kAIC
				10	10			31					100kA SPD	
								TOTAL	LOAD	(A)				
											-			

TOTAL LOAD (A)

208/120 VOLTS						LP-3	3-M0	CC-1					TYPE:	NEMA 4X
3 PHASE, 4 WIRE						MAIN	BRE	EAKER				M	OUNT:	SURFACE
						10	00A :	3P				LOC	ATION:	CORRIDOR (SECOND FLOOR)
DESCRIPTION	TDID	DOL E	CKT	KILO-	-VOLT-AMI	PERES	П	KILO-	VOLT-AMF	ERES	СКТ	DOL 5	TDID	DECODIFICAL
DESCRIPTION	TRIP	POLE	No.	Α	В	С	1 [Α	В	С	No.	POLE	TRIP	DESCRIPTION
MAINT. CLOSET, WC (212 & 213) - LTG & RECEPTACLES	20	1	1	1.2			1 [1.2			2	1	20	FLOCCUTLATOR & SKIMMER AREA - RECEPTACLES - 1
OPEN OFFICE (214) - LTG - 1	20	1	3		1.2] [1.2		4	1	20	FLOCCUTLATOR & SKIMMER AREA - RECEPTACLES - 2
OPEN OFFICE (214) - LTG - 2	20	1	5			1.2] [1.4	6	1	20	EF-06, EF-08
OPEN OFFICE (214) - RECEPTACLES - 1	20	1	7	1.2] [0.4			8	1	20	MOV-3100
OPEN OFFICE (214) - RECEPTACLES - 2	20	1	9		1.2		7 [0.4		10	1	20	MOV-3110
VESTIBULE (210) - LTG	20	1	11			1.2	1 [0.4	12	1	20	MOV-3120
VESTIBULE (210) - RECEPTACLES	20	1	13	1.2		-	7 [0.4			14	1	20	MOV-3130
ELEV. CONTROL ROOM - LTG & RECEPTACLES	20	1	15	-	1.2		7 [0.4		16	1	20	MOV-3210
SUPPLY ROOM & CHIEF OFFICE (209 & 210) - LTG & RECEPTACLES	20	1	17			1.2	7 [0.4	18	1	20	MOV-3220
HVAC ROOM (215) - LTG - 1	20	1	19	1.2			1 [0.4			20	1	20	MOV-3130
HVAC ROOM (215) - LTG - 2	20	1	21		1.2		1 [0.4		22	1	20	MOV-3230
HVAC ROOM (215) - RECEPTACLES - 1	20	1	23			1.2	7 [0.4	24	1	20	MOV-3140
HVAC ROOM (215) - RECEPTACLES - 2	20	1	25	1.2			7 [0.4			26	1	20	MOV-3240
FLOCCUTLATOR & SKIMMER AREA - LTG - 1	20	1	27		2.0		1 [1.2		28	1	20	CONTROL AND SCADA ROOM - LTG
FLOCCUTLATOR & SKIMMER AREA - LTG - 2	20	1	29			2.0] [1.2	30	1	20	CONTROL ROOM - RECEPTACLES
			31	1.7] [1.2			32	1	20	CONTROL ROOM - RECEPTACLES
DWH-01	20	3	33		1.7] [0.3		34	1	20	GMU-01
			35			1.7] [0.3	36	1	20	ET-01
PV-01	20	1	37	0.7] [0.3			38	1	20	HWB-01
PV-02	20	1	39		0.7] [0.3		40	1	20	HWB-02
RCP-02	20	1	41			0.2] [1.2	42	1	20	MICROWAVE
												_		
			TOTAL	8	9	9] [4	4	5	TOTAL			NOTES:
				Р	HASE TOT	AL] [TOT	AL LOAD (KVA)				22kAIC
				13	13	14] [40					100kA SPD
								TO	TAL LOAD	(A)				
									111					

208/120 VOLTS						LP-2	-MCC-1					TYPE:	NEMA 4X
3 PHASE, 4 WIRE						MAIN B	BREAKER				M	OUNT:	SURFACE
						80.	A 3P				LOC	ATION:	DEWATERING ROOM
DESCRIPTION	TDID	POLE	CKT	KILO-	VOLT-AMF	PERES	KILO-	VOLT-AMI	PERES	СКТ	POLE	TRID	DESCRIPTION
DESCRIPTION	11311	I OLL	No.	Α	В	С	Α	В	С	No.	I OLL	IIXII	DESCRIPTION
SPARE	20	1	1	-			1.2			2	1	20	HVAC ROOM (208)- RECEPTACLES 2
SPARE	20	1	3		-			0.3		4	1	20	EF-05
P-6330	20	1	5			0.9			0.5	6	1	20	M-6330
P-6340	20	1	7	0.9			0.5			8	1	20	M-6340
DEWATERING ROOM - LTG 1	20	1	9		1.2			0.2		10	1	20	UH-01
DEWATERING ROOM - LTG 2	20	1	11			1.2			0.5	12	1	20	FACP-01
DEWATERING ROOM - RECEPTACLES 1	20	1	13	1.2			1.0			14	2	20	GATE POWER
DEWATERING ROOM - RECEPTACLE 2	20	1	15		1.2			1.0		16		20	GATE POWER
OUTDOOR LTG. (SOUTH EAST SIDE)	20	1	17			1.2			0.1	18	1	20	EXIT SIGNS
OUTDOOR LTG. (SOUTH EAST SIDE)	20	1	19	1.2			-			20	1	20	SPARE
CORRIDOR (C01) LTG - 2	20	1	21		1.6			-		22	1	20	SPARE
CORRIDOR (C01) RECEPTACLE - 2	20	1	23			1.2			-	24	1	20	SPARE
HVAC ROOM (208)- LTG 1	20	1	25	1.2			-			26	1	20	SPARE
HVAC ROOM (208)- LTG 2	20	1	27		1.2			-		28	1	20	SPARE
HVAC ROOM (208)- RECEPTACLES 1	20	1	29			1.2			-	30	1	20	SPARE
											,		
			TOTAL	5	5	6	3	2	1	TOTAL			NOTES:
				Р	HASE TOT	AL	ТОТ	AL LOAD	(KVA)	1			22kAIC
				7	7	7		21					100kA SPD
							TO	TAL LOAD) (A)				
								58					

208/120 VOLTS							-MCC-2						NEMA 1
3 PHASE, 4 WIRE							BREAKER						SURFACE
							5A 3P				LOC	ATION:	ELECTRICAL ROOM 203
DESCRIPTION	TRIP	POLE	CKT No.	KILO-	VOLT-AMF	C	KILO-	VOLT-AMF B	C	CKT No.	POLE	TRIP	DESCRIPTION
	+		1	1.2	-	Ŭ	1.2			2	1	20	HVAC ROOM (201) - LTG
ACCU-04	25	3	3		1.2			1.2		4	1	20	HVAC ROOM (201) - RECEPTACLES
			5			1.2			2.4	6	1	20	CORRIDOR (C03) - LTG
			7	1.2			<u> </u>			8	1	20	SPARE
ACCU-06	25	3	9		1.2			1.2		10		00	1001104
			11			1.2			1.2	12	2	30	ACCU-01
1001100	-		13	1.2			1.2			14			
ACCU-03	30	2	15		1.2			1.2		16	2	30	ACCU-02
SPARE	20	1	17			-			-	18	1	20	SPARE
SPARE	20	1	19	-			-			20	1	20	SPARE
SPARE	20	1	21		-			-		22	1	20	SPARE
ELECTRICAL ROOM - LTG 1	20	1	23			1.2			-	24	1	20	SPARE
ELECTRICAL ROOM - LTG 2	20	1	25	1.2			1 -			26	1	20	SPARE
ELECTRICAL ROOM - RECEPTACLES 1	20	1	27		1.2			-		28	1	20	SPARE
ELECTRICAL ROOM - RECEPTACLES 2	20	1	29			1.2			2.94	30		00	E111.02
PROCESS ANALYSIS ROOM - LTG	20	1	31	1.2			2.94			32	2	20	EUH-03
PROCESS ANALYSIS ROOM - RECEPTACLES	20	1	33		1.2			2.0		34	1	20	CORRIDOR (C03) - RECEPTACLES
AIR SCOUR - LTG	20	1	35			1.2			2.4	36	1	20	COORIDOR (C04) - LTG
AIR SCOUR - RECEPTACLES	20	1	37	1.2			1.2			38	1	20	COORIDOR (C04) - RECEPTACLES
STOR ROOM - LTG AND RECEPTACLES	20	1	39		1.2			2.9		40		20	EUL 04
EXIT SIGNS	20	1	41			0.1			2.90	42	2	20	EUH-04
	,	•			•						•	•	•
			TOTAL	7	7	6	7	9	12	TOTAL]		NOTES:
				Р	HASE TOT	AL	ТОТ	AL LOAD ((KVA)		-		22kAIC
				14	16	18		47		1			100kA SPD
			'		-	-	ТО	TAL LOAD) (A)	1			
								132		1			

WARNING
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Y: APENA					PROJECT ENGINEER:	R. FROST	
PM BY:					DESIGNED BY:	Y. ABDALLA	
3:41					DRAWN BY:	P. NUGENT	BID SET
4/15/2025					CHECKED BY:	G. MARKOU	
DATE: 4					IF THIS BAR DOES NOT MEASURE 1" THEN DRAWING	0 1/2" 1"	
LOT I	REV	ISSUED FOR	DATE	BY	IS NOT TO FULL SCALE		

POFESSIONAL

HAZEN AND SAWYER
498 SEVENTH AVENUE, 11th FLOOR
NEW YORK, NEW YORK 10018

WESTCHESTER JOINT WATER WORKS MAMARONECK, NY

RYE LAKE WATER FILTRATION PLANT HARRISON, NY ELECTRICAL
PANEL BOARD SCHEDULES - SHEET 3

DATE: FEB 2025

HAZEN NO.: 90388-000

CONTRACT NO.: A1364-A

DRAWING NUMBER:

E-014

CODOCSUHAZEN AND SAMMEDSONS88 000 DVE 1 AKE EII TDATIONISDO IECT EII ESIDDO IECTMISEIEI ECTDICALIE 011 BID Saved hv ADENA Save date :

LP-2-MCC-2

MAIN BREAKER

TYPE: NEMA 4X

MOUNT: SURFACE

208/120 VOLTS						LP-3	-MCC-2					TYPE:	NEMA 4X
3 PHASE, 4 WIRE						MAIN E	BREAKER				M	OUNT:	SURFACE
						50	A 3P				LOC	ATION:	FLOCULATOR AREA
DESCRIPTION	TDID	POLE	CKT	KILO-	VOLT-AMF	PERES	KILO-	VOLT-AMF	ERES	CKT	DOLE	TRIP	DESCRIPTION
DESCRIPTION	TIXIF	FOLE	No.	Α	В	С	Α	В	С	No.	FOLE	HXIF	DESCRIPTION
MOV-3310	20	1	1	0.4			1.2			2	1	20	FLOCCULATOR & SKIMMER AREA - LTG
MOV-3320	20	1	3		0.4			1.2		4	1	20	FLOCCULATOR & SKIMMER AREA - RECEPTACLES
MOV-3410	20	1	5			0.4			1.2	6	1	20	FLOCCULATOR & SKIMMER AREA - RECEPTACLES
MOV-3420	20	1	7	0.4			1.2			8	1	20	OUTDOOR LTG (NORTH WEST)
MOV-3510	20	1	9		0.4			1.2		10	1	20	OUTDOOR LTG (NORTH WEST)
MOV-3520	20	1	11			0.4			1.2	12	1	20	FLOCCULATOR & SKIMMER AREA - LTG
MOV-3610	20	1	13	0.4			0.4			14	1	20	MOV-3710
MOV-3620	20	1	15		0.4			0.4		16	1	20	MOV-3720
FLOCULATOR INSIDE TANK LIGHT	20	1	17			0.1			-	18	1	20	SPARE
SPARE	20	1	19	-			-			20	1	20	SPARE
SPARE	20	1	21		-			-		22	1	20	SPARE
SPARE	20	1	23			-			-	24	1	20	SPARE
SPARE	20	1	25	-			-			26	1	20	SPARE
SPARE	20	1	27		-			-		28	1	20	SPARE
SPARE	20	1	29			-			-	30	1	20	SPARE
SPARE	20	1	31	-			-			32	1	20	SPARE
SPARE	20	1	33		-			-		34	1	20	SPARE
SPARE	20	1	35			-			-	36	1	20	SPARE
SPARE	20	1	37	-			-			38	1	20	SPARE
SPARE	20	1	39		-			-		40	1	20	SPARE
SPARE	20	1	41			-			-	42	1	20	SPARE
			TOTAL	1	1	1	3	3	2	TOTAL			NOTES:
				Р	HASE TOT	AL	TOT	AL LOAD (KVA)				22kAIC
				4	4	3		11]			100kA SPD
							TO	TAL LOAD	(A)				
								31					

208/120 VOLTS						I P-4-	MCC-2	2					TYPF:	NEMA 4X
3 PHASE, 4 WIRE						MAIN B						M		SURFACE
							A 3P							FILTER WATER PUMPING ROOM
			СКТ	KILO-	VOLT-AMI	PERES	Т	KILO-V	OLT-AMP	ERES	СКТ			
DESCRIPTION	TRIP	POLE	No.	А	В	С		А	В	С	No.	POLE	TRIP	DESCRIPTION
MOV-3190	20	1	1	0.5			_	1.2			2	1	20	SODIUM HYDROXIDE ROOM - RECEPTACLES 1
MOV-3290	20	1	3		0.5				1.2		4	1	20	SODIUM HYDROXIDE ROOM - RECEPTACLES 2
MOV-3390	20	1	5			0.5				1.2	6	1	20	SODIUM HYDROXIDE ROOM - LTG 1
			7	0.2			-	1.2			8	1	20	SODIUM HYDROXIDE ROOM - LTG 2
EF-03	20	3	9		0.2				1.2		10	1	20	PIPE GALLERY EL.406 - LTG-1
			11			0.2				1.2	12	1	20	PIPE GALLERY EL.406 - LTG-2
			13	0.2			,	1.2			14	1	20	PIPE GALLERY EL.406 - LTG-3
EF-04	20	3	15		0.2				1.2		16	1	20	PIPE GALLERY EL.406 - RECEPTACLES 1
			17			0.2				1.2	18	1	20	PIPE GALLERY EL.406 - RECEPTACLES 2
MOV-7351	20	1	19	0.4			,	1.2			20	1	20	PIPE GALLERY EL.406 - RECEPTACLES 3
MOV-7361	20	1	21		0.4				1.2		22	1	20	FILTER WATER PUMP ROOM - RECEPTACLES 1
FILTER WATER PUMP ROOM - LTG 1	20	1	23			1.2				1.2	24	1	20	FILTER WATER PUMP ROOM - RECEPTACLES 2
FILTER WATER PUMP ROOM - LTG 2	20	1	25	1.2				1.2			26	1	20	STAIR (SC) & VESTIBLE (124) - LTG
OUTDOOR LTG. (NORTH EAST SIDE) - 1	20	1	27		1.2				1.2		28	1	20	STAIR (SC) & VESTIBULE (124) - RECEPTACLES
OUTDOOR LTG. (NORTH EAST SIDE) - 2	20	1	29			1.2				1.2	30	1	20	ROOF LTG & RECEPTACLES
SPARE	20	1	31	-			,	1.2			32	1	20	OUTDOOR LTG. (WEST SIDE)
SPARE	20	1	33		-				0.1		34	1	20	EXIT SIGNS FILTERED WATER, SODIUM HYDROXIDE
SPARE	20	1	35			-				-	36	1	20	SPARE
SPARE	20	1	37	-				-			38	1	20	SPARE
SPARE	20	1	39		-				-		40	1	20	SPARE
SPARE	20	1	41			-				-	42	1	20	SPARE
			•											•
			TOTAL	3	3	3		7	6	6	TOTAL]		NOTES:
					HASE TOT	AL		TOTA	L LOAD (I			-		22kAIC
				10	9	9			28		1			100kA SPD
					-			TOT	AL LOAD	(A)]			
									77		1			

208/120 VOLTS						LP-5-N	ICC-2					TYPE:	NEMA 4X
3 PHASE, 4 WIRE						MAIN BR	EAKER				M	OUNT:	SURFACE
						100A	3P				LOC	ATION:	PIPE GALLERY (BASEMENT LEVEL)
DESCRIPTION	TDID	DOL E	СКТ	KILO-	VOLT-AMF	PERES	KILO	-VOLT-AMF	PERES	CKT	DOL E	TDID	DECODIDATION
DESCRIPTION	TRIP	POLE	No.	А	В	С	Α	В	С	No.	POLE	IRIP	DESCRIPTION
			1	0.7			-			2	1	20	SPARE
SP-01	20	3	3		0.7			-		4	1	20	SPARE
			5			0.7			-	6	1	20	SPARE
			7	-			-			8	1	20	SPARE
SP-02	20	3	9		-			-		10	1	20	SPARE
			11			-			-	12	1	20	SPARE
RCP-01	20	1	13	0.1			-			14	1	20	SPARE
PIPE GALLERY EL.384 - LTG 1	20	1	15		2.0			-		16	1	20	SPARE
SP-03	20	1	17			-			-	18	1	20	SPARE
PIPE GALLERY EL.384 - LTG 2	20	1	19	3.2			-			20	1	20	SPARE
PIPE GALLERY EL.384 - LTG 3	20	1	21		2.0			-		22	1	20	SPARE
PIPE GALLERY EL.384 - RECEPTACLES 1	20	1	23			2.0			-	24	1	20	SPARE
PIPE GALLERY EL.384 - RECEPTACLES 2	20	1	25	1.2			-			26	1	20	SPARE
PIPE GALLERY EL.384 - RECEPTACLES 3	20	1	27		1.2			-		28	1	20	SPARE
PIPE GALLERY EXIT SIGNS	20	1	29			0.1			-	30	1	20	SPARE
SPARE	20	1	31	-			-			32	1	20	SPARE
SPARE	20	1	33		-			-		34	1	20	SPARE
SPARE	20	1	35			-			-	36	1	20	SPARE
SPARE	20	1	37	-			-			38	1	20	SPARE
SPARE	20	1	39		-			-		40	1	20	SPARE
SPARE	20	1	41			-			-	42	1	20	SPARE
											_		
			TOTAL	5	6	3	0	0	0	TOTAL]		NOTES:
				PI	HASE TOT	AL	TO	TAL LOAD (KVA)] _			22kAIC
				5	6	3		14]			100kA SPD
							TO	OTAL LOAD	(A)]			
								39					

WARNING
IT IS A VIOLATION OF SECTION 7209.2 OF THE NEW YORK STATE EDUCATION LAW FOR ANY PERSON, UNLESS ACTING UNDER THE DIRECTION OF A LICENSED PROFESSIONAL ENGINEER, TO ALTER IN ANY WAY PLANS, SPECIFICATIONS, PLATS OR REPORTS TO WHICH THE SEAL OF A PROFESSIONAL ENGINEER HAS BEEN APPLIED. IF AN ITEM BEARING THE SEAL OF A PROFESSIONAL ENGINEER IS ALTERED, THE ALTERING ENGINEER SHALL AFFIX TO THE ITEM HIS SEAL AND THE NOTATION "ALTERED BY" FOLLOWED BY HIS SIGNATURE, THE DATE, AND A SPECIFIC DESCRIPTION OF THE ALTERATION.

208/120 VOLTS

3 PHASE, 4 WIRE

Y: APEN	-				PROJECT ENGINEER:	R. FROST	
PM BY					DESIGNED BY:	Y. ABDALLA	
3:41					DRAWN BY:	P. NUGENT	BID SET
4/15/2025					CHECKED BY:	G. MARKOU	
DATE: 4					IF THIS BAR DOES NOT MEASURE 1" THEN DRAWING	0 1/2" 1"	
.0T	REV	ISSUED FOR	DATE	BY	IS NOT TO FULL SCALE		

OF NEW PORGE MARGO PARTIES OF THE STORY OF T

HAZEN AND SAWYER
498 SEVENTH AVENUE, 11th FLOOR
NEW YORK, NEW YORK 10018

WESTCHESTER JOINT WATER WORKS
MAMARONECK, NY

RYE LAKE WATER FILTRATION PLANT HARRISON, NY ELECTRICAL
PANEL BOARD SCHEDULES - SHEET 4

DATE:	FEB 2025
HAZEN NO.:	90388-000
CONTRACT NO.:	A1364-A
DRAWING NUMBER:	
	E-015

IP-1-MCC-1

TYPE: NEMA 1

208/120 VOLTS						IP-2-	MCC-1					TYPE:	NEMA 4X
3 PHASE, 4 WIRE		MAIN BREAKER									M	OUNT:	SURFACE
						50,	A 3P				LOC	ATION:	CORRIDOR (C01)
DECORIDATION	TRIP	POLE	CKT	KILO-	VOLT-AMF	PERES	KILO-	VOLT-AMF	ERES	CKT	חסוב	TDID	DESCRIPTION
DESCRIPTION	IRIP	POLE	No.	Α	В	С	А	В	С	No.	POLE	TRIP	DESCRIPTION
SCADA ROOM - Receptacles	20	1	1	1.0			0.06			2	1	20	LIT-6414
RLWTP PLC PANEL	20	1	3		2.40			0.06		4	1	20	YSK-6420
FILTER-PLC 1	20	1	5			2.40			0.06	6	1	20	YSK-6430
SPARE	20	1	7				0.06			8	1	20	LIT-6431
CLIENTS WORK STATION 3	20	1	9		1.80			0.06		10	1	20	YSK-6440
SPARE	20	1	11						0.06	12	1	20	LIT-6441
CENT-PLC-1	20	1	13	2.40			0.1			14	1	20	LAS-5100
CENT-PLC-2	20	1	15		2.40			0.1		16	1	20	LAS-5200
LIT-6111	20	1	17			0.06			0.1	18	1	20	LAS-5300
LIT-6211	20	1	19	0.1			0.1			20	1	20	LAS-5400
LIT-6251	20	1	21		0.1			0.1		22	1	20	LAS-5500
FIT-6330	20	1	23			0.06			-	24	1	20	SPARE
YSK-6410	20	1	25	0.1			-			26	1	20	SPARE
LIT-6412	20	1	27		0.1			-		28	1	20	SPARE
LIT-6413	20	1	29			0.06			-	30	1	20	SPARE
WIT-6312	20	1	31	0.06			-			32	1	20	SPARE
WIT-6342	20	1	33		0.06			-		34	1	20	SPARE
SECURITY PANEL	20	1	35			0.10			-	36	1	20	SPARE
SPARE	20	1	37	-			-			38	1	20	SPARE
SPARE	20	1	39		-			-		40	1	20	SPARE
SPARE	20	1	41			-			-	42	1	20	SPARE
												-	
			TOTAL	4	7	3	0	0	0	TOTAL			NOTES:
				PI	HASE TOT	AL	TOT	AL LOAD (KVA)				22kAIC
				4	7	3		14]			100kA SPD
							ТО	TAL LOAD	(A)]			
								39					

208/120 VOLTS						IP-3	-MC	C-1					TYPE:	NEMA 4X
3 PHASE, 4 WIRE						MAIN E	BRE	AKER				М	OUNT:	SURFACE
						50	0A 3I	P				LOC	ATION:	PIPE GALLERY (PLATFORM AREA)
DESCRIPTION	TDID	POLE	CKT	KILO-	VOLT-AMF	PERES		KILO-	VOLT-AMF	PERES	CKT	DOLE	TRIP	DESCRIPTION
DESCRIPTION	TIXII	I OLL	No.	Α	В	С	IJL	Α	В	С	No.	I OLL	HXII	DESCRI TION
AIT-3113	20	1	1	0.06			ΙL	0.06			2	1	20	LSH-5300
AIT-3114	20	1	3		0.06		IJL		0.06		4	1	20	LIT-5311
FIT-3116	20	1	5			0.06	J L			0.06	6	1	20	LSHH-5312
FIT-3118	20	1	7	0.06				0.06			8	1	20	LIT-5321
AIT-3213	20	1	9		0.06				0.06		10	1	20	LSHH-5322
AIT-3214	20	1	11			0.06				0.06	12	1	20	LIT-5351
FIT-3216	20	1	13	0.06			1 [-			14	1	20	SPARE
FIT-3218	20	1	15		0.06		Т		-		16	1	20	SPARE
RIO-70	20	1	17			2.50	П			-	18	1	20	SPARE
SPARE	20	1	19	-				-			20	1	20	SPARE
SPARE	20	1	21		-				-		22	1	20	SPARE
SPARE	20	1	23			-				-	24	1	20	SPARE
			TOTAL	0	0	3	IJĹ	0	0	0	TOTAL			NOTES:
				Р	HASE TOT	AL		TOT	AL LOAD (KVA)		-		22kAIC
				0	0	3			3					100 kA SPD
			•					TO	TAL LOAD	(A)				
							Г		9		1			

208/120 VOLTS						IP-1-N	MCC-2					TYPE:	NEMA 1
3 PHASE, 4 WIRE						MAIN B	REAKER				М	OUNT:	SURFACE
						100	A 3P				LOC	ATION:	ELECTRICAL ROOM 203
DESCRIPTION	TDID	POLE	СКТ	KILO-	VOLT-AM	PERES	KILO-	VOLT-AMF	PERES	СКТ	POLE	TRIP	DESCRIPTION
DESCRIPTION	IKIF	POLE	No.	Α	В	С	Α	В	С	No.	FOLE	IKIP	DESCRIPTION
RIO-MCC-2	20	1	1	1.0			-			2			
			3	2.0				-		4	3	20	SPARE
IP-3-MCC-2	50	3	5		2.0				-	6			
			7			2.0	-			8			
			9	2.0				-		10	3	50	SPARE
IP-4-MCC-2	50	3	11		2.0				-	12			
			13			2.0	0.4			14	1	20	MOV-3330
			15	2.0				0.4		16	1	20	MOV-3430
IP-6-MCC-2	50	3	17		2.0				0.4	18	1	20	MOV-3530
			19	-		2.0	0.4			20	1	20	MOV-3630
SPARE	20	1	21		-			0.4		22	1	20	MOV-3730
SPARE	20	1	23			-			0.4	24	1	20	MOV-3340
SPARE	20	1	25	-			0.4			26	1	20	MOV-3440
SPARE	20	1	27		-			0.4		28	1	20	MOV-3540
SPARE	20	1	29			-			0.4	30	1	20	MOV-3640
											1		
			TOTAL	7	6	6	1	1	1	TOTAL]		NOTES:
					HASE TOT		ТОТ	AL LOAD ((KVA)	4			22kAIC
				8	7	7		23		4			100kA SPD
							ТО	TAL LOAD) (A)				
								63					

208/120 VOLTS						IP-2-	MCC-2					TYPE:	NEMA 1
3 PHASE, 4 WIRE						MAIN E	REAKER				М	OUNT:	SURFACE
						100	A 3P				LOCA	ATION:	ELECTRICAL ROOM 203
DECORIDATION	TRIP	POLE	СКТ	KILO-	-VOLT-AMI	PERES	KILO	-VOLT-AMF	PERES	СКТ	POLE	TDID	DESCRIPTION
DESCRIPTION	IRIP	POLE	No.	А	В	С	А	В	С	No.	POLE	IRIP	DESCRIPTION
SPARE	20	1	1	-			-			2			
			3		-			-		4	3	50	SPARE
SPARE	50	3	5			-			-	6			
			7	-			-			8			
			9		2.0			-		10	3	50	SPARE
IP-5-MCC-2	50	3	11			2.0			-	12			
			13	2.0			0.4			14	1	20	MOV-3740
			15		2.0			0.4		16	1	20	MOV-7120
IP-7-MCC-2	50	3	17			2.0			0.4	18	1	20	MOV-5297
			19	2.0			0.4			20	1	20	MOV-5291
SPARE	20	1	21		-			0.4		22	1	20	MOV-5292
SPARE	20	1	23			-			0.4	24	1	20	MOV-5293
SPARE	20	1	25	-			0.4			26	1	20	MOV-5294
SPARE	20	1	27		-			0.4		28	1	20	MOV-5295
SPARE	20	1	29			-			0.4	30	1	20	MOV-5296
											_		
			TOTAL	4	4	4	1	1	1	TOTAL			NOTES:
				Р	HASE TOT	AL	ТО	TAL LOAD (KVA)				22kAIC
			[5	5	5		16					100 kA SPD
			_				T	OTAL LOAD	(A)				
								43					

WARNING
IT IS A VIOLATION OF SECTION 7209.2 OF THE NEW YORK STATE EDUCATION LAW FOR ANY PERSON, UNLESS ACTING UNDER THE DIRECTION OF A LICENSED PROFESSIONAL ENGINEER, TO ALTER IN ANY WAY PLANS, SPECIFICATIONS, PLATS OR REPORTS TO WHICH THE SEAL OF A PROFESSIONAL ENGINEER HAS BEEN APPLIED. IF AN ITEM BEARING THE SEAL OF A PROFESSIONAL ENGINEER IS ALTERED, THE ALTERING ENGINEER SHALL AFFIX TO THE ITEM HIS SEAL AND THE NOTATION "ALTERED BY" FOLLOWED BY HIS SIGNATURE, THE DATE, AND A SPECIFIC DESCRIPTION OF THE ALTERATION.

208/120 VOLTS

Y: APEN					PROJECT ENGINEER:	R. FROST	
PM BY					DESIGNED BY:	Y. ABDALLA	
3:42					DRAWN BY:	P. NUGENT	BID SET
4/15/2025					CHECKED BY:	G. MARKOU	
DATE: 4					IF THIS BAR DOES NOT MEASURE 1" THEN DRAWING	0 1/2" 1"	
10-	REV	ISSUED FOR	DATE	BY	IS NOT TO FULL SCALE		

OF NEW PORGE MARGO PARTIES OF NEW PORGE MARGO PARTIES OF NEW PORGE MARGO PARTIES OF THE PORGE PARTIES OF THE PORTI

HAZEN AND SAWYER
498 SEVENTH AVENUE, 11th FLOOR
NEW YORK, NEW YORK 10018

WESTCHESTER JOINT WATER WORKS
MAMARONECK, NY

RYE LAKE WATER FILTRATION PLANT HARRISON, NY ELECTRICAL
PANEL BOARD SCHEDULES - SHEET 5

DATE: FEB 2025

HAZEN NO.: 90388-000

CONTRACT NO.: A1364-A

DRAWING NUMBER:

E-016

ACCIONAL MAN CANAND CANAND CANAND CANADA CAN

208/120 VOLTS						IP-5	-MCC	-2					TYPE:	NEMA 4X
3 PHASE, 4 WIRE						MAIN	BREA	KER				M	OUNT:	SURFACE
						50	0A 3P					LOC	ATION:	PIPE GALLERY (PLATFORM AREA)
DESCRIPTION	TDID	POLE	СКТ	KILO-	VOLT-AMP	ERES	\prod	KILO-	/OLT-AMF	PERES	СКТ	DOLE	TRIP	DESCRIPTION
DESCRIPTION	IRIP	POLE	No.	А	В	С] [Α	В	С	No.	POLE	IKIP	DESCRIPTION
AIT-3613	20	1	1	0.06] [-			2	1	20	SPARE
AIT-3614	20	1	3		0.06] [-		4	1	20	SPARE
FIT-3616	20	1	5			0.06] [-	6	1	20	SPARE
FIT-3618	20	1	7	0.06] [-			8	1	20	SPARE
AIT-3713	20	1	9		0.06] [-		10	1	20	SPARE
AIT-3714	20	1	11			0.06				-	12	1	20	SPARE
FIT-3716	20	1	13	0.06				-			14	1	20	SPARE
FIT-3718	20	1	15		0.06				-		16	1	20	SPARE
LIT-7511	20	1	17			0.06] [-	18	1	20	SPARE
LIT-7551	20	1	19	0.06] [-			20	1	20	SPARE
FIT-7591	20	1	21		0.06				-		22	1	20	SPARE
SPARE	20	1	23			-] [-	24	1	20	SPARE
												1		
			TOTAL	0	0	0	⇃⇂	0	0	0	TOTAL]		NOTES:
				P	HASE TOTA		⇃⇂	TOT	AL LOAD (KVA)	4			22kAIC
				0	0	0	┙┝		1		-			100kA SPD
							\vdash	ТО	TAL LOAD	(A)	-			
									2					

208/120 VOLTS						IP-7-I	MCC-2					TYPE:	NEMA 4X
3 PHASE, 4 WIRE						MAIN B	REAKER				M	OUNT:	SURFACE
						50/	\ 3P				LOC	ATION:	CORRIDOR(C01)
DESCRIPTION	TRIP	POLE	СКТ	KILO-	VOLT-AMP	ERES	KILO-	VOLT-AMF	ERES	СКТ	POLE	TDID	DESCRIPTION
DESCRIF HON	IIXIF	FOLE	No.	Α	В	С	А	В	С	No.	FOLE	HXIF	DESCRIPTION
RIO-40	20	1	1	2.40			0.06			2	1	20	LIT-5411
RIO-50	20	1	3		2.40			0.06		4	1	20	LSHH-5412
LSH-5100	20	1	5			0.06			0.06	6	1	20	LIT-5451
LSHH-5112	20	1	7	0.06			0.06			8	1	20	LIT-5511
LSHH-5122	20	1	9		0.06			0.06		10	1	20	LSH-5511
LSH-5200	20	1	11			0.06			0.06	12	1	20	LSHH-5512
LIT-5211	20	1	13	0.06			0.06			14	1	20	WIT-5551
LSHH-5212	20	1	15		0.06			1.0		16	1	20	LCP-6330
LIT-5221	20	1	17			0.06			1.0	18	1	20	LCP-6340
LSHH-5222	20	1	19	0.06			-			20	1	20	SPARE
LIT-5251	20	1	21		0.06			-		22	1	20	SPARE
LSH-5400	20	1	23			0.06			-	24	1	20	SPARE
	•	•			•				•		•	•	•
			TOTAL	3	3	0	0	1	1	TOTAL]		NOTES:
		1		P	HASE TOTA	AL	TOT	AL LOAD (KVA)		-		22kAIC
		3	4	1	8					100kA SPD			
				TOTAL LOAD (A)									
								22		1			

WARNING
S A VIOLATION OF SECTION 7209.2 OF THE NEW YORK STATE EDUCATION LAW FOR ANY RISON, UNLESS ACTING UNDER THE DIRECTION OF A LICENSED PROFESSIONAL SINEER, TO ALTER IN ANY WAY PLANS, SPECIFICATIONS, PLATS OR REPORTS TO WHICH ES SEAL OF A PROFESSIONAL ENGINEER HAS BEEN APPLIED. IF AN ITEM BEARING THE ALL OF A PROFESSIONAL ENGINEER IS ALTERED. THE ALTERING ENGINEER SHALL AFFIX
THE ITEM HIS SEAL AND THE NOTATION "ALTERED BY" FOLLOWED BY HIS SIGNATURE, EDATE, AND A SPECIFIC DESCRIPTION OF THE ALTERATION.

: APEN					PROJECT ENGINEER:	R. FROST	
PM BY:					DESIGNED BY:	Y. ABDALLA	
3:42					DRAWN BY:	P. NUGENT	BID SET
4/15/2025					CHECKED BY:	G. MARKOU	
DATE: 4					IF THIS BAR DOES NOT MEASURE 1" THEN DRAWING	0 1/2" 1"	
LOT	REV	ISSUED FOR	DATE	BY	IS NOT TO FULL SCALE		

Hazen HAZEN AND SAWYER 498 SEVENTH AVENUE, 11th FLOOR NEW YORK, NEW YORK 10018

WESTCHESTER JOINT WATER WORKS

208/120 VOLTS

3 PHASE, 4 WIRE

RYE LAKE WATER FILTRATION PLANT HARRISON, NY

MAMARONECK, NY

50A 3P LOCATION: PIPE GALLERY (PLATFORM AREA) KILO-VOLT-AMPERES KILO-VOLT-AMPERES CKT POLE TRIP DESCRIPTION DESCRIPTION RIO-33 2.40 0.06 1 20 FIT-3516 RIO-34 1 20 FIT-3518 2.40 0.06 AIT-3313 0.06 1 20 RIO-70 AIT-3314 1 20 SPARE 0.06 8 FIT-3316 1 20 SPARE 0.06 FIT-3318 20 SPARE 0.06 1 20 SPARE AIT-3413 20 1 13 0.06 14 AIT-3414 0.06 1 20 SPARE FIT-3416 1 20 SPARE 0.06 FIT-3418 1 20 SPARE 20 1 1 19 0.06 20 AIT-3513 1 20 SPARE AIT-3514 1 20 SPARE 20 1 23 0.06 24 0 TOTAL LOAD (KVA) 22kAIC PHASE TOTAL 3 3 3 8 100kA SPD TOTAL LOAD (A) 22

IP-4-MCC-2

MAIN BREAKER


TYPE: NEMA 4X


MOUNT: SURFACE


208/120 VOLTS						IP-6-	-MC	CC-2					TYPE:	NEMA 4X
3 PHASE, 4 WIRE						MAIN E	BRE	EAKER				M	OUNT:	SURFACE
						50	Α:	3P				LOCA	ATION:	PIPE GALLERY (PLATFORM AREA)
DESCRIPTION	TRIP	POLE	СКТ	KILO-	VOLT-AMF	PERES	Ш	KILO-	VOLT-AMP	ERES	СКТ	POLE	TRIP	DESCRIPTION
DEGGRII HON	TIXII	I OLL	No.	Α	В	С	Ш	Α	В	С	No.	I OLL	TIXII	BESOMI HON
_IT-7350	20	1	1	0.06				1			2	1	20	SPARE
_IT-7360	20	1	3		0.06				-		4	1	20	SPARE
FIT-7370	20	1	5			0.06				0.06	6	1	20	AIT-4792
AIT-4111	20	1	7	0.06				0.06			8	1	20	AIT-4793
AIT-4112	20	1	9		0.06				0.06		10	1	20	AIT-4794
AIT-4113	20	1	11			0.06				2.4	12	1	20	PLC-UV-001
_IT-4201	20	1	13	0.06				2.4			14	1	20	PLC-UV-002
_IT-4301	20	1	15		0.06				2.4		16	1	20	PLC-UV-003
_IT-7401	20	1	17			0.06				-	18	1	20	SPARE
FIT-7403	20	1	19	0.06				-			20	1	20	SPARE
AIT-4711	20	1	21		0.06				-		22	1	20	SPARE
AIT-4712	20	1	23			0.06				-	24	1	20	SPARE
FIT-4412	20	1	25	0.06				-			26	1	20	SPARE
FIT-4512	20	1	27		0.06				-		28	1	20	SPARE
FIT-4612	20	1	29			0.06				-	30	1	20	SPARE
S-4110	20	1	31	0.06				-			32	1	20	SPARE
S-4120	20	1	33		0.06				-		34	1	20	SPARE
S-4710	20	1	35			0.06				-	36	1	20	SPARE
RIO-60	20	1	37	2.40				-			38	1	20	SPARE
SPARE	20	1	39		-				-		40	1	20	SPARE
SPARE	20	1	41			-				-	42	1	20	SPARE
			TOTAL	3	0	0		2	2	2	TOTAL]		NOTES:
				PI	HASE TOT	AL		TOT	AL LOAD (KVA)		_		22kAIC
			ĺ	5	3	3			11]			100kA SPD
							TOTAL LOAD (A)							

ELECTRICAL PANEL BOARD SCHEDULES - SHEET 6


DATE:	FEB 2025
HAZEN NO.:	90388-000
CONTRACT NO.:	A1364-A
DRAWING NUMBER:	
	E-017

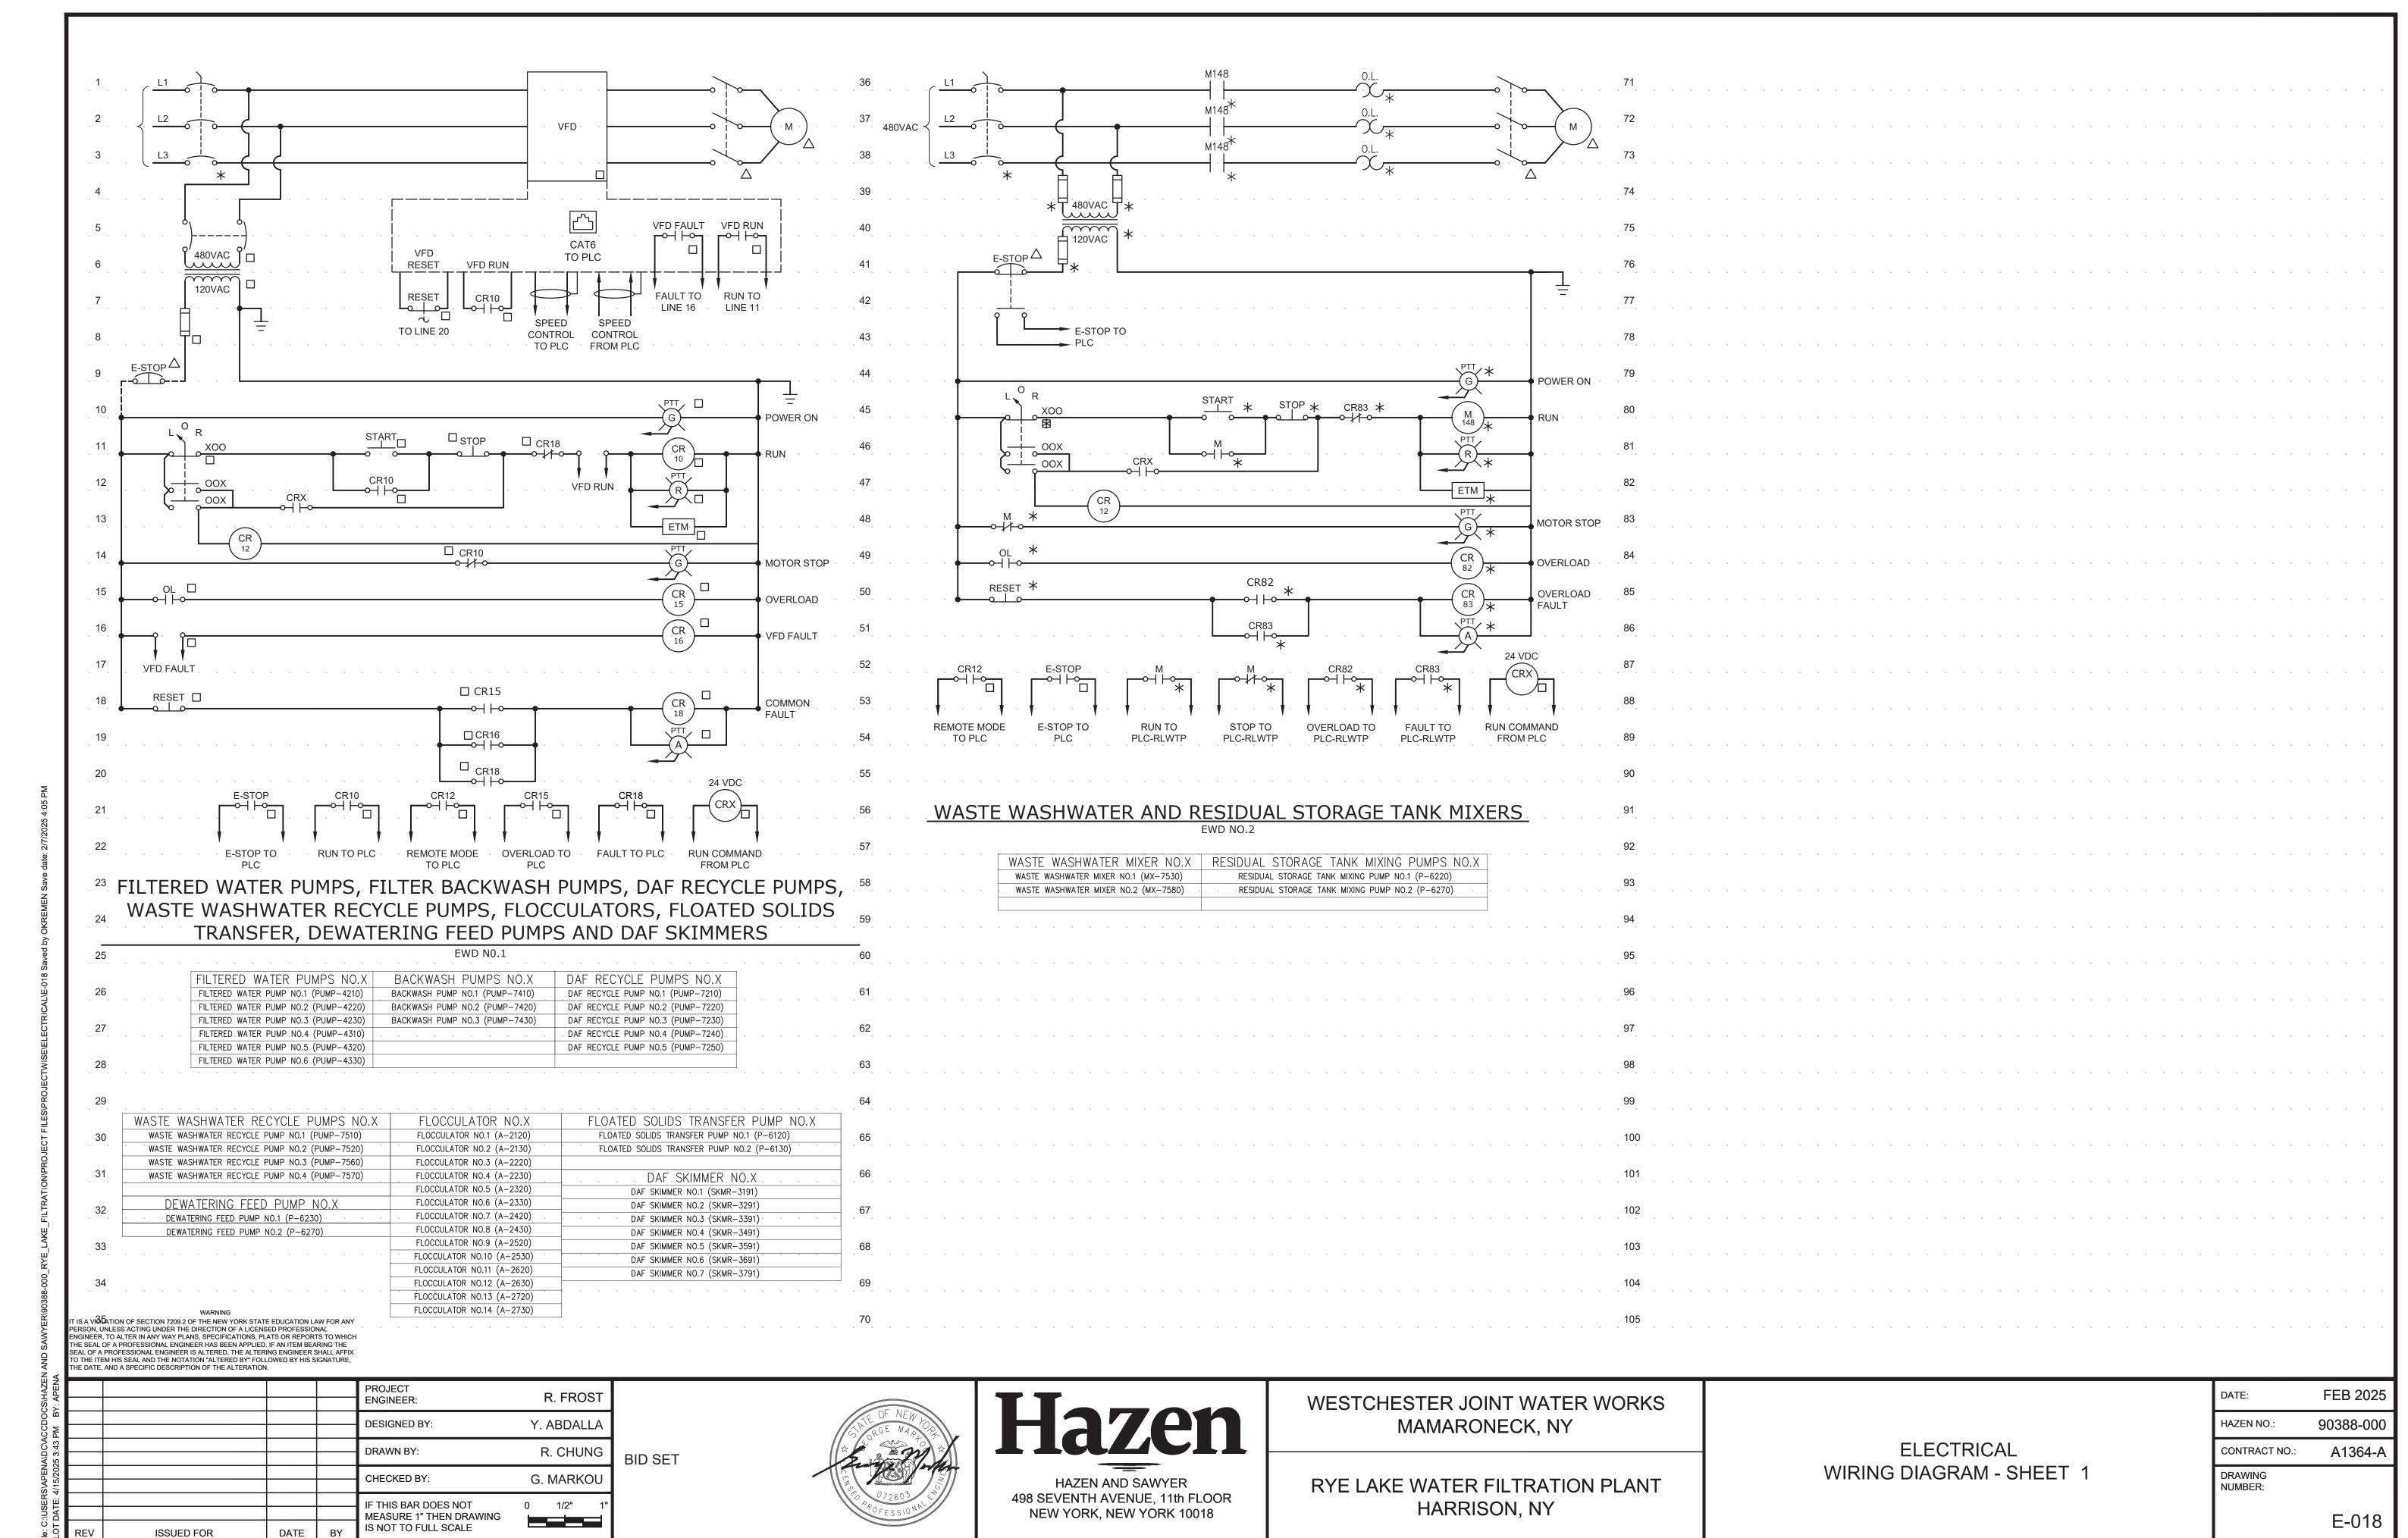

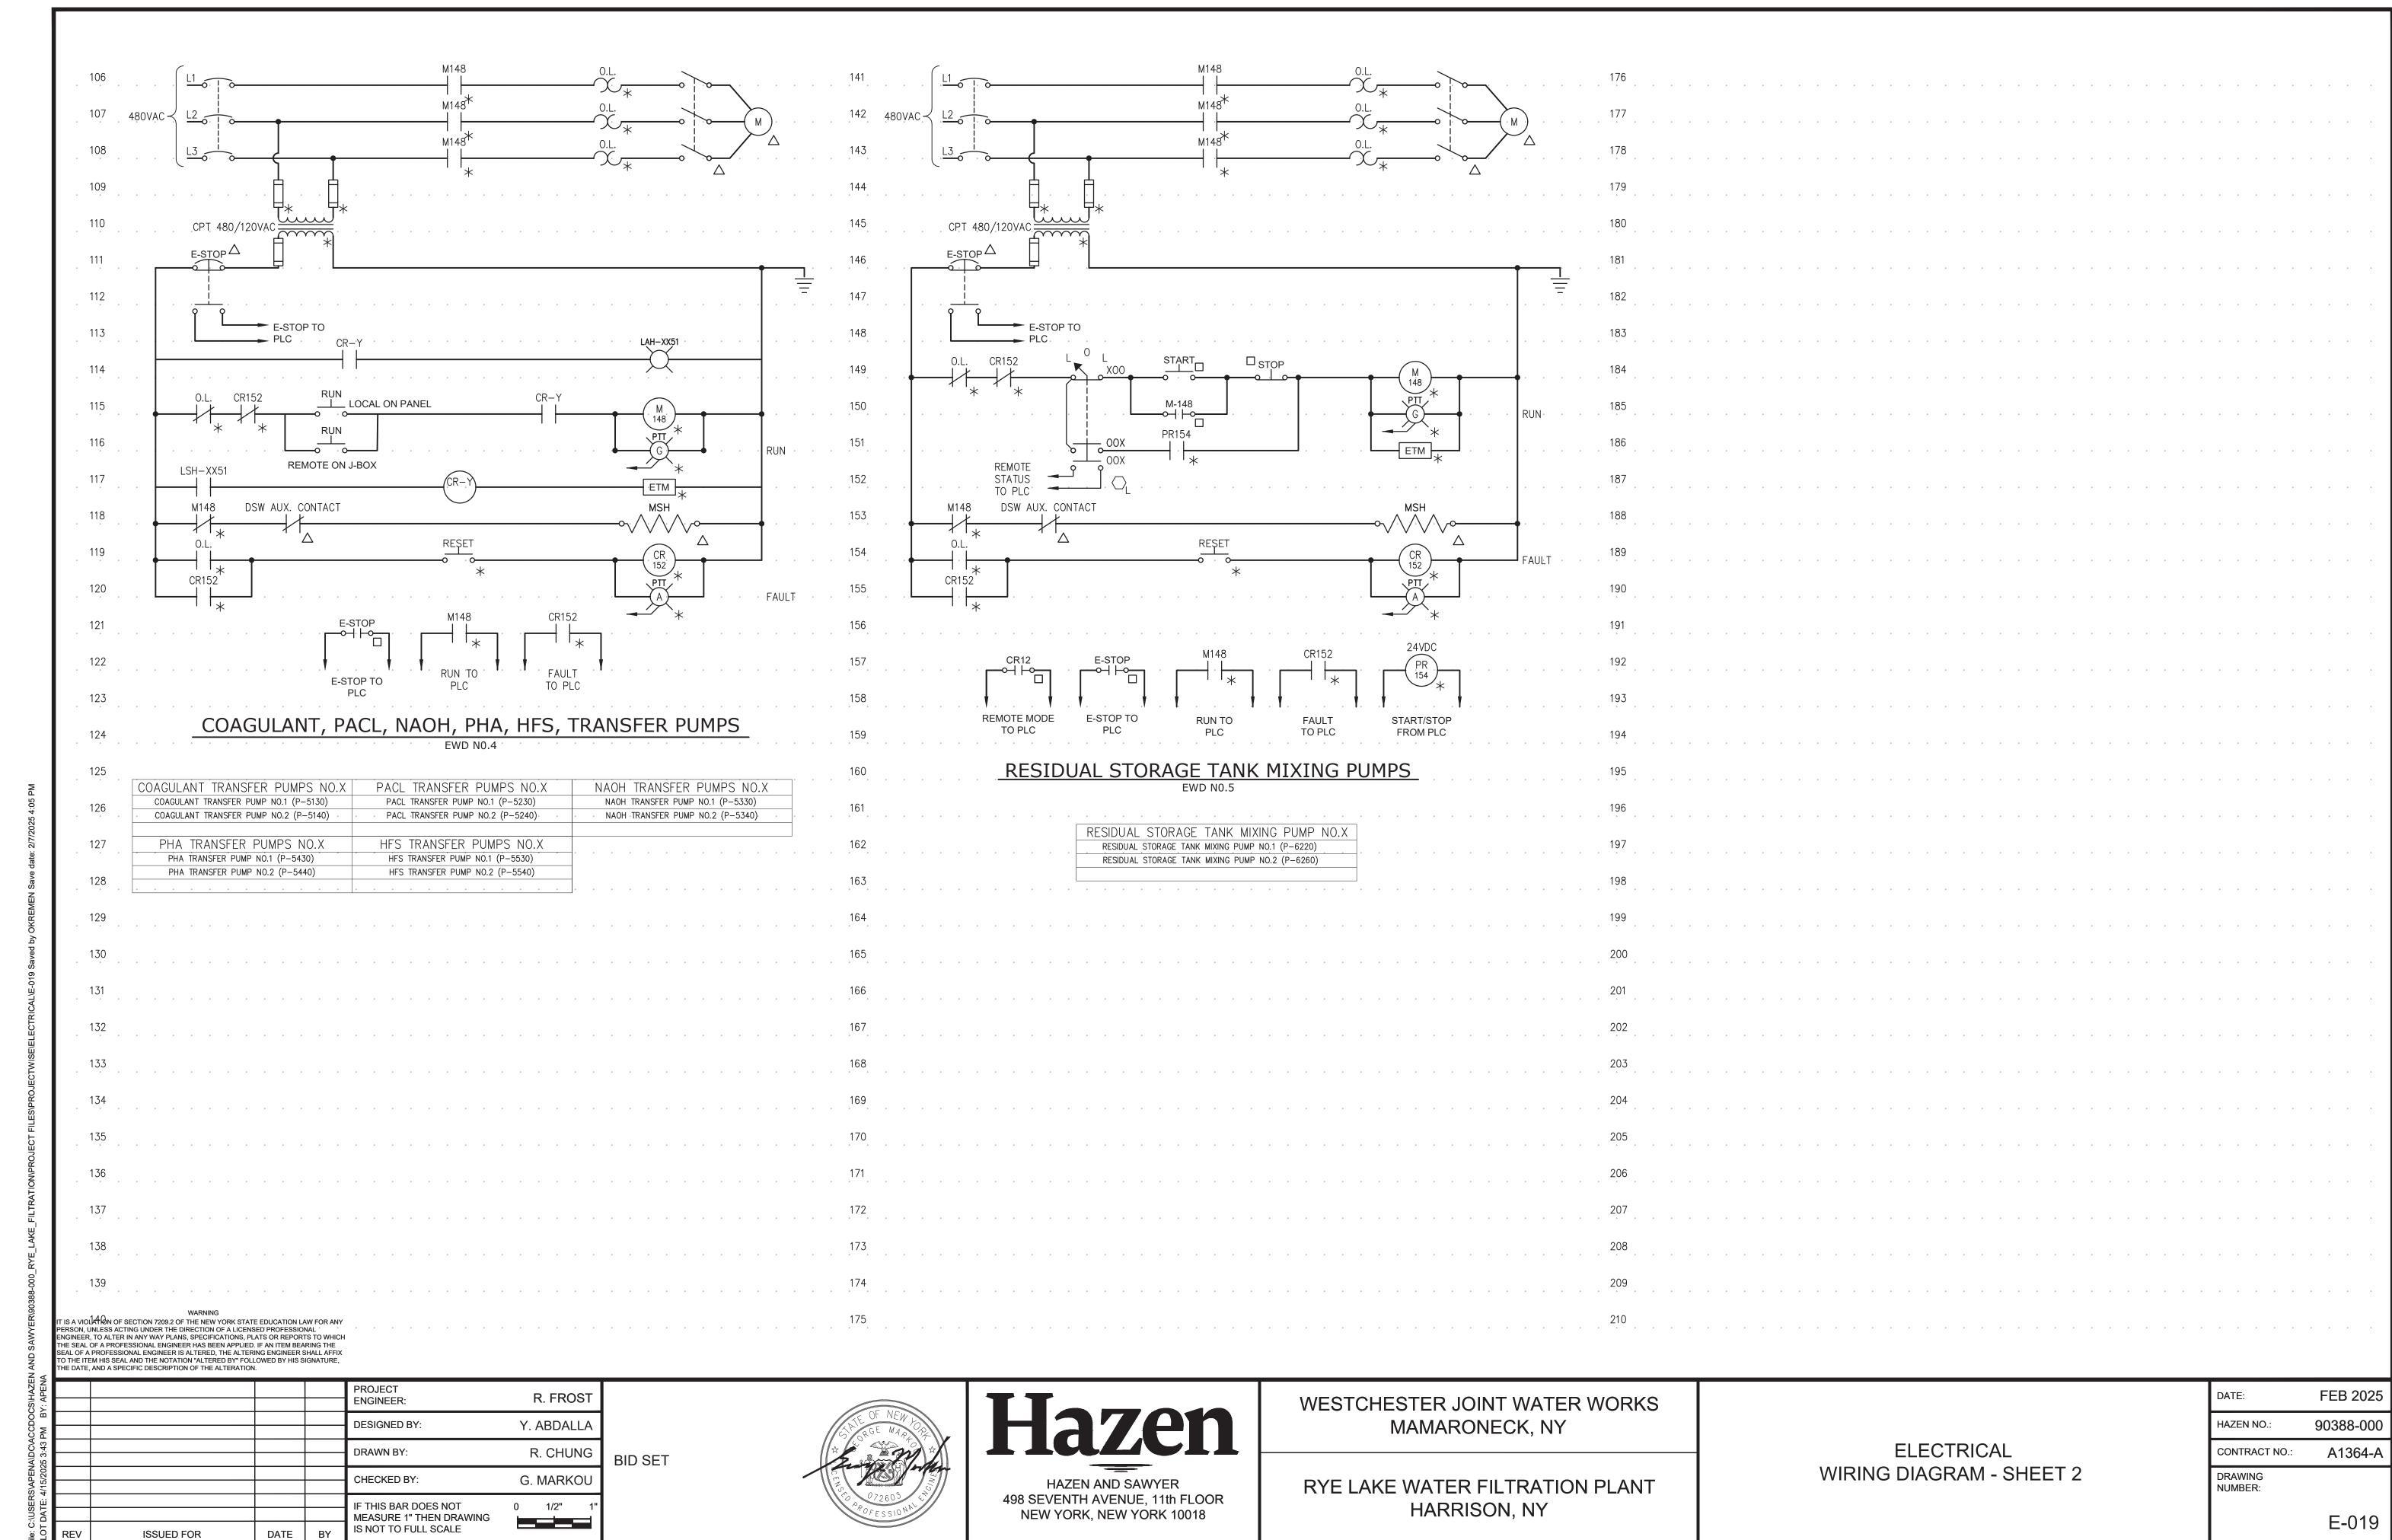


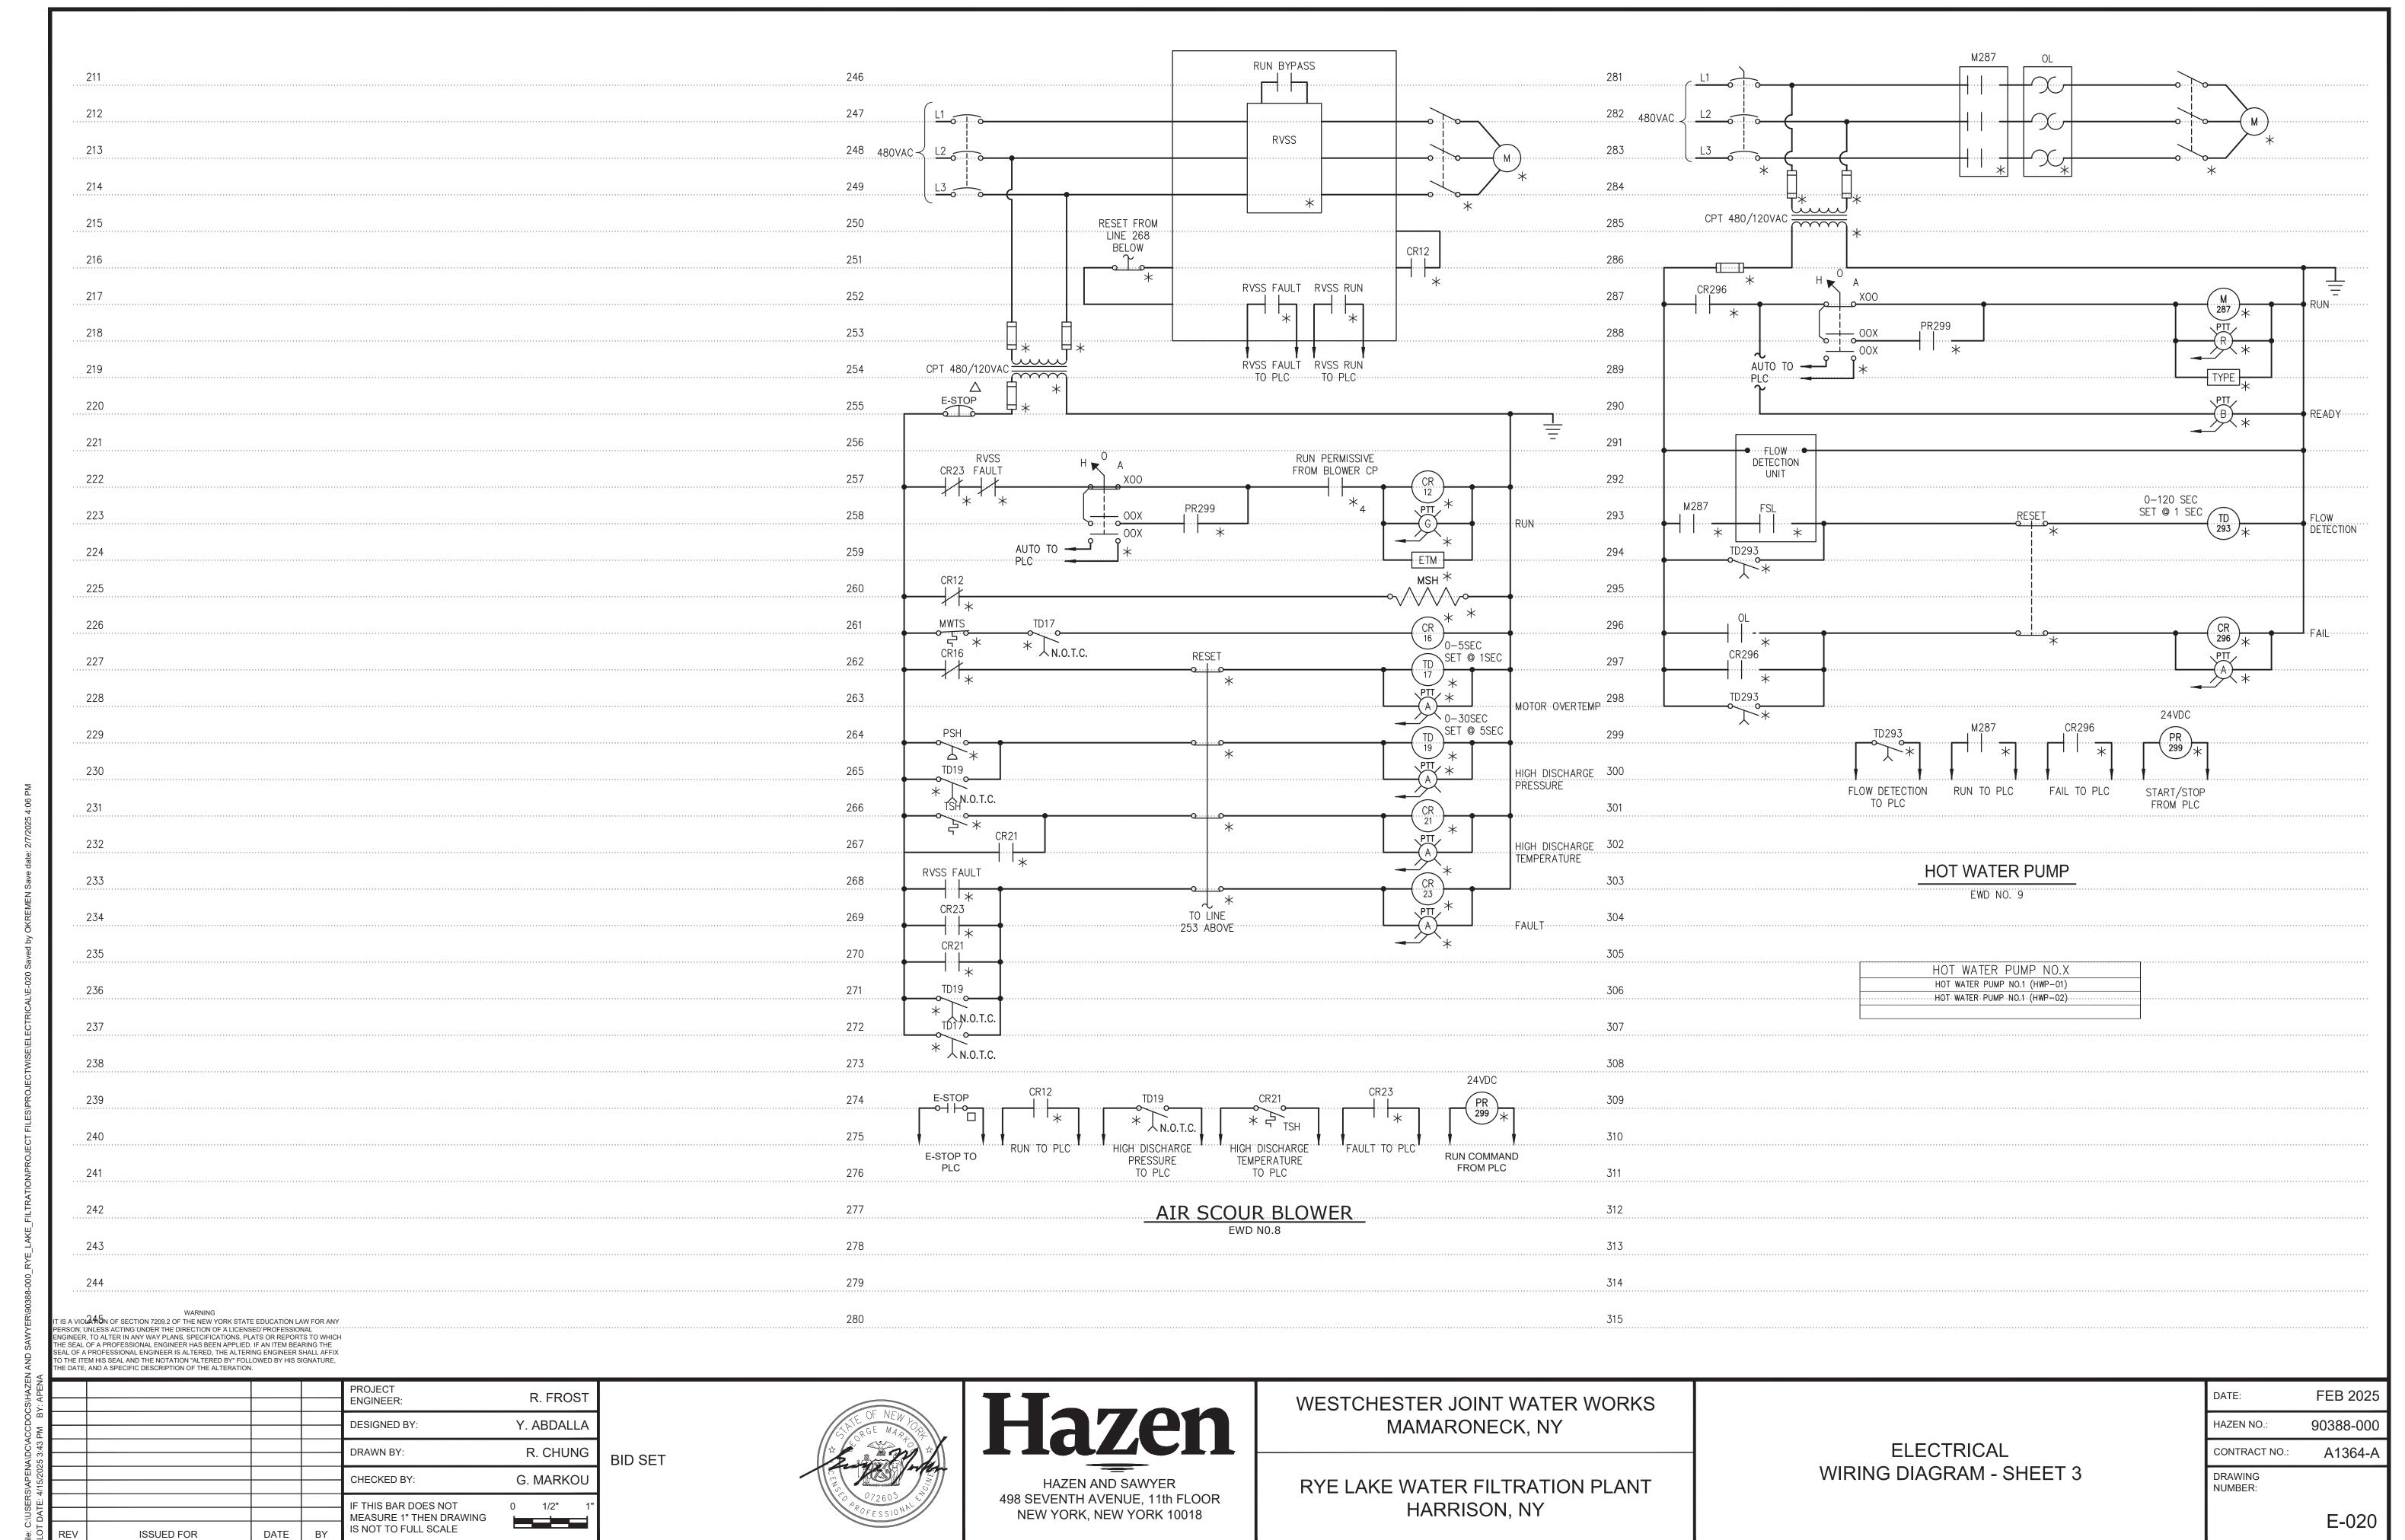



325 of 392

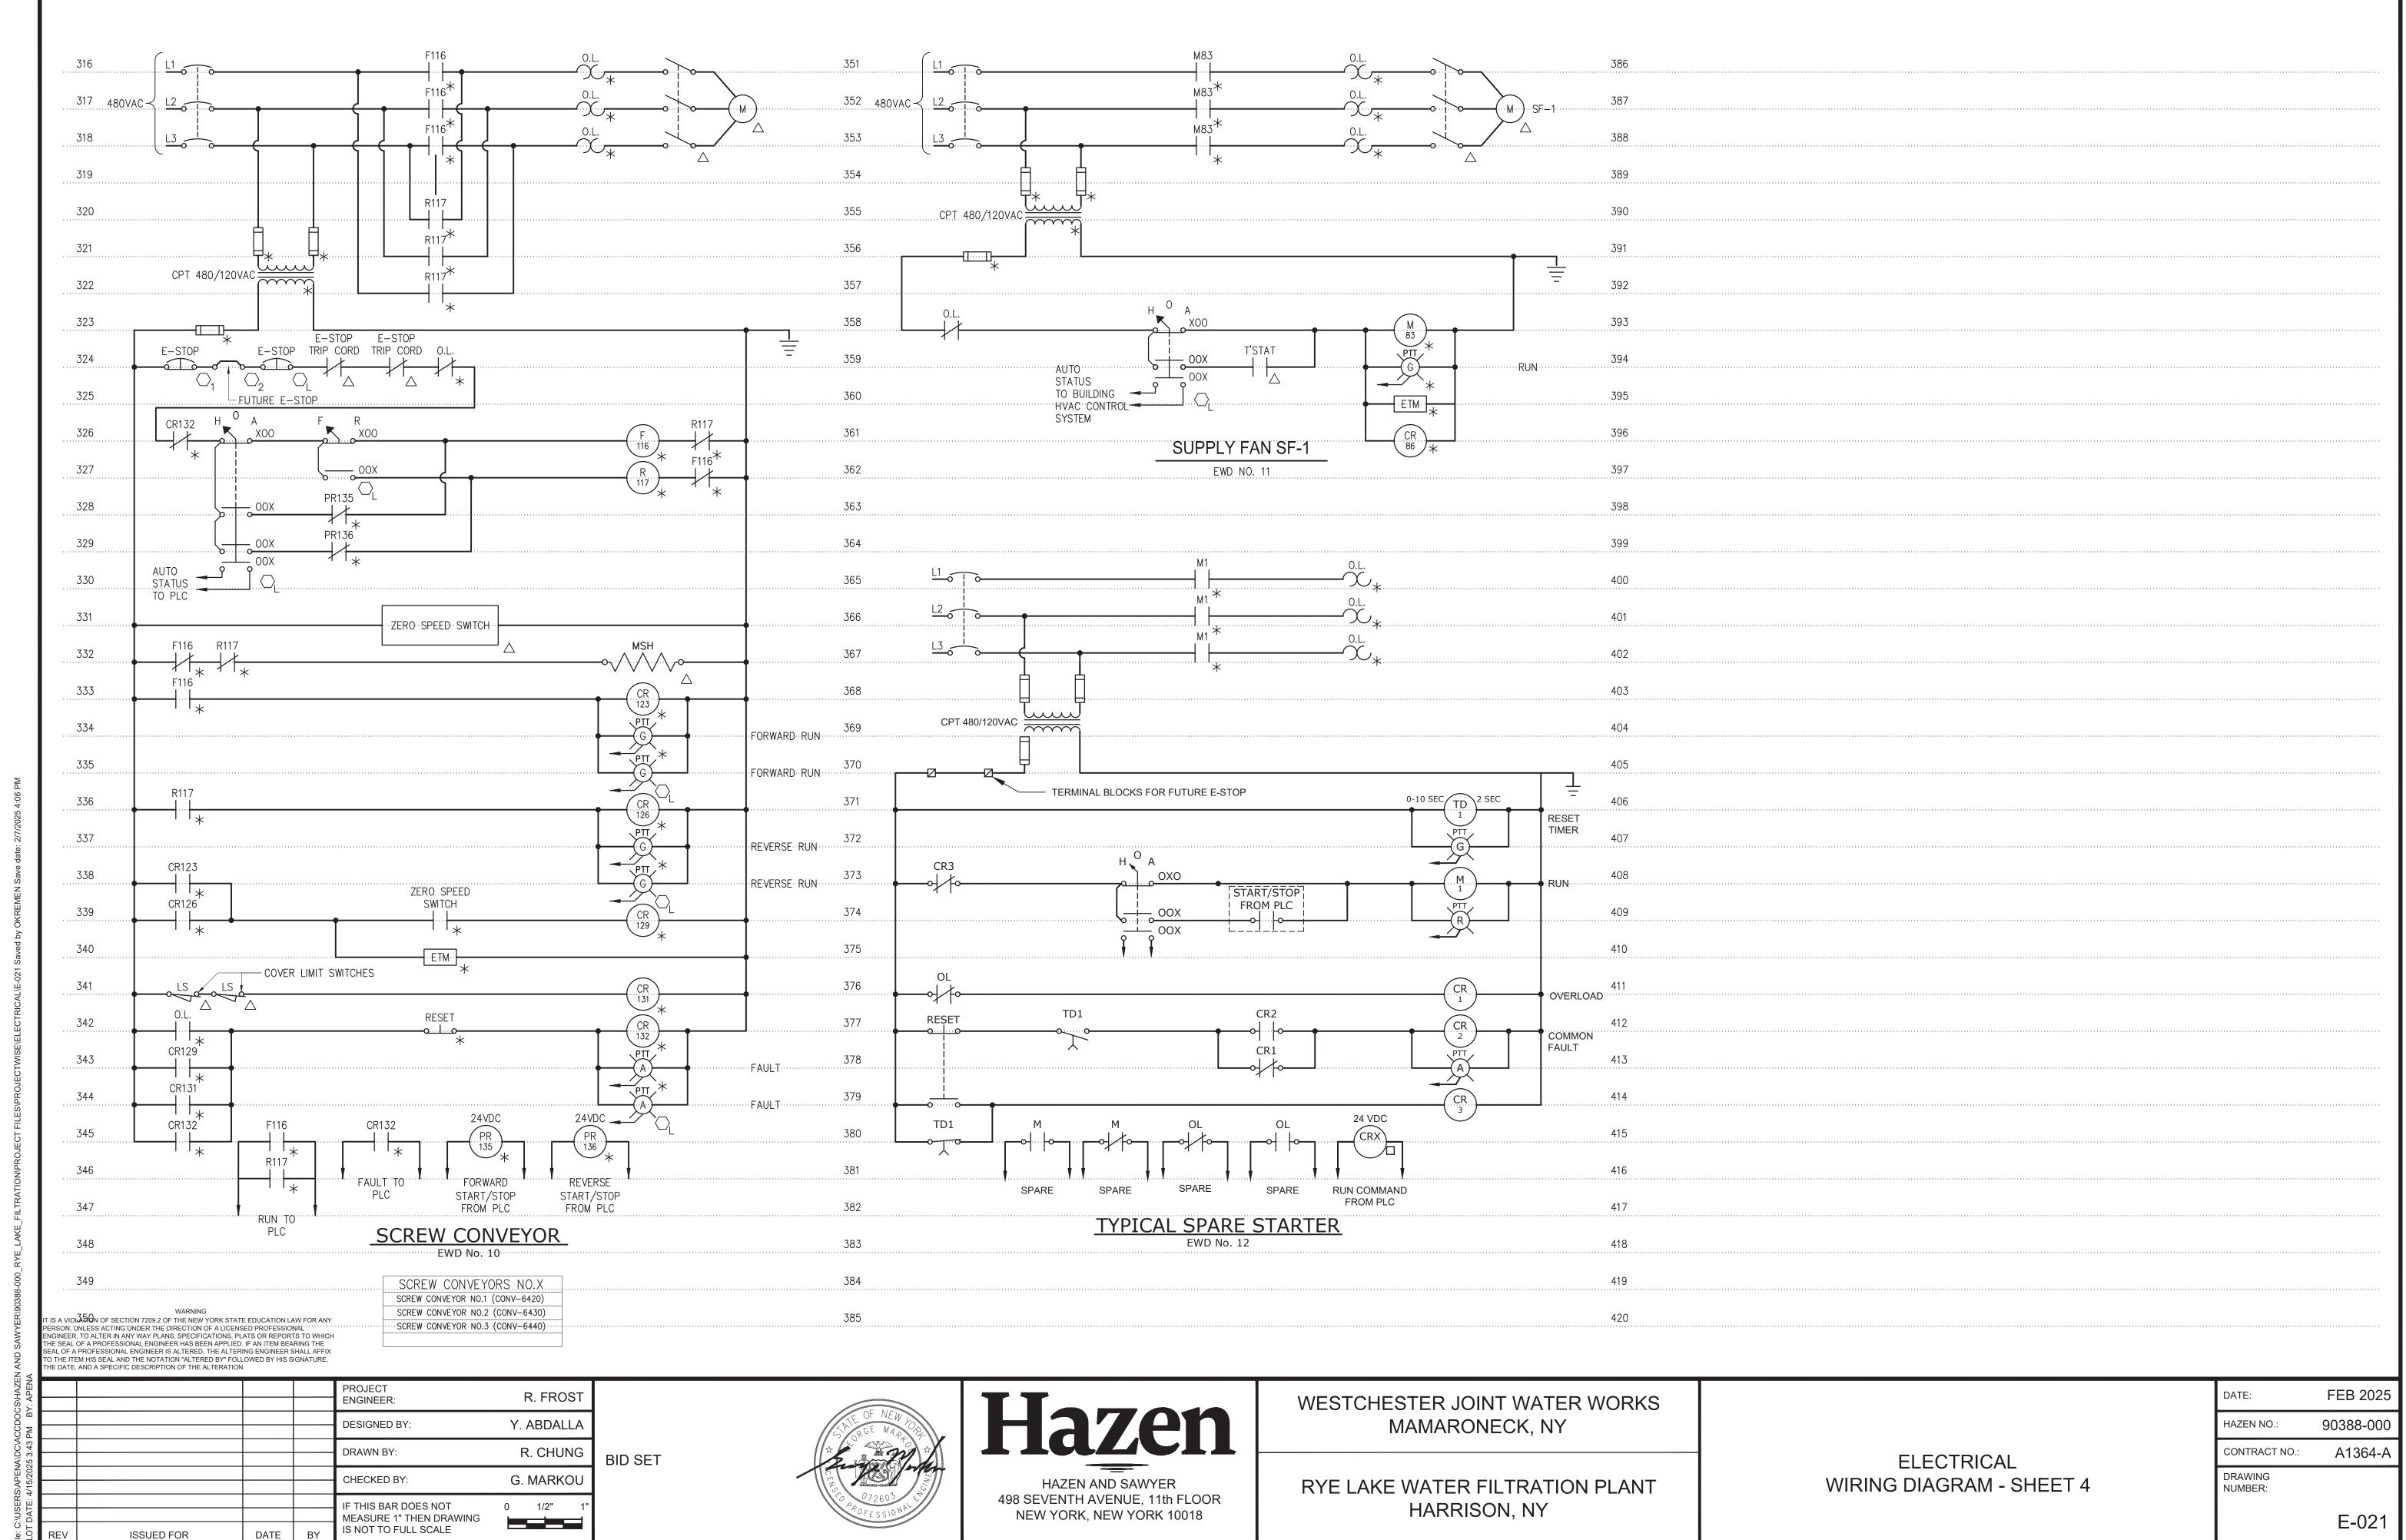



326 of 392

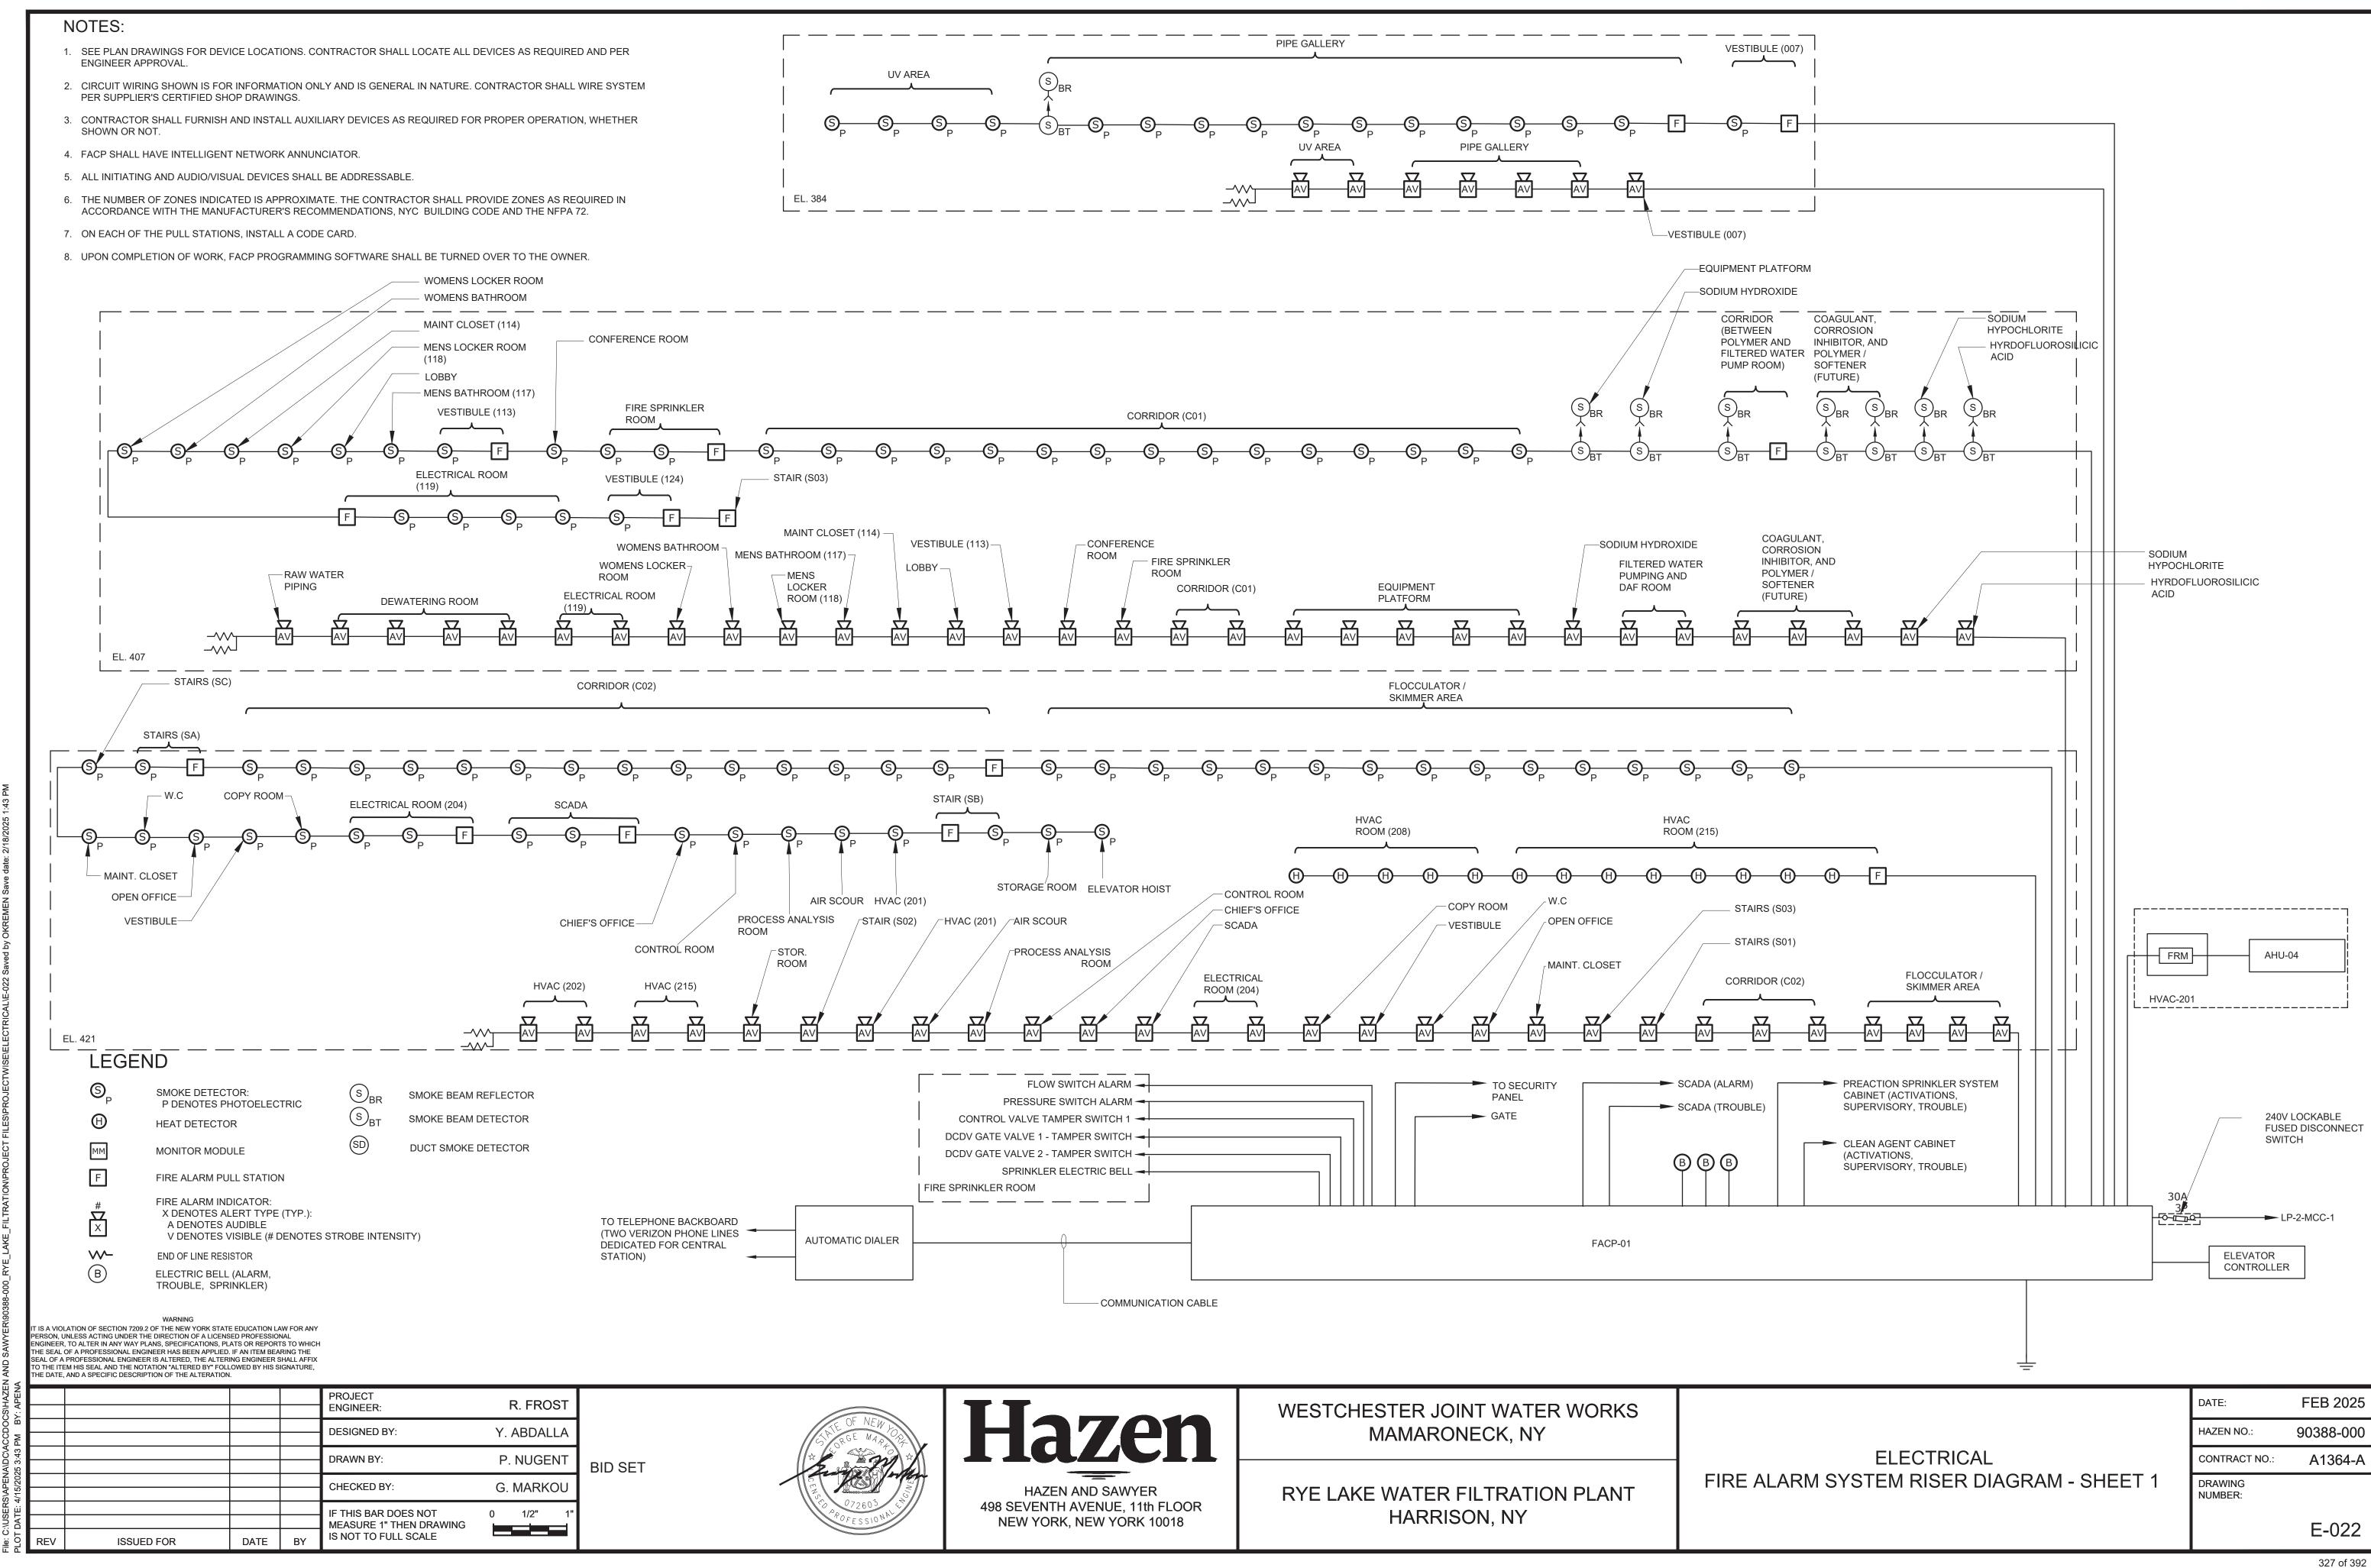


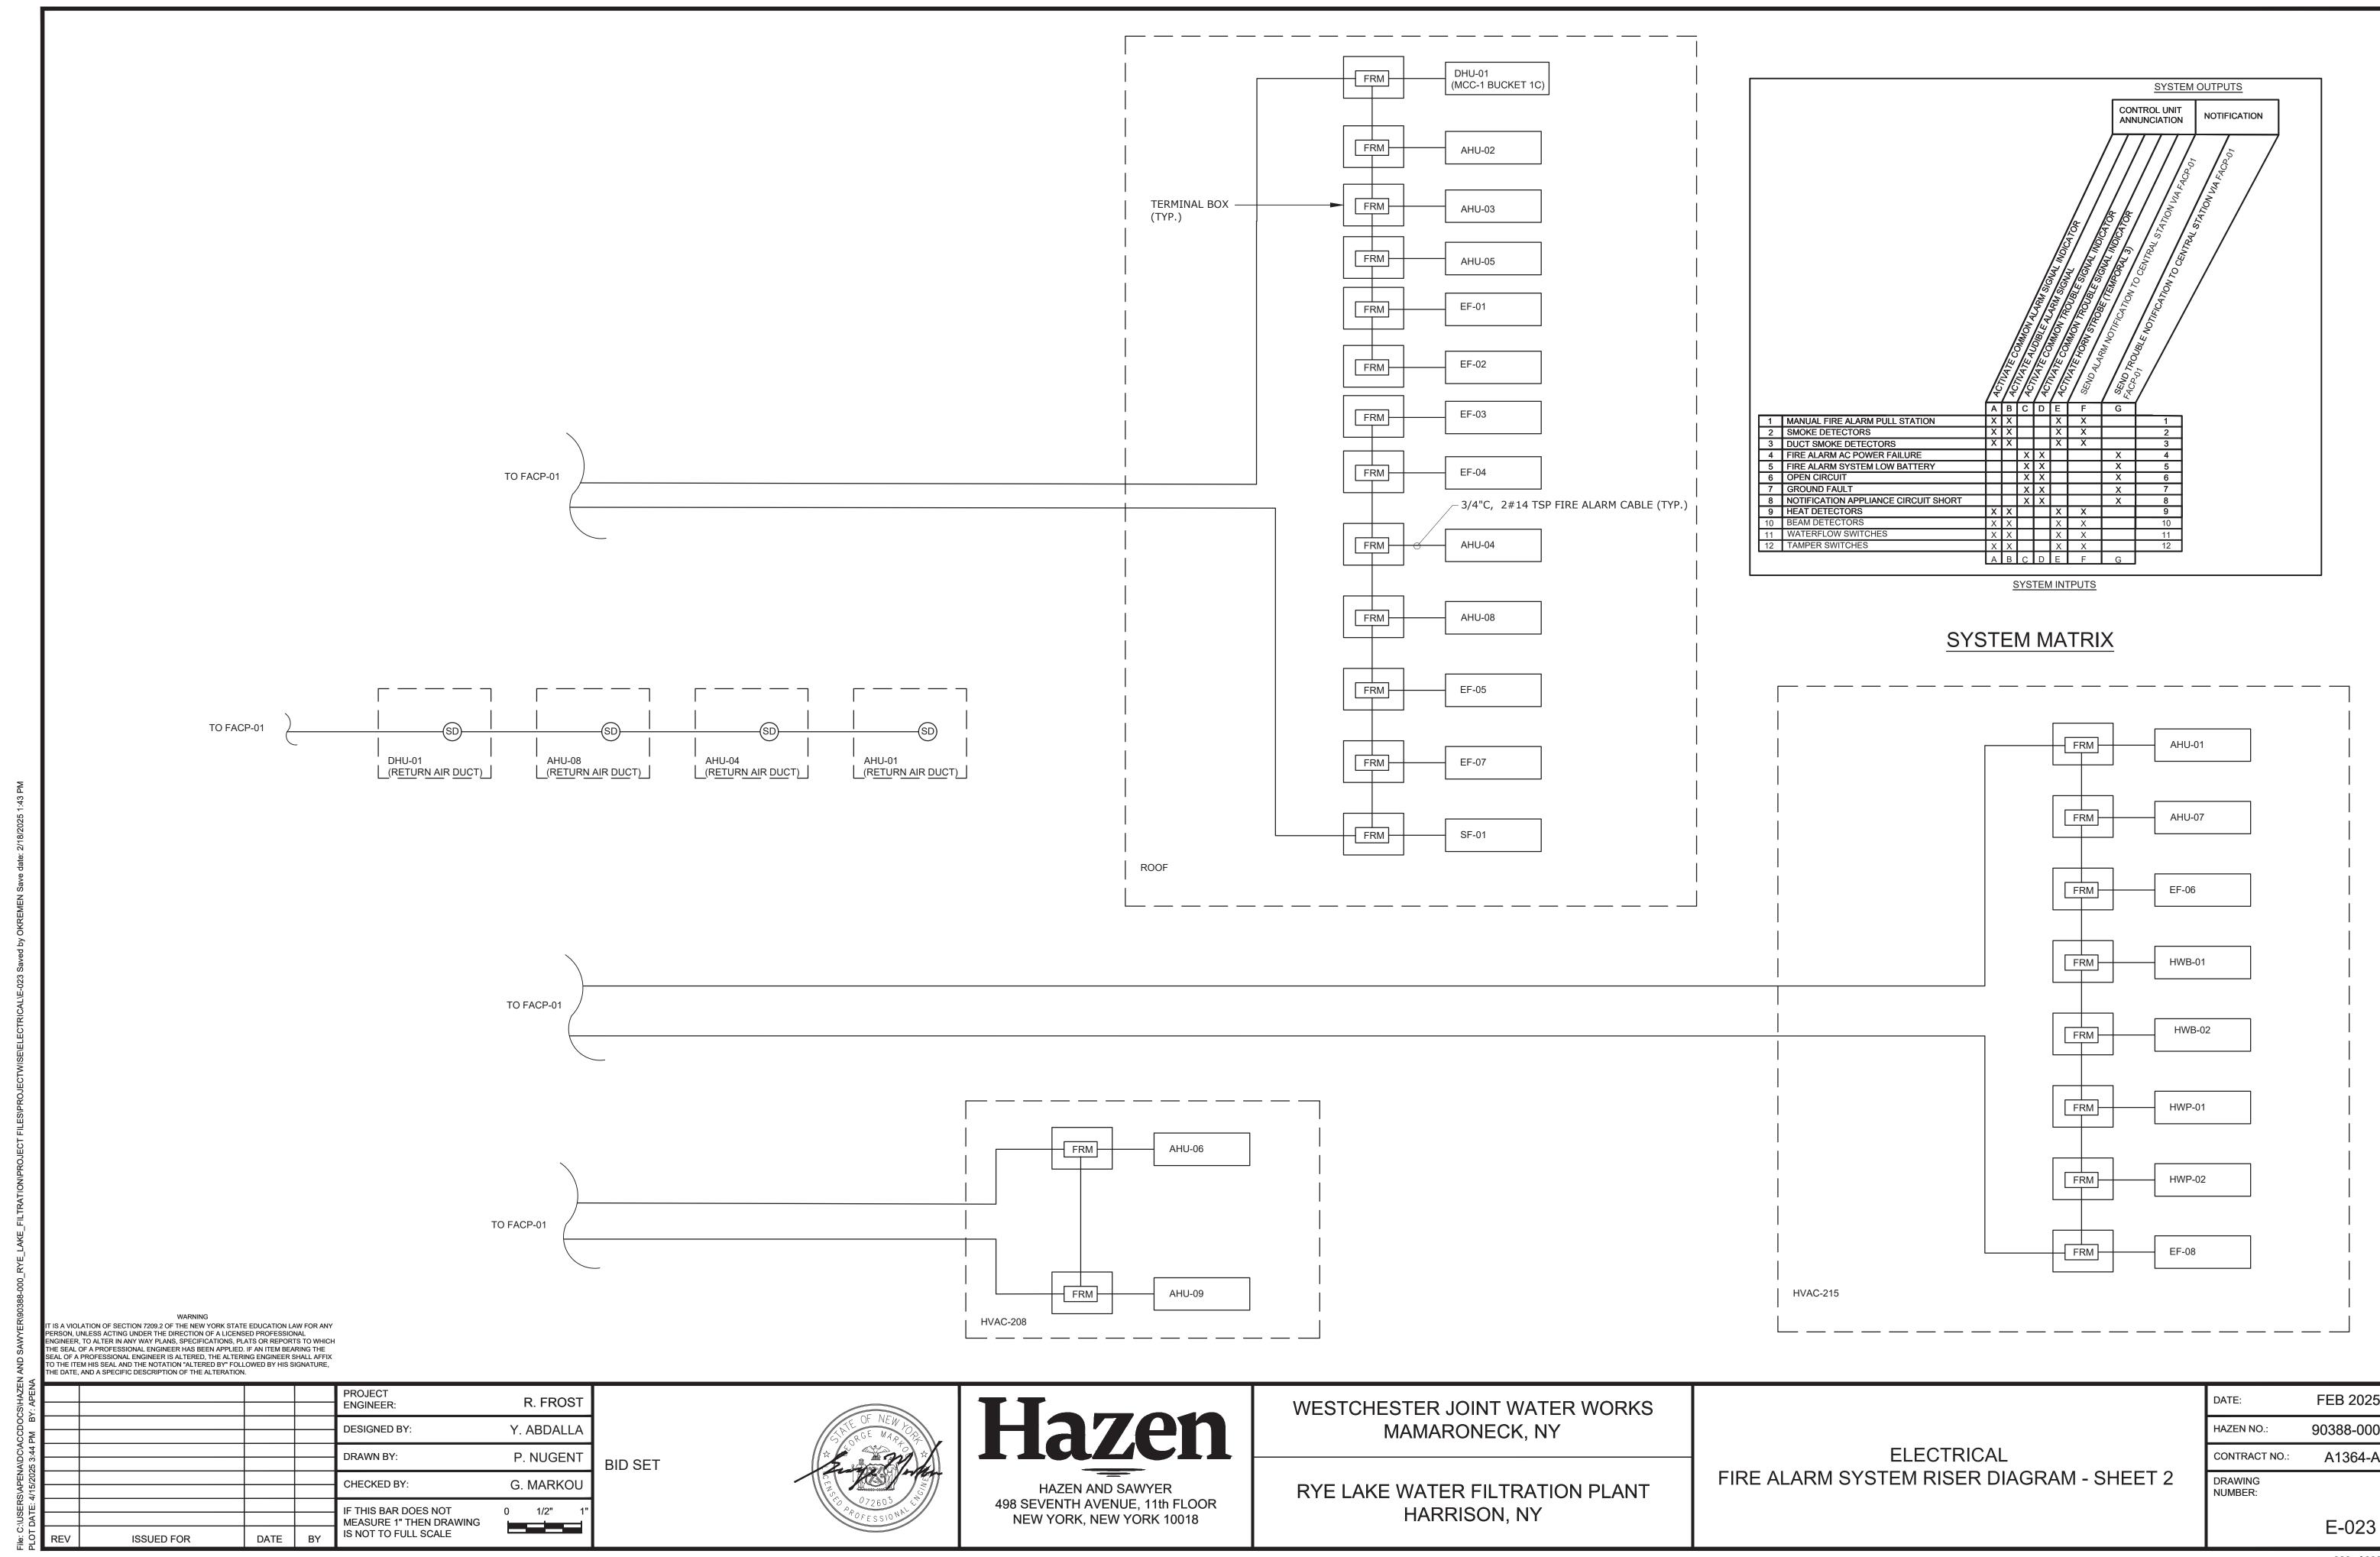


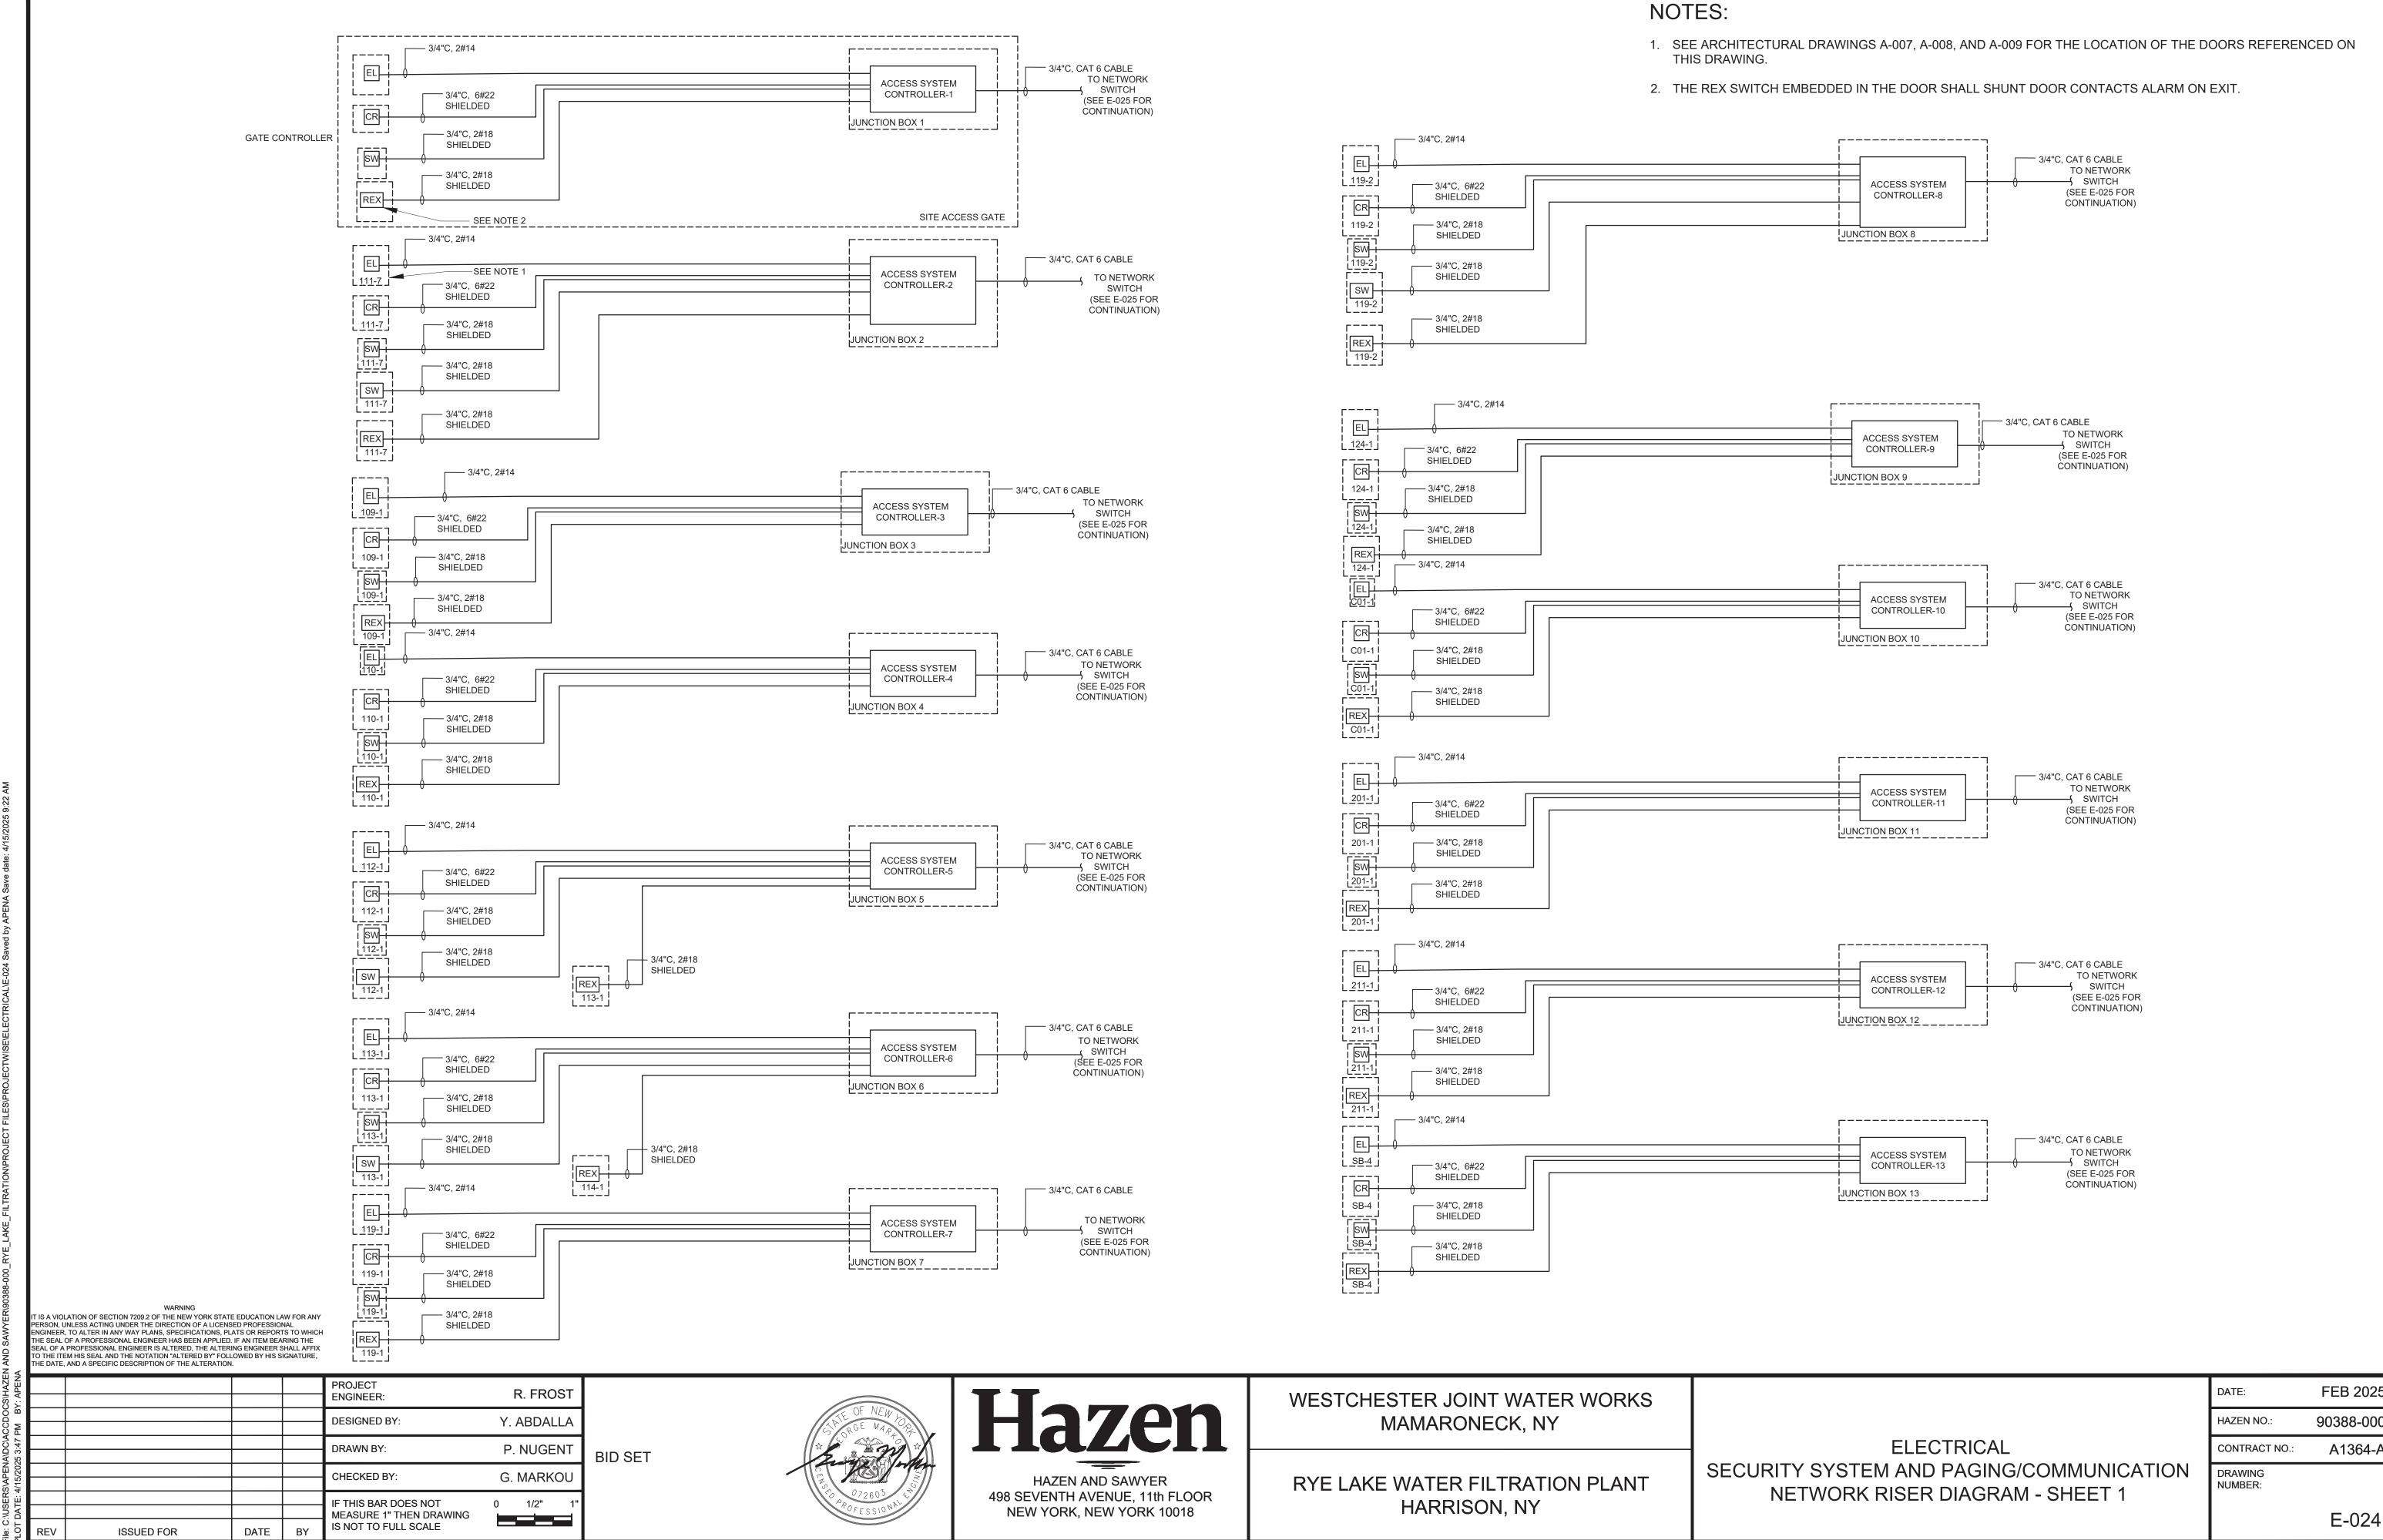


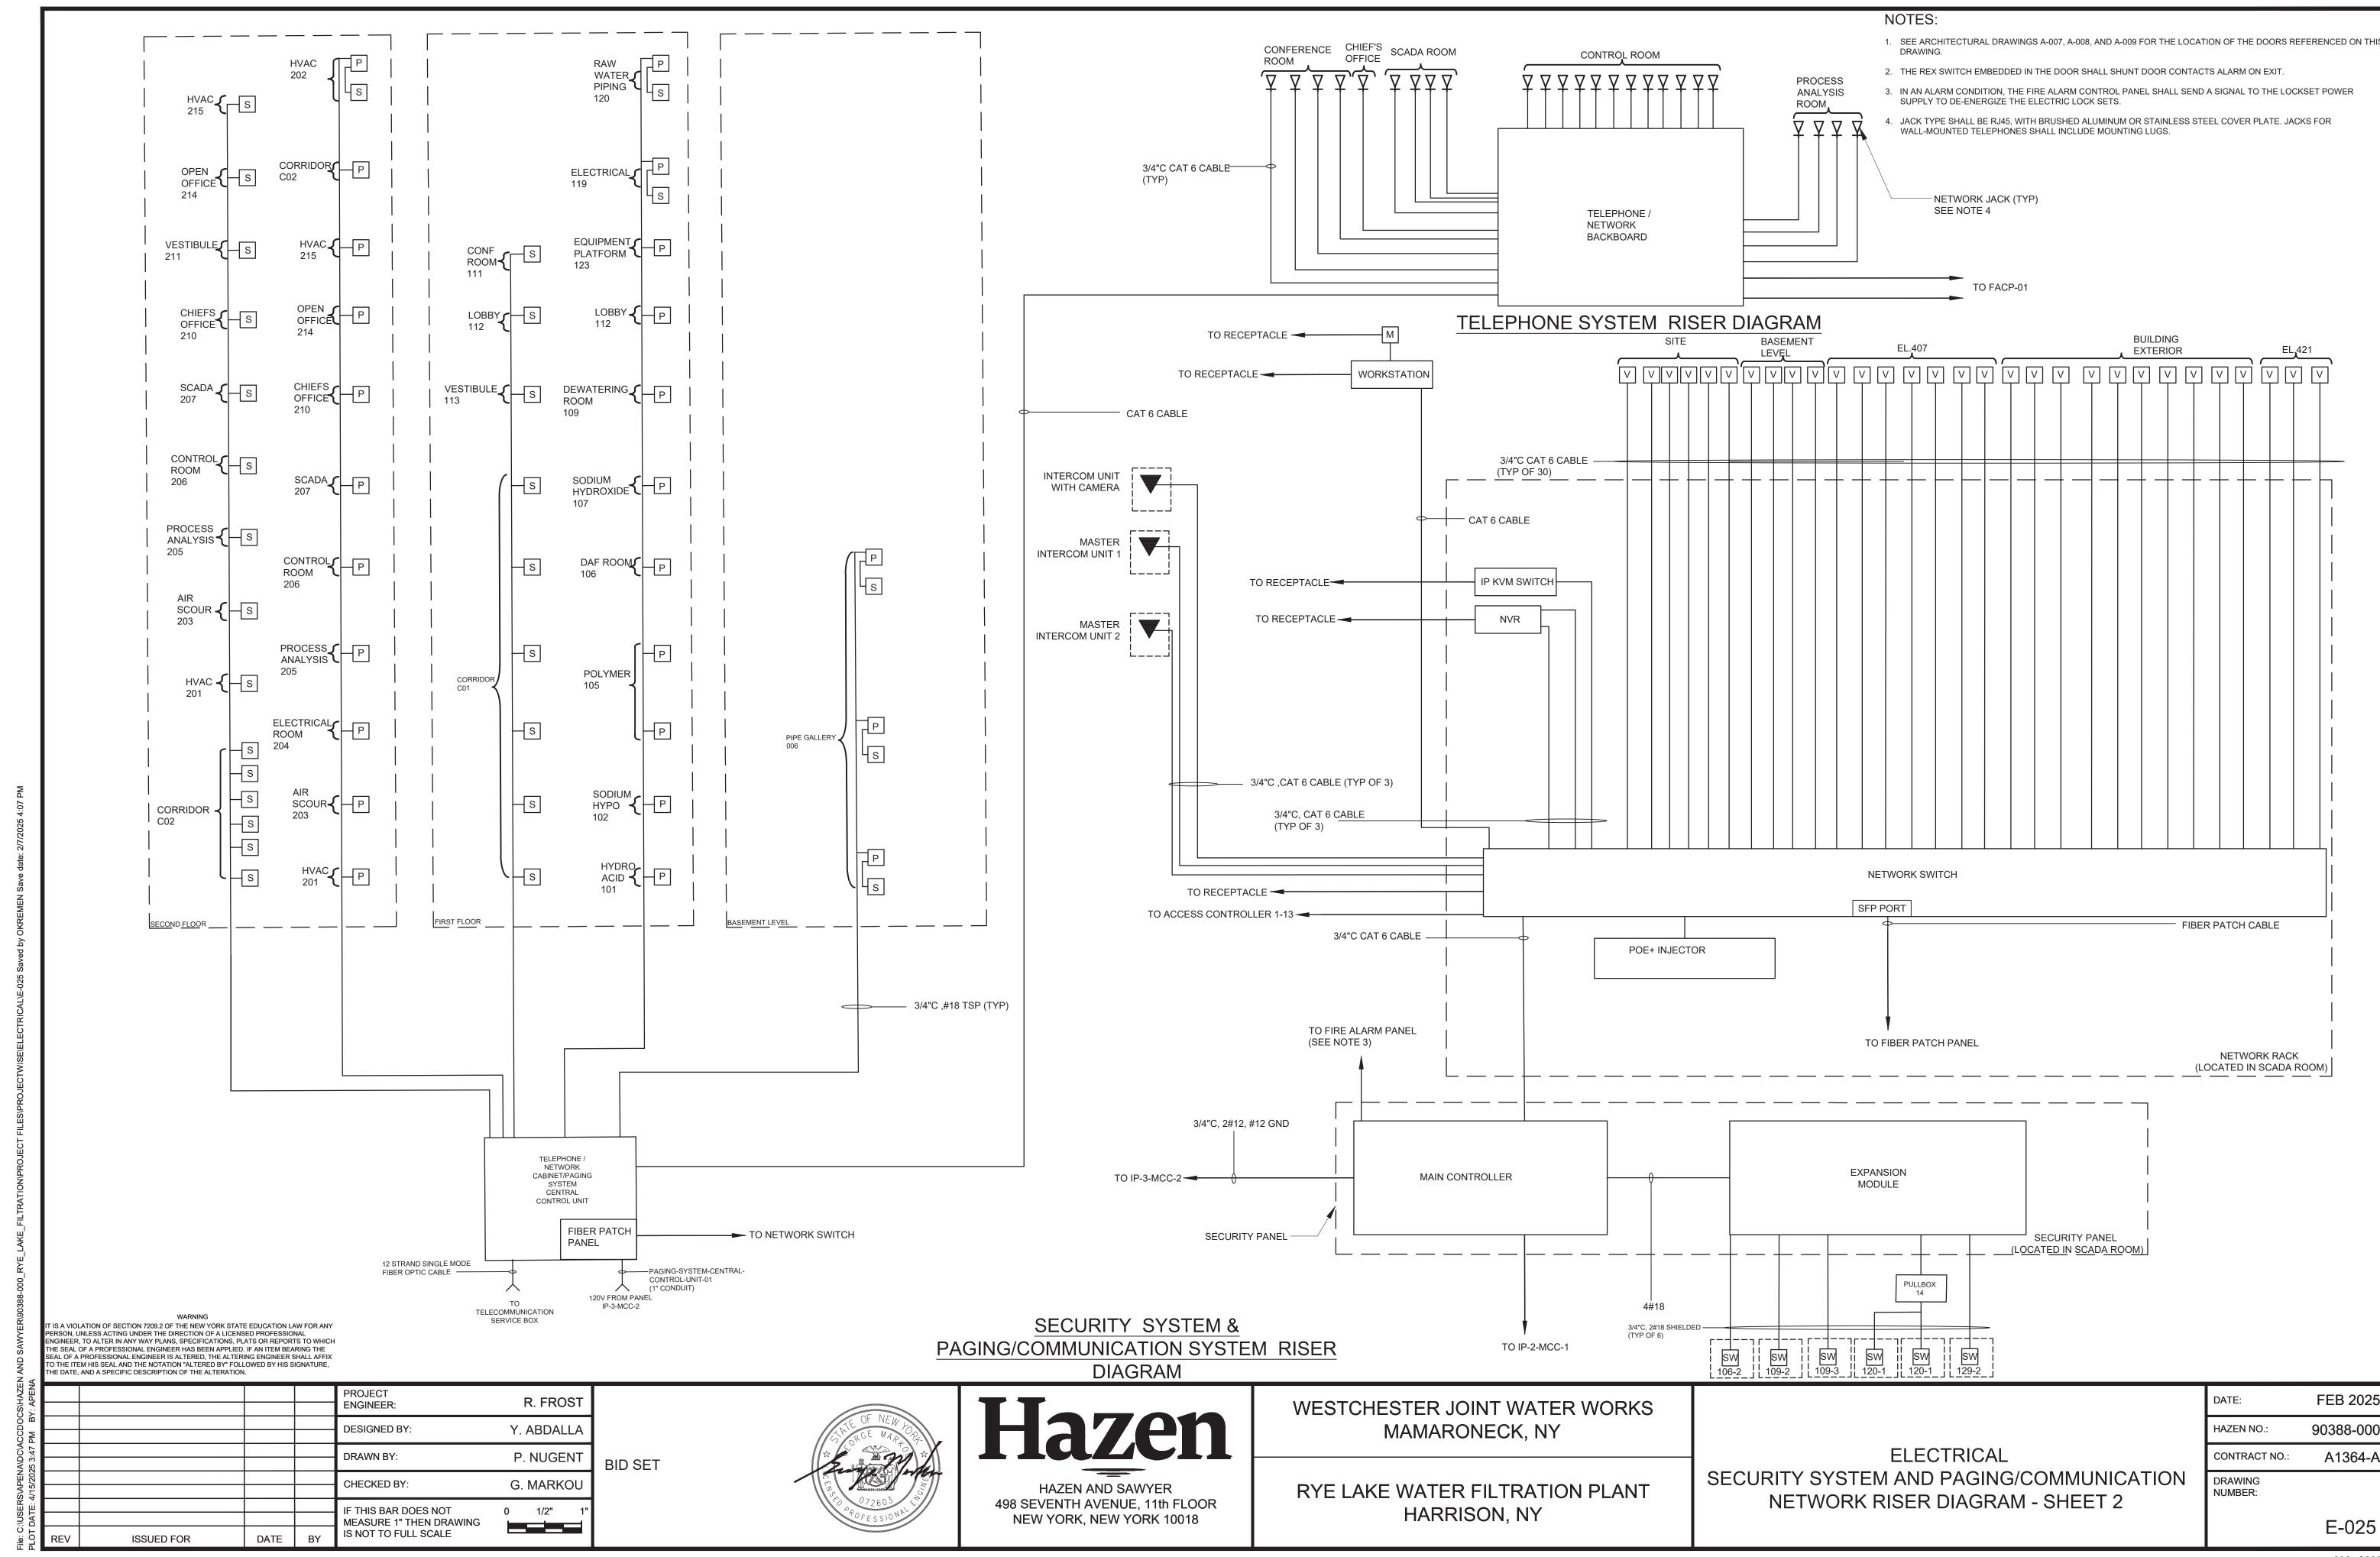

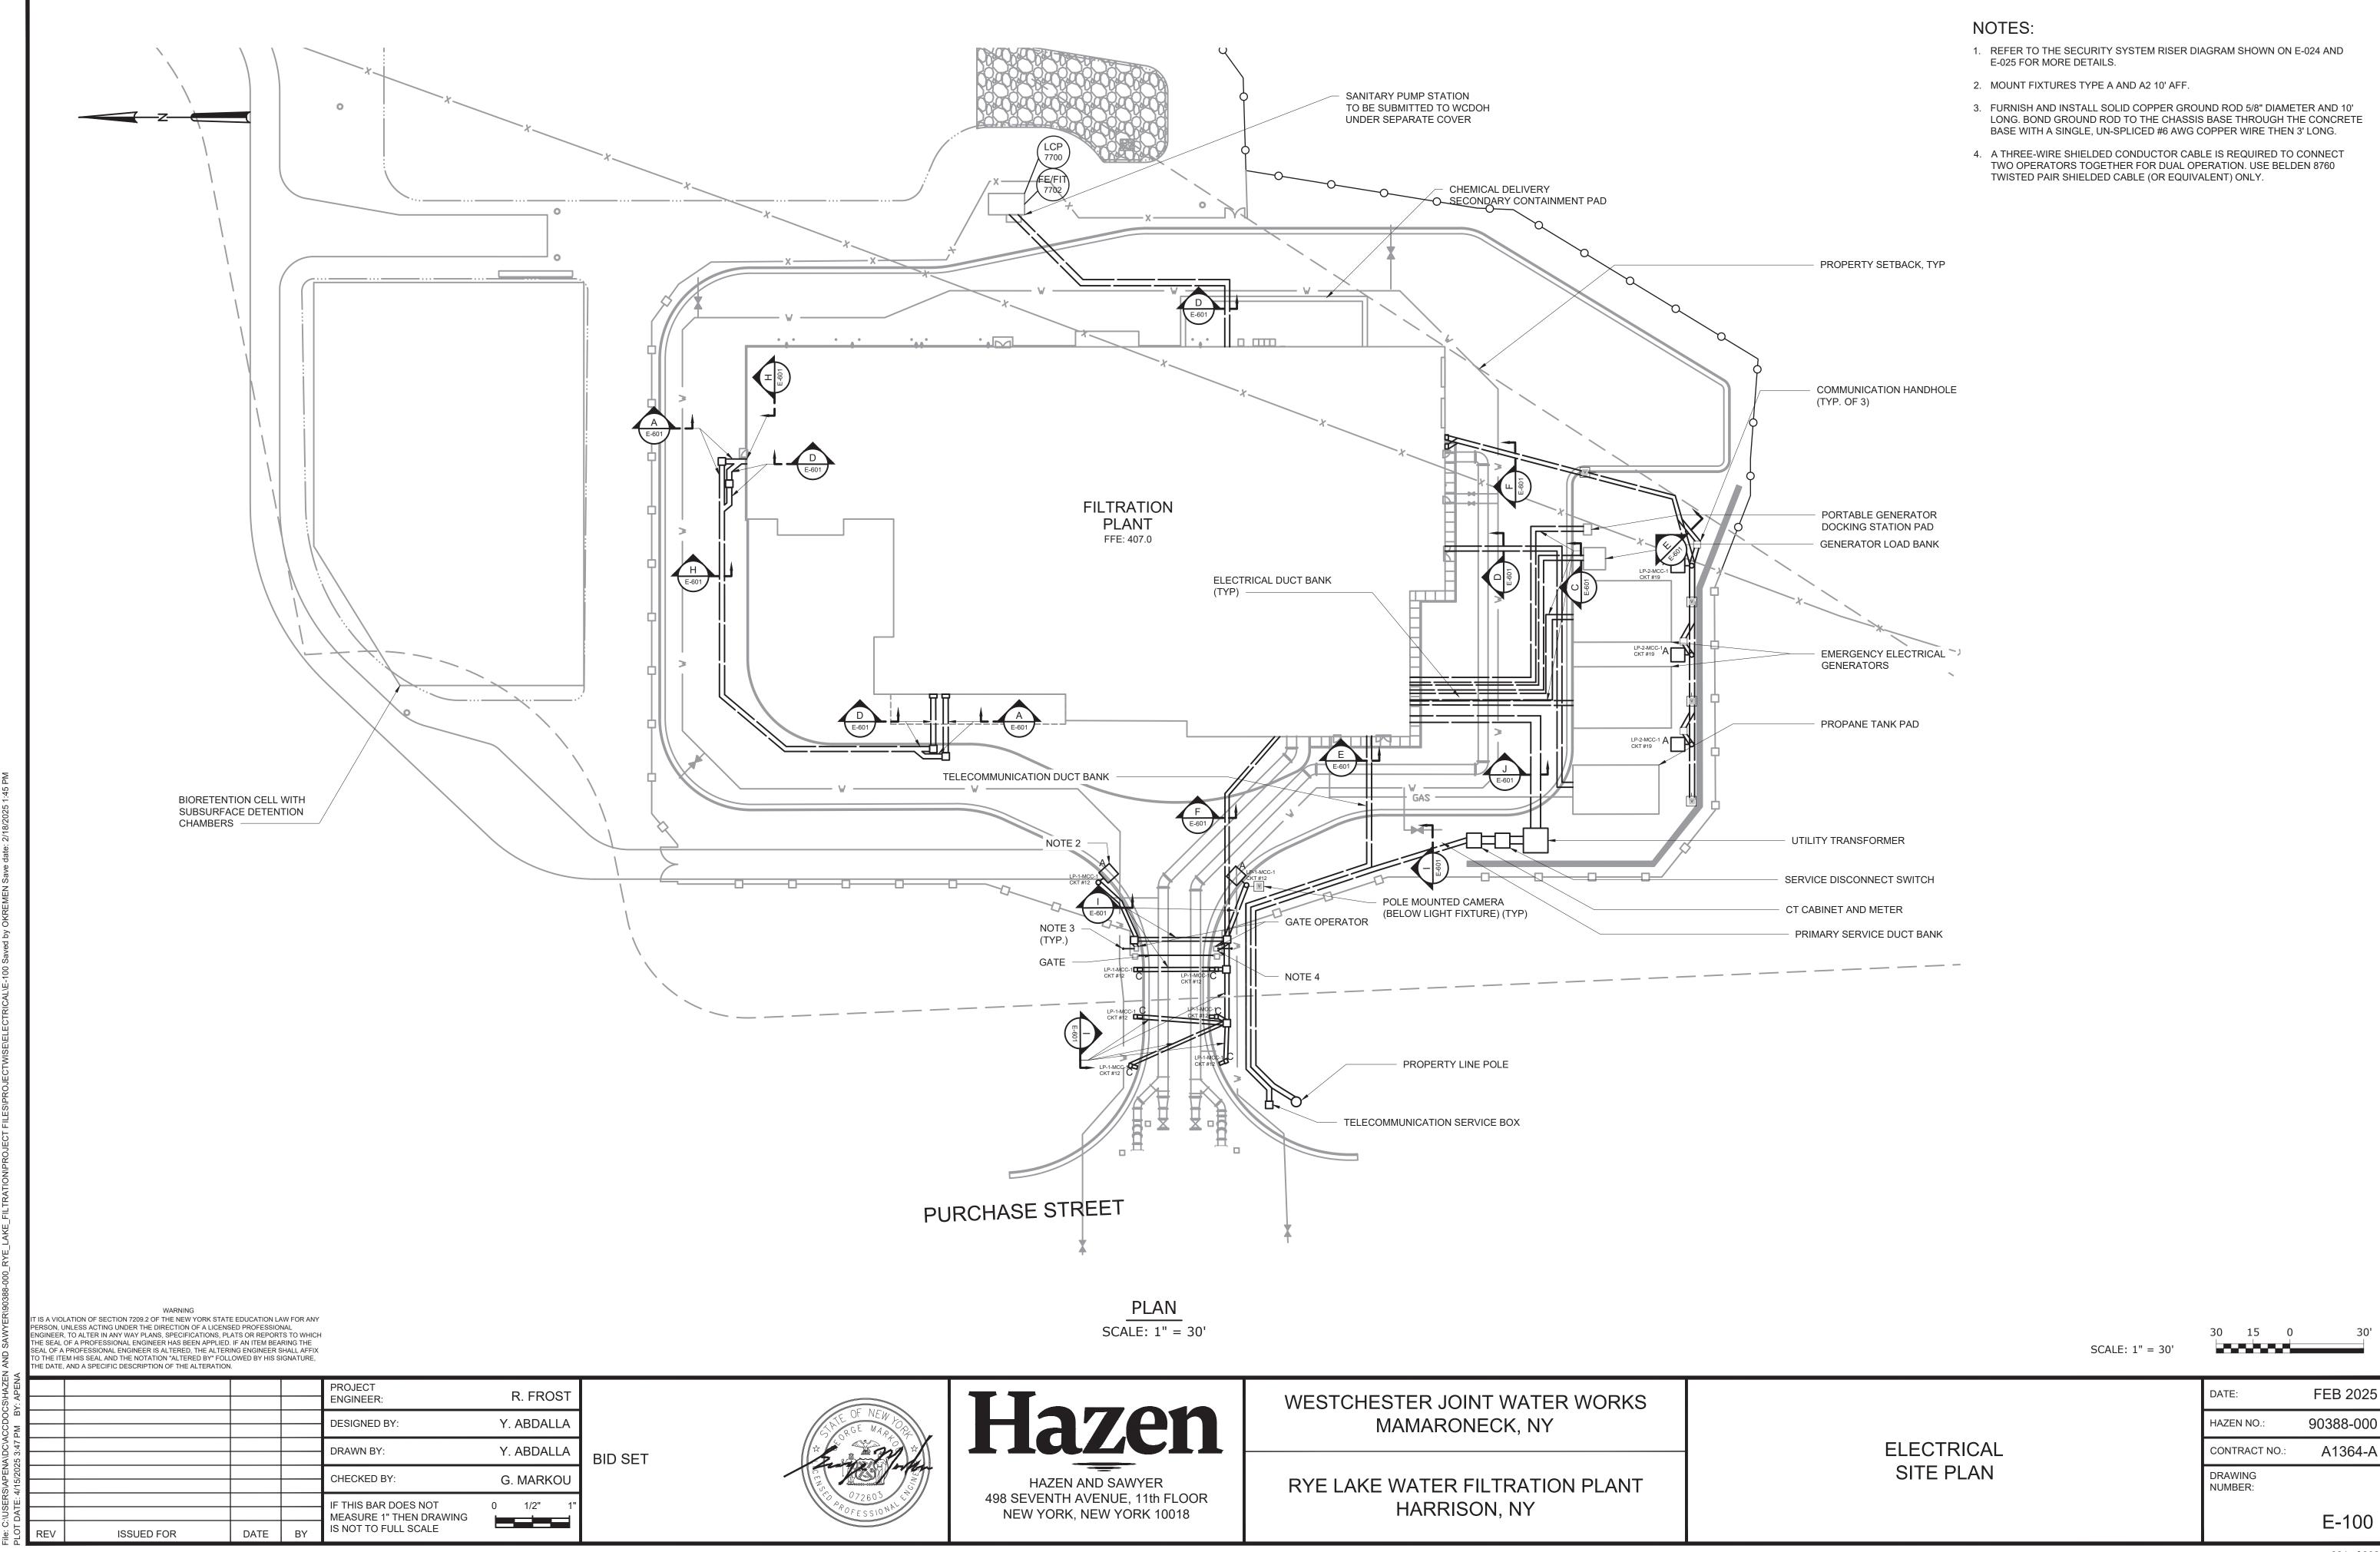

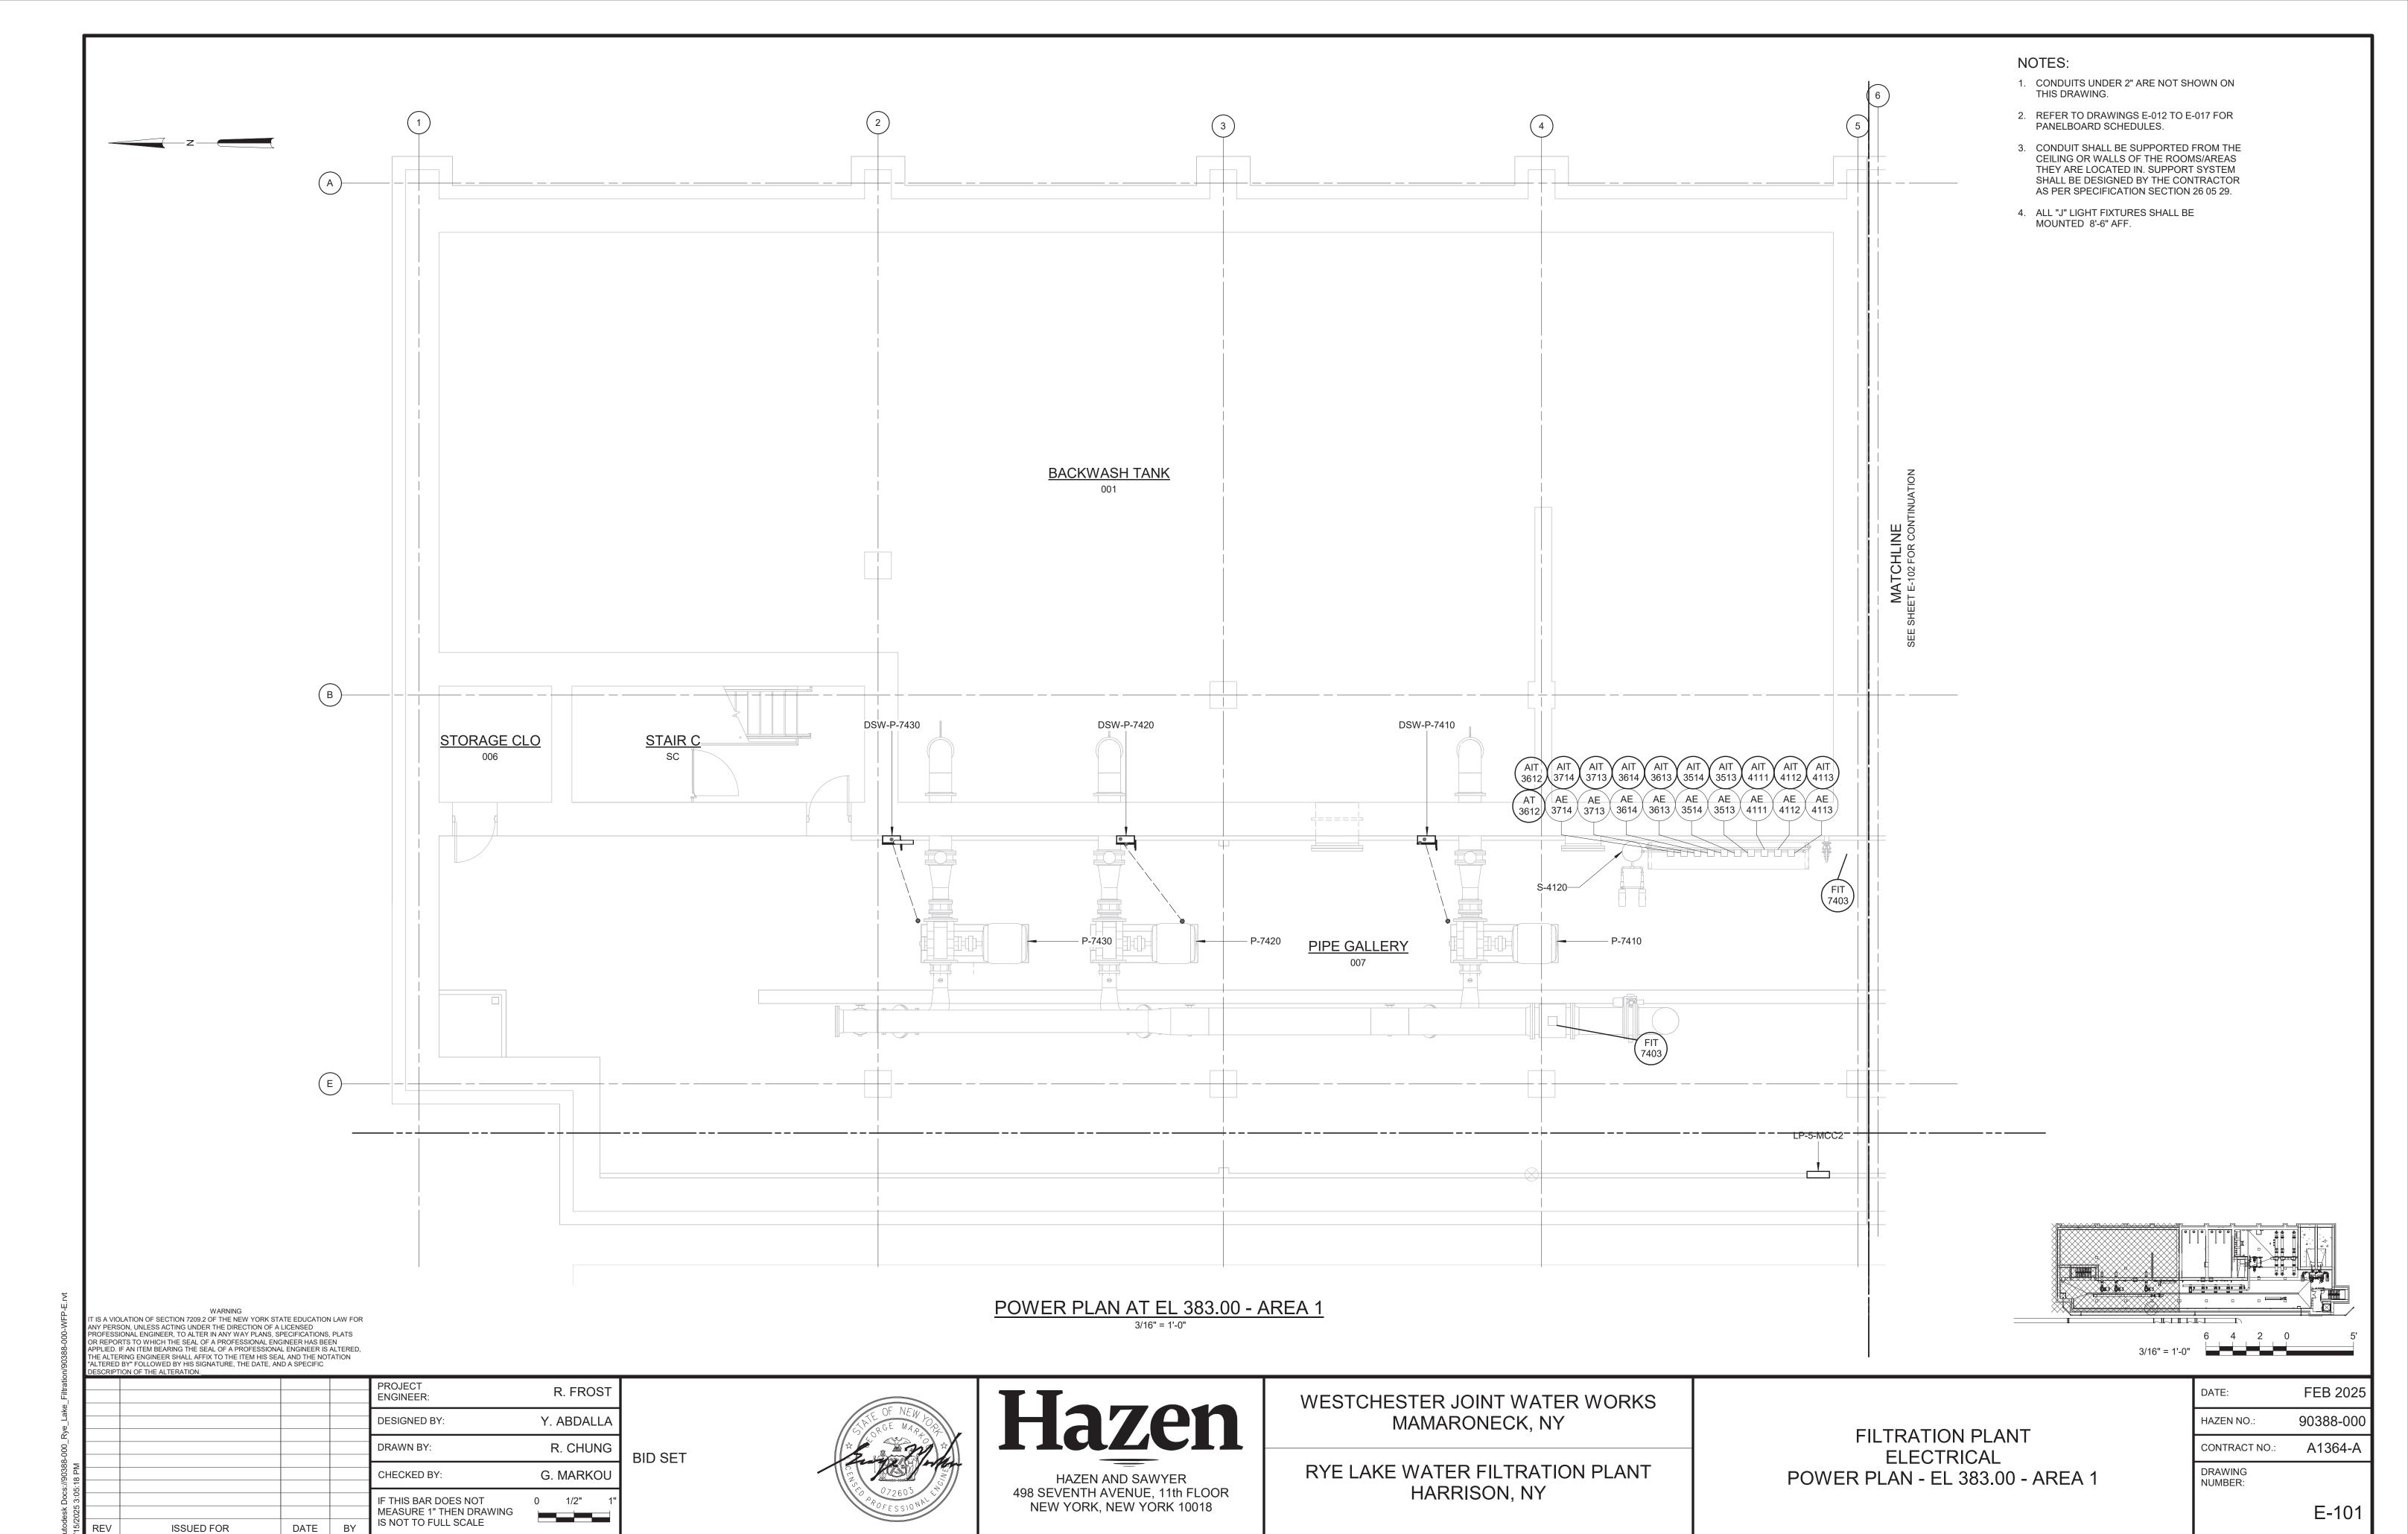

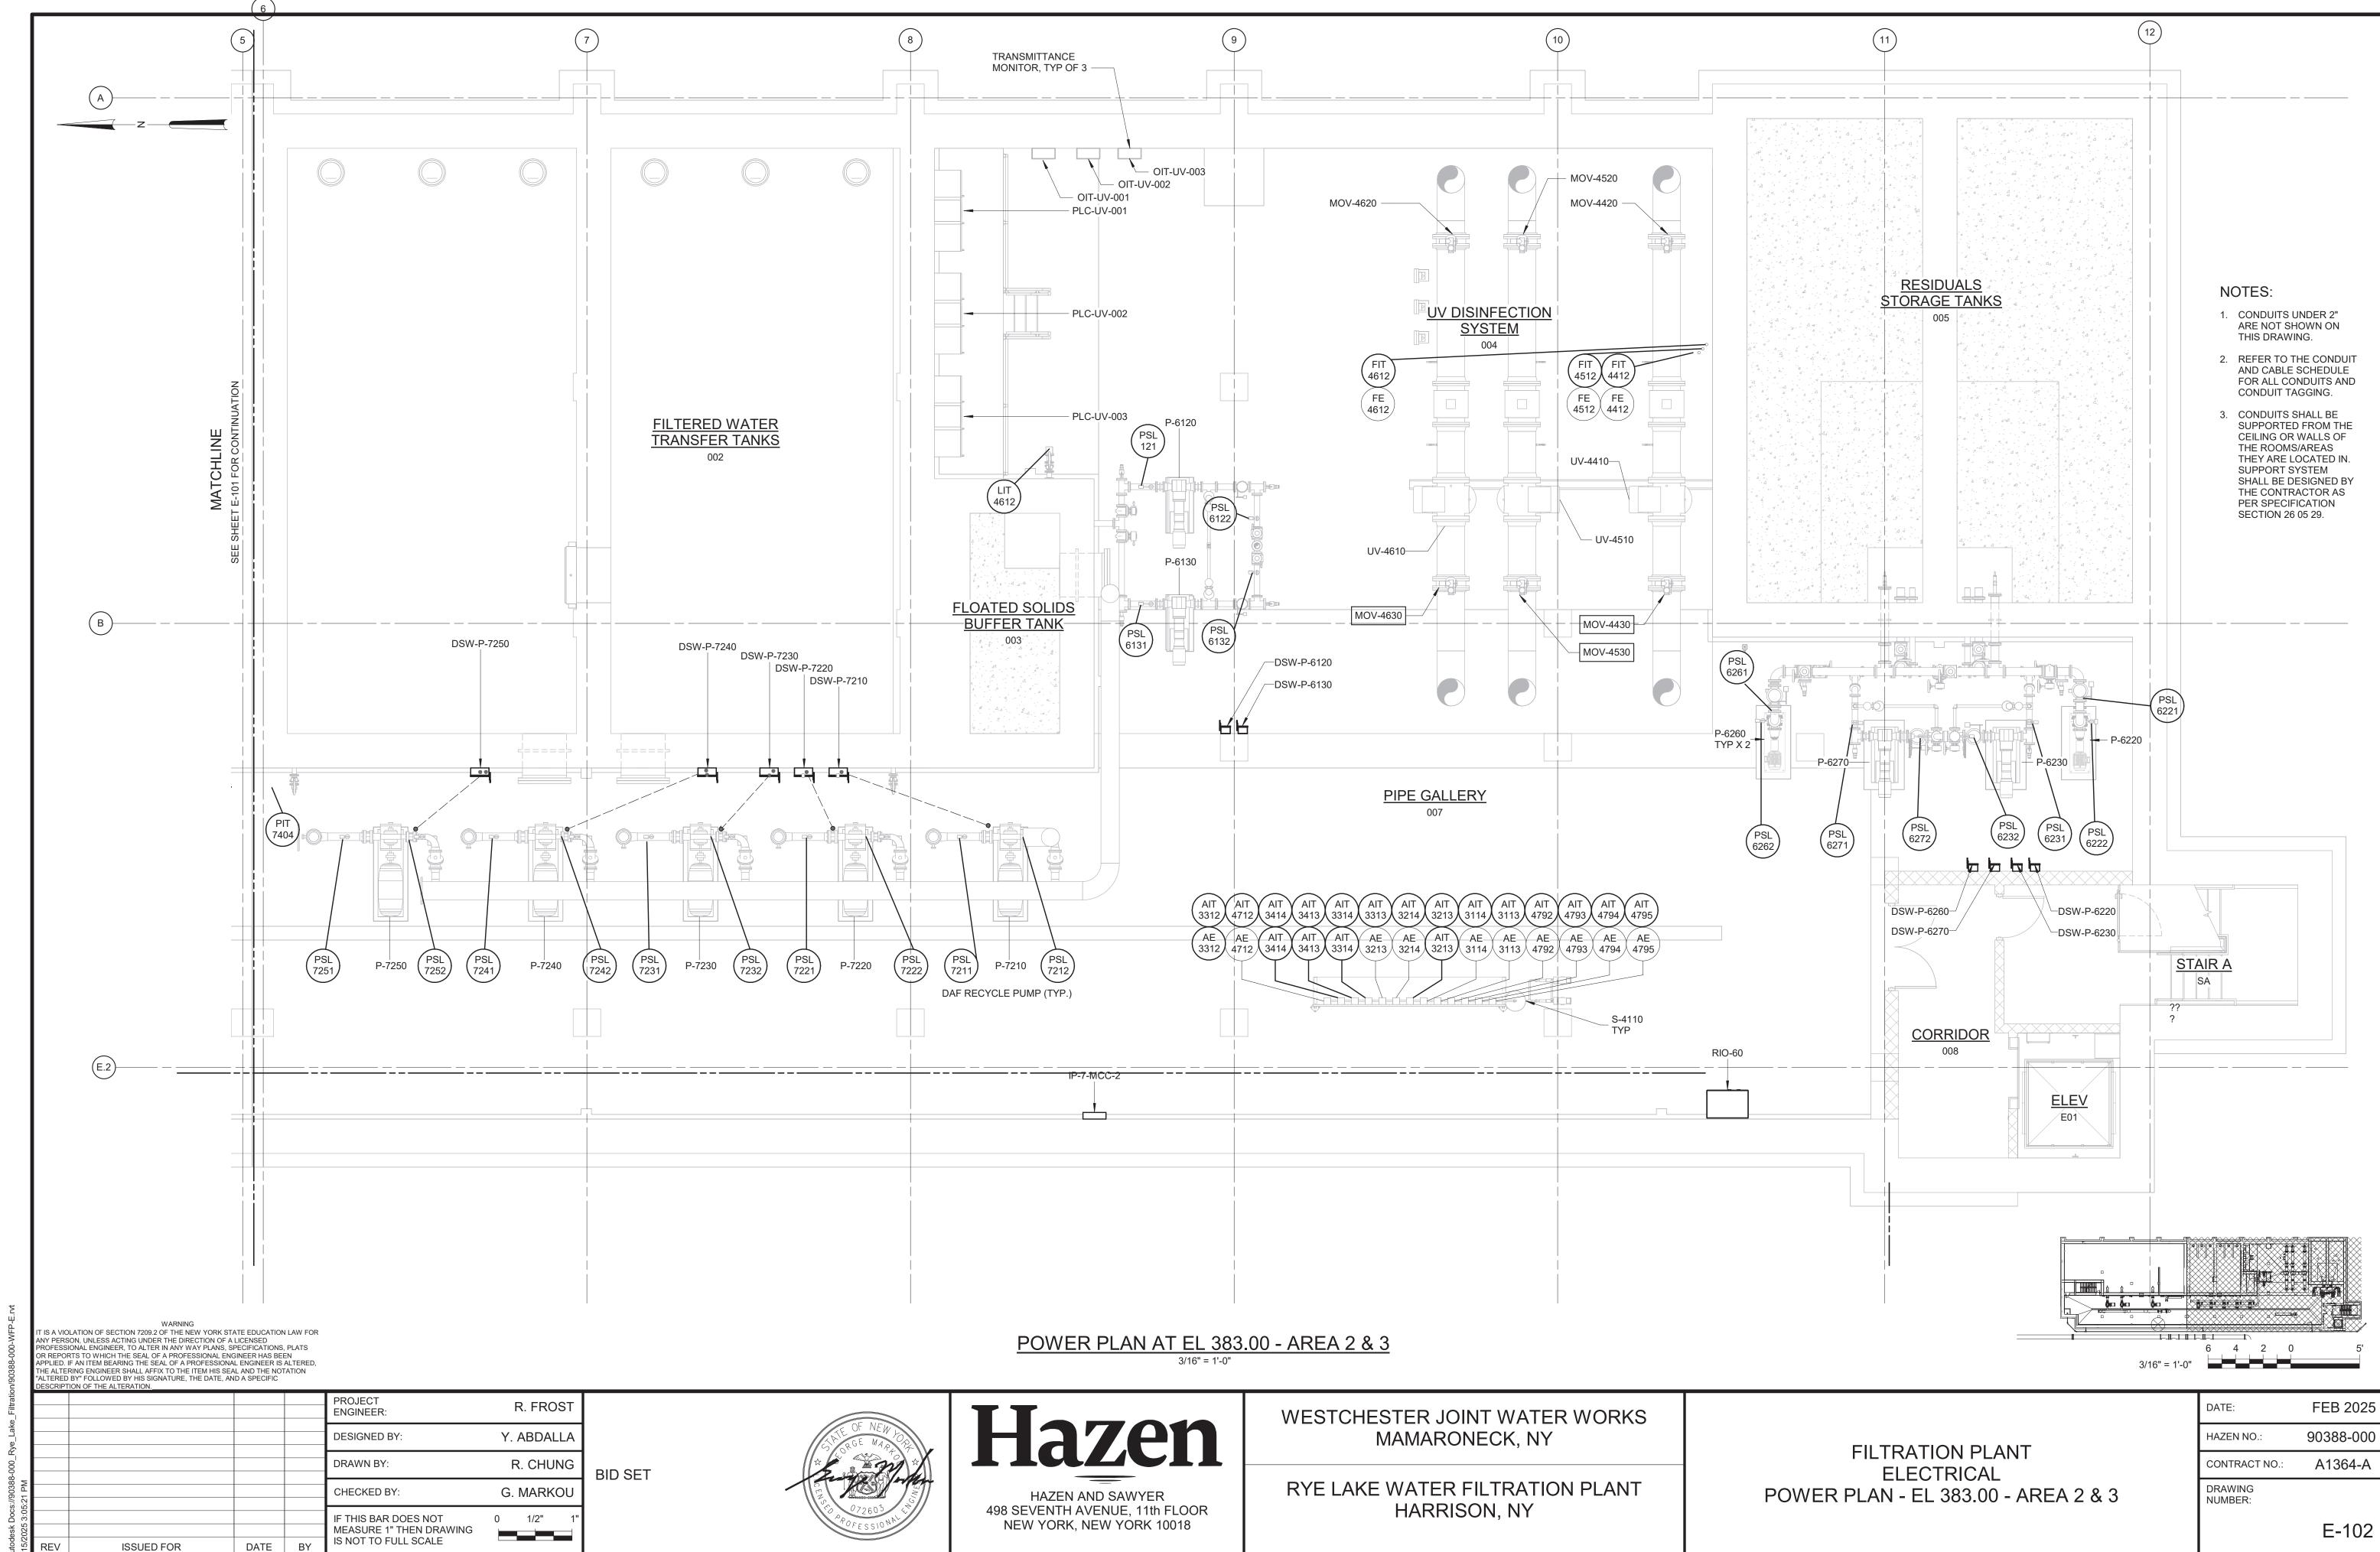

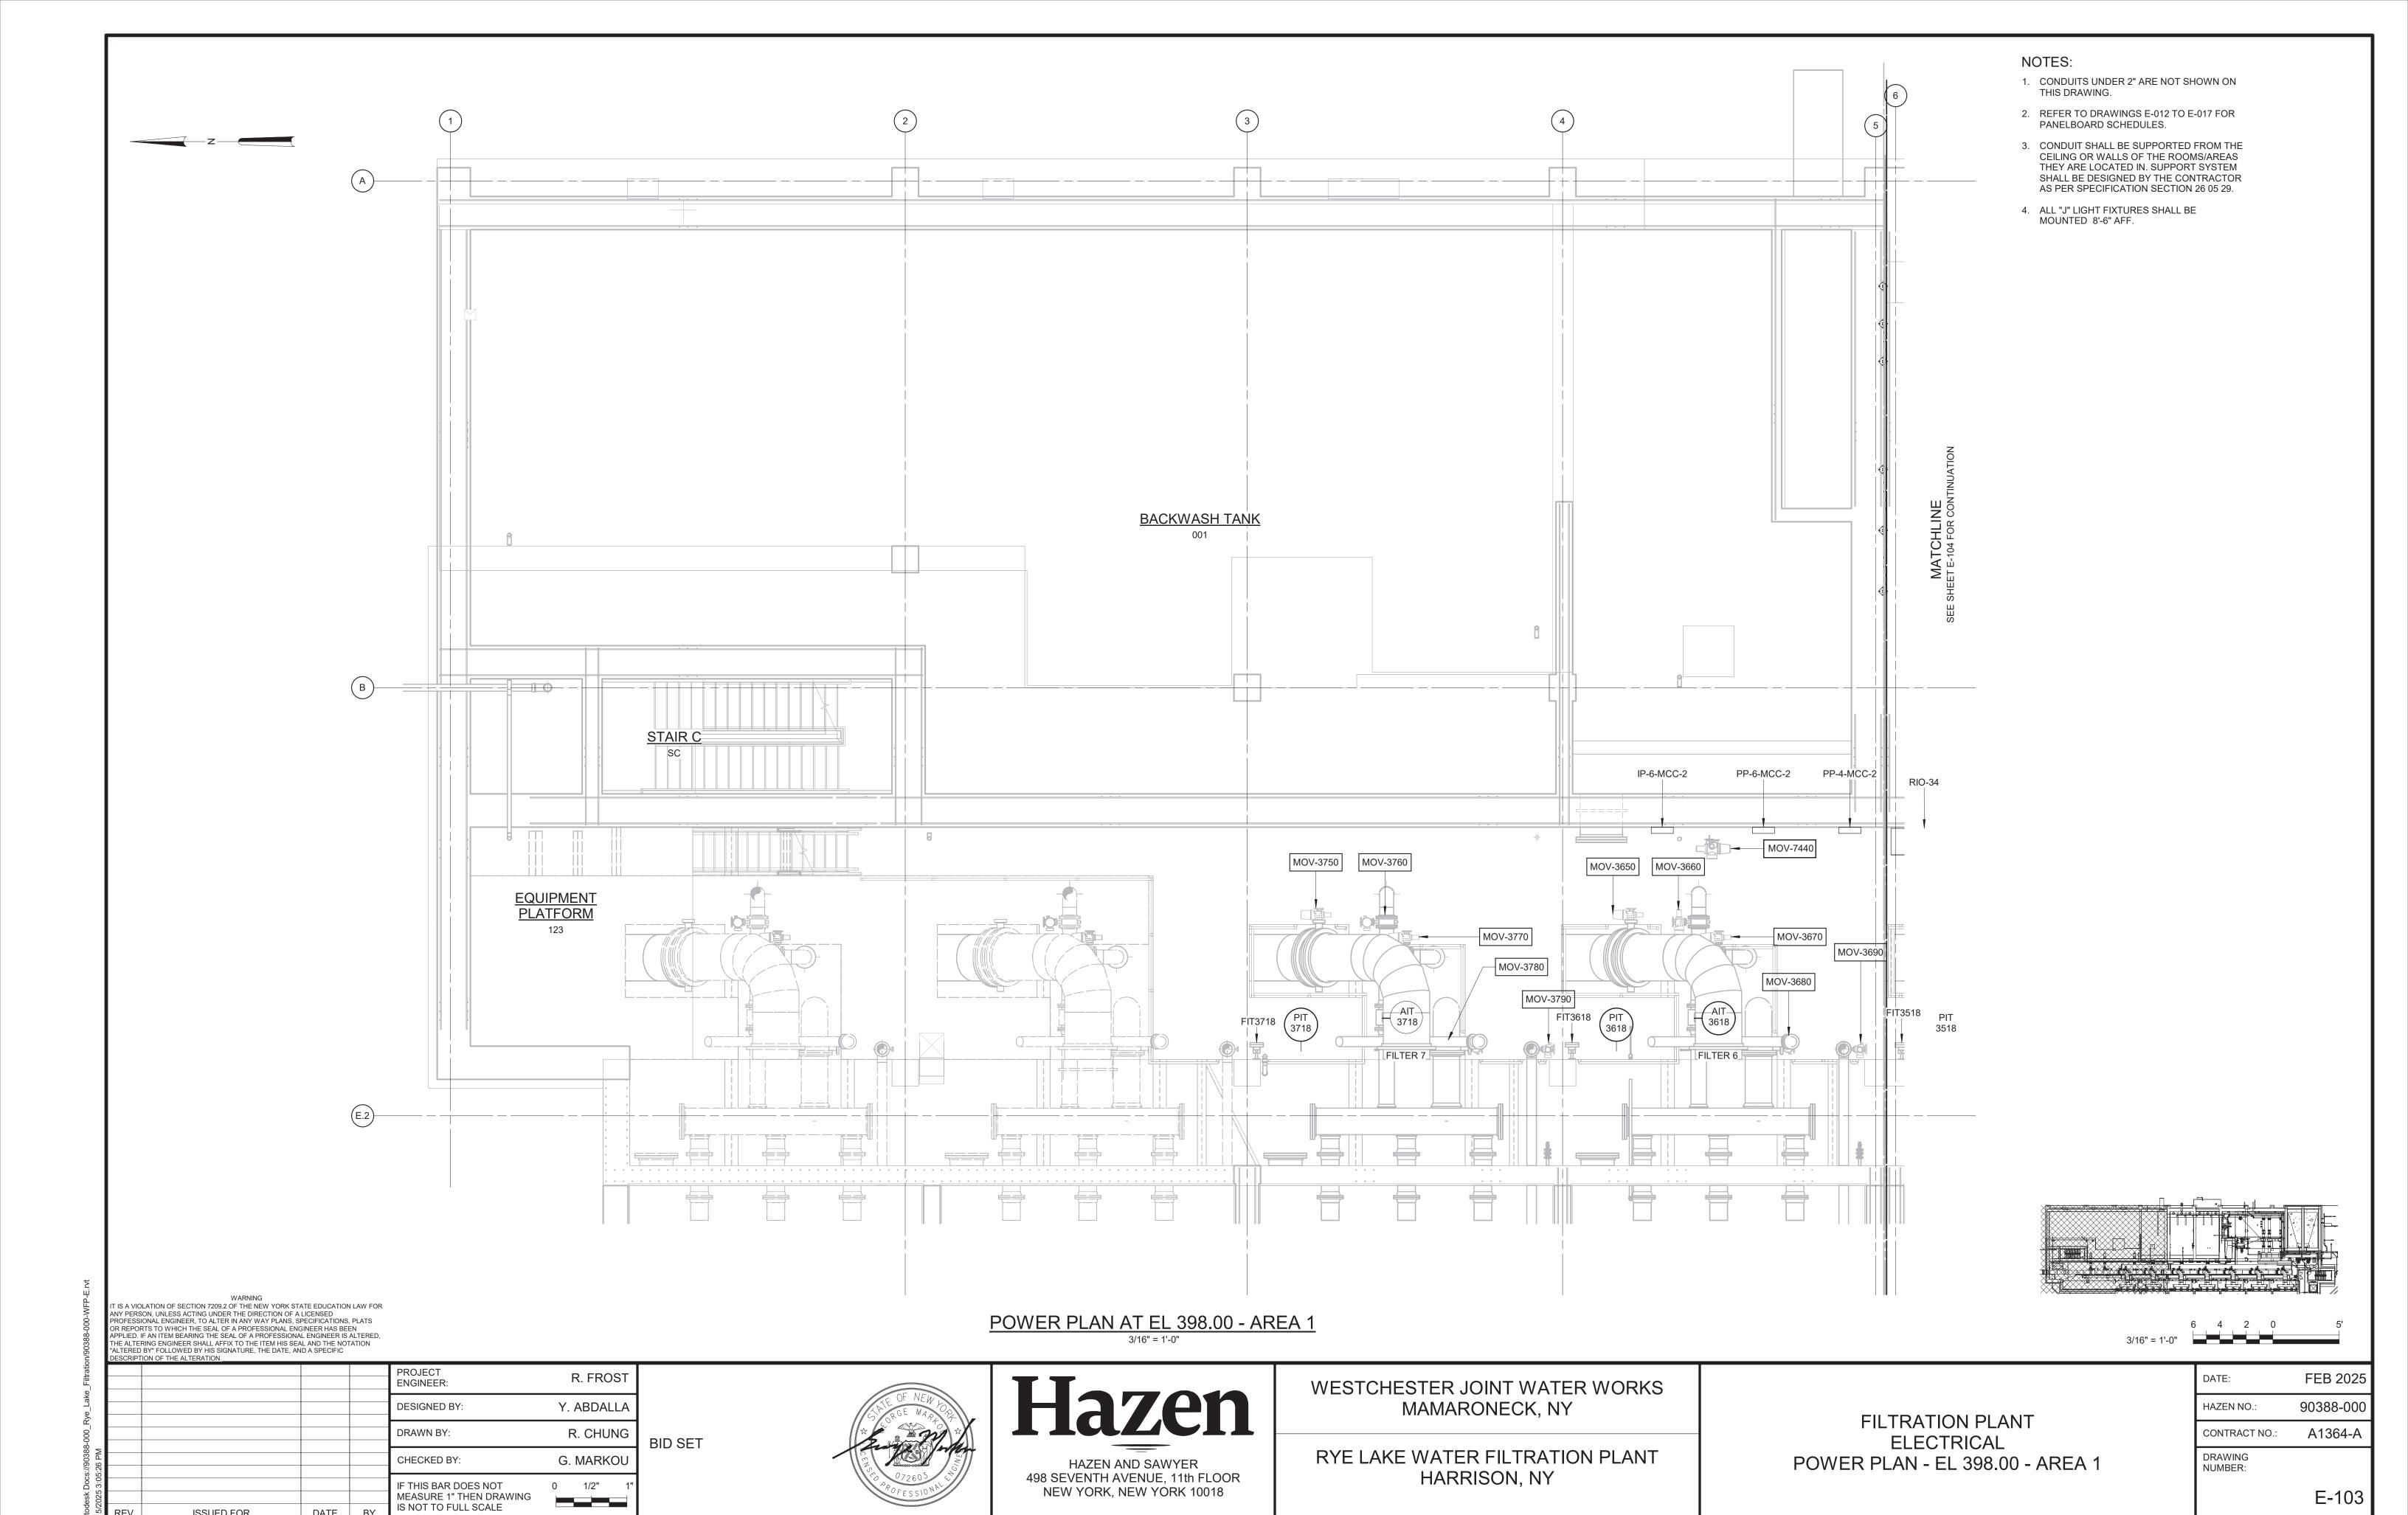


NEW YORK, NEW YORK 10018


0 1/2"

ISSUED FOR

DATE BY

E-103

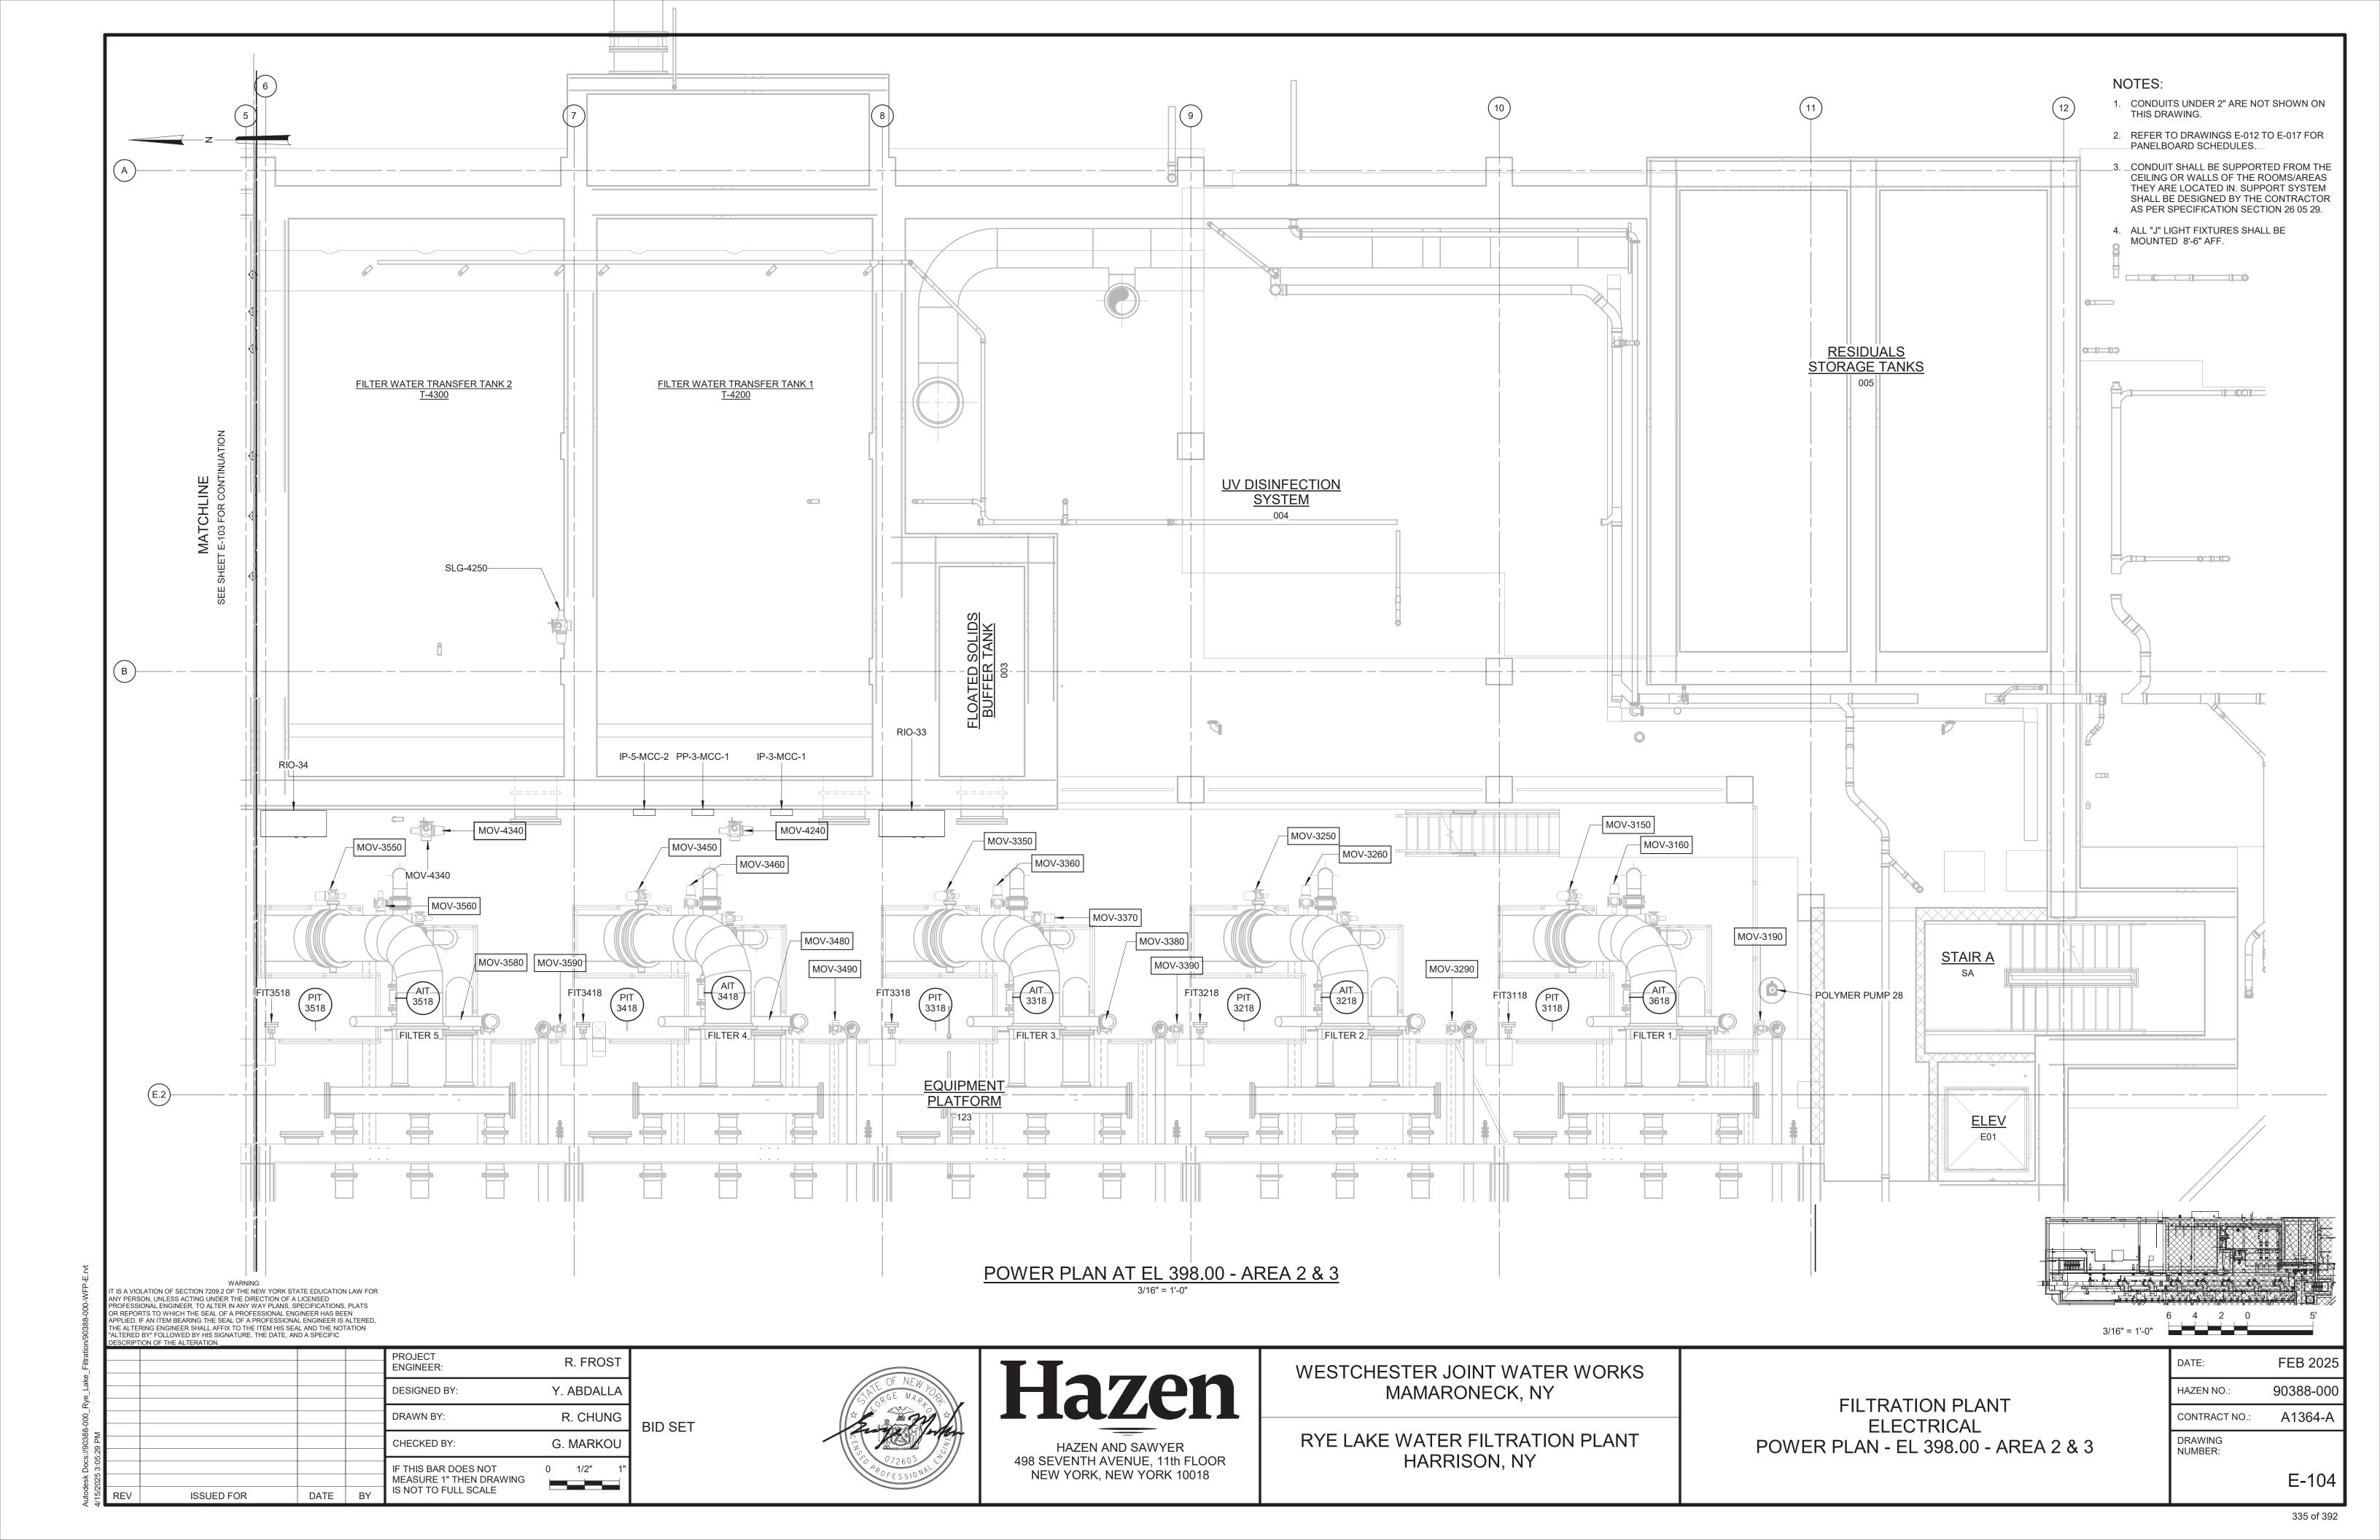

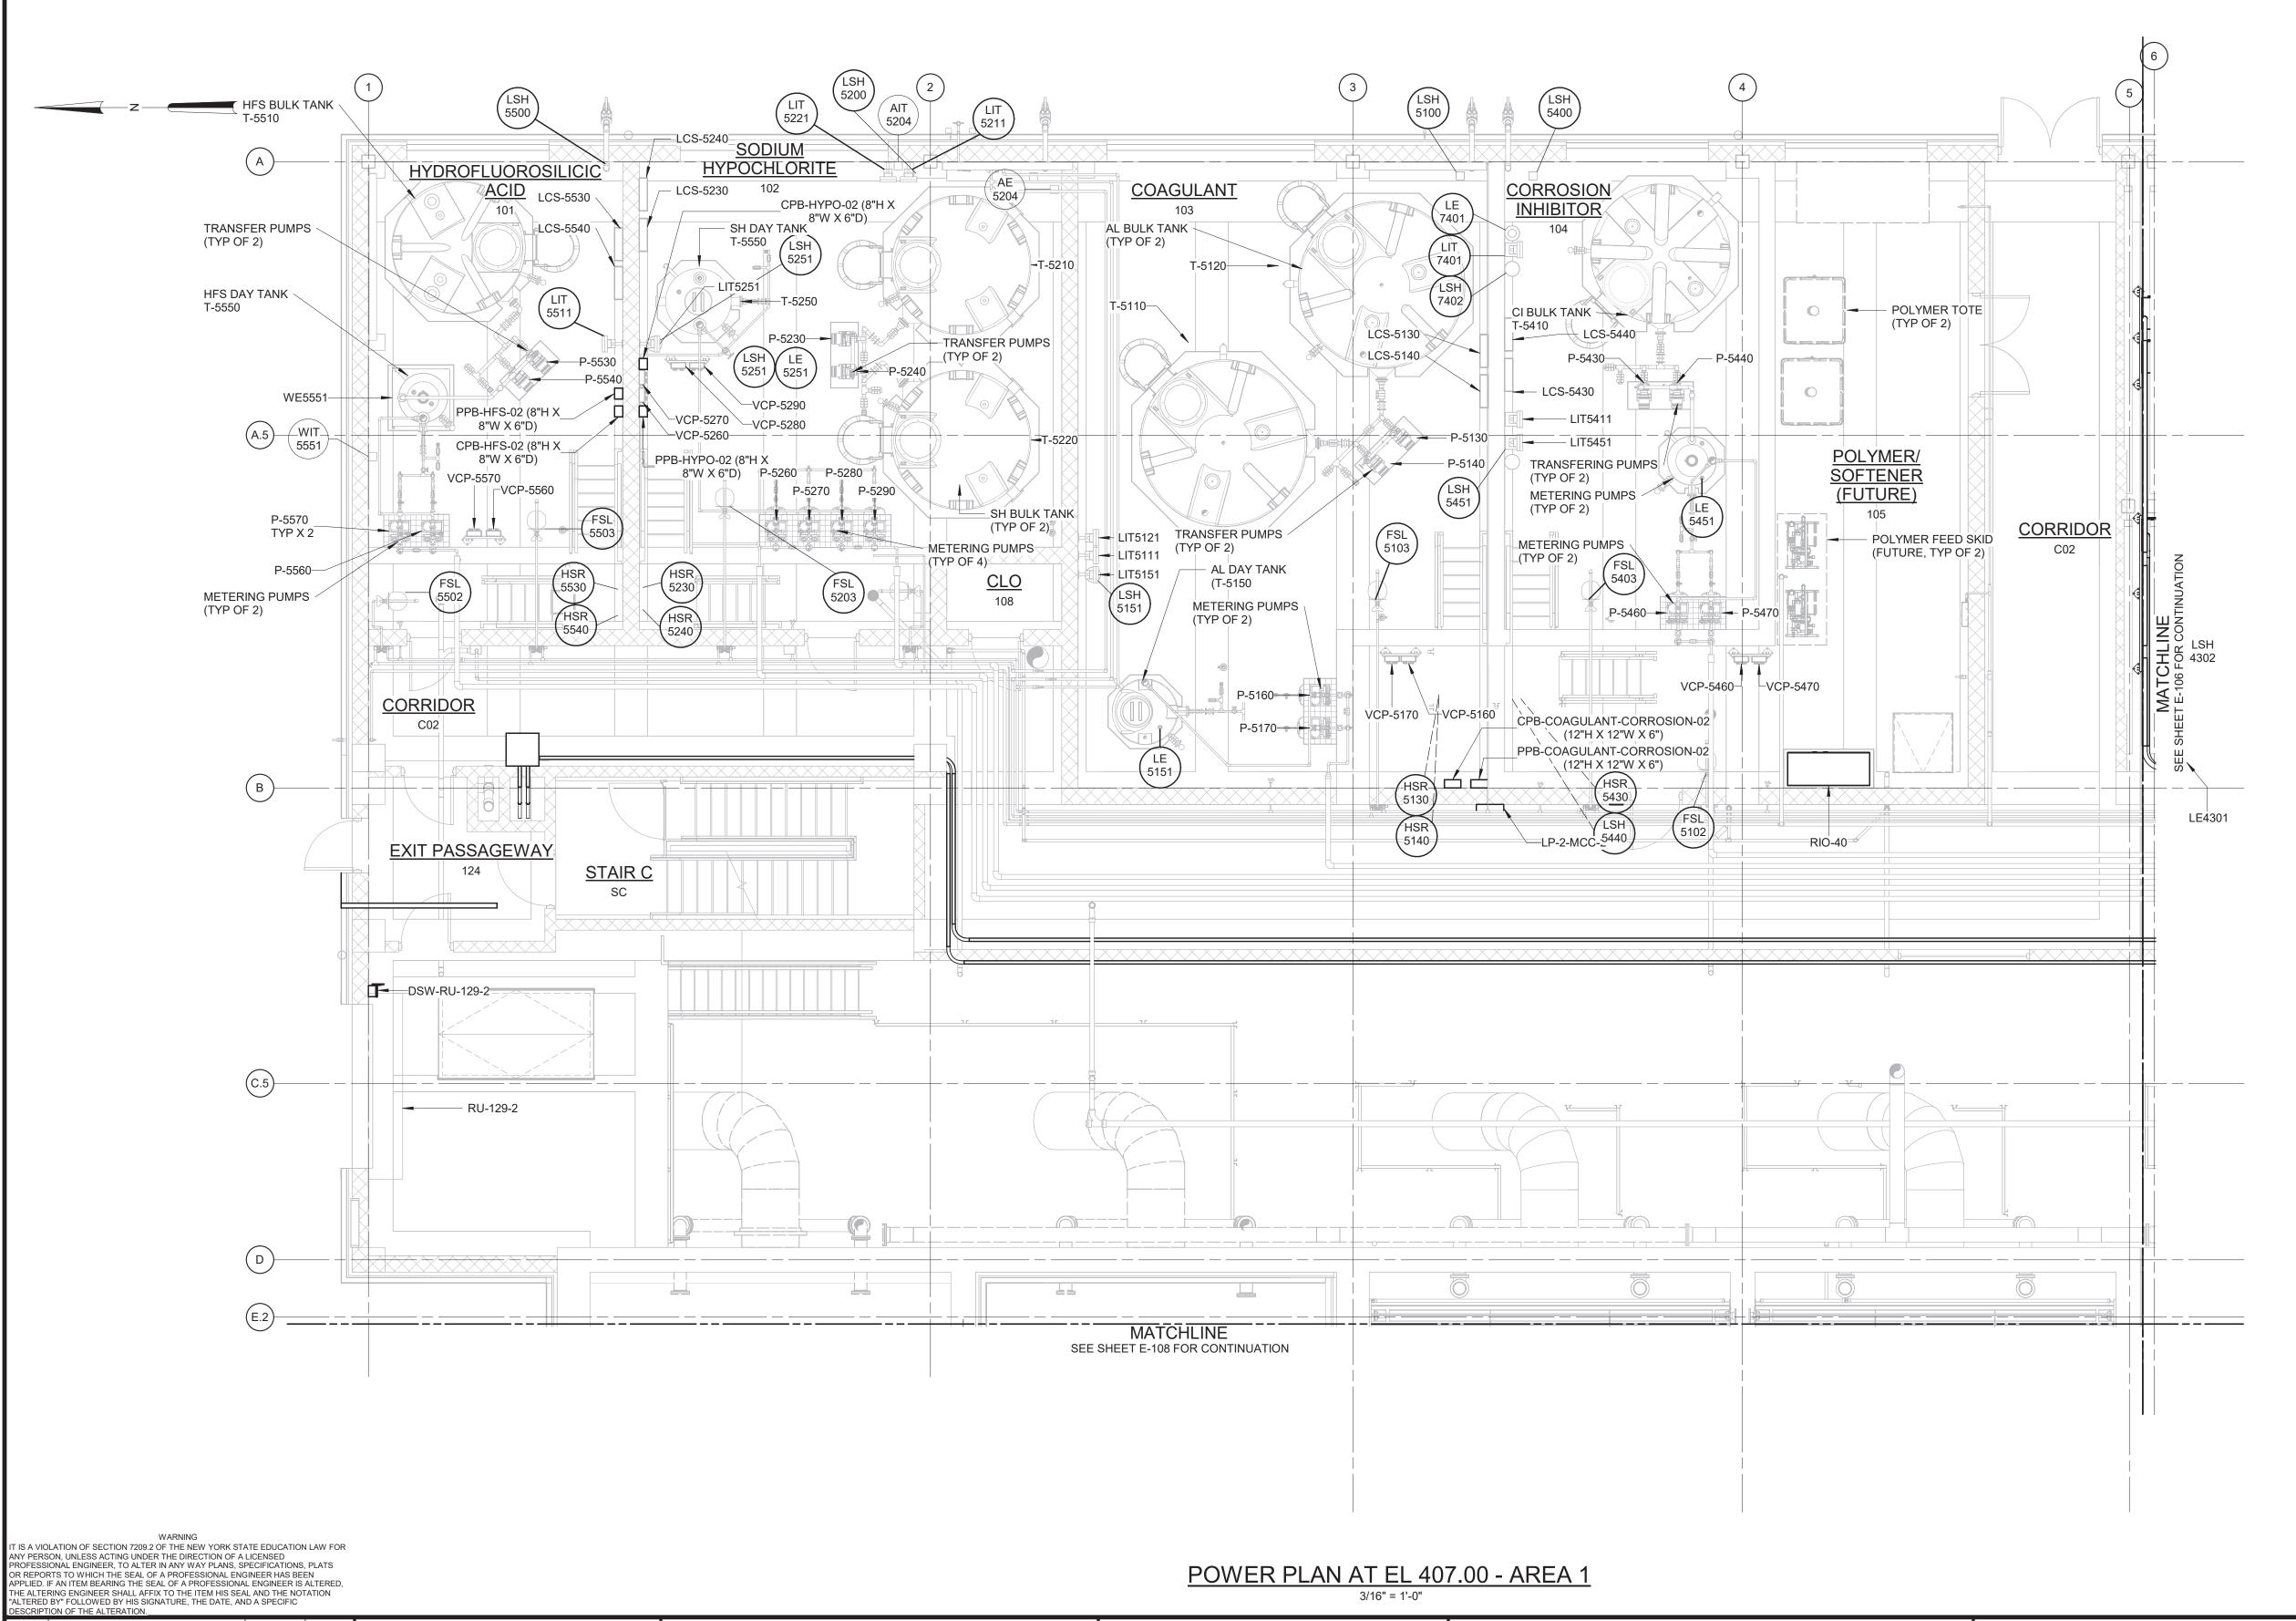

NOTES:

- CONDUITS UNDER 2" ARE NOT SHOWN ON THIS DRAWING.
- 2. REFER TO THE CONDUIT AND CABLE SCHEDULE FOR ALL CONDUITS AND CONDUIT TAGGING.
- 3. CONDUITS SHALL BE SUPPORTED FROM THE CEILING OR WALLS OF THE ROOMS/AREAS THEY ARE LOCATED IN. SUPPORT SYSTEM SHALL BE DESIGNED BY THE CONTRACTOR AS PER SPECIFICATION SECTION 26 05 29.

THE ALTER DESTRICTION TO THE SIGNATURE, THE DATE, AND A SPECIFIC DESCRIPTION OF THE ALTERATION.

PROJECT ENGINEER:

DESIGNED BY:

Y. ABDALLA

DRAWN BY:

CHECKED BY:

CHECKED BY:

G. MARKOU

IF THIS BAR DOES NOT MEASURE 1" THEN DRAWING IS NOT TO FULL SCALE

REV ISSUED FOR DATE BY

R. FROST

O 1/2" 1"

MEASURE 1" THEN DRAWING IS NOT TO FULL SCALE

OF NEW LONG OF RESIDENCE OF NEW LONG OF THE STORY OF THE


HAZEN AND SAWYER
498 SEVENTH AVENUE, 11th FLOOR

NEW YORK, NEW YORK 10018

WESTCHESTER JOINT WATER WORKS MAMARONECK, NY


RYE LAKE WATER FILTRATION PLANT HARRISON, NY FILTRATION PLANT ELECTRICAL POWER PLAN - EL 407.00 - AREA 1

DATE:	FEB 2025
HAZEN NO.:	90388-000
CONTRACT NO.:	A1364-A
DRAWING NUMBER:	
	E-105

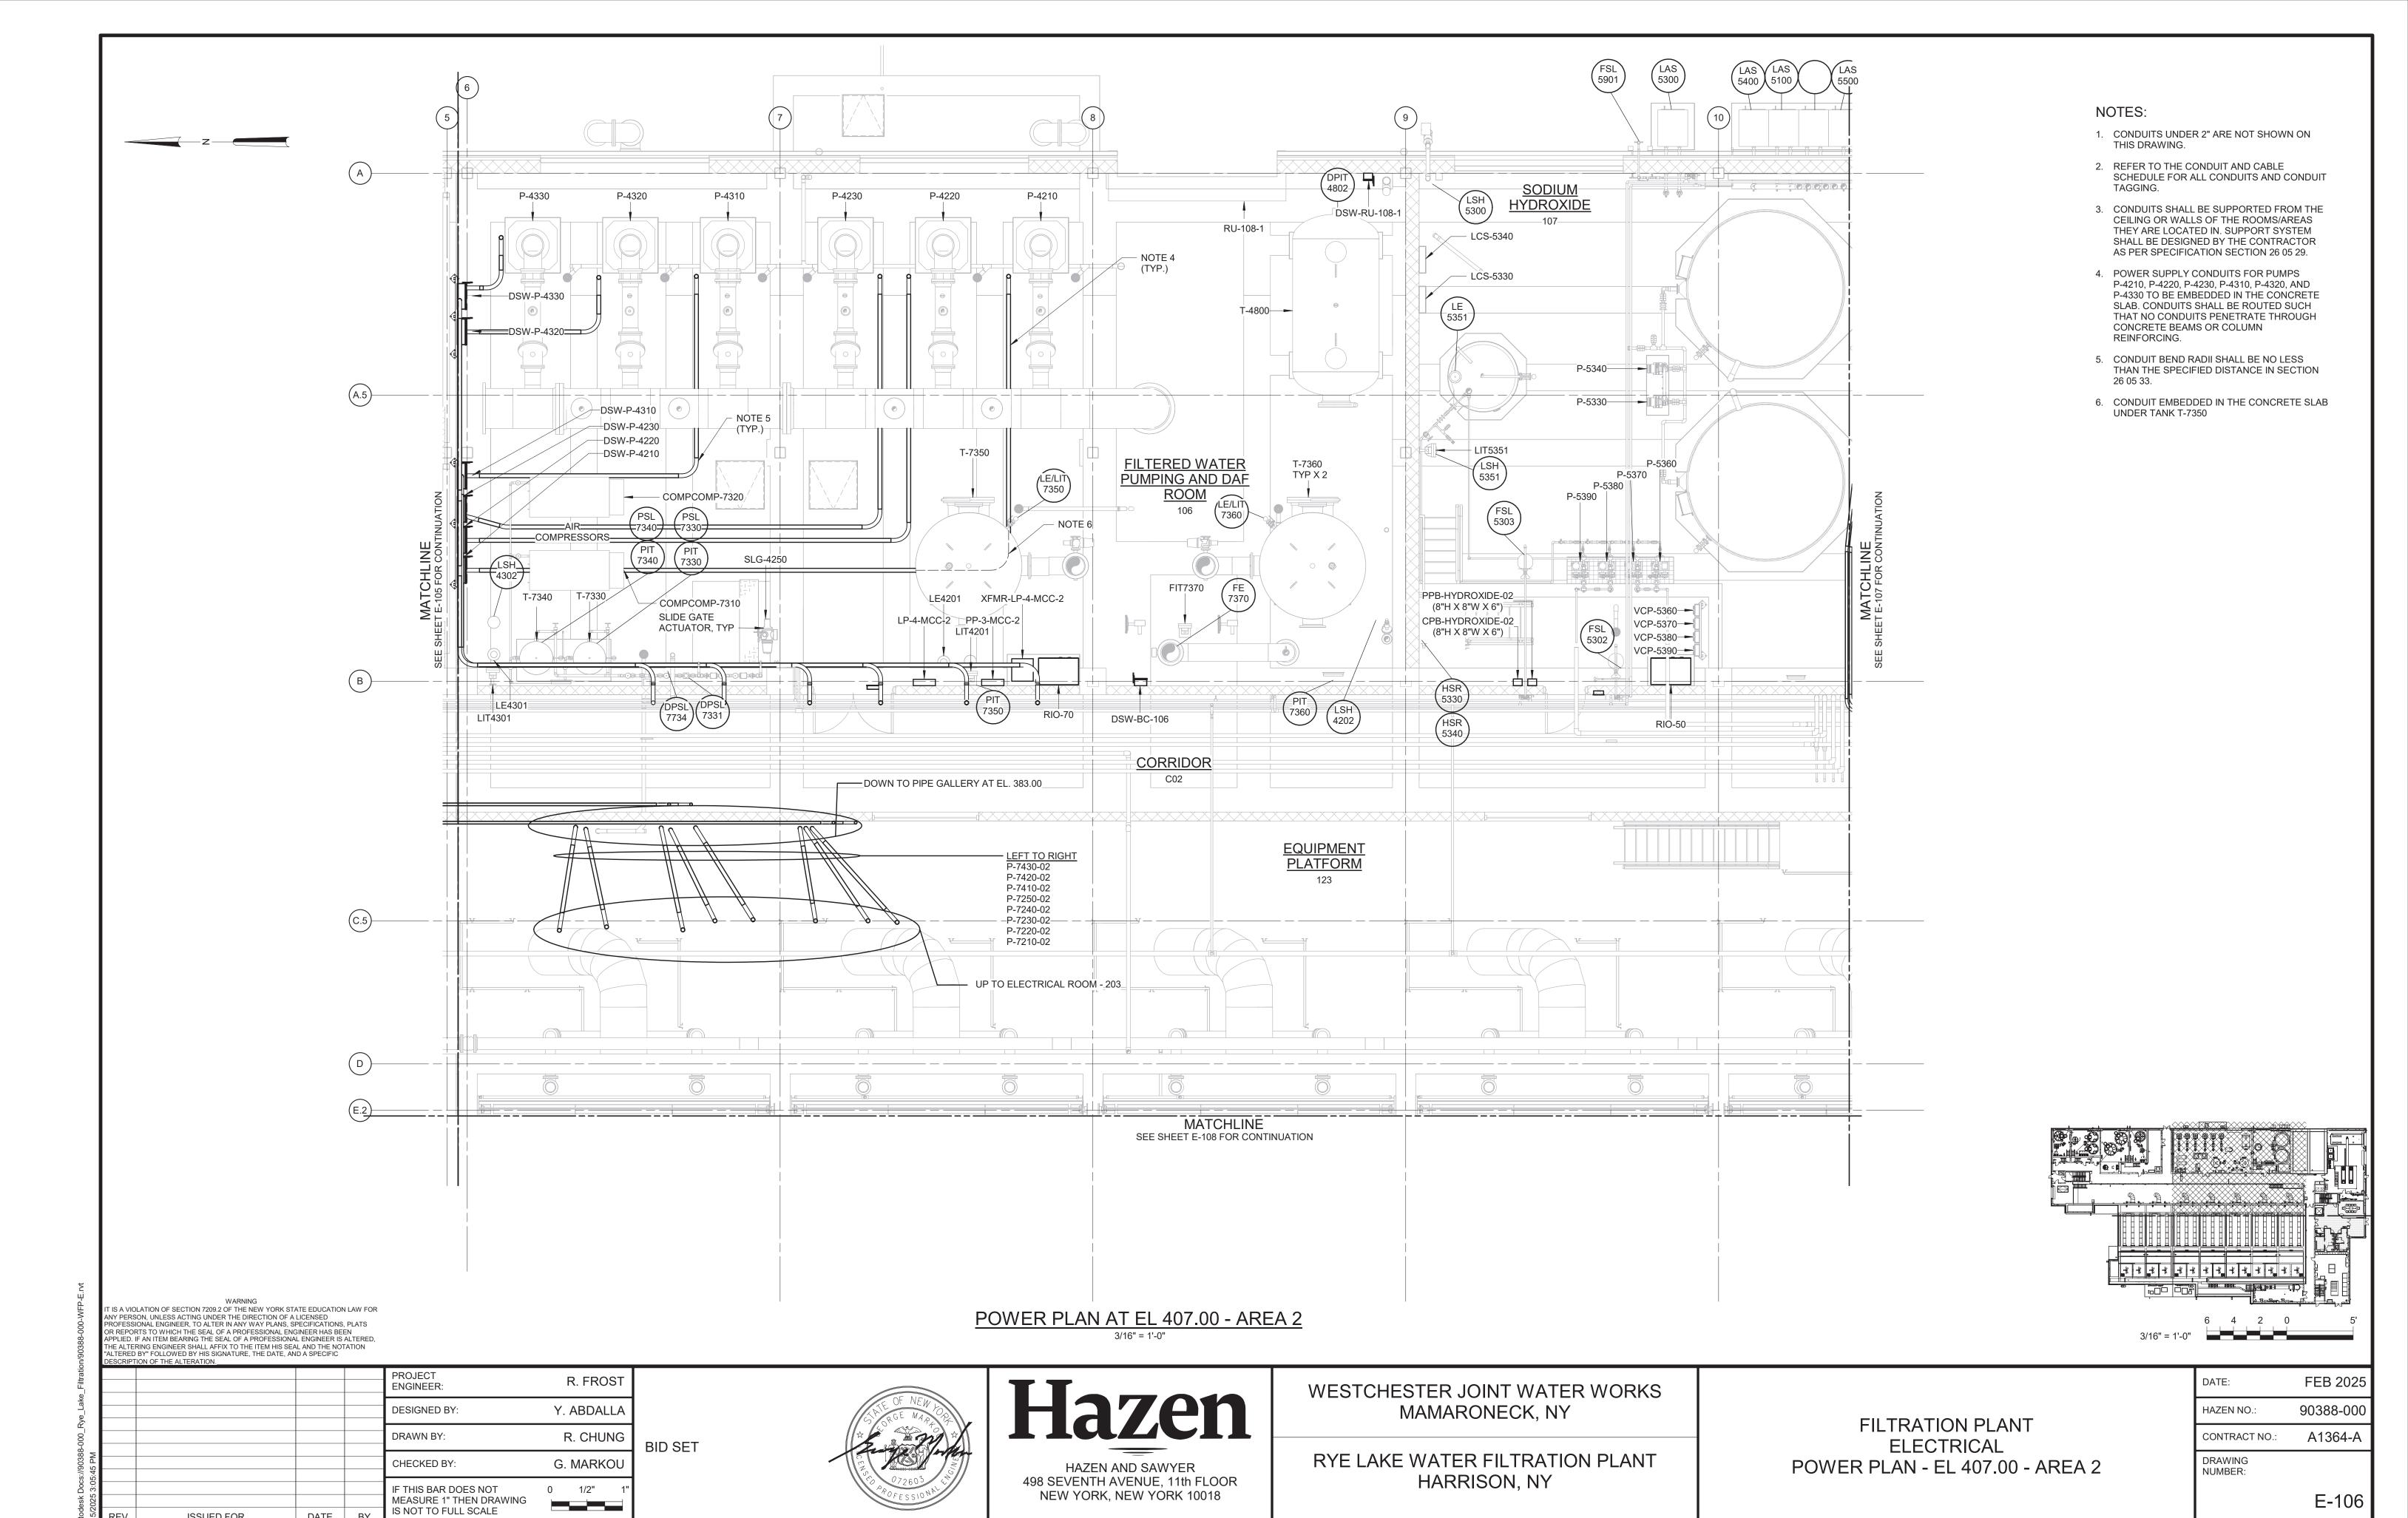


ISSUED FOR

DATE BY

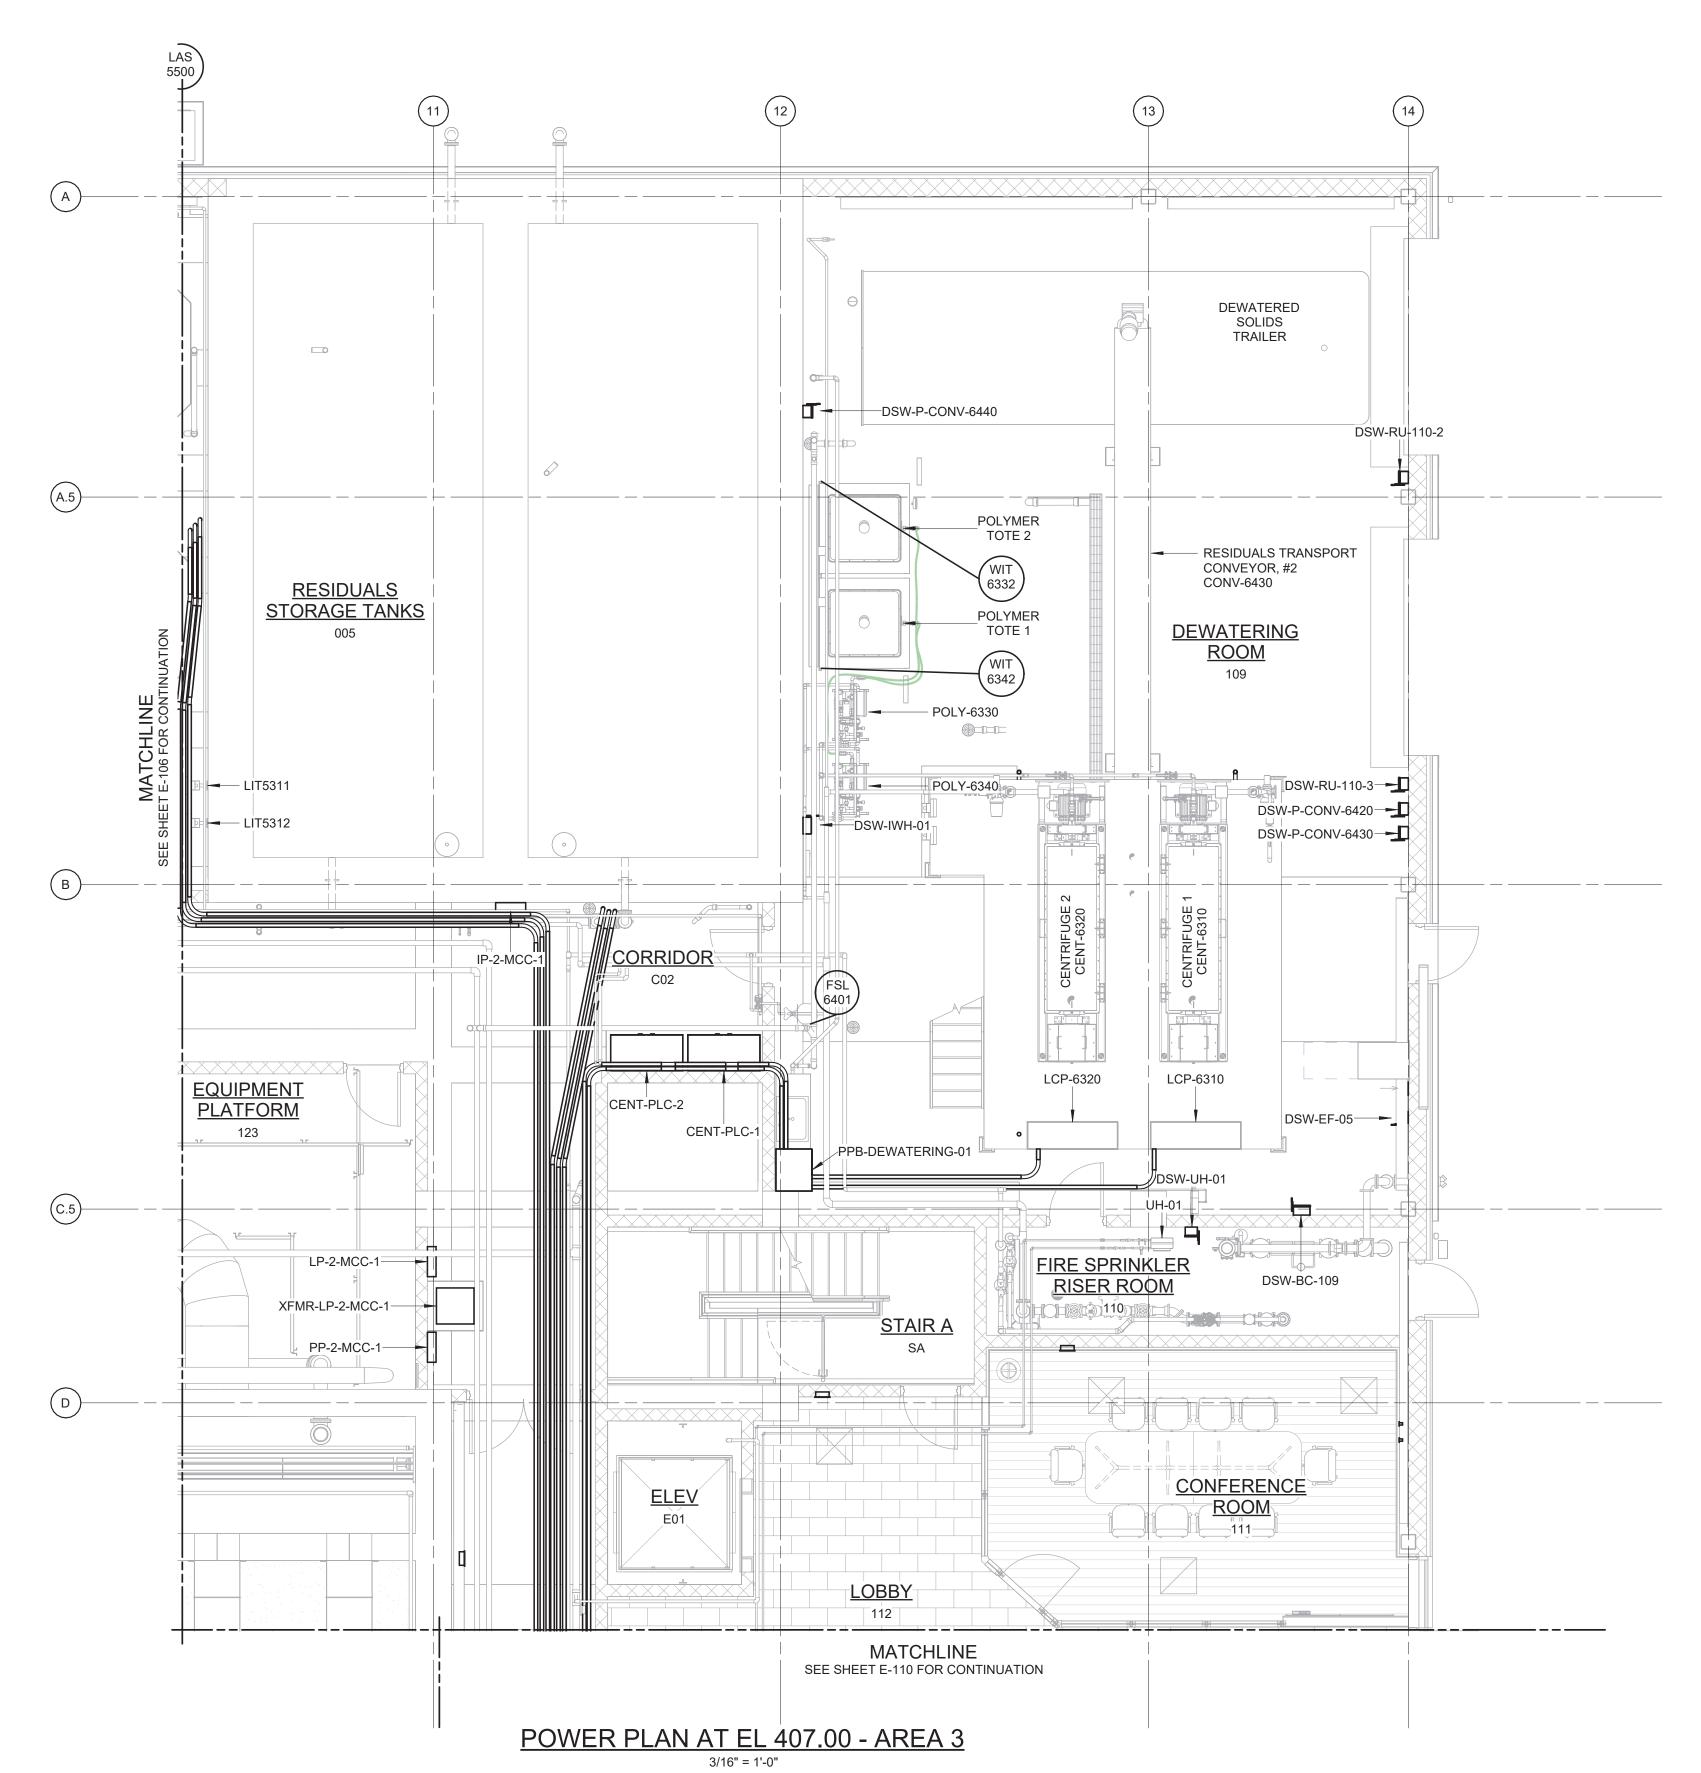

NOTES:

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6 4 2 0

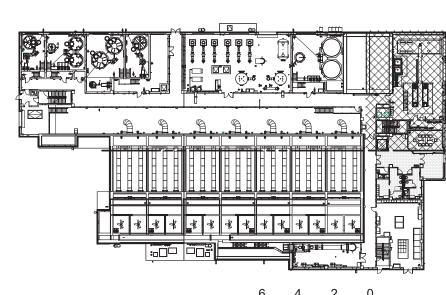WARNING
IT IS A VIOLATION OF SECTION 7209.2 OF THE NEW YORK STATE EDUCATION LAW FOR
ANY PERSON, UNLESS ACTING UNDER THE DIRECTION OF A LICENSED
PROFESSIONAL ENGINEER, TO ALTER IN ANY WAY PLANS, SPECIFICATIONS, PLATS
OR REPORTS TO WHICH THE SEAL OF A PROFESSIONAL ENGINEER HAS BEEN
APPLIED. IF AN ITEM BEARING THE SEAL OF A PROFESSIONAL ENGINEER IS ALTERED,
THE ALTERING ENGINEER SHALL AFFIX TO THE ITEM HIS SEAL AND THE NOTATION
"ALTERED BY" FOLLOWED BY HIS SIGNATURE, THE DATE, AND A SPECIFIC

	"ALTERED BY" FOLLOWED BY HIS SIGNATURE, THE DATE, AND A SPECIFIC DESCRIPTION OF THE ALTERATION.								
					PROJECT ENGINEER:		R. FRO	ST	
					DESIGNED BY:	Y.	ABDAL	.LA	
					DRAWN BY:	F	R. CHUI	NG	
:32 PM					CHECKED BY:	G.	MARK	OU	
025 4:31					IF THIS BAR DOES NOT MEASURE 1" THEN DRAWING	0	1/2"	1" —	
1/15/2025	REV	ISSUED FOR	DATE	BY	Y IS NOT TO FULL SCALE				

BID SET



HAZEN AND SAWYER


498 SEVENTH AVENUE, 11th FLOOR


NEW YORK, NEW YORK 10018


WESTCHESTER JOINT WATER WORKS MAMARONECK, NY

RYE LAKE WATER FILTRATION PLANT HARRISON, NY FILTRATION PLANT ELECTRICAL POWER PLAN - EL 407.00 - AREA 3

DATE:	FEB 2025
HAZEN NO.:	90388-000
CONTRACT NO.:	A1364-A
DRAWING NUMBER:	
	E-107

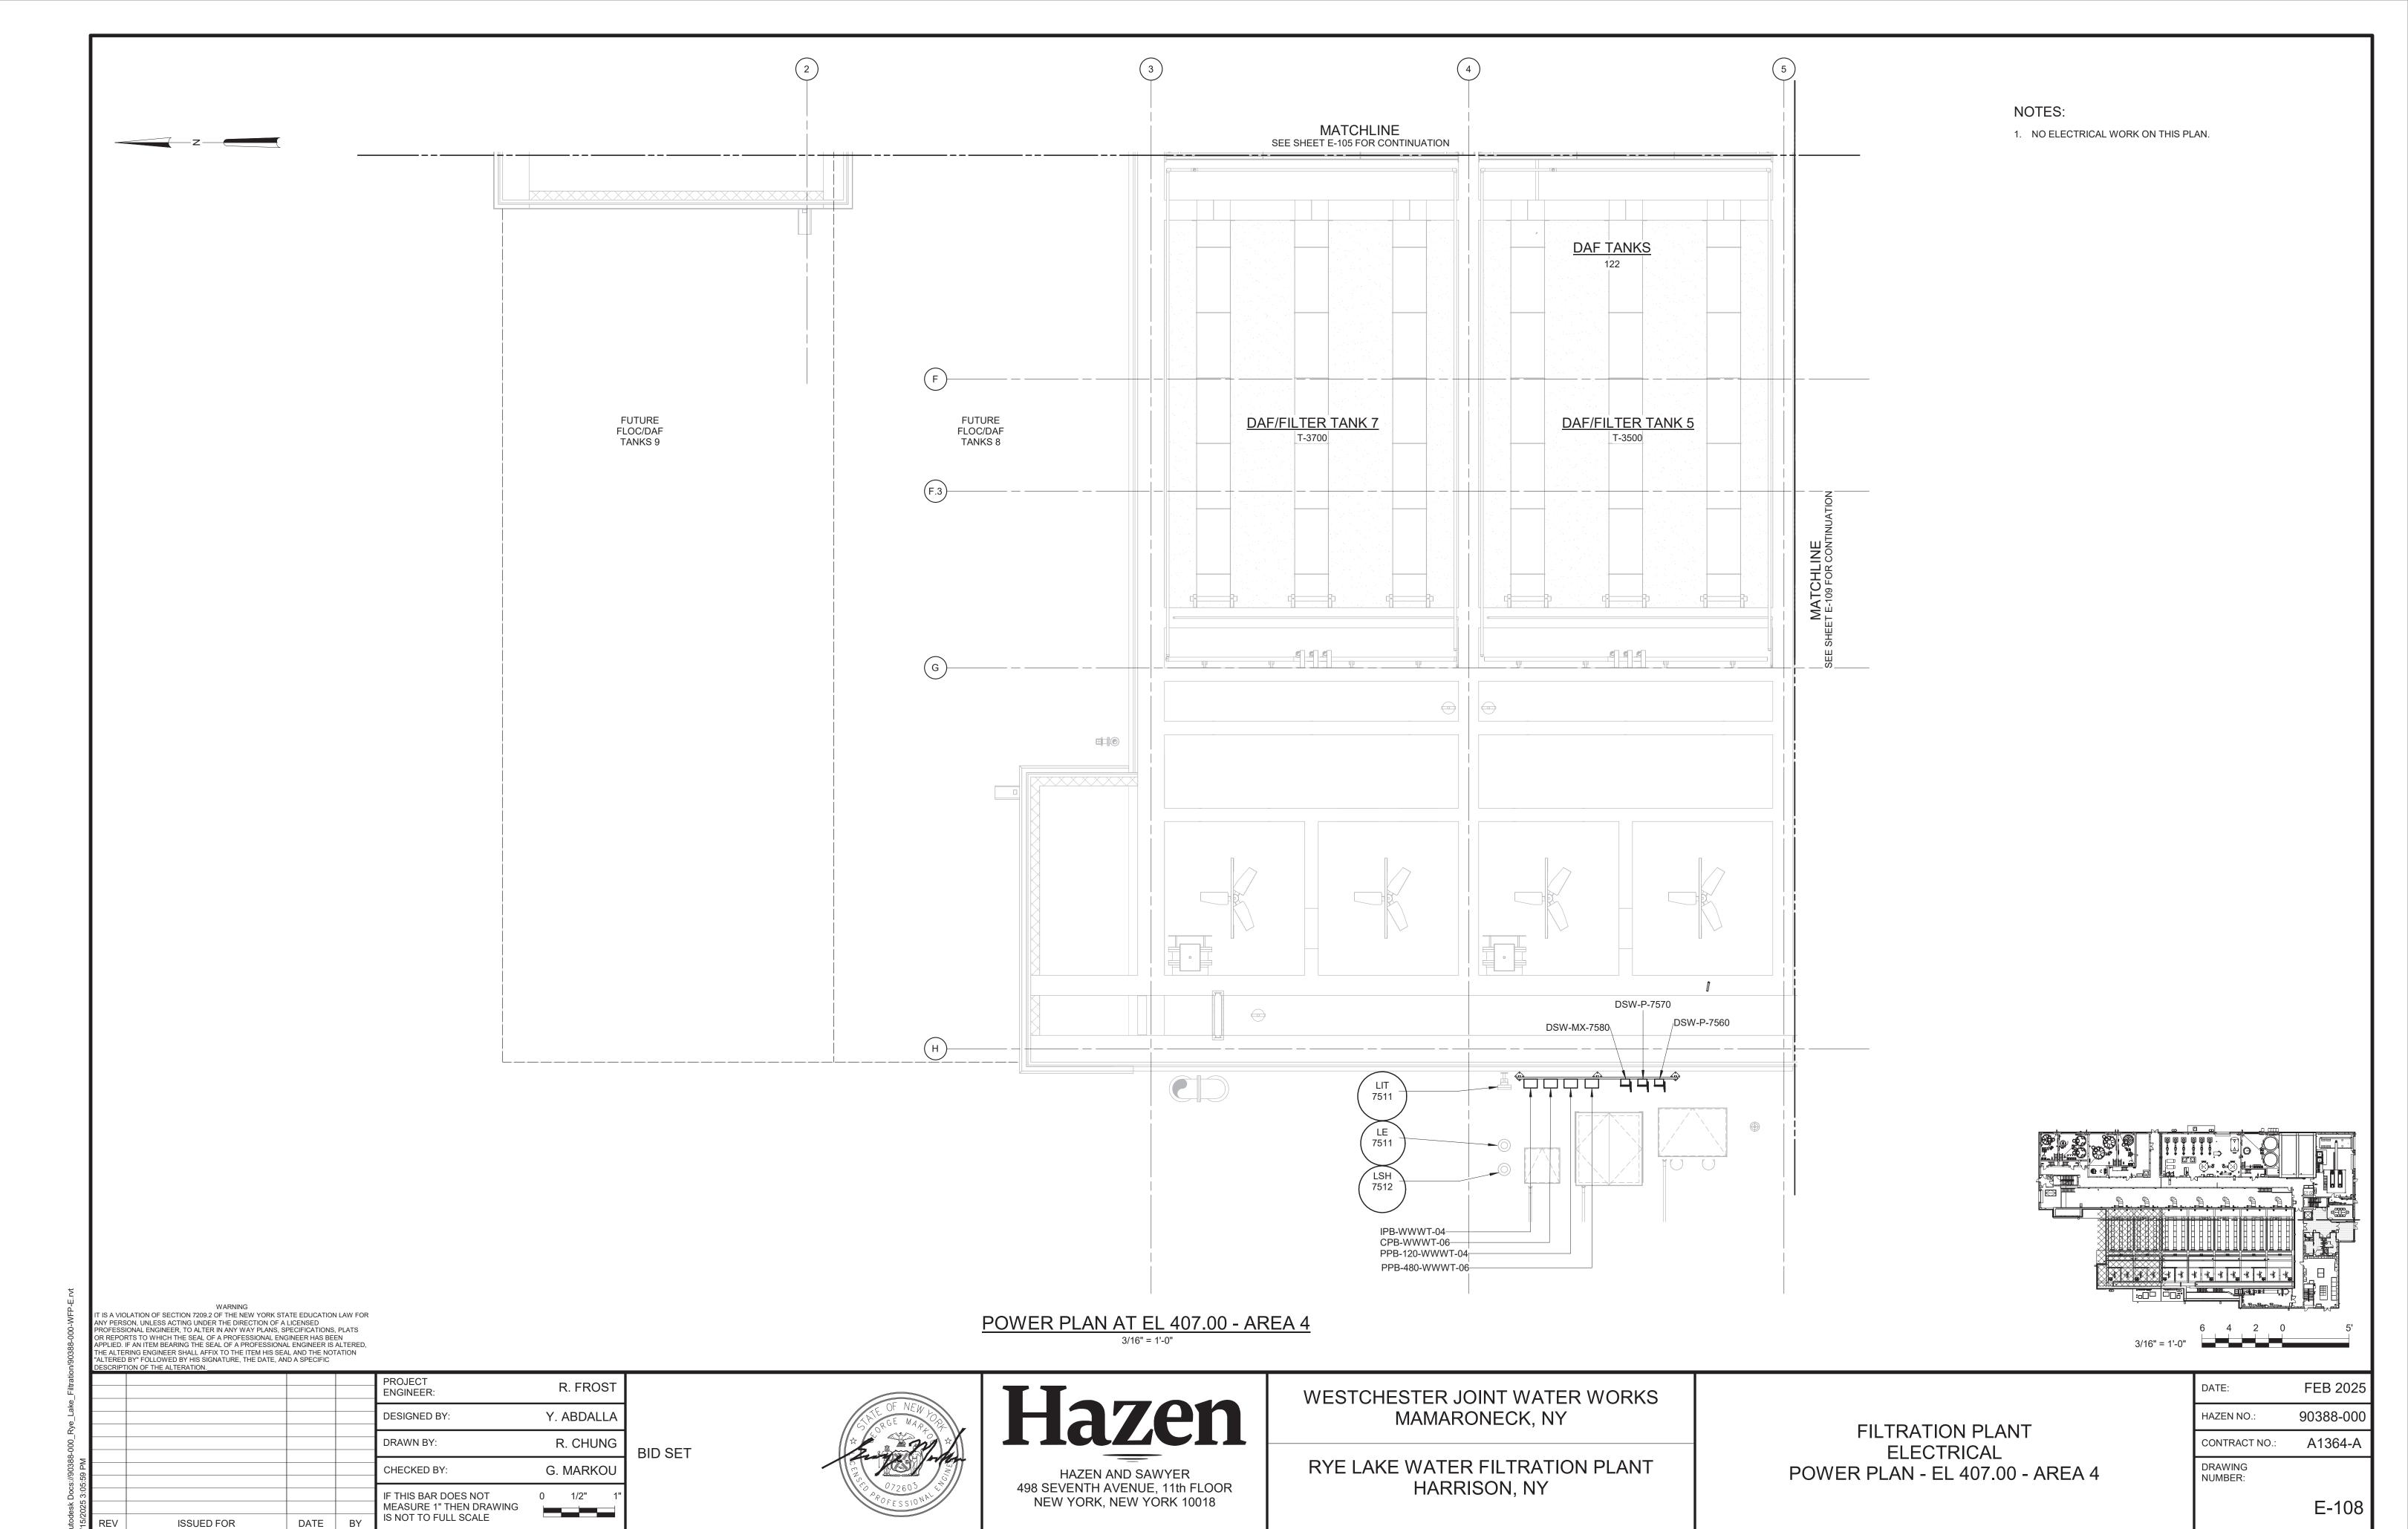

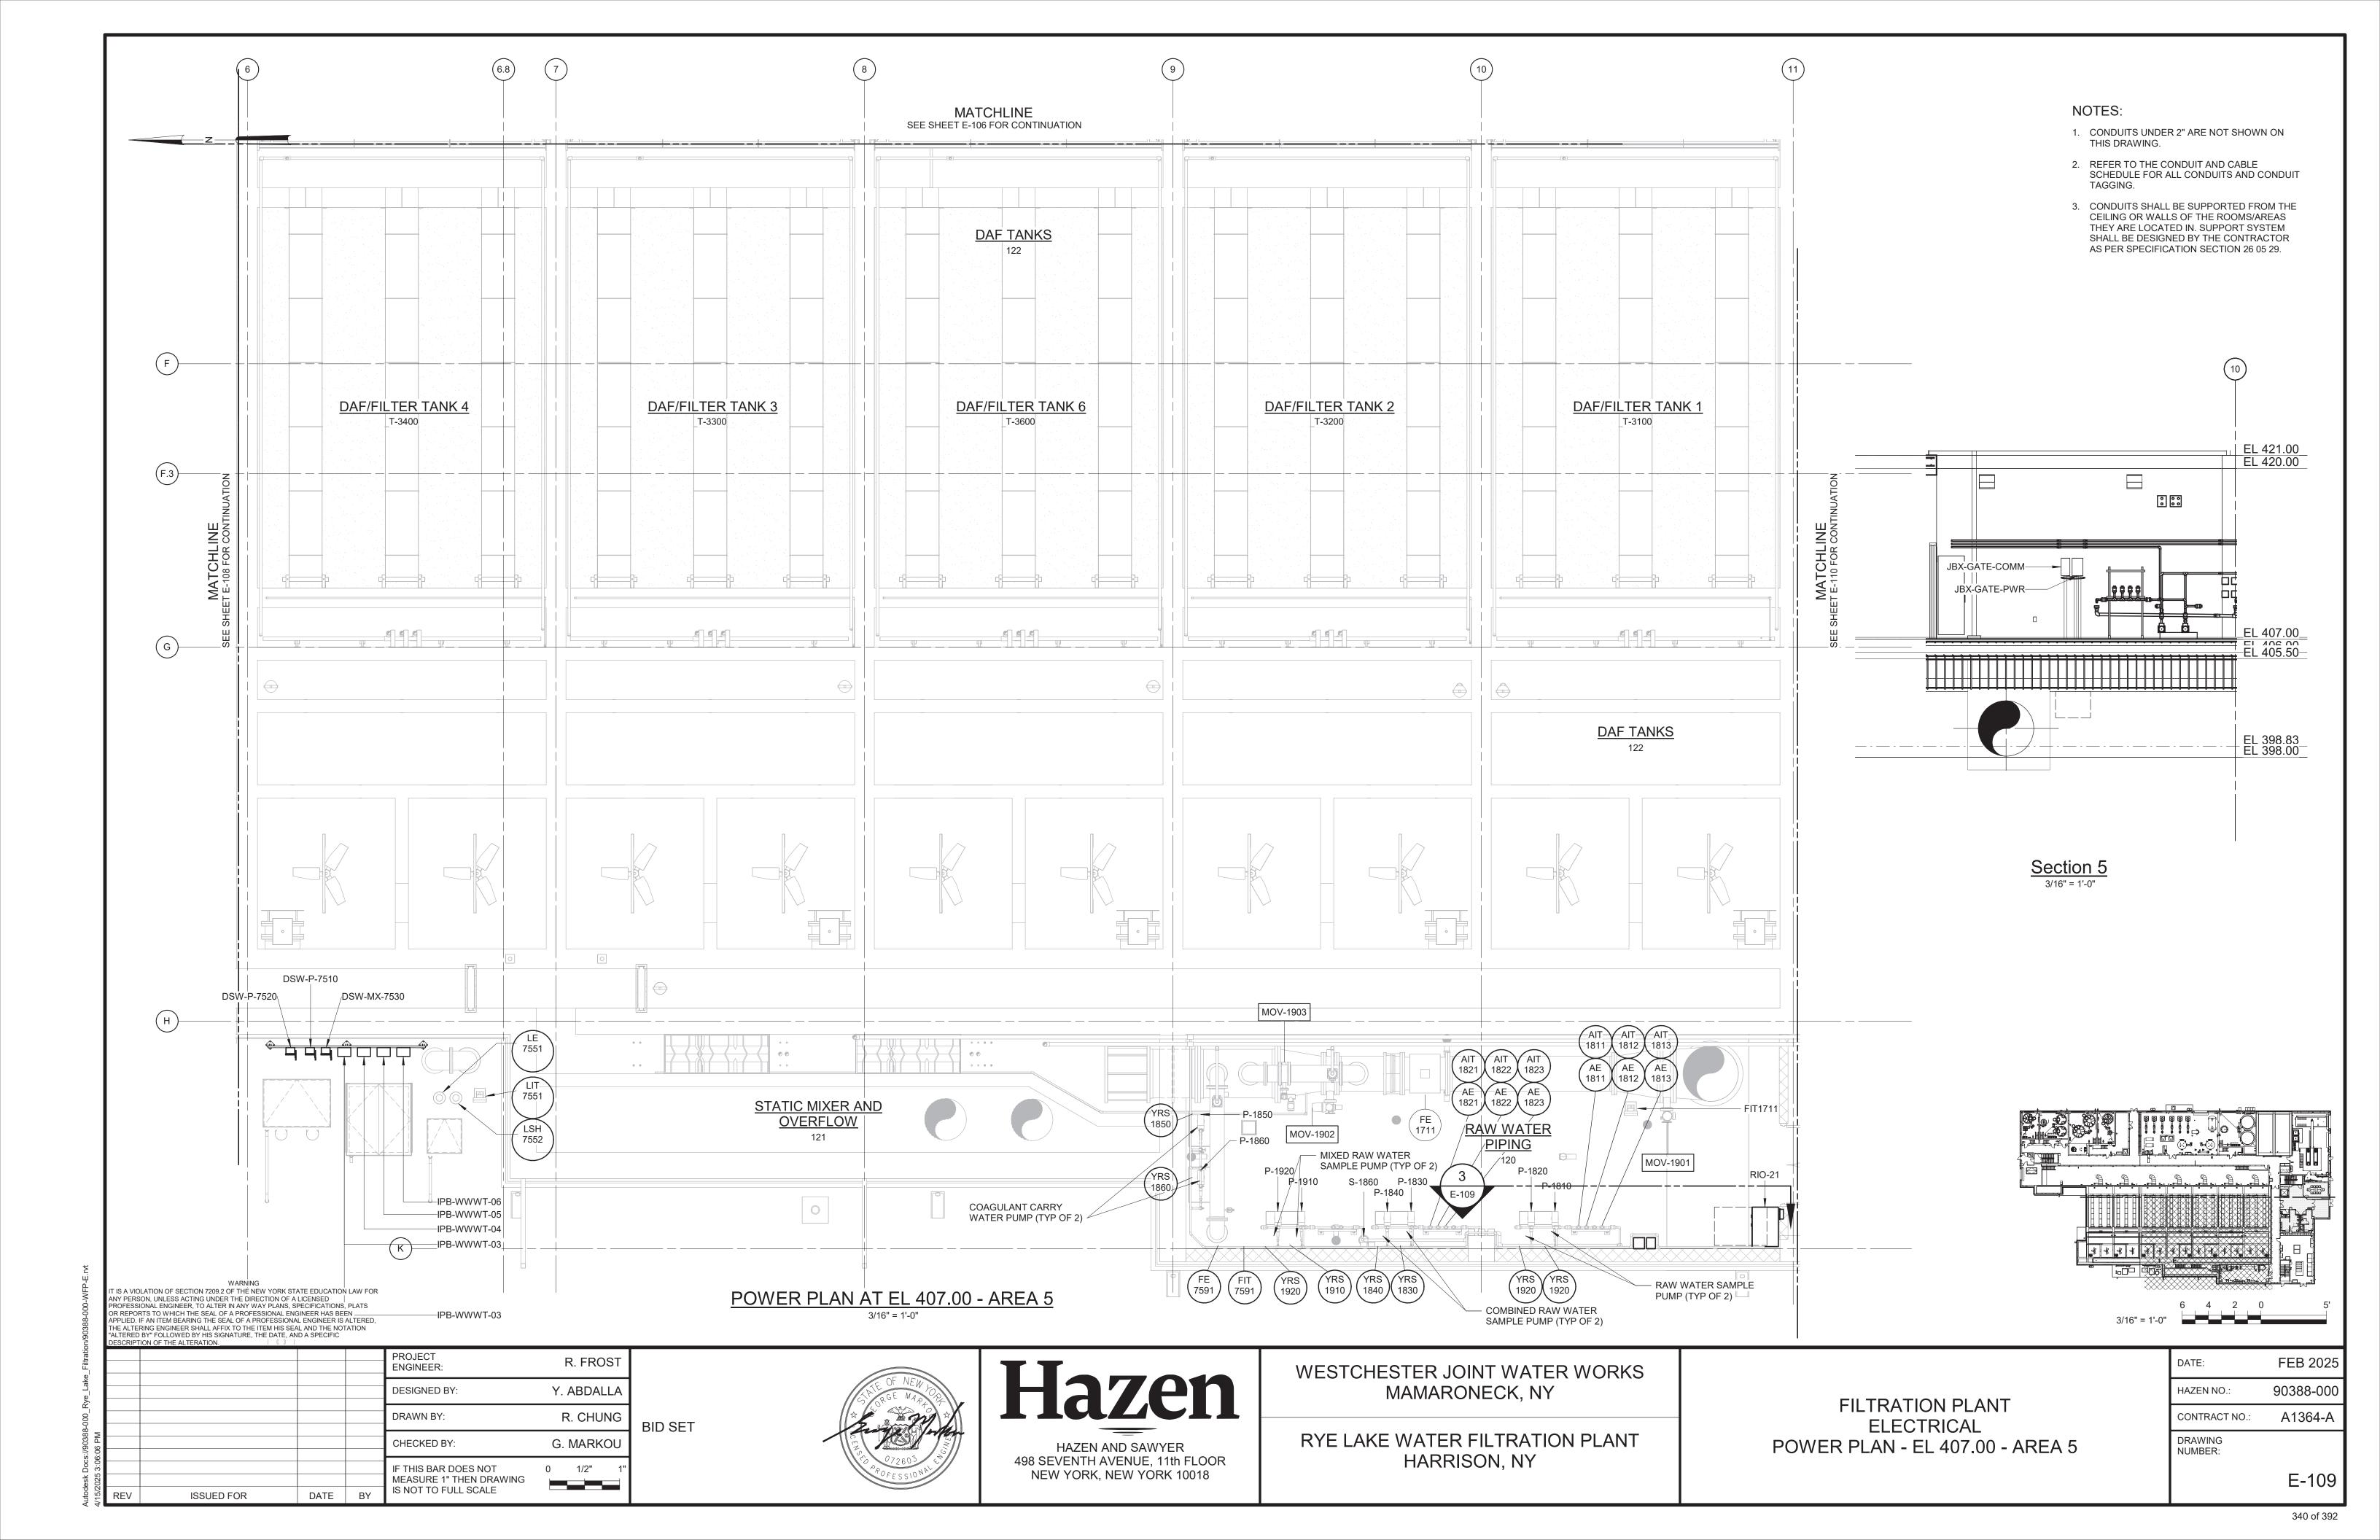

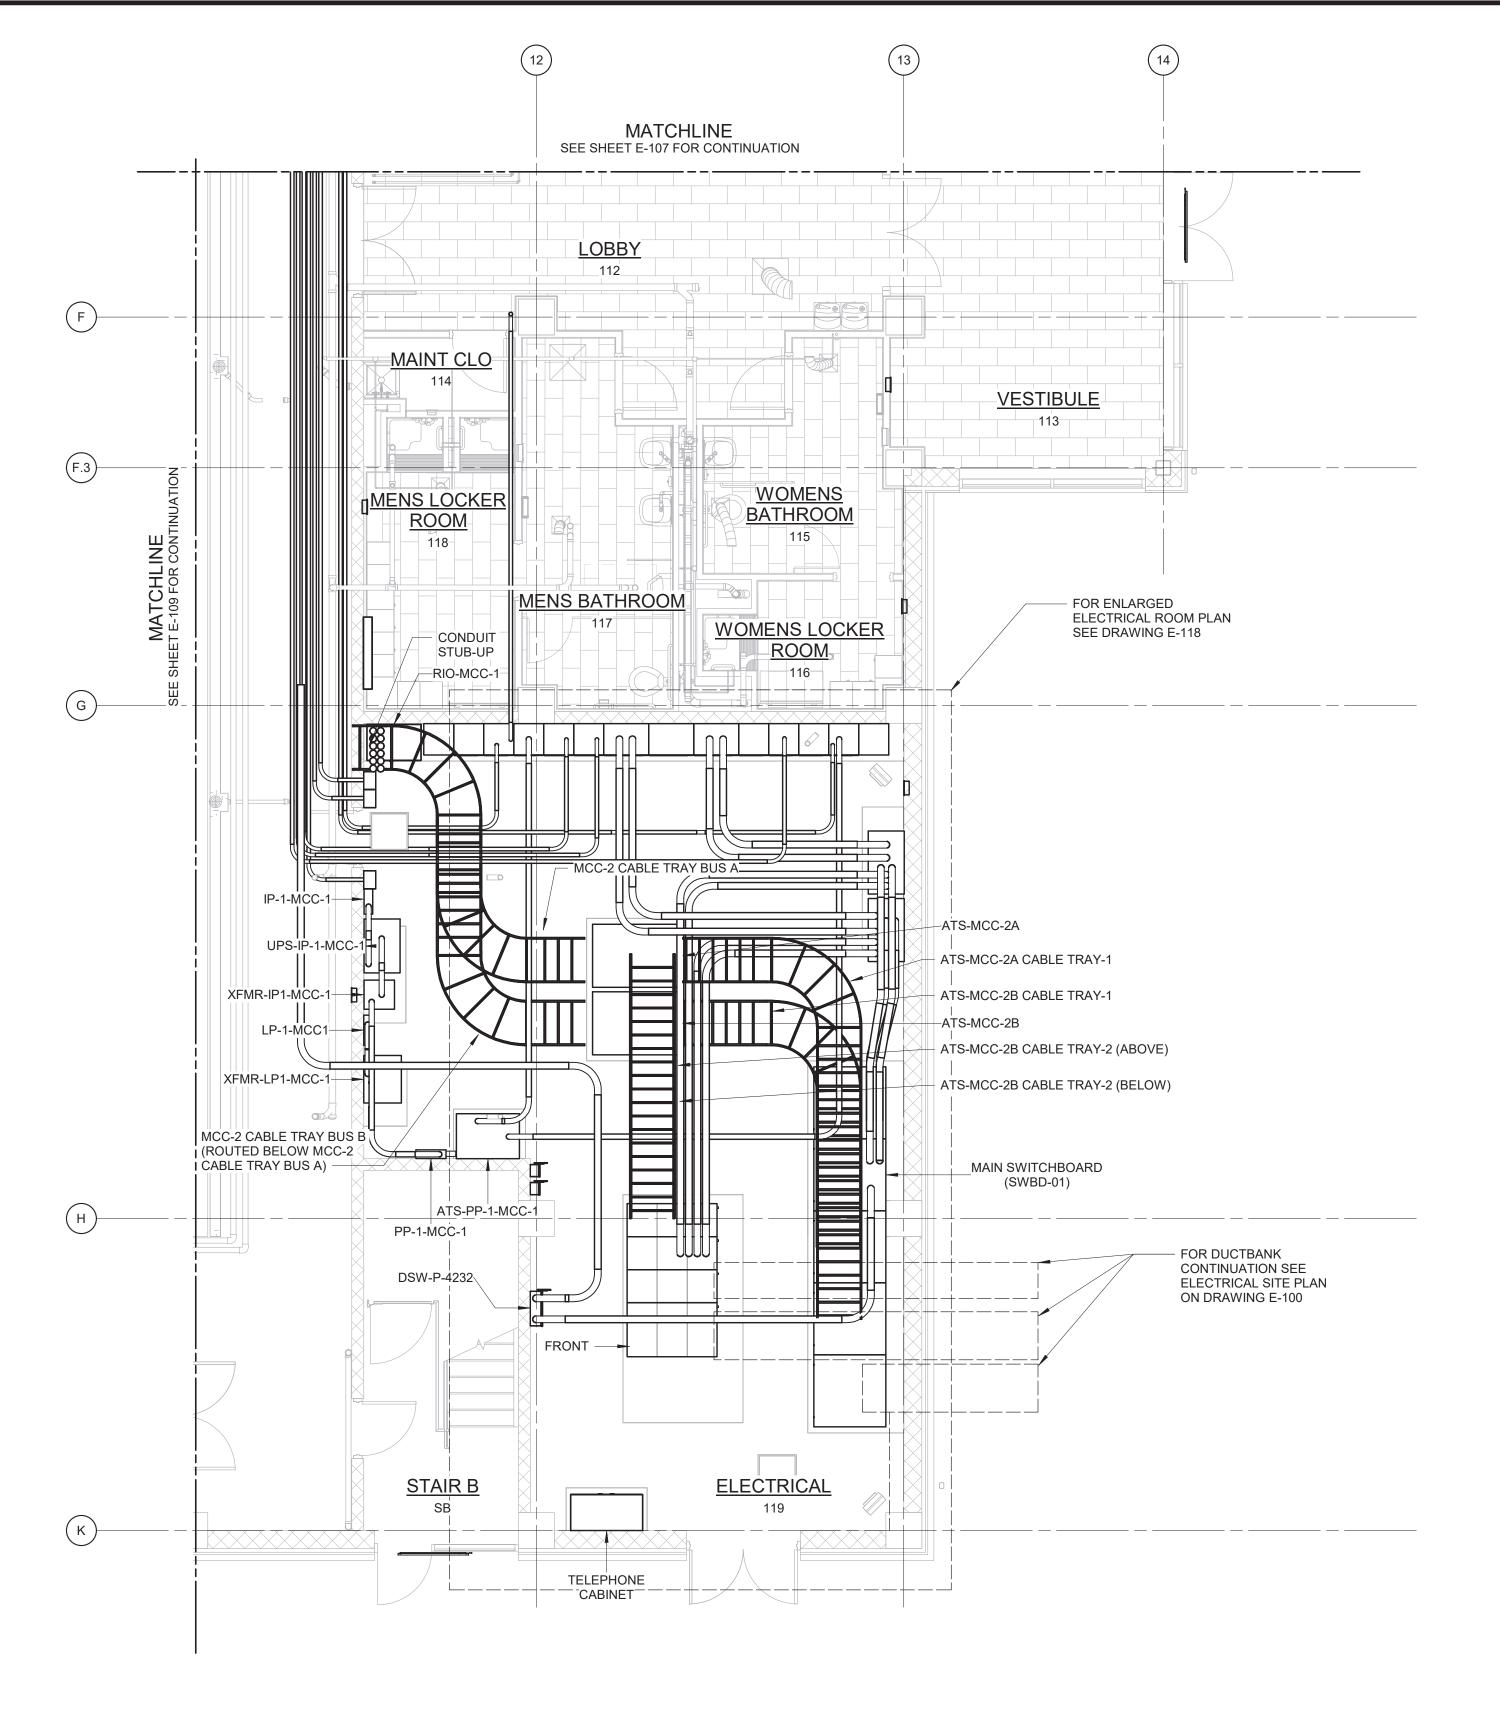

NOTES:

- CONDUITS UNDER 2" ARE NOT SHOWN ON THIS DRAWING.
- REFER TO THE CONDUIT AND CABLE SCHEDULE FOR ALL CONDUITS AND CONDUIT TAGGING.
- 3. CONDUITS SHALL BE SUPPORTED FROM THE CEILING OR WALLS OF THE ROOMS/AREAS THEY ARE LOCATED IN. SUPPORT SYSTEM SHALL BE DESIGNED BY THE CONTRACTOR AS PER SPECIFICATION SECTION 26 05 29.

POWER PLAN AT EL 407.00 - AREA 6

WARNING

IT IS A VIOLATION OF SECTION 7209.2 OF THE NEW YORK STATE EDUCATION LAW FOR ANY PERSON, UNLESS ACTING UNDER THE DIRECTION OF A LICENSED PROFESSIONAL ENGINEER, TO ALTER IN ANY WAY PLANS, SPECIFICATIONS, PLATS OR REPORTS TO WHICH THE SEAL OF A PROFESSIONAL ENGINEER HAS BEEN APPLIED. IT HE ALTERNIS ENGINEER SHALL AFTIX TO THE ITEM HIS SEAL AND THE NOTATION "ALTERED BY" FOLLOWED BY HIS SIGNATURE, THE DATE, AND A SPECIFIC DESCRIPTION OF THE ALTERATION.

PROJECT ENGINEER:

DESIGNED BY:

V. ABDALLA

DRAWN BY:

R. CHUNG

CHECKED BY:

CHECKED BY:

G. MARKOU

REV ISSUED FOR DATE BY

IS NOT TO FULL SCALE



HAZEN AND SAWYER
498 SEVENTH AVENUE, 11th FLOOR


NEW YORK, NEW YORK 10018

WESTCHESTER JOINT WATER WORKS MAMARONECK, NY

RYE LAKE WATER FILTRATION PLANT HARRISON, NY

FILTRATION PLANT			
ELECTRICAL			
POWER PLAN - EL 407.00 - AREA 6			

DATE:	FEB 2025
HAZEN NO.:	90388-000
CONTRACT NO.:	A1364-A
DRAWING NUMBER:	
	E-110

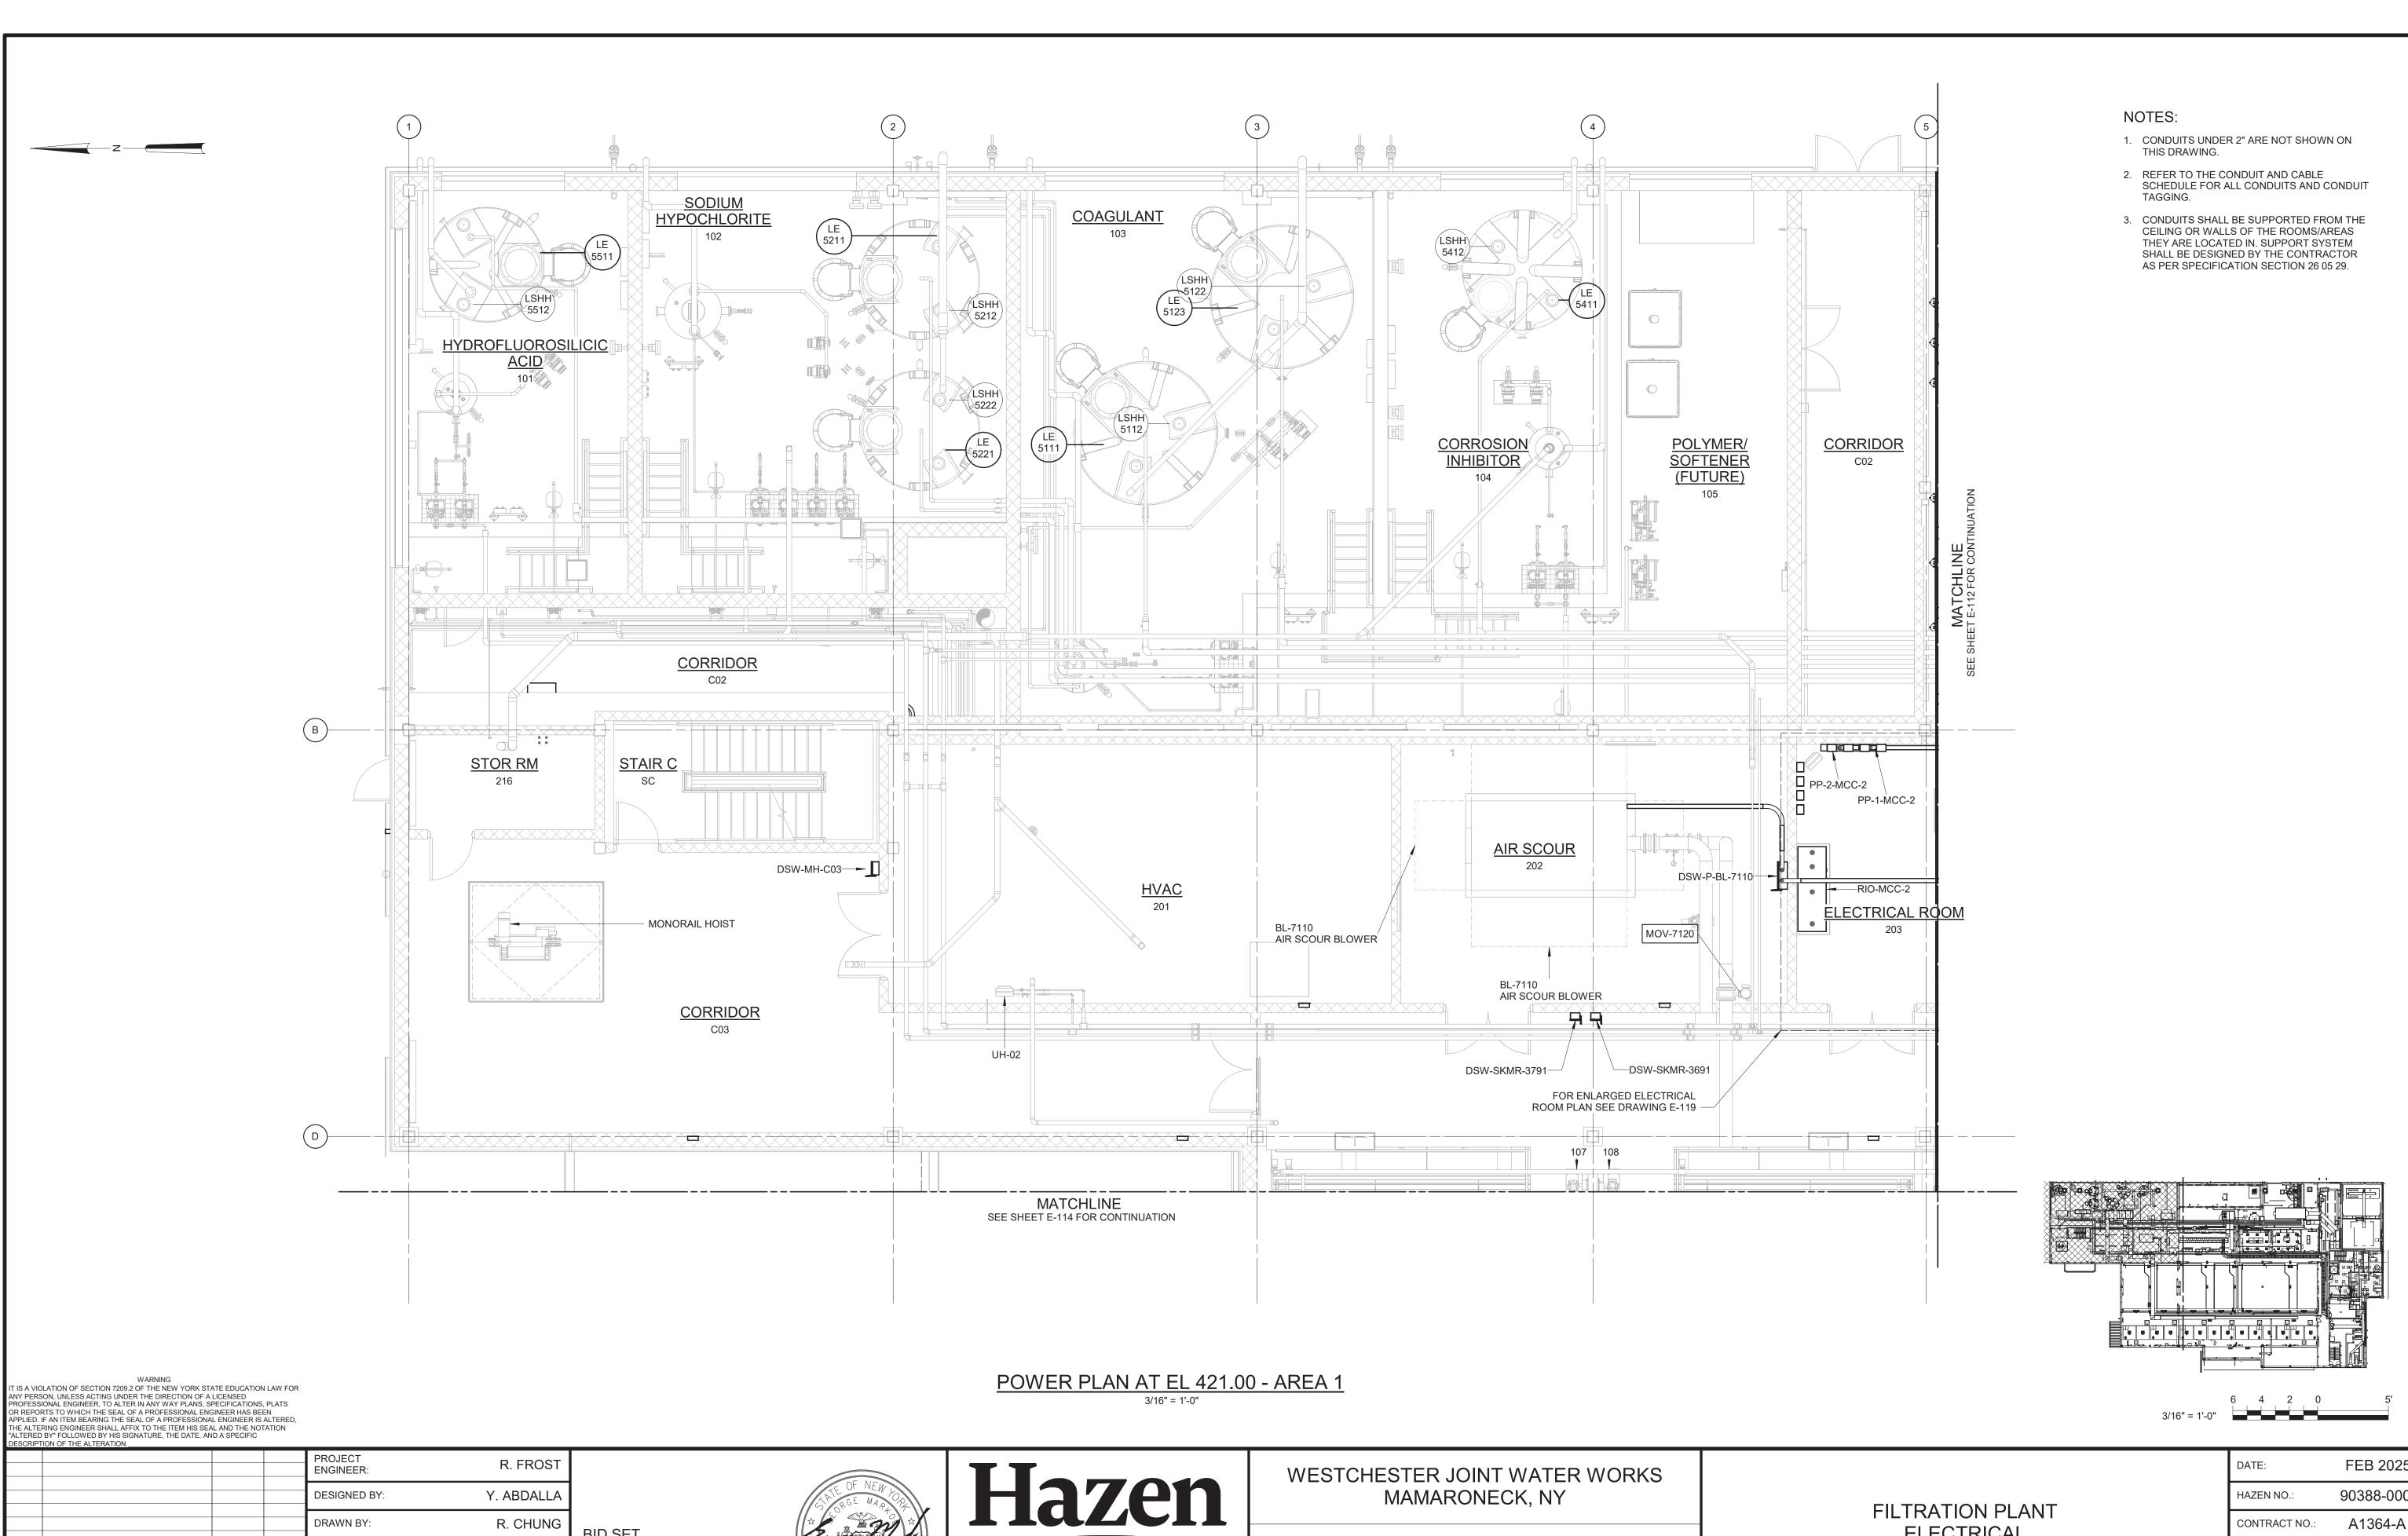

HAZEN AND SAWYER

498 SEVENTH AVENUE, 11th FLOOR

NEW YORK, NEW YORK 10018

RYE LAKE WATER FILTRATION PLANT

HARRISON, NY

BID SET

G. MARKOU

0 1/2"

CHECKED BY:

DATE BY

ISSUED FOR

IF THIS BAR DOES NOT

MEASURE 1" THEN DRAWING IS NOT TO FULL SCALE


342 of 392

E-111

DRAWING NUMBER:

ELECTRICAL

POWER PLAN - EL 421.00 - AREA 1

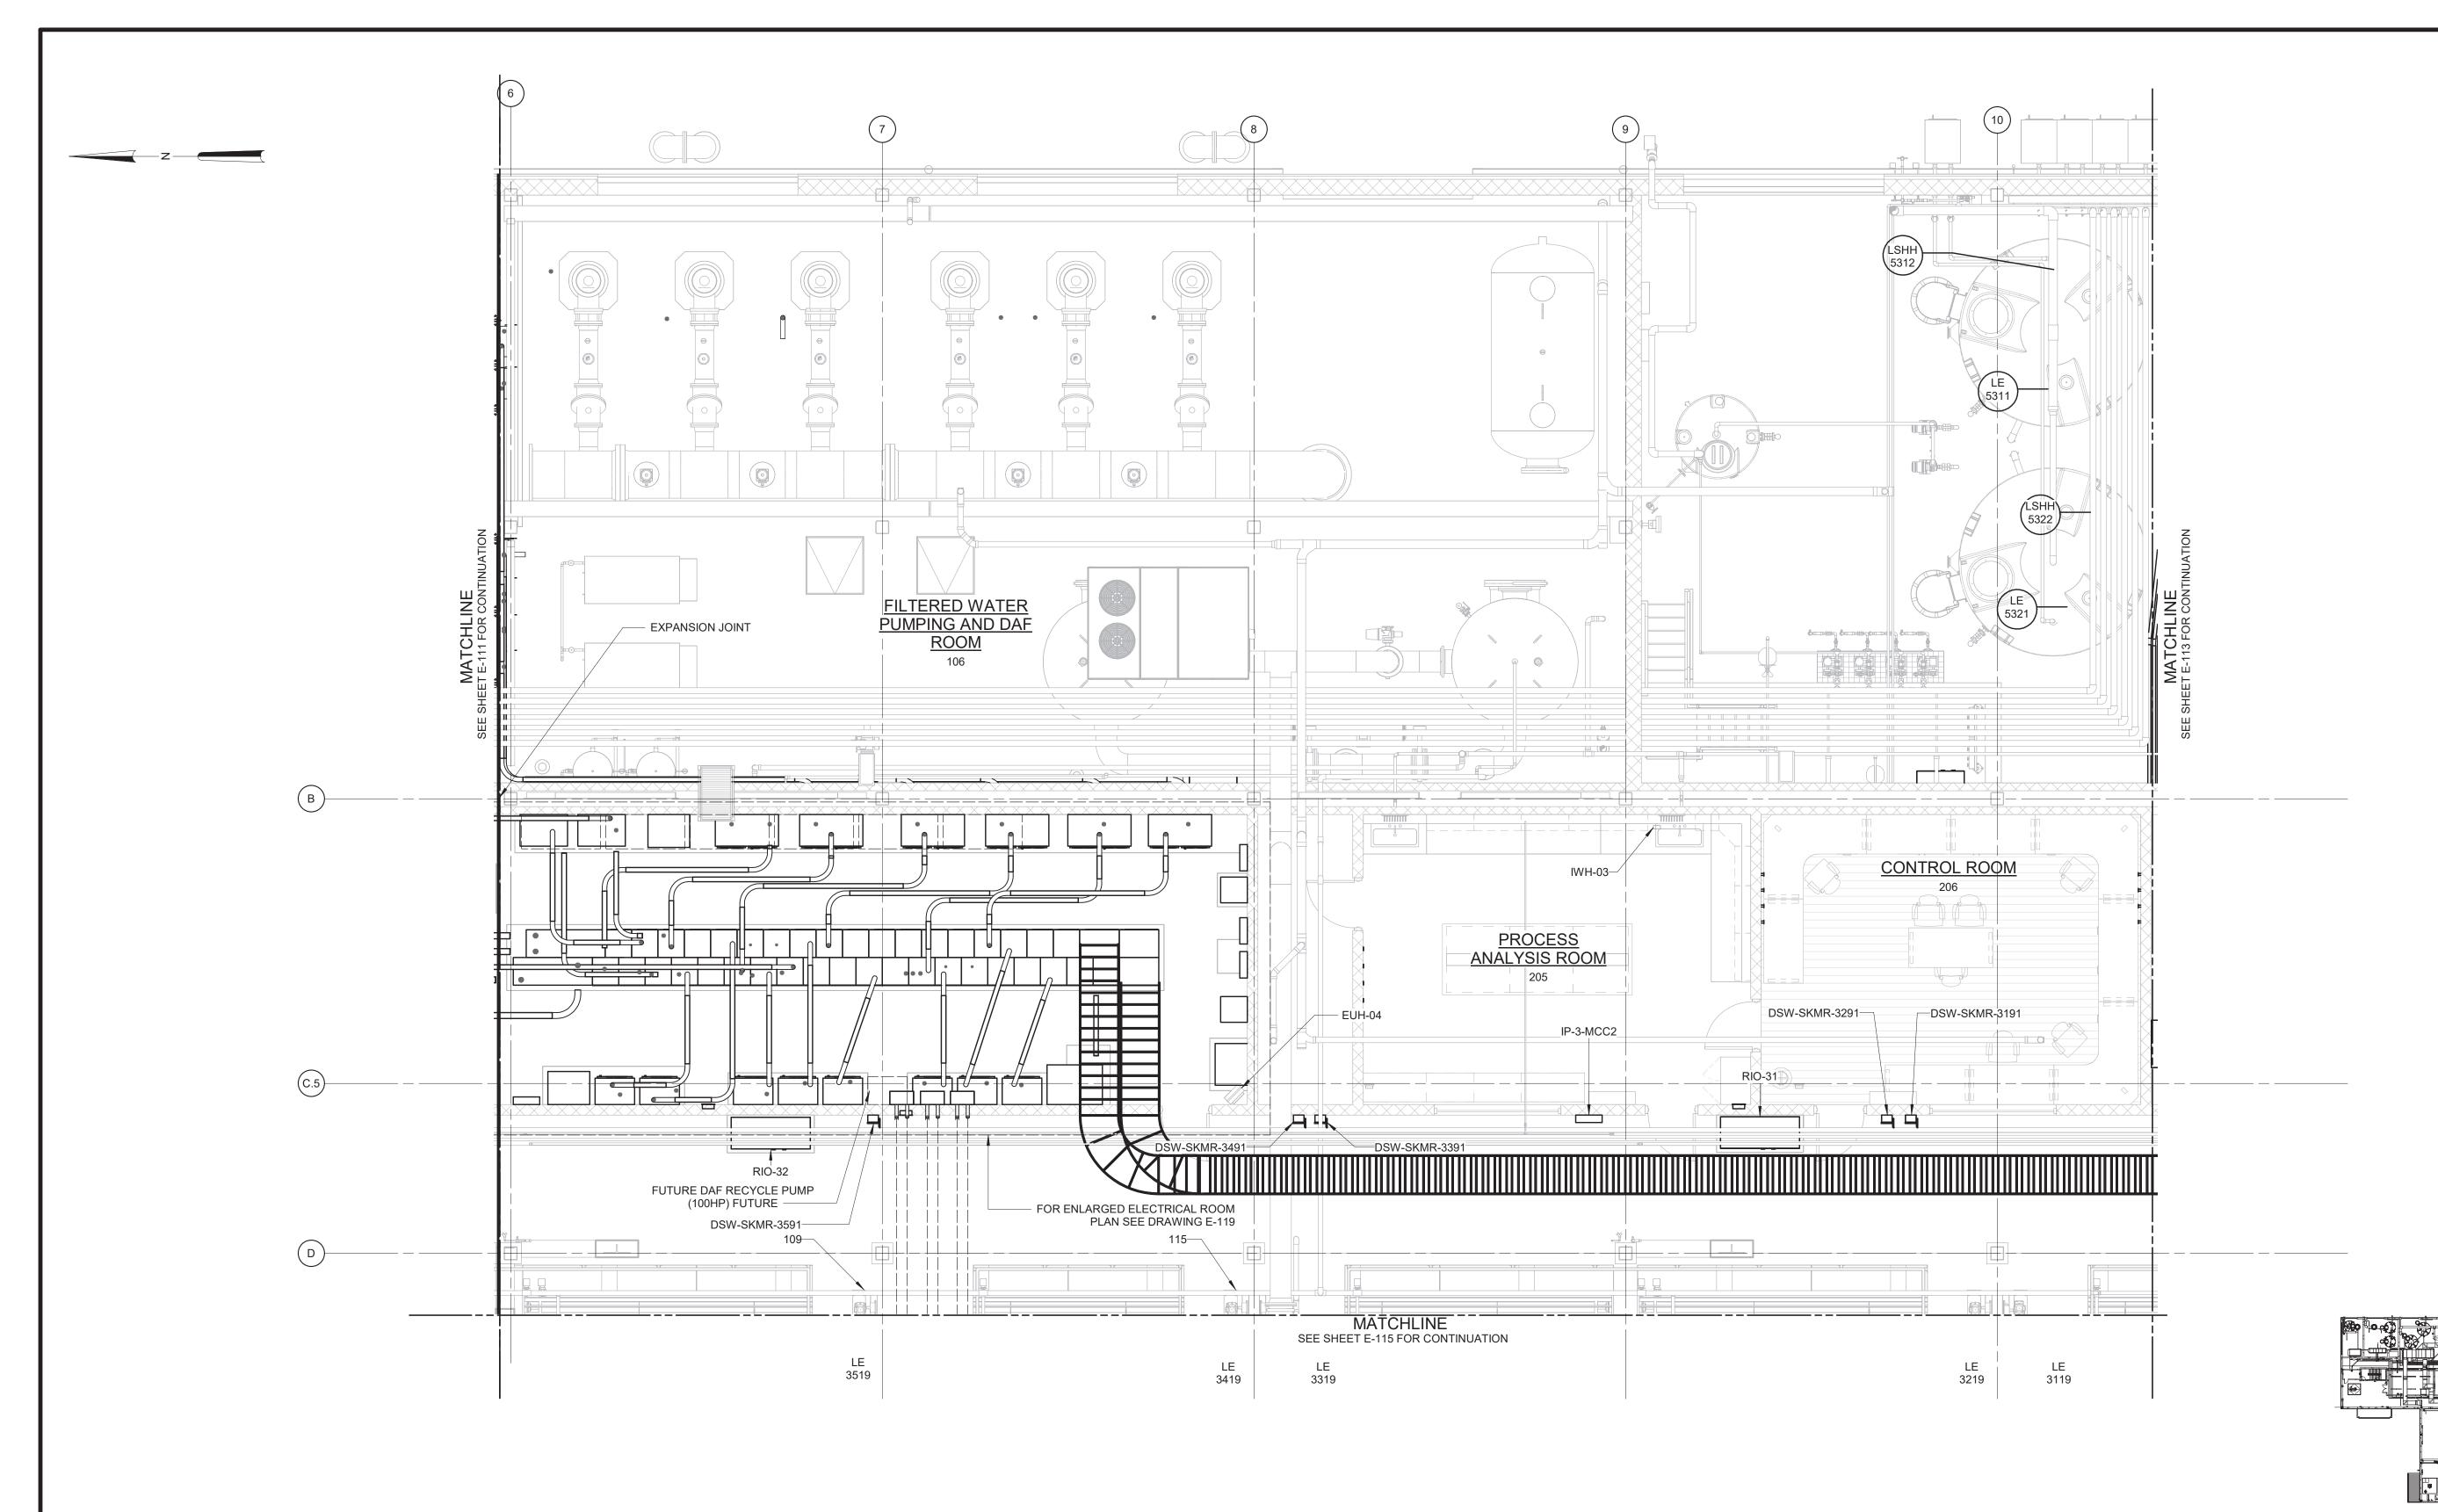

POWER PLAN AT EL 421.00 - AREA 2

	ANY PERS PROFESSI OR REPOF APPLIED. I THE ALTER "ALTERED	LATION OF SECTION 7209.2 OF THE NEW YORK STA ON, UNLESS ACTING UNDER THE DIRECTION OF A L ONAL ENGINEER, TO ALTER IN ANY WAY PLANS, SPRIS TO WHICH THE SEAL OF A PROFESSIONAL ENG F AN ITEM BEARING THE SEAL OF A PROFESSIONAL RING ENGINEER SHALL AFFIX TO THE ITEM HIS SEAL BY" FOLLOWED BY HIS SIGNATURE, THE DATE, ANION OF THE ALTERATION.	LICENSED PECIFICATIONS SINEER HAS BEI L ENGINEER IS L AND THE NOT	, PLATS EN ALTERED,			
					PROJECT ENGINEER:	R. FROST	
					DESIGNED BY:	Y. ABDALLA	
					DRAWN BY:	R. CHUNG	BID SET
. ZZ PINI					CHECKED BY:	G. MARKOU	5.5 62.
2025 3:00:					IF THIS BAR DOES NOT MEASURE 1" THEN DRAWING	0 1/2" 1"	
2/5	DE\/	ISSUED FOR	DATE	BV	IS NOT TO FULL SCALE		

WARNING IT IS A VIOLATION OF SECTION 7209.2 OF THE NEW YORK STATE EDUCATION LAW FOR



HAZEN AND SAWYER
498 SEVENTH AVENUE, 11th FLOOR
NEW YORK, NEW YORK 10018

WESTCHESTER JOINT WATER WORKS MAMARONECK, NY

RYE LAKE WATER FILTRATION PLANT HARRISON, NY FILTRATION PLANT ELECTRICAL POWER PLAN - EL 421.00 - AREA 2

DATE:	FEB 2025
HAZEN NO.:	90388-000
CONTRACT NO.:	A1364-A
DRAWING NUMBER:	
	E-112

NOTES:


TAGGING.

 CONDUITS UNDER 2" ARE NOT SHOWN ON THIS DRAWING.

2. REFER TO THE CONDUIT AND CABLE SCHEDULE FOR ALL CONDUITS AND CONDUIT

3. CONDUITS SHALL BE SUPPORTED FROM THE CEILING OR WALLS OF THE ROOMS/AREAS THEY ARE

LOCATED IN. SUPPORT SYSTEM
SHALL BE DESIGNED BY THE
CONTRACTOR AS PER
SPECIFICATION SECTION 26 05 29.

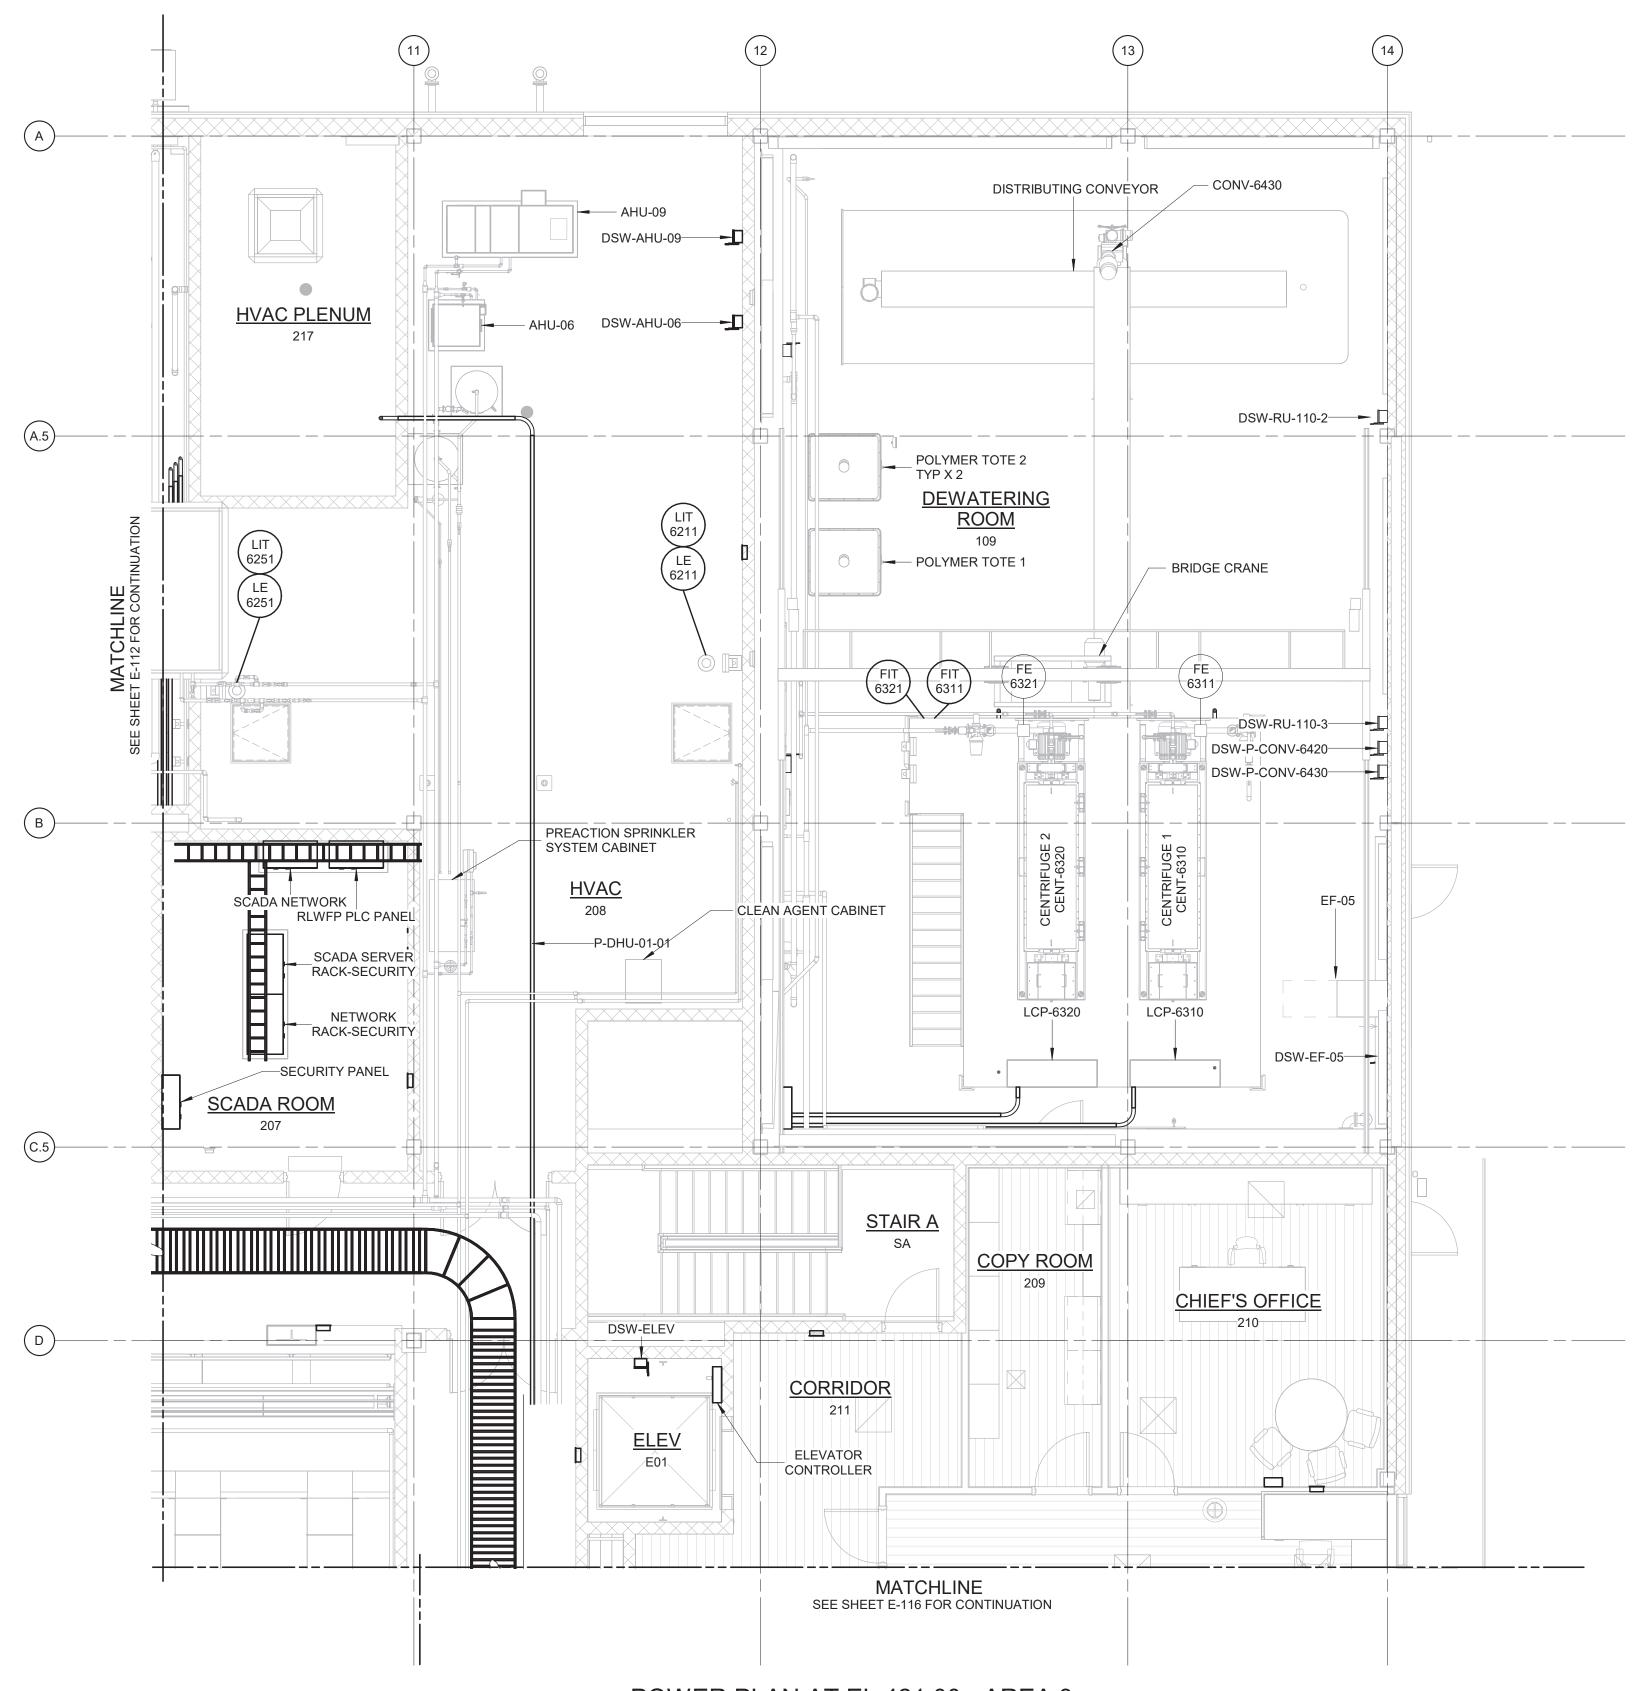

- CONDUITS UNDER 2" ARE NOT SHOWN ON THIS DRAWING.
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POWER PLAN AT EL 421.00 - AREA 3

	ANY PERSO PROFESSIO OR REPORT APPLIED. IF THE ALTER "ALTERED E	WARNING ATION OF SECTION 7209.2 OF THE NEW YORK STAIN, UNLESS ACTING UNDER THE DIRECTION OF A BYAL ENGINEER, TO ALTER IN ANY WAY PLANS, S IS TO WHICH THE SEAL OF A PROFESSIONAL ENG AN ITEM BEARING THE SEAL OF A PROFESSIONAL ING ENGINEER SHALL AFFIX TO THE ITEM HIS SEA SY" FOLLOWED BY HIS SIGNATURE, THE DATE, AN ON OF THE ALTERATION.	LICENSED PECIFICATIONS, PL GINEER HAS BEEN AL ENGINEER IS AL' AL AND THE NOTAT	LATS TERED,			
ı					PROJECT ENGINEER:	R. FROST	
15/2025 3:06:27 PM					DESIGNED BY:	Y. ABDALLA	
					DRAWN BY:	R. CHUNG	BID SET
					CHECKED BY:	G. MARKOU	DID 021
					IF THIS BAR DOES NOT MEASURE 1" THEN DRAWING	0 1/2" 1"	
	REV	ISSUED FOR	DATE	BY	IS NOT TO FULL SCALE		




HAZEN AND SAWYER
498 SEVENTH AVENUE, 11th FLOOR
NEW YORK, NEW YORK 10018

WESTCHESTER JOINT WATER WORKS MAMARONECK, NY

RYE LAKE WATER FILTRATION PLANT HARRISON, NY

FILTRATION PLANT ELECTRICAL POWER PLAN - EL 421.00 - AREA 3

DATE:	FEB 2025
HAZEN NO.:	90388-000
CONTRACT NO.:	A1364-A
DRAWING NUMBER:	
	E-113

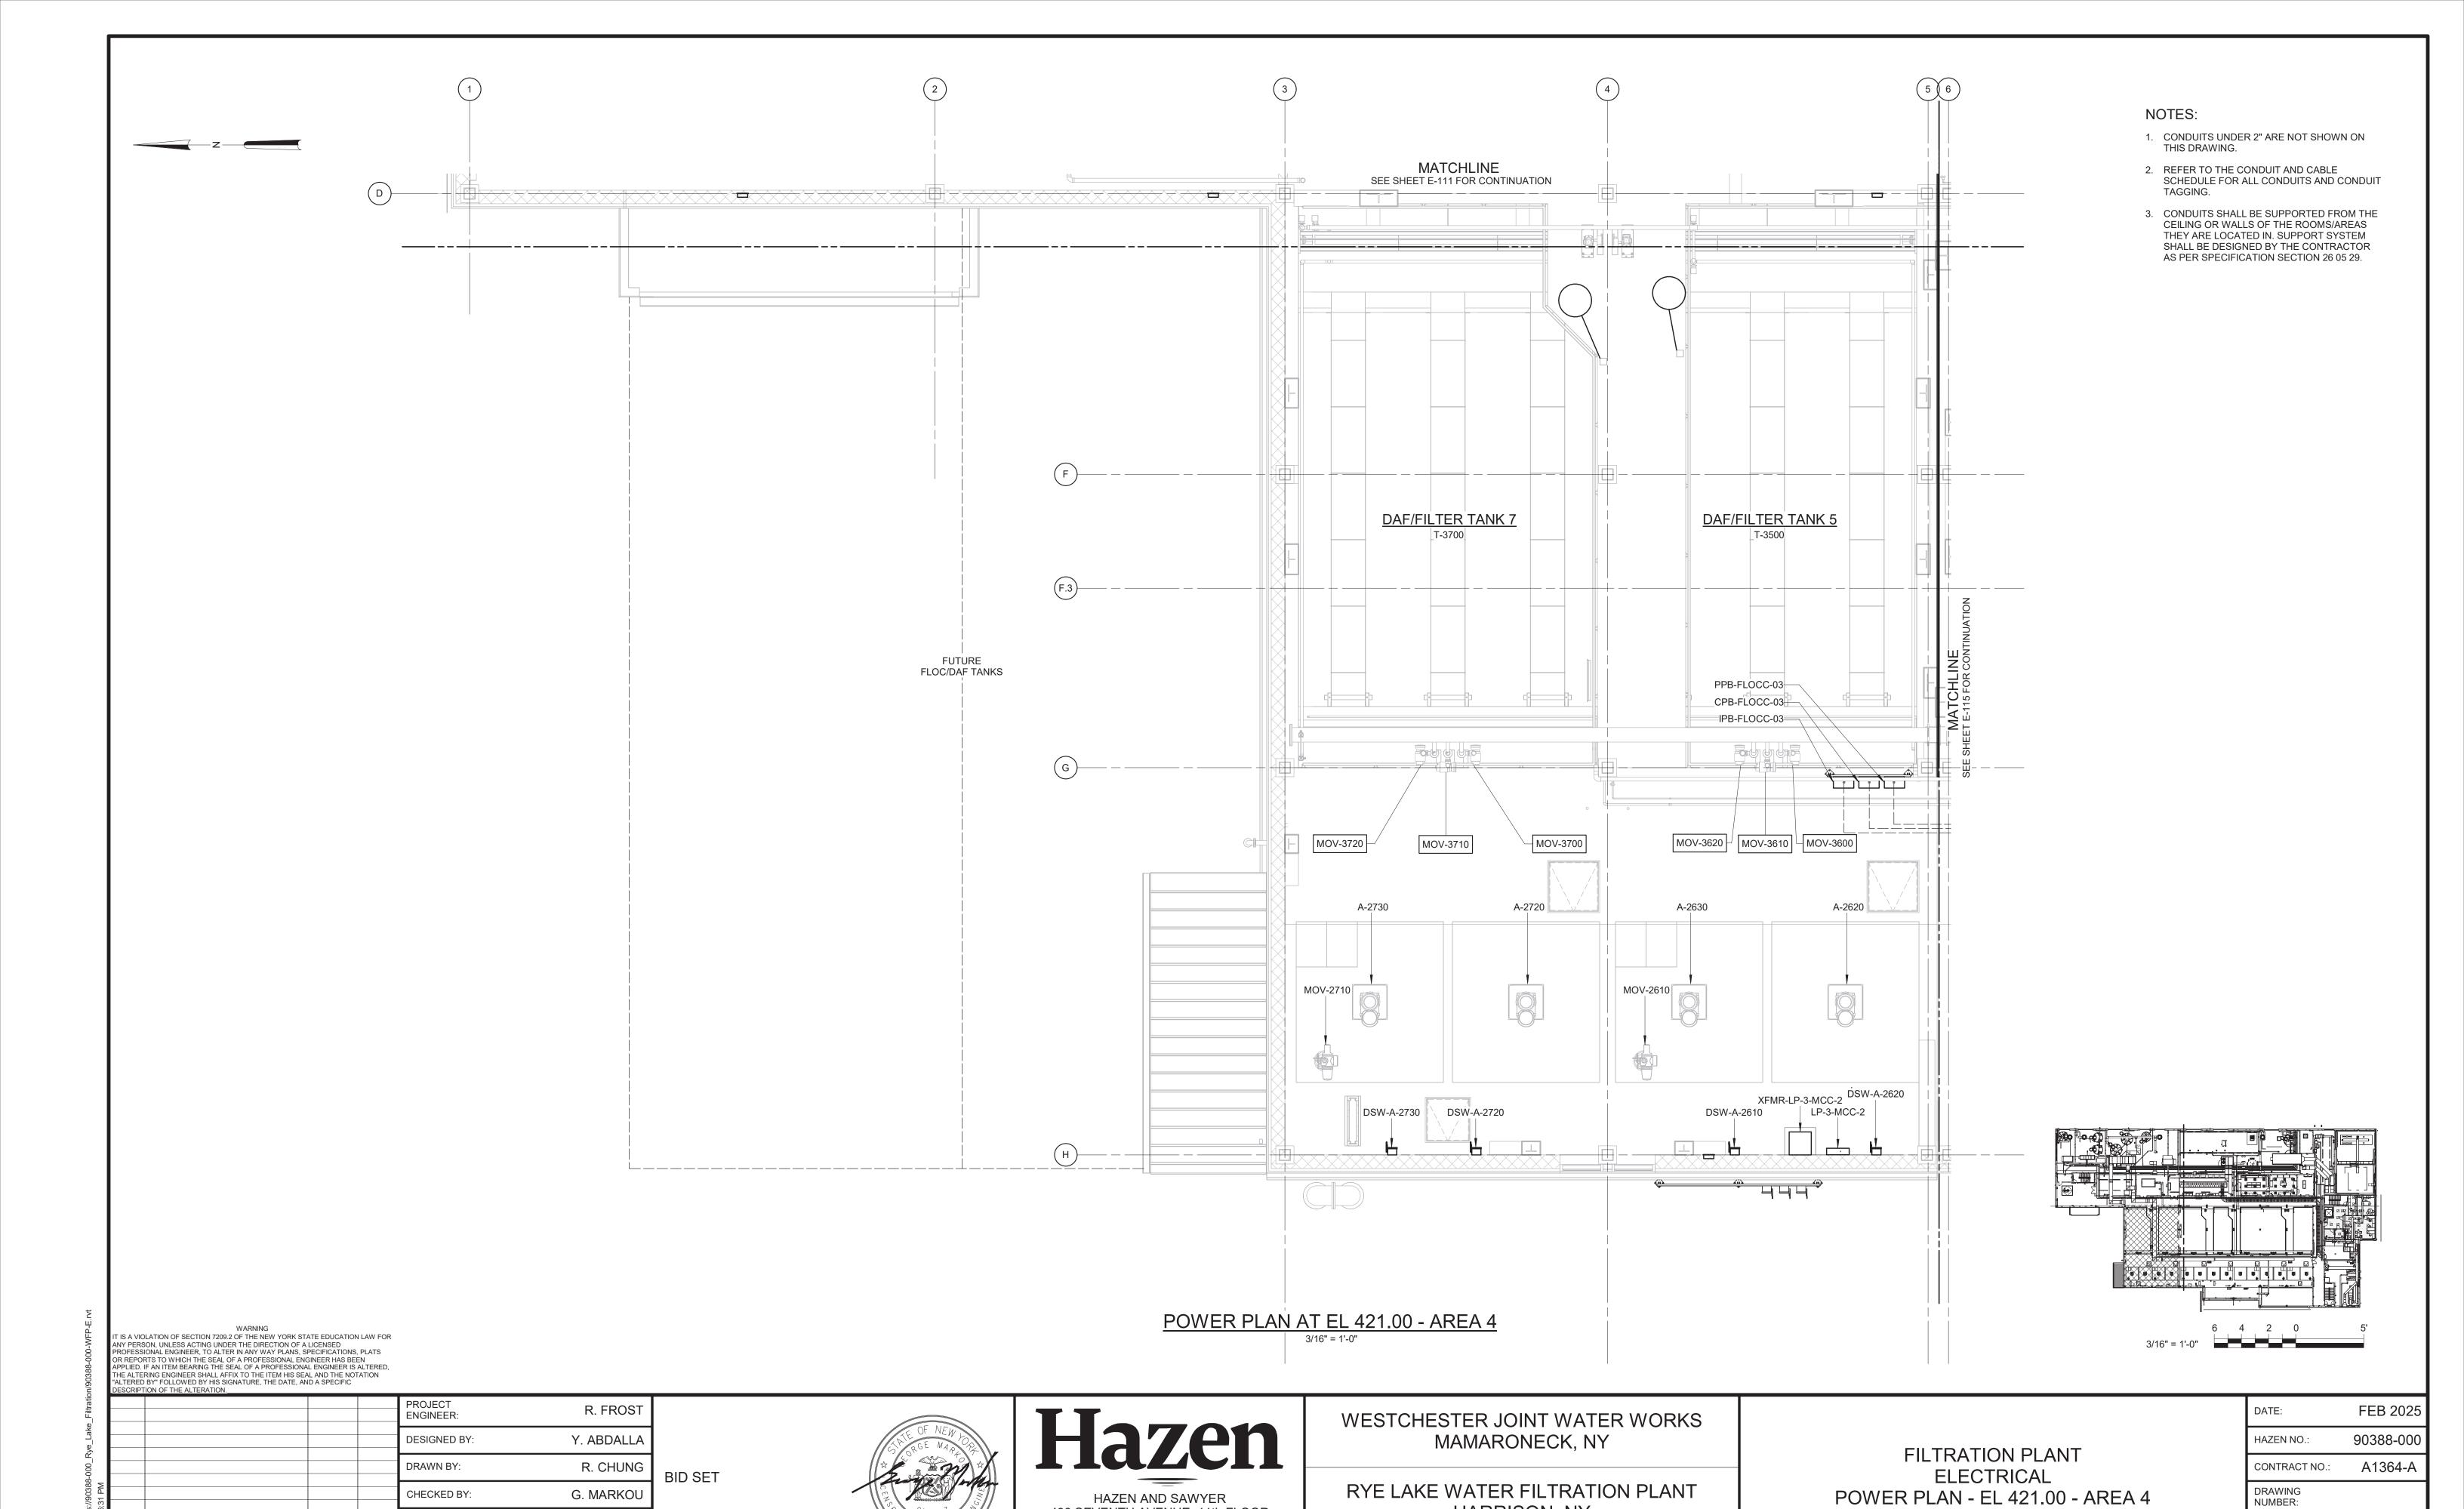

498 SEVENTH AVENUE, 11th FLOOR

NEW YORK, NEW YORK 10018

IF THIS BAR DOES NOT

DATE BY

ISSUED FOR


MEASURE 1" THEN DRAWING IS NOT TO FULL SCALE


0 1/2"

HARRISON, NY

345 of 392

E-114

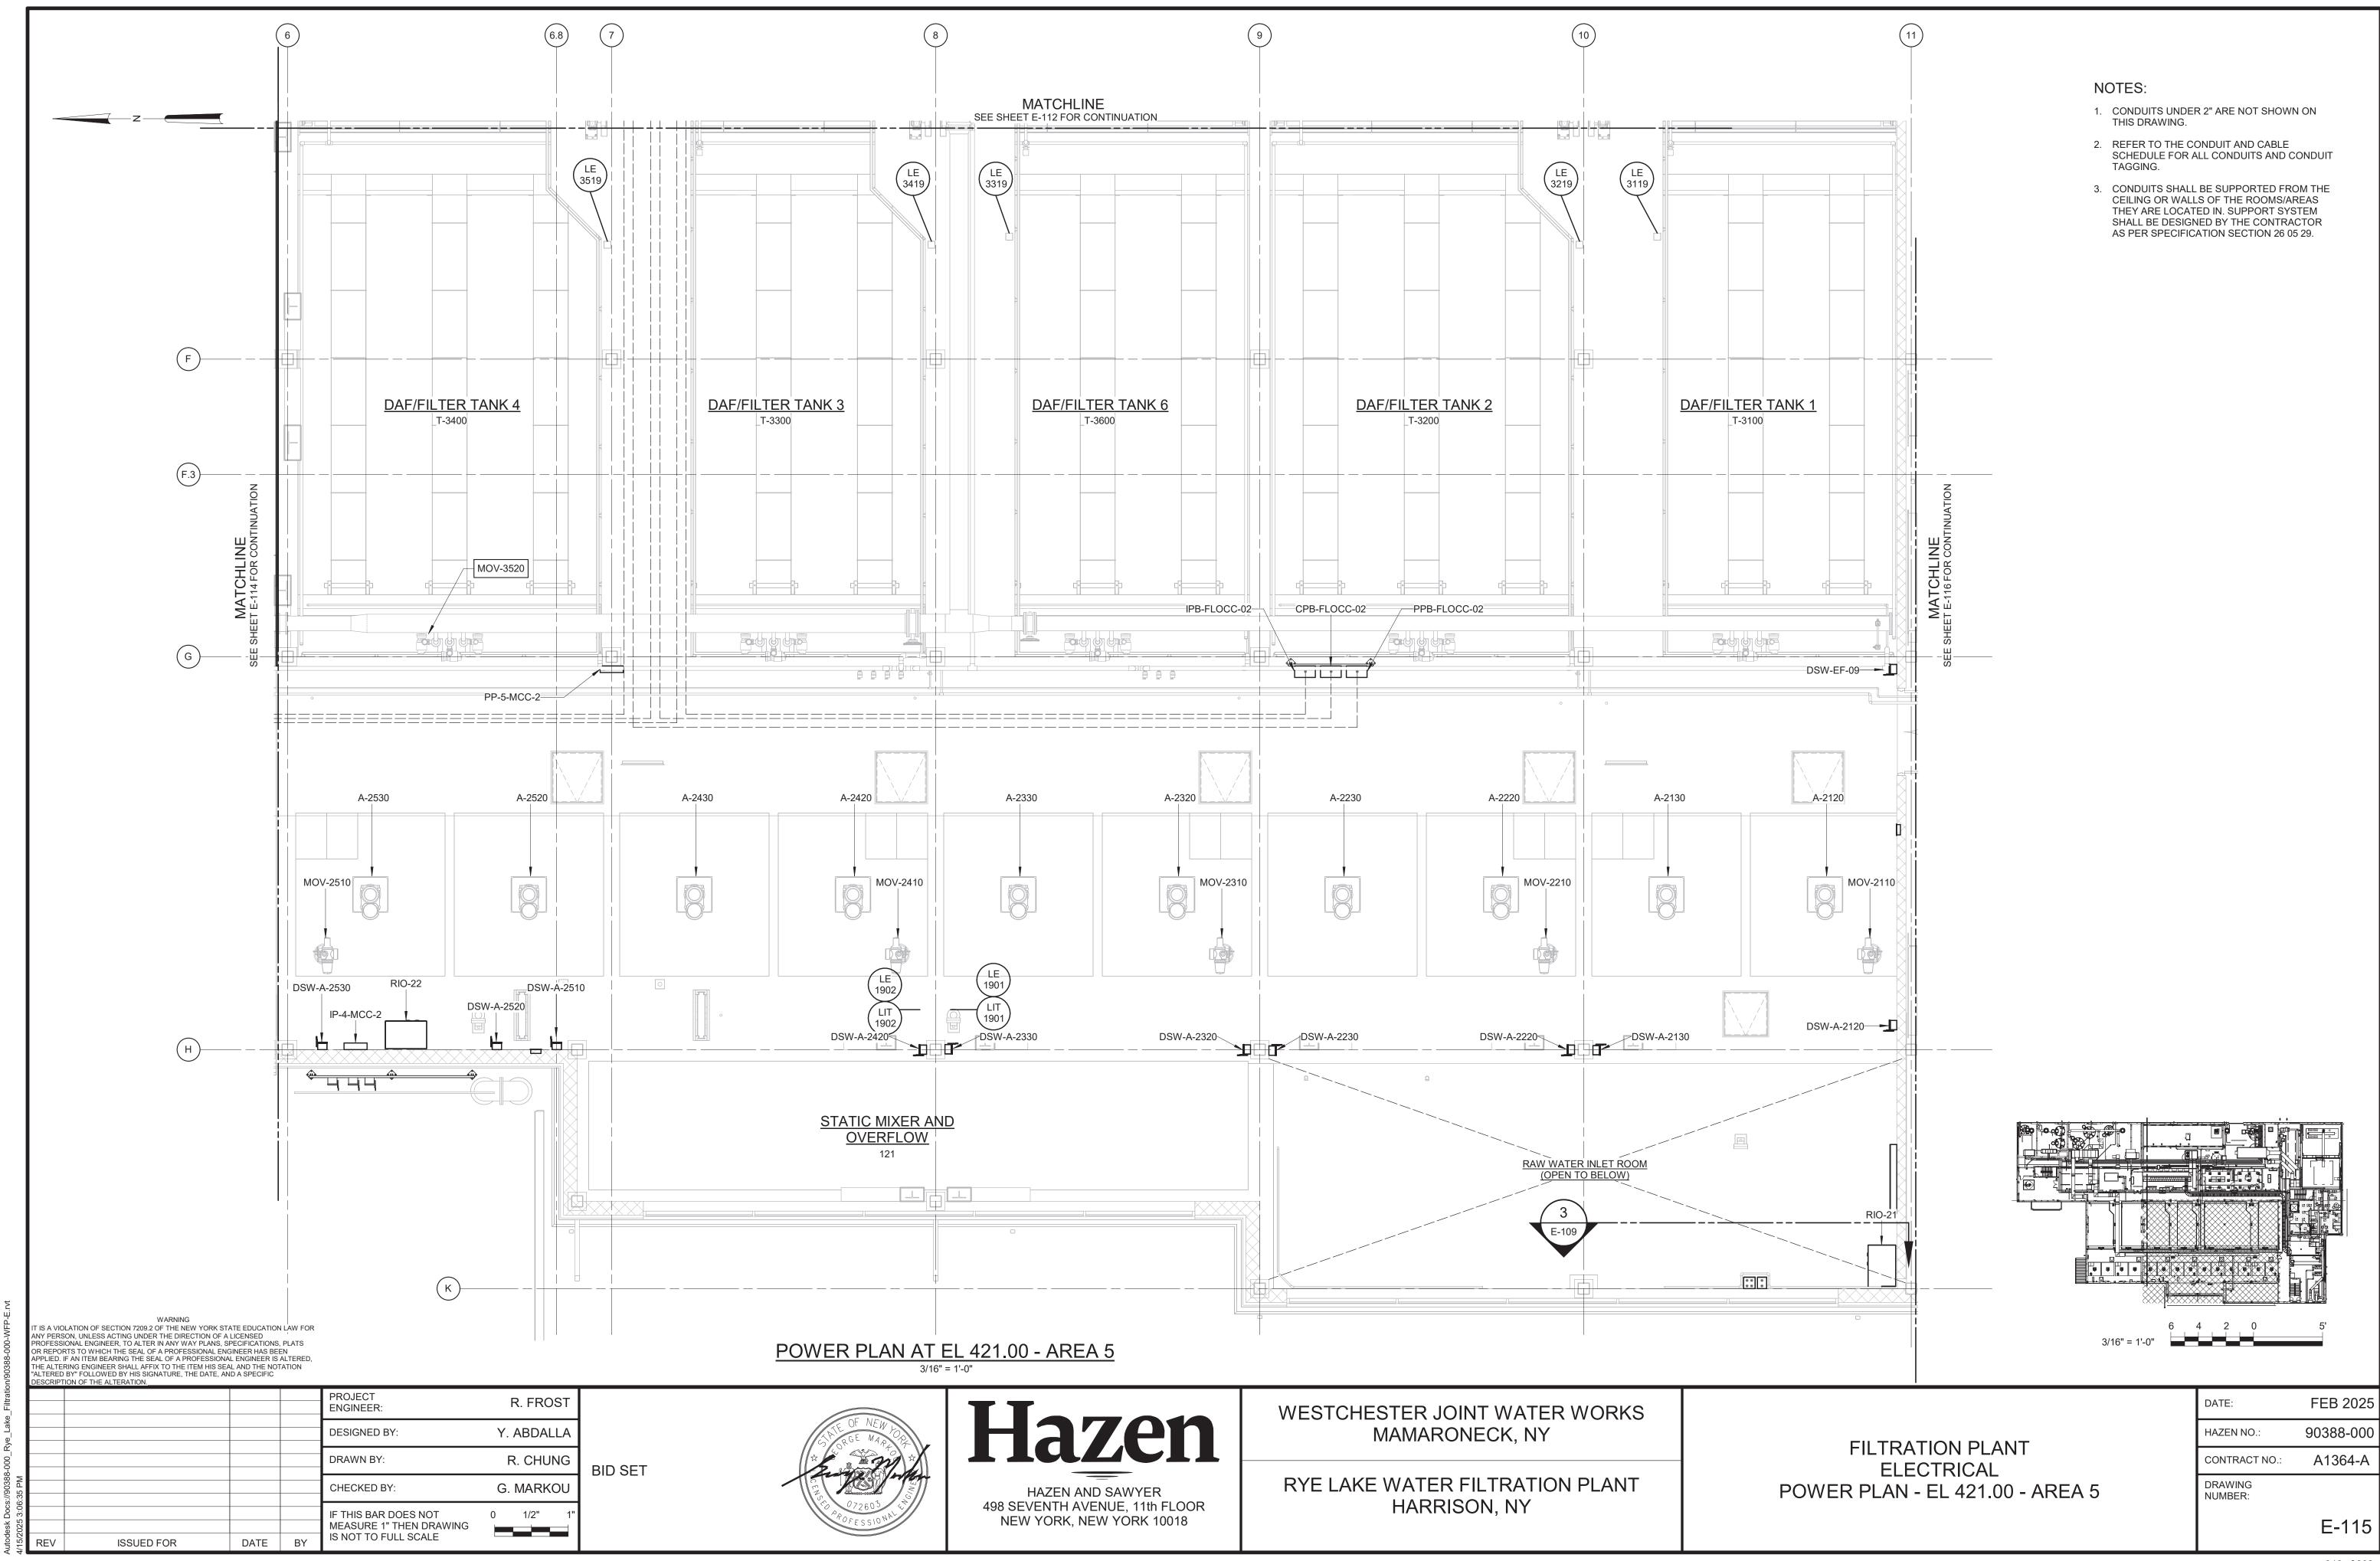

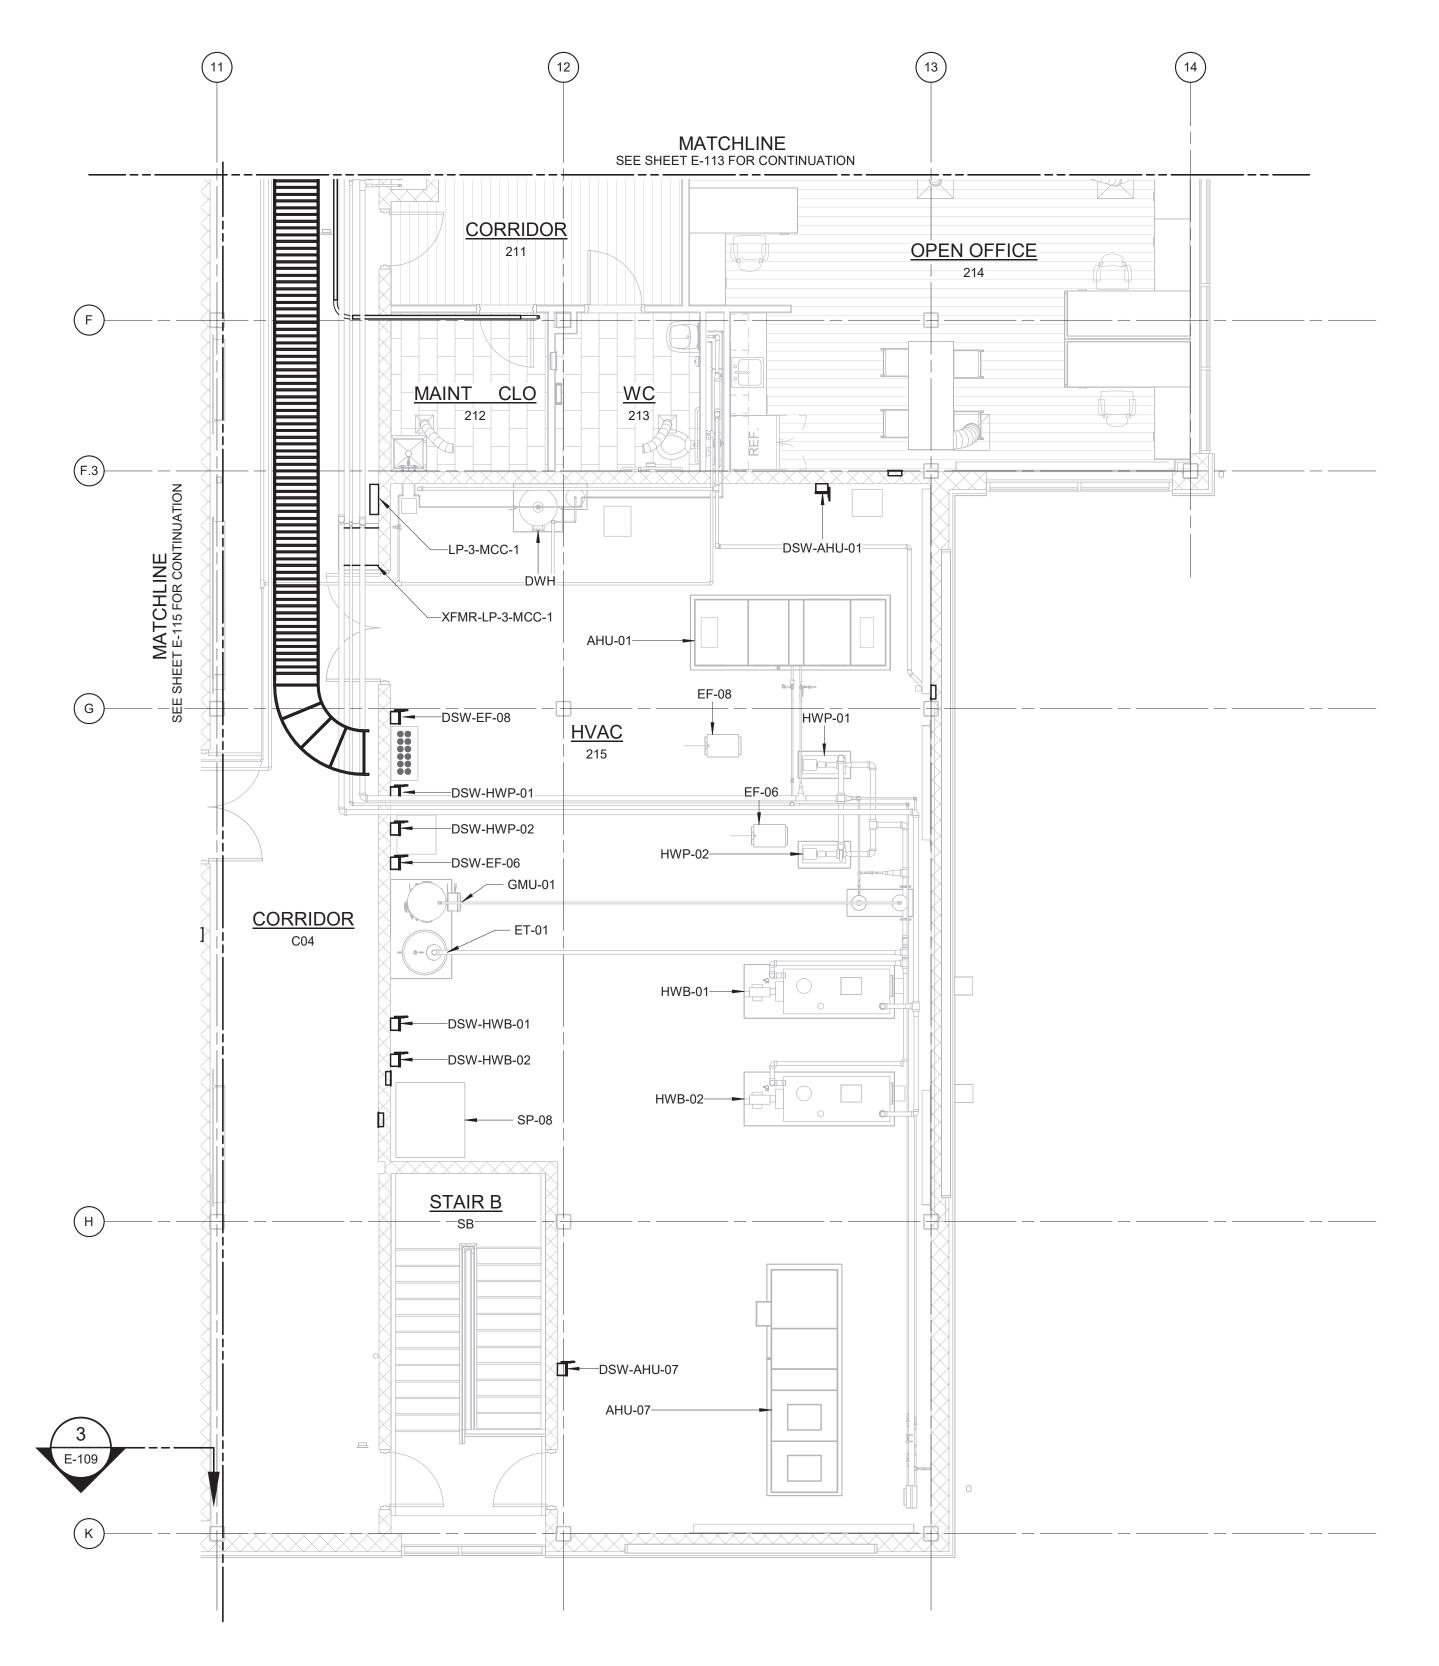

POWER PLAN AT EL 421.00 - AREA 6

	ANY PERS PROFESS OR REPOI APPLIED. THE ALTE "ALTERED	WARNING LATION OF SECTION 7209.2 OF THE NEW YORK STA ON, UNLESS ACTING UNDER THE DIRECTION OF A I ONAL ENGINEER, TO ALTER IN ANY WAY PLANS, SF RTS TO WHICH THE SEAL OF A PROFESSIONAL ENG F AN ITEM BEARING THE SEAL OF A PROFESSIONAI RING ENGINEER SHALL AFFIX TO THE ITEM HIS SEA BY" FOLLOWED BY HIS SIGNATURE, THE DATE, AN ION OF THE ALTERATION.	LICENSED PECIFICATIONS SINEER HAS BEI L ENGINEER IS L AND THE NO	, PLATS EN ALTERED,			
					PROJECT ENGINEER:	R. FROST	
					DESIGNED BY:	Y. ABDALLA	
					DRAWN BY:	R. CHUNG	BID SET
3:06:39 PM					CHECKED BY:	G. MARKOU	DID 021
3:06					IF THIS BAR DOES NOT MEASURE 1" THEN DRAWING	0 1/2" 1"	
15/2025	REV	ISSUED FOR	DATE	BY	IS NOT TO FULL SCALE		

DATE BY

ISSUED FOR

Hazen HAZEN AND SAWYER 498 SEVENTH AVENUE, 11th FLOOR NEW YORK, NEW YORK 10018

WESTCHESTER JOINT WATER WORKS MAMARONECK, NY

RYE LAKE WATER FILTRATION PLANT HARRISON, NY

FILTRATION PLANT ELECTRICAL POWER PLAN - EL 421.00 - AREA 6

DATE:	FEB 2025
HAZEN NO.:	90388-000
CONTRACT NO.:	A1364-A
DRAWING NUMBER:	
	F-116

□-110

NOTES:

THIS DRAWING.

TAGGING.

1. CONDUITS UNDER 2" ARE NOT SHOWN ON

SCHEDULE FOR ALL CONDUITS AND CONDUIT


3. CONDUITS SHALL BE SUPPORTED FROM THE

CEILING OR WALLS OF THE ROOMS/AREAS

THEY ARE LOCATED IN. SUPPORT SYSTEM SHALL BE DESIGNED BY THE CONTRACTOR

AS PER SPECIFICATION SECTION 26 05 29.

2. REFER TO THE CONDUIT AND CABLE

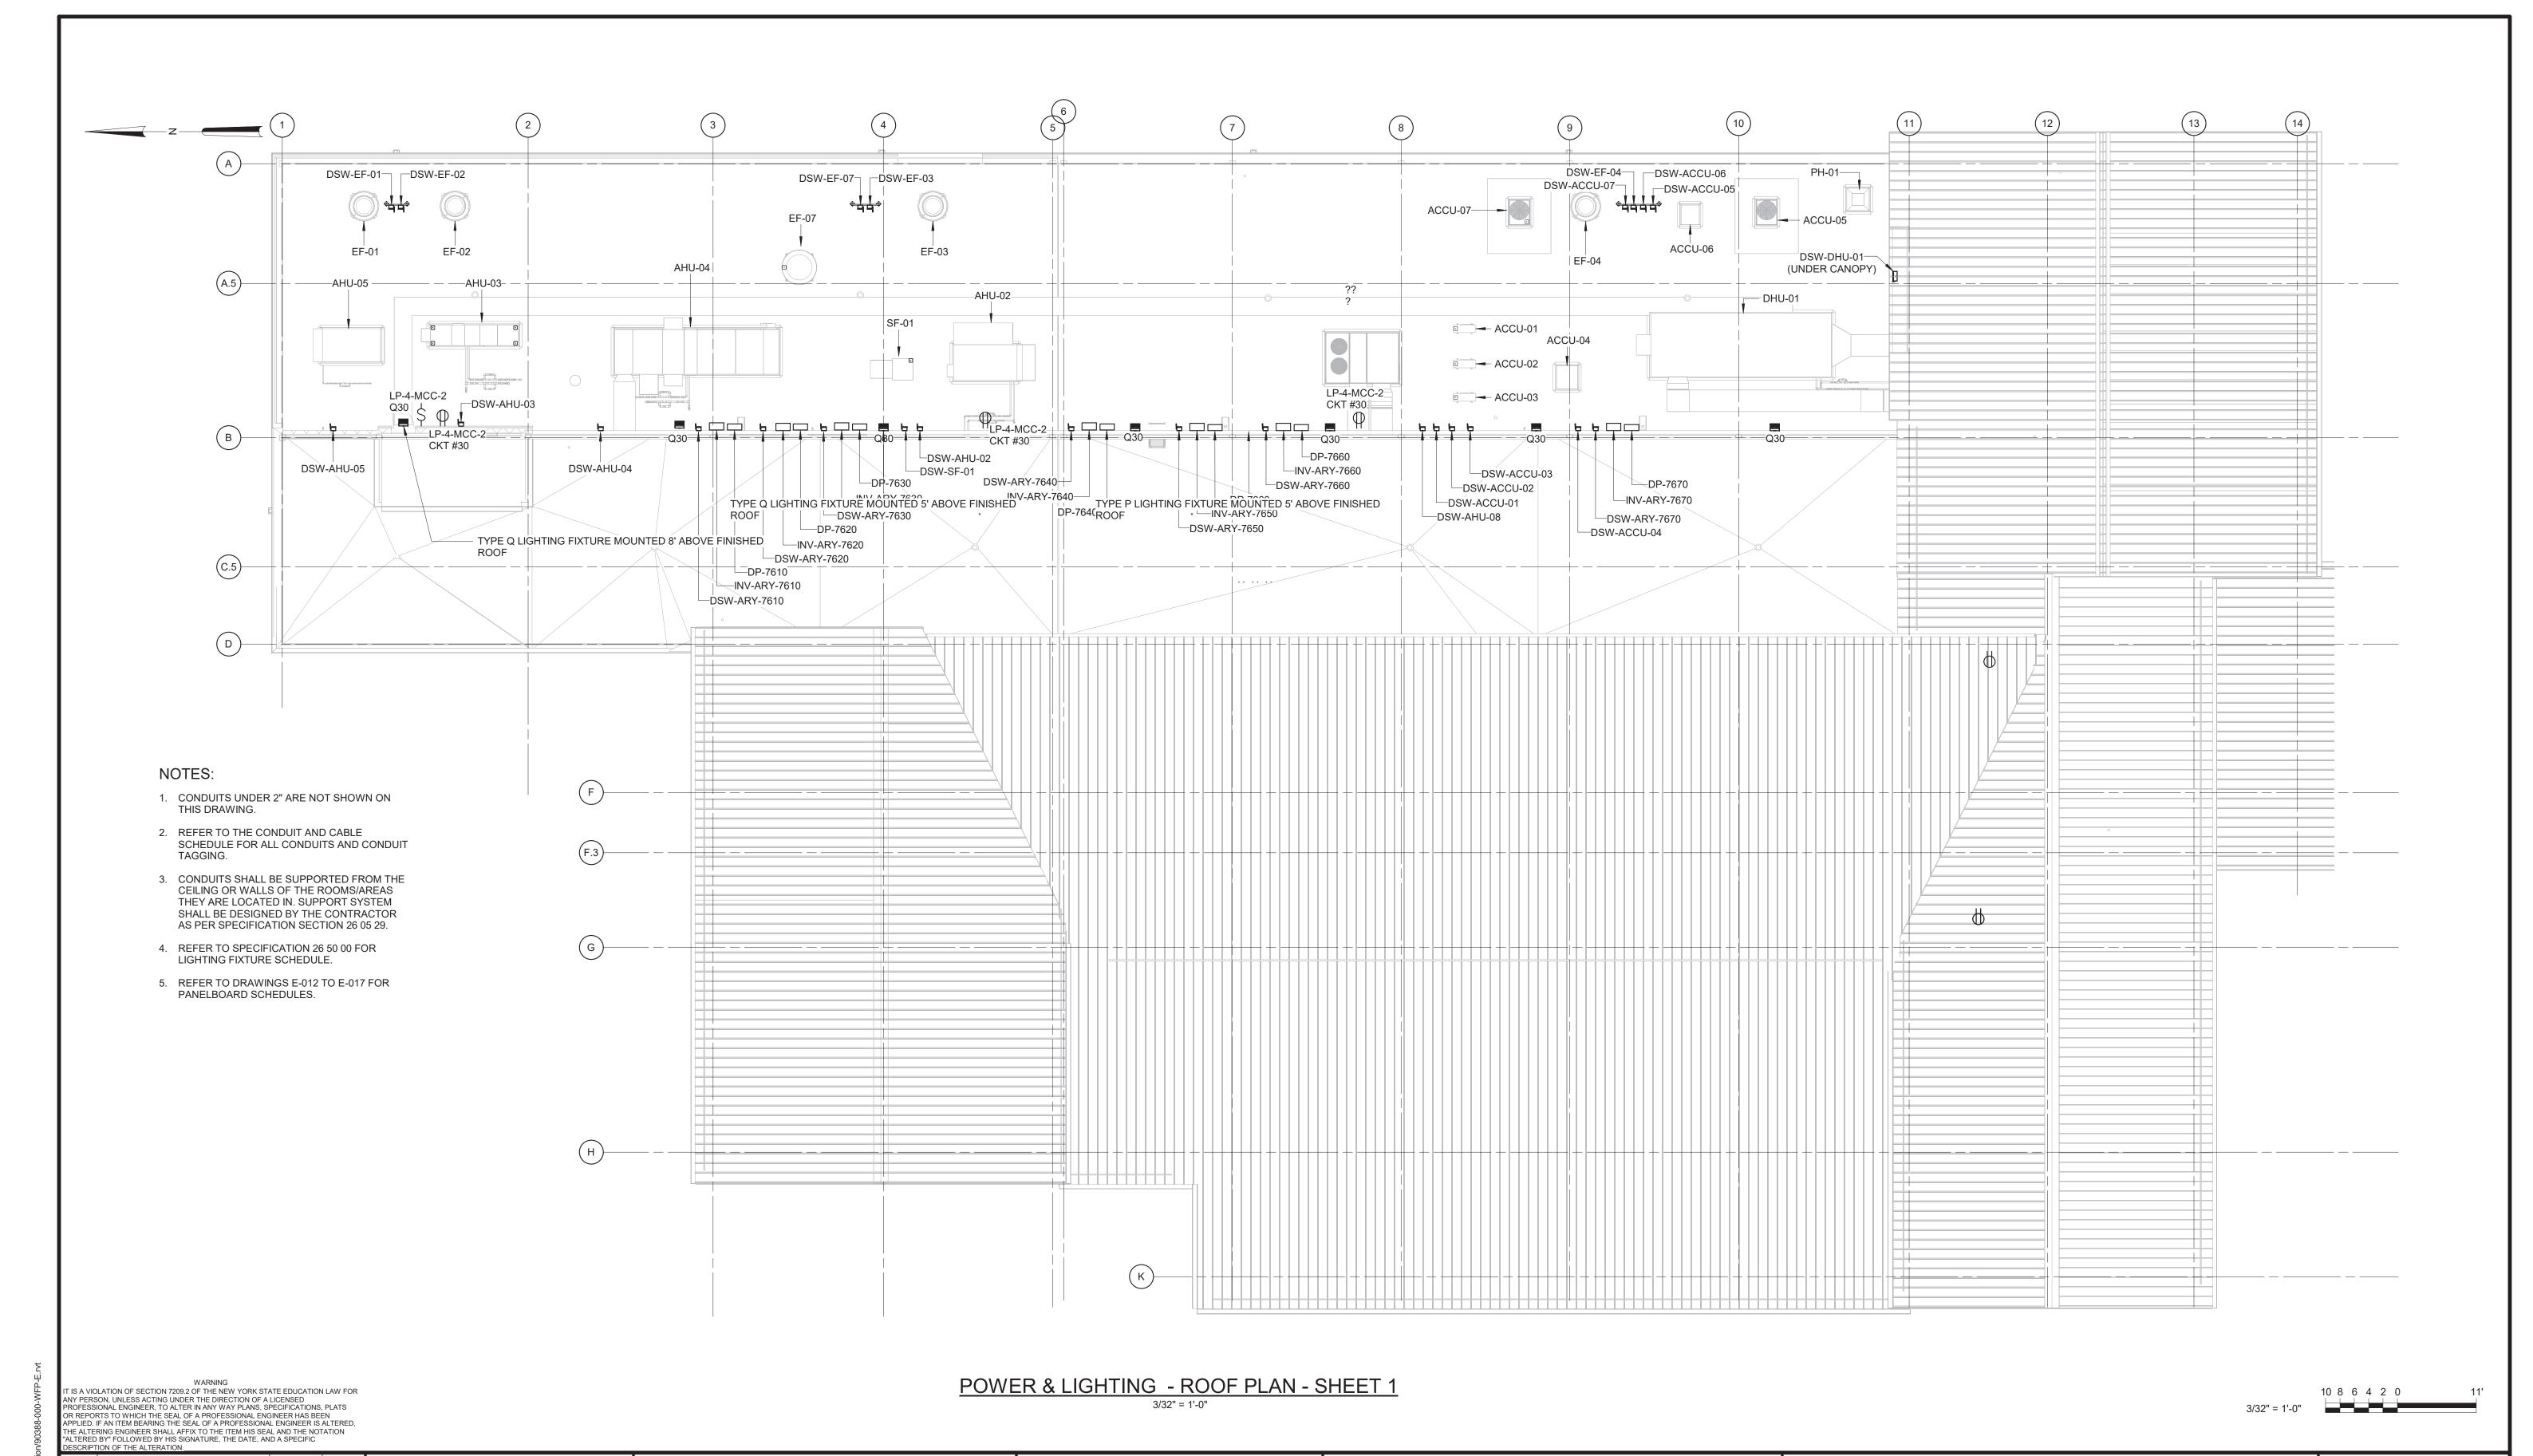

PROJECT ENGINEER:

DESIGNED BY:

DESIGNED BY:

DESIGNED BY:

DESIGNED BY:

CHECKED BY:

CHECKED BY:

CHECKED BY:

Solution of the Alteration.

PROJECT ENGINEER:

DESIGNED BY:

CHECKED BY:

G. MARKOU

IF THIS BAR DOES NOT MEASURE 1" THEN DRAWING IS NOT TO FULL SCALE

REV ISSUED FOR DATE BY

OF NEW JORGE MARTON AND PROFESSIONAL

HAZEN AND SAWYER
498 SEVENTH AVENUE, 11th FLOOR
NEW YORK, NEW YORK 10018

WESTCHESTER JOINT WATER WORKS MAMARONECK, NY

RYE LAKE WATER FILTRATION PLANT HARRISON, NY FILTRATION PLANT ELECTRICAL POWER AND LIGHTING PLAN - EL 436.50 - ROOF


DATE: FEB 2025

HAZEN NO.: 90388-000

CONTRACT NO.: A1364-A

DRAWING NUMBER:

E-117

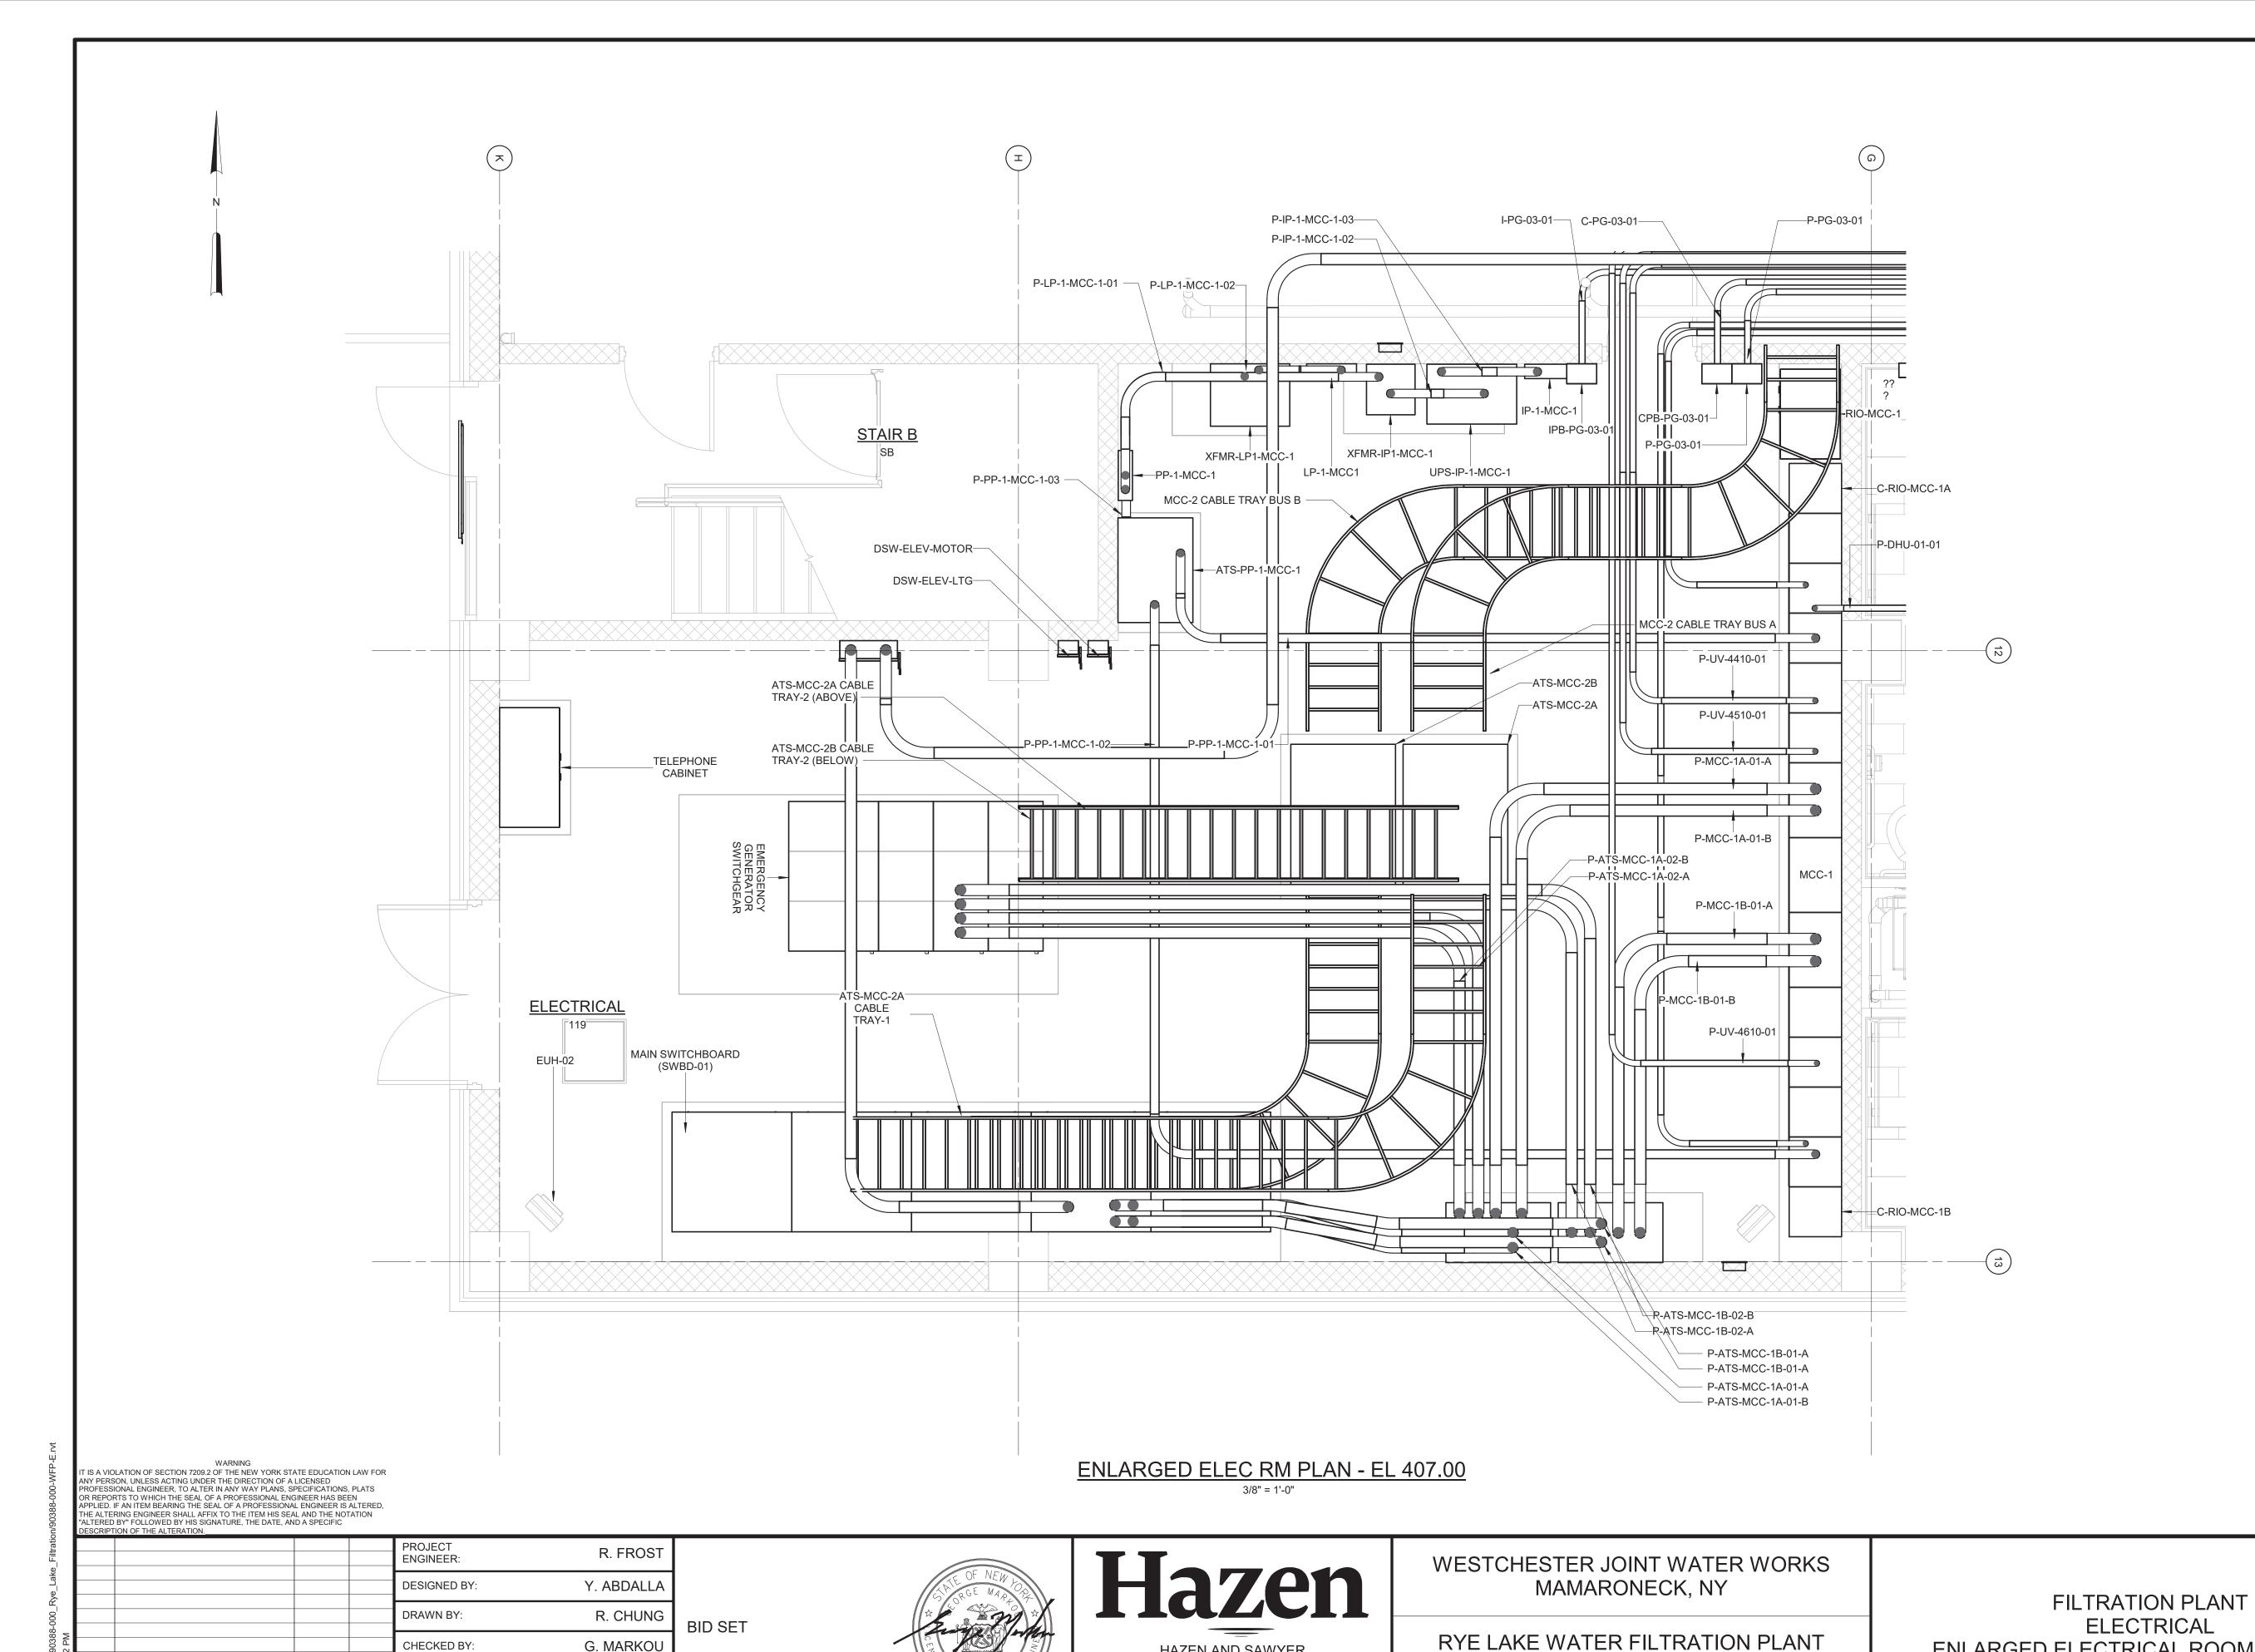

HAZEN AND SAWYER

498 SEVENTH AVENUE, 11th FLOOR

NEW YORK, NEW YORK 10018

HARRISON, NY

G. MARKOU

0 1/2"

CHECKED BY:

DATE BY

ISSUED FOR

IF THIS BAR DOES NOT

MEASURE 1" THEN DRAWING IS NOT TO FULL SCALE

NOTES:

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ENLARGED ELECTRICAL ROOM - EL 407.00

FEB 2025 90388-000 HAZEN NO.: A1364-A CONTRACT NO.: DRAWING NUMBER:


12" 0 1 2

E-118

349 of 392



- CONDUITS UNDER 2" ARE NOT SHOWN ON THIS DRAWING.
- 2. REFER TO THE CONDUIT AND CABLE SCHEDULE FOR ALL CONDUITS AND CONDUIT TAGGING.
- 3. CONDUITS SHALL BE SUPPORTED FROM THE CEILING OR WALLS OF THE ROOMS/AREAS THEY ARE LOCATED IN. SUPPORT SYSTEM SHALL BE DESIGNED BY THE CONTRACTOR AS PER SPECIFICATION SECTION 26 05 29.

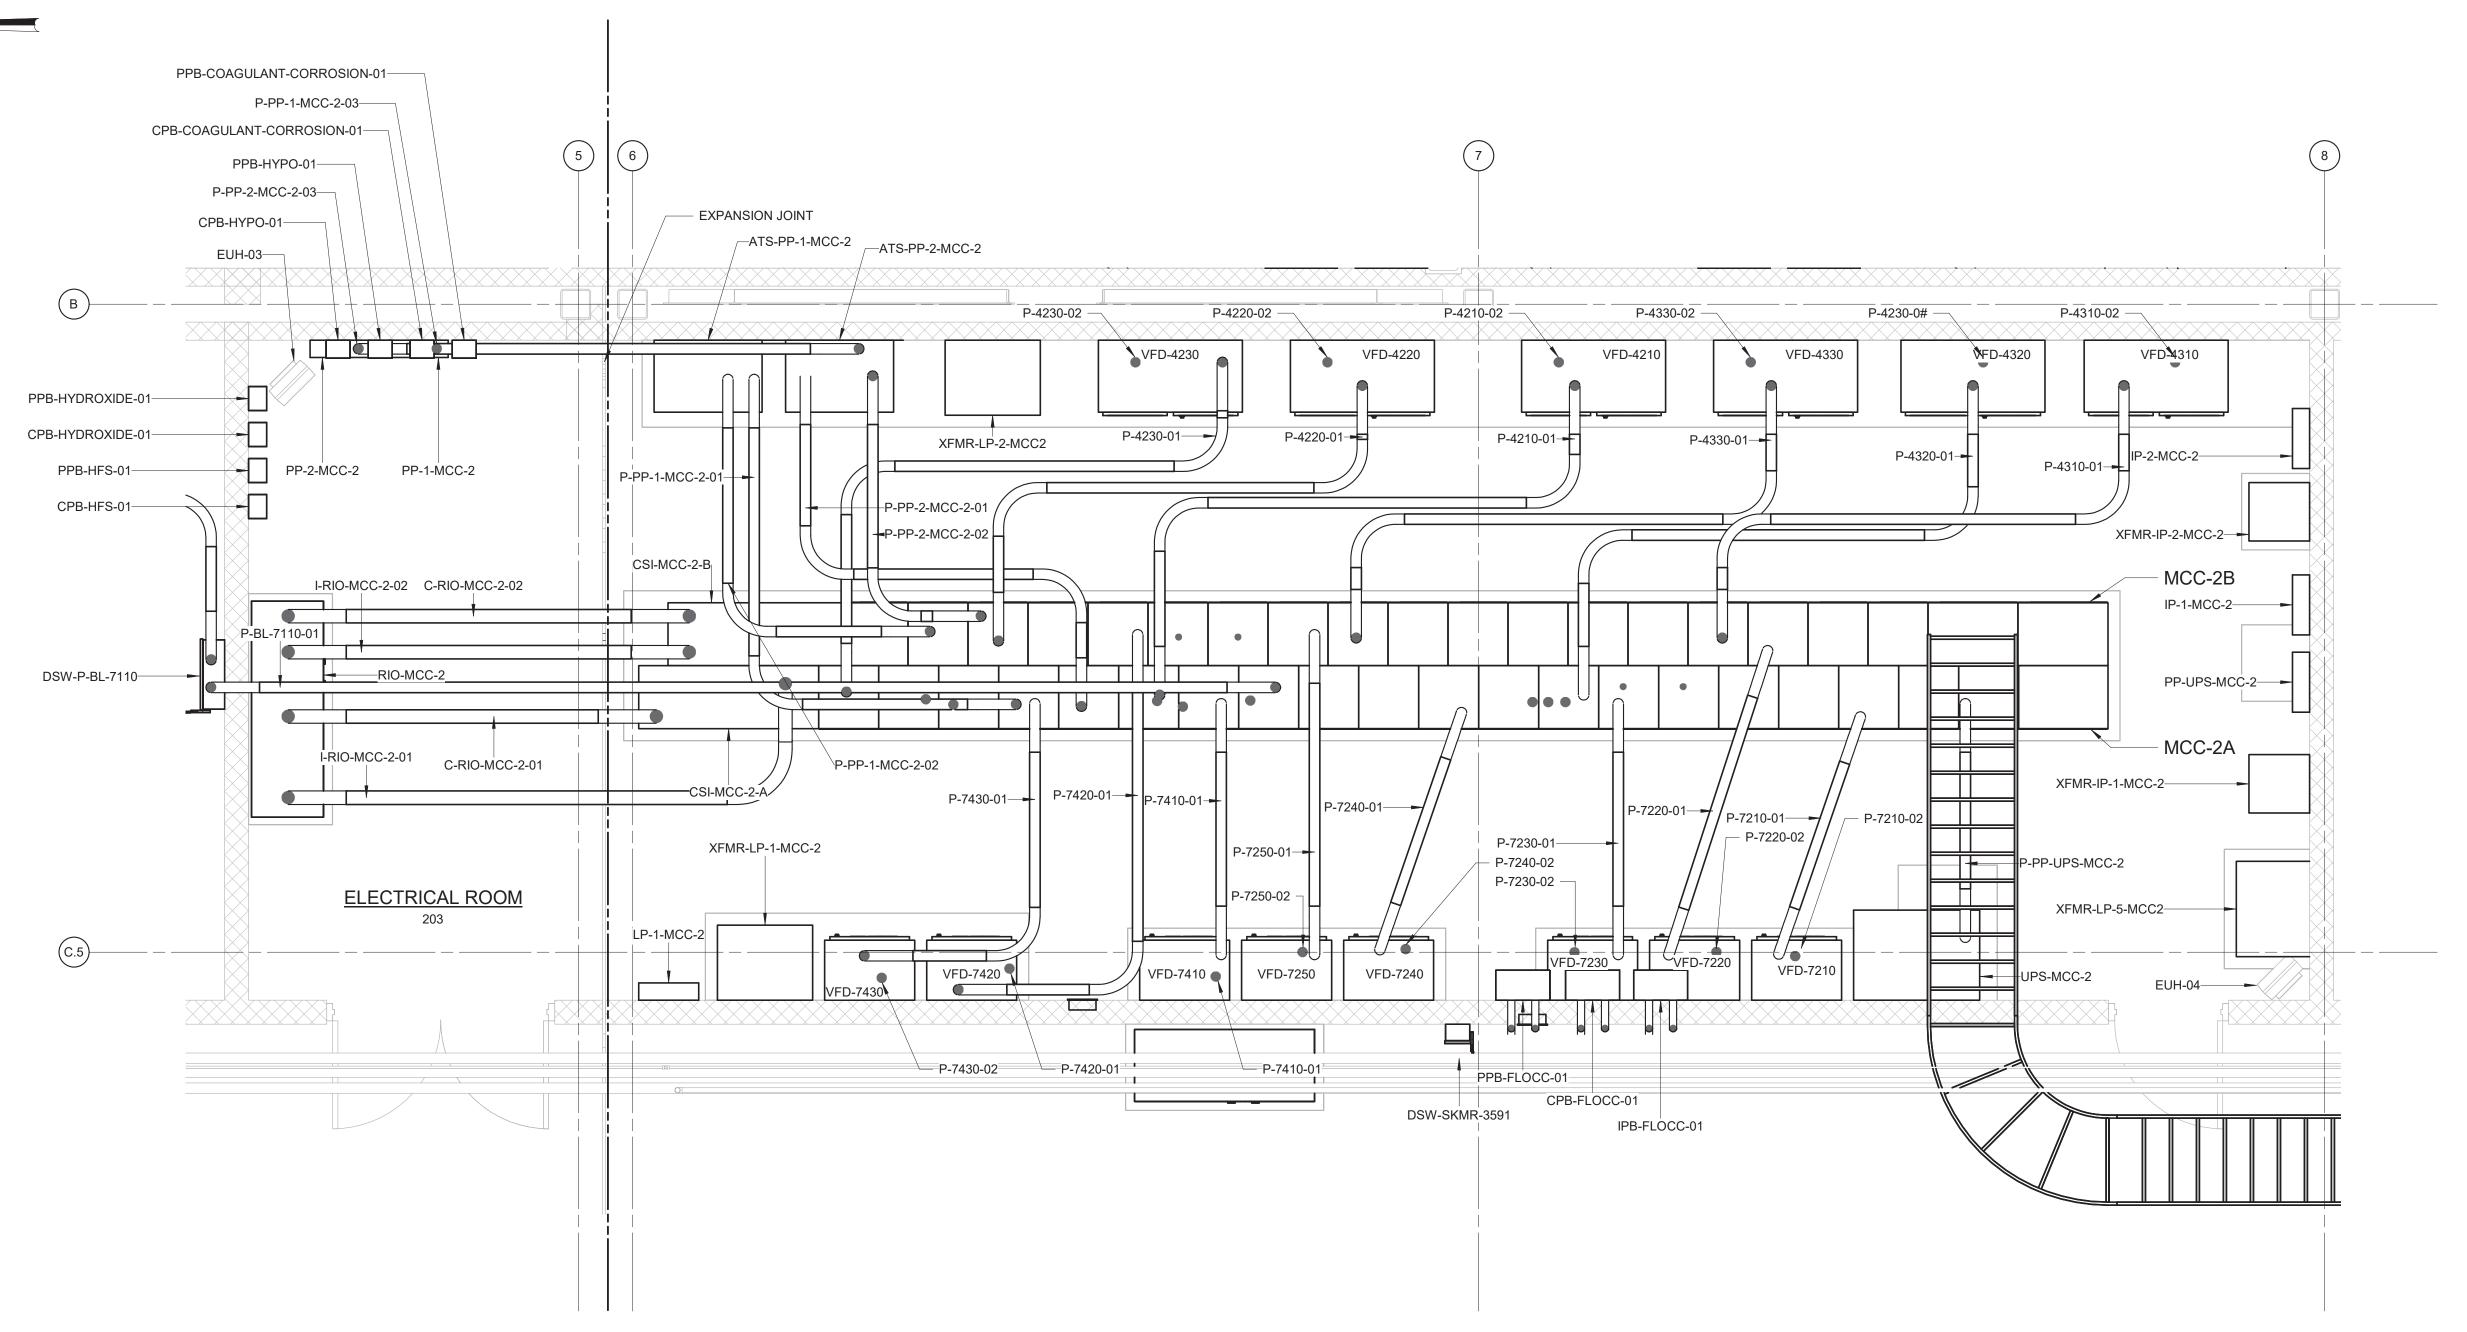

ENLARGED ELEC RM PLAN - EL 421.00



	ANY PERS PROFESS OR REPOI APPLIED. THE ALTE "ALTERED	WARNING DLATION OF SECTION 7209.2 OF THE NEW YORK STA SON, UNLESS ACTING UNDER THE DIRECTION OF A IONAL ENGINEER, TO ALTER IN ANY WAY PLANS, SI RTS TO WHICH THE SEAL OF A PROFESSIONAL ENG IF AN ITEM BEARING THE SEAL OF A PROFESSIONA RING ENGINEER SHALL AFFIX TO THE ITEM HIS SEA BY" FOLLOWED BY HIS SIGNATURE, THE DATE, AN TION OF THE ALTERATION.	LICENSED PECIFICATIONS, I BINEER HAS BEEI LENGINEER IS A LAND THE NOTA	PLATS N LTERED,			
ı					PROJECT ENGINEER:	R. FROST	
 					DESIGNED BY:	Y. ABDALLA	
					DRAWN BY:	R. CHUNG	BID SET
:43 PM					CHECKED BY:	G. MARKOU	B.B 02.
25 3:06:43					IF THIS BAR DOES NOT MEASURE 1" THEN DRAWING	0 1/2" 1"	
5/2025	REV	ISSUED FOR	DATE	BY	IS NOT TO FULL SCALE		

OF NEW JORGE MARAON AND APOFESSIONAL


HAZEN AND SAWYER
498 SEVENTH AVENUE, 11th FLOOR
NEW YORK, NEW YORK 10018


WESTCHESTER JOINT WATER WORKS MAMARONECK, NY

RYE LAKE WATER FILTRATION PLANT HARRISON, NY

FILTRATION PLANT	
ELECTRICAL	
ENLARGED ELECTRICAL ROOM - EL 421.00)


DATE:	FEB 2025
HAZEN NO.:	90388-000
CONTRACT NO.:	A1364-A
DRAWING NUMBER:	
	E-119

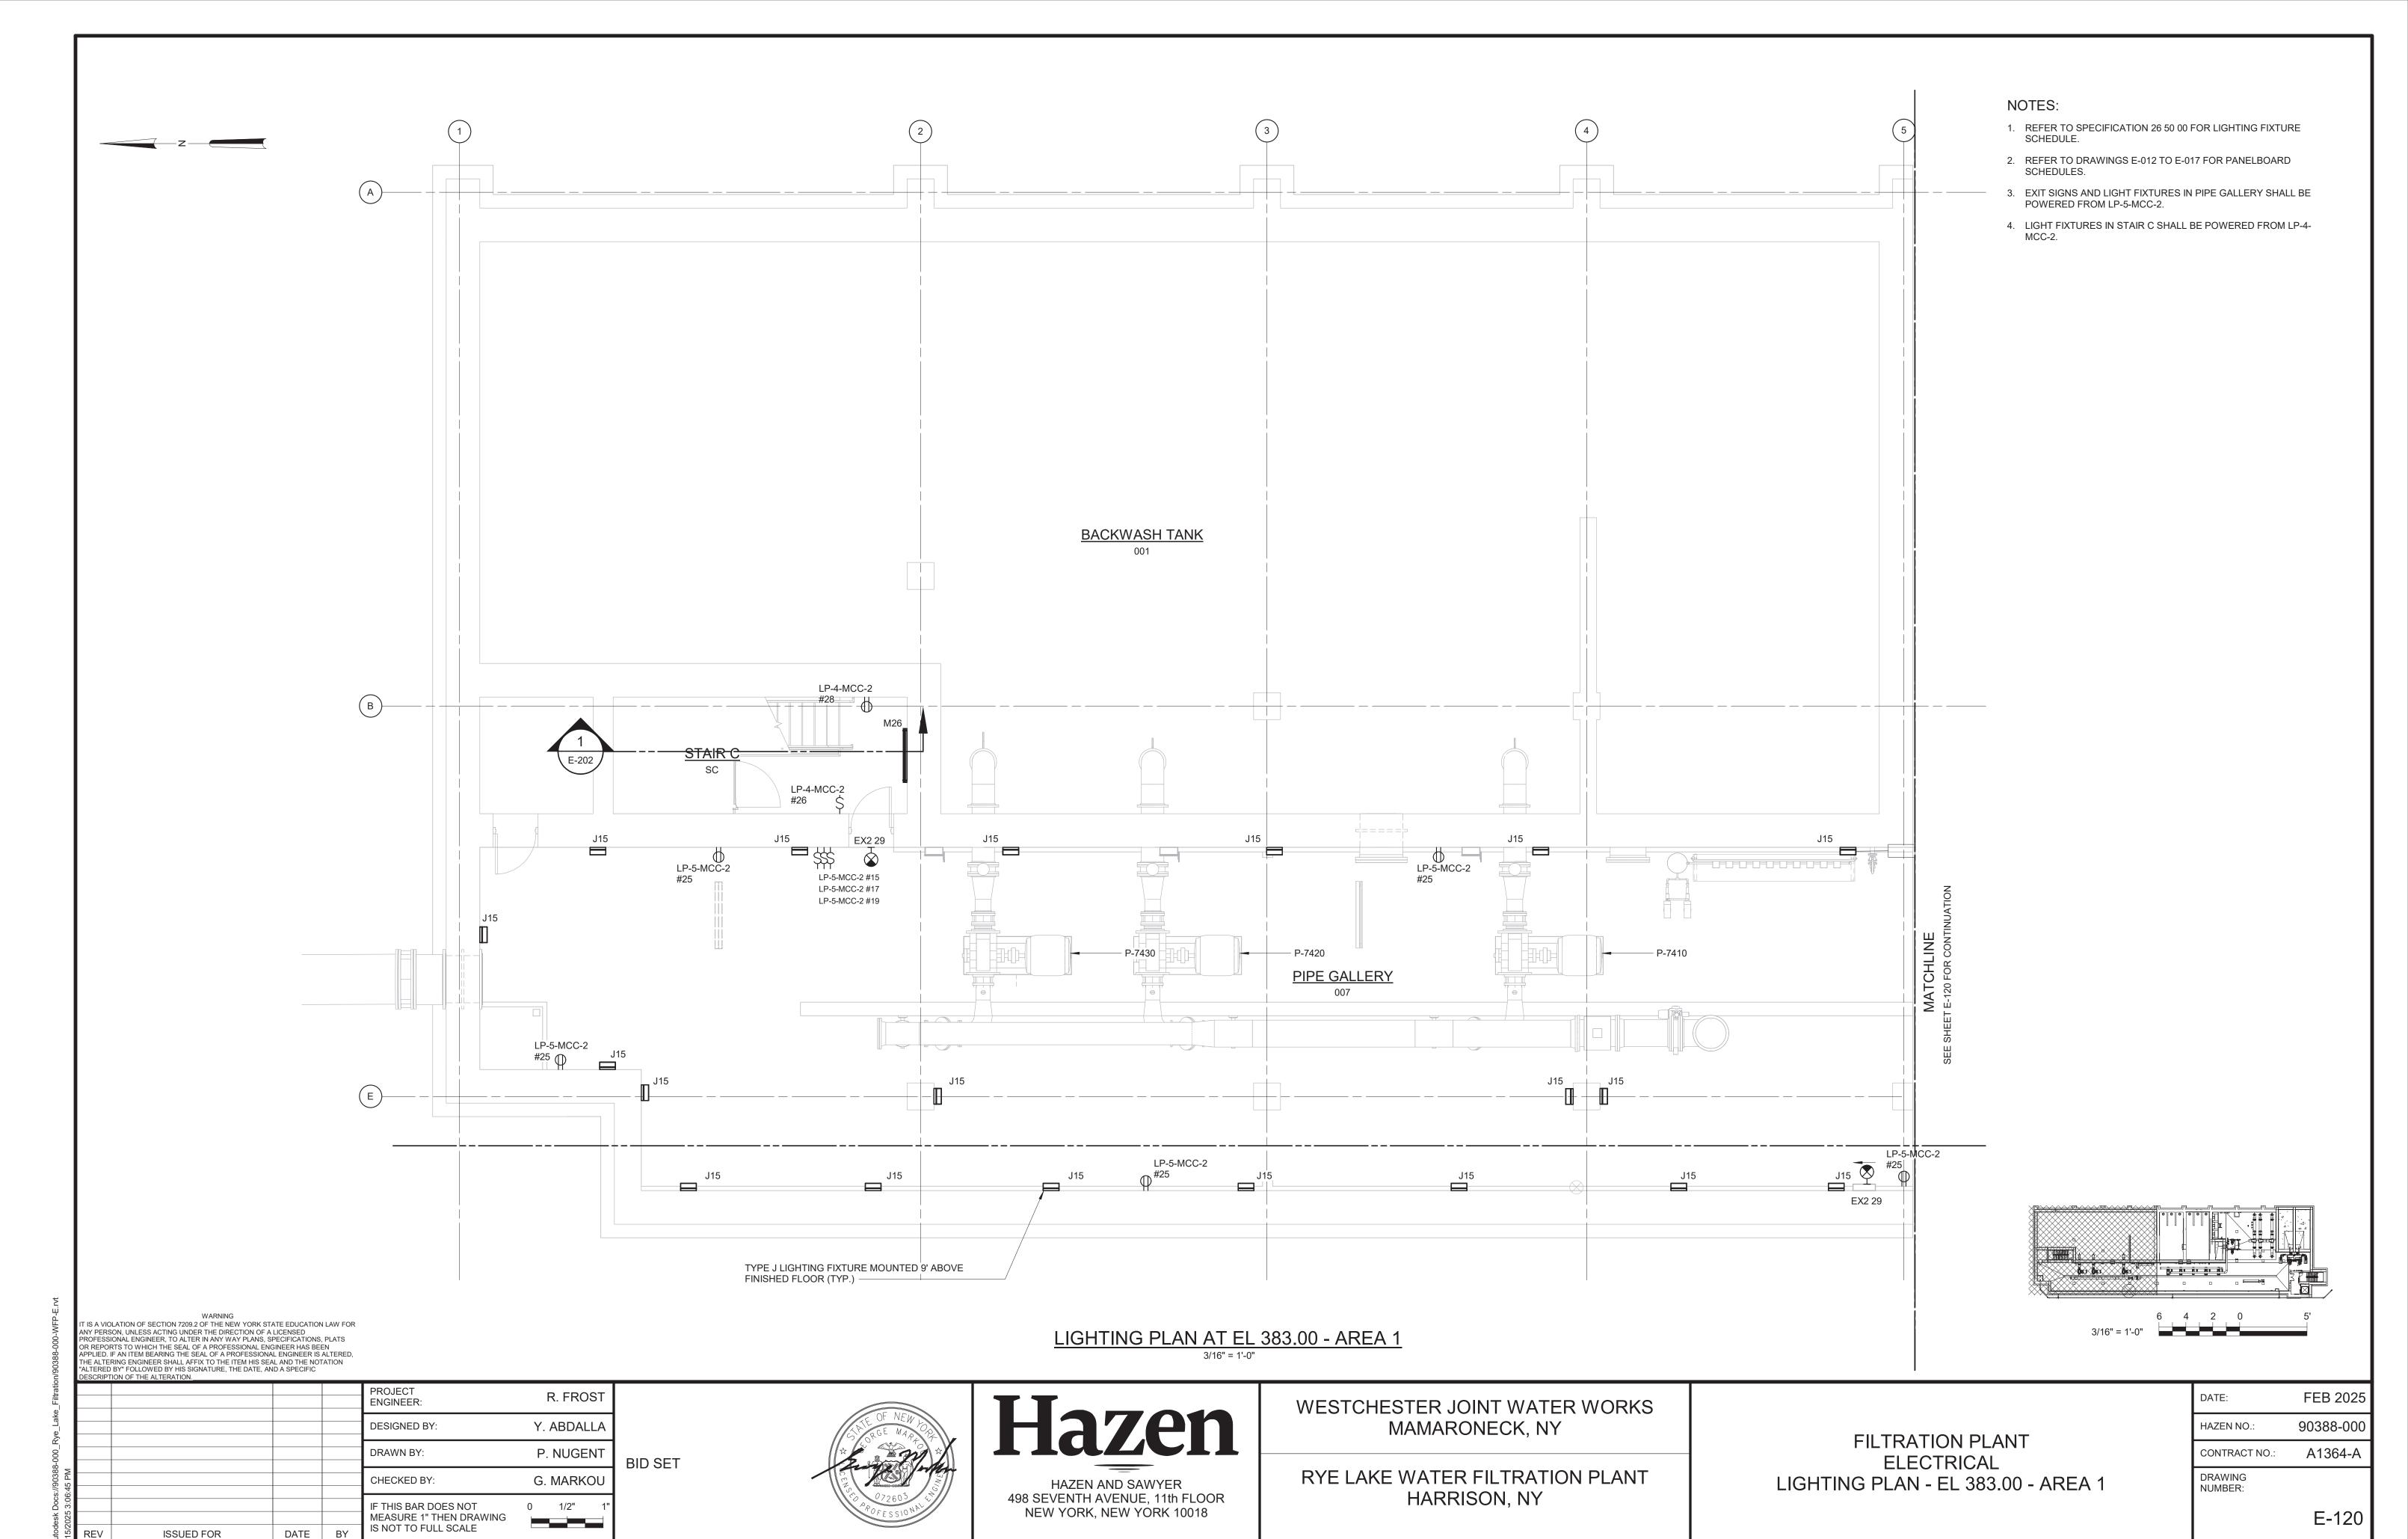

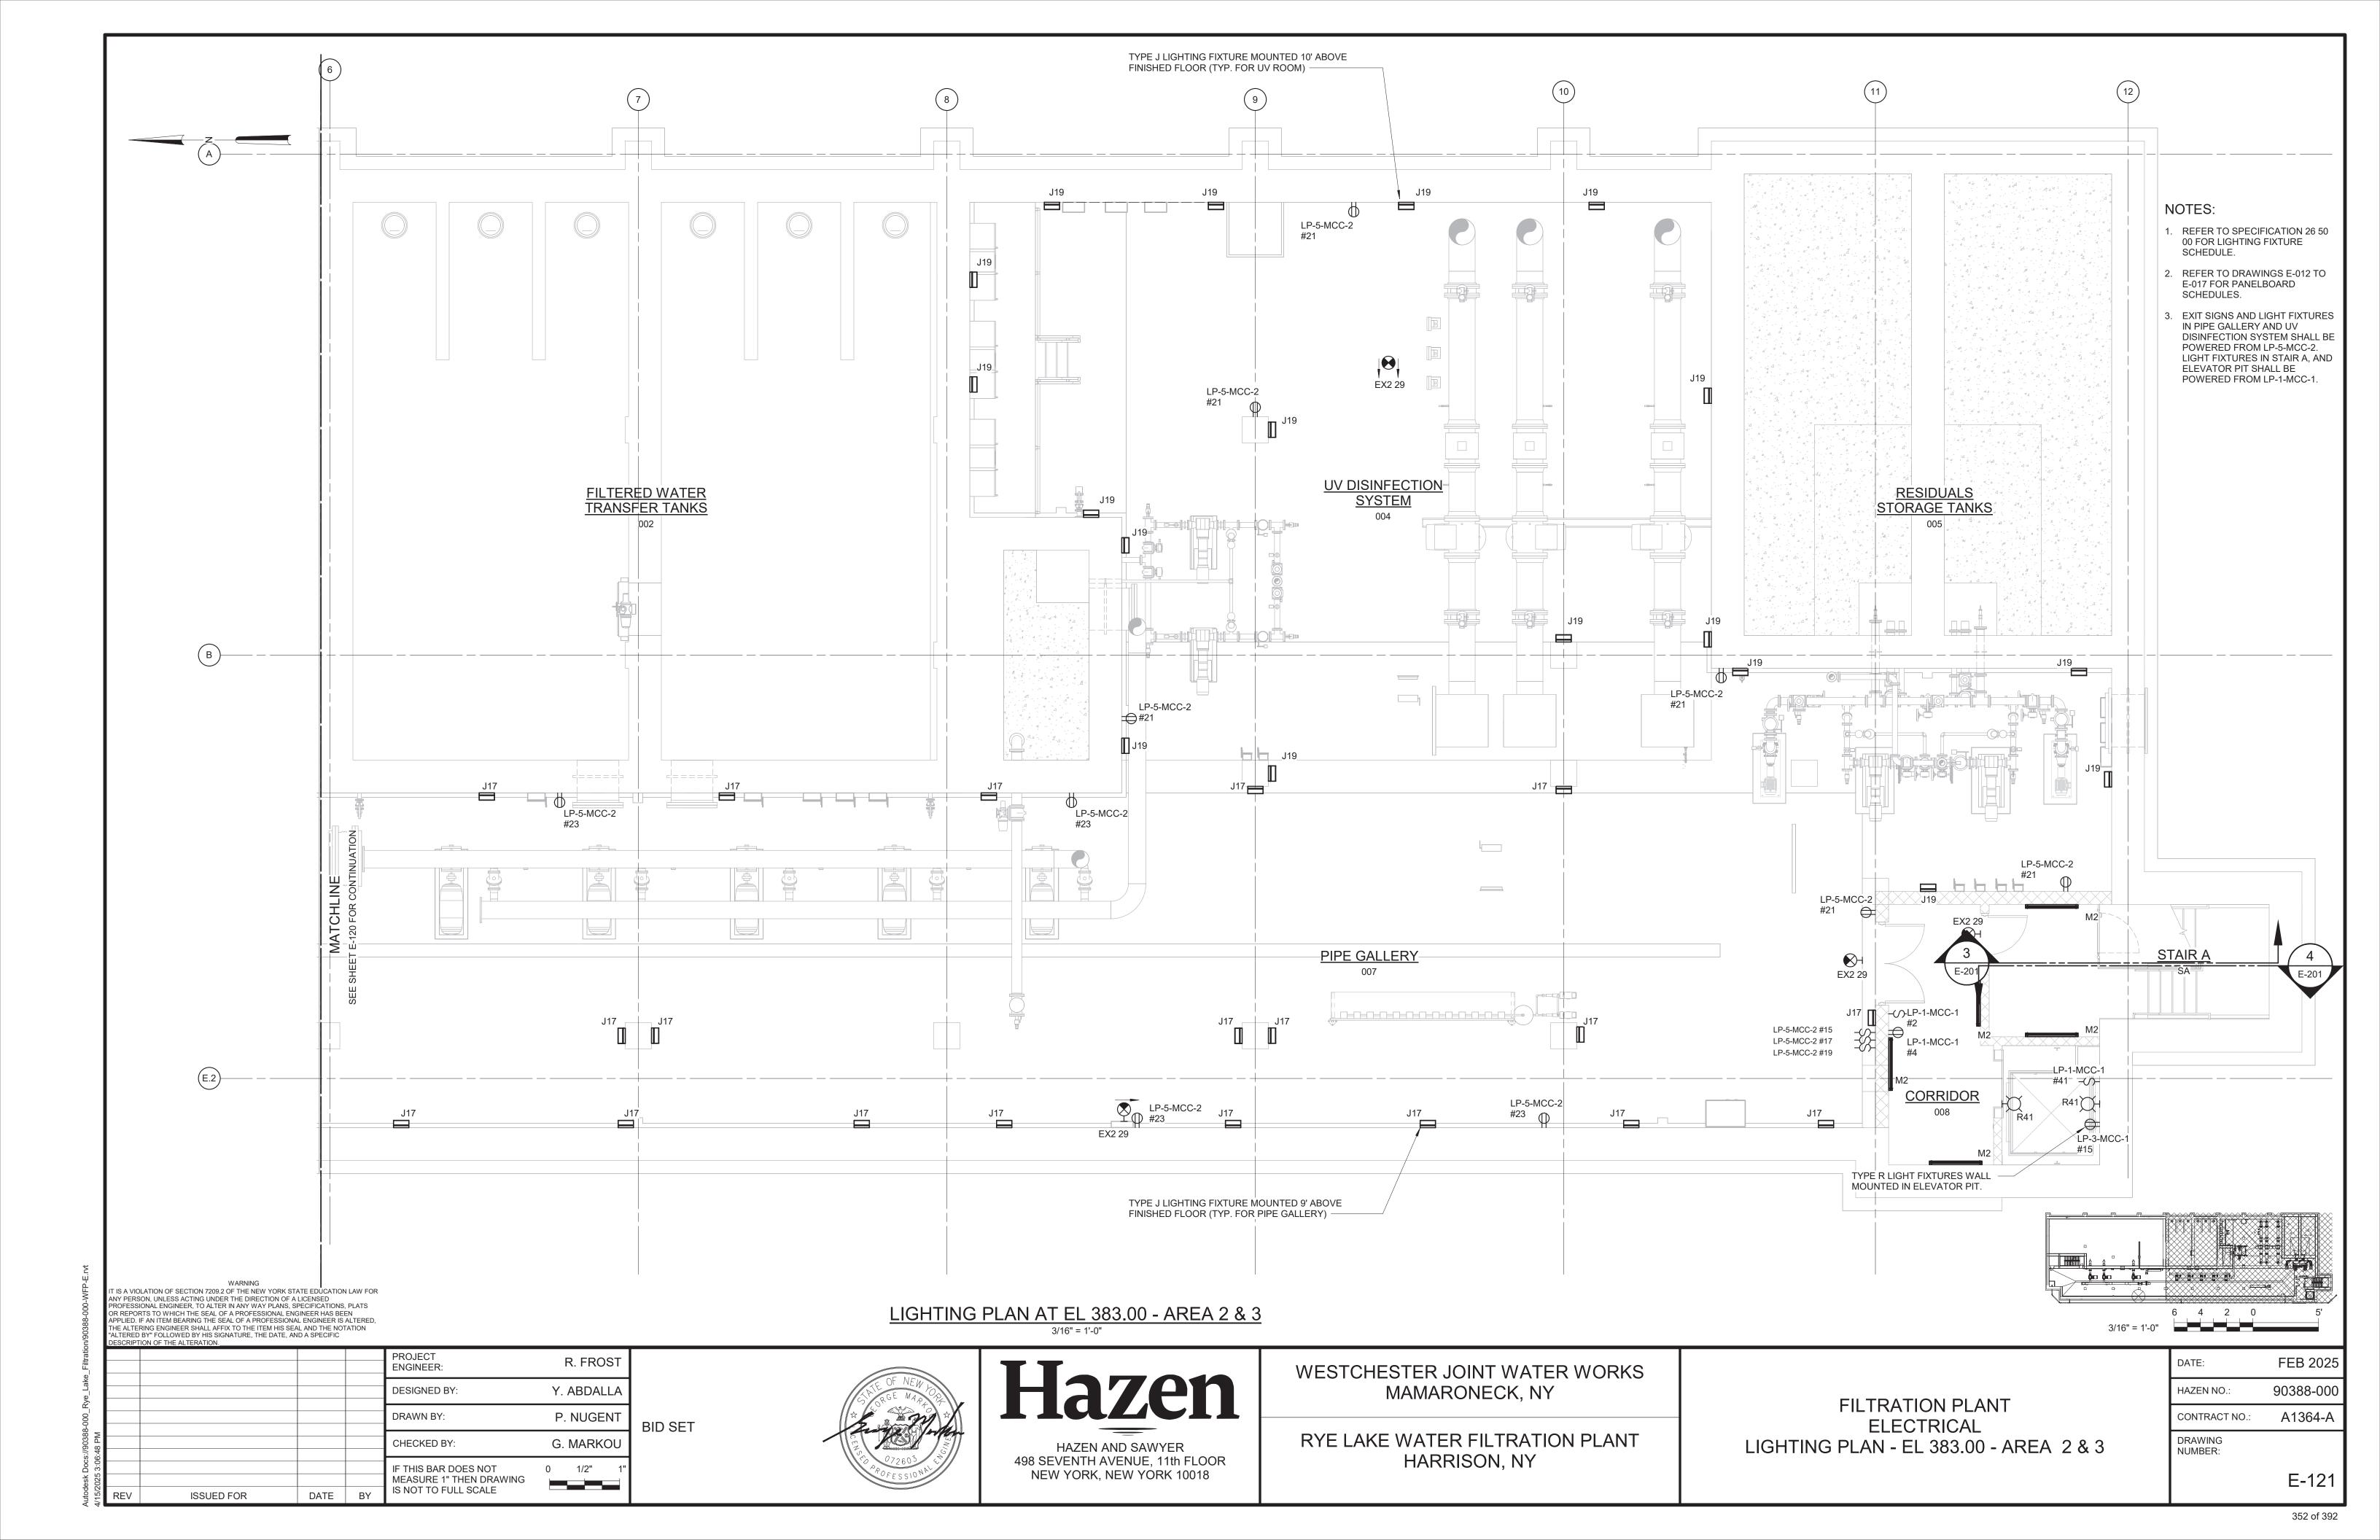


- 1. CONDUITS UNDER 2" ARE NOT SHOWN ON THIS DRAWING.
- REFER TO DRAWINGS E-012 TO E-017 FOR PANELBOARD SCHEDULES.
- 3. CONDUIT SHALL BE SUPPORTED FROM THE CEILING OR WALLS OF THE ROOMS/AREAS THEY ARE LOCATED IN. SUPPORT SYSTEM SHALL BE DESIGNED BY THE CONTRACTOR AS PER SPECIFICATION SECTION 26 05 29.
- 4. ALL "J" LIGHT FIXTURES SHALL BE MOUNTED 8'-6" AFF.



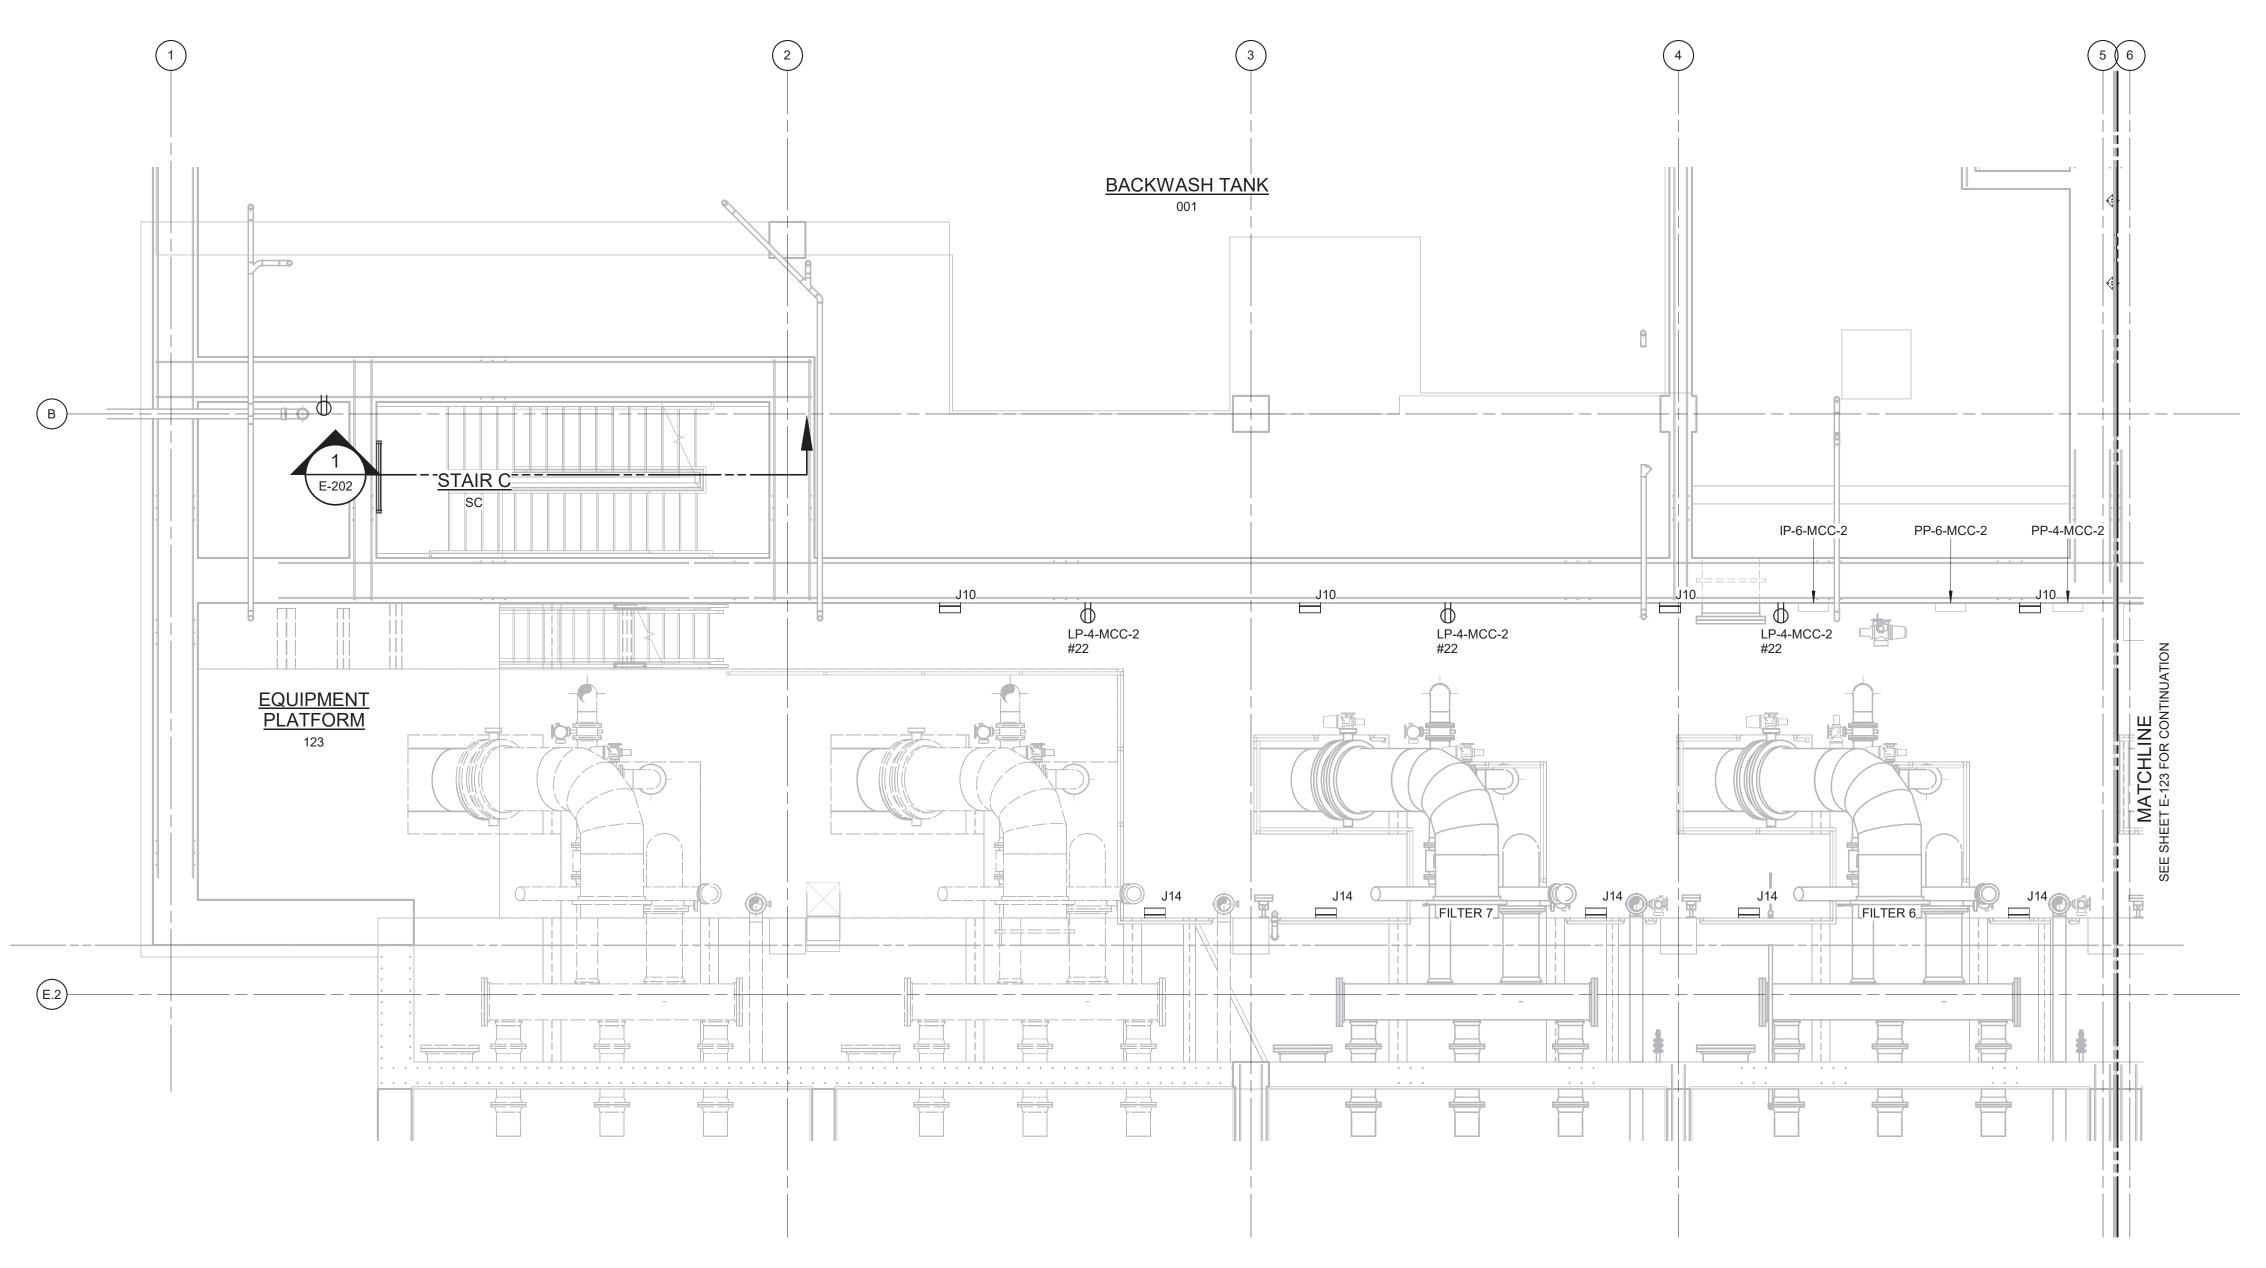

<u>LIGHTING PLAN - EL 398.00 - AREA 1</u>
3/16" = 1'-0"

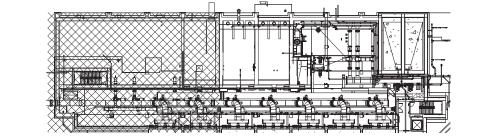


	ANY PERS PROFESSI OR REPOF APPLIED. I THE ALTEI "ALTERED	WARNING DIATION OF SECTION 7209.2 OF THE NEW YORK ST. SON, UNLESS ACTING UNDER THE DIRECTION OF A IONAL ENGINEER, TO ALTER IN ANY WAY PLANS, S RTS TO WHICH THE SEAL OF A PROFESSIONAL ENGIF AN ITEM BEARING THE SEAL OF A PROFESSIONA IF AN ITEM BEARING THE SEAL OF THE ITEM HIS SEAL BY" FOLLOWED BY HIS SIGNATURE, THE DATE, AN ION OF THE ALTERATION.	LICENSED SPECIFICATIONS, GINEER HAS BEI AL ENGINEER IS AL AND THE NOT	, PLATS EN ALTERED,			
,					PROJECT ENGINEER:	R. FROST	
I					DESIGNED BY:	Y. ABDALLA	
l					DRAWN BY:	P. NUGENT	BID SET
:51 PM					CHECKED BY:	G. MARKOU	DID 02 1
15/2025 3:06:51					IF THIS BAR DOES NOT MEASURE 1" THEN DRAWING	0 1/2" 1"	
	REV	ISSUED FOR	DATE	BY	IS NOT TO FULL SCALE		

Hazen HAZEN AND SAWYER 498 SEVENTH AVENUE, 11th FLOOR NEW YORK, NEW YORK 10018

WESTCHESTER JOINT WATER WORKS MAMARONECK, NY

RYE LAKE WATER FILTRATION PLANT HARRISON, NY

DATE:	FEB 2025
HAZEN NO.:	90388-000
CONTRACT NO.:	A1364-A
DRAWING NUMBER:	
	E-122

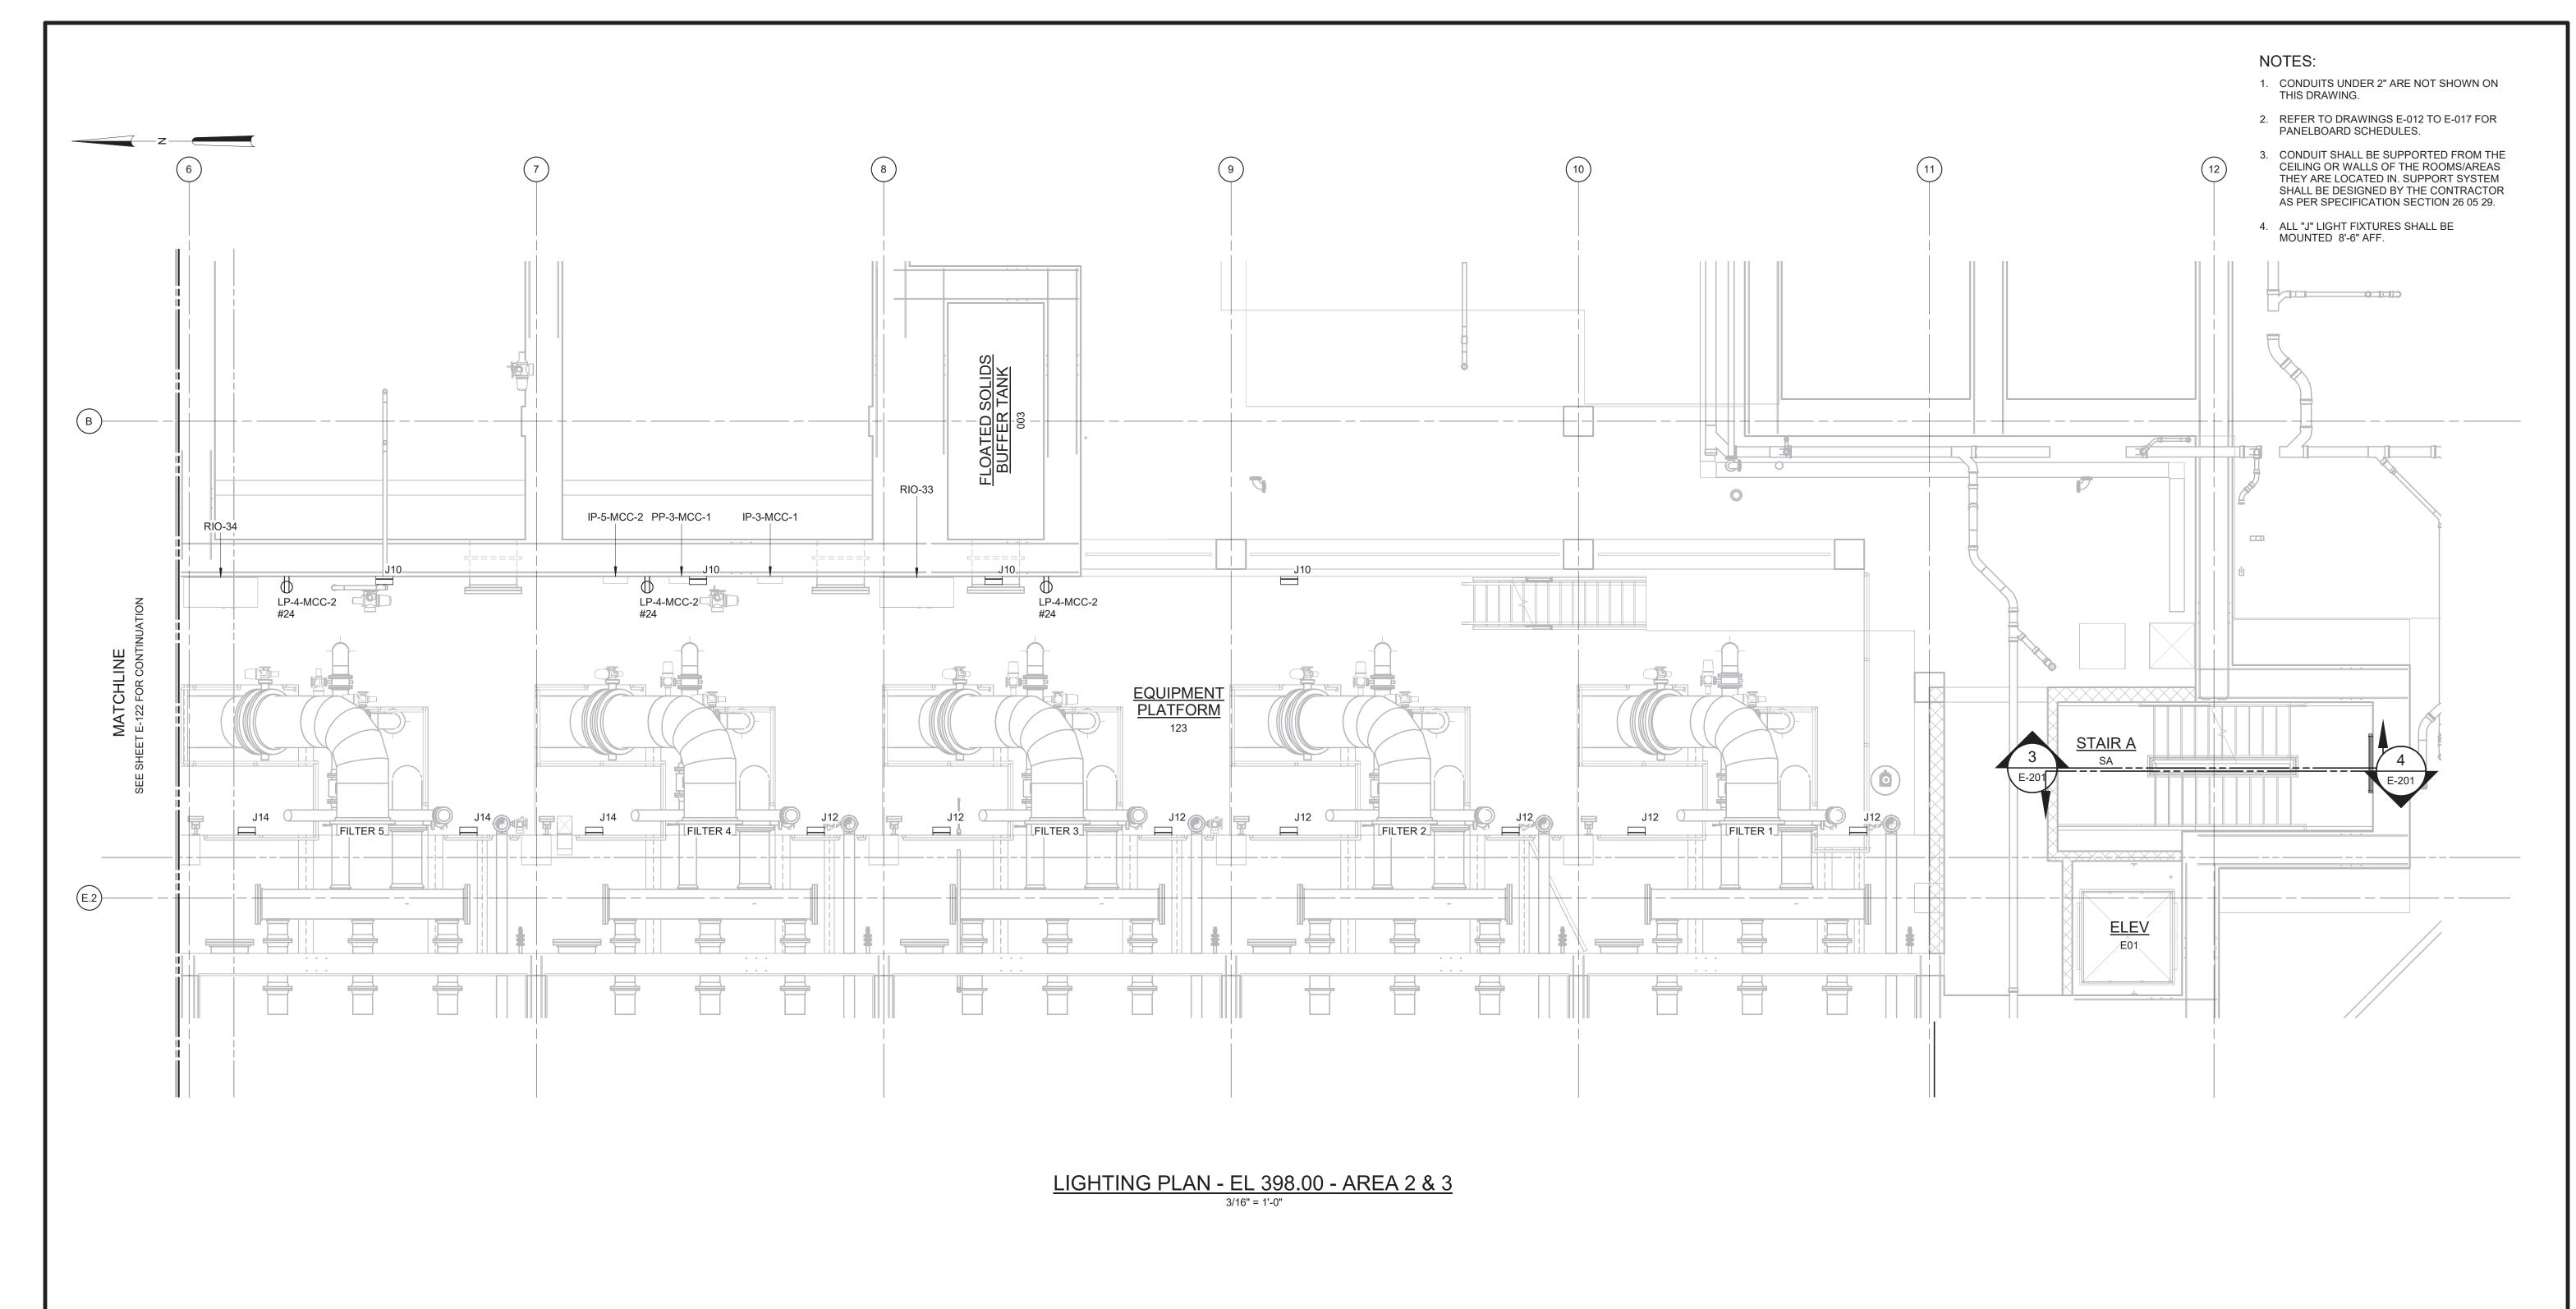

3/16" = 1'-0"

	ANY PERSO PROFESSION OR REPOR APPLIED. II THE ALTER "ALTERED"	WARNING LATION OF SECTION 7209.2 OF THE NEW YORK ST. ON, UNLESS ACTING UNDER THE DIRECTION OF A ONAL ENGINEER, TO ALTER IN ANY WAY PLANS, S ITS TO WHICH THE SEAL OF A PROFESSIONAL ENG F AN ITEM BEARING THE SEAL OF A PROFESSIONAL SING ENGINEER SHALL AFFIX TO THE ITEM HIS SEA BY' FOLLOWED BY HIS SIGNATURE, THE DATE, AN ON OF THE ALTERATION.	LICENSED PECIFICATIONS GINEER HAS BEI AL ENGINEER IS AL AND THE NOT	, PLATS EN ALTERED,		
					PROJECT ENGINEER:	R. FROST
					DESIGNED BY:	Y. ABDALLA
					DRAWN BY:	P. NUGENT
:54 PM					CHECKED BY:	G. MARKOU
25 3:06:54					IF THIS BAR DOES NOT MEASURE 1" THEN DRAWING	0 1/2" 1"
5/2025	REV/	ISSUED FOR	DATE	BY	IS NOT TO FULL SCALE	

OF NEW PORCE MARTON AND PROFESSIONAL


BID SET

HAZEN AND SAWYER
498 SEVENTH AVENUE, 11th FLOOR
NEW YORK, NEW YORK 10018

WESTCHESTER JOINT WATER WORKS MAMARONECK, NY

RYE LAKE WATER FILTRATION PLANT HARRISON, NY

DATE:	FEB 2025
HAZEN NO.:	90388-000
CONTRACT NO.:	A1364-A
DRAWING NUMBER:	
	E-123

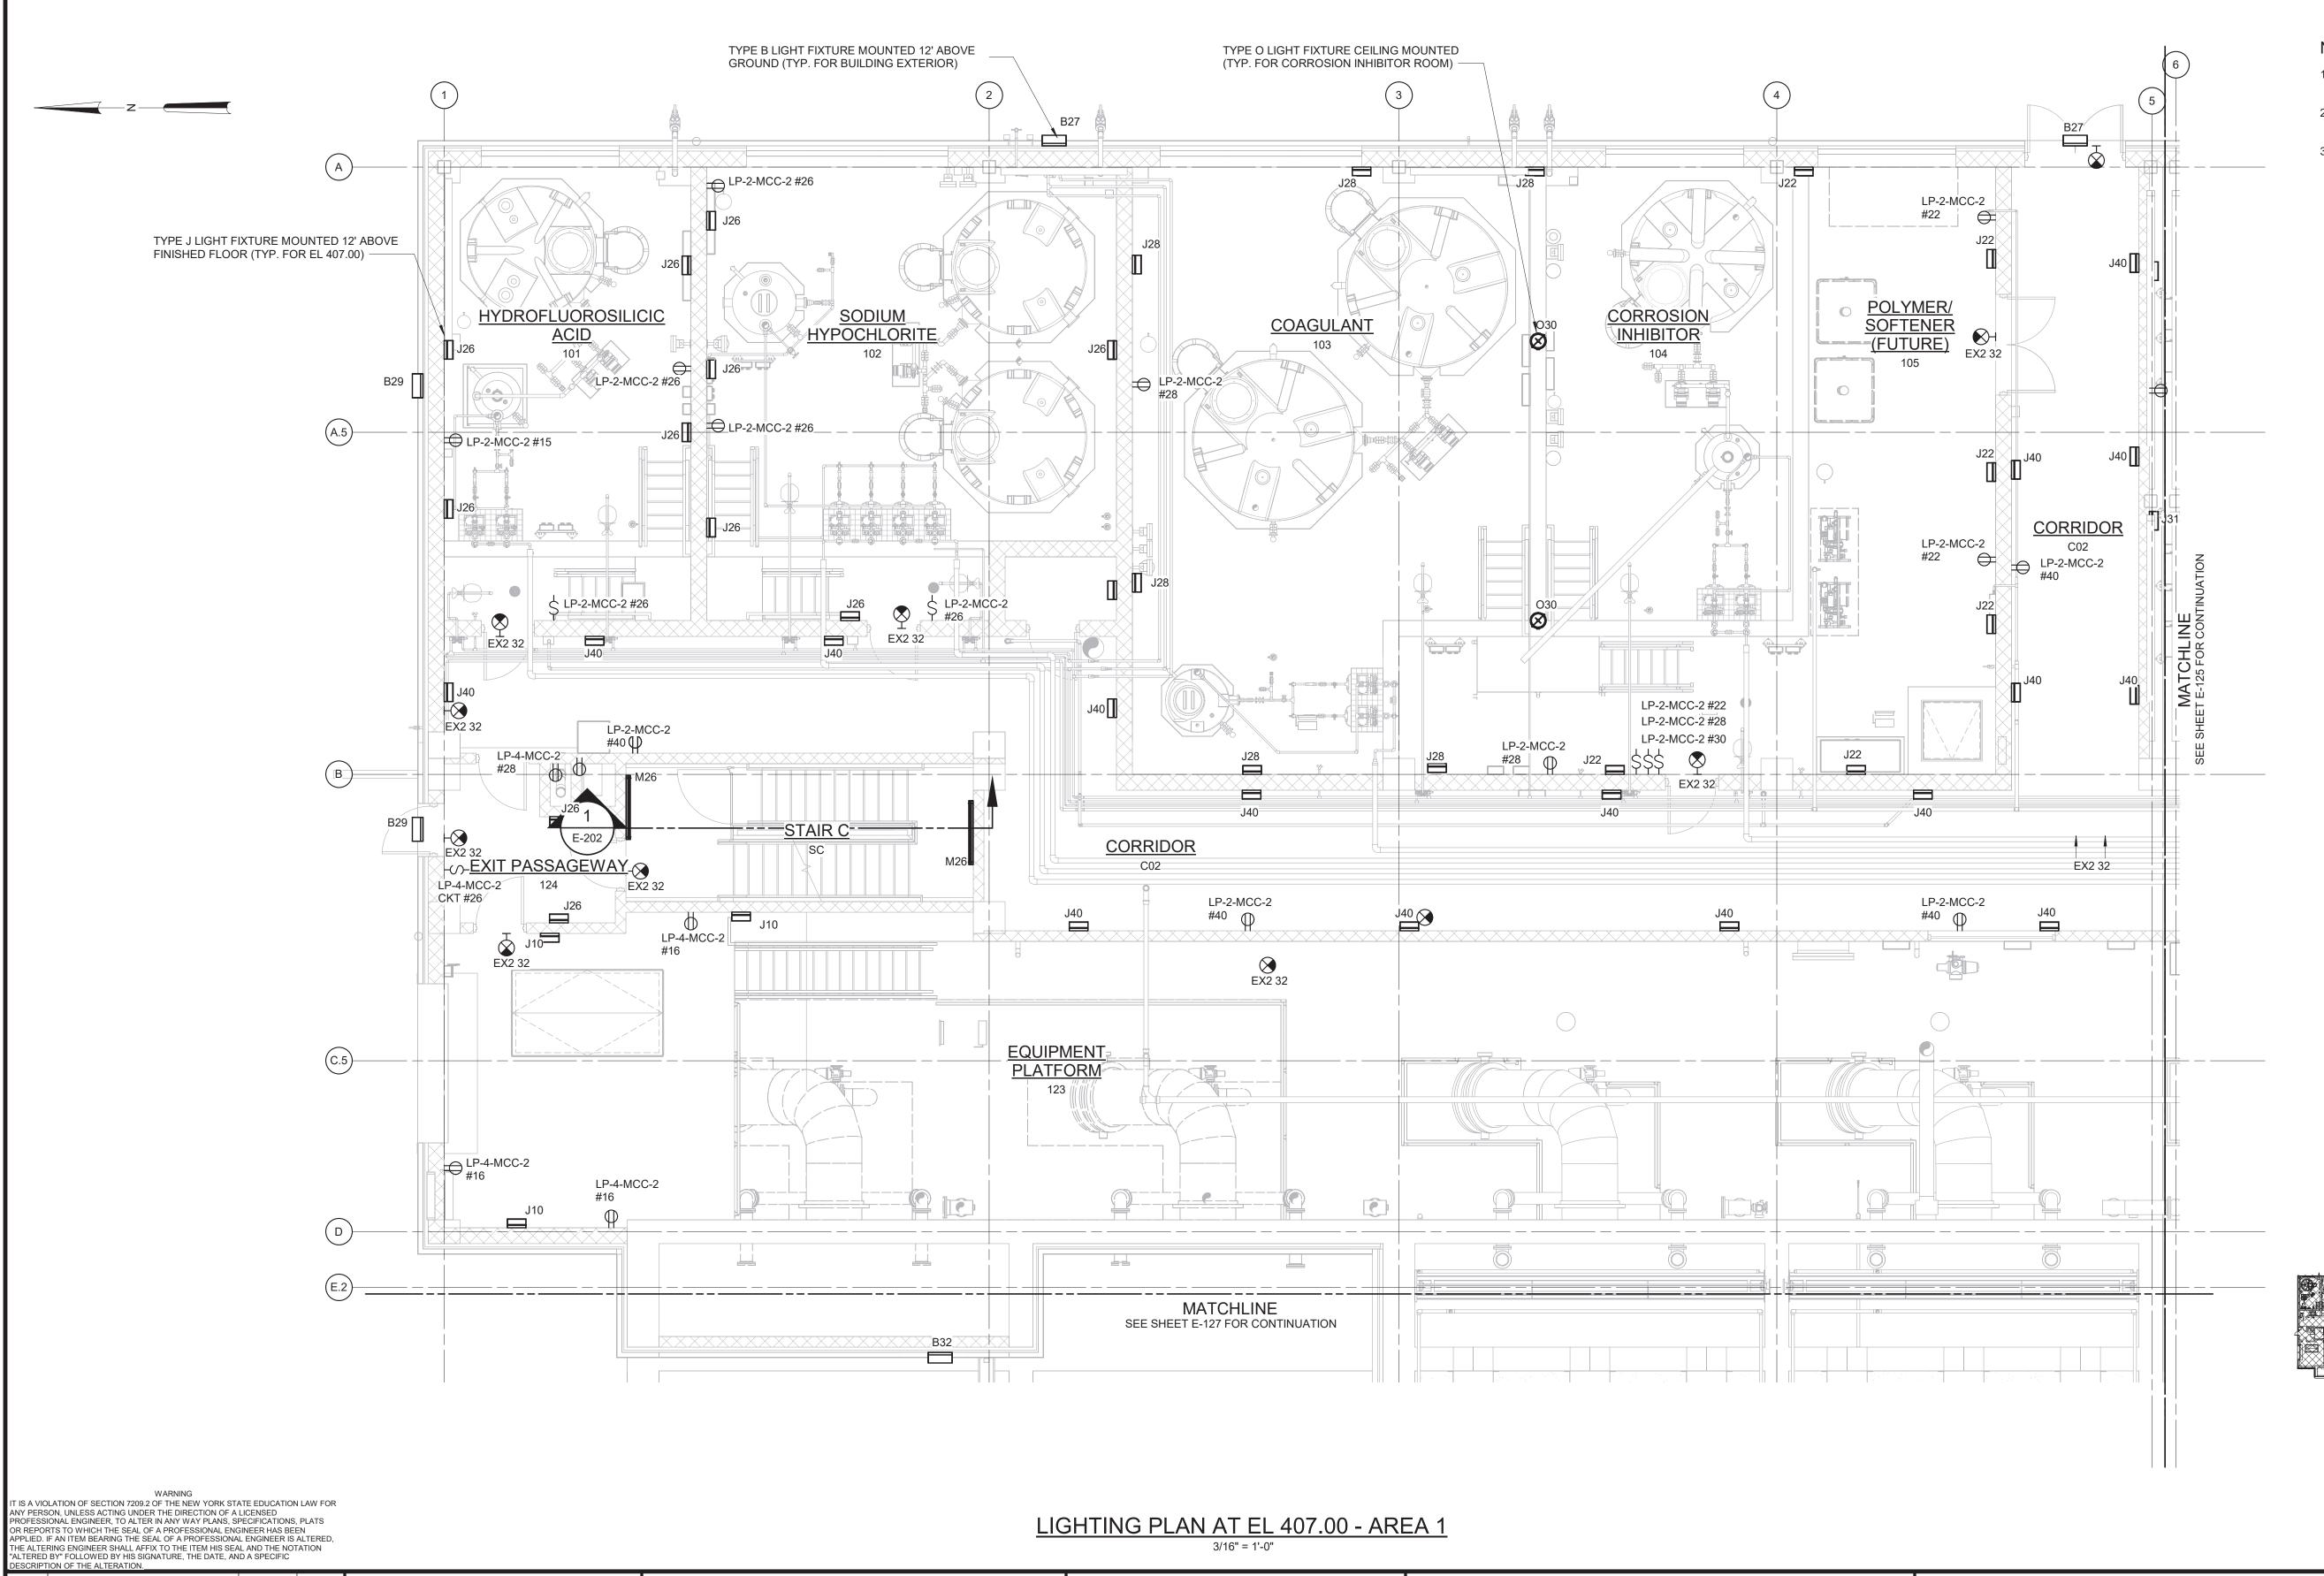

- REFER TO SPECIFICATION 26 50 00 FOR LIGHTING FIXTURE SCHEDULE.
- 2. REFER TO DRAWINGS E-012 TO E-017 FOR PANELBOARD SCHEDULES.
- 3. LIGHT FIXTURES IN STAIR C, VESTIBULE, EQUIPMENT PLATFORM, AND BUILDING EXTERIOR SHALL BE POWERED FROM LP-4-MCC-2. EXIT SIGNS, AND ALL OTHER LIGHTING SHALL BE POWERED FROM LP-2-MCC-2.

PROJECT ENGINEER:

DESIGNED BY:

DESIGNED BY

OF NEW PORCE MARRIED AND PROPERTY OF A STORY OF A STORY

HAZEN AND SAWYER
498 SEVENTH AVENUE, 11th FLOOR


NEW YORK, NEW YORK 10018

WESTCHESTER JOINT WATER WORKS MAMARONECK, NY

RYE LAKE WATER FILTRATION PLANT HARRISON, NY

FILTRATION PLANT
ELECTRICAL
IGHTING PLAN - EL 407.00 - AREA 1

DATE:	FEB 2025
HAZEN NO.:	90388-000
CONTRACT NO.:	A1364-A
DRAWING NUMBER:	
	E-124

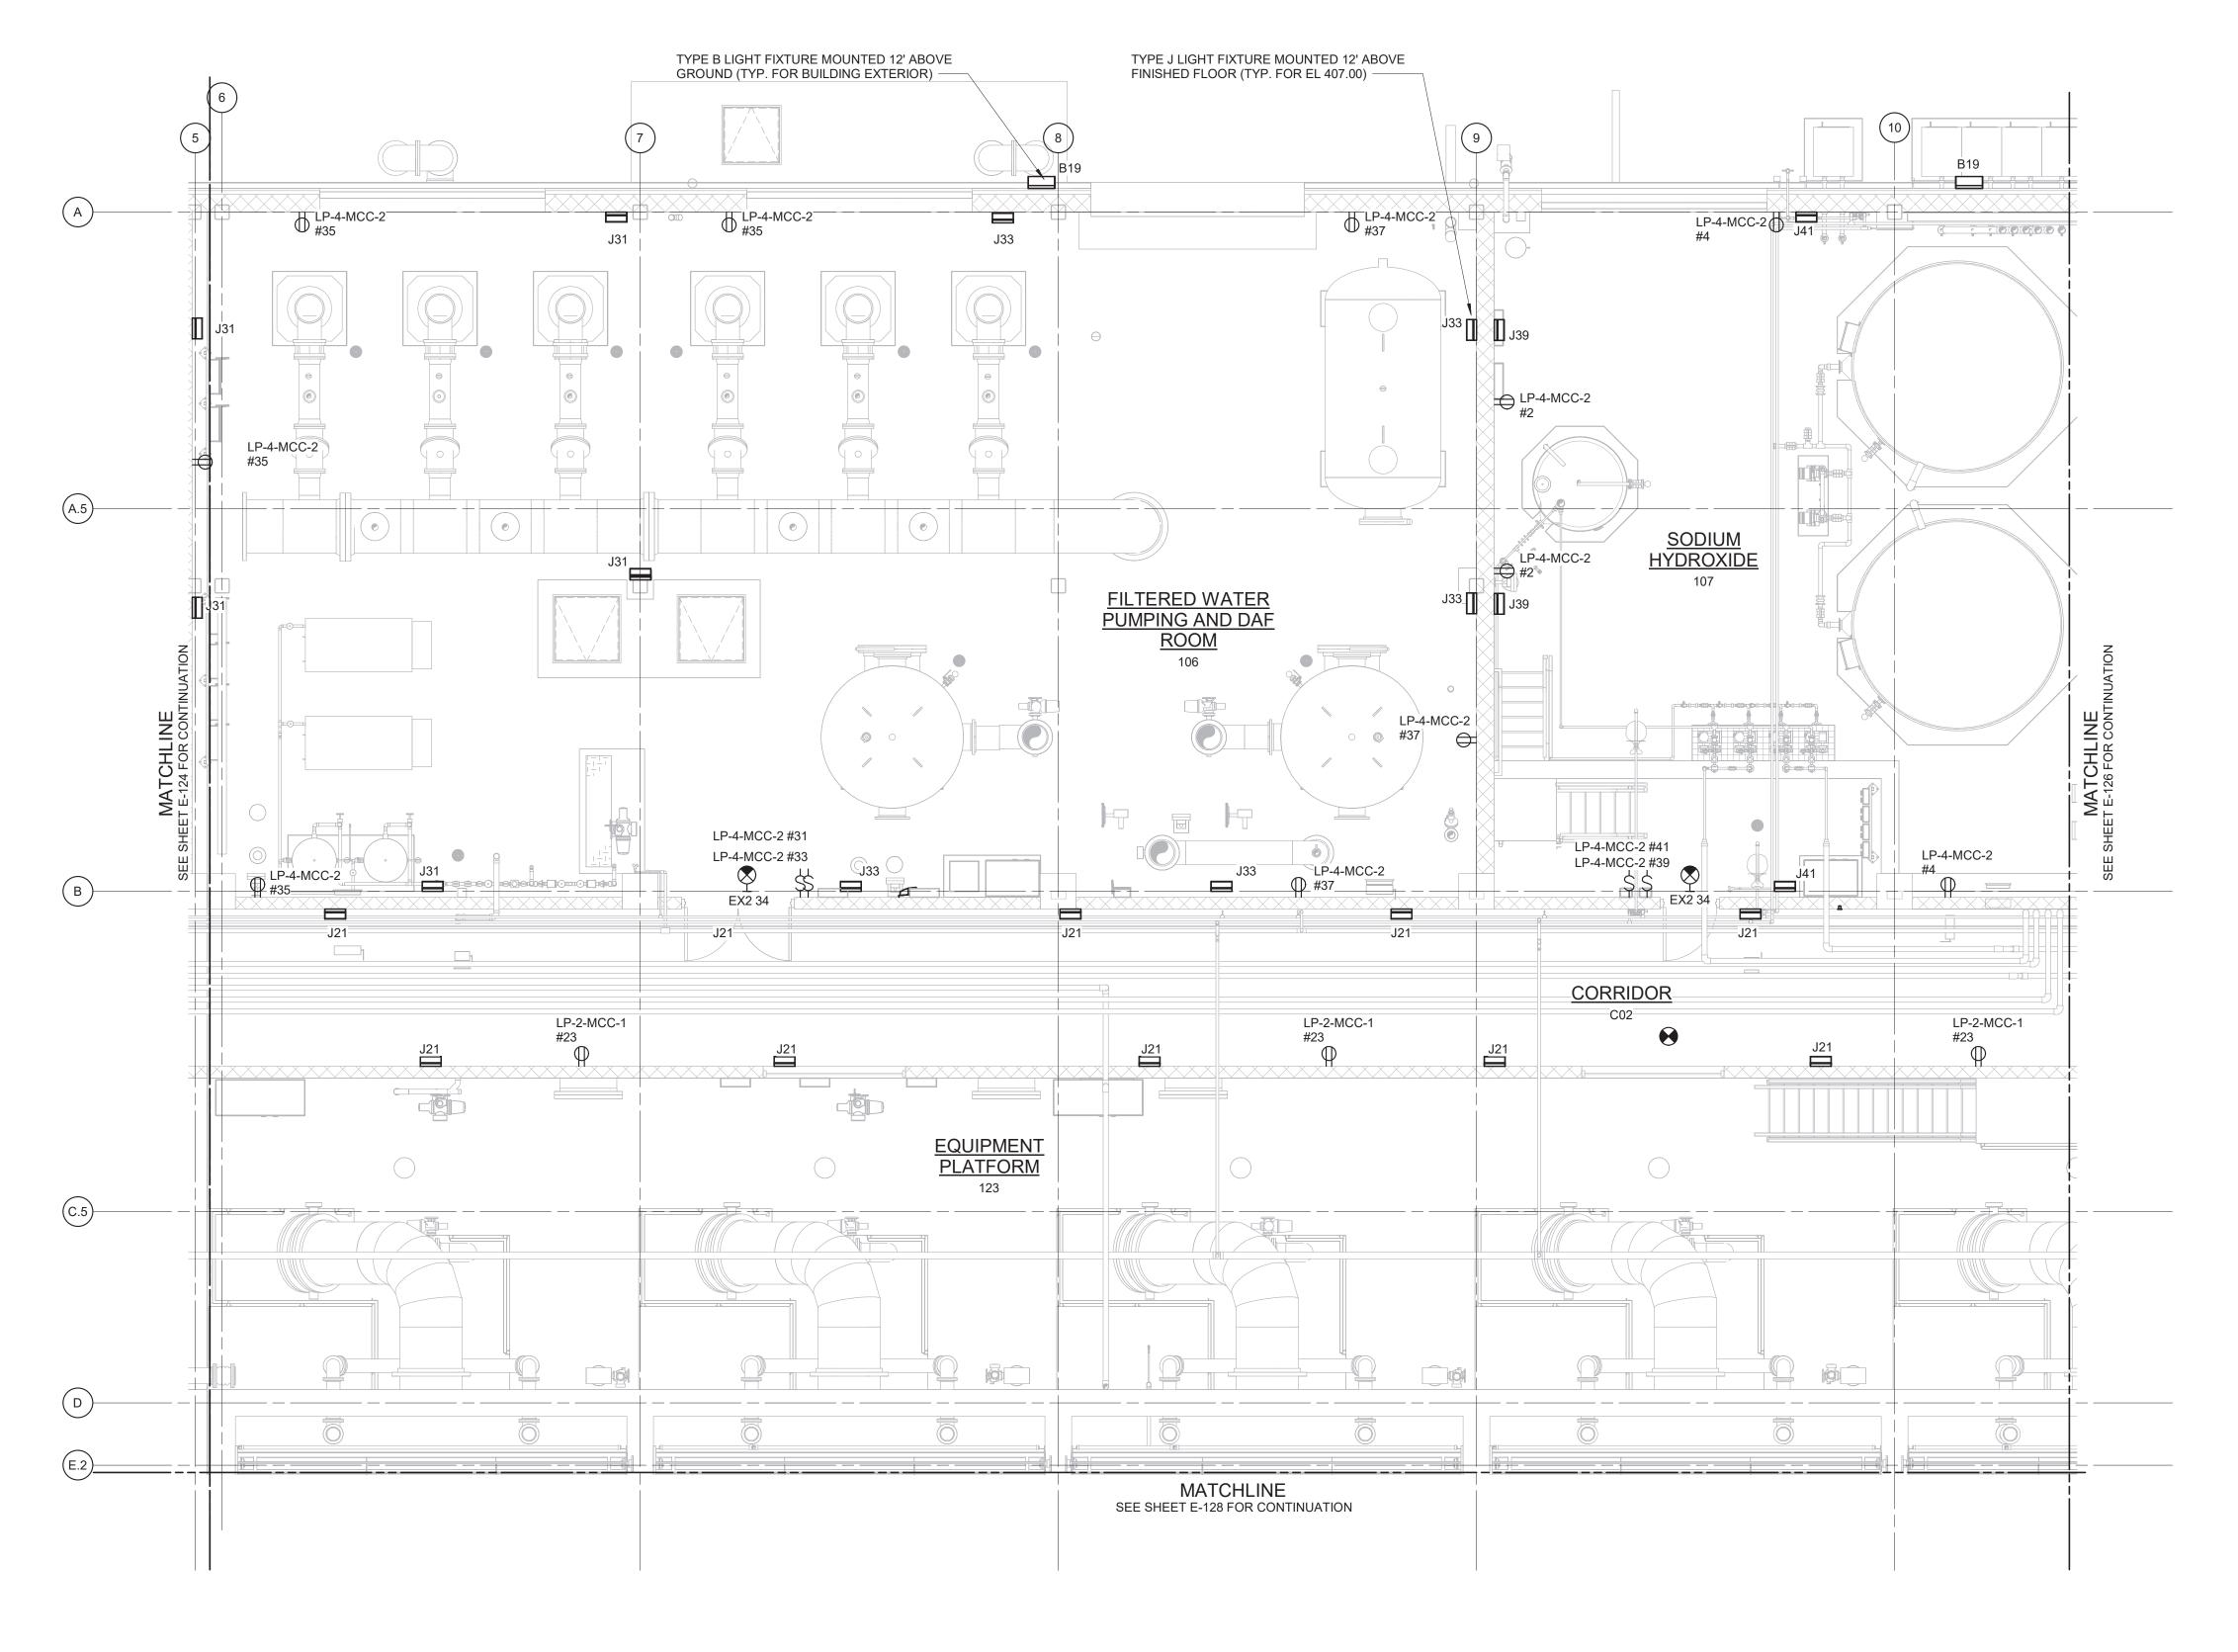

- REFER TO SPECIFICATION 26 50 00 FOR LIGHTING FIXTURE SCHEDULE.
- 2. REFER TO DRAWINGS E-012 TO E-017 FOR PANELBOARD SCHEDULES.
- LIGHT FIXTURES IN CORRIDOR (C02) AND BUILDING EXTERIOR SHALL BE POWERED FROM LP-2-MCC-1. EXIT SIGNS, AND ALL OTHER LIGHT FIXTURES SHALL BE POWERED FROM LP-4-MCC-2.

LIGHTING PLAN AT EL 407.00 - AREA 2

	ANY PERSO PROFESSIO OR REPORT APPLIED. IF THE ALTER "ALTERED E	WARNING ATION OF SECTION 7209.2 OF THE NEW YORK ST. DN, UNLESS ACTING UNDER THE DIRECTION OF A NAL ENGINEER, TO ALTER IN ANY WAY PLANS, S TS TO WHICH THE SEAL OF A PROFESSIONAL ENG AN ITEM BEARING THE SEAL OF A PROFESSIONAL ING ENGINEER SHALL AFFIX TO THE ITEM HIS SEA 3Y" FOLLOWED BY HIS SIGNATURE, THE DATE, AN DN OF THE ALTERATION.	LICENSED SPECIFICATIONS GINEER HAS BE AL ENGINEER IS AL AND THE NO	, PLATS EN ALTERED,			
					PROJECT ENGINEER:	R. FROST	
					DESIGNED BY:	Y. ABDALLA	
					DRAWN BY:	P. NUGENT	BID SET
:09 PM					CHECKED BY:	G. MARKOU	5.5 52.
25 3:07:09					IF THIS BAR DOES NOT MEASURE 1" THEN DRAWING	0 1/2" 1"	
15/2025	REV	ISSUED FOR	DATE	BY	IS NOT TO FULL SCALE		


OF NEW PORCE MARRON TO THE STREET OF NEW PORCE MARRON TO THE STREET OF T

HAZEN AND SAWYER
498 SEVENTH AVENUE, 11th FLOOR
NEW YORK, NEW YORK 10018


WESTCHESTER JOINT WATER WORKS MAMARONECK, NY

RYE LAKE WATER FILTRATION PLANT HARRISON, NY

DATE:	FEB 2025
HAZEN NO.:	90388-000
CONTRACT NO.:	A1364-A
DRAWING NUMBER:	
	E-125

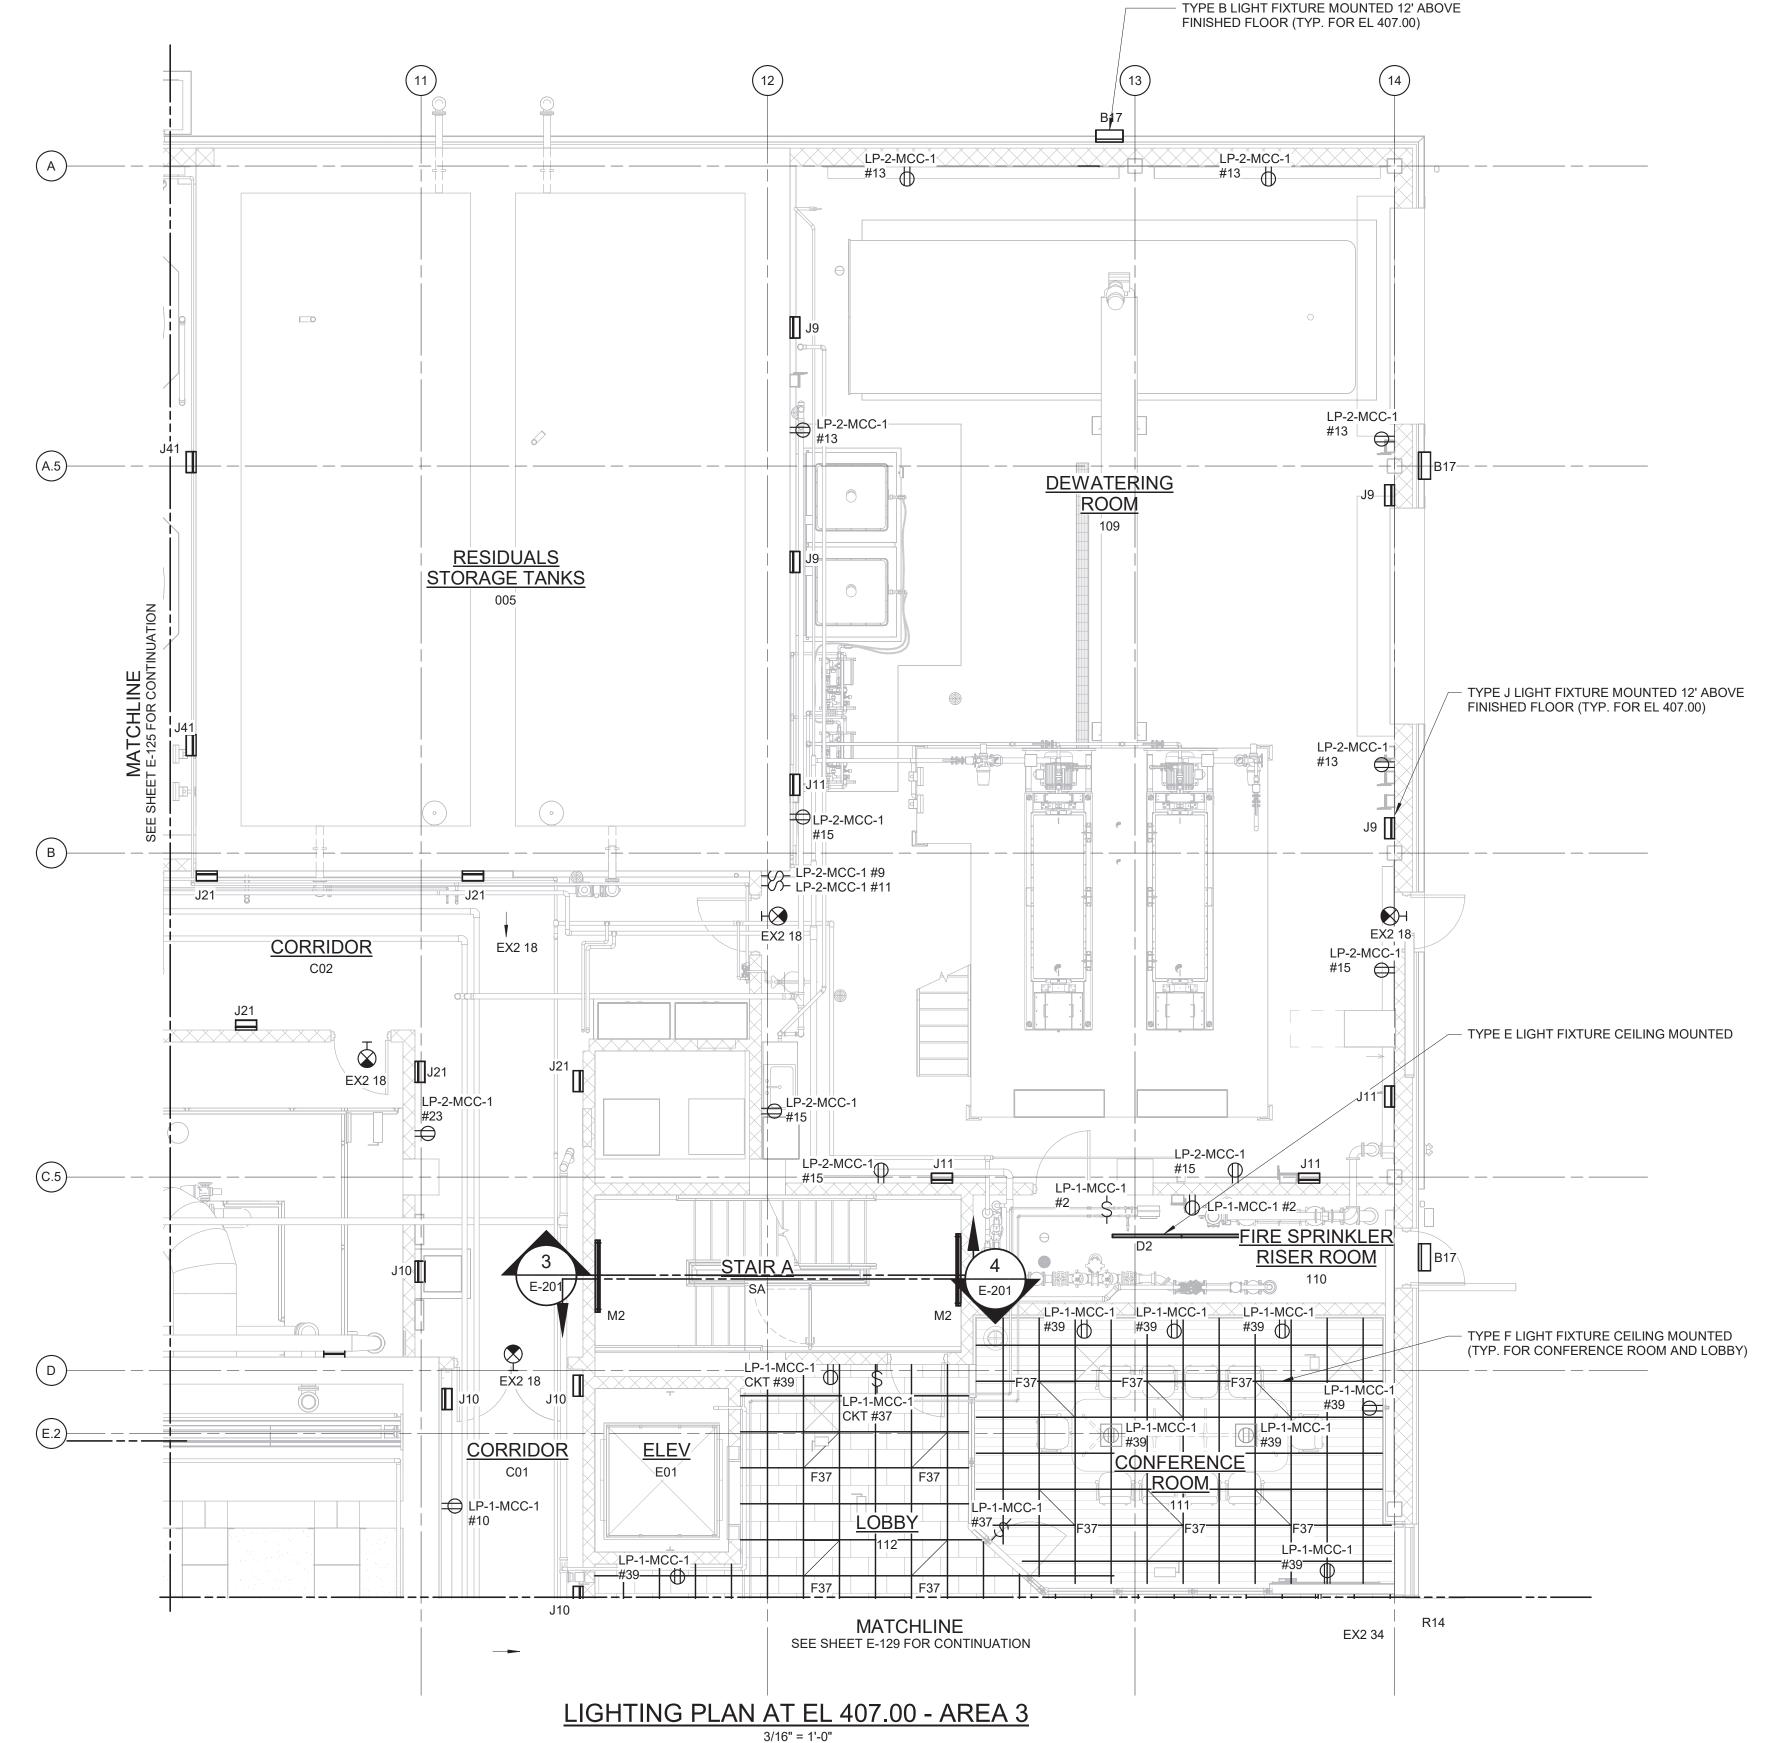

- 1. REFER TO SPECIFICATION 26 50 00 FOR LIGHTING FIXTURE SCHEDULE.
- 2. REFER TO DRAWINGS E-012 TO E-017 FOR PANELBOARD SCHEDULES.
- 3. LIGHT FIXTURES IN CORRIDOR (C02), DEWATERING ROOM, EXIT SIGNS, AND BUILDING EXTERIOR SHALL BE POWERED FROM LP-2-MCC-1. LIGHT FIXTURES IN CONFERENCE ROOM, LOBBY, CORRIDOR (C01), AND STAIR A SHALL BE POWERED FROM LP-1-MCC-1. LIGHT FIXTURES IN SODIUM HYDROXIDE ROOM SHALL BE POWERED FROM LP-4-MCC-2.

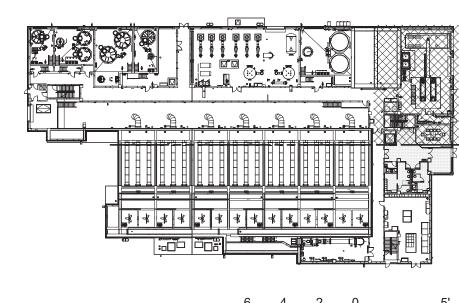

3/16" = 1'-0"

WARNING

IT IS A VIOLATION OF SECTION 7209.2 OF THE NEW YORK STATE EDUCATION LAW FOR ANY PERSON, UNLESS ACTING UNDER THE DIRECTION OF A LICENSED PROFESSIONAL ENGINEER, TO ALTER IN ANY WAY PLANS, SPECIFICATIONS, PLATS OR REPORTS TO WHICH THE SEAL OF A PROFESSIONAL ENGINEER HAS BEEN APPLIED. IT HE ALTERNIS ENGINEER SHALL AFTIX TO THE ITEM HIS SEAL AND THE NOTATION "ALTERED BY" FOLLOWED BY HIS SIGNATURE, THE DATE, AND A SPECIFIC DESCRIPTION OF THE ALTERATION.

PROJECT ENGINEER:

DESIGNED BY:

V. ABDALLA

DRAWN BY:

P. NUGENT

BID SET

CHECKED BY:

G. MARKOU

IF THIS BAR DOES NOT MEASURE 1" THEN DRAWING IS NOT TO FULL SCALE


OF NEW JORGE MARRONA POPESSIONAL HAZEN AND SAWYER
498 SEVENTH AVENUE, 11th FLOOR

NEW YORK, NEW YORK 10018


WESTCHESTER JOINT WATER WORKS MAMARONECK, NY

RYE LAKE WATER FILTRATION PLANT HARRISON, NY

DATE:	FEB 2025
HAZEN NO.:	90388-000
CONTRACT NO.:	A1364-A
DRAWING NUMBER:	
	E-126

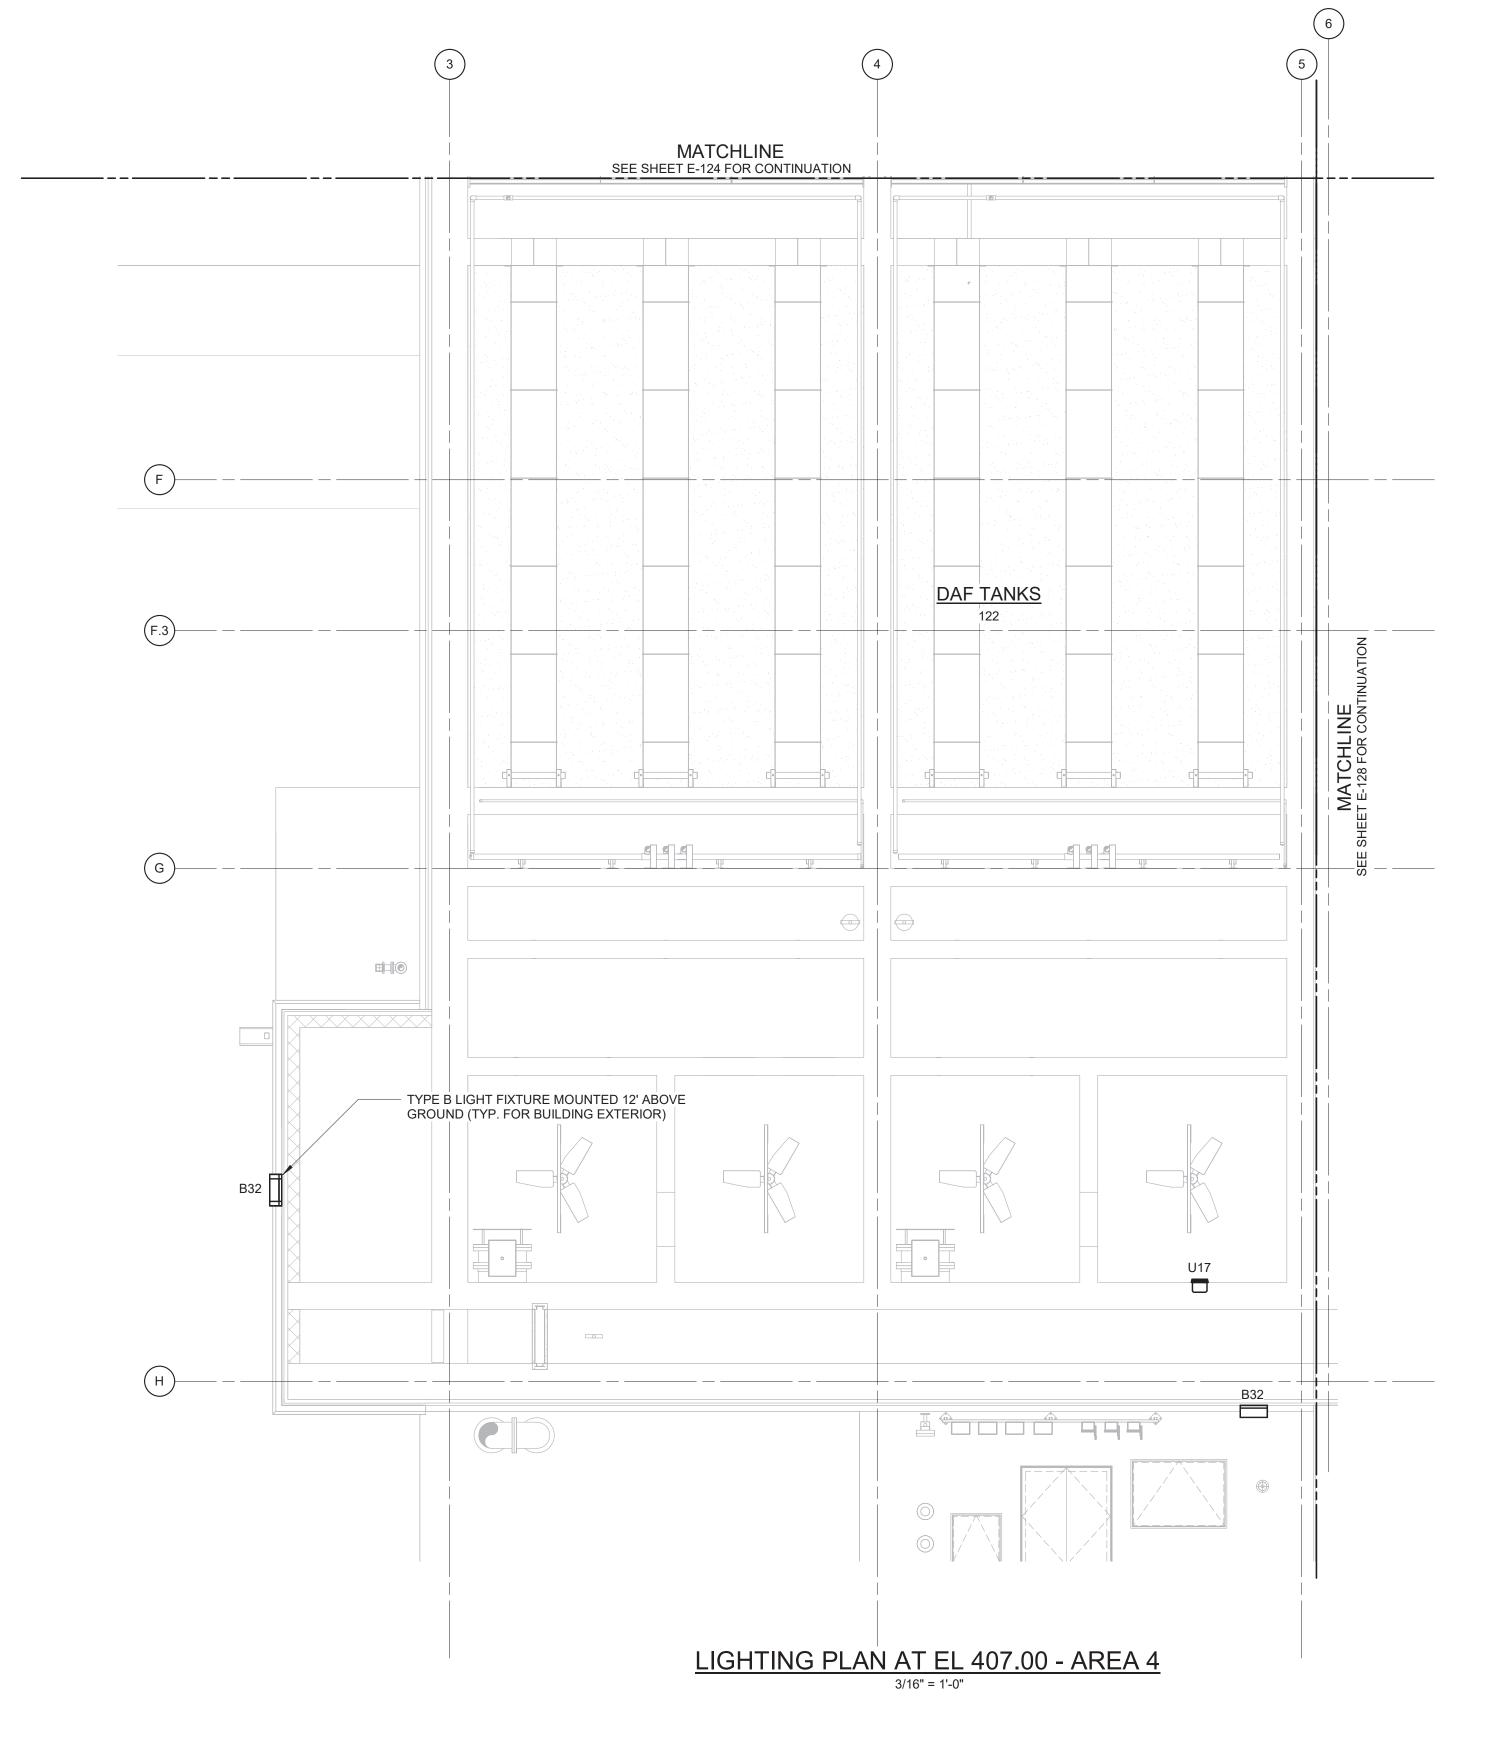

- 1. REFER TO SPECIFICATION 26 50 00 FOR LIGHTING FIXTURE
- 2. REFER TO DRAWINGS E-012 TO E-017 FOR PANELBOARD
- 3. LIGHTING FIXTURES ON BUILDING EXTERIOR SHALL BE POWERED FROM LP-4-MCC-2

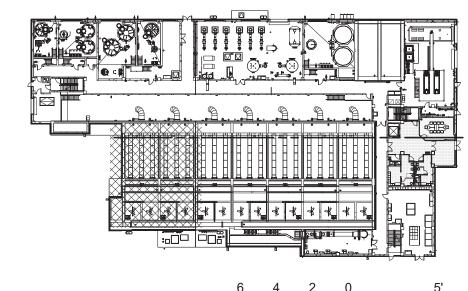


WARNING
IT IS A VIOLATION OF SECTION 7209.2 OF THE NEW YORK STATE EDUCATION LAW FOR ANY PERSON, UNLESS ACTING UNDER THE DIRECTION OF A LICENSED PROFESSIONAL ENGINEER, TO ALTER IN ANY WAY PLANS, SPECIFICATIONS, PLATS OR REPORTS TO WHICH THE SEAL OF A PROFESSIONAL ENGINEER HAS BEEN APPLIED. IF AN ITEM BEARING THE SEAL OF A PROFESSIONAL ENGINEER IS ALTERED, THE ALTERING ENGINEER SHALL AFFIX TO THE ITEM HIS SEAL AND THE NOTATION "ALTERED BY" FOLLOWED BY HIS SIGNATURE, THE DATE, AND A SPECIFIC DESCRIPTION OF THE ALTERATION. PROJECT ENGINEER: R. FROST Y. ABDALLA DESIGNED BY: P. NUGENT DRAWN BY: **BID SET** G. MARKOU CHECKED BY: IF THIS BAR DOES NOT MEASURE 1" THEN DRAWING IS NOT TO FULL SCALE 0 1/2" DATE BY ISSUED FOR


Hazen HAZEN AND SAWYER 498 SEVENTH AVENUE, 11th FLOOR NEW YORK, NEW YORK 10018

WESTCHESTER JOINT WATER WORKS MAMARONECK, NY


RYE LAKE WATER FILTRATION PLANT HARRISON, NY

DATE:	FEB 2025
HAZEN NO.:	90388-000
CONTRACT NO.:	A1364-A
DRAWING NUMBER:	
	E-127

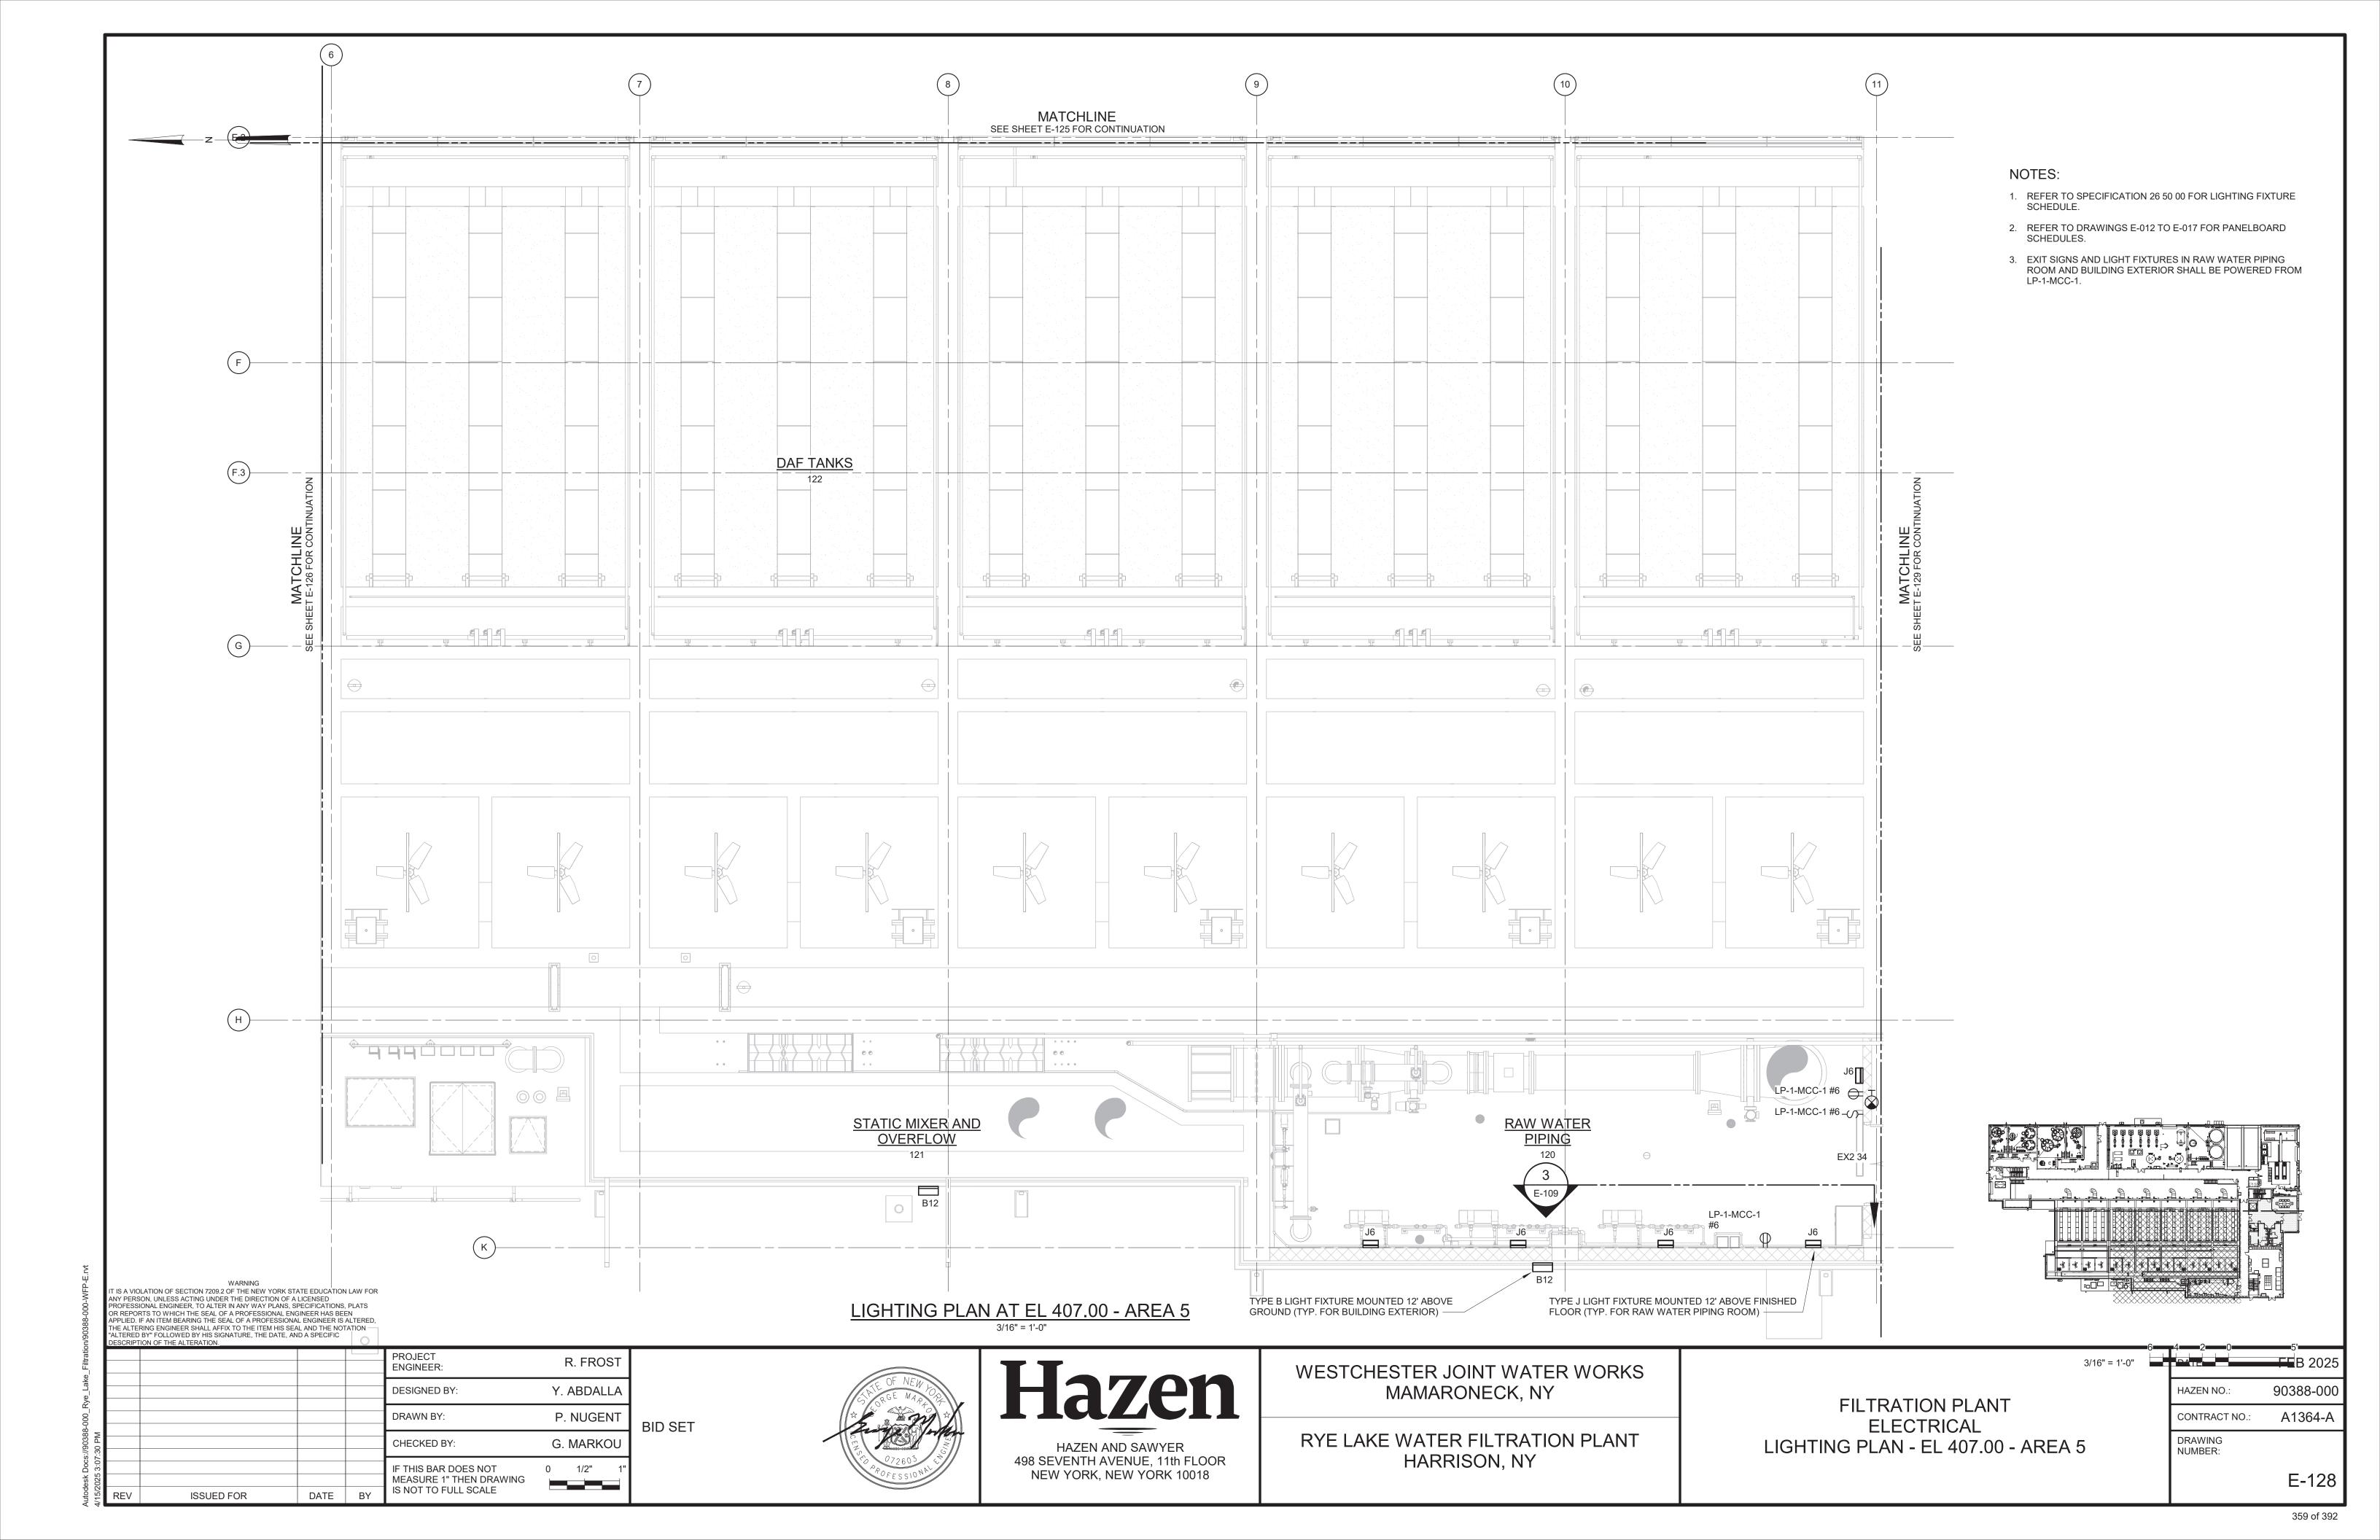

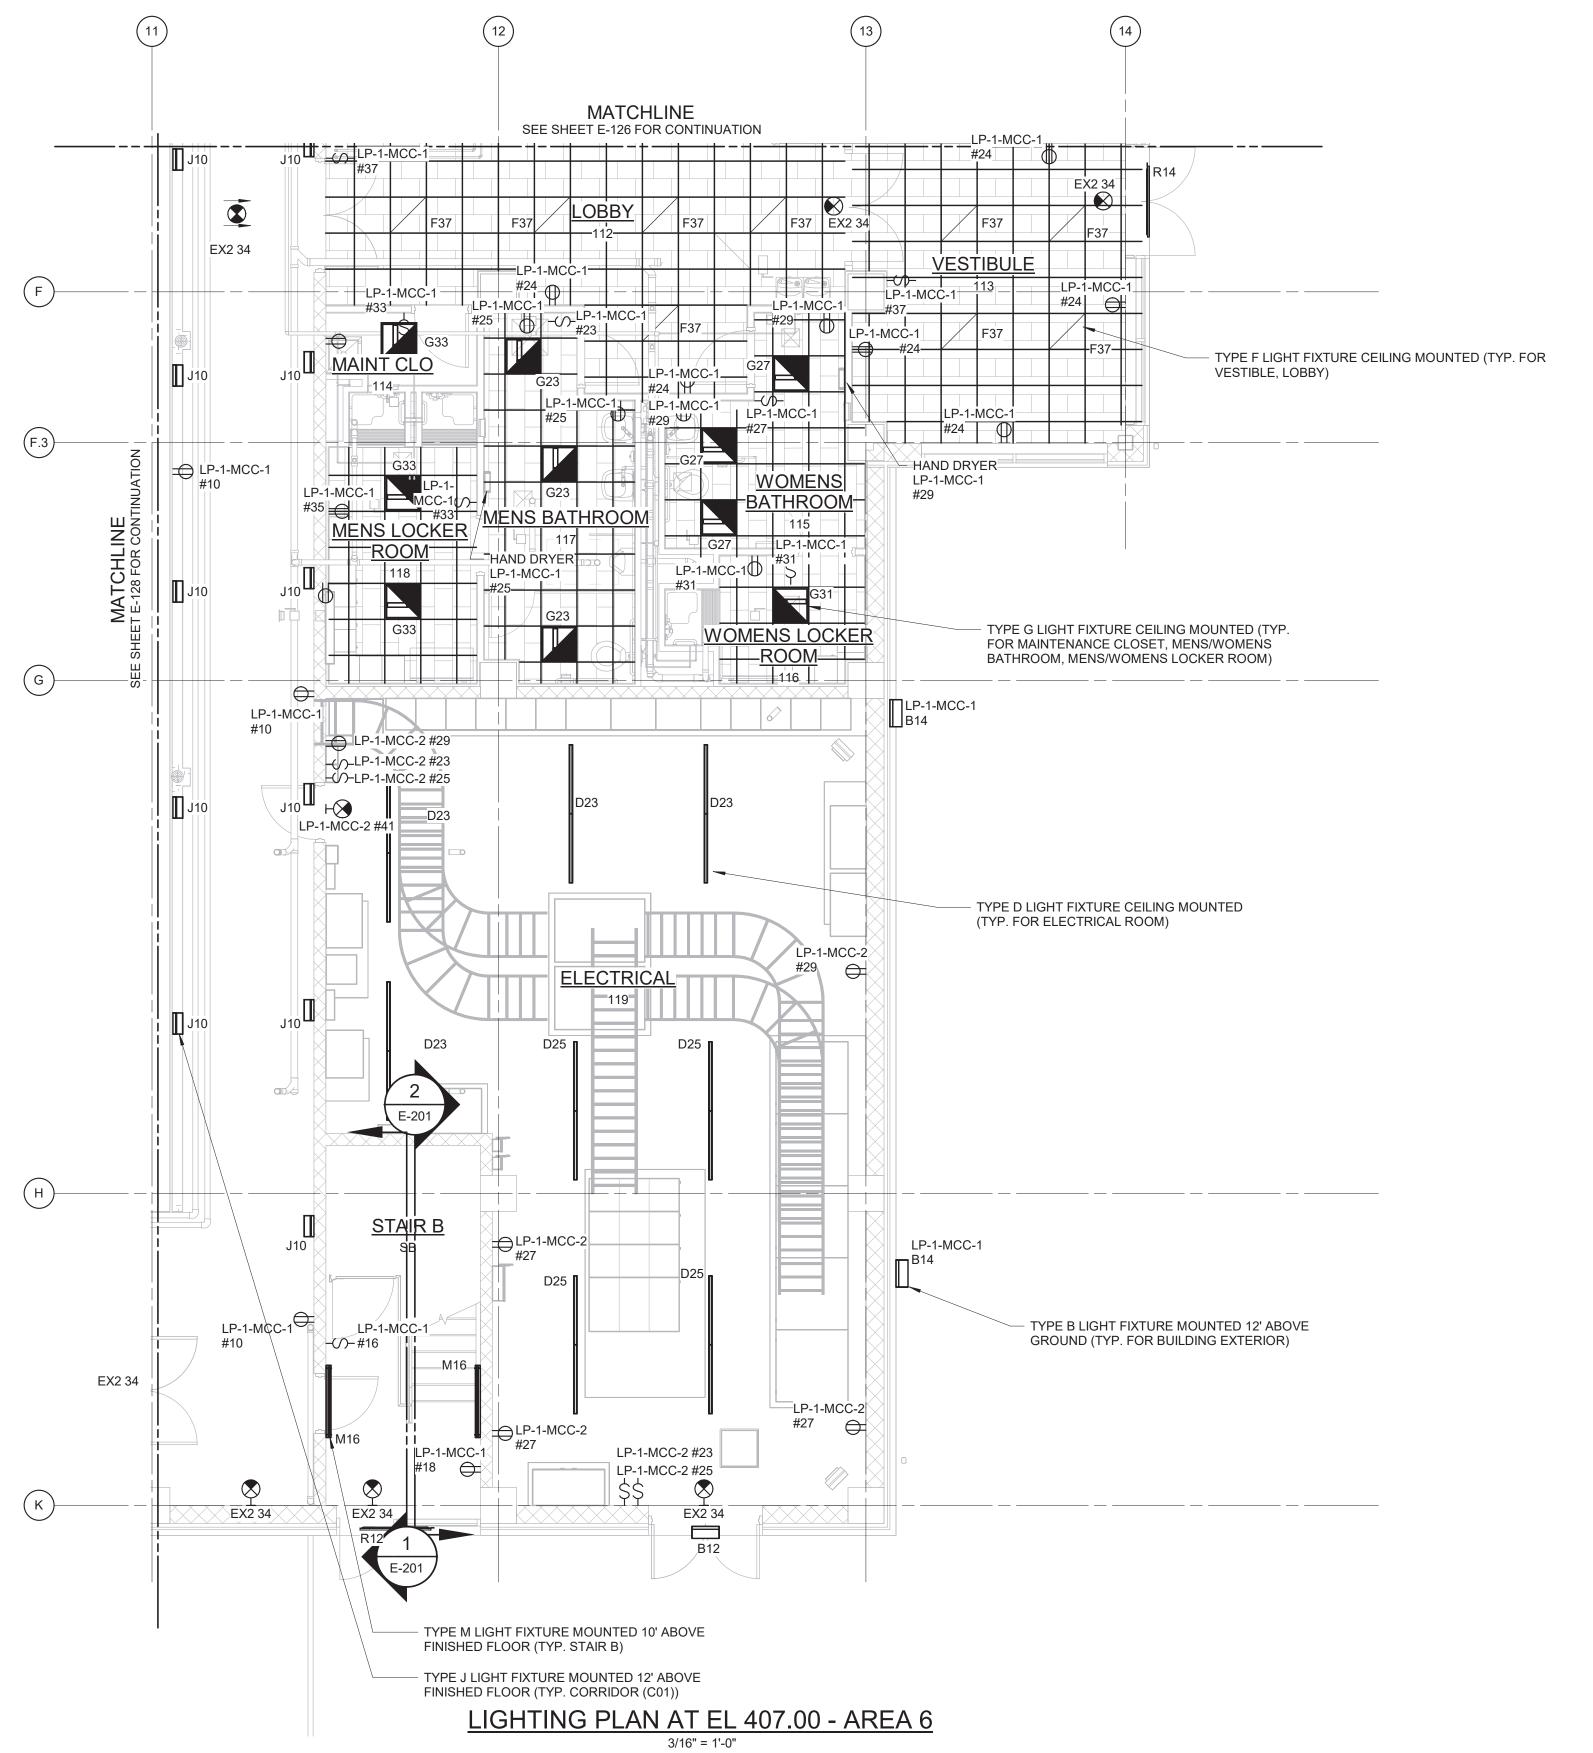

- 1. REFER TO SPECIFICATION 26 50 00 FOR LIGHTING FIXTURE SCHEDULE.
- 2. REFER TO DRAWINGS E-012 TO E-017 FOR PANELBOARD SCHEDULES.
- 3. LIGHT FIXTURES IN ELECTRICAL ROOM SHALL BE POWERED FROM LP-1-MCC-2. EXIT SIGNS AND ALL OTHER LIGHT FIXTURES SHALL BE POWERED FROM LP-1-MCC-1.

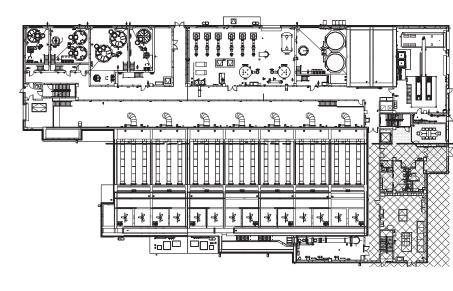

OR REPORTS TO WHICH THE SEAL OF A PROFESSIONAL ENGINEER HAS BEEN APPLIED. IF AN ITEM BEARING THE SEAL OF A PROFESSIONAL ENGINEER IS ALTERED, THE ALTERING ENGINEER SHALL AFFIX TO THE ITEM HIS SEAL AND THE NOTATION "ALTERED BY" FOLLOWED BY HIS SIGNATURE, THE DATE, AND A SPECIFIC DESCRIPTION OF THE ALTERATION. PROJECT ENGINEER: R. FROST Y. ABDALLA DESIGNED BY: P. NUGENT DRAWN BY: G. MARKOU CHECKED BY: IF THIS BAR DOES NOT 0 1/2" MEASURE 1" THEN DRAWING IS NOT TO FULL SCALE ISSUED FOR DATE BY

IT IS A VIOLATION OF SECTION 7209.2 OF THE NEW YORK STATE EDUCATION LAW FOR ANY PERSON, UNLESS ACTING UNDER THE DIRECTION OF A LICENSED PROFESSIONAL ENGINEER, TO ALTER IN ANY WAY PLANS, SPECIFICATIONS, PLATS
OR REPORTS TO WHICH THE SEAL OF A PROFESSIONAL ENGINEER HAS BEEN

BID SET

Hazen

HAZEN AND SAWYER 498 SEVENTH AVENUE, 11th FLOOR


NEW YORK, NEW YORK 10018

WESTCHESTER JOINT WATER WORKS MAMARONECK, NY


RYE LAKE WATER FILTRATION PLANT HARRISON, NY

DATE:	FEB 2025
HAZEN NO.:	90388-000
CONTRACT NO.:	A1364-A
DRAWING NUMBER:	
	E-129

- 1. REFER TO SPECIFICATION 26 50 00 FOR LIGHTING FIXTURE SCHEDULE.
- 2. REFER TO DRAWINGS E-012 TO E-017 FOR PANELBOARD SCHEDULES.
- 3. LIGHT FIXTURES IN CORRIDOR (C03), STORAGE ROOM, HVAC (201) ROOM, AIR SCOUR ROOM, EXIT SIGNS, AND ELECTRICAL ROOM SHALL BE POWERED FROM LP-1-MCC-2. LIGHT FIXTURES IN STAIR C SHALL BE POWERED FROM LP-4-MCC-2. LIGHT FIXTURES IN DAF TANKS ROOM SHALL BE POWERED FROM LP-1-MCC-1.

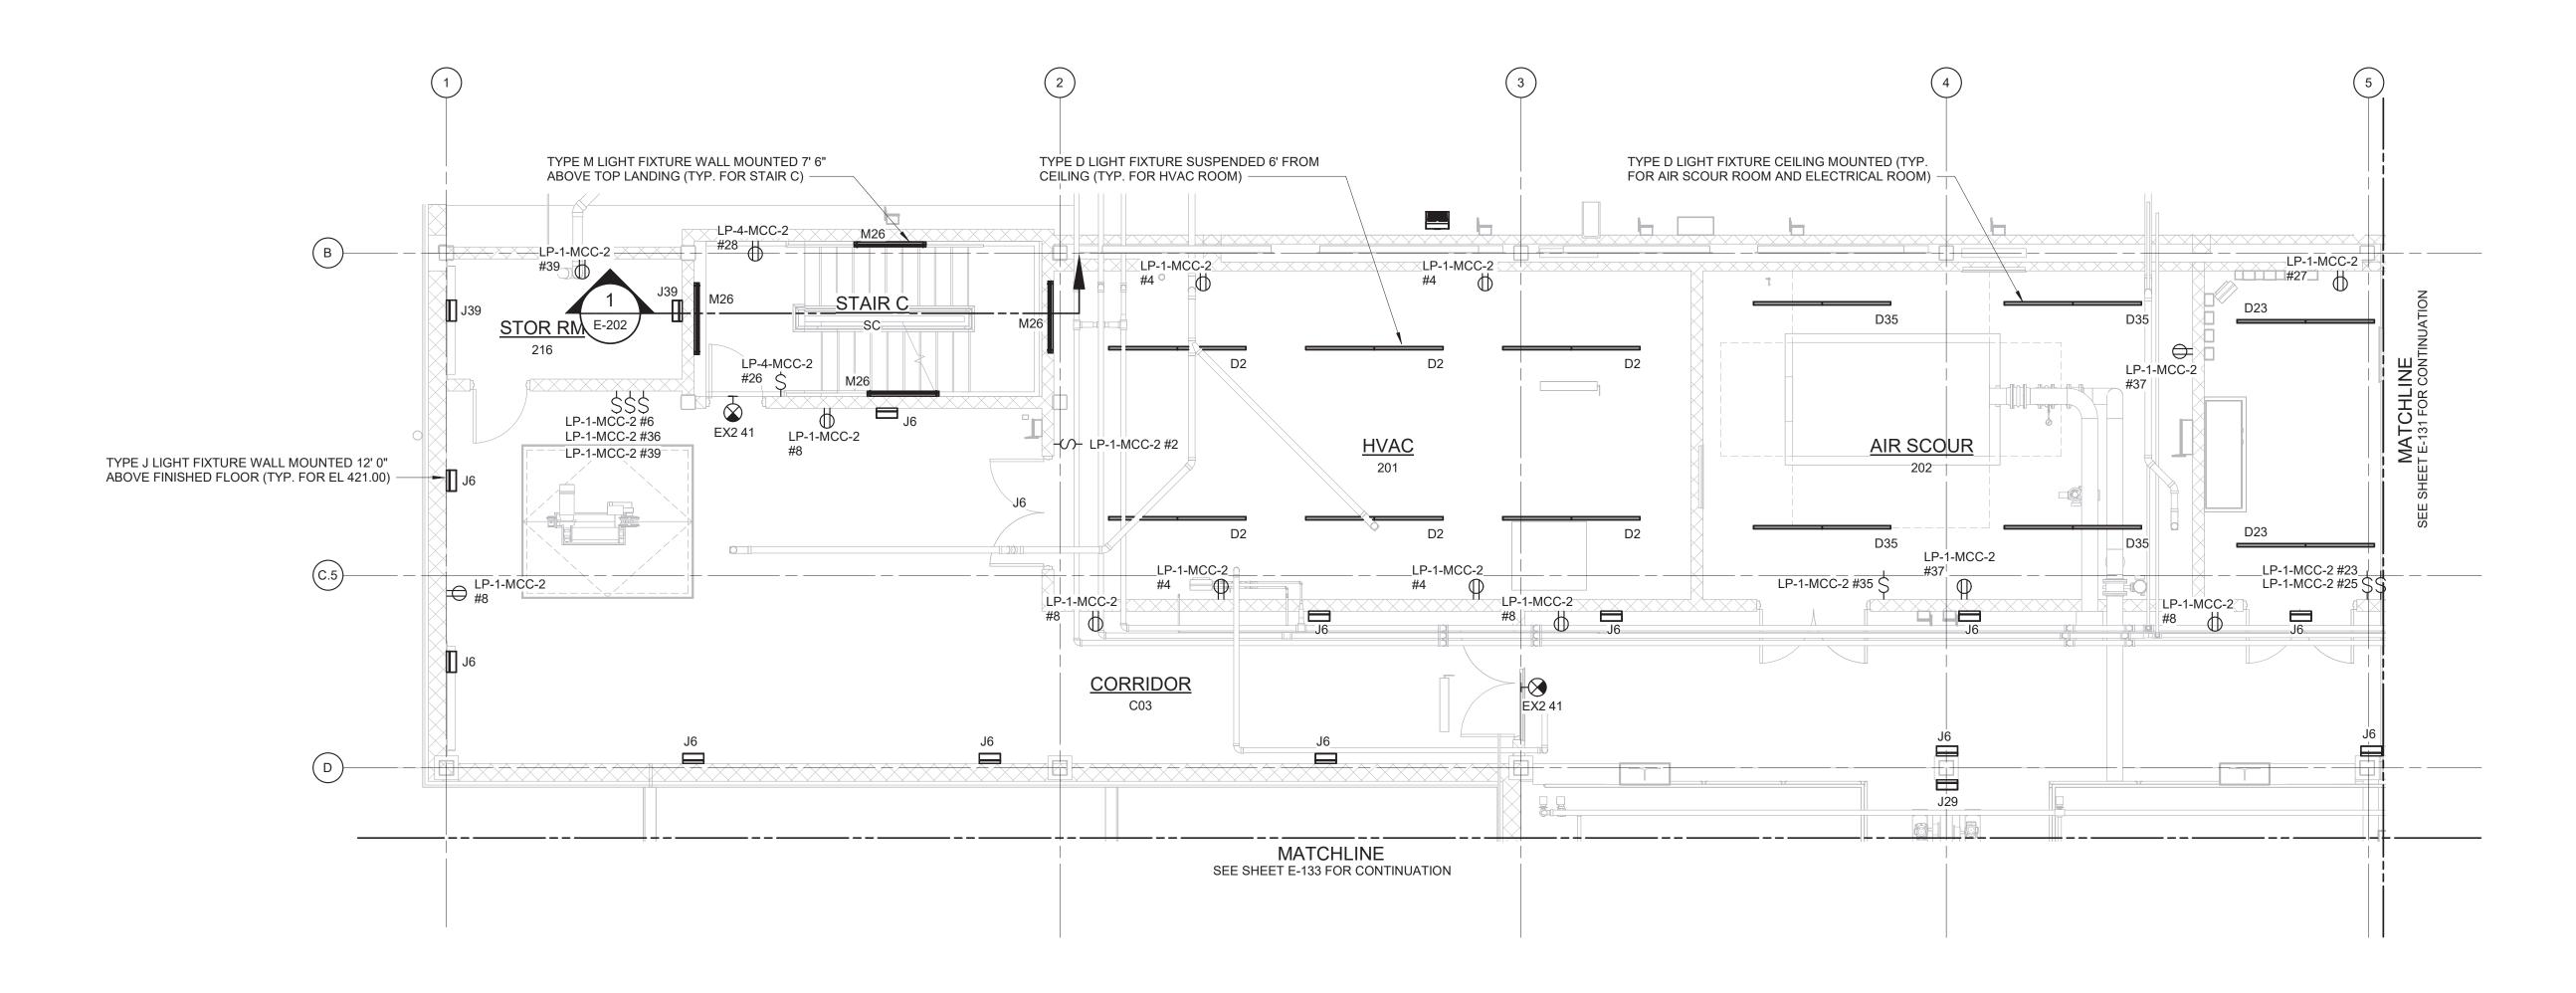

LIGHTING PLAN AT EL 421.00 - AREA 1

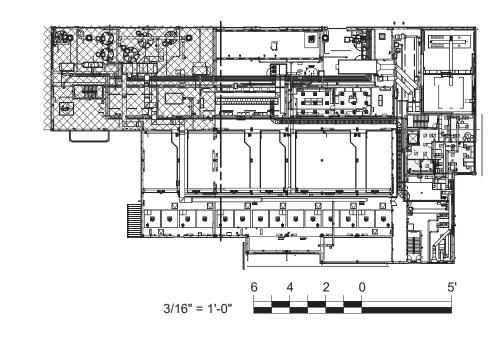

WARNING
IT IS A VIOLATION OF SECTION 7209.2 OF THE NEW YORK STATE EDUCATION LAW FOR
ANY PERSON, UNLESS ACTING UNDER THE DIRECTION OF A LICENSED
PROFESSIONAL ENGINEER, TO ALTER IN ANY WAY PLANS, SPECIFICATIONS, PLATS
OR REPORTS TO WHICH THE SEAL OF A PROFESSIONAL ENGINEER HAS BEEN
APPLIED. IF AN ITEM BEARING THE SEAL OF A PROFESSIONAL ENGINEER IS ALTERED,
THE ALTERING ENGINEER SHALL AFFIX TO THE ITEM HIS SEAL AND THE NOTATION
"ALTERED BY" FOLLOWED BY HIS SIGNATURE, THE DATE, AND A SPECIFIC
DESCRIPTION OF THE ALTERATION.

	DESCRIPTIO	ON OF THE ALTERATION.						
I					PROJECT ENGINEER:		R. FRO	ST
I					DESIGNED BY:	Y.	ABDAL	.LA
1					DRAWN BY:	Р	. NUGE	NT
:41 PM					CHECKED BY:	G.	MARK	OU
025 3:07:41					IF THIS BAR DOES NOT MEASURE 1" THEN DRAWING	0	1/2"	1"
15/2025	REV	ISSUED FOR	DATE	BY	IS NOT TO FULL SCALE			-

OF NEW JORGE MARTOR

BID SET


HAZEN AND SAWYER
498 SEVENTH AVENUE, 11th FLOOR
NEW YORK, NEW YORK 10018

WESTCHESTER JOINT WATER WORKS MAMARONECK, NY


RYE LAKE WATER FILTRATION PLANT HARRISON, NY

DATE:	FEB 2025
HAZEN NO.:	90388-000
CONTRACT NO.:	A1364-A
DRAWING NUMBER:	
	E-130

- 1. REFER TO SPECIFICATION 26 50 00 FOR LIGHTING FIXTURE SCHEDULE.
- 2. REFER TO DRAWINGS E-012 TO E-017 FOR PANELBOARD SCHEDULES.
- 3. LIGHT FIXTURES IN ELECTRICAL ROOM, PROCESS ANALYSIS ROOM, AND CORRIDOR (C03) SHALL BE POWERED FROM LP-1-MCC-2. LIGHT FIXTURES IN CONTROL ROOM SHALL BE POWERED FROM LP-3-MCC-1. LIGHT FIXUTRES IN DAF TANKS ROOM SHALL BE POWERED FROM LP-1-MCC-1.

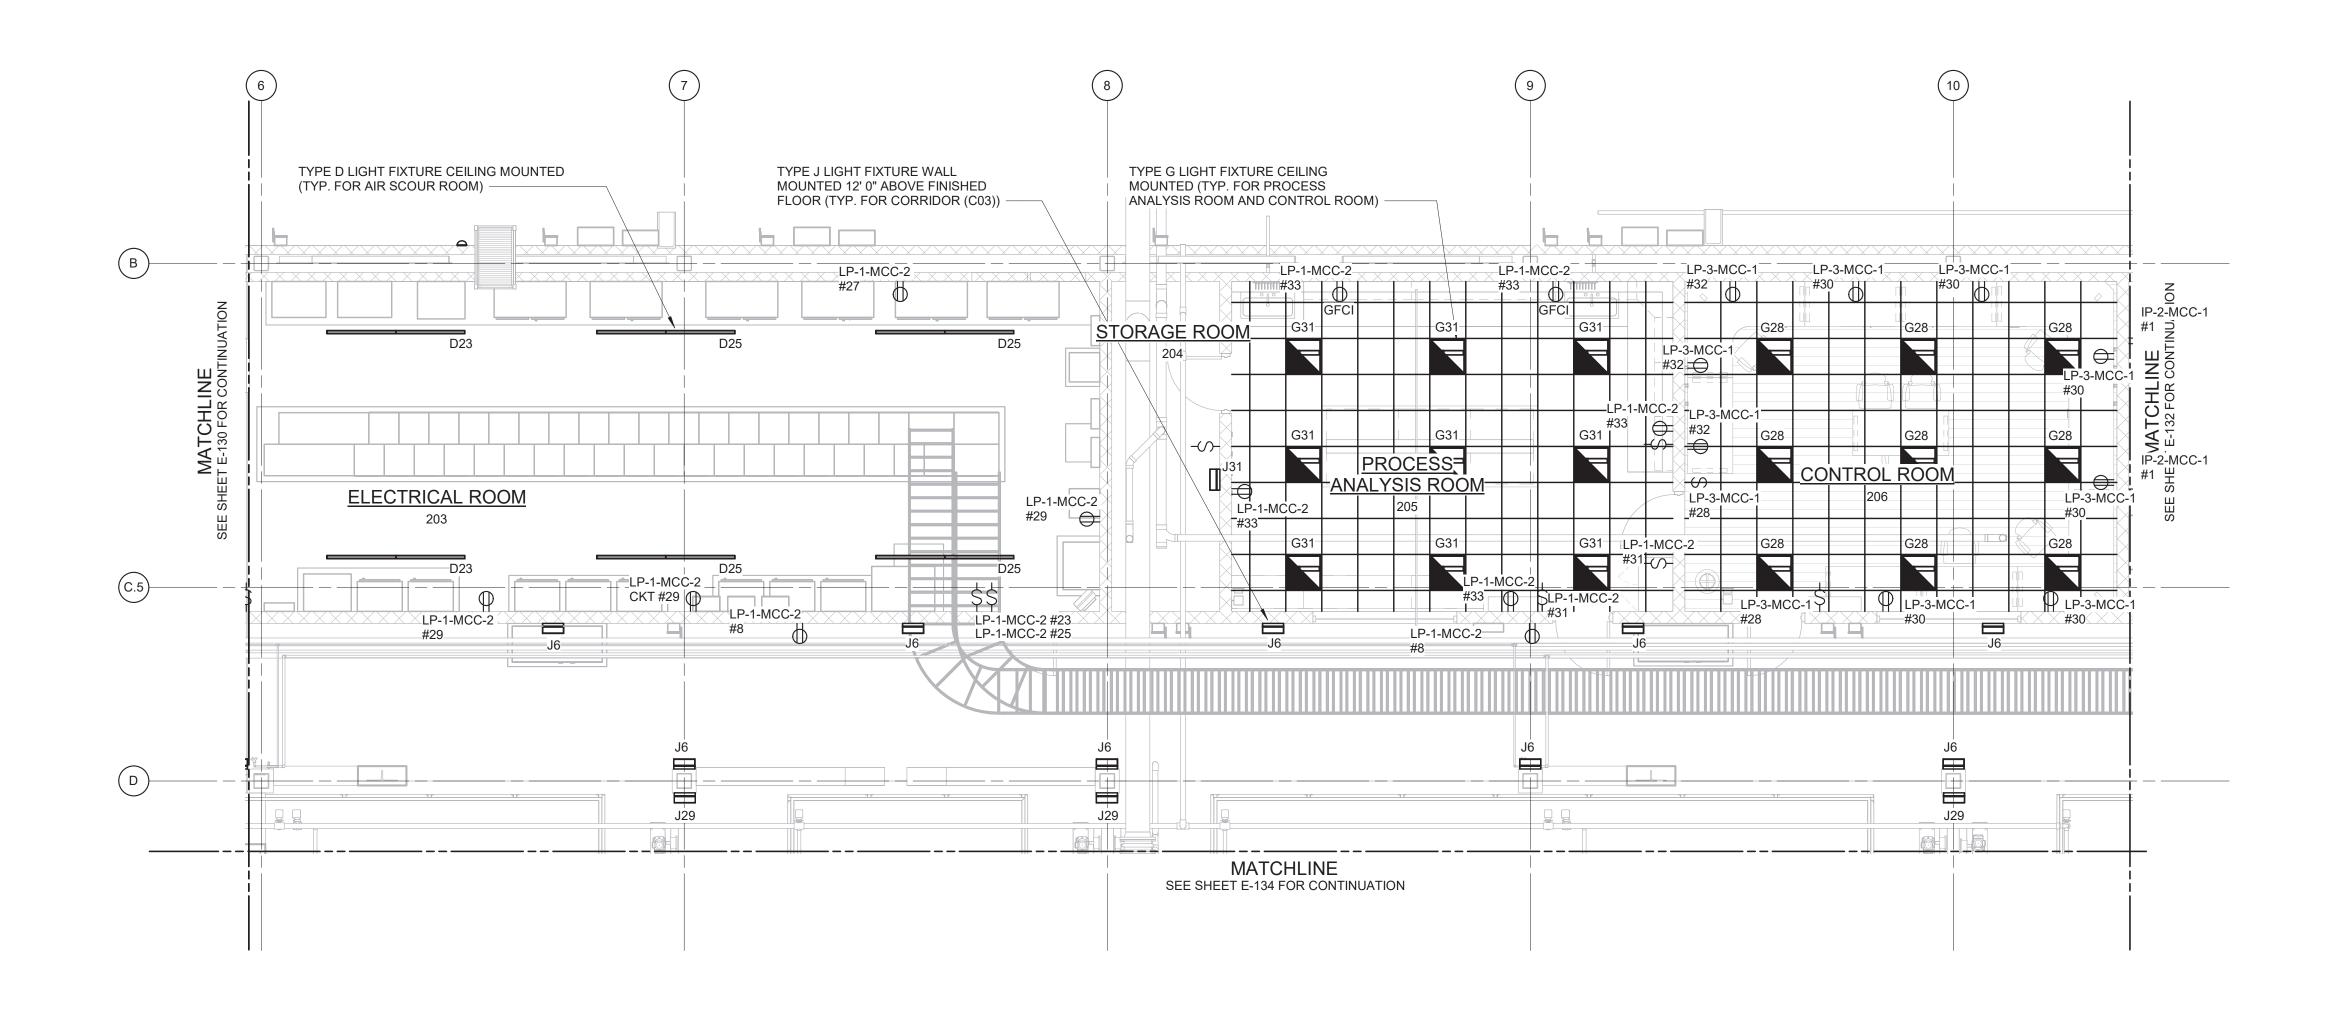

LIGHTING PLAN AT EL 421.00 - AREA 2

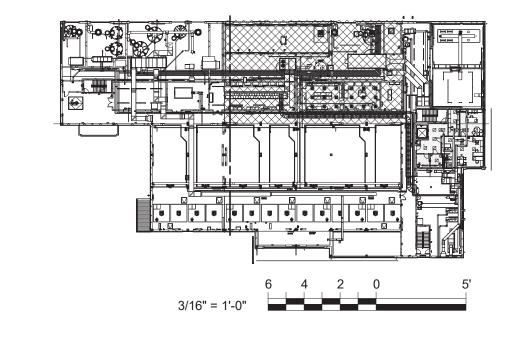

WARNING
IT IS A VIOLATION OF SECTION 7209.2 OF THE NEW YORK STATE EDUCATION LAW FOR
ANY PERSON, UNLESS ACTING UNDER THE DIRECTION OF A LICENSED
PROFESSIONAL ENGINEER, TO ALTER IN ANY WAY PLANS, SPECIFICATIONS, PLATS
OR REPORTS TO WHICH THE SEAL OF A PROFESSIONAL ENGINEER HAS BEEN
APPLIED. IF AN ITEM BEARING THE SEAL OF A PROFESSIONAL ENGINEER IS ALTERED,
THE ALTERING ENGINEER SHALL AFFIX TO THE ITEM HIS SEAL AND THE NOTATION
"ALTERED BY" FOLLOWED BY HIS SIGNATURE, THE DATE, AND A SPECIFIC
DESCRIPTION OF THE ALTERATION

DESCRIPTION	OF THE ALTERATION.				
				PROJECT ENGINEER:	R. FROST
				DESIGNED BY:	Y. ABDALLA
				DRAWN BY:	P. NUGENT
746 PM				CHECKED BY:	G. MARKOU
VEV				IF THIS BAR DOES NOT MEASURE 1" THEN DRAWING	0 1/2" 1"
REV	ISSUED FOR	DATE	BY	IS NOT TO FULL SCALE	

OF NEW OR RGE MARROW APPROPRIES NO. 12 PROFESSIONAL


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WESTCHESTER JOINT WATER WORKS MAMARONECK, NY

RYE LAKE WATER FILTRATION PLANT HARRISON, NY

DATE:	FEB 2025
HAZEN NO.:	90388-000
CONTRACT NO.:	A1364-A
DRAWING NUMBER:	
	E-131



- REFER TO SPECIFICATION 26 50 00 FOR LIGHTING FIXTURE SCHEDULE.
- 2. REFER TO DRAWINGS E-012 TO E-017 FOR PANELBOARD SCHEDULES.
- 3. LIGHT FIXTURES IN SCADA ROOM, CHIEF'S OFFICE, VESTIBULE, OPEN OFFICE, AND ELEVATOR SHAFT SHALL BE POWERED FROM LP-3-MCC-1. EXIT SIGNS AND LIGHT FIXTURES IN HVAC ROOM (208) SHALL BE POWERED FROM LP-2-MCC-1. LIGHT FIXTURES IN CORRIDORS (C03) AND (C04) SHALL BE POWERED FROM LP-1-MCC-2. LIGHT FIXTURES IN STAIR A SHALL BE POWERED FROM LP-1-MCC-1.

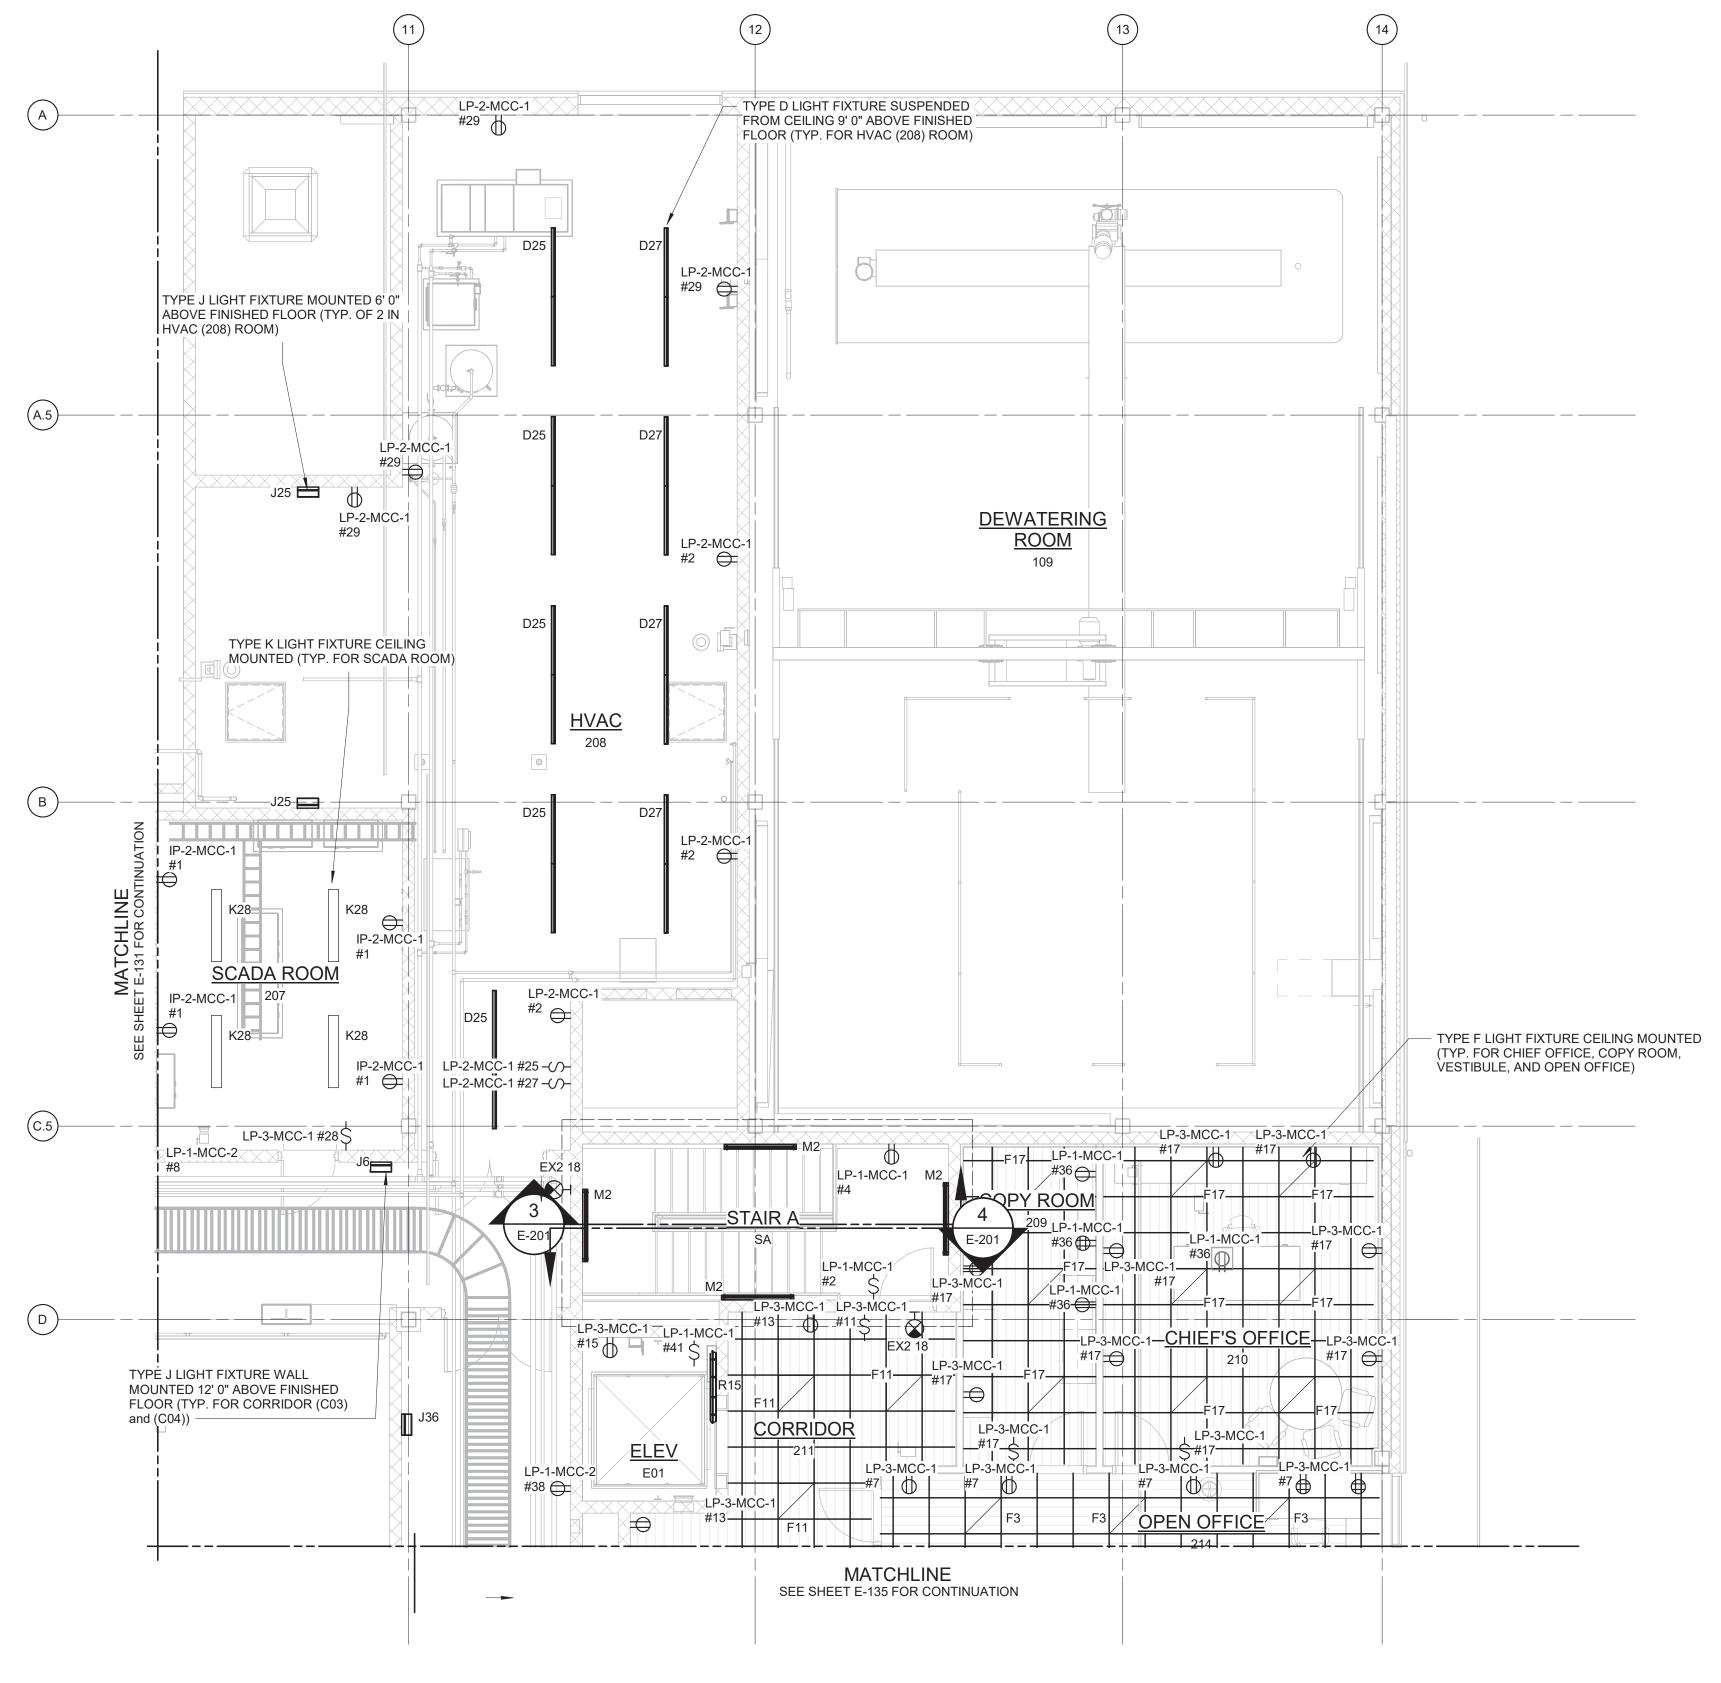LIGHTING PLAN AT EL 421.00 - AREA 3

	ANY PERSON PROFESSION OR REPORTS APPLIED. IF A THE ALTERIN "ALTERED BY	TION OF SECTION 7209.2 OF THE NEW YORK STAIN, UNLESS ACTING UNDER THE DIRECTION OF A I AL ENGINEER, TO ALTER IN ANY WAY PLANS, STO WHICH THE SEAL OF A PROFESSIONAL ENGINITEM BEARING THE SEAL OF A PROFESSIONAI GENGINEER SHALL AFFIX TO THE ITEM HIS SEAT OF THE ITEM HIS SEAT OF THE ITEM HIS SEAT OF THE DATE, AN OF THE ALTERATION.	LICENSED PECIFICATIONS, BINEER HAS BEI L ENGINEER IS L AND THE NOT	PLATS EN ALTERED,			
					PROJECT ENGINEER:	R. FROST	
					DESIGNED BY:	Y. ABDALLA	BID SET
					DRAWN BY:	P. NUGENT	
:50 PM					CHECKED BY:	G. MARKOU	5.5 02.
125 3:07:50				IF THIS BAR DOES NOT MEASURE 1" THEN DRAWING	0 1/2" 1"		
/15/202	REV	ISSUED FOR	DATE	BY	IS NOT TO FULL SCALE		

WARNING IT IS A VIOLATION OF SECTION 7209.2 OF THE NEW YORK STATE EDUCATION LAW FOR

OF NEW ORGE MARAGORY

O72603

POFESSIONAL


HAZEN AND SAWYER
498 SEVENTH AVENUE, 11th FLOOR

NEW YORK, NEW YORK 10018


WESTCHESTER JOINT WATER WORKS MAMARONECK, NY

RYE LAKE WATER FILTRATION PLANT HARRISON, NY

DATE:	FEB 2025
HAZEN NO.:	90388-000
CONTRACT NO.:	A1364-A
DRAWING NUMBER:	
	E-132

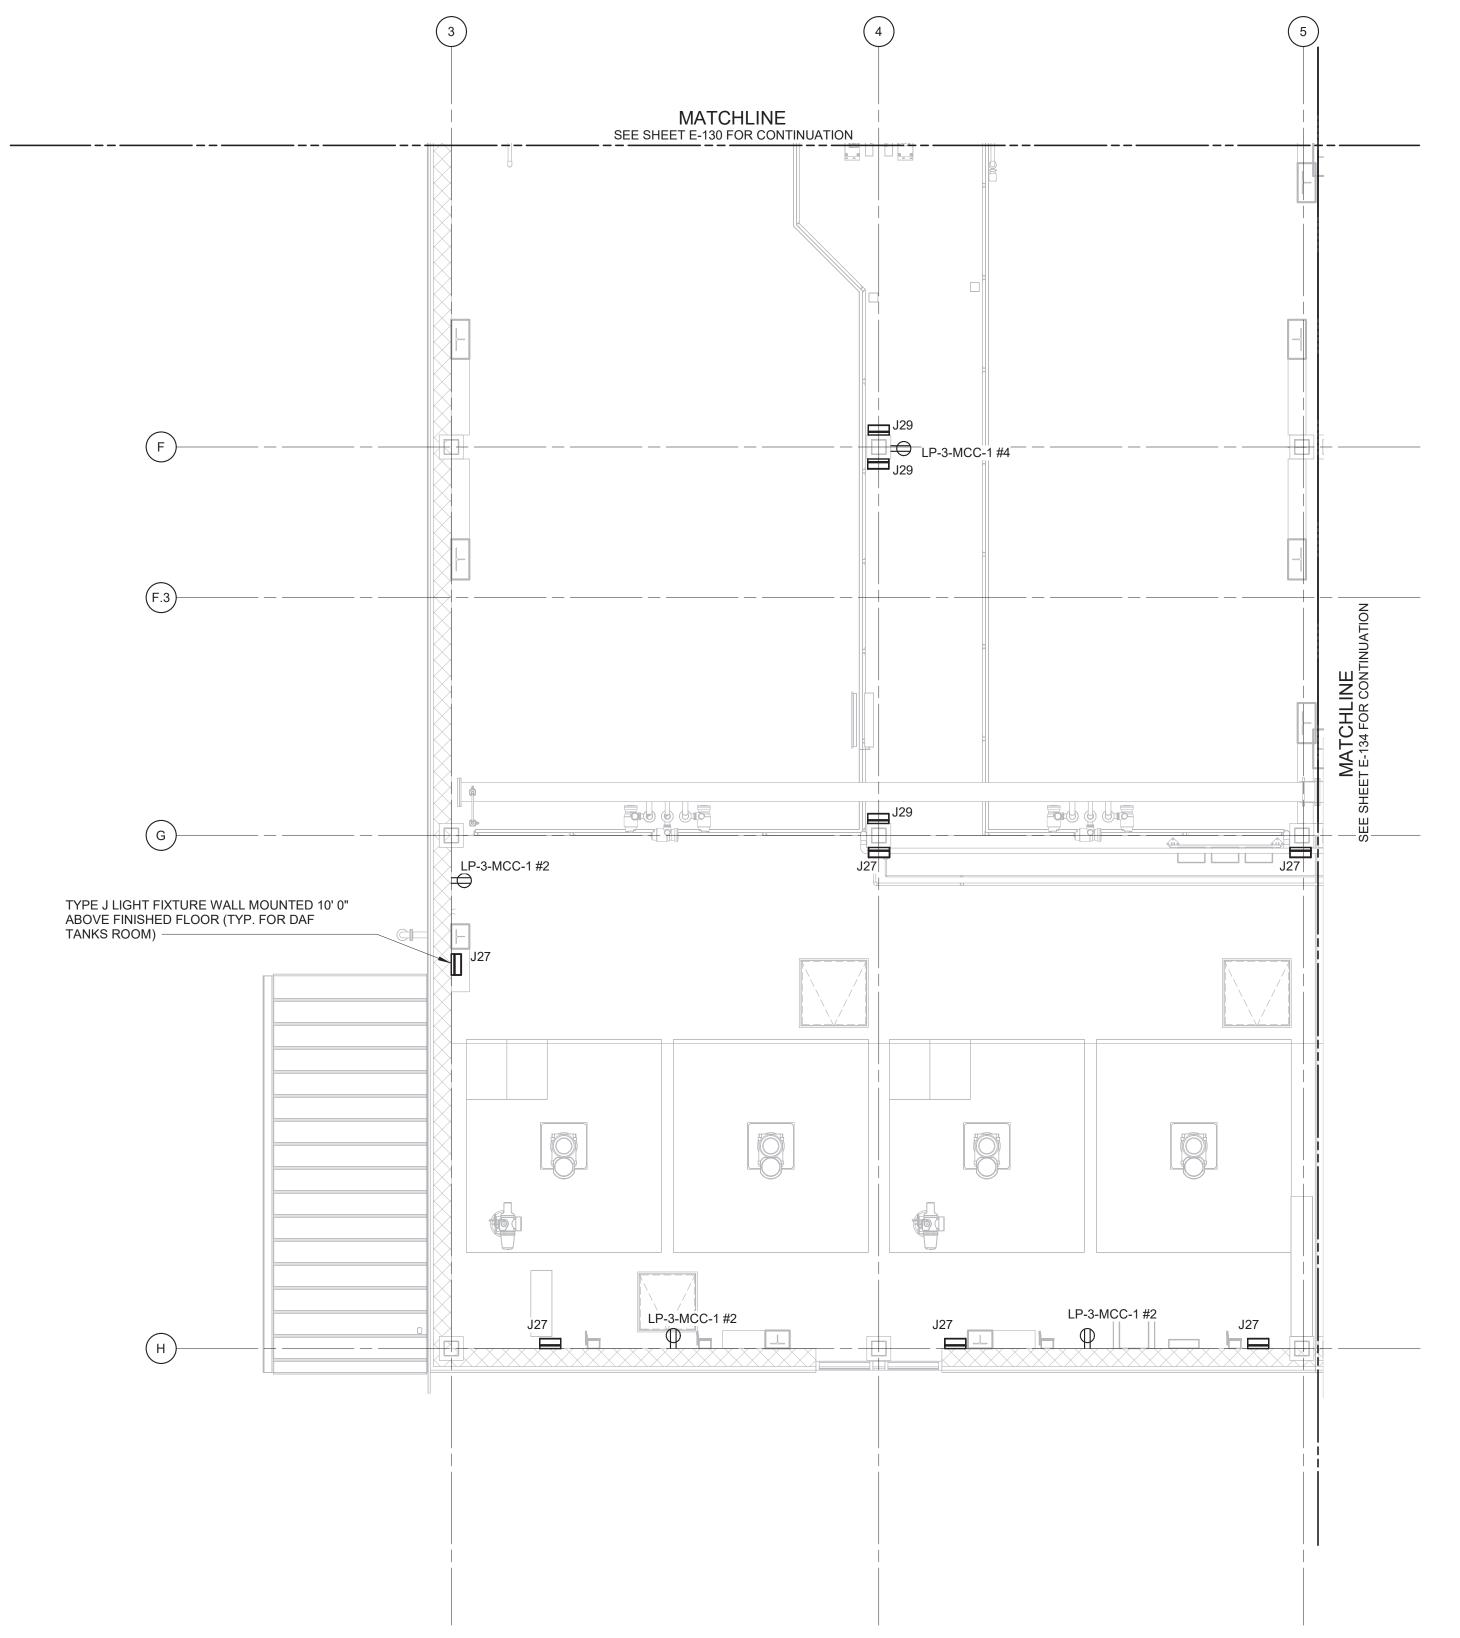

- REFER TO SPECIFICATION 26 50 00 FOR LIGHTING FIXTURE SCHEDULE.
- 2. REFER TO DRAWINGS E-012 TO E-017 FOR PANELBOARD SCHEDULES.
- 3. LIGHT FIXTURES IN DAF TANKS ROOM SHALL BE POWERED FROM LP-3-MCC-1.

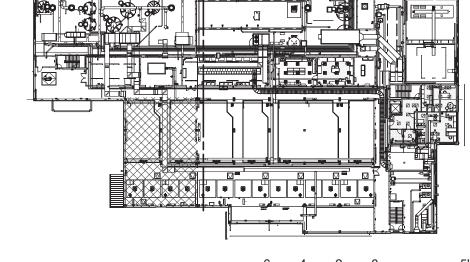

3/16" = 1'-0"

<u>LIGHTING PLAN AT EL 421.00 - AREA 4</u>
3/16" = 1'-0"

	ANY PERS PROFESSI OR REPOF APPLIED. I THE ALTER "ALTERED"	WARNING LATION OF SECTION 7209.2 OF THE NEW YORK ST. ON, UNLESS ACTING UNDER THE DIRECTION OF A ONAL ENGINEER, TO ALTER IN ANY WAY PLANS, S RTS TO WHICH THE SEAL OF A PROFESSIONAL ENG F AN ITEM BEARING THE SEAL OF A PROFESSIONA F AN ITEM BEARING THE SEAL OF THE ITEM HIS SEAL BY" FOLLOWED BY HIS SIGNATURE, THE DATE, AN TION OF THE ALTERATION.	LICENSED SPECIFICATIONS, GINEER HAS BEE AL ENGINEER IS A AL AND THE NOT	PLATS EN ALTERED,			
ı					PROJECT ENGINEER:	R. FROST	
1					DESIGNED BY:	Y. ABDALLA	
I					DRAWN BY:	P. NUGENT	BID SET
:55 PM					CHECKED BY:	G. MARKOU	BIB 021
25 3:07:55					IF THIS BAR DOES NOT MEASURE 1" THEN DRAWING	0 1/2" 1"	
15/2025	REV	ISSUED FOR	DATE	BY	IS NOT TO FULL SCALE		


OF NEW JORGE MARTON TO PROFESSIONAL


HAZEN AND SAWYER
498 SEVENTH AVENUE, 11th FLOOR
NEW YORK, NEW YORK 10018

WESTCHESTER JOINT WATER WORKS MAMARONECK, NY

RYE LAKE WATER FILTRATION PLANT HARRISON, NY

DATE:	FEB 2025
HAZEN NO.:	90388-000
CONTRACT NO.:	A1364-A
DRAWING NUMBER:	
	E-133

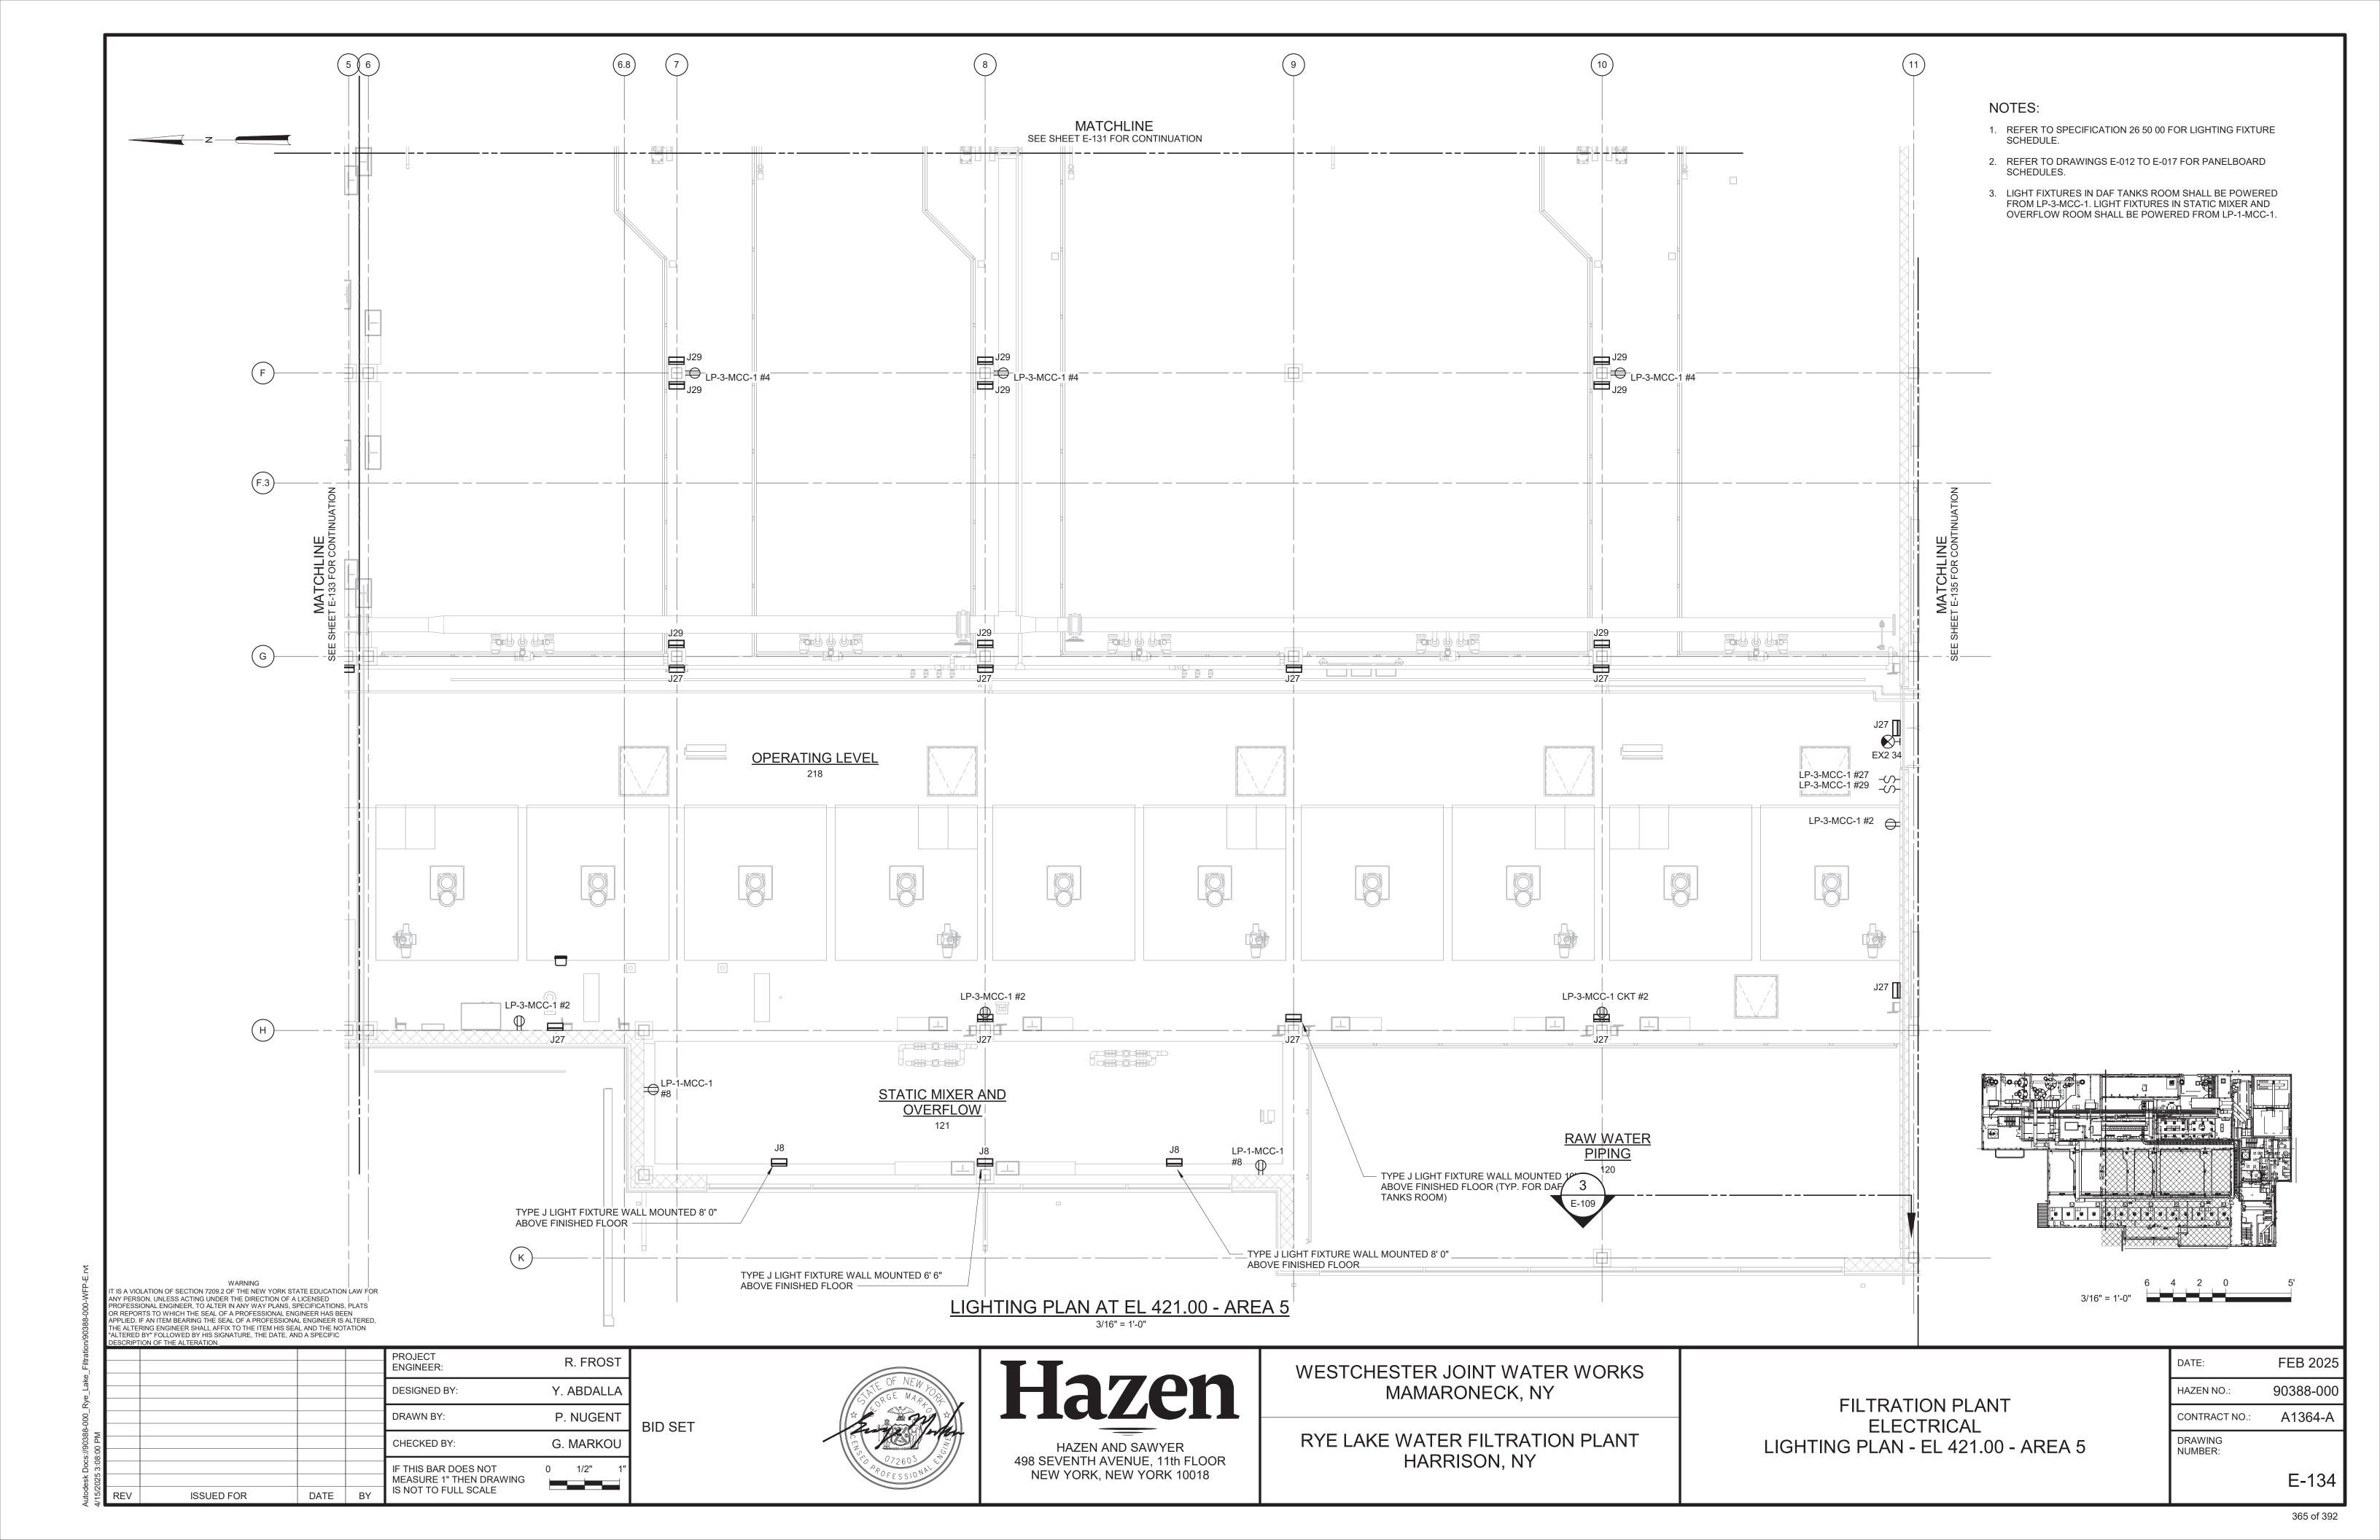

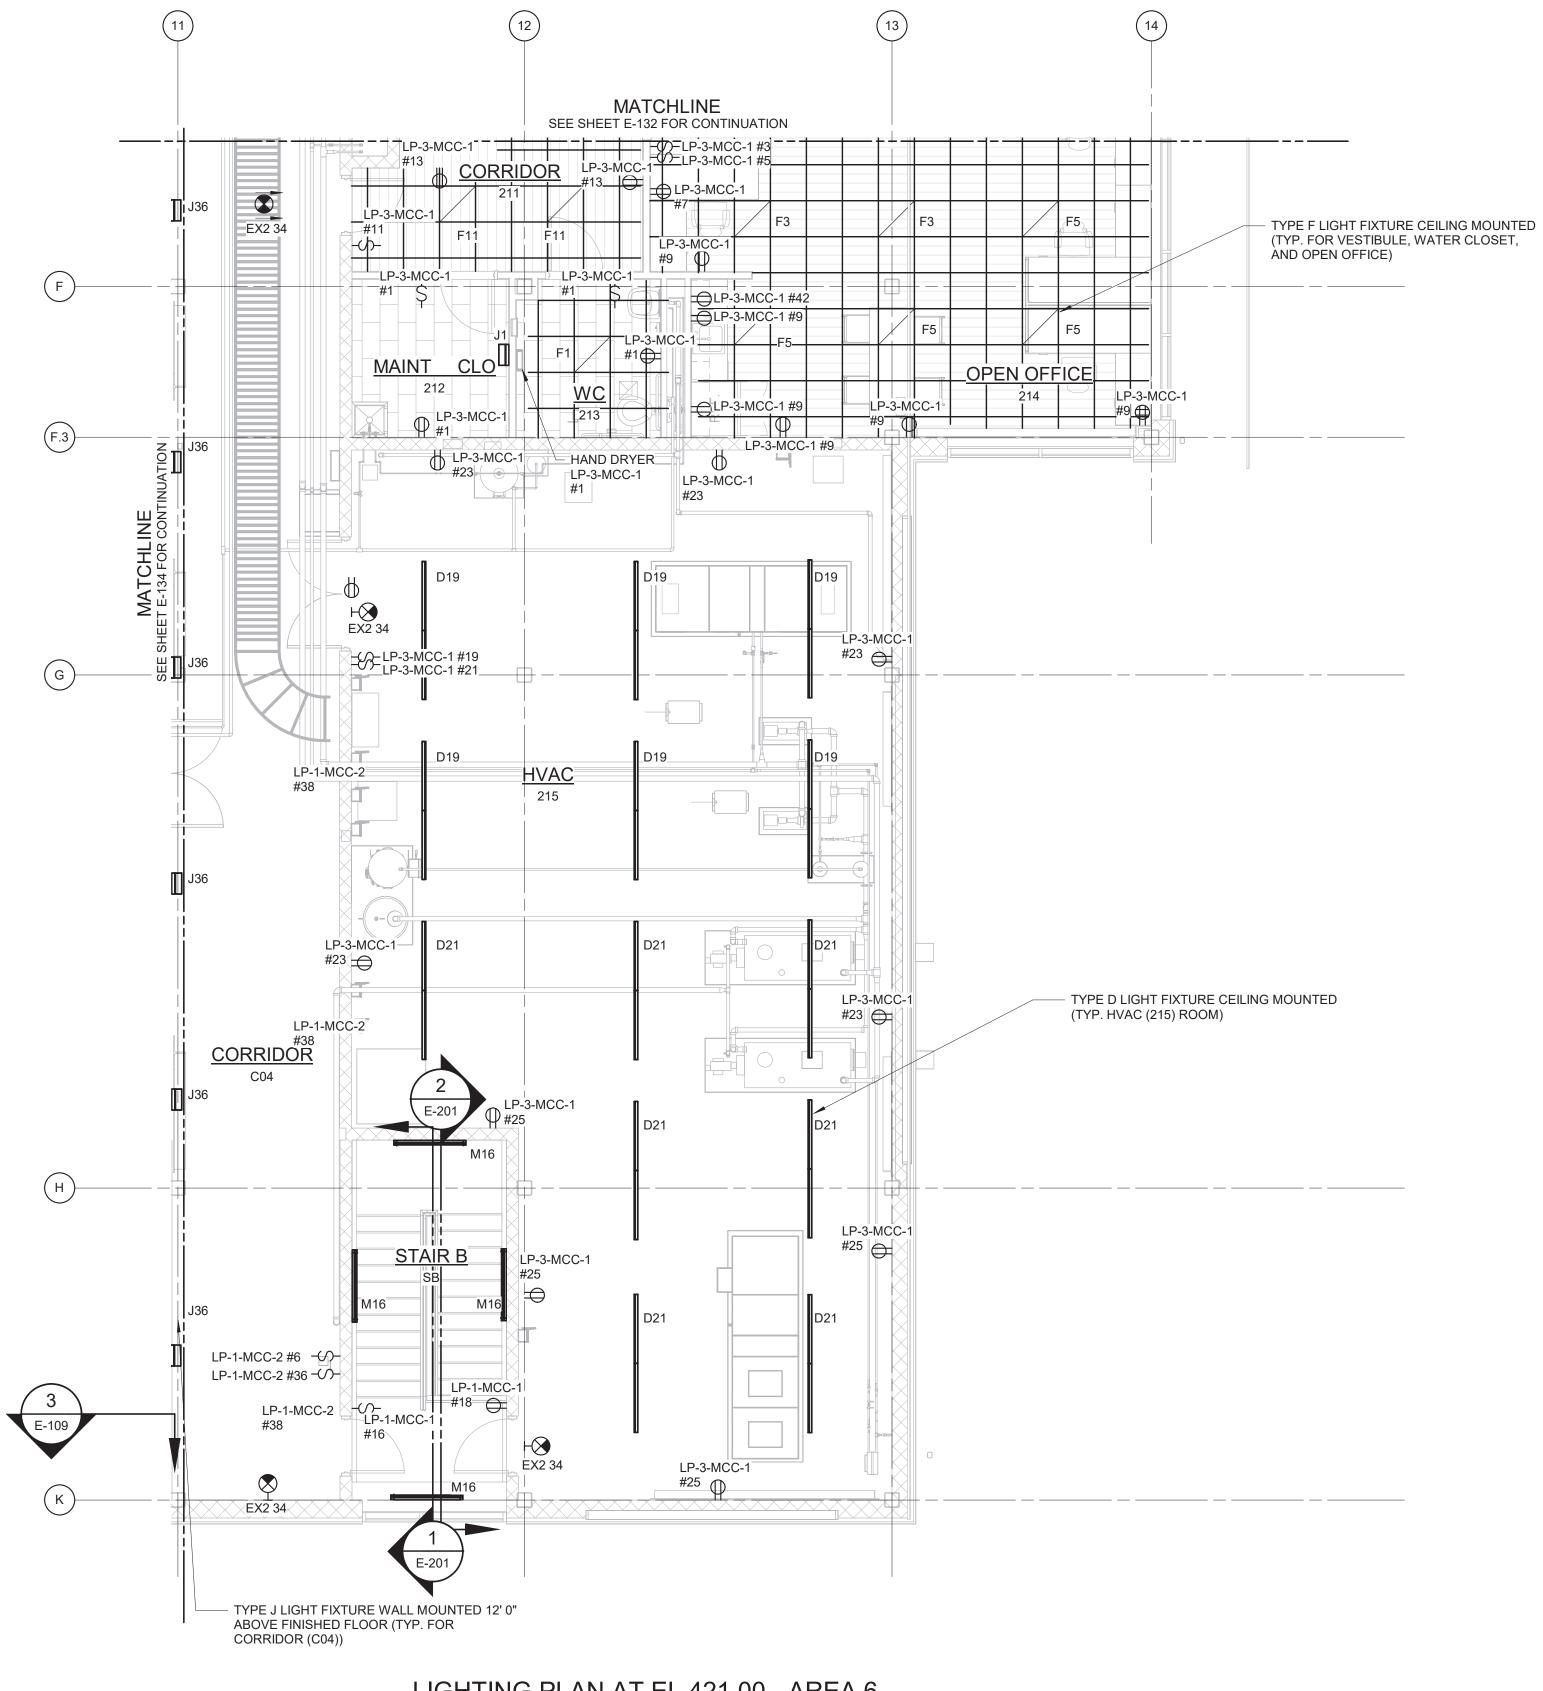

- 1. REFER TO SPECIFICATION 26 50 00 FOR LIGHTING FIXTURE SCHEDULE.
- 2. REFER TO DRAWINGS E-012 TO E-017 FOR PANELBOARD SCHEDULES.
- 3. LIGHT FIXTURES IN OPEN OFFICE, WATER CLOSET, MAINTENANCE CLOSET, VESTIBULE, AND HVAC (215) ROOM SHALL BE POWERED FROM LP-3-MCC-1. LIGHT FIXTURES IN CORRIDOR (C04) SHALL BE POWERED FROM LP-1-MCC-2. EXIT SIGNS AND LIGHT FIXTURES IN STAIR B SHALL BE POWERED FROM LP-1-MCC-1.

LIGHTING PLAN AT EL 421.00 - AREA 6

	ANY PERS PROFESS OR REPOI APPLIED. THE ALTE "ALTERED	WARNING LATION OF SECTION 7209.2 OF THE NEW YORK STA ON, UNLESS ACTING UNDER THE DIRECTION OF A ONAL ENGINEER, TO ALTER IN ANY WAY PLANS, SF RTS TO WHICH THE SEAL OF A PROFESSIONAL ENG F AN ITEM BEARING THE SEAL OF A PROFESSIONAI RING ENGINEER SHALL AFFIX TO THE ITEM HIS SEA BY" FOLLOWED BY HIS SIGNATURE, THE DATE, AN ION OF THE ALTERATION.	LICENSED PECIFICATIONS SINEER HAS BEI L ENGINEER IS L AND THE NOT	, PLATS EN ALTERED,			
					PROJECT ENGINEER:	R. FROST	
					DESIGNED BY:	Y. ABDALLA	
					DRAWN BY:	P. NUGENT	BID SET
:05 PM					CHECKED BY:	G. MARKOU	DID OLI
25 3:08:05					IF THIS BAR DOES NOT MEASURE 1" THEN DRAWING	0 1/2" 1"	
5/2025	DE\/	ISSUED FOR	DATE	DV	IS NOT TO FULL SCALE		




Hazen HAZEN AND SAWYER 498 SEVENTH AVENUE, 11th FLOOR


NEW YORK, NEW YORK 10018


WESTCHESTER JOINT WATER WORKS MAMARONECK, NY

RYE LAKE WATER FILTRATION PLANT HARRISON, NY

DATE:	FEB 2025
HAZEN NO.:	90388-000
CONTRACT NO.:	A1364-A
DRAWING NUMBER:	
	E-135

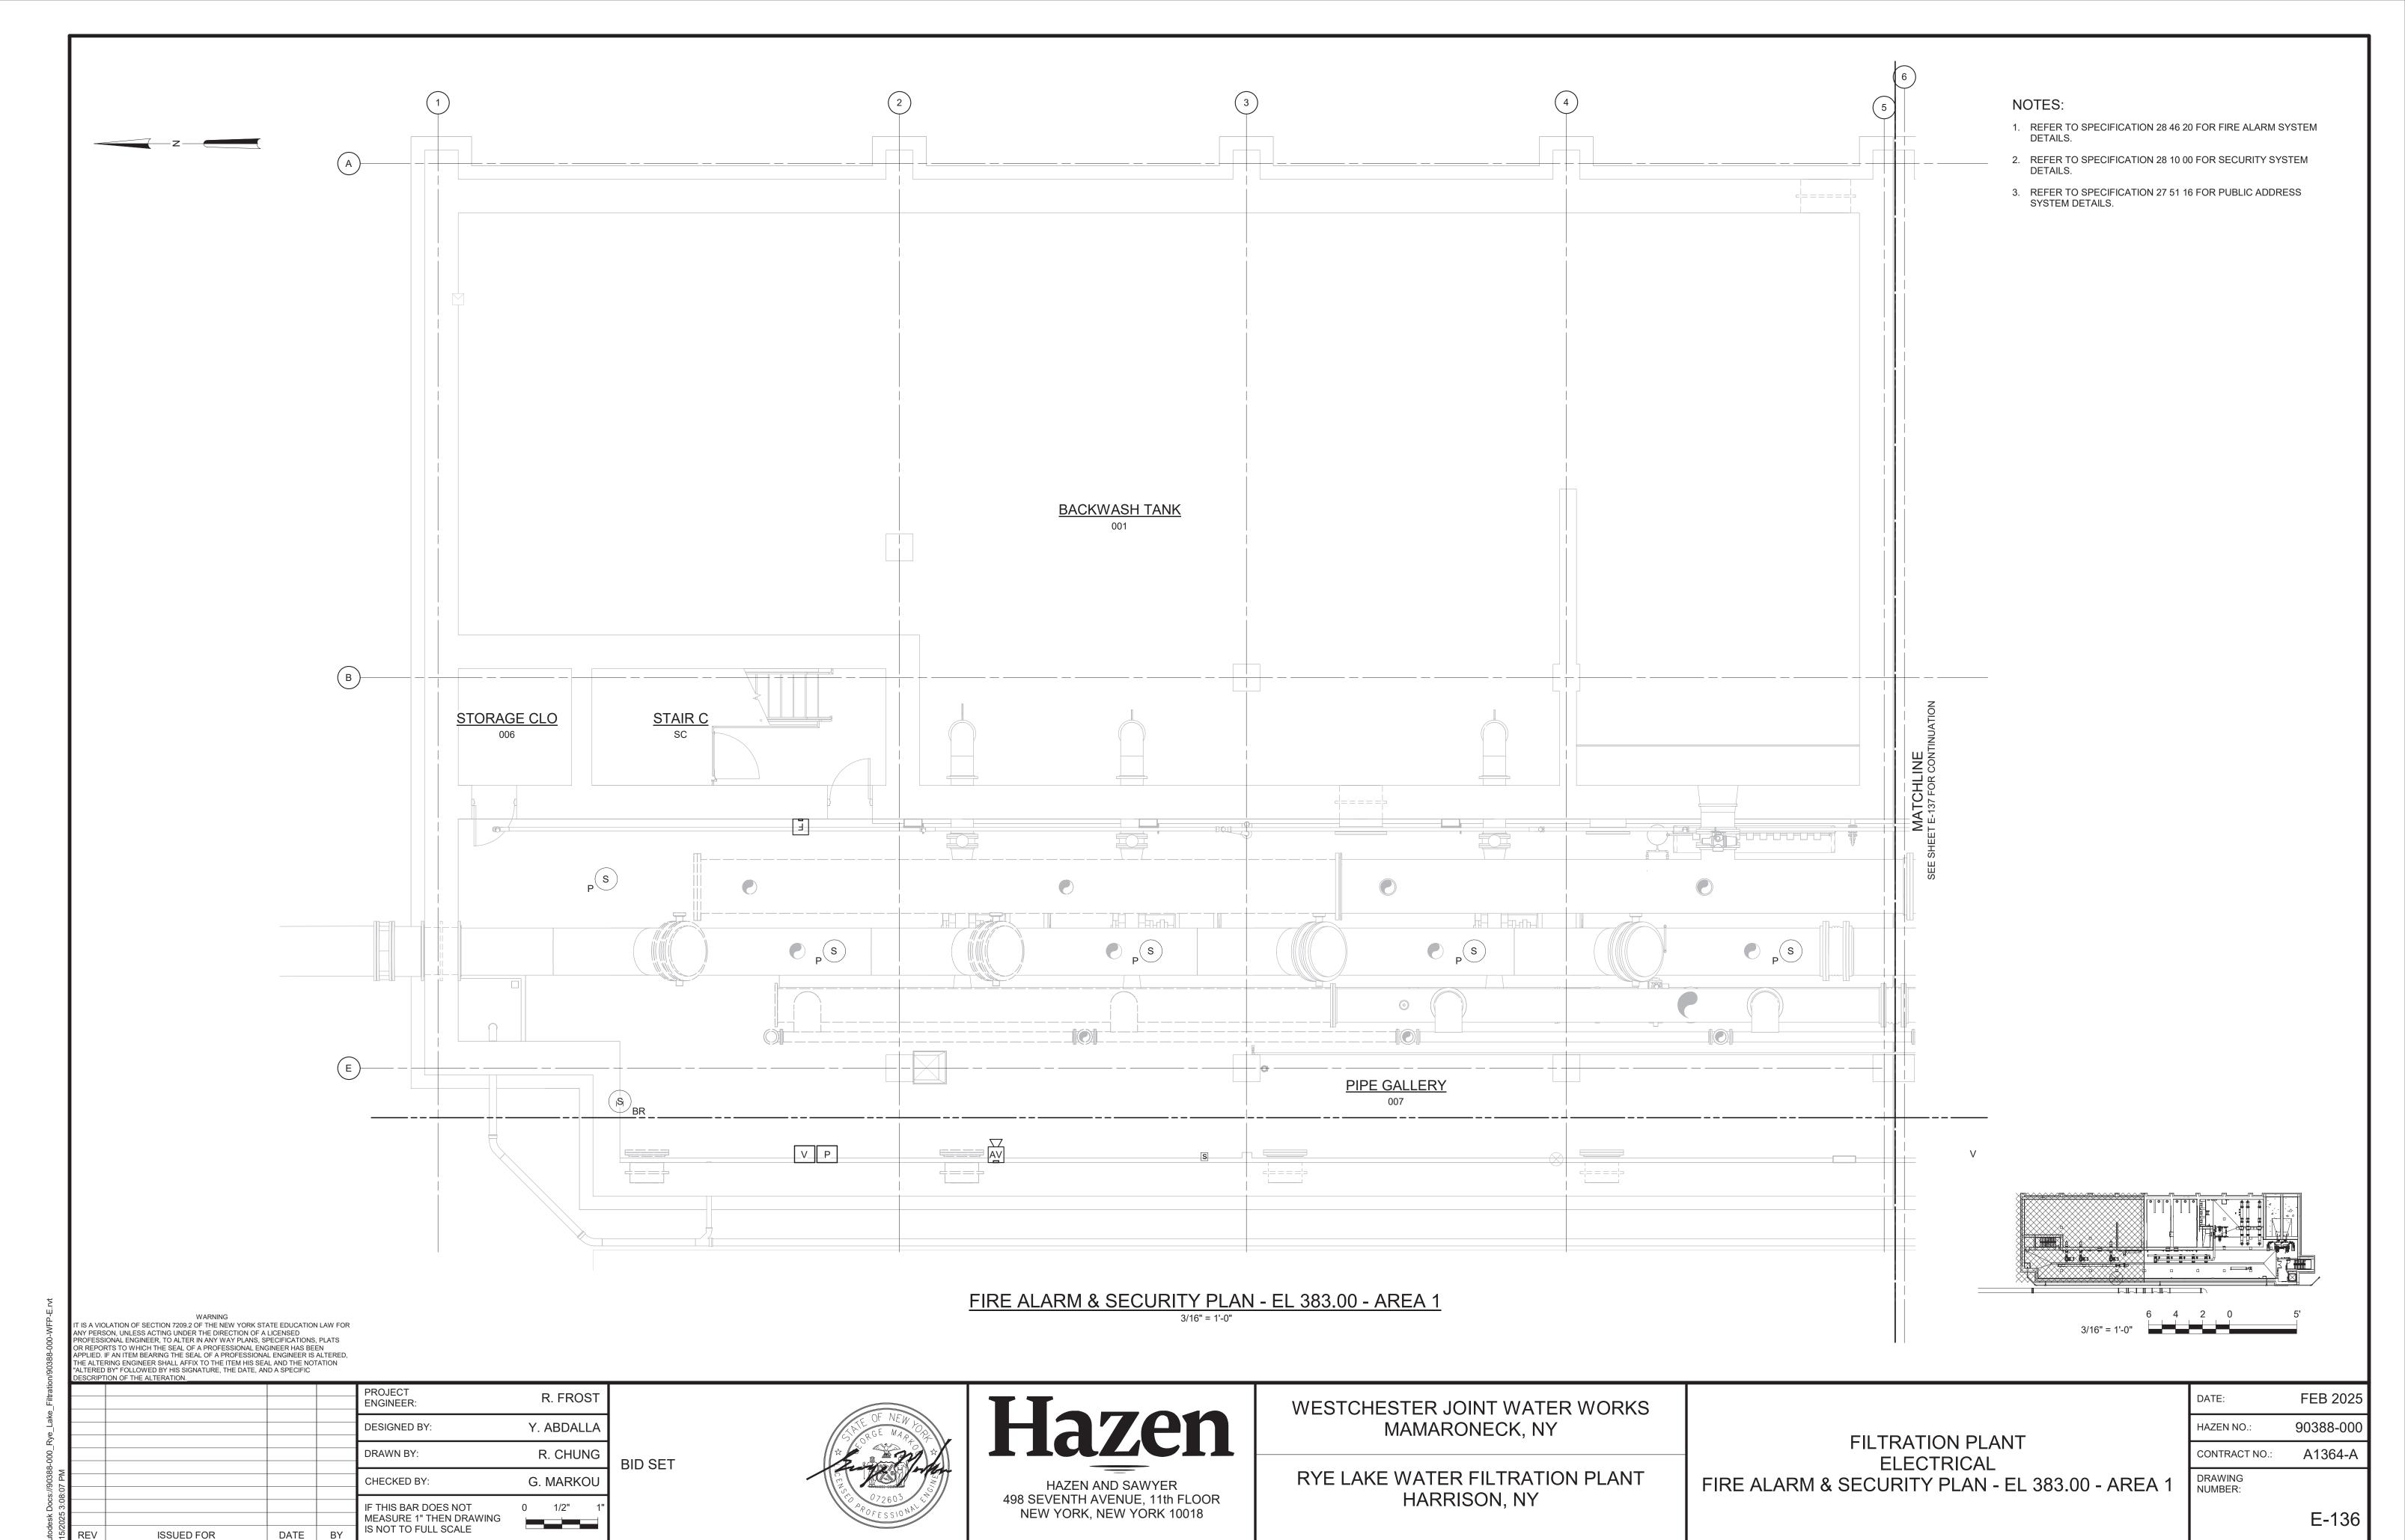


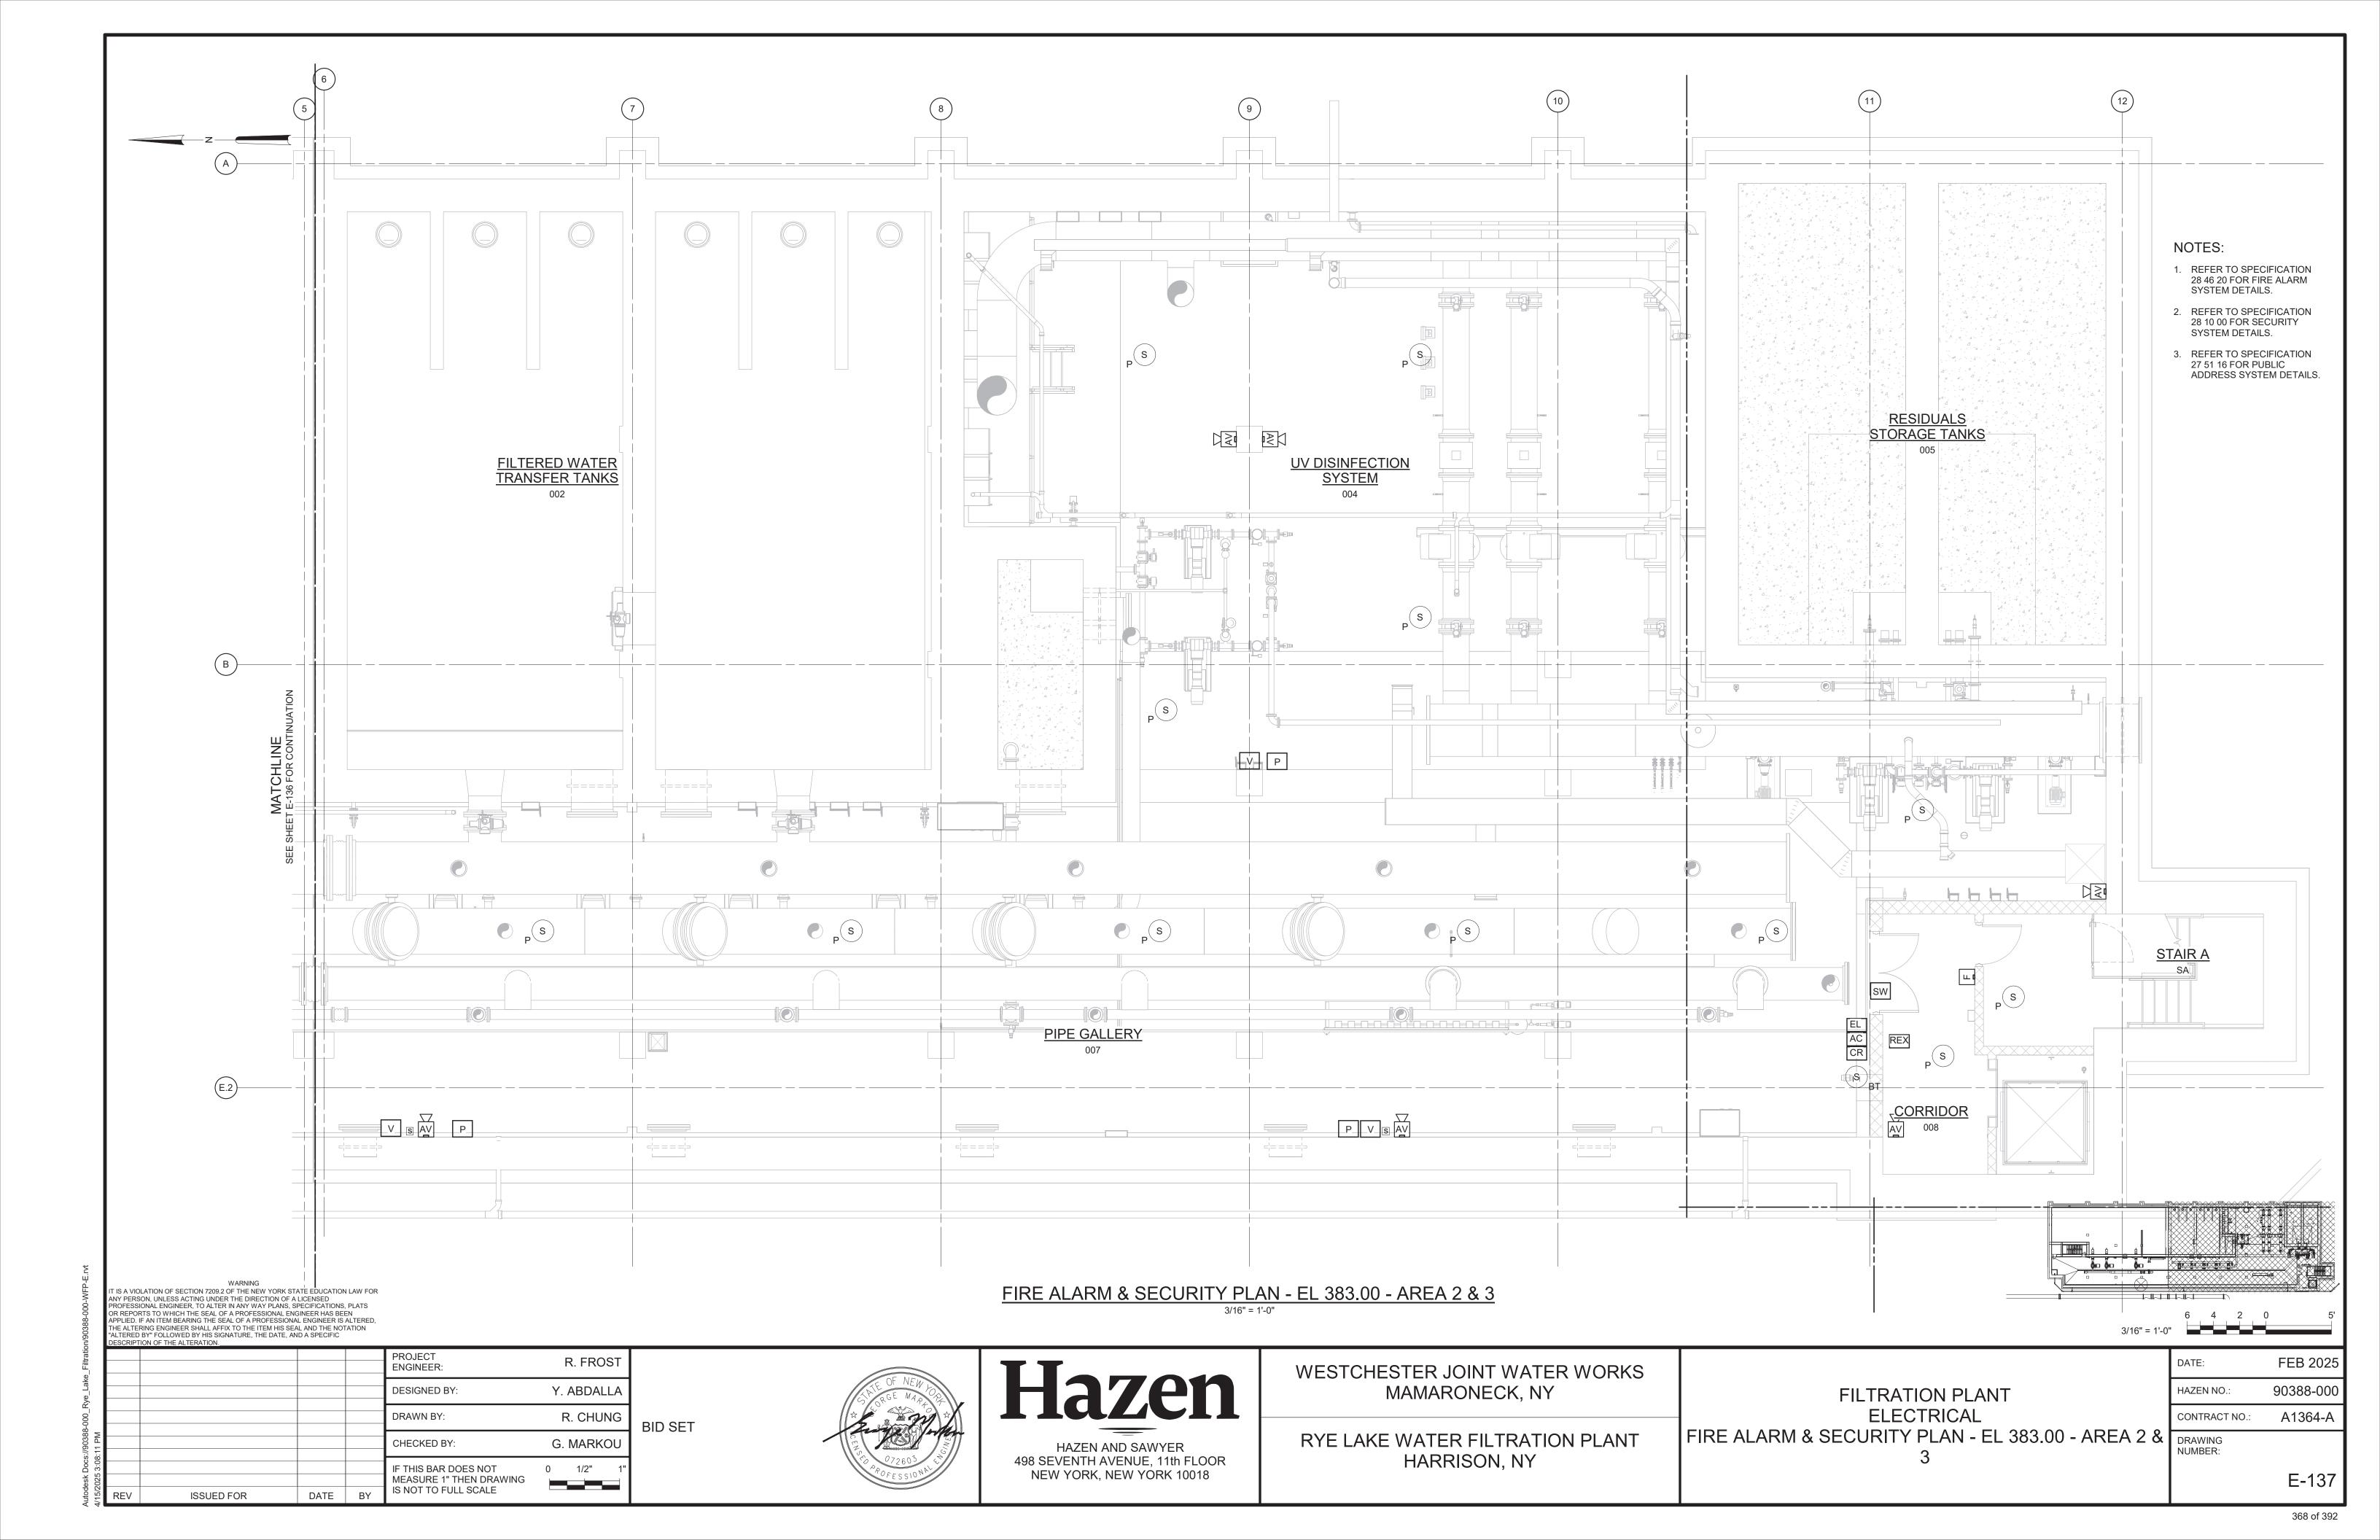


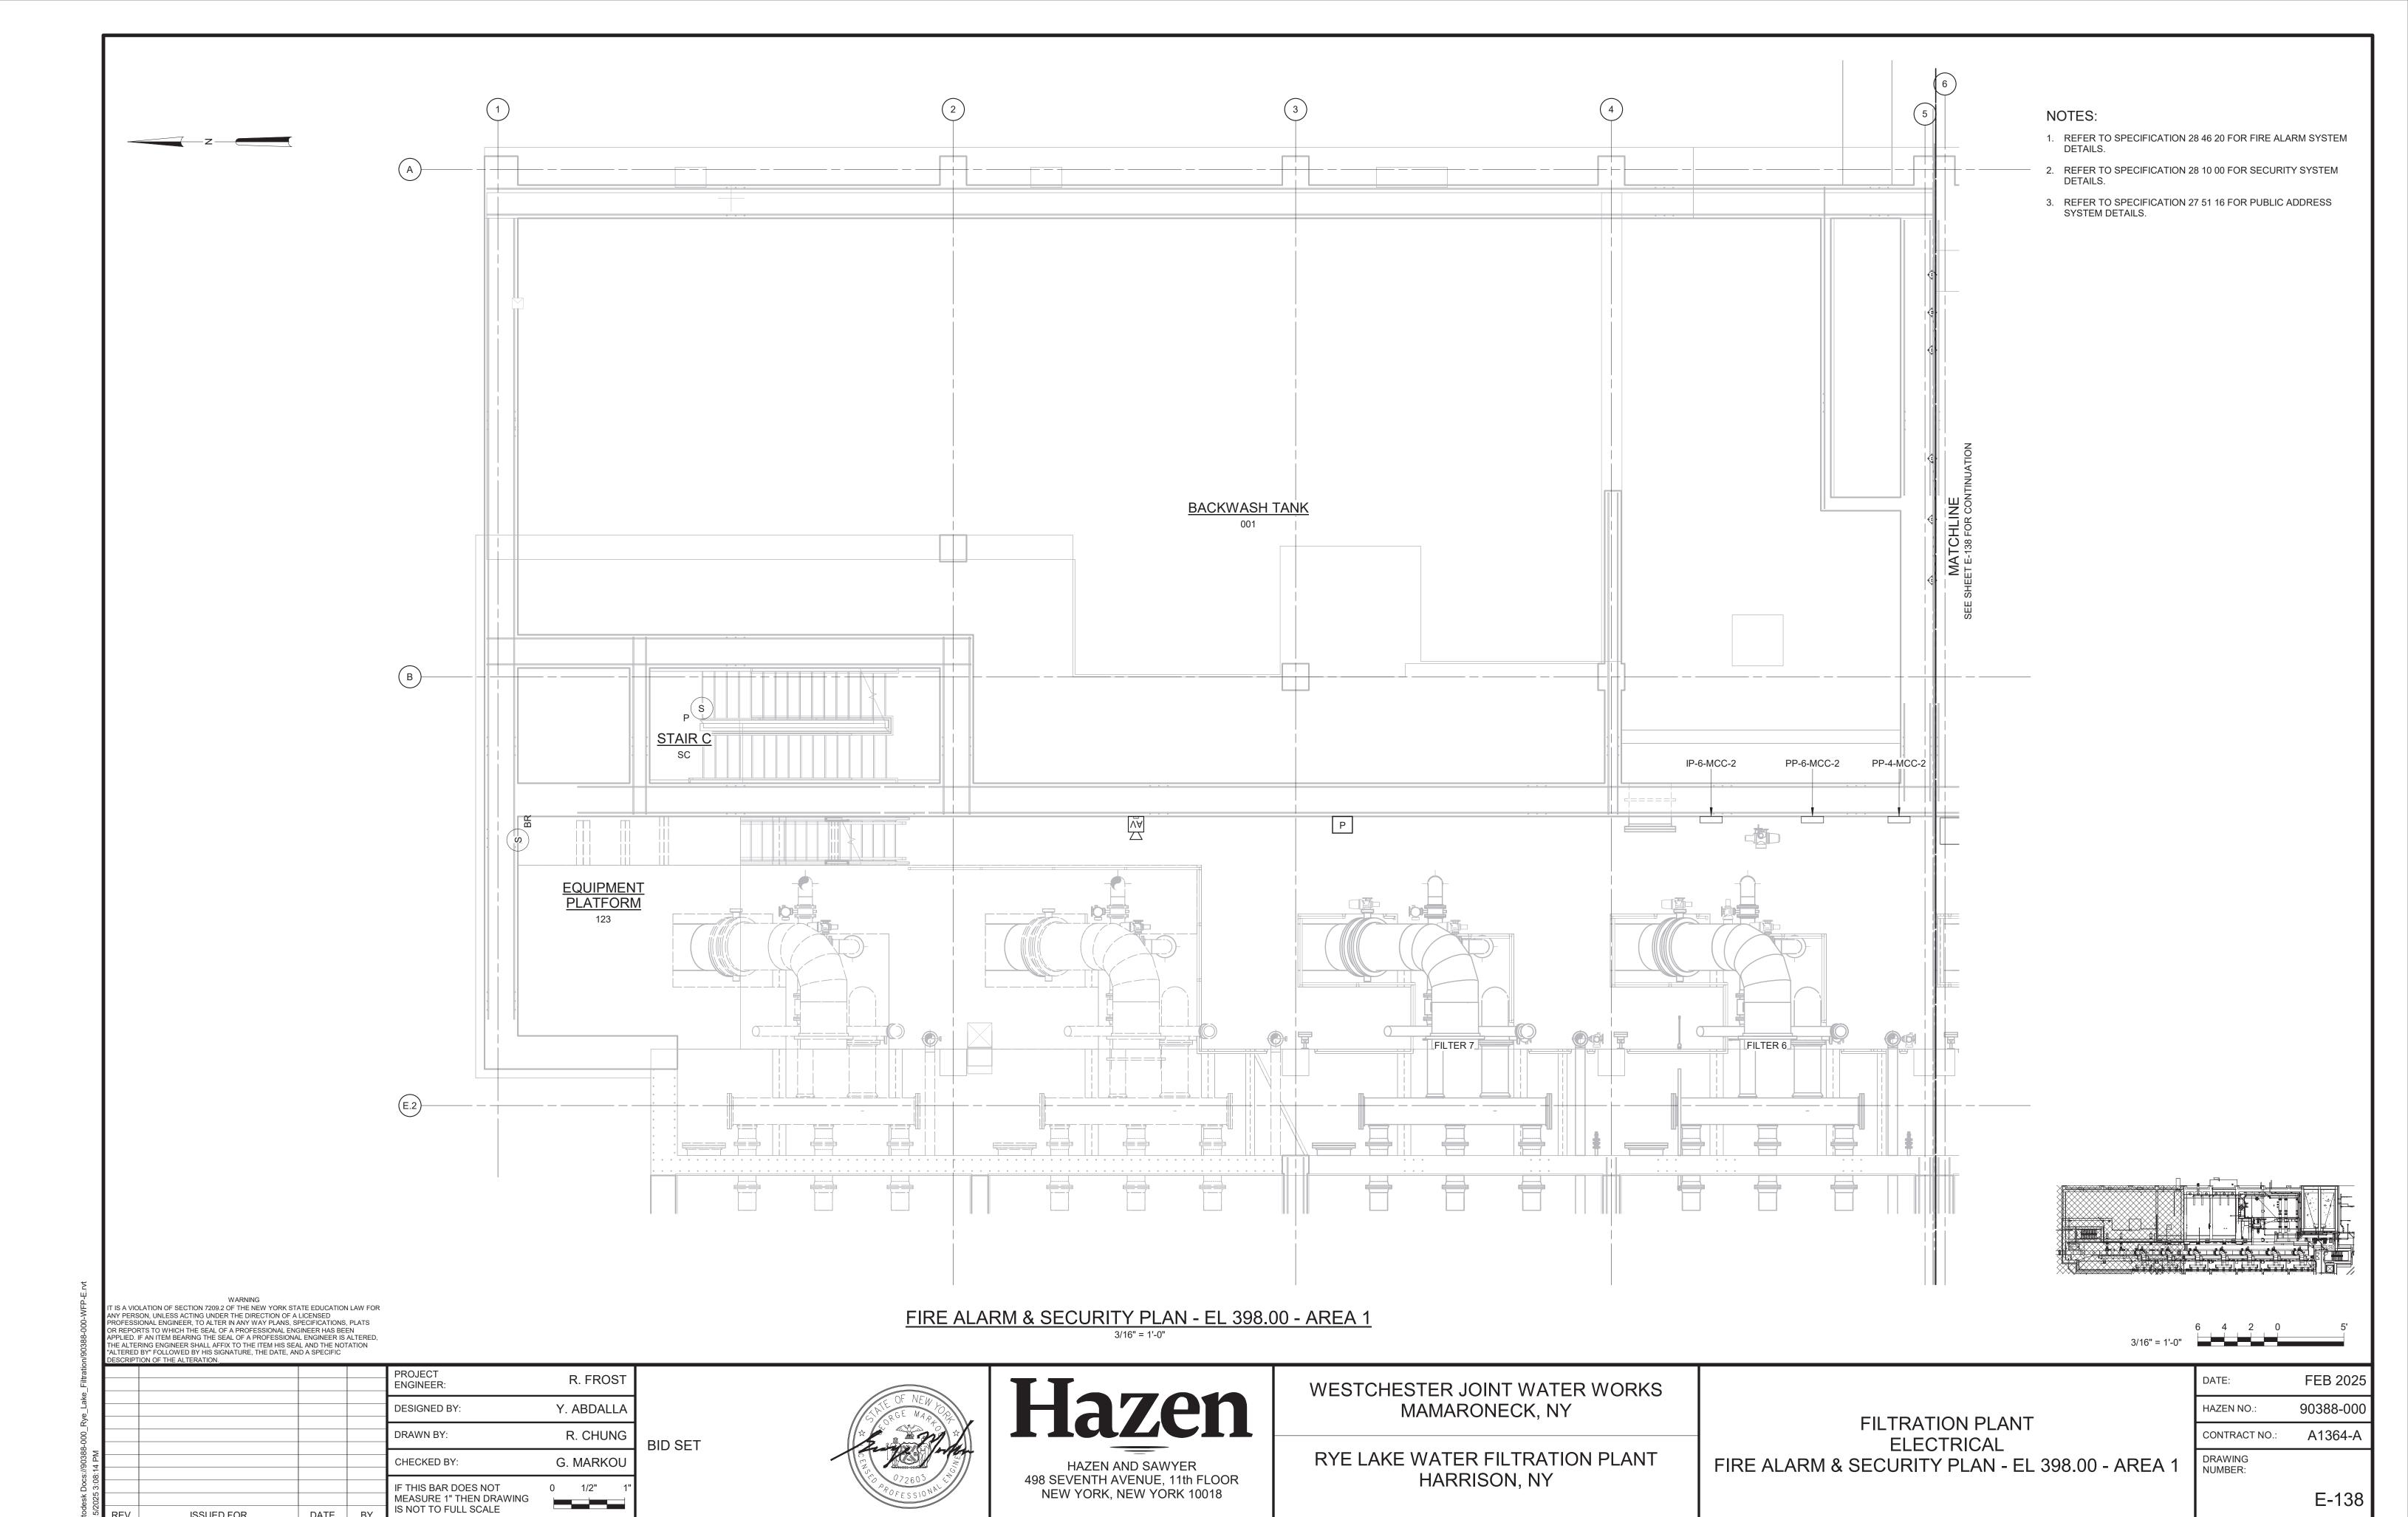

ISSUED FOR

DATE BY

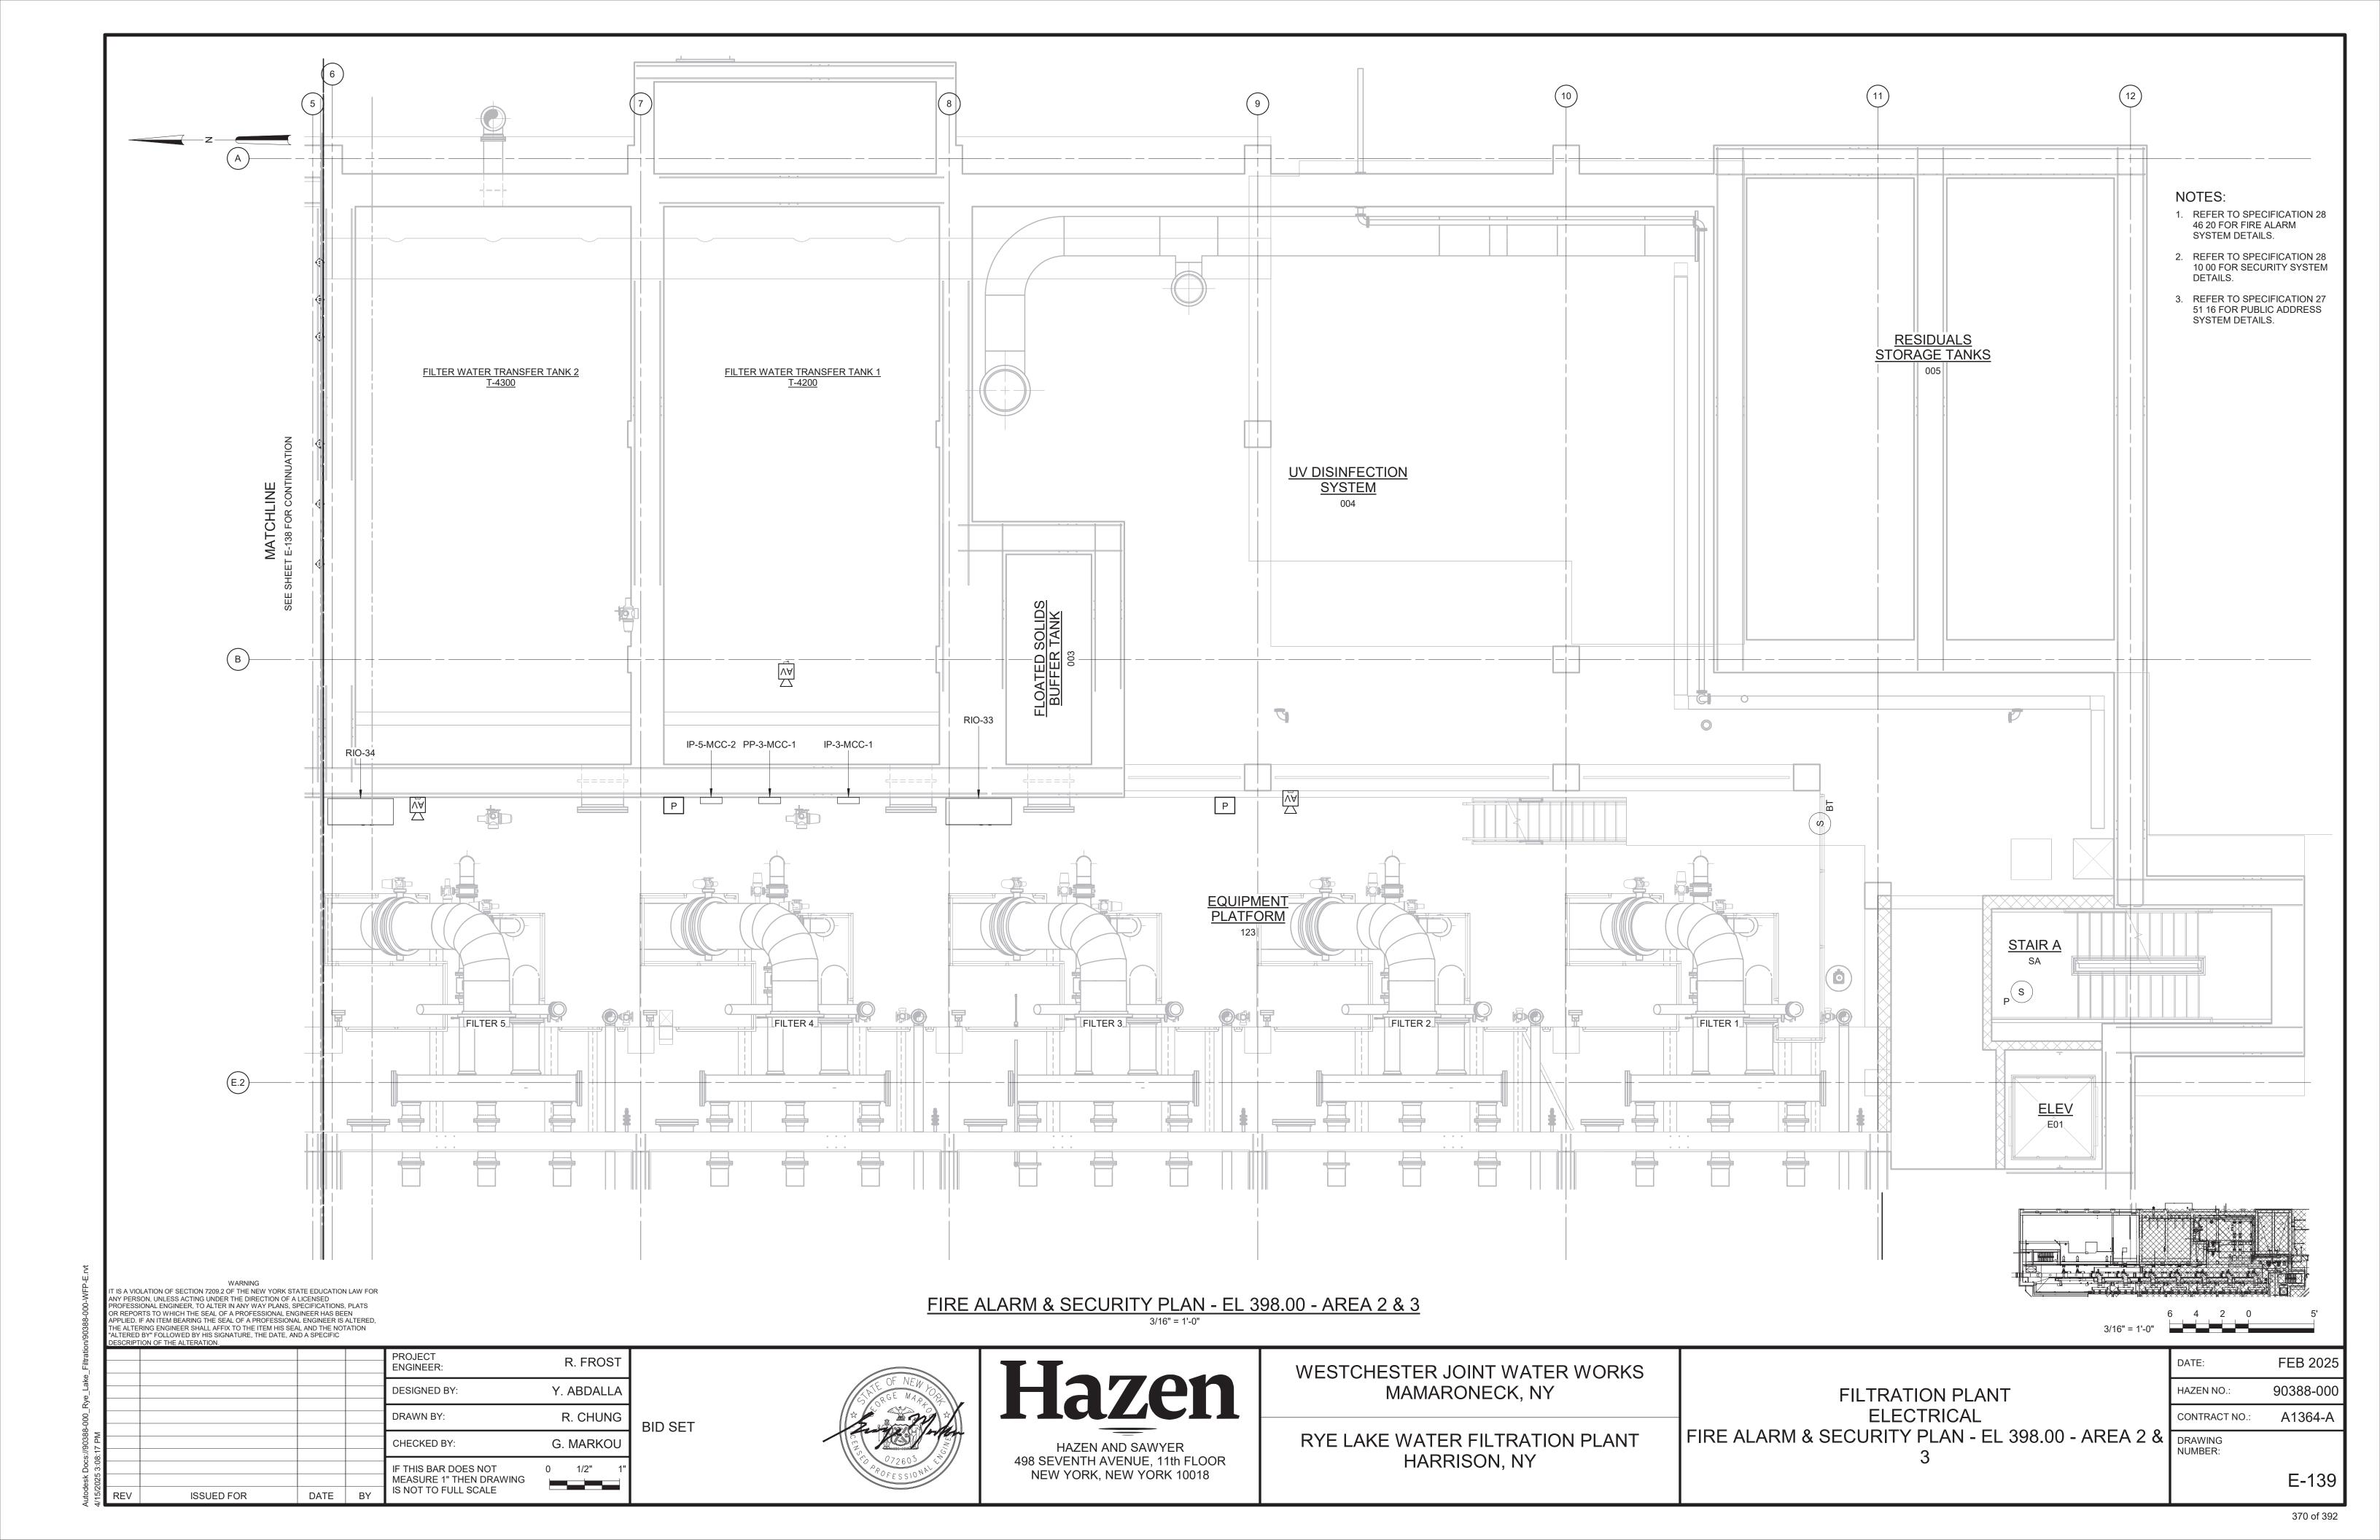

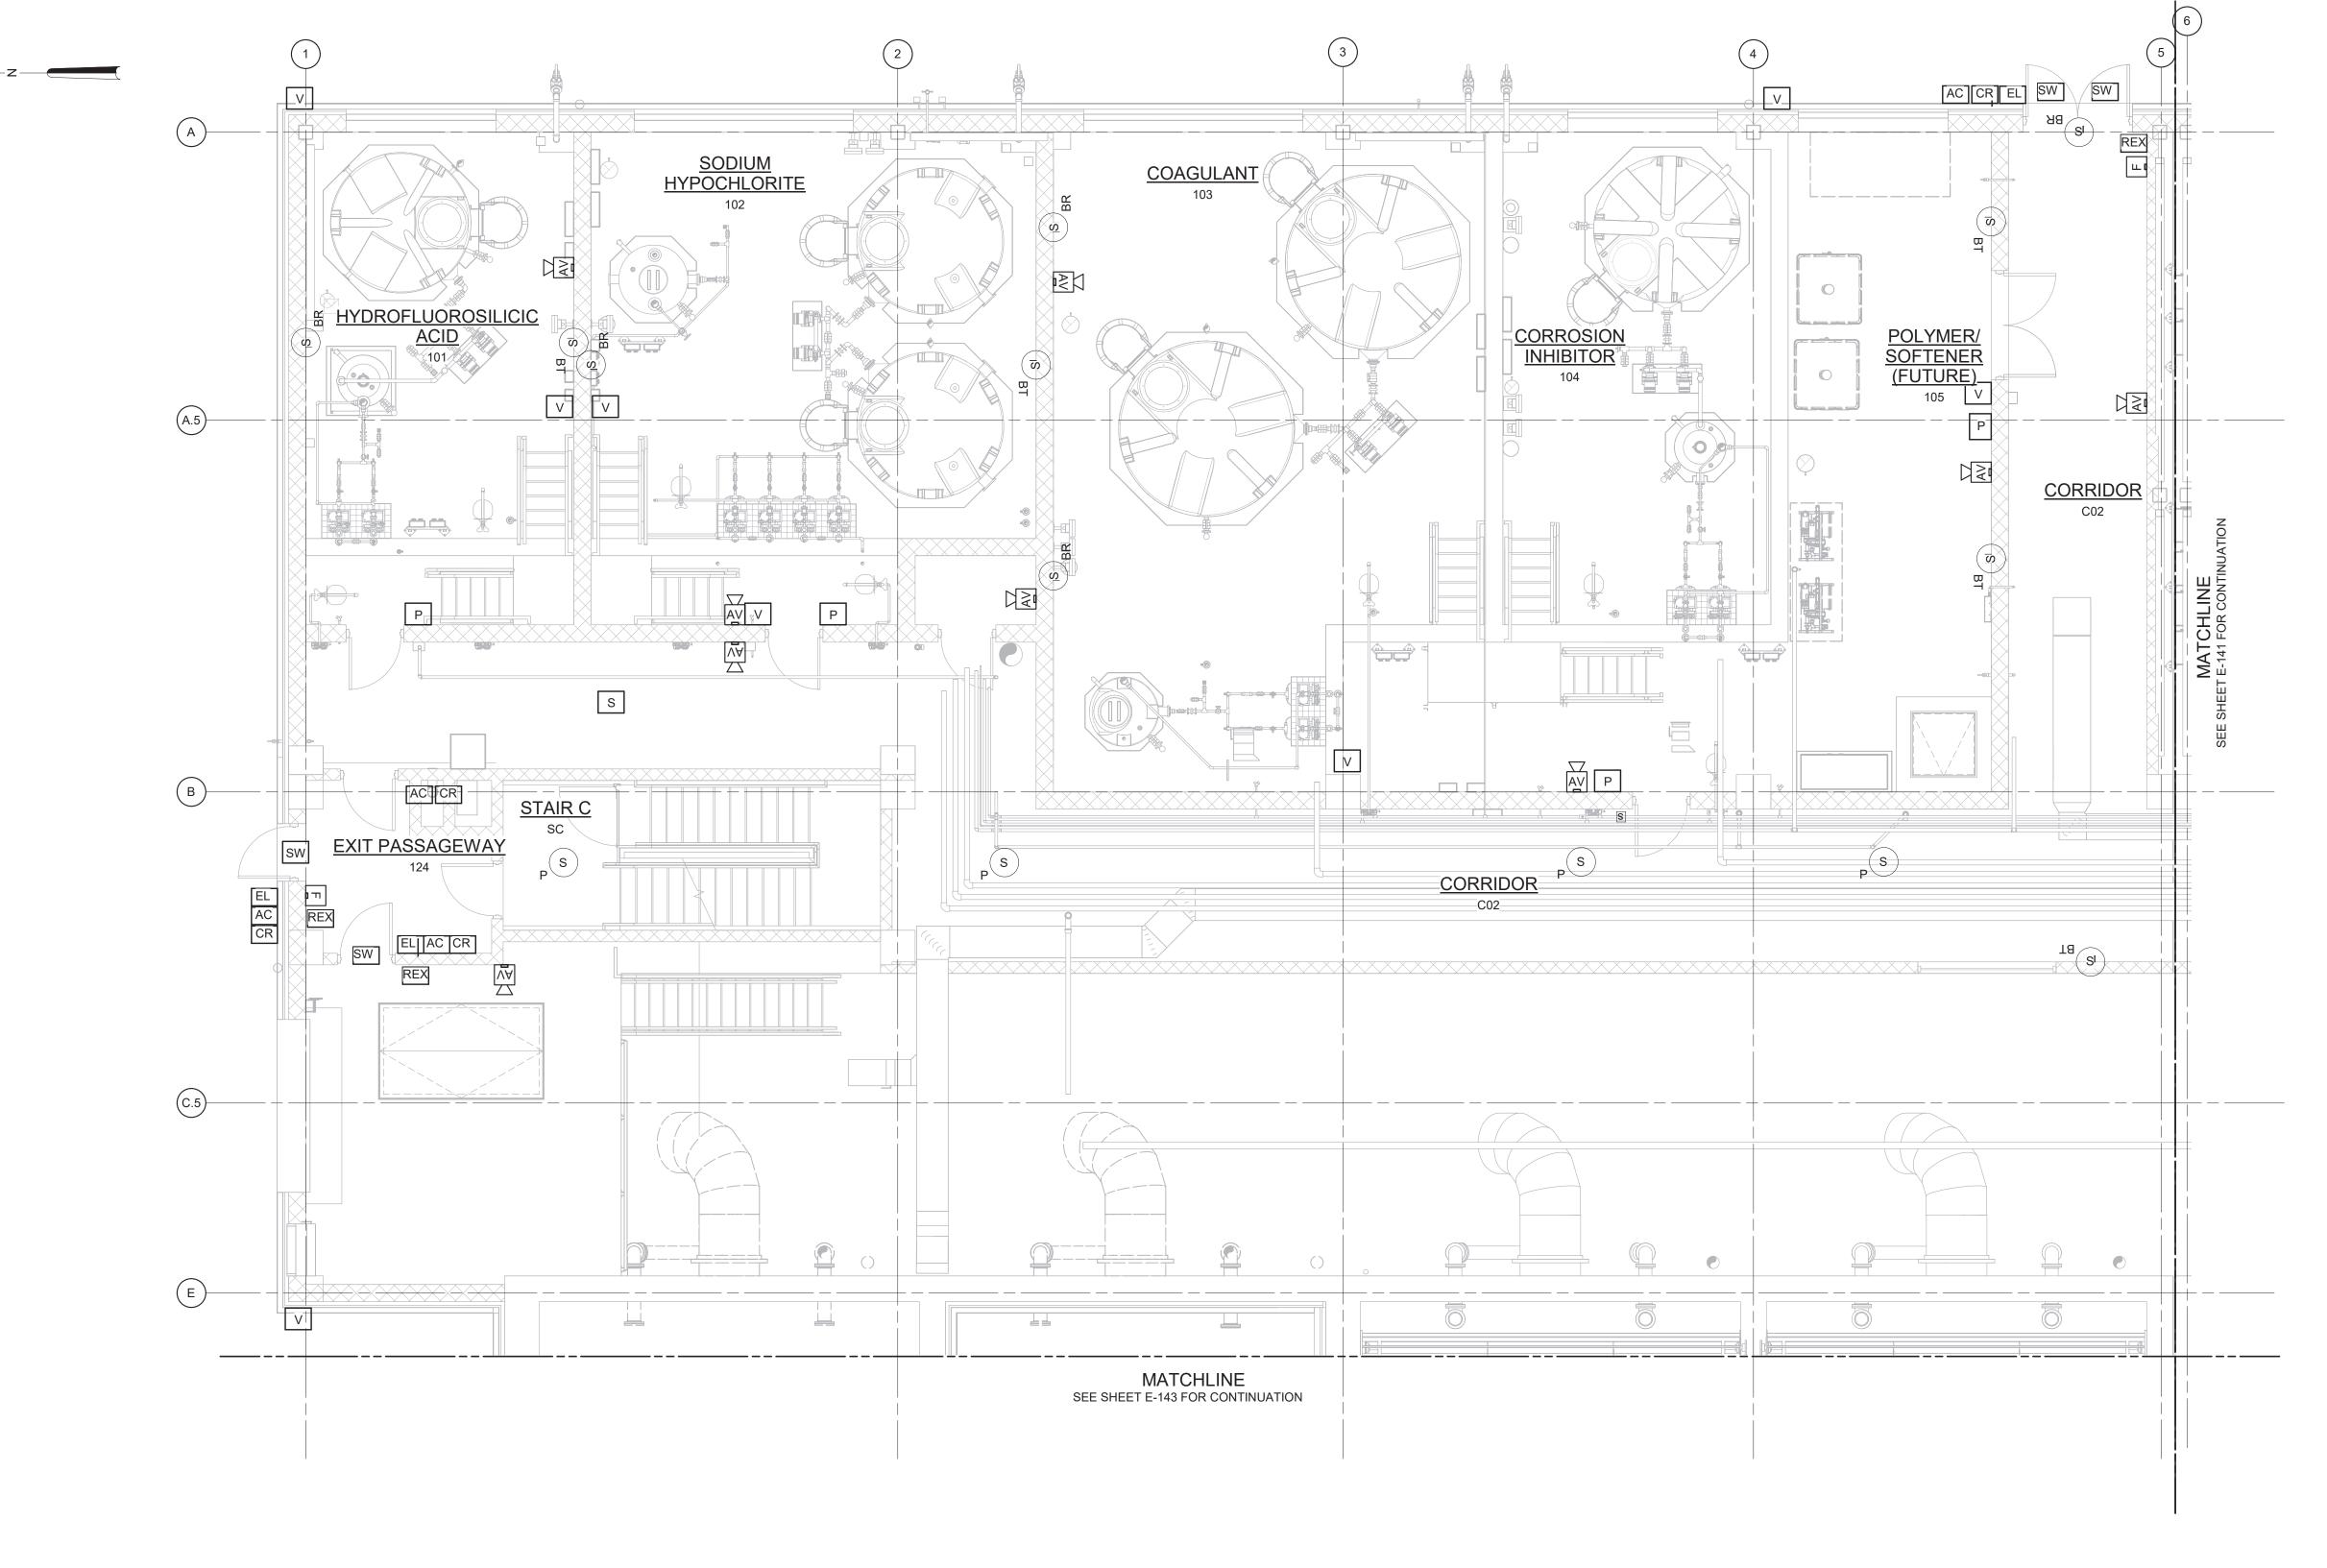

- REFER TO SPECIFICATION 28 46 20 FOR FIRE ALARM SYSTEM DETAILS.
- 2. REFER TO SPECIFICATION 28 10 00 FOR SECURITY SYSTEM DETAILS.
- 3. REFER TO SPECIFICATION 27 51 16 FOR PUBLIC ADDRESS SYSTEM DETAILS.

FIRE ALARM & SECURITY PLAN - EL 407.00 - AREA 1

	ANY PERS PROFESSI OR REPOR APPLIED. I THE ALTEI "ALTERED	WARNING DLATION OF SECTION 7209.2 OF THE NEW YORK ST. SON, UNLESS ACTING UNDER THE DIRECTION OF A IONAL ENGINEER, TO ALTER IN ANY WAY PLANS, S RTS TO WHICH THE SEAL OF A PROFESSIONAL ENGIF AN ITEM BEARING THE SEAL OF A PROFESSIONA' RING ENGINEER SHALL AFFIX TO THE ITEM HIS SEAL BY" FOLLOWED BY HIS SIGNATURE, THE DATE, AN TION OF THE ALTERATION.	LICENSED PECIFICATIONS GINEER HAS BEI AL ENGINEER IS AL AND THE NOT	, PLATS EN ALTERED,			
ı					PROJECT ENGINEER:	R. FROST	
					DESIGNED BY:	Y. ABDALLA	
1					DRAWN BY:	R. CHUNG	BID SET
:25 PM					CHECKED BY:	G. MARKOU	DID 021
25 3:08:25					IF THIS BAR DOES NOT MEASURE 1" THEN DRAWING	0 1/2" 1"	
15/2025	REV	ISSUED FOR	DATE	BY	IS NOT TO FULL SCALE		

OF NEW LORGE MARROW AND PROPERTY OF A POFESSIONAL


HAZEN AND SAWYER
498 SEVENTH AVENUE, 11th FLOOR
NEW YORK, NEW YORK 10018

WESTCHESTER JOINT WATER WORKS MAMARONECK, NY

RYE LAKE WATER FILTRATION PLANT HARRISON, NY

FILTRATION PLANT
ELECTRICAL
FIRE ALARM & SECURITY PLAN - EL 407.00 - AREA 1

	DATE:	FEB 2025
	HAZEN NO.:	90388-000
	CONTRACT NO.:	A1364-A
. 1	DRAWING NUMBER:	
		E-140

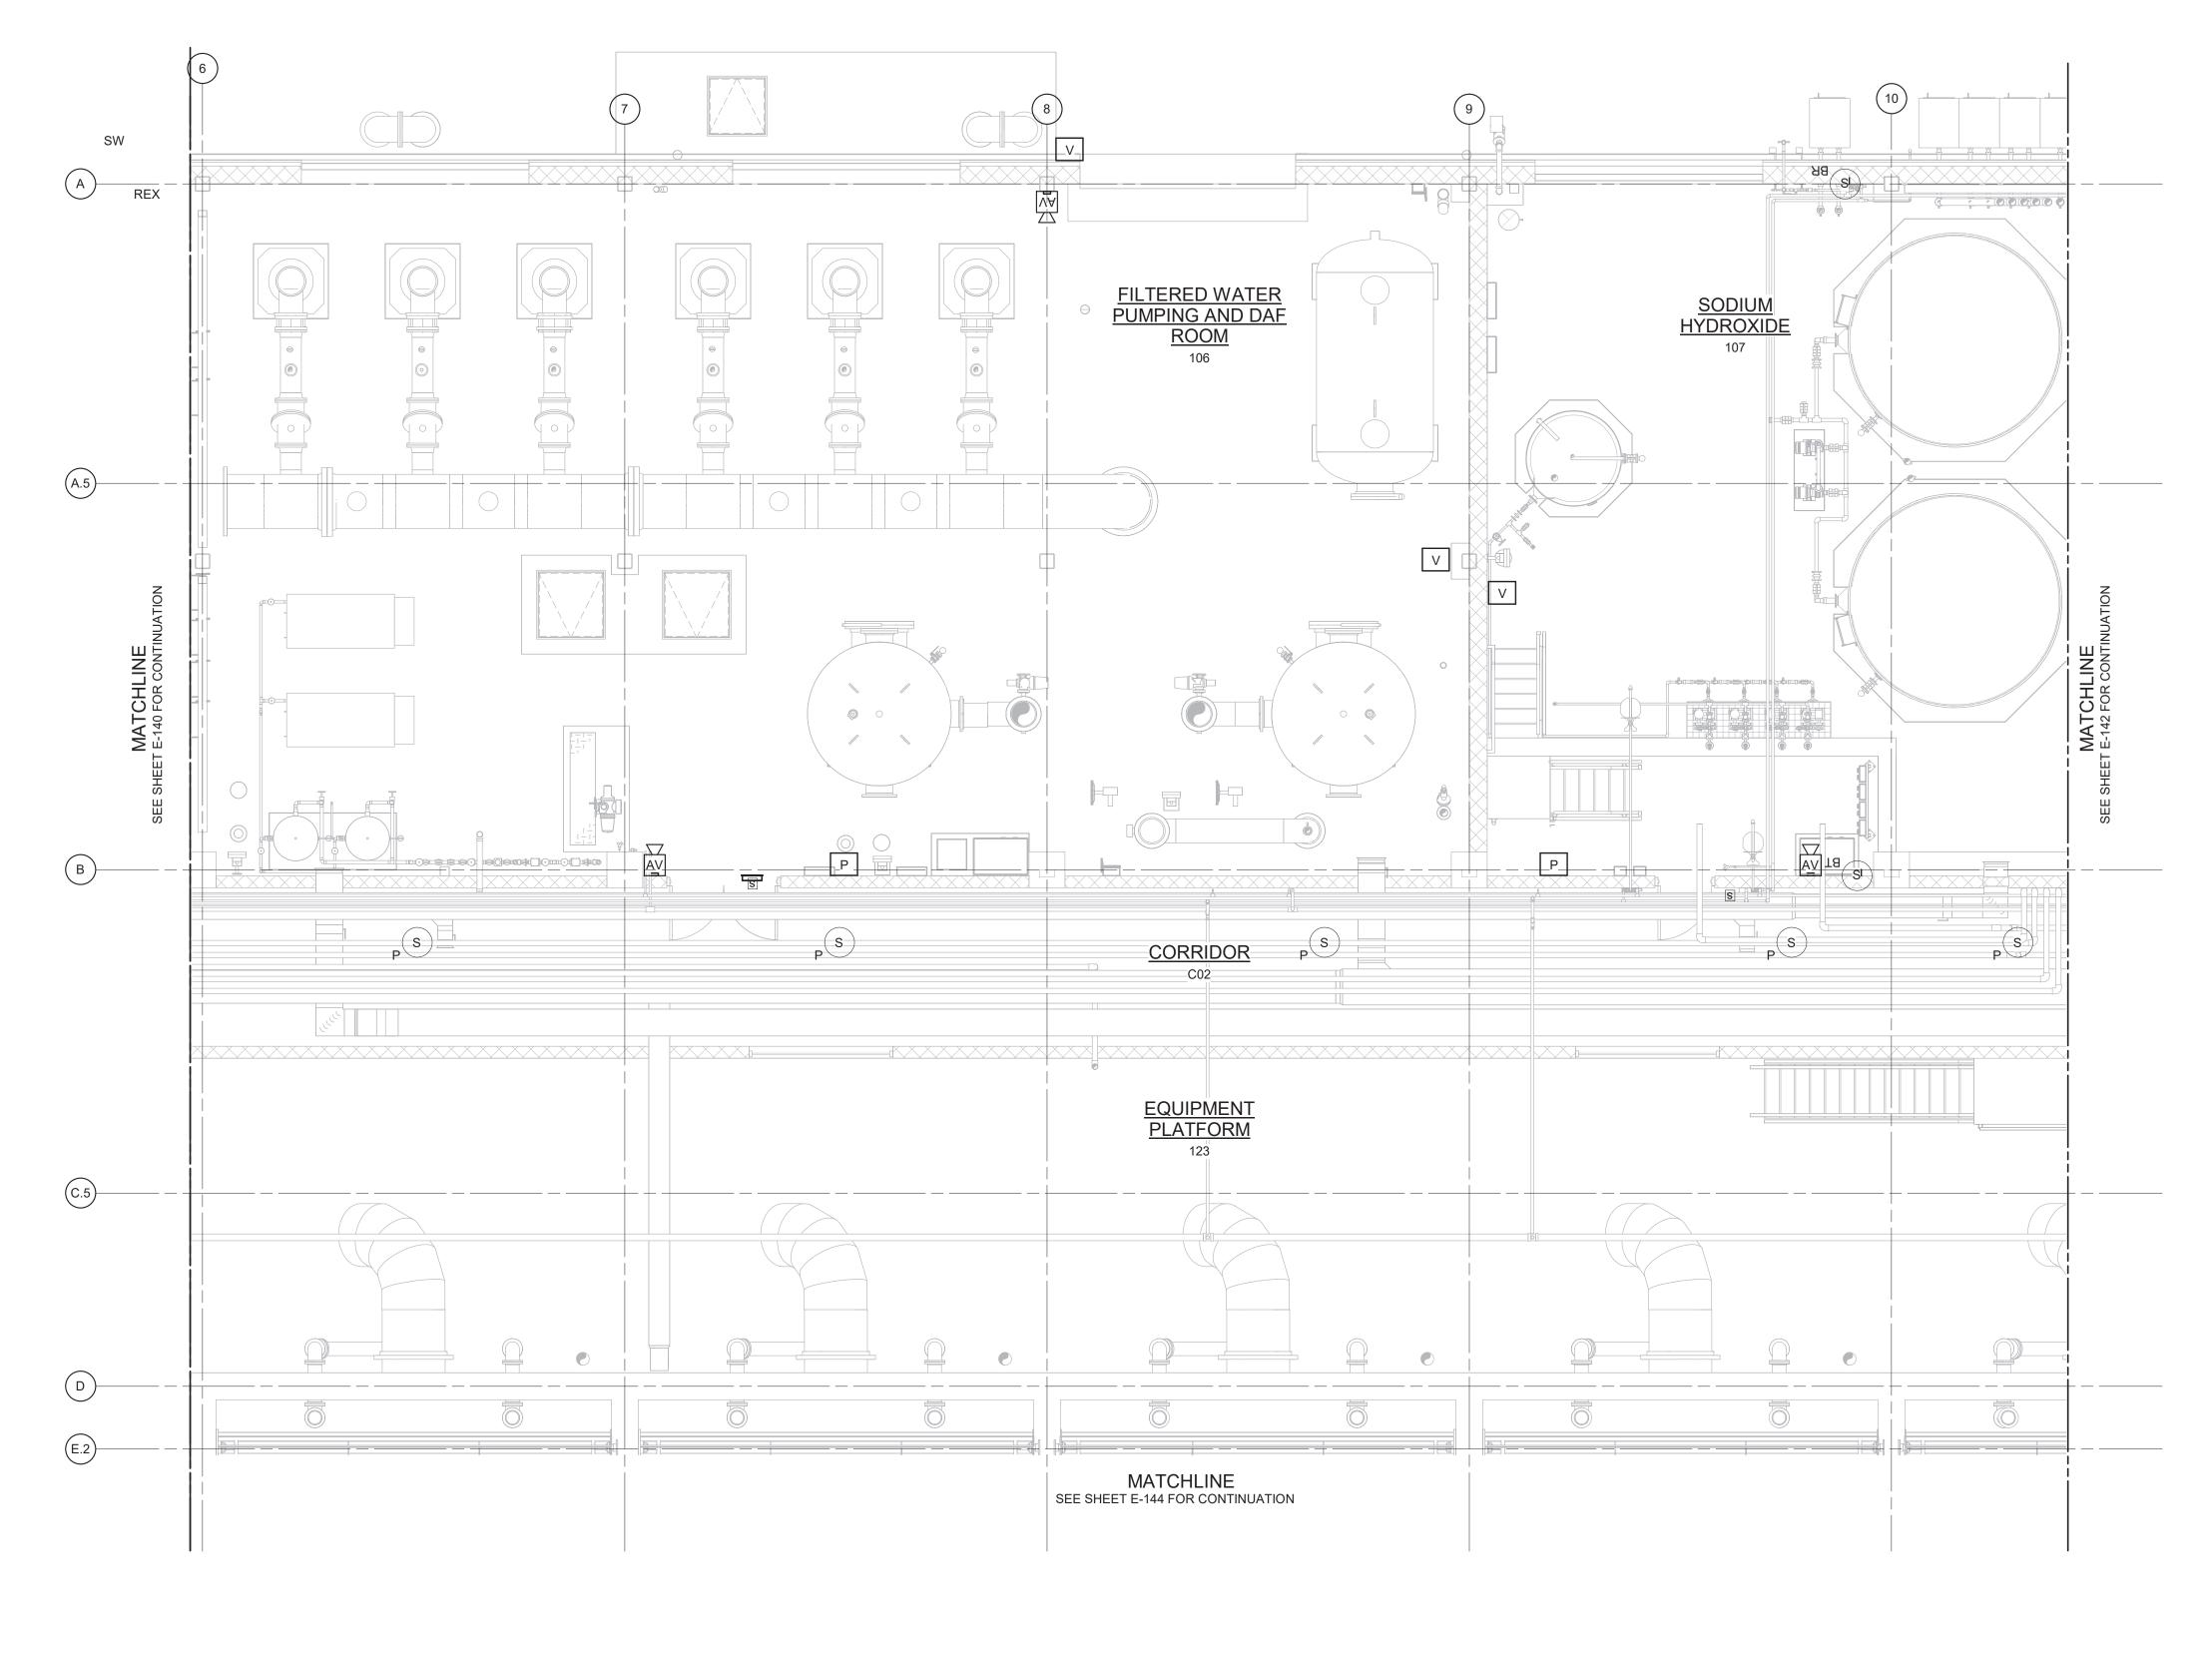

- REFER TO SPECIFICATION 28 46 20 FOR FIRE ALARM SYSTEM DETAILS.
- 2. REFER TO SPECIFICATION 28 10 00 FOR SECURITY SYSTEM DETAILS.
- 3. REFER TO SPECIFICATION 27 51 16 FOR PUBLIC ADDRESS SYSTEM DETAILS.

FIRE ALARM & SECURITY PLAN - EL 407.00 - AREA 2

3/16" = 1'-0"

WARNING
IT IS A VIOLATION OF SECTION 7209.2 OF THE NEW YORK STATE EDUCATION LAW FOR ANY PERSON, UNLESS ACTING UNDER THE DIRECTION OF A LICENSED PROFESSIONAL ENGINEER, TO ALTER IN ANY WAY PLANS, SPECIFICATIONS, PLATS OR REPORTS TO WHICH THE SEAL OF A PROFESSIONAL ENGINEER HAS BEEN APPLIED. IF AN ITEM BEARING THE SEAL OF A PROFESSIONAL ENGINEER IS ALTERED, THE ALTERNIGE ENGINEER SHALL AFTX TO THE ITEM HIS SEAL AND THE NOTATION "ALTERED BY" FOLLOWED BY HIS SIGNATURE, THE DATE, AND A SPECIFIC DESCRIPTION OF THE ALTERATION.

PROJECT ENGINEER:

DESIGNED BY:

V. ABDALLA

DRAWN BY:

R. CHUNG

CHECKED BY:

G. MARKOU

IF THIS BAR DOES NOT
MEASURE 1" THEN DRAWING
IS NOT TO FULL SCALE




HAZEN AND SAWYER
498 SEVENTH AVENUE, 11th FLOOR
NEW YORK, NEW YORK 10018

WESTCHESTER JOINT WATER WORKS MAMARONECK, NY


RYE LAKE WATER FILTRATION PLANT HARRISON, NY

FILTRATION PLANT
ELECTRICAL
FIRE ALARM & SECURITY PLAN - EL 407.00 - AREA 2

	DATE:	FEB 2025
	HAZEN NO.:	90388-000
	CONTRACT NO.:	A1364-A
A 2	DRAWING NUMBER:	
		E-141

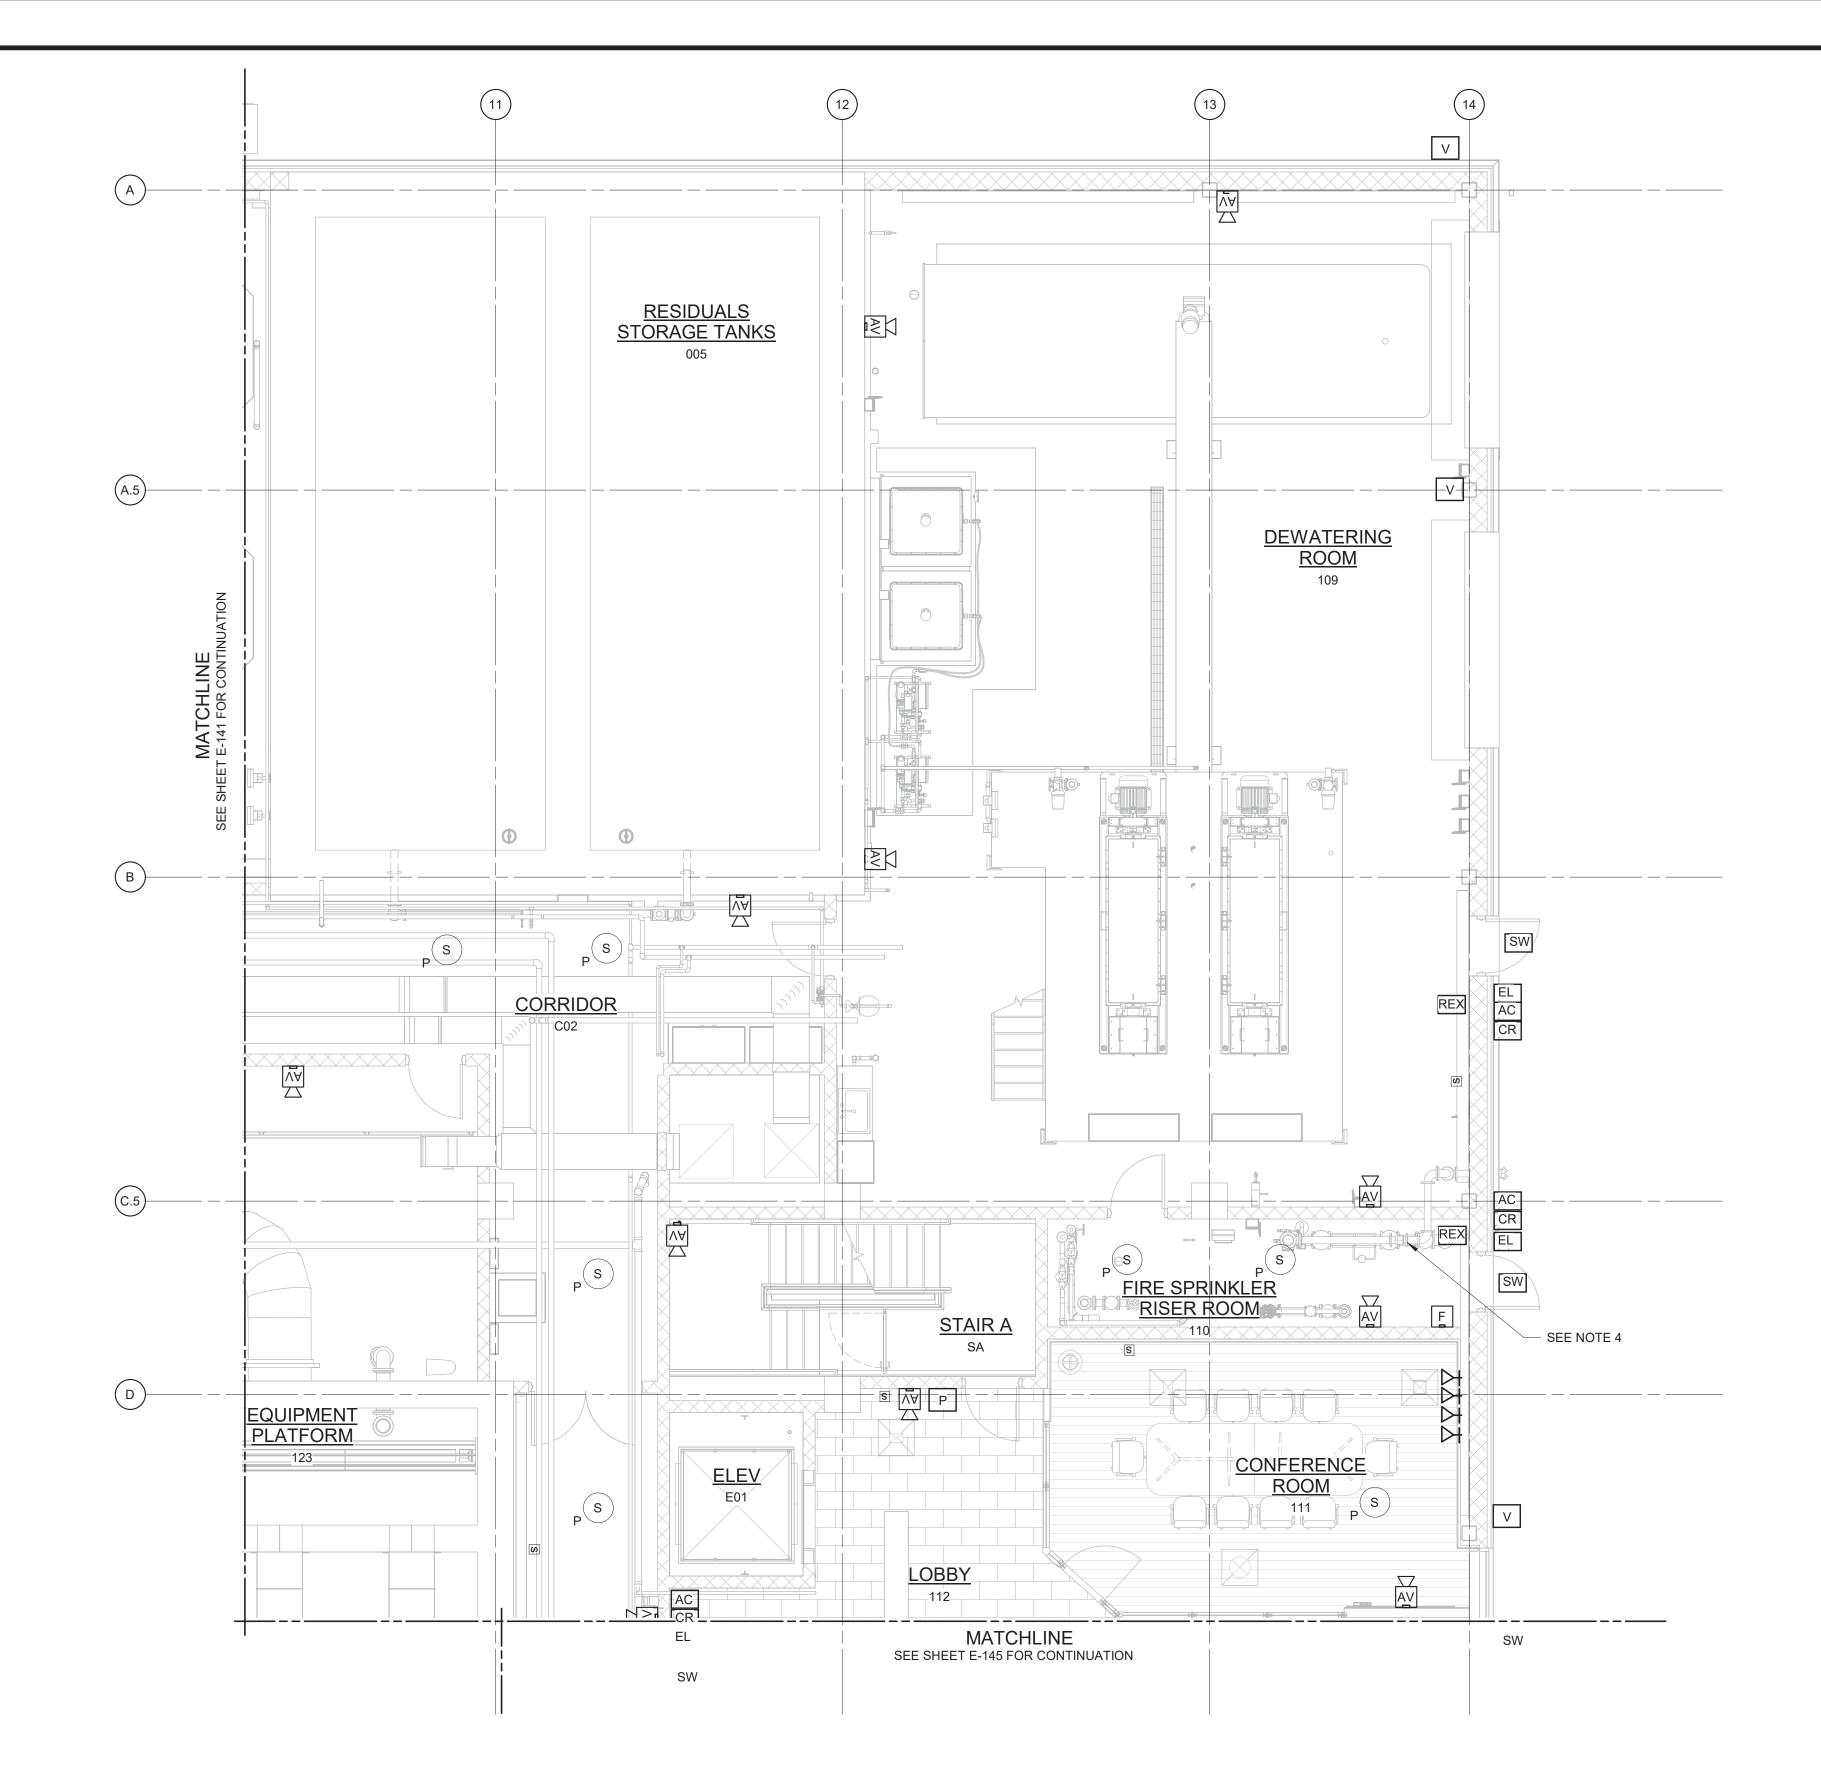

- REFER TO SPECIFICATION 28 46 20 FOR FIRE ALARM SYSTEM DETAILS.
- 2. REFER TO SPECIFICATION 28 10 00 FOR SECURITY SYSTEM DETAILS.
- 3. REFER TO SPECIFICATION 27 51 16 FOR PUBLIC ADDRESS SYSTEM DETAILS.
- 4. FLOW SWITCH ALARM, PRESSURE ALARM, CONTROL VALVE TAMPER SWITCH 1, DCDV GATE VALVE 1 TAMPER SWITCH AND DCDV GATE VALVE 2 TAMPER SWITCH LOCATED IN WET SPRINKLER SYSTEM.

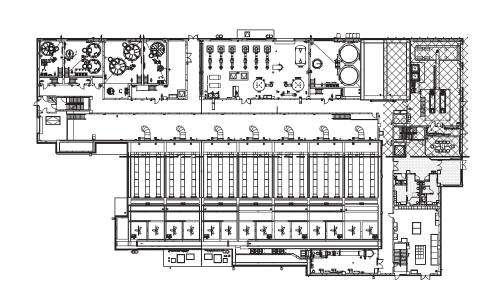



FIRE ALARM & SECURITY PLAN - EL 407.00 - AREA 3

WARNING
IT IS A VIOLATION OF SECTION 7209.2 OF THE NEW YORK STATE EDUCATION LAW FOR ANY PERSON, UNLESS ACTING UNDER THE DIRECTION OF A LICENSED PROFESSIONAL ENGINEER, TO ALTER IN ANY WAY PLANS, SPECIFICATIONS, PLATS OR REPORTS TO WHICH THE SEAL OF A PROFESSIONAL ENGINEER IS ALTERED, APPLIED. IF AN ITEM BEARING THE SEAL OF A PROFESSIONAL ENGINEER IS ALTERED, THE ALTERING ENGINEER SHALL AFFIX TO THE ITEM HIS SEAL AND THE NOTATION "ALTERED BY" FOLLOWED BY HIS SIGNATURE, THE DATE, AND A SPECIFIC DESCRIPTION OF THE ALTERATION.

PROJECT ENGINEER:

DESIGNED BY:

V. ABDALLA

DRAWN BY:

R. CHUNG

CHECKED BY:

G. MARKOU

REV ISSUED FOR DATE BY

IF THIS BAR DOES NOT MEASURE 1" THEN DRAWING IS NOT TO FULL SCALE



HAZEN AND SAWYER
498 SEVENTH AVENUE, 11th FLOOR

NEW YORK, NEW YORK 10018


WESTCHESTER JOINT WATER WORKS MAMARONECK, NY

RYE LAKE WATER FILTRATION PLANT HARRISON, NY FILTRATION PLANT ELECTRICAL FIRE ALARM & SECURITY PLAN - EL 407.00 - AREA 3


	DATE:	FEB 2025
	HAZEN NO.:	90388-000
	CONTRACT NO.:	A1364-A
3	DRAWING NUMBER:	

373 of 392

E-142

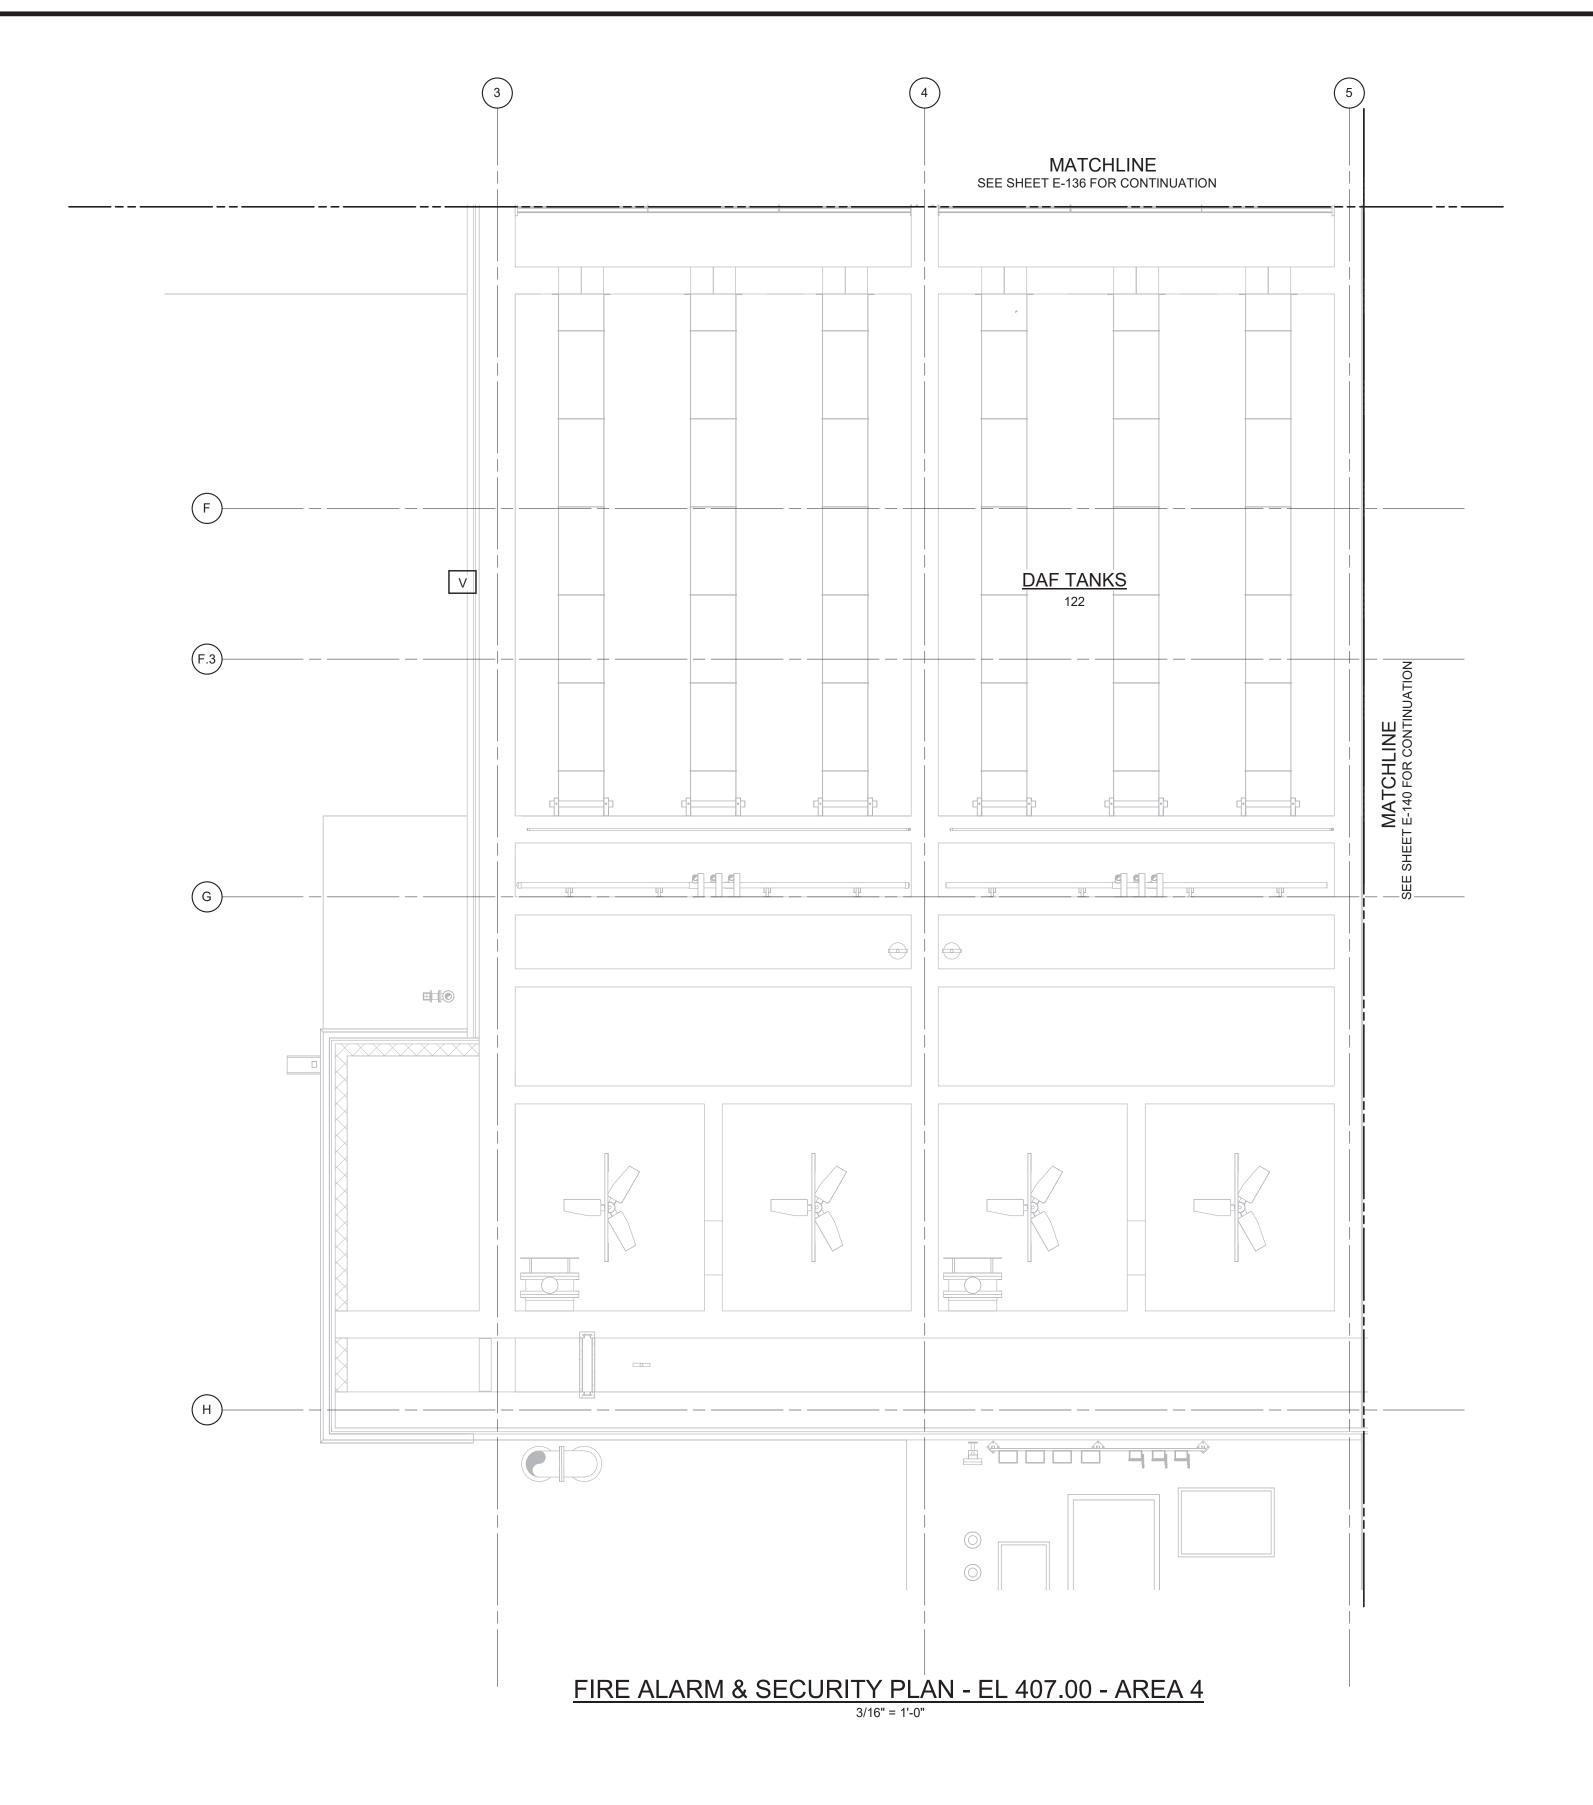

- 1. REFER TO SPECIFICATION 28 46 20 FOR FIRE ALARM SYSTEM
- 2. REFER TO SPECIFICATION 28 10 00 FOR SECURITY SYSTEM DETAILS.
- 3. REFER TO SPECIFICATION 27 51 16 FOR PUBLIC ADDRESS SYSTEM DETAILS.

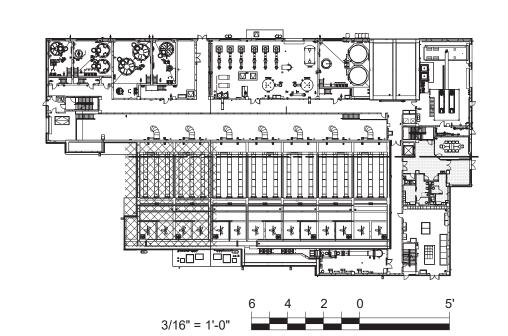

	ANY PERS PROFESSI OR REPOR APPLIED. I THE ALTEI "ALTERED	WARNING LATION OF SECTION 7209.2 OF THE NEW YORK STA ON, UNLESS ACTING UNDER THE DIRECTION OF A ONAL ENGINEER, TO ALTER IN ANY WAY PLANS, SF RTS TO WHICH THE SEAL OF A PROFESSIONAL ENG F AN ITEM BEARING THE SEAL OF A PROFESSIONAI RING ENGINEER SHALL AFFIX TO THE ITEM HIS SEA BY" FOLLOWED BY HIS SIGNATURE, THE DATE, AN ION OF THE ALTERATION.	LICENSED PECIFICATIONS BINEER HAS BEI L ENGINEER IS JL AND THE NOT	, PLATS EN ALTERED,			
					PROJECT ENGINEER:	R. FROST	
					DESIGNED BY:	Y. ABDALLA	
					DRAWN BY:	R. CHUNG	BID SET
:46 PM					CHECKED BY:	G. MARKOU	5.5 02.
5/2025 3:08:46					IF THIS BAR DOES NOT MEASURE 1" THEN DRAWING	0 1/2" 1"	
15/2	REV	ISSUED FOR	DATE	BY	IS NOT TO FULL SCALE		

ISSUED FOR


Hazen HAZEN AND SAWYER 498 SEVENTH AVENUE, 11th FLOOR NEW YORK, NEW YORK 10018


WESTCHESTER JOINT WATER WORKS MAMARONECK, NY

RYE LAKE WATER FILTRATION PLANT HARRISON, NY


FILTRATION PLANT ELECTRICAL FIRE ALARM & SECURITY PLAN - EL 407.00 - AREA

	DATE:	FEB 2025
	HAZEN NO.:	90388-000
	CONTRACT NO.:	A1364-A
4	DRAWING NUMBER:	
		E-143

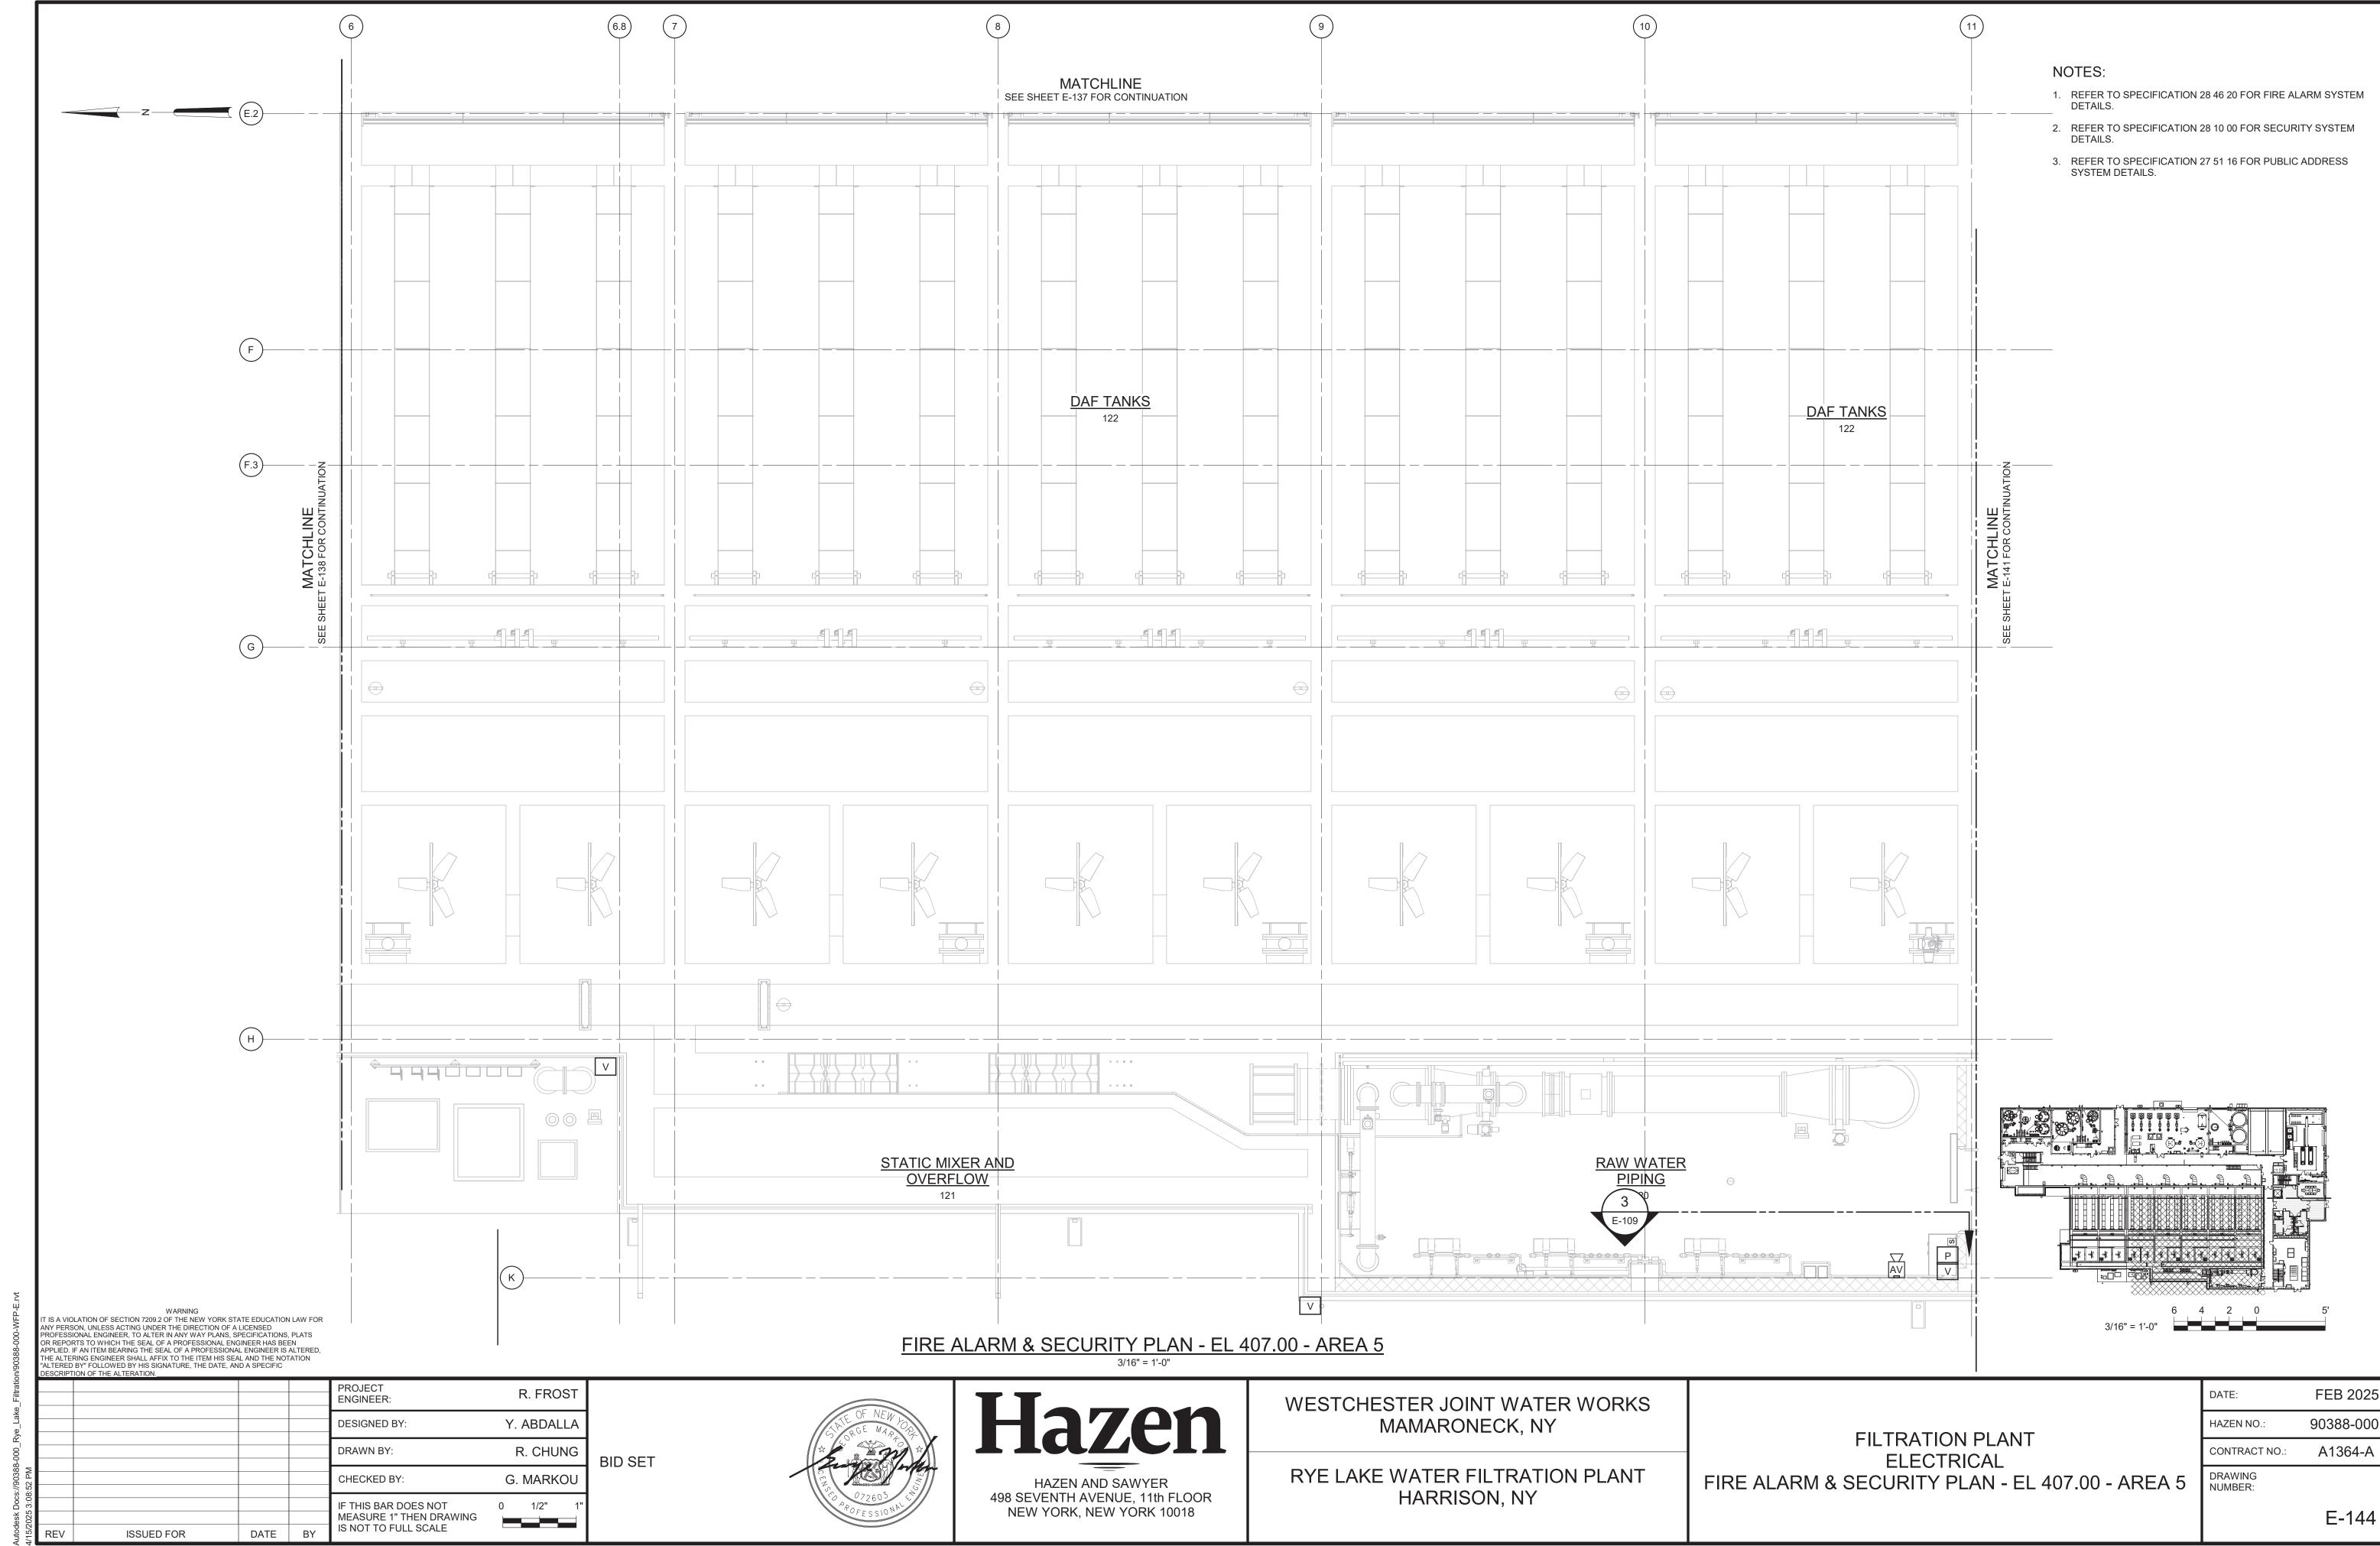

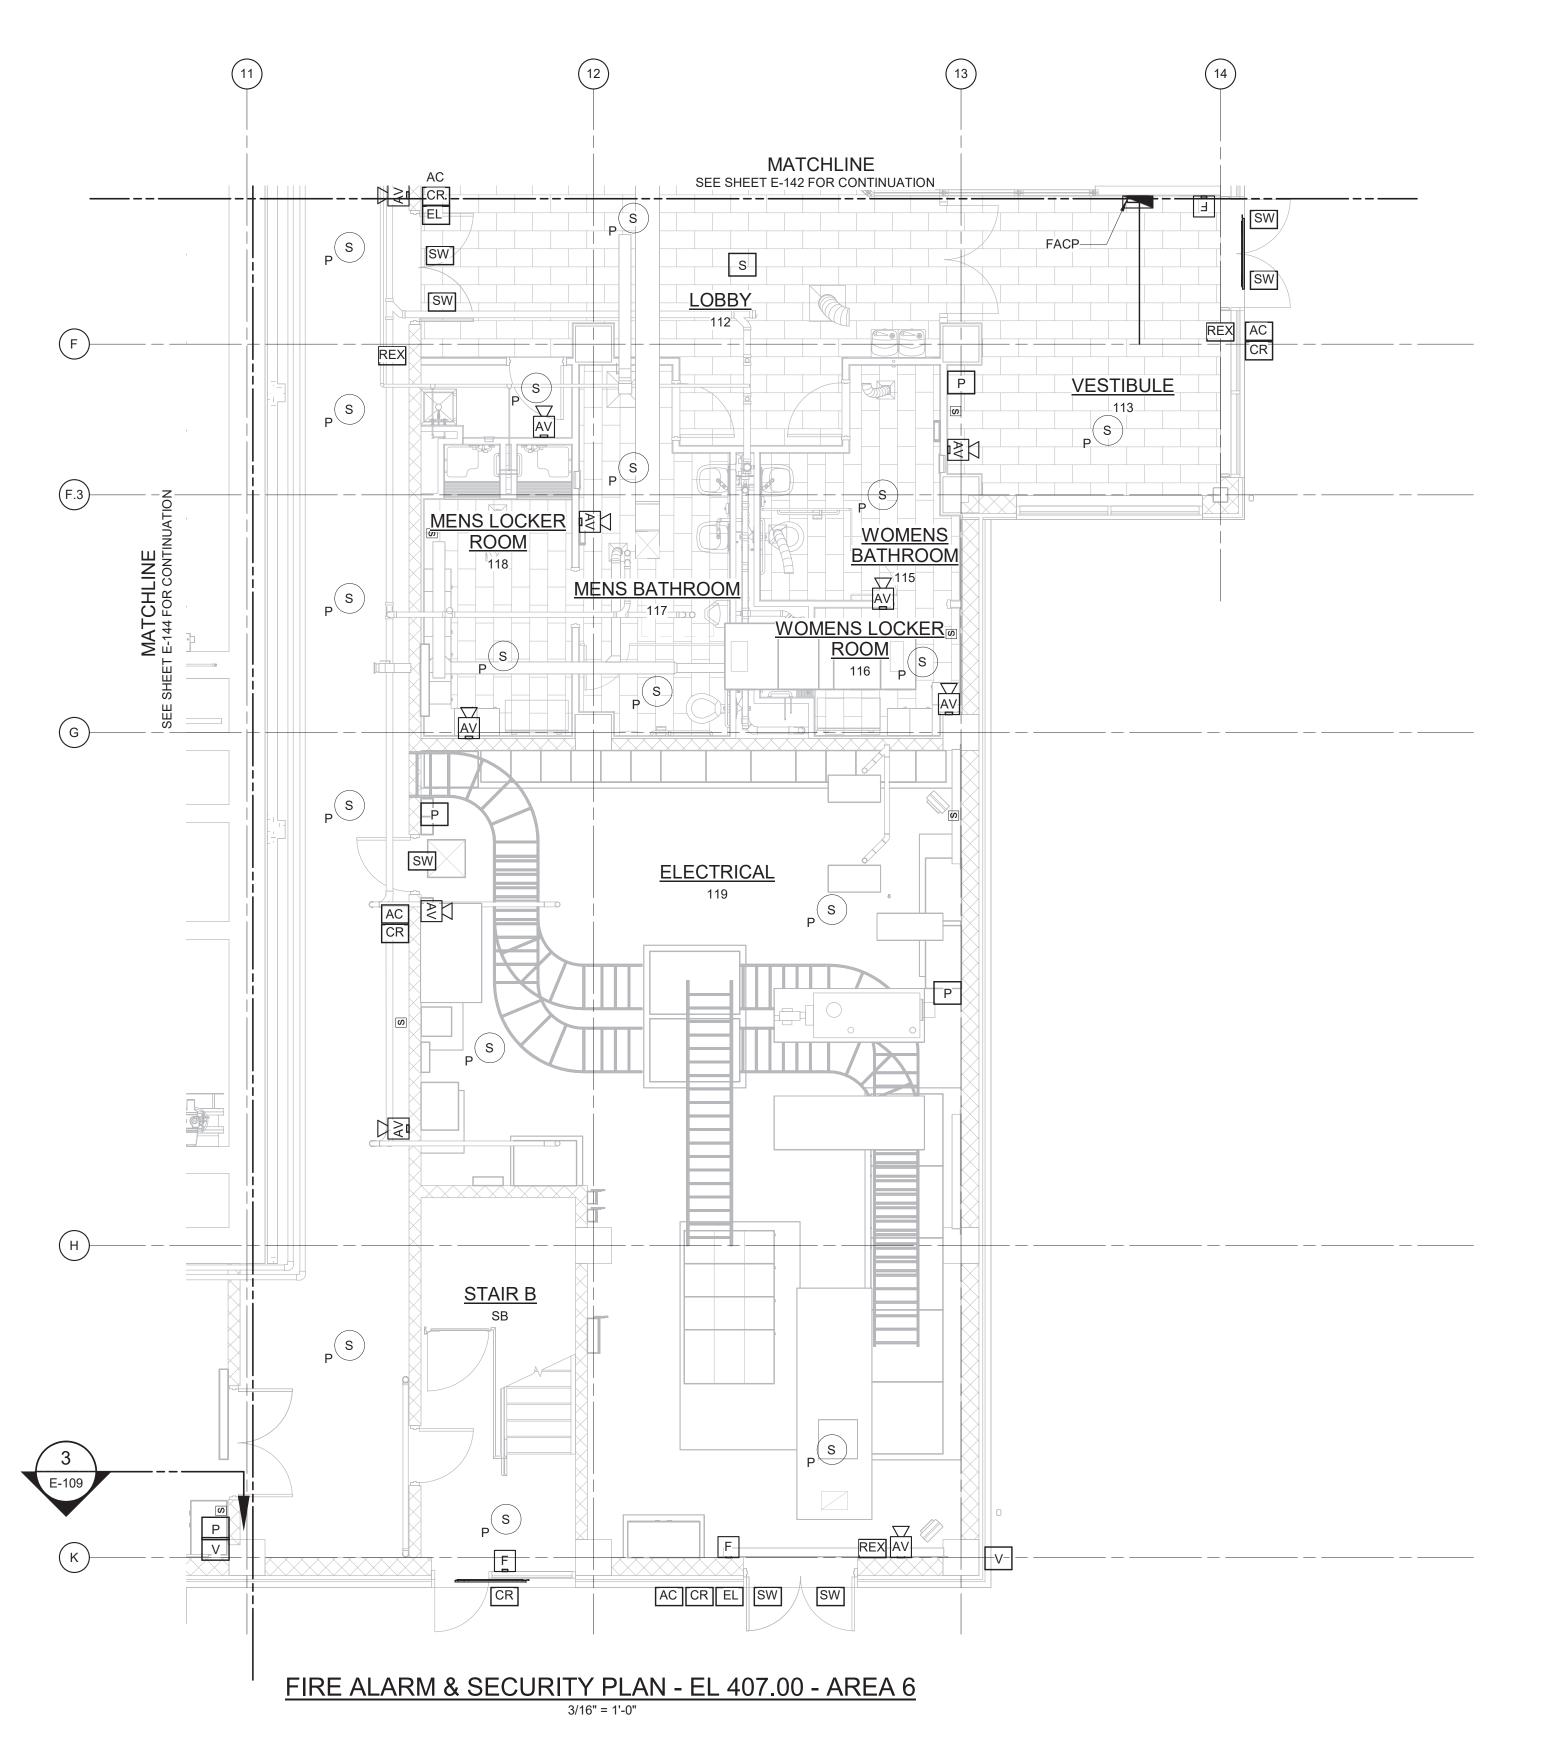

- REFER TO SPECIFICATION 28 46 20 FOR FIRE ALARM SYSTEM DETAILS.
- 2. REFER TO SPECIFICATION 28 10 00 FOR SECURITY SYSTEM DETAILS.
- 3. REFER TO SPECIFICATION 27 51 16 FOR PUBLIC ADDRESS SYSTEM DETAILS.

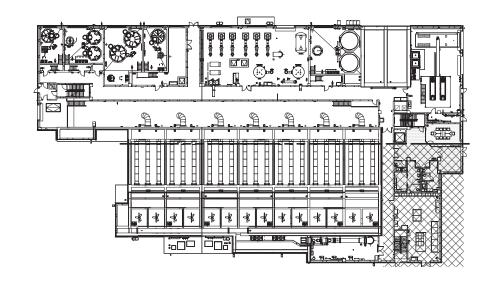

3/16" = 1'-0"

WARNING
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PROJECT ENGINEER:

DESIGNED BY:

V. ABDALLA

DRAWN BY:

R. CHUNG

BID SET

CHECKED BY:

G. MARKOU

IF THIS BAR DOES NOT

MEASURE 1" THEN DRAWING IS NOT TO FULL SCALE

OF NEW JORGE MARTON TO PROFESSIONAL

HAZEN AND SAWYER
498 SEVENTH AVENUE, 11th FLOOR


NEW YORK, NEW YORK 10018

WESTCHESTER JOINT WATER WORKS MAMARONECK, NY

RYE LAKE WATER FILTRATION PLANT HARRISON, NY

FILTRATION PLANT ELECTRICAL FIRE ALARM & SECURITY PLAN - EL 407.00 - AREA 6

	DATE:	FEB 2025
	HAZEN NO.:	90388-000
	CONTRACT NO.:	A1364-A
6	DRAWING NUMBER:	
		E-145

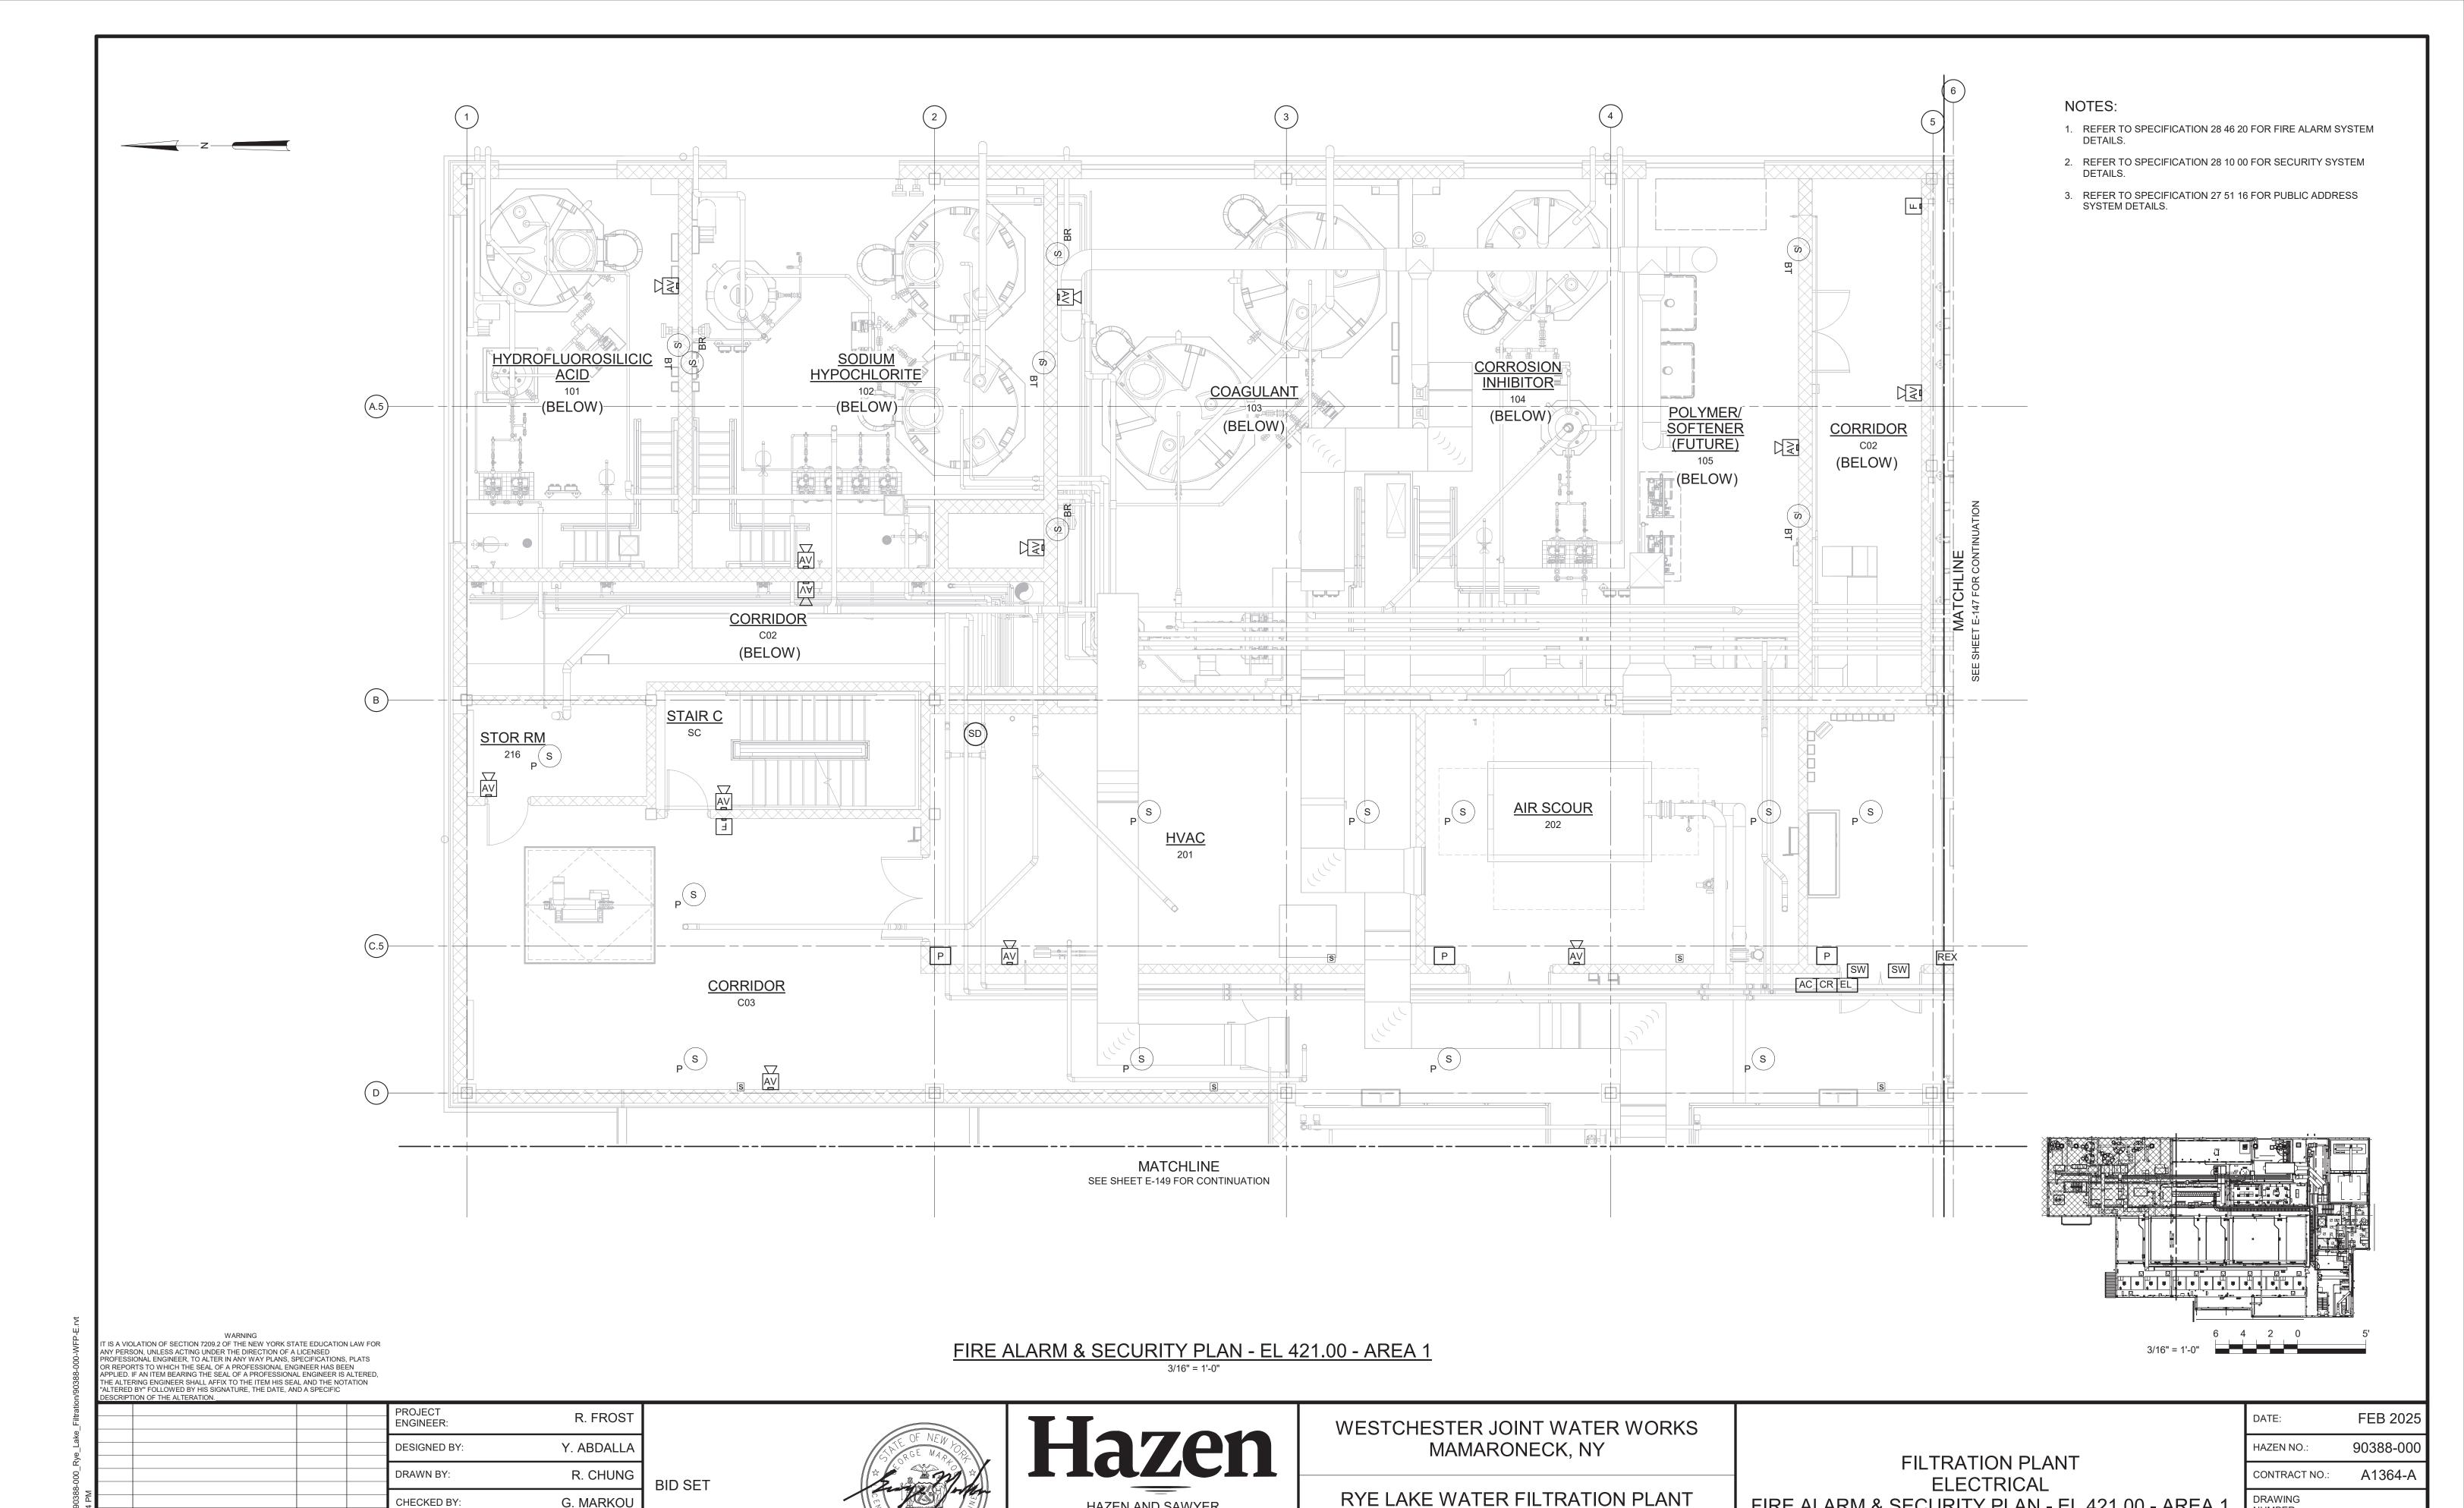

HAZEN AND SAWYER

498 SEVENTH AVENUE, 11th FLOOR

NEW YORK, NEW YORK 10018

HARRISON, NY

G. MARKOU

0 1/2"

CHECKED BY:

DATE BY

ISSUED FOR


IF THIS BAR DOES NOT

MEASURE 1" THEN DRAWING IS NOT TO FULL SCALE

E-146

DRAWING NUMBER:

FIRE ALARM & SECURITY PLAN - EL 421.00 - AREA 1

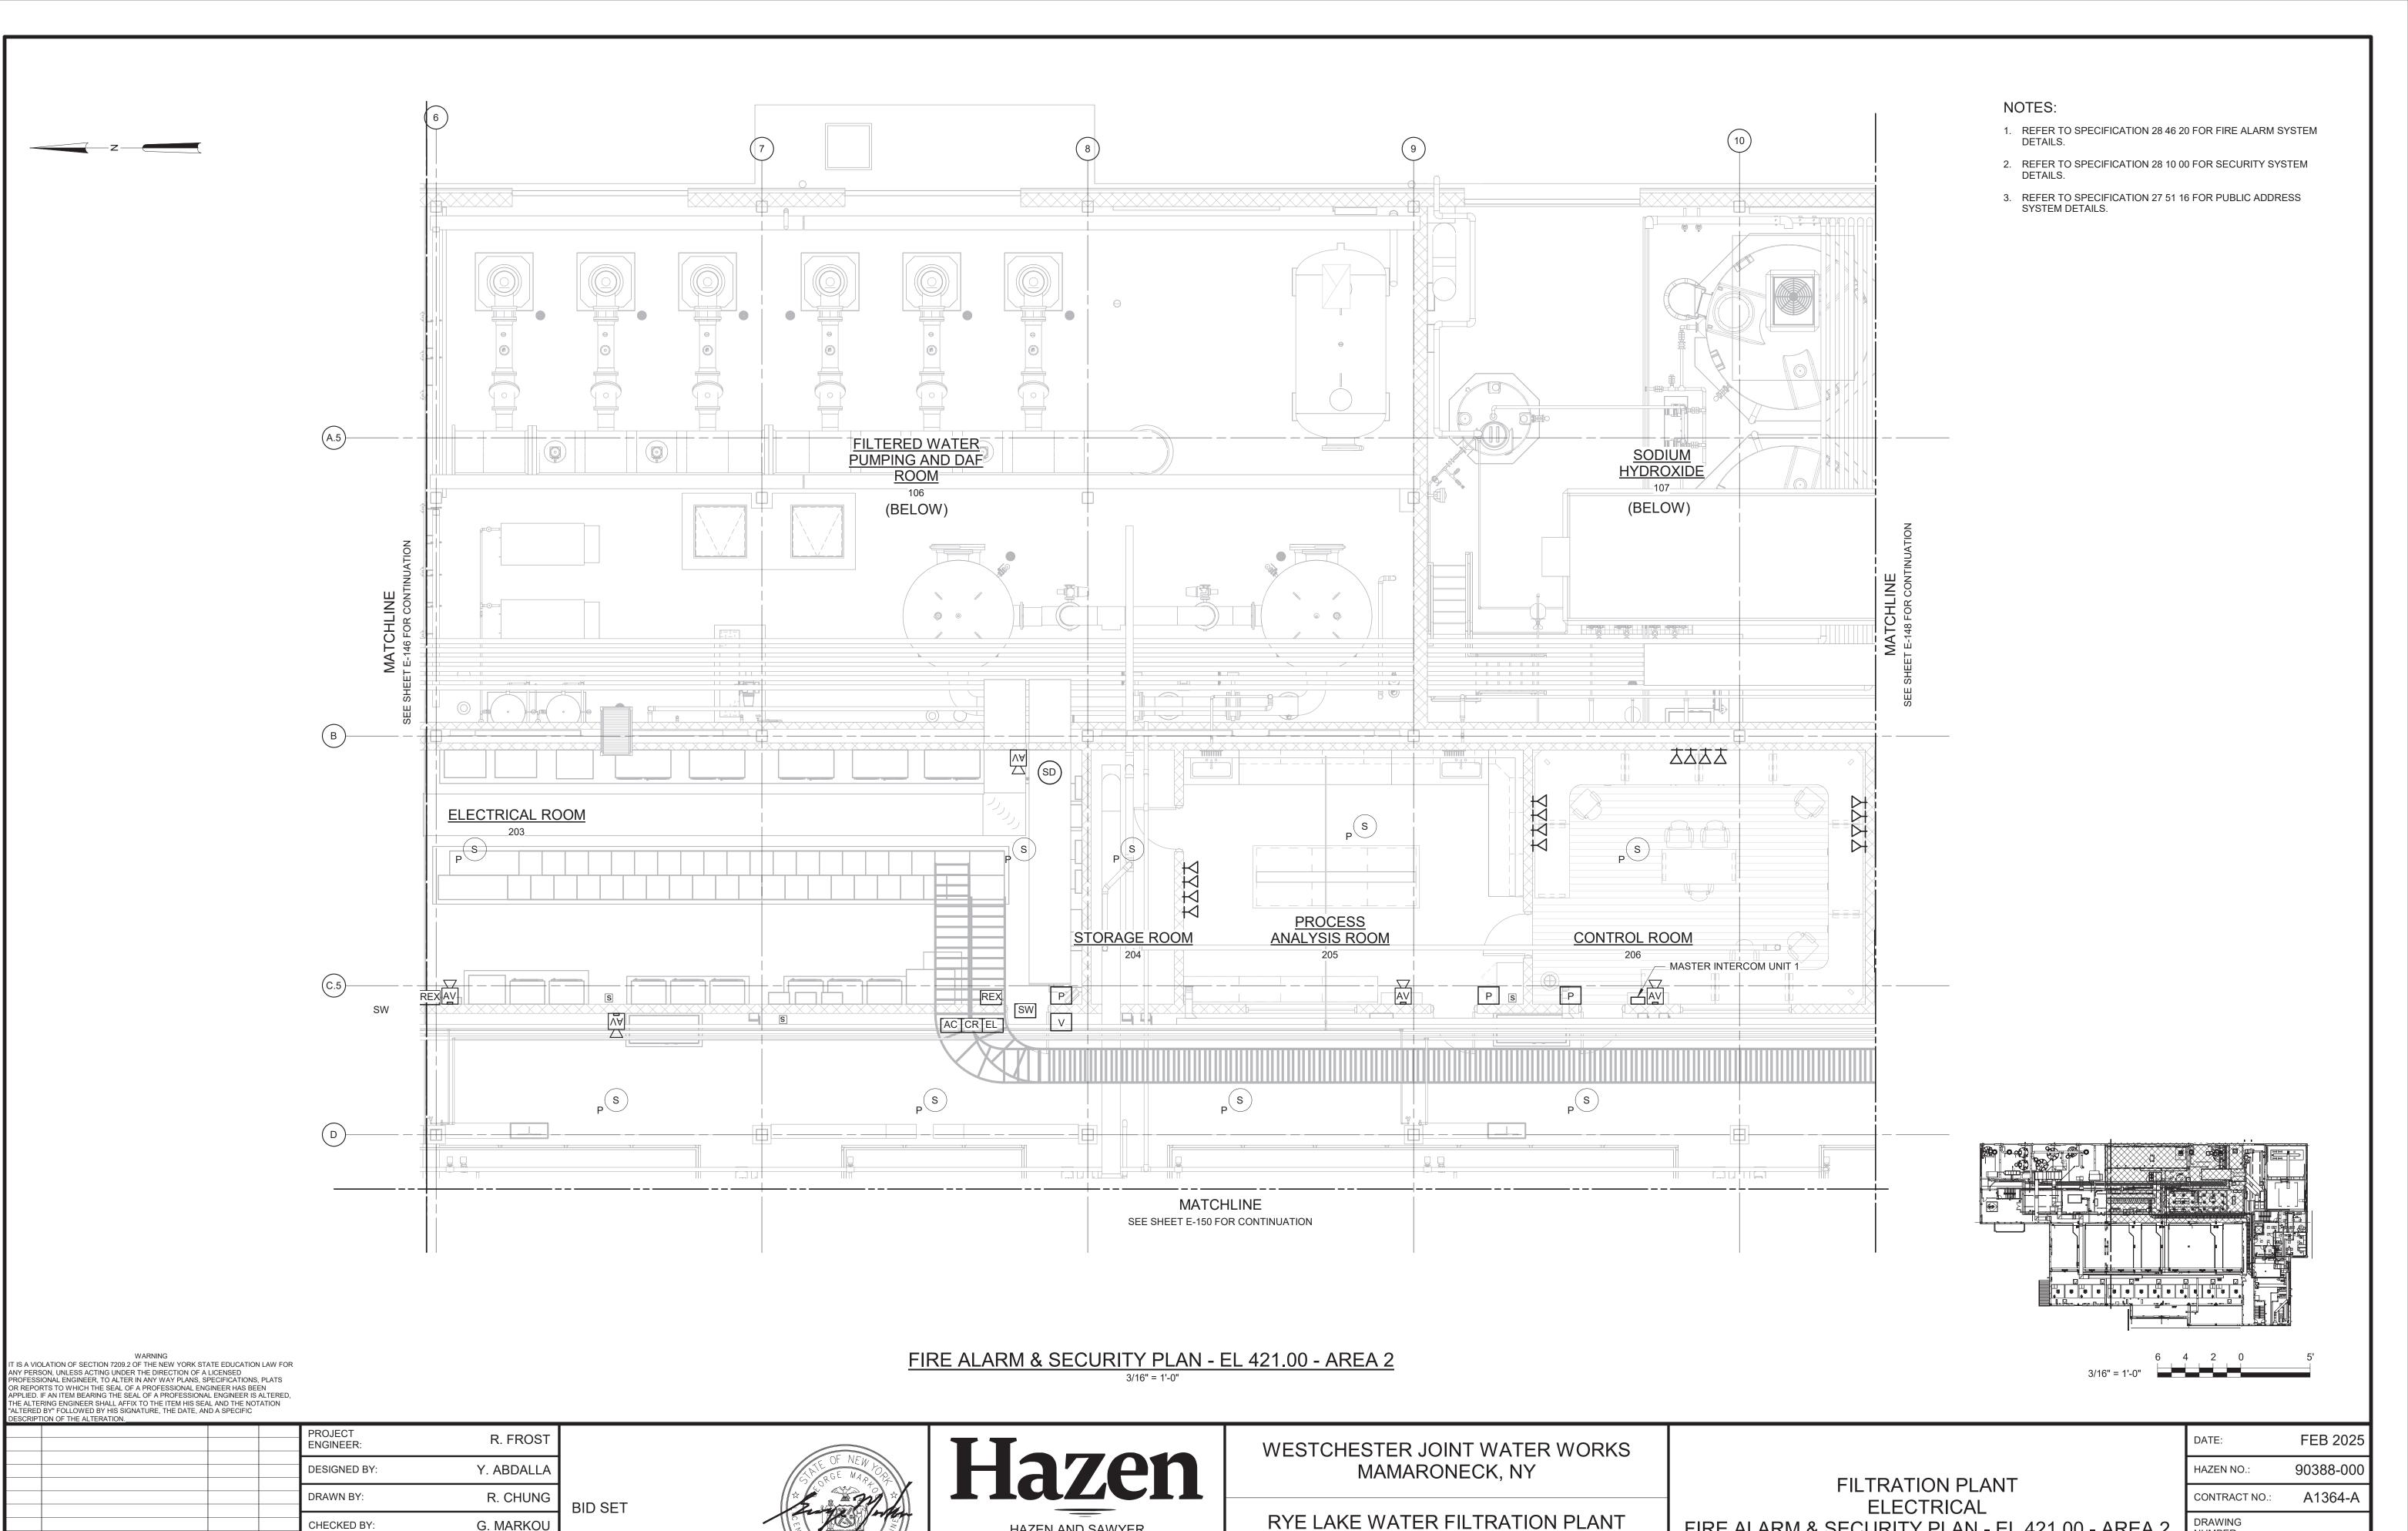

HARRISON, NY

HAZEN AND SAWYER

498 SEVENTH AVENUE, 11th FLOOR

NEW YORK, NEW YORK 10018

G. MARKOU

0 1/2"

CHECKED BY:

DATE BY


ISSUED FOR

IF THIS BAR DOES NOT

MEASURE 1" THEN DRAWING IS NOT TO FULL SCALE

E-147 378 of 392

FIRE ALARM & SECURITY PLAN - EL 421.00 - AREA 2

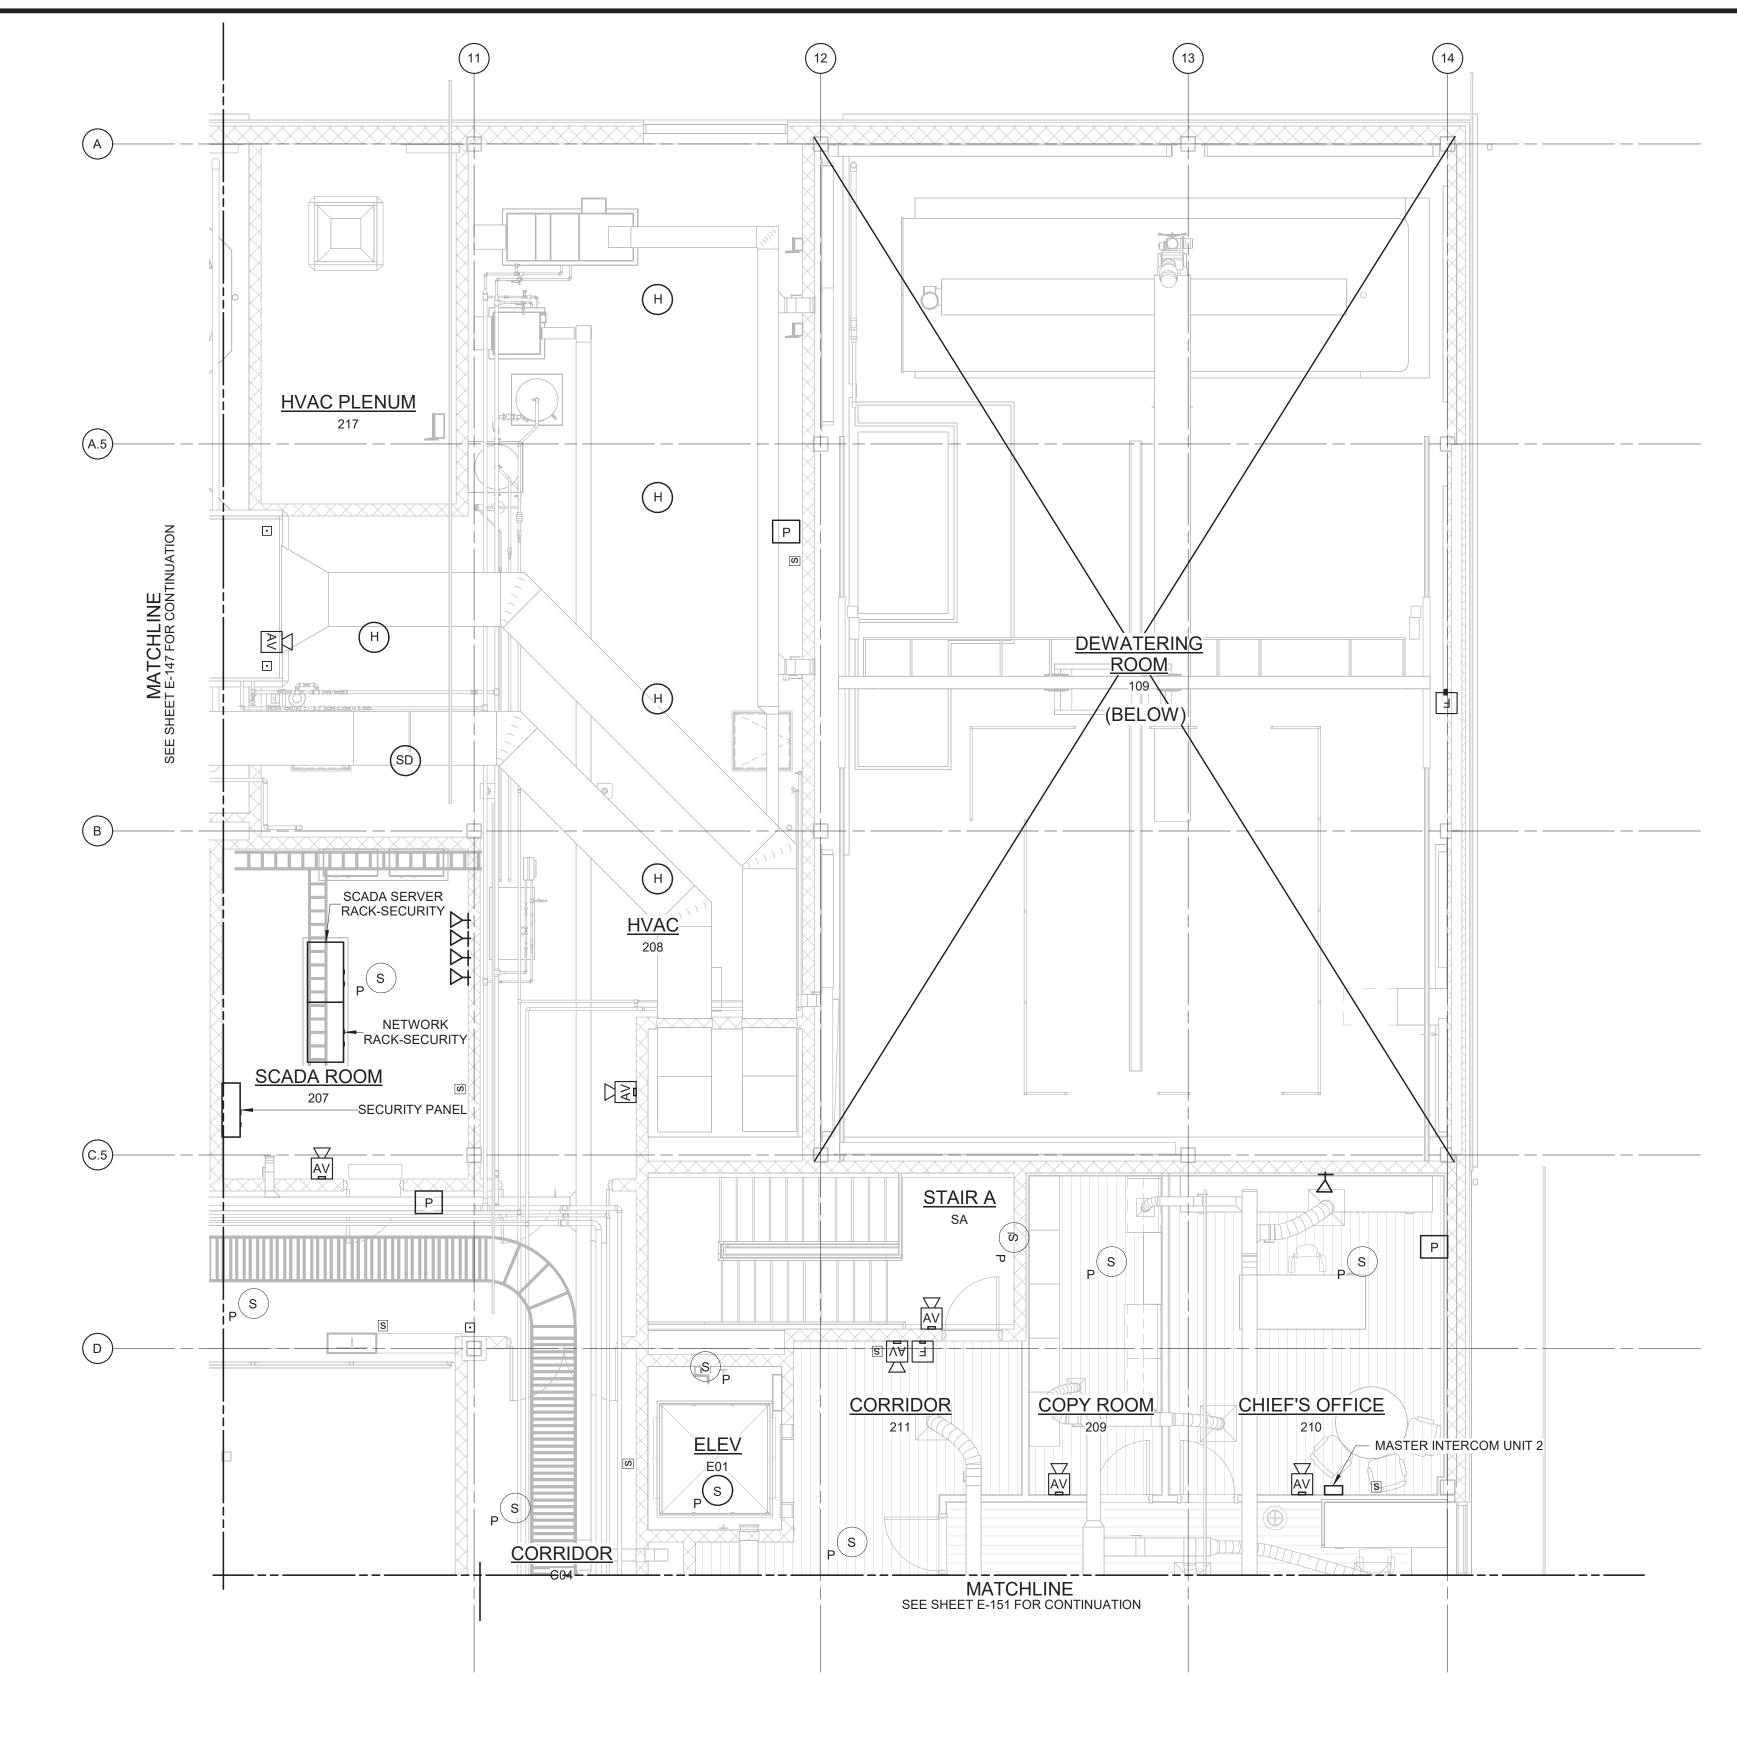

- REFER TO SPECIFICATION 28 46 20 FOR FIRE ALARM SYSTEM DETAILS.
- 2. REFER TO SPECIFICATION 28 10 00 FOR SECURITY SYSTEM
- 3. REFER TO SPECIFICATION 27 51 16 FOR PUBLIC ADDRESS SYSTEM DETAILS.

6 4 2 0 3/16" = 1'-0"

FIRE ALARM & SECURITY PLAN - EL 421.00 - AREA 3

	ANY PERS PROFESS OR REPOR APPLIED. THE ALTE "ALTERED	WARNING DIATION OF SECTION 7209.2 OF THE NEW YORK STA SON, UNLESS ACTING UNDER THE DIRECTION OF A L IONAL ENGINEER, TO ALTER IN ANY WAY PLANS, SP RTS TO WHICH THE SEAL OF A PROFESSIONAL ENG IF AN ITEM BEARING THE SEAL OF A PROFESSIONAL RING ENGINEER SHALL AFFIX TO THE ITEM HIS SEAL BY" FOLLOWED BY HIS SIGNATURE, THE DATE, ANI TION OF THE ALTERATION.	LICENSED PECIFICATIONS SINEER HAS BEI L ENGINEER IS L AND THE NO	, PLATS EN ALTERED,			
					PROJECT ENGINEER:	R. FROST	
					DESIGNED BY:	Y. ABDALLA	
					DRAWN BY:	R. CHUNG	BID SET
:15 PM					CHECKED BY:	G. MARKOU	DID 021
25 3:09:15					IF THIS BAR DOES NOT MEASURE 1" THEN DRAWING	0 1/2" 1"	
5/2025	DEV	ISSUED FOR	DATE	DV	IS NOT TO FULL SCALE		




HAZEN AND SAWYER
498 SEVENTH AVENUE, 11th FLOOR
NEW YORK, NEW YORK 10018


WESTCHESTER JOINT WATER WORKS MAMARONECK, NY

RYE LAKE WATER FILTRATION PLANT HARRISON, NY FILTRATION PLANT ELECTRICAL FIRE ALARM & SECURITY PLAN - EL 421.00 - AREA 3

	DATE:	FEB 2025
	HAZEN NO.:	90388-000
	CONTRACT NO.:	A1364-A
3	DRAWING NUMBER:	
		E-148

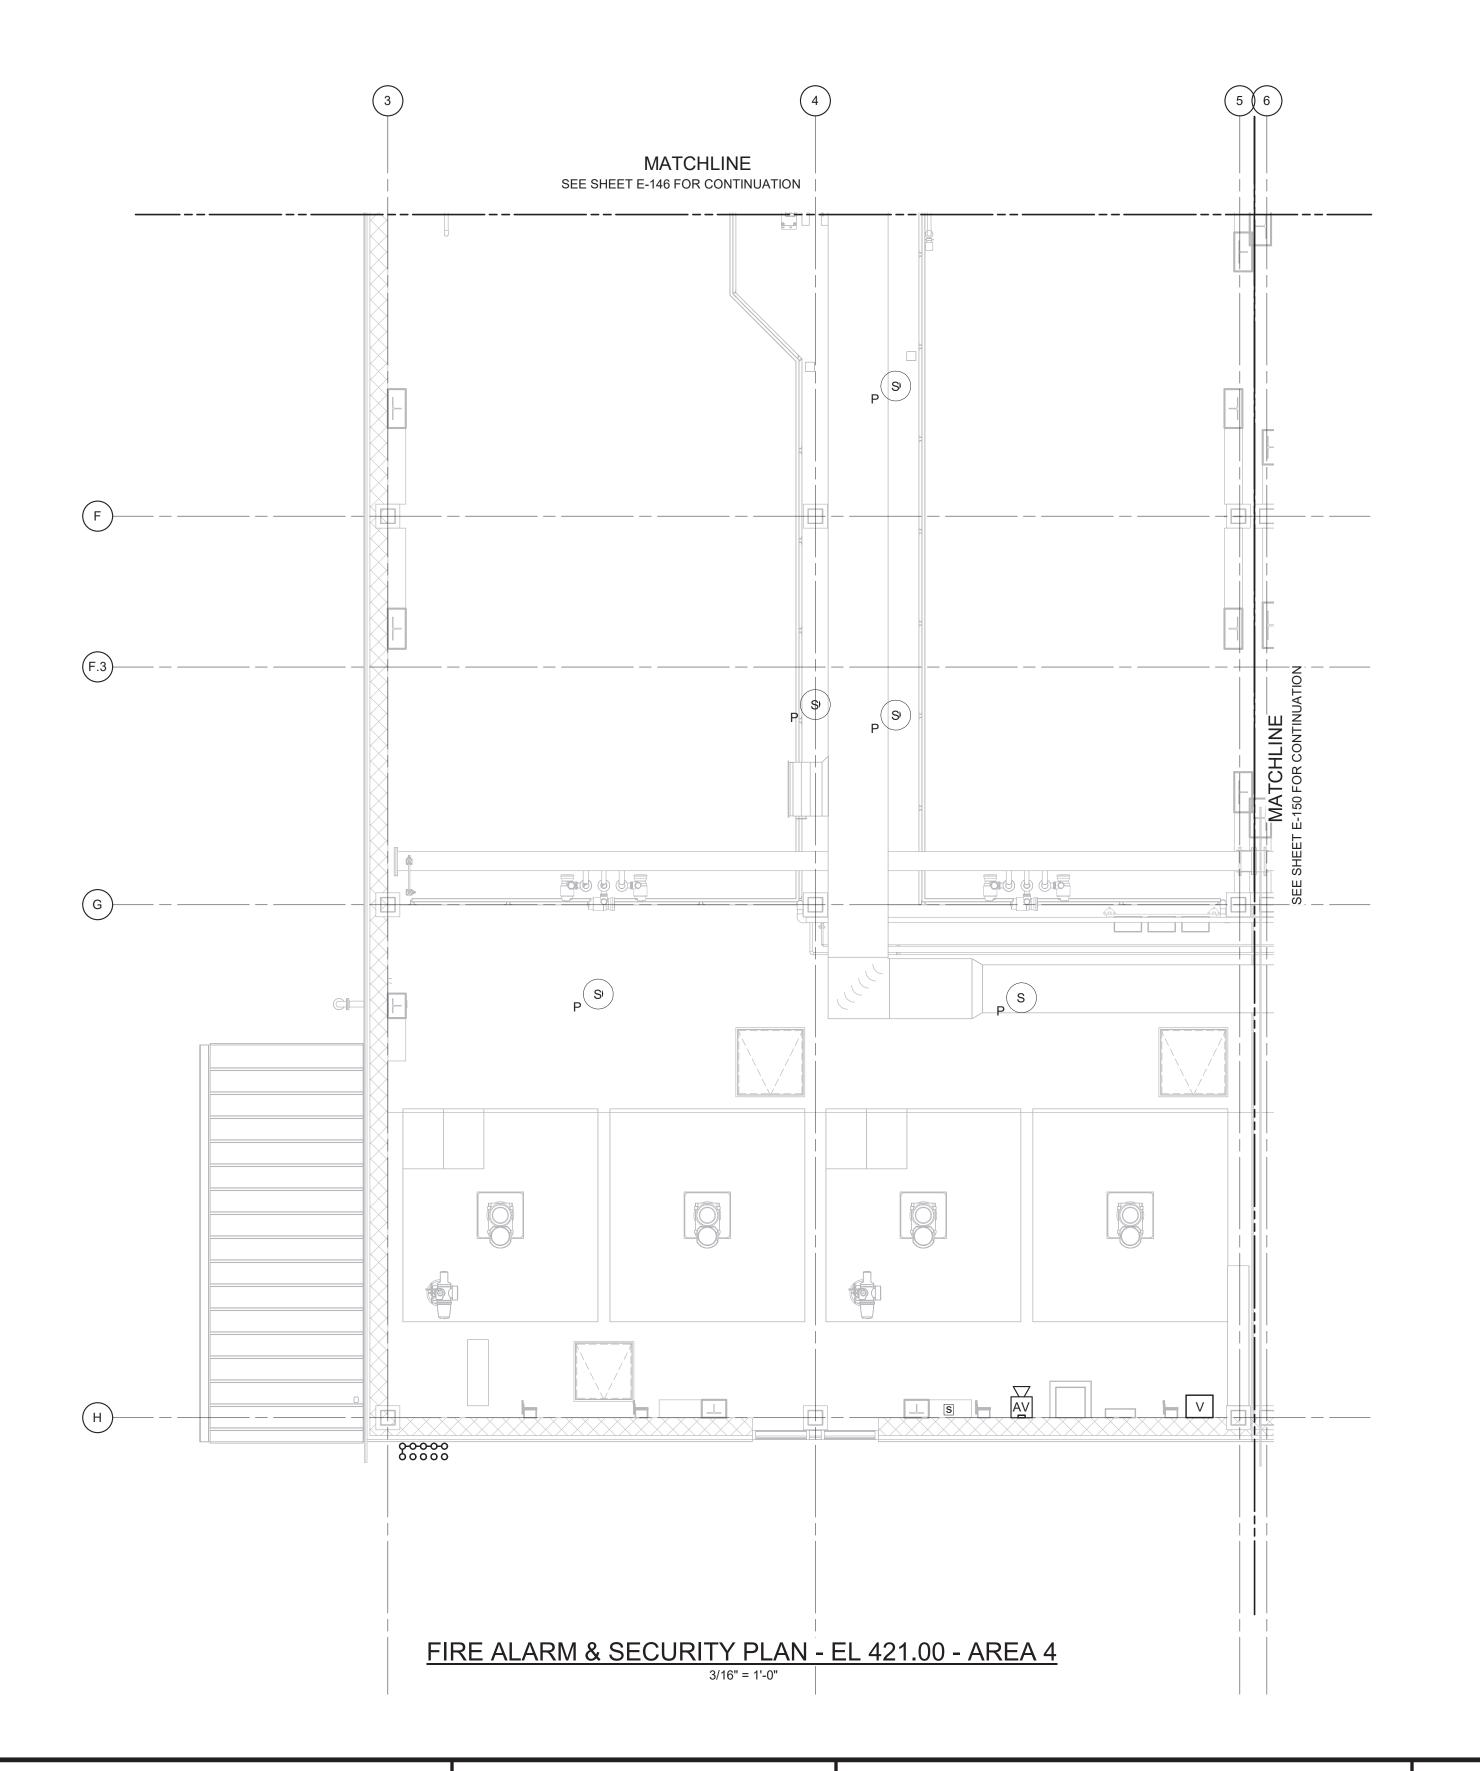

- REFER TO SPECIFICATION 28 46 20 FOR FIRE ALARM SYSTEM DETAILS.
- 2. REFER TO SPECIFICATION 28 10 00 FOR SECURITY SYSTEM DETAILS.
- 3. REFER TO SPECIFICATION 27 51 16 FOR PUBLIC ADDRESS SYSTEM DETAILS.

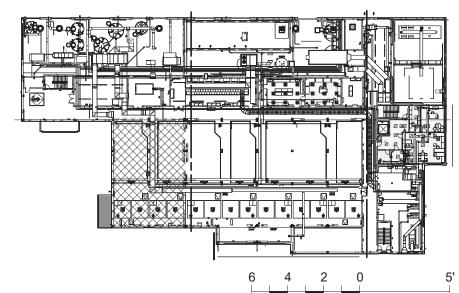

3/16" = 1'-0"

WARNING
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	DESCRIPT	TON OF THE ALTERATION.					
I					PROJECT ENGINEER:	R. FROST	
-					DESIGNED BY:	Y. ABDALLA	
1					DRAWN BY:	R. CHUNG	BID SET
1.19 PM					CHECKED BY:	G. MARKOU	J.D 01.
325 3:09:19					IF THIS BAR DOES NOT MEASURE 1" THEN DRAWING	0 1/2" 1"	
5/2025	REV	ISSUED FOR	DATE	BY	IS NOT TO FULL SCALE		

OF NEW ORGE MARROW AND APPENSIONAL APPENSI


HAZEN AND SAWYER
498 SEVENTH AVENUE, 11th FLOOR
NEW YORK, NEW YORK 10018


WESTCHESTER JOINT WATER WORKS MAMARONECK, NY

RYE LAKE WATER FILTRATION PLANT HARRISON, NY


FILTRATION PLANT ELECTRICAL FIRE ALARM & SECURITY PLAN - EL 421.00 - AREA 4

	DATE:	FEB 2025
	HAZEN NO.:	90388-000
	CONTRACT NO.:	A1364-A
4	DRAWING NUMBER:	
		E-149

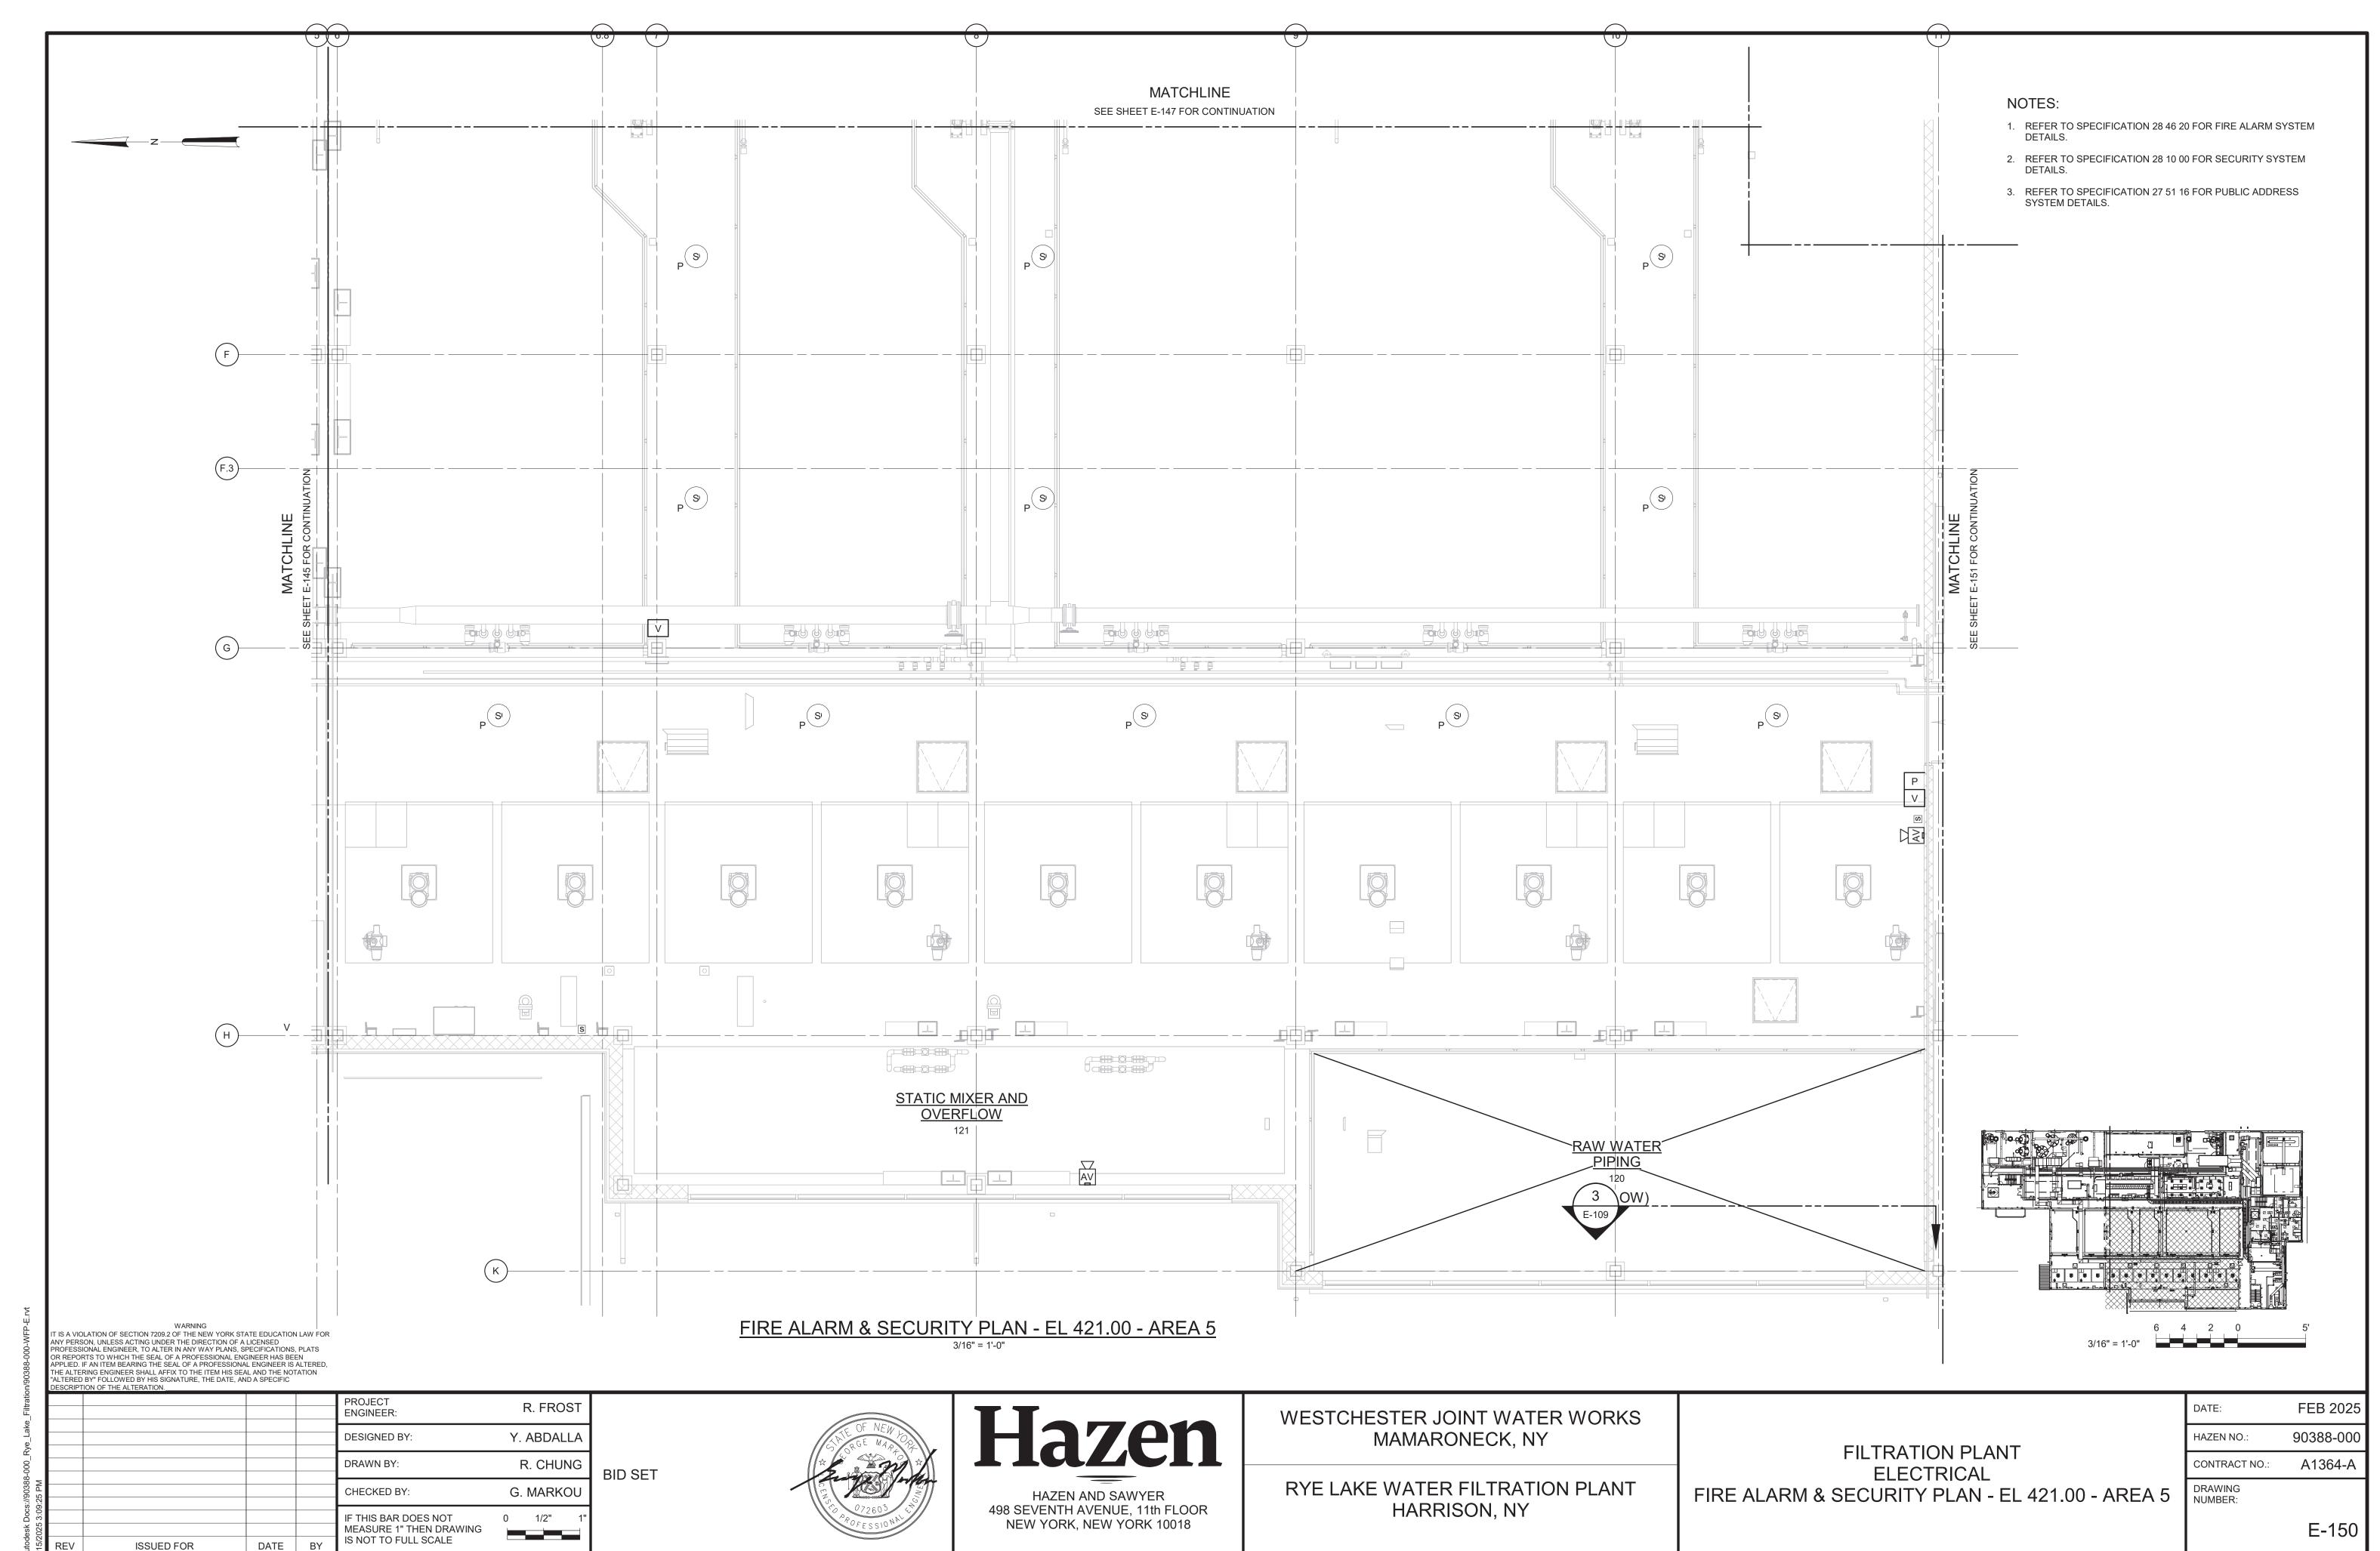

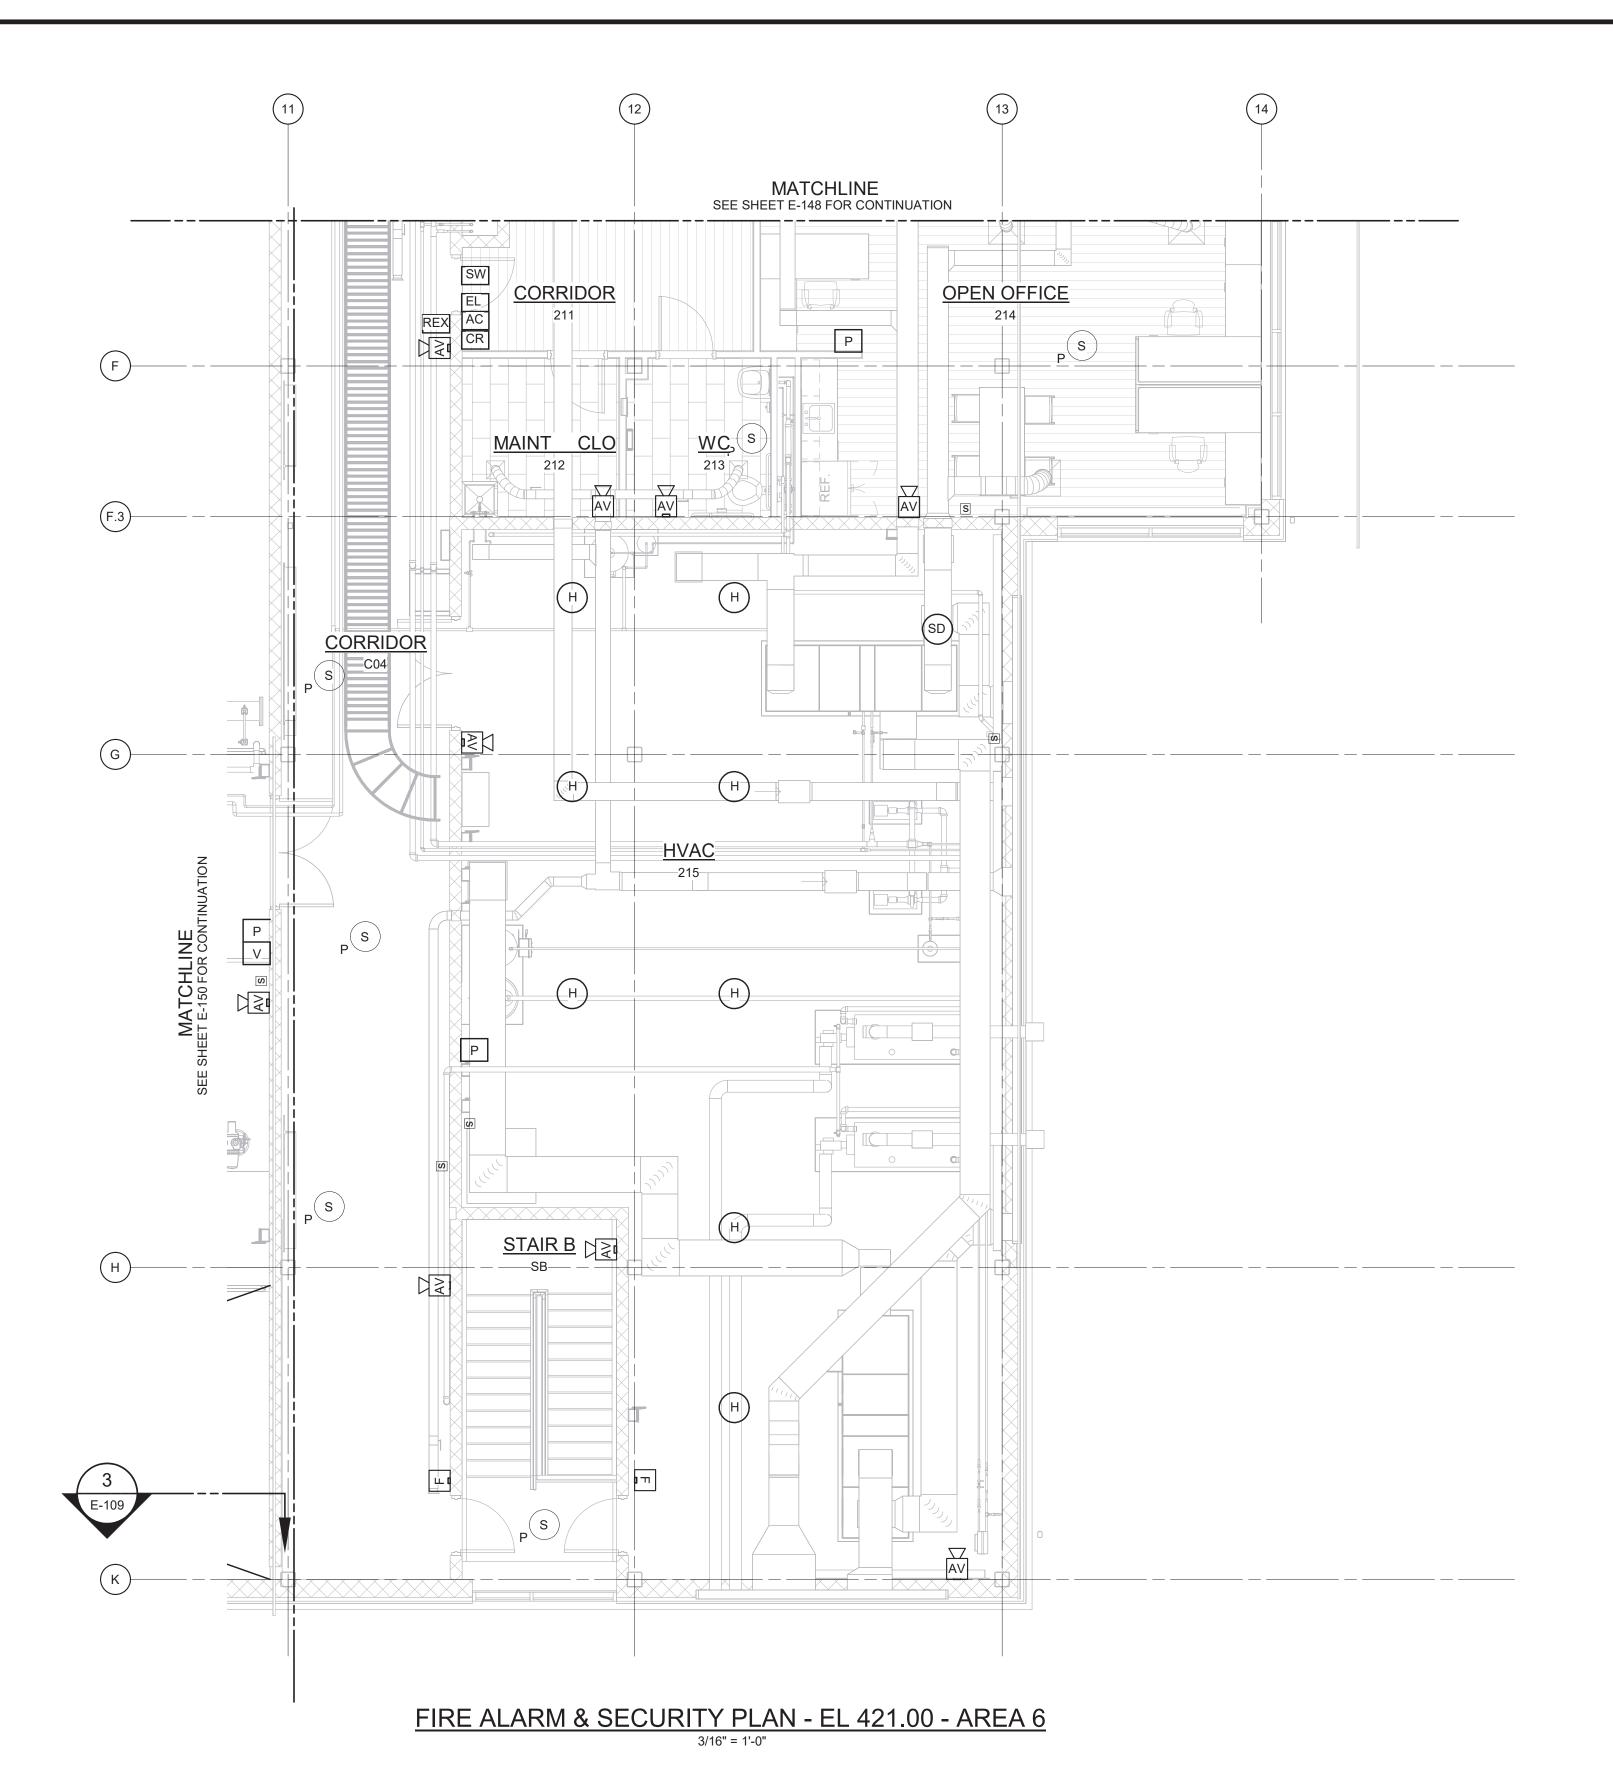

- 1. REFER TO SPECIFICATION 28 46 20 FOR FIRE ALARM SYSTEM
- 2. REFER TO SPECIFICATION 28 10 00 FOR SECURITY SYSTEM
- 3. REFER TO SPECIFICATION 27 51 16 FOR PUBLIC ADDRESS SYSTEM DETAILS.

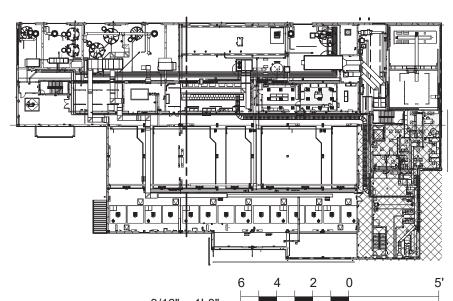

WARNING
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PROJECT ENGINEER: R. FROST Y. ABDALLA DESIGNED BY: DRAWN BY: R. CHUNG **BID SET** G. MARKOU CHECKED BY: IF THIS BAR DOES NOT MEASURE 1" THEN DRAWING IS NOT TO FULL SCALE 0 1/2" ISSUED FOR DATE BY


Hazen HAZEN AND SAWYER 498 SEVENTH AVENUE, 11th FLOOR NEW YORK, NEW YORK 10018

WESTCHESTER JOINT WATER WORKS MAMARONECK, NY

RYE LAKE WATER FILTRATION PLANT HARRISON, NY

FILTRATION PLANT ELECTRICAL FIRE ALARM & SECURITY PLAN - EL 421.00 - AREA

	DATE:	FEB 2025
	HAZEN NO.:	90388-000
	CONTRACT NO.:	A1364-A
6	DRAWING NUMBER:	
		E-151

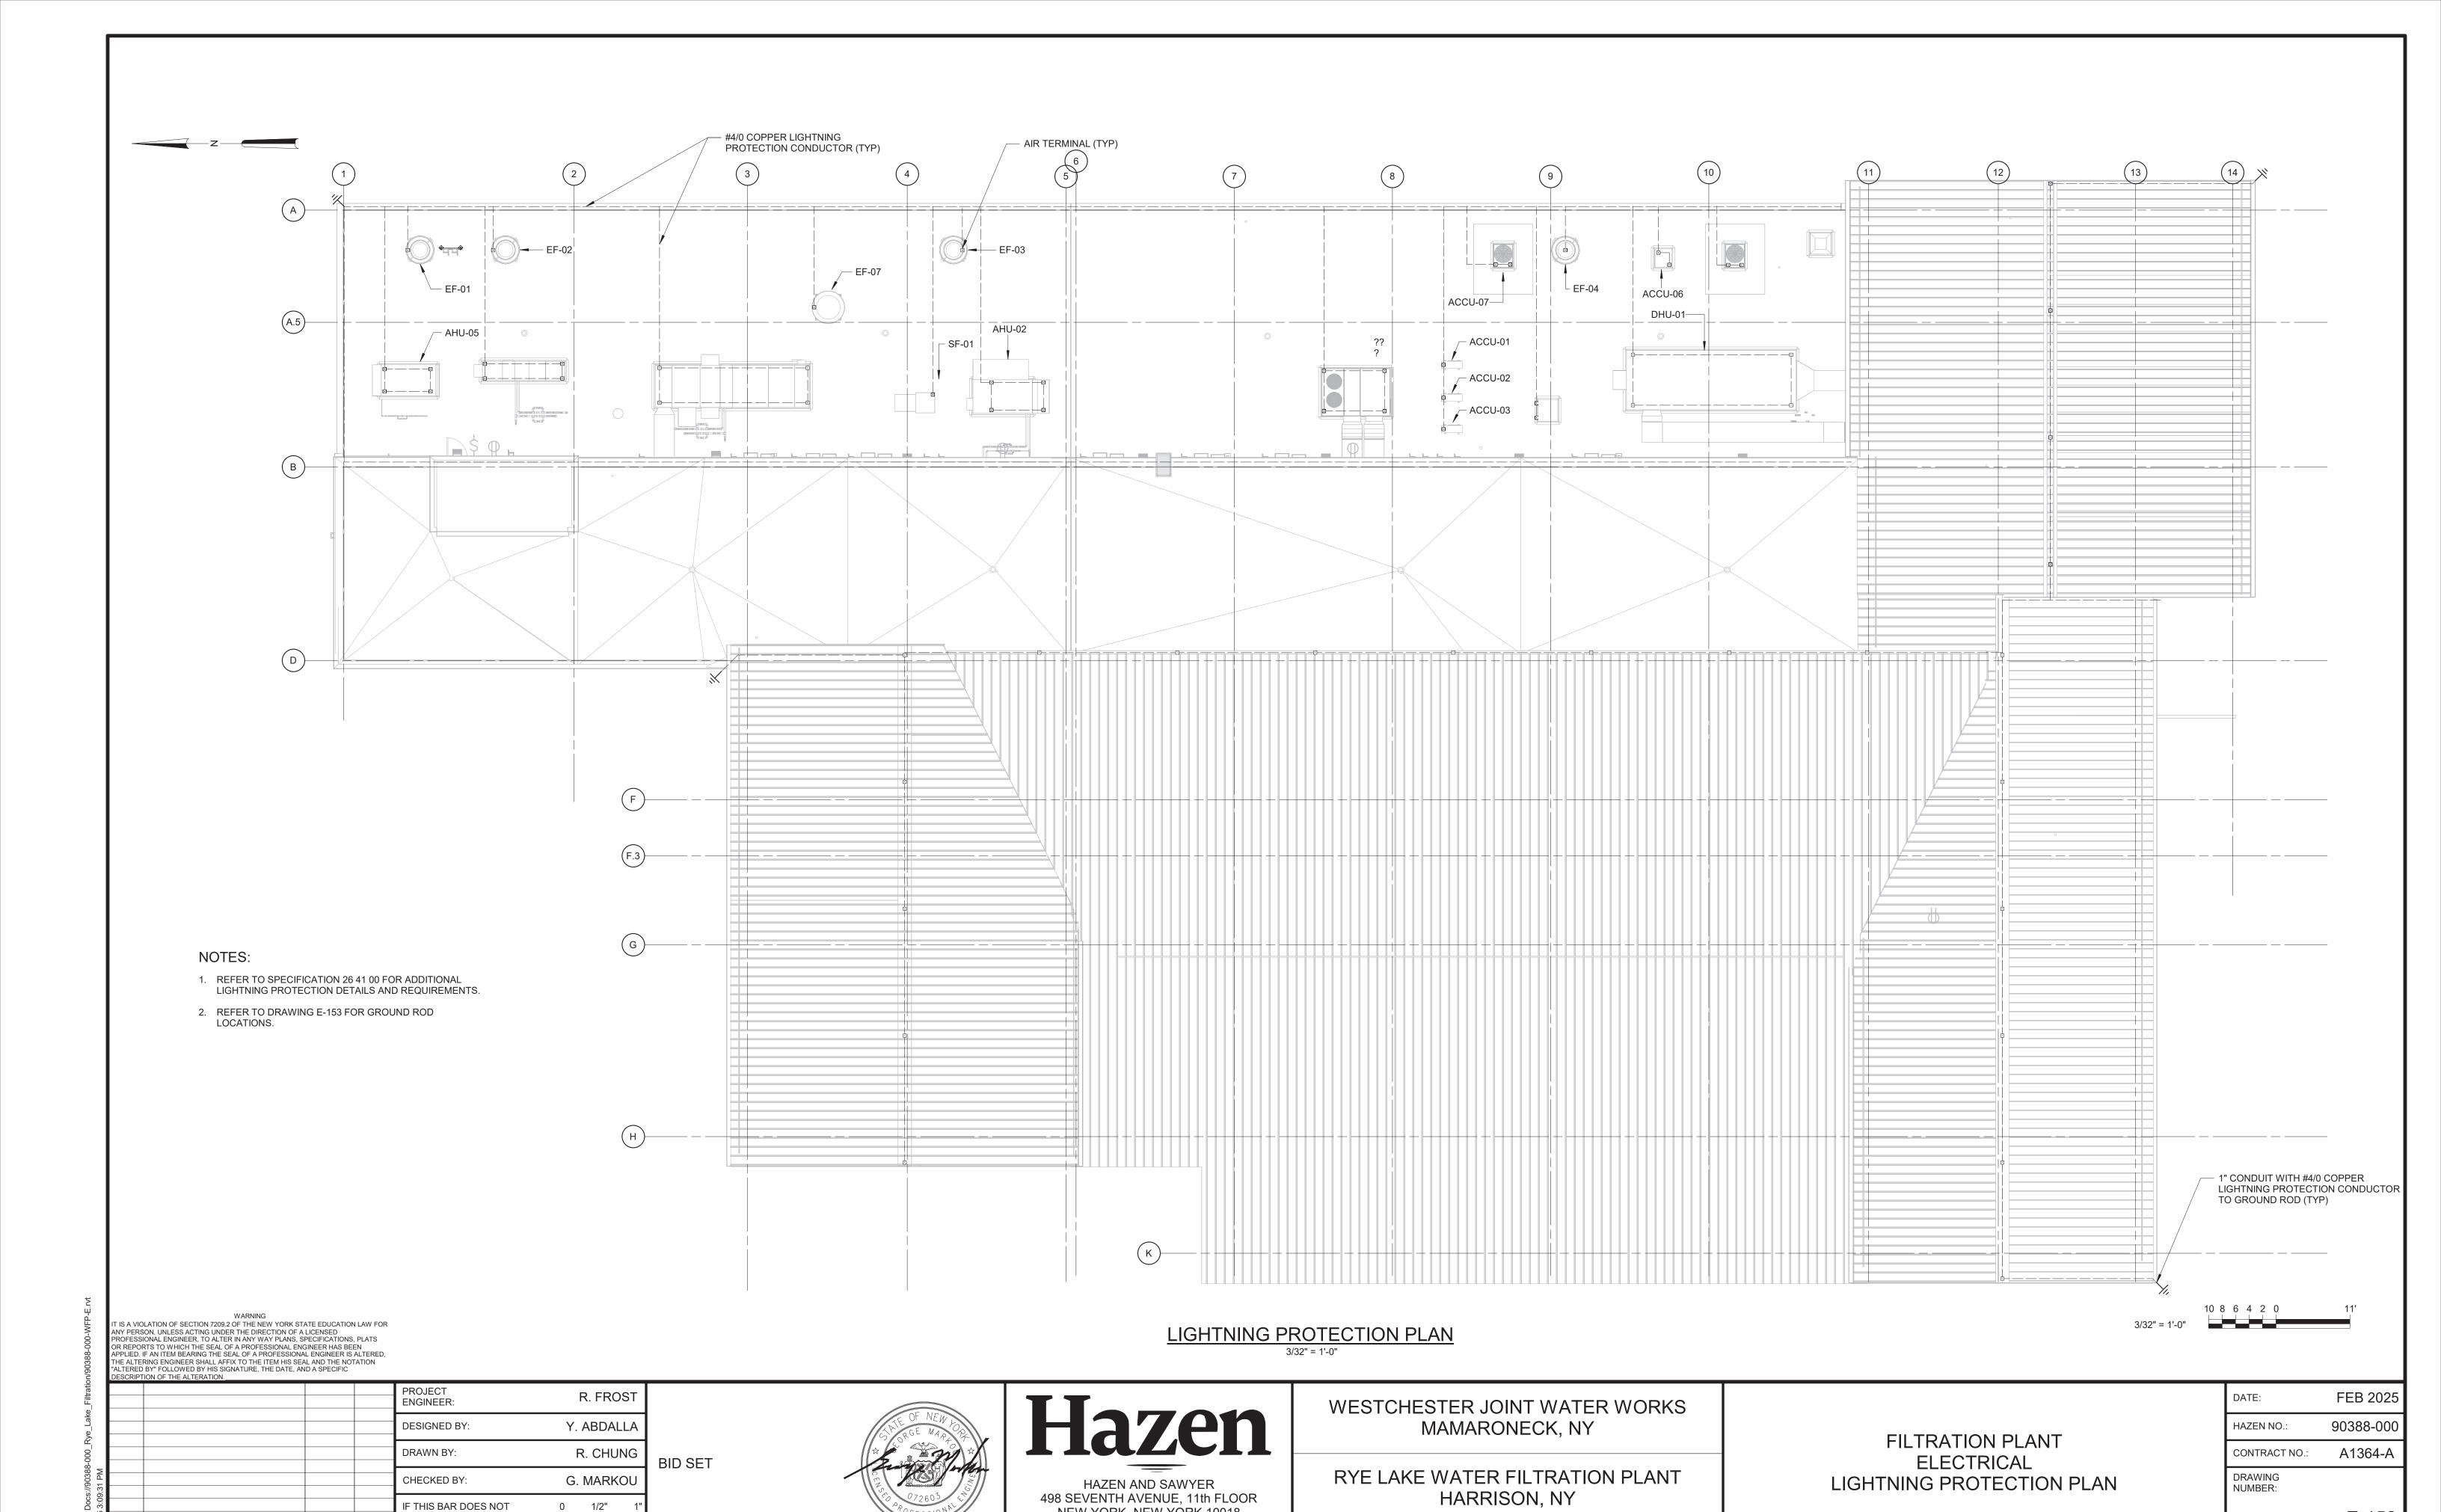

NEW YORK, NEW YORK 10018


MEASURE 1" THEN DRAWING IS NOT TO FULL SCALE


ISSUED FOR

DATE BY


383 of 392


E-152

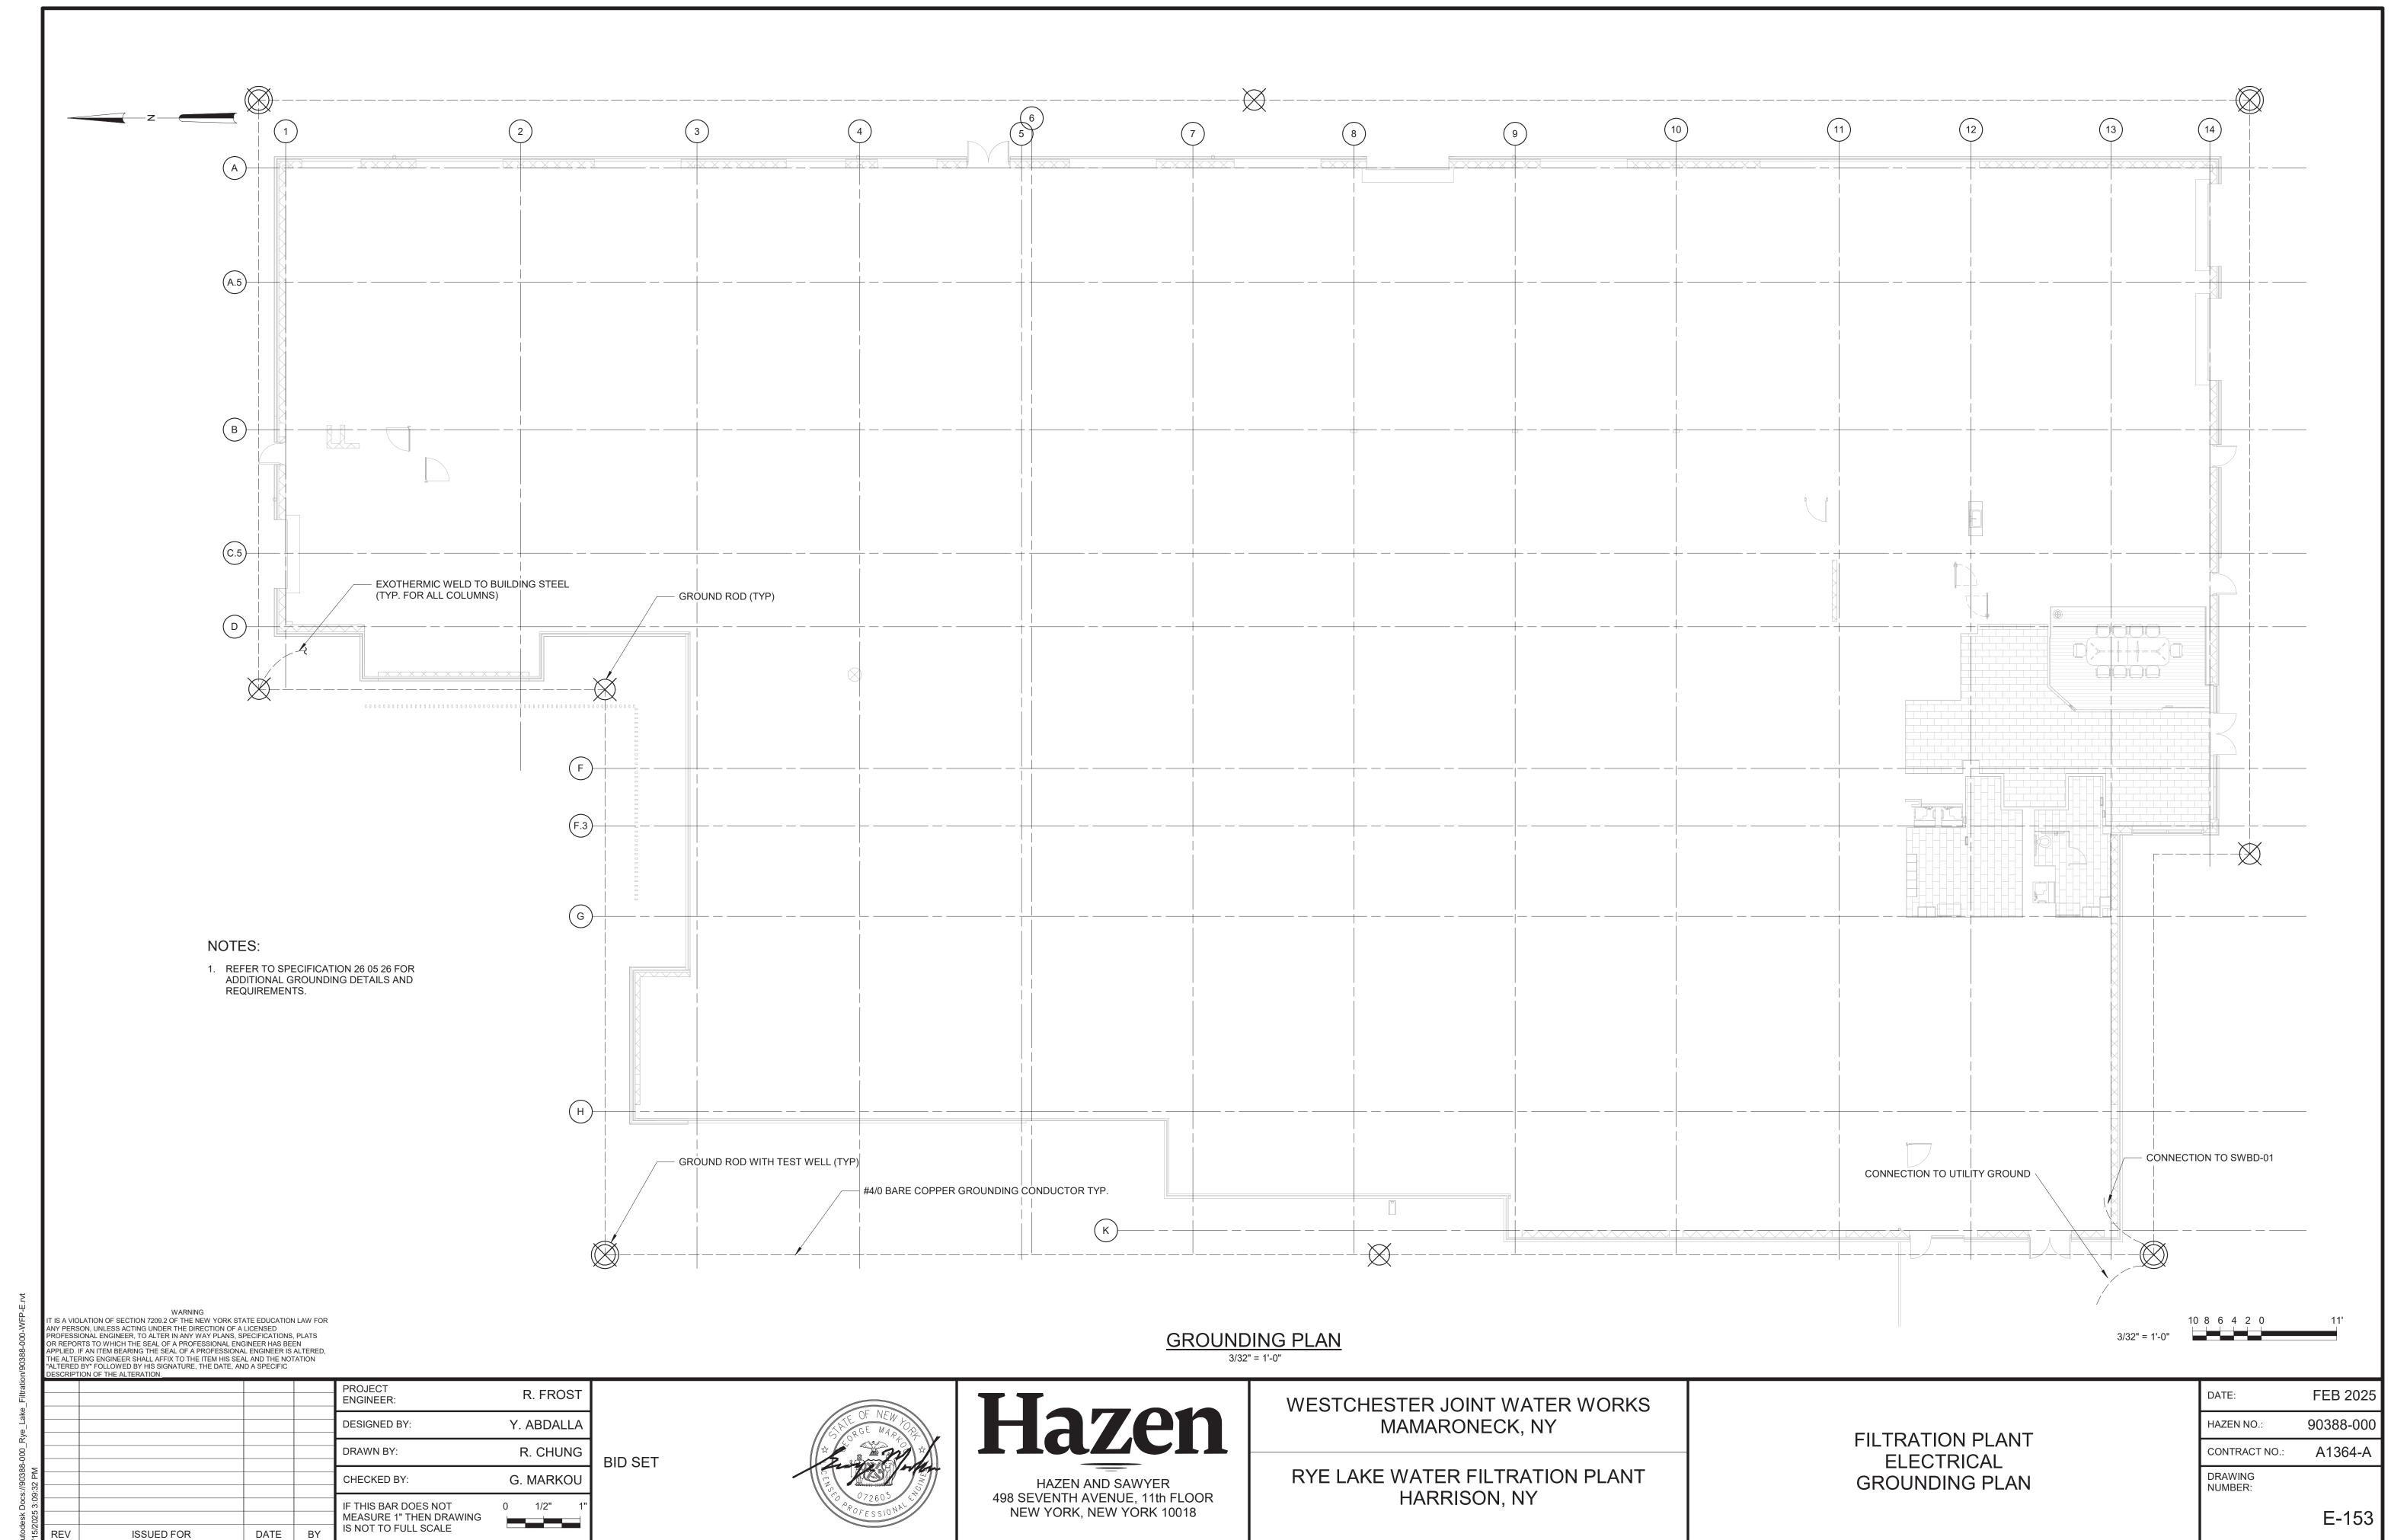

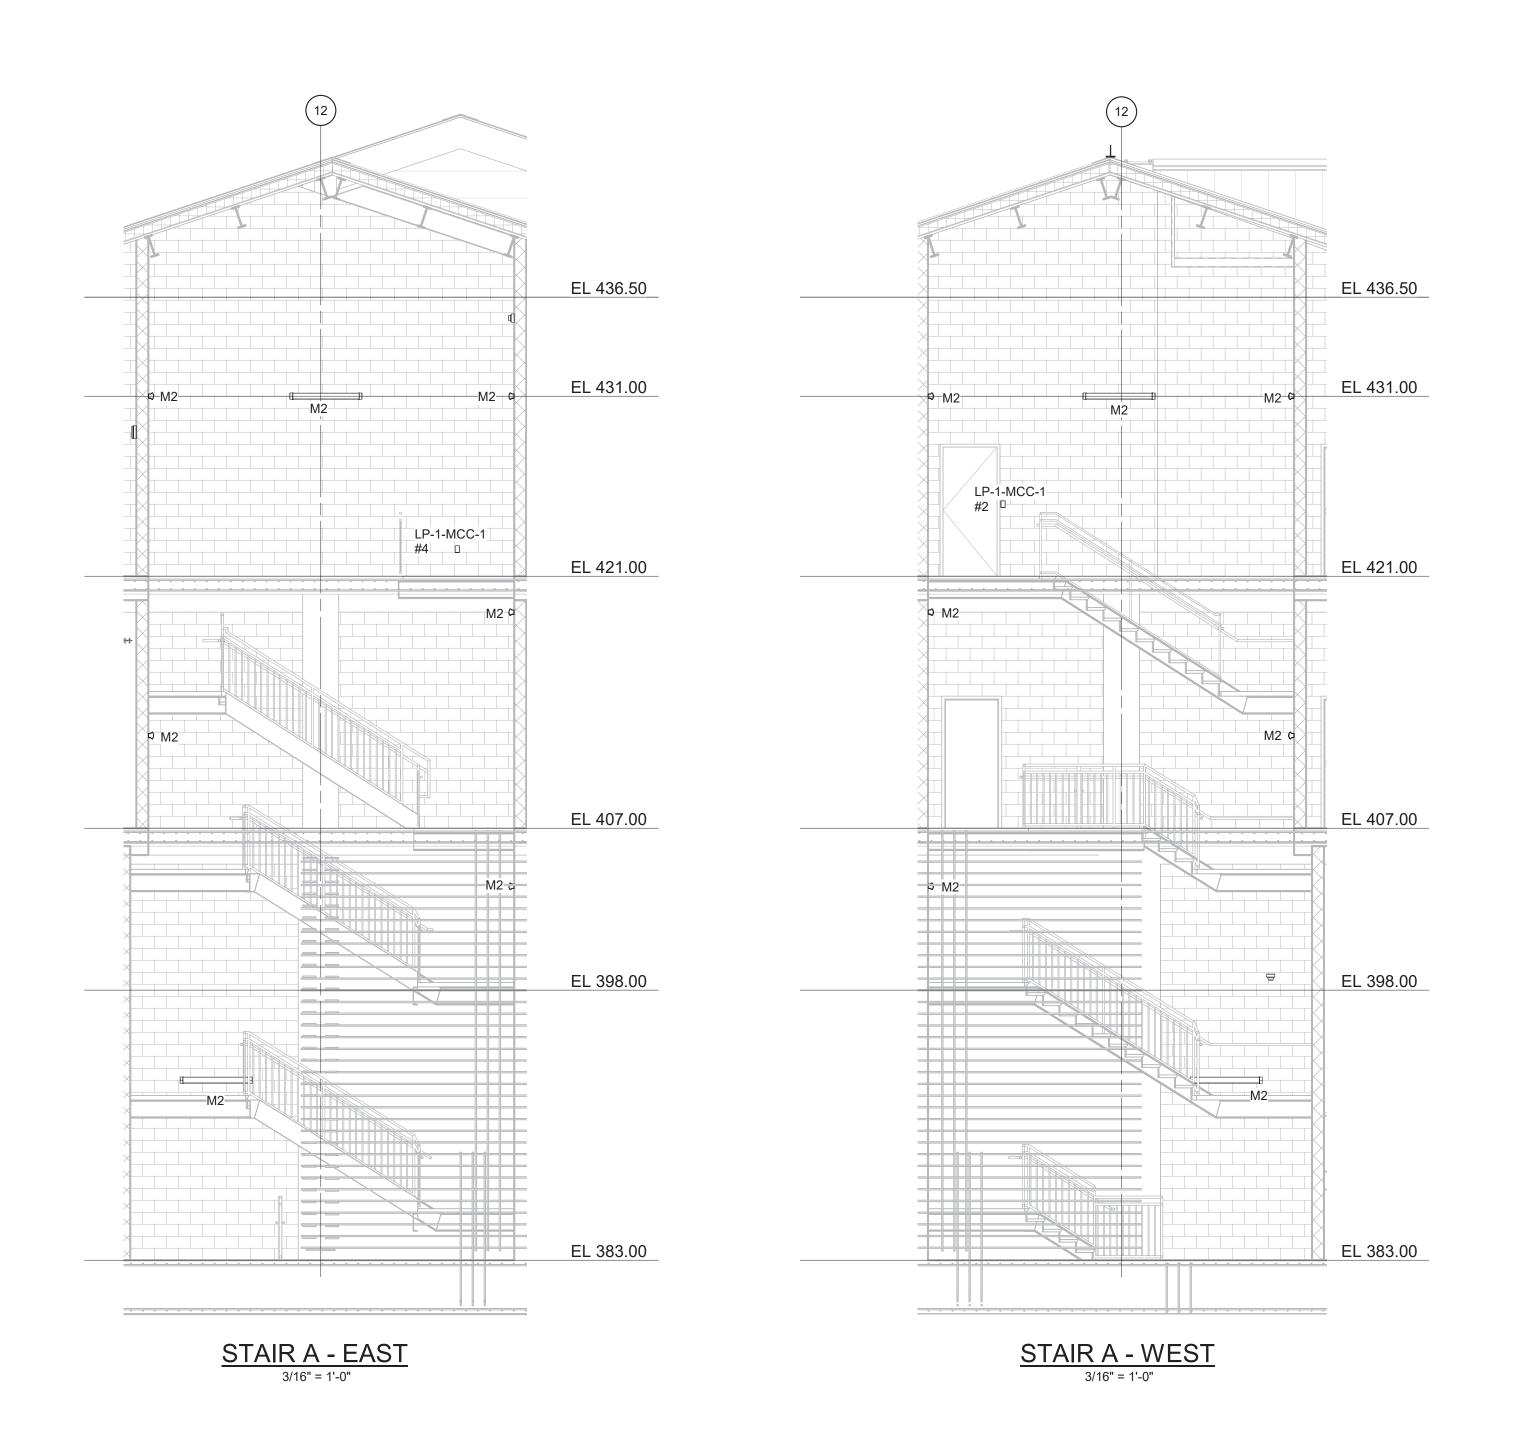

BID SET

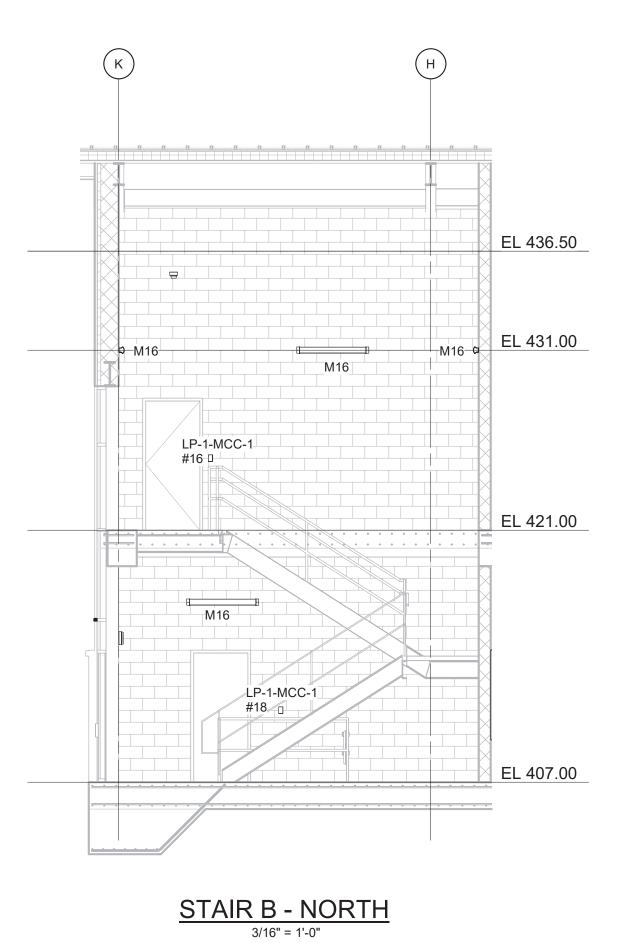

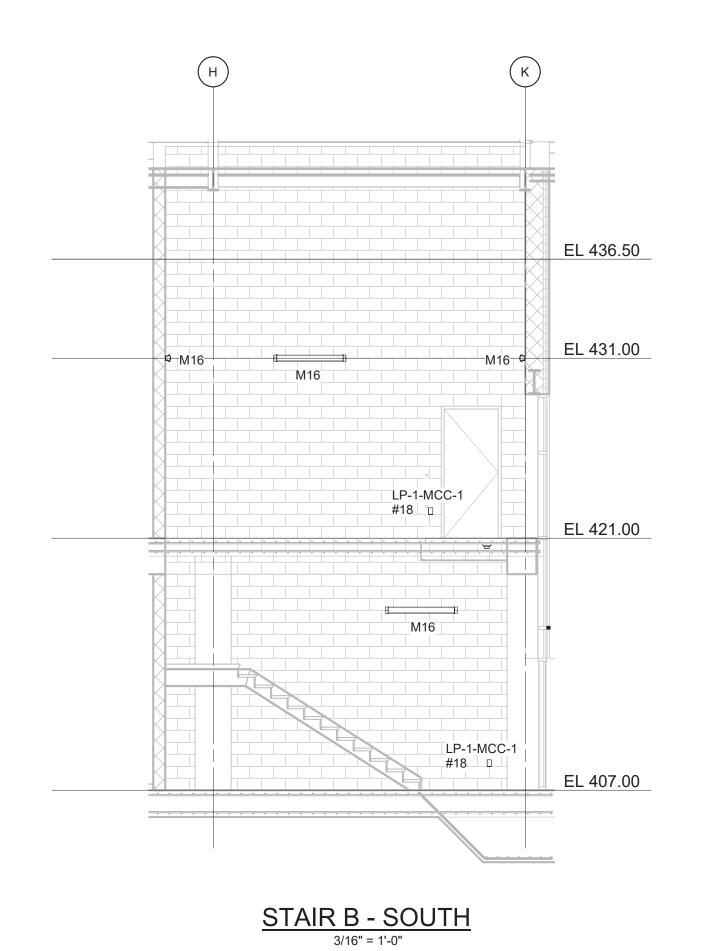

NOTES:

- REFER TO SPECIFICATION 26 50 00 FOR LIGHTING FIXTURE SCHEDULE.
- REFER TO DRAWINGS E-012 TO E-017 FOR PANELBOARD SCHEDULES.

WARNING
IT IS A VIOLATION OF SECTION 7209.2 OF THE NEW YORK STATE EDUCATION LAW FOR ANY PERSON, UNLESS ACTING UNDER THE DIRECTION OF A LICENSED PROFESSIONAL ENGINEER, TO ALTER IN ANY WAY PLANS, SPECIFICATIONS, PLATS OR REPORTS TO WHICH THE SEAL OF A PROFESSIONAL ENGINEER HAS BEEN APPLIED. IF AN ITEM BEARING THE SEAL OF A PROFESSIONAL ENGINEER IS ALTERED, THE ALTEREING ENGINEER SHALL AFFIX TO THE ITEM HIS SEAL AND THE NOTATION "ALTERED BY" FOLLOWED BY HIS SIGNATURE, THE DATE, AND A SPECIFIC DESCRIPTION OF THE ALTERATION.

	DESCRIPTI	ION OF THE ALTERATION.				
_					PROJECT ENGINEER:	R. FROST
					DESIGNED BY:	Y. ABDALLA
					DRAWN BY:	P. NUGENT
35 PM					CHECKED BY:	G. MARKOU
325 3:09:35					IF THIS BAR DOES NOT MEASURE 1" THEN DRAWING	0 1/2" 1"
15/2025	REV	ISSUED FOR	DATE	BY IS NOT TO FULL SCALE		

OF NEW PORGE MARTON OF THE STORY OF THE STOR

HAZEN AND SAWYER
498 SEVENTH AVENUE, 11th FLOOR
NEW YORK, NEW YORK 10018


WESTCHESTER JOINT WATER WORKS MAMARONECK, NY

RYE LAKE WATER FILTRATION PLANT HARRISON, NY

FILTRATION PLANT ELECTRICAL STAIRCASE SECTIONS - SHEET 1

DATE:	FEB 2025
HAZEN NO.:	90388-000
CONTRACT NO.:	A1364-A
DRAWING NUMBER:	
	E-201

- REFER TO SPECIFICATION 26 50 00 FOR LIGHTING FIXTURE SCHEDULE.
- REFER TO DRAWINGS E-012 TO E-017 FOR PANELBOARD SCHEDULES.

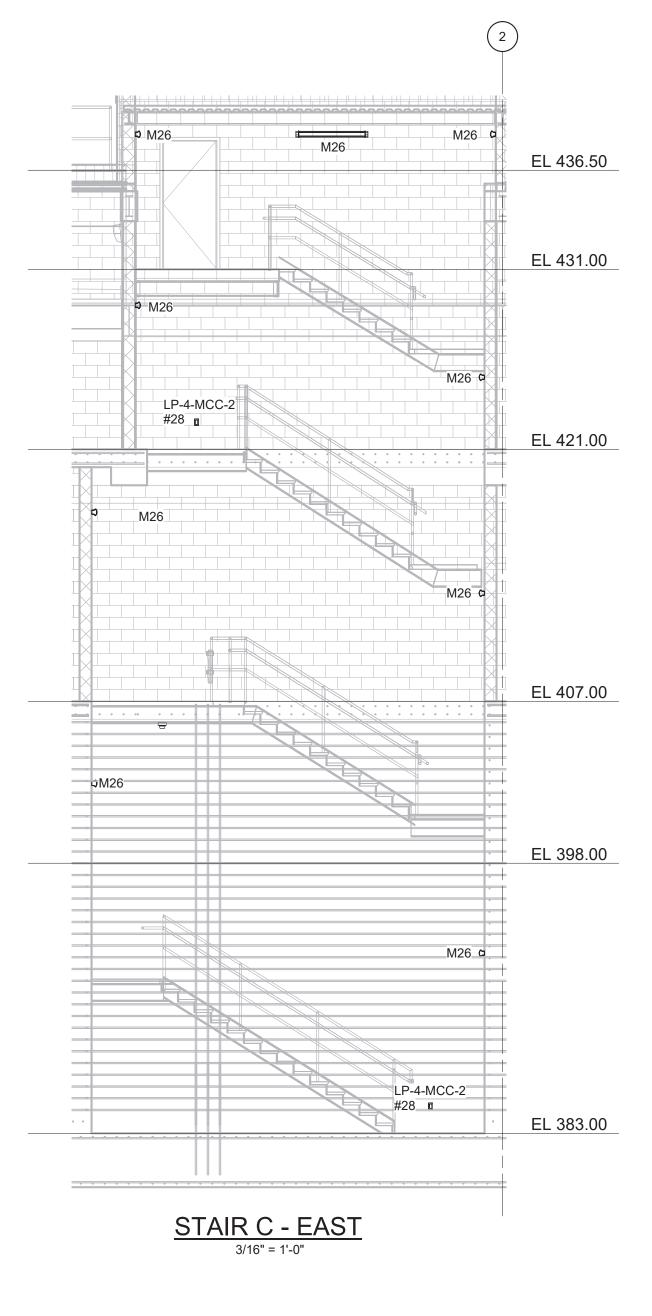

WARNING
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DESCRIP	PTION OF THE ALTERATION.					
				PROJECT ENGINEER:	R. FROST	
				DESIGNED BY:	Y. ABDALLA	
				DRAWN BY:	P. NUGENT	BID SET
:35 PM				CHECKED BY:	G. MARKOU	J.D 01.
025 3:09:35				IF THIS BAR DOES NOT MEASURE 1" THEN DRAWING	0 1/2" 1"	
15/2025 REV	ISSUED FOR	DATE	BY	IS NOT TO FULL SCALE		

OF NEW PORTER OF


HAZEN AND SAWYER
498 SEVENTH AVENUE, 11th FLOOR
NEW YORK, NEW YORK 10018

WESTCHESTER JOINT WATER WORKS MAMARONECK, NY


RYE LAKE WATER FILTRATION PLANT HARRISON, NY

FILTRATION PLANT
ELECTRICAL
STAIRCASE SECTIONS - SHEET

DATE:	FEB 2025
HAZEN NO.:	90388-000
CONTRACT NO.:	A1364-A
DRAWING NUMBER:	
	E-202

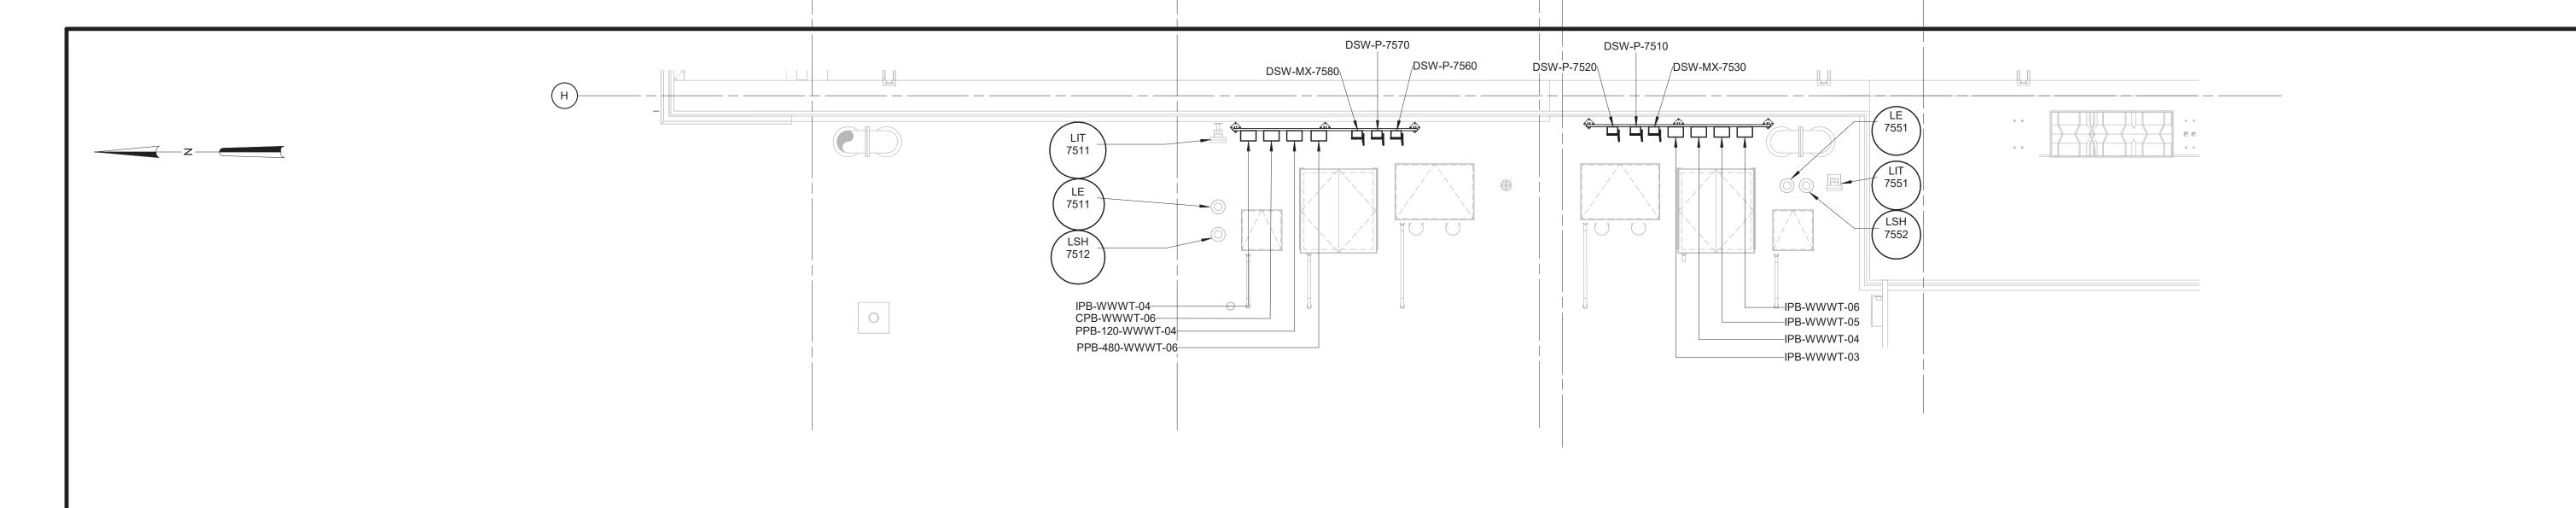

POWER PLAN EL. 407.00 - WASTE WASHWATER TANK

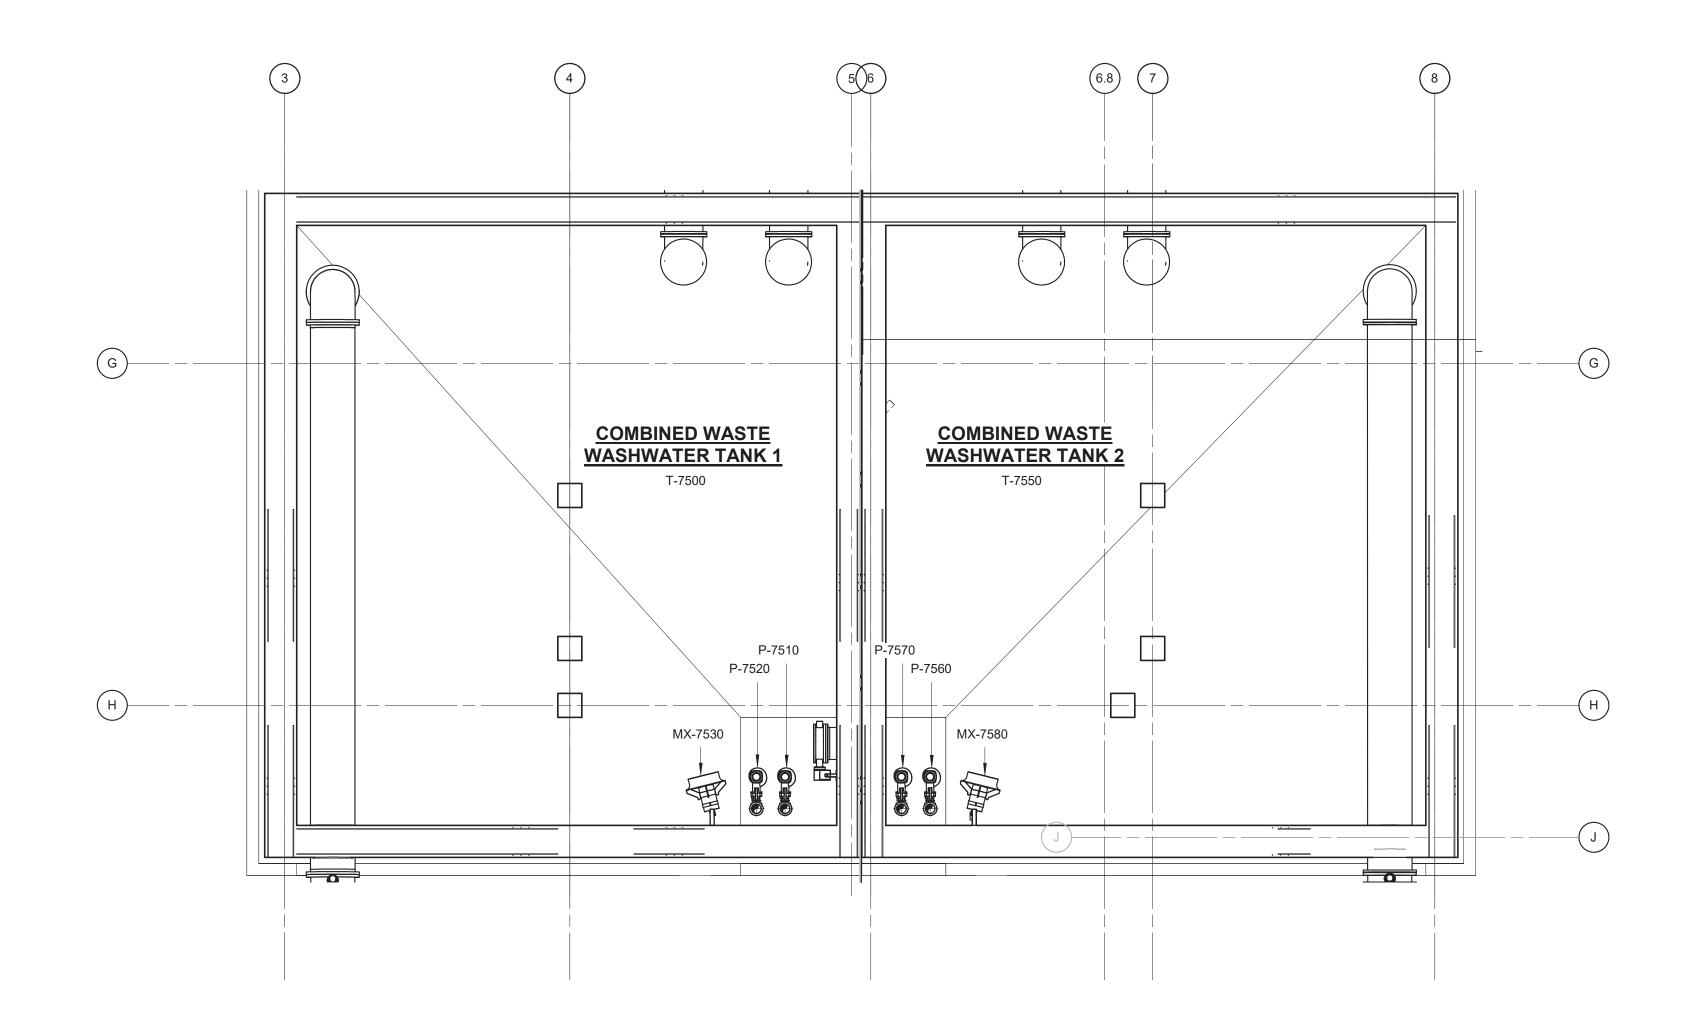


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POWER PLAN EL. 400.00 - WASTE WASHWATER TANKS - 400.00

1/8" = 1'-0"

	TION OF THE ALTERATION.	NB/YOF EOII 10				
				PROJECT ENGINEER:	R. FROST	
				DESIGNED BY:	Y. ABDALLA	
				DRAWN BY:	A. PENA	BID SET
				CHECKED BY:	G. MARKOU	J.5 32.
				IF THIS BAR DOES NOT MEASURE 1" THEN DRAWING	0 1/2" 1"	
REV	ISSUED FOR	DATE	BY	IS NOT TO FULL SCALE		

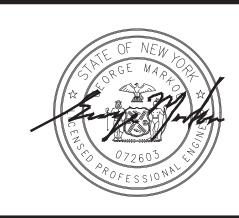


HAZEN AND SAWYER
498 SEVENTH AVENUE, 11th FLOOR
NEW YORK, NEW YORK 10018


WESTCHESTER JOINT WATER WORKS MAMARONECK, NY

RYE LAKE WATER FILTRATION PLANT HARRISON, NY WASTE WASHEWATER TANK
ELECTRICAL
WASTE WASHWATER TANK - POWER PLAN

DATE:	FEB 2025
HAZEN NO.:	90388-000
CONTRACT NO.:	A1364-A
DRAWING NUMBER:	
	E-501

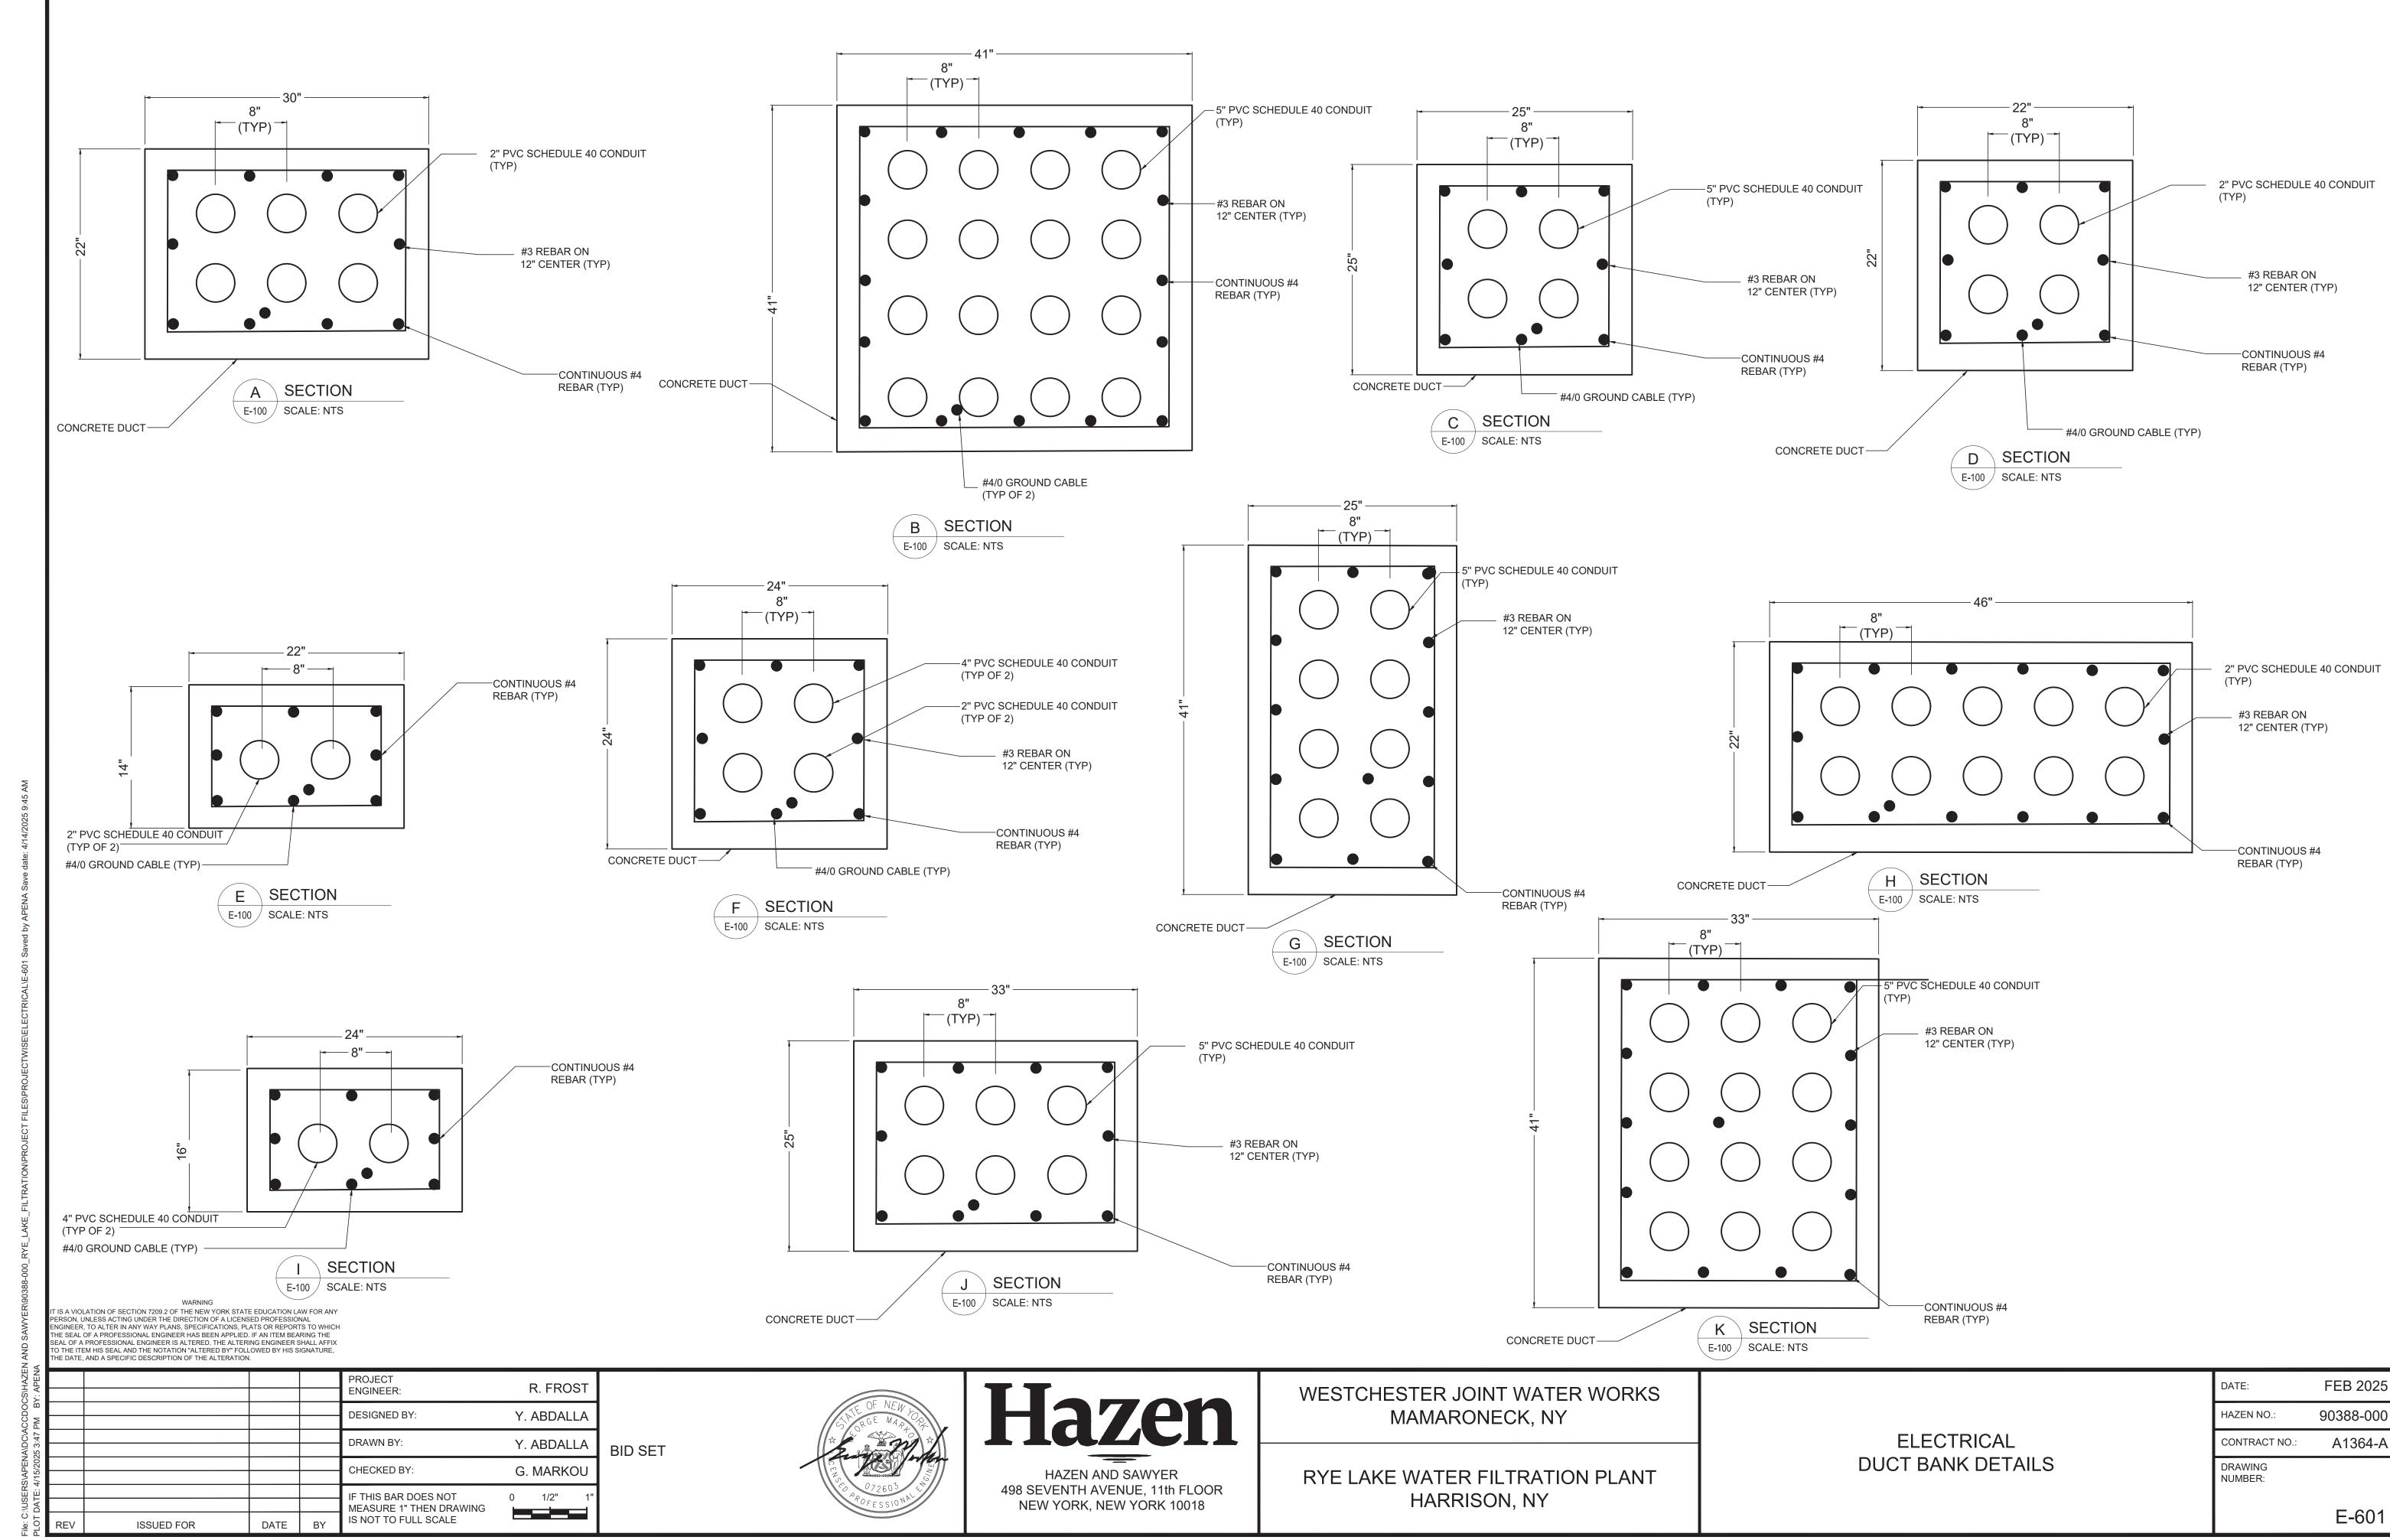


FLOOR STUB-UP FOR FUTURE CONDUIT E-26-0101

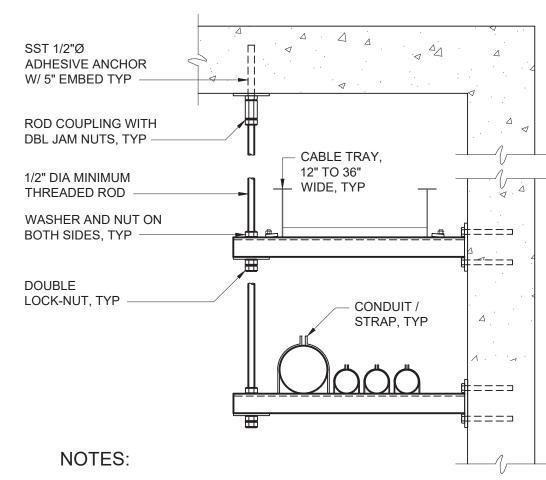

- 1. SPACE SUPPORTS AT 5'-0" MAXIMUM. HANGER SPACING SHALL BE BASED ON MAXIMUM LOAD.
- 2. ALL THREAD ROD SHALL BE USED ONLY FOR DUAL TRAY.
- 3. REFER TO AREA DESIGNATION DRAWINGS AND SPECIFICATIONS FOR REQUIRED MATERIALS OF CONSTRUCTION.
- 4. STRUT SHALL BE 12 GAUGE MINIMUM.


WALL MOUNTED RACEWAY SUPPORT RACK
E-26-0202

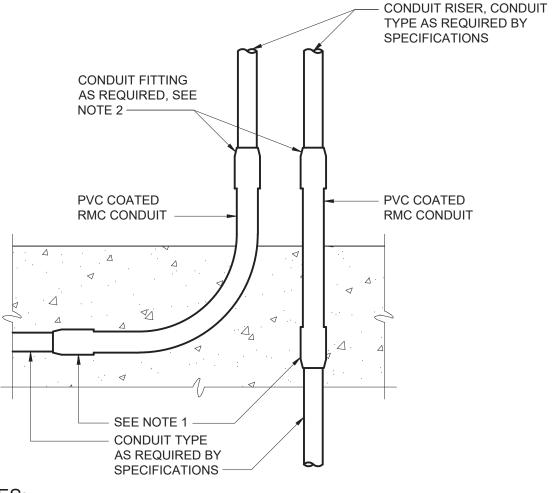

NOTES:

- 1. FOR ENCASED PVC CONDUIT USE PVC TERMINAL ADAPTER. FOR ALL OTHER CONDUIT TYPES, USE PVC COATED RMC COUPLINGS.
- 2. IF ANY THREADS OF THE PVC COATED RMC CONDUIT ARE EXPOSED AFTER INSTALLATION OF THE CONDUIT FITTING, THE CONDUIT FITTING SHALL BE PVC COATED TYPE WITH APPROPRIATE PVC SKIRTS. IF THE THREADS OF THE PVC COATED RMC CONDUIT ARE PROPERLY CUT SO THAT THEY ARE NOT EXPOSED AFTER INSTALLATION OF THE CONDUIT FITTING, THE CONDUIT MATERIAL SHALL BE AS REQUIRED BY THE SPECIFICATIONS, BASED ON THE MATERIAL OF THE CONDUIT RISER.

CONDUIT EXITING CONCRETE ENCASEMENT E-26-0102

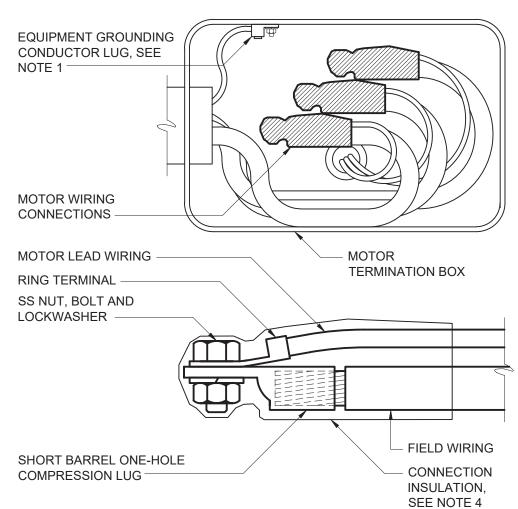


NOTES:

- 1. EQUIPMENT GROUNDING CONDUCTOR LUG SHALL BE ATTACHED WITH NUT AND LOCKWASHER TO THE MOTOR GROUNDING STUD. WHERE PROVIDED, FACTORY INSTALLED EQUIPMENT GROUNDING CONDUCTOR LUGS ARE ACCEPTABLE IN LIEU OF THE FIELD INSTALLED EQUIPMENT GROUNDING CONDUCTOR LUG.
- 2. RING TERMINALS ON MOTOR LEADS SHALL BE FACTORY INSTALLED BY THE MOTOR MANUFACTURER.
- 3. INSTALL SHORT BARREL COMPRESSION CONNECTOR ON FIELD WIRING WITH MANUFACTURER'S RECOMMENDED COMPRESSION TOOL AND CRIMPING DIE. CONNECTORS SHALL HAVE SMOOTHLY ROUNDED EDGES.
- 4. HEAT SHRINK OR COLD APPLIED CONNECTOR INSULATION LISTED FOR THE PURPOSE AND AS SPECIFIED.

LOW VOLTAGE MOTOR TERMINATION


E-26-0301

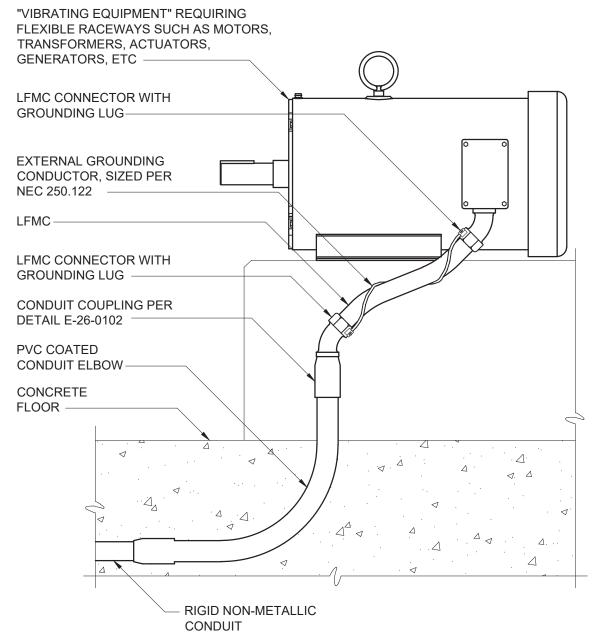

NOTES:

1. WHERE NON-METALLIC CONDUIT TRANSITIONS TO RIGID METALLIC CONDUIT AND / OR LIQUIDTIGHT FLEXIBLE METALLIC CONDUIT, (LFMC), TO FEED VIBRATING TYPE LOADS, THE CONTRACTOR SHALL FURNISH AND INSTALL AN EXTERNAL BARE COPPER GROUNDING CONDUCTOR AND APPROVED GROUNDING LFMC CONNECTORS TO ENSURE GROUND CONTINUITY TO THE RIGID METALLIC CONDUIT AS SHOWN. THE GROUNDING CONDUCTOR SHALL BE SIZED ACCORDING TO NEC 250.122 AND BE NEATLY WRAPPED AROUND LFMC AS SHOWN. LFMC INSTALLED IN THIS MANNER CANNOT BE USED FOR A CONTINUOUS GROUND PATH PER NEC 350.60.


LFMC CONDUIT GROUND STRAP E-26-0104

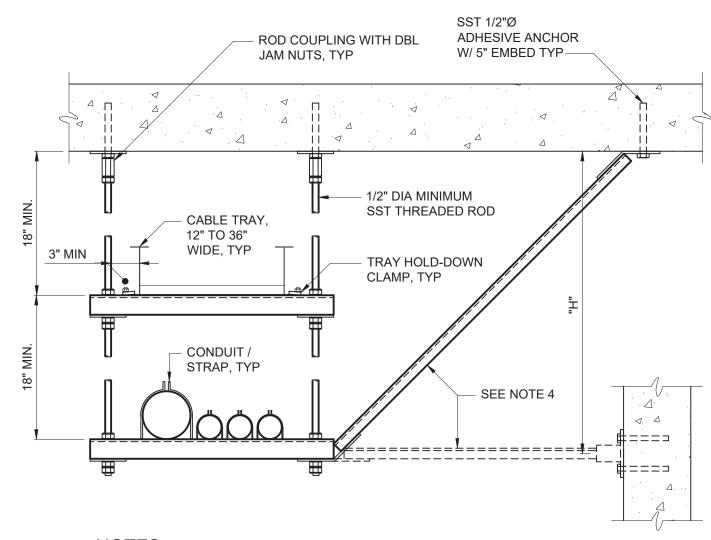

NOTES:

- 1. SPACE SUPPORTS AT 5'-0" MAXIMUM. HANGER SPACING SHALL BE BASED ON MAXIMUM LOAD.
- 2. ALL THREAD ROD SHALL BE USED ONLY FOR DUAL TRAYS / RACKS.
- 3. REFER TO AREA DESIGNATION DRAWINGS AND SPECIFICATIONS FOR REQUIRED MATERIALS OF CONSTRUCTION.
- 4. PREFORMED BRACING CHANNEL AT 30'-0" SPACING MAX. BRACE AT INTERMEDIATE LEVEL WHEN "H" DIMENSION EXCEEDS 6'-0".
- 5. STRUT SHALL BE 12 GAUGE MINIMUM.

SUSPENDED RACEWAY SUPPORT RACK
E-26-0201

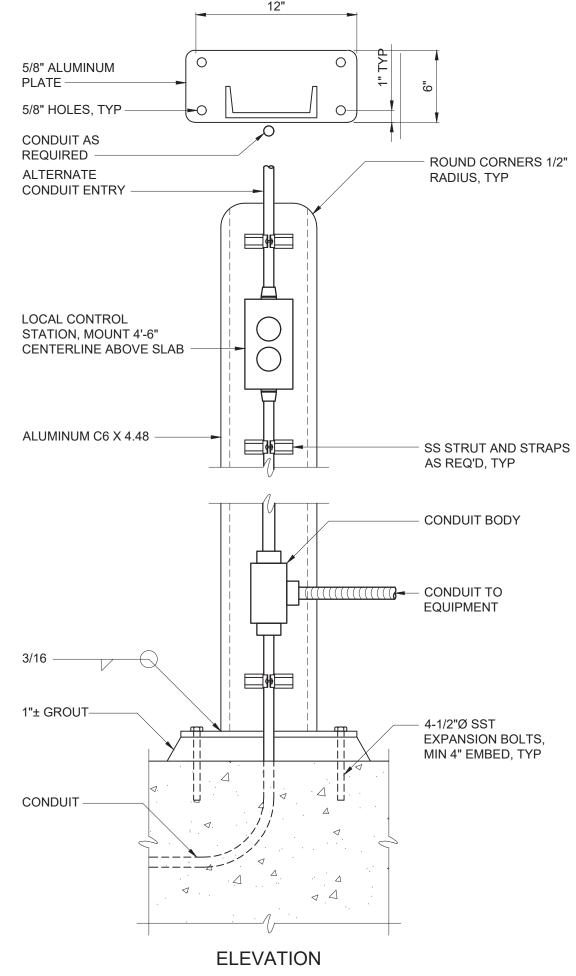

NOTES:

- COAT ALUMINUM SURFACES IN CONTACT WITH CONCRETE PER SPECIFICATIONS.
- 2. CONSTRUCT 1'-2" DIAMETER X 2'-6" DEEP FOUNDATION WHERE MOUNTING SURFACE IS NOT AVAILABLE.
- 3. USE SST WASHERS, NUTS AND BOLTS FOR MOUNTING DEVICES.

TYPICAL LOCAL CONTROL STATION E-26-0401

WARNING
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۷l										
4/15/2025 3:47 PM BY: APENA					PROJECT ENGINEER:		R. FROST			
					DESIGNED BY:	Y. ABDALLA		.LA		
					DRAWN BY:	Y.	ABDAL	.LA		
					CHECKED BY:	G. MARKOU		OU		
DATE: 4					IF THIS BAR DOES NOT MEASURE 1" THEN DRAWING	0	1/2"	1"		
- 10	REV	ISSUED FOR	DATE	BY	IS NOT TO FULL SCALE					

BID SET



Hazen and sawyer

498 SEVENTH AVENUE, 11th FLOOR

NEW YORK, NEW YORK 10018

WESTCHESTER JOINT WATER WORKS MAMARONECK, NY

RYE LAKE WATER FILTRATION PLANT HARRISON, NY ELECTRICAL STANDARD DETAILS - SHEET 1

DATE:	FEB 2025
HAZEN NO.:	90388-000
CONTRACT NO.:	A1364-A
DRAWING NUMBER:	
	E-602

- 1. COAT ALUMINUM SURFACES IN CONTACT WITH CONCRETE PER SPECIFICATIONS.
- 2. CONSTRUCT 1'-2" DIAMETER X 2'-6" DEEP FOUNDATION WHERE MOUNTING SURFACE IS NOT
- 3. USE SST WASHERS, LOCKWASHERS, NUTS AND BOLTS FOR MOUNTING EQUIPMENT AND STRUT SUPPORTS TO CHANNEL. DRILL EQUIPMENT MOUNTING TABS AS NECESSARY TO COORDINATE WITH
- 4. REFERENCE STANDARD DETAIL E-26-0102 WHERE CONDUIT EMERGES FROM CONCRETE.
- 5. COORDINATE MOUNTING HEIGHT ABOVE CONCRETE WITH AREA CLASSIFICATION REQUIREMENTS.


30 AND 60 AMP DISCONNECT SWITCH E-26-0403

CHECKED BY:

IF THIS BAR DOES NOT


IS NOT TO FULL SCALE

MEASURE 1" THEN DRAWING

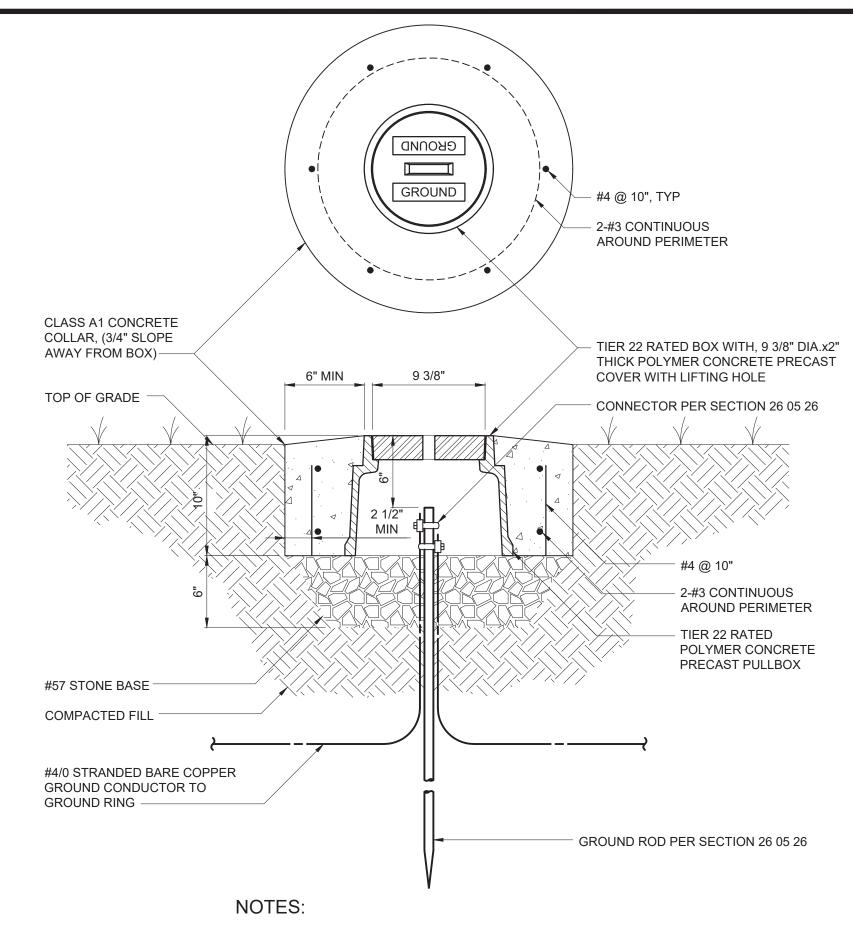

1. PRECAST PULLBOX AND COVER SHALL BE OLDCASTLE PART NUMBER 09101187, OR APPROVED EQUAL.

> **GROUND ROD TEST WELL** E-26-0501

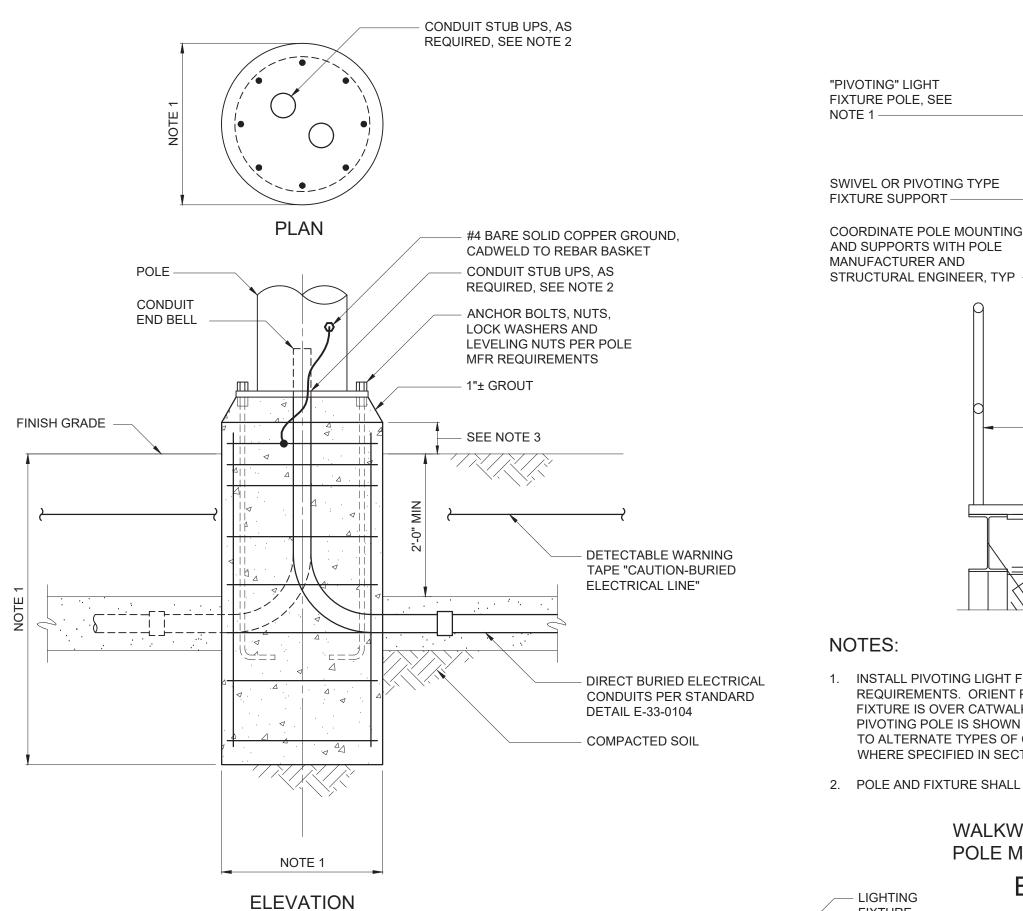

NOTES:

- LIGHTING

FIXTURE

"PIVOTING" LIGHT

NOTE 1 —

FIXTURE POLE, SEE

FIXTURE SUPPORT -

SWIVEL OR PIVOTING TYPE

COORDINATE POLE MOUNTING

AND SUPPORTS WITH POLE

MANUFACTURER AND

1. INSTALL PIVOTING LIGHT FIXTURE POLE PER MANUFACTURER'S REQUIREMENTS. ORIENT POLE SUCH THAT PIVOTED POSITION OF FIXTURE IS OVER CATWALK/WALKWAY OR PLATFORM. THOUGH A PIVOTING POLE IS SHOWN FOR REFERENCE, THIS DETAIL ALSO APPLIE TO ALTERNATE TYPES OF COLLAPSIBLE POLES (E.G. TELESCOPING) WHERE SPECIFIED IN SECTION 26 50 00.

WALKWAY/

CATWALK OR PLATFORM -

2. POLE AND FIXTURE SHALL BE AS SPECIFIED IN SECTION 26 50 00.


WALKWAY OR PLATFORM POLE MOUNTED FIXTURE

E-26-0604

- 1. DIAMETER, DEPTH AND REINFORCEMENT SHALL BE DETERMINED BY POLE MANUFACTURER IN ACCORDANCE WITH SECTION 26 50 00. LOADING SHALL BE IN
- 2. CONTRACTOR SHALL CAREFULLY COORDINATE LOCATION AND QUANTITY OF CONDUITS IN THE BASE SO THAT WHEN POLE IS INSTALLED, IT WILL FIT OVER THE CONDUITS.
- 3. PROJECTED HEIGHT ABOVE GRADE SHALL BE AS DESCRIBED IN THE POLE SCHEDULE IN 26 50 00.

POLE-MOUNTED LIGHTING FIXTURE BASE

E-26-0601

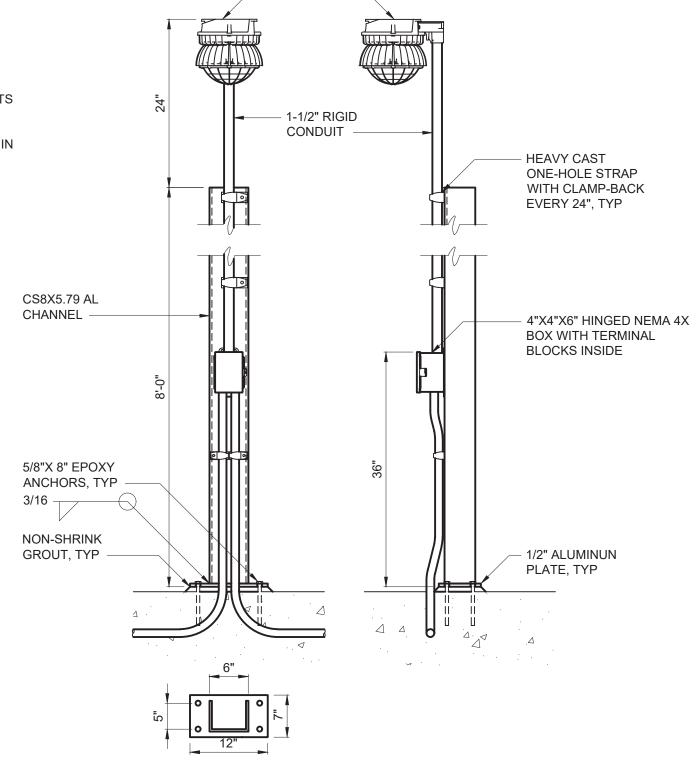

STANCHION MOUNTED LIGHT FIXTURE (CHANNEL BASE)

E-26-0603

Hazen HAZEN AND SAWYER 498 SEVENTH AVENUE, 11th FLOOR

NEW YORK, NEW YORK 10018

WESTCHESTER JOINT WATER WORKS MAMARONECK, NY

NOTES:

ELECTRICAL STANDARD DETAILS - SHEET 2

DATE:	FEB 2025
HAZEN NO.:	90388-000
CONTRACT NO.:	A1364-A
DRAWING NUMBER:	
	E-603

PROJECT ENGINEER: DESIGNED BY: DRAWN BY:

IS A VIOLATION OF SECTION 7209.2 OF THE NEW YORK STATE EDUCATION LAW FOR ANY RSON. UNLESS ACTING UNDER THE DIRECTION OF A LICENSED PROFESSIONAL

O THE ITEM HIS SEAL AND THE NOTATION "ALTERED BY" FOLLOWED BY HIS SIGNATURE, HE DATE, AND A SPECIFIC DESCRIPTION OF THE ALTERATION.

ISSUED FOR

NGINEER, TO ALTER IN ANY WAY PLANS, SPECIFICATIONS, PLATS OR REPORTS TO WHICH THE SEAL OF A PROFESSIONAL ENGINEER HAS BEEN APPLIED. IF AN ITEM BEARING THE SEAL OF A PROFESSIONAL ENGINEER IS ALTERED, THE ALTERING ENGINEER SHALL AFFIX

> **BID SET** G. MARKOU

R. FROST

Y. ABDALLA


Y. ABDALLA

0 1/2"

RYE LAKE WATER FILTRATION PLANT HARRISON, NY

- 1. ADDITIONAL SEISMIC SUPPORTS MAY BE REQUIRED, SEE CODE SUMMARY DRAWING AND DRAWING E1 FOR SEISMIC CLASSIFICATIONS.
- 2. CONDUIT TYPE AND MATERIALS OF CONSTRUCTION FOR SUPPORTS AND HARDWARE SHALL BE AS REQUIRED FOR THE AREA IN WHICH THE FIXTURE IS INSTALLED AS SHOWN ON THE DRAWINGS AND IN ACCORDANCE WITH THE SPECIFICATIONS.
- 3. REFER TO AREA DESIGNATION DRAWINGS AND SPECIFICATIONS FOR REQUIRED MATERIALS OF CONSTRUCTION.

INDIVIDUAL PENDANT MOUNTED LINEAR FIXTURE E-26-0605

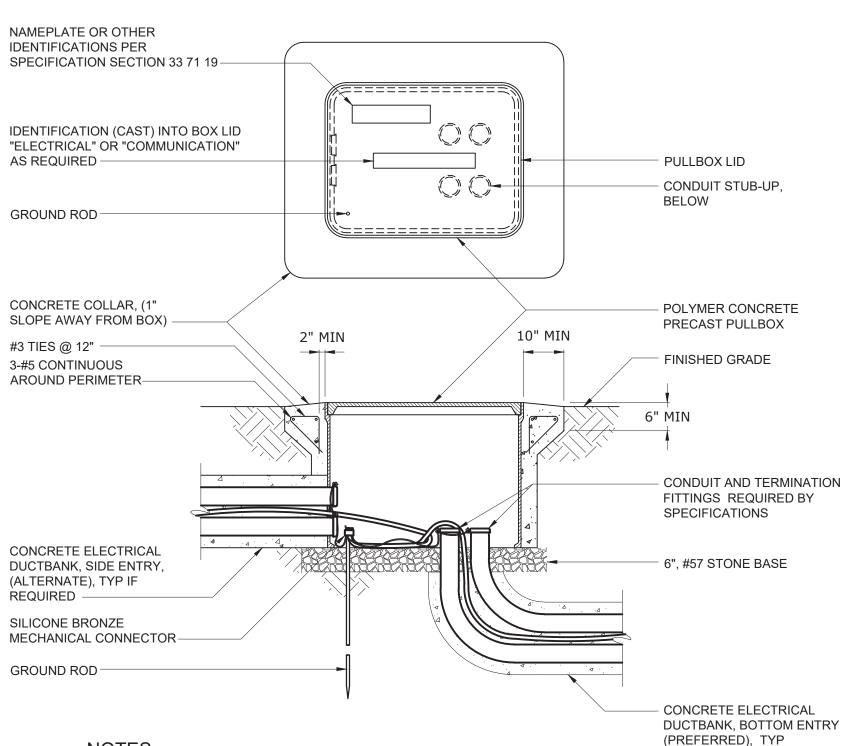


- NOTES:
- 1. FOR SIDE ENTRY, CONDUIT DUCTBANK SHALL ENTER PULLBOX AT LOWEST POINT
- 2. GROUND CONDUCTORS WITHIN DUCTBANK SHALL BE BOLTED TOGETHER AND TO GROUND ROD.
- 3. CONDUIT BONDING BUSHINGS (IF REQUIRED) SHALL BE BONDED TO GROUND ROD.
- 4. FOR SIDE ENTRY, CONDUIT SHALL ENTER IN INDIVIDUAL CIRCULAR HOLES APPROPRIATELY SIZED FOR THE CONDUIT. LARGE SINGLE RECTANGULAR OPENINGS FOR MULTIPLE CONDUITS ARE NOT ACCEPTABLE
- 5. DUCTBANK REINFORCING REBAR SHALL PENETRATE THE SIDEWALLS OF THE BOX NO LONGER THAN 1".

WARNING
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RSON. UNLESS ACTING UNDER THE DIRECTION OF A LICENSED PROFESSIONAL GINEER, TO ALTER IN ANY WAY PLANS, SPECIFICATIONS, PLATS OR REPORTS TO WHICH THE SEAL OF A PROFESSIONAL ENGINEER HAS BEEN APPLIED. IF AN ITEM BEARING THE SEAL OF A PROFESSIONAL ENGINEER IS ALTERED, THE ALTERING ENGINEER SHALL AFFIX O THE ITEM HIS SEAL AND THE NOTATION "ALTERED BY" FOLLOWED BY HIS SIGNATURE, HE DATE, AND A SPECIFIC DESCRIPTION OF THE ALTERATION.

ISSUED FOR

E-33-0103



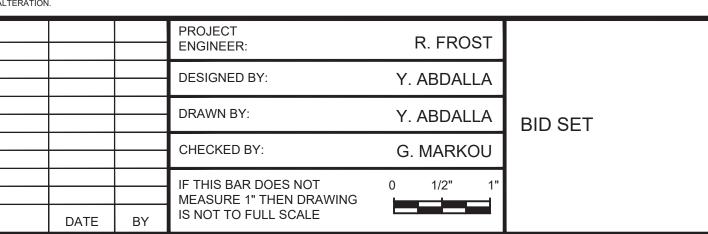

Hazen HAZEN AND SAWYER

498 SEVENTH AVENUE, 11th FLOOR NEW YORK, NEW YORK 10018

WESTCHESTER JOINT WATER WORKS MAMARONECK, NY

RYE LAKE WATER FILTRATION PLANT HARRISON, NY

ELECTRICAL

STANDARD DETAILS - SHEET 3

CONDUIT RISER CONDUIT EXPANSION FITTINGS -BUILDING EXTERIOR CHAMFER EDGE OF CONCRETE AND SLOPE TO PROMOTE WATER DRAINAGE CONCRETE DUCTBANK EXTENDED ABOVE GRADE FINISHED GRADE-ELECTRICAL SLAB ON GRADE DUCTBANK CONSTRUCTION 30# FELT BOND BREAKER

SEE NOTE 4

- 1 5/8" X 1 5/8" CHANNEL

1/4" SPRING NUT

DUCTBANK ABUTMENT (FLOATING) TO STRUCTURE E-33-0108

DUCTBANK REINFORCING PER STANDARD DETAIL

E-33-0101, TYP

NOTES:

1/2" LFMC BETWEEN

FIXTURE -

CAST BOX AND EACH

3/8" X 2" **EXPANSION**

4"X4" JUNCTION BOX

3/4" MINERALLAC STYLE

HANGER SCREWED TO

SIDE OF CHANNEL

ATTACHED TO SIDE

OF CHANNEL -

ANCHOR, TYP

1. ADDITIONAL SEISMIC SUPPORTS MAY BE REQUIRED, SEE CODE SUMMARY DRAWING AND DRAWING E1 FOR SEISMIC CLASSIFICATIONS.

3/8" ROD COUPLING

- 3/8" NUT

- 2. CONDUIT TYPE AND MATERIALS OF CONSTRUCTION FOR SUPPORTS AND HARDWARE SHALL BE AS REQUIRED FOR THE AREA IN WHICH THE FIXTURE IS INSTALLED AS SHOWN ON THE DRAWINGS AND IN ACCORDANCE WITH THE SPECIFICATIONS.
- 3. REFER TO AREA DESIGNATION DRAWINGS AND SPECIFICATIONS FOR REQUIRED MATERIALS OF CONSTRUCTION.
- 4. 45 DEGREE ANGLE BRACES SHALL BE INSTALLED TO PREVENT LATERAL MOVEMENT OF FIXTURE SUPPORTS. BRACES SHALL BE INSTALLED AT 8' INTERVALS ALONG ENTIRE LENGTH OF SUPPORT CHANNEL. TRANSVERSE MOVEMENT SHALL BE PREVENTED IN SIMILAR FASHION AT EACH END OF THE SUPPORT CHANNEL.

BAR JOIST OR STRUCTURAL STEEL

MALLEABLE IRON

BEAM CLAMP

3/8" HEX NUT

3/8" NUT &

LOCK WASHER -

SIDE OF CHANNEL

LINEAR LIGHTING

FIXTURE

3/4" MINERALLAC STYLE

HANGER ATTACHED TO

SUPPORT CHANNEL MOUNTED LINEAR FIXTURES

3/8" ALL

THREAD, TYP ---

E-26-0606


CONCRETE CEILING

3/4" RIGID CONDUIT ATTACHED TO

SIDE OF CHANNEL WITH


- 1 5/8" X 1 5/8" CHANNEL

MINERALLAC STYLE HANGERS

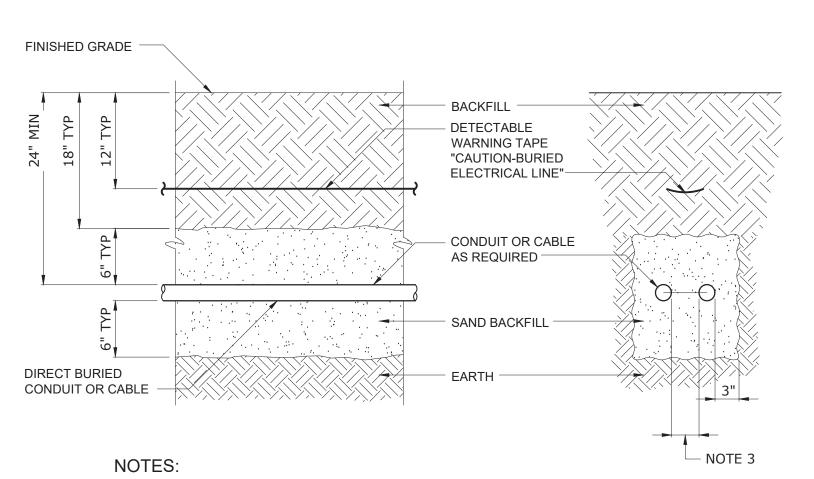

- 1. CONDUIT SHALL BE FURNISHED AND INSTALLED IN ACCORDANCE WITH SPECIFICATION SECTION 26 05 33.13.
- 2. BACKFILL THAT CONTAINS LARGE ROCKS, PAVING MATERIALS, CINDERS, LARGE OR SHARPLY ANGULAR SUBSTANCES, OR CORROSIVE MATERIAL SHALL NOT BE USED.
- 3. MAINTAIN A MINIMUM OF 2" BETWEEN POWER, CONTROL, AND INSTRUMENTATION CONDUITS OR CONDUCTORS.

TYPICAL DIRECT BURIED CONDUIT & CABLE E-33-0104

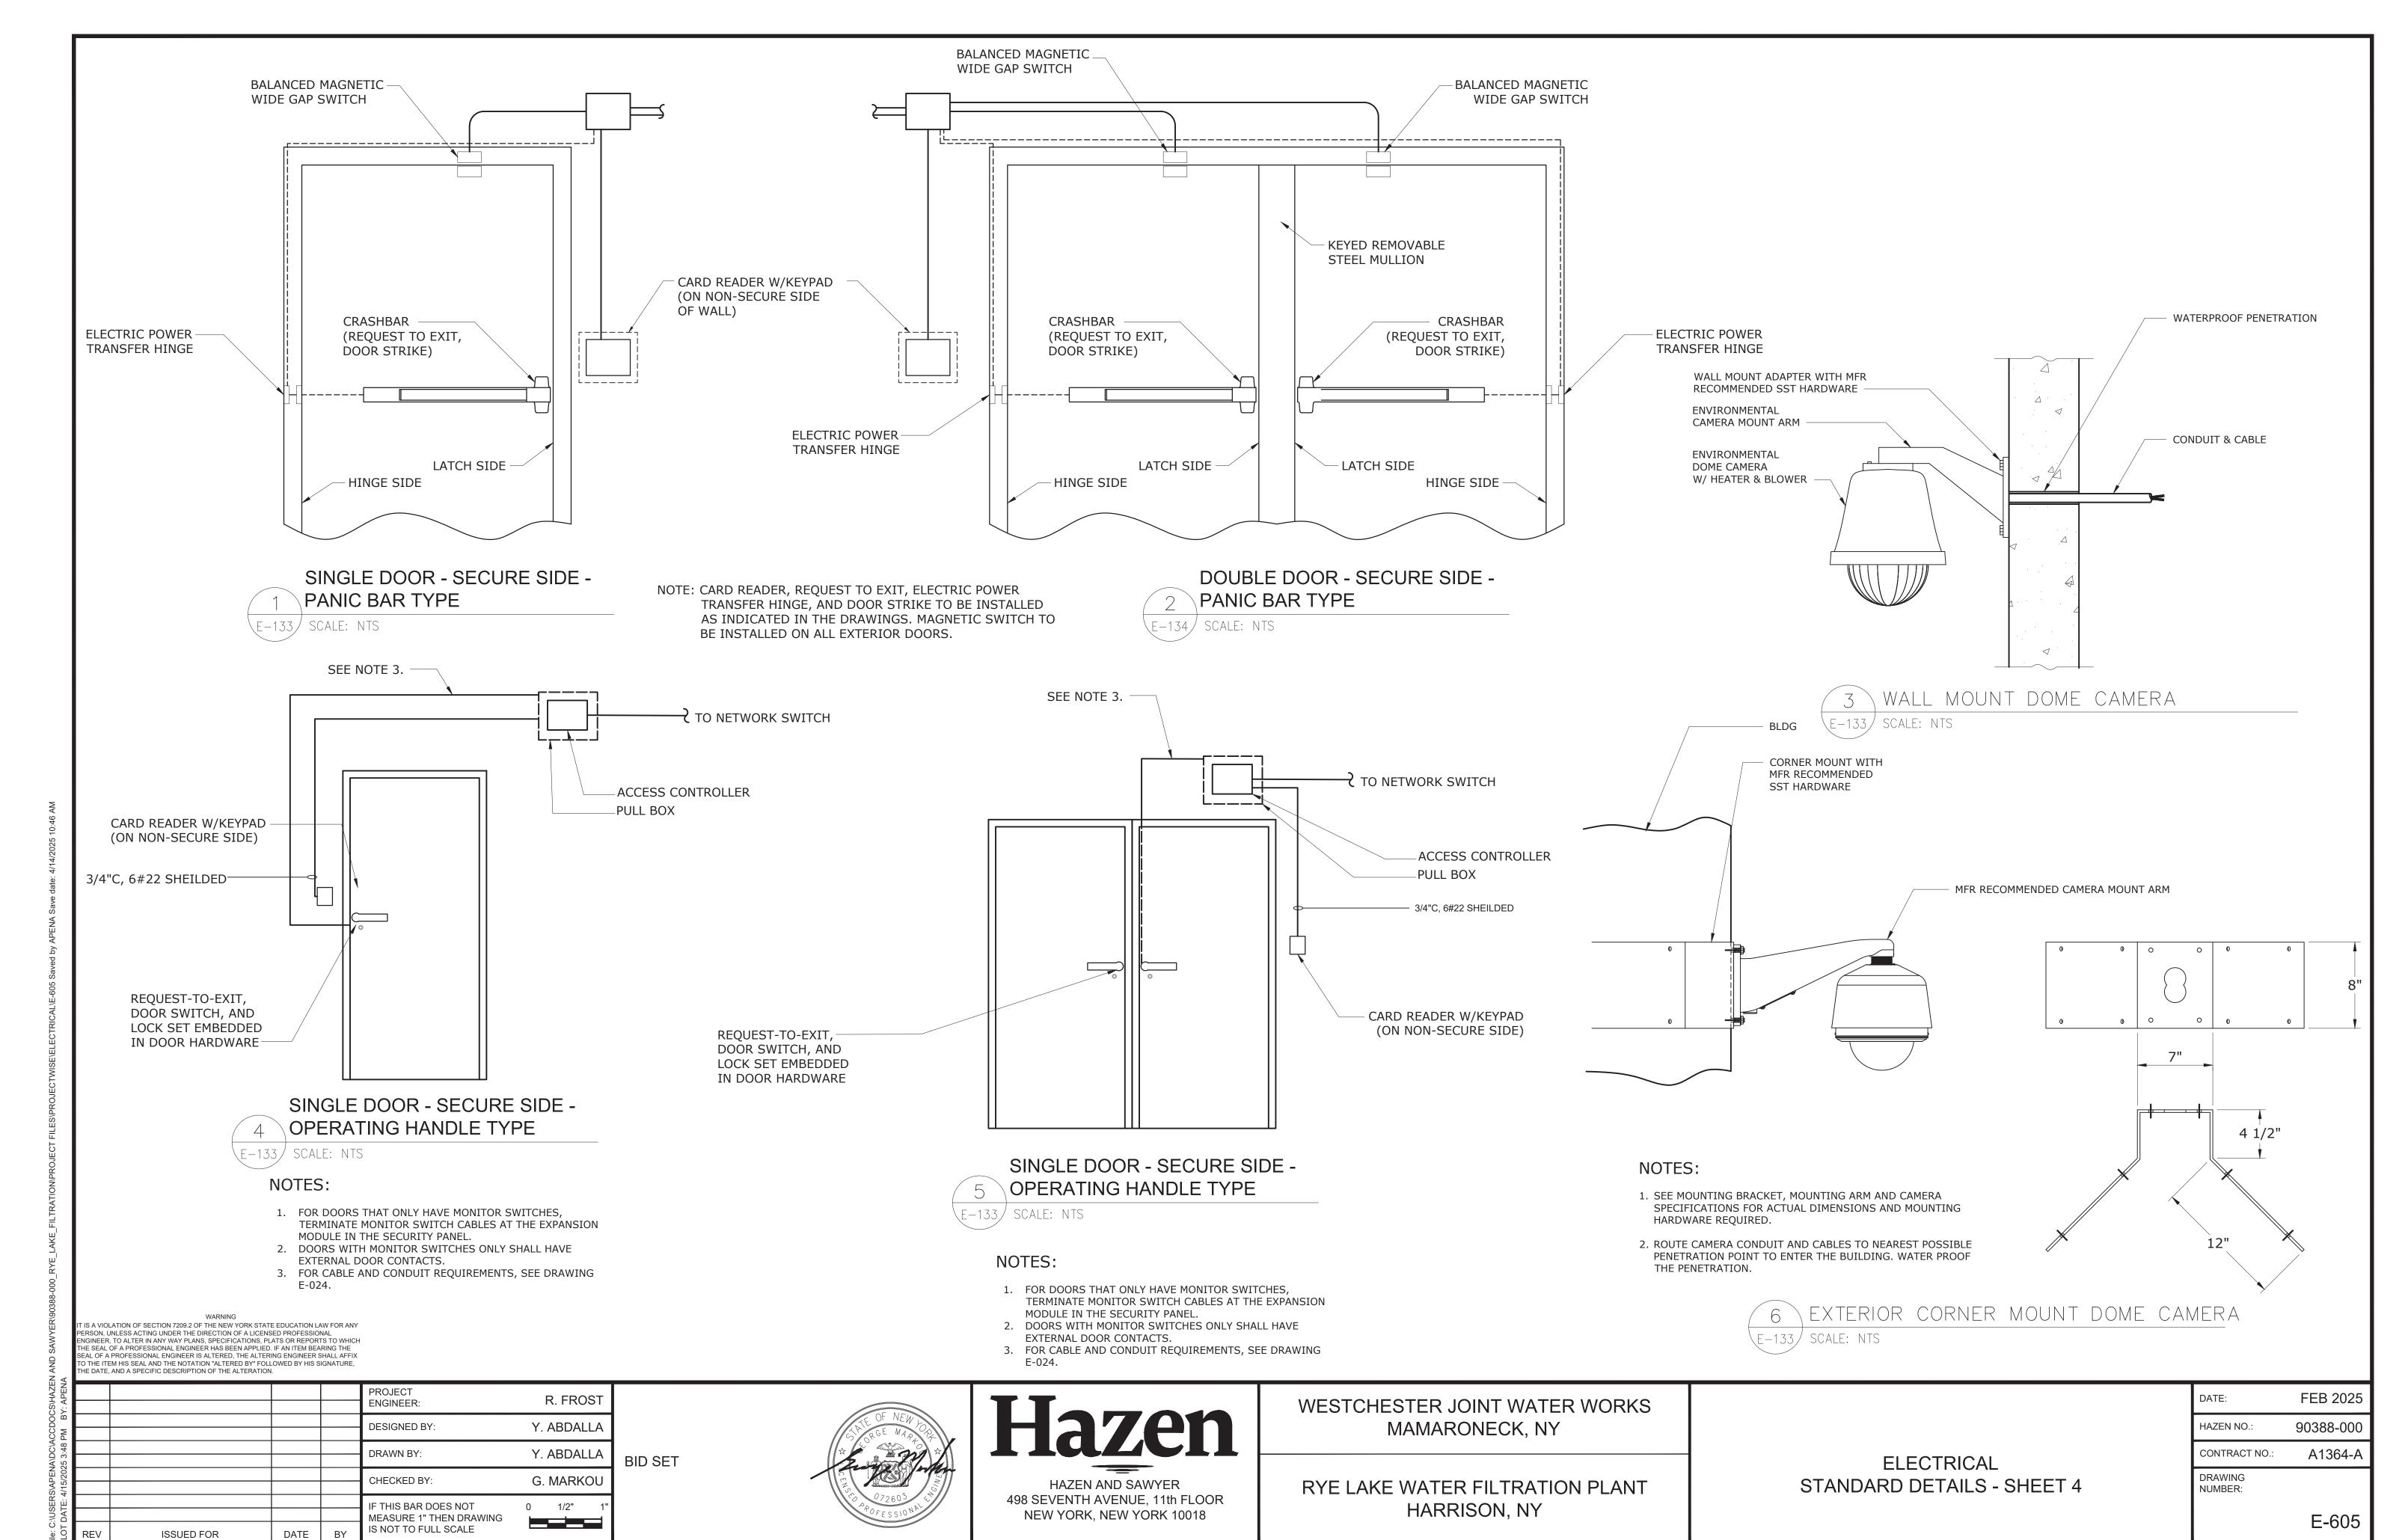

392 of 392