
WESTCHESTER JOINT WATER WORKS MAMARONECK, NEW YORK



A1364-A: RYE LAKE WATER FILTRATION PLANT 30 MGD HARRISON, NY BID SET

FEBRUARY 2025



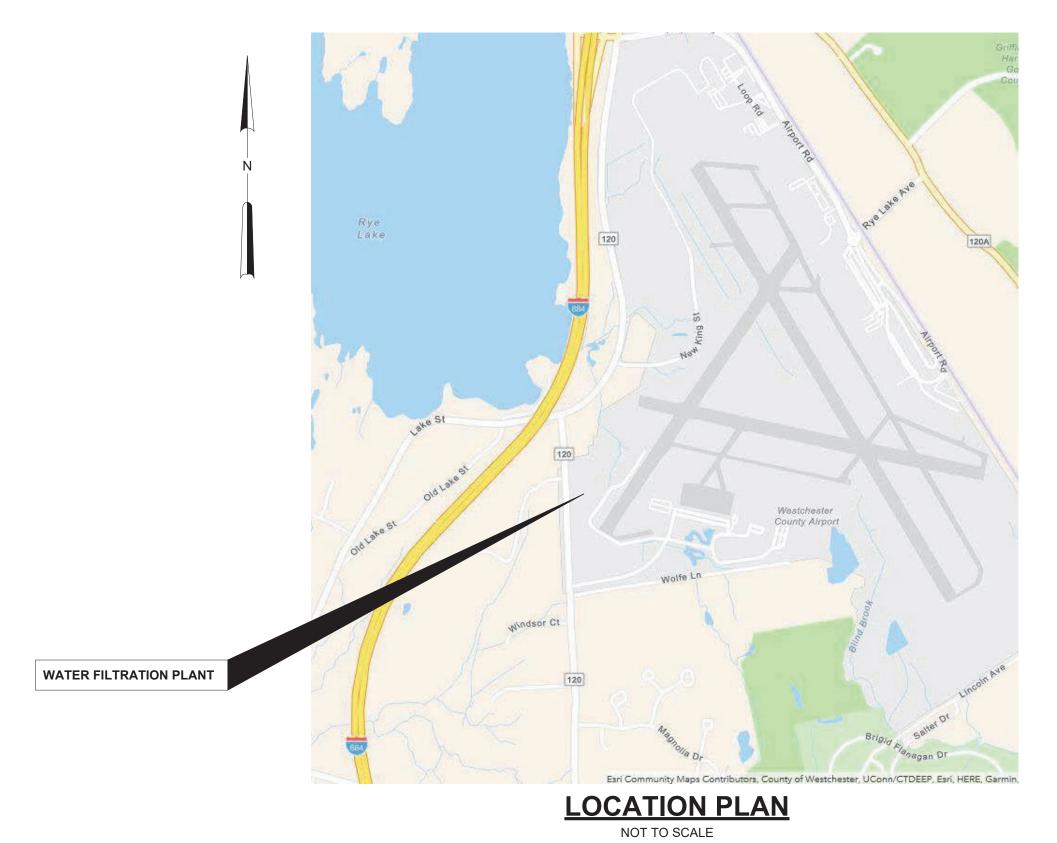



HAZEN AND SAWYER 498 SEVENTH AVENUE, 11th FLOOR NEW YORK, NEW YORK 10018

NO.	DWG	TITLE	INCLUDED
1	G-001	GENERAL	X
2	G-002	DRAWING INDEX - SHEET 1	X
3	G-003	DRAWING INDEX - SHEET 2	Х
4	G-004	GENERAL NOTES, SYMBOLS AND ABBREVIATIONS	Х
5	G-005	GENERAL AREA DESIGNATION TABLES	Х
6	G-010	HYDRAULIC PROFILE	Х
7	G-011	PROCESS FLOW SCHEMATIC	Х
8	G-100	GENERAL ARRANGEMENT PLAN EL 384.00	Х
9	G-101	GENERAL ARRANGEMENT PLAN EL 407.00	Х
10	G-102	GENERAL ARRANGEMENT PLAN EL 421.00	Х
11	G-103	GENERAL ARRANGEMENT PLAN ROOF	Х
		DEMOLITION	
12	D-500	EXISTING RYE LAKE CHEMICAL BUILDING DEMOLITION PLAN BELOW EL 358.50'	X
		EXISTING RYE LAKE CHEMICAL BUILDING	
13	D-501	DEMOLITION PLAN EL 358.50	X
		CIVIL	
14	C-001	GENERAL NOTES, LEGEND AND ABBREVIATIONS	Х
15	C-101	OVERALL SITE PLAN	Х
16	C-102	EXISTING CONDITIONS AND DEMOLITION PLAN	Х
		-AREA 1 EXISTING CONDITIONS AND DEMOLITION PLAN	
17	C-103	-AREA 2	X
18	C-111	EROSION AND SEDIMENT CONTROL PHASING PLAN - PHASE I	X
19	C-112	EROSION AND SEDIMENT CONTROL PHASING PLAN -	X
		PHASE II EROSION AND SEDIMENT CONTROL PHASING PLAN -	
20	C-113	PHASE III	Х
21	C-114	EROSION AND SEDIMENT CONTROL PHASING PLAN - PHASE IV	X
	0.445	EROSION AND SEDIMENT CONTROL PHASING PLAN -	
22	C-115	PHASE V	X
23	C-121	GRADING AND DRAINAGE PLAN - AREA 1	X
24	C-122	GRADING AND DRAINAGE PLAN - AREA 2	X
25	C-131	YARD PIPING PLAN - AREA 1	Х
26	C-132	YARD PIPING PLAN - AREA 2	Х
27	C-141	FINAL SITE PLAN - AREA 1	X
28	C-142	FINAL SITE PLAN - AREA 2	X
29	C-151	STAKING PLAN - AREA 1	X
30	C-152	STAKING PLAN - AREA 2	X
31	C-153	STAKING TABLES	Х
32	C-201	PLANT ACCESS DRIVEWAY PLAN AND PROFILE	X
33	C-202	PLANT ACCESS ROAD PLAN AND PROFILE - STA 10+00 TO STA 14+50	X
34	C-203	PLANT ACCESS ROAD PLAN AND PROFILE - STA	X
J4	C-203	14+50 TO STA 20+20	^
35	C-204	VEGETATED ACCESS ROAD PLAN AND PROFILE -SHEET 1 OF 2	X
36	C-205	VEGETATED ACCESS ROAD PLAN AND PROFILE -SHEET 2 OF 2	X
37	C-206	ROADWAY DETAILS	X
38	C-211	STORMWATER MANAGEMENT PLAN	X
39	C-212	STORMWATER MANAGEMENT CROSS SECTIONS	X
40	C-212	STORMWATER DRAINAGE PROFILES -SHEET 1 OF 3	X
41	C-214	STORMWATER DRAINAGE PROFILES -SHEET 2 OF 3	X
42	C-215	STORMWATER DRAINAGE PROFILES -SHEET 3 OF 3	X
43	C-216	STORMWATER DETAILS - SHEET 1 OF 6	X
44	C-217	STORMWATER DETAILS - SHEET 2 OF 6	X
45	C-218	STORMWATER DETAILS - SHEET 3 OF 6	X
46	C-219	STORMWATER DETAILS - SHEET 4 OF 6	X
47	C-220	STORMWATER DETAILS - SHEET 5 OF 6	X
48	C-220	STORMWATER DETAILS - SHEET 6 OF 6	X
49	C-221	SANITARY DRAIN PLAN AND PROFILE	X
50	C-231	SANITARY FM - STA 0+00 TO STA 5+00	X
51	C-232	SANITARY FM - STA 5+00 TO STA 9+29	X
52	C-234	SANITARY AND STORM DRAIN DETAILS	X
	0 20 .	RAW WATER TRANSMISSION MAIN PLAN AND	
53	C-241	PROFILE	Х
54	C-242	FINISHED WATER TRANSMISSION MAIN PLAN AND PROFILE - SHEET 1 OF 2	×
55	C-243	FINISHED WATER TRANSMISSION MAIN PLAN AND	X
	52.5	PROFILE - SHEET 2 OF 2	

56	C-244	WATER MAIN EXTENSION PROFILE	X
57	C-245	PW AND FP PROFILES	Х
58	C-246	WWR AND FUD PROFILE	Х
59	C-247	OVERFLOW PROFILE - SHEET 1 OF 2	Х
60	C-248	OVERFLOW PROFILE - SHEET 2 OF 2	X
61	C-249	WWW PROFILE	X
62	C-250	GALLERY DRAIN PROFILE	X
63	C-251	YARD PIPING DETAILS - SHEET 1 OF 2	Х
64	C-252	YARD PIPING DETAILS - SHEET 2 OF 2	X
65	C-301	EROSION AND SEDIMENT CONTROL NOTES	X
66	C-302	EROSION AND SEDIMENT CONTROL DETAILS	X
67	C-303	EROSION AND SEDIMENT CONTROL DETAILS	Х
68	C-304	SITE DETAILS	Х
69	C-305	TRUCK DELIVERY CONTAINMENT DETAIL	X
70	C-306	MAINTENANCE OF TRAFFIC DETAIL	X
70	C-300	WAINTENANCE OF THAIT IS BETAIL	
71	L-101	PLAN - SHEET 1	X
72	L-102	PLAN - SHEET 2	X
73	L-301	SCHEDULE	X
74	L-302	DETAILS	X
		ARCHITECTURAL	
75	A-001	STANDARD NOTES, SYMBOLS AND ABBREVIATIONS	Х
76	A-002	CODE COMPLIANCE SUMMARY 1 OF 3	X
77	A-003	CODE COMPLIANCE SUMMARY 2 OF 3	X
78	A-004	CODE COMPLIANCE SUMMARY 3 OF 3	X
79	A-004 A-005	NOTES -SHEET 1 of 2	X
		110.20.0020	
80	A-006	NOTES -SHEET 2 of 2	X
81	A-101	BASEMENT PLAN EL 383.00	X
82	A-102	FIRST FLOOR PLAN EL 407.00	X
83	A-103	SECOND FLOOR PLAN EL 421.00	X
84	A-104	ROOF PLAN	Х
85	A-201	EXTERIOR ELEVATIONS -SHEET 1 OF 2	Х
86	A-202	EXTERIOR ELEVATIONS -SHEET 2 OF 2	X
87	A-203	BUILDING SECTIONS -SHEET 1 OF 4	X
88	A-204	BUILDING SECTIONS -SHEET 2 OF 4	X
	_		
89	A-205	BUILDING SECTIONS -SHEET 3 OF 4	X
90	A-206	BUILDING SECTIONS -SHEET 4 OF 4	Х
91	A-207	WALL SECTION & DETAILS -SHEET 1 OF 3	X
92	A-208	WALL SECTION & DETAILS -SHEET 2 OF 3	X
93	A-209	WALL SECTION & DETAILS -SHEET 3 OF 3	Х
94	A-301	FIRST FLOOR -ENLARGED PLAN AND RCP	Х
95	A-302	FIRST FLOOR -INTERIOR ELEVATIONS	X
96	A-303	SECOND FLOOR -ENLARGED PLAN AND RCP	X
97	A-304	SECOND FLOOR -INTERIOR ELEVATIONS	X
97	A-304	PROCESS ANALYSIS AND CONTROL ROOM -	^
98	A-305	ENLARGED PLANS AND RCP	X
99	A-306	PROCESS ANALYSIS AND CONTROL ROOM - INTERIOR ELEVATIONS	X
100	A-307	ELEVATOR PLANS, SECTION AND DETAILS	X
101	A-308	STAIR PLANS, SECTIONS AND DETAILS - SHEET 1	X
101	A-300	OF 2	^
102	A-309	STAIR PLANS, SECTIONS AND DETAILS - SHEET 2 OF 2	X
103	A-401	STAIR AND RAILING DETAILS	Х
104	A-402	PLAN DETAILS	X
105	A-403	ROOF DETAILS -SHEET 1 OF 2	X
106	A-403	ROOF DETAILS -SHEET 2 OF 2	X
107	A-501	SITE ENTRANCE PLAN AND DETAILS	X
108	A-601	PARTITION TYPES AND DETAILS	X
109	A-602	WINDOW SCHEDULE AND DETAILS	X
110	A-603	DOOR SCHEDULE AND DETAILS	X
111	A-604	FINISH, IDENTIFYING DEVICES AND LOUVER	Х
		SCHEDULES AND DETAILS	
112	A-605	IDENTIFYING DEVICES	X
113	A-606	FIRESTOPPING DETAILS	Х
		STRUCTURAL	
114	S-001	GENERAL NOTES	Х
115	S-002	LOAD DIAGRAMS	Х
		SOIL TIEDOWN PLAN AREA 1, 2, AND 3	X
116	S-100	TOOLE TIEDOWITT ENTRY INC. TO SELECT	

117	S-101	SOIL TIEDOWN PLAN AREA 4 AND 5	X
118	S-102	PLAN AT EL 374.08 - AREA 4 AND 5	X
119	S-103	PLAN AT EL 383.00 - AREA 1	X
120	S-104	PLAN AT EL 383.00 - AREA 2	X
121	S-105	PLAN AT EL 383.00 - AREA 3	X
122	S-106	PLAN AT EL 398.83 - AREA 1 AND 4	Х
123	S-107	PLAN AT EL 398.83 - AREA 2 AND 5	Х
124	S-108	PLAN AT EL 407.00 - AREA 1	Х
125	S-109	PLAN AT EL 407.00 - AREA 2	Х
126	S-110	PLAN AT EL 407.00 - AREA 3 AND FLOOR SLOPE	X
120	3-110	PLAN AT EL 407.00 - AREA 1 AND 2	
127	S-111	PLAN AT EL 407.00 - AREA 4	X
128	S-112	PLAN AT EL 407.00 - AREA 5	X
129	S-113	PLAN AT EL 407.00 - AREA 6 AND CLASS A6 CONCRETE LOCATION PLAN AT EL 407.00	X
130	S-114	PLAN AT EL 421.00 - AREA 1	X
131	S-115	PLAN AT EL 421.00 - AREA 2	X
132	S-116	PLAN AT EL 421.00 - AREA 3	X
133	S-117	PLAN AT EL 421.00 - AREA 4	X
134	S-118	PLAN AT EL 421.00 - AREA 5	X
135	S-119	PLAN AT EL 421.00 - AREA 6	X
136	S-120	FLAT ROOF FRAMING PLAN - AREA 1	X
137	S-121	FLAT ROOF FRAMING PLAN - AREA 2	X
138	S-122	FLAT ROOF FRAMING PLANS - AREA 4 AND TOP OF STEEL 439.67	×
120	C 100		
139	S-123	SHED ROOF FRAMING PLAN - AREA 5	X
140	S-124	GABLE ROOF FRAMING PLAN - AREA 3	X
141	S-125	ROOF FRAMING PLANS - AREA 6	X
142	S-126	PLANS	X
143	S-200	SECTIONS - SHEET 1	X
144	S-201	SECTIONS - SHEET 2	X
145	S-202	SECTIONS - SHEET 3	X
146	S-203	SECTIONS - SHEET 4	X
147	S-204	SECTIONS - SHEET 5	X
148	S-205	SECTIONS - SHEET 6	X
149	S-206	SECTIONS - SHEET 7	X
150	S-207	SECTIONS - SHEET 8	X
151	S-208	SECTIONS - SHEET 9	X
152	S-209	SECTIONS - SHEET 10	X
153	S-210	SECTIONS - SHEET 11	X
154	S-211	SECTIONS - SHEET 12	X
155	S-212	SECTIONS - SHEET 13	X
156	S-213	SECTIONS - SHEET 14	X
157	S-214	SECTIONS - SHEET 15	X
158	S-215	SECTIONS - SHEET 16	X
159	S-216	SECTIONS - SHEET 17	X
160	S-217	SECTIONS - SHEET 18	X
161	S-218	FRAMING ELEVATIONS - SHEET 1	Х
162	S-219	FRAMING ELEVATIONS - SHEET 2	Х
163	S-220	FRAMING ELEVATIONS - SHEET 3	Х
164	S-221	FRAMING ELEVATIONS - SHEET 4	Х
165	S-222	FRAMING ELEVATIONS - SHEET 5	Х
166	S-223	FRAMING ELEVATIONS - SHEET 6	X
167	S-224	FRAMING ELEVATIONS - SHEET 7	Х
168	S-300	BEAM SCHEDULE AND DETAILS	X
169	S-301	DETAILS - SHEET 1	X
170	S-302	DETAILS - SHEET 2	X
171	S-303	DETAILS - SHEET 3	X
172	S-304	DETAILS - SHEET 4	X
173	S-305	DETAILS - SHEET 5	X
174	S-306	DETAILS - SHEET 6	X
175	S-307	DETAILS - SHEET 7	X
176	S-507	PLANS AND SECTIONS	X
177	S-600	STANDARD DETAILS SHEET 1	X
178	S-601	STANDARD DETAILS SHEET 2	X
178	S-602	STANDARD DETAILS SHEET 3	X
180	S-603	STANDARD DETAILS SHEET 4	X
		STANDARD DETAILS SHEET 4 STANDARD DETAILS SHEET 5	X
181	S-604		
182	S-605	STANDARD DETAILS SHEET 6	X

	S-606	STANDARD DETAILS SHEET 7	X
184	S-607	STANDARD DETAILS SHEET 8	Х
		MECHANICAL	
185	M-001	GENERAL NOTES, SYMBOLS AND ABBREVIATIONS	X
186	M-101	PARTIAL PLAN AT EL 383.00 - AREA 1	X
187	M-102	PARTIAL PLAN AT EL 383.00 - AREA 2 & 3	X
188	M-103	PARTIAL PLAN AT EL 398.00 - AREA 1	X
189	M-104	PARTIAL PLAN AT EL 497.00 AREA 2 & 3	X
190	M-105	PARTIAL PLAN AT EL 407.00 - AREA 1	X
191	M-106	PARTIAL PLAN AT EL 407.00 - AREA 2	X
192	M-107	PARTIAL PLAN AT EL 407.00 - AREA 3	X
193	M-108	PARTIAL PLAN AT EL 407.00 - AREA 4	X
194 195	M-109 M-110	PARTIAL PLAN AT EL 407.00 - AREA 5 PARTIAL PLAN AT EL 421.00 - AREA 1	X
195	M-110	PARTIAL PLAN AT EL 421.00 - AREA 1	X
196	M-111	PARTIAL PLAN AT EL 421.00 - AREA 2 PARTIAL PLAN AT EL 421.00 - AREA 3	X
197	M-112	PARTIAL PLAN AT EL 421.00 - AREA 3 PARTIAL PLAN AT EL 421.00 - AREA 4	X
190	M-114	PARTIAL PLAN AT EL 421.00 - AREA 4	X
200	M-201	SECTIONS - SHEET 1	X
200	M-202	SECTIONS - SHEET 2	X
202	M-203	SECTIONS - SHEET 3	X
203	M-204	SECTIONS - SHEET 4	X
204	M-205	SECTIONS - SHEET 5	X
205	M-206	SECTIONS - SHEET 6	X
206	M-207	SECTIONS - SHEET 7	X
207	M-501	PLANS	X
208	M-502	SECTIONS	X
209	M-503	PLANS	X
210	M-504	SECTIONS	X
211	M-601	DETAILS - SHEET 1	X
212	M-602	DETAILS - SHEET 2	X
213	M-603	DETAILS - SHEET 3	Х
214	M-604	DETAILS - SHEET 4	Х
215	M-605	DETAILS - SHEET 5	Х
216	M-606	DETAILS - SHEET 6	Х
217	M-607	DETAILS - SHEET 7	Х
218	M-608	DETAILS - SHEET 8	Х
219	M-609	DETAILS - SHEET 9	X
220	M-610	DETAILS - SHEET 10	Х
221	M-611	DETAILS - SHEET 11	X
	_	INSTRUMENTATION	
222	I-001	GENERAL NOTES, SYMBOLS AND LEGEND	X
223	I-002	CONTROL SYSTEM BLOCK DIAGRAM	X
224	I-003	FACILITY SIGNAL COORDINATION - PROCESS AND INSTRUMENT DIAGRAM	X
225	1-004	MIXER AND FLOCCULATORS - PROCESS AND	X
	1-004	INSTRUMENT DIAGRAM	^
226	I-005	DISSOLVED AIR FLOTATION (DAF) - PROCESS AND INSTRUMENT DIAGRAM	X
227	I-006	FILTERS AND DAF RECYCLE PUMPS - PROCESS AND	X
<i>L L L L</i>	1-000	INSTRUMENT DIAGRAM	^
228	I-007	DAF RECYCLE SATURATION SYSTEM - PROCESS AND INSTRUMENT DIAGRAM	X
220	1-008	AIR SCOUR BLOWER SYSTEM - PROCESS AND	X
229	Ι-υυδ	INSTRUMENT DIAGRAM	^
230	I-009	FILTERED WATER AND BACKWASH SYSTEM - PROCESS AND INSTRUMENT DIAGRAM	X
224	1.040	COMBINED WASTE WASHWATER SYSTEM -	V
231	I-010	PROCESS AND INSTRUMENT DIAGRAM	X
232	I-011	FLOATED SOLIDS TRANSFER SYSTEM - PROCESS AND INSTRUMENT DIAGRAM	X
222	1.040	DEWATERING CENTRIFUGE - PROCESS AND	
233	I-012	INSTRUMENT DIAGRAM	X
234	I-013	RESIDUALS HANDLING SYSTEM - PROCESS AND INSTRUMENT DIAGRAM	Х
005	1011	CHEMICAL SYSTEMS - COAGULANT - PROCESS AND	
235	I-014	INSTRUMENT DIAGRAM	Х
236	I-015	CHEMICAL SYSTEMS - SODIUM HYPOCHLORITE - PROCESS AND INSTRUMENT DIAGRAM	X
007	1015	CHEMICAL SYSTEMS - SODIUM HYDROXIDE -	
237	I-016	PROCESS AND INSTRUMENT DIAGRAM	Х
		CHEMICAL SYSTEMS - CORROSION INHIBITOR -	X

WARNING
IT IS A VIOLATION OF SECTION 7209.2 OF THE NEW YORK STATE EDUCATION LAW FOR ANY PERSON, UNLESS ACTING UNDER THE DIRECTION OF A LICENSED PROFESSIONAL ENGINEER, TO ALTER IN ANY WAY PLANS, SPECIFICATIONS, PLATS OR REPORTS TO WHICH THE SEAL OF A PROFESSIONAL ENGINEER HAS BEEN APPLIED. IF AN ITEM BEARING THE SEAL OF A PROFESSIONAL ENGINEER IS ALTERED, THE ALTERING ENGINEER SHALL AFFIX TO THE ITEM HIS SEAL AND THE NOTATION "ALTERED BY" FOLLOWED BY HIS SIGNATURE, THE DATE, AND A SPECIFIC DESCRIPTION OF THE ALTERATION.

2	DESCRIP1	TION OF THE ALTERATION.				
					PROJECT ENGINEER:	R. FROST
ye_Lar					DESIGNED BY:	R. FROST
					DRAWN BY:	B. CASULL
3:51 AM					CHECKED BY:	E. FELDMAN
26/2025 9:53:51					IF THIS BAR DOES NOT MEASURE 1" THEN DRAWING	0 1/2" 1"
26/2	REV	ISSUED FOR	DATE	BY	IS NOT TO FULL SCALE	

BID SET



HAZEN AND SAWYER
498 SEVENTH AVENUE, 11th FLOOR
NEW YORK, NEW YORK 10018

WESTCHESTER JOINT WATER WORKS MAMARONECK, NY

RYE LAKE WATER FILTRATION PLANT HARRISON, NY GENERAL DRAWING INDEX - SHEET 1

DATE:	FEB 2025
HAZEN NO.:	90388-000
CONTRACT NO.:	A1364-A
DRAWING NUMBER:	
	G-002

239	I-018	CHEMICAL SYSTEMS - HYDROFLUOROSILICIC ACID - PROCESS AND INSTRUMENT DIAGRAM	Х
240	I-019	UV AND FINAL CHEMICAL ADDITION - PROCESS AND	X
241	I-020	RESIDUAL POLYMER SYSTEMS - PROCESS AND	X
242	I-021	INSTRUMENT DIAGRAM SUPPORT SYSTEMS - PROCESS AND INSTRUMENT	X
242	I-021	DIAGRAM INSTALLATION DETAILS SHEET 1	X
243	I-022	INSTALLATION DETAILS SHEET 2	X
245	I-024	INSTALLATION DETAILS SHEET 3	X
		HVAC	
246	H-001	GENERAL NOTES, SYMBOLS AND ABBREVIATIONS	Х
247	H-002	CONTROL DIAGRAMS - SHEET 1	Х
248	H-003	CONTROL DIAGRAMS - SHEET 2	X
249	H-004	CONTROL DIAGRAMS - SHEET 3	X
250	H-005	CONTROL DIAGRAMS - SHEET 4	X
251	H-006	CONTROL DIAGRAMS - SHEET 5	X
252 253	H-007 H-100	CONTROL DIAGRAMS - SHEET 6 EL. 383.00 - OVERALL PLAN	X
253	H-100	EL. 407.00 - AREA 1	X
255	H-102	EL. 407.00 - AREA 2	X
256	H-103	EL. 407.00 - AREA 3	X
257	H-104	EL. 407.00 - AREA 6	X
258	H-105	EL. 421.00 & EL. 429.33 - OVERALL PLAN	Х
259	H-106	EL. 421.00 & EL. 429.33 - AREA 1	Х
260	H-107	EL. 421.00 & EL. 429.33 - AREA 2	Х
261	H-108	EL. 421.00 - AREA 3	Х
262	H-109	EL. 421.00 - AREA 4	X
263	H-110	EL. 421.00 - AREA 5	X
264	H-111	EL. 421.00 - AREA 6	Х
265	H-200	SECTIONS - SHEET 1	X
266	H-201	SECTIONS - SHEET 2	X
267	H-202	SECTIONS - SHEET 3	X
268 269	H-600 H-601	SCHEDULES - SHEET 1 SCHEDULES - SHEET 2	×
270	H-602	SCHEDULES - SHEET 3	X
271	H-603	SCHEDULES - SHEET 4	X
272	H-604	DETAILS - SHEET 1	X
273	H-605	DETAILS - SHEET 2	Х
274	H-606	DETAILS - SHEET 3	Х
		PLUMBING	
275	P-001	GENERAL NOTES, SYMBOLS AND ABBREVIATIONS	X
276	P-002	DOMESTIC WATER RISER DIAGRAM	Х
277	P-003	SANITARY RISER DIAGRAM -SHEET 1	X
278	P-004	SANITARY RISER DIAGRAM -SHEET 2	X
279 280	P-005 P-100	STORM RISER DIAGRAM	×
281	P-100 P-101	BASEMENT PLAN EL 383.00 EL. 407.00 -AREA 1	X
282	P-101 P-102	EL. 407.00 -AREA 1	X
283	P-103	EL. 407.00 -AREA 3	X
284	P-104	EL. 407.00 -AREA 5	X
285	P-105	EL. 407.00 -AREA 6	X
286	P-106	BACKFLOW PREVENTION PLAN	Х
287	P-107	SECOND FLOOR PLAN EL 421.00	X
288	P-108	EL. 421.00 -AREA 1	Х
289	P-109	EL. 421.00 -AREA 2	X
290	P-110	EL. 421.00 -AREA 3	X
291	P-111	EL. 421.00 -AREA 4	X
292	P-112	EL. 421.00 -AREA 5	X
293	P-113	EL. 421.00 -AREA 6	X
294 295	P-114 P-200	ROOF PLAN SECTIONS	X
295	P-200 P-600	SECTIONS SCHEDULES -SHEET 1	X
290	P-601	SCHEDULES -SHEET 2	X
298	P-602	DETAILS -SHEET 1	X
299	P-603	DETAILS -SHEET 2	X
300	P-604	DETAILS -SHEET 3	X
	1		

301	FP-001	GENERAL NOTES, SYMBOLS AND ABBREVIATIONS	Х
302	FP-002	DETAILS -SHEET 1	X
303	FP-100	EL. 383.00 -OVERALL PLAN	X
304	FP-101	EL. 407.00 -OVERALL PLAN	X
305	FP-102	EL. 421.00 -OVERALL PLAN	X
		ELECTRICAL	
306	E-001	LEGENDS, AND SYMBOLS	X
307	E-002	GENERAL NOTES & ABBREVIATIONS	X
308	E-003	OVERALL SINGLE LINE DIAGRAM	X
309	E-004 E-005	MCC-1 SINGLE LINE DIAGRAM MCC-2 SINGLE LINE DIAGRAM SHEET 1	X
311	E-006	MCC-2 SINGLE LINE DIAGRAM SHEET 2	X
312	E-007	MCC-2 SINGLE LINE DIAGRAM SHEET 3	X
		SWITCHBOARD AND GENERATOR SWITCHGEAR	
313	E-008	ELEVATIONS	X
314	E-009	MCC-1 ELEVATION	X
315	E-010	MCC-2 ELEVATION	X
316	E-011	SOLAR SYSTEM RISER DIAGRAM	X
317	E-012	PANEL BOARD SCHEDULES - SHEET 1	X
318	E-013	PANEL BOARD SCHEDULES - SHEET 2	X
319	E-014	PANEL BOARD SCHEDULES - SHEET 3	X
320 321	E-015 E-016	PANEL BOARD SCHEDULES - SHEET 4 PANEL BOARD SCHEDULES - SHEET 5	X
321 322	E-016 F-017	PANEL BOARD SCHEDULES - SHEET 6	X
322 323	E-017	WIRING DIAGRAM - SHEET 1	X
324	E-019	WIRING DIAGRAM - SHEET 2	X
325	E-020	WIRING DIAGRAM - SHEET 3	X
326	E-021	WIRING DIAGRAM - SHEET 4	X
327	E-022	FIRE ALARM SYSTEM RISER DIAGRAM - SHEET 1	X
328	E-023	FIRE ALARM SYSTEM RISER DIAGRAM - SHEET 2	X
329	E-024	SECURITY SYSTEM AND PAGING/COMMUNICATION	X
	L-024	NETWORK RISER DIAGRAM - SHEET 1	
330	E-025	SECURITY SYSTEM AND PAGING/COMMUNICATION NETWORK RISER DIAGRAM - SHEET 2	X
331	E-100	SITE PLAN	Х
332	E-101	POWER PLAN - EL 383.00 -AREA 1	Х
333	E-102	POWER PLAN - EL 383.00 -AREA 2 & 3	Х
334	E-103	POWER PLAN - EL 398.00 -AREA 1	Х
335	E-104	POWER PLAN - EL 398.00 -AREA 2 & 3	Х
336	E-105	POWER PLAN - EL 407.00 -AREA 1	X
337	E-106	POWER PLAN - EL 407.00 -AREA 2	X
338	E-107	POWER PLAN - EL 407.00 -AREA 3	X
339	E-108	POWER PLAN - EL 407.00 -AREA 4	X
340	E-109	POWER PLAN - EL 407.00 -AREA 5	X
341	E-110	POWER PLAN - EL 407.00 -AREA 6	X
342	E-111	POWER PLAN - EL 421.00 -AREA 1	X
343	E-112	POWER PLAN - EL 421.00 -AREA 2	X
344	E-113	POWER PLAN - EL 421.00 - AREA 3	X
345	E-114	POWER PLAN - EL 421.00 - AREA 4	X
346	E-115	POWER PLAN - EL 421.00 -AREA 5	X
347	E-116 E-117	POWER PLAN - EL 421.00 -AREA 6 POWER AND LIGHTING PLAN - EL 436.50 -ROOF	X
348	E-117 E-118	ENLARGED ROOM - EL 407.00	X
350	E-118 E-119	ENLARGED ROOM - EL 407.00	X
351	E-119	LIGHTING PLAN - EL 383.00 -AREA 1	X
352	E-120	LIGHTING PLAN - EL 383.00 -AREA 2 & 3	X
353	E-122	LIGHTING PLAN - EL 398.00 -AREA 1	X
354	E-123	LIGHTING PLAN - EL 398.00 -AREA 2 & 3	X
355	E-124	LIGHTING PLAN - EL 407.00 -AREA 1	X
356	E-125	LIGHTING PLAN - EL 407.00 -AREA 2	X
357	E-126	LIGHTING PLAN - EL 407.00 -AREA 3	X
358	E-127	LIGHTING PLAN - EL 407.00 -AREA 4	X
359	E-128	LIGHTING PLAN - EL 407.00 -AREA 5	X
360	E-129	LIGHTING PLAN - EL 407.00 -AREA 6	X
361	E-130	LIGHTING PLAN - EL 421.00 -AREA 1	X
362	E-131	LIGHTING PLAN - EL 421.00 -AREA 2	X
363	E-132	LIGHTING PLAN - EL 421.00 -AREA 3	Х
364	E-133	LIGHTING PLAN - EL 421.00 -AREA 4	Х
365	E-134	LIGHTING PLAN - EL 421.00 -AREA 5	X

366	E-135	LIGHTING PLAN - EL 421.00 -AREA 6	Х
367	E-136	FIRE ALARM & SECURITY PLAN - EL 383.00 -AREA 1	Х
368	E-137	FIRE ALARM & SECURITY PLAN - EL 383.00 -AREA 2 & 3	Х
369	E-138	FIRE ALARM & SECURITY PLAN - EL 398.00 -AREA 1	Х
370	E-139	FIRE ALARM & SECURITY PLAN - EL 398.00 -AREA 2 & 3	Х
371	E-140	FIRE ALARM & SECURITY PLAN - EL 407.00 -AREA 1	Х
372	E-141	FIRE ALARM & SECURITY PLAN - EL 407.00 -AREA 2	Х
373	E-142	FIRE ALARM & SECURITY PLAN - EL 407.00 -AREA 3	Х
374	E-143	FIRE ALARM & SECURITY PLAN - EL 407.00 -AREA 4	Х
375	E-144	FIRE ALARM & SECURITY PLAN - EL 407.00 -AREA 5	Х
376	E-145	FIRE ALARM & SECURITY PLAN - EL 407.00 -AREA 6	Х
377	E-146	FIRE ALARM & SECURITY PLAN - EL 421.00 -AREA 1	Х
378	E-147	FIRE ALARM & SECURITY PLAN - EL 421.00 -AREA 2	Х
379	E-148	FIRE ALARM & SECURITY PLAN - EL 421.00 -AREA 3	X
380	E-149	FIRE ALARM & SECURITY PLAN - EL 421.00 -AREA 4	X
381	E-150	FIRE ALARM & SECURITY PLAN - EL 421.00 -AREA 5	X
382	E-151	FIRE ALARM & SECURITY PLAN - EL 421.00 -AREA 6	Х
383	E-152	LIGHTNING PROTECTION PLAN	X
384	E-153	GROUNDING PLAN	X
385	E-201	STAIRCASE SECTIONS -SHEET 1	X
386	E-202	STAIRCASE SECTIONS -SHEET 2	X
387	E-501	WASTE WASHWATER TANK -POWER PLAN	X
388	E-601	STANDARD DETAILS - SHEET 1	Х
389	E-602	STANDARD DETAILS - SHEET 2	Х
390	E-603	STANDARD DETAILS - SHEET 3	Х
391	E-604	STANDARD DETAILS - SHEET 4	X
392	E-605	STANDARD DETAILS - SHEET 5	Х

WARNING
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<u>.</u> 0	DESCRIPT	ION OF THE ALTERATION.				
_Lake_Filtration					PROJECT ENGINEER:	R. FROST
- 1					DESIGNED BY:	R. FROST
Docs://90388-000_Rye_ 9:53:51 AM					DRAWN BY:	B. CASULL
s://9038 3:51 AM					CHECKED BY:	E. FELDMAN
					IF THIS BAR DOES NOT MEASURE 1" THEN DRAWING	0 1/2" 1"
utodesk 26/2025	REV	ISSUED FOR	DATE	BY	IS NOT TO FULL SCALE	

BID SET



HAZEN AND SAWYER
498 SEVENTH AVENUE, 11th FLOOR
NEW YORK, NEW YORK 10018

WESTCHESTER JOINT WATER WORKS MAMARONECK, NY

RYE LAKE WATER FILTRATION PLANT HARRISON, NY


GENERAL DRAWING INDEX - SHEET 2 DATE: FEB 2025

HAZEN NO.: 90388-000

CONTRACT NO.: A1364-A

DRAWING NUMBER:

G-003

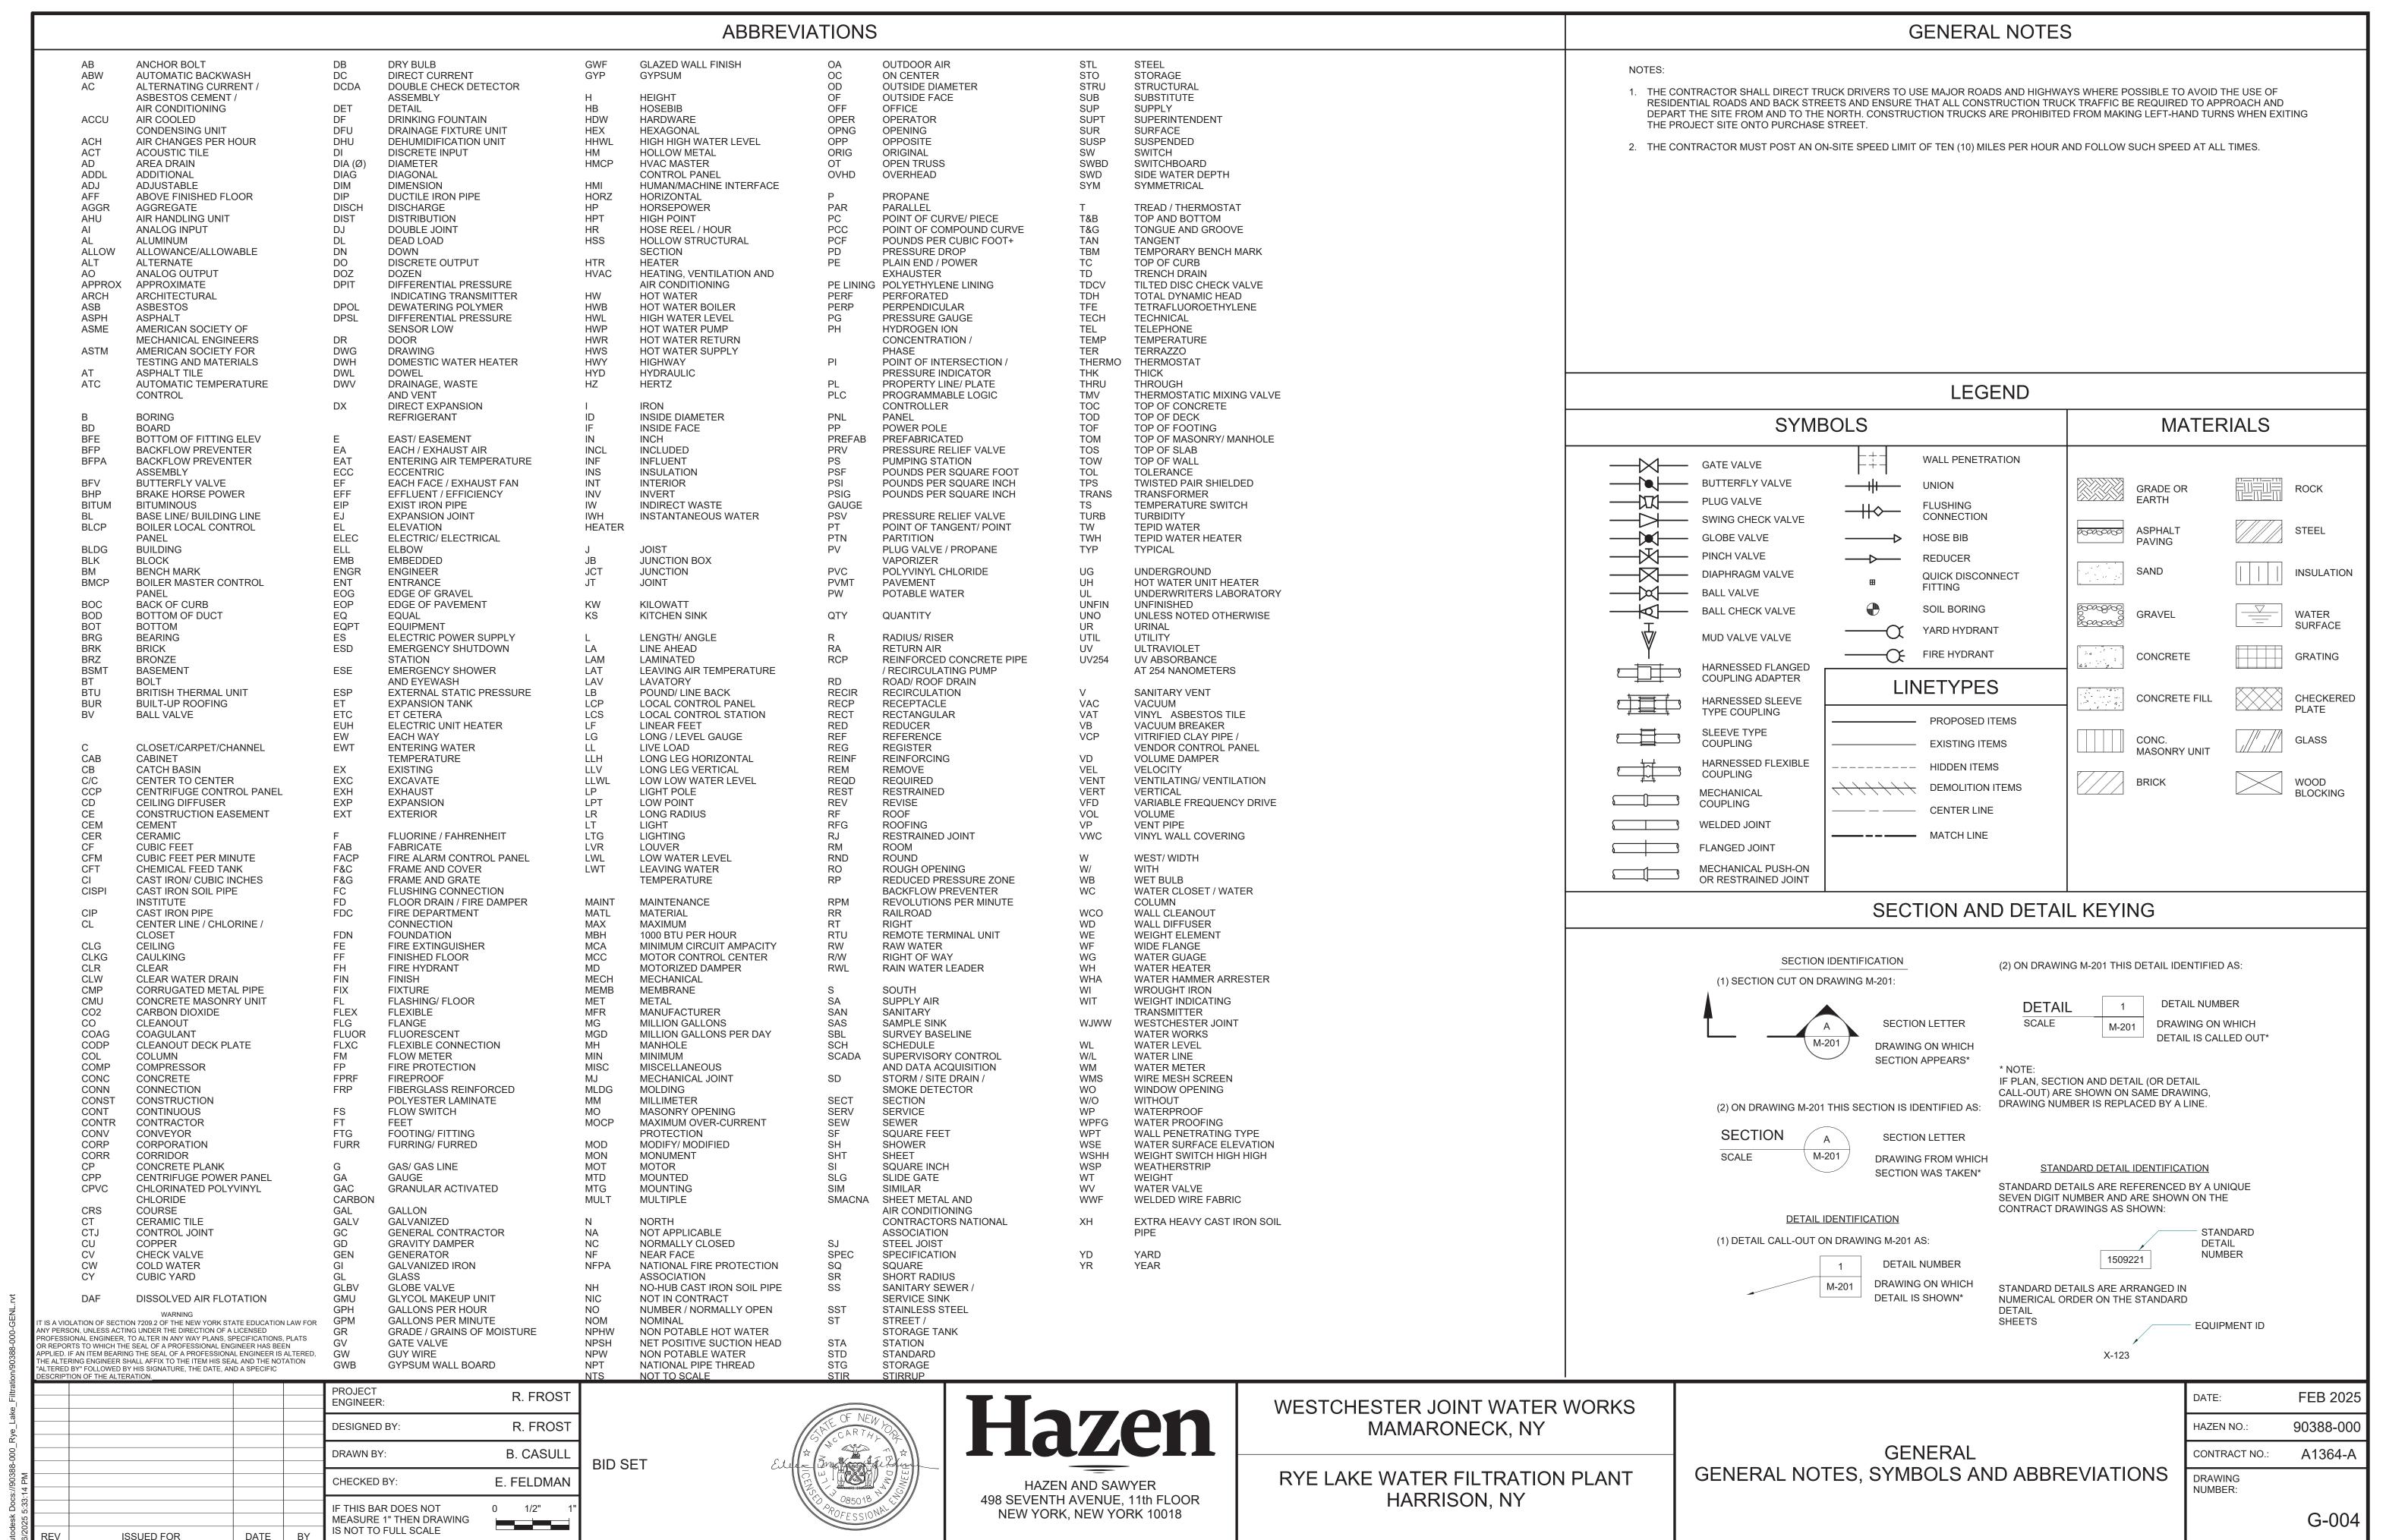

ROOM NUMBER	BUILDING NAME	AREA/ROOM DESIGNATION AREA/ROOM NAME	AREA/ROOM DESIGNATION
001	FILTRATION PLANT	BACKWASH TANK	INDOOR WET PROCESS AREA
002	FILTRATION PLANT	FILTERED WATER TRANSFER TANKS	INDOOR WET PROCESS AREA
003	FILTRATION PLANT	FLOATED SOLIDS BUFFER TANK	INDOOR WET PROCESS AREA
004	FILTRATION PLANT	UV DISINFECTION SYSTEM	INDOOR WET PROCESS AREA
005	FILTRATION PLANT	RESIDUALS STORAGE TANKS	INDOOR WET PROCESS AREA
006	FILTRATION PLANT	STORAGE CLOSET	INDOOR DRY NON-PROCESS AREA
007	FILTRATION PLANT	PIPE GALLERY	INDOOR WET PROCESS AREA
008	FILTRATION PLANT	VESTIBULE	INDOOR DRY NON-PROCESS AREA
101	FILTRATION PLANT	HYDROFLUOROSILICIC ACID	TYPE 1 CHEMICAL STORAGE / TRANSFER AREA
102	FILTRATION PLANT	SODIUM HYPOCHLORITE	TYPE 1 CHEMICAL STORAGE / TRANSFER AREA
103	FILTRATION PLANT	COAGULANT	TYPE 2 CHEMICAL STORAGE / TRANSFER AREA
104	FILTRATION PLANT	CORROSION INHIBITOR	TYPE 2 CHEMICAL STORAGE / TRANSFER AREA
105	FILTRATION PLANT	POLYMER/SOFTENER (FUTURE)	TYPE 2 CHEMICAL STORAGE / TRANSFER AREA
106	FILTRATION PLANT	FILTERED WATER PUMPING & DAF ROOM	INDOOR WET PROCESS AREA
107	FILTRATION PLANT	SODIUM HYDROXIDE	TYPE 2 CHEMICAL STORAGE / TRANSFER AREA
	FILTRATION PLANT		INDOOR DRY NON-PROCESS AREA
108		CLOSET PEWATERING ROOM	
109	FILTRATION PLANT	DEWATERING ROOM	INDOOR WET PROCESS AREA
110	FILTRATION PLANT	FIRE SPRINKLER RISER ROOM	INDOOR DRY NON-PROCESS AREA
111	FILTRATION PLANT	CONFERENCE ROOM	INDOOR DRY NON-PROCESS AREA
112	FILTRATION PLANT	LOBBY	INDOOR DRY NON-PROCESS AREA
113	FILTRATION PLANT	VESTIBULE	INDOOR DRY NON-PROCESS AREA
114	FILTRATION PLANT	MAINTENANCE CLOSET	INDOOR DRY NON-PROCESS AREA
115	FILTRATION PLANT	WOMENS BATHROOM	INDOOR DRY NON-PROCESS AREA
116	FILTRATION PLANT	WOMENS LOCKER ROOM	INDOOR DRY NON-PROCESS AREA
117	FILTRATION PLANT	MENS BATHROOM	INDOOR DRY NON-PROCESS AREA
118	FILTRATION PLANT	MENS LOCKER ROOM	INDOOR DRY NON-PROCESS AREA
119	FILTRATION PLANT	ELECTRICAL	INDOOR DRY NON-PROCESS AREA
120	FILTRATION PLANT	RAW WATER PIPING	INDOOR WET PROCESS AREA
121	FILTRATION PLANT	STATIC MIXER AND OVERFLOW	INDOOR WET PROCESS AREA
122	FILTRATION PLANT	DAF TANKS	INDOOR WET PROCESS AREA
123	FILTRATION PLANT	EQUIPMENT PLATFORM	INDOOR WET PROCESS AREA
124	FILTRATION PLANT	VESTIBULE	INDOOR DRY NON-PROCESS AREA
201	FILTRATION PLANT	HVAC	INDOOR DRY NON-PROCESS AREA
202	FILTRATION PLANT	AIR SCOUR	INDOOR DRY PROCESS AREA
203	FILTRATION PLANT	ELECTRICAL ROOM	INDOOR DRY NON-PROCESS AREA
204	FILTRATION PLANT	STORAGE ROOM	INDOOR DRY NON-PROCESS AREA
205	FILTRATION PLANT	PROCESS ANALYSIS ROOM	INDOOR WET PROCESS AREA
206	FILTRATION PLANT	CONTROL ROOM	INDOOR DRY NON-PROCESS AREA
207	FILTRATION PLANT	SCADA ROOM	INDOOR DRY NON-PROCESS AREA
208	FILTRATION PLANT	HVAC	INDOOR DRY NON-PROCESS AREA
209	FILTRATION PLANT	COPY ROOM	INDOOR DRY NON-PROCESS AREA
210	FILTRATION PLANT	CHIEF'S OFFICE	INDOOR DRY NON-PROCESS AREA
211	FILTRATION PLANT	VESTIBULE	INDOOR DRY NON-PROCESS AREA
212	FILTRATION PLANT	MAINTENANCE CLOSET	INDOOR DRY NON-PROCESS AREA
213	FILTRATION PLANT	WC	INDOOR DRY NON-PROCESS AREA
214	FILTRATION PLANT	OPEN OFFICE	INDOOR DRY NON-PROCESS AREA
215	FILTRATION PLANT	HVAC	INDOOR DRY NON-PROCESS AREA
216	FILTRATION PLANT	STORAGE ROOM	INDOOR DRY NON-PROCESS AREA
217	FILTRATION PLANT	HVAC PLENUM	INDOOR DRY NON-PROCESS AREA
218	FILTRATION PLANT	OPERATING LEVEL	INDOOR WET PROCESS AREA
C01	FILTRATION PLANT	CORRIDOR	INDOOR DRY NON-PROCESS AREA
C02	FILTRATION PLANT	CORRIDOR	INDOOR DRY NON-PROCESS AREA
C03	FILTRATION PLANT	CORRIDOR	INDOOR DRY NON-PROCESS AREA
E01	FILTRATION PLANT	ELEVATOR	INDOOR DRY NON-PROCESS AREA
SA	FILTRATION PLANT	STAIR A	INDOOR DRY NON-PROCESS AREA
SB	FILTRATION PLANT	STAIR B	INDOOR DRY NON-PROCESS AREA
SC	FILTRATION PLANT	STAIR C	INDOOR DRY NON-PROCESS AREA
	ELECTRICAL SERVICE BUILDING	ELECTRICAL ROOM	INDOOR DRY NON-PROCESS AREA
	FILTRATION PLANT	INDOOR AREAS/ ROOMS NOT LISTED	INDOOR WET PROCESS AREA
	PUMP STATION	INDOOR AREAS/ ROOMS NOT LISTED	INDOOR WET PROCESS AREA
	SITE	OUTDOOR AREAS	OUTDOOR AREA
	FILTRATION PLANT	OUTDOOR AREAS	OUTDOOR AREA
	PUMP STATION	OUTDOOR AREAS	OUTDOOR AREA

PROCESS MECHANICAL PIPE SUPPORTS PIPE SUPPORTS PIPE SUPPORTS Per Section 40 05 07 PIPE SUPPORT ANCHORS PIPE SUPPORT ANCHORS PIPE SUPPORT ANCHORS PIPE SUPPORT FASTENING HARDWARE AND THREADED ROD STRUCTURAL GUARDS & RAILINGS GRATING GRATING GRATING GUARDS, RAILINGS, & GRATING ANCHORS GRATING ALUMINUM OR FRP GUARDS, RAILINGS, & GRATING FASTENING HARDWARE GUARDS, RAILINGS, & GRATING FASTENING HARDWARE WATERSTOPS PVC HVAC DUCT HANGERS DUCT HANGER ANCHORS DUCT HANGER FASTENING HARDWARE AND THREADED ROD PLUMBING PIPE HANGERS 304L SST 304L SST HANGER ANCHORS 304L SST 306L SST 306L SST	See Section 40 05 07 304L SST, NOTE 2 316L SST 316L SST Per Section 40 05 07	INDOOR DRY NON- PROCESS AREA See Section 40 05 08 304L SST 304L SST 316L SST HOT DIP GALV ALUMINUM OR FRP ALUMINUM OR FRP	TYPE 1 CHEMICAL STORAGE/TRANSFER AREA FRP FRP HASTELLOY C HASTELLOY C FRP FRP	TYPE 2 CHEMICAL STORAGE/TRANSFER AREA FRP FRP 316L SST 316L SST FRP	316L SST, NOTE 2 304L SST, NOTE 2 316L SST, NOTE 2 316L SST 316L SST
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WATERSTOPS PVC HVAC DUCT HANGERS DUCT HANGER ANCHORS DUCT HANGER FASTENING HARDWARE AND THREADED ROD PLUMBING PIPE HANGERS 316L SST 316L SST 316L SST 316L SST	304L SST	304L SST	HASTELLOY C	316L SST	316L SST
HVAC DUCT HANGERS DUCT HANGER ANCHORS DUCT HANGER FASTENING HARDWARE AND THREADED ROD 316L SST PLUMBING PIPE HANGERS 304L SST	304L SST	304L SST	316L SST	316L SST	304L SST
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DUCT HANGER FASTENING HARDWARE AND THREADED ROD 316L SST PLUMBING PIPE HANGERS 304L SST	304L SST	HOT DIP GALV	FRP, NOTE 3	316L SST	304L SST
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PIPE HANGERS 304L SST					
66.12.601	304L SST	HOT DIP GALV	FRP, NOTE 3	316L SST	304L SST
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HANGER FASTENING HARDWARE AND THREADED ROD 304L SST	304L SST	HOT DIP GALV	FRP, NOTE 3	316L SST	304L SST
ELECTRICAL					
SUPPORT CHANNELS AND THREADED ROD 316L SST		HOT DIP GALV	FRP	316L SST	304L SST
ANCHORS 316L SST	HOT DIP GALV		HASTELLOY C	316L SST	316L SST
FASTENING HARDWARE 316L SST	HOT DIP GALV 304L SST	304L SST		316L SST	304L SST

NOTES:
1. THIS TABLE PROVIDES MINIMUM ACCEPTABLE MATERIAL REQUIREMENTS IF NO FURTHER GUIDANCE IS GIVEN IN DRAWINGS AND SPECIFICATIONS. ALTERNATE MATERIALS MAY BE REQUIRED WHERE SPECIFICALLY IDENTIFIED IN DRAWINGS OR SPECIFICATIONS.
2. PIPE SUPPORT MATERIALS (SUPPORTS, ANCHORS, FASTENING HARDWARE) SUBMERGED OR PARTIALLY SUBMERGED IN A PROCESS TANK SHALL BE CONSTRUCTED OF 316L SST.
3. VERIFY RESIN IS COMPATIBLE WITH THE CHEMICAL ENVIRONMENT. SEE SPECIFICATION 06 51 00 GLASS FIBER AND RESIN FABRICATION FOR FURTHER INFORMATION.

4. FOR ANCHROS EXPOSED TO SODIUM HYPOCHLORITE AND FERRIC CHLORIDE, TITANIUM ANCHORS MAY BE USED IN LIEU OF HASTELLOY C ANCHORS. FIBERGLASS FASTENERS MAY BE USED AS AN ALTERNATIVE TO HASTELLOY C ANCHORS PROVIDED ANCHOR STRENGTH CRITERIA CAN BE MET.

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PROFESSIONAL ENGINEER, TO ALTER IN ANY WAY PLANS, SPECIFICATIONS, PLATS
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THE ALTERING ENGINEER SHALL AFFIX TO THE ITEM HIS SEAL AND THE NOTATION
"ALTERED BY" FOLLOWED BY HIS SIGNATURE THE DATE AND A SPECIFIC.

		BY" FOLLOWED BY HIS SIGNATURE, THE DATE, AN ION OF THE ALTERATION.	ID A SPECIFIC			
- LIIII a					PROJECT ENGINEER:	R. FROST
ye_Lar					DESIGNED BY:	R. FROST
Autouesa Docs.//sosso-000_ Nye_Lake_Filliatio!//s 2/6/2025 5:33:14 PM					DRAWN BY:	B. CASULL
					CHECKED BY:	E. FELDMAN
					IF THIS BAR DOES NOT MEASURE 1" THEN DRAWING	0 1/2" 1"
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BID SET





WESTCHESTER JOINT WATER WORKS MAMARONECK, NY


RYE LAKE WATER FILTRATION PLANT HARRISON, NY

GENERAL				
GENERAL AREA DESIGNATION TABLES				

DATE:	FEB 2025
HAZEN NO.:	90388-000
CONTRACT NO.:	A1364-A
DRAWING NUMBER:	
	G-005

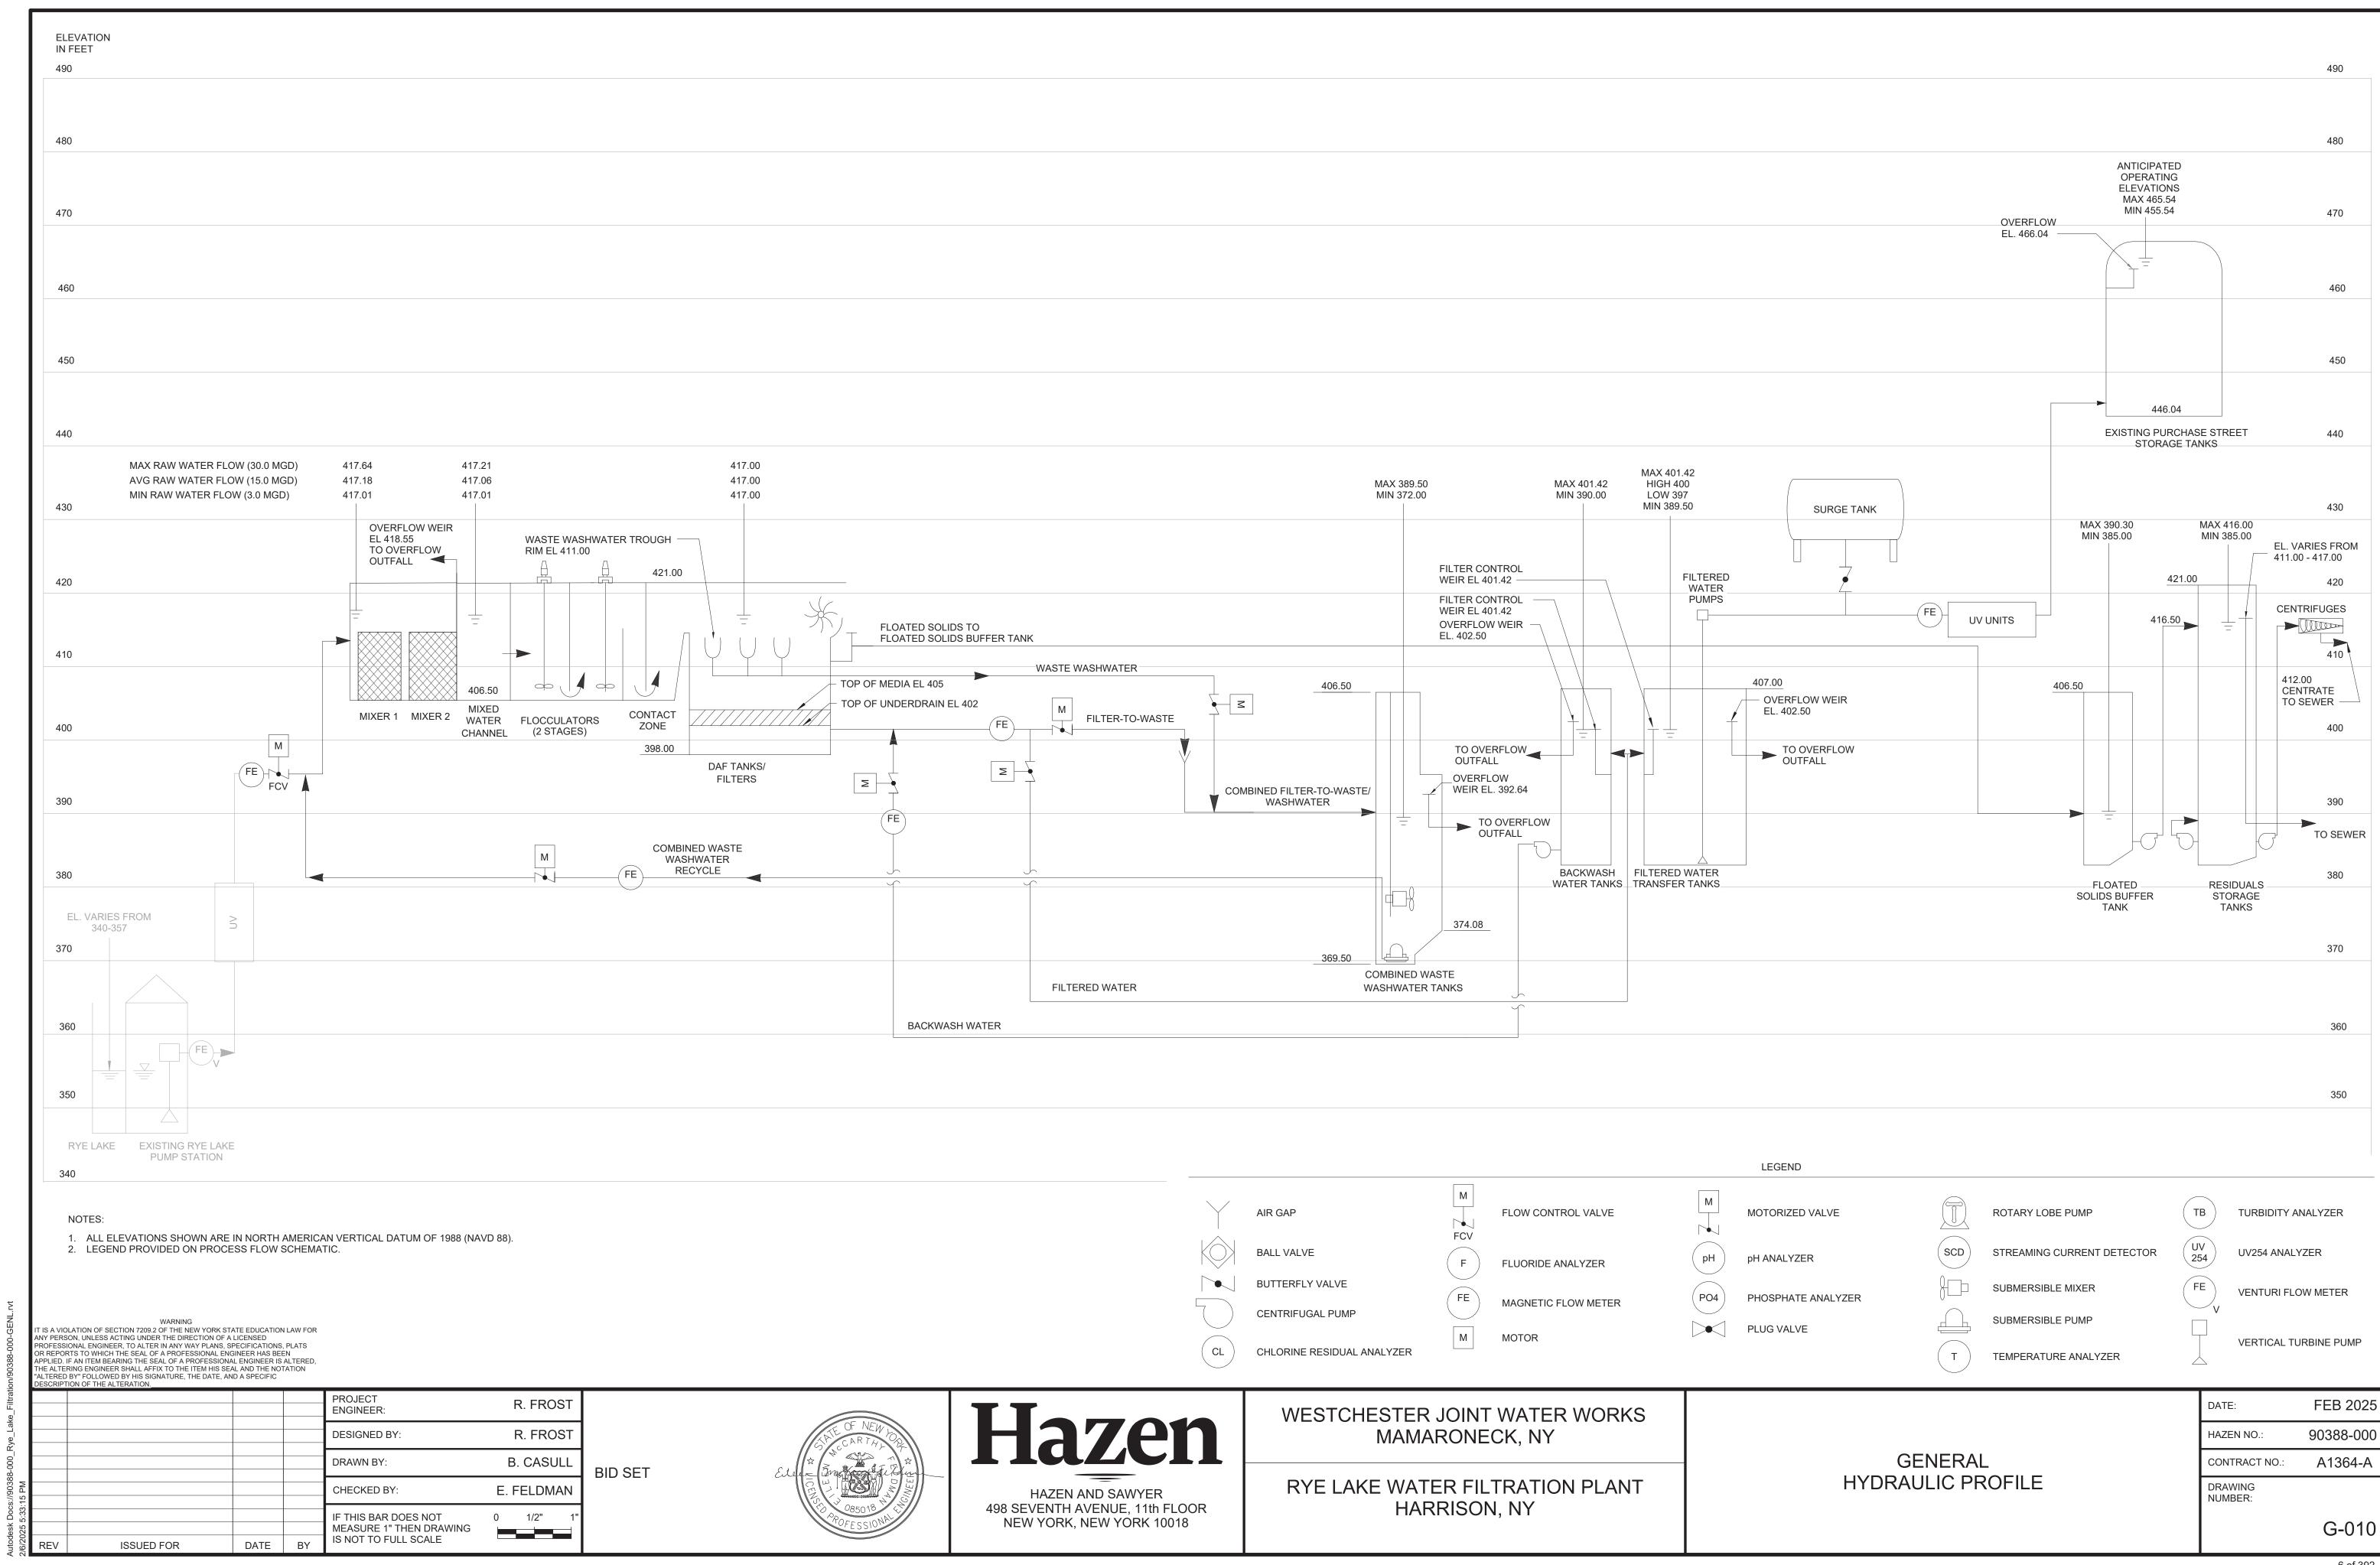

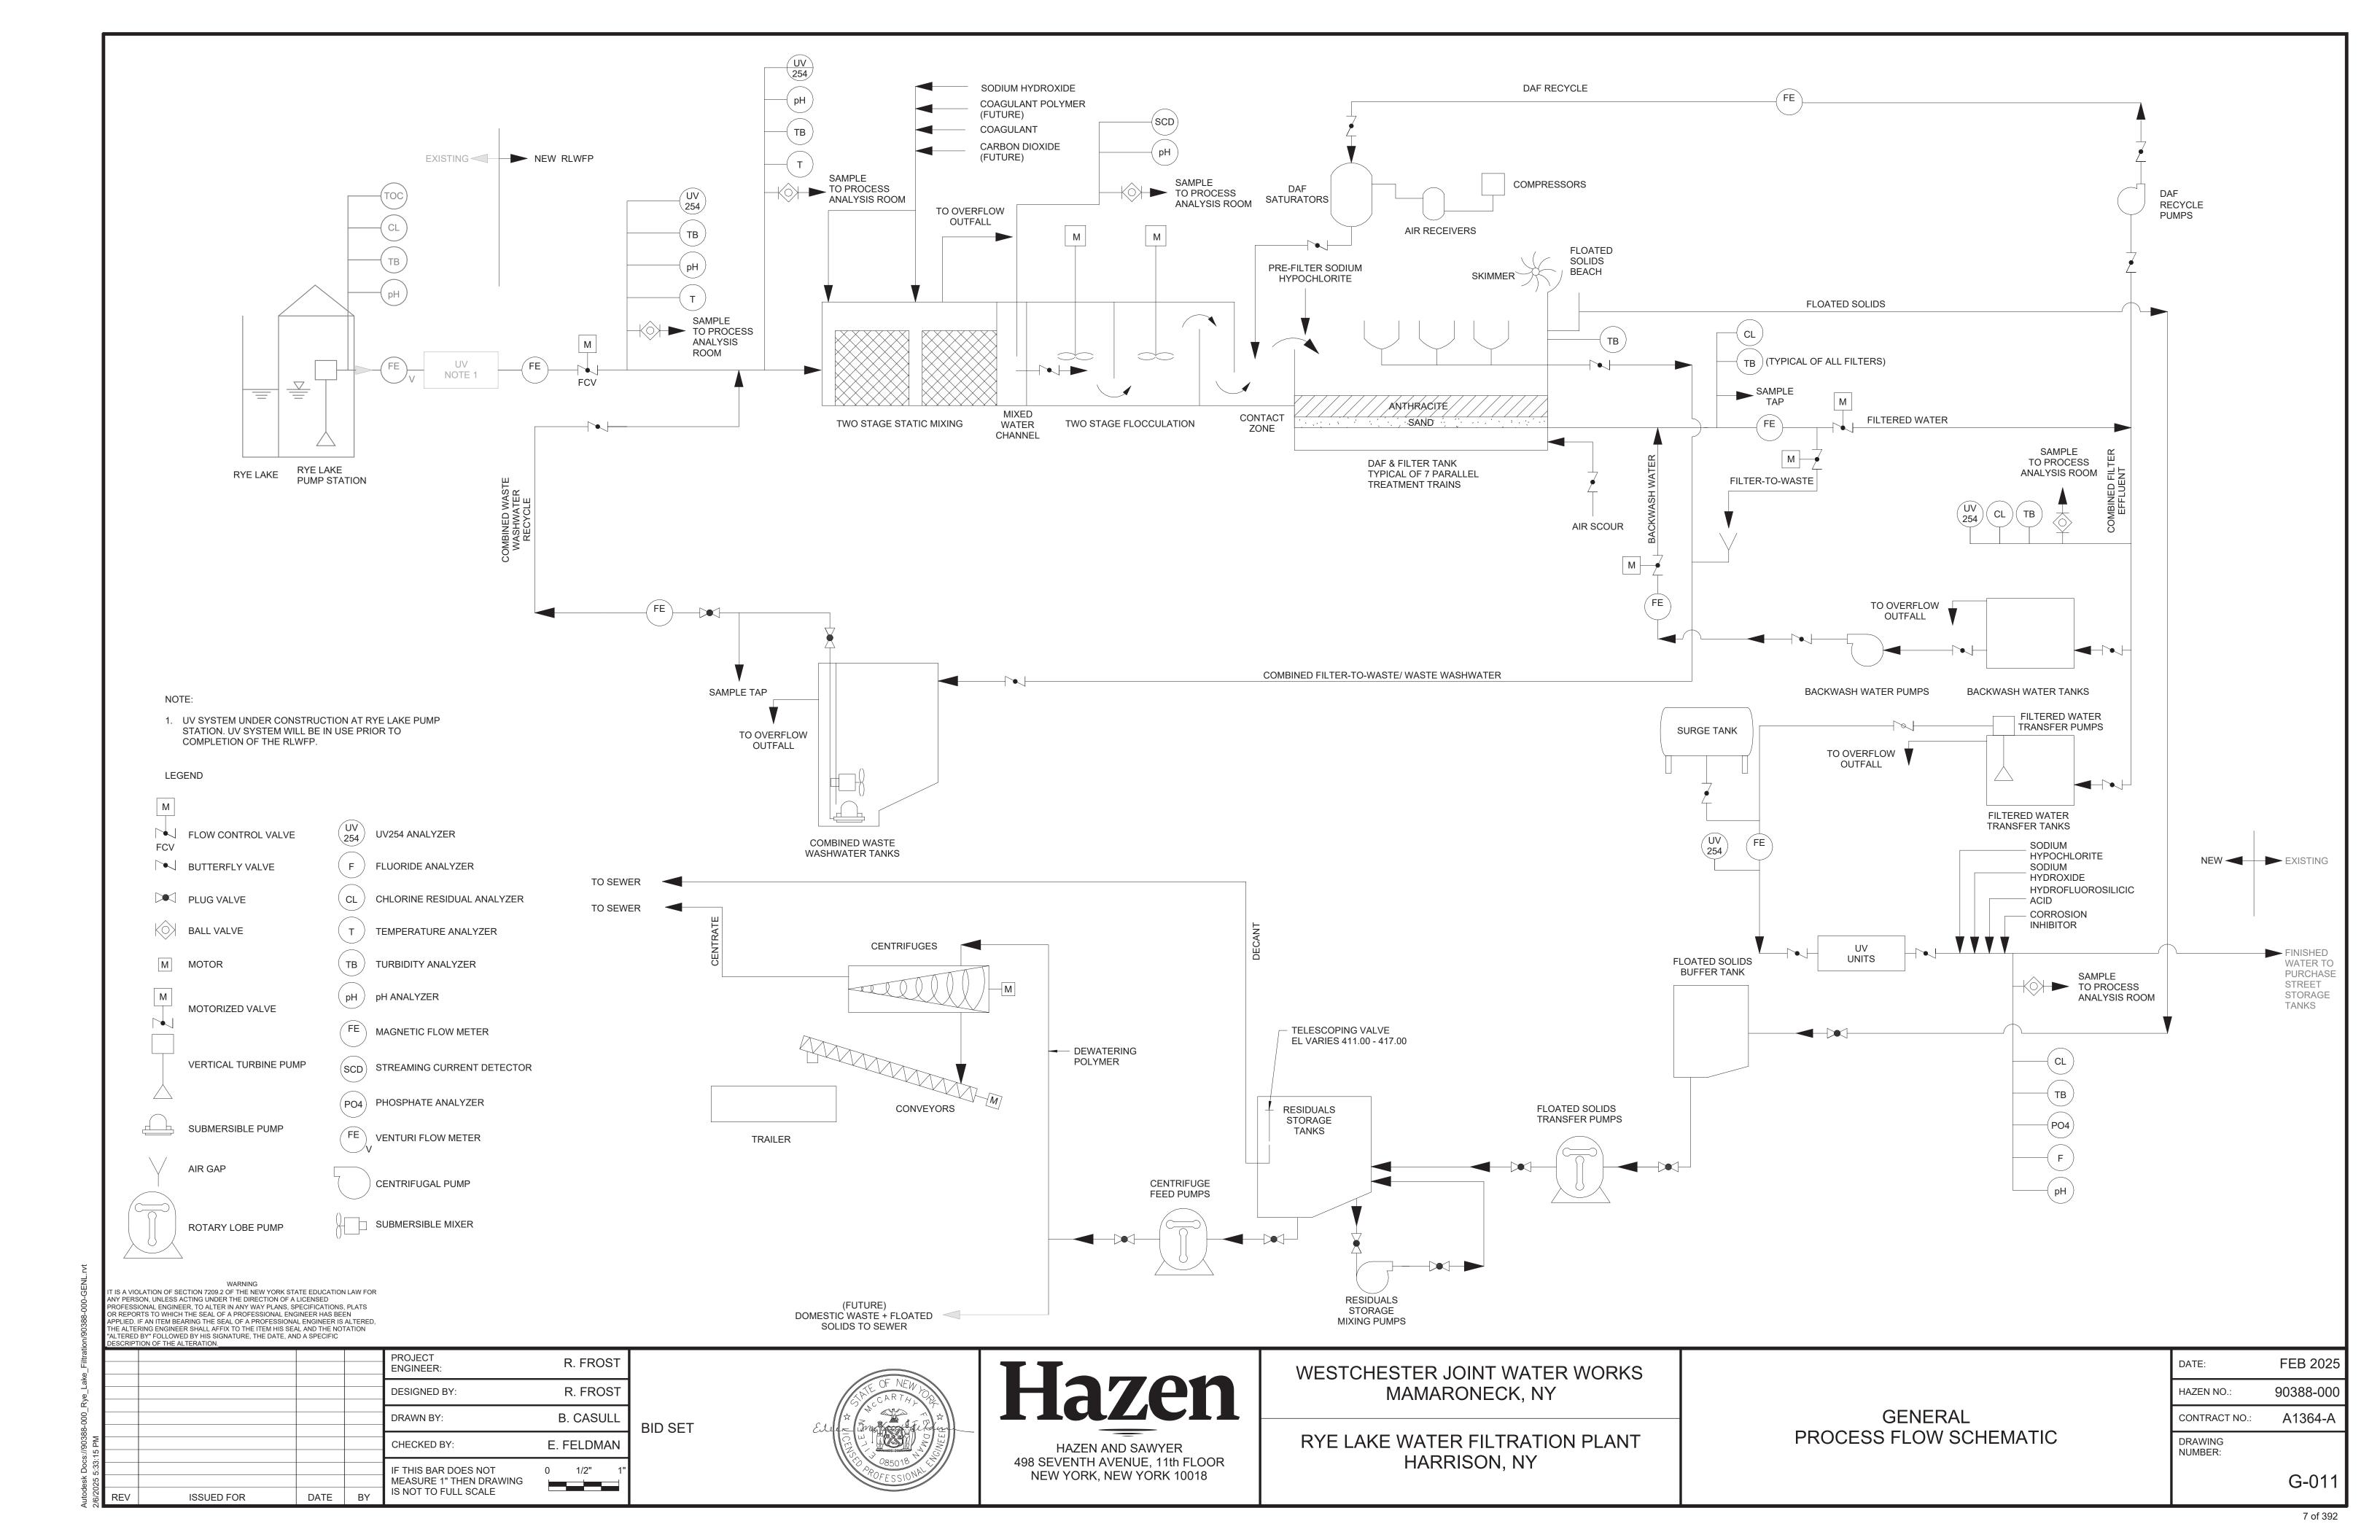

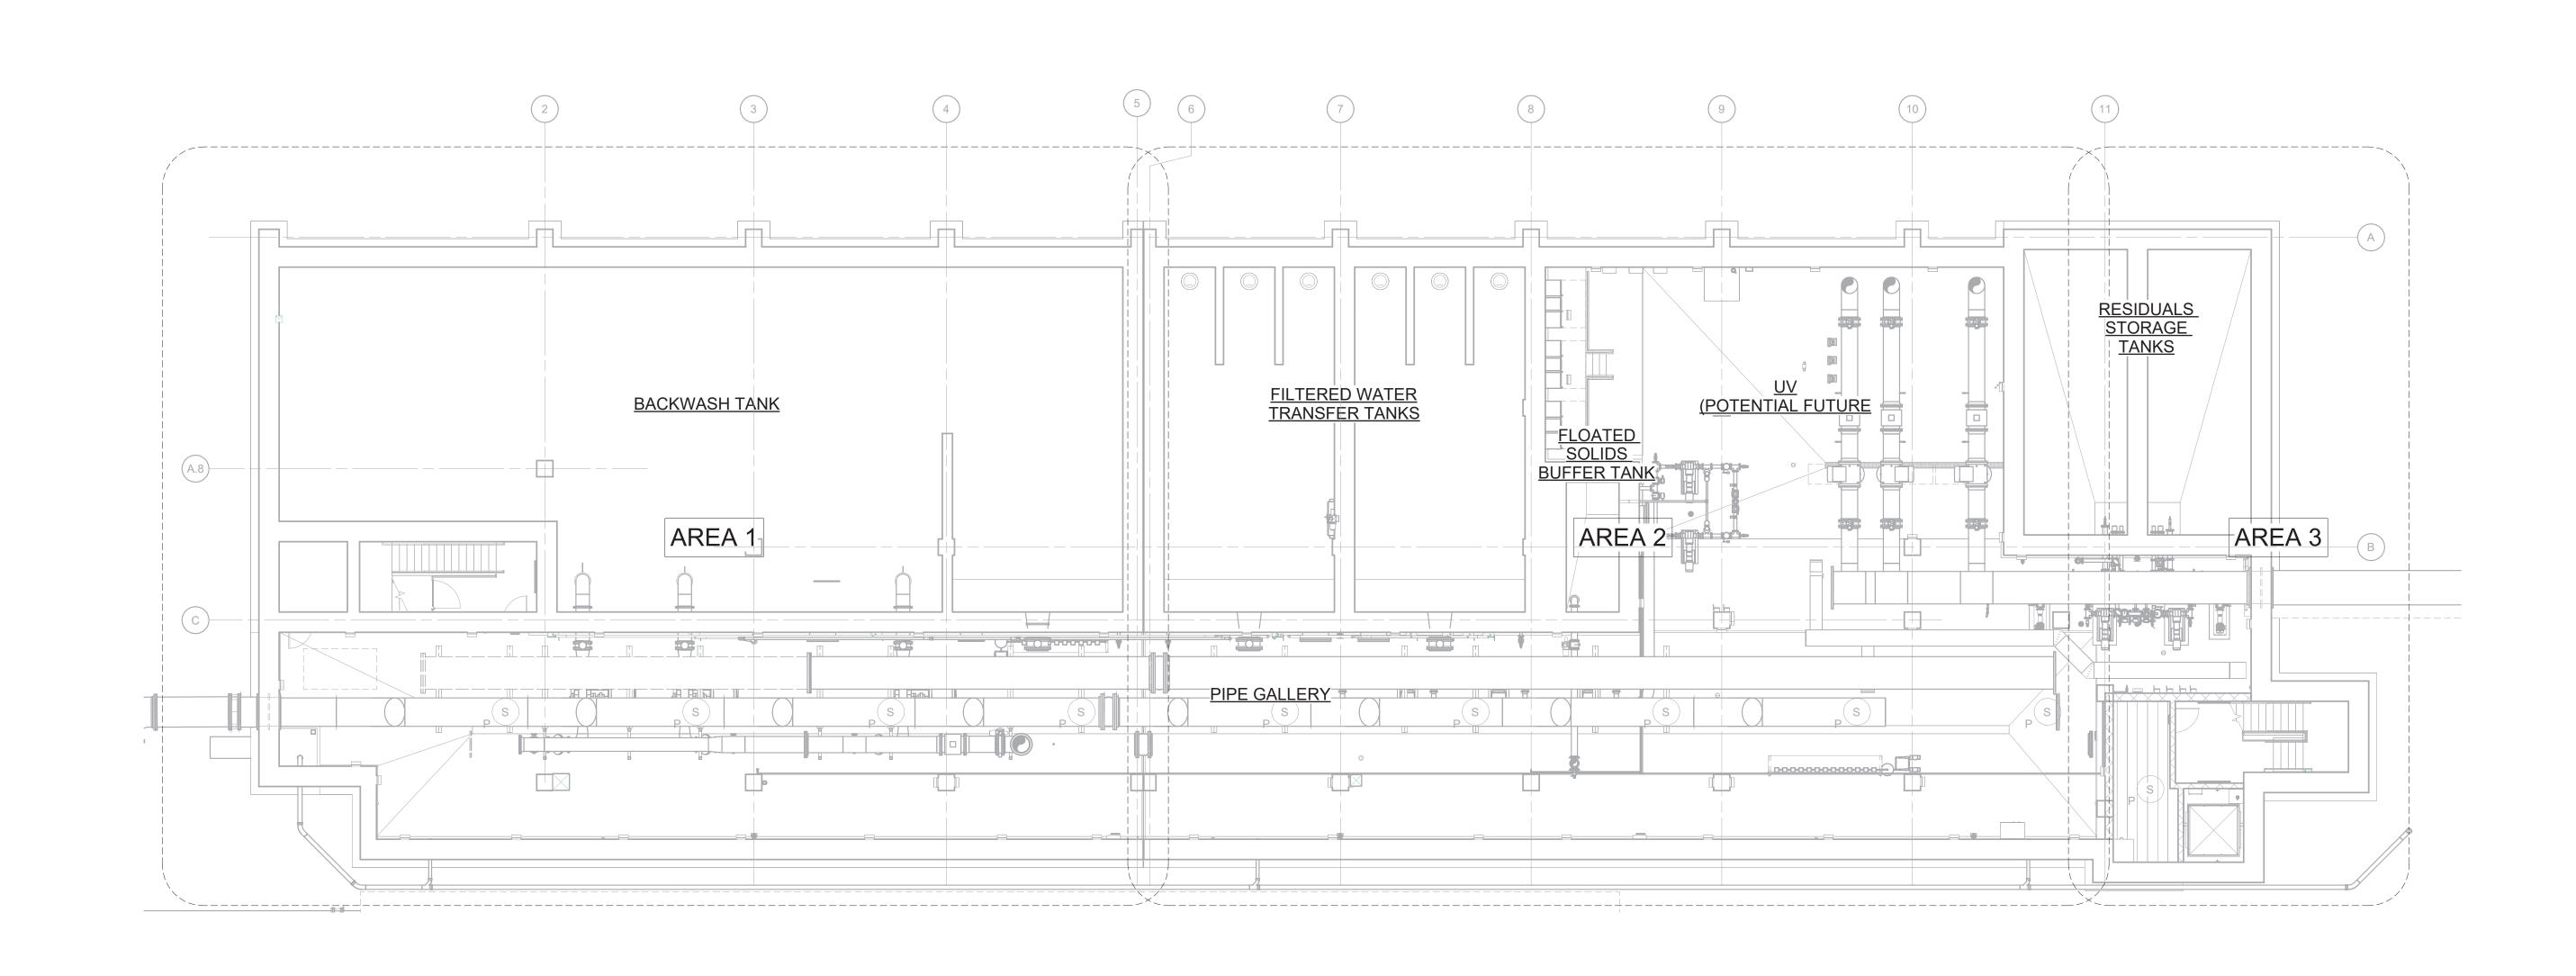

GENERAL ARRANGEMENT PLAN EL 384.00
3/32" = 1'-0"

WARNING
IT IS A VIOLATION OF SECTION 7209.2 OF THE NEW YORK STATE EDUCATION LAW FOR
ANY PERSON, UNLESS ACTING UNDER THE DIRECTION OF A LICENSED
PROFESSIONAL ENGINEER, TO ALTER IN ANY WAY PLANS, SPECIFICATIONS, PLATS
OR REPORTS TO WHICH THE SEAL OF A PROFESSIONAL ENGINEER HAS BEEN
APPLIED. IF AN ITEM BEARING THE SEAL OF A PROFESSIONAL ENGINEER IS ALTERED,
THE ALTERING ENGINEER SHALL AFFIX TO THE ITEM HIS SEAL AND THE NOTATION
"ALTERED BY" FOLLOWED BY HIS SIGNATURE, THE DATE, AND A SPECIFIC

DY FOLLOWED BY HIS SIGNATURE, THE DATE, AND A SPECIFIC ON OF THE ALTERATION.		
PROJECT ENGINEER:	R. FROST	
DESIGNED BY:	R. FROST	
DRAWN BY:	B. CASULL	BID SET
CHECKED BY:	E. FELDMAN	
IF THIS BAR DOES NOT MEASURE 1" THEN DRAWING	0 1/2" 1"	

ELLU CARTHUDE CARTHUDE WALLEY OF NEW 10 CONTROL OF NEW 10 CONTROL

HAZEN AND SAWYER
498 SEVENTH AVENUE, 11th FLOOR
NEW YORK, NEW YORK 10018

WESTCHESTER JOINT WATER WORKS MAMARONECK, NY

RYE LAKE WATER FILTRATION PLANT HARRISON, NY

GENERAL GENERAL ARRANGEMENT PLAN EL 384.00

DATE:	FEB 2025
HAZEN NO.:	90388-000
CONTRACT NO.:	A1364-A
DRAWING NUMBER:	
	G-100

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