
NORTH ROCKLAND CENTRAL SCHOOL DISTRICT STUDENT DROP OFF LOOP & WATER HEATER REPLACEMENT CONTRACT 03, 04, & 05 STONY POINT ELEMENTARY SCHOOL

7 GURNEE DRIVE STONY POINT, NY 10980

GENERAL	
G000	COVER
G101	LIFE SAFETY PLANS
CIV/II	
CIVIL C-100	SITE PREPARATION & DEMOLITION PLAN
C-200	LAYOUT & MATERIALS PLAN
C-300	GRADING AND DRAINAGE PLAN
C-400	CODE COMPLIANCE PLAN
C-500	DETAILS
C-501	DETAILS
C-502	DETAILS
STRUCTURAL	
STRUCTURAL S-200	RETAINING WALL DETAILS AND NOTES
S-200	RETAINING WALL DETAILS AND NOTES
S-200 PLUMBING	
S-200 PLUMBING P000	RETAINING WALL DETAILS AND NOTES PLUMBING LEGEND, NOTES & SYSTEM DIAGRAMS BOILER ROOM DEMOLITION PLAN
S-200 PLUMBING P000 P100	PLUMBING LEGEND, NOTES & SYSTEM DIAGRAMS
S-200 PLUMBING P000 P100 P200	PLUMBING LEGEND, NOTES & SYSTEM DIAGRAMS BOILER ROOM DEMOLITION PLAN
S-200 PLUMBING P000	PLUMBING LEGEND, NOTES & SYSTEM DIAGRAMS BOILER ROOM DEMOLITION PLAN BOILER ROOM NEW WORK PLAN
S-200 PLUMBING P000 P100 P200 P700	PLUMBING LEGEND, NOTES & SYSTEM DIAGRAMS BOILER ROOM DEMOLITION PLAN BOILER ROOM NEW WORK PLAN PLUMBING SCHEDULE AND PIPING SCHEMATIC
S-200 PLUMBING P000 P100 P200 P700	PLUMBING LEGEND, NOTES & SYSTEM DIAGRAMS BOILER ROOM DEMOLITION PLAN BOILER ROOM NEW WORK PLAN PLUMBING SCHEDULE AND PIPING SCHEMATIC
S-200 PLUMBING P000 P100 P200 P700 P800	PLUMBING LEGEND, NOTES & SYSTEM DIAGRAMS BOILER ROOM DEMOLITION PLAN BOILER ROOM NEW WORK PLAN PLUMBING SCHEDULE AND PIPING SCHEMATIC

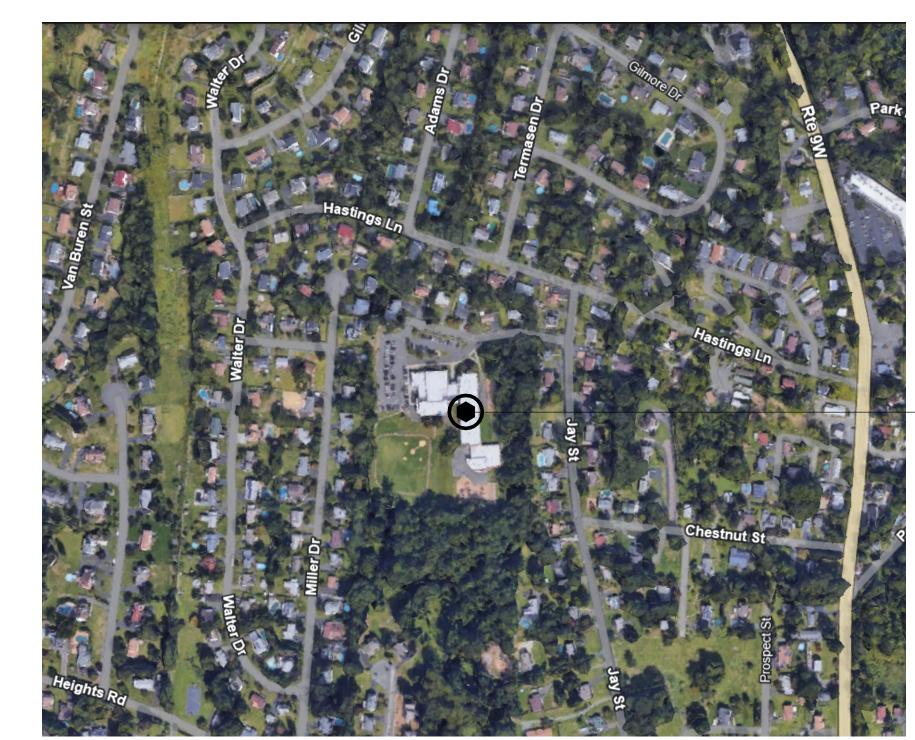

-STONY POINT ELEMENTARY SCHOOL 7 GURNEE DRIVE, STONY POINT, NY 10980

ARCHITECT CERTIFICATION

TO THE BEST OF MY KNOWLEDGE, INFORMATION AND BELIEF, THE PLANS AND SPECIFICATIONS ARE IN ACCORDANCE WITH APPLICABLE REQUIREMENTS OF THE BUILDING CODE OF NEW YORK STATE, THE ENERGY CONSERVATION CONSTRUCTION CODE OF NEW YORK STATE, NYSDOL INDUSTRIAL CODE RULE 56 AND THE MANUAL OF PLANNING STANDARDS OF THE NEW YORK STATE EDUCATION DEPARTMENT. NO ASBESTOS CONTAINING MATERIALS ARE SPECIFIED FOR USE IN NEW CONSTRUCTION.

	037878	5/28/25
LAUREN TARSIO		
Registered Architect	N.Y.S. Registration No.	Date

ARCHITECT



CPL | Architecture Engineering Planning CPLteam.com

Lauren Tarsio - Itarsio@cplteam.com NY ENGINEERING FIRM CERTIFICATE #0021419

OWNER



NORTH ROCKLAND CENTRAL SCHOOL DISTRICT 65 CHAPEL STREET GARNERVILLE, NY 10923 T. 845.942.3000

https://www.northrockland.org/

Poughkeepsie, NY 12601



PROJECT INFORMATION

R25.17697.00

7 GURNEE DRIVE STONY POINT, NY 10980


■ STONY POINT ELEMENTARY SCHOOL SED #50-02-01-06-0-014-015

PROFESSIONAL STAMPS

SHEET INFORMATION

05/27/25 Project Status

COVER

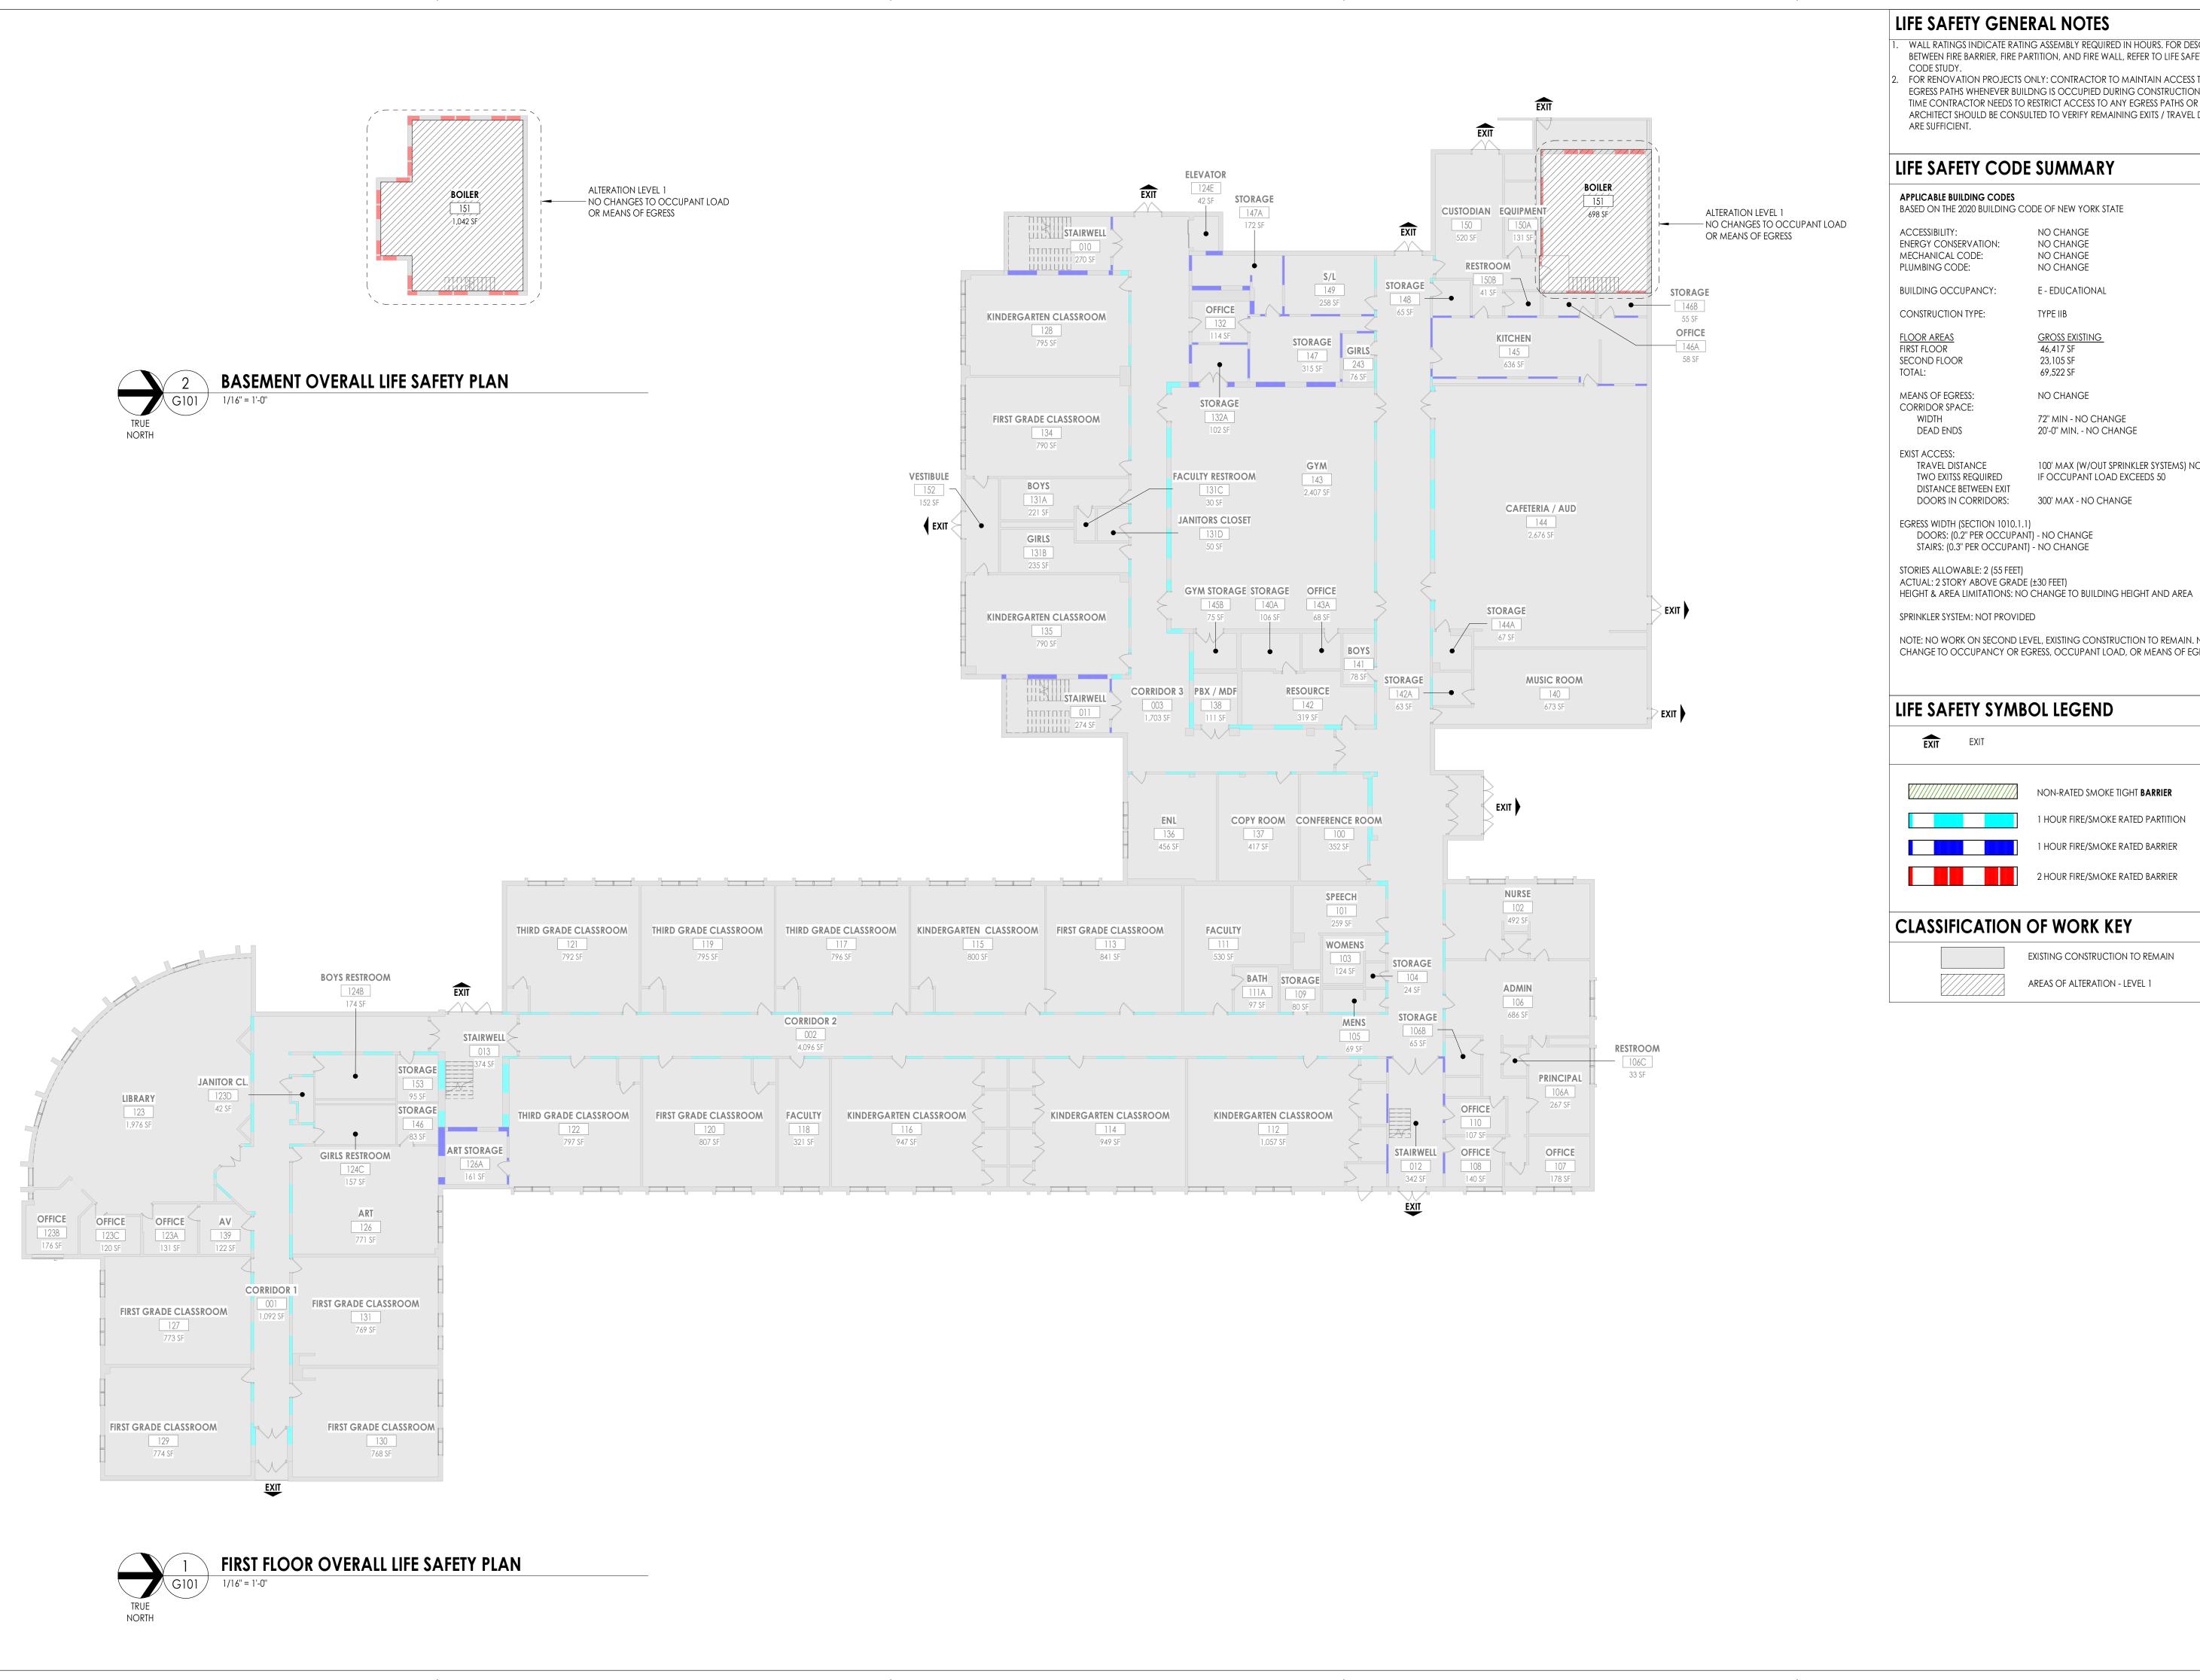

LIFE SAFETY GENERAL NOTES

WALL RATINGS INDICATE RATING ASSEMBLY REQUIRED IN HOURS. FOR DESGINATIONS BETWEEN FIRE BARRIER, FIRE PARTITION, AND FIRE WALL, REFER TO LIFE SAFETY PLANS &

FOR RENOVATION PROJECTS ONLY: CONTRACTOR TO MAINTAIN ACCESS TO ALL EGRESS PATHS WHENEVER BUILDING IS OCCUPIED DURING CONSTRUCTION. IF AT ANY TIME CONTRACTOR NEEDS TO RESTRICT ACCESS TO ANY EGRESS PATHS OR EXITS, ARCHITECT SHOULD BE CONSULTED TO VERIFY REMAINING EXITS / TRAVEL DISTANCES

LIFE SAFETY CODE SUMMARY

BASED ON THE 2020 BUILDING CODE OF NEW YORK STATE

NO CHANGE NO CHANGE NO CHANGE NO CHANGE E - EDUCATIONAL

TYPE IIB

GROSS EXISTING 46,417 SF 23,105 SF 69,522 SF

NO CHANGE 72" MIN - NO CHANGE

> 100' MAX (W/OUT SPRINKLER SYSTEMS) NO CHANGE IF OCCUPANT LOAD EXCEEDS 50

20'-0" MIN. - NO CHANGE

300' MAX - NO CHANGE

EGRESS WIDTH (SECTION 1010.1.1) DOORS: (0.2" PER OCCUPANT) - NO CHANGE

STORIES ALLOWABLE: 2 (55 FEET) ACTUAL: 2 STORY ABOVE GRADE (±30 FEET)

NOTE: NO WORK ON SECOND LEVEL, EXISTING CONSTRUCTION TO REMAIN. NO CHANGE TO OCCUPANCY OR EGRESS, OCCUPANT LOAD, OR MEANS OF EGRESS

NON-RATED SMOKE TIGHT BARRIER

1 HOUR FIRE/SMOKE RATED PARTITION 1 HOUR FIRE/SMOKE RATED BARRIER

CLASSIFICATION OF WORK KEY

EXISTING CONSTRUCTION TO REMAIN

AREAS OF ALTERATION - LEVEL 1

CPL | Architecture Engineering Planning 26 IBM Road Poughkeepsie, NY 12601

CPLteam.com

NY ENGINEERING FIRM CERTIFICATE #0021419

PROJECT INFORMATION

R25.17697.00 Client Name

NORTH ROCKLAND CENTRAL SCHOOL DISTRICT


STONY POINT ELEMENTARY SCHOOL STUDENT DROP OFF LOOP & WATER HEATER REPLACEMENT

7 GURNEE DRIVE STONY POINT, NY 10980

PROJECT ISSUE & REVISION SCHEDULE

■ STONY POINT ELEMENTARY SCHOOL SED #50-02-01-06-0-014-015

PROFESSIONAL STAMPS

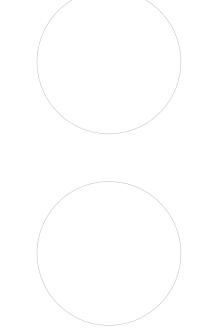

SHEET INFORMATION Issued 05/27/25 As indicated

Project Status BID Drawn By GJB

Drawing Title LIFE SAFETY PLANS

GENERAL NOTES

- SURVEY INFORMATION DERIVED FROM A SURVEY TITLED "RECORD SURVEY CPL STONY POINT ELEMENTARY SCHOOL" DATED 30 DECEMBER, 2024 AND LAST REVISED 08 APRIL, 2025 PREPARED BY CONTROL POINT ASSOCIATES, INC., P.C..
- 2. PRIOR TO COMMENCING ANY EXCAVATION WORK, THE CONTRACTOR SHALL CONTACT U.F.P.O. (1-800-962-7962) AND THE PROPER LOCAL AUTHORITIES OR RESPECTIVE UTILITY COMPANY HAVING JURISDICTION TO CONFIRM THE LOCATION OF ALL EXISTING UTILITIES BEFORE COMMENCING WORK. ANY COSTS INCURRED BY THE CONTRACTOR DUE TO FAILURE TO CONTACT THE PROPER AUTHORITIES SHALL BECOME THE RESPONSIBILITY OF THE CONTRACTOR.
- 3. THE CONTRACTOR SHALL VERIFY ALL SITE CONDITIONS IN THE FIELD AND REPORT ANY DISCREPANCY BETWEEN THE PLANS AND THE ACTUAL FIELD CONDITIONS TO THE OWNERS DESIGNATED REPRESENTATIVE
- 4. THE CONTRACTOR SHALL ESTABLISH PERMANENT BENCH MARKS. MAINTAIN ALL ESTABLISHED BOUNDS AND BENCH MARKS AND REPLACE ANY WHICH ARE DESTROYED OR DISTURBED.
- 5. CONTRACTOR SHALL PROTECT AND SUSTAIN IN NORMAL SERVICE ALL EXISTING UTILITIES, STRUCTURES, EQUIPMENT, ROADWAYS AND DRIVEWAYS.
- 6. THE CONTRACTOR SHALL BE RESPONSIBLE TO COORDINATE HIS EFFORTS OF DEMOLITION, REMOVALS AND OR RELOCATION WORK WITH ALL TRADES, IF APPLICABLE. CONSULT ALL DRAWINGS AND SPECIFICATIONS FOR COORDINATION REQUIREMENTS BEFORE COMMENCING CONSTRUCTION.
- 7. CONTRACTOR SHALL MAINTAIN PROPER SIGNS, BARRICADES, FENCES, TO PROPERLY PROTECT THE WORK, EQUIPMENT, PERSONS AND PROPERTY FROM DAMAGE. ALL DAILY TRAFFIC IN THE VICINITY OF THE SITE SHALL NOT BE IMPEDED.
- 8. HEAVY EQUIPMENT IS PROHIBITED OUTSIDE OF THE LIMIT OF CONSTRUCTION.
- 9. FINAL COORDINATION OF STAGING REQUIRED WITH OWNER PRIOR TO IMPLEMENTATION.
- 10. CONTRACTOR SHALL SUBMIT AND PAY FOR ALL PERMIT/APPROVALS REQUIRED TO WORK WITHIN THE PUBLIC RIGHT-OF-WAY.

EROSION & SEDIMENT CONTROL NOTES

- 1. ALL APPLICABLE EROSION AND SEDIMENT CONTROL PRACTICES SHALL BE IN PLACE PRIOR TO ANY GRADING OPERATION AND/OR INSTALLATION OF PROPOSED STRUCTURES OR UTILITIES.
- 2. SOIL EROSION AND SEDIMENT CONTROL PRACTICES ON THIS PLAN SHALL BE CONSTRUCTED IN ACCORDANCE WITH NEW YORK STATE STANDARDS FOR EROSION AND SEDIMENT CONTROL REQUIREMENTS.
- 3. APPLICABLE EROSION AND SEDIMENT CONTROL PRACTICES SHALL BE LEFT IN PLACE UNTIL CONSTRUCTION IS COMPLETED AND/OR THE AREA IS STABILIZED.
- 4. THE CONTRACTOR SHALL PERFORM ALL WORK, FURNISH ALL MATERIALS AND INSTALL ALL MEASURES REQUIRED TO REASONABLY CONTROL SOIL EROSION RESULTING FROM CONSTRUCTION OPERATIONS AND PREVENT EXCESSIVE FLOW OF SEDIMENT FROM THE CONSTRUCTION SITE.
- 5. THE SITE SHALL AT ALL TIMES BE GRADED AND MAINTAINED SUCH THAT ALL STORMWATER RUNOFF IS DIVERTED TO SOIL EROSION AND SEDIMENT CONTROL FACILITIES
- 6. ALL SEDIMENTATION STRUCTURES SHALL BE INSPECTED AND MAINTAINED BY THE CONTRACTOR ON A REGULAR BASIS AND AFTER EVERY STORM EVENT.
- 7. A CRUSHED STONE, TIRE CLEANING PAD WILL BE INSTALLED WHEREVER A CONSTRUCTION ACCESS EXISTS. THE STABILIZED PAD WILL BE INSTALLED ACCORDING TO THE STANDARD FOR STABILIZED CONSTRUCTION ACCESS.
- 8. PAVED AREAS MUST BE KEPT CLEAN AT ALL TIMES.
- 9. ALL CATCH BASIN INLETS SHALL BE PROTECTED FROM SEDIMENTATION.
- 10. ALL STORM DRAINAGE OUTLETS SHALL BE STABILIZED, AS REQUIRED, BEFORE THE DISCHARGE POINTS BECOME OPERATIONAL.

- 11. MULCHING IS REQUIRED ON ALL SEEDED AREAS TO PREVENT EROSION BEFORE GRASS IS ESTABLISHED TO PROMOTE EARLIER VEGETATION COVER IN ACCORDANCE WITH NYSDEC STANDARDS.AREAS TO BE UNDISTURBED FOR MORE THAN 14 DAYS WILL BE TEMPORARILY STABILIZED BY SEEDING. DISTURBED AREAS WILL BE RESEEDED AND MULCHED IMMEDIATELY AFTER FINAL CONTOURS ARE RE-ESTABLISHED AND NO MORE THAN 14 DAYS AFTER THE COMPLETION OF CONSTRUCTION AT THAT SITE.
- 12. ANY AREAS THAT CANNOT BE SEEDED TO TURF BY OCTOBER 1 OR EARLIER SHALL RECEIVE A TEMPORARY SEEDING. THE TEMPORARY SEEDING WILL CONSIST OF WINTER RYE SEEDED AT THE RATE OF 120 POUNDS PER ACRE (2.5 POUNDS PER 1,000 SQUARE FEET) OR STABILIZED AS PER THE TEMPORARY STABILIZATION FOR WINTER CONSTRUCTION/FROZEN CONDITIONS.
- 13. OFFSITE SEDIMENT DISTURBANCE MAY REQUIRE ADDITIONAL CONTROL MEASURES TO BE DETERMINED BY THE OWNER'S REPRESENTATIVE.

14. MAXIMUM SIDE SLOPES OF ALL EXPOSED SURFACES SHALL NOT BE CONSTRUCTED

15. DUST SHALL BE CONTROLLED BY AN APPROVED METHOD ACCORDING TO DEC

STEEPER THAN 3:1.

STANDARDS

- 16. ADJOINING PROPERTIES SHALL BE PROTECTED FROM EXCAVATION AND FILLING OPERATIONS ON THE PROPOSED SITE.
- 17. USE STAGED CONSTRUCTION METHODS TO MINIMIZE EXPOSED SURFACES, WHERE APPLICABLE.
- 18. ALL VEGETATIVE MATERIAL SHALL BE SELECTED IN ACCORDANCE WITH AMERICAN STANDARDS FOR NURSERY STOCK OF THE AMERICAN ASSOCIATION OF THE NURSERYMAN AND IN ACCORDANCE WITH DEC STANDARDS.

SITE PREPARATION NOTES

- 1. ALL ITEMS REQUIRING REMOVAL SHALL BE REMOVED TO FULL DEPTH INCLUDING BASE MATERIAL AND FOOTINGS OR FOUNDATIONS AS APPLICABLE, AND LEGALLY DISPOSED OF OFF-SITE BY CONTRACTOR.
- ALL REFUSE, DEBRIS AND MISCELLANEOUS ITEMS TO BE REMOVED, THAT ARE NOT TO BE STOCKPILED FOR LATER USE ON THE PROJECT OR DELIVERED TO THE OWNER, SHALL BE LEGALLY DISPOSED OF OFF-SITE BY THE CONTRACTOR.
- 3. THE CONTRACTOR IS RESPONSIBLE FOR ANY DAMAGE TO EXISTING CONDITIONS THAT ARE DUE TO CONTRACTOR OPERATIONS.
- 4. ALL POINTS OF CONSTRUCTION INGRESS AND EGRESS SHALL BE PROTECTED TO PREVENT TRACKING OF MUD ONTO PUBLIC WAYS. ANY MUD ON PUBLIC WAYS ORIGINATING FROM THE JOB SITE SHALL BE CLEANED BY THE CONTRACTOR DAILY.
- 5. AT ALL LOCATIONS WHERE EXISTING PAVEMENT ABUTS NEW CONSTRUCTION, THE EDGE OF THE EXISTING PAVEMENT SHALL BE SAW CUT TO A CLEAN, SMOOTH EDGE. WHERE NEW PAVING MEETS EXISTING PAVING, MEET LINE AND GRADE OF EXISTING WITH NEW.
- 6. TOPSOIL SHALL BE SCREENED PRIOR TO BEING STOCKPILE. SEE EARTHWORK SPECIFICATIONS FOR REQUIREMENTS. CONTRACT 02 IS RESPONSIBLE FOR STRIPPING, SCREENING, AND STOCKPILING INCLUDING EROSION CONTROLS AROUND STOCKPILE. CONTRACT 03 IS RESPONSIBLE FOR SPREADING OF TOPSOIL AND ALL SITE RESTORATION. CONTRACT 03 IS RESPONSIBLE FOR EXPORT AND DISPOSAL OF EXCESS TOPSOIL AT COMPLETION OF PROJECT.
- 7. TREES AND VEGETATION HAVE BEEN REMOVED BY OTHERS. CONTRACT 02 IS RESPONSIBLE FOR CLEARING AND GRUBBING OF ALL REMAINING STUMPS, ROOT MATTER, AND LEFTOVER WOODY DEBRIS. NOTE THAT PLAN INDICATES SEVERAL STUMPS WITHIN AREA TO BE CLEARED BUT STUMPS UNDER 12" IN DIAMETER ARE NOT SHOWN ON PLAN. CONTRACT 02 IS EXPECTED TO BE FAMILIAR WITH SITE AND AWARE OF THE EXTENTS OF WOODY MATERIAL TO BE REMOVED.

The LA GROUP

Landscape Architecture & Engineering P.C.

People. Purpose. Place.

NY 12866 www.thelagroup.com

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40 Long Alley p. 518-587-8100

Saratoga Springs £ 518-587-0180

New York State Education Law.

Prepared for:

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North Rockland Central School District

65 Chapel Street Garnerville, New York 10923

■ STONY POINT ELEMENTARY SCHOOL SED #50-02-01-06-0-014-015

CONTRACT NOTES

- 1. THIS DRAWING IS FOR USE BY CONTRACT 03 ONLY.
- 2. CONTRACT 02 SCOPE IS SHOWN FOR REFERENCE ONLY AND EXPECTED TO BE COMPLETE PRIOR TO START OF CONTRACT 03.
- 3. ANY SCOPE LISTED ON THIS DRAWING IS CONTRACT 03 RESPONSIBILITY UNLESS SPECIFICALLY NOTED OTHERWISE.
- 4. SEE DRAWING C-200 FOR ADDITIONAL SCOPE CLARIFICATIONS.

LEGEND

XXXXXXXX

—_x—_x—_x—

Duningt Titl

Stony Point Student Drop Off Loop

7 Gurnee Drive Stony Point, New York 10980

 Project No.:
 2024108

 Design:
 JFK

 Drawn:
 MLD
 Ch'k'd:
 DBH

 Date:
 05/27/25
 Scale:
 1"=20'

 Rev:
 Description:
 Date:

Rev: Description: Date:

Drawing Title


SITE PREPARATION
AND DEMOLITION


COMPOST SILT FILTER SOCK

Drawing No.

PLAN

C-100

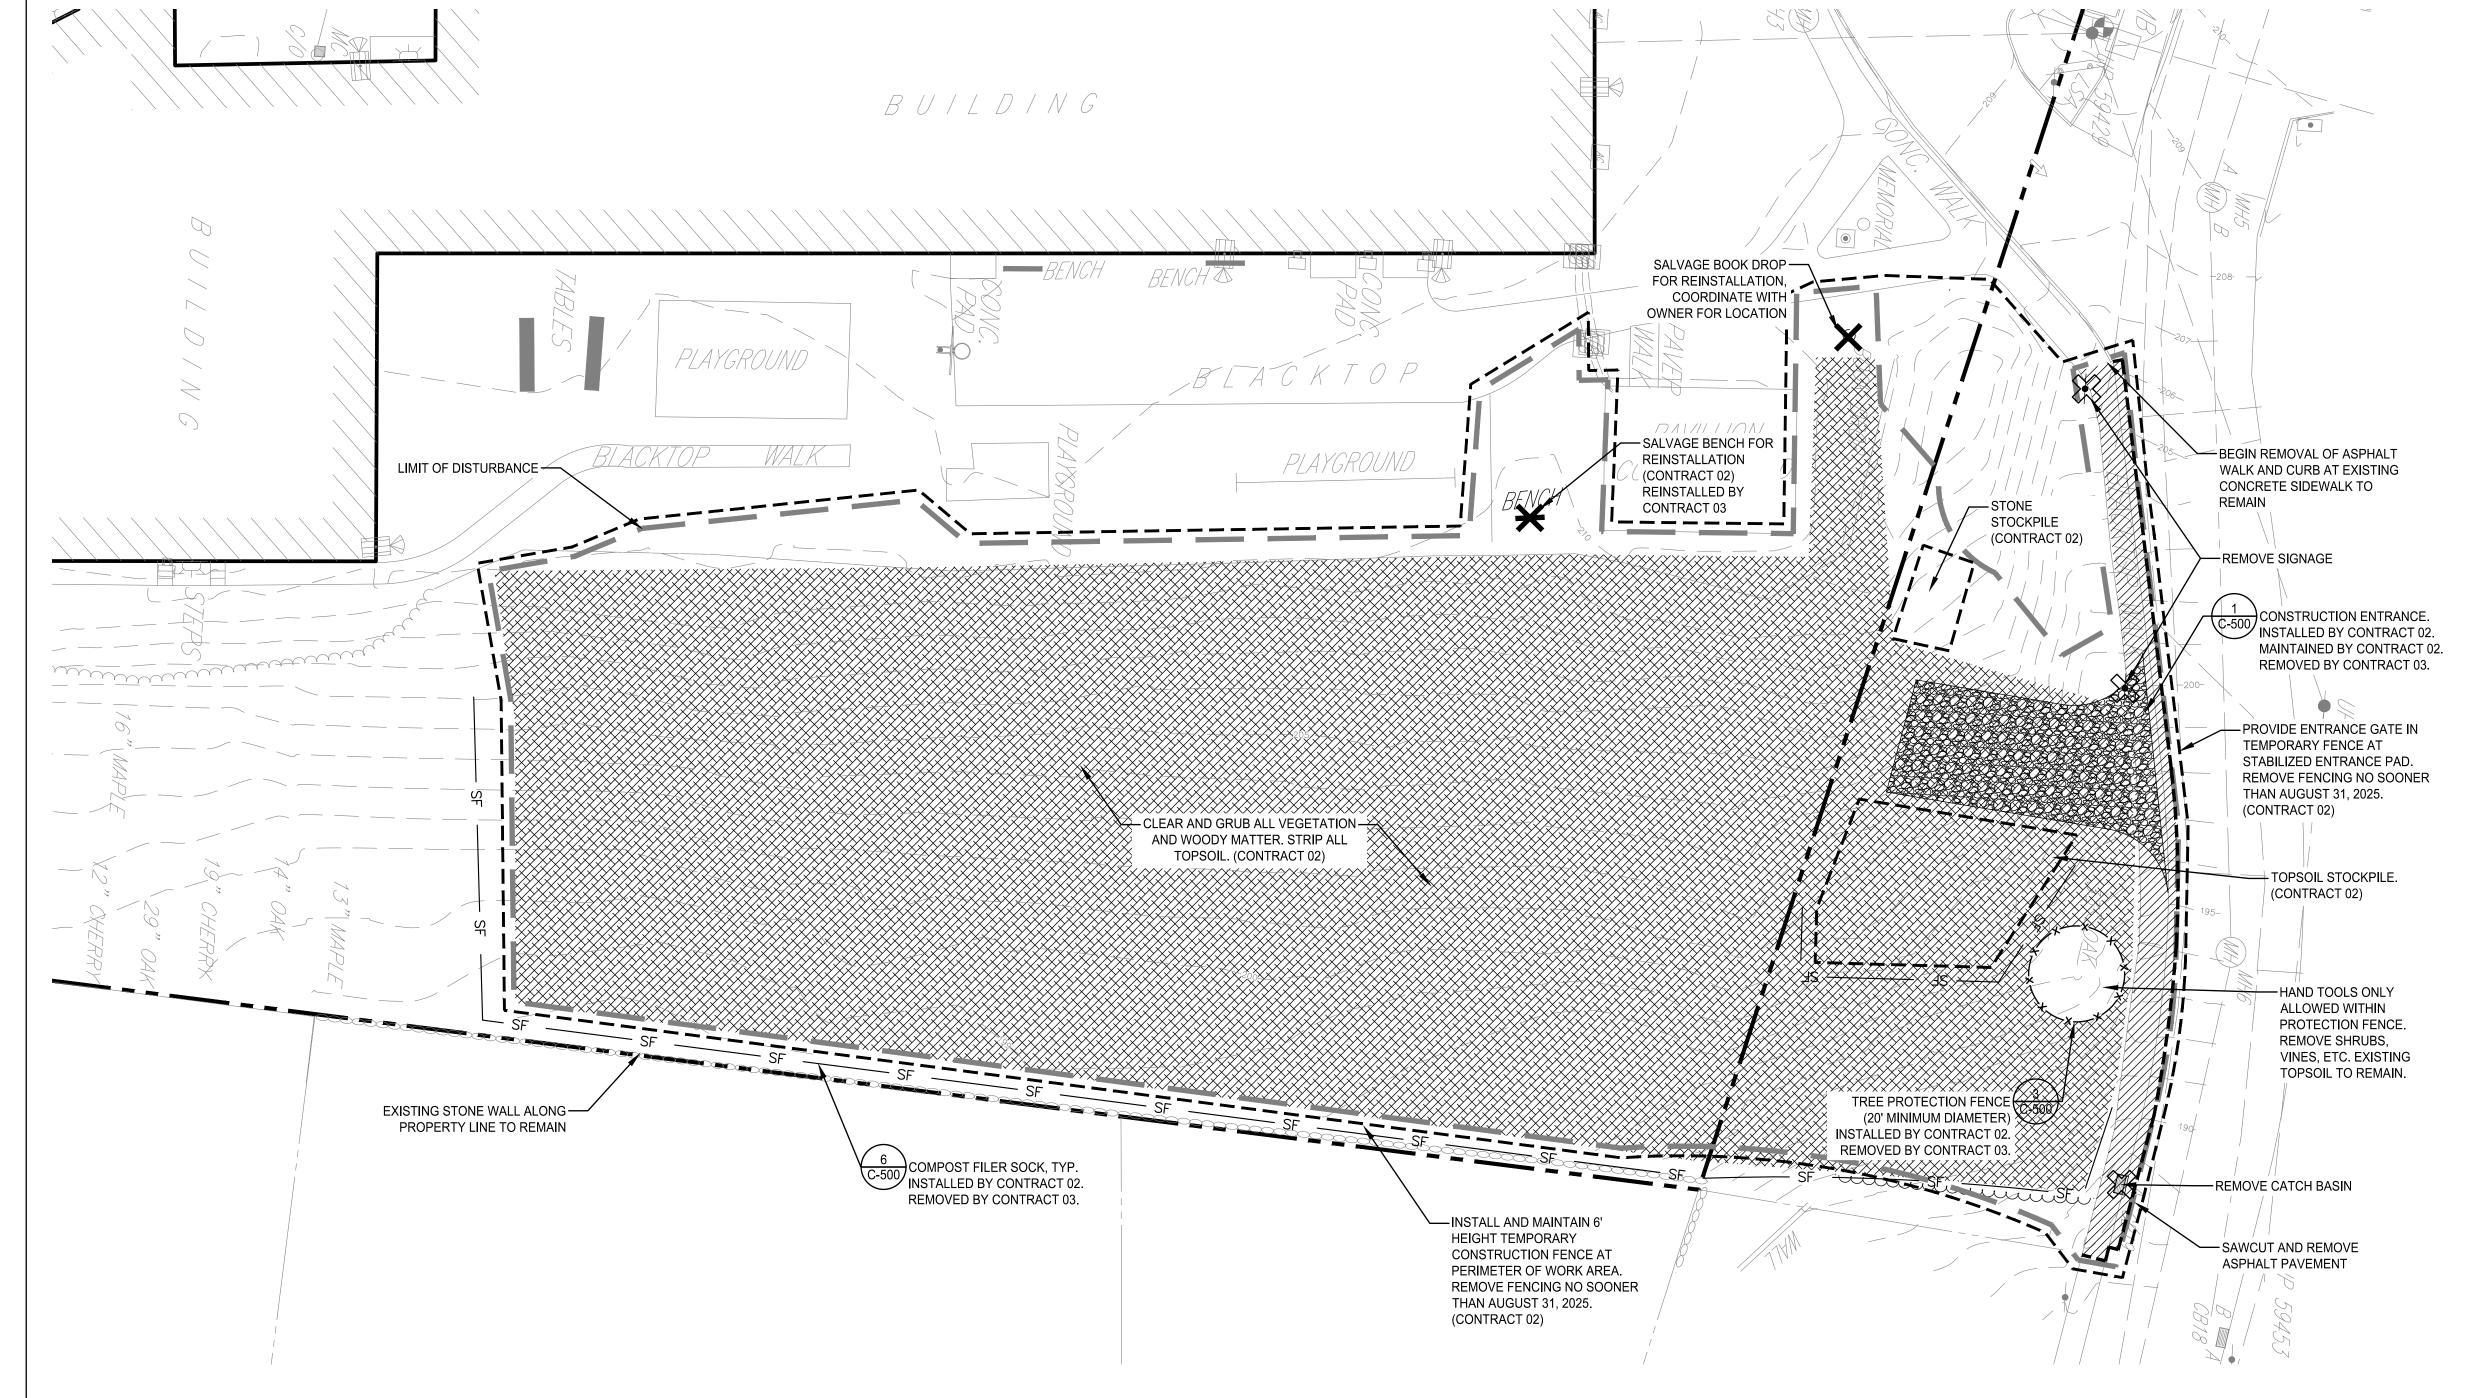

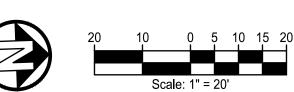

ITEM TO BE REMOVED

REMOVE ITEM


TREE PROTECTION

LIMIT OF DISTURBANCE (0.98 AC)

STABILIZED CONSTRUCTION ENTRANCE

CLEAR AND GRUB VEGETATION (CONTRACT 2)

LAYOUT & MATERIALS NOTES 1. ALL LINES AND DIMENSIONS ARE PARALLEL OR PERPENDICULAR TO THE LINES FROM WHICH THEY ARE MEASURED UNLESS OTHERWISE INDICATED. 2. ALL LINE AND GRADE PER DRAWINGS SHALL BE LAID OUT BY A NEW YORK STATE REGISTERED SURVEYOR ENGAGED BY THE CONTRACTOR. 3. THE CONTRACTOR SHALL VERIFY ALL EXISTING CONDITIONS IN THE FIELD PRIOR TO CONSTRUCTION AND REPORT ANY DISCREPANCIES IN THE SITE SURVEY PRIOR TO STARTING WORK. 4. AT ALL LOCATIONS WHERE EXISTING CURBING, BITUMINOUS CONCRETE ROADWAY OR CONCRETE SIDEWALK ABUT NEW CONSTRUCTION. THE EDGE OF THE EXISTING CURB OR PAVEMENT SHALL BE SAW CUT TO A CLEAN, SMOOTH EDGE. PROVIDE PAVEMENT KEY AS DETAILED. TACK COAT EXPOSED EDGES OF EXISTING BITUMINOUS CONCRETE PRIOR TO PLACEMENT OF NEW BITUMINOUS CONCRETE PAVEMENT. 5. DIMENSIONS ON PARKING LOTS AND ROADWAYS ARE FROM FACE OR BOTTOM OF CURB TO FACE OR BOTTOM OF CURB. 6. ALL EXISTING UTILITIES SHOWN IN THEIR RELATIVE POSITION. THE CONTRACTOR IS RESPONSIBLE FOR VERIFYING THE VERTICAL AND HORIZONTAL POSITION OF EXISTING UTILITIES PRIOR TO CONSTRUCTION. 7. ALL NEW WORK SHALL BE STAKED OUT PRIOR TO CONSTRUCTION. THE OWNER'S REPRESENTATIVE SHALL BE NOTIFIED OF ANY DISCREPANCIES. FIELD ADJUSTMENTS MUST BE APPROVED BY THE OWNER'S REPRESENTATIVE PRIOR TO CONSTRUCTION. 8. CONTRACTOR SHALL COORDINATE LOCATION OF ALL UTILITIES (LINES, DUCTS, CONDUITS, SLEEVES, FOOTINGS, ETC.) WITH LOCATIONS OF PROPOSED LANDSCAPE ELEMENTS (WALLS, FENCE, FOOTINGS, TREE ROOT BALLS, PROPOSED LIGHTING FOOTINGS, ETC.). CONTRACTOR SHALL REPORT ANY DISCREPANCIES TO OWNER'S REPRESENTATIVE PRIOR TO CONTINUING WORK.

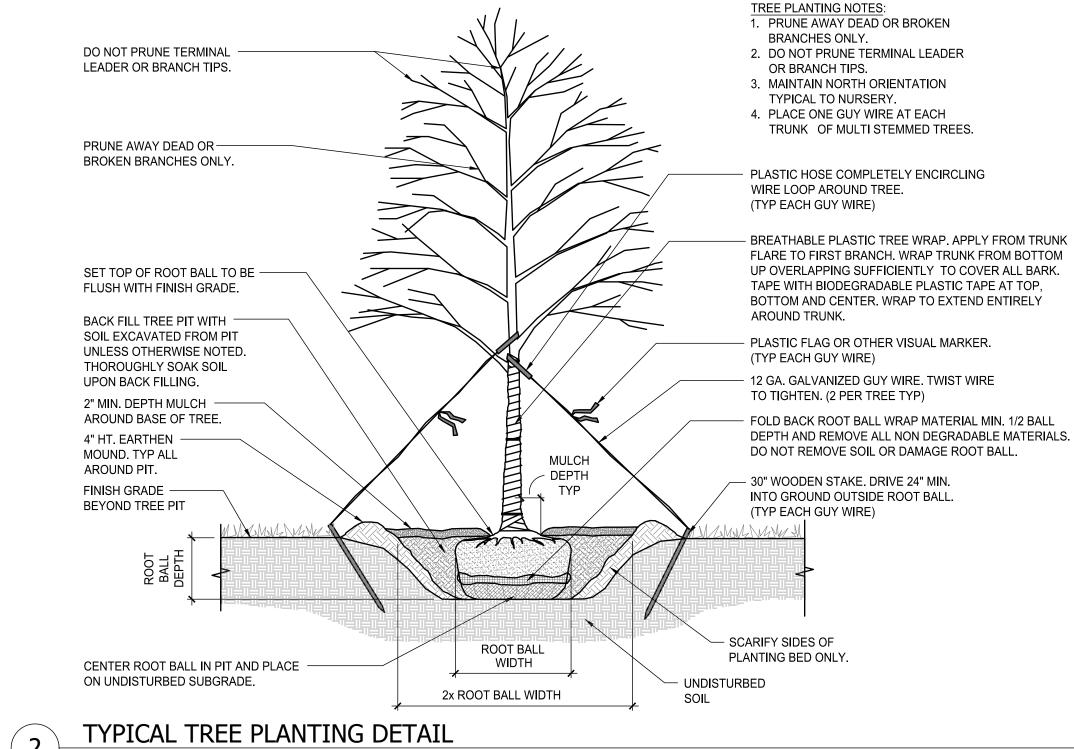

ROOT COMMON NAME SIZE NOTES QUANTITY **BOTANICAL NAME** OCTOBER GLORY RED MAPLE ACER RUBRUM 'OCTOBER GLORY' 3"-3.5" CAL. SEE DETAIL 2/C-200. CELTIS OCCIDENTALIS COMMON HACKBERRY 3"-3.5" CAL. SEE DETAIL 2/C-200. PICEA PUNGENS COLORADO BLUE SPRUCE 8-10' HEIGHT SEE DETAIL 2/C-200 (SIMILAR) QUERCUS PALUSTRIS PIN OAK 3"-3.5" CAL. B&B SEE DETAIL 2/C-200. PLANTING SCHEDULE SCALE: N.T.S. BUILDING **CONTRACT NOTES** — MEET EXISTING 3.1. ALL REMAINING DEMOLITION AND REMOVALS NOT OTHERWISE COMPLETE BY PAVEMENT SMOOTH AND FLUSH CONTRACT 02. → MATCH EXISTING SIDEWALK FLUSH REINSTALL SALVAGED ALL CONCRETE PAVING. BENCH, PROVIDE NEW ALL TRAFFIC SIGNAGE. **CONCRETE FOOTERS** CONCRETE EXTENSION -RESTORATION OF PAVEMENT BELOW CONCRETE PLAYGROUND MULCH CONTRACT 02. SÚŔFACE. SURFACE 4' TALL CHAIN LINK FENCE C-501 SLOPED CONCRETE WALK WITH (NO SLATS), INSTALLED IN PLACEMENT OF ALL ROCK/BOULDER COVERAGE "SLEEVE-IT" BASE CONCRETE STAIRS HANDRAIL ALL LAWN SEEDING AND TREE PLANTINGS. C-500 WITH INTEGRAL CURB 4' TALL CHAIN LINK FENCE WITH PRIVACY SLATS, INSTALLED IN "SLEEVE-IT" C-501 CONCRETE CURB RAMP KEY NEW PAVEMENT INTO EXISTING TEMPORARY CONSTRUCTION FENCE INSTALLED, 20.00' (TYP.) — SEGMENTAL BLOCK — H-CURB RAMP MAINTAINED, AND REMOVED 36" LONG, 4" WIDE AUGUST 31, 2025. RETAINING WALL (CONTRACT 02) BY CONTRACT 02. C-500 CONCRETE CURB (4) TRAFFIC ARROW (TYP) SOLID YELLOW LINE SPACED 20' O.C. ALONG FACE OF CURB. CONTRACT 03 SCOPE. ENTER SIGN CROSSWALK (C-50 10.00' 24.00' SUBGRADE WITH SLOPES NO STEEPER THAN 3H:1V. & STOP SIGN GRADING PLAN. EXISTING OAK 4" SINGLE YELLOW TREE TO REMAIN C-500 CONCRETE SIDEWALK WITH INTEGRAL CURB SOLID LINE PAVEMENT CURB RAMP MARKING CONNECTION BY CONTRACT 03. V 4' TALL CHAIN LINK FENCE WITH PRIVACY SLATS INSTALLED IN -ONE-WAY SIGN "SLEEVE-IT" BASE **PAVEMENT** CURB RAMF RETAINING WALL (CONTRACT O2) CONCRETE SIDEWALK WITH NEW TREE PLANTING ALONG PROPERTY LINE.— INTEGRAL CURB ALTERNATE BETWEEN (8) HACKBERRY AND NEW BLUE SPRUCE — (8) RED MAPLE FOR (16) TOTAL TREES. TYPICAL OF (3) MEET EXISTING -ALL DISTURBED AREAS UNLESS NOTED AS —


PAVEMENT OR PLAYGROUND SURFACING

SHALL BE RESTORED AS LAWN.

ASPHALT SIDEWALK

FLUSH, TYP.

- 1. THIS DRAWING IS FOR USE BY CONTRACT 03 ONLY.
- 2. CONTRACT 02 SCOPE IS SHOWN FOR REFERENCE ONLY AND EXPECTED TO BE COMPLETE PRIOR TO START OF CONTRACT 03.
- 3. CONTRACT 03 IS RESPONSIBLE FOR THE FOLLOWING:
- 3.2. ALL EARTHWORK REQUIRED TO COMPLETE PROJECT.
- ALL ASPHALT PAVING, BASE STONE, AND PAVEMENT MARKINGS.
- ALL CHAIN LINK FENCING RETAINING WALL SLEEVE-IT BASE INSTALLED BY
- CONCRETE STAIRS AND HANDRAILS.
- HANDRAIL ALONG RAMPED WALK.
- 3.10. ALL TOPSOIL SPREADING AND DISPOSAL OF EXCESS TOPSOIL
- ALL STORM UTILITIES PIPE CONNECTIONS BENEATH RETAINING WALLS ARE BY
- CONTRACT 02 FOR CONTRACT 03 CONTINUATION.
- REMOVAL OF EROSION CONTROLS AFTER COMPLETION OF PROJECT.
- 3.14. REPAIRS, MAINTENANCE, AND REMOVAL OF CONSTRUCTION ENTRANCE.
- 3.15. ANY REMAINING SCOPE REQUIRED FOR PROJECT COMPLETION NOT OTHERWISE SPECIFICALLY NOTED AS CONTRACT 02 SCOPE.
- 4. CONTRACT 02 IS RESPONSIBLE FOR THE FOLLOWING
- 4.1. INSTALLATION AND CONTINUED MAINTENANCE OF ALL EROSION CONTROLS AS SHOWN ON SITE PREPARATION DRAWING. REMOVAL BY CONTRACT 03.
- INSTALLATION, MAINTENANCE, AND REMOVAL OF 6' TEMPORARY CONSTRUCTION FENCING. ENCLOSE ENTIRE AREA OF WORK. REMOVE FENCE NO SOONER THAN
- 4.3. INSTALLATION AND MAINTENANCE DURING CONSTRUCTION OF STABILIZED CONSTRUCTION ENTRANCE IN CONTRACT 02 SCOPE. REPAIRS, MAINTENANCE DURING CONSTRUCTION, AND REMOVAL OF CONSTRUCTION ENTRANCE IN
- 4.4. ALL VEGETATION, STUMPS, AND WOODY MATERIAL GRUBBING AND DISPOSAL.
 - ALL TOPSOIL STRIPPING, SCREENING, AND STOCKPILING.
- ALL SCOPE NECESSARY FOR CONSTRUCTION OF RETAINING WALLS.
- BACKFILL OF SUBGRADE FOR RETAINING WALLS AS NEEDED TO COVER GEOGRID REINFORCEMENT AND EXTENDING BEYOND AS NECESSARY TO MEET EXISTING
- 4.8. INSTALLATION OF SLEEVE-IT BASES BEHIND RETAINING WALLS SPACED NO GREATER THAN 10' ON CENTER AND SET TO FINISH GRADES PROVIDED ON
- 4.9. INSTALLATION OF PERFORATED DRAIN PIPES BEHIND RETAINING WALLS. SEE GRADING PLAN FOR OUTLET LOCATIONS TO BE PICKED UP BY CONTRACT 03.
- 4.10. INSTALLATION OF STORM PIPE CONNECTIONS AS SHOWN ON GRADING PLAN PASSING BENEATH RETAINING WALL FOR FUTURE TRENCH DRAIN AND

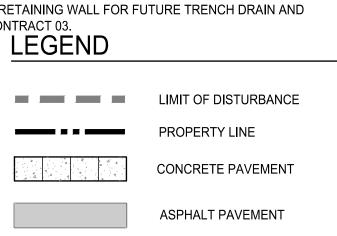

SOD LAWN

SEED LAWN

C-200

Drawing No.

Drawing Title

LAYOUT AND

MATERIALS PLAN

Landscape Architecture & Engineering P.C.

40 Long Alley p: 518-587-8100

Saratoga Springs £ 518-587-0180

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North Rockland

Garnerville, New York 10923

■ STONY POINT ELEMENTARY SCHOOL SED #50-02-01-06-0-014-015

Central School

New York State Education Law.

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Prepared for:

District

Project Title:

Stony Point Student

Drop Off Loop

Stony Point, New York 10980

MLD

Description:

05/27/25 Scale:

Ch'k'd:

2024108

DBH

1"=20'

7 Gurnee Drive

Scale: N.T.S.


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NY 12866

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UTILITY NOTES

- 1. THE CONTRACTOR SHALL CONTACT U.F.P.O. (1-800-962-7962) AND THE PROPER LOCAL AUTHORITIES OR RESPECTIVE UTILITY COMPANY HAVING JURISDICTION TO CONFIRM THE LOCATION OF ALL EXISTING UTILITIES BEFORE COMMENCING WORK. ANY COSTS INCURRED BY THE CONTRACTOR DUE TO FAILURE TO CONTACT THE PROPER AUTHORITIES SHALL BECOME THE RESPONSIBILITY OF THE CONTRACTOR.
- 2. CONTRACTOR SHALL COORDINATE AND PAY FOR ALL REQUIRED UTILITY INSPECTIONS BY THE AUTHORITY HAVING JURISDICTION IN ACCORDANCE WITH THEIR RESPECTIVE REQUIREMENTS.
- 3. ALL UTILITY INSTALLATIONS SHALL BE IN ACCORDANCE WITH ALL REGULATORY, LOCAL MUNICIPAL AND BUILDING CODE REQUIREMENTS.
- 4. THE LOCATION OF UNDERGROUND UTILITIES SHOWN ON THIS PLAN ARE DIAGRAMMATIC FOR INFORMATION ONLY, AND MUST BE VERIFIED BY THE CONTRACTOR PRIOR TO CONSTRUCTION. ALL UTILITIES MAY NOT BE SHOWN. CONTRACTOR SHALL COORDINATE LOCATION OF ALL UTILITIES (LINES, DUCTS, CONDUITS, SLEEVES, FOOTINGS, ETC.) WITH LOCATIONS OF PROPOSED LANDSCAPE ELEMENTS (WALLS, FENCE, FOOTINGS, TREE ROOTBALLS, PROPOSED LIGHTING FOOTINGS, ETC.) AND IMMEDIATELY REPORT ANY DISCREPANCIES TO THE OWNER'S REPRESENTATIVE. ANY DAMAGE AND INCURRED COSTS DUE TO FAILURE OF THE CONTRACTOR TO VERIFY UTILITY LOCATIONS SHALL BE BORNE BY THE CONTRACTOR.
- 5. EXTEND DESIGNATED LIMIT OF WORK AS NECESSARY TO ACCOMPLISH SITE UTILITY WORK AS REQUIRED BY THESE DRAWINGS AND SPECIFICATIONS.
- 6. CONTRACTOR SHALL PROTECT AND SUSTAIN IN NORMAL SERVICE ALL EXISTING UTILITIES, STRUCTURES, EQUIPMENT ROADWAYS AND DRIVEWAYS FOR THE DURATION OF CONSTRUCTION.

GRADING AND DRAINAGE NOTES:

- ALL PROPOSED GRADES SHALL BE SET IN THE FIELD BY A NEW YORK STATE LICENSED LAND SURVEYOR.
- CONTRACTOR SHALL ESTABLISH PERMANENT SECONDARY BENCHMARKS PRIOR TO THE START OF CONSTRUCTION. ALL SECONDARY BENCHMARKS SHALL BE SO LOCATED THAT THEY WILL NOT BE DISTURBED BY CONSTRUCTION.
- 3. PITCH EVENLY BETWEEN SPOT GRADES. ALL PAVED AREAS MUST PITCH TO DRAIN AT A MINIMUM SLOPE OF ONE-EIGHTH INCH (1/8") PER FOOT. MAXIMUM CROSSPITCH OF ALL SIDEWALKS IS 2%. ANY DISCREPANCIES NOT ALLOWING THIS TO OCCUR SHALL BE REPORTED TO THE OWNER'S REPRESENTATIVE PRIOR TO CONTINUING WORK.
- 4. MAXIMUM CROSSPITCH OF ALL SIDEWALKS IS 2%. RAMPS SHALL NOT EXCEED 1 IN 12 OR 30' IN LENGTH. ANY DISCREPANCIES NOT ALLOWING THIS TO OCCUR SHALL BE REPORTED TO THE OWNER'S REPRESENTATIVE PRIOR TO CONTINUING WORK.
- 5. ALL PROPOSED TOP OF VERTICAL CURB ELEVATIONS ARE SIX INCHES (6") ABOVE BOTTOM OF CURB UNLESS SHOWN OTHERWISE
- 6. WHERE NEW PAVING MEETS EXISTING PAVING, NEW PAVING SHALL MEET THE LINE AND GRADE OF THE EXISTING PAVING.
- 7. SET CATCH BASIN AND DROP INLET RIMS TO DRAIN SURROUNDING AREAS AND AT SAME PITCH AS SLOPING PAVEMENT. IF STRUCTURE IS SHOWN ADJACENT TO CURB, SET GRATE TIGHT TO FACE OF CURB.
- 8. EXCAVATION REQUIRED WITHIN 3 FEET OF EXISTING UTILITY LINE SHALL BE DONE BY HAND. CONTRACTOR SHALL REPAIR ANY DAMAGE TO EXISTING UTILITY LINES OR STRUCTURES INCURRED DURING CONSTRUCTION OPERATIONS AT NO ADDITIONAL COST TO OWNER.

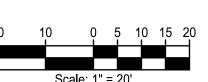- 9. CONTRACTOR SHALL STRIP AND STOCKPILE EXISTING
 TOPSOIL TO FULL DEPTH WITHIN LIMIT OF GRADING BEFORE
 COMMENCING EXCAVATION AND GRADING OPERATIONS. NO
 TOPSOIL SHALL BE REMOVED FROM SITE WITHOUT PRIOR
 AUTHORIZATION FROM OWNER. TOPSOIL SHALL BE
 STOCKPILED FOR RE-USE ON SITE OR LEGALLY DISPOSED
 OF OFFSITE.
- 10. ALL AREAS REQUIRING FILL SHALL BE BROUGHT TO REQUIRED GRADE IN 6" MAXIMUM COMPACTED LIFTS. GENERAL FILL SHALL BE FREE OF DELETERIOUS MATERIAL, CONTAIN NO GRAVEL LARGER THAN 2", AND SHALL BE COMPACTED IN ACCORDANCE WITH PROJECT PLANS AND DETAILS.
- 11. GRADE AREAS ADJACENT TO BUILDING LINES TO DRAIN AWAY FROM STRUCTURE AND PREVENT PONDING. FINISH SURFACES SHALL BE FREE FROM IRREGULAR SURFACE CHANGES.
- 12. EXCAVATION REQUIRED WITHIN DRIP LINE OF TREES DESIGNATED TO REMAIN SHALL BE DONE BY HAND. PLANT MATERIALS DAMAGED BY CONTRACTOR SHALL BE REPLACED IN KIND.
- 13. SLOPE SIDES OF EXCAVATIONS TO COMPLY WITH LOCAL CODES AND ORDINANCES HAVING JURISDICTION AND OSHA REGULATIONS. MAINTAIN SIDE SLOPES OF EXCAVATIONS IN A SAFE CONDITION UNTIL COMPLETION OF BACKFILLING.
- 14. CONTRACTOR SHALL BLEND NEW EARTHWORK SMOOTHLY INTO EXISTING, PROVIDING VERTICAL CURVES OR ROUNDINGS AT ALL TOP AND BOTTOM OF SLOPES.
- 15. CONTRACTOR SHALL MAINTAIN THE INTEGRITY OF THE EXISTING DRAINAGE SYSTEM AT ALL TIMES. DURING EARTHWORK OPERATIONS, DRAINAGE OF THE SITE AND ADJACENT AREAS SHALL BE MAINTAINED CONTINUOUSLY TO PREVENT EROSION OR DAMAGE RESULTING FROM

- INTERRUPT THE EXISTING DRAINAGE PATTERNS AND/OR UTILITIES, PROVIDE TEMPORARY FACILITIES UNTIL WORK IS PERMANENTLY STABILIZED AND APPROVED BY OWNER'S REPRESENTATIVE.
- 16. CONTRACTOR SHALL MAINTAIN OR ADJUST TO NEW FINISH GRADE AS NECESSARY ALL UTILITY AND SITE STRUCTURES SUCH AS LIGHT POLES, SIGN POLES, MAN HOLES, CATCH BASINS, HAND HOLES, WATER AND GAS GATES, HYDRANTS, ETC., FROM MAINTAINED UTILITY AND SITE SYSTEMS UNLESS OTHERWISE NOTED ON THE UTILITY DRAWINGS OR AS DIRECTED BY THE OWNER'S REPRESENTATIVE.
- 17. IN ALL LAWN AREAS, ROUGH GRADE SHALL BE BROUGHT TO WITHIN 4" OF FINISHED GRADE UNLESS OTHERWISE NOTED.
- 18. THE SIDES OF ANY NEW CUT AND/OR FILL SLOPES SHALL BE CONSTRUCTED W/ SLOPES NO STEEPER THAN 1 FOOT (VERTICAL) ON 2 FOOT (HORIZONTAL).

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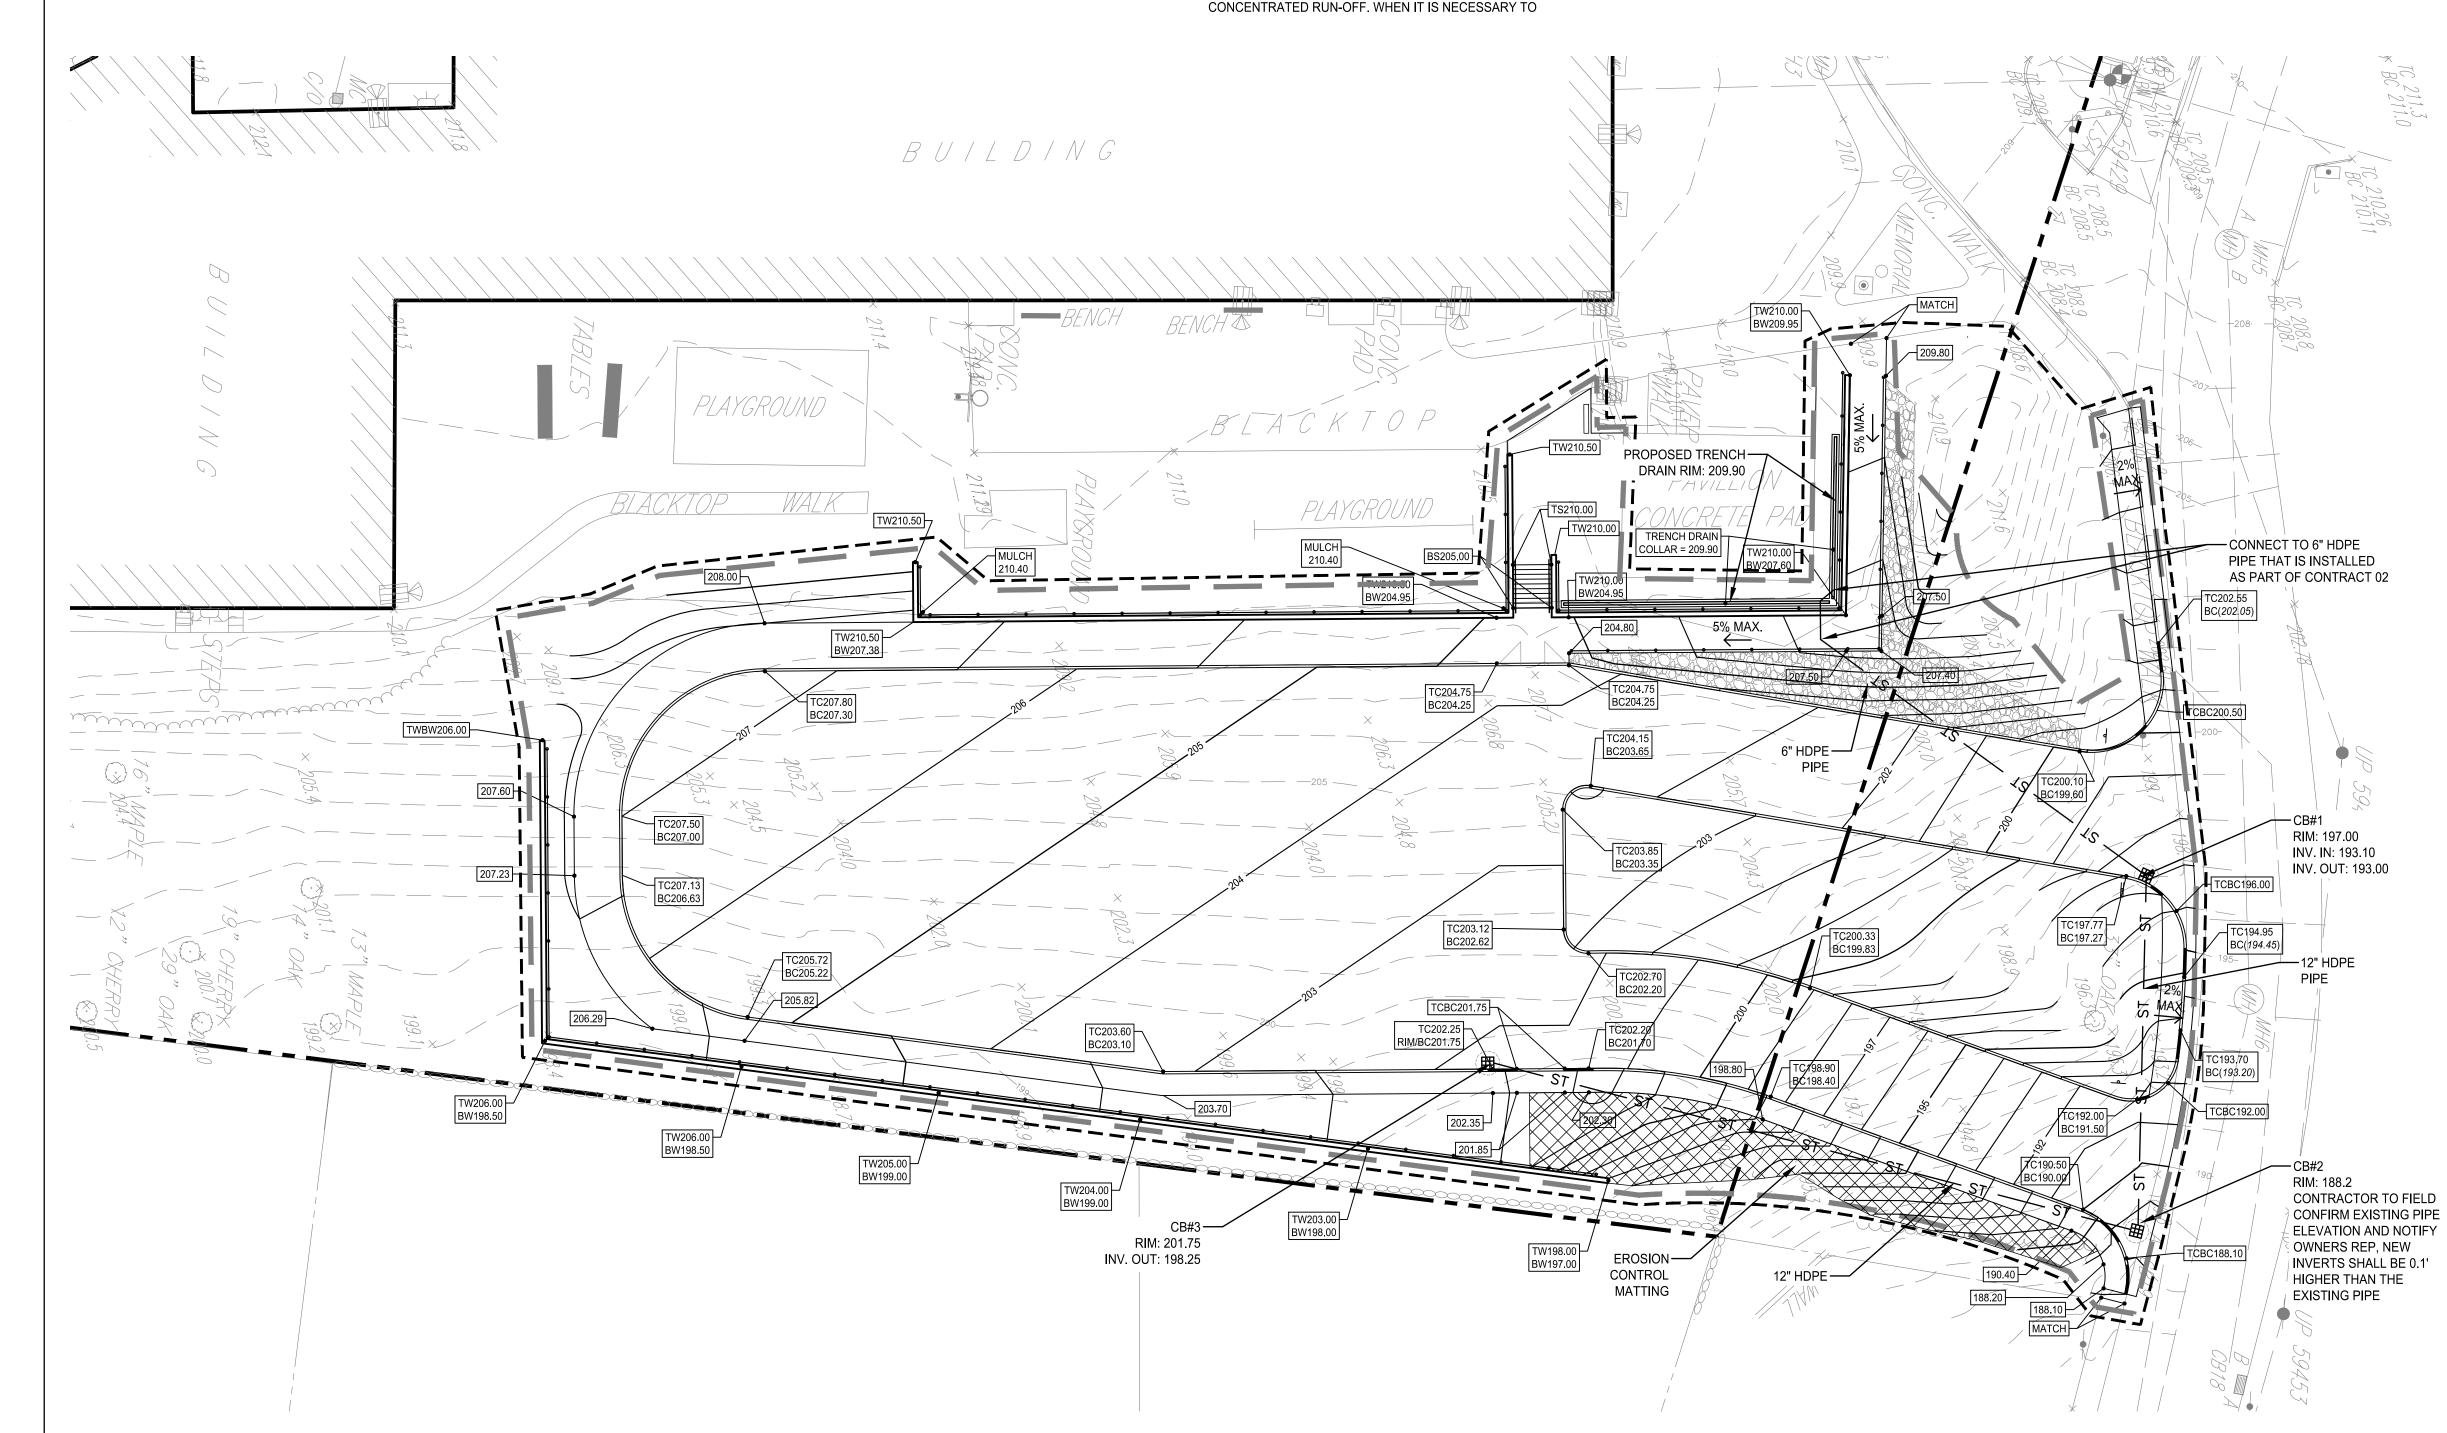
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■ STONY POINT ELEMENTARY SCHOOL SED #50-02-01-06-0-014-015



LEGEND

LIMIT OF DISTURBANCE

PROPERTY LINE
PROPOSED STORM PIPE


EXISTING CONTOUR LINE
PROPOSED CONTOUR LINE
PROPOSED CATCH BASIN

PROPOSED SPOT ELEVATION

188.00 TS

TOP OF STEP BOTTOM OF STEP

20 10 0 5 1

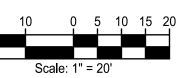

Stony Point Student Drop Off Loop

7 Gurnee Drive Stony Point, New York 10980

 Project No.:
 2024108

 Design:
 JFK

 Drawn:
 MLD
 Ch'k'd:
 DBH

 Date:
 05/27/25
 Scale:
 1"=20'

T. Description: Date:

Drawing Title

GRADING AND DRAINAGE PLAN

Drawing No.

(PER IBC TABLE 1106.1 - ACCESSIBLE PARKING SPACES) TOTAL PARKING SPACES MINIMUM NUMBER OF SPACES REQUIRED 51 TO 75 76 TO 100 101 TO 150 151 TO 200 201 TO 300 301 TO 400 401 TO 500 501 TO 1,000 OVER 1,000

HIGH SCHOOL - SED PARKING TABLE

122 TOTAL STANDARD PARKING SPACES <u>5</u> ACCESSIBLE SPACES REQUIRED 5 ACCESSIBLE SPACES PROVIDED ON PLANS


20 PLUS 1 FOR EACH 100 OVER 1,000

NOTE: PARKING SPACES USED EXCLUSIVELY FOR BUSES, TRUCKS AND OTHER DELIVERY VEHICLES, AND LAW ENFORCEMENT VEHICLES ARE EXEMPT FROM IBC TABLE 1106.1.

ACCESSIBLE PARKING TABLE - HS

ADA Site Notes

- THE MAXIMUM SLOPE OF ACCESSIBLE PARKING STALLS AND ASSOCIATED ACCESS AISLE SHALL BE 2% (1V:50H).
- THE MAXIMUM SLOPE IN THE DIRECTION OF TRAVEL ON ACCESSIBLE PATHS SHALL BE 5% (1V:20H).
- THE MAXIMUM CROSS SLOPE ON ACCESSIBLE PATHS SHALL BE 2% (1V:50H).
- THE MAXIMUM SLOPE IN THE DIRECTION OF TRAVEL ON ACCESSIBLE RAMPS AND CURB RAMPS SHALL BE 8.33% (1V:12H), AS INDICATED ON THE DETAILS.
- GROUND SURFACES ON ACCESSIBLE PATHS SHALL BE STABLE, FIRM, AND SLIP RESISTANT.

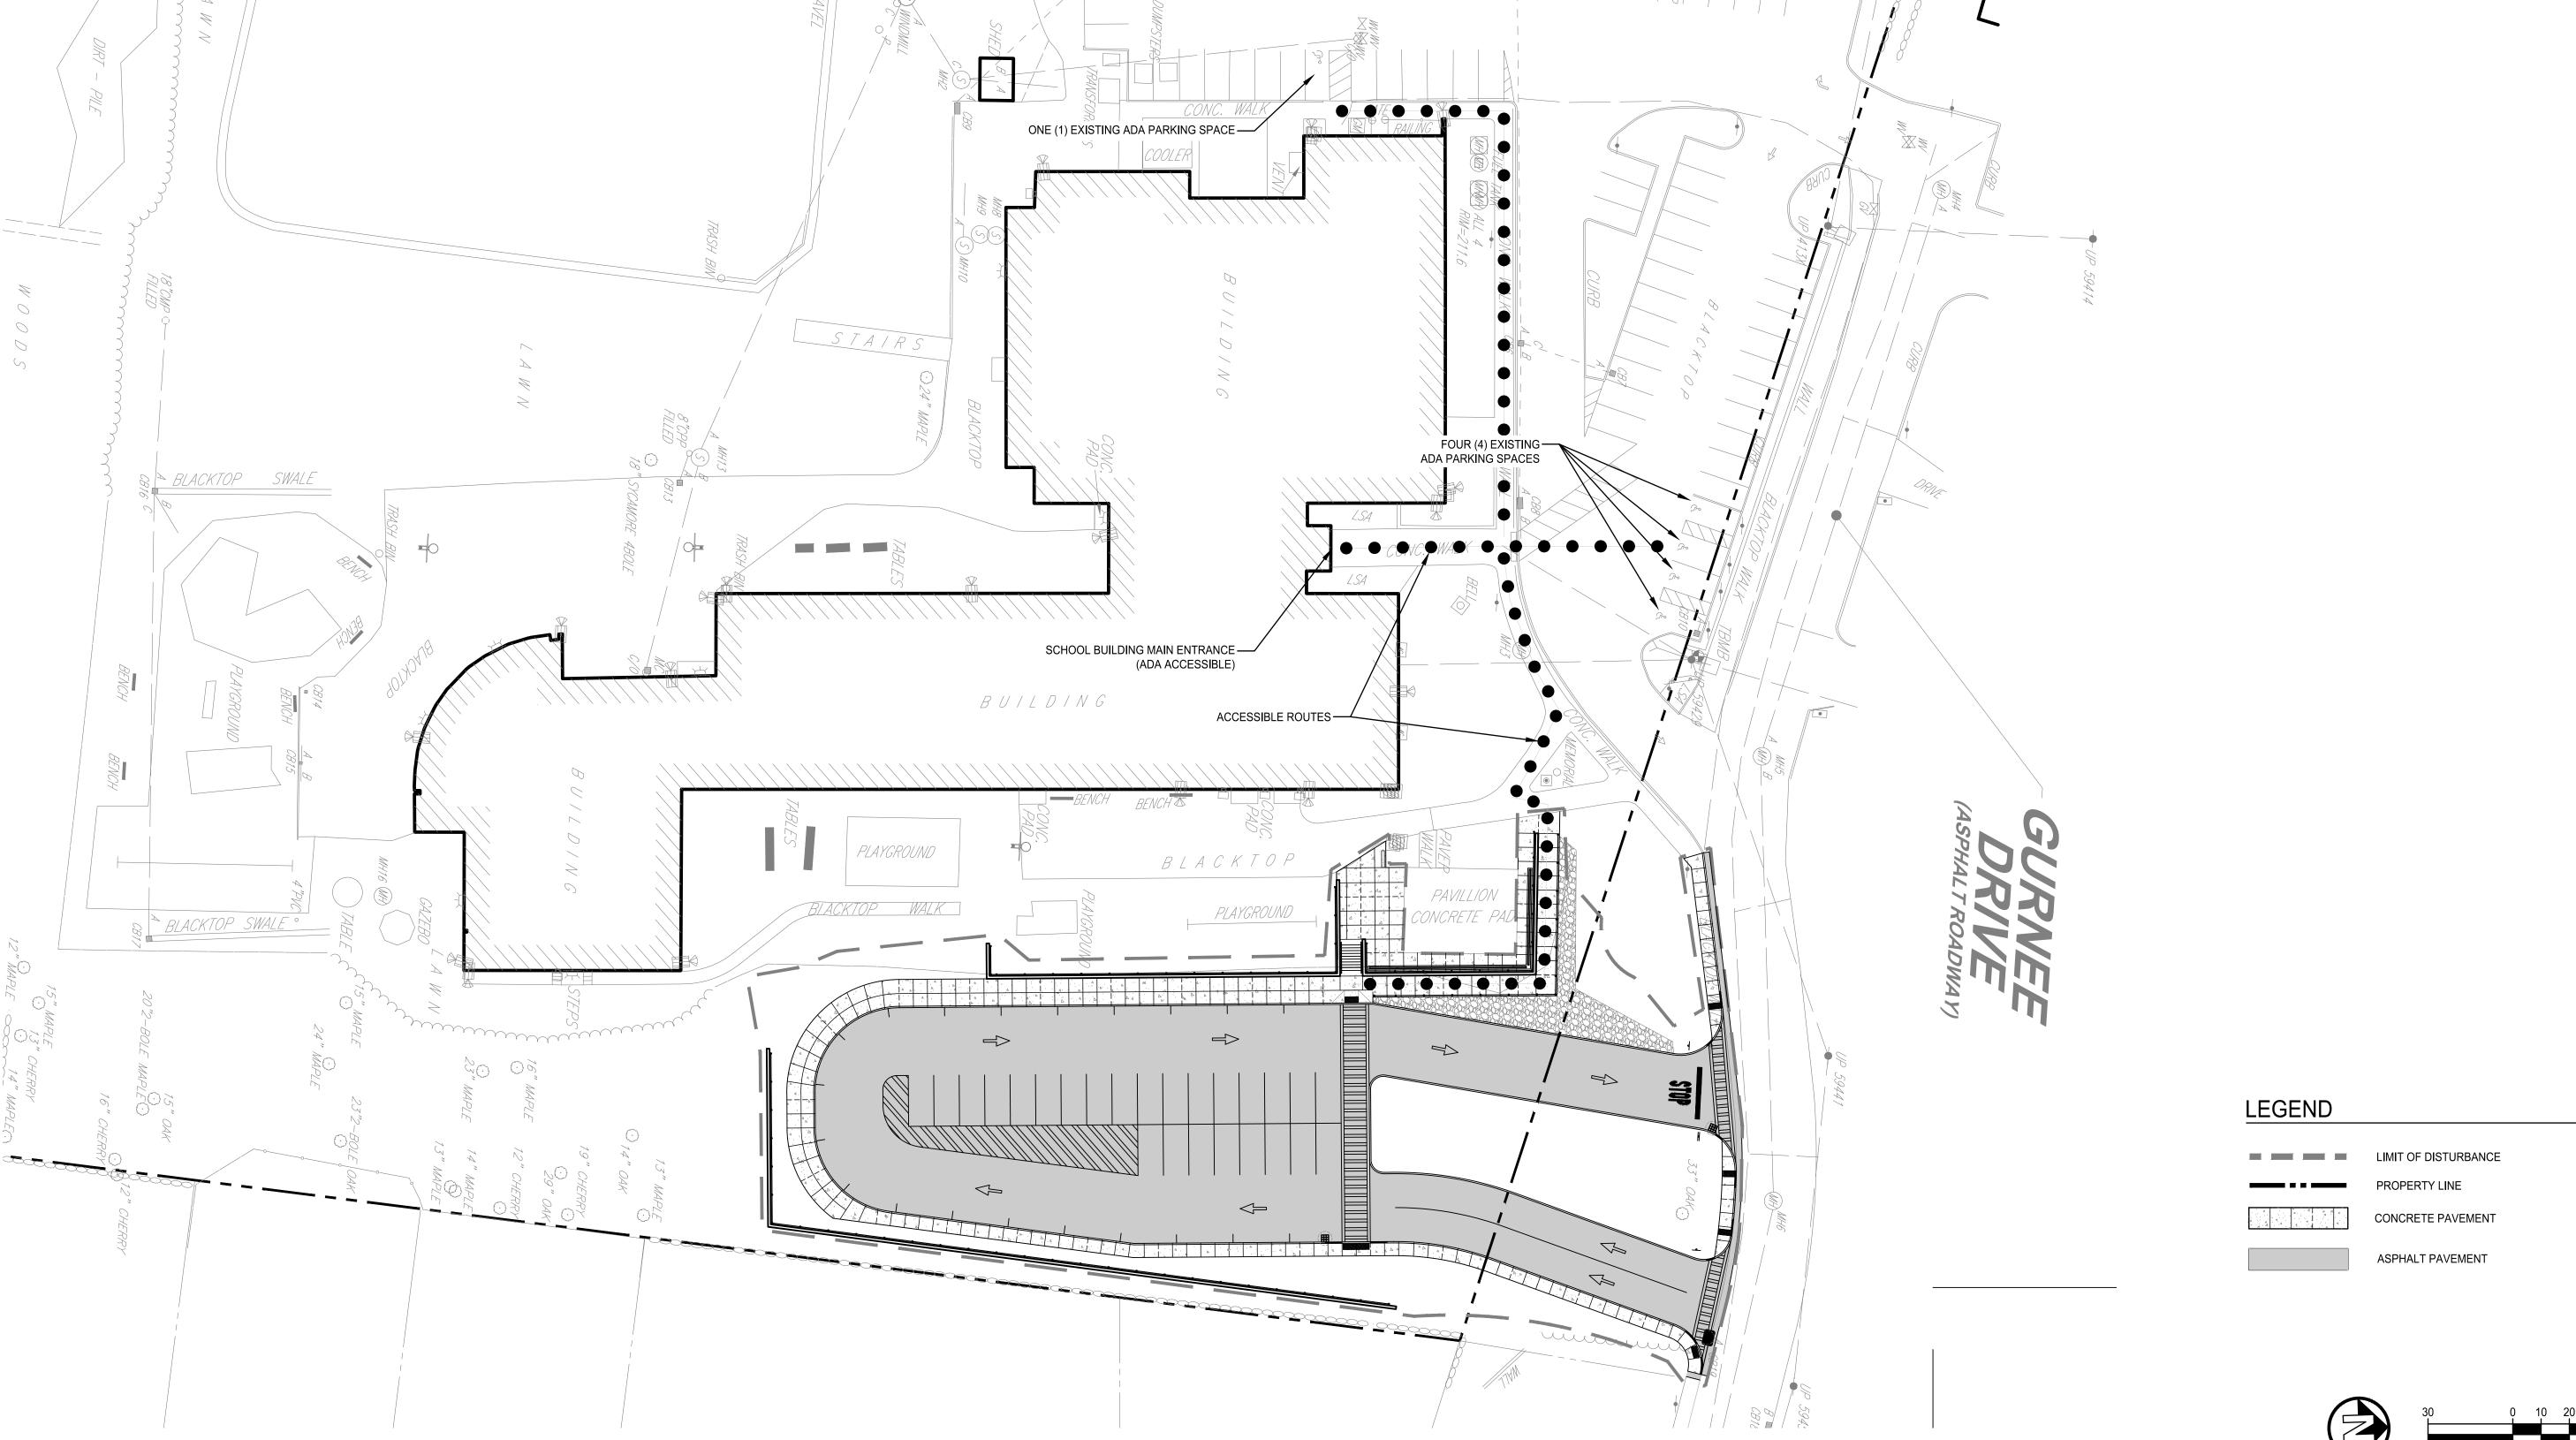



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Stony Point Student Drop Off Loop


7 Gurnee Drive Stony Point, New York 10980


2024108 ERS Ch'k'd: DBH 5/27/2025 Scale: 1"=30'

Drawing Title

CODE COMPLIANCE PLAN

Drawing No.

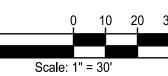

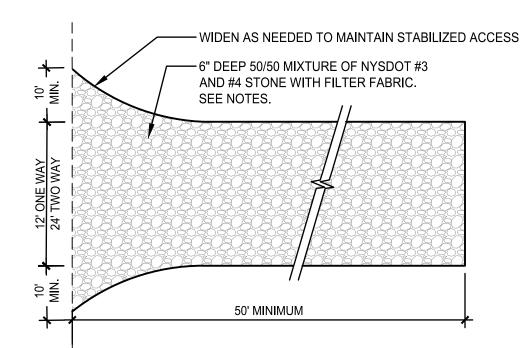


CONSTRUCTION SPECIFICATIONS

MINIMUM STONE SIZE SHALL BE 1"-4" STONE, INSTALLED OVER FILTER FABRIC TO A MINIMUM DEPTH OF 6". MINIMUM WIDTH SHALL BE 12' FOR ONE WAY TRAFFIC, 24' FOR TWO WAY TRAFFIC. MINIMUM LENGTH SHALL BE 50'. ALL SURFACE WATER FLOWING OR DIVERTED TOWARD CONSTRUCTION ACCESSES SHALL BE PIPED BENEATH ACCESS. IF IMPRACTICAL, A MOUNTABLE DIVERSION BERM PREVENTING RUNOFF ONTO ADJACENT ROAD SHALL BE PERMITTED. ACCESS SHALL BE MAINTAINED IN A CONDITION WHICH WILL PREVENT TRACKING OR FLOWING OF SEDIMENT ONTO PUBLIC RIGHTS-OF-WAY, ALL SEDIMENT SPILLED, DROPPED, WASHED OR TRACKED ONTO PUBLIC RIGHTS-OF-WAY SHALL BE REMOVED IMMEDIATELY.


ALL VEHICLE WASHING SHALL BE DONE IN A STONE STABILIZED AREA WHICH DRAINS INTO AN APPROVED SEDIMENT

TRAPPING DEVICE. INSPECT AND MAINTAIN AS NEEDED TO CONFORM TO SPECIFICATIONS AND STORMWATER POLLUTION PREVENTION PLAN.


CONSTRUCTION ENTRANCE

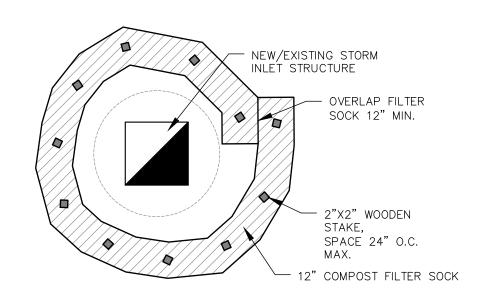

INLET PROTECTION

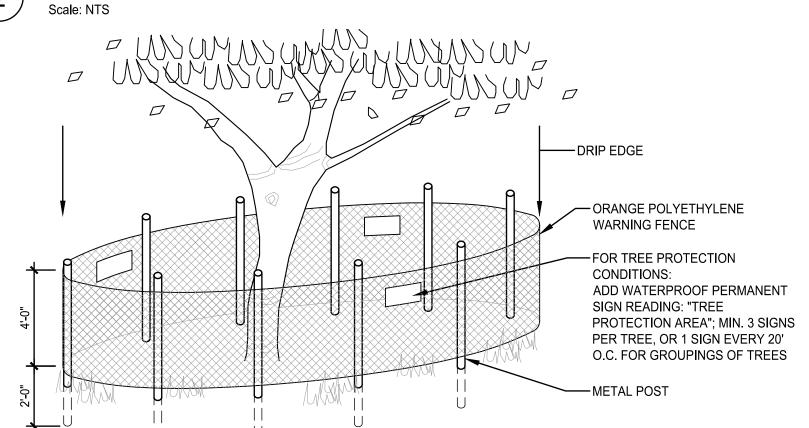


TREE PROTECTION

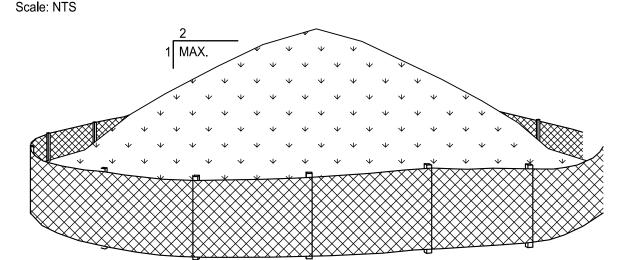

- AREA CHOSEN FOR STOCKPILING OPERATIONS SHALL BE DRY AND STABLE.
- MAXIMUM SLOPE OF STOCKPILE SHALL BE 2:1. MAXIMUM HEIGHT SHALL BE 12 FEET. 3. EACH PILE SHALL BE SURROUNDED WITH EITHER SILT FENCING OR STRAW BALE DIKE
- IN ACCORDANCE WITH PROJECT DETAILS.
- 4. IF DEEMED NECESSARY BY THE QUALIFIED INSPECTOR, A PERIMETER DIKE/SWALE
- SHALL BE LOCATED UP-SLOPE OF THE TOPSOIL STOCKPILE.

STOCKPILE

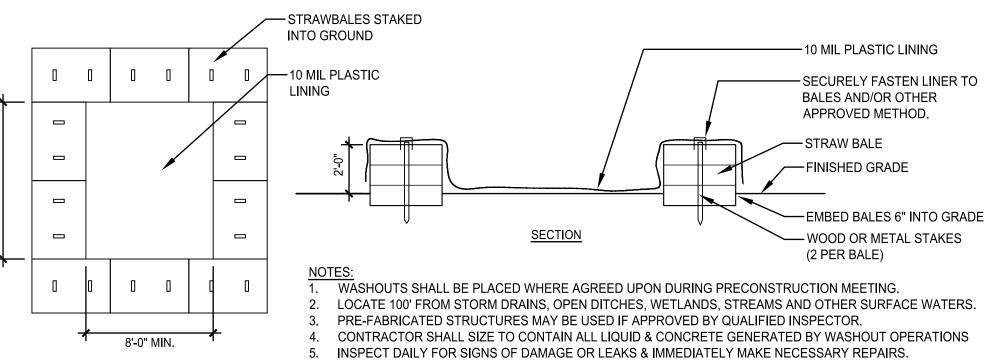


6. CLEAN, OR CONSTRUCT NEW FACILITY WHEN WASHOUT BECOMES 75% FULL. REPLACE PLASTIC LINER WITH EACH 7. WHEN FACILITIES ARE NO LONGER NEEDED, REMOVE HARDENED CONCRETE, SLURRY & WASHOUT MATERIALS &


LEGALLY DISPOSE OF OFF SITE OR RECYCLE.

CONCRETE WASHOUT Scale: NTS

<u>PLAN</u>

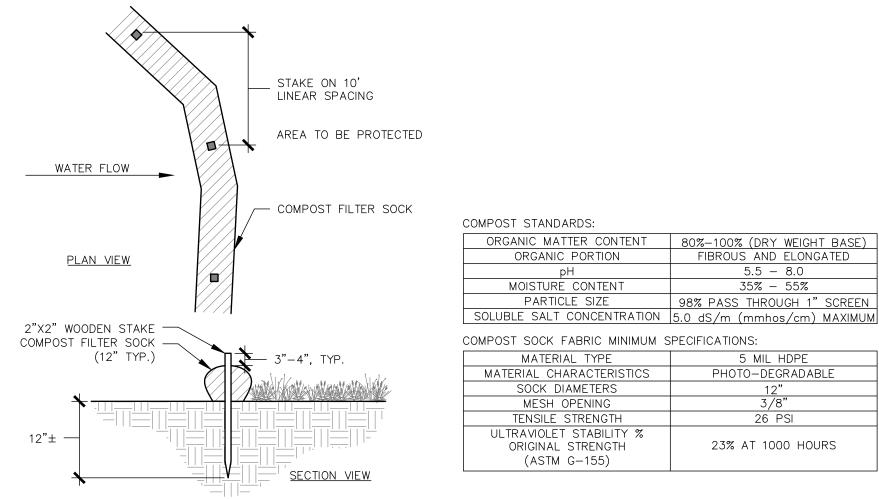


COMPOST FILTER SOCK

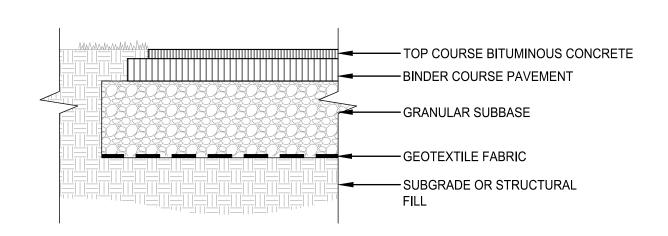


TOP	BINDER	GRAVEL
COURSE	COURSE	COURSE
1 ½"	2"	


ASPHALT PAVEMENT

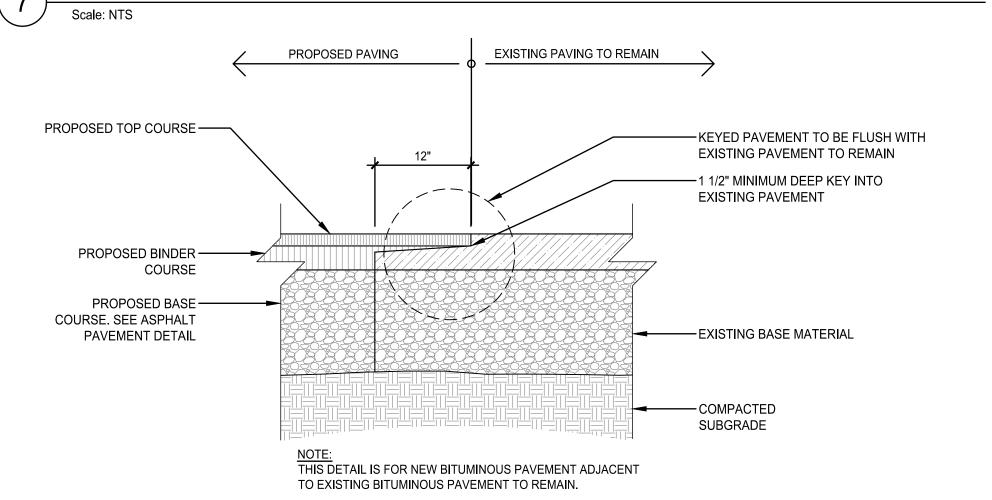


ASPHALT PAVEMENT KEY

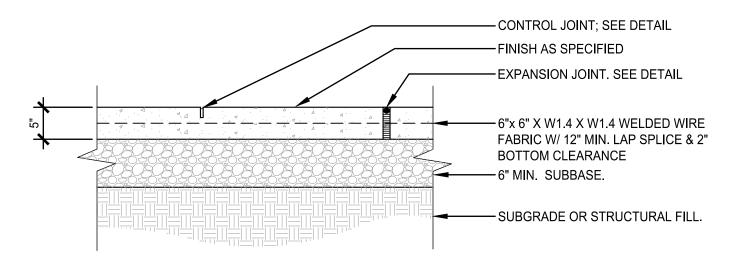


CONCRETE PAVEMENT

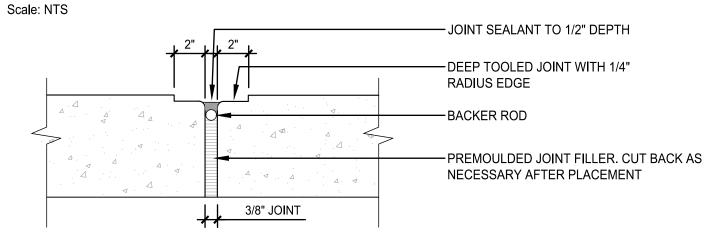


EXPANSION JOINT

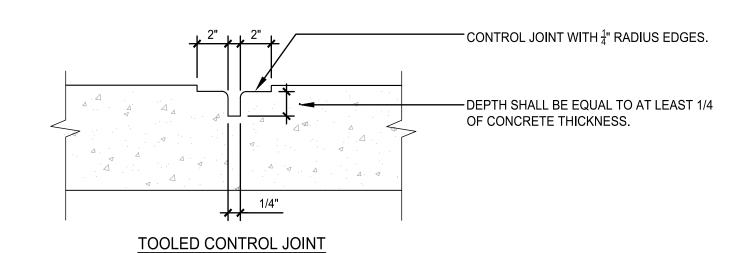

CONCRETE JOINTS

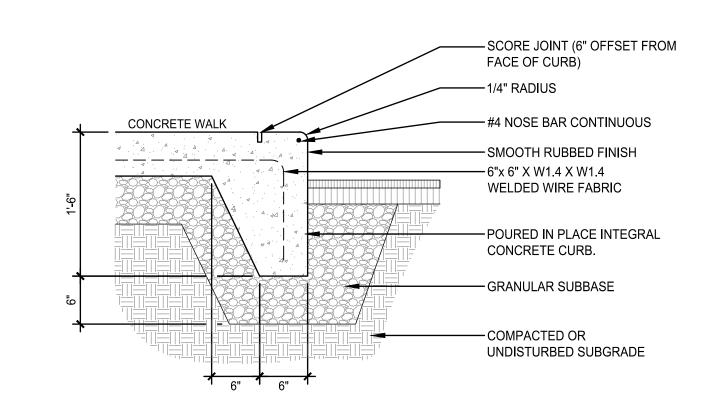

INTEGRAL CONCRETE CURB

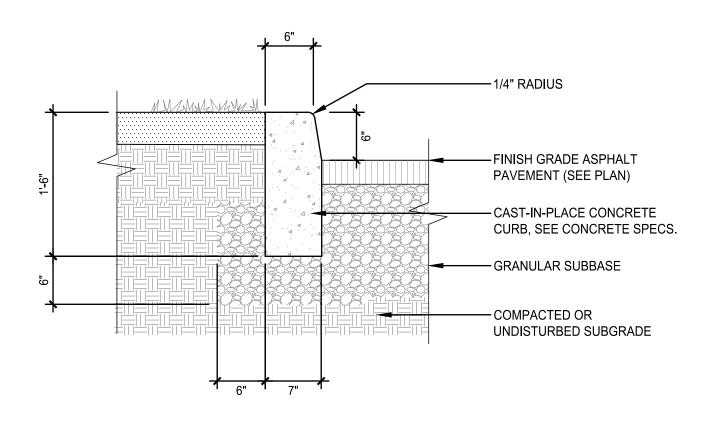

CONCRETE CURB

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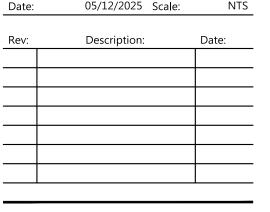
■ STONY POINT ELEMENTARY SCHOOL SED #50-02-01-06-0-014-015

Project Title:

Stony Point Student Drop Off Loop


7 Gurnee Drive Stony Point, New York 10980

Project No.:			2024108
Design:			DBH
Drawn:	MLD	Ch'k'd:	DBH
	05 /1 2 /2025		NITC



Drawing Title **DETAILS**

Drawing No.

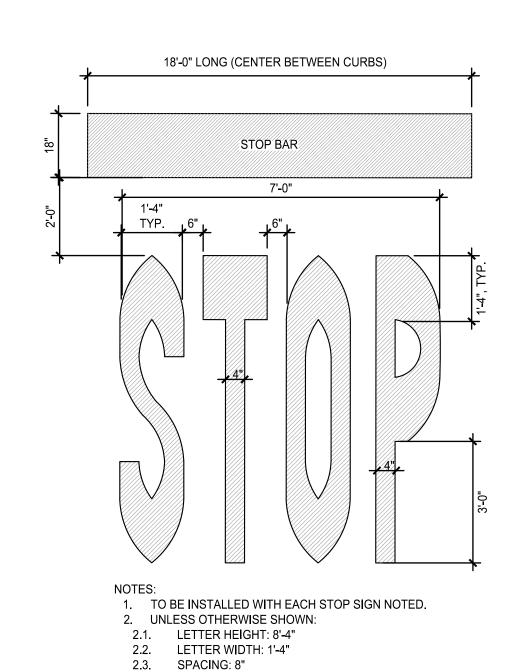


2.4. USE EQUAL SPACING BETWEEN LETTERS AND CENTER


ENTIRE SYMBOL IN LANE.

STOP BAR MARKING

Scale: NTS

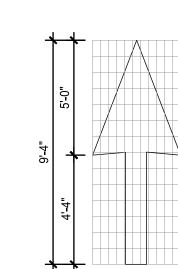

DIRECTIONAL ARROW MARKING

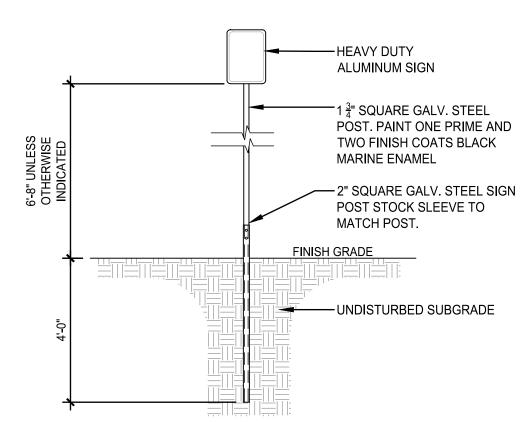


		SIGN SCHEDU	LE	
	SIGN	LETTER SIZE / TYPE	SIZE	M.U.T.C.D. #
А	DO NOT ENTER	SEE M.U.T.C.D.	30" X 30"	R5-1
В	STOP	SEE M.U.T.C.D.	30" X 30"	R1-1
С	ONE WAY	SEE M.U.T.C.D.	12" X 18"	R6-2L

NOTES: 1. OWNER SHALL APPROVE LOCATIONS PRIOR TO INSTALLATION. 2. LOCATED SIGNS 2' OFF EDGE OF CURB OR WALK.

SIGNAGE

Scale: NTS

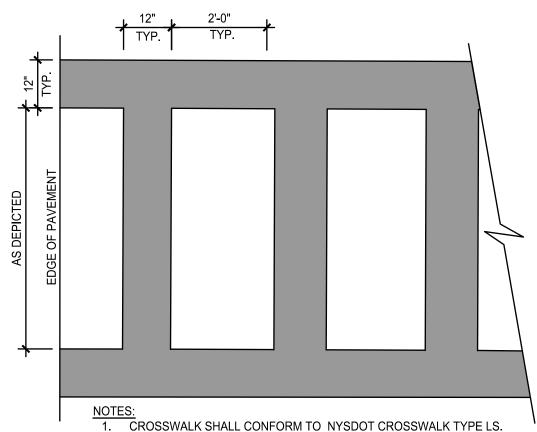

CROSSWALK

EDGE OF PAVEMENT TYP. TYP. TYP. TYP. TYP.
NOTES: 1. CROSSWALK SHALL CONFORM TO NYSDOT CROSSWALK TYPE LS. 2. ALL CROSSWALK MARKINGS SHALL BE WHITE.

—FINISHED GRADE 7'-6" TYPICAL, SEE PLAN. —1-1/2"Ø POSTS AT MAX. 6'-0" O.C. 6" DEEP CORE AND — GROUT WITH 1" DEEP SEALANT, TYPICAL CONCRETE PAVEMENT — MAX. 2%,MIN. 1% --- GRANULAR SUBBASE COMPACTED SUBGRADE COMPACTED SUBGRADE —

- 12" HANDRAIL EXTENSION AT TOP OF SLOPED SIDEWALK SLOPED SIDEWALK, SEE PLAN -1-1/2 GALV. STL. PIPE HANDRAIL WITH BLACK POWDER COAT. SET EXPANSION SLEEVES AT 24'O.C., 12" HANDRAIL EXTENSION — AT BTM. OF RAMP - ADJACENT WALK, SEE PLAN COMPACTED SUBGRADE GRANULAR SUBBASE LANDING DETAILS AT SLOPED SIDEWALK

SECTION AT SLOPED SIDEWALK

- TERMINAL POST WITH POST TOP. SELVAGE KNUCKLED REQUIRED AT FENCE ENDS, GATES AND DIRECTION CHANGE. FENCE FABRIC ON THE OUTSIDE OF POSTS —LINE POST LOOP TOP TOP RAIL — -LINE POST -PRIVACY SLATS, WHERE -INDICATED WIRE TIES 15" O.C. MAX. — TENSION BAR — TENSION BAND WITH CARRIAGE BOLTS AND NUTS -BOTTOM SELVAGE KNUCKLED BOTTOM RAIL — FILL SLEEVE-IT BASE WITH 3,000 -UNDISTURBED OR COMPACTED PSI CONCRETE TO ANCHOR SUBGRADE FENCE POST; 12" DIAMETER AND 2' DEEP

NOTE: 1. ALL POST, RAILS, AND MESH SHALL BE GALVANIZED WITH BLACK PVC VINYL COATING. ALL HARDWARE BLACK FINISH. SEE PLANS.

2. FENCE TO BE SET IN SLEEVE-IT BASES INSTALLED PREVIOUSLY BY CONTRACT 02. 3. SEE PLAN FOR SECTIONS OF FENCE REQUIRING VINYL PRIVACY SLATS.

CHAIN LINK FENCE Scale: NTS

- ADA APPROVED DETECTABLE

SEE SPECIFICATIONS

WARNING SURFACE. 24" WIDE.

FLUSH CURB: 1/4 " REVEAL

ADA APPROVED DETECTABLE — WARNING SURFACE. 24" WIDE FROM BACK OF CURB. SEE SPECIFICATIONS HEAVY BROOM OR — IMPRINTED FINISH (TYP.) - TEXTURE WARNING 6" CURB (TYP.) -

1. ALL DROP CURBS SHALL BE INSTALLED IN ACCORDANCE WITH NYS DOT AND ADA CURB RAMP REQUIREMENTS. 2. LANDINGS SHALL HAVE A MINIMUM CLEAR DIMENSION OF A 5'-0" x 5'-0" SQUARE. THE MAXIMUM CROSS SLOPE AT

LANDINGS IS 2% IN ANY DIRECTION. 3. THE MAXIMUM CROSS SLOPE OF CURB RAMPS SHALL BE 2%. CURB RAMP SURFACES SHALL LIE IN CONTINUOUS PLANES WITH A MINIMUM OF SURFACE WARP.

4. THE SURFACE OF ALL CURB RAMPS SHALL BE STABLE, FIRM AND SLIP RESISTANT. PROVIDE A COARSE BROOM


FINISH RUNNING PERPENDICULAR TO THE SLOPE ON CONCRETE RAMP SURFACES, EXCLUSIVE OF THE DETECTABLE WARNING FIELDS. 5. RAMP TRANSITIONS BETWEEN WALKS AND/OR STREETS SHALL BE FLUSH AND FREE OF ABRUPT VERTICAL

CHANGES (1/4" MAX). DROP CURB

HEAVY BROOM OR —

6" CURB (TYP.) —

IMPRINTED FINISH (TYP.)

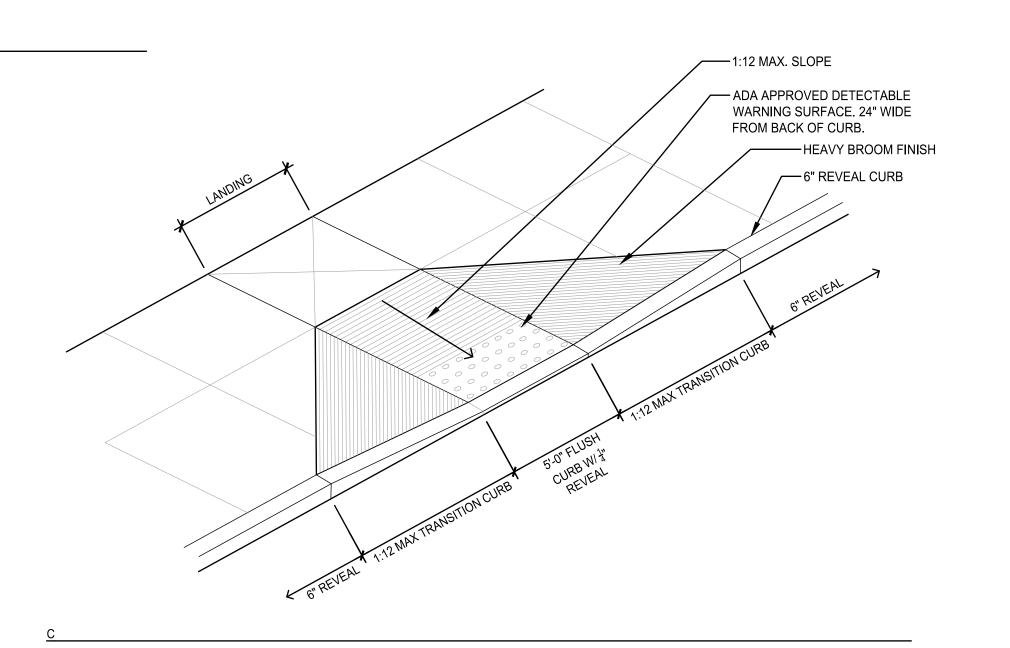

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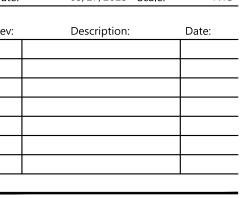
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Stony Point Student Drop Off Loop

7 Gurnee Drive Stony Point, New York 10980

2024108 DBH MLD Ch'k'd: Date: 05/27/2025 Scale:




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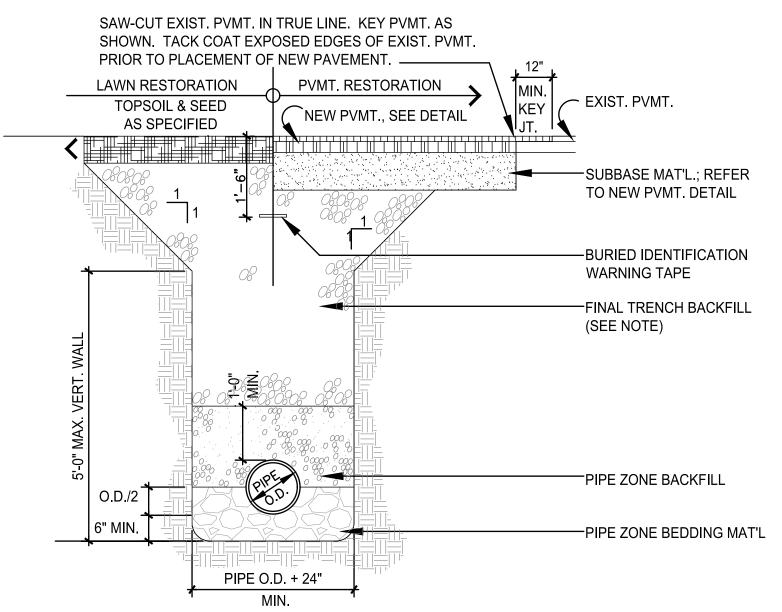
Drawing No.

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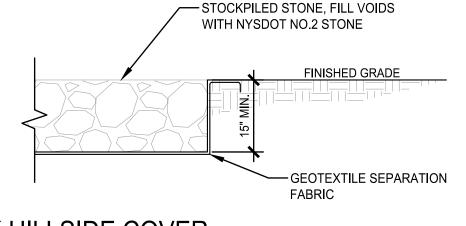
CATCH BASIN Scale: NTS




ITEM	DEPTH	MATERIAL	NYSDOT SIZE	METHOD OF PLACEMENT
PIPE ZONE BEDDING	6" MIN. + PIPE O.D./2	CRUSHED AGGREGATE	1 & 2	MECHANICAL COMPACTION
PIPE ZONE BACKFILL	12' MIN. COVER	CRUSHED AGGREGATE	1 & 2	MECHANICAL COMPACTION
FINAL TRENCH BACKFILL	VARIES	SEE NOTES	SEE NOTE	MECHANICAL COMPACTION

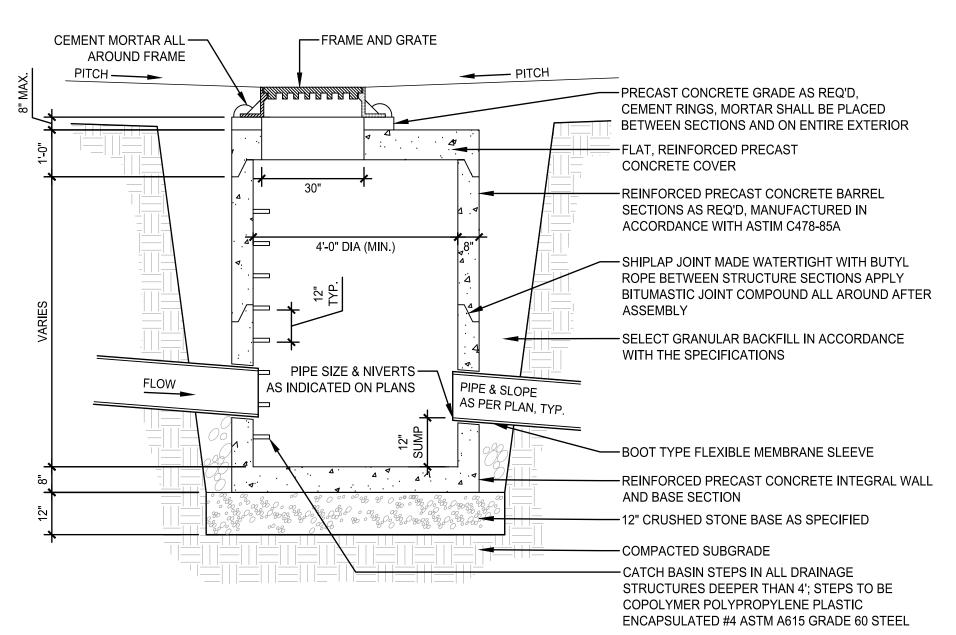- FINAL TRENCH BACKFILL
- IN NON-PAVED AREAS, FINAL TRENCH BACKFILL SHALL BE EXCAVATED MATERIAL WHEN DETERMINED SUITABLE BY THE ENGINEER OF RECORD; OTHERWISE IT SHALL BE STRUCTURAL FILL.
- IN PAVED AREAS, FINAL TRENCH BACKFILL SHALL BE STRUCTURAL FILL.

PIPE TRENCH Scale: NTS



ROCK HILLSIDE COVER

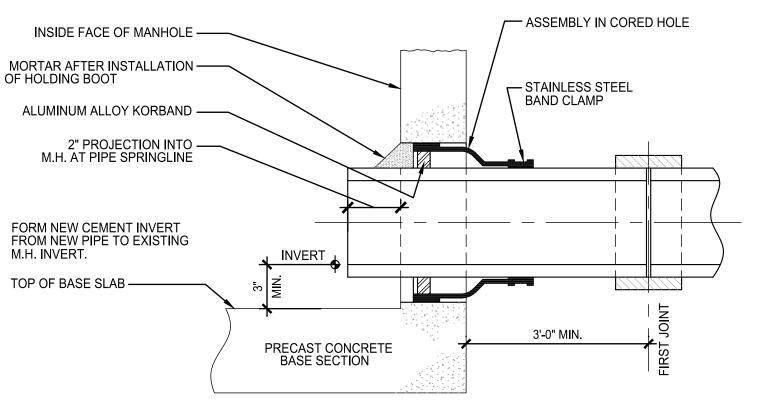

CONNECTION TO EXISTING STRUCTURE

19.69" -PROVIDE 0.5% PROVIDE 0.5% ——— SLOPE TO SLOPE TO INVERT OUT INVERT OUT

LONGITUDINAL CROSS SECTION AT IN-LINE DRAIN

NOTES:

- 1. THE CHANNEL SHALL BE SET $\frac{1}{8}$ " BELOW FINISH GRADE OF SURROUNDING CONCRETE. 2. PROVIDE 1" DEEP WITH $\frac{1}{4}$ " RADIUS TOOLED CONTROL JOINT IN CONCRETE AT EVERY OTHER
- TRENCH DRAIN SECTION. 3. PROTECT EXPOSED TRENCH DRAIN SURFACES FROM CONCRETE SPLATTER AND DEBRIS.


CROSS SECTION LONGITUDINALLY TOWARDS THE INLINE DRAIN.

EXPANSION JOINT-AND SEALANT -CONTROL JOINT - TRENCH DRAIN, AS SPECIFIED. CONCRETE ENCASEMENT — COMPACTED GRAVEL

NOTE: TRENCH DRAIN SHALL SLOPE INTERNALLY AT 0.5%

TRENCH DRAIN

STAIR DETAIL

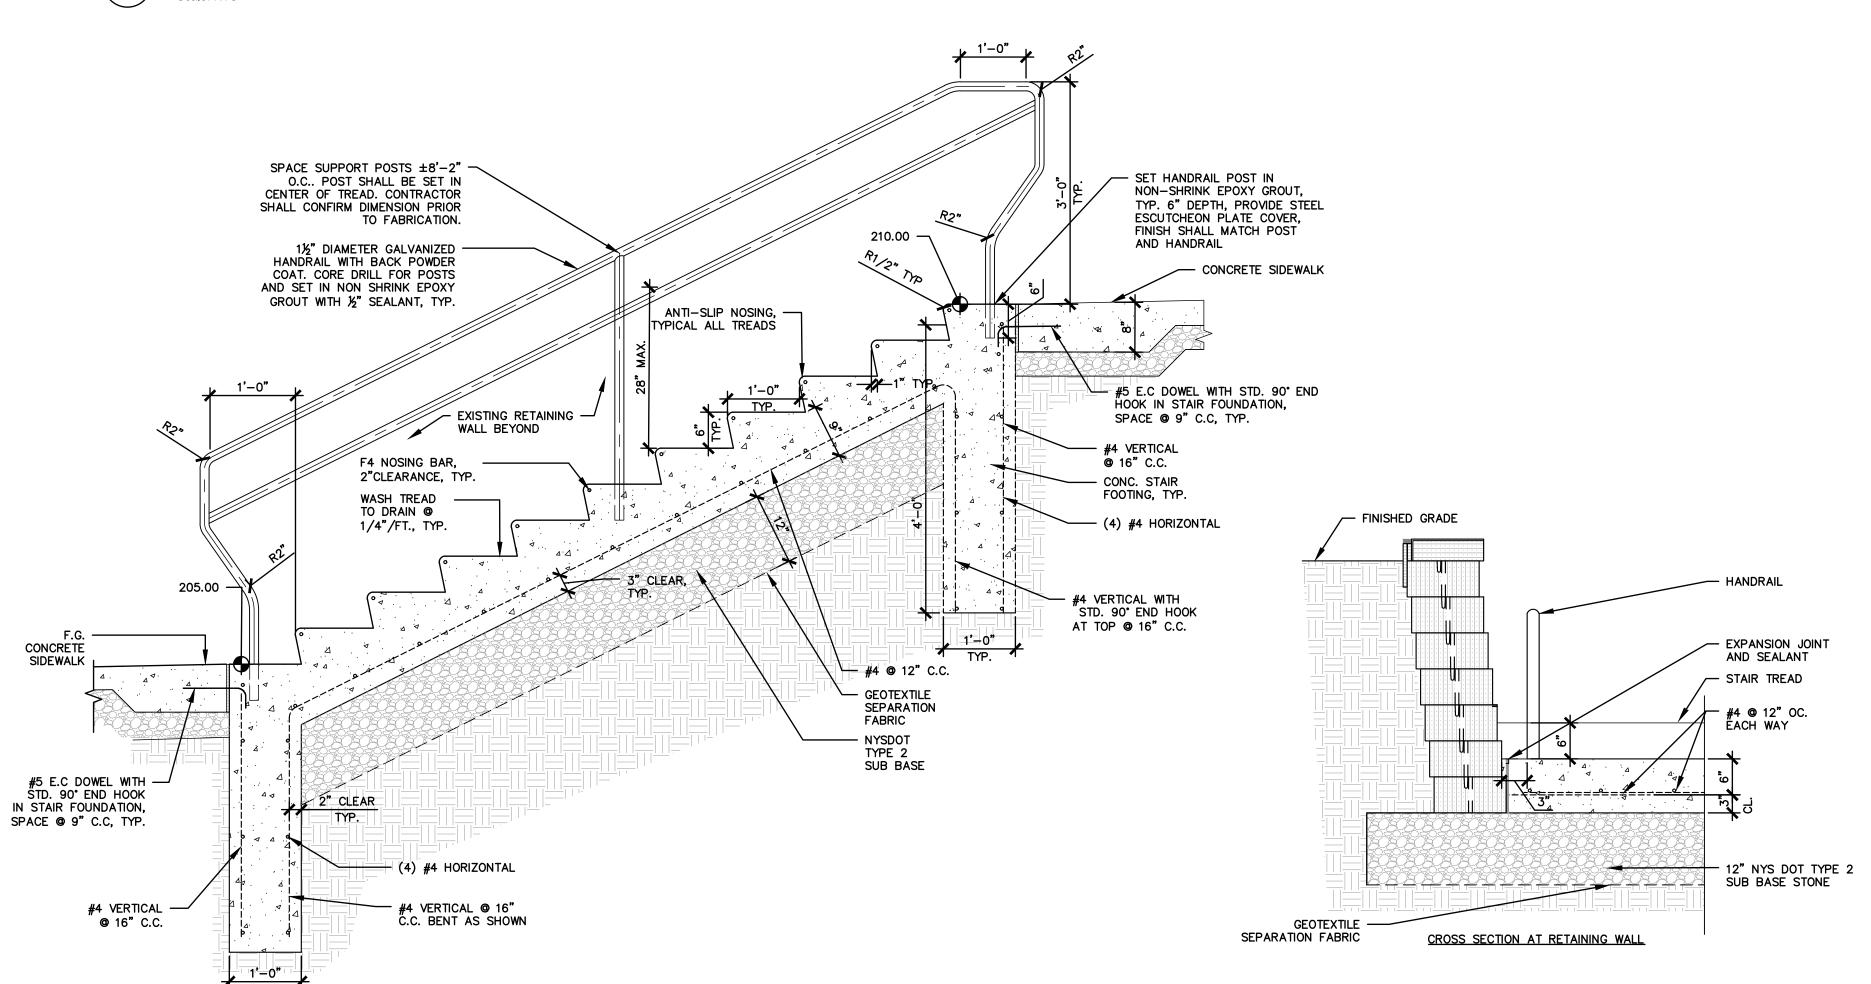

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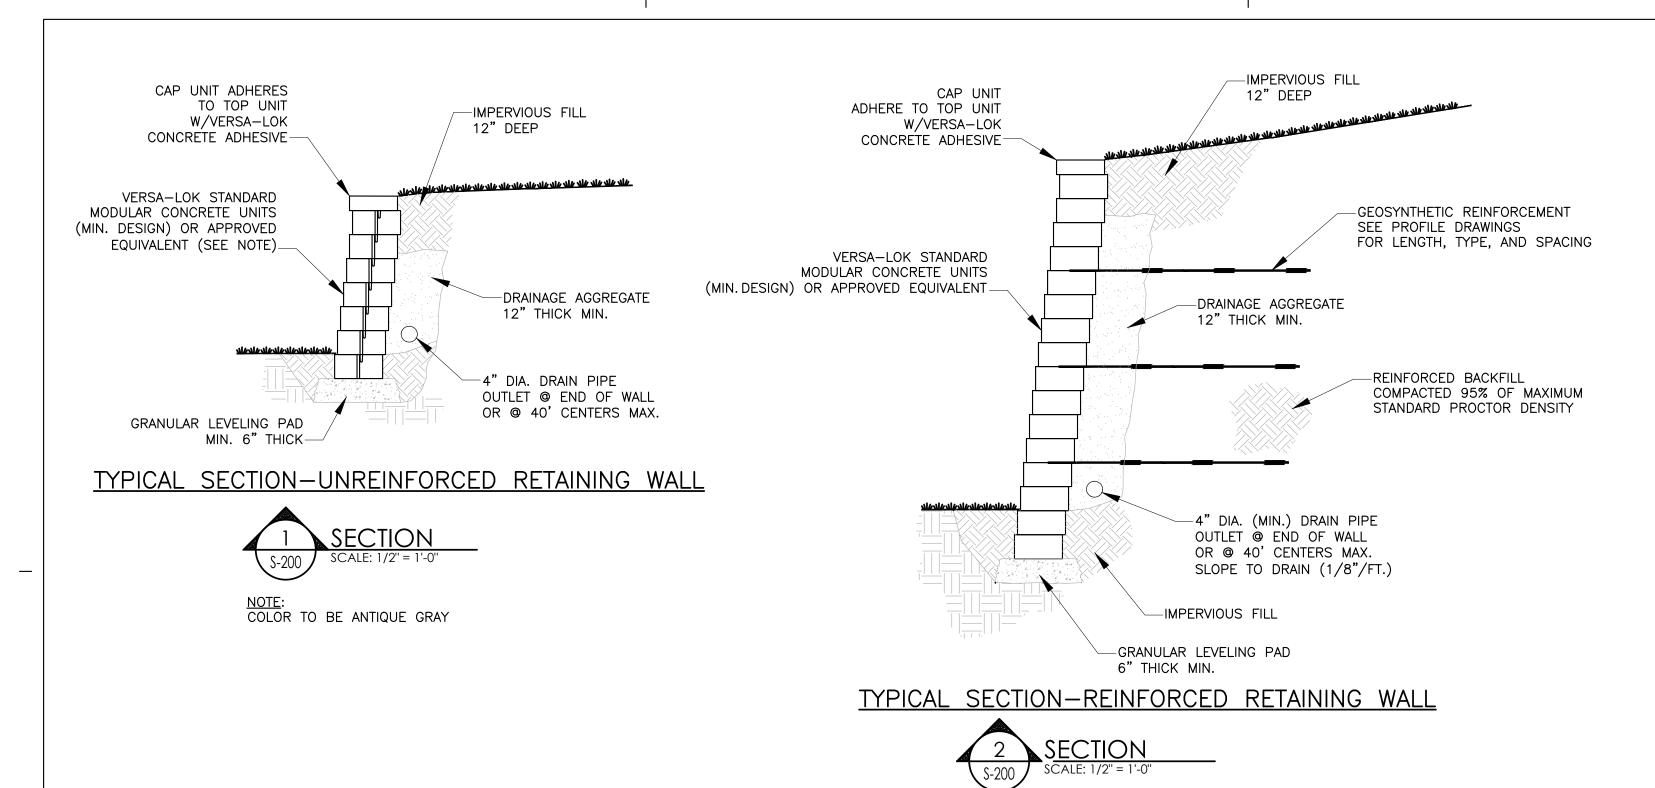
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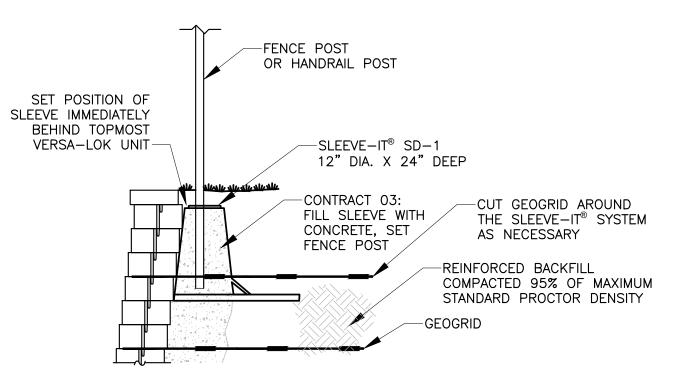
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Drawing Title **DETAILS**

Drawing No.





TOWER——PERFORATED LID TOWER——POCKET UNIT BACK SI FEVE-IT® SD-1

SLEEVE-IT® SD-1
SYSTEM COMPONENTS

SEE SLEEVE-IT® SYSTEM MANUFACTURER,
STRATA SYSTEMS FOR COMPLETE
SPECIFICATIONS, AND TECHNICAL GUIDANCE

FENCE POST DETAIL W/ SLEEVE-IT® SD-1



NOTE: FENCING BY CONTRACT 3. ALL OTHER WORK BY CONTRACT 02, U.N.O.

EXCAVATION & BACKFILL NOTES

- 1. EXCAVATIONS TO BE SHEETED AND BRACED, OR LAID BACK TO PREVENT SLOUGHING IN OF THE EXCAVATED AREAS PER OSHA REGULATIONS.
- PLACE ALL BLOCK ON FIRM, DRY, LEVEL, ACCEPTABLE BEARING SOIL.
 REMOVE AND DISPOSE OF LEGALLY FROM SITE; UNACCEPTABLE BEARING
- SOIL, EXCESS EXCAVATED MATERIAL, ASPHALT MATERIAL (SEE SITE PLANS).
- 4. THE DESIGN OF WALLS RETAINING EARTH DOES NOT INCLUDE HYDROSTATIC PRESSURE LOADS UNLESS NOTED OTHERWISE, AND ASSUMES A DRAINAGE SYSTEM IS IN PLACE WHERE REQUIRED.
- 5. FILL COMPACTION: WITHIN BUILDING 95% DRY DENSITY MODIFIED PROCTOR OUTSIDE OF BUILDING 95% DRY DENSITY MODIFIED PROCTOR.

GENERAL NOTES

- 1. THE STRUCTURE SHOWN ON THESE DRAWING IS SOUND ONLY IN ITS COMPLETED FORM. THE CONTRACTOR SHALL BE RESPONSIBLE FOR PROVIDING THE DESIGN, ADEQUACY, SAFETY AND STABILITY OF TEMPORARY ERECTION BRACING AND SHORING.
- 2. WHERE A DETAIL, TYPICAL DETAIL, SECTION, TYPICAL SECTION OR PLAN NOTE IS SHOWN FOR ONE CONDITION, IT SHALL APPLY FOR ALL SIMILAR OR LIKE CONDITIONS UNLESS NOTED OTHERWISE.
- 3. ALL DESIGN, INCLUDING MATERIAL STRESSES AND METHODS OF CONSTRUCTION SHALL BE IN COMPLIANCE WITH THE 2020 BUILDING CODE OF NEW YORK STATE; THE UNIFORM BUILDING CODE, OSHA AND GOVERNING AGENCIES HAVING JURISDICTION.
- 4. REFER TO THE "SPECIAL INSPECTIONS" SECTION OF THE SPECIFICATIONS FOR PROJECT REQUIREMENTS AND PERTINENT INFORMATION.
- 5. THE CONTRACTOR SHALL FIELD VERIFY ALL DIMENSIONS, ELEVATIONS AND SITE CONDITIONS SHOWN ON THE DRAWINGS AND IMMEDIATELY NOTIFY THE OWNER'S REPRESENTATIVE OF ANY DISCREPANCIES PRIOR TO ORDERING OR FABRICATING MATERIALS OR OTHERWISE PROCEEDING WITH THE WORK.
- 6. THE CONTRACTOR SHALL BE RESPONSIBLE FOR MEANS, METHODS, TECHNIQUES, SEQUENCES, AND PROCEDURES IN ORDER TO COMPLY WITH THE CONSTRUCTION DOCUMENTS. THE CONTRACTOR SHALL PROVIDE ALL LABOR, MATERIAL, EQUIPMENT AND SERVICES REQUIRED TO EXECUTE AND COMPLETE ALL ITEMS OF WORK AS SHOWN OR INDICATED ON THE DRAWINGS AND AS SPECIFIED HEREIN, INCLUDING INCIDENTAL ITEMS TO EFFECT A FINISHED AND COMPLETE JOB, EVEN THOUGH SUCH ITEMS ARE NOT SHOWN OR PARTICULARLY MENTIONED.
- 7. THE GENERAL CONTRACTOR SHALL USE CONSTRUCTION METHODS THAT ARE IN STRICT ACCORDANCE WITH MANUFACTURER'S SPECIFICATIONS.
- 8. CONTRACTOR SHALL BE COMPLETELY RESPONSIBLE FOR ADEQUATELY SHORING AND BRACING EXISTING CONSTRUCTION WHILE PERFORMING NEW WORK.
- 9. DIMENSIONS ARE NOT TO BE DERIVED BY SCALING THESE DRAWINGS. IF THERE ARE ANY QUESTIONS REGARDING DIMENSIONS, CONTACT THE ARCHITECT/ENGINEER FOR INFORMATION PRIOR TO SUBMITTING SHOP DRAWINGS.
- 10. THE CONTRACTOR SHALL RESTORE TO ITS ORIGINAL CONDITION ALL SITE APPURTENANCES DAMAGED UNDER THIS CONTRACT AT NO ADDITIONAL COST TO THE OWNER.
- 11. INFORMATION IN THESE STRUCTURAL NOTES IS A SELECTED SUMMARY OF REQUIREMENTS. REFER TO SPECIFICATIONS FOR AMPLIFICATIONS OF REQUIREMENTS.
- 12. THESE DRAWINGS DO NOT INCLUDE NECESSARY COMPONENTS FOR CONSTRUCTION SAFETY. CONTRACTOR SHALL BE SOLELY RESPONSIBLE FOR CONSTRUCTION SAFETY.
- 13. DETAILS SHOWN ARE FROM VERSA—LOK RETAINING WALL SYSTEMS. COORDINATE WITH VENDOR FOR REINFORCEMENT BASE MATERIAL, EMBEDMENT, UNIT SIZE AND CONFIGURATION, ETC. NEEDED PER HEIGHT OF WALL.

DESIGN CRITERIA NOTES


- 1. GENERAL BUILDING CODE
- THE CONSTRUCTION DOCUMENTS ARE BASED ON THE REQUIREMENTS OF THE 2020 NEW YORK STATE BUILDING CODE.
- 2. RISK CATEGORY OF BUILDING AND OTHER STRUCTURES
- THE BUILDING HAS BEEN ASSIGNED AN RISK CATEGORY IN ACCORDANCE WITH PREVIOUSLY MENTIONED BUILDING CODE WITH THE FOLLOWING CRITERIA:

 A. RISK CATEGORY: III, SCHOOL
- 3. DEAD AND LIVE LOADS
 - THE DEAD LOADS ARE THE SELF WEIGHT OF MATERIALS OF CONSTRUCTION.
- 4. GROUND SNOW LOAD DATA
- SNOW LOADS ARE BASED ON CHAPTER 7 OF THE AMERICAN SOCIETY OF CIVIL ENGINEERS, MINIMUM DESIGN LOADS FOR BUILDINGS AND OTHER STRUCTURES, ASCE 7 AND THE FOLLOWING CRITERIA:

 A. GROUND SNOW LOAD (Pg): 66 PSF

5. WIND DESIGN DATA

- WIND PRESSURES ARE BASED ON CHAPTER 26 OF THE AMERICAN SOCIETY OF CIVIL ENGINEERS, MINIMUM DESIGN LOADS FOR BUILDINGS AND OTHER STRUCTURES, ASCE 7 AND THE FOLLOWING CRITERIA:
- A. ULTIMATE DESIGN WIND SPEED (Vuit): 122 MPH (3 SECOND GUST)
- B. RISK CATEGORY:C. WIND EXPOSURE CATEGORY:
- 6. SEISMIC DESIGN DATA
- THE STRUCTURE AND COMPONENTS OF THE BUILDING HAVE BEEN DESIGNED IN ACCORDANCE WITH THE PREVIOUSLY MENTIONED BUILDING CODE WITH THE FOLLOWING CRITERIA:
- A. RISK CATEGORY:
- B. SEISMIC IMPORTANCE FACTOR, le: 1.25
 C. 0.2 SEC. MAPPED SPECTRAL ACCELERATION (Ss): 0.27
- D. 1 SEC. MAPPED SPECTRAL ACCELERATION (S1): 0.051
 E. SITE CLASS: D
- F. 0.2 SEC SPECTRAL RESPONSE COEFF. (SDS): .2
 G. 1 SEC SPECTRAL RESPONSE COEFF. (SD1): .072
 H. SEISMIC DESIGN CATEGORY: B
- ANALYTICAL PROCEDURE: EQUIVALENT LATERAL FORCE PROCEDURE (ELFP)

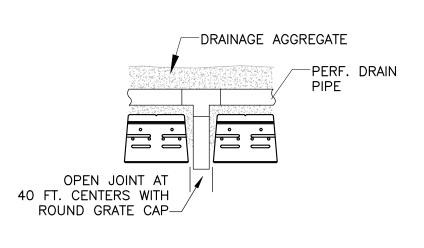

DRAIN DETAIL



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26 IBM Road

Poughkeepsie, NY 12601

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NY ENGINEERING FIRM CERTIFICATE #0021419



PROJECT INFORMATION

Project Number R25.17697.00

NORTH ROCKLAND CENTRAL SCHOOL DISTRICT

STONY POINT ELEMENTARY
SCHOOL STUDENT DROP OFF
LOOP & WATER HEATER
REPLACEMENT

7 GURNEE DRIVE STONY POINT, NY 10980

■ STONY POINT ELEMENTARY SCHOOL SED #50-02-01-06-0-014-015

PROFESSIONAL STAMPS

NEW YORK STATE EDUCATION STATEMENT

I S A VIOLATION OF THE NEW YORK STATE EDUCATION LAW AND THE COMMISSIC
REGULATIONS FOR ANY PERSON, UNLESS ACTING UNDER THE DIRECTION OF A LICE
RECHIECT FROMINFER OR LAND RIVEYYOR TO A LITER AN ITEM IN ANY WAY I.F. AN

THEIR SIGNATURE AND THE DATE OF SUCH ALTERATION, AND A ALTERATION.

SHEET INFORMATION

Issued Scale
05/27/25 As indicated

Project Status
BID

L.W.
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RETĂINING WALL DETAILS AND NOTES

Drawing Number

200

A. ALL WORK SHALL COMPLY WITH STATE AND LOCAL CODES. AND SPECIAL OCCUPANCY STANDARDS. B. DOMESTIC WATER LINES SHALL BE TYPE L COPPER, LEAD FREE JOINTS. INSULATE ALL PIPING WITH PREFORMED FIBERGLASS PIPE INSULATION WITH ASJ COVER SIZED PER STATE ENERGY CODE. ALL FITTINGS AND VALVES TO BE COVERED WITH PREFORMED PVC FITTING COVERS. ALL EXPOSED VERTICAL FIXTURE SUPPLY LINES TO BE COVERED WITH PVC JACKET TO 7' ABOVE FINISHED FLOOR, UNLESS OTHERWISE NOTED ON PLANS OR SPECS. C. PROVIDE WATER HAMMER ARRESTORS AS REQUIRED BY STATE PLUMBING CODE ON TEE OUTLET - UP CONNECTION - BOTTOM CONNECTION - BOTTOM CONNECTION TOP ELBOW - TURNED DOWN	
B. DOMESTIC WATER LINES SHALL BE TYPE L COPPER, LEAD FREE JOINTS. INSULATE ALL PIPING WITH PREFORMED FIBERGLASS PIPE INSULATION WITH ASJ COVER SIZED PER STATE ENERGY CODE. ALL FITTINGS AND VALVES TO BE COVERED WITH PREFORMED PVC FITTING COVERS. ALL EXPOSED VERTICAL FIXTURE SUPPLY LINES TO BE COVERED WITH PVC JACKET TO 7' ABOVE FINISHED FLOOR, UNLESS OTHERWISE NOTED ON PLANS OR SPECS. TEE OUTLET - DOWN CONNECTION - BOTTOM CONNECTION TOP ELBOW - TURNED UP	— X — EXISTING PIPING CW COLD WATER HW HOT WATER
PIPING WITH PREFORMED FIBERGLASS PIPE INSULATION WITH AS J COVER SIZED PER STATE ENERGY CODE. ALL FITTINGS AND VALVES TO BE COVERED WITH PREFORMED PVC FITTING COVERS. ALL EXPOSED VERTICAL FIXTURE SUPPLY LINES TO BE COVERED WITH PVC JACKET TO 7' ABOVE FINISHED FLOOR, UNLESS OTHERWISE NOTED ON PLANS OR SPECS. CONNECTION - BOTTOM FLBOW - TURNED UP	CW COLD WATER HW HOT WATER
PVC FITTING COVERS. ALL EXPOSED VERTICAL FIXTURE SUPPLY LINES TO BE COVERED WITH PVC JACKET TO 7' ABOVE FINISHED FLOOR, UNLESS OTHERWISE NOTED ON PLANS OR SPECS. CONNECTION TOP ELBOW - TURNED UP	HW HOT WATER
NOTED ON PLANS OR SPECS. ELBOW - TURNED UP	THE THE MEAN
C. PROVIDE WATER HAMMER ARRESTORS AS REQUIRED BY STATE PLUMBING CODE ON	HWR HOT WATER RECIRCULATING
	THE WATER RECIRCOLATION
BRANCH PIPING TO EACH TOILET ROOM, LAUNDRY ROOM, SOLENOID VALVE, FAST CLOSING VALVE OR AS OTHERWISE REQUIRED BY CODE. [FILL FILL LINE
D. UNDERGROUND SANITARY AND VENT PIPING SHALL BE SERVICE WEIGHT CAST IRON, UNION UNION	NG NATURALGAS
HUB AND SPIGOT WITH RUBBER GASKET PUSH JOINTS. ABOVE GROUND SANITARY AND VENT PIPING SHALL BE NO-HUB CAST IRON OR DWV COPPER WITH DWV BALL VALVE	V VENT
COPPER FITTINGS. BALANCING VALVE BALANCING VALVE	GV GAS VENT
E. UNDERGROUND STORM PIPING SHALL BE SERVICE WEIGHT CAST IRON, HUB AND SPIGOT WITH RUBBER GASKET PUSH JOINTS. ABOVE GROUND STORM PIPING SHALL CHECK VALVE	
BE NO-HUB CAST IRON. ROOF DRAIN BODIES AND HORIZONTAL ABOVE GRADE PIPING SHALL BE INSULATED WITH PREFORMED FIBERGLASS PIPE INSULATION. BUTTERFLY VALVE	
F. SANITARY AND STORM CLEANOUTS TO BE PROVIDED AS PER STATE PLUMBING CODE ————————————————————————————————————	WAY
AT END OF EACH BRANCH, AT LEAST EVERY 100' ALONG THE MAINS AND AT 90 DEGREE CHANGE IN DIRECTION. GATE VALVE	
G. NATURAL GAS PIPING BELOW GRADE SHALL BE HDPE. NATURAL GAS PIPING ABOVE PLUG VALVE	
GRADE SHALL BE ASTM A53 SCH 40 BLACK STEEL. WITH SCREWED JOINTS IN PIPE UP TO 2 1/2" AND WELDED JOINTS IN PIPE 3" AND ABOVE. ALL EXTERIOR EXPOSED GAS PRESSURE REDUCING VALVE	
PIPE SHALL BE PAINTED (GREY, YELLOW OR AS OTHERWISE SPECIFIED BY THE ARCHITECT). PIPE GUIDE	
H. IT IS THE RESPONSIBILITY OF THE PLUMBING CONTRACTOR TO FIELD VERIFY EXISTING PIPE ANCHOR	
CONDITIONS WITHIN THE BUILDING PRIOR TO COMMENCEMENT OF ALL DEMOLITION AND NEW WORK. FLEXIBLE PIPE CONNECTOR	
I. IT IS THE RESPONSIBILITY OF THE PLUMBING CONTRACTOR TO REMOVE AND EXPANSION JOINT	
REPLACE EXISTING CEILINGS UNLESS OTHERWISE NOTED ON THE ARCHITECTURAL DRAWINGS, FOR PERFORMING DEMOLITION OR NEW WORK WITHIN THE BUILDING. FLOW SWITCH	
THE CONTRACTOR SHALL REINSTALL THE CEILING SYSTEMS TO MATCH THE ORIGINAL INSTALLATION. ANY CEILING SYSTEM COMPONENT DAMAGED DURING VS TAMPER SWITCH	
DEMOLITION, STORAGE, OR RE-INSTALLATION SHALL BE REPLACED WITH A NEW AT NO EXPENSE TO THE OWNER. AQUASTAT PRESSURE	
J. UNLESS SHOWN ON THE ARCHITECTURAL DRAWINGS. IT IS THE RESPONSIBILITY OF THE PLUMBING CONTRACTOR TO PATCH AND FINISH ALL EXISTING PIPE THERMOMETER	
PENETRATIONS AND TRENCHING THRU FLOOR AND WALLS AFTER DEMOLITION. IN ADDITION, ALL NEW PENETRATIONS AND TRENCHING SHALL BE PROVIDED FOR INLINE PUMP	
INSTALLATION OF PLUMBING SYSTEM INCLUDING, BUT NOT LIMITED TO, EQUIPMENT, PIPING, ETC. SHOWER HEAD	
K. ALL PIPING AND CONDUIT PENETRATIONS THRU RATED WALLS OR FLOORS SHALL BE	
PROVIDED WITH FIRE/SMOKE STOPPING.	
L. ALL PIPING SYSTEMS SHALL BE PRESSURE TESTED, PURGED, DISINFECTED AND/OR AIR REMOVED AS DICTATED BY CODE, MANUFACTURER SPECIFICATION, HEALTH POINT OF REMOVAL POINT OF REMOVAL	
DEPARTMENT AND/OR OTHER RELATED INDUSTRY STANDARDS. TEST REPORTS SHALL BE SUBMITTED FOR DOCUMENTATION.	
M. COORDINATE MOUNTING OF FIXTURES AND TRIM WITH ARCHITECTURAL ELEVATIONS, MILLWORK, SPECIALTY EQUIPMENT AND ADA GRAB BARS.	
N. FLOOR DRAINS AND FLOOR SINKS SHALL BE FLUSH TO FLOOR AND LOCATED AT A LOW POINT IN FLOOR UNLESS OTHERWISE NOTED ON THE PLANS. FLOOR DRAINS SHALL HAVE EITHER A TRAP PRIMER OR TRAP GUARD INSTALLED.	
O. SLOPE SANITARY DRAINAGE PIPING 2 1/2" AND LESS MINIMUM OF 1/4" PER FOOT. SLOPE SANITARY DRAINAGE PIPING 3" AND LESS MINIMUM OF 1/8" PER FOOT.	
P. PROVIDE SHUTOFF VALVES IN ALL DOMESTIC WATER PIPING SYSTEM BRANCHES SERVING TWO OR MORE FIXTURES.	

Q. INSTALL PIPING SO ALL VALVES, STRAINERS, TRAPS, ETC. ARE ACCESSIBLE.





PROJECT INFORMATION

R25.17697.00 Client Name

NORTH ROCKLAND CSD


Project Name STONY POINT ELEMENTARY SCHOOL STUDENT DROP OFF LOOP & WATER HEATER REPLACEMENT

Project Address
7 GURNEE DRIVE STONY POINT, NY 10980

Date Description

■ STONY POINT ELEMENTARY SCHOOL SED #50-02-01-06-0-014-015


PROFESSIONAL STAMPS

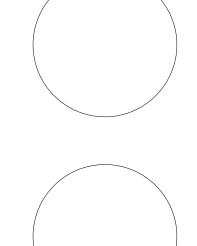

SHEET INFORMATION Issued

05/27/2025 As indicated Project Status BID Drawn By Checked By AJS AJE

PLUMBING LEGEND, NOTES, & SYSTEM DIAGRAMS

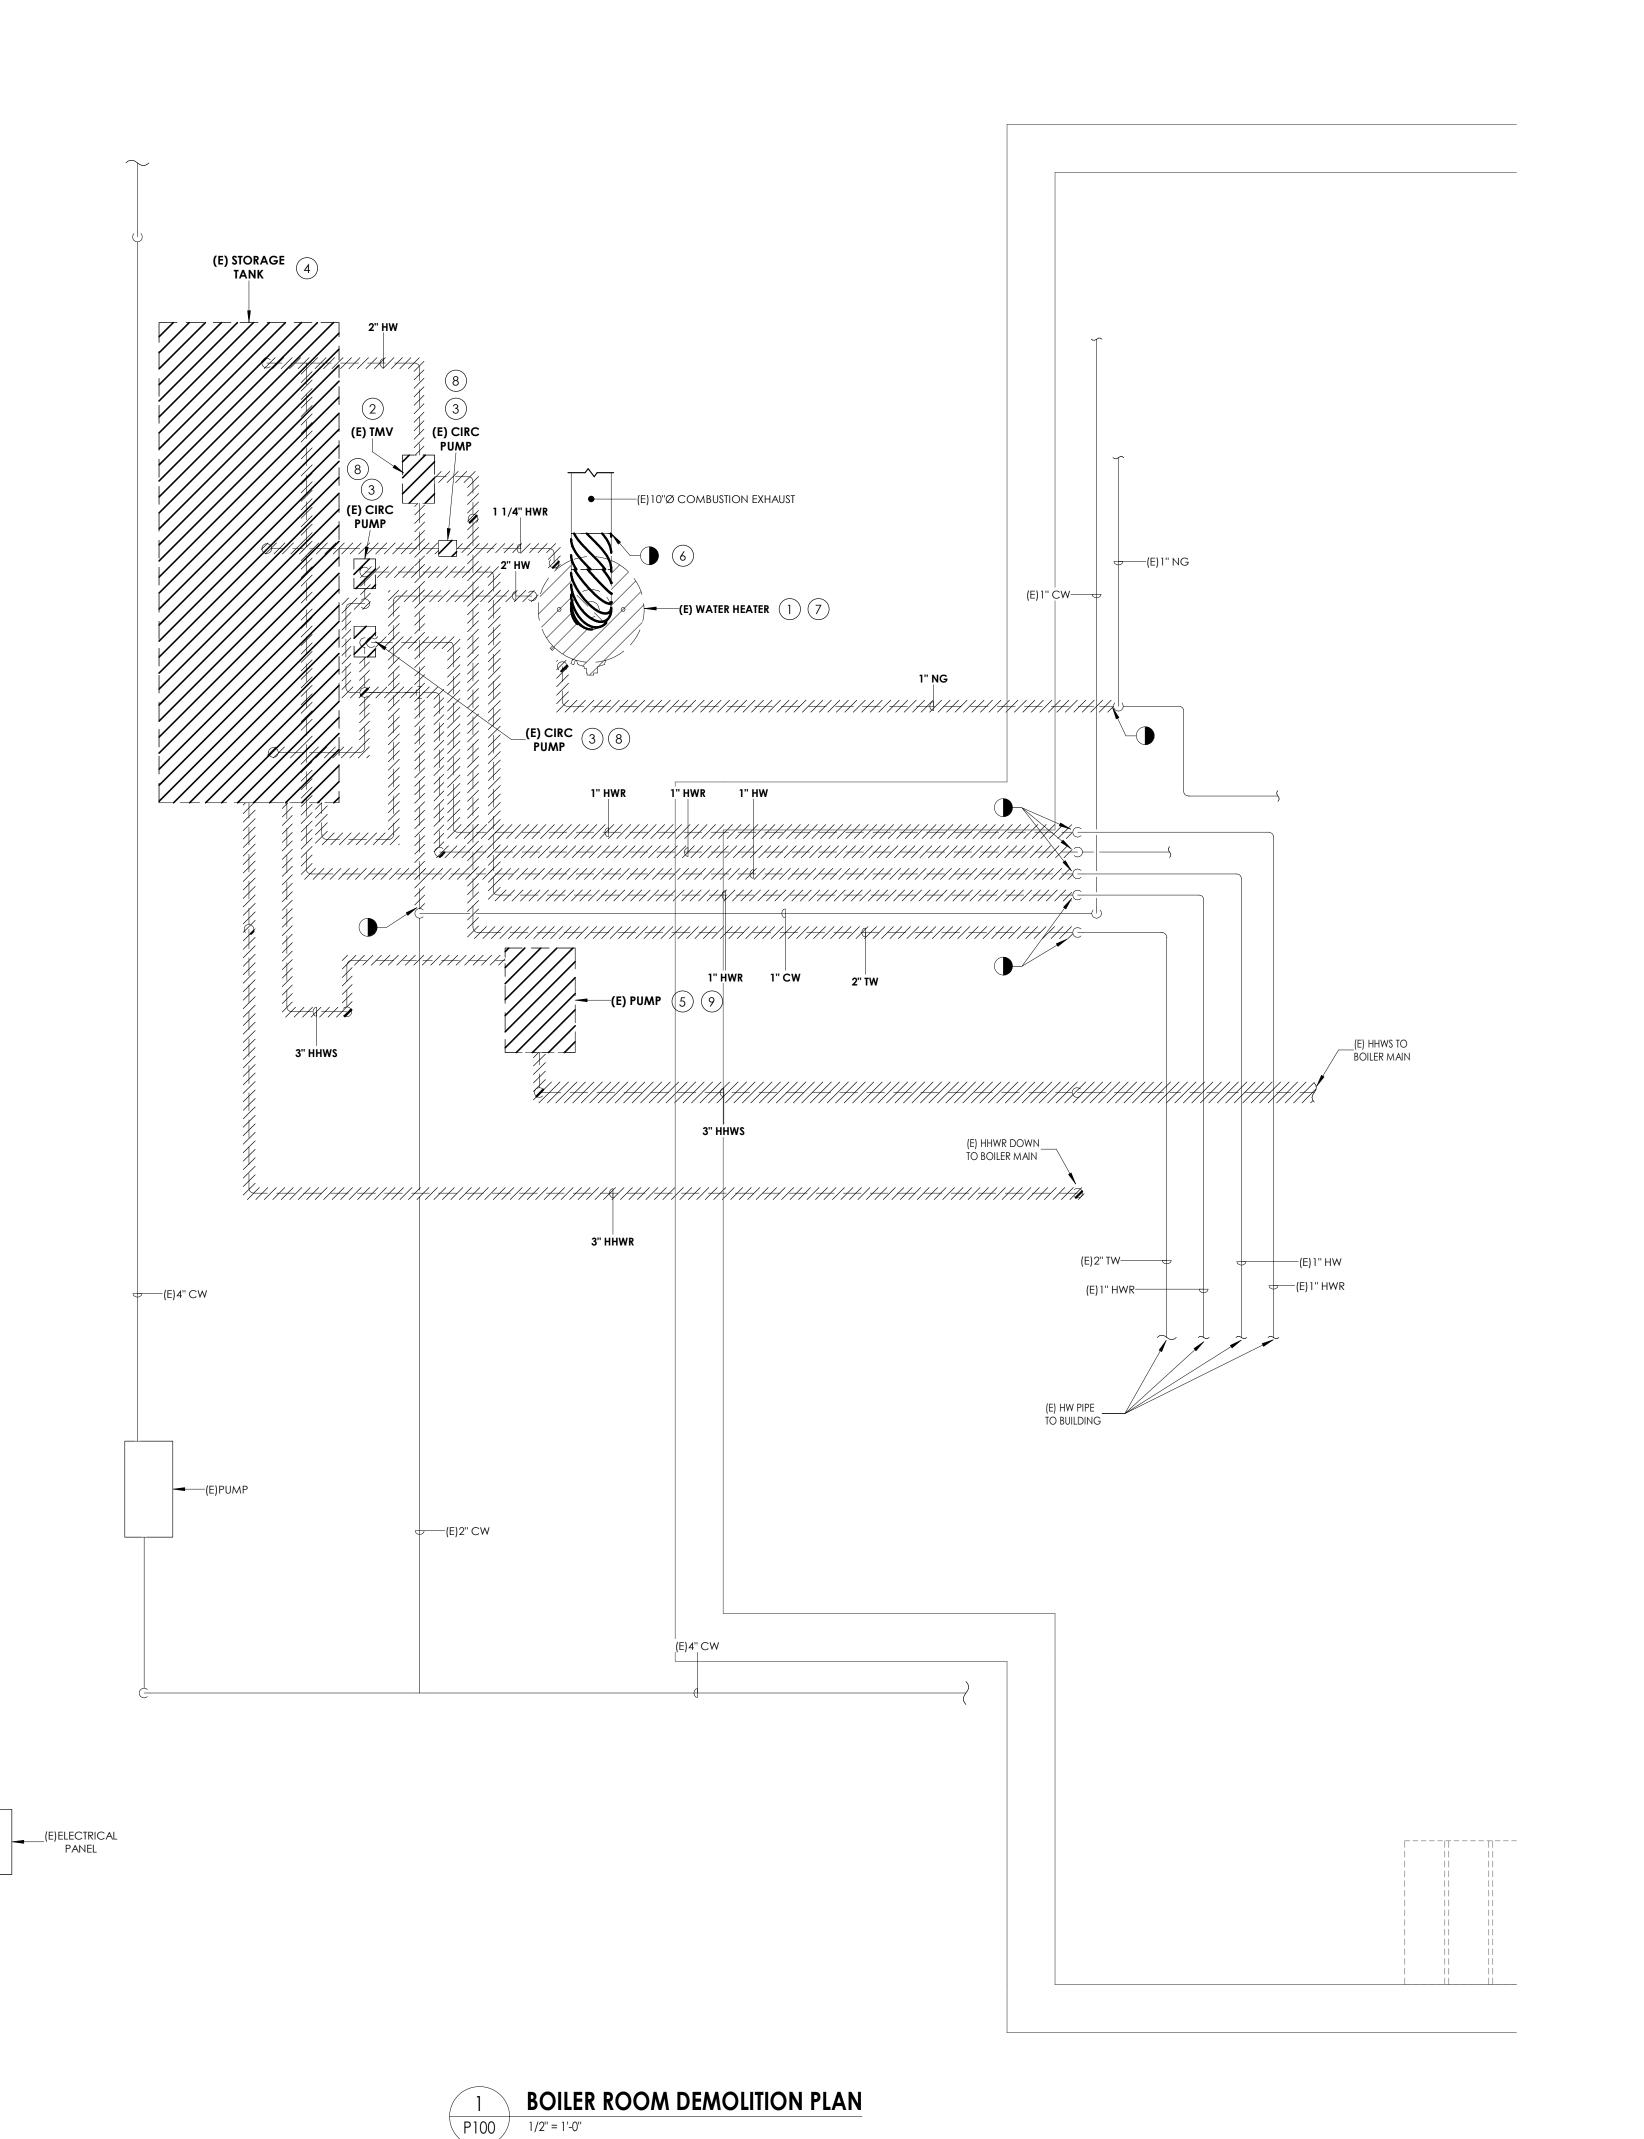

KEY NOTES

- (1) REMOVE EXISTING WATER HEATER IN ITS ENTIRETY INCLUSIVE OF ALL HOT WATER AND COLD WATER PIPING TO POINTS INDICATED. DISCONNECT NATURAL GAS PIPING FROM EXISTING WATER HEATER. PREPARE PIPING FOR CONNECTION TO NEW EQUIPMENT.
- (2) REMOVE THERMOSTATIC MIXING VALVE IN ITS ENTIRETY INCLUSIVE OF ALL PIPING AND CONTROL ACCESSORIES. PREPARE FOR INSTALLATION OF NEW EQUIPMENT.
- REMOVE CIRCULATION PUMP IN ITS ENTIRETY INCLUSIVE OF ALL PIPING AND CONTROL ACCESSORIES. PREPARE FOR INSTALLATION OF NEW EQUIPMENT
- (4) REMOVE HOT WATER STORAGE TANK IN ITS ENTIRETY INCLUSIVE OF ALL PIPING AND EQUIPMENT SUPPORT, PREPARE FOR INSTALLATION OF NEW EQUIPMENT.
- (5) REMOVE ABANDONED PUMP IN ITS ENTIRETY INCLUSIVE OF CONCRETE PAD. REMOVE ALL HOT WATER PIPING BACK TO BOILER MAINS AND CAP.
- (6) REMOVE EXISTING COMBUSTION EXHAUST DUCTWORK TO POINT INDICATED. PREPARE DUCTWORK FOR RECONNECTION.
- 7) DISCONNECT EXISTING CONDUIT AND WIRING FROM WATER HEATER AND
- 8) DISCONNECT EXISTING CONDUIT AND WIRING FROM CIRC PUMPS AND REMOVE BACK TO SOURCE PANEL.

REMOVE BACK TO OVERHEAD JUNCTION BOX. TAG FOR REUSE.

9 DISCONNECT EXISTING CONDUIT AND WIRING TO PUMP AND REMOVE BACK TO SOURCE PANEL.





PROJECT INFORMATION

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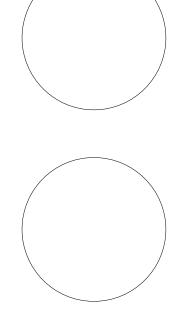
STONY POINT ELEMENTARY SCHOOL STUDENT DROP OFF LOOP & WATER HEATER REPLACEMENT

7 GURNEE DRIVE STONY POINT, NY 10980

PROJECT ISSUE & REVISION SCHEDULE

■ STONY POINT ELEMENTARY SCHOOL SED #50-02-01-06-0-014-015

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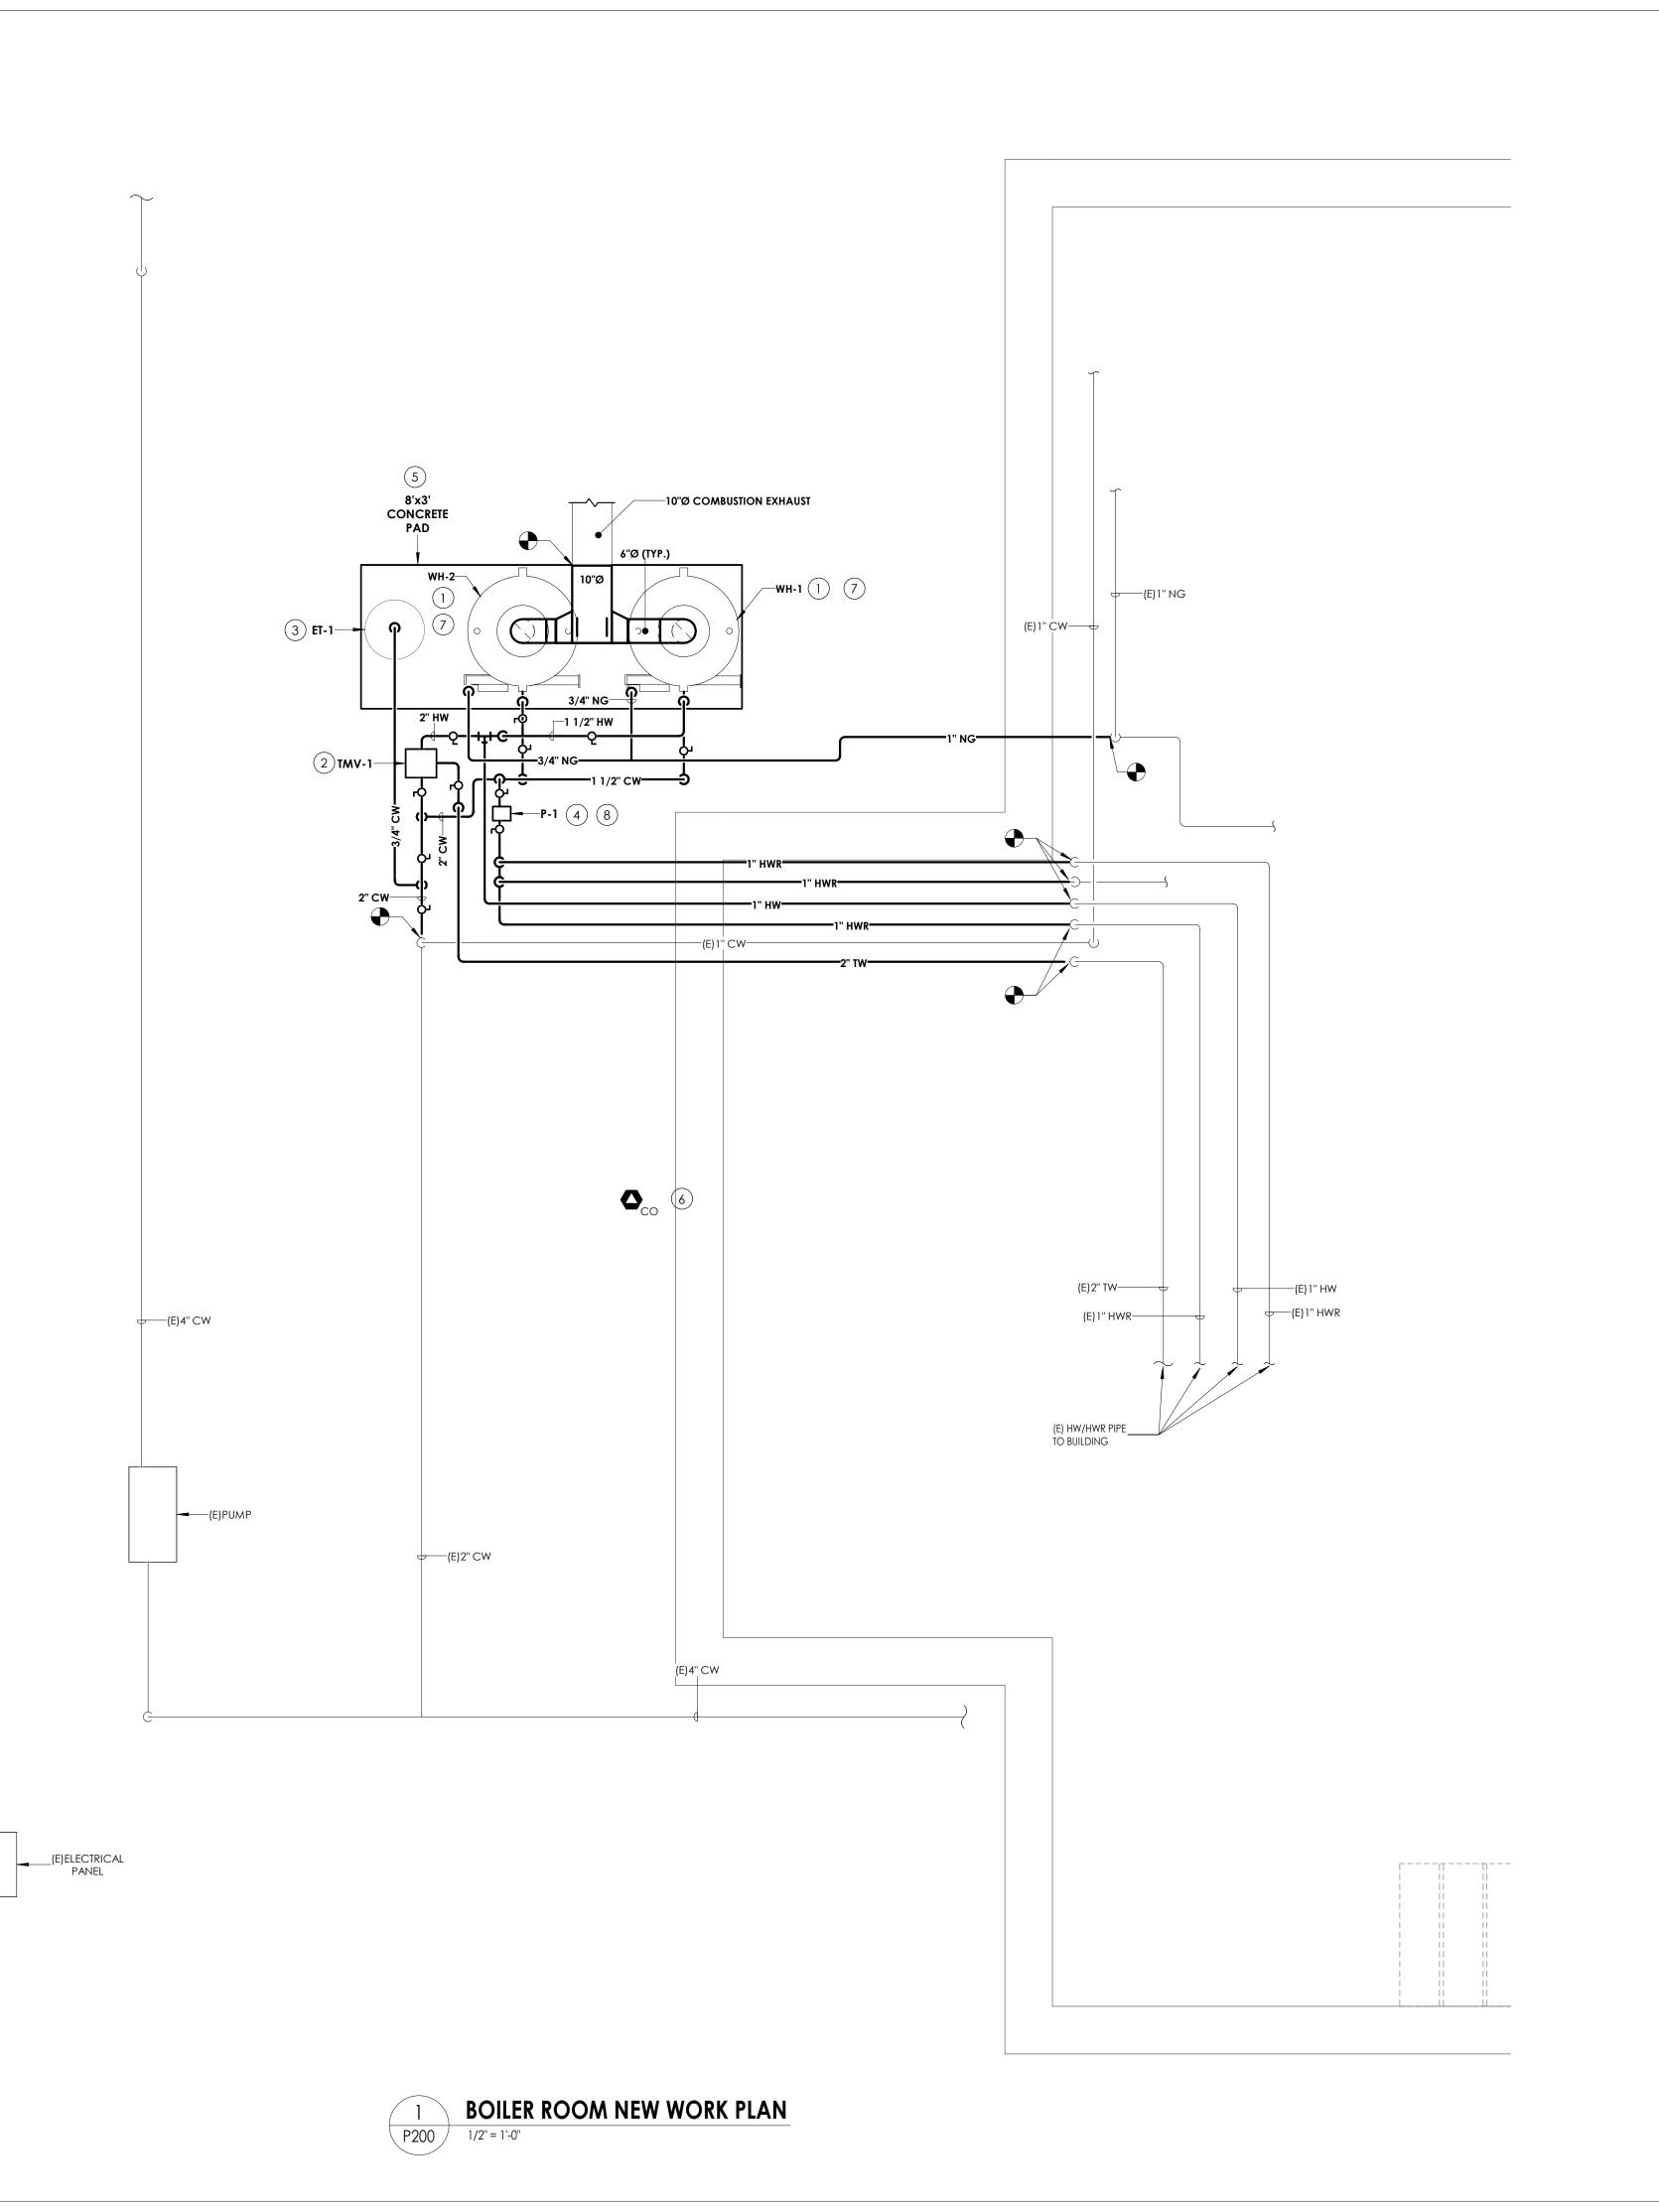


SHEET INFORMATION

Issued 05/27/2025 As indicated Project Status BID Drawn By

BOILER ROOM DEMOLITION PLAN

AJE



KEY NOTES

- PROVIDE NEW GAS FIRED WATER HEATER AND ALL ASSOCAITED HOT WATER, COLD WATER, AND NATURAL GAS PIPING. RECONNECT PIPING AT POINTS INDICATED. PROVIDE COMBUSTION AIR EXHAUST DUCTWORK AND CONNECT TO EXISTING DUCTWORK AT POINT INDICATED.
- 2 PROVIDE NEW THERMOSTATIC MIXING VALVE AND ALL ASSOCAITED HOT WATER AND COLD WATER PIPING. RECONNECT PIPING AT POINTS INDICATED.
- WATER PIPING.

(3) PROVIDE NEW EXPANSION TANK AND ALL ASSOCIATED HOT WATER AND COLD

- PROVIDE NEW CIRC PUMP AND ASSOCIATED HOT WATER PIPING. RECONNECT PIPING AT POINTS INDICATED.
- 5 PROVIDE NEW CONCRETE EQUIPMENT PAD. SEE DETAIL 6/P800.
- 6) PROVIDE NEW CARBON MONOXIDE SENSOR.
- CONNECT NEW WATER HEATERS TO EXISTING TAGGED WATER HEATER CIRCUIT. PROVIDE (2) #12, (1) #12GND IN 3/4" CONDUIT TO EACH WATER HEATER FROM THAT CIRCUITS JUNCTION BOX.
- 8 PROVIDE (2) #12, (1) #12GND IN 3/4" CONDUIT FROM PUMP TO PANEL EX, SPARE CIRCUIT 4.



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NORTH ROCKLAND CSD


Project Name
STONY POINT ELEMENTARY
SCHOOL STUDENT DROP OFF
LOOP & WATER HEATER
REPLACEMENT

Project Address 7 GURNEE DRIVE STONY POINT, NY 10980

PROJECT ISSUE & REVISION SCHEDULE

■ STONY POINT ELEMENTARY SCHOOL SED #50-02-01-06-0-014-015

PROFESSIONAL STAMPS

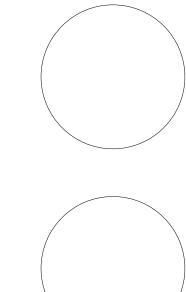

NEW YORK STATE EDUCATION STATEMENT

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SHEET INFORMATION

Issued Scale
05/27/2025 As indicated
Project Status
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AJE AJS

Drawing Title

BOILER ROOM NEW WORK PLAN

SP P200

						EXPANSION TAN	NK SCHEDULE (ET)						
TAG	LOCATION	SERVICE	MANUFACTURER	MODEL	ACCEPTANCE GALLONS	TOTAL VOLUME	PRE-CHARGE PRESSURE (PSI)	WATER HEATER RELIEF VALVE SETTING (PSI)	CONNECTION SIZE (IN.)	DIAMETER (IN.)	HEIGHT (IN.)	WEIGHT (LBS)	NOTES
ET-1	BOILER ROOM	WH-1/WH-2	AMTROL	ST-25V	10.3	10.3	50	150	3/4	15-3/8	19-1/4	23	-
NOTES:													

					GAS FIRED	DOMESTIC WAT	ER HEATER SCHEDULE					
MARK	MANUFACTURER	MODEL	ENERGY SOURCE	STORAGE (GAL)	INPUTS (BTU/HR)	GPH @ 100°F TEMP. RISE	WATER CONNECTIONS	GAS CONNECTION	VOLTS/HZ	VENT	WEIGHT (LBS)	NOTES
WH-1	AO SMITH	BTR-200 (A)	NATURAL GAS	100	199,000	193	1/-1/2	1/2"	120/60	8"	725	1,2,3,4,5,6
WH-2	AO SMITH	BRT-200 (A)	NATURAL GAS	100	199,000	193	1/-1/2	1/2"	120/60	8"	725	1,2,3,4,5,6
NOTEC.	1 DULINADINIC CONTRACTOR DES		OW VOLTACE CONT	DOL WIDING							·	

NOTES: 1. PLUMBING CONTRACTOR RESPONSIBLE FOR ALL LOW VOLTAGE CONTROL WIRING.
2. COORDINATE WITH ELECTRICAL CONTRACTOR FOR ELECTRICAL CONNECTONS.

3. FACTORY INSTALLED AUTOMATIC FLUE DAMPER


4. FACTORY INSTALLED, CSA CERTIFIED & ASME RATED T&P VALVE

5. FULLY AUTOMATIC CONTROL SYSTEM

6. ASME TANK CONSTRUCTION

			THERMOSTA	ATIC MIXING VALVE	CHEDULE (TMV)			
TAG	MANUFACTURER	MODEL	MIN. TW FLOW RATE TO ASSE STANDARD (GPM)	MAX. FLOW RATE (GPM)	TW SETTING (°F)	PRESURE DROP (PSI)	TW OUTLET (NPS)	CW/HW OUTLET (NPS)	NOTES
TMV-1 NOTES:	WATTS	2" LFN170-M3	7	59	110	10	2	1 1/4	-

					PUMP S	SCHEDULE (P))						
TAC	CED//ICE	A A A NILIE A CTUDED	MODEL	TVDE	- FLUID	AAAV CDAA	A A A V LIE A D /FT \A/C \	DDM	LID		ELECTRICA		NOTES
TAG	AG SERVICE	MANUFACTURER	MODEL	TYPE	FLUID	MAX GPM	MAX HEAD (FT.WG.)	RPM	HP	V	PH	HZ	NOTES
P-1	DOMESTIC HOT WATER	BELL & GOSSETT	PL-100	CIRC. PUMP	WATER	55	10	3350	2/5	115	1	60	-

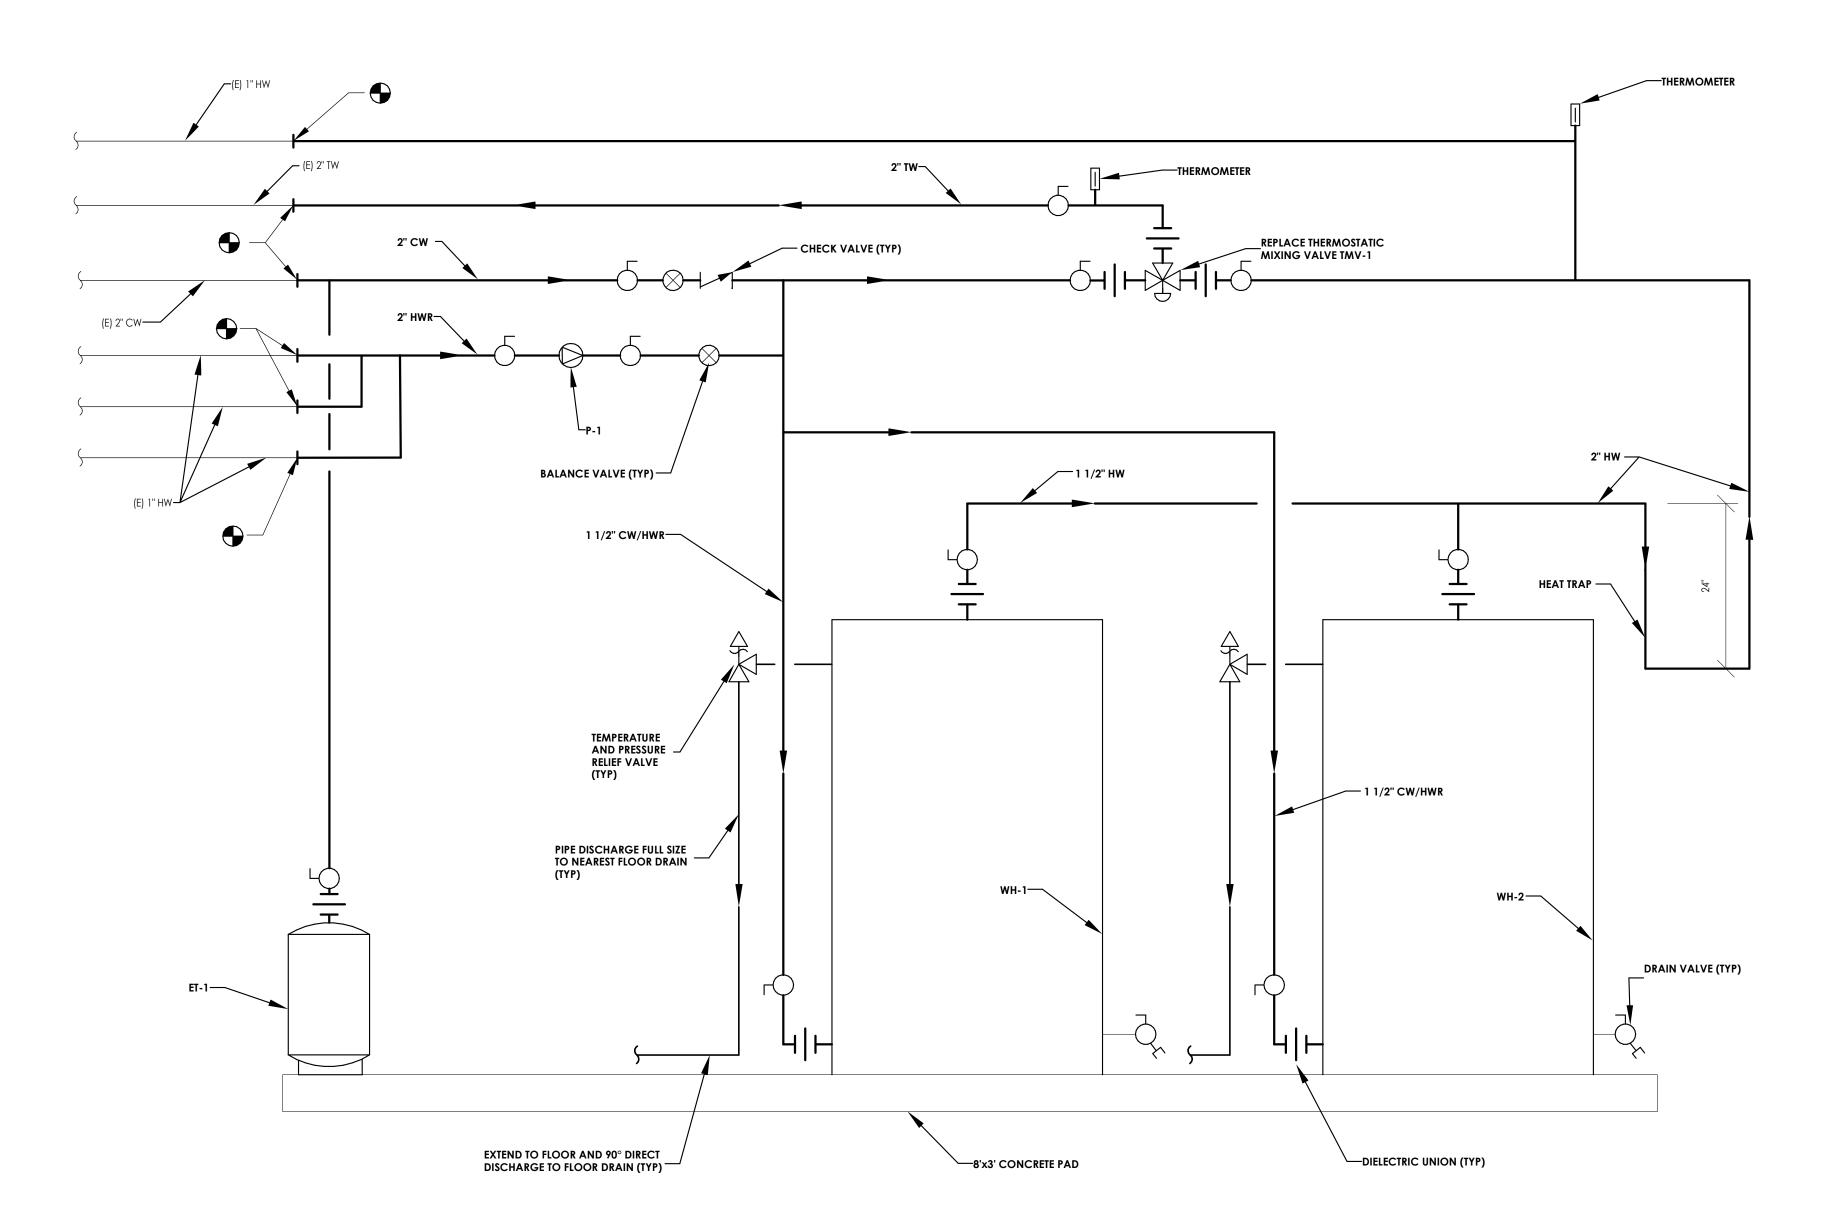



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PROJECT INFORMATION

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Client Name

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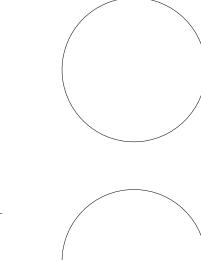
STONY POINT ELEMENTARY
SCHOOL STUDENT DROP OFF
LOOP & WATER HEATER
REPLACEMENT

Project Address 7 GURNEE DRIVE STONY POINT, NY 10980

PROJECT ISSUE & REVISION SCHEDULE

■ STONY POINT ELEMENTARY SCHOOL SED #50-02-01-06-0-014-015

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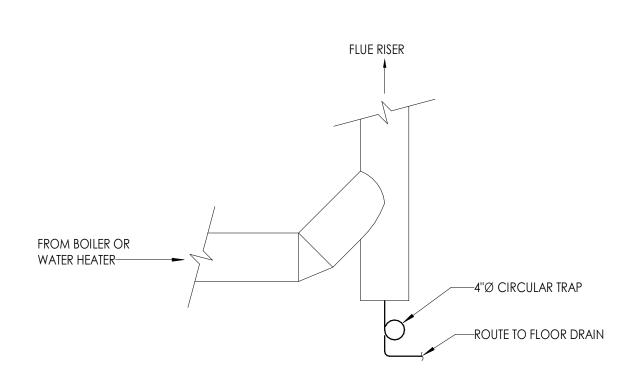
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AJE AJS

PLUMBING SCHEDULE AND PIPING SCHEMATIC


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SP P700


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HEATING HOT WATER BOILERS & DOMESTIC WATER HEATER FLUE RISER DRAIN REQUIREMENTS P800 NOT TO SCALE




INSULATED PIPE HANGER DETAIL P800 NOT TO SCALE

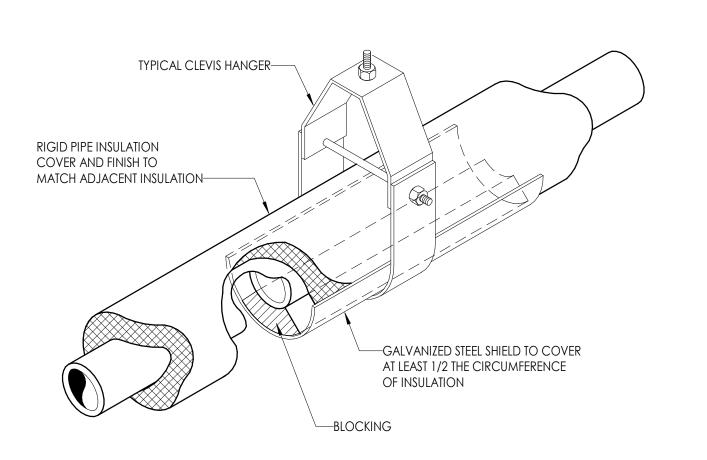


PIPE SUPPORT DETAIL P800 NOT TO SCALE

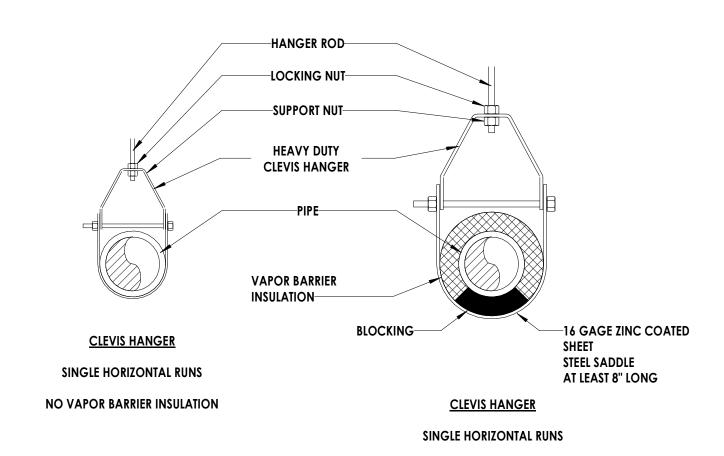
WITH VAPOR BARRIER INSULATION

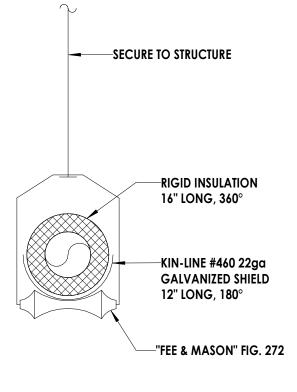




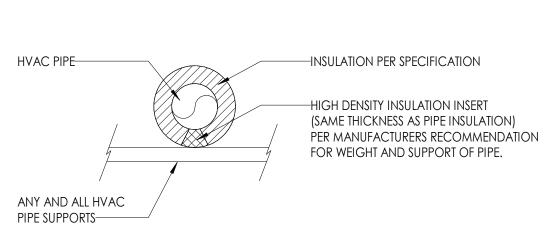



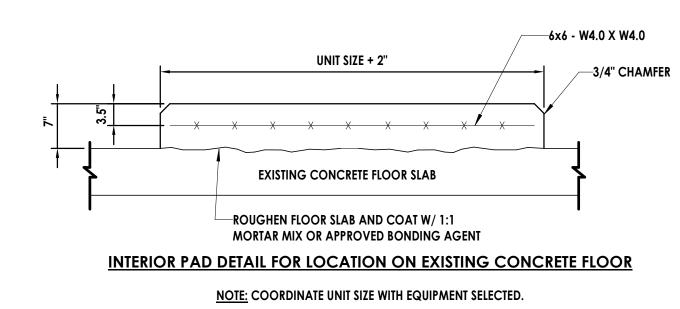



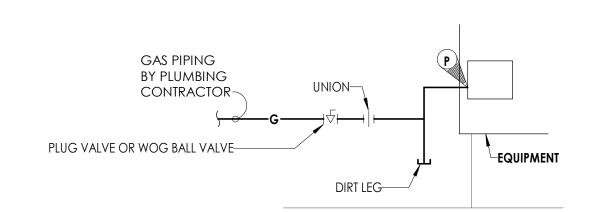







NY ENGINEERING FIRM CERTIFICATE #0021419

PROJECT INFORMATION

R25.17697.00

Client Name NORTH ROCKLAND CSD


STONY POINT ELEMENTARY SCHOOL STUDENT DROP OFF LOOP & WATER HEATER REPLACEMENT

Project Address
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PROJECT ISSUE & REVISION SCHEDULE

■ STONY POINT ELEMENTARY SCHOOL SED #50-02-01-06-0-014-015

PROFESSIONAL STAMPS



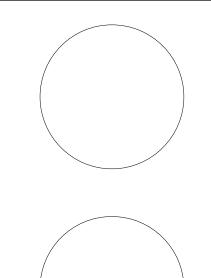

SHEET INFORMATION Issued Scale 05/27/2025 NOT TO SCALE Project Status BID

Drawn By Checked By AJE AJS Drawing Title PLUMBING DETAILS

P800

GENERAL:

THE INSTALLATION SHALL COMPLY WITH ALL REQUIREMENTS OF THE LATEST ADOPTED EDITION OF THE NATIONAL ELECTRICAL CODE (NFPA 70) AND WITH THE NEW YORK STATE BUILDING CODE.

CONTRACTOR IS RESPONSIBLE TO REVIEW AND UNDERSTAND ALL DRAWINGS AND ALL WORK OF ALL TRADES TO ENSURE A COMPLETE AND THOROUGH PROJECT. CONTRACTOR SHALL COOPERATE AND COORDINATE ALL PHASES OF WORK WITH OTHER DISCIPLINES AND GENERAL CONTRACTOR.

CONTRACTOR SHALL VISIT THE SITE AND THOROUGHLY FAMILIARIZE HIMSELF WITH EXISTING CONDITIONS, VERIFY LOCATIONS, CONDUIT ROUTINGS, ETC. BEFORE SUBMITTING A BID. ANY DISCREPANCIES SHALL BE REPORTED TO THE ARCHITECT A MINIMUM OF 6 DAYS PRIOR TO BID DATE.

FURNISH ALL MATERIALS, EQUIPMENT, SERVICES, AND LABOR FOR A COMPLETE OPERABLE ELECTRICAL INSTALLATION AS INDICATED ON THE DRAWINGS. ALL MATERIAL SHALL BE NEW AND BEAR THE UNDERWRITERS LABORATORIES, INC. (UL) LABEL WHERE AVAILABLE. INCIDENTAL ITEMS NOT INDICATED ON THE DRAWINGS, NOR MENTIONED IN THE SPECIFICATIONS, THAT CAN BE LEGITIMATELY & REASONABLE BE INFERRED TO BELONG TO THE WORK DESCRIBED OR BE NECESSARY IN GOOD PRACTICE TO PROVIDE A COMPLETE SYSTEM, SHALL BE FURNISHED & INSTALLED AS THOUGH ITEMIZED HERE IN EVERY DETAIL.

ALL WORK SHALL BE EXECUTED IN ACCORDANCE WITH RECOGNIZED STANDARDS OF WORKMANSHIP. ALL WORK SHALL BE INSTALLED IN A NEAT AND ORDERLY MANNER.

ALL EQUIPMENT SUPPLIED SHALL BE THE STANDARD EQUIPMENT OF THE MANUFACTURER.

SUBMIT DATA FOR APPROVAL ON THE FOLLOWING EQUIPMENT: LIGHTING FIXTURES, LIGHTING POLES, POLE BASES, LIGHTING CONTROLS, CONDUIT, HANDHOLES, AND WIRING

ELECTRICAL WORK TO BE INSPECTED BY A LICENSED THIRD PARTY INSPECTION AGENCY. INSPECTION FEE TO BE PAID BY CONTRACTOR AND REPORT SHALL BE SUBMITTED TO ENGINEER/ARCHITECT.

GROUNDING:

THE CONTRACTOR SHALL PROVIDE, INSTALL, AND CONNECT A COMPLETE SYSTEM OF GROUNDING FOR ALL EQUIPMENT AND STRUCTURES. A GOOD MECHANICAL AND ELECTRICAL CONNECTION SHALL BE MADE WITH APPROVED GROUNDING CONNECTORS.

ALL METAL RACEWAYS, INCLUDING CONDUIT, WIRE TROUGHS, WIREMOLD, ETC., SHALL BE GROUNDED. ALL CONNECTIONS IN METAL RACEWAYS SHALL BE COMPLETED IN SUCH A MANNER AS TO MAINTAIN A CONTINUOUS PATH TO GROUND THROUGHOUT THE ENTIRE LENGTH OF THE RACEWAY.

THE METALLIC CONDUIT SYSTEM SHALL BE USED AS PERMITTED BY THE ELECTRICAL CODE FOR EQUIPMENT AND ENCLOSURE GROUNDING SYSTEM. PROVIDE, AS DEFINED BY THE ELECTRICAL CODE, GROUNDING LUGS, STRAPS AND GREEN INSULATED COPPER GROUNDING CONDUCTORS, SIZED ACCORDING TO THE ELECTRICAL CODE.

GROUND CONDUCTOR SHALL BE SUPPLIED IN ALL NON-METALLIC CONDUIT.

GROUNDING CONDUCTORS SHALL BE COPPER. USE EXOTHERMIC WELDED CONNECTIONS TO STRUCTURAL STEEL AND FOR UNDERGROUND CONNECTIONS. USE BOLTED PRESSURE CLAMPS FOR ALL OTHER CONNECTIONS.

MAKE ALL JOINTS AND CONNECTIONS OF THE CONDUIT SYSTEM TIGHT TO MAINTAIN CONTINUITY OF MECHANICAL AND

RACEWAYS & WIRING:

ELECTRICAL GROUND THROUGHOUT ENTIRE SYSTEM.

CONDUIT RUNS SHOWN ARE SCHEMATICAL AND DO NOT INDICATE THE NECESSARY FITTINGS AND JUNCTION BOXES THAT ARE INCLUDED IN THE SCOPE OF THE WORK.

ALL CONDUIT ROUTES SHOWN ARE APPROXIMATE ONLY. CONTRACTOR SHALL FIELD VERIFY FINAL ROUTE.

JUNCTION, PULL AND OUTLET BOXES SHALL BE INSTALLED SUCH THAT THE WIRING CONTAINED IN BOX MAY BE RENDERED

ALL ELECTRICAL EQUIPMENT OUTSIDE SHALL BE IN NEMA-3R OR 4X ENCLOSURES.

USE ELECTRICAL METALLIC TUBING (EMT) FOR INTERIOR DRY LOCATIONS.

NON-METALLIC SCHEDULE 80 PVC CONDUIT OR RIGID GALVANIZED STEEL CONDUIT IS TO BE USED FOR ALL EXTERIOR SURFACE MOUNT AND UNDERGROUND APPLICATIONS.

USE COLOR CODED ADHESIVE MARKING TAPE FOR RACEWAYS, WIRES AND CABLES. CODE WIRING AS FOLLOWS: PHASE A: BLACK, PHASE B: RED, NEUTRAL: WHITE, GROUND: GREEN.

CONDUCTORS SHALL BE COPPER, 600 VOLTS, THHN-THWN, 75 DEGREES C. INSULATION. MINIMUM SIZE BRANCH CIRCUIT CONDUCTORS SHALL BE NUMBER 12 AWG. ALL CONDUCTORS SHALL BE IN CONDUIT.

NUMBER 12 AWG SHALL BE SOLID, AND NUMBER 10 AWG AND LARGER SHALL BE STRANDED.

UNLESS NOTED OTHERWISE ON THE DRAWINGS, EACH BRANCH CIRCUIT SHALL BE THREE (3) #12 AWG THHN/THWN (1 HOT, 1 NEUTRAL & 1 EQUIPMENT GROUND) IN 3/4" EMT CONDUIT. PROTECT EACH CIRCUIT WITH A 20 AMPERE, 1-POLE OVERCURRENT DEVICE UNLESS OTHERWISE NOTED. PROVIDE #10 AWG FOR 120V BRANCH CIRCUITS LONGER THAN 100 FEET. COMBINED NEUTRALS ARE NOT PERMITTED.

ELECTRICAL DEVICES AND LIGHTING:

COORDINATE ALL EQUIPMENT CONNECTIONS WITH EQUIPMENT SUPPLIER PRIOR TO ROUGH-IN. PROVIDE ADDITIONAL FUSED DISCONNECT SWITCHES & CONTROLS IF OVERCURRENT PROTECTION OR CONTROLS ARE NOT INTEGRAL WITH UNITS.

TIME CLOCK TO BE DIGITAL, ELECTRONIC, SOLID-STATE PROGRAMMABLE UNIT WITH ALPHANUMERIC DISPLAY. UNIT SHALL COMPLY WITH UL917.

- 1. PROGRAM: SINGLE CHANNEL, [2 ON-OFF SET POINTS ON A 24-HOUR SCHEDULE, ALLOWING DIFFERENT SET POINTS FOR EACH DAY OF THE WEEK] [AND AN ANNUAL HOLIDAY SCHEDULE THAT OVERRIDES THE WEEKLY OPERATION ON HOLIDAYS].
- 2. PROGRAMS: 4 CHANNELS.
- a. For each channel, [8 on-off set points on a 24-hour schedule] [2 on-off set points on a 24-hour SCHEDULE WITH SKIP-A-DAY WEEKLY SCHEDULE] [2 ON-OFF SET POINTS ON 24-HOUR SCHEDULE, ALLOWING DIFFERENT SET POINTS FOR EACH DAY OF THE WEEK].
- b. FOR EACH CHANNEL, 40 ON-OFF OPERATIONS PER WEEK AND AN ANNUAL HOLIDAY SCHEDULE THAT OVERRIDES
- THE WEEKLY OPERATION ON HOLIDAYS. C. FOR EACH CHANNEL, 40 ON-OFF OPERATIONS PER WEEK, PLUS 4 SEASONAL SCHEDULES THAT MODIFY THE BASIC
- PROGRAM, AND AN ANNUAL HOLIDAY SCHEDULE THAT OVERRIDES THE WEEKLY OPERATION ON HOLIDAYS. 3. ASTRONOMICAL TIME.
- 4. BATTERY BACKUP: FOR SCHEDULES AND TIME CLOCK.

MULTIPOLE CONTACTORS AND RELAYS

- A. DESCRIPTION: ELECTRICALLY OPERATED AND MECHANICALLY HELD, AND COMPLYING WITH UL 508 AND NEMA ICS 2.
- 1. CURRENT RATING FOR SWITCHING: UL LISTING OR RATING CONSISTENT WITH TYPE OF LOAD SERVED.
- 2. CONTROL COIL VOLTAGE: MATCH CONTROL POWER SOURCE.

COORDINATION:

THE ELECTRICAL CONTRACTOR SHALL COORDINATE SEQUENCE OF WORK WITH ALL OTHER TRADES.

NOTIFY ENGINEER IMMEDIATELY OF POSSIBLE CONFLICTS WITH EXISTING OR NEW SITE FEATURES. WHERE JOB CONDITIONS REQUIRE REASONABLE CHANGES IN LOCATIONS & ARRANGEMENT OF INDICATED EQUIPMENT, CONDUIT, OUTLETS, OR WIRING, CONTRACTOR SHALL MAKE SUCH CHANGES WITHOUT COST TO OWNER.

IT SHALL BE THIS CONTRACTOR'S RESPONSIBILITY, PRIOR TO ANY INDIVIDUAL CIRCUIT'S INSTALLATION, TO VERIFY WITH ALL OTHER TRADES CONCERNED THAT THE CIRCUIT WITH DEVICES AS DRAWN IS ADEQUATE IN SIZE FOR THE EQUIPMENT TO BE INSTALLED. IF ANY CONFLICT IN VOLTAGE, PHASE OR LOAD IS ENCOUNTERED WHICH WOULD ALTER THE CIRCUIT SIZE, THIS CONTRACTOR SHALL NOTIFY THE ENGINEER OR OWNER IMMEDIATELY. FAILURE TO DO SO SHALL PLACE THE RESPONSIBILITY FOR ANY SUBSEQUENT CIRCUIT CHANGE DIRECTLY UPON THE CONTRACTOR.

CIRCUIT BREAKERS ADDED TO EXISTING PANELS SHALL MATCH EXISTING BREAKERS TYPE, MANUFACTURER AND I/C RATING. UPDATE DIRECTORIES IN EXISTING PANELS TO REFLECT CHANGES BY THIS RENOVATION.

WARRANTY/COMPLETION OF WORK:

CONTRACTOR SHALL GUARANTEE WORK INSTALLED UNDER THE CONTRACT TO BE FREE FROM DEFECTIVE WORKMANSHIP & MATERIALS, USUAL WEAR EXCEPTED. SHOULD ANY SUCH DEFECTS DEVELOP WITHIN A PERIOD OF ONE YEAR ACCEPTANCE, THIS CONTRACTOR SHALL REPAIR AND/OR REPLACE ANY DEFECTIVE ITEMS & DAMAGE RESULTING FROM FAILURE OF THESE ITEMS, AT NO EXPENSE TO THE OWNER.

PERTINENT CERTIFICATES SHALL BE DELIVERED TO THE OWNER'S REPRESENTATIVE, PRIOR TO FINAL BILLING.

BEFORE FINAL ACCEPTANCE BY THE OWNER WILL BE GRANTED, THE CONTRACTOR SHALL CLEAN ALL LIGHTING FIXTURES, PANELBOARD, AND OTHER ITEMS FURNISHED UNDER THIS CONTRACT.

AT COMPLETION OF WORK, ELECTRICAL CONTRACTOR SHALL DELIVER TO OWNER (2) SETS OF O&M MANUALS AND AS-BUILT DRAWINGS SHOWING LOCATION AND SIZE OF ALL ELECTRICAL WORK. AS-BUILT TO INCLUDE LOCATION OF UNDERGROUND CONDUIT WITH ACCURATE DIMENSIONING TO KNOWN ABOVE GROUND FEATURES.

EVERY PART OF THE INSTALLATION SHALL BE TESTED, OPERATED, AND LEFT IN PERFECT WORKING ORDER.

ELECTRICAL INSPECTION AGENCY REPORT TO BE SUBMITTED TO OWNER'S REPRESENTATIVE.

CONSTRUCTION SEQUENCE NOTES:

THE OWNER WILL MAINTAIN AND OPERATE EXISTING FACILITY AT CURRENT LEVEL UP TO AND UNTIL THAT TIME AT WHICH THE CONTRACTOR REQUIRES ACCESS AS DETAILED BELOW FOR DEMOLITION OR RENOVATION PURPOSES.

GENERAL AND ELECTRICAL CONTRACTORS ARE REQUIRED TO COORDINATE ALL CONSTRUCTION WITH EACH OTHER.

THE OWNER WILL PAY ALL NECESSARY UTILITY CHARGES RELATED TO THE OPERATION OF THE EXISTING FACILITY AND THOSE NEWLY-CONSTRUCTED FACILITIES DEEMED OPERATIONAL BY THE ENGINEER. THESE SHALL INCLUDE BUT NOT BE LIMITED TO ANY TEMPORARY ELECTRIC AND TELEPHONE SERVICE REQUIRED.

THE ELECTRICAL CONTRACTOR SHALL BEAR ALL UTILITY COSTS ASSOCIATED WITH UTILITY SERVICE WORK REQUIRED FOR

THE CONTRACTOR SHALL PROVIDE AND INSTALL ALL TEMPORARY FACILITIES REQUIRED TO PERFORM HIS WORK.

THE CONTRACTOR SHALL COORDINATE ALL OPERATIONAL CHANGES WITH THE OWNER AND ENGINEER. THE CONTRACTOR SHALL TEST AND SUCCESSFULLY START-UP ALL NEW AND RECONDITIONED UNITS. WHEN AN AREA IS TURNED OVER TO THE OWNER FOR THEIR OPERATION, THE WARRANTY PERIOD BEGINS FOR THAT AREA.

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NY ENGINEERING FIRM CERTIFICATE #0021419



PROJECT INFORMATION

R25.17697.00

NORTH ROCKLAND CENTRAL

SCHOOL DISTRICT

STONY POINT ELEMENTARY SCHOOL STUDENT DROP OFF LOOP & WATER HEATER REPLACEMENT


Project Address 7 GURNEE DRIVE STONY POINT, NEW YORK 10980

PROJECT ISSUE & REVISION SCHEDULE

No. Date Description

■ STONY POINT ELEMENTARY SCHOOL SED #50-02-01-06-0-014-015

PROFESSIONAL STAMPS

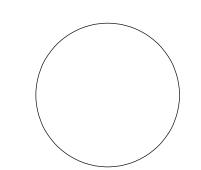

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SHEET INFORMATION ssued 05/27/2025

Project Status BID Drawn By


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AS INDICATED

ELECTRICAL SPECIFICATIONS

Drawing Number

JLR

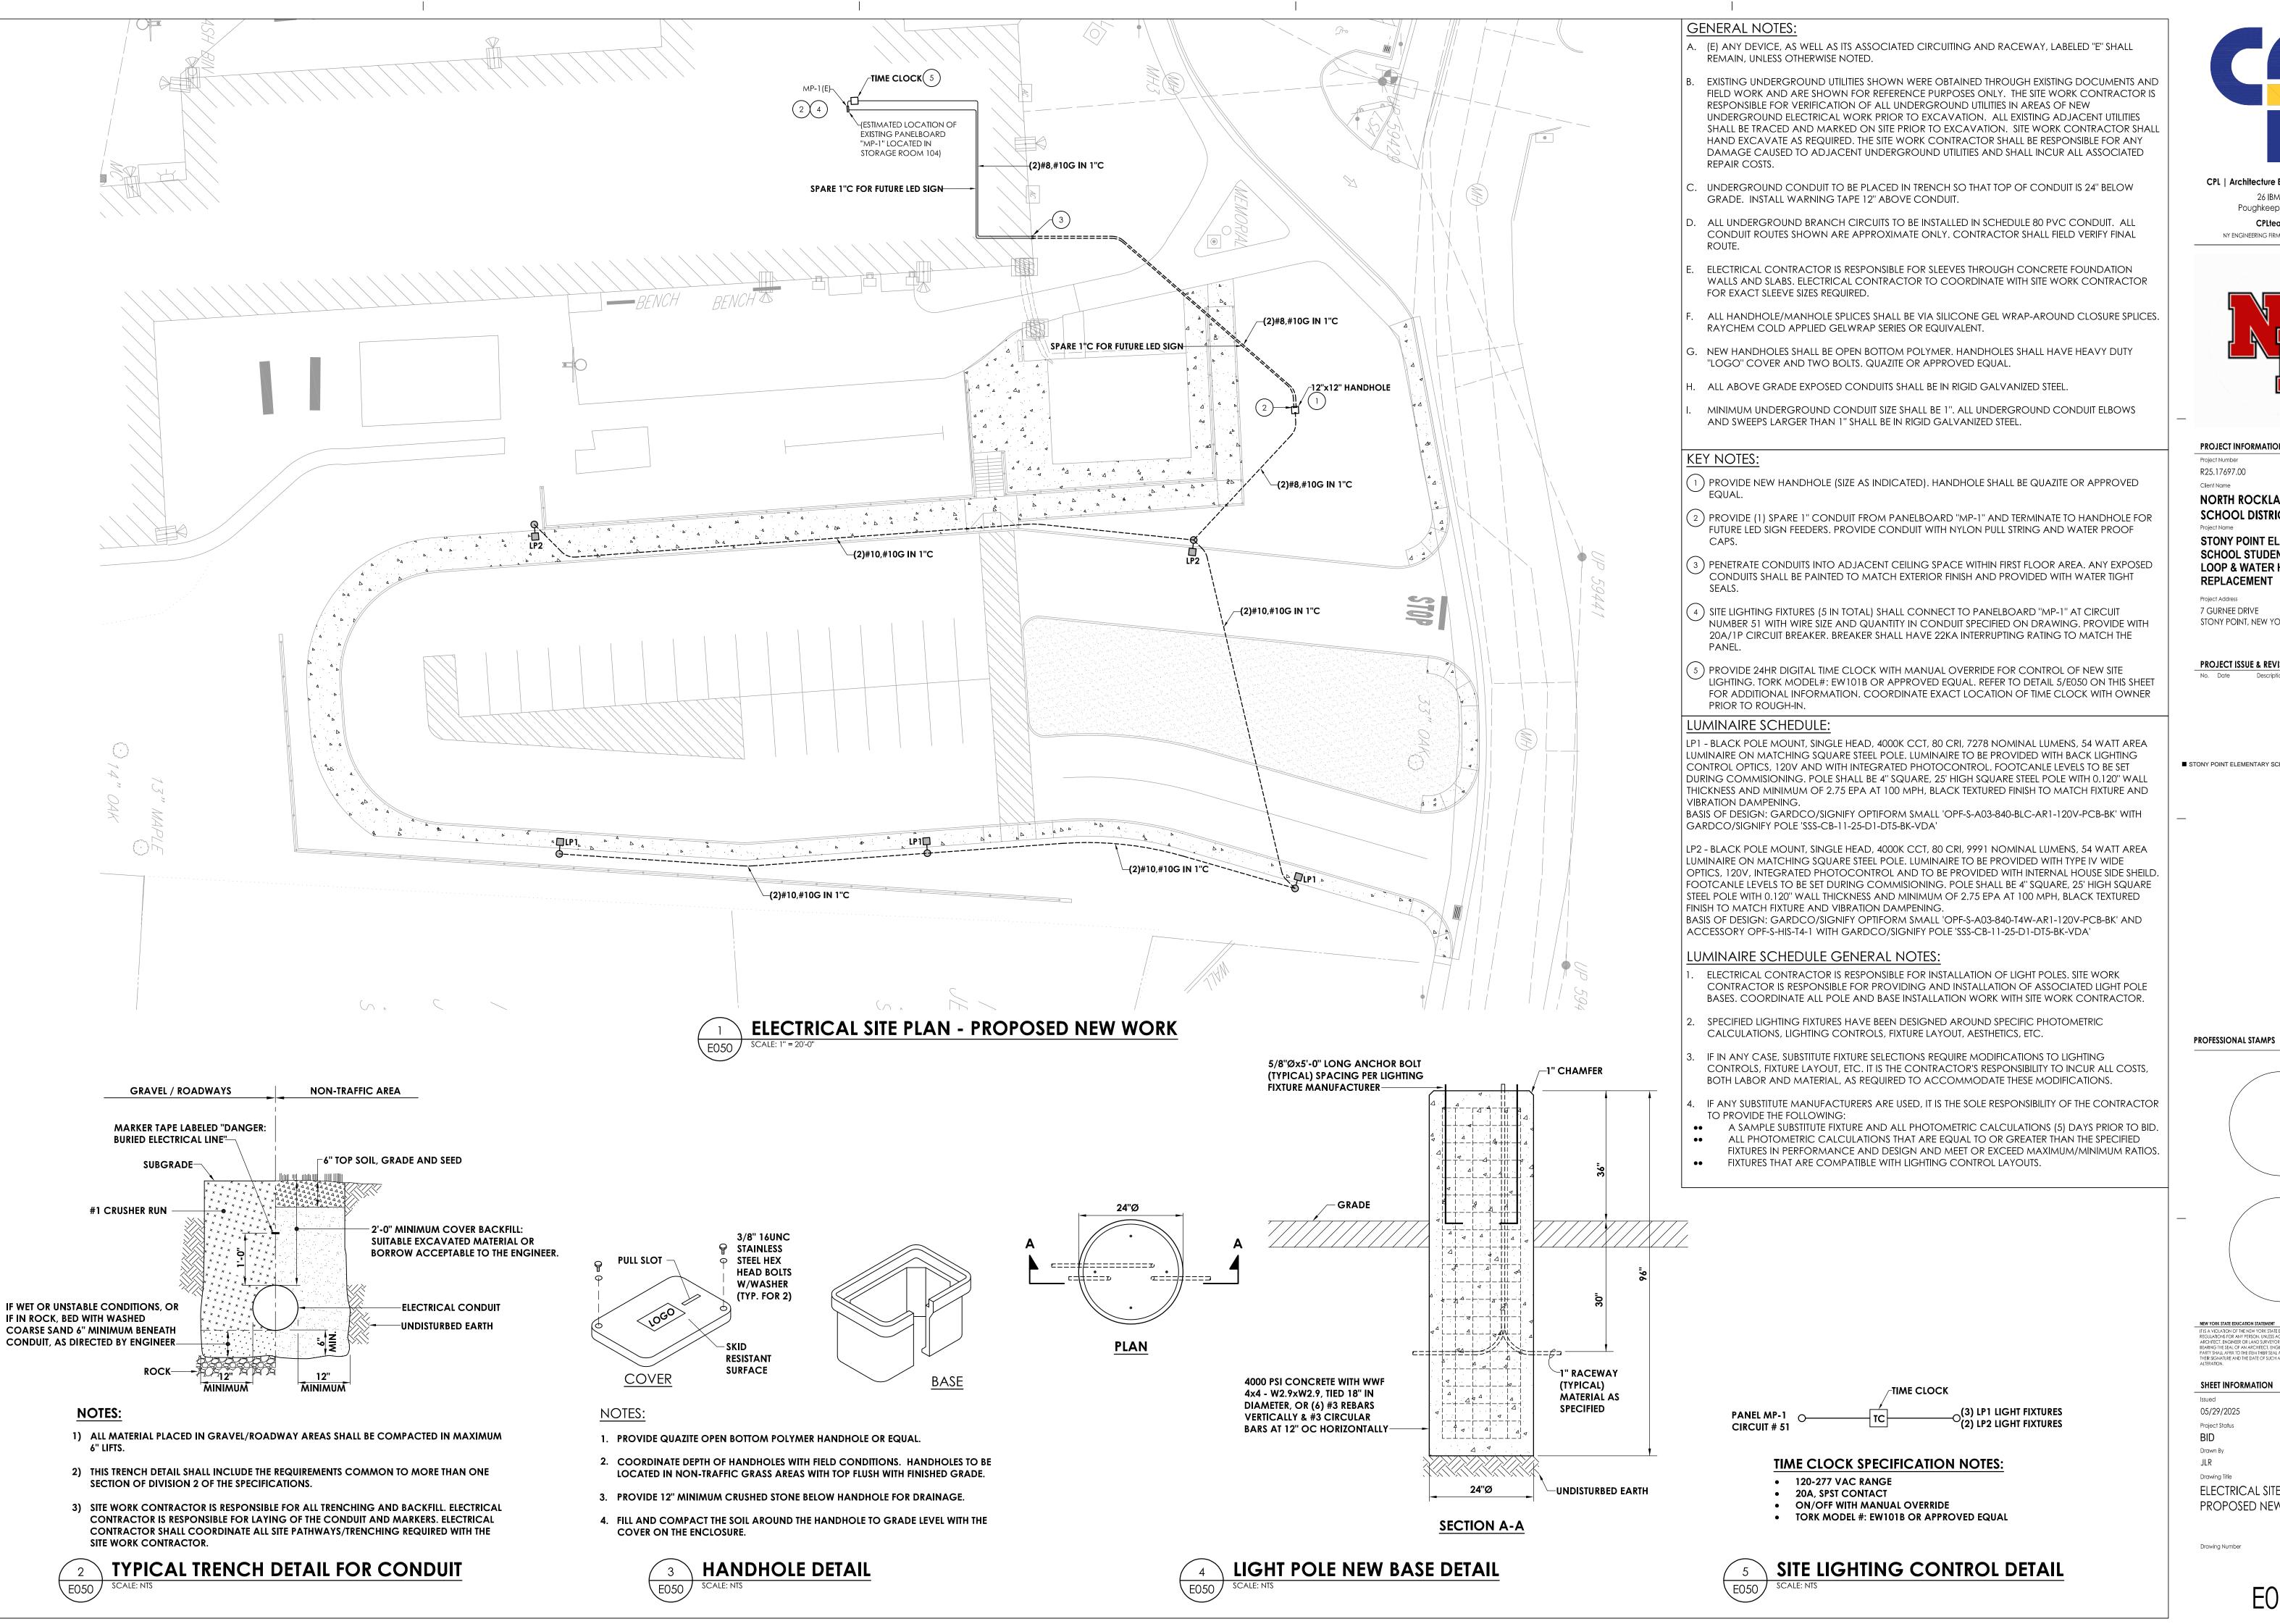

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PROJECT INFORMATION

R25.17697.00


NORTH ROCKLAND CENTRAL SCHOOL DISTRICT

STONY POINT ELEMENTARY SCHOOL STUDENT DROP OFF LOOP & WATER HEATER **REPLACEMENT**

7 GURNEE DRIVE STONY POINT, NEW YORK 10980

PROJECT ISSUE & REVISION SCHEDULE

■ STONY POINT ELEMENTARY SCHOOL SED #50-02-01-06-0-014-015

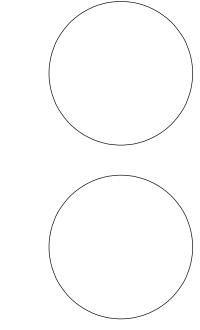

NEW YORK STATE EDUCATION STATEMEN

SHEET INFORMATION

ssued 05/29/2025 AS INDICATED Proiect Status BID

Drawn By JLR Drawing Title

ELECTRICAL SITE PLAN -PROPOSED NEW WORK

Drawing Number