# PROPOSED

# Croton-on-Hudson Harmon Firehouse Station #3 & EMS Addition / Alterations

# 30 Wayne Street Croton-On-Hudson New York 10520

# **ABBREVIATIONS**

ABV A.C.T.	ABOVE ACOUSTICAL CEILING TILE	JC TL	JANITOR'S CLOSET JOINT
ADJ	ADJACENT	<b>.</b>	
ADA	AMERICANS DISABILITY ACT	LAV	LAVATORY
AFF ALT	ABOVE FINISH FLOOR ALTERNATE/ALTERNATIVE	LH	LEFT HAND
ALUM	ALUMINUM	L	LENGTH
APPD	APPROVED	MFGR	MANUFACTURER
APPROX	APPROXIMATE	MATL	MATERIAL
ARCH	ARCHITECTURAL AUTOMATIC	MAX	MAXIMUM
AUT <i>O</i> AVG	AVERAGE	MECH	MECHANICAL
, , , ,	,	MEP MTL	MECH, ELEC, PLUMB METAL
BLKG	BLOCKING	MIN	MINIMUM
BD BC	BOARD BRICK COURSE	MISC	MISCELLANEOUS
BLDG	BUILDING	MNTG	MOUNTING
CB.	CATCH BASIN	N	NORTH
CB CL	CENTERLINE	N/A NIC	NOT APPLICABLE NOT IN CONTRACT
CER	CERAMIC	NTS	NOT TO SCALE
CT	CERAMIC TILE	1113	1,011000/1,01
CLO	CLOSET	00	ON CENTER
COL COMM	COLUMN COMMUNICATION	OPNG	OPENING
CONC	CONCRETE	OPP OVHD	OPPOSITE OVERHEAD
CMU	CONCRETE MASONRY UNIT	UYED	UYLNHEAD
CONST	CONSTRUCTION	PR	PAIR
CONT COORD	CONTINUOUS COORDINATE	PART.	PARTIAL
CORR	CORRIDOR	PH PLUMB	PHASE PLUMBING
		PC PC	PLUMBING CONTRACTOR
DEMO	DEMOLITION	PLYMD	PLYMOOD
D DETL	DEPTH DETAIL	POLY	POLYETHYLENE
DIA	DIAMETER	PROJ	PROJECT
DR	DOOR	RD	ROUND
DN	DOWN	RE	REFER
DMG DF	DRAMING DRINKING FOUNTAIN	REINF	REINFORCEMENT
		REQD	REQUIRED
EA	EACH	RH RM	RIGHT HAND ROOM
ELEC	ELECTRICAL	R.O.B.	RUN OF BANK
EC EL/ELEV	ELECTRICAL CONTRACTOR ELEVATION		
ENGR	ENGINEER	SCH	SCHEDULE
EQ	EQUAL	SECT	SECTION
EQUIP	EQUIPMENT	SHT SIM	SHEET SIMILAR
EF EX	EXHAUST FAN EXISTING	5K	SKETCH
ETR	EXISTING EXISTING TO REMAIN	<b>5</b> C	SOLID CORE
EJ	EXPANSION JOINT	SPEC	SPECIFICATION
EXT	EXTERIOR	SQ SF	SQUARE SQUARE FOOT/FEET
FIN.	FINISH	55MR	STANDING SEAM METAL ROO
FF	FINISH FLOOR	STL	STEEL
FE	FIRE EXTINGUISHER	STG	STORAGE
FL 	FLOOR	STRUCT SYMB	STRUCTURAL SYMB <i>O</i> LS
FT FTG	FOOT/FEET FOOTING	311110	31112023
FDN	FOUNDATION	TEMP	TEMPORARY
FR	FRAME	TK TO"	THICK
		TOIL T&G	TOILET TONGUE & GROOVE
GALV GA	GALYANIZED GAUGE	T.O.	TOP OF
GA GC	GENERAL CONTRACTOR	TYP	TYPICAL
GMB	GYPSUM WALL BOARD	UON	UNLESS OTHERWISE NOTED
HDW	HARDWARE		VINELUU VIIIENMUL NOIED
H/HT	HEIGHT	VB	VAPOR BARRIER
НМ	HOLLOW METAL	VIF	VERIFY IN FIELD VERTICAL
HORIZ	HORIZONTAL	VERT VEST	VERTICAL VESTIBULE
HR	HOUR	VCT	VINYL COMPOSITION TILE
IN	INCH	IALIAI <del>C</del>	MELDED MIDE EXECTS
NCL	INCLUDE	MMF M	MELDED MIRE FABRIC MIDTH
INS	INSULATION	M/	WITH


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MITHOUT

MOOD

INTERIOR

# SYMBOLS & MAT'LS.

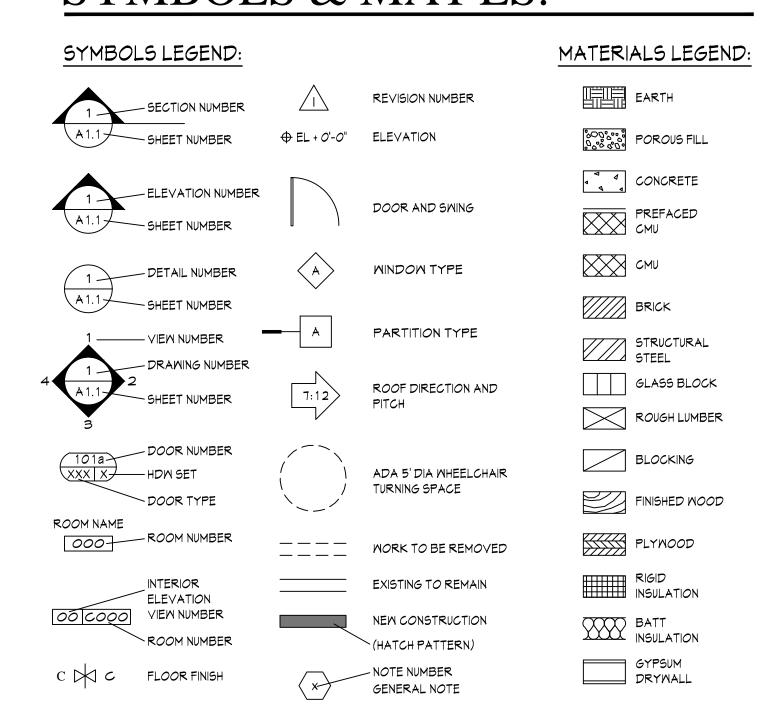

# LOCATION MAP



# GENERAL NOTES

- THE INTENT OF THE CONSTRUCTION DOCUMENTS IS TO ACCOMPLISH A COMPLETE PROJECT. ANYTHING REASONABLY IMPLIED OR INTENDED SHALL BE INCLUDED. THE WORK INCLUDED CONSISTS OF ALL LABOR, MATERIALS, TRANSPORTATION, TOOLS AND EQUIPMENT NECESSARY FOR THE CONSTRUCTION OF THE PROJECT LEAVING ALL WORK CLEAN AND READY FOR USE. IF ANY DISCREPANCIES, DOCUMENTS, THE CONTRACTOR SHALL NOTIFY THE ARCHITECT IMMEDIATELY, ASSUME THE HIGHER QUALITY WORK AND REFRAIN FROM STARTING / COMPLETING SUCH WORK, OR DEPENDENT WORK UNTIL CLARIFIED BY THE ARCHITECT AND TOLD TO PROCEED
- EACH CONTRACTOR SHALL REVIEW THE CONSTRUCTION DOCUMENTS FOR COMPLETE UNDERSTANDING AND KNOWLEDGE OF THE WORK. ALL WORK SHALL BE DONE BY REQUIRED LICENSED CONTRACTORS IN COMPLIANCE WITH INDUSTRY STANDARDS AND ALL CODE REQUIREMENTS. ALL MORK SHALL BE INSTALLED TRUE, SAFETY IS THE RESPONSIBILITY OF EACH CONTRACTOR.
- SITE PRIOR TO COMMENCING WORK. VERIFY CLEARANCES FOR FLUES, VENTS, CHASES, SOFFITS, FIXTURES, ETC. BEFORE ANY CONSTRUCTION, ORDERING, OR INSTALLATION OF ANY ITEMS OF WORK. NOTIFY ARCHITECT SHOULD DISCREPANCIES OCCUR PRIOR TO PERFORMING WORK.
- 4. DIMENSIONS ARE TO EDGE OF SLAB, FACE OF STUD, DOOR/WINDOW OPENING, CENTER OF PLUMBING FIXTURE, UNLESS OTHERWISE NOTED. WRITTEN DIMENSIONS TAKE PRECEDENCE. DO NOT SCALE
- 5. DETAILS AND NOTES ARE TYPICAL. SIMILAR DETAILS AND NOTES APPLY IN SIMILAR CONDITIONS.
- 6. UNTIL PERMANENT FIRE PROTECTION NEEDS ARE MET, INSTALL FIRE EXTINGUISHERS PER CODE TO PROVIDE TEMPORARY FIRE PROTECTION. OBTAIN APPROVAL OF THE BUILDING AND FIRE DEPARTMENTS AND THE ARCHITECT PRIOR TO INSTALLATION.
- 7. INSTALL ALL FIXTURES, EQUIPMENT AND MATERIAL PER MANUFACTURER'S RECOMMENDATIONS.

# PROJECT TEAM

### ARCHITECT:

SULLIVAN ARCHITECTURE P.C. 31 MAMARONECK AVENUE WHITE PLAINS, NY 10601 (914) 761-6006

#### STRUCTURAL ENGINEER:

CONLON ENGINEERING, LLC 246 FEDERAL ROAD, SUITE B23 BROOKFIELD, CT 06804 (203) 740-0990

# DRAWINGS LIST

### ARCHITECTURAL:

- LIFE SAFTEY AND CODE ANALYSIS
- LIFE SAFTEY A-2 FOUNDATION PLAN
- FIRST FLOOR REFLECTED CEILING PLAN SECOND FLOOR PLAN SECOND FLOOR POWER/TELE/DATA PLAN
- SECOND FLOOR REFLECTED CEILING PLAN
- ROOF PLAN
- BUILDING SECTIONS
- **MALL SECTIONS**
- DOOR, SCHEDULE, TYPES AND HARDWARE DOOR DETAILS AND TRANSITIONS
- FINISH SCHEDULE AND MATERIALS
- BATHROOM DETAILS AND ELEVATIONS
- ROOF DETAILS
- ROOF DETAILS

## STRUCTURAL

- FOUNDATION AND FRAMING PLANS
- TYPICAL FOUNDATION DETAILS
- STEEL AND COLD STEEL SECTIONS GENERAL NOTES AND MATERIAL SPECIFICATIONS

- FIRST FLOOR PLAN FIRST FLOOR POWER/TELE/DATA PLAN
- EXTERIOR ELEVATIONS
- BUILDING SECTIONS
- STAIR 3 PLANS, SECTIONS & DETAILS
- PARTITION TYPES
- MINDOM DETAILS AND SCHEDULE
- MILLWORK ELEVATIONS AND DETAILS
- ROOF DETAILS A-23
- A-25 ROOF DETAILS

- TYPICAL COLD FORMED STEEL DETAILS

Checked by

Sullivan Architecture,

Date Issue

/18/2024 CLIENT REVIEW SET 4/8/2024 CLIENT REVIEW SET

/7/24 CONSTRUCTION SET

herby state to the best of my professional knowledge and

abilities that the proposed building design represented in

specifications, and other calculations submitted with the

York State Energy Conservation Construction Code and

It is a violation of the law for any person, unless acting

under the direction of a licensed architect, to alter an item

in any way. If an item bearing the seal of an architect is

altered, the altering architect shall affix to his item the seal

and the notation "altered by" followed by his signature and

the date of such alteration, and a specific description of the

Croton-on-Hudson

Harmon Firehouse

Station #3 & EMS

30 Wayne Street

Croton-On-Hudson

New York 10520

TITLE SHEET

adopted Stretch Code. The signature and seal on such

documents attests to the above statement.

Project Title

Drawing Title

Drawing by

these documents is consistent with the building plans,

permit application. The proposed building has been designed to meet the requirements of the Current New


31 Mamaroneck Avenue


White Plains, New York 1060 914-761-6006 (F) 914-761-4919 1 P. Sullivan, FAIA - Lisc. # 017185 Registered through 9/30/


Drawing No.

202222

7.21.2023

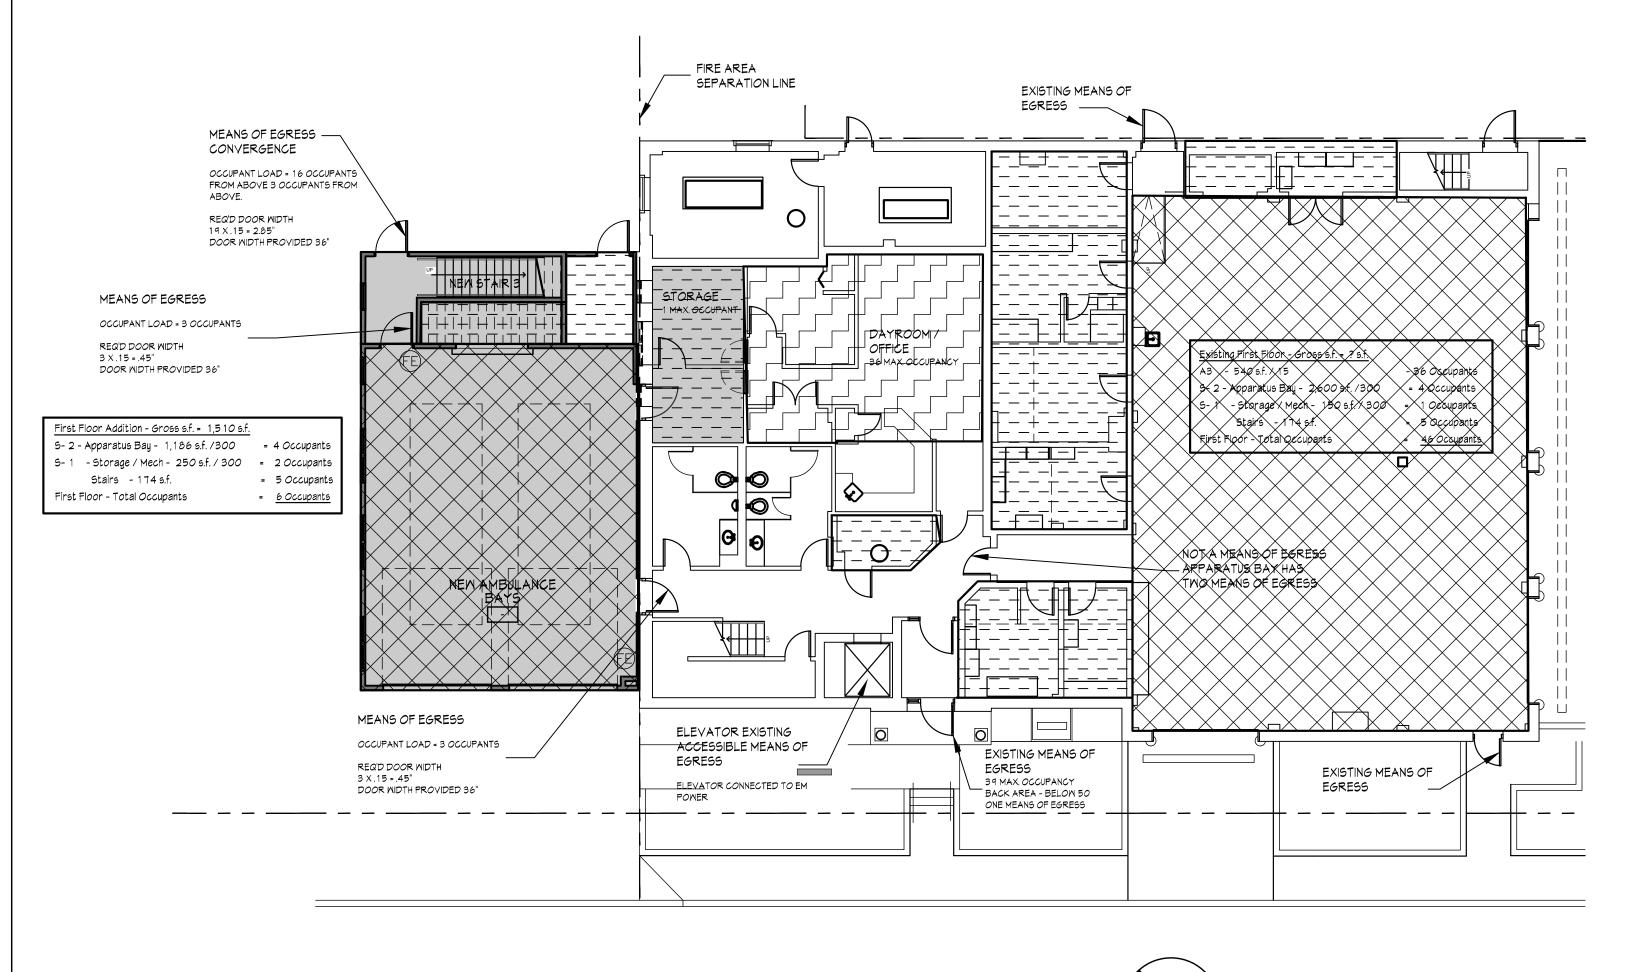

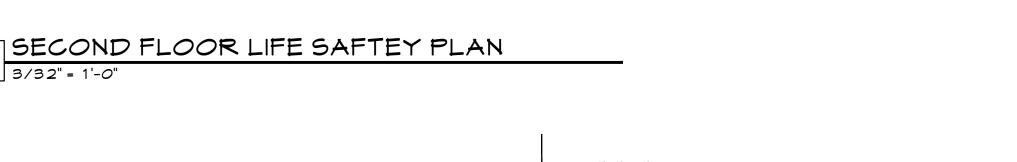

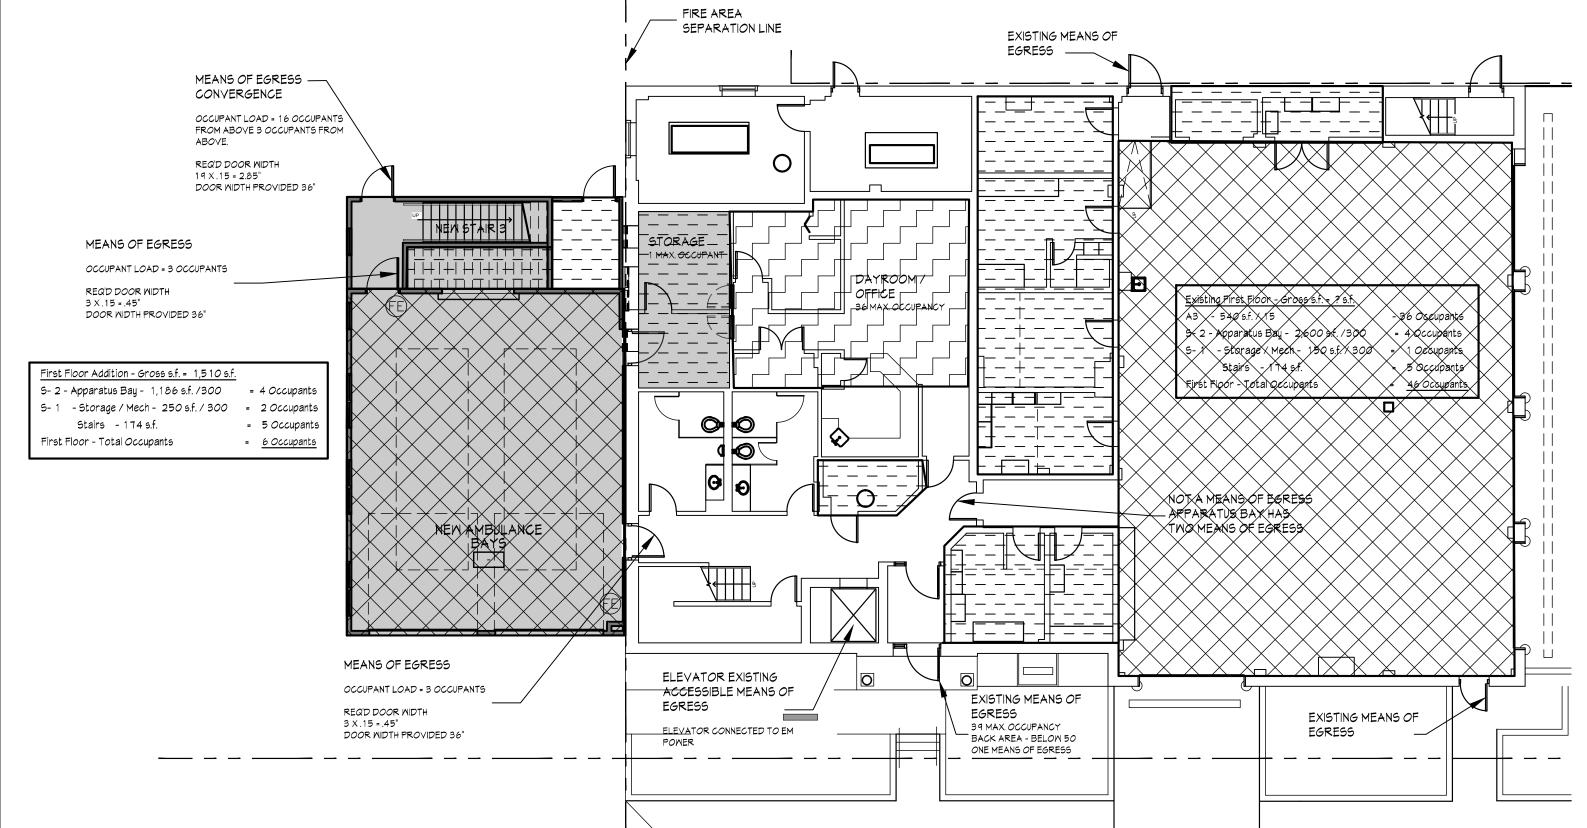

LEGEND

NEW ADDITION

OCCUPANCY AREAS

BUSNIESS AREA

ASSEMBLY (OCCUPANCY A-3)

ACCESSORY STORAGE /

MECH & ELECTRICAL AREAS

RECESSED FIRE EXTINGUISHER CABINET
SEE SPECIFICATIONS

MALL MOUNTED PORTABLE FIRE EXTINGUISHER

# Code Analysis:

#### PROJECT SCOPE:

The project is proposing an addition to the existing building and creating a mixed use building, but occupancies are separated as a mixed use building as per NYS Building Code.

#### Summary of - Existing and Proposed

First Floor 1,510 s.f.
Second Floor 1,510 s.f.
Total = 3,020 s.f.

# <u>List of applicable State Codes, Reference Codes and Standards:</u>

2020 Building Code of New York State
2020 NYStretch Energy Code - 2018 IECC
2020 Fire Code of New York State

2020 Property Maintenance Code of New York State 2020 Mechanical Code of New York State

2020 Plumbing Code of New York State 2020 Fuel Gas Code of New York State

2020 New York State Supplement
NFPA 70 (National Electrical Code)

2020 Energy Conservation Construction Code

ICC/ANSI A 1 1 7.1-2009 Accessible and Usable Buildings and Facilities

CHAPTER 3 - OCCUPANCY CLASSIFICATION AND USE

# Comply with applicable sections of this Chapter Including;

302.10ccupancy classification.

National Fire Underwriter Code

Comply with applicable sections of this Chapter Including;

Occupancy classification is the formal designation of the primary purpose of the building, structure or portion thereof. Structures shall be classified into one or more of the occupancy groups listed in this section based on the nature of the hazards and risks to building occupants generally associated with the intended purpose of the building or structure. An area, room or space that is intended to be occupied at different times for different purposes shall comply with all applicable requirements associated with such potential multipurpose. Structures containing multiple occupancy groups shall comply with Section 508. Where a structure is proposed for a purpose that is not specifically listed in this section, such structure shall be classified in the occupancy it most nearly resembles based on the fire safety and relative hazard.

#### Assembly (see Section 303): Groups A-3

Business (see Section 304): Group B.

Storage (see Section 311): Groups 5-1.

Storage (see Section 311): Groups 5-2.

#### CHAPTER 5 - GENERAL BUILDING HEIGHTS AND AREAS

Comply with applicable sections of this Chapter Including;

#### 504.1General.

The height, in feet, and the number of stories of a building shall be determined based on the type of construction, occupancy classification and whether there is an automatic sprinkler system installed throughout the building.

#### 504.2Mixed occupancy.

In a building containing mixed occupancies in accordance with Section 508, no individual occupancy shall exceed the height and number of story limits specified in this section for the applicable occupancies.

#### 504.3Height in feet.

The maximum height, in feet, of a building shall not exceed the limits specified in Table 504.3. Table 504.3 - Occupancy B - Non Sprinklered - Type IIB - 55'-0"

## 504.4Number of stories.

The maximum number of stories of a building shall not exceed the limits specified in Table 504.4.

Table 504.4 - Occupancy B - Sprinklered - Type IIB - 3 stories

#### 505.2.2Means of egress.

The means of egress for mezzanines shall comply with the applicable provisions of Chapter 10.

#### 506.2Allowable area determination.

The allowable area of a building shall be determined in accordance with the applicable provisions of Sections 506.2.1 through 506.2.4 and Section 506.3. Table 506.2 - (NS) Non Sprinklered - Type IIB - 2 stories - 23,000 s.f.

#### 508.4Separated occupancies.

Buildings or portions of buildings that comply with the provisions of this section shall be considered as separated occupancies.

TABLE 508.4 REQUIRED SEPARATION OF OCCUPANCIES

B to 5-2-2 hour required

#### CHAPTER 6 - TYPES OF CONSTRUCTION

Comply with applicable sections of this Chapter Including;

Group B (table 601) - Type IIB Construction w/ No Sprinklers Primary Structural frame - Ohr.

Bearing Walls - O hr. (Interior)

Non-bearing Walls - O hr. (Interior)

Floor Construction - O hr

Bearing Walls - Ohr. (Exterior)

Floor Construction - O hr.

Roof Construction - O hr.

Doors in walls noted above to be rated as per code and have rated labels accordingly.

#### 602.2Types I and II.

Types I and II construction are those types of construction in which the building elements listed in Table 601 are of noncombustible materials, except as permitted in Section 603 and elsewhere in this code.

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White Plains, New York 10601
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on P. Sullivan, FAIA - Lisc. # 017185 Registered through 9/30/2

I herby state to the best of my professional knowledge and abilities that the proposed building design represented in these documents is consistent with the building plans, specifications, and other calculations submitted with the

permit application. The proposed building has been

designed to meet the requirements of the Current New

York State Energy Conservation Construction Code and adopted Stretch Code. The signature and seal on such documents attests to the above statement.

It is a violation of the law for any person, unless acting under the direction of a licensed architect, to alter an item in any way. If an item bearing the seal of an architect is altered, the altering architect shall affix to his item the seal

and the notation "altered by" followed by his signature and the date of such alteration, and a specific description of the

Project Title

alteration.

Date Issue

/18/2024 CLIENT REVIEW SET

4/8/2024 CLIENT REVIEW SET

5/7/24 CONSTRUCTION SET


# Croton-on-Hudson Harmon Firehouse Station #3 & EMS

30 Wayne Street Croton-On-Hudson New York 10520

# Drawing Title LIFE SAFETY CODE REVIEW

Project No.	202222
Date	7.21.2023
Scale	AS NOTED
Drawing by	KA

Checked by

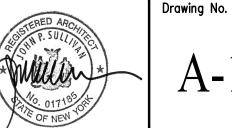

tion in which the ble materials, except

FIRST FLOOR LIFE SAFTEY PLAN

3/32" = 1'-0"

CHAPTER 6 - TYPES OF CONSTRUCTION

Comply with applicable sections of this Chapter Including;

Group B (table 601) - Type IIB Construction w/ Sprinklers

Type IIB - with added sprinklers Primary Structural frame - Ohr

Bearing Walls - O hr. (Exterior) Bearing Walls - O hr. (Interior)

Non-bearing Walls - O hr. (Interior) Floor Construction - Ohr

Roof Construction - Ohr.

Doors in walls noted above to be rated as per code and have rated labels accordingly.

#### 602.2Types I and II.

Types I and II construction are those types of construction in which the building elements listed in Table 601 are of noncombustible materials, except as permitted in Section 603 and elsewhere in this code.

CHAPTER 7 - FIRE AND SMOKE PROTECTION FEATURES Comply with applicable sections of this Chapter Including;

SECTION 101 - FIRE BARRIERS

#### 707.1General.

Fire barriers installed as required elsewhere in this code or the Fire Code of New York State shall comply with this section.

#### 707.3.1Shaft enclosures.

The fire-resistance rating of the fire barrier separating building areas from a shaft shall comply with Section 713.4.

#### 707.3.5Horizontal exit.

The fire-resistance rating of the separation between building areas connected by a horizontal exit shall comply with Section 1026.1.

#### 707.3.6Atriums.

The fire-resistance rating of the fire barrier separating atriums shall comply with Section 404.6

#### 707.3.7Incidental uses

The fire barrier separating incidental uses from other spaces in the building shall have a fire-resistance rating of not less than that indicated in Table 509.

#### 707.3.9Separated occupancies.

Where the provisions of Section 508.4 are applicable, the fire barrier separating mixed occupancies shall have a fire-resistance rating of not less than that indicated in Table 508.4 based on the occupancies being separated.

SECTION 712 - VERTICAL OPENINGS

#### 712.1General.

Each vertical opening shall comply in accordance with one of the protection methods in Sections 712.1.1 through 712.1.16.

#### 712.1.1Shaft enclosures.

Vertical openings contained entirely within a shaft enclosure complying with Section 713 shall be permitted.

#### 7 13.4Fire-resistance rating.

Shaft enclosures shall have a fire-resistance rating of not less than than 1 hour where connecting less than two stories. The number of stories connected by the shaft enclosure shall include any basements but not any mezzanines. Shaft enclosures shall have a fire-resistance rating not less than the floor assembly penetrated, but need not exceed 2 hours. Shaft

### CHAPTER 8 - INTERIOR FINISHES

Comply with applicable sections of this Chapter Including;

enclosures shall meet the requirements of Section 703.2.1.

#### 802.1 Interior wall and ceiling finish.

The provisions of Section 803 shall limit the allowable fire performance and smoke development of interior wall and ceiling finish materials based on occupancy classification.

SECTION803-WALL AND CEILING FINISHES

#### 802.5Application.

Combustible materials shall be permitted to be used as finish for walls, ceilings, floors and other interior surfaces of buildings.

### 803.1General.

Interior wall and ceiling finish materials shall be classified for fire performance and smoke development in accordance with Section 803.1.1 or 803.1.2, except as shown in Sections 803.1.3 through 803.15. Materials tested in accordance with Section 803.1.1 shall not be required to be tested in accordance with Section 803.1.2.

#### 803.1.1 Interior wall and ceiling finish materials tested in accordance with NFPA 286.

Interior wall and ceiling finish materials shall be classified in accordance with NFPA 286 and comply with Section 803.1.1.1. Materials complying with Section 803.1.1.1 shall be considered to also comply with the requirements of Class A.

Interior and Ceiling Finish Requirements by Occupancy - (table 803.13)

Class B - Interior exit stairways

Class C - Corridors Class C - Rooms and Enclosed spaces

#### SECTION804 - INTERIOR FLOOR FINISH

#### 804.1General.

Interior floor finish and floor covering materials shall comply with Sections 804.2 through 804.4.2.

Exception: Floor finishes and coverings of a traditional type, such as wood, vinul, linoleum or terrazzo, and resilient floor covering materials that are not comprised of fibers.

#### 804.2Classification

Interior floor finish and floor covering materials required by Section 804.4.2 to be of Class I or II materials shall be classified in accordance with ASTM E648 or NFPA 253. The classification referred to herein corresponds to the classifications determined by ASTM E648 or NFPA 253 as follows: Class I, 0.45 watts/cm2 or greater; Class II, 0.22 watts/cm2 or greater.

#### 804.3Testing and identification.

Interior floor finish and floor covering materials shall be tested by an agency in accordance with ASTM E648 or NFPA 253 and identified by a hang tag or other suitable method so as to identify the manufacturer or supplier and style, and shall indicate the interior floor finish or floor covering classification in accordance with Section 804.2. Carpet-type floor coverings shall be tested as proposed for use, including underlayment. Test reports confirming the information provided in the manufacturer's product identification shall be furnished to the building official upon request.

#### 804.4Interior floor finish requirements.

Interior floor covering materials shall comply with Sections 804.4.1 and 804.4.2 and interior floor finish materials shall comply with Section 804.4.2.

#### 804.4.1 Test requirement.

In all occupancies, interior floor covering materials shall comply with the requirements of the DOC FF-1 "pill test" (CPSC 16 CFR Part 1630) or with ASTM D2859.

#### 804.4.2 Minimum critical radiant flux.

In all occupancies, interior floor finish and floor covering materials in enclosures for stairways and ramps, exit passageways, corridors and rooms or spaces not separated from corridors by partitions extending from the floor to the underside of the ceiling shall withstand a minimum critical radiant flux. The minimum critical radiant flux shall be not less than Class I in Groups I- 1, I-2 and I-3 and not less than Class II in Groups A, B, E, H, I-4, M, R-1, R-2 and S.

Exception: Where a building is equipped throughout with an automatic sprinkler system in accordance with Section 903.3.1.1 or 903.3.1.2, Class II materials are permitted in any area where Class I materials are required, and materials complying with DOC FF-1 "pill test" (CPSC 16 CFR Part 1630) or with ASTM D2859 are permitted in any area where Class II materials are required.

SECTION 808 - ACOUSTICAL CEILING SYSTEMS

#### 808.1 Acoustical ceiling systems.

The quality, design, fabrication and erection of metal suspension systems for acoustical tile and lay-in panel ceilings in buildings or structures shall conform to generally accepted engineering practice, the provisions of this chapter and other applicable requirements of this code.

#### 808.1.1.1 Suspended acoustical ceilings.

Suspended acoustical ceiling systems shall be installed in accordance with the provisions of ASTM C635 and ASTM C636.

## CHAPTER 9 - FIRE PROTECTION AND LIFE SAFETY SYSTEMS

Comply with applicable sections of this Chapter Including:

#### CHAPTER 10 - MEANS OF EGRESS

Comply with applicable sections of this Chapter Including;

#### 1003.2Ceiling height.

The means of egress shall have a ceiling height of not less than 7 feet 6 inches (2286 mm) above the finished floor.

1003.45lip-resistant surface. Circulation paths of the means of egress shall have a slip-resistant surface and be securely attached.

# 1003.6 Means of egress continuity.

The path of egress travel along a means of egress shall not be interrupted by a building element other than a means of egress component as specified in this chapter. Obstructions shall not be placed in the minimum width or required capacity of a means of egress component except projections permitted by this chapter. The minimum width or required capacity of a means of egress system shall not be diminished along the path of egress travel.

#### 1003.7Elevators, escalators and moving walks.

Elevators, escalators and moving walks shall not be used as a component of a required means of egress from any other part of the building.

Exception: Elevators used as an accessible means of egress in accordance with Section 1009.4.

SECTION 1004 - OCCUPANT LOAD

#### 1004.1Design occupant load.

In determining means of egress requirements, the number of occupants for whom means of egress facilities are provided shall be determined in accordance with this section.

#### Max. Floor Area Allowances per Occupant per Table 1004.5

Business Areas 150 gross 15 net - if over 750 s.f. of not 150 gross Assembly: Accessory Stor. / Mech. 300 gross

Garages 200 gross

Area / Occupant - Building Summary

See Plans

#### SECTION 1005 - MEANS OF EGRESS SIZING

#### 1005.3Required capacity based on occupant load.

The required capacity, in inches (mm), of the means of egress for any room, area, space or story shall be not less than that determined in accordance with Sections 1005.3.1 and 1005.3.2.

#### 1005.3.1Stairways.

The capacity, in inches, of means of egress stairways shall be calculated by multiplying the occupant load served by such stairways by a means of egress capacity factor of 0.3 inch (7.6 mm) per occupant. Where stairways serve more than one story, only the occupant load of each story considered individually shall be used in calculating the required capacity of the stairways serving that story.

#### 1005.3.20ther egress components.

The capacity, in inches, of means of egress components other than stairways shall be calculated by multiplying the occupant load served by such component by a means of egress capacity factor of 0.2 inch (5.1 mm) per occupant.

#### 1005.4Continuity.

The minimum width or required capacity of the means of egress required from any story of a building shall not be reduced along the path of egress travel until arrival at the public way.

SECTION 1006 -NUMBER OF EXITS AND EXIT ACCESS DOORWAYS

#### 1006.1General.

The number of exits or exit access doorways required within the means of egress system shall comply with the provisions of Section 1006.2 for spaces, including mezzanines,

#### 1006.2Egress from spaces.

Rooms, areas or spaces, including mezzanines, within a story or basement shall be provided with the number of exits or access to exits in accordance with this section.

# 1006.2.1Egress based on occupant load and common path of egress travel

Two exits or exit access doorways from any space shall be provided where the design occupant load or the common path of egress travel distance exceeds the values listed in Table 1006.2.1. The cumulative occupant load from adjacent rooms, areas or spaces shall be determined in accordance with Section 1004.2.

#### 1006.3.2 Egress based on occupant load.

Each story and occupied roof shall have the minimum number of separate and distinct exits, or access to exits, as specified in Table 1006.3.2. A single exit or access to a single exit shall be permitted in accordance with Section 1006.3.3. The required number of exits, or exit access stairways or ramps providing access to exits, from any story or occupied roof shall be maintained until arrival at the exit discharge or a public way.

#### TABLE 1006.3.2

MINIMUM NUMBER OF EXITS OR ACCESS TO EXITS PER STORY 1-500 - 2 Exits

MEANS OF EGRESS ILLUMINATION

#### 1008.21|lumination required.

The means of egress serving a room or space shall be illuminated at all times that the room or space is occupied.

#### 1008.2.1 Illumination level under normal power.

The means of egress illumination level shall be not less than 1 footcandle (11 lux) at the walking surface.

#### 1008.3 Emergency power for illumination.

The power supply for means of egress illumination shall normally be provided by the premises' electrical supply.

### 1008.3.1 General.

In the event of power supply failure in rooms and spaces that require two or more means of egress, an emergency electrical system shall automatically illuminate all of the following areas:

#### 1.Aisles. 2.Corridors.

3.Exit access stairways and ramps.

#### 1008.3.2 Buildings.

In the event of power supply failure in buildings that require two or more means of egress, an emergency electrical system shall automatically illuminate all of the following areas:

#### 1.Interior exit access stairways and ramps.

2.Interior and exterior exit stairways and ramps.

#### 3.Exit passageways.

4. Vestibules and areas on the level of discharge used for exit discharge in accordance with Section 1028.1.

#### 5.Exterior landings as required by Section 1010.1.6 for exit doorways that lead directly to the exit discharge.

## 1008.3.3Rooms and spaces.

In the event of power supply failure, an emergency electrical system shall automatically illuminate all of the following areas:

#### 1.Electrical equipment rooms.

2. Fire command centers. 3. Fire pump rooms.

4.Generator rooms. 5. Public restrooms with an area greater than 300 square feet (27.87 m2).

### 1009.4Elevators.

In order to be considered part of an accessible means of egress, an elevator shall comply with Sections 1009.4.1 and 1009.4.2.

# 1009.4.1Standby power.

The elevator shall meet the emergency operation and signaling device requirements of Section 2.27 of ASME A 17.1/CSA B44. Standby power shall be provided in accordance with Chapter 27 and Section 3003.

CHAPTER 11 - ACCESSIBILITY

Comply with applicable sections of this Chapter Including;

CHAPTER 12 INTERIOR ENVIRONMENT:

Comply with applicable sections of this Chapter Including; See MEP Documents

#### CHAPTER 13 ENERGY EFFICIENCY

Comply with applicable sections of this Chapter Including; See Com Check and MEP Documents.

#### CHAPTER 14 EXTERIOR WALLS

Comply with applicable sections of this Chapter Including;

#### CHAPTER 15 ROOF ASSEMBLIES AND ROOF TOP STRUCTURES: Comply with applicable sections of this Chapter Including;

#### 504.1 Wind resistance of roofs

Roof decks and roof coverings shall be designed for wind loads in accordance

with Chapter 16 and Sections 1504.2, 1504.3 and 1504.4.

#### 1504.5 Edge securement for low-slope roofs.

Low-slope built-up, modified bitumen and single-ply roof system metal edge securement, except gutters, shall be designed and installed for wind loads in accordance with Chapter 16 and tested for resistance in accordance with Test Methods RE-1, RE-2 and RE-3 of ANSI/SPRI ES-1, except basic design wind speed, V, shall be determined from Figures 1609.3(1) through <u>1609.3(8) as applicable.</u>

TABLE 1505.1. - MINIMUM ROOF COVERING CLASSIFICATION FOR TYPES OF CONSTRUCTION

### 1505.4 Class C roof assemblies

Construction type IIB - Class C roof assemblies are those that are effective against light fire-test exposure. Class C roof assemblies and roof coverings shall be listed and identified as Class C by an approved testing agency.

#### CHAPTER 16 STRUCTURAL DESIGN:

See Consulting Structural Engineers Documents.

#### Comply with applicable sections of this Chapter Including; SEE STATEMENT OF SPECIAL INSPECTIONS AND STRUCTURAL DOCUMENTS

CHAPTER 17 SPECIAL INSPECTIONS:

Geotechnical Report and Boring Logs.

CHAPTER 18 SOILS AND FOUNDATIONS: Comply with applicable sections of this Chapter Including;

See Consulting Civil Engineers Documents and See

Comply with applicable sections of this Chapter Including;

# CHAPTER 19 CONCRETE

Comply with applicable sections of this Chapter Including; See Consulting Structural Engineers Documents.

## Comply with applicable sections of this Chapter Including;

CHAPTER 20 ALUMINUM:

CHAPTER 21 MASONRY: Comply with applicable sections of this Chapter Including;

CHAPTER 22 STEEL Comply with applicable sections of this Chapter Including; See Consulting Structural Engineers Documents.

#### CHAPTER 23 MOOD: (AS APPLICABLE) Comply with applicable sections of this Chapter Including;

CHAPTER 24 GLASS AND GLAZING:

See Consulting Structural Engineers Documents.

## Comply with applicable sections of this Chapter Including;

CHAPTER 25 GYPSUM BOARD, GYPSUM PANEL PRODUCTS AND PLASTER: Comply with applicable sections of this Chapter Including;

## CHAPTER 26 PLASTIC:

CHAPTER 27 ELECTRICAL: Comply with applicable sections of this Chapter Including;

Comply with applicable sections of this Chapter Including;

#### See Consulting MEP Engineering Documents

See Consulting MEP Engineering Documents

See Consulting MEP Engineering Documents

CHAPTER 29 PLUMBING SYSTEMS:

CHAPTER 28 MECHANICAL SYSTEMS: Comply with applicable sections of this Chapter Including;

Comply with applicable sections of this Chapter Including;

# Sullivan Architecture, P.C.

31 Mamaroneck Avenue White Plains, New York 10601 914-761-6006 (F) 914-761-4919 n P. Sullivan, FAIA - Lisc. # 017185 Registered through 9/30/2

Date Issue /18/2024 CLIENT REVIEW SET 4/8/2024 CLIENT REVIEW SET 5/7/24 CONSTRUCTION SET

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alteration. Project Title

Croton-on-Hudson Harmon Firehouse Station #3 & EMS

New York 10520

CODE REVIEW


Drawing Title LIFE SAFETY

30 Wayne Street

Croton-On-Hudson

Project No. 202222 Date 7.21.2023 Scale AS NOTED Drawing by

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31 Mamaroneck Avenue White Plains, New York 10601 914-761-6006 (F) 914-761-4919 John P. Sullivan, FAIA - Lisc. # 017185 Registered through 9/30/2
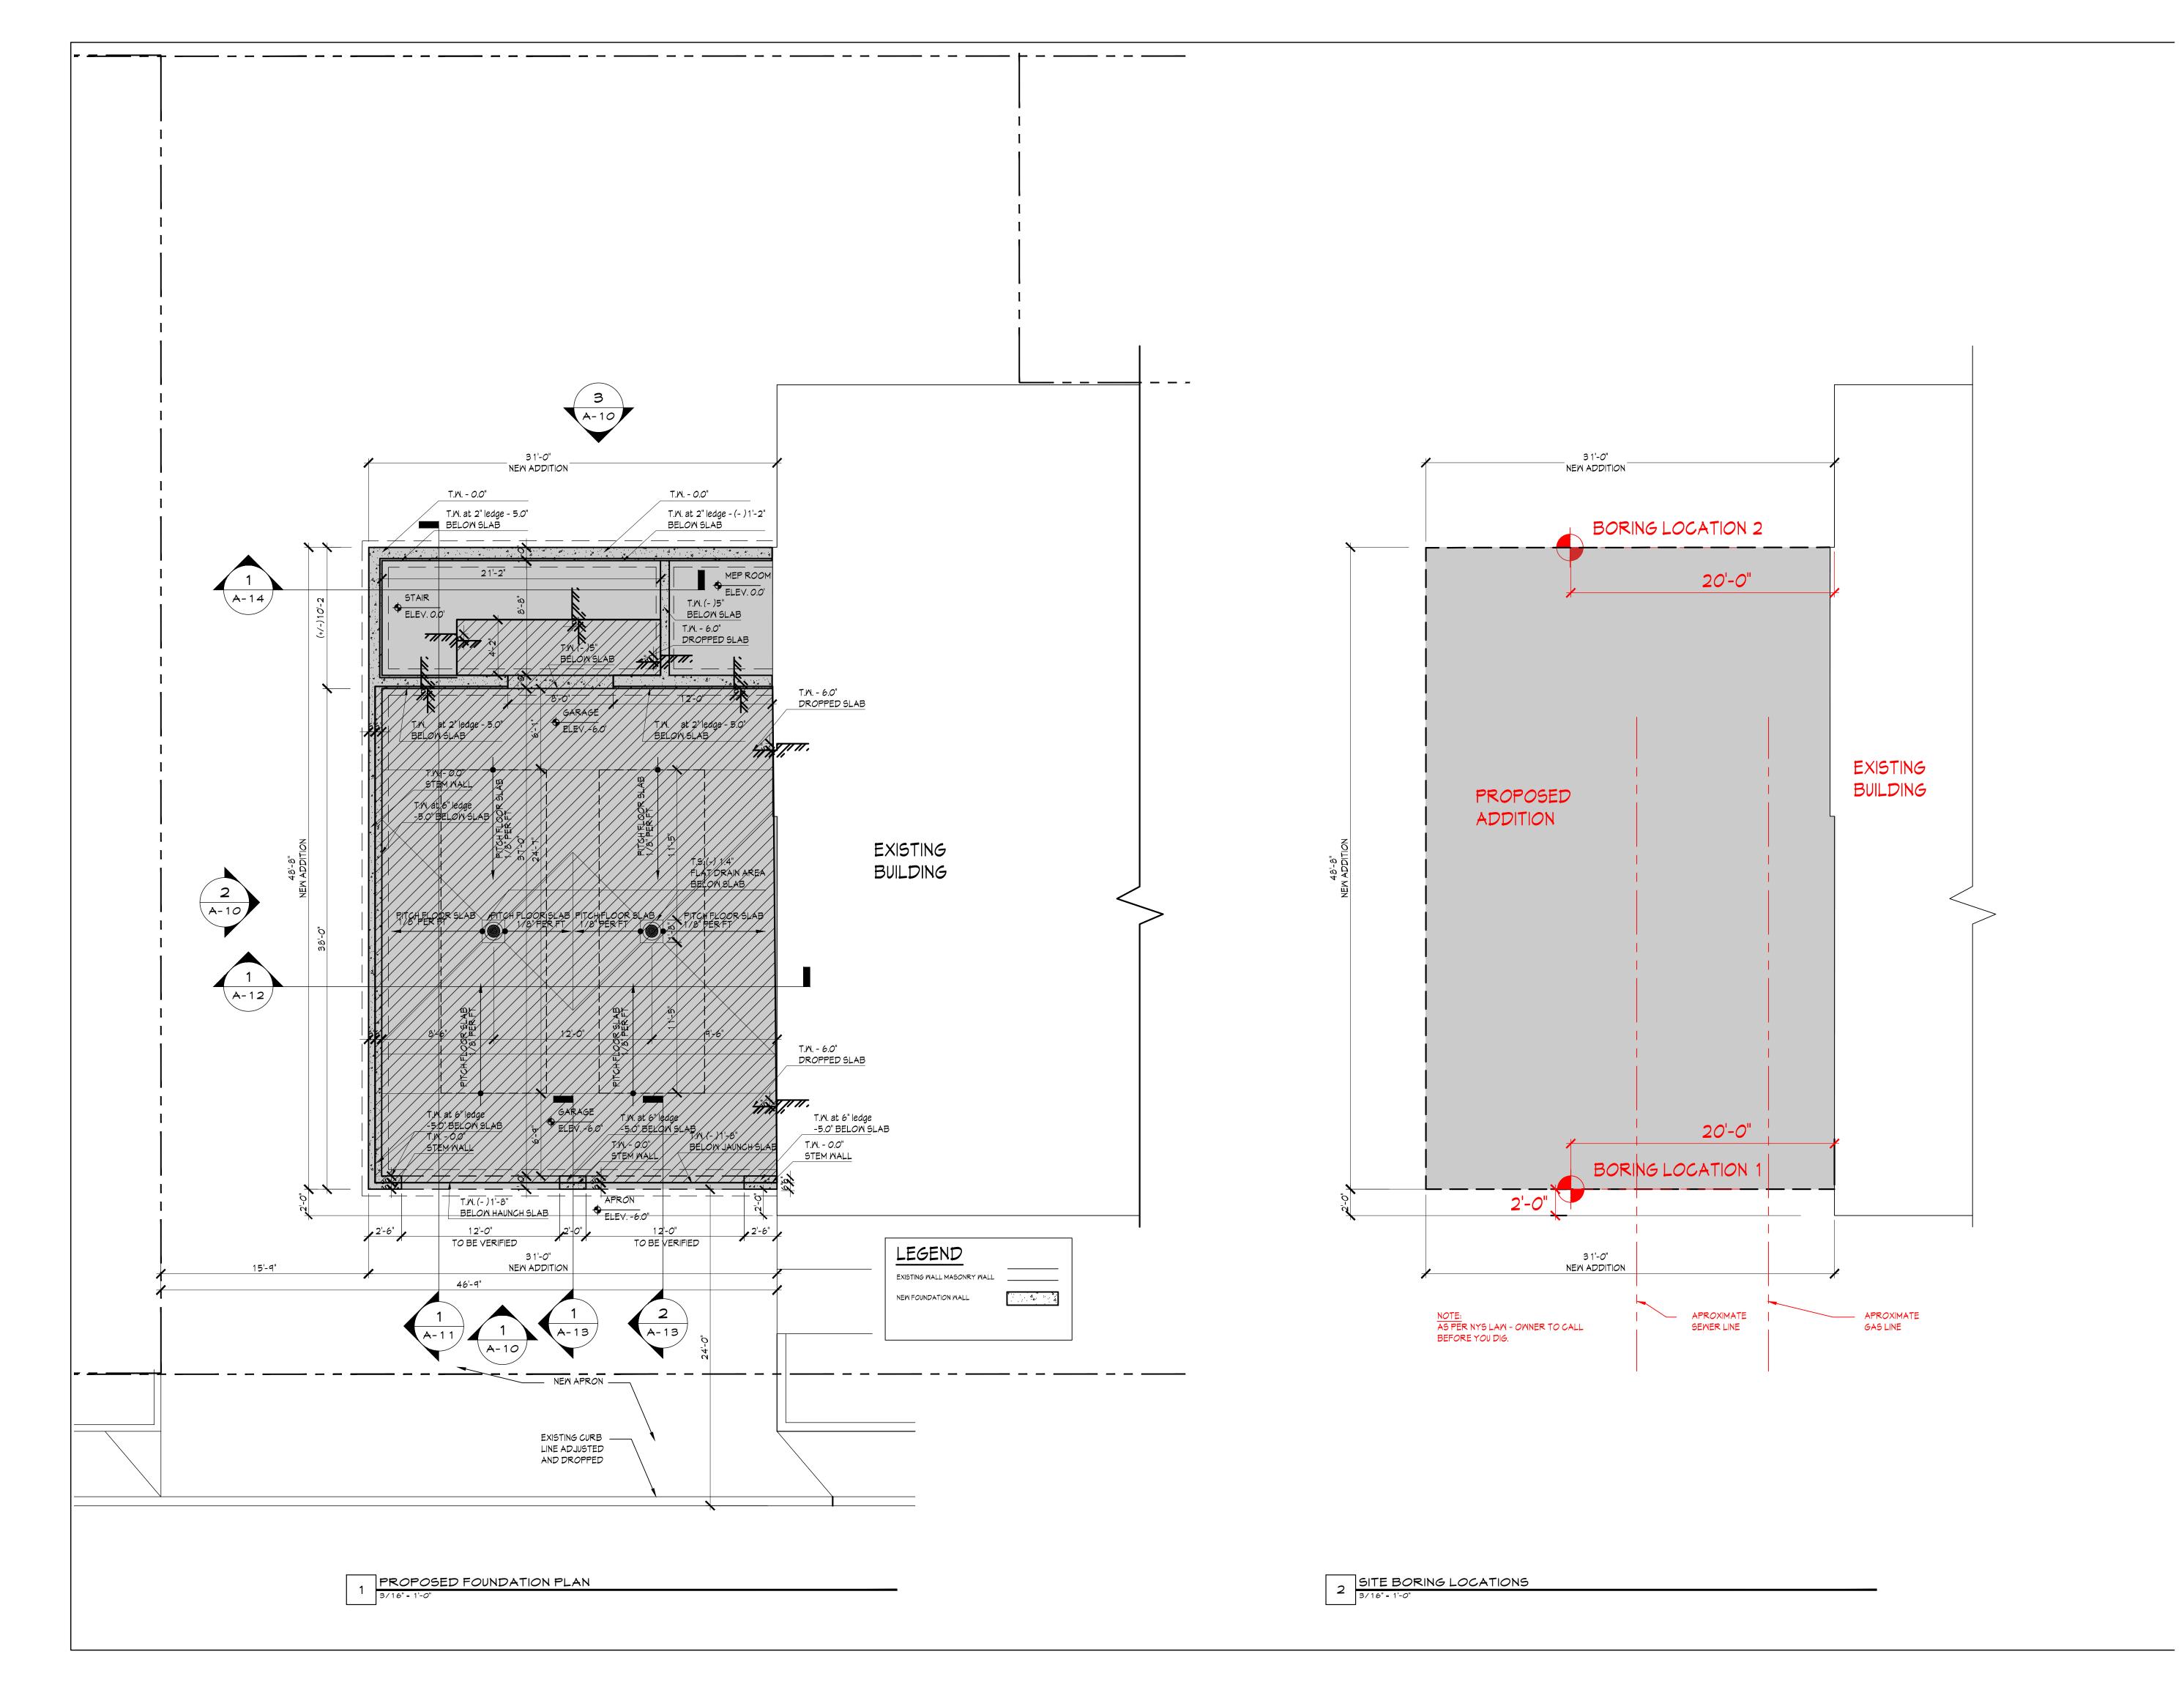
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Project Title

# Croton-on-Hudson Harmon Firehouse Station #3 & EMS

30 Wayne Street Croton-On-Hudson New York 10520

Drawing Title

FOUNDATION PLAN

Project No.	202222
Date	7.21.2023
Scale	
Drawing by	KA

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A-2.0

# 3 1'-0" NEW ADDITION 24'-7" FIRE RATED HORIZONTAL SHAFT WALL BELOW STAIR AND LANDING AT UTILITY ROOM EMS STORAGE FD OFFICE / STORAGE FD DAY ROOM - REMOVE AND RELOCATE DOOR AND FRAMES REMOVE WINDOW AND INFILL WITH 2 HR. SHAFT MALL ASSEMBLY. PARTITION TYPE 1 1A 1 EMS STORAGE REMOVE WINDOW AND SECTION OF WALL AND PROVIDE NEW DOOR AS SHOWN FD STORAGE EMS SIZES TO BE VERIFIED EMS SIZES — TO BE VERIFIED EX1 57 E NEW DOOR REVERSE SWING NEW AMBULANCE ROOF DRAIN VERTICAL SHAFT PROVIDE 2 HR SHAFT 12'-0" TO BE VERIFIED 12'-0" TO BE VERIFIED LEGEND EX1 3 1'-0" NEW ADDITION MALL AROUND PARTITION TYPE '1a' EXISTING WALL MASONRY WALL EXISTING WALL ADJUSTED DRIVE AND WALKWAY NEW WALL ASSEMBLY A-13 NEW CONCRETE - OWNER TO ADJUST WALL AND SIDEWALK TO COORDINATE WITH TURNING RADIUS EXISTING CURB LINE ADJUSTED AND DROPPED

PROPOSED FIRST FLOOR PLAN
3/16" = 1'-0"

# Sullivan Architecture, P.C.

31 Mamaroneck Avenue White Plains, New York 10601 914-761-6006 (F) 914-761-4919 https://phiscology.com/picked/black/picked

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Project Title

# Croton-on-Hudson Harmon Firehouse Station #3 & EMS

30 Wayne Street Croton-On-Hudson New York 10520

Drawing Title

FIRST FLOOR PLAN

Project No.	202222
Date	7.21.2023
Scale	
Drawing by	KA

Checked by



A-3 0

# 36" aff GFI MP AT CEILING CONNECTED TO BUILDING SYSTEM\_ MALL MOUNTED EXHAUST FAN W/GO2 SENSOR MOUNTED UP NEAR 36" aff 36" aff GFI MP GFI MP 20 amp circuit pull down reel 20 amp circuit pull down reel Overhead | door power tbd NEW AMBULANCE | BAYS| | | - | | - HYDRONICUNIT HYDRONIC UNIT AT CEILING CONNECTED TO BUILDING SYSTEM — AT CEILING CONNECTED TO BUILDING SYSTEM 36" aff PROPOSED FIRST FLOOR POWER/TELE/DATA PLAN 3/16" = 1'-0"

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Project Title

# Croton-on-Hudson Harmon Firehouse Station #3 & EMS


30 Wayne Street Croton-On-Hudson New York 10520


#### Drawing Title

# FIRST FLOOR POWER TELE DATA


Project No.	202222
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Scale	
Drawing by	KA

Checked by

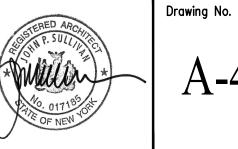


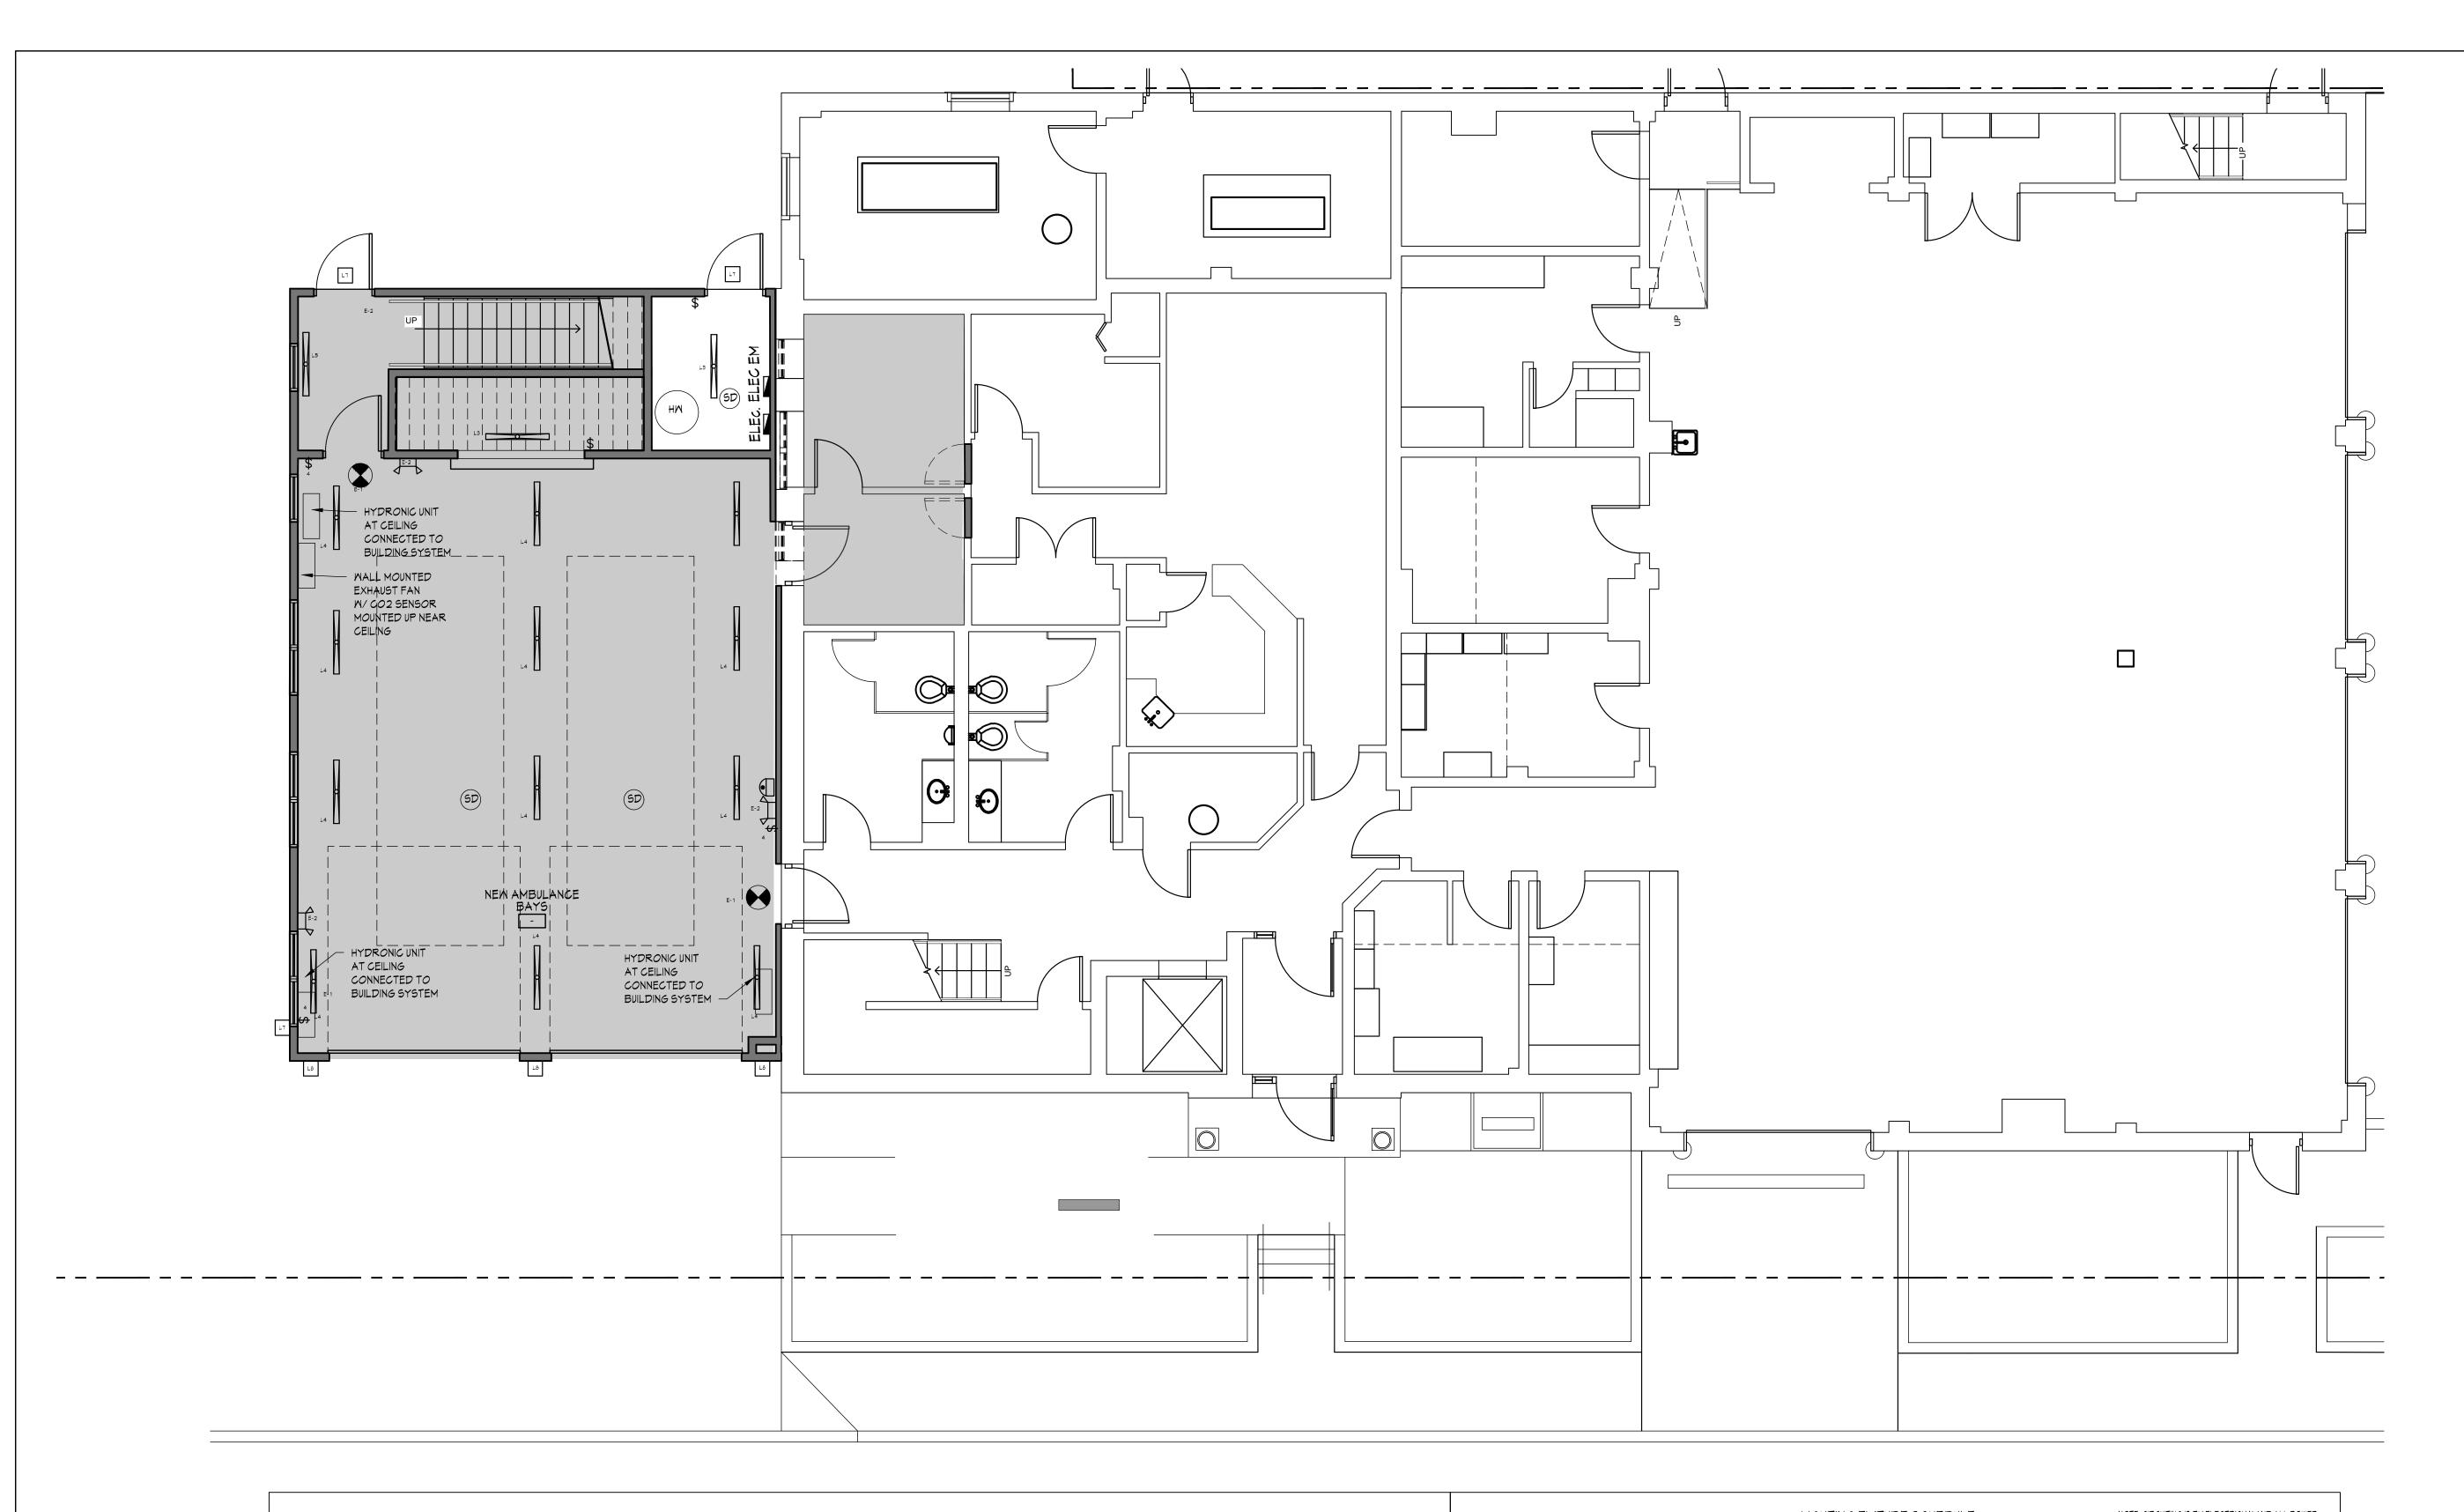

## CEILING FINISH LEGEND

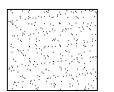

PAINTED GMB AS NOTED ON FINSIH SCHEDULE FLAT CEILING

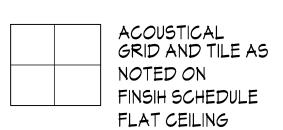

### NOTES:

- 1. LIGHTING TO BE WORKED OUT AS SHOWN IN FIELD AND COORDINATED WITH LIGHTING DOCUMENTS BY OTHERS
- 2. LIGHTS TO BE CENTERED BETWEEN WALLS, SOFFITS AND CEILING ELEMENTS, UON
- 3. COORDINATE ALL CONDUIT AND DRAG LINES FOR CEILING MOUNTED DEVICES. SEE POWER TELE PLAN AND ENGINEERING DOCUMENTS.

# CEILING GENERAL NOTES

- A. ALL EXTERIOR LIGHT FIXTURES SHALL BE CONNECTED
- LIGHT PHOTOCELL SENSOR. SEE ENGINEERING DOCUMENTS.

  B. SEE ELECTRICAL ENGINEERING DOCUMENTS FOR ADDITIONAL
- SCOPE AND INFORMATION.
- C. SIGNED AND SEALED SHOP DRAWINGS WILL BE SUBMITTED BY THE SPRINKLER CONTRACTOR DURING CONSTRUCTION AND THE ELECTRICIAN IS REQUIRED TO WIRE ALL DEVICES ACCORDINGLY.
- D. ALL WALL AND JOIST CAVITIES THAT HAVE SPRINKLER PIPING
  IN THEM SHALL HAVE SPRAY FOAM INSTALLED PRIOR TO PIPING
  TO ENSURE PIPE IS ON WARM SIDE OF ASSEMBLY. THIS IS
  REGUARDLESS OF WALL TYPE OR WALL SECTION NOTATIONS.

			LIGHTING FIXTURE SCHEDULE		NOTE: CIRCUITING IS BY ELECTRICIAN AND ALL POWER AND LIGHTING CONNECTED TO EM PANEL
SYMB <i>O</i> L	FIXTURE	TYPE/DESCRIPTION	PRODUCT INFORMATION	MANUFACTURER	REMARKS
0	L1	LIGHTOLIER - 5" SLIM SURAFCE	95R830KTMZ10U	LIGHTOLIER	
	L2	DAY-BRITE RECESSED EVO GRID 2X2	2EVG30L835 - 2 - D - UNV - DIM	DAY-BRITE	
	L3 CLOSET	DAY-BRITE INDUSTRIAL 4FL LINEAR	F5X-4-4000-835-UNV-BLANK	DAY-BRITE	
	L4 BAYS	DAY-BRITE INDUSTRIAL 4FL LINEAR	F9X-4-8000-835-UNV-BLANK	DAY-BRITE	
	L5 STAIRS	JAYLUM LED WALL MOUNTED SCONCE	JM - ML - 30L - 9 - 35 - 1D - UNV - STD-M-SUMA -4	CORELITE	
	L6	MAXIM - SPEC VANITY	52000 - POLISHED CHROME	MAXIM	
	L7	MAXIM - PATHFINDER	52120PHC - BLACK FINISH	MAXIM	
$\Box$	L8	MAXIM - LIGHTHOUSE	5866CLFTAR - BLACK FINISH W/ ACESSORY PHOTOCELL	MAXIM	CONTRACTOR TO PROVIDE COMPLIANT LED GREEN BULE
<b>\$</b>	E-1	COOPER - SURE-LITES LPX SERIES	LPX 6 (WALL MOUNT)	COOPER	REFER TO RCP FOR DIRECTION CHEVRONS
$\Box$	E-2	COOPER - SURE-LITES	AP25QLED30 EMERGENCY LIGHT	COOPER	

## Sullivan Architecture, P.C

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ohn P. Sullivan, FAIA - Lisc. # 017185 Registered through 9/30/2

Date Issue			
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4/8/2024	CLIENT REVIE	M SET	
5/7/24 00	NSTRUCTION	SET	

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Project Title

# Croton-on-Hudson Harmon Firehouse Station #3 & EMS

30 Wayne Street Croton-On-Hudson New York 10520

Drawing Title


FIRST FLOOR RCP PLAN

Project No.	202222	
Date	7.21.2023	
Scale		
Drawing by	KA	

Checked by



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31 Mamaroneck Avenue White Plains, New York 10601 914-761-6006 (F) 914-761-4919 Ohn P. Sullivan, FAIA - Lisc. # 017185 Registered through 9/30/2
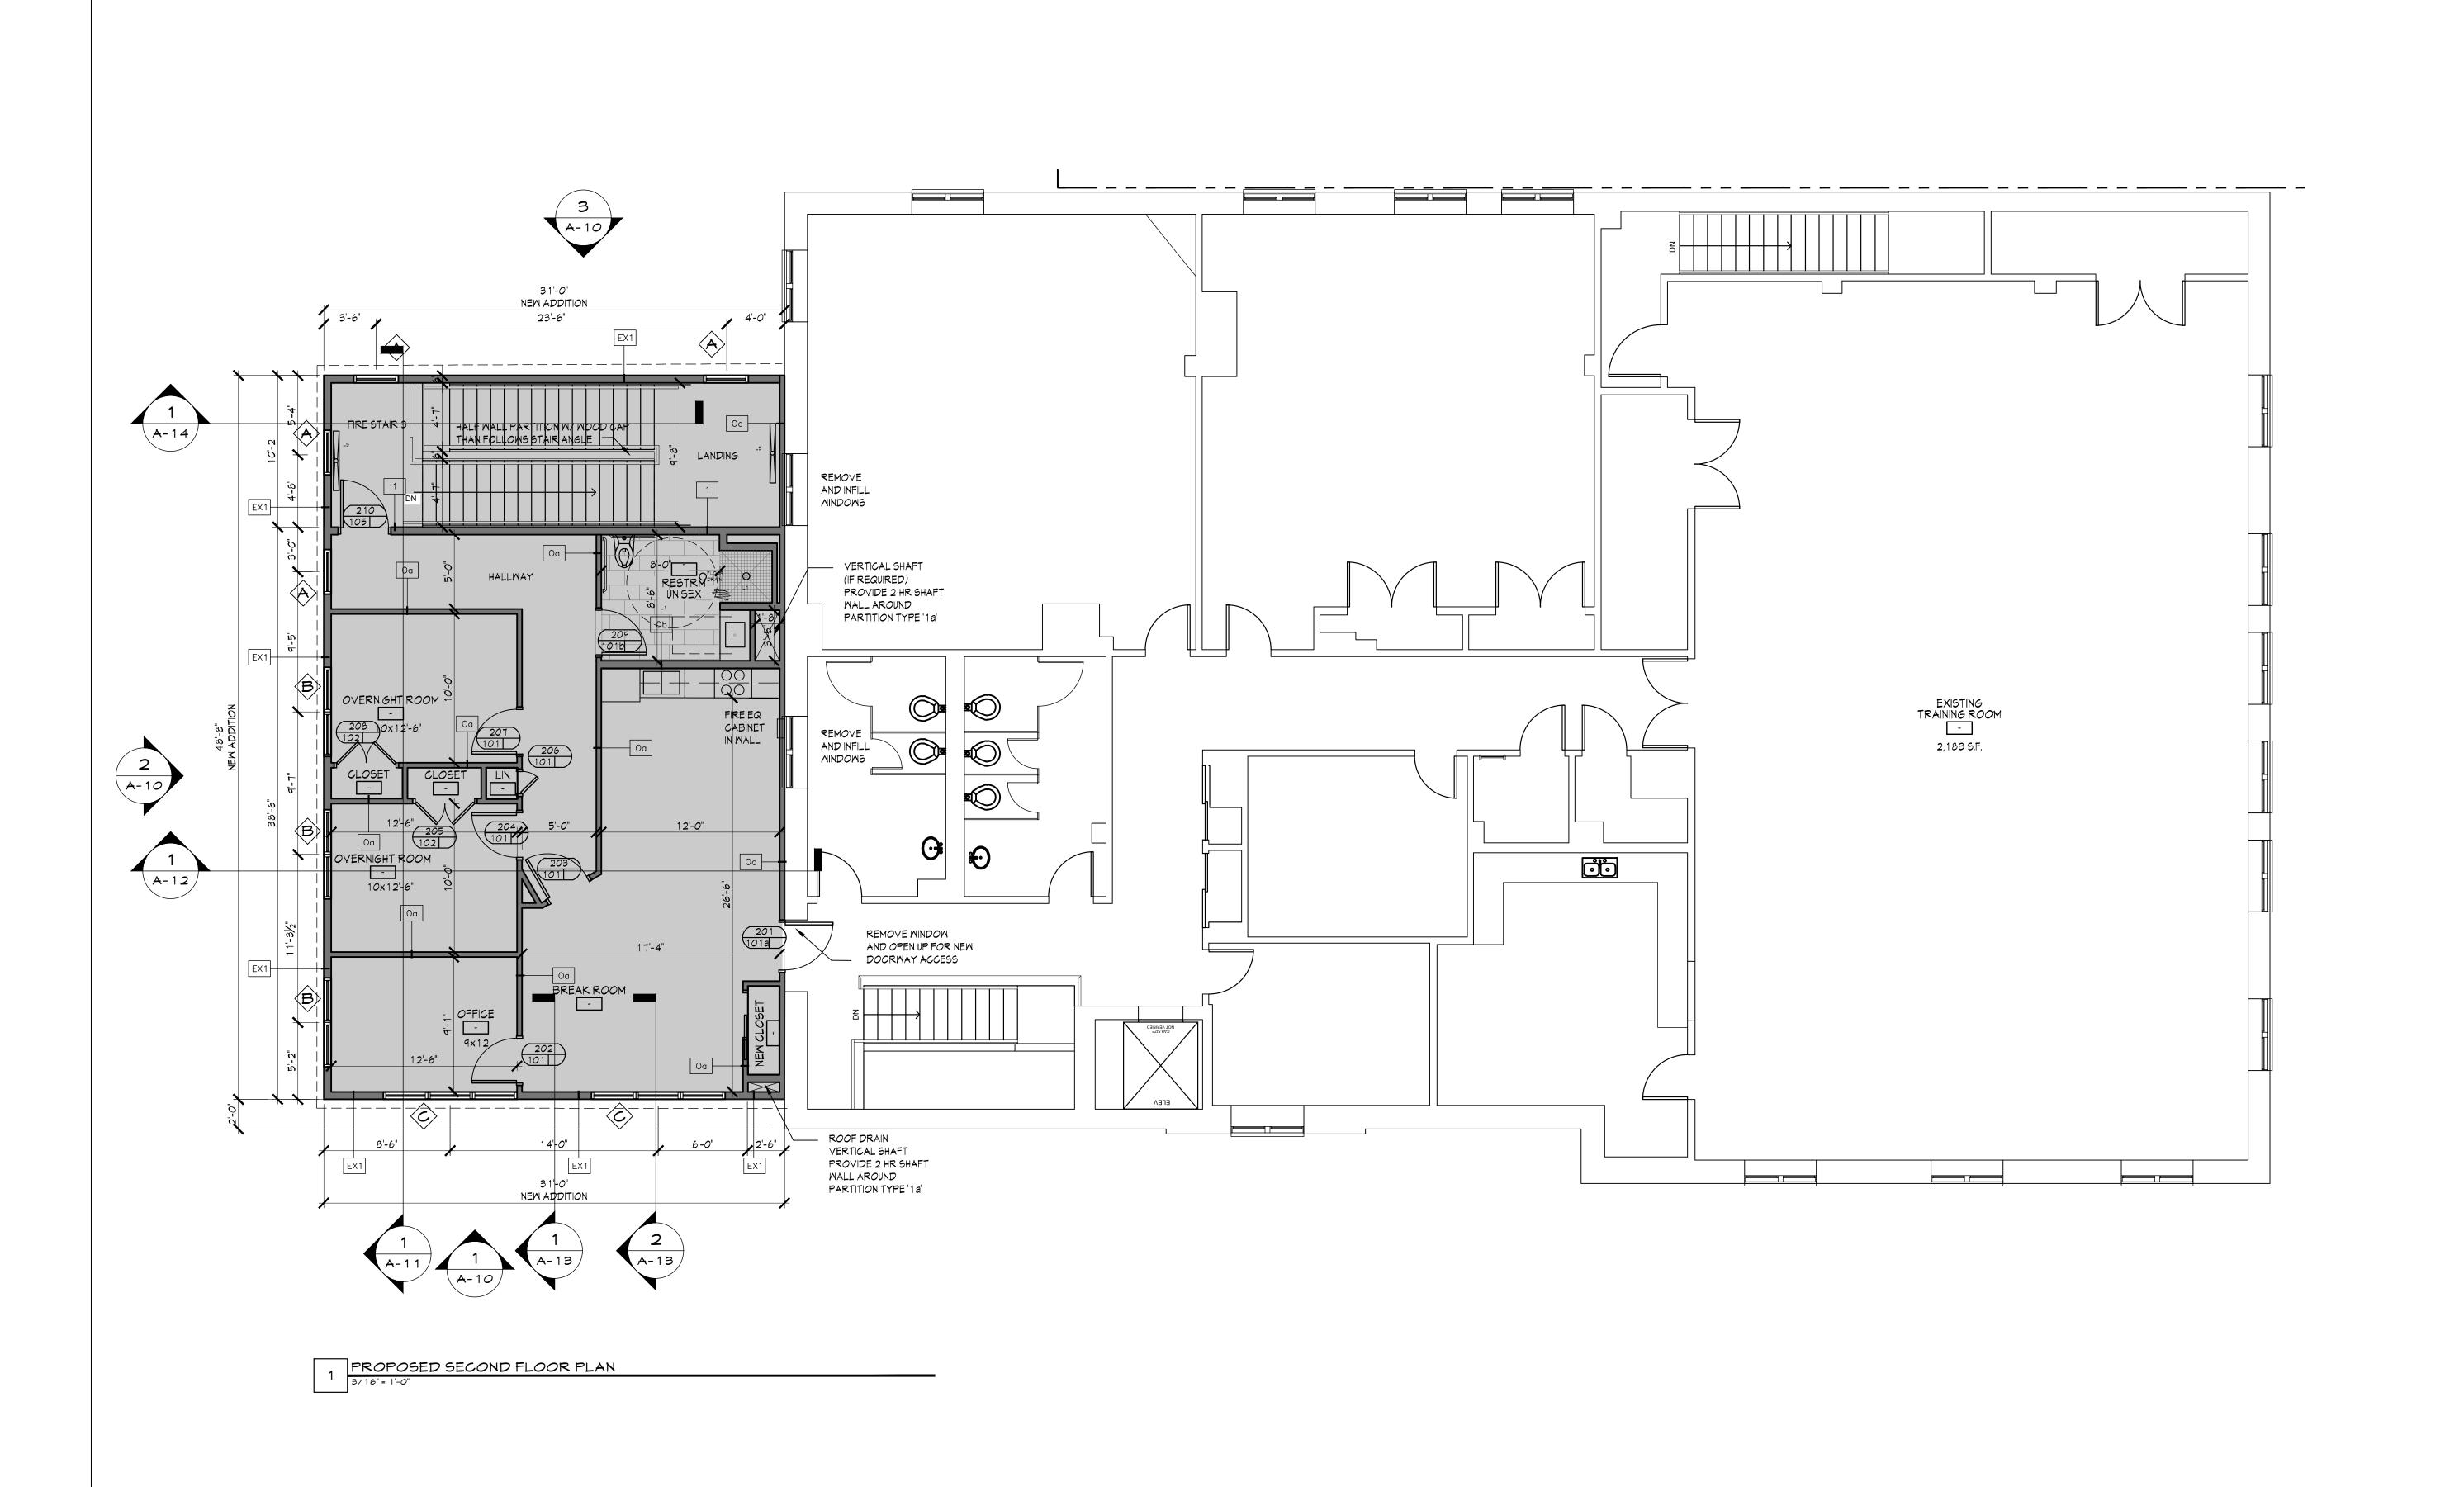
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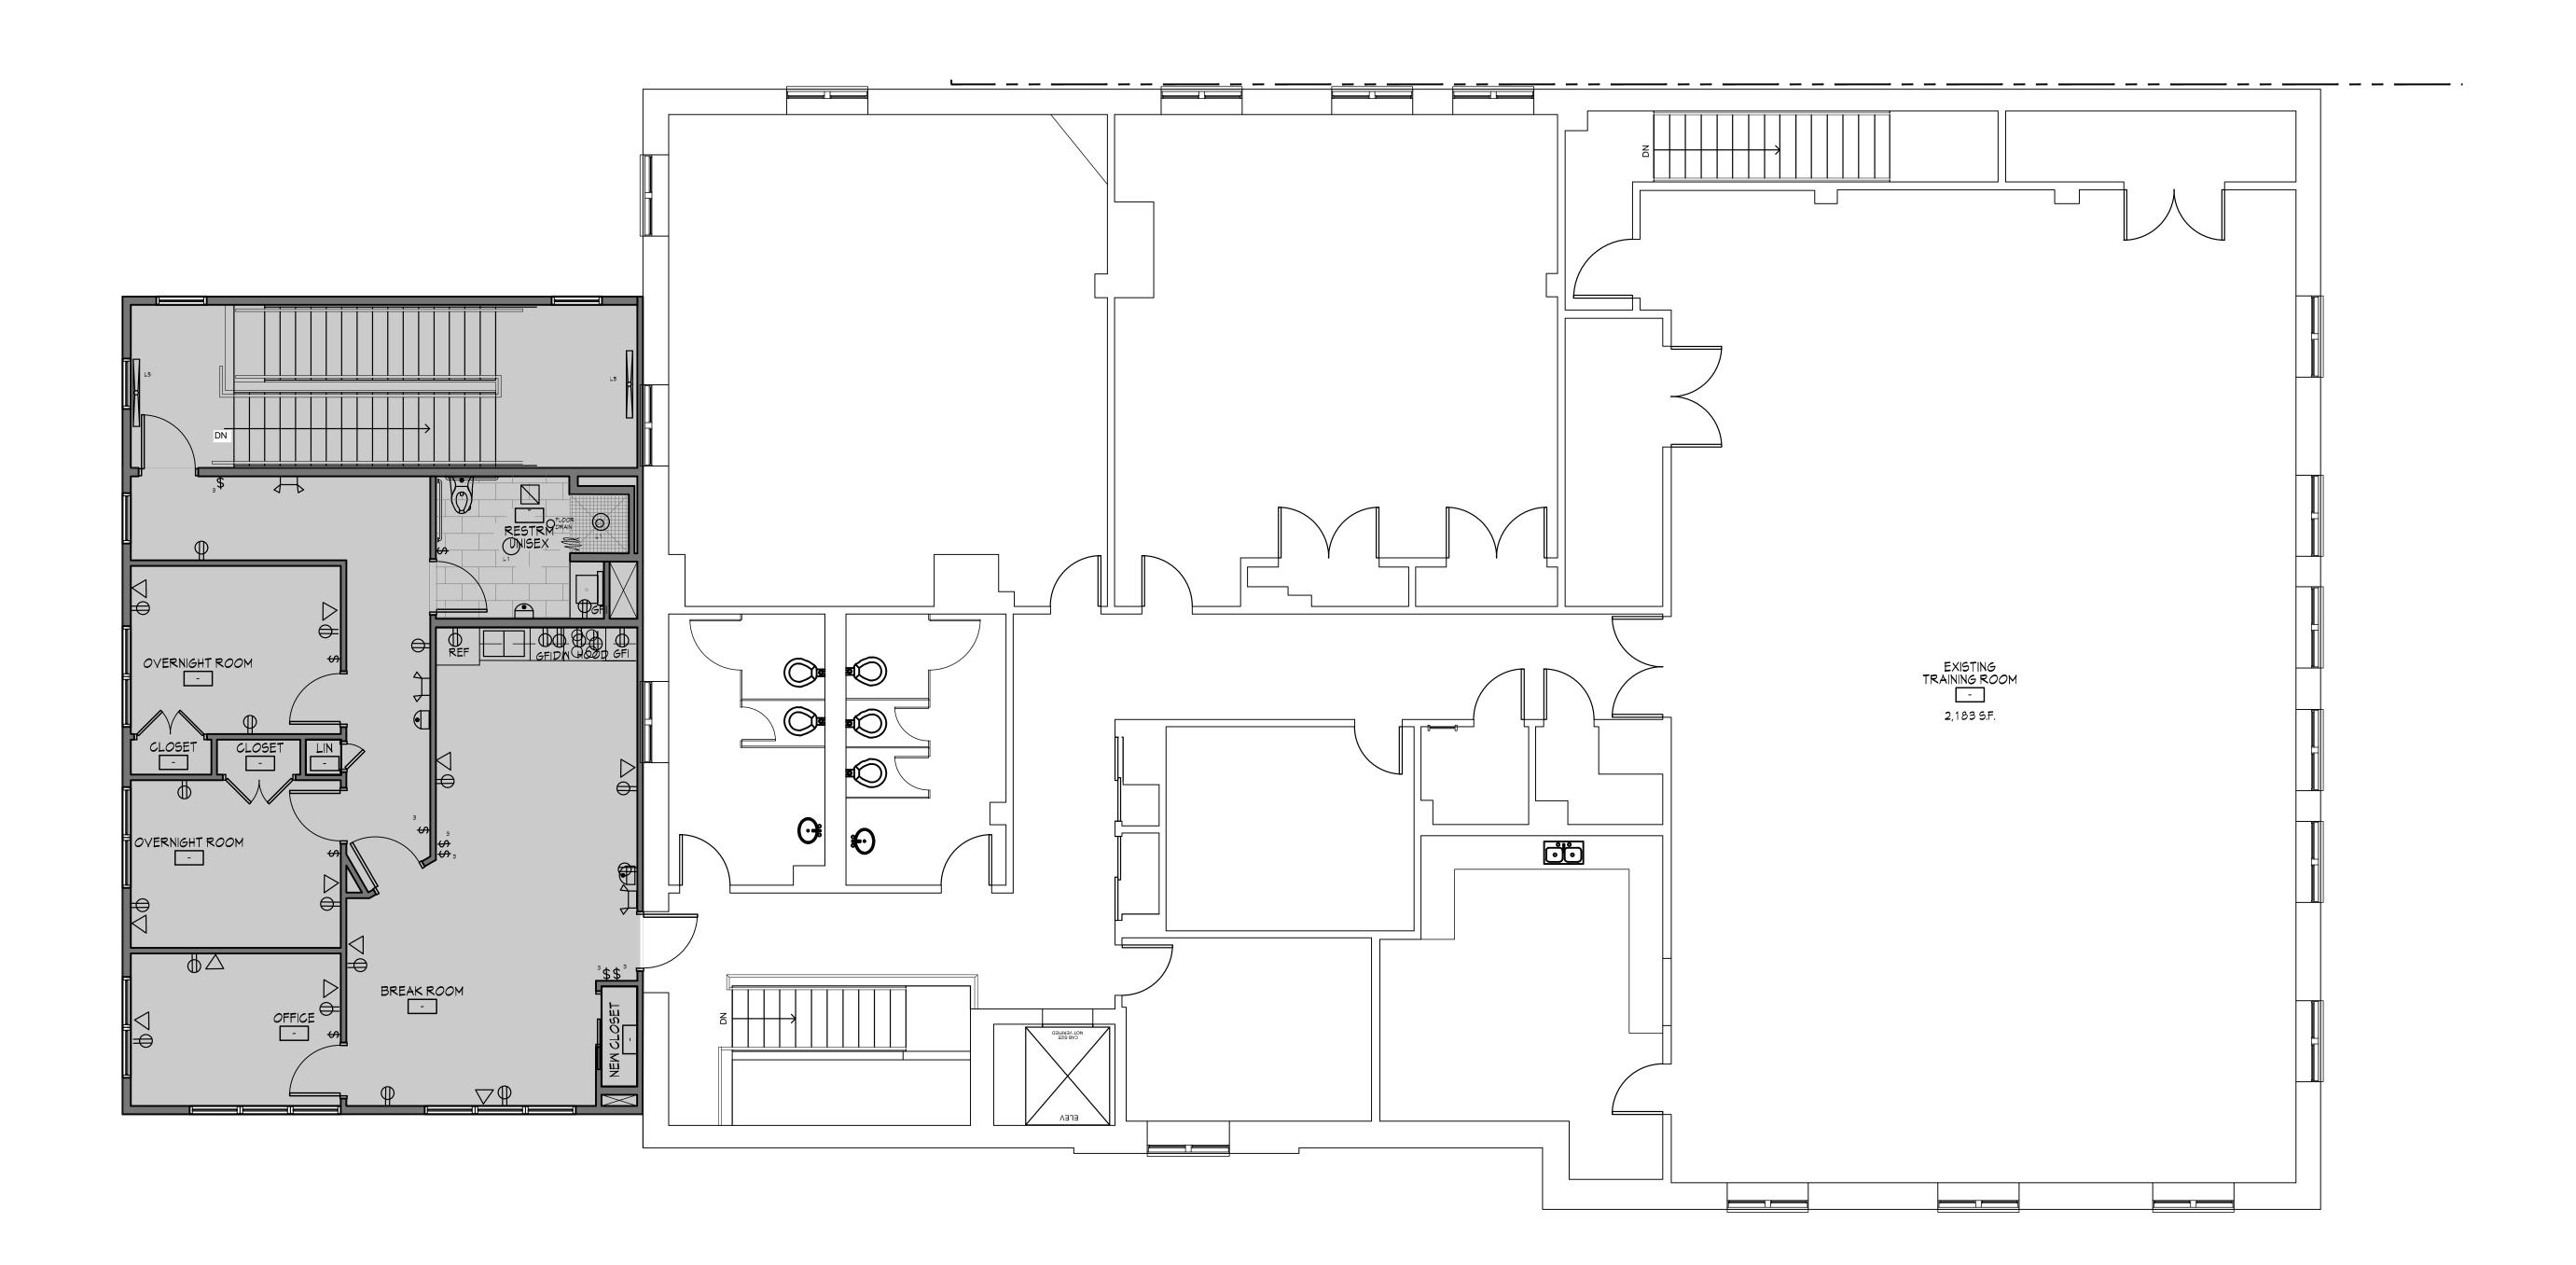
## SECOND FLOOR PLAN

Project No.	202222
Date	7.21.2023
Scale	
Drawing by	KA

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A-6.0



1 PROPOSED SECOND FLOOR POWER/TELE/DATA PLAN

# Sullivan Architecture, P.C.

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30 Wayne Street Croton-On-Hudson New York 10520


#### Drawing Title

# SECOND FLOOR POWER TELE DATA

Project No.	202222	
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Scale		
Drawing by	KA	

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# CEILING FINISH LEGEND

PAINTED GMB AS NOTED ON FINSIH SCHEDULE FLAT CEILING

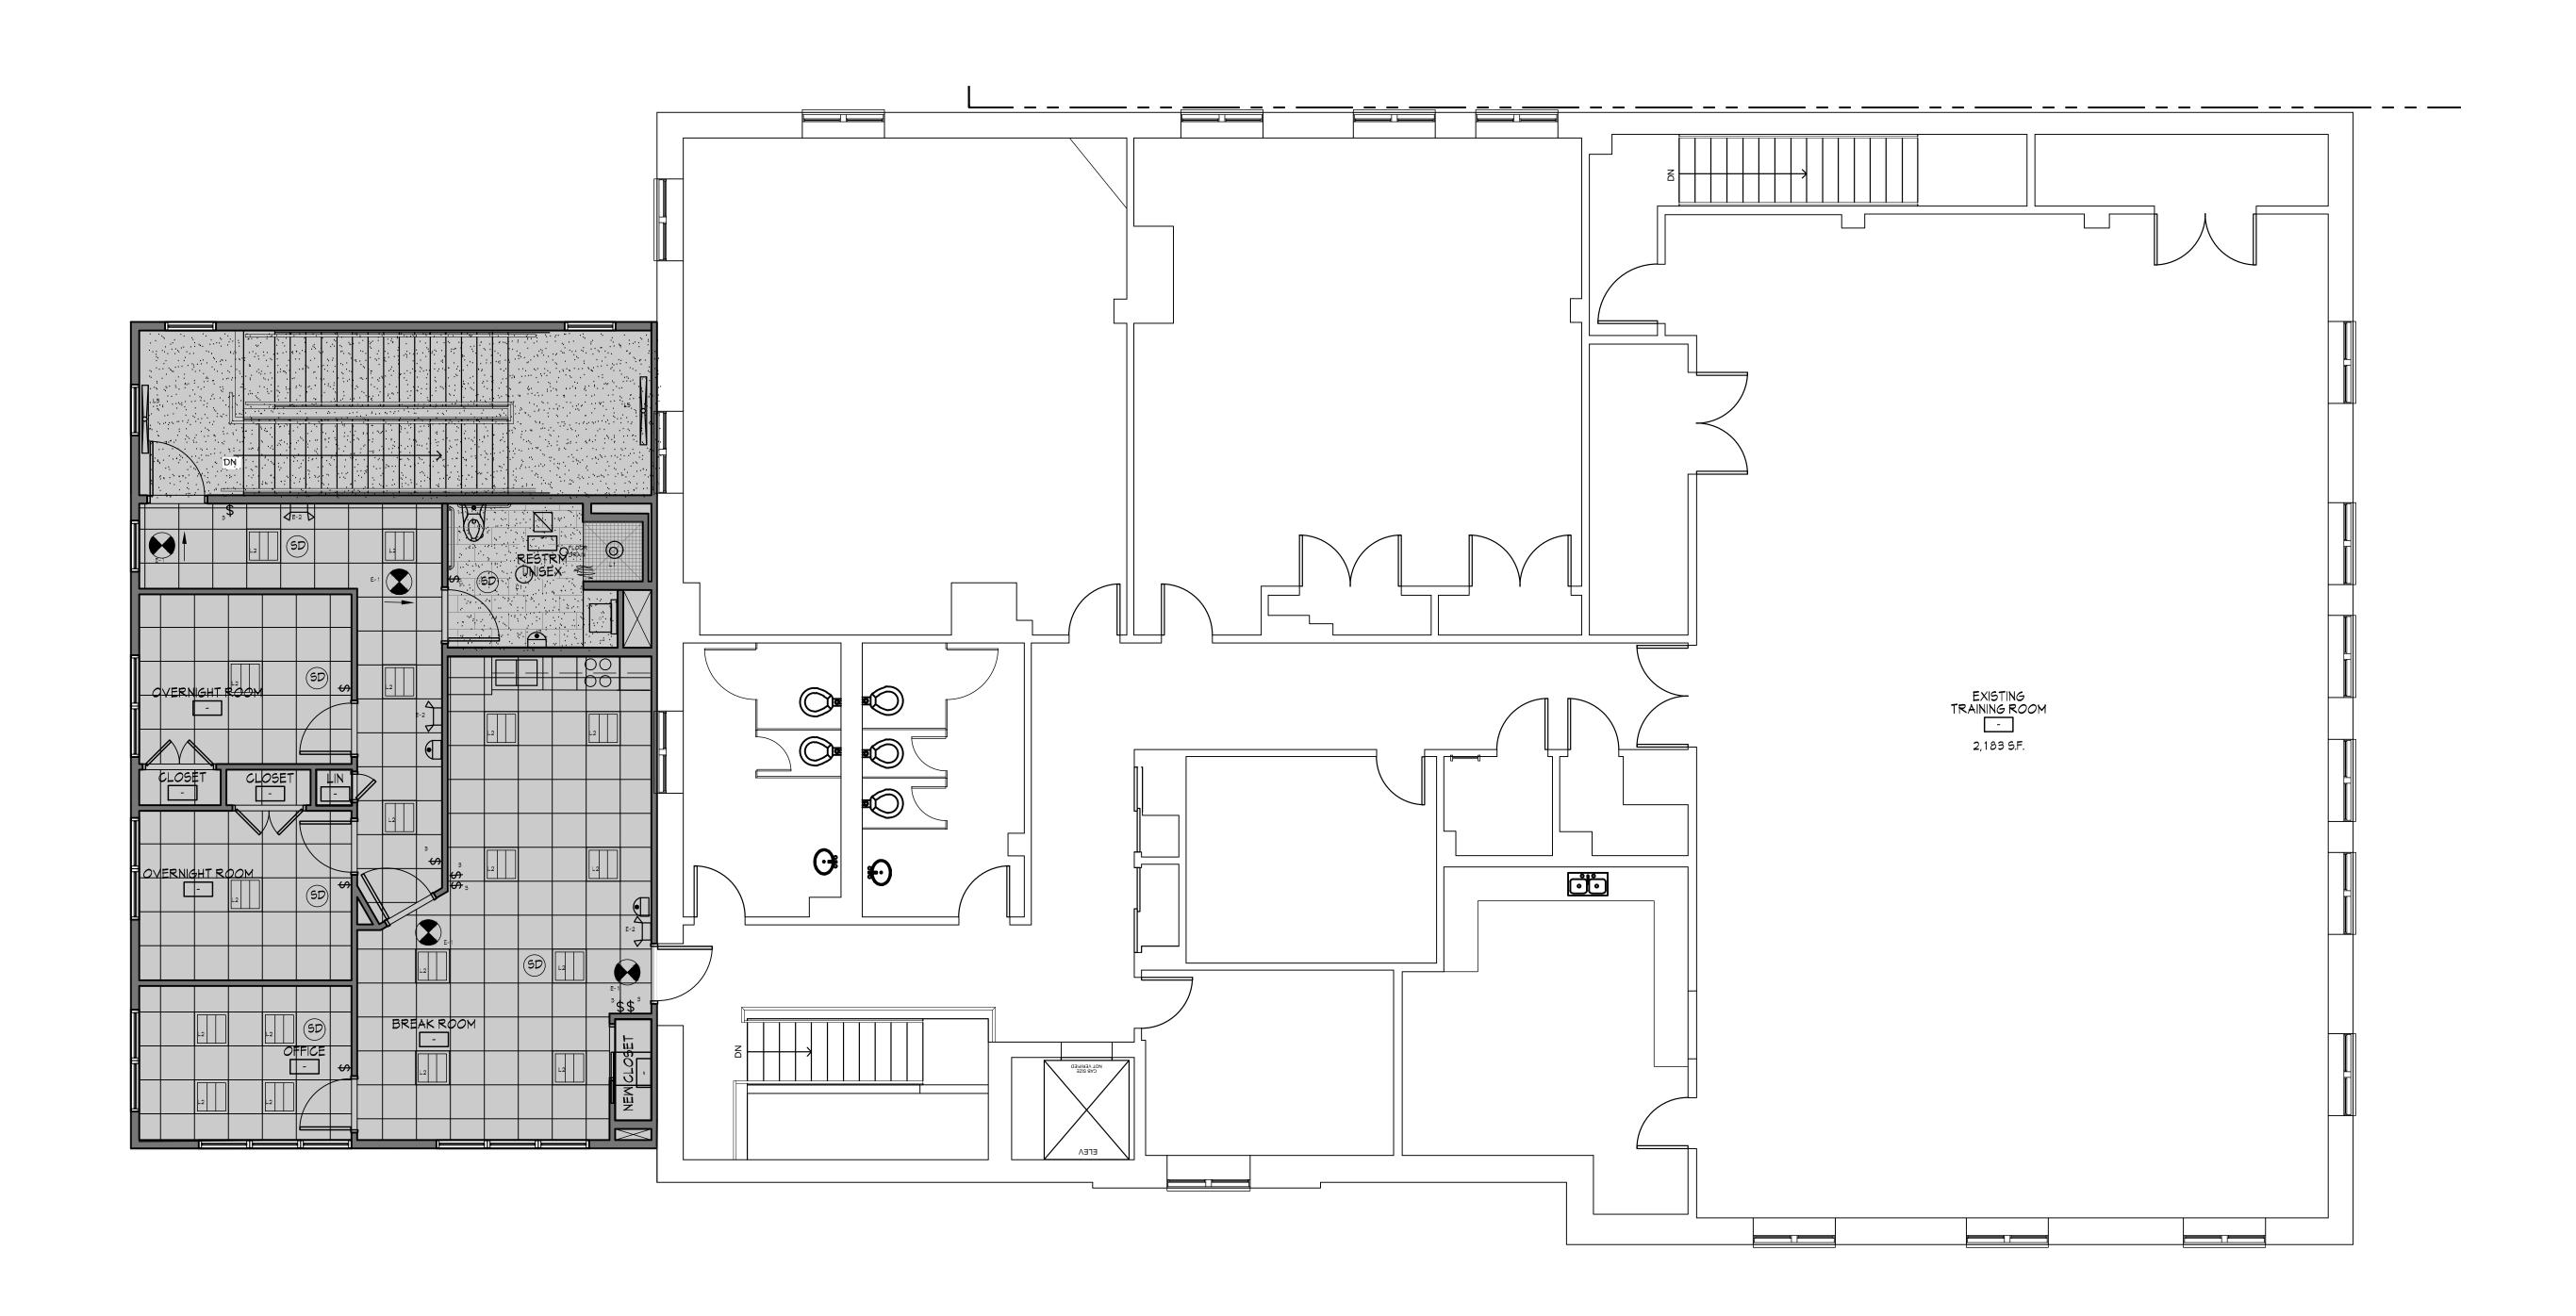ACOUSTICAL GRID AND TILE AS NOTED ON FINSIH SCHEDULE FLAT CEILING

- LIGHTING TO BE WORKED OUT AS SHOWN IN FIELD AND COORDINATED WITH LIGHTING DOCUMENTS BY OTHERS
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	L2	DAY-BRITE RECESSED EVO GRID 2X2	2EVG30L835 - 2 - D - UNV - DIM	DAY-BRITE	
	L3 CL <i>O</i> SET	DAY-BRITE INDUSTRIAL 4FL LINEAR	F5X-4-4000-835-UNY-BLANK	DAY-BRITE	
	L4 BAYS	DAY-BRITE INDUSTRIAL 4FL LINEAR	F9X-4-8000-835-UNV-BLANK	DAY-BRITE	
	L5 STAIRS	JAYLUM LED WALL MOUNTED SCONCE	JM - WL - 30L - 9 - 35 - 1D - UNV - STD-M-SUMA -4	CORELITE	
	L6	MAXIM - SPEC VANITY	52000 - POLISHED CHROME	MAXIM	
	L7	MAXIM - PATHFINDER	52120PHC - BLACK FINISH	MAXIM	
$\Box$	L8	MAXIM - LIGHTHOUSE	5866CLFTAR - BLACK FINISH W/ ACESSORY PHOTOCELL	MAXIM	CONTRACTOR TO PROVIDE COMPLIANT LED GREEN BULBS
<b>*</b>	E-1	COOPER - SURE-LITES LPX SERIES	LPX 6 (MALL MOUNT)	COOPER	REFER TO RCP FOR DIRECTION CHEVRONS
$\Box$	E-2	COOPER - SURE-LITES	AP25QLED30 EMERGENCY LIGHT	GOOPER	

PROPOSED SECOND FLOOR RCP PLAN

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Project Title

# Croton-on-Hudson Harmon Firehouse Station #3 & EMS

30 Wayne Street Croton-On-Hudson New York 10520


Drawing Title

SECOND FLOOR RCP PLAN

Project No.	202222
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Drawing by	KA

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Project Title

# Croton-on-Hudson Harmon Firehouse Station #3 & EMS

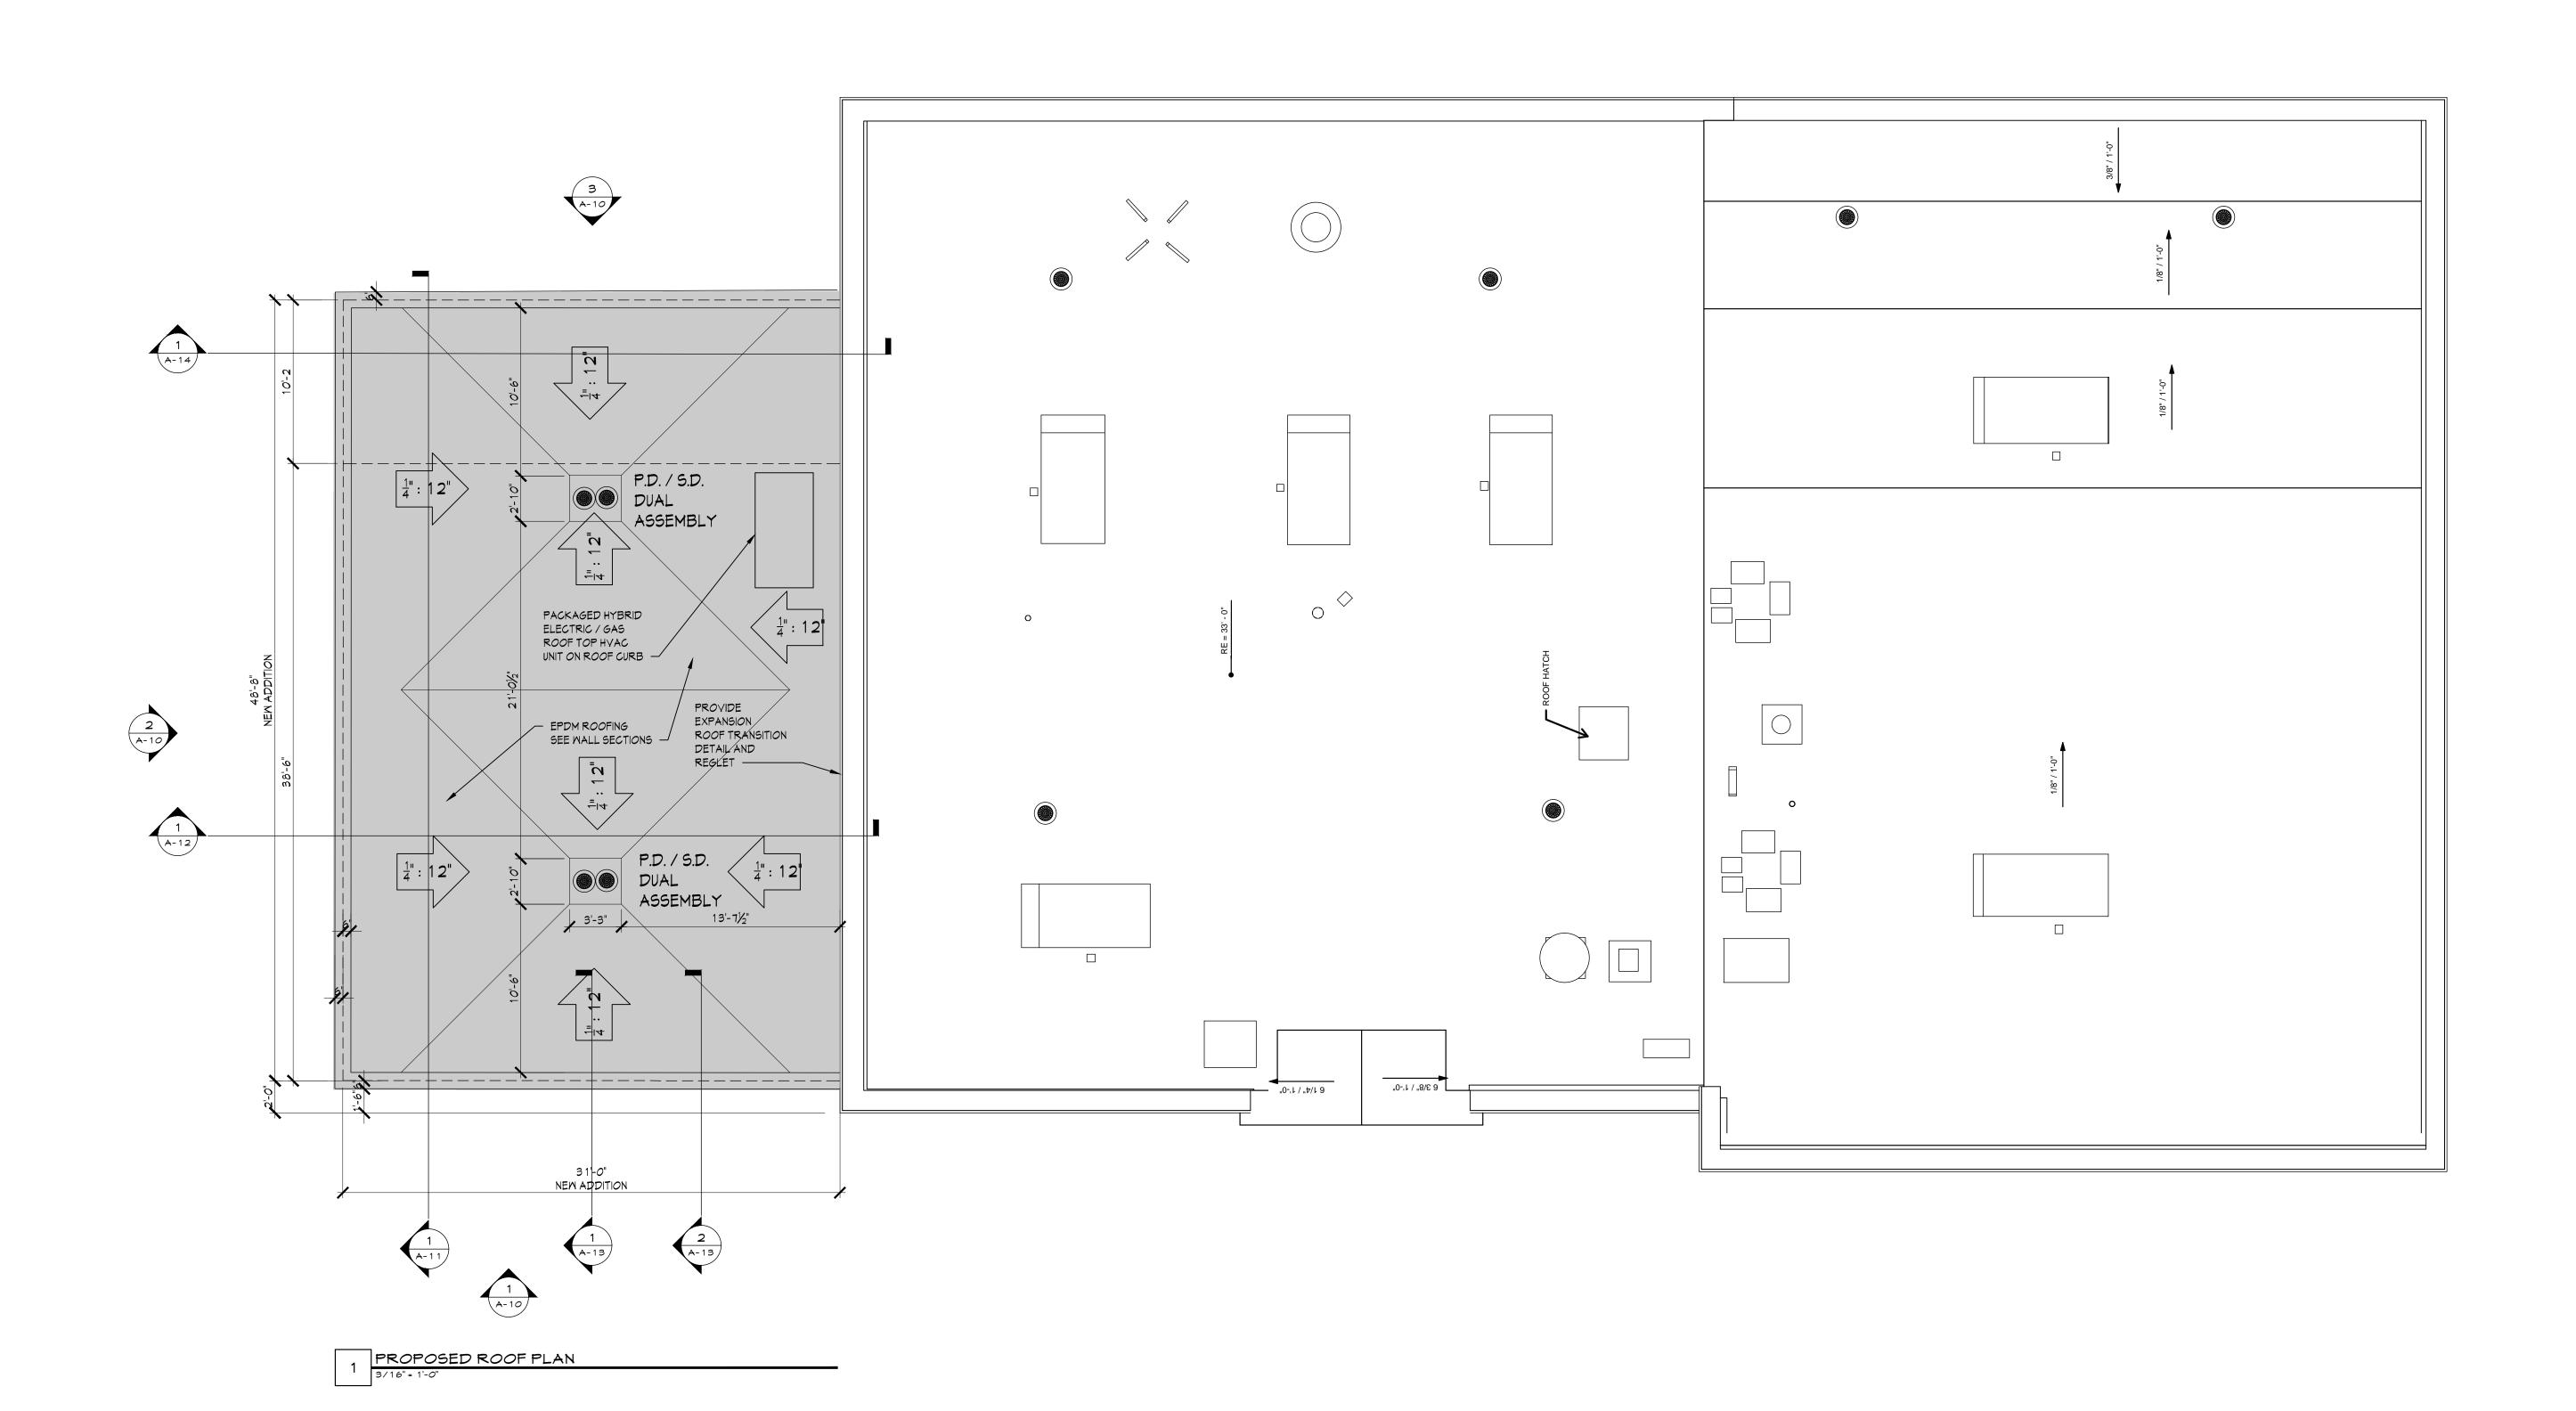30 Wayne Street Croton-On-Hudson New York 10520


Drawing Title

ROOF PLAN


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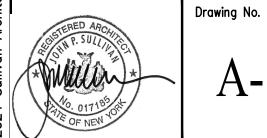
30 Wayne Street Croton-On-Hudson New York 10520


Drawing Title


ELEVATIONS
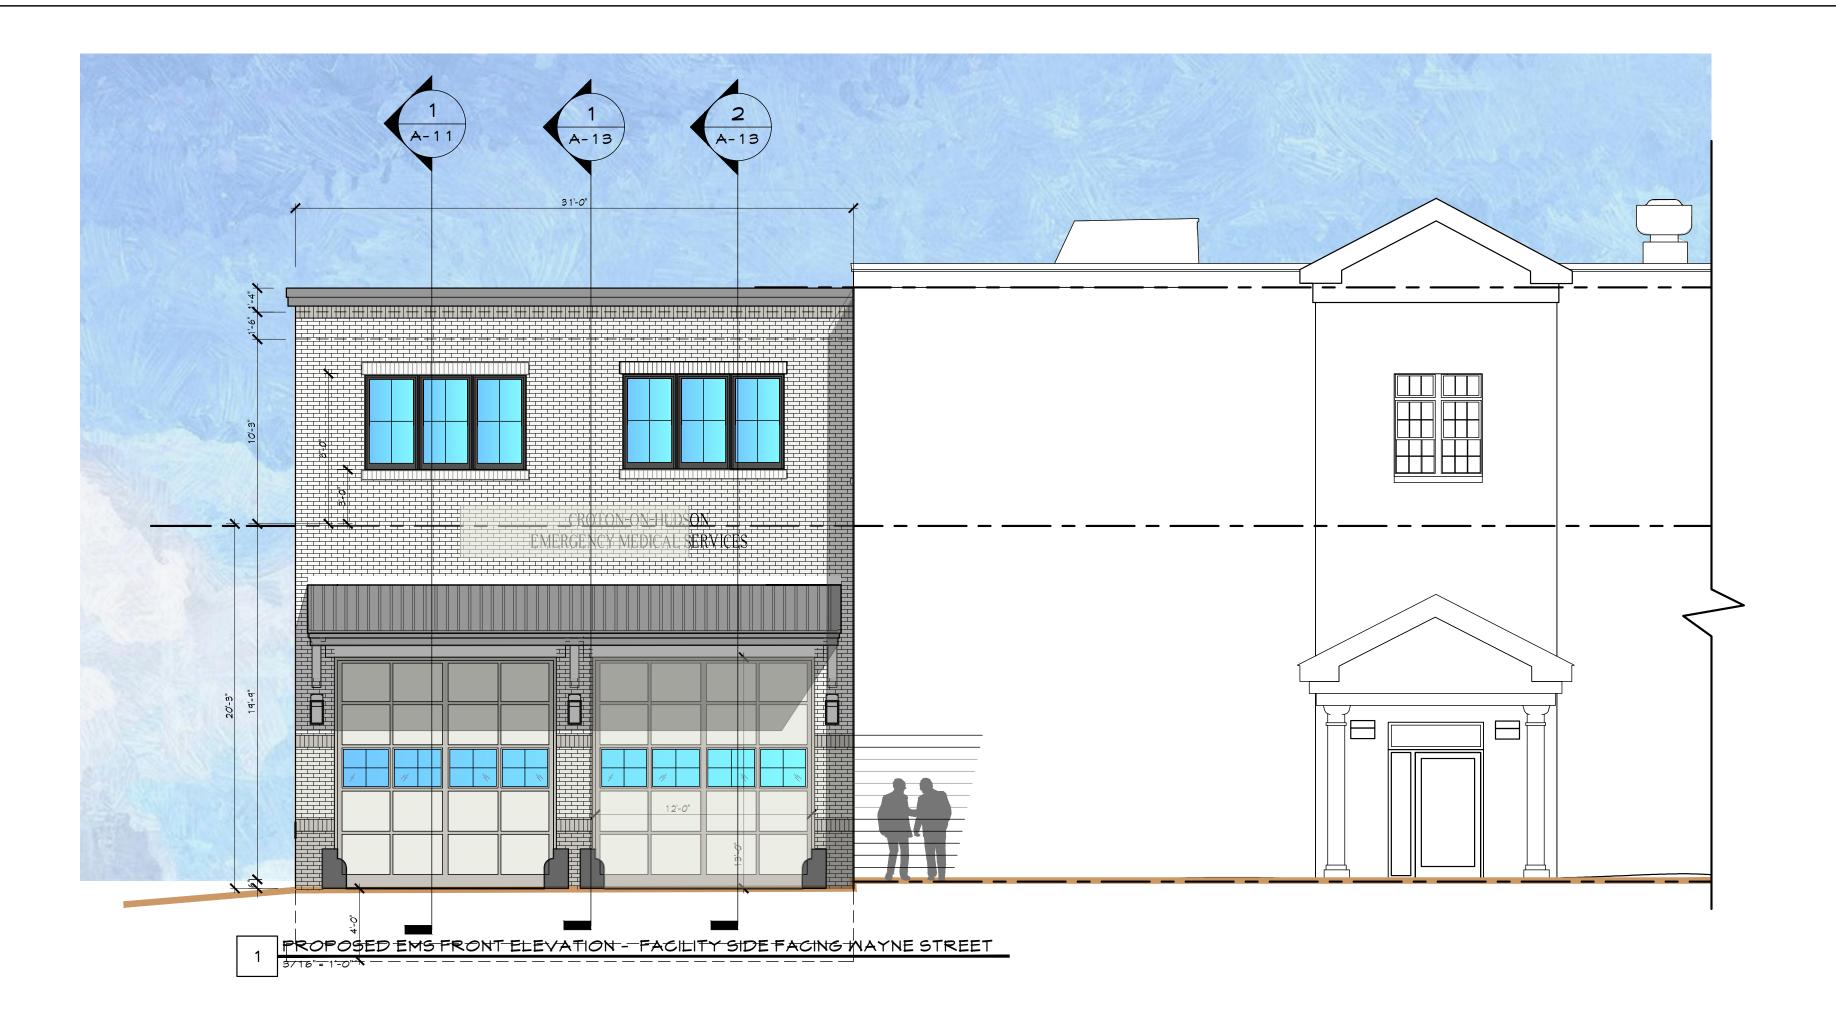
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Drawing Title


## BUILDING SECTIONS
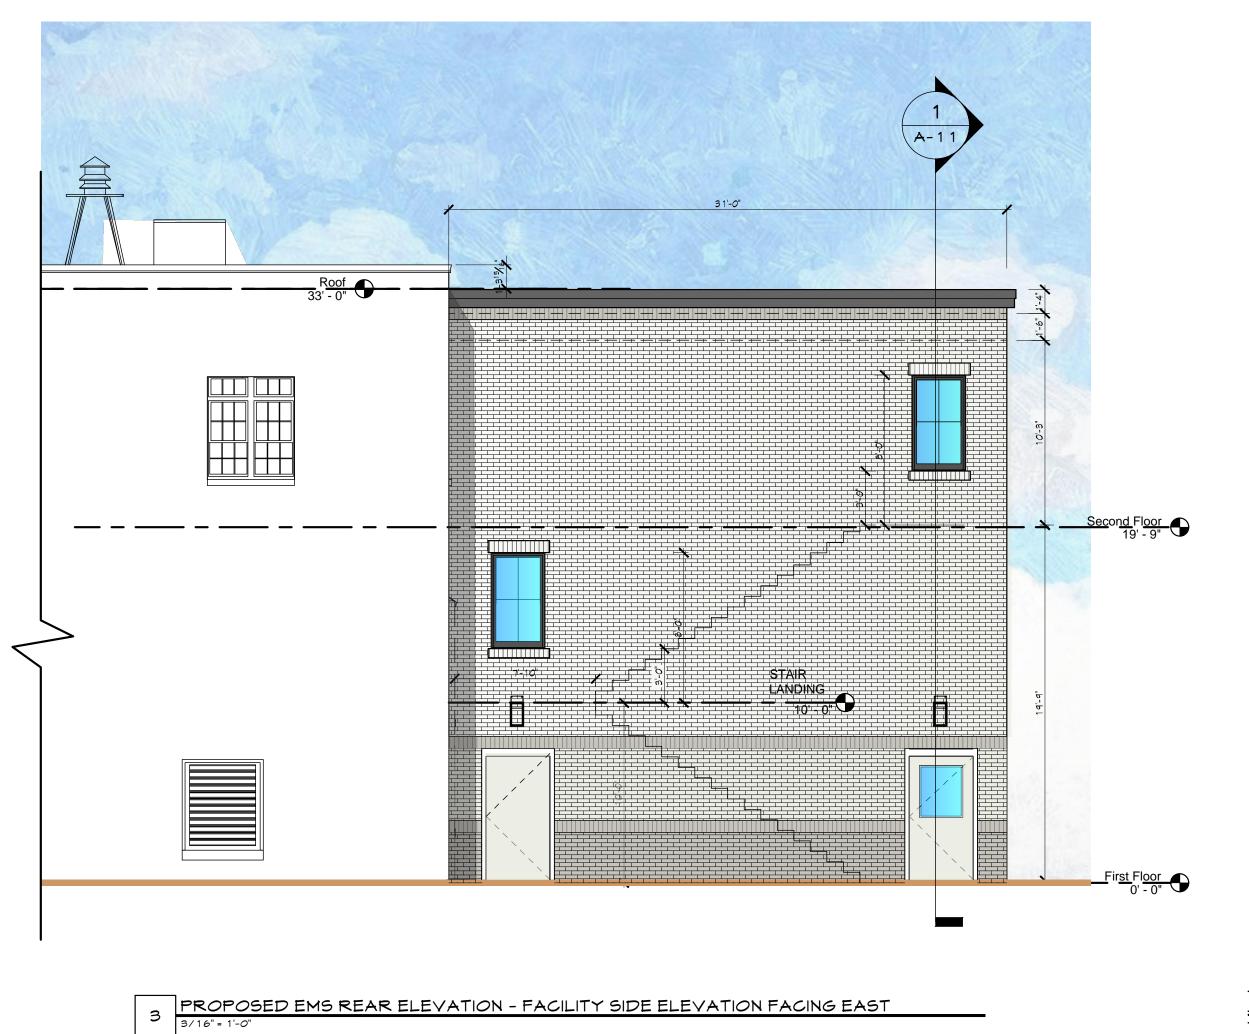
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Scale	
Drawing by	KA

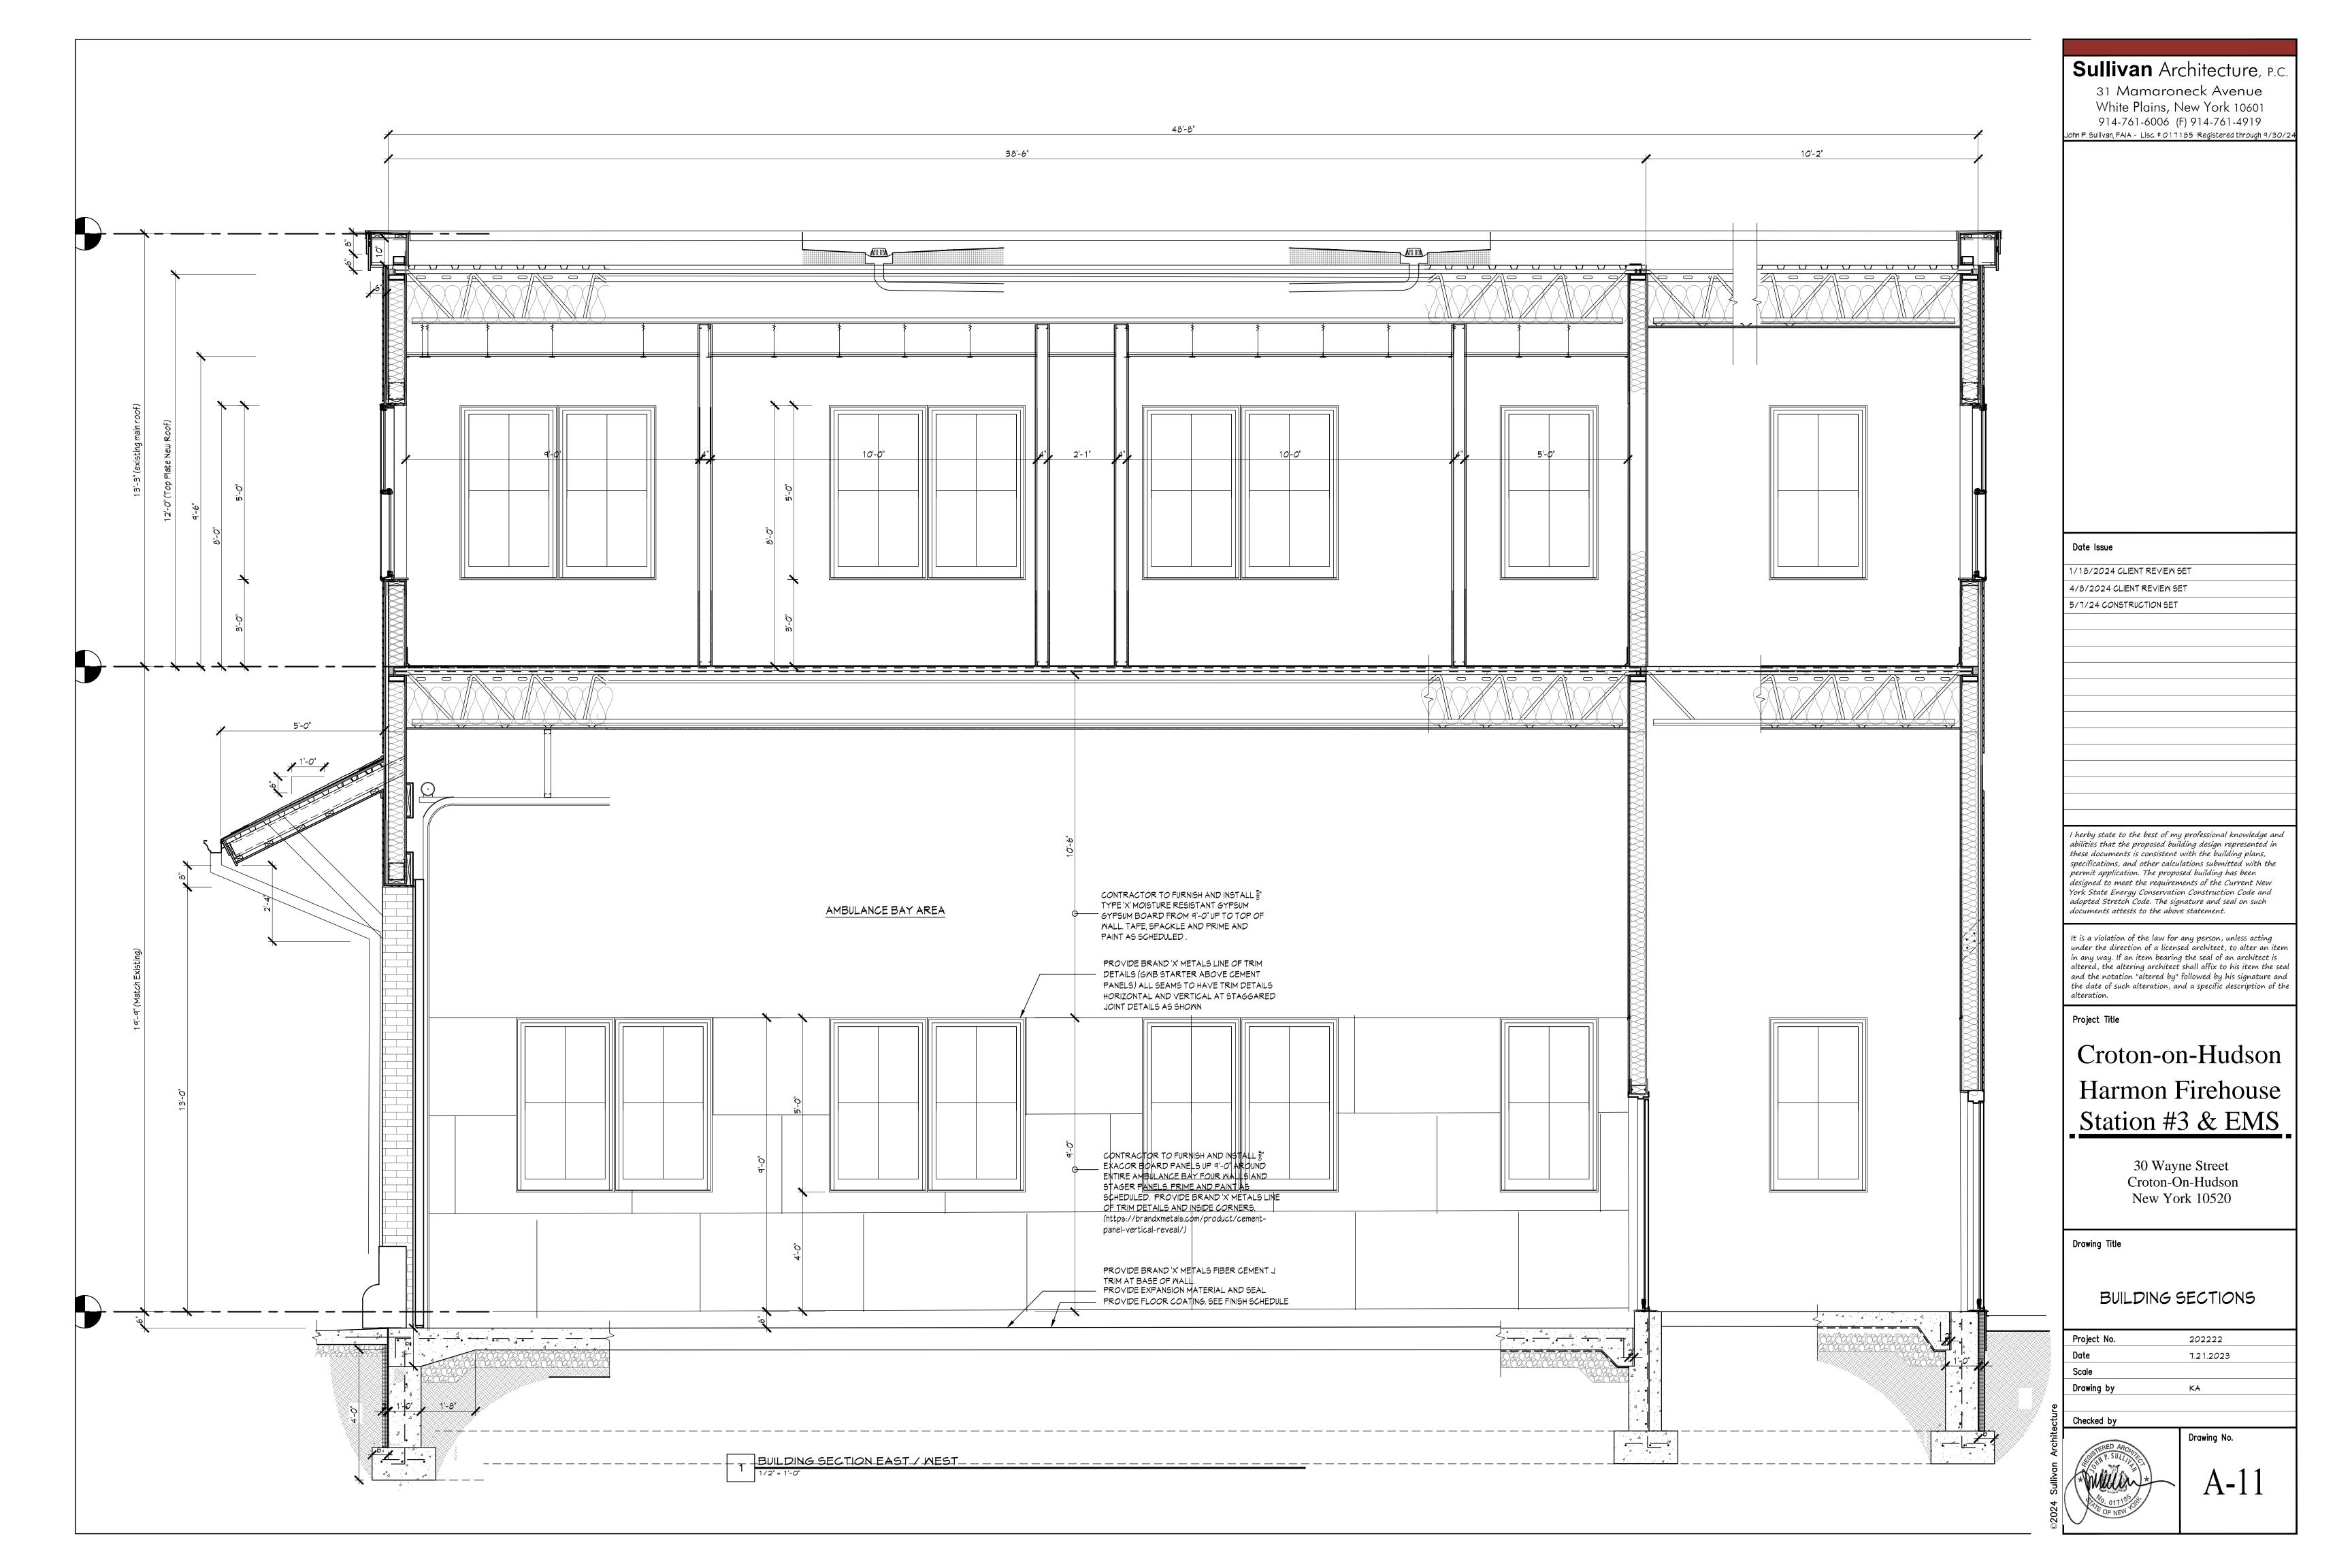Checked by

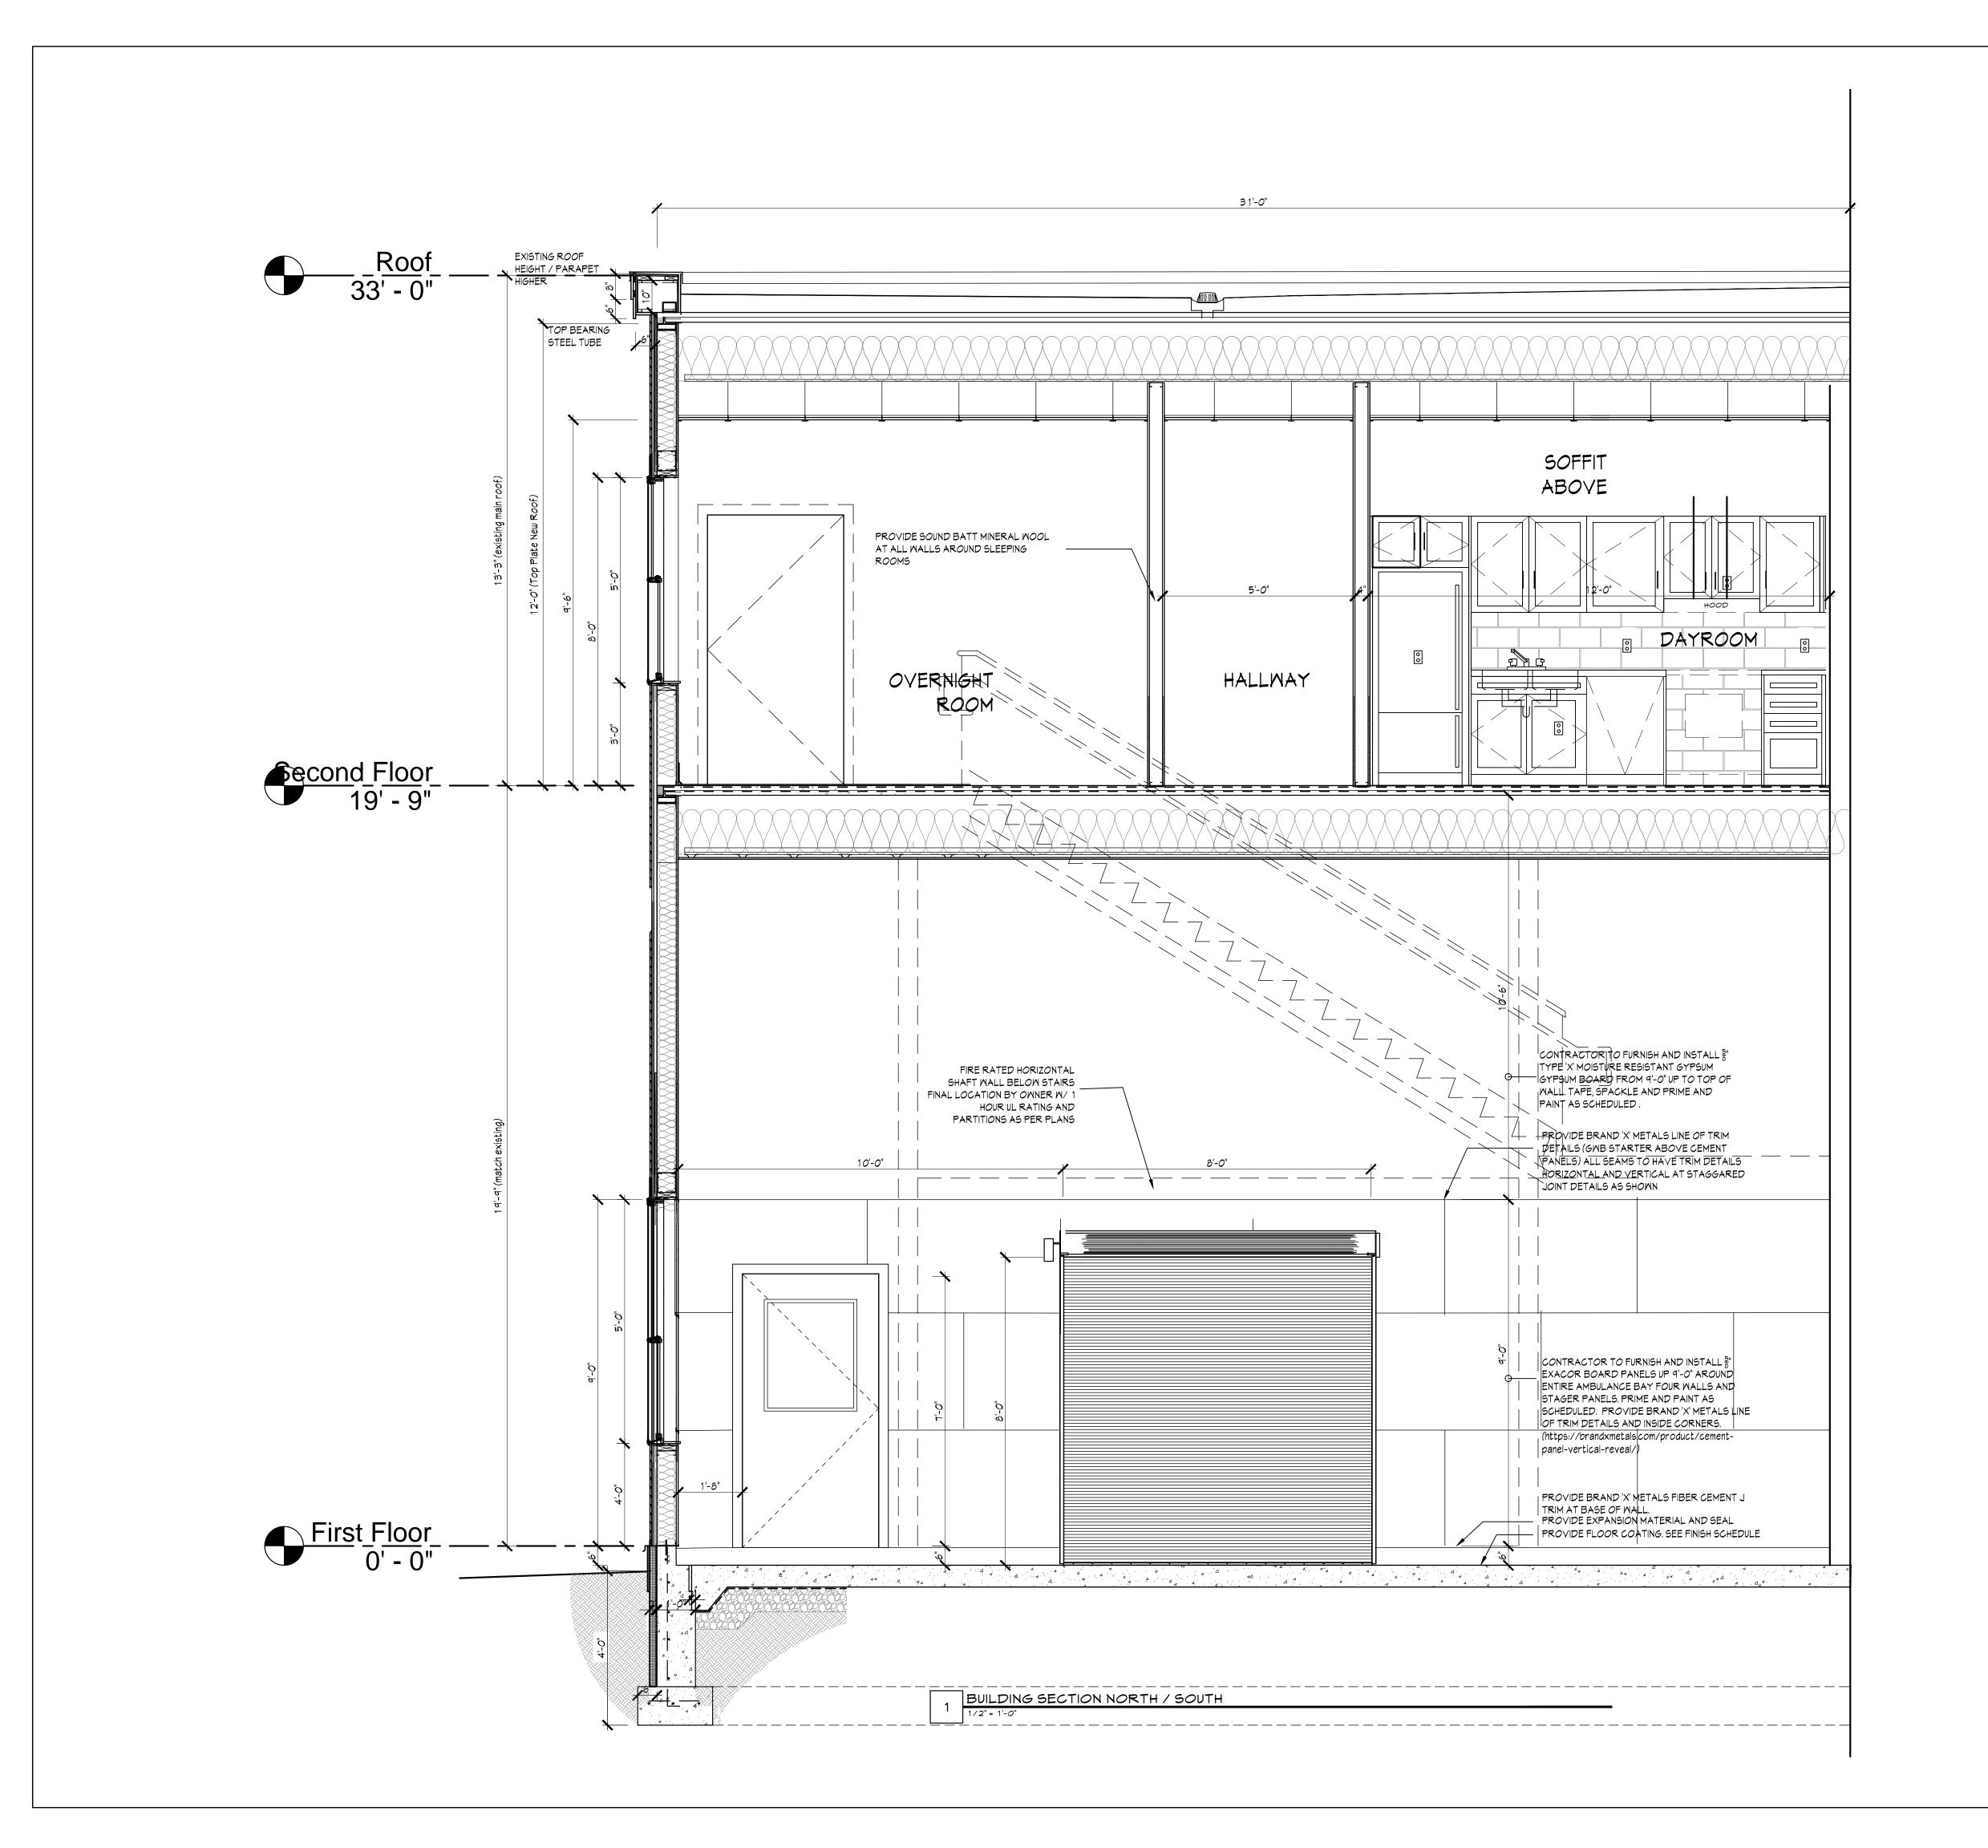

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31 Mamaroneck Avenue
White Plains, New York 10601
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Project Title

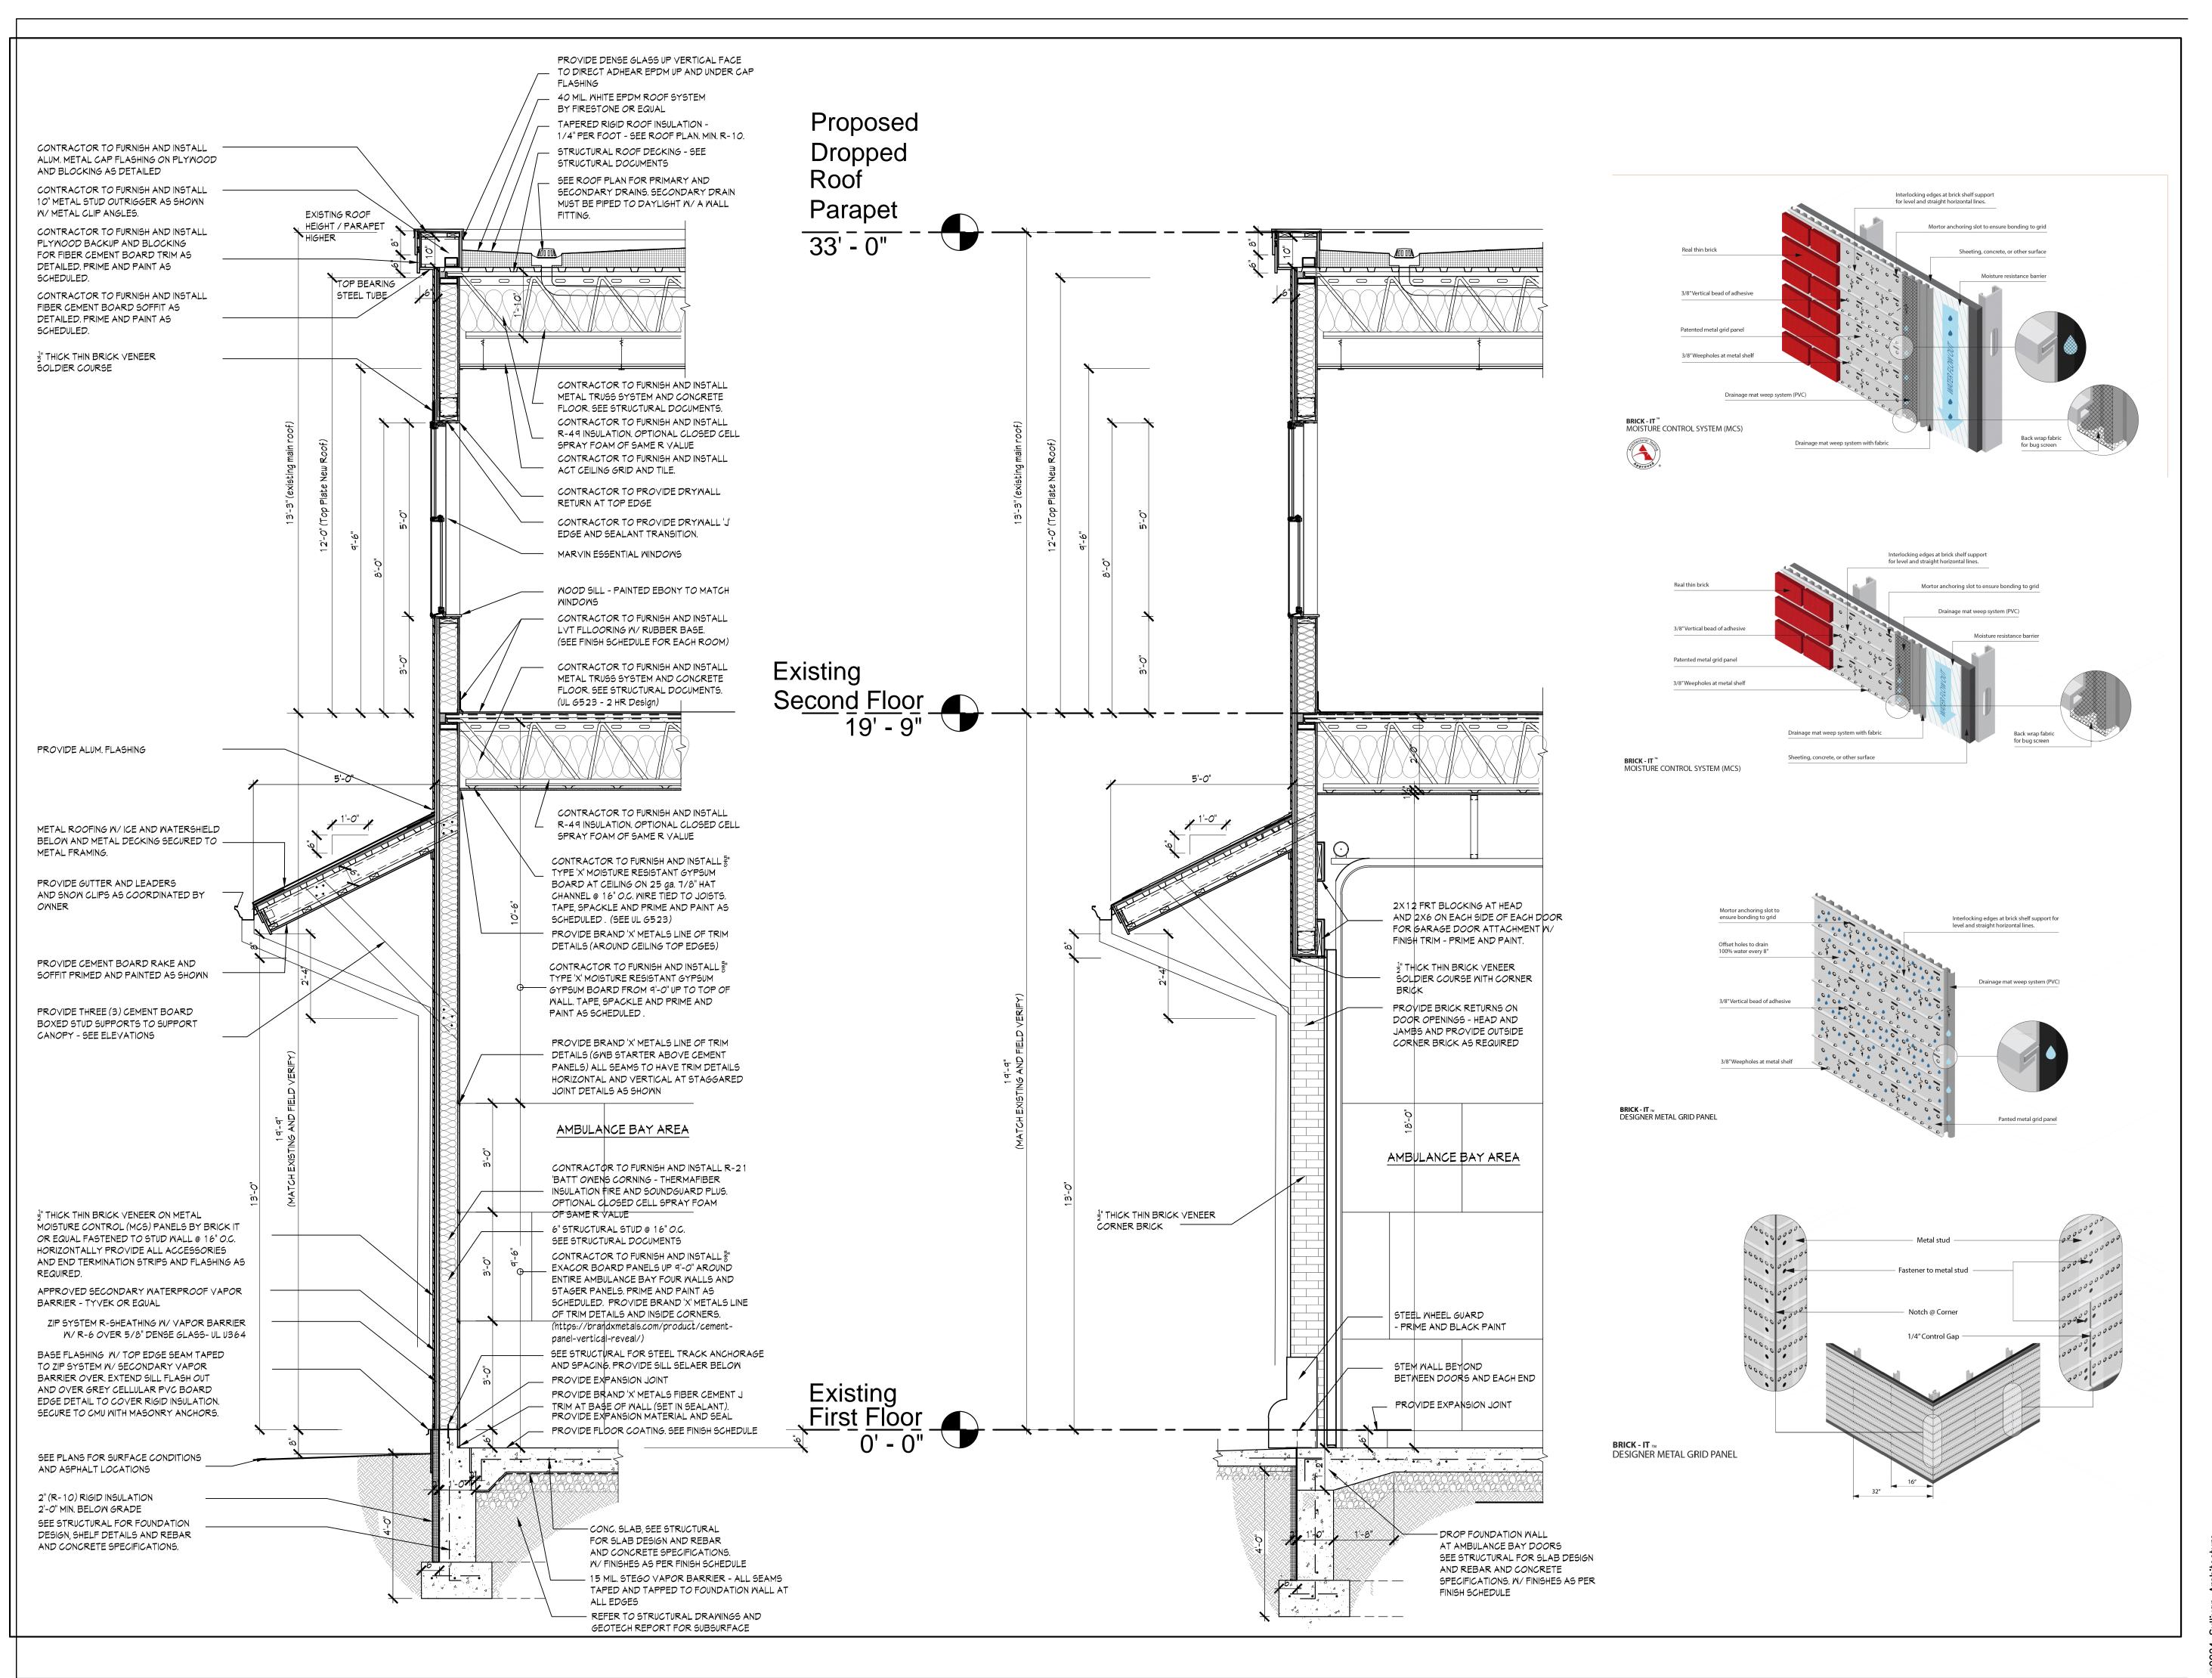Date Issue

/18/2024 CLIENT REVIEW SET

4/8/2024 CLIENT REVIEW SET

5/7/24 CONSTRUCTION SET

# Croton-on-Hudson Harmon Firehouse Station #3 & EMS

30 Wayne Street Croton-On-Hudson New York 10520


Drawing Title


WALL SECTIONS

	Project No.	202222
	Date Scale	7.21.2023
	Drawing by	KA
စ္		
	Checked by	
cnitecture	ERED ARO	Drawing No.



A-13

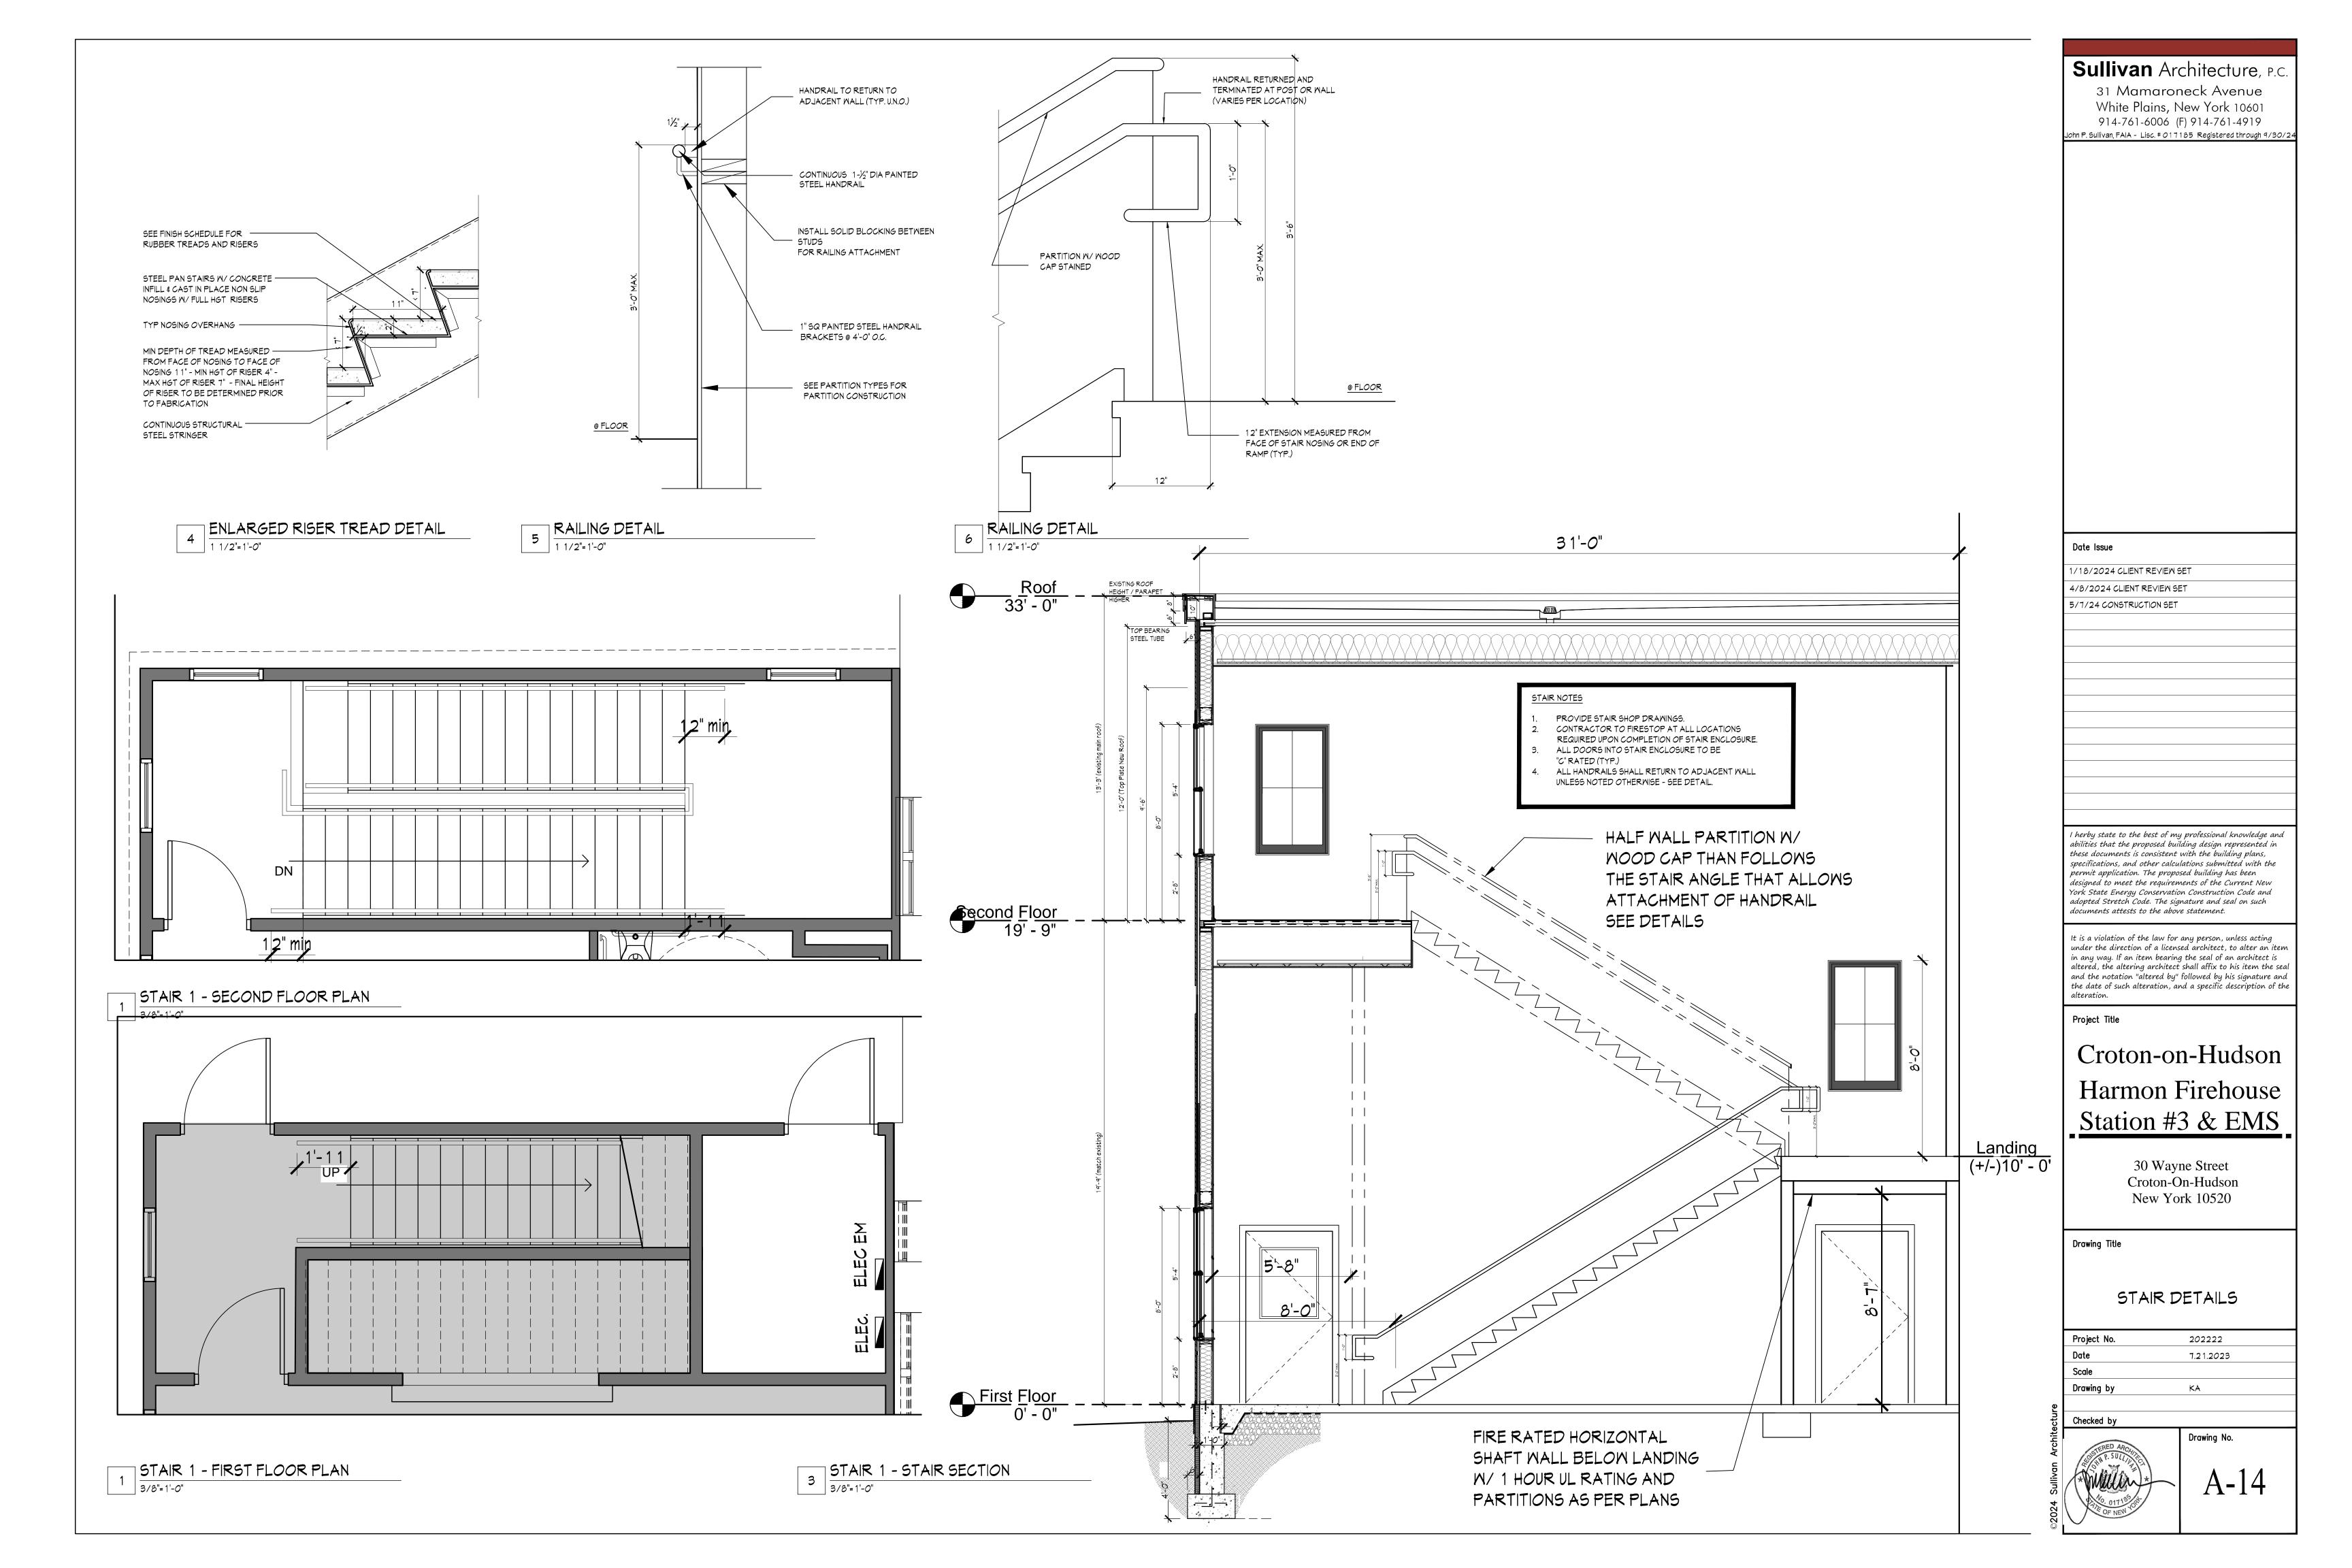

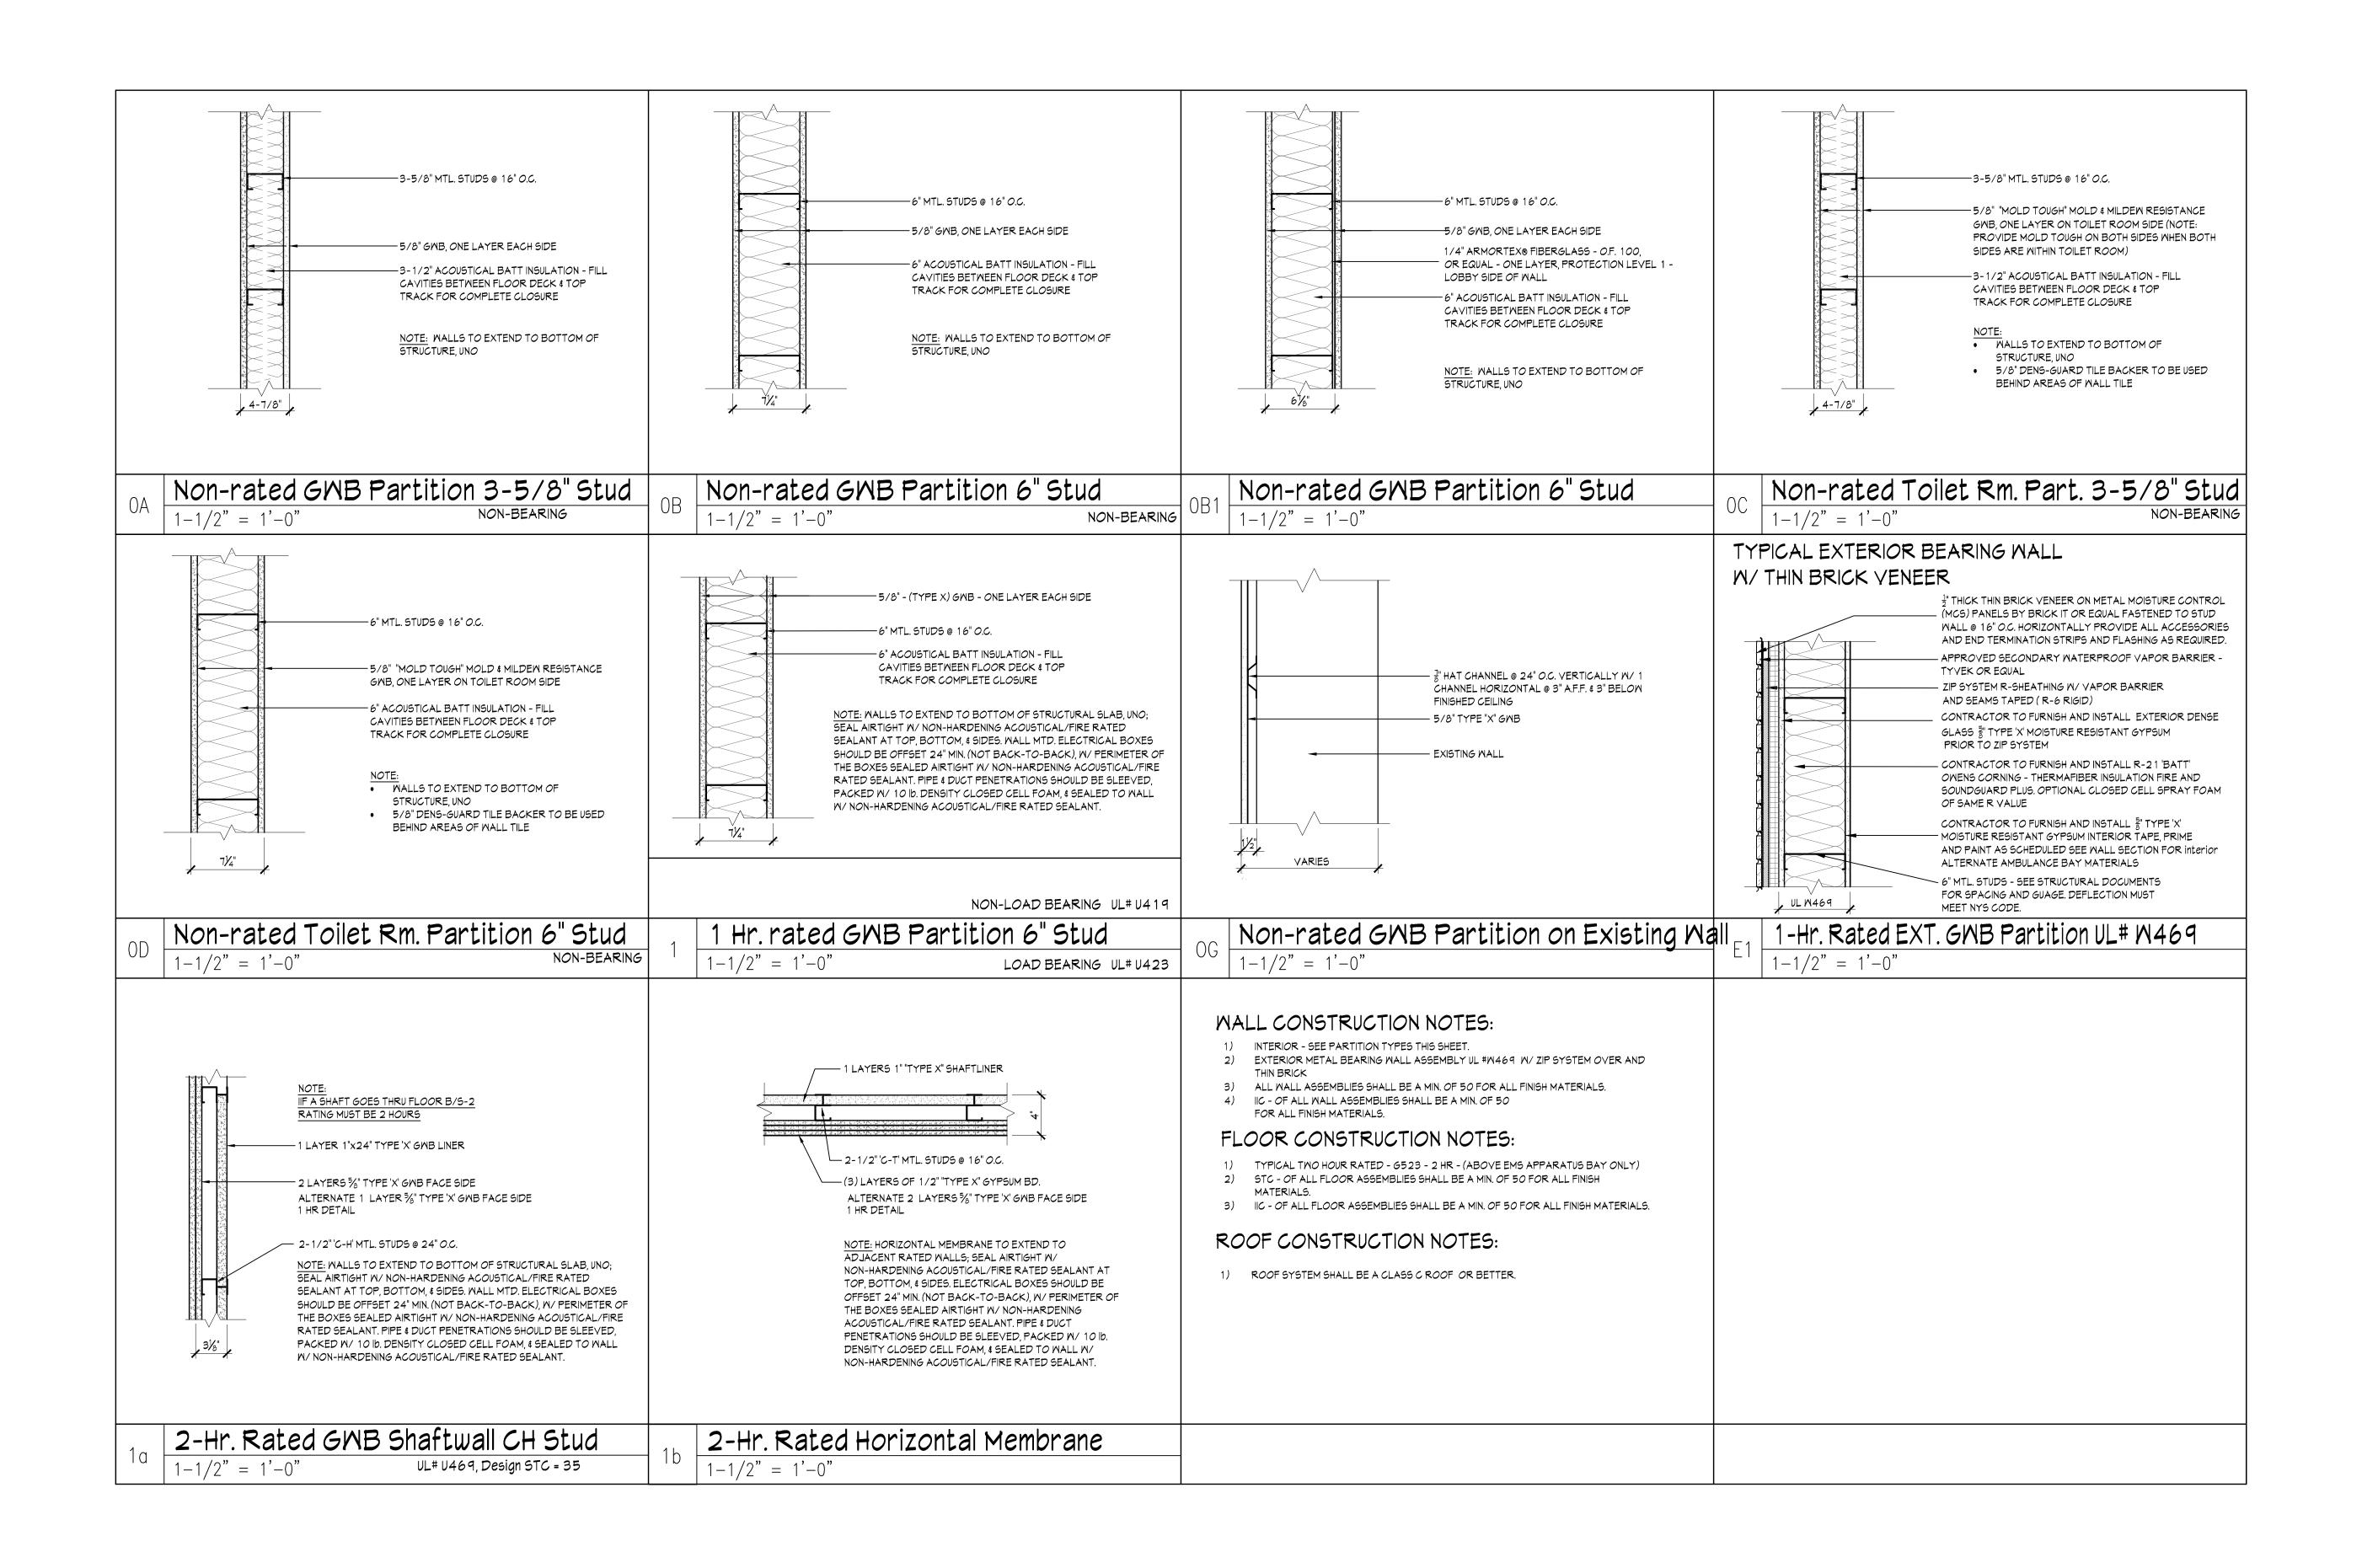

31 Mamaroneck Avenue
White Plains, New York 10601
914-761-6006 (F) 914-761-4919

an P. Sullivan, FAIA - Lisc. # 017185 Registered through 9/30/2

Date Issue	
1/18/2024 CLIENT REVIEW SET	
4/8/2024 CLIENT REVIEW SET	
5/7/24 CONSTRUCTION SET	
_	

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abilities that the proposed building design represented in

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Project Title

# Croton-on-Hudson Harmon Firehouse Station #3 & EMS

30 Wayne Street Croton-On-Hudson New York 10520

Drawing Title


PARTITION DETAILS

Project No.	202222
Date	7.21.2023
Scale	
Drawing by	KA

Checked by



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								D	OOF	R SCH				
DOOR NUMBER	ROOM NAME	~ Rete	, Marr.	DOC MIDTH	SIZE	THICK.	1, Qtv		DOOR HEAD	FRAME DETAIL JAMB	SILL	HAROGET	ABE	REMARKS
FIRS	T FLOOR													
101	CORRIDOR	106A	нм	3'-6"	6'-8"	1 3/4"	F 1	нм	нз	J1	54	1	В	INSULATED DOOR
102	not used		_											
103	EMS BAY GARAGE DR	108	ALUM									9		SECTIONAL OVERHEAD DOOR
104	EMS BAY GARAGE DR	108	ALUM									9		SECTIONAL OVERHEAD DOOR
105	EMS STORAGE DOOR	107	нм	8'-0"	8'-0"						51	10		COIL DOOR
106	EMS BAY EXIT DOOR	106	нм	3'-6"	6'-8"	1 3/4"	F 1	нм	H 1	J1	54	2	c	INSULATED DOOR
107	FIRE STAIR 3	106A	нм	3'-6"	6'-8"	1 3/4"	F 1	нм	нз	J1	54	1		INSULATED EXTERIOR DOOR
108	MEP ROOM	103	нм	3'-6"	6'-8"	1 3/4"	F 1	нм	нз	J1	54	7		INSULATED EXTERIOR DOOR
109	EMS STORAGE DOOR	103	нм	3'-6"	6'-8"	1 3/4"	F 1	нм	нз	J1	54	5	В	INSULATED DOOR
SEC	OND FLOOR											!		
201	CORRIDOR	101A	MD	3'-0"	6'-8"	1 3/4"	F 1	нм	нз	J1	56	з	В	
202	OFFICE	101	ND	3'-0"	6'-8"	1 3/4"	F 1	нм	H 1					
										J1	59	5		
203	HALLMAY	101	MD	3'-0"	6'-8"	1 3/4"	F 1	нм	H 1	J1	56	5		
203	HALLWAY  OVERNIGHT ROOM	101	MD	3'-0"	6'-8"	1 3/4"		нм нм	H 1					
			MD				F1	нм		J1	56	4		
204	OVERNIGHT ROOM	101	MD	3'-0"	6'-8"	1 3/4"	F1 F2	нм	H 1	J1	56 59	4		
204	OVERNIGHT ROOM CLOSET DOOR	101	MD	3'-0" (2)2"-0" 1'-6"	6'-8"	1 3/4"	F1 F2 F1	HM HM HM	H 1	J1 J1	56 59 57	4 6 8		
204 205 206	OVERNIGHT ROOM  CLOSET DOOR  LIN CLOSET	101	MD MD MD	3'-0" (2)2"-0" 1'-6"	6'-8" 6'-8" 6'-8"	1 3/4" 1 3/4" 1 3/4"	F1 F2 F1 F2	HM HM HM	H1 H1	J1 J1 J1	56 59 57 56	4 6 8		
204 205 206 201	OVERNIGHT ROOM  CLOSET DOOR  LIN CLOSET  OVERNIGHT ROOM	101 102 101 101	MD MD MD MD	3'-0" (2)2"-0" 1'-6" 3'-0"	6'-8" 6'-8" 6'-8"	1 3/4" 1 3/4" 1 3/4" 1 3/4"	F1 F2 F1 F2 F1	HM HM HM HM HM	H1 H1 H1	J1 J1 J1 J1 J1 J1	56 59 57 56 59	4 6 8 4		
204 205 206 207 208	OVERNIGHT ROOM  CLOSET DOOR  LIN CLOSET  OVERNIGHT ROOM  CLOSET DOOR	101 102 101 101 102	MD MD MD MD	3'-0" (2)2"-0" 1'-6" 3'-0"	6'-8" 6'-8" 6'-8" 6'-8"	1 3/4" 1 3/4" 1 3/4" 1 3/4"	F1 F2 F1 F2 F1	HM HM HM HM HM HM HM HM HM	H1 H1 H1 H1	J1 J1 J1 J1 J1 J1 J1	56 59 57 56 59	4 6 8 4 6	C	
204 205 206 207 208 209	OVERNIGHT ROOM  CLOSET DOOR  LIN CLOSET  OVERNIGHT ROOM  CLOSET DOOR  BATHROOM	101 102 101 101 102 101B	MD MD MD MD MD	3'-0" (2)2"-0" 1'-6" 3'-0" (2)2"-0" 3'-0"	6'-8" 6'-8" 6'-8" 6'-8" 6'-8"	1 3/4" 1 3/4" 1 3/4" 1 3/4" 1 3/4"	F1 F2 F1 F2 F1	HM HM HM HM HM HM HM HM HM	H1 H1 H1 H1 H1	J1 J1 J1 J1 J1 J1 J1 J1 J1	56 59 57 56 59 57 53	4 6 8 4 6 8	C	
204 205 206 207 208 209	OVERNIGHT ROOM  CLOSET DOOR  LIN CLOSET  OVERNIGHT ROOM  CLOSET DOOR  BATHROOM	101 102 101 101 102 101B	MD MD MD MD MD	3'-0" (2)2"-0" 1'-6" 3'-0" (2)2"-0" 3'-0"	6'-8" 6'-8" 6'-8" 6'-8" 6'-8"	1 3/4" 1 3/4" 1 3/4" 1 3/4" 1 3/4"	F1 F2 F1 F2 F1	HM HM HM HM HM HM HM HM HM	H1 H1 H1 H1 H1	J1 J1 J1 J1 J1 J1 J1 J1 J1	56 59 57 56 59 57 53	4 6 8 4 6 8	C	
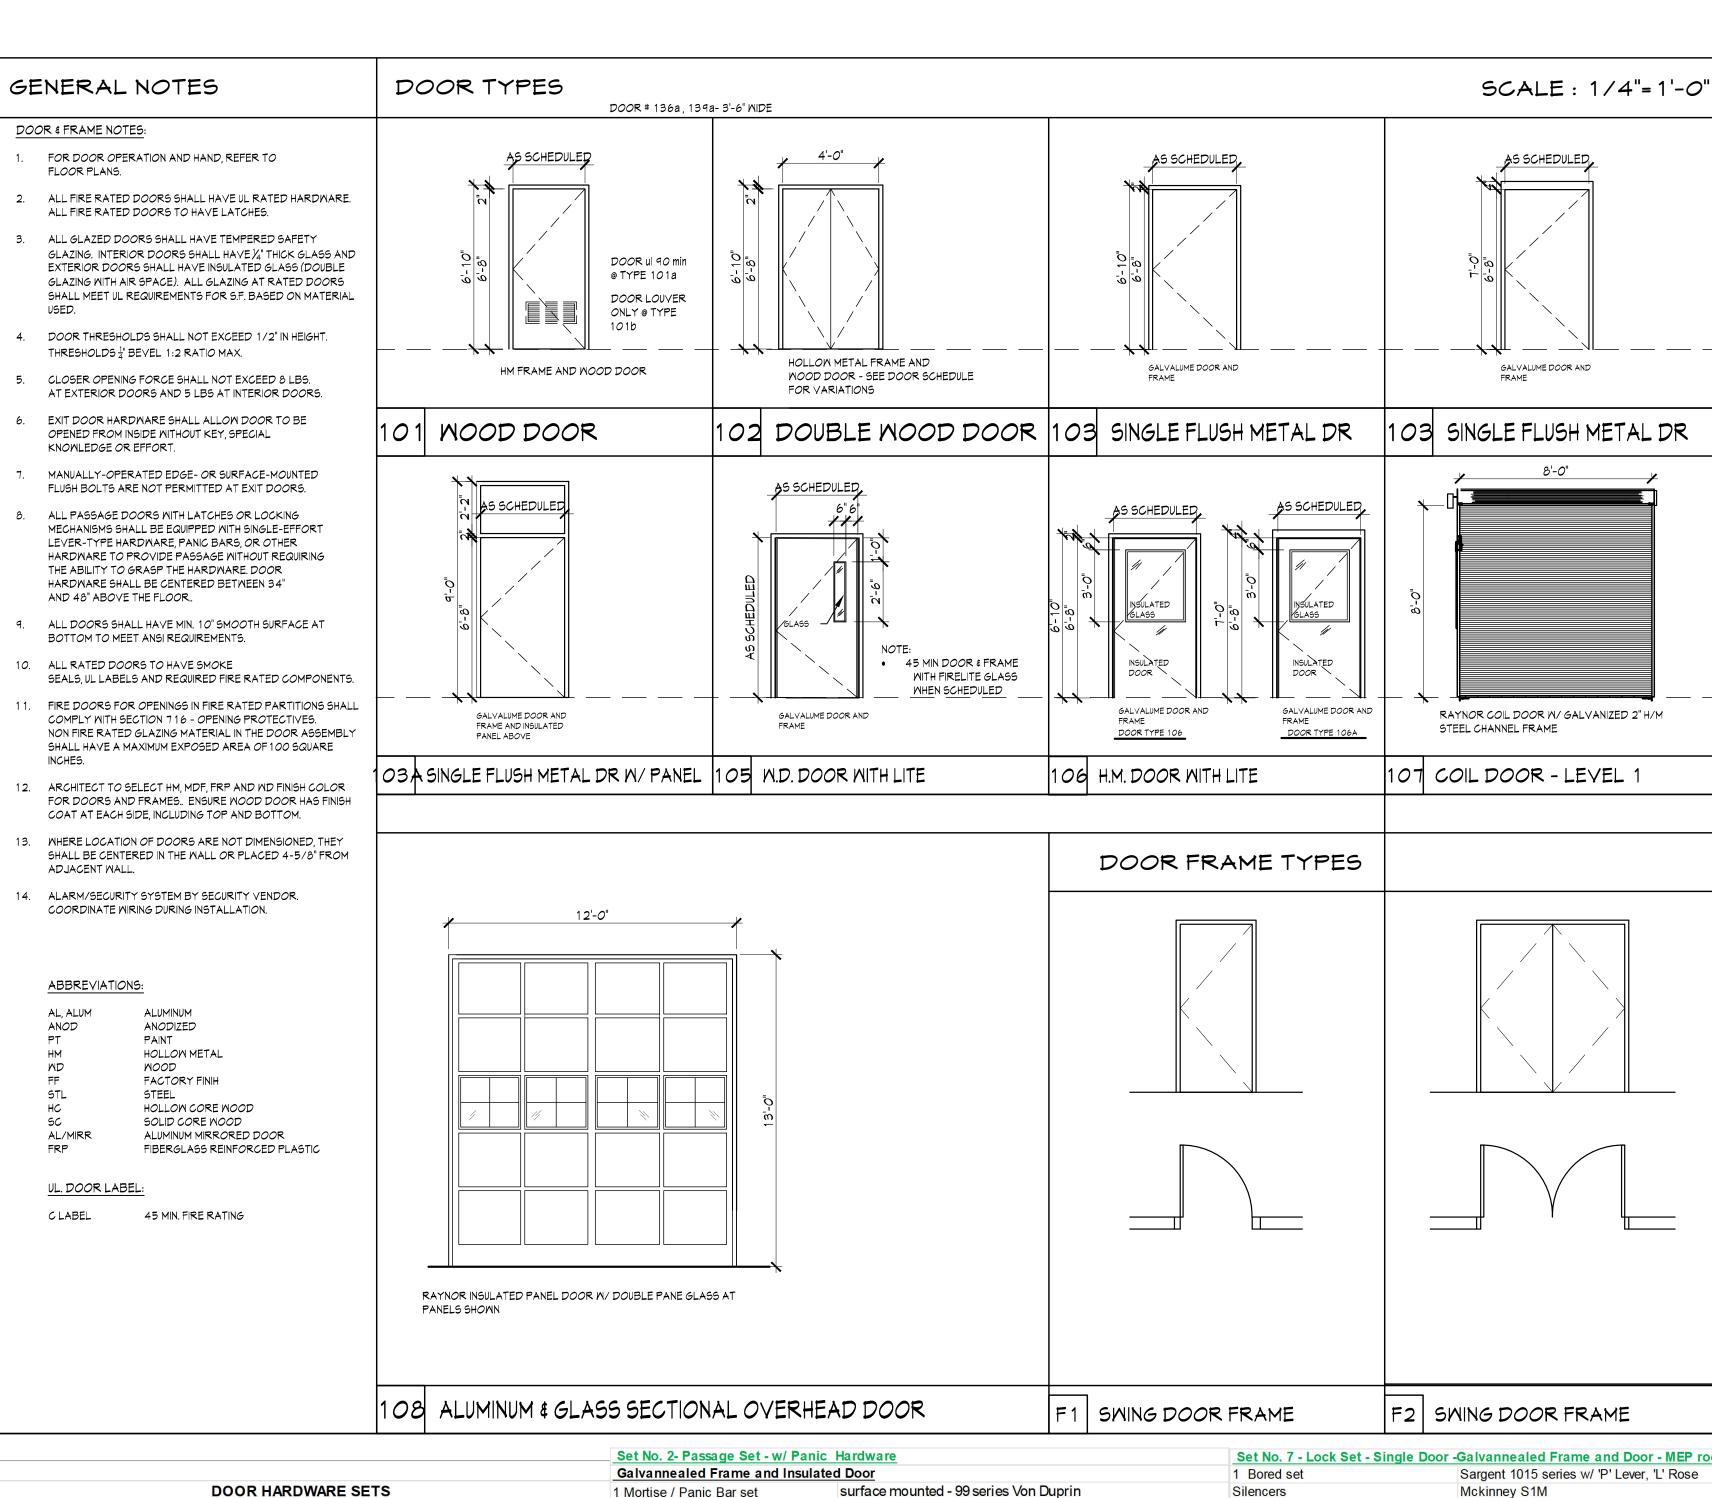
#### Set No. 7 - Lock Set - Single Door -Galvannealed Frame and Door - MEP room Sargent SG 421-CTHB-EN-AL LCN-2030 Concealed Closer Closer General Notes: Hagar/US26D 1 1/2 Stainless Steel Pair hinges Mckinney T4A3786 Heavy Weight Hinge 1 1/2 Pair hinges Mckinney WS04 (US26D) / Mckinney 598S - US26D Wall Stop or Overhead Stop (1) Provide heavy duty ball hinges at all solid core doors. Mckinney WS04 (US26D) / Mckinney 598S - US26D Floor / Wall Stop Ives SR64 Silencer (2) Provide st. stl hinges at all doors located at exterior or unconditioned spaces. Ives SR64 Zero 119A Kickplate both sides of door Aplied Weather stripping (3) See elec. dwgs. for doors with electrical requirements for security/access elements. Edge Seals Zero - 770AA Head & Jamb (4) Provide all Fire rated componets at fire rated doors as noted on door schedule. ADA Sill Zero -105,68,675 or equal (5) 1 1/2 Pair hinges for 7'-0" doors & 2 Pair at 8'-0" doors or as noted. Set No. 3 - Interior Fire Stair Doors and door from existing building at second floor Door Sweep Zero 328G (6) Provide Power supplies for all equipment specified surface mounted - 99 series Von Duprin 1 Mortise / Panic Bar set Zero - Surface Mounted 365 (7) All access control devices to be connected to EM power & Fail safe Door Bottom Seal Electric Strike Von Duprin 6400 series (8) Alarm system & door monitoring contacts are shown on security documents. Drip Cap at exterior frames only LCN-2030 Concealed Closer (9) Functions as show on Hardware sets notes 1 1/2 Pair hinges Hagar/US26D (10) All Electromechanical lock set doors to be coordinated with Electric Strike **DOUBLE DOORS** Floor / Wall Stop Mckinney WS04 (US26D) / Mckinney 598S - US26D (11) See Security Documents for balance of scope of Security Hardware and alarm scope Silencer Set No. 8- Passage C (12) All Hardware Fishes shall be US26D unless otherwise noted Sargent 1015 series w/ 'P' Lever, 'L' Rose 2 dummy 1/2 sets Motion Sensor GE RCR/REX DUAL INFARED/DOPPLER Motion Detector (13) All hardware must have interchangable cores and be set up for master/sub - key system -Hagar/US26D Push Button request to exit SDC - 422A w/ ADA symbol 3 pair hinges see specifications 2 roller catches Rockwood #590/US26D FOB w/ power supply (14) New door assemblies in fire-resistance rated corridors shall be tested in accordance Ives SR64 Silencer connect to fire alarm - fail safe see note 16 with NFPA 252 or UL 10C without the hose stream test Floor / Wall Stop Rockwood No. 442/US26D Zero - Surface Mounted 365 Door Bottom Seal (15) New door assemblies in fire-resistance rated corridors shall meet the requirements for Kickplate both sides of door smoke and draft control door assemblies, tested for air leakage in accordance with UL 1784. SPECIALTY DOORS Set No. 4- Passage Set - Single Door Hallway & Lien Closet Set No. 9- Commercial Ovehead Apparatus Bay Doors (16) in all electrified sets listed if a fire rated door electrified hardware must be fail secure a in such cases provide push button reqest to exit - SDC - 422A w/ ADA symbol Sargent 1015 series w/ 'P' Lever, 'L' Rose Raynor AlumaView® AV300 Series - 3" thick assembly - Full Glass Sectional Doors 1 Bored set Mckinney S1M w/ power supply as per NFPA 80 - verify w/ owner on case by case basis Silencers Insulated and Impact Rated Glass w/ Red anodized finish and grey panels Closer Sargent SG 421-CTHB-EN-AL Wind Rated Assemblies to meet code Set No. 1- Entry Lockset Set - Single FOB Access - w/ Panic Hardware 1 1/2 Pair hinges Mckinney T4A3786 Heavy Weight Hinge Enduracote Hardware system with springs, track and hardware coated Black Wall Stop or Overhead Stop Mckinney WS04 (US26D) / Mckinney 598S - US26D Galvannealed Frame and Insulated Door Control Hoist 2.0 Optima Drive Motor - Motor operated (w/ manual override and chain) surface mounted - 99 series Von Duprin W/ standard LCD Control Panels - (All Door Controls to be Moisture Resistant) 1 Mortise / Panic Bar set Set No. 5 - Lock Set - Single Door Raynor supplied option Alarm contact Electric Strike Von Duprin 6400 series Sargent 1015 series w/ 'P' Lever, 'L' Rose 3" Customized Track to provide the greatest headroom possible LCN-2030 Concealed Closer 1 Bored set Mckinney S1M Head Seal, Jamb seals, Bottoom Bulb Seal Silencers 1 1/2 Pair hinges Hagar/US26D Mckinney T4A3786 Heavy Weight Hinge 1 1/2 Pair hinges High Cycle Counter Balance System for 100,000- cycle life Floor / Wall Stop Mckinney WS04 (US26D) / Mckinney 598S - US26D Wall Stop or Overhead Stop Mckinney WS04 (US26D) / Mckinney 598S - US26D Jam Locks Ives SR64 Silencer Wall-mounted interior controls opener Motion Sensor GE RCR/REX DUAL INFARED/DOPPLER Motion Detector Coat Hook at door 202 SDC - 422A w/ ADA symbol Power supply as required for key pad access Push Button request to exit Set No. 6- Overnight / Restroom Photo Eye - safety shut-off FOB w/ power supply / Privacy Set - Single Door 1 Bored set Sargent 1015 series w/ 'P' Lever, 'L' Rose connect to fire alarm - fail safe see note 16 Electric reversing edge Silencers Mckinney S1M (10) Universal car visor remote entry controls Aplied Weather stripping Zero 119A Sargent SG 421-CTHB-EN-AL Zero - 770AA Head & Jamb Edge Seals Set No. 10- Coil Door - Exterior Rated 1 1/2 Pair hinges Mckinney T4A3786 Heavy Weight Hinge **ADA SIII** Zero -105,68,675 or equal Raynor coil Door Sweep Zero 328G Wall Stop or Overhead Stop Mckinney WS04 (US26D) / Mckinney 598S - US26D Zero - Surface Mounted 365 Lockset Door Bottom Seal Coat Hook - overnight rm's Baldwin 0743 (US26D) Door Tracks, Header Brush, Flame Baffle, Guide Brush, Curtain Hood Kickplate both sides of door Aplied Weather stripping - overnight Zero 119A Lock & Seals Drip Cap at exterior frames only

Zero - 770AA Head & Jamb

Flat Slats Door Design

Edge Seals - overnight

## **Sullivan** Architecture, p.c

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Project Title

Date Issue

/18/2024 CLIENT REVIEW SET

Croton-on-Hudson
Harmon Firehouse
Station #3 & EMS

30 Wayne Street Croton-On-Hudson New York 10520

Drawing Title


DOOR SCHEDULE

	Project No.	202222	
	Date	7.21.2023	
	Scale		
	Drawing by	KA	
ω.			


Checked by



A-16

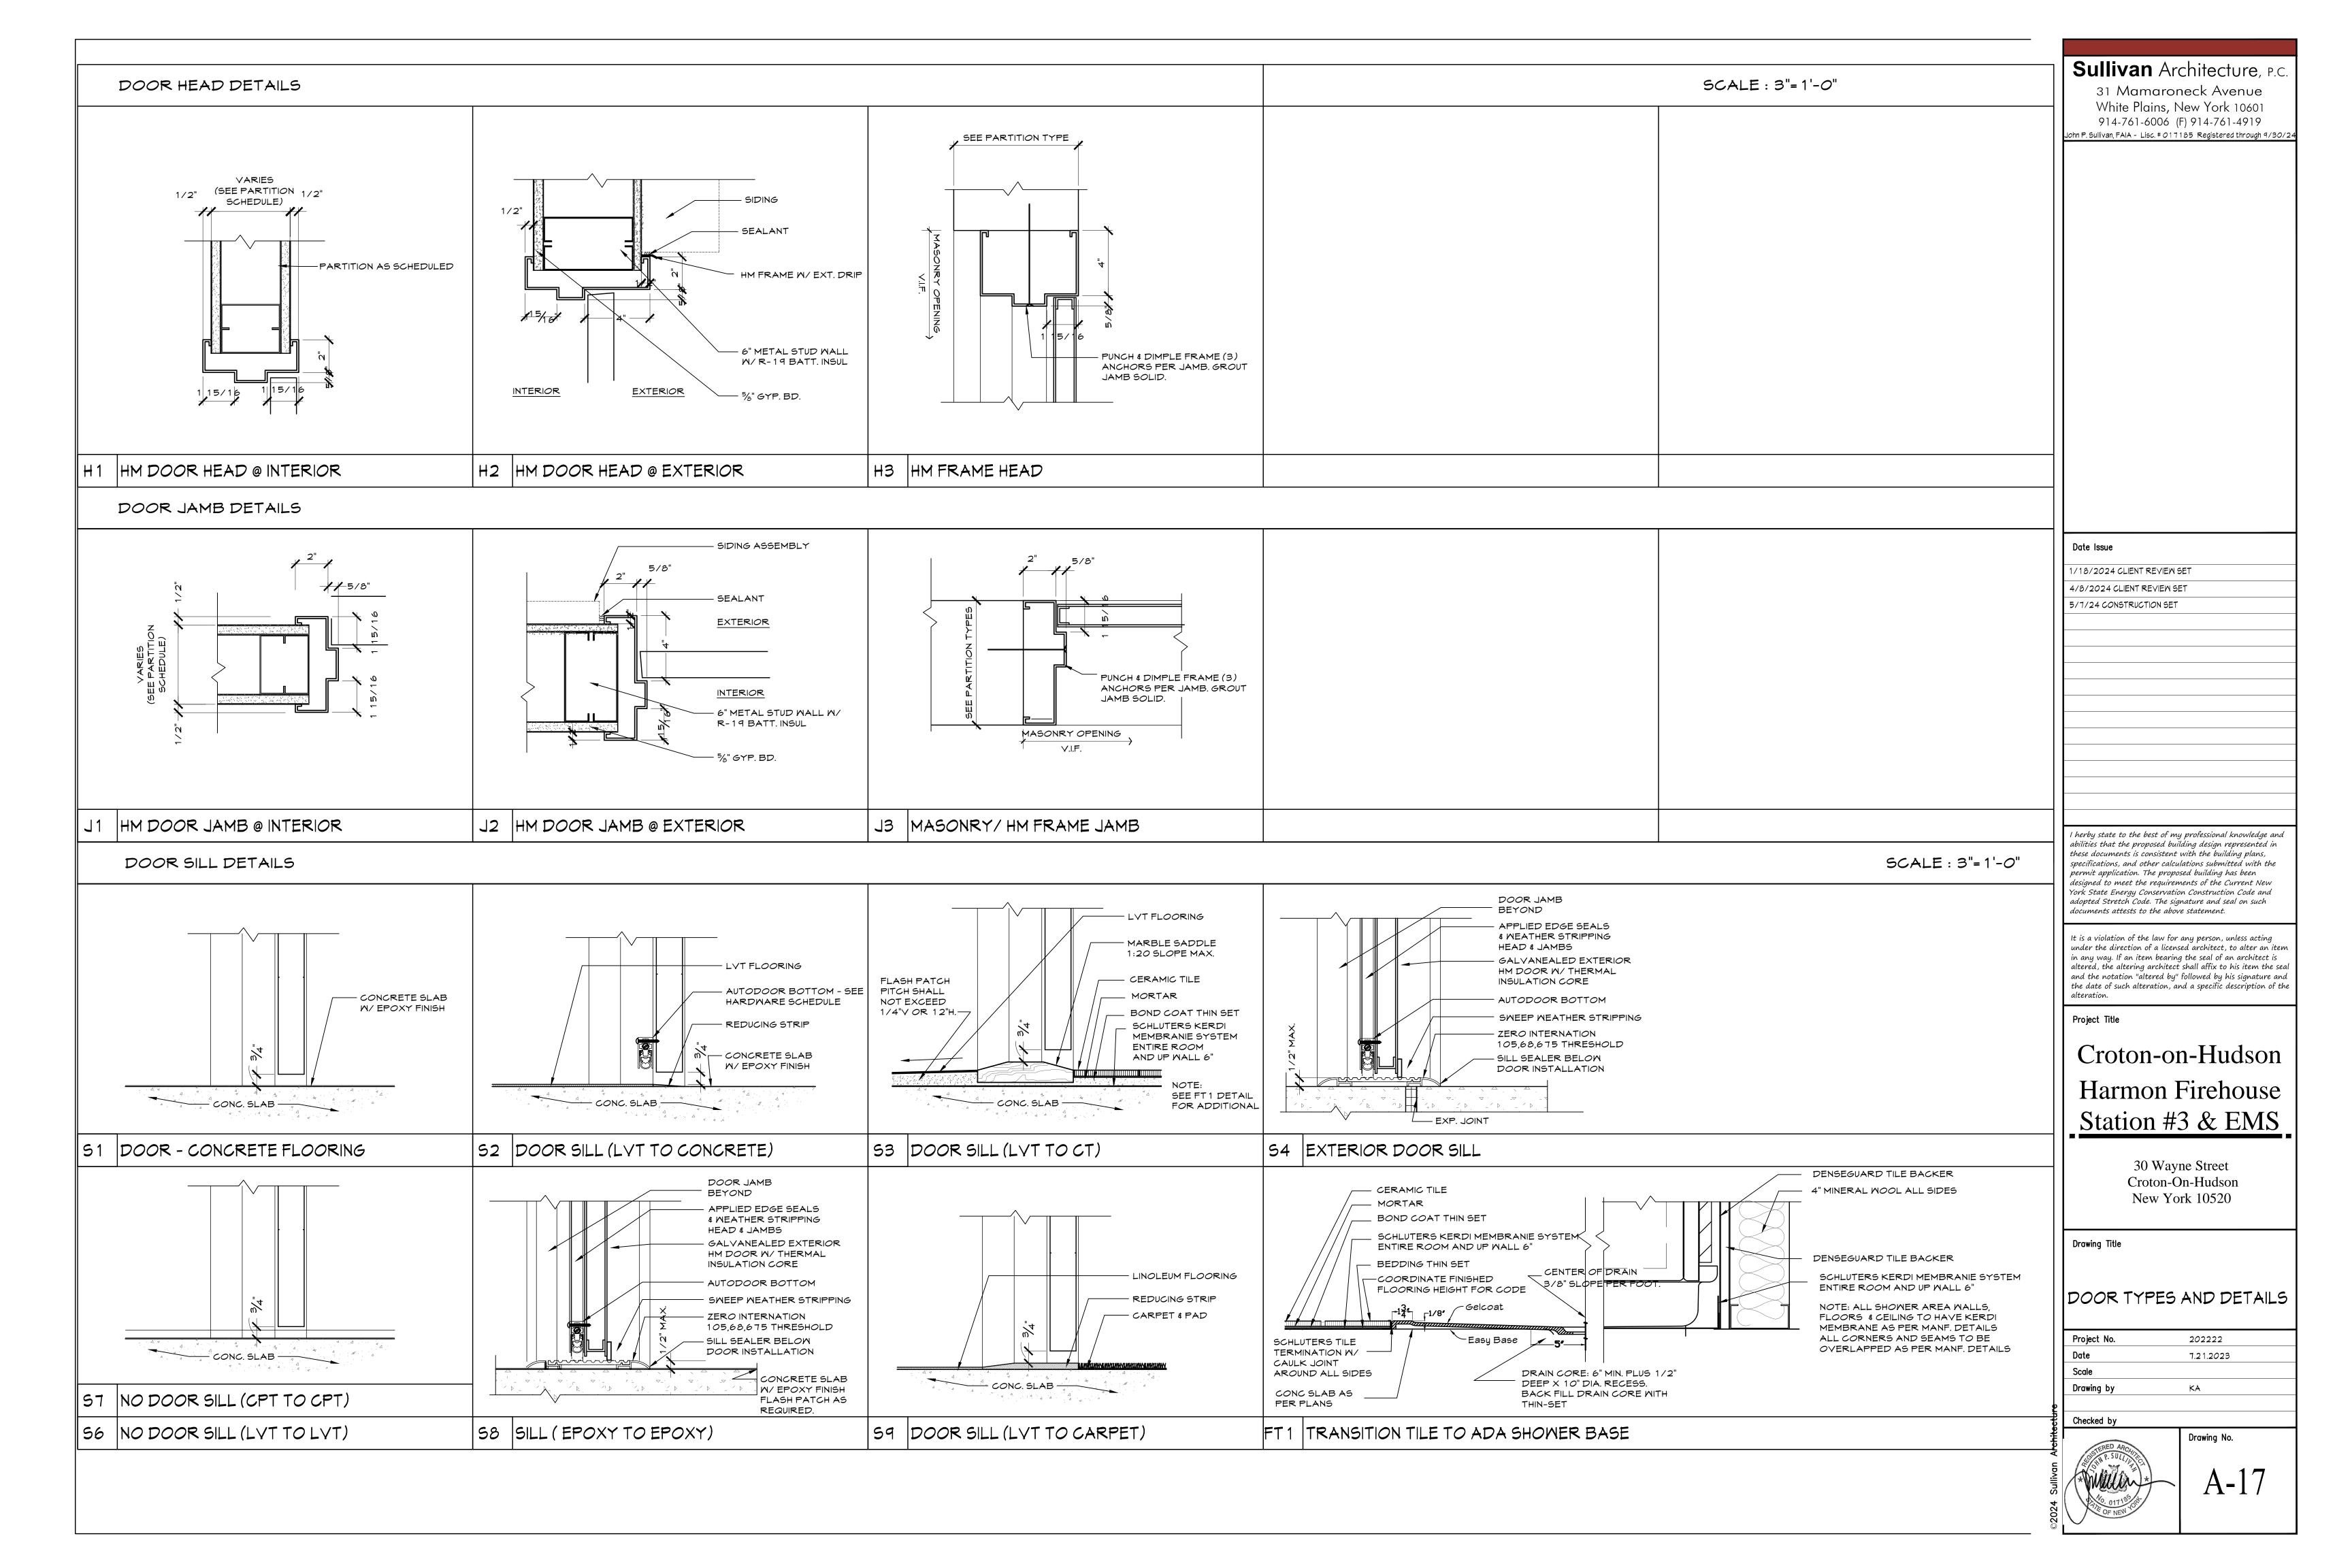

	MINDOM SCHEDULE (SEE PLANS FOR SYMBOLS AND COUNTS)													
SYMB0	MANUFACTURER	MINDOM	TYPE	FIN	NSH	FINISH		GLAZING		INSECT S	SCREEN	GRILL TYPE	REMARKS	5YMB <i>o</i> L
BIMBO	MANUFACTURER	MODEL		EXTERIOR	INTERIOR	COLOR	THICKNESS	TYPE	FINISH	FRAME	TYPE	— GRILL TIFL	NIMANO	51 MDCL
A	MARVIN	"ESSENTIAL" ESCA3050	CASEMENTS	FIBERGLASS	FIBER <i>G</i> LASS	BLACK (INTERIOR / EXTERIOR)	7/8"	LOW E2 (ARGON)	CLEAR	EXTRUDED	ALUMINUM	SIM. DIVIDED LITE		A
В	MARVIN	"ESSENTIAL" ESCA3050 - 2 Mide	CASEMENTS	FIBERGLASS	FIBER <i>G</i> LASS	BLACK (INTERIOR / EXTERIOR)	7/8"	LOW E2 (ARGON)	CLEAR	EXTRUDED	ALUMINUM	SIM. DIVIDED LITE	MULLED UNITS	В
C	MARVIN	"ESSENTIAL" ESCA3050 - 3 Mide	CASEMENT	FIBERGLASS	FIBER <i>G</i> LASS	BLACK (INTERIOR / EXTERIOR)	7/8"	LOW E2 (ARGON)	CLEAR	EXTRUDED	ALUMINUM	SIM. DIVIDED LITE	MULLED UNITS	c

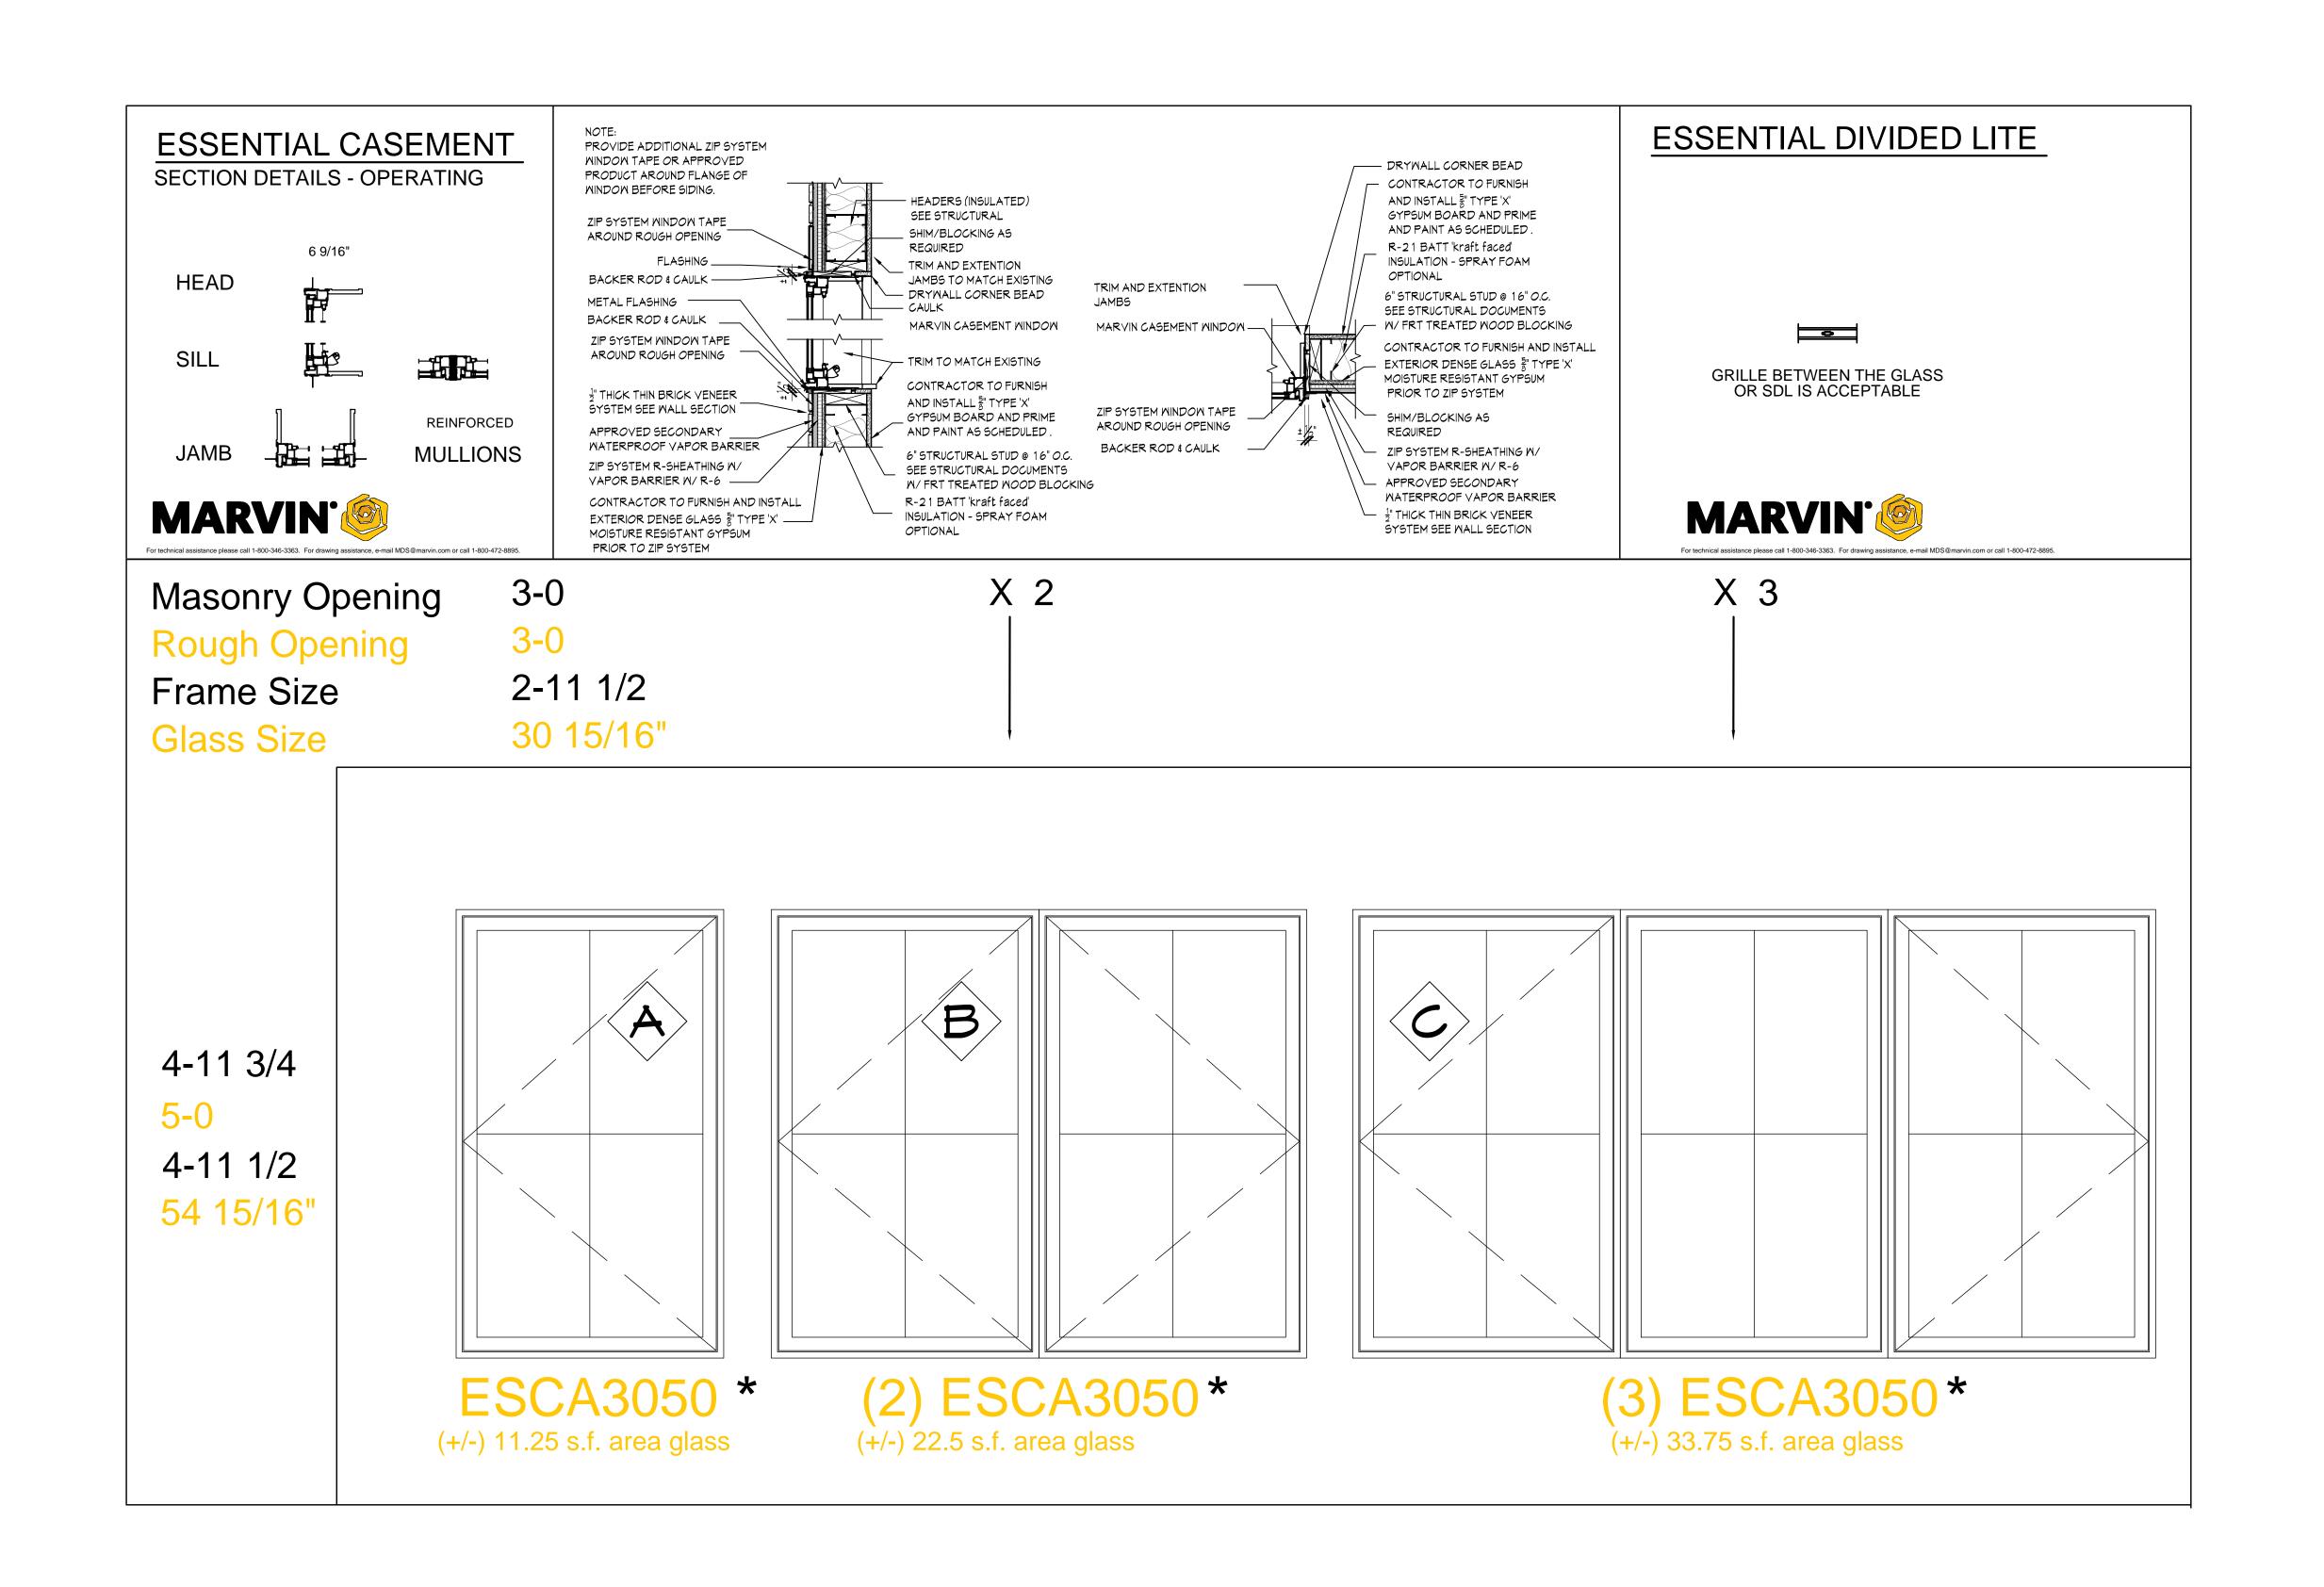

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Project Title

# Croton-on-Hudson Harmon Firehouse Station #3 & EMS

30 Wayne Street Croton-On-Hudson New York 10520

Drawing Title

## MINDOM TYPES AND DETAILS

Project No.	202222	
Date	7.21.2023	
Scale		
Drawing by	KA	

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A-18

FINISH SCHEDULE										FINISH MATERIALS - All MATERI	ALS TO BE SUBMITTED FOR APPROVAL All MATERIALS NOTED ARE FOR BUD		BY ARCHITECT -	
ROOM NUMBER	FI	LOOR	i	BASE	V	MALL		CEILING	REMARKS					<del></del>
AND NAME	MATERIAL	FINISH	MATERIAL	FINISH	MATERIAL	FINISH	MATERIAL	FINISH		Paint-1 - Typical Mall	FLR 1 - LVT	CT-1 Ceramic Tile Manufacture: NEM 'STONEF	Base-1	
										Manufacture: Benjamin Moore Style: Eggshell	Mohawk LVT	'SIMPLY MODERN' PORCEL	AIN Style: RUBBER BASE - JOHNSONITE	
										Color: Swiss Coffee OC-45	Collection: Vivid Step Stone Collection	GLAZED 12X24 FLOOR TII 'CREME' Located at mens & I	vomens GREY	
EMS APARATUS BAYS	CONCRETE	FLR-2	RUBBER	Epoxy Base or BASE - 1	GMB-2/GMB-3	PAINT -2	GMB-2	PAINT -4	GWB-3 5 EXACOR BOARD PANELS UP 9'-0" AROUND	Paint-2 - Wall at EM5 Bay Manufacture: Benjamin Moore	Style: 5928 Charcoal Grey Size: 12"x24"	rooms as scheduled. Provide MARFIL - ADA TAPERED marble s	addle AOT-T	
									ENTIRE AMBULANCE BAY FOUR	Style: Epoxy - Pro Industrial High		transition at entry door for room. Grout - TO BE SELEC		
									WALLS AND STAGER PANELS W/ GWB - 2 ABOVE PRIME AND	Performance -Semi Gloss Color: Swiss Coffee OC-45	Contact - cell 914-953-5368 John_talio@mohawkind.com	BY ARCHITECT.	Suspension System - 15/16"	
									PAINT ALL WALLS AND CEILING	Paint-3 - Gypsum Ceilings	Mohawkgroup.com	CT-2 Ceramic Tile 'STONE	PEAK' all-aluminum system with	
STORAGE CLOSET	CONCRETE / EPOXY	FLR-2	RUBBER	BASE - 1	GMB-2/GMB-3	PAINT -2	GMB-2	PAINT -4	CEILING HORIZONTAL SHAFT WALL PARTITION TYPE 1B BELOW STAIR	Manufacture: Ben jamin Moore Style: Matte flat	<b>-</b>	'SIMPLY MODERN' PORCE GLAZED 6X12 COVE	LAIN MILLENNIA® ClimaPlus™ Acoustical Ceiling Panels	
FIRE STAIR	CONCRETE	FLR-1	RUBBER	BASE - 1	GMB	PAINT - 1	GMB	PAINT-1		Color: Super White	FLR - 2	BASE IN 'CREME'	-	
	CONORLIE	1 2							CEILING HORIZONTAL SHAFT WALL	Paint-4 - Gypsum Ceilings at	EXPOXY FLOOR SYSTEM (By Owner – TBD)	CT-3 Ceramic wall Tile NEW 'STONEPEAK' 'SIMPL'	CABINETS - https://www.bertch.com/products/kitchen/do	or styles/detail/iE/visage/
1ECHANICAL AREA	CONCRETE				GMB	PAINT - 1	GMB	PAINT-2	PARTITION TYPE 1B BELOW STAIR	EMS Bay Manufacture: Ben jamin Moore	CPT-1	MODERN'		or-styles/detail/13/ visage/
XISTING OVERNIGHT RM ONVERTED TO STORAGE									MATCH EXISTING FINISHES AS REQUIRED	Style: Epoxy - Pro Industrial High Performance - Flat		PORCELAIN GLAZED 12) IN 'CREME'	Door Style: Visage (Marketplace)  Wood: Birch	
XISTING OVERNIGHT RM									MATCH EXISTING FINISHES	Color: Super White	Mohawk CPT-1- CARPET PLANK Collection	CT-4 Ceramic wall ACCEN	Colon Liebthouse	
CONVERTED TO STORAGE									AS REQUIRED	Paint-5 - Bathroom	Style: Digital Terrain - 978 Mineral Size: 12"x36" Plank	NEW 'STONEPEAK' 'SIMPL' MODERN'		_
										Manufacture: Benjamin Moore Style: Eggshell		PORCELAIN GLAZED 2X2		
DAY ROOM	CONCRETE	FLR-1	RUBBER	BASE - 1	GMB	PAINT - 1	ACT-1	N/A		Color: Swiss Coffee OC-45	Contact - cell 914-953-5368 <u>John_talio@mohawkind.com</u>	MOSAIC TILE IN 'GREY'	Tread and riser system - w/ tactile edge	
					CT-6 AT KITCHENETTE					Paint-5 - <i>Doo</i> rs frames Manufacture: To be selected	Mohawkgroup.com	CT-5 Ceramic wall Tile TO	stringers and railing componets primed and painted painted to match color	
					BACKSPLASH					Style: Semi Gloss	QUARTZ TOP - 1 -	TERMINATION 'STONEPEA' 'SIMPLY MODERN' PORCE	selected by architect.	
OFFICE	CONCRETE	FLR-1	RUBBER	BASE - 1	GMB	PAINT - 1	ACT-1	N/A		Color: Super White	for Counters at kitchen and	GLAZED	· · · · · · · · · · · · · · · · · · ·	
OVERNIGHT ROOM 1	CONCRETE	CPT-1	RUBBER	BASE - 1	GMB	PAINT - 1	ACT-1	N/A		Paint-6 - Trimwork (window sill and extentions) Manufacture: Ben jamin Moore	bathroom https://www.wilsonart.com/north-cascades Wilsonart / North Cascades / Quartz	12X24 TILE IN 'CREME' UP TO CLG. HT.		
OVERNIGHT ROOM 2	CONCRETE	CPT-1	RUBBER	BASE - 1	GMB	PAINT - 1	ACT-1	N/A		Style: Solid Color: Black	Q4035	CT-6 Tile Backsplash at K 'STONEPEAK'	itchen	
HALLWAY	CONCRETE	FLR-1	RUBBER	BASE - 1	GMB	PAINT - 1	ACT-1	N/A				Shadows - white - 4"x12"	Matte	
BATHROOM	CONCRETE	CT-1	CERAMIC TILE	CT-2	CERAMIC TILE	CT-3,4\$5 W/ GMB-2	GWB-1	PT-3		FINISH MATERIAL AND GENERA	AL NOTES		FINISH DETAILS - BASE SEE WINDOW AND DOOR DETAILS	
						ABOVE W/ PAINT - 1				ENICH CATERIAL CENERAL NOTES				
										FINISH MATERIAL GENERAL NOTES:			½".	
											TIONAL NOTES AND INFORMATION. NT GYPSUM BOARD SHALL USG 'MOLD TOUGH' GREE	EN BOARD OR EQUAL.		
											NT GYPSUM BOARD SHALL BE 'AQUA TOUGH - AR' TI NT EXACORE PANELS -SEE WALL SECTIONS	LE BACKER BOARD OR EQUAL.		
										E. ALL TILE AREAS EXCEPT SHOWE	RS UNITS ARE THIN SET APPLICATIONS.			
											OOM FLOOR,WALL AND CEILING FINISHES AS NOTED.		<b>.</b> .	
										GENERAL NOTES:  1. ALL BATHROOMS SHALL RECEIVED	VE MOISTURE RESISTANT GYPSUM WALL BOARD AT	ALL WALLS . TILED		
											R (REFER TO PARTITION TYPES). D CEILINGS TO BE PRIMED AND RECEIVE TWO COAT	'S OF FINISH PAINT		
										3. ALL CEILING GRIDS TO BE CENT	ERED IN EACH INDIVIDUAL SPACE, BUT DO NOT ALLO			
	•	•	•	•	•				•	AGAINST WALLS. SEE RCP'S FOR 4. ALL DOOR FRAMES TO BE PAIN	TED.			
										5. ALL CLOSETS SHALL HAVE A SH CHROME PLATED.	HELF AND ROD - SEE DETAIL. HANGING RODS SHALL	BE 1-1/4" ROUND	* <del>7,4</del>	
										6. THE EPOXY FLOOR FINISH SCOP OUT IN FLOOR PATTERNS DETER	E OF MORK SHALL INCLUDE A MINIMUM OF (3) EPOXY	Y COLORS TO BE LAID		
										7. WHERE SCHEDULED AS WALL FIN	NISH, EPOXY PAINT TO EXTEND UP THE FULL HEIGHT C			
											EPOXY MALL PAINT TO EXTEND UP 6" PAST CEILING SURFACES AS PART OF THE MEANS OF EGRESS SHAI			
										SLIP-RESISTANT SURFACE AND	BE SECURELY ATTACHED.			
													JOHNSONITE PERCEPTIONS	
													RECESS W/ TOE	
													4.25"	
												<u>-</u>		

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Croton-on-Hudson
Harmon Firehouse
Station #3 & EMS

30 Wayne Street Croton-On-Hudson New York 10520

Drawing Title


FINISH SCHEDULE AND MATERIALS


Project No.	202222
Date	7.21.2023
Scale	
Drawing by	KA


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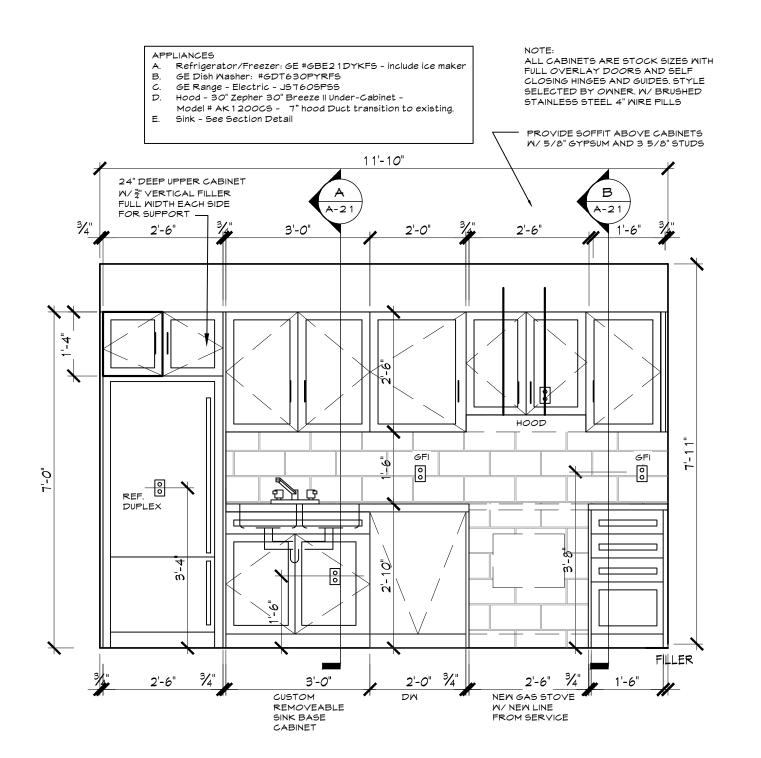





1 ENLARGED KITCHEN ELEVATION

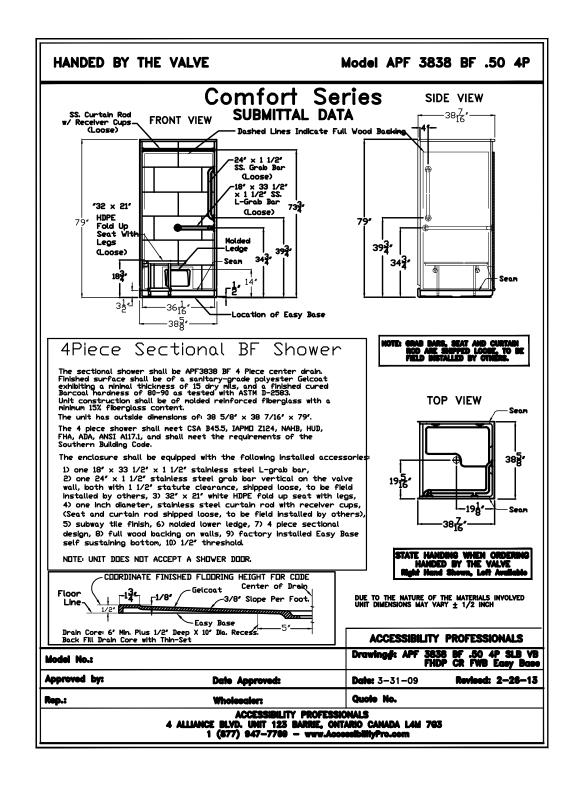2 TYPICAL ADA MOUNTING HEIGHTS

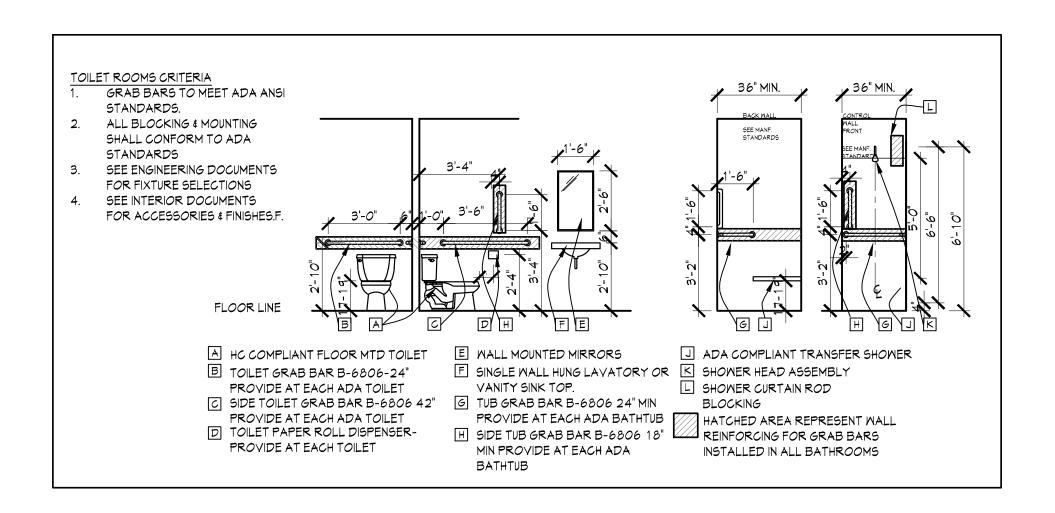1/2" = 1'-0"

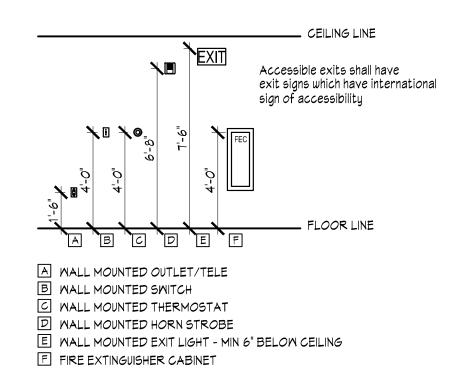

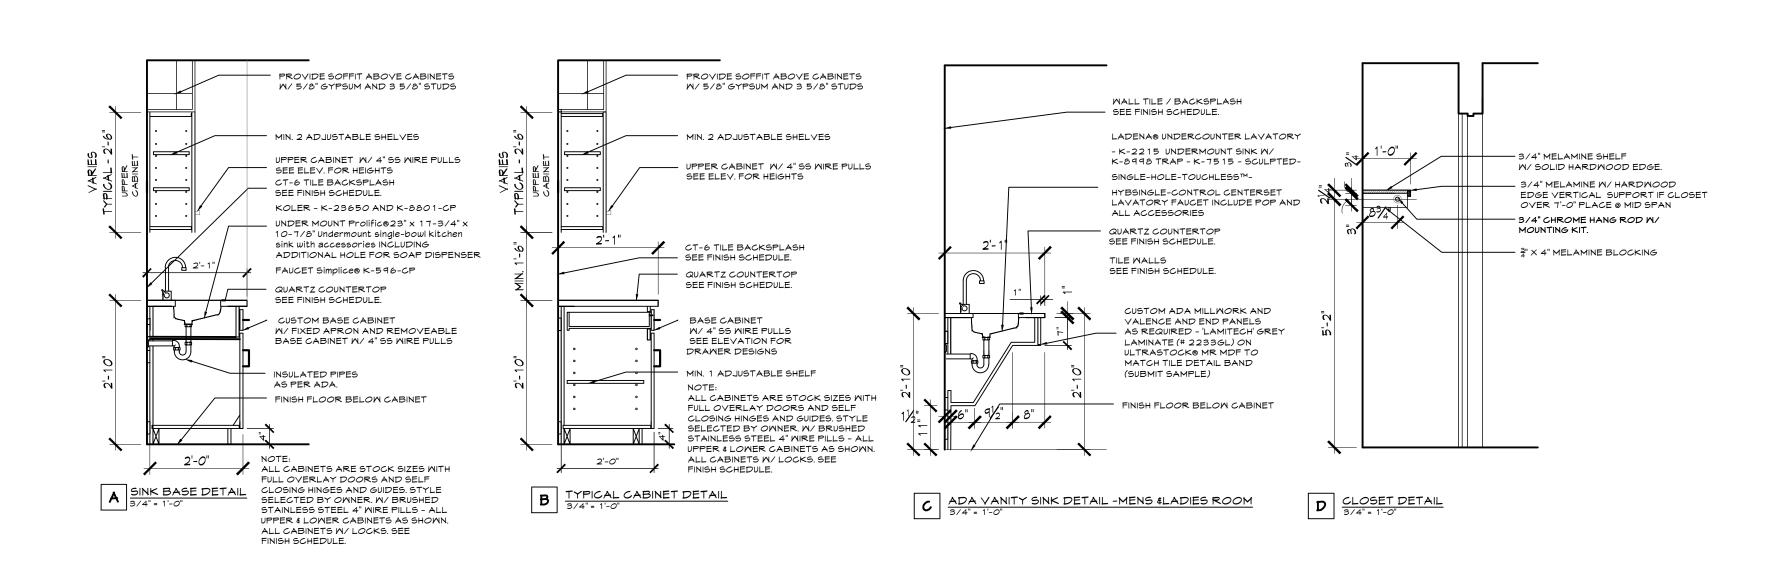

1 ENLARGED KITCHEN ELEVATION

# Sullivan Architecture, P.C.

31 Mamaroneck Avenue
White Plains, New York 10601
914-761-6006 (F) 914-761-4919
ohn P. Sullivan, FAIA - Lisc. # 017185 Registered through 9/30/2

Date Issue

1/18/2024 CLIENT REVIEW SET

4/8/2024 CLIENT REVIEW SET

5/7/24 CONSTRUCTION SET

I herby state to the best of my professional knowledge and

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Project Title

# Croton-on-Hudson Harmon Firehouse Station #3 & EMS


30 Wayne Street Croton-On-Hudson New York 10520


Drawing Title


MILLWORK DETAILS


Project No.	202222
Date	7.21.2023
Scale	
Drawing by	KA
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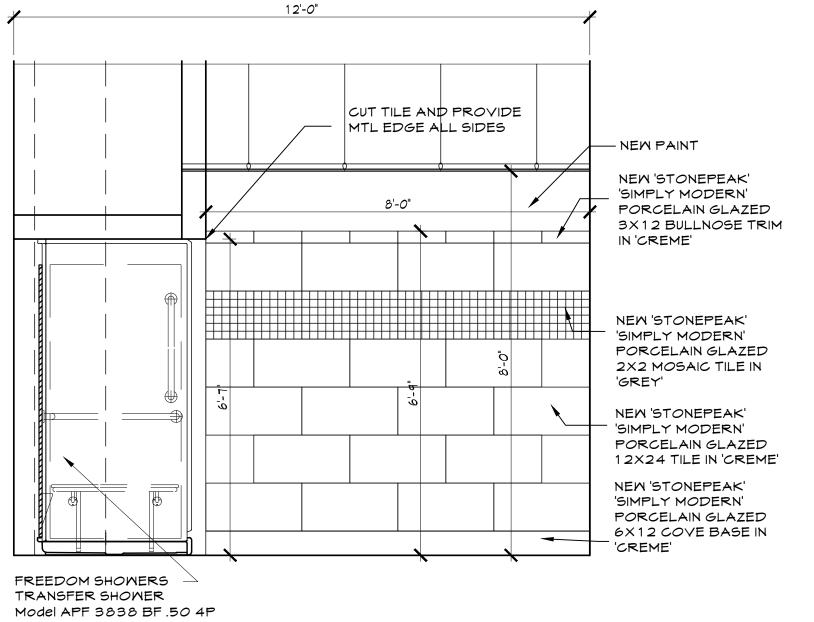
Checked by




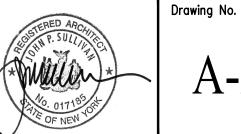

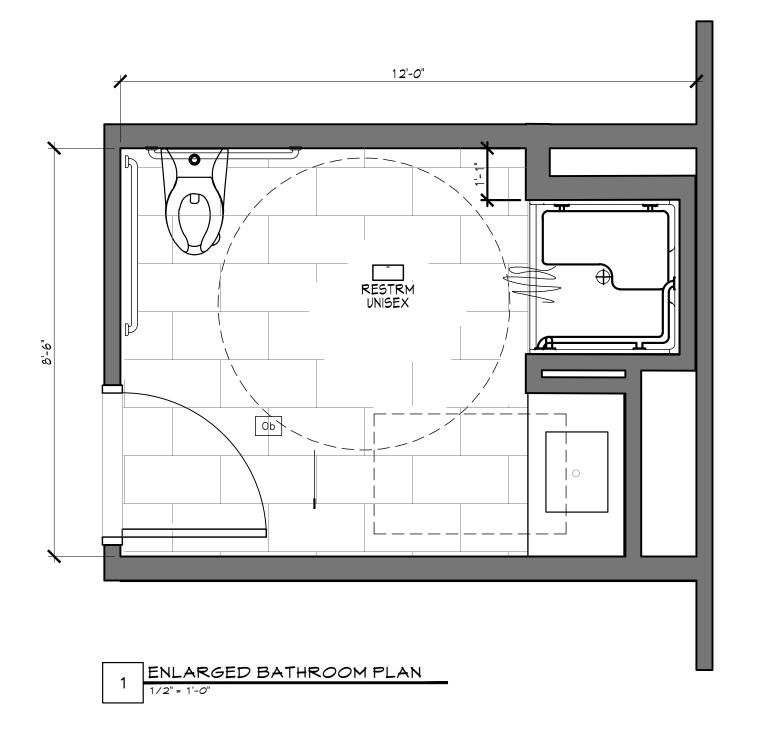

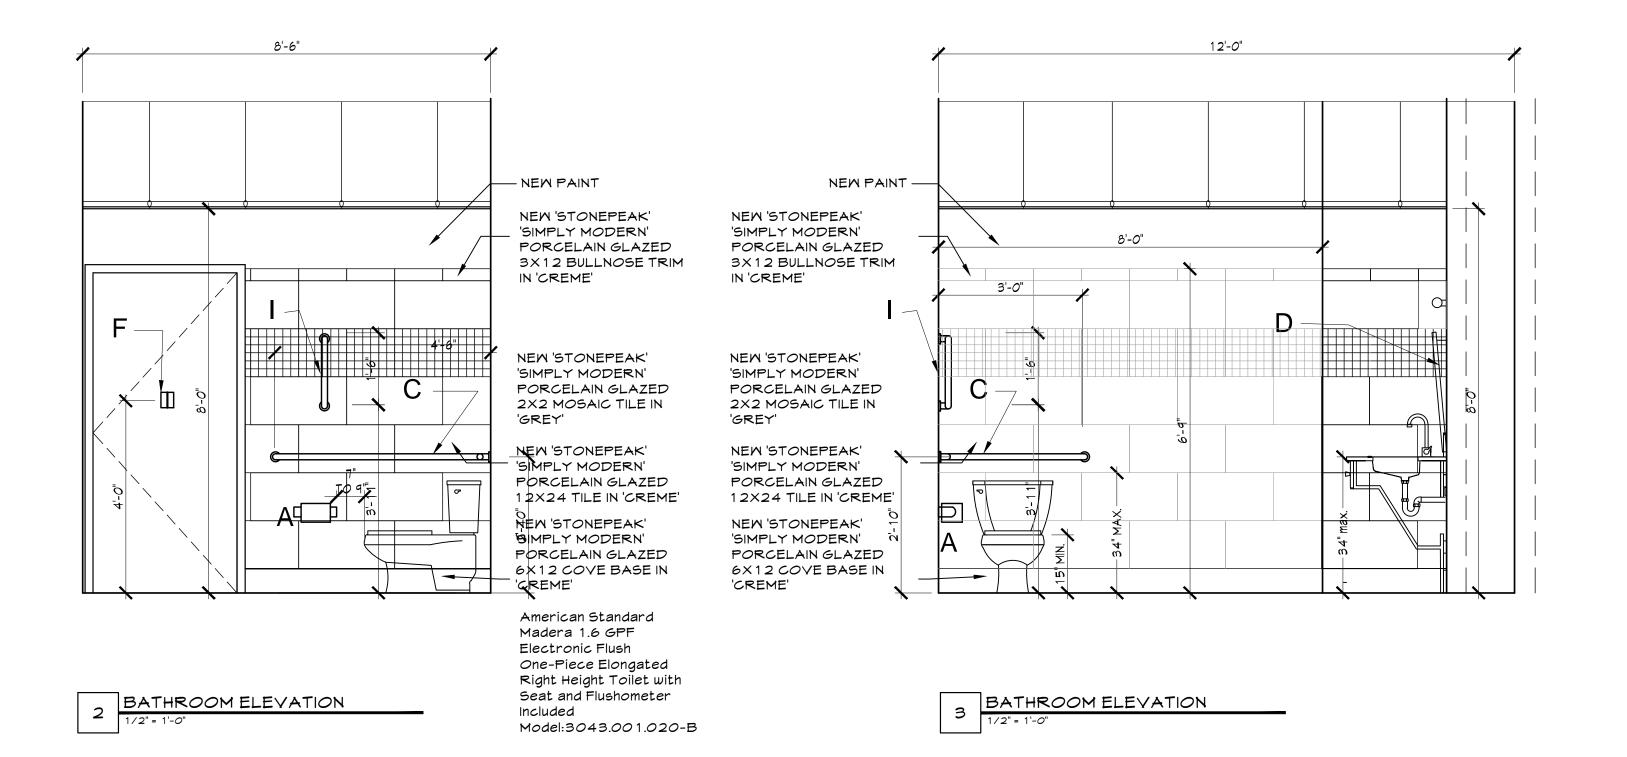

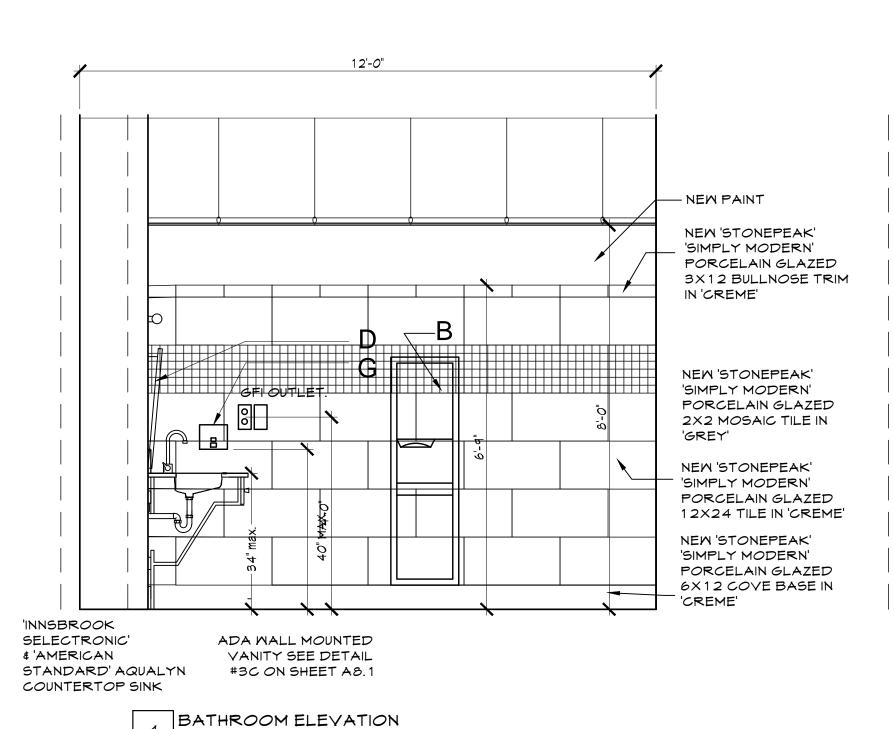

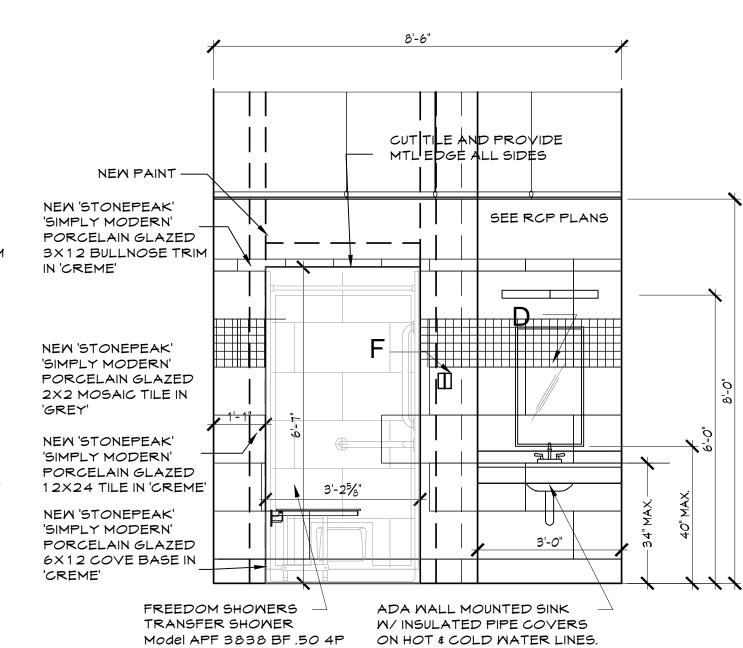

BATHROOM ELEVATION

1/2" = 1'-0"

BATHROOM ELEVATION

1/2" = 1'-0"

TAG	DESCRIPTION	MANUFACTURER	REMARKS	NOTES:
*	TOILET TISSUE DISPENSER	B-4288		1. MANUFACTURER FOR ALL ACCESSORIES TO BE "BOBRICK" UNLESS OTHER MISE NOTED
3	HAND TISSUE DISPENSER UNIT	B43944 - SURFACE MOUNTED		2. ALL WORK SHALL BE DONE IN ACCORDANCE WITH MANUFACTURER'S RECOMMENDATIONS AND SPECIFICATIONS.
c	ADA-ACCESSIBLE GRAB BARS	BOBRICK - MISC. AS SHOWN		3.COORDINATE WORK WITH ALL RELATED TRADES
D	MIRROR	B-294 TILTING ADA MIRROR		4, PROVIDE ROUGH FRAMING AND BLOCKING FOR ALL ACCESSORIES.
E	MARBLE SADDLE - ½" MAX. FLR. TRANS.			
F	HOOK	B-212 HOOK M/ BUMPER		
G	SOAP DISPENSER	B-4112		
Н	SMING UP ADA GRAB BAR	N/A		
I	VERTICAL GRAB BAR	18" CUSTOM GRAB BAR - MOUNTED TO MINDOM JAMB & CUSTOM BENT TO MEET ADA.		
J	ADA TRANSFER SHOWER - FREE DOM SHOWER - COMFORT SERIES	Model APF 3838 BF .50 4P	INCLUDE ALL ACCESSORIES - INCLUDING FITURE AND FITTINGS AND DRAIN AND SHOWER ROD, CURTAIN AND HOOKS	

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Project Title

Date Issue

# Croton-on-Hudson Harmon Firehouse Station #3 & EMS

30 Wayne Street Croton-On-Hudson New York 10520

Drawing Title


BATHROOM DETAILS


	Project No.	202222	
	Date	7.21.2023	
	Scale		
	Drawing by	KA	
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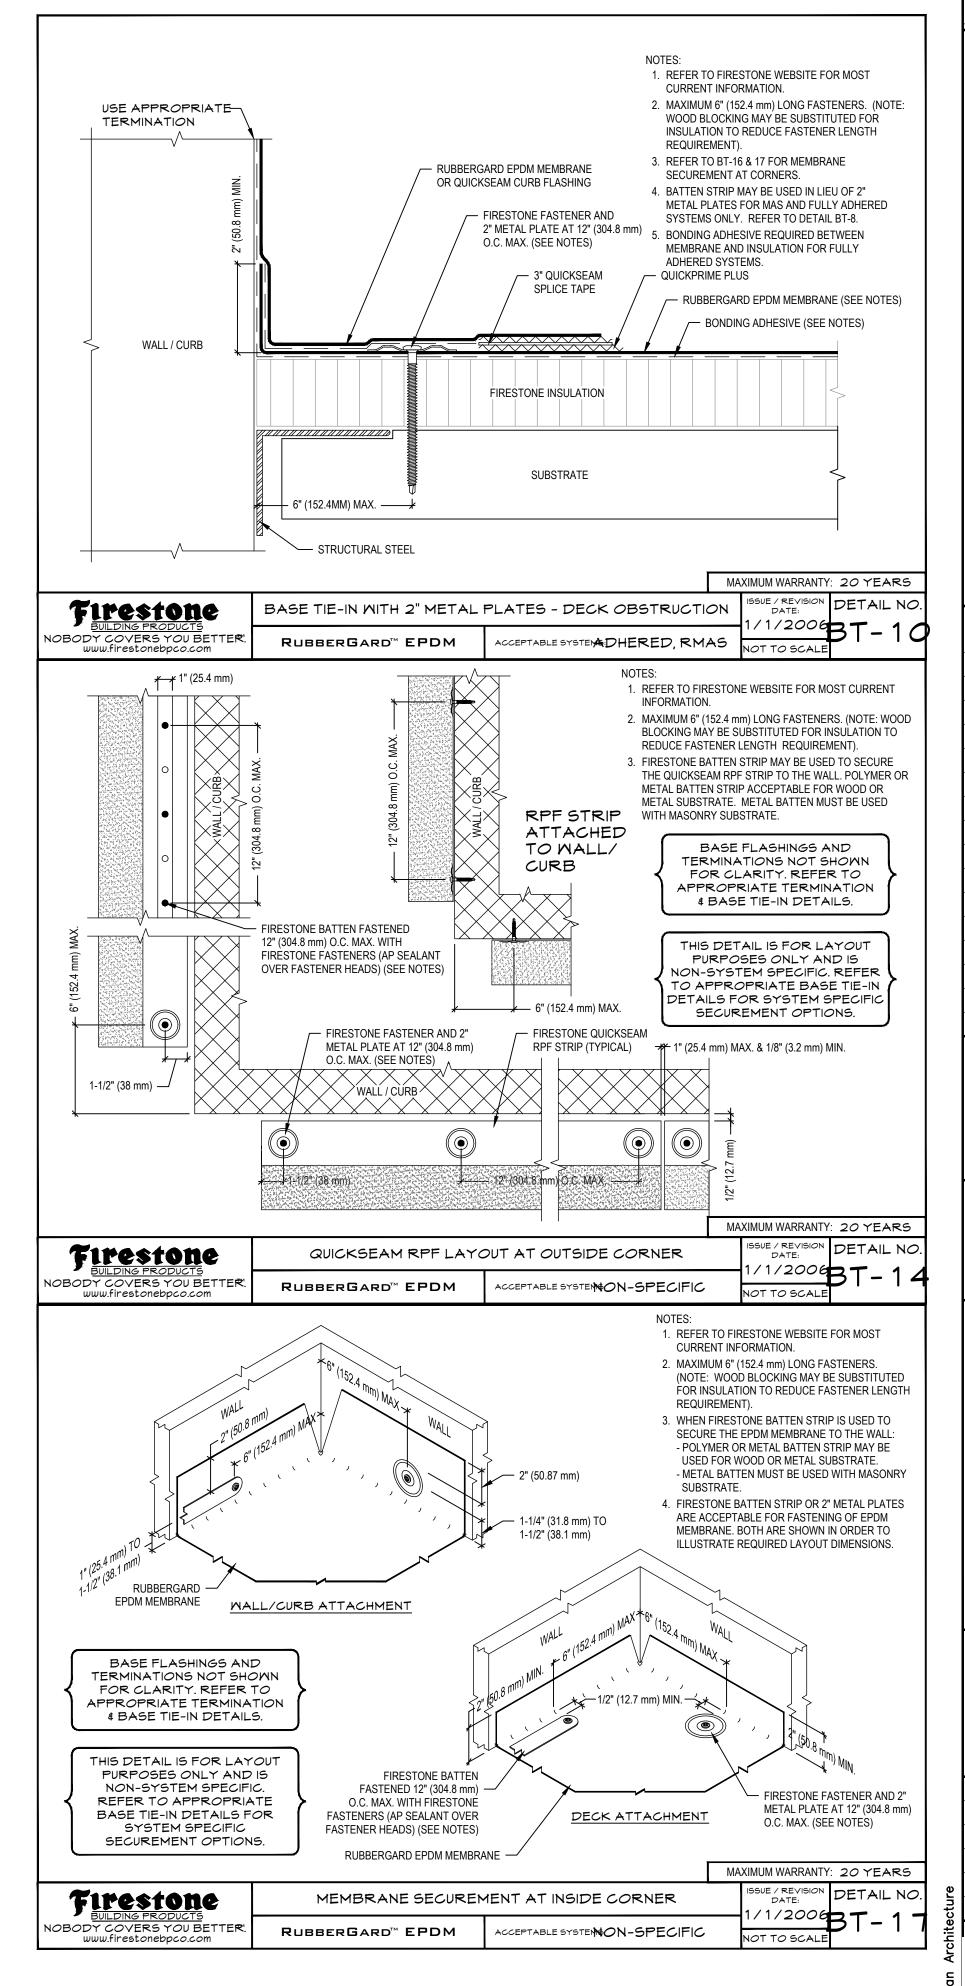
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A-21





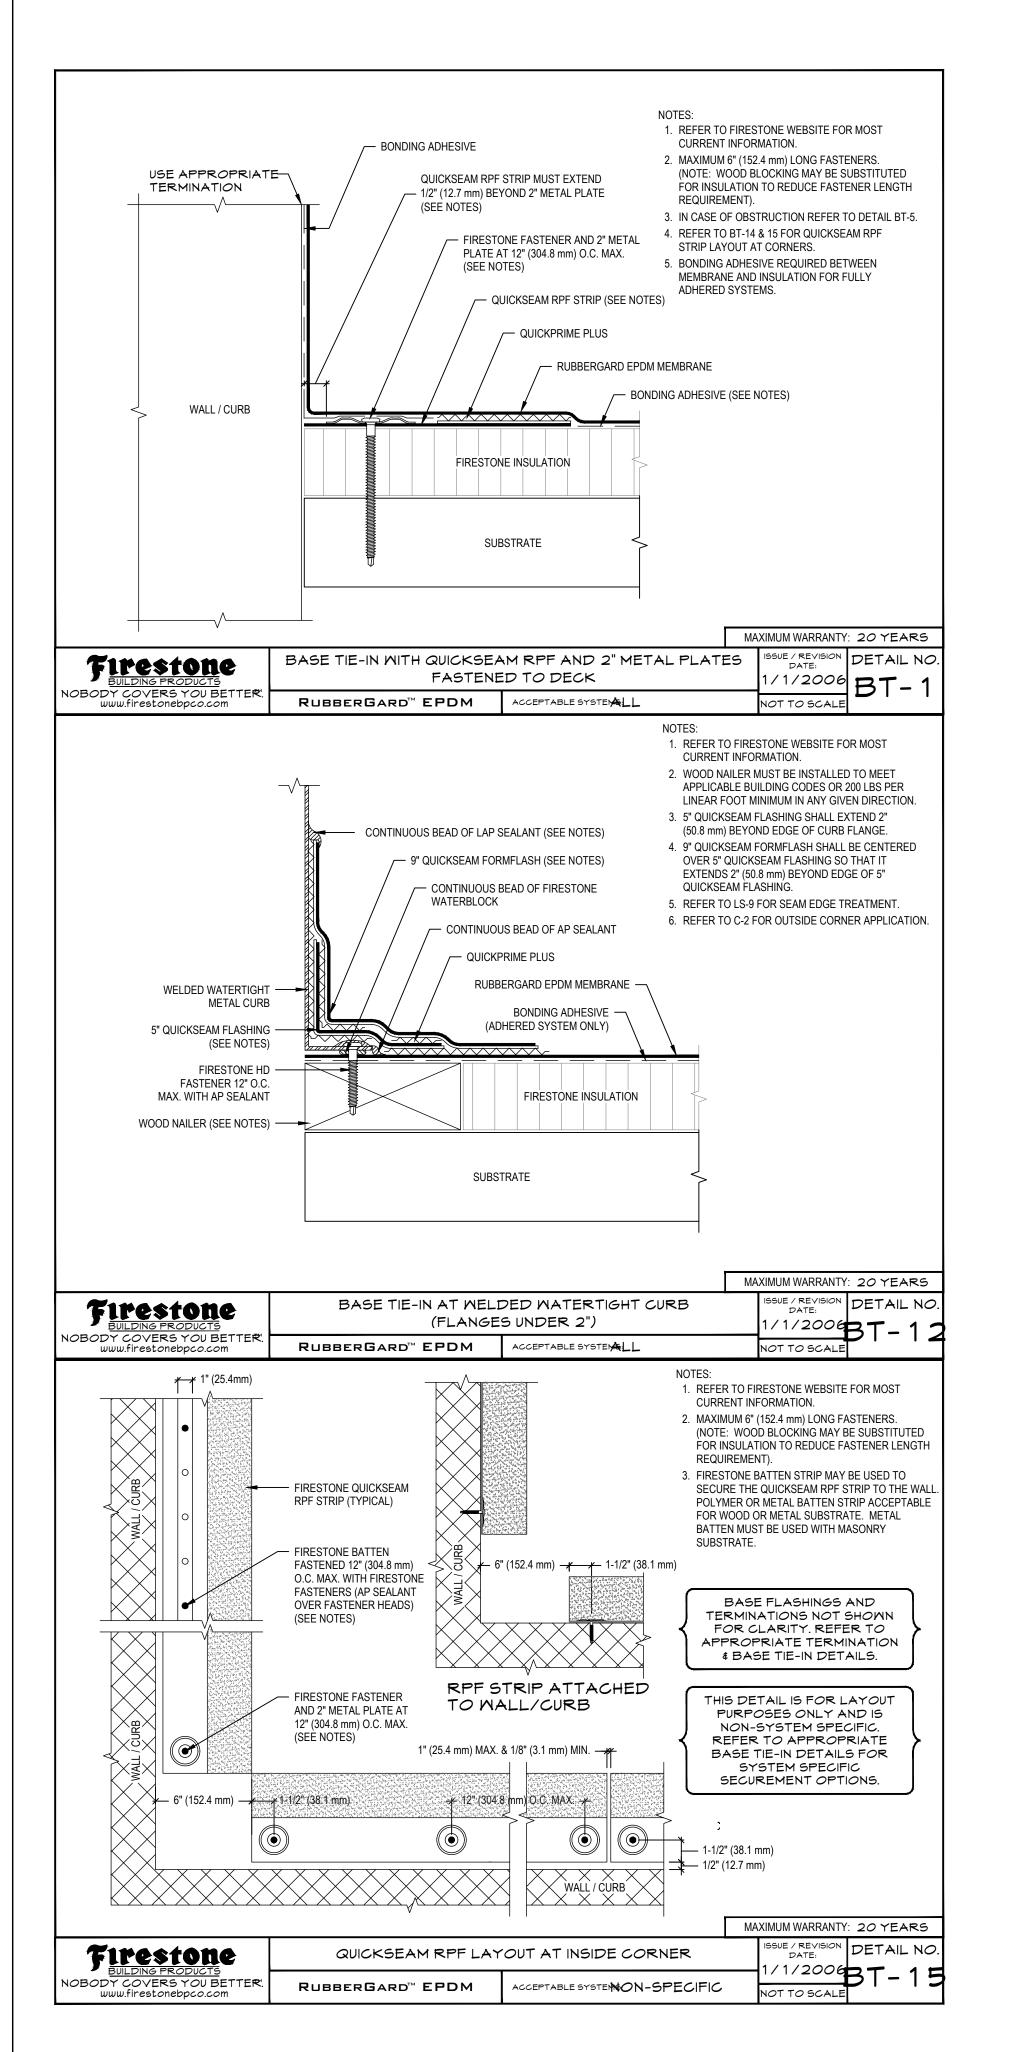

31 Mamaroneck Avenue
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Croton-on-Hudson

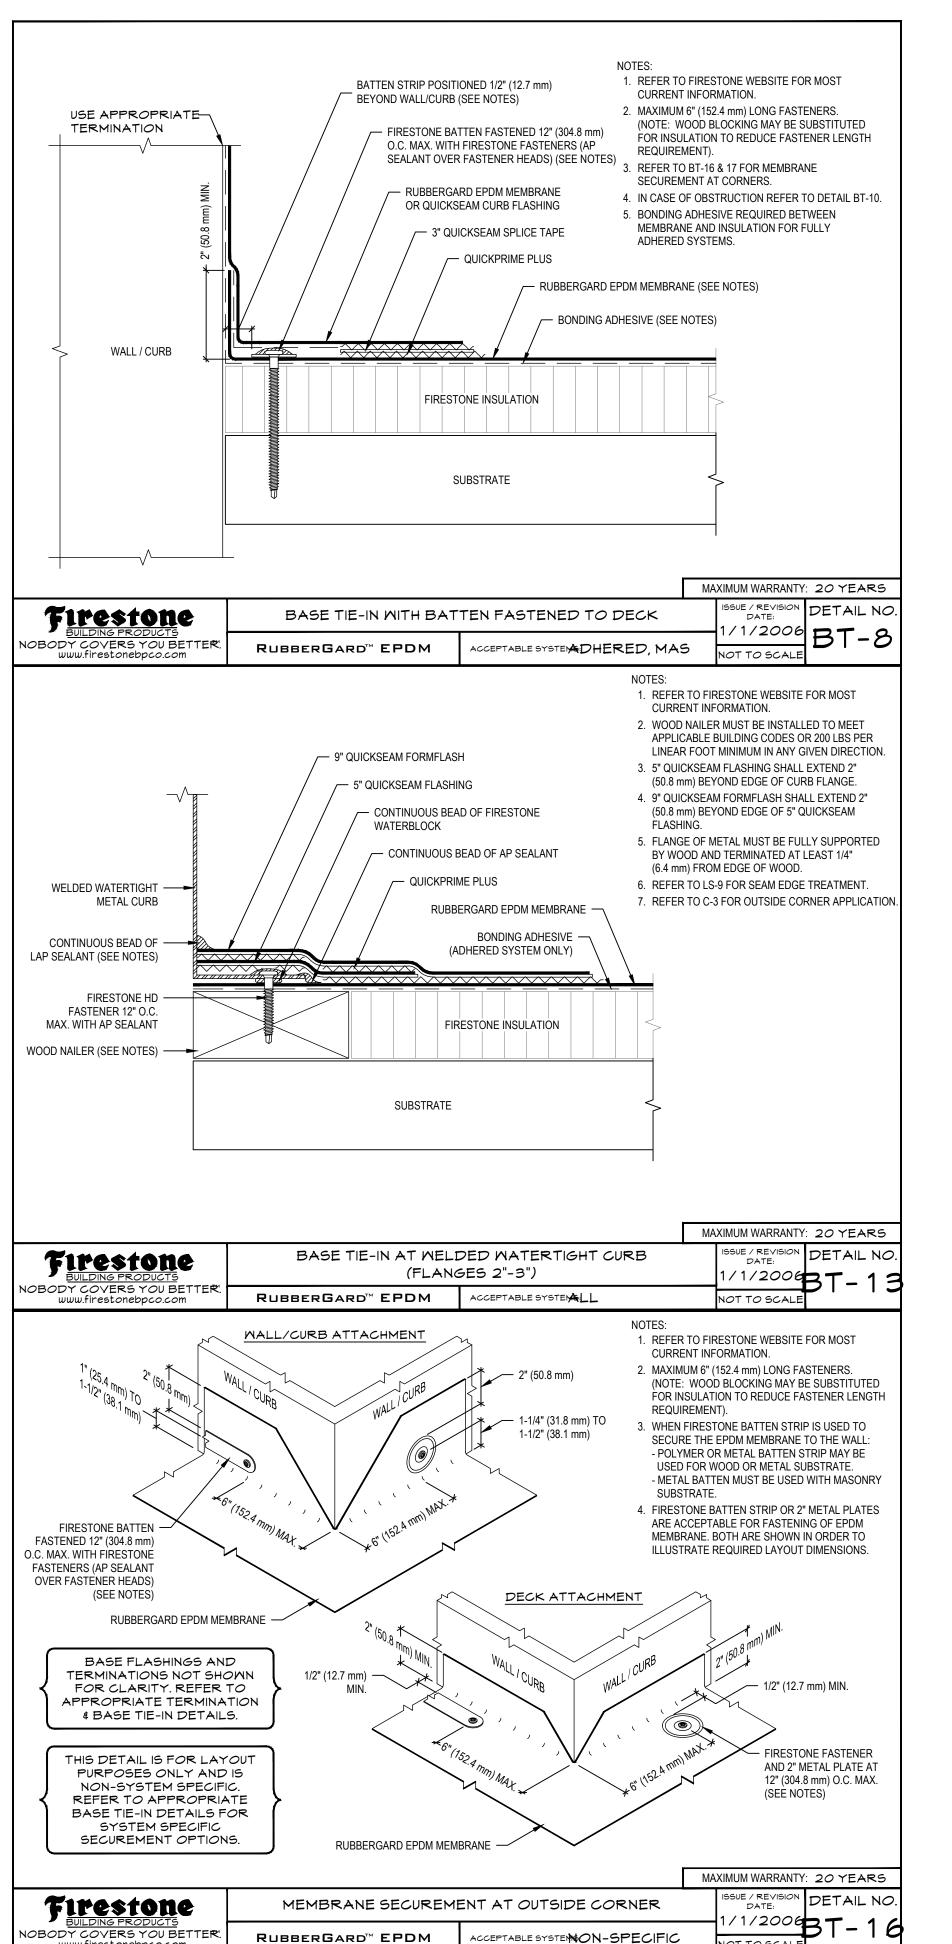Harmon Firehouse

Station #3 & EMS

30 Wayne Street

Croton-On-Hudson

New York 10520

ROOF DETAILS

202222

7.21.2023

Drawing No.

ΚA

alteration.

Project Title

Drawing Title

Project No.

Drawing by

Checked by

Date


Scale


Date Issue


18/2024 CLIENT REVIEW SET

4/8/2024 CLIENT REVIEW SET

5/7/24 CONSTRUCTION SET

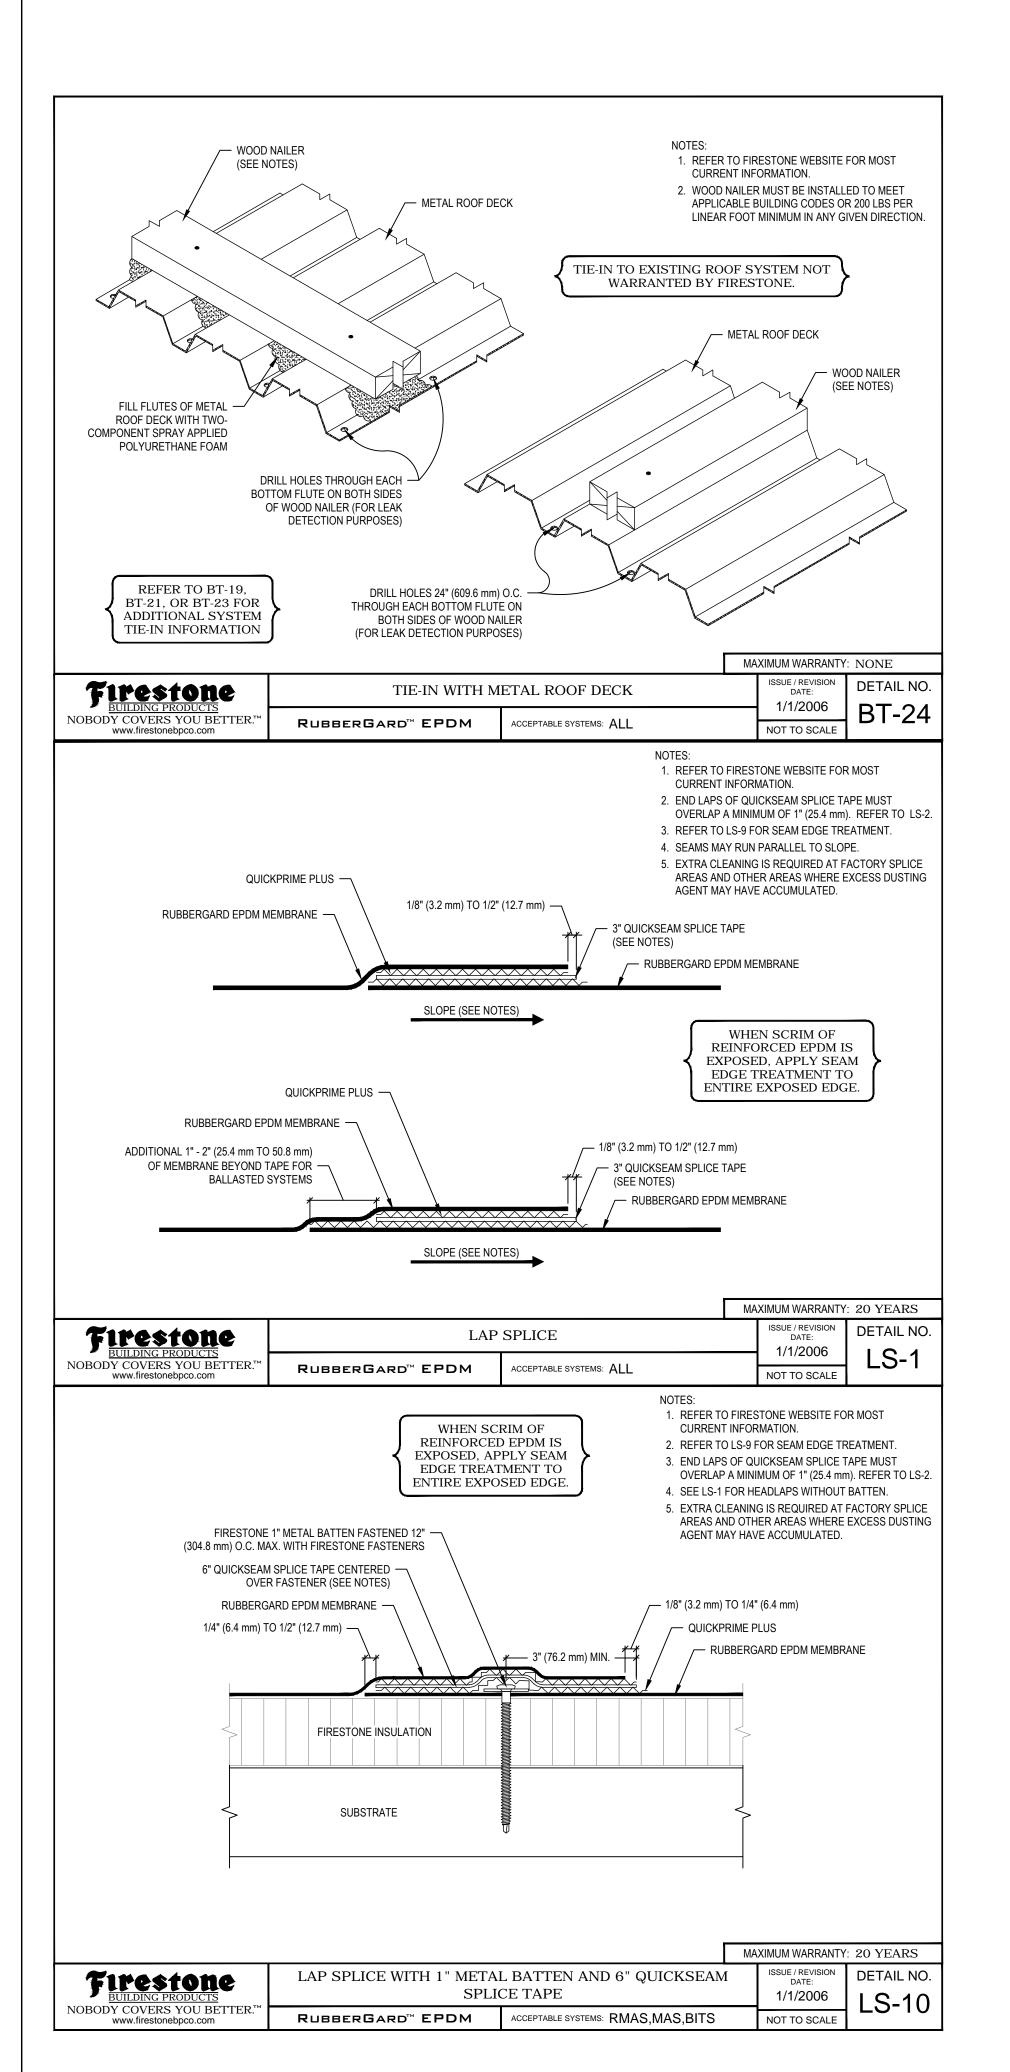

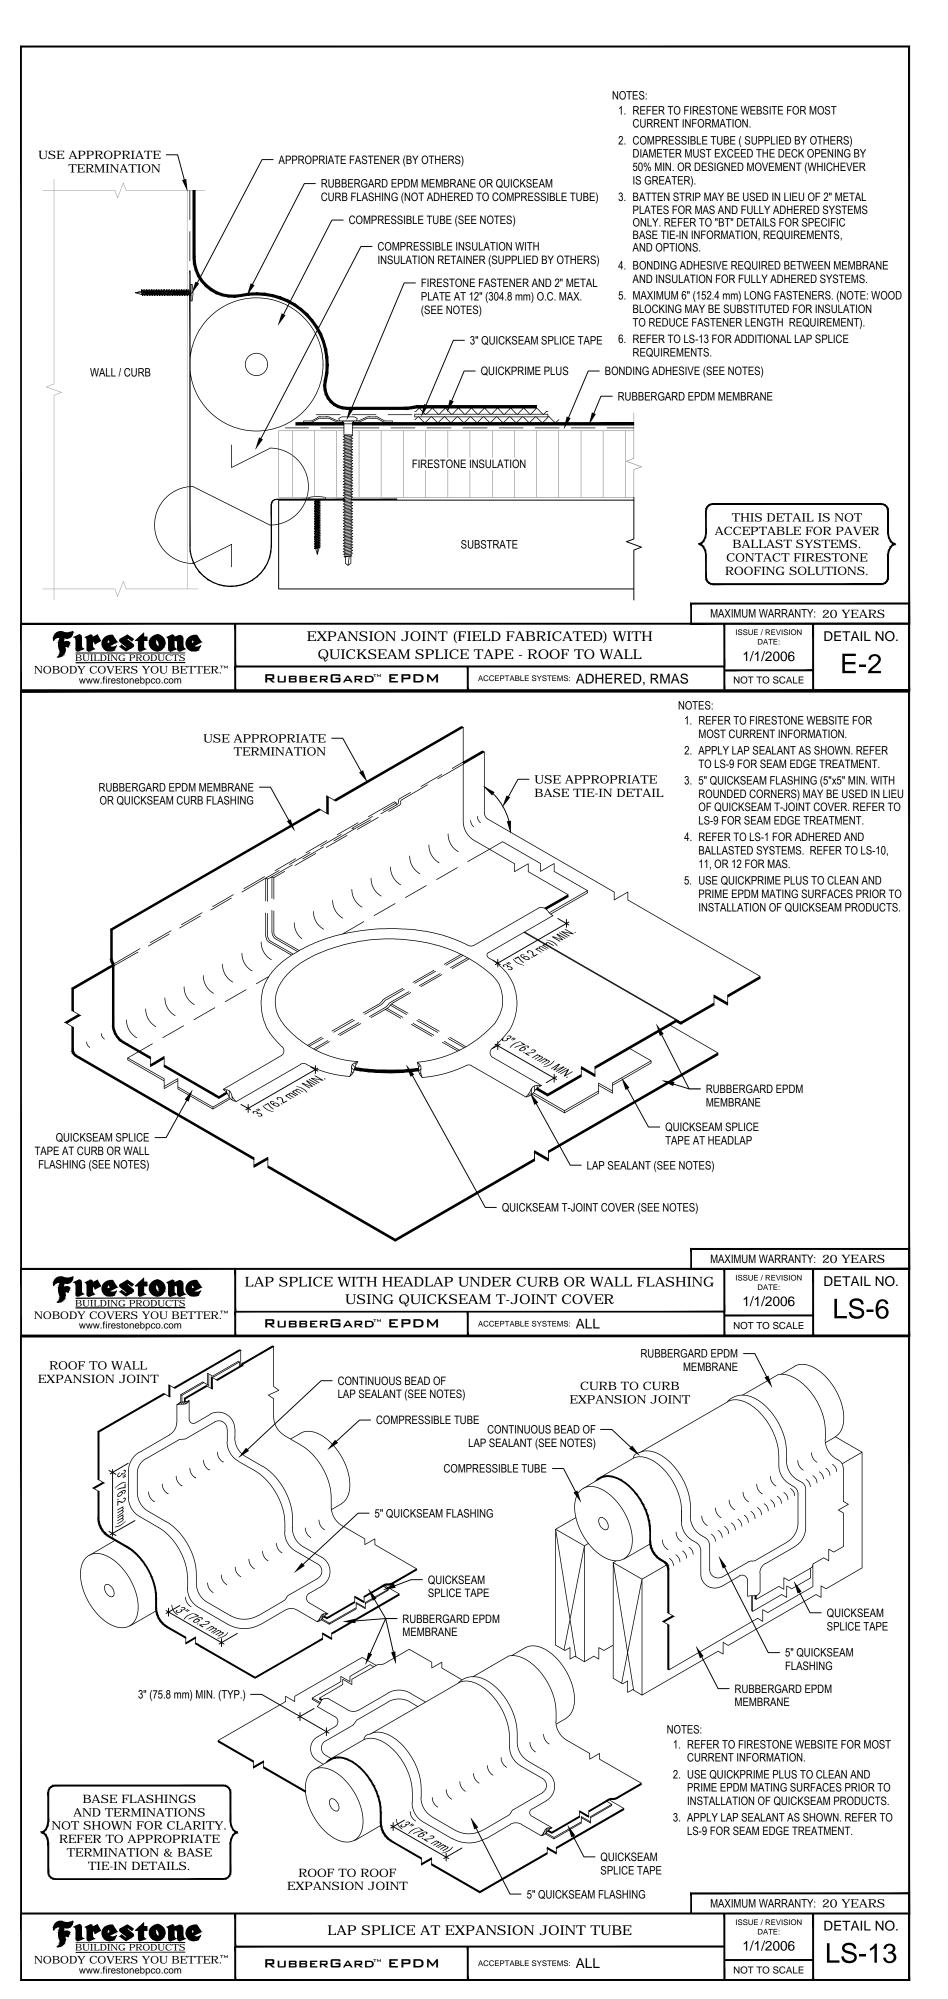

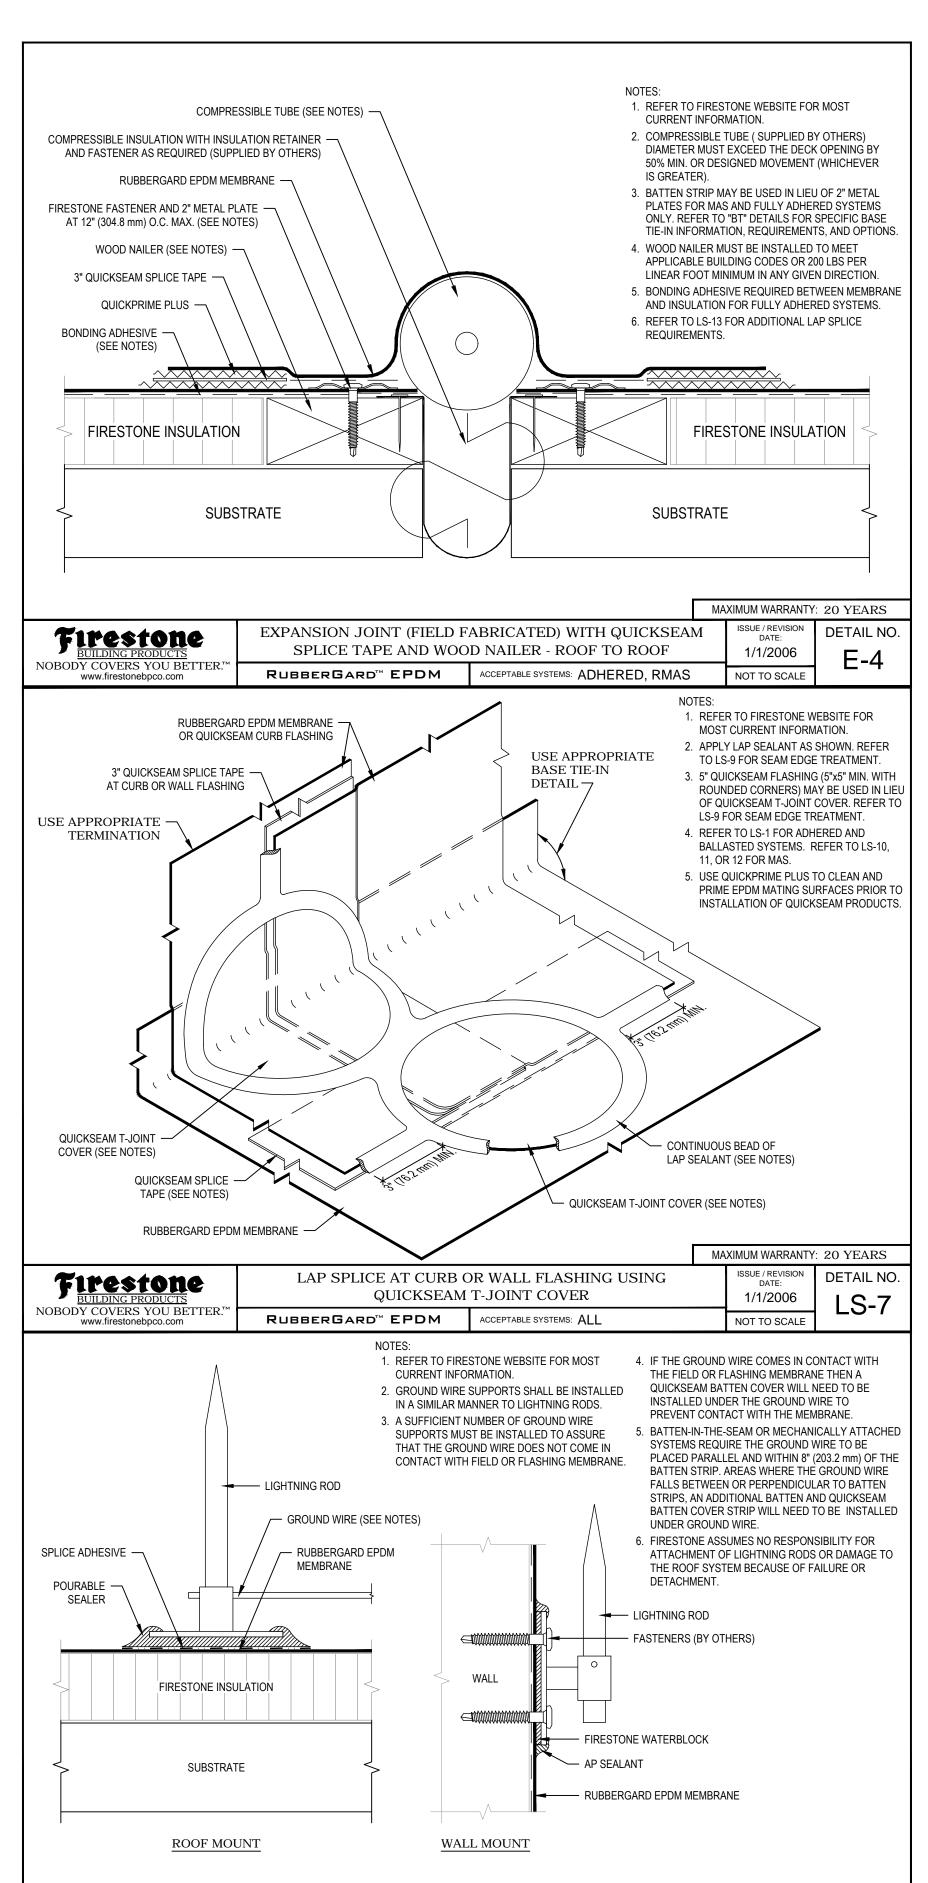

LIGHTNING ROD

ACCEPTABLE SYSTEMS: ALL

RubberGard™ EPDM

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30 Wayne Street Croton-On-Hudson New York 10520

Drawing Title

MAXIMUM WARRANTY: 20 YEARS

DETAIL NO.

M-6

SSUE / REVISION

1/1/2006

NOT TO SCALE

alteration.

Project Title

ROOF DETAILS


Project No. 202222


Date 7.21.2023


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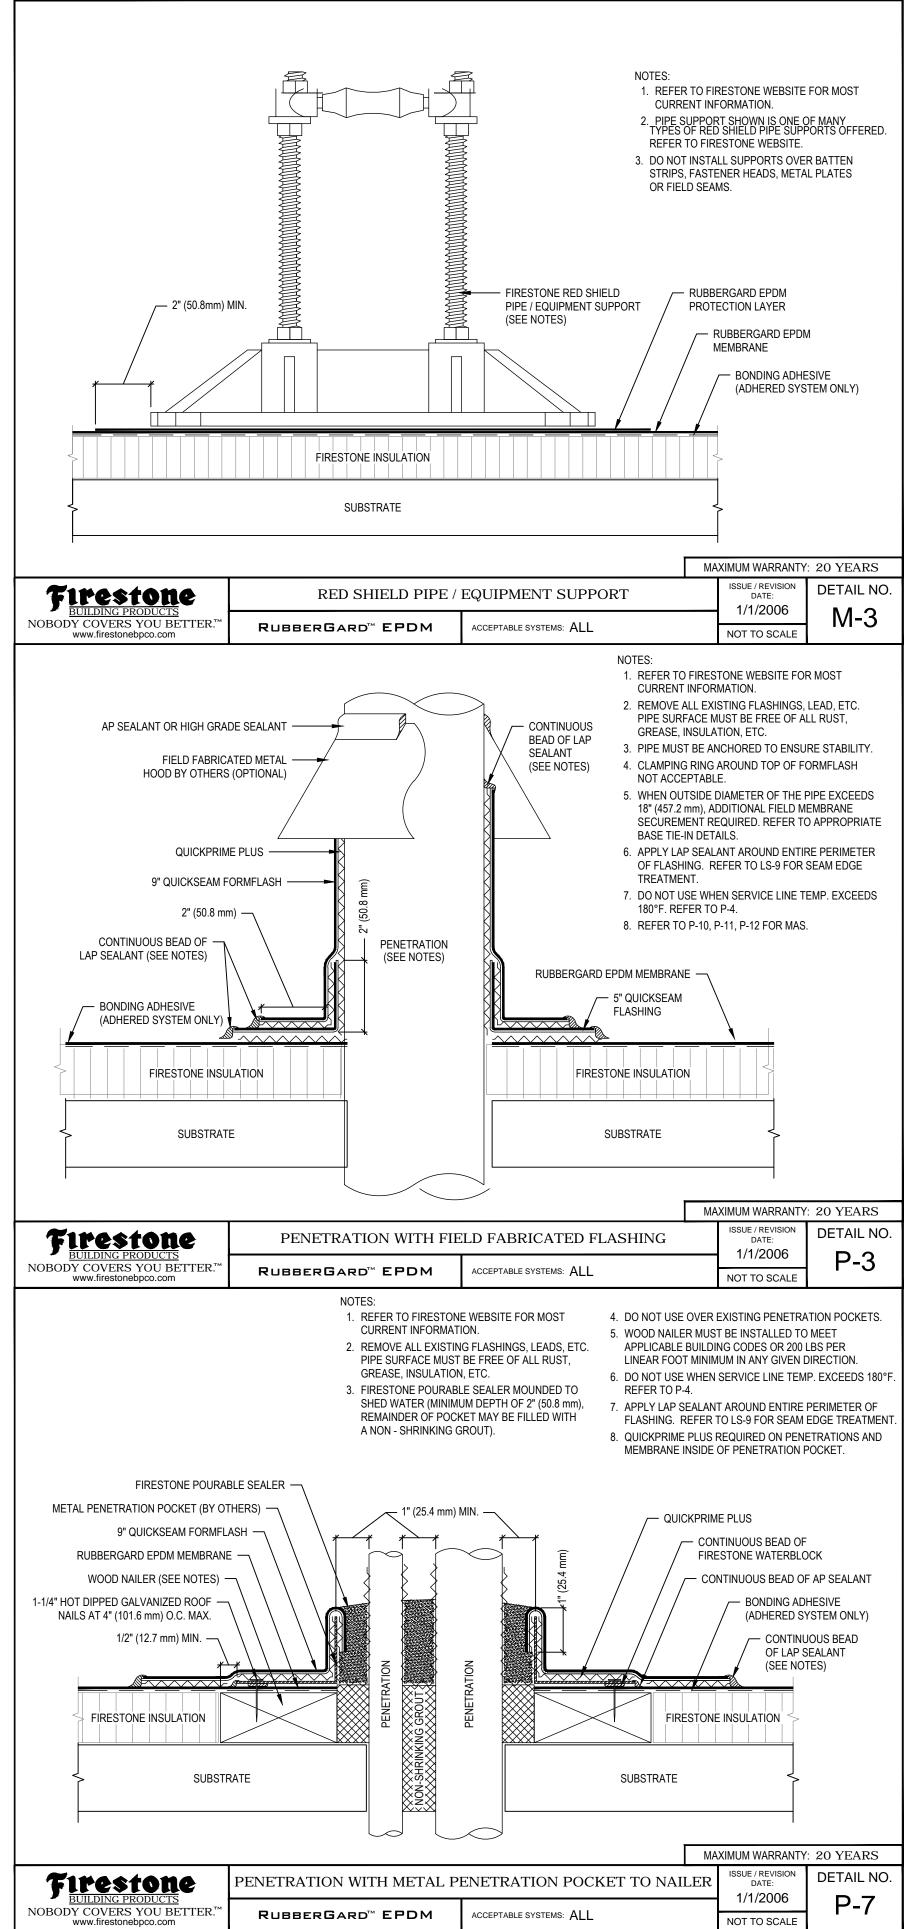
Drawing by KA

Checked by



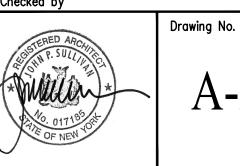

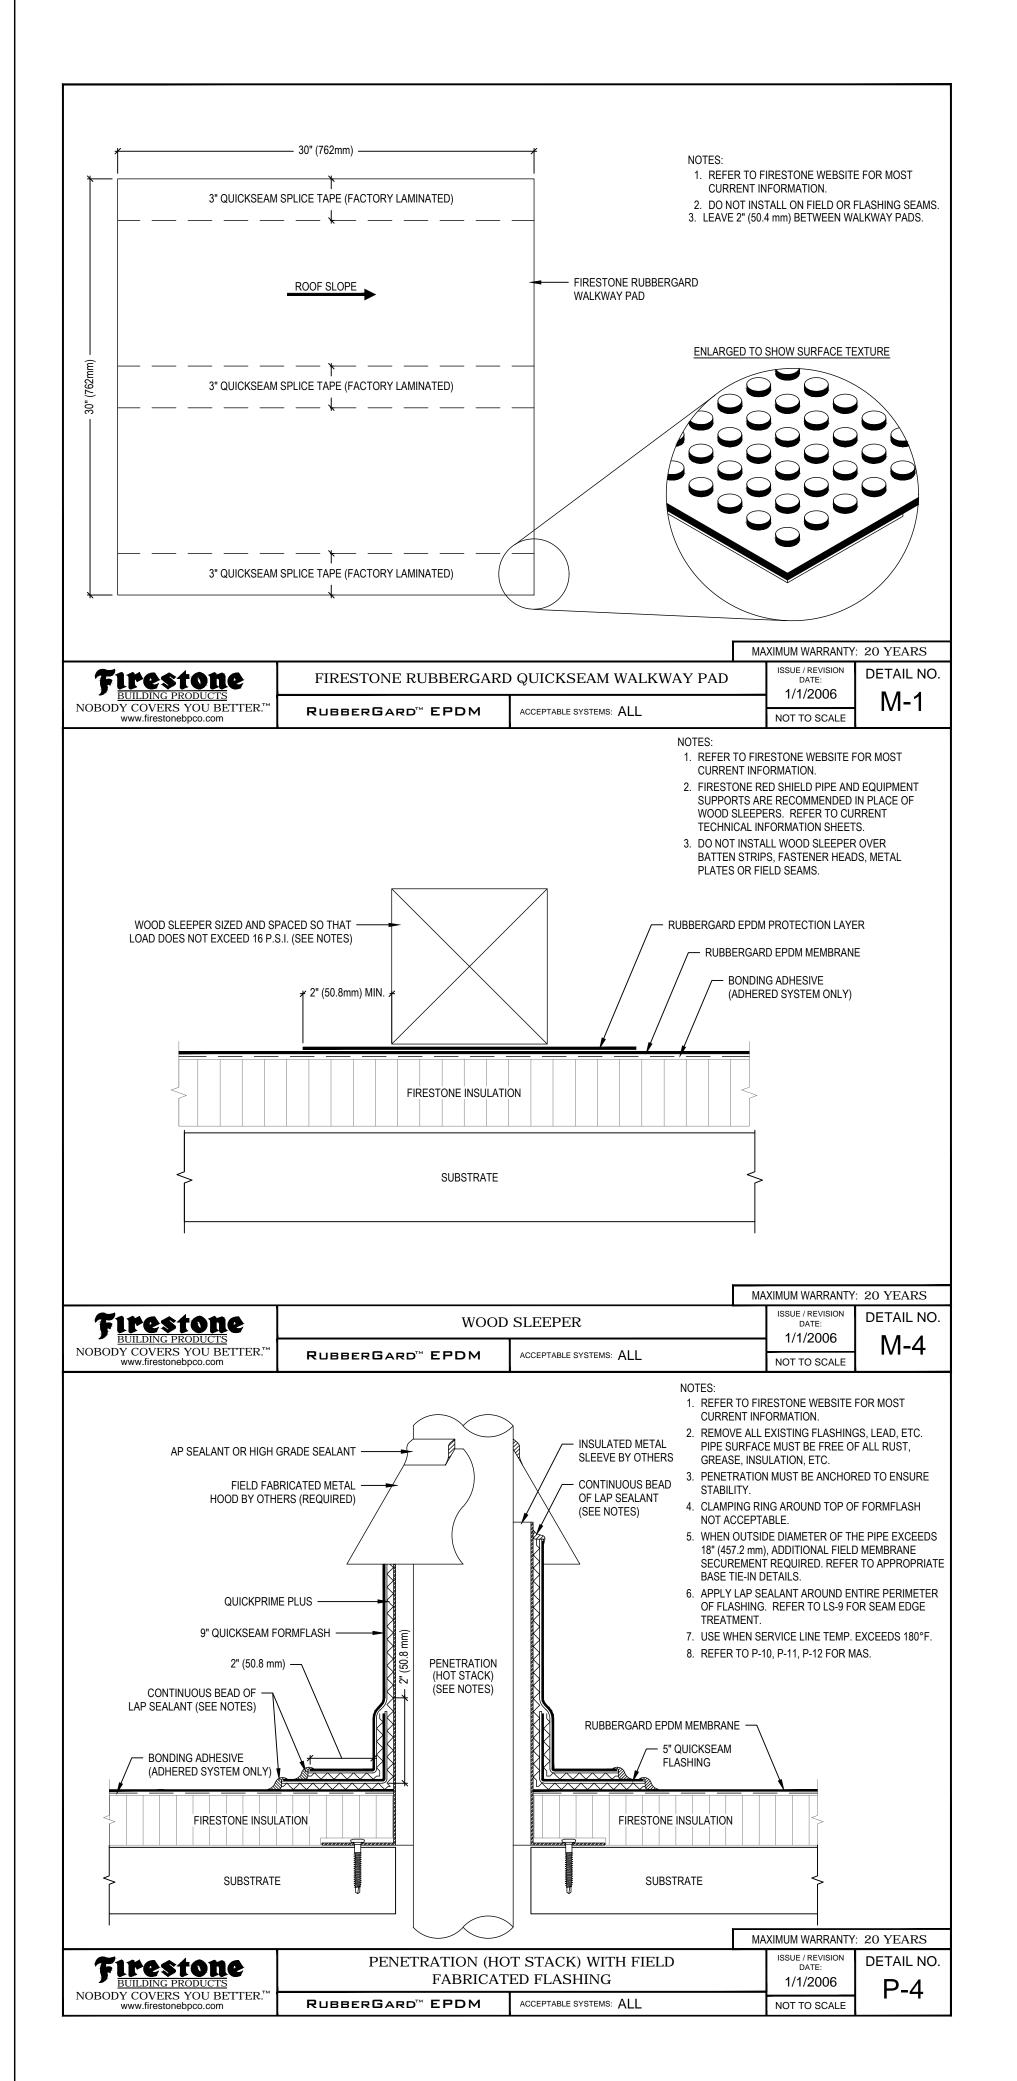

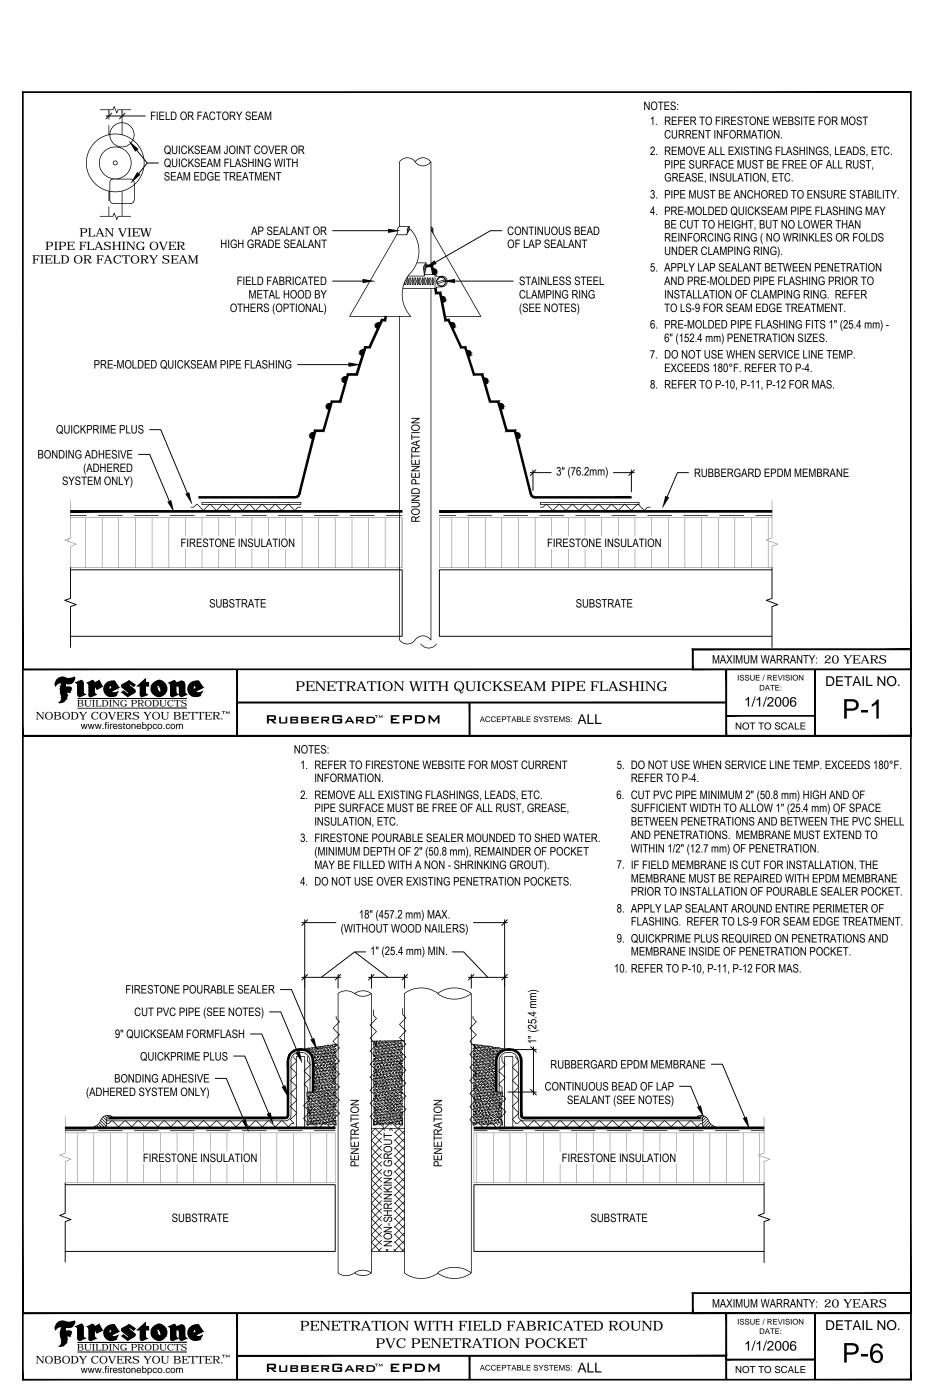

31 Mamaroneck Avenue White Plains, New York 1060 914-761-6006 (F) 914-761-4919 nn P. Sullivan, FAIA - Lisc. # 017185 Registered through 9/30/2

/18/2024 CLIENT REVIEW SET 4/8/2024 CLIENT REVIEW SET 5/7/24 CONSTRUCTION SET herby state to the best of my professional knowledge and abilities that the proposed building design represented in

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Project Title Croton-on-Hudson Harmon Firehouse

> 30 Wayne Street Croton-On-Hudson New York 10520


Station #3 & EMS


Drawing Title


alteration.


ROOF DETAILS

Project No. 202222 Date 7.21.2023 Scale Drawing by ΚA Checked by

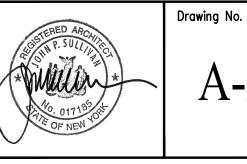

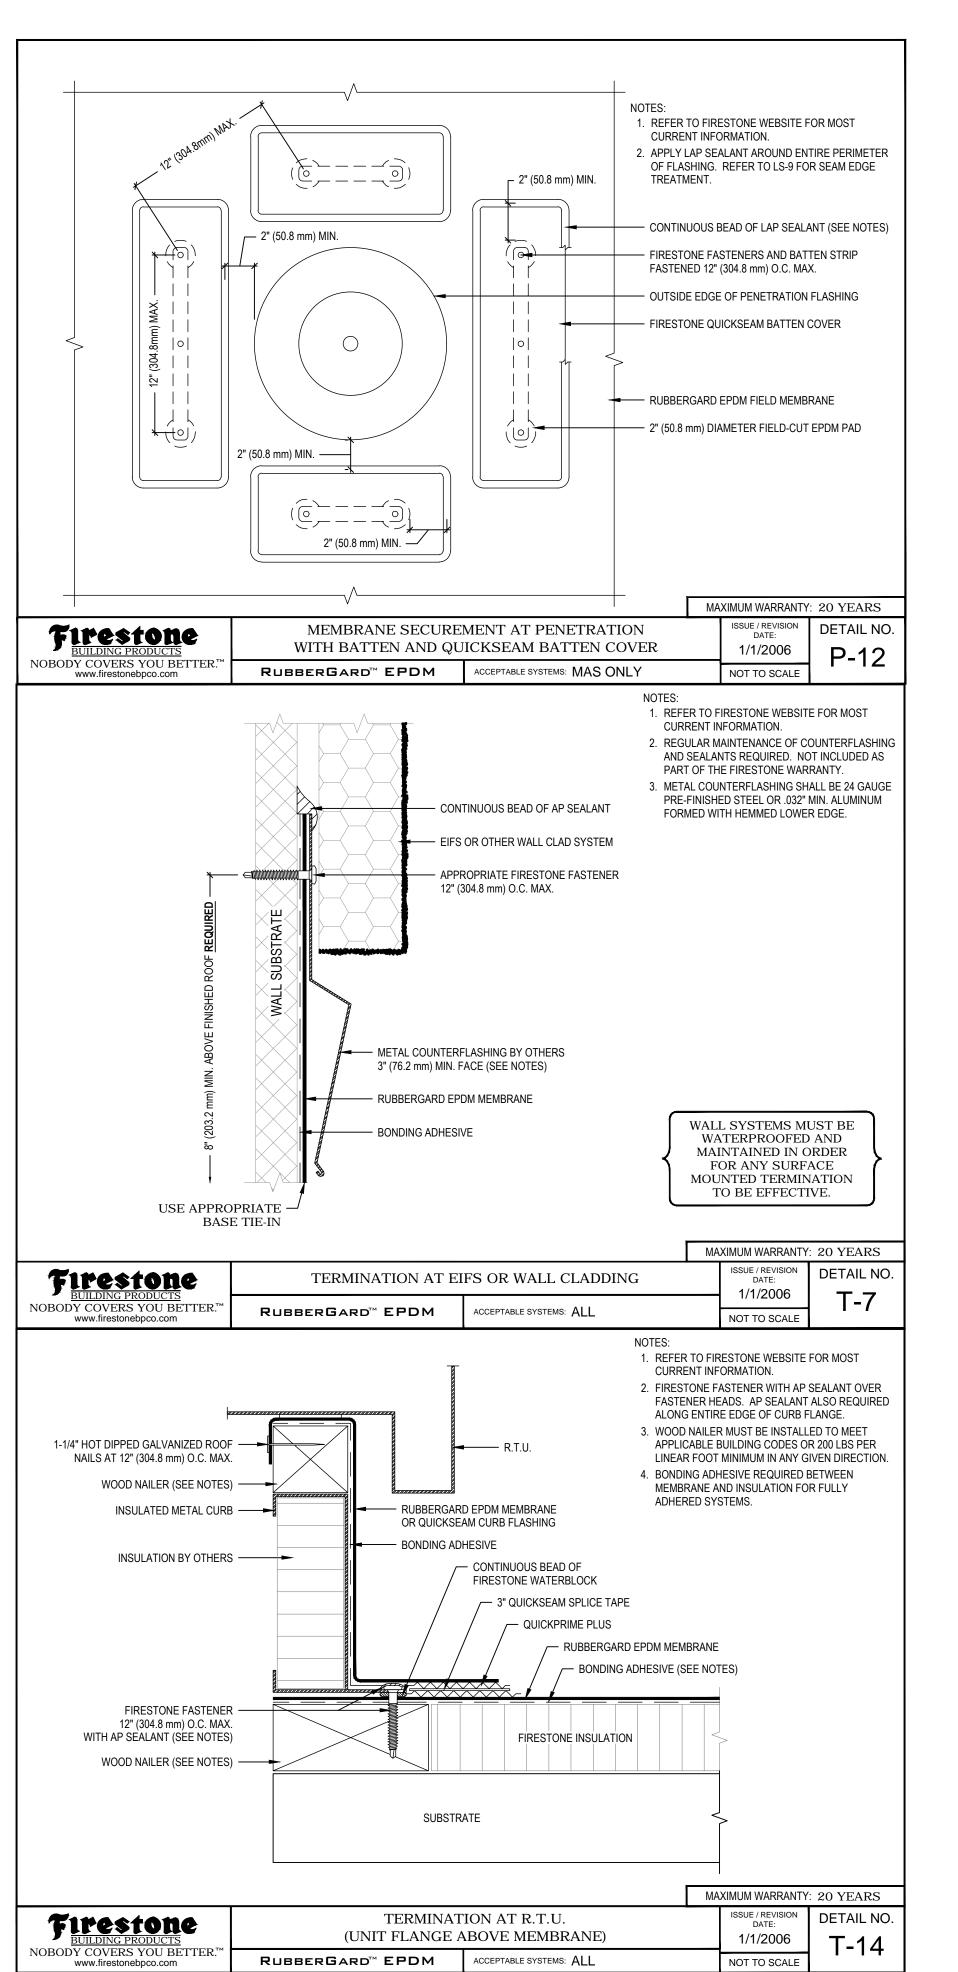

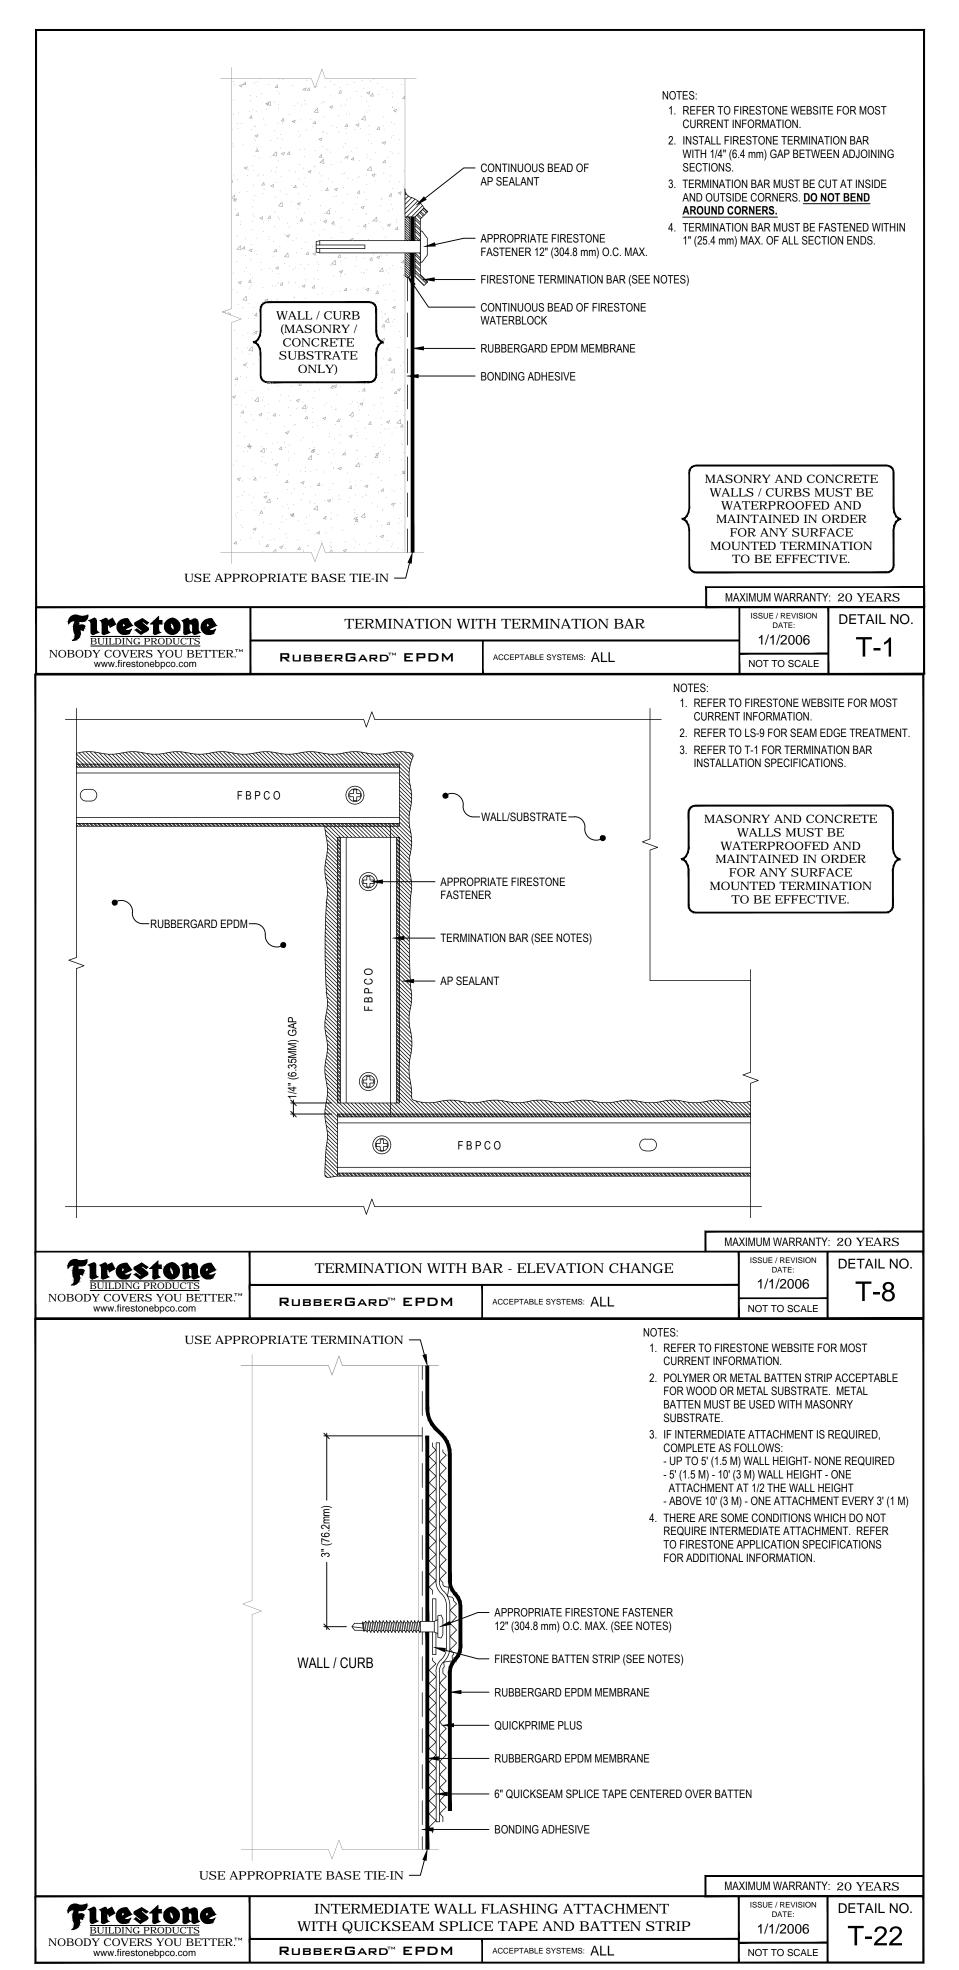

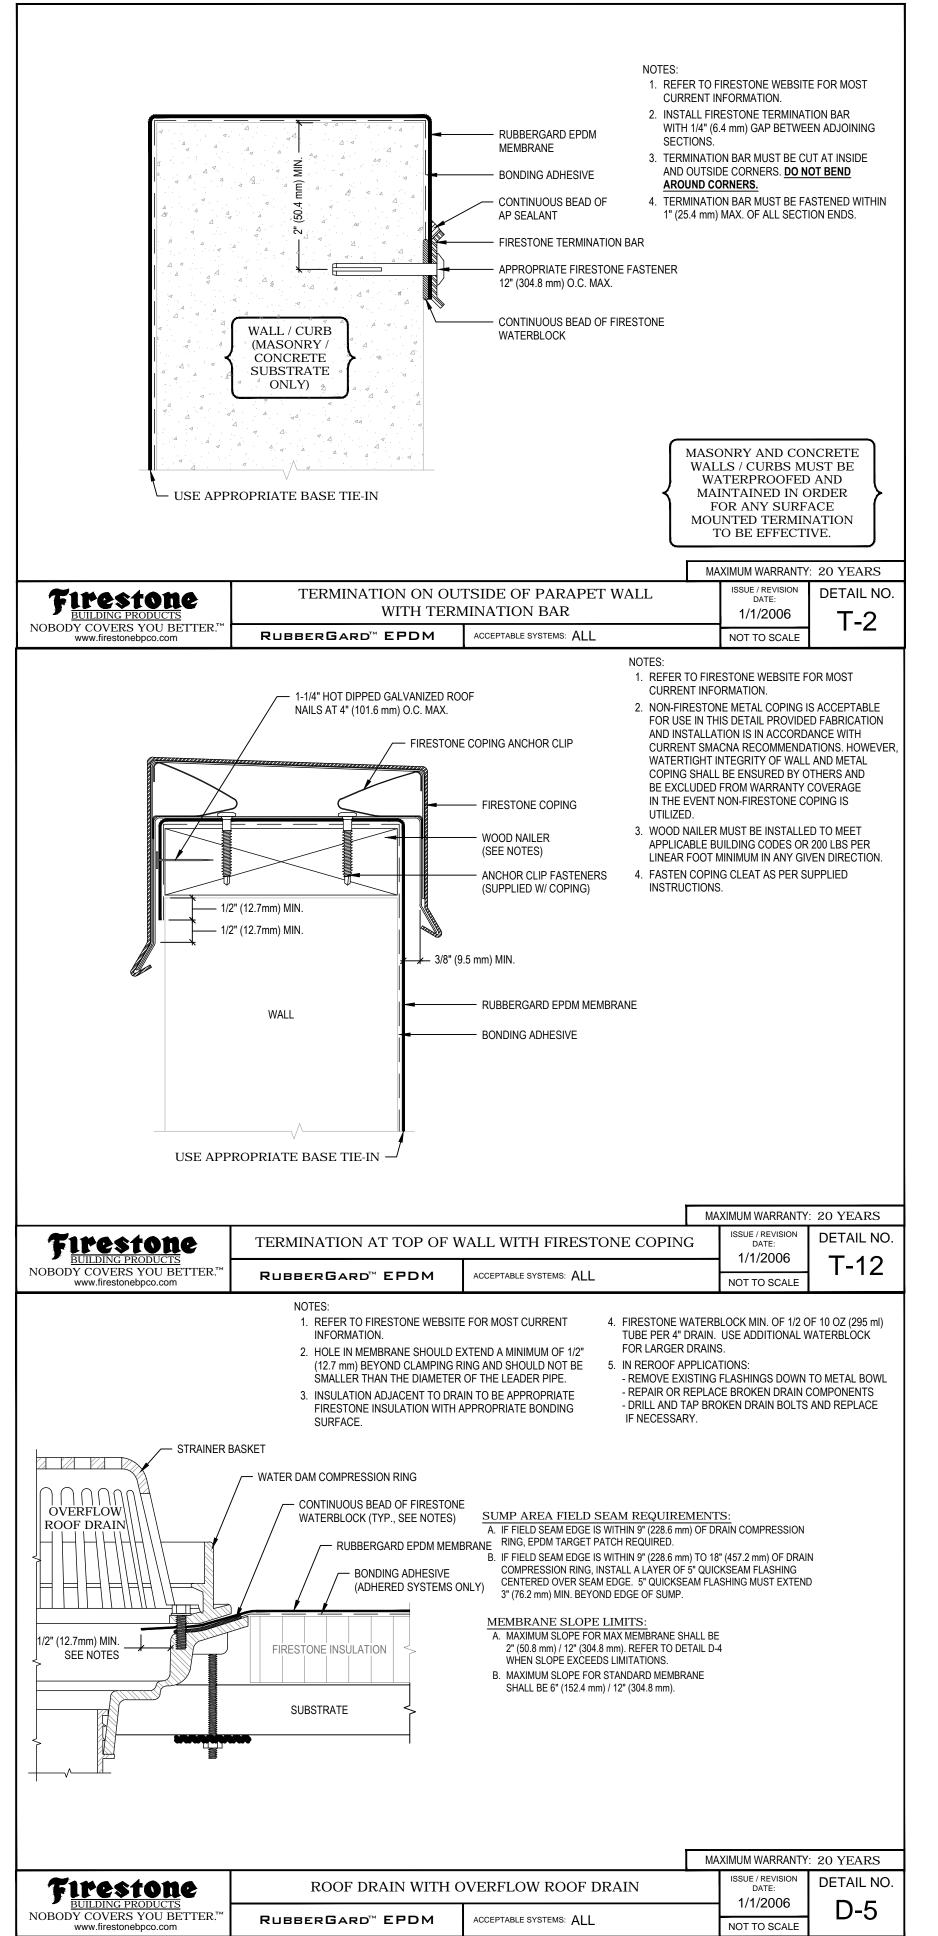

31 Mamaroneck Avenue
White Plains, New York 10601
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ohn P. Sullivan, FAIA - Lisc. # 017185 Registered through 9/30/2

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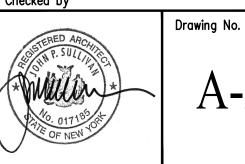
Harmon Firehouse
Station #3 & EMS

30 Wayne Street Croton-On-Hudson New York 10520


Drawing Title

ROOF DETAILS

	Project No.	202222	
	Date	7.21.2023	
	Scale		
	Drawing by	KA	
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ecture	Checked by		
Ø,			



A-25

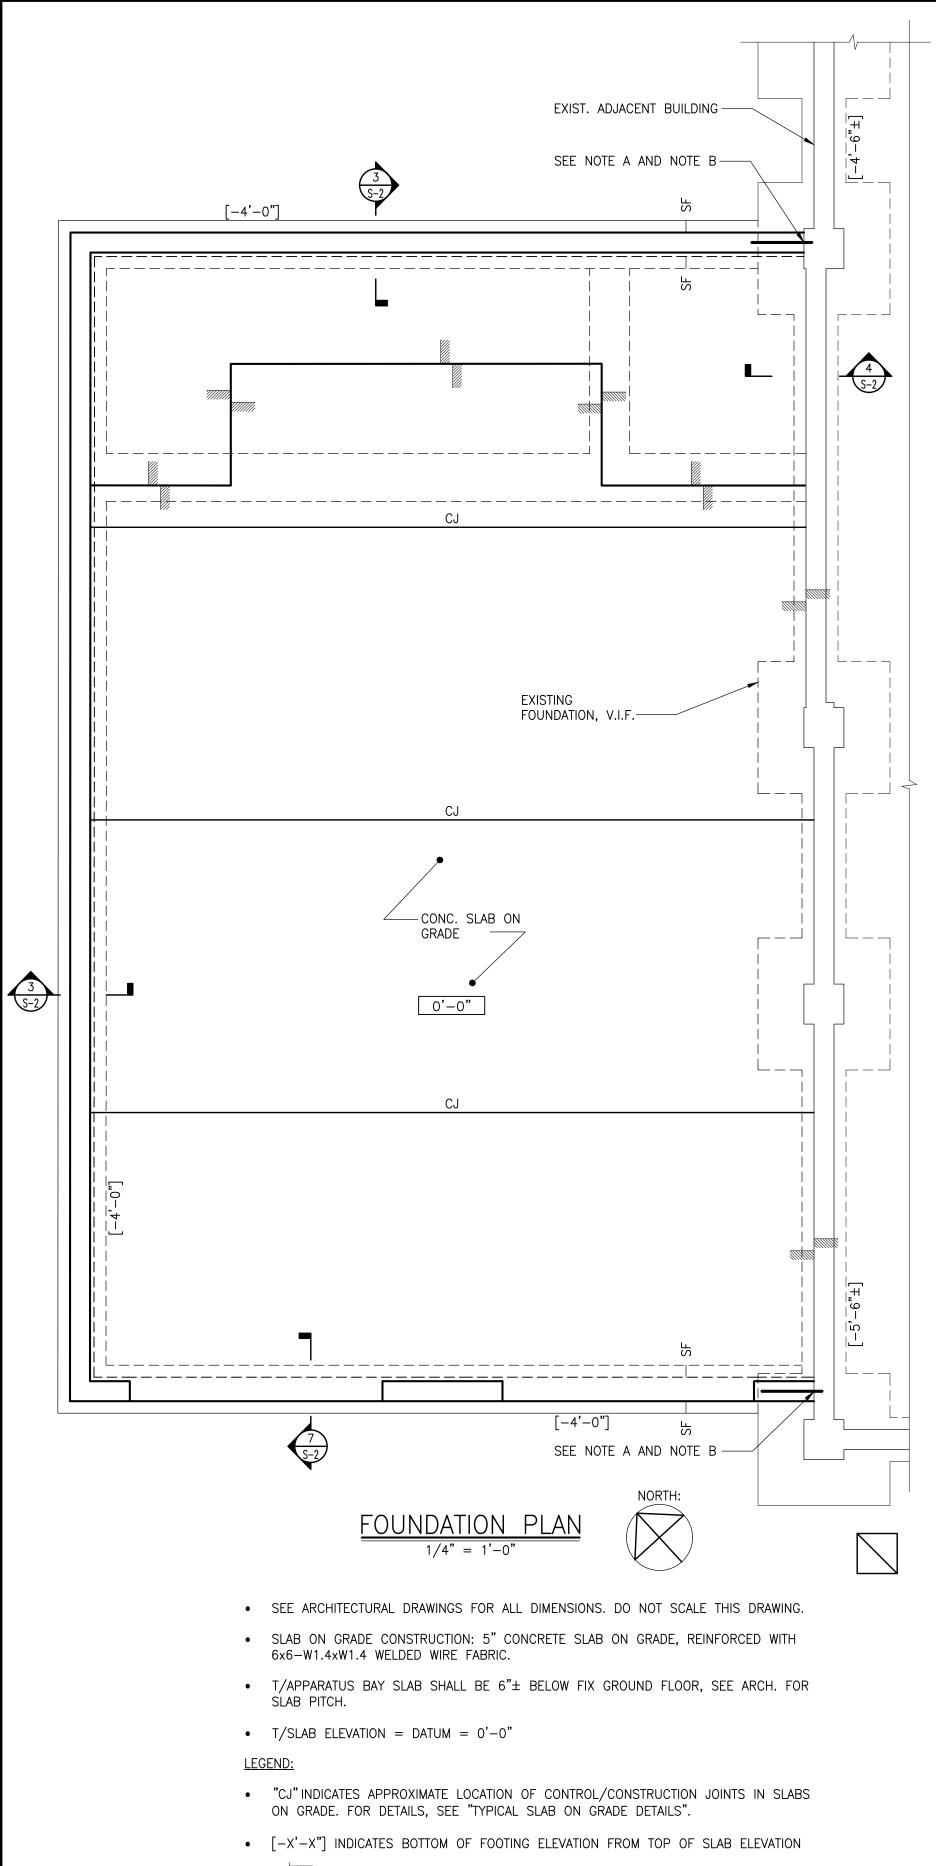

- DROP: INDICATES CHANGE IN ELEVATION.
- LOCATION AND ELEVATION WITH SITE GRADING AND MECHANICAL, ELECTRICAL AND PLUMBING DRAWINGS. FOR DETAILS, SEE "TYPICAL STEPPED FOOTING DETAIL".


• "SF" INDICATES APPROXIMATE LOCATION OF STEPS IN FOOTINGS ON PLAN. COORDINATE

AT ALL LOCATIONS WHERE NEW FND. WALL AND FOOTING MEETS EXISTING FND. WALL AND FOOTING, PROVIDE #4 x 4'-0" LONG DOWELS (BENT OR STRAIGHT) AT 12"o.c. DRILL AND EMBED DOWEL INTO FND. WALL AS FOLLOWS:

CONCRETE WALL: 4" W/ DEWALT AC100+ GOLD ADHESIVE
 ACCOUNTY WALL: 4" W/ DEWALT AC100+ GOLD ADHESIVE

• MASONRY WALL: 4" W/ DEWALT AC100+ GOLD ADHESIVE

NOTE "B":
EXISTING BOTTOM OF FOOTING ELEVATION TO BE V.I.F. IF EXISTING BOTTOM OF FOOTING ELEVATION IS LESS THAN 3'-6" BELOW FINISH GRADE ELEVATION, CONCRETE UNDERPINNING SHALL BE REQ'D. BOTTOM OF NEW FOOTING ELEVATION SHALL MATCH BOTTOM OF EXISTING FOOTING OR BOTTOM OF UNDERPINNING, WHICHEVER IS LOWER.

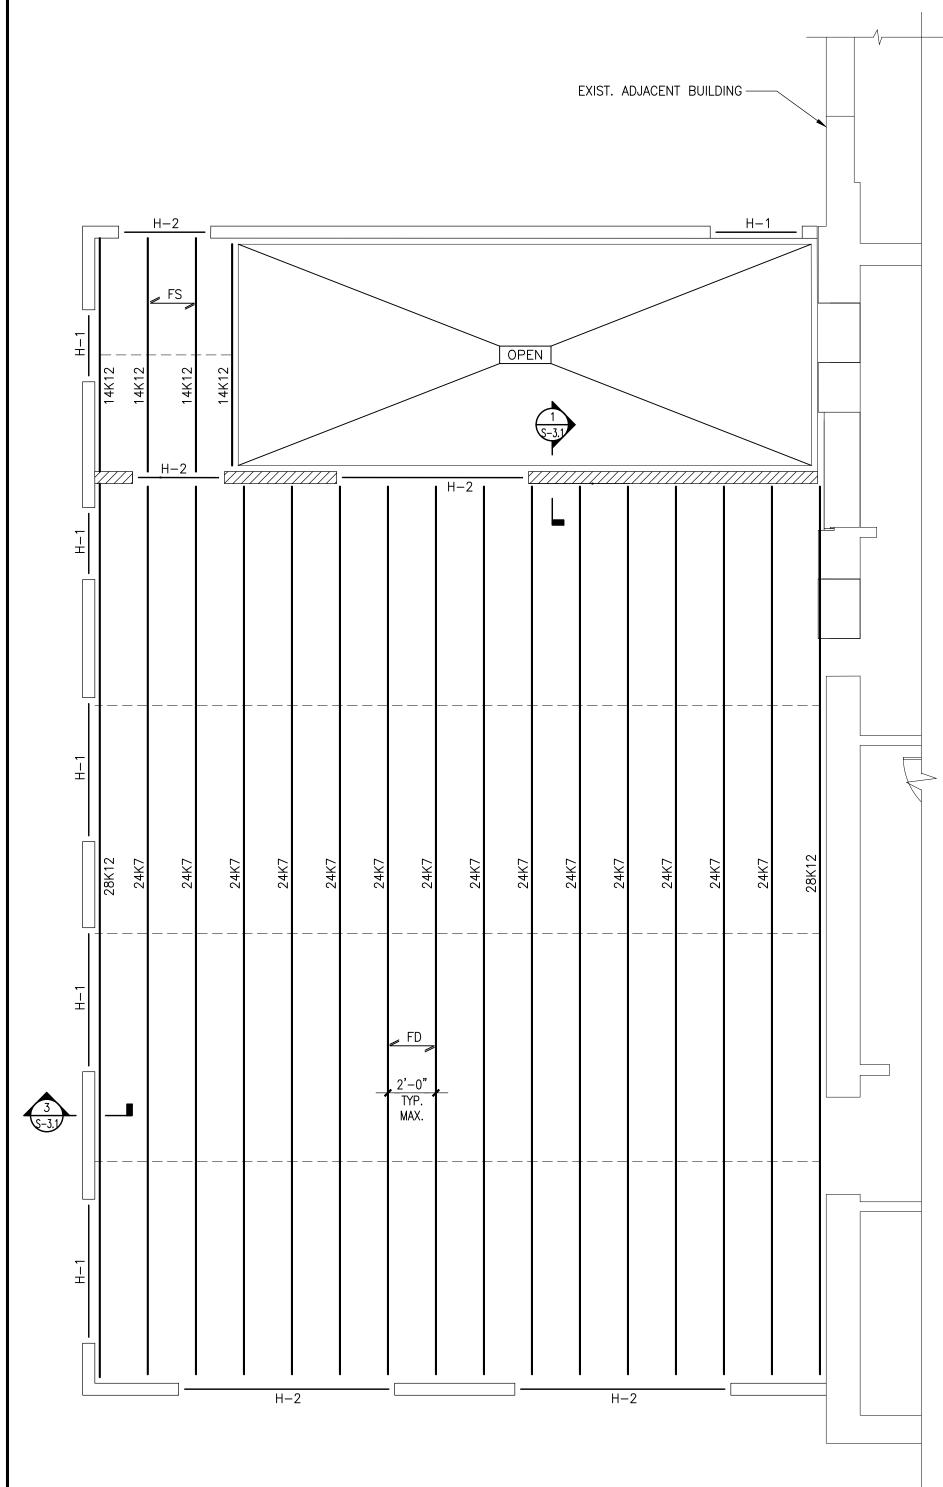


# SECOND FLOOR FRAMING PLAN



- SEE ARCHITECTURAL DRAWINGS FOR ALL DIMENSIONS. DO NOT SCALE THIS DRAWING.
- TYPICAL WALL CONSTRUCTION SHALL BE 600S200-54 AT 16"o.c. WITH (4)600S200-54 TO ALIGN WITH FLOOR JOISTS.
- NON-COMPOSITE FORM DECK FLOOR CONSTRUCTION: 3 1/2" CONCRETE SLAB = 2 1/2" NORMAL WEIGHT CONCRETE REINFORCED WITH 6x6-W1.4xW1.4 WELDED WIRE FABRIC ON 1" STEEL FORM DECK PER STEEL DECK NOTES.
- TOP OF 2ND FLOOR SLAB SHALL MATCH EXISTING TOP OF 2ND FLOOR SLAB, SEE ARCH.
- ALL EXTERIOR WALLS SHALL BE CONSTRUCTED AS SW-1 SHEAR WALLS PER 1/S-3.

### LEGEND:

- FD INDICATES SPAN DIRECTION OF SLAB ON METAL FORM DECK.
- $\bullet$  --- Indicates continuous Horizontal Bridging equally spaced along span of steel joist.

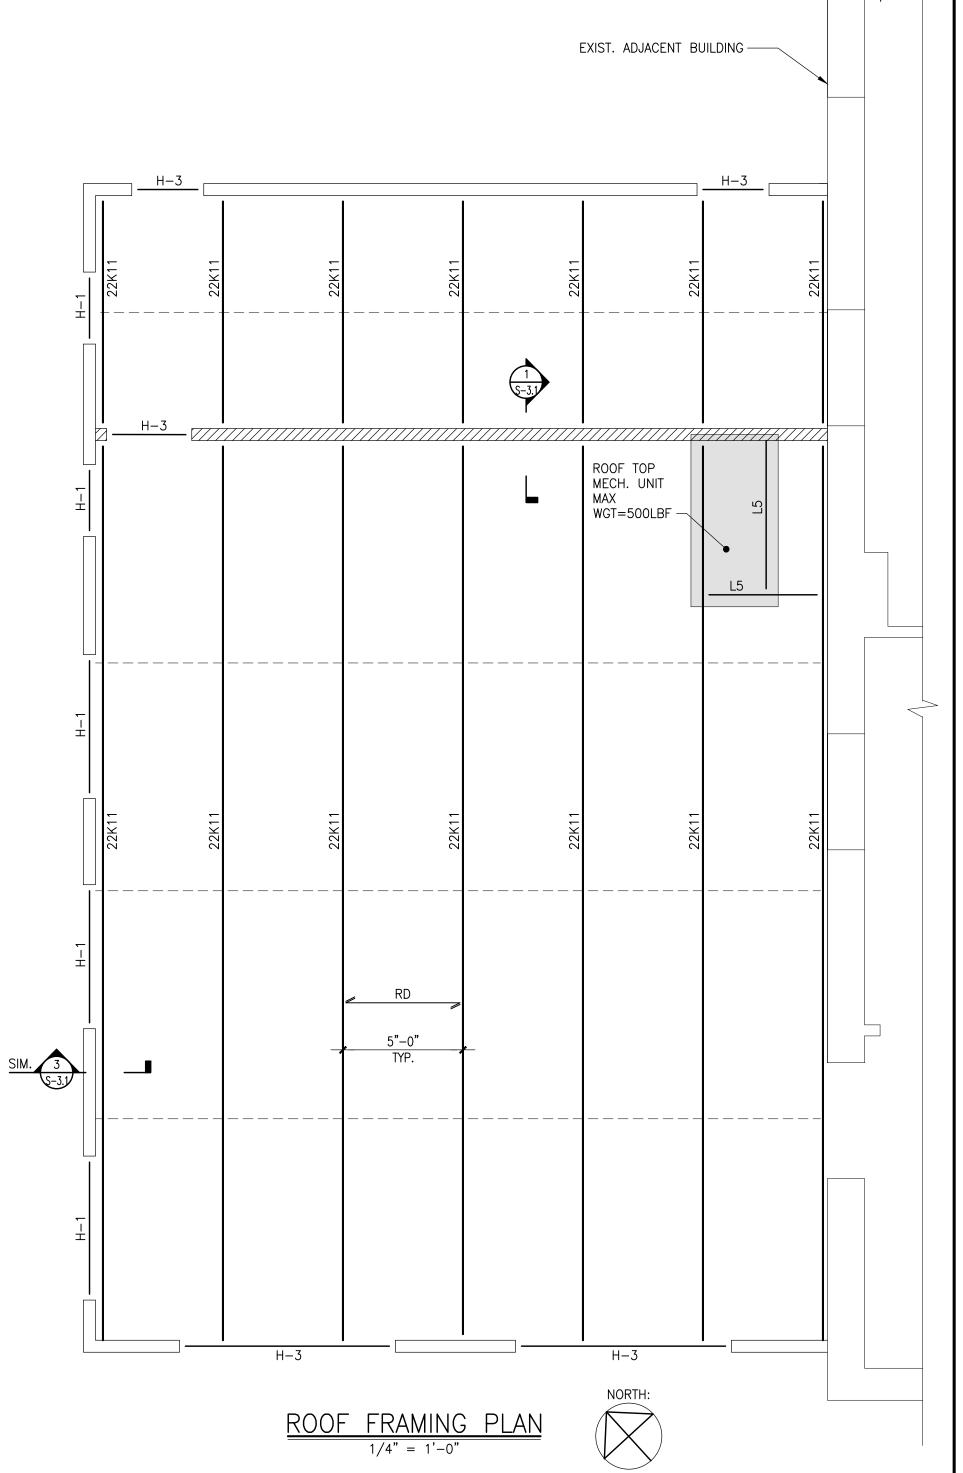

- SEE ARCHITECTURAL DRAWINGS FOR ALL DIMENSIONS. DO NOT SCALE THIS DRAWING.
- ROOF CONSTRUCTION: 20GA. 1 1/2" TYPE B STEEL ROOF DECK
- TYPICAL WALL CONSTRUCTION SHALL BE 600S200-54 AT 16"o.c. WITH (3)600S200-54 TO ALIGN WITH ROOF JOISTS.
- COORDINATE SIZE AND LOCATION OF ALL ROOF PENETRATIONS WITH ARCHITECTURAL, MECHANICAL, AND ELECTRICAL DRAWINGS. ALL ROOF PENETRATIONS SHALL BE REVIEWED BY THE ENGINEER PRIOR TO FABRICATION AND INSTALLATION OR PENETRATION FRAMING ELEMENTS. PROVIDE FRAMING AS INDICATED IN "TYPICAL ROOF/FLOOR OPENING DETAIL".
- ALL EXTERIOR WALLS SHALL BE CONSTRUCTED AS SW-1 SHEAR WALLS PER 1/S-3.
- ROOF FUTURE SOLAR PANEL LOADS MAX 10PSF (INCLUDING SOLAR PANEL AND EQUIPMENT MOUNT WITH BALLASTED SYSTEM)


#### LEGEND:

- RD INDICATES SPAN DIRECTION OF METAL ROOF DECK.
- "L5" INDICATES RTU/ROOF OPENING SUPPORT ANGLE, SEE 2/S3.1 FOR SIZE AND CONNECTION DETAILS.
- ---- INDICATES CONTINUOUS HORIZONTAL BRIDGING EQUALLY SPACED ALONG SPAN OF STEEL JOIST.

HEADER SCHEDULE			
MARK SIZE (WIDTH x DEPTH) # KING STUDS # JACK STUD			# JACK STUDS
H-1	(2) 800S200-54	(2) 600S200-68	(2) 600S200-68
H-2	(3) 1400S200-118	(2) 600S200-68	(2) 600S200-68
H-3	(3) 1200S200-97	(2) 600S200-68	(2) 600S200-68

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246 Federal Road, Suite B23 | Brookfield, CT 06804 | (203) 740-0990

Date Issue

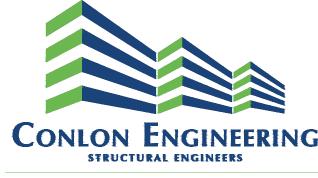2/14/2024 FOR BID

5/7/2024 FOR CONSTRUCTION

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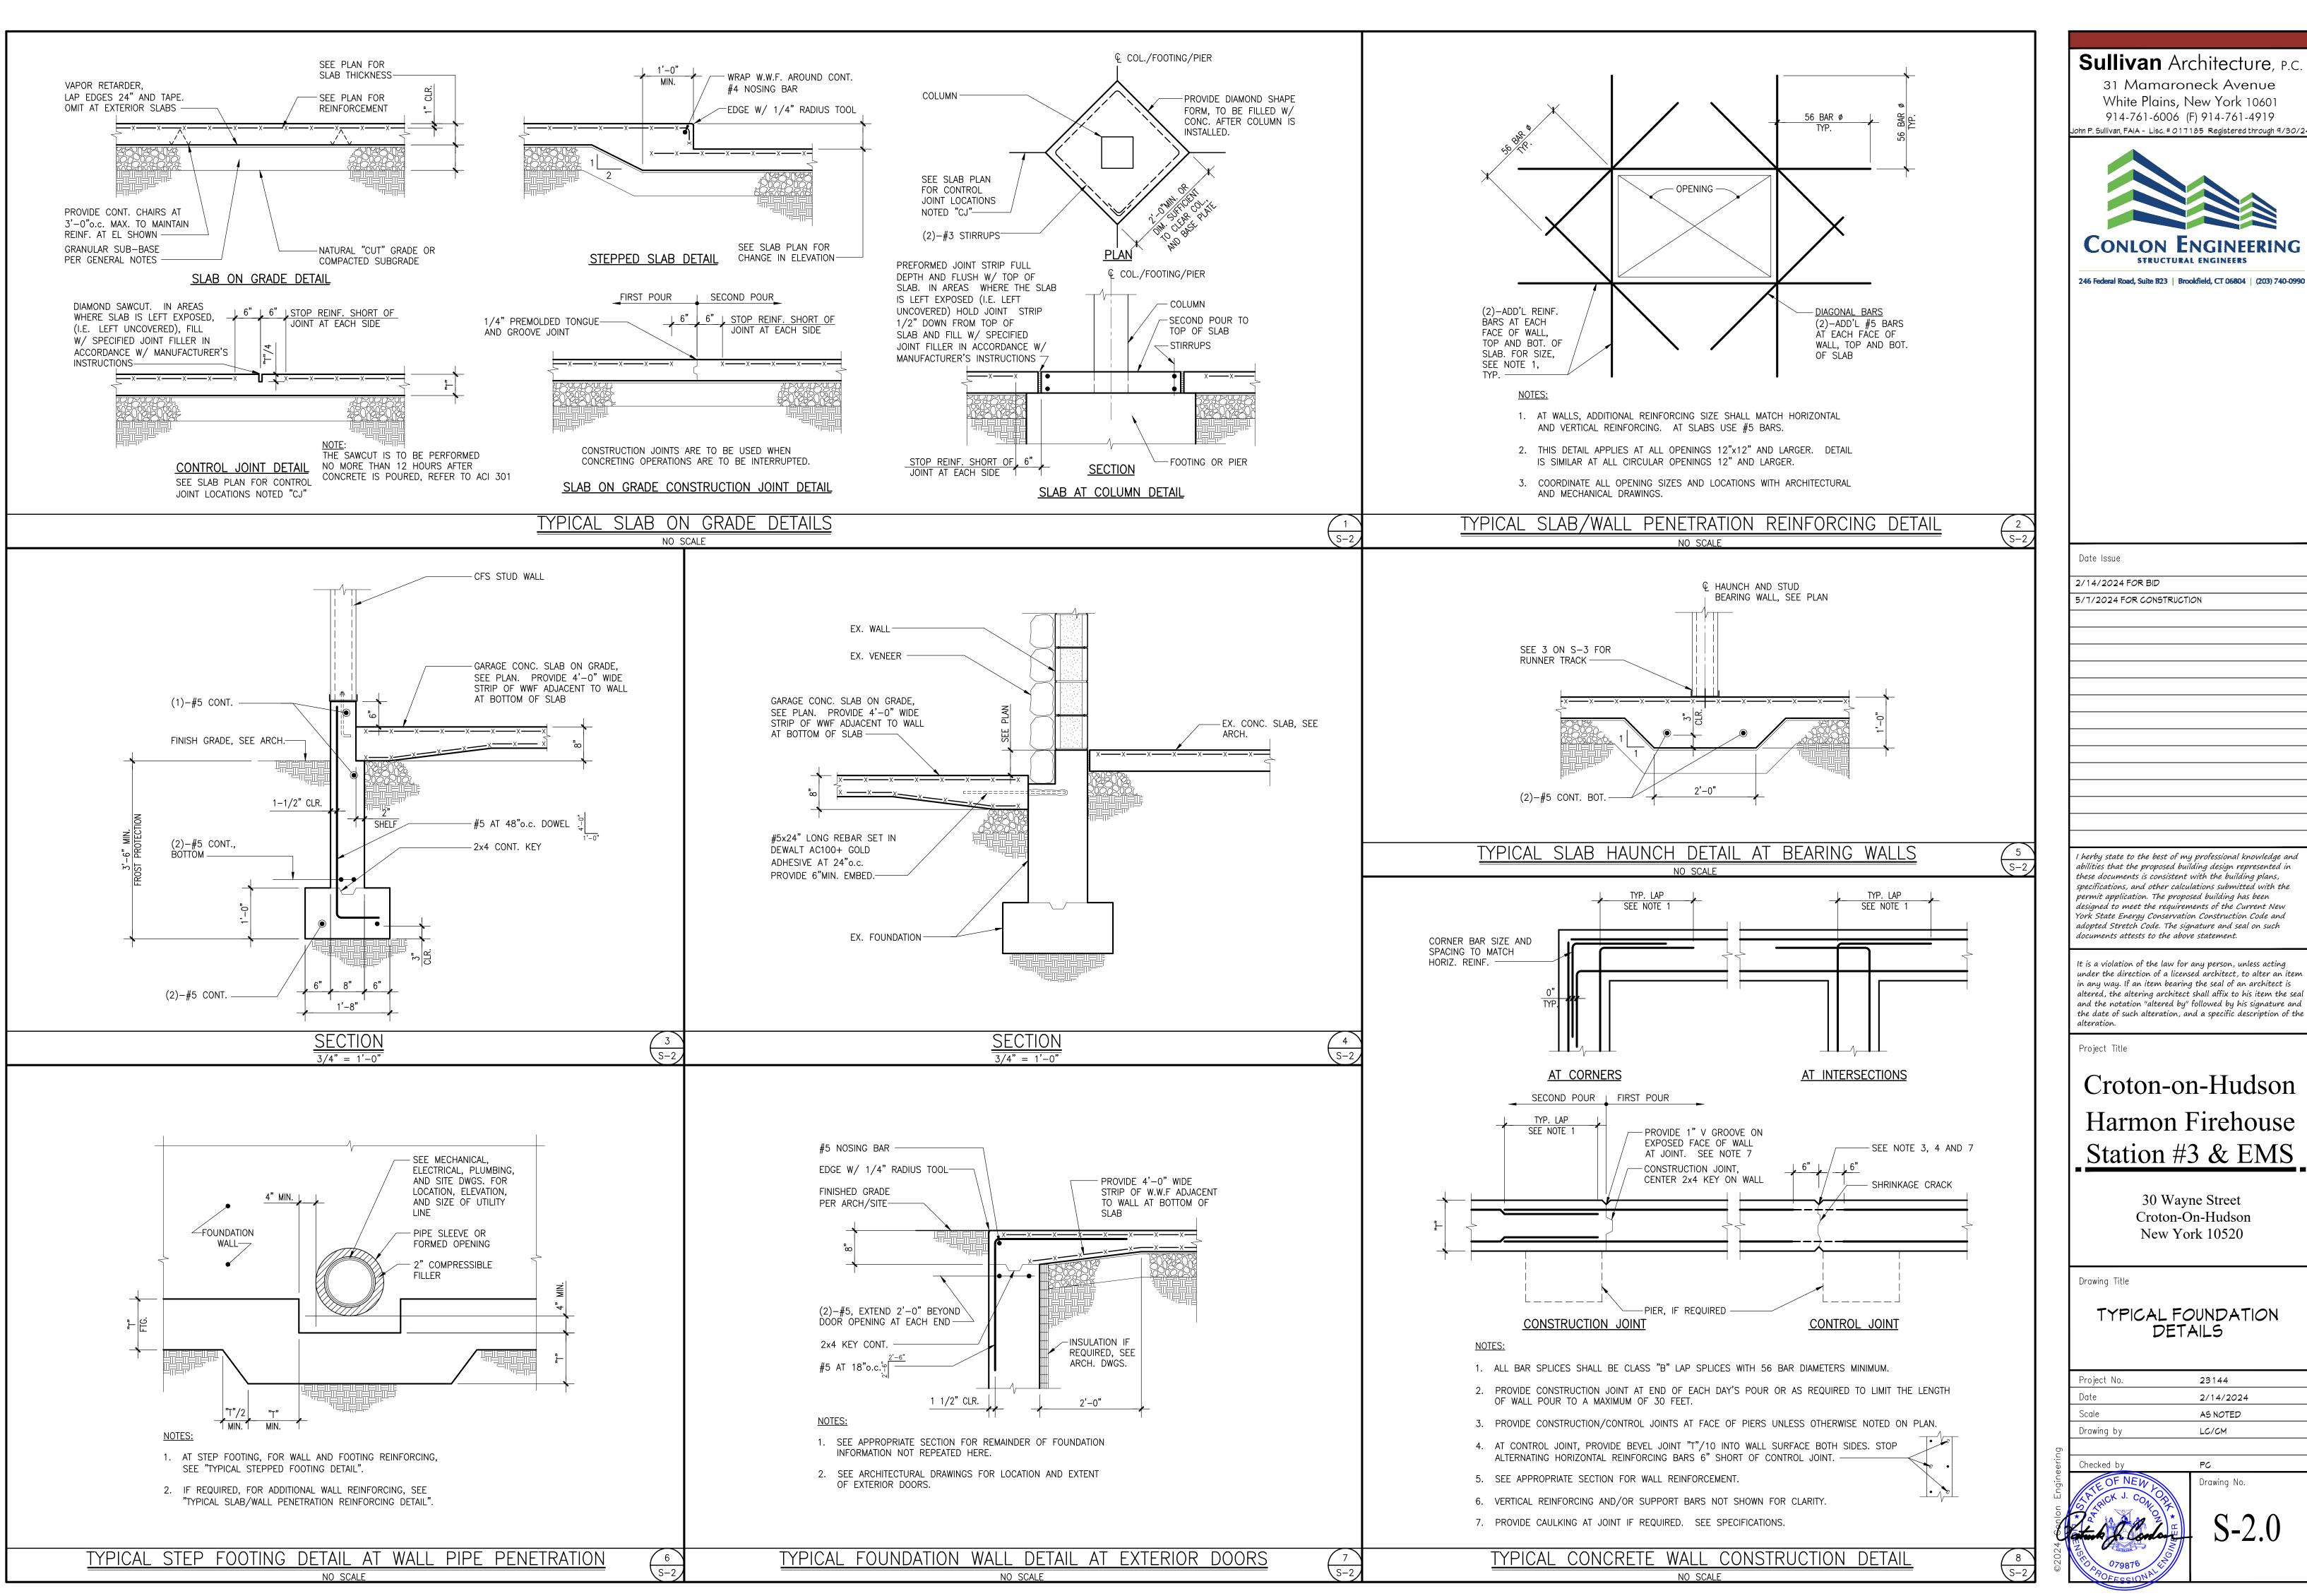
Drawing Title

FOUNDATION AND FRAMING PLANS

Project No.	23144	
Date	2/14/2024	
Scale	AS NOTED	
Drawing by	LC/CM	

Drawing No.

THE OF NEW J. CONTO



31 Mamaroneck Avenue White Plains, New York 10601 914-761-6006 (F) 914-761-4919



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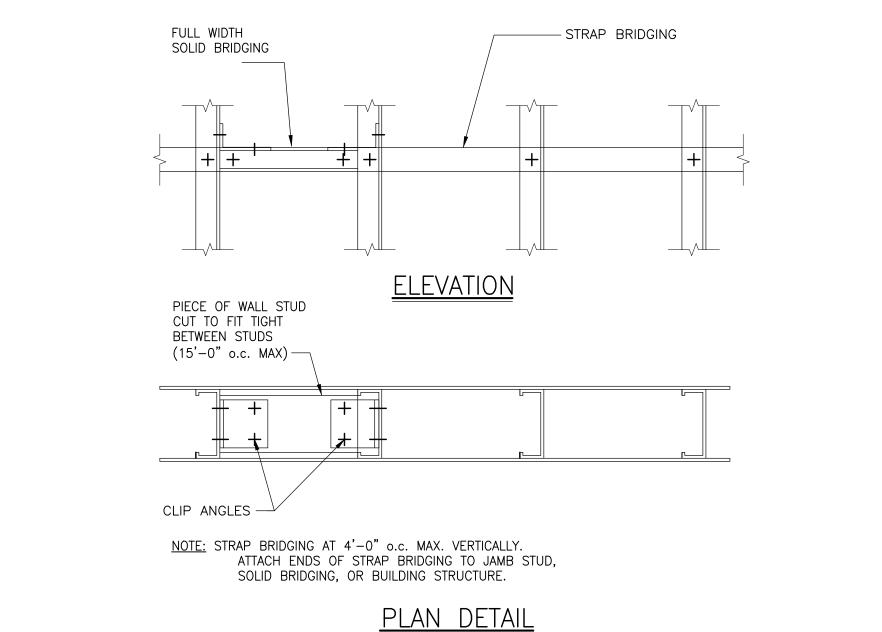
TYPICAL FOUNDATION DETAILS


23144 2/14/2024 AS NOTED LC/CM

	SHEATHING PANEL		ANCHORAGE OF TRACK	SHEATHING PANEL			SIMPSON HOLDOW	<b>VN</b>	
MARK	THICKNESS	# OF SHEATHED FACES	TO TOP OF FOUNDATION WALL / HAUNCH SLAB	EDGES TO VERT. STUDS AND HORIZ. BLOCKING	MODEL	ANCHOR TO FOUNDATION / WALL BELOW	DRILL AND EPOXY W/ SET, ANCH'D EMBED. DEPTH (MIN.)	END POST SCREWS (CONNECTING SIMPSON HOLDOWN TO END POST)	MIN. END POST SIZE
SW-1	15/32"	1	SEE 3/S-3	#10-16 SCREWS AT 4" o.c.	S/HDU6	5/8"ø A307 THR'D ROD	10"	(12) - #14 SCREWS	(2)-6SW16 (BACK TO BACK)

#### NOTES:

- 1. "ATR" INDICATES ALL THREADED ROD WITH NUT AND WASHER AT TOP.
- 2. SHEATHING PANELS SHALL BE OF THE INDICATED THICKNESS, AND IN CONFORMANCE WITH THE "GENERAL NOTES AND MATERIAL SPECIFICATIONS" SHEET.
- 3. HOLDOWNS INDICATED ARE TO BE LOCATED AT BOTH SHEARWALL END POSTS AND SHALL ANCHOR THE BOTTOM OF THE SHEARWALL END POST IN THE FOLLOWING WAY:
- A. AT FIRST FLOOR SHEARWALLS, ANCHOR TO THE FOUNDATION WALL OR HAUNCH SLAB WITH A THREADED ROD OF INDICATED DIAMETER. RODS SHALL BE DRILLED IN AND EPOXY ANCHORED USING SIMPSON SET EPOXY ANCHORING SYSTEM WITH THE INDICATED EMBEDMENT DEPTH.



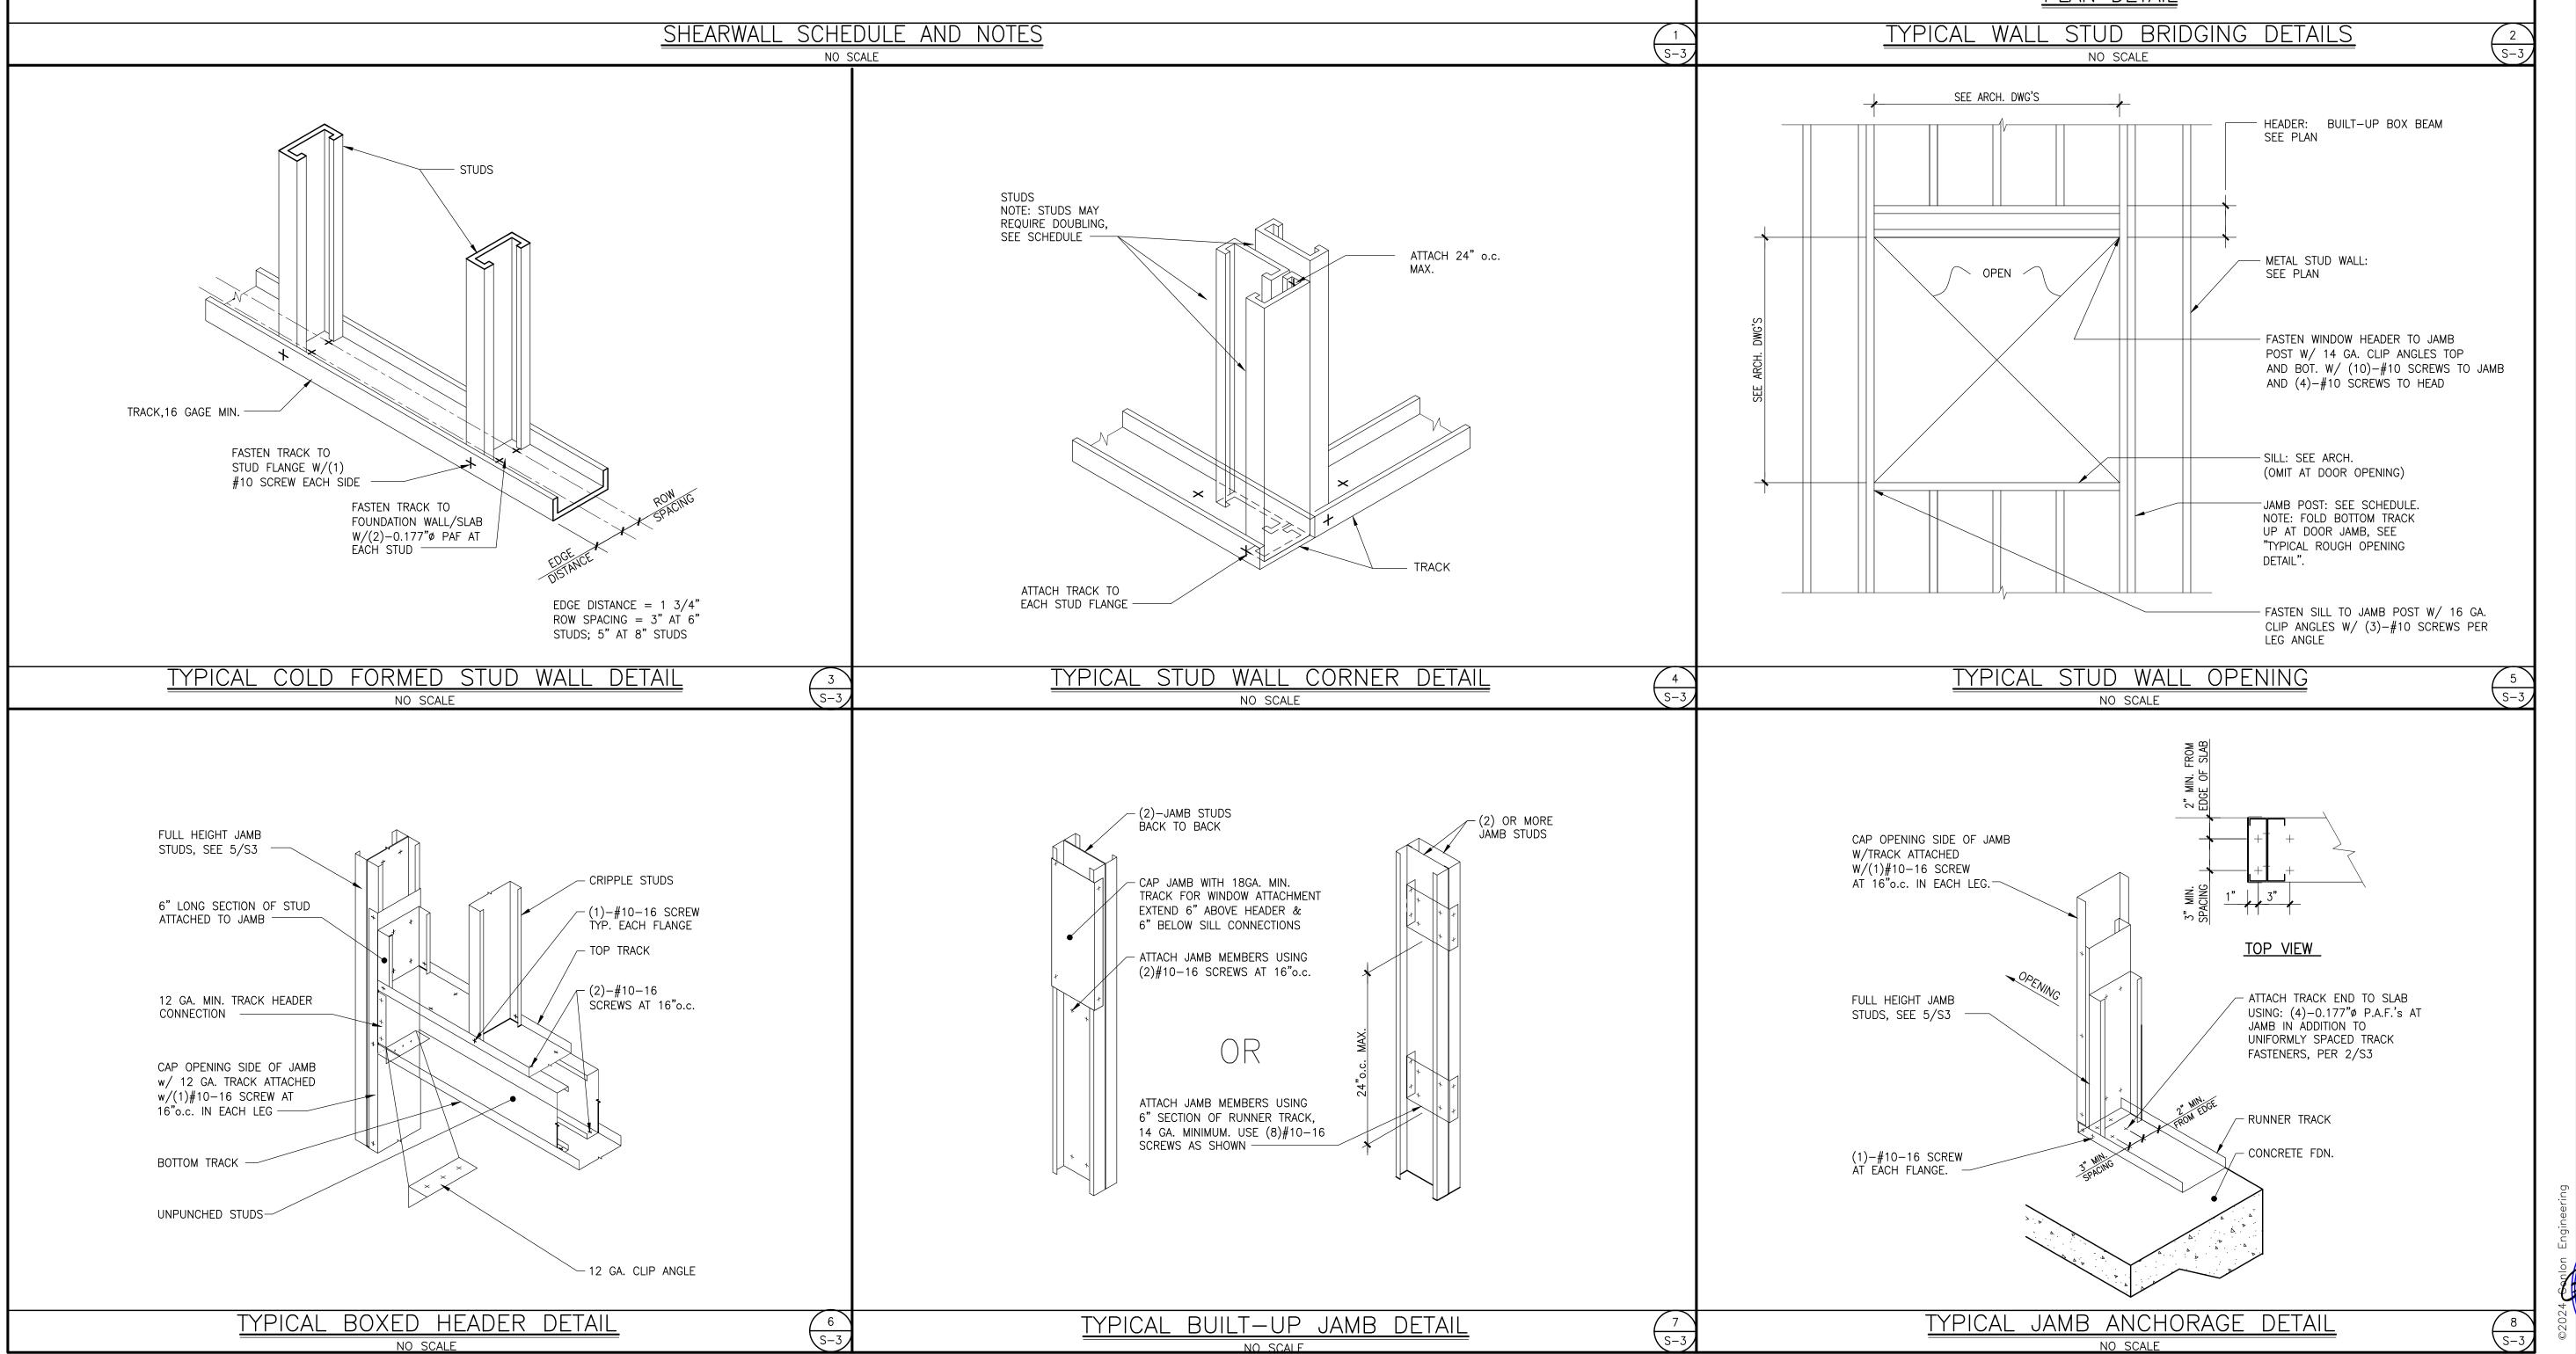

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Project Title

# Croton-on-Hudson Harmon Firehouse Station #3 & EMS

30 Wayne Street Croton-On-Hudson New York 10520

Drawing Title

TYPICAL COLD FORMED STEEL DETAILS

 Project No.
 23144


 Date
 2/14/2024


 Scale
 A5 NOTED

 Drawing by
 LC/CM

FOF NEW Drawing No.

S-3.0

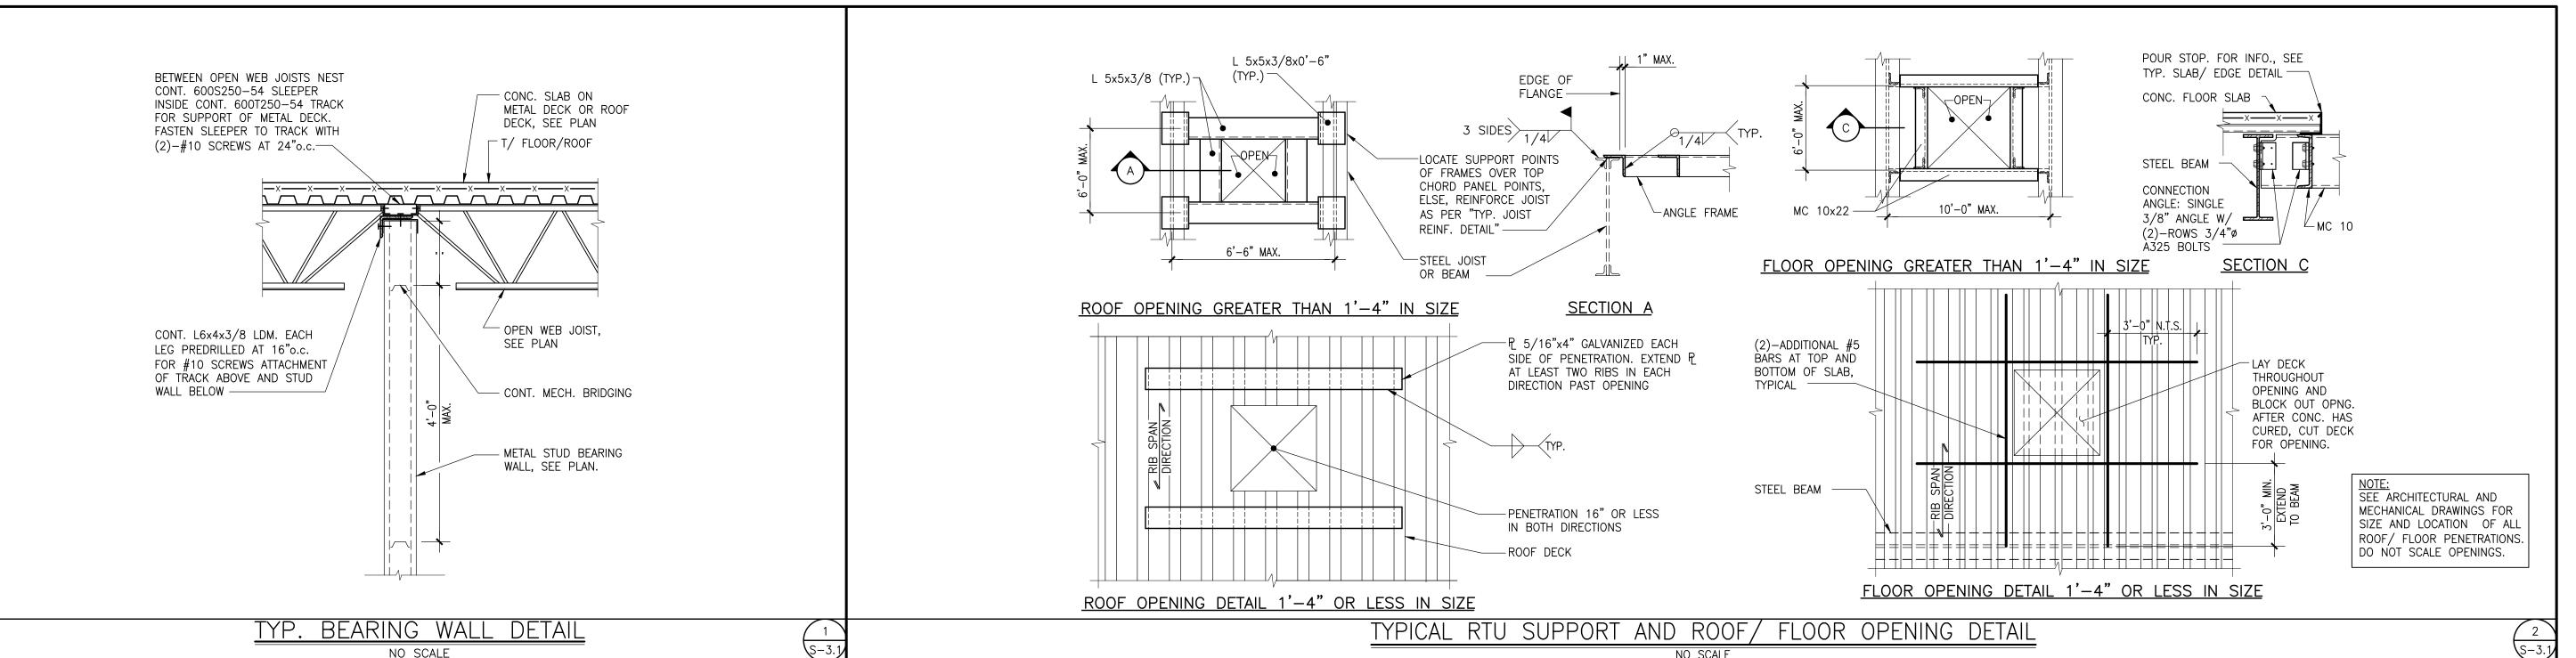

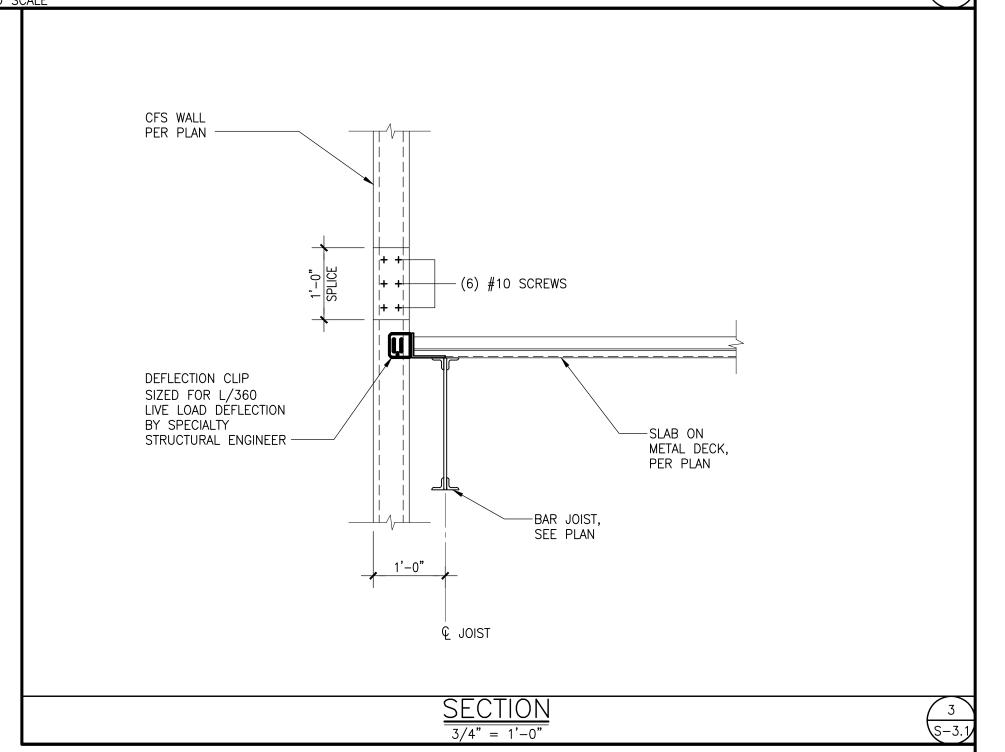

# Sullivan Architecture, P.C. 31 Mamaroneck Avenue

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Date Issue 2/14/2024 FOR BID

5/7/2024 FOR CONSTRUCTION

I herby state to the best of my professional knowledge and abilities that the proposed building design represented in these documents is consistent with the building plans, specifications, and other calculations submitted with the permit application. The proposed building has been designed to meet the requirements of the Current New York State Energy Conservation Construction Code and

adopted Stretch Code. The signature and seal on such

documents attests to the above statement.

It is a violation of the law for any person, unless acting under the direction of a licensed architect, to alter an item in any way. If an item bearing the seal of an architect is altered, the altering architect shall affix to his item the seal and the notation "altered by" followed by his signature and the date of such alteration, and a specific description of the

Project Title

Croton-on-Hudson Harmon Firehouse Station #3 & EMS

> 30 Wayne Street Croton-On-Hudson New York 10520

Drawing Title

STEEL AND COLD FORMED STEEL SECTIONS

Project No.	23144
Date	2/14/2024
Scale	AS NOTED
Drawing by	LC/CM



- THE PURPOSE OF THESE DRAWINGS IS TO SHOW THE STRUCTURAL WORK ASSOCIATED WITH. CROTON—ON—HUDSON HARMON FIREHOUSE AT 30 WAYNE ST. CROTON—ON—HUDSON, NEW YORK.
- 2. THE STRUCTURAL COMPONENTS HAVE BEEN DESIGNED FOR THE FOLLOWING LOADS:
- A. FLOOR LIVE LOAD: 50 PSF + 15 PSF PARTITION TOILET ROOMS
- B. ROOF LOADS:
- RISK CATEGORY GROUND SNOW LOAD, Pg EXPOSURE FACTOR, Ce THERMAL FACTOR, Ct
- MPORTANCE FACTOR, Is FLAT ROOF SNOW LOAD, PI SLOPED ROOF AND ADDITIONAL SNOW LOAD DUE TO DRIFT, SLIDING AND UNBALANCED SNOW PER BUILDING CODE RAIN LOADS: IN ACCORDANCE WITH SECTION 1611
- WIND LOADS HAVE BEEN DETERMINED BASED ON SECTION 1609.6, SIMPLIFIED PROVISIONS FOR LOW RISE BUILDINGS SECTION 1609.1.1 IN ACCORDANCE WITH ASCE 7-16, CHAPTER 27 (DIRECTIONAL PROCEDURE)

100 PSF

30 PSF

127 MPH

- BASIC (ULTIMATE) WIND SPEED (3—SECOND GUST) EXPOSURE INTERNAL PRESSURE COEFFICIENT "a" DIMENSION FOR USE WITH COMPONENTS AND CLADDING
- EARTHQUAKE DESIGN DATA:
- SEISMIC IMPORTANCE FACTOR, Ie:
  MAPPED SHORT PERIOD SPECTRAL RESPONSE ACCELERATIONS, SS: IAPPED 1 SECOND PERIOD SPECTRAL RESPONSE ACCELERATIONS, S1: 0.061 g DESIGN SHORT PERIOD SPECTRAL RESPONSE ACCELERATIONS, SDS: 0.305 g DESIGN 1 SECOND PERIOD SPECTRAL RESPONSE ACCELERATIONS, SD1: 0.098 g SEISMIC DESIGN CATEGORY:
- THIS STRUCTURE HAS BEEN DESIGNED TO BE SELF—SUPPORTING AND STABLE AFTER THE CONSTRUCTION OF THE BUILDING HAS BEEN COMPLETED. THE STABILITY OF THE STRUCTURE PRIOR TO COMPLETION IS SOLELY THE RESPONSIBILITY OF THE CONTRACTOR. THIS RESPONSIBILITY EXTENDS TO ALL RELATED ASPECTS OF THE CONSTRUCTION ACTIVITY INCLUDING, BUT NOT LIMITED TO, ERECTION METHODS, ERECTION SEQUENCE, TEMPORARY BRACING, FORMS, SHORING, USE OF EQUIPMENT, AND SIMILAR CONSTRUCTION PROCEDURES. REVIEW OF THE CONSTRUCTION BY THE ENGINEER IS FOR CONFORMANCE WITH DESIGN ASPECTS ONLY. NOT TO REVIEW THE CONTRACTOR'S CONSTRUCTION OCEDURES. LACK OF COMMENT ON THE PART OF THE ENGINEER WITH REGARD TO CONSTRUCTION PROCEDURES IS NOT TO BE INTERPRETED AS APPROVAL OF THOSE PROCEDURES.
- 4. THIS STRUCTURE UTILIZES CFS SHEAR WALLS, BRACING ELEMENTS, AND MOMENT FRAMES TO PROVIDE LATERAL STABILITY. THEREFORE, TEMPORARY BRACING, GUYS, ETC., MUST BE MAINTAINED UNTIL ALL SHEAR WALLS HAVE BEEN ERECTED AND ATTACHED TO THE STEEL FRAMING AND BRACING AND MOMENT FRAMES HAVE BEEN ERECTE
- JOBSITE SAFETY AND CONSTRUCTION PROCEDURES ARE SOLELY THE RESPONSIBILITY OF THE CONTRACTOR. REVIEW OF THE CONSTRUCTION BY THE ENGINEER IS FOR CONFORMANCE WITH DESIGN ASPECTS ONLY, NOT TO REVIEW THE CONTRACTOR'S PROVISIONS FOR JOB SITE SAFETY. LACK OF COMMENT BY THE ENGINEER IS NOT TO BE INTERPRETED AS APPROVAL OF THOSE ASPECTS OF WORK
- 6. TESTING AND INSPECTION OF CONCRETE STEEL REINFORCING BARS (CONCRETE CONSTRUCTION), BAR JOISTS, STEEL DECK, COLD-FORMED STEEL FRAMING, PLYWOOD SHEATHING, AND OTHER WORK IS DESCRIBED IN THE PROJECT "STATEMENT OF SPECIAL INSPECTIONS". THE CONTRACTOR SHALL REVIEW THE "STATEMENT OF SPECIAL INSPECTIONS" AND COORDINATE HE SCHEDULING OF INSPECTIONS WITH THE SPECIAL INSPECTOR.
- 7. IF FAULTY CONSTRUCTION PROCEDURES, OR MATERIAL, RESULT IN DEFECTIVE WORK THAT REQUIRES ADDITIONAL ENGINEERING TIME TO DEVISE CORRECTIVE MEASURES, PROFESSIONAL FEES MAY BE CHARGED TO THE CONTRACTOR AT THE STANDARD HOURLY RATE OF ADDITIONAL SERVICES. SUCH FEES MAY BE WITHHELD FROM THE GENERAL CONTRACTOR'S PAYMENT.
- 8. LOADS OPENINGS AND STRUCTURE IN ANY WAY RELATED TO REQUIREMENTS OF OTHER (NON-STRUCTURAL) DISCIPLINES ARE SHOWN FOR BIDDING PURPOSES ONLY. HOWEVER, THESE PLANS DO NOT SHOW THE FULL SCOPE OF OPENINGS, IN ROOFS, FLOORS AND WALLS. FOR SIZE AND LOCATION OF ALL OPENINGS, SEE ARCHITECTURAL, AND MECHANICAL DRAWINGS. DO NOT SCALE OPENINGS. THE CONTRACTOR SHALL OBTAIN FROM THE HEATING AND VENTILATING, ELECTRICAL, PLUMBING AND OTHER TRADES THE FINAL APPROVED SIZE AND LOCATION OF ALL OPENINGS, EQUIPMENT AND WORK TO BE PROVIDED FOR THEIR TRADE FOR ROOFS, FLOORS AND WALLS, WHETHER SHOWN OR NOT SHOWN ON STRUCTURAL DRAWINGS. EXCESS COST RELATED TO VARIATION IN REQUIREMENTS OR EQUIPMENT ARE NOT TO BE BORNE BY THE
- 9. THE CONTRACTOR SHALL VERIFY ALL DIMENSIONS, ELEVATIONS AND ANGLES WITH ARCHITECTURAL DRAWINGS AND EXISTING CONDITIONS BEFORE PROCEEDING WITH ANY WORK.
- 10. THE CONTRACTOR SHALL <u>FIELD VERIFY EXISTING CONDITIONS</u> BEFORE PROCEEDING WITH ANY WORK, THE CONTRACTOR SHALL FIELD VERIFY ALL DIMENSIONS NOTED "±" THAT ARE INDICATED ON THE DRAWINGS.
- 11. THESE DRAWINGS ARE SUPPLEMENTED BY A DETAILED TECHNICAL SPECIFICATION. THE NOTES SHOWN UNDER CERTAIN CATEGORIES OF WORK ARE INTENDED TO SUMMARIZE BASIC REQUIREMENTS.
- 12. WORK SHOWN AS "TYPICAL DETAILS" APPLY THROUGHOUT THE PROJECT AS REQUIRED. WORK SHOWN AS "SECTIONS" SHALL BE CONSIDERED TO APPLY FOR THE SAME AND SIMILAR CONDITIONS IN THE BUILDING.
- 13. SOME DETAILS OF THE WORK ARE SHOWN ON THE ARCHITECTURAL DRAWINGS. A CAREFUL REVIEW AND STUDY OF THESE DETAILS ARE NECESSARY BEFORE THE FULL SCOPE OF THE WORK CAN BE COMPREHENDED.
- 14. DO NOT SCALE DRAWINGS. FOUNDATION NOTES:
- THE FOUNDATIONS HAVE BEEN DESIGNED TO REST ON INORGANIC, UNDISTURBED SOIL OR COMPACTED GRANULAR FILL HAVING A BEARING VALUE OF 6000 PSF AS RECOMMENDED IN THE GEOTECHNICAL ENGINEERING REPORT PREPARED BY JAMES E. QUILL AND DATED 03/13/2024 SUCH BEARING STRATA IS ANTICIPATED AT THE BOTTOM OF FOOTING ELEVATIONS NOTED ON THE FOUNDATION PLAN. ALL BEARING STRATA SHALL BE REVIEWED BY THE GEOTECHNICAL ENGINEER PRIOR TO PLACING CONCRETE IN ORDER TO VERIFY THE BEARING VALUE
- SEE ABOVE REFERENCED GEOTECHNICAL REPORT FOR STRUCTURAL FILL MATERIAL SPECIFICATION. RECOMMENDATIONS FOR THE PREPARATION OF SOIL BEARING SURFACES, BACKFILL AND DRAINAGE STATED IN THE GEOTECHNICAL REPORT ARE TO
- THE SLAB-ON-GRADE SUB-BASE SHALL BE A CRUSHER RUN STONE FREE FROM SOFT DISINTEGRATED PIECES, MUD, DIRT, OR OTHER INJURIOUS MATERIAL. THE MATERIAL SHALL HAVE NO STONE GREATER THAN 2 INCHES IN ANY ONE
- 4. THE BOTTOM OF EXTERIOR FOOTINGS NOT ON SOLID ROCK SHALL BE AT LEAST 4'-0" BELOW FINISHED GRADE. 5. ALL SOIL SURROUNDING AND UNDER FOOTINGS SHALL BE PROTECTED FROM FREEZING AND FROST ACTION DURING THE COURSE OF CONSTRUCTION.
- 6. STEP FOOTINGS WHERE ELEVATIONS CHANGE AT A MAXIMUM SLOPE OF ONE VERTICAL ON TWO HORIZONTAL AND PLACE
- FOUNDATION WALLS SHALL BE TEMPORARILY BRACED UNTIL THE FLOOR SLAB AT THE TOP OF THE WALL HAS BEEN POURED AND THE CONCRETE HAS ATTAINED ITS SPECIFIED COMPRESSIVE STRENGTH UNLESS BACKFILL IS PLACED ON
- BOTH SIDES SIMULTANEOUSLY AND TO THE SAME LEVEL. 8. MINIMUM ANCHOR BOLT REQUIREMENTS FOR ATTACHMENT OF SUPERSTRUCTURE TO FOUNDATION SHALL BE 3/4" DIAMETER AT 4'-0" o.c. SPACING FOR FULL HEIGHT BASEMENTS AND 1/2" DIAMETER AT 6'-0" o.c. SPACING FOR CRAWL SPACES
- AND SLABS ON GRADE. EMBED ANCHOR BOLTS A MINIMUM OF 15" INTO MASONRY, AND 7" INTO CAST CONCRETE. ANCHOR BOLTS ARE TO BE PLACED WITHIN 1'-0" OF ALL CORNERS ON ALL EXTERIOR WALLS. ALL PIECES OF SILL PLATE SHALL HAVE A MINIMUM OF TWO ANCHOR BOLTS. 9. KEEP FOUNDATION EXCAVATIONS FREE OF WATER AT ALL TIMES.
- 10. USE LEAN CONCRETE (f'c=1500 PSI) OR CONTROLLED COMPACTED FILL FOR OVER-EXCAVATION OF FOOTINGS.
- 11. EXISTING UTILITIES: LOCATE EXISTING UNDERGROUND UTILITIES IN AREAS OF EXCAVATION WORK. PROVIDE ADEQUATE MEANS OF SUPPORT AND PROTECTION DURING EARTHWORK OPERATIONS.
- 12. WHERE FOOTINGS ARE IN CLOSE PROXIMITY OF SUB-SURFACE PIPING, BOTTOM OF FOOTINGS SHALL BE AT LEAST 8"
- BELOW ELEVATION OF PIPING, UNLESS OTHERWISE SHOWN ON THE DRAWINGS. 13. SUBMITTALS TO THE ENGINEER ARE REQUIRED FOR STRUCTURAL FILL, AND SLAB SUB-BASE AND FINE-GRADED GRANULAR
- CONCRETE NOTES: 1. CONCRETE SHALL BE THE SPECIFIED WEIGHT AND DEVELOP A MINIMUM STRENGTH IN 28 DAYS AS FOLLOWS;

		IVIII VIIVI CIVI	
<u>LOCATION</u>	WEIGHT	STRENGTH .	MAXIMUM W/C RATIO
FOOTINGS	NORMAL	3,000 PSI	0.50
SLABS ON GRADE (INTERIOR)	NORMAL	4,000 PSI	0.45
SLABS ON METAL DECK	NORMAL	3,000 PSI	0.45

- 3. ALL DETAILING FABRICATION, AND ERECTION OF REINFORCING BARS, UNLESS OTHERWISE NOTED, MUST FOLLOW THE LATEST ACI CODE AND THE LATEST ACI "MANUAL OF STANDARD PRACTICE FOR DETAILING REINFORCED CONCRETE
- 4. CONCRETE DESIGN MIX SHALL BE SUBMITTED TO THE ENGINEER FOR REVIEW, TOGETHER WITH LABORATORY REPORTS ATTESTING THAT THE MIXES CAN ATTAIN THE MINIMUM STRENGTH REQUIRED IN ACCORDANCE WITH ACI 301. 5. PORTLAND CEMENT SHALL BE TYPE I OR TYPE II AND CONFORM TO ASTM C150.
- 6. OTHER CEMENTITIOUS MATERIAL SUCH AS FLYASH OR GROUND GRANULATED BLAST- FURNACE SLAG MAY BE BLENDED WITH CEMENT FOR USE IN THE CONCRETE MIX. FLYASH SHALL CONFORM TO ASTM C618 AND MAY REPLACE CEMENT IF THE FOLLOWING RANGES FOR THE 2 CLASSES OF FLYASH; CLASS C, 20 TO 35%; CLASS F, 15 TO 25%. GROUND ILATED BLAST- FURNACE SLAG SHALL CONFORM TO ASTM C989 AND MAY NOT EXCEED 50% OF TOTAL WEIGHT OF
- 7. COARSE AGGREGATE SHALL BE 3/4" AND CONFORM TO ASTM C33.
- 8. NO ADMIXTURES ARE PERMITTED WITHOUT THE ENGINEERS WRITTEN PERMISSION OTHER THAN ENTRAINED AIR. ALL LIGHTWEIGHT CONCRETE AND CONCRETE EXPOSED TO THE WEATHER, SUCH AS THAT USED IN FOUNDATION WALLS, SHALI CONTAIN 5%  $\pm$  1% ENTRAINED AIR. DO NOT USE AIR ENTRAINMENT ADMIXTURE FOR INTERIOR NORMALWEIGHT CONCRETE
- 9. LIMIT WATER-SOLUBLE, CHLORIDE-ION CONTENT IN HARDENED CONCRETE TO 0.30 PERCENT BY WEIGHT OF CEMENT. 10. REINFORCING STEEL SHALL CONFORM TO ASTM A 615, GRADE 60.
- 11. WELDED WIRE FABRIC SHALL CONFORM TO ASTM A 185 WITH A MINIMUM YIELD STRENGTH OF 75 KSI. LAP ONE MESH
- 12. VAPOR BARRIER SHALL BE STEGO WRAP (15 MIL) VAPOR BARRIER BY STEGO INDUSTRIES LLC AND SHALL HAVE A WATER VAPOR PERMEANCE AFTER CONDITIONING (ASTM E 1745, PARAGRAPHS 7.1.2 - 7.1.5) THAT IS LESS THAN 0.01 PERMS AND MEETS THE REQUIREMENTS OF CLASS A. PLACE AS PER ASTM E 1643 AND MANUFACTURER'S WRITTEN
- 13. THE FOLLOWING CONCRETE COVER SHALL BE PROVIDED FOR REINFORCEMENT:

COVER (INCHES) CONCRETE CAST AGAINST AND CONCRETE EXPOSED TO EARTH OR WEATHER: #6 THROUGH #18 BARS #5 BAR AND SMALLER 1-1/2

CONCRETE NOT EXPOSED TO WEATHER OR IN CONTACT WITH GROUND: SLABS, WALLS, JOISTS: #14 AND #18 BARS #11 BAR AND SMALLER

- 14. THE CONVEYANCE, PLACEMENT AND PROTECTION OF THE CONCRETE SHALL CONFORM TO ACI 318 PER "REFERENCE STANDARD TABLE". MECHANICAL VIBRATORS ARE TO BE USED TO CONSOLIDATE THE FRESHLY CAST CONCRETE AROUND THE REINFORCING AND AGAINST FORM SURFACES AND TO PREVENT THE FORMATION OF AIR OR STONE POCKETS, IONEYCOMBING, PITTING OR PLANES OF WEAKNESS. HOWEVER, CARE MUST BE USED TO AVOID OVER VIBRATION THAT CAN LEAD TO AGGREGATE SEGREGATION.
- 15. NO WELDING OF REINFORCING WILL BE PERMITTED.
- 16. ALL LAP SPLICES SHALL BE CLASS B, IN ACCORDANCE WITH ACI 318 INDICATED IN THE "REFERENCE STANDARD TABLE". 17. CONCRETE PIERS: PLACE CONCRETE PIERS AND WALLS TOGETHER. SET PIER REINFORCING AND SET WALL REINFORCING THROUGH PIER VERTICAL BARS. PROVIDE DOWELS WITH STANDARD HOOK FROM FOOTING AT ALL PIERS. SIZE AND QUANTITY OF DOWELS TO MATCH VERTICAL PIER REINFORCING (CLASS "B" SPLICE).
- 18. THE CONTRACTOR SHALL BE RESPONSIBLE FOR LIMITING POURS TO MINIMIZE SHRINKAGE CRACKING. IN GENERAL, WALLS SHALL NOT BE POURED IN CONTINUOUS LENGTHS EXCEEDING 30 FEET WITHOUT PROVIDING CONSTRUCTION JOINTS OR CONTROL JOINTS. THE LOCATION AND CONFIGURATION OF JOINTS EXPOSED TO VIEW SHALL BE COORDINATED WITH THE
- 19. FINISH ELEVATED FLOOR SLABS FLAT AND LEVEL WITHIN A TOLERANCE OF +/- 1/4 INCHES TO THE ELEVATION INDICATED ON THE DRAWINGS. PROVIDE ADDITIONAL CONCRETE REQUIRED DUÉ TO FORMWORK AND FLOOR FRAMING DEFLECTION TO ACHIEVE THIS FINISHED TOP OF SLAB ELEVATION. THE ANTICIPATED DEFLECTION FOR BOTH BEAMS AND SIRDERS IS 1 1/4". DESIGN OF FLOOR FRAMING MEMBERS INCLUDES THE ADDITIONAL CONCRETE FOR THIS ANTICIPATED
- 20. THE INSTALLATION OF SLABS SHALL CONFORM TO THE REQUIREMENTS OF ACI 302.1R. INTERIOR FINISH SLAB SURFACES ARE TO HAVE A STEEL TROWEL FINISH. SURFACES OF SLABS FORMING THE SUBSTRATE FOR MUD JOBS ARE TO HAVE A CLEAN TEXTURED (SCRATCHED) SURFACE. EXTERIOR SLAB SURFACES ARE TO HAVE A BROOM FINISH UNLESS SPECIFIED
- 21. EXPANSION AND ISOLATION-JOINT-FILLER STRIPS: ASTM D 1751, ASPHALT-SATURATED CELLULOSIC FIBER, OR ASTM D
- 22. WATERSTOPS: FLEXIBLE PVC WATERSTOP CONFORMING TO CORP OF ENGINEERS SPECIFICATION CE CRD-C 572, WITH FLAT DUMBBELL AND CENTER BULB. INSTALL AS PER MANUFACTURER'S INSTRUCTIONS. 23. THE CURING AND PROTECTION OF CONCRETE SHALL CONFORM TO THE REQUIREMENTS OF ACI 318 INDICATED IN THE
- "REFERENCE STANDARD TABLE". CONCRETE SLABS SHALL BE PROTECTED FROM LOSS OF SURFACE MOISTURE FOR NOT LESS THAN 7 DAYS USING A CURING COMPOUND CONFORMING TO ASTM C309 OR CONSTANTLY WETTED BURLAP. CURING COMPOUNDS SHALL BE COMPATIBLE WITH ANY INTENDED FLOORING OVERLAY. DO NOT INSTALL FINISH FLOORING UNTIL SLAB HAS ADEQUATELY DRIED PER THE FLOORING MANUFACTURER'S SPECIFICATIONS.
- 24. CONCRETE SIDEWALKS SHALL BE TREATED WITH A CLEAR WATER REPELLANT PENETRATING SEALER SUCH AS HYDROZO NVIROSEAL 40 AFTER THE CONCRETE HAS BEEN ALLOWED TO CURE FOR A MINIMUM OF 28 DAYS BUT BEFORE THE FIRST WINTER SEASON AND/OR THE APPLICATION OF DE-ICING CHEMICALS, WHICHEVER COMES FIRST.
- 25. COLD WEATHER CONCRETE PLACEMENT: IF COLD WEATHER CONCRETING CONDITIONS EXIST AS DEFINED BY A PERIOD OF MORE THAN THREE DAYS WHEN THE AVERAGE OUTDOOR TEMPERATURE. (HIGH + LOW)/2, IS LESS THAN 40 DEG. F. THE PROCEDURES OUTLINED IN ACI 306.1 STANDARD SPECIFICATION FOR "COLD WEATHER CONCRETING" SHALL BE UTILIZED.
- 26. HOT WEATHER CONCRETE PLACEMENT: MAINTAIN CONCRETE TEMPERATURE BELOW 90 DEG. F. AT TIME OF PLACEMENT AND 27. ACCURATELY POSITION, SUPPORT, AND SECURE REINFORCEMENT AGAINST DISPLACEMENT. LOCATE AND SUPPORT REINFORCEMENT WITH BAR SUPPORTS TO MAINTAIN MINIMUM CONCRETE COVER. DO NOT TACK WELD CROSSING
- BOLSTERS, CHAIRS, SPACERS, AND OTHER DEVICES FOR SPACING, SUPPORTING, AND FASTENING REINFORCING BARS AND WELDED WIRE REINFORCEMENT IN PLACE. MANUFACTURE BAR SUPPORTS FROM STEEL WIRE, PLASTIC, OR PRECAST CONCRETE ACCORDING TO CRSI'S "MANUAL OF STANDARD PRACTICE," OF GREATER COMPRESSIVE STRENGTH THAN

REINFORCING BARS. PROVIDE BAR SUPPORTS AS FOLLOWS:

PROGRAM FOR QUALITY ASSURANCE OF INSTALLATION.

- 28. SUBMITTALS TO THE ENGINEER ARE REQUIRED FOR CEMENT, REINFORCING BARS, ADMIXTURES, AND AGGREGATES. AS SPECIFIED IN SPECIFICATION SECTION 033000. STEEL DECK NOTES:
- 1. NON-COMPOSITE FORMED STEEL FLOOR DECK TO BE 1" INCH DEEP, 24 GAGE (UNCOATED STEEL THICKNESS = 0.0239"), UNIFORM, GALVANIZED (G60 COATING), UNITED STEEL DECK TYPE UFS UFX-36 DECK AS MANUFACTURED BY CANAM
- FORMED STEEL ROOF DECK TO BE 1-1/2" DEEP, 20 GAGE (UNCOATED STEEL THICKNESS = 0.0358"), GALVANIZED (G60 COATING), WIDE RIB, UNITED STEEL DECK "B" DECK PROFILE, AS MANUFACTURED BY CANAM STEEL DECK, INCORPORATED OR AN APPROVED EQUAL
- THE STEEL DECK SHALL BE SUPPLIED IN MINIMUM LENGTHS AS REQUIRED TO PROVIDE A "3-SPAN" CONDITION. END CLOSURES, ROOF SUMPS, CLOSURES AT PENETRATIONS, AND ALL OTHER ACCESSORIES NECESSARY FOR A COMPLETE
- NON-COMPOSITE FORMED STEEL FLOOR DECK WITH A THICKNESS OF 24 GAGE OR LESS SHALL BE WELDED TO SUPPORTING STEEL WITH 3/8" DIAMETER FUSION WELDS THROUGH 16 GAGE WELDING WASHERS. NON-COMPOSITE FORMED STEEL FLOOR DECK WITH A THICKNESS OF 22 GAGE OR GREATER SHALL BE WELDED TO SUPPORTING STEEL WITH 5/8" DIAMETER PUDDLE WELDS. SPACE WELDS AT 15" ON CENTER MAXIMUM AT END SUPPORTS AND 30" ON CENTER MAXIMUM AT INTERMEDIATE SUPPORTS (FOR CONNECTION OF FORMED STEEL FLOOR DECK TO COLD FORMED FRAMING, USE NO. 10 SELF TAPPING SCREWS AT 12" ON CENTER). INTERMEDIATE SIDE CONNECTIONS SHALL BE MADE AT MID-SPAN OR 3'-0" ON CENTER, WHICHEVER IS SMALLER. END LAPS OF SHEETS SHALL BE A MINIMUM OF 2" AND SHALL OCCUR OVER SUPPORTS.
- 5. FORMED STEEL ROOF DECK SHALL BE WELDED TO SUPPORTING STEEL WITH 5/8" DIAMETER PUDDLE WELDS AT ALL EDGE RIBS PLUS A SUFFICIENT NUMBER OF INTERIOR RIBS TO LIMIT THE SPACING BETWEEN ADJACENT POINTS OF ATTACHMENT TO 6" ON CENTER. TO THE DECK ATTACHMENT PATTERN SHOWN ON THE DRAWINGS. (FOR CONNECTION OF METAL ROOF DECK TO COLD FORMED FRAMING, USE NO. 10 SELF TAPPING SCREWS AT 12" ON CENTER). INTERMEDIATE SIDE CONNECTIONS SHALL BE MADE WITH #10 SELF-TAPPING SCREWS AT MID-SPAN OR 3'-0" ON CENTER, WHICHEVER IS SMALLER. END LAPS OF SHEETS SHALL BE A MINIMUM OF 2" AND SHALL OCCUR OVER SUPPORTS. IN LIEU OF PUDDLE WELDS, POWDER ACTUATED FASTENERS HAVING THE SAME CAPACITY AS THE SPECIFIED PUDDLE WELDS, MAY BE USED. FASTENERS SHALL BE MANUFACTURED BY HILTI, INC. OR AN APPROVED EQUAL. SHOP DRAWINGS SHALL BE SUBMITTED FOR APPROVAL TO THE ENGINEER INDICATING FASTENER DATA INCLUDING SIZE VS. STEEL BSTRATE MATERIAL, SPACINGS, CAPACITIES, INCLUDING DIAPHRAGM SHEAR CAPACITIES, METHOD OF INSTALLATION AND
- IN LIEU OF PUDDLE WELDS, PNEUMATICALLY APPLIED FASTENERS HAVING THE SAME CAPACITY AS THE SPECIFIED PUDDLE WELDS, MAY BE USED. FASTENERS SHALL BE MANUFACTURED BY PNEUTEK, INC. OR AN APPROVED EQUAL. SHOP DRAWINGS SHALL BE SUBMITTED FOR APPROVAL TO THE ENGINEER INDICATING FASTENER DATA INCLUDING SIZE VS. STEEL SUBSTRATE MATERIAL, SPACINGS, CAPACITIES, INCLUDING DIAPHRAGM SHEAR CAPACITIES, METHOD OF INSTALLATION AND PROGRAM FOR QUALITY ASSURANCE OF INSTALLATION.
- STEEL DECK MUST BE PROTECTED BEFORE AND AFTER ERECTION AND ALL DEBRIS CLEANED FROM ITS SURFACE WHERE CONCRETE WILL BE POURED OR ROOFING IS TO BE PLACED. COLD-FORMED METAL FRAMING NOTES:
- 1. ALL STUDS AND/OR JOISTS AND ACCESSORIES SHALL BE OF THE TYPE, SIZE, STEEL THICKNESS AND SPACING SHOWN ON THE DRAWINGS. STUDS, TRACKS, BRACING AND BRIDGING SHALL BE MANUFACTURED PER ASTM C955.
- 2. ALL STUDS, JOISTS AND ACCESSORIES SHALL BE FORMED FROM STEEL THAT CONFORMS TO THE REQUIREMENTS OF ASTM A-1003 WITH A YIELD AS FOLLOWS: 16 GA. (0.0598") OR HEAVIER 50 KSI 18 GA. (0.0474") OR LIGHTER 33 KSI
- 3. ALL STUDS, JOISTS AND ACCESSORIES SHALL BE GALVANIZED WITH A MINIMUM G-60 COATING.
- 4. TOUCHUP PAINT: IMMEDIATELY AFTER FABRICATION AND ERECTION, CLEAN WELDS, FASTENERS, AND DAMAGED GALVANIZED SURFACES. TOUCHUP AND REPAIR SURFACES WITH GALVANIZED REPAIR PAINT IN ACCORDANCE WITH ASTM A780, APPLIED BY BRUSH OR SPRAY TO PROVIDE MINIMUM DRY FILM THICKNESS OF 2.0 MILS.
- 5. COLD FRAMED METAL SIZES AND ATTACHMENTS SHALL NOT BE LESS THAN THOSE INDICATED ON THE CONTRACT DOCUMENTS.
- WHERE FRAMING SYSTEMS ARE NOT SHOWN ON THE DRAWINGS, DESIGN FRAMING SYSTEMS FOR THE DESIGN LOADS INDICATED IN THE CONTRACT DOCUMENTS. PROVIDE FOR MOVEMENT OF FRAMING MEMBERS WITHOUT DAMAGE OR OVERSTRESSING, SHEATHING FAILURE, CONNECTION FAILURE, UNDUE STRAIN ON FASTENERS AND ANCHORS, OR OTHER DETRIMENTAL EFFECTS WHEN SUBJECT TO A MAXIMUM AMBIENT TEMPERATURE OF 120 DEG F. DESIGN FRAMING SYSTEM TO MAINTAIN CLEARANCES AT OPENINGS, TO ALLOW FOR CONSTRUCTION TOLERANCES, AND TO ACCOMMODATE LIVE LOAD DEFLECTION OF PRIMARY BUILDING STRUCTURE FOR AN UPWARD AND DOWNWARD MOVEMENT OF 1 INCH L/360 FOR
- CONNECTIONS SHALL BE ACCOMPLISHED WITH SELF-DRIVING SCREWS OR WELDING SO THAT THE CONNECTION MEETS OR EXCEEDS THE DESIGN LOADS REQUIRED AT THAT CONNECTION. ALL CONNECTIONS SHALL BE MADE USING A MINIMUM OF FOUR (4) #12-16 SCREWS, UNLESS OTHERWISE SHOWN ON SCREW SPACING AND EDGE DISTANCE SHALL NOT BE LESS THAN 1".
- MINIMUM CONNECTION ANGLE THICKNESS SHALL BE 14 GAGE, BUT NO THINNER THAN THE MATERIAL OF THE MEMBERS THAT ARE BEING CONNECTED, WELDING SHALL CONFORM TO STRUCTURAL WELDING CODE D1.1 AND SPECIFICATION FOR WELDING SHEET IN STRUCTURES
- E1.3 OF THE AMERICAN WELDING SOCIETY AND BE PERFORMED BY A CERTIFIED WELDER IN ACCORDANCE WITH AWS
- 9. TEMPORARY BRACING SHALL BE PROVIDED AND LEFT IN PLACE UNTIL WORK IS PERMANENTLY STABILIZED. 10. JOISTS SHALL BE LOCATED DIRECTLY OVER BEARING STUDS OR A LOAD DISTRIBUTION MEMBER SHALL BE PROVIDED TO
- 11. ALL BUILT-UP FRAMING MEMBERS SHALL BE OF WELDED CONSTRUCTION, UNLESS OTHERWISE NOTED. 12. AVOID HOLES AT ENDS OF MEMBERS. HOWEVER, SHOULD HOLES OCCUR, PROVIDE ADDITIONAL REINFORCING AT THE
- 13. PROVIDE LATERAL BLOCKING, BRIDGING, AND WEB STIFFENERS FOR VERTICAL AND HORIZONTAL FRAMING MEMBERS, AND OTHER FRAMING MEMBERS AS REQUIRED AND IN ACCORDANCE WITH MANUFACTURER'S SPECIFICATIONS OR RECOMMENDATIONS, UNLESS INDICATED OTHERWISE ON THE DRAWINGS.
- 14. TRACK: 14 GAGE MINIMUM. SECURELY ANCHORED TO ADJACENT STRUCTURE OR MEMBER

ENDS OF THE MEMBER WHERE HOLES OCCUR, UNLESS OTHERWISE NOTED.

- 15. ALL FRAMING COMPONENTS: CUT SQUARELY OR AT AN ANGLE TO FIT SQUARELY AGAINST ABUTTING MEMBERS. ALL BERS: HELD FIRMLY IN POSITION UNTIL PROPERLY FASTENED, ERECT MEMBER LEVEL, PLUMB, AND TRUE TO LINE AND 16. STUDS: SEATED SQUARELY IN THE TRACK WITH THE STUD WEB AND FLANGES ABUTTING THE TRACK WEB, AND SECURELY ATTACHED TO THE FLANGES OR WEB OF BOTH TRACKS.
- 17. SPLICES IN STUDS AND OTHER FRAMING COMPONENTS: NOT PERMITTED. STEEL JOIST NOTES:
- JOISTS SHALL BE SUPPLIED WITH ALL ATTACHMENT DEVICES, BRIDGING, AND SIMILAR ACCESSORIES REQUIRED FOR STRICT CONFORMANCE WITH THE STEEL JOIST INSTITUTE'S SPECIFICATIONS. JOIST ERECTION SHALL BE IN STRICT CONFORMANCE WITH THE OCCUPATIONAL SAFETY AND HEALTH ADMINISTRATION (OSHA) REQUIREMENTS. ALL OF THE ABOVE INFORMATION SHALL BE SHOWN ON THE SHOP DRAWINGS.
- JOISTS SHALL BE FIELD WELDED TO THEIR SUPPORTING MEMBERS BY A CERTIFIED WELDER AS DEFINED BY THE
- 3. JOISTS AT ALL COLUMN LINES SHALL BE FIELD BOLTED TO THE COLUMN AND HAVE THEIR LOWER CHORDS EXTENDED
- 4. EXTEND JOISTS 1 INCH PAST CENTERLINE OF SUPPORTING MEMBER WHERE POSSIBLE. ON MASONRY WALLS 12 INCHES R MORE IN THICKNESS, THE MINIMUM BEARING LENGTH SHALL BE 6 INCHES, UNLESS OTHERWISE NOTED.
- 5. JOISTS SHALL BE CLEANED IN ACCORDANCE WITH THE STEEL STRUCTURES PAINTING COUNCIL SPECIFICATION SP-2- OR SP3 AND PAINTED AS PER SSPC PAINT NO. 15 OR MANUFACTURER'S STANDARD SHOP PRIMER COMPLYING WITH THE PERFORMANCE REQUIREMENTS IN SSPC PAINT NO. 15.

7. ADJACENT JOISTS OF THE SAME DEPTH SHALL HAVE WEB MEMBERS IN LINE TO PERMIT PASSAGE OF MECHANICAL DUCTS.

6. BRIDGING SHALL BE AS SHOWN AND NOT LESS THAN CALLED FOR BY THE SJI SPECIFICATION, PER "STANDARD REFERENCE TABLE".

- 8. JOIST MANUFACTURER SHALL DESIGN SPECIAL JOISTS, DESIGNATED "SP", FOR LOAD AND DEFLECTION CRITERIA SHOWN ON THE DRAWINGS, JOIST MANUFACTURER SHALL COORDINATE AND VERIFY WEIGHT, SIZE AND LOCATION OF MECHANICAL EQUIPMENT AND ANY OTHER ATTACHED EQUIPMENT/APPURTENANCE WITH THE GENERAL AND MECHANICAL CONTRACTORS.
- A. WELD ALL JOISTS TO SUPPORTING STEEL WITH 1 1/2" OF 3/16" FILLET WELD EACH SIDE OF BEARING, UNLESS
- B. PROVIDE 5" DEEP BEARING ENDS ON JOISTS WHICH SHARE A COMMON BEARING GIRDER WITH "LH" JOISTS.

OTHERWISE SHOWN.

- A. WELD ALL JOISTS TO SUPPORTING STEEL WITH 2" OF 1/4" FILLET WELD EACH SIDE OF BEARING, UNLESS
- 914-761-6006 (F) 914-761-4919 John P. Sullivan, FAIA - Lisc. # 017185 Registered through 9/30/2

STRUCTURAL ENGINEERS

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Date Issue 2/14/2024 FOR BID 5/7/2024 FOR CONSTRUCTION

herby state to the best of my professional knowledge and abilities that the proposed building design represented in these documents is consistent with the building plans, specifications, and other calculations submitted with the permit application. The proposed building has been designed to meet the requirements of the Current New York State Energy Conservation Construction Code and adopted Stretch Code. The signature and seal on such documents attests to the above statement.

It is a violation of the law for any person, unless acting under the direction of a licensed architect, to alter an item in any way. If an item bearing the seal of an architect is altered, the altering architect shall affix to his item the seal and the notation "altered by" followed by his signature and the date of such alteration, and a specific description of the

Project Title

Croton-on-Hudson Harmon Firehouse Station #3 & EMS

> 30 Wayne Street Croton-On-Hudson New York 10520

Drawing Title

2020 BUILDING CODE OF NEW YORK STATE

ITEM

STRUCTURAL COLD FORMED STEEL | AISI S100-16

INTERNATIONAL BUILDING CODE

STRUCTURAL CONCRETE

STEEL DECK

STRUCTURAL STEEL JOIST

L CONSTRUCTION MATERIAL SHALL COMPLY WITH REFERENCE STANDARD AS INDICATED BEL

REFERENCE STANDARD

SJI 100-15 AND SJI 200-15 FOR COMPOSITE JOI

SDI NC/RD-10 (NONCOMPOSITE AND ROOF STEEL DECK)

SDI C-11 (COMPOSITE STEEL DECK)

GENERAL NOTES AND MATERIAL

Project No.	23144
Date	2/14/2024
Scale	AS NOTED
Drawing by	LC/CM

Checked b