NYACK UNION FREE SCHOOL DISTRICT OLD NYACK HIGH SCHOOL BOILER REPLACEMENT

131 N Midland Ave Nyack, NY, 10960

ISSUED FOR BID

APRIL 18, 2025

OLD NYACK HIGH SCHOOL BOILER REPLACEMENT

NY SED Project Control No.

KG+D Project No. **2024-1037**

DESIGN TEAM

ARCHITECT


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LIST OF DRAWINGS

GENERAL
G000 COVER SHEET
G001 GENERAL LEGENDS, ABBREVIATIONS & NOTES

CODE COMPLIANCE
CC001 CODE COMPLIANCE INFORMATION

MECHANICAL
H001 LEGEND, NOTES & ABBREVIATIONS
H101 BOILER ROOM PLAN (REMOVALS)
H201 BOILER ROOM PLAN (NEW WORK)
H301 SCHEDULES & DETAILS
H401 DETAILS


ELECTRICAL
E001 LEGEND, ABBREVIATIONS, AND NOTES
E101 BOILER ROOM REMOVAL PLAN
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RISER, SCHEDULES, AND DETAILS

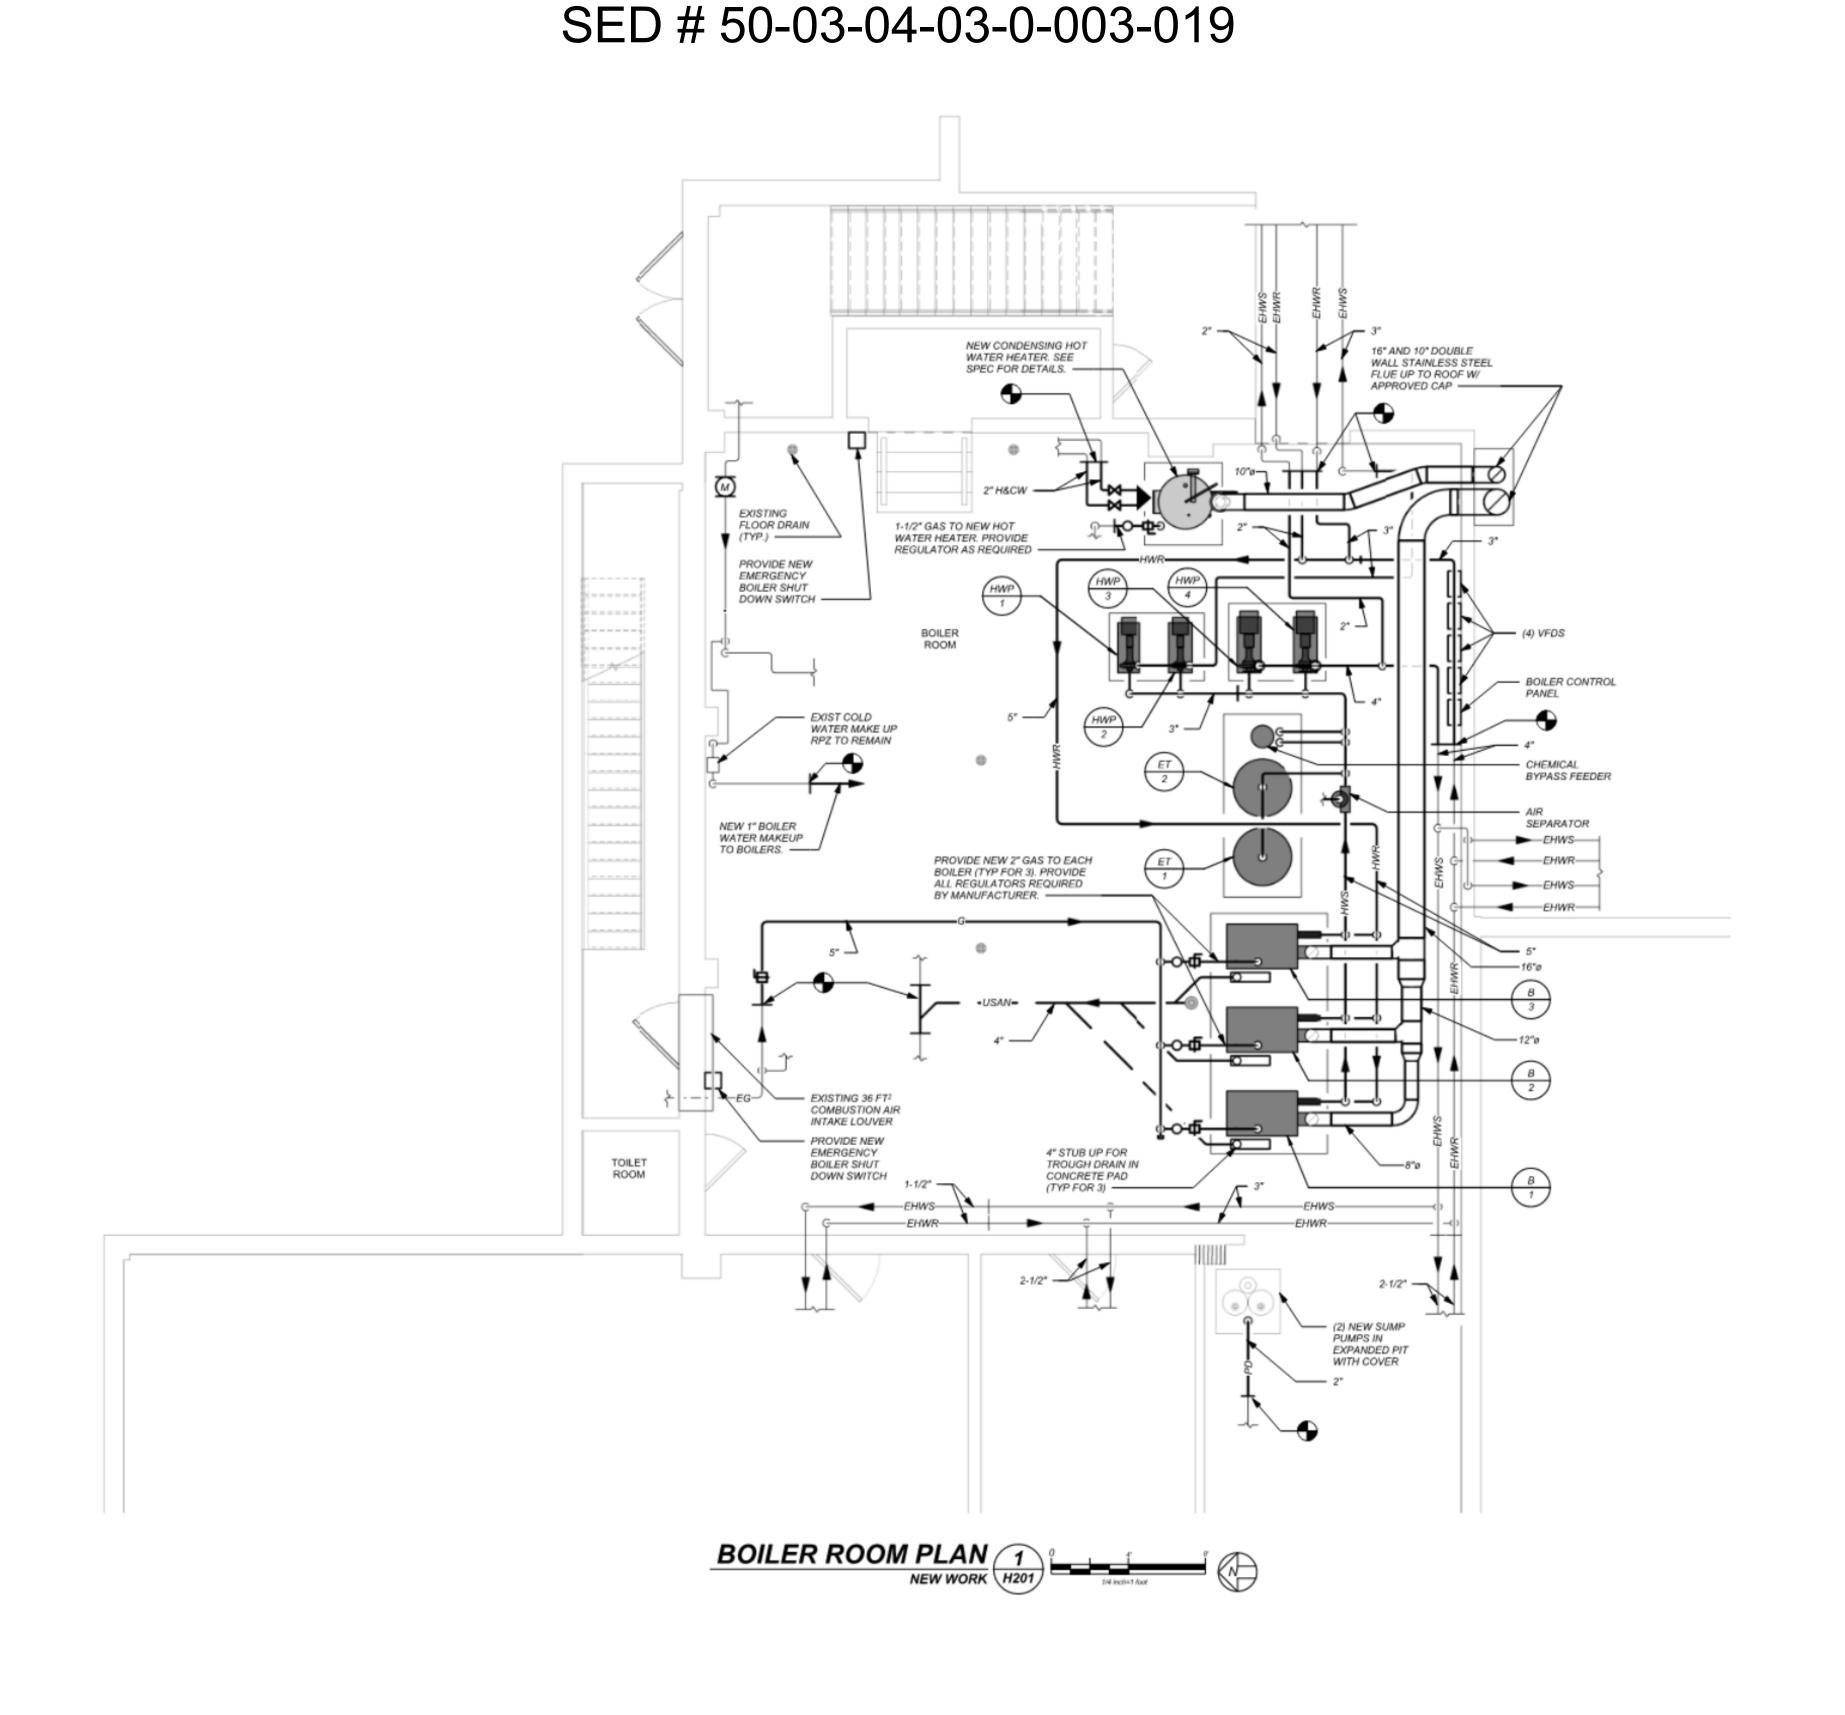Sheet total: 13

COVER SHEET

G000

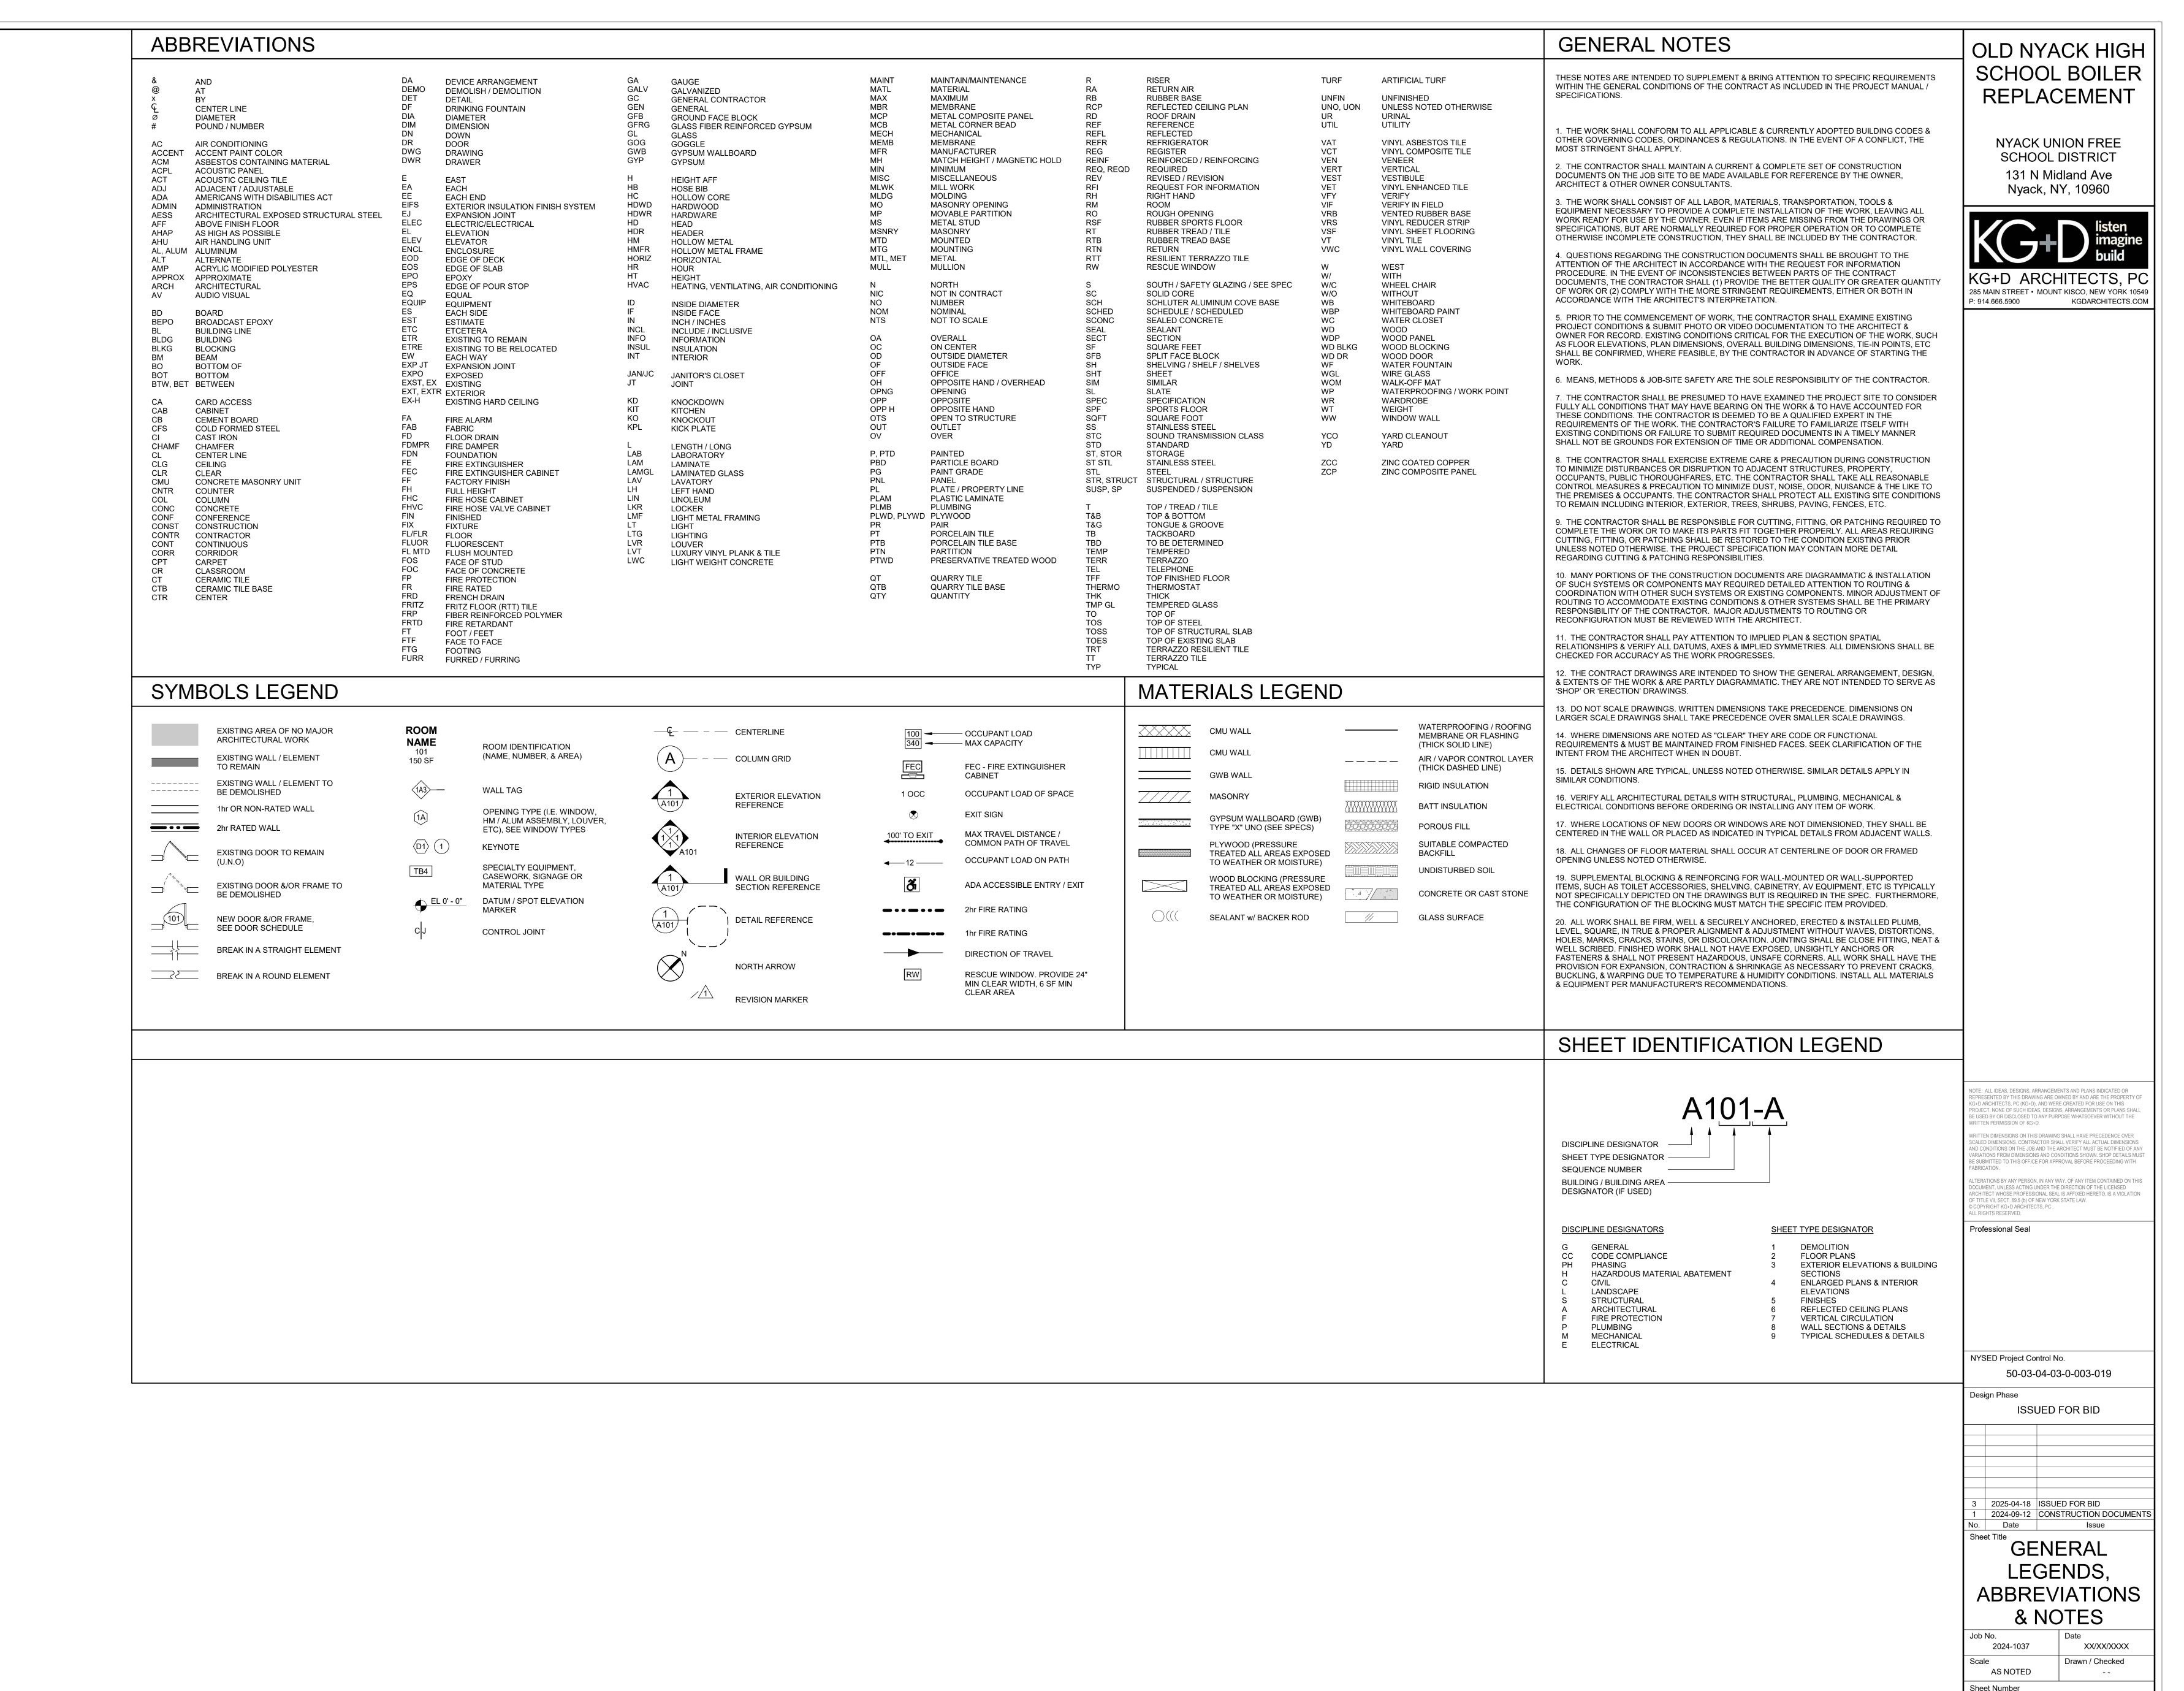

G001

BCNYS C OCCUPA HEIGHTS
EXISTING BUILDING
USE & OCCUPA CLASSIFICATION TYPE OF CONS
FIRE-RESISTANCE RAT
PRIMARY STRU FLOORS: ROOFS: BEARING WALL: NON-BEARING \
BEARING WALL: NON-BEARING \

CHAPTERS 3 - 6: ANCY CLASSIFICATION & USE; BUILDING S & AREAS; TYPES OF CONSTRUCTION

ANCY ON(S): EDUCATIONAL GROUP E

STRUCTION:

TING FOR BUILDING ELEMENTS 0 HRS UCTURAL FRAME: 0 HRS LLS (EXT, INT): G WALLS (EXT, INT): 0, 0 HRS 0, 0 HRS

PROJECT INFORMATION

NYSED CONTROL NUMBER: 50-03-04-03-0-003-019 DISTRICT NAME / OWNER: NYACK UNION FREE SCHOOL DISTRICT 13A DICKINSON AVENUE

BUILDING NAME / LOCATION:

TYPE OF PROJECT:

PROJECT DESCRIPTION:

PROJECT COMMENCEMENT

PROJECTED COMPLETION:

APPLICABLE CODES:

NYACK, NY 10960 OLD NYACK HIGH SCHOOL 131 N MIDLAND AVENUE

NYACK, NY 10960 **LEVEL 1 ALTERATIONS** BOILER REPLACEMENT

SUMMER 2025 FALL 2025

2020 NEW YORK STATE UNIFORM FIRE PREVENTION & BUILDING CODE (BCNYS)

2020 ENERGY CONSERVATION

2022 MANUAL OF PLANNING STANDARDS, THE UNIVERSITY OF THE STATE OF NEW YORK, THE STATE EDUCATION DEPARTMENT


CONSTRUCTION CODE OF NEW YORK STATE

OLD NYACK HIGH SCHOOL BOILER REPLACEMENT

NYACK UNION FREE SCHOOL DISTRICT 131 N Midland Ave Nyack, NY, 10960



LOCATION MAP

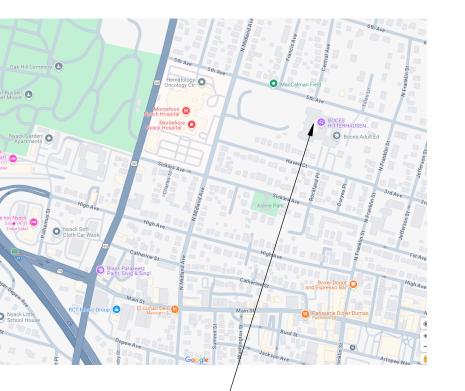

PROJECT LOCATION -

UNIFORM SAFETY STANDARDS FOR SCHOOL CONSTRUCTION & MAINTENANCE PROJECTS

THE OCCUPIED PORTION OF THE EXISTING SCHOOL BUILDING SHALL ALWAYS COMPLY WITH THE MINIMUM REQUIREMENTS NECESSARY TO MAINTAIN A CERTIFICATE OF OCCUPANCY.

HAVE BEEN OR WILL BE TESTED FOR LEAD & ASBESTOS. GENERAL SAFETY & SECURITY STANDARDS FOR CONSTRUCTION PROJECTS:

ALL SCHOOL AREAS TO BE DISTURBED DURING RENOVATION OR DEMOLITION

A. ALL CONSTRUCTION MATERIALS SHALL BE STORED IN A SAFE &

- SECURE MANNER. B. FENCES AROUND CONSTRUCTION SUPPLIES OR DEBRIS SHALL
- BE MAINTAINED. GATES SHALL ALWAYS BE LOCKED UNLESS A WORKER IS IN
- ATTENDANCE TO PREVENT UNAUTHORIZED ENTRY. DURING EXTERIOR RENOVATION WORK, OVERHEAD PROTECTION SHALL BE PROVIDED FOR ANY SIDEWALKS OR AREAS IMMEDIATELY BENEATH THE WORK SITE OR SUCH AREAS SHALL BE FENCED OFF & PROVIDED WITH WARNING SIGNS TO PREVENT
- WORKERS SHALL BE REQUIRED TO WEAR PHOTO-IDENTIFICATION BADGES AT ALL TIMES FOR IDENTIFICATION & SECURITY PURPOSES WHILE WORKING AT OCCUPIED SITES.

SEPARATION OF CONSTRUCTION AREAS FROM OCCUPIED SPACES:

CONSTRUCTION AREAS WHICH ARE UNDER THE CONTROL OF A CONTRACTOR & THEREFORE NOT OCCUPIED BY DISTRICT STAFF OR STUDENTS SHALL BE SEPARATED FROM OCCUPIED AREAS. PROVISIONS SHALL BE MADE TO PREVENT THE PASSAGE OF DUST & CONTAMINANTS INTO OCCUPIED PARTS OF THE BUILDING. PERIODIC INSPECTION & REPAIRS OF THE CONTAINMENT BARRIERS MUST BE MADE TO PREVENT EXPOSURE TO DUST OR CONTAMINANTS. GYPSUM BOARD MUST BE USED IN EXIT WAYS OR OTHER AREAS THAT REQUIRE FIRE RATED SEPARATION. HEAVY DUTY PLASTIC SHEETING MAY BE USED ONLY FOR A VAPOR, FINE DUST OR AIR INFILTRATION BARRIER, & SHALL NOT BE USED TO SEPARATE OCCUPIED SPACES FROM CONSTRUCTION AREAS.

- A. A SPECIFIC STAIRWELL &/OR ELEVATOR SHOULD BE ASSIGNED FOR CONSTRUCTION WORKER USE DURING WORK HOURS. IN GENERAL, WORKERS MAY NOT USE CORRIDORS, STAIRS OR
- ELEVATORS DESIGNATED FOR STUDENTS OR SCHOOL STAFF. LARGE AMOUNTS OF DEBRIS MUST BE REMOVED BY USING ENCLOSED CHUTES OR A SIMILAR SEALED SYSTEM. THERE SHALL BE NO MOVEMENT OF DEBRIS THROUGH HALLS OF OCCUPIED SPACES OF THE BUILDING. NO MATERIAL SHALL BE
- DROPPED OR THROWN OUTSIDE THE WALLS OF THE BUILDING. ALL OCCUPIED PARTS OF THE BUILDING AFFECTED BY RENOVATION ACTIVITY SHALL BE CLEANED AT THE CLOSE OF EACH WORKDAY. SCHOOL BUILDINGS OCCUPIED DURING A CONSTRUCTION PROJECT SHALL MAINTAIN REQUIRED HEALTH, SAFETY AND EDUCATIONAL CAPABILITIES AT ALL TIMES THAT CLASSES ARE IN SESSION.

A PLAN DETAILING HOW EXITING REQUIRED BY THE APPLICABLE BUILDING CODE WILL BE MAINTAINED. A PLAN DETAILING HOW ADEQUATE VENTILATION WILL BE MAINTAINED DURING

CONSTRUCTION. CONSTRUCTION & MAINTENANCE OPERATIONS SHALL NOT PRODUCE NOISE IN EXCESS OF 60 DBA IN OCCUPIED SPACES OR SHALL BE SCHEDULED FOR TIMES WHEN THE BUILDING OR AFFECTED BUILDING SPACES ARE NOT OCCUPIED OR ACOUSTICAL ABATEMENT MEASURES SHALL BE TAKEN.

THE CONTRACTOR SHALL BE RESPONSIBLE FOR THE CONTROL OF CHEMICAL FUMES, GASES, & OTHER CONTAMINATES PRODUCED BY WELDING, GASOLINE OR DIESEL ENGINES, ROOFING, PAVING, PAINTING, ETC. TO ENSURE THEY DO NOT ENTER OCCUPIED PORTIONS OF THE BUILDING OR AIR INTAKES.

THE CONTRACTOR SHALL BE RESPONSIBLE TO ENSURE THAT ACTIVITIES & MATERIALS WHICH RESULT IN "OFF-GASSING" OF VOLATILE ORGANIC COMPOUNDS SUCH AS GLUES, PAINTS, FURNITURE, CARPETING, WALL COVERING, DRAPERY, ETC. ARE SCHEDULED, CURED OR VENTILATED IN ACCORDANCE WITH MANUFACTURERS RECOMMENDATIONS BEFORE A SPACE CAN BE OCCUPIED.

LARGE & SMALL ASBESTOS ABATEMENT PROJECTS AS DEFINED BY 12NYCRR56 SHALL NOT BE PERFORMED WHILE THE BUILDING IS OCCUPIED". NOTE, IT IS OUR INTERPRETATION THAT THE TERM "BUILDING", AS REFERENCED IN THIS SECTION, MEANS A WING OR MAJOR SECTION OF A BUILDING THAT CAN BE COMPLETELY ISOLATED FROM THE REST OF THE BUILDING WITH SEALED NON COMBUSTIBLE CONSTRUCTION. THE ISOLATED PORTION OF THE BUILDING MUST CONTAIN EXITS THAT DO NOT PASS THROUGH THE OCCUPIED PORTION & VENTILATION SYSTEMS MUST BE PHYSICALLY SEPARATED & SEALED AT THE ISOLATION BARRIER.

EXTERIOR WORK SUCH AS ROOFING, FLASHING, SIDING, OR SOFFIT WORK MAY BE PERFORMED ON OCCUPIED BUILDINGS PROVIDED PROPER VARIANCES ARE IN PLACE AS REQUIRED, & COMPLETE ISOLATION OF VENTILATION SYSTEMS & AT WINDOWS IS PROVIDED. CARE MUST BE TAKEN TO SCHEDULE WORK SO THAT CLASSES ARE NOT DISRUPTED BY NOISE OR VISUAL DISTRACTION.

SURFACES THAT WILL BE DISTURBED BY RECONSTRUCTION MUST HAVE A DETERMINATION MADE AS TO THE PRESENCE OF LEAD. PROJECTS WHICH DISTURB SURFACES THAT CONTAIN LEAD SHALL HAVE IN THE SPECIFICATIONS A PLAN PREPARED BY A CERTIFIED LEAD RISK ASSESSOR OR SUPERVISOR WHICH DETAILS PROVISIONS FOR OCCUPANT PROTECTION, WORKSITE PREPARATION, WORK METHODS, CLEANING & CLEARANCE TESTING WHICH ARE IN GENERAL ACCORDANCE WITH THE HUD GUIDELINES.

IOTE: ALL IDEAS, DESIGNS, ARRANGEMENTS AND PLANS INDICATED OR RESENTED BY THIS DRAWING ARE OWNED BY AND ARE THE PROPERTY OF D ARCHITECTS, PC (KG+D), AND WERE CREATED FOR USE ON THIS ROJECT. NONE OF SUCH IDEAS, DESIGNS, ARRANGEMENTS OR PLANS SHAL USED BY OR DISCLOSED TO ANY PURPOSE WHATSOEVER WITHOUT THE TTEN PERMISSION OF KG+D. CALED DIMENSIONS. CONTRACTOR SHALL VERIFY ALL ACTUAL DIMENSIONS ND CONDITIONS ON THE JOB AND THE ARCHITECT MUST BE NOTIFIED OF ANY SUBMITTED TO THIS OFFICE FOR APPROVAL BEFORE PROCEEDING WITH

LTERATIONS BY ANY PERSON, IN ANY WAY, OF ANY ITEM CONTAINED ON THIS DCUMENT, UNLESS ACTING UNDER THE DIRECTION OF THE LICENSED RCHITECT WHOSE PROFESSIONAL SEAL IS AFFIXED HERETO. IS A VIOLATION OF TITLE VII, SECT. 69.5 (b) OF NEW YORK STATE LAW.

Professional Seal

NYSED Project Control No.

50-03-04-03-0-003-019

Design Phase

ISSUED FOR BID

2025-04-18 ISSUED FOR BID 2025-04-16 SED ADDENDUM 2024-09-12 CONSTRUCTION DOCUMENTS No. Date Issue Sheet Title

CODE COMPLIANCE **INFORMATION**

2024-1037 Drawn / Checked AS NOTED

Sheet Number CC001

XX/XX/XXXX

	ABBREVIATIONS
AD	ACCESS DOOR
AFF	ABOVE FINISHED FLOOR
ATC	AUTOMATIC TEMPERATURE CONTROL TRADE CONTRACTOR
ATC	AUTOMATIC TEMPERATURE CONTROL SYSTEM
BMS	BUILDING MANAGEMENT SYSTEM (ATC)
BR	BOTTOM WALL REGISTER
CD	CEILING DIFFUSER
CFM	CUBIC FEET PER MINUTE
CR	CEILING REGISTER
со	CLEAN OUT (DOOR)
CV	MOTORIZED CONTROL VALVE
EC	ELECTRICAL CONTRACTOR
EMS	ENERGY MANAGEMENT SYSTEM (ATC)
FC	FLEXIBLE CONNECTION
FD	FIRE DAMPER
FSC	FULL SIZE CONNECTION
FSD	FIRE/SMOKE DAMPER
GC	GENERAL TRADES CONTRACTOR
HVAC	HEATING, VENTILATING, AIR CONDITIONING CONTRACTOR
MFR	MANUFACTURER
MD	MOTORIZED DAMPER
OAI/FAI	OUTSIDE (FRESH) AIR INTAKE
PFRE	PRE-FINISHED SHEET METAL ENCLOSURE
PL	PLUMBING CONTRACTOR
SMRE	SHEET METAL RISER ENCLOSURE (PRE-FINISHED)
TD	TRANSFER DUCT
TR	TOP WALL REGISTER
WMG	1/2" SQ. WIRE MESH GRILLE
VIF	VERIFY IN FIELD
VFD	VARIABLE FREQUENCY DRIVE

GENERAL NOTES

- BEFORE SUBMITTING A PROPOSAL, BIDDERS SHALL EXAMINE ALL CONDITIONS RELATED TO THIS WORK AND SHALL BECOME FULLY INFORMED AS TO THE EXTENT AND CHARACTER OF THE WORK REQUIRED AND ITS RELATION TO THE OTHER WORK IN THE BUILDING.
- BEFORE COMMENCING WORK, THE CONTRACTOR WILL EXAMINE ALL CONDITIONS OF THE PROJECT UPON WHICH HIS WORK IS IN ANY WAY DEPENDENT FOR PERFECT WORKMANSHIP ACCORDING TO THE INTENT OF THE DRAWINGS AND SPECIFICATIONS. NO "WAIVER OF RESPONSIBILITY" FOR INCOMPLETE, INADEQUATE OR DEFECTIVE ADJOINING WORK WILL BE CONSIDERED UNLESS NOTICE HAS BEEN FILED BY THIS CONTRACTOR AND ACCEDED TO BY THE OWNER'S REPRESENTATIVE IN WRITING BEFORE THE CONTRACTOR BEGINS ANY PART OF THE
- THE CONTRACTOR WILL PAY FOR ALL LICENSES, PERMITS AND INSPECTION FEES REQUIRED BY CIVIL AUTHORITIES HAVING JURISDICTION. COMPLY WITH ALL LAWS, ORDINANCES, REGULATIONS, AND FIRE UNDERWRITER'S REQUIREMENTS APPLICABLE TO WORK HEREIN SPECIFIED WITHOUT ADDITIONAL EXPENSE TO THE OWNER.
- SMALL SCALE DRILLING THROUGH WALLS AND FLOORS OR CUTTING OF PIPING INSULATION WHICH MAY CONTAIN ASBESTOS SHALL BE PERFORMED BY A PERSON WITH A "RESTRICTED ASBESTOS HANDLER ALLIED TRADES CERTIFICATE" AND SHALL HAVE A COPY OF IT IN HIS POSSESSION AT ALL TIMES WHILE WORKING OF THE PROJECT. THIS SHALL ALSO APPLY TO REMOVAL OF PIPING, DUCTWORK OR EQUIPMENT INSULATION.
- IT IS SPECIFICALLY INTENDED THAT ANYTHING (WHETHER MATERIAL OR LABOR), WHICH IS USUALLY FURNISHED AS A PART OF SUCH EQUIPMENT. AS IS HEREINAFTER CALLED FOR (AND WHICH IS NECESSARY FOR THE COMPLETION AND PROPER OPERATION) SHALL BE FURNISHED AS PART OF THIS CONTRACT WITHOUT ADDITIONAL COST THE OWNER, WHETHER OR NOT SHOWN IN DETAIL OR DESCRIBED IN THE SPECIFICATIONS.
- WHEN DRAWINGS AND SPECIFICATIONS CONFLICT OR THERE IS A QUESTION AS TO THE PROPER INTENT OF THIS CONTRACT. THE CONTRACTOR SHALL ASSUME THE GREATER QUANTITY. THE HIGHER QUALITY AND/OR THE MORE EXPENSIVE METHOD IN HIS PRICING. ALL QUESTIONS SHALL BE DIRECTED TO THE ARCHITECT/ENGINEER IN WRITING ONLY AND ONLY UP TO TEN (10) DAYS
- THE DRAWINGS INDICATE THE GENERAL RUNS OF THE PIPING, DUCTWORK, ETC. SYSTEMS AND THE LOCATION OF EQUIPMENT AND APPARATUS. HOWEVER IT SHALL BE UNDERSTOOD THAT THE RIGHT IS RESERVED BY THE ARCHITECT/ENGINEER TO CHANGE THE LOCATION OF PIPING, DUCTWORK. EQUIPMENT AND APPARATUS TO A REASONABLE EXTENT AS BUILDING CONDITIONS MAY DICTATE, PRIOR TO THEIR INSTALLATION WITHOUT EXTRA COST TO THE OWNER.
- ALL DUCT DIMENSIONS SHOWN ARE CLEAR INSIDE DIMENSIONS. THE CONTRACTOR SHALL ACCOUNT FOR ANY LINING IN SIZING OF SHEET METAL.
- ALL COMPONENTS SUPPLIED BY THIS CONTRACTOR SHALL BE UL LISTED AND/OR ETL LABELED AND SHALL CONFORM TO ASHRAE STANDARD 15.
- ANY CHANGES FROM THE DRAWINGS AND SPECIFICATIONS AND ANY INTERPRETATION THEREOF SHALL HAVE THE PRIOR APPROVAL OF THE ARCHITECT/ENGINEER. THE CONTRACTOR SHALL SUBMIT IN WRITING, AT THE TIME OF SIGNING THE CONTRACT, ANY ITEMS OF NECESSARY LABOR AND MATERIALS, WHICH, IN HIS OPINION, ARE LACKING IN REQUIREMENTS OF THE DRAWINGS AND SPECIFICATIONS TO INSURE A COMPLETE JOB IN ALL RESPECTS. NO CONSIDERATION WILL BE GRANTED TO ALLEGED MISUNDERSTANDING OF MATERIALS TO BE FURNISHED, WORK TO BE DONE, OR CONDITIONS TO BE COMPLIED WITH. IT BEING UNDERSTOOD THAT THE TENDER OF A PROPOSAL CARRIES WITH IT THE AGREEMENT TO ALL ITEMS AND CONDITIONS REFERRED TO HEREIN, OR INDICATED ON THE ACCOMPANYING DRAWINGS.
- FURNISH ALL COMBINATION MOTOR STARTER/DISCONNECTS FOR EQUIPMENT (WITH THE EXCEPTION OF STARTERS AND ELECTRIC ITEMS ALREADY MOUNTED ON EQUIPMENT OR EQUIPMENT NOT REQUIRING SAME). FAN MOTOR STARTER/DISCONNECTS SHALL HAVE CONTACTS FOR ATC CONNECTION AND A TERMINAL BLOCK CONNECTION FOR FIRE ALARM FAN SHUTDOWN. STARTERS PER MANUFACTURERS RECOMMENDATIONS. UNDERWRITERS INSPECTION AND CERTIFICATE REQUIRED. COORDINATE WITH ELECTRICAL CONTRACTOR.
- THIS CONTRACTOR SHALL COORDINATE WITH OTHER TRADES PROVIDING ELECTRIC, GAS, WATER, ETC. CONNECTIONS TO SYSTEMS OR EQUIPMENT THAT ARE PART OF THIS CONTRACT. PROVIDE EQUIPMENT CUTS AND EXACT LOCATIONS, INCLUDING ORIENTATION, OF ALL SYSTEMS AND EQUIPMENT REQUIRING SUCH CONNECTIONS. THIS SHALL BE DONE WELL IN ADVANCE OF THOSE TRADES INSTALLING THEIR CONNECTION WORK.
- 3. COORDINATION DRAWINGS (IF APPLICABLE): ATTENTION IS DIRECTED TO DIVISION 1 FOR COORDINATION DRAWING REQUIREMENTS FOR THIS PROJECT. THESE DRAWINGS ARE CRITICAL TO THE PROPER EXECUTION OF THE WORK AND FAILURE TO HONOR THESE REQUIREMENTS MAY BECOME THE BASIS FOR DENIAL OF ANY AND ALL CLAIMS FOR EITHER OR BOTH "TIME" AND
- 14. LOCATION AND SIZES OF EXISTING PIPING, DUCTWORK, EQUIPMENT, ETC. ARE APPROXIMATE. EXACT SIZES AND LOCATIONS OF ALL EXISTING WORK SHALL BE VERIFIED ON THE JOB.
- 15. BEFORE FABRICATION THIS CONTRACTOR SHALL VERIFY ALL MEASUREMENTS AND CONDITIONS ON JOB AND COORDINATE HIS WORK WITH THE WORK OF ALL OTHER CONTRACTORS.
- THE CONTRACTOR SHALL COORDINATE WITH THE OWNER PRIOR TO SUBMISSION OF BID TO DETERMINE WHAT WORK MUST BE PERFORMED AFTER NORMAL BUSINESS HOURS. UNLESS OTHERWISE DIRECTED ANY NOISY WORK (CHOPPING, CORE DRILLING, HAMMERING, ETC.) AND BUILDING POWER INTERRUPTIONS SHALL BE PERFORMED OUTSIDE OF NORMAL BUSINESS HOURS. CONFIRM NORMAL BUSINESS HOURS WITH BUILDING OWNER. NO ADDITIONAL COST WILL BE CHARGED TO OWNER FOR WORK PERFORMED OUTSIDE NORMAL BUSINESS HOURS.
- REFER TO ARCHITECT'S REFLECTED CEILING PLAN FOR EXACT LOCATION OF ALL CEILING MOUNTED ITEMS.
- OPENINGS AROUND PENETRATIONS THROUGH FIRE RESISTANCE RATED WALLS, PARTITIONS, FLOORS OR CEILINGS SHALL BE FIRE STOPPED USING APPROVED METHODS. ALL SLEEVES MUST HAVE BUSHINGS. SEALANT SHALL BE 3 HOUR FIRE BARRIER #CP-25 (NO LESS THAN 3' THICK BACKED UP WITH MINERAL WOOL).
- PREPARE 'AS-BUILT' DRAWINGS THAT REFLECT ACTUAL CONSTRUCTION AND SHOW DEVIATIONS FROM DESIGN DRAWINGS.

OLD NYACK HIGH **LEGEND** SCHOOL BOILER EXISTING DUCTWORK, EQUIPMENT, ETC. TO REMAIN EXISTING DUCTWORK, EQUIPMENT, ETC. POINT OF CHANGE IN DUCT SIZE NEW DUCTWORK **₩** NEW DUCTWORK NEW DUCTWORK SQUARE DUCT TURN WITH TURNING VAN COLD WATER PIPING HOT WATER PIPING HOT WATER RETURN PIPING — G — GAS PIPING HOT WATER HEATING SUPPLY PIPING ——HWS—— ——HWR—— HOT WATER HEATING RETURN PIPING ——EHWS —— EXISTING HOT WATER HEATING SUPPLY EXISTING HOT WATER HEATING RETURN —— EHWR —— EXISTING FUEL OIL SUPPLY PIPING ——EFOS —— —— EFOR —— EXISTING FUEL OIL RETURN PIPING — — USAN— — SANITARY PIPING (UNDERGROUND) FLOW DIRECTION WITHIN PIPE GATE VALVE (HORIZONTAL/VERTICAL) COMBINATION BALANCING & SHUT-OFF V. 2 - WAY CONTROL VALVE 3 - WAY CONTROL VALVE -17-Ø---CHECK VALVES GAS SHUT OFF COCK PIPE CONNS. (BOTTOM; TOP 45 OR 90; PIF AUTOMATIC AIR VENT IDENTIFICATION THERMOMETER PRESSURE GAUGE (WITH SHUT-OFF COC BOILER IDENTIFICATION EXPANSION TANK IDENTIFICATION HOT WATER PUMP IDENTIFICATION

GENERAL REMOVAL NOTES

SECTION/ELEVATION IDENTIFICATION

— SECTION/DETAIL/ELEVATION/PART PLAN NUMBER

EXISTING HOT WATER PUMP IDENTIFICATION

POINT OF CONNECTION, NEW TO EXISTING

--- DRAWING NUMBER


THE SCOPE OF REMOVAL SHOWN ON "REMOVALS" DRAWINGS IS DIAGRAMMATIC ONLY AND INDICATES THE INTENT OF THE WORK TO BE PERFORMED AND NOT THE COMPLETE SCOPE OF DEMOLITION AND/OR REMOVAL WORK. IT SHALL BE THE RESPONSIBILITY OF THIS CONTRACTOR TO REMOVE ANY RELATED MECHANICAL DEVICES EVEN IF NOT SPECIFICALLY INDICATED TO BE REMOVED ON THESE DRAWINGS IN ORDER TO ACCOMMODATE NEW WORK.

POINT OF DISCONNECTION

•

- DEVICES SHOWN CROSS HATCHED ON DRAWINGS ARE ITEMS TO BE REMOVED. ANY DEVICES REMOVED SHALL INCLUDE (BUT SHALL NOT BE LIMITED TO) THE REMOVAL OF ALL ASSOCIATED PIPING, CONTROLS, ETC. THAT ARE NOT INCORPORATED IN THE NEW LAYOUT, UNTIL SUCH REMOVAL IS COMPLETE. THIS CONTRACTOR SHALL PERFORM ALL WORK REQUIRED TO INSURE CONTINUITY OF SERVICE TO EXISTING REMAINING EQUIPMENT. NO EXTRAS RELATING TO THE SCOPE OF WORK DESCRIBED WILL BE ALLOWED.
- EQUIPMENT, PIPING, ETC., REQUIRED TO RECONNECT SHALL BE INSTALLED CONCEALED WITHIN THE NEW SUSPENDED CEILINGS, PARTITIONS AND/OR WALLS, FLOORS, NO SURFACE MOUNTED OR EXPOSED EQUIPMENT, PIPING, ETC., SHALL BE PERMITTED, UNLESS SPECIFICALLY INDICATED.
- 4. ALL ITEMS TO BE REMOVED SHALL BE REVIEWED WITH THE OWNER PRIOR TO REMOVAL. OWNER SHALL HAVE FIRST SALVAGE RIGHTS. ITEMS THE OWNER WISHES TO KEEP SHALL BE REMOVED WITH CARE AND STORED AS DIRECTED BY OWNER. ITEMS THE OWNER DOES NOT WISH TO KEEP SHALL BE REMOVED FROM THE SITE AND DISPOSED OF PROPERLY.
- 5. REMOVE OR RELOCATE ALL DEVICES LOCATED ON THE EXTERIOR OF THE BUILDING OR ON THE INTERIOR OF EXTERIOR WALLS AS REQUIRED TO ACCOMMODATE A NEW BUILDING ADDITION OR TO ALLOW THE ADDITION OF DOORWAYS INTO THE NEW ADDITION.
- 6. REMOVALS SHALL BE COORDINATED WITH OTHER TRADES AFFECTED.
- REMOVAL OF ANY PIECE OF EQUIPMENT OR TERMINAL DEVICE SHALL INCLUDE REMOVAL OF CONNECTING DUCTWORK AND PIPING BACK TO EXISTING MAINS THAT REMAIN. CAP EACH BRANCH AIR/WATER-TIGHT. CONTROLS AND CONTROL COMPONENTS SHALL ALSO BE REMOVED. DO NOT LEAVE COMPONENTS (CONTROLLERS, PNEUMATICS, ETC.) THAT HAVE NO FUNCTION. PROVIDE CONTROL WIRING, DUCTWORK, PIPING, ETC. AS NECESSARY TO MAINTAIN CONTINUITY OF SERVICE FOR EQUIPMENT OR TERMINAL DEVICES TO REMAIN.
- 8. ALL PIPING TO BE REMOVED SHALL BE PROPERLY PLUGGED OR CAPPED BENEATH FINISHED SURFACES, SO THAT UPON COMPLETION OF ALL NEW WORK, ALL ABANDONED PIPING SHALL BE CONCEALED IN FINISHED AREAS.
- 9. NO DEAD ENDS SHALL BE LEFT ON ANY PIPING UPON COMPLETION OF JOB. BRANCHES SHALL BE CUT AND CAPPED AT MAINS. THE EXISTING SYSTEM SHALL BE LEFT IN PERFECT WORKING ORDER UPON COMPLETION OF NEW WORK.
- 10. CHIMNEY INSPECTION AND SOOT REMOVAL: ON PROJECTS INCLUDING BOILER REMOVAL OR REPLACEMENT, CONTRACTOR SHALL GATHER TOGETHER WITH A VACUUM-CLEANING MACHINE ALL ACCUMULATIONS OF SOOT. HE SHALL REMOVE ALL SOOT FROM THE BASE OF THE CHIMNEY. THE CHIMNEY SHALL BE INSPECTED AND ANY DEFICIENCIES NOTED IN A WRITTEN REPORT.

EXISTING DUCTWORK, EQUIPMENT, ETC. TO REMAIN	REPLACEMENT
EXISTING DUCTWORK, EQUIPMENT, ETC. TO BE REMOVED	KEPLACEMENT
POINT OF CHANGE IN DUCT SIZE NEW DUCTWORK 1" THERMAL ACOUSTIC LINING-DUCT SIZES ON PLANS ARE CLEAR INSIDE DIMENSIONS	OLD NYACK HIGH SCHOOL
THERMAL ACOUSTIC LINING NEW DUCTWORK FLEXIBLE CONNECTION / POINT OF CHANGE IN DUCT SIZE	OLD WINGING TOOLS OF
FLEXIBLE CONNECTION NEW DUCTWORK POINT OF CHANGE IN DUCT SIZE	131 N Midland Ave Nyack, NY, 10960
SQUARE DUCT TURN WITH TURNING VANES	14yack, 141, 10300
COLD WATER PIPING	
HOT WATER PIPING	listen imagine build
HOT WATER RETURN PIPING	build
GAS PIPING	KG+D ARCHITECTS, PC
HOT WATER HEATING SUPPLY PIPING	285 MAIN STREET • MOUNT KISCO, NEW YORK 10549 P: 914.666.5900 KGDARCHITECTS.COM
HOT WATER HEATING RETURN PIPING	
EXISTING HOT WATER HEATING SUPPLY PIPING	
EXISTING HOT WATER HEATING RETURN PIPING	
EXISTING FUEL OIL SUPPLY PIPING	3696
EXISTING FUEL OIL RETURN PIPING	BARILE GALLAGHER & ASSOCIATES
SANITARY PIPING (UNDERGROUND)	CONSULTING ENGINEERS 39 MARBLE AVE PLEASANTVILLE, NY 10570
FLOW DIRECTION WITHIN PIPE — CONNECTION TO EQUIPMENT ABOVE	PHONE: 914.328.6060 FAX: 914.328.9304 General@BGA-Eng.com
GATE VALVE (HORIZONTAL/VERTICAL)	
COMBINATION BALANCING & SHUT-OFF VALVE (CIRCUIT SETTER)	
2 - WAY CONTROL VALVE	
3 - WAY CONTROL VALVE	
CHECK VALVES	
GAS SHUT OFF COCK	
PIPE CONNS. (BOTTOM; TOP 45 OR 90; PIPE UP)	
AUTOMATIC AIR VENT IDENTIFICATION	
THERMOMETER	
PRESSURE GAUGE (WITH SHUT-OFF COCK)	
BOILER IDENTIFICATION	
EXPANSION TANK IDENTIFICATION	
HOT WATER PUMP IDENTIFICATION	
DOMESTIC HOT WATER CIRCULATOR PUMP IDENTIFICATION	
EXISTING DOMESTIC HOT WATER CIRCULATOR PUMP IDENTIFICATION	
EXISTING BOILER IDENTIFICATION	
EXISTING EXPANSION TANK IDENTIFICATION	

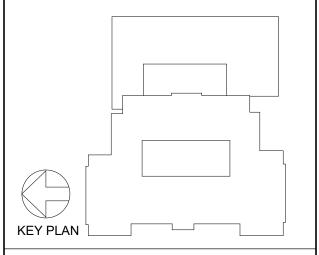

NOTE: ALL IDEAS DESIGNS ARRANGEMENTS AND PLANS INDICATED OR REPRESENTED BY THIS DRAWING ARE OWNED BY AND ARE THE PROPERTY OF G+D ARCHITECTS, PC (KG+D), AND WERE CREATED FOR USE ON THIS PROJECT. NONE OF SUCH IDEAS, DESIGNS, ARRANGEMENTS OR PLANS SHALL BE USED BY OR DISCLOSED TO ANY PURPOSE WHATSOEVER WITHOUT THE RITTEN PERMISSION OF KG+D. WRITTEN DIMENSIONS ON THIS DRAWING SHALL HAVE PRECEDENCE OVER

SCALED DIMENSIONS. CONTRACTOR SHALL VERIFY ALL ACTUAL DIMENSIONS AND CONDITIONS ON THE JOB AND THE ARCHITECT MUST BE NOTIFIED OF ANY BE SUBMITTED TO THIS OFFICE FOR APPROVAL BEFORE PROCEEDING WITH

ALTERATIONS BY ANY PERSON, IN ANY WAY, OF ANY ITEM CONTAINED ON THIS ARCHITECT WHOSE PROFESSIONAL SEAL IS AFFIXED HERETO, IS A VIOLATION OF TITLE VII, SECT. 69.5 (b) OF NEW YORK STATE LAW. ALL RIGHTS RESERVED.

Professional Seal

NYSED Project Control No.

50-03-04-03-0-003-019

Design Phase ISSUE FOR BID

04/18/2025 ISSUE FOR BID 09/12/2024 CONSTRUCTION DOCUMENTS Date Sheet Title LEGEND, NOTES,


ABBREVIATIONS

2024-1035 AS NOTED

BGA / BGA H001

04/18/2025

Drawn / Checked

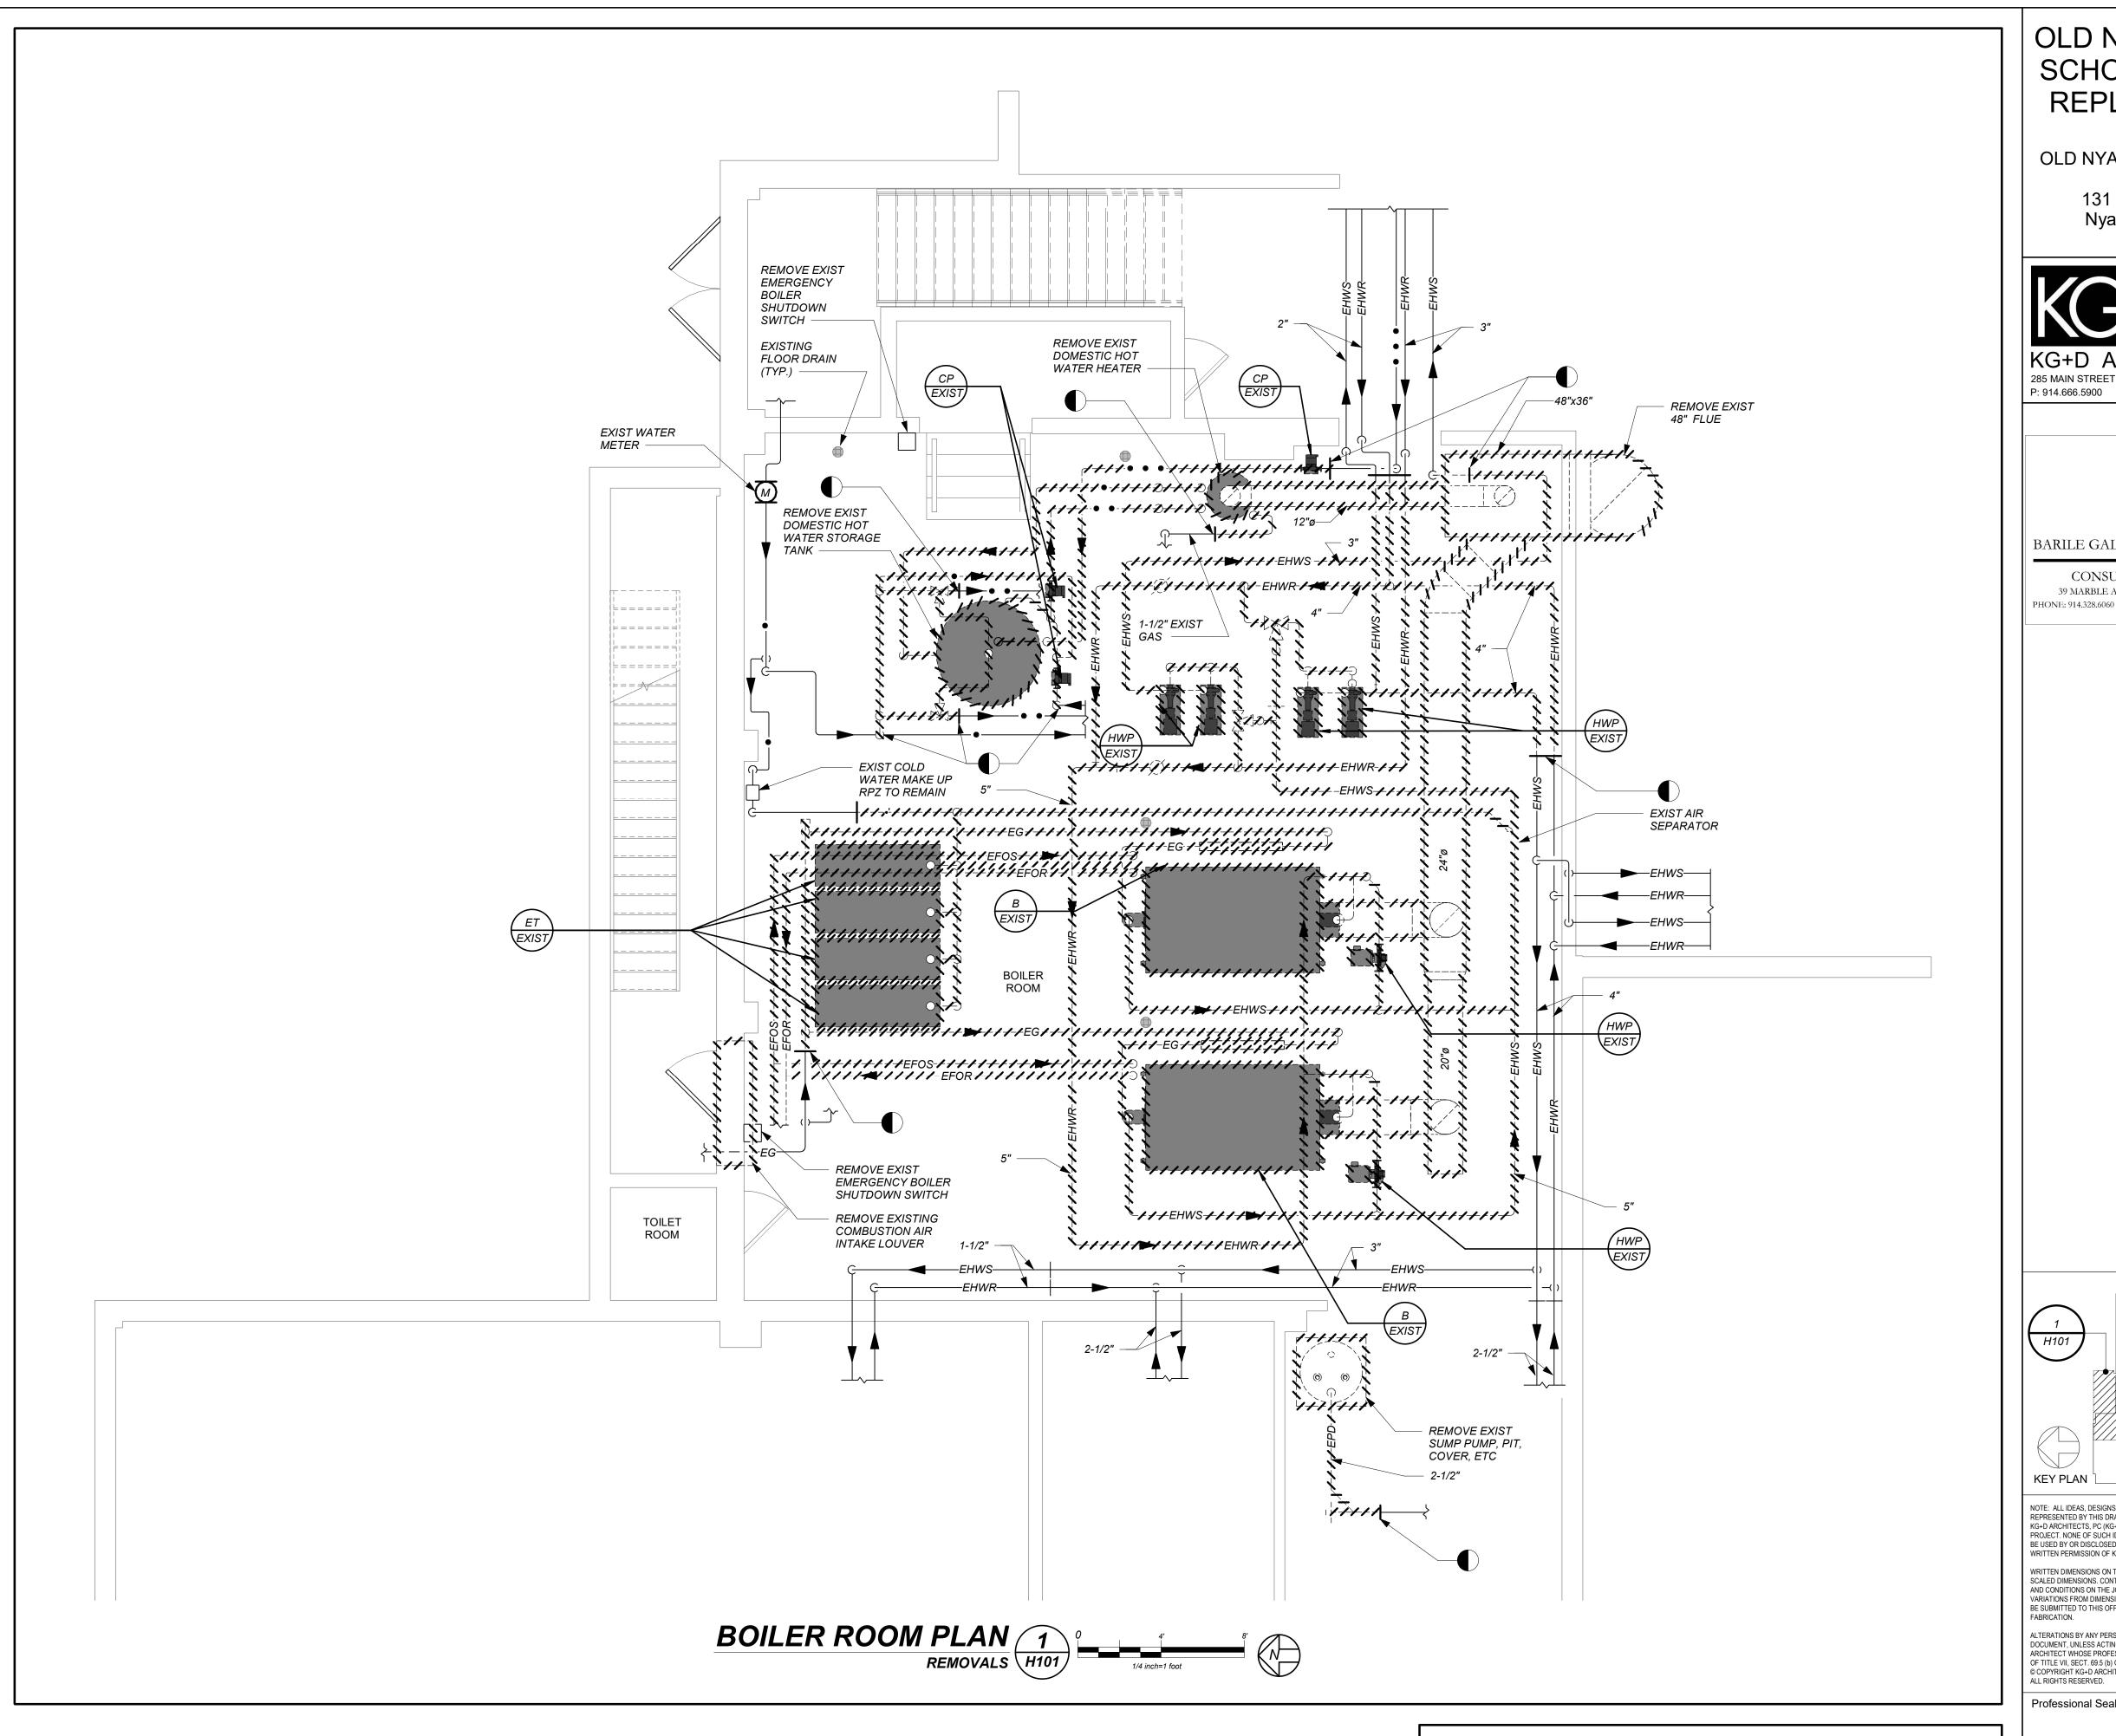

NOTE:

BEFORE COMMENCEMENT OF ANY REMOVAL WORK, THIS CONTRACTOR SHALL TEST HOT WATER FLOW AT EXISTING PUMPS AND ALL HOT WATER MAINS AND PRIMARY BRANCHES THAT ARE TO REMAIN. UPON THE CONCLUSION OF THE NEW WORK, ALL WATER FLOWS SHALL BE RETURNED TO THESE CONDITIONS.

OLD NYACK HIGH SCHOOL BOILER REPLACEMENT

OLD NYACK HIGH SCHOOL 131 N Midland Ave

Nyack, NY, 10960




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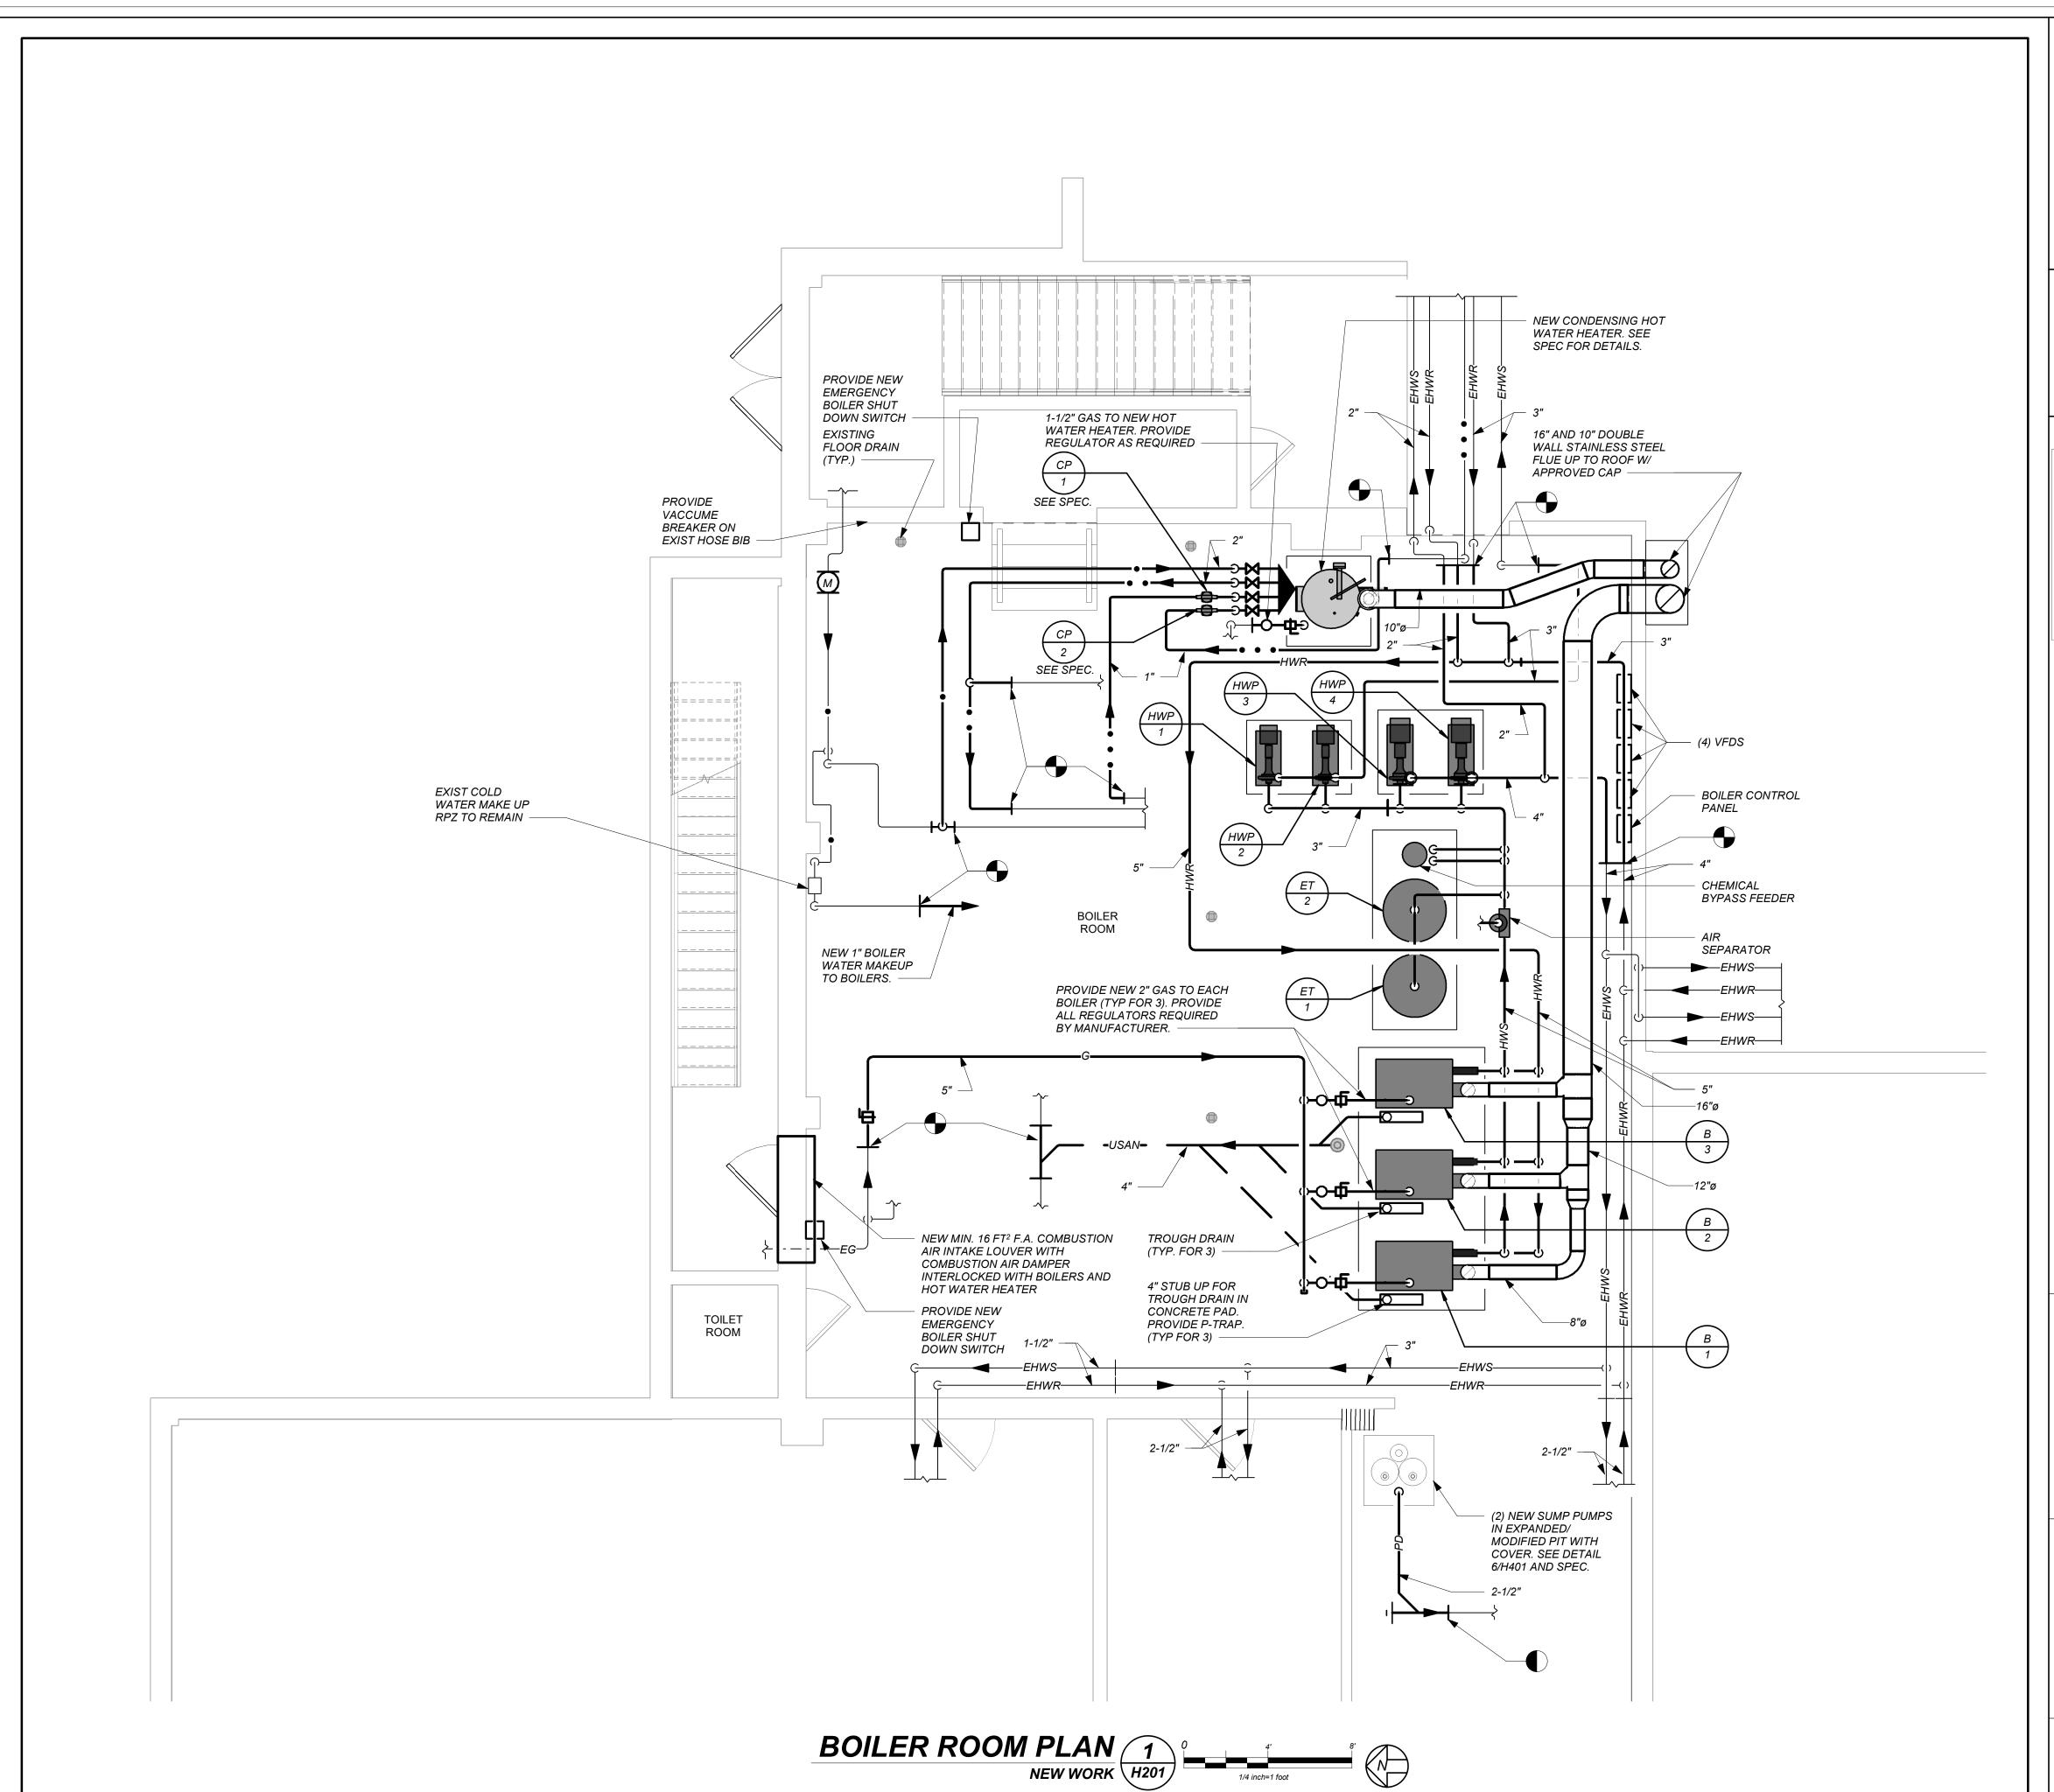
2 04/18/2025 ISSUE FOR BID 09/12/2024 CONSTRUCTION DOCUMENTS

No. Date Sheet Title **BOILER ROOM**

PLAN (REMOVALS)

04/18/2025 2024-1035 Drawn / Checked AS NOTED BGA / BGA Sheet Number

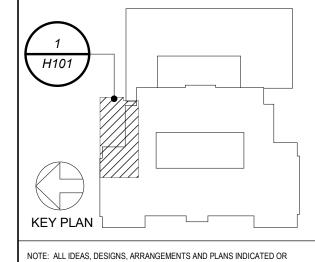H101



OLD NYACK HIGH SCHOOL BOILER REPLACEMENT

OLD NYACK HIGH SCHOOL

131 N Midland Ave




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No. Date Issue
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BOILER ROOM

PLAN (NEW WORK)

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 2024-1035
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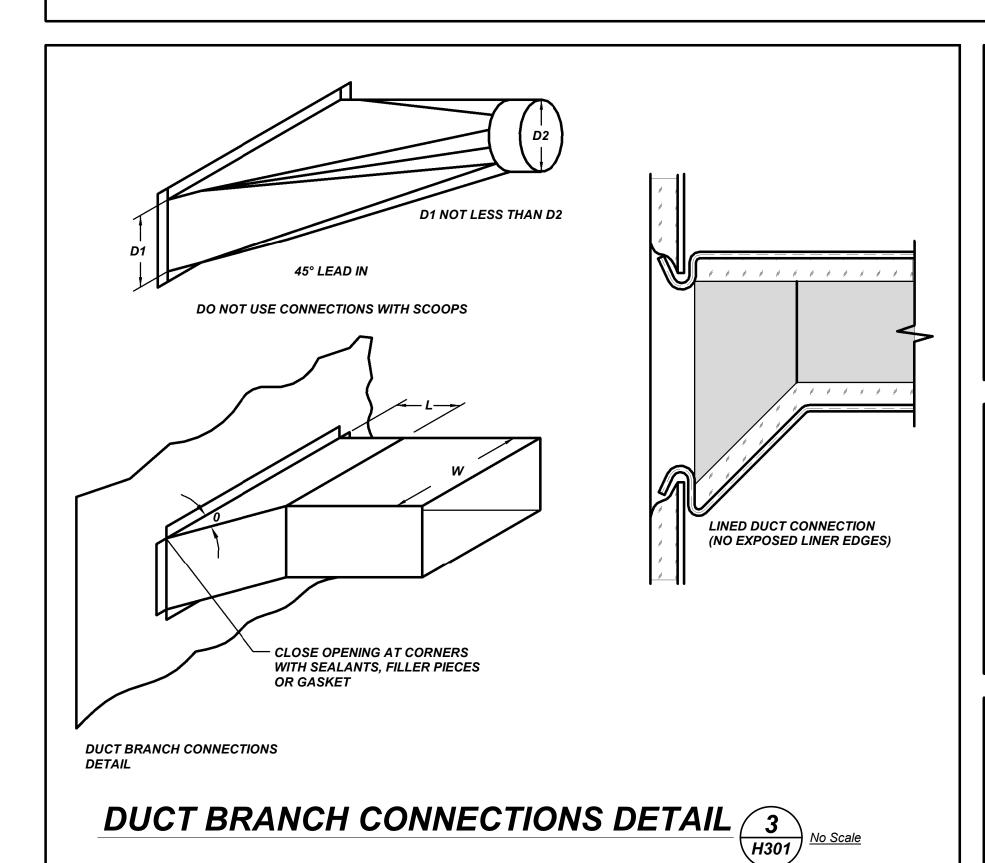
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Sheet Number

H201

	SCHEDULE OF BOILERS																		
	BOILER DATA				BURNER D	DATA			и	/ATER DATA				ELE	ECTRIC/	4 <i>L</i>	PH	IYSICAL DATA	
MARK	LOCATION	MODEL No ①	INPUT (CFH)	OUTPUT (MBH)	FUEL		MIN-MAX GAS PRESSURE	OPERATING PRESSURE	RELIEF VALVE PRESSURE	RATED PRESSURE	WATER LWT	R TEMP EWT	MIN / MAX FLOW	SERVICE	FLA	BURNER MOTOR HP	LxWxH(IN)	WEIGHT (LBS)	REMARKS
$\begin{pmatrix} B \\ 1 \end{pmatrix} \begin{pmatrix} B \\ 2 \end{pmatrix} \begin{pmatrix} B \\ 3 \end{pmatrix}$	BOILER ROOM	BMK-2000	2000	1900	NATURAL GAS	94.6%	4 - 14 IN W.C.	25 PSIG	50 PSIG	160 PSIG	180 F	160 F	25/350 GPM	120/1/60	16	1.6 HP	58 x 28 x 78	1760	REFER TO 234

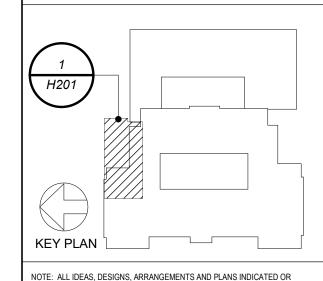- $\stackrel{N}{\bigcirc}$ (1) AS MANUFACTURED BY "AERCO".
- 2 INSTALL PER MANUFACTURER'S RECOMMENDATIONS.
- PROVIDE BOILER SEQUENCER W/ HW RESET, BOILER SEQUENCING VALVE AND CONTROLLER, SINGLE RETURN INLET CONNECTION, CHECK VALVE ON EACH INLET CONNECTION, AND CONDENSATE NEUTRALIZER FOR EACH BOILER AND COMMON FLUE DRAINS.
- VENTLESS GAS TRAIN, MIN TURNDOWN: 15:1, MAX NOX: 9 PPM, 3% O2 CORRECTION, NATIVE BACNET BMS COMMUNICATION, BOILER STAGING POINT TO NOT EXCEED 40%.




	SCHEDULE OF HOT WATER PUMPS								
MARK	LOCATION	SERVICE	MODEL No 🛈	GPM	HEAD FT H20	RPM	MOTOR HP	ELECTRIC SERVICE	REMARKS
HWP 1	BOILER ROOM	1949 ADDITION	E-1510 1.5BC	125	78	1800	5	208/3/60	REFER TO 23
HWP 2	BOILER ROOM	1949 ADDITION	E-1510 1.5BC	125	78	1800	5	208/3/60	REFER TO 234
HWP 3	BOILER ROOM	ORIGINAL BUILDING	E-1510 2.5BB	215	83	1800	10	208/3/60	REFER TO 23
HWP 4	BOILER ROOM	ORIGINAL BUILDING	E-1510 2.5BB	215	83	1800	10	208/3/60	REFER TO 234


- N ① AS MANUFACTURED BY "BELL & GOSSETT".
- 2) INSTALL PER MANUFACTURER'S RECOMMENDATIONS.
- 3 PROVIDE VFD.

5.

SCHEDULE OF EXPANSION TANKS										
LOCATION	SERVICE	MODEL No 1	TANK VOLUME GALS.	ACCEPTANCE VOLUME GALS.	REMARKS					
BOILER ROOM	BMK-2000	B1000	264	264	REFER TO 23					
BOILER ROOM	BMK-2000	B1000	264	264	REFER TO 23					

- N ① AS MANUFACTURED BY "BELL & GOSSETT".
 O
 T ② INSTALL PER MANUFACTURER'S RECOMMENDATIONS.
- E INSTALL PER MANUFACTURER'S RECOMMENDATION
- S 3 ASME RATED, VERTICAL FLOOR MOUNTING

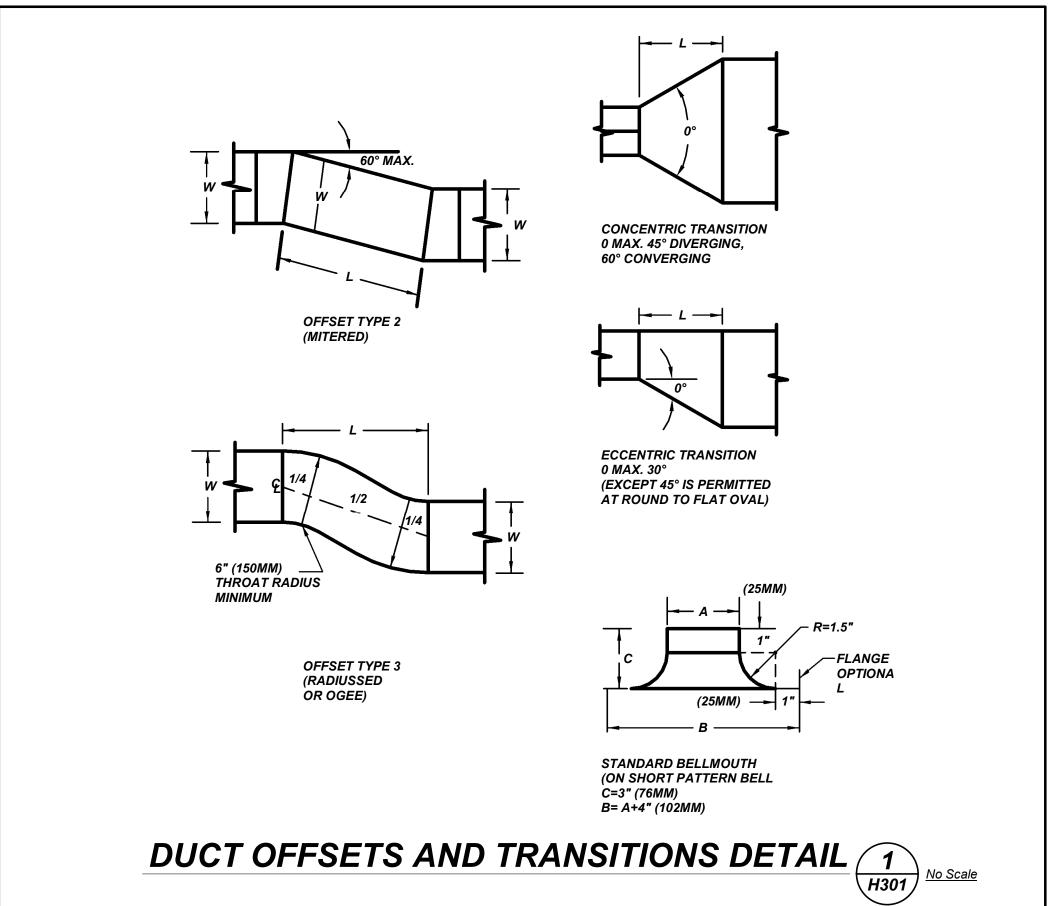

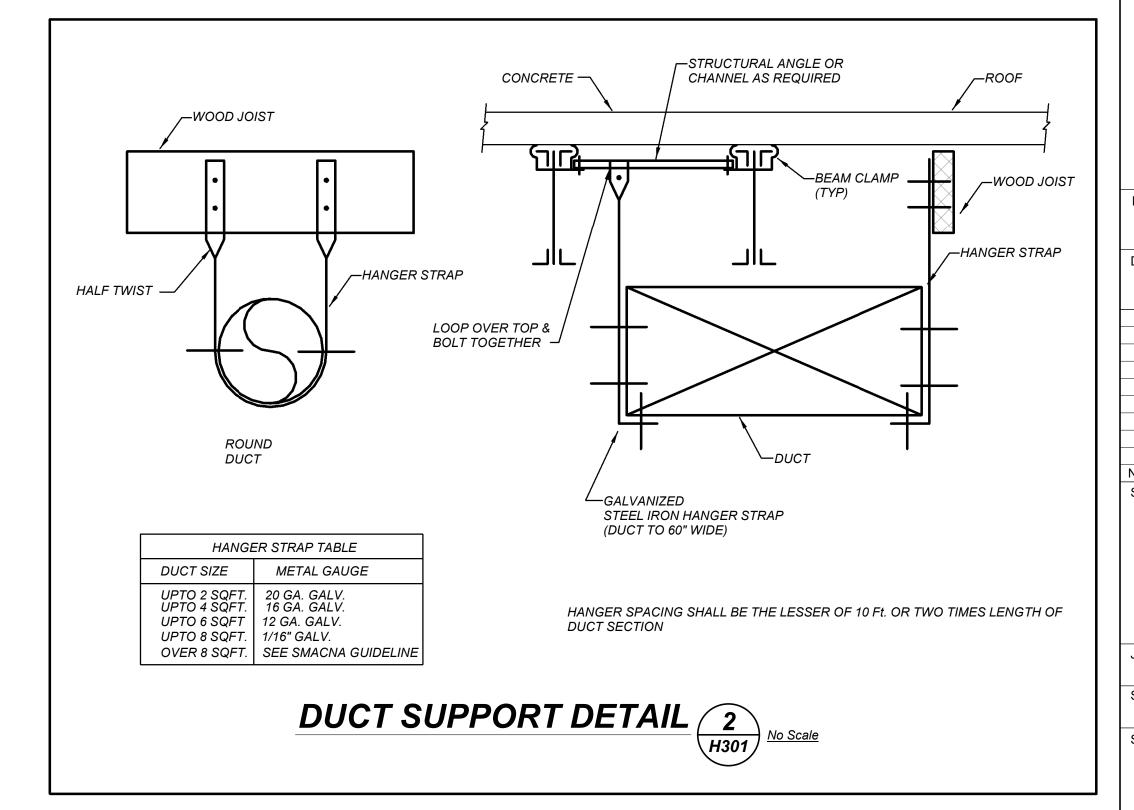

OLD NYACK HIGH SCHOOL BOILER REPLACEMENT

OLD NYACK HIGH SCHOOL

131 N Midland Ave



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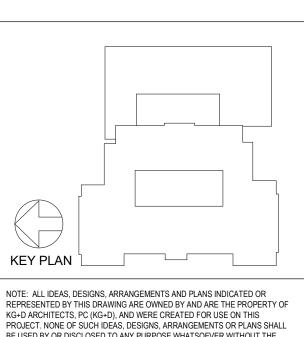
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SCHEDULES & DETAILS


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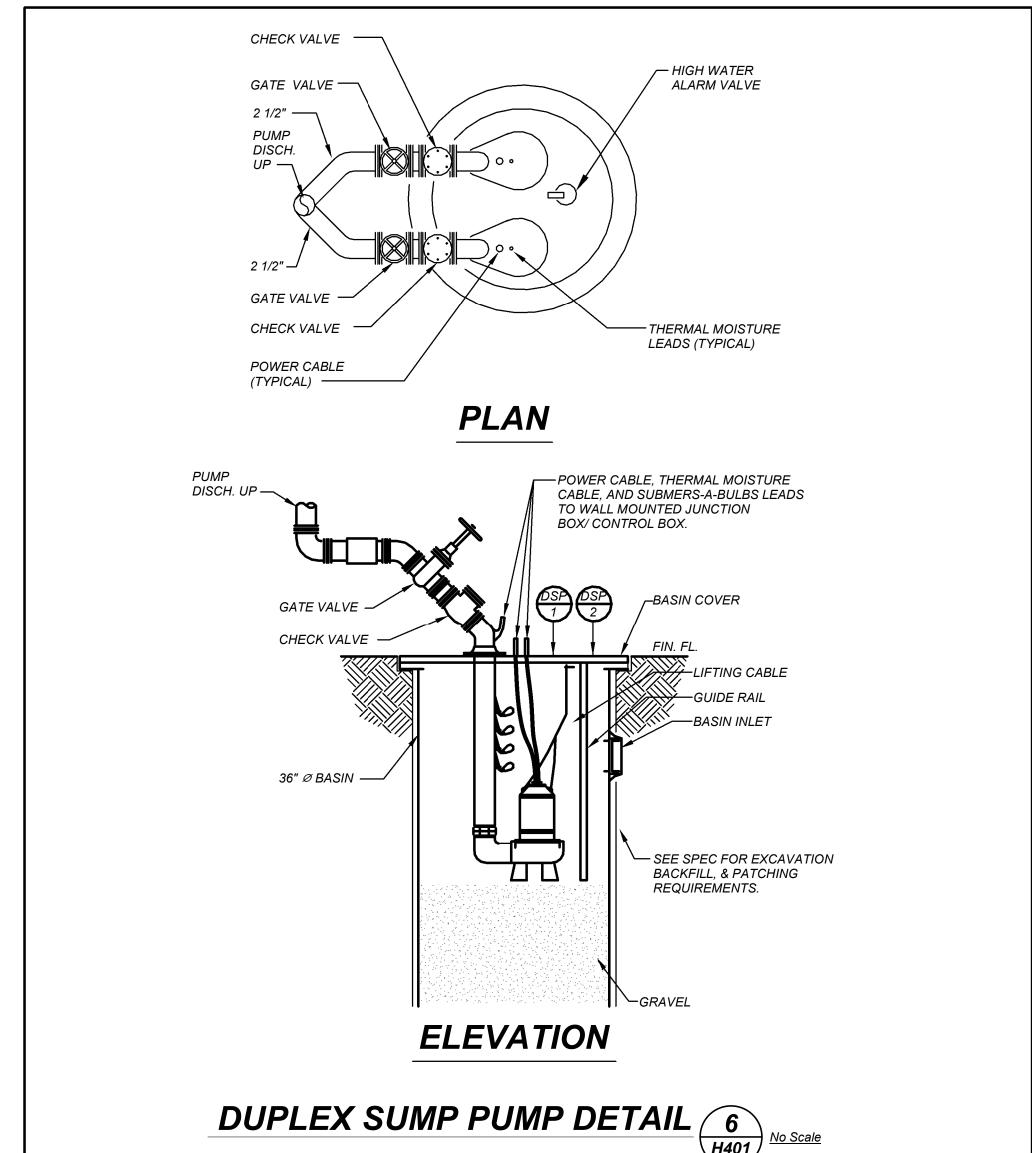
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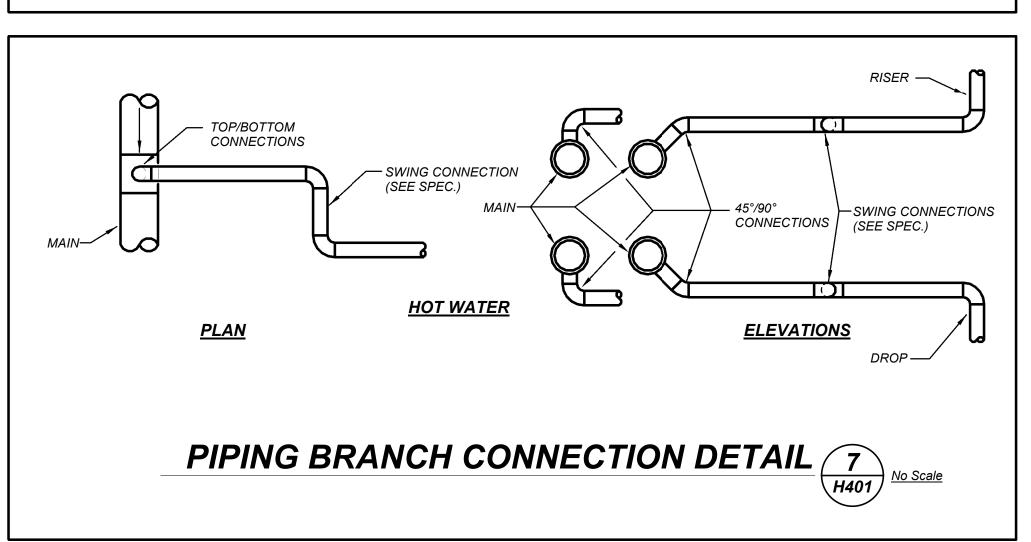
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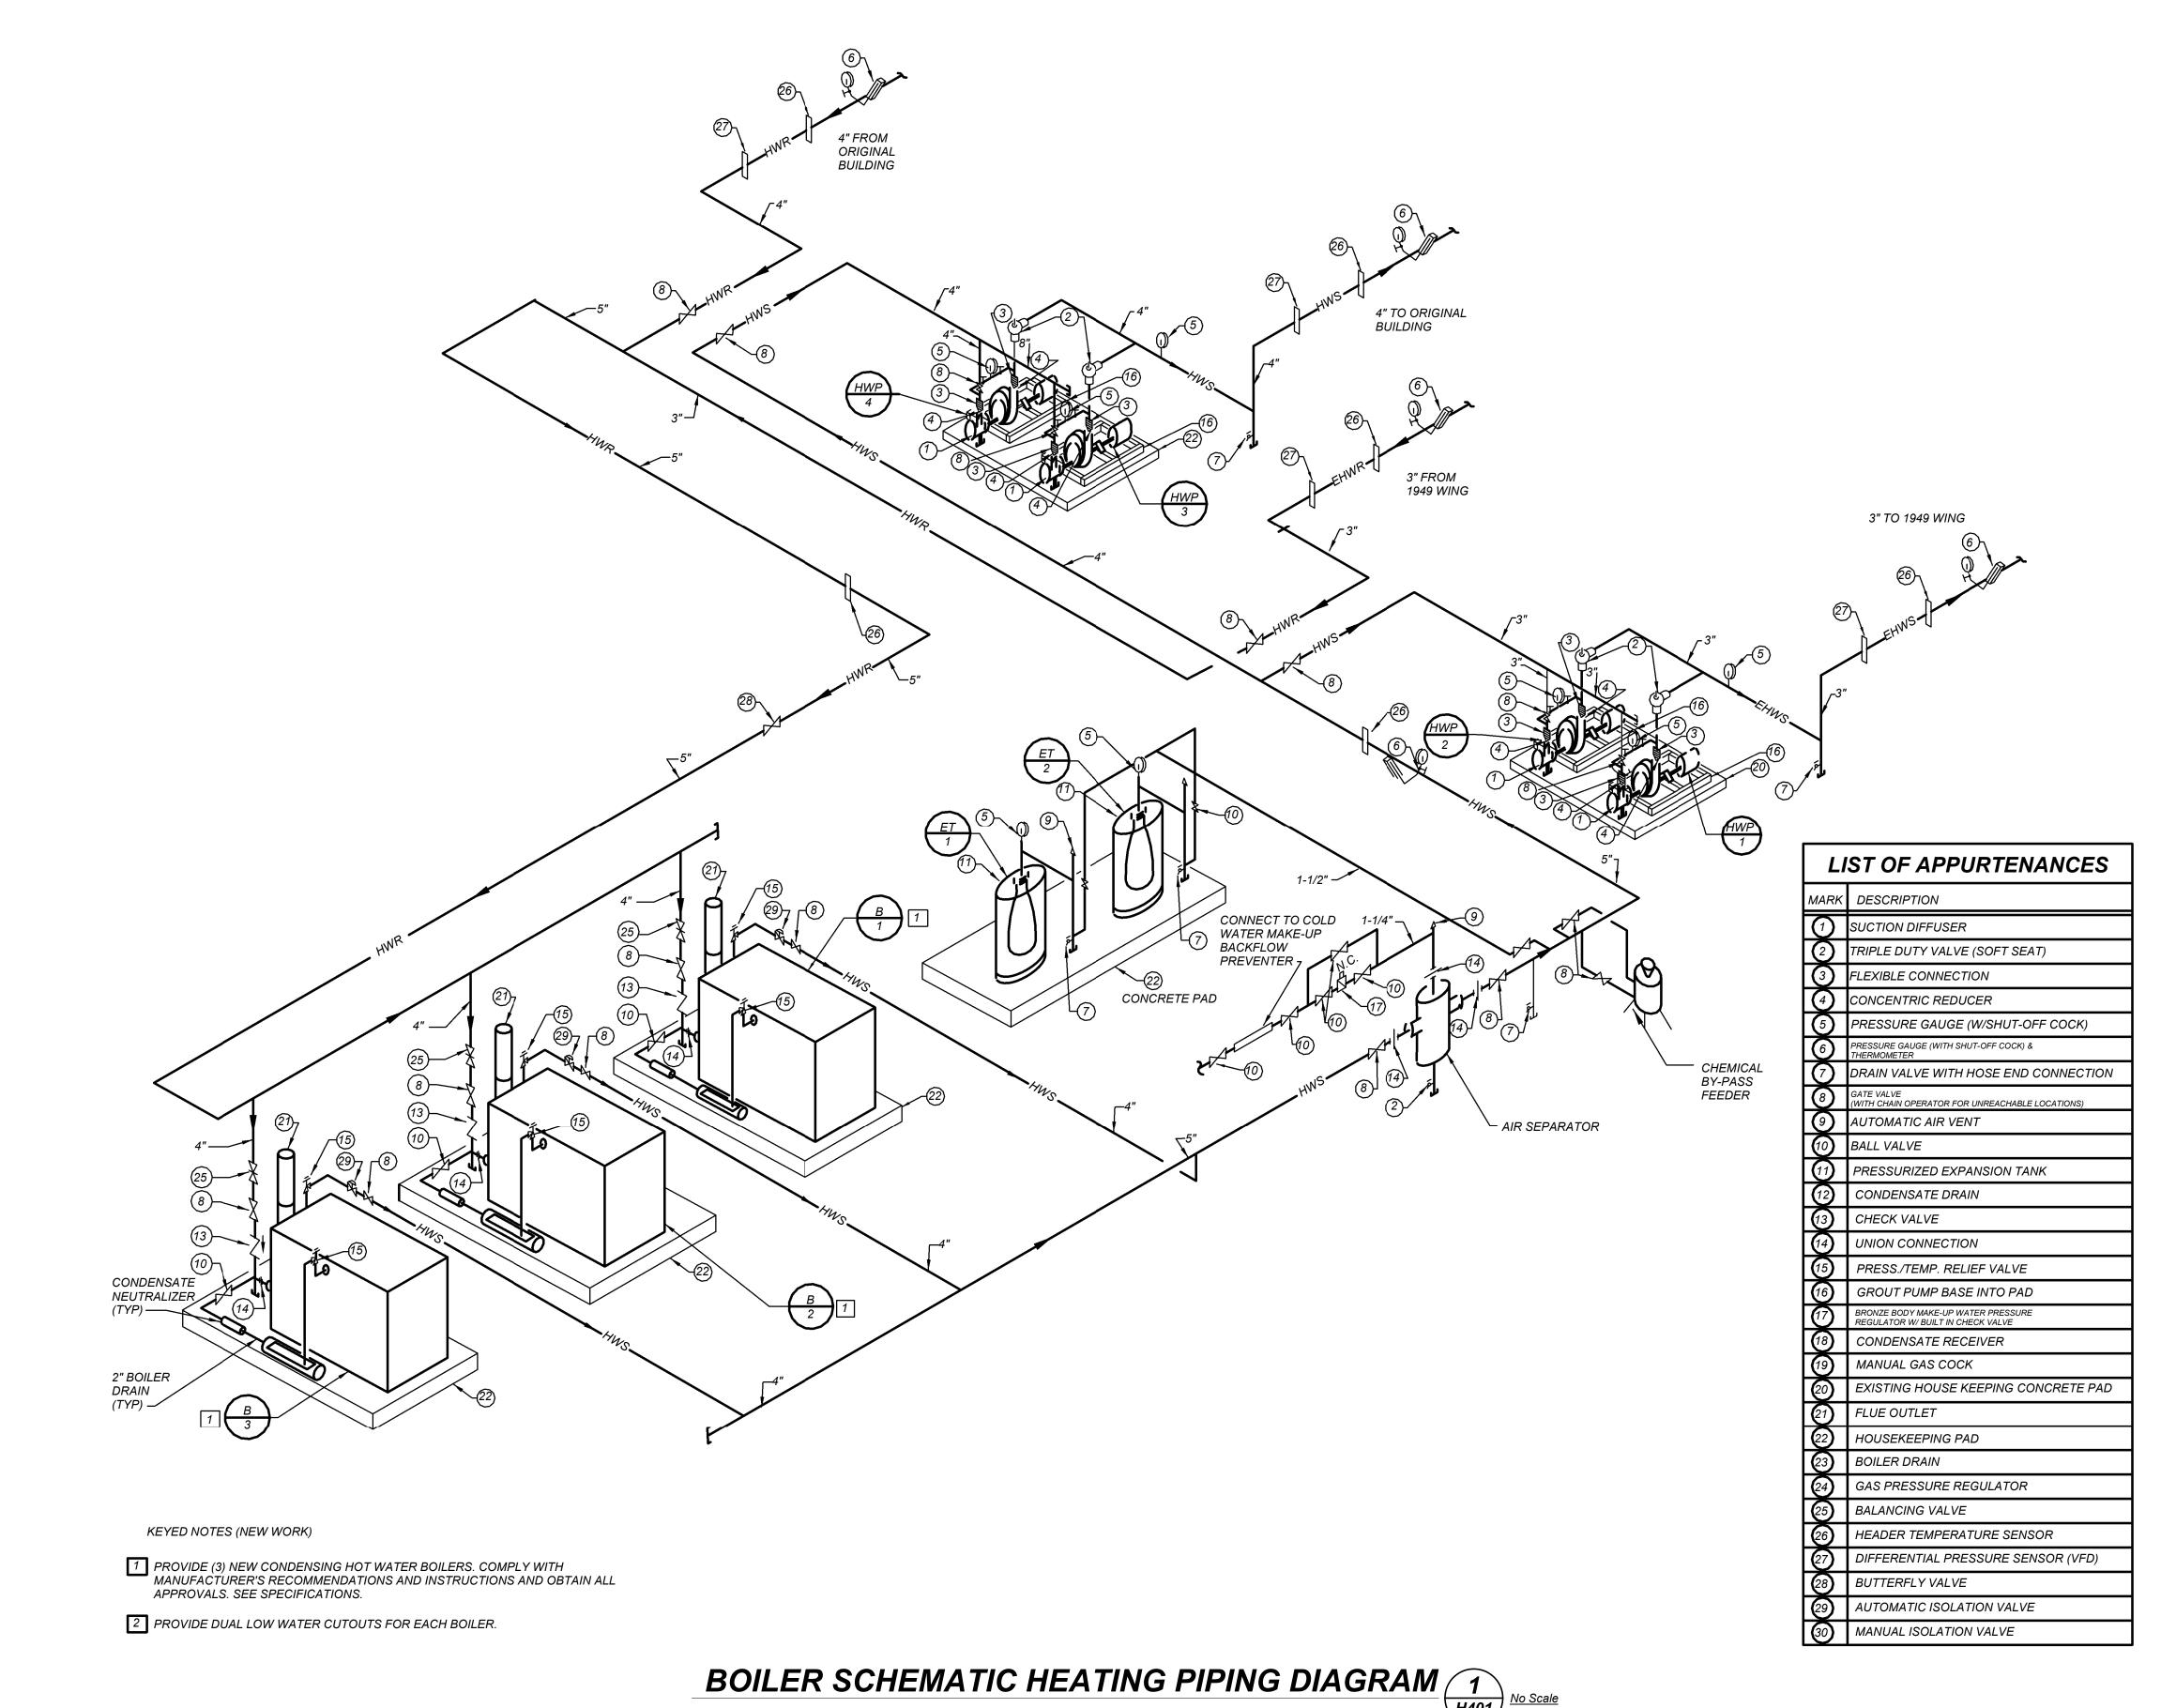
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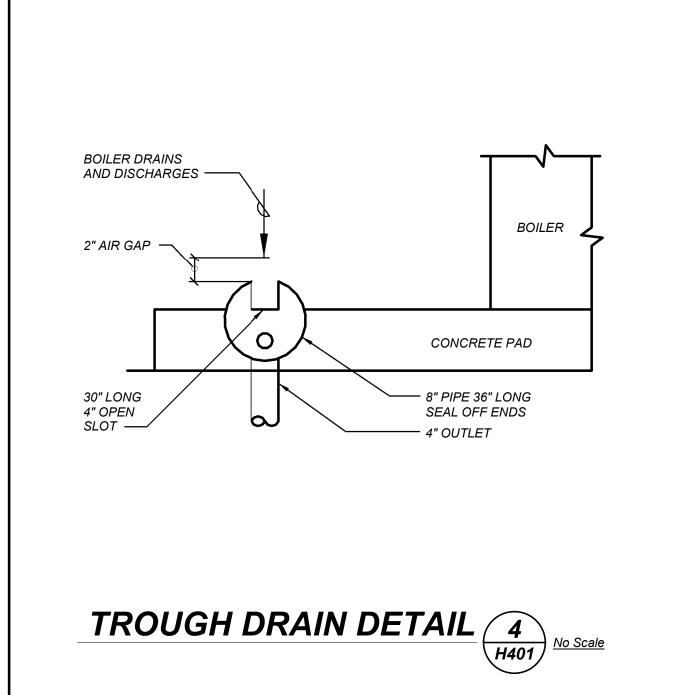
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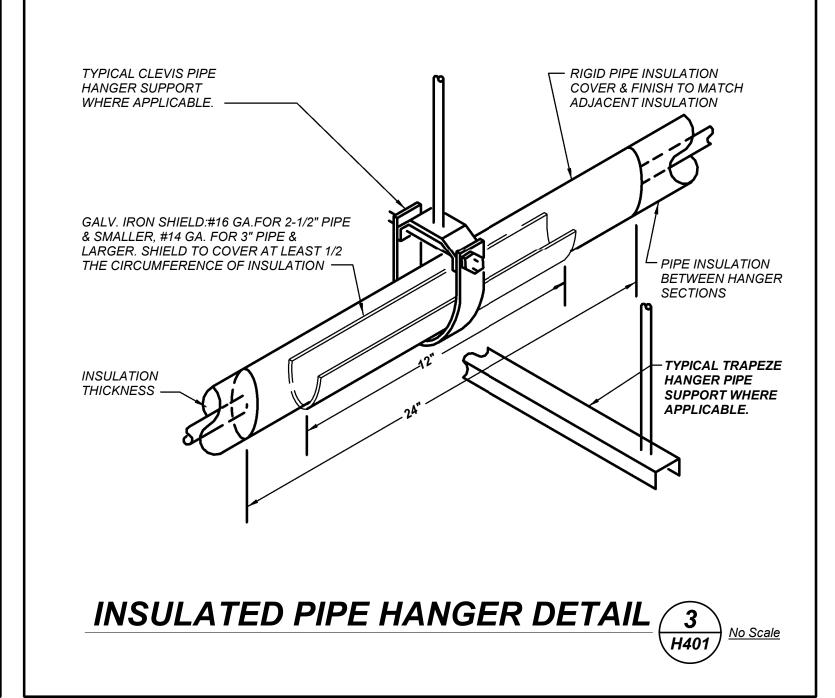











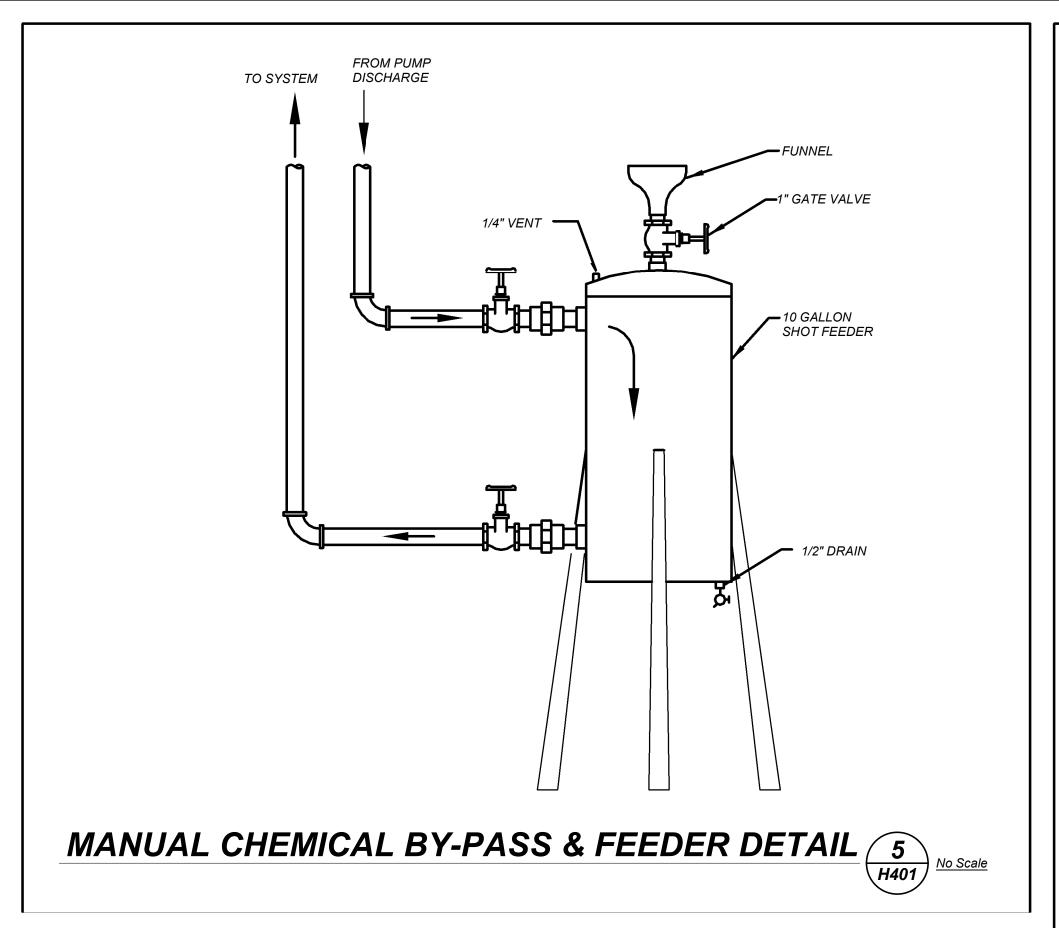

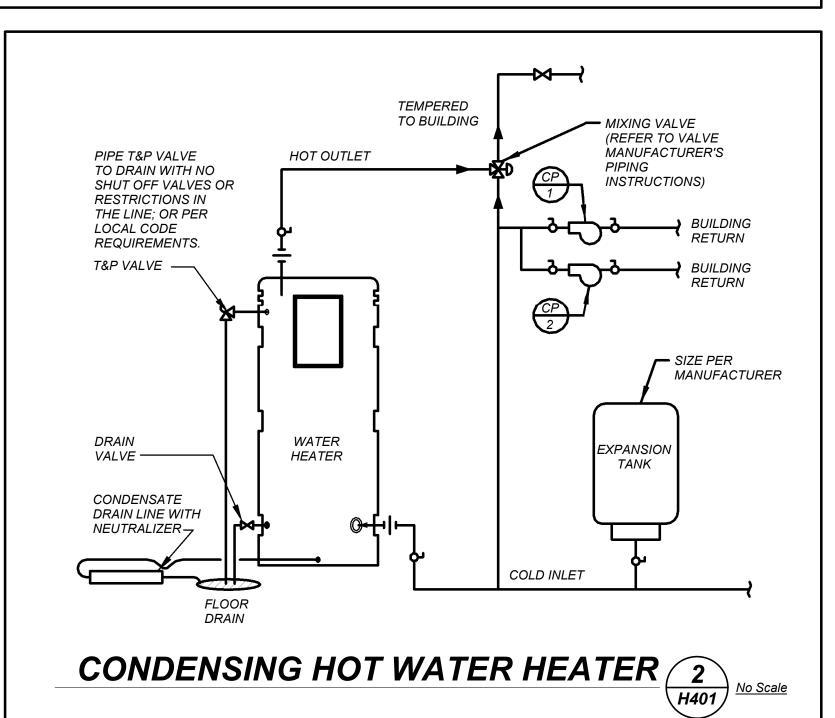



OLD NYACK HIGH SCHOOL

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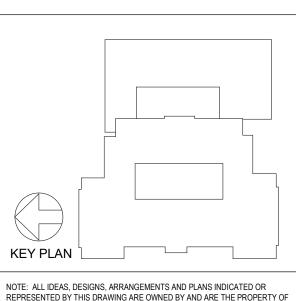


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Job No. Date 2024-1035 04/18/

 Job No.
 Date

 2024-1035
 04/18/2025

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Sheet Number H401

GENERAL NOTES

COORDINATED IN FIELD WITH RESPECTIVE CONTRACTOR/OWNER.

- DRAWINGS ARE DIAGRAMMATIC AND INDICATE THE GENERAL ARRANGEMENT OF SYSTEMS AND WORK. CONTRACTOR SHALL FURNISH ALL NECESSARY OUTLETS, SUPPORTS, FITTINGS AND ACCESSORIES TO FULFILL APPLICABLE CODES, REGULATIONS, BUILDING STANDARDS AND THE BEST PRACTICES OF THE TRADE FOR FIRST CLASS ELECTRICAL INSTALLATION.
- THE DRAWINGS INDICATE SIZE AND GENERAL LOCATION OF WORK. SCALED DIMENSIONS SHALL NOT BE USED. THE EXACT LOCATION AND ELEVATION OF ALL ELECTRICAL EQUIPMENT SHALL BE
- WHERE PANELBOARDS, SWITCHES, CIRCUIT BREAKERS, ETC. ARE EXISTING AND TO BE REUSED THE CONTRACTOR SHALL CLEAN AND REFURBISH THE EQUIPMENT. THIS SHALL INCLUDE TIGHTENING ALL CONNECTIONS, REPLACING DEFECTIVE MECHANISMS AND PROVIDING ALL REQUIRED AND NECESSARY MISCELLANEOUS COMPONENTS SO THAT THE EQUIPMENT SHALL BE IN PERFECT WORKING ORDER.
- THE CONTRACTOR SHALL COORDINATE WITH THE OWNER PRIOR TO SUBMISSION OF BID TO DETERMINE WHAT WORK MUST BE PERFORMED AFTER NORMAL BUSINESS HOURS. UNLESS OTHERWISE DIRECTED ANY NOISY WORK (CHOPPING, CORE DRILLING, HAMMERING, ETC.) AND BUILDING POWER INTERRUPTIONS SHALL BE PERFORMED OUTSIDE OF NORMAL BUSINESS HOURS. CONFIRM NORMAL BUSINESS HOURS WITH BUILDING OWNER. NO ADDITIONAL COST WILL BE CHARGEDTO OWNER FOR WORK PERFORMED OUTSIDE NORMAL BUSINESS HOURS.
- ALL WORK WHERE SHOWN WITH DARK/SOLID LINES ON THE DRAWINGS IS NEW UNLESS OTHERWISE NOTED. WHERE SHOWN WITH DASHED LINES WITH LETTER (E) IS EXISTING TO REMAIN, WITH LETTER (R) IS EXISTING TO BE REMOVED, WITH LETTER (ER) IS EXISTING RELOCATED. WITH LETTER (RN) IS EXISTING TO BE REPLACED WITH NEW AND WITH LETTER (RR) IS EXISTING TO BE REMOVED AND RELOCATED.
- CIRCUIT NUMBERS TO EXISTING PANELS ARE SHOWN FOR INTENT ONLY. ACTUAL CIRCUIT NUMBERS TO BE USED SHALL BE AS PER FIELD CONDITIONS BY UTILIZING SPARE CIRCUITS, BREAKERS OR SPACES IN EXISTING PANEL, SIZE AS INDICATED ON THE PLANS. THE ELECTRICAL CONTRACTOR SHALL BALANCE LOAD OF CIRCUITS EVENLY ON ALL PHASES.
- FEEDERS AND BRANCH CIRCUITRY SHALL BE RUN IN MINIMUM 3/4" CONDUIT UNLESS OTHERWISE NOTED. FINAL CONNECTIONS TO MOTORS MAY BE MADE WITH FLEXIBLE METALLIC CONDUIT (NO LONGER THAN 18"). IN UNFINISHED AREAS CONDUIT SHALL BE RUN EXPOSED AND IN FINISHED AREAS CONDUIT SHALL BE RUN CONCEALED.
- PROVIDE PANEL NAME PLATE MADE OF BLACK LAMINATED PLASTIC WITH WHITE ENGRAVED LETTERING AND TYPE WRITTEN DIRECTORY FOR ALL NEW AND EXISTING PANELS BEING USED FOR
- 9. ALL CONDUCTORS SHALL BE COPPER, TYPE THHN/THWN INSULATED. ALL CONDUCTORS SHALL HAVE 600 VOLT RATED INSULATION UNLESS OTHERWISE NOTED.
- 10. PROVIDE LOCK-ON CIRCUIT BREAKERS FOR CIRCUITS SERVING EXIT SIGN FIXTURES AND EMERGENCY BATTERY PACK FIXTURES.
- 11. REFER TO ARCHITECT'S REFLECTED CEILING PLAN FOR EXACT LOCATION OF ALL CEILING MOUNTED LIGHTING FIXTURES AND OTHER CEILING INSTALLED ITEMS.
- 12. THE USE OF FLEXIBLE CONDUIT FROM LIGHTING FIXTURES TO JUNCTION BOX IS PERMITTED ONLY WEN A SEPARATE GROUND WIRE IS INSTALLED WITH THE CONDUCTORS INSIDE FLEXIBLE CONDUIT. THE GROUND WIRE MUST BOND THE FIXTURE HOUSING TO THE JUNCTION BOX. MAXIMUM LENGTH 6'-0".
- 13. EXACT LOCATION AND MOUNTING HEIGHTS OF ALL DEVICES SHALL BE COORDINATED WITH THE ARCHITECT PRIOR TO THE INSTALLATION.
- WALL MOUNTED EQUIPMENT (SWITCHES, RECEPTACLES, ETC.,) SHALL BE SURFACE MOUNTED IN UNFINISHED AREAS AND ON EXISTING CONCRETE BLOCK WALLS AND FLUSH MOUNTED IN NEW WALLS/PARTITIONS.
- 15. CONDUIT RUNS SHALL BE PARALLEL WITH OR AT RIGHT ANGLES TO WALLS AND CEILINGS. CONDUIT SHALL BE SUPPORTED BY APPROVED MEANS. SUPPORTS FOR HORIZONTAL RUNS OF CONDUIT SHALL NOT EXCEED SEVEN FEET ON CENTERS.
- 16. PROVIDE PULL BOXES, JUNCTION BOXES, CONDUIT ELBOWS AND OFFSETS TO SUIT FIELD CONDITIONS AND THE NATIONAL ELECTRICAL CODE.
- 17. CONTRACTOR SHALL COORDINATE WITH THE FIRE DEPARTMENT AND F.A. VENDOR BEFORE PROCEEDING WITH WORK INVOLVING FIRE ALARM SYSTEM.
- 18. ALL EMPTY CONDUIT SHALL BE PROVIDED WITH A DRAGWIRE.
- 19. THE MINIMUM WIRE SIZE FOR 120 VOLT BRANCH CIRCUITS SHALL BE NO. 12 AWG, EXCEPT OVER 100' IN LENGTH SHALL BE NO. 10 AWG.
- 20. PROVIDE ALL REQUIRED AND NECESSARY ACCESSORIES (EX. CONNECTORS, ADAPTERS. BUSHINGS, CLAMPS, ETC.) TO FACILITATE COMPLETE INSTALLATION.
- 21. COORDINATE LOCATION OF ALL MECHANICAL EQUIPMENT WITH HVAC CONTRACTOR IN FIELD. FUSES FOR ALL MOTOR LOADS SHALL BE DUAL ELEMENT TIME DELAY TYPE.
- 22. ALL JUNCTION OR OUTLET BOXES SHALL BE INSTALLED SO AS TO ALLOW ACCESS TO COVER. PROVIDE ARCHITECT APPROVED ACCESS DOORS OR PLATES AS REQUIRED IN AREAS WHERE UNOBSTRUCTED ACCESS TO BOX OR OUTLET IS NOT POSSIBLE.
- 23. PRIOR TO ORDERING LIGHTING FIXTURES, COORDINATE WITH ARCHITECTURAL DRAWINGS AND SPECIFICATIONS. IF DISCREPANCIES EXIST BETWEEN ARCHITECTURAL AND ENGINEERING INFORMATION OBTAIN CLARIFICATION PRIOR TO PROCEEDING. 24. MULTIPLE SWITCHES SHOWN IN SAME LOCATION SHALL BE GANGED TOGETHER WITH A COMMON
- FACEPLATE. 25. ALL LIGHTING FIXTURES UTILIZING ELECTRONIC BALLASTS SHALL BE PROVIDED WITH A DEDICATED
- NEUTRAL OR AN OVERSIZED NEUTRAL WHEN SHARED. 26. ALL LIGHTING FIXTURES CONTROLLED BY DIMMER SWITCHES SHALL BE PROVIDED WITH A
- DEDICATED NEUTRAL CONDUCTOR. 27. ALL EMERGENCY LIGHT FIXTURES DESIGNATED 'EM' SHALL BE SWITCHED UNLESS OTHERWISE NOTED. PROVIDE UL924 EMERGENCY RELAY TO BYPASS SWITCH UPON INTERRUPTION OF NORMAL POWER AND ILLUMINATE REGARDLESS OF SWITCH POSITION.
- 28. OPENINGS AROUND ELECTRICAL PENETRATIONS THROUGH FIRE RESISTANCE RATED WALLS, ALL SLEEVES MUST HAVE BUSHINGS. SEALANT SHALL BE 3 HOUR FIRE BARRIER #CP-25 (NO LESS THAN 3" THICK BACKED UP WITH MINERAL WOOL).
- 29. ALL PANELBOARD COVERS SHALL BE INSTALLED IN PLACE AT THE COMPLETION OF EACH DAYS WORK 30. PREPARE 'AS-BUILT' DRAWINGS THAT REFLECT ACTUAL CONSTRUCTION AND SHOW DEVIATIONS
- FROM DESIGN DRAWINGS. 31. LIGHT FIXTURES SHALL BE CONSTRUCTED TO SUIT PARTICULAR TYPE OF CEILING AND WALL CONSTRUCTION AND SHALL BE PROVIDED WITH APPROPRIATE TRIMS, MOUNTING FRAMES AND ADAPTERS AS REQUIRED.
- 32. CONTRACTOR IS OBLIGATED TO INSTALL THE LIGHTING SYSTEM AND CONTROLS IN OBSERVANCE OF ALL APPLICABLE LOCAL AND NATIONAL CODES IN ACCORDANCE WITH APPROVED SUBMITTALS,
- INCLUDING ALL NOTES AND REVISIONS. 33. LIGHTING CONTROL SYSTEM MANUFACTURER OR REPRESENTATIVE SHALL PROVIDE ORCHESTRATE PROJECT MANAGEMENT AND QUALIFIED STARTUP OR COMMISSIONING SERVICES TO MEET THE SPECIFICATION AND CONTROL INTENT.
- 34. CONTRACTOR SHALL BE RESPONSIBLE FOR THE PROPER INSTALLATION, WIRING, PLACEMENT, AND ADJUSTMENT OF ALL SENSORS AS PER MANUFACTURER'S SPECIFICATIONS, ENGINEER'S DESIGN INTENT, AND APPROVED SUBMITTALS.

GENERAL REMOVAL NOTES

- BEFORE COMMENCING WORK. EXAMINE ALL ADJOINING AREAS THAT MAY BE AFFECTED BY REMOVAL. REPORT TO THE GENERAL CONTRACTOR ANY CONDITION THAT PREVENTS PERFORMANCE OF THE WORK.
- BECOME THOROUGHLY FAMILIAR WITH EXISTING CONDITIONS WHERE CONNECTIONS MUST BE MADE, CHANGED OR ALTERED. THE INTENT OF THE WORK IS SHOWN ON THE DRAWINGS AND DESCRIBED HEREINAFTER AND NO CONSIDERATION WILL BE GRANTED BY REASON OF LACK OF FAMILIARITY ON THE PART OF THE CONTRACTOR WITH ACTUAL PHYSICAL CONDITIONS AT THE SITE. INSPECT EACH AND EVERY AREA AFFECTED BY THE ALTERATION OF THE SPACE BEFORE SUBMITTAL OF BID.
- ALL CONDUCTORS AND CONDUIT ASSOCIATED WITH REMOVED ELECTRICAL EQUIPMENT SHALL BE REMOVED COMPLETELY BACK TO ITS SOURCE OF POWER AND DISCONNECTED.
- ALL POWER CONDUCTORS, CONTROL WIRING AND CONDUIT ASSOCIATED WITH MECHANICAL EQUIPMENT SUCH AS FANS, AIR CONDITIONING UNITS, PUMPS, ETC. DESIGNATED FOR REMOVAL ON THE HVAC AND PLUMBING REMOVAL DRAWINGS SHALL BE REMOVED CLEAR BACK TO THE SOURCE OF POWER AND DISCONNECTED. ALL MOTOR STARTERS, DISCONNECT SWITCHES, CONTROL DEVICES, ETC. SHALL BE REMOVED. REFER TO MECHANICAL AND PLUMBING DRAWINGS FOR ADDITIONAL INFORMATION.
- CIRCUIT BREAKERS AND/OR SWITCHES IN PANELBOARD(S) OR DISTRIBUTION BOARD(S) MADE SPARE DUE TO REMOVAL SHALL BE DESIGNATED AS SUCH ON THE PANEL SCHEDULE.
- THE ELECTRICAL CONTRACTOR SHALL BE RESPONSIBLE TO TRACE AND RELOCATE ALL EXISTING FEEDERS AND BRANCH CIRCUIT WIRING WHICH PASSES THROUGH THE REMOVAL AREA THAT SERVE EXISTING OCCUPIED SPACES TO REMAIN. COORDINATE WITH BUILDING MANAGER PRIOR TO ANY SHUTDOWNS OR DISRUPTIONS THAT MAY BE REQUIRED TO ACCOMPLISH THIS.
- DISPOSE OF ALL REMOVED EQUIPMENT. WHICH IS NOT INTENDED TO BE REUSED. PRIOR TO DISPOSAL, CONTACT BUILDING MANAGER TO DETERMINE IF ANY REMOVED EQUIPMENT IS DESIRED FOR STOCK.
- ALL FIRE ALARM DEVICES IN THE AREA OF WORK ARE EXISTING TO REMAIN UNLESS OTHERWISE NOTED.
- EXISTING EQUIPMENT DESIGNATED FOR REUSE SHALL BE CLEANED, REFURBISHED AND RESTORED TO OPTIMUM PERFORMANCE. THIS SHALL INCLUDE BUT NOT LIMITED TO CLEANING OF LIGHT FIXTURES, REPLACEMENT OF INOPERABLE BALLASTS AND LAMPS, RESISTANCE TESTING OF BRANCH CIRCUITRY AND FEEDERS, ETC.
- EXTEND EXISTING CIRCUITRY TO THOSE DEVICES THAT ARE TO BE RELOCATED. MATCH EXISTING TYPE AND SIZE. RELOCATION OF EXISTING EQUIPMENT SHALL BE PERFORMED ONLY UPON OWNERS ACCEPTANCE OF EXISTING EQUIPMENT.
- EXTEND EXISTING CIRCUITS SERVING EQUIPMENT TO REMAIN FROM PANELS THAT ARE TO BE REMOVED TO NEW PANELS OR EXISTING PANELS THAT ARE TO

DISPOSAL OF MERCURY **CONTAINING LAMPS**

- ALL FLUORESCENT AND HID LAMPS WITHIN REMOVED LIGHT FIXTURES ARE CONSIDERED MERCURY CONTAINING AND SHALL BE TREATED AS HAZARDOUS
- FLUORESCENT AND HID LAMPS SHALL BE REMOVED FROM DEMOLISHED LIGHT FIXTURES AND DISPOSED OF AS PER NEW YORK STATE DEC REGULATIONS AND
- LAMPS MUST BE BAGGED IN NON-LEACHING PLASTIC BAGS AND SEALED TO PREVENT LEAKING.
- EACH LAMP OR BAGGED CONTAINER IN WHICH THESE LAMPS ARE CONTAINED MUST BE LABELED OR MARKED CLEARLY WITH ONE OF THE FOLLOWING PHRASES; UNIVERSAL WASTE LAMPS, OR WASTE LAMPS, OR USED LAMPS
- THESE MARKED BAGS MUST BE DELIVERED TO THE PROPER NEW YORK STATE D.E.C. AUTHORIZED LANDFILL OR RECYCLE CENTERS.

LAMPS

TYPE

MOUNTING

AC | AIR CONDITIONING UNIT A.F.F. | ABOVE FINISHED FLOOR AHU | AIR HANDLING UNIT AIC AMP INTERRUPTING CURRENT ATS AUTOMATIC TRANSFER SWITCH AWG | AMERICAN WIRE GAUGE CONDUIT C.B. CIRCUIT BREAKER CABINET HEATER CH CKT CIRCUIT CONDENSING UNIT CU EM EMERGENCY E.C. | ELECTRICAL CONTRACTOR EF EXHAUST FAN F.A.C.P. | FIRE ALARM CONTROL PANEL F.B.O FURNISHED BY OTHERS G,GRD GROUND GFI GROUND FAULT INTERRUPTER HEATING. VENTILATING AND HVAC AIR-CONDITIONING UNIT HWH HOT WATER HEATER THOUSAND CIRCULAR MILLS KVA | KILOVOLT AMPERE KW KILOWATT LTG LIGHTING MCB | MAIN CIRCUIT BREAKER MDP | MAIN DISTRIBUTION PANEL MLO MAIN LUGS ONLY MTD MOUNTED NTS NOT TO SCALE P.A. PUBLIC ADDRESS PNL PANEL RECPT RECEPTACLE TRANSFER VOLTAGE SURGE TVSS SUPPRESSION SYSTEM TYPICAL UNIT HEATER UHU.O.N. UNLESS OTHERWISE NOTED UV UNIT VENTILATOR W WATT WP WEATHERPROOF

MANUFACTURER & CAT.#

ABBREVIATIONS

DESCRIPTION

AMP/AMPERE

	A a	2'x4' LED LIGHT FIXTURE. UPPER CONTROL. FIXTURE SCHEDULE
	A EM	2'x4' LED LIGHT FIXTUREFOR CO TYPE,LOWER CASE LETTER DEI
	⊗/\$	CEILING/WALL MOUNTED EXIT L INDICATES ILLUMINATED FACE.
	S	FLUSH WALL MOUNTED LIGHTIN
	S _T	THERMAL SWITCH, CUTLER-HAI WHERE INDICATED WITH `WP' P
	S 2T	208 VOLT, SINGLE PHASE 2 POL SIMILAR TO EATON #AH4361 + #.
	3 <i>K</i> S <i>a</i>	FLUSH WALL MOUNTED LIGHTIN INDICATES KEY SWITCH. '3' INDI
	s ^M	FLUSH WALL MOUNTED LOW VO LVSW-100. WORK WITH CEILING
	s V	WALL RECESS MOUNTED DUAL DSW-100. MANUAL ON, AUTO O
	① / ②	CEILING/WALL MOUNTED JUNCT
	3	HOMERUN TO DESIGNATED PAN CONSIST OF 2#12-3/4"C U.O.N.
	2,4,6	HOMERUN TO DESIGNATED PAN U.O.N.
	Φ	125V-2P-3W-20A GROUNDED TY RECEPTACLE SIMILAR TO HUBE
	#	SAME AS ABOVE EXCEPT DOUB
		125V-2P-3W-20A GROUNDED TY MOUNTED DUPLEX RECEPTACL
	Φ	20A FLUSH WALL MOUNTED GRO #GF5362.
		SURFACE MOUNTED NEW ELEC
	240/3 60 40 WP	HEAVY DUTY TYPE DISCONNEC CONNECTION. 240 INDICATES V RATING, NF INDICATES NON-FU DRAWINGS FOR ENCLOSURE. 'V (NEMA 3R).
	VFD	VARIABLE FREQUENCY DRIVE. FINSTALLED BY ELECTRICAL CONMECHANICAL UNIT INTER CONNWIRE FROM VFD TO DESIGNATE FOR CONDUIT WIRE AND SIZE
	S	WALL MOUNTED COMBINATION
	F	WALL MOUNTED FIRE ALARM M.
	(S)	CEILING MOUNTED IONIZATION

	LEGEND
A	2'x4' LED LIGHT FIXTURE. UPPER CASE LETTER DENOTES TYPE,LOWER CASE LETTER DENOTES SWITCH CONTROL. FIXTURE SCHEDULE DENOTES TYPE.
A EM	2'x4' LED LIGHT FIXTUREFOR CONNECTED TO EMERGENCY SOURCE 'EM'. UPPER CASE LETTER DENOTES TYPE,LOWER CASE LETTER DENOTES SWITCH CONTROL. FIXTURE SCHEDULE DENOTES TYPE.
⊗/№	CEILING/WALL MOUNTED EXIT LIGHT WITH OUTLET BOX, DIRECTIONAL ARROWS SHADED PORTION INDICATES ILLUMINATED FACE. SCHEDULE DENOTES TYPE.
S	FLUSH WALL MOUNTED LIGHTING CONTROL TOGGLE SWITCH.
S _T	THERMAL SWITCH, CUTLER-HAMMER MS SERIES MANUAL STARTERS SINGLE-PHASE 20AMP, 12OV U.O.N. WHERE INDICATED WITH `WP' PROVIDE WATERTIGHT ENCLOSURE TYPE 3.
S 2T	208 VOLT, SINGLE PHASE 2 POLE, THERMAL OVERLOAD PROTECTED TOGGLE TYPE SWITCH. SIMILAR TO EATON #AH4361 + #AH27940G NEMA 1 ENCLOSURE.
3 <i>K</i> S a	FLUSH WALL MOUNTED LIGHTING CONTROL SWITCH CONTROLLING OUTLET "a". 'K' WHERE USED INDICATES KEY SWITCH. '3' INDICATES 3-WAY SWITCH; '4' INDICATES 4-WAY SWITCH.
s ^M	FLUSH WALL MOUNTED LOW VOLTAGE MOMENTARY CONTACT SWITCH, SIMILAR TO WATTSTOPPER LVSW-100. WORK WITH CEILING SENSORS (DT-300) FOR MANUAL ON, AUTO OFF OPERATION.
s V	WALL RECESS MOUNTED DUAL TECHNOLOGY VACANCY SENSOR, SIMILAR TO WATTSTOPPER MODEL# DSW-100. MANUAL ON, AUTO OFF.
①/①	CEILING/WALL MOUNTED JUNCTION BOX.
3	HOMERUN TO DESIGNATED PANEL, ARROWHEAD INDICATES SINGLE POLE CIRCUIT. HOMERUN SHALL CONSIST OF 2#12-3/4"C U.O.N.
2,4,6	HOMERUN TO DESIGNATED PANEL, NUMBERS INDICATE MULTIPLE CIRCUIT, I.E. 3-HOTS AND 1-GROUND U.O.N.
Ф	125V-2P-3W-20A GROUNDED TYPE, SPECIFICATION GRADE TAMPER RESISTANCE WALL MOUNTED DUPLEX RECEPTACLE SIMILAR TO HUBBELL #5362WTR
#	SAME AS ABOVE EXCEPT DOUBLE DUPLEX RECEPTACLE.
	125V-2P-3W-20A GROUNDED TYPE, SPECIFICATION GRADE TAMPER RESISTANCE USB PORT WALL MOUNTED DUPLEX RECEPTACLE SIMILAR TO HUBBELL #USB 20A5W
Q	20A FLUSH WALL MOUNTED GROUND FAULT INTERRUPTING TYPE DUPLEX RECEPTACLE HUBBELL #GF5362.
	SURFACE MOUNTED NEW ELECTRICAL PANELBOARD.
240/3 60 40 WP	HEAVY DUTY TYPE DISCONNECT SWITCH WITH FINAL FLEXIBLE EQUIPMENT CONNECTION. 240 INDICATES VOLTAGE, 3 INDICATES NO. OF POLES, 60 INDICATES AMPERE RATING, NF INDICATES NON-FUSED(OR FUSE SIZE) U.O.N. REFER TO SPECIFICATION AND DRAWINGS FOR ENCLOSURE. 'WP' WHERE USED INDICATES WEATHERPROOF ENCLOSURE (NEMA 3R).
VFD	VARIABLE FREQUENCY DRIVE. FURNISHED BY MECHANICAL CONTRACTOR, WIRED AND INSTALLED BY ELECTRICAL CONTRACTOR. THE CONDUIT AND WIRING FROM VFD TO MECHANICAL UNIT INTER CONNECTION SHALL MATCH THE SAME SIZE AND CONDUIT AND WIRE FROM VFD TO DESIGNATED PANELBOARD. REFER TO PANEL SCHEDULE OR NOTES FOR CONDUIT WIRE AND SIZE
S	WALL MOUNTED COMBINATION FIRE ALARM SPEAKER/STROBE DEVICE.
F	WALL MOUNTED FIRE ALARM MANUAL PULL STATION
(S)	CEILING MOUNTED IONIZATION TYPE SMOKE DETECTOR
©/©	CEILING OR WALL MOUNTED CARBON MONOXIDE DETECTOR
@/ <u>©</u>	CEILING OR WALL MOUNTED GAS LEAK DETECTOR
$\langle H \rangle$	CEILING MOUNTED HEAT DETECTOR
ST	WALL MOUNTED FIRE ALARM STROBE LIGHT.
FACP	FIRE ALARM CONTROL PANEL.
ANN	FIRE ALARM ALPHANUMERIC ANNUNCIATOR PANEL.
IM	INTERFACE MODULE CONSISTING OF CONTROL RELAY AND MONITOR MODULES. IN NEMA 1 ENCLOSURE. ALSO PROVIDE LOAD RELAY AS REQUIRED IF EXISTING DISCONNECT/STARTERS DO NOT HAVE A SET OF DRY CONTACTS TO TIE-IN FOR FAN SHUTDOWN.
B/G	BREAK GLASS STATION FOR BOILER SHUTDOWN.
1	TAG SYMBOL. NUMERAL DENOTES REFERENCE TO A WORK NOTE.
	MECHANICAL EQUIPMENT IDENTIFICATION:
* 7	EQUIPMENT ABBREVIATION (FE, SF, HV, ETC. SEE ABBREVIATIONS ON THIS DWG.) EQUIPMENT NUMBER
*	DETAIL/PART PLAN NUMBER IDENTIFICATION:
*	———DETAIL/PART PLAN NUMBER ——DRAWING NUMBER

OLD NYACK HIGH SCHOOL BOILER REPLACEMENT

OLD NYACK HIGH SCHOOL 131 N Midland Ave



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04/18/2025 ISSUE FOR BID

09/12/2024 CONSTRUCTION DOCUMENTS No. Date Sheet Title LEGEND,

ABBREVIATIONS AND NOTES

2024-1035 AS NOTED

Sheet Number

E001

04/18/2025

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LBX LINEAR PENDANT MOUNTED LIGHT SIGNIFY DAY-BRITE 41 WATTS FIXTURE 8.5" X 48" 5500 LUMENS, LBX-55L-835-UNV-W-FD LED RECESSED LBX-HANGER BKT 3500K COLOR TEMP. PROVIDE HANGING BRACKET INCLUDING CHAINS AND WIRE LBX-WGUD4. GUARDS. SIGNIFY DAY-BRITE 41 WATTS SAME AS TYPE "A" WITH EMERGENCY A EM RECESSED LBX-55L-835-UNV-W-FD-EMLED LED BATTERY BACK UP LBX-HANGER BKT UNV LBX-WGUD4. L.E.D. STEEL HOUSING EXIT COMBINATION **ENCORE LIGHTING** 6 WATTS W/HEADS WITH 90 MINUTE EMERGENCY #LC8-2-PER DWG WALLLED BATTERY PACK MOUNT UNVED EXIT LIGHTS, STEEL HOUSING, **ENCORE LIGHTING** CEILING NUMBER OF FACES AND DIRECTIONAL #LSE-6-R-1/U /WALLARROWS AS INDICATED ON PLANS. SELF MOUNT UNV. POWERED MODEL WITH 90 MINUTE BATTERY. NEMA 4X EXTERIOR WEATHERPROOF LED **EXTERIOR ENCORE LIGHTING** EXIT LIGHTS, NUMBER OF FACES AND #LE4X-6-R-1/U WALLDIRECTIONAL ARROWS AS INDICATED ON MOUNT UNV. PLANS. SELF POWERED MODEL WITH 90 MINUTE BATTERY.


LIGHTING FIXTURE SCHEDULE

DESCRIPTION

BEFORE FABRICATION THIS CONTRACTOR SHALL VERIFY ALL MEASUREMENTS AND CONDITIONS ON JOB AND COORDINATE THEIR WORK WITH THE WORK OF ALL OTHER CONTRACTORS.

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REMOVAL WORK NOTES

- EXISTING BOILER CONTROL PANEL TO BE REMOVED BY OTHERS. ELECTRICAL CONTRACTOR SHALL REMOVE ALL ASSOCIATED WIRING,

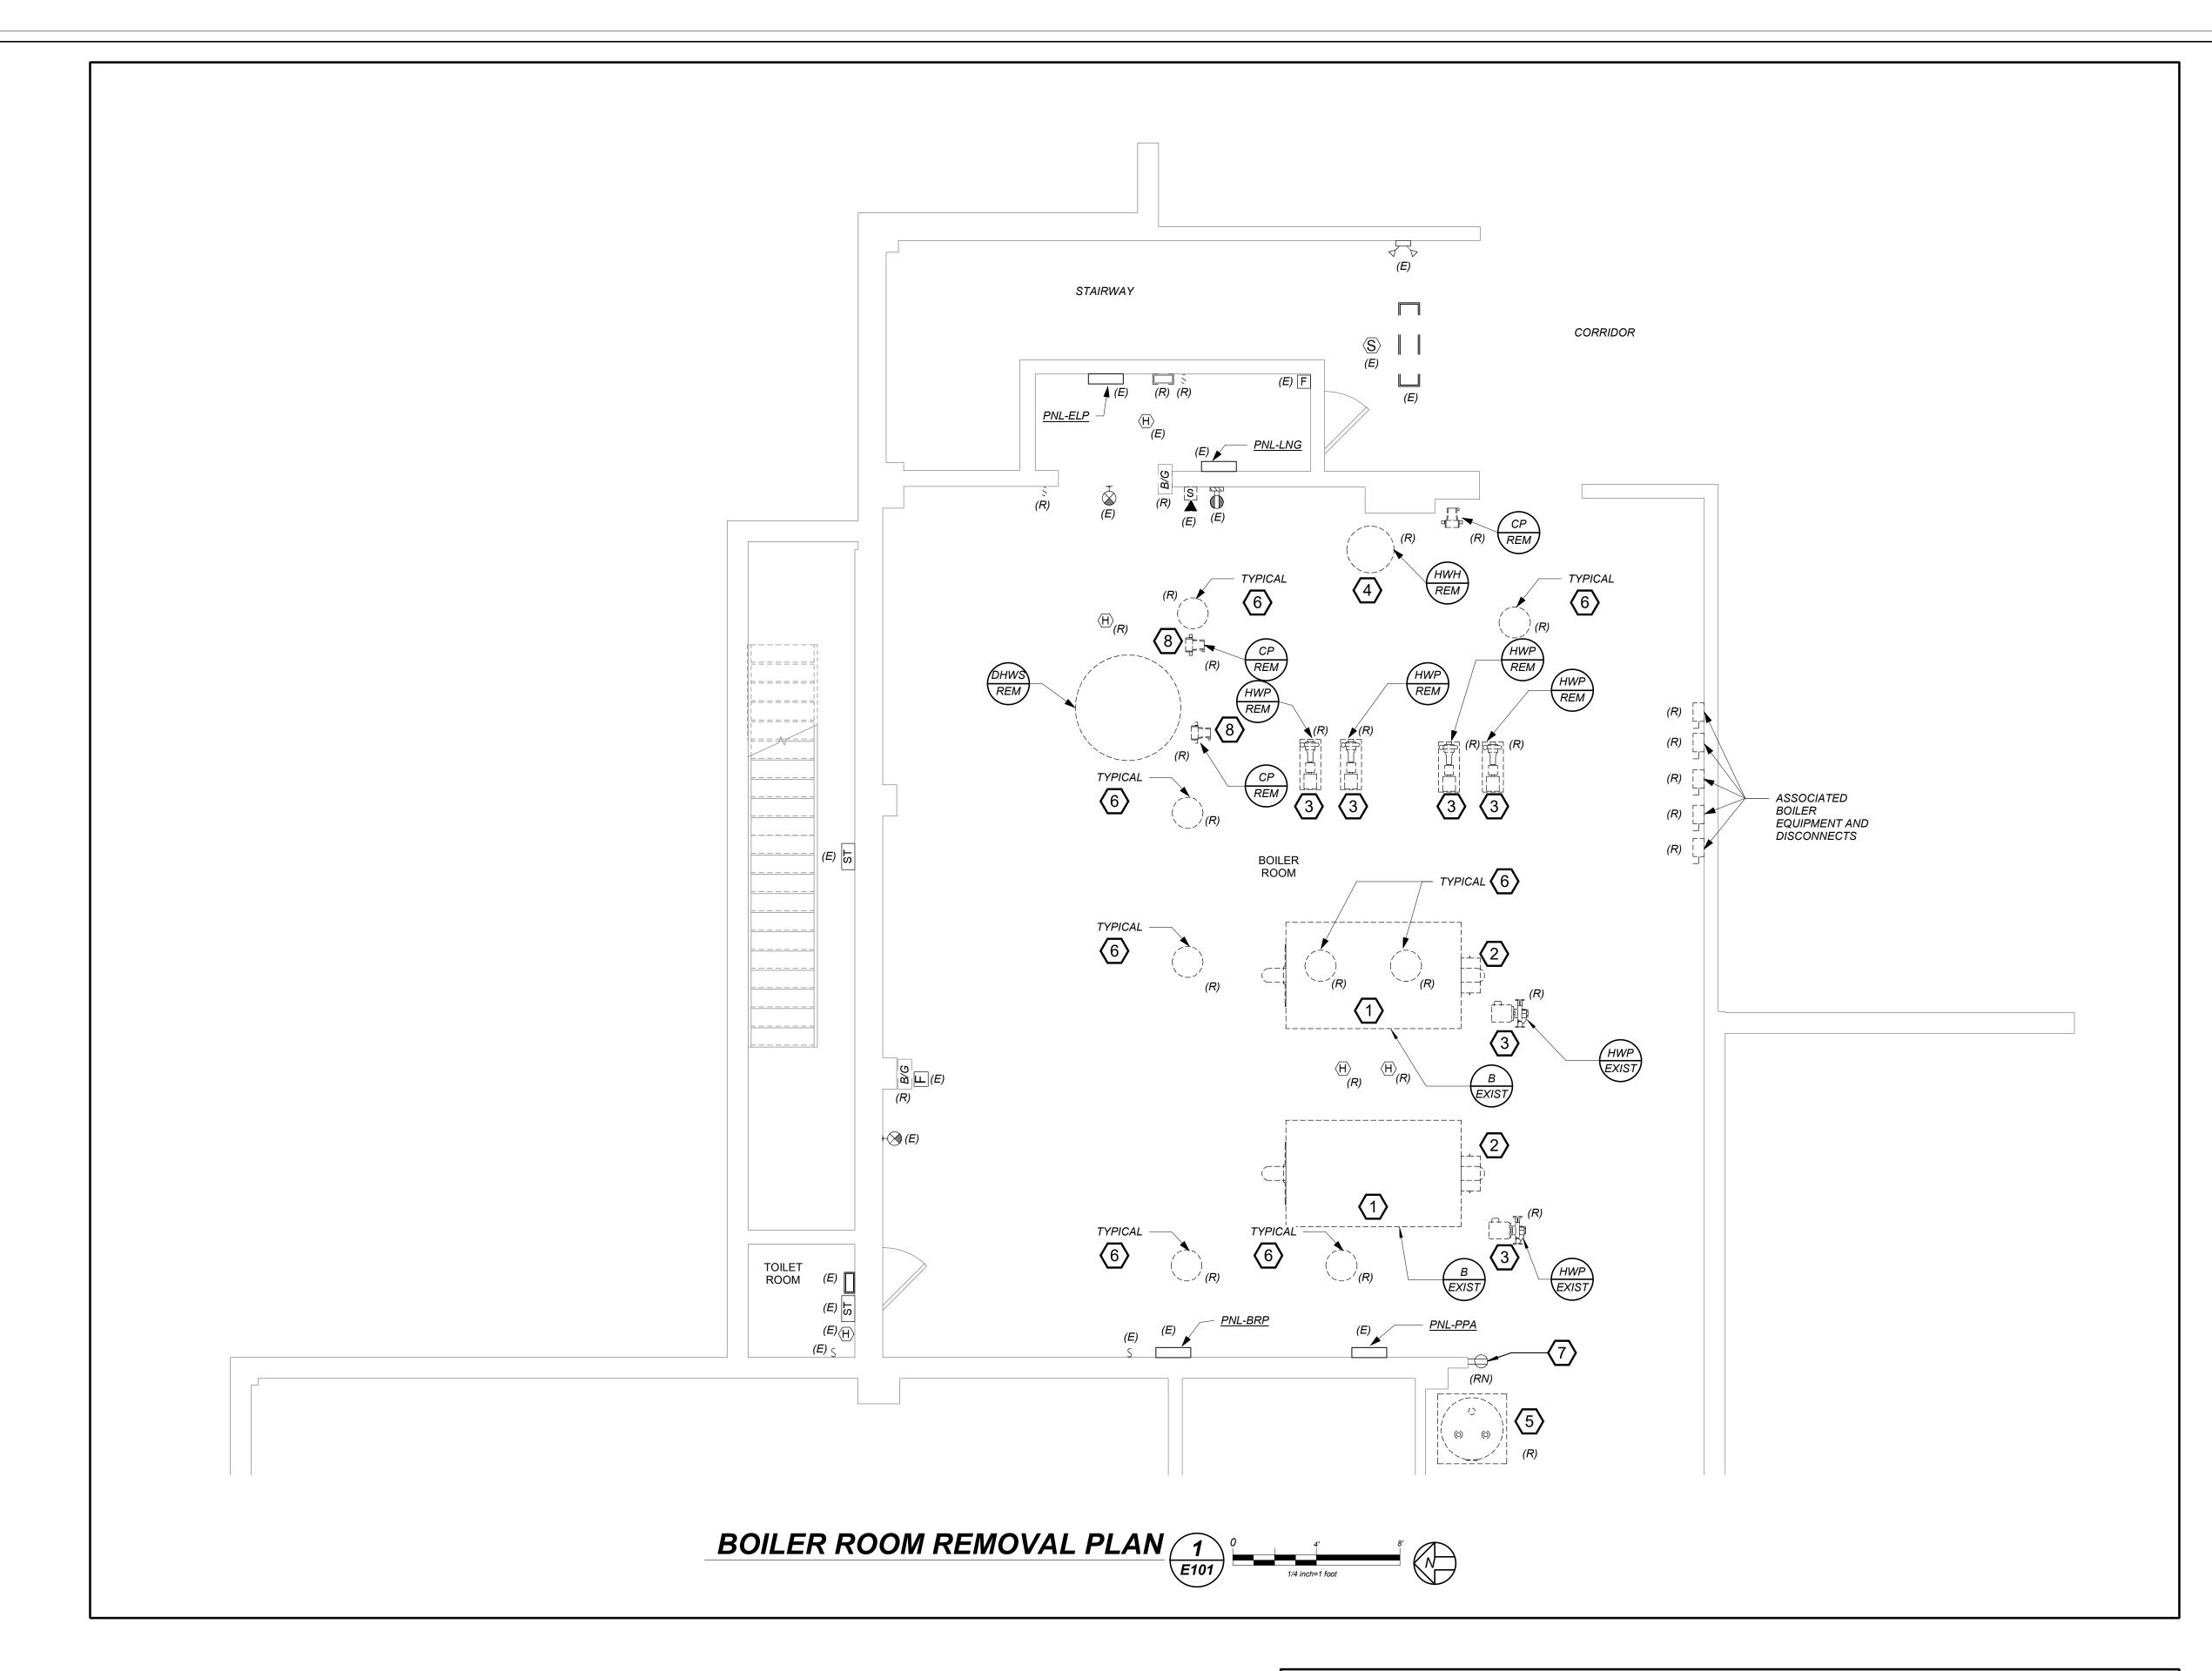- EXISTING SUMP PUMP TO BE REMOVED BY OTHERS. EC SHALL REMOVE ALL ASSOCIATED WIRING, CONDUITS, DISCONNECT SWITCHES AND ACCESSORIES IN ITS ENTIRETY BACK TO THE POWER SOURCE.
- 6 EXISTING LIGHTING AND LIGHTING SWITCHES IN BOILER ROOM SHALL BE REMOVED AND REPLACED WITH NEW BY ELECTRICAL CONTRACTOR. REMOVE ALL ASSOCIATED WIRING, CONDUITS AND SWITCHING IN ITS ENTIRETY BACK TO THE POWER SOURCE. SEE 1/E201 FOR NEW
- $\langle 7 \rangle$ EXISTING RECEPTACLE SHALL BE REPLACED WITH NEW 120V, 20 AMPERE RATED GFCI RECEPTACLE.
- (8) EXISTING PUMP TO BE REMOVED BY OTHERS. EC SHALL REMOVE ALL ASSOCIATED WIRING, CONDUITS, DISCONNECT SWITCHES AND ACCESSORIES IN ITS ENTIRETY BACK TO THE POWER SOURCE.

OLD NYACK HIGH SCHOOL BOILER REPLACEMENT

OLD NYACK HIGH SCHOOL

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BARILE GALLAGHER & ASSOCIATES

CONSULTING ENGINEERS 39 MARBLE AVE PLEASANTVILLE, NY 10570 PHONE: 914.328.6060 FAX: 914.328.9304 General@BGA-Eng.com

KEY PLAN

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BOILER ROOM

REMOVAL PLAN

E101

04/18/2025

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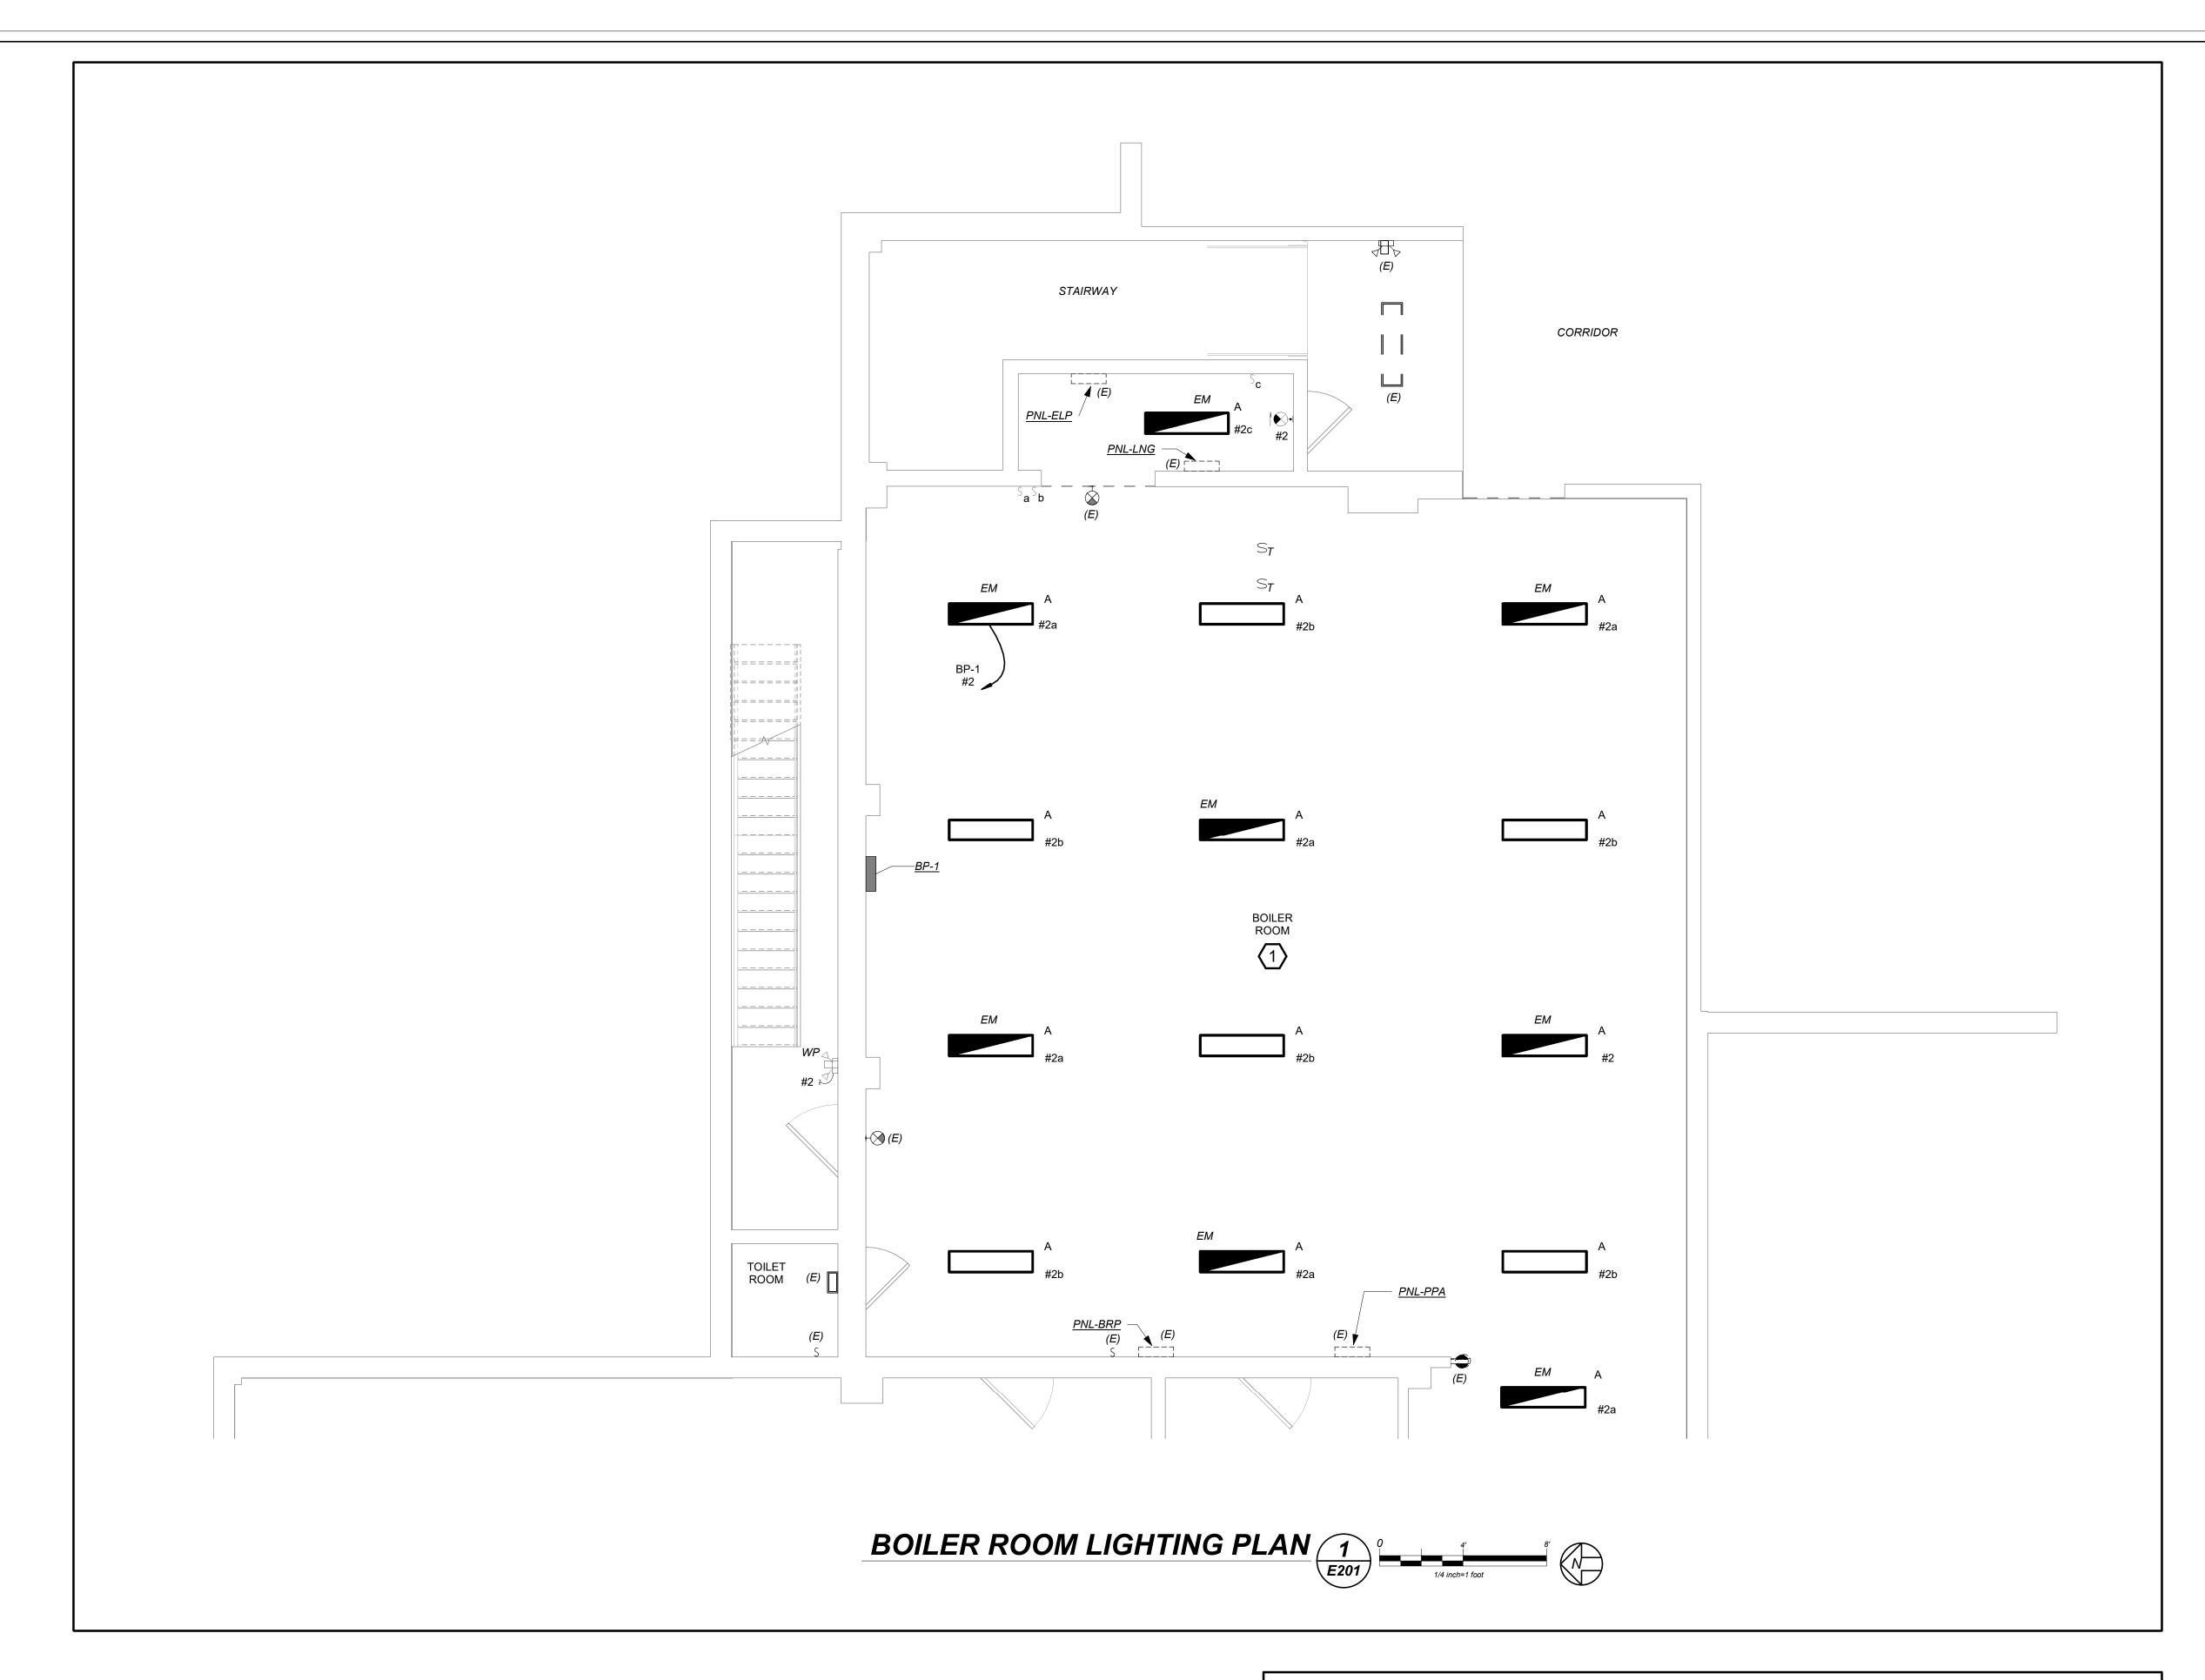
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WORK NOTES

COORDINATE LIGHTING FIXTURE LAYOUT WITH MECHANICAL CONTRACTOR BASED ON EQUIPMENT AND DUCT WORK LAYOUT TO OBTAIN OPTIMUM FIXTURE LAYOUT / ILLUMINANCE.

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OLD NYACK HIGH SCHOOL


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BOILER ROOM


BOILER ROOM LIGHTING PLAN

Job No. 2024-1035 Scale AS NOTED

Sheet Number

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04/18/2025

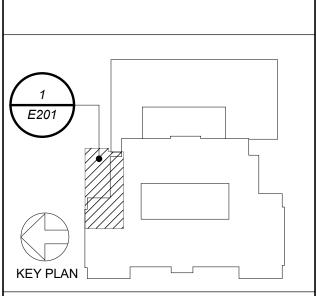

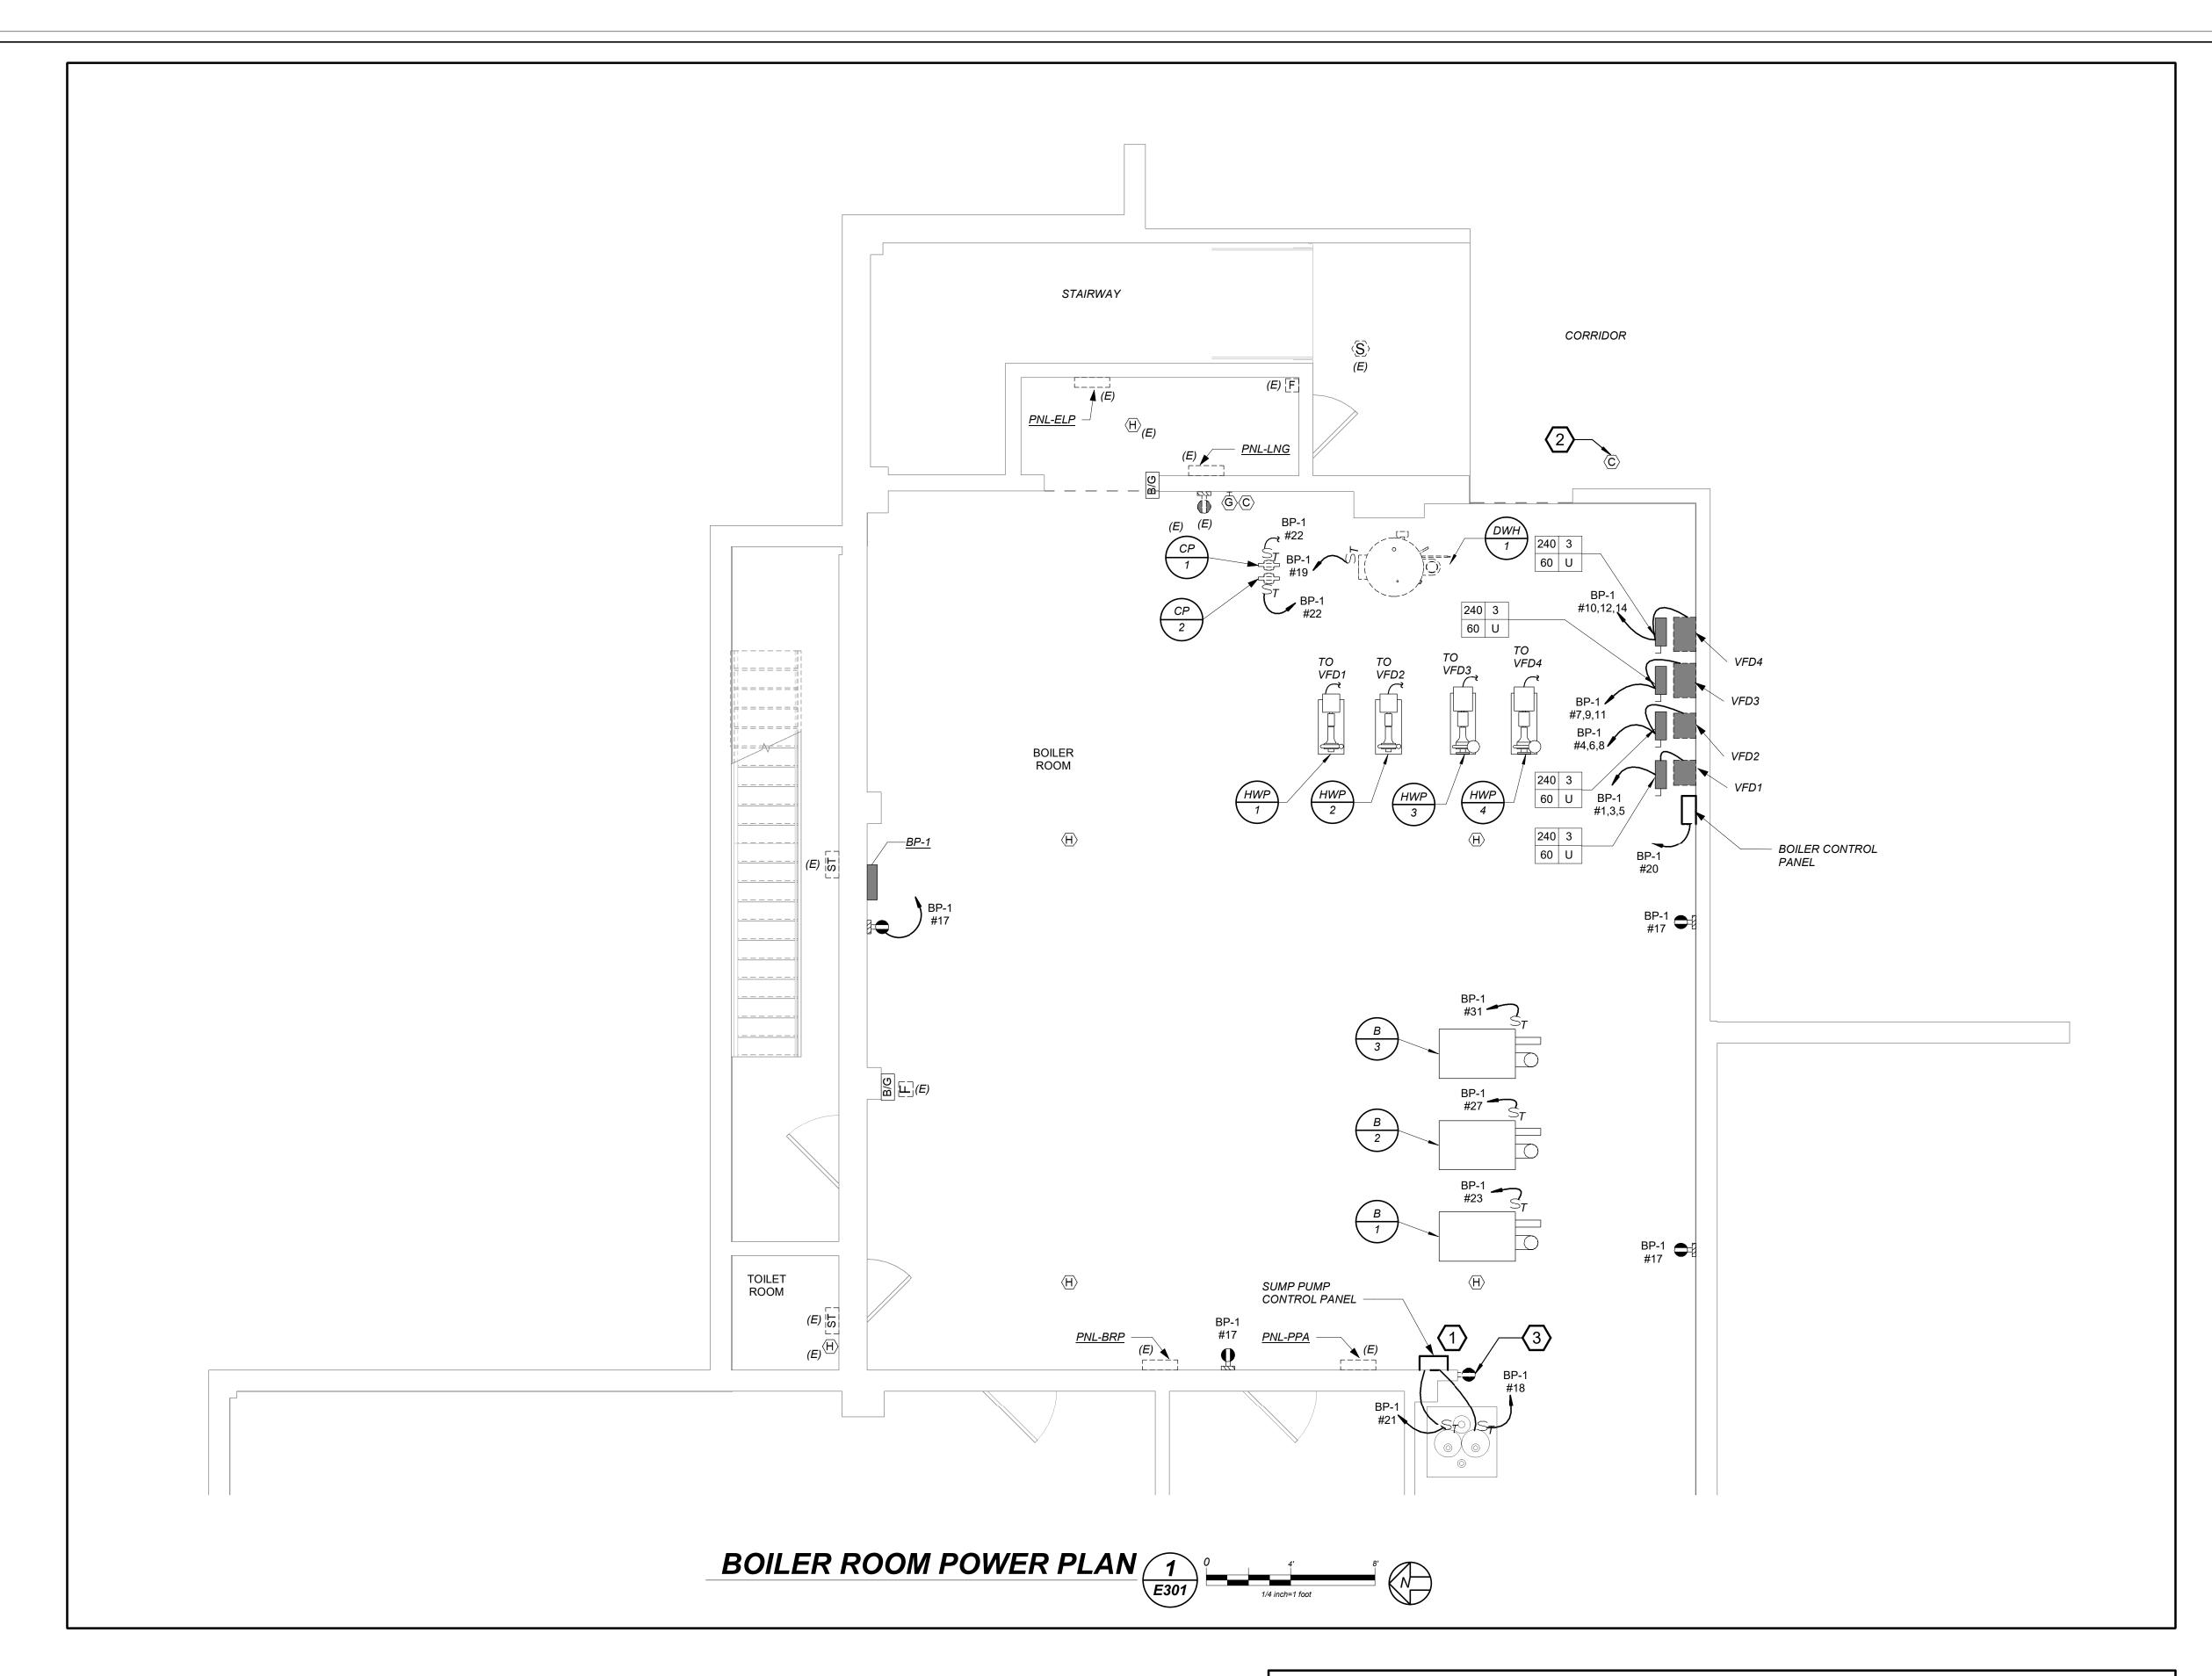WORK NOTES

- 1 NEW SUMP PUMP CONTROL PANEL. ELECTRICAL CONTRACTOR SHALL COORDINATE EXACT LOCATION IN FIELD WITH PLUMBING CONTRACTOR.

 2 NEW CARRON MONOYIDE DETECTOR SHALL BE MOUNTED IN THE CORRIDOR OUTSIDE OF THE ROLLER POOM. COORDINATE EXALL OCATION.
- 2 NEW CARBON MONOXIDE DETECTOR SHALL BE MOUNTED IN THE CORRIDOR OUTSIDE OF THE BOILER ROOM. COORDINATE EXAT LOCATION WITH ARCHITECT PRIOR TO INSTALLATION.

WITH ARCHITECT PRIOR TO INSTALLATION. (3) EXISTING RECEPTACLE SHALL BE REPLACED WITH NEW 120V, 20 AMPERE RATED GFCI RECEPTACLE.

OLD NYACK HIGH SCHOOL BOILER REPLACEMENT

OLD NYACK HIGH SCHOOL

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1 E301

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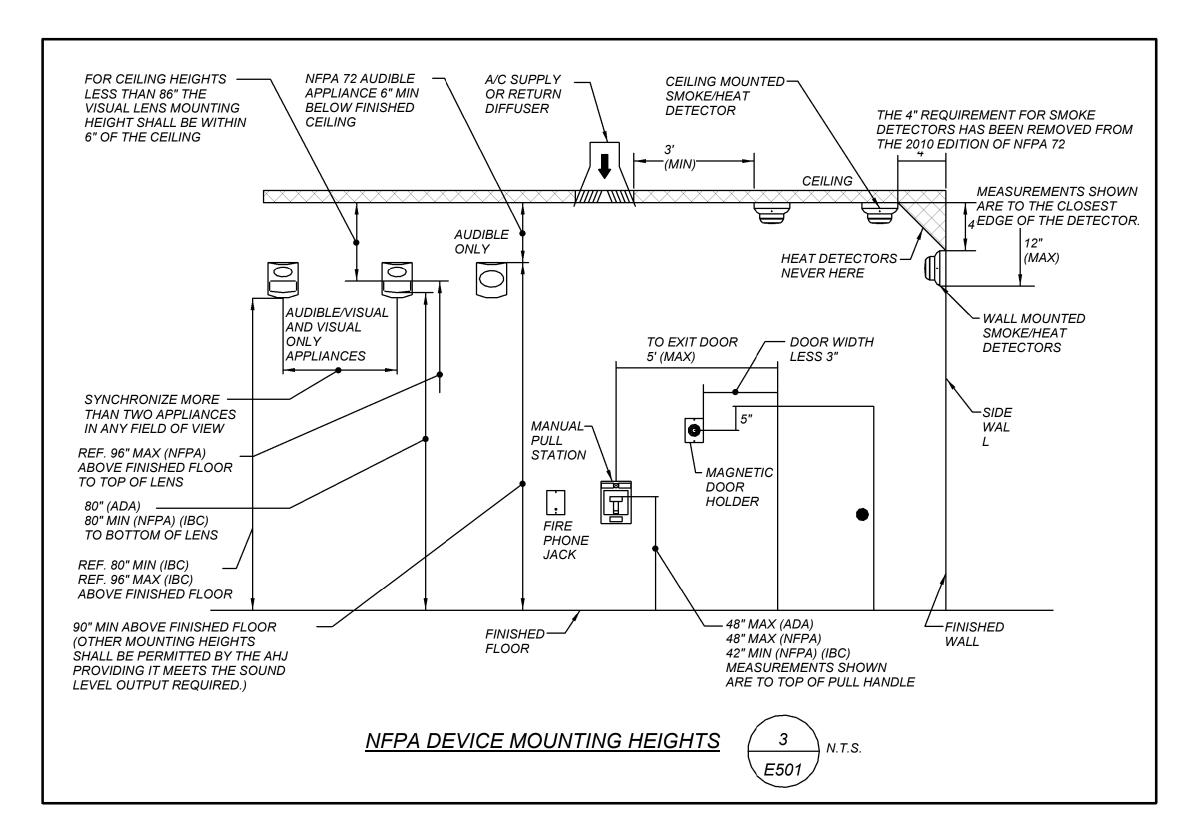
BOILER ROOM


POWER PLAN


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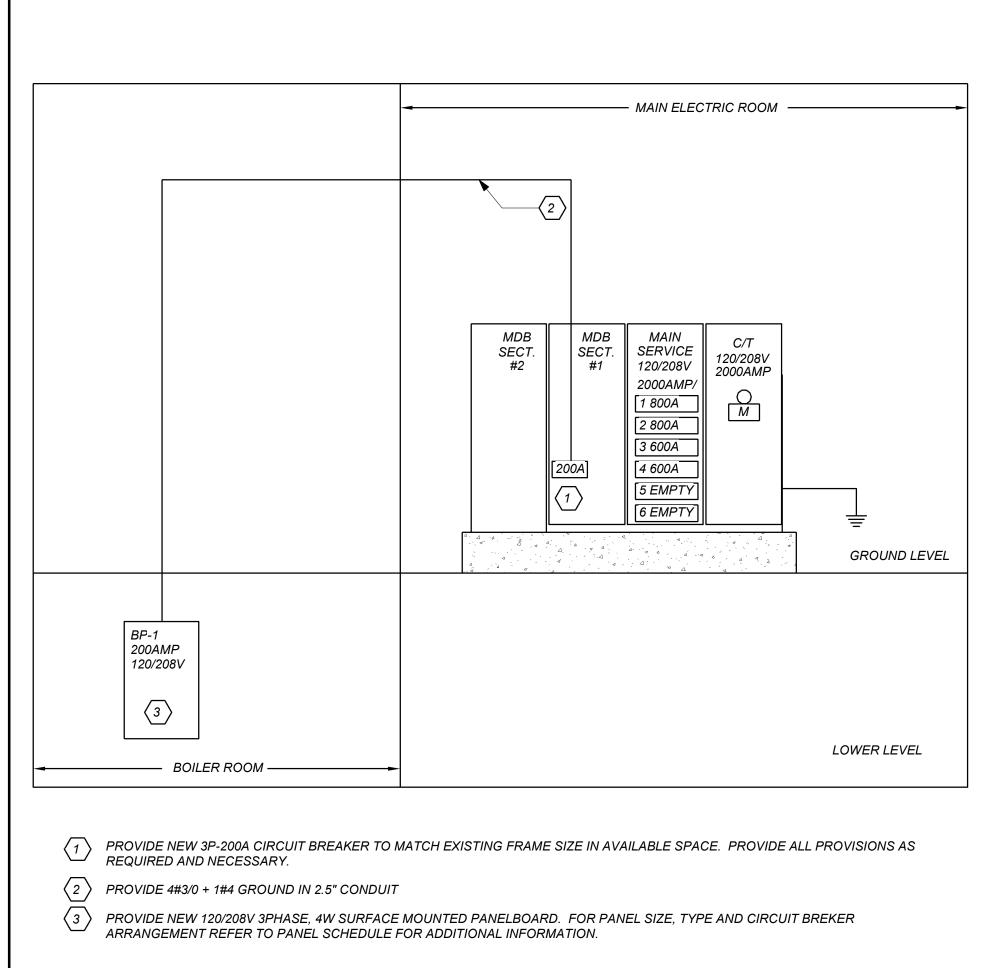
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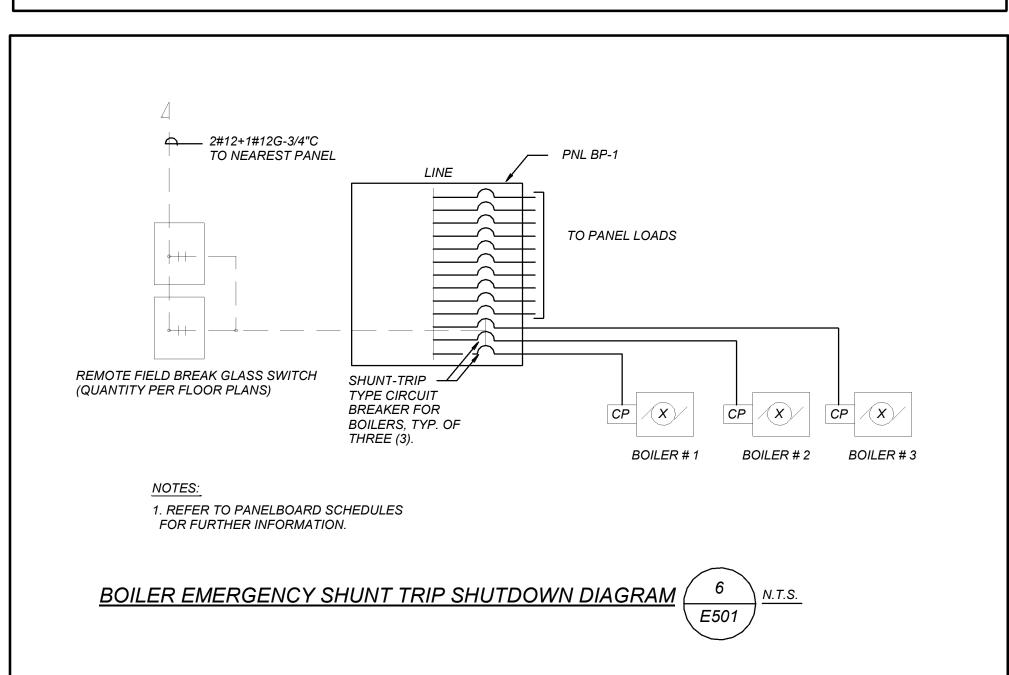
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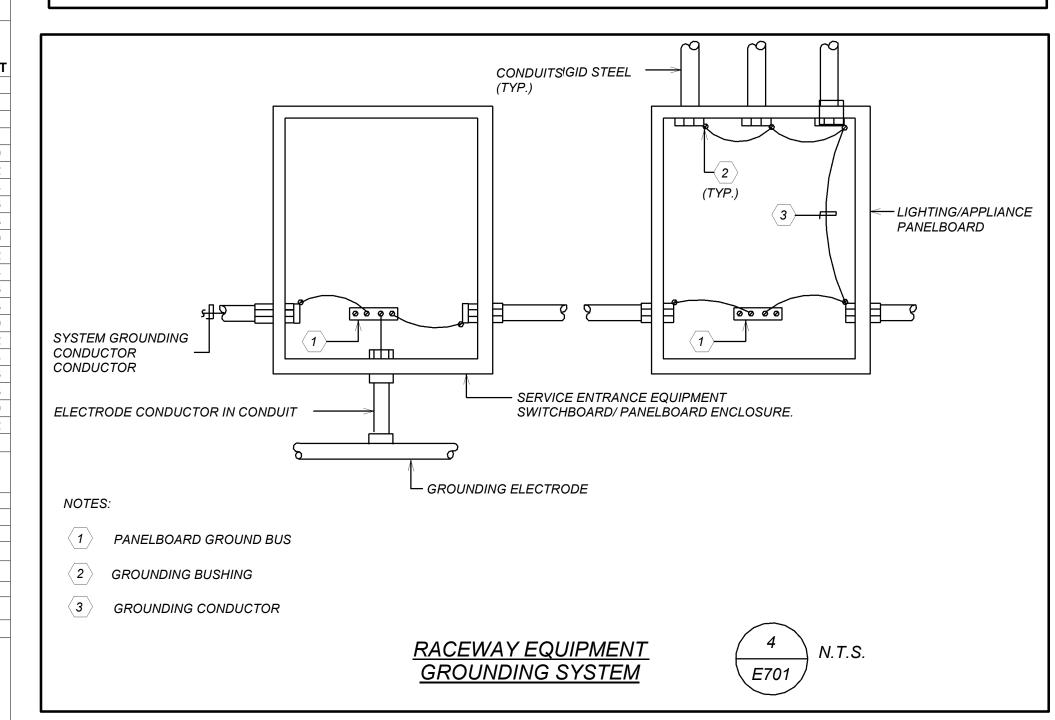







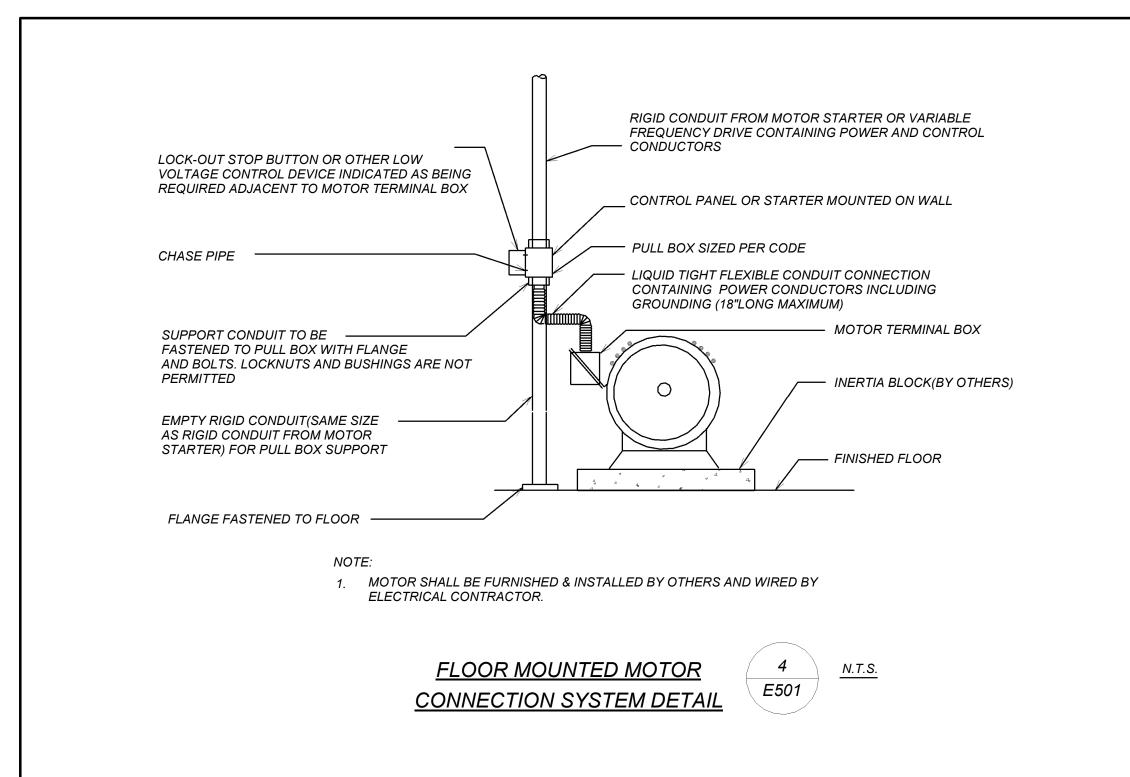

POWER RISER DIAGRAM

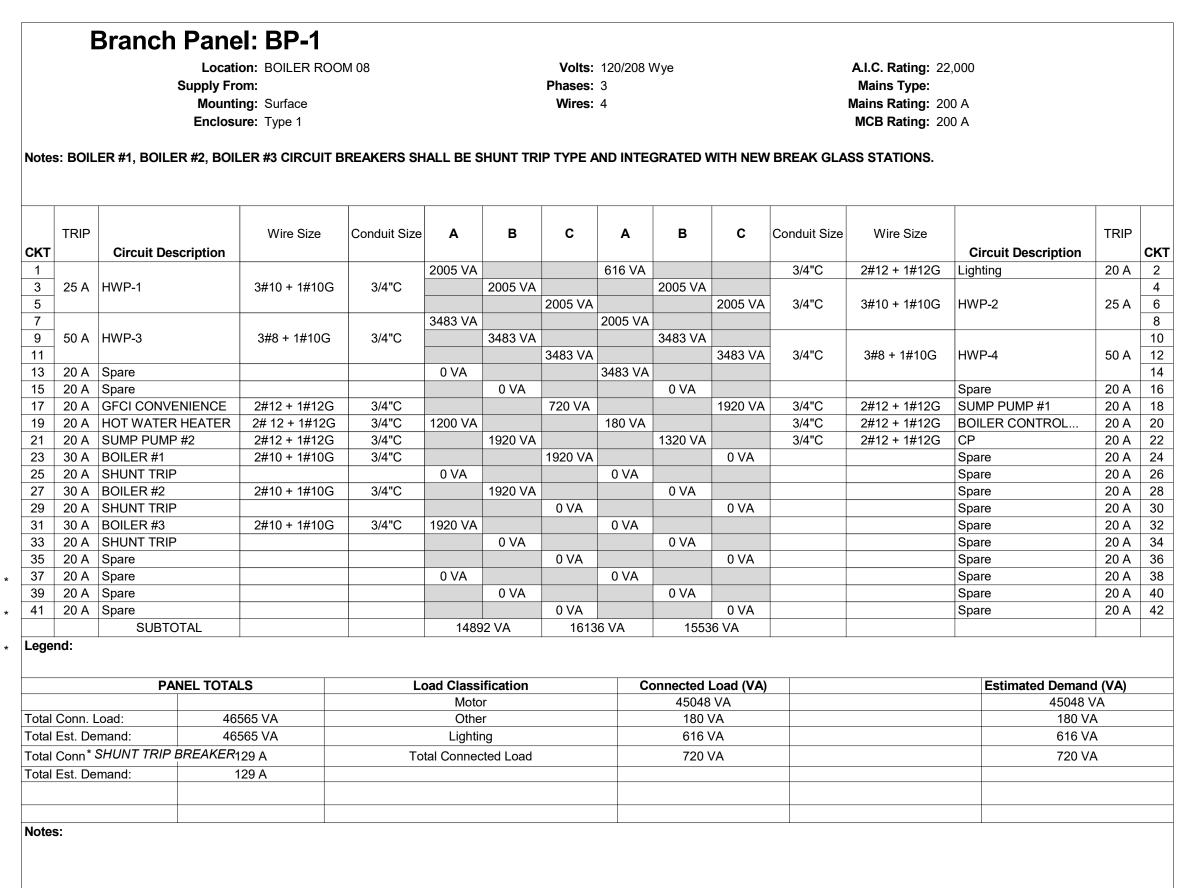

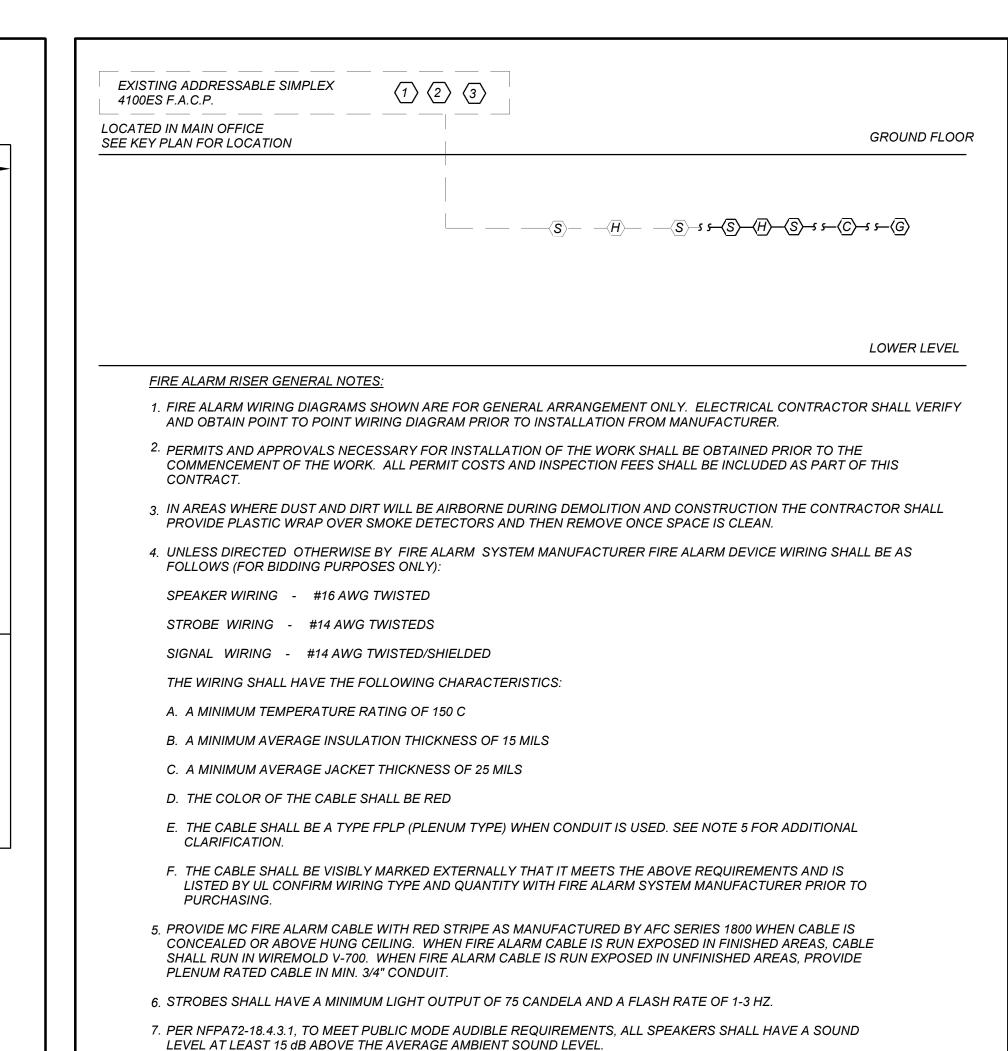

8. WALL MOUNTED SPEAKER STROBE UNITS SHALL NOT HAVE ANY OTHER DEVICES OR APPURTENANCES WITHIN 5

FEET OF THE DEVICE. THE ENTIRE LENS OF THE UNIT SHALL NOT BE LESS THAN 80", AND NOT GREATER THAN 96" ABOVE FINISHED FLOOR, WHILE MAINTAINING 6" BELOW THE CEILING . DEVICES SHALL BE FLUSH MOUNTED

9. SHUTDOWN OF HVAC SYSTEM EQUIPMENT (NOT LIMITED TO, ROOF TOP, EXHAUST FANS, ETC.) OF 1000 CFM OR

GREATER, SHALL BE PERFORMED VIA A RELAY INTERFACE SYSTEM. SEND SIGNAL TO BUILDING AUTOMATED

TEMPERATURE CONTROL (ATC) SYSTEM INDICATING SHUTDOWN HAS OCCURRED. EQUIPMENT RESTART SHALL

BE BY BUILDING 'ATC' SYSTEM UPON FIRE ALARM RESET TO NORMAL MODE. RESTART OF EQUIPMENT SHALL BE

10. AFTER THE SYSTEM IS COMPLETE, TEST ALL COMPONENTS IN ACCORDANCE WITH SEQUENCE OF OPERATION

14. ALL DEVICES SHALL BE SUPERVISED AS PER N.F.P.A. 72. PROVIDE END OF LINE RESISTORS AS REQUIRED PER INDIVIDUAL MANUFACTURER. PROVIDE LOAD RELAYS AS REQUIRED FOR PROPER OPERATION OF EQUIPMENT.

15. PROVIDE WIRE GUARDS FOR ALL FIRE ALARM DEVICES LOCATED IN GYM'S, BOILER ROOMS, LOCKER ROOMSAND

16. CARBON MONOXIDE AND GAS LEAK DETECTOR SHALL RING LOCAL TROUBLE BELL AT FIRE ALARM CONTROL

17. THE CARBON MONOXIDE DETECTOR SHALL HAVE AN SOUNDER BASE AND INITIATE A SUPERVISORY SIGNAL

WHEN 70 PARTS PER MILLION (ppm) ARE REACHED WITHIN 60 TO 240 MINUTES OR 150ppm ARE REACHED WITHIN

11. ALL PULL STATIONS SHALL BE PROVIDED WITH CLEAR PROTECTIVE LEXAN COVER. COVER SHALL BE AS

MANUFACTURED BY SAFETY TECHNOLOGY INTERNATIONAL INC. CAT. #STI 1100 STOPPER II.

IN ALL FINISHED AREAS. PROVIDE DOUBLE DEEP DEVICE BOX IN WALL.

13. VERIFY EXACT QUANTITIES OF FIRE ALARM DEVICES WITH PLANS.


PRIOR TO FIRE DEPARTMENT INSPECTION.

12. COORDINATE F.A WORK WITH F.A VENDOR.

MECHANICAL EQUIPMENT ROOMS.

REQUIRED BY UL 1484.

PANEL FOR SUPERVISORY CONDITION ONLY.

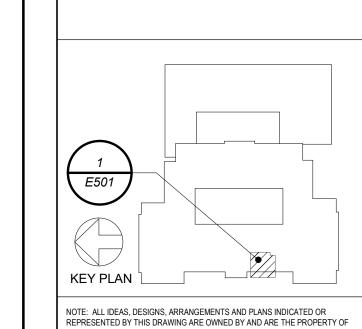

OLD NYACK HIGH

SCHOOL BOILER

REPLACEMENT

OLD NYACK HIGH SCHOOL

131 N Midland Ave

285 MAIN STREET • MOUNT KISCO, NEW YORK 10549

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RISER, SCHEDULES AND **DETAILS**

2024-1035 04/18/2025 Drawn / Checked AS NOTED BGA / BGA Sheet Number

E501

VERIFY ALL MEASUREMENTS AND CONDITIONS ON JOB AND COORDINATE THEIR WORK WITH THE WORK OF ALL OTHER CONTRACTORS.

BEFORE FABRICATION THIS CONTRACTOR SHALL

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CONDUIT PENETRATION THRU FIRE RATED WALL NOTES: 1. USE WHERE CONDUITS PASS THRU FIRE RATED WALL 2. WHERE CONDUITS PASS THRU CONCRETE BEAM, BRICK WALL, OR WATER PROOF FLOORS, USE PIPE SLEEVES. CONDUIT PENETRATION DETAILS

CONDUIT—

10 TO 50 MINUTES, OR 400ppm ARE REACHED WITHIN 4 TO 15 MINUTES AS REQUIRED BY UL 2034. 18. THE GAS DETECTOR SHALL MONITOR PROPANE (LP), AND NATURAL (METHANE) TYPE HEATING GASES. THE GAS DETECTOR SHALL INITIATE A SUPERVISORY SIGNAL WHEN 25% LOWER EXPLOSIVE LIMIT (LEL) IS REACHED AS 19. THIS CONTRACTOR IS RESPONSIBLE FOR ALL PROGRAMMING AND MAPPING OF EACH DEVICE AS REQUIRED. FIRE ALARM RISER DIAGRAM WRITTEN DIMENSIONS ON THIS DRAWING SHALL HAVE PRECEDENCE OVER

FIRE RATED WALL