CITY SCHOOL DISTRICT OF NEW ROCHELLE DANIEL WEBSTER ELEMENTARY SCHOOL 2023 CAPITAL PROJECT - PHASE 2A



95 GLENMORE DR. NEW ROCHELLE, NY 10801

ISSUED FOR BID: 03/14/2025



CSARCH - ARCHITECTS


GREENMAN - PEDERSEN, INC. - MEP & STRUCTURAL ENGINEER

STATE EDUCATION DEPARTMENT PROJECT CONTROL NUMBER:

2023 CAPITAL PROJECT - PHASE 2A 66-11-00-01-0-015-018

THE DESIGN OF THIS PROJECT CONFORMS TO APPLICABLE PROVISIONS OF THE NEW YORK STATE UNIFORM FIRE PREVENTION AND BUILDING CODE, THE NEW YORK STATE ENERGY CONSERVATION CONSTRUCTION CODE, AND THE MANUAL OF PLANNING STANDARDS OF THE NEW YORK STATE EDUCATION DEPARTMENT.


CSArch PROJECT NO. 188-2301.02

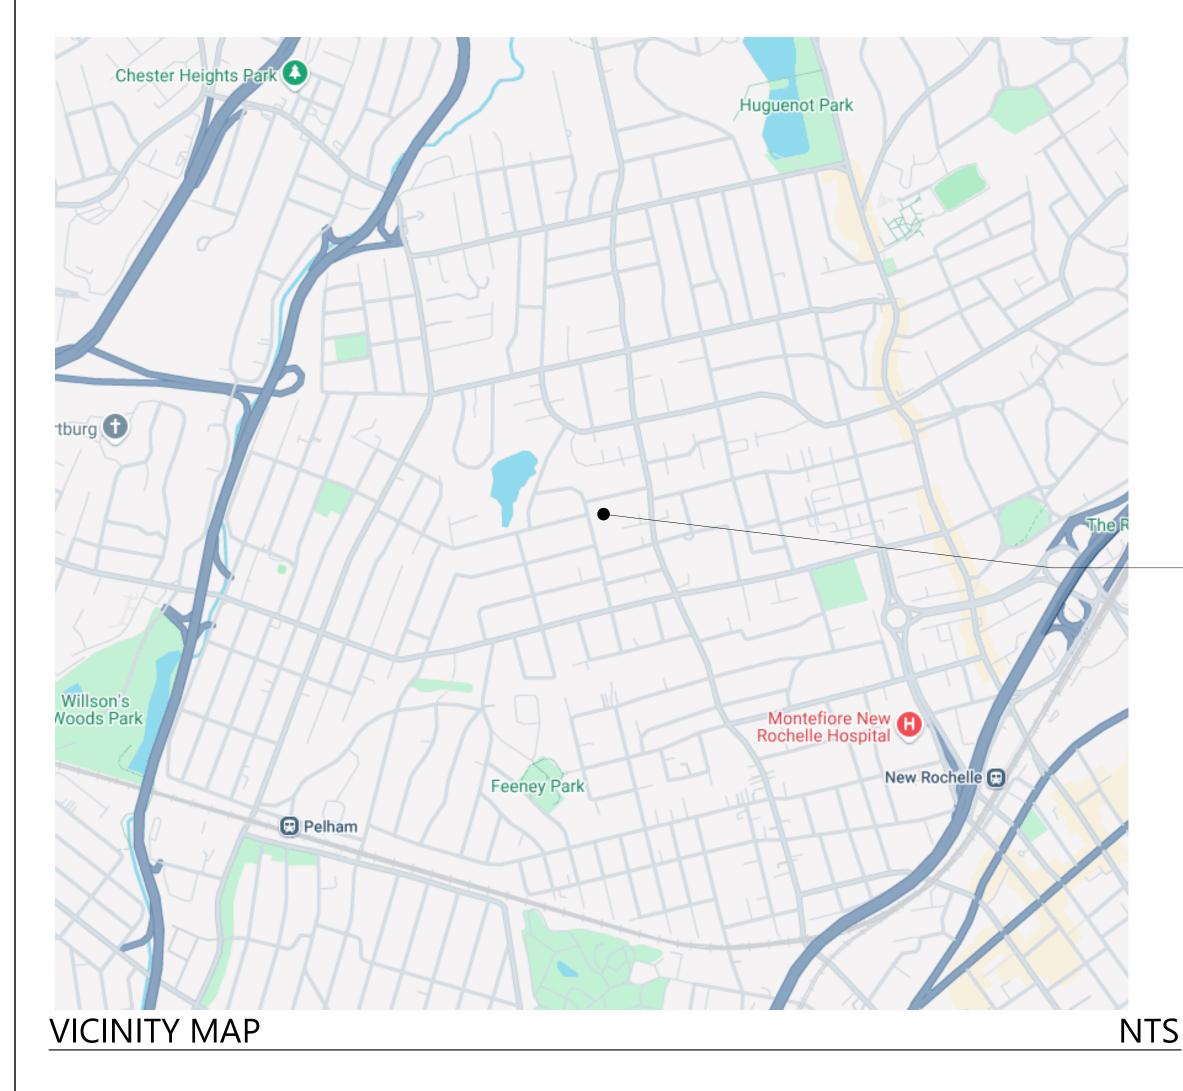


DANIEL WEBSTER
ELEMENTARY SCHOOL
95 GLENMORE DRIVE
NEW ROCHELLE, NY 10801

DRAWING LIST - VOLUME 6

OLIVLIV	AL DRAWINGS
G001	SYMBOLS, ABBREVIATIONS, AND MISC
G101	OVERALL GROUND FLOOR PLAN
G111	OVERALL FIRST FLOOR PLAN
G121	OVERALL SECOND FLOOR PLAN
	FETY DRAWINGS
LS101	GROUND FLOOR LIFE SAFETY PLAN
LS102	FIRST FLOOR LIFE SAFETY PLAN
LS103	SECOND FLOOR LIFE SAFETY PLAN
LS104	LIFE SAFETY DIAGRAMS
ARCHIT	ECTURAL DEMOLITION
AD112	AREA 'B' - PARTIAL FIRST FLOOR DEMOLITION PLAN
AD601	ENLARGED MAIN OFFICE DEMOLITION PLAN
AD812	AREA 'B' PARTIAL FIRST FLOOR DEMO RCP
	ECTURAL DRAWINGS
A112	AREA 'B' - PARTIAL FIRST FLOOR PLAN
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A602	ENLARGED PLANS, INTERIOR ELEVATIONS, AND DETA
A651	CASEWORK DETAILS
A701	PARTITION TYPES
A812	AREA 'B' - FIRST FLOOR NEW WORK RCP
A901	DOOR SCHEDULE, ELEVATIONS, AND DETAILS
ARCHIT	ECTURAL FINISH DRAWINGS
AF001	AREA 'B' - PARTIAL FIRST FLOOR FINISH PLAN
PLUMBI	NG GENERAL
PLUMBI P001	
	NG GENERAL PLUMBING LEGEND AND ABBREVIATIONS
P001 PLUMBI	PLUMBING LEGEND AND ABBREVIATIONS NG DEMOLITION
P001 PLUMBI	PLUMBING LEGEND AND ABBREVIATIONS
P001 PLUMBI PD101	PLUMBING LEGEND AND ABBREVIATIONS NG DEMOLITION
P001 PLUMBI PD101 PLUMBI	PLUMBING LEGEND AND ABBREVIATIONS NG DEMOLITION PLUMBING REMOVAL PLAN NG DRAWINGS
PUMBI PD101 PLUMBI PLUMBI	PLUMBING LEGEND AND ABBREVIATIONS NG DEMOLITION PLUMBING REMOVAL PLAN NG DRAWINGS PLUMBING PLAN
PUMBI PD101 PLUMBI PLUMBI P101 P201	PLUMBING LEGEND AND ABBREVIATIONS NG DEMOLITION PLUMBING REMOVAL PLAN NG DRAWINGS
PUMBI PD101 PLUMBI P101 P201 P301	PLUMBING LEGEND AND ABBREVIATIONS NG DEMOLITION PLUMBING REMOVAL PLAN NG DRAWINGS PLUMBING PLAN PLUMBING PLAN PLUMBING RISER DIAGRAMS & DETAILS PLUMBING SCHEDULES
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P001 PLUMBI PD101 PLUMBI P101 P201 P301 MECHAI M002 MECHAI MD101 MECHAI MD101 ELECTR ED101 ELECTR	PLUMBING LEGEND AND ABBREVIATIONS NG DEMOLITION PLUMBING REMOVAL PLAN NG DRAWINGS PLUMBING PLAN PLUMBING RISER DIAGRAMS & DETAILS PLUMBING SCHEDULES NICAL GENERAL MECHANICAL LEGENDS AND SCHEDULES MECHANICAL DETAILS NICAL DEMOLITION MECHANICAL REMOVALS PLAN NICAL DRAWINGS MECHANICAL NEW WORK PLAN ICAL GENERAL ELECTRICAL LEGEND AND ABBREVIATIONS ICAL DEMOLITION FIRST FLOOR ELECTRICAL REMOVALS PLAN
P001 PLUMBI PD101 PLUMBI P101 P201 P301 MECHAI M002 MECHAI MD101 MECHAI MD101 ELECTR ED101 ELECTR ED101 ELECTR E100	PLUMBING LEGEND AND ABBREVIATIONS NG DEMOLITION PLUMBING REMOVAL PLAN NG DRAWINGS PLUMBING PLAN PLUMBING RISER DIAGRAMS & DETAILS PLUMBING SCHEDULES NICAL GENERAL MECHANICAL LEGENDS AND SCHEDULES MECHANICAL DETAILS NICAL DEMOLITION MECHANICAL REMOVALS PLAN NICAL DRAWINGS MECHANICAL NEW WORK PLAN LICAL GENERAL ELECTRICAL LEGEND AND ABBREVIATIONS LICAL DEMOLITION FIRST FLOOR ELECTRICAL REMOVALS PLAN LICAL DRAWINGS GROUND FLOOR ELECTRICAL PLAN
P001 PLUMBI PD101 PLUMBI P101 P201 P301 MECHAI M002 MECHAI MD101 MECHAI MD101 ELECTR ED101 ELECTR	PLUMBING LEGEND AND ABBREVIATIONS NG DEMOLITION PLUMBING REMOVAL PLAN NG DRAWINGS PLUMBING PLAN PLUMBING RISER DIAGRAMS & DETAILS PLUMBING SCHEDULES NICAL GENERAL MECHANICAL LEGENDS AND SCHEDULES MECHANICAL DETAILS NICAL DEMOLITION MECHANICAL REMOVALS PLAN NICAL DRAWINGS MECHANICAL NEW WORK PLAN ICAL GENERAL ELECTRICAL LEGEND AND ABBREVIATIONS ICAL DEMOLITION FIRST FLOOR ELECTRICAL REMOVALS PLAN

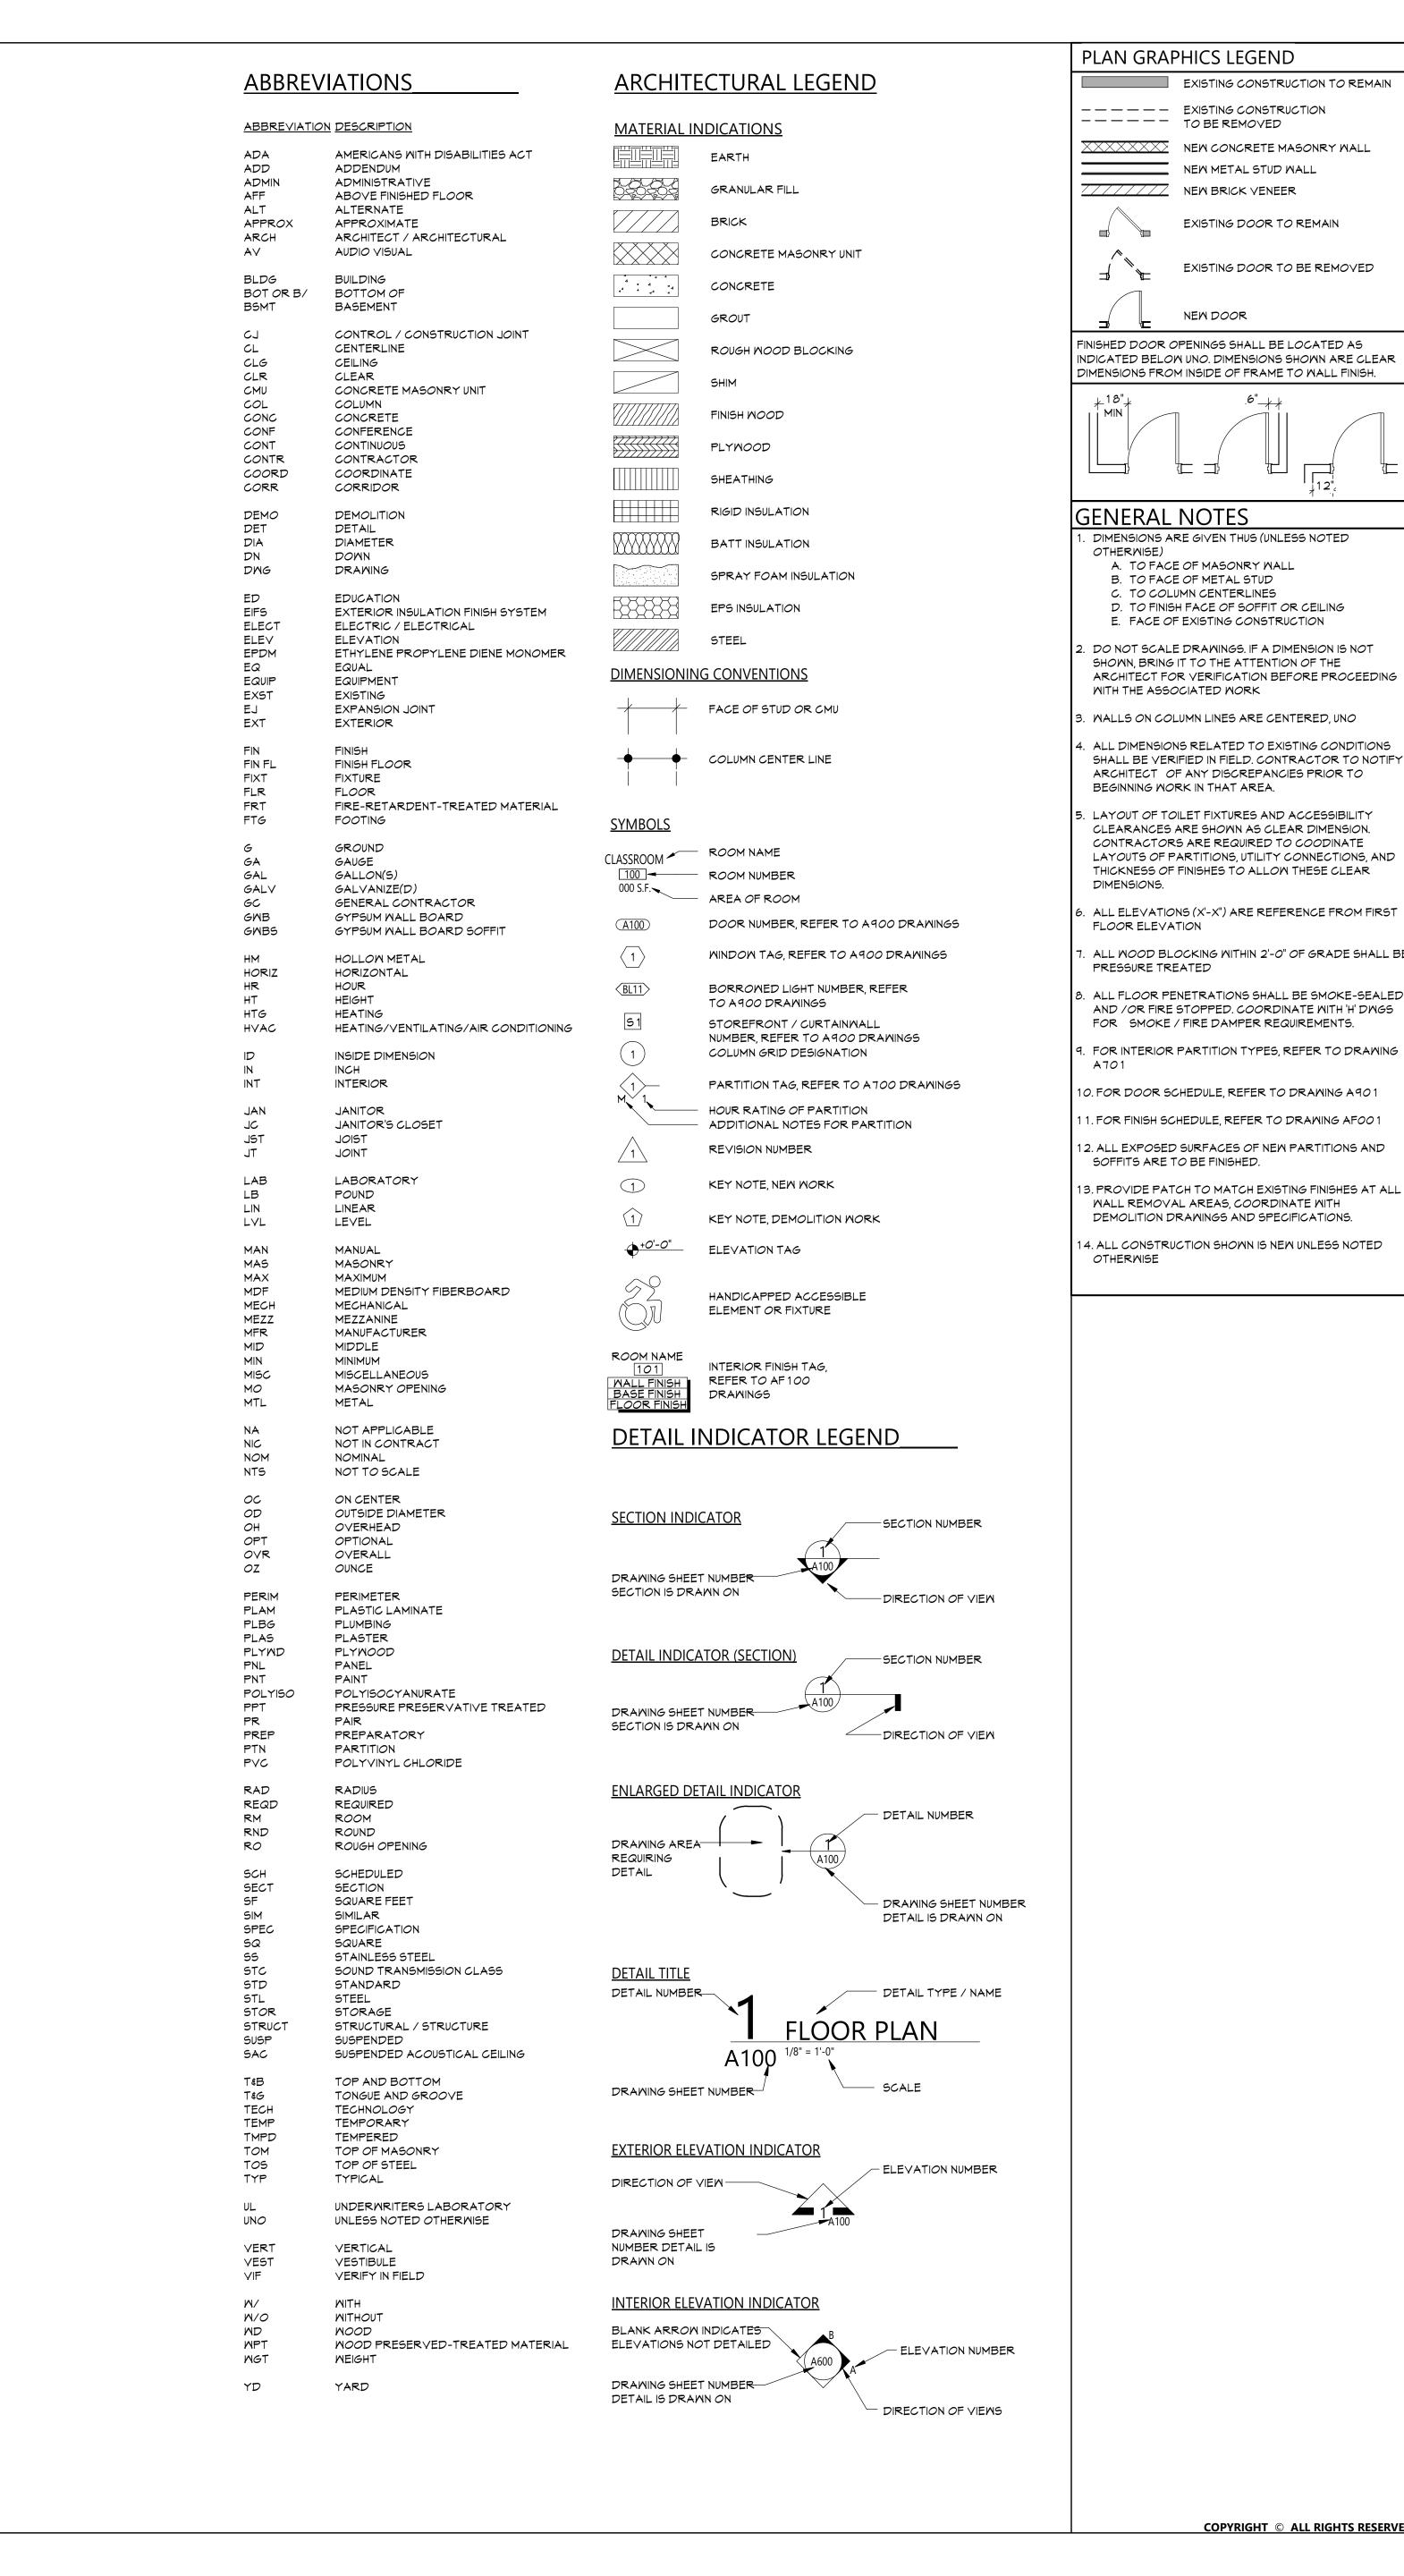

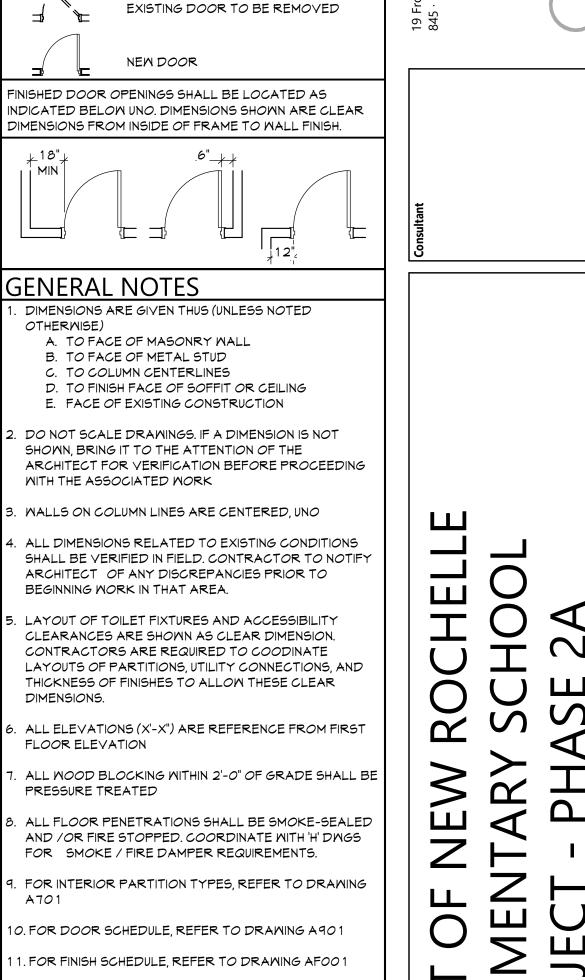

EXISTING CONSTRUCTION TO REMAIN

XXXXXXXX NEW CONCRETE MASONRY WALL

NEW DOOR

FLOOR ELEVATION

PRESSURE TREATED

SOFFITS ARE TO BE FINISHED.

OTHERWISE

WALL REMOVAL AREAS, COORDINATE WITH

DEMOLITION DRAWINGS AND SPECIFICATIONS.

NEW METAL STUD WALL

EXISTING DOOR TO REMAIN

---- EXISTING CONSTRUCTION

---- TO BE REMOVED

////// NEW BRICK VENEER


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SYMBOLS, **ABBREVIATIONS AND MISC**

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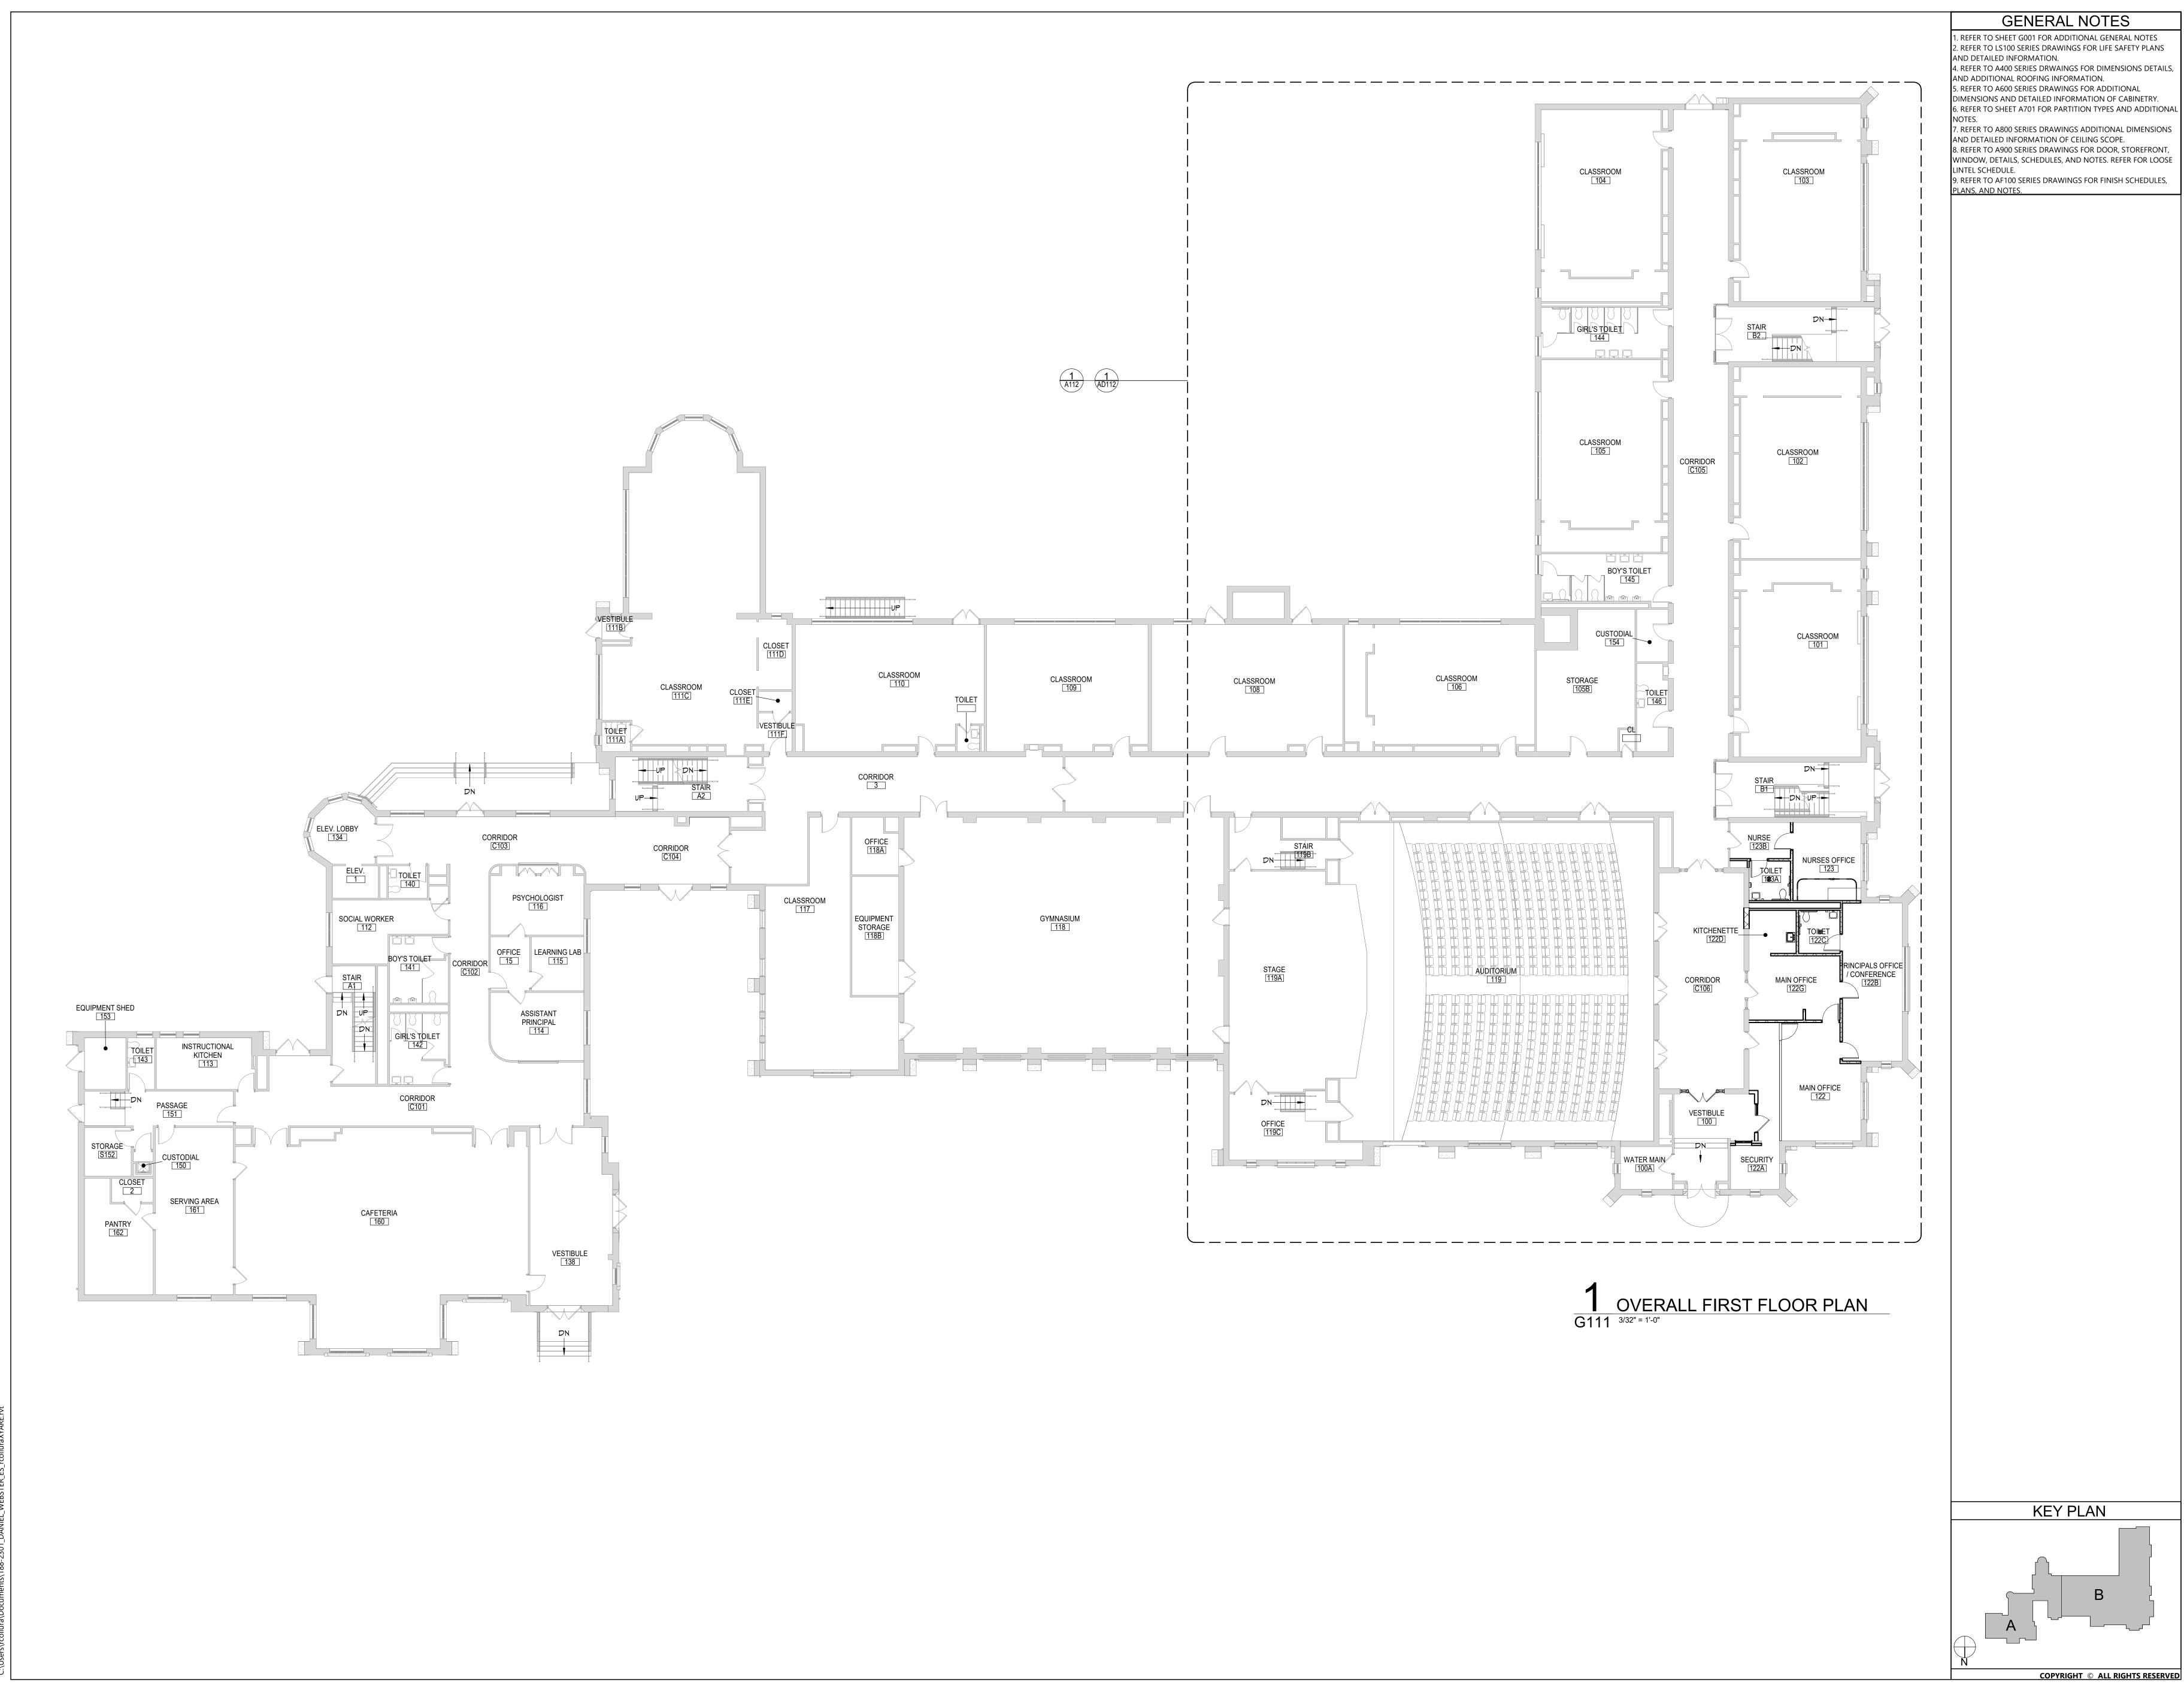
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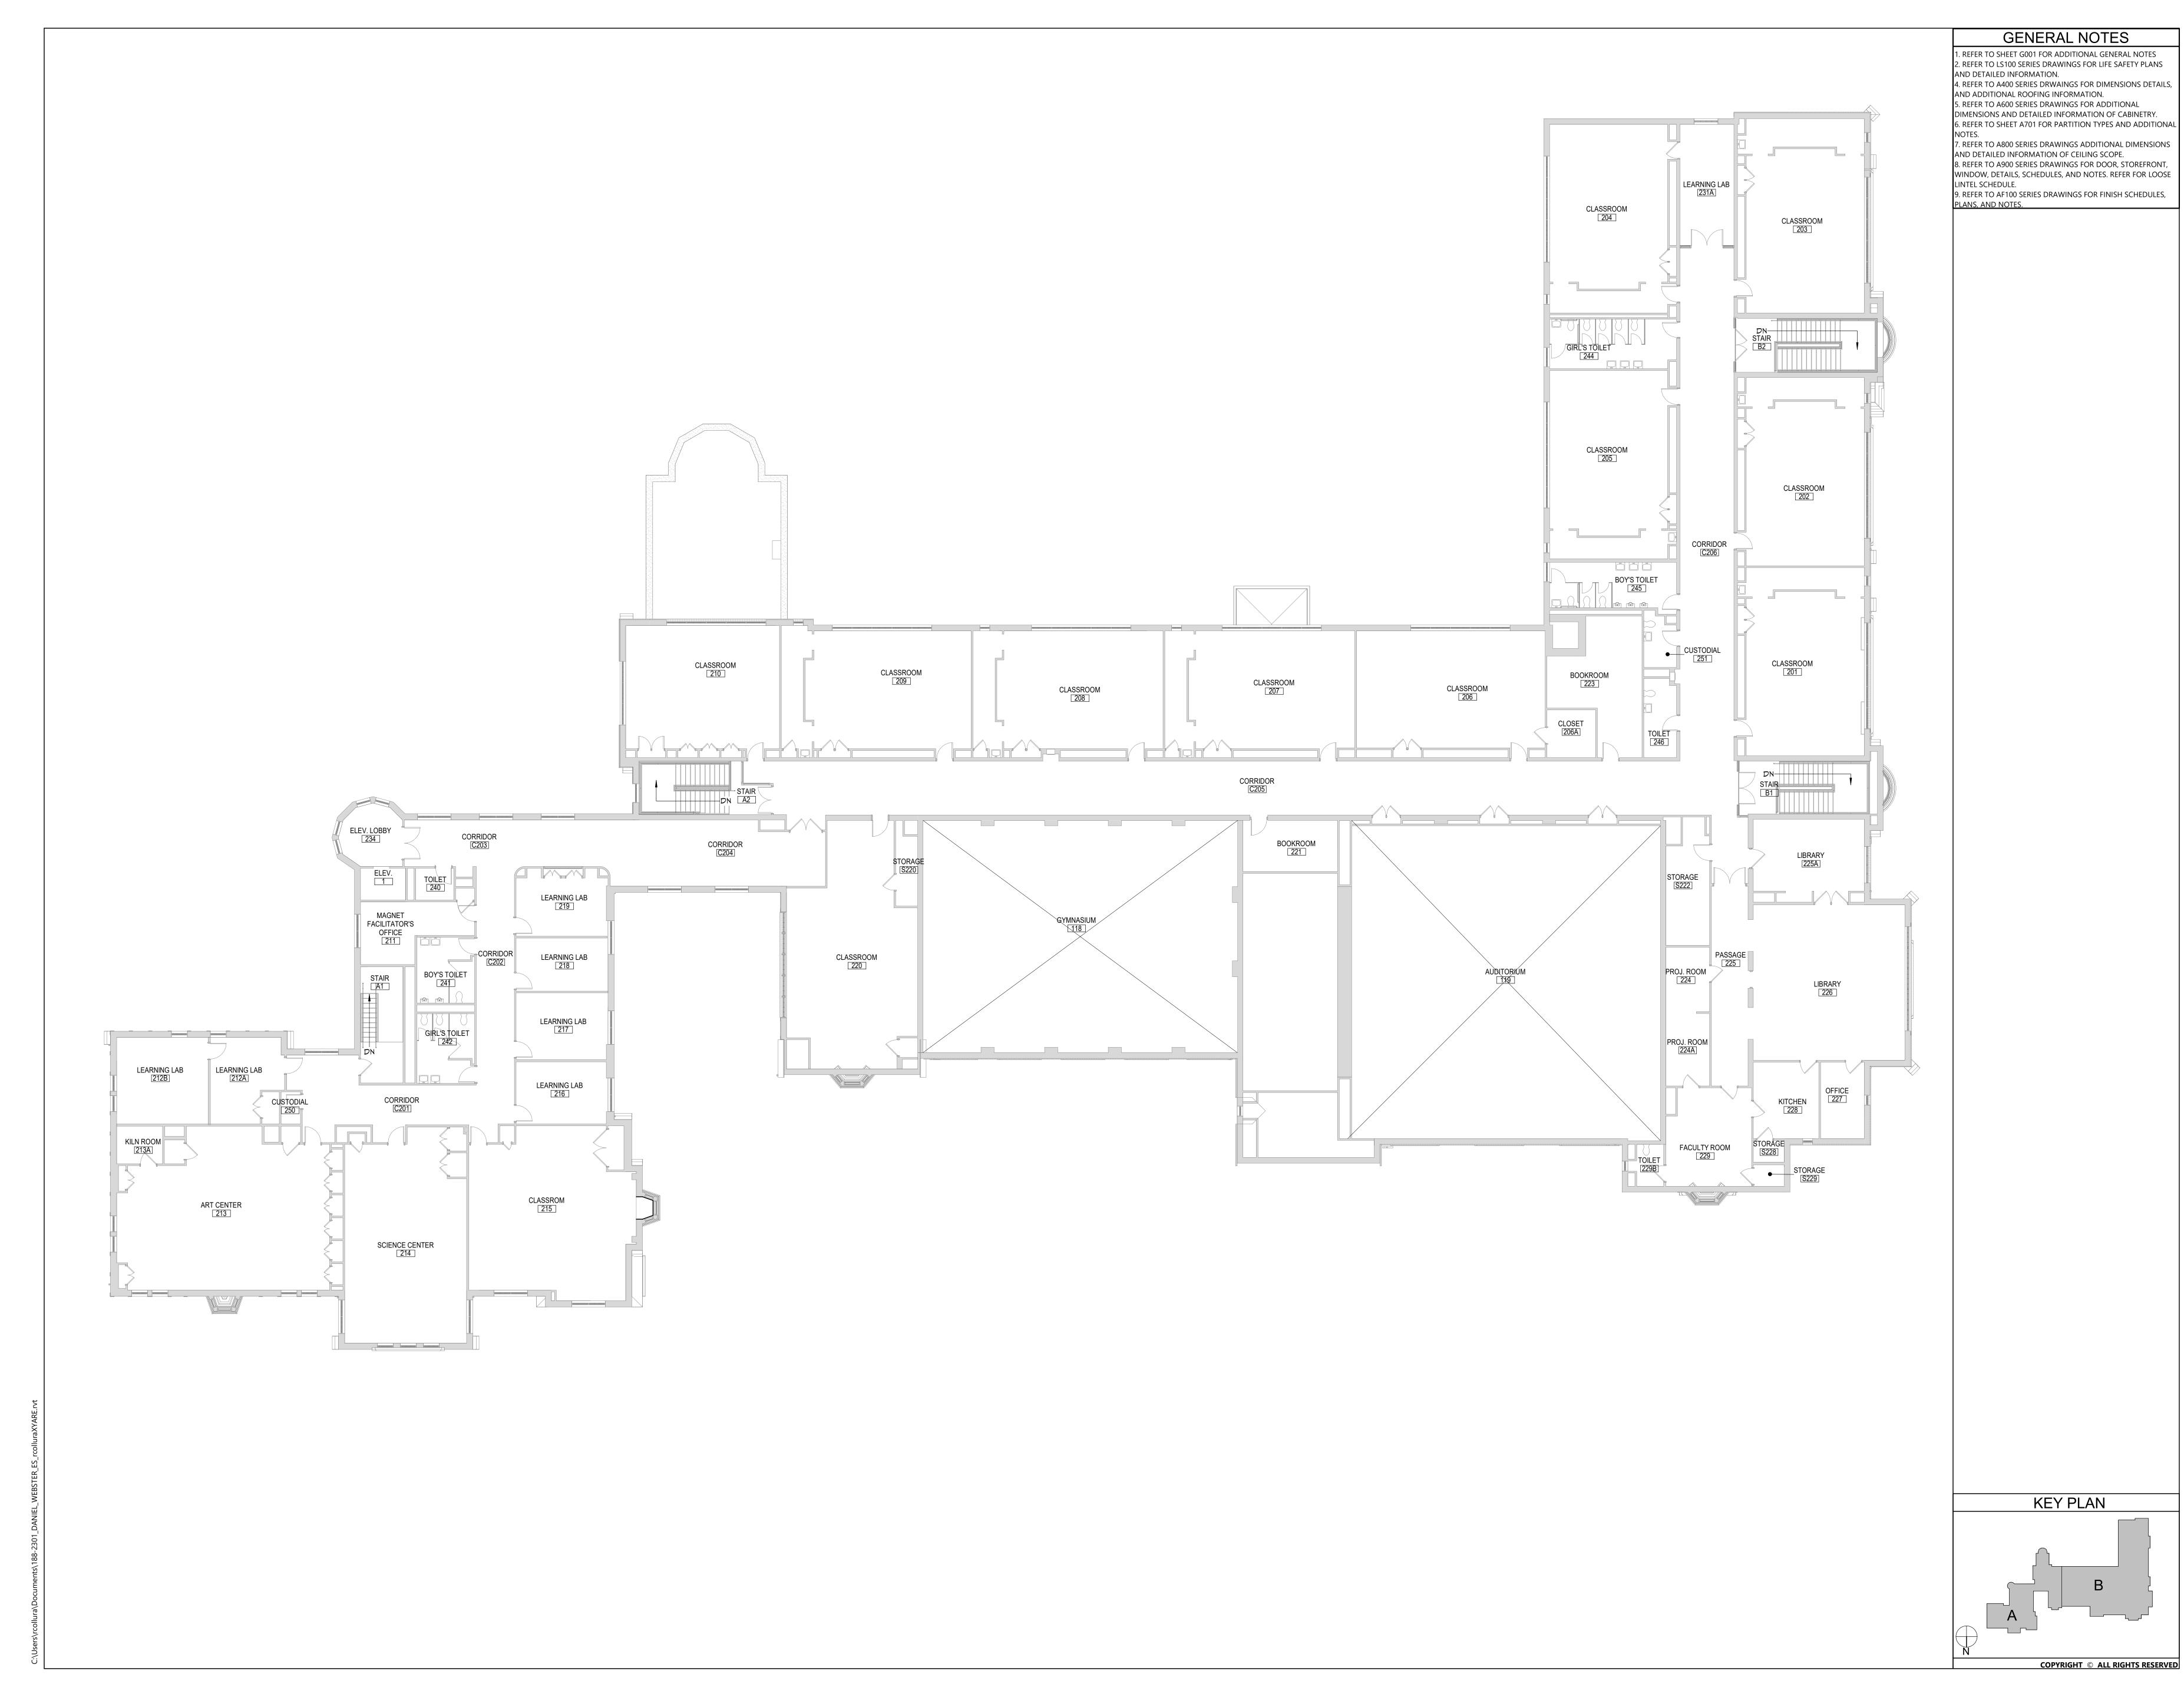
OVERALL GROUND FLOOR PLAN





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OVERALL FIRST

FLOOR PLAN

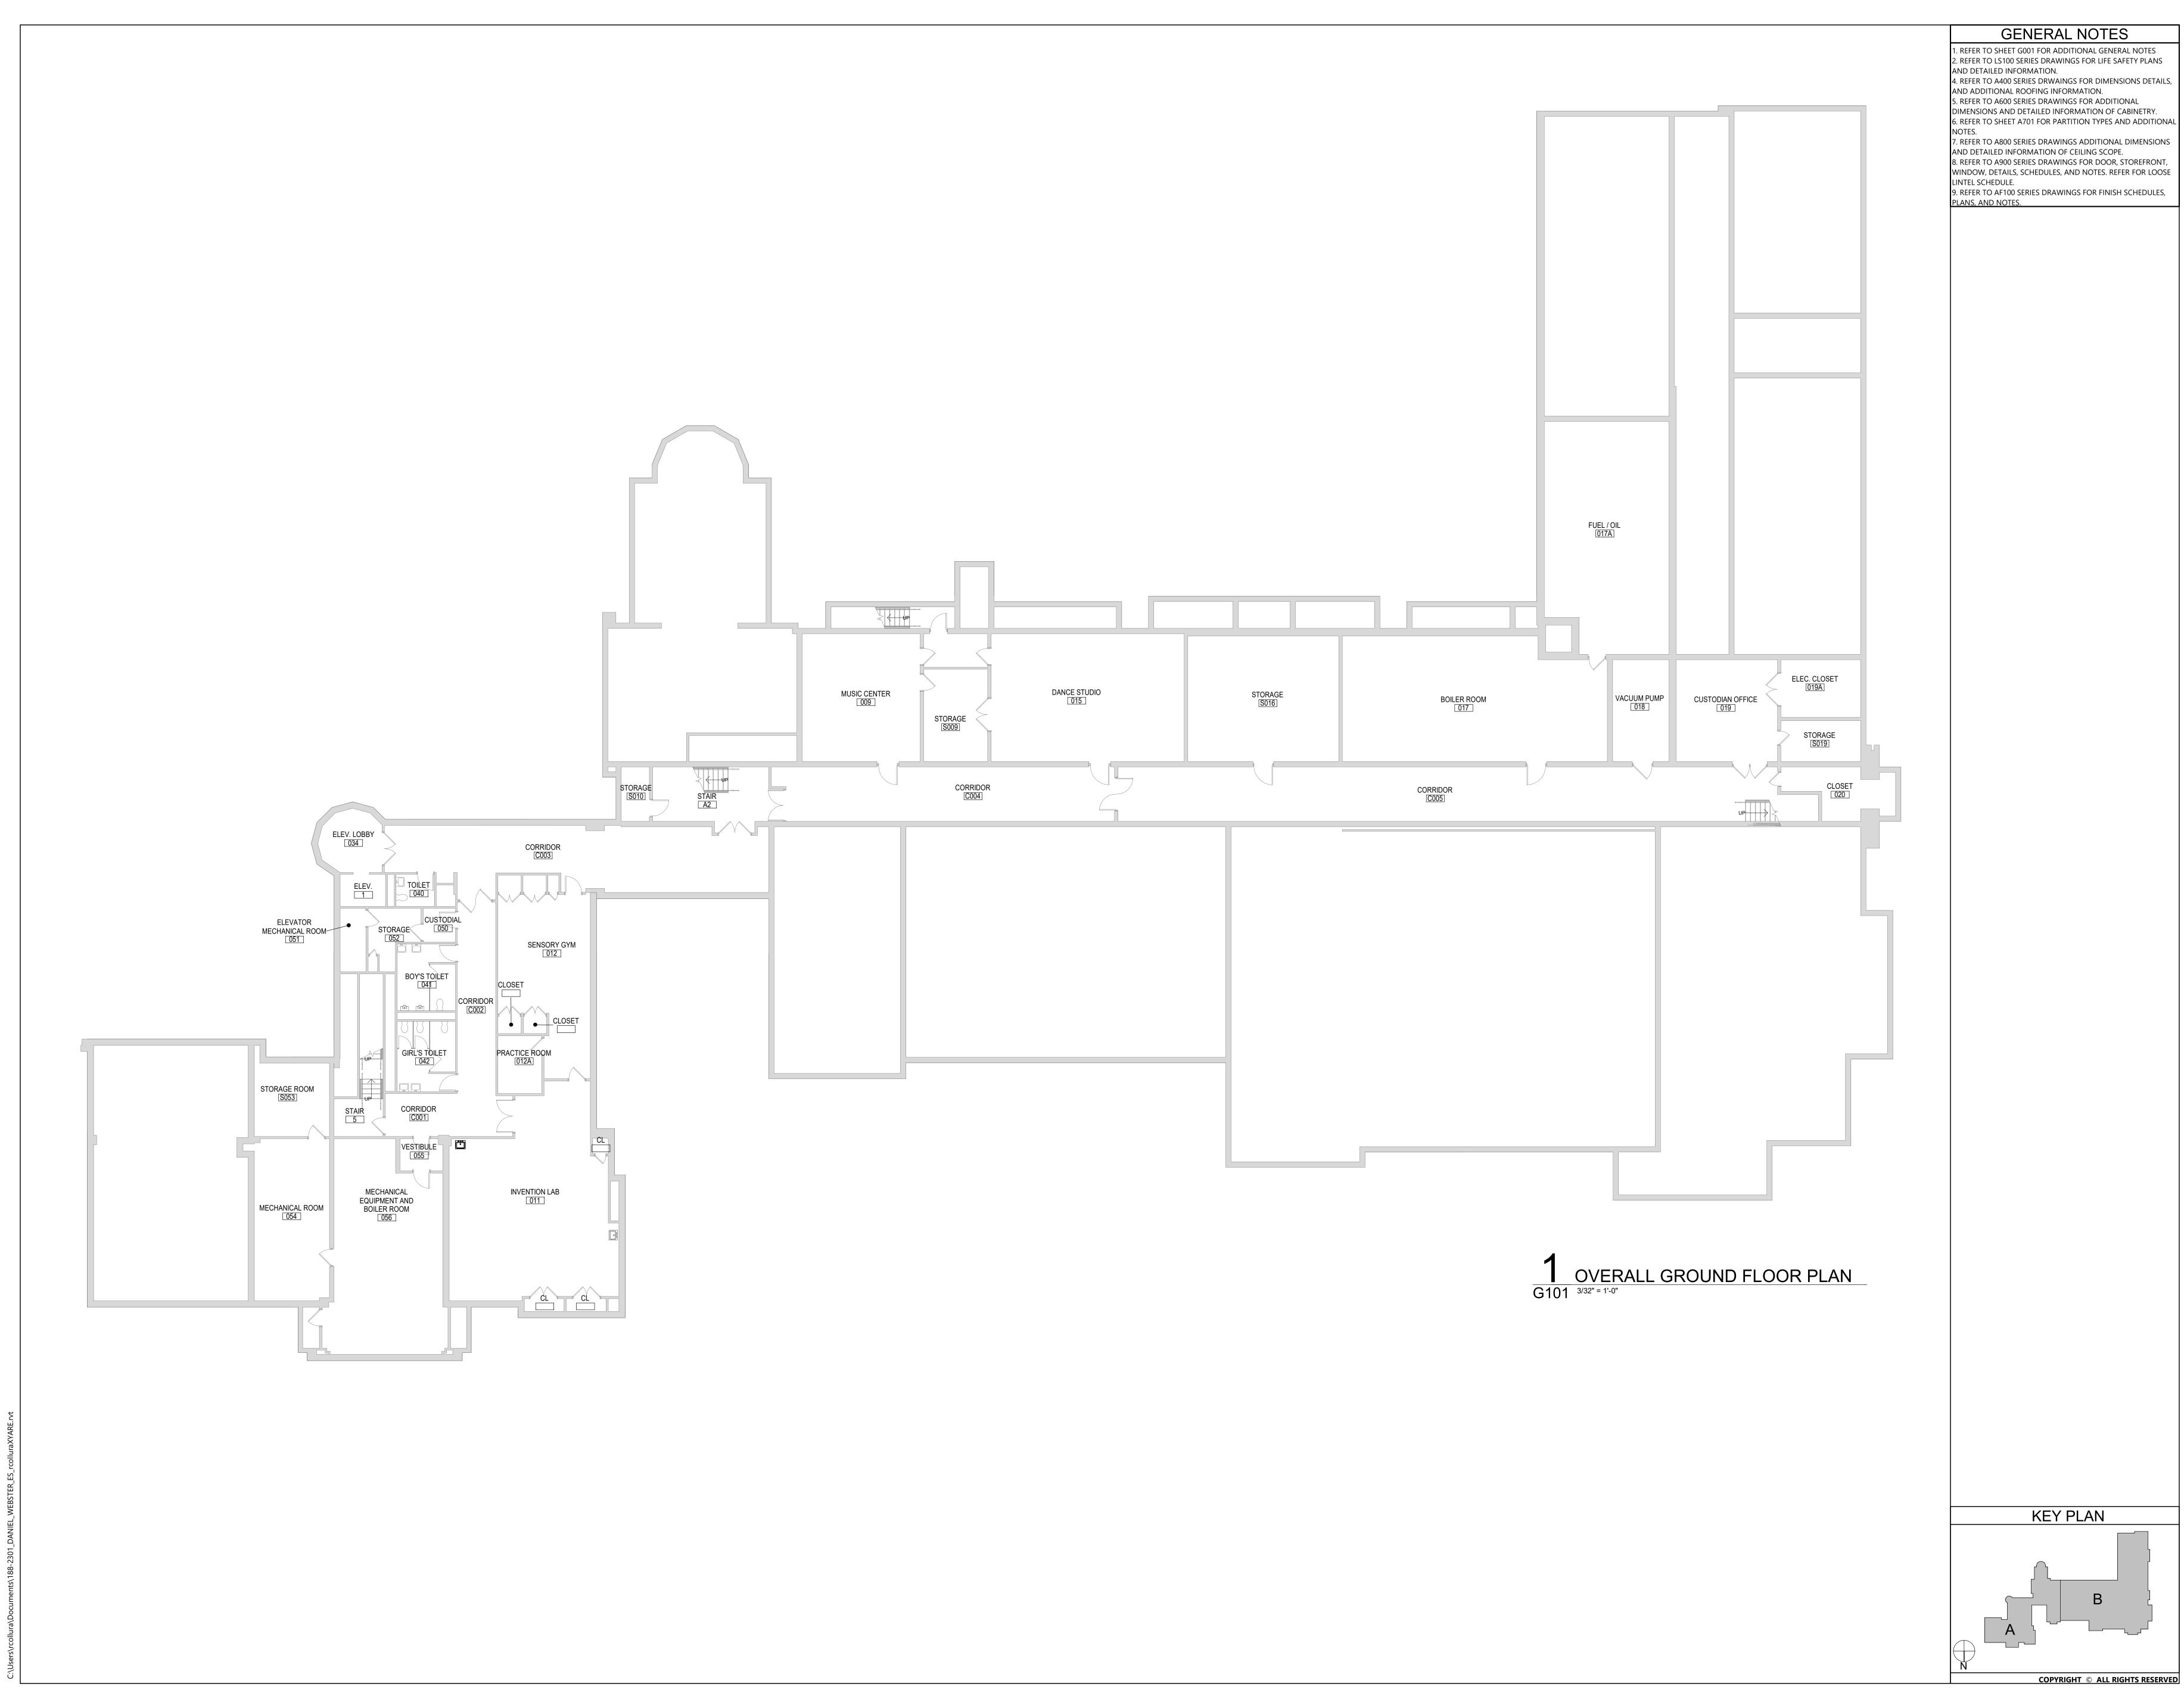





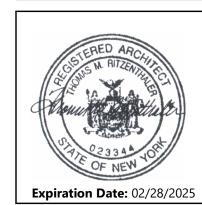

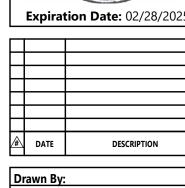
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OVERALL SECOND FLOOR PLAN



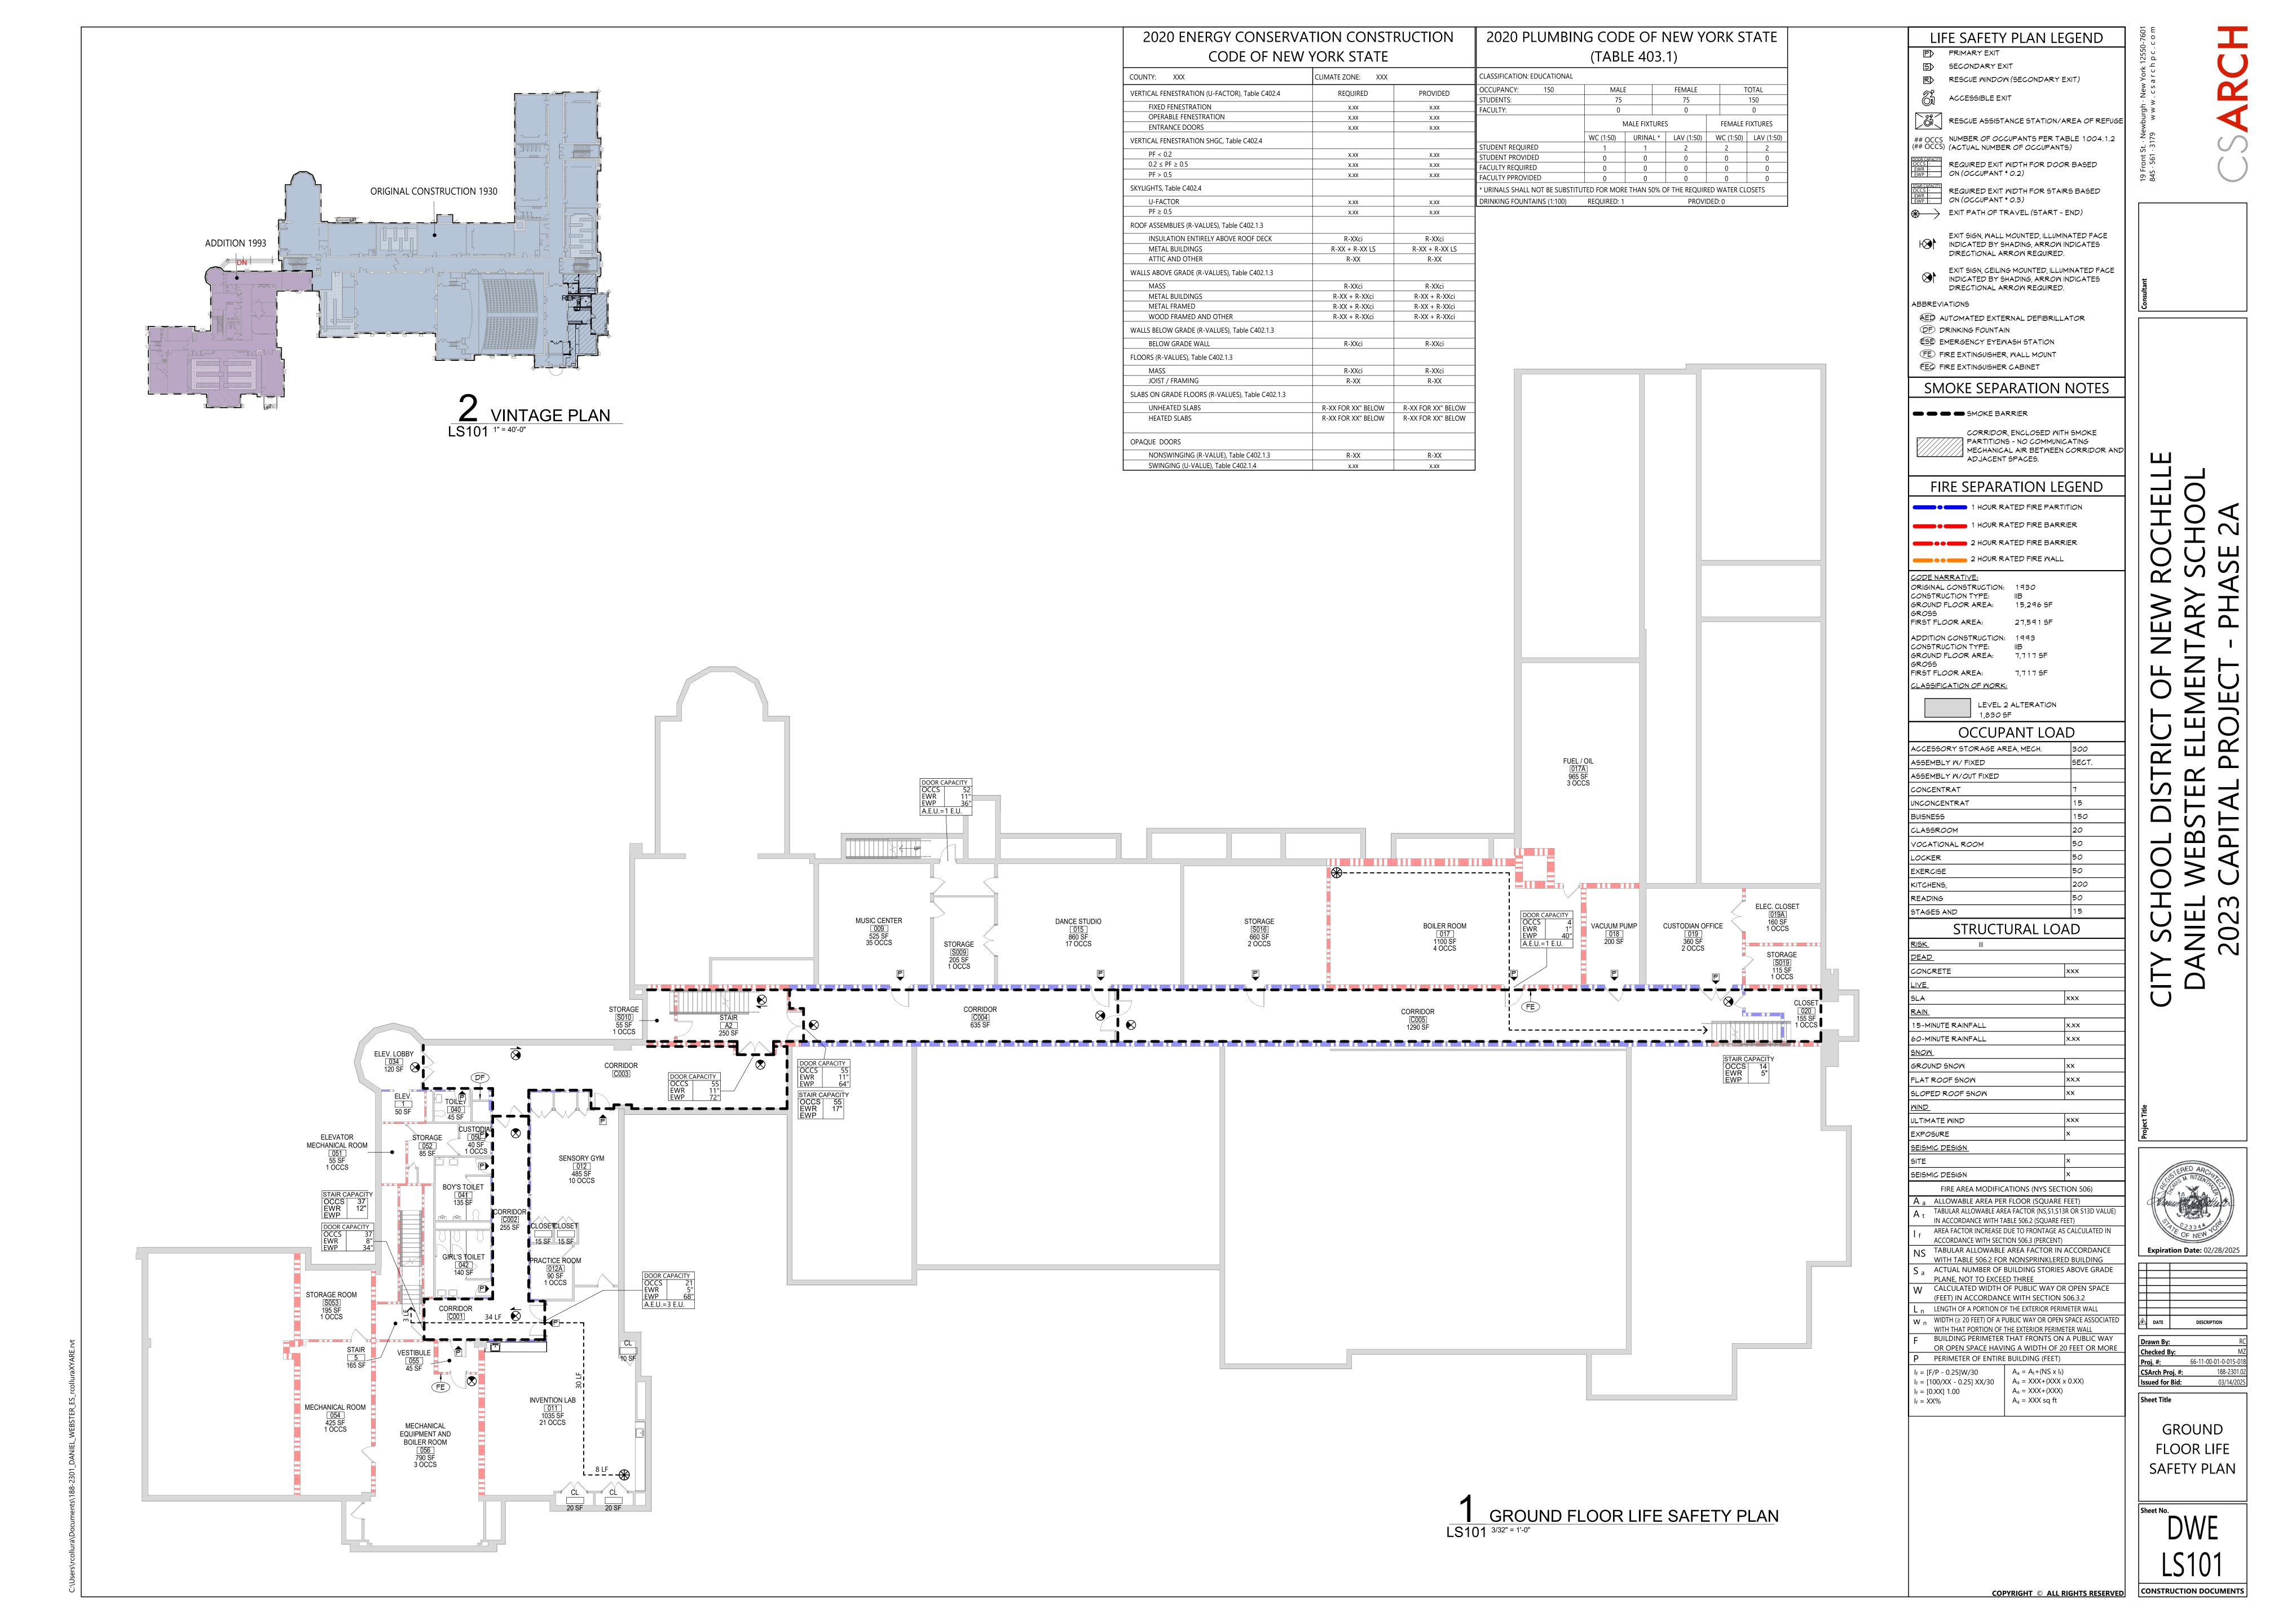

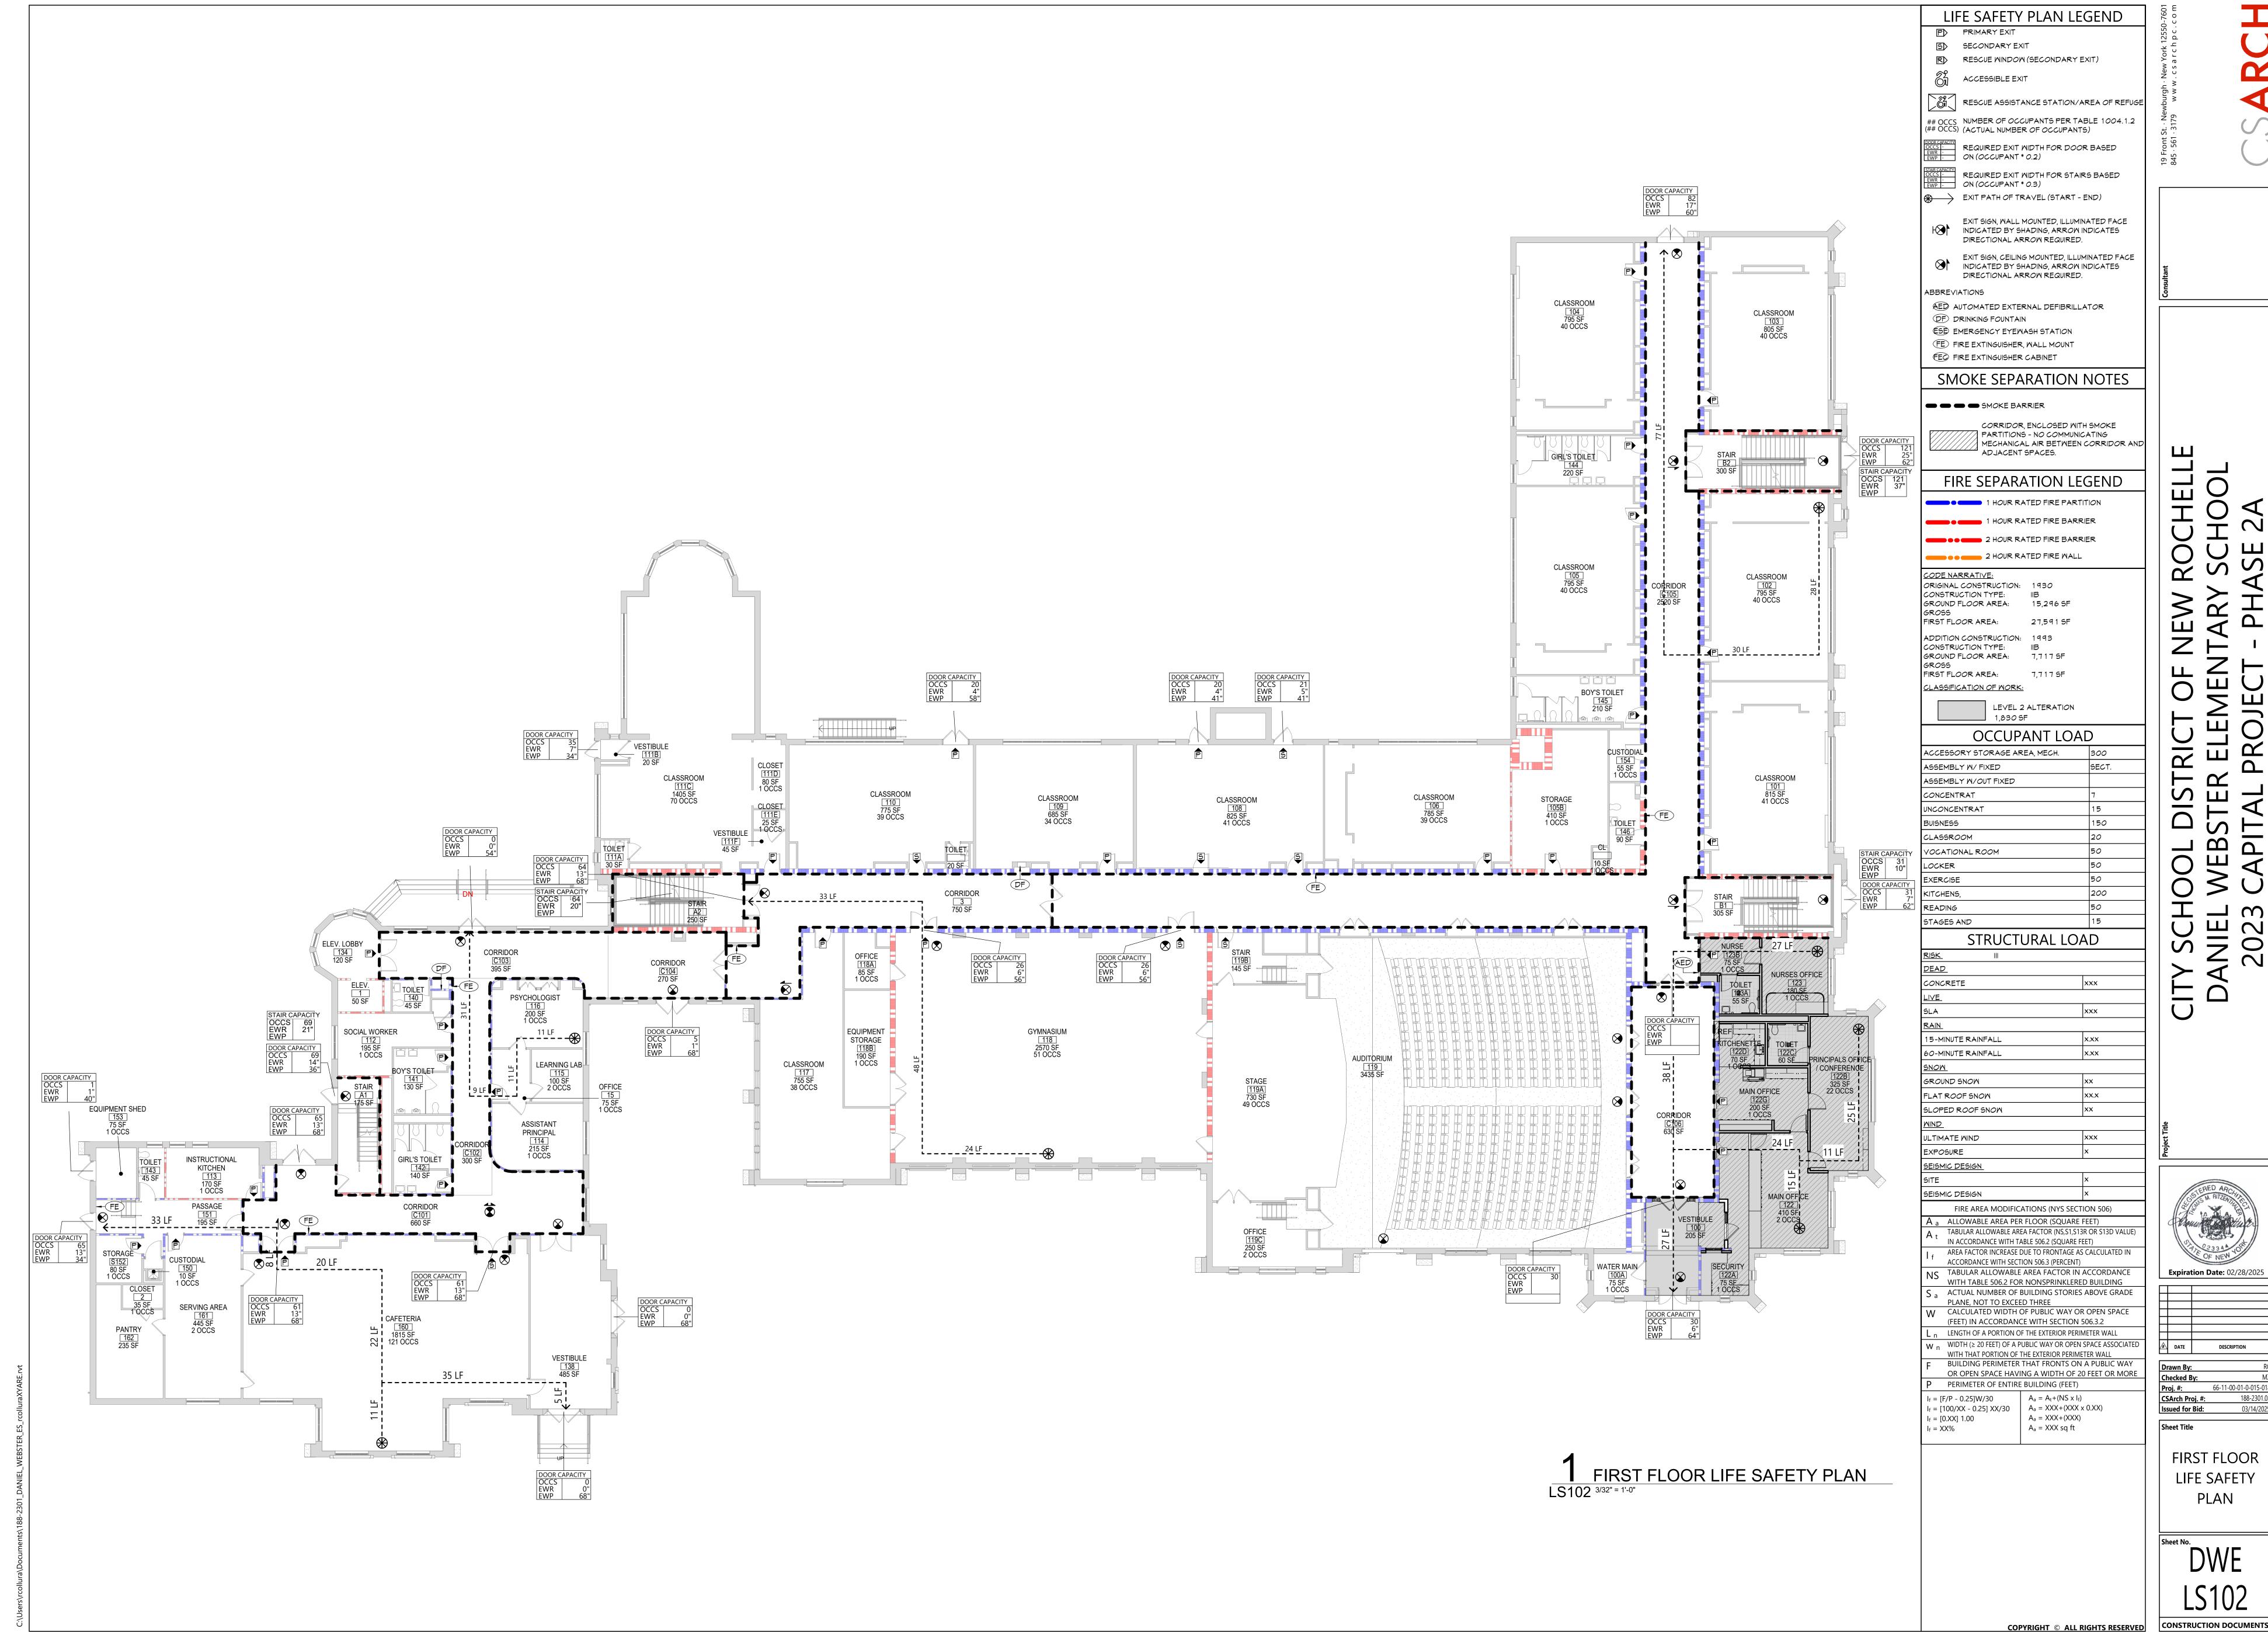
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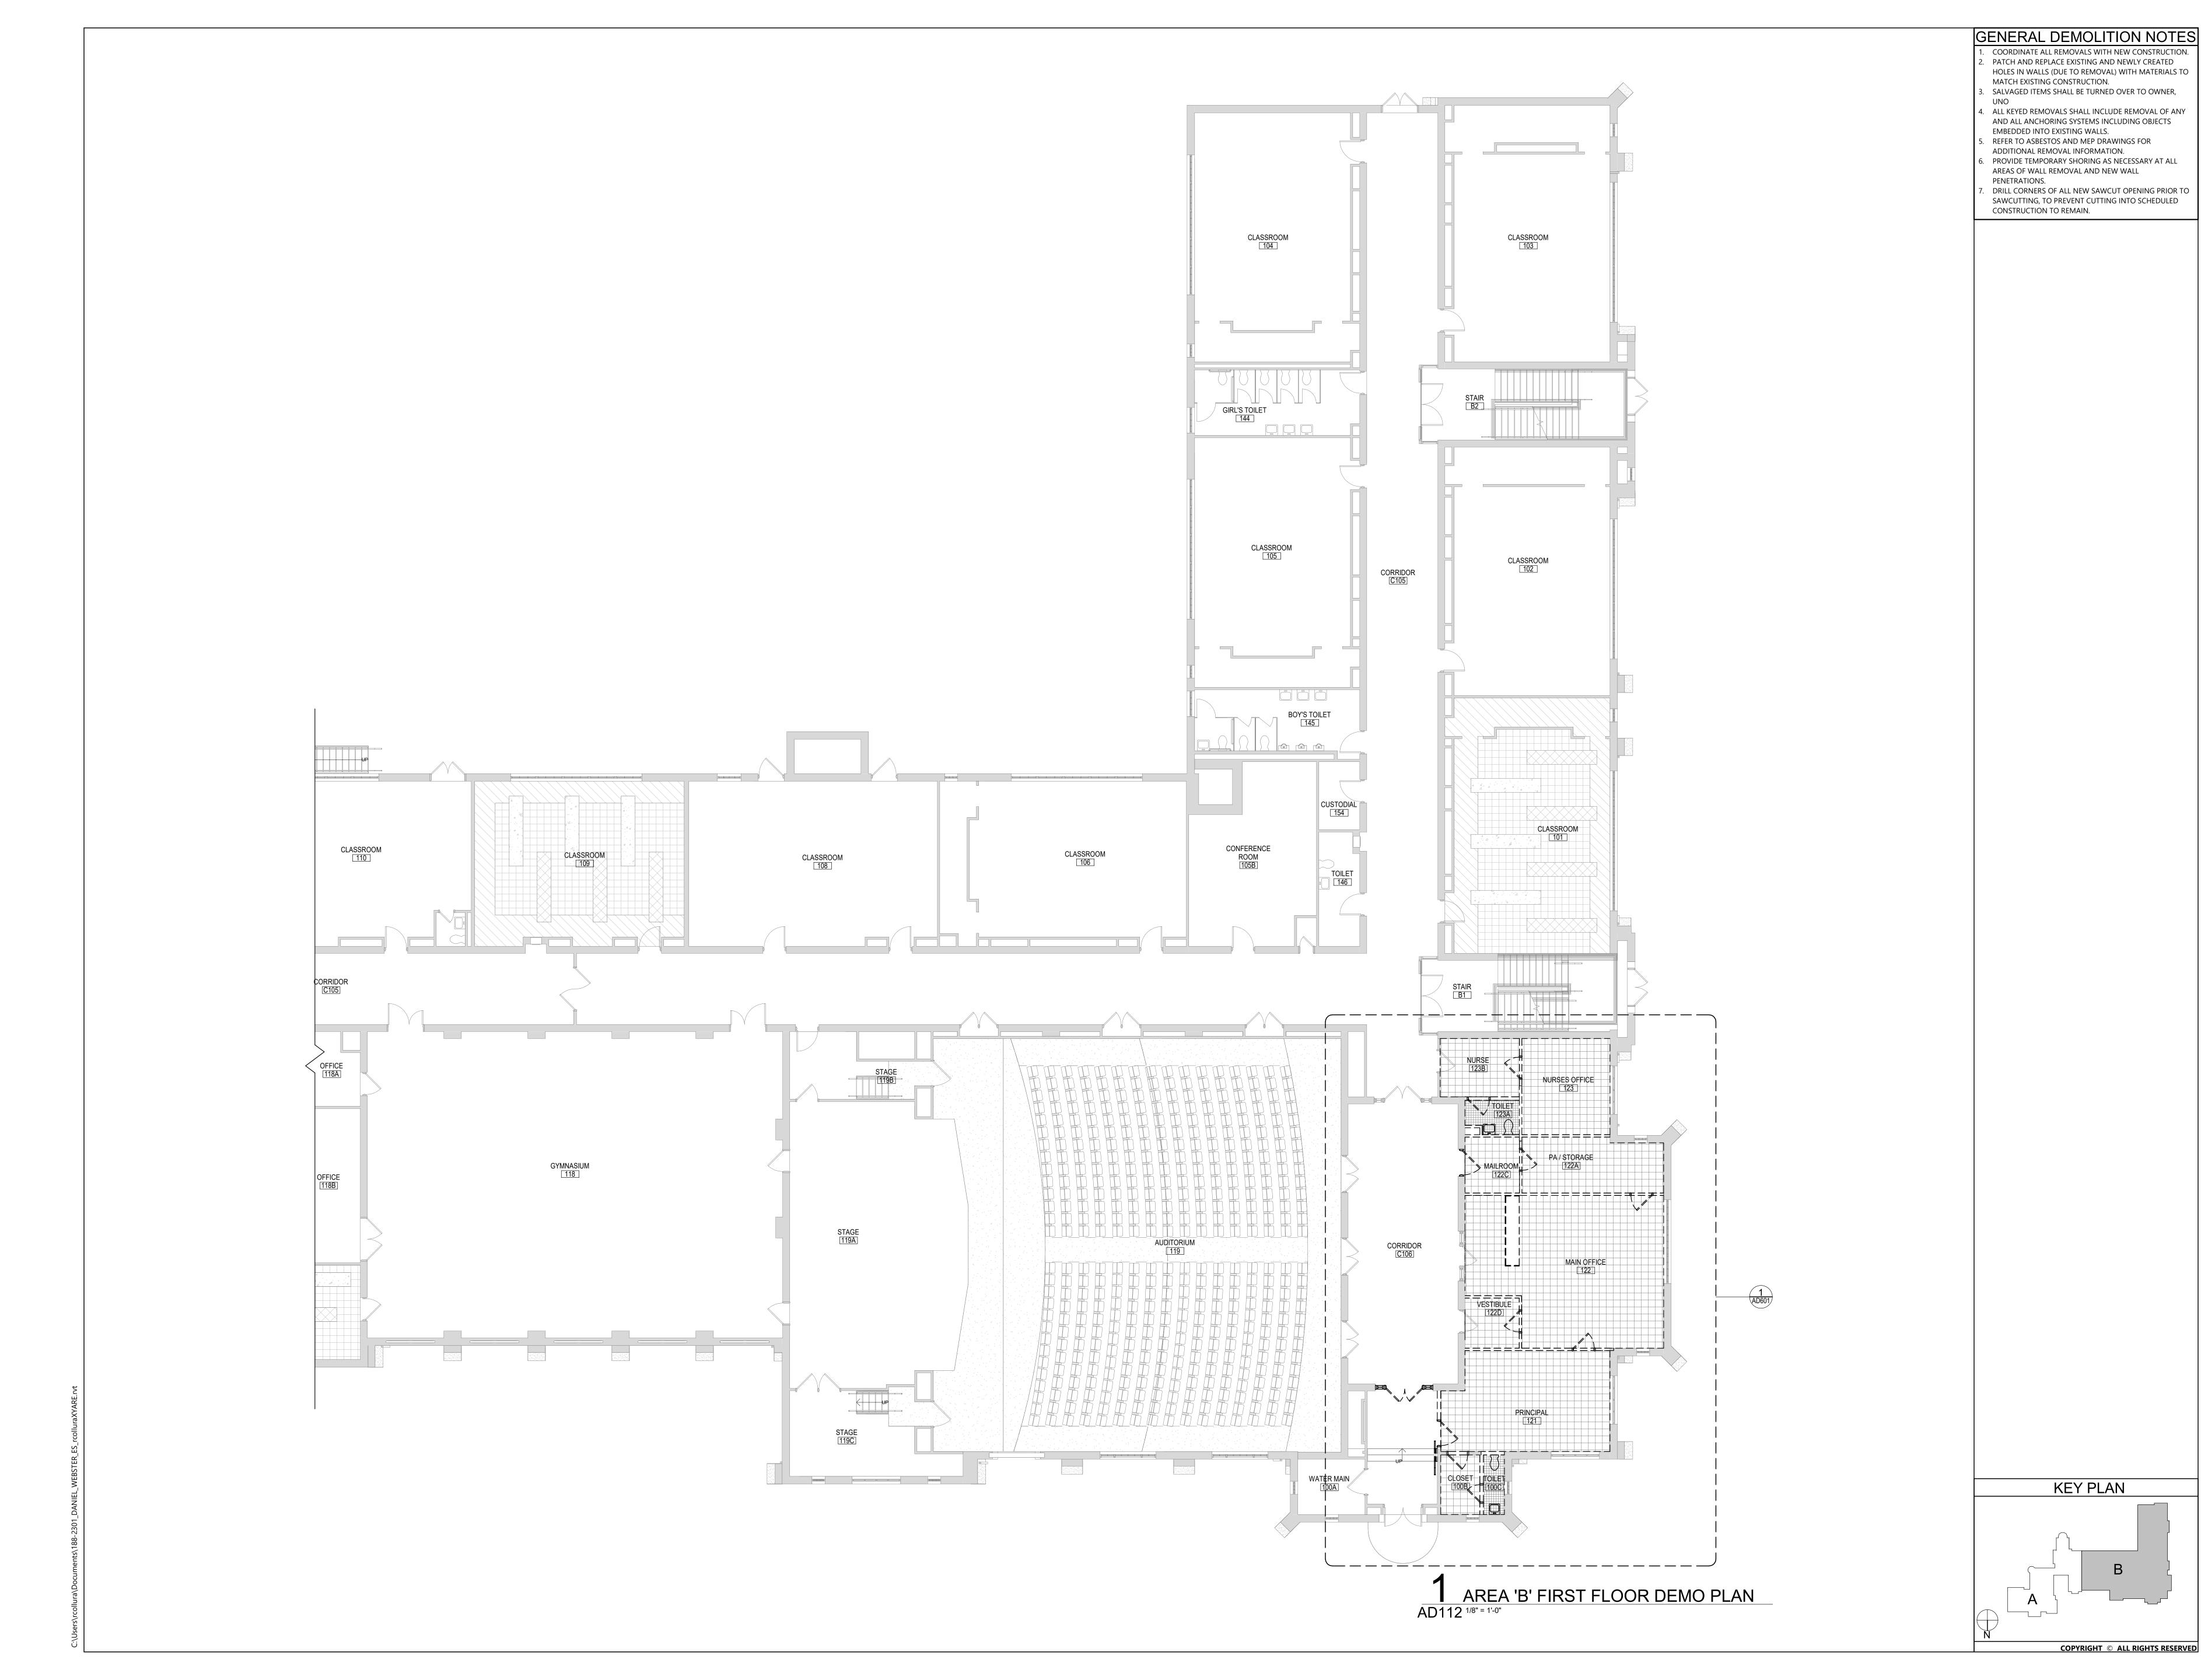



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SECOND FLOOR LIFE SAFETY PLAN

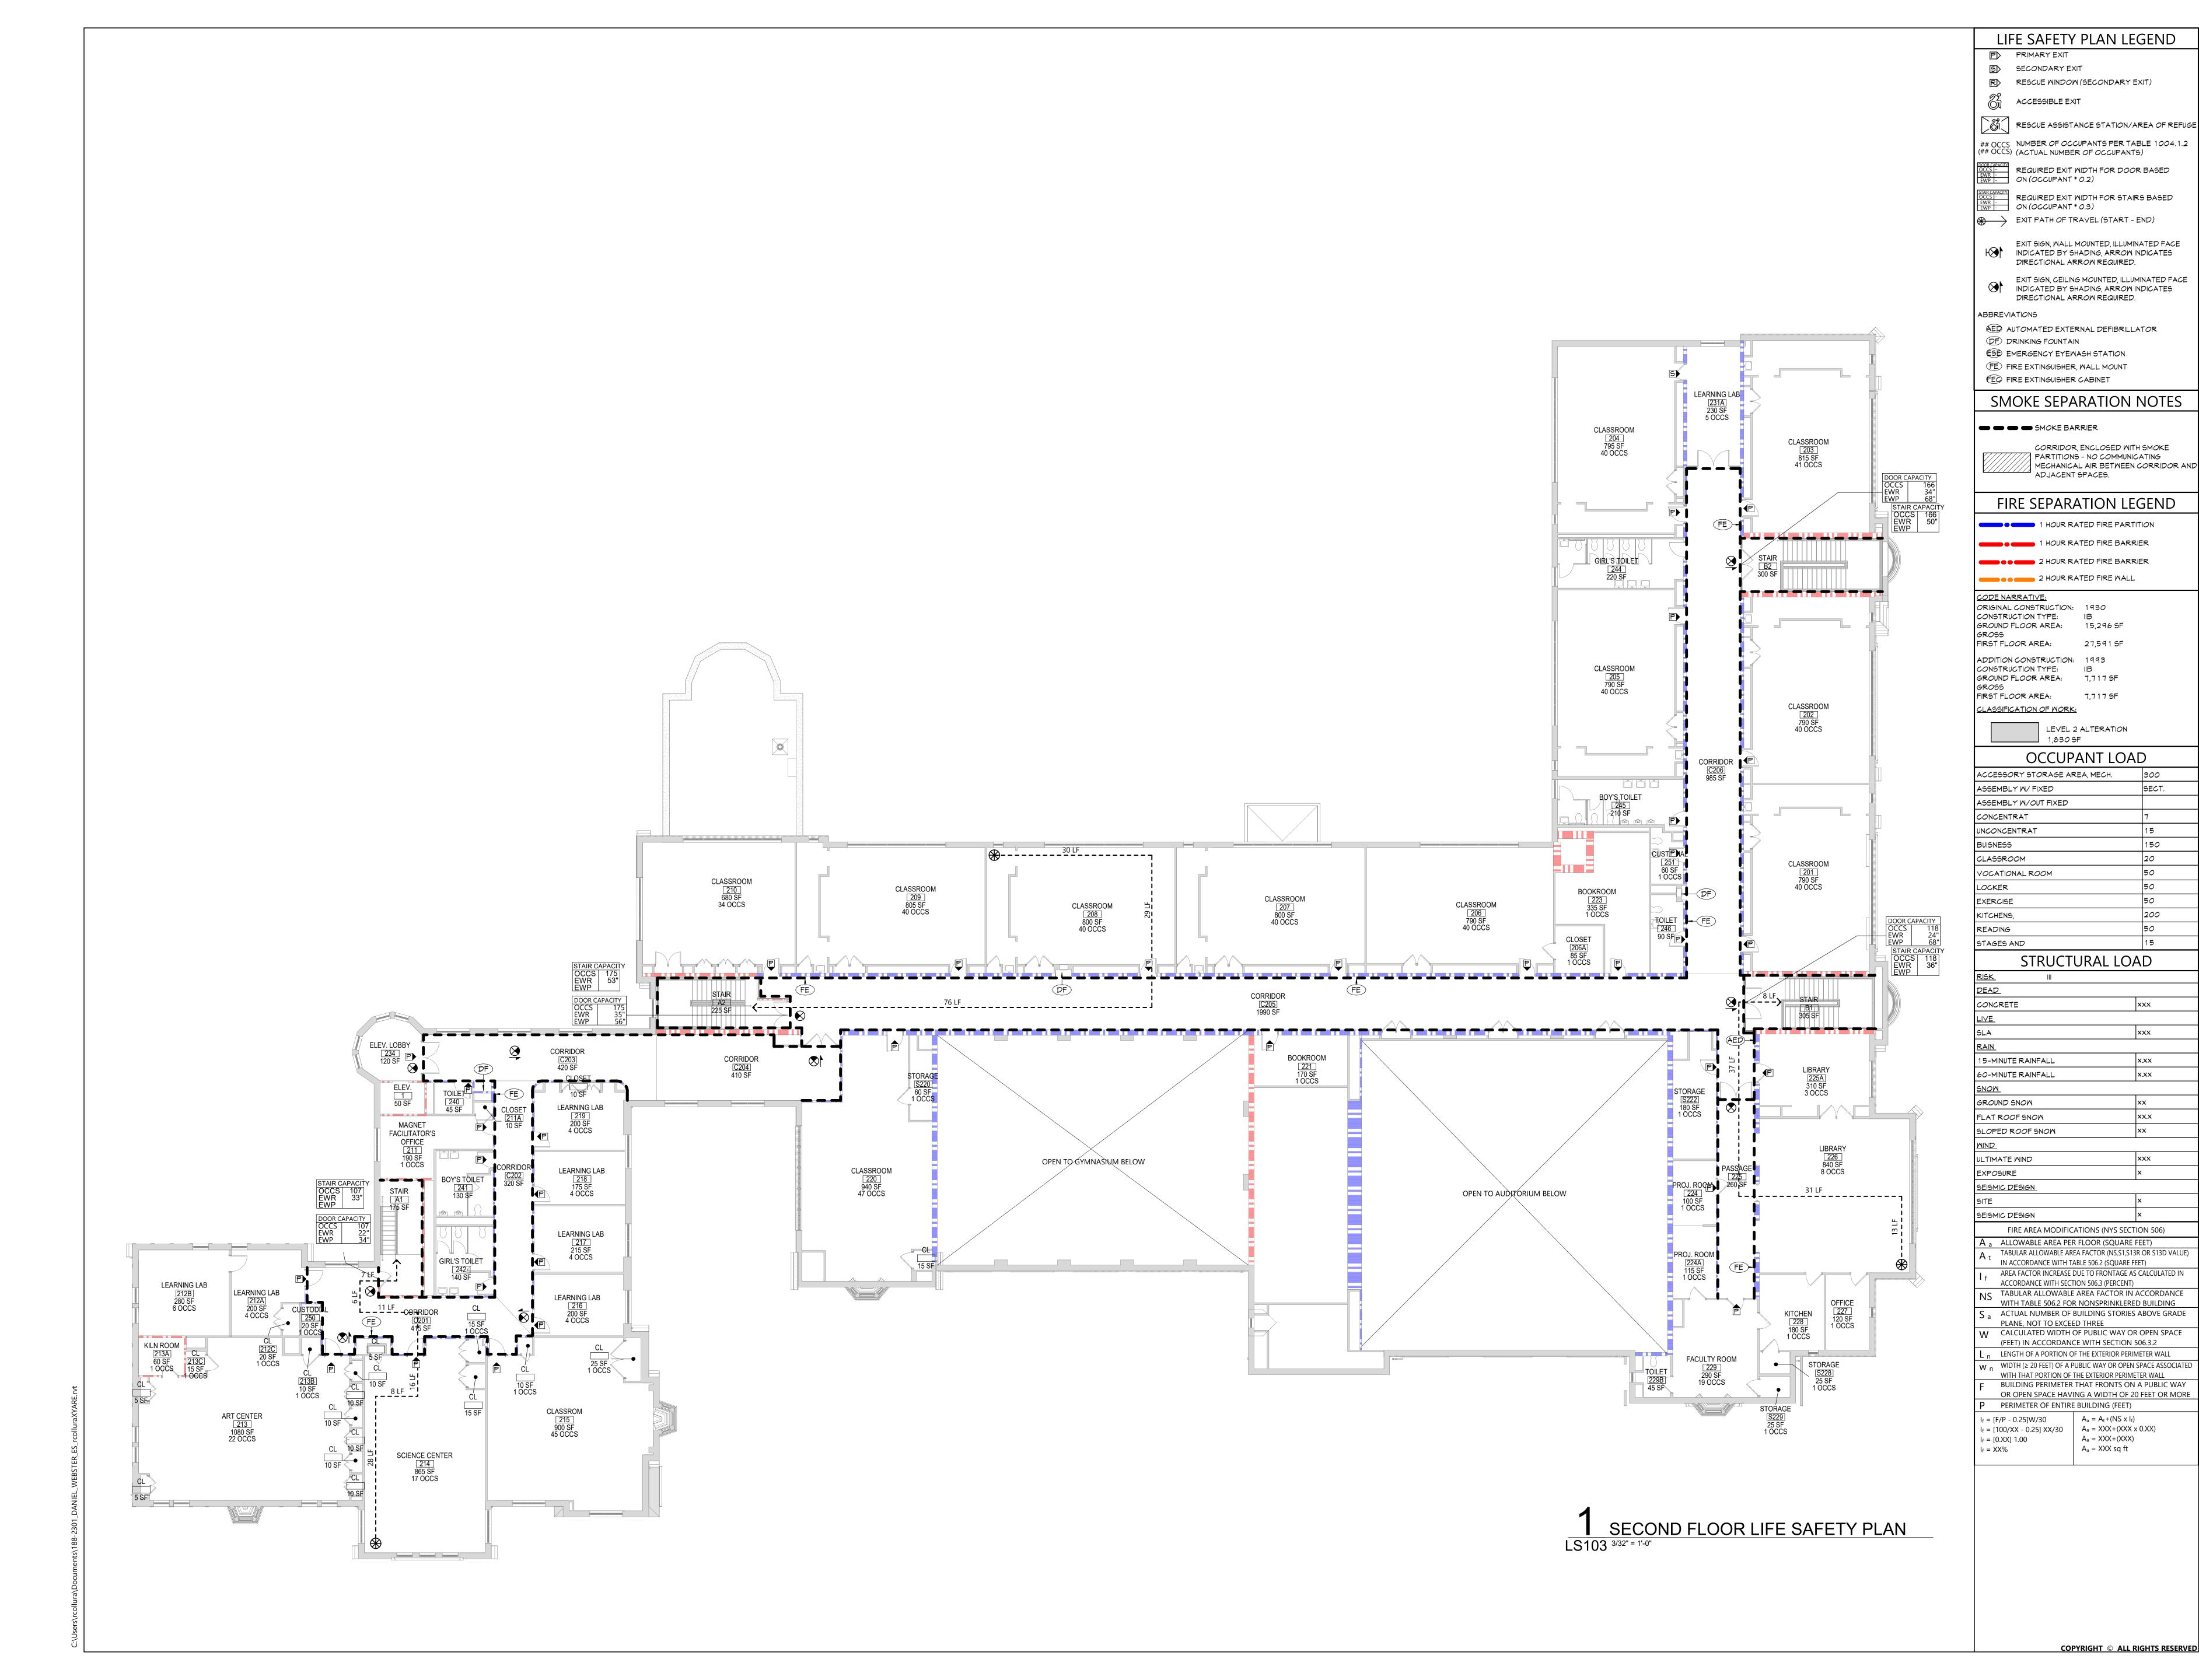DWE LS103






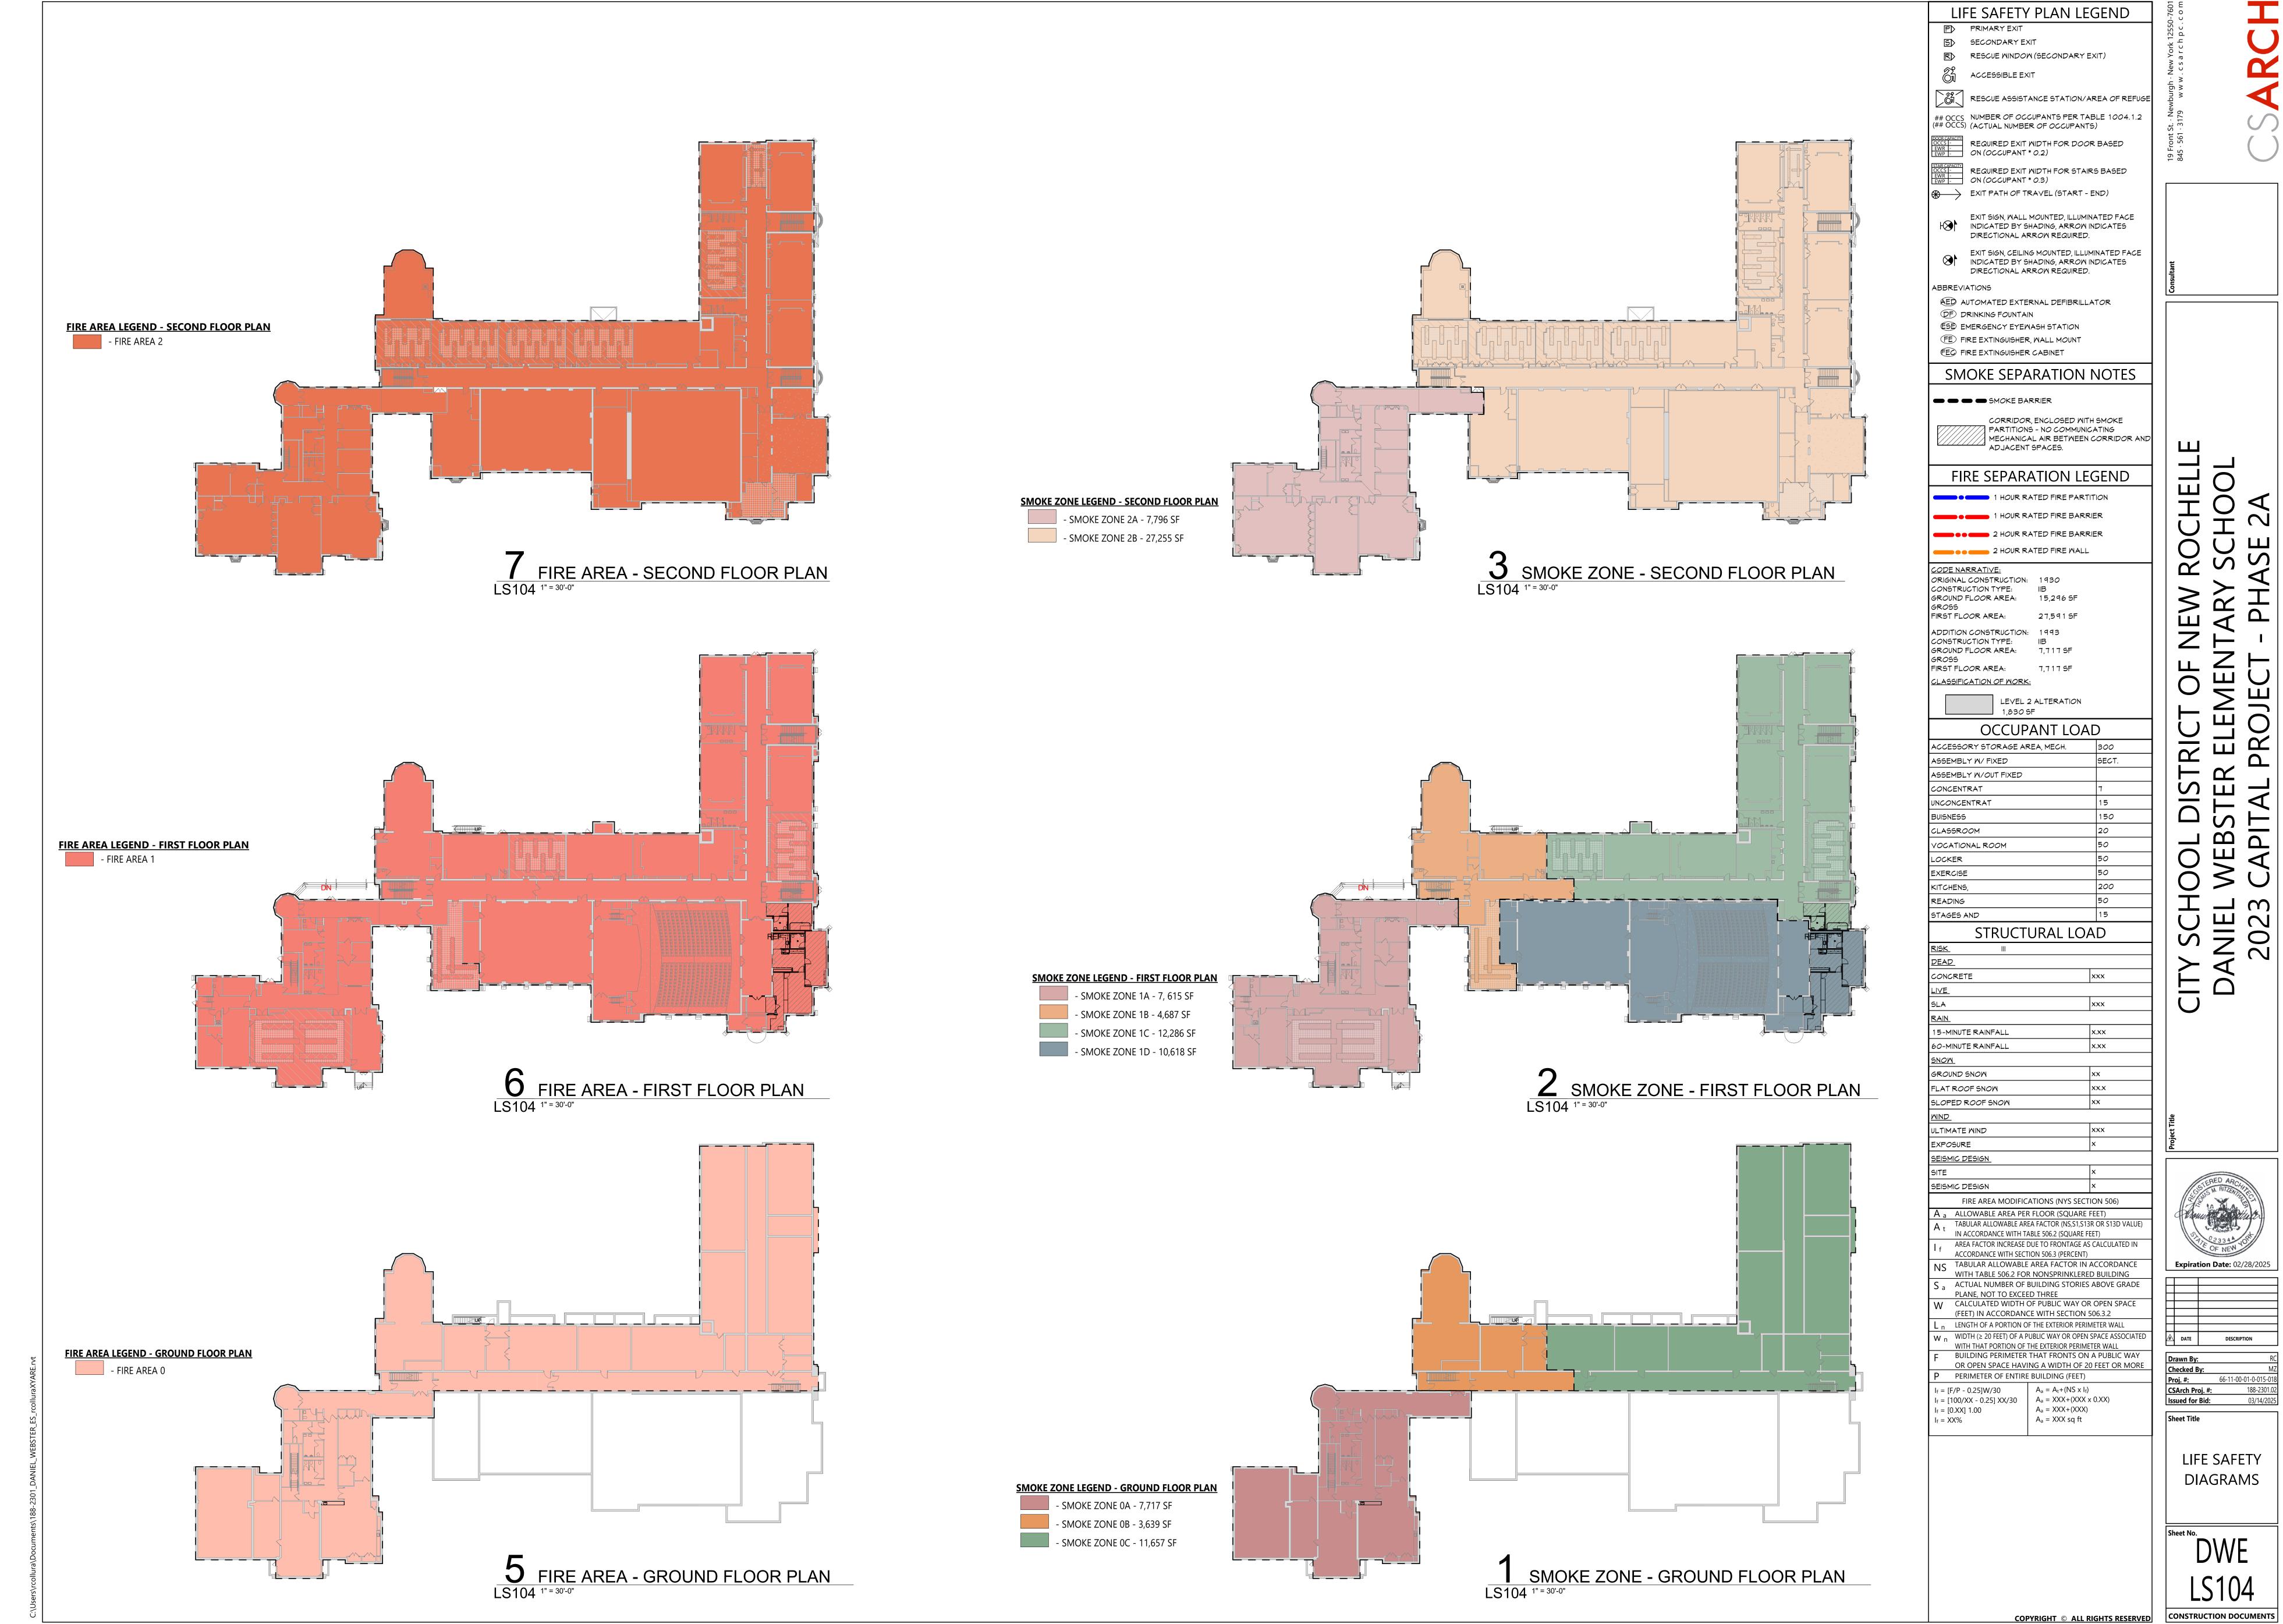

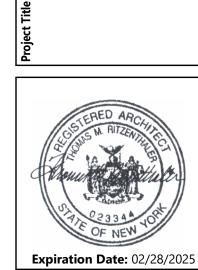Sheet Title AREA 'B' -

PARTIAL FIRST FLOOR DEMOLITION PLAN

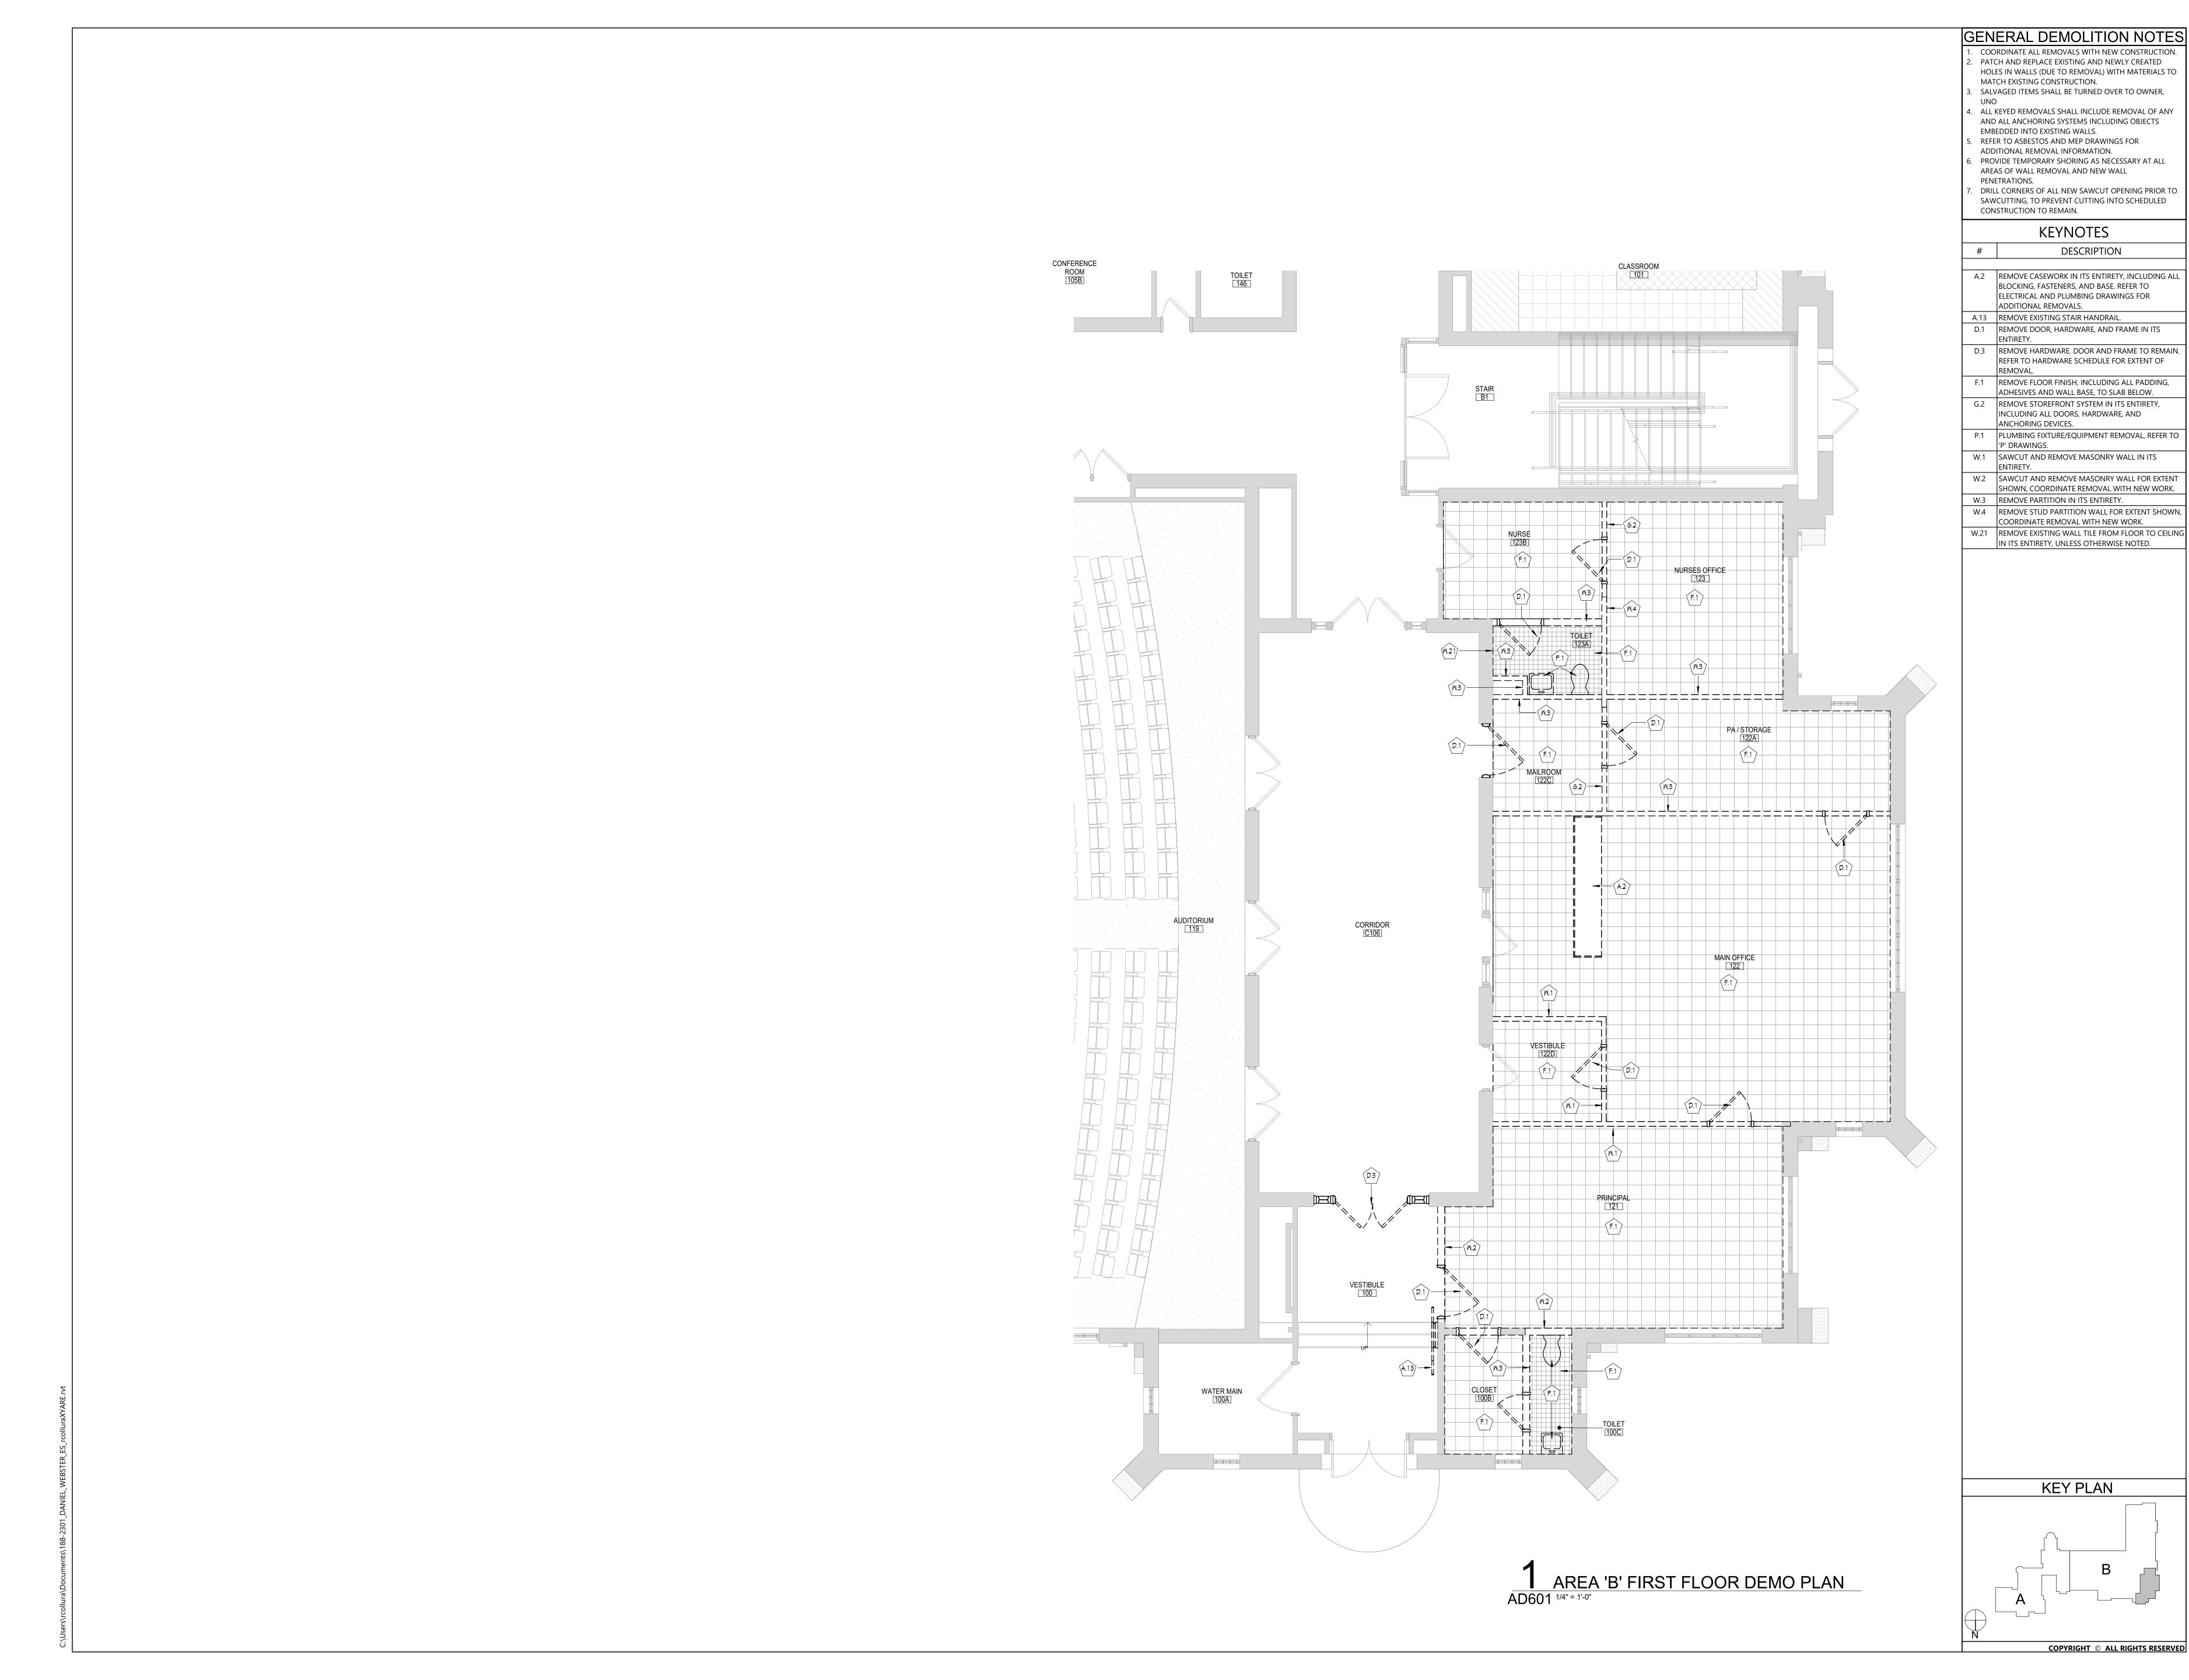

CLOF NEW KOCHELLE
LEMENTARY SCHOOL

Project Title

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Proj. #: 66-11-00-01-0-0
CSArch Proj. #: 188Issued for Bid: 03/1

ENLARGED

MAIN OFFICE

DEMOLITION

PLAN DWE

AD601

CONSTRUCTION DOCUMENTS



AREA 'B' FIRST FLOOR DEMOLITION RCP
AD812 1/4" = 1'-0"

GENERAL DEMOLITION NOTES

COORDINATE ALL REMOVALS WITH NEW CONSTRUCTION.
 PATCH AND REPLACE EXISTING AND NEWLY CREATED
HOLES IN WALLS (DUE TO REMOVAL) WITH MATERIALS TO

HOLES IN WALLS (DUE TO REMOVAL) WITH MATERIALS TO MATCH EXISTING CONSTRUCTION.

3. SALVAGED ITEMS SHALL BE TURNED OVER TO OWNER, UNO

UNO

4. ALL KEYED REMOVALS SHALL INCLUDE REMOVAL OF ANY AND ALL ANCHORING SYSTEMS INCLUDING OBJECTS EMBEDDED INTO EXISTING WALLS.

5. REFER TO ASBESTOS AND MEP DRAWINGS FOR

PROVIDE TEMPORARY SHORING AS NECESSARY AT ALL

AREAS OF WALL REMOVAL AND NEW WALL PENETRATIONS.

7. DRILL CORNERS OF ALL NEW SAWCUT OPENING PRIOR TO SAWCUTTING, TO PREVENT CUTTING INTO SCHEDULED CONSTRUCTION TO REMAIN.

ADDITIONAL REMOVAL INFORMATION.

CEILING DEMOLITION

GWB OR PIESCER TO DETAILS
AND ROOM FINISH SCHEDULE
SUSPENDED ACOUSTICAL CEILING TILE SYSTEM

CEILING HEIGHT ABOVE FINISHED FLOOR,

ELECTRICAL EQUIPMENT, REFER TO ELECTRICAL DRAWINGS FOR ADDITIONAL INFORMATION.

⊨=∃ ==== ∃ 1'x LIGHT FIXTURE ==== ∃

-(|)- PENDANT LIGHT FIXTURE

• RECESSED DOWN LIGHT

CEILING MOUNTED EXIT SIGN

CEILING MOUNTED OCCUPANCY SENSOR

S CEILING MOUNTED SMOKE DETECTOR

(H) CEILING MOUNTED HEAT DETECTOR

(\$) CEILING MOUNTED HEAT DETECTOR

(\$) CEILING MOUNTED PA SPEAKER

(J) CEILING MOUNTED SECURITY J-BOX

MS CEILING MOUNTED MOTION SENSOR

MECHANICAL EQUIPMENT, REFER TO MECHANICAL DRAWINGS FOR ADDITIONAL INFORMATION.

HVAC SUPPLY GRILLE

CEILING MOUNTED DATA J-BOX

HVAC RETURN GRILLE

KEYNOTES DESCRIPTION

C.1 REMOVE EXISTING SUSPENDED CEILING SYSTEM IN ITS ENTIRETY, INCLUDING ALL HANGERS AND FASTENERS.
REFER TO ELECTRICAL AND MECHANICAL DRAWINGS FOR EQUIPMENT REMOVALS.

C.2 REMOVE EXISTING PLASTER CEILING SYSTEM IN ITS ENTIRETY, INCLUDING ALL FRAMING AND FASTENERS. REFER TO ELECTRICAL AND MECHANICAL DRAWINGS FOR EQUIPMENT REMOVALS.

KEY PLAN

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FOR EQUIPMENT REMOVALS.


E.1 LIGHT FIXTURE REMOVAL, REFER TO 'E' DRAWINGS AND ABATEMENT DRAWINGS AND REPORT.

AND ABATEMENT DRAWINGS AND REPORT.

E.2 ELECTRICAL REMOVAL, TYPICAL REFER TO 'E'
DRAWINGS.

Y SCHOOL DISTRICT
ANIEL WEBSTER ELEN

Project Title

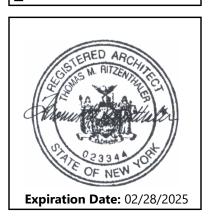

DATE DESCRIPTION

Drawn By:
Checked By:
Proj. #: 66-11-00-01-0-015-0

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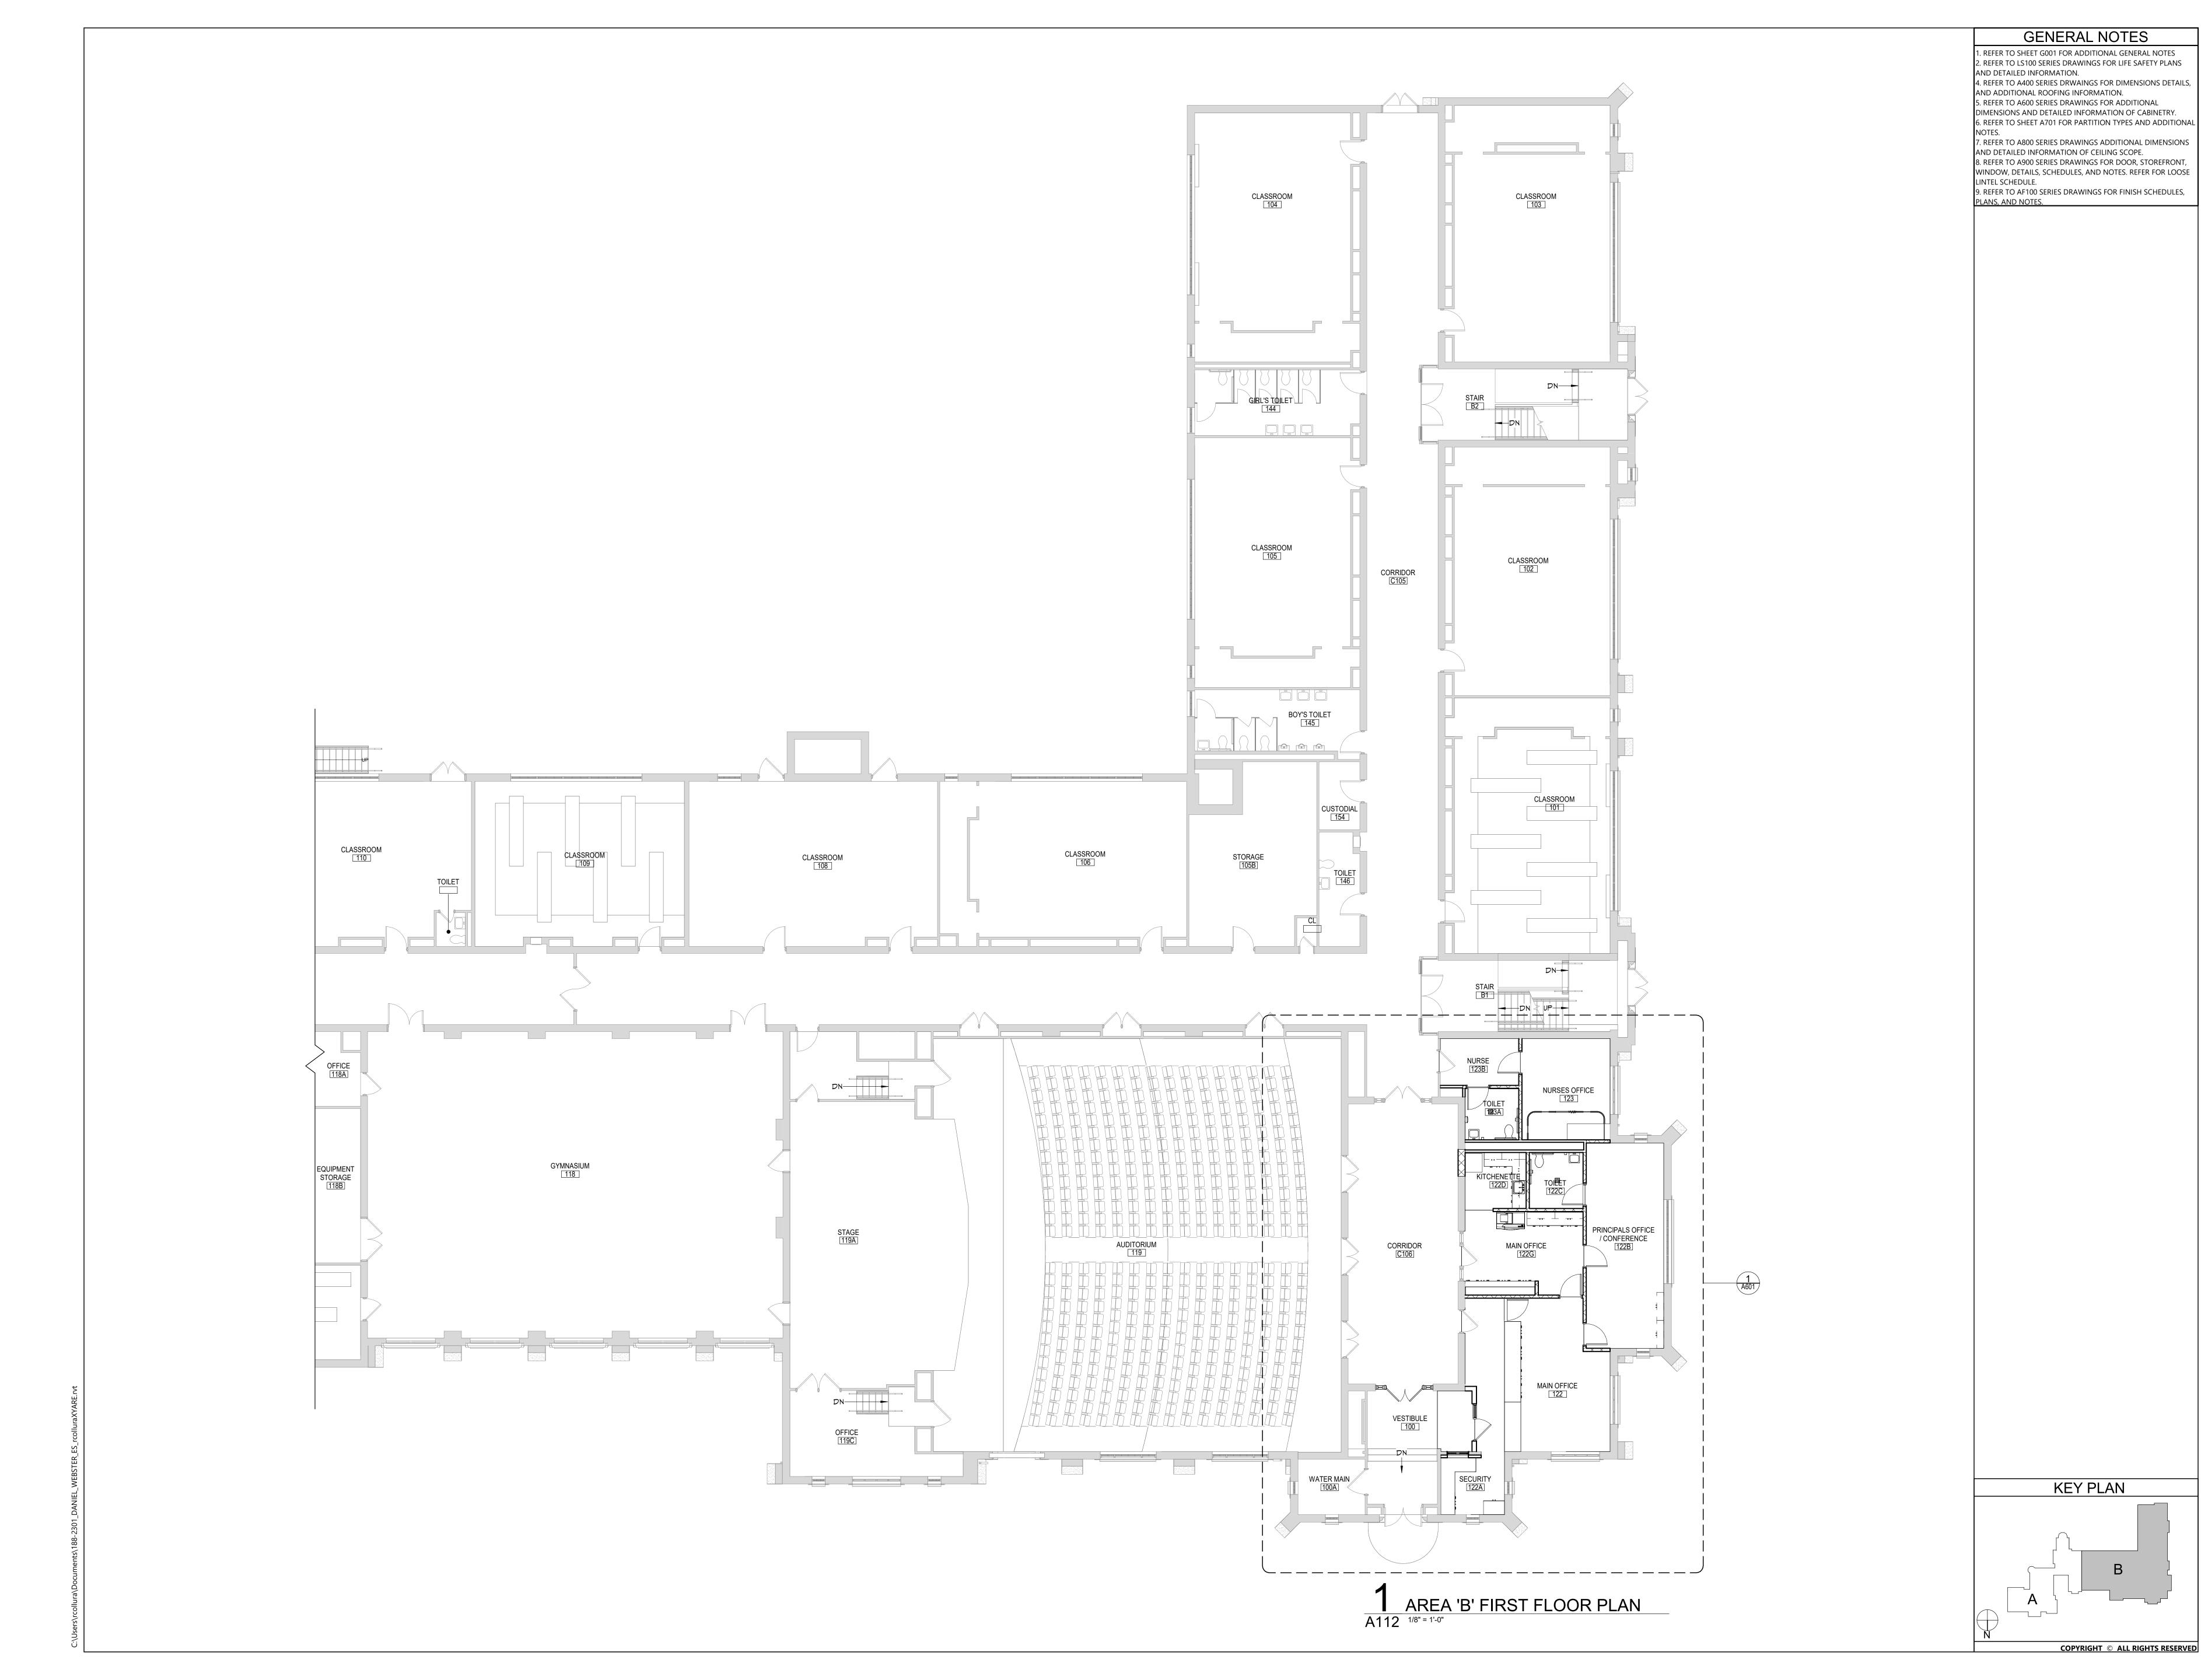
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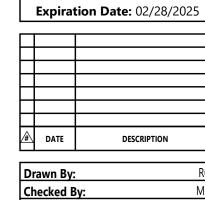
AREA 'B'

AREA 'B'
PARTIAL FIRST
FLOOR DEMO
RCP


DWE AD812



Expiration Date: 02/28/2025



AREA 'B' -PARTIAL FIRST FLOOR PLAN

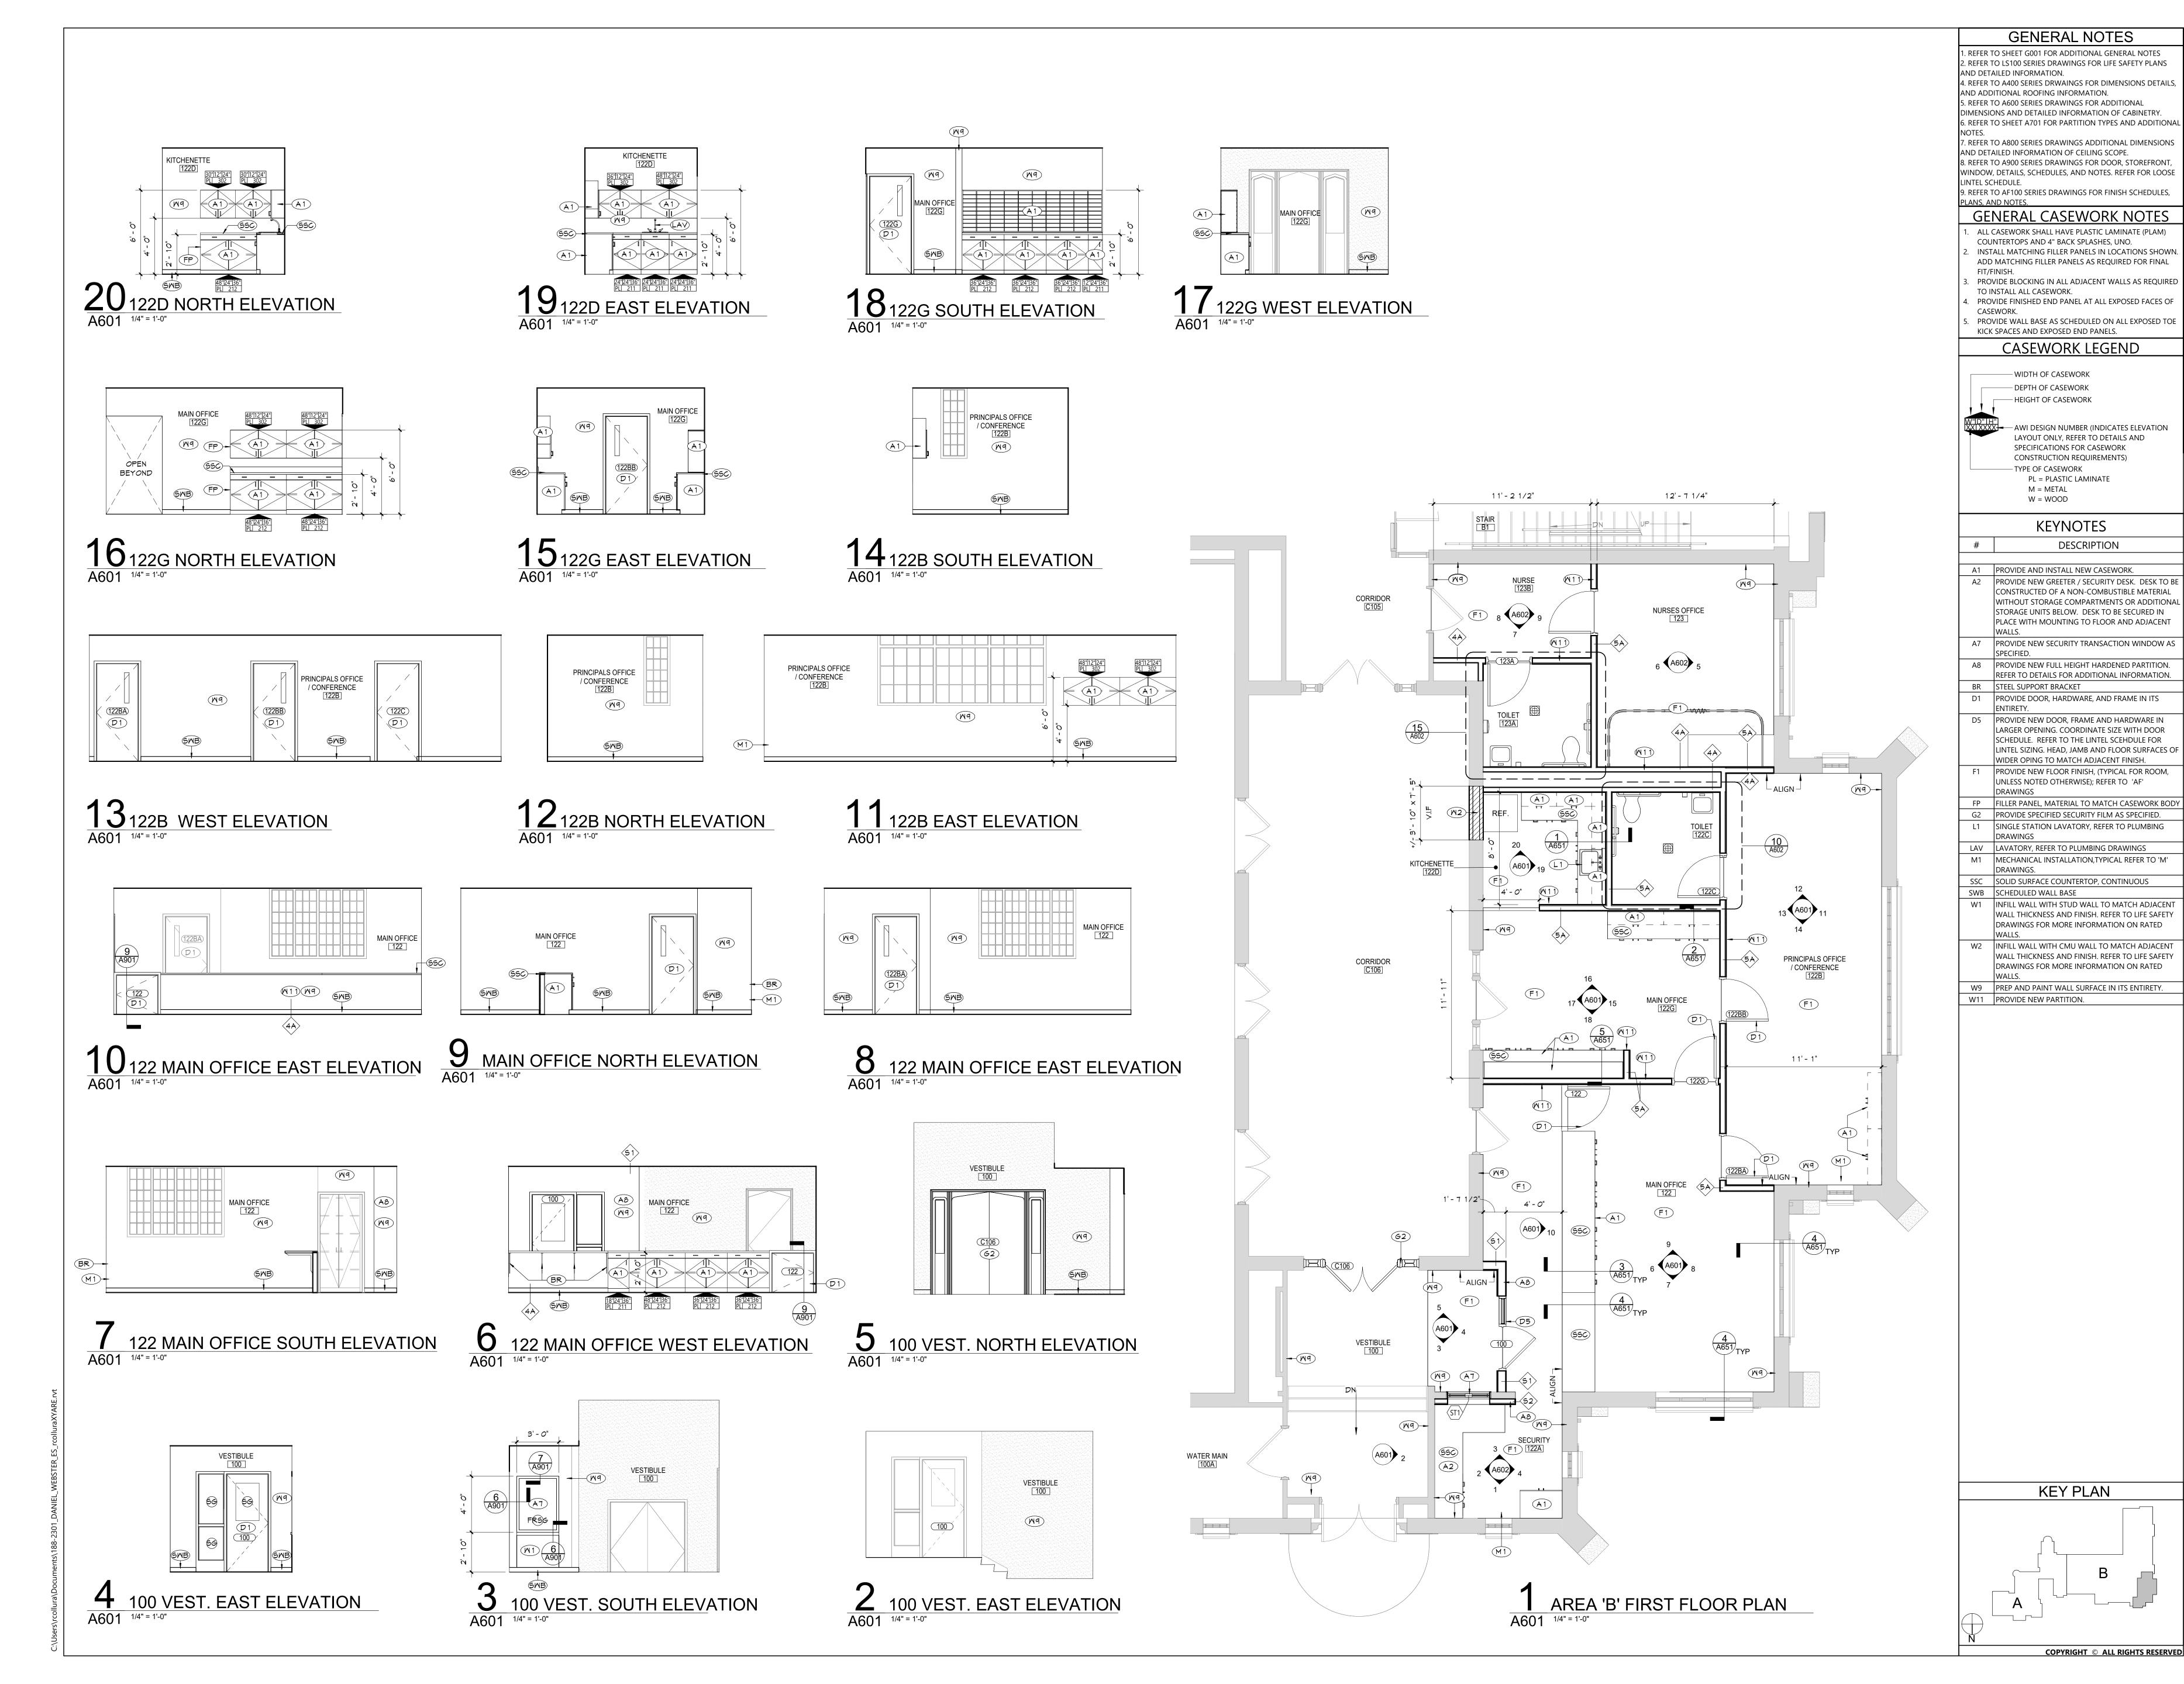

Expiration Date: 02/28/2025

ENLARGED PLANS AND INTERIOR

ELEVATIONS

3 122A NORTH ELEVATION

5 123 EAST ELEVATION A602 1/4" = 1'-0"

4 122A EAST ELEVATION
A602 1/4" = 1'-0"

Expiration Date: 02/28/2025

Sheet Title ENLARGED PLANS,

INTERIOR ELEVATIONS, AND DETAILS


A602

CONSTRUCTION DOCUMENTS

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122A SOUTH ELEVATION
A602 1/4" = 1'-0"

122A WEST ELEVATION

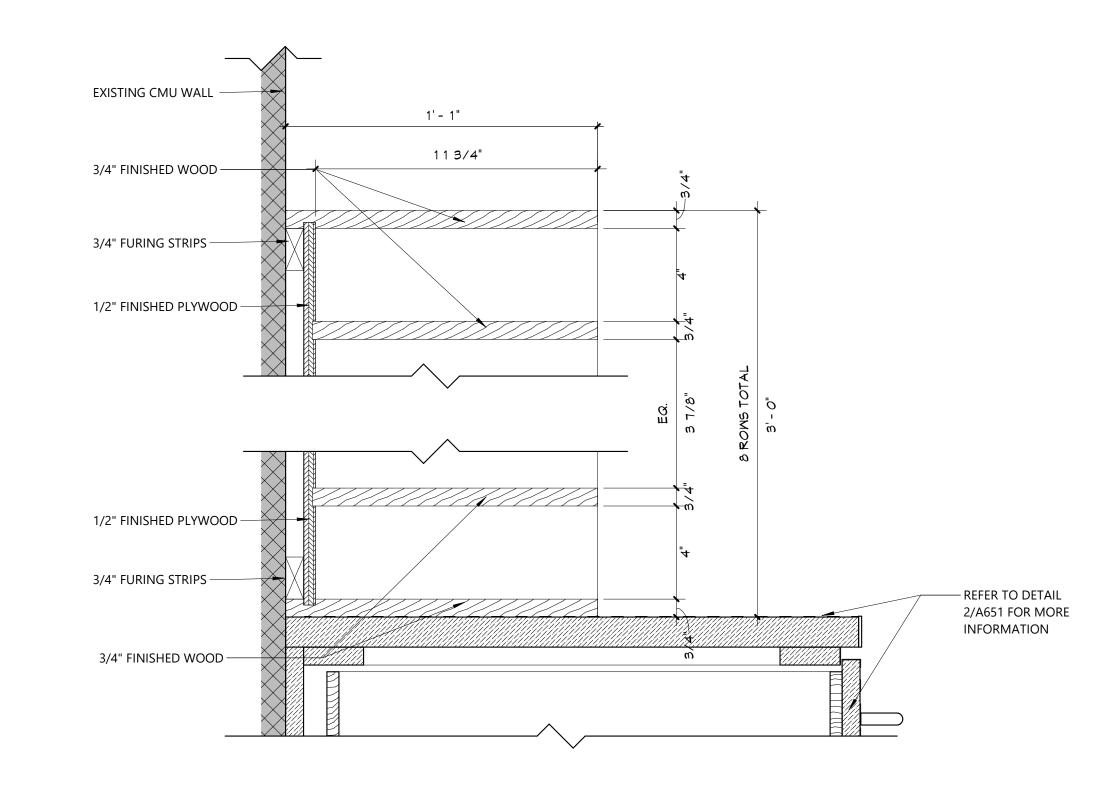

MAILBOX DETAIL
A651 6" = 1'-0"

1'-0" (UNO)

– 3/4" X 2-1/2" WOOD STRETCHER CLEAT TOP AND BOTTOM

SIDES, TOP AND BOTTOM PLASTIC LAMINATE ON

3/4" PARTICLE BOARD WITH PLASTIC LAMINATE

MELAMINE FACED 1/4" HARDBOARD, FULL

10 INCHES DEEP MELAMINE COVERED 3/4"

PARTICLE BOARD WITH 1mm EDGE BAND.

FRONT EDGE WITH RECESSED BOTTOM:

5mm MULTIPLE HOLE PIN SUPPORTS AT 1" ON

CENTER. (NOTE: AT CABINET SPANS 30" OR MORE

PLASTIC LAMINATE ON 3/4" PARTICLE BOARD WITH

PLASTIC LAMINATE ON 2" X 3/4" PARTICLE BOARD.

SELF EDGE BAND. PLASTIC LAMINATE BALANCED INTERIOR

- SOLID SURFACE. ADHERE TO WALL

SOLID SURFACE COUNTERTOP.

— 3/4" X 2-1/2" WEB FRAME.

— DRAWER FRONT:

DRAWER BOX:

- CABINET BODY:

TOE KICK:

CABINET AT ADJACENT SIDEWALLS, TYP.

PLASTIC LAMINATE AT VISIBLE EDGE.

AND CAULK AS REQUIRED. RETURN TO FRONT OF

PLASTIC LAMINATE ON 3/4" PARTICLE BOARD WITH

1/4" PLYWOOD BOTTOM SET IN DADO AT ALL SIDES.

PLASTIC LAMINATE ON 3/4" PARTICLE BOARD

WITH PLASTIC LAMINATE SELF EDGE. .

3/4" PARTICLE BOARD. RUBBER BASE BY

CENTER IN CABINETS GREATER THAN

- WOOD OR PANEL PRODUCT STRETCHERS ON

FLOORING CONTRACTOR.

30 INCHES WIDE.

SELF EDGE (ALL DOOR AND DRAWERS ONLY.

1/2" SOLID HARDWOOD SIDES WITH

- CABINET BODY:


- CABINET BACK:

RABBET BOUND.


- ADJUSTABLE SHELF:

SHELF SHALL BE 1" THICK)

6 MAILBOX DETAIL
A651 3" = 1'-0"

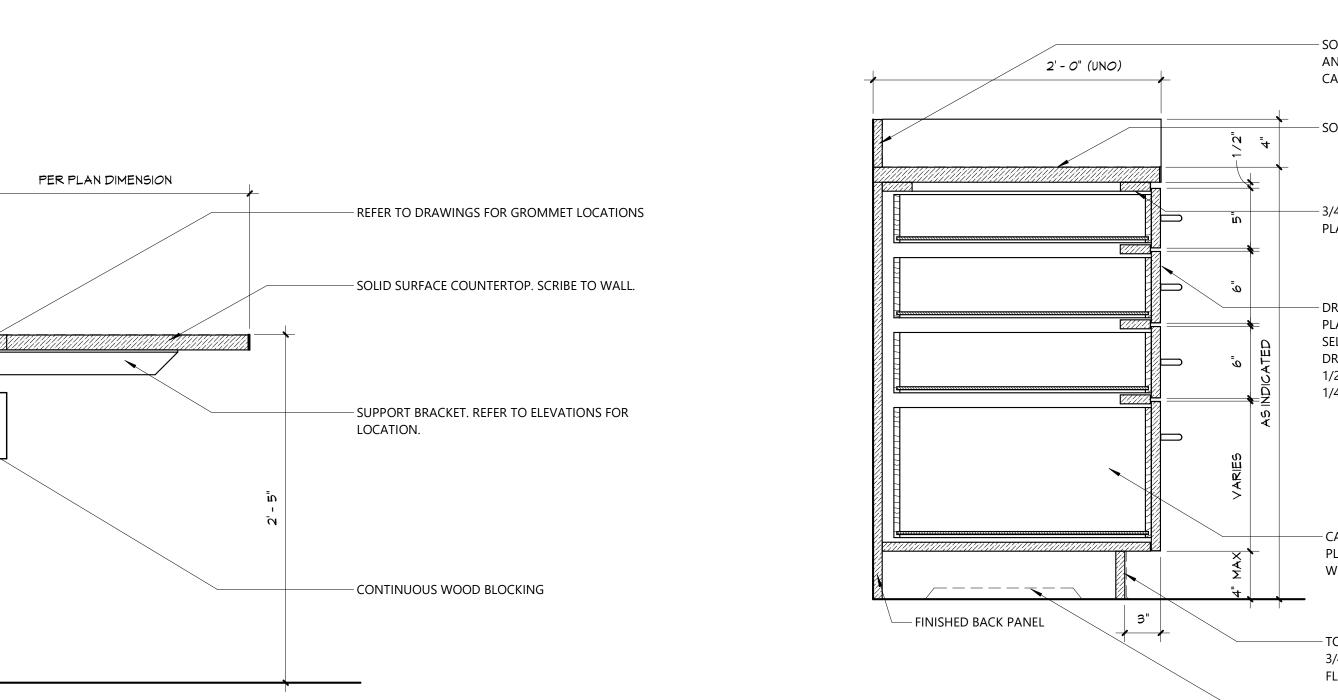

CASEWORK DETAIL
A651 1 1/2" = 1'-0"

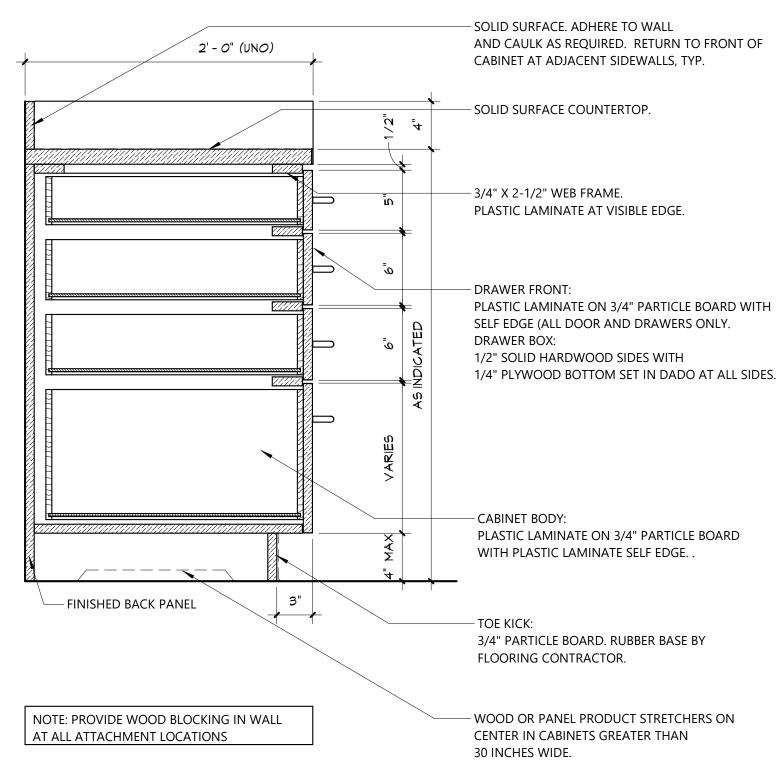

CASEWORK DETAIL


A651 1 1/2" = 1'-0"

HOLD BACK PANEL

AT ALL ATTACHMENT LOCATIONS

CLEAR OF FLOOR.

NOTE: PROVIDE WOOD BLOCKING IN WALL

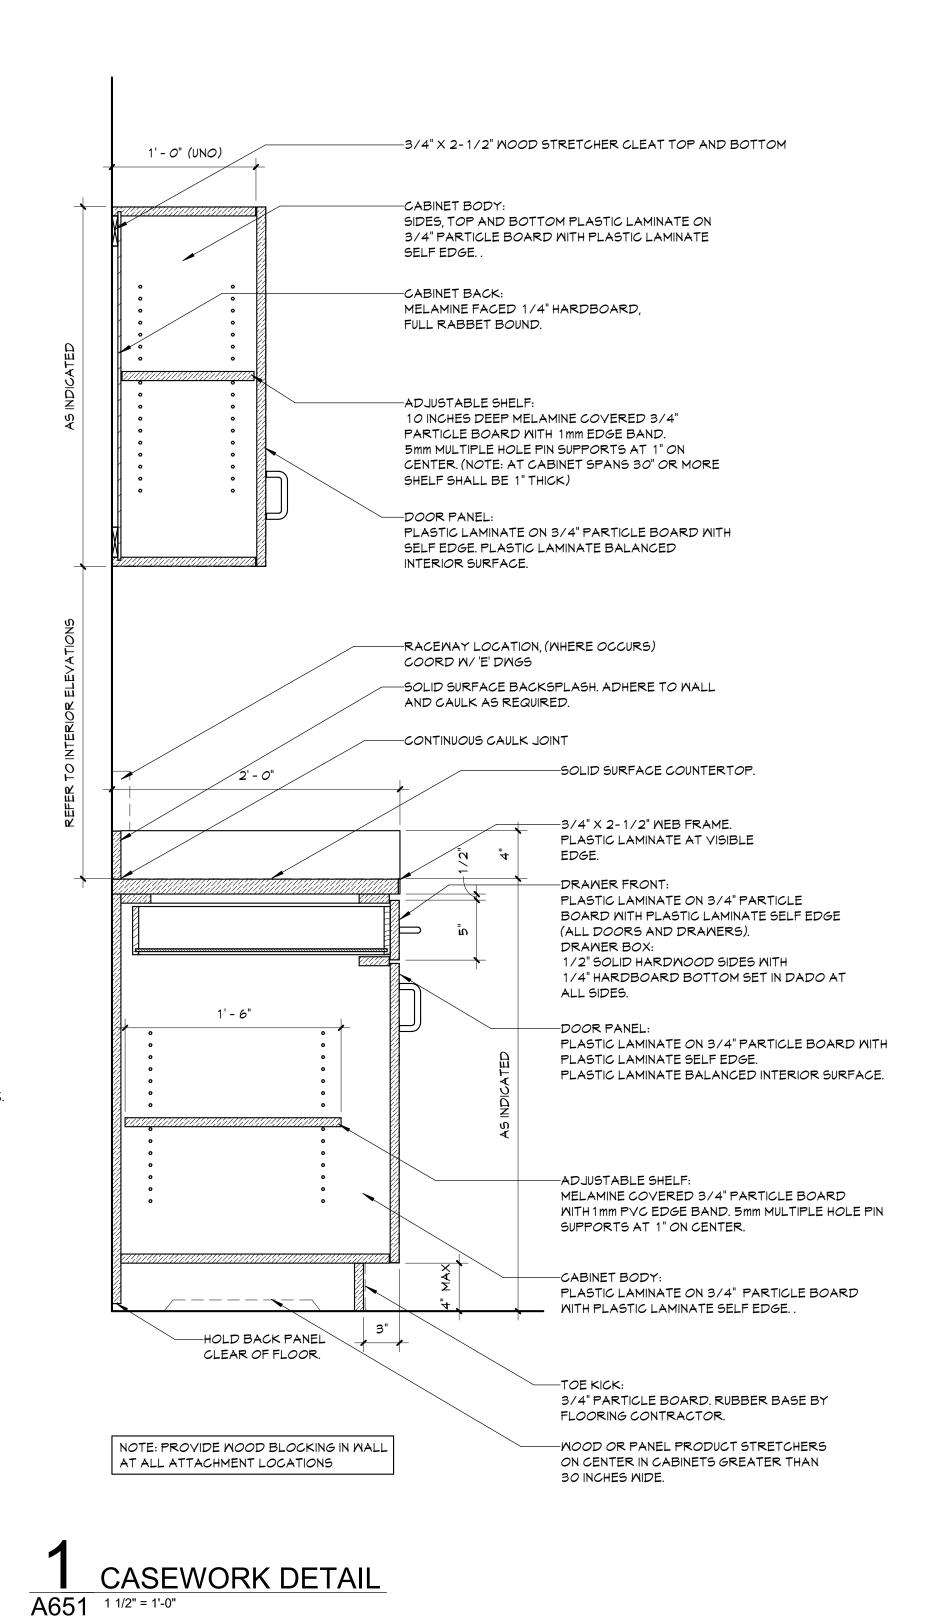

2' - 0" (UNO)

 Checked By:
 MZ

 Proj. #:
 66-11-00-01-0-015-018

 CSArch Proj. #:
 188-2301.02

 Construction Documents:
 04/08/2024
 Sheet Title **CASEWORK DETAILS**


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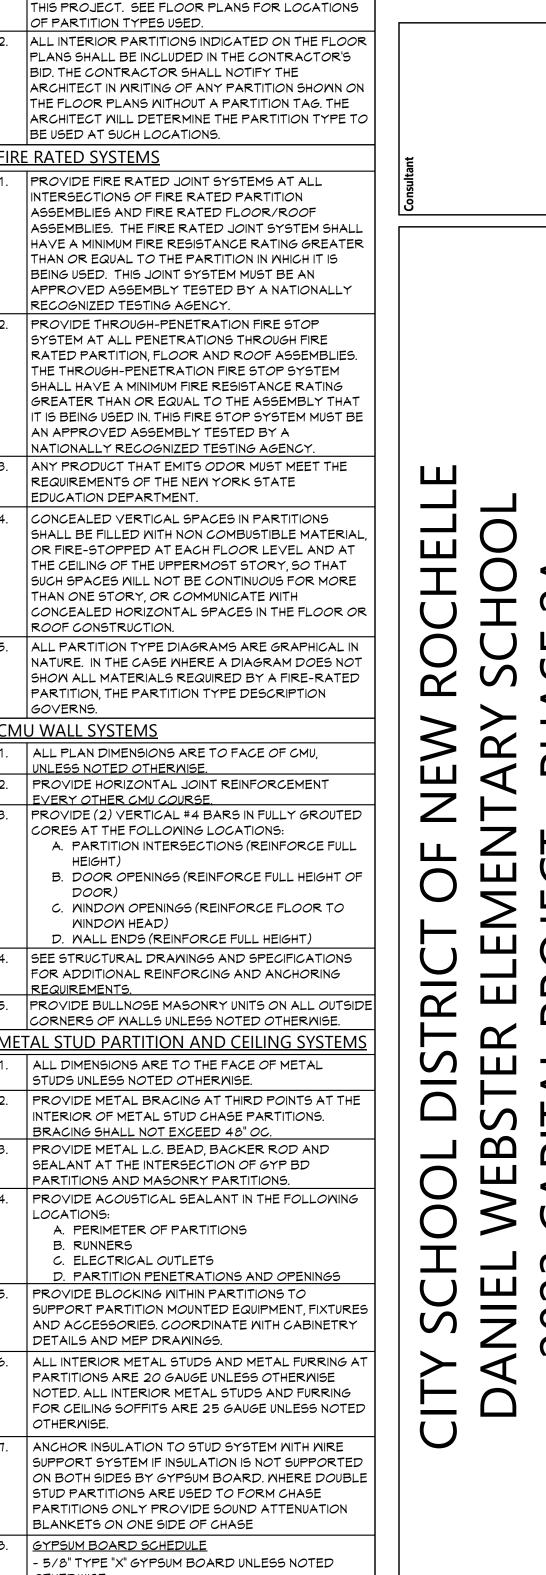
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DWE CONSTRUCTION DOCUMENTS

4 COUNTER DETAIL
A651 1 1/2" = 1'-0"





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AREA

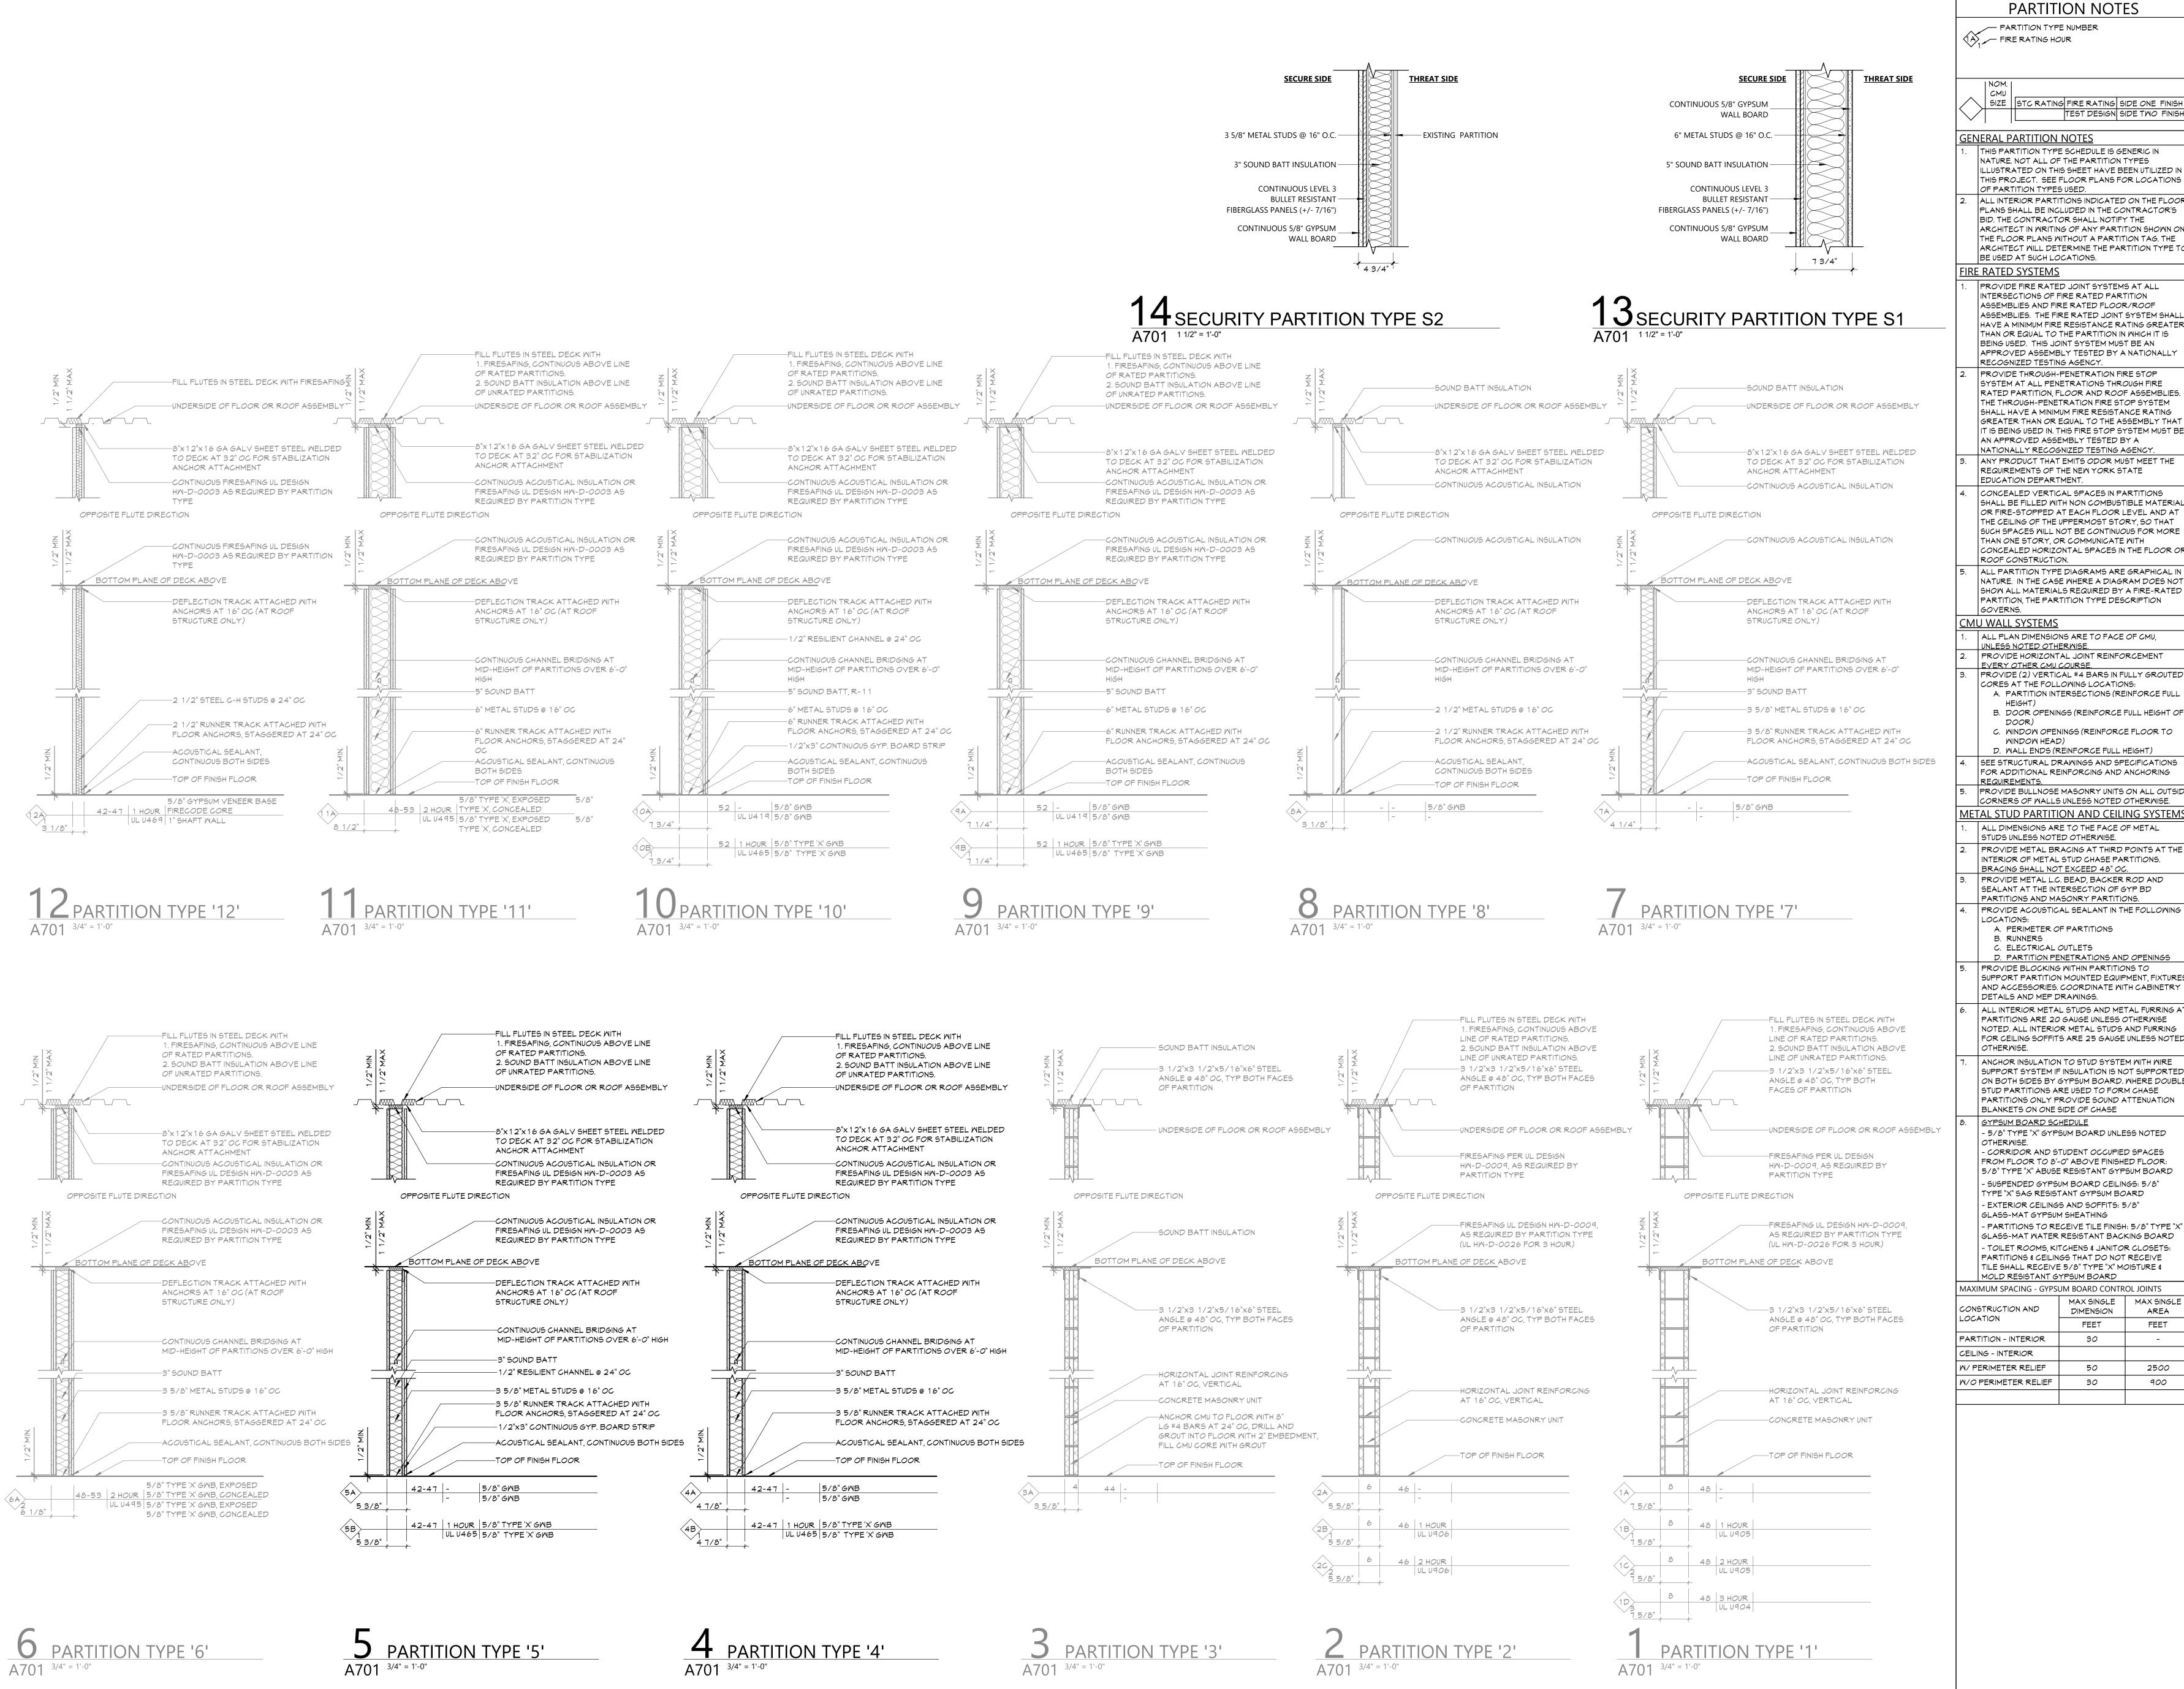
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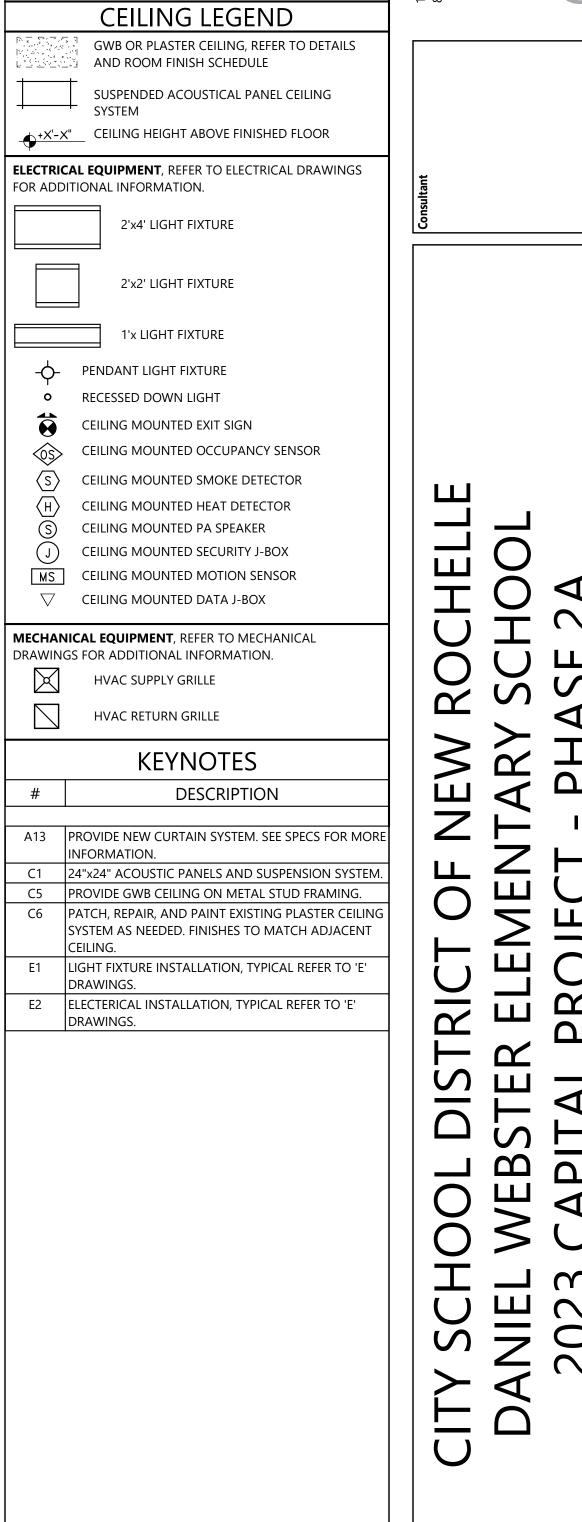
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PARTITION TYPES

DWE





CEILING NOTES

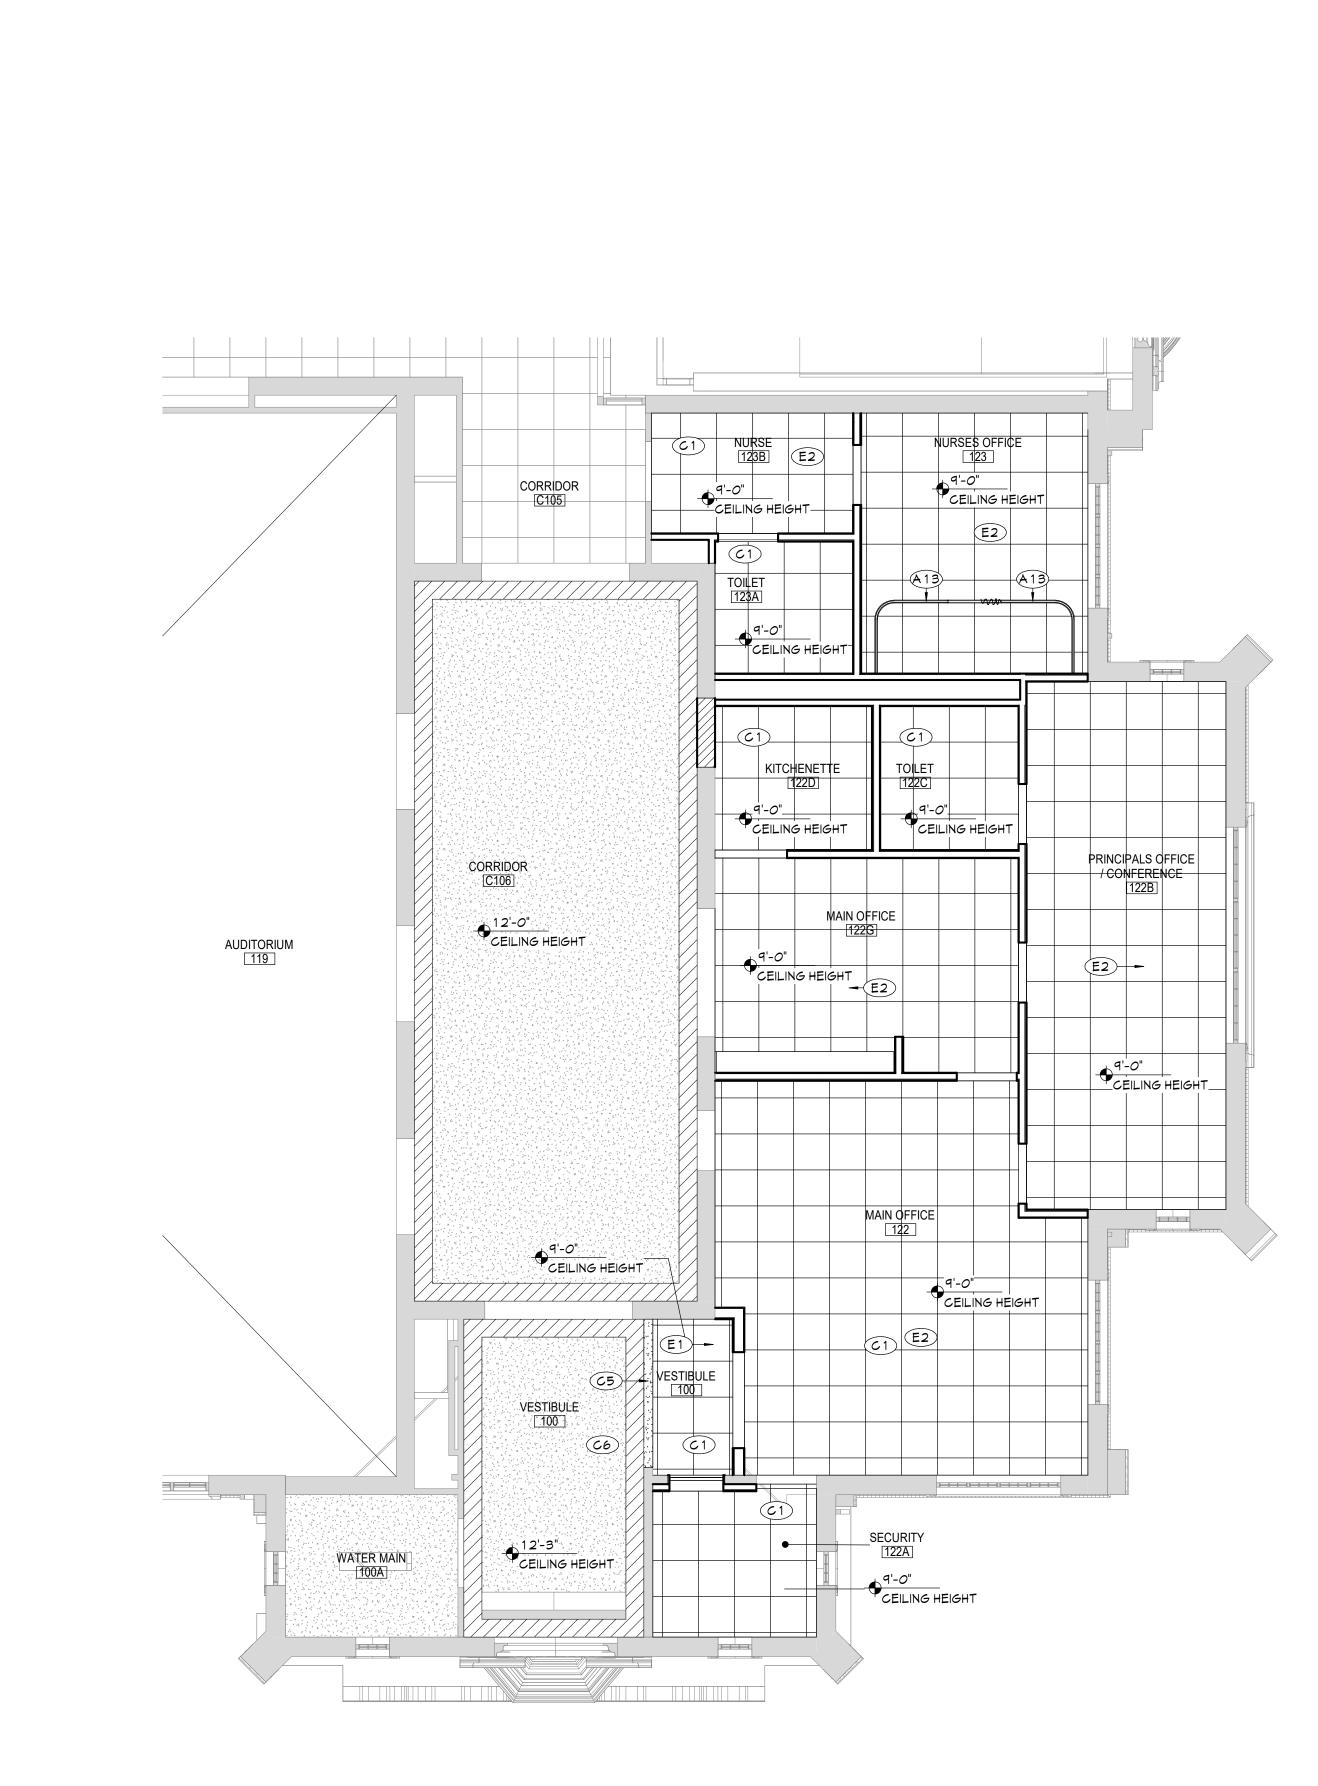. INSTALL CEILING GRIDS CENTERED IN THE ROOM, UNO. IN ROOMS OTHER THAN RECTANGULAR SHAPED, INSTALL GRIDS CENTERED ON WALLS OR OTHER BUILT FEATURES AS

INSTALLATION HEIGHTS OF THE CEILINGS MAY VARY SLIGHTLY FROM PLANS IN ROOMS WITH EXTERIOR

. FINAL INSTALLED CEILINGS SHALL HAVE HEIGHTS

APPROVED BY THE ARCHITECT.

WINDOWS. ACTUAL CEILING HEIGHT TO BE VERIFIED IN THE

COORDINATED WITH OTHER CONTRACTORS WITH ABOVE CEILING WORK AND VERIFIED WITH FIELD CONDITIONS. ALL CHANGES IN CONFIGURATION OR HEIGHTS ARE TO BE

Expiration Date: 02/28/2025

AREA 'B' -FIRST FLOOR **NEW WORK**


CONSTRUCTION DOCUMENTS

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KEY PLAN

1/4" = 1'-0"

									D	OOR	SCHE	DULE	- All								
						DOOR							FRAME						7	O	
DOOR NUMBER	QUANTITY	FROM	ТО	WIDTH	HEIGHT	THICKNESS	TYPE	MATERIAL	FINISH	TYPE	MATERIAL	FINISH	HEAD DETAIL	JAMB DETAIL	SILL DETAIL	LABEL (MIN)	GLAZING	HARDWARE	MAG HOLD-OPEN	ACCESS CONTR SS SS	DOOR NUMBER
100	Ī ₁	VESTIBULE	MAIN OFFICE	3' - 0"	7' - 0"	1 3/4"	G	WD	FF	2	НМ	ТРТ	1/A901	2/A901		20	SG	35.0	L	YES	100
122	1	MAIN OFFICE		3' - 0"	2' - 10"	1 3/4"	lF	WD	FF	1	HM	PT	9/A901	8/A901	-	120		36.0	_		122
122BA	1		PRINCIPALS OFFICE / CONFERENCE		7' - 0"	1 3/4"	N	WD	FF	1	НМ	PT	2/A901	1/A901	-	-	LM	37.0	-	-	122BA
122BB	1		PRINCIPALS OFFICE / CONFERENCE		7' - 0"	1 3/4"	N	WD	FF	1	НМ	PT	2/A901	1/A901	-	-	LM	38.0	-	-	122BB
122C	1	TOILET	PRINCIPALS OFFICE / CONFERENCE	3' - 0"	7' - 0"	1 3/4"	F	WD	FF	1	НМ	PT	2/A901	1/A901	-	-	LM	39.0	-	-	122C
122G	1	MAIN OFFICE	MAIN OFFICE	3' - 0"	7' - 0"	1 3/4"	N	WD	FF	1	НМ	PT	2/A901	1/A901	-	-	LM	40.0	-	-	122G
123A	1	NURSE	TOILET	3' - 0"	7' - 0"	1 3/4"	F	WD	FF	1	НМ	PT	2/A901	1/A901	-	-	LM	41.0	-	-	123A
C106	PR	VESTIBULE	CORRIDOR	5' - 2"	7' - 0"	1 3/4"	G	ETR		ETR	ETR	ETR	-	-	-	-		42.0		APPLY SECURITY FILM TO EXISTING GLAZING	C106
C107	1	NURSE	NURSES OFFICE	3' - 0"	7' - 0"	1 3/4"	N	WD	FF	1	НМ	PT	2/A901	1/A901	-	-	LM	43.0	-	-	C107
Grand total	al: 9																				

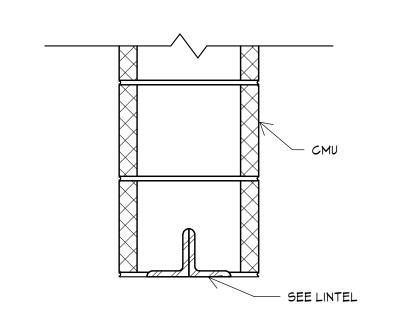

STEEL ANGL		
MASONRY OPENING	ANGLE SIZE	LABEL
UP TO	L3 1/2" x 3	L
OVER 4'-0" TO	L4" x 3 1/2" x	L
OVER 5'-0" TO	L4" x 3 1/2" x	L
OVER 6'-0" TO	L6" x 3 1/2" x	L

10 LOOSE LINTEL SCHEDULE

A901 1 1/2" = 1'-0"


NOTES:
1. PROVIDE 1 ANGLE FOR EACH 4" OF MASONRY WIDTH.
2. BEAR LINTELS 6" MINIMUM EACH END OF OPENING.


- BEAR LINTELS 6" MINIMUM EACH END OF OPENING.
 PROVIDE SOLID MASONRY AT LINTEL BEARING.
 WHERE LINTEL BEARING INTERFERES WITH CONTROL JOINT PLACEMENT, PROVIDE FLEXIBLE CAULK JOINT AT THIS LOCATION.
 ALL EXTERIOR/EXPOSED LINTELS ARE TO BE HOT-DIP GALVANIZED.
- 7. CONSULT THE ENGINEER TO CONFIRM LINTEL REQUIREMENTS WHEN THE LINTEL SIZE IS NOT SHOWN ON PLAN AND ONE OF THE FOLLOWING

SEE ARCH AND MECH DRAWINGS FOR SIZE AND LOCATION OF

- A. WHEN LINTEL OPENING OCCURS IN BEARING WALLS.
 B. THE HEIGHT OF CMU ABOVE LINTEL IS LESS THAN THE OPENING WIDTH.
 C. A CONTROL JOINT IS LOCATED DIRECTLY ABOVE OR WITHIN
- 16" OF THE JAMB OPENING.

 8. PLANS DO NOT SHOW THE FULL SCOPE OF STEEL LINTELS REQUIRED FOR NEW WALL OPENINGS FOR DOORS, WINDOWS, DUCTS, LOUVERS, ETC. FOR MASONRY OPENING SIZE, SEE ARCH AND MECH DRAWINGS.

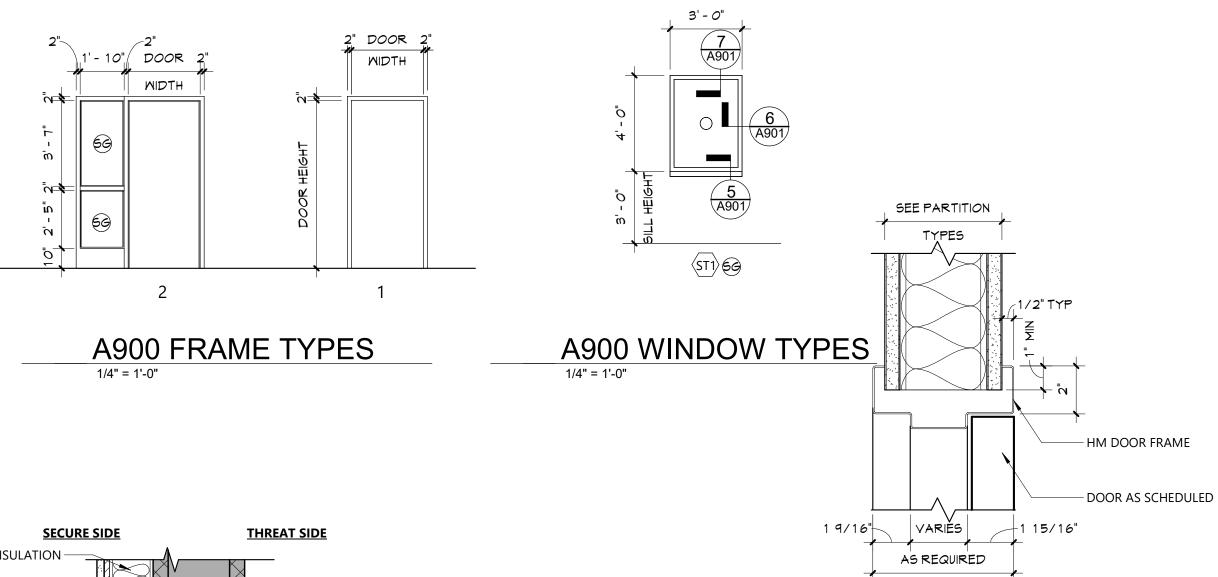


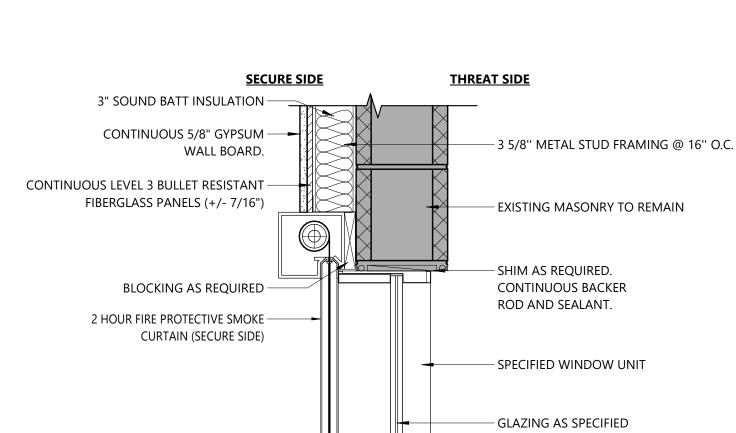


HEAD DETAIL - SECURITY WINDOW


A901 1 1/2" = 1'-0"


4 HEAD DETAIL
A901 3" = 1'-0"

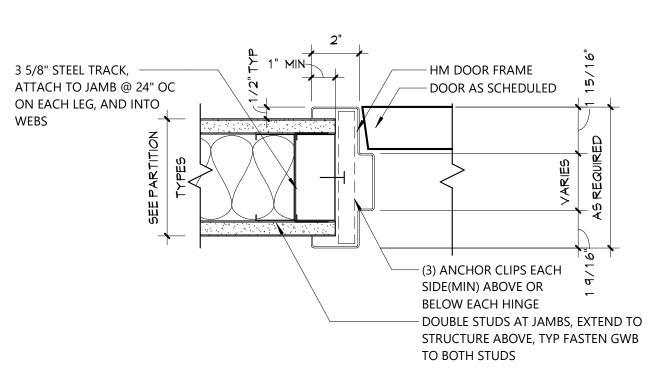


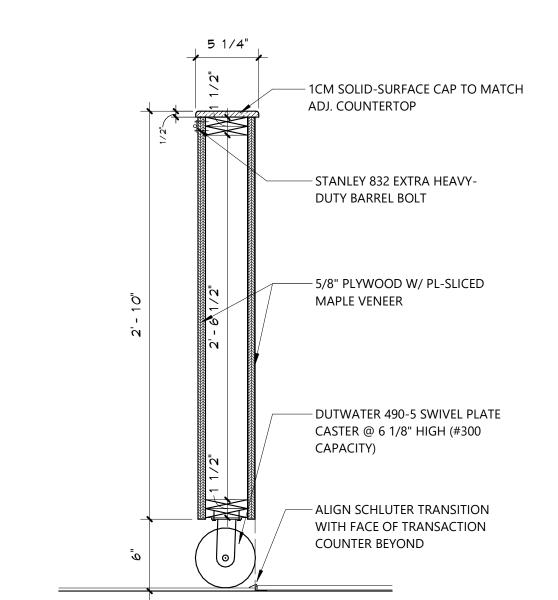




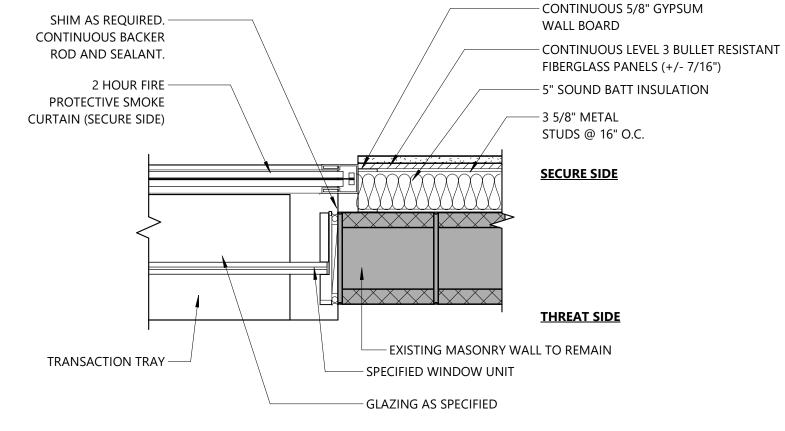


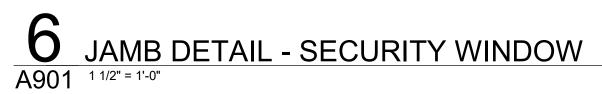

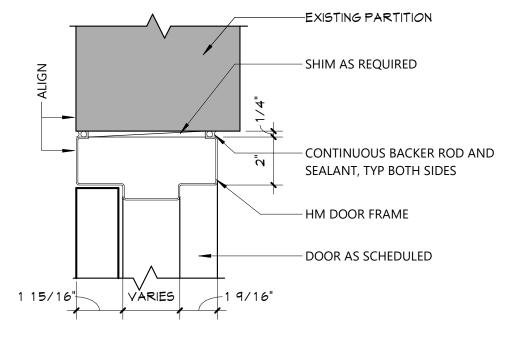


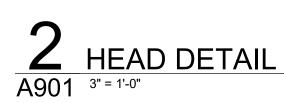


3 JAMB DETAIL A901 3" = 1'-0"

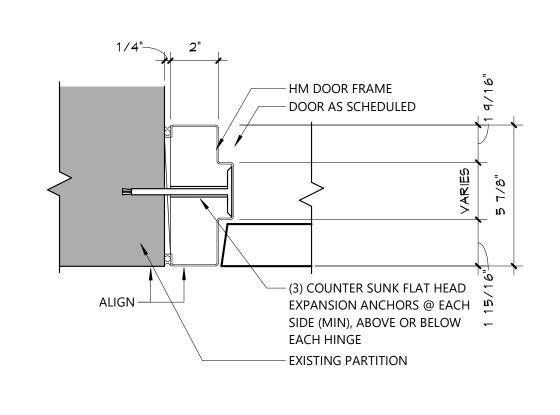


1	JAMB	DETAIL	
901	3" = 1'-0"		

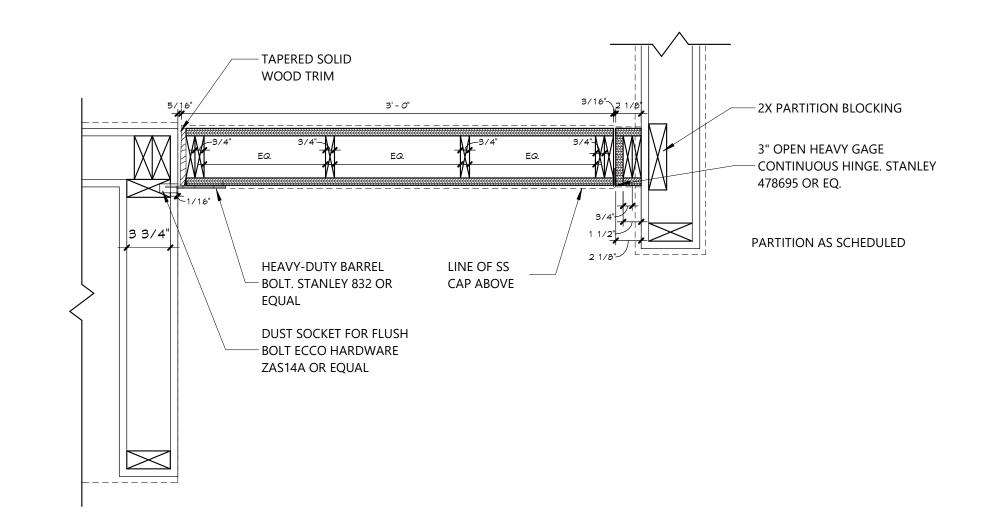

8 COUNTER DOOR DETAIL
A901 11/2" = 1'-0"

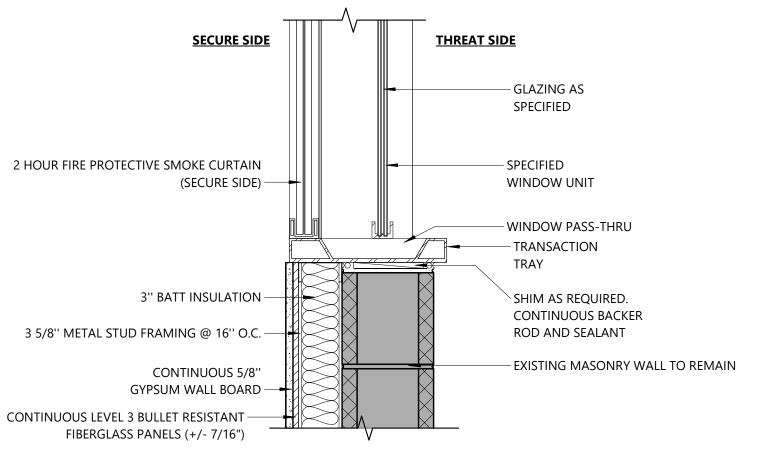

5 SILL DETAIL - SECURITY WINDOW
A901 11/2" = 1'-0"

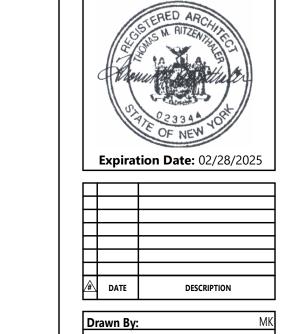

Sheet Title

DOOR

SCHEDULE,

ELEVATIONS,

AND DETAILS

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CSArch Proj. #:

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A901

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GLAZING TYPES

FRSG FIRE RATED SECURITY GLASS

FR FIRE RATED GLASS

LM LAMINATED GLASS


FT FULLY TEMPERED GLASS


SECURITY GLASS


SPANDREL GLASS

CLEAR INSULATED GLASS

MATERIALS LEGEND								
MATERIAL	MANUFACTURER	MODEL	COLOR #/NAME	SIZE	NOTE			
CERAMIC TILE	RASE							
CTB-1	DALTILE	COLOR WHEEL LINEAR - COVE	X114 DESERT GRAY GLOSSY	4" X 12"	TYP. BASE @ TOILETS			
CTB-2	DALTILE		AS SELECTED FROM FULL RANGE OF COLOR / MATCH EXISTING		PATCH CORRIDOR			
CERAMIC WAL	I TII F							
CWT-1	DALTILE	COLOR WHEEL LINEAR	0190 ARCTIC WHITE GLOSSY	6"X18"	TYP. WALL TILE @ TOILETS			
CWT-2	DALTILE	COLOR WHEEL LINEAR	X114 DESERT GRAY GLOSSY	6"X18"	TYP. WALL TILE @ TOILETS			
FD0)/// FL00D			•		<u> </u>			
EPF-1	STONHARD	STONBLEND	CRUSHED SLATE	SEAMLESS	TYP. FLOOR @ TOILETS			
LUXURY VINYL	TILE	,						
LVT-1	MOHAWK GROUP	MATUTO PLUS STONE	915A FROSTBITE STONE	12" X 24"	TYP. FLOOR			
PAINT								
PNT-1	SHERWIN WILLIAMS	EGGSHELL	SW 7064 PASSIVE		TYP. WALL			
PNT-2	SHERWIN WILLIAMS	EGGSHELL	SW 9147 FAVORITE JEANS		ACCENT WALL PAINT			
PNT-3	SHERWIN WILLIAMS	EGGSHELL	AS SELECTED FROM FULL RANGE OF COLOR / MATCH EXISTING		PATCH @ CORRIDOR/ VESTIBULE			
PNT-5	SHERWIN WILLIAMS	SEMI-GLOSS	SW 7650 ELLIE GRAY		HM DOOR FRAMES			
PLASTIC LAMIN	NATF							
PLAM-1	WILSONART	PLASTIC LAMINATE	FAWN CYPRESS		CASEWORK			
	•							
RUBBER BASE				T				
RB-1	TARKETT/ JOHNSONITE	BASEWORKS	COLONIAL GRAY	4"	TYP. BASE			
SOLID SURFAC	Œ							
SS-1	WILSONART	SOLID SURFACE	BLUESTONE 9074EA	1	COUNTERTOPS			

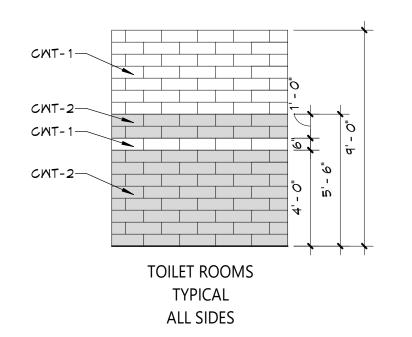

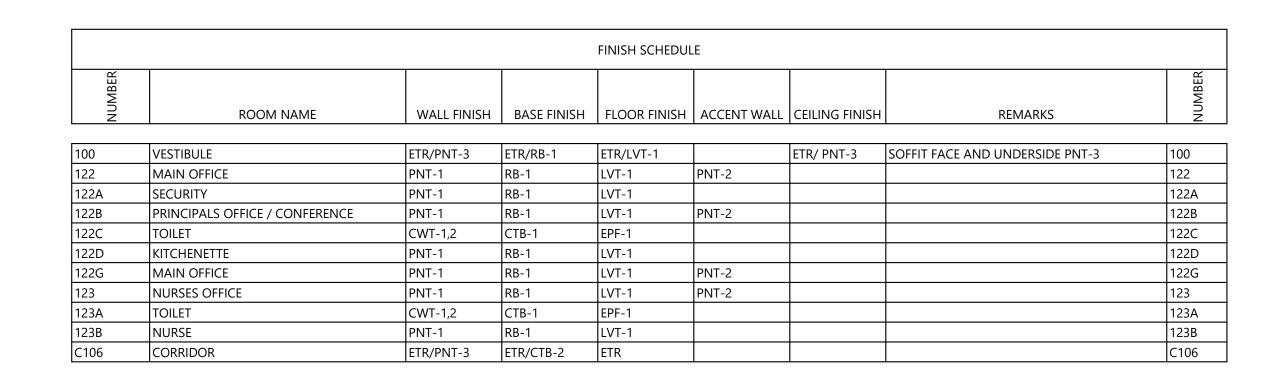

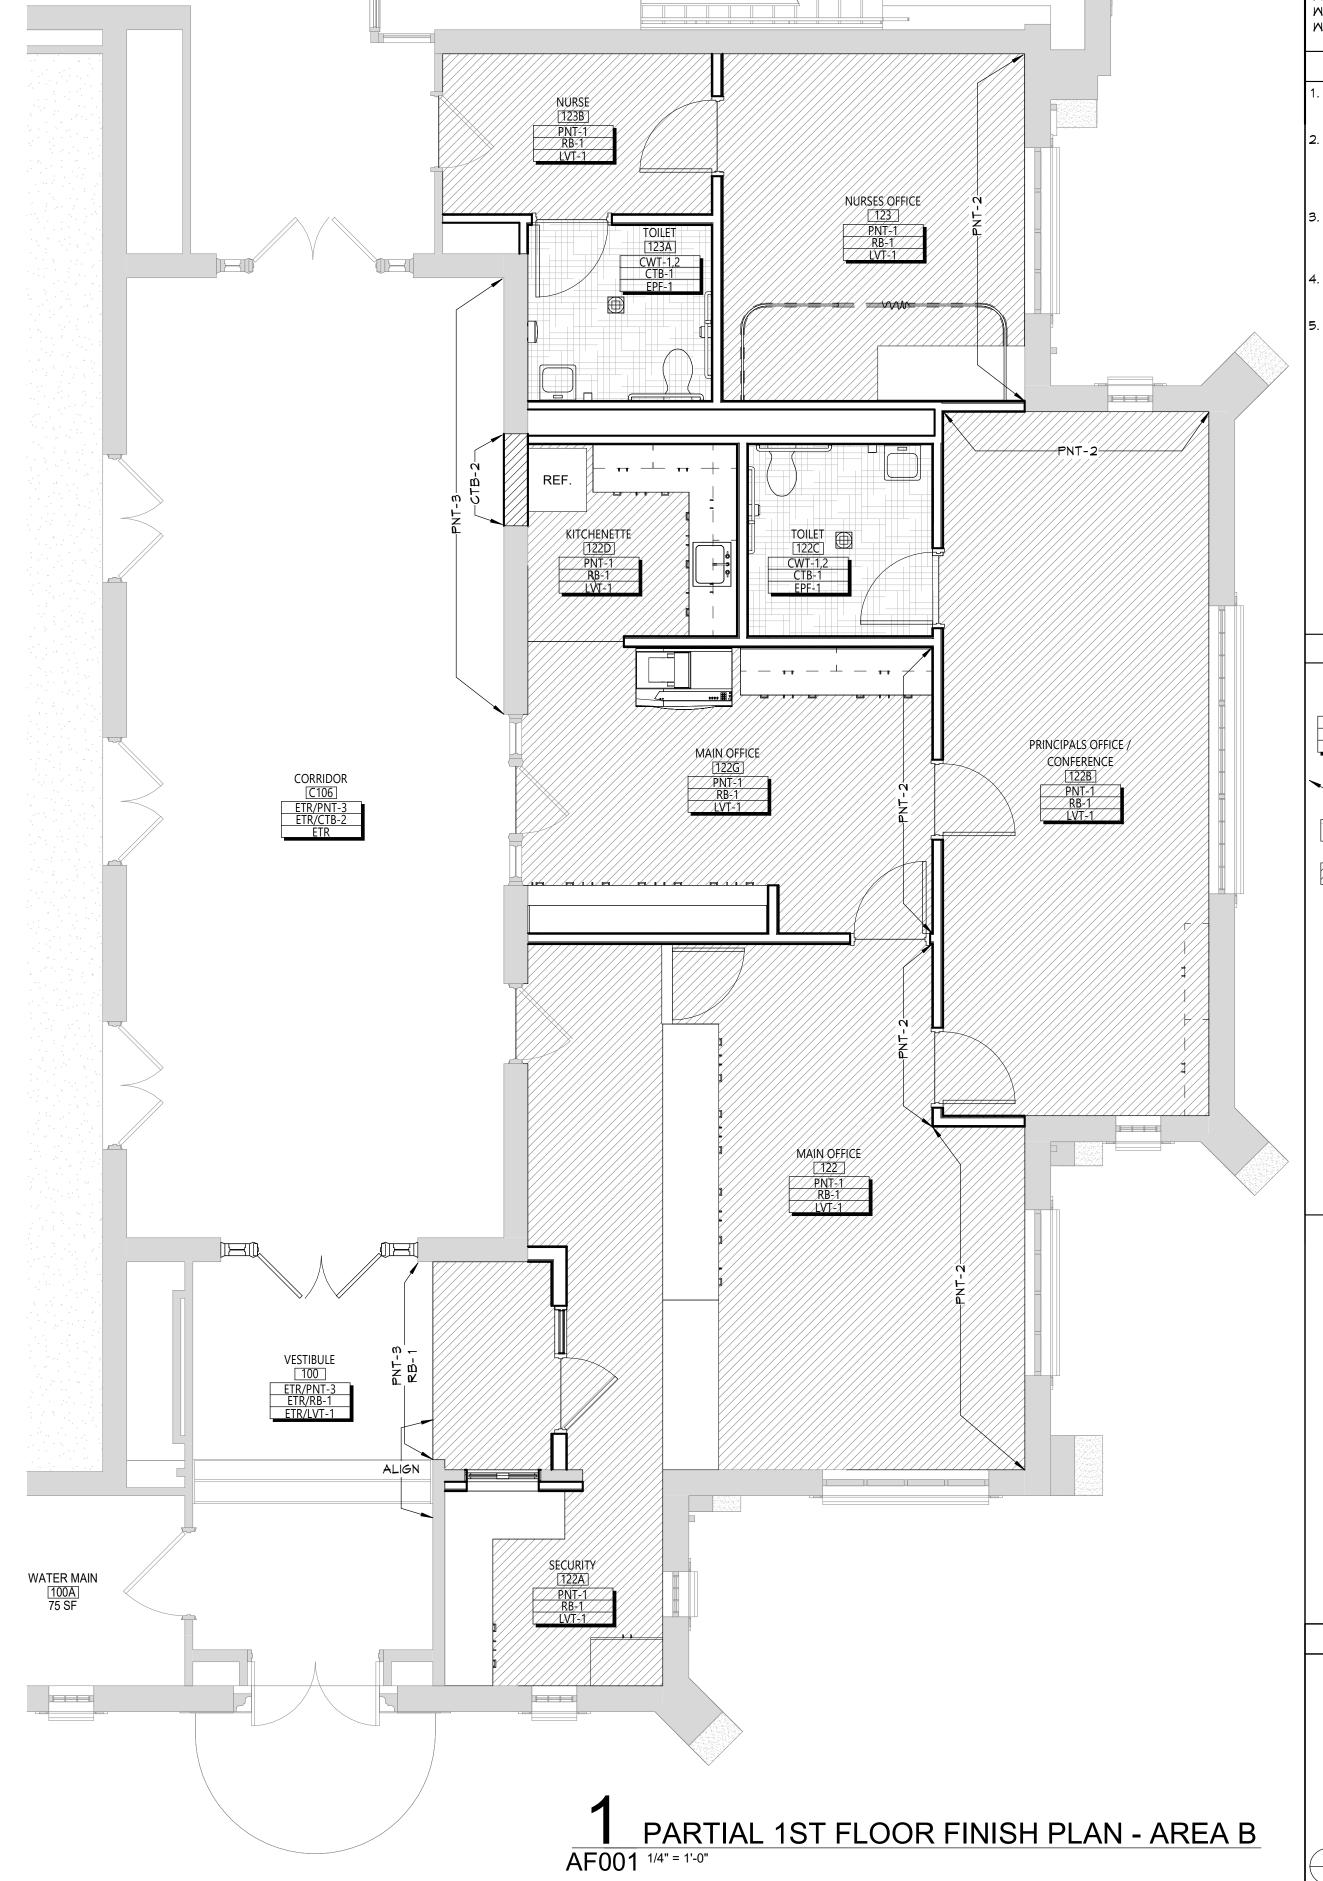

DISCLAIMER NOTE MANUFACTURER'S NAMES AND FINISH INFORMATION ARE INDICATED AS REFERENCED TO THE ARCHITECT'S BASIS-OF-DESIGN SELECTIONS AND HAVE BEEN DETERMINED PRIOR TO BID. THE CONTRACTOR AND OWNER ARE HEREBY NOTIFIED THAT FINISHES INSTALLED IN THE WORK ARE SUBJECT TO CHANGE IN RESPONSE TO SUBMITTALS, CONFIRMED SELECTIONS, PRODUCT AVAILABILITY AND THE SUBSEQUENT COORDINATION OF FINISHES BY ARCHITECT AND MAY DIFFER FROM PRODUCTS LISTED

ABBREVIATIONS

ARCHITECTURAL CONCRETE MASONRY UNIT ACOUSTICAL CEILING TILE APC
BBT
BRK
CFT
CONC
CPT
CTB
CWT
EPF ACOUSTICAL PANEL CEILING BIO-BASED TILE CERAMIC FLOOR TILE CONCRETE MASONRY UNIT CONCRETE CARPET CERAMIC TILE BASE CERAMIC WALL TILE EPOXY FLOOR EXISTING TO REMAIN **EXPOSED** EXST EXISTING FAC/FF FACTORY FINISH GYPSUM WALL BOARD LINEAR METAL CEILING MUSIC STORAGE SYSTEM METAL WALL PANEL

POLISHED CONCRETE PLASTIC LAMINATE PLASTER RESILIENT ATHLETIC FLOORING RUBBER BASE RESINOUS FLOORING RUBBER STAIR TREAD / LANDING RUBBER TILE FLOORING SEALED CONCRETE

SOLID SURFACE SYNTHETIC TURF FLOORING TERRAZZO TOILET PARTITIONS TYPICAL VINYL COMPOSITION TILE VCTAS VINYL COMPOSITION TILE ANTI-STATIC VINYL WALLCOVERING MOOD ATHLETIC FLOORING

MALK-OFF MAT GENERAL FINISH NOTES ALL EXPOSED SURFACES OF NEW PARTITIONS ARE TO BE PAINTED.

MOOD

WHEN ANY WORK IS PERFORMED ON ANY EXISTING WALL, THE ENTIRE WALL SURFACE IS TO BE PAINTED CORNER TO CORNER, UNLESS NOTED OTHERWISE.

ALL ELECTRIC, MECHANICAL COMPONENTS AND TELEPHONE PANELS EXPOSED IN A ROOM TO MATCH WALL COLOR.

ALL NEW GWB CEILINGS, FASCIAS, AND SOFFITS TO

BE PAINTED PNT-4, UNO. NEW HM DOORS, DOOR FRAMES AND WINDOW FRAMES AND ETR CORRIDOR DOOR & WINDOW FRAMES AS SCHEDULED ON A900 SERIES DRAWINGS, PNT-5..

FINISH KEYS

KEY PLAN


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PNT-# ACCENT PAINT LOCATION

Expiration Date: 02/28/2025

AREA 'B' -PARTIAL FIRST FLOOR FINISH

PLAN

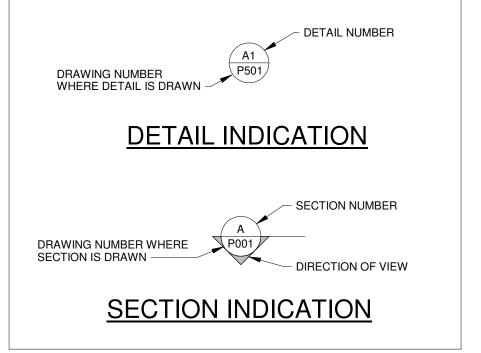


PLUMBING ABBREVIATIONS PLUMBING SYMBOLS ABOVE FINISHED FLOOR SAN SANITARY DRAINAGE ABOVE GROUND AIR COMPRESSOR — — SAN — — SANITARY DRAINAGE UNDER GROUND ACCESS DOOR ---- EXSAN---- EXISTING SANITARY DRAINAGE ABOVE GROUND AREA DRAIN — — EXSAN— — EXISTING SANITARY DRAINAGE UNDER GROUND ACCESS PANEL KSAN KITCHEN SANITARY DRAINAGE ABOVE GROUND BACKFLOW PREVENTER — — KSAN— KITCHEN SANITARY DRAINAGE UNDER GROUND BACKWATER VALVE EXISTING KITCHEN SANITARY DRAINAGE ABOVE GROUND **BOTTOM OF PIPE** — – EXKSAN- — EXISTING KITCHEN SANITARY DRAINAGE UNDER GROUND CATCH BASIN STORM DRAINAGE ABOVE GROUND CAST IRON — ST— STORM DRAINAGE UNDER GROUND CLG CEILING EXISTING STORM DRAINAGE ABOVE GROUND CO **CLEAN OUT** — — EXST— — EXISTING STORM DRAINAGE UNDER GROUND CONT CONTINUED COLD WATER PIPING CLEAN OUT DECK PLATE —— – – HOT WATER PIPING COTG CLEAN OUT TO GRADE —— – – — HOT WATER RETURN PIPING COWP CLEAN OUT WALL PLATE **————** VENT PIPING CTE CONNECT TO EXISTING EXISTING COLD WATER PIPING CW COLD WATER EXISTING HOT WATER PIPING DN DOWN —— - - - — EXISTING HOT WATER RETURN PIPING DWG DRAWING ---- EXISTING VENT PIPING DRINKING FOUNTAIN —— G ——— GAS PIPING ELEV **ELEVATION** —— EXG —— EXISTING GAS PIPING **EMST** EMERGENCY STORM (OVERFLOW) EWC ELECTRIC WATER COOLER CLEAN OUT DECK PLATE EXCODP EXISTING FLOOR CLEANOUT DECK PLATE EXISTING FLOOR DRAIN LINE CLEAN OUT EXFS EXISTING FLOOR SINK NON-FREEZE WALL HYDRANT OR HOSE BIBB **EXMSB** EXISTING MOP SINK BASIN EXSAN EXISTING SANITARY FLOOR DRAIN OR FLOOR SINK EXSK EXISTING SINK TRAP EXSS EXISTING SERVICE SINK ——≫ EXST EXISTING STORM FRESH AIR INLET FLOOR DRAIN GATE VALVE FLR FLOOR GLOBE VALVE FINISHED FLOOR BALL VALVE FLOOR SINK PLUG VALVE GAS CHECK VALVE HOSE BIBB SOLENOID VALVE HOT WATER CURB BOX & VALVE HOT WATER RETURN INVERT ELEVATION RELIEF VALVE LAVATORY LAV LDR LEADER STRAINER MSB MOP SINK BASIN NON-FREEZE WALL HYDRANT THERMOMETER NOT IN CONTRACT NTS NOT TO SCALE PRESSURE GAUGE PRESSURE GAUGE PRESSURE REDUCING VALVE ELBOW UP **ROOF DRAIN** ----- **ELBOW DOWN** SOIL SHOCK ARRESTOR SANITARY BRANCH OFF TOP OF MAIN SHOWER SINK BRANCH OFF BOTTOM OF MAIN SERVICE SINK STORM CONNECT TO EXISTING TEMPERATURE TEMPERATURE LIMITING DEVICE EXTENT OF REMOVAL -X X X X — EXISTING PIPING TO BE REMOVED VALVE IN VERTICAL HEAT TRACED PIPING VERIFY IN FIELD SHOCK ARRESTOR VENT THRU ROOF WATER CLOSET WASH FOUNTAIN



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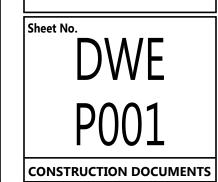
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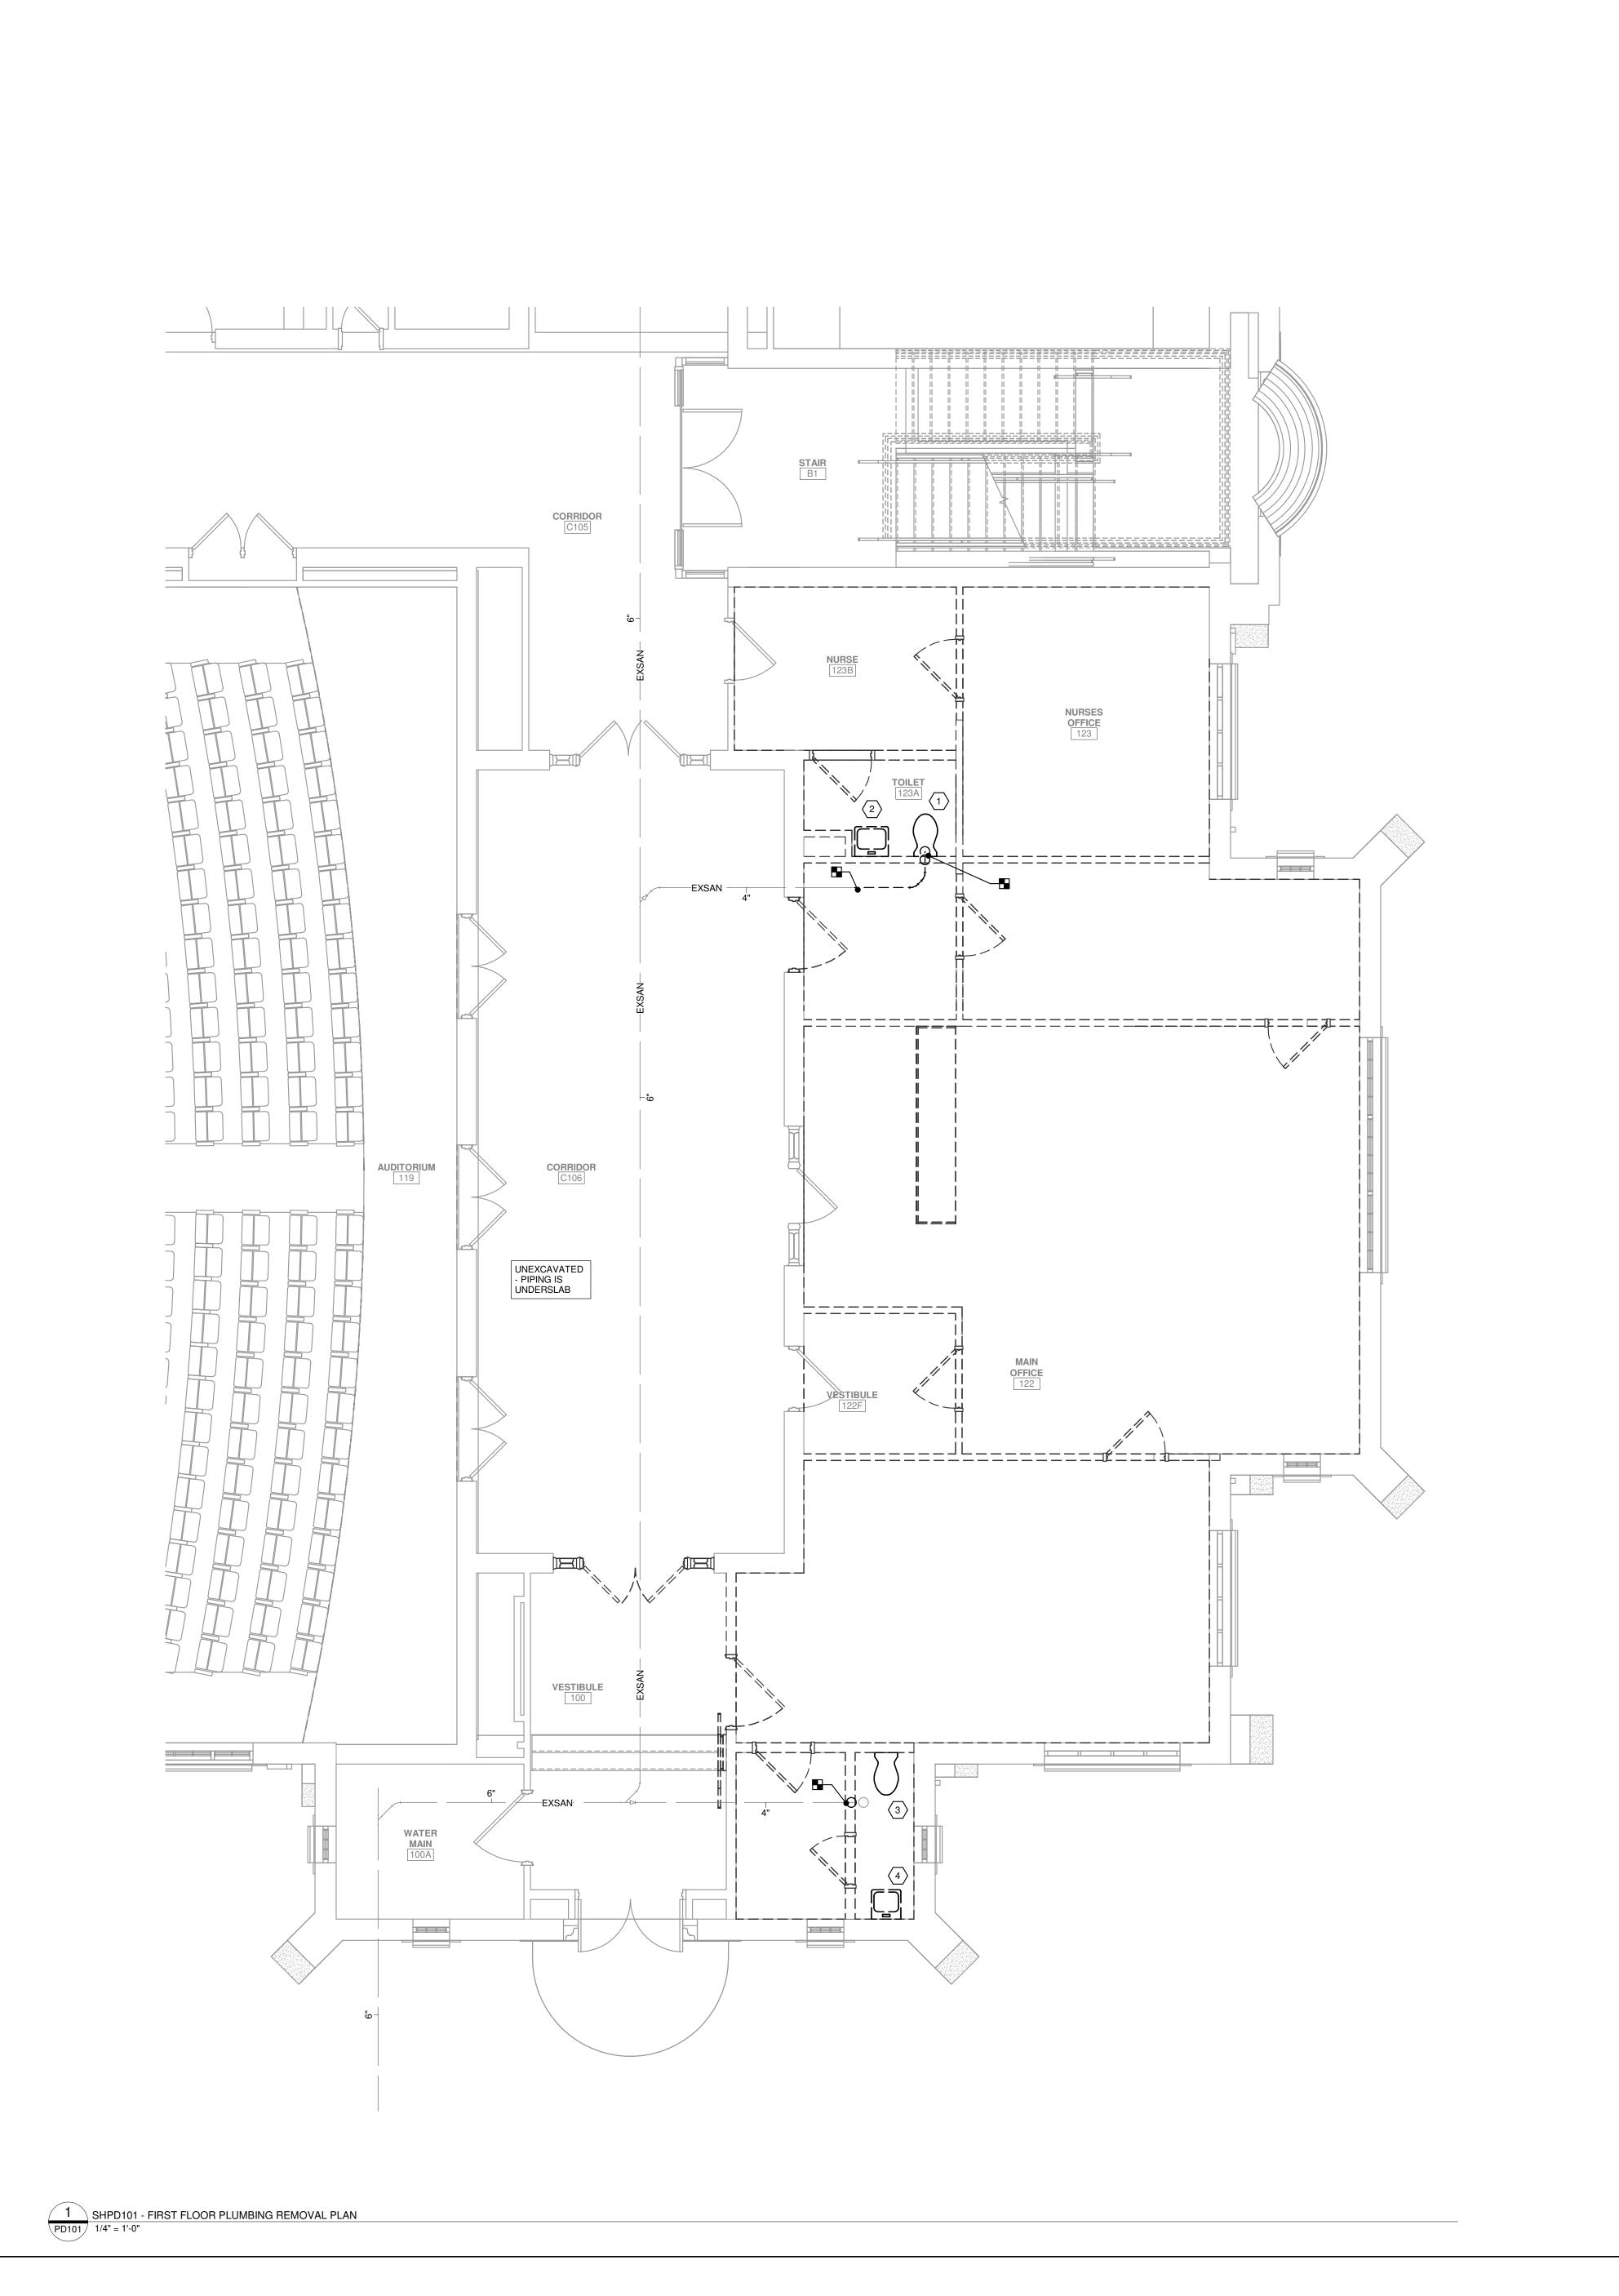
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 188-2301.02

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 03/14/2025

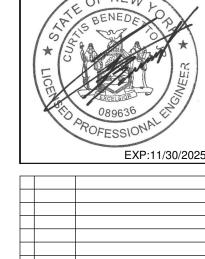PLUMBING LEGEND AND ABBREVIATIONS





GENERAL REMOVAL NOTES A. UNLESS NOTED OTHERWISE, ALL ITEMS INDICATED ARE TO BE REMOVED "COMPLETE". REMOVAL SHALL INCLUDE ALL COMPONENTS, PIPING, HANGERS, SUPPORTS, ASSOCIATED WITH THE EQUIPMENT.

- B. CONTRACTOR IS TO INSPECT EQUIPMENT THAT IS TO BE REUSED AND DETERMINE THAT IT IS COMPLETE AND IN GOOD WORKING ORDER. IF NOT, REPORT FINDINGS TO
- THE ARCHITECT/ENGINEER. C. EVERY EFFORT HAS BEEN MADE TO INDICATE ALL EQUIPMENT THAT IS TO BE REMOVED THROUGH FIELD OBSERVATIONS, HOWEVER, THE CONTRACTOR IS TO
- VISIT THE SITE PRIOR TO BIDDING AND VERIFY ALL D. ALL ITEMS BEING REMOVED AND NOT REUSED SHALL BE TURNED OVER TO THE OWNER FOR FUTURE USE. IF OWNER DECIDES THE FIXTURES ARE NOT REUSABLE, THE PLUMBING CONTRACTOR SHALL DISPOSE OF THEM.
 COORDINATE WITH OWNER TO WALK THRU THE AREA TO
- DETERMINE FIXTURES TO BE SALVAGED PRIOR TO ANY DEMOLITION WORK. E. IF THERE IS A QUESTION REGARDING A REMOVAL, THE
- CONTRACTOR IS TO VERIFY WITH THE OWNER OR THE OWNER'S REPRESENTATIVE AS TO THE REMOVAL STATUS BEFORE PROCEEDING.
- F. ALL INTERRUPTIONS OF SERVICE SHALL BE SCHEDULED AND COORDINATED WITH THE OWNER. PLUMBING SYSTEMS FEEDING FROM OR THROUGH THE CONTRACT
- G. COORDINATE ALL WORK WITH PROJECT PHASING REQUIREMENTS.
- H. WORK THIS DRAWING WITH ARCHITECTURAL DRAWINGS
- FOR EXTENT OF NEW WALL AND CEILING WORK. I. COORDINATE THIS PLAN WITH NEW WORK PLAN.

AREA SHALL BE MAINTAINED.


* KEYED NOTES FOR DRAWING PD101 REMOVE EXISTING WATER CLOSET AND TRIM INCLUDING ALL COMPONENTS. REMOVE EXISTING CW, SOIL & VENT PIPING BACK TO POINT OF DISCONNECTION. TEMPORARILY CAP FOR RECONNECTION TO NEW


- REMOVE EXISTING LAVATORY INCLUDING TRIM AND WALL CARRIER. REMOVE EXISTING WASTE, VENT, HW & CW PIPING BACK TO POINT OF DISCONNECTION. TEMPORARILY CAP FOR RECONNECTION TO NEW FIXTURE.
- REMOVE EXISTING WATER CLOSET AND TRIM INCLUDING ALL COMPONENTS. REMOVE EXISTING CW, & VENT PIPING BACK TO MAINS. REMOVE SOIL PIPING DN TO SLAB. TEMPORARILY CAP FOR RECONNECTION TO NEW
- 4 REMOVE EXISTING LAVATORY INCLUDING TRIM AND WALL CARRIER. REMOVE EXISTING VENT, HW & CW PIPING BACK TO MAINS. REMOVE WASTE PIPING TO BELOW SLAB. CAP OR FILL WITH CONCRETE.



PLUMBING REMOVAL PLAN

KEY PLAN

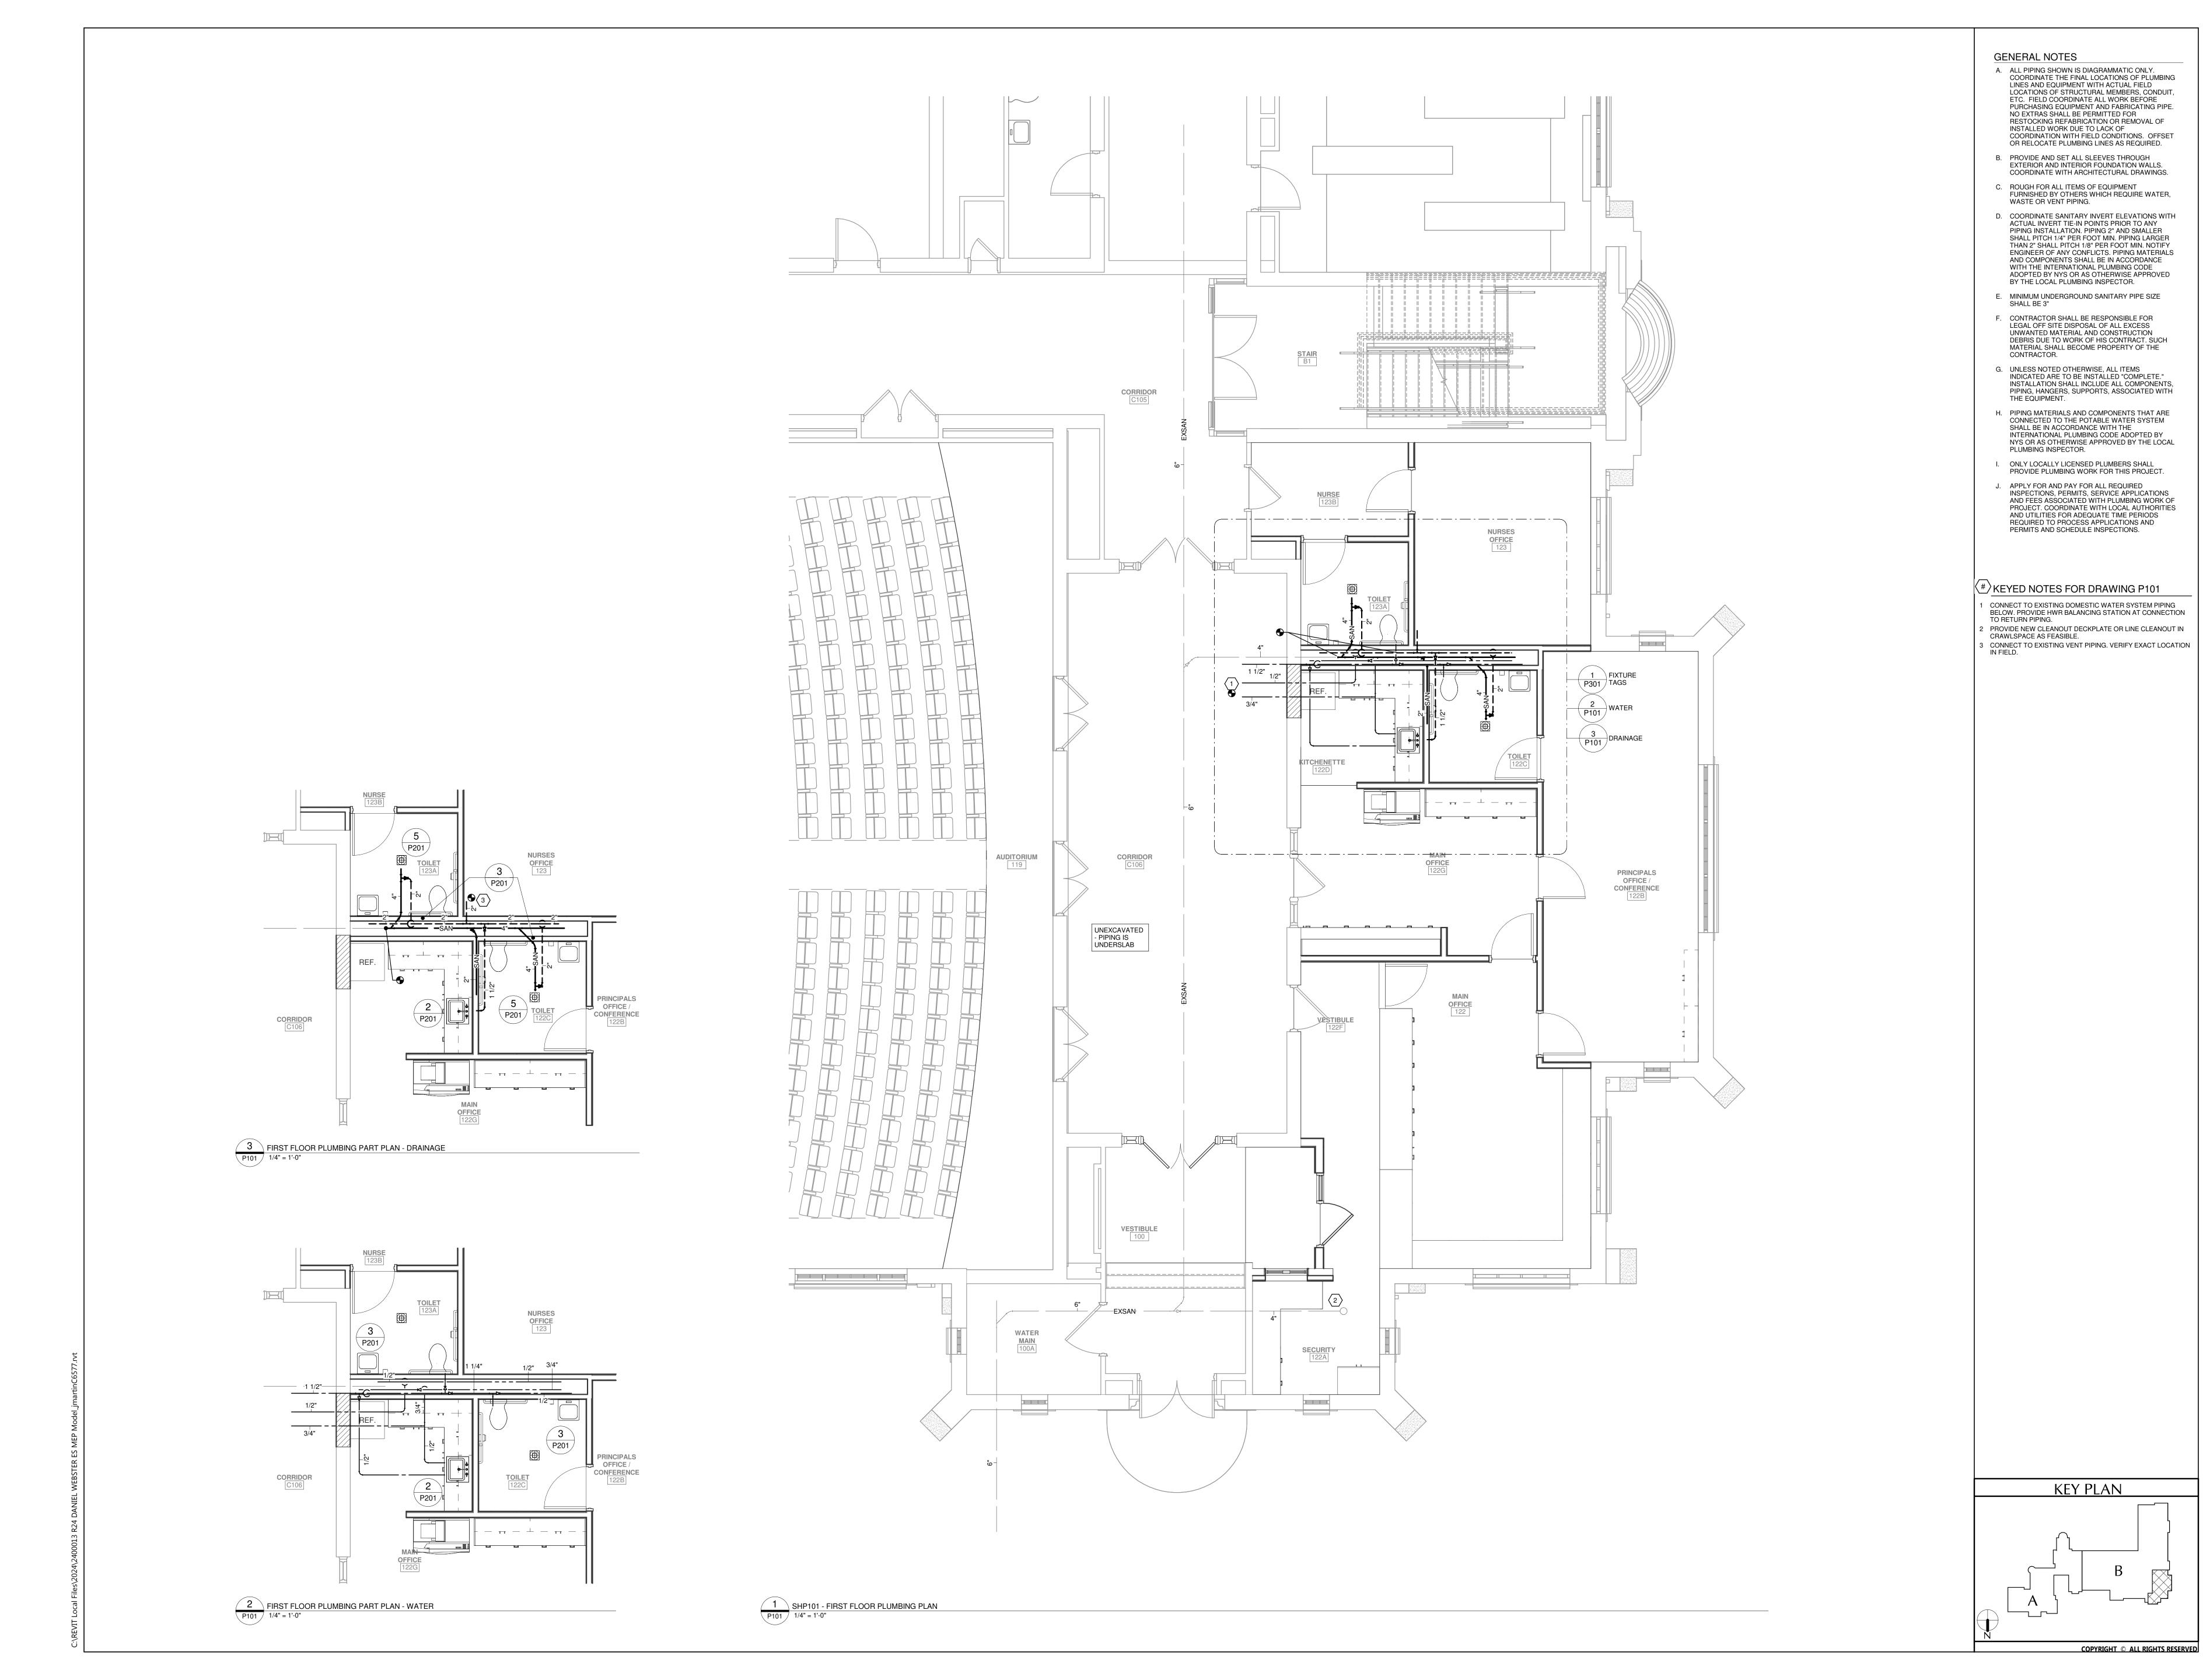

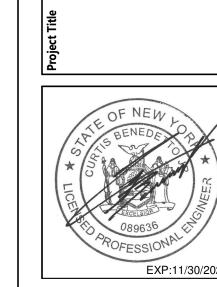

PLUMBING PLAN

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CSArch Proj. #: 188-2301
Issued for Bid: 03/14/20
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PLUMBING

RISER

RISER
DIAGRAMS &
DETAILS


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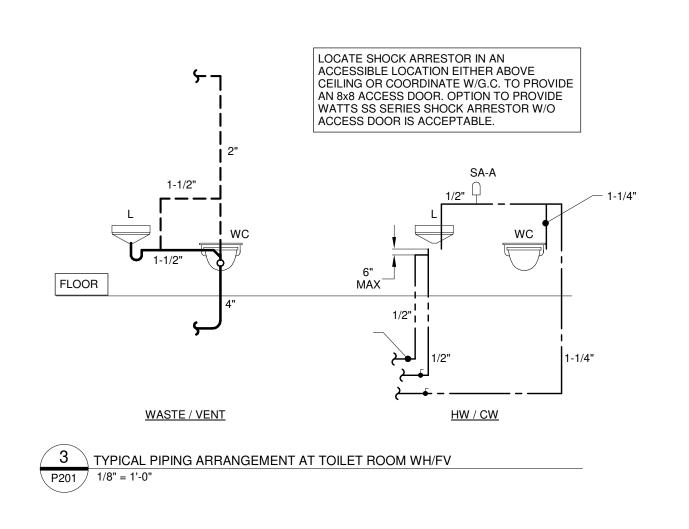
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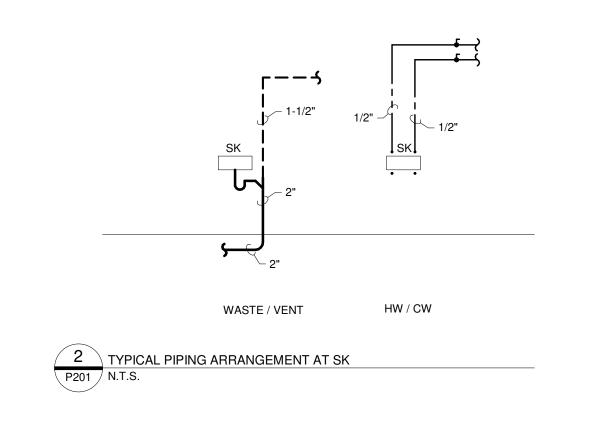
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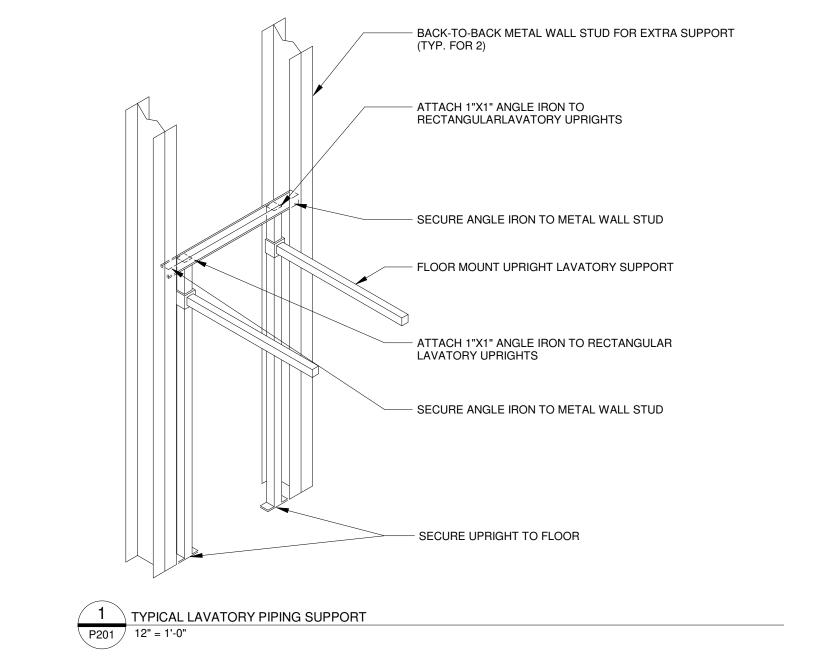
Consultant


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	PLUMBING FIXTURE SCHEDULE								
TAG	DESCRIPTION	WASTE	VENT	HOT WATER	COLD WATER	MANUFACTURER & MODEL NO.	REMARKS / APPLICATIONS		
WC-A	VITREOUS CHINA ELONGATED WALL MOUNTED WATER CLOSET, W/1.28 GPF MANUAL FLUSH VALVE ELONGATED OPEN FRONT NO COVER SEAT WITH CONCEALED CHECK HINGE	4"	2"	-	1-1/4"	KOHLER MODEL NO. K-84325 WITH SLOAN MODEL NO. 111-1.28 AND CHURCH NO. 9500SSCT SEAT <u>ALTERNATE MANUFACTURERS</u> AMERICAN STANDARD GERBER / ZURN	17" AFF TO RIM - PROVIDE FLUSH VALVE HANDLE ON RIGHT SIDE AS REQUIRED FOR ADA APPROACH		
LAV-A	20x18 VITREOUS CHINA WALL MOUNTED LAVATORY WITH 0.5 GPM MANUAL BLADE TYPE HANDLE, SELF CLOSING FAUCET, ASSE 1070 TEMPERATURE LIMITING DEVICE, GRID STRAINER	1-1/2"	1-1/2"	1/2"	1/2"	KOHLER MODEL NO. K-2005 WITH SYMMONS MODEL NO. SLC-6000, ACORN ST-70 AND MCGUIRE MODEL NO. PW155WC ALTERNATE MANUFACTURERS AMERICAN STANDARD GERBER	MOUNT AT 34" AFF. OFFSET TRAP AT WALL. INSULATE TRAP AND SUPPLY PIPING.		
SK-A	19x18x5.5 STAINLESS STEEL COUNTER TOP SINK WITH ADA 2 HANDLE KITCHEN SINK FAUCET.	2"	1-1/2"	1/2"	1/2"	ELKAY MODEL NO. LRAD191855 WITH ELKAY MODEL NO. LKAD35 AND ELKAY MODEL NO. LK810AT08T4 <u>ALTERNATE MANUFACTURERS</u> JUST MANUFACTURING KOHLER			
NOTES:									


- 1. SEE PLUMBING DRAWINGS FOR PLUMBING FIXTURE TAGS.
- 2. ALL FIXTURES SHALL HAVE INDIVIDUAL CHROME ANGLE STOPS, TRAPS AND ESCUTCHEONS.
- 4. ALL WALL MOUNTED FIXTURES SHALL BE SUPPORTED BY CONCEALED, FLOOR MOUNTED PLUMBING FIXTURE CARRIERS. WALL BRACKETS OR CLIPS ARE NOT ACCEPTABLE. NOTIFY ENGINEER OF ANY CONFLICTS WITH INSTALLATION OF CONCEALED CARRIERS.
- 5. WC-A SHALL BE SUPPORTED BY JAY R. SMITH FIG. 0210 FIXTURE CARRIER OR EQUIVALENT.


3. ALL FIXTURES SHALL BE LEAD FREE AND INCOMPLIANCE WITH NSF 61 AND NSF 372.

- 6. <u>LAV-A</u> SHALL BE SUPPORTED BY JAY R. SMITH FIG. 700 FIXTURE CARRIER OR EQUIVALENT.
- 7. MODEL NUMBERS LISTED IN SCHEDULE ARE FOR GENERAL REFERENCE ONLY AND NOT FOR ORDERING. CONTRACTOR SHALL REVIEW MODEL NUMBERS AND SPECIFIED FEATURES WITH THE FACTORY PRIOR TO PLACING THEIR FINAL ORDER.
- 8. OWNER TO REVIEW PLUMBING FIXTURE SELECTION AND APPROVE PRIOR TO ORDERING.
- 9. PROVIDE LEAD TESTING PER DOH AND SED REQUIREMENTS.

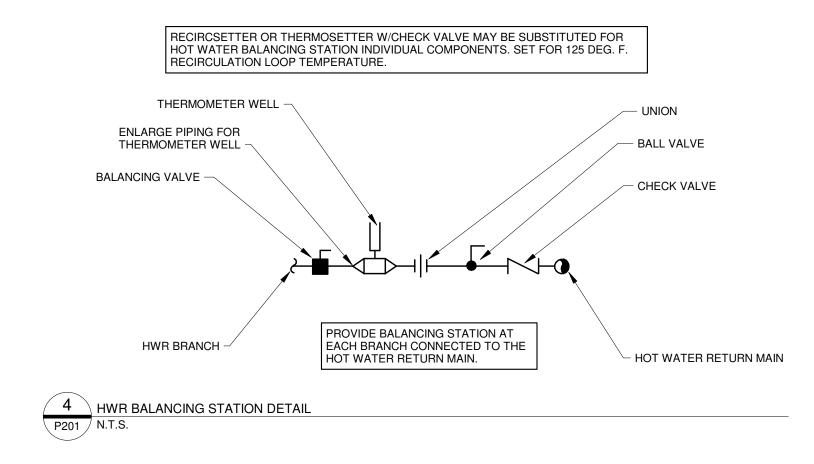	FLOOR DRAIN & CLEANOUT SCHEDULE								
TAG	DESCRIPTION	MANUFACTURER & MODEL	ALTERNATE MANUFACTURER'S	NOTES					
FD-A	FLOOR DRAIN - GENERAL PURPOSE	JAY R. SMITH FIG. 2010	ZURN / JOSAM	1, 2, 3, 4, 5					
<u>CODP</u>	CLEANOUT DECKPLATE	JAY R. SMITH FIG. 4020	ZURN / JOSAM	4, 5					
COWP	CLEANOUT WALL PLATE	JAY R. SMITH FIG. 9776	ZURN / JOSAM	4, 5					

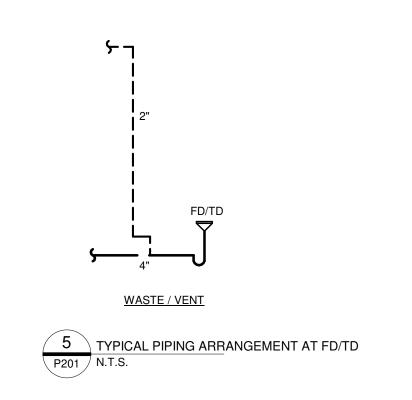- 1. COORDINATE FLOOR DRAINS WITH FLOORING MANUFACTURER/INSTALLER AND LAYOUT.
- 2. PROVIDE SURE SEAL WATERLESS INLINE TRAP SEALER FOR FLOOR DRAINS AND FLOOR SINKS.
- 3. REFER TO PLUMBING PLANS FOR FLOOR DRAIN SIZES. COORDINATE FINISH WITH ARCHITECT.
- 4. COORDINATE INTERIOR LOCATIONS WITH ARCHITECT.
- 5. MODEL NUMBERS LISTED IN SCHEDULE ARE FOR GENERAL REFERENCE ONLY AND NOT FOR ORDERING. CONTRACTOR SHALL REVIEW MODEL NUMBERS AND SPECIFIED REATURES WITH THE FACTORY BEFORE PLACING THEIR FINAL ORDER.

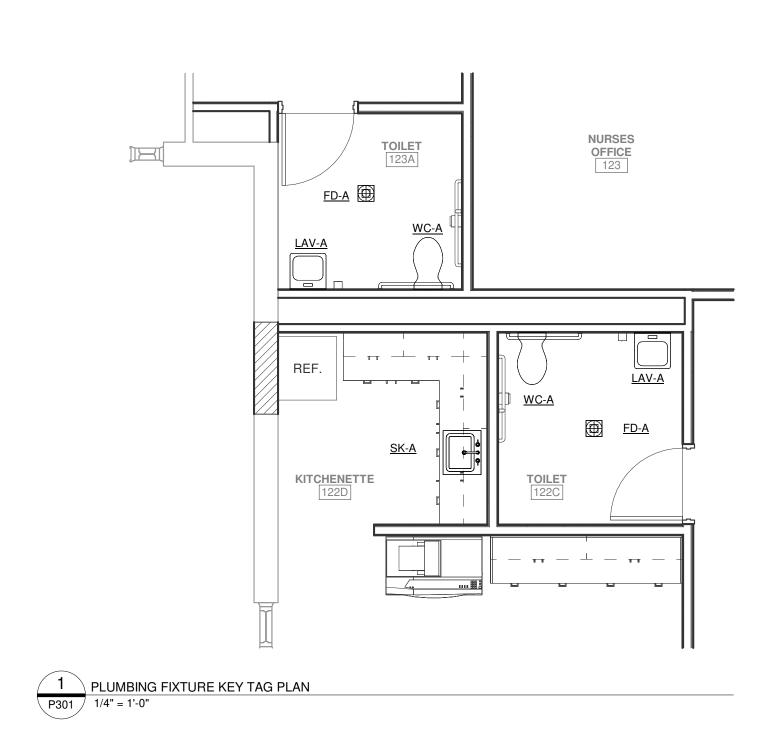

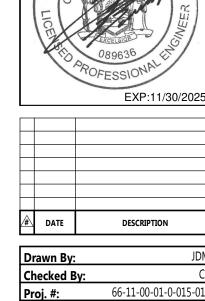

 Checked By:
 CB

 Proj. #:
 66-11-00-01-0-015-018

 CSArch Proj. #:
 188-2301.02

 Issued for Bid:
 03/14/2025

PLUMBING SCHEDULES

Sheet No.

DWE

P301 CONSTRUCTION DOCUMENTS

OFFICE SPACE 200

50 EA / WC

0.06

OFFICE SPACE

MAIN OFFICE

NURSES OFFICE TOILET

NURSE

1) OCCUPANCY BASED ON SEATING.

REMARKS:

ABBREVIATION LEGEND ABBREVIATION DESCRIPTION

AIR-COOLED CONDENSER AIR-COOLED CONDENSING UNT ACCESS DOOR AIR FILTER ABOVE FINISHED FLOOR AIR FLOW MEASURING DEVICE AIR HANDLING UNIT AIR PURIFIER AIR PRESSURE DROP AUTOMATIC AIR VENT COOLING COIL CLOSED CIRCUIT COOLER CEILING DIFFUSER CEILING EXHAUST FAN **CUBIC FEET PER MINUTE** CLEAN OUT CONTINUED CEILING RETURN **COOLING TOWER**

BRITISH THERMAL UNITS PER HOUR CABINET UNIT HEATER DECIBELS DRY BULB TEMPERATURE DIAMETER DEW POINT TEMPERATURE EXHAUST AIR ENTERING AIR TEMPERATURE ELECTRICAL CONTRACTOR EXHAUST FAN ENTERING FLUID TEMPERATURE EXHAUST GRILLE ELECTRIC HEATING COIL EXHAUST REGISTER ENERGY RECOVERY COIL ELECTRIC RADIANT PANEL EXPANSION TANK ENTERING WATER TEMPERATURE EXISTING FAN COIL UNIT FIRE DAMPER COMBINATION FIRE/SMOKE DAMPER FINAL FILTER FLOOR FEET PER MINUTE FEET GALLONS GALLONS PER MINUTE GLYCOL SUPPLY GRAVITY ROOF VENTILATION GLYCOL SUPPLY HUMIDIFIER **HEATING COIL** HEIGHT HORSEPOWER OR HEAT PUMP HEAT RECOVERY UNIT HEAT EXCHANGER KII OWATT LEAVING AIR TEMPERATURE LBS/HR POUNDS PER HOUR LINEAR DIFFUSER LEAVING FLUID TEMPERATURE LOW PRESSURE CONDENSATE RETURN LOW PRESSURE STEAM (15 PSIG AND BELOW) LINEAR SLOT DIFFUSER LEAVING WATER TEMPERATURE MAXIMUM ONT THOUSAND BRITISH THERMAL UNITS PER HOUR MECHANICAL CONTRACTOR MOTORIZED DAMPER MINIMUM MEDIUM PRESSURE CONDENSATE RETURN MEDIUM PRESSURE STEAM (16-59 PSIG) NOT IN CONTRACT NOMINAL OUTSIDE AIR PUMPED CONDENSATE PRESSURE DROP PRESSURE REDUCING VALVE OR POWER ROOF VENTILATOR POUND PER SQUARE INCH - GAUGE RETURN AIR RETURN FAN RETURN GRILLE REHEAT COIL ROOM ROTARY VENTILATOR REVOLUTIONS PER MINUTE RETURN REGISTER ROOF-TOP UNIT SUPPLY AIR SMOKE DAMPER SUPPLY FAN STATIC PRESSURE SUPPLY REGISTER TRANSFER OPENING UNLESS NOTED OTHERWISE UNIT VENTILATOR **VENTILATION AIR** VARIABLE AIR VOLUME **VOLUME DAMPER** VARIABLE FREQUENCY DRIVE VACUUM PUMP VACUUM STEAM CONDENSATE RETURN

WET BULB TEMPERATURE

WATER PRESSURE DROP


WATER GAUGE WIRE MESH SCREEN


DATE DESCRIPTION


Proj. #: 66-11-00-01-0-015-01

MECHANICAL LEGENDS AND SCHEDULES

CONSTRUCTION DOCUMENTS

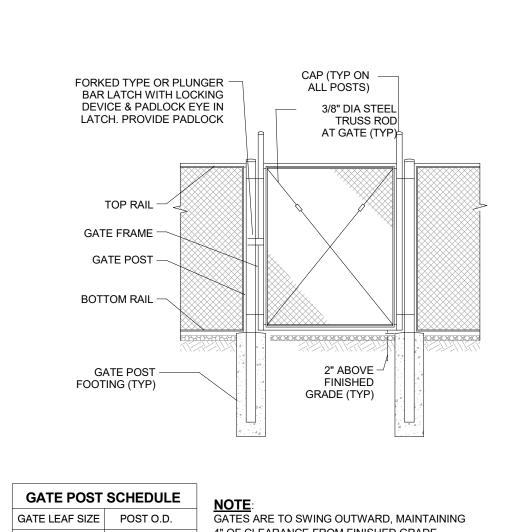


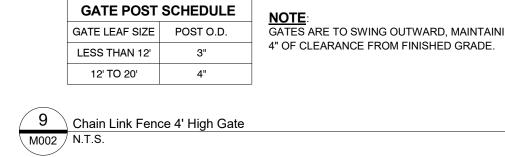

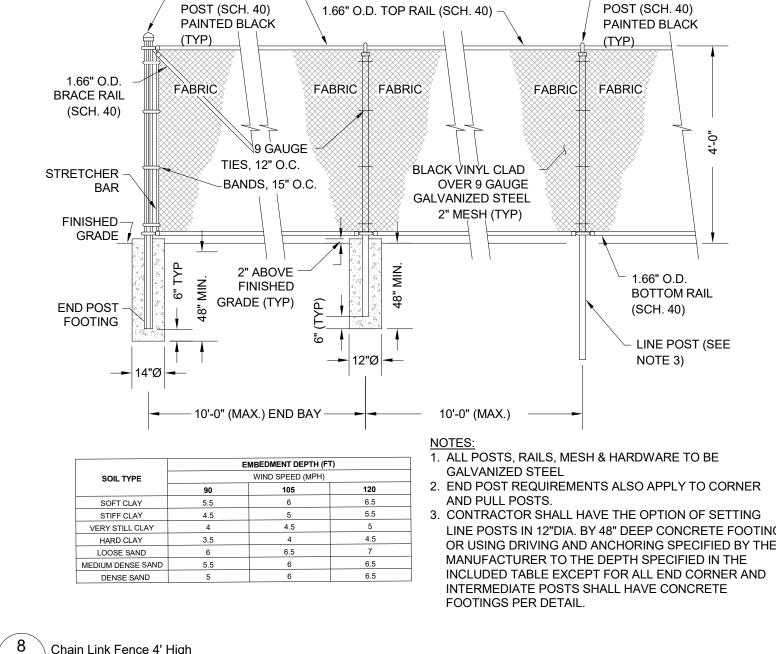



TIES - 24" O.C. —


— 2.875" O.D. END

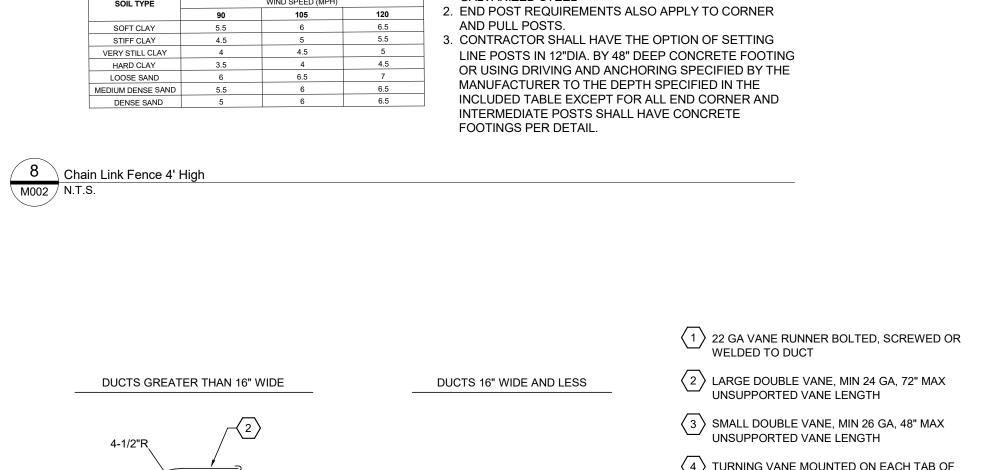


_ 2.375" O.D. LINE

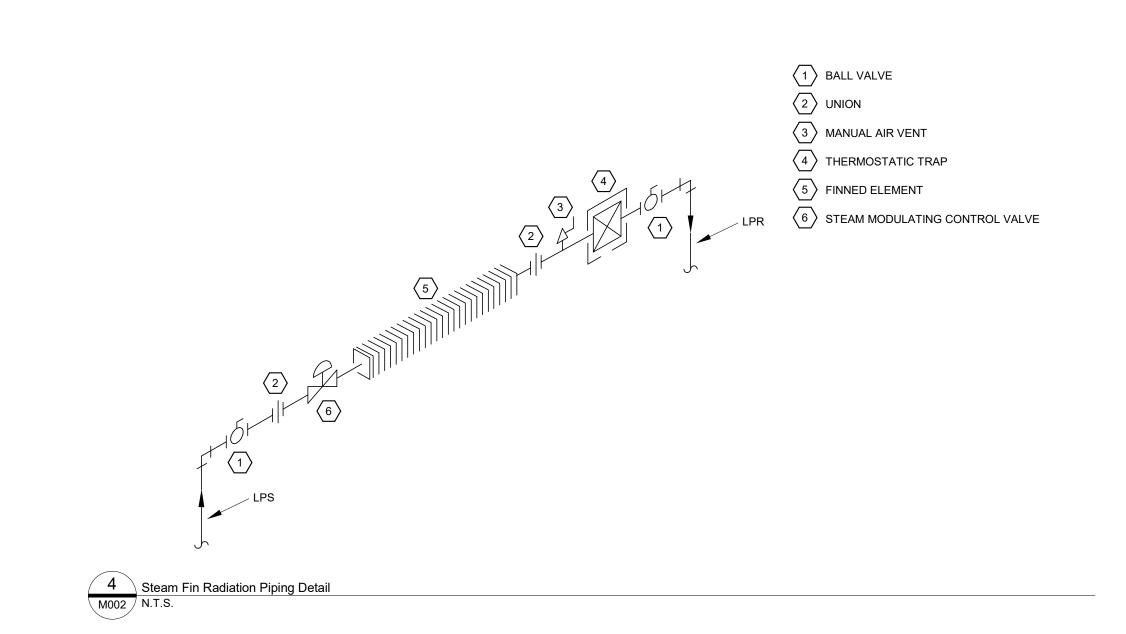


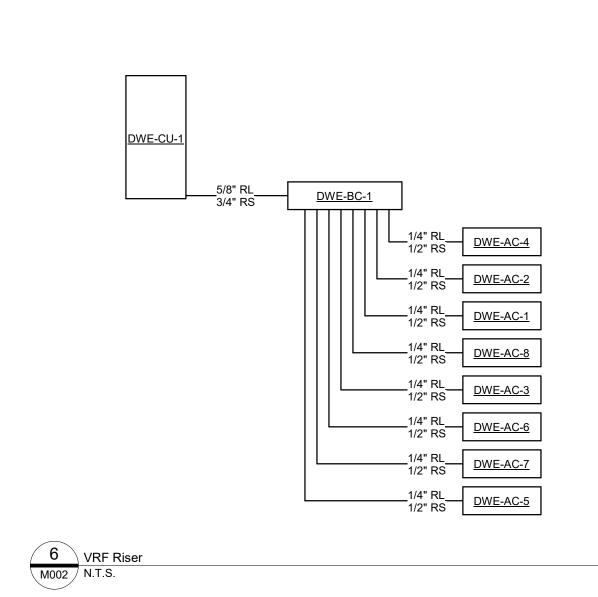


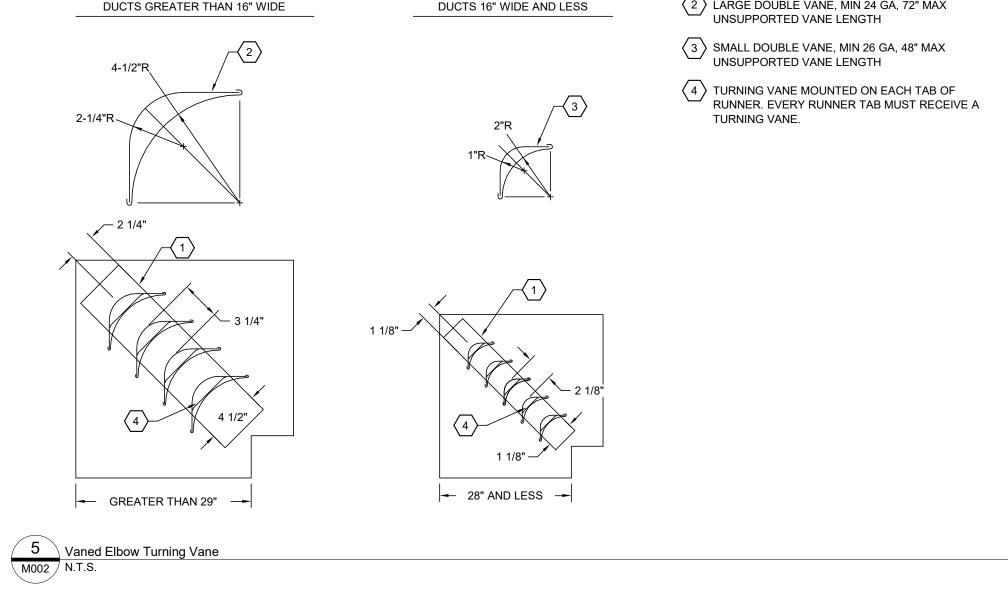


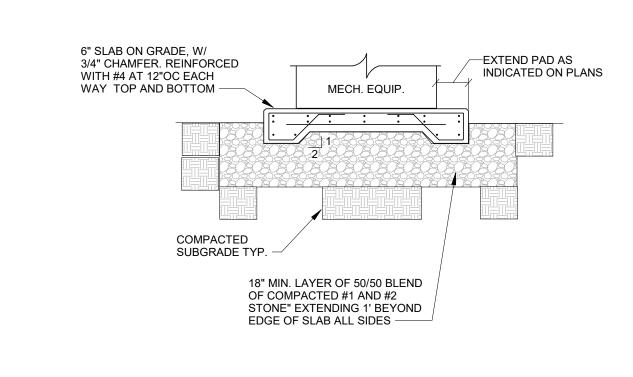


Bequipment Pad Detail M002 N.T.S.

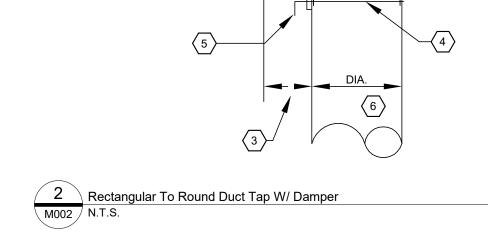

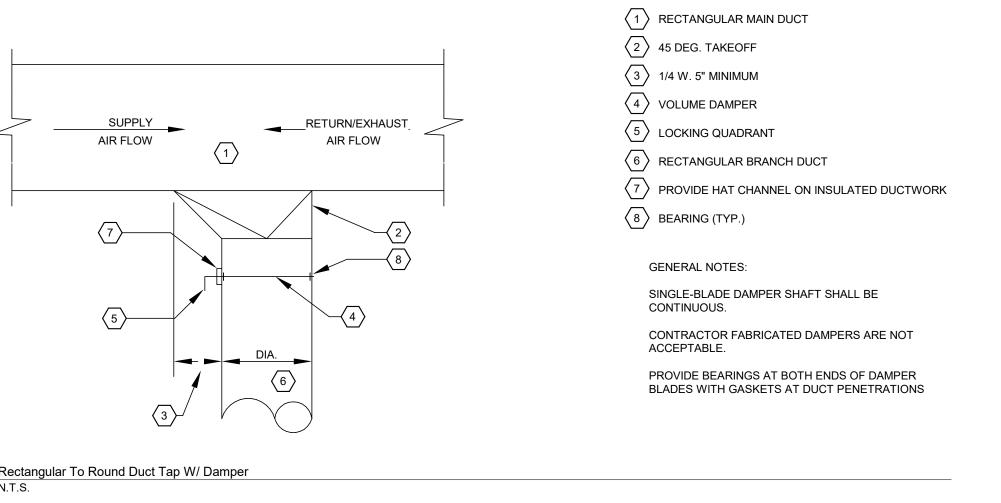

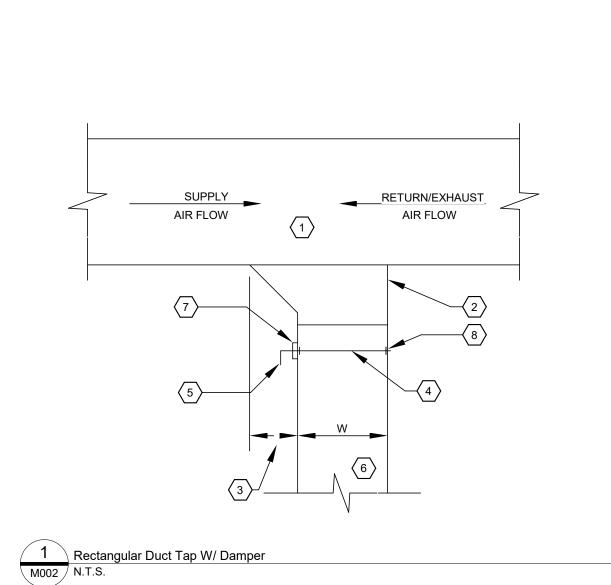

7 Steam Cabinet Heater Piping Detail M002 N.T.S.

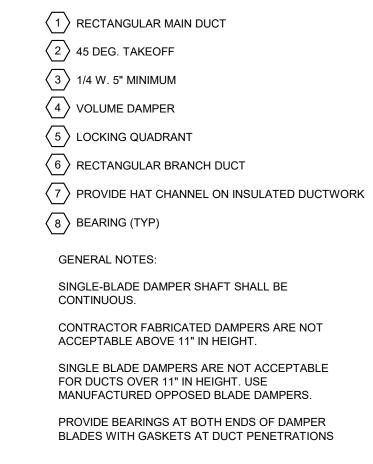

EXP:11/30/2025 # DATE DESCRIPTION
 Checked By:
 JM

 Proj. #:
 66-11-00-01-0-015-018
 CSArch Proj. #:

> **MECHANICAL DETAILS**

CONSTRUCTION DOCUMENTS

GENERAL REMOVALS NOTES

ALL REMOVALS.

- A. REMOVALS INDICATED BY HEAVY DASHED LINE. B. UNLESS NOTED OTHERWISE, ALL ITEMS INDICATED ARE TO BE REMOVED "COMPLETE". REMOVAL SHALL INCLUDE ALL COMPONENTS, DUCTWORK, PIPING, HANGERS, SUPPORTS AND ACCESSORIES, ASSOCIATED WITH THE EQUIPMENT.
- CONTRACTOR IS TO INSPECT EQUIPMENT THAT IS TO BE REUSED AND DETERMINE THAT IT IS COMPLETE
 AND IN GOOD WORKING ORDER. IF NOT, REPORT

IS TO VISIT THE SITE PRIOR TO BIDDING AND VERIFY


- FINDINGS TO THE ARCHITECT/ENGINEER. D. EVERY EFFORT HAS BEEN MADE TO INDICATE ALL EQUIPMENT THAT IS TO BE REMOVED THROUGH FIELD OBSERVATIONS, HOWEVER, THE CONTRACTOR
- E. ALL ITEMS BEING REMOVED AND NOT REUSED SHALL BE TURNED OVER TO THE OWNER FOR FUTURE USE. IF OWNER DECIDES THE ITEMS ARE NOT REUSABLE, THE MECHANICAL CONTRACTOR SHALL DISPOSE OF
- F. IF THERE IS A QUESTION REGARDING A REMOVAL, THE CONTRACTOR IS TO VERIFY WITH THE OWNER OR THE OWNER'S REPRESENTATIVE AS TO THE REMOVAL STATUS BEFORE PROCEEDING.
- SCHEDULED AND COORDINATED WITH THE OWNER. MECHANICAL SYSTEMS FEEDING FROM OR THROUGH THE CONTRACT AREA SHALL BE MAINTAINED. H. COORDINATE THIS DRAWING WITH ARCHITECTURAL


G. ALL INTERRUPTIONS OF SERVICE SHALL BE

- DRAWINGS FOR EXTENT OF NEW WALL AND CEILING
- I. COORDINATE THIS PLAN WITH NEW WORK PLAN.

CODED REMOVALS NOTES


- DISCONNECT, REMOVE AND SALVAGE EXISTING AIR PURIFIER INCLUDING WALL MOUNTED SHELF. DISCONNECT AND REMOVE EXISTING STEAM RADIATOR INCLUDING LOCAL PIPING VALVES AND TRAPS. PREPARE EXISTING PIPING FOR CONNECTION
- 3 DISCONNECT AND REMOVE EXISTING WALL MOUNTED DUCTLESS SPLIT AIR CONDITIONING UNIT COMPLETE INCLUDING ALL ASSOCIATED REFRIGERANT & CONDENSATE DRAIN PIPING, ASSOCIATED THERMOSTAT AND CONTROLS.
- DISCONNECT AND REMOVE EXISTING GRADE MOUNTED CONDENSING UNIT COMPLETE INCLUDING ALL ASSOCIATED REFRIGERANT PIPING, SUPPORTS AND FENCING. DISCONNECT AND REMOVE EXISTING EXHAUST FAN AND ALL ASSOCIATED EXHAUST DUCTWORK AND GRILLES COMPLETE INCLUDING DAMPERS, HANGERS AND CONTROLS.
- 6 EXISTING EXHAUST LOUVER AND PLENUM TO REMAIN. PREPARE FOR CONNECTION WITH NEW WORK. DISCONNECT AND REMOVE EXISTING STEAM PIPING FROM BELOW FLOOR TO ABOVE CEILING LEVEL. PREPARE EXISTING PIPING FOR CONNECTION TO
- DISCONNECT AND REMOVE EXHAUST GRILLE AND DUCTWORK BACK TO POINT OF DISCONNECTION COMPLETE. CAP AND SEAL AIRTIGHT.

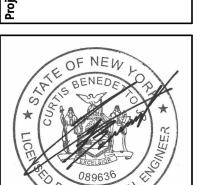

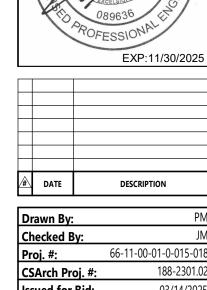

MECHANICAL REMOVALS PLAN

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GENERAL NOTES

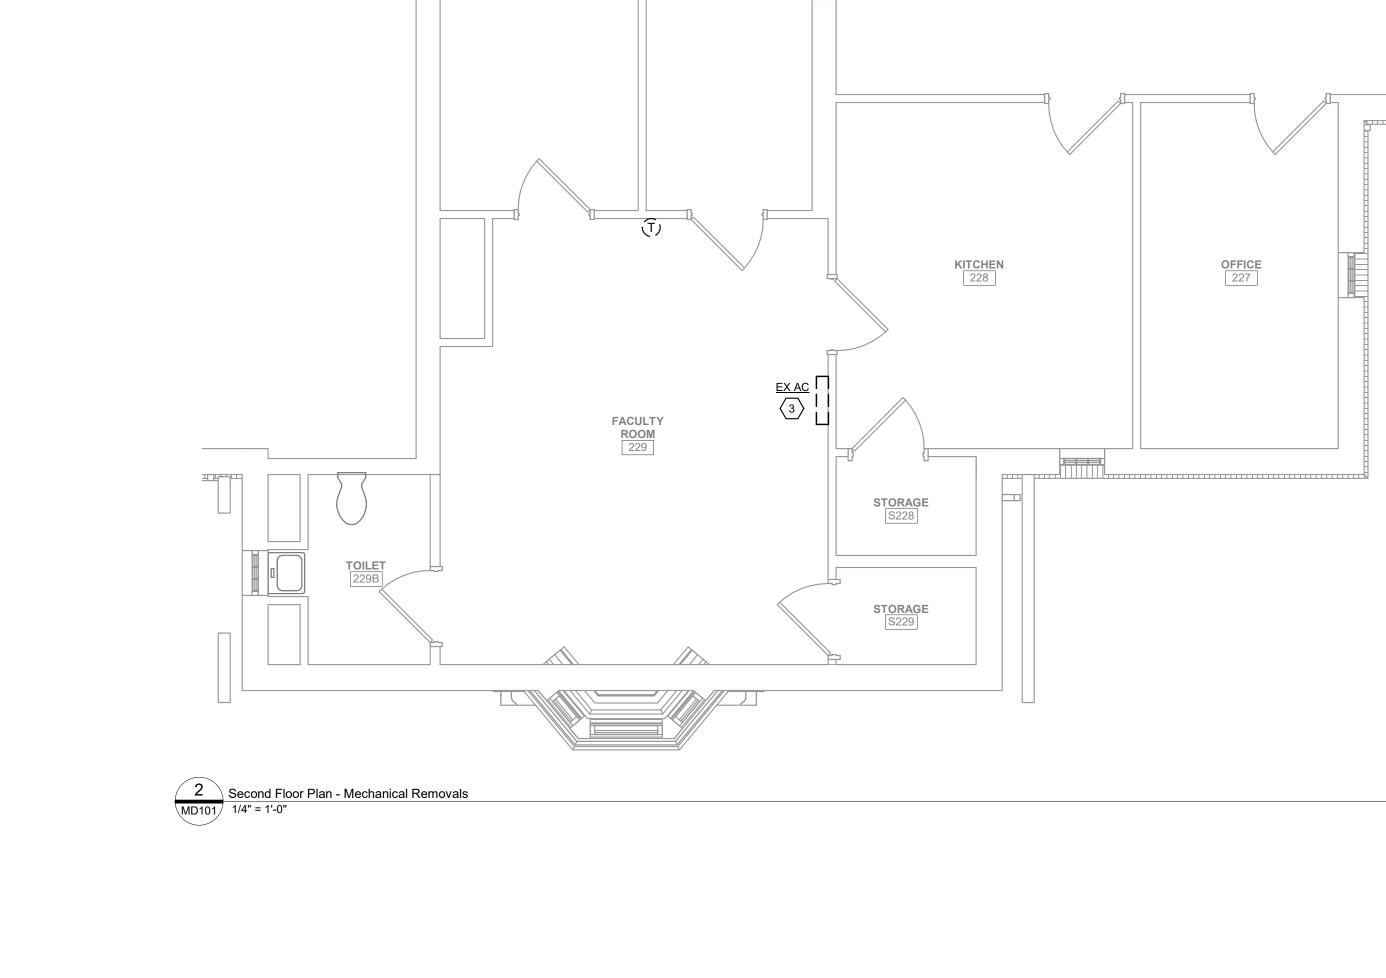- A. CONTRACTOR IS TO INSPECT EQUIPMENT THAT IS TO BE REUSED AND DETERMINE THAT IT IS COMPLETE
- B. EVERY EFFORT HAS BEEN MADE TO TO VERIFY CLEARANCE OF NEW INSTALLATIONS THROUGH FIELD OBSERVATIONS, HOWEVER, THE CONTRACTOR IS TO VERIEV ALL JOB INSTALLATIONS PRIOR TO PROVIDING
- VERIFY ALL JOB INSTALLATIONS PRIOR TO PROVIDING NEW WORK.

 C. ALL ITEMS BEING REMOVED AND NOT REUSED SHALL BE TURNED OVER TO THE OWNER FOR FUTURE USE. IF OWNER DECIDES THE FIXTURES ARE NOT REUSABLE, THE MECHANICAL CONTRACTOR SHALL

AND IN GOOD WORKING ORDER. IF NOT, REPORT

- DISPOSE OF THEM.

 D. IF THERE IS A QUESTION REGARDING EXISTING MECHANICAL SYSTEMS THE CONTRACTOR IS TO VERIFY WITH THE OWNER OR THE OWNER'S REPRESENTATIVE AS TO THE STATUS BEFORE
- PROCEEDING.

 E. ALL INTERRUPTIONS OF SERVICE SHALL BE SCHEDULED AND COORDINATED WITH THE OWNER. MECHANICAL SYSTEMS FEEDING FROM OR THROUGH THE CONTRACT AREA SHALL BE MAINTAINED.
- F. COORDINATE ALL WORK WITH PROJECT PHASING REQUIREMENTS.
 G. COORDINATE THIS DRAWING WITH ARCHITECTURAL DRAWINGS FOR EXTENT OF NEW WALL AND CEILING
- WORK

 H. COORDINATE THIS PLAN WITH REMOVAL PLAN.

 I. ALL EQUIPMENT, DUCTWORK, DIFFUSERS,
- REGISTERS, AND PIPING SHOWN WITH LIGHT LINE WEIGHT IS EXISTING TO REMAIN.

 J. PROVIDE ACCESS DOORS AT ALL FIRE AND FIRE/SMOKE DAMPERS FOR SERVICE.
- FIRE/SMOKE DAMPERS FOR SERVICE.

 K. PROVIDE VOLUME DAMPERS AT EACH BRANCH TAKEOFF
- CODED NOTES

 1 REINSTALL EXISTING SA
 - REINSTALL EXISTING SALVAGED AIR PURIFIER IN NEW LOCATION INCLUDING WALL MOUNTED SHELF.

 PROVIDE STEAM FIN TUBE RADIATION IN SAME
 - LOCATION AS REMOVED RADIATOR. PROVIDE LPS & LPR PIPING, VALVES, TRAP (SPIRAX SARCO RT-125) AND CONTROLS. CONNECT TO EXISTING PIPING.

 3 PROVIDE ENERGY RECOVERY VENTILATOR PER SCHEDULE LOCATED ABOVE CEILING SUSPENDED
- FROM STRUCTURE ABOVE.

 4 PROVIDE VRF CEILING CASSETTE HEAT PUMP UNIT PER SCHEDULE. PIPE CONDENSATE TO EXTERIOR OF BUILDING. CD PIPING SHALL LIFT AT UNIT TO ALLOW GRAVITY DRAIN TO EXTERIOR.
- PROVIDE VRF WALL MOUNTED DUCTLESS HEAT PUMP UNIT PER SCHEDULE. PIPE CONDENSATE DOWN THROUGH FLOOR.
- 6 PROVIDE GRADE MOUNTED VRF HEAT PUMP CONDENSING UNIT PER SCHEDULE AND NEW CONCRETE EQUIPMENT PAD. PROVIDE QUICK-SLING STAND. MAINTAIN ALL SERVICE CLEARANCES.

 7 PROVIDE VRF BRANCH BOX ABOVE CEILING. PROVIDE
- CONDENSATE PUMP (CP-1: LITTLE GIANT, VCCA-20-P, 120V/1PH) AND PIPE CONDENSATE TO EXTERIOR OF BUILDING.
- PROVIDE LOUVER ABOVE WINDOW PER SCHEDULE.
 PROVIDE 18" DEEP INSULATED PLENUM WITH SLOPED BOTTOM.
- 9 PROVIDE MOTORIZED SHUTOFF DAMPER.

 10 PROVIDE NEW STEAM PIPING CONNECTED TO EXISTING BELOW FLOOR. ROUTE UP THROUGH FLOOR AGAINST EXTERIOR WALL AND OFFSET ABOVE CEILING TO CONNECT TO EXISTING STEAM PIPING.
- PROVIDE EXHAUST DUCTWORK TO CONNECT TO EXISTING LOUVER PLENUM. MODIFY OPENING AS REQUIRED AND SEAL AIRTIGHT. INSULATE ENTIRE PLENUM.
- PROVIDE CONDENSATE PIPING DOWN EXTERIOR OF BUILDING AND TERMINATE WITH A 45° ELBOW AWAY FROM BUILDING AT 12" ABOVE GRADE.
- PROVIDE RECESSED WALL STEAM CABINET HEATER IN LOCATION OF REMOVED RADIATOR. MODIFY EXISTING WALL OPENING TO ACCOMMODATE NEW HEATER. PROVIDE VALVES, TRAPS (SPIRAX SARCO RT-125), AND CONTROLS. CONNECT LPS AND LPR PIPING TO EXISTING.
- PROVIDE CONCRETE PAD PER DETAILS. PROVIDE 4'
 HIGH, BLACK CHAIN LINK FENCE AROUND ENTIRE
 CONCRETE PAD. PROVIDE 36" WIDE GATE IN FENCE.
 CONCRETE PAD SHALL EXTEND PAST FENCE.

Project

WEN

OF NEW

DATE DESCRIPTION

Drawn By: PN
Checked By: JM
Proj. #: 66-11-00-01-0-015-018
CSArch Proj. #: 188-2301.02

Drawn By:

Checked By:

Proj. #: 66-11-00-01-0-01

CSArch Proj. #: 188-23

Issued for Bid: 03/14/

Sheet Title

MECHANICAL NEW WORK PLAN

Sheet No.

DWE

M101

CONSTRUCTION DOCUMENTS

KEY PLAN

B

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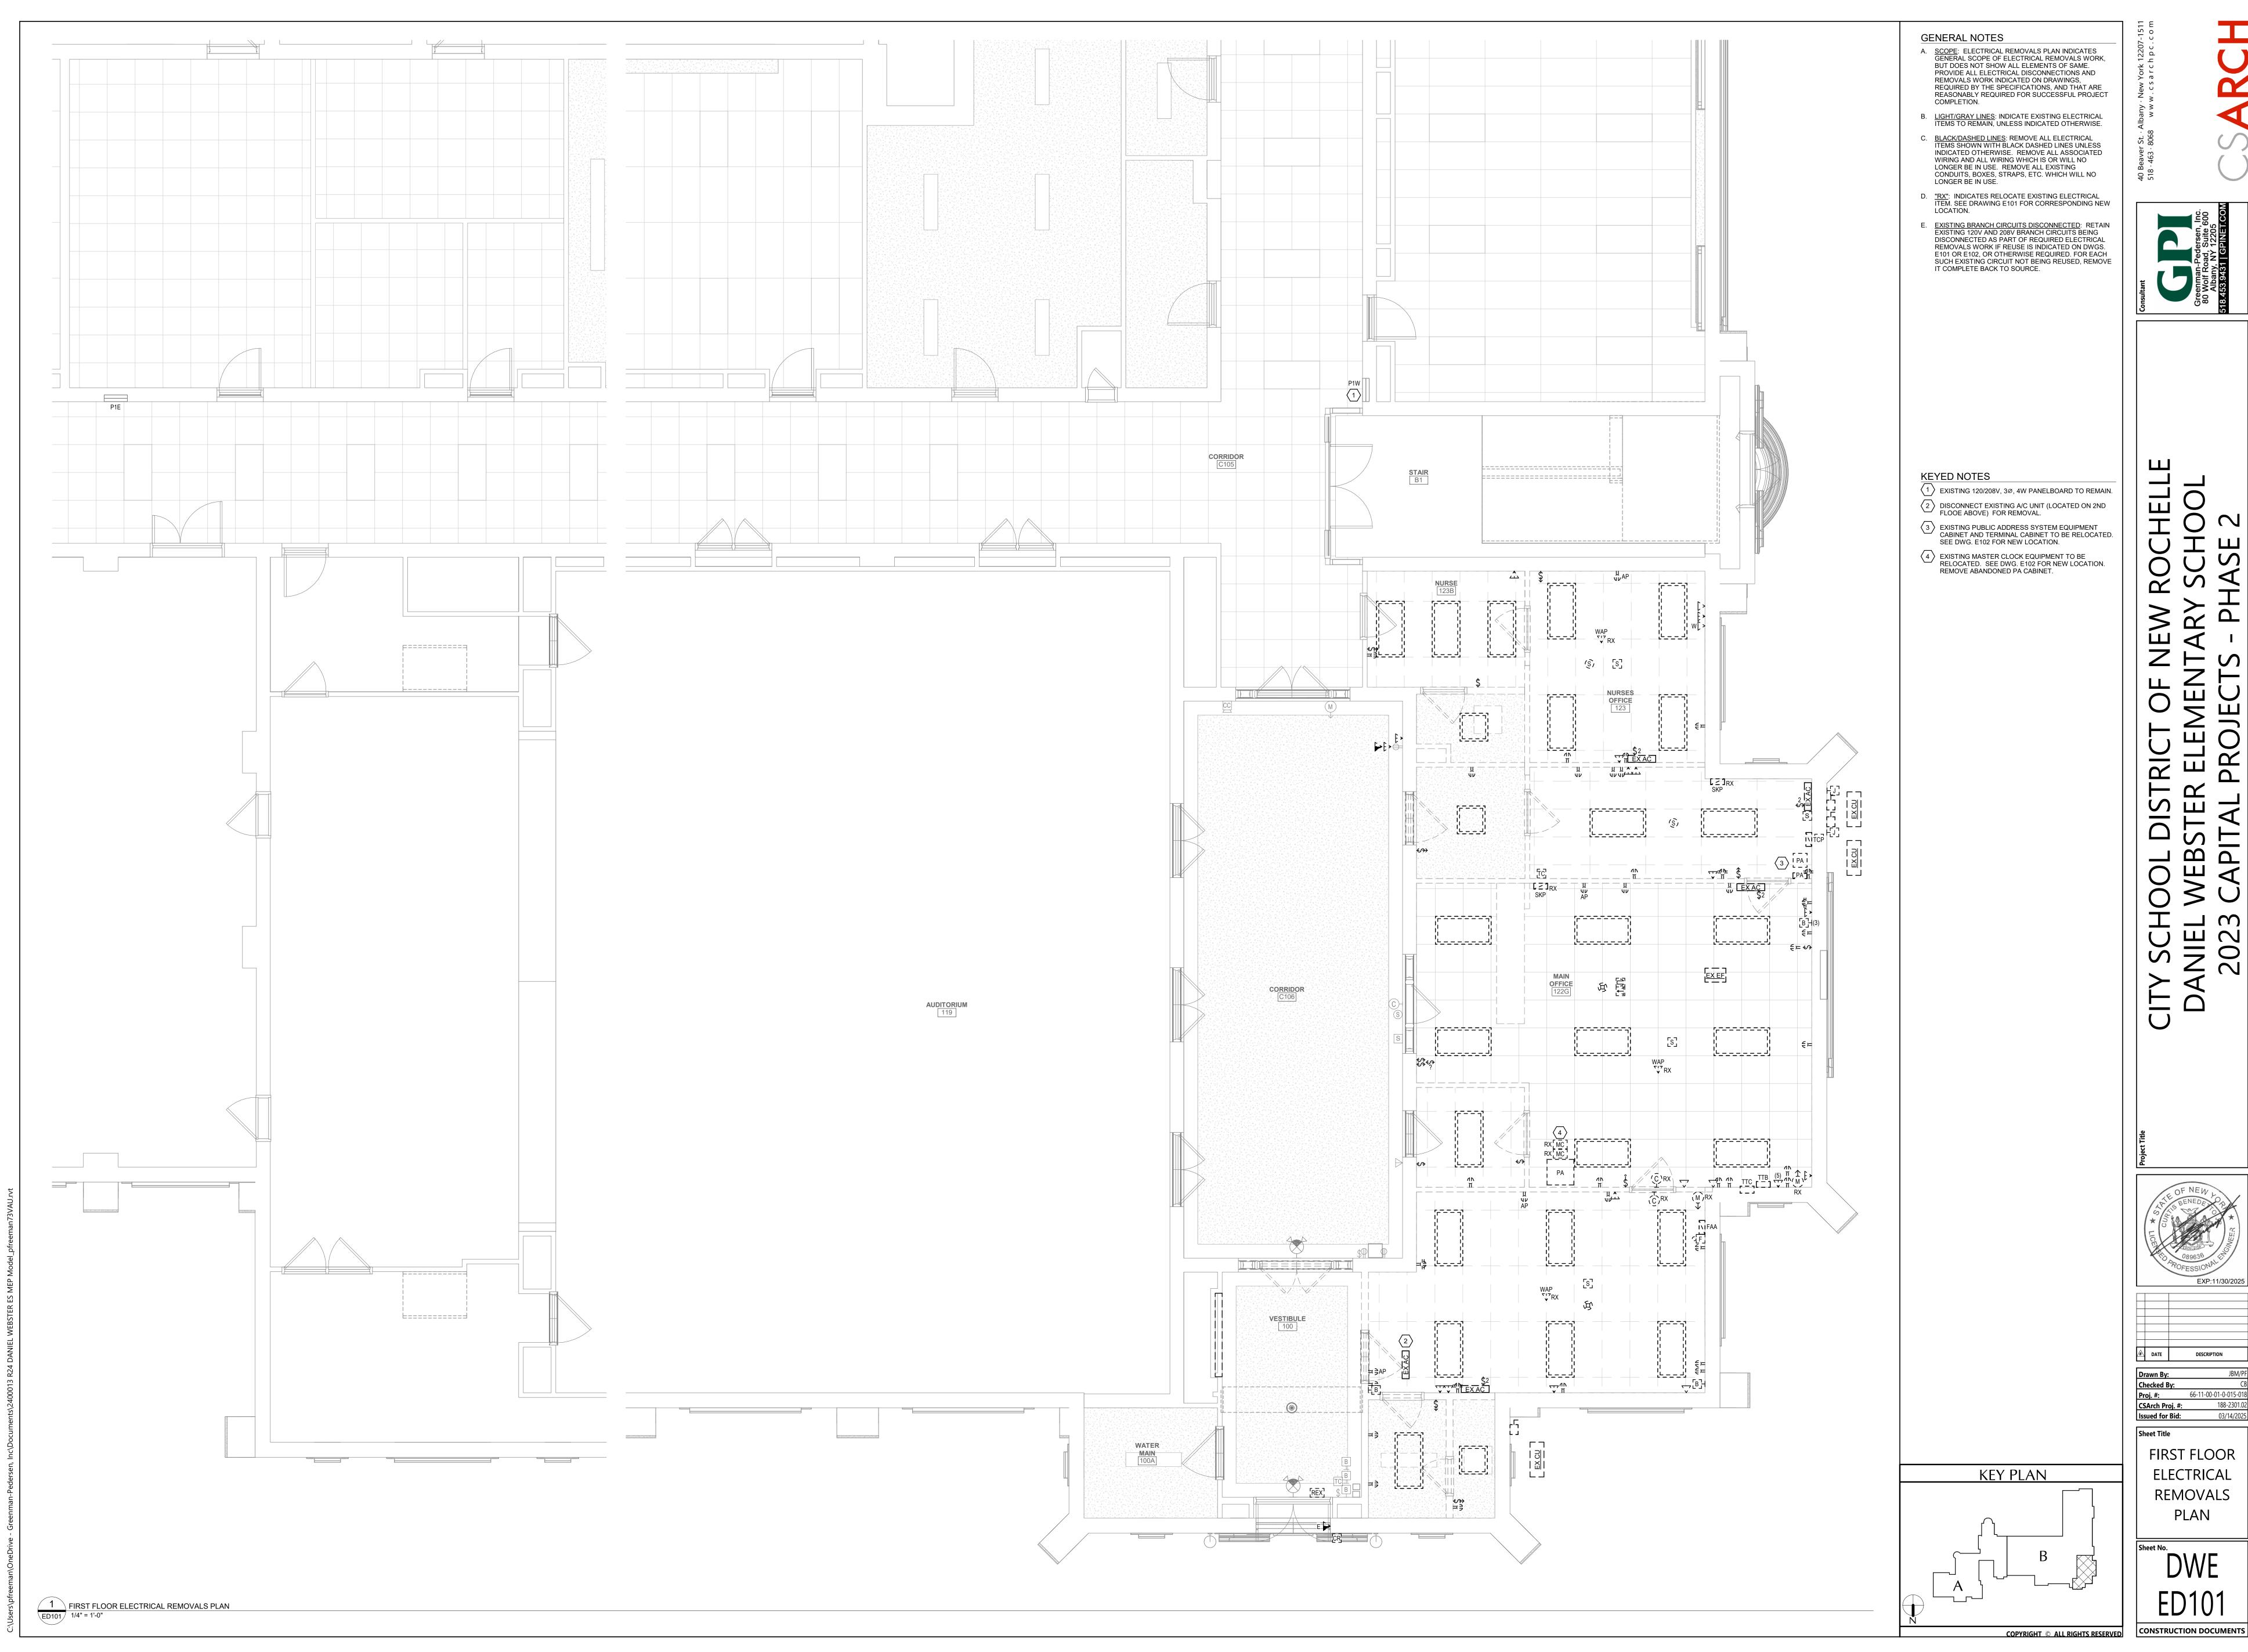
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ELECTRICAL LEGEND AND ABBREVIATIONS

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	ABBREVIATIONS	RACEWAY SYSTEMS	DEVICES AND OUTLETS	POWER DISTRIBUTION EQUIPMENT	ELECTRICAL DRAWING LIST	
A AMPERE(S) AC ALTERNATING CURRENT ACC AIR COOLED CONDENSING UNIT AFF ABOVE FINISHED FLOOR AFG ABOVE FINISHED GRADE AIC AMPERE INTERRUPTING CAPACITY ASD ADJUSTABLE SPEED DRIVE ATS AUTOMATIC TRANSFER SWITCH AUTO AUTOMATIC AUX AUXILIARY AWG AMERICAN WIRE GAUGE B BOILER BKR BREAKER BLDG BUILDING C CONDUIT CB CIRCUIT BREAKER CCT CIRCUIT CKT CIRCUIT CLG CEILING COL COLUMN COMB COMBINATION CU CONDENSING UNIT A DELTA CONNECTION D DEEP DIA DIAMETER DN DOWN DP DISTRIBUTION PANEL DWG DRAWING E EAST EA EACH EC ELECTRICAL CONTRACTOR EF EXHAUST FAN ELEC ELECTRIC(AL) ELU EMERGENCY LIGHTING UNIT EM, EMER. EMERGENCY EMT ELECTRICAL METALLIC TUBING EQUIP EQUIPMENT EWC ELECTRIC WATER COOLER	J JUNCTION BOX KCMIL THOUSAND CIRCULAR MILS KVA KILOVOLT-AMPERE KW KILOWATT(S) LTG LIGHTING LIGHT(S) MAX MAXIMUM MC METAL CLAD MCB MAIN CIRCUIT BREAKER MCM THOUSAND CIRCULAR MILS WP WATT, WEST, WIRE MCM THOUSAND CIRCULAR MILS MCB MAIN CIRCUIT BREAKER MCM THOUSAND CIRCULAR MILS MECH MECHANICAL MFR MANUFACTURER MIN MINIMUM MLO MAIN LUGS ONLY MT MOUNT MTD MOUNTED N NORTH, NEUTRAL NAC NOTIFICATION APPLIANCE CIRCUIT NC NORMALLY CLOSED, NURSE CALL NEC NATIONAL ELECTRICAL CODE NF NON-FUSED NIC NOT IN CONTRACT NO NORMALLY OPEN NTS NOT TO SCALE OH OVERHEAD OO ON-OFF P PANEL, POLE(S) PB PULL BOX, PUSHBUTTON PF POWER FACTOR PH, Ø PHASE PL PILOT LIGHT PP POWER POLE PR PAIR	CONDUIT OR CABLE AS SPECIFIED CONDUIT OR CABLE TURNING UP CONDUIT OR CABLE TURNING DOWN CONDUIT STUB (REAMED AND BUSHED) CONNECTION TO EQUIPMENT CONDUIT CUT P/1,2,3 HOMERUN TO PANELBOARD (PANEL AND CIRCUITS INDICATED) UGC UNDERGROUND CABLE TV LINE UGFO UNDERGROUND FIBER OPTIC LINE UGP UNDERGROUND PRIMARY LINE UGP UNDERGROUND PRIMARY LINE UGS UNDERGROUND SECONDARY LINE UGT UNDERGROUND TELECOMMUNICATIONS LINE JUNCTION BOX	G NOTE: "G" = INDICATES GROUND FAULT CIRCUIT INTERRUPTER TYPE "U" = INDICATES USB TYPE RECEPTACLE DOT INDICATES 6" ABOVE BACKSPLASH OF COUNTER/OR SINK (VERTICALLY) (OR 6" ABOVE COUNTER/OR SINK WHEN NO BACKSPLASH EXISTS) DUPLEX RECEPTACLE - (18" AFF) DOUBLE DUPLEX (QUAD) RECEPTACLE - (18" AFF) SIMPLEX RECEPTACLE - (18" AFF) G-20R SPECIAL PURPOSE RECEPTACLE - (18" AFF) (NEMA CONFIGURATION INDICATED) QUADRUPLEX RECEPTACLE (FLOOR) DUPLEX RECEPTACLE (CEILING)	DISTRIBUTION PANEL 2777/480V,3Ø,4W DISTRIBUTION PANEL 120/208V,3Ø,4W BRANCH CIRCUIT PANELBOARD 2777/480V,3Ø,4W BRANCH CIRCUIT PANELBOARD 120/208V,3Ø,4W NON-FUSED SAFETY SWITCH AMPS/NO. OF POLES FUSE SIZE B CIRCUIT BREAKER SS SURGE SUPPRESSOR T TRANSFORMER GROUND ROD GROUND BAR GROUNDING CONNECTION/POINT METER SOCKET	E001 ELECTRICAL LEGEND AND ABBREVIATIONS ED101 FIRST FLOOR ELECTRICAL REMOVALS PLAN E100 GROUND FLOOR ELECTRICAL PLAN E101 FIRST FLOOR LIGHTING AND SYSTEMS PLAN E102 FIRST FLOOR POWER AND TELECOM PLAN	
EWH ELECTRIC WALL HEATER EXIST EXISTING F FUSE(D) FA FIRE ALARM FACP FIRE ALARM CONTROL PANEL	PVC POLYVINYL CHLORIDE REC RECEPTACLE RECEPT RECEPTACLE RP REFRIGERATION POWER RGS RIGID GALVANIZED STEEL CONDUIT	B BLANK OUTLET	ABOVE SYMBOLS MAY BE COMBINED FOR VARIOUS APPLICATIONS THERMOSTAT - (60" AFF)			
FC FAN COIL UNIT FIXT FIXTURE FLEX FLEXIBLE FLR FLOOR FLUOR FLUORESCENT FS FOOD SERVICE FURN FURNISH(ED) FUT FUTURE	RM ROOM RTH RADIANT TUBE HEATER RTU ROOF TOP UNIT S SOUTH SCHED SCHEDULE SCP SECURITY CONTROL PANEL SEC SECONDARY SFL SUB-FEED LUGS	NOTE - LINES MAY BE SHOWN CURVED OR STRAIGHT.	R RELAY TC TIME SWITCH PC PHOTOSWITCH	MOTORS, EQUIPMENT& CONTROLS MOTOR STARTER COMBINATION MOTOR STARTER	MISCELLANEOUS EQUIPMENT DO DOOR OPERATOR DOOR OPERATOR PUSH PLATE - (48" AFF)	
G GROUND GC GENERAL CONTRACTOR GEC GROUNDING ELECTRODE CONDUCTOR GFI GROUND FAULT INTERRUPTER GND GROUND H HIGH HIGH HIGH INTENSITY DISCHARGE HO HIGH OUTPUT HOA HAND-AUTO-OFF HP HORSEPOWER HPS HIGH PRESSURE SODIUM HTR HEATER IG ISOLATED GROUND I/L INTERLOCK	SPC SPACE SPKR SPEAKER SPR SPARE SS START-STOP SW SWITCH TCP TEMPERATURE CONTROL PANEL TEL TELEPHONE TS TIME SWITCH T-STAT THERMOSTAT TTB TELECOMM. TERMINAL BOARD TV TELEVISION TVSS TRANSIENT VOLTAGE SURGE SUPPRESSER TYP TYPICAL	1. CONNECT EACH LIGHTING FIXTURE, SWITCH, RECEPTACLE, MOTOR, AND OTHER ITEM REQUIRING ELECTRICAL CONNECTIONS TO PANELBOARD AND CIRCUIT(S) INDICATED. HOMERUNS AND CONNECTIONS BETWEEN ITEMS MAY OR MAY NOT BE SHOWN. 2. P-XXX INDICATES ALL ELECTRICAL ITEMS IN RESPECTIVE ROOM TO BE CONNECTED TO THE DESIGNATED PANELBOARD, UNLESS INDICATED OTHERWISE. 3. NUMBER(S) SHOWN ADJACENT TO ELECTRICAL SYMBOLS GENERALLY INDICATE RESPECTIVE CIRCUIT NUMBER(S). 4. CONFIRM CORRECT CIRCUITING BY CORRELATING THE FLOOR PLANS WITH THE PANELBOARD SCHEDULES.	B BUZZER PUSHBUTTON TELECOM/POWER POLE	D DAMPER CH CABINET HEATER CUH CABINET UNIT HEATER EFT ELECTRIC FIN TUBE HEATER EF EXHAUST FAN AC A/C INDOOR UNIT HP HEAT PUMP CU A/C CONDENSING UNIT PTAC PACKAGE TERMINAL AIR CONDITIONING UNIT		
LIGHTING FIXTURE	S LIGHTING CONTROLS	TELECOMMUNICATIONS	SECURITY SYSTEMS	FIRE ALARM SYSTEM	NOTES TO ELECTRICAL SYMBOLS	
FIXTURE IDENTIFICATION A1 FIXTURE TYPE INDICATED ADJACENT TO OR NEAR FIXTUSYMBOL SWITCH/ CONTROL DESIGNAT LIGHTING FIXTURES WALL MOUNTED LIGHTING FIX RECESSED SQUARE LIGHT FIX 2'X2' SURFACE/RECESSED FIX 1'X4' SURFACE/RECESSED FIX 4' STRIP LIGHT RECESSED DOWNLIGHT BATTERY EMERGENCY LIGHTING (SURFACE WALL MOUNT) BATTERY EMERGENCY LIGHTING (RECESSED CEILING MOUNT) EXIT SIGNS EXIT SIGN (SINGLE-FACE, ARROW(S) AS INDICED TO SUR A RECENCY LIGHTING (SURFACE, ARROW(S) AS INDICED TO SUR A RECESSED COLUMN COMPANY CRECESSED CEILING MOUNT)	SA SWITCH, 3-WAY - (48" AFF) \$4 SWITCH, 4-WAY - (48" AFF) SWITCH SUBSCRIPTS: LOWER CASE LETTERS INDICATE CONTROL D = DIMMER K = KEY OPERATED SWITCH LV = LOW VOLTAGE STURE \$ PILOT LIGHT WALL SWITCH \$ OCCUPANCY SENSOR WALL SWITCH WITH 0-10V DIMMING LOW VOLTAGE LOP LIGHTING CONTROL PANEL LIGHTING CONTROL PANEL LIGHTING CONTROL PHOTOCELL S UNIT \$ ON-OFF SWITCH (X = QUANTITY, IF MORE THAN ONE; D= 0-10V DIMMING) S UNIT \$ ON-OFF SWITCH (X = QUANTITY OF SWITCHES, IF MORE THAN ONE; D= 0-10V DIMMING) S UNIT \$ ON-OFF SWITCH (X = QUANTITY OF CIRCUITS, IF MORE THAN ONE; D= 0-10V DIMMING) LOWER CASE LETTERS ARE USED TO CORROLATE CONTROLLED LOWER CASE LETTERS ARE USED TO CORROLATE CONTROLLED LOWER CASE LETTERS ARE USED TO CORROLATE CONTROLLED.	NOTE: - "W" INDICATES WALL MOUNTED AT 48"AFF - DOT INDICATES 6" ABOVE BACKSPLASH OF COUNTER/OR SINK (VERTICALLY) (OR 6" ABOVE COUNTER/OR SINK WHEN NO BACKSPLASH EXISTS) WR TELECOMM. WIRING RACK \[\begin{array}{l} \text{TELECOMM. OUTLET- WALL} (VOICE, DATA, AND OR CABLE) - (18" AFF) \[\begin{array}{l} \text{TELECOMM. OUTLET- FLOOR BOX} (VOICE, DATA, AND OR CABLE) \[\begin{array}{l} \text{TELECOMM. OUTLET- CLIING} (VOICE, DATA, AND OR CABLE) \[\begin{array}{l} \text{WWALL TELEPHONE OUTLET- (48" AFF)} \end{array} \] \[\text{WAP WIRELESS ACCESS POINT} \[\begin{array}{l} \text{PUBLIC ADDRESS SYSTEM} \] \[\begin{array}{l} \text{PUBLIC ADDRESS SYSTEM EQUIPMENT RACK} \[\begin{array}{l} \text{S} & SPEAKER \end{array} \] \[\text{S} & COMBINATION SPEAKER & CLOCK \[\begin{array}{l} \text{V} & VOLUME CONTROL \end{array} \] \[\text{CLOCK SYSTEM} \] \[\text{MC} & MASTER CLOCK \[\begin{array}{l} \text{MC} & MASTER CLOCK \ \begin{array}{l} \text{MC} & MASTER CLOCK \ \begin{array}{l} \text{CLOCK (SECONDARY OR 120V)} \end{array}	DAY DAY AUTOMATION SECURITY SYSTEM CABINET SKP SECURITY KEYPAD CC. VIDEO SURVEILLANCE CAMERA DL ELECTRIC DOOR LOCK CR CREDENTIAL READER REX REQUEST TO EXIT DEVICE DC DOOR CONTACT LD LOCKDOWN PUSH BUTTON STATION - (48"AFF) W M INTERCOM/VIDEO MONITOR MASTER STATION T E INTERCOM/VIDEO CAMERA ENTRY STATION	FAA FIRE ALARM ANNUNCIATOR FACE FIRE ALARM CONTROL PANEL FIRE ALARM POWER SUPPLY FIRE ALARM MANUAL STATION - (48" AFF) FIRE ALARM STROBE (WALL/CEILING MOUNT) FIF FOR FIRE ALARM HORN/STROBE (WALL/CEILING MOUNT) H HEAT DETECTOR (ADDRESSABLE TYPE) S AREA TYPE SMOKE DETECTOR S SB AREA TYPE SMOKE DETECTOR THE TRANSMITTER RERCENER/REFLECTOR FIRE ALARM MONITOR MODULE FR FIRE ALARM MONITOR MODULE FR FIRE ALARM RELAY MODULE H MAGNETIC DOOR HOLDER SD SMOKE DAMPER SH SMOKE HATCH CO CARBON MONOXIDE DETECTOR W/ INTEGRAL HEAT DETECTOR CO SC CARBON MONOXIDE STROBE (CEILING/WALL MOUNT) FS FLOW SWITCH TAMPER SWITCH PRESSURE SWITCH RS ROLLING COUNTER SMOKE SHUTTER OCC ROLLING SHUTTER OPEN-CLOSE-STOP CONTROL STATION	1. ALL ABBREVIATIONS AND SYMBOLS MAY OR MAY NOT BE USED. 2. MOUNTING HEIGHTS: FOR ALL WALL MOUNTED DEVICES, ETC., LOCATE CENTERLINE OF DEVICE VERTICALLY AT INDICATED MOUNTING HEIGHT (E.G. 18" AFF; AND IN ACCORDANCE WITH THE NOTES BELOW, UNLESS INDICATED OTHERWISE. MOUNTING HEIGHTS (E.G. 42") INDICATED ADJACENT TO SYMBOLS ON PLANS, AND MOUNTING HEIGHTS SHOWN ON ELEVATIONS OR DETAILS OR BY NOTES TAKE PRECEDENCE OVER STANDARD MOUNTING HEIGHTS. 3. ELECTRICAL DEVICE PLACEMENT: WHERE MULTIPLE ELECTRICAL DEVICES (E.G. SWITCHES, RECEPTACLES, CLOCKS, FIRE ALARM DEVICES, EXIT SIGNS, TELECOMMUNICATION OUTLETS, ETC.) ARE SHOWN NEAR EACH OTHER, ORGANIZE EXACT LOCATIONS IN GROUPS WHICH ALIGN ON COMMON HORIZONTAL AND VERTICAL CENTER LINES. 4. WIRING DEVICE GANGING; WHERE ADJACENT WIRING DEVICES ARE INDICATED, GROUP ALL SUCH DEVICES WITH A COMMON MULTI-GANG COVERPLATE UNLESS INDICATED OTHERWISE. 5. INDIVIDUAL CIRCUIT BREAKERS, SAFETY SWITCHES, STARTERS, AND THE LIKE: WHEREVER PRACTICABLE, MOUNT WITH CENTER LINE OF ENCLOSURE AT 60" AFF, BUT ADJUST AS NECESSARY SO THAT TOP OF ENCLOSURE IS AT MAXIMUM 72" AFF. 6. EMERGENCY LIGHTING UNITS: MOUNT AT 96" AFF TO CENTER LINE OF UNIT, OR WITH TOP OF DOOR FRAME AND CEILING LINE, WHICHEVER IS LESS. 7. EXIT SIGNS: WHERE LOCATED ABOVE DOOR, CENTER EXIT SIGN'S WHERE LOCATED ABOVE DOOR, CENTER EXIT SIGN'S IN VICINITY BUT NOT LOCATED ABOVE DOOR. 8. FIRE ALARM NOTIFICATION APPLIANCES: (E.G. HORNISTROBES, STROBES, ETC.). MOUNT AT 80" AFF TO CENTER LINE OF EMALM, UNILESS INDICATED OTHERWISE. 10. DASHED DARK/BLACK LINES: INDICATE EXISTING ELECTRICAL ITEMS TO REMAIN, UNLESS INDICATED OTHERWISE. 11. SOLID DARK/BLACK LINES: INDICATE EXISTING ELECTRICAL ITEMS TO REMAIN, UNLESS INDICATED OTHERWISE.	




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 JBM/PF

 Checked By:
 CB

 Proj. #:
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 CSArch Proj. #:
 188-2301.02

FIRST FLOOR ELECTRICAL REMOVALS

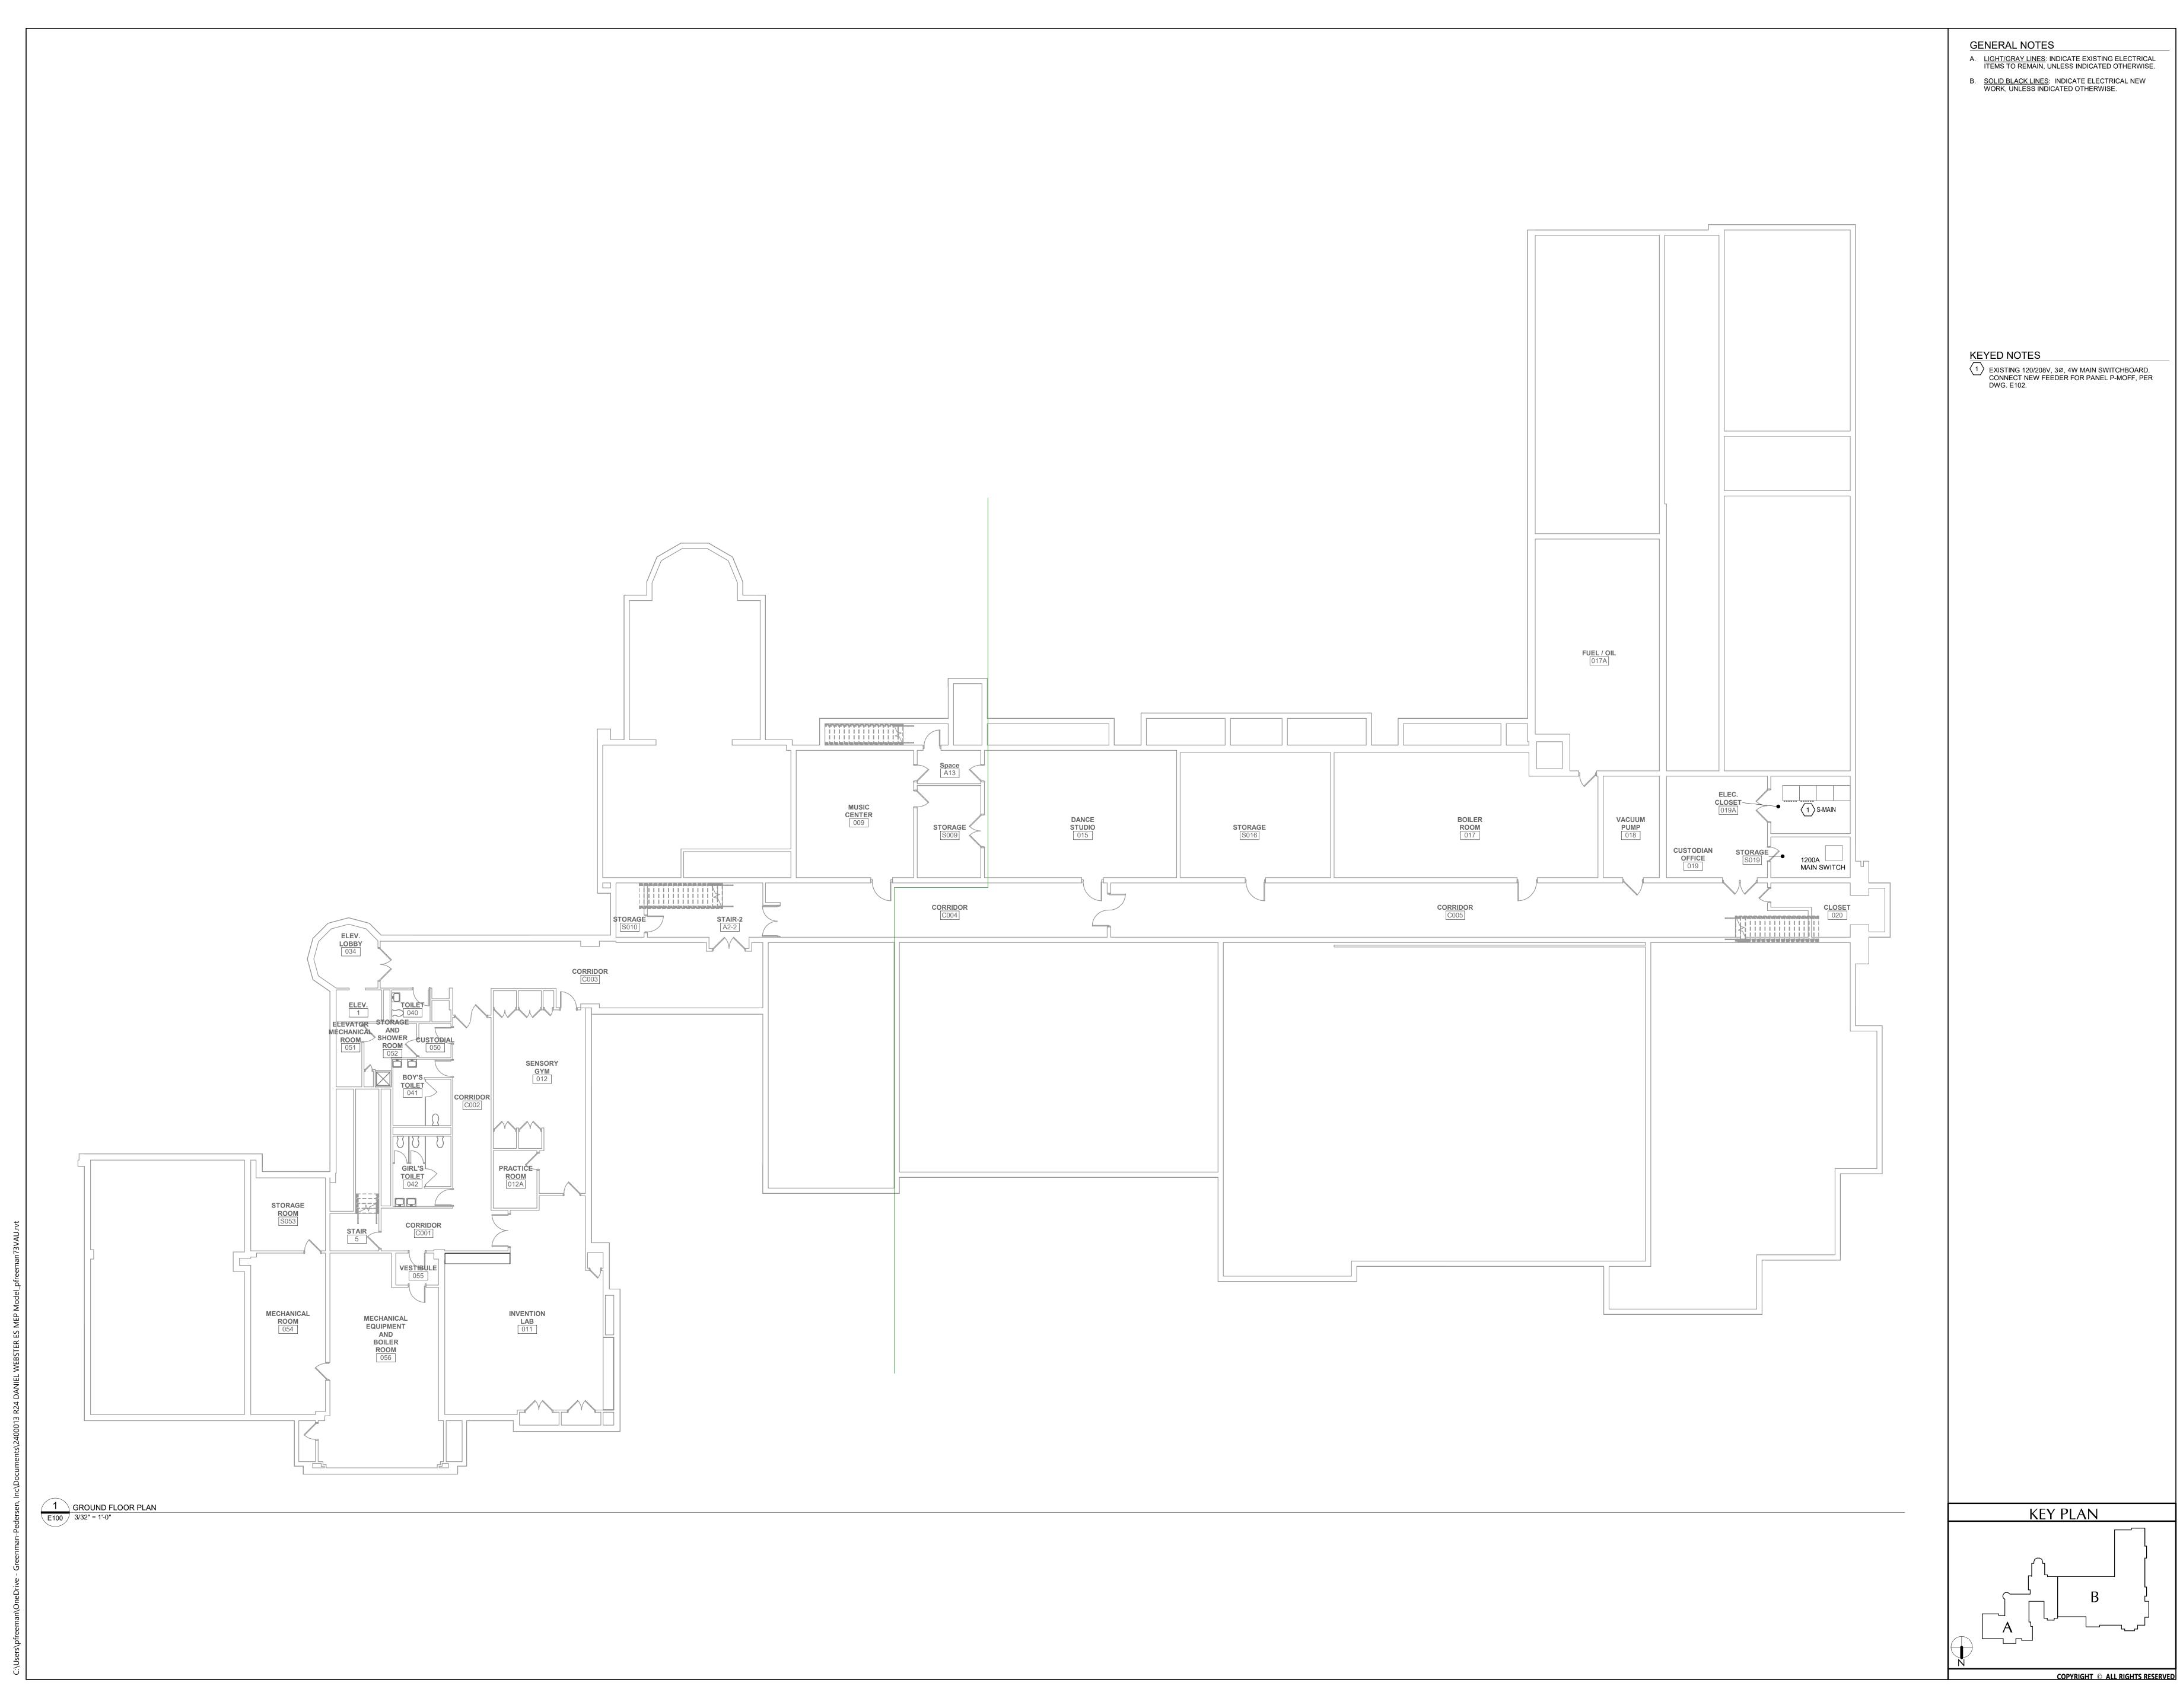

DANIEL WEBSTER ELEMENTARY SCHOOL

Delect Title


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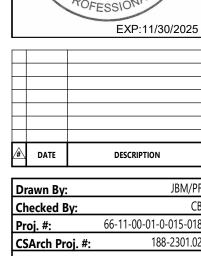
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Checked By: CB
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CSArch Proj. #: 188-2301.02
Issued for Bid: 03/14/2025

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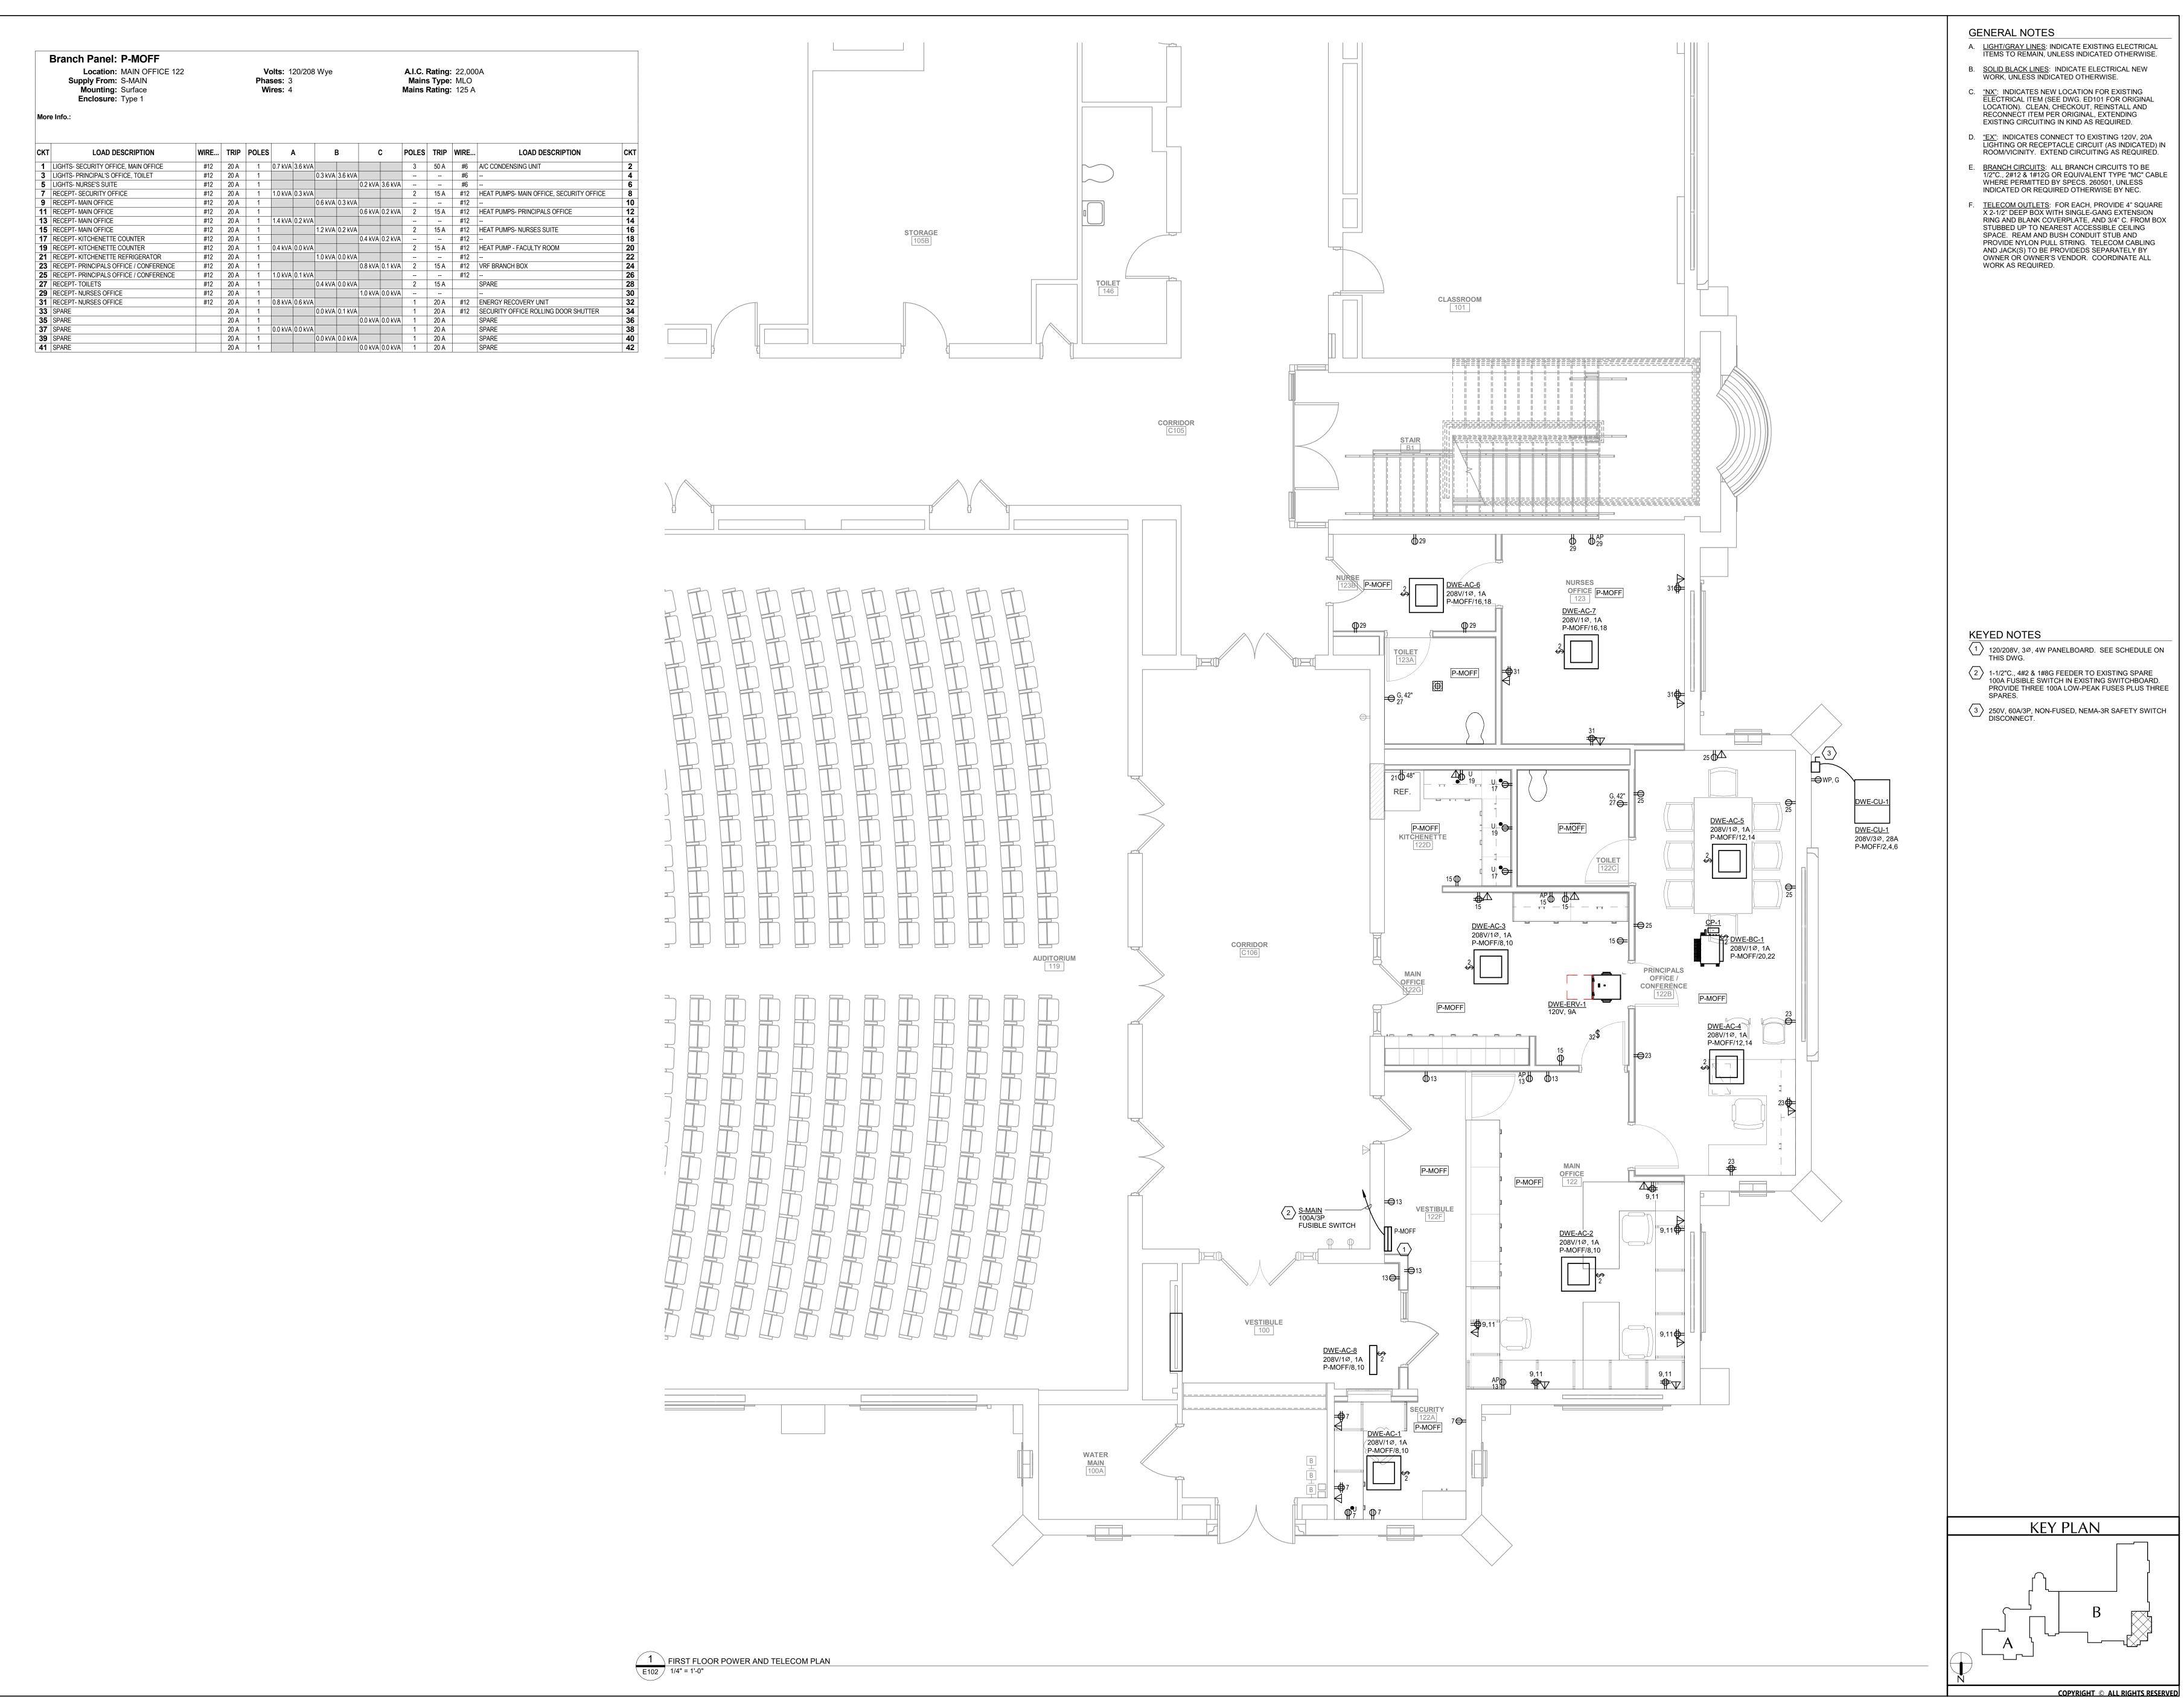








FIRST FLOOR

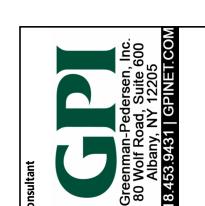LIGHTING AND SYSTEMS PLAN



A. <u>LIGHT/GRAY LINES</u>: INDICATE EXISTING ELECTRICAL ITEMS TO REMAIN, UNLESS INDICATED OTHERWISE.

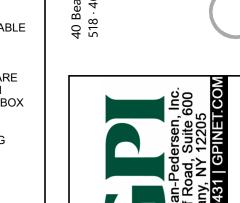

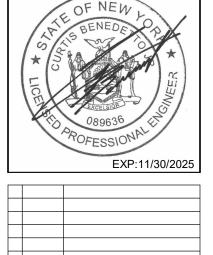

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FIRST FLOOR POWER AND TELECOM