



## PLUMBING NOTES

1. ALL NEW DOMESTIC HOT AND COLD WATER SUPPLY AND HOT WATER RETURN PIPES SHALL BE COPPER TUBING AND SHALL ORIGINATE ON THE SAME FLOOR FROM THE NEAREST WET COLUMN WITH PROPER ACCESS FOR MAINTENANCE. IF ATTACHED TO DISSIMILAR METAL, A CORROSION INHIBITOR IS TO BE PROVIDED.
2. INSULATE ALL DOMESTIC HOT AND COLD WATER SUPPLY AND HOT WATER RETURN PIPES.
3. WASTE LINES SHALL BE PROPERLY PITCHED TO PREVENT "TRAPPED" WATER. INSTALL WASTE LINE CONNECTIONS WITH LONG TERM OR 45° "Y" FITTINGS.
4. RETAIN EXISTING CLEAN OUT CONNECTIONS AND PROVIDE CLEAN OUT CONNECTIONS AT NEW FITTINGS.
5. WHEN CONNECTING NEW DOMESTIC HOT AND COLD WATER SUPPLY AND HOT WATER RETURN PIPES TO EXISTING RISERS, CONTRACTORS SHALL LEAVE A PLUGGED VALVED OUTLET FOR EACH, FOR FUTURE USE.
6. ALL NEW DOMESTIC HOT AND COLD WATER SUPPLY AND HOT WATER RETURN PIPES ATTENDANT FITTINGS MUST BE PROPERLY INSULATED AND COVERED.
7. INDIVIDUAL SHUT-OFF VALVES MUST BE SUPPLIED AND INSTALLED FOR EACH NEW FIXTURE, INCLUDING WATER COOLERS.
8. ALL NEW PIPES ARE TO BE SUPPORTED FROM SLAB OR STEEL BEAMS, NOT FROM EXISTING PIPES OR DUCT WORK.
9. ALL WATER SHUTDOWNS TO BE COORDINATED THROUGH THE BUILDING MANAGER. ALL WATER SHUTDOWNS ARE TO BE PERFORMED OR SUPERVISED BY BUILDING PERSONNEL, AT THE DISCRETION OF THE BUILDING MANAGER.
10. PLUMBER SHALL BE RESPONSIBLE THAT ENTIRE INSTALLATION IS IN ACCORDANCE WITH LOCAL AND STATE CODES.
11. PRIVATE BATHROOMS MUST BE INSTALLED ON MINIMUM 4" WASTE LINE.
12. ALL VALVES ARE TO BE PROPERLY TAGGED.
13. ANY WET COLUMNS USED SHOULD BE PROVIDED WITH A 24" x 24" STEEL SURFACE MOUNTED ACCESS DOOR.
14. HOT WATER HEATERS SERVING PRIVATE BATHROOMS, KITCHENS, ETC. ARE TO BE SUPPLIED FROM THE WET COLUMN THAT SUPPLIES THE COLD WATER TO THESE AREAS.

## LINE REPRESENTATION

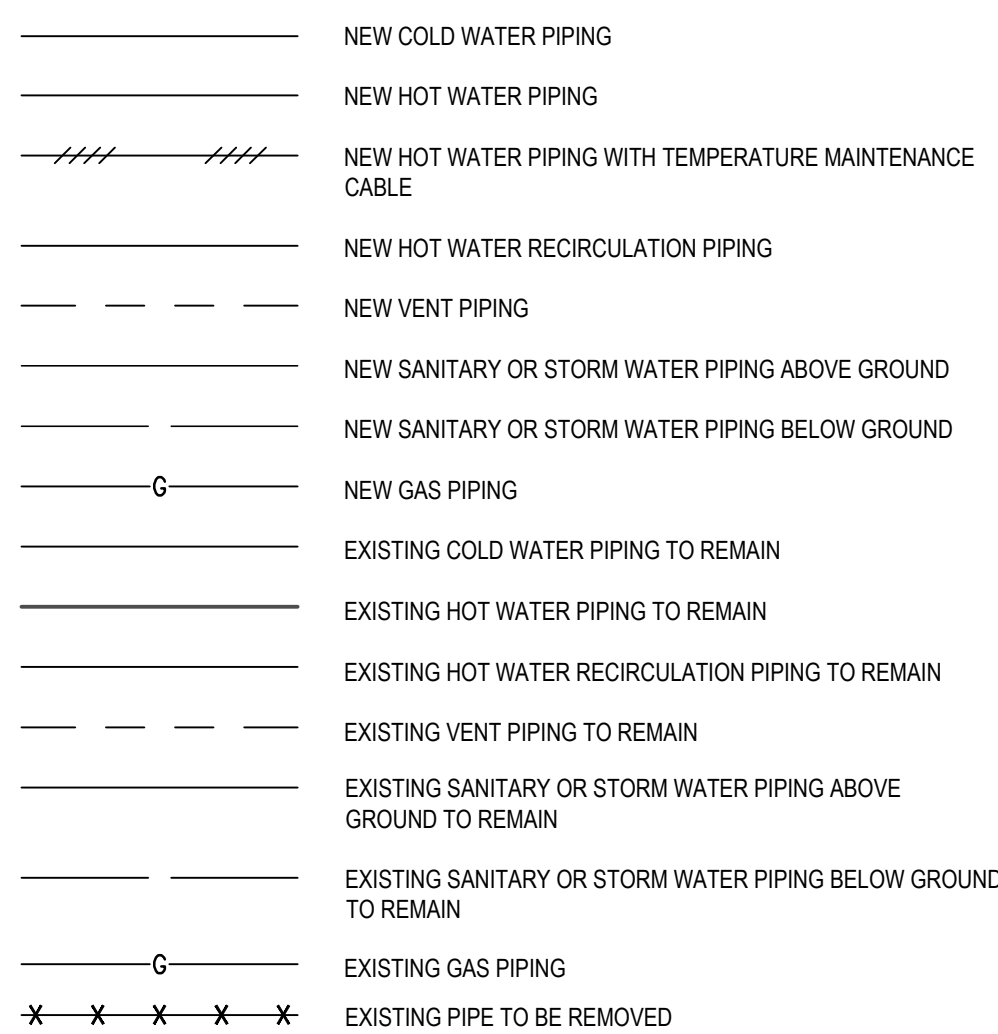


## PLUMBING LEGEND

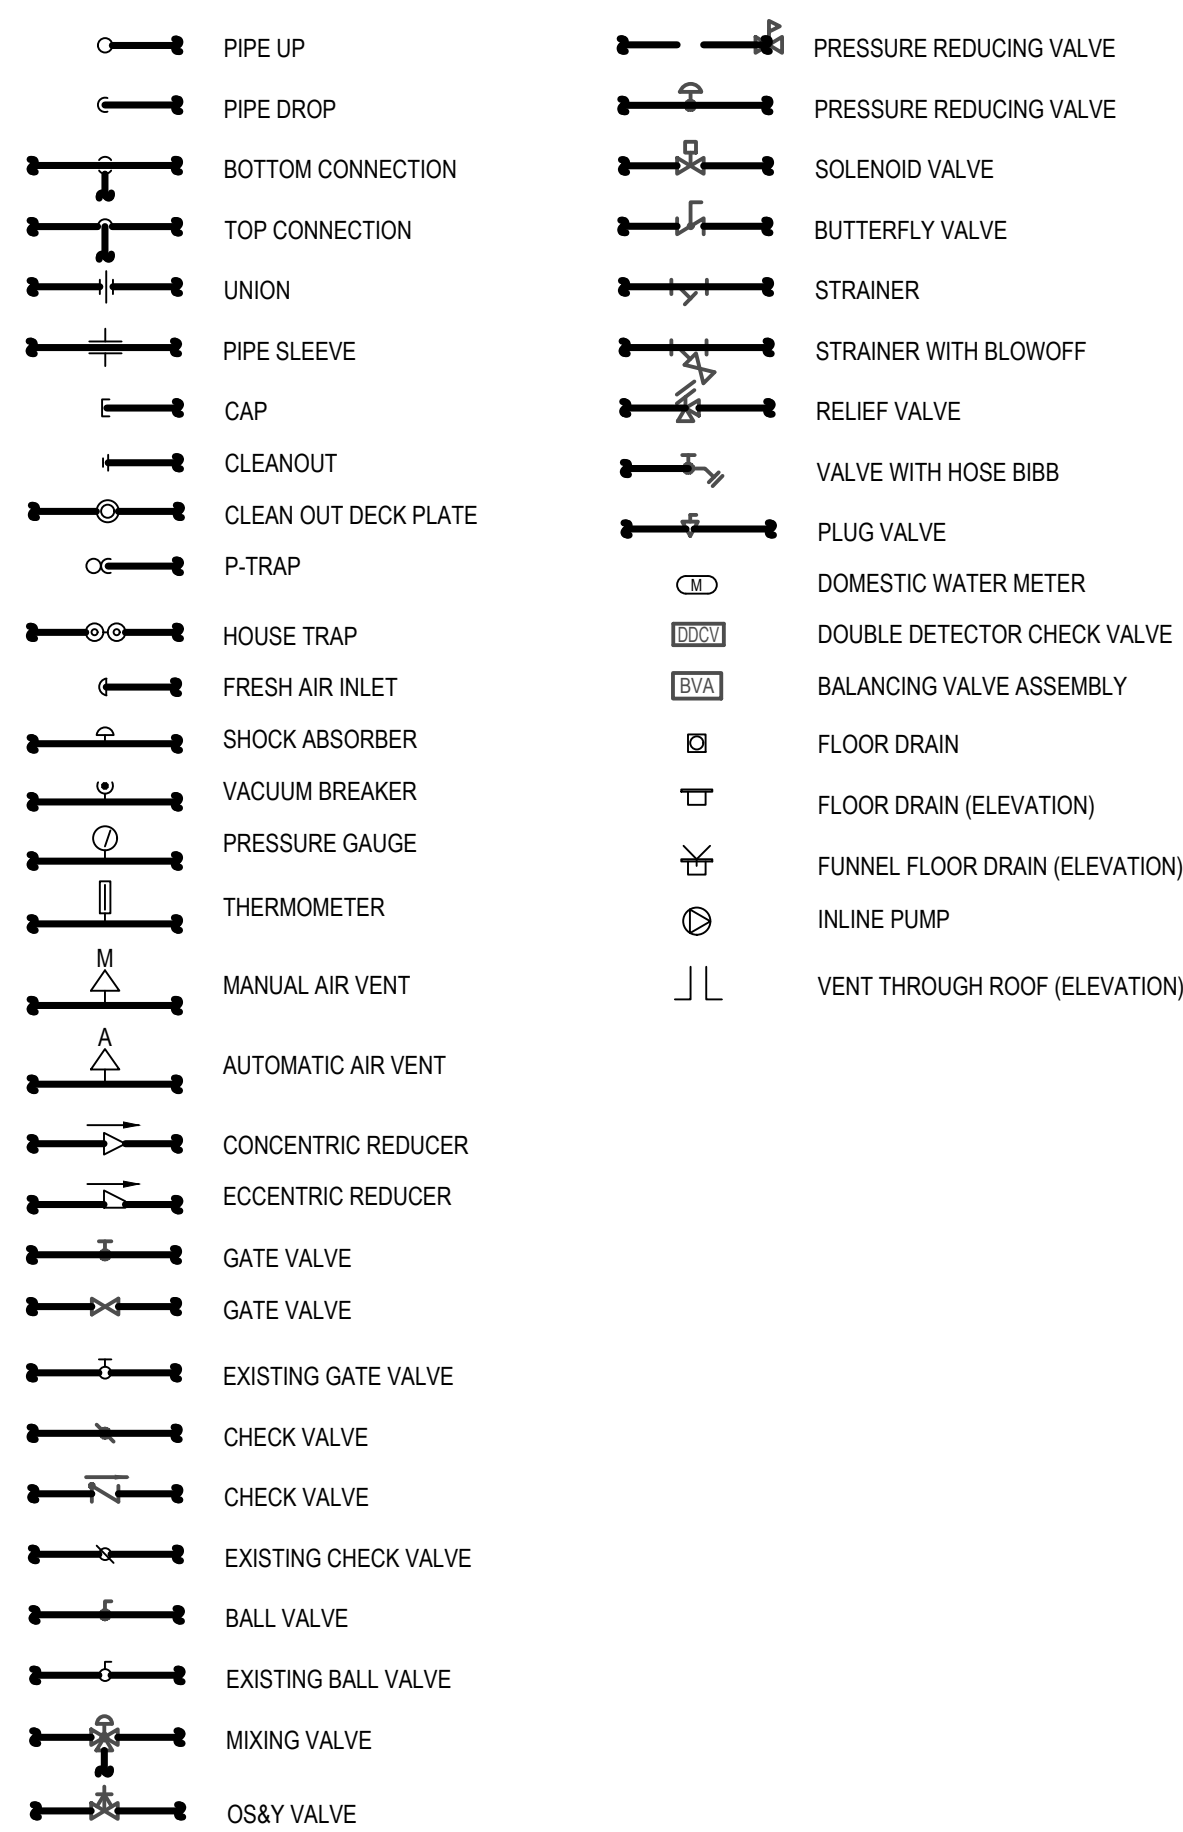

## PLUMBING DRAWING LIST

- |                        |  |
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| <a href="#">P-101a</a> | PLUMBING L1 FLOOR PLAN QUADRANT 1                        |
| <a href="#">P-102</a>  | PLUMBING L1 FLOOR PLAN QUADRANT 2                        |
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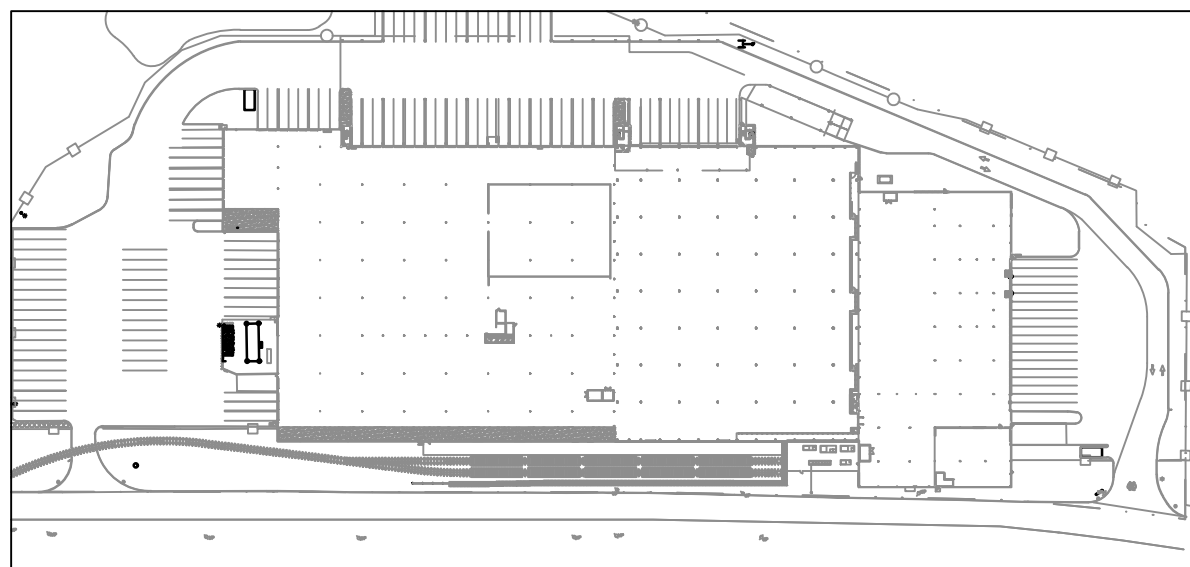
## -DRAWING NOTATIONS

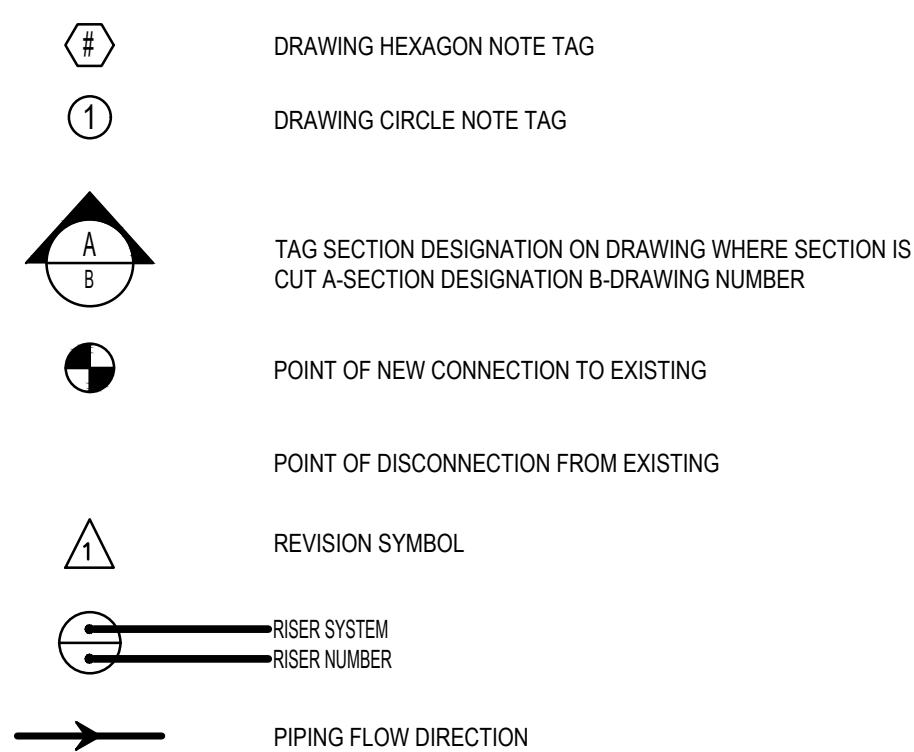

## ABBREVIATIONS

AF	ABOVE FINISHED FLOOR
BFP	BACKFLOW PREVENTER
BVA	BALANCING VALVE ASSEMBLY
CM	COFFEE MAKER
CODP	CLEAN OUT DECK PLATE
CW	COLD WATER
DIA	DIAMETER
DN	DOWN
EWC	ELECTRIC WATER COOLER
FAI	FRESH AIR INLET
FD	FLOOR DRAIN
FFD	FUNNEL FLOOR DRAIN
FL	FLOOR
FS	FLOOR SINK
G	GAS
HB	HOSE BIBB
HW	HOT WATER
HWR	HOT WATER RECIRCULATION
IM	ICE MAKER
LAV	LAVATORY
LDR	LEADER
MIN	MINIMUM
MR	MOP RECEPTOR
P	PLUMBING
RD	ROOF DRAIN
RPZ	REDUCED PRESSURE ZONE
RTU	ROOF TOP UNIT
S	SANITARY
SH	SHOWER SERVICE
SK	SINK
ST	STORM
UR	URINAL
V	VENT
VB	VACUUM BREAKER
VIF	VERIFY IN FIELD
VTR	VENT THRU ROOF
W	WASTE
WH	WALL HYDRANT
WC	WATER CLOSET

## PLOT PLAN



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TO THE BEST KNOWLEDGE, BELIEF AND PROFESSIONAL JUDGEMENT,  
THESE PLANS AND SPECIFICATIONS ARE IN COMPLIANCE WITH THE 2020  
ENERGY CONSERVATION CONSTRUCTION CODE OF NEW YORK STATE.

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SUFFERN, NEW YORK

## KEY PLAN

REV	DESCRIPTION	DATE
	ISSUED FOR DOB SUBMISSION	09/10/2021
	ISSUED FOR BID	10/15/2021
	ISSUED FOR PROGRESS	01/18/2022
	ISSUED FOR BID	08/30/2022

DRAWN BY : M.ESPINAL

CHECKED BY : J.CLARK

APPROVED BY : J.MIZRAHI

DATE : 04/16/21

SCALE : NOT TO SCALE

DRAWING TITLE:

## PLUMBING LEGEND AND NOTES

DWG NUMBER :

P-001