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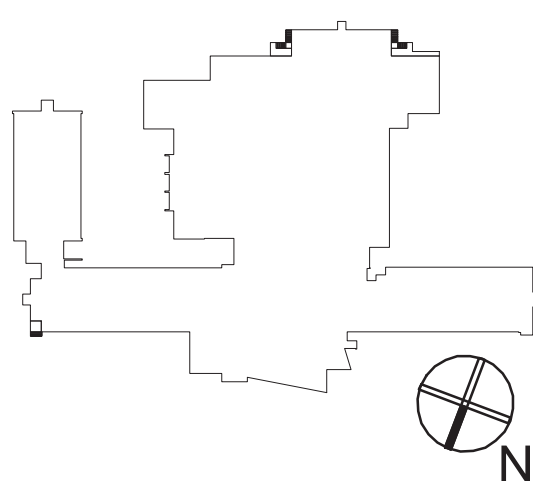
NUFSD BOND PROJECTS PH3

SED#50-01-08-03-0-003-035 (HIGH SCHOOL)
SED#50-01-08-03-0-004-020 (BARR MIDDLE SCHOOL)

High School
103 Church St.
Nanuet, NY 10954

Barr Middle School
50 Blauvelt Rd #1
Nanuet, NY 10954

KEY PLAN



REVISIONS

No.	Description	Date

ISSUED: BID SET ISSUANCE

DATE: 06/06/2023


SCALE: 1/16" = 1'-0"

SHEET NAME:
OVERALL FIRST FLOOR
PLAN

SHEET NUMBER:

HS-M101

ISSUE FOR BID SET

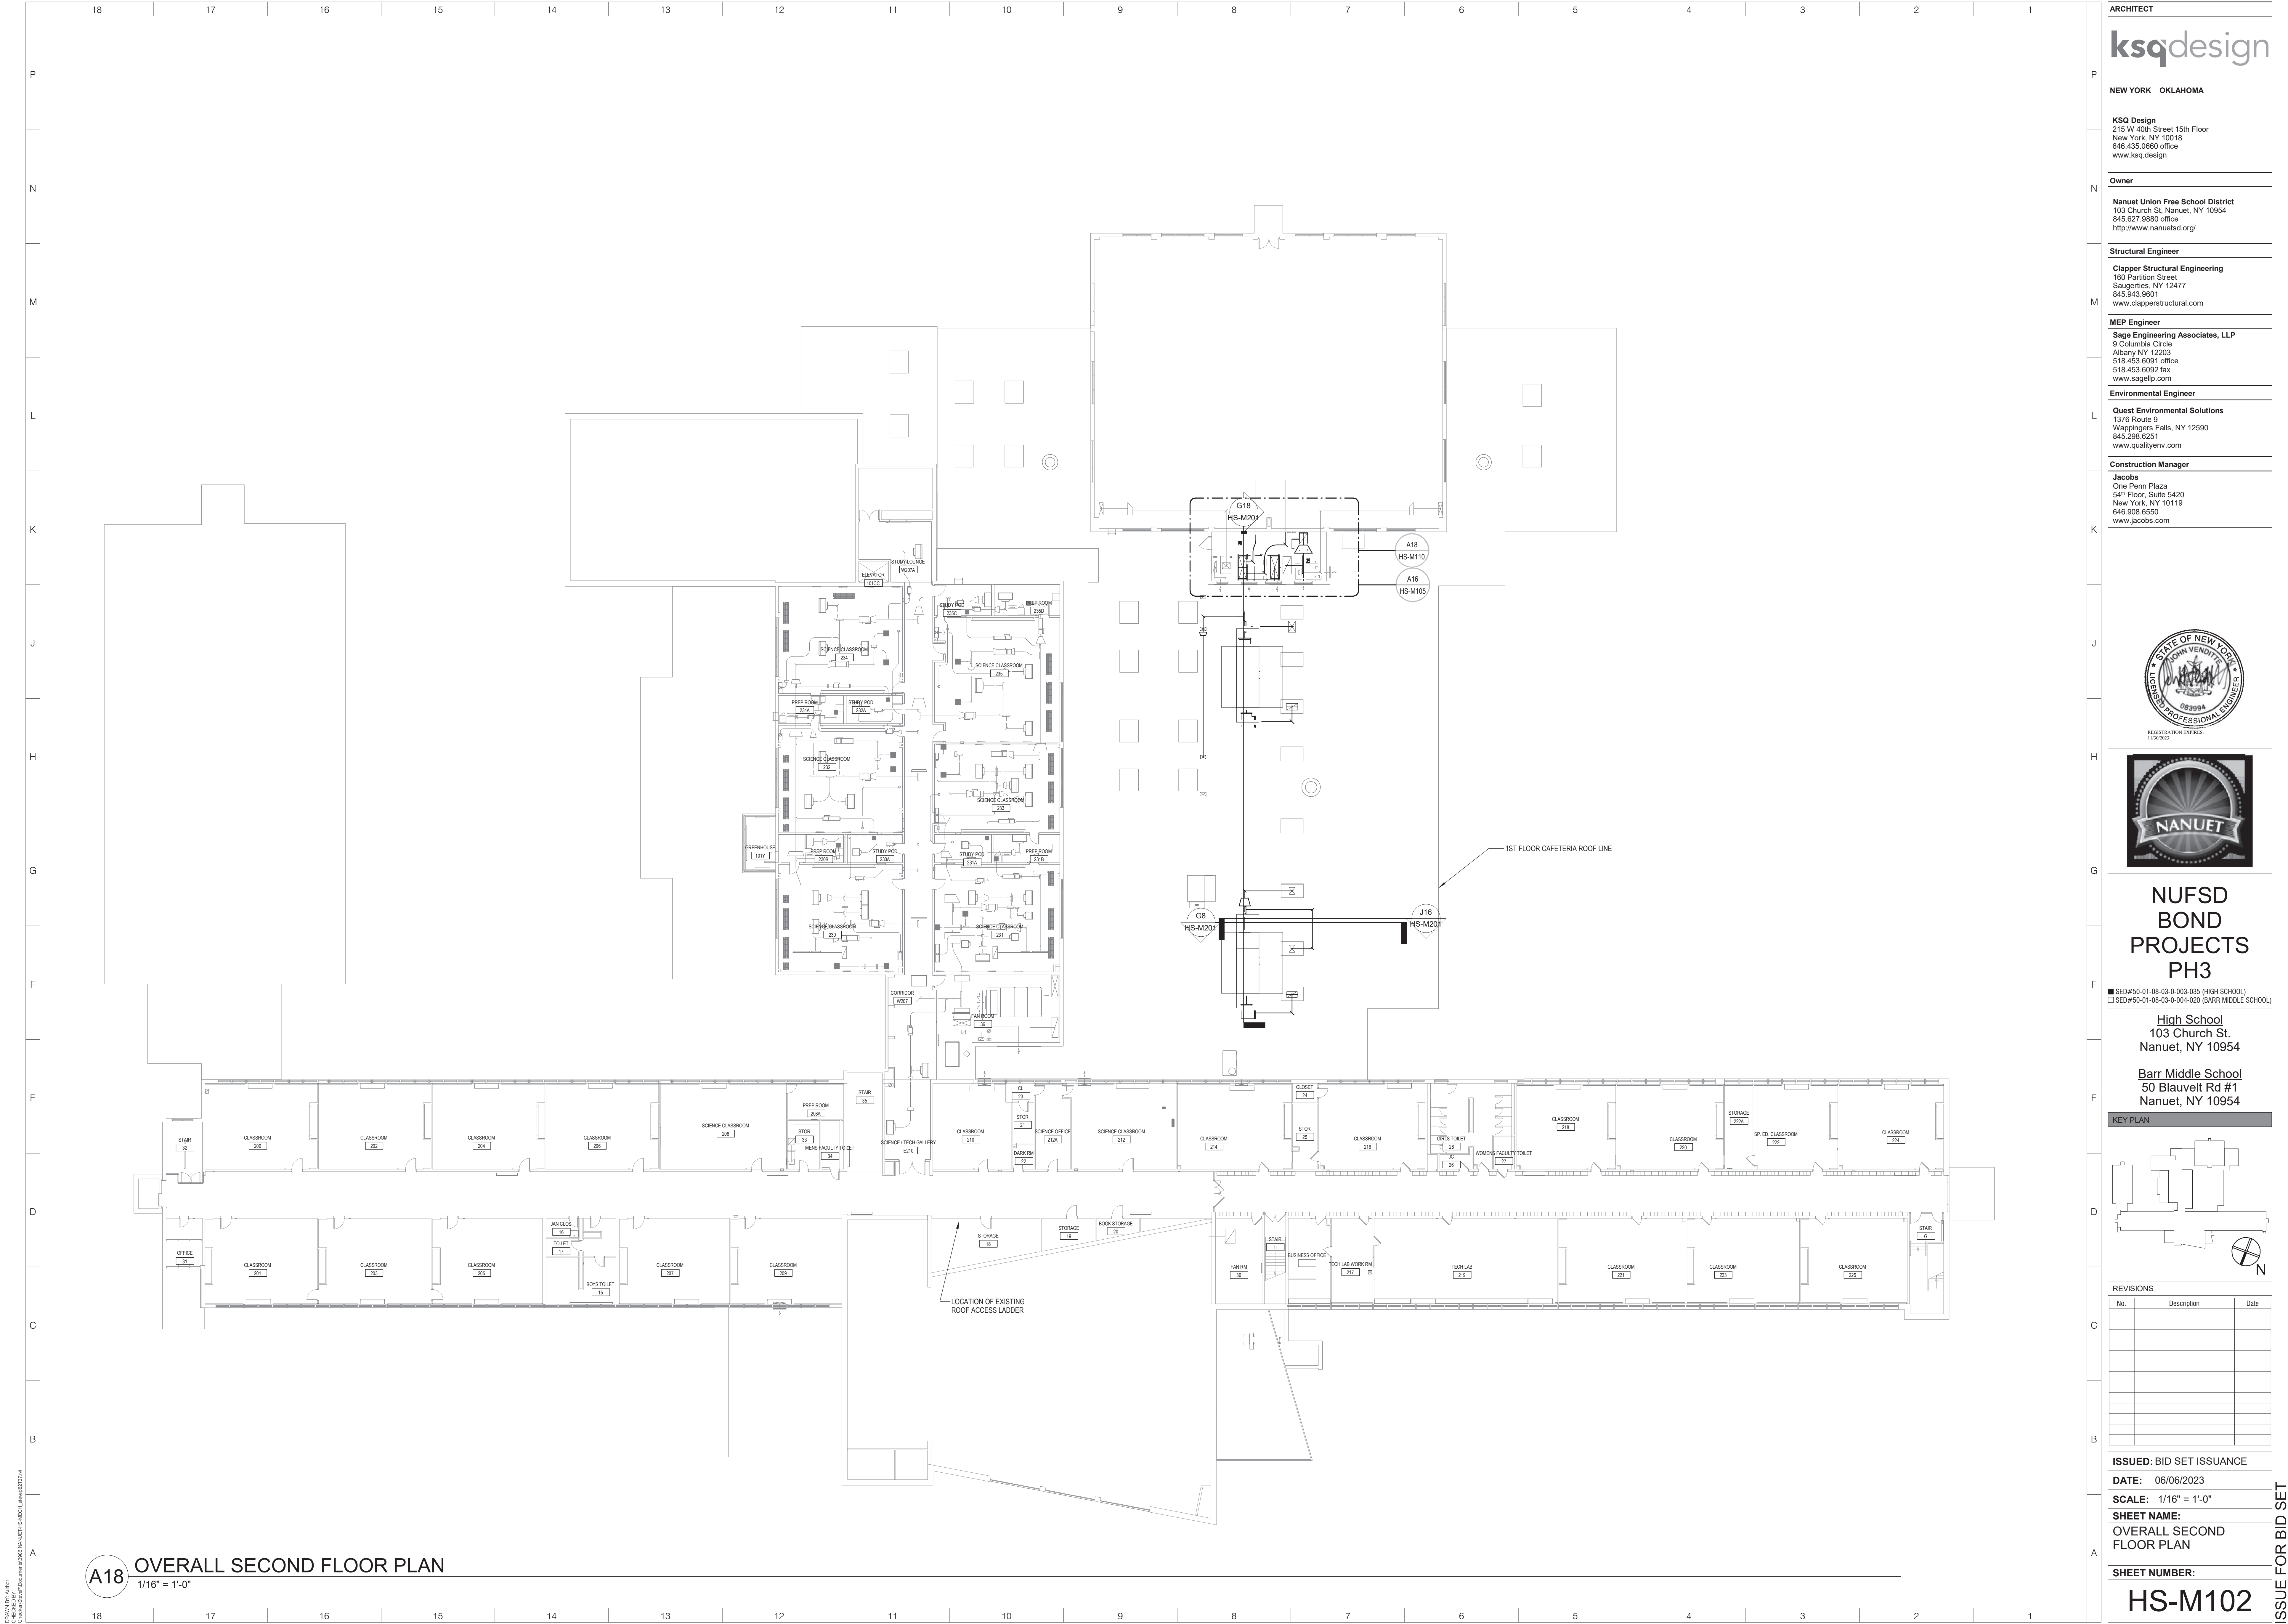

A18 OVERALL SECOND FLOOR PLAN
1/16" = 1'-0"

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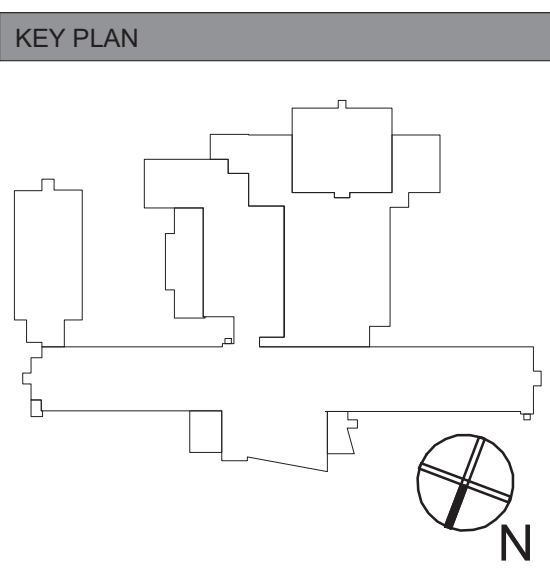


**NUFSD
BOND
PROJECTS
PH3**

SED#50-01-08-03-0-003-035 (HIGH SCHOOL)
SED#50-01-08-03-0-004-020 (BARR MIDDLE SCHOOL)

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Barr Middle School
50 Blauvelt Rd #1
Nanuet, NY 10954




REVISIONS

No.	Description	Date

ISSUED: BID SET ISSUANCE
DATE: 06/06/2023
SCALE: 1/16" = 1'-0"
SHEET NAME:
**OVERALL SECOND
FLOOR PLAN**
SHEET NUMBER:
HS-M102

ISSUE FOR BID SET

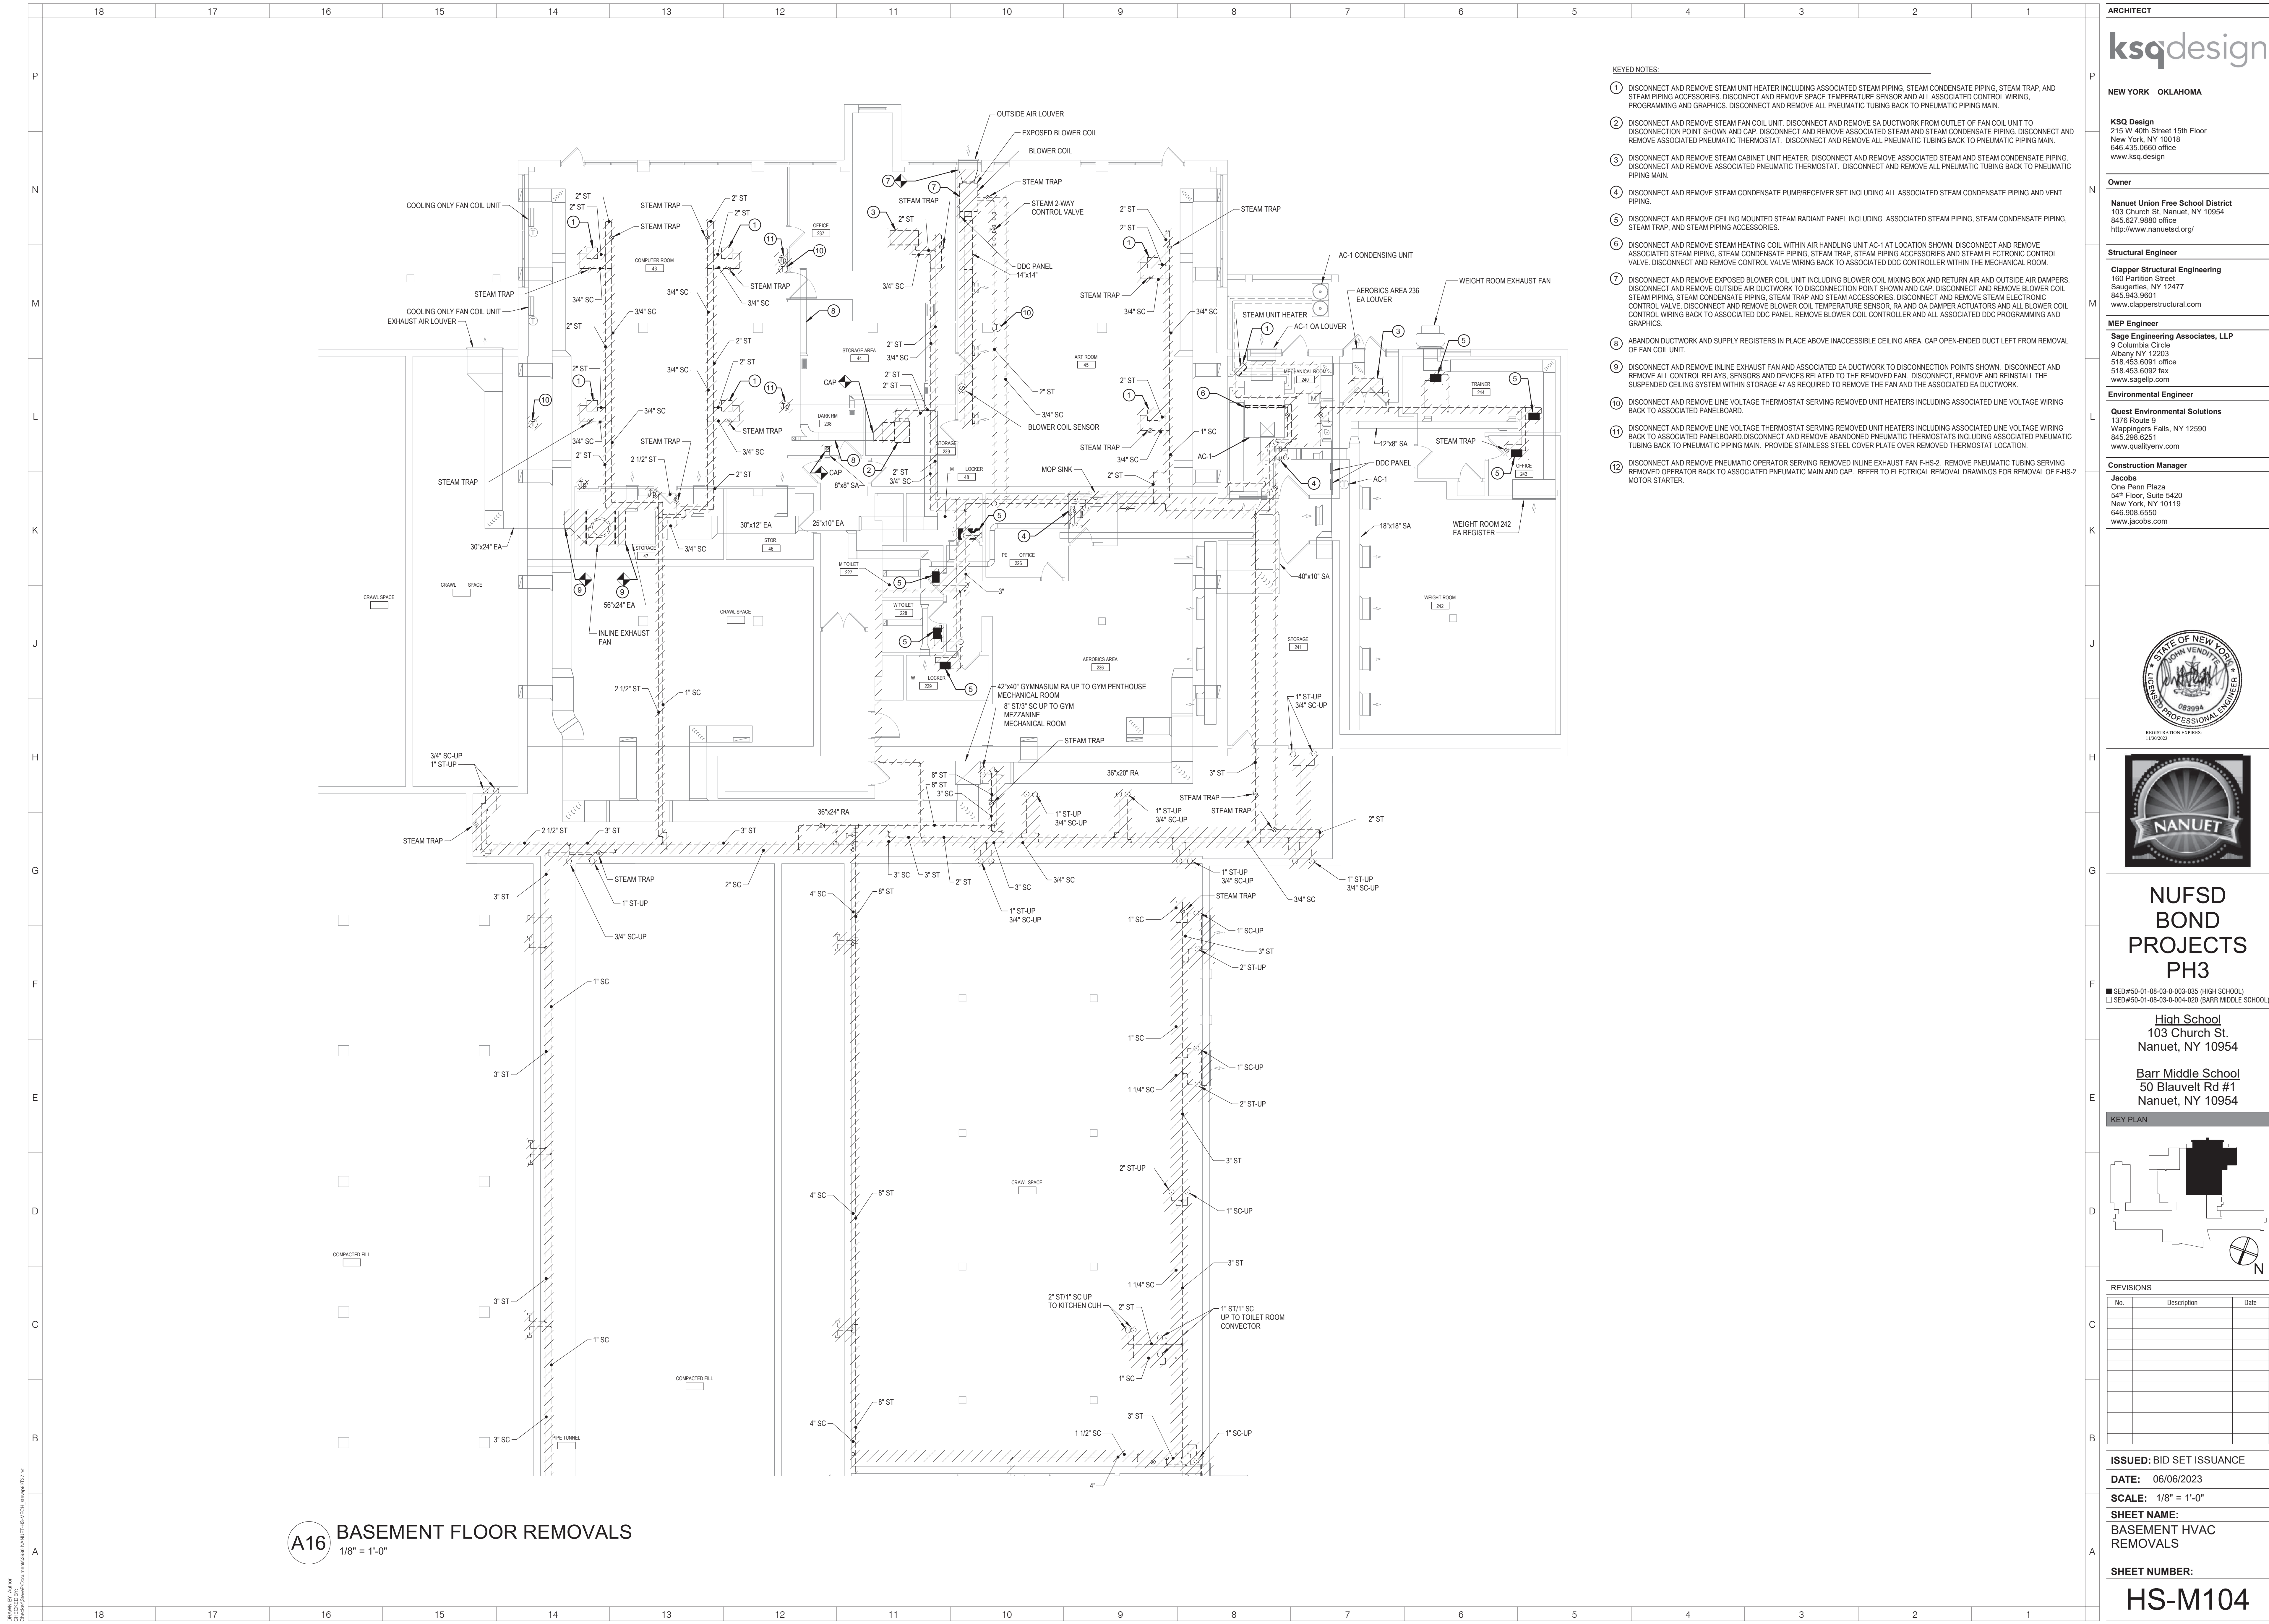

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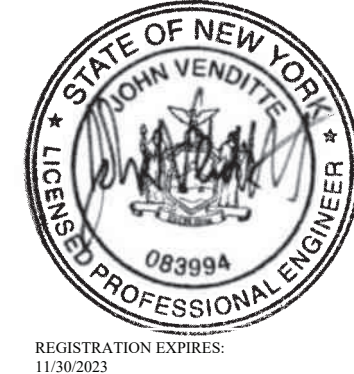
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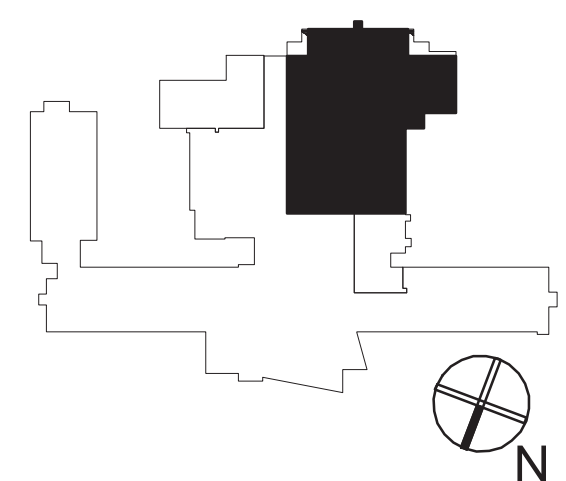
**NUFSD
BOND
PROJECTS
PH3**

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□ SED#50-01-08-03-0-004-020 (BARR MIDDLE SCHOOL)

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Barr Middle School
50 Blauvelt Rd #1
Nanuet, NY 10954

KEY PLAN



REVISIONS

No.	Description	Date

ISSUED: BID SET ISSUANCE

DATE: 06/06/2023

SCALE: 1/8" = 1'-0"

SHEET NAME:
BASEMENT HVAC
REMOVALS

SHEET NUMBER:

HS-M104

ISSUE FOR BID SET




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☐ SED#50-01-08-03-0-004-020 (BARR MIDDLE SCHOOL)

Barr Middle School
50 Blauvelt Rd #1
Nanuet, NY 10954

KEY PLAN



ISSUED: BID SET ISSUANCE

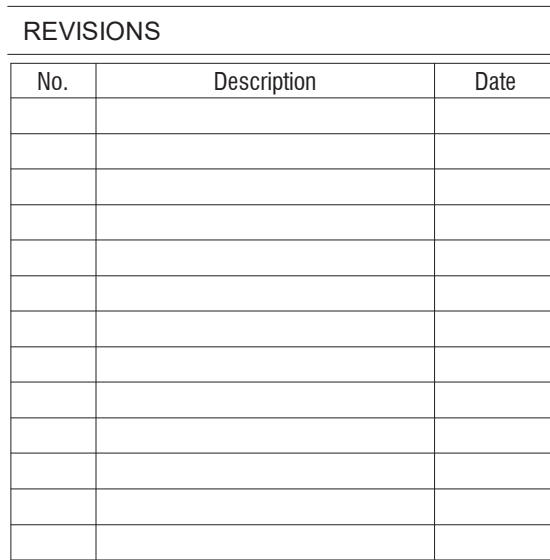DATE: 06/06/2023

SCALE: 1/2" = 1'-0"

SHEET NAME:

GYMNASIUM FAN ROOM
REMOVALS

SHEET NUMBER:


HS-M105


$$1/8'' = 1'-0''$$

- ② DISCONNECT AND REMOVE REMOTE SPACE TEMPERATURE SENSOR FOR THE EXISTING UNIT VENTILATOR.
- ③ PROVIDE REPLACEMENT SPACE TEMPERATURE SENSOR AT LOCATION SHOWN AND UTILIZE FOR SPACE TEMPERATURE CONTROL OF THE UNIT VENTILATOR AS REQUIRED. PROVIDE CONTROLLER WIRING BETWEEN SENSIT UNIT VENTILATOR DDC CONTROLLER AS REQUIRED.
- ⑤ DISCONNECT AND REMOVE FLOW MOUNTED UNIT VENTILATOR INTEGRAL MICROTECH II CONTROLLER LOCATED WITHIN THE UNIT VENTILATOR ACCESS ENCLOSURE. DISCONNECT AND REMOVE ALL ASSOCIATED CONTROLLER WIRING BETWEEN CONTROLLER AND REMOVED SPACE THERMOSTAT AND BETWEEN CONTROLLER AND UNIT VENTILATOR SENSORS, RELAYS, DAMPER ACTUATORS, AND CONTROL VALVE AS REQUIRED. MAINTAIN UNIT VENTILATOR CONTROL VALVE, DAMPER ACTUATOR, AND FACEBYPASS DAMPER UNIT VENTILATOR AND ACTUATOR.
- ④ PROVIDE DDC SYSTEM EQUIPMENT CONTROLLER WITHIN THE EXISTING ACCESS ENCLOSURE AREA OF EXISTING FLOW MOUNTED UNIT VENTILATOR AT LOCATION SHOWN. PROVIDE TWO CONTACT POINTS PER CONTACT DRAWING LOCATED ON A10HSA-0602. PROVIDE CONTROLLING WIRING FROM CONTROLLER TO FLOW MOUNTED SPACE TEMPERATURE SENSOR AND FLOW MOUNTED UNIT VENTILATOR AND EXISTING UNIT VENTILATOR WATER VALVE. PROVIDE CONTROLLING WIRING TO REMOVED SPACE THERMOSTAT, REMOVED DDC CONTROLLER AND EXISTING UNIT VENTILATOR DAMPER ACTUATOR AND FACEBYPASS DAMPER ACTUATOR. PROVIDE WIRING AS REQUIRED AND PROVIDE CONTROLLER WIRING TO ALL START/STOP OPERATION OF EXISTING UNIT VENTILATOR MECHANICAL COOLING SYSTEM.

ISSUE FOR BID SET

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A18 BASEMENT FLOOR PLAN
1/8" = 1'-0"

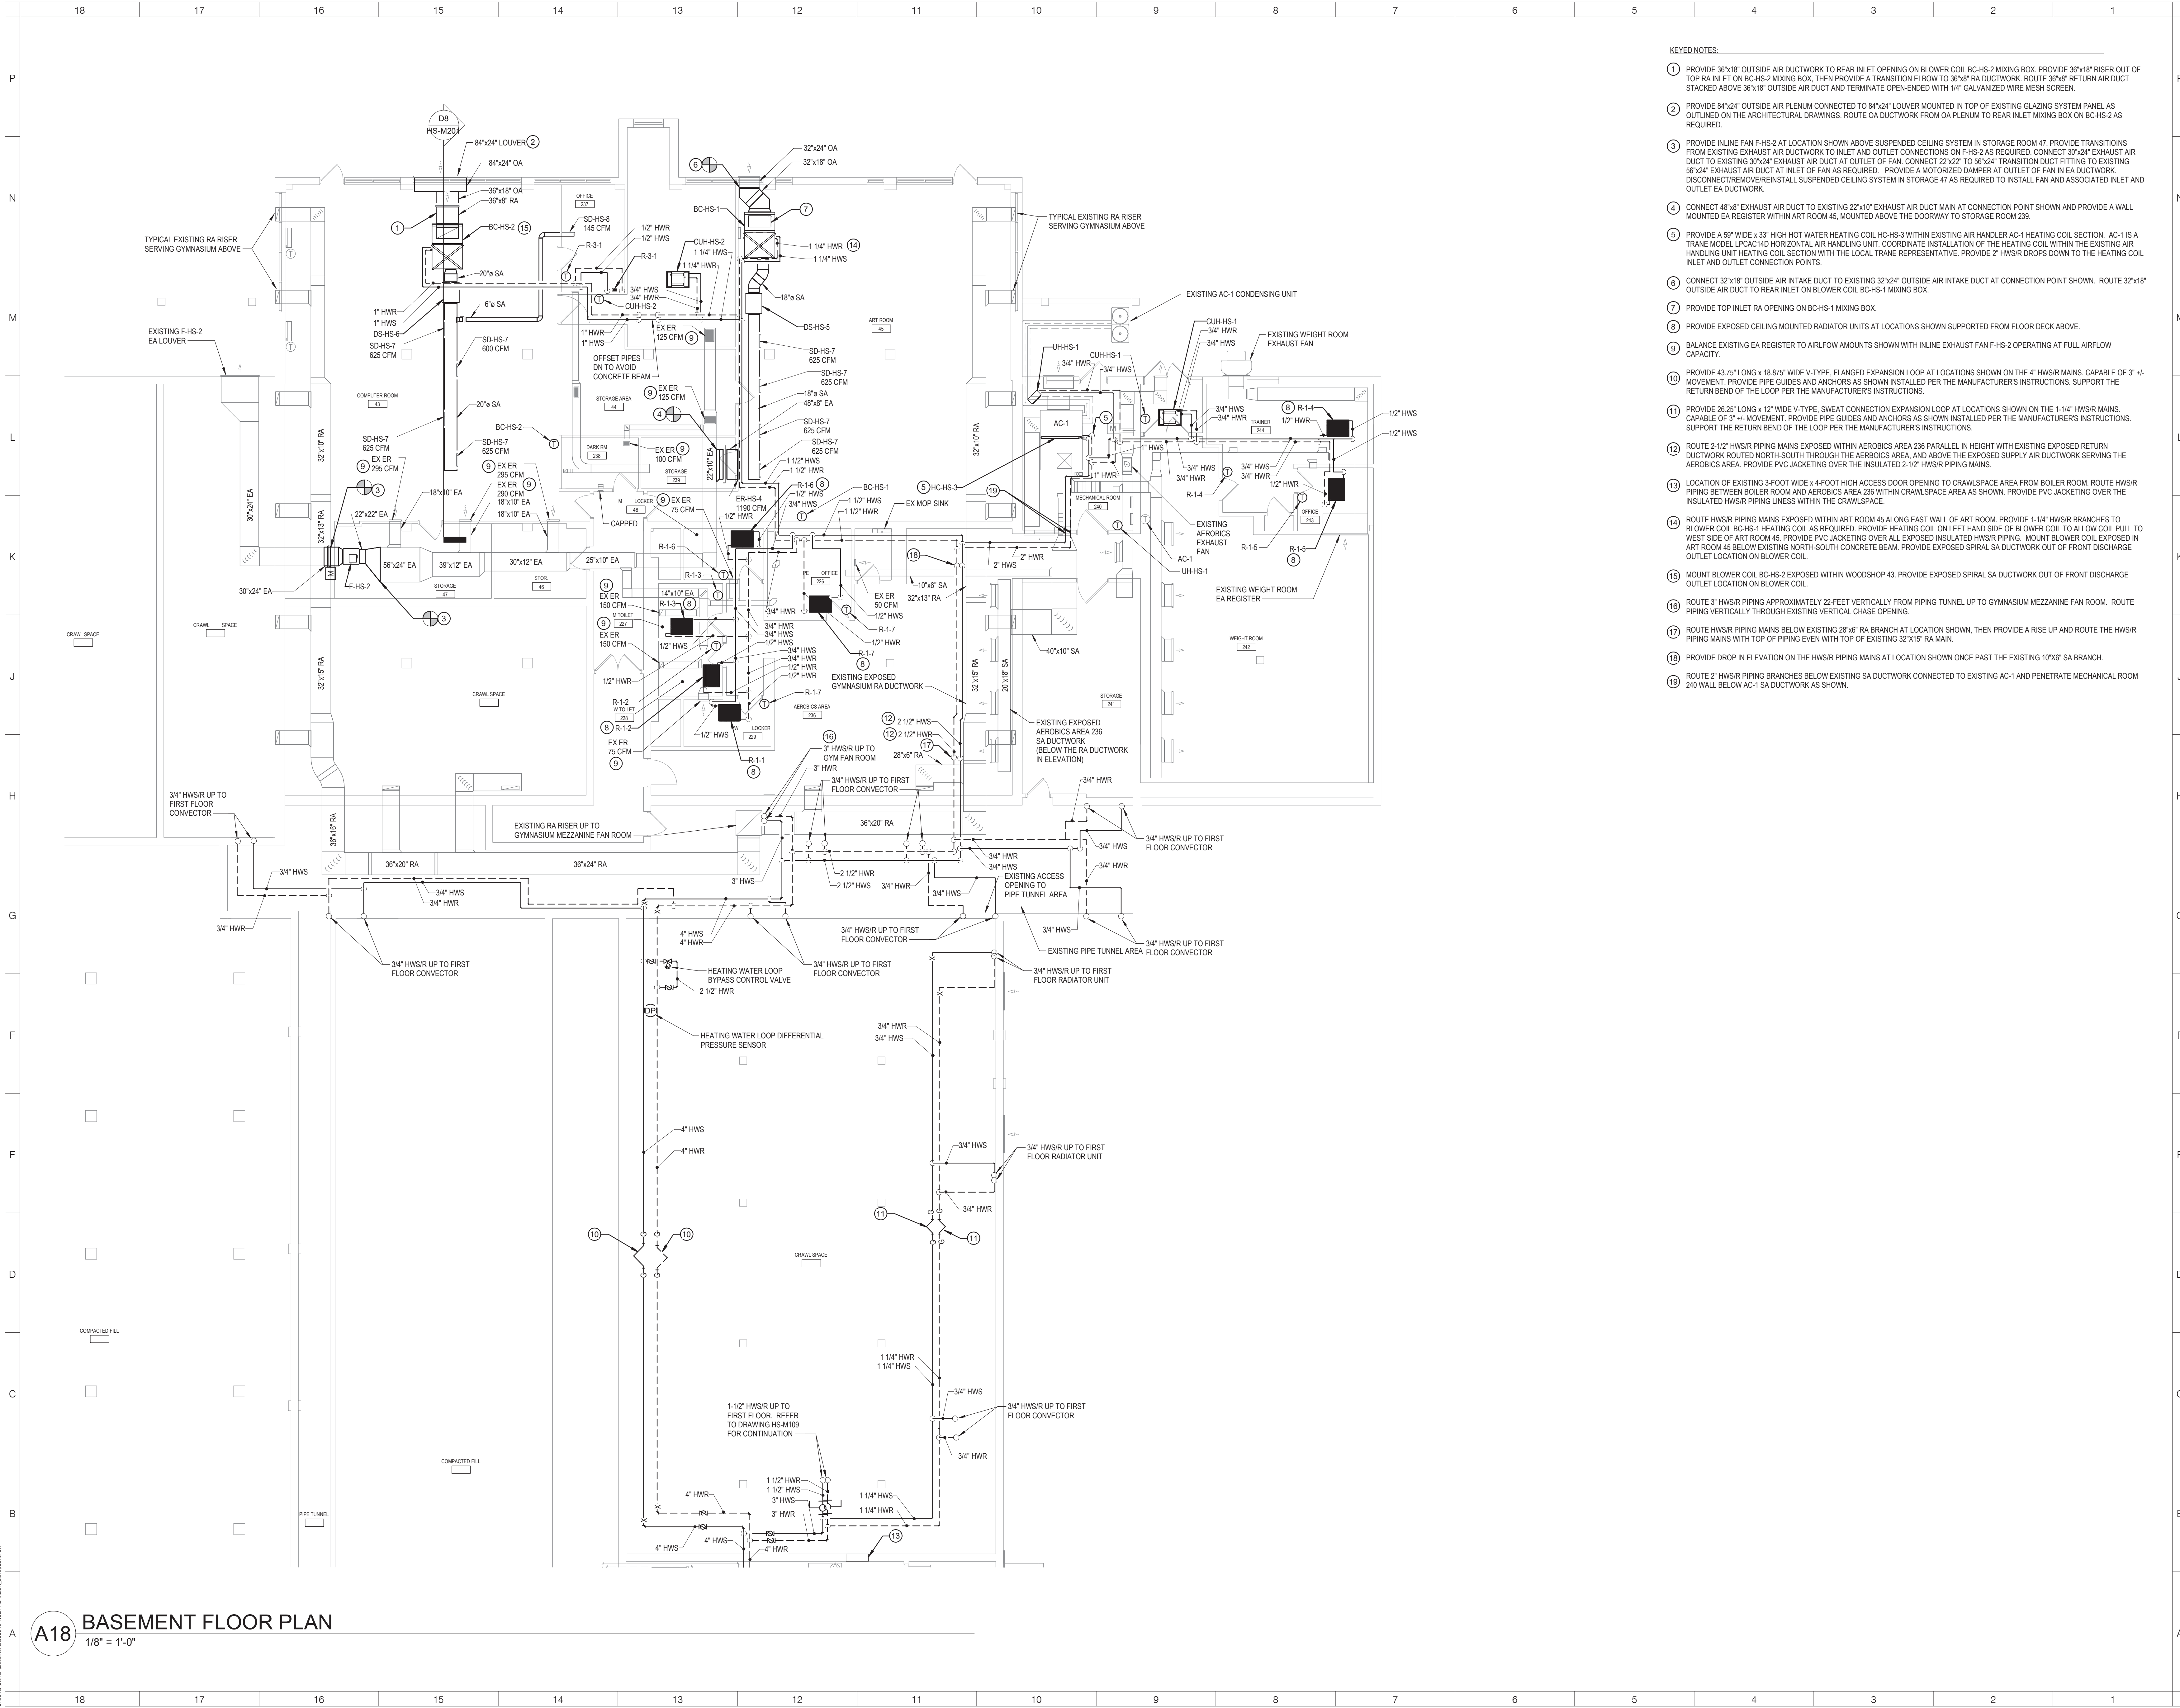KEYED NOTES:

- 1 PROVIDE 36"x18" OUTSIDE AIR DUCTWORK TO REAR INLET OPENING ON BLOWER COIL BC-HS-2 MIXING BOX. PROVIDE 36"x18" RISER OUT OF TOP RA INLET ON BC-HS-2 MIXING BOX. THEN PROVIDE A TRANSITION ELBOW TO 36"x18" RA DUCTWORK. ROUTE 36"x18" RETURN AIR DUCT STACKED ABOVE 36"x18" OUTSIDE AIR DUCT AND TERMINATE OPEN-ENDED WITH 1/4" GALVANIZED WIRE MESH SCREEN.
- 2 PROVIDE 84"x24" OUTSIDE AIR PLENUM CONNECTED TO 84"x24" LOUVER MOUNTED IN TOP OF EXISTING GLAZING SYSTEM PANEL AS OUTLINED ON THE ARCHITECTURAL DRAWINGS. ROUTE OA DUCTWORK FROM OA PLENUM TO REAR INLET MIXING BOX ON BC-HS-2 AS REQUIRED.
- 3 PROVIDE INLINE FAN F-HS-2 AT LOCATION SHOWN ABOVE SUSPENDED CEILING SYSTEM IN STORAGE ROOM 47. PROVIDE TRANSITIONS FROM EXISTING EXHAUST AIR DUCTWORK TO INLET AND OUTLET CONNECTIONS ON F-HS-2 AS REQUIRED. CONNECT 30"x24" EXHAUST AIR DUCT TO EXISTING 30"x24" EXHAUST AIR DUCT AT OUTLET OF FAN. CONNECT 22"x22" TRANSITION DUCT FITTING TO EXISTING 56"x24" EXHAUST AIR DUCT AT INLET OF FAN AS REQUIRED. PROVIDE A MOTORIZED DAMPER AT OUTLET OF FAN IN EA DUCTWORK. DISCONNECT/REMOVE/REINSTALL SUSPENDED CEILING SYSTEM IN STORAGE 47 AS REQUIRED TO INSTALL FAN AND ASSOCIATED INLET AND OUTLET EA DUCTWORK.
- 4 CONNECT 48"x8" EXHAUST AIR DUCT TO EXISTING 22"x10" EXHAUST AIR DUCT MAIN AT CONNECTION POINT SHOWN AND PROVIDE A WALL MOUNTED EA REGISTER WITHIN ART ROOM 45, MOUNTED ABOVE THE DOORWAY TO STORAGE ROOM 239.
- 5 PROVIDE A 59" WIDE x 33" HIGH HOT WATER HEATING COIL HC-HS-3 WITHIN EXISTING AIR HANDLER AC-1 HEATING COIL SECTION. AC-1 IS A TRANE MODEL LPAC4HD HORIZONTAL AIR HANDLING UNIT. COORDINATE INSTALLATION OF THE HEATING COIL WITHIN THE EXISTING AIR HANDLING UNIT HEATING COIL SECTION WITH THE LOCAL FRAMING REPRESENTATIVE. PROVIDE 2" HWSR DROPS DOWN TO THE HEATING COIL INLET AND OUTLET CONNECTION POINTS.
- 6 CONNECT 32"x18" OUTSIDE AIR INTAKE DUCT TO EXISTING 32"x24" OUTSIDE AIR INTAKE DUCT AT CONNECTION POINT SHOWN. ROUTE 32"x18" OUTSIDE AIR DUCT TO REAR INLET ON BLOWER COIL BC-HS-1 MIXING BOX.
- 7 PROVIDE TOP INLET RA OPENING ON BC-HS-1 MIXING BOX.
- 8 PROVIDE EXPOSED CEILING MOUNTED RADIATOR UNITS AT LOCATIONS SHOWN SUPPORTED FROM FLOOR DECK ABOVE.
- 9 BALANCE EXISTING EA REGISTER TO AIRFLOW AMOUNTS SHOWN WITH INLINE EXHAUST FAN F-HS-2 OPERATING AT FULL AIRFLOW CAPACITY.
- 10 PROVIDE 43.75' LONG x 18.875' WIDE V-TYPE, FLANGED EXPANSION LOOP AT LOCATIONS SHOWN ON THE 4" HWSR MAINS, CAPABLE OF 3" +/- MOVEMENT. PROVIDE PIPE GUIDES AND ANCHORS AS SHOWN INSTALLED PER THE MANUFACTURER'S INSTRUCTIONS. SUPPORT THE RETURN BEND OF THE LOOP PER THE MANUFACTURER'S INSTRUCTIONS.
- 11 PROVIDE 26.25' LONG x 12" WIDE V-TYPE, SWEAT CONNECTION EXPANSION LOOP AT LOCATIONS SHOWN ON THE 1-1/4" HWSR MAINS CAPABLE OF 3" +/- MOVEMENT. PROVIDE PIPE GUIDES AND ANCHORS AS SHOWN INSTALLED PER THE MANUFACTURER'S INSTRUCTIONS. SUPPORT THE RETURN BEND OF THE LOOP PER THE MANUFACTURER'S INSTRUCTIONS.
- 12 ROUTE 2-1/2" HWSR PIPING MAINS EXPOSED WITHIN AEROBICS AREA 236 PARALLEL IN HEIGHT WITH EXISTING EXPOSED RETURN DUCTWORK ROUTED NORTH-SOUTH THROUGH THE AEROBICS AREA, AND ABOVE THE EXPOSED SUPPLY AIR DUCTWORK SERVING THE AEROBICS AREA. PROVIDE PVC JACKETING OVER THE INSULATED 2-1/2" HWSR PIPING MAINS.
- 13 LOCATION OF EXISTING 3-FOOT WIDE x 4-FOOT HIGH ACCESS DOOR OPENING TO CRAWLSPACE AREA FROM BOILER ROOM. ROUTE HWSR PIPING BETWEEN BOILER ROOM AND AEROBICS AREA 238 WITHIN CRAWLSPACE AREA AS SHOWN. PROVIDE PVC JACKETING OVER THE INSULATED HWSR PIPING LINES WITHIN THE CRAWLSPACE.
- 14 ROUTE HWSR PIPING MAINS EXPOSED WITHIN ART ROOM 45 ALONG EAST WALL OF ART ROOM. PROVIDE 1-1/4" HWSR BRANCHES TO BLOWER COIL BC-HS-1 HEATING COIL AS REQUIRED. PROVIDE HEATING COIL ON LEFT HAND SIDE OF BLOWER COIL TO ALLOW COIL PULL TO WEST SIDE OF ART ROOM 45. PROVIDE PVC JACKETING OVER ALL EXPOSED INSULATED HWSR PIPING. MOUNT BLOWER COIL EXPOSED IN ART ROOM 45 BELOW EXISTING NORTH-SOUTH CONCRETE BEAM. PROVIDE EXPOSED SPIRAL SA DUCTWORK OUT OF FRONT DISCHARGE OUTLET LOCATION ON BLOWER COIL.
- 15 MOUNT BLOWER COIL BC-HS-2 EXPOSED WITHIN WOODSHOP 43. PROVIDE EXPOSED SPIRAL SA DUCTWORK OUT OF FRONT DISCHARGE OUTLET LOCATION ON BLOWER COIL.
- 16 ROUTE 3" HWSR PIPING APPROXIMATELY 22-FEET VERTICALLY FROM PIPING TUNNEL UP TO GYMNASIUM MEZZANINE FAN ROOM. ROUTE PIPING VERTICALLY THROUGH EXISTING VERTICAL CHASE OPENING.
- 17 ROUTE HWSR PIPING MAINS BELOW EXISTING 28"x6" RA BRANCH AT LOCATION SHOWN, THEN PROVIDE A RISE UP AND ROUTE THE HWSR PIPING MAINS WITH TOP OF PIPING EVEN WITH TOP OF EXISTING 32"x15" RA MAIN.
- 18 PROVIDE DROP IN ELEVATION ON THE HWSR PIPING MAINS AT LOCATION SHOWN ONCE PAST THE EXISTING 10"x6" SA BRANCH.
- 19 ROUTE 2" HWSR PIPING BRANCHES BELOW EXISTING SA DUCTWORK CONNECTED TO EXISTING AC-1 AND PENETRATE MECHANICAL ROOM 240 WALL BELOW AC-1 SA DUCTWORK AS SHOWN.

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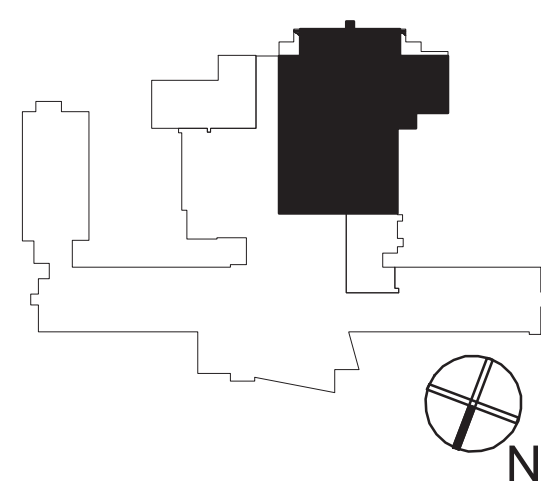
**NUFSD
BOND
PROJECTS
PH3**

■ SED#50-01-08-03-0-003-035 (HIGH SCHOOL)
□ SED#50-01-08-03-0-004-020 (BARR MIDDLE SCHOOL)

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KEY PLAN



REVISIONS

No.	Description	Date

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DATE: 06/06/2023


SCALE: 1/8" = 1'-0"

SHEET NAME:
BASEMENT HVAC PLAN

SHEET NUMBER:

HS-M107

ISSUE FOR BID SET

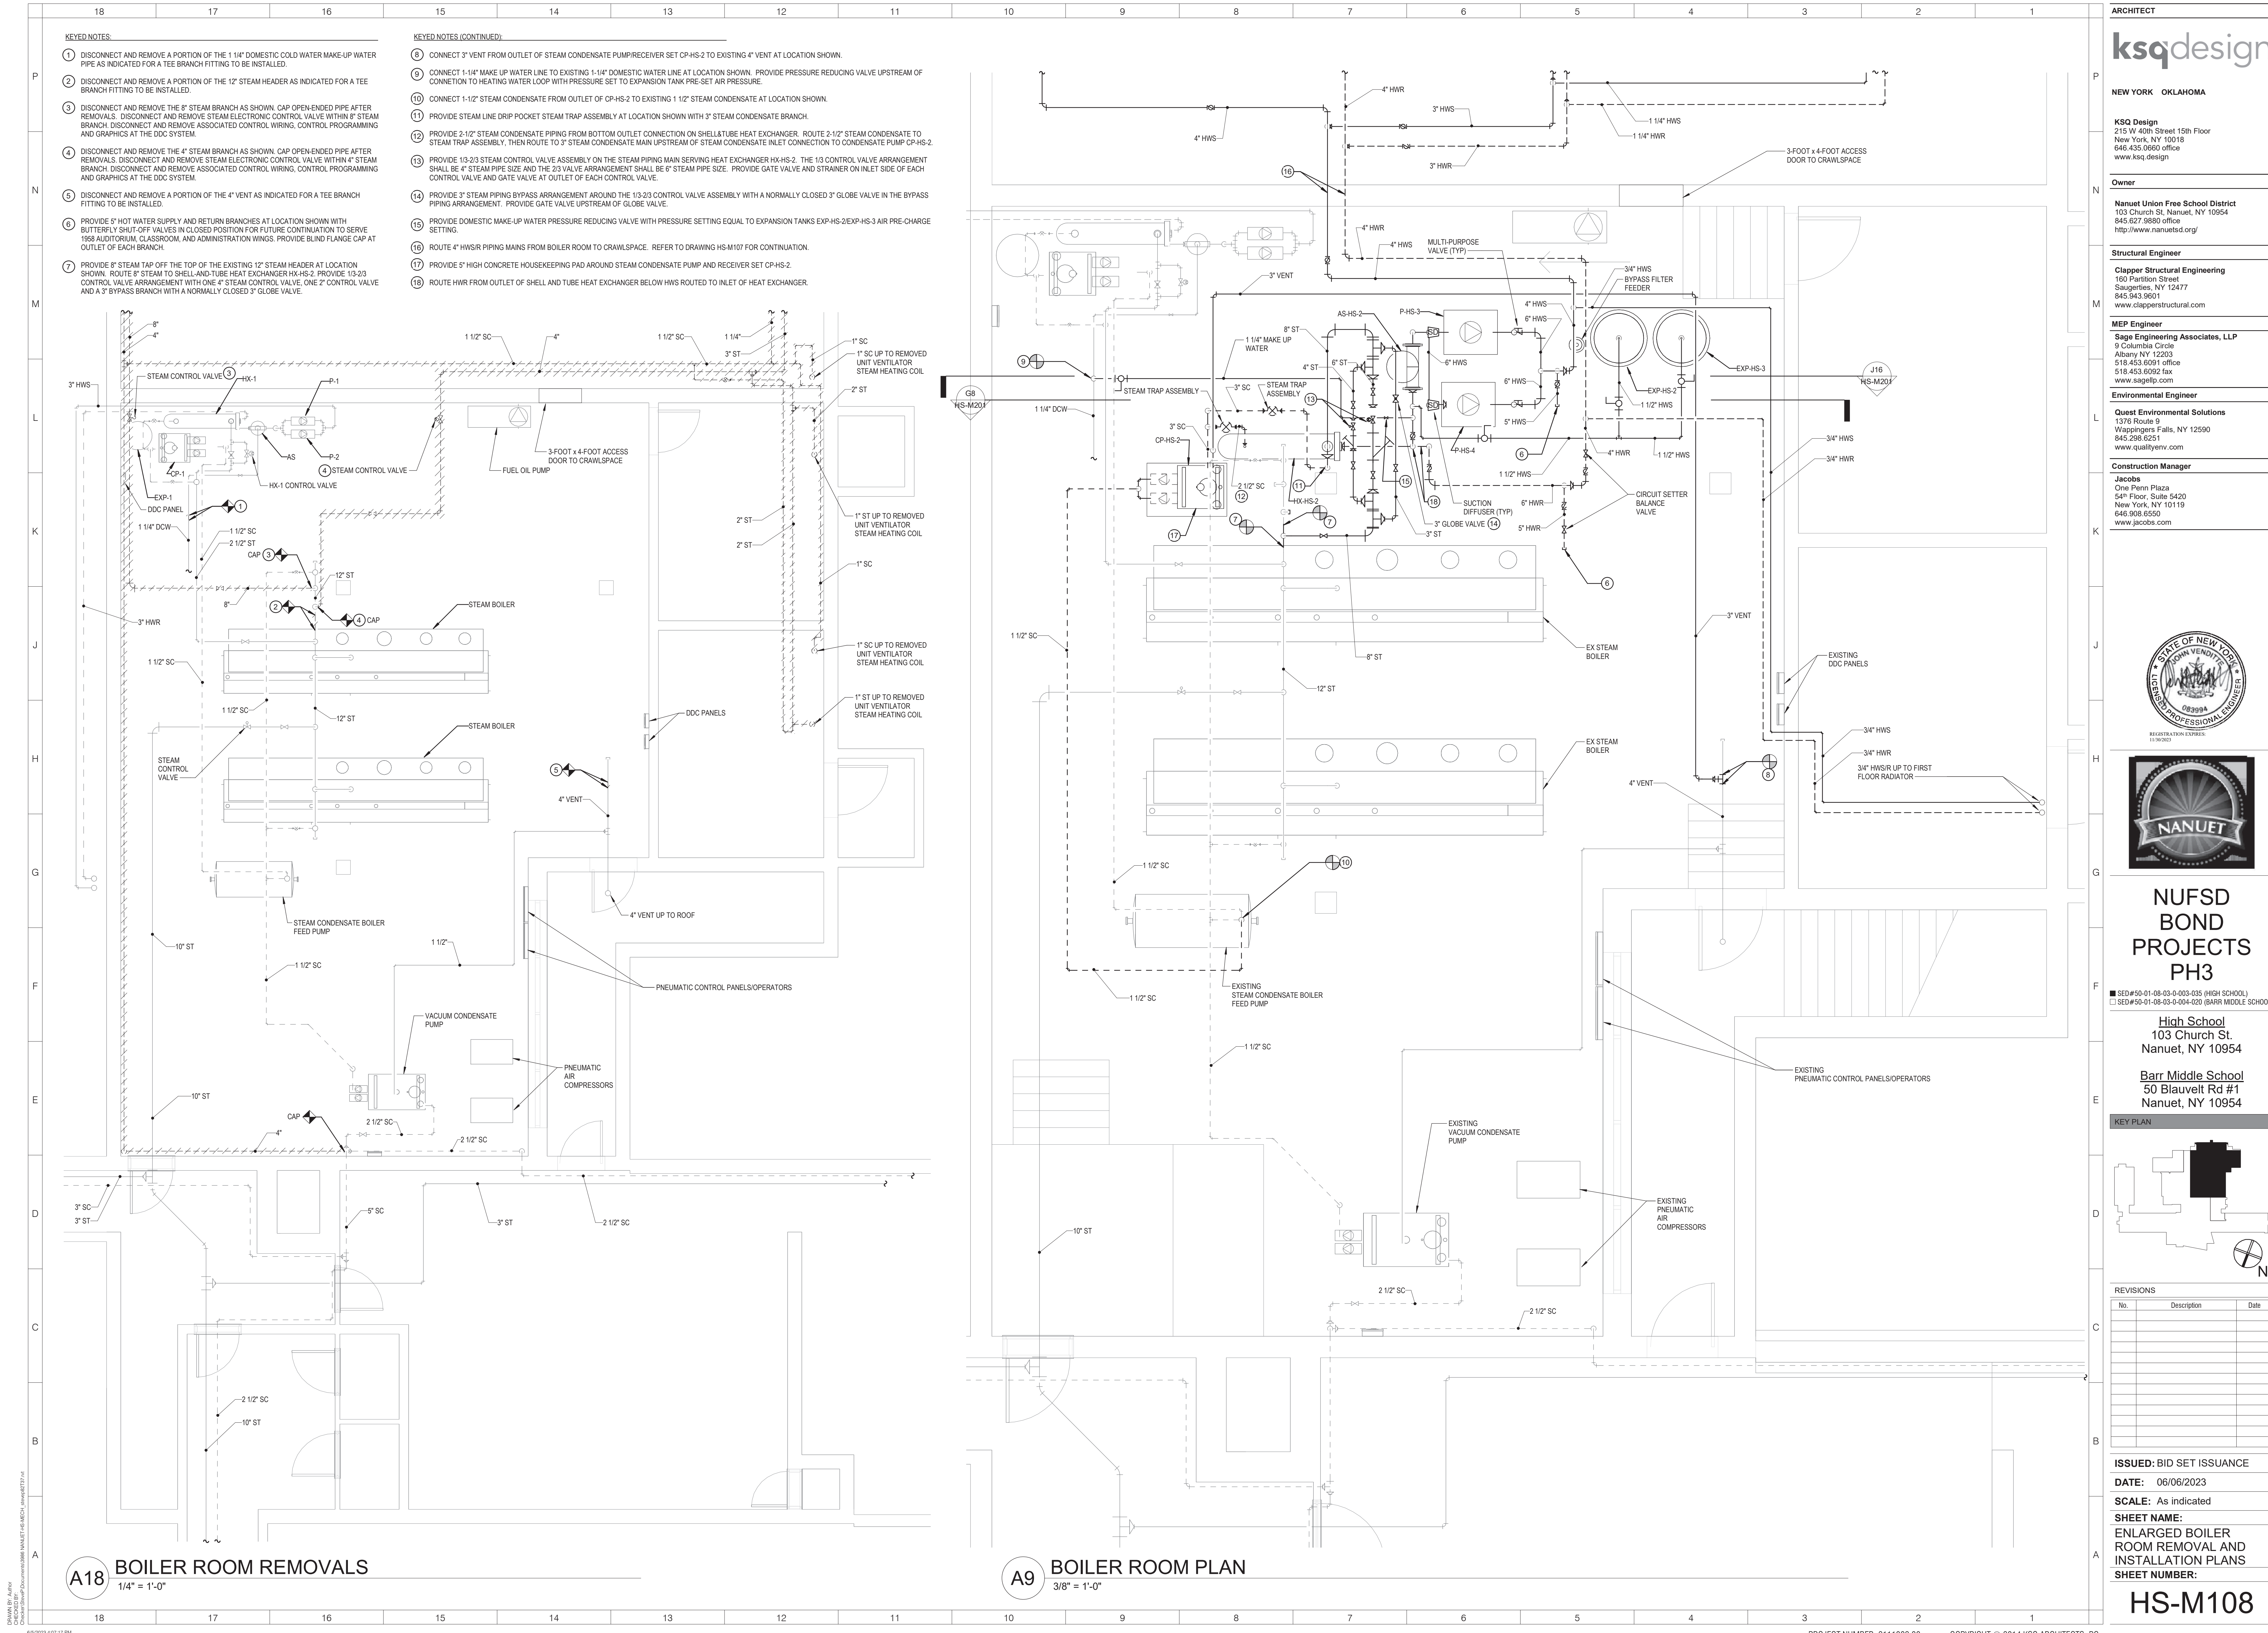

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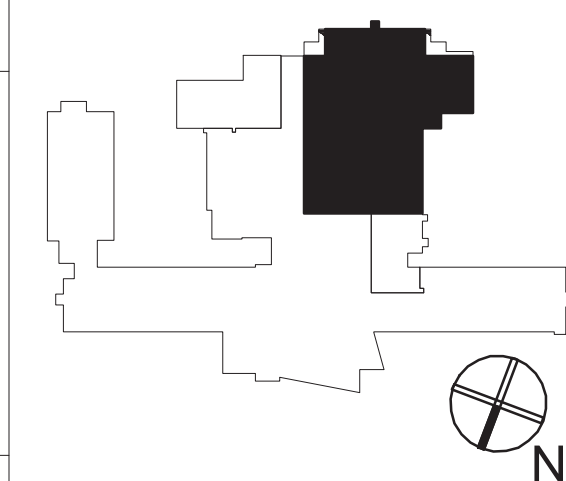
NUFSD BOND PROJECTS PH3

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KEY PLAN



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SCALE: As indicated


SHEET NAME:
ENLARGED BOILER
ROOM REMOVAL AND
INSTALLATION PLANS

SHEET NUMBER:

HS-M108

ISSUE FOR BID SET



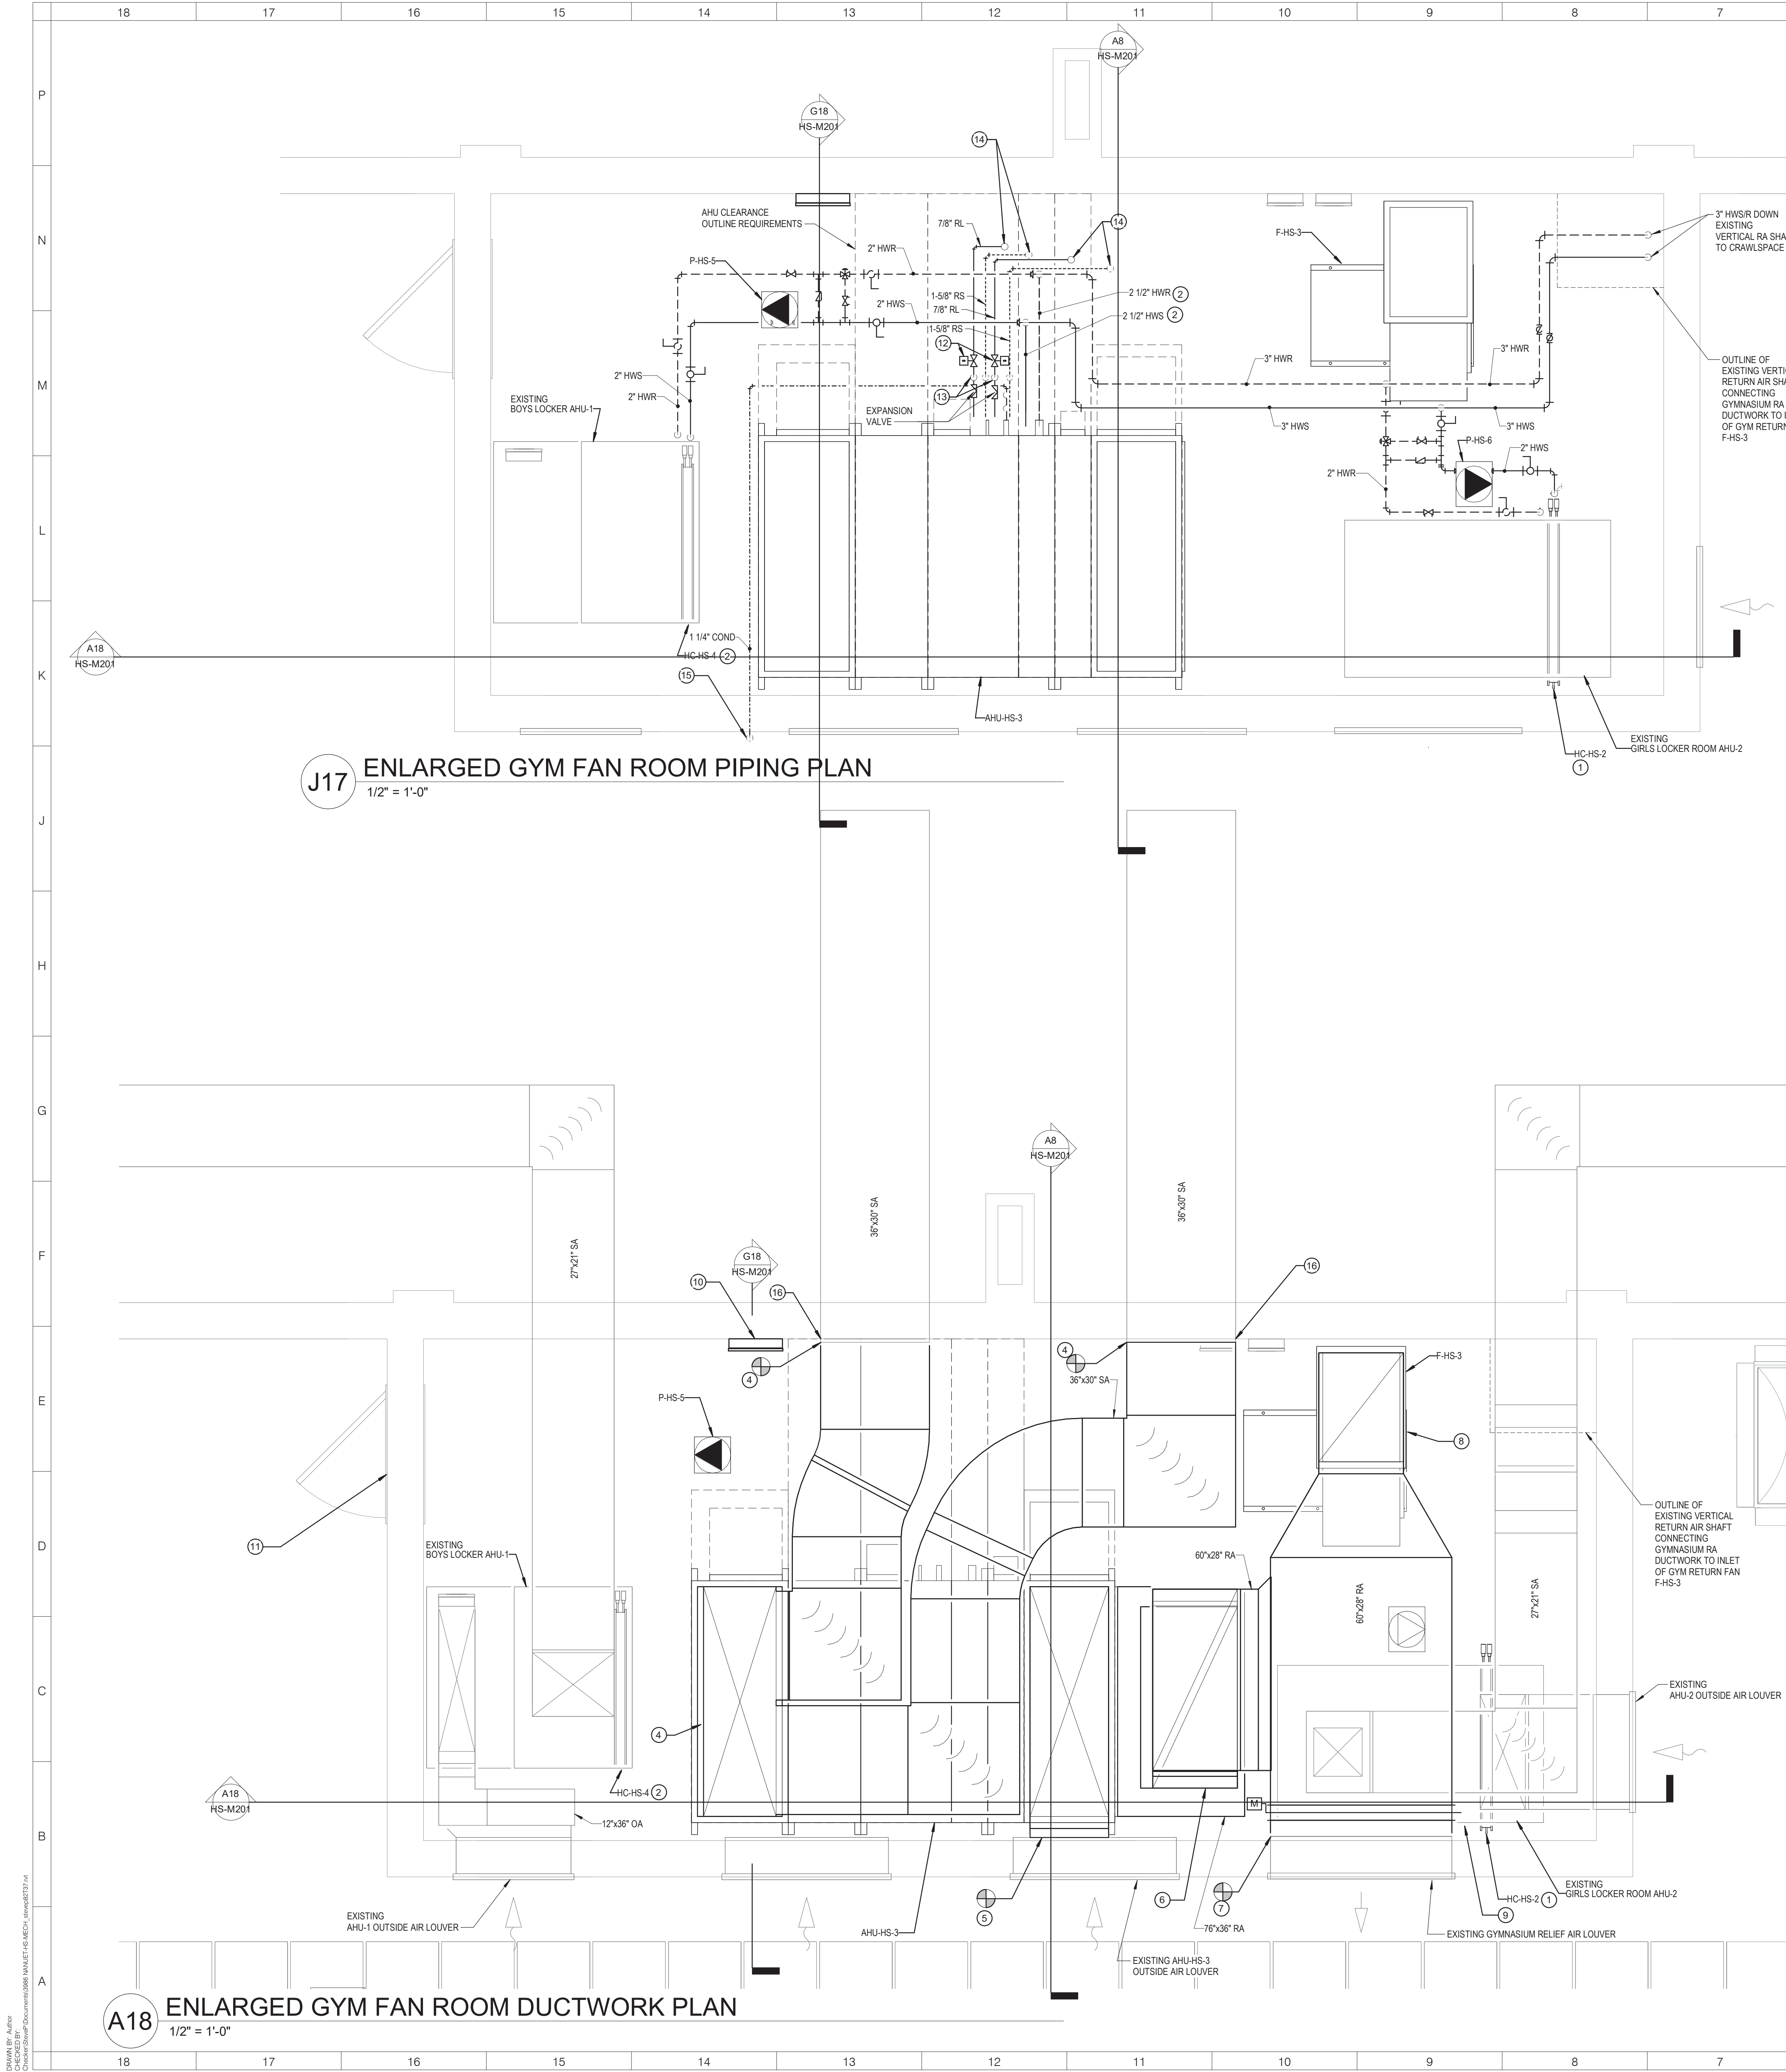

KEYED NOTES:

- 1 PROVIDE A 54" WIDE x 27" HIGH HOT WATER HEATING COIL HC-HS-2 WITHIN EXISTING AIR HANDLER AHU-2 HEATING COIL SECTION. AHU-2 IS A TRANE MODEL MCB2B10 HORIZONTAL AIR HANDLING UNIT. COORDINATE INSTALLATION OF THE HEATING COIL WITHIN THE EXISTING AIR HANDLING UNIT HEATING COIL SECTION WITH THE LOCAL DAKIN MCQUAY REPRESENTATIVE. PROVIDE 2" HWS/R DROPS DOWN TO THE HEATING COIL INLET AND OUTLET CONNECTION POINTS.
- 2 PROVIDE A 51" WIDE x 27" HIGH HOT WATER HEATING COIL HC-HS-4 WITHIN EXISTING AIR HANDLER AHU-1 HEATING COIL SECTION. AHU-1 IS A MCQUAY MODEL CAH0808HAM STACKED AIR HANDLING UNIT. COORDINATE INSTALLATION OF THE HEATING COIL WITHIN THE EXISTING AIR HANDLING UNIT HEATING COIL SECTION WITH THE LOCAL DAKIN MCQUAY REPRESENTATIVE. PROVIDE 2" HWS/R DROPS DOWN TO THE HEATING COIL INLET AND OUTLET CONNECTION POINTS.
- 3 PROVIDE 2 1/2" HWS/R BRANCH CONNECTIONS OFF THE 3" HWS/R MAINS AND ROUTE 2 1/2" HWS/R PIPING TO AHU-HS-3 STACKED HEATING COIL. PROVIDE SEPARATE 2" HWS/R CONNECTIONS TO THE BOTTOM AND TOP HEATING COILS ON AHU AS REQUIRED.
- 4 PROVIDE A 36"x54" SA RISER OUT OF TOP DISCHARGE OUTLET CONNECTION ON AHU-HS-3 AND PROVIDE TWO 36"x30" SA BRANCHES OFF THE RISER, THEN CONNECT TO THE EXISTING 36"x30" SA BRANCHES AT CONNECTION POINTS SHOWN. PROVIDE 1-1/2" THICK GLASS FIBER BOARD INSULATION WITH FIELD APPLIED WEATHERPROOFING JACKETING OVER ALL NEW AND EXISTING SUPPLY AIR DUCTWORK LOCATED WITHIN THE MEZZANINE FAN ROOM.
- 5 PROVIDE A 26"x36" OUTSIDE AIR CONNECTION TO THE EXISTING 54"x36" OUTSIDE AIR PLENUM AT CONNECTION POINT SHOWN, THEN PROVIDE A MITERED TRANSITION ELBOW FROM THE 26"x36" OA BRANCH AND DROP DOWN TO THE TOP 76"x26" INLET CONNECTION ON AHU-HS-3 MIXING BOX AS REQUIRED.
- 6 CONNECT TO THE EXISTING 60"x28" HORIZONTAL RA MAIN AT CONNECTION POINT SHOWN ON BOTTOM OF RA MAIN AND PROVIDE A 26"x60" RA DROP TO REAR RA INLET ON AHU-HS-3. PROVIDE A 26"x60" VERTICAL 45 DEGREE ENTRY TAP INTO THE 76"x36" HORIZONTAL RA DUCT CONNECTED TO THE REAR RA INLET OF AHU AS REQUIRED.
- 7 PROVIDE A TRANSITION FROM TOP OUTLET OF FLOOR MOUNTED UTILITY FAN F-HS-3 AND ROUTE 60"x28" RA MAIN TO EXISTING RELIEF AIR DUCT MAIN UPSTREAM OF EXISTING RELIEF AIR LOUVER AT CONNECTION POINT SHOWN.
- 8 PROVIDE OPEN-ENDED RA INLET TO FLOOR MOUNTED UTILITY FAN F-HS-3. PROVIDE INLET GUARD OVER OPENING. RETURN AIR TO FAN IS ACCOMPLISHED VIA THE EXISTING VERTICAL RA SHAFT CONNECTING THE GYM RA DUCTWORK TO THE GYM MECHANICAL PENTHOUSE.
- 9 PROVIDE AN ELECTRONIC MOTORIZED DAMPER AND ACTUATOR UPSTREAM OF THE RELIEF AIR LOUVER AND PROVIDE CONTROL WIRING TO THE ACTUATOR CONNECTED TO THE DDC CONTROLLERS LOCATED WITHIN THE GYMNASIUM FAN ROOM.
- 10 PROVIDE A DDC CONTROL PANEL ENCLOSURE AT LOCATION SHOWN TO HOUSE THE DDC CONTROLLERS SERVING THE NEW CONTROL EQUIPMENT WITHIN THE GYMNASIUM FAN ROOM.
- 11 RIG AIR HANDLING UNIT AHU-HS-3 TO CAFETERIA ROOFTOP OUTSIDE GYMNASIUM PENTHOUSE DOORWAY AS REQUIRED. RIG UNIT IN 5 SECTIONS: MIXING BOX SECTION, PANEL FILTER/HOT WATER COIL SECTION, DX COIL SECTION, SUPPLY FAN ARRAY SECTION AND DISCHARGE PLENUM SECTION. COMPLETELY DISASSEMBLE EACH INDIVIDUAL AHU SECTION OUTSIDE THE PENTHOUSE, THEN DELIVER THE AHU SECTION PIECES TO THE INSTALLATION LOCATION WITHIN THE PENTHOUSE, THEN RE-ASSEMBLE THE AHU SECTIONS AS REQUIRED. THE SUPPLY FAN MODULE SECTION SHALL INCLUDE FOUR CENTRIFUGAL PLENUM FANS IN A 2 ROW x 2 COLUMN ARRANGEMENT. COORDINATE THE DISASSEMBLY/RE-ASSEMBLY OF THE UNIT WITH THE AHU MANUFACTURER'S REPRESENTATIVE. THE MAXIMUM LENGTH OF EACH SECTION SHALL BE 32" WITH MAXIMUM WIDTH OF 80" AND MAXIMUM HEIGHT OF 72".
- 12 PROVIDE 120-VOLT LINE VOLTAGE SOLENOID VALVES ON THE TWO REFRIGERANT LIQUID LINE CIRCUITS UPSTREAM OF THE COOLING COIL CONNECTIONS. THE SOLENOID VALVES ON THE LIQUID LINES SHALL BE INSTALLED UPSTREAM OF THE THERMAL EXPANSION VALVES AND SIGHT GLASSES AND DOWNSTREAM OF THE LIQUID LINE FILTER DRIERS.
- 13 PROVIDE TRAP ON REFRIGERANT LIQUID PIPING LINES UPSTREAM OF COOLING COIL LIQUID CONNECTIONS TO PROTECT THERMAL EXPANSION VALVES. COORDINATE LOCATION AND SIZE OF TRAP WITH MANUFACTURER'S REPRESENTATIVE PRIOR TO INSTALLATION.
- 14 PROVIDE TWO REFRIGERANT PIPING CIRCUITS BETWEEN ROOFTOP AIR COOLED CONDENSING UNIT ACCU-HS-2 AND DX COOLING COIL WITHIN AHU-HS-3. EACH CIRCUIT SHALL INCLUDE 1-5/8" REFRIGERANT SUCTION-7/8" REFRIGERANT LIQUID LINES. PROVIDE TRAPS AT BASE OF EACH REFRIGERANT SUCTION LINE PRIOR TO RISER PENETRATIONS UP THROUGH ROOF. COORDINATE SIZE OF ALL PIPING LINES WITH MANUFACTURER'S REPRESENTATIVE PRIOR TO INSTALLATION.
- 15 ROUTE 1-1/4" CONDENSATE DRAIN PIPING FROM AHU-HS-3 DRAIN PAN OUTLET OUT THROUGH EXTERIOR WALL. TERMINATE WITH MITER CUT ELBOW OPEN-ENDED FACING ROOF SURFACE.
- 16 PROVIDE CLOSED CELL, SPRAY FOAM INSULATION WITHIN THE MASONRY WALL GAPS SEPARATING THE MEZZANINE FAN ROOM AND THE GYMNASIUM AROUND THE EXISTING SUPPLY DUCTS PENETRATION THE WALL TO AVOID CONDENSATION ON THE OUTER SURFACE OF THE DUCTWORK ONCE MECHANICAL AIR CONDITIONING IS OPERATIONAL.

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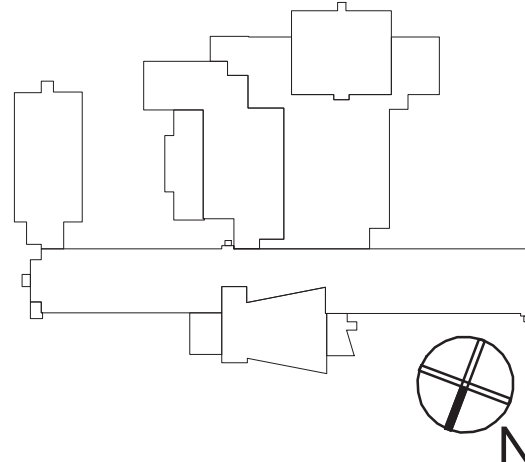
**NUFSD
BOND
PROJECTS
PH3**

■ SED#50-01-08-03-0-003-035 (HIGH SCHOOL)
□ SED#50-01-08-03-0-004-020 (BARR MIDDLE SCHOOL)

High School
103 Church St.
Nanuet, NY 10954

Barr Middle School
50 Blauvelt Rd #1
Nanuet, NY 10954

KEY PLAN



REVISIONS

No.	Description	Date

ISSUED: BID SET ISSUANCE

DATE: 06/06/2023


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SHEET NAME:
GYMNASIUM FAN ROOM
PLAN

SHEET NUMBER:

HS-M110

ISSUE FOR BID SET

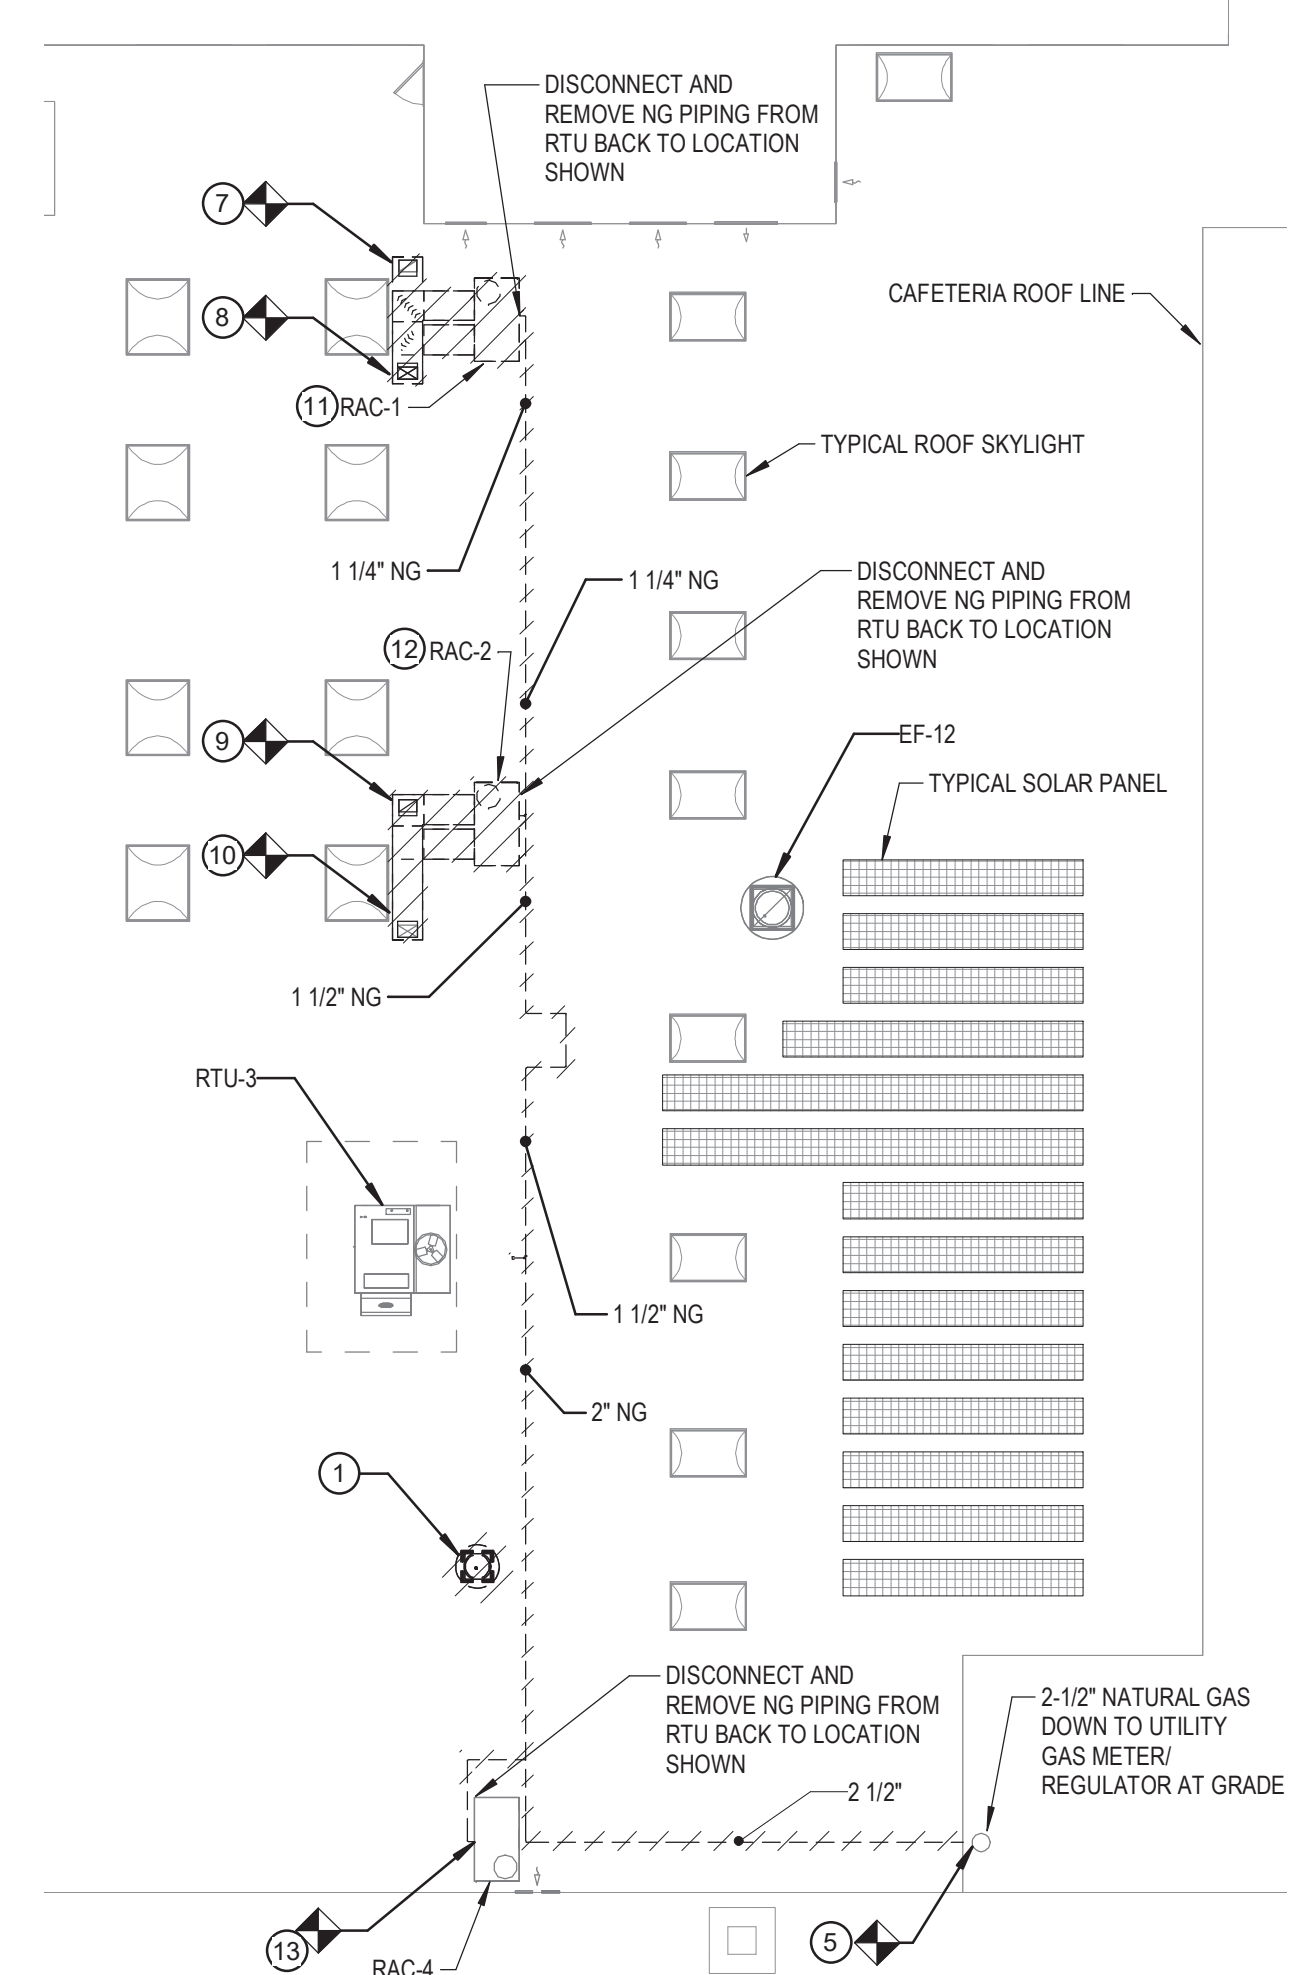

A4 OVERALL ROOF HVAC REMOVALS
1/16" = 1'-0"

A4 OVER.
1/16" = 1'-0"

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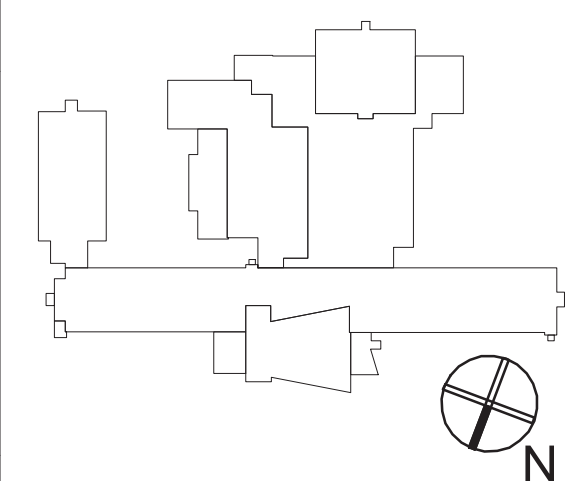
NUFSD
BOND
PROJECTS
PH3

☒ SED#50-01-08-03-0-003-035 (HIGH SCHOOL)
☐ SED#50-01-08-03-0-004-020 (BARR MIDDLE SCHOOL)

High School
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Nanuet, NY 10954

Barr Middle School
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Nanuet, NY 10954

KEY PLAN

[illegible]

ISSUED: BID SET ISSUANCE

DATE: 06/06/2023

SCALE: As indicated

SHEET NAME:
OVERALL ROOF HVAC
PLAN

SHEET NUMBER:


HS-M111

ISSUE FOR BID SET



NOTE:

1. THE MECHANICAL CONTRACTOR SHALL PROVIDE IMMERSION WELLS WITHIN THE HWS&R PIPING WITHIN THE BOILER ROOM TO PROVIDE THE TEMPERATURE SENSORS OUTLINED IN THE CONTROL DIAGRAM.

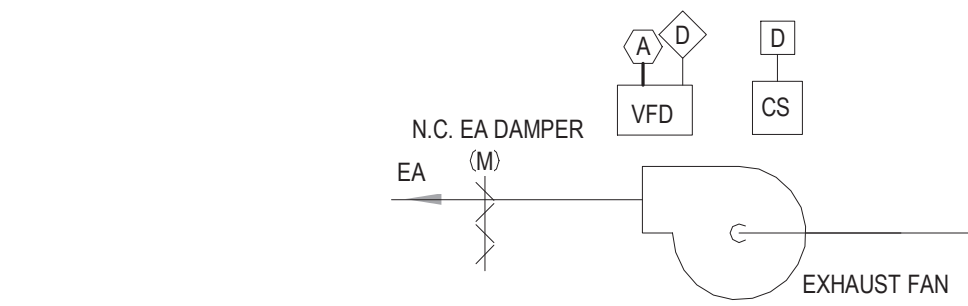

WOODSHOP-ART ROOM EXHAUST FAN CONTROL DIAGRAM
NOT TO SCALE

NOT TO SCALE




G18 FLOOR HEATING RADIATION CONTROL DIAGRAM
NOT TO SCALE



D18 HEATING COIL CONTROL DIAGRAM
NOT TO SCALE



G9 HEATING COIL CONTROL DIAGRAM - 2-WAY CONTROL VALVES
NOT TO SCALE

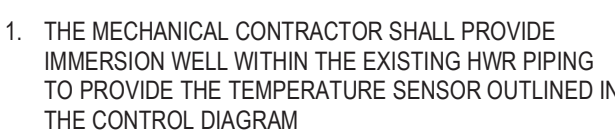

NOTE: THE DDC SYSTEM CONTROLLER SHALL SEND A 0-10 VDC SIGNAL TO THE AHUs ASSOCIATED AIR COOLED CONDENSING UNIT REFRIGERATION SYSTEM CONTROLLER TO ALLOW THE RTU TO MODULATE THE COOLING.



D6 BLOWER COIL UNIT CONTROL DIAGRAMS
NOT TO SCALE



ITEM	DIGITAL		ANALOG		NOTES
	INPUT	OUTPUT	INPUT	OUTPUT	
SUPPLY FAN START / STOP		X			RT, T
EXHAUST FAN START / STOP		X			RT, T
OUTSIDE AIR DAMPER				X	T
RETURN AIR DAMPER				X	T
SUPPLY FAN SPEED				X	T
EXHAUST FAN SPEED				X	T
OUTSIDE AIR TEMPERATURE			X		T
MIXED AIR TEMPERATURE			X		T
RETURN AIR TEMPERATURE			X		T
SUPPLY DISCHARGE AIR TEMPERATURE			X		T
FILTER STATUS			X		A
HIGH TURNDOWN MODULATING NATURAL GAS HEAT EXCHANGER				X	T

NOTES:

1. THE DDC SYSTEM CONTROLLER SHALL SEND A 0-10 VDC SIGNAL TO THE RTU REFRIGERATION SYSTEM CONTROLLER TO ALLOW THE RTU TO MODULATE THE COOLING.
2. THE DDC SYSTEM CONTROLLER SHALL SEND A 0-10 VDC SIGNAL TO THE RTU GAS HEATING CONTROLLER TO ALLOW THE RTU TO MODULATE THE HEATING.



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KEY PLAN

[illegible]

ISSUED: BID SET ISSUANCE

DATE: 06/06/2023

SCALE: NOT TO SCALE

SHEET NAME:
CONTROL DIAGRAMS

SHEET NUMBER:

HS-M603