

DESIGN DATA:

STRUCTURAL DESIGN HAS BEEN PERFORMED IN ACCORDANCE WITH THE FOLLOWING CODES AND STANDARDS:

- A) 2021 NEW YORK STATE BUILDING CODE.
B) ACI 318-14, BUILDING CODE REQUIREMENTS FOR STRUCTURAL CONCRETE
C) AISC, MANUAL OF STEEL CONSTRUCTION, ALLOWABLE STRESS DESIGN, 14TH ED.

- 1. DEAD LOADS
SELF WEIGHT +
ROOF: 10 PSF
CEILING: 10 PSF
FLOOR: 15 PSF
2. LIVE LOADS
FLOOR - 100 PSF
3. WIND LOADS
BASIC WIND SPEED: 115 MPH (3-second gust)
RISK CATEGORY: III
EXPOSURE CATEGORY: B
4. SNOW LOADS
GROUND SNOW LOAD: 30 PSF
DESIGN FLAT ROOF SNOW LOAD: 30 PSF
5. SEISMIC
RISK CATEGORY: III
SITE CLASS: D
Sds: 0.264g
Sd1: 0.093g
SEISMIC DESIGN CATEGORY: B

GENERAL INFORMATION:

(UNLESS OTHERWISE NOTED OR SHOWN ON PLAN, THE FOLLOWING SHALL APPLY)

- "LOADS" INDICATED ON THIS DRAWING ARE THOSE FOR THE DESIGN OF THE BUILDING SUPERSTRUCTURE
1. ALL DETAILS MARKED "TYPICAL" IN THE SET OF STRUCTURAL DRAWINGS SHALL BE APPLIED THROUGHOUT THE PROJECT AS REQUIRED TO SATISFY THE REQUIREMENTS OF THE CONSTRUCTION DOCUMENTS. THE CONTRACTOR SHALL COORDINATE REQUIREMENTS FOR QUANTITY AND LOCATION WHERE THE "TYPICAL" DETAILS APPLY.
2. FAILURE ON THE PART OF THE CONTRACTOR TO REVIEW THE DRAWINGS OF OTHER DISCIPLINES (i.e. ARCHITECTURAL, MECHANICAL, ELECTRICAL, PLUMBING, ETC.) TOGETHER WITH THE FULL EXTENT OF THE PROJECT SPECIFICATIONS DOES NOT RELIEVE THEM OF THE RESPONSIBILITY TO FURNISH AND INSTALL ITEMS THAT ARE PART OF THEIR WORK AS INDICATED BY THE DRAWINGS AND SPECIFICATIONS OF OTHER TRADES. ALL STRUCTURAL TRADE CONTRACTORS AND SUB-CONTRACTORS ARE PROHIBITED FROM EXCLUDING STRUCTURAL WORK FROM THEIR CONTRACT NOT SHOWN IN THE STRUCTURAL DRAWINGS.
3. ALL CONTRACTORS AND SUBCONTRACTORS WORKING ON THIS PROJECT TO HAVE A MINIMUM OF 5 YEARS VERIFIABLE EXPERIENCE IN THEIR RESPECTIVE FIELDS.
4. THE CONTRACTOR SHALL VERIFY ALL DIMENSIONS IN FIELD PRIOR TO ORDERING AND PRE-FABRICATED ITEMS, INCLUDED BY NOT LIMITED TO; TRUSSES, SIPs, PLANK AND STEEL.
5. DRAWINGS MAY NOT BE SCALED. USE NOTES AND DIMENSIONS SPECIFIED ON DRAWINGS AND CONFIRM THESE DIMENSIONS WITHIN FIELD MEASUREMENTS DURING CONSTRUCTION.
6. DISCREPANCIES, OMISSIONS OR UNFORESEEN PROBLEMS DISCOVERED AT SITE SHALL BE REPORTED TO THE ENGINEER FOR IMMEDIATE CONSULTATION AND AMENDMENT.
7. TEMPORARY SHORING AND SHORING OF EXCAVATION IS BY OTHERS. THESE DRAWINGS SHOW FINAL CONDITIONS ONLY.

STRUCTURAL STEEL GENERAL NOTES

(UNLESS OTHERWISE NOTED OR SHOWN ON PLAN, THE FOLLOWING SHALL APPLY)

- 1. STRUCTURAL STEEL SHALL CONFORM TO THE A.I.S.C. STEEL CONSTRUCTION MANUAL 14TH EDITION.
2. UNLESS OTHERWISE NOTED, ALL MATERIALS SHALL BE IN ACCORDANCE WITH THE FOLLOWING SPECIFICATIONS.
MEMBER A.S.T.M. MIN. STRENGTH
ROLLED SHAPES A992 50 KSI
BASE PLATES A572 42 KSI
PLATES, CHANNELS, & ANGLES A36 36 KSI
CONNECTION BOLTS A325 92 KSI
ANCHOR BOLTS F1554 ---
THREADED BOLTS A36 36 KSI
NON-SHRINK GROUT C1107 8,000 PSI
3. WELDING SHALL BE IN ACCORDANCE WITH A.W.S. D.1.1 USING E70XX ELECTRODES. UNLESS OTHERWISE NOTED, PROVIDE CONTINUOUS MINIMUM SIZED FILLET WELDS PER A.I.S.C. REQUIREMENTS. FILLER MATERIAL SHALL HAVE A MINIMUM YIELD STRENGTH OF 58 K.S.I.
4. MOMENT CONNECTIONS DENOTED THUS (▶) ON PLAN. SEE TYPICAL DETAILS.
5. HOLES IN STEEL BEAMS SHALL BE DRILLED OR PUNCHED. ALL SLOTTED HOLES SHALL BE PROVIDED WITH SMOOTH EDGES. BURNING OF HOLES AND TORCH CUTTING AT THE SITE IS NOT PERMITTED.
6. THE STRUCTURAL STEEL ERECTOR SHALL PROVIDE TEMPORARY GUYING AND BRACING AS REQUIRED. COLUMNS, ANCHOR BOLTS, BASE PLATES, ETC. HAVE BEEN DESIGNED FOR THE FINAL COMPLETE CONDITION, AND HAVE NOT BEEN INVESTIGATED FOR POTENTIAL LOADINGS ENCOUNTERED DURING STEEL ERECTION AND CONSTRUCTION. ANY INVESTIGATION OF THE COLUMNS, ANCHOR BOLTS, FRAMING, ETC. FOR ADEQUACY DURING THE STEEL ERECTION AND CONSTRUCTION PROCESS IS THE SOLE RESPONSIBILITY OF THE CONTRACTOR.

CAST-IN-PLACE CONCRETE GENERAL NOTES:

(UNLESS OTHERWISE NOTED OR SHOWN ON PLAN, THE FOLLOWING SHALL APPLY)

- 1. CONCRETE WORK SHALL CONFORM WITH THE REQUIREMENTS OF THE AMERICAN CONCRETE INSTITUTE ACI 318 (LATEST EDITION).
2. UNLESS OTHERWISE INDICATED ON DRAWINGS, CAST-IN-PLACE CONCRETE SHALL DEVELOP A STRENGTH OF 3,500 PSI (FOOTINGS, FOUNDATION WALLS AND RETAINING WALLS); 3,500 PSI (SLAB ON GRADE) AT 28 DAYS.
3. TEMPERATURE REINFORCING SHALL BE SUFFICIENTLY EMBEDDED TO DEVELOP FULL STRENGTH IN CONCRETE WALLS AND SLABS.
4. PROVIDE ADEQUATE TIES FOR REINFORCEMENT IN SLABS, BEAMS, PIERS AND WALLS. REINFORCEMENT TO BE HELD AT CORRECT DISTANCE FROM FORMS AND EARTH BY STEEL CHAIRS OR TIES.
5. FOLLOW C.R.S.I. RULES FOR PLACING OF REINFORCING STEEL AND ACCESSORIES.
6. THIS CONTRACTOR SHALL COOPERATE WITH OTHER TRADES AND WHERE REQUIRED INSTALL ALL BUILT-IN WORK, SLEEVES, INSERTS, ETC., AS REQUIRED FOR A COMPLETE JOB.
7. STRUCTURAL MEMBERS SHALL BE POURED FOR THEIR FULL DEPTHS IN ONE OPERATION. CONSTRUCTION JOINTS SUCH AS A DAY'S POUR JOINTS SHALL BE LOCATED IN THE MIDDLE THIRD OF THE SPAN, MAIN REINFORCING TO RUN THROUGH THE JOINT, KEY AND ROUGHEN JOINTS TO EXPOSE AGGREGATE FOR CHEMICAL BOND.
8. NO HORIZONTAL JOINTS SHALL BE PLACED IN WALLS EXCEPT AS SHOWN ON THE DRAWINGS, WITHOUT THE APPROVAL OF THE ENGINEER.
9. STRUCTURAL SLABS ON GRADE SHALL BE OF A THICKNESS AND REINFORCED AS INDICATED ON DRAWINGS.
10. SLABS-ON-GRADE SHALL HAVE THICKENINGS, DEPRESSIONS, OPENINGS, ETC., AS REQUIRED OR AS SHOWN HEREIN OR ON ARCHITECTURAL DRAWINGS.
11. PROVIDE 100% CONTINUITY OVER SUPPORTS FOR CONTINUOUS SLABS AND BEAMS.
12. TOP ELEVATION OF SLABS SHALL VARY ACCORDING TO FINISH FLOOR MATERIAL. SEE ARCHITECTURAL DRAWINGS.
13. SEE MECHANICAL AND ARCHITECTURAL DRAWINGS FOR SIZE AND LOCATION OF OPENINGS IN, FLOORS AND WALLS NOT SHOWN ON STRUCTURAL DRAWINGS.
15. MAXIMUM STEP OF FOOTINGS SHALL BE ONE VERTICALLY TO TWO HORIZONTALLY WHERE ELEVATIONS CHANGE.
16. CONCRETE SHALL CONSIST OF THE FOLLOWING:
- READY MIX CONCRETE (ASTM C94)
- MAX WATER TO CEMENT RATIO = 0.50
- MAX AGGREGATE CONTENT SIZE OF 3/4 INCH (ASTM C33)
- MAX SLUMP OF 5" + OR - AN INCH (ASTM C143)
- PORTLAND CEMENT: ASTM-C 150, TYPE 1
- CLEAN POTABLE DRINKING WATER
- AIR CONTENT TO BE 6% +/- 1.5% (INTERIOR SLABS TO HAVE 0% AIR)
17. REINFORCING STEEL SHALL CONSIST OF THE FOLLOWING:
- REINFORCING BARS: ASTM -A 615 GRADE 60 KSI
- WELDED WIRE FABRIC: ASTM-A 185
18. PROVIDE CONTINUOUS REINFORCING WHEREVER POSSIBLE, PLACE ONLY AS SHOWN OR APPROVED, STAGGER SPLICES WHERE POSSIBLE.
19. ALL REINFORCING STEEL AND EMBEDMENT TO BE HELD SECURELY IN PLACE PRIOR TO PLACING CONCRETE. PROVIDE SUFFICIENT SUPPORTS TO ALLOW WALKING ON REINFORCEMENT.
20. DETAIL ACCORDING TO ACI STANDARD 315, MANUAL OF STANDARD PRACTICE FOR DETAILING REINFORCING CONCRETE STRUCTURES.
21. CONCRETE MEMBERS SHALL NOT BE LOADED UNTIL SATISFACTORY CONCRETE STRENGTH HAS BEEN OBTAINED.
22. NO ADMIXTURES MAY BE USED UNLESS PRIOR APPROVAL BY THE OWNER/ENGINEER.
23. COLD WEATHER REQUIREMENT SHALL BE USED DURING FREEZING OR NEAR FREEZING WEATHER - ACI 306.1-90. COLD WEATHER IS DEFINED AS 3 DAYS WITH AVG. TEMP. BELOW 40F.
24. DURING HOT WEATHER CONCRETE SHALL BE PLACED AND CURED IN ACCORDANCE WITH ACI 305.

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EXP. DATE: 2/28/2026



NUFSD BOND PROJECT PHASE 5 - BARR MS

- SED#50-01-08-03-0-002-020 (HIGHVIEW ES)
SED#50-01-08-03-7-007-002 (Maintenance)
SED#50-01-08-03-7-012-004 (OEC)
SED#50-01-08-03-0-001-026 (MILLER ES)
SED#50-01-08-03-0-004-022 (BARR MS)

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Miller Elementary School
50 Blauvelt Rd Unit1
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A MacArthur Barr Middle School
143 Church St
Nanuet, NY 10954

KEY PLAN

REVISIONS

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ISSUED: BID SET

DATE: 06/21/2024


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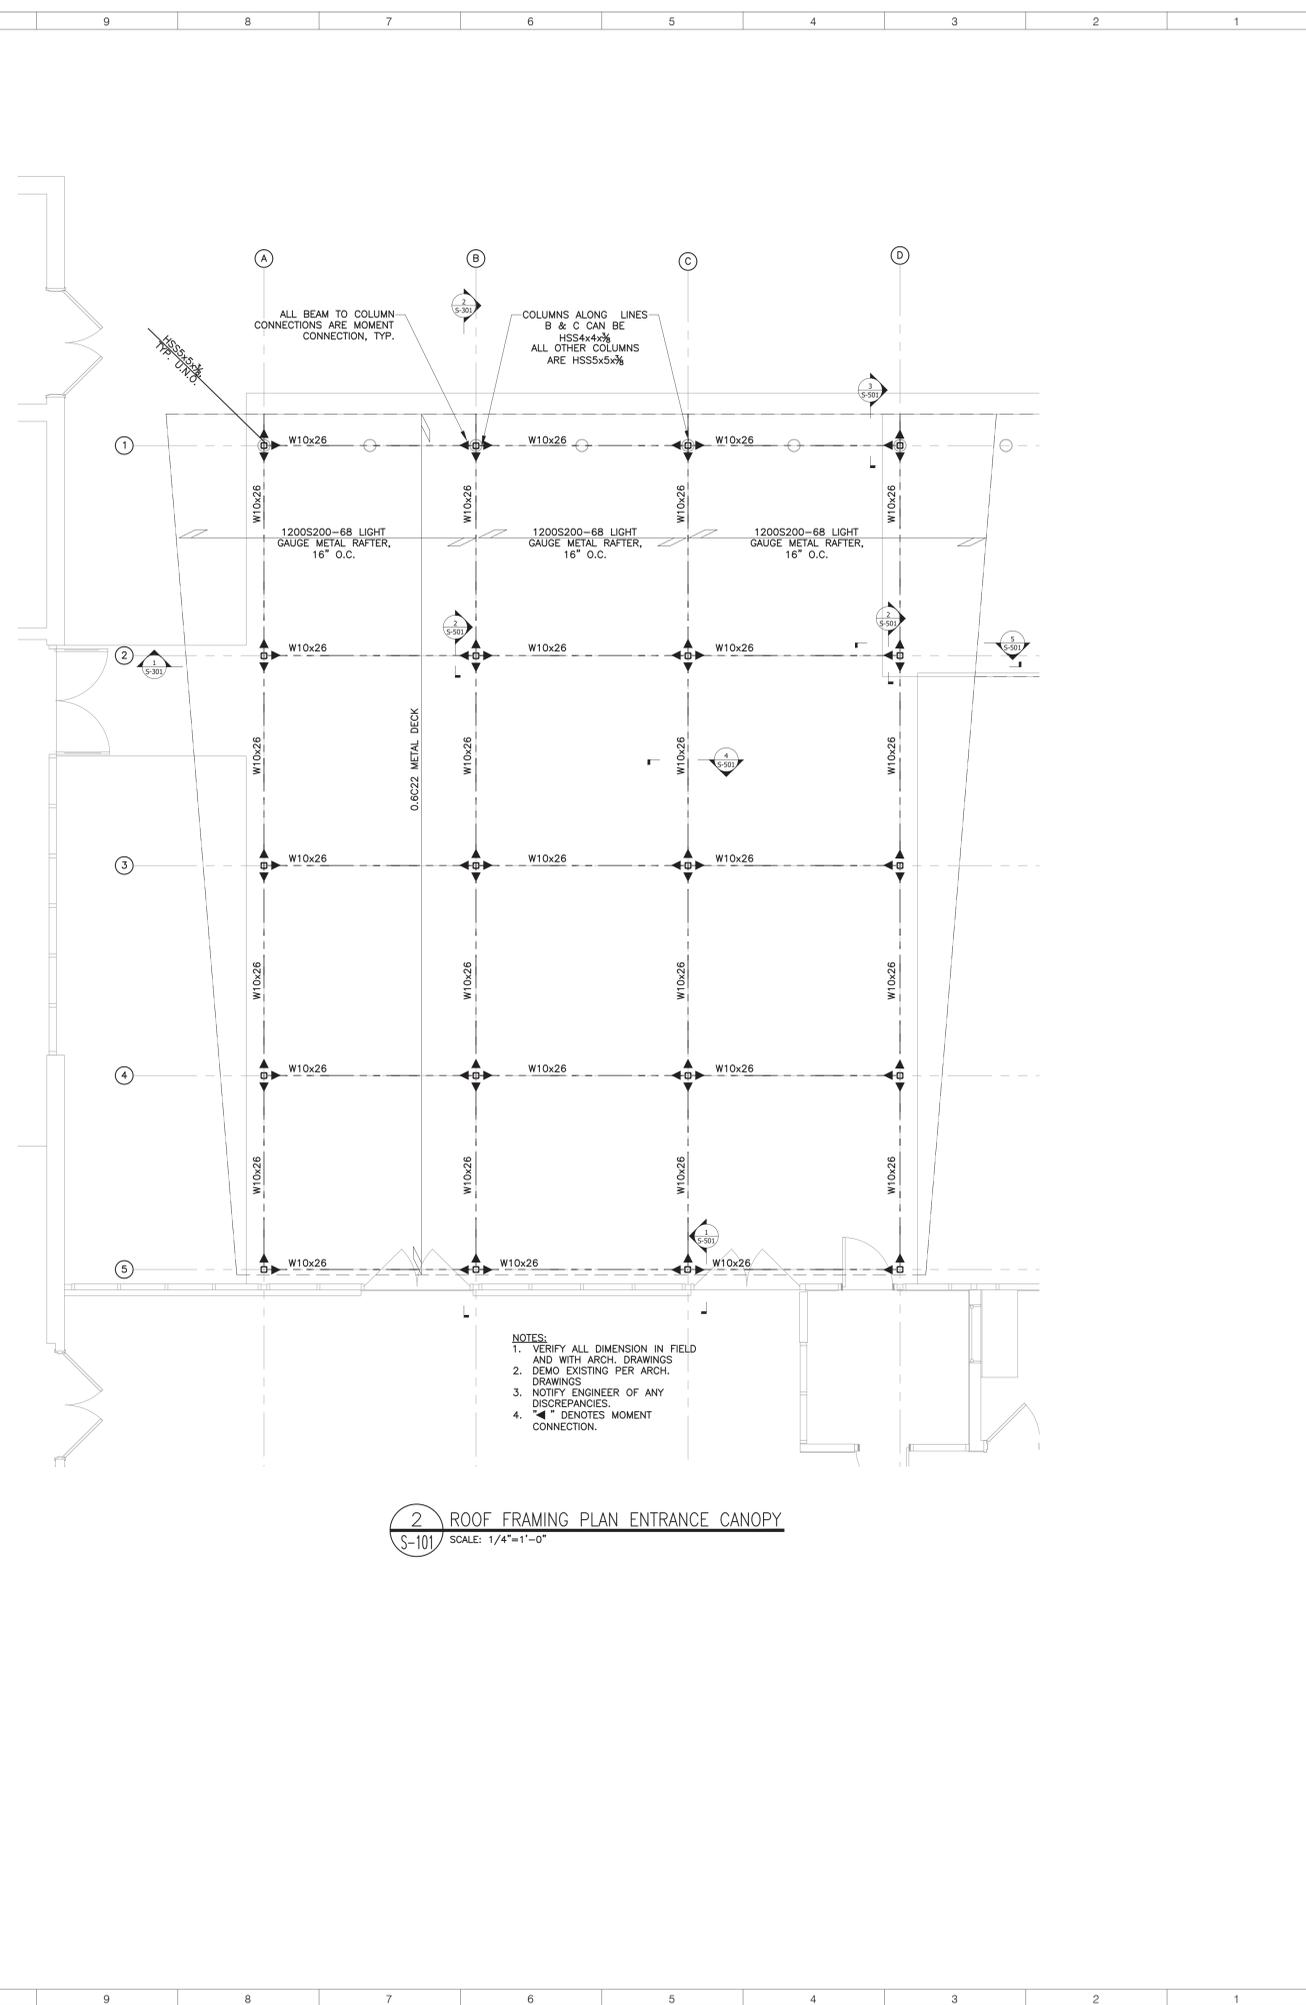
STRUCTURAL NOTES

SHEET NUMBER:

BM-S001



1 FOUNDATION PLAN ENTRANCE CANOPY
SCALE: 1/4"=1'-0"

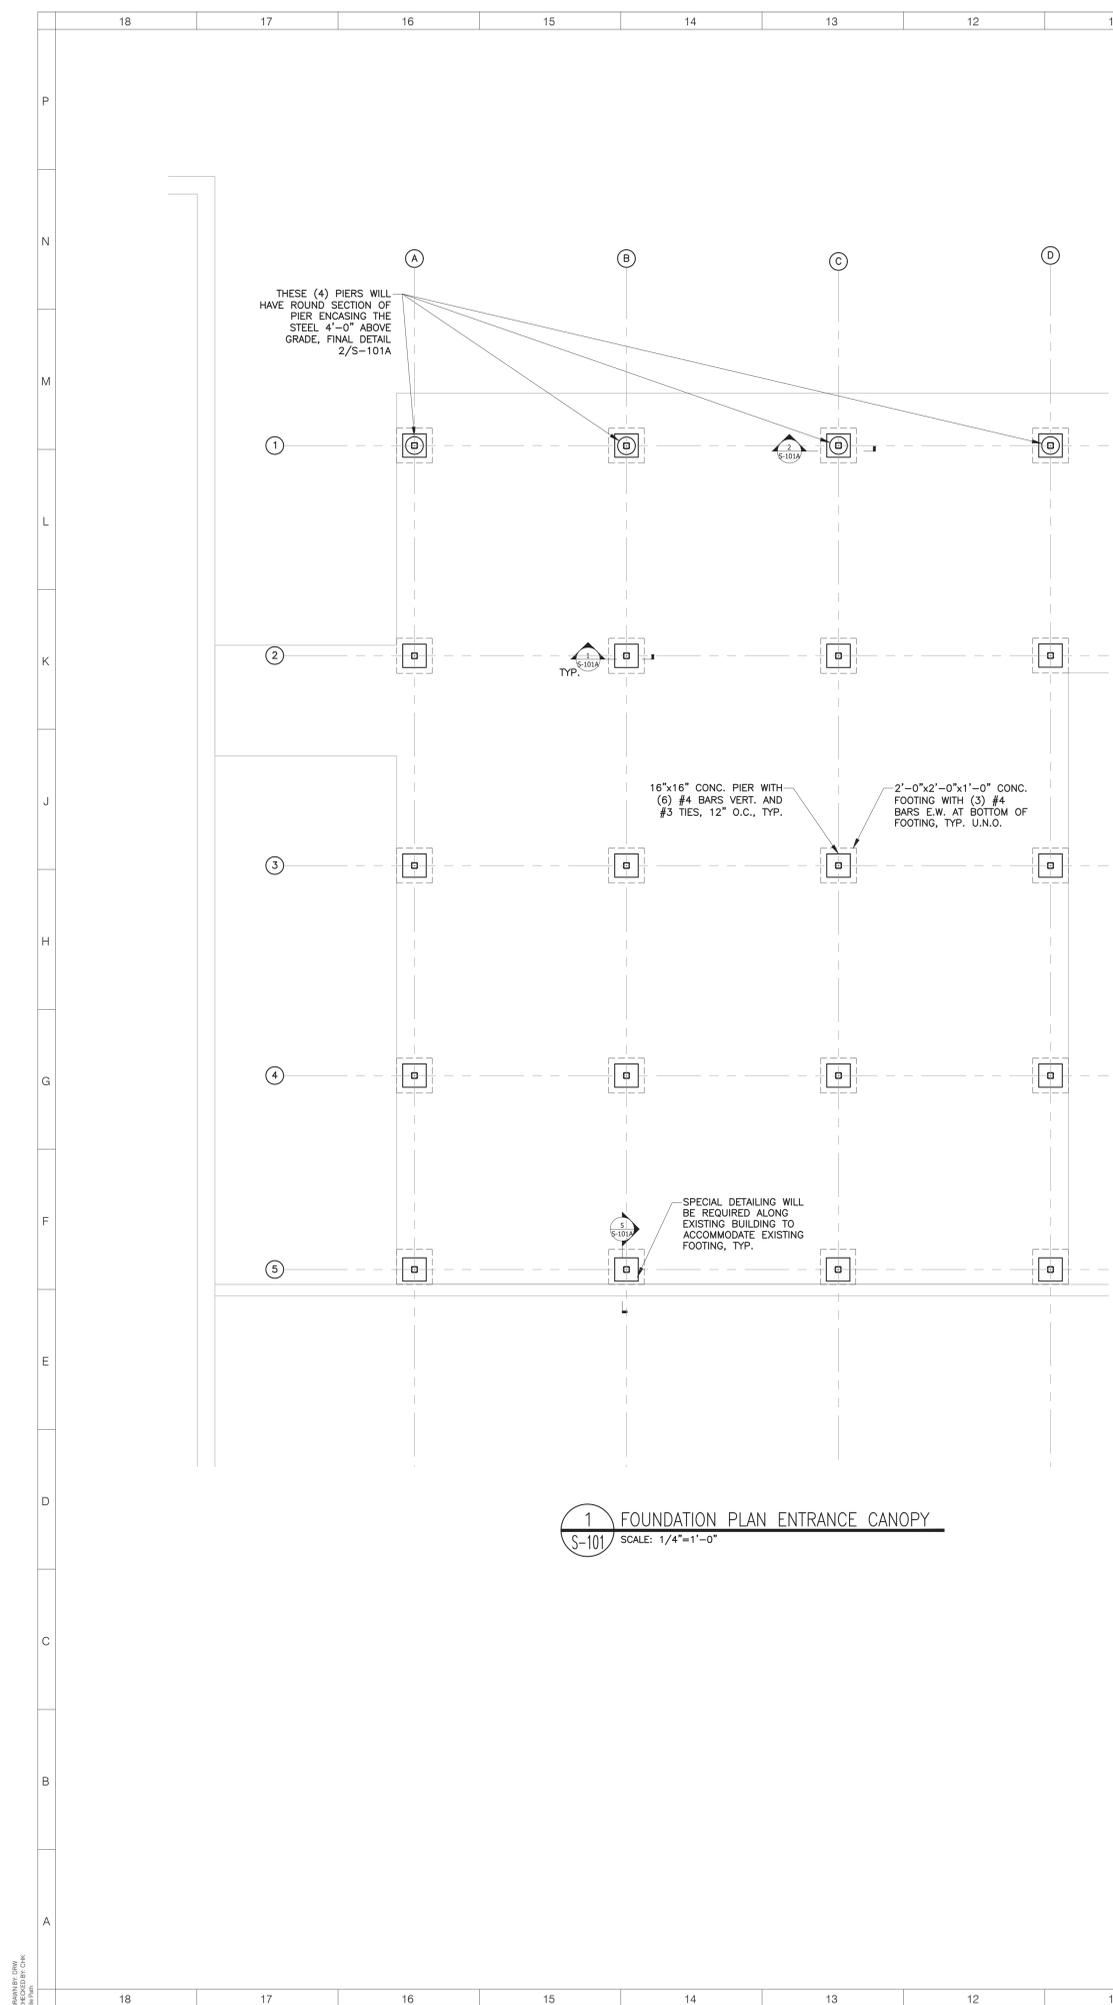

2 ROOF FRAMING PLAN ENTRANCE CANOPY
SCALE: 1/4"=1'-0"

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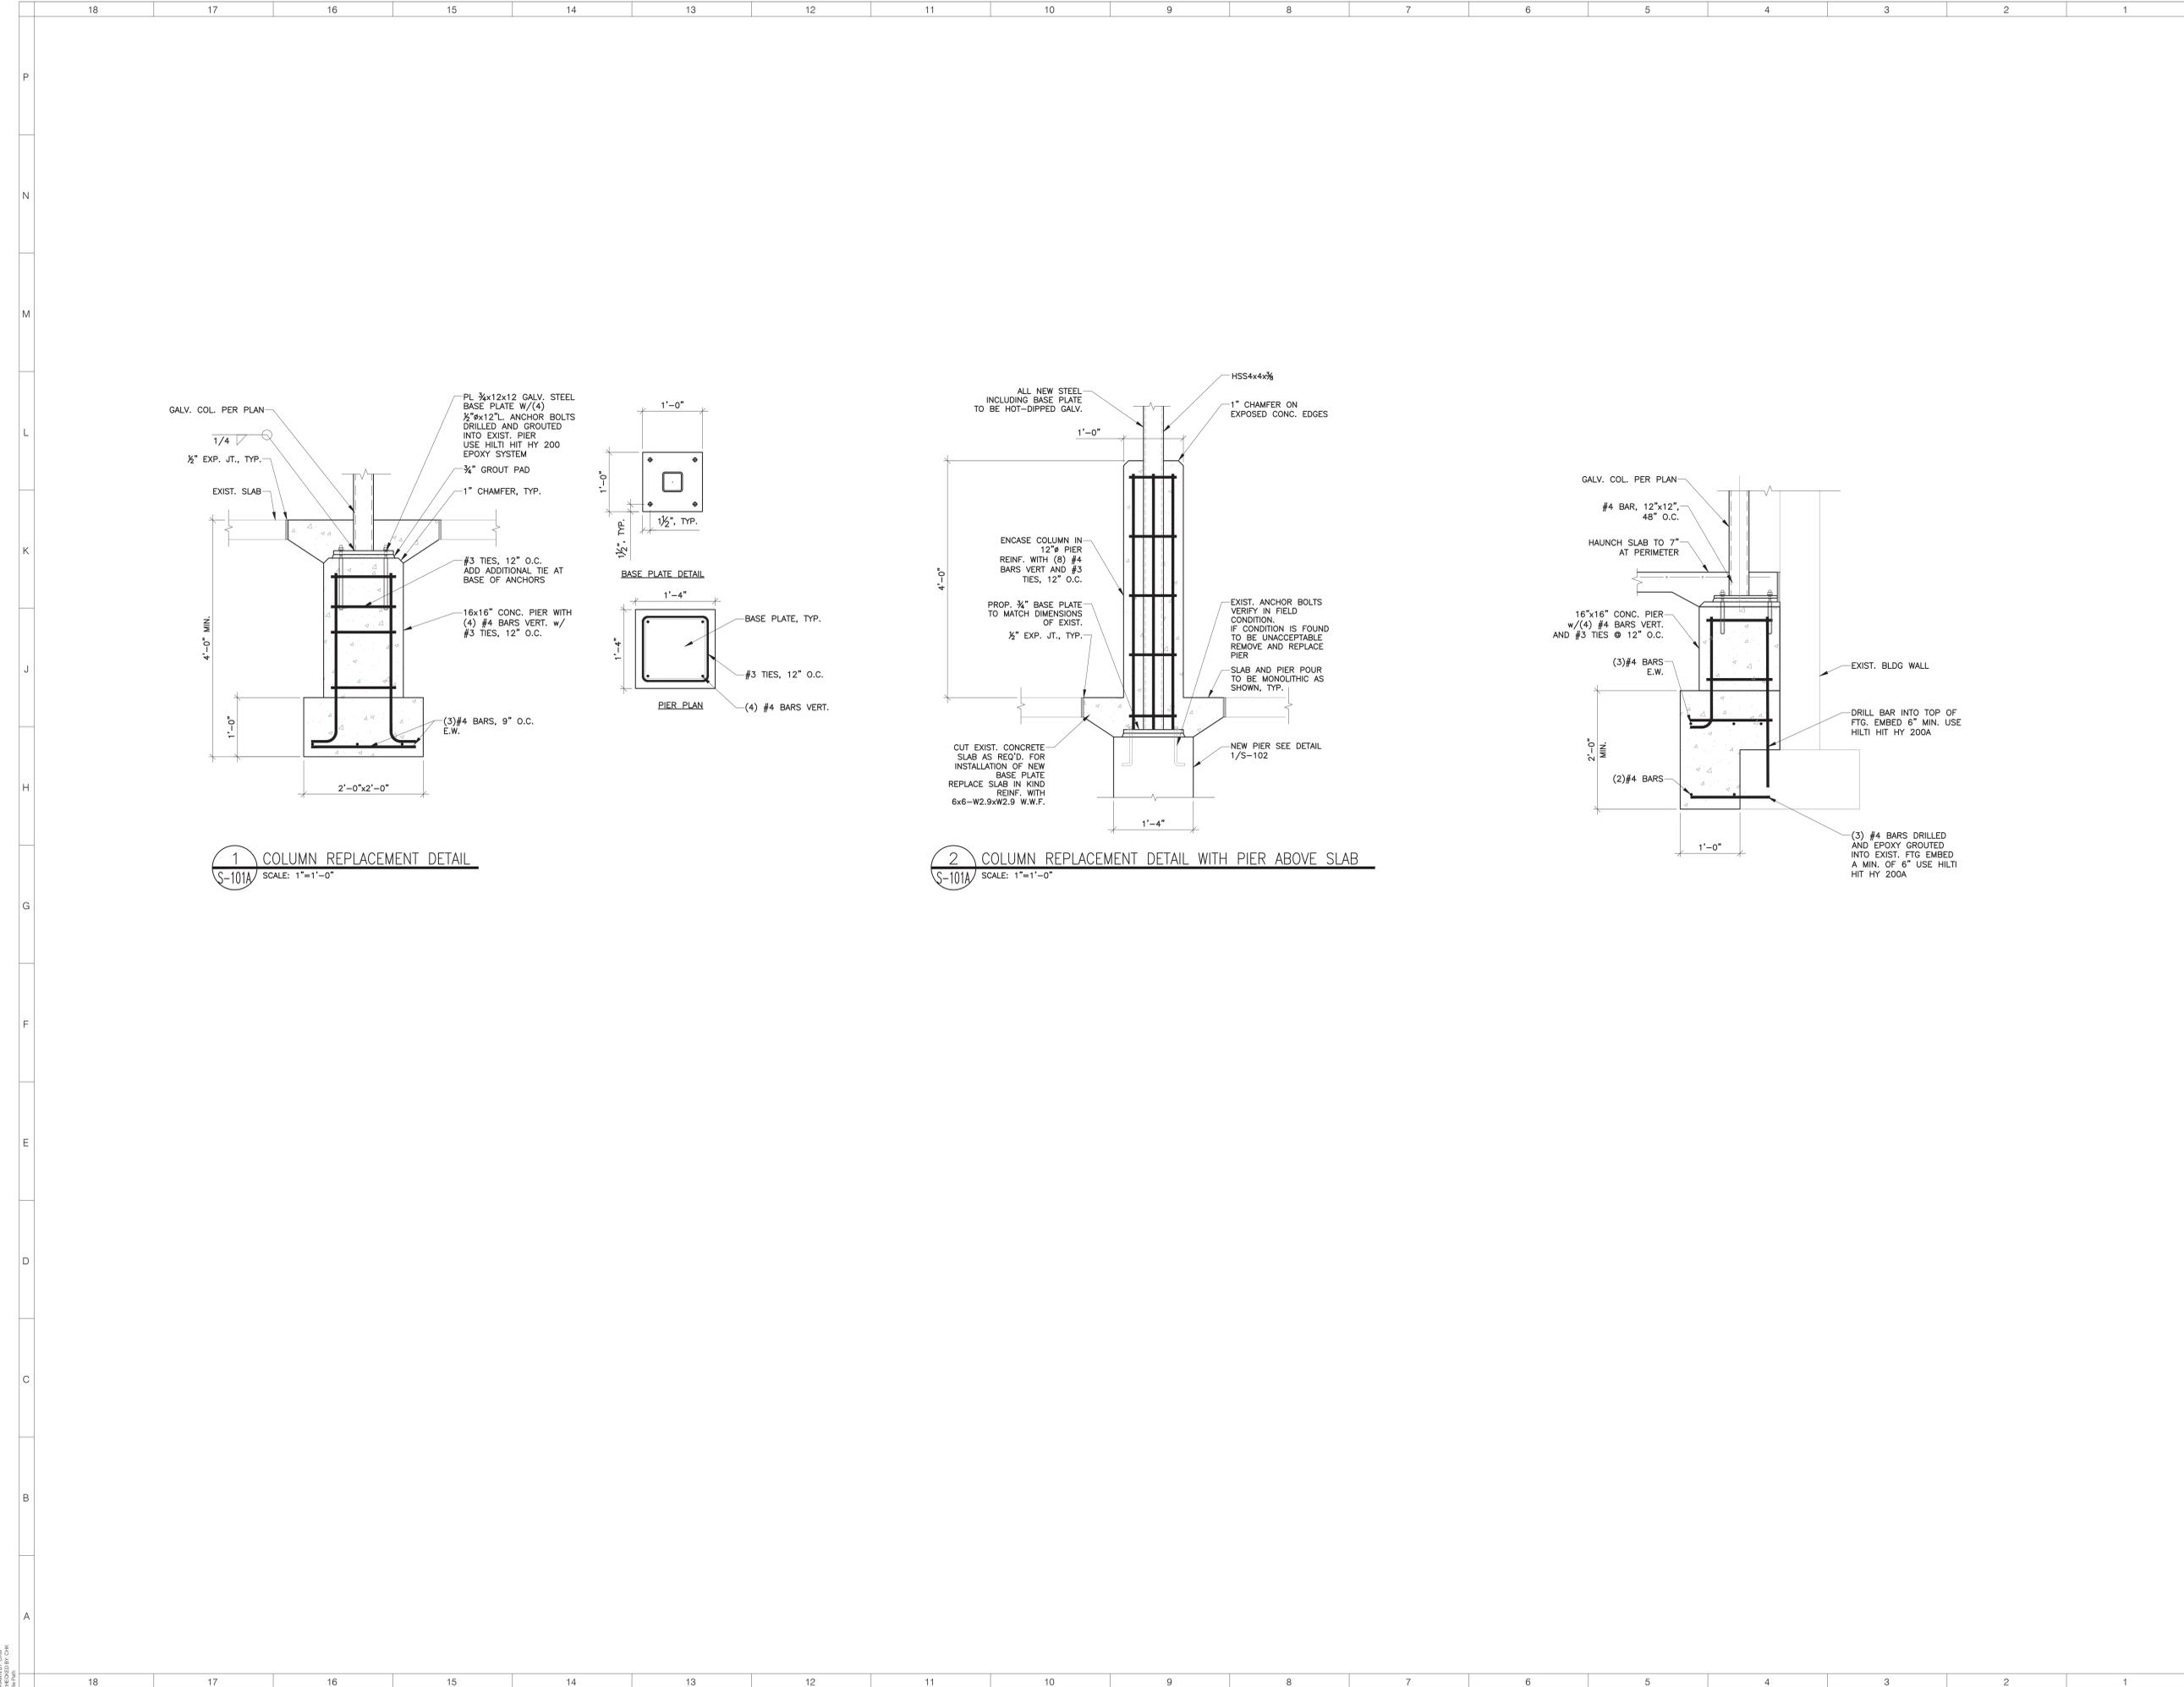
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SHEET NAME:
 STRUCTURAL PLANS
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SHEET NUMBER:
BM-S101



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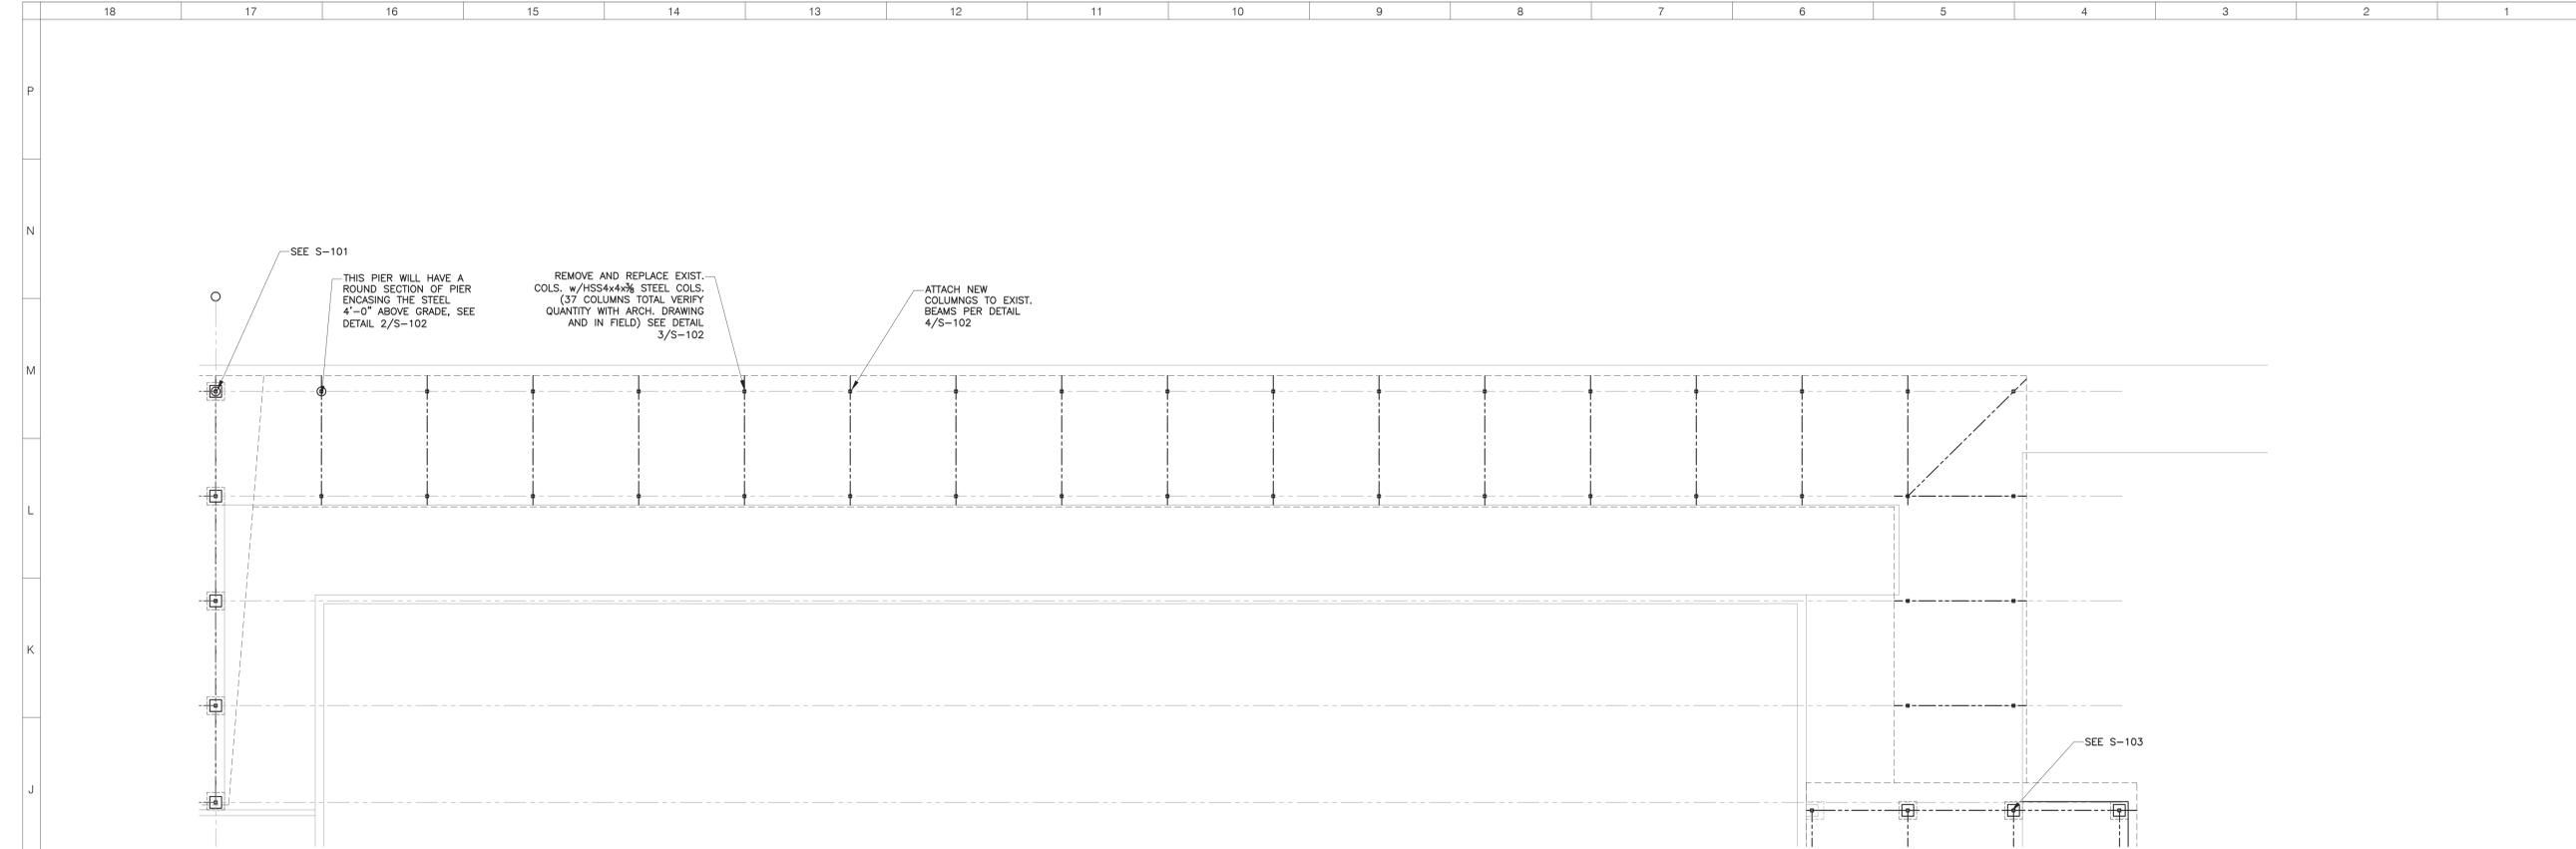
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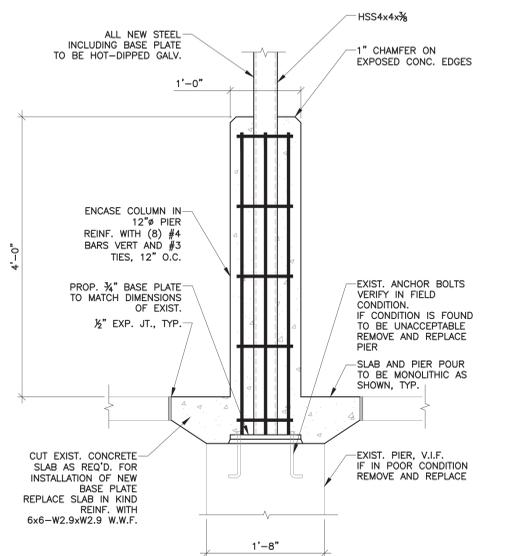
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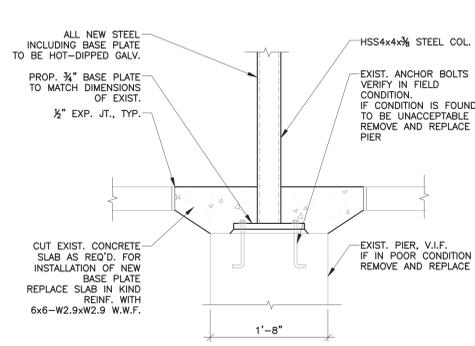
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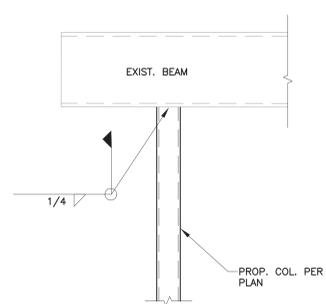
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2 COLUMN REPLACEMENT DETAIL WITH PIER ABOVE SLAB
SCALE: 1"=1'-0"



3 COLUMN REPLACEMENT DETAIL
SCALE: 1"=1'-0"



4 COLUMN ATTACHMENT DETAIL
SCALE: N.T.S.

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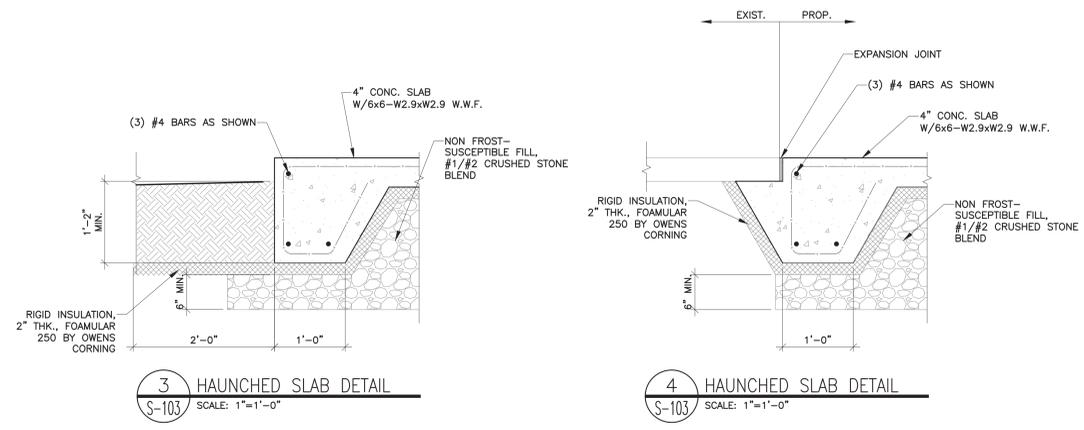
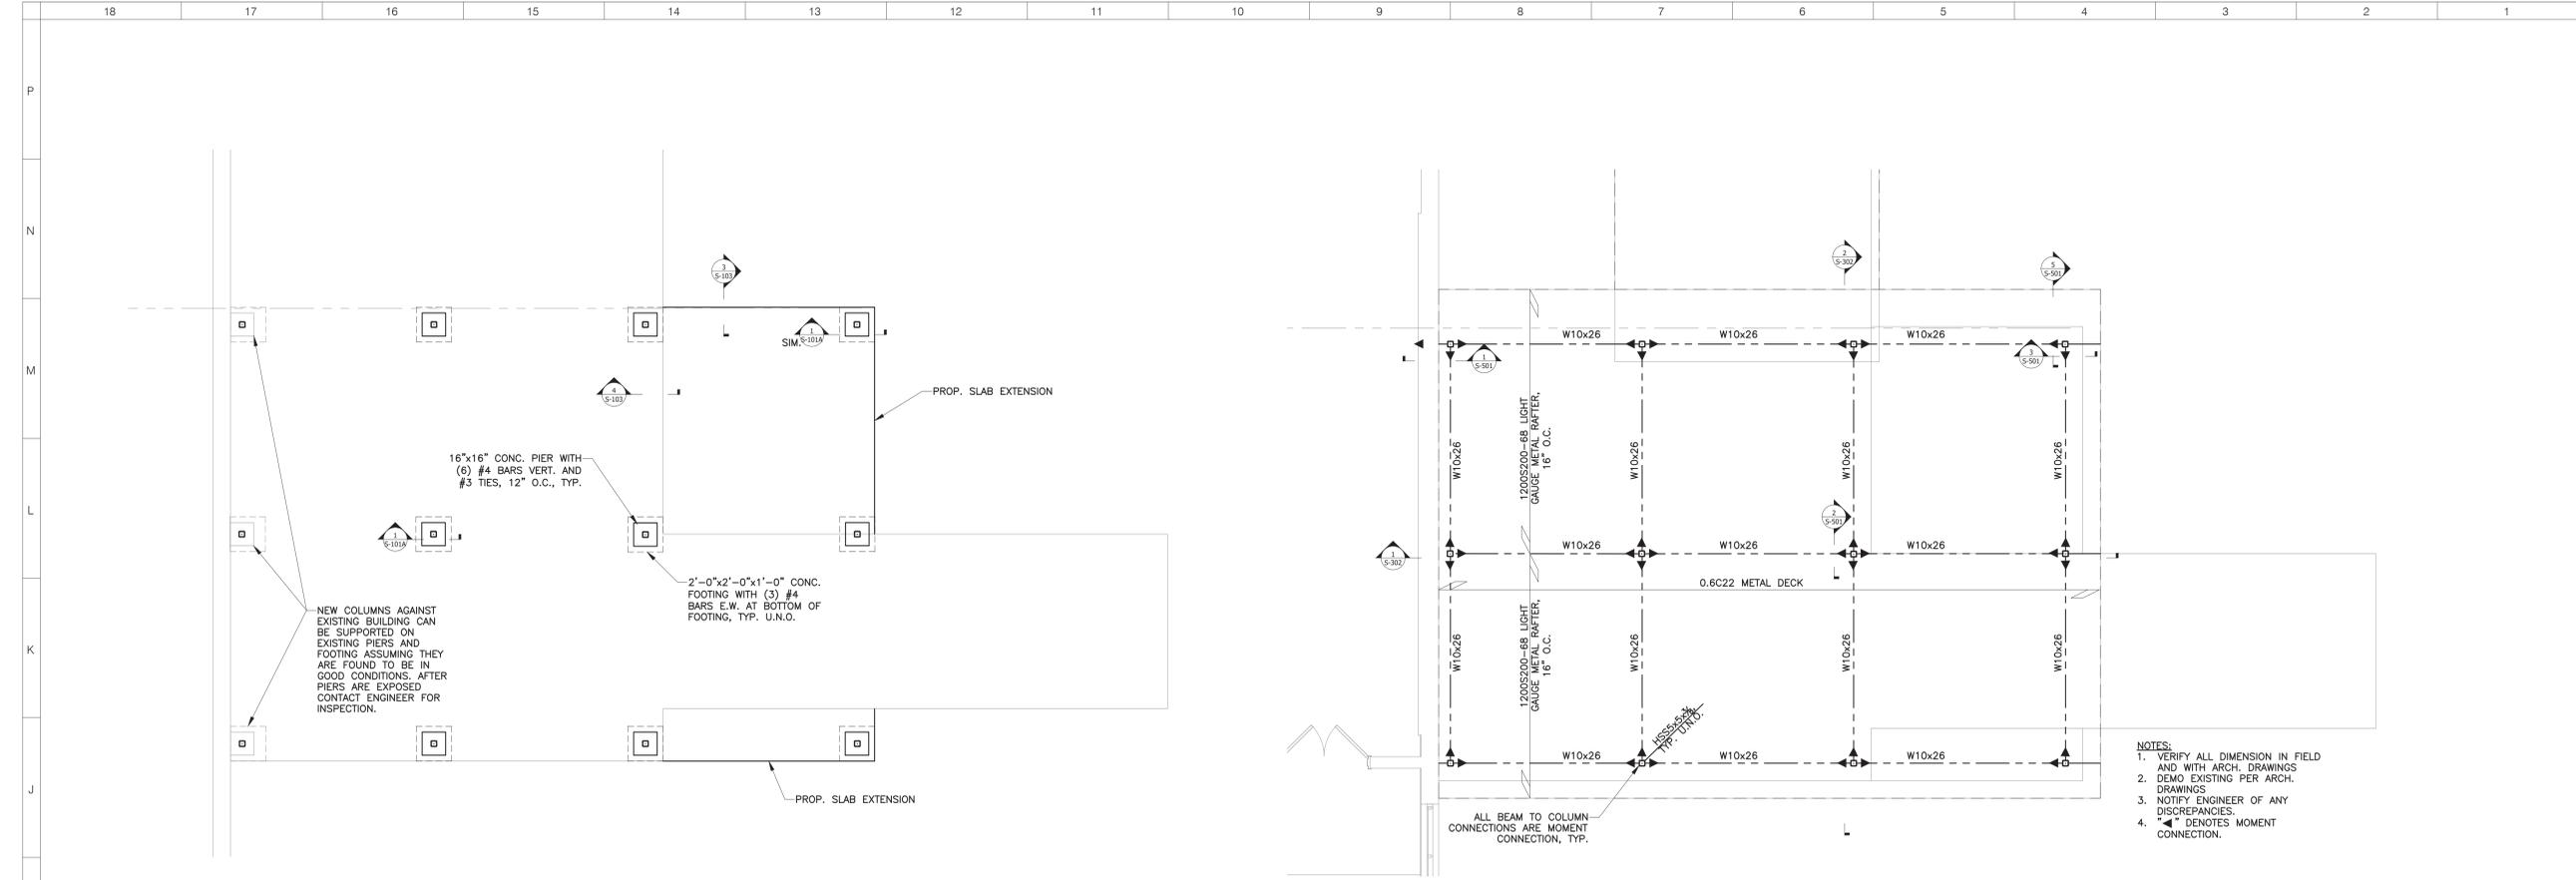
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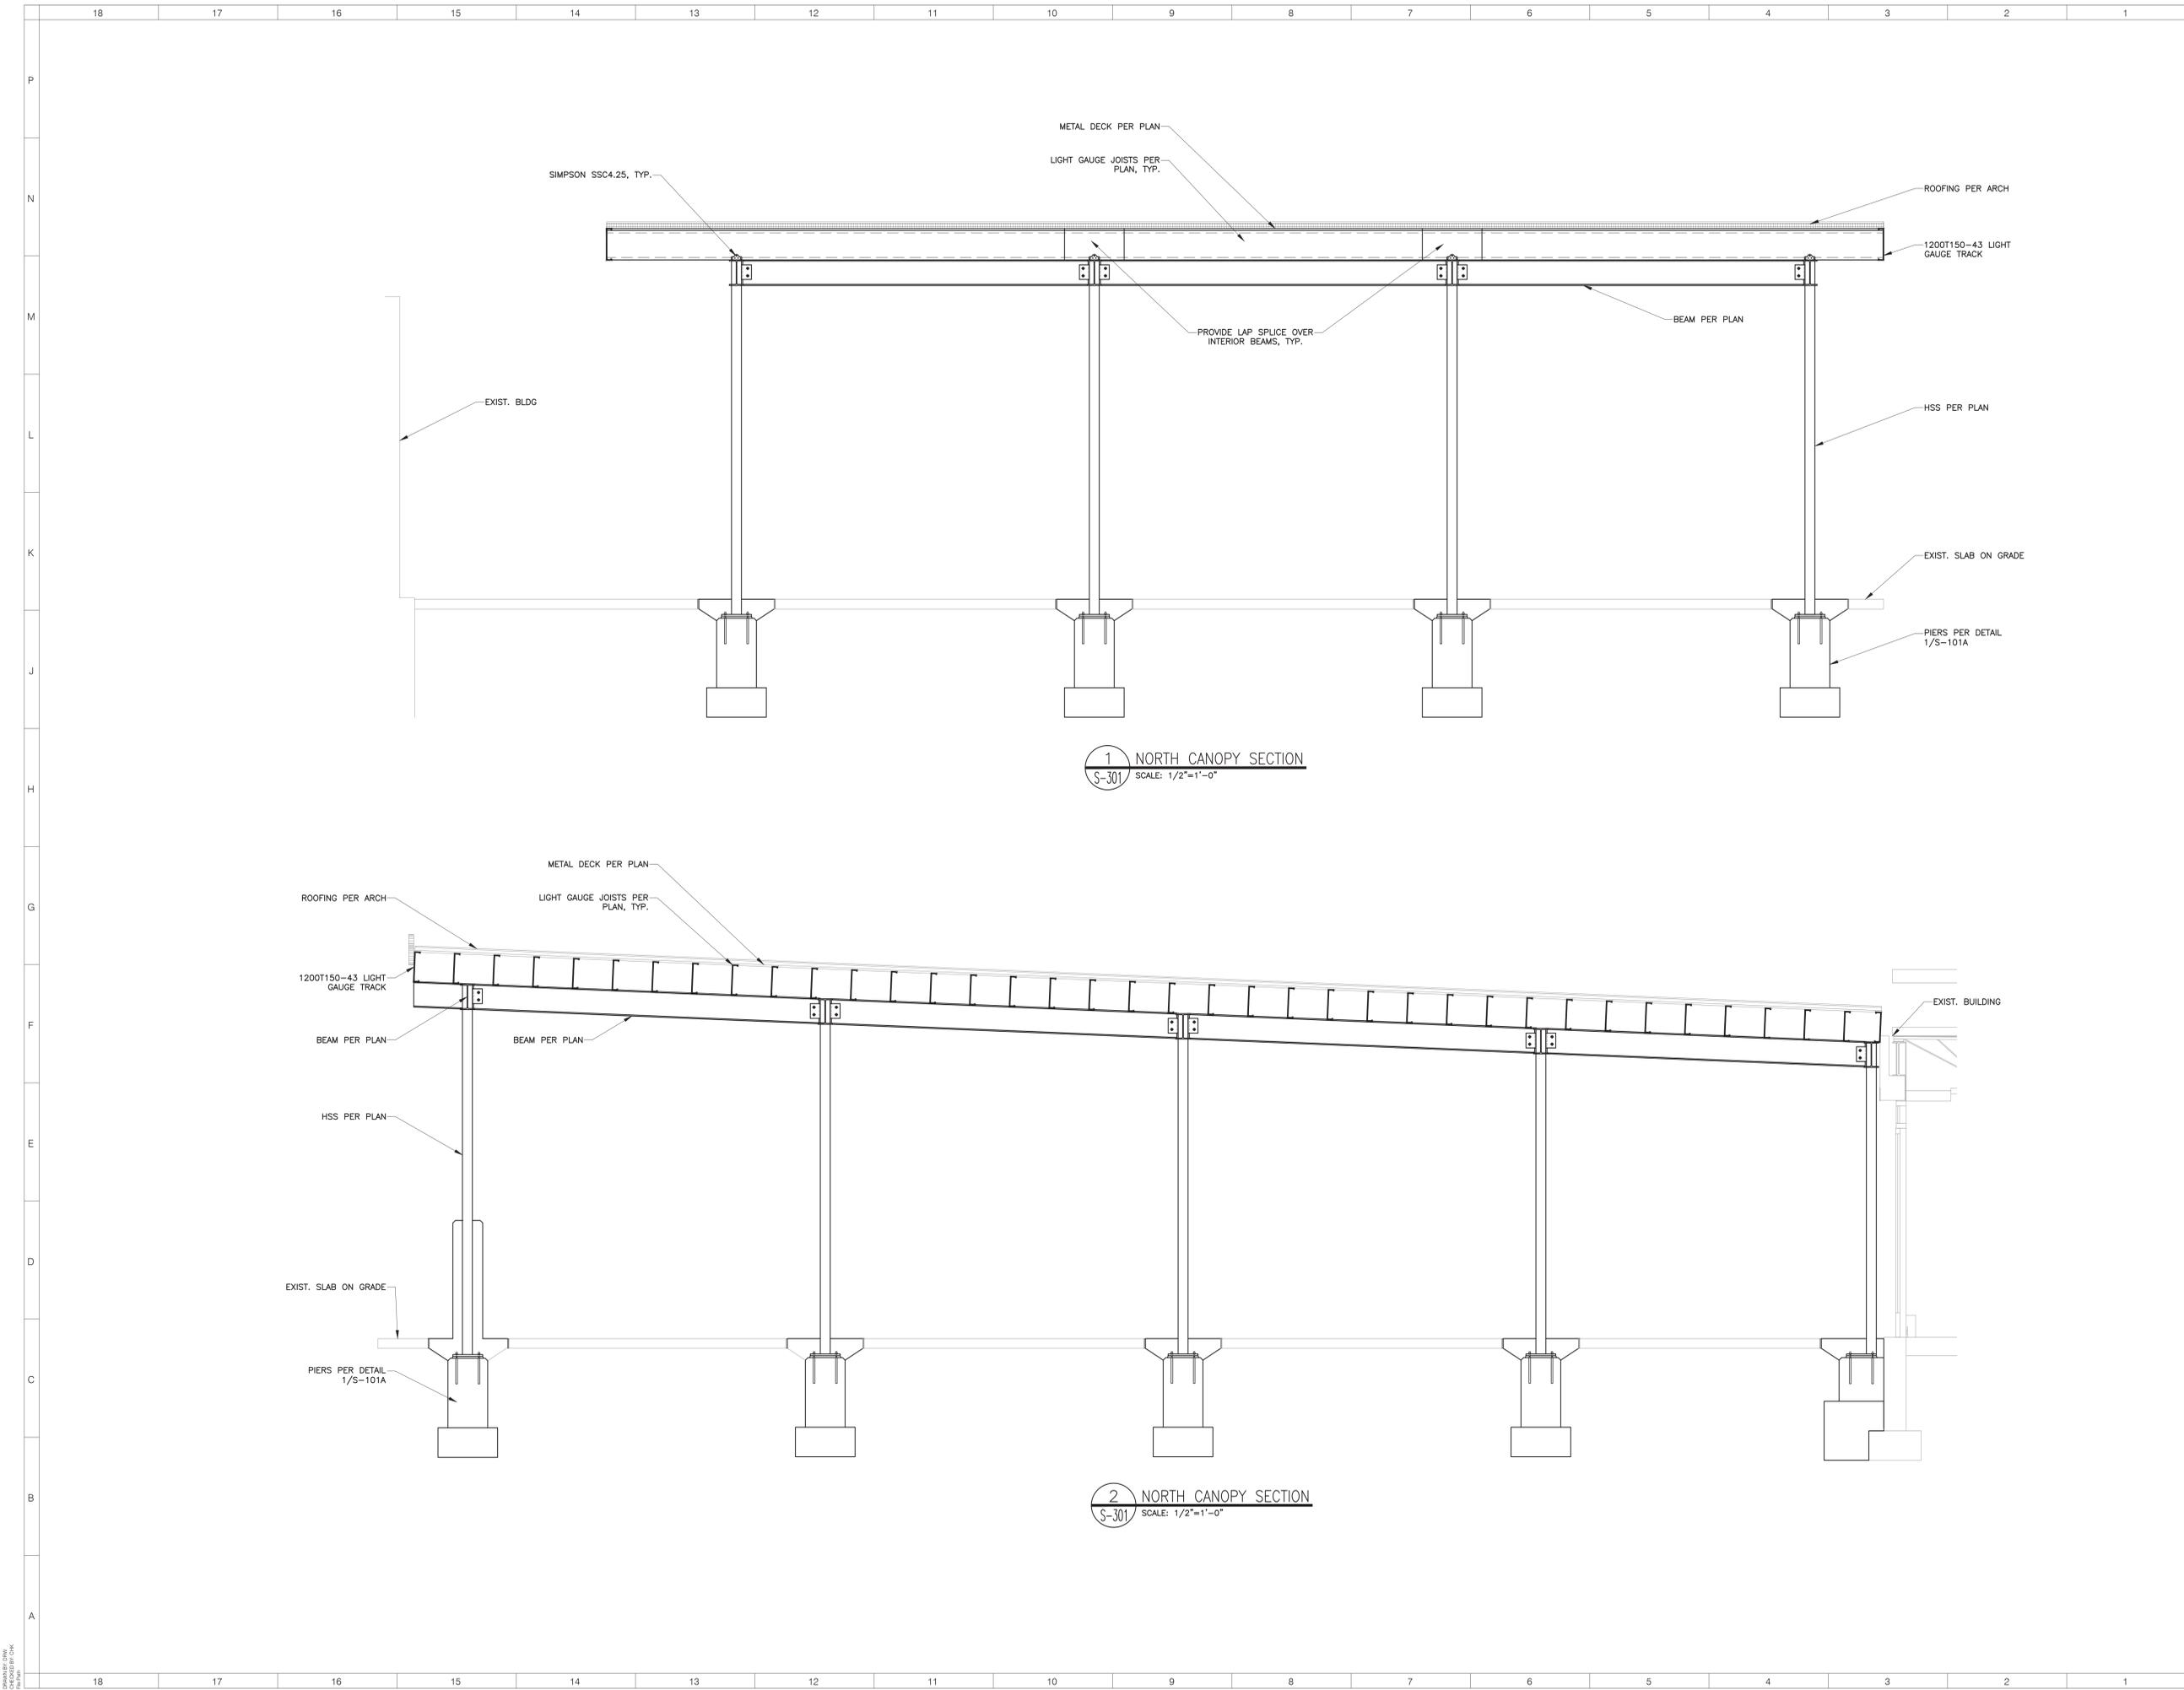
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BM-S103



1 NORTH CANOPY SECTION
S-301 SCALE: 1/2"=1'-0"

2 NORTH CANOPY SECTION
S-301 SCALE: 1/2"=1'-0"



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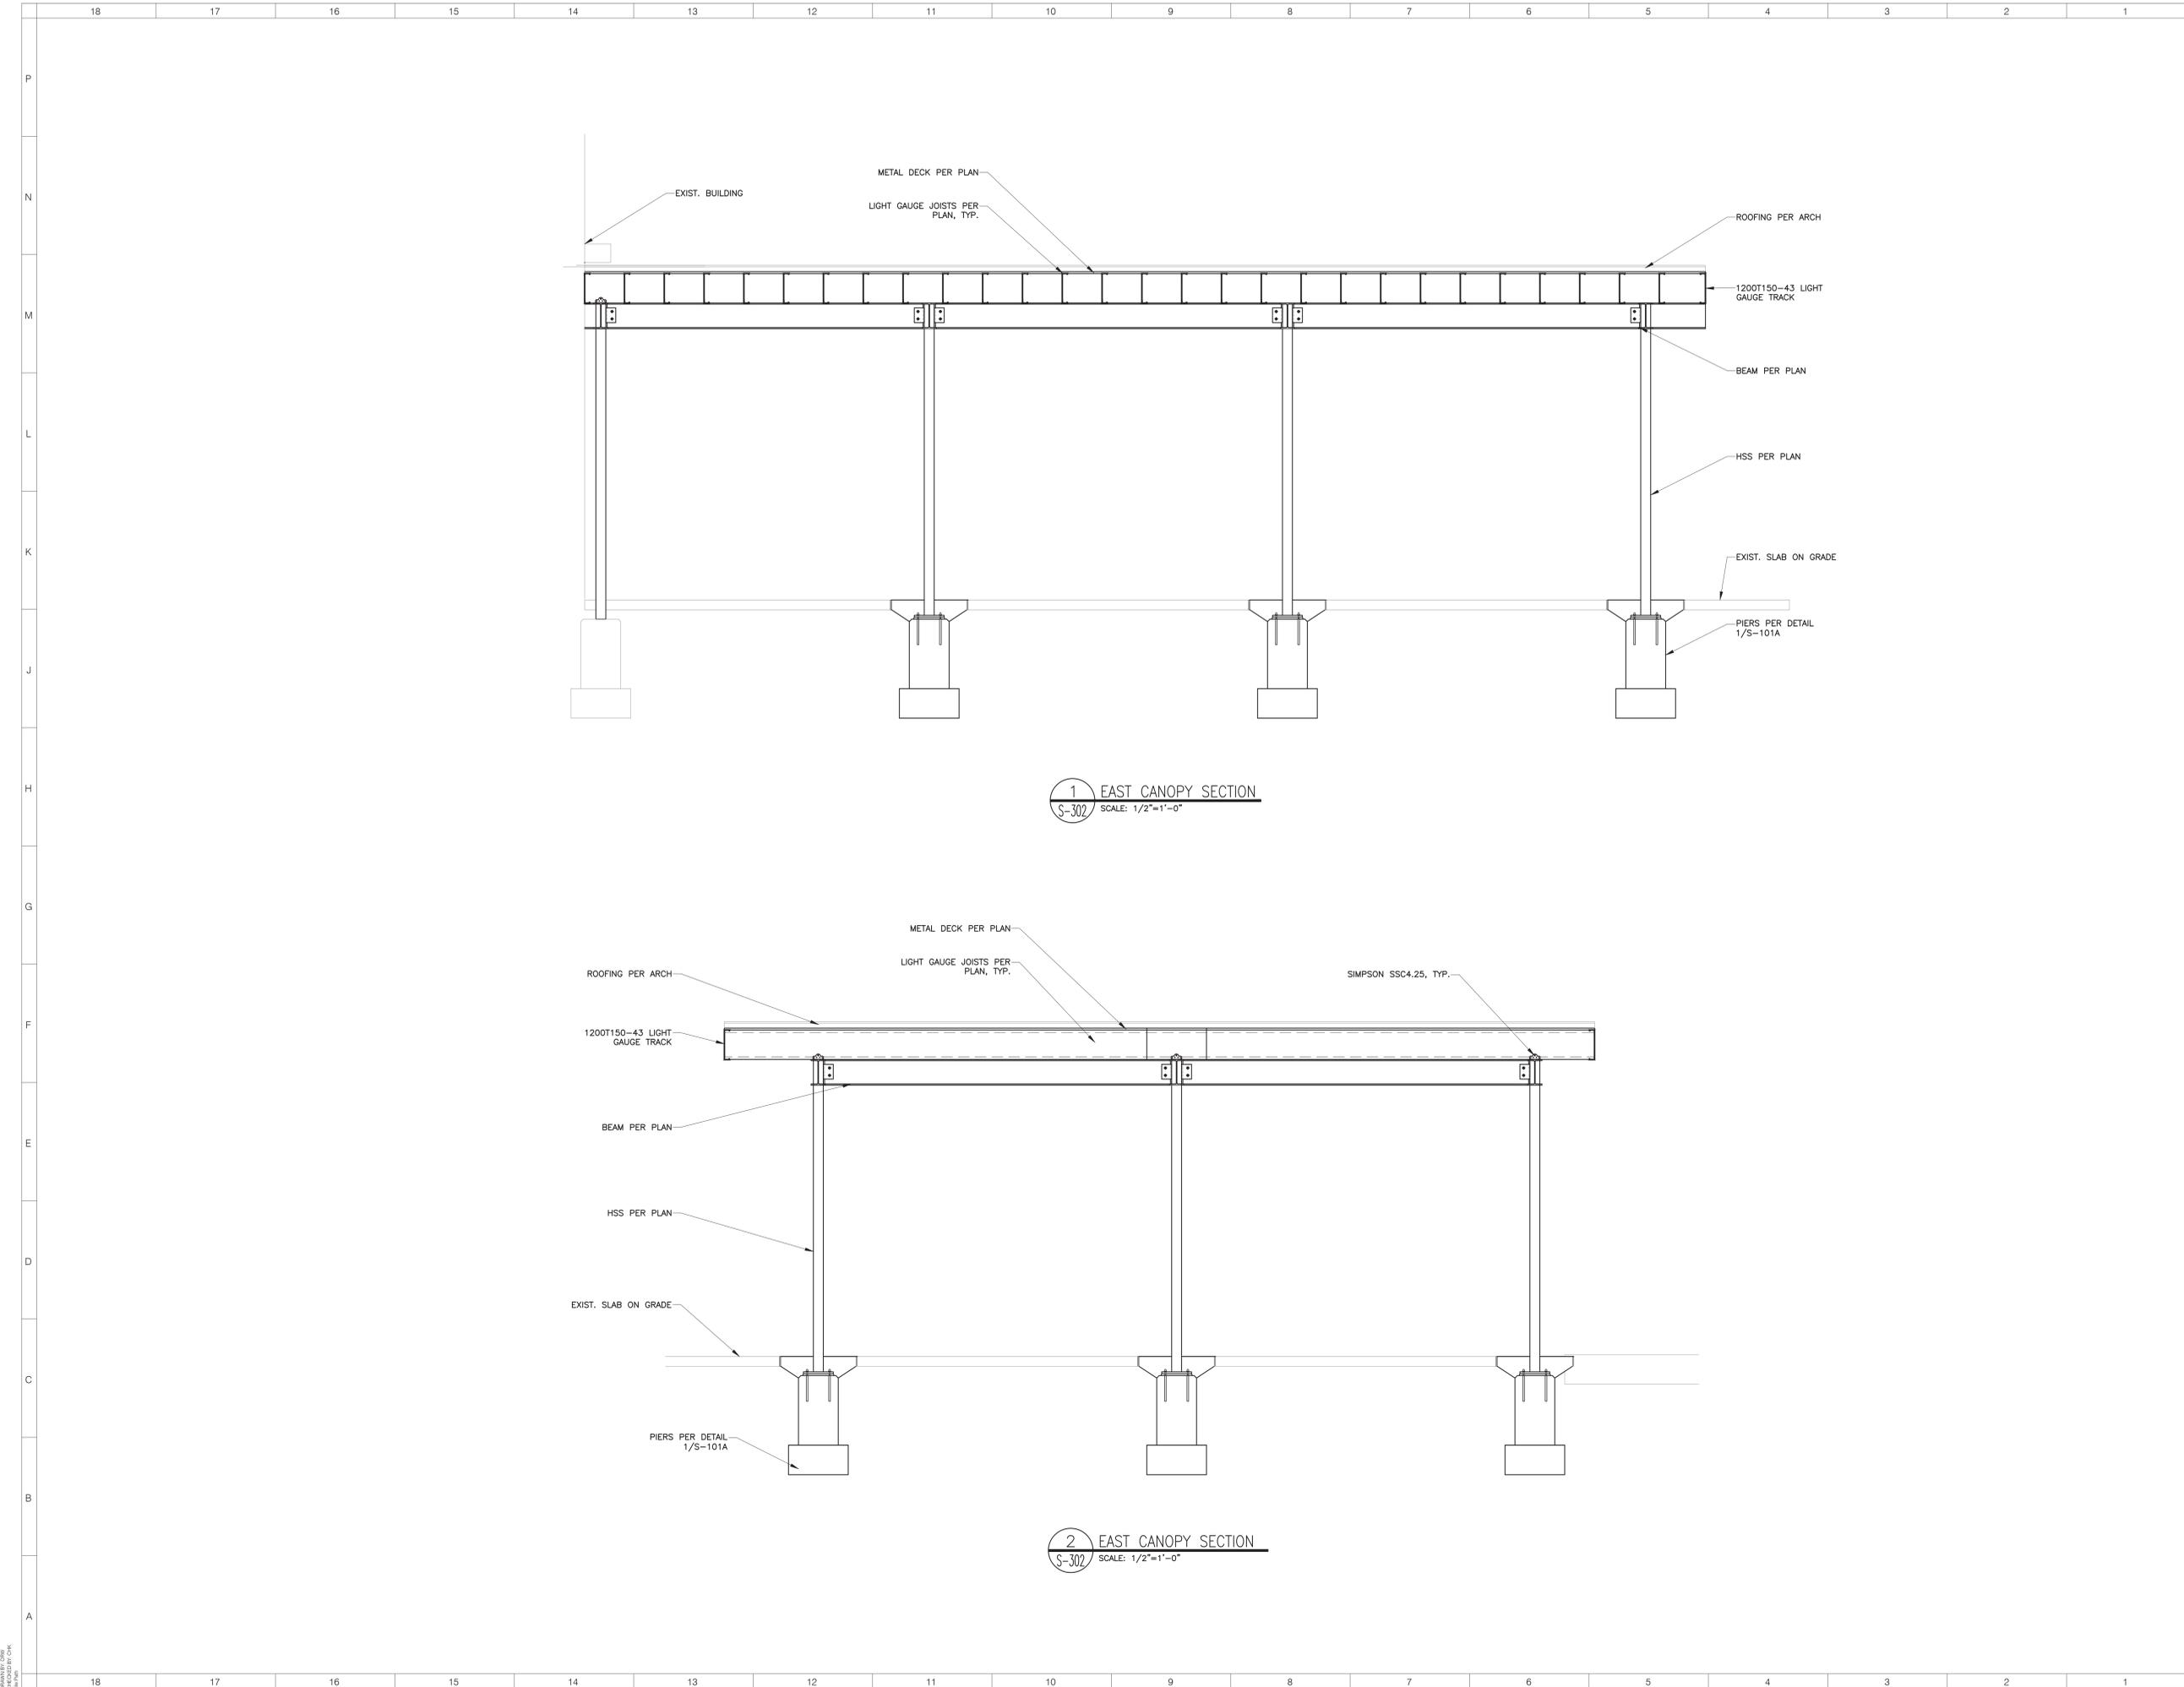
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BM-S301



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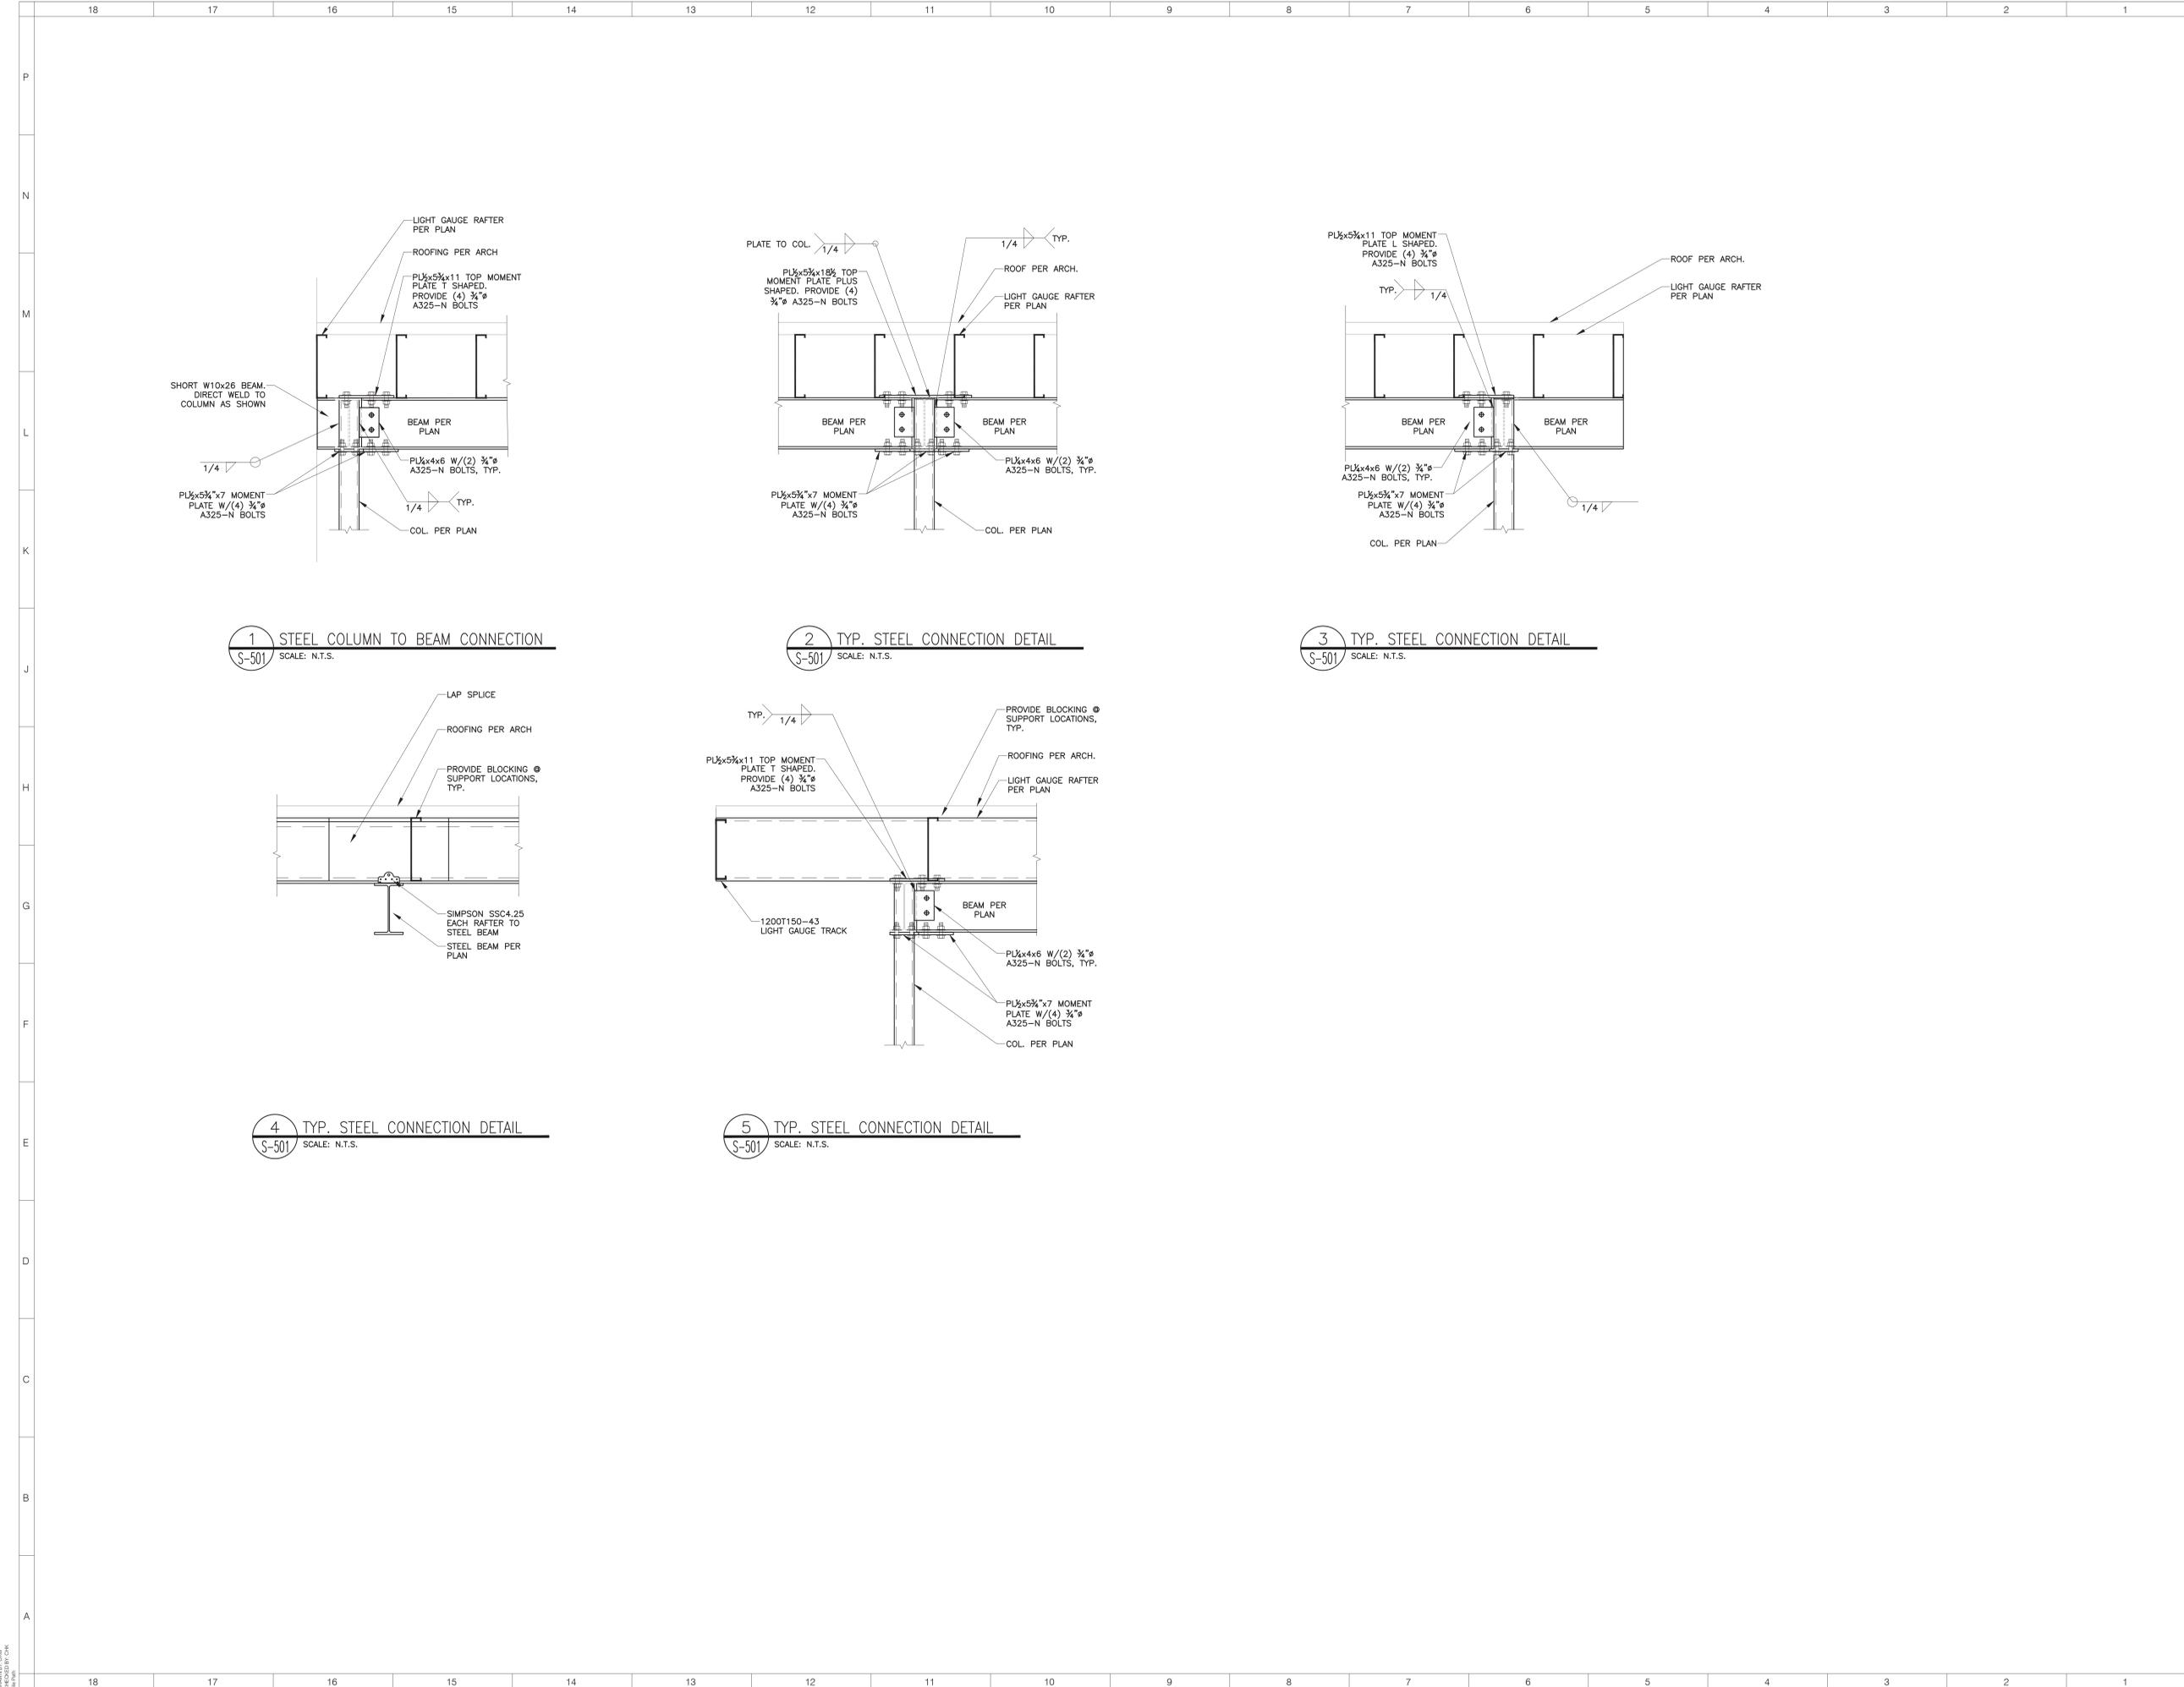
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BM-S302



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